

FOUNDATION AND SLAB ON GRADE PLAN

- DO NOT SCALE THIS PLAN. SEE ARCH. FOR ALL DIMENSIONS AND ELEVATIONS.
- APPARATUS BAY CONCRETE SLAB ON GRADE CONSTRUCTION: 8" THICK CONCRETE SLAB, REINFORCED WITH #5 BARS EACH WAY AT 12"o.c. SEE SPECIFICATIONS FOR REQUIRED ADMIXTURES. SEE M3.1 FOR COORDINATION OF RADIANT FLOOR HEATING WORK.
- OFFICE AND EXTERIOR SLAB ON GRADE CONSTRUCTION: 5" CONCRETE SLAB ON GRADE, REINFORCED WITH 6x6-W1.4xW1.4 WELDED WIRE FABRIC.

<u>LEGEND</u>

- INDICATES CMU SHEAR WALL, SEE "TYPICAL CONCRETE" MASONRY WALL REINFORCEMENT DETAIL".
- "CA" INDICATES STEEL COLUMN ABOVE, SEE COLUMN SCHEDULE ON 1/S3.3.
- "CJ" INDICATES APPROXIMATE LOCATION OF CONTROL/CONSTRUCTION JOINTS IN SLABS ON GRADE. FOR DETAILS, SEE "TYPICAL SLAB ON GRADE DETAILS".
- P-## INDICATES PIER TYPE, SEE "PIER SCHEDULE AND PIER DETAILS".

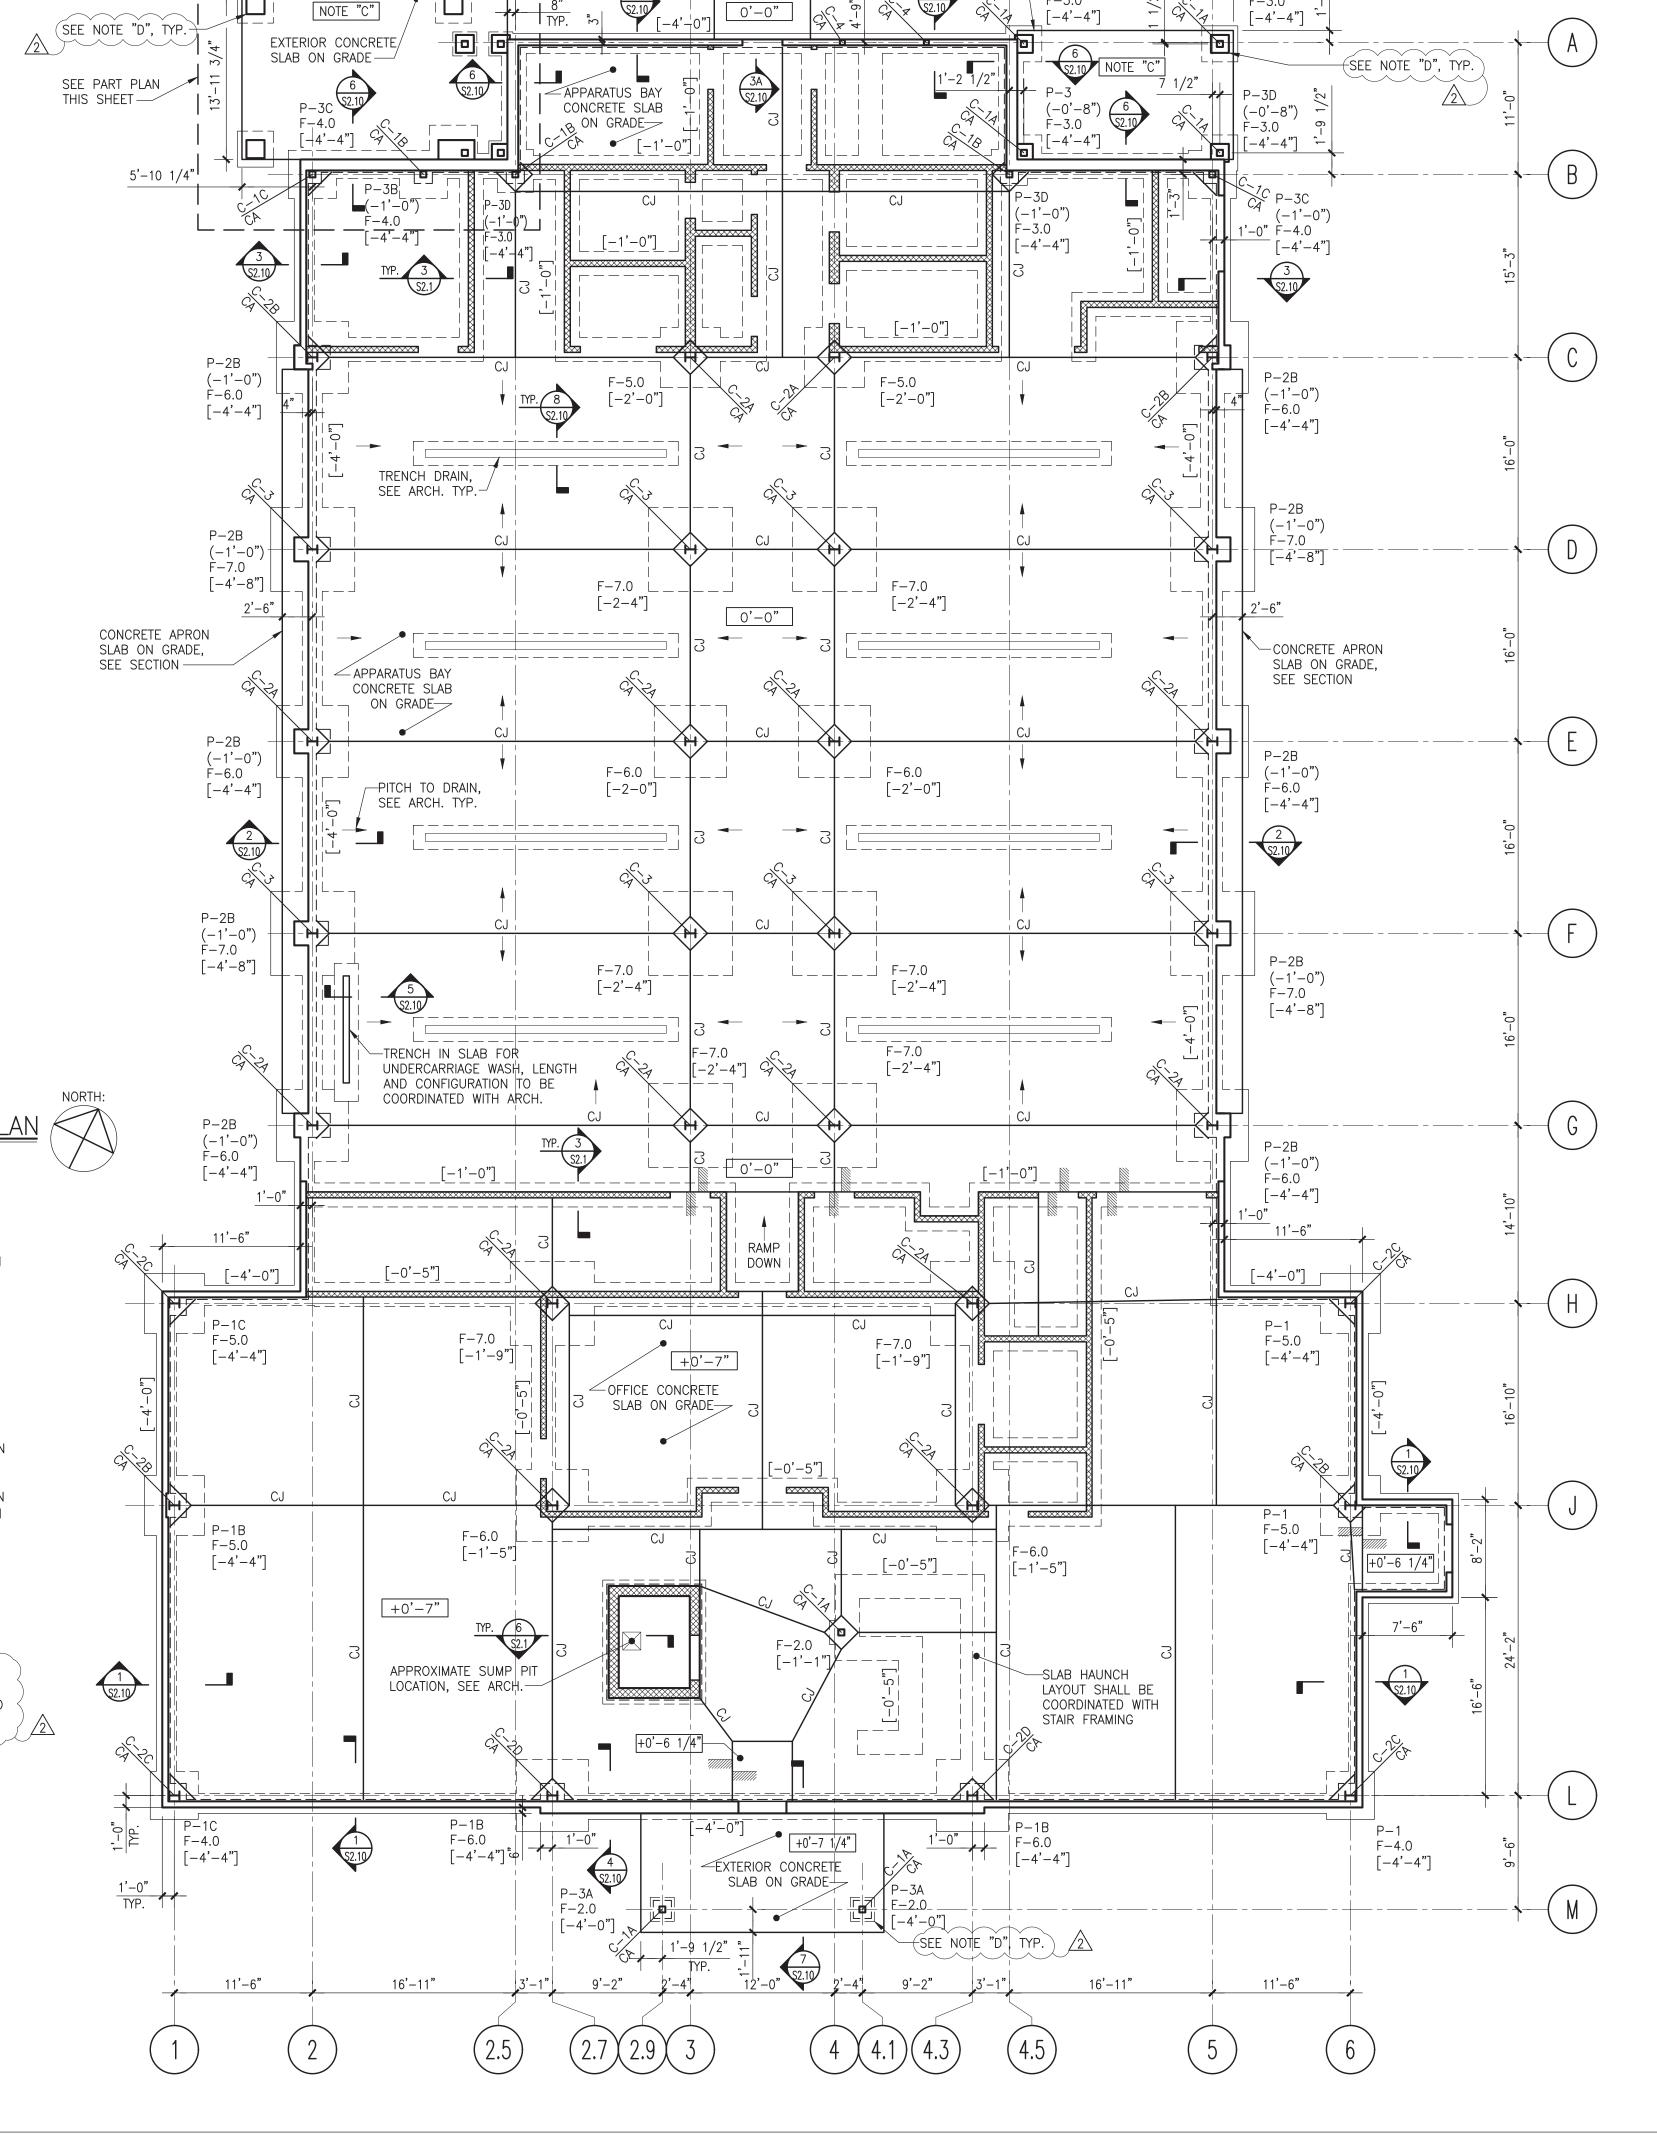
NOTE "C"
ELEVATION OF EXTERIOR SLAB ON GRADE SHALL MATCH ELEVATION OF ADJACENT SIDEWALKS, SEE CIVIL.

NOTE "D" \rightarrow AT EACH CONCRETE PIER PROVIDE MIN. (2) #5 x 1'-6" DOWELS W/ STD. 90 DEGREE HOOK CENTERED IN EXTERIOR SLAB. DRILL AND EMBED 4" INTO CONCRETE PIER WITH HILTI HY-200 ADHESIVE.

	FOOTING SCHEDULE (ALLOWABLE BEARING PRESSURE: 3000 PSF)					
	MARK	PLAN SIZE		THICKNESS	BOTTOM REINF.	
		N-S	E-W	IHICKNESS	N-S	E-W
	F-2.0	2'-0"	2'-0"	1'-0"	(3)-#5	(3)-#5
	F-3.0	3'-0"	3'-0"	1'-4"	(4)-#5	(4)-#5
	F-4.0	4'-0"	4'-0"	1'-4"	(5)-#5	(5)-#5
	F-5.0	5'-0"	5'-0"	1'-4"	(6)-#5	(6)-#5
	F-6.0	6'-0"	6'-0"	1'-4"	(7)-#5	(7)-#5
	F-7.0	7'-0"	7'-0"	1'-8"	(10)-#5	(10)-#5

REFER TO TYPICAL FOOTING DETAIL AND FOUNDATION NOTES IN USING THIS SCHEDULE.

REFERENCE ELEVATION SCHEDULE					
ITEM	DESCRIPTION	TOPO ELEV.	FROM PROJ. REF. ELEV. (U.O.N.)	FROM DRW. REF. ELEV. (U.O.N.)	SYMBOL FROM DWG. REF. ELEV.
PROJECT REF. ELEV.	T/APPARATUS BAY SLAB	376.0'		0'-0"	
DRAWING REF. ELEV.	T/APPARATUS BAY SLAB		0'-0"		±X'-XX"
FRAMING ELEV.	T/ SLAB			SEE PLAN	±X'-XX"
	B/FOOTING			SEE PLAN	[±X'-XX"]
	T/PIER			-0'-1"	(±X'-XX")
	T/FND. WALL			SFF SECTION	(±X'-XX")



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Bedford Village Fire District

34 Village Green

Bedford, NY 10506

Structural Engineering:



Structural Engineers 246 Federal Rd, Suite B23 Brookfield, CT 06804 203.740.0990

01.15.21 ISSUED FOR BID 03.15.21 ADDENDUM 3 03.17.21 ADDENDUM 4

Date Issue

Project Title

Bedford Fire Headquarters

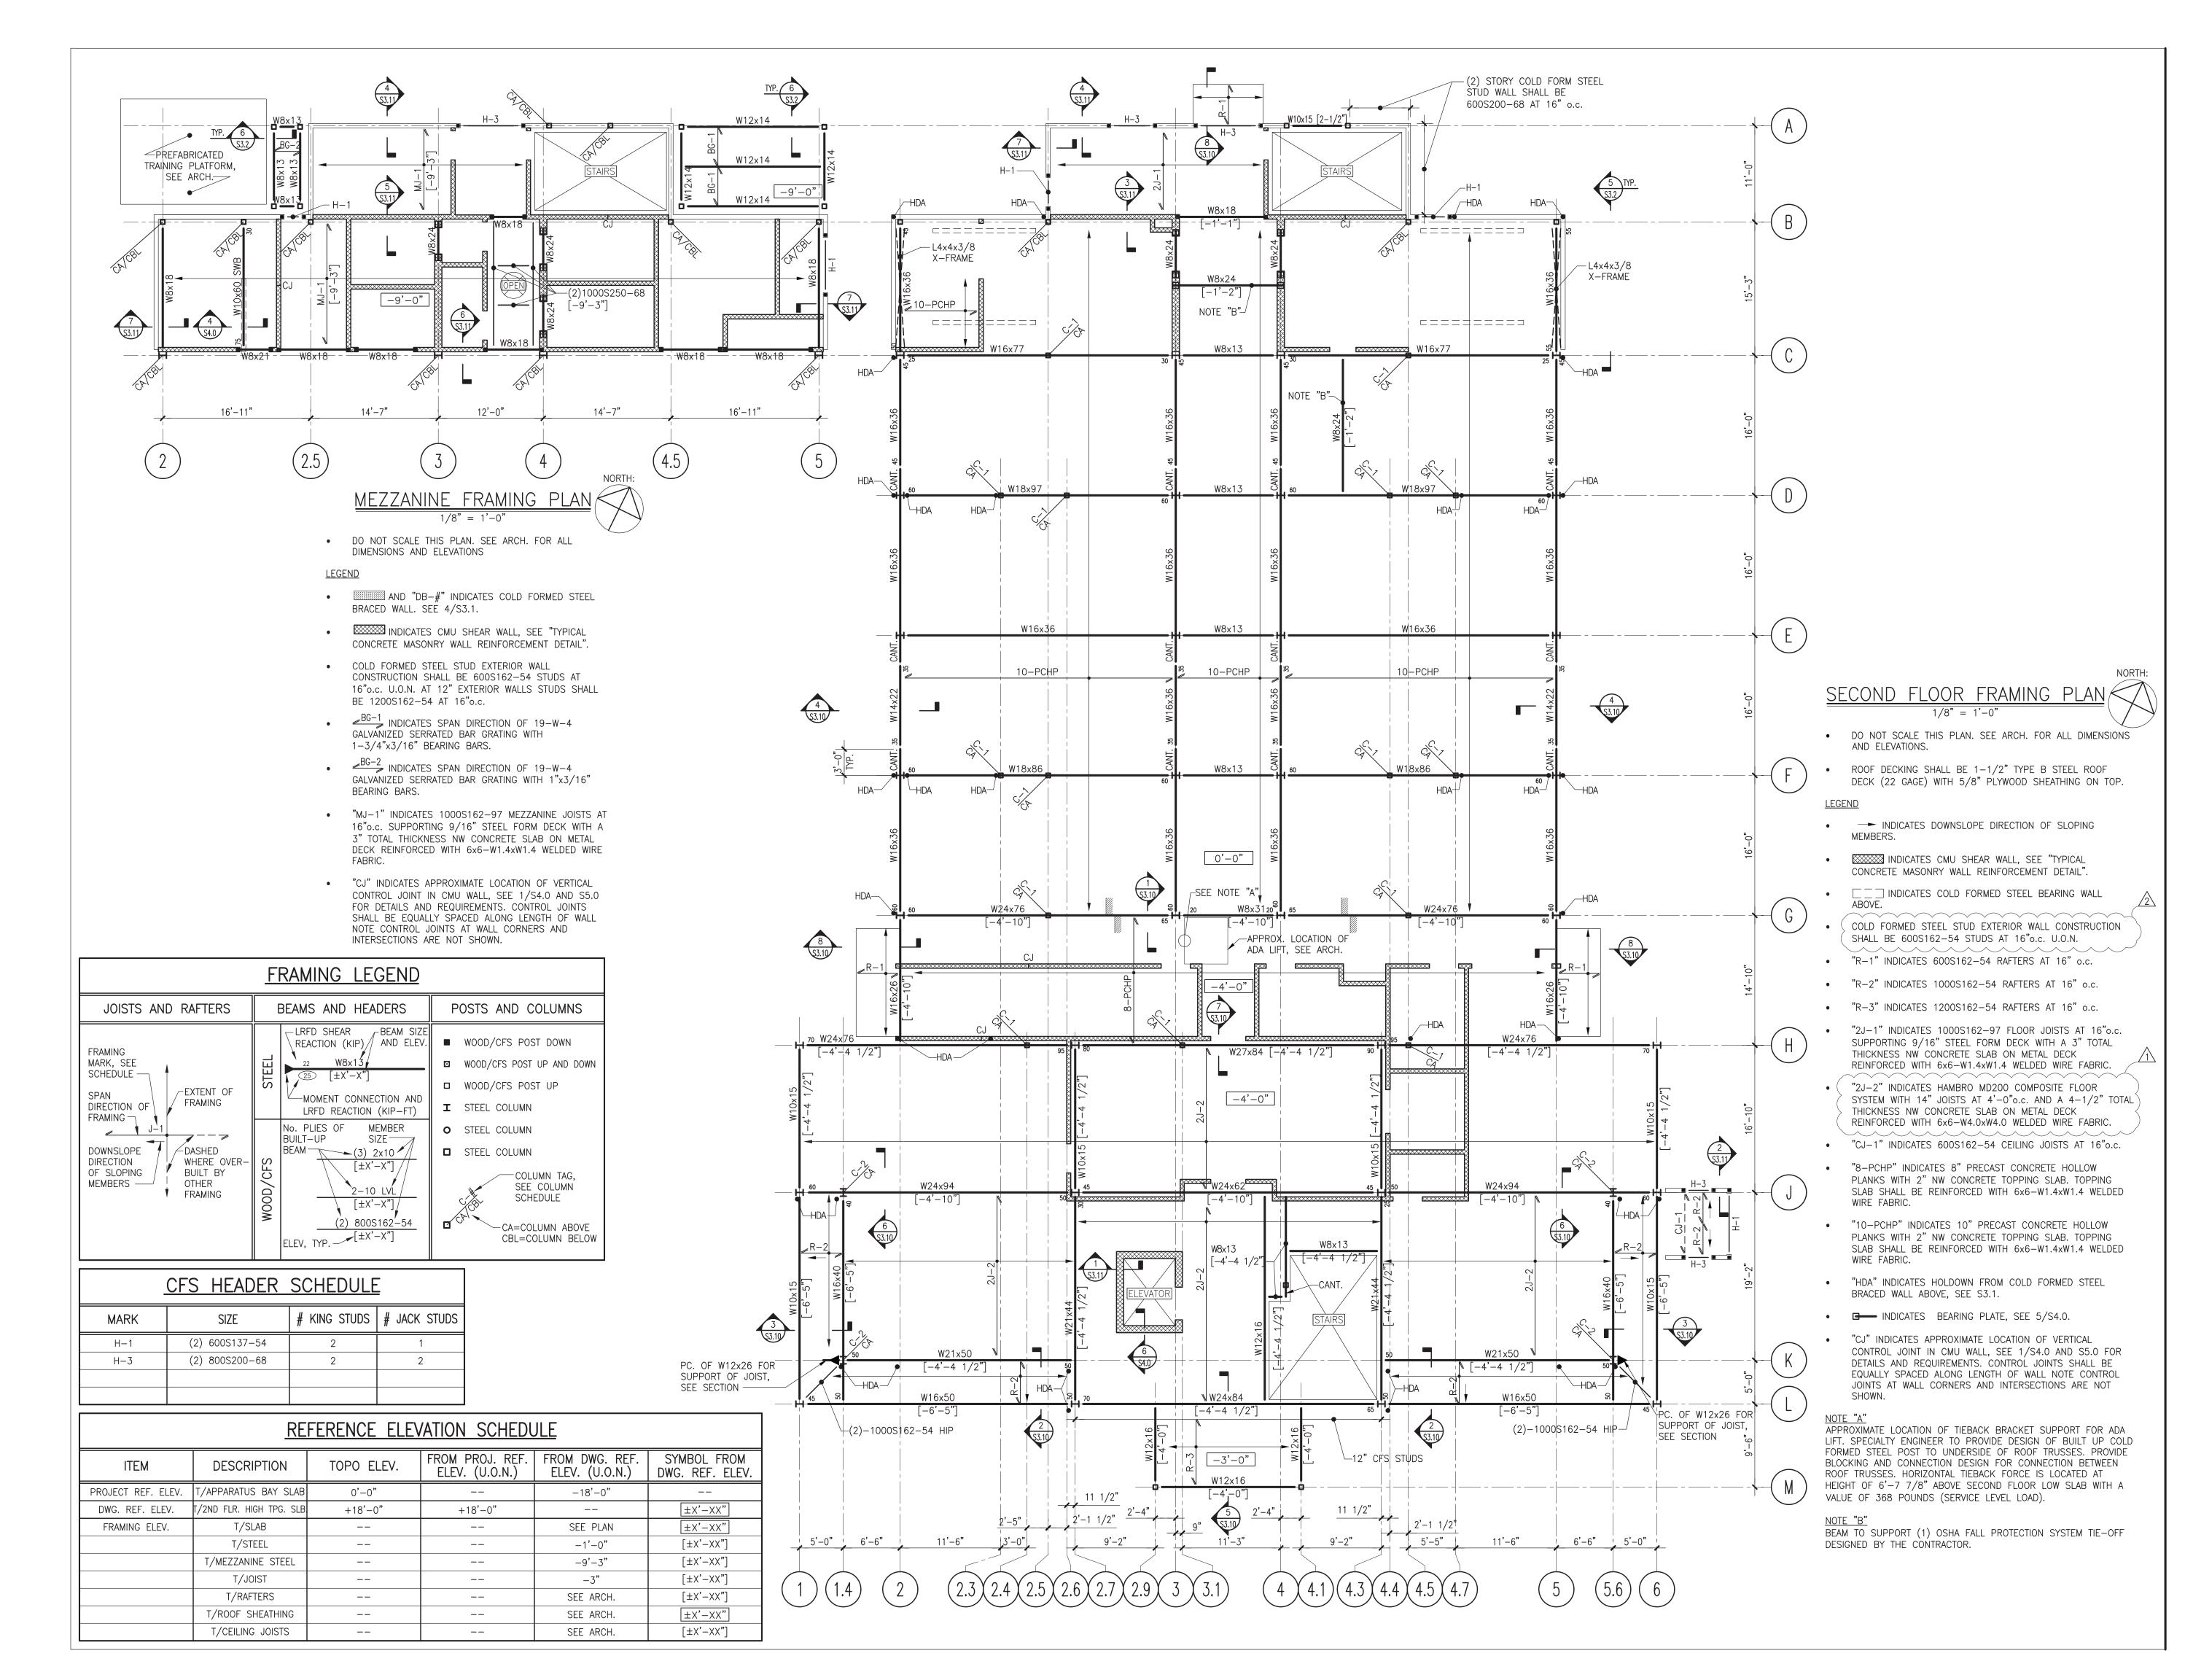
550 Old Post Road Bedford, NY 10506

Drawing Title

FOUNDATION AND SLAB ON GRADE PLAN

Project No. 03-25-2020 Scale AS NOTED Drawing by VL / LAM

PJC Checked by Drawing No.



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Bedford, NY 10506

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Drawing Title

SECOND FLOOR AND MEZZANINE FRAMING PLANS

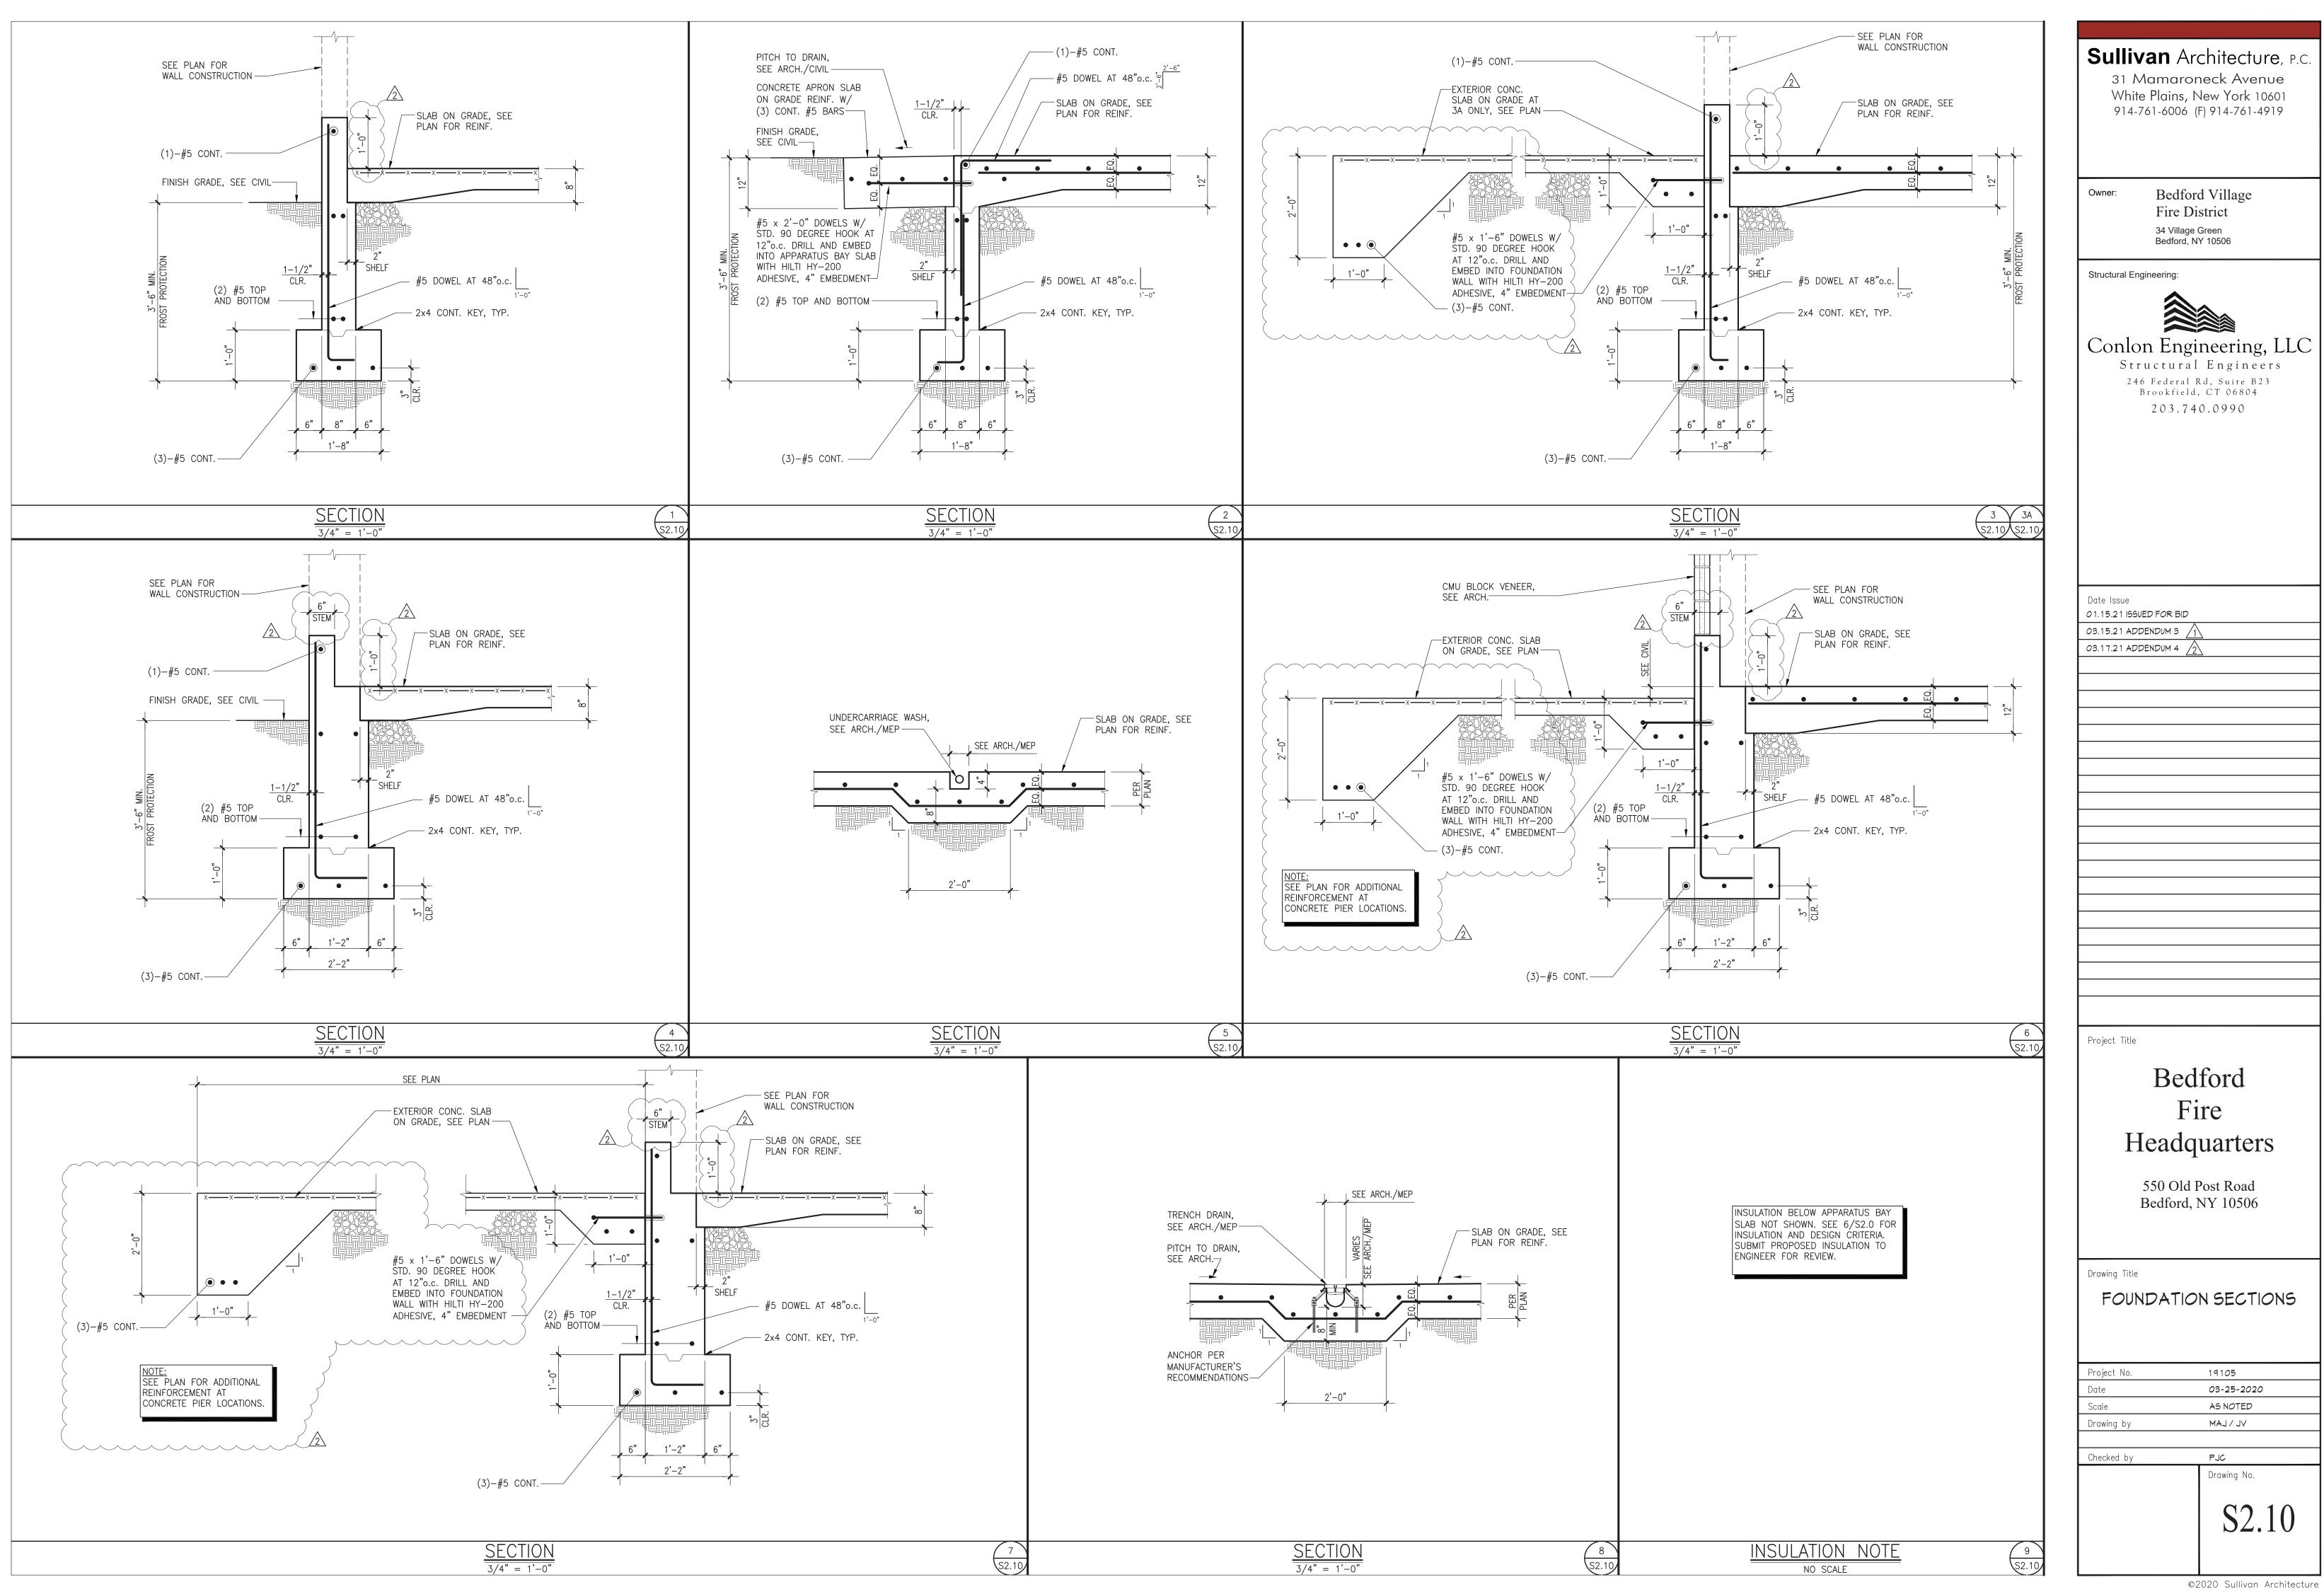
Project No.	19105
Date	03-25-2020
Scale	AS NOTED
Drawing by	VL \ LAM

Checked by PJC

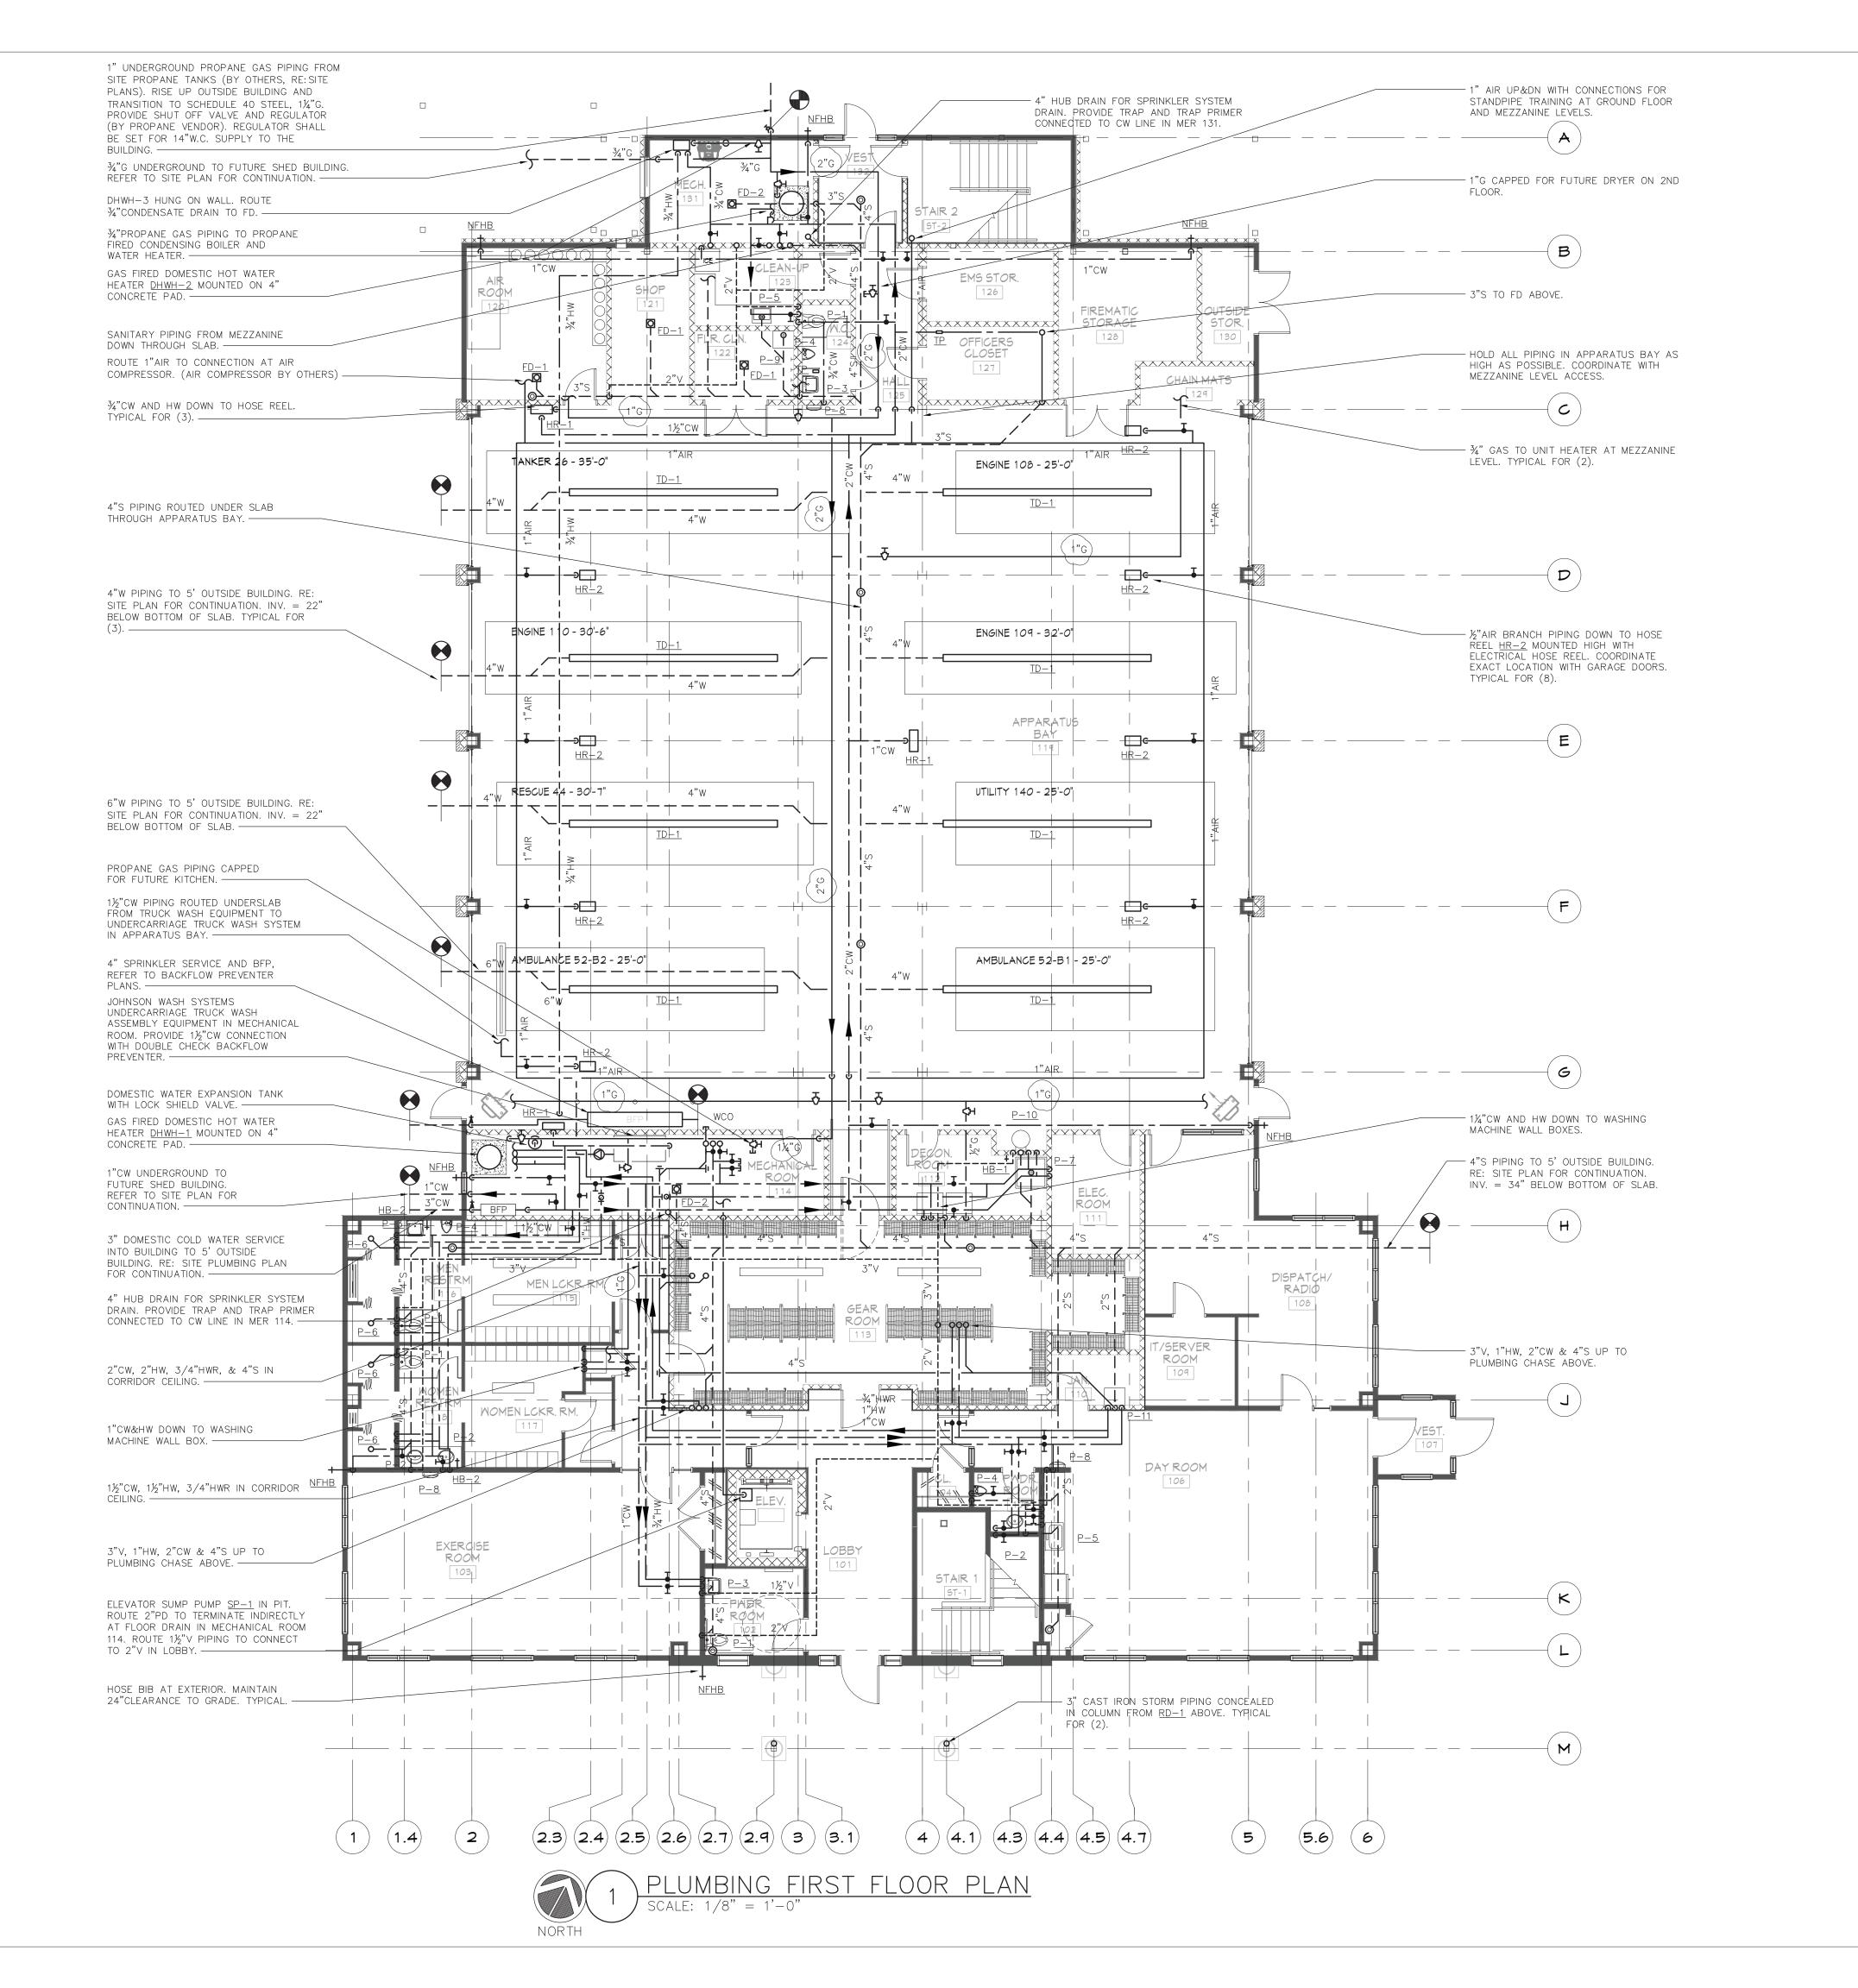
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MEP Engineer: OLA Consulting Engineers

50 Broadway, Hawthorne, NY 10532 8 West 38th St. Suite 501, New York, NY Tel: 914-747-2800

Date Issue

03.10.20 MEETING
03.27.20 DESIGN DEVELOPMENT

05.07.20 PROGRESS

05.08.20 CD PROGRESS SET

05.28.20 CD PROGRESS SET

06.30.20 CD REVIEW SET
09.01.20 CONSTRUCTION PROGRESS

09.15.20 ICC SUBMISSION

01.15.21 ISSUED FOR BID

03.19.21 REVISED FOR ADDENDUM #4

Project Title

Bedford Fire Headquarters

550 Old Post Road Bedford, NY 10506

PLUMBING FIRST FLOOR PLAN

Project No. NSPC0070.00

Date 03-27-20

Scale AS NOTED

Drawing by JRT

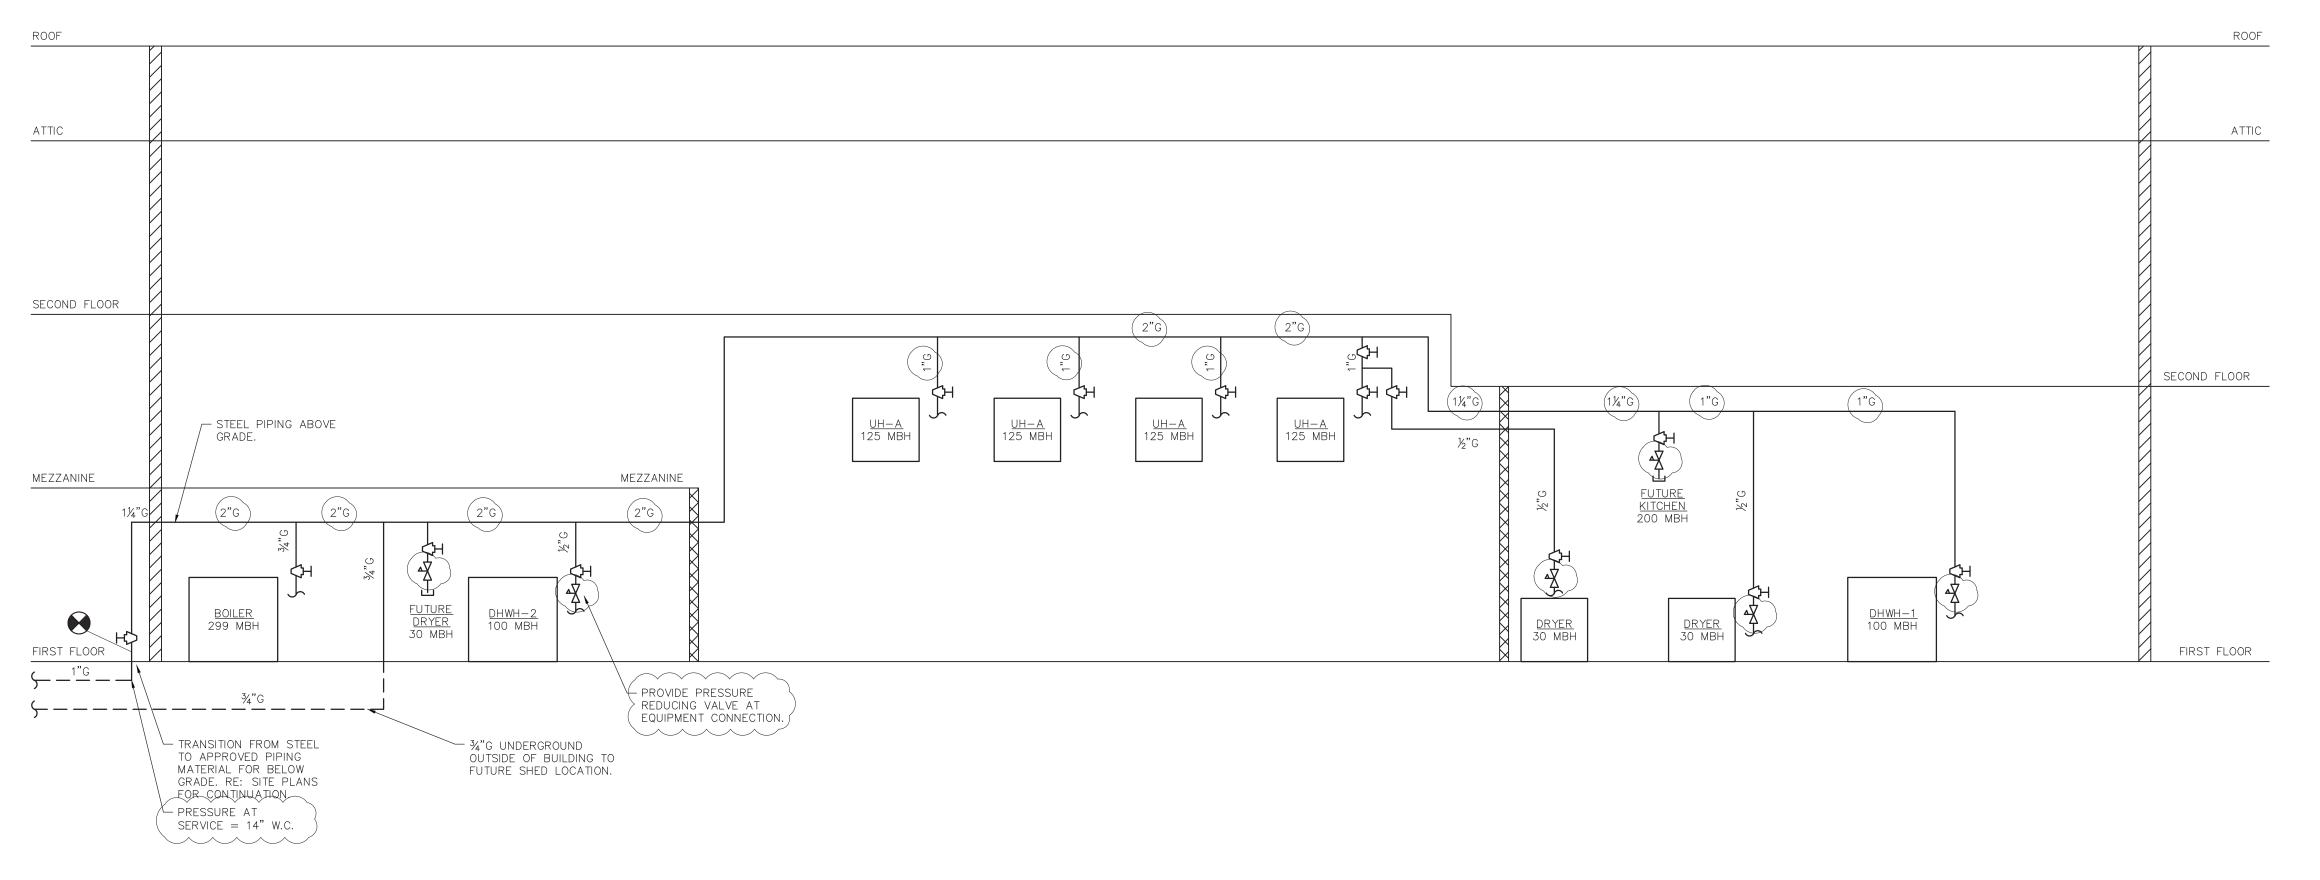
Checked by

OF NEW

OF

JF/R5
Drawing No.
P2.1

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1 PLUMBING PROPANE GAS RISER DIAGRAM
SCALE: NONE

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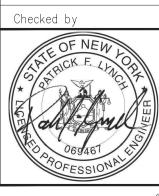
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PLUMBING GAS RISER DIAGRAM

Project No.	NSPC0070.00
Date	03-27-20
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JF/RS
Drawing No.

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