

	ECTRICAL ARREST (IATIONIC	NTS	NOT TO SCALE
ELI	ECTRICAL ABBREVIATIONS	OC	ON CENTER
ON	DESCRIPTION	OD	OUTSIDE DIAMETER
011	SINGLE POLE	Р	POLE(S)
	TWO POLE	PA	PUBLIC ADDRESS SYSTEM
	THREE POLE	PB	PULL BOX
	AMPERES	PC	PERSONAL COMPUTER
	ABOVE CENTER	PH	PHASE
	ABOVE FINISHED FLOOR	PM	POWER MONITOR
	AUTOMATIC TRANSFER SWITCH	PNL	PANEL
	AUTOMATIC	PS	PRESSURE SWITCH
	AUDIO-VISUAL	PT	POTENTIAL TRANSFORMER
	AMERICAN WIRE GAUGE	PWR	POWER
	BUILDING	Ø	PHASE
	BUILDING MANAGEMENT SYSTEM	(RE)	RELOCATED EXISTING (RELOCATED EXISTING DEVICE AT NEW LOCATION)
	CONDUIT	RECEPT, RCPT	RECEPTACLE
	CABINET	RGS	RIGID GALVANIZED STEEL
	CONSTANT AIR VOLUME	RM	ROOM
	CLOSET	(RRO)	REMOVE AND RETURN TO OWNER
	CIRCUIT BREAKER	SD	SMOKE DAMPER, SMOKE DETECTOR
	CLOSED CIRCUIT TELEVISION	SO	SOUTH
	CIRCUIT(S)	SP	SPARE
	CONSTRUCTION MANAGER	SPD	SURGE PROTECTIVE DEVICE
	COMMUNICATION	SPST	SINGLE POLE SINGLE THROW
	CONNECTED	STD	STANDARD
	CONTINUATION	SW	SWITCH
	CONDENSATE PUMP	SWGR	SWITCHGEAR
	CURRENT TRANSFORMER	SYM	SYMMETRICAL
	COPPER	SYS	SYSTEM
	CABINET UNIT HEATER	TBD	TO BE DETERMINED
	DEMOLISH	TEL	TELEPHONE
	DECIBEL	TEMP	TEMPERATURE
	DEGREE	TP	TAMPER-RESISTANT
	DIAMETER	TRANS, XFMR	TRANSFORMER
	DISTRIBUTION PANEL	TS, VS	TAMPER SWITCH (VALVE SUPERVISORY SWITCH)
	DISCONNECT SWITCH	TV	TELEVISION
	DRAWING	TVSS	TRANSIENT VOLTAGE SURGE SUPPRESSION
	DEGREES CELSIUS	TYP	TYPICAL
	DEGREES FAHRENHEIT	UH	UNIT HEATER
	EXISTING TO REMAIN	UNF	UNFUSED
	EACH	U.O.N.	UNLESS OTHERWISE NOTED
	EMPTY CONDUIT, ELECTRICAL CONTRACTOR	UTP	UNSHIELDED TWISTED-PAIR
	ELEVATOR	V	VOLT, VOLTAGE
	EMERGENCY	VA	VOLT AMPERE
	EMERGENCY POWER OFF	VFD	VARIABLE FREQUENCY DRIVE
	EQUIPMENT	VM	VOLTMETER
	EXISTING TO BE REMOVED	VP	VAPORPROOF
	EXISTING TO BE REMOVED AND RELOCATED	W	WATT, WIRE
	ELECTRIC REHEAT COIL	WP	WEATHER-RESISTANT (NEMA 3R ENCLOSURE, U.O.N.)
	ELECTRIC WATER COOLER	WT	WATERTIGHT
	FIRE ALARM	XP	EXPLOSION-RESISTANT
	FIRE ALARM CONTROL PANEL	L	'
	FURNISHED BY OTHER DIVISION OF WORK		
	FIRE COMMAND CENTER		
	FAN COIL UNIT		ELECTRICAL DRAMING LIST
	FLOOR		ELECTRICAL DRAWING LIST

ABBREVIATION

FLUORESCENT

FEET / FOOT

GENERATOR

HUNG CEILING

HAND DRYER

HORSEPOWER

HIGH VOLTAGE

INSIDE DIAMETER

ISOLATED GROUND JUNCTION BOX

KILOVOLT AMPERES

KILOWATT HOURS

LOCAL AREA NETWORK LINE ISOLATION MOITOR

MEDICAL GAS MASTER ALARM PANEL

MINIMUM CIRCUIT AMPACITY

MAIN CIRCUIT BREAKER

MOTORIZED DAMPER

MAIN FUSED SWITCH

MAIN LUGS ONLY

NOT IN CONTRACT

NORMALLY OPEN

MOUNTED

MOUNTING

NEUTRAL

MOPD, MOCP

MOTOR CONTROL CENTER

MAIN DISTRIBUTION PANEL

MECHANICAL EQUIPMENT ROOM

MANUAL TRANSFER SWITCH

NATIONAL ELECTRICAL CODE (NFPA 70)

MAXIMUM OVERCURRENT PROTECTION DEVICE

KILOWATTS

MAXIMUM

MECHANICAL

GROUND

FULL LOAD AMPERES

FIRE/SMOKE DAMPER

GENERAL CONTRACTOR

HIGH INTENSITY DISCHARGE

THOUSAND CIRCULAR MILS

GROUND FAULT CIRCUIT INTERRUPTER

EM, EMER

V V	With the second	
WP	WEATHER-RESISTANT (NEMA 3R ENCLOSURE, U.O.N.)	
WT	WATERTIGHT	
XP	EXPLOSION-RESISTANT	
ELECTRICAL DRAWING LIST		
E-001.00	ELECTRICAL COVER SHEET	
E-002.00	ELECTRICAL SPECIFICATIONS	
E-003.00	ELECTRICAL NOTES	
E-101.00	LEVEL 1 POWER DEMOLITION PART PLAN	
E-201.00	LEVEL 1 POWER PART PLAN	
E-202.00	ROOF LEVEL POWER PART PLAN	
E-301.00	LEVEL 1 LIGHTING PART PLAN	
E-401.00	ELECTRICAL RISER DIAGRAM	
E-501.00	ELECTRICAL SCHEDULES	
E-601.00	ELECTRICAL DETAILS	
E-602.00	ELECTRICAL DETAILS	

E-603.00 | ELECTRICAL DETAILS

Architect of Record:

ARRAY-ARCHITECTS.COM 470 PARK AVE SOUTH, 11th FLOOR **NEW YORK, NY. 10016** 212-689-3110

CONSULTANTS:

STRUCTURAL ENGINEER

REUTHER + BOWEN 326 WARD STREET DUNMORE, PA 18512 PHONE: 570.496.7020

MEP ENGINEER

LORING CONSULTING ENGINEERS, INC 360 WEST 31ST STREET, 14th FL. NEW YORK, NY 10001 PHONE: 646.674.6100

ESTIMATING


COST CONCEPTS, INC. 104 BEDELL PLACE MELVILLE, NY, 11747 PHONE: 631.423.7960

OWNER:

COLUMBIA DOCTOR'S **TARRYTOWN**

PROJECT: NEW MRI

155 WHITE PLAINS ROAD TARRYTOWN, NY 10591

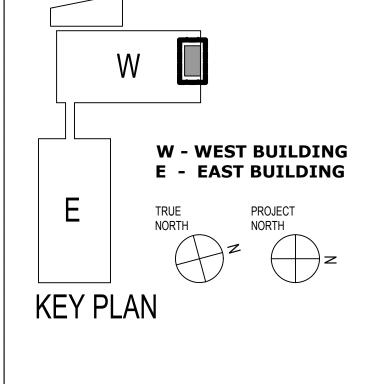

1	CD SUBMISSION	6-18-21		
NO.	DESCRIPTION	DATE		
REVISIONS/ISSUES				

SHEET TITLE: ELECTRICAL COVER

SEAL:

DATE: 7/23/2020 CON/REF No. **CONTRACT No. SCALE:** As indicated **PROJECT No.** 12384 **CHECKED:** Checker **DRAWN:** MC

SHEET NO. E-001.00

THIS PLAN IS APPROVED ONLY FOR WORK INDICATED ON THE APPLICATION SPECIFICATION SHEET. ALL OTHER MATTERS SHOWN

This document is a copyright protected instrument of service, property of Array Architects and licensed for use in the title project only. Reproduction or use of this document without written permission of Array Architects is illegal and will be

prosecuted under the law. COPPRIGHT - 2020 ARRAY-ARCHITECTS P.C.

ARE NOT TO BE RELIED UPON, OR TO BE CONSIDERED AS EITHER BEING APPROVED OR IN ACCORDANCE WITH APPLICABLE CODES.

ACODES AND STANDARDS A. ALL WORK SHALL BE SYSTEMATICALLY, CAREFULLY AND NEATLY PERFORMED AND SHALL CONFORM TO THE FOLLOWING STANDARDS: a. ALL WORK SHALL CONFORM TO ALL REQUIREMENTS OF THE BUILDING CODE OF THE STATE OF NEW YORK, AND ALL AUTHORITIES HAVING JURISDICTION. b. NATIONAL ELECTRICAL CODE- NFPA 70. c. UNDERWRITERS' LABORATORIES, INC. d. OSHA, AND ALL AGENCIES HAVING JURISDICTION. e. STANDARDS FOR BUILDING ALTERATIONS AND CONSTRUCTION. WORK SCOPE A. THE SCOPE OF WORK SHALL CONSIST OF THE FOLLOWING: a. FURNISHING, INSTALLING AND CONNECTING ALL PANELBOARDS, FEEDERS, POWER OUTLETS, LIGHT FIXTURES, SWITCHES, CONTROLS, CONDUITS, AND WIRING. b. FURNISHING AND INSTALLING NEW TELEPHONE/COMMUNICATION OUTLETS AND RACEWAY. c. FURNISHING AND INSTALLING NEW CIRCUIT BREAKERS. d. OTHER WORK SHOWN ON DRAWING AND INDICATED IN SPECIFICATIONS. B. THE CONTRACTOR SHALL BE RESPONSIBLE FOR OBTAINING ALL PERMITS AND APPROVALS AND SHALL PAY ALL ASSOCIATED COSTS AND FEES. REQUIRED TO ACCOMMODATE THE EXISTING INSTALLATION. OTHER TRADES.

SPECIFIED UNDER THIS DIVISION:

A. SUBMIT THE FOLLOWING INFORMATION AS APPLICABLE AND AS REQUIRED FOR ALL WORK

B. SUBSTITUTIONS TO SPECIFIED ITEMS MUST COMPLY WITH ALL SPECIFICATION REQUIREMENTS

A. CONTRACTOR SHALL PROVIDE AS-BUILT DRAWINGS INDICATING ANY DEVIATION FROM THE

OF AS-BUILT DRAWINGS TO THE BUILDING MANAGER UPON COMPLETION OF WORK.

ORIGINAL ELECTRICAL DESIGN. THE REVISED DRAWING SHALL BE STAMPED "AS-BUILT" WITH

CONTAINING AUTOCAD FILES SHALL BE DELIVERED TO THE ENGINEER BEFORE FINAL PAYMENT

IS MADE. AFTER REVIEW AND APPROVAL OF AS-BUILT CONTRACTOR SHALL DELIVER COMPACT

COMPREHENSIVE DETAILED INFORMATION ON THE APPROVED INSTALLATION, OPERATION AND

A. MATERIALS, EQUIPMENT AND INSTALLATION SHALL CONFORM TO THE LATEST EDITION OF ALL

B. MATERIALS, EQUIPMENT AND INSTALLATION SHALL CONFORM TO THE LATEST EDITION OF THE

APPLICABLE REFERENCE STANDARDS PUBLISHED BY THE NFPA, UL, ANSI, IEEE AND NEMA.

COMPLEXITY SIMILAR TO THOSE REQUIRED UNDER THIS CONTRACT. ALL WORKMEN SHALL BE

AND/OR WORKMANSHIP FOR A PERIOD OF ONE YEAR FROM THE DATE OF FINAL ACCEPTANCE

REPRESENTATIVE FOR COMPLIANCE WITH THE REQUIREMENTS OF THE CONTRACT DRAWINGS

OWNERS REPRESENTATIVE MAY REQUIRE TO FACILITATE ACCESS AND INSPECTION AT THE

A. COORDINATE ALL WORK WITH THE WORK OF OTHER TRADES PRIOR TO INSTALLATION, ASSIST

COORDINATED WITH BUILDING OPERATING PERSONNEL. WORK TO ACCOMMODATE OFF-HOUR

ALL WORK SHALL BE WARRANTED IN WRITING TO BE FREE FROM DEFECTS IN MATERIALS

BY THE OWNER. WARRANTY SHALL INCLUDE ALL COSTS OF PARTS, LABOR, TRAVEL AND

A. ALL STAGES OF THE INSTALLATION WILL BE INSPECTED BY THE OWNER AND/OR OWNERS

REQUIREMENTS TO THE SATISFACTION OF THE ENGINEER SHALL BE REPLACED AT NO

AND SPECIFICATIONS. ANY PORTION OF THE CONSTRUCTION NOT MEETING THOSE

B. PROVIDE PROPER EQUIPMENT AND REASONABLE ASSISTANCE AS THE OWNER AND/OR

IN THE PREPARATION OF COORDINATION DRAWINGS AS REQUIRED BY THE GENERAL

. CUT AND PATCH NON STRUCTURAL SURFACES AS REQUIRED. REPAIRS SHALL MATCH

ORIGINAL FINISH, PENETRATIONS OF FIRE RATED PARTITIONS SHALL BE SEALED WITH

APPROVED MATERIAL TO PROVIDE THE SAME RATING AS THE PARTITION. REFER TO

D. PROVIDE EXPANSION FITTINGS WHERE RACEWAYS CROSS BUILDING EXPANSION JOINTS.

A. ALL EQUIPMENT SHALL BE DELIVERED IN MANUFACTURER'S ORIGINAL PROTECTIVE

PACKAGING AND STORED IN A CLEAN, DRY PLACE PROTECTED FROM WEATHER, FUMES,

WATER, DUST AND PHYSICAL DAMAGE. TOUCH UP DAMAGED FINISHES TO MATCH THE

PROVIDE ALL LABOR, MATERIALS, EQUIPMENT AND SERVICES REQUIRED FOR COMPLETE

B. OBTAIN ALL PERMITS AND APPROVALS REQUIRED BY AUTHORITIES HAVING JURISDICTION AND

VERIFY EXISTING CONDITIONS IN FIELD AND INCLUDE IN THE BID PRICE ALL WORK REQUIRED

D. PROVIDE TEMPORARY LIGHT AND POWER SYSTEM (AS PART OF THE CONTRACT) ADEQUATE

SHALL BE DISCONNECTED AND REMOVED WHEN PERMANENT SERVICE IS IN OPERATION.

FOR THE REQUIREMENTS OF ALL TRADES DURING CONSTRUCTION. TEMPORARY SYSTEM

 λ . $\;$ MATERIAL AND EQUIPMENT DESIGNATED FOR "SPECIAL INSPECTION" UNDER THE PROVISIONS

OR UNDER THE SUPERVISION OF AN ACCREDITED SPECIAL INSPECTOR. EMPLOYED BY THE

DEPARTMENT TR-1 FORM. CONTRACTORS SHALL PROVIDE ALL REQUESTED ASSISTANCE TO

THE SPECIAL INSPECTOR, INCLUDING MATERIAL AND LABOR, TO COMPLETE THE SPECIAL

OWNER, WHO SHALL BE RESPONSIBLE FOR FILING PROPERLY EXECUTED BUILDING

A. RIGID GALVANIZED STEEL (RGS) CONDUIT SHALL CONFORM TO UL 6. FITTINGS SHALL BE

B. ELECTRICAL METALLIC TUBING (EMT) SHALL CONFORM TO UL 797. FITTINGS SHALL BE STEEL

C. FLEXIBLE METALLIC CONDUIT SHALL CONFORM TO UL 1. LIQUID TIGHT FLEXIBLE METAL

D. ALL CONDUIT FITTINGS AND CONNECTORS SHALL BE STEEL OR MALLEABLE IRON WITH

INSULATED THROATS. DIE-FORMED ZINC OR MALLEABLE IRON FITTINGS ARE NOT

BRANCH CIRCUIT CONDUITS TERMINATING AT PANELBOARDS.

b. MECHANICAL EQUIPMENT ROOMS; FIRE ALARM SYSTEMS.

ACCEPTABLE. BUSHINGS SHALL BE PROVIDED AT ALL CONDUIT TERMINATIONS. BUSHINGS

MINIMUM RACEWAY SIZE SHALL BE 3/4". RACEWAYS SHALL BE RUN PARALLEL TO BUILDING

STRUCTURAL LINES. RACEWAYS SHALL NOT BE RUN HORIZONTALLY BELOW 8'-0" AFF IN

ALL WIRING BETWEEN JUNCTION BOXES AND FOR CIRCUIT HOMERUNS BETWEEN FIRST

a. RIGID GALVANIZED STEEL (RGS) - IN CONCRETE SLABS; EXPOSED IN ALL

d. EXPOSED LOCATIONS; EXPOSED IN MECHANICAL ROOMS ABOVE 8'-0" AFF;

c. ELECTRICAL METALLIC TUBING (EMT) - INTERIOR CONCEALED AND

PARTITIONS. ALL EMPTY RACEWAYS SHALL BE FURNISHED WITH A 200LB TEST NYLON DRAG

OUTLET SERVED BY THE BRANCH CIRCUIT AND THE PANELBOARD SHALL BE RUN IN EMT OR

LARGER THAN 1" SHALL BE GROUNDING TYPE. PVC BUSHINGS MAY BE UTILIZED ONLY FOR 3/4"

OF THE NEW YORK STATE BUILDING CODE SHALL BE INSPECTED, TESTED, AND WITNESSED BY,

INSTALLATION OF ALL WORK INDICATED ON THE DRAWINGS OR SPECIFIED HEREIN.

EQUIPMENT, DEVICES AND ENCLOSURES SHALL BE RATED NEMA 1 FOR INTERIOR LOCATIONS

PROVIDE 4" HIGH SEALED CONCRETE HOUSEKEEPING PADS BELOW ALL FLOOR MOUNTED

EQUIPMENT AND AROUND ALL CONDUITS PENETRATING FLOORS OF MECHANICAL EQUIPMENT

B. ALL SHUTDOWN OF BUILDING POWER, FIRE ALARM AND SIGNAL SYSTEMS SHALL BE

SHUTDOWNS SHALL BE PERFORMED AT NO ADDITIONAL COST TO THE OWNER.

ARCHITECTURAL DRAWINGS FOR LOCATIONS OF FIRE RATED PARTITIONS.

NEMA 3R FOR DAMP LOCATIONS AND NEMA 4 FOR WET LOCATIONS.

PAY THE ASSOCIATED PRINTING AND FILING COSTS.

TO ACCOMMODATE THE EXISTING INSTALLATION.

BUILDING MANAGEMENT. ALL WORK SHALL BE PERFORMED IN STRICT ACCORDANCE WITH THE

APPLICABLE CODES AND THE REQUIREMENTS OF ALL AUTHORITIES HAVING JURISDICTION,

INCLUDING THE NEW YORK STATE BUILDING CODE AND ELECTRICAL CODE, OSHA AND

BUILDING STANDARDS AND THE REQUIREMENTS OF THE LOCAL UTILITY COMPANY.

C. THE CONTRACTOR SHALL HAVE COMPLETED AT LEAST TWO PROJECTS OF SIZE AND

LIVING EXPENSES REQUIRED TO REPAIR OR REPLACE DEFECTIVE ITEMS.

DISK TO THE OWNER. CONTRACTOR SHALL PROVIDE THREE (3) PRINTS AND A COMPACT DISK

3. FURNISH TO THE ARCHITECT THREE (3) BOUND AND INDEXED COPIES OF OPERATIONS AND

MAINTENANCE DATA MANUALS FOR THE INSTALLATION. THE MANUAL SHALL PROVIDE

THE DATE AND CONTRACTOR'S SIGNATURE. ONE (1) SET OF PRINTS AND A COMPACT DISK

MANUFACTURERS' PRODUCT DATA SHEETS AND SAMPLES WHERE REQUIRED.

AND WILL ONLY BE PERMITTED WHERE SUBMITTED AND APPROVED IN WRITING.

b. SHOP DRAWINGS INCLUDING DIMENSIONED EQUIPMENT LAYOUTS,

d. REPRODUCIBLE DRAWINGS, PDF, OR AUTOCAD FILES.

CERTIFIED FACTORY AND FIELD TEST REPORTS.

e. OPERATION AND MAINTENANCE MANUALS.

AS-BUILT DRAWINGS AND MAINTENANCE MANUALS

USE, MAINTENANCE AND PARTS LIST.

SKILLED IN THEIR RESPECTIVE TRADE.

ADDITIONAL COST TO THE OWNER.

CONSTRUCTION SITE.

BASIC MATERIAL AND METHODS

CONDITIONS.

ROOMS.

DELIVERY, STORAGE AND HANDLING

ORIGINAL FINISH.

SPECIAL INSPECTIONS

THREADED.

INSPECTION PROCESS.

GLAND AND RING COMPRESSION TYPE.

CONDUIT SHALL CONFORM TO UL 360.

G. RACEWAY UTILIZATION SHALL BE AS FOLLOWS:

POINT-TO-POINT WIRING DIAGRAMS AND SEQUENCES OF OPERATION.

g. MANUFACTURERS' CERTIFICATIONS, WARRANTIES AND SPARE PARTS.

J. ALL VERTICAL RUNS OF CONDUIT OR TUBING TERMINATING IN THE BOTTOMS OF WALL BOXES OR CABINETS, OR SIMILAR LOCATIONS, SHALL BE PROTECTED FROM THE ENTRANCE OF VERIFY ALL EXISTING CONDITIONS IN THE FIELD AND INCLUDE IN THE BID PRICE ALL WORK FOREIGN MATERIAL PRIOR TO THE INSTALLATION OF CONDUCTORS K. UNLESS OTHERWISE SPECIFIED, ALL CONDUIT AND TUBING SHALL BE INSTALLED CONCEALED. D. ELECTRICAL CONNECTIONS TO EQUIPMENT, MOTORS, ETC FURNISHED BY THE OWNER AND/OR IN GENERAL, ALL CONDUIT AND TUBING SHALL BE RUN IN HUNG CEILINGS AND FURRED SPACES WHERE THEY EXIST. WHERE CONDUIT IS RUN EXPOSED IT SHALL BE SECURELY

CONNECTIONS.

SUPPORTED WITH ZINC COATED MALLEABLE IRON CONDUIT STRAPS OR OTHER APPROVED MEANS. ALL CONDUITS SHALL BE SUPPORTED FROM STRUCTURAL MEMBERS. EVERY CONDUIT SYSTEM SHALL BE INSTALLED COMPLETE BEFORE ANY CONDUCTORS ARE DRAWN IN. WIRE PULLING LUBRICANTS, WHEN UTILIZED, SHALL BE IN ACCORDANCE WITH THE REQUIREMENTS OF UNDERWRITERS' LABORATORIES, INC., APPLICABLE TO THE SPECIFIC CONDUCTOR OR CABLE INSULATION AND RACEWAY MATERIAL.

f. FLEXIBLE METALLIC CONDUIT - FINAL CONNECTIONS TO TRANSFORMERS (MAXIMUM LENGTH

METAL CLAD CABLE (MC) - FINAL CONNECTIONS ONLY FROM JUNCTION BOXES ABOVE

CONDUIT AND TUBING RUNS SHALL BE MECHANICALLY AND ELECTRICALLY CONTINUOUS FROM

SECURELY CONNECTED TO A CABINET, JUNCTION BOX, PULLBOX OR OUTLET BOX BY MEANS

OF LOCKNUTS ON THE OUTSIDE AND INSIDE AND AN INSULATED BUSHING ON THE INSIDE. IN

TUBING OR FLEXIBLE METAL CONDUIT THE ONE COMPRESSION LOCKNUT SHALL BE MADE

WRENCH-TIGHT. ALL LOCKNUTS SHALL BE THE BONDING TYPE WITH SHARP EDGES FOR

AND BUSHINGS ARE NOT REQUIRED WHERE CONDUITS ARE SCREWED INTO TAPPED

DIGGING INTO THE METAL WALL OF AN ENCLOSURE AND SHALL BE INSTALLED IN A MANNER

THAT WILL ASSURE A LOCKING AND ELECTRICALLY CONTINUOUS INSTALLATION. LOCKNUTS

SERVICE STARTING TO ALL OUTLETS AND EQUIPMENT. CONDUIT SHALL ENTER AND BE

g. LIQUID TIGHT FLEXIBLE CONDUIT - FINAL CONNECTIONS TO MOTORS AND

H. ALL CONDUIT AND TUBING SHALL BE CUT SQUARE AND REAMED AT THE ENDS.

3'-0") AND LIGHTING FIXTURES IN INTERIOR LOCATIONS (MIN. LENGTH 18", MAXIMUM LENGTH

e. INTERIOR COMMUNICATIONS WIRING.

MECHANICAL EQUIPMENT.

6'-0"); WHERE ACCEPTABLE TO ENGINEER.

FEEDERS TO MECHANICAL EQUIPMENT.

M. WHERE REQUIRED BY THE ENGINEER, EXTRA DEEP OR EXTRA SHALLOW OUTLET BOXES SHALL BE USED TO FACILITATE THE INSTALLATION OF THE CONDUIT SYSTEM.

A. OUTLET, PULL AND JUNCTION BOXES SHALL BE FABRICATED FROM STEEL AND CONFORM TO

- GALVANIZED SHEET STEEL. BOXES FOR MECHANICAL ROOMS SHALL BE CAST STEEL WITH GASKETED COVERS. B. BOXES SHALL CONTAIN SUITABLE KNOCKOUTS. BARRIERS SHALL BE FURNISHED AS REQUIRED
- BY CODE AND TO SEPARATE SWITCHES FOR 277 VOLT CIRCUITS ON DIFFERENT PHASES.

UL 50, UL 514 AND NEMA OS1. BOXES FOR INTERIOR LOCATIONS SHALL BE CODE GAUGE,

- C. BOXES SHALL BE SIZED AS REQUIRED BY CODE FOR NUMBER AND GAUGE OF CONDUCTORS THEREIN, EXCEPT WHERE NOTED TO BE LARGER, THE MINIMUM BOX SHALL BE 4" SQUARE BY 1-1/2" DEEP. COVERS GREATER THAN 50LB SHALL BE DIVIDED INTO MULTIPLE SECTIONS.
- D. WIREWAYS AND AUXILIARY GUTTERS SHALL BE TWO-PIECE STEEL CONSTRUCTION WITH ANSI 61 GRAY ENAMEL FINISH. COVERS SHALL BE COMBINATION HINGED AND SCREW-ON TYPE. HOUSINGS SHALL HAVE REGULARLY SPACED KNOCKOUTS FOR CONDUIT ENTRY. WIREWAYS SHALL BE MANUFACTURED BY SQUARE D OR APPROVED EQUAL. PROVIDE ALL END PIECES, CONNECTORS AND REQUIRED ACCESSORIES.

- A. PROVIDE INSERTS, EXPANSION SHIELD LUGS, ANCHORS, BOLTS WITH NUTS AND WASHERS, SHIMS OR ANY OTHER TYPE OF FASTENING DEVICES REQUIRED TO FASTEN PANELS OR OTHER EQUIPMENT TO FLOORS, WALLS OR CEILINGS. UNLESS OTHERWISE SPECIFIED HEREIN OR SHOWN ON THE CONTRACT DRAWINGS, ALL FASTENERS SHALL BE HOT-DIPPED GALVANIZED, OF SIZES AND TYPES RECOMMENDED BY THE EQUIPMENT MANUFACTURER AND AS APPROVED BY THE ENGINEER.
- 14. WIRES, CABLES, SPLICES AND TERMINATIONS
- A. POWER AND CONTROL WIRING SHALL BE COPPER, MINIMUM 98% CONDUCTIVITY, WITH TYPE THHN/THWN INSULATION RATED 600 VOLTS. MINIMUM WIRE SIZE SHALL BE #12 AWG. CONDUCTORS SHALL BE SOLID FOR WIRE SIZED #10 AWG AND SMALLER AND STRANDED FOR WIRE SIZES #8 AWG AND LARGER.
- B. METAL CLAD CABLE SHALL BE HOSPITAL GRADE, 90°C RATED CODE TYPE HCF WITH TWO (2) GROUNDING CONDUCTORS; A SEPARATE FULL-SIZED GREEN INSULATED GROUND COPPER CONDUCTOR AND AN ARMOR BONDED FULL-SIZED ALUMINUM GROUND CONDUCTOR IN ACCORDANCE WITH UL 4. JACKET SHALL BE GALVANIZED STEEL ARMOR.

C. CONDUCTORS SHALL BE COLOR CODED AS FOLLOWS: B ORANGE RED

WHITE WITH TRACER NEUTRAL FOR GFI CIRCUIT GROUND GREEN D. CONDUCTOR SIZES SHALL BE INCREASED WHERE REQUIRED BY CODE AND/OR THE ENGINEER TO COMPENSATE FOR VOLTAGE DROP AND HIGH AMBIENT TEMPERATURE.

NEUTRAL

- E. COMMUNICATIONS CABLING RUN EXPOSED IN AIR HANDLING PLENUMS SHALL BE TYPE CMP PI FNUM RATED
- F. SPLICES FOR WIRE SIZES #10 AWG AND SMALLER SHALL BE MADE WITH SPRING CONNECTORS AND TAPE. SPLICES FOR WIRE SIZES #8 AWG AND LARGER SHALL BE HYDRAULIC COMPRESSION TYPE WITH PRE-MOLDED COVER AND TAPE.

YFI I OW

GRAY OR WHITE WITH TRACER GREEN

G. TERMINATIONS OF POWER AND CONTROL WIRING SHALL BE COMPRESSION TYPE, WITH TWO-HOLE LUGS FOR WIRE SIZES #8 AWG AND LARGER. MECHANICAL LUGS MAY ONLY BE UTILIZED FOR TERMINATIONS AT BRANCH CIRCUIT PANELBOARDS.

15. WIRING DEVICES A. WIRING DEVICES SHALL BE MANUFACTURED BY HUBBELL, LEVITON, PASS & SEYMOUR OR

BLUE

WHITE

- APPROVED EQUAL B. WIRING DEVICES SHALL BE HOSPITAL GRADE WITH NEMA CONFIGURATIONS AS INDICATED ON
- OTHERWISE BE MODEL#

C. EMERGENCY RECEPTACLES SHALL MATCH THE COLOR THROUGH THE FACILITY OR

- D. NORMAL RECEPTACLES COLOR SHALL SHALL BE AS SELECTED BY THE ARCHITECT
- E. PEDIATRIC CARE AREA RECEPTACLES SHALL BE TAMPER RESISTANT. F. MODEL HUBBELL INC. HBL 8300 SG00SGA, LEVITON TBR 20, PASS & SEYMOUR/LEGRAND TR

16. BRANCH CIRCUIT PANELBOARDS

- G. PILOT LIGHT SWITCHES SHALL BE FURNISHED WITH LIGHTED HANDLE OR SEPARATE GLASS
- JEWEL INDICATING LIGHT WIRED TO BE ILLUMINATED WHEN THE SWITCH IS ON. H. FACEPLATES SHALL BE NON-MAGNETIC STAINLESS STEEL WITH BRUSHED FINISH UNLESS

SPECIFIED BY THE ARCHITECT. EMERGENCY CIRCUIT RECEPTACLE FACEPLATES SHALL BE RED

AND SHALL IDENTIFIED THE PANEL AND CIRCUIT NUMBER SUPPLYING THEM. FACEPLATES SHALL BE FURNISHED FOR ALL COMMUNICATIONS OUTLETS AND SHALL BE CONFIGURED TO SUIT THE SYSTEM SUPPLIERS' REQUIREMENTS.

DEVICES MOUNTED ADJACENT TO EACH OTHER SHALL BE FURNISHED WITH A COMMON

- FACEPLATE AND BE GANGED IN ONE BOX.
- J. WALL MOUNTED DIMMER SWITCHES SHALL BE LUTRON "NOVA-T" SERIES OR APPROVED EQUAL. SWITCHES SHALL BE RATED FOR EITHER INCANDESCENT, ELECTRONIC OR MAGNETIC LOW VOLTAGE AND/OR FLUORESCENT DIMMING BALLASTS. COORDINATE SWITCH TYPE WITH LIGHT FIXTURES BEING CONTROLLED. MULTIPLE SWITCHES SHALL BE ALIGNED AND BUTTED TOGETHER WITH MULTI-GANG OUTLET BOX.
- K. PILOT LIGHT SWITCHES SHALL BE FURNISHED WITH LIGHTED HANDLE OR SEPARATE GLASS JEWEL INDICATING LIGHT WIRED TO BE ILLUMINATED WHEN THE SWITCH IS ON.
- L. FACEPLATES SHALL BE NON-MAGNETIC STAINLESS STEEL WITH BRUSHED FINISH UNLESS SPECIFIED BY THE ARCHITECT.
- M. FACEPLATES SHALL BE FURNISHED FOR ALL COMMUNICATIONS OUTLETS AND SHALL BE CONFIGURED TO SUIT THE SYSTEM SUPPLIERS' REQUIREMENTS.
- a. DEVICES MOUNTED ADJACENT TO EACH OTHER SHALL BE FURNISHED WITH A COMMON
- FACEPLATE AND BE GANGED IN ONE BOX. b. WALL MOUNTED DIMMER SWITCHES SHALL BE LUTRON "NOVA-T" SERIES OR APPROVED EQUAL. SWITCHES SHALL BE RATED FOR EITHER INCANDESCENT, ELECTRONIC OR MAGNETIC LOW VOLTAGE AND/OR FLUORESCENT DIMMING BALLASTS. COORDINATE SWITCH TYPE WITH
- TOGETHER WITH MULTI-GANG OUTLET BOX. c. CONTRACTOR SHALL UTILIZE THE FLOOR CELL WHEREVER POSSIBLE. PROVIDE SOURCE 1 FITTING CONFIGURATION TO MATCH FLOOR PLAN. WHEN FLOOR CELL CANNOT BE UTILIZED
- CONTRACTOR SHALL PROVIDE AND INSTALL POKE-THRU FITTING WIREMOLD MODEL RC-4 WITH COM75 ADAPTOR, AND ASSOCIATED CONDUIT(S). COORDINATE CORING WITH BUILDING MANAGEMENT. TRENCHING OF THE SLAB IS NOT ALLOWED. PROVIDE POWER AND TELECOMMUNICATION OUTLETS AS INDICATED ON PLANS.

LIGHT FIXTURES BEING CONTROLLED. MULTIPLE SWITCHES SHALL BE ALIGNED AND BUTTED

- d. CONTRACTOR SHALL PROVIDE AND INSTALL POKE-THRU FITTING WIREMOLD MODEL RC-4 WITH COM75 ADAPTOR, AND ASSOCIATED CONDUIT(S), COORDINATE CORING WITH BUILDING MANAGEMENT. TRENCHING OF THE SLAB IS NOT ALLOWED. PROVIDE POWER AND TELECOMMUNICATION OUTLETS AS INDICATED ON PLANS. e. CONTRACTOR SHALL PROVIDE AND INSTALL FLOOR BOX WIREMOLD MODEL OMNI 880 SERIES AND ASSOCIATED CONDUIT(S). COORDINATE TRENCHING OF THE SLAB WITH STRUCTURAL ENGINEER, ARCHITECT, AND BUILDING MANAGEMENT. PROVIDE POWER AND
- TELECOMMUNICATION OUTLETS AS INDICATED ON PLANS. WALL MOUNTED DIGITAL PROGRAMMABLE TIMER SWITCH FOR AUTOMATIC CONTROL OF 26. <u>LIGHTING CONTACTOR(NOT USED)</u> LIGHTING WITH MANUAL OVERRIDE PROVISIONS SHALL BE BY PASS & SEYMOUR MODEL RT24 g. ALL DEVICES SHALL BE MOUNTED AT LOCATIONS AND HEIGHTS AS INDICATED ON
- ARCHITECTURAL DRAWINGS. h. WHERE NEW, EXISTING OR NEW AND EXISTING SWITCHES ARE MOUNTED AT SAME LOCATION, MOUNT SWITCHES BEHIND COMMON FACEPLATE. DOOR CHIME SHALL BE HARD-WIRED, 'NUTONE' MODEL LA14WH OR APPROVED EQUAL. PUSHBUTTON SHALL BE HARD-WIRED, 'NUTONE' MODEL PB67AB OR APPROVED EQUAL.

CONFIGURATION WITH COPPER BUS BARS, NEUTRAL BUS AND SEPARATE GROUND BUS BONDED TO PANEL ENCLOSURE. PROVIDE 200% NEUTRAL AND ISOLATED GROUND BUS WHERE INDICATED ON DRAWINGS. CABLE LUGS SHALL BE MECHANICAL TYPE. PANELBOARDS SHALL BE MANUFACTURED BY SCHNEIDER ELECTRIC/SQUARE D, GENERAL ELECTRIC, SIEMENS, OR CUTLER-HAMMER. CEILINGS TO RECEPTACLES (MAXIMUM LENGTH 20'-0"). NOT TO BE USED FOR HOMERUNS OR B. CIRCUIT BREAKERS SHALL BE MOLDED CASE, BOLT-IN-PLACE WITH THERMAL-MAGNETIC TRIP ELEMENT. MINIMUM INTERRUPTING RATINGS SHALL BE 22,000 AIC FOR 208/120V AND 65,000 AIC FOR 480/277V. CIRCUIT BREAKERS FOR UNSWITCHED LIGHTING CIRCUITS SHALL BE RATED FOR

A. BRANCH CIRCUIT PANELBOARDS SHALL BE 480/277V AND/OR 208/120V, 3Ø, 4-WIRE

- SWITCHING DUTY. MAIN CIRCUIT BREAKERS SHALL BE MOUNTED SEPARATELY FROM BRANCH BREAKERS AT TOP OR BOTTOM. C. PANELBOARD ENCLOSURES SHALL BE GALVANIZED CODE GAUGE STEEL. TRIMS SHALL BE SURFACE TYPE IN UNFINISHED SPACES AND FLUSH TYPE IN FINISHED SPACES, WITH ANSI 61 GRAY ENAMEL FINISH. DOORS SHALL BE DOOR IN DOOR TYPE CONSTRUCTION AND SHALL BE LOCKABLE AND ALL LOCKS SHALL BE KEYED ALIKE. FURNISH ONE KEY FOR EACH PANEL. D. PANELS SHALL HAVE A MINIMUM OF 4" GUTTER SPACE ON BOTH SIDES.
- E. FURNISH AND INSTALL TYPEWRITTEN DIRECTORIES FOR EACH PANELBOARD, NEW AND EXISTING, INDICATING DEVICES SERVED.
- F. PANELS NOT MOUNTED ON STRUCTURAL WALLS SHALL BE SUPPORTED FROM THE FLOOR INDEPENDENTLY OF WALL CONSTRUCTION BUT LATERALLY SECURED TO WALL FLUSH

MOUNTED PANELBOARDS SHALL BE PROVIDED WITH (3) 1" EMPTY CONDUITS TERMINATED

G. PANELS MOUNTED ON MASONRY WALLS SHALL BE SHIMMED WITH WASHERS TO PROVIDE A 1/2" SPACE BETWEEN PANELBOARD AND WALL.

18. <u>DISTRIBUTION PANELBOARDS (FUSED SWITCHES) (</u>NOT USED)

17. <u>DISTRIBUTION PANELBOARDS (CIRCUIT BREAKERS) (NOT USED)</u>

ABOVE THE FINISHED CEILING.

- A. SAFETY DISCONNECT SWITCHES SHALL BE 250V OR 600V AS REQUIRED, HEAVY DUTY, HORSEPOWER RATED, QUICK-MAKE, QUICK-BREAK DESIGN IN NEMA 1 ENCLOSURE. ENCLOSURES EXPOSED TO WET OR RAIN CONDITIONS SHALL BE IN NEMA 3R ENCLOSURE.
- B. PROVIDE INTERLOCKS TO PREVENT OPENING THE COVER WITH THE SWITCH IN THE "ON" POSITION OR CLOSING OF THE SWITCH WITH THE DOOR OPEN, EXCEPT THAT THE INTERLOCK SHALL BE TOOL RELEASABLE BY A QUALIFIED PERSON FOR INSPECTION OF THE CONTACTS OF
- C. PROVIDE FOR PADLOCKING HANDLE IN THE OFF POSITION.
- D. PROVIDE NEUTRAL ASSEMBLY WHERE SCHEDULED.
- E. SWITCHES SHALL BE CAPABLE OF WITHSTANDING THE AVAILABLE FAULT OR LET THROUGH CURRENT BEFORE THE FUSE OPERATES WITHOUT DAMAGE OR CHANGE IN RATING. THE SHORT CIRCUIT INTERRUPTING RATING OF THE FUSE SWITCH COMBINATION SHALL BE 100,000 RMS SYMMETRICAL AMPERES AND 12 TIMES THE CONTINUOUS CURRENT RATING WHEN UNFUSED AT RATED VOLTAGE.
- CURRENT LIMITING FUSES ONLY AND SHALL BE SIZED TO ACCEPT FUSES OF THE PROPER AMPERE RATING. G. PROVIDE GROUND LUG IN EACH SWITCH.

F. FUSE CLIPS SHALL BE OF THE REJECTION TYPE, SHALL ACCOMMODATE DUAL ELEMENT,

- A. FUSES SHALL BE UL LISTED, TIME DELAY, CURRENT LIMITING AND HAVE AN INTERRUPTING CAPASTATE OF AT LEAST 200,000 AMPERES RMS SYMMETRICAL
- B. THE TIME-CURRENT CHARACTERISTICS AND RATINGS SHALL BE SUCH THAT POSITIVE SELECTIVE COORDINATION IS ASSURED.
- C. FUSE VOLTAGE RATINGS SHALL BE 600V OR 250V AS REQUIRED. D. CLASS RK1 (TIME DELAY) FUSES, REJECTION TYPE.
- a. BUSSMANN TYPE LPN-RK (250V) OR TYPE LPS-RK (600V) b. FERRAZ-SHAWMUT A2D (250V) OR A6D (600V)
- c. LITTELFUSE TYPE LLN-RK (250V) OR LLS-RK (600V) d. CLASS L (TIME DELAY)
- e. BUSSMANN TYPE KRP-C f. LITTELFUSE TYPE KLP-C
- a. FERRAZ-SHAWMUT A4B0 CLASS CC (TIME DELAY) FUSES, REJECTION TYPE
- BUSSMANN TYPE LP-CC FERRAZ-SHAWMUT ATDR

21. MOTOR STARTERS AND CONTROLS (NOT USED)

k. LITTELFUSE TYPE KLDR

22. <u>LIGHTING FIXTURES AND EQUIPMENT</u>

- A. LIGHTING FIXTURES SHALL BE SPECIFICATION GRADE AND FURNISHED COMPLETE WITH ALL REQUIRED MOUNTING HARDWARE. FIXTURES SPECIFIED IN THE LIGHTING FIXTURE SCHEDULE ESTABLISH THE PERFORMANCE REQUIREMENTS. SUBSTITUTIONS MUST MEET OR EXCEED THE PERFORMANCE OF THE SPECIFIED FIXTURE.
- B. SUBMIT SCALED LAYOUT DRAWINGS FOR CONTINUOUS FIXTURES. SUBMIT SAMPLES WHEN REQUIRED BY THE LIGHTING FIXTURE SCHEDULE OR WHEN REQUESTED FOR SUBSTITUTIONS.
- C. LAMPS SHALL BE OF THE TYPES SPECIFIED IN THE LIGHTING FIXTURE SCHEDULE. ALL LAMPS OF ANY ONE TYPE SHALL BE THE PRODUCT OF ONE MANUFACTURER. FURNISH 10% SPARE LAMPS OF EACH TYPE SPECIFIED.
- D. BALLASTS SHALL BE CBM CERTIFIED, UL CLASS P, ELECTRONIC, RAPID START, HIGH POWER FACTOR, ENERGY EFFICIENT TYPE, NEMA SOUND RATING A OR BETTER AND COMPATIBLE WITH THE LAMPS FURNISHED. ELECTRONIC BALLASTS SHALL BE FULLY SOLID STATE, HIGH FREQUENCY WITH RFI PROTECTION. THREE AND FOUR LAMP FIXTURES SHALL UTILIZE ONE AND TWO LAMP BALLASTS.
- E. CONTRACTOR SHALL ENSURE COMPATIBILITY BETWEEN FIXTURE TRIMS AND CEILING SYSTEMS. FIXTURES RECESSED IN ACCESSIBLE CEILINGS SHALL BE FURNISHED WITH SEISMIC RESTRAINTS. FIXTURES RECESSED IN NON-ACCESSIBLE CEILINGS SHALL BE DESIGNED FOR BALLAST OR TRANSFORMER ACCESS THROUGH THE FIXTURE OPENING.
- F. TANDEM WIRING FOR MULTI-LAMP BALLASTS SHALL BE USED. TANDEM WIRING FOR MULTI-LAMP BALLASTS BETWEEN FIXTURES SHALL BE ACCEPTED IN ACCORDANCE WITH MANUFACTURER'S RECOMMENDATIONS TO MINIMIZE THE AMOUNT OF BALLASTS REQUIRED. FOR A 3 LAMP BALLAST, THE BALLAST SHALL BE HOUSED IN THE CENTRALLY LOCATED FIXTURE TO THE LAMPS SERVED. THE FOLLOWING ARE EXEMPT FROM TANDEM WIRING:
- a. SURFACE MOUNTED OR PENDANT MOUNTED FIXTURES THAT ARE NOT CONTINUOUS. RECESSED FIXTURES THAT ARE SPACED MORE THAN 10'-0" ON CENTER. c. FIXTURES THAT ARE ON EMERGENCY CIRCUITS.

23. <u>LIGHTING CONTROLS</u> A. SENSORS AND SWITCH CONTROL SYSTEMS SHALL BE MANUFACTURED BY COOPER

#ONW-P-0451-MV

- CONTROLS, SENSOR SWITCH OR APPROVED EQUAL. SYSTEM SHALL CONSIST OF THE
- CEILING MOUNTED OCCUPANCY SENSOR EATON CONTROLS MODEL #OAC-DT-1000-R. b. CEILING MOUNTED VACANCY SENSOR - EATON CONTROLS MODEL #VAC-DT-1000-R. c. WALL MOUNTED OVERRIDE SWITCH FOR CEILING MOUNTED OCCUPANCY/VACANCY SENSORS
- EATON EATON MODEL #GMDS-W. d. WALL MOUNTED OCCUPANCY SENSOR SWITCH - COOPER CONTROLS MODEL
- e. WALL MOUNTED VACANCY SENSOR SWITCH COOPER CONTROLS MODEL #VNW-D-1001-MV-W.
- f. WALL MOUNTED DIGITAL SWITCH EATON CONTROLS MODEL #GBS g. DUAL RELAY SWITCH PACK- EATON CONTROLS MODEL #SPD20-MV-NO
- h. EMERGENCY POWER CONTROL EATON EATON MODEL #CEPC i. RELAY PANEL WITH TIME CLOCK - EATON EATON MODEL #LCP
- CKT16-12/277-SS4-SLO-STO-SHVBO-SHVD0 j. ALL ASSOCIATED WIRING AS PER MANUFACTURERS SPECIFICATIONS. B. SENSORS SHALL UTILIZE A COMBINATION OF PASSIVE INFRARED AND ULTRASONIC
- ADJUSTMENTS FOR COVERAGE PATTERN AND SENSITIVITY, TIME DELAY TO OFF (1 MIN. 20 MIN.) WITH LED DISPLAYS. C. BEFORE THE TENANT MOVE-IN DATE AND TURN OVER OF THE PROJECT, THE ELECTRICAL CONTRACTOR SHALL COORDINATE THE SENSITIVITY, CALIBRATION AND ADJUSTMENTS OF ALL

TECHNOLOGY TO ACTIVATE AND/OR MAINTAIN LIGHTING. SENSORS SHALL INCLUDE

- SENSORS IN THE FIELD IN CORRELATION WITH LIGHTING REQUIREMENTS, USAGE, AND THE
- D. ALL REQUIRED POWER PACKS ARE TO BE PROVIDED WITH TRANSFORMERS AND RELAYS AS REQUIRED.
- F. WHERE MULTIPLE ZONE EXIST IN A PARTICULAR ROOM, PROVIDE SEPARATE SWITCHPACK FOR EACH LIGHTING ZONE IN THAT ROOM.

E. PROVIDE 10' OF LOW VOLTAGE CABLE SLACK BETWEEN SENSOR AND SWITCHPACK.

- G. ALL VACANCY SENSORS SHALL COMPLY WITH NYS LOCAL LAW NO. 48.
- 1. DIMMING SYSTEM (NOT USED)

25. TIME CLOCK (NOT USED)

27. RELAYS, CONTACTORS AND CONTROLS (NOT USED)

28. DOOR ACCESS CONTROL EQUIPMENT (NOT USED)

A. THE DISTRIBUTION SYSTEM SHALL BE COMPLETELY AND PROPERLY GROUNDED USING APPROVED FITTINGS. SEPARATE INSULATED GROUND CONDUCTORS SHALL BE RUN WITH ALL

29. DRY TYPE TRANSFORMERS WITH HARMONIC FILTER AND TVSS (NOT USED)

- FEEDERS WHERE INDICATED, RECEPTACLE BRANCH CIRCUITS AND FLEXIBLE CONNECTIONS TO LIGHTING FIXTURES AND EQUIPMENT. B. METAL RACEWAYS, METAL ENCLOSURES OF ELECTRICAL DEVICES AND OTHER EQUIPMENT
- SHALL BE COMPLETELY GROUNDED IN AN APPROVED MANNER. PROPER HARDWARE REQUIRED FOR A COMPLETE GROUNDING SYSTEM SHALL BE INSTALLED BY THE CONTRACTOR. C. WYE-CONNECTED TRANSFORMER SECONDARY SHALL BE GROUNDED TO BUILDING STEEL,
- COLD WATER PIPING OR A DRIVEN GROUND ROD IN ACCORDANCE WITH CODE REQUIREMENTS FOR DERIVED SYSTEMS.
- D. CONDUITS TERMINATING AT CABLE TRAYS SHALL B BONDED TO THE TRAY WITH A #6 BARE COPPER JUMPER.

E. GROUND RODS SHALL BE 3/4 X 10'-0" COPPERWELD TYPE WITH EXOTHERMICALLY WELDED

CONNECTIONS. RAISED FLOORS SHALL BE GROUNDED WITH #6 AWG BARE COPPER CONDUCTORS BONDED TO EVERY SECOND PEDESTAL IN EVERY OTHER ROW OF PEDESTALS. TWO(2) DIAGONAL CORNER PEDESTALS OF THE FLOOR SYSTEM SHALL BE BONDED WITH AB APPROVED GROUNDING CLAMP AND #6 GROUNDING CABLE TO NEAREST BUILDING STEEL. EXOTHERMIC WELD CABLE TO FLANGE OF BUILDING STEEL. FLOOR GROUND CONDUCTOR LAYOUT SHALL NOT CREATE LOOPS.

SPLICES AND TERMINATIONS

- A. NO SPLICES OR JOINTS WILL BE PERMITTED IN EITHER FEEDER OR BRANCHES EXCEPT AT OUTLETS OR ACCESSIBLE TERMINAL, SPLICE OR JUNCTION BOXES.
- B. ALL MATERIALS REQUIRED FOR MAKING SPLICES AND/OR TERMINATIONS SHALL BE SUPPLIED IN COMPLETE KITS NOT OLDER THAN 6 MONTHS. THE CONTRACTOR SHALL ALSO BE RESPONSIBLE FOR ENSURING THAT ALL MATERIALS FURNISHED WILL NOT ADVERSELY AFFECT. THE PHYSICAL OR ELECTRICAL PROPERTIES OF OTHER MATERIALS FURNISHED OR OF THE WIRE OR CABLE ITSELF.
- C. WHERE THE CONTRACTOR MAKES CONNECTIONS TO EXISTING WIRES, HE SHALL OPEN AND DISCONNECT THE EXISTING SPLICES FROM SUCH WIRES AND INSTALL NEW SPLICES TO INCLUDE THE EXISTING WIRES AS REQUIRED.
- D. ALL SPLICES FOR WIRE SIZES #10 AWG AND SMALLER SHALL BE MADE WITH INSULATED SPRING CONNECTOR APPLIED TO TWISTED CONDUCTORS. TWO HALF LAPPED LAYERS OF VINYL TAPE EXTENDING A DISTANCE OF NOT LESS THAN ONE INCH FROM THE CONNECTOR SHALL BE APPLIED. SPLICES OTHER THAN THE AFOREMENTIONED WILL BE PERMITTED AT THE DISCRETION OF THE ENGINEER.
- E. ALL SPLICES FOR WIRE SIZES #8 AWG AND LARGER SHALL BE MADE WITH COMPRESSION TYPE CONNECTORS WITH PRE-MOLDED COVER OVER WHICH TWO HALF LAPPED LAYERS OF VINYL TAPE EXTENDING A DISTANCE OF NOT LESS THAN ONE (1) INCH FROM THE CONNECTOR SHALL BE APPLIED.

32. <u>REMOVALS</u>

- A. NOTES AND GRAPHIC REPRESENTATIONS ON THE DRAWINGS SHALL NOT LIMIT THE EXTENT OF REMOVALS REQUIRED. THE CONTRACTOR SHALL VISIT THE SITE AND CAREFULLY EXAMINE EXISTING CONDITIONS AND SHALL PERFORM ALL WORK REQUIRED TO ACHIEVE THE FINAL DESIGN INTENT AS REQUIRED BY THE CONTRACT DOCUMENTS. THE EXTENT OF ALL REMOVAL WORK SHALL BE COORDINATED WITH THE ARCHITECT
- B. WHERE PORTIONS OF AN EXISTING BRANCH CIRCUIT ARE REMOVED, WIRING TO REMAIN DEVICES ON THE CIRCUIT SHALL BE RECONNECTED OR MODIFIED IN AN APPROVED MANNER AS REQUIRED TO MAINTAIN CONTINUITY OF THE AFFECTED BRANCH CIRCUIT AND OPERATION OF THE REMAINING DEVICES.
- C. ALL WORK REQUIRED TO REMAIN IN SERVICE BUT INTERFERING WITH THE ALTERATION SHALL BE RELOCATED AND RECONNECTED USING MATERIALS AND STANDARDS OF THIS CONTRACT. D. THE REMOVAL OF ALL TELEPHONE AND DATA DEVICES AND ASSOCIATED CABLE SHALL BE
- COORDINATED WITH THE APPROPRIATE BUILDING OPERATING PERSONNEL. E. IN THE PROCESS OF REMOVING WIRING DEVICES, LIGHTING FIXTURES AND OTHER ELECTRICA EQUIPMENT AND MATERIALS, THIS CONTRACTOR SHALL EXERCISE EXTREME CAUTION TO
- PREVENT DAMAGE TO ARCHITECTURAL SURFACES AND MATERIALS WHICH ARE TO REMAIN INCLUDING WALLS, FLOORS, CEILINGS, WINDOWS, DOORS, MOLDINGS, STRUCTURAL MEMBERS, ETC. THE COST TO REPAIR OR REPLACE ANY MATERIAL DEEMED BY THE ARCHITECT TO HAVE BEEN UNDULY DAMAGED BY THIS CONTRACTOR DURING DEMOLITION OR CONSTRUCTION SHALL BE PAID BY THIS CONTRACTOR AT NO ADDITIONAL COST TO THE OWNER.
- F. ALL EXISTING UNUSED CONDUIT AND WIRING SHALL BE DROPPED TO THE FLOOR BY THE ELECTRICIAN FOR REMOVAL FROM THE BUILDING BY DEMOLITION OR GENERAL CONTRACTOR.

- A. ALL PANELBOARDS, EQUIPMENT AND CABINETS SPECIFIED HEREIN SHALL BE CLEARLY IDENTIFIED WITH THE EQUIPMENT DESIGNATION, VOLTAGE AND AMPERE RATING, FUSE RATING, EQUIPMENT SERVED AND ORIGIN OF THE INCOMING FEED. IDENTIFICATION SHALL BE WHITE ON BLACK PLASTIC NAMEPLATE WITH 1/2" MINIMUM LETTERING ATTACHED BY SCREWS.
- B. FACEPLATES OF SWITCHES FOR EQUIPMENT SUCH AS REMOTE FANS AND MOTORIZED SCREENS SHALL BE IDENTIFIED WITH THE NAME OF THE DEVICE CONTROLLED. IDENTIFICATION SHALL BE BY INDELIBLE MARKER IN CONCEALED LOCATIONS AND ADHESIVE LABELS IN EXPOSED LOCATIONS. EMERGENCY DEVICES SHALL BE IDENTIFIED IN RED.
- C. EMPTY CONDUITS SHALL BE IDENTIFIED WITH TAGS AT BOTH ENDS INDICATING THE LOCATION OF TERMINATION AT THE OPPOSITE END.
- D. BALLAST COMPARTMENTS FOR FIXTURES OPERATING AT GREATER THAN 120 VOLTS SHALL BE IDENTIFIED WITH A BRIGHT ORANGE ADHESIVE WARNING LABEL INDICATING VOLTAGE.
- E. ALL WIRES SHALL BE IDENTIFIED BY PANEL AND CIRCUIT NUMBER AT ALL TERMINATION AND SPLICE POINTS BY THE USE OF BRADY B-500 VINYL CLOTH TAPE OR EQUIVALENT METHOD.
- F. ALL JUNCTION BOXES SHALL BE IDENTIFIED WITH PANEL AND CIRCUIT NUMBERS OF ALL CIRCUITS OR NAME OF COMMUNICATIONS SYSTEM CABLING CONTAINED WITHIN. JUNCTION BOXES IN EXPOSED LOCATIONS SHALL BE CLEARLY MARKED WITH IDENTIFYING LABELS. JUNCTION BOXES IN CONCEALED LOCATIONS SHALL BE MARKED WITH A BOLD, INDELIBLE MARKING PEN. LETTERING SHALL BE NEATLY AND LEGIBLY PRINTED, JUNCTION BOXES ON EMERGENCY SERVICE SHALL BE PAINTED RED AND LABELED AS EMERGENCY.
- G. CONDUIT RUNS FOR BRANCH CIRCUITING AND/OR COMMUNICATIONS CABLING SHALL BE IDENTIFIED AT EVERY 50 FEET OF LENGTH, AND AT EACH OUTLET AND PULL BOX WITH CIRCUIT NUMBER OR SYSTEM NAME.

34. INSTALLATION OF LIGHTING FIXTURES

A. LOCATIONS OF LIGHTING FIXTURES INDICATED ON THE DRAWINGS ARE APPROXIMATE. CONTRACTOR SHALL REFER TO ARCHITECTURAL REFLECTED CEILING PLANS FOR EXACT LOCATIONS, MODELS, AND TRIM TYPES OF ALL LIGHTING FIXTURES PRIOR TO INSTALLATION.

B. RECESSED FIXTURES SHALL BE FURNISHED COMPLETE WITH MOUNTING DEVICES AND

C. FIXTURES SHALL BE ATTACHED TO CEILING SUPPORTING MEMBERS, AND SHALL NOT DEPEND UPON LATHING OR PLASTER FOR ALIGNMENT OR SUPPORT. FIXTURES IN SUSPENDED CEILINGS SHALL BE SUPPORTED BY SADDLE HANGERS OR TIE-BARS ATTACHED TO RUNNERS OR BETWEEN CROSSBARS OF CEILING SYSTEMS. MOUNTING SPLINES OR OTHER POSITIVE

MEANS OF MAINTAINING ALIGNMENT AND RIGIDITY SHALL BE PROVIDED. SUPPORTING

MEMBERS SHALL BE SURFACE PASSIVATED AND SHALL BE PRIMED OR PAINT DIPPED TO

- RESIST CORROSION. FASTENING DEVICES SHALL BE OF A POSITIVE, LOCKING TYPE, AND SHALL NOT REQUIRE THE USE OF SPECIAL TOOLS TO REMOVE. TIE WIRES SHALL NOT BE USED IN PLACE OF FASTENING DEVICES. D. HANGING OF LIGHTING FIXTURES IS TO BE DONE IN ACCORDANCE WITH THE NEW YORK STATE ELECTRICAL CODE AND BUILDING CODE OF THE STATE OF NEW YORK. LIGHTING FIXTURES WEIGHING UP TO AND INCLUDING 40 POUNDS MAY BE SUPPORTED FROM THE STEEL "Z" BARS. LIGHTING FIXTURES WEIGHING FROM 41 POUNDS UP TO AND INCLUDING 80 POUNDS MAY BE
- SUPPORTED FROM THE PURLINS. LIGHTING FIXTURES WEIGHING OVER 80 POUNDS SHALL BE SUPPORTED FROM THE BUILDING STRUCTURE AND NOT FROM THE CEILING SUSPENSION

F. SEPARATELY MOUNTED OUTLET BOXES AND FLEXIBLE CONDUIT PIGTAIL CONNECTIONS

(MAXIMUM LENGTH OF 6'-0") SHALL BE PROVIDED FOR LIGHTING FIXTURES RECESSED IN HUNG

- E. SPLICES SHALL NOT BE PERMITTED IN ANY RUN OF LIGHTING FIXTURE HOOKUP WIRE.
- CEILINGS WITH ACCESSIBLE TILES. ONE (1) OUTLET BOX MAY SERVE UP TO A MAXIMUM OF FOUR (4) RECESSED LIGHTING FIXTURES. G. ALL LIGHTING FIXTURES OPERATING AT 277V SHALL BE IDENTIFIED WITH AN ORANGE ADHESIVE WARNING LABEL ATTACHED TO COVER A BALLAST COMPARTMENT INDICATING THE
- 35. <u>CUTTING AND PATCHING</u> A. ALL CUTTING AND PATCHING REQUIRED FOR EQUIPMENT INCLUDED IN THESE SPECIFICATIONS
- B. THIS CONTRACTOR SHALL NOT DO ANY CUTTING THAT MAY IMPAIR THE STRENGTH OF BUILDING CONSTRUCTION. NO HOLES ARE TO BE DRILLED INTO ANY STRUCTURAL MEMBERS. CLAMPS OR OTHER APPROVED HOLDING DEVICES ARE TO BE USED.
- SO AS TO MINIMIZE DAMAGE TO ADJACENT MATERIALS. PATCHING OF ALL SURFACES SHALL BE PERFORMED IN A MANNER APPROVED BY THE ARCHITECT TO INSURE COMPLETE MATCHING WITH ADJACENT FINISHES AFTER FINAL TREATMENT OF SURFACES. 36. CORE DRILLING

C. ALL CUTTING OF EXISTING FLOORS, CEILINGS AND WALLS SHALL BE PERFORMED IN A MANNER

VOI TAGE

SHALL BE DONE BY THIS CONTRACTOR.

- A. CORED HOLES SHALL BE REVIEWED BY A STRUCTURAL ENGINEER PRIOR TO STARTING. B. CORE DRILLING IS PERMITTED DURING OVERTIME HOURS ONLY. COORDINATE ALL DRILLING
- WITH BUILDING MANAGEMENT PRIOR TO BEGINNING AND DRILLING.

D. CONTRACTOR SHALL USE A BAR LOCATOR TO DETERMINE IF REBARS INTERFERE WITH PROPOSED HOLE. IF THERE IS INTERFERENCE, THE CORE HOLE SHALL BE SHIFTED TO A NEW

C. FOR REMOVED OR ABANDONED OUTLETS. THE EXISTING CORED HOLE IN THE CONCRETE SLAB

SHALL BE FILLED WITH NON-SHRINK GROUT. THE FILLED HOLE SHALL BE ADJUSTED TO GRADE

- LOCATION ACCEPTABLE TO THE TENANT, STRUCTURAL ENGINEER AND ARCHITECT. E. WHEN AN EXISTING HOLE IS TO BE REACTIVATED, INSPECT TO SEE IF REBARS HAVE BEEN CUT
- IF REBARS HAVE BEEN CUT, INFORM THE GENERAL CONTRACTOR TO PROCEED TO REPAIR REBARS. PROCEED WITH A NEW CORE HOLE AS DESCRIBED ABOVE.

37. <u>SEALING OF PENETRATIONS</u>

- A. ALL PENETRATIONS OF WALLS, FLOORS OR CEILINGS MUST BE SEALED IN AN APPROVED MANNER USING AN OUTER CIRCUMFERENTIAL SLEEVE FILLED INSIDE AND OUT.
- B. ALL PENETRATIONS OF FIRE RATED WALLS, FLOORS OR CEILINGS SHALL BE SEALED WITH APPROVED MATERIAL TO PROVIDE SAME RATING AS FLOOR, WALL OR CEILING ASSEMBLY.

REFER TO ARCHITECTURAL DRAWINGS FOR LOCATIONS OF FIRE RATED PARTITIONS.

39. POWER INTERRUPTION NOTE

ADVANCE NOTICE.

- THREADED RODS SHALL BE FULLY GALVANIZED, MINIMUM 3/8" DIAMETER. MODULAR CHANNEL SUPPORTS SHALL BE GALVANIZED STEEL. SUPPORT CLIPS AND FASTENERS SHALL BE LISTED AND APPROVED FOR THE APPLICATION. STRAPS AND CLAMPS SHALL BE MALLEABLE IRON.
- WITH MODULAR CHANNEL SUPPORTS SECURED TO THE BUILDING STRUCTURE.
- ALL ELECTRICAL WORK WHERE REQUIRED BY LOCAL BUILDING CODES AND THE AUTHORITIES HAVING JURISDICTION.

A. ELECTRICAL POWER MUST BE SHUT OFF PRIOR TO THE CONTRACTOR PERFORMING ANY

WORK IN RACEWAYS WITH LIVE ELECTRICAL CIRCUITS OR ANY OTHER LIVE ELECTRICAL

- B. TAPS INTO LIVE RISERS ARE NOT PERMITTED.
- a. THE CONTRACTOR, PRIOR TO FINAL ACCEPTANCE, SHALL CLEAN ALL PANELS, SWITCHES, CABINETS, DEVICES PLATES, FIXTURES AND OTHER ITEMS FURNISHED UNDER THIS
- B. IN ADDITION TO OTHER TESTS WHICH MAY BE REQUIRED BY OTHER DIVISIONS, PERFORM FIELD TESTS IN THE PRESENCE OF THE ENGINEER, TO DEMONSTRATE THE PROPER FUNCTIONING OF THE ELECTRICAL INSTALLATION. THE ENGINEER SHALL BE GIVEN A MINIMUM OF 48 HOURS ADVANCE NOTICE OF ALL TESTS. REQUIRED FIELD TESTS SHALL INCLUDE, BUT NOT BE LIMITED
- a. OPERATION OF ALL ELECTRICAL EQUIPMENT FOR A PERIOD FOR A PERIOD OF 24 HOURS WITHOUT INTERRUPTION. b. 1,000 VOLT MEGOHMMETER TEST FOR ALL WIRES AND CABLES FURNISHED. CONTRACTOR
- C. ALL DEFECTIVE FIXTURES CABLES OR OTHER EQUIPMENT ENCOUNTERED DURING THE
- COURSE OF TESTING SHALL BE PROMPTLY REPLACED AND RETESTED TO THE SATISFACTION OF THE ENGINEER.
- FORM A-433 (APPLICATION FOR ELECTRICAL INSPECTION) WITH THE FIRE DEPARTMENT. A WRITE-OFF MUST BE GIVEN TO THE BUILDING MANAGER AT THE COMPLETION OF JOB. SEE PAGE 31 OF RUDIN MANAGEMENTS PROCEDURES FOR ALTERATIONS INVOLVING CLASS "E" FIRE ALARM AND/OR COMMUNICATION SYSTEMS.

41. UNIT PRICE NOTES

- A. CONTRACTOR IS TO SUBMIT UNIT PRICES FOR THE FOLLOWING LISTED ITEMS:
- a. ALL CONDUITS REQUIRED FOR THIS JOB b. ALL RECEPTACLES, WALL AND WORKSTATION MOUNTED
- e. TELEPHONE OUTLETS

42. PROJECT CLOSEOUT

- CONTRACTOR SHALL GIVEN WRITTEN NOTICE THAT THE FOLLOWING ITEMS HAVE BEEN COMPLETED:
- a. REQUIRED AGENCY APPROVALS. b. FINAL CLEANING AND ADJUSTMENT OF LIGHTING FIXTURES AND EQUIPMENT.
- e. TURNOVER OF SPARE LAMPS, KEYS, AND ANY REQUIRED SPARE PARTS OR TOOLS. f. SYSTEM STARTUP, TESTING AND ADJUSTMENT.

43. TEMPORARY LIGHTING AND RECEPTACLE

d. AS-BUILT DRAWINGS.

- A. THE CONTRACTOR FOR ELECTRICAL WORK SHALL FURNISH, AND CONNECT TO A DESIGNATED CIRCUIT BREAKER PANEL, A SYSTEM OF TEMPORARY LIGHTING TO ILLUMINATE THE ENTIRE AREA WHERE WORK IS BEING PERFORMED AND POINTS ADJACENT TO THE WORK. THE TEMPORARY LIGHTING SYSTEM SHALL CONSIST OF FACTORY-MANUFACTURED TEMPORARY LIGHTING STRINGS. THE STRINGS SHALL CONSIST OF A HEAVY-DUTY CABLE WITH INTEGRAL MOLDED LIGHT SOCKETS FOR 23 WATT SCREW-IN COMPACT, FLUORESCENT LAMPS. THE LIGHT SOCKETS SHALL HAVE A MOLDED FLANGED WITH A HOLE, SIZED TO SUPPORT THE LAMP SOCKET AND CABLE, AND SHALL BE EQUIPPED WITH A STEEL WIRE LOCKING-TYPE LAMP GUARD. TEMPORARY LIGHTING SHALL BE POWERED FROM A GFI CIRCUIT BREAKER.
- B. RECEPTACLES FOR TEMPORARY POWER SHALL BE PROVIDED IN WORK AREAS AT MAXIMUM INTERVALS OF 25 FEET. ALL TEMPORARY RECEPTACLES SHALL BE GROUND-FAULT INTERRUPTING TYPE, OR SHALL BE PROTECTED BY GROUND-FAULT CIRCUIT-INTERRUPTING TYPE CIRCUIT BREAKERS. RECEPTACLES SHALL BE MOUNTED IN CAST ALUMINUM OUTLET BOXES WITH THREADED HUBS AND SHALL PROVIDED WITH IN-USE WET LOCATION COVERS. TEMPORARY WIRING (WITHIN THE EXISTING BUILDING) FOR TEMPORARY RECEPTACLES SHALL BE TYPE MC CABLE WITH AN INTEGRAL INSULATED GROUND CONDUCTOR. A MAXIMUM OF THREE (3) DUPLEX RECEPTACLES SHALL BE CONNECTED TO A 20 AMPERE, 120 VOLT CIRCUIT.

THIS PLAN IS APPROVED ONLY FOR WORK INDICATED ON THE

APPLICATION SPECIFICATION SHEET. ALL OTHER MATTERS SHOWN

212-689-3110 **CONSULTANTS:**

470 PARK AVE SOUTH, 11th FLOOR

ARRAY-ARCHITECTS.COM

NEW YORK, NY. 10016

Architect of Record:

STRUCTURAL ENGINEER

REUTHER + BOWEN

DUNMORE, PA 18512 PHONE: 570.496.7020

326 WARD STREET

MEP ENGINEER

LORING CONSULTING ENGINEERS, INC 360 WEST 31ST STREET, 14th FL. NEW YORK, NY 10001 PHONE: 646.674.6100


ESTIMATING

COST CONCEPTS, INC.

104 BEDELL PLACE MELVILLE, NY, 11747 PHONE: 631.423.7960

PROJECT:

155 WHITE PLAINS ROAD

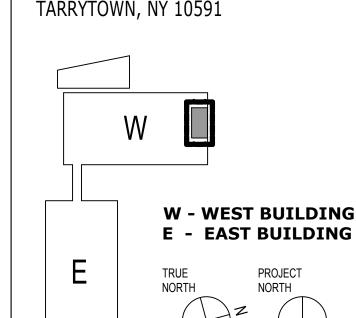

CD SUBMISSION 6-18-21 DATE DESCRIPTION **REVISIONS/ISSUES**

SHEET TITLE:

SEAL:

SHEET NO.

CHECKED: Checker DRAWN: MC

DATE: 7/23/2020

CON/REF No.

CONTRACT No.

SCALE: As indicated

PROJECT No. 12384

E-002.00

This document is a copyright protected instrument of service,

property of Array Architects and licensed for use in the title project only. Reproduction or use of this document without prosecuted under the law.

COPYRIGHT - 2020 ARRAY-ARCHITECTS P.C.

written permission of Array Architects is illegal and will be

ARE NOT TO BE RELIED UPON, OR TO BE CONSIDERED AS EITHER BEING APPROVED OR IN ACCORDANCE WITH APPLICABLE CODES.

B. SUPPORTS SHALL BE SIZED TO ACCOMMODATE THE LOAD REQUIRED. ALL WORK SHALL BE SUPPORTED INDEPENDENTLY OF THE WORK OF OTHER TRADES, INCLUDING CEILING SYSTEM

C. PANELS AND EQUIPMENT LOCATED ON OTHER THAN MASONRY WALLS SHALL BE MOUNTED

CIRCUITS OR EQUIPMENT. ANY POWER INTERRUPTION SHALL BE COORDINATED WITH THE OWNER AND BUILDING OPERATING PERSONNEL, PROVIDING A MINIMUM OF SEVEN (7) DAYS

ADDITIONAL COST TO THE OWNER.

40. FINAL CLEANUP AND FIELD TESTS A. AFTER COMPLETION OF THE ENTIRE ELECTRICAL INSTALLATION:

CONTRACT AND SHALL ENSURE THAT ALL PANELBOARD DIRECTORIES ARE IN PLACE AND COMPLETED OR REVISED AS REQUIRED BY THE WORK, AND THAT ALL IDENTIFICATION AND MARKING OF EQUIPMENT, CABLES, ALL JUNCTION BOXES AND OTHER ITEMS IS COMPLETED. b. THE CONTRACTOR SHALL REPAIR OR REPLACE, AS DIRECTED BY THE ENGINEER, ANY ITEM

DAMAGED DUE TO INSTALLATION OR RELOCATION OF EQUIPMENT OR DEVICES AT NOT

- TO THE FOLLOWING:
- SHALL FURNISH A TEST REPORT TO THE ENGINEER INDICATING TEST METHOD USED AND
- D. $\,$ ELECTRIC WIRING TO CLASS "E" SYSTEMS FOR INSTALLATION AND RELOCATION OF FIRE ALARM DEVICES SHALL BE APPROVED BY THE FIRE DEPARTMENT. CONTRACTOR MUST FILE

- c. ALL LIGHT FIXTURES d. ALL SWITCHES
- A. AFTER COMPLETION OF PROJECT AND PRIOR TO REQUESTING FINAL PAYMENT, THE
- c. RESOLUTION OF OUTSTANDING SUBMITTALS AND PUNCH LIST ITEMS.
- MANUFACTURER'S CERTIFICATIONS, WARRANTIES AND O&M MANUALS. h. DEMONSTRATIONS AND OWNER INSTRUCTION.

FIRE-RATED WIRING

CONSTRUCTION

PUMP ROOM

CONTROL WIRING

OTHER WIRING).

WIRING NOTES 1 AND 2 ABOVE.

SHALL BE AS FOLLOWS:

OTHER SYSTEMS.

A. 120V, 20A CIRCUIT

B. 277V, 20A CIRCUIT

PERFORM THE SPLICES.

CORRESPONDING SPACE.

A.A. 12 AWG - 35 FEET

A.B. 10 AWG - 60 FEET

A.C. 8 AWG - 95 FEET

A.D. 6 AWG - 145 FEET

A.E. 4 AWG - 230 FEET

B.A. 12 AWG - 85 FEET

B.B. 10 AWG - 140 FEET

B.C. 8 AWG - 215 FEET

B.D. 6 AWG - 340 FEET

AND AMPERE INTERRUPTING CAPACITY.

ELECTRICAL BRANCH CIRCUITING NOTES

A. LIGHTING FIXTURES - 2 #12, #12 GRD. - 3/4" C.

BRANCH CIRCUIT BREAKERS (277 VOLT) - 1P, 20A BRANCH CIRCUIT BREAKERS (120 VOLT) - 1P, 20A

VOLTAGE DROP TO LESS THAN 2.0% ON THE BRANCH CIRCUIT:

RECEPTACLES - 2#12, #12 GRD. - 3/4" C.

SOME WIRES AND CABLE PROVISIONS INSIDE OF THE BUILDING SHALL MEET ONE

a. FEEDERS OF THE LIFE SAFETY BRANCH SHALL BE PROVIDED WITH

BE A 2-HOUR RATED LISTED CABLE SYSTEM (FOR EXAMPLE, RHW-2 CABLE.

OF THE FOLLOWING REQUIREMENTS TO ACHIEVE A 2-HOUR FIRE RATING:

MI CABLE) INSTALLED PER MANUFACTURER REQUIREMENTS.

THE WIRES AND CABLES THAT SHALL MEET THE REQUIREMENTS IDENTIFIED IN

A. LIFE SAFETY BRANCH FEEDERS THAT ARE NOT INSTALLED IN SPACES OR

AREAS THAT ARE FULLY PROTECTED BY A SPRINKLER SYSTEM OR

B. FIRE PUMP NORMAL AND EMERGENCY FEEDERS AND CONTROL WIRING

b. EXCEPTION: SUPPLY CONDUCTORS LOCATED OUTDOORS.

PRESSURIZATION SYSTEM) NORMAL AND EMERGENCY FEEDERS AND

D. GENERATOR CONTROL WIRING (INSTALLED ENTIRELY INDEPENDENT OF ALL

THE FINAL PROVISIONS OF 2-HOUR RATED WIRES AND CABLES SHALL BE IN FULL

COMPLIANCE WITH THE REQUIREMENTS OF APPLICABLE ELECTRICAL AND

ALL BRANCH CIRCUIT HOME RUNS SHALL BE 2#12 & 1#12 GROUND IN 3/4"

ON THE DRAWINGS (APPLICABLE FOR WIRING OF LIGHTING FIXTURES,

RECEPTACLES, MEDICAL EQUIPMENT, MECHANICAL EQUIPMENT, ETC.).

CONDUIT, UNLESS OTHERWISE NOTED, TO PANEL ON CIRCUIT INDICATED.

MAXIMUM OF THREE HOME RUNS PER CONDUIT. PROVIDE A SEPARATE NEUTRAL

WIRE AND A SEPARATE GROUND WIRE FOR EACH 120V AND 277V CIRCUIT SHOWN

WHERE EQUIPMENT, LIGHTING FIXTURES AND WIRING DEVICES ARE SHOWN WITH

CIRCUIT NUMBERS ONLY, THE MINIMUM BRANCH CIRCUITING REQUIREMENTS

HOMERUNS TO PANELBOARDS SHALL CONTAIN NO MORE THAN (3)

F. 208/120 VOLT 480/277 VOLT WIRING SHALL BE RUN IN SEPARATE RACEWAY

G. EMERGENCY SERVICES SHALL BE RUN IN SEPARATE RACEWAYS FROM ALL

H. WHERE LIGHTING SWITCH INDICATIONS ARE NOT SHOWN, SWITCHES SHALL

BE CONNECTED TO CONTROL ALL SWITCHED FIXTURES WITHIN THE

WHERE CONDUIT AND WIRING CONNECTIONS ARE NOT SHOWN ON THE PLANS.

SPLICE WIRES WHICH ARE 8 AWG AND LARGER WITH 10 AWG WIRE TO PERMIT

POSSIBLE TO THE LOADS. PROVIDE A SEPARATE JUNCTION BOX IF REQUIRED TO

PROVIDE CIRCUITRY FOR ALL "NON-STANDARD" WIRING DEVICES (OTHER THAN

FOR ALL NEW CIRCUIT BREAKERS BEING INSTALLED IN AN EXISTING PANEL: NEW

CAPACITY SHALL MATCH EXISTING CIRCUIT BREAKERS' TYPE, MANUFACTURER,

CIRCUIT NUMBERS SHOWN ON THE DRAWINGS ARE FOR REFERENCE PURPOSES

REQUIRED. EXISTING FIELD CONDITIONS SHALL PREVAIL. REUSE CIRCUITS MADE

REFER TO MECHANICAL DRAWINGS FOR VAV BOX LOCATIONS. CONNECT UP TO

(8) VAV BOXES PER SPARE 20A/1P CIRCUIT BREAKER IN THE NEAREST EQUIPMENT

BRANCH PANEL. PROVIDE MINIMUM 2#10+1#10G-3/4"C. AT EACH VAV BOX PROVIDE

CONNECT UP TO (8) FIRE/SMOKE DAMPERS PER SPARE 20A/1P CIRCUIT BREAKER

LOCATIONS AND QUANTITIES OF MAGNETIC DOOR HOLDERS. CONNECT UP TO (8)

A. BRANCH CIRCUITING SHALL BE IN ACCORDANCE WITH CONTROL SCHEMES

B. RELAY CONTROLLED AND DIMMER SYSTEM BRANCH CIRCUITS SHALL RUN

D. IN GENERAL, 120V LIGHTING CONNECTED LOAD SHALL NOT EXCEED 1600

E. IN GENERAL, 277V LIGHTING CONNECTED LOAD SHALL NOT EXCEED 3300

COORDINATE FINAL LOCATIONS, QUANTITIES, MOUNTING, AND TYPES OF

CONTROL DEVICES (SWITCHES, SENSORS, ETC.) WITH ARCHITECT AND

LOCATIONS AND QUANTITIES SHALL BE PROVIDED AS REQUIRED TO MEET

COORDINATED WITH LIGHTING CONSULTANT, ARCHITECT, AND EQUIPMENT

PROTECTION DEVICE LOCATED IN PANEL OR LIGHTING SYSTEM EQUIPMENT.

LIGHTING CONSULTANT. OCCUPANCY AND VACANCY SENSORS FINAL

EACH ZONE SHALL BE PROVIDED WITH AN OVERRIDE SWITCH.

MINIMUM SIZE OF BRANCH CIRCUIT CONDUIT SHALL BE 3/4".

THE DEVICE MANUFACTURER'S RECOMMENDATIONS.

MINIMUM SIZE OF BRANCH CIRCUIT WIRE SHALL BE #12 AWG.

PROVIDE 20% SPARE LIGHTING RELAYS / DIMMER MODULES.

J. FINAL DIMMING AND LIGHTING CONTROL REQUIREMENTS SHALL BE

K. EACH LIGHTING CIRCUIT SHALL BE PROVIDED WITH A 20A OVERCURRENT

2#10+1#10G-3/4"C. DO NOT PROVIDE TOGGLE-TYPE DISCONNECT SWITCHES AT

MAKING FINAL TERMINATIONS AT LOADS. SPLICES SHALL BE AS CLOSE AS

20A, 120V OUTLETS) ON THE BASIS OF ONE RECEPTACLE PER CIRCUIT,

"NON-STANDARD" WIRING DEVICE WIRED TO THE PANEL AS REQUIRED.

OVERCURRENT DEVICE IN PANEL SIZED TO MATCH AMPERE RATING OF

CIRCUIT BREAKERS' TYPE, MANUFACTURER, AND AMPERE INTERRUPTING

ONLY. SPARES AND SPACES SHALL BE UTILIZED BY THE CONTRACTOR AS

SPARE BY THE DEMOLITION WORK IN CONJUNCTION WITH THE NEW WORK.

A TOGGLE-TYPE DISCONNECT SWITCH. AT EACH VAV BOX PROVIDE A

IN THE NEAREST LIFE SAFETY BRANCH PANEL. PROVIDE MINIMUM

FIRE/SMOKE DAMPERS. AT EACH FIRE/SMOKE DAMPER PROVIDE A

BRANCH PANEL. PROVIDE MINIMUM 2#10+1#10G-3/4"C.

VIA LIGHTING CONTROL EQUIPMENT AS REQUIRED.

11. LIGHTING CIRCUITRY GROUND RULES:

SHOWN ON PLANS.

CEILING-MOUNTED JUNCTION BOX WITH LIQUIDTIGHT FLEXIBLE METALLIC

CONDUIT FOR FINAL EQUIPMENT CONNECTION (5 FOOT MAXIMUM LENGTH).

REFER TO MECHANICAL DRAWINGS FOR FIRE/SMOKE DAMPER LOCATIONS.

CEILING-MOUNTED JUNCTION BOX WITH LIQUIDTIGHT FLEXIBLE METALLIC

REFER TO FIRE ALARM DRAWINGS AND ARCHITECTURAL DRAWINGS FOR

UNITS PER SPARE 20A/1P CIRCUIT BREAKER IN THE NEAREST LIFE SAFETY

CONDUIT FOR FINAL EQUIPMENT CONNECTION (5 FOOT MAXIMUM LENGTH).

BRANCH CIRCUIT SIZES AND MAXIMUM LENGTHS SHALL BE AS FOLLOWS, TO LIMIT

C. 208V/1-PHASE, 20A CIRCUIT

C.A. 12 AWG - 65 FEET

C.C. 8 AWG - 160 FEET

C.D. 6 AWG - 255 FEET

480V/1-PHASE, 20A CIRCUIT

D.A. 12 AWG - 150 FEET

D.B. 10 AWG - 250 FEET

C.B. 10 AWG - 105 FEET

BUILDING CODES AND AUTHORITIES HAVING JURISDICTION. SEE FIRE-RATED

C. SMOKEPROOF ENCLOSURE VENTILATION SYSTEM (STAIRWELL

EXCEPTION: CONDUCTORS LOCATED OUTDOORS.

b. EXCEPTION: CONDUCTORS LOCATED OUTDOORS.

DRY-TYPE SYSTEM, E.G. FEEDERS THAT ARE INSTALLED ABOVE A HUNG

EXCEPTION: SUPPLY CONDUCTORS LOCATED IN THE ELECTRICAL

EXCEPTION: CONDUCTORS LOCATED IN ROOMS OR ENCLOSURES

EXCEPTION: CONDUCTORS LOCATED IN ROOMS OR ENCLOSURES

EQUIPMENT ROOM WHERE THEY ORIGINATE, OR LOCATED IN THE FIRE

A. BE PROTECTED BY AN ENCLOSURE WITH 2-HOUR FIRE-RATED

B. BE ENCASED IN A MINIMUM OF 2 INCHES OF CONCRETE.

DEDICATED ENCLOSURES.

FIRE-RATED WIRING NOTE 1 ABOVE ARE AS FOLLOWS:

THAT ARE 2-HOUR FIRE-RATED.

THAT ARE 2-HOUR FIRE-RATED.

ELECTRICAL DEMOLITION NOTES

THE CONTRACTOR SHALL INCLUDE IN BID ALL COSTS ASSOCIATED WITH REMOVALS AND RELOCATIONS OF ELECTRICAL WORK AS SHOWN ON THE DRAWINGS AND AS DESCRIBED IN THE SPECIFICATIONS WITH ALLOWANCES FOR EXPECTED OR UNFORESEEN DIFFICULTIES WHEN CONCEALED WORK HAS BEEN OPENED. NO ADDITIONAL ALLOWANCE WILL BE MADE TO THE CONTRACTOR DUE TO NEGLECT

2. REFER TO ARCHITECTURAL DRAWINGS FOR THE ENTIRE SCOPE OF WORK, THE EXTENT OF THE DEMOLITION WORK IN PARTICULAR, AND ADDITIONAL

OR FAILURE TO COMPLY WITH THE SPECIFIED REQUIREMENTS.

- NOTES AND GRAPHIC REPRESENTATIONS SHALL NOT LIMIT THE EXTENT OF DEMOLITION REQUIRED. CONTRACTOR SHALL VISIT THE SITE, CAREFULLY EXAMINE EXISTING CONDITIONS AND SHALL PERFORM ALL DEMOLITION REQUIRED TO ACHIEVE THE FINAL DESIGN INTENT AS REQUIRED BY THE CONTRACT DOCUMENTS. EXTENT OF ALL DEMOLITION WORK SHALL BE COORDINATED WITH THE ARCHITECT.
- 4. ALL WORK REQUIRED TO REMAIN IN SERVICE BUT INTERFERING WITH THE ALTERATIONS SHALL BE RELOCATED AND RECONNECTED USING MATERIALS AND STANDARDS OF THIS CONTRACT.
- 5. EQUIPMENT AND WIRING TO BE REMOVED SHALL BE DE-ENERGIZED PRIOR TO ANY DEMOLITION WORK. TEMPORARY LIGHTING SHALL BE PROVIDED ON THE ENTIRE FLOOR BEING DEMOLISHED UNTIL THE WORK IS COMPLETE.
- DISPOSED OF IN ACCORDANCE WITH APPLICABLE LAWS AND ENVIRONMENTAL REGULATIONS. EQUIPMENT REQUIRED TO BE TURNED OVER TO THE OWNER SHALL BE PLACED IN A MUTUALLY ACCEPTABLE LOCATION. THE WORK SHALL INCLUDE THE REMOVAL OF MATERIALS AS DIRECTED. PRIOR TO

6. EQUIPMENT INDICATED TO BE REMOVED SHALL BE TAKEN FROM THE SITE AND

- REMOVING FOUIPMENT AND MATERIALS FROM THE PROJECT SITE. THE OWNER'S MANAGER SHALL INSPECT AND ADVISE WHICH ITEMS WILL BE RESTORED.
- 8. THE CONTRACTOR SHALL BE RESPONSIBLE FOR REMOVAL FROM THE PREMISES ALL DEBRIS RESULTING FROM REMOVAL OF ELECTRICAL WORK.
- 9. DEMOLITION AND REMOVAL WORK SHALL BE PERFORMED IN A NEAT AND WORKMANLIKE MANNER. THE CONTRACTOR SHALL PATCH, REPAIR, FIREPROOF, OR OTHERWISE RESTORE ANY DAMAGED INTERIOR OR EXTERIOR BUILDING SURFACES (INCLUDING OPENINGS IN FLOORS OR WALLS CREATED BY REMOVAL OF CONDUITS OR WIRE) TO THEIR ORIGINAL CONDITION.
- 10. THIS CONTRACTOR SHALL MAINTAIN CONTINUITY OF SERVICE TO EXISTING BUILDING FIRE ALARM SYSTEM. COORDINATE WITH BUILDING MANAGER.
- 11. THE CONTRACTOR SHALL PERFORM DEMOLITION AND REMOVAL WORK WITH MINIMUM INTERFERENCE WITH FUNCTIONING ELECTRICAL SYSTEMS THAT ARE TO REMAIN. ALL AFFECTED SYSTEMS SHALL BE RECONNECTED AND RESTORED.
- 12. OUTSIDE THE SCOPE OF WORK AREAS, MAINTAIN CONTINUITY OF ALL EXISTING SERVICES (LIGHTING, POWER, DATA/TELEPHONE SYSTEMS, AUDIO-VISUAL SYSTEMS, SECURITY SYSTEMS, FIRE ALARM SYSTEM, ETC.). WHERE DEMOLITION WORK DISRUPTS EXISTING WIRING THAT IS TO REMAIN, THE CONTRACTOR SHALL INSTALL JUNCTION BOXES AND OTHER DEVICES AND PROVIDE BYPASS CONNECTIONS NECESSARY TO MAKE CIRCUITS AFFECTED CONTINUOUS AND READY FOR OPERATION. OTHERWISE, WIRING AND CONDUIT SHALL BE REMOVED BACK TO THE NEAREST ELECTRICAL JUNCTION BOX THAT IS TO REMAIN OR TO PANELBOARD.
- 13. THE CONTRACTOR SHALL NOT DISCONNECT OR REMOVE ANY EXIT LIGHTS, PULL STATIONS AND/OR FIRE ALARM SPEAKERS LOCATED AT STAIR ENTRANCES UNLESS OTHERWISE NOTED.
- 14. THE REMOVAL OF ALL FIRE ALARM, COMMUNICATIONS, DATA AND SECURITY EQUIPMENT AND ASSOCIATED CABLING SHALL BE COORDINATED WITH BUILDING OPERATING PERSONNEL. EXISTING BASE BUILDING FIRE ALARM SYSTEM SHALL REMAIN IN OPERATION DURING BOTH DEMOLITION AND CONSTRUCTION STAGES OF THIS PROJECT.
- 15. DEMOLITION WORK SHALL INCLUDE THE FURNISHING OF ALL MATERIAL CUTTINGS. EXTENSIONS, CONNECTIONS, REPAIRING, ADAPTING AND OTHER WORK INCIDENTAL THERETO, TOGETHER WITH SUCH TEMPORARY CONNECTIONS AS MAY BE
- 16. THIS CONTRACTOR SHALL PROVIDE ADEQUATE TEMPORARY LIGHT AND POWER TO ENSURE THE SAFETY OF PERSONNEL AND POWER REQUIREMENTS OF THE
- 17. WHERE PRESENT WORK IS DAMAGED IN THE EXECUTION OF THIS CONTRACT, OR WHERE OPENINGS ARE LEFT DUE TO THE REMOVAL OF PIPES, EQUIPMENT OR APPARATUS, THE SAME SHALL BE REPAIRED TO CORRESPOND IN MATERIALS. QUALITY, SHAPE AND FINISH WITH THAT OF SIMILAR AND ADJOINING WORK, UNLESS
- 18. CONTRACTOR SHALL ASSURE THAT THE LIGHTING AND POWER TO TOILETS REMAIN IN WORKING CONDITION.
- 19. WHERE REMOVAL OF EXISTING ELECTRICAL EQUIPMENT WILL RESULT IN OUTAGES IN AREAS NOT TO BE DEMOLISHED, THE CONTRACTOR SHALL COORDINATE IN ADVANCE AND OBTAIN THE APPROVAL OF THE BUILDING MANAGER.
- 20. COORDINATE WITH OWNER WHICH FIXTURES, DEVICES AND EQUIPMENT, IF ANY, ARE TO BE REMOVED, KEPT INTACT AND RETURNED TO THE OWNER. IN GENERAL, ALL DEVICES, WIRING, RACEWAYS, BOXES, SUPPORTS AND OTHER APPURTENANCES WHICH ARE TO BE REMOVED SHALL BE REMOVED FROM THE SITE AND PROPERLY DISPOSED. ALL EXISTING MATERIAL AND EQUIPMENT IN USABLE CONDITION, WHICH IS TO BE REMOVED UNDER THIS CONTRACT, SHALL REMAIN THE PROPERTY OF THE OWNER OR SHALL BE DISPOSED OF BY THE CONTRACTOR, AS DIRECTED BY THE OWNER.
- 21. CONTRACTOR IS TO DISCONNECT AND REMOVE ONLY WIRING AND RACEWAY SERVING FLOOR AREAS OF DEMOLITION. DO NOT REMOVE ANY BASE BUILDING HOMERUN CONDUITS.
- 22. FOR FEEDERS AND BRANCH CIRCUITS TO BE REMOVED, CONDUIT, SUPPORTS, AND WIRING SHALL BE REMOVED TO THE PANEL OF ORIGIN. WHERE EMPTY CONDUITS REMAIN, INSTALL A PULL STRING AND IDENTIFY AT BOTH ENDS.
- 23. FOR FEEDERS AND BRANCH CIRCUITS TO BE RE-USED, REMOVE CONDUIT AND WIRING TO LOCATIONS WHICH AVOID CONFLICTS WITH NEW WORK. INSTALL JUNCTION BOXES, TAPE OFF CONDUCTORS, AND IDENTIFY WITH PANEL AND CIRCUIT NUMBER.
- 24. PROVIDE ADDITIONAL SUPPORT FOR ALL EXISTING CONDUITS, LOW VOLTAGE CABLING, AND DEVICES TO REMAIN WHICH ARE AFFECTED BY DEMOLITION OF EXISTING CEILINGS AND PARTITIONS.
- 26. THIS CONTRACTOR SHALL BE RESPONSIBLE FOR ASCERTAINING THE FOLLOWING:

25. ALL EXISTING UNUSED CONDUIT AND WIRING SHALL BE DROPPED TO THE FLOOR

BY THE ELECTRICIAN FOR REMOVAL FROM THE BUILDING BY THE DEMOLITION OR

SERVICE TO SUCH EQUIPMENT BY EITHER NEW CIRCUITRY OR EXTENSION OF

- A. WHICH EXISTING CIRCUITS ARE CONNECTED TO CONSTANT CIRCUITS (NIGHT LIGHT, EXIT LIGHTS, ETC.). WHICH EXISTING CIRCUITS ARE CONNECTED TO EXISTING EQUIPMENT TO REMAIN (TOILETS, JANITOR'S CLOSET, SERVICE ELEVATOR, LOBBY AND RECEPTACLES IN CORE CORRIDORS) AND SHALL MAINTAIN CONTINUITY OF
- 27. THE CONTRACTOR SHALL BE RESPONSIBLE TO TRACE AND RELOCATE ALL EXISTING FEEDERS AND BRANCH CIRCUIT WIRING WHICH PASS THROUGH THE DEMOLITION AREA THAT SERVE EXISTING OCCUPIED SPACES TO REMAIN. COORDINATE WITH BUILDING MANAGEMENT PRIOR TO ANY SHUTDOWNS OR DISRUPTIONS THAT MAY BE REQUIRED TO ACCOMPLISH THIS WORK.

EXISTING CIRCUITRY.

28. THE CONTRACTOR SHALL REMOVE ALL ELECTRICAL OUTLETS, SWITCHES AND OTHER DEVICES, COMPLETE WITH ASSOCIATED WIRING, CONDUITS, ETC., FROM PARTITIONS THAT ARE TO BE REMOVED. WHERE THE REMOVAL OF THESE ITEMS DISRUPTS EXISTING WIRING THAT IS TO REMAIN. THE CONTRACTOR SHALL INSTALL JUNCTION BOXES & OTHER DEVICES AND PROVIDE BYPASS CONNECTIONS NECESSARY TO MAKE CIRCUITS AFFECTED CONTINUOUS AND READY FOR OPERATION. OTHERWISE, WIRING SHALL BE REMOVED BACK TO THE NEAREST

ELECTRICAL JUNCTION BOX THAT IS TO REMAIN OR TO PANELBOARD.

- 29. UNLESS OTHERWISE INDICATED ON THE DRAWINGS, CONTRACTOR SHALL DISCONNECT AND REMOVE THE FOLLOWING EXISTING EQUIPMENT AND DEVICES: A. ELECTRICAL PANELS SHOWN AS BEING REMOVED WITH ASSOCIATED WIRING TROUGHS, INCOMING FEEDERS (WIRING AND CONDUIT), AND BRANCH
- CIRCUITS (WIRING AND CONDUIT) B. ALL WALL, COLUMN, CEILING, AND FLOOR MOUNTED OR RAISED FLOOR MOUNTED (BELOW RAISED FLOOR OR INSIDE RAISED FLOOR POWER, DATA, AND TELEPHONE OUTLETS.
- WIREMOLDS WITH BUILT-IN POWER, DATA AND TELEPHONE OUTLETS. DATA/TELEPHONE STRIP CABINETS AND ASSOCIATED TERMINAL BLOCKS.
- DATA/TELEPHONE CABLES, AUDIO VISUAL OUTLETS, AUDIO VISUAL CABLES, TV OUTLETS, TV CABLES, CLOCK OUTLETS.
- F. LIGHTING FIXTURES, LIGHTING CONTROL SWITCHES, OCCUPANCY SENSORS, LIGHTING CONTROL TIMERS, LIGHTING CONTROL CONTACTORS, TOGGLE SWITCHES WITH PILOT LIGHT.
- G. CARD READERS, ELECTRIC DOOR LOCKS, SECURITY SYSTEMS CONTROL PANELS, CCTV CAMERAS, DOOR CONTACTS, DOOR RELEASE PUSH BUTTONS,
- PAGING SPEAKERS. H. LOCAL CIRCUIT BREAKERS, LOCAL DISCONNECT SWITCHES (INCLUDING SWITCHES SERVING HVAC, KITCHEN OR PLUMBING EQUIPMENT. WATER DETECTION CONTROL PANELS WITH WITH ASSOCIATED WATER
- DETECTORS AND WIRING. J. ALL POWER SUPPLIES TO EXISTING CONTROL PANELS (WIRING AND
- K. LOCAL CONTROL PANELS AND STARTERS ASSOCIATED WITH HVAC, KITCHEN AND PLUMBING EQUIPMENT.
- EMERGENCY POWER OFF SWITCHES (EPO'S, BREAK GLASS SWITCHES). M. KITCHEN ANSUL FIRE SUPPRESION CONTROL PANELS AND ASSOCIATED MANUAL RELEASE PULL STATIONS.

- N. ALL FIRE ALARM RELATED DEVICES SUCH AS MANUAL PULL STATIONS, SPEAKER/STROBES. SMOKE DETECTORS. WARDEN STATIONS. FIRE/SMOKE DAMPERS, INTERFACE RELAYS, ETC.
- 30. COMPLETELY REMOVE ALL EXISTING ABANDONED OUTLETS, LIGHTING FIXTURES. DISCONNECT SWITCHES, CONTROL SWITCHES, JUNCTION BOXES, PULL BOXES, SPLICE BOXES, EMPTY CONDUITS, ELECTRICAL WIRING, COMMUNICATION (DATA/TELEPHONE) AND SECURITY SYSTEMS WIRING AND/OR CABLES, ETC. LOCATED WITHIN THE SCOPE OF WORK AREAS. ALL SUCH EXISTING EQUIPMENT AND DEVICES SHALL BE COMPLETELY REMOVED WITH ALL ASSOCIATED WIRING. CABLES, CONDUITS, CONDUIT SUPPORTS, PULL BOXES, SPLICE BOXES, JUNCTION BOXES, WIRING TROUGHS, CABLE TRAYS, ETC. ALL ASSOCIATED WIRING AND CONDUITS SHALL BE REMOVED BACK TO SOURCE (PANEL). UNDER THE RAISED FLOOR WHERE THE EXISTING RAISED FLOOR IS BEING REMOVED: DISCONNECT AND REMOVE ALL EXISTING ACTIVE AND ABANDONED POWER AND DATA/TELEPHONE OUTLETS, CONDUITS, JUNCTION BOXES, WIRING, CABLES, SMOKE DETECTORS, GROUNDING PLATES AND ASSOCIATED GROUNDING WIRES CONNECTED TO BUILDING STEEL AND RAISED FLOOR PEDESTALS. REMOVE ALL EXISTING PULL BOXES AND/OR SPLICE BOXES.
- 31. DISCONNECT AND COMPLETELY REMOVE ALL ELECTRICAL WORK ASSOCIATED WITH THE MECHANICAL, PLUMBING, AND FIRE PROTECTION EQUIPMENT BEING REMOVED BY OTHER TRADES (EXAMPLE: AC UNITS, EXHAUST FANS, PUMPS, MOTORIZED DAMPERS, VAV BOXES, HOT WATER HEATERS, DUCT HEATERS, ETC.). DISCONNECT AND REMOVE EQUIPMENT ASSOCIATED LOCAL DISCONNECT SWITCHES, LOCAL CONTROL PANELS, REMOTE CONTROL SWITCHES (AS APPLICABLE), VAV BOXES, ETC. WITH ALL ASSOCIATED WIRING AND CONDUIT BACK TO SOURCE (EXACT POWER SOURCE TO BE DETERMINED IN THE FIELD BY THIS CONTRACTOR), FOR HVAC UNITS BEING REMOVED (LARGE AC UNITS, EXHAUST FANS) ALSO DISCONNECT AND REMOVE ASSOCIATED PLENUM LIGHTING FIXTURES AND LIGHTING CONTROL SWITCHES, PLENUM RECEPTACLES, FIRE ALARM RELATED WORK SUCH AS DUCT MOUNTED SMOKE DETECTORS, COMBINATION FIRE/SMOKE DAMPERS, INTERFACE RELAYS, FIRE ALARM POWER SUPPLIES, ETC. AS APPLICABLE, WITH ALL ASSOCIATED WIRING AND CONDUIT, COORDINATE ALL FIRE ALARM RELATED DEMOLITION WORK ALSO WITH BUILDING FIRE ALARM MAINTENANCE CONTRACTOR.
- 32. COORDINATE THE ENTIRE DEMOLITION WORK ASSOCIATED WITH MECHANICAL. PLUMBING, AND FIRE PROTECTION EQUIPMENT WITH THE RESPECTIVE TRADE. DURING THE BIDDING PROCESS, REFER TO THE OTHER TRADES' CONTRACT DRAWINGS FOR THE FULL EXTENT OF THEIR DEMOLITION WORK AND RELATED ELECTRICAL DEMOLITION WORK: INCLUDE ALL ASSOCIATED ELECTRICAL DEMOLITION COSTS IN THE BID PRICE.
- 33. ALL RACEWAYS WHICH BECOME EXPOSED DURING THE ALTERATION WORK SHALL BE REMOVED AND REROUTED CONCEALED BEHIND FINISHED SURFACES.
- 34. IN THE PROCESS OF REMOVING WIRING DEVICES, LIGHTING FIXTURES AND OTHER ELECTRICAL EQUIPMENT AND MATERIALS, THIS CONTRACTOR SHALL EXERCISE EXTREME CAUTION TO PREVENT DAMAGE TO ARCHITECTURAL SURFACES WHICH ARE TO REMAIN. THE COST TO REPAIR OR REPLACE ANY MATERIAL DEEMED BY THE ARCHITECT TO HAVE BEEN UNDULY DAMAGED BY THIS CONTRACTOR DURING DEMOLITION OR CONSTRUCTION SHALL BE PAID BY THIS CONTRACTOR AT NO ADDITIONAL COST TO THE OWNER.
- 35. PROVIDE BLANK COVER PLATES AT OPEN BOXES WHERE EXISTING RECEPTACLES OR ELECTRICAL DEVICES ARE REMOVED FROM ENCLOSURES, EQUIPMENT, OR SURFACES NOT INDICATED TO BE REPAIRED OR REFINISHED. ALL UNUSED OUTLET BOXES OR CAPPED FLOOR OUTLETS SHALL BE PROVIDED WITH MATCHING BLANK
- 36. ALL WORK SHALL BE PROPERLY IDENTIFIED AFTER DEMOLITION. UPDATE ALL PANEL SCHEDULES TO REFLECT EQUIPMENT AND CIRCUIT REMOVALS.
- 37. CONTRACTOR SHALL RECYCLE ALL LIGHTING FIXTURE LAMPS AND BALLASTS TO BE REMOVED. COORDINATE WITH BUILDING MANAGEMENT.
- 38. THE CONTRACTOR SHALL REMOVE AND/OR RELOCATE ALL EXISTING ELECTRICAL WORK WHICH INTERFERES WITH THE NEW ARCHITECTURAL AND ELECTRICAL LAYOUTS IN FULL COORDINATION WITH THE ARCHITECT'S DEMOLITION PLANS. ALL SYSTEMS WHICH ARE NO LONGER REQUIRED TO FUNCTION SHALL BE DE-ENERGIZED AND DISCONNECTED AT THE SOURCE OF POWER SUPPLY
- 39. PROVIDE REVISED, TYPED-UP DIRECTORIES FOR ALL PANELBOARDS AFFECTED BY THE DEMOLITION AND NEW WORK. TO REFLECT ALL EXISTING CONDITIONS AND BRANCH CIRCUIT WIRING CHANGES. REMOVE THE ENTIRE EXISTING PANEL DIRECTORIES AND REPLACE WITH TYPED-UP NEW PANEL DIRECTORIES AS INDICATED ABOVE.
- 40. PORTIONS OF FEEDER RUNS TO BE REMOVED OR ABANDONED AS A RESULT OF DEMOLITION WORK, BUT WHICH ARE REQUIRED TO REMAIN ENERGIZED, SHALL BE CUT AT CONVENIENT LOCATIONS, REROUTED AND RECONNECTED. NEW FEEDER EXTENSIONS SHALL MATCH EXISTING ONES IN ALL RESPECTS, CABLE TYPE, CONDUCTOR QUANTITIES AND SIZES, CONDUIT SIZES, ETC.
- 41. THE CONTRACTOR SHALL NOTIFY THE OWNER AT THE APPROPRIATE TIME OF THE PROJECTED DEMOLITION AND PHASING SCHEDULE SO THAT REMOVAL OR RELOCATION OF AFFECTED UTILITIES MAY BE CARRIED OUT IN COORDINATION WITH THE PROJECT AND OWNER'S SPECIFIC REQUIREMENTS. THE CONTRACTOR SHALL FOLLOW CLOSELY THE ARCHITECT'S OR CONSTRUCTION MANAGER'S DEMOLITION AND CONSTRUCTION PHASING SCHEDULE AND PROCEED IN THE SPECIFIED SEQUENCE. EXISTING PANELS SHOWN AS BEING REMOVED, ASSOCIATED INCOMING FEEDERS (WIRING AND CONDUIT), BRANCH CIRCUITS (WIRING AND CONDUIT). ASSOCIATED LOADS SERVED (LIGHTING FIXTURES. RECEPTACLES, VENTILATION EQUIPMENT, ETC.) AND ANY OTHER EXISTING ELECTRICAL DEVICES OR EQUIPMENT BEING REMOVED, SHALL BE DE-ENERGIZED DISCONNECTED AND REMOVED ONLY AT THE DATES AND TIMES INDICATED BY THE DEMOLITION AND CONSTRUCTION PHASING SCHEDULE APPROVED BY THE OWNER.
- 42. ARRANGE TO WORK CONTINUOUSLY, INCLUDING OVERTIME, IF REQUIRED, TO ASSURE THAT SYSTEMS WILL BE SHUT DOWN ONLY DURING THE TIME ACTUALLY REQUIRED TO MAKE THE NECESSARY FINAL CONNECTIONS TO THE EXISTING
- 43. THE SHUTDOWN OF EXISTING BUILDING ELECTRICAL SERVICES SHALL BE COORDINATED WITH THE OWNER. SUBMIT PROPOSED POWER SHUTDOWN SCHEDULE (DATE, TIME, SHUTDOWN DURATION) FOR APPROVAL BY THE OWNER. MAKE ARRANGEMENTS AT LEAST 5 BUSINESS DAYS PRIOR TO A SHUTDOWN. IN ORDER TO MINIMIZE THE POWER SHUTDOWN DURATION, INSTALL ALL NEW ELECTRICAL EQUIPMENT AND ASSOCIATED FEEDERS AND REMOVE CERTAIN EXISTING SERVICE EQUIPMENT AS INDICATED ON THE DRAWINGS, PRIOR TO REQUIRING THE POWER SHUTDOWN: THE ACTUAL POWER SHUTDOWN WILL BE REQUIRED JUST TO MAKE THE FINAL CONNECTIONS TO NEW ELECTRICAL EQUIPMENT. COORDINATE WORK ALSO WITH UTILITY COMPANY IF POWER SHUTDOWN OF EXISTING INCOMING ELECTRICAL SERVICES IS REQUIRED, IN WHICH CASE PAY ALL FEES REQUIRED BY UTILITY COMPANY.
- 44. TYPICAL FOR EACH EXISTING PANEL LOCATED WITHIN THE SCOPE OF DEMOLITION WORK AREAS SHOWN AS BEING REMOVED UNLESS OTHERWISE NOTED: A. REMOVE EXISTING PANEL.
 - REMOVE EXISTING ASSOCIATED INCOMING FEEDER (WIRING AND CONDUIT) PER RISER DIAGRAMS REMOVE ALL EXISTING ASSOCIATED BRANCH CIRCUITS (WIRING AND CONDUIT) UP TO THE NEAREST CEILING LOCATED WITHIN THE NOT IN SCOPE
- OF DEMOLITION WORK AREAS IF THE BRANCH CIRCUIT DOES NOT TERMINATE WITHIN THE SCOPE OF DEMOLITION WORK. CUT AND CAP CONDUIT INSIDE THE NOT IN SCOPE OF DEMOLITION WORK AREAS. D. THE INTENT IS TO COMPLETELY REMOVE ALL EXISTING INCOMING FEEDERS (WIRING AND CONDUIT) AND ALL EXISTING BRANCH CIRCUITS (WIRING AND
- CONDUITS) LOCATED WITHIN THE SCOPE OF WORK AREAS. MAINTAIN CONTINUITY OF ALL EXISTING FEEDERS AND EXISTING BRANCH CIRCUITS LOCATED OUTSIDE THE SCOPE OF WORK AREAS. THE CONTRACTOR SHALL INSTALL JUNCTION BOXES AND OTHER DEVICES AND PROVIDE BYPASS CONNECTIONS NECESSARY TO MAKE CIRCUITS AFFECTED CONTINUOUS AND READY FOR OPERATION.
- 45. TYPICAL FOR EACH EXISTING PANEL LOCATED OUTSIDE THE SCOPE OF DEMOLITION WORK AREAS (PANEL DE-ENERGIZED PER THIS DEMOLITION WORK): IF EXISTING ASSOCIATED BRANCH CIRCUITS (WIRING AND CONDUIT) SERVE LOADS LOCATED WITHIN THE SCOPE OF DEMOLITION WORK AREAS. ONLY REMOVE THOSE BRANCH CIRCUIT SECTIONS LOCATED WITHIN THE SCOPE OF DEMOLITION WORK AREAS. CUT AND CAP CONDUITS INSIDE THE NOT IN SCOPE OF DEMOLITION WORK AREAS. MAINTAIN CONTINUITY OF ALL EXISTING FEEDERS AND EXISTING BRANCH CIRCUITS LOCATED OUTSIDE THE SCOPE OF WORK AREAS. THE CONTRACTOR SHALL INSTALL JUNCTION BOXES AND OTHER DEVICES AND PROVIDE BYPASS CONNECTIONS NECESSARY TO MAKE CIRCUITS AFFECTED CONTINUOUS AND READY FOR OPERATION.
- 46. FOR EXISTING DEVICES SHOWN AS BEING REMOVED AND RELOCATED (NOTATION (ERR) NEXT TO DEVICE), DISCONNECT EXISTING DEVICES FROM THEIR ASSOCIATED WIRING AND CONDUIT, RELOCATE EXISTING DEVICES AT THEIR NEW RELOCATED POSITION AND EXTEND EXISTING ASSOCIATED WIRING AND CONDUIT FROM THEIR PRESENT LOCATION WITH NEW WIRING AND CONDUIT AS REQUIRED, UP TO THE EXISTING DEVICE'S NEW RELOCATED POSITION. NEW WIRING AND CONDUIT EXTENSION SIZES SHALL MATCH EXISTING WIRING AND CONDUIT SIZES (SAME NUMBER OF WIRES, SAME WIRE SIZES, SAME CONDUIT SIZE).
- 47. TEMPORARILY DISCONNECT AND REMOVE ALL EXISTING CEILING-MOUNTED LIGHTING FIXTURES, LIGHTING CONTROL DEVICES, FIRE ALARM INITIATION DEVICES AND NOTIFICATION APPLIANCES, NURSE CALL DEVICES, POWER RECEPTACLES, AND IT/AV/SECURITY DEVICES AS REQUIRED FOR ABOVE-CEILING WORK ASSOCIATED WITH ARCHITECTURAL, MECHANICAL, PLUMBING, AND FIRE PROTECTION WORK. DE-ENERGIZE POWER CIRCUITS ASSOCIATED WITH CEILING-MOUNTED EQUIPMENT FROM ASSOCIATED PANELS PRIOR TO REMOVAL OF EQUIPMENT, REFER TO ARCHITECTURAL, MECHANICAL, PLUMBING, AND FIRE PROTECTION DRAWINGS FOR ABOVE-CEILING SCOPE OF WORK AREAS. RETAIN EXISTING WIRING AND CONDUIT ABOVE THE CEILING FOR REUSE. STORE REMOVED EQUIPMENT IN AN AREA AS DIRECTED BY THE OWNER FOR THE DURATION OF THE ABOVE-CEILING WORK. COVER ALL REMOVED EQUIPMENT TO PROTECT FROM DAMAGE AND DEBRIS. REINSTALL ALL REMOVED EQUIPMENT IN THEIR ORIGINAL LOCATIONS UPON COMPLETION OF THE ABOVE-CEILING WORK. EXTEND EXISTING WIRING AND CONDUIT AS REQUIRED TO THE EQUIPMENTS' INSTALLED LOCATIONS. NEW WIRING AND CONDUIT SHALL MATCH EXISTING WIRING AND CONDUIT. RE-ENERGIZE ASSOCIATED POWER CIRCUITS AT ASSOCIATED PANELS FOLLOWING REINSTALLATION OF CEILING-MOUNTED EQUIPMENT.

48. PRIOR TO THE START OF DEMOLITION WORK, WHITE PLAINS ENGINEERING SHALL TRACE ALL BRANCH CIRCUITS IN ALL ELECTRICAL PANELS IN THE SCOPE OF WORK AREAS ON THE 3RD FLOOR, ALL PANELS IN ELECTRICAL CLOSET 3647 AND ELECTRICAL CLOSET 3650. THE CONTRACTOR SHALL PROVIDE TO THE ENGINEER A REPORT WITH ACCOMPANYING FLOOR PLANS AND REFLECTED CEILING PLANS INDICATING THE EXACT NUMBER OF WIRES, WIRE SIZE, AND CONDUIT SIZE AND THE LOADS SERVED (RECEPTACLES, LIGHTING FIXTURES, ETC.) AND ASSOCIATED LOCATIONS ON THE PLANS, INSIDE AND OUTSIDE OF THE PROJECT SCOPE OF WORK FOR EACH BRANCH CIRCUIT. FINAL CIRCUITING ON THE PROJECT SHALL BE PREFORMED AFTER THE ENGINEER'S REVIEW OF THE CIRCUITING REPORT SUBMITTED BY THE CONTRACTOR PRIOR TO THE DEMOLITION WORK. THIS FINAL CIRCUITING WORK WILL INCLUDE RELOCATION OF EXISTING BRANCH CIRCUITS AS REQUIRED TO FACILITATE THE APPROPRIATE SEPARATION OF THE NORMAL AND EMERGENCY BRANCHES OF POWER.

COMMUNICATIONS SYSTEMS NOTES

- 1. COMMUNICATIONS SYSTEMS INCLUDE SYSTEMS SUCH AS: A. TELECOMMUNICATIONS
- SECURITY AUDIO/VISUA
- NURSE CALL PUBLIC ADDRESS
- LIGHTING CONTROLS G. OTHER SYSTEMS AS REQUIRED.
- THE CONTRACTOR SHALL PROVIDE ALL OF THE FOLLOWING AS REQUIRED FOR A COMPLETE INSTALLATION OF THE COMMUNICATIONS SYSTEMS. ALL THE BELOW LISTED DEVICES, MATERIALS, ETC. AND ASSOCIATED LABOR REQUIRED FOR THEIR COMPLETE INSTALLATION SHALL BE INCLUDED IN THE ELECTRICAL BID PRICE. DURING THE BIDDING PROCESS AND DURING CONSTRUCTION COORDINATE ELECTRICAL SCOPE OF WORK AND RESPONSIBILITIES
- WITH THE RESPECTIVE SYSTEM TRADE CONTRACTOR. A. CABLES & WIRING

SYSTEMS REQUIRED FOR THIS PROJECT.

- B. CONDUITS CABLE TRAYS
- RECEPTACLES
- FLOOR BOXES, JUNCTION BOXES, PULL BOXES, POKE-THROUGHS CORE DRILLS
- CABLE TRAYS, TROUGHS
- GROUNDING BARS, GROUNDING WIRING AND CONDUIT GROUNDING OF COMMUNICATIONS EQUIPMENT RACKS, CABLE TRAYS, AND CONDUITS FIRE RETARDANT PLYWOOD ADDITIONAL POWER OUTLETS, DATA AND COMMUNICATIONS OUTLETS, ETC. NOT

SHOWN ON ELECTRICAL DRAWINGS AND ASSOCIATED WITH COMMUNICATIONS

- SPECIFIC REQUIREMENTS OF EACH SYSTEM SHALL BE AS OUTLINED IN RELEVANT COMMUNICATIONS SYSTEM CONTRACT DOCUMENTS.
- 4. THE CONTRACTOR SHALL FURNISH, INSTALL, AND INTEGRATE ALL LOW-VOLTAGE SYSTEMS ON THE PROJECT, PROVIDE ALL REQUIRED POWER CIRCUITRY AS REQUIRED FOR THE COMMUNICATIONS SYSTEMS, CENTRAL EQUIPMENT, AND DEVICES. FINAL LOCATIONS AND POWER REQUIREMENTS FOR THESE ITEMS SHALL BE COORDINATED WITH RESPECTIVE CONSULTANTS, OWNER, AND ARCHITECT.
- WHERE FLOOR-MOUNTED POWER OUTLET AND LOW-VOLTAGE SYSTEM OUTLET (IT, AUDIO, VIDEO, ETC.) OCCUR AT THE SAME LOCATION, POWER AND LOW-VOLTAGE SYSTEM DEVICES SHALL BE PROVIDED WITH A MULTIPLE GANG BOX UNDER A SINGLE COVER PLATE AS REQUIRED. FINAL LOCATIONS, COLORS, AND FINISHES OF FLOOR BOXES SHALL BE BY THE ARCHITECT.
- THE CONTRACTOR SHALL PREPARE AND SUBMIT SHOP DRAWINGS SHOWING FINAL DETAILED AND FULLY COORDINATED POWER AND LOW-VOLTAGE RACEWAY SYSTEM FOR ENGINEER'S REVIEW AND APPROVAL. IN ADDITION, THE SHOP DRAWINGS SHALL INCLUDE INSTALLATION DETAILS OF FLOOR RACEWAY SYSTEMS AND ALL FLOOR OUTLETS AND BOXES.
- COORDINATE WITH OWNER'S COMMUNICATIONS VENDORS FOR EXACT LOCATION AND ROUTING OF WIRE MANAGEMENT PATHWAY SYSTEM, OUTLETS, AND LAYOUTS THROUGHOUT THE BUILDING TO TELECOM CLOSETS.
- ALL EMPTY CONDUITS FOR COMMUNICATIONS SYSTEMS SHALL BE PROVIDED WITH (3) DRAG WIRES INSIDE. ALL DRAG LINES SHALL BE TAGGED AND LABELED AT BOTH ENDS. TERMINATE CONDUITS WITH INSULATED BUSHINGS AT BOTH ENDS, PROVIDE CAP AT EACH END. FROM UNDER FLOOR CONDUIT RUNS STUB-UP IN COLUMN OR DRYWALL PARTITION TO HUNG CEILING. PROVIDE ANTI-SHORT BUSHING ON CONDUIT TERMINATION ABOVE THE CEILING.
- EMPTY COMMUNICATIONS RACEWAY RUNS: PROVIDE PULL BOXES EVERY 100 FEET FOR STRAIGHT RUNS, AND AT EVERY 180-DEGREE BENDS. BENDING RADIUS SHALL NOT BE LESS THAN 10 TIMES INTERNAL CONDUIT DIAMETER. COORDINATE LOCATIONS WITH OTHER
- 10. CONTRACTOR SHALL REFER TO THE COMMUNICATIONS DRAWINGS AND SPECIFICATIONS ON THIS PROJECT FOR ADDITIONAL WORK AND SCOPE INFORMATION NOT SHOWN ON THE ELECTRICAL DRAWINGS AND SPECIFICATIONS, INCLUDING LOCATIONS, QUANTITIES, INSTALLATION DETAILS, AND THE FULL EXTENT OF ELECTRICAL WORK AND RESPONSIBILITIES ASSOCIATED WITH EACH SEPARATE COMMUNICATIONS SYSTEM.

Architect of Record:

470 PARK AVE SOUTH, 11th FLOOR **NEW YORK, NY. 10016** 212-689-3110

CONSULTANTS:

ARRAY-ARCHITECTS.COM

STRUCTURAL ENGINEER

REUTHER + BOWEN 326 WARD STREET DUNMORE, PA 18512 PHONE: 570.496.7020

MEP ENGINEER

LORING CONSULTING ENGINEERS, INC 360 WEST 31ST STREET, 14th FL. NEW YORK, NY 10001 PHONE: 646.674.6100

ESTIMATING


COST CONCEPTS, INC. 104 BEDELL PLACE MELVILLE, NY, 11747 PHONE: 631.423.7960

OWNER:

COLUMBIA DOCTOR'S

PROJECT:

155 WHITE PLAINS ROAD TARRYTOWN, NY 10591

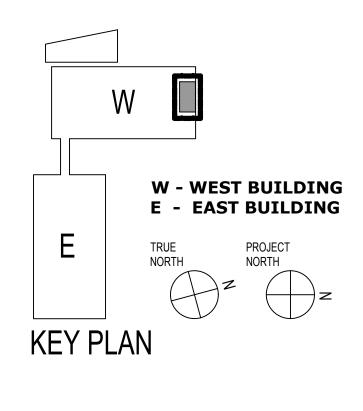

CD SUBMISSION DATE DESCRIPTION **REVISIONS/ISSUES**

SHEET TITLE:

SEAL:

CON/REF No. CONTRACT No. **SCALE:** As indicated **PROJECT No.** 12384 **CHECKED:** Checker **DRAWN:** MC


DATE: 7/23/2020


SHEET NO. E-003.00

This document is a copyright protected instrument of service, property of Array Architects and licensed for use in the title project only. Reproduction or use of this document without written permission of Array Architects is illegal and will be prosecuted under the law.

COPYRIGHT - 2020 ARRAY-ARCHITECTS P.C.

THIS PLAN IS APPROVED ONLY FOR WORK INDICATED ON THE APPLICATION SPECIFICATION SHEET. ALL OTHER MATTERS SHOWN ARE NOT TO BE RELIED UPON, OR TO BE CONSIDERED AS EITHER BEING APPROVED OR IN ACCORDANCE WITH APPLICABLE CODES.

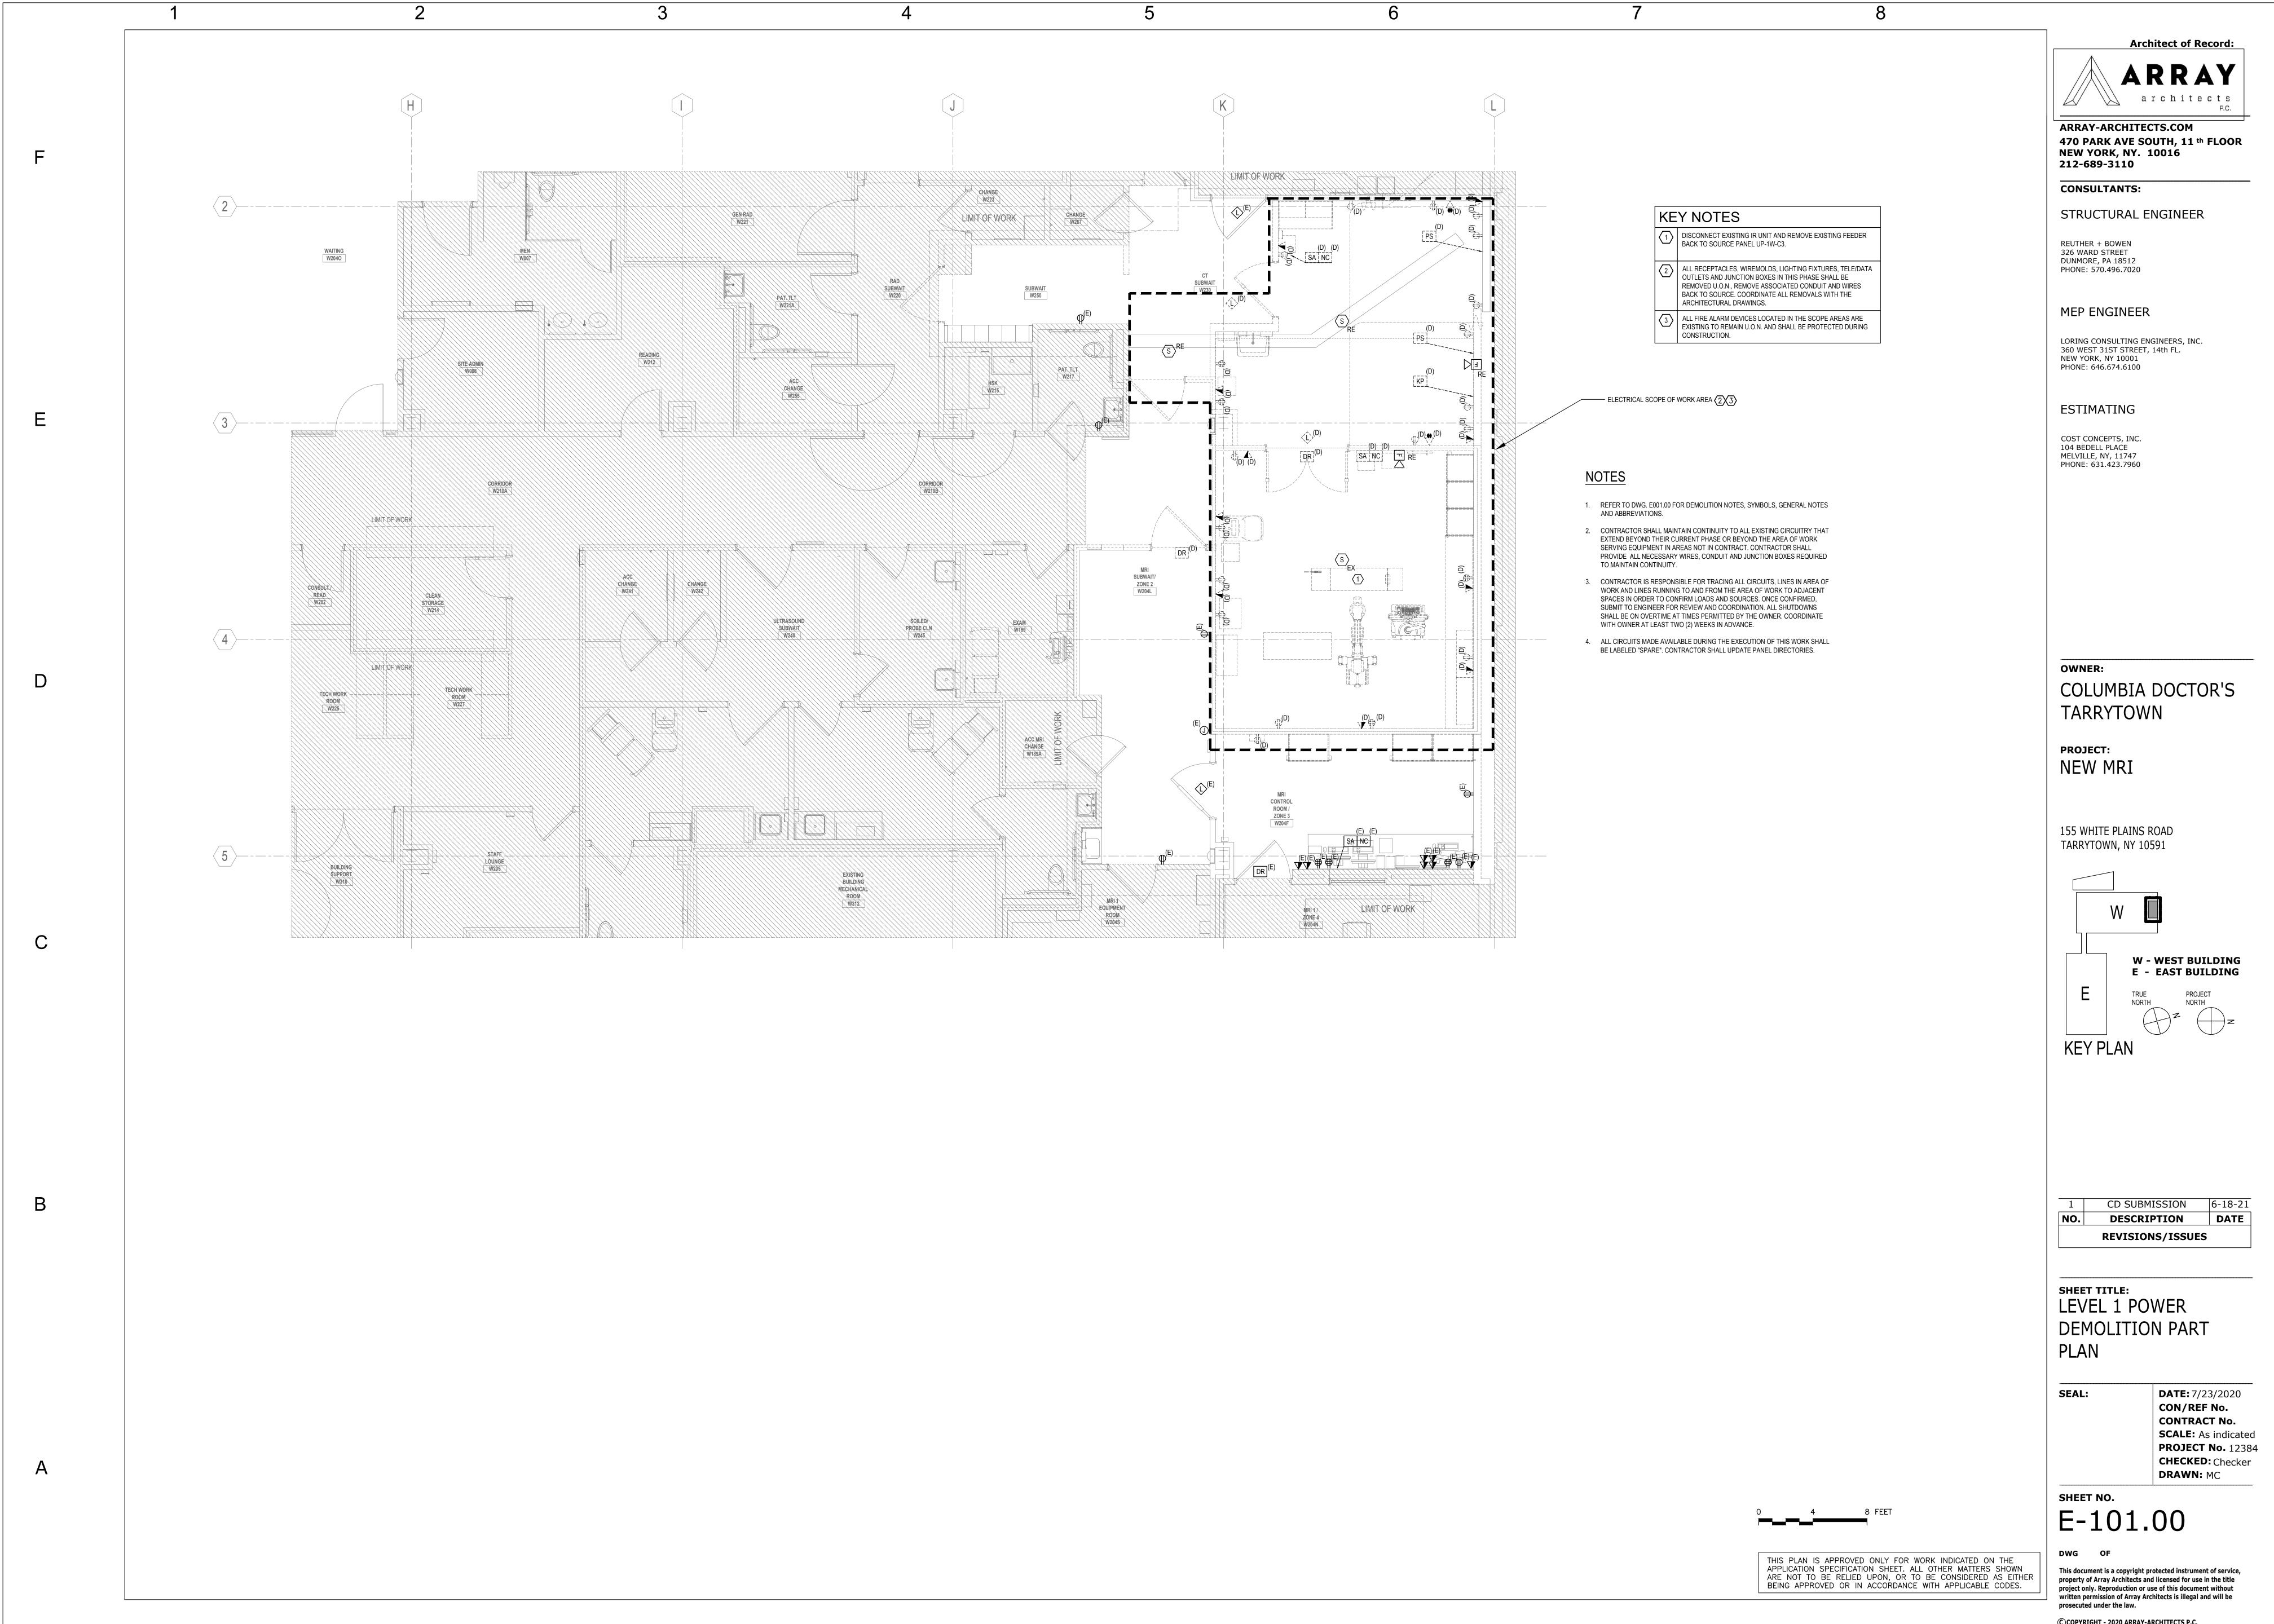

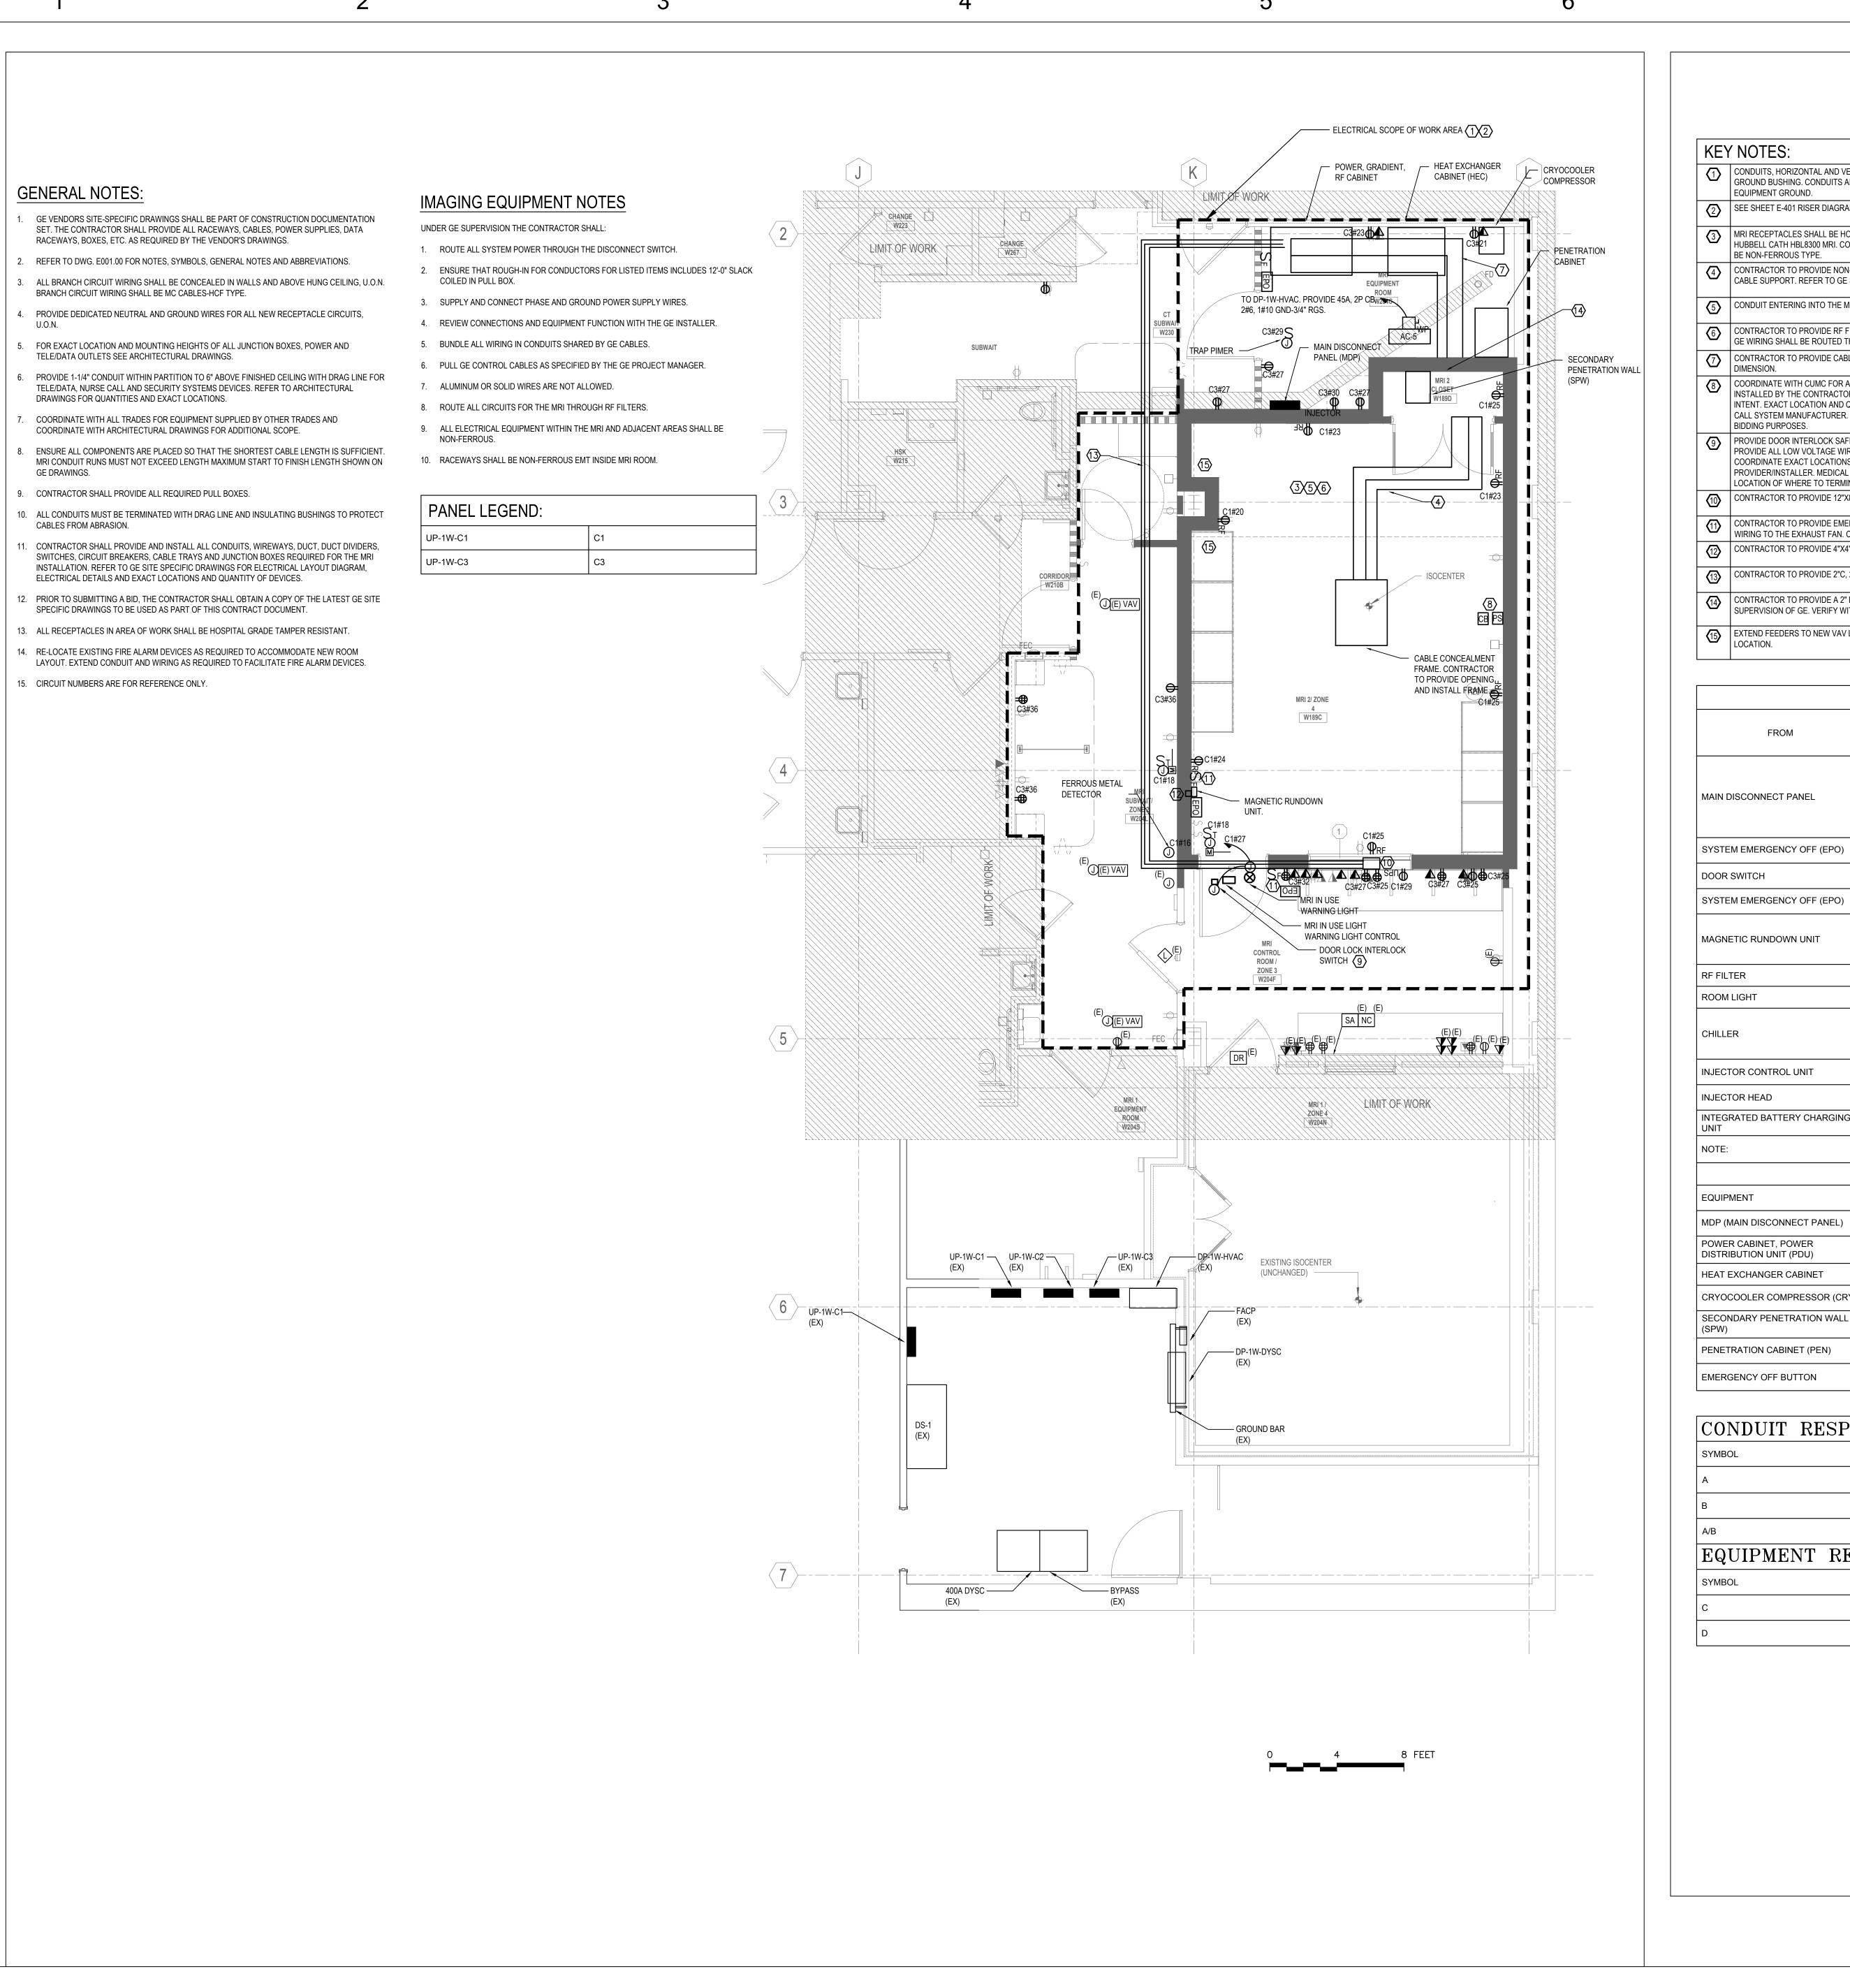

CONDUITS, HORIZONTAL AND VERTICAL ELECTRICAL DUCTS SHALL BE TERMINATED WITH GROUND BUSHING. CONDUITS AND ELECTRICAL DUCTWORK SHALL BE BONDED TO EQUIPMENT GROUND. SEE SHEET E-401 RISER DIAGRAM MRI RECEPTACLES SHALL BE HOSPITAL GRADE MRI RECEPTACLE AS MANUFACTURED BY HUBBELL CATH HBL8300 MRI. COLOR BY ARCHITECT. RECEPTACLES IN MRI ROOM SHALL BE NON-FERROUS TYPE. CONTRACTOR TO PROVIDE NON-FERROUS CABLE LADDERS AND NON-FERROUS UNISTRUT CABLE SUPPORT. REFER TO GE SITE SPECIFICS FOR DIMENSIONS. CONDUIT ENTERING INTO THE MRI ROOM SHALL BE NON FERROUS TYPE. 6 CONTRACTOR TO PROVIDE RF FILTERS FOR ALL NON GE WIRING IN MRI ROOM. ALL NON GE WIRING SHALL BE ROUTED THROUGH RF FILTERS. CONTRACTOR TO PROVIDE CABLE LADDERS. REFER TO GE SITE SPECIFICS FOR (8) COORDINATE WITH CUMC FOR ALL REQUIRED NURSE CALL. CONDUITS AND BOXES TO BE INSTALLED BY THE CONTRACTOR. DRAWINGS INDICATE NURSE CALL DEVICES FOR DESIGN INTENT. EXACT LOCATION AND QUANTITY OF DEVICES TO BE COORDINATED WITH NURSE CALL SYSTEM MANUFACTURER. PROVIDE AN ALLOWANCE FOR ADDITIONAL DEVICES FOR BIDDING PURPOSES. PROVIDE DOOR INTERLOCK SAFETY SWITCH TO BE TIED INTO THE MEDICAL EQUIPMENT. PROVIDE ALL LOW VOLTAGE WIRING FROM DOOR INTERLOCK TO THE EQUIPMENT ROOM. COORDINATE EXACT LOCATIONS OF THE SWITCH WITH DOOR FROM THE PROVIDER/INSTALLER. MEDICAL EQUIPMENT PROVIDER NEEDS TO INDICATE EXACT LOCATION OF WHERE TO TERMINATE CABLES. CONTRACTOR TO PROVIDE 12"X8"X6" JUNCTION BOX. CONTRACTOR TO PROVIDE EMERGENCY EXHAUST FAN SWITCH. CONNECT CONTROL WIRING TO THE EXHAUST FAN. COORDINATE WITH THE EXHAUST FAN MANUFACTURER. CONTRACTOR TO PROVIDE 4"X4"X2" JUNCTION BOX. CONTRACTOR TO PROVIDE 2"C, 2-1/2"C & 3"C. CONDUIT TO RUN ABOVE RF SCREEN. CONTRACTOR TO PROVIDE A 2" DIAMETER HOLE FOR INJECTOR CABLE UNDER THE SUPERVISION OF GE. VERIFY WITH GE BEFORE CUTTING A HOLE. EXTEND FEEDERS TO NEW VAV LOCATION. REFER TO MECHANICAL DRAWINGS FOR EXACT

FROM	ТО	QUANTITY OF CONDUIT (#) AND CONDUIT SIZE (IN) CONTRACTOR SUPPLY AND INSTALL	CABLES	RESP ONSI BILIT Y	EX/NEV
	POWER, GRADIENT, RF CABINET	1-1/2"C	3#1/0,1#1/0G	В	NEW
MAIN DISCONNECT PANEL	HEAT EXCHANGER CABINET	3/4"C	3#8,1#8G	В	NEW
	SYSTEM EMERGENCY OFF (EPO)	3/4"C		В	NEW
SYSTEM EMERGENCY OFF (EPO)	SECONDARY PENETRATION WALL	3/4"C	GE	А	NEW
DOOR SWITCH	POWER, GRADIENT, RF CABINET	3/4"C	GE	A	NEW
SYSTEM EMERGENCY OFF (EPO)	SECONDARY PENETRATION WALL	3/4"C	GE	А	NEW
MAGNETIC RUNDOWN UNIT	MAGNET	1"C	GE	А	NEW
	120-V 1PH POWER FROM RF FILTER	3/4"C		В	NEW
RF FILTER	120-V 1PH POWER	3/4"C		В	NEW
ROOM LIGHT	RF FILTER	3/4"C		В	NEW
CHILLER	REMOTE GRAPHIC DISPLAY	3/4"C			NEW
CHILLER	FACILITY POWER	1-1/4"RGS		В	NEW
INJECTOR CONTROL UNIT		2-1/2"C	GE	Α	NEW
INJECTOR HEAD	WAVEGUIDE OR RF FILTER		GE	А	NEW
INTEGRATED BATTERY CHARGING UNIT					NEW

REMARKS

CONDUIT RESPONSIBILITY MATRIX			
SYMBOL	DESCRIPTION		
A	CABLE SUPPLIED BY GE. INSTALLED BY GE.		
В	CABLE SUPPLIED AND INSTALLED BY CONTRACTOR		
A/B	CABLE SUPPLIED BY GE. INSTALLED BY CONTRACTOR UNDER THE SUPERVISION OF GE.		
EQUIPMENT RESPONSIBILITY MATRIX			
SYMBOL	DESCRIPTION		
С	EQUIPMENT SUPPLIED BY GE. INSTALLED BY CONTRACTOR UNDER THE SUPERVISION OF GE.		
D	EQUIPMENT SHALL BE FURNISHED AND INSTALLED BY THE CONTRACTOR		

RESPONSIBILITY



ARRAY-ARCHITECTS.COM 470 PARK AVE SOUTH, 11 th FLOOR **NEW YORK, NY. 10016** 212-689-3110

CONSULTANTS:

STRUCTURAL ENGINEER

REUTHER + BOWEN 326 WARD STREET DUNMORE, PA 18512 PHONE: 570.496.7020

MEP ENGINEER

LORING CONSULTING ENGINEERS, INC. 360 WEST 31ST STREET, 14th FL. NEW YORK, NY 10001

ESTIMATING


PHONE: 646.674.6100

COST CONCEPTS, INC. 104 BEDELL PLACE MELVILLE, NY, 11747 PHONE: 631.423.7960

OWNER: COLUMBIA DOCTOR'S TARRYTOWN

PROJECT: NEW MRI

155 WHITE PLAINS ROAD TARRYTOWN, NY 10591

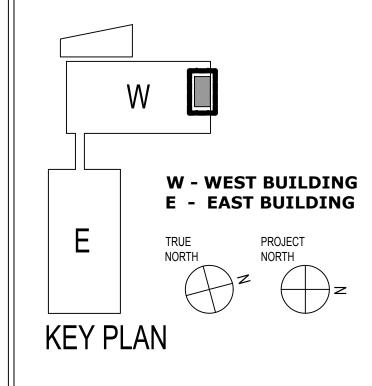

6-18-21 CD SUBMISSION **DESCRIPTION** DATE **REVISIONS/ISSUES**

SHEET TITLE: LEVEL 1 POWER PART PLAN

SEAL:

DATE: 7/23/2020 CON/REF No. CONTRACT No. **SCALE:** As indicated **PROJECT No.** 12384 CHECKED: Checker **DRAWN:** Author

SHEET NO.

E-201.00

THIS PLAN IS APPROVED ONLY FOR WORK INDICATED ON THE APPLICATION SPECIFICATION SHEET. ALL OTHER MATTERS SHOWN


BEING APPROVED OR IN ACCORDANCE WITH APPLICABLE CODES.

ARE NOT TO BE RELIED UPON, OR TO BE CONSIDERED AS EITHER

This document is a copyright protected instrument of service, property of Array Architects and licensed for use in the title project only. Reproduction or use of this document without written permission of Array Architects is illegal and will be

© COPYRIGHT - 2020 ARRAY-ARCHITECTS P.C.

prosecuted under the law.

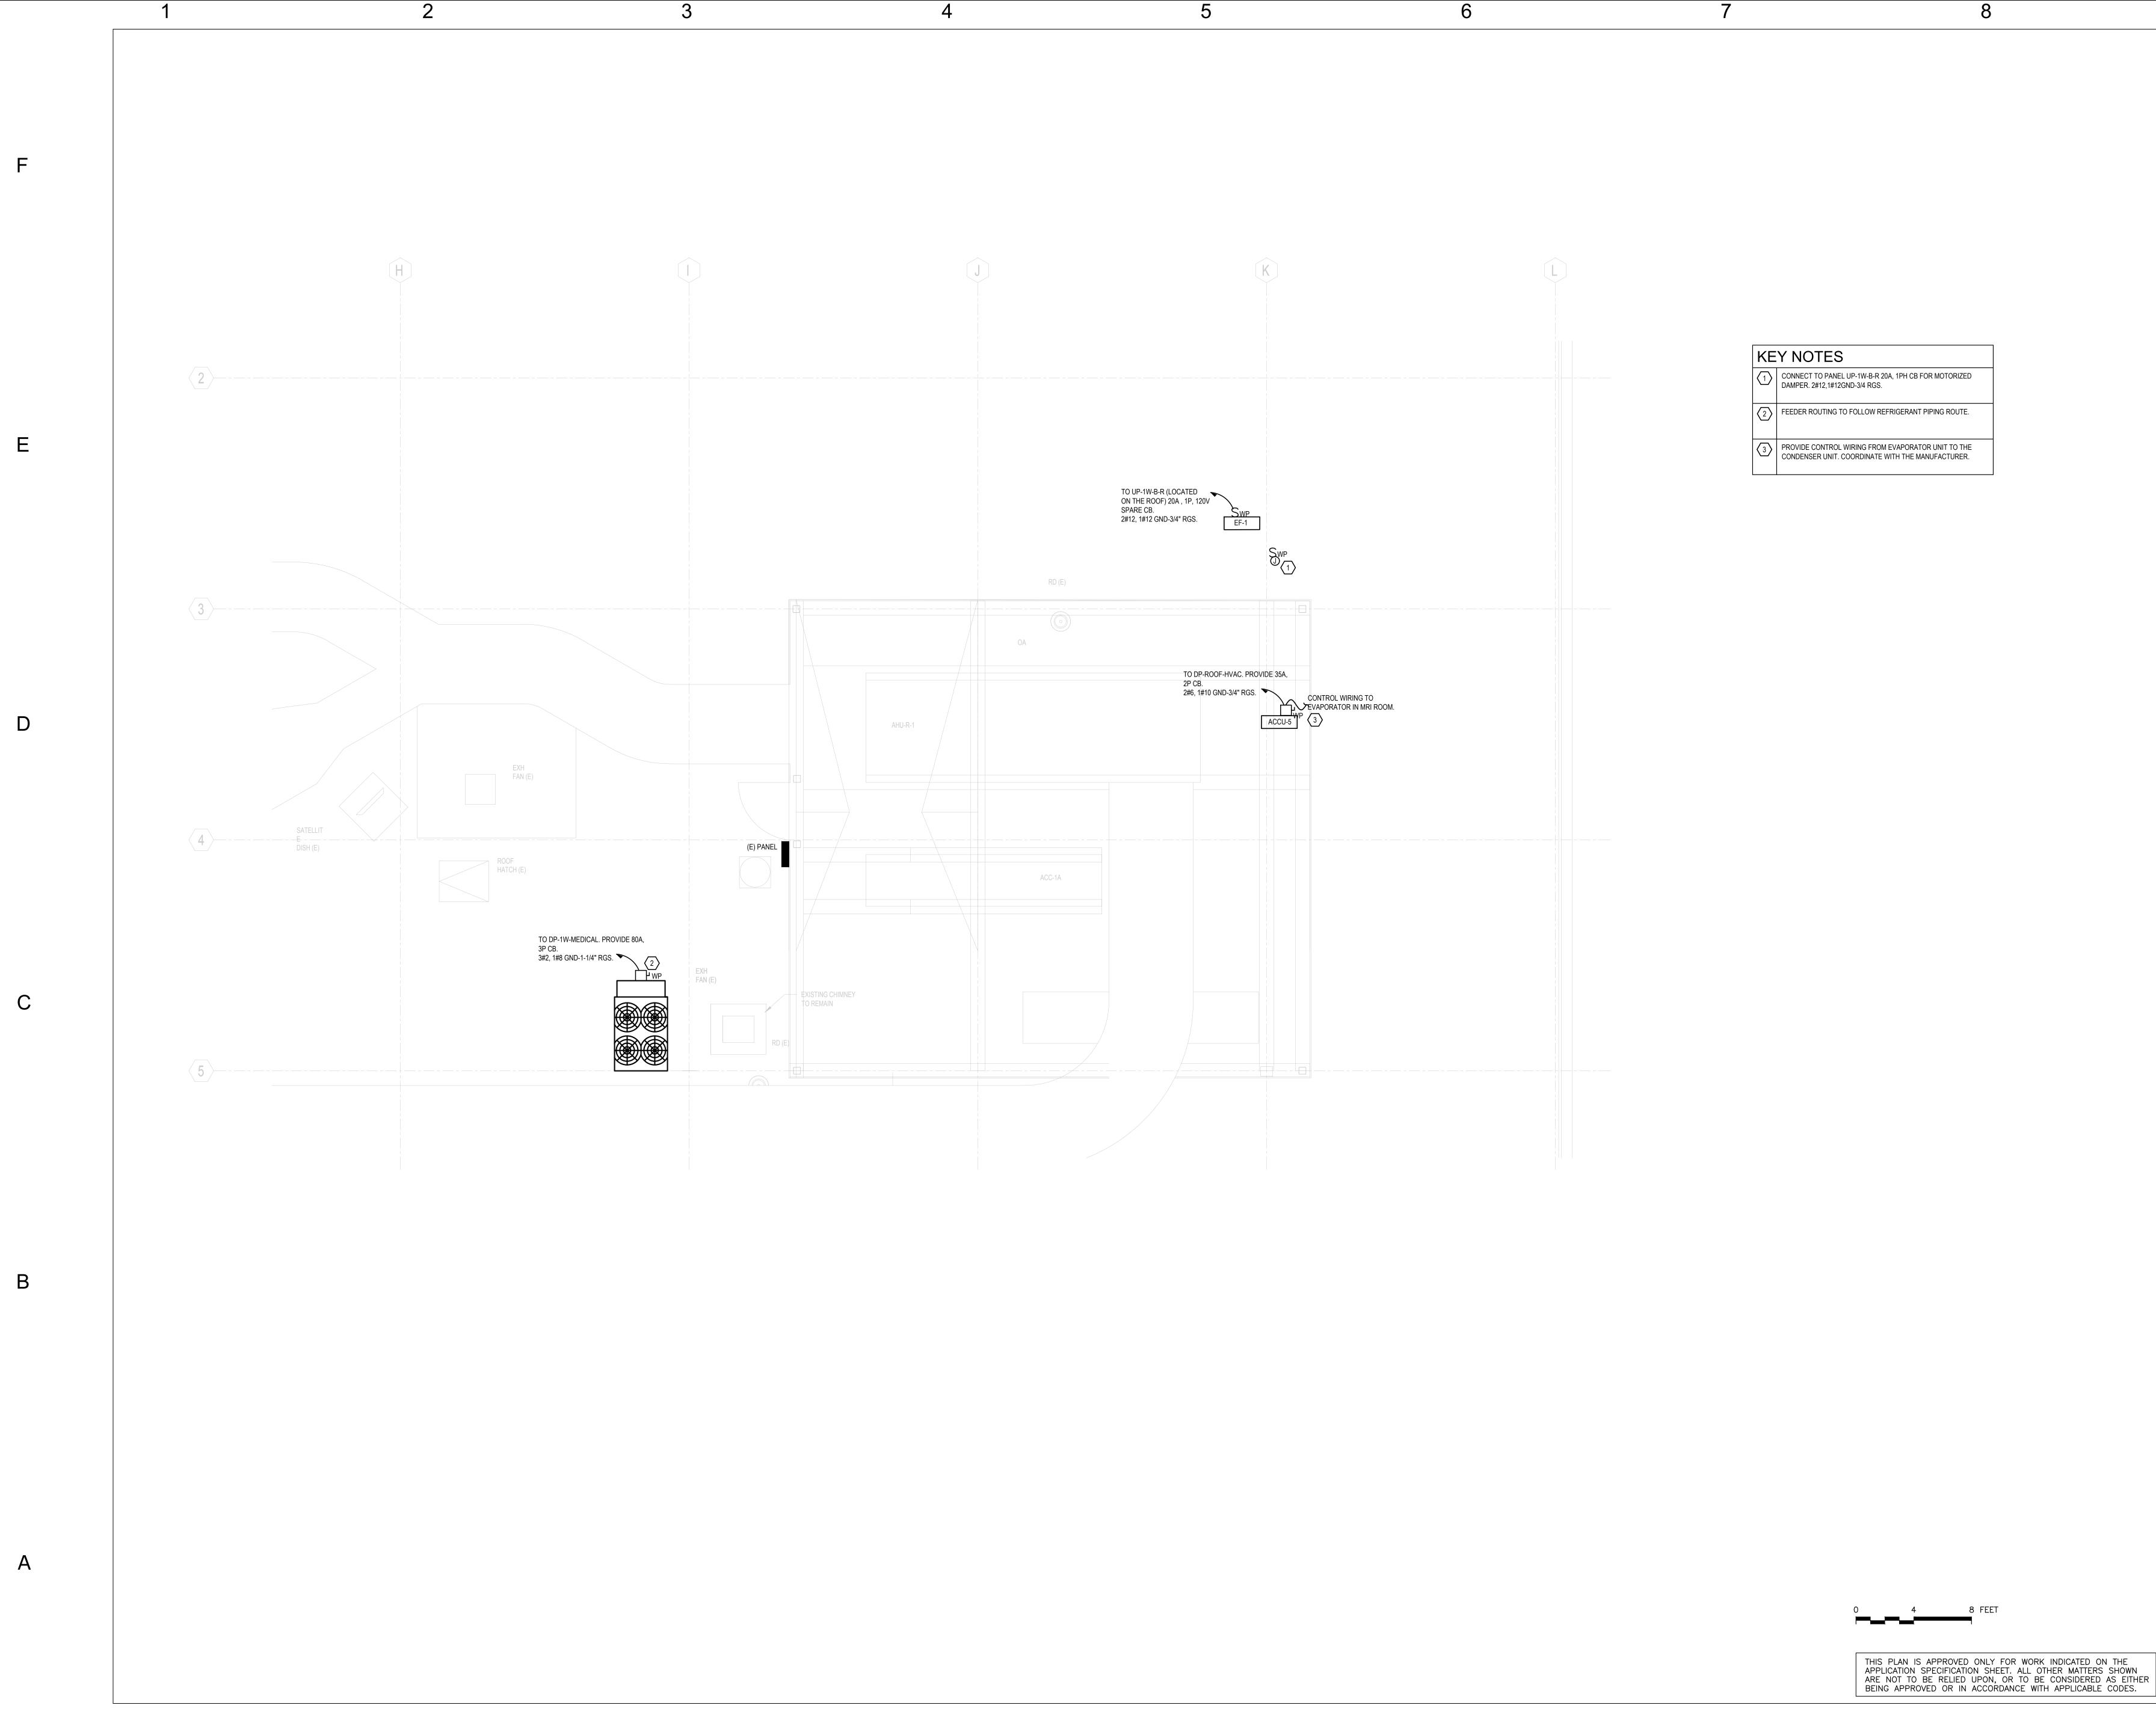



ARRAY-ARCHITECTS.COM 470 PARK AVE SOUTH, 11th FLOOR NEW YORK, NY. 10016 212-689-3110

CONSULTANTS:

STRUCTURAL ENGINEER

REUTHER + BOWEN 326 WARD STREET DUNMORE, PA 18512 PHONE: 570.496.7020

MEP ENGINEER

LORING CONSULTING ENGINEERS, INC. 360 WEST 31ST STREET, 14th FL. NEW YORK, NY 10001 PHONE: 646.674.6100

ESTIMATING


COST CONCEPTS, INC. 104 BEDELL PLACE MELVILLE, NY, 11747 PHONE: 631.423.7960

OWNER:

COLUMBIA DOCTOR'S TARRYTOWN

PROJECT: NEW MRI

155 WHITE PLAINS ROAD TARRYTOWN, NY 10591

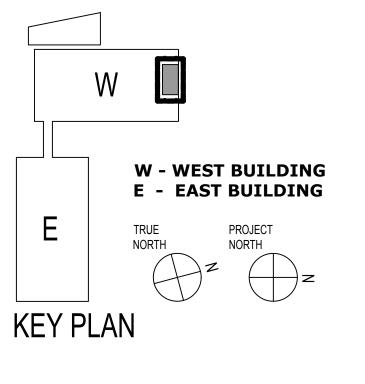

CD SUBMISSION 6-18-21 DATE DESCRIPTION **REVISIONS/ISSUES**

SHEET TITLE:
ROOF LEVEL POWER PART PLAN

SEAL:


DATE: 7/23/2020 CON/REF No. CONTRACT No. **SCALE:** As indicated **PROJECT No.** 12384 CHECKED: Checker **DRAWN:** Author

SHEET NO.

E-202.00

This document is a copyright protected instrument of service, property of Array Architects and licensed for use in the title project only. Reproduction or use of this document without written permission of Array Architects is illegal and will be prosecuted under the law.

© COPYRIGHT - 2020 ARRAY-ARCHITECTS P.C.

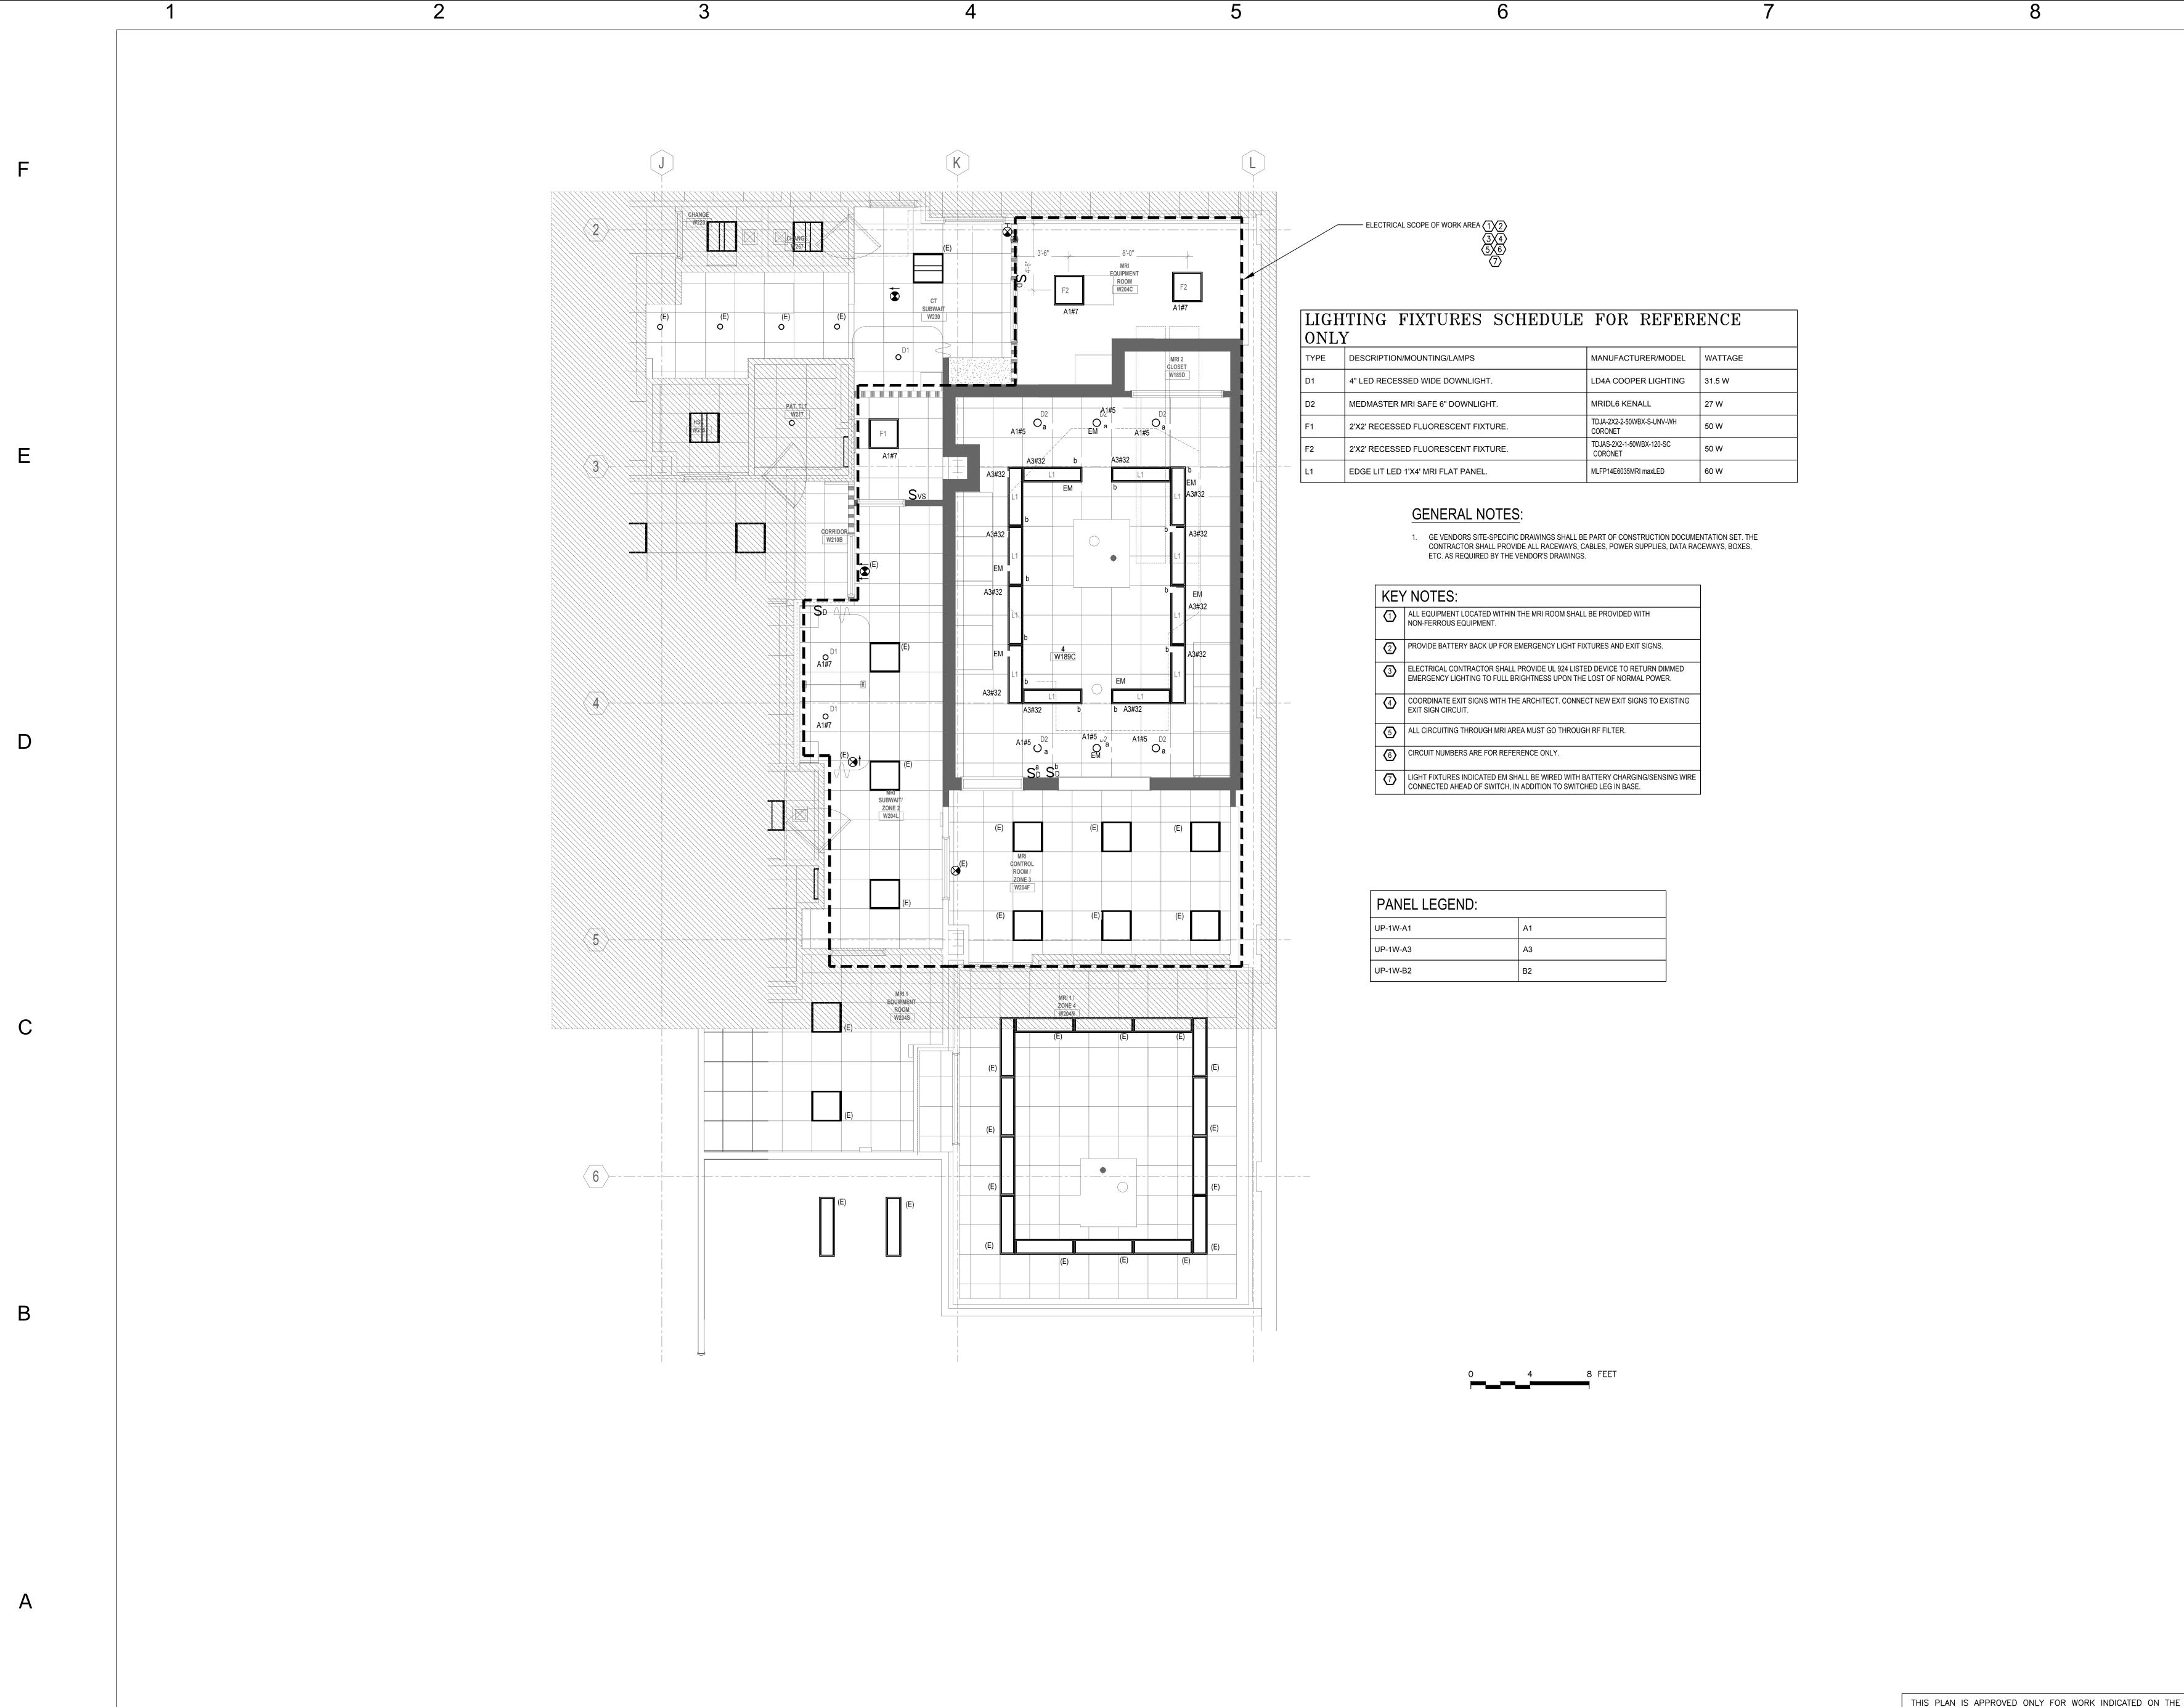



ARRAY-ARCHITECTS.COM
470 PARK AVE SOUTH, 11 th FLOOR
NEW YORK, NY. 10016
212-689-3110

CONSULTANTS:

STRUCTURAL ENGINEER

REUTHER + BOWEN 326 WARD STREET DUNMORE, PA 18512 PHONE: 570.496.7020

MEP ENGINEER

LORING CONSULTING ENGINEERS, INC. 360 WEST 31ST STREET, 14th FL. NEW YORK, NY 10001 PHONE: 646.674.6100

ESTIMATING


COST CONCEPTS, INC. 104 BEDELL PLACE MELVILLE, NY, 11747 PHONE: 631.423.7960

OWNER:

COLUMBIA DOCTOR'S TARRYTOWN

project: NEW MRI

155 WHITE PLAINS ROAD TARRYTOWN, NY 10591

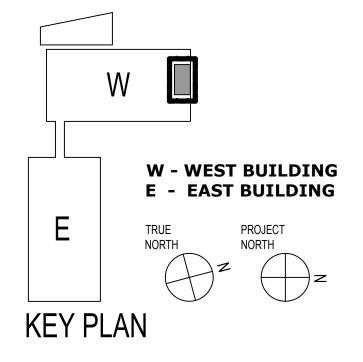

1 CD SUBMISSION 6-18-21

NO. DESCRIPTION DATE

REVISIONS/ISSUES

SHEET TITLE:
LEVEL 1 LIGHTING
PART PLAN

SEAL:

DATE: 7/23/2020
CON/REF No.
CONTRACT No.
SCALE: As indicated
PROJECT No. 12384
CHECKED: Checker
DRAWN: MC

SHEET NO.

E-301.00

DWG OF


APPLICATION SPECIFICATION SHEET. ALL OTHER MATTERS SHOWN

ARE NOT TO BE RELIED UPON, OR TO BE CONSIDERED AS EITHER BEING APPROVED OR IN ACCORDANCE WITH APPLICABLE CODES.

This document is a copyright protected instrument of service, property of Array Architects and licensed for use in the title project only. Reproduction or use of this document without written permission of Array Architects is illegal and will be

prosecuted under the law.

©)COPYRIGHT - 2020 ARRAY-ARCHITECTS P.C.

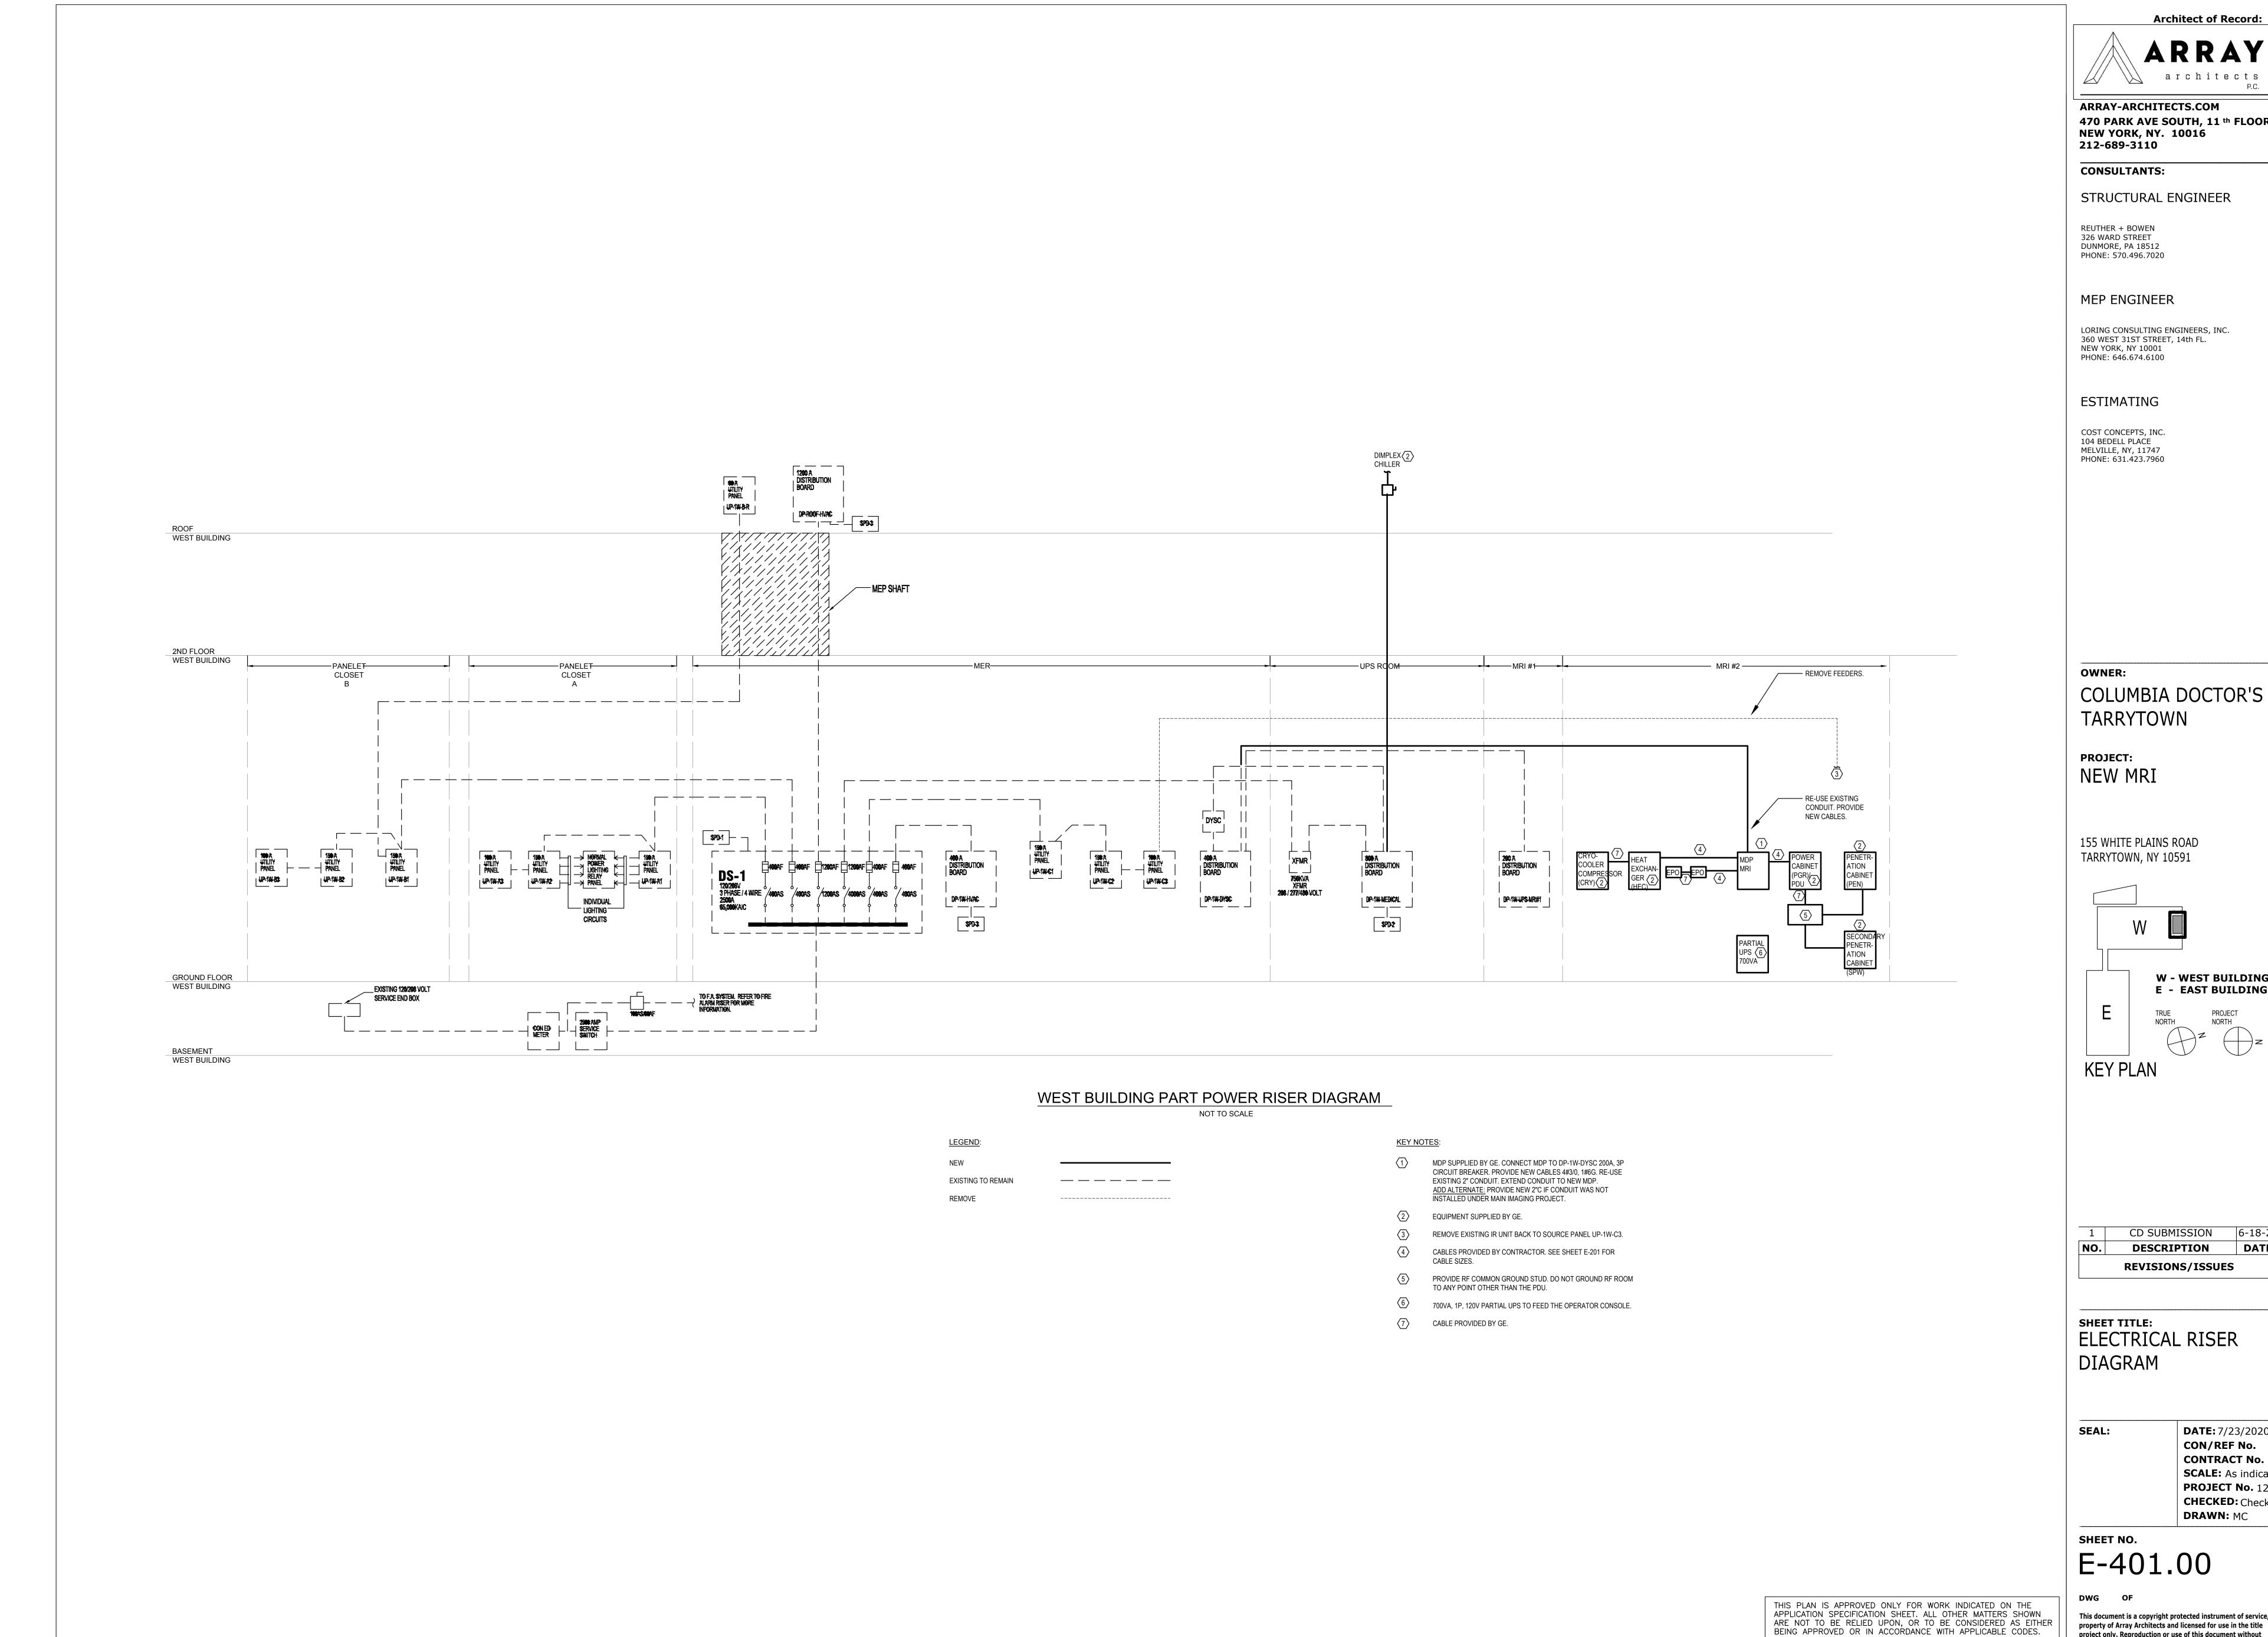


ARRAY-ARCHITECTS.COM 470 PARK AVE SOUTH, 11 th FLOOR

LORING CONSULTING ENGINEERS, INC. 360 WEST 31ST STREET, 14th FL. NEW YORK, NY 10001

COLUMBIA DOCTOR'S

155 WHITE PLAINS ROAD

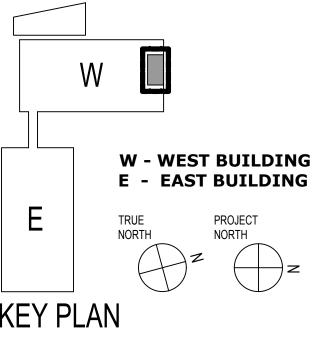

REVISIONS/ISSUES				
NO.	DESCRIPTION	DATE		
1	CD SUBMISSION	6-18-21		

SHEET TITLE: ELECTRICAL RISER

DATE: 7/23/2020 CON/REF No. CONTRACT No. **SCALE:** As indicated **PROJECT No.** 12384 CHECKED: Checker DRAWN: MC

E-401.00

This document is a copyright protected instrument of service, property of Array Architects and licensed for use in the title project only. Reproduction or use of this document without written permission of Array Architects is illegal and will be

prosecuted under the law. COPPRIGHT - 2020 ARRAY-ARCHITECTS P.C



LOCATION: ELECT CLOSET 81

LOCATION: ELECT CLOSET 89

FEEDER SIZE

MOUNTING: SURFACE

FEEDER SIZE

MOUNTING: SURFACE

FEEDER TAG

FEEDER TAG

Architect of Record: architects

ARRAY-ARCHITECTS.COM 470 PARK AVE SOUTH, 11 th FLOOR **NEW YORK, NY. 10016** 212-689-3110

CONSULTANTS:

STRUCTURAL ENGINEER

REUTHER + BOWEN 326 WARD STREET DUNMORE, PA 18512 PHONE: 570.496.7020

MEP ENGINEER

LORING CONSULTING ENGINEERS, INC. 360 WEST 31ST STREET, 14th FL. NEW YORK, NY 10001 PHONE: 646.674.6100

ESTIMATING


COST CONCEPTS, INC. 104 BEDELL PLACE MELVILLE, NY, 11747 PHONE: 631.423.7960

OWNER:

COLUMBIA DOCTOR'S TARRYTOWN

project: NEW MRI

155 WHITE PLAINS ROAD TARRYTOWN, NY 10591

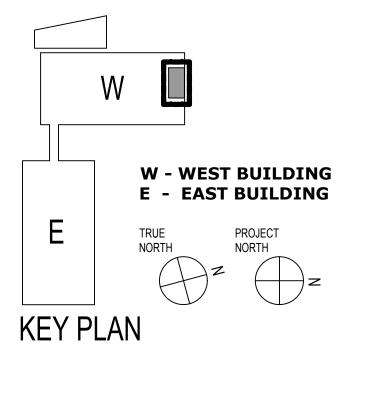

REVISIONS/ISSUES			
NO.	DESCRIPTION	DATE	
1	CD SUBMISSION	6-18-21	

SHEET TITLE: ELECTRICAL SCHEDULES

SEAL:

DATE: 7/23/2020 CON/REF No. CONTRACT No. **SCALE:** As indicated **PROJECT No.** 12384 CHECKED: Checker **DRAWN:** MC

SHEET NO.

E-501.00

This document is a copyright protected instrument of service, property of Array Architects and licensed for use in the title project only. Reproduction or use of this document without written permission of Array Architects is illegal and will be

prosecuted under the law. COPYRIGHT - 2020 ARRAY-ARCHITECTS P.C.

EXISTING PANEL

Circuit

Number

SPARE

DP-1W-UPS-MRI#1

DP-1W-UPS-MRI#2

DP-1W-RAD#1

DP-1W-RAD#2

SPARE

1 EX. CT SCAN

EX TVSS

EX. CHILLER

EX. MEGA DYSC.

NEW DIMPLEX CHILLER

8 SPARE

EXISTING PANEL

Circuit

Number

SPD

BUS AMPERAGE:

400 AMPS

MAIN: 400 MCB

SERVICE

BUS AMPERAGE: 1200 AMPS

SERVICE

MAIN: 800 MCB

DISTRIBUTION BOARD DP-1W-DYSC

Connected

0.00

0.00

0.00

DISTRIBUTION BOARD DP-1W-MEDICAL

4 WIRE + GND

C Connected Demand

0.00

0.00

Total KVA

4 WIRE + GND

Total KVA

VOLT: 480/277

PHASE: 3

0.00 0.00

0.00 0.00

VOLT: 480/277

0.00

0.00

0.00

0.00

0.00 0.00 0.00 0.00

PHASE: 3

KVA Load

0.00 0.00 0.00

0.00 0.00

0.00

0.00 0.00

0.00

0.00 0.00 0.00

0.00 0.00 0.00

0.00 0.00 0.00

KVA Load

0.00

AIC: 65k AMPS RMS SYM

Demand

0.00

0.00

0.00

0.00

AIC: 65k AMPS RMS SYM

0.00

0.00

0.00

Overcurrent Device

Frame Trip Pole

100

EXIS. 100 3

Overcurrent Device

Frame Trip Pole

EXIS. 150 3

400

EXIS. 400 3

EXIS.

EXIS.

60 3

125 3

EXIS.

EXIS.


EXIS. 200

EXIS. 200

EXIS. 100

EXIS. 100

THIS PLAN IS APPROVED ONLY FOR WORK INDICATED ON THE APPLICATION SPECIFICATION SHEET. ALL OTHER MATTERS SHOWN ARE NOT TO BE RELIED UPON, OR TO BE CONSIDERED AS EITHER BEING APPROVED OR IN ACCORDANCE WITH APPLICABLE CODES.

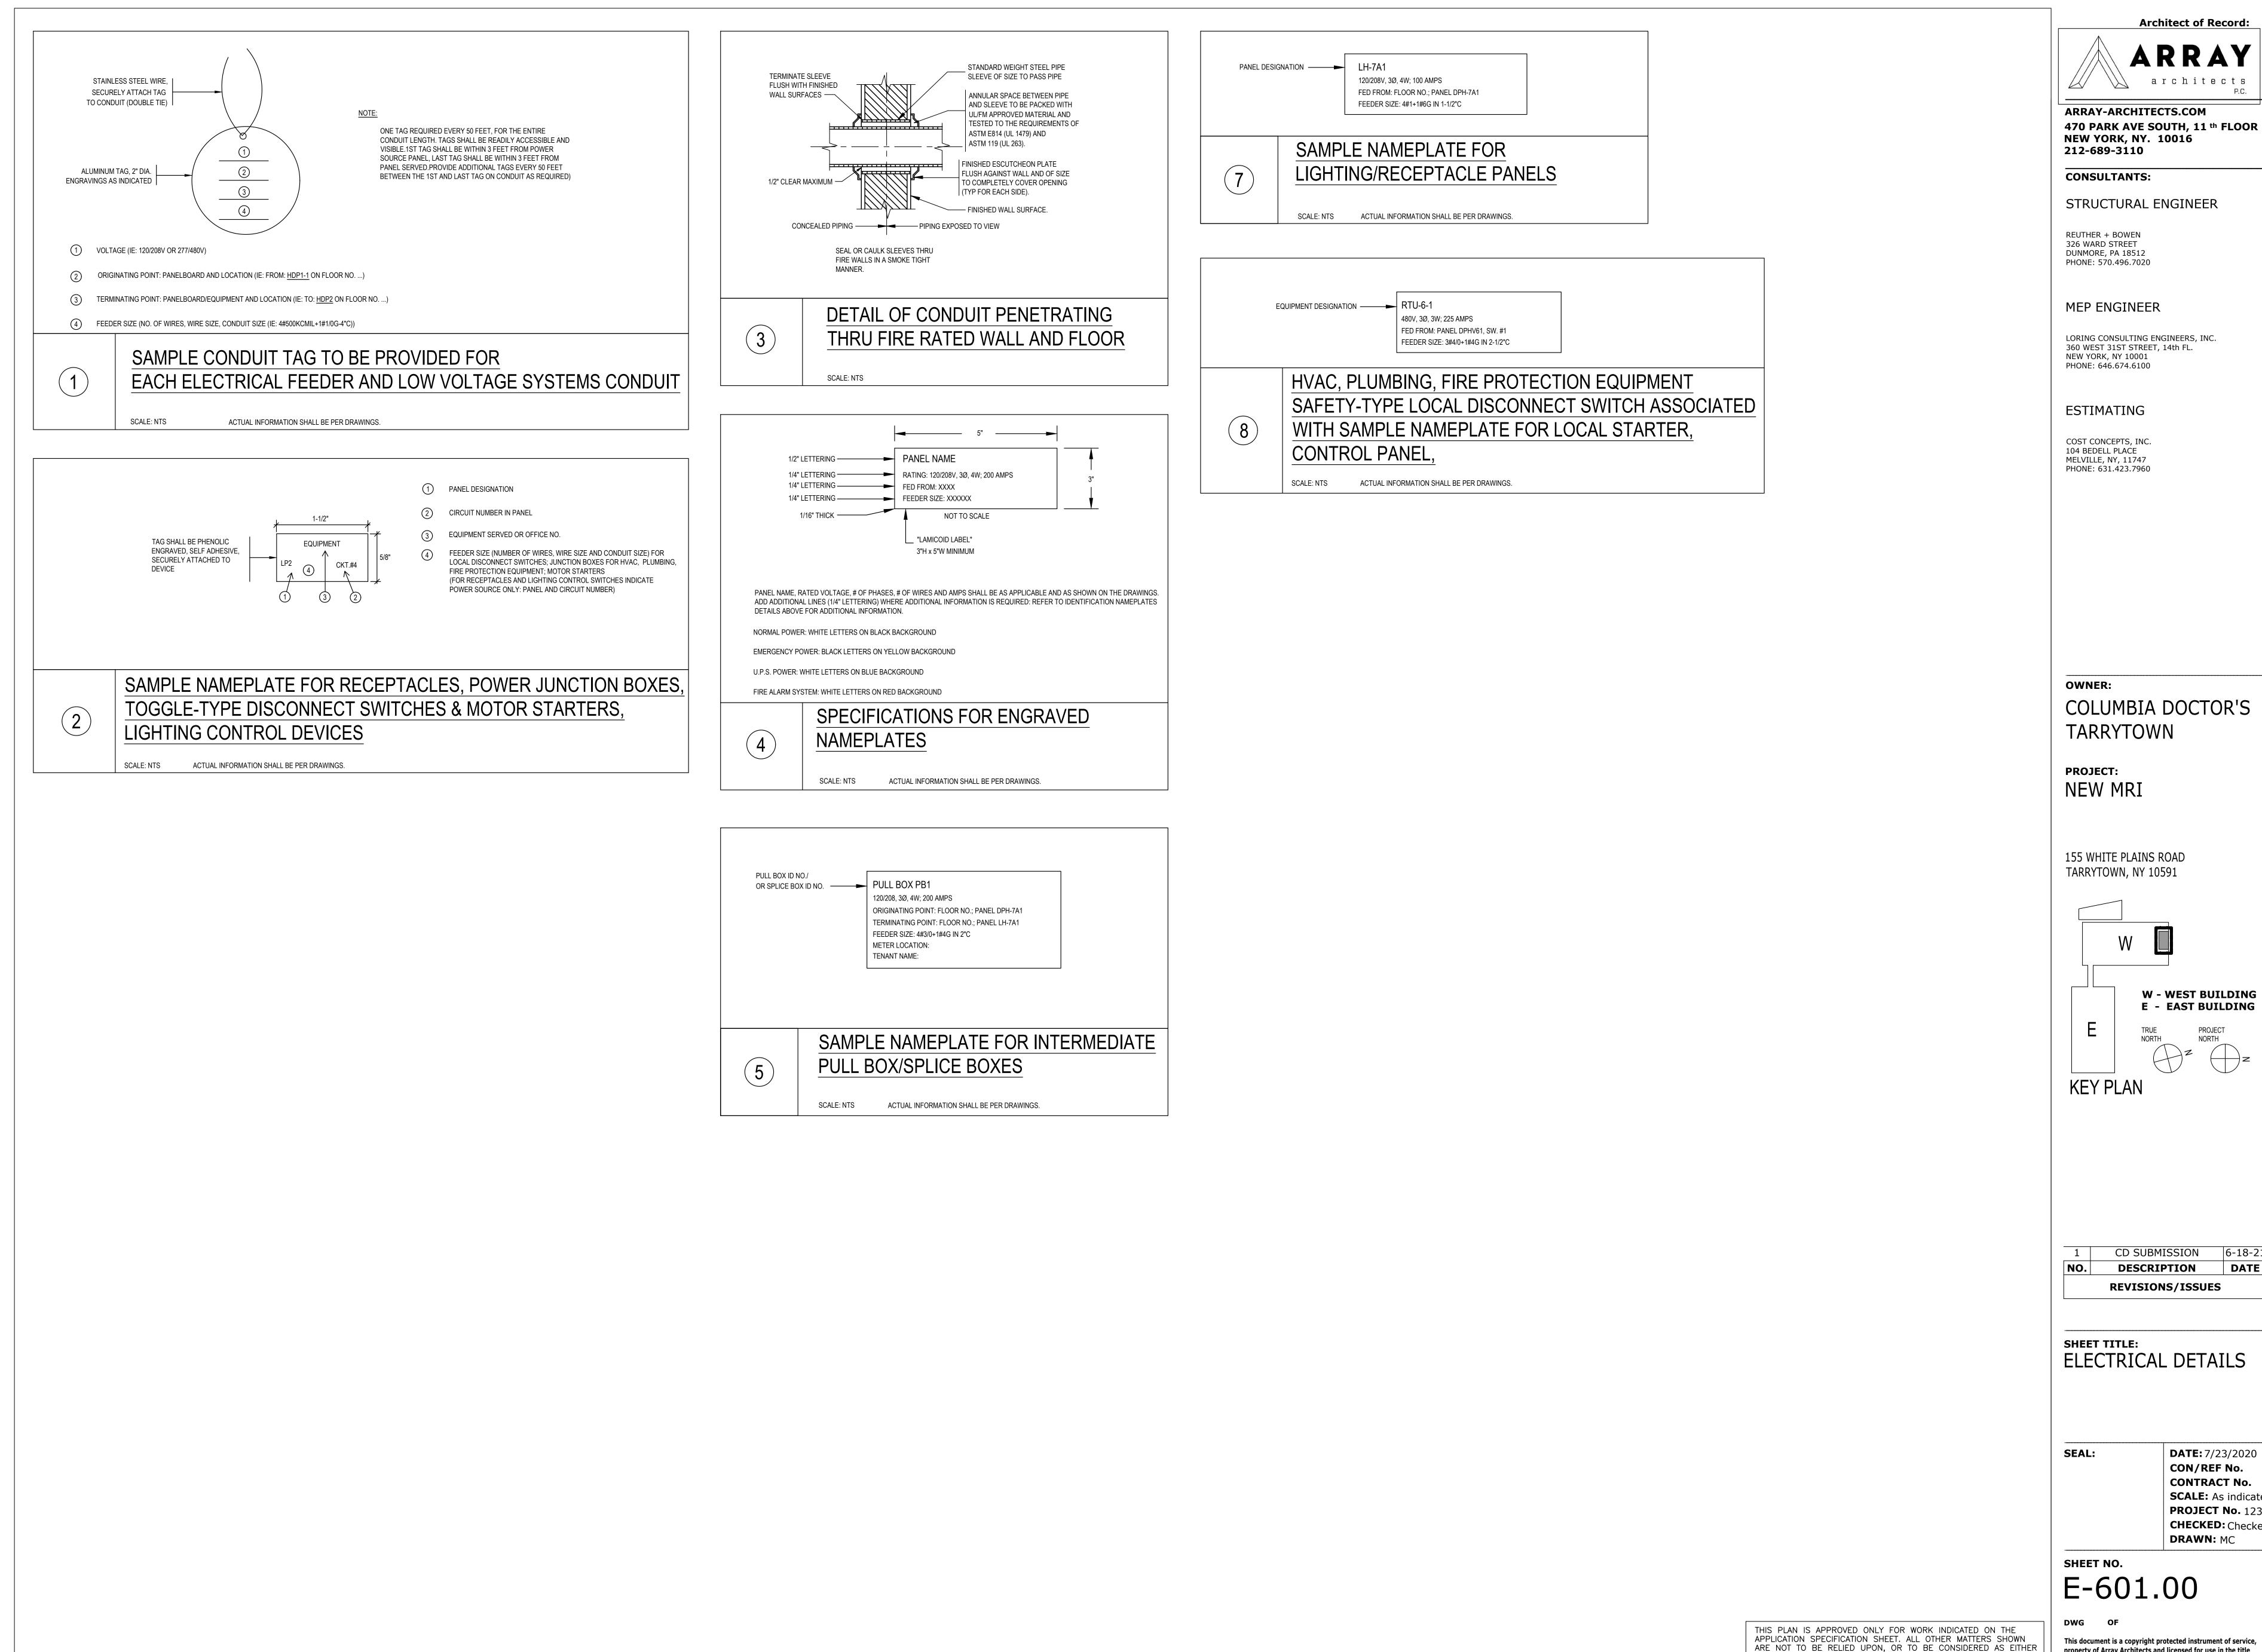

prosecuted under the law.

BEING APPROVED OR IN ACCORDANCE WITH APPLICABLE CODES.

COPPRIGHT - 2020 ARRAY-ARCHITECTS P.C.

STRUCTURAL ENGINEER

DUNMORE, PA 18512 PHONE: 570.496.7020

MEP ENGINEER


LORING CONSULTING ENGINEERS, INC 360 WEST 31ST STREET, 14th FL. NEW YORK, NY 10001

MELVILLE, NY, 11747 PHONE: 631.423.7960

COLUMBIA DOCTOR'S TARRYTOWN

NEW MRI

155 WHITE PLAINS ROAD TARRYTOWN, NY 10591

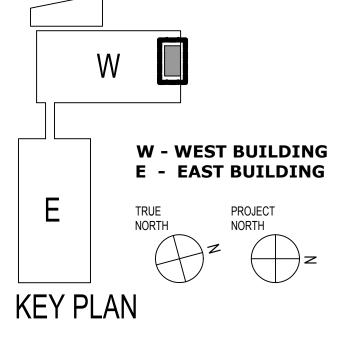


6-18-21 CD SUBMISSION DATE **DESCRIPTION REVISIONS/ISSUES**


SHEET TITLE: ELECTRICAL DETAILS

> **DATE:** 7/23/2020 CON/REF No. **CONTRACT No. SCALE:** As indicated **PROJECT No.** 12384 CHECKED: Checker **DRAWN:** MC

E-601.00

property of Array Architects and licensed for use in the title project only. Reproduction or use of this document without written permission of Array Architects is illegal and will be

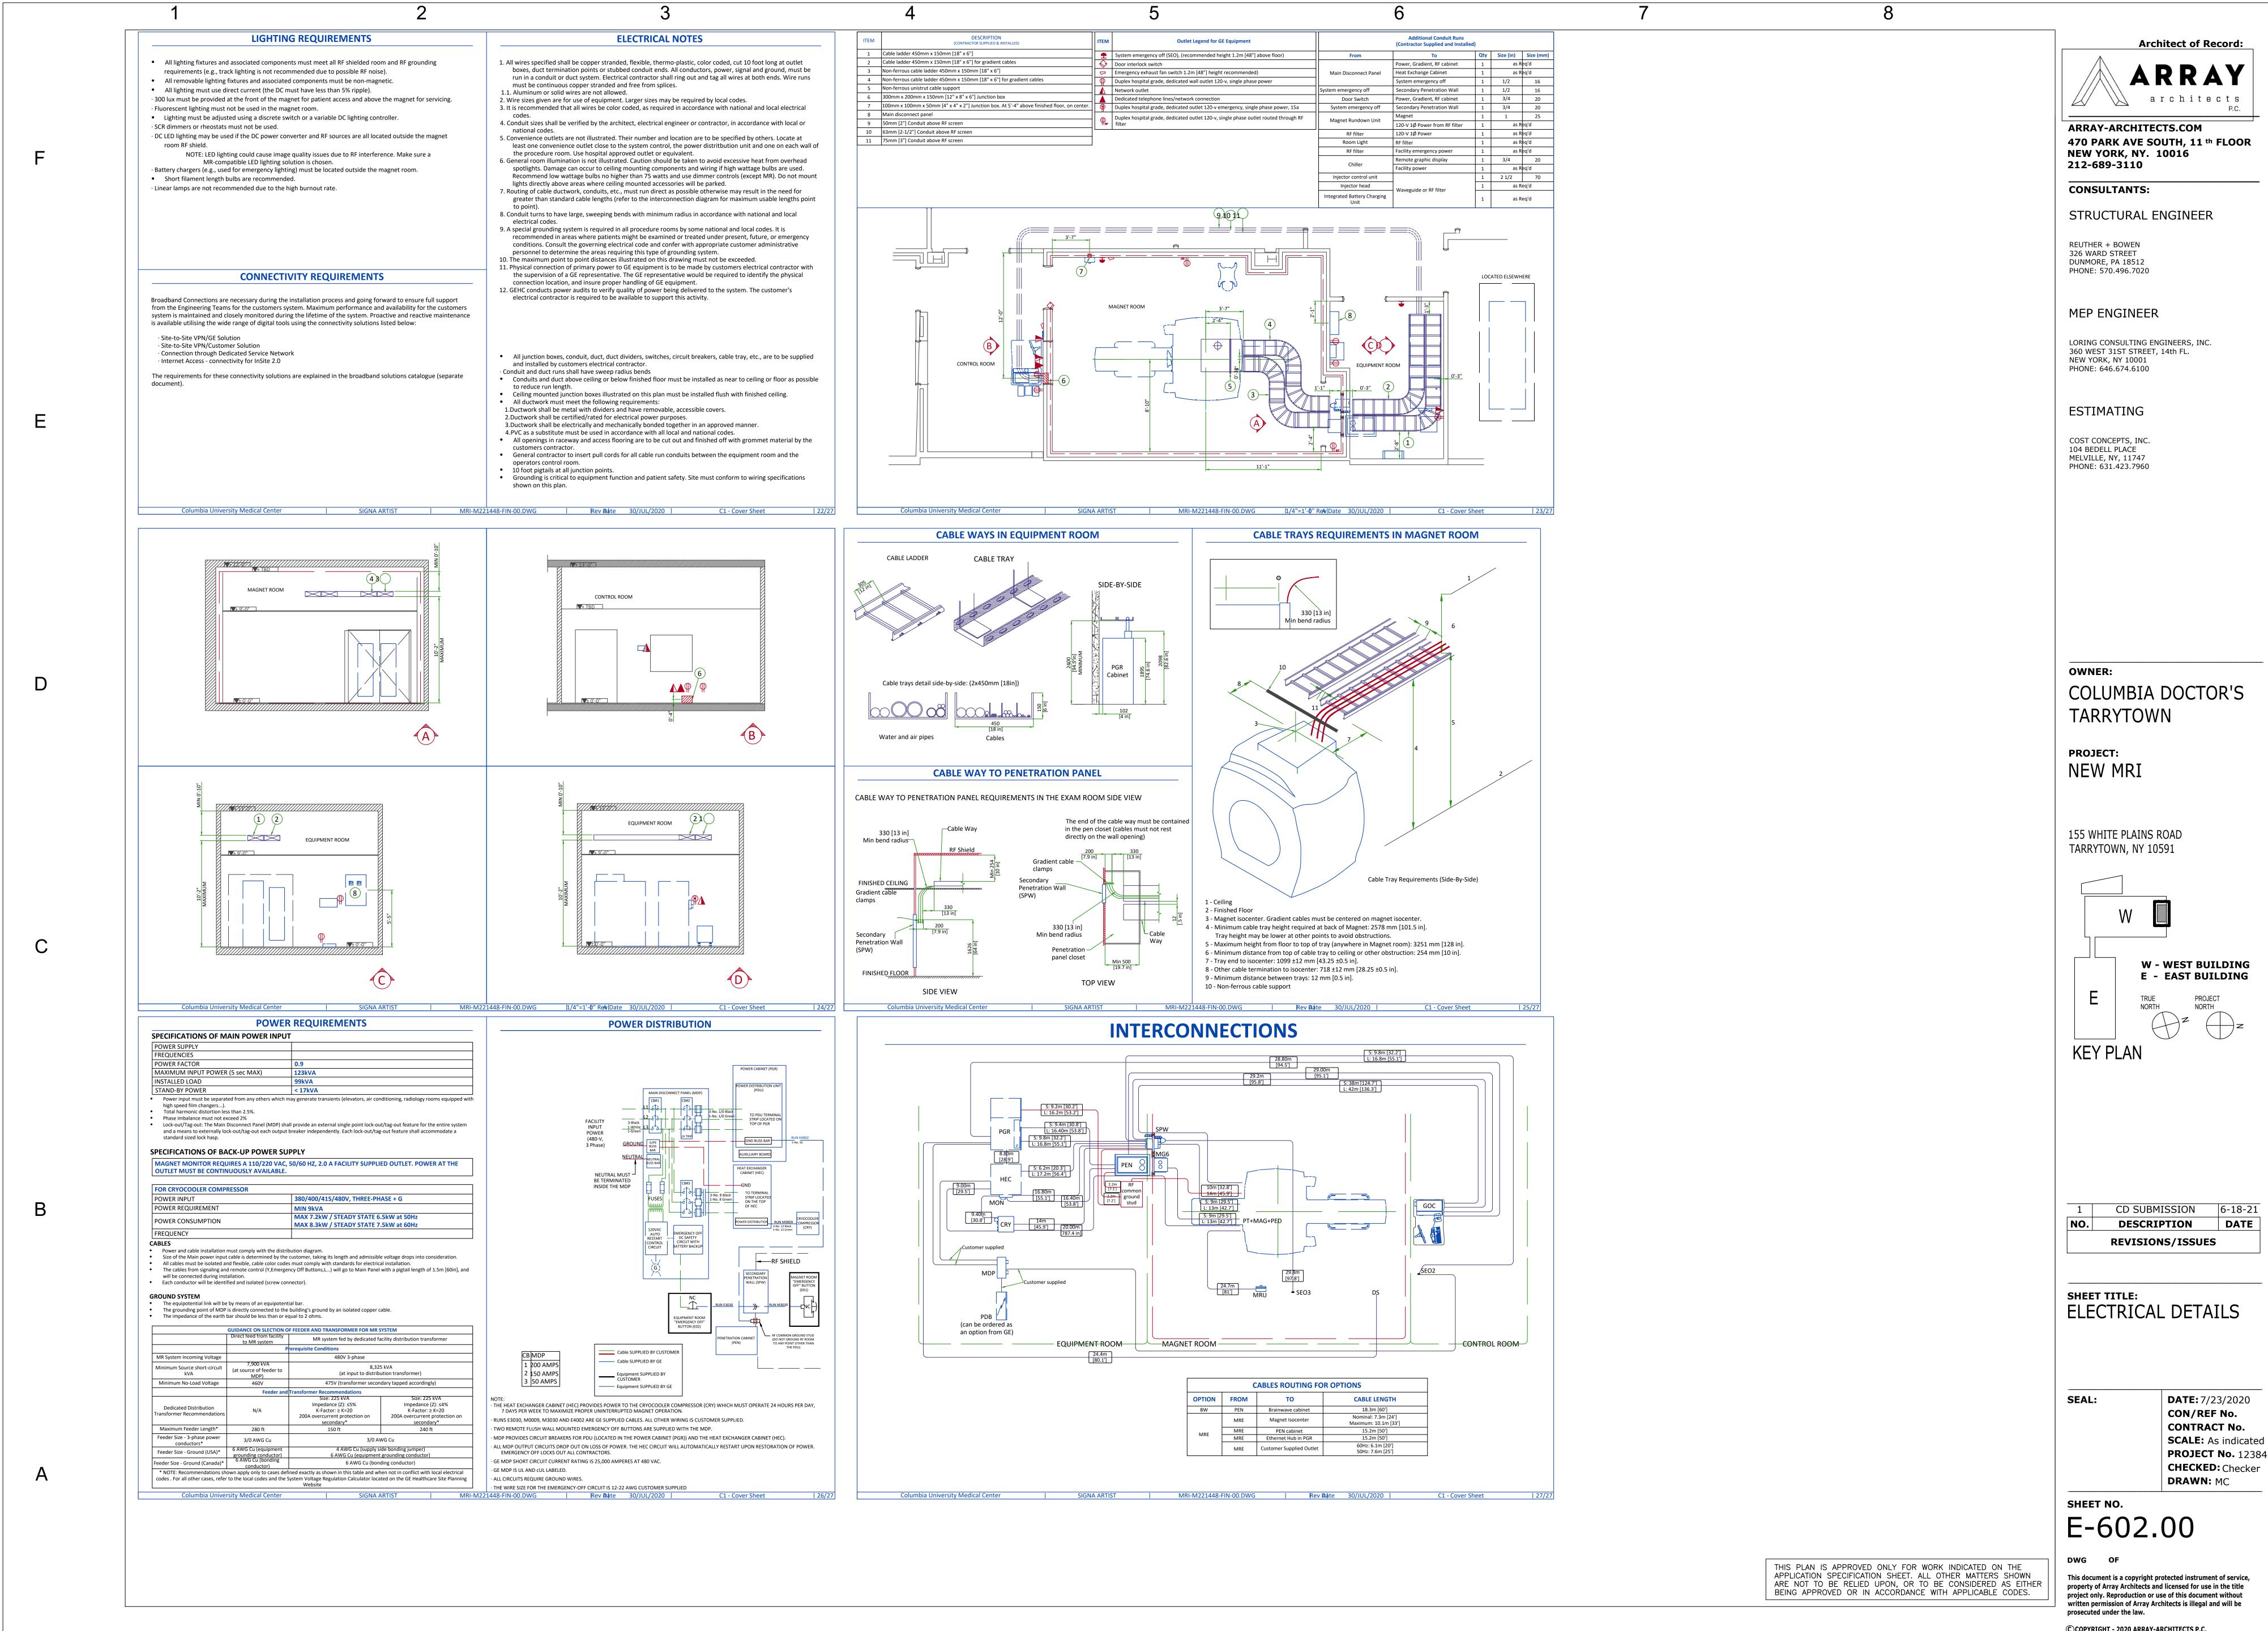


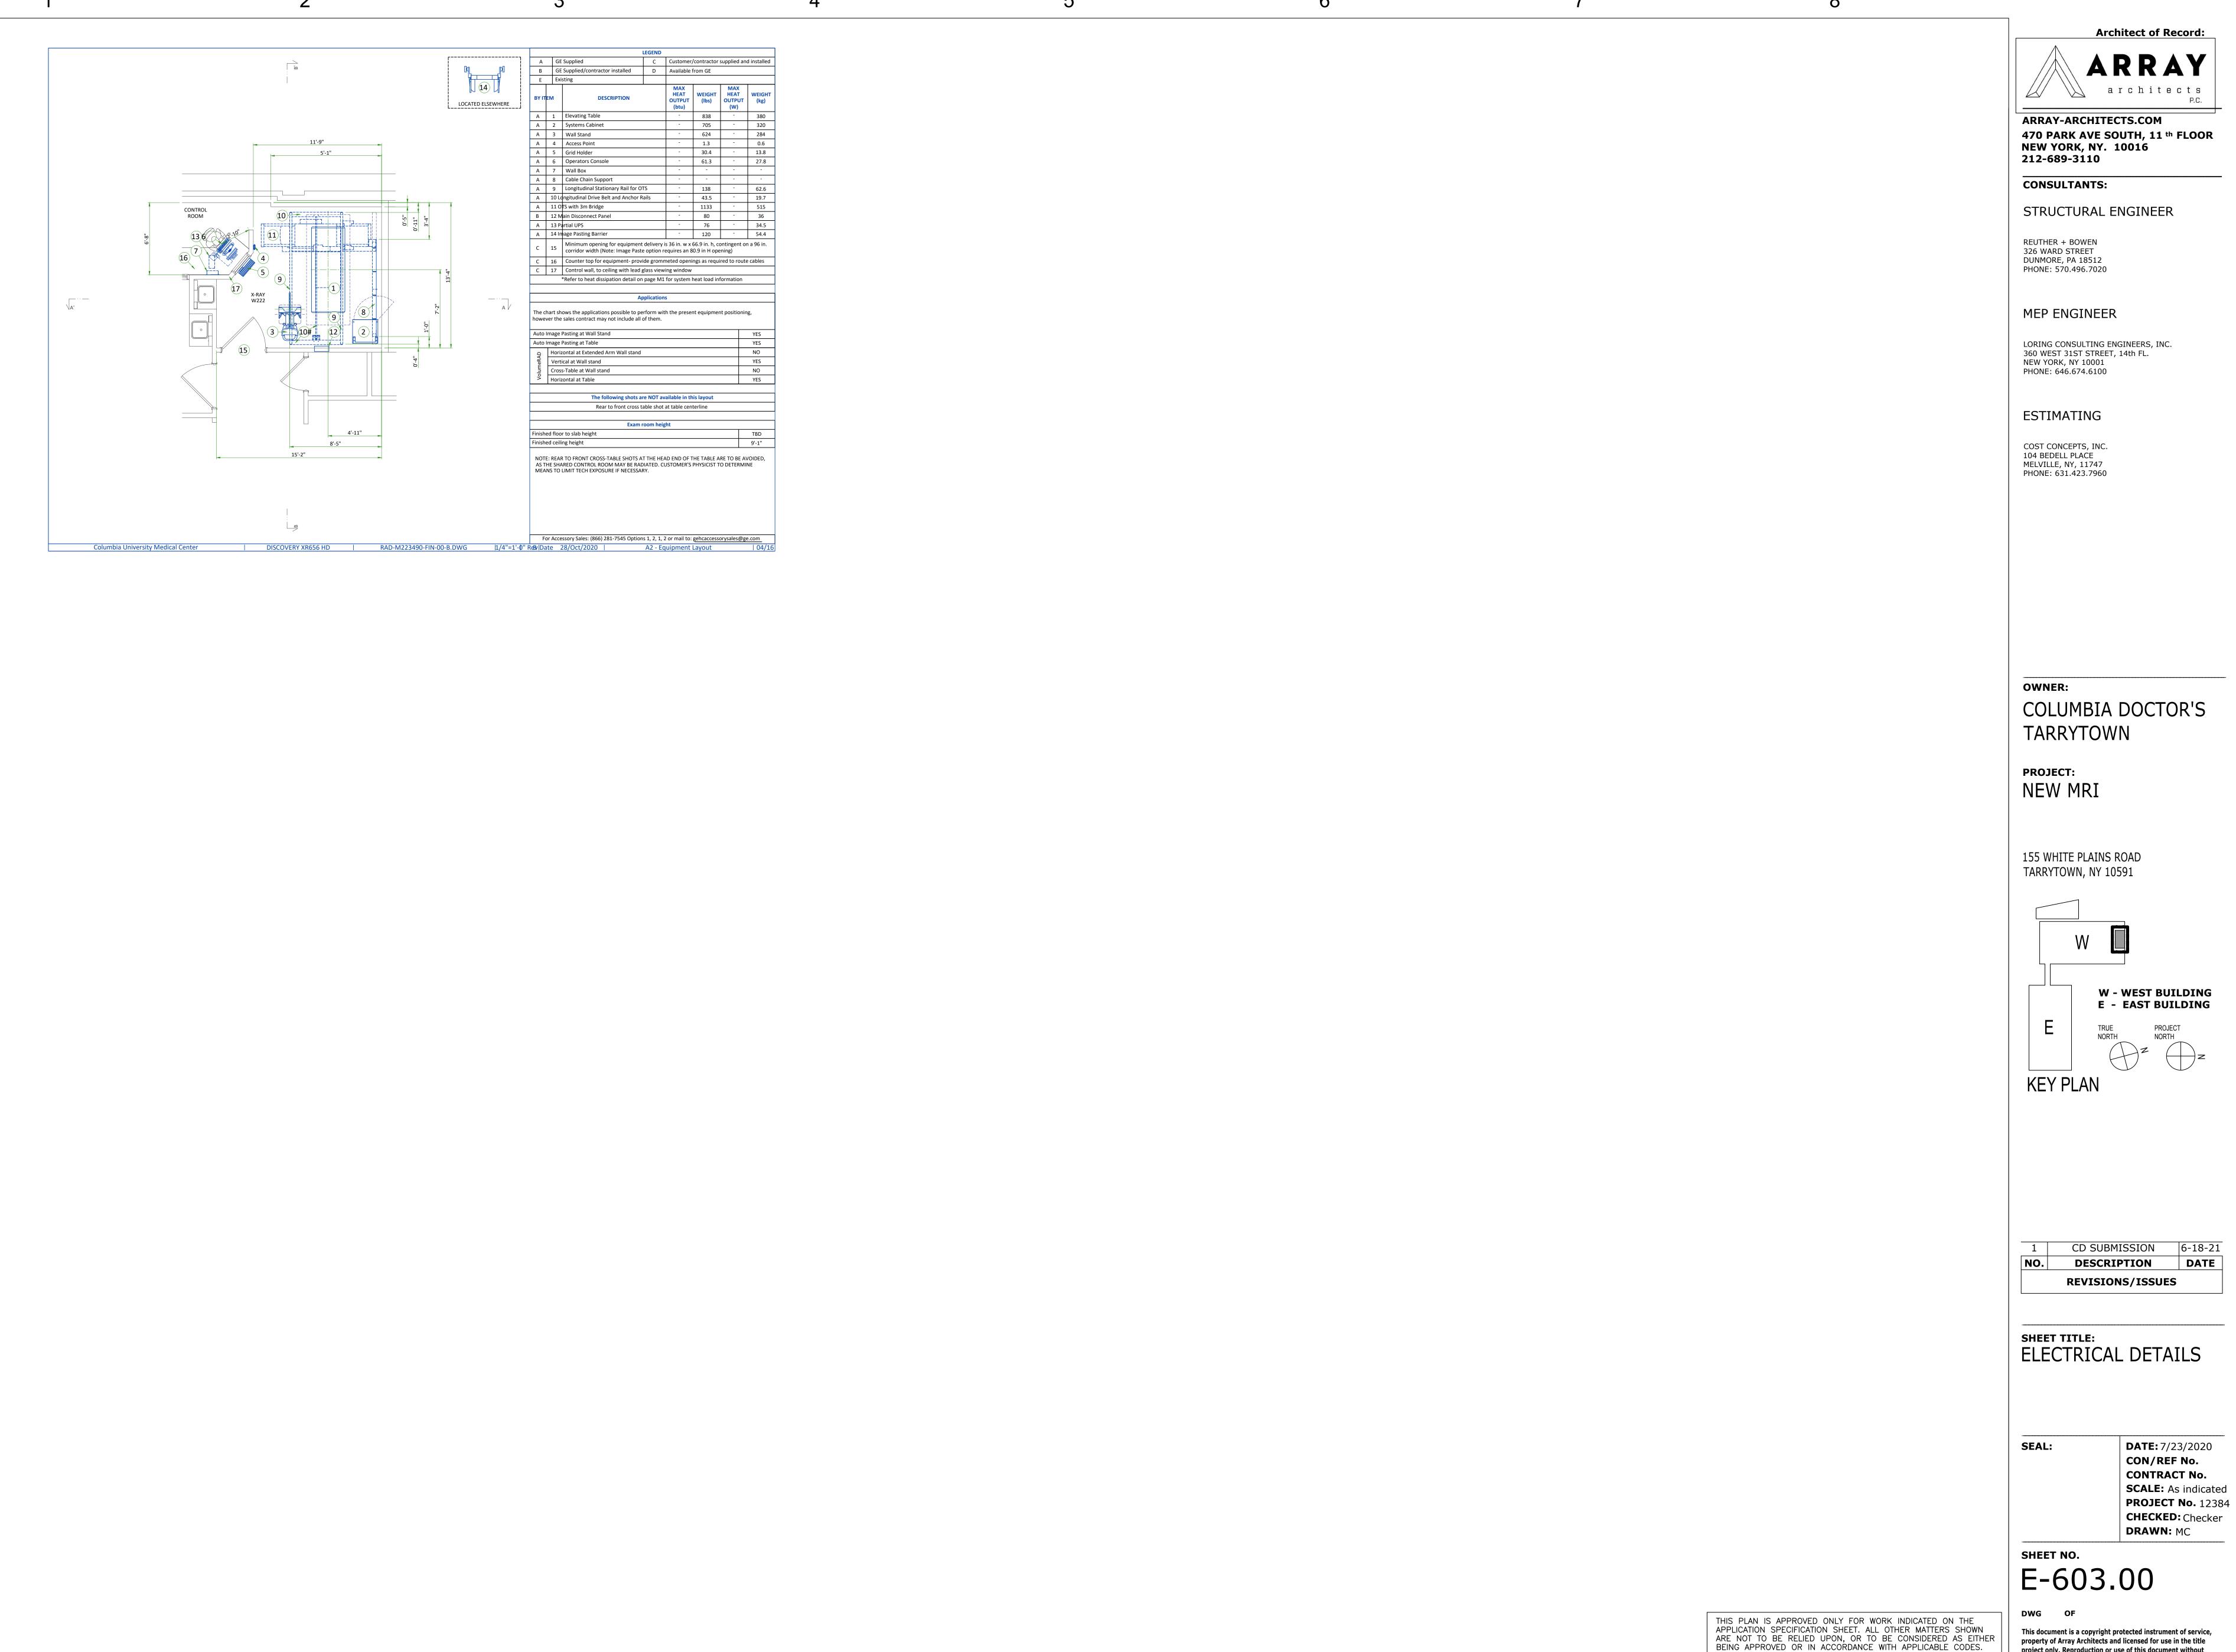

COPPRIGHT - 2020 ARRAY-ARCHITECTS P.C

6-18-21

project only. Reproduction or use of this document without written permission of Array Architects is illegal and will be prosecuted under the law.

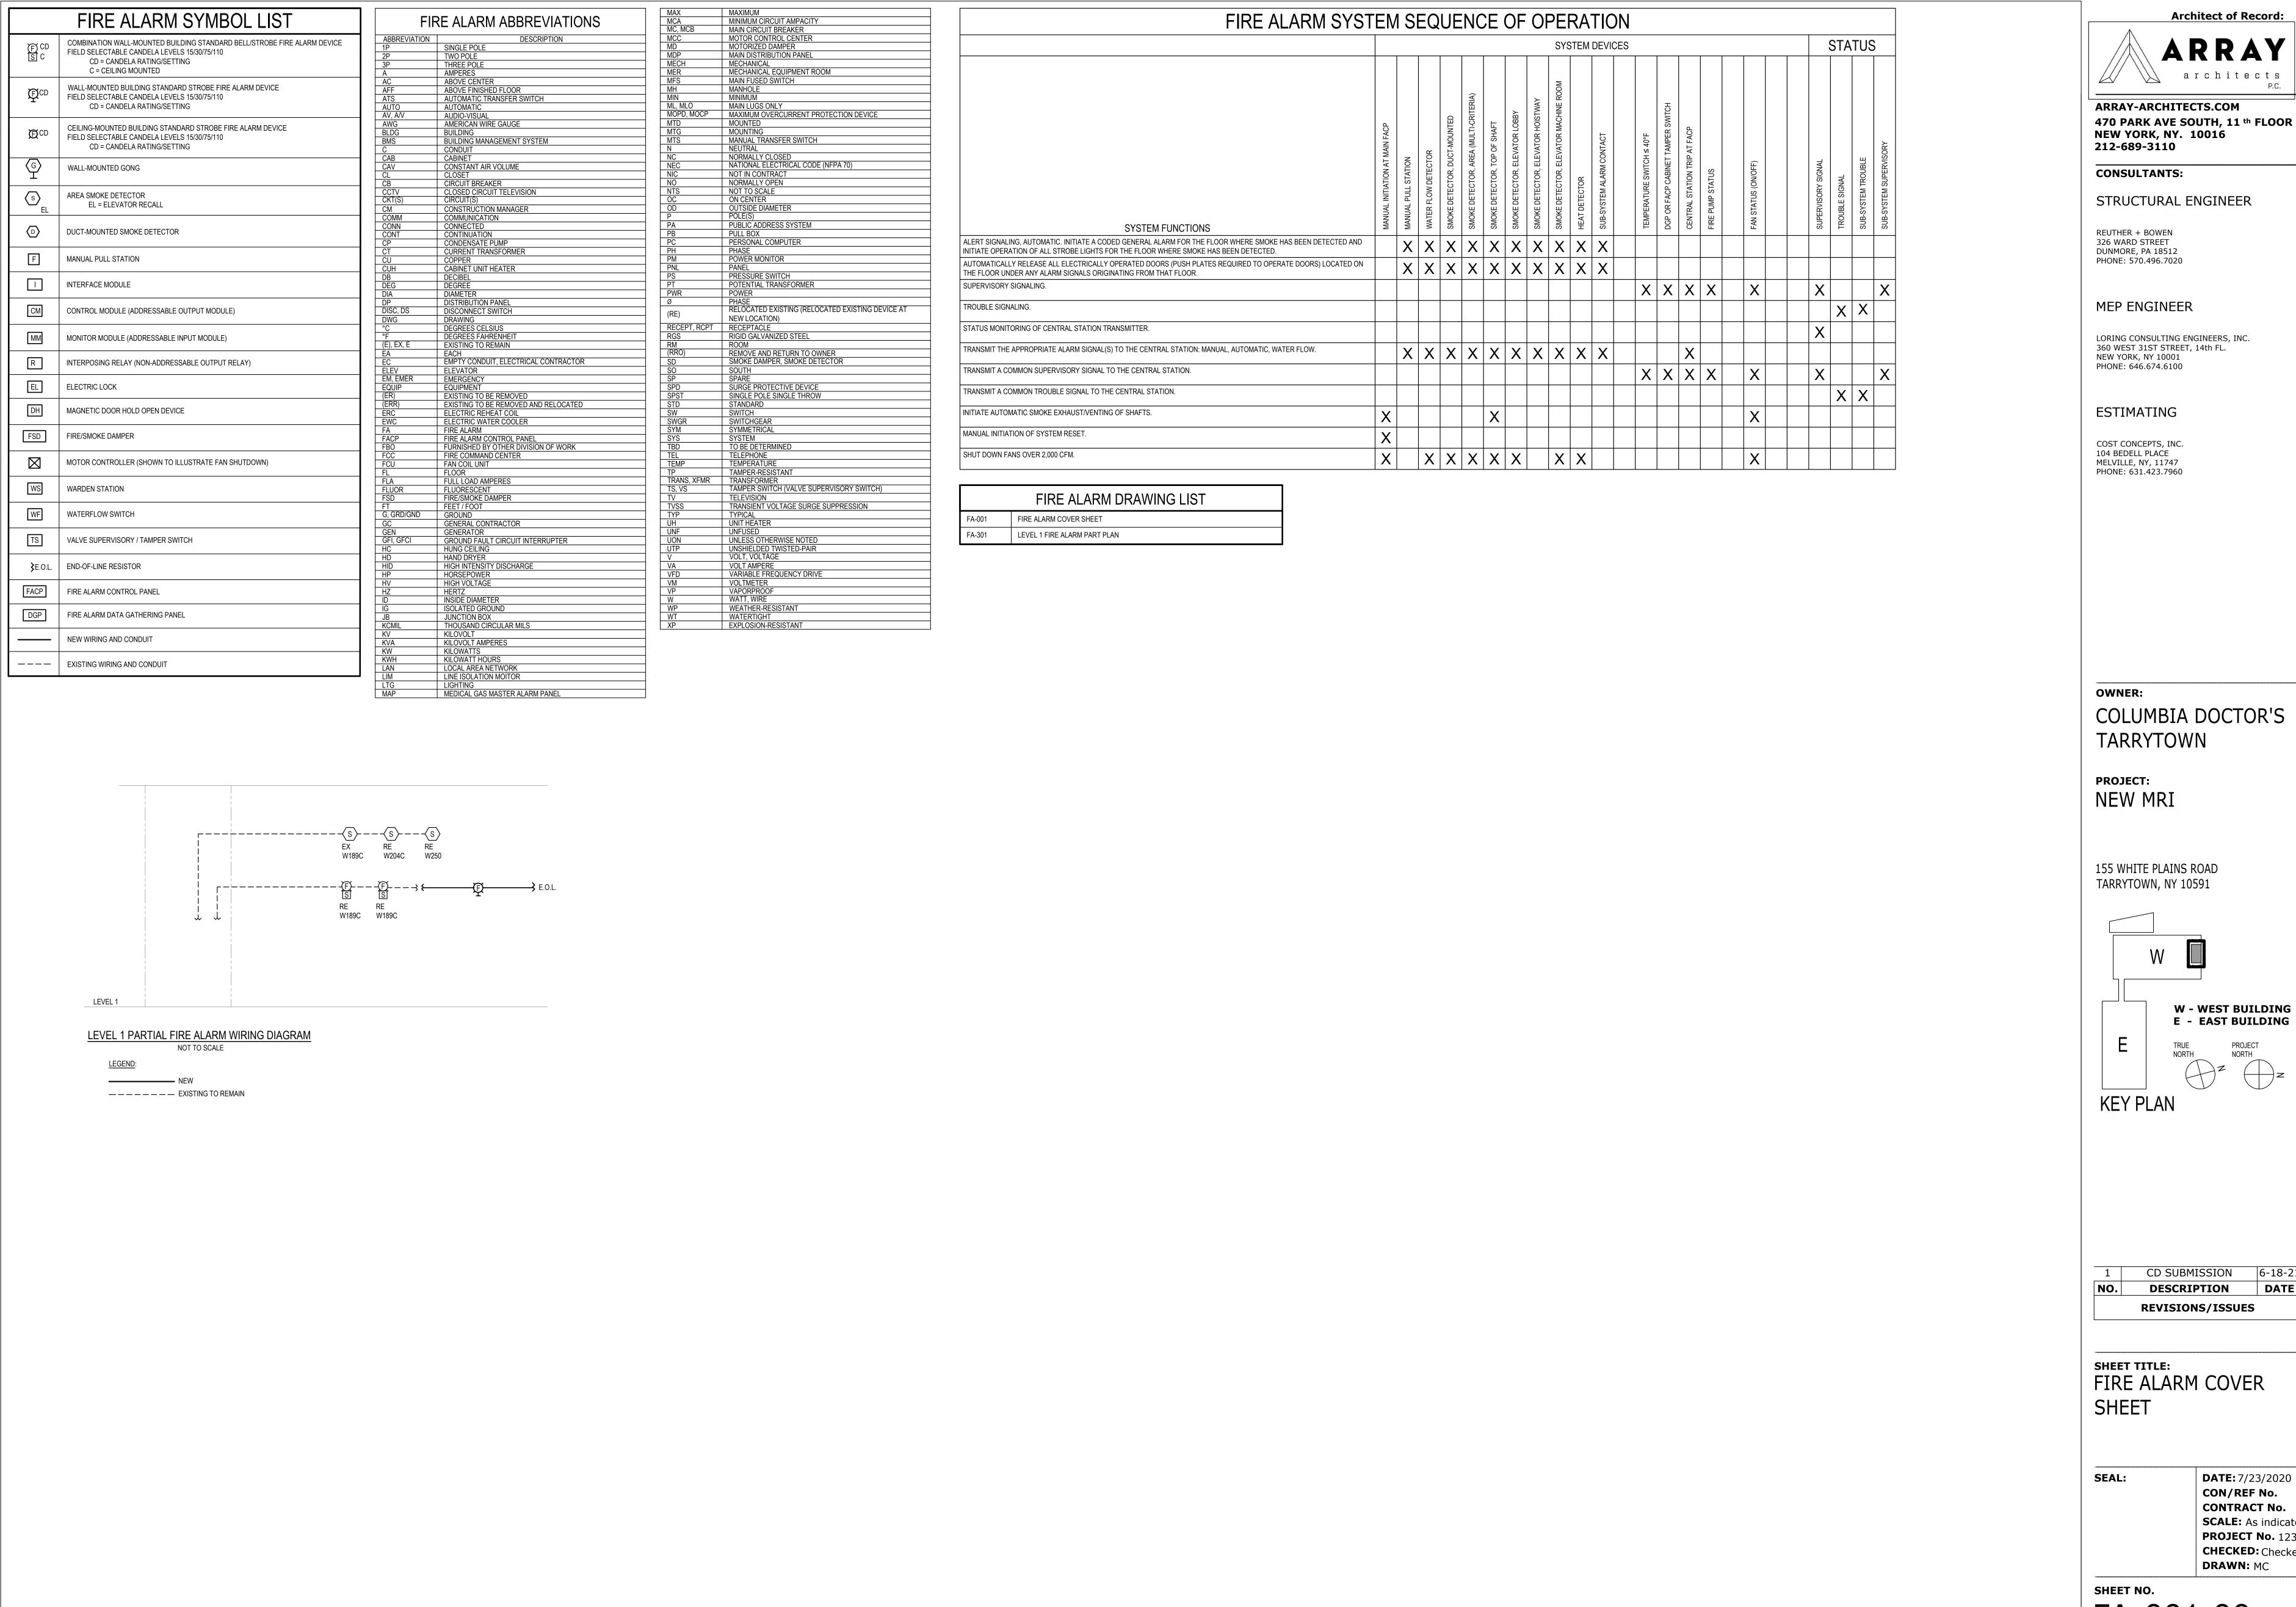

THIS PLAN IS APPROVED ONLY FOR WORK INDICATED ON THE APPLICATION SPECIFICATION SHEET. ALL OTHER MATTERS SHOWN This document is a copyright protected instrument of service, ARE NOT TO BE RELIED UPON, OR TO BE CONSIDERED AS EITHER BEING APPROVED OR IN ACCORDANCE WITH APPLICABLE CODES.

ARRAY-ARCHITECTS.COM

STRUCTURAL ENGINEER


PHONE: 570.496.7020

LORING CONSULTING ENGINEERS, INC. 360 WEST 31ST STREET, 14th FL. NEW YORK, NY 10001

COST CONCEPTS, INC.

COLUMBIA DOCTOR'S

155 WHITE PLAINS ROAD

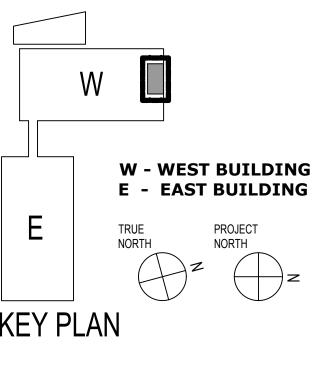

6-18-21 CD SUBMISSION DATE **DESCRIPTION REVISIONS/ISSUES**


SHEET TITLE: FIRE ALARM COVER

> **DATE:** 7/23/2020 CON/REF No. **CONTRACT No. SCALE:** As indicated **PROJECT No.** 12384 **CHECKED:** Checker **DRAWN:** MC

FA-001.00

property of Array Architects and licensed for use in the title project only. Reproduction or use of this document without written permission of Array Architects is illegal and will be

prosecuted under the law. COPPRIGHT - 2020 ARRAY-ARCHITECTS P.C.

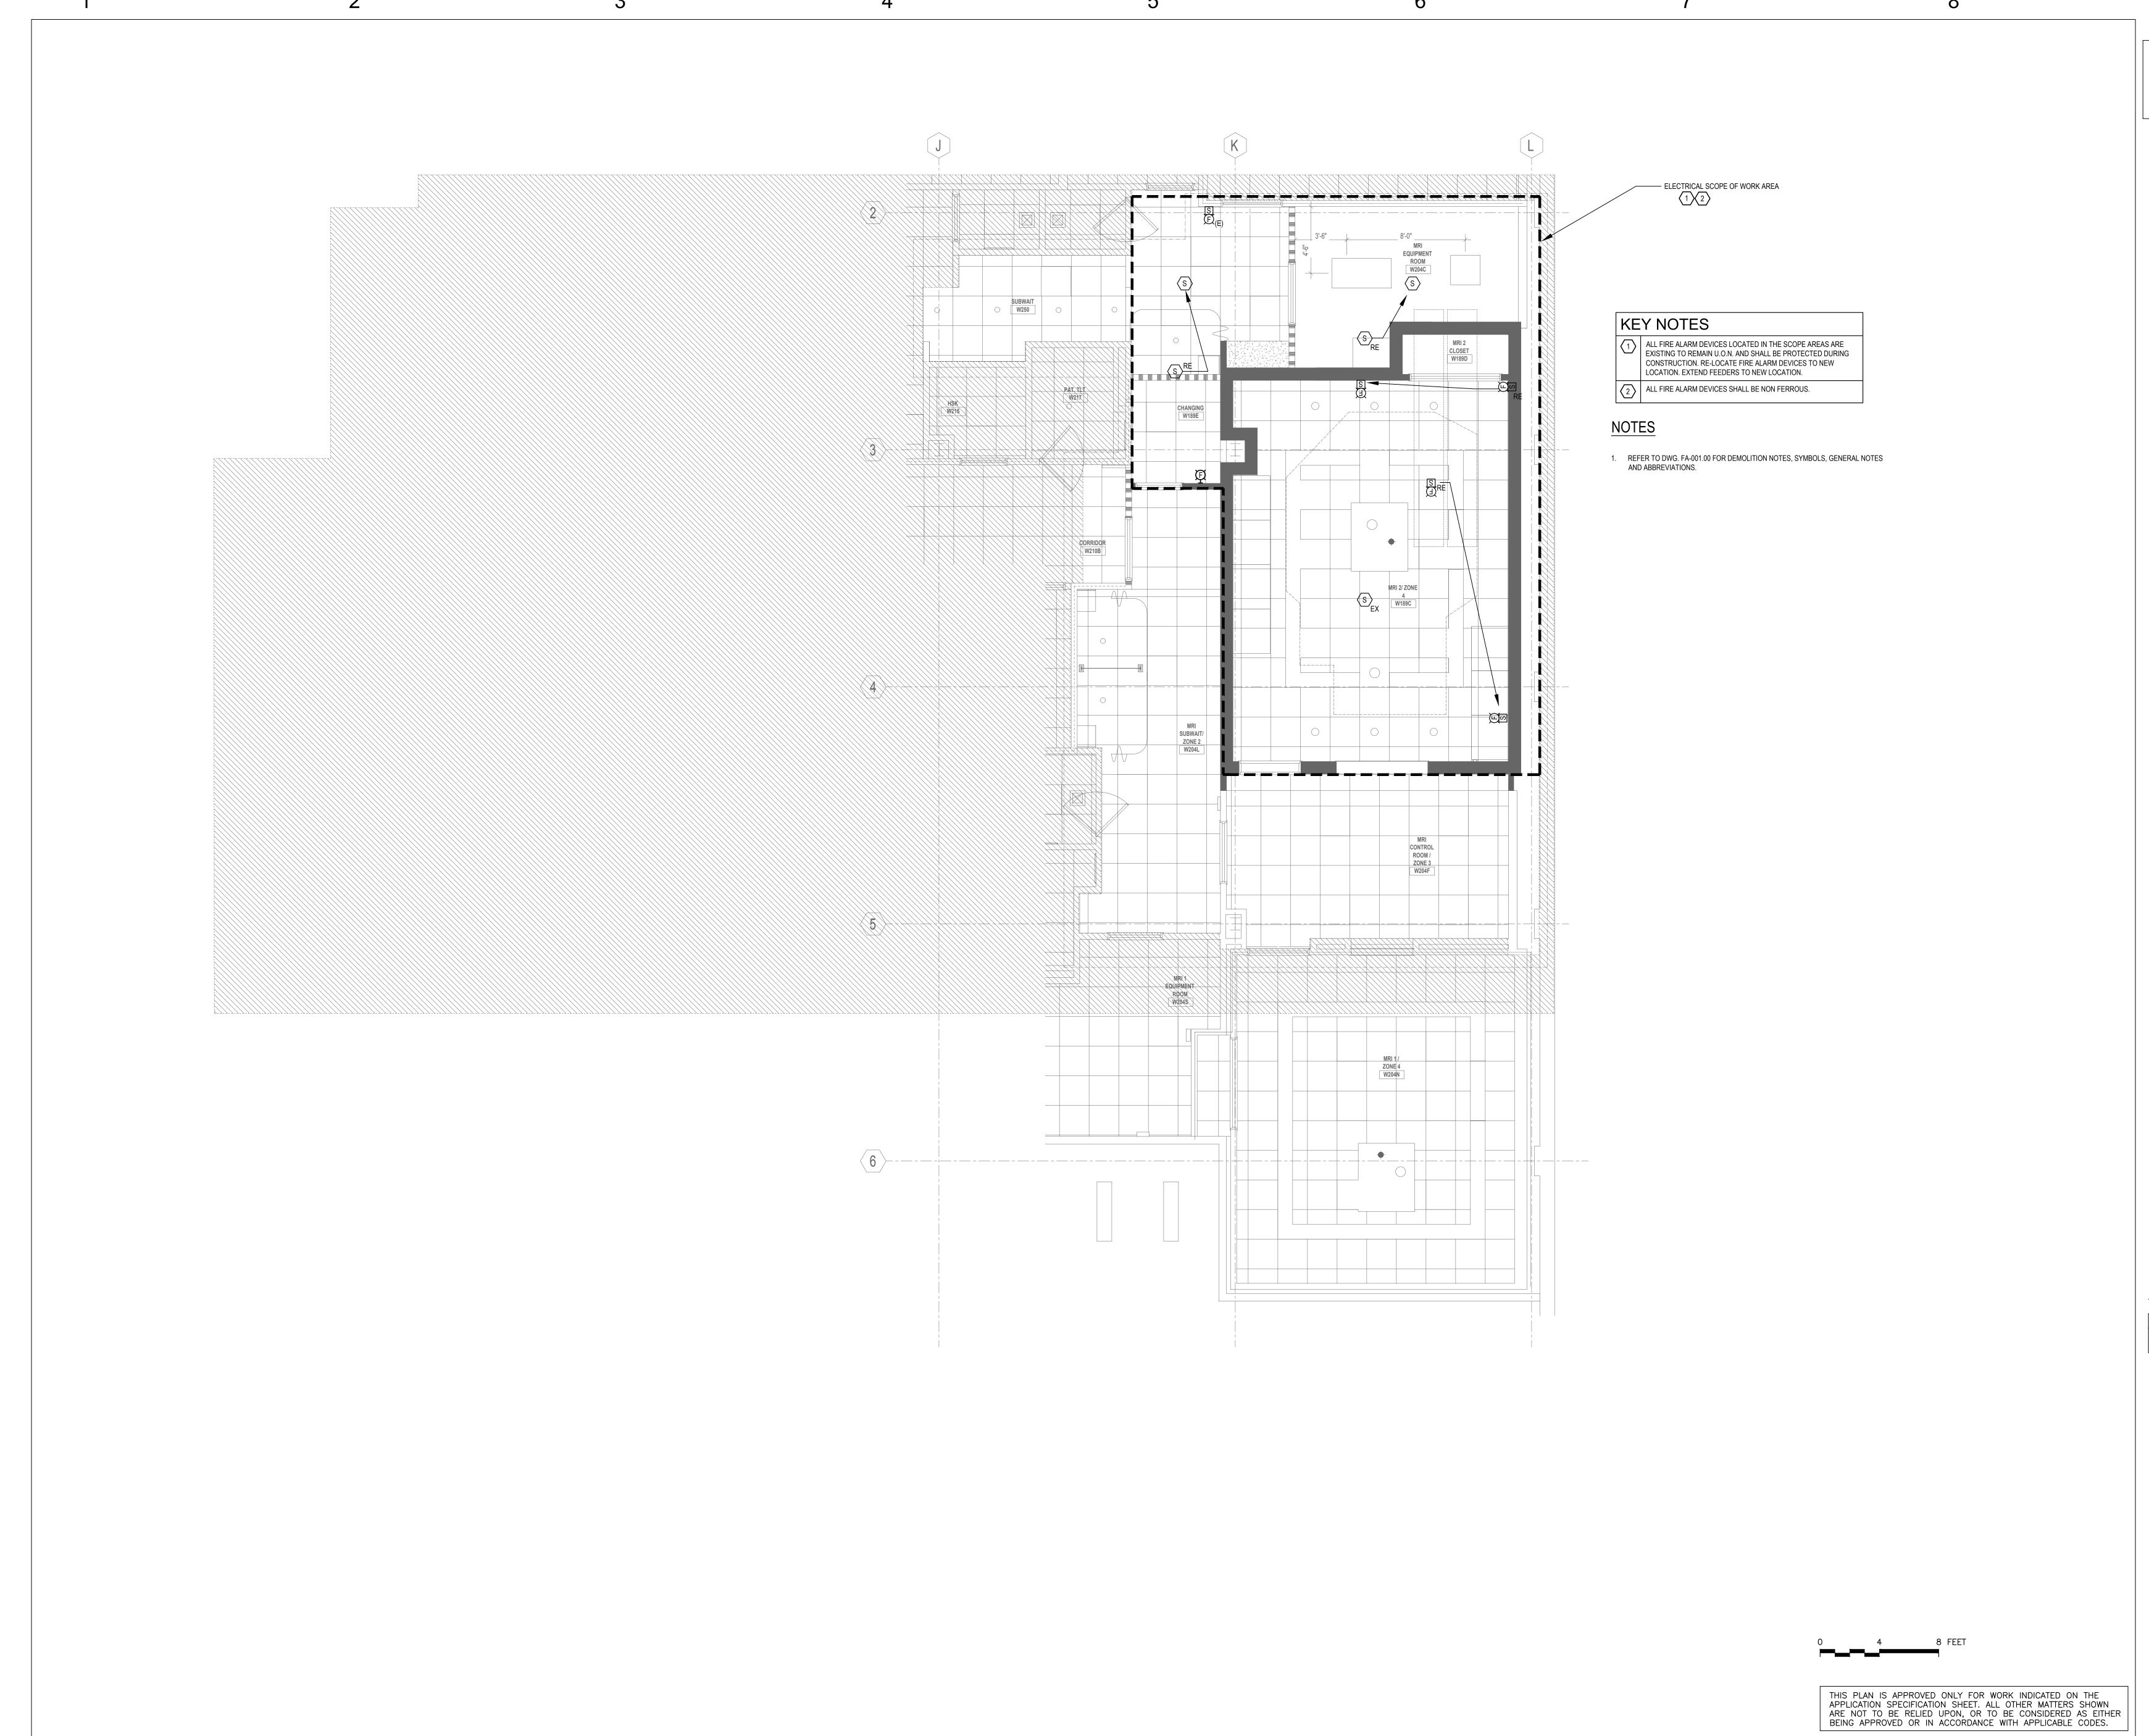

Architect of Record:

ARRAY

architect s

P.C.

ARRAY-ARCHITECTS.COM
470 PARK AVE SOUTH, 11 th FLOOR
NEW YORK, NY. 10016
212-689-3110

CONSULTANTS:

STRUCTURAL ENGINEER

REUTHER + BOWEN 326 WARD STREET DUNMORE, PA 18512 PHONE: 570.496.7020

MEP ENGINEER

LORING CONSULTING ENGINEERS, INC. 360 WEST 31ST STREET, 14th FL. NEW YORK, NY 10001 PHONE: 646.674.6100

ESTIMATING


COST CONCEPTS, INC. 104 BEDELL PLACE MELVILLE, NY, 11747 PHONE: 631.423.7960

OWNER:

COLUMBIA DOCTOR'S TARRYTOWN

project: NEW MRI

155 WHITE PLAINS ROAD TARRYTOWN, NY 10591

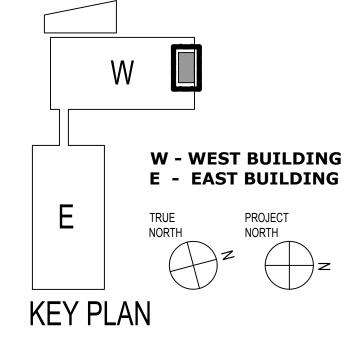

1 CD SUBMISSION 6-18-21

NO. DESCRIPTION DATE

REVISIONS/ISSUES

SHEET TITLE:
LEVEL 1 FIRE ALARM
PART PLAN

SEAL:

DATE: 7/23/2020
CON/REF No.
CONTRACT No.
SCALE: As indicated
PROJECT No. 12384
CHECKED: Checker
DRAWN: MC

SHEET NO.

FA-301.00

DWG OF

This document is a copyright protected instrument of service, property of Array Architects and licensed for use in the title project only. Reproduction or use of this document without written permission of Array Architects is illegal and will be prosecuted under the law.

© COPYRIGHT - 2020 ARRAY-ARCHITECTS P.C.