

BUILDING RENOVATIONS MOUNT VERNON DISTRICT OFFICE AND MOUNT VERNON DISTRICT OFFICE ANNEX **100 EAST FIRST STREET AND 9 UNION AVENUE** MOUNT VERNON, NEW YORK

IN CHARGE OF:	J. GRANT, R.A.	
CHECKED BY:	J. GRANT, R.A.	_
MADE BY:	C. YAM	_



WESTCHESTER COUNTY, NEW YORK DEPARTMENT OF PUBLIC WORKS AND TRANSPORTATION DIVISION OF ENGINEERING

CONTRACT No. 18-508

IEET NO.	SHEET	SHEET TITLE	DPW#
	GENERAL		
1	T-001.00	TITLE SHEET & INDEX OF DRAWINGS	54-24-T-344-0
2	G-001.00	SCOPE OF WORK, GENERAL NOTES & SCAFFOLD INFORMATION	54-24-G-345-0
3	G-002.00	ABBREVIATIONS, SYMBOLS, MATERIAL LEGENDS & NOTES	54-24-G-346-0
	ARCHITECTU		
4	A-101.00	100 EAST FIRST STREET - BASEMENT PLAN	54-24-A-347-0
5	A-102.00	100 EAST FIRST STREET - 1ST FLOOR PLAN	54-24-A-348-0
6	A-110.00	100 EAST FIRST STREET - 10TH FLOOR PLAN	54-24-A-349-0
7	A-111.00	100 EAST FIRST STREET - ROOF & BULKHEAD PLANS	54-24-A-350-0
8	A-201.00	100 EAST FIRST STREET - EXTERIOR BUILDING ELEVATIONS - NORTH	54-24-A-351-0
9	A-202.00	100 EAST FIRST STREET - EXTERIOR BUILDING ELEVATIONS - EAST & NORTHWEST	54-24-A-352-0
10	A-203.00	100 EAST FIRST STREET - EXTERIOR BUILDING ELEVATIONS - SOUTH	54-24-A-353-0
11	A-204.00	100 EAST FIRST STREET - EXTERIOR BUILDING ELEVATIONS - WEST	54-24-A-354-0
12	A-205.00	100 EAST FIRST STREET - PARAPET, 10TH FLOOR & BULKHEAD ELEVATIONS	54-24-A-355-0
13	A-206.00	9 UNION AVENUE HOUSE 1 - EXTERIOR BUILDING ELEVATIONS	54-24-A-356-0
14	A-207.00	9 UNION AVENUE HOUSE 2 - EXTERIOR BUILDING ELEVATIONS	54-24-A-357-0
15	A-401.00	MASONRY DETAILS	54-24-A-358-0
16	A-402.00	MASONRY & GUTTER/DOWNSPOUT DETAILS	54-24-A-359-0
17	A-501.00	STAIR & RAMP RAILING DETAILS	54-24-A-360-0
18	A-701.00	DOOR SCHEDULE & DETAILS	54-24-A-361-0
19	A-702.00	WINDOW SCHEDULE & DETAILS	54-24-A-362-0
20	EL-001.00	ELEVATOR SHAFT REPAIR & MACHINE ROOM PLANS	54-24-A-363-0
21	EL-002.00	TYPICAL ELEVATOR CAB INTERIOR DETAILS	54-24-A-364-0
	STRUCTURAL		
22	S-001.00	GENERAL NOTES	54-24-S-365-0
23	DM-100.00	UNION AVENUE - BLDG. 2 RAMP DEMOLITION	54-24-S-366-0
24	S-101.00	UNION AVENUE - BLDG. 2 RAMP FRAMING	54-24-S-367-0
25	S-006.00	TYPICAL DETAILS	54-24-S-368-0
	ENVIRONMEN		54 04 11 200 4
26	H-100.00	GENERAL NOTES & SCOPE OF WORK TABLES	54-24-H-369-0
27	H-101.00	EXTERIOR BUILDING ELEVATION - NORTH - ABATEMENT PLAN	54-24-H-370-0
28	H-102.00	EXTERIOR BUILDING ELEVATIONS - SOUTH - ABATEMENT PLAN	54-24-H-371-0 54-24-H-372-0
29	H-103.00	EXTERIOR BUILDING ELEVATIONS - WEST - ABATEMENT PLAN	54-24-H-372-0 54-24-H-373-0
30	H-104.00	EXTERIOR BUILDING ELEVATIONS - EAST & NORTH WEST - ABATEMENT PLAN	54-24-H-373-0 54-24-H-374-0
31	H-105.00	100 EAST FIRST STREET - ROOF & BULKHEAD - ABATEMENT PLAN	54-24-H-374-0
32	H-106.00	9 UNION AVENUE HOUSE 1- EXTERIOR BUILDING ELEVATIONS - ABATEMENT PLAN	04-24-11-0/0-0

100% BID DOCUMENTS

Alla Vaple RECOMMENDED FOR DESIGN


5-20-21 DATE

ADAM KAPLINSKI, R.A ASSOCIATE ARCHITECT DEPARTMENT OF PUBLIC WORKS AND TRANSPORTATION

glean 5.20.2021 DATE APPROVED FOR CONSTRUCTION APPROVED FOR CONSTRUCTION

HUGH J. GREECHAN JR., P.E. COMMISIONER

GAYLE KATZMAN, P.E. FIRST DEPUTY COMMISSIONER DEPARTMENT OF PUBLIC WORKS AND TRANSPORTATION

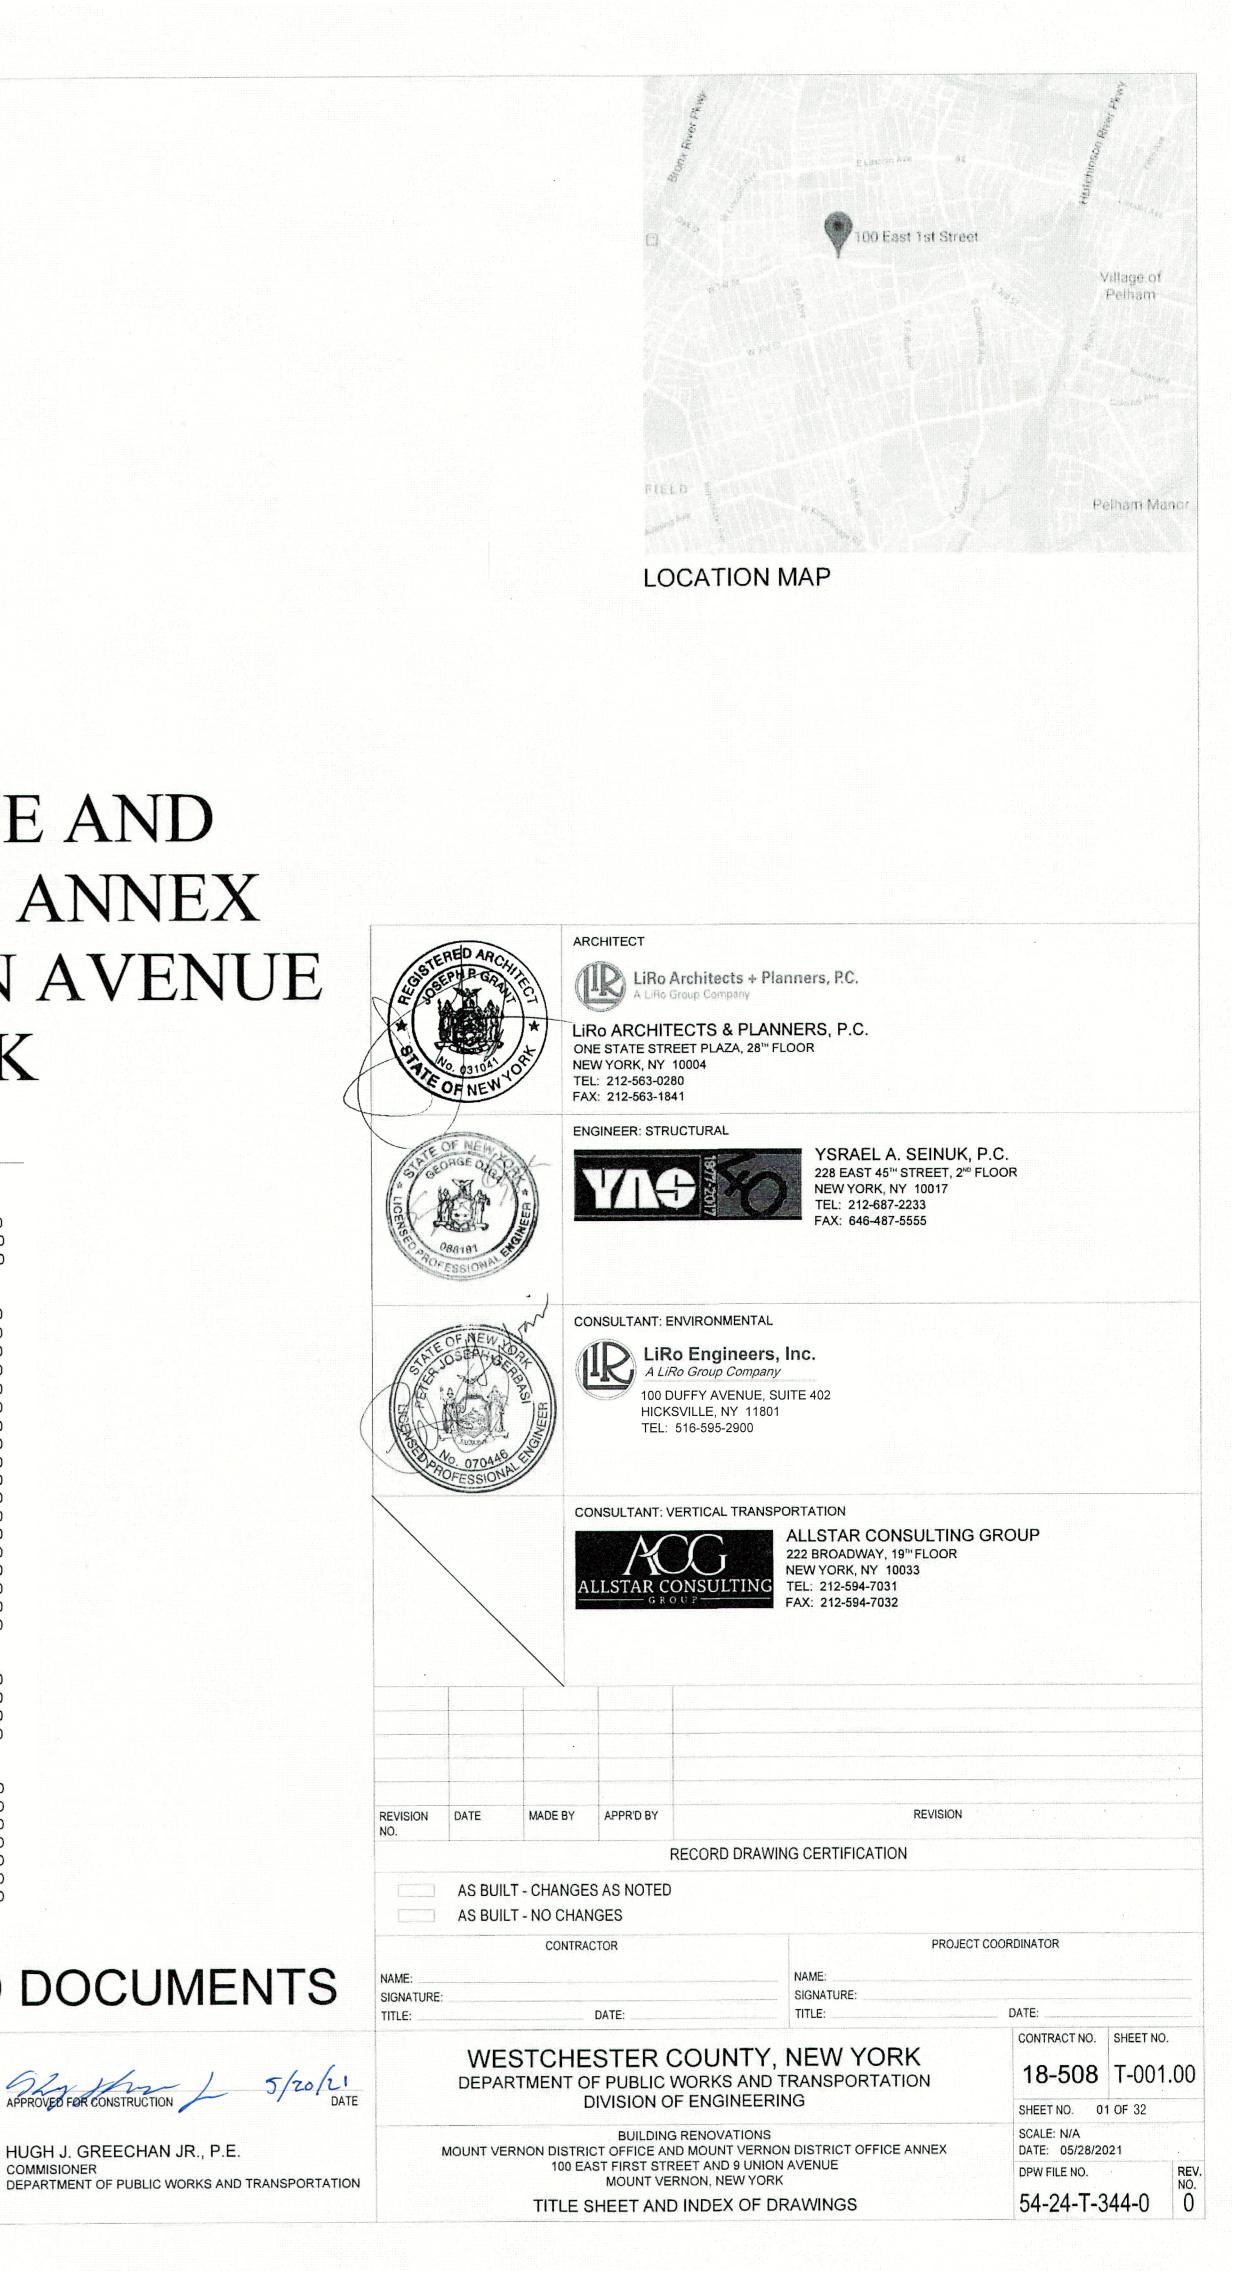

SCOPE OF WORK

MOUNT VERNON DISTRICT OFFICES (100 EAST FIRST STREET)

- EXTERIOR MASONRY REPAIRS INCLUDING REPLACEMENT AND REPOINTING.
- REPLACEMENT IN-KIND OF EXISTING ORNAMENTAL STONE.
- RESETTING OF DISPLACED ORNAMENTAL STONE. 4. PATCH/REPAIR CRACKS IN LIMESTONE.
- 5. REMOVE EXISTING CEMENTITIOUS COATING OVER FACADES; PROVIDE BREATHABLE MASONRY COATING.
- 6. REPLACEMENT OF EXISTING FAILED EXTERIOR CAULKING.. 7. STRUCTURAL STEEL:
- a. REPLACEMENT OF STEEL LINTELS.
- b. REPAIR OF STRUCTURAL BEAM AT DSS INTAKE ENTRANCE.
- 7. REPLACEMENT OF FIRST FLOOR STOREFRONT WINDOWS. REPLACEMENT OF BASEMENT WINDOWS.
- RESTORE WINDOW GUARDS AT BASEMENT WINDOWS.
- 10. REPLACEMENT OF THREE (3) ENTRANCE DOORS: MEZZANINE, BASEMENT, AND DSS INTAKE.
- 11. REPLACEMENT OF GUTTERS AND DOWNSPOUTS. 12. REPLACEMENT OF SCUPPERS AND ASSOCIATED ROOFING SURROUND.
- 13. PATCH/REPAIR/PAINT LIMITED AREAS OF INTERIOR FINISH.
- 14. REPLACEMENT/MODERNIZATION OF FOUR (4) EXISTING ELEVATORS: THREE (3) PASSENGER, (1) PASSENGER/SERVICE. 15. RESTORATION OF FOUR (4) EXISTING ELEVATOR HOISTWAY INTERIORS. 16. ELEVATOR MACHINE ROOM:
- a. REPLACEMENT OF FOUR (4) EXISTING ELEVATOR EQUIPMENT.
- b. UPGRADE HVAC TO COMPLY WITH CURRENT BUILDING CODES AND STANDARDS. 17. PATCH/REPAIR/PAINT LIMITED AREAS OF INTERIOR FINISH.
- MOUNT VERNON DISTRICT OFFICE ANNEX HOUSE 1 & HOUSE 2 (9 UNION AVENUE)
- EXTERIOR MASONRY REPAIRS INCLUDING BRICK INFILL, REPLACEMENT, & REPOINTING.
- REPAIR OF LINTELS. REMOVE EXISTING CEMENTATIOUS COATING OVER FACADES; PROVIDE BREATHABLE MASONRY COATING
- 4. REPLACEMENT OF EXISTING FAILED EXTERIOR CAULKING.
- REPLACEMENT OF GUTTERS AND DOWNSPOUTS.
- 6. EXTERIOR MASONRY REPAIRS INCLUDING BRICK INFILL, REPLACEMENT, & REPOINTING.
- REPAIR OF LINTELS. 8. REMOVE EXISTING CEMENTATIOUS COATING OVER FACADES; PROVIDE BREATHABLE MASONRY COATING
- 9. REPLACEMENT OF EXISTING FAILED EXTERIOR CAULKING.
- 10. REPLACEMENT OF GUTTERS AND DOWNSPOUTS. 11. RESTORATION OF EXISTING DETERIORATED VEHICULAR RAMP

BUILDING CODE DATA


PERMITTING BUILDING CODE: IBC 2015 & UCS 2017

OCCUPANCY GROUP IBC 304: B (BUSINESS)

FIRE-RESISTANCE RATING REQUIREMENTS FOR BUILDING ELEMENTS (HOURS) TABLE 601: FOR A BUILDING TYPE IB

STRUCTURAL FRAME - 2HR **BEARING WALLS EXTERIOR - 2HR**

FIRE-RESISTANCE RATING REQUIREMENTS FOR EXTERIOR WALLS BASED ON FIRE SEPARATION DISTANCE (HOURS) TABLE

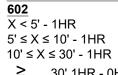

≥ 30' 1HR - 0HR

MAXIMUM AREA OF EXTERIOR WALL OPENINGS BASED ON FIRE SEPARATION DISTANCE AND DEGREE OF OPENING **PROTECTION TABLE 705.8** 25' < X < 30' - NO LIMIT (FOR UNPROTECTED AND PROTECTED OPENINGS)

30' OR GREATER - NO LIMIT (FOR UNPROTECTED AND PROTECTED OPENINGS)

704.11 BOTTOM FLANGE PROTECTION

FIRE PROTECTION IS NOT REQUIRED AT THE BOTTOM FLANGE OF LINTELS, SHELF ANGLES AND PLATES SINCE THEY ARE NOT PART OF THE STRUCTURAL FRAME.

ENERGY CODE COMPLIANCE:

TO THE BEST OF MY KNOWLEDGE, BELIEF AND PROFESSIONAL JUDGEMENT, ALL PLANS AND APPLICATION ARE IN COMPLIANCE WITH THE 2015 NEW YORK STATE ENERGY CONSERVATION CODE

2015 ENERGY CONSERVATION CONSTRUCTION CODE OF NEW YORK STATE.

CLIMATE ZONE: 4 ALL OTHER

BUILDING ENVELOPE FENESTRATION MAXIMUM U-FACTOR AND SHGC REQUIREMENTS TABLE C402.4

U-FACTOR	REQUIRED	PROVIDED
FIXED FENESTRATION	0.38	0.38
OPERABLE FENESTRATION	0.45	0.45
ENTRANCE DOORS	0.77	0.77
SHGC: PF < 0.2	REQUIRED	PROVIDED
ORIENTATION: SEW	0.40	0.40
ORIENTATION: NORTH	0.53	0.53

TENANT SAFETY AND PROTECTION PLAN NOTES

- 1. ALL WORK TO BE CARRIED OUT IN ACCORDANCE WITH BUILDING MANAGEMENT'S ALTERATION STANDARDS, INCLUDING AFTER-HOURS PERMITS/VARIANCES WHERE NECESSARY FOR NOISY WORK.
- 2. ALL MEANS OF EGRESS TO REMAIN FREE OF OBSTRUCTIONS DURING COURSE OF CONSTRUCTION AND AT ANY TIME EXCEPT WHERE APPROVED BY THE COMMISSIONER.
- 3. UTILITY, HEAT, ELECTRICAL SERVICES TO BE UNINTERRUPTED DURING COURSE OF CONSTRUCTION. 4. CONTRACTOR SHALL CARRY OUT ALL WORK IN A THOROUGH AND WORKMANLIKE MANNER, AND TO MINIMIZE DUST, NOISE AT SITE DURING COURSE OF CONSTRUCTIONS.
- 5. UNAUTHORIZED PERSONS SHALL NOT BE PERMITTED TO ENTER CONSTRUCTION SITE DURING THE COURSE OF CONSTRUCTION.
- 6. FIRE SAFETY, ALL NECESSARY LAWS, CONTROLS INCLUDING THOSE RESPECT TO OCCUPIED TENANCIES, AS WELL AS ADDITIONAL SAFETY MEASURES NECESSITATED BY THE CONSTRUCTION STRICTLY OBSERVED.

SPECIAL INSPECTIONS	
INSPECTIONS AND TEST:	BCNYS REFERENCE
 STEEL CONSTRUCTION INSPECTION TASK BEFORE, DURING AND AFTER WELDING CONCRETE CONSTRUCTION MASONRY CONSTRUCTION 	1705.2 1705.2.1 1705.3 1705.4
ENERGY CONSERVATION CODE	C104
4. FRAMING AND ROUGH-IN INSPECTION	C104.2.2

GENERAL NOTES

- ADDITION, CONTRACTOR SHALL NOTIFY THE ARCHITECT OF ANY DEFECTIVE CONSTRUCTION UNCOVERED DURING CONSTRUCTION.
- GENERAL CONTRACTOR

- CODES AND STANDARDS OF GOOD PRACTICE. WORK
- IN A BROOM CLEAN CONDITION.
- TENANTS, AND THE GENERAL PUBLIC.
- GENERALLY ACCEPTED STANDARDS.
- CODES AND SHALL BE PERFORMED BY LICENSED CONTRACTORS.
- WORK. HOWEVER, EXISTING BEAMS OR STRUCTURAL MEMBERS SHALL NOT BE CUT OR NOTCHED WITHOUT CONSULTATION WITH THE ARCHITECT.
- AND INSPECTED BY ENGINEER AND MUNICIPAL AUTHORITIES. FOLLOWING REQUIREMENTS:
- REGULATIONS.
- DURING OCCUPANCY, IN EXITS AND THEIR ACCESS FACILITIES. JURISDICTION.
- 18. CONTRACTOR SHALL COORDINATE ALL WORK PROCEDURES WITH REQUIREMENTS OF LOCAL AUTHORITIES AND
- BUILDING MANAGEMENT
- EXECUTION OF THE WORK
- (PLUMBING, ELECTRICAL, ETC.).

- AND/OR ANY AND ALL OTHER CONSULTANTS.
- COMPLETION OF THE WORK/PROJECT.
- 25. DRAWINGS ARE NOT TO BE SCALED.
- NOMINAL SIZE.

- ARCHITECTS AND NOTIFICATION TO LIRO ARCHITECTS TO BE MADE PRIOR TO INSTALLATION.
- OR TENANT/OWNER MOVE IN, WHICHEVER IS LATER.
- PLANS, DRAWINGS, AND SPECIFICATIONS AND TO HAVE FOUND THEM IN PROPER FORM FOR EXECUTION.
- CONDITIONS SHALL BE INCLUDED IN THE BID.
- WORK
- SHALL BE PROVIDED AS THOUGH ON ALL RELATED DOCUMENTS.
- WILL BE REQUIRED AND INCLUDE COSTS AT TIME OF BID.
- WALL AND AROUND PENETRATIONS, SUCH AS PIPES, DUCTS, ETC.
- 40. ALL WORK SHALL COMPLY WITH APPLICABLE LOCAL AND MUNICIPAL BUILDING CODES AS WELL AS ANY AND ALL
- NOTES SHALL APPLY TO ALL DRAWINGS.
- OWNER PROPERTIES
- 45. REFER TO ALL OTHER PLANS INCLUDING ENGINEERING PLANS FOR RELATED WORK. DOCUMENTS.

1. THE ARCHITECT DOES NOT CERTIFY DIMENSIONS OR CONDITIONS OF EXISTING CONSTRUCTION. CONTRACTOR SHALL NOTIFY ARCHITECT IMMEDIATELY OF ANY DISCREPANCY BETWEEN DRAWINGS AND EXISTING CONDITIONS. IN

2. ALL INSURANCE AND PERMITS REQUIRED BY LAW FOR CONSTRUCTION SHALL BE THE RESPONSIBILITY OF THE

3. CONTRACTOR SHALL BE RESPONSIBLE FOR SHORING UP EXISTING STRUCTURE DURING DEMOLITION AND CONSTRUCTION, AND SHALL MAINTAIN THE STABILITY OF THE EXISTING BUILDING. 4. CONTRACTOR SHALL BE RESPONSIBLE FOR ADEQUATELY BRACING AND PROTECTING ALL WORK DURING CONSTRUCTION AGAINST DAMAGE, BREAKAGE, COLLAPSE, DISTORTIONS, AND OFF ALIGNMENTS ACCORDING TO

5. CONTRACTOR SHALL BE LIABLE FOR AND REPAIR ANY DAMAGES TO THE OWNER'S PROPERTY RESULTING FROM THEIR 6. CONTRACTOR SHALL KEEP WORK SITE FREE FROM DEBRIS AND ACCUMULATED REFUSE, AND SHALL HAVE SOLE

RESPONSIBILITY FOR PROTECTING ALL DANGEROUS AREAS FROM ENTRY BY UNAUTHORIZED PARTIES. ALL CONSTRUCTION SCRAPS, DIRT, AND DEBRIS SHALL BE REMOVED FROM THE PREMISES DAILY. SITE SHALL BE LEFT BROOM CLEAN AT THE END OF EACH WORKING DAY. AT THE COMPLETION OF THE WORK, THE PREMISES SHALL BE LEFT

7. CONTRACTOR SHALL DEVISE AND PROVIDE PROTECTIVE MEASURES TO INSURE THE SAFETY OF THE OWNER, THE

8. ALL WORK TO BE PERFORMED IN A WORKMANLIKE FASHION. MATERIALS UTILIZED SHALL BE AS SPECIFIED ON THE DRAWINGS OR IN THE JOB SPECIFICATIONS, OR, IF GENERIC, IN COMPLIANCE WITH ASTM, NEW YORK CODE, OR OTHER

9. ALL PLUMBING, ELECTRICAL, AND MECHANICAL EQUIPMENT INSTALLATIONS TO COMPLY WITH APPLICABLE BUILDING 10. CONTRACTOR SHALL PERFORM ALL THE NECESSARY CUTTING AND PATCHING FOR THE COMPLETION OF THE NEW

11. WHERE EXISTING EQUIPMENT OR CONSTRUCTION IS REMOVED OR ALTERED, ALL REMAINING SURFACES AND FINISHES AFFECTED SHALL BE PATCHED AND FINISHED TO MATCH ADJACENT CONSTRUCTION/PRE-EXISTING CONDITION. 12. WHERE NEW HEATING, ELECTRICAL, AND PLUMBING LINES ARE CONCEALED IN WALLS OR CEILINGS, THE FINISH SURFACE SHALL NOT BE INSTALLED UNTIL THE NEW HEATING, ELECTRICAL AND PLUMBING LINES HAVE BEEN TESTED

13. ALL MATERIALS, ASSEMBLIES, FORMS AND METHODS OF CONSTRUCTION AND SERVICE EQUIPMENT SHALL MEET THE

A. IT SHALL HAVE BEEN ACCEPTABLE PRIOR TO THE EFFECTIVE DATE OF THE CODE BY THE BOARDS, OR B. IT SHALL HAVE BEEN ACCEPTED FOR USE UNDER THE PRESCRIBED CODE TEST METHODS BY THE COMMISSIONER. 13. INSPECTION REQUIREMENTS SHALL BE AS PER THIS SET OF DRAWINGS AND/OR LOCAL BUILDING DEPARTMENT

14. ALL EXITS SHALL BE KEPT READILY ACCESSIBLE AND UNOBSTRUCTED AT ALL TIMES. 15. ILLUMINATION OF AT LEAST 5 FOOT CANDLES MEASURED AT THE FLOOR LEVEL SHALL BE MAINTAINED CONTINUOUSLY

16. GENERAL CONTRACTOR SHALL SECURE ALL REQUIRED PERMITS AND APPROVALS FROM ALL DEPARTMENTS HAVING

17. MINOR DETAILS NOT USUALLY SHOWN OR SPECIFIED, BUT NECESSARY FOR PROPER CONSTRUCTION OF ANY PART OF THE WORK SHALL BE INCLUDED AS IF THEY WERE INDICATED IN THE DRAWINGS.

19. CONTRACTOR SHALL BE RESPONSIBLE FOR THE PROTECTION OF ALL CONDITIONS, DEVICES (INCLUDING BUT NOT LIMITED TO DATA AND TELECOM ANTENNAE), AND MATERIALS WITHIN THE PROPOSED CONSTRUCTION AREA. CONTRACTOR SHALL DESIGN AND INSTALL ADEQUATE SHORING AND BRACING FOR ALL STRUCTURAL OR REMOVAL TASKS. CONTRACTOR SHALL HAVE SOLE RESPONSIBILITY FOR ANY DAMAGE OR INJURIES CAUSED BY OR DURING THE

20. CONTRACTOR SHALL LAY OUT HIS OWN WORK AND SHALL PROVIDE ALL DIMENSIONS REQUIRED FOR OTHER TRADES

21. CONTRACTOR IS RESPONSIBLE FOR ASCERTAINING CONSTRUCTION RULES AND REGULATIONS OF THE BUILDINGS MANAGEMENT AND FOR ACCOMMODATING THESE REQUIREMENTS IN THEIR PRICE. 22. ALL WORK IS TO CONFORM WITH DRAWINGS AND SPECIFICATIONS WHETHER BY LIRO ARCHITECTS, ENGINEERS,

23. COORDINATION OF ALL WORK UNDER THIS CONTRACT SHALL BE MAINTAINED TO ENSURE THE QUALITY AND TIMELY

24. CONTRACTOR IS TO MAINTAIN A COMPLETE AND UP TO DATE SET OF DRAWINGS ON THE JOB AT ALL TIMES INCLUDING THE CONTRACT DOCUMENTS AND SHOP DRAWINGS.

26. SIZE OF MASONRY UNITS AND WOOD MEMBERS ON PLANS, BUILDING ELEVATIONS, AND SECTIONS ARE SHOWN AS

27. ALL DIMENSIONS GIVEN ARE FINISH SURFACE TO FINISH SURFACE BETWEEN WALLS, PARTITIONS, AND OTHER ITEMS EXCLUSIVE OF FINISHES, UNLESS OTHERWISE NOTED; REFER TO CONSTRUCTION PLAN.

28. CONTRACTOR SHALL CONTINUOUSLY MAINTAIN ADEQUATE PROTECTION OF ALL REMAINING EXISTING CONDITIONS AND NEW WORK FROM DAMAGE. CONTRACTOR SHALL PROTECT THE TENANT AND THE BUILDING'S PROPERTY FROM INJURY OR LOSS ARISING IN CONNECTION WITH THE WORK. ALL FINISHED SURFACES SHALL BE PROTECTED BY THE CONTRACTOR GENERALLY, BUT NOT LIMITED TO: DOORS, JAMBS, AND PASSAGEWAYS. CONTRACTOR SHALL, WITHOUT EXTRA COMPENSATION, REFINISH ALL SURFACES IN SUCH SPACES WHERE THESE SURFACES PROVE TO HAVE BEEN INADEQUATELY PROTECTED, AND ARE DAMAGED BY THE CONTRACTOR'S SUBCONTRACTORS.

29. MATERIALS FROM SPECIFIC MANUFACTURER(S) IDENTIFIED FOR BASIS OF DESIGN, WHERE MANUFACTURER'S NAMES AND PRODUCT NUMBERS ARE INDICATED ON DRAWINGS, IT SHALL BE CONSTRUED TO MEAN THE ESTABLISHMENT OF QUALITY AND PERFORMANCE STANDARDS OF SUCH ITEMS. WHERE THE CONTRACTOR IS PROPOSING AN APPROVED EQUAL IT SHALL BE UNDERSTOOD THAT THE SUBSTITUTE SHALL BE BY JUDGMENT AND APPROVAL OF LIRO

30. CONTRACTOR SHALL CONSULT WITH AND ADHERE TO REGULATIONS OF THE BUILDING AS TO TIME AND METHOD OF DELIVERY, DEBRIS REMOVAL, USE OF BUILDING ELEVATORS, HOURS OF DEMOLITION AND NOISY CONSTRUCTION, AND MAKING ARRANGEMENTS FOR CONSTRUCTION PERSONNEL TO ENTER BUILDING. 31. ALL WORK SHALL BE GUARANTEED FOR THE PERIOD OF ONE YEAR FROM THE DATE OF SUBSTANTIAL COMPLETION

32. CONTRACTOR SHALL NOTIFY LIRO ARCHITECTS OF ANY ERRORS, OMISSIONS, CONFLICTS, OR AMBIGUITIES BETWEEN THE PLANS, DRAWINGS, AND SPECIFICATIONS PRIOR TO PROCEEDING WITH THAT PORTION OF THE WORK. IF SUCH NOTICE IS NOT FURNISHED LIRO ARCHITECTS, THE CONTRACTOR SHALL BE DEEMED TO HAVE INSPECTED THE

33. IT SHALL BE THE RESPONSIBILITY OF THE CONTRACTOR TO DISTRIBUTE ADEQUATE COPIES OF THESE DRAWINGS TO ALL APPLICABLE TRADES AT ALL TIMES DURING THE PROGRESS OF THE JOB (I.E. REVISIONS)

34. CONTRACTOR IS REQUIRED, PRIOR TO BID, TO FIELD CHECK CONDITIONS OF EXISTING STRUCTURE (I.E. ARCH, BEAMS SLABS, ETC.) INCLUDING INTEGRITY OF EXISTING FIREPROOFING AND TO INCLUDE ALL COSTS NECESSARY FOR SUPPORTS AND BRACING FOR ALL WORK. ALL SUPPORT METHODS SHALL MEET ALL APPLICABLE CODES AND AGENCY REQUIREMENTS AND BUILDING STANDARDS. NO ADDITIONAL COSTS FOR SUPPORTS WILL BE ACCEPTED AFTER THE

BID. IN ADDITION, SAID INSPECTION AND REQUIRED WORK FOR FIREPROOFING AND FIRE STOPPING OF EXISTING 35. CONSTRUCTOR SHALL SUBMIT TWO (2) SETS OF SHOP DRAWINGS AND THREE (3) PRODUCT SAMPLES AS REQUIRED BY

LIRO ARCHITECTS AND OTHER PROJECT CONSULTANTS FOR LIRO ARCHITECTS REVIEW PRIOR TO COMMENCEMENT OF 36. ALL CONSTRUCTION DOCUMENTS ARE COMPLEMENTARY (ARCH., ENG., ETC.) AND WHAT IS CALLED FOR BY ANY WILL

BE BINDING AS IF CALLED FOR BY ALL. ANY WORK SHOWN OR REFERRED TO ON ANY CONSTRUCTION DOCUMENTS 37. CONTRACTOR TO FIELD INSPECT EXISTING FLOOR SLAB CONDITIONS AT LOCATIONS OF DOOR REMOVAL/

REPLACEMENT TO DETERMINE IF ANY FLOOR LEVELING IS REQUIRED. INFORM LIRO ARCHITECTS OF ANY WORK THAT 38. PARTITIONS OR BAFFLES EXTENDING TO THE SLAB, WHERE SPECIFIED SHALL BE SEALED TO THE SLAB, PERIMETER


39. ALL EXISTING WALLS TO REMAIN, WHERE AFFECTED BY DEMOLITION AND/OR NEW CONSTRUCTION, TO BE PATCHED. PROVIDE CORNER BEADS IF REQUIRED, TAPE, AND SPACKLE. PREPARE TO ACCEPT NEW FINISHES


REGULATORY AGENCIES INCLUDING, BUT NOT LIMITED TO OSHA, AMERICAN DISABILITIES ACT (ADA), ETC. GENERAL

41. CONTRACTOR SHALL INCLUDE IN THEIR BID ALL COSTS FOR DISCONNECTION, TRANSPORTATION, AND REINSTALLATION OF ALL ITEMS AT THE OWNER'S EXISTING PREMISES WHICH ARE DESIGNATED TO BE RELOCATED. 42. CONTRACTOR SHALL SUBMIT FOR APPROVAL COORDINATED SHOP DRAWINGS OF ALL TRADES HAVING AN IMPACT ON EACH OTHER, INCLUDING BUT NOT LIMITED TO HVAC, LIGHTING, ETC. IF CONFLICTS OCCUR AFTER INSTALLATION OF ANY TRADE'S WORK, IT SHALL BE THE RESPONSIBILITY OF THE CONTRACTOR TO RECTIFY SAME AT NO COST TO THE

43. THERE WILL BE NO CHANGE IN USE, EGRESS, OR OCCUPANCY BECAUSE OF THE WORK OF THIS CONTRACT. 44. PROPERTY WILL REQUIRE CONTRACTOR TO FINALIZE LICENSING AGREEMENT WITH "OWNERS" OF ADJOINING

46. ADDITIONAL NOTES WHICH ARE APPLICABLE TO THIS PROJECT MAY BE FOUND THROUGHOUT THE CONTRACT

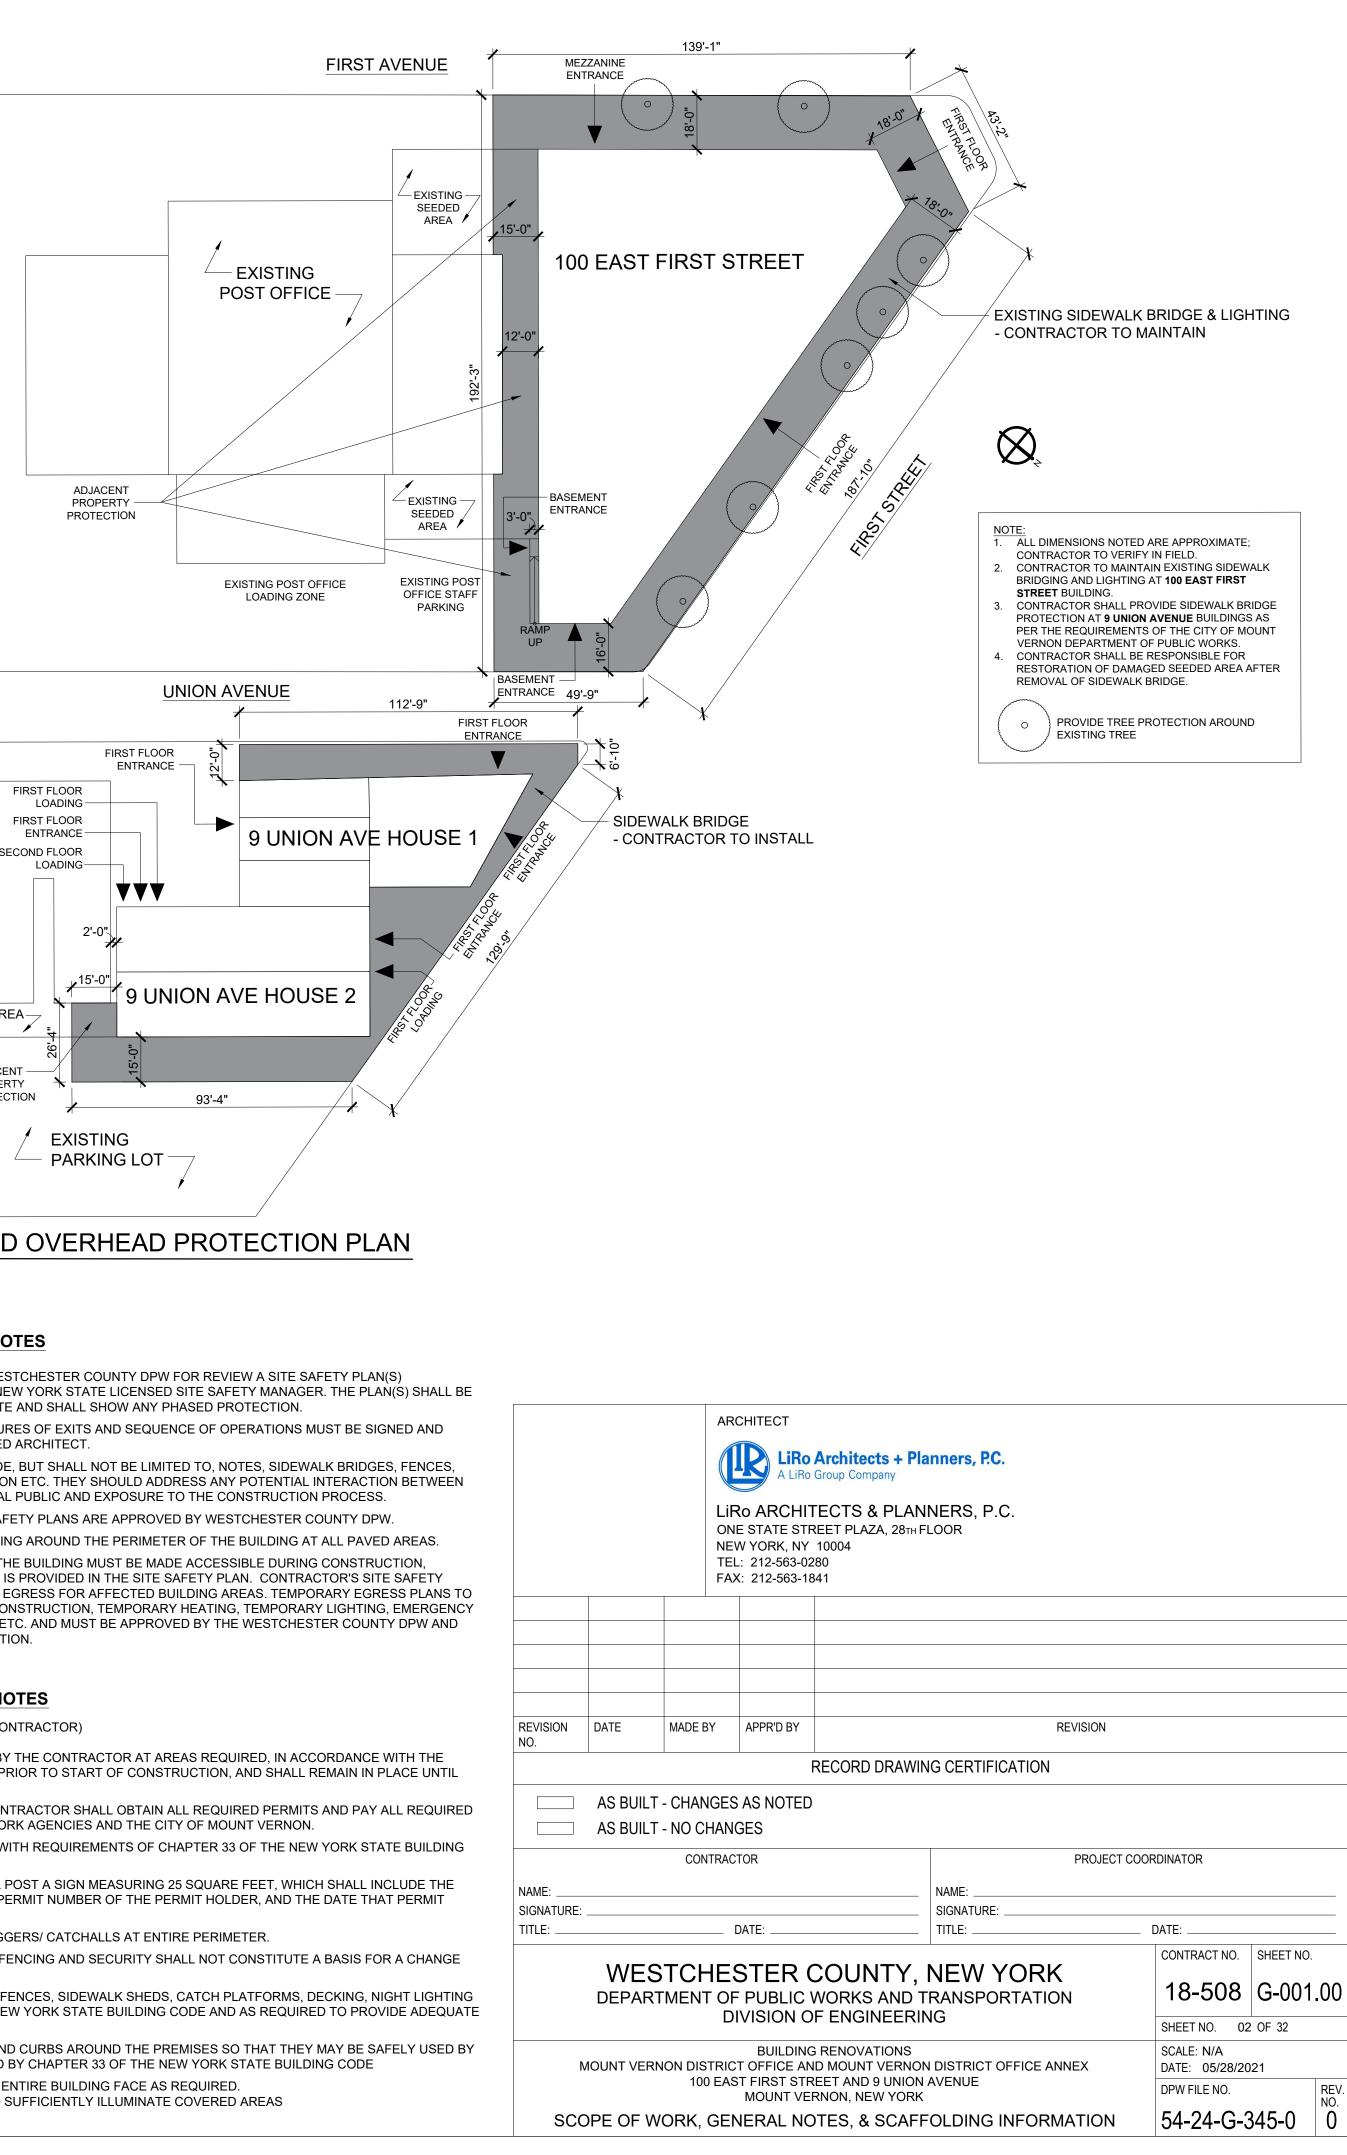

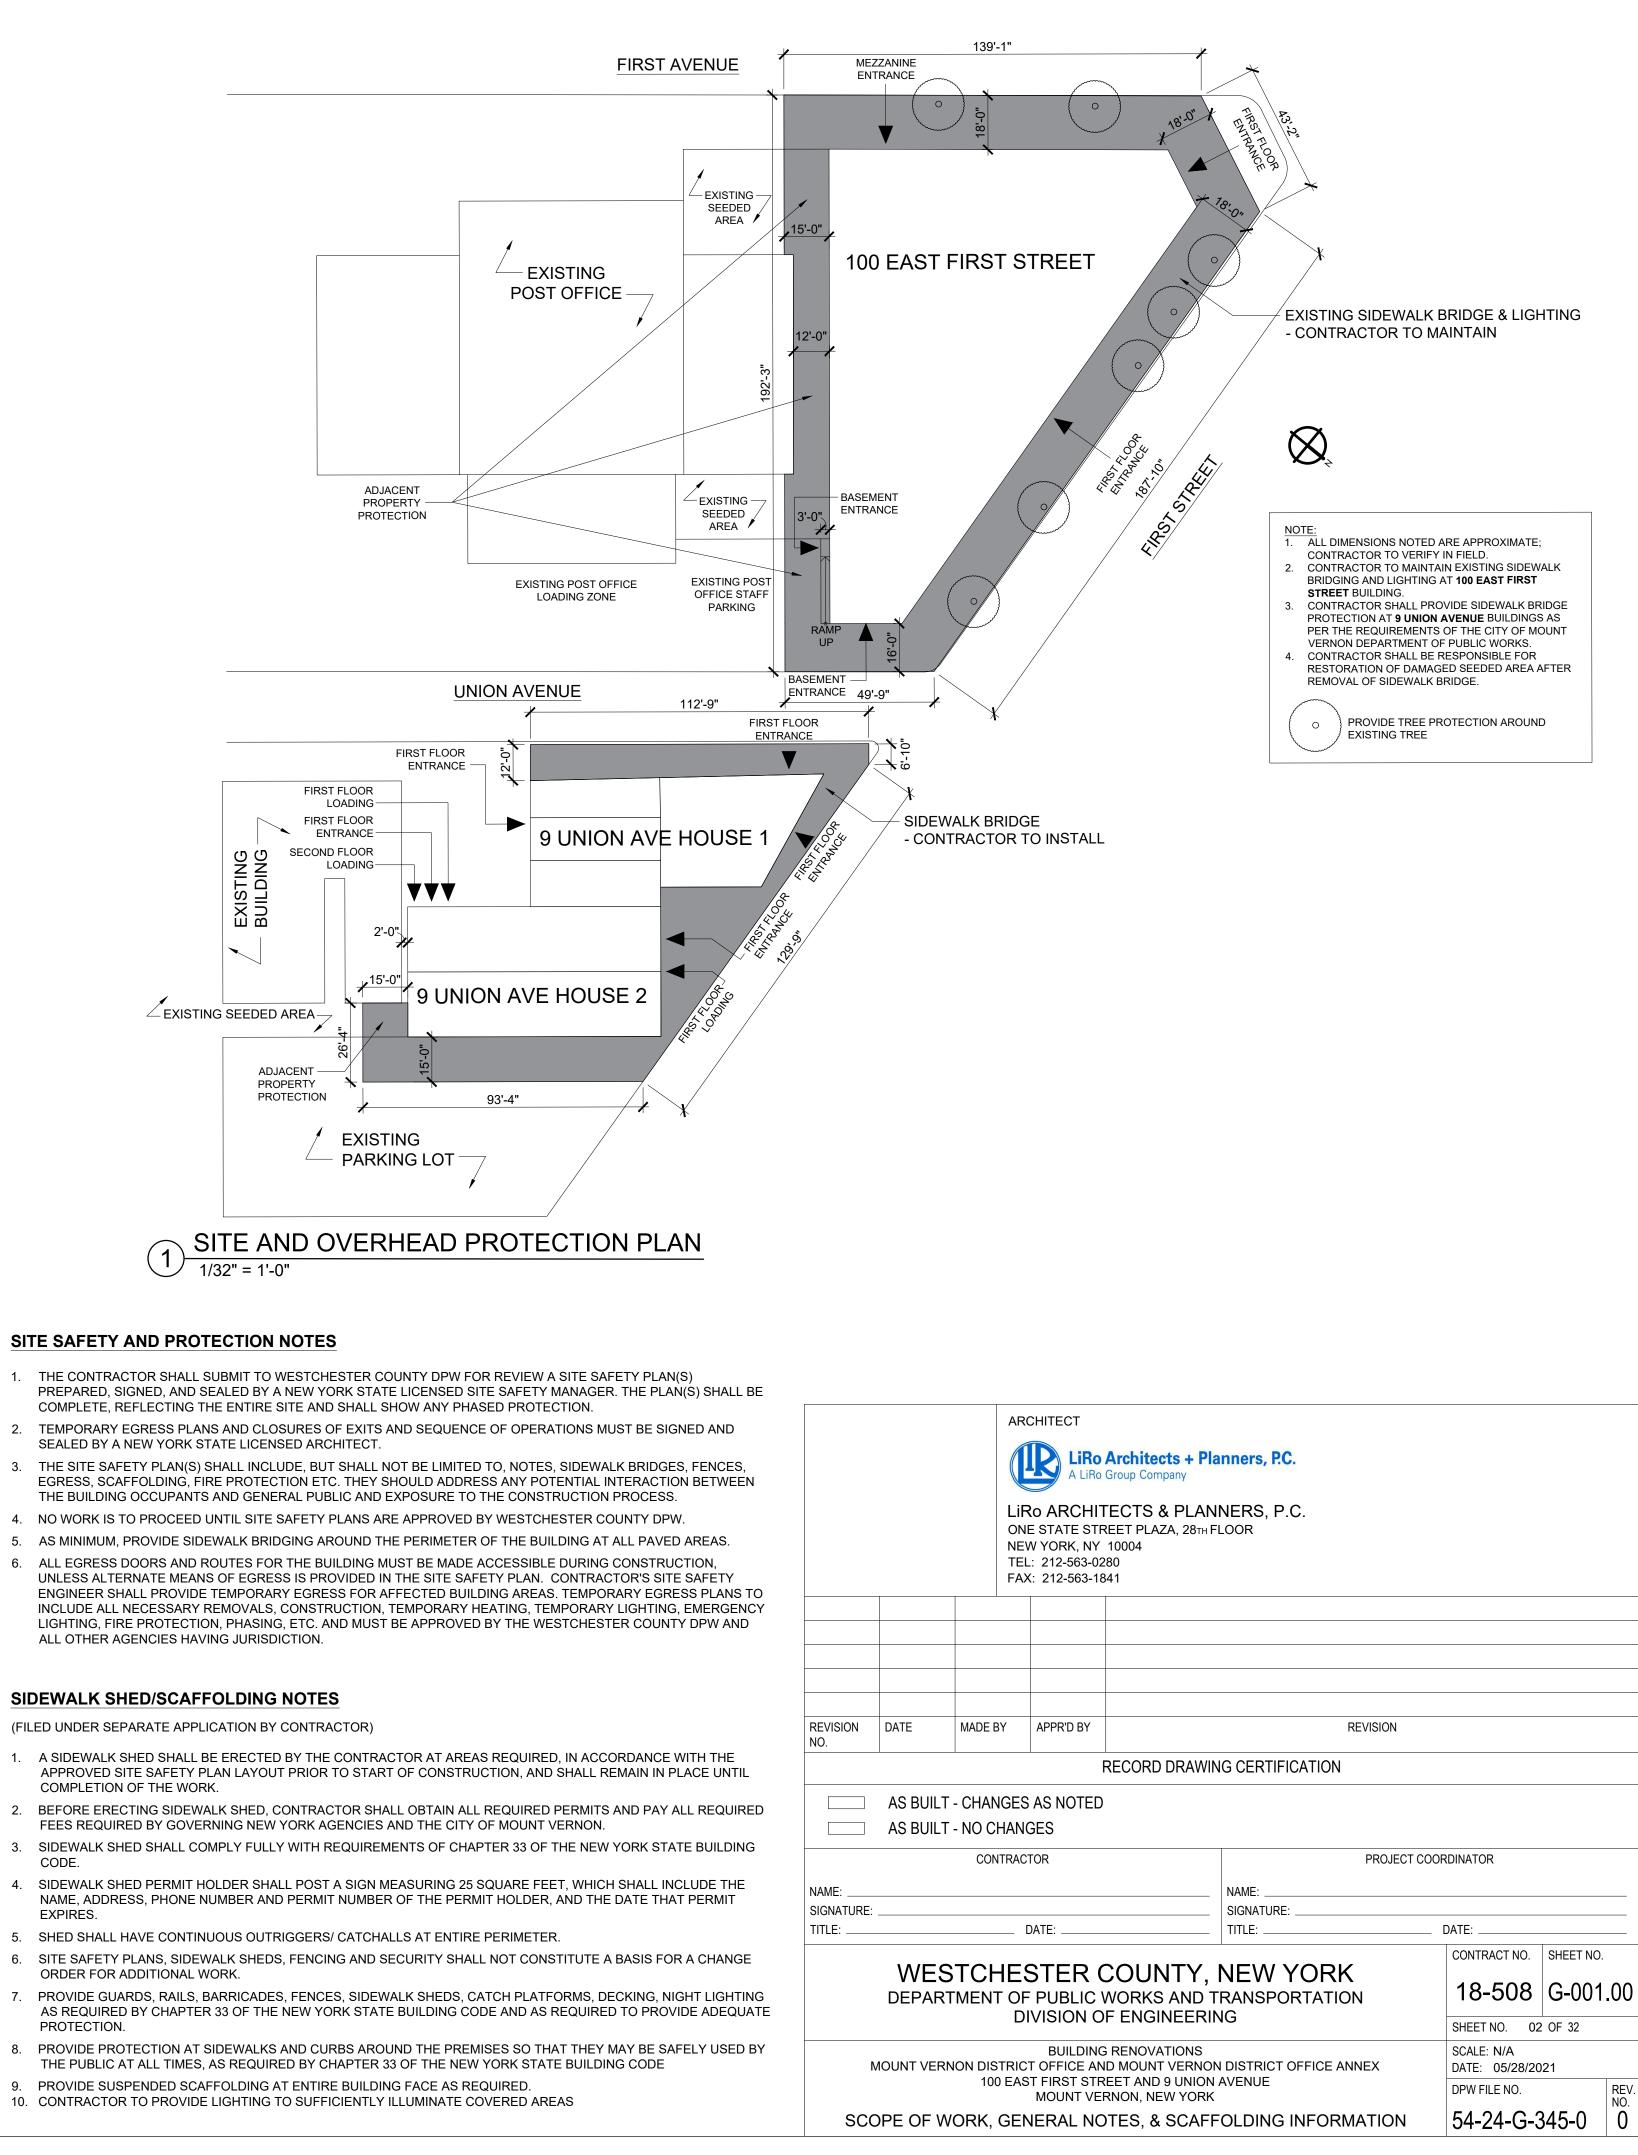

SITE SAFETY AND PROTECTION NOTES

1. THE CONTRACTOR SHALL SUBMIT TO WESTCHESTER COUNTY DPW FOR REVIEW A SITE SAFETY PLAN(S) COMPLETE, REFLECTING THE ENTIRE SITE AND SHALL SHOW ANY PHASED PROTECTION.

- SEALED BY A NEW YORK STATE LICENSED ARCHITECT.
- THE BUILDING OCCUPANTS AND GENERAL PUBLIC AND EXPOSURE TO THE CONSTRUCTION PROCESS.
- 6. ALL EGRESS DOORS AND ROUTES FOR THE BUILDING MUST BE MADE ACCESSIBLE DURING CONSTRUCTION, ALL OTHER AGENCIES HAVING JURISDICTION.

SIDEWALK SHED/SCAFFOLDING NOTES

(FILED UNDER SEPARATE APPLICATION BY CONTRACTOR)

- COMPLETION OF THE WORK.
- FEES REQUIRED BY GOVERNING NEW YORK AGENCIES AND THE CITY OF MOUNT VERNON.
- CODE.
- EXPIRES
- 5. SHED SHALL HAVE CONTINUOUS OUTRIGGERS/ CATCHALLS AT ENTIRE PERIMETER.
- ORDER FOR ADDITIONAL WORK.
- PROTECTION.
- THE PUBLIC AT ALL TIMES, AS REQUIRED BY CHAPTER 33 OF THE NEW YORK STATE BUILDING CODE 9. PROVIDE SUSPENDED SCAFFOLDING AT ENTIRE BUILDING FACE AS REQUIRED.
- 10. CONTRACTOR TO PROVIDE LIGHTING TO SUFFICIENTLY ILLUMINATE COVERED AREAS

LIST OF ABBREVIATIONS

<u>A</u> AB. A.D. ADJ.		<u>F</u> F.B.R. FIN.	- FACE BRICK REPLACEMENT - FINISH	PAV. PAV. P&D
ALUM. APP'D. APPROX ARCH. ASPH.	- ALUMINUM - APPROVED - APPROXIMATELY - ARCHITECT - ASPHALT	FL. FLASH'G. F.A.I. F.P. FR.	- FLOOR - FLASHING - FRESH AIR INTAKE	P.L. P.P. PH
ATC AUD. AUX. & <u>B</u>	 ARCHITECTURAL TERRA COTTA AUDITORIUM AUXILIARY AND ANGLE AT 	<u>G</u> GA. GALV. G.B.W. G.C. G.I.	 GAUGE GALVANIZED GLASS BLOCK WINDOW GENERAL CONTRACTOR GALVANIZED IRON 	<u>R</u> R. RAIL'G. RAD. R.D. REINF. RET. RM.
BR B.C. B.L. BLD'G.	- BUILDING LINE - BUILDING	G.I. GL. GRNT. <u>H</u>	- GALVANIZED IRON - GLASS - GRANITE	<u>S</u> S.A.E. S.S. SPEC.
BLK. BM. B.S. B.S.&A. B.S.P. B.U.R.	 BLOCK BEAM BLUE STONE (OR) BRONZE SADDLE BOARD OF STANDARDS AND APPEALS BRICK STITCHING PATTERNS 	11 H.C. HDCP HT. H.M. HORIZ. H.P. H&V	 HORIZONTAL CRACK HANDICAPPED HEIGHT HOLLOW METAL HORIZONTAL HIGH POINT HEATING & VENTILATION 	SFEC. S.F. STD. STL. S.L. STRUC [*] STD.DE S.Y. SFT
C. CAB'T. CL C.I. C.J. CLG. COL. CONT	- CASEMENT - CABINET - CENTER LINE - CAST IRON - CONTROL JOINT - CEILING - COLUMN - CONTINUOUS	INSTR. INSUL. L.P.	- LOW POINT	<u>T</u> TH. T.O.S. T.P.O. T.W.
	- CONCRETE - CLASSROOM - CUBIC FEET	L.S. LT. L.F. L	- LIMESTONE - LIGHT - LINEAR FOOT - NEW LEADER	TYP. T.C. U
D DEPT. DET. D.H. DIA. DIM. DN. DO. DR. DWG. D.C.	 DEPARTMENT DETAIL DOUBLE HUNG DIAMETER DIMENSION DOWN DITTO DOOR DRAWING DIAGONAL CRACK 	MAT. MAX. MECH. M.H. MIN. M.I.S. M.O. M.S.	 MATERIAL MAXIMUM MECHANICAL MANHOLE MINIMUM METAL INSECT SCREEN MASONRY OPENING MINERAL SURFACED 	U.V. U.O.N. VENT. VERT. V.I.F. V. V.C. W
E EG. EL. EL. EMG. ENT. EQ.	 EXTERIOR WIRE MESH GUARD EXPANSION JOINT ELEVATION EXPANDED METAL GUARD ENTRANCE EQUAL 	<u>N</u> N.D. N.I.C. NO. NOM. N.T.S. <u>O</u> O.A.I.	 NOMINAL DIAMETER NOT IN CONTRACT NUMBER NOMINAL NOT TO SCALE OUTSIDE AIR INTAKE 	W/ WD. W.F. W.H. W.I. W.M. W.M.G.
EQUIP. E.W. EXP. EXIST. EXT. E.C.	- EQUIPMENT - EACH WAY - EXPANSION - EXISTING - EXTERIOR - ELECTRICAL CONDUIT	0.C. 0.D. 0.G.	- ON CENTER - OUTSIDE DIAMETER - OBSCURE GLAZING	W.P. WT. W.W.F



MASONRY **TERRA COTTA** REPLACEMENT REPLACEMENT LIMESTONE FACE BRICK REPLACEMENT REPLACEMENT STONE REMOVAL & MASONRY INFILL RESETTING REPLACEMENT OF LINTEL & SOLDIER BRICKS BRICK POINTING BREATHABLE COATING STEEL

= EXPANSION JOINT

EXISTING DOOR

DOOR DESIGNATION

(121) DOOR NUMBER

WINDOW DESIGNATION


– M.O./

WINDOW NUMBER

DESIGNATION

(SEE PLANS & ELEVATIONS DWGS FOR ADDITIONAL SHEET SPECIFIC HATCHES)

DRAFTING SYMBOLS LEGEND CJ = CONTROL JOINT

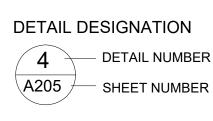

SECTION DESIGNATION



ELEVATION DESIGNATION



ROOM DATA DESIGNATION XXX — ROOM NAME

99



PAV. P&D	- PAVEMENT - PLUMBING AND DRAINAGE
P.L. P.P. PH	- PROPERTY LINE - PITCH POCKET - PENTHOUSE
<u>R</u> R. RAIL'G. RAD. R.D. REINF. RET. RM.	- RADIUS - RAILING - RADIATOR - ROOF DRAIN - REINFORCING - RETAINING - ROOM
SA.E. S.S. SPEC. S.F. STD. STL. ST.PL. S.L. STRUCT. STD.DET. S.Y. SFT	 SAME AS EXISTING STAINLESS STEEL SPECIFICATION SQUARE FEET STANDARD STEEL STEEL PLATE SECURITY LIGHT STRUCTURAL STANDARD DETAIL SQUARE YARD STRUCTURAL FACING TILE
<u>T</u> TH. T.O.S. T.P.O. T.W. TYP. T.C.	 THICKNESS TOP OF SLAB THERMOPLASTIC POLYOLEFIN ROOFING TOP OF WALL TYPICAL TERRA COTTA
<u>U</u> U.V. U.O.N.	 UNIT VENTILATOR UNLESS OTHERWISE NOTED
VENT. VERT. V.I.F. V. V.C.	 VENTILATOR VERTICAL VERIFY IN FIELD VENT VERTICAL CRACK
W W/ WD. W.F. W.H. W.I. W.M. W.M.G. W.P. WT. W.W.F	 WITH WOOD WIRE FENCE (OR) WIDE FLANGE WEEPHOLE WROUGHT IRON WIRE MESH WIRE MESH GUARD WATERPROOFING WEIGHT WELDED WIRE FABRIC

BATT INSULATION WOOD BLOCKING WOOD **RIGID INSULATION**

= BUILDING ACCESS

AIR CONDITIONER DESIGNATION

AC

DRAWING REVISION DESIGNATION

/1\

CONSTRUCTION NOTE DESIGNATION

WALL TYPE DESIGNATION

EXISTING CONDITIONS, CUTTING, AND PATCHING

- SURFACES.
- 5. COSTS FOR ALL THE ABOVE SHALL BE BORNE BY CONTRACTOR.

INSPECTION OF STEEL AND REMEDIAL REPAIR NOTES

- MASONRY BEING EXPOSED SO THAT IT CAN BE INSPECTED.
- TO THE FOLLOWING: a) INSPECT FLANGES AND WEBS OF STEEL MEMBERS.
- EXCESSIVE CORROSION
- c) INSPECT CLIP ANGLE, CONNECTING LINTELS TO BEAMS FOR LOOSE BOLTS, LOOSE RIVETS, AND EXCESSIVE CORROSION. d) DENOTE LOCATION AND EXTENT OF AREAS OF STEEL WHERE SIGNIFICANT CORROSION DAMAGE HAS
- OCCURRED. BY THE ENGINEER TO MAKE THE INSPECTIONS.

- 09900.

STRUCTURAL STEEL AND WELDING NOTES

STRUCTURAL STEEL NOTES:

- CONFORM TO ASTM A36 WITH A MINIMUM YIELD STRENGTH OF 36,000 PSI.

- STEEL TO BE REPLACED.
- EXPOSED TO VIEW SHALL BE PAINTED.

TENSION OR COMPRESSION:

2" M
EPC
23"
30"
38"

WELDING NOTES:

#6

#7

39"

50"

- 3. ALL FILLET WELD SIZES NOT SHOWN ON THE DRAWINGS SHALL BE NOT LESS THAN SIZE AS PER AISC MANUAL SPECIFICATIONS.

GENERAL LINTEL NOTES

- DO NOT OTHERWISE INDICATE A SPECIFIC LINTEL DESIGN.

- MASONRY OPENING AND THE OUTERMOST FACE OF COLUMN
- REQUIREMENTS.

1. SOME EXISTING CONDITIONS REPRESENTED ON THESE DOCUMENTS WERE OBTAINED FROM DRAWINGS FURNISHED BY THE OWNER AS WELL AS FROM FIELD OBSERVATIONS BY THE ARCHITECT. SUCH INFORMATION MAY NOT BE ENTIRELY RELIABLE DUE TO INACCURACIES OF THE EXISTING DRAWINGS.

2. CONSTRUCTION OPERATIONS SHALL NOT INVOLVE INTERRUPTION OF HEATING, WATER OR ELECTRICAL SERVICES TO OCCUPANTS OF THE BUILDING WITHOUT PRIOR WRITTEN PERMISSION OF THE OWNER.

3. THE CONTRACTOR SHALL, AS MAY BE REQUIRED BY THE NEW WORK, RELOCATE, MODIFY, CUT AND PATCH, WITHOUT COMPROMISING THE QUALITY OF WORK, ANY EXISTING ITEMS THAT INTERFERE WITH, OR ARE OTHERWISE AFFECTED BY, THE EXECUTION OF NEW WORK, WHETHER SHOWN OR NOT IN THE DRAWINGS. 4. THE CONTRACTOR SHALL PATCH AND REPAIR ALL FLOORS, WALLS, CEILINGS, SOFFITS, ETC. WHICH WERE AFFECTED BY THE EXECUTION OF THE WORK AND FINISH THEM TO MATCH ADJOINING FINISHES UP TO THE CLOSEST EXISTING CORNER. FINISHING INCLUDES, BUT IS NOT LIMITED TO, PAINTING PREVIOUSLY PAINTED

6. THE CONTRACTOR SHALL PATCH AND REPAIR ALL FLOORS, WALLS, CEILINGS, ETC. DAMAGED OR EXPOSED DUE TO WORK OR REMOVALS AND FINISH TO MATCH ADJOINING SURFACES.

1. STEEL MEMBERS EXPOSED BY REMOVAL INCLUDING WINDOW LINTELS ARE SUBJECT TO INSPECTION BY THE ENGINEER OF RECORD UPON REMOVAL OF THE DAMAGED MASONRY TO ASCERTAIN THEIR CONDITION. 2. THE CONTRACTOR SHALL NOTIFY THE ARCHITECT/ENGINEER OF RECORD 48 HOURS PRIOR TO THE STEEL AND

3. THE ENGINEER OF RECORD WILL INSPECT THE EXPOSED STEEL MEMBERS AND CONNECTIONS TO ASCERTAIN AND REPORT IN WRITING, ANY DAMAGE OF STEEL DUE TO CORROSION. INSPECTION WILL INCLUDE BUT NOT BE LIMITED

b) INSPECT ALL EXPOSED BEAM TO BEAM, BEAM TO COLUMN CONNECTIONS FOR LOOSE BOLTS, LOOSE RIVETS AND

4. THE CONTRACTOR SHALL PROVIDE ALL SCAFFOLD EQUIPMENT, SAFETY GEARS AND LABOR ASSISTANCE REQUIRED

5. EXPOSED STEEL AREAS FOUND TO BE UNSATISFACTORY WILL BE EVALUATED BY THE ENGINEER OF RECORD TO DETERMINE IF CORRECTIVE WORK IS NECESSARY (SEE PROVISIONS FOR STEEL WORK ON STRUCTURAL DRAWINGS).

6. ALL EXPOSED STEEL AREA MUST BE PROTECTED BY THE CONTRACTOR AND MUST REMAIN OPEN UNTIL THE STEEL HAS BEEN INSPECTED AND FOUND SATISFACTORY OR UNTIL CORRECTIVE WORK HAS BEEN COMPLETED.

7. ALL EXPOSED SURFACES OF STEEL SHALL BE CLEANED TO AN SSPC-SP3 (POWER TOOL CLEANING) SURFACE PREPARATION PRIOR TO REPAIR AND PAINTING. ALL AREAS OF WELD SHALL BE CLEANED TO SHINY METAL.

8. NEW STEEL AND EXISTING STEEL SHALL BE PAINTED WITH A HIGH PERFORMANCE CATALYZED EPOXY COATING SUCH AS TNEMEC SERIES 135 CHEMBUILD TO A THICKNESS OF 7.0 TO 9.0 MILLS. APPLY PAINT TO DRY SURFACES ONLY WHEN THE SURFACE TEMPERATURE IS ABOVE DEW POINT BY BRUSH OR ROLLER THOROUGHLY AND EVENLY IN STRICT ACCORDANCE WITH THE MANUFACTURER'S INSTRUCTIONS. STEEL EXPOSED TO VIEW AND THE ELEMENTS SHALL BE PAINTED WITH A SECOND COAT OF EPOXY AND A FINAL COAT OF ALIPHATIC URETHANE. SEE SECTION

1. ALL STRUCTURAL STEEL WIDE FLANGES SHALL CONFORM TO ASTM A992 WITH A MINIMUM YIELD STRENGTH OF 50,000 PSI. ALL OTHER STRUCTURAL STEEL SHAPES INCLUDING CHANNELS, ANGLES, AND PLATES SHALL

2. ALL DESIGN, DETAILING, FABRICATION AND ERECTION SHALL CONFORM TO AISC MANUAL OF STEEL CONSTRUCTION, LATEST EDITION, AS MODIFIED BY THE 2015 NEW YORK STATE BUILDING CODE.

3. THE CONTRACTOR SHALL EXPOSE THE EXISTING STEEL AFTER REMOVAL OF BRICK AND CLEAN STEEL SURFACES. THE STEEL SHALL BE PAINTED AFTER VISUAL INSPECTION AND/OR REPAIR OF STEEL IS COMPLETED.

THE STEEL CONTRACTOR SHALL FURNISH MILL TEST REPORTS FROM THE PRODUCER OF STEEL CERTIFYING THAT THE STEEL MEETS THE MINIMUM REQUIREMENTS AS SPECIFIED BY THE ASTM SPECIFICATIONS. 5. SUBMIT SHOP DRAWINGS SHOWING ALL DIMENSIONS AND CONNECTION DETAILS FOR APPROVAL FOR CORRODED

6. ALL NEW STEEL FOR LINTELS AND SHELF ANGLES SHALL BE GALVANIZED BY THE ZINC METALLIZING PROCESS AND FINISHED WITH A SECOND COAT OF EPOXY AND FINAL COAT OF ALIPHATIC URETHANE AFTER WELDING. LINTELS

7. MASONRY REINFORCED BAR LAP SPLICE LENGTHS AS REQUIRED BY THE MASONRY CODE FOR MEMBERS IN

PER ACI 530-05, FOR 60 KSI REINFORCING BARS IN MASONRY WITH fm' = 1500PSI /INIMUM)

OXY COATED

59"

75"

FOR WELDING BETWEEN NEW STEEL MEMBERS, USE E70XX ELECTRODES.

2. FOR WELDING NEW STEEL MEMBERS TO EXISTING MEMBERS, USE E7018 LOW HYDROGEN ELECTRODES. BEFORE WELDING WORK, THE CONTRACTOR SHALL MACHINE TOOL CLEAN ALL SURFACES OF STEEL TO RECEIVE WELDING WORK TO SHINY METAL. FOLLOW ALL PREHEAT AND INTERPASS HEATING REQUIREMENTS.

4. ALL WELDING SHALL BE PERFORMED BY THE NEW YORK STATE LICENSED WELDER AND IS SUBJECT TO SPECIAL INSPECTION AS REQUIRED BY THE NEW YORK STATE BUILDING CODE.

1. EXTERIOR LINTELS SHALL BE GALVANIZED. REFER TO SPECIFICATIONS.

2. REFER TO ARCHITECTURAL DRAWINGS FOR SIZE AND LOCATION OF OPENINGS.

3. CONSULT WITH THE ARCHITECT TO CONFIRM LINTEL REQUIREMENTS WHEN OPENINGS OCCUR IN BEARING WALLS OR WHEN A CONTROL JOINT IS LOCATED DIRECTLY ABOVE OR WITHIN 16" OF THE JAMB OPENING AND DRAWINGS

4. LINTELS OVER ADJACENT OPENINGS WITH PIERS BETWEEN LESS THAN 2'-4" WIDE SHALL BE CONTINUOUS OVER PIERS. MASONRY UNITS OF SUCH PIERS SHALL BE FILLED WITH GROUT FOR FULL HEIGHT OF PIER.

5. CONNECT LINTEL TO STRUCTURAL STEEL COLUMNS WHEN THERE IS LESS THAN 16" OF MASONRY BETWEEN THE

6. REFER TO STRUCTURAL DRAWINGS FOR NOTES AND DETAILS REGARDING REINFORCING AND GROUTING

PARAPET / MASONRY NOTES

- 1. FACE BRICKS SHALL COMPLY WITH REQUIREMENTS OF ASTM C216. MORTAR SHALL COMPLY WITH ASTM C270 AND BIA M1-88. THE USE OF MASONRY CEMENT IS PROHIBITED.
- 2. AFTER REMOVAL OF MASONRY, REPAIR BACK-UP BY REMOVING LOOSE MATERIAL AND FILLING IN ALL OPEN JOINTS AND VOIDS. WHEN REBUILDING, COLLAR JOINTS, HEAD AND BED JOINTS ARE TO BE FILLED COMPLETELY.
- 3. PROTECT OPEN PARAPETS AND OTHER AREAS OF MASONRY REMOVAL FROM WATER PENETRATION.
- 4. DO NOT REMOVE PARAPETS OR OTHER MASONRY UNTIL NEW BRICKS ARE ON SITE.
- 5. SUBMIT SHOP DRAWINGS FOR APPROVAL AT EACH AREA OF POINTING OF BRICK AND STONE JOINTS, AND BRICK REPAIR WORK FOR LOCATIONS AND EXTENT OF WORK PRIOR TO START OF WORK.
- 6. CONTRACTOR IS RESPONSIBLE FOR COORDINATING TRANSPORT, STORAGE, AND PROTECTION OF OWNER PURCHASED CAST STONE UNITS, CURRENTLY HOUSED IN THE AUTHORITY'S STORAGE FACILITY (LOCATED WITHIN THE TRI-STATE AREA). UNITS SHALL BE OBTAINED AND RESIDE IN CONTRACTOR'S STORAGE FACILITY AT BEGINNING OF CONTRACT AND UNTIL INSTALLATION OF UNITS. CONTRACTOR IS ALSO RESPONSIBLE FOR MODIFYING STONES. PROVIDING ANCHORS TO PROPERLY INSTALL UNITS, AND FOR COMPLETE INSTALLATION.

WINDOW NOTES

- 1. ALL WORK IS TO CONFORM TO ALL APPLICABLE REQUIREMENTS OF LOCAL GOVERNING CODES, HEALTH CODE, FIRE DEPARTMENT REGULATIONS, NBFU AND UTILITY CODES, OSHA CODES AND NEW YORK STATE BUILDING CODE.
- ALL CONTINUOUS INTEGRAL PULLS TO HAVE ROUNDED AND SMOOTH EDGES.
- 3. INTERIOR WINDOW SILL STOOLS AND APRONS SHALL HAVE CLOSED END CAPS, SAME GAUGE AS STOOLS. 4. ALL WINDOW COVERINGS, CURTAINS, AND ANY OTHER ITEMS THAT ARE ATTACHED TO WINDOW FRAMES OR SILLS
- ARE TO BE REMOVED AND STORED FOR REINSTALLATION BY THE CONTRACTOR.
- 5. ALL STAFF TOILETS, LOCKER ROOMS MUST HAVE OBSCURE GLAZING.
- 6. EXISTING WINDOW GUARDS THAT ARE TO BE REINSTALLED SHALL BE WIRE BRUSHED AND PAINTED WITH EPOXY COAT SYSTEM PRIOR TO REINSTALLATION. 7. THE CONTRACTOR SHALL PROVIDE AND INSTALL INSULATION IN ALL HEADS, JAMBS, SILLS MULLIONS AND STOOLS.
- 8. PROVIDE LOCKABLE STOPS TO LIMIT TRAVEL OF LOWER SASH TO 5" AT ALL WINDOWS.
- 9. DURING CONSTRUCTION, TEMPORARY BAFFLES TO SEAL OPENINGS TO PREVENT DUST AND DIRT FROM FILTERING INTO OCCUPIED AREAS ARE TO BE PROVIDED BY THE CONTRACTOR.
- 10. TEST ALL WINDOW CONDITIONERS PRIOR TO REMOVAL. PROVIDE A LOG LISTING THE OPERABILITY OF EACH UNIT BY ROOM AND SUBMIT TO WESTCHESTER COUNTY DPW.
- 11. PERIMETER RADIATORS AND UNIT VENTILATORS AT WINDOWS MUSST BE PROTECTED AND TO REMAIN INTACT AND IN OPERATION. AT THE END OF CONSTRUCTION, ALL RADIATORS AND UNIT VENTILATORS ARE TO BE VACUUM CLEANED. ENCLOSURES AND RADIATOR SHIELDS SHALL BE SCRAPED AND PAINTED.


DOOR NOTES

- 1. ALL EXTERIOR DOORS INCLUDING BULKHEAD DOORS INSTALLED UNDER THIS CONTRACT SHALL HAVE A MAXIMUM OPENING FORCE OF 8.5 LBS. AS PER ANSI 117.1
- 2. THE HARDWARE FOR EXTERIOR DOORS SHALL BE PANIC AND HANDICAPPED ACCESSIBLE HARDWARE.

INTERIOR REPAIR NOTES

- 1. INTERIOR FINISHES DISTURBED BY REMOVALS, CONSTRUCTION, INSTALLATIONS, ETC. TO BE PATCHED, REPAIRED, AND PAINTED TO MATCH EXISTING ADJACENT SURFACE(S). a. AFFECTED AREA = APPROXIMATELY 6" +/- ALL AROUND.
- REMOVE AND RESET ALL ELECTRICAL AND LOW VOLTAGE ELECTRICAL DEVICES IN EXISTING LOCATION. IN AREAS OF FINISH. REMOVE AND RESET ALL CONDUIT RACEWAY, AND WIRING AFFECTED BY REPAIR WORK. CONTRACTOR RESPONSIBLE FOR SURVEYING INTERIOR DAMAGE TO DETERMINE EXTENT OF WORK.

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TRAINING B-07 CLOSET 🔌 TRAINING B-06 AREAWAY 009 139-STAIR B-35 1 A-201

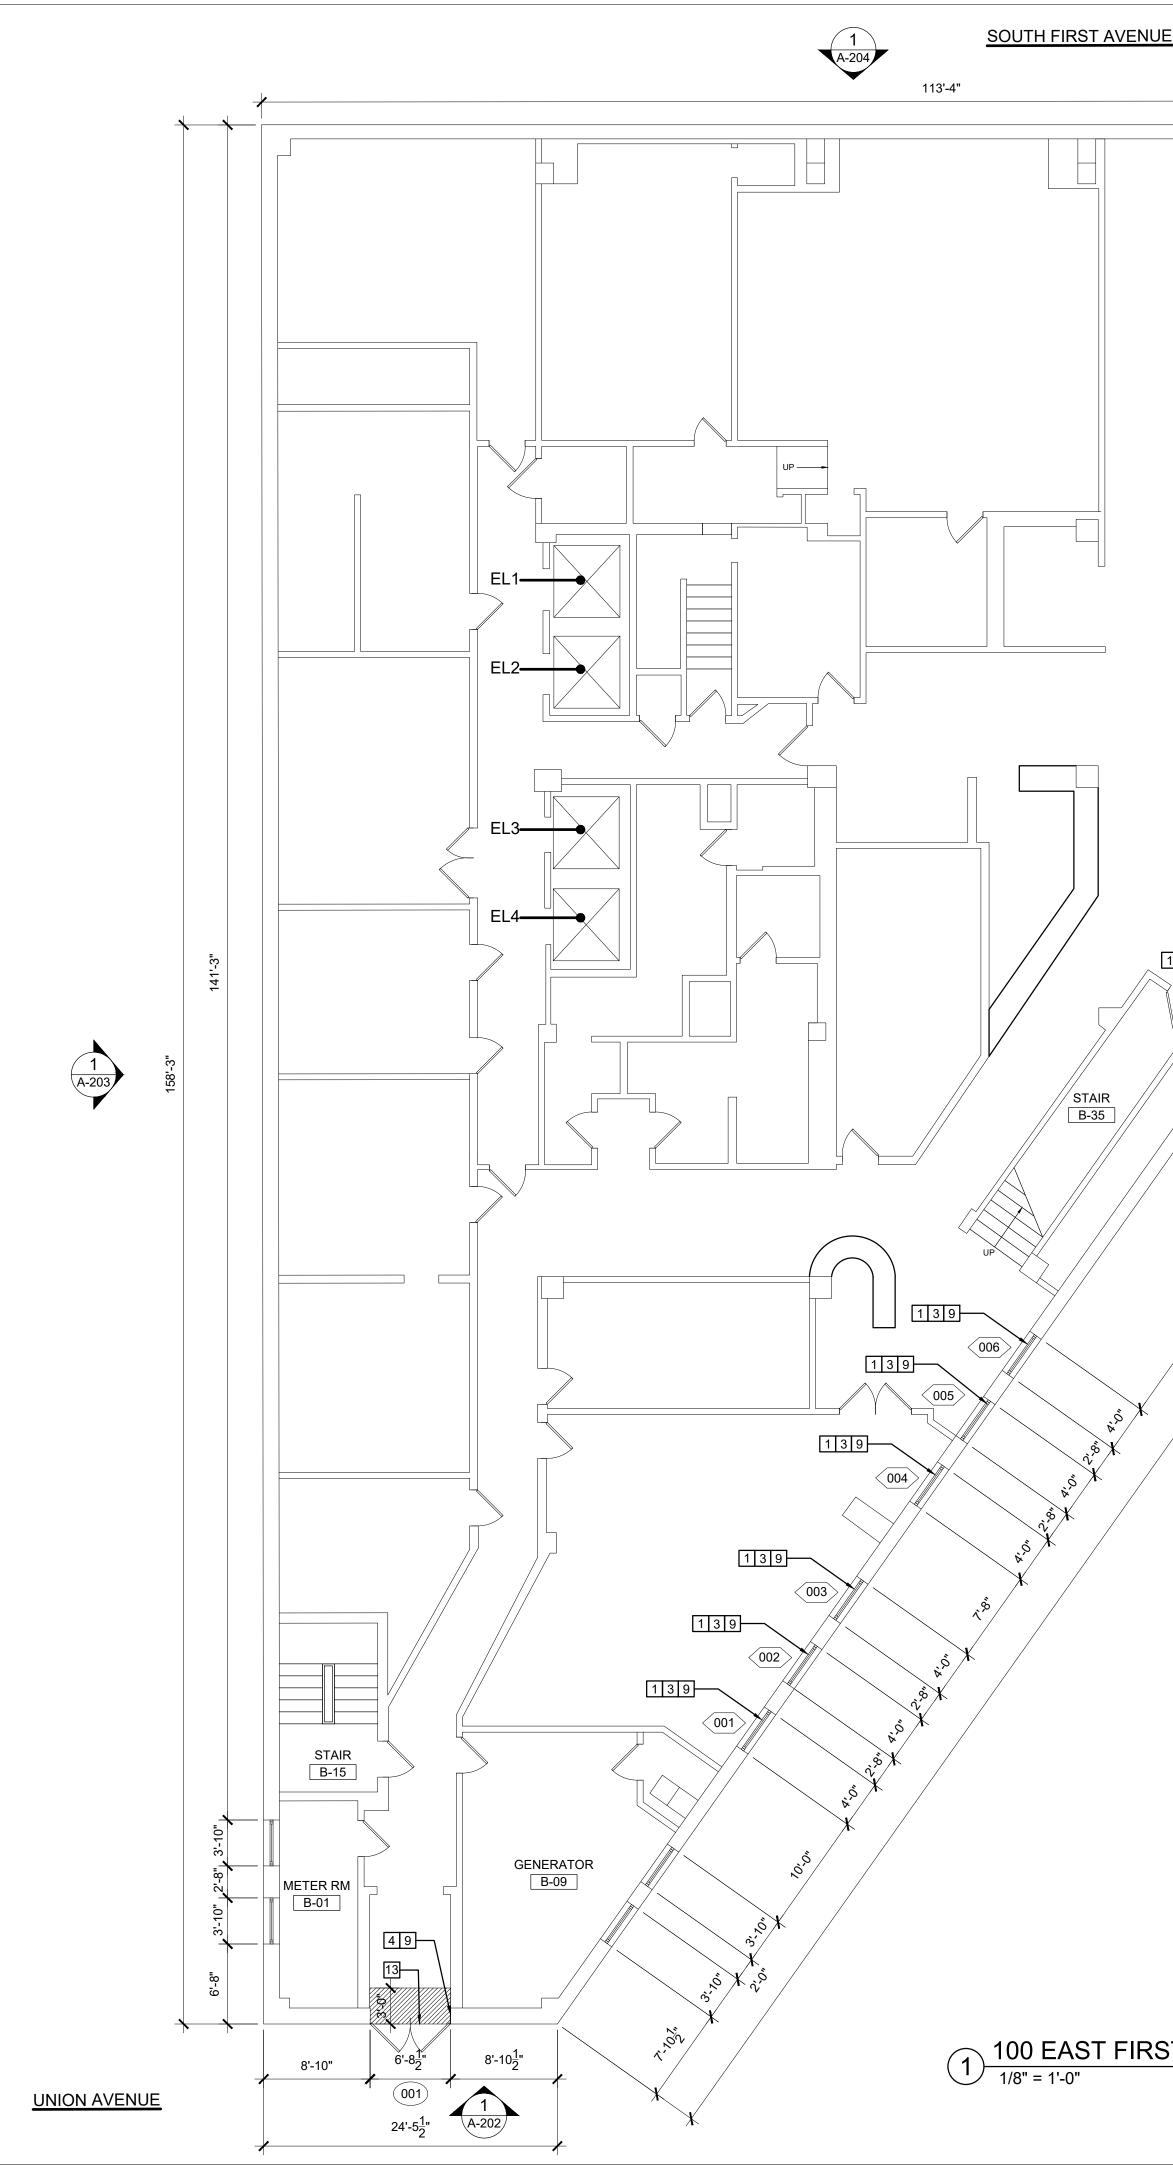
- 2 REMOVE & REPLACE EXISTING STOREFRONT WINDOW, TRANSOM & FRAME. REFER TO WINDOW DETAILS ON A-702.
- 3 REMOVE EXISTING EXTERIOR WINDOW GUARD. SCRAPE, CLEAN, RESTORE & REINSTALL. APPLY RUST INHIBITING COATING.
- 4 REMOVE & REPLACE EXISTING DOOR & FRAME. REFER TO DOOR DETAILS ON A701.
- 5 REMOVE & REPLACE EXISTING DOOR, FRAME, & TRANSOM/SIDELIGHTS. REFER TO DOOR DETAILS ON A-701.
- 6 REMOVE & REINSTALL EXISTING SIDEWALK GRATING, IF REQUIRED, TO ACCESS REMOVAL & REPLACEMENT OF EXISTING WINDOWS.
- 7 REMOVE EXISTING DECORATIVE EXTERIOR TRIM/FRAME AROUND WINDOW. SCRAPE, CLEAN, RESTORE AND REINSTALL OVER NEW WINDOW. COORDINATE WITH MANUFACTURER OF NEW WINDOWS.
- 8 PROVIDE STICKER/DECAL SIGNAGE ON DOOR GLAZING TO MATCH EXISTING. CONFIRM TEXT WITH WCDPW PRIOR TO INSTALLATION.
- 9 PATCH, REPAIR, & PAINT TO MATCH EXISTING ADJACENT SURFACES, ANY FINISHES DISTURBED BY WINDOWS & DOORS REMOVAL/ INSTALLATION -APPROXIMATELY 6 +/- ALL AROUND FOR REPAIR. PAINT TO NEAREST CORNER.
- 10 REMOVE & REPLACE EXISTING STEEL LINTEL ABOVE WINDOW. REMOVE & REINSTALL THREE COURSES OF BRICK (INCLUDING BRICK ARCHES & TERRA COTTA KEYSTONE) ABOVE & BELOW LINTEL FOR ACCESS. APPLY RUST INHIBITING COATING TO NEW STEEL LINTEL. REFER TO DETAIL 1 & 2/A-401.00
- 11 PATCH, REPAIR, & PAINT TO MATCH EXISTING ADJACENT SURFACES, ANY FINISHES DISTURBED BY LINTEL WORK, APPROXIMATELY 6" +/- ALL AROUND WINDOW.
- [12] REMOVE EXISTING SCUPPER OUTLET, GUTTER, AND LEADER. REMOVE THREE (3) COURSES OF BRICK ABOVE AND BELOW FOR ACCESS. REPLACE WITH NEW SCUPPER OUTLET, GUTTER, AND LEADER. NEW BRICK SURROUNDING AT ROOF SIDE TO MATCH EXISTING ADJACENT. REPAIR AREAS OF FLASHING MEMBRANES DISTURBED BY REMOVAL OF SCUPPER AT CORNICE SIDE TO MATCH EXISTING ADJACENT. REFER TO DETAIL 9/A-402
- 13 REMOVE EXISTING STONE SADDLE. LEVEL FLOOR AS REQUIRED TO ACCOMMODATE NEW DOOR INSTALLATION. INSTALL FLASHING & WATERPROOFING. INSTALL NEW STONE SADDLE PRIOR TO DOOR INSTALLATION.
- 14 REMOVE EXISTING FAILED CAULKING AT BUILDING/SIDEWALK JOINT. REMOVE PORTION OF CONCRETE SIDEWALK TO EXPOSE TOP OF SLAB WALL. REPAIR CRACKS IN SLAB WALL WITH EPOXY INJECTION. PROVIDE WATERPROOFING AT SLAB WALL. RESTORE CONCRETE SIDEWALK APPROXIMATELY 10 CUBIC FEET OF CONCRETE TO MATCH EXISTING GRADE. PROVIDE SEALANT AT BUILDING/SIDEWALK JOINT.


REMOVAL & CONSTRUCTION KEY NOTES:

NOTE: SEE PLAN FOR APPLICABILITY OF CONSTRUCTION KEY NOTES.

1 REMOVE & REPLACE EXISTING WINDOW. REFER TO WINDOW DETAILS ON A702.

- 15 REMOVE & REPLACE EXISTING OVERFLOW SCUPPER & ASSOCIATED ROOFING: APPROXIMATELY 24" +/- AROUND SCUPPER. PROVIDE GUTTER, LEADER DOWN TO MAIN ROOF LEVEL, & SPLASHBLOCK.
- 16 REMOVE & REPLACE EXISTING VENT FLASHING & ASSOCIATED ROOFING; APPROXIMATELY 12" +/- AROUND VENT. REFER TO DETAIL 13/A-402
- 17 PROVIDE NEW RAINHOOD & WATERPROOFING AT DUCT PENETRATION.
- 18 PATCH, REPAIR, & PAINT TO MATCH EXISTING ADJACENT SURFACES, ANY FINISHES DAMAGED BY LEAK. PAINT TO NEAREST CORNER.
- 19 REMOVE EXISTING CEMENTITIOUS COATING. APPLY BREATHABLE MASONRY COATING.
- 20 PROTECT EXISTING ELECTRICAL, DATA, TELECOM, ETC. DEVICES AT AREAS OF WORK. COORDINATE WITH DATA/TELECOM SERVICE PROVIDER FOR ANY DEVICES THAT MAY REQUIRE TEMPORARY RELOCATION.
- 21 REMOVE EXISTING DAMAGED/SPALLED CONCRETE BEAM ENCASEMENT TO EXPOSE EXISTING STEEL BEAM. REMOVE RUST & PATCH/REPAIR STEEL BEAM. APPLY RUST INHIBITING COATING. RESTORE CONCRETE ENCASEMENT AT STEEL BEAM. REFER TO STRUCTURAL DRAWINGS.
- 22 REMOVE PORTION OF CONCRETE SIDEWALK TO EXPOSE TOP OF SLAB WALL. REPAIR CRACKS IN SLAB WALL WITH EPOXY INJECTION. PROVIDE WATERPROOFING AT SLAB WALL. RESTORE CONCRETE SIDEWALK APPROXIMATELY 10 CUBIC FEET OF CONCRETE TO MATCH EXISTING GRADE.
- 23 PROVIDE TWO (2) 18"x18" OPENINGS IN TOP OF HOISTWAY. PROVIDE 18"x18" DUCT CONNECTIONS FROM OPENING AND COMBINE DUCTS TO A 25"x25" DUCT HEADER. TERMINATE DUCT AT INDICATED FIRE DAMPER. ALL DUCTS TO BE IN 2HR RATED FIRE WRAP. COMPLY WITH NYS BUILDING CODE SECTION BC 3004 HOISTWAY VENTING. REFER TO DETAIL 6/A-205.
- 24 REMOVE PORTION OF EXISTING MASONRY WALL (25"x25") TO ACCOMMODATE NEW EXHAUST FIRE DAMPER AND LOUVER COMBINATION WITH MINIMUM 4 SF FREE AREA AND BIRDSCREEN (GREENHECK MODEL DFD-230 OR SIMILAR). COMPLY WITH NYS BUILDING CODE SECTION BC 3004 HOISTWAY VENTING. PATCH/REPAIR ANY SURFACE(S) DISTURBED TO MATCH EXISTING. REFER TO DETAIL 6/A-205.
- NOTE:
- 1. GC TO COORDINATE AND ABATE ALL HAZARDOUS MATERIAL AT LOCATIONS AFFECTED BY SCOPE OF WORK. REFER TO ENVIRONMENTAL DOCUMENTS FOR ITEMS CONTAINING HAZARDOUS MATERIAL AND LOCATIONS.

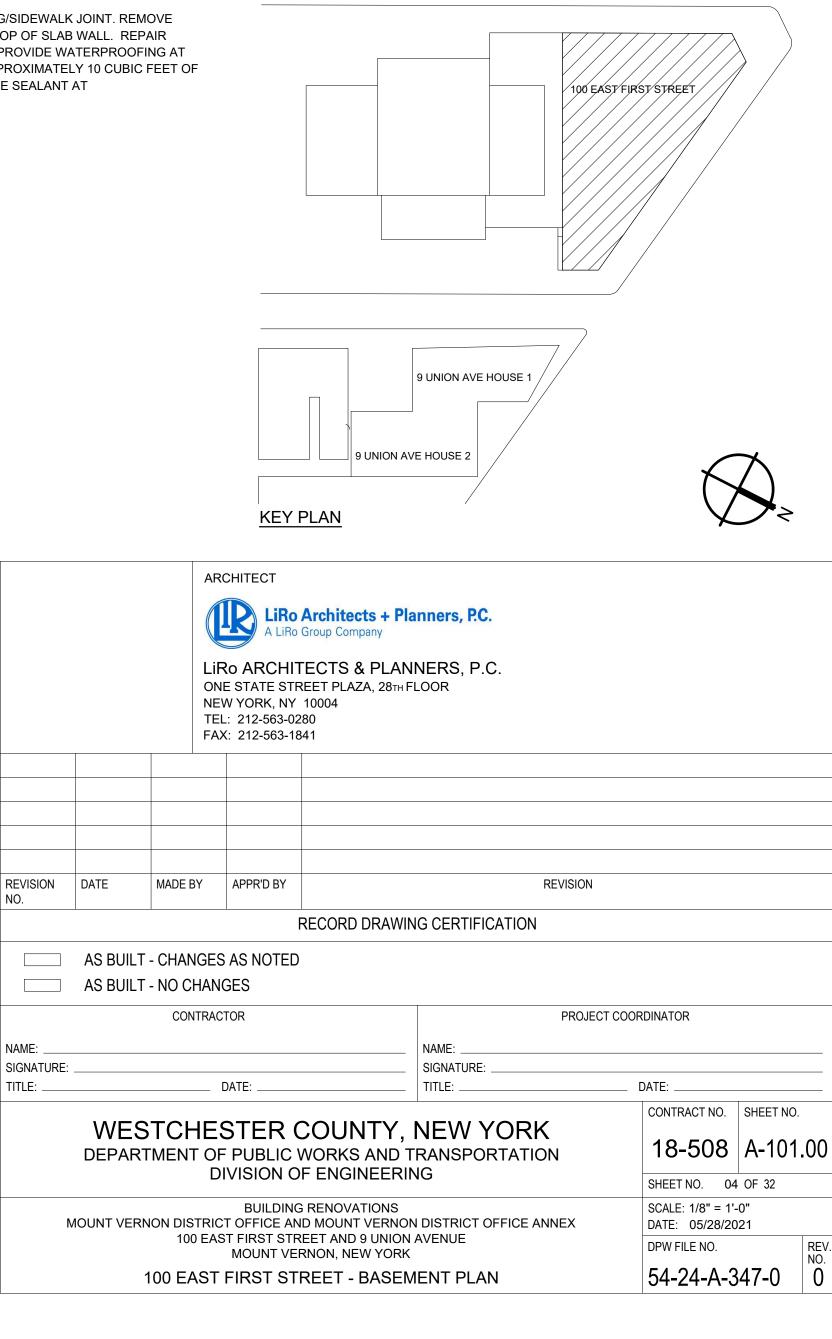

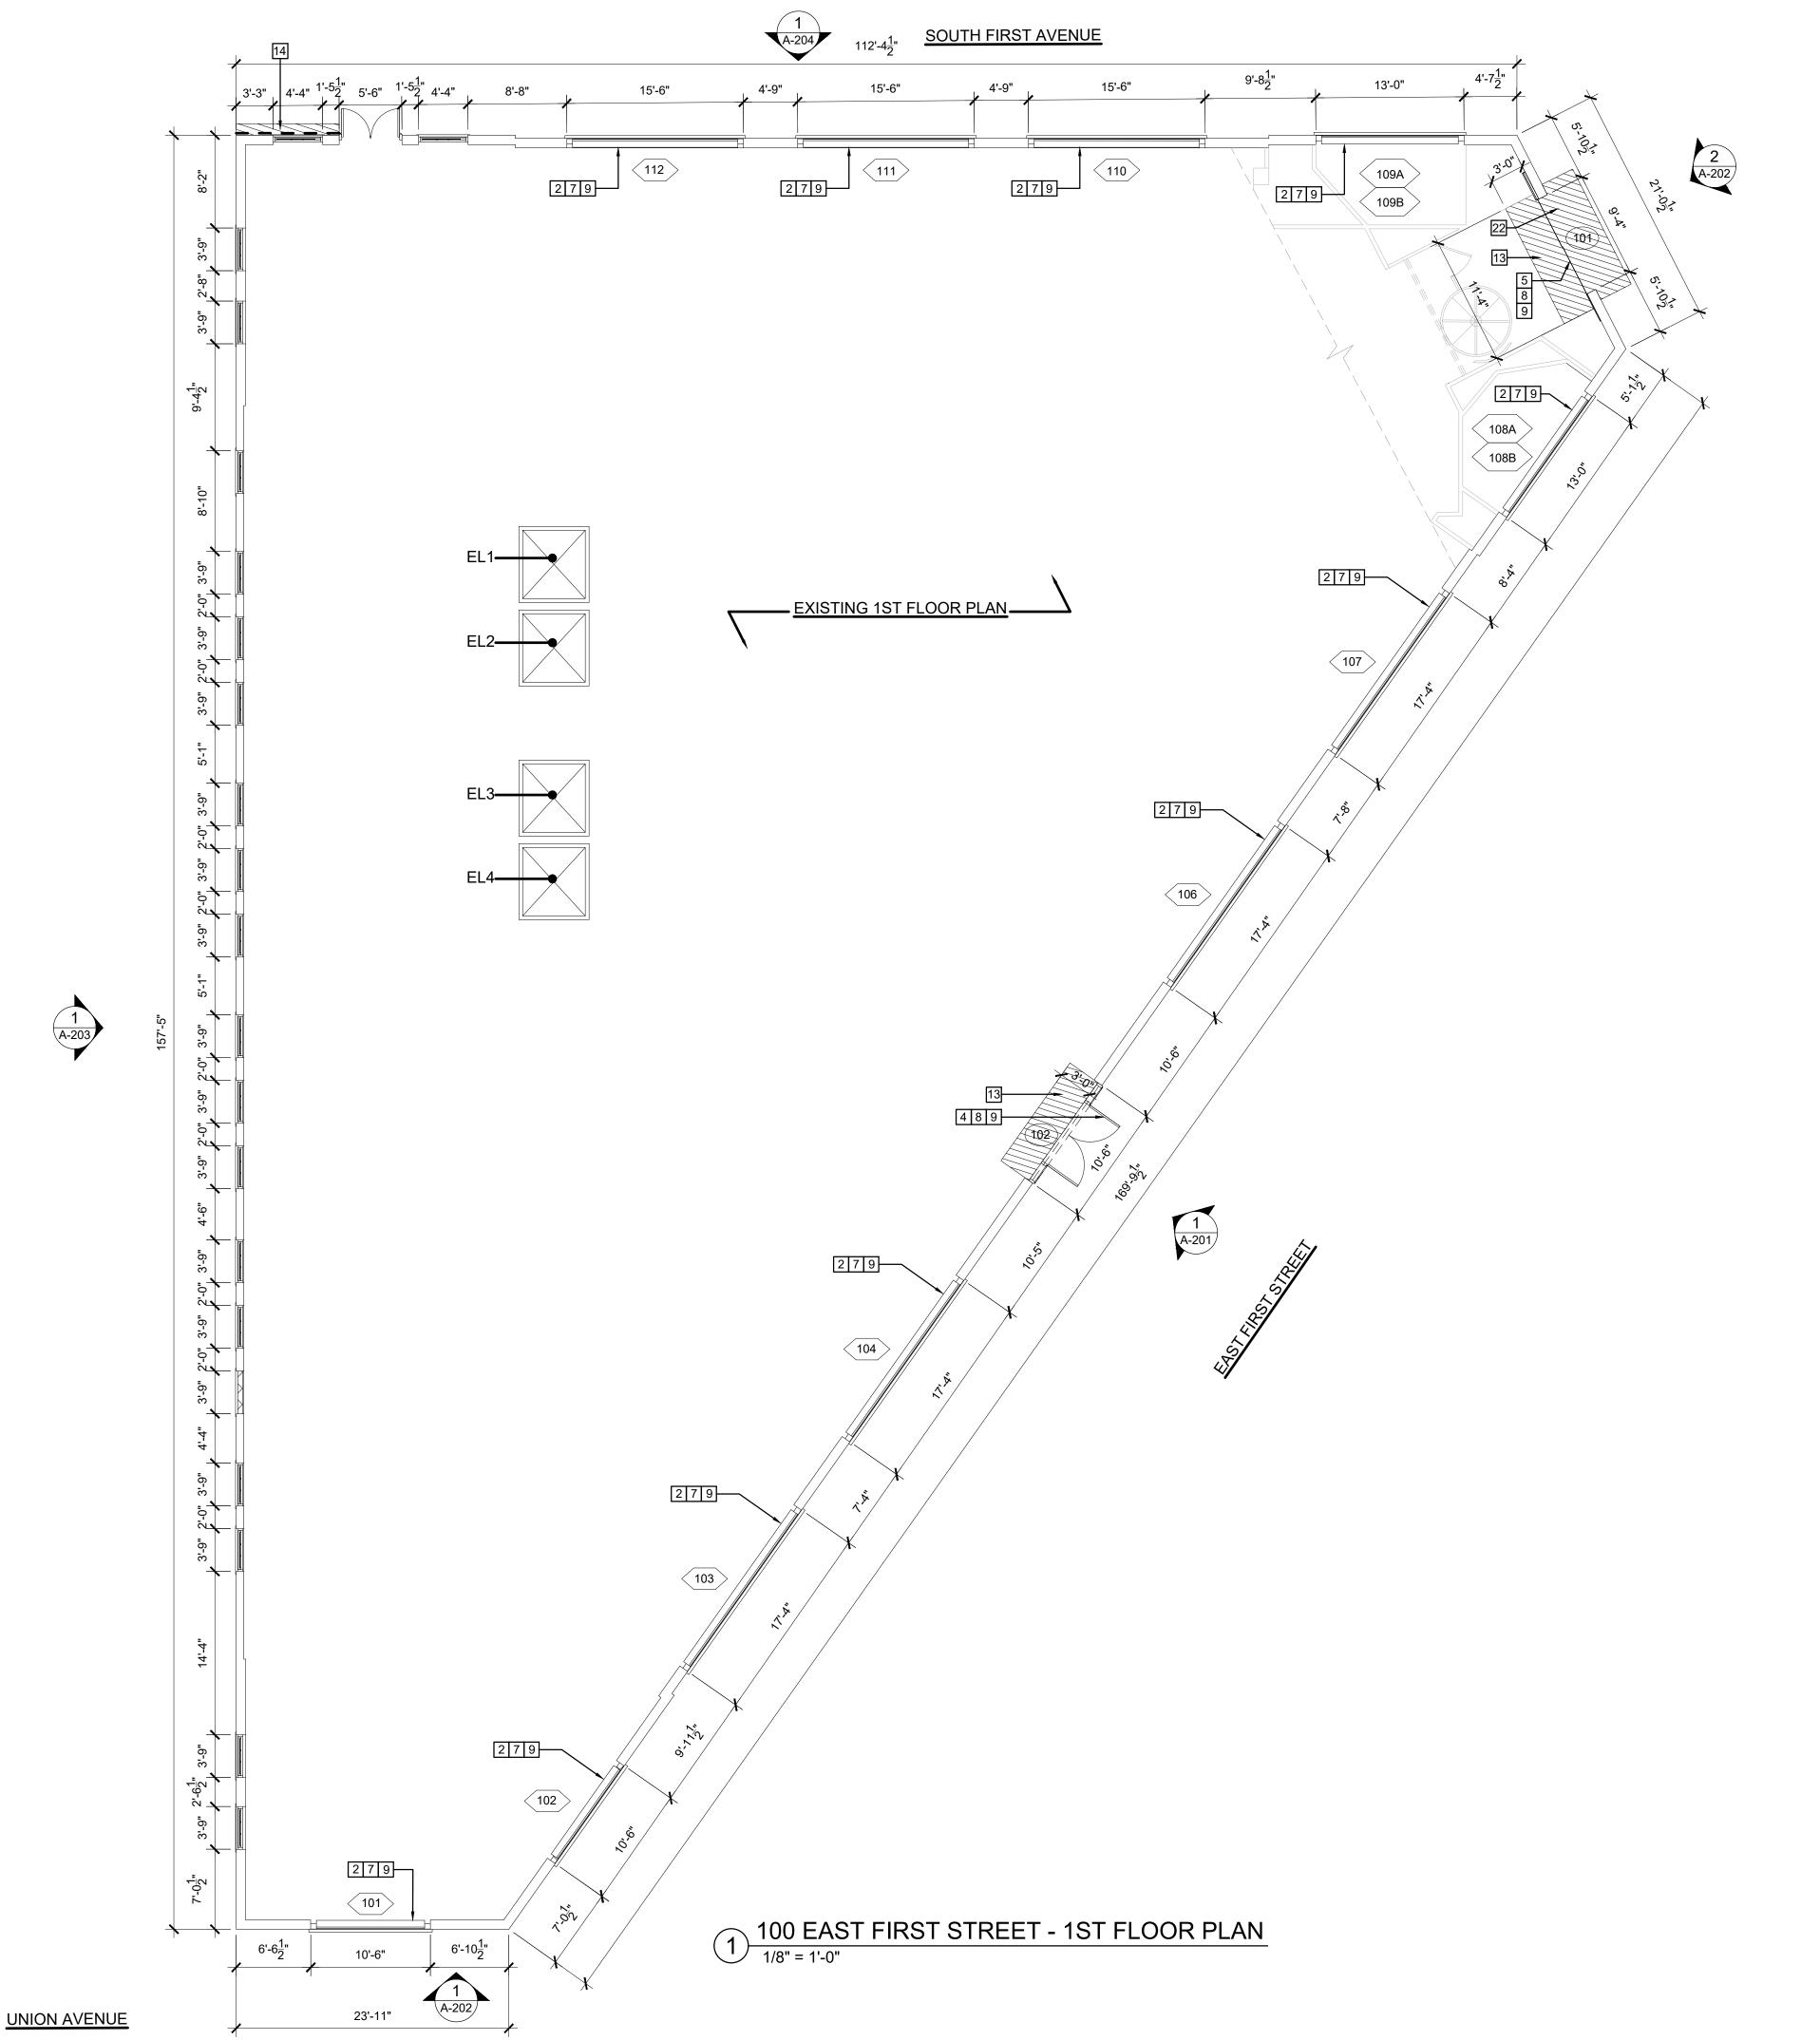



REMOVAL & CONSTRUCTION KEY NOTES: NOTE: SEE PLAN FOR APPLICABILITY OF CONSTRUCTION KEY NOTES.

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- 9 PATCH, REPAIR, & PAINT TO MATCH EXISTING ADJACENT SURFACES, ANY FINISHES DISTURBED BY WINDOWS & DOORS REMOVAL/ INSTALLATION -APPROXIMATELY 6 +/- ALL AROUND FOR REPAIR. PAINT TO NEAREST CORNER.
- 10 REMOVE & REPLACE EXISTING STEEL LINTEL ABOVE WINDOW. REMOVE & REINSTALL THREE COURSES OF BRICK (INCLUDING BRICK ARCHES & TERRA COTTA KEYSTONE) ABOVE & BELOW LINTEL FOR ACCESS. APPLY RUST INHIBITING COATING TO NEW STEEL LINTEL. REFER TO DETAIL 1 & 2/A-401.00
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- 13 REMOVE EXISTING STONE SADDLE. LEVEL FLOOR AS REQUIRED TO ACCOMMODATE NEW DOOR INSTALLATION. INSTALL FLASHING & WATERPROOFING. INSTALL NEW STONE SADDLE PRIOR TO DOOR INSTALLATION.
- 14 REMOVE EXISTING FAILED CAULKING AT BUILDING/SIDEWALK JOINT. REMOVE PORTION OF CONCRETE SIDEWALK TO EXPOSE TOP OF SLAB WALL. REPAIR CRACKS IN SLAB WALL WITH EPOXY INJECTION. PROVIDE WATERPROOFING AT SLAB WALL. RESTORE CONCRETE SIDEWALK APPROXIMATELY 10 CUBIC FEET OF CONCRETE TO MATCH EXISTING GRADE. PROVIDE SEALANT AT BUILDING/SIDEWALK JOINT.

1 REMOVE & REPLACE EXISTING WINDOW. REFER TO WINDOW DETAILS ON A702.

- 15 REMOVE & REPLACE EXISTING OVERFLOW SCUPPER & ASSOCIATED ROOFING: APPROXIMATELY 24" +/- AROUND SCUPPER. PROVIDE GUTTER, LEADER DOWN TO MAIN ROOF LEVEL, & SPLASHBLOCK.
- 16 REMOVE & REPLACE EXISTING VENT FLASHING & ASSOCIATED ROOFING; APPROXIMATELY 12" +/- AROUND VENT. REFER TO DETAIL 13/A-402
- 17 PROVIDE NEW RAINHOOD & WATERPROOFING AT DUCT PENETRATION.
- 18 PATCH, REPAIR, & PAINT TO MATCH EXISTING ADJACENT SURFACES, ANY FINISHES DAMAGED BY LEAK. PAINT TO NEAREST CORNER.
- 19 REMOVE EXISTING CEMENTITIOUS COATING. APPLY BREATHABLE MASONRY COATING.
- 20 PROTECT EXISTING ELECTRICAL, DATA, TELECOM, ETC. DEVICES AT AREAS OF WORK. COORDINATE WITH DATA/TELECOM SERVICE PROVIDER FOR ANY DEVICES THAT MAY REQUIRE TEMPORARY RELOCATION.
- 21 REMOVE EXISTING DAMAGED/SPALLED CONCRETE BEAM ENCASEMENT TO EXPOSE EXISTING STEEL BEAM. REMOVE RUST & PATCH/REPAIR STEEL BEAM. APPLY RUST INHIBITING COATING. RESTORE CONCRETE ENCASEMENT AT STEEL BEAM. REFER TO STRUCTURAL DRAWINGS.
- 22 REMOVE PORTION OF CONCRETE SIDEWALK TO EXPOSE TOP OF SLAB WALL. REPAIR CRACKS IN SLAB WALL WITH EPOXY INJECTION. PROVIDE WATERPROOFING AT SLAB WALL. RESTORE CONCRETE SIDEWALK APPROXIMATELY 10 CUBIC FEET OF CONCRETE TO MATCH EXISTING GRADE.
- 23 PROVIDE TWO (2) 18"x18" OPENINGS IN TOP OF HOISTWAY. PROVIDE 18"x18" DUCT CONNECTIONS FROM OPENING AND COMBINE DUCTS TO A 25"x25" DUCT HEADER. TERMINATE DUCT AT INDICATED FIRE DAMPER. ALL DUCTS TO BE IN 2HR RATED FIRE WRAP. COMPLY WITH NYS BUILDING CODE SECTION BC 3004 HOISTWAY VENTING. REFER TO DETAIL 6/A-205.
- 24 REMOVE PORTION OF EXISTING MASONRY WALL (25"x25") TO ACCOMMODATE NEW EXHAUST FIRE DAMPER AND LOUVER COMBINATION WITH MINIMUM 4 SF FREE AREA AND BIRDSCREEN (GREENHECK MODEL DFD-230 OR SIMILAR). COMPLY WITH NYS BUILDING CODE SECTION BC 3004 HOISTWAY VENTING. PATCH/REPAIR ANY SURFACE(S) DISTURBED TO MATCH EXISTING. REFER TO DETAIL 6/A-205.
- 1. GC TO COORDINATE AND ABATE ALL HAZARDOUS MATERIAL AT LOCATIONS AFFECTED BY SCOPE OF WORK. REFER TO ENVIRONMENTAL DOCUMENTS FOR ITEMS CONTAINING HAZARDOUS MATERIAL AND LOCATIONS.

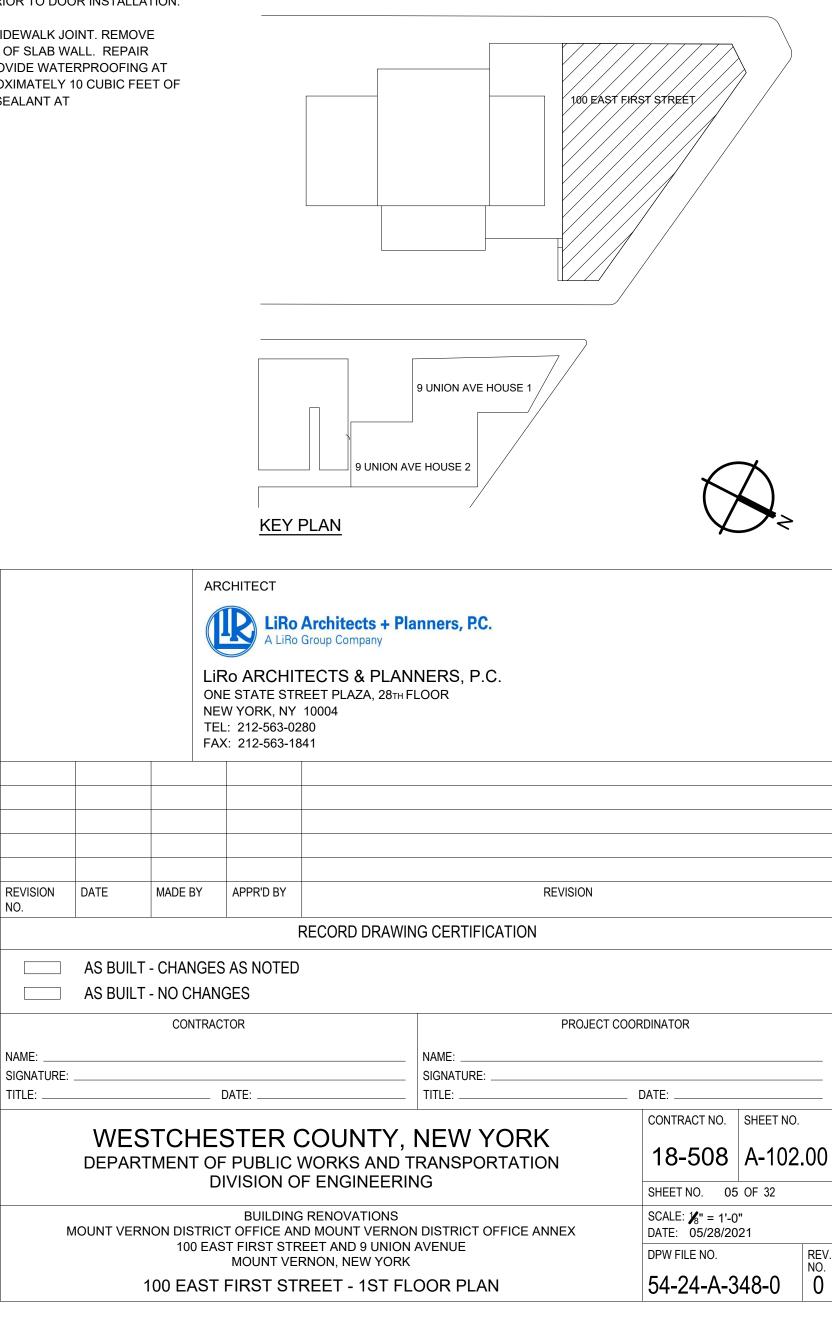

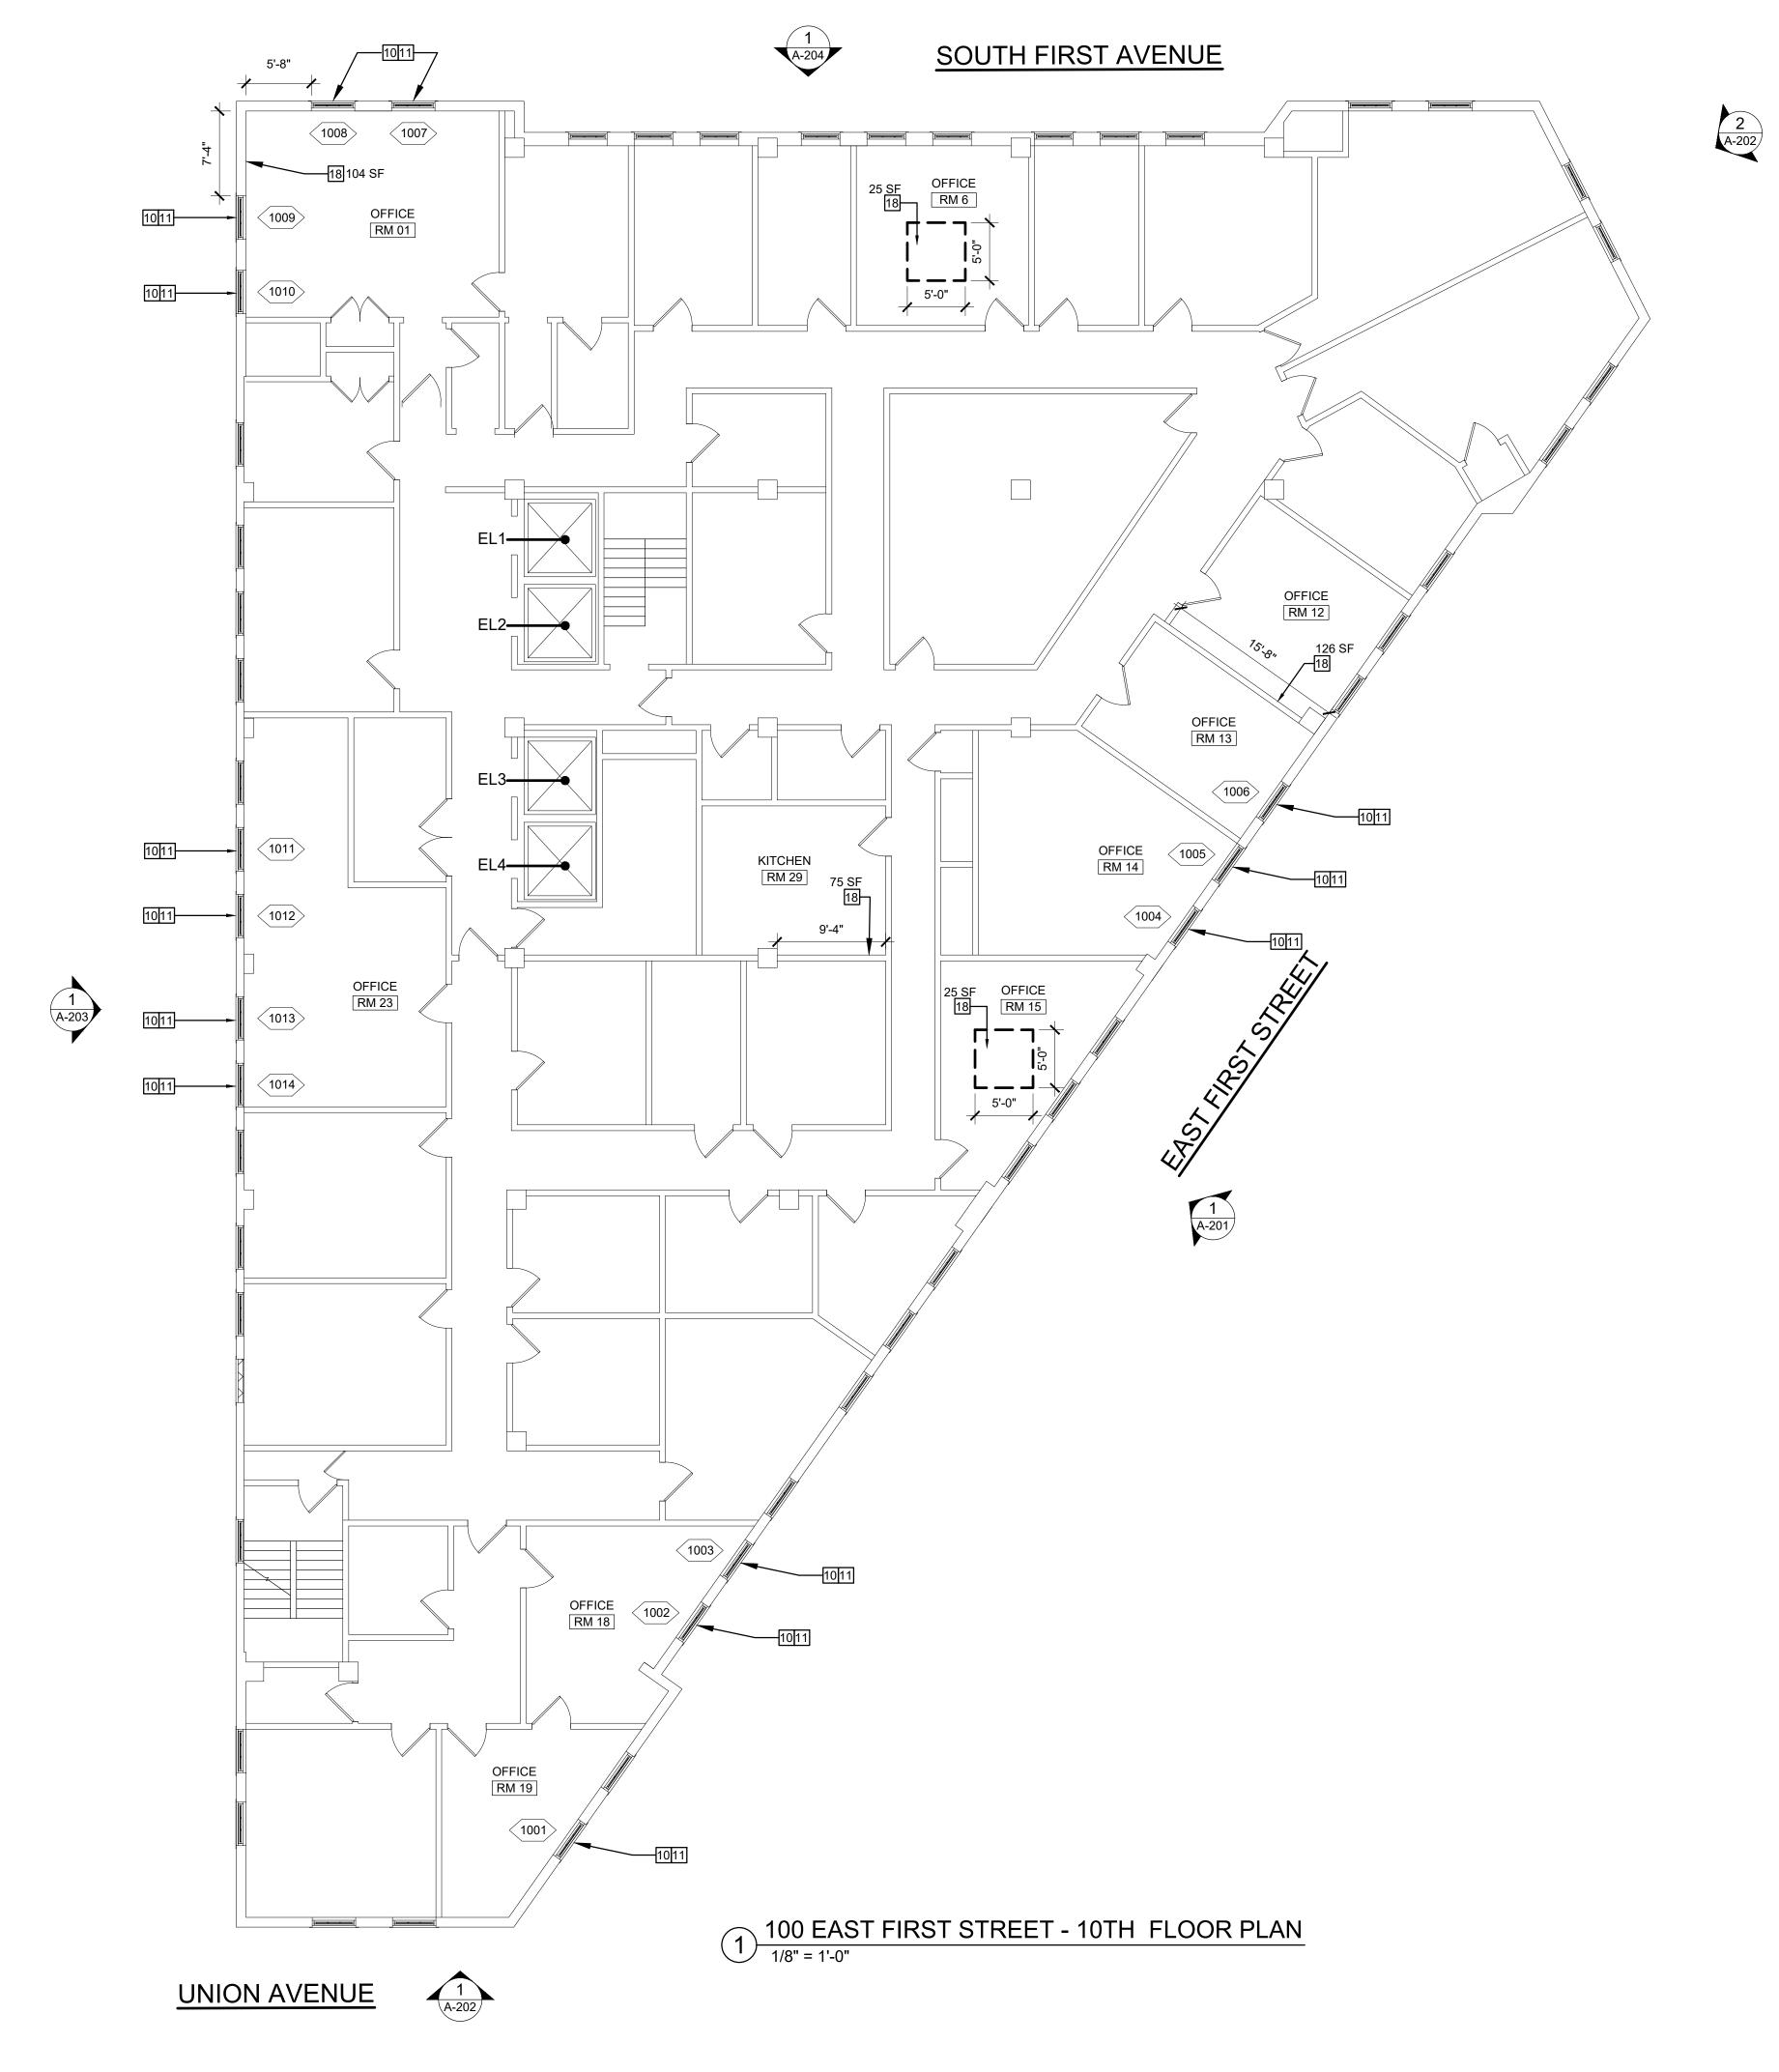

REFER TO WINDOW DETAILS ON A-702.

A701

TO DOOR DETAILS ON A-701.

REMOVAL & REPLACEMENT OF EXISTING WINDOWS.

WINDOW.

BUILDING/SIDEWALK JOINT.

REMOVAL & CONSTRUCTION KEY NOTES:


NOTE: SEE PLAN FOR APPLICABILITY OF CONSTRUCTION KEY NOTES.


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- 5 REMOVE & REPLACE EXISTING DOOR, FRAME, & TRANSOM/SIDELIGHTS. REFER
- 6 REMOVE & REINSTALL EXISTING SIDEWALK GRATING, IF REQUIRED, TO ACCESS
- 7 REMOVE EXISTING DECORATIVE EXTERIOR TRIM/FRAME AROUND WINDOW. SCRAPE, CLEAN, RESTORE AND REINSTALL OVER NEW WINDOW. COORDINATE WITH MANUFACTURER OF NEW WINDOWS.
- 8 PROVIDE STICKER/DECAL SIGNAGE ON DOOR GLAZING TO MATCH EXISTING. CONFIRM TEXT WITH WCDPW PRIOR TO INSTALLATION.
- 9 PATCH, REPAIR, & PAINT TO MATCH EXISTING ADJACENT SURFACES, ANY FINISHES DISTURBED BY WINDOWS & DOORS REMOVAL/ INSTALLATION -APPROXIMATELY 6 +/- ALL AROUND FOR REPAIR. PAINT TO NEAREST CORNER.
- 10 REMOVE & REPLACE EXISTING STEEL LINTEL ABOVE WINDOW. REMOVE & REINSTALL THREE COURSES OF BRICK (INCLUDING BRICK ARCHES & TERRA COTTA KEYSTONE) ABOVE & BELOW LINTEL FOR ACCESS. APPLY RUST INHIBITING COATING TO NEW STEEL LINTEL. REFER TO DETAIL 1 & 2/A-401.00
- 11 PATCH, REPAIR, & PAINT TO MATCH EXISTING ADJACENT SURFACES, ANY FINISHES DISTURBED BY LINTEL WORK, APPROXIMATELY 6" +/- ALL AROUND
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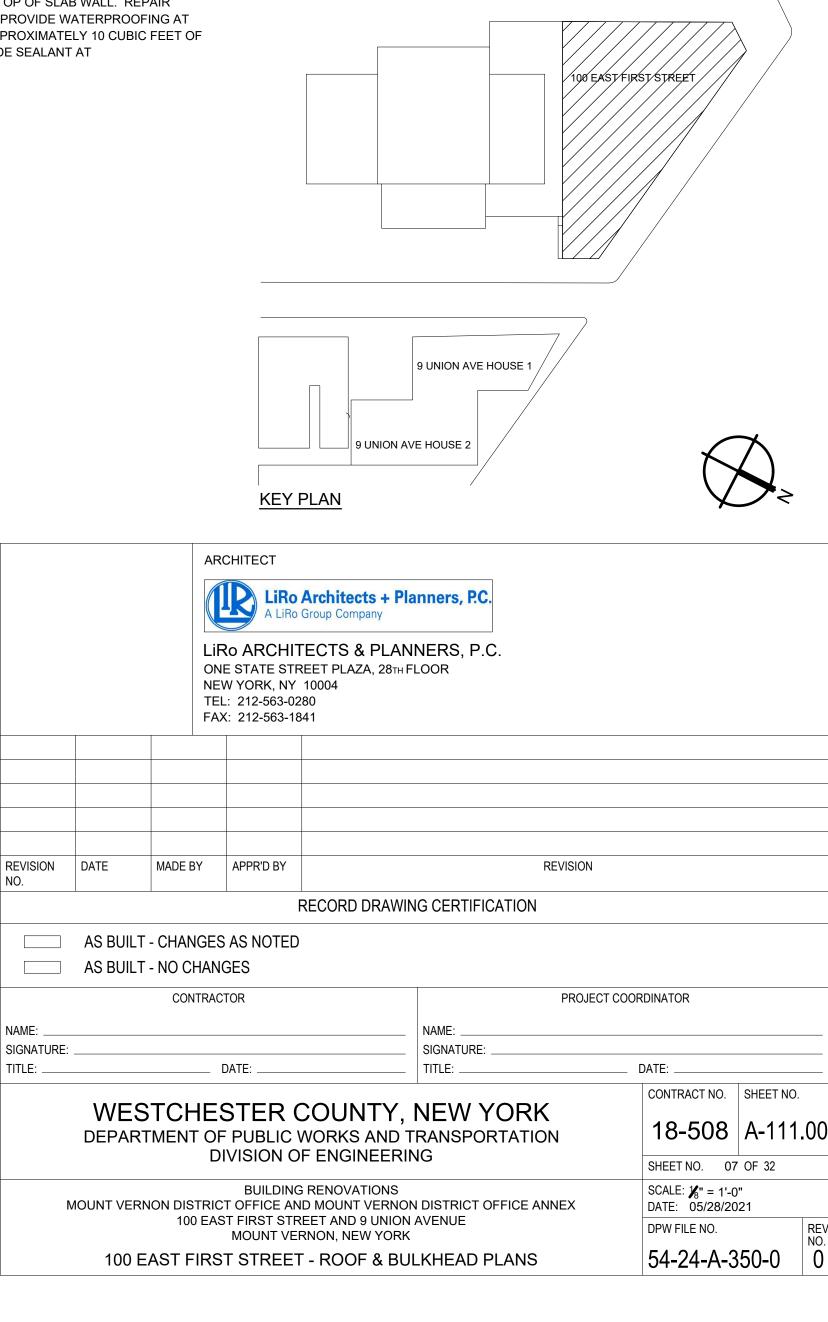
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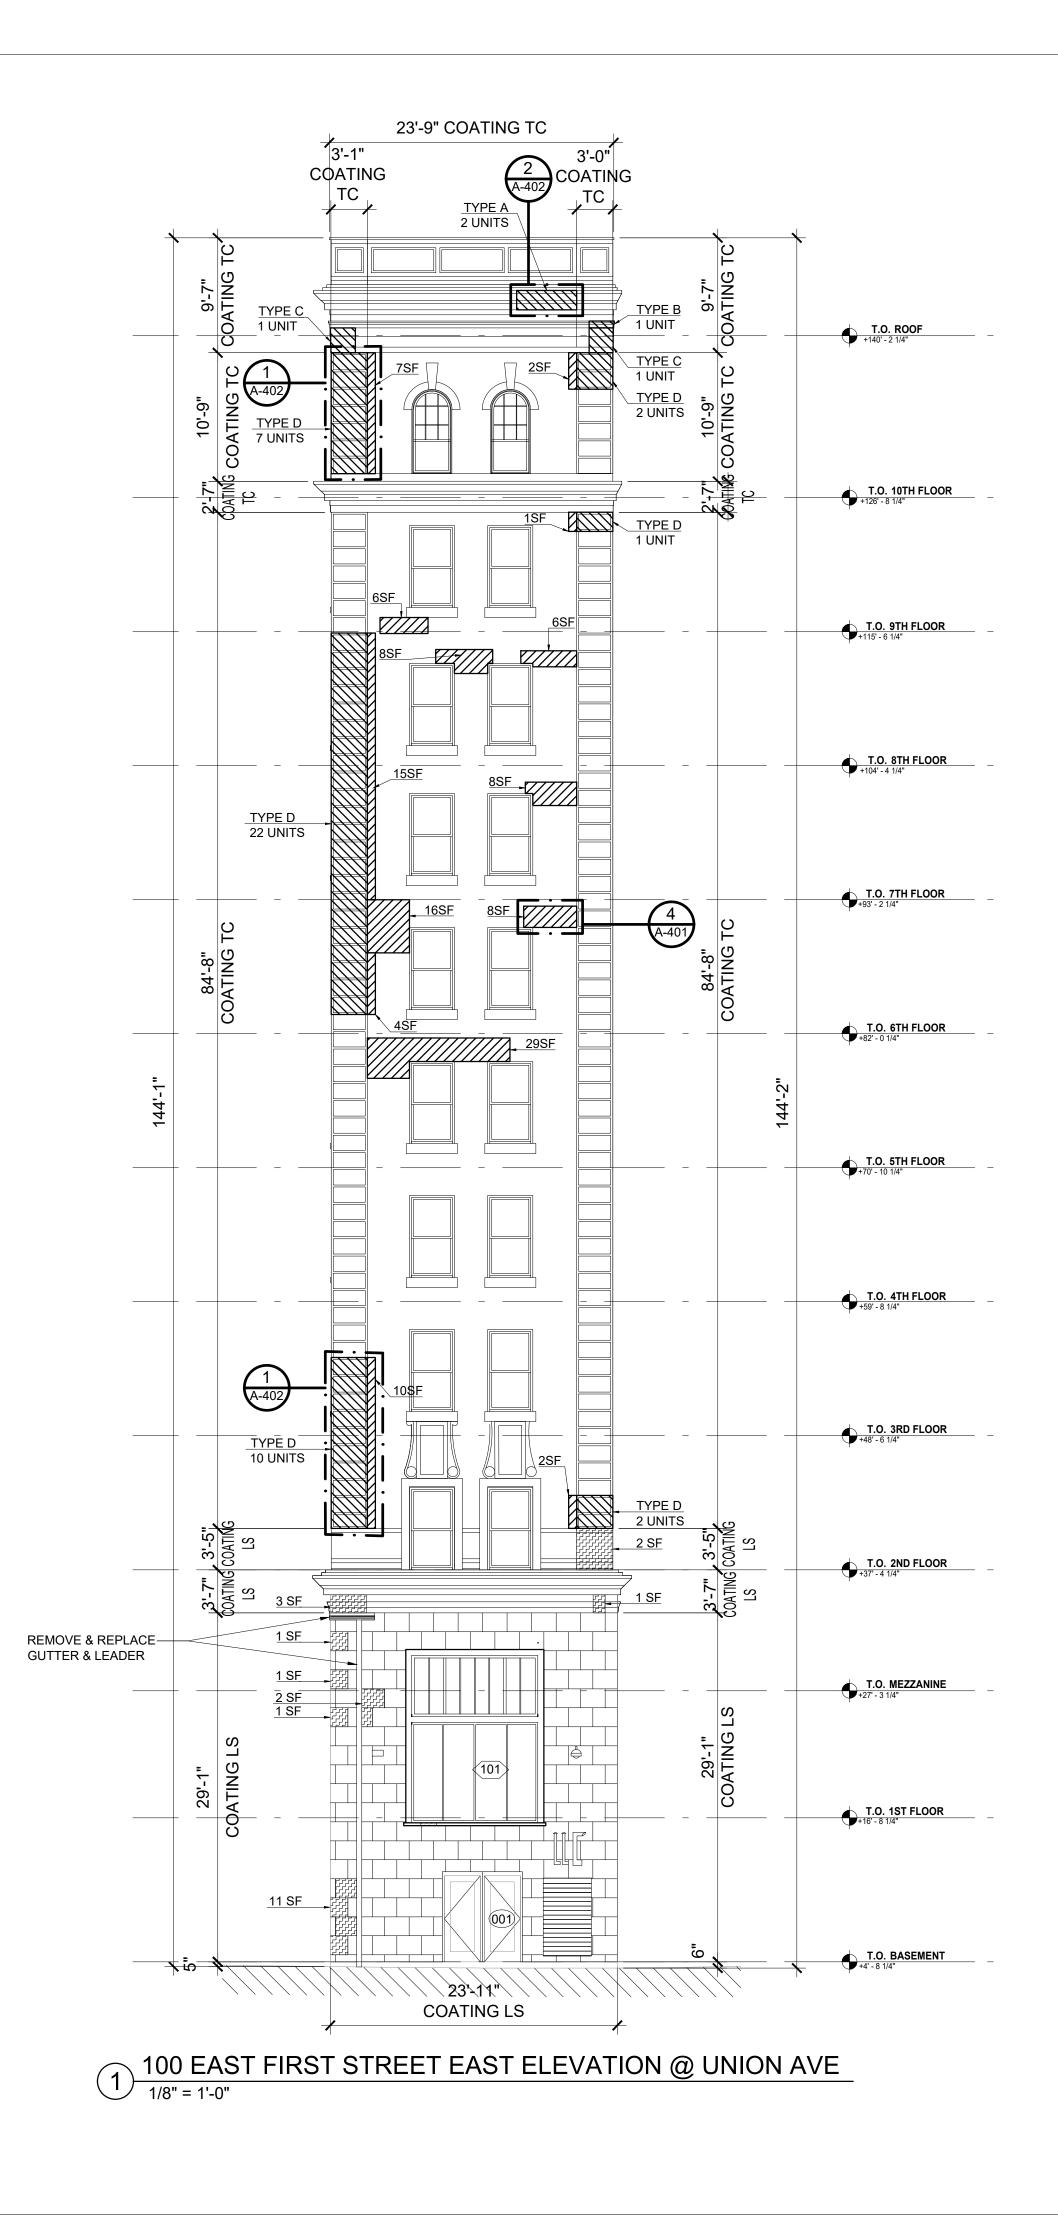





100 E FIRST STREET - NORTH ELEVATION 1/8" = 1'-0"

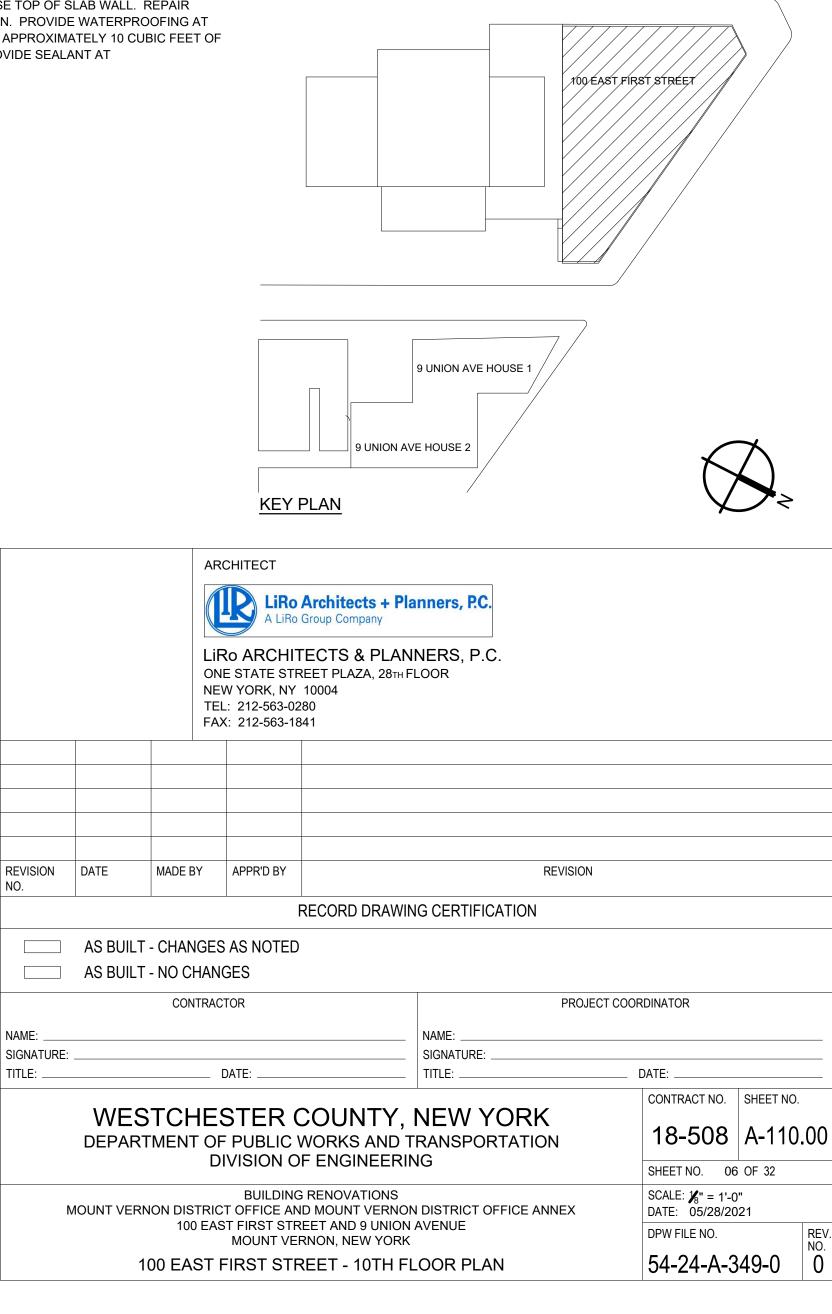


			LEGEND	
			REMOVE & REPLACE DAMAGED BRICK: - 3 COURSES ABOVE & BELOW AT HORIZONTAL CRAC - APPROX. 12" ALL AROUND LINE OF DIAGONAL CRAC	
			REMOVE & REPLACE DAMAGED TERRA COTTA UNIT, REFER TO DETAILS ON A-402	
	L			
			⁺ ⁺	
	T.O. ROOF +140' - 2 1/4"			
				WINDOW,
			L REMOVE & REPLACE EXISTING LINTEL FLASHING ABO WINDOW, REFER TO DETAIL 1/A-402.	DVE
			TERRA COTTA UNITS (SINGLE) BY TYPE	
	T.O. 10TH FLOOR +126' - 8 1/4"		$ \begin{array}{ccc} \underline{\text{UNIT TYPE}} & \underline{\text{DIMENSIONS}(\text{APPROXIMATE})} \\ \hline \text{TYPE A:} & 30"W \times 18"H \pm (V.I.F.) \\ \hline \text{TYPE B:} & 24"W \times 6"H \pm (V.I.F.) \\ \hline \text{TYPE C:} & 24"W \times 24"H \pm (V.I.F.) \\ \hline \text{TYPE D:} & 36"W \times 18"H \pm (V.I.F.) \\ \hline \text{TYPE E:} & 18"W \times 5"H \pm (V.I.F.) \\ \hline \text{TYPE F:} & 12"W \times 27"H \pm (V.I.F.) \\ \hline \end{array} $	
	T.O. 9TH FLOOR +115' - 6 1/4"		DIMENSIONS NOTING "COATING": REFERS TO AREAS OF EXISTING CEMENTITIOUS COATING. FOR T LOCATIONS, CONTRACTOR TO REMOVE ALL EXISTING CEMENTITI COATING & APPLY BREATHABLE COATING.	
	T.O. 8TH FLOOR		100 EAST 1ST STREET: ON ALL TERRA COTTA (TC) & LIMESTONE (LS) - INCLUDES PARAPE (STREET SIDE), CORNICES, SCROLLS ABOVE WINDOWS, BASE BEI WINDOWS, BALLUSTRADES & GROUND LEVEL. ON BRICK - INCLUDES PARAPETS (ROOF SIDE).	
	Y +104' - 4 1/4"		<u>9 UNION AVENUE:</u> ON ALL BRICK SURFACES AS INDICATED.	
			NOTES: IN ADDITION TO WORK INDICATED ON PLANS & ELEVATIO PROVIDE THE FOLLOWING IN BASE BID:)NS,
	T.O. 7TH FLOOR +93' - 2 1/4"		 ALLOWANCE FOR 2,000 SF OF REPOINTING AT DISCRETION O OWNER/AoR BASED ON FIELD CONDITIONS DURING CONSTRUCTION. REFER TO DETAIL 7/A-401. ALLOWANCE FOR REPLACEMENT OF THREE (3) UNITS OF TEF COTTA KEYSTONE (TYPE F) AT BRICK ARCHES. ALLOWANCE FOR 1,000 SF OF BRICK REPLACEMENT. ALLOWANCE FOR 50 LF OF LINTEL REPLACEMENT. ALLOWANCE FOR 500 SF OF PATCHING & REPAIR OF MASONF 	RRA
135'-5"	T.O. 6TH FLOOR +82' - 0 1/4"			
	T.O. 5TH FLOOR +70' - 10 1/4"			
	T.O. 4TH FLOOR +59' - 8 1/4") \
	T.O. 3RD FLOOR +48' - 6 1/4"	<u>KE</u> Y	<u>PLAN</u>	\rightarrow
	T.O. 2ND FLOOR +37' - 4 1/4"	LiRo ARCH		
		FAX: 212-563-		
	T.O. MEZZANINE +27' - 3 1/4"			
	T.O. 1ST FLOOR	REVISION DATE MADE BY APPR'D BY NO.	REVISION	
_		AS BUILT - CHANGES AS NOTE	RECORD DRAWING CERTIFICATION	
		AS BUILT - NO CHANGES		
	T.O. BASEMENT +4' - 8 1/4"	CONTRACTOR	PROJECT COORDINATOR	
	 +4' - 8 1/4"	SIGNATURE: TITLE:		
		DEPARTMENT OF PUBLIC	COUNTY, NEW YORK WORKS AND TRANSPORTATION OF ENGINEERING	
		MOUNT VERNON DISTRICT OFFICE	IG RENOVATIONS ND MOUNT VERNON DISTRICT OFFICE ANNEX DATE: 05/28/2021	
		MOUNT V	REET AND 9 UNION AVENUE ERNON, NEW YORK ERIOR BUILDING ELEVATIONS - NORTH 54-24-A-351	REV. NO. 0

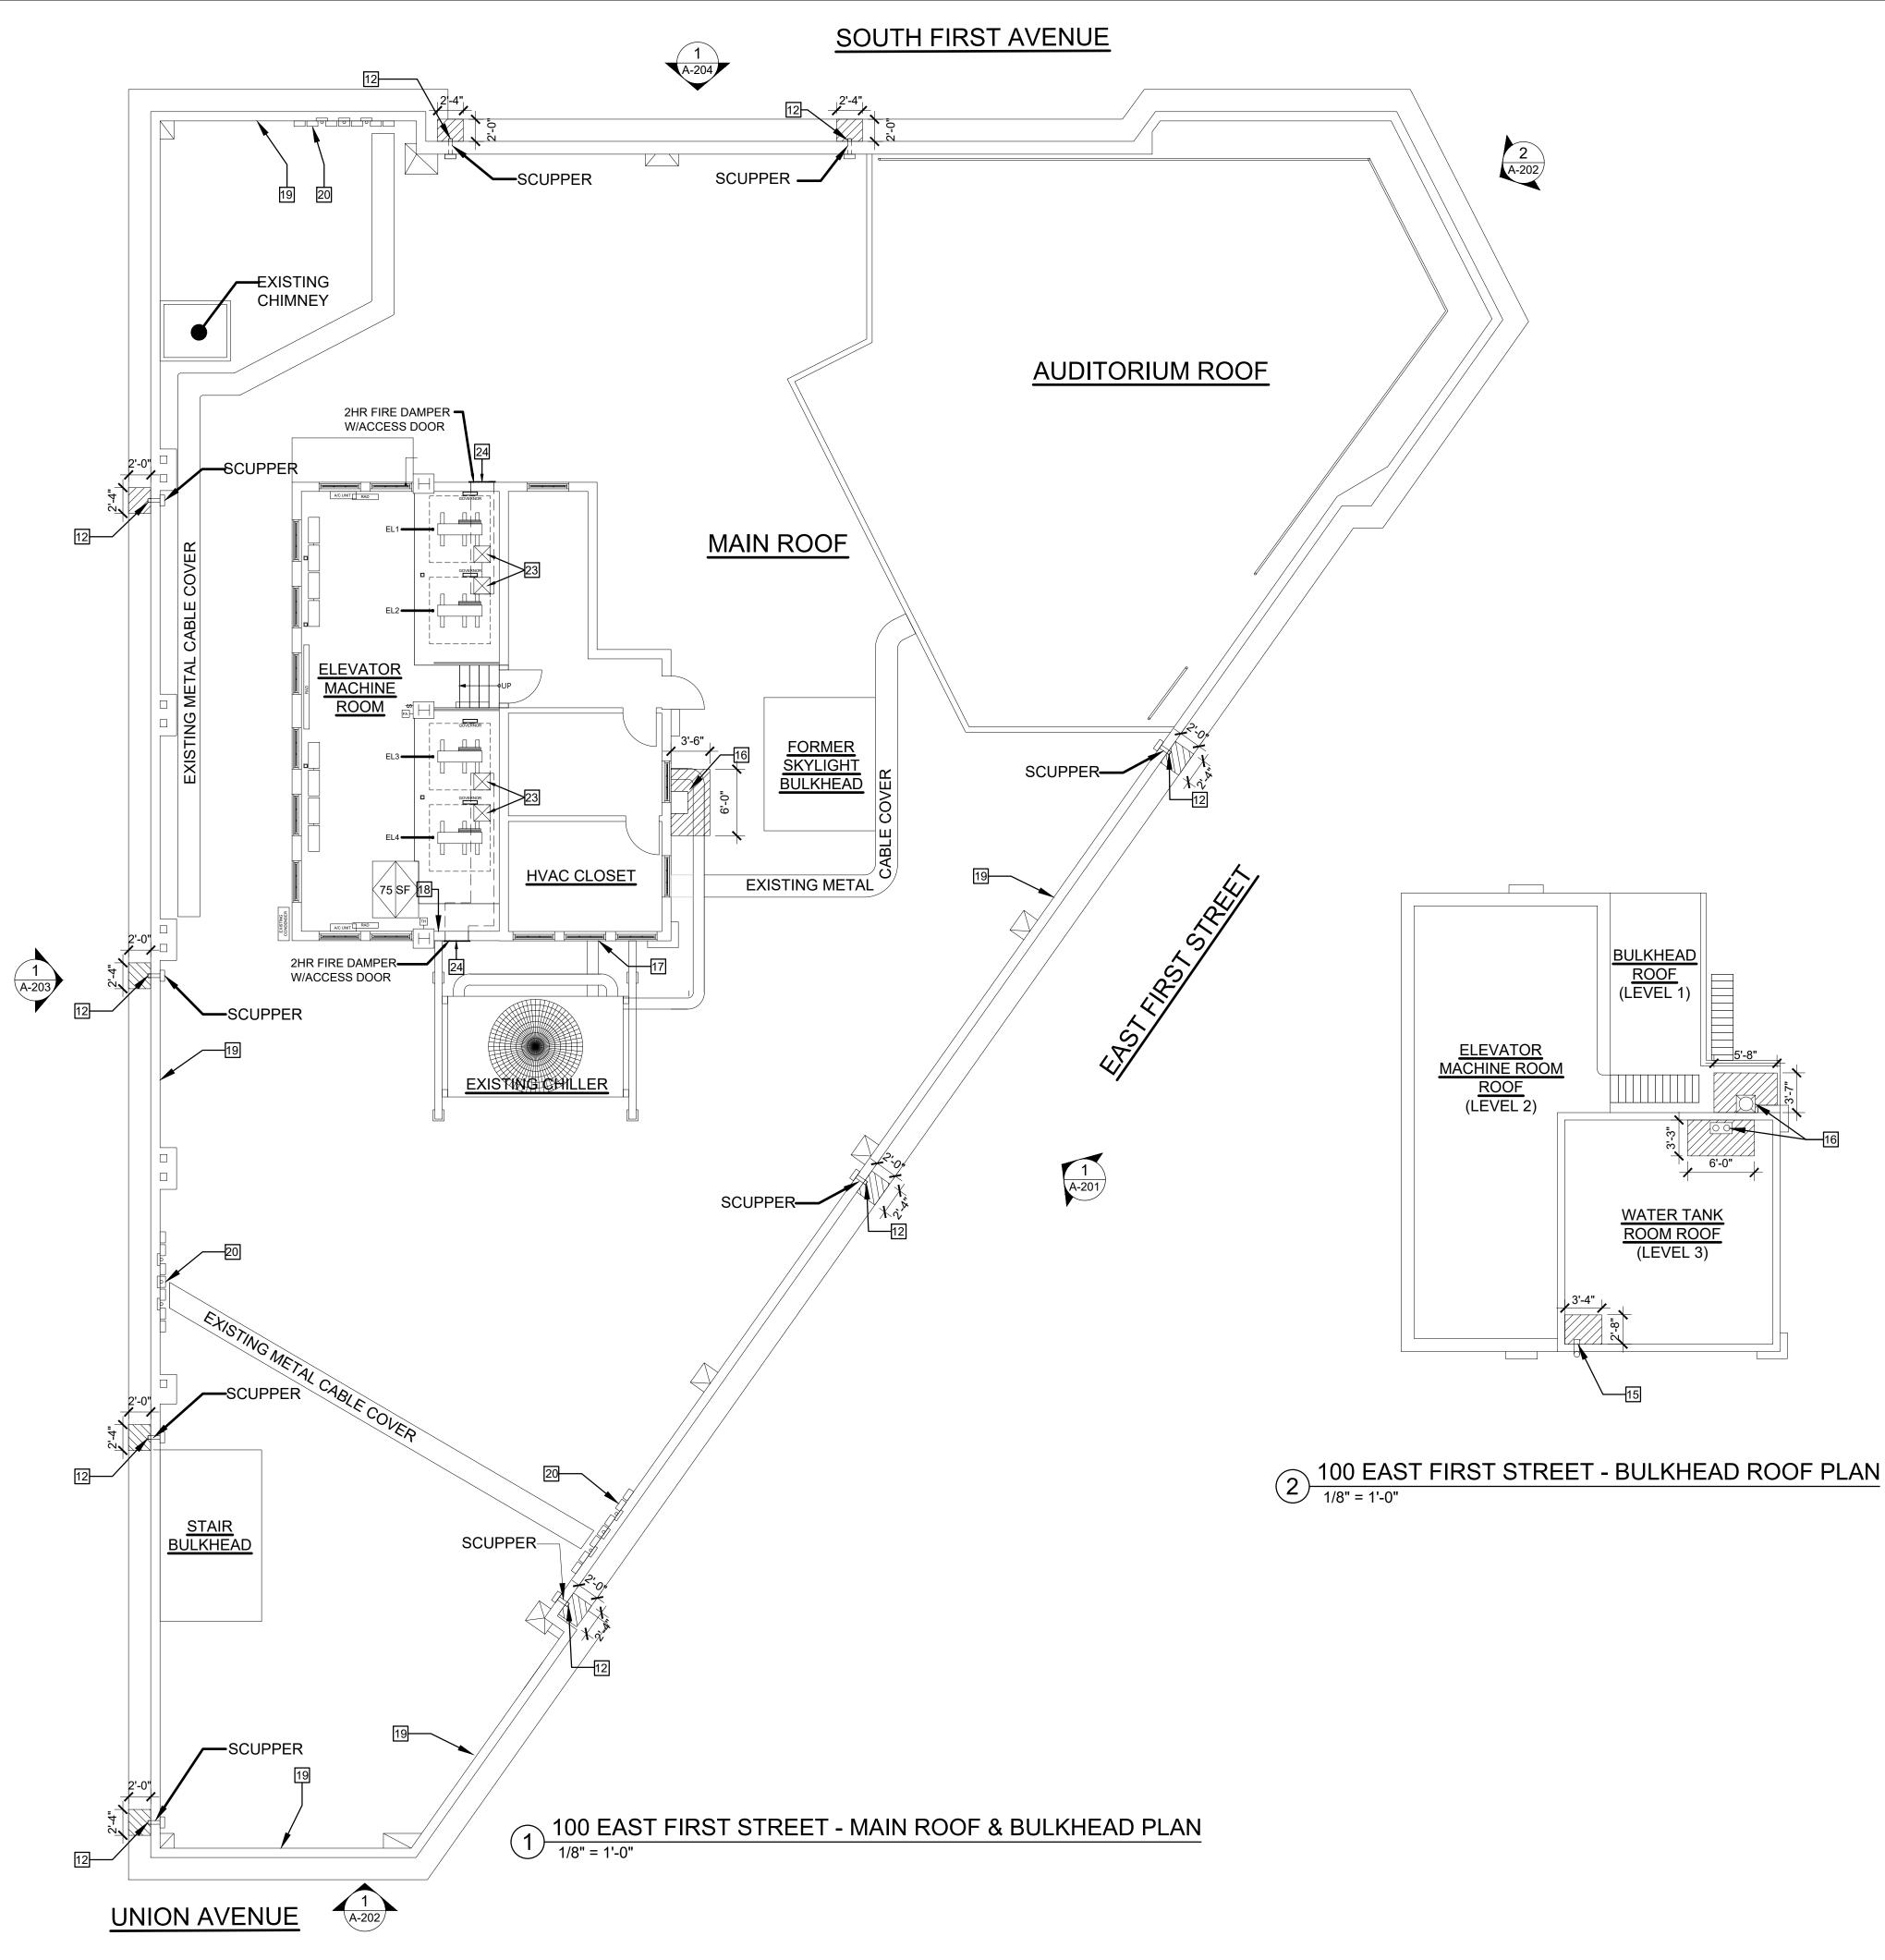

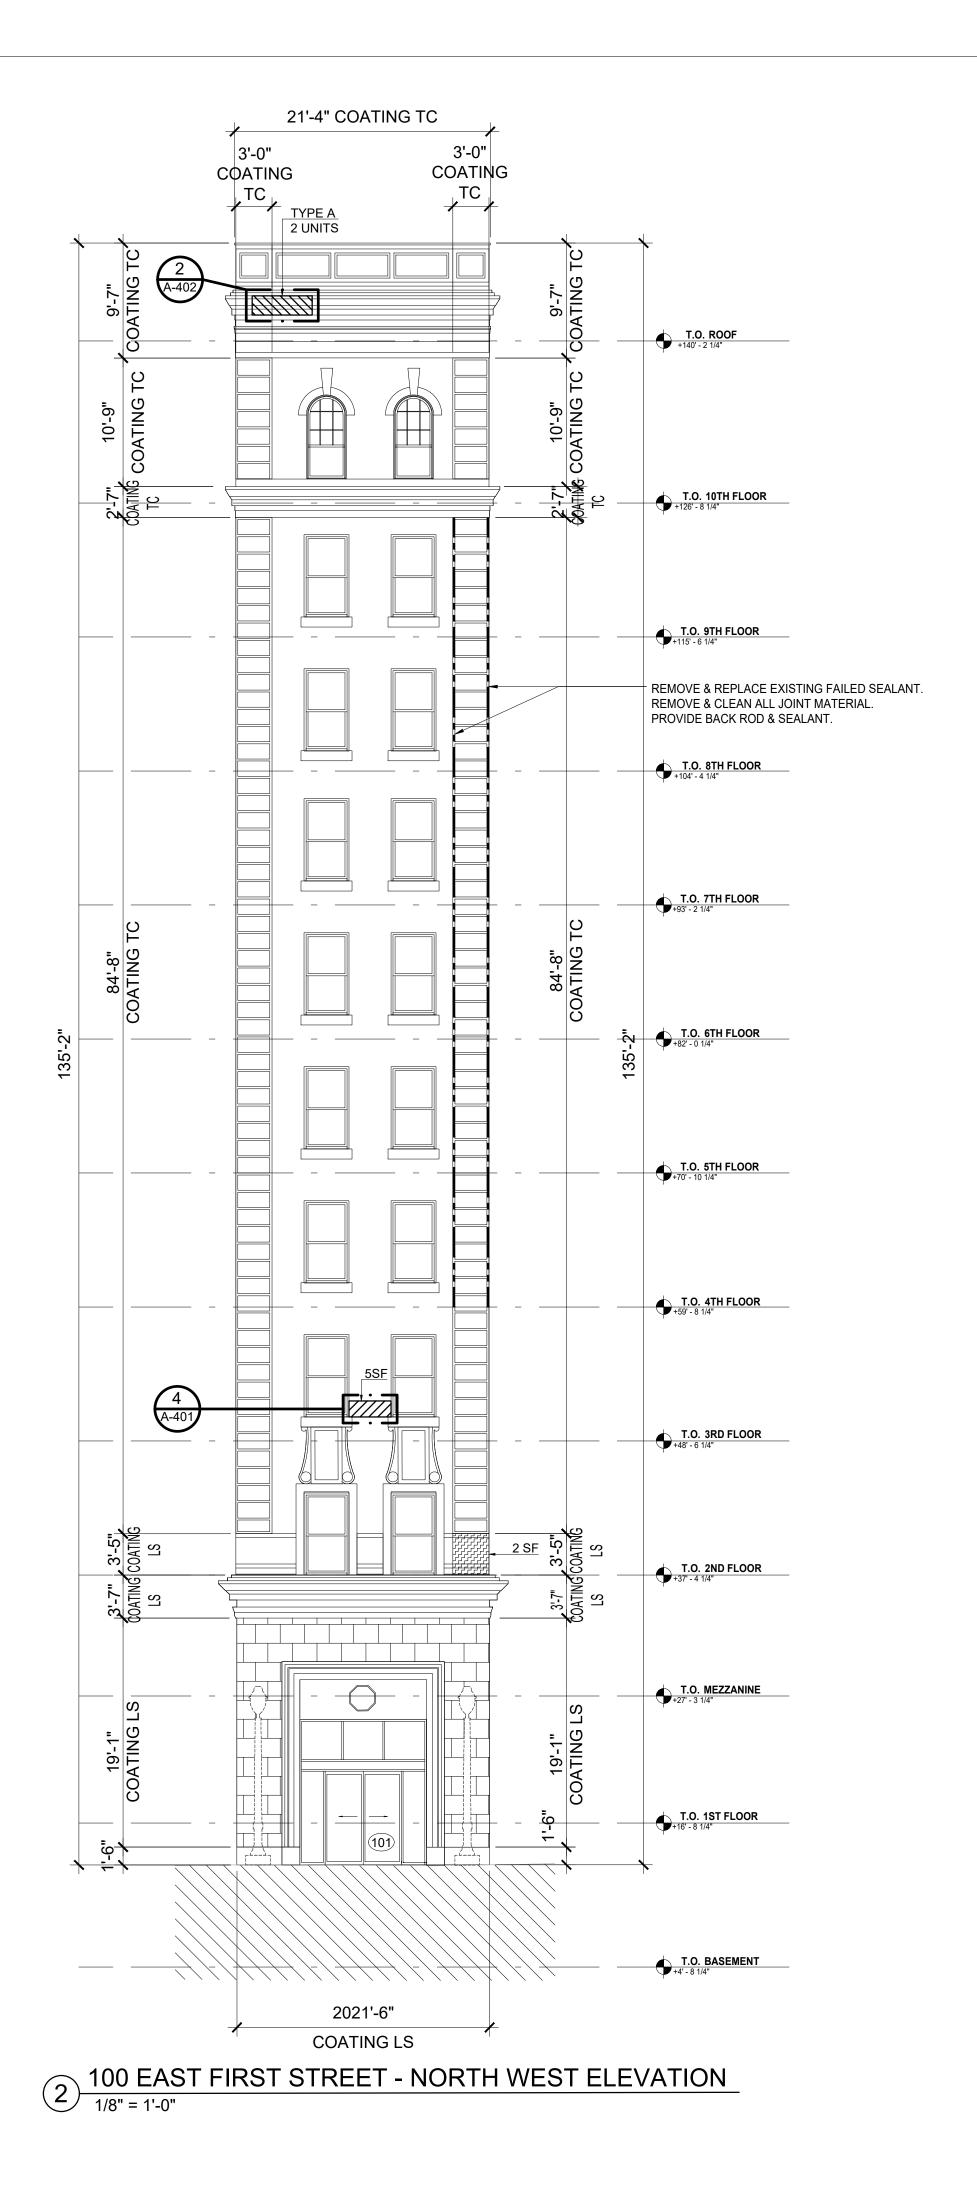

LEGEND	
	REMOVE & REPLACE DAMAGED BRICK: - 3 COURSES ABOVE & BELOW AT HORIZONTAL CRACKS - APPROX. 12" ALL AROUND LINE OF DIAGONAL CRACKS
	REMOVE & REPLACE DAMAGED TERRA COTTA UNIT, REFER TO DETAILS ON A-402
	PATCH DAMAGED LIMESTONE UNIT
$ \begin{array}{c} + & + & + & + & + \\ + & + & + & + & + &$	REMOVE AND RESET STONE
	RAKE AND POINT MASONRY JOINTS
	REMOVE & REPLACE EXISTING STEEL LINTEL ABOVE WINDOW, REFER TO DETAIL 1/A-402.
	REMOVE & REPLACE EXISTING LINTEL FLASHING ABOVE WINDOW, REFER TO DETAIL 1/A-402.
TERRA CO	TTA UNITS (SINGLE) BY TYPE
UNIT TYPE	
TYPE A: TYPE B:	30"W x 18"H ± (V.I.F.) 24"W x 6"H ± (V.I.F.)
TYPE C: TYPE D:	24"W x 24"H ± (V.I.F.) 36"W x 18"H ± (V.I.F.)
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REFERS TO LOCATION	NS NOTING "COATING": D AREAS OF EXISTING CEMENTITIOUS COATING. FOR THESE S, CONTRACTOR TO REMOVE ALL EXISTING CEMENTITIOUS & APPLY BREATHABLE COATING.
ON ALL TE (STREET S WINDOWS)	<u>ST STREET:</u> RRA COTTA (TC) & LIMESTONE (LS) - INCLUDES PARAPETS IDE), CORNICES, SCROLLS ABOVE WINDOWS, BASE BELOW , BALLUSTRADES & GROUND LEVEL. - INCLUDES PARAPETS (ROOF SIDE).
9 UNION AV	
NOTES: IN	ADDITION TO WORK INDICATED ON PLANS & ELEVATIONS, HE FOLLOWING IN BASE BID:
OWNE	VANCE FOR 2,000 SF OF REPOINTING AT DISCRETION OF R/AoR BASED ON FIELD CONDITIONS DURING
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5. ALLOV	VANCE FOR 500 SF OF PATCHING & REPAIR OF MASONRY
	2
	100 EAST FIRST STREET
KEY PLAN	
ARCHITECT	
LiRo Architects + Pla	nners, P.C.
LiRo ARCHITECTS & PLAN	NERS, P.C.
ONE STATE STREET PLAZA, 28тн FI NEW YORK, NY 10004	,
TEL: 212-563-0280	
FAX: 212-563-1841	
APPR'D BY	REVISION
RECORD DRAWIN	IG CERTIFICATION
ES AS NOTED	
ANGES	PROJECT COORDINATOR
ACTOR	
	SIGNATURE:
_ DATE:	TITLE: DATE:


		NE TE	NE STATE STR W YORK, NY EL: 212-563-02 X: 212-563-18	280	LOOR			
REVISION NO.	DATE	MADE BY	APPR'D BY		REVISION			
				RECORD DRAWIN	IG CERTIFICATION			
		T - CHANGES T - NO CHAN)				
		CONTRAC	CTOR		PROJECT COC	RDINATOR		
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			DATE:		TITLE:	DATE:		
						CONTRACT NO.	SHEET NO).
		RTMENT OF	F PUBLIC	WORKS AND T	NEW YORK RANSPORTATION	18-508	A-202	2.00
		D	IVISION C	F ENGINEERIN	NG	SHEET NO. 09	OF 32	
BUILDING RENOVATIONS MOUNT VERNON DISTRICT OFFICE AND MOUNT VERNON DISTRICT OFFICE ANNEX 100 EAST FIRST STREET AND 9 UNION AVENUE				SCALE: ½ " = 1'-0" DATE: 05/28/2021				
		100 EA		RNON, NEW YORK	AVENUE	DPW FILE NO.		RE
100 EAS	T FIRST	STREET - EX	XTERIOR B	UILDING ELEVA	TIONS - EAST & NORTHWEST	54-24-A-3	352-0	C
1								

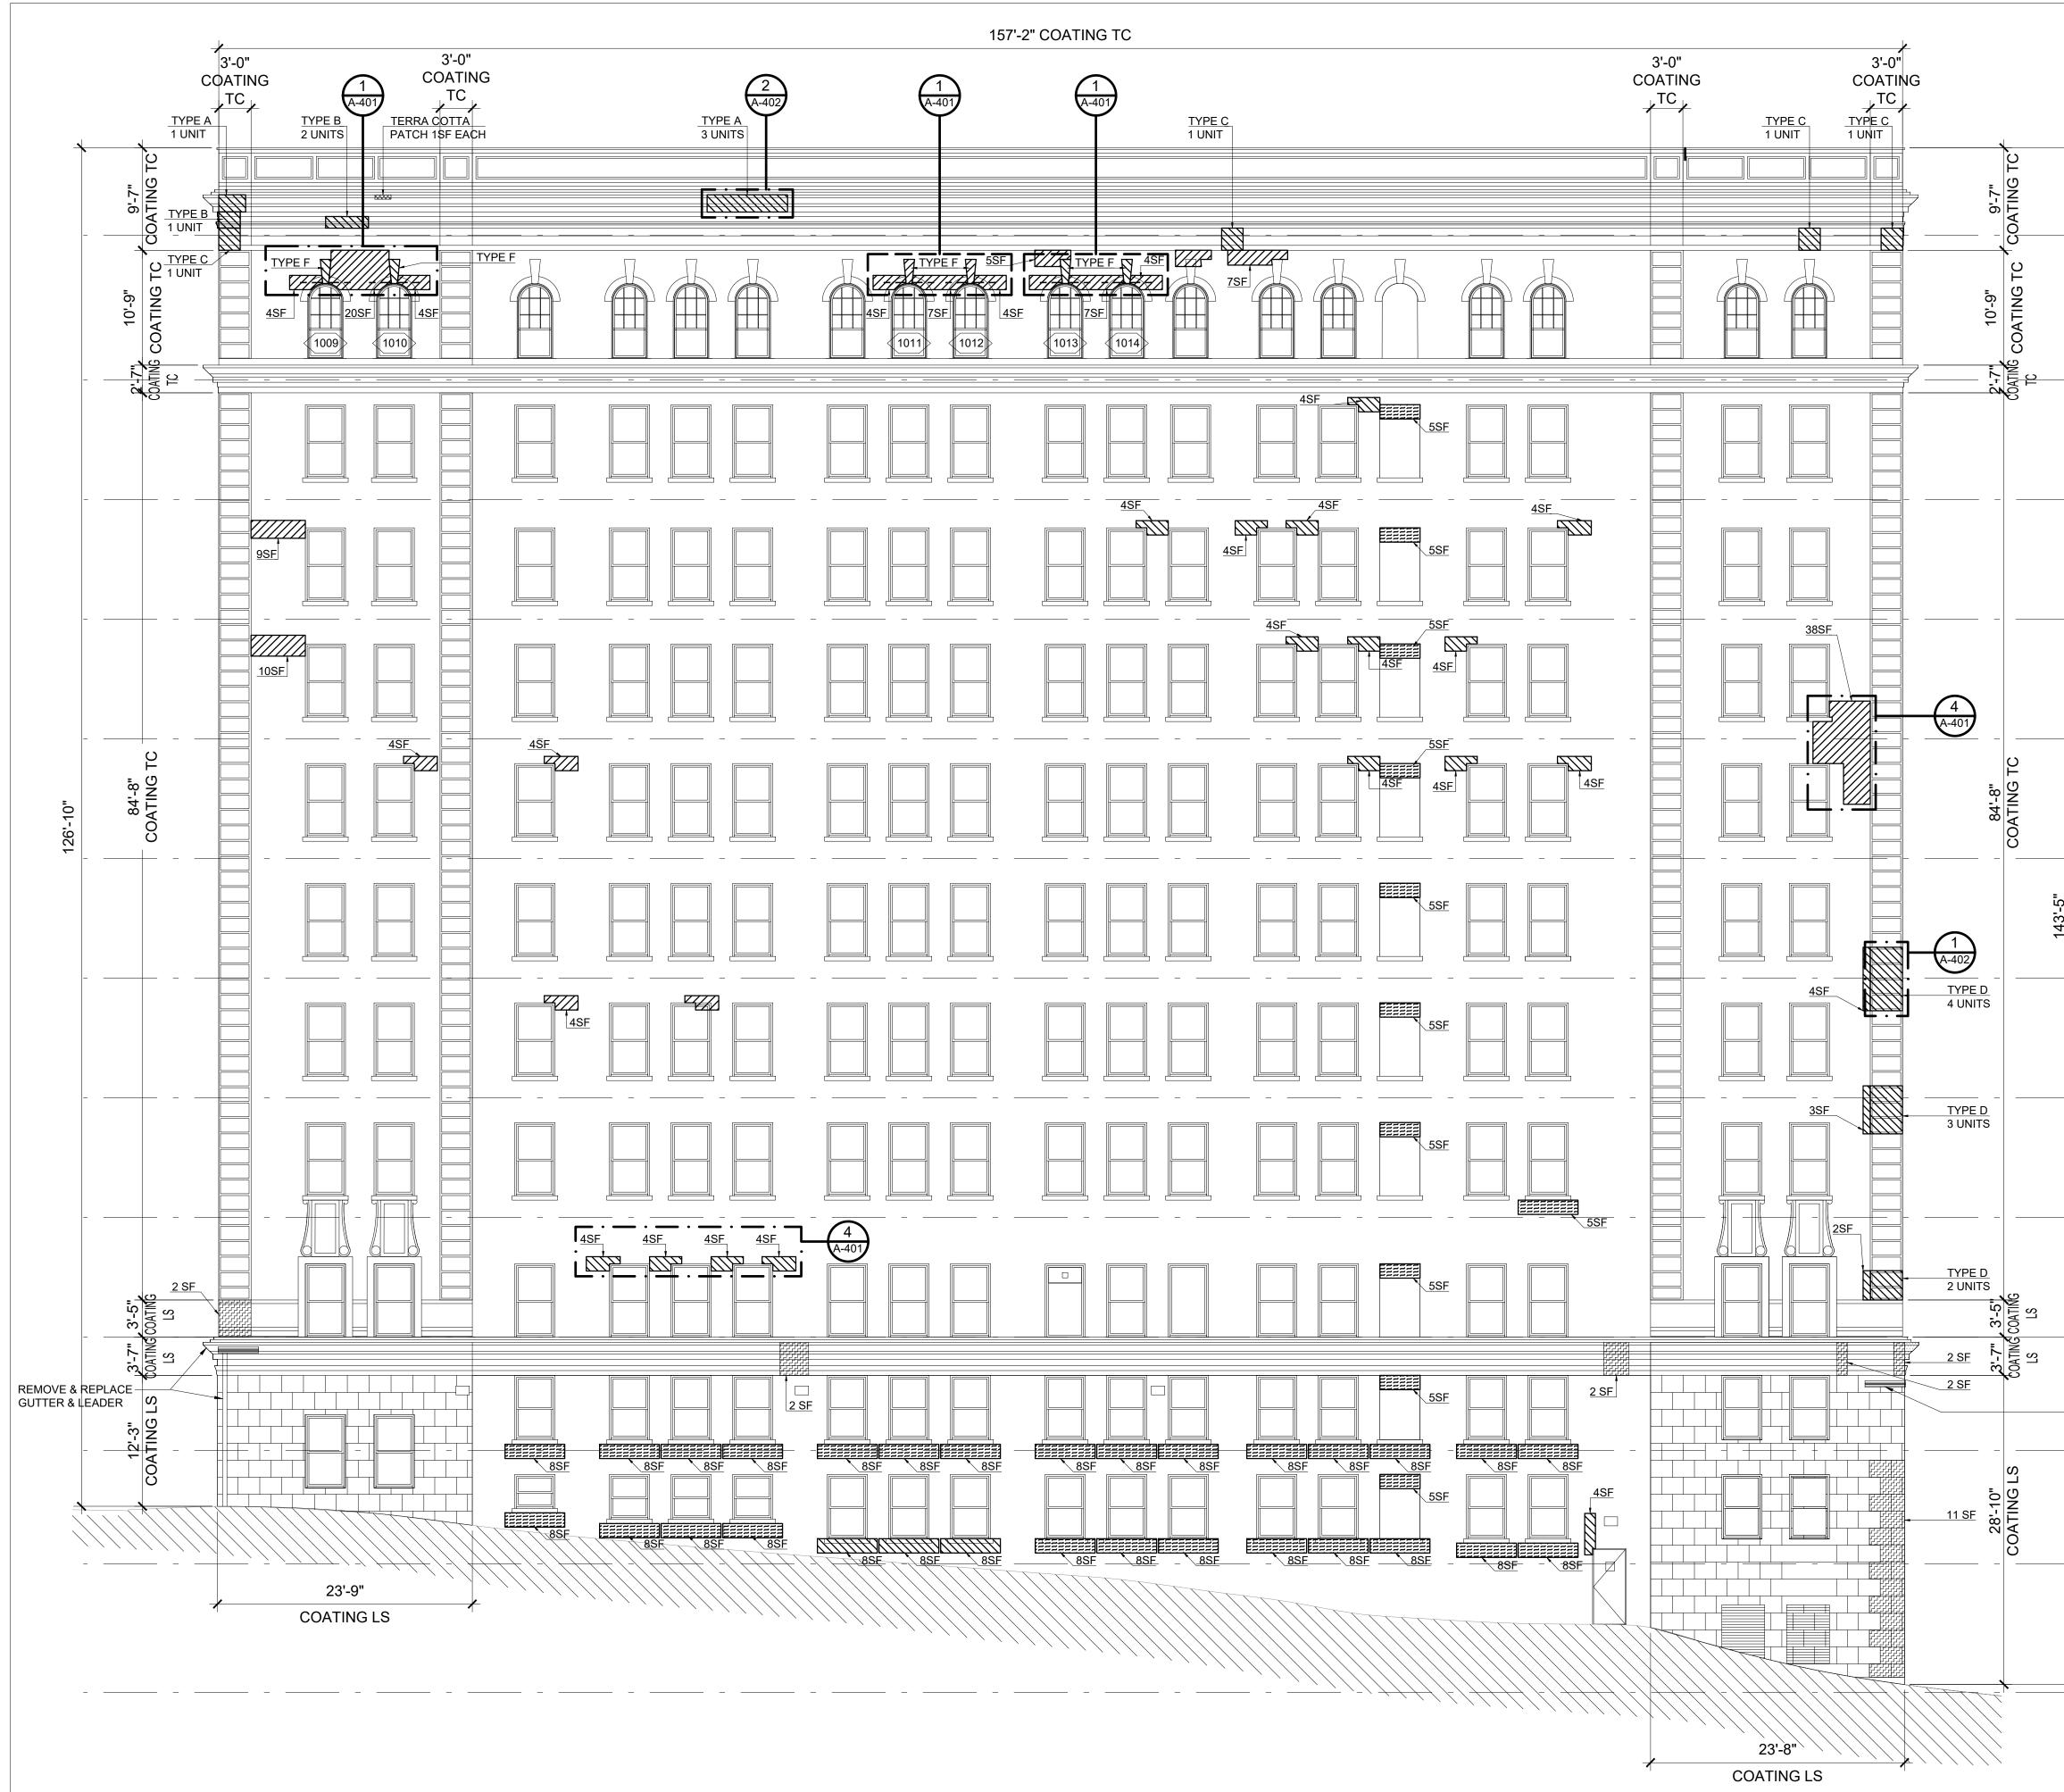

1 100 EAST FIRST STREET - SOUTH ELEVATION 1/8" = 1'-0"

				LEGEND		
					REMOVE & REPLACE DAMAGED - 3 COURSES ABOVE & BELOW - APPROX. 12" ALL AROUND LIN	AT HORIZONTAL CRACKS
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T.O. ROOF +140' - 2 1/4"				$\begin{array}{c} + & + & + & + \\ + & + & + & + & + \\ + & + &$	REMOVE AND RESET STONE	
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					REMOVE & REPLACE EXISTING WINDOW, REFER TO DETAIL 1/A	
T.O. 10TH FLOOR +126' - 8 1/4"				TERRA CO	TTA UNITS (SINGLE) BY TYPE	
T.O. 9TH FLOOR +115' - 6 1/4"				UNIT TYPE TYPE A: TYPE B: TYPE C: TYPE C: TYPE D: TYPE E: TYPE F: DIMENSION	$\frac{\text{DIMENSIONS} (\text{APPROXIMATE}}{30"W \times 18"H \pm (V.I.F.)} \\ 24"W \times 6"H \pm (V.I.F.) \\ 24"W \times 24"H \pm (V.I.F.) \\ 36"W \times 18"H \pm (V.I.F.) \\ 18"W \times 5"H \pm (V.I.F.) \\ 12"W \times 27"H \pm (V.I.F.) \\ \text{NOTING "COATING":} \\ \end{array}$)
				REFERS TO	AREAS OF EXISTING CEMENTIT S, CONTRACTOR TO REMOVE ALI	
T.O. 8TH FLOOR +104' - 4 1/4"				100 EAST 1 ON ALL TEF (STREET S WINDOWS,	<u>ST STREET:</u> RRA COTTA (TC) & LIMESTONE (L IDE), CORNICES, SCROLLS ABOV BALLUSTRADES & GROUND LEV INCLUDES PARAPETS (ROOF SI	E WINDOWS, BASE BELOW EL.
			_	9 UNION AN	/ <u>ENUE:</u> ICK SURFACES AS INDICATED.	
T.O. 7TH FLOOR					ADDITION TO WORK INDICATED HE FOLLOWING IN BASE BID:	ON PLANS & ELEVATIONS,
+93'-2 1/4"				OWNE CONST 2. ALLOW COTTA 3. ALLOW	VANCE FOR 2,000 SF OF REPOINT R/AoR BASED ON FIELD CONDITION RUCTION. REFER TO DETAIL 7/A VANCE FOR REPLACEMENT OF TH VEYSTONE (TYPE F) AT BRICK A VANCE FOR 1,000 SF OF BRICK RE	DNS DURING A-401. HREE (3) UNITS OF TERRA RCHES. EPLACEMENT.
T.O. 6TH FLOOR +82' - 0 1/4"					VANCE FOR 50 LF OF LINTEL REP VANCE FOR 500 SF OF PATCHING	
T.O. 5TH FLOOR +70' - 10 1/4"						FIRST/STREET
T.O. 4TH FLOOR +59' - 8 1/4"						
Π						\sim
T.O. 3RD FLOOR +48' - 6 1/4"			KEY PLAN			
		AR		_		
T.O. 2ND FLOOR +37' - 4 1/4"			LiRo Archit A LiRo Group C	ompany	nners, P.C.	
		ON	RO ARCHITECTS E STATE STREET PI W YORK, NY 10004			
 REMOVE & REPLACE GUTTER & LEADER T.O. MEZZANINE 		TEI	L: 212-563-0280 X: 212-563-1841			
T.O. MEZZANINE +27' - 3 1/4"						
T.O. 1ST FLOOR +16' - 8 1/4"	REVISION DATE NO.	MADE BY	APPR'D BY RECOF	RD DRAWIN	REVISION G CERTIFICATION	
			AS NOTED			
T.O. BASEMENT	AS BUILT	- NO CHAN CONTRAC			PROJECT C	OORDINATOR
+4' - 8 1/4"	NAME:					
	TITLE:					DATE: CONTRACT NO. SHEET NO.
				,	NEW YORK RANSPORTATION	18-508 A-203.00
		-	IVISION OF EN	GINEERIN		SHEET NO. 10 OF 32
	MOUNT VERM		ST FIRST STREET AN	NT VERNON	DISTRICT OFFICE ANNEX AVENUE	SCALE: ½ " = 1'-0" DATE: 05/28/2021 DPW FILE NO. REV
	100 EAST FI	RST STRE	MOUNT VERNON, ET - EXTERIOR		ELEVATIONS - SOUTH	54-24-A-353-0 0



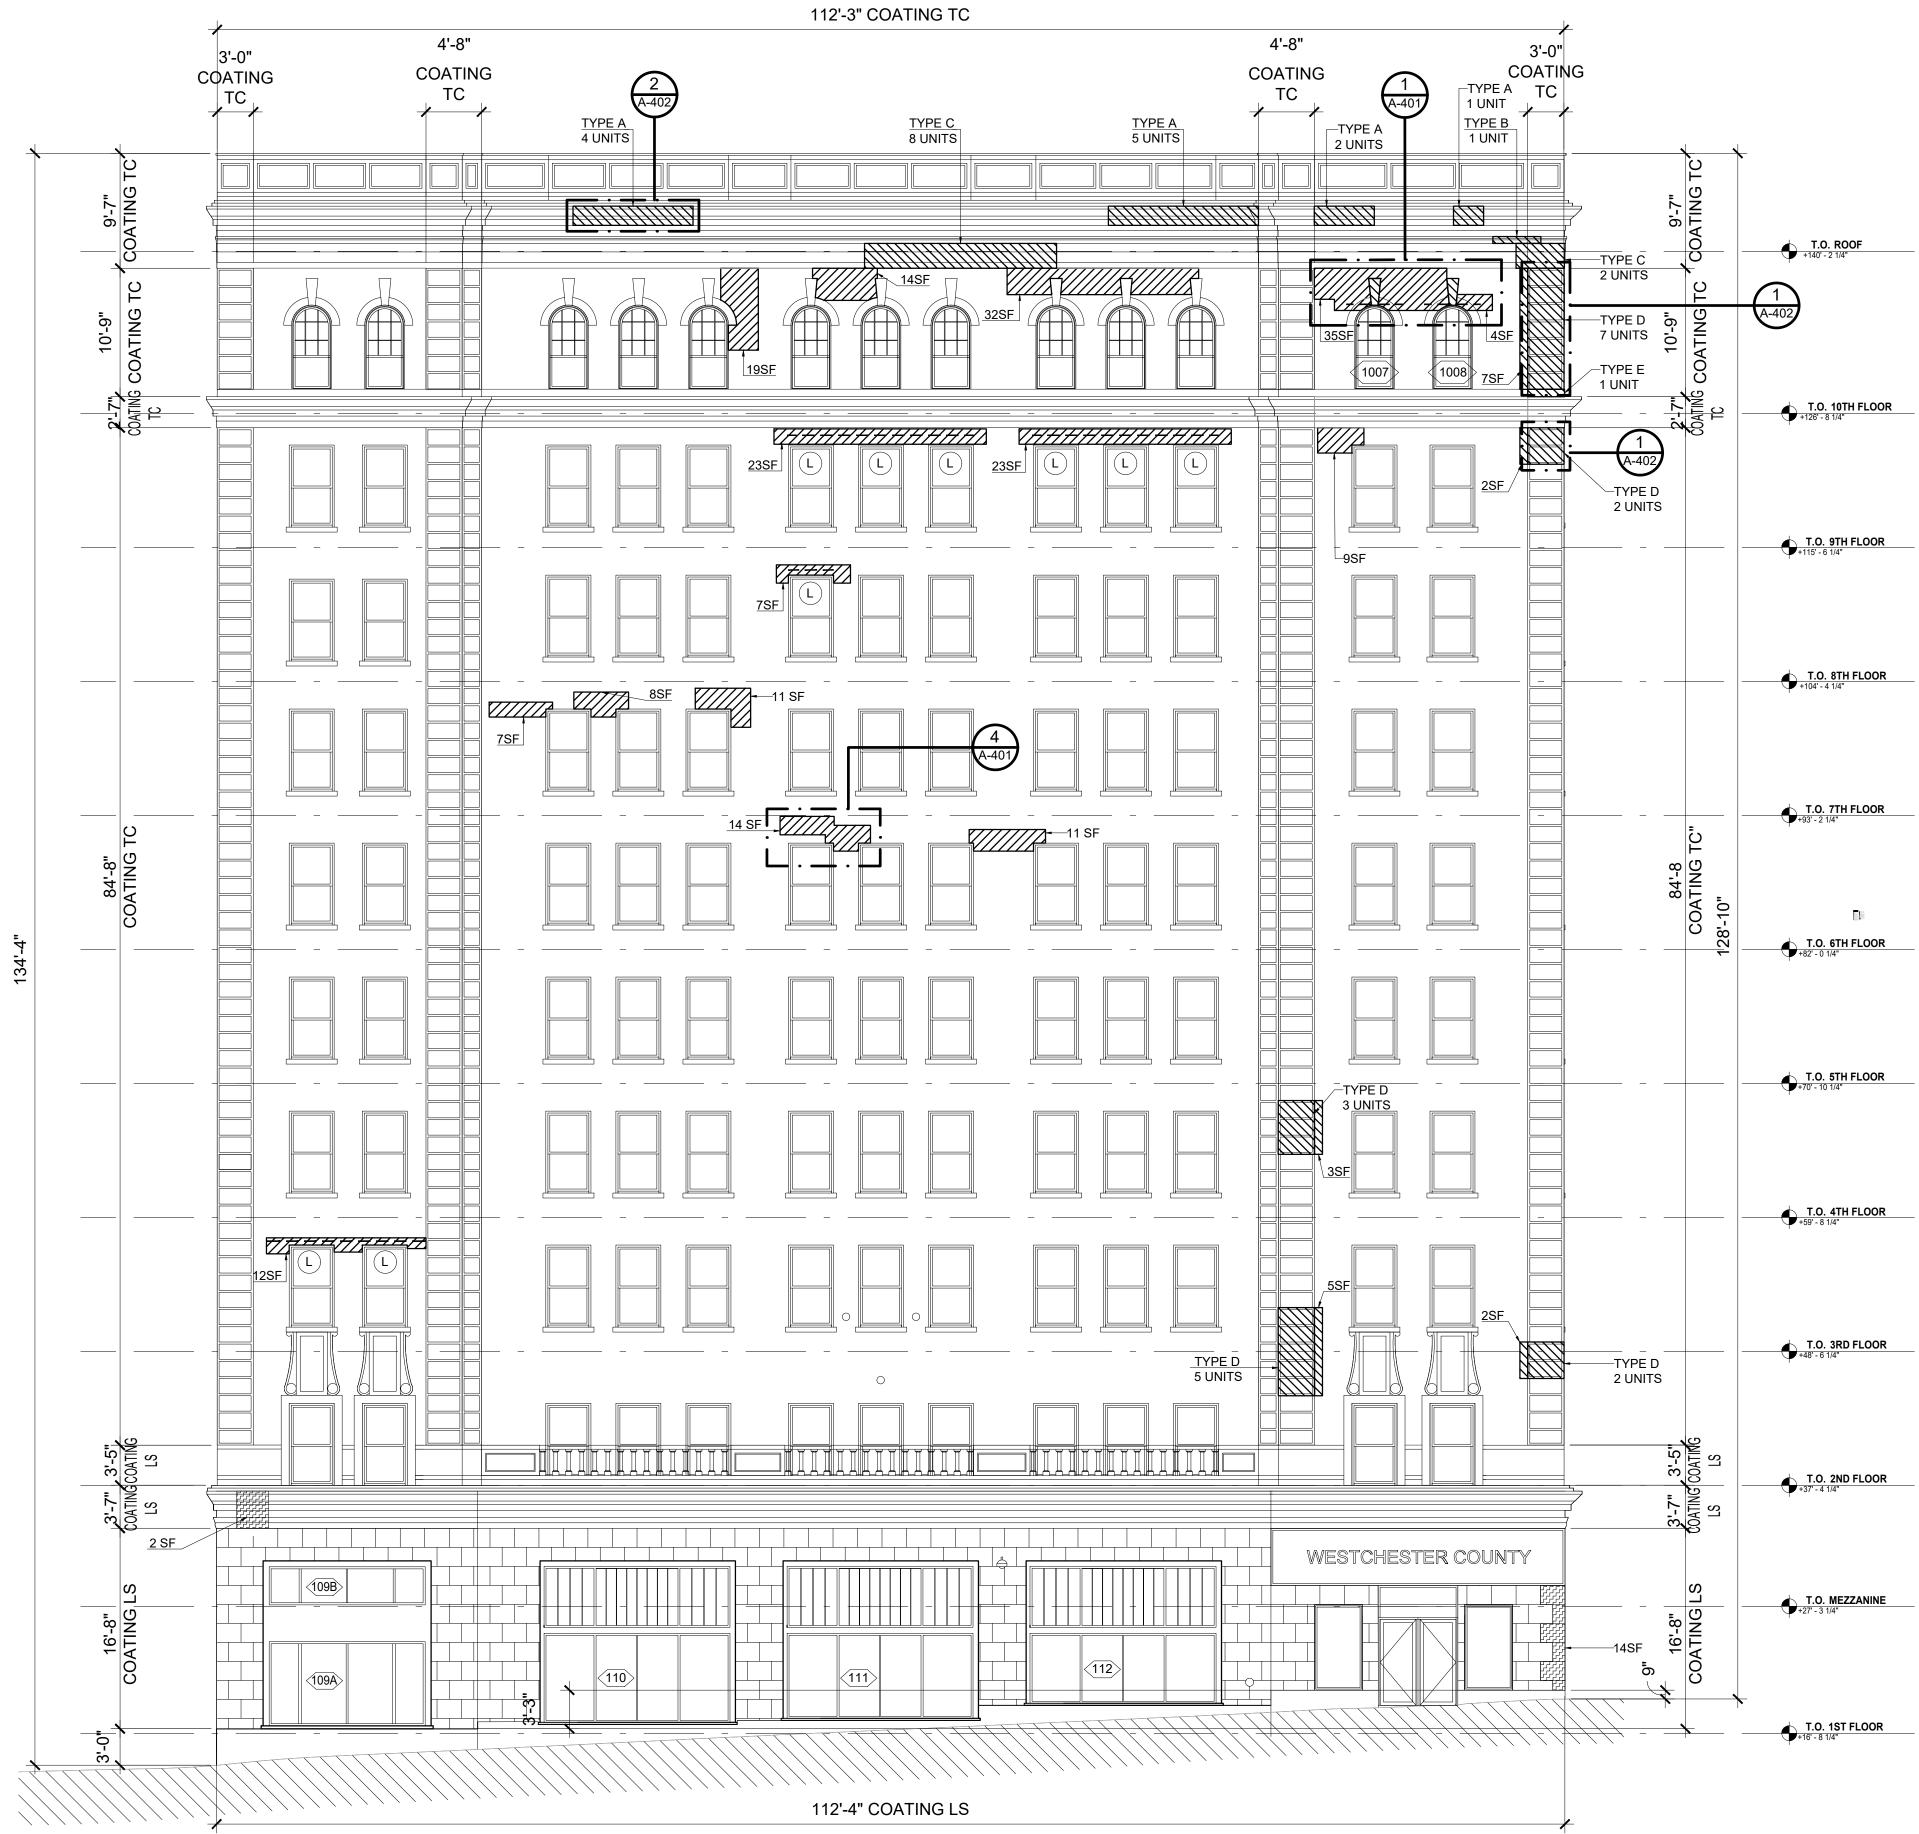

				LEGEND			
					REMOVE & REPLACE DAMAG - 3 COURSES ABOVE & BELC - APPROX. 12" ALL AROUND	W AT HORIZONTAL CRACKS	
					REMOVE & REPLACE DAMAG REFER TO DETAILS ON A-402		
					PATCH DAMAGED LIMESTON	IE UNIT	
				$\begin{array}{c} + & + & + & + & + \\ + & + & + & + & + \\ + & + &$	REMOVE AND RESET STONE		
					RAKE AND POINT MASONRY	JOINTS	
					REFER TO DETAIL 1/A-402.	NG STEEL LINTEL ABOVE WINDOV NG LINTEL FLASHING ABOVE	V,
				Ĺ	WINDOW, REFER TO DETAIL		
				TERRA CO	TA UNITS (SINGLE) BY TYPE		
				<u>UNIT TYPE</u> TYPE A:	DIMENSIONS (APPROXIMA 30"W x 18"H ± (V.I.F.)	<u>NTE)</u>	
				TYPE B: TYPE C:	24"W x 6"H ± (V.I.F.) 24"W x 24"H ± (V.I.F.)		
				TYPE D: TYPE E: TYPE F:	36"W x 18"H ± (V.I.F.) 18"W x 5"H ± (V.I.F.) 12"W x 27"H ± (V.I.F.)		
				REFERS TO		TITIOUS COATING. FOR THESE ALL EXISTING CEMENTITIOUS IG.	
				ON ALL TEF (STREET SI WINDOWS,			
				9 UNION AV	ENUE: CK SURFACES AS INDICATED		
				NOTES: IN		ED ON PLANS & ELEVATIONS,	
				1. ALLOW	ANCE FOR 2,000 SF OF REPC		
				CONST	R/AoR BASED ON FIELD COND RUCTION. REFER TO DETAIL	7/A-401.	
				COTTA	KEYSTONE (TYPE F) AT BRIC		
				4. ALLOW	ANCE FOR 1,000 SF OF BRICH ANCE FOR 50 LF OF LINTEL F ANCE FOR 500 SF OF PATCH	REPLACEMENT.	
					100 E.	AST/FIRST/STREET	
			<u>KEY I</u>	PLAN		$\langle \rangle$	
		ARC	CHITECT				
			R LiRo	Architects + Plan Group Company	nners, P.C.		
		LiR	o ARCHIT	ECTS & PLAN	IERS, P.C.		
		ONE NEV TEL		EET PLAZA, 28тн FL 10004 80			
	D.475						
evision Io.	DATE	MADE BY	APPR'D BY				
	AS BI III T	- CHANGES					
		- NO CHANC					
		CONTRACT	ſOR		PROJEC	CT COORDINATOR	
IAME:					NAME:		

WESTCHESTER COUNTY, NEW YORK DEPARTMENT OF PUBLIC WORKS AND TRANSPORTATION DIVISION OF ENGINEERING

DATE:

SIGNATURE:

DATE: __

CONTRACT NO. SHEET NO.

SHEET NO. 11 OF 32

SCALE: **½**" = 1'-0" DATE: 05/28/2021

DPW FILE NO.

18-508 A-204.00

54-24-A-354-0 0

REV. NO.

TITLE:

REVISION DATE


NO.

NAME: SIGNATURE: _


TITLE:

BUILDING RENOVATIONS MOUNT VERNON DISTRICT OFFICE AND MOUNT VERNON DISTRICT OFFICE ANNEX 100 EAST FIRST STREET AND 9 UNION AVENUE MOUNT VERNON, NEW YORK

100 EAST FIRST STREET - EXTERIOR BUILDING ELEVATIONS - WEST

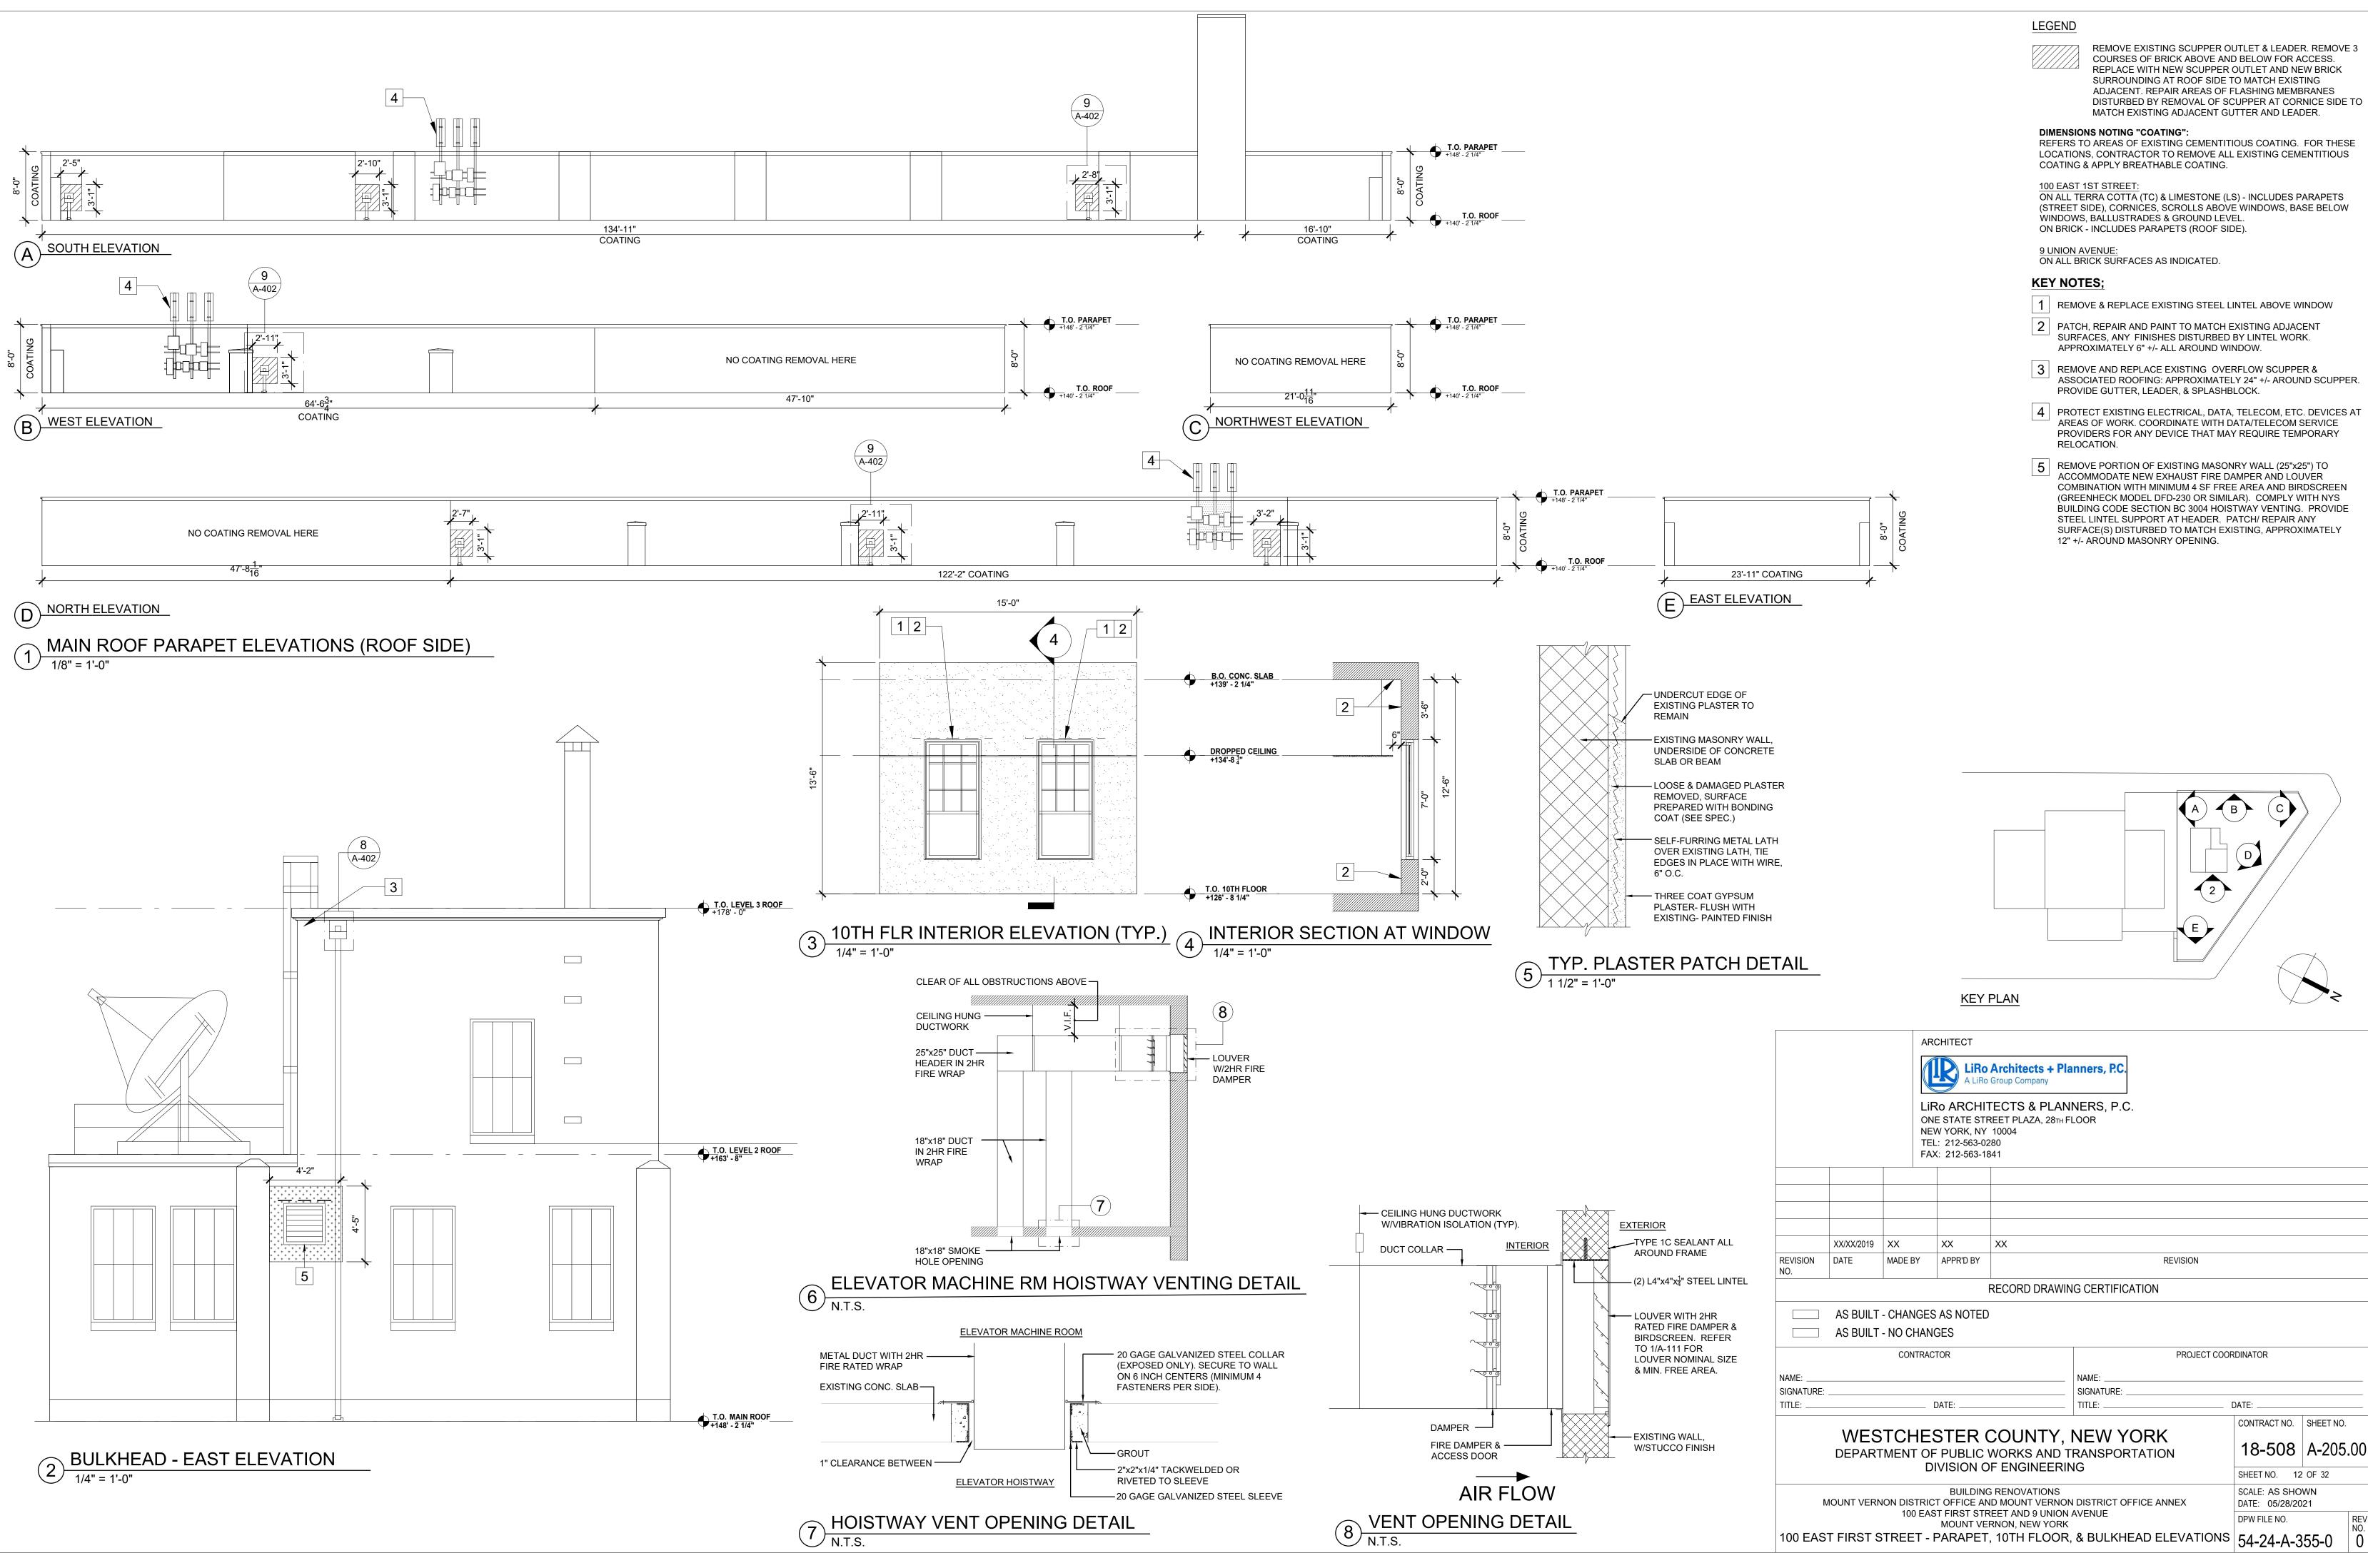



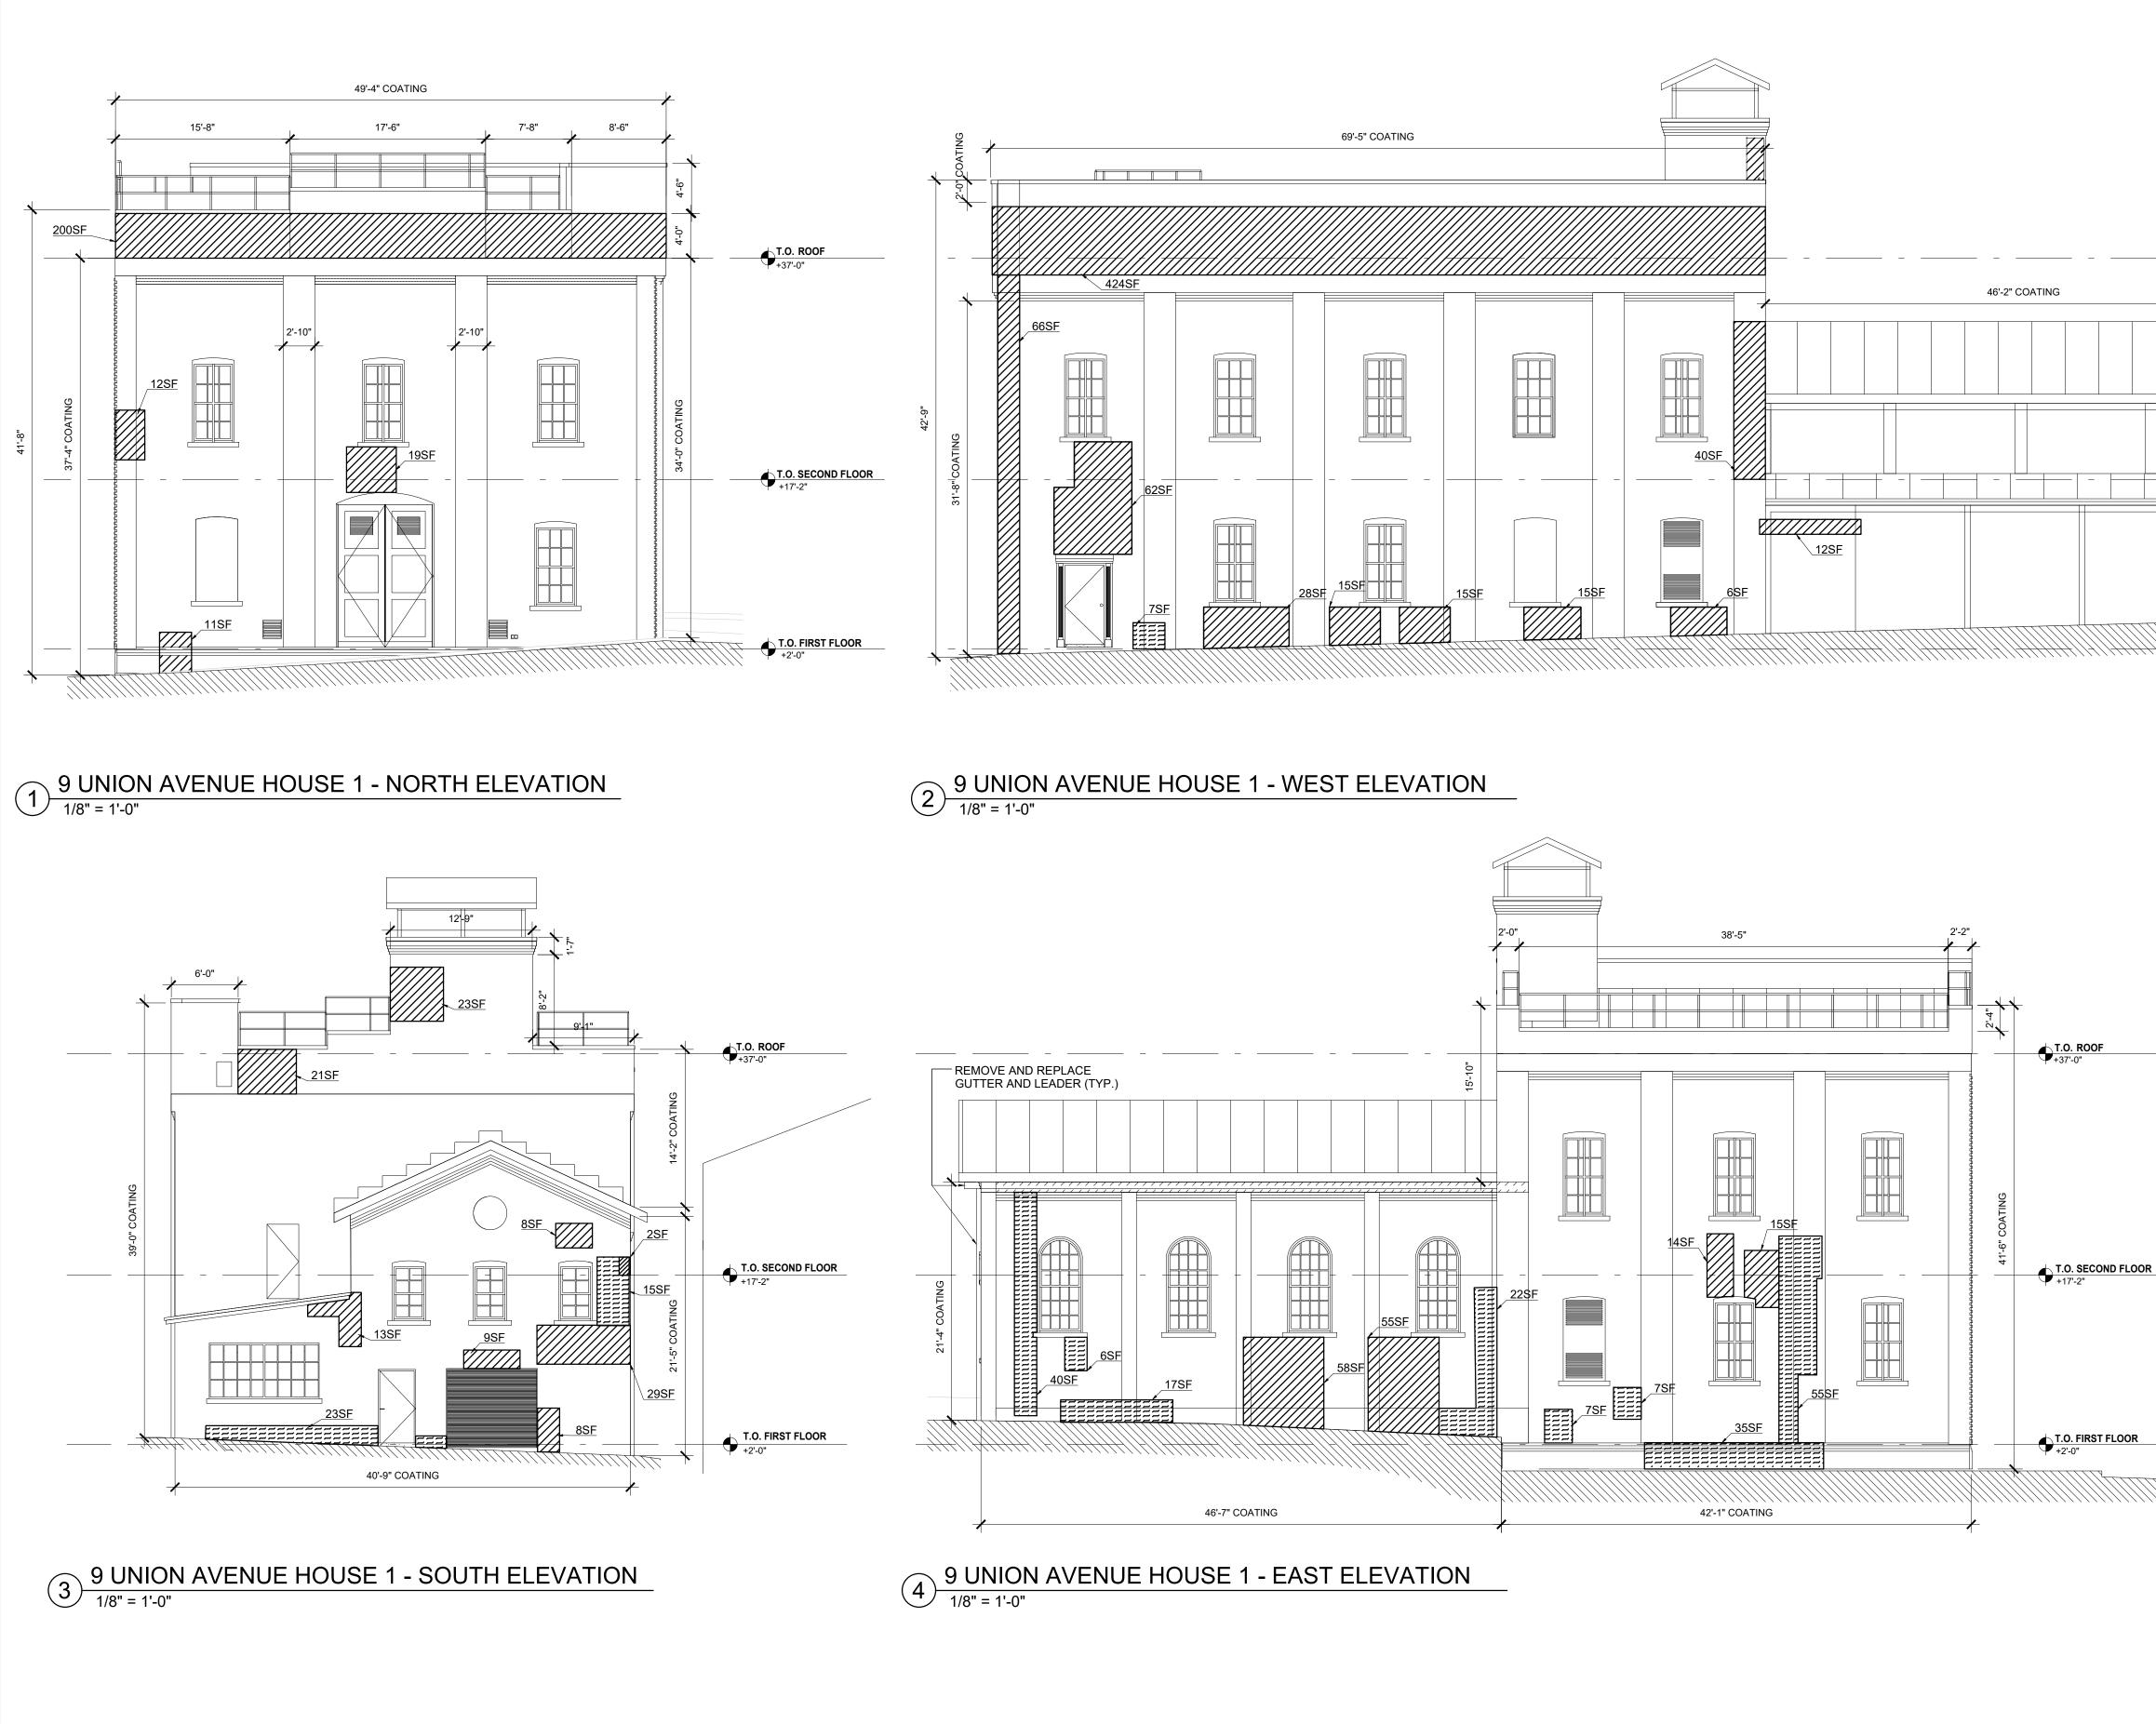

T.O. ROOF +37'-0" WINDOWS, BALLUSTRADES & GROUND LEVEL. ON BRICK - INCLUDES PARAPETS (ROOF SIDE). 9 UNION AVENUE: ON ALL BRICK SURFACES AS INDICATED. NOTES: IN ADDITION TO WORK INDICATED ON PLANS & ELEVATIONS, PROVIDE THE FOLLOWING IN BASE BID: 1. ALLOWANCE FOR 2,000 SF OF REPOINTING AT DISCRETION OF OWNER/AOR BASED ON FIELD CONDITIONS DURING CONSTRUCTION. REFER TO DETAIL 7/A-401. 2. ALLOWANCE FOR REPLACEMENT OF THREE (3) UNITS OF TERRA COTTA KEYSTONE (TYPE F) AT BRICK ARCHES. - REMOVE AND REPLACE 3. ALLOWANCE FOR 1,000 SF OF BRICK REPLACEMENT. GUTTER AND LEADER (TYP.) 4. ALLOWANCE FOR 50 LF OF LINTEL REPLACEMENT. T.O. SECOND FLOOR +17'-2" 5. ALLOWANCE FOR 500 SF OF PATCHING & REPAIR OF MASONRY **T.O. FIRST FLOOR** +2'-0" 100 EAST FIRST STREET 2 3 9/UNION/AVÉ HOUSE/1 9 UNION AVE HOUSE 2 <u>KEY PLAN</u> ARCHITECT LiRo Architects + Planners, P.C. A LiRo Group Company LIRO ARCHITECTS & PLANNERS, P.C. ONE STATE STREET PLAZA, 28TH FLOOR NEW YORK, NY 10004 TEL: 212-563-0280 FAX: 212-563-1841 REVISION REVISION DATE MADE BY APPR'D BY NO RECORD DRAWING CERTIFICATION AS BUILT - CHANGES AS NOTED AS BUILT - NO CHANGES CONTRACTOR PROJECT COORDINATOR NAME: NAME: SIGNATURE: SIGNATURE: TITLE: _ DATE: _ TITLE: DATE: __ CONTRACT NO. SHEET NO. WESTCHESTER COUNTY, NEW YORK 18-508 A-206.00 DEPARTMENT OF PUBLIC WORKS AND TRANSPORTATION **DIVISION OF ENGINEERING** SHEET NO. 13 OF 32 SCALE: **½**" = 1'-0" DATE: 05/28/2021 BUILDING RENOVATIONS MOUNT VERNON DISTRICT OFFICE AND MOUNT VERNON DISTRICT OFFICE ANNEX 100 EAST FIRST STREET AND 9 UNION AVENUE DPW FILE NO. REV. MOUNT VERNON, NEW YORK 54-24-A-356-0 0 9 UNION AVENUE HOUSE 1 - EXTERIOR BUILDING ELEVATIONS

LEGEND


REMOVE & REPLACE DAMAGED BRICK: - 3 COURSES ABOVE & BELOW AT HORIZONTAL CRACKS - APPROX. 12" ALL AROUND LINE OF DIAGONAL CRACKS

RAKE AND POINT MASONRY JOINTS


DIMENSIONS NOTING "COATING":

REFERS TO AREAS OF EXISTING CEMENTITIOUS COATING. FOR THESE LOCATIONS, CONTRACTOR TO REMOVE ALL EXISTING CEMENTITIOUS COATING & APPLY BREATHABLE COATING.

100 EAST 1ST STREET: ON ALL TERRA COTTA (TC) & LIMESTONE (LS) - INCLUDES PARAPETS (STREET SIDE), CORNICES, SCROLLS ABOVE WINDOWS, BASE BELOW

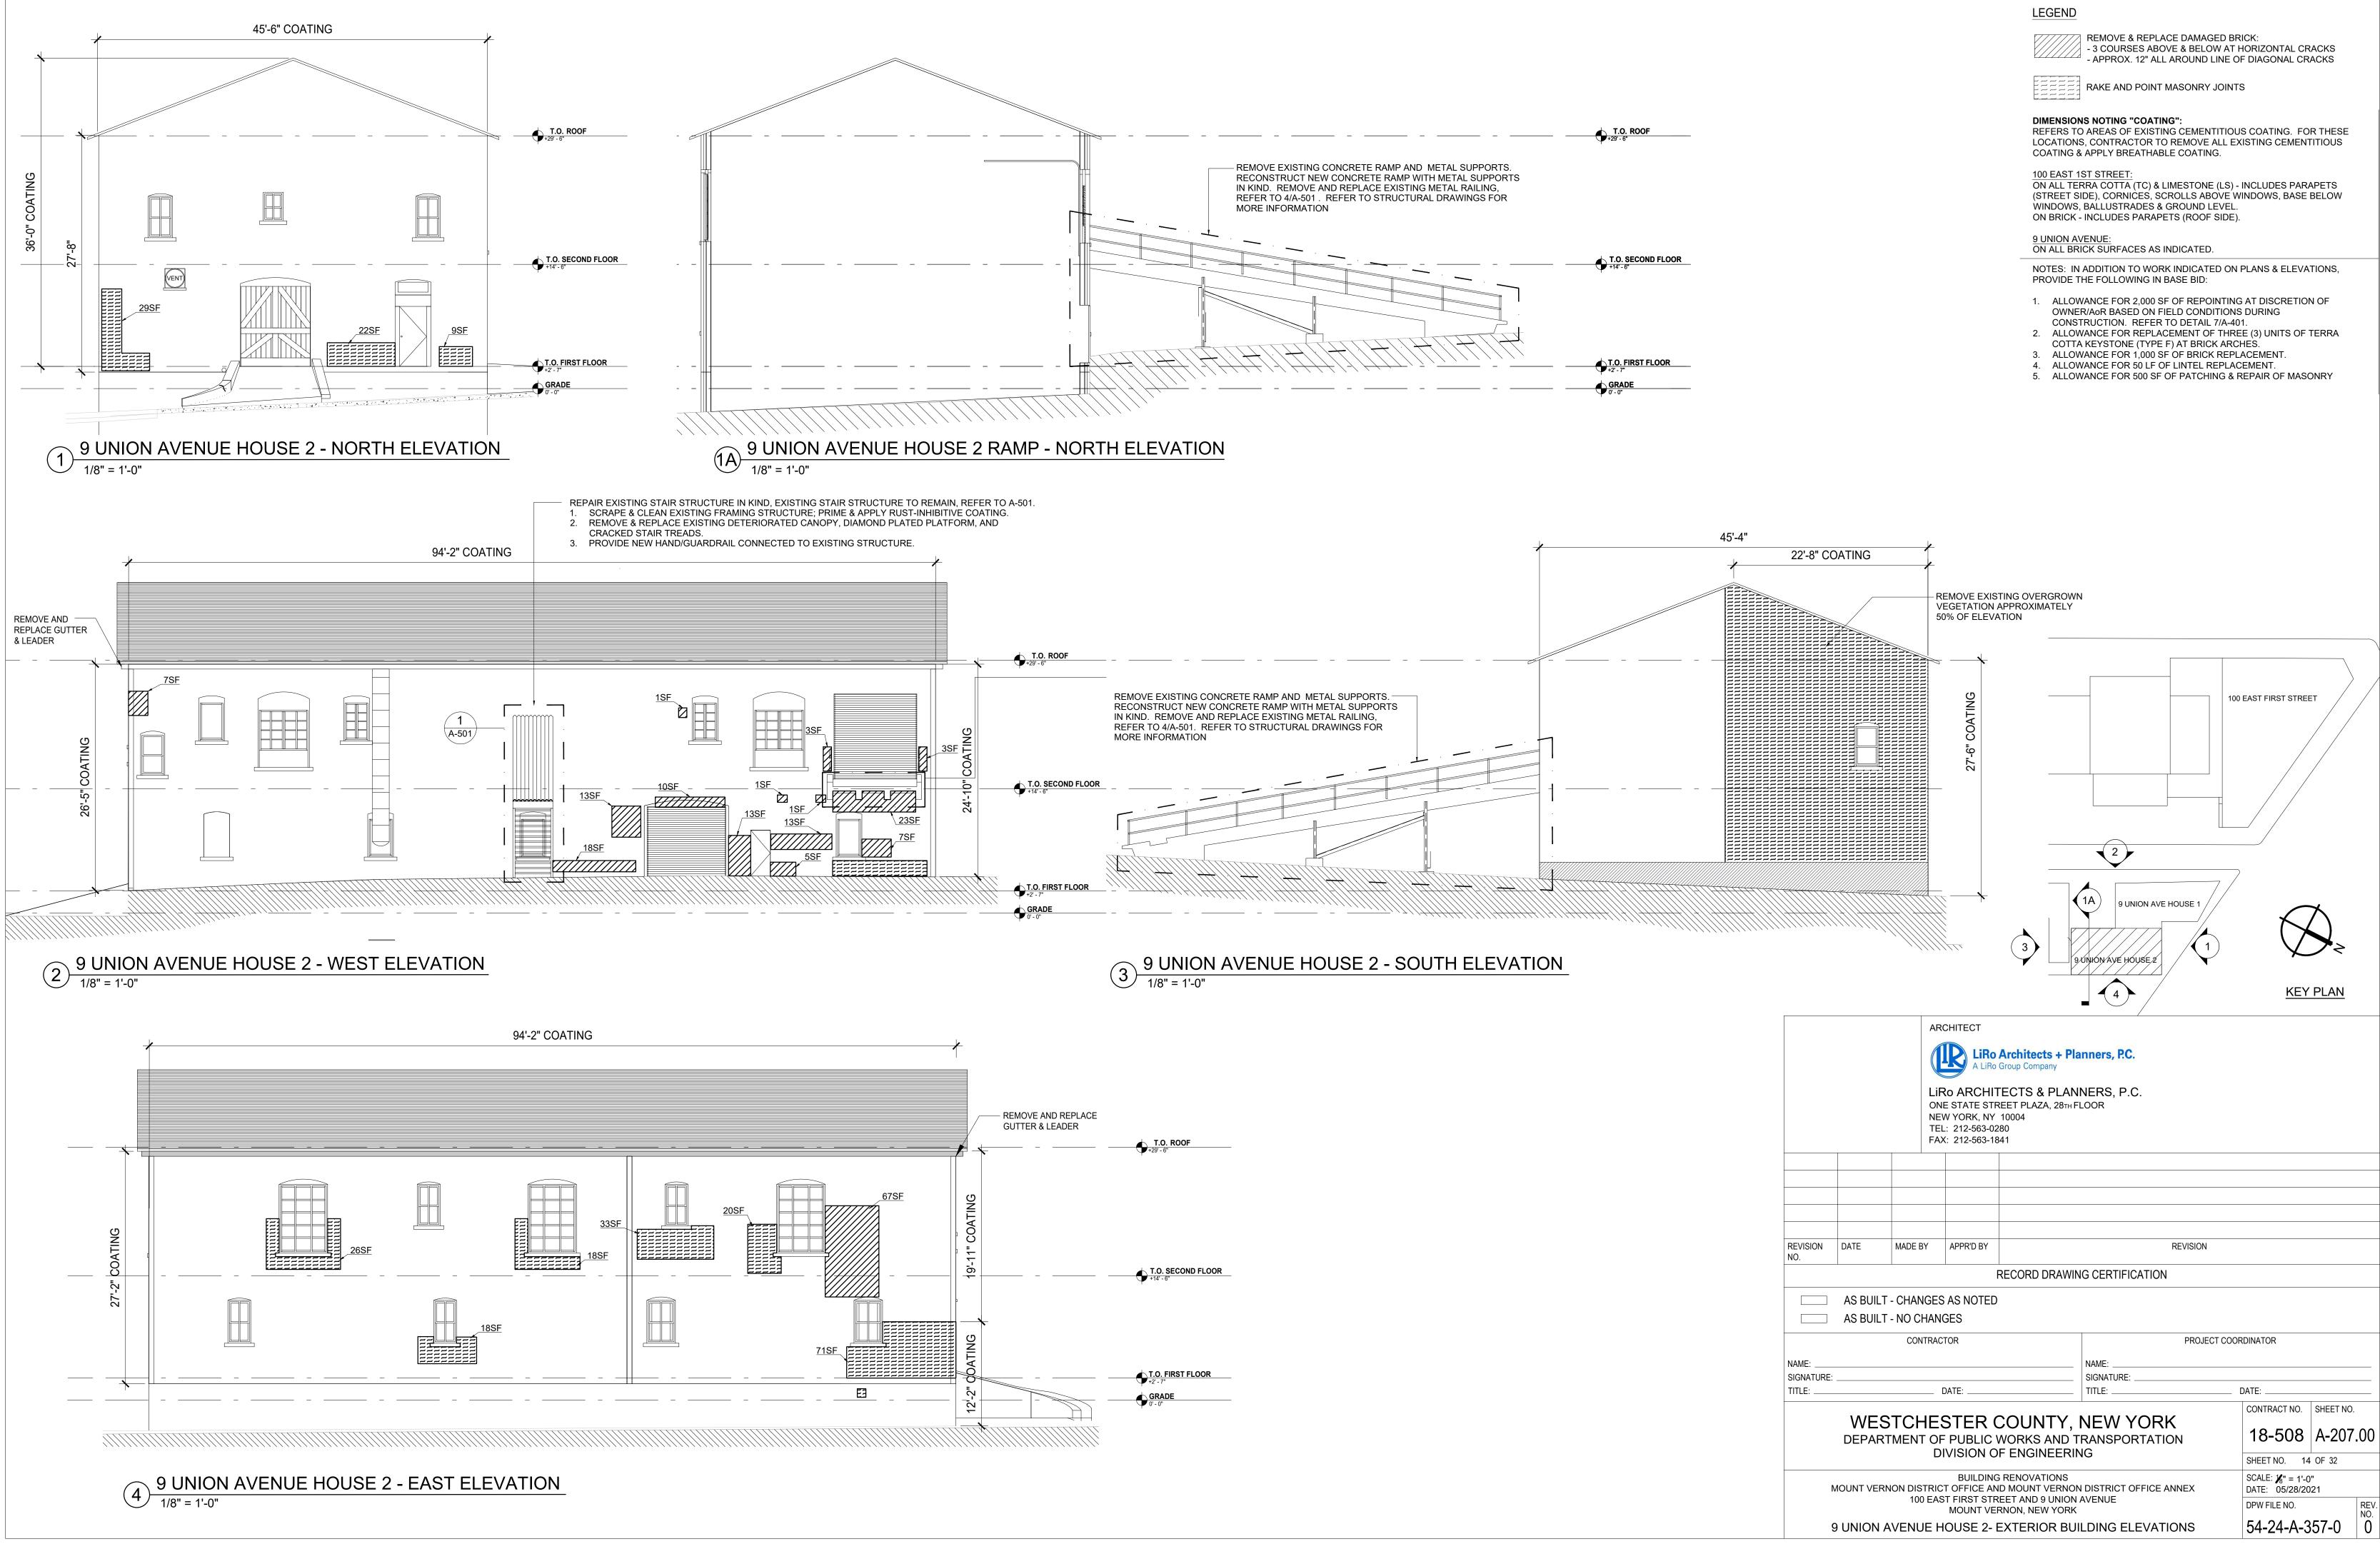

REMOVE & REPLACE DAMAGED BRICK:
REMOVE & REPLACE DAMAGED BRICK: - 3 COURSES ABOVE & BELOW AT HORIZ - APPROX. 12" ALL AROUND LINE OF DIA
- APPROX, 12" ALL AROUND LINE OF DIA

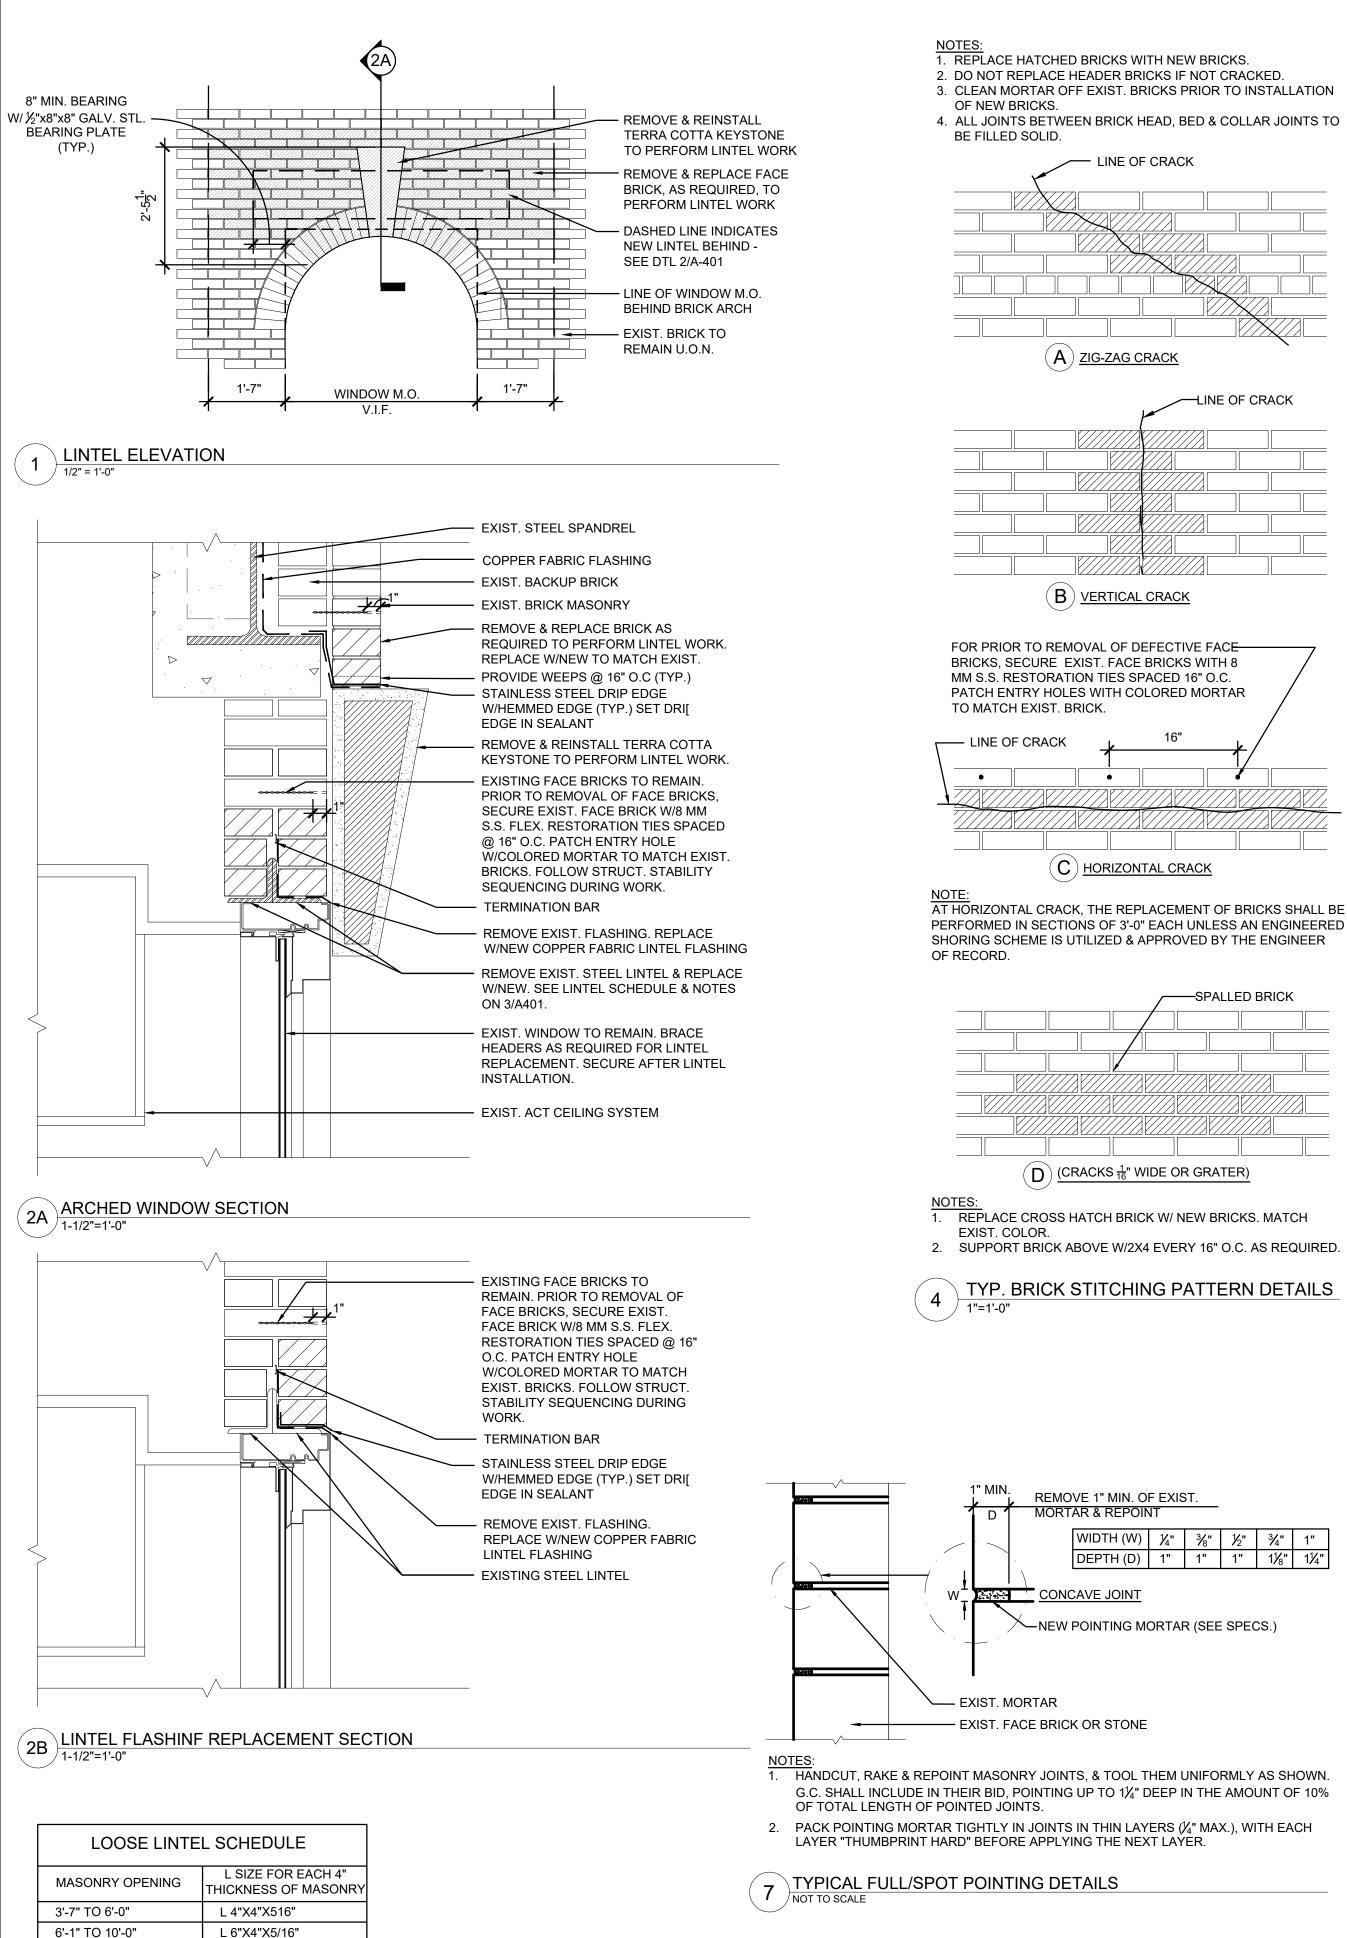

10'-1" TO 12'-0" L 7"X4"X5/16" NOTES:


1. LOOSE LINTEL (L.L.) LENGTH =

MASONRY OPENING (M.O.) + 1'-0" (6" EACH END") 2. PROVIDE SUPPORT HANGERS @ 4'-0" O.C. FOR

L.L. WHEN M.O. IS GREATER THAN 4'-0".


3. NO JOINTS ARE TO OCCUR OVER M.O.

3 LOOSE LINTEL SCHEDULE

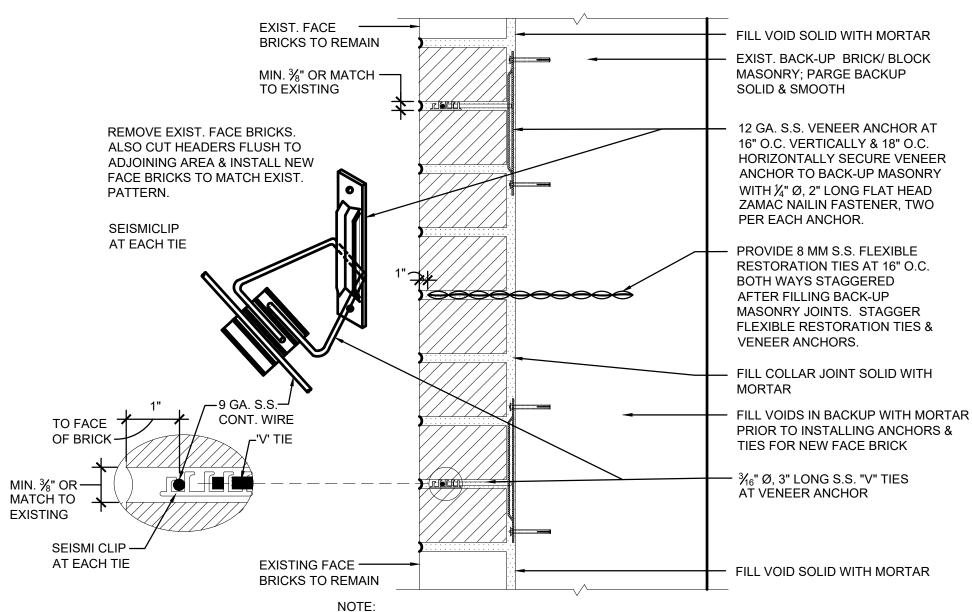


1. ALL HEAD, BED, & COLLAR JOINTS TO BE FILLED SOLID WITH MORTAR.


5 FACE BRICK REPLACEMENT FOR SOLID MASONRY CONSTRUCTION

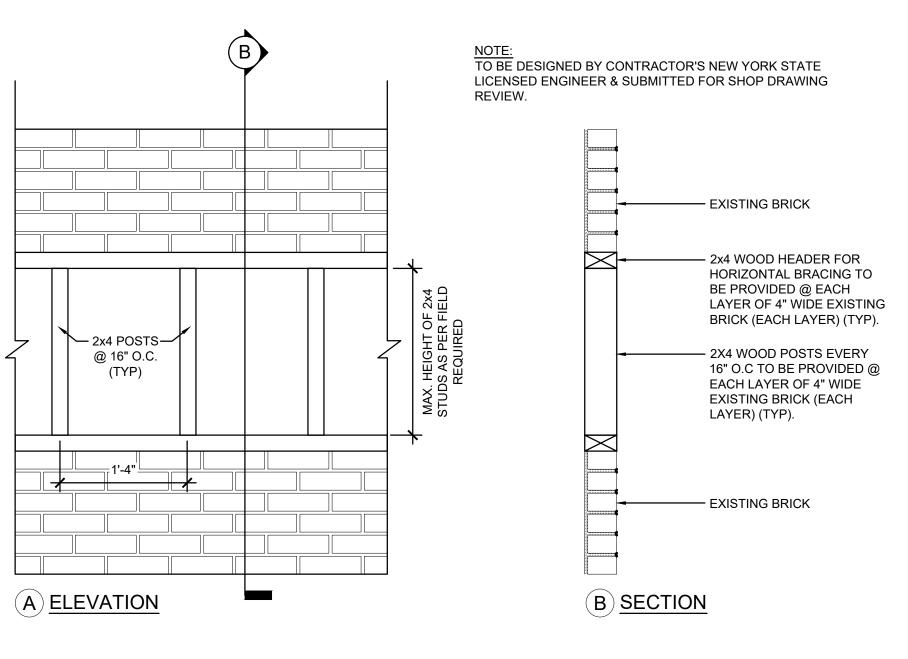

8 TYPICAL BRICK SHORING DETAIL N.T.S.

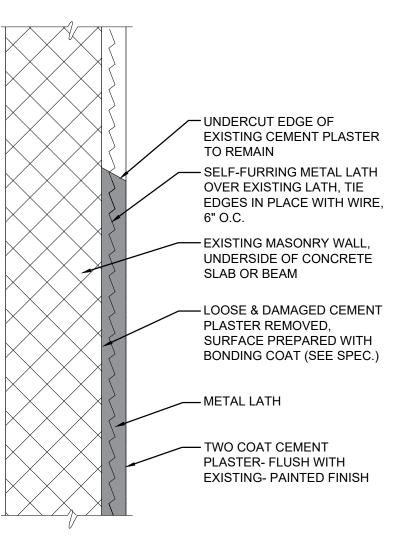



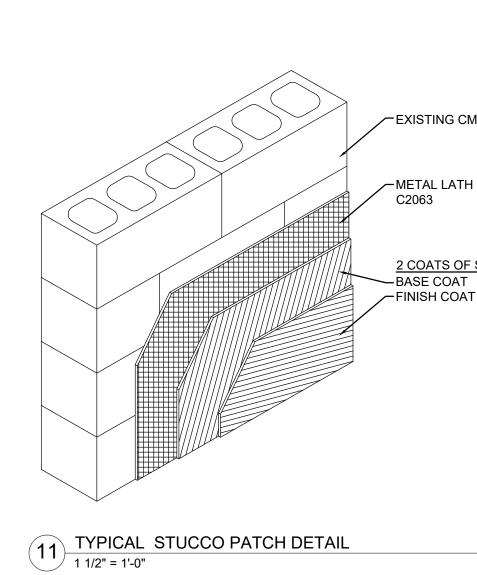

C2063


MORTAR
/ BLOCK
KUP

CUT, RAKE ALL JOINTS IN -----BRICK & TERRA COTTA & REPLACE WITH MORTAR TO MATCH. CLEAN & REMOVE ALL ----RUST & PAINT FROM STL LINTELS ON EACH M.O., PREP. & PAINT STL CUT, RAKE & POINT ALL -----VERTICAL & HORIZONTAL JOINTS IN HATCHED AREA 71/2"

TYP. RETURN AT WINDOW JAMB

6


/ 1/2" = 1'-0"

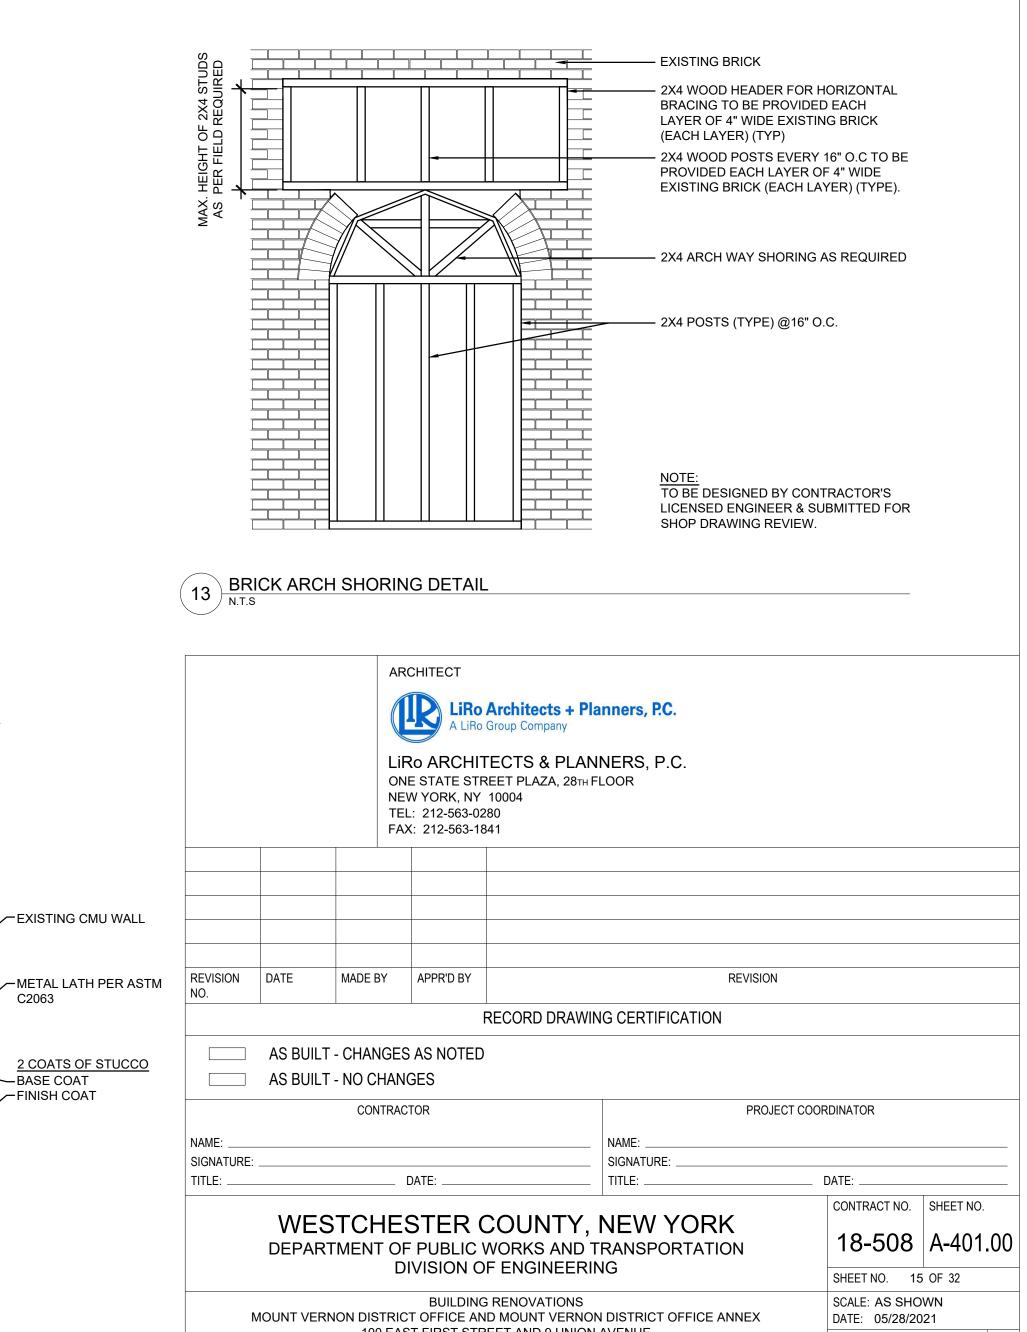


100 EAST FIRST STREET AND 9 UNION AVENUE MOUNT VERNON, NEW YORK MASONRY DETAILS


DPW FILE NO.

54-24-A-358-0 0

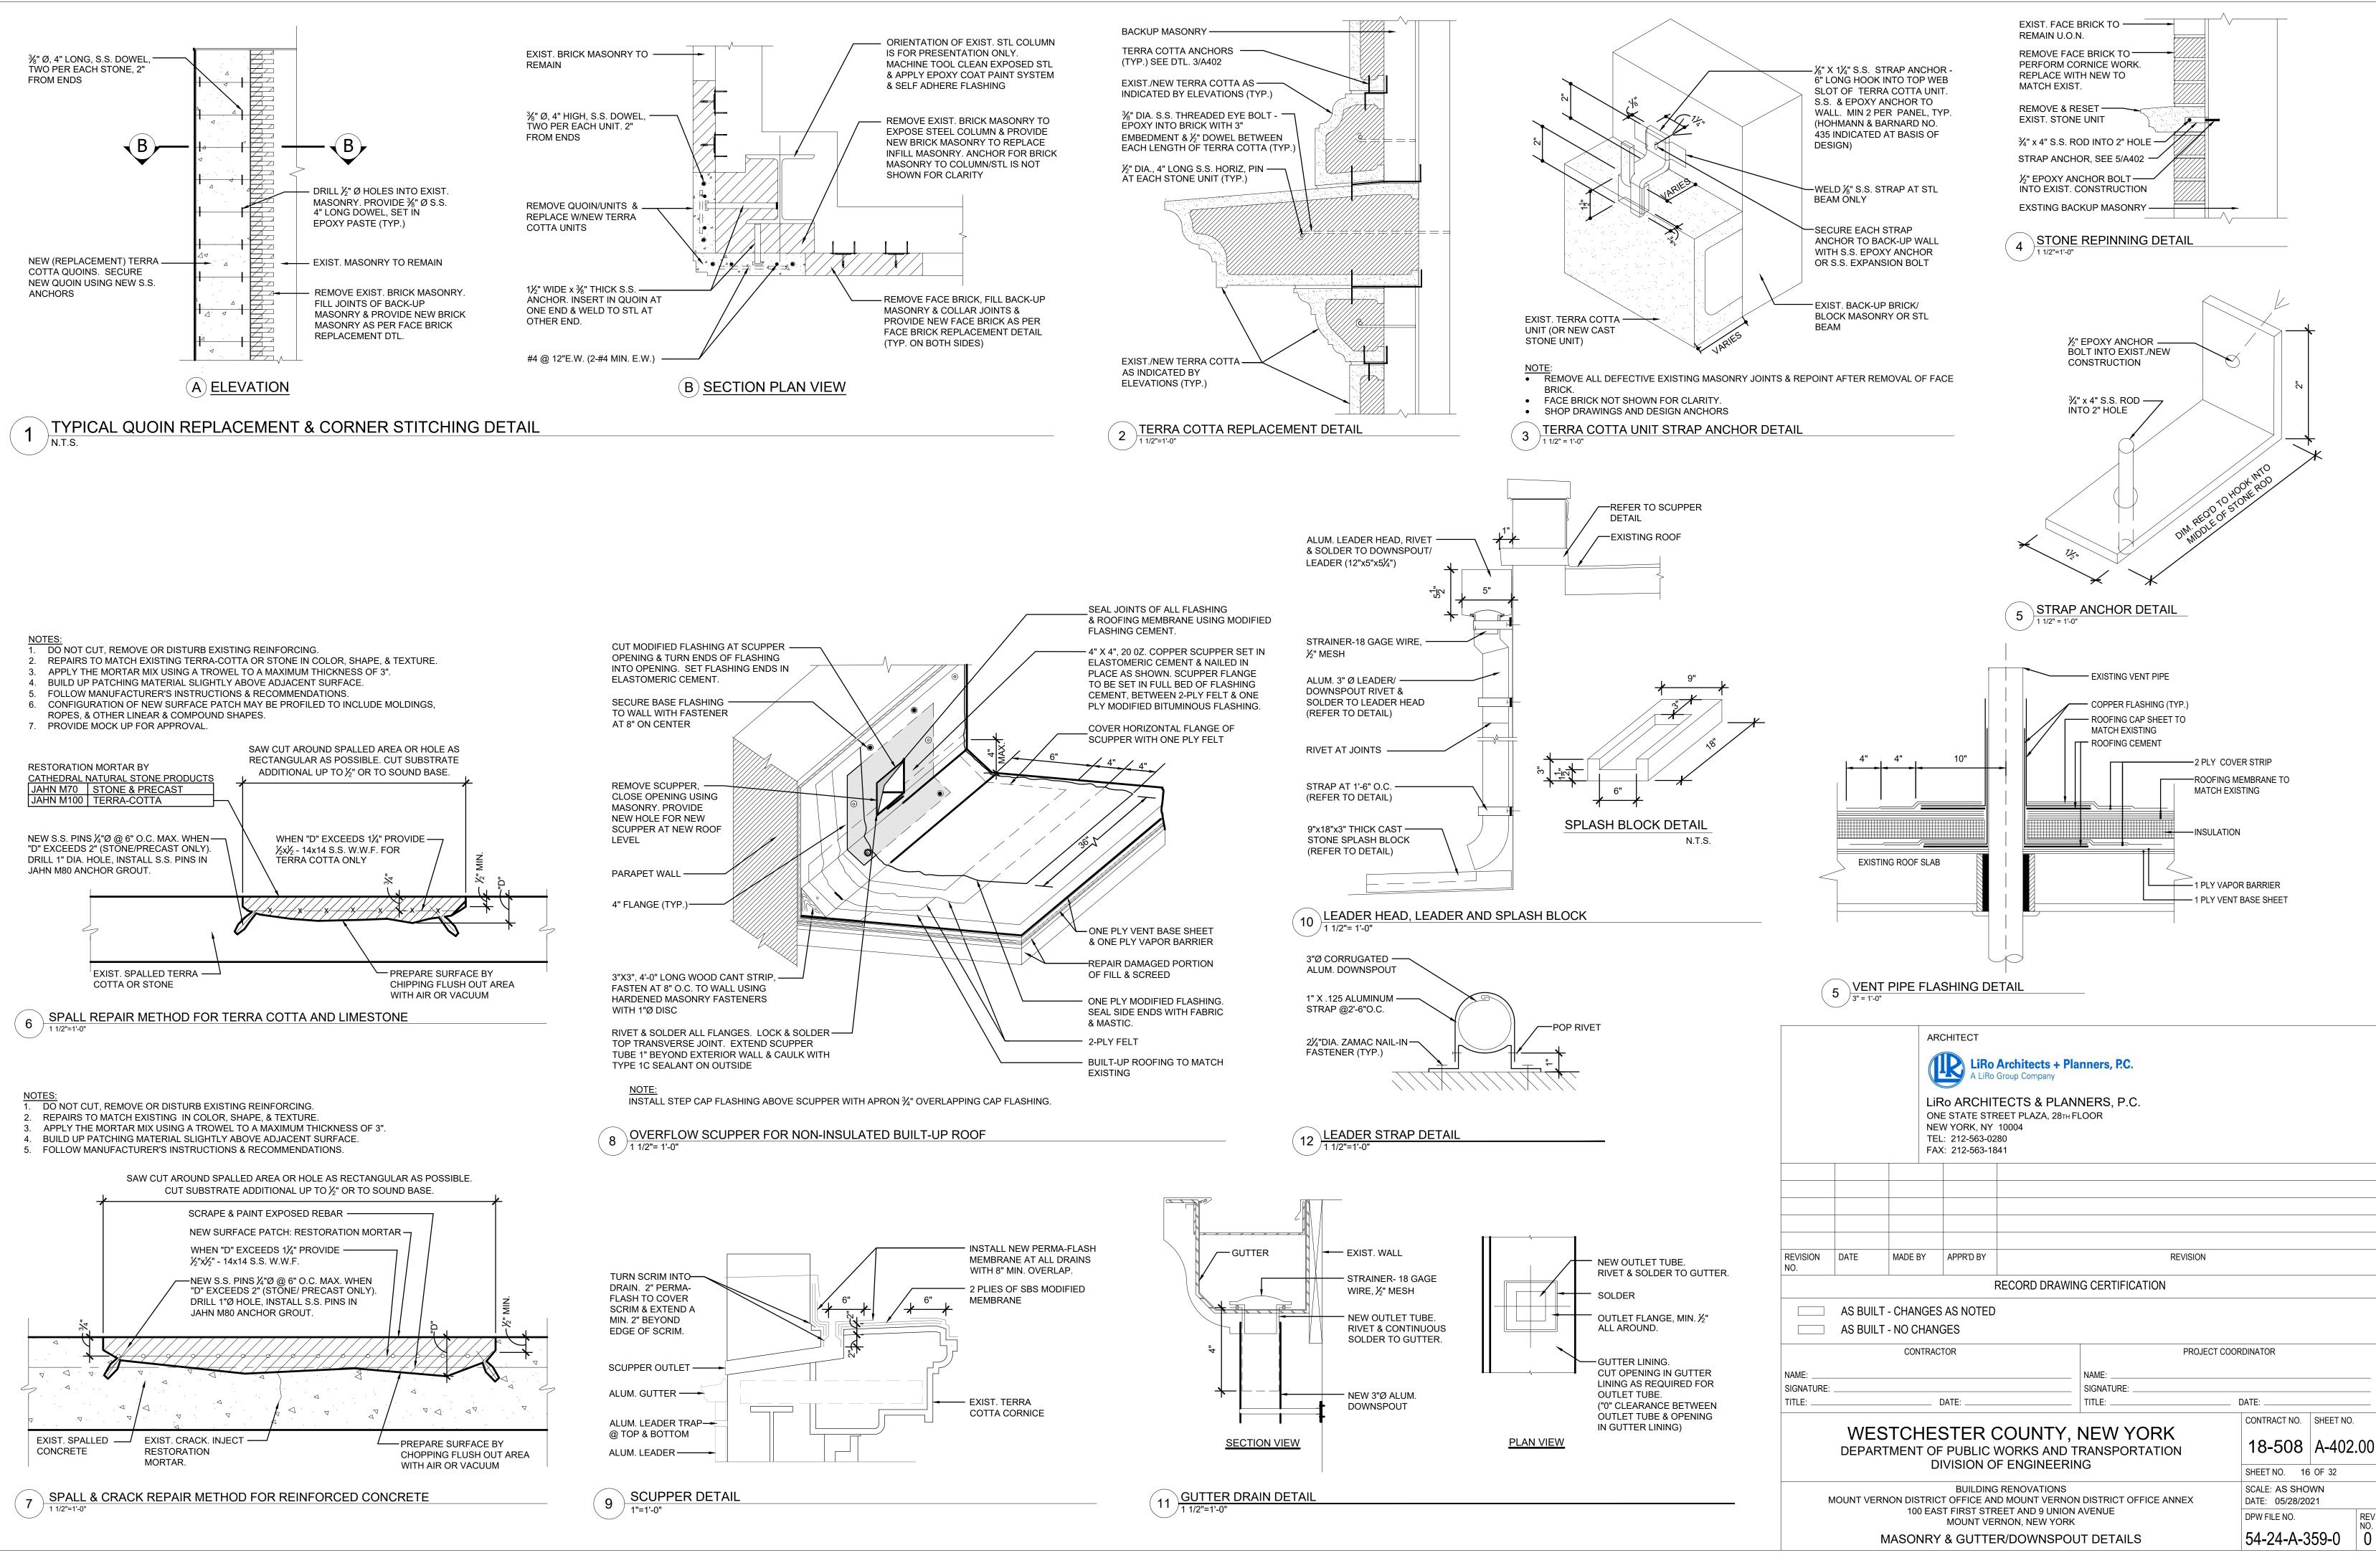




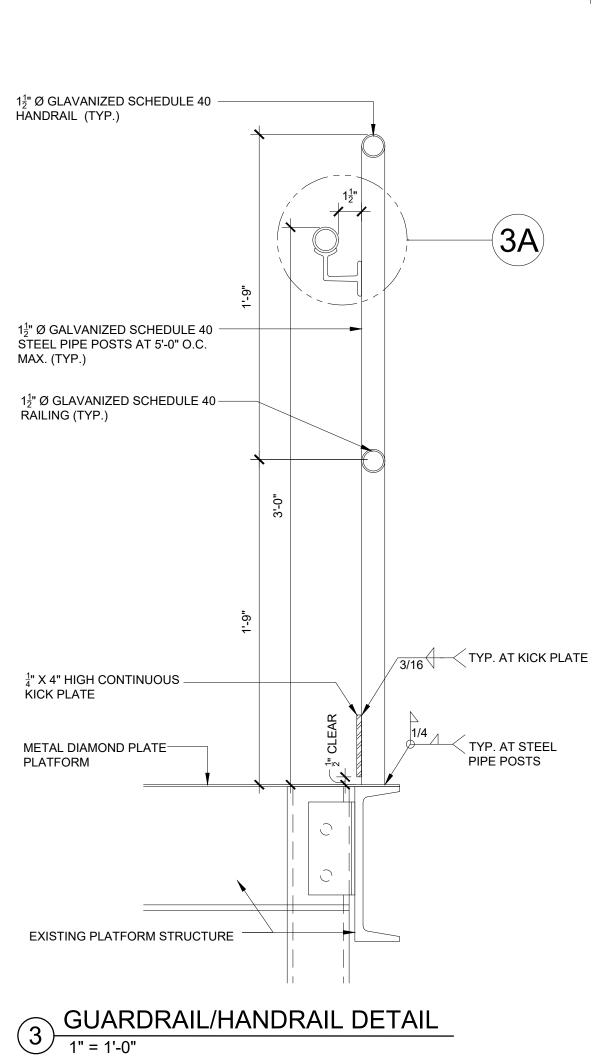

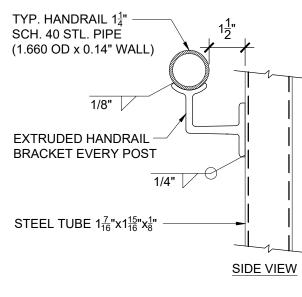





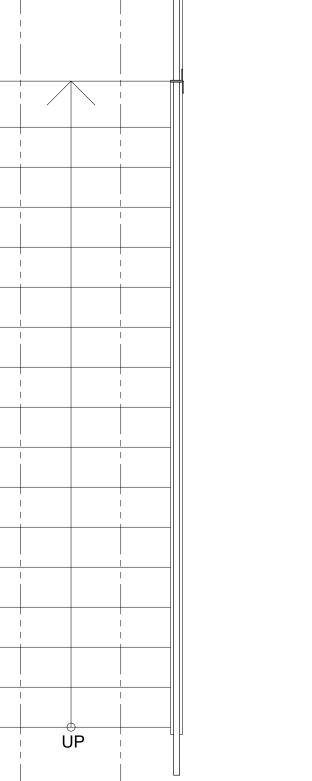

STAIR KEY PLAN

2 A-501 EXISTING BUILDING LINE (9 UNION AVENUE HOUSE 2)

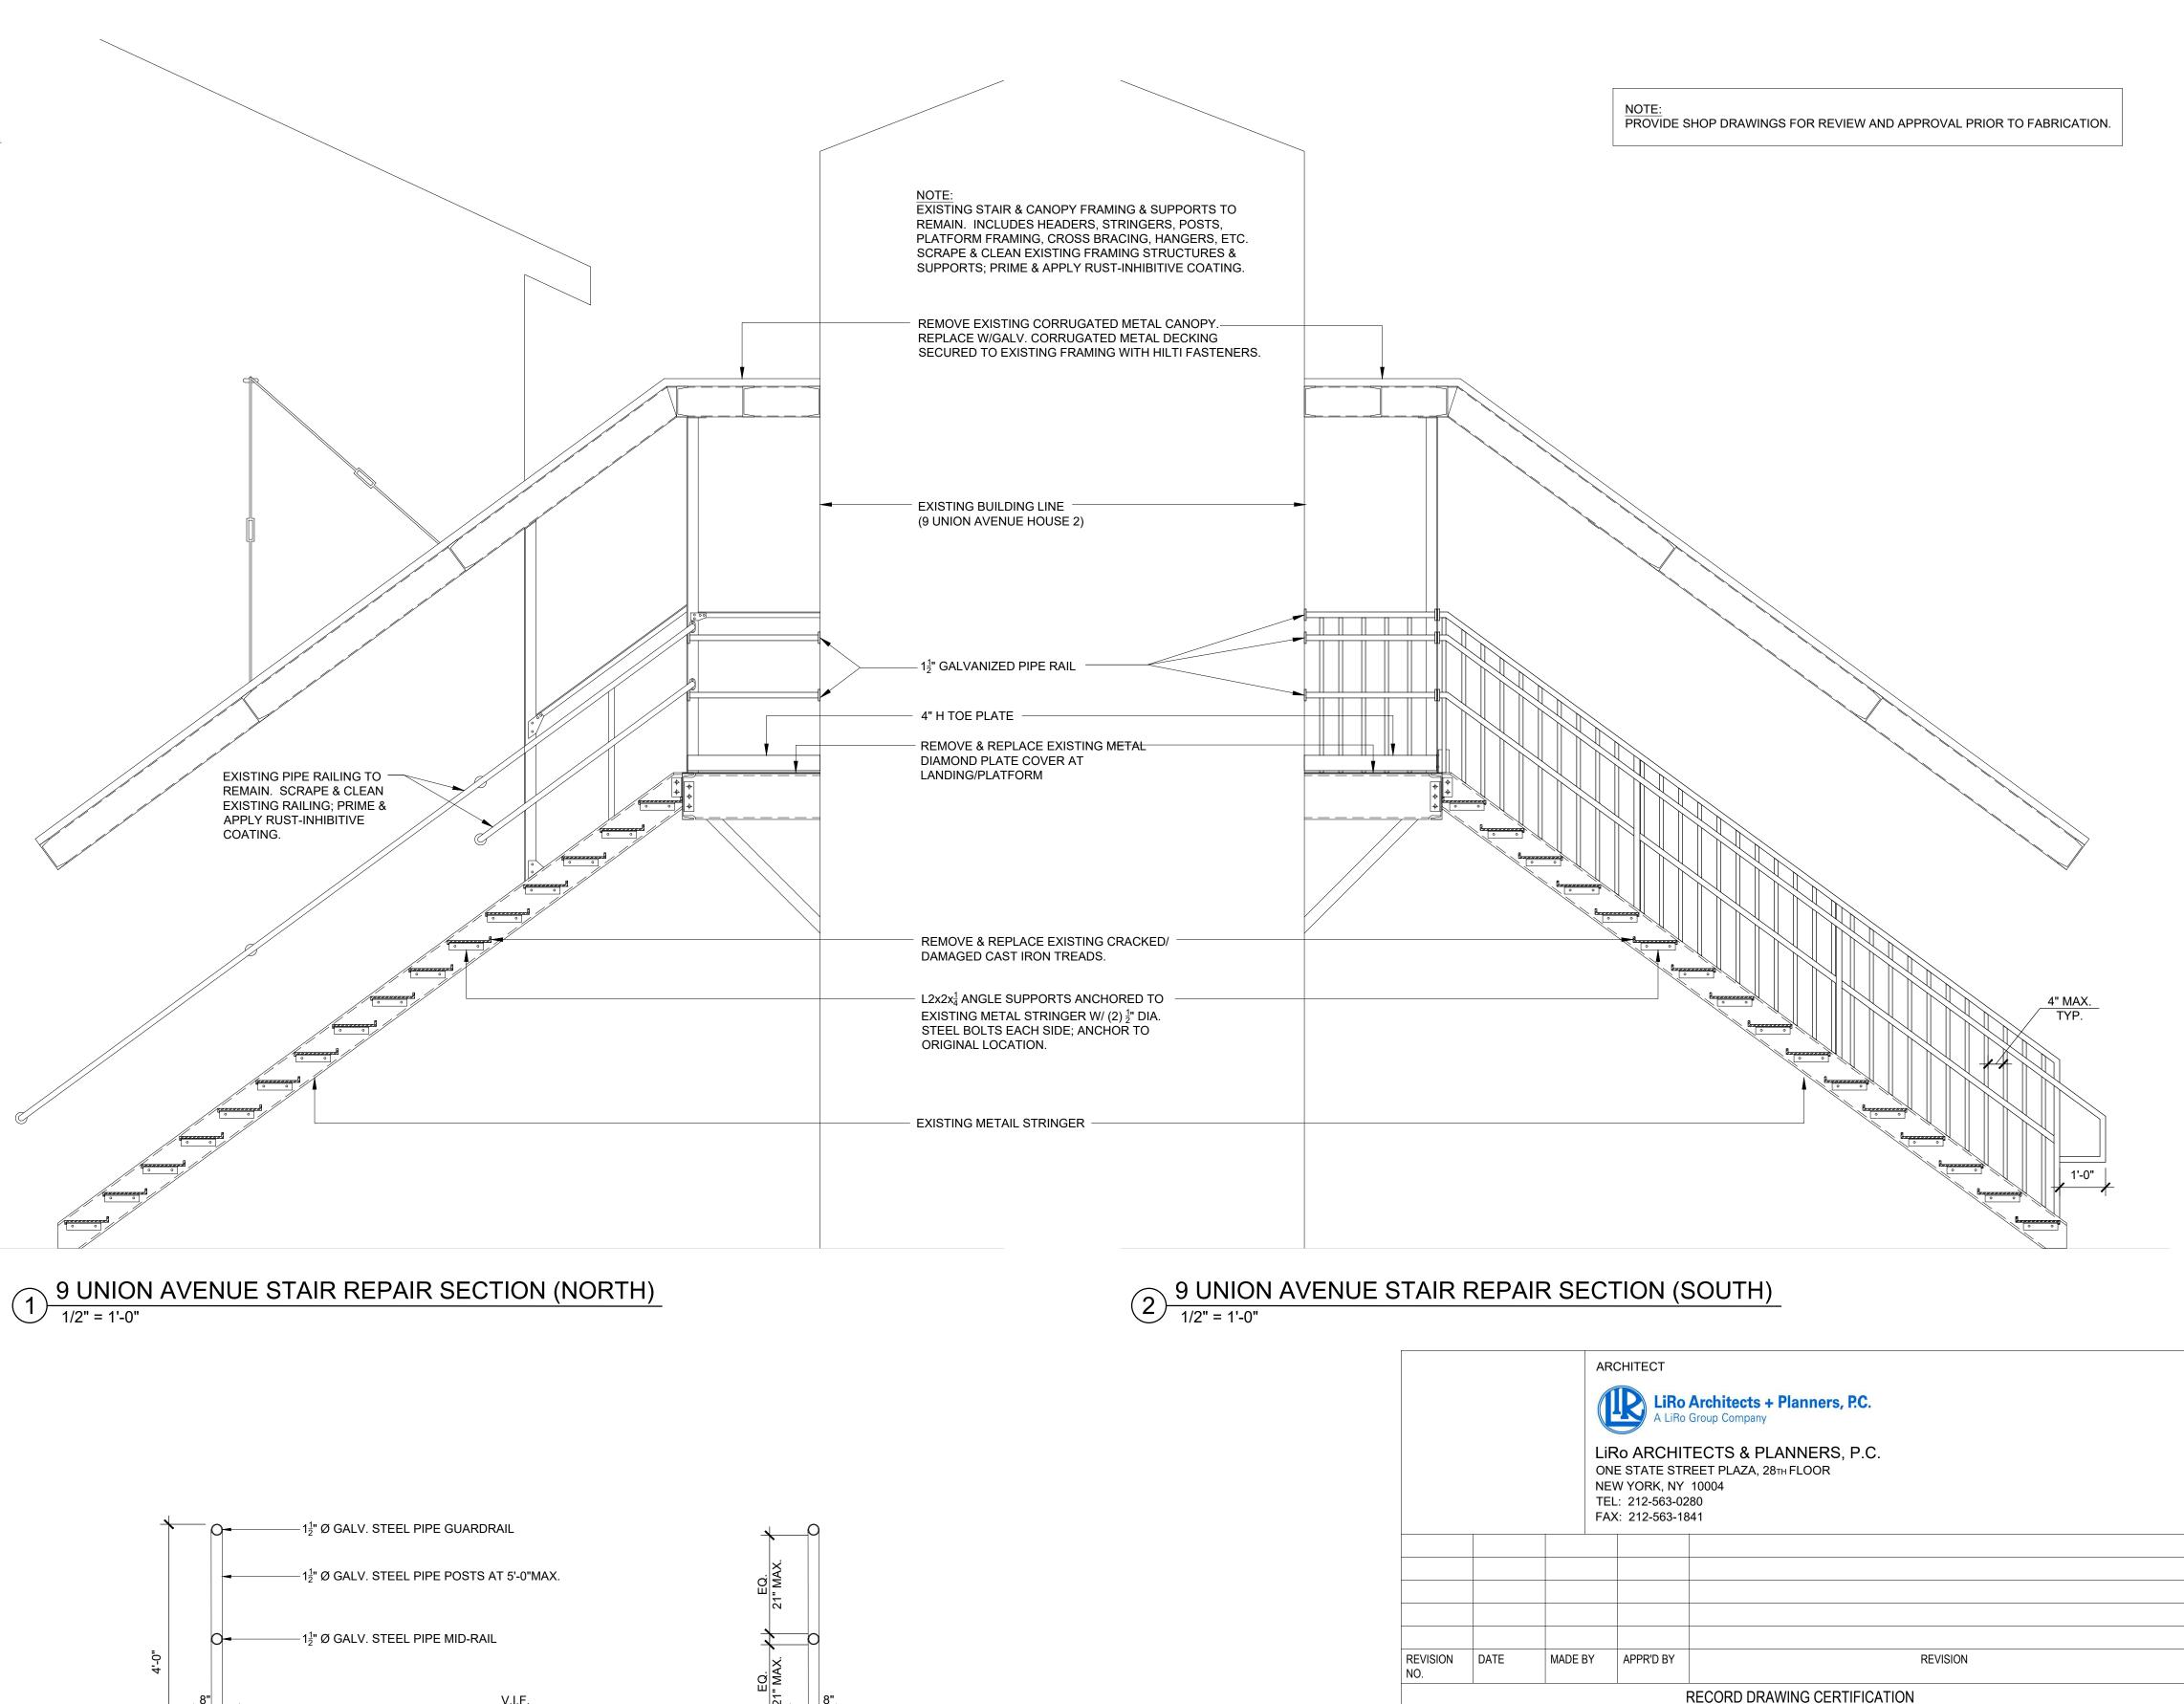

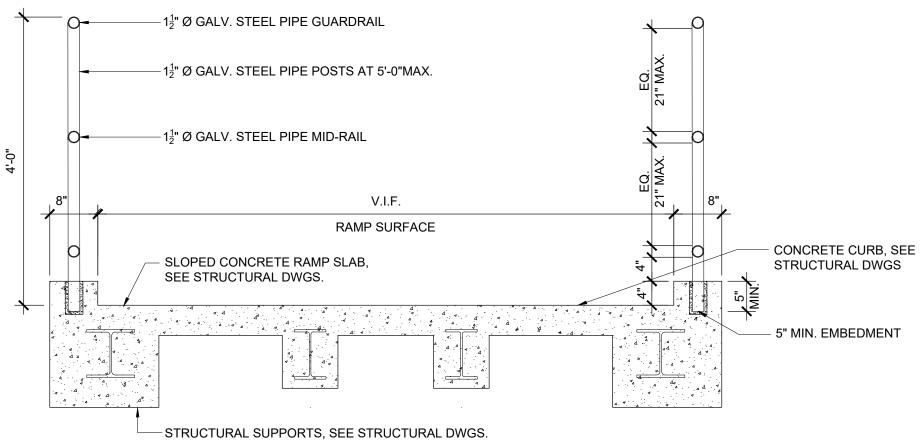

4 GUARDRAIL DETAIL AT VEHICULAR SERVICE RAMP

		ON NE TE)						
REVISION NO.	DATE	MADE BY	APPR'D BY	REVISION						
		·	R	ECORD DRAWING	CERTIFICATION					
	AS BUIL	T - CHANGE	S AS NOTED							
	AS BUIL	T - NO CHAN	GES							
		CONTRAC	CTOR		PRC	PROJECT COORDINATOR				
				NA	NAME:					
TITLE:			DATE:	ווד	۲LE:	DATE:				
						CONTRACT NO.	SHEET NO).		
		RTMENT O	F PUBLIC V	•	EVV YORK	18-508	A-501	.00		
		D	IVISION OF	ENGINEERING		SHEET NO. 1	7 OF 32			
r	MOUNT VE		CT OFFICE AND		STRICT OFFICE ANNEX	SCALE: N/A DATE: 05/28/2	SCALE: N/A DATE: 05/28/2021			
		100 EAS		ET AND 9 UNION AVE NON, NEW YORK	ENUE	DPW FILE NO.		REV NO.		
STAIR & RAMP RAILING DETAILS						54-24-A-	54-24-A-360-0 0			

DOOR SCHEDULE - 100 EAST 1ST STREET

R: FIRE RATED

	DOON	CONFRONT			- 1				
					OPEN	NINGS			
	DOOR NO.	FLOOR	LOCATION	INT./ EXT.	WIDTH	HEIGHT	TYPE	MATERIAL	FIF RA
	001	BASEMENT	UNION AVE	EXT.	6'-4"	7'-4"	FVR	ALUM	1 ¹ / ₂
	101	1ST FLOOR	EAST 1ST STREET/ SOUTH 1ST AVE	EXT.	10'-7"	12'-1 <u>4</u> "	FVTR	ALUM	1 <u>1</u> 2
	102	1ST FLOOR	EAST 1ST STREET	EXT.	6'-8"	8'-3"	FVR	ALUM	$1\frac{1}{2}$
	TYPICAL DOOR TYPE TYPICAL FRAME TYPE				L SASH TYPE	TYPICA	CAL GLAZING TYPE		
F: FLUSH DOOR V: VISION PANEL S: SIDELIGHT T: TRANSOM		PANEL D	SF: SINGLE FRAME DF: DOUBLE FRAME M: MULLION		JLATED GLASS JLATED PANEL		INSULATED) GLASS	


DOOR								F					
FIRE	N	NOMINAL SIZE		VISION			TRANSOM TYPE	TYPE MATERIAL	DETAIL				REMARKS
RATING V	WIDTH	HEIGHT	THICK	PANEL	SIDELIGHT	TRANSOM			HEAD	JAMB	SILL	TRANSOM	
1 ¹ / ₂ HR	(2) 3'-0"	7'-2"	1 <u>3</u> "	IG/GL-03	-	-	DMF1	ALUM	13	18	15		SWING (AUTOMATIC)
1 ¹ / ₂ HR	(2) 3'-2"	7'-10"	1 <u>3</u> "	IG/GL-03	IG/GL-03	IG/GL-03	DMF2	ALUM	2	8	4	1, 2, 5, 7	SLIDING (AUTOMATIC)
1 ¹ / ₂ HR	(2) 3'-2"	8'-1"	1 <u>3</u> "	IG/GL-03	-	-	DMF1	ALUM	13	18	15		SWING (MANUAL)


NOTES: 1. ALL MASONRY OPENING DIMENSIONS SHALL BE VERIFIED IN FIELD (V.I.F) AND REFLECTED IN THE REQUIRED SHOP DRAWINGS.

2. ALL DOOR & FRAME DIMENSIONS SHALL BE VERIFIED IN FIELD (V.I.F.) AND REFLECTED


IN THE REQUIRED SHOP DRAWINGS. 3. REFER TO SPECIFICATIONS FOR GLAZING TYPE INFORMATION.


4. PROVIDE SHOP DRAWINGS FOR REVIEW AND APPROVAL PRIOR TO FABRICATION.

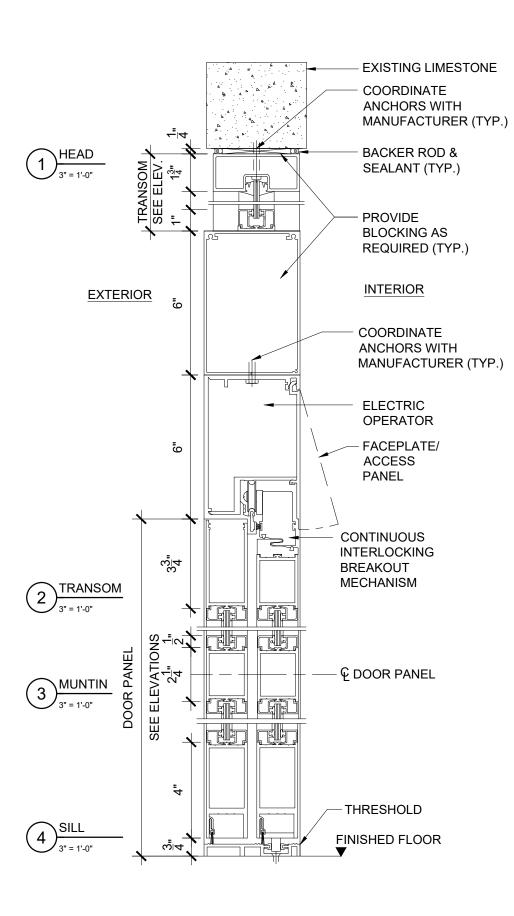


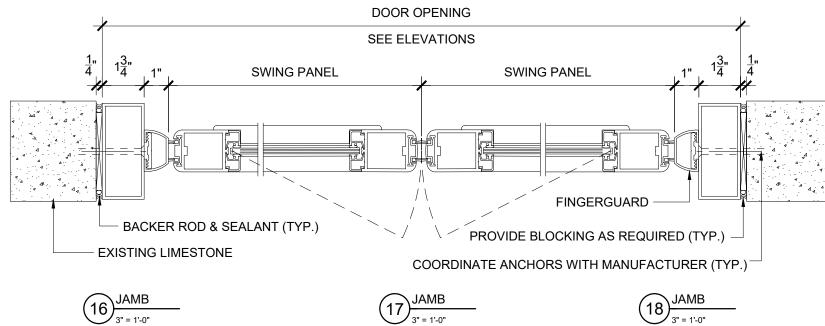





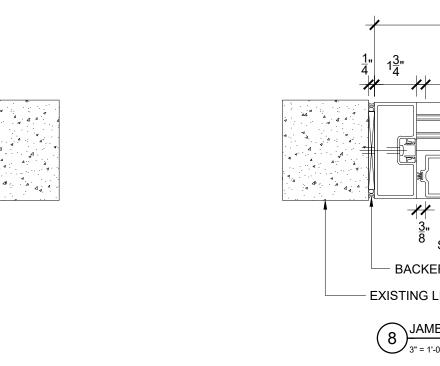


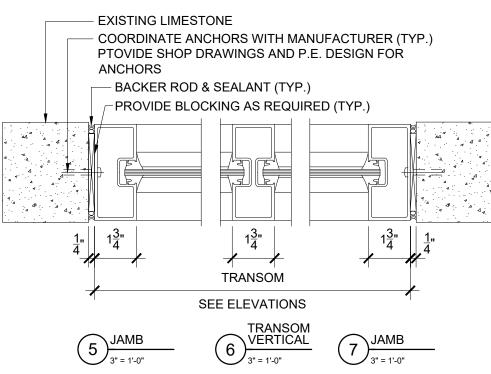


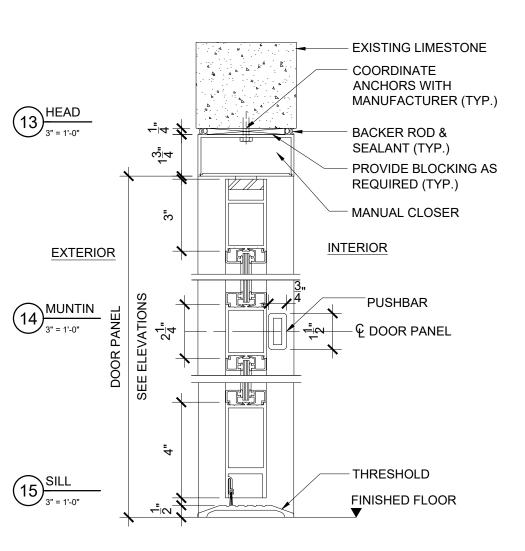

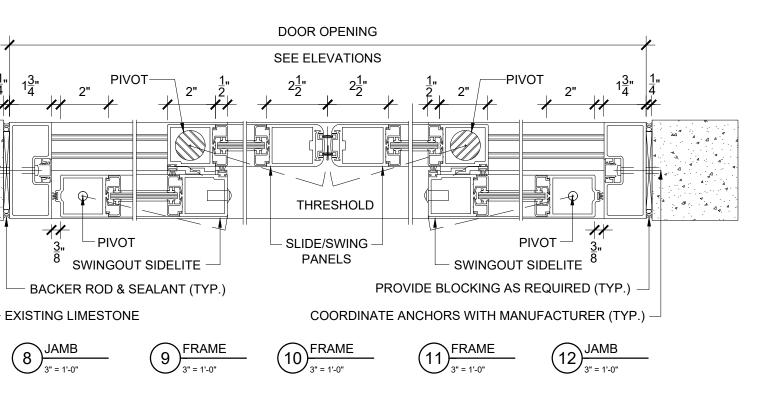

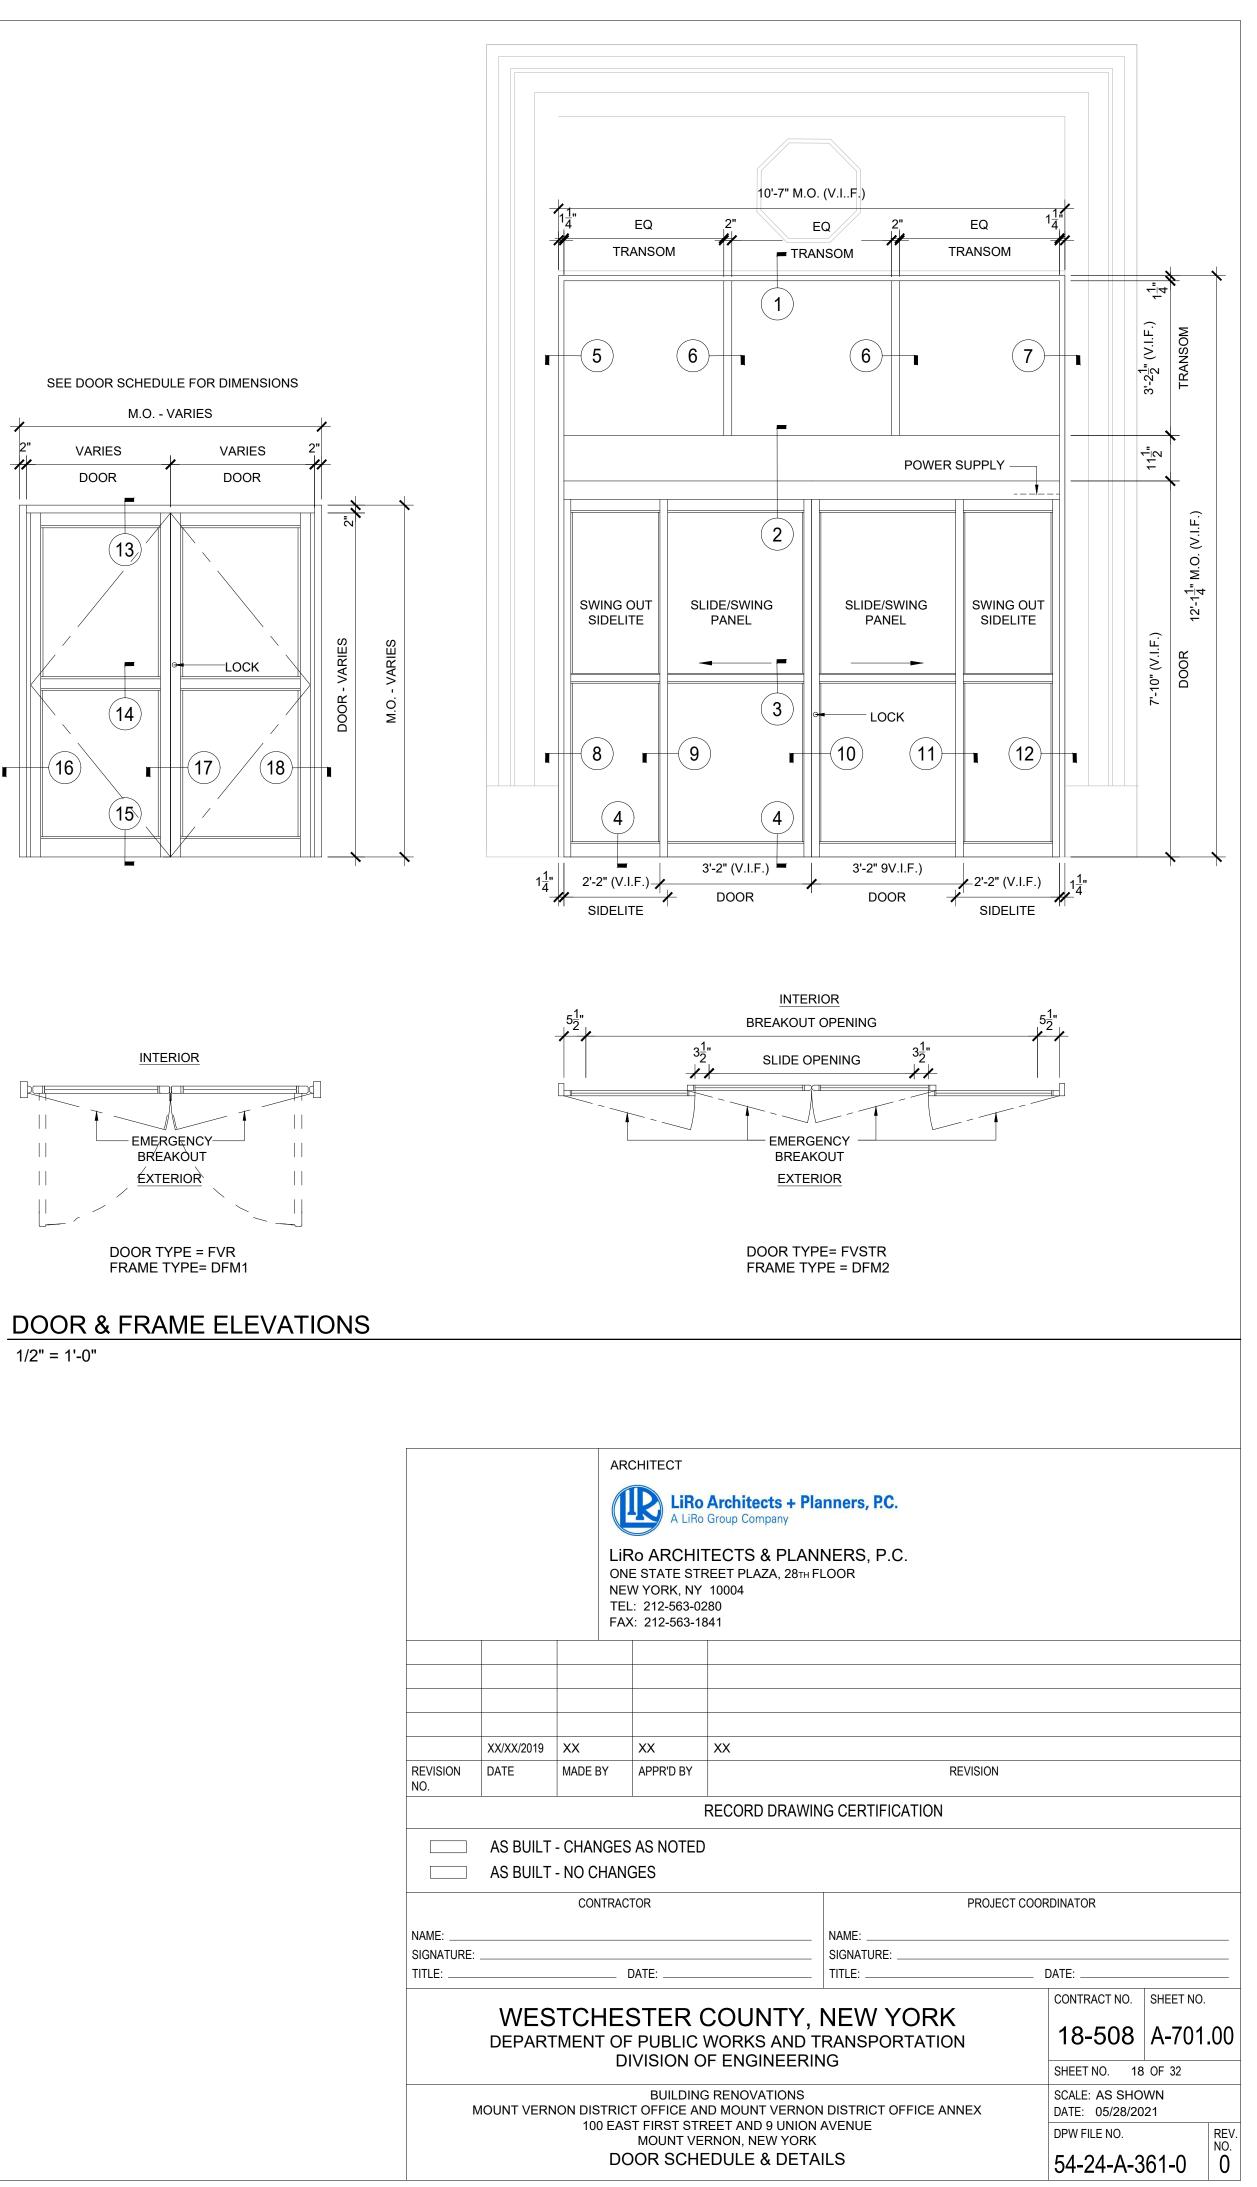


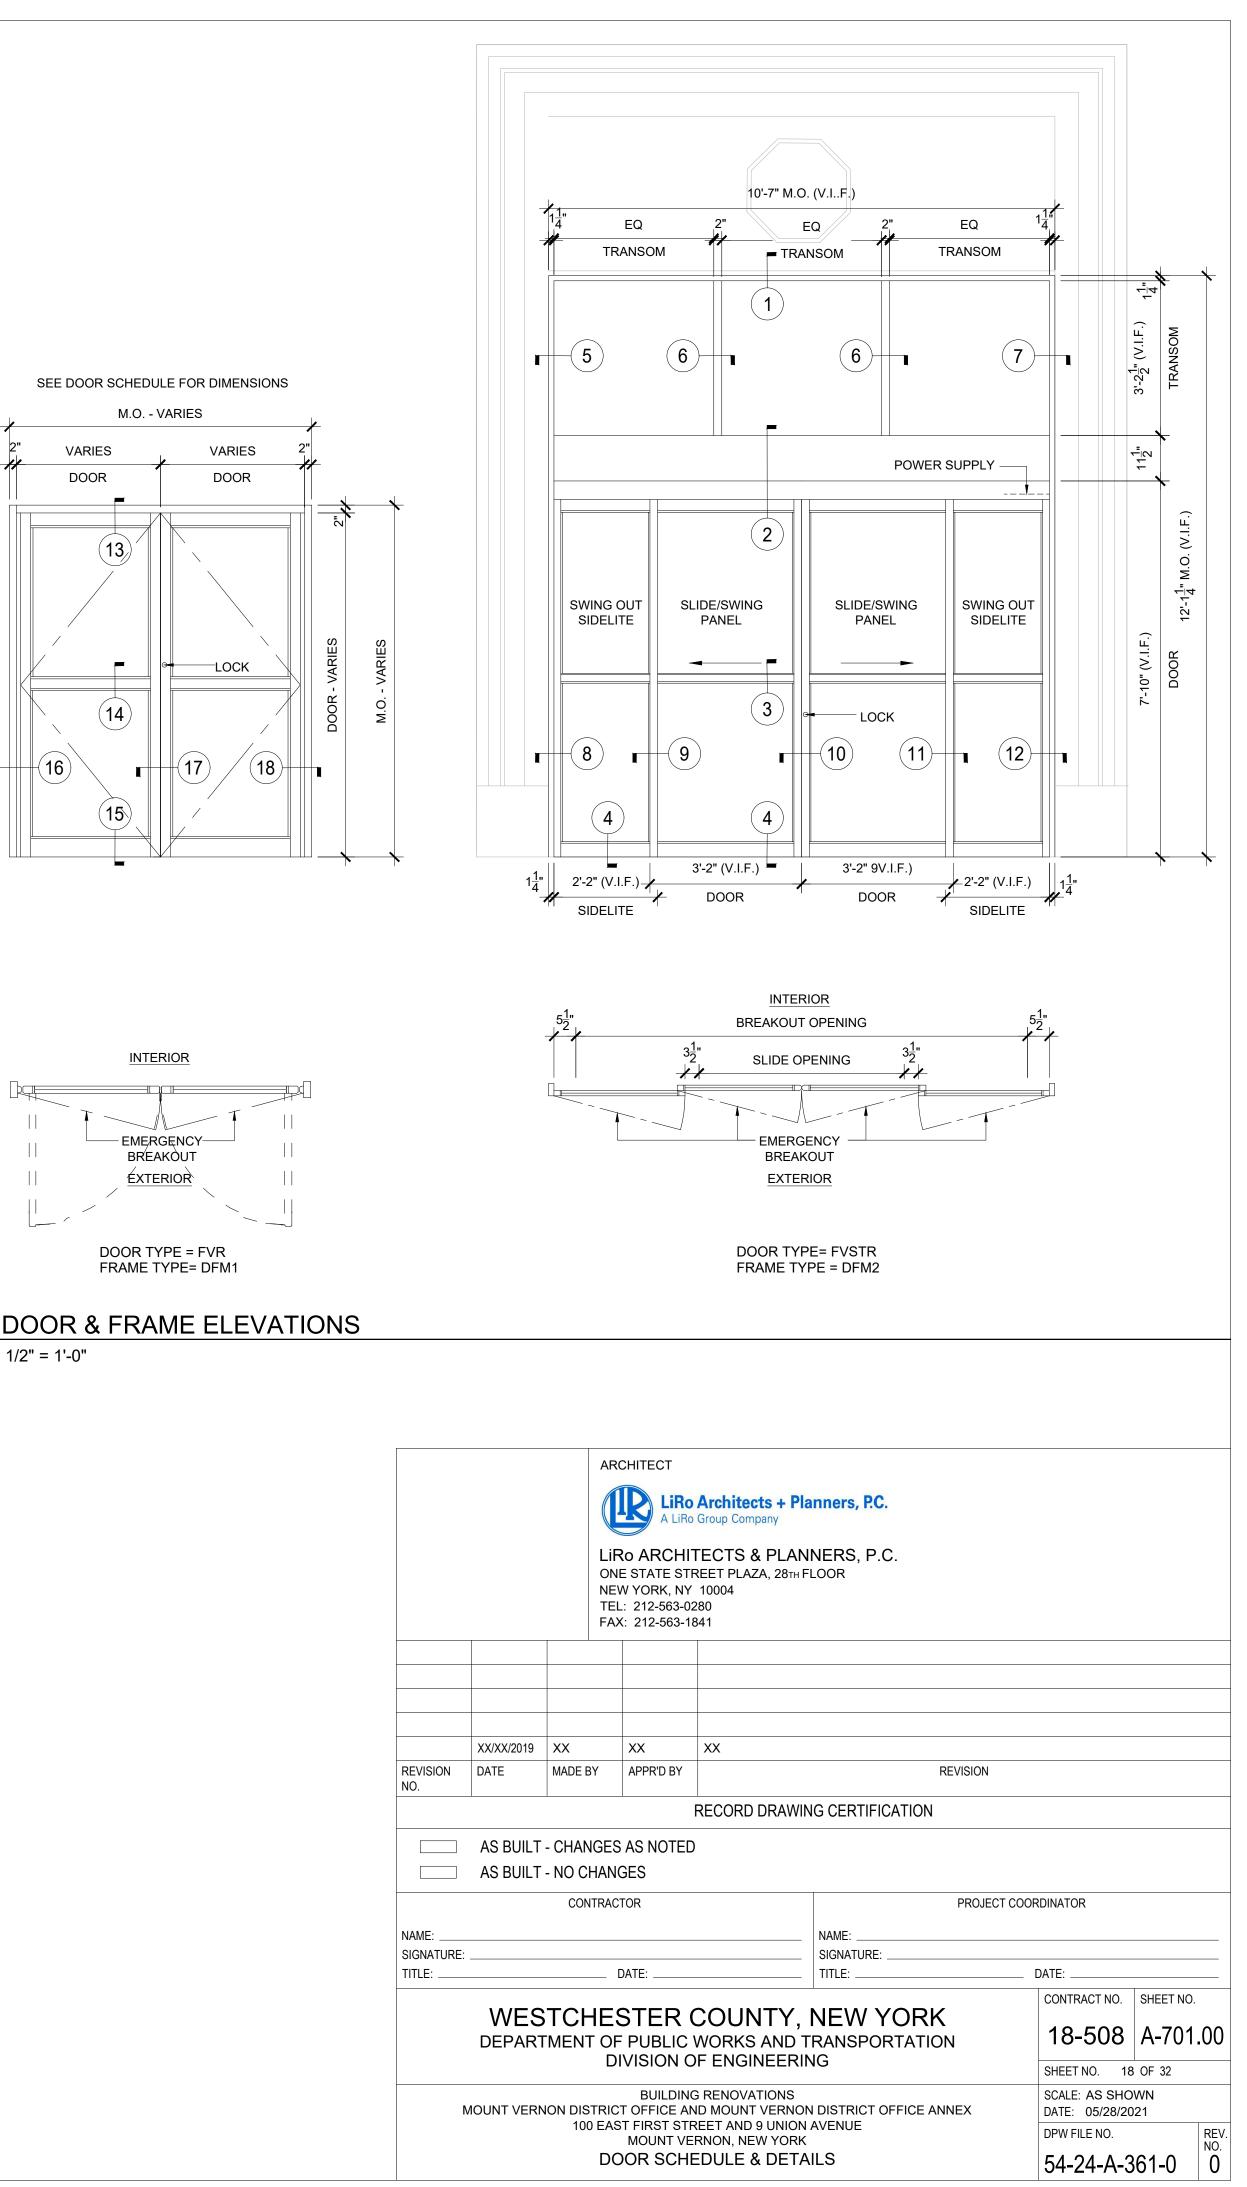


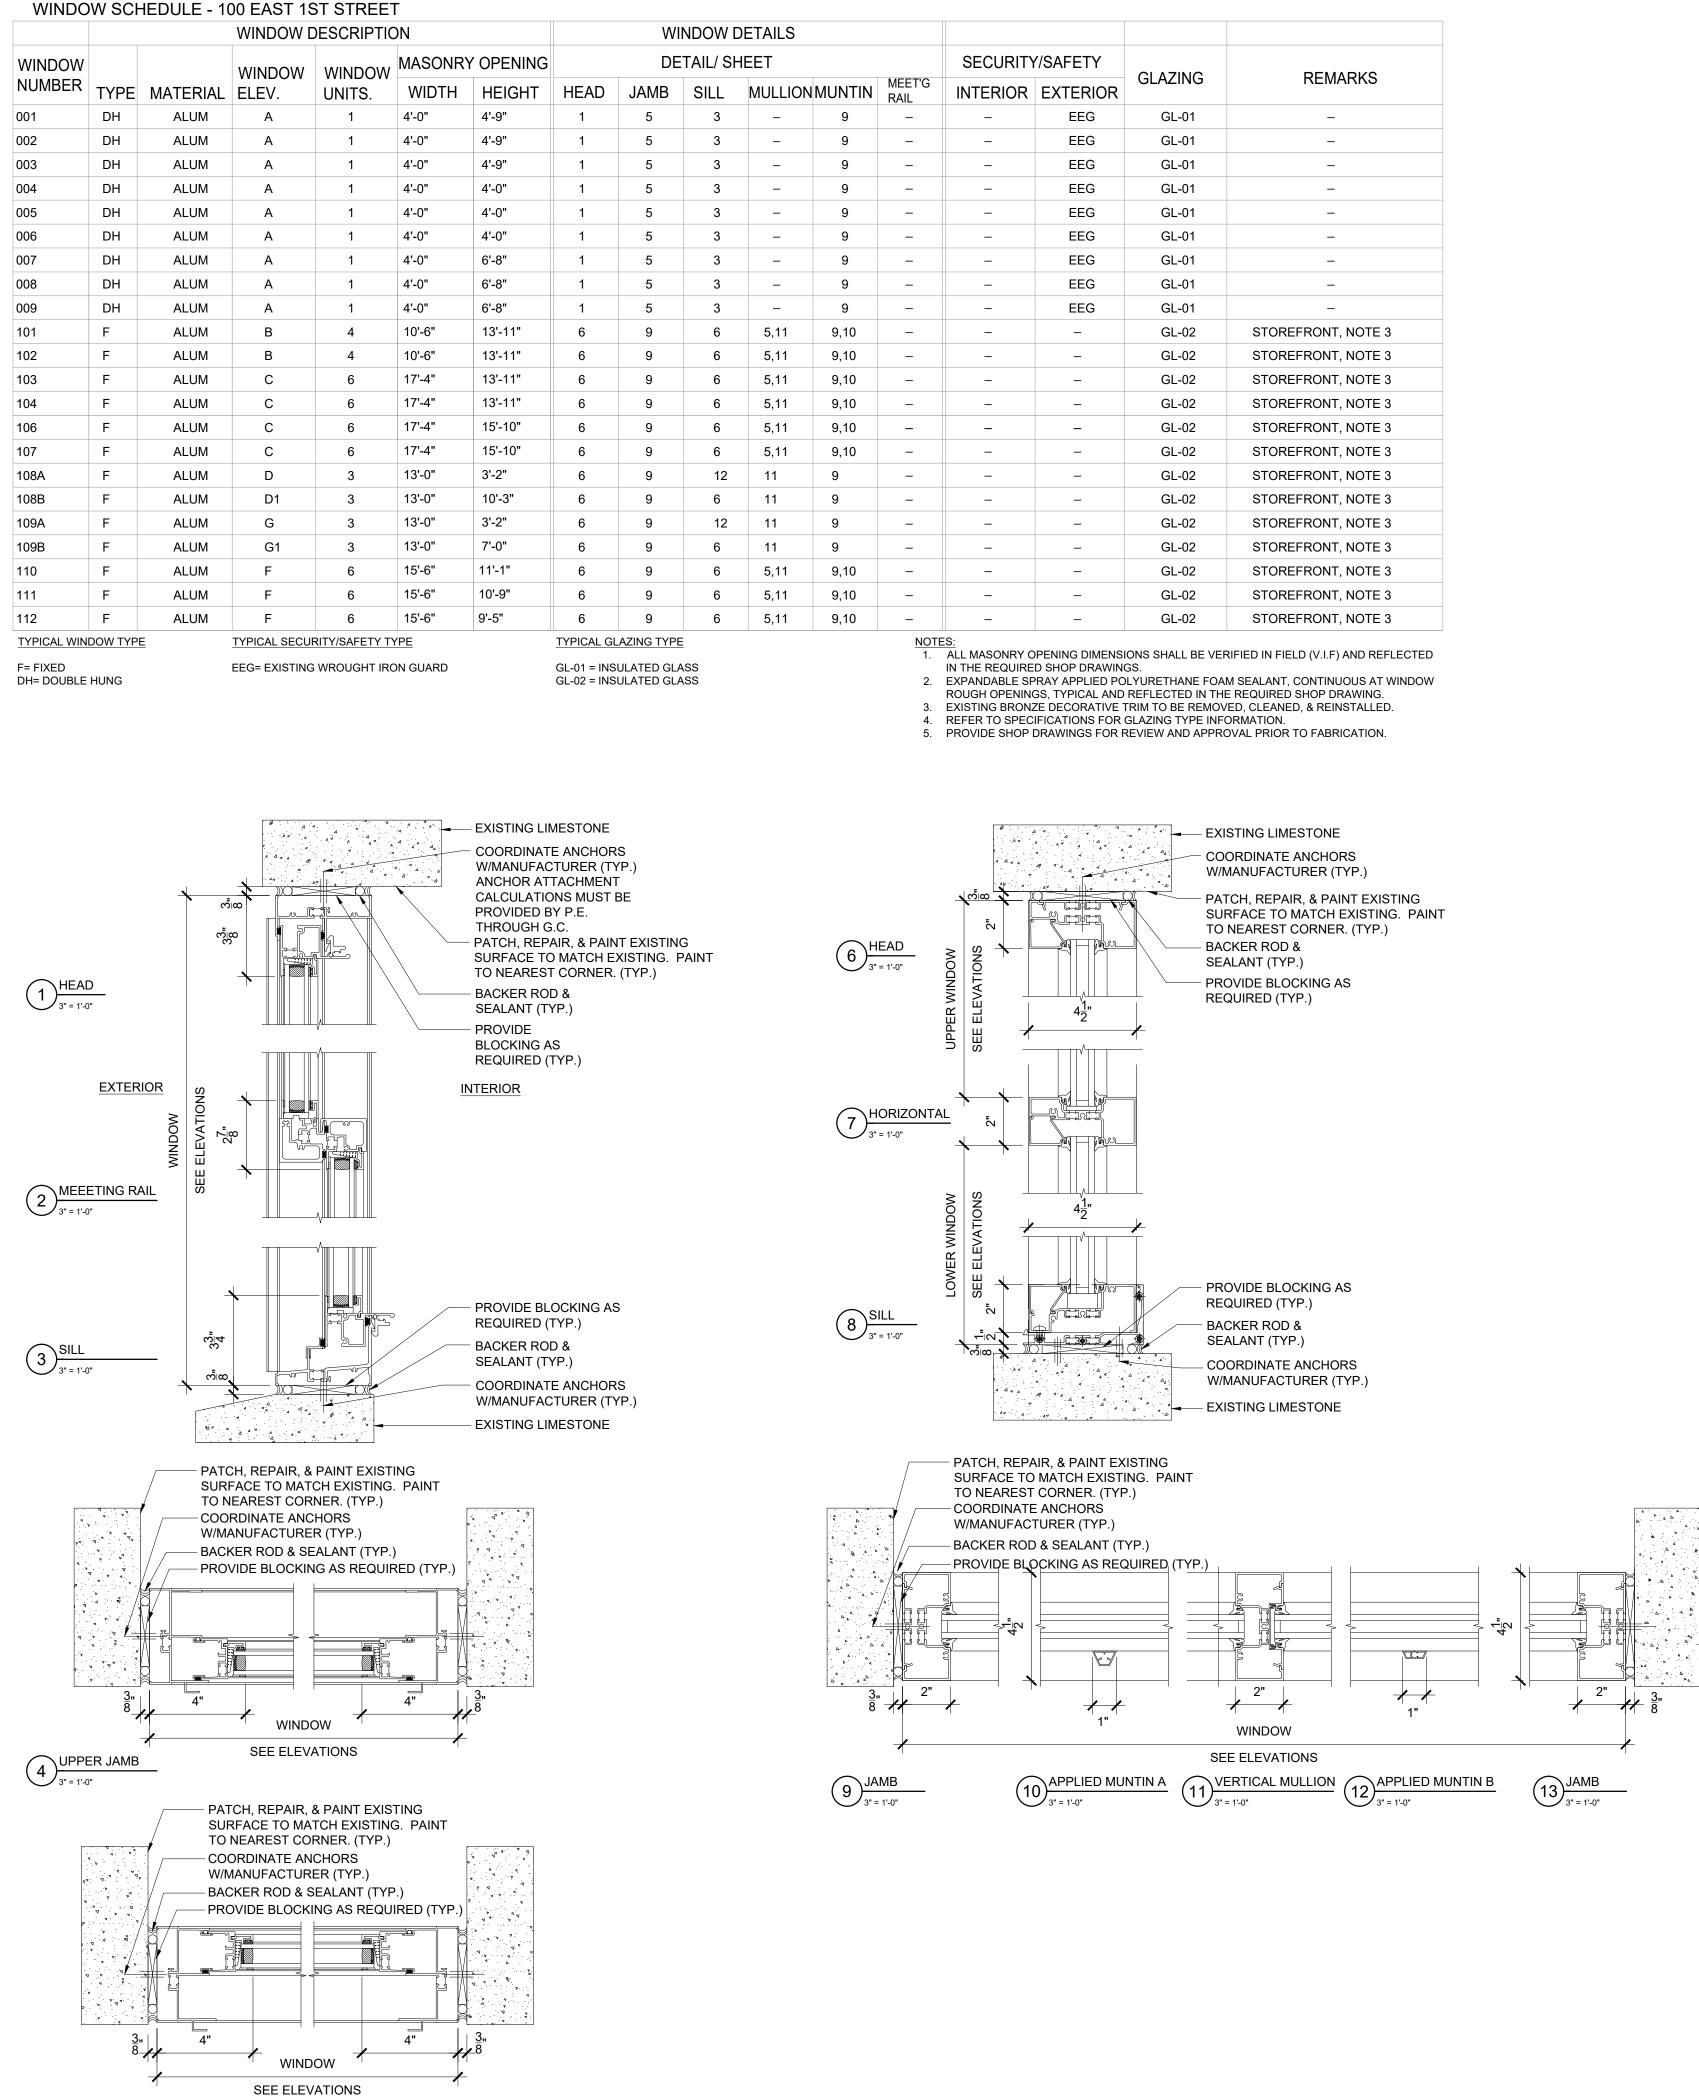


5 <u>1" = 1'-0"</u>

(GLAZING	REMARKS
OR		
	GL-01	_
	GL-02	STOREFRONT, NOTE 3

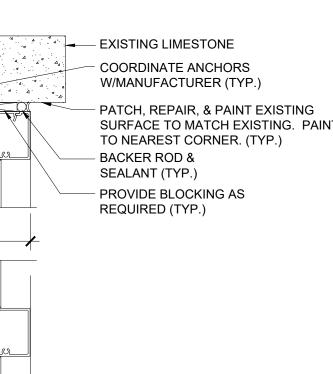


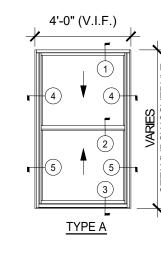


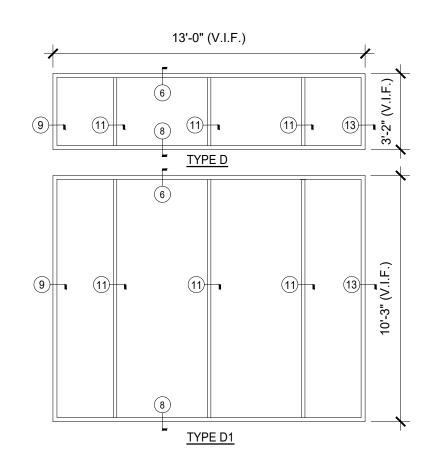



WINDOW ELEVATIONS

1/4" = 1'-0"

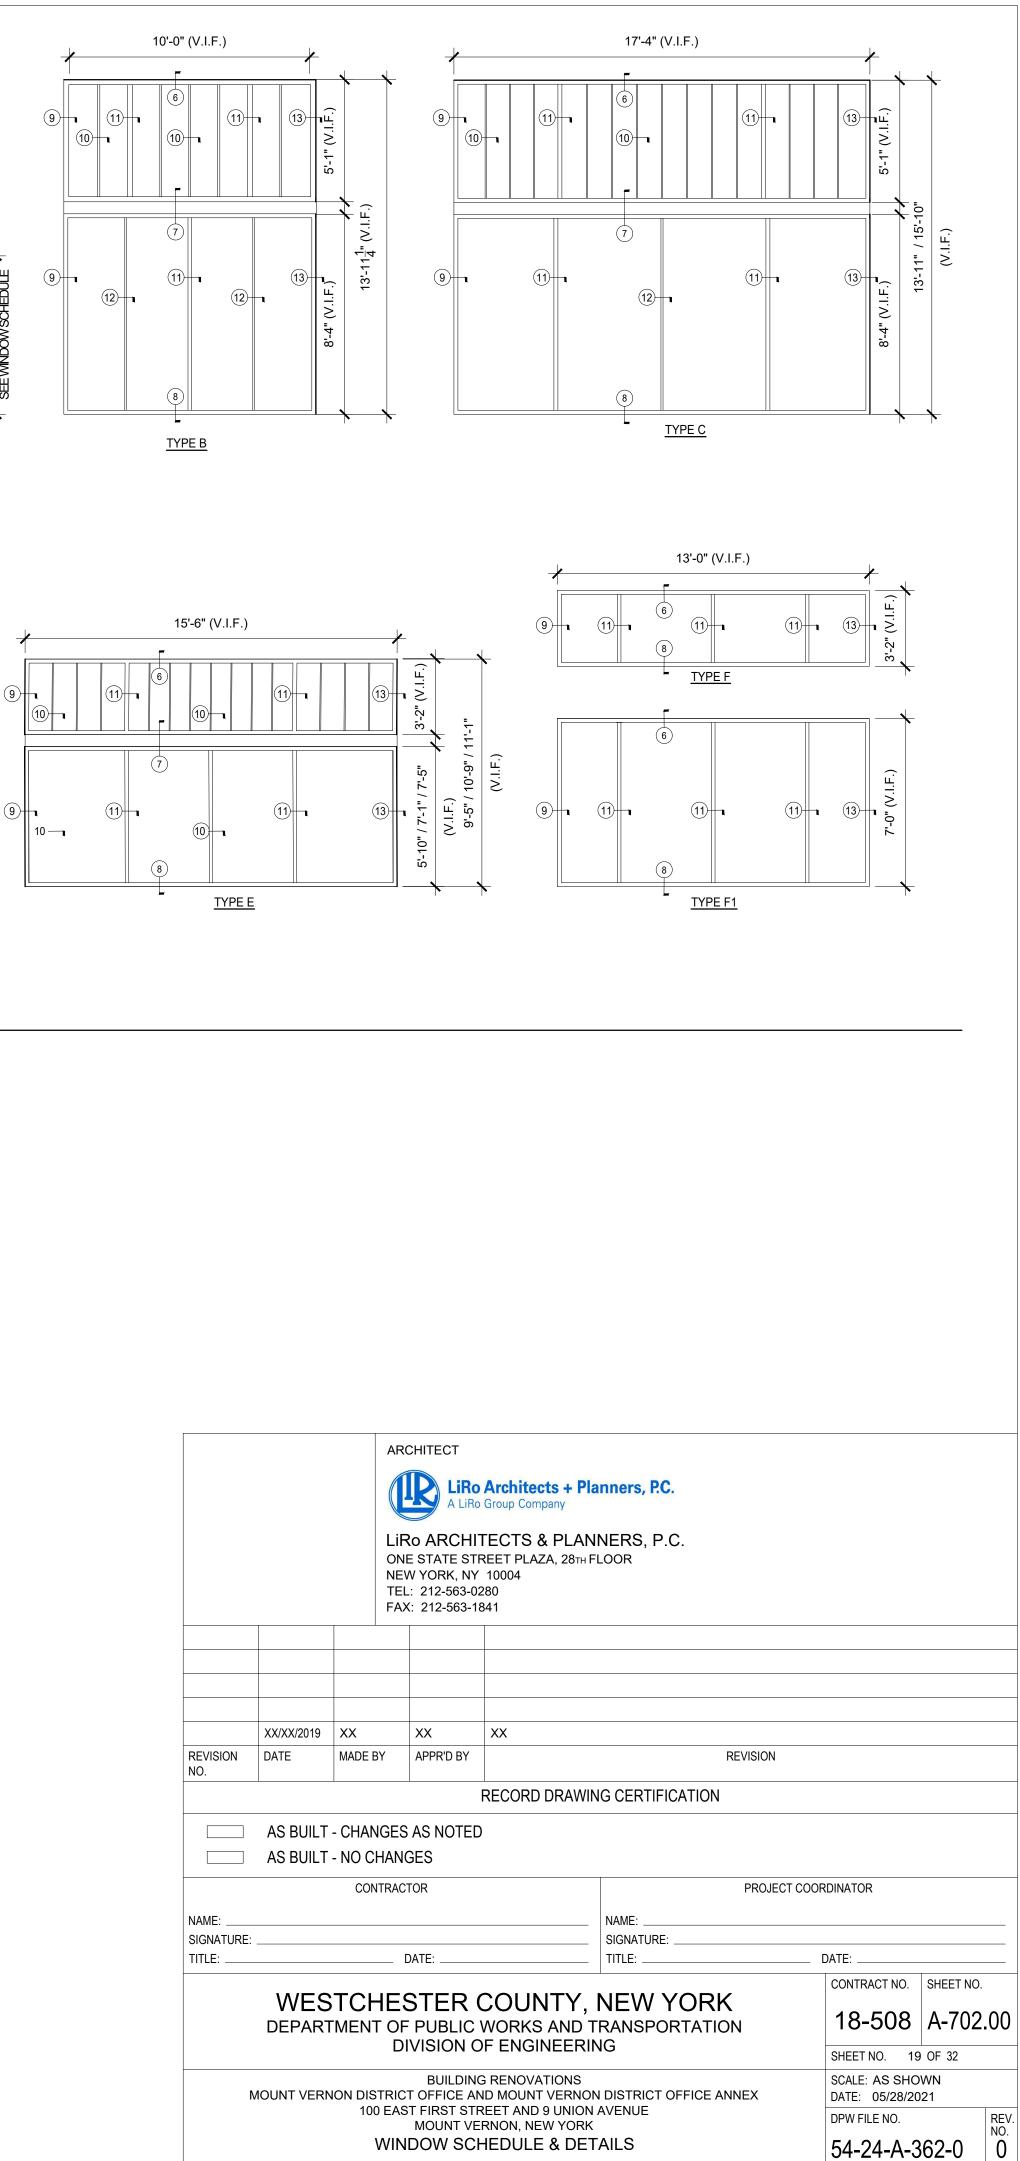


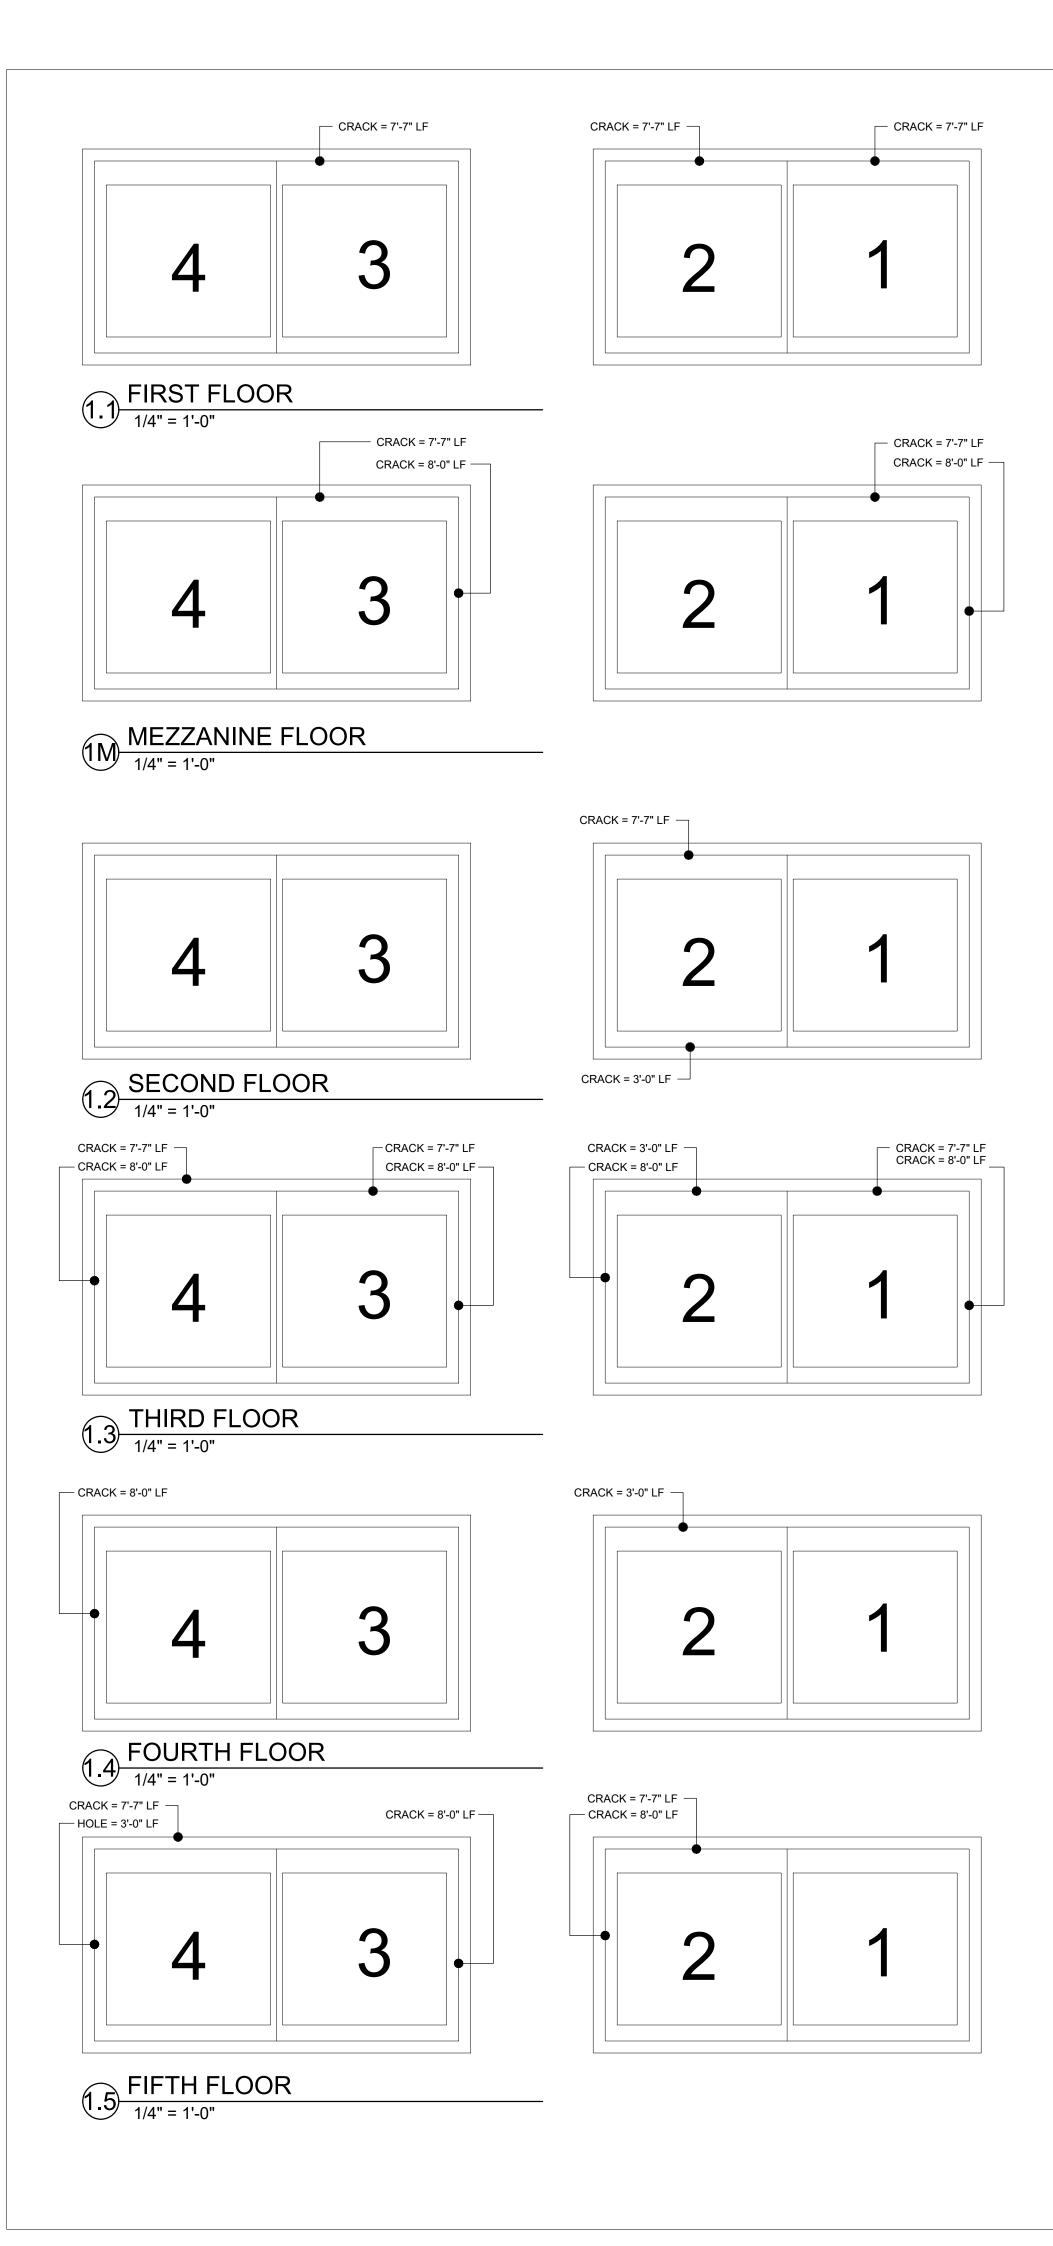

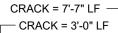


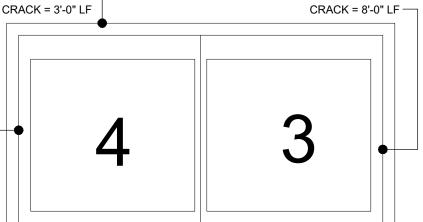


1.6 SIXTH FLOOR

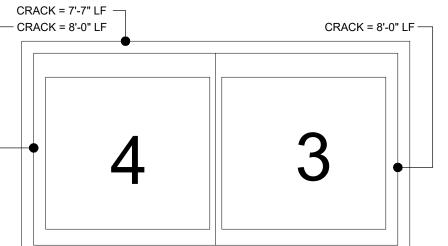


1.7 SEVENTH FLOOR

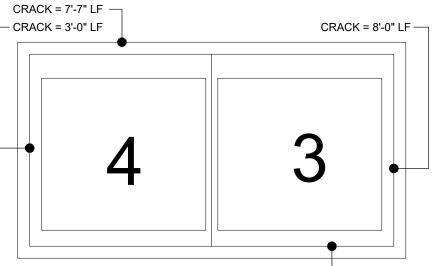

EIGHTH FLOOR 1/4" = 1'-0" CRACK = 7'-7" LF —

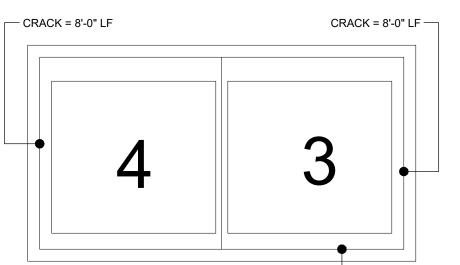


CRACK = 7'-7" LF — 1.9 NINTH FLOOR

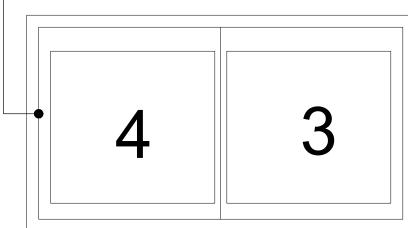



1.10 TENTH FLOOR


NOTE: REMOVE DAMAGED/SPALLED CONCRETE PARGING AT EXISTING CRACKS ON SURFACE OF ELEVATOR SHAFTS. PATCH/REPAIR APPROXIMATELY 6" +/- ALL AROUND DAMAGED SURFACE. AREAS OF DEFECTS ARE IDENTIFIED ON PLANS AS "CRACK". REFER TO DETAILS 10 & 11/A-401.00


REPAIRED AREAS MUST MEET FIRE RATING OF REST OF SHAFT

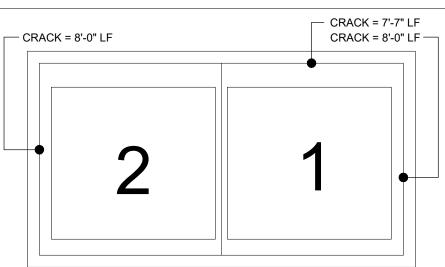


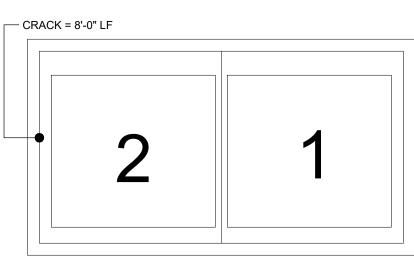


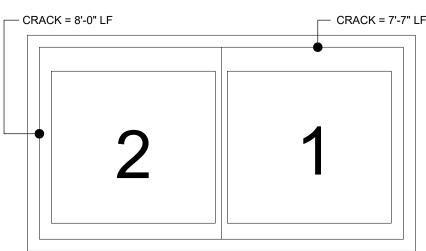


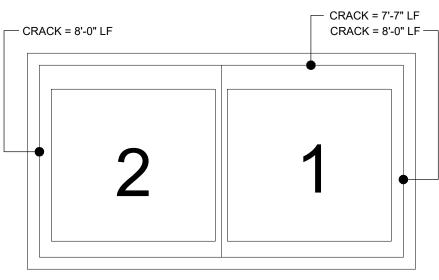


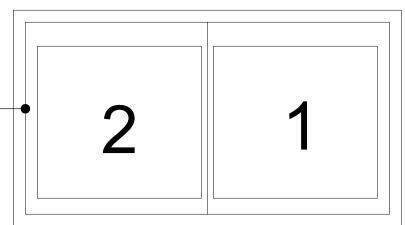


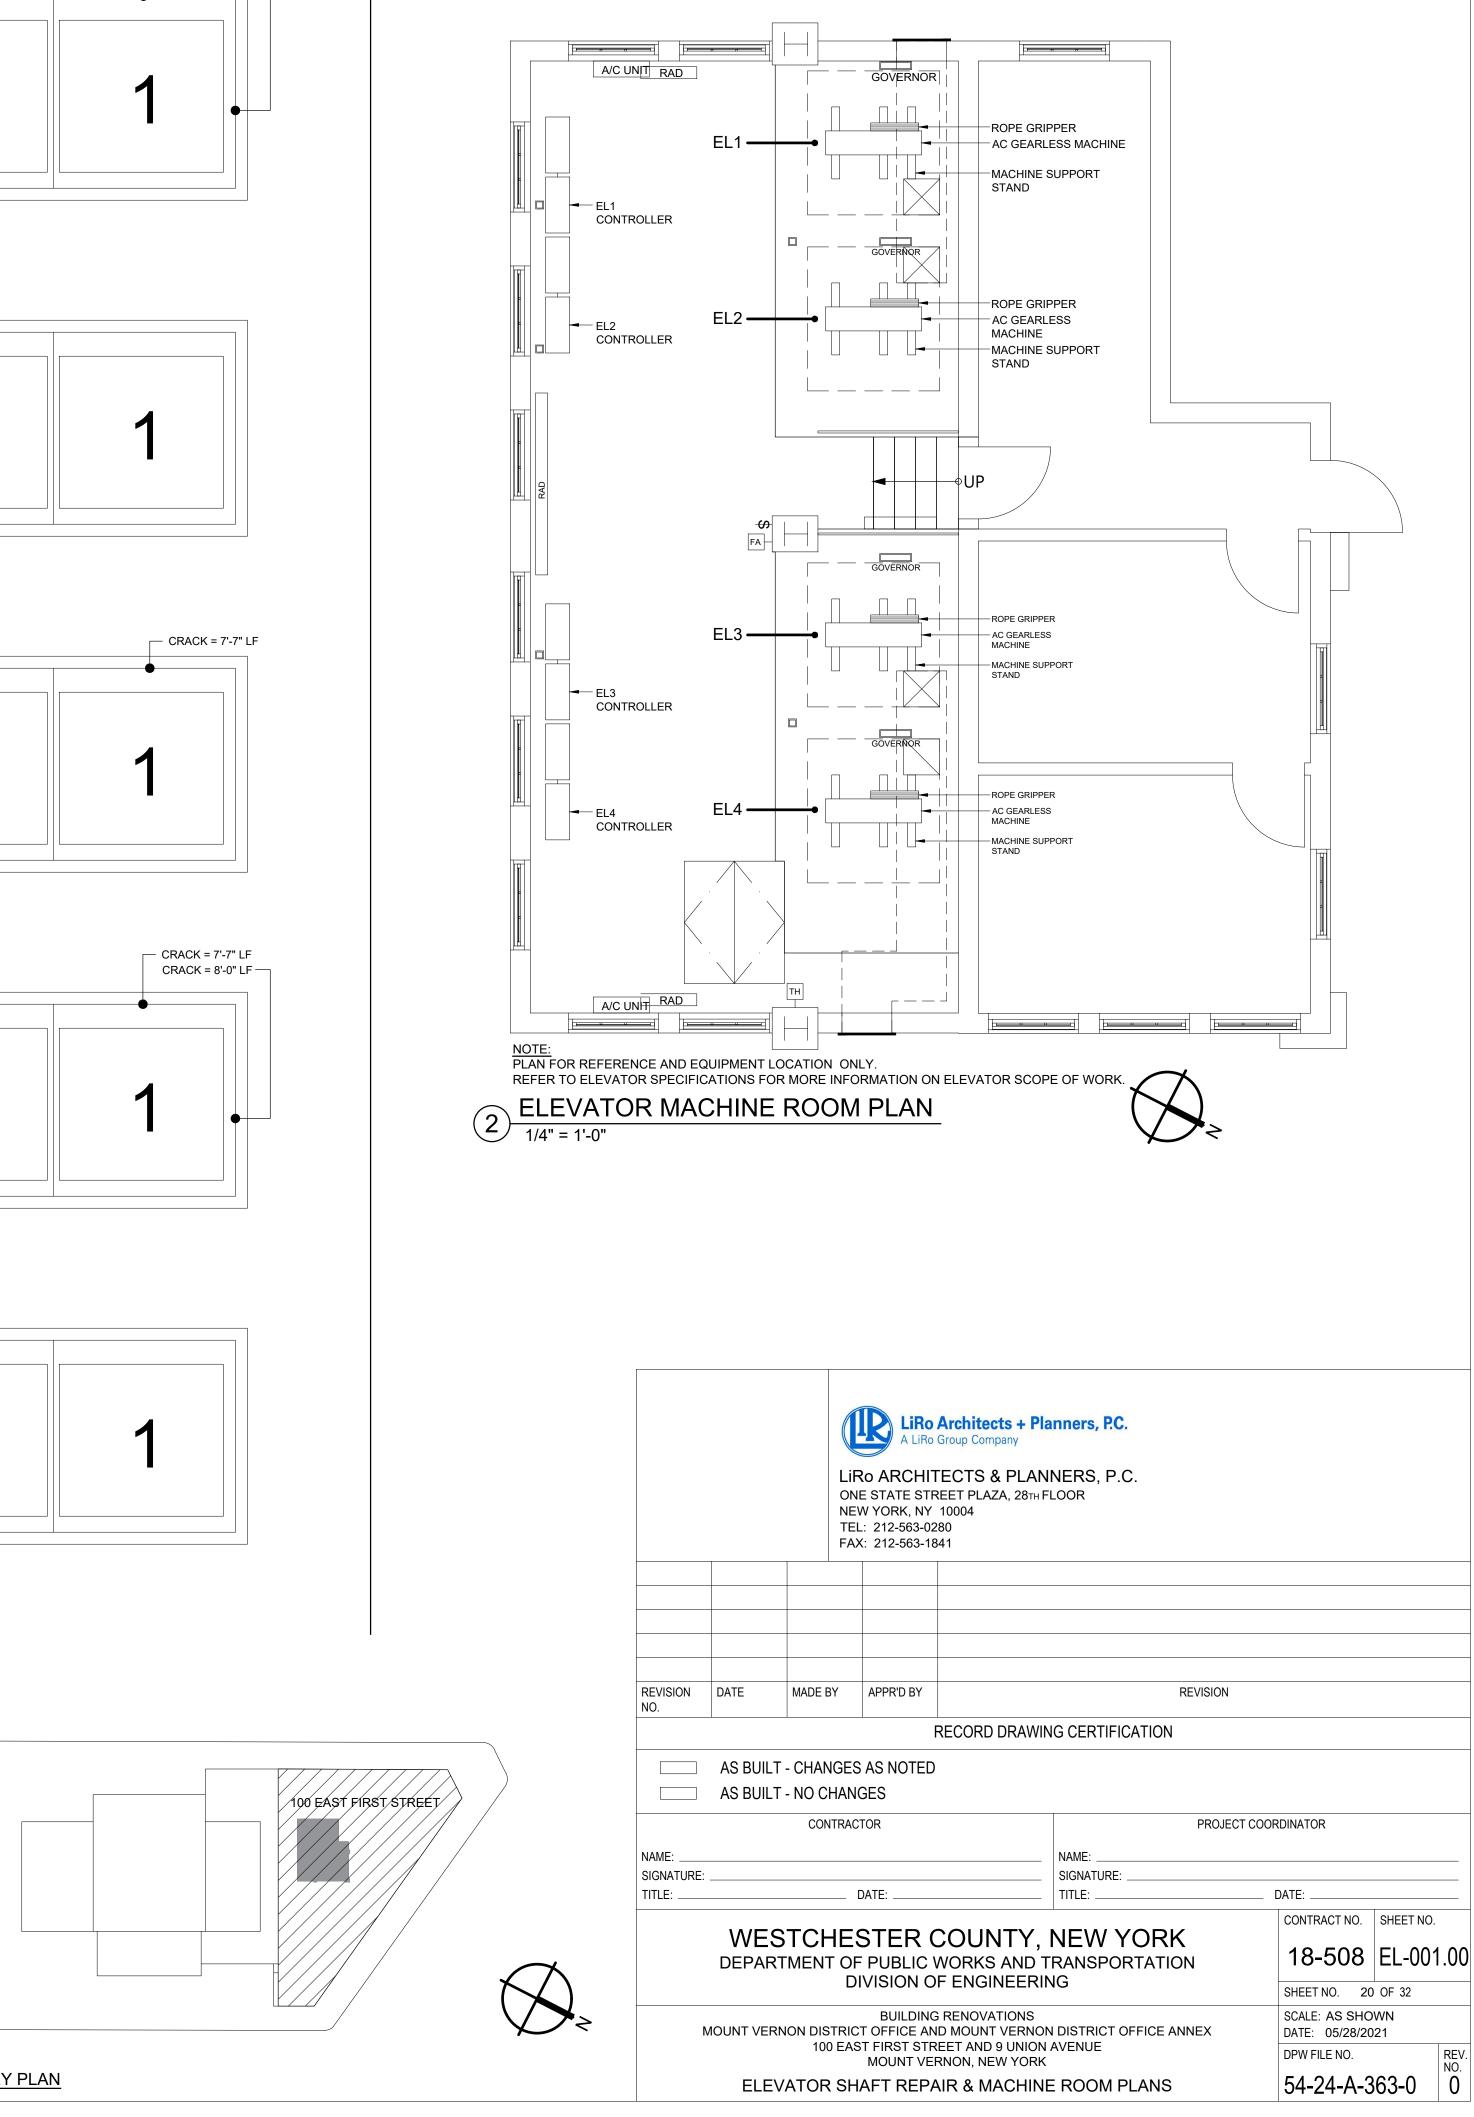

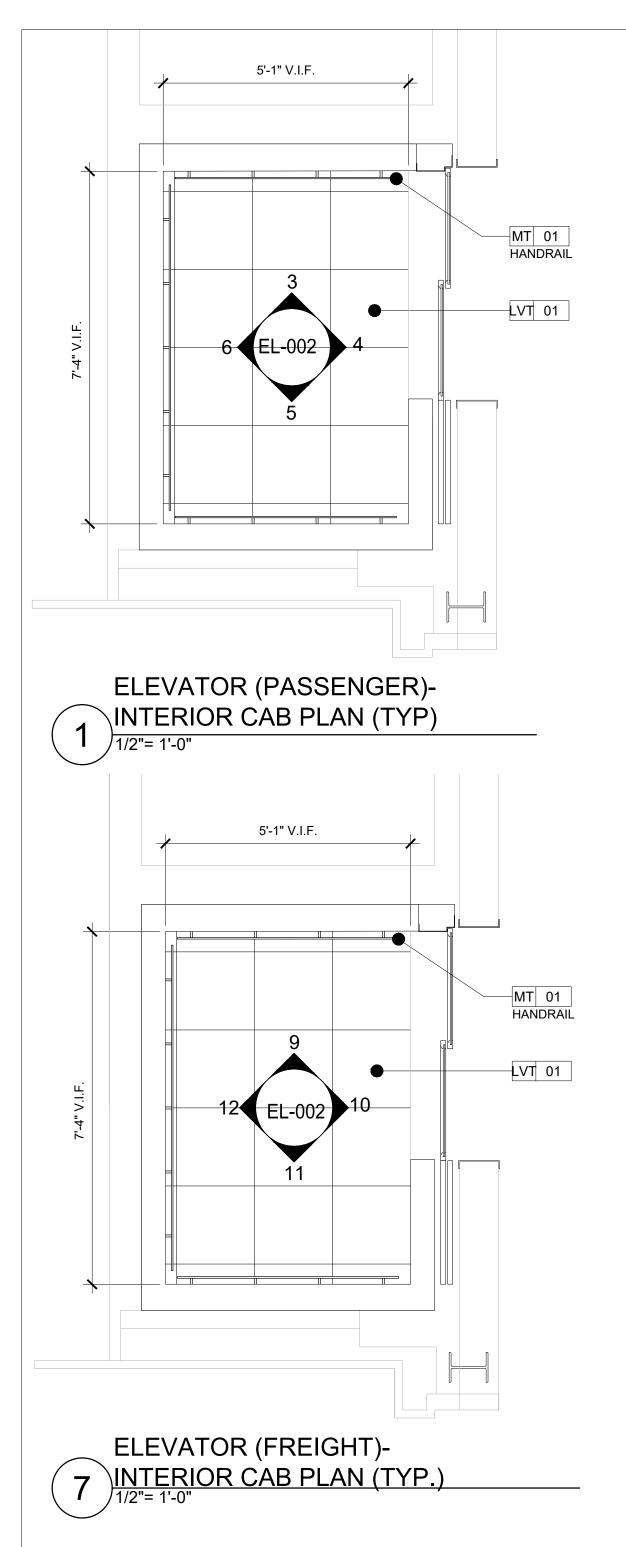

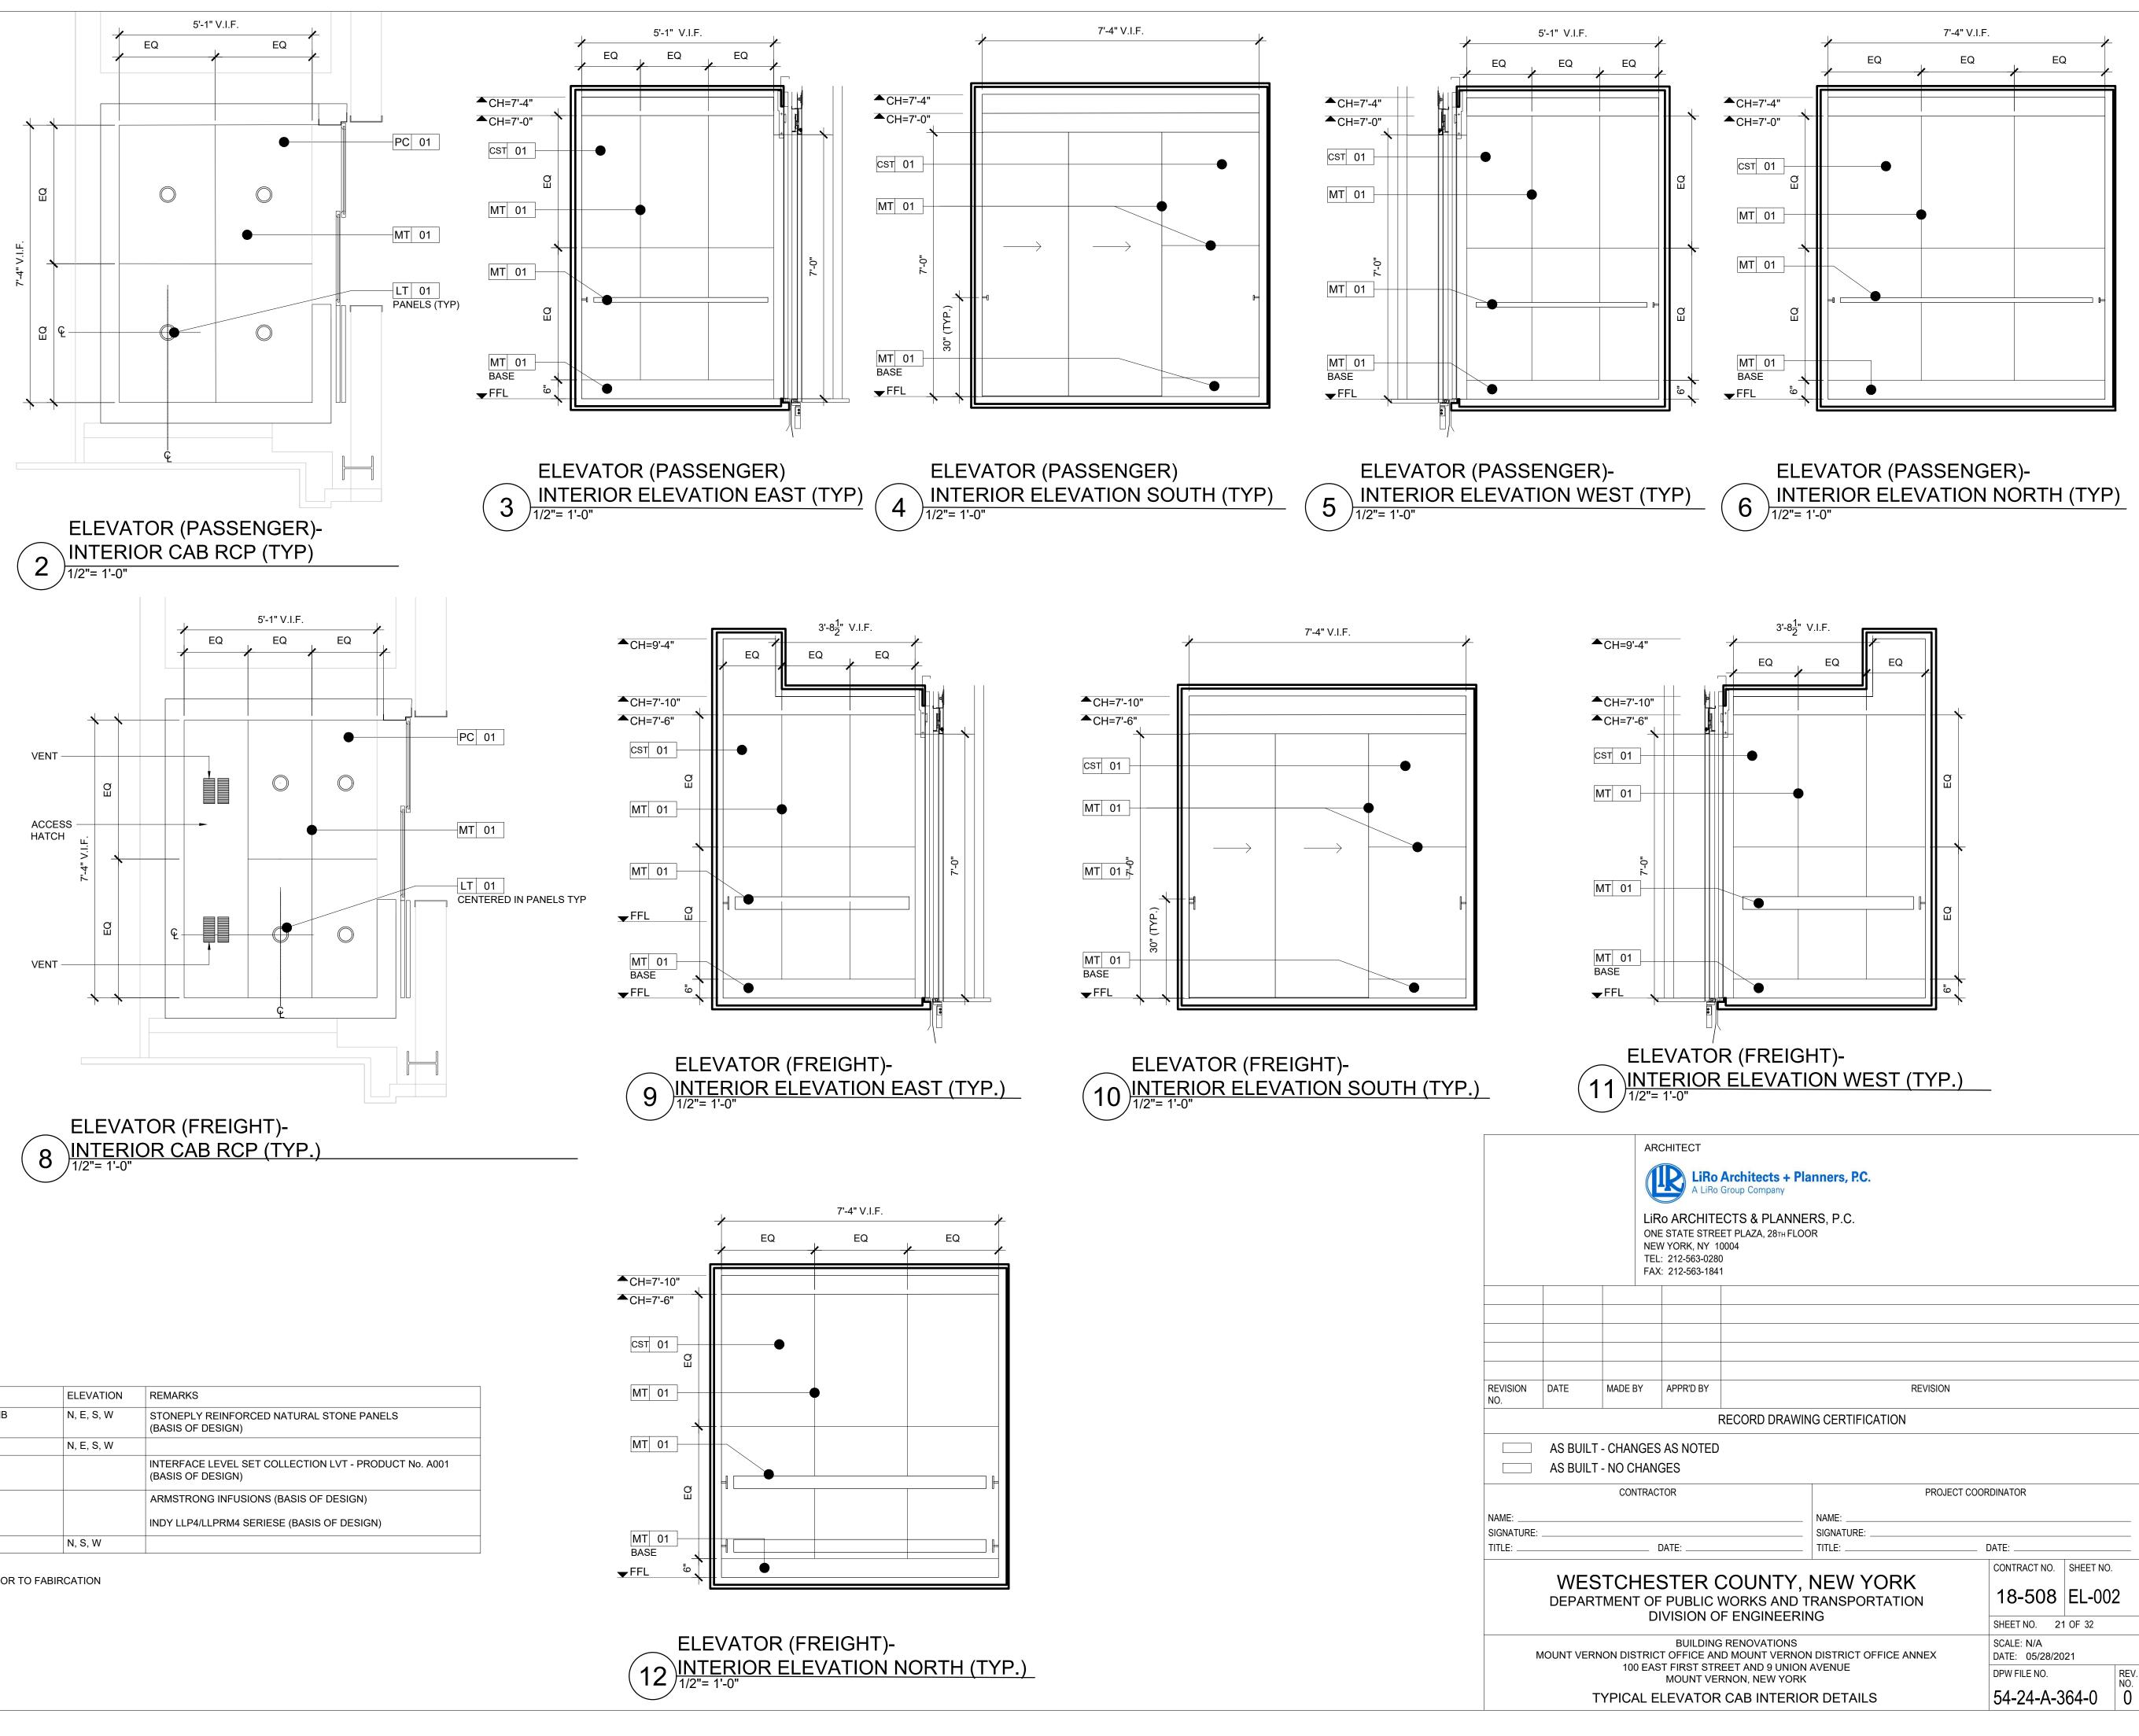

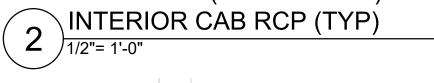

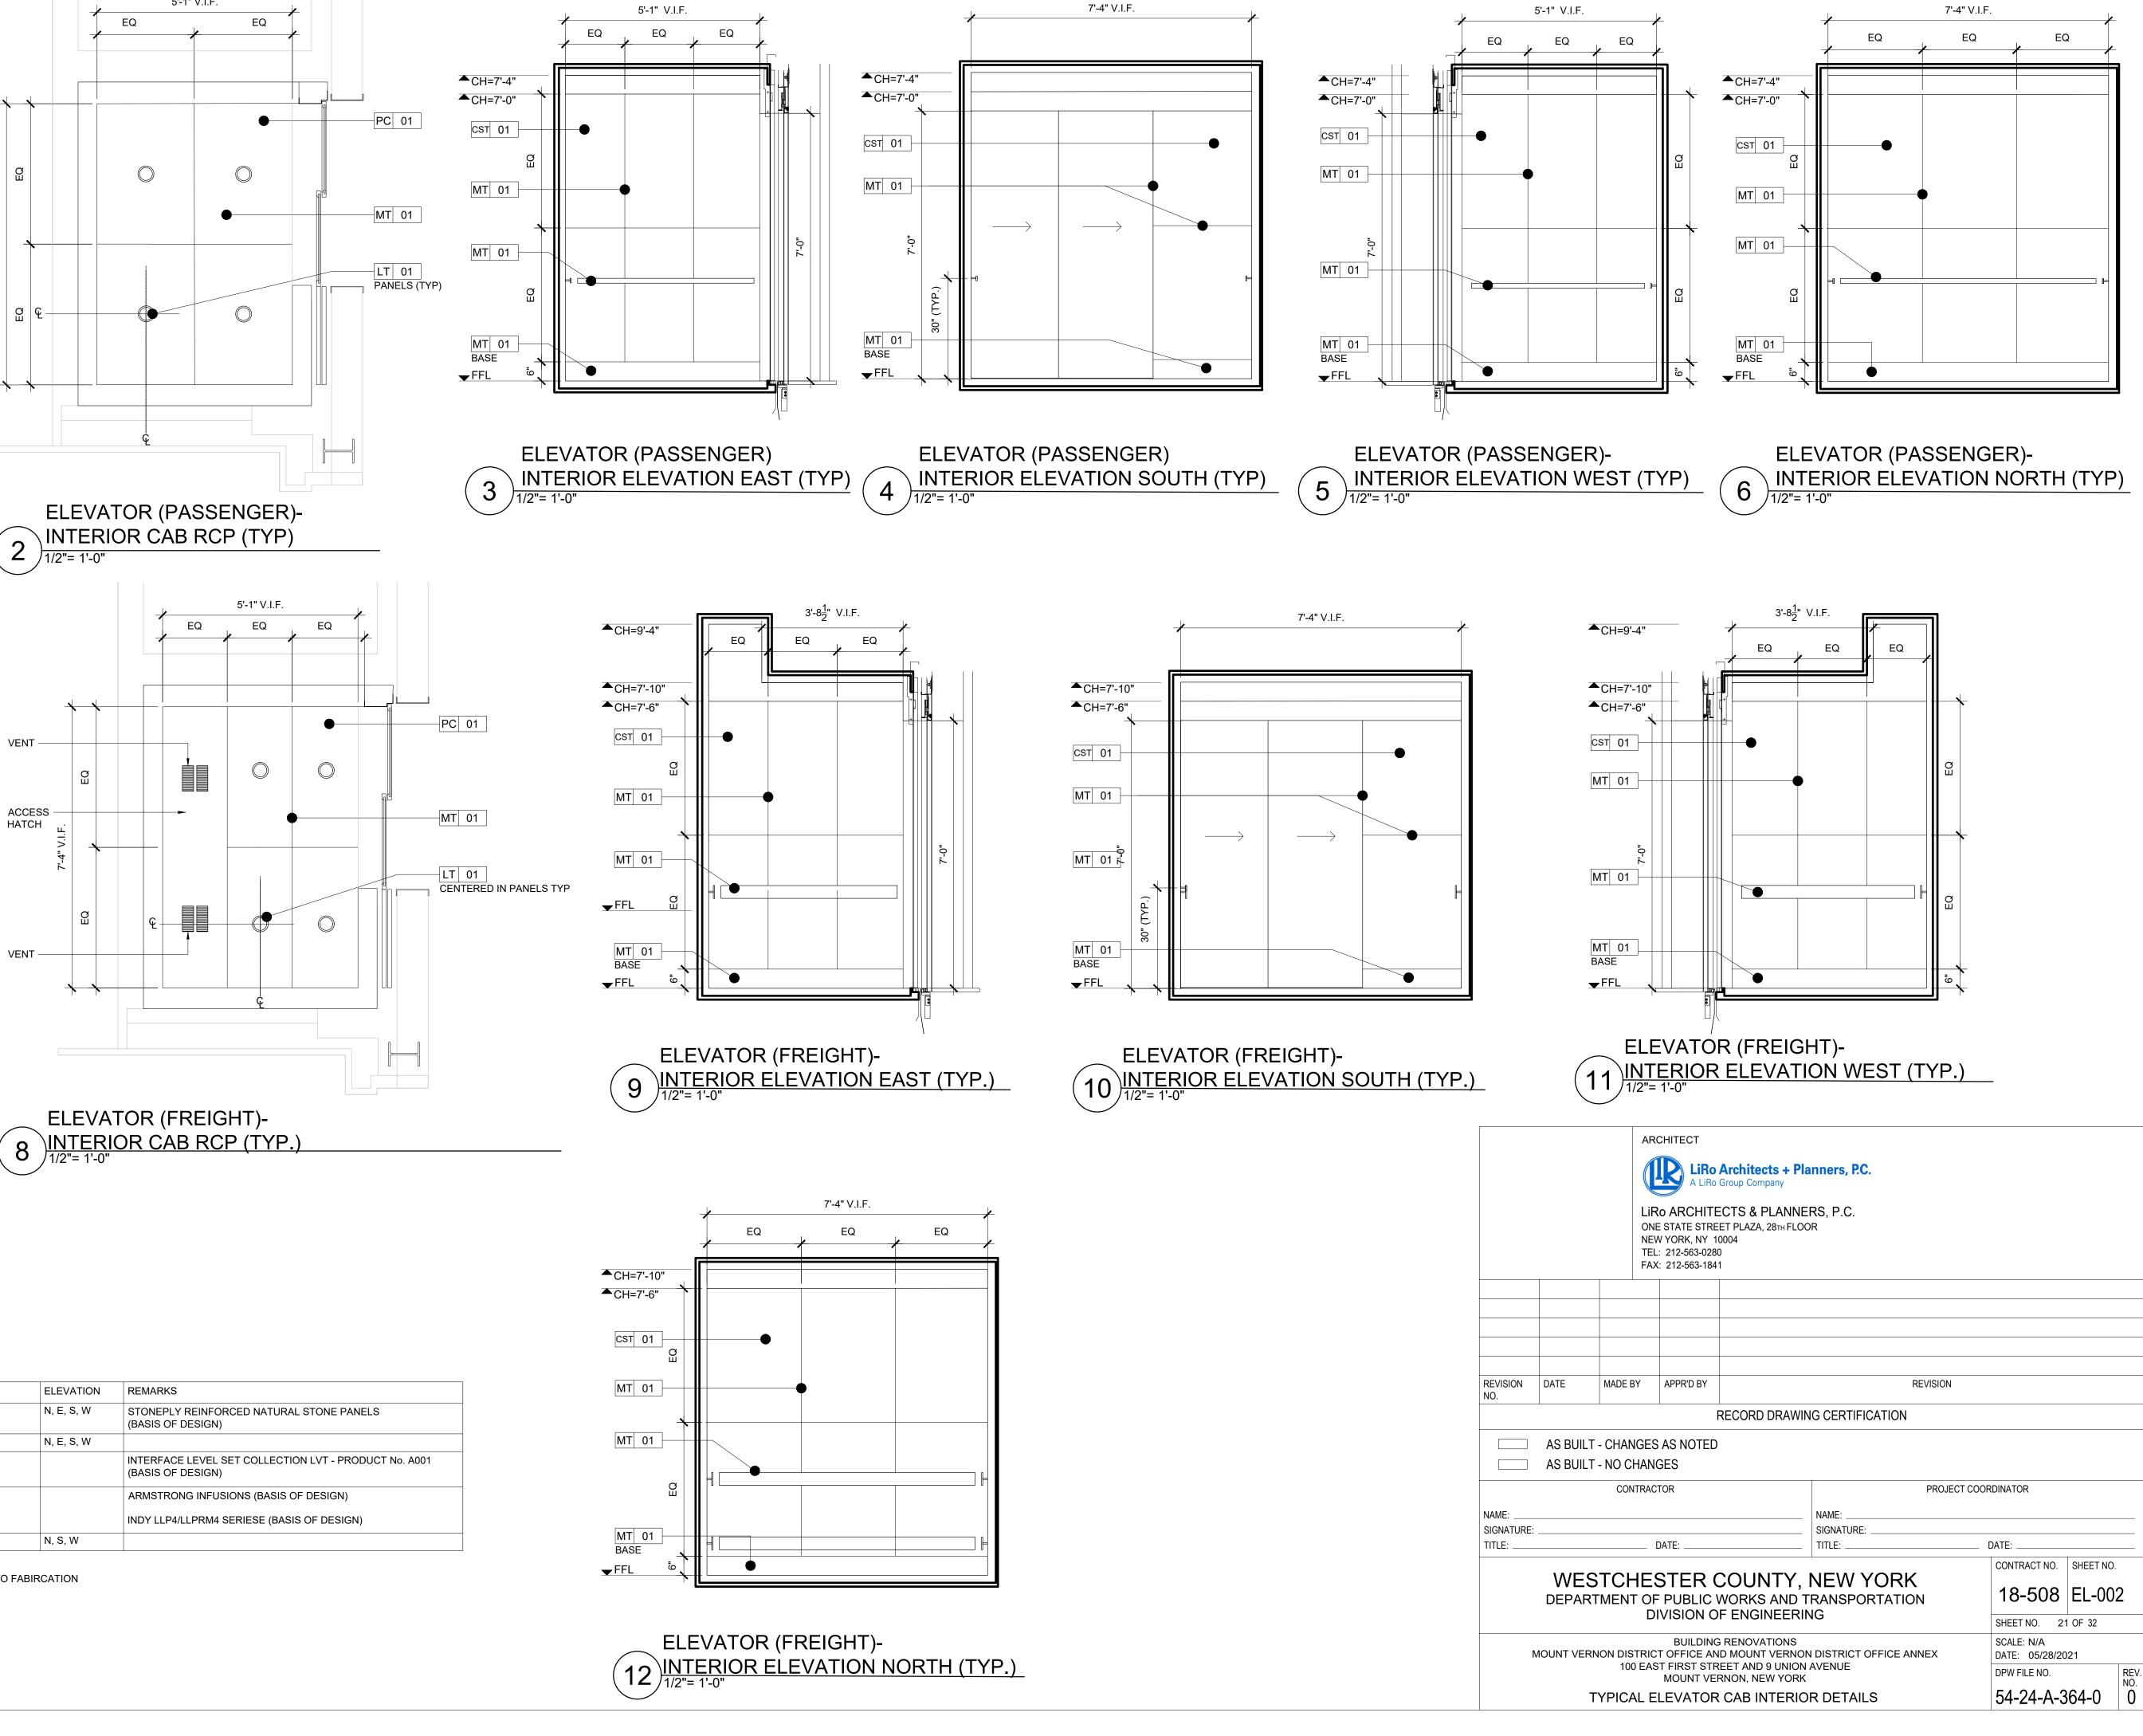


FINISH SCHEDULE

ELEVATOR (CAB (TYP) - INT	ERIOR		
SURFACE	FINISH ID	MATERIAL/FINISH	ELEVATION	REMARKS
WALLS	CST-01 MT-01	COMPOSITE STONE FINISH ON ALUMINUM HONEYCOMB S.S. EDGE TRIM (#4 FINISH)	N, E, S, W	STONEPLY REINFORCED NATURAL STONE PANELS (BASIS OF DESIGN)
BASE	MT-01	S.S. BASE (#4 FINISH)	N, E, S, W	
FLOOR	LVT-01	LUXURY VINYL TILE - NATURAL STONE		INTERFACE LEVEL SET COLLECTION LVT - PRODUC (BASIS OF DESIGN)
CEILING	PC-01 MT-01 LT-01	TRANSLUCENT POLYCARBONATE PANEL S.S. EDGE TRIM (#4 FINISH) RECESSED LED DOWN LIGHT		ARMSTRONG INFUSIONS (BASIS OF DESIGN) INDY LLP4/LLPRM4 SERIESE (BASIS OF DESIGN)
HANDRAIL	MT-01	S.S. FLAT STYLE (#4 FINISH)	N, S, W	

NOTE:

ALL INTERIOR AND AESTHETIC MUST BE APPROVED BY OWNER AND ARCHITECT PRIOR TO FABIRCATION



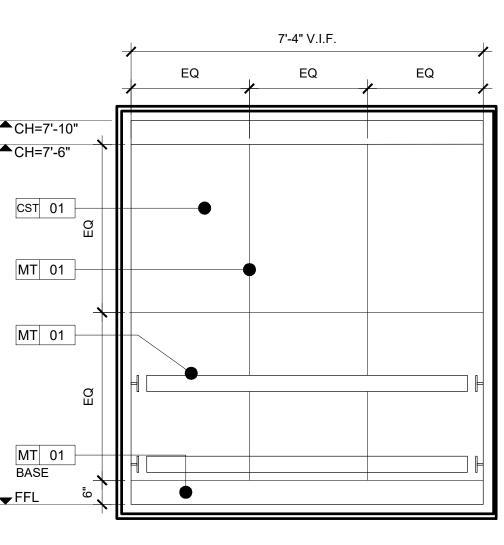

DEMOLITION NOTES

- 1. ALL DEMOLITION WORK IS TO BE CONDUCTED IN ACCORDANCE WITH THE 2020 NYS BUILDING CODE, 2020 NYS EXISTING BUILDING CODE, ALL OSHA REQUIREMENTS & GUIDELINES, AND ALL OTHER APPLICABLE CODES & STANDARDS.
- 2. ALL DEMOLITION AND REMOVAL WORK SHALL BE COMPLETED AS INDICATED AND NOTED ON THE DRAWINGS AND AS SPECIFIED. FOR DEMOLITION, FOR REMOVAL, AND DISPOSAL OF ASBESTOS MATERIALS, SEE ABATEMENT DRAWINGS AND SPECIFICATIONS.
- 3. PRIOR TO THE START OF DEMOLITION, THE CONTRACTOR SHALL CALL TO THE ATTENTION OF THE OWNER ANY DAMAGE, CRACKS OR OTHER IMPERFECTIONS IN THE WORK ADJACENT TO DEMOLITION AREAS. THESE AREAS SHALL BE NOTED AS PRE-EXISTING CONDITIONS.
- 4. CONTRACTOR IS RESPONSIBLE FOR PROVIDING TEMPORARY PARTITIONS, DEBRIS PROTECTION, DUST SCREENS, ETC. BETWEEN AREAS OF CONSTRUCTION AND AREAS WHERE NO WORK IS TAKING PLACE. UNDER NO CIRCUMSTANCES SHALL DUST ENTER ADJACENT OCCUPIED SPACES. LOCATION OF SUCH PROTECTION SHALL BE VERIFIED WITH THE OWNER PRIOR TO COMMENCING WORK AND COORDINATION WITH THE PROGRESSION OF THE WORK SCHEDULE. PROTECTION MUST BE MAINTAINED AT ALL TIMES. SUBMIT TEMPORARY PROTECTION SHOP DRAWINGS FOR REVIEW AND APPROVAL.
- 5. PRE CONSTRUCTION SURVEY OF ALL EXISTING BUILDINGS AND UTILITIES AT PROJECT SITE SHALL BE PERFORMED BY THE CONTRACTOR. THE SURVEY SHALL PROVIDE THE WITH DOCUMENTATION OF EXISTING CONDITIONS IN CASE OF FUTURE DAMAGE CLAIM. THE SURVEY SHOULD BE CONDUCTED BY A PROFESSIONAL ENGINEER EXPERIENCED IN SUCH SURVEY WORK. THE SURVEY SHOULD INCLUDE PHOTOGRAPHS, DIMENSIONED SKETCHES, AND MEASUREMENTS OF AMBIENT VIBRATIONS.
- 6. TO ENSURE ACCURACY OF THESE DERIVED DIMENSIONS, THE CONTRACTOR IS TO PRODUCE LAYOUT DRAWINGS FOR COORDINATION WITH OTHER TRADES, AS WELL AS DETAILED SHOP DRAWINGS. ALTHOUGH THEY WILL NOT BE CHECKED, THESE LAYOUT DRAWING ARE TO BE SUBMITTED AT THE SAME TIME AS THE RELEVANT SHOP DRAWING.

CONCRETE NOTES

A. CODES AND TESTS

- 1. THE STRUCTURE HAS BEEN DESIGNED UNDER THE PROVISIONS OF THE NYS BUILDING CODE 2020 AND A.C.I 318-14.
- 2. ALL CONTROLLED CONCRETE SHALL COMPLY WITH THE A.C.I. BUILDING CODE. APPLICATION FOR CONTROLLED CONCRETE WITH CONCRETE TESTS AND CURVES OF TESTS FOR THE PRELIMINARY DESIGN MIX PREPARED BY AN APPROVED LABORATORY MUST BE SUBMITTED TO THE ENGINEER FOR FILING WITH THE BUILDING DEPARTMENT. NO CONCRETE SHALL BE PLACED WITHOUT THE DESIGN MIX BEING APPROVED BY THE ENGINEER OF RECORD.
- 3. DESIGN AND CONSTRUCTION OF FORMWORK IS TO COMPLY WITH THE A.C.I. AND NYS BUILDING CODE AS AMENDED.

SPECIAL INSPECTIONS AND TESTING NOTES

SPECIAL INSPECTIONS (2020 NYS BUILDING CODE)							
SPECIAL INSPECTIONS REQUIRED IN ACCORDANCE WITH CHAPTER 17 AND THE APPLICABLE SECTIONS OF THE 2020 NYS CONSTRUCTION CODE ARE LISTED IN THE FOLLOWING TABLES: THE CONTRACTOR MUST NOTIFY THE ARCHITECT OR ENGINEER FOR SPECIAL INSPECTIONS AT LEAST 72 HOURS BEFORE THE SPECIFIC WORK COMMENCES. THE FOLLOWING SPECIAL INSPECTIONS ARE TO BE COMPLETED:							
STRUCTURAL STEEL – WELDING	1705.2.1 & AISC 360-10 TABLES N5.4-1, N5.4-2, & N5.4-3						
STRUCTURAL STEEL – BOLTING	1705.2.1 & AISC 360-10 TABLES N5.6-1, N5.6-2 & N5.6-3						
SEISMIC FORCE-RESISTING SYSTEMS	1705.12 & AISC 341 TABLES J6-1, J6-2, J6-3, J7-1, J7-2, & J7-3						
REINFORCED CONCRETE	1705.3 & TABLE 1705.3.1, 1705.3.2, 1705.3.3, 1705.3.4, 1705.3.5, 1705.3.6, 1705.3.7, 1705.3.8, 1705.3.12						

1. SPECIAL INSPECTIONS SHALL BE IN ACCORDANCE WITH THE APPLICABLE BUILDING CODE SECTIONS. SIGNED COPIES OF ALL TESTS AND INSPECTIONS REPORTS SHALL BE FILED WITH THE DEPARTMENT OF BUILDINGS THROUGH THE APPLICANT.

 G.C. SHALL PROVIDE THE TESTING AGENCY THE FOLLOWING: A FULL SET OF STRUCTURAL DRAWINGS, APPROVED SUBMITTALS AND GENERAL NOTES AND APPLICABLE SPECIFICATIONS.

- 2.1 SUFFICIENT NOTICE, AS AGREED AT THE START OF THE PROJECT, PRIOR TO THE WORK TO PERFORM TESTING WITHOUT DELAYING THE WORK.2.2 EASY ACCESS TO ALL MATERIALS AND COMPONENTS TO BE TESTED.
- 3. THE TESTING AGENCY SHALL SUBMIT RESULTS OF ALL TESTS TO THE OWNER AND ARCHITECT. THE TESTING AGENCY WILL BE RESPONSIBLE FOR CONDUCTING AND INTERPRETING THE TESTS AND WILL PREPARE REPORTS WHICH STATE WHETHER OR NOT THE RESULTS COMPLY WITH THE CONTRACT DOCUMENTS. REPORTS SHALL SUMMARIZE THE TYPE OF TEST, THE LOCATION OR COMPONENT TESTED, AND RECOMMEND ANY REMEDIAL MEASURES REQUIRED. THE REPORT SHALL ALSO NOTE ANY OTHER DEVIATIONS FROM THE CONTRACT DOCUMENTS.
- 4. MINIMUM QUALIFICATIONS FOR SPECIAL INSPECTOR
 - 4.1 WELDING: CONFORM TO QUALIFICATIONS REQUIREMENTS AS PER 1704.2.1 OF 2020 NYS BUILDING CODE.
 4.2 HIGH STRENGTH BOLTING AND STEEL FRAMING AS PER 1704.2.1 OF 2020 NYS BUILDING CODE.

5. THE FOLLOWING ITEMS OF WORK, AS APPROPRIATE, SHALL BE SUBJECT TO SPECIAL INSPECTION:

- 5.1 STRUCTURAL STEEL
 - 5.1.1. HIGH STRENGTH BOLTING 5.1.2. WELDING
 - THE OWNER WILL RETAIN AN INDEPENDENT TESTING AGENCY TO CARRY OUT THE SPECIAL INSPECTIONS AND STRUCTURAL OBSERVATIONS SEE NOTES BELOW FOR ADDITIONAL TESTS, ETC. REQUIRED FOR WELDING, BOLTING, AND CONCRETE.
- 5.2 <u>WELDS SHALL BE TESTED AS FOLLOWS</u>
 - 5.2.1. VISUALLY INSPECT ALL WELDS
 - 5.2.2. FULL PENETRATION WELDS: ULTRASONIC TESTING OR MAGNETIC PARTICLE TESTING 100% OF WELDS.
 - 5.2.3. PARTIAL PENETRATION BUTT WELDS AND FILLET WELDS WITH A LEG LENGTH GREATER THAN 1/2":
 - ULTRASONIC TESTING OR MAGNETIC PARTICLE TESTING: 20% OF WELDS.
 - 5.2.4. ALL OTHER FILLET WELDS : MAGNETIC PARTICLE TESTING OF 10% OF WELDS.
 - 5.2.5. MAGNETIC PARTICLE TESTING TO CONFORM TO ASTM E709 AND ULTRASONIC TESTING TO CONFORM TO AWS D1.1 SECTION 6, NDT LEVEL II.
 - 5.2.6. ULTRASONIC TESTING OF ALL GROOVE WELDS AND ALL FILLET WELDS OF LEG LENGTH GREATER THAN 3/8" IN WELDED MOMENT JOINTS AND IN BASE METAL GREATER THAN 1 3/8" THICK. THIS EXAMINATION IS TO CONFIRM THE ABSENCE OF BOTH LAMINATION AND LAMELLAR TEARING. THE PRESENCE OF EITHER WILL BE CONSIDERED A CAUSE FOR REJECTION. THE ULTRASONIC EXAMINATION WILL INCLUDE THE PARENT MATERIAL TO A DISTANCE OF 6" ON EACH SIDE OF THE WELD.
 - 5.2.7. ALL GROOVE WELDS AND FILLET WELDS WITH LEG LENGTH OVER 3/8" IN MATERIAL GREATER THAN 1 3/8" THICK SHALL BE ULTRASONICALLY INSPECTED A SECOND TIME A MINIMUM OF 2 WEEKS AFTER COMPLETION OF THE WELDS.

STRUCTURAL NOTES

<u>A – GENERAL</u>

- 1. DESIGN IS IN ACCORDANCE WITH THE REQUIREMENTS OF THE 2020 NYS BUILDING CODE.
- 2. VERIFY ALL FIELD DIMENSIONS BY MEASUREMENT AT THE JOB SITE BEFORE SUBMITTING SHOP DRAWINGS.
- 3. DO NOT PLACE CONCRETE WITHOUT APPROVED STRUCTURAL SHOP DRAWINGS AND MECHANICAL/ARCHITECTURAL SHOP DRAWINGS RELATED TO THE CONCRETE WORK. RELATED ITEMS INCLUDE LOCATIONS OF OPENINGS; PIPE SLEEVES; REGLETS; DOVETAIL SLOTS, DRIPS, INSERTS FOR MECHANICAL EQUIPMENT AND/OR HUNG CEILINGS AND ANY OTHER ITEMS REQUIRED TO BE INSTALLED AND/OR COORDINATED BY THE ARCHITECTURAL AND MECHANICAL TRADES.
- 4. FOR LOCATION OF CURBS, CONCRETE PADS, FLOOR DEPRESSIONS, ROOF AND FLOOR DRAINS, SEE ARCHITECTURAL AND MEP DRAWINGS.
- 5. FOR FOUNDATION AND SITEWORK REQUIREMENTS, REFER TO FOUNDATION AND SITEWORK NOTES.

<u>B – STRUCTURAL STEEL</u>

- 1. THE DESIGN OF STRUCTURAL STEEL SHALL BE IN ACCORDANCE WITH
- a) SPECIFICATION FOR STRUCTURAL STEEL BUILDINGS (AISC 360-10)
- b) AISC SPECIFICATIONS FOR THE DESIGN OF STEEL HOLLOW STRUCTURAL SECTIONS (AISC-HSS.)
 c) ALL LOADS SHOWN ON STRUCTURAL DRAWINGS ARE SERVICE LOADS.

<u>C – CONCRETE REINFORCEMENT</u>

1. ALL REINFORCING BARS SHALL BE DEFORMED BILLET STEEL BARS AND SHALL CONFORM TO ASTM A615 GRADE 60. REINFORCEMENT TO BE WELDED SHALL CONFORM TO ASTM A706, GRADE 60. WELDED WIRE FABRIC (WIRE MESH) SHALL CONFORM TO ASTM A185. PROVIDE EPOXY-COATED REINFORCEMENT OR ZINC COATED(GALZANIZED) REINFORCEMENT IN ACCORDANCE WITH ASTM A775 FOR STEEL BARS AND ASTM A933 FOR WIRE MESH FOR CONCRETE EXPOSED TO THE ELEMENTS.

2. THE CONTRACTOR SHALL SUBMIT CHECKED SHOP DRAWINGS CONSISTING OF COMPLETE PLANS AND DETAILS OF REINFORCEMENT, LOCATIONS OF POUR LINES, CONSTRUCTION JOINTS, ETC. FOR APPROVAL BEFORE PROCEEDING WITH THE WORK.

3. ALL DETAILING, FABRICATION AND ERECTION OF REINFORCING BARS SHALL COMPLY WITH THE REQUIREMENTS OF ACI 315 AND ACI 318-14, CHAPTERS 7 AND 12, AND SECTION SECTION 1907 OF THE 2010 NYS BUILDING CODE.

4. ALL SPLICES SHALL BE IN ACCORDANCE WITH ACI 318–14, CHAPTER 12. THE LOCATIONS SHALL BE INDICATED ON THE SHOP DRAWINGS AND APPROVED BY THE ENGINEER OF RECORD. GENERALLY, ALL SPLICES SHALL BE STAGGERED AND LOCATED AWAY FROM THE SECTION OF MAXIMUM TENSILE STRESS.

ALL REINFORCEMENT SHALL BE ACCURATELY PLACED AND SECURELY WIRED TO PREVENT DISLOCATION FROM PROPER POSITION.
 PROVIDE CHAIRS FOR SUPPORT OF ALL REINFORCEMENT. LIFTING OF BARS OR MESH DURING PLACEMENT OF CONCRETE IS NOT PERMITTED.

7. WHERE NOT OTHERWISE INDICATED, PROVIDE A MINIMUM OF 2-#5 BARS TOP AND BOTTOM AT ALL SIDES OF UNFRAMED

OPENINGS. 8. CONCRETE PROTECTION FOR BARS IN SLAB SHALL BE 3/4" CLEAR UNLESS OTHERWISE NOTED.

9. WELDING OF REINFORCING BARS SHALL CONFORM TO STRUCTURAL WELDING CODE AWS D1.4.

10. THE DETAILING OF REINFORCEMENT AND CONNECTION BETWEEN CONCRETE MEMBER AS RELATED TO REQUIREMENTS FOR STRUCTURAL INTEGRITY SHALL COMPLY WITH PROVISIONS OF ACI 318-14, SECTION 7.13.

<u>D – SHOP DRAWING NOTES</u>

1. THE GENERAL CONTRACTOR OR CONSTRUCTION MANAGER SHALL SUBMIT STRUCTURAL SHOP DRAWINGS TO THE ARCHITECT AFTER THE GENERAL CONTRACTOR OR CONSTRUCTION MANAGER HAS REVIEWED AND NOTED ON THESE SUBMITTALS THAT THEY ARE IN CONFORMANCE WITH CONTRACT REQUIREMENTS. THE STRUCTURAL ENGINEER, UPON RECEIPT OF THESE SUBMITTALS FROM THE ARCHITECT, WILL REVIEW AND APPROVE OR TAKE OTHER APPROPRIATE ACTION UPON AND RETURN TO THE ARCHITECT FOR FINAL DISPOSITION.

ABBREVIATIONS & SYMBOLS:

INDICATES NUMBER OF SHEAR CONNECTORS <....> INDICATES CAMBER IN INCHES [....] MC OR - INDICATES MOMENT CONNECTION DESIGNED FOR FULL CAPACITY OF LARGEST MEMBER. SEE DETAILS INDICATES DIRECTION OF DECK SPAN 4 INDICATES DROP OF SLAB CONCRETE FILL OR HOUSEKEEPING PAD E.P. INDICATES EMBEDDED PLATE INDICATES COLUMN ABOVE (STARTS AT THIS LEVEL) INDICATES COLUMN BELOW (STARTS AT THIS LEVEL) $(\widehat{\mathbf{P}})$ INDICATES POST ABOVE OR BELOW INDICATES HANGER ABOVE OR BELOW CANT. INDICATES CANTILEVER BEAM WITH MC AT THE COLUMN BACK-UP BEAM ALSO TO RECEIVE MC AT THE → SAME COLUMN BP OR $|\frac{L}{L}|$ INDICATES BEARING PLATE IN NEW CONC. WALL SEE TYPICAL DETAILS FO-200 SERIES DWG'S. INDICATES GRID LINE

PARTIAL JOINT PENETRATION

ON S-600 SERIES DWG'S

P.J.P.

INDICATES BEAM PENETRATION CENTERED IN WEB U.O.N. SEE TYP. BM. OPENING REINFORCEMENT DETAIL


INDICATES END PLATE CONNECTION W/DRILLED IN ADHESIVE ANCHORS TO EXISTING CONC.


STRUCTURAL STEEL. CENTER LINE AND BOTH FLANGES SHOWN.


INDICATES BEARING WALL BLOCK.


FLOOR DRAIN W/DEPRESSION, (COORD. W/MEP & ARCH. REQUIREMENTS.)

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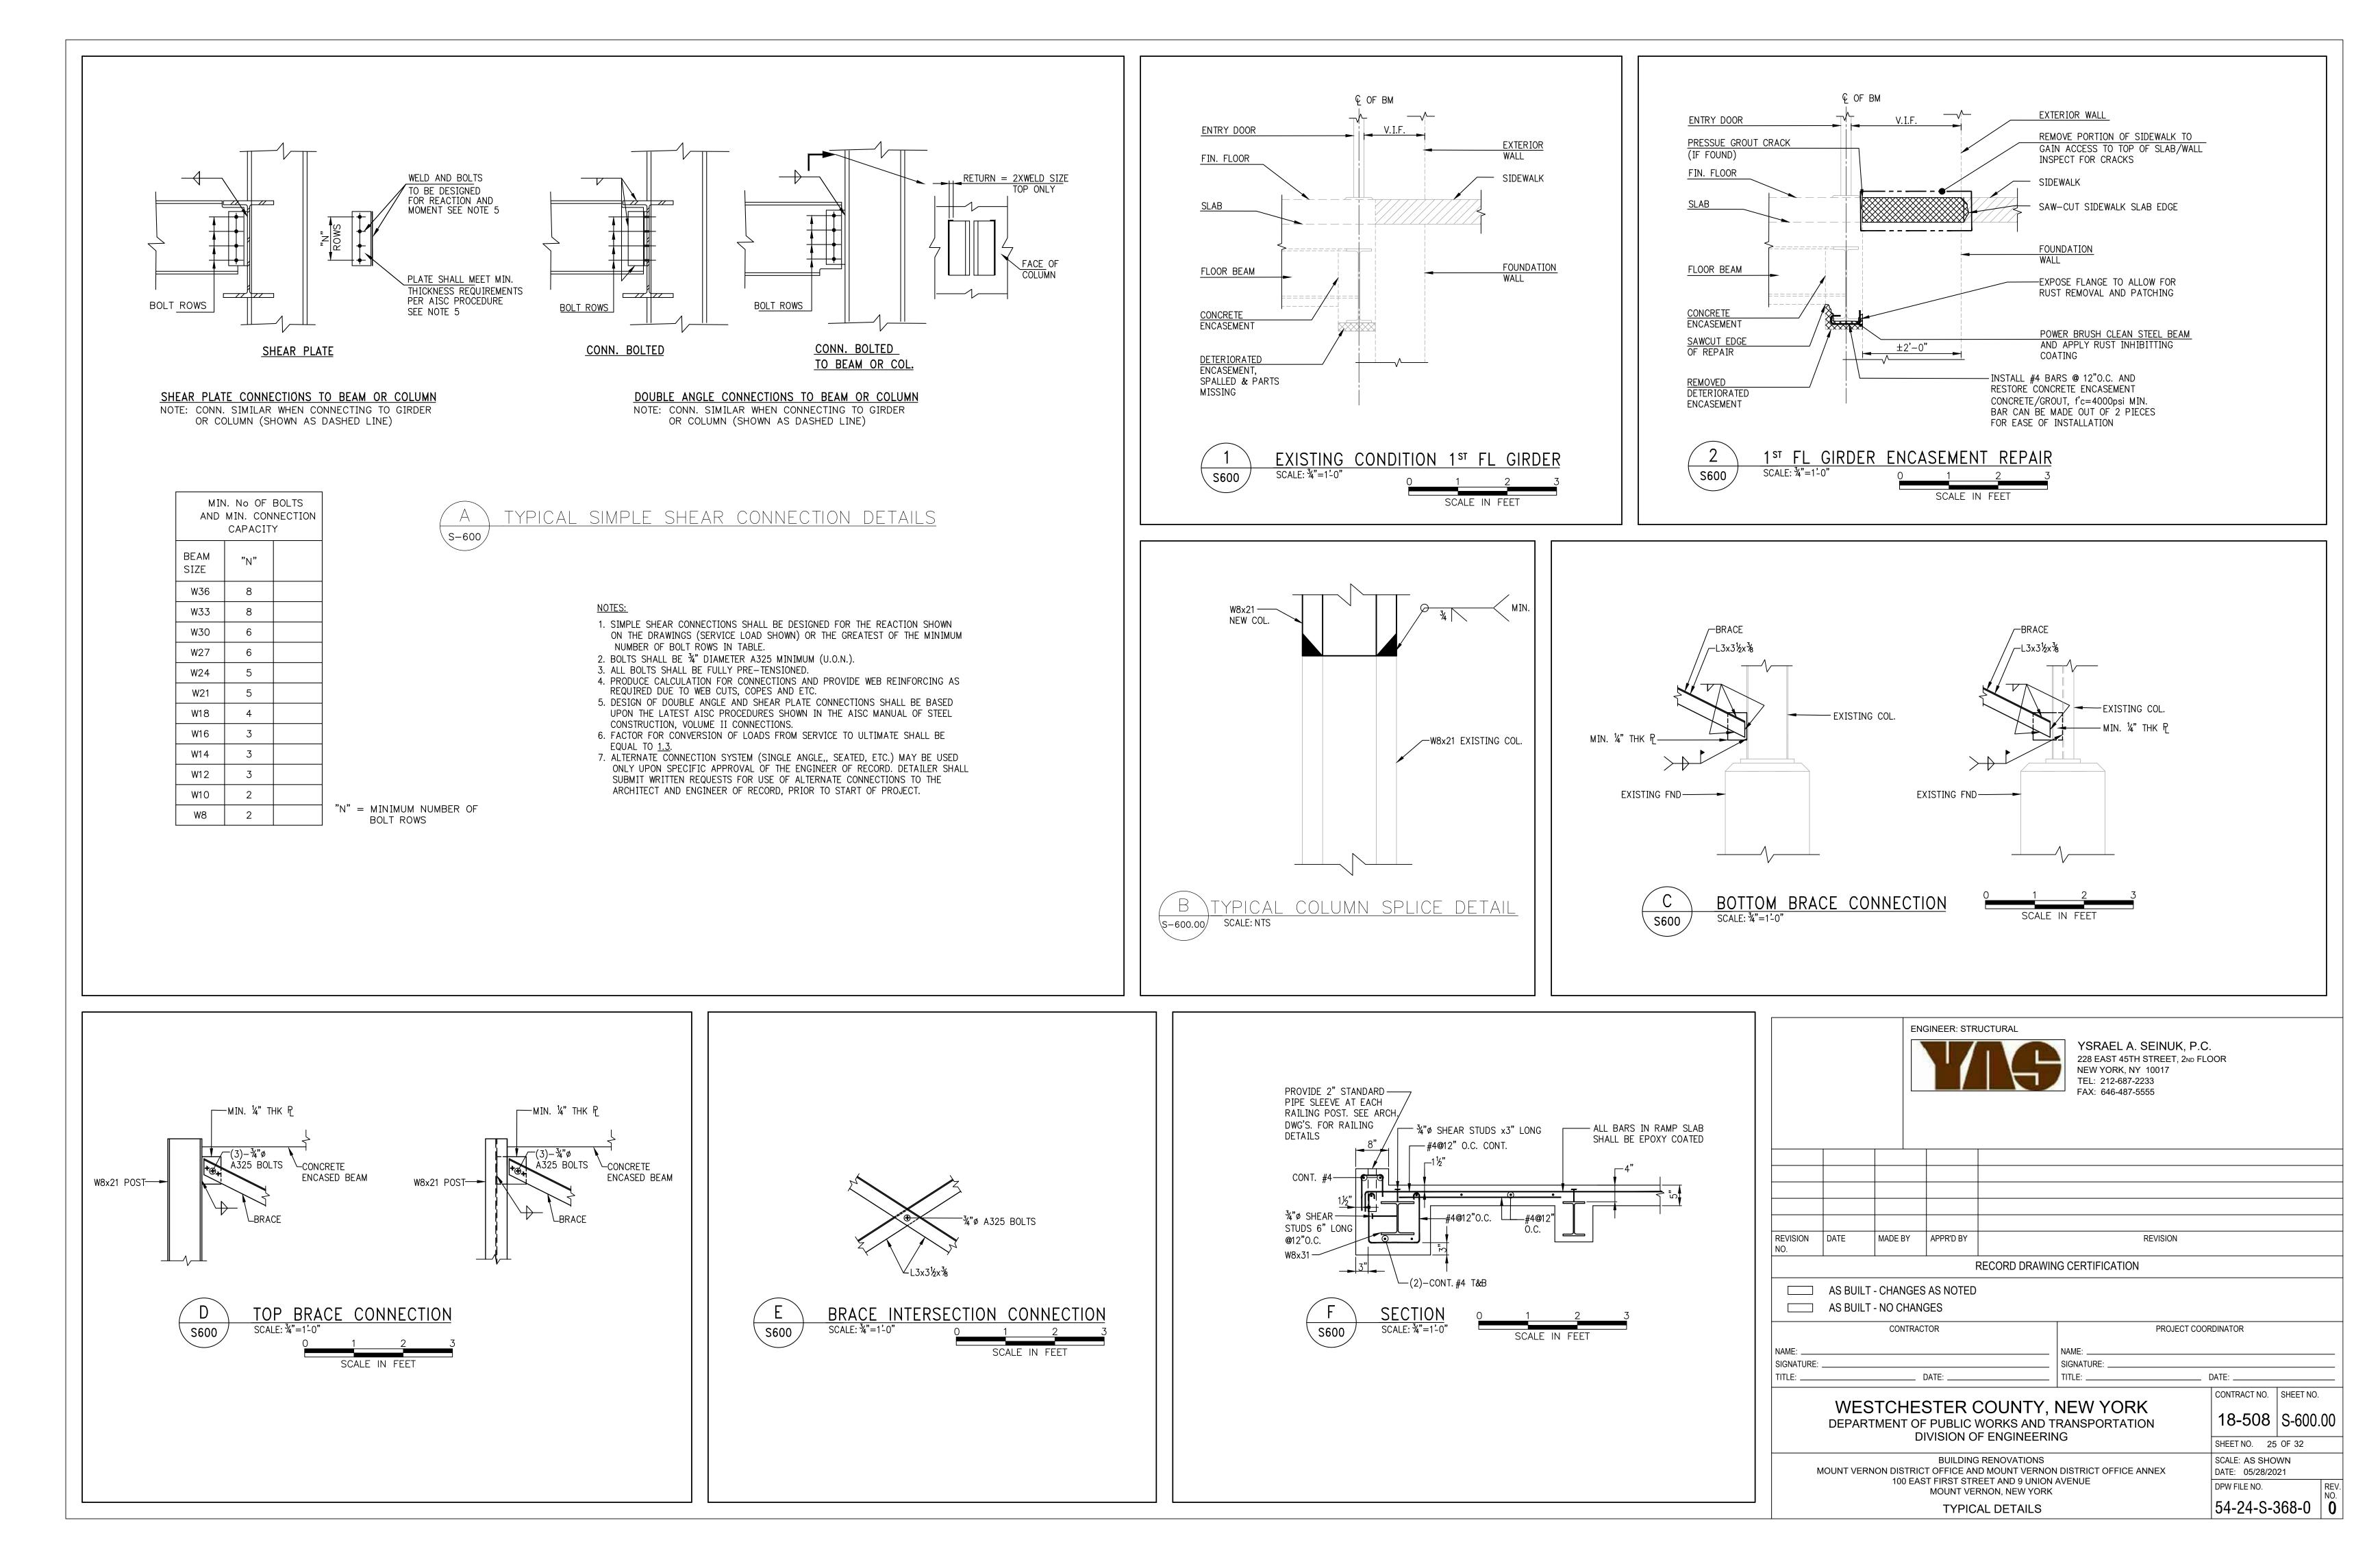
RAMP SECTION scale: ¼"=1'-0" 2 ∖ S−101 /

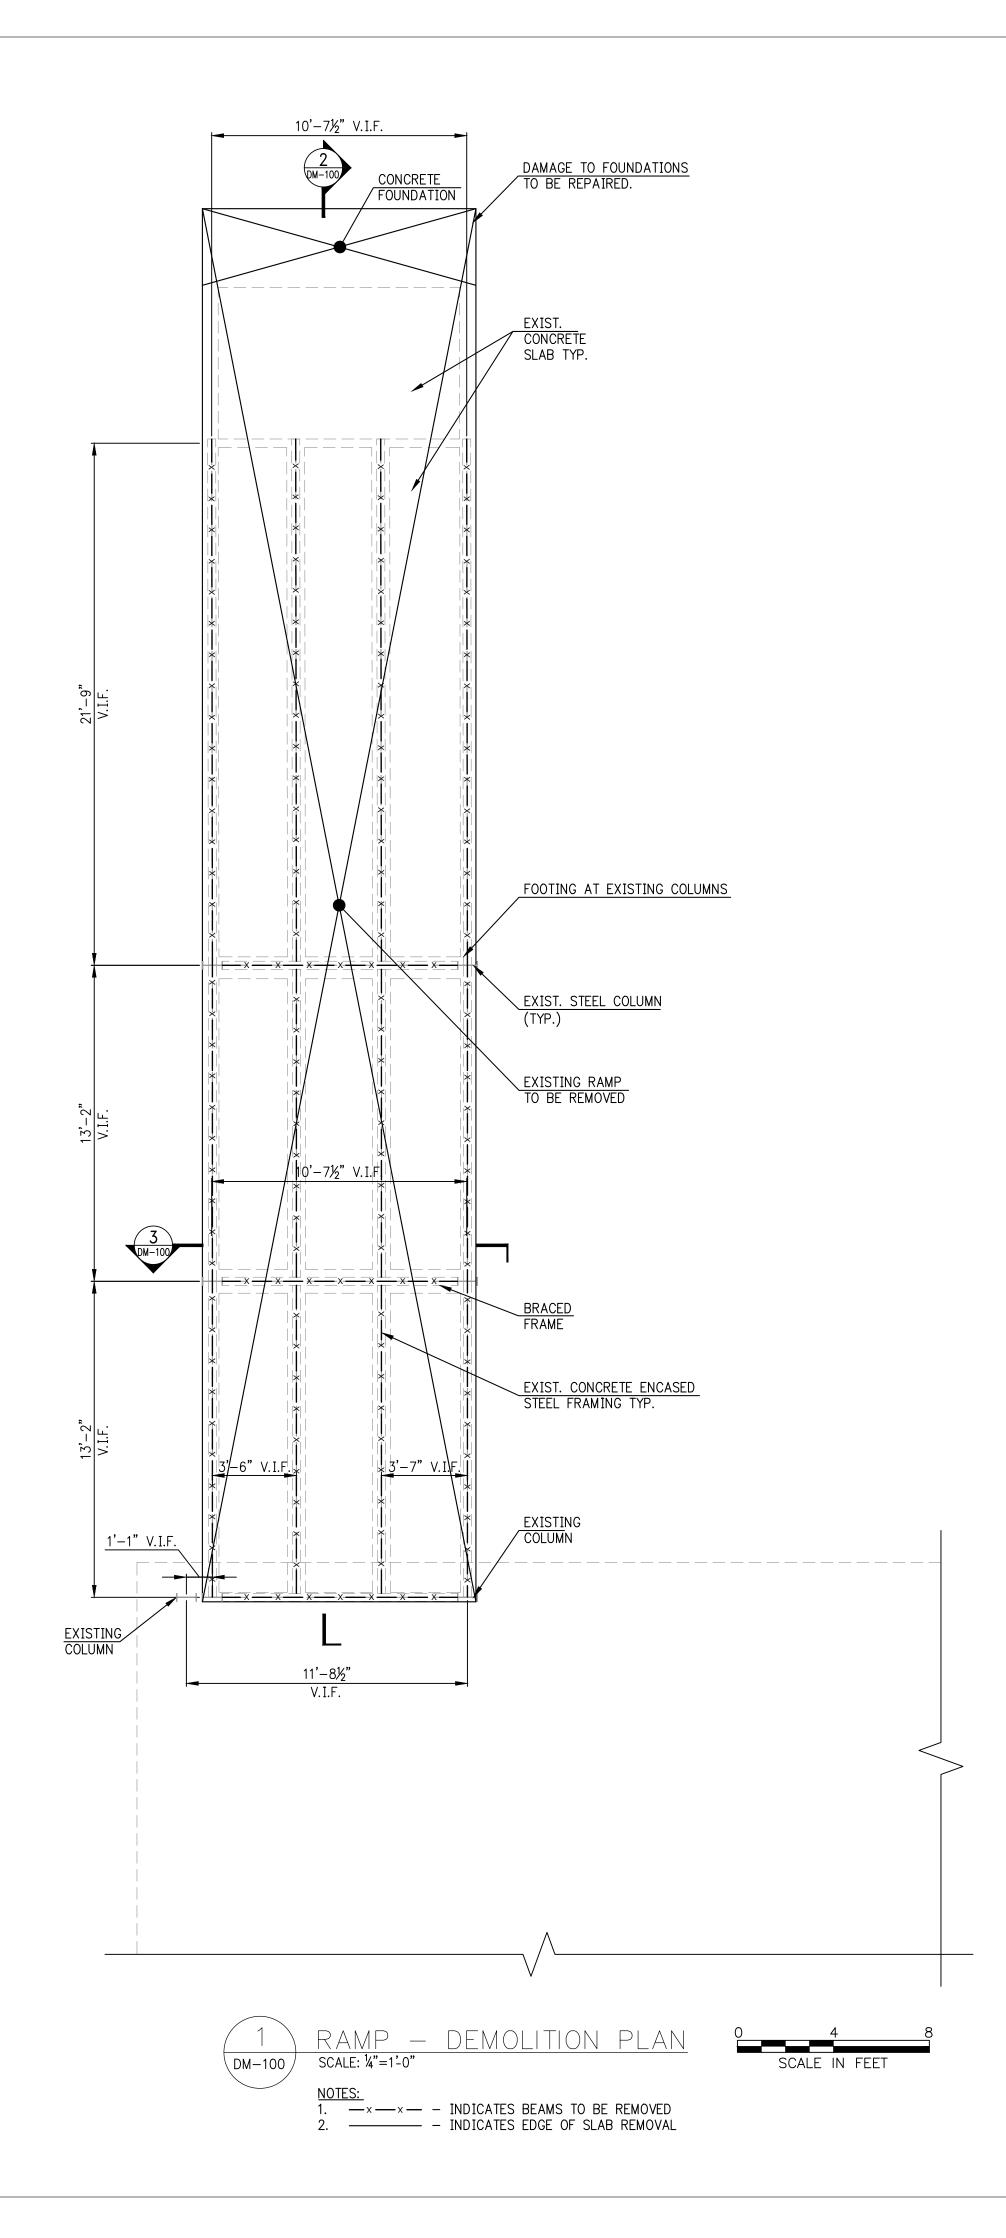NOTES: 1. EXISTING STUB UP NEEDS TO BE PREPARED FOR FULL PENETRATION WELD CONNECTING NEW POST TO IT. 2. ALL EXISTING CONDITIONS NEED TO BE FIELD VERIFIED.

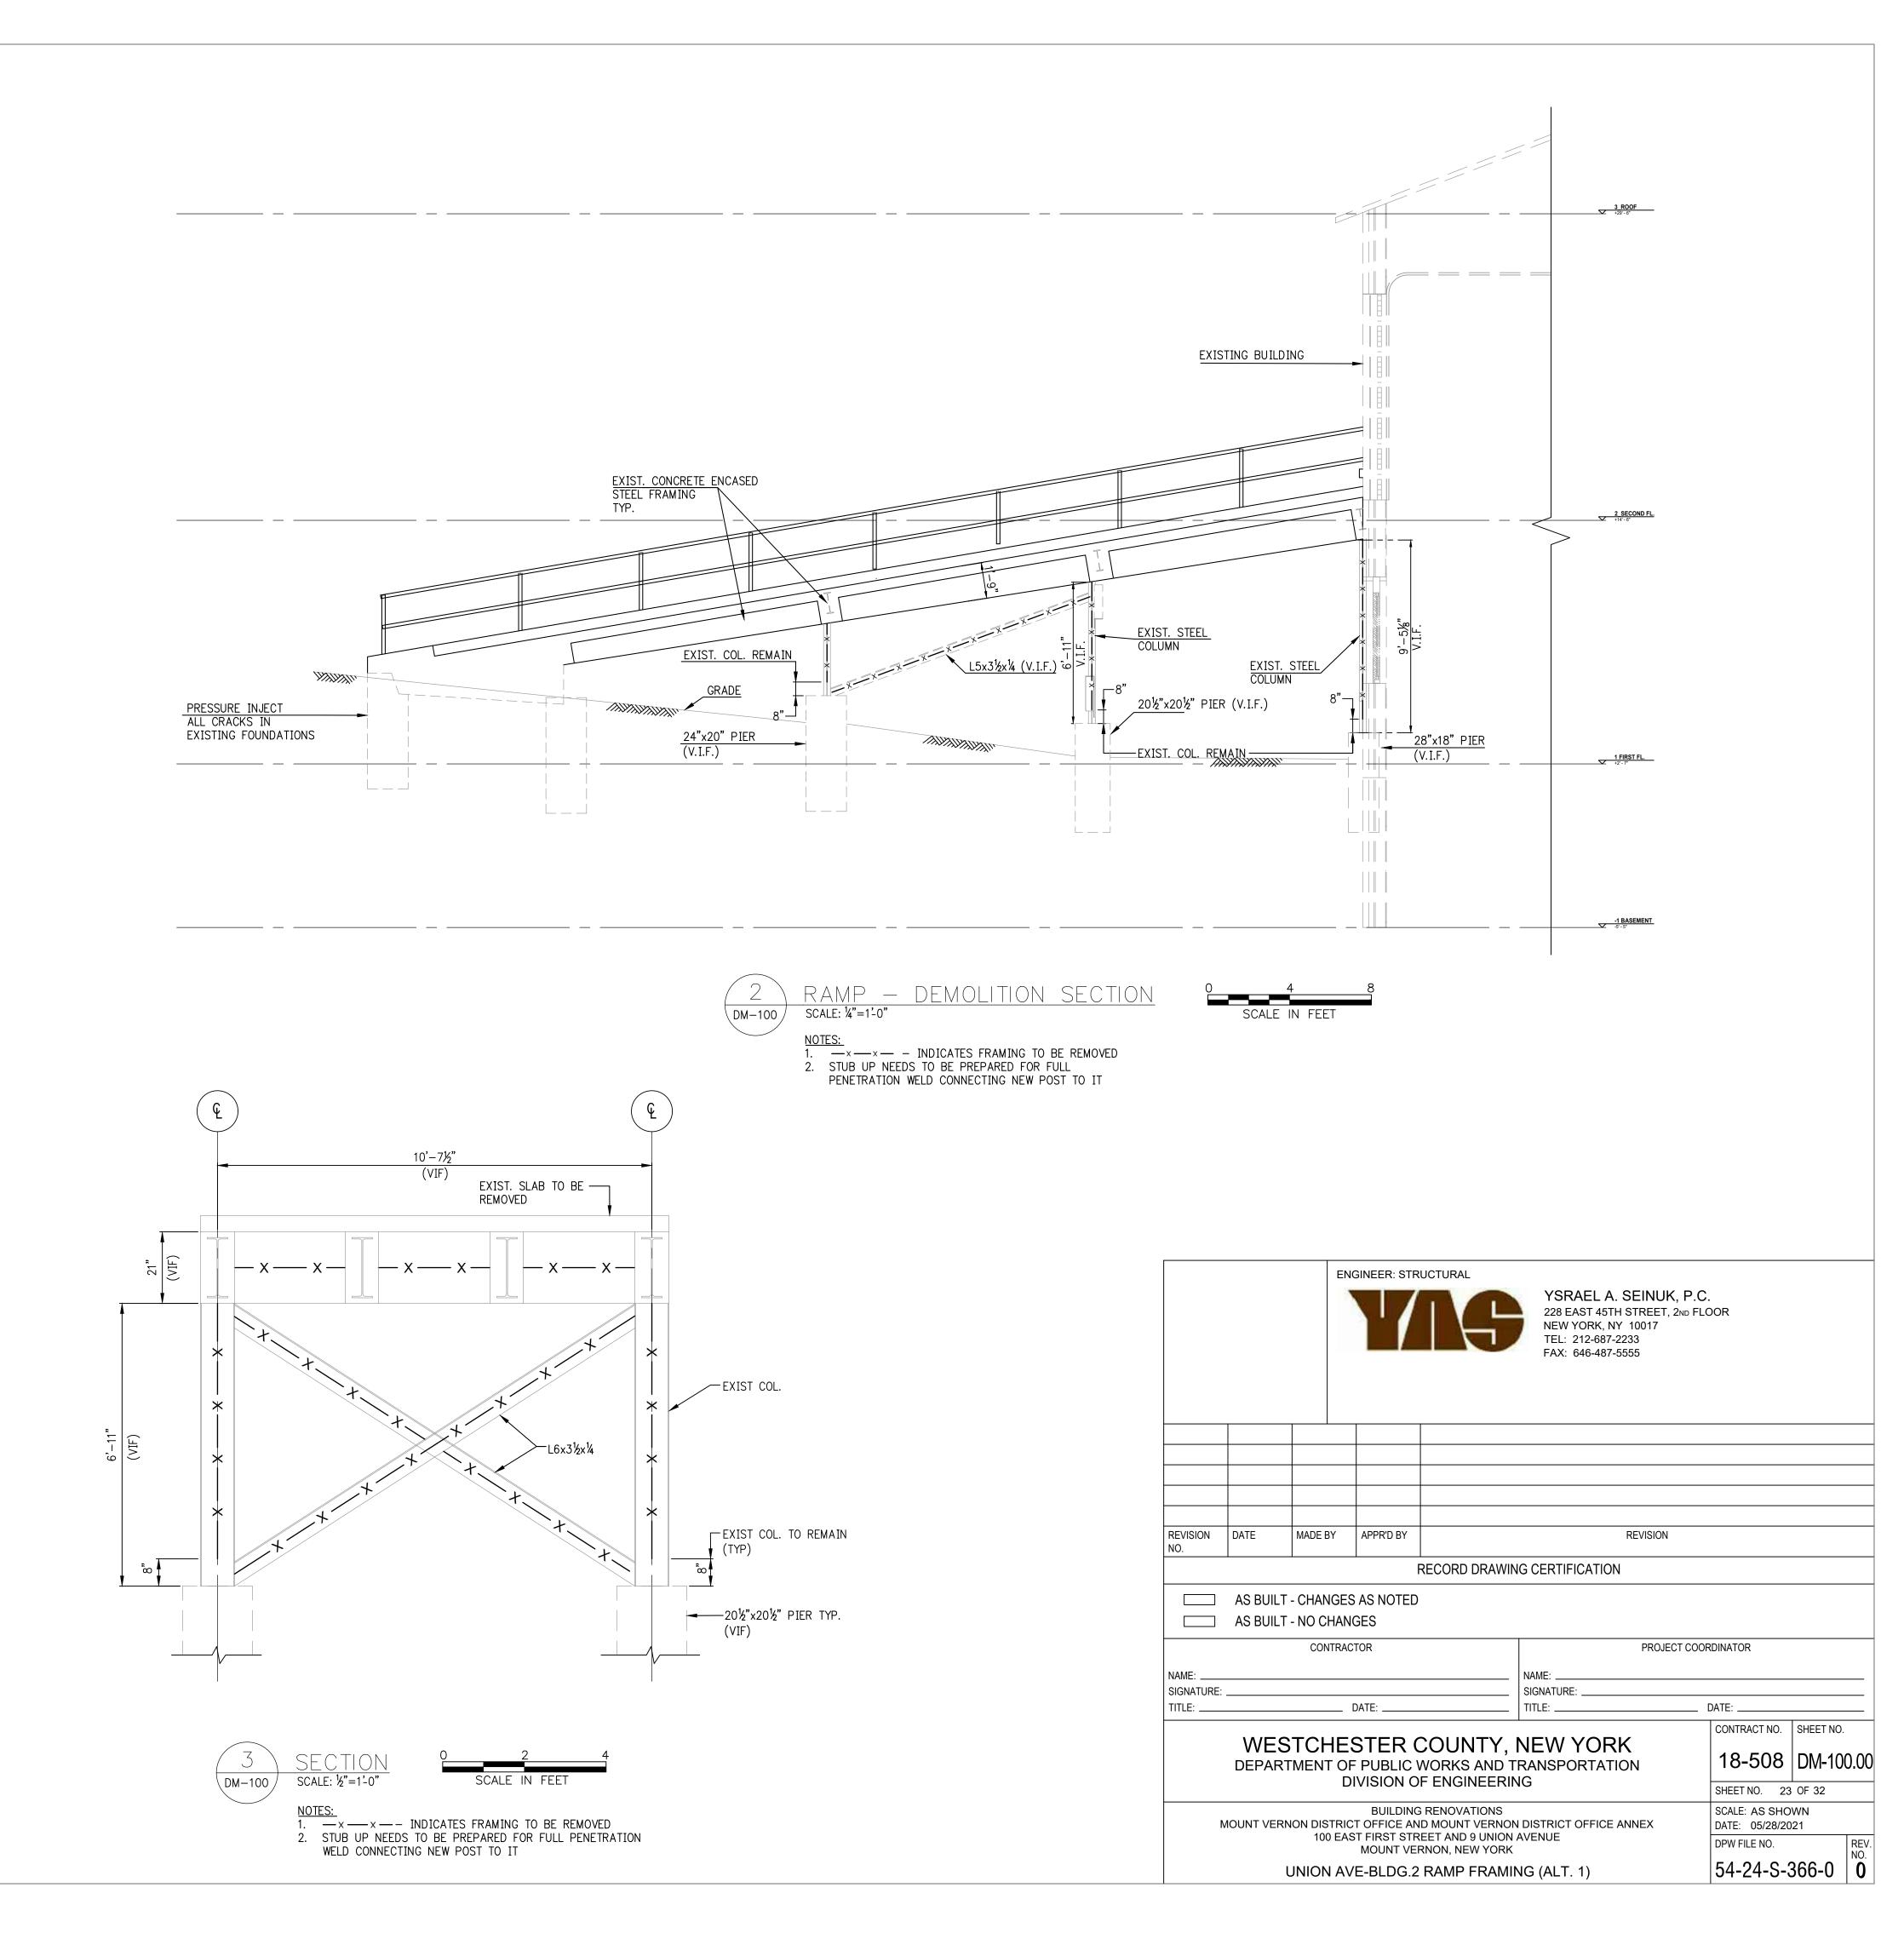€ POST € POST SEE DETAIL <u>5" THK., NORMAL WEIGHT</u> CONCRETE SLAB, SEE F/S-600 ------RAMP SLAB DETAIL F/S-600. W8x31 W8x31 W8x21 -W8X21 PC COLUMN SPLICE, SEE (TYP.) DETAIL B/S-600, TYP EXIST. COL. REMAIN —L6x3½x⅔ -CLEAN E FREE OF R RUST INHI —EXISTING PLATE (1 8"— EXIST. F 3 S-101 SCALE: ³4"=1-0" SCALE IN FEET <u>NOTES</u> EXISTING STUB UP NEEDS TO BE PREPARED FOR FULL PENETRATION WELD CONNECTING NEW POST TO IT.
 ALL EXISTING CONDITIONS NEED TO BE FIELD VERIFIED.

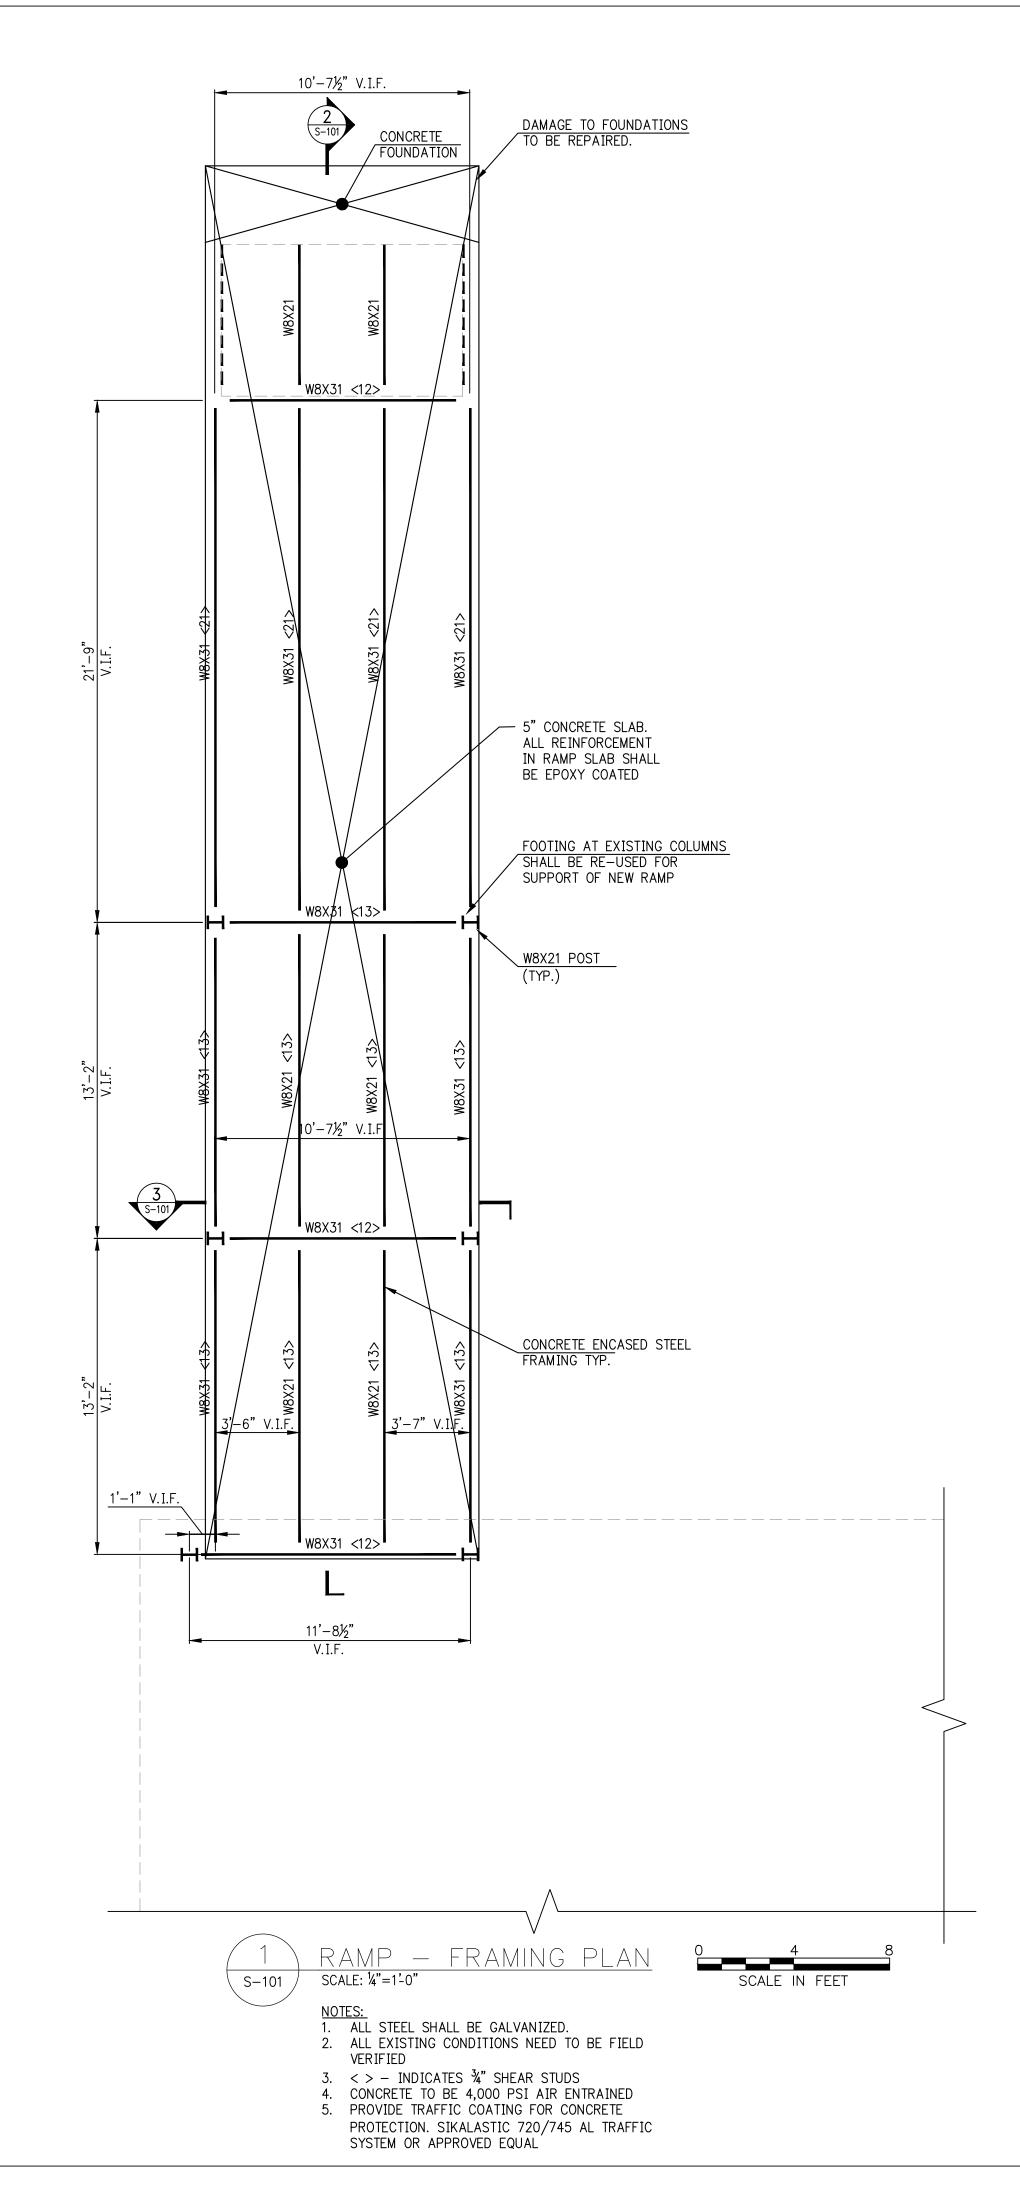


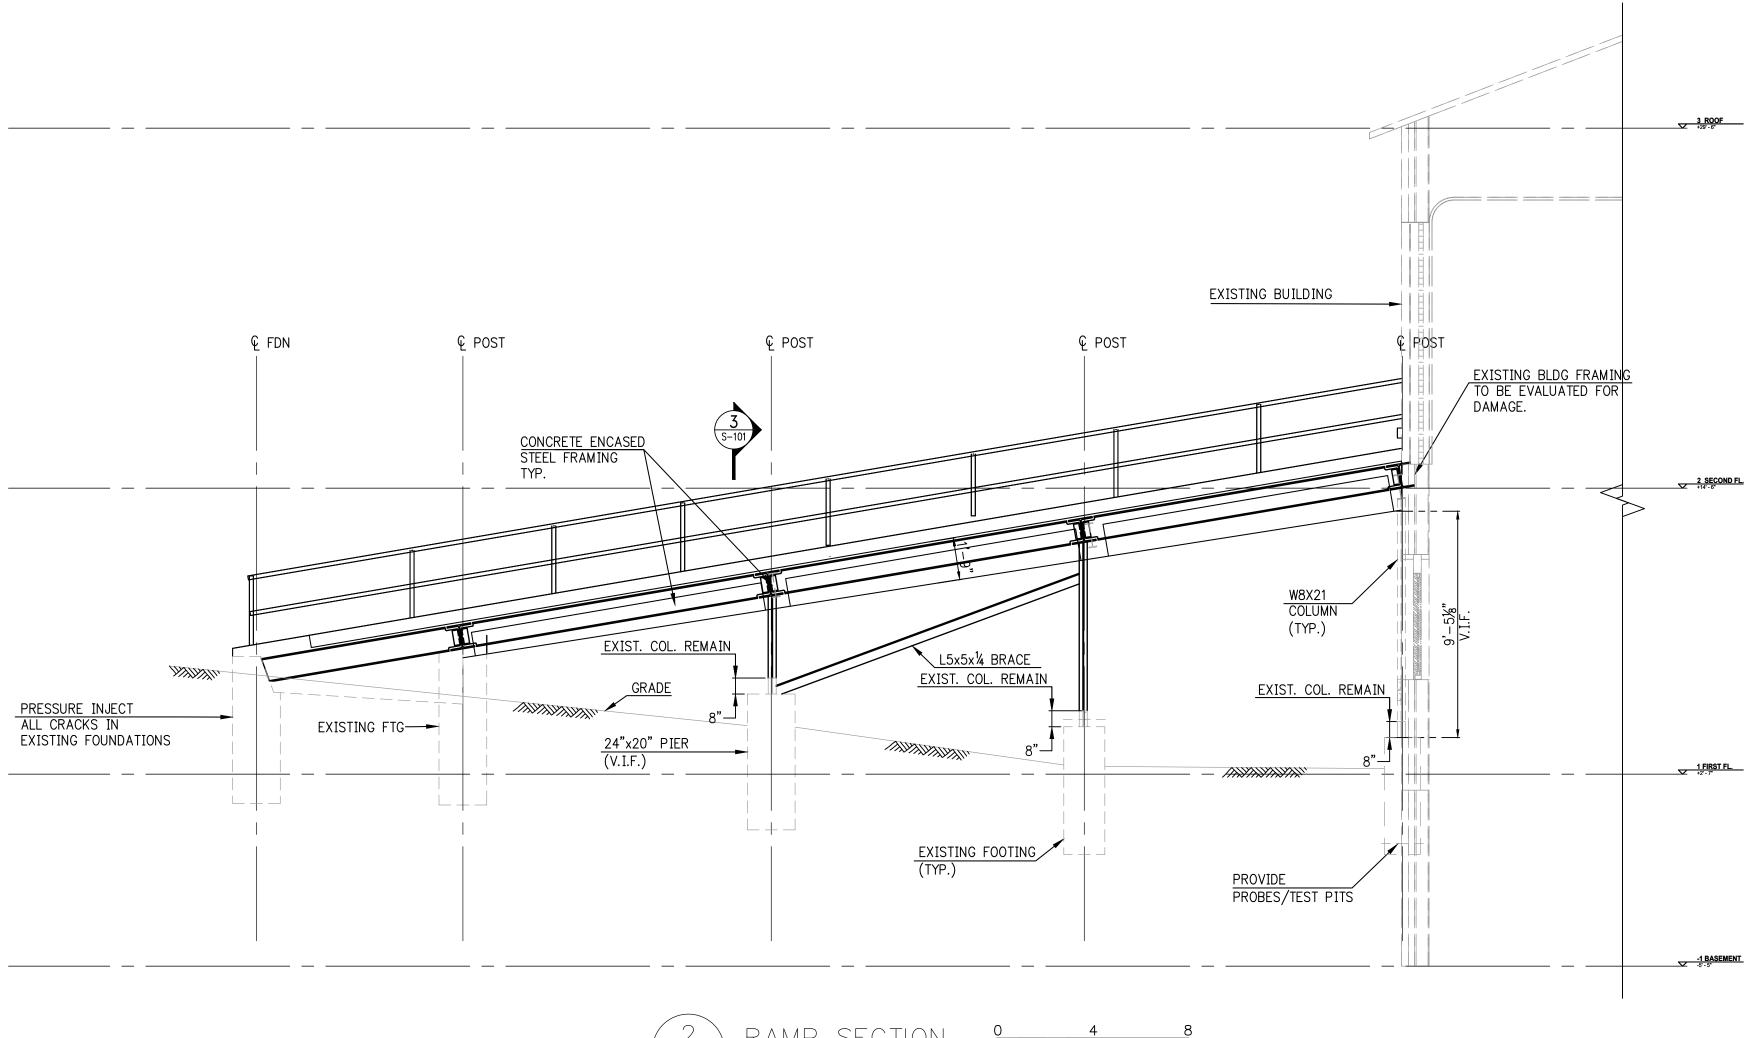									
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Project Notes:

- 1. The contractor shall field verify the amount of ACM and familiarize himself in all variable field conditions in the building before the submission of their bid.
- 2. The abatement contractor is responsible for filing and acquiring all permits in connection with this abatement work. The abatement of the materials noted above shall be performed in accordance with NYS DOL ICR 56.
- 3. Temporary electricity shall be from an electrical panel demarcated by the facility personnel.
- 4. Temporary water shall be from a spigot demarcated by the facility personnel.
- 5. Abatement will take place in the identified work area in accordance with the specification unless approved otherwise by the Authority.
- 6. Any waste transported through the building shall use canvas carts covered and lined with plastic sheeting at a time provided by the facility.
- 7. The contractor shall limit the extent of operations to those areas where work is to be performed and shall not interfere with daily activities within the building or otherwise affect daily campus operations.
- 8. Prior to final air sampling, the project monitor and contractor's supervisor shall inspect the area to verify that all asbestos-containing materials have been abated. Given the nature of the facility, air clearance will be established using Phase Contrast Microscopy analysis of area air samples as per ICR 56-9.
- 9. The asbestos contractor shall be responsible for all repairs to finish surfaces which are damaged during the course of the abatement work which are not included in the proposed scope of work.
- 10. In work areas which require the removal of ACM, contractor shall remove the materials down to a substrate which is free and clear of any residues and ready for replacement materials.
- 11. Any material not tested must be assumed to be asbestos containing until sampled and analyzed.
- 12. The contractor is advised to be alert to possible concealed material beneath the outer facade brick that might be ACM. If suspect material is observed, it should not be disturbed without testing for asbestos.
- 13. All assumed materials shall be tested prior to removal.




Scope of Work Tables:

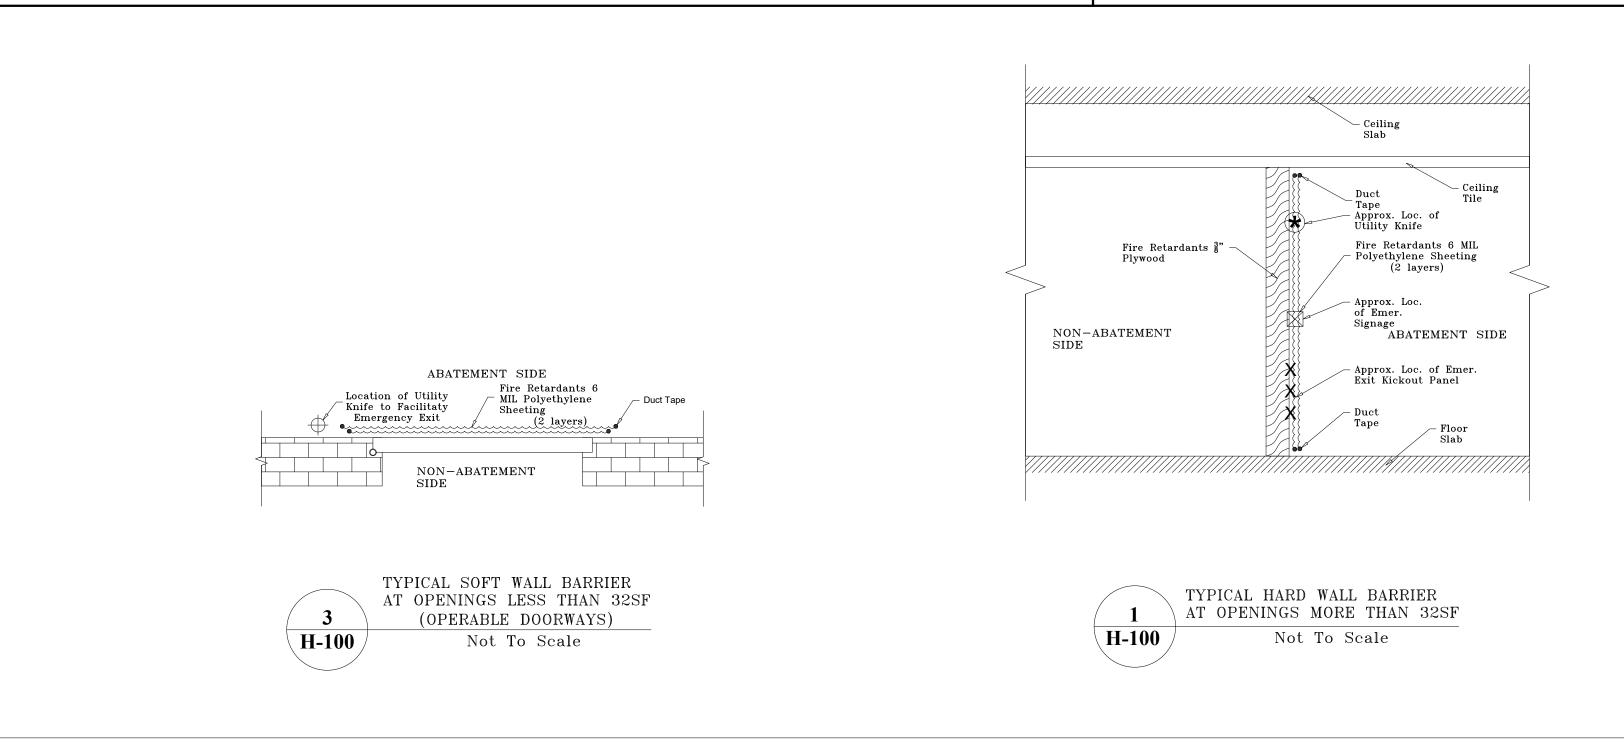WA	Floor	Location	Material	Quantity	Procedure
			100 East First Street		
1	Basement	Exterior Windows	Window Guard Paint and Assumed Concealed Caulking between Window Frames and Masonry Opening	60.0 SF (9 Masonry Openings; 6 upper window guards @ 4.0 SF/MO)	ICR 56 11.6 via Exterior Projects
2	1^{st}	Exterior Windows	Window Caulking (Top and Bottom Layer) and Glazing (Old and New)	44.0 SF (11 Masonry Openings @ 4.0 SF/MO)	ICR 56 11.6 via Exterior Projects
3	1 st	Exterior Doors	Assumed Concealed Caulking between Door Frames and Masonry Opening	15.0 SF (3 Doors @ 5.0 SF/Door)	ICR 56 11.6 via Exterior Projects
4	1 st and 10 th	Exterior Windows	Assumed Window Lintel Flashing and Window Lintel Rust Inhibitor Paint	28.0 SF (14 Masonry Openings @ 2.0 SF/MO)	ICR 56 11.6 via Exterior Projects
5	Roof	HVAC/Elevator Machine Room/ Water Tank Room	Tar on Terracotta Wall	4.0 SF	ICR 56 11.7 via Minor Projects
			TOTAL ACM:	1	51.0 SF

Assumed Materials:

Reference Number	Floor	Location	Location Material		Procedure
			100 East First Street		
<2>	Roof	Scuppers and Bulkheads	Assumed Tar Flashing in Scuppers	65.0 SF (13 Locations @ 5.0 SF Ea.)	ICR 56 11.6 via Exterior Projects
		9 Unior	n Avenue, House 1 and House 2		
6	Exterior	North Elevation metal Staircase	Assumed Non-Friable Material associated with the Canopy	50.0 SF	ICR 56 11.6 via Exterior Projects
			TOTAL ACM:]	115.0 SF

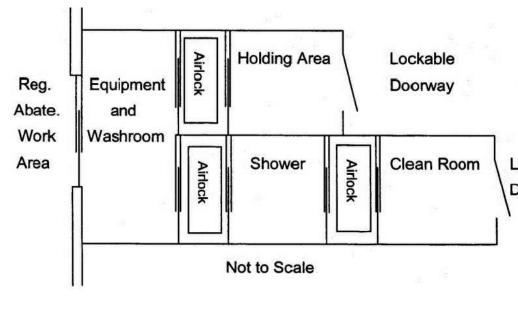

SIDE BY SIDE WORKER/WASTE DECONTAMINA H-100 / Not To Scale

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		T.O. M +27'-3 1/4"
		WORK AREA 2
		<u>T.O. B.</u> +4'-8 1/4"
WORK AREA 1 —	PW F	$\left \begin{array}{c} 1 \\ G \end{array} \right $

	LEGEND	
		BASEMENT WINDOW GUARD PAINT AND ASSUMED CONCEALED CAULKING BETWEEN WINDOW FRAMES AND MASONRY OPENINGS - 36.0SF (WA1)
	523	FIRST FLOOR WINDOW CAULKING AND GLAZING - 44.0SF (WA2)
. O. ROOF y'- 2 1/4"		TENTH FLOOR ASSUMED WINDOW LINTEL FLASHING AND WINDOW LINTEL RUST INHIBITOR PAINT - 28.0SF (WA4)
	PW R #	REMOTE DECONTAMINATION UNIT ON UNION AVE.
0. 10TH FLOOR - 8 1/4*	W	TEMPORARY WATER SOURCE
	G	TEMPORARY ELECTRIC GENERATOR
D. 9TH FLOOR - 6 1/4"		

T.O. 8TH FLOOR +104' - 4 1/4"

T.O. 7TH FLOOR +93' - 2 1/4" SEE PROJECT NOTE 12 ON H-100.00 (TYP.)

T.O. 6TH FLOOR +82' - 0 1/4"

T.O. 5TH FLOOR +70' - 10 1/4"

T.O. 4TH FLOOR +59' - 8 1/4"

T.O. 3RD FLOOR +48' - 6 1/4"

100 EAST FIRST STREET

KEY PLAN

1)

T.O. 2ND FLOOR +37' - 4 1/4" CONSULTANT: ENVIRONMENTAL The LiRo Group 100 DUFFY AVENUE, SUITE 402 HICKSVILLE, NY 11801 **T.O. MEZZANINE** +27' - 3 1/4" TEL: 516-595-2900 **T.O. 1ST FLOOR** +16' - 8 1/4" 11/17 REVISION DATE REVISION MADE BY APPR'D BY NO. RECORD DRAWING CERTIFICATION **T.O. BASEMENT** +4' - 8 1/4" AS BUILT - CHANGES AS NOTED AS BUILT - NO CHANGES CONTRACTOR PROJECT COORDINATOR NAME: NAME: SIGNATURE: _ SIGNATURE: TITLE: TITLE: _ DATE: __ DATE: __ CONTRACT NO. SHEET NO. WESTCHESTER COUNTY, NEW YORK 18-508 H-101.00 DEPARTMENT OF PUBLIC WORKS AND TRANSPORTATION DIVISION OF ENGINEERING SHEET NO. 27 OF 32 BUILDING RENOVATIONS SCALE: NTS MOUNT VERNON DISTRICT OFFICE AND MOUNT VERNON DISTRICT OFFICE ANNEX DATE: 05/28/2021 100 EAST FIRST STREET AND 9 UNION AVENUE DPW FILE NO. REV. NO. MOUNT VERNON, NEW YORK 54-24-H-370-0 EXTERIOR BUILDING ELEVATION - NORTH - ABATEMENT PLAN

	WORK AREA 4		
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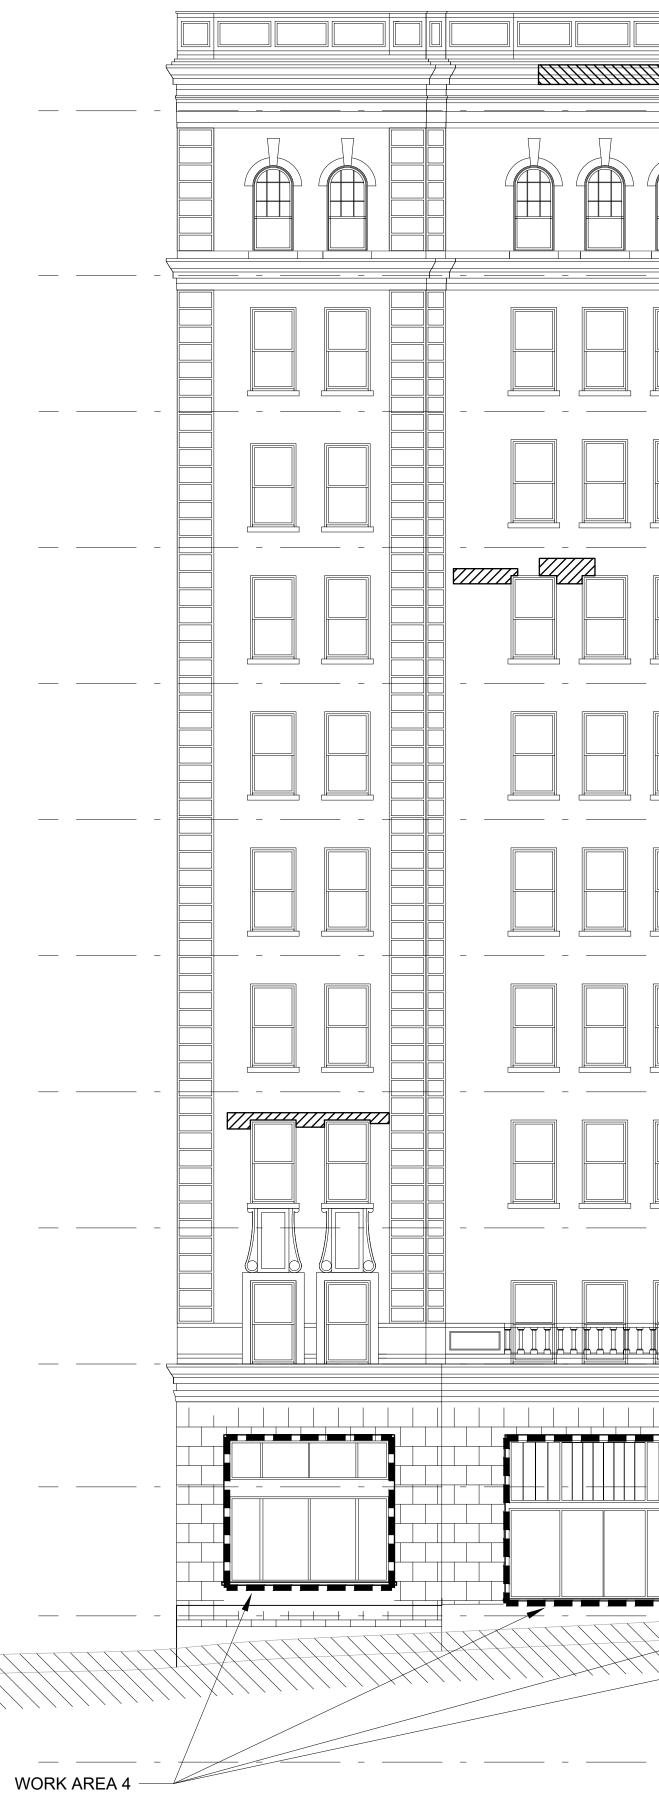
1 100 EAST FIRST STREET - SOUTH ELEVATION

*NOTE: REMOTE DECONTAMINATION UNIT, WATER SOURCE, AND GENERATOR ARE LOCATED ON UNION AVENUE.

	TENTH FLOOR ASSUMED WINDOW LINTEL FLASHING AND WINDOW LINTEL RUST INHIBITOR PAINT - 28.0SF (WA4)
PW R #	REMOTE DECONTAMINATION UNIT ON UNION AVE.
W	TEMPORARY WATER SOURCE
G	TEMPORARY ELECTRIC GENERATOR

T.O. 9TH FLOOR T.O. 8TH FLOOR +104' - 4 1/4" - SEE PROJECT NOTE 12 ON H-100.00 (TYP.) **T.O. 7TH FLOOR T.O. 6TH FLOOR** +82' - 0 1/4" 100 EAST FIRST STREET **T.O. 5TH FLOOR** (1)**T.O. 4TH FLOOR** +59' - 8 1/4" **T.O. 3RD FLOOR** +48' - 6 1/4" <u>KEY PLAN</u> **T.O. 2ND FLOOR** +37' - 4 1/4" CONSULTANT: ENVIRONMENTAL The LiRo Group 100 DUFFY AVENUE, SUITE 402 HICKSVILLE, NY 11801 **T.O. MEZZANINE** +27' - 3 1/4" TEL: 516-595-2900 **T.O. 1ST FLOOR** REVISION DATE REVISION MADE BY APPR'D BY NO. RECORD DRAWING CERTIFICATION **T.O. BASEMENT** AS BUILT - CHANGES AS NOTED AS BUILT - NO CHANGES CONTRACTOR PROJECT COORDINATOR NAME: NAME: SIGNATURE: _ SIGNATURE:

> TITLE: TITLE: DATE: __ DATE: __ CONTRACT NO. SHEET NO. WESTCHESTER COUNTY, NEW YORK 18-508 H-102.00 DEPARTMENT OF PUBLIC WORKS AND TRANSPORTATION DIVISION OF ENGINEERING SHEET NO. 28 OF 32 SCALE: NTS DATE: 05/28/2021 BUILDING RENOVATIONS MOUNT VERNON DISTRICT OFFICE AND MOUNT VERNON DISTRICT OFFICE ANNEX 100 EAST FIRST STREET AND 9 UNION AVENUE DPW FILE NO. REV. NO. MOUNT VERNON, NEW YORK 54-24-H-371-0 0 EXTERIOR BUILDING ELEVATIONS - SOUTH - ABATEMENT PLAN




1 100 E FIRST STREET - WEST ELEVATION

				1	
					T.O. ROOF +140' - 2 1/4"
					– WORK AREA 4
					T.O. 10TH FLOOR +126" - 8 1/4"
<u>_</u>					T.O. 9TH FLOOR +115' - 6 1/4"
					T.O. 8TH FLOOR +104' - 4 1/4"
					T.O. 7TH FLOOR +93' - 2 1/4"
					T.O. 6TH FLOOR +82' - 0 1/4"
					T.O. 5TH FLOOR +70' - 10 1/4"
					T.O. 4TH FLOOR +59' - 8 1/4"
					·
					T.O. 3RD FLOOR +48' - 6 1/4"
				ŋ — <u> </u>	T.O. 2ND FLOOR +37' - 4 1/4"
					T.O. MEZZANINE +27' - 3 1/4"
				- WORK AREA 3	T.O. 1ST FLOOR +16' - 8 1/4"
	 	 		 	T.O. BASEMENT +4' - 8 1/4"
			* <u>NOT</u>		

WATER SOURCE, AND GENERATOR ARE LOCATED ON UNION AVENUE.


LEGEND	
::::	FIRST FLOOR WINDOW CAULKING AND GLAZING - 44.0SF (WA2)
	TENTH FLOOR ASSUMED WINDOW LINTEL FLASHING AND WINDOW LINTEL RUST INHIBITOR PAINT - 28.0SF (WA4)
PW R #	REMOTE DECONTAMINATION UNIT ON UNION AVE.
W	TEMPORARY WATER SOURCE
G	TEMPORARY ELECTRIC GENERATOR


SEE PROJECT NOTE 12 ON H-100.00 (TYP.)

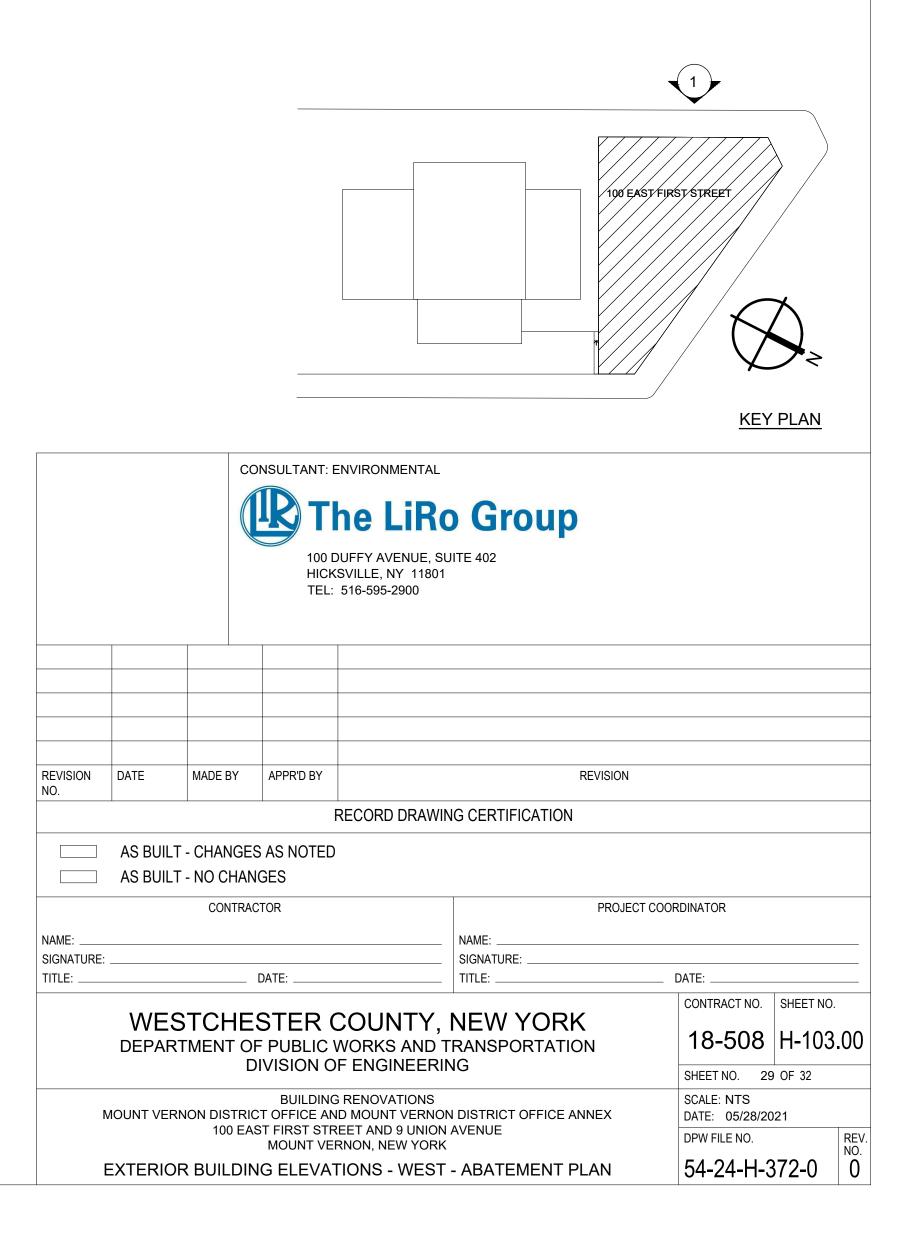





*NOTE: REMOTE DECONTAMINATION UNIT, WATER SOURCE, AND GENERATOR ARE LOCATED ON UNION AVENUE.

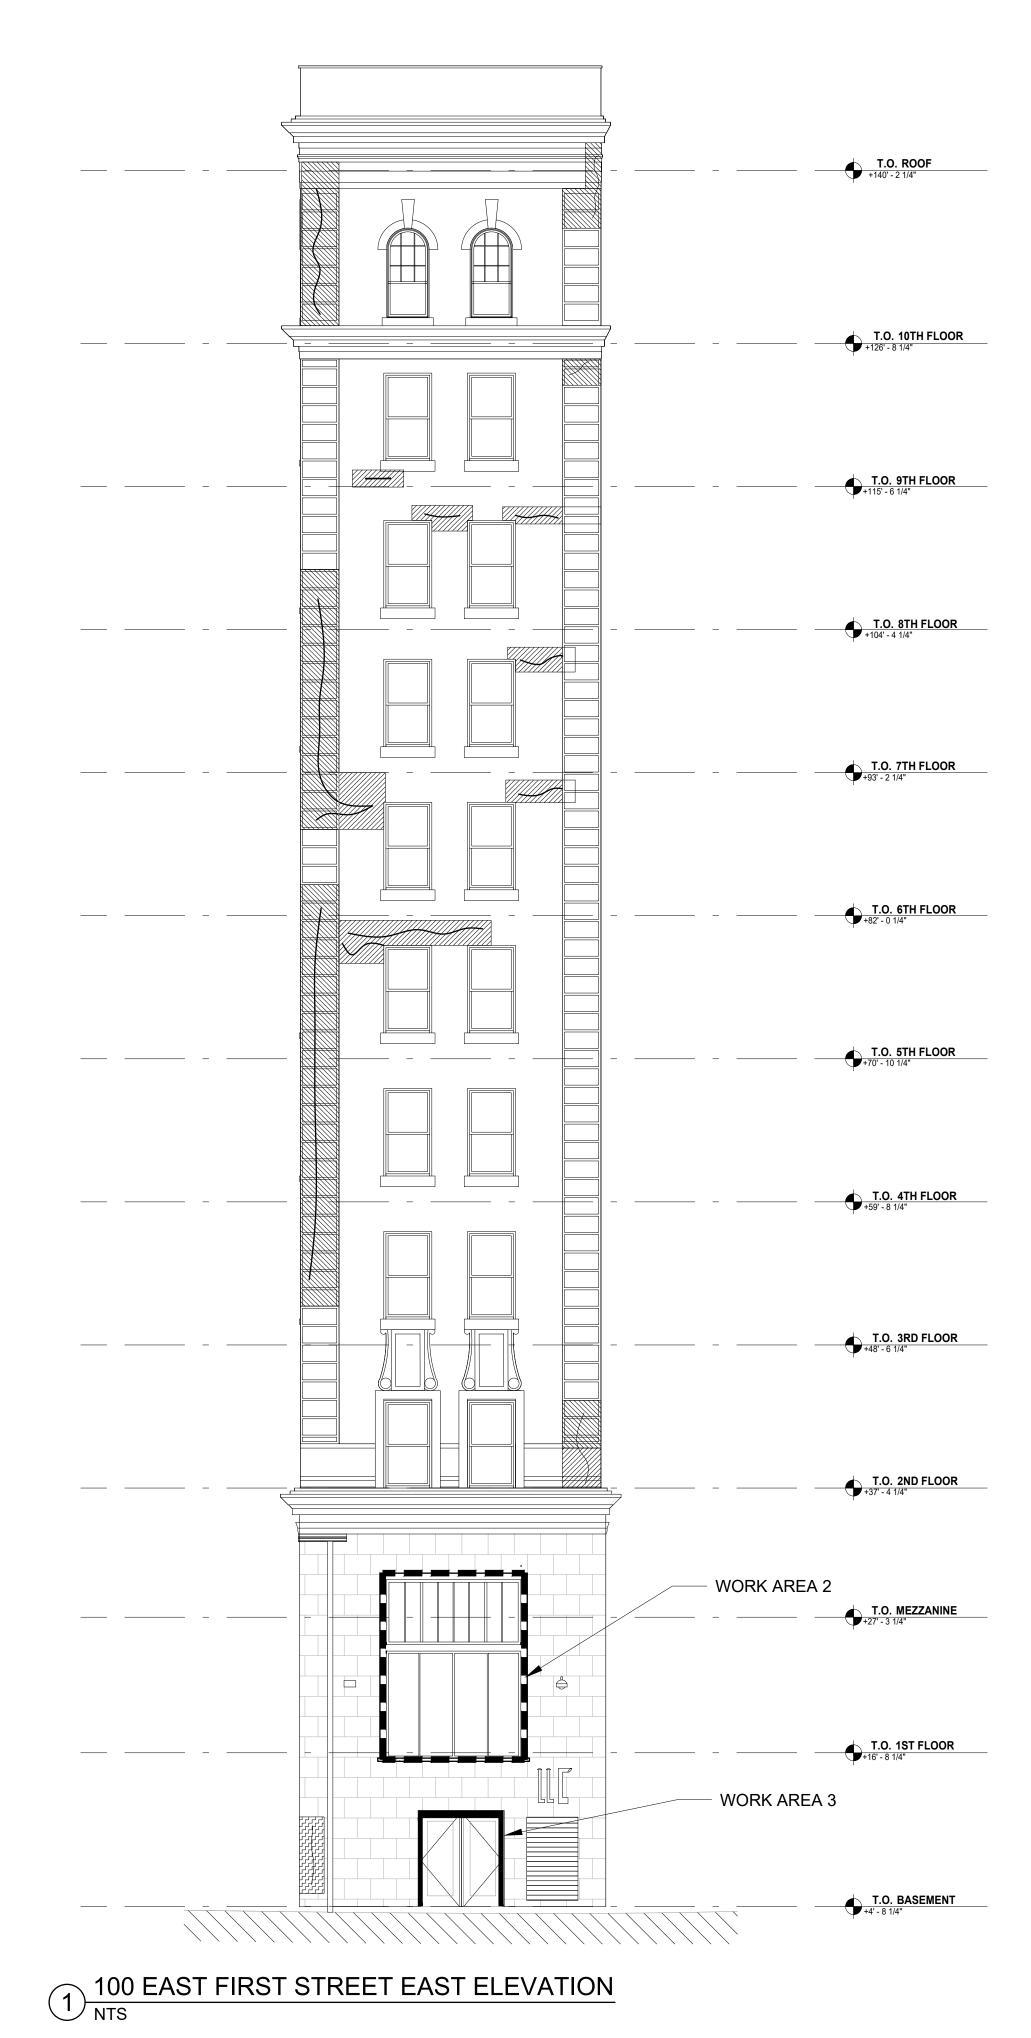


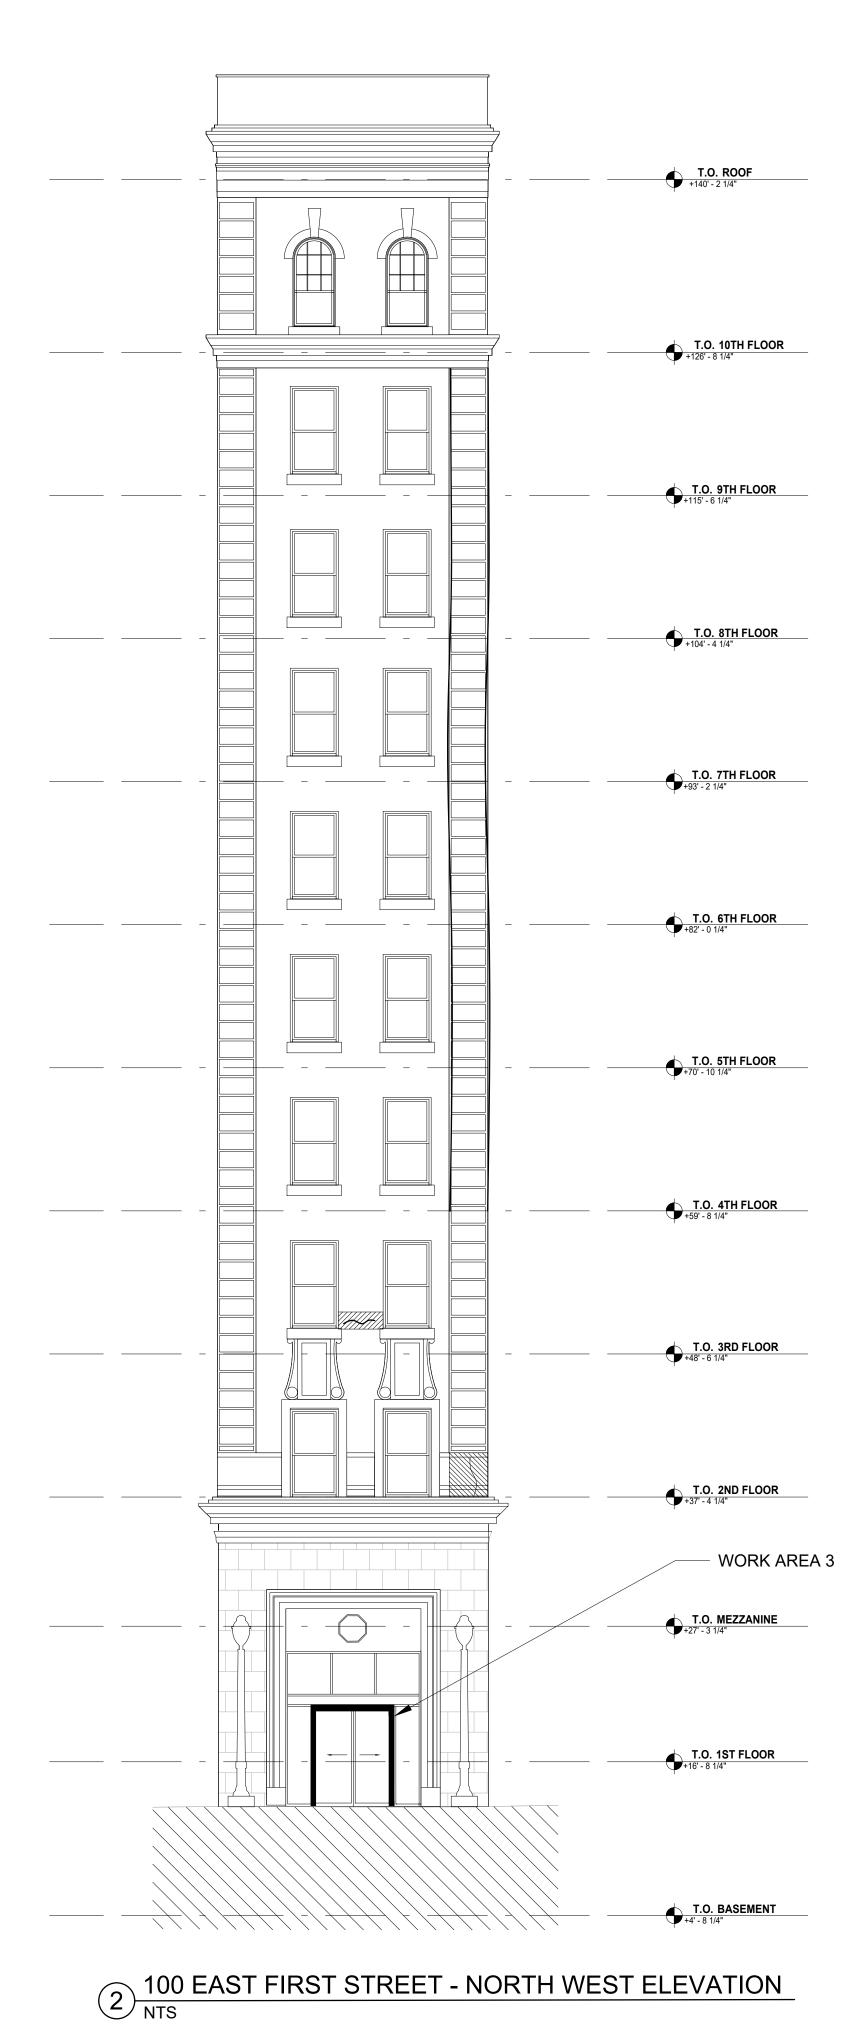

LEGEND	
::::	FIRST FLOOR WINDOW CAULKING AND GLAZING - 44.0SF (WA2)
	ASSUMED DOOR FRAME CAULKING (WA3)
PW R #	REMOTE DECONTAMINATION UNIT ON UNION AVE.
W	TEMPORARY WATER SOURCE
G	TEMPORARY ELECTRIC GENERATOR

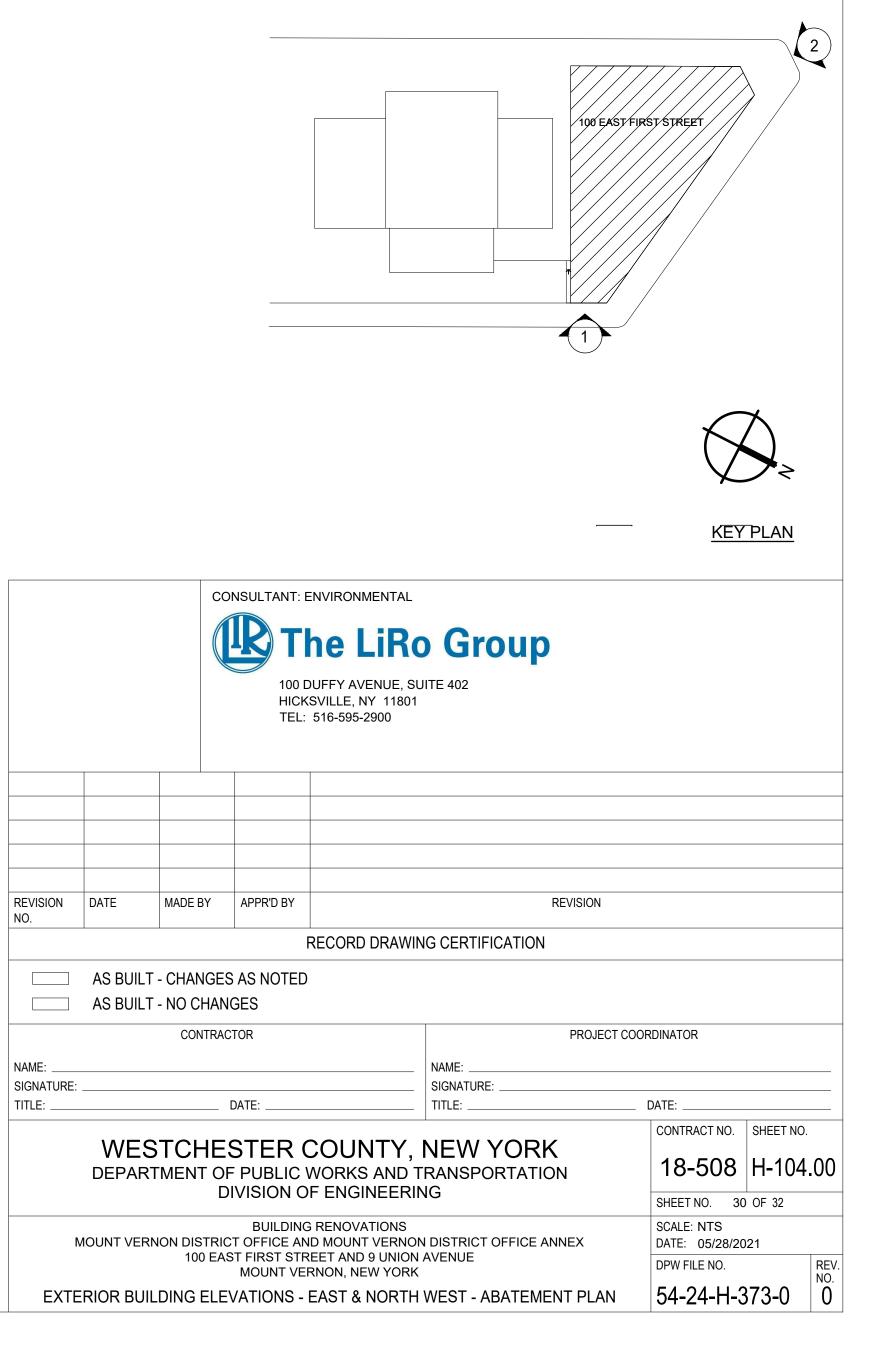


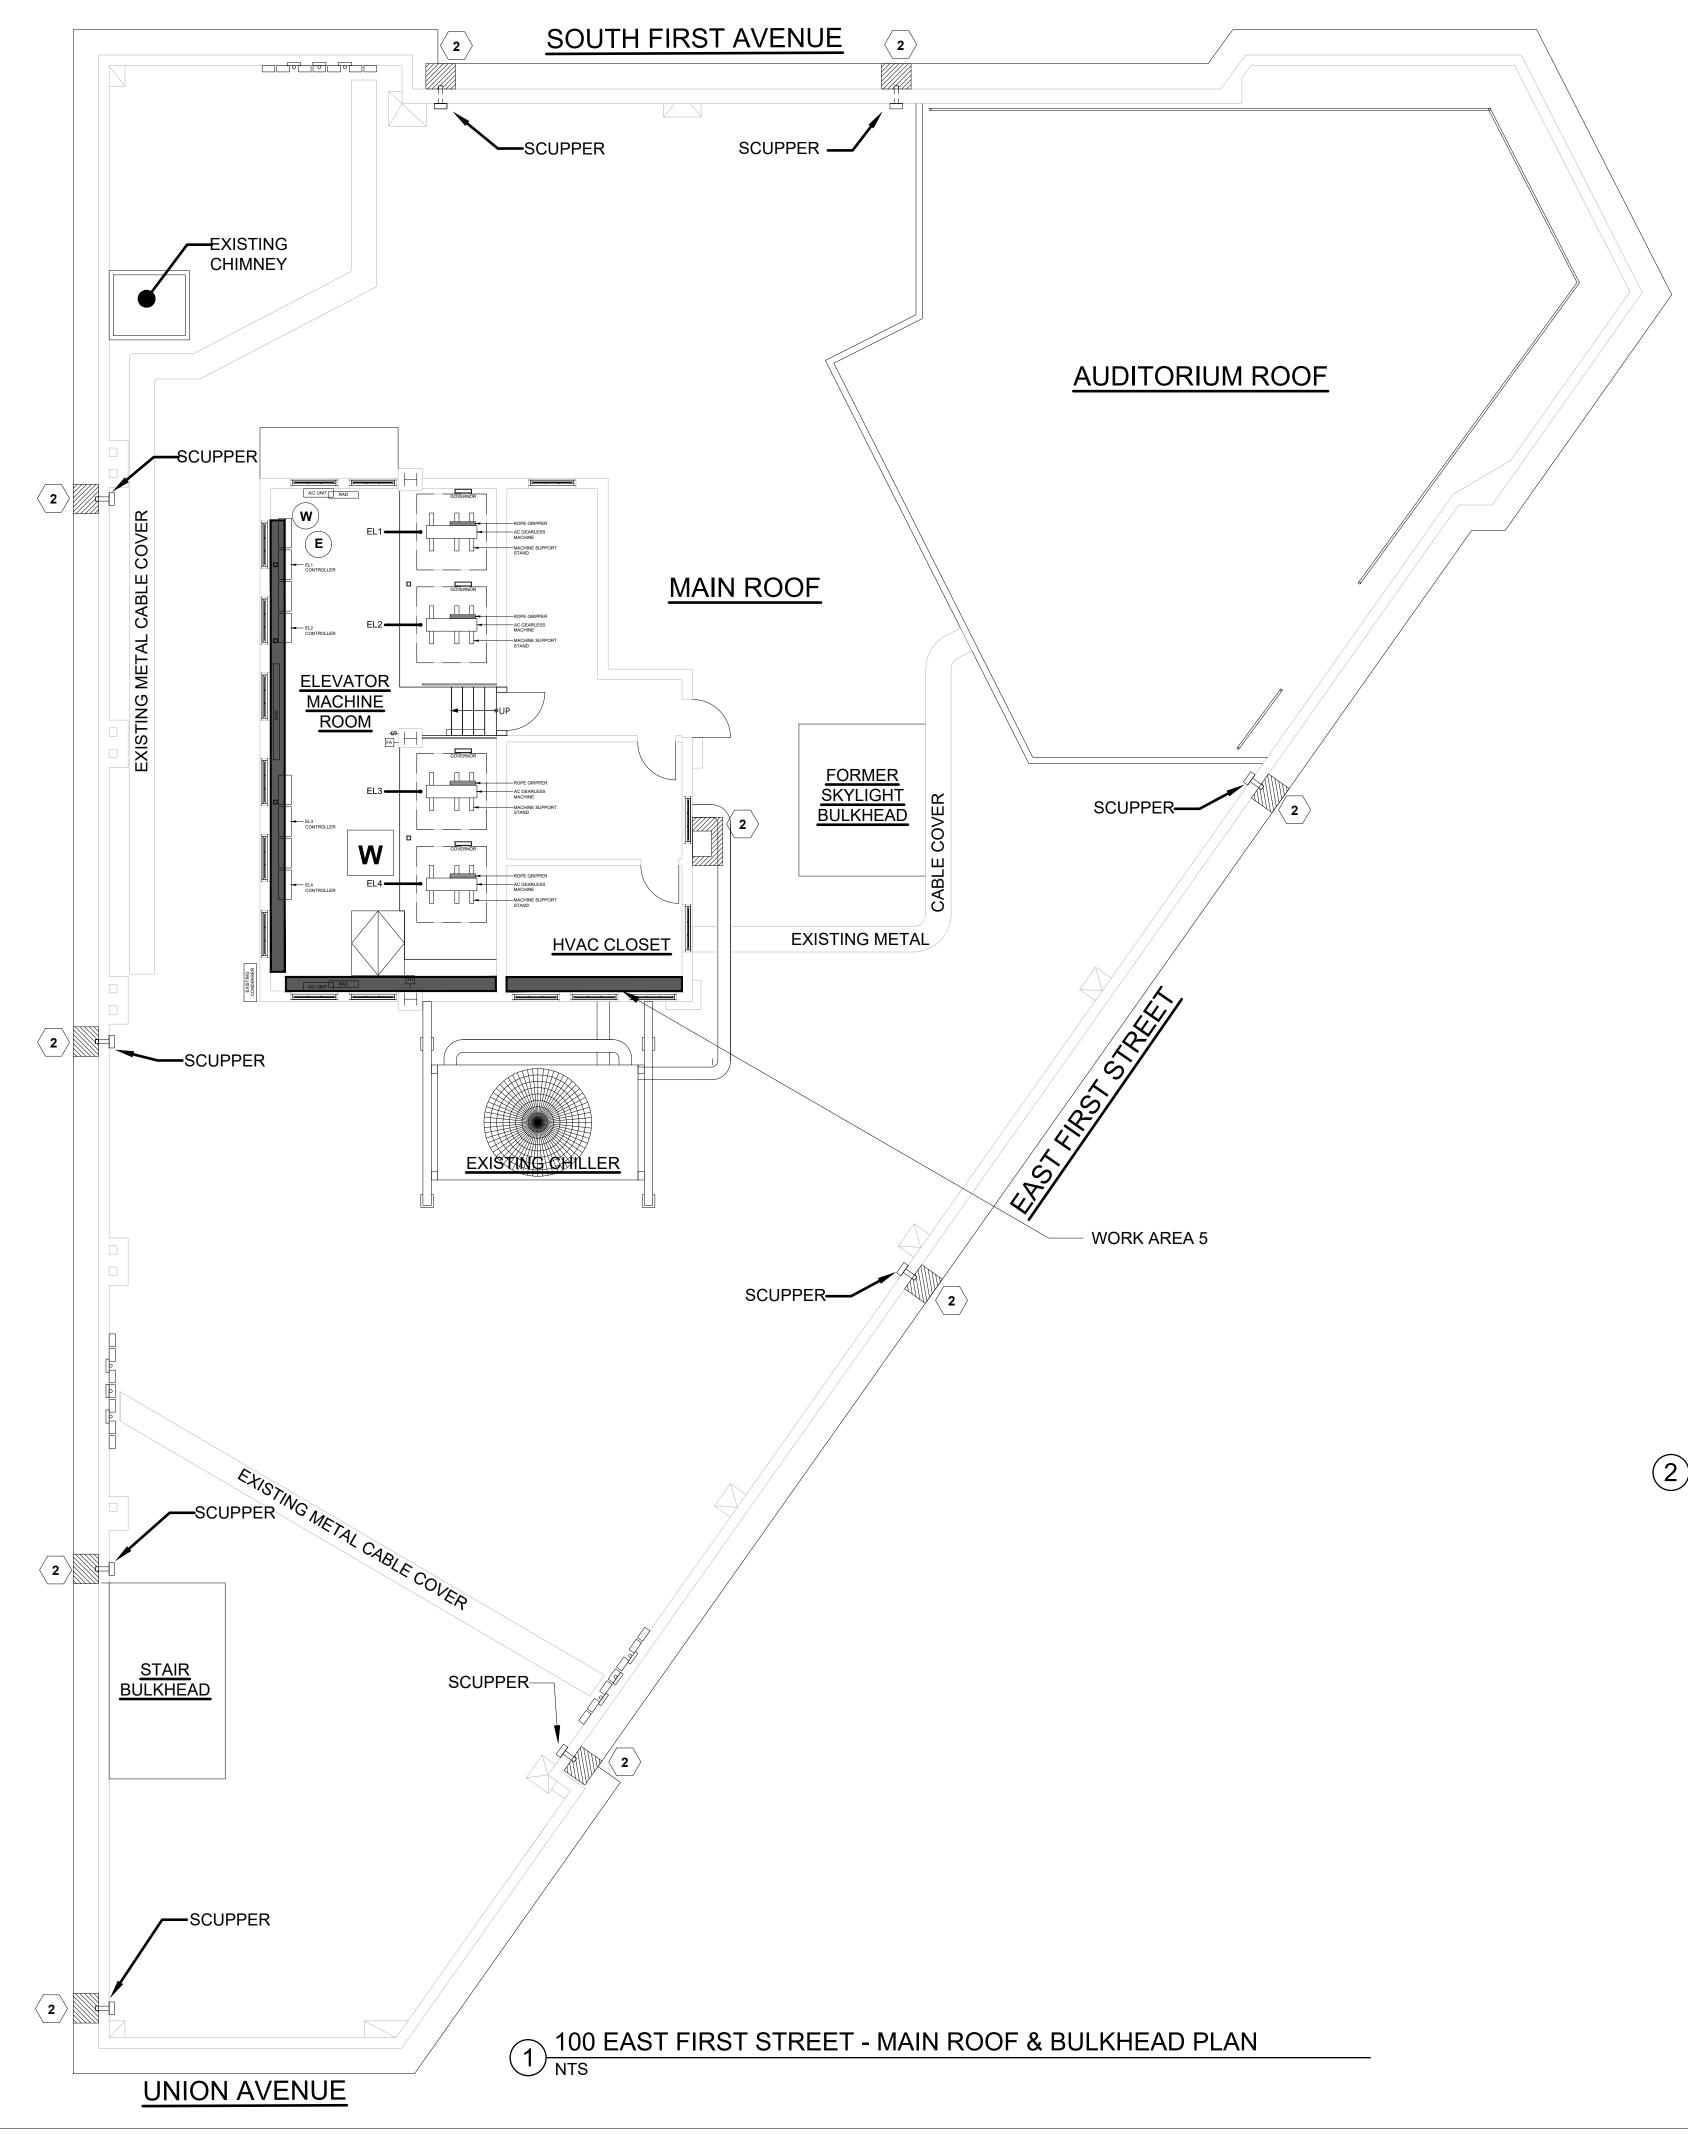

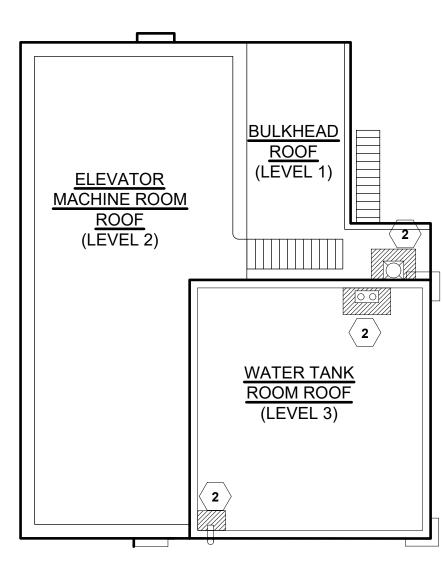

2 100 EAST FIRST STREET - BULKHEAD ROOF PLAN


LEGEND	
	TAR ON TERRACOTTA WALL - 4.0SF (WA5)
2	ROOF AT SCUPPERS AND BULKHEADS - ASSUMED TAR FLASHING INSIDE SCUPPERS - 65.0 SF
W	OSHA WASH STATION
W	TEMPORARY WATER SOURCE
G	TEMPORARY ELECTRIC GENERATOR

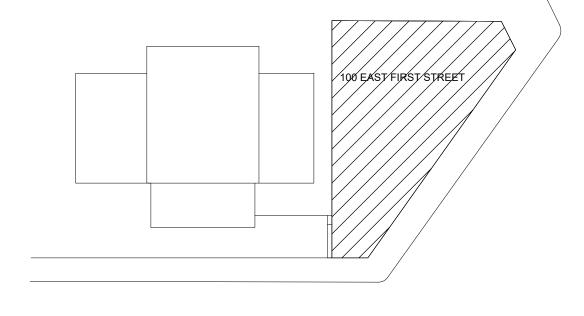

KEY PLAN



		С	ONSULTANT: E	INVIRONMENTAL					
			100 D	UFFY AVENUE, SU	Group				
				SVILLE, NY 11801 516-595-2900					
EVISION IO.	DATE	MADE BY	APPR'D BY		F	REVISION			
			F	RECORD DRAWIN	G CERTIFICATION				
		- CHANGE - NO CHA	ES AS NOTED NGES						
CONTRACTOR					PROJECT COORDINATOR				
IAME:					NAME:				
					SIGNATURE:				
ITLE:			DATE:		TITLE:		DATE:		
	WES	STCHE	ESTER (COUNTY,	NEW YORK	- -	CONTRACT NO.		
DEPARTMENT OF PUBLIC WORKS AND TRANSPORTATION							18-508	H-105	.00
DIVISION OF ENGINEERING							SHEET NO. 310F 32		
BUILDING RENOVATIONS MOUNT VERNON DISTRICT OFFICE AND MOUNT VERNON DISTRICT OFFICE ANNEX						INEX	SCALE: NTS DATE: 05/28/2021		
100 EAST FIRST STREET AND 9 UNION A MOUNT VERNON, NEW YORK					AVENUE		DPW FILE NO.		REV. NO.
10	0 EAST F	IRST STR	REET - ROC	F & BULKHEA	O - ABATEMENT	PLAN	54-24-H-3	74-0	0

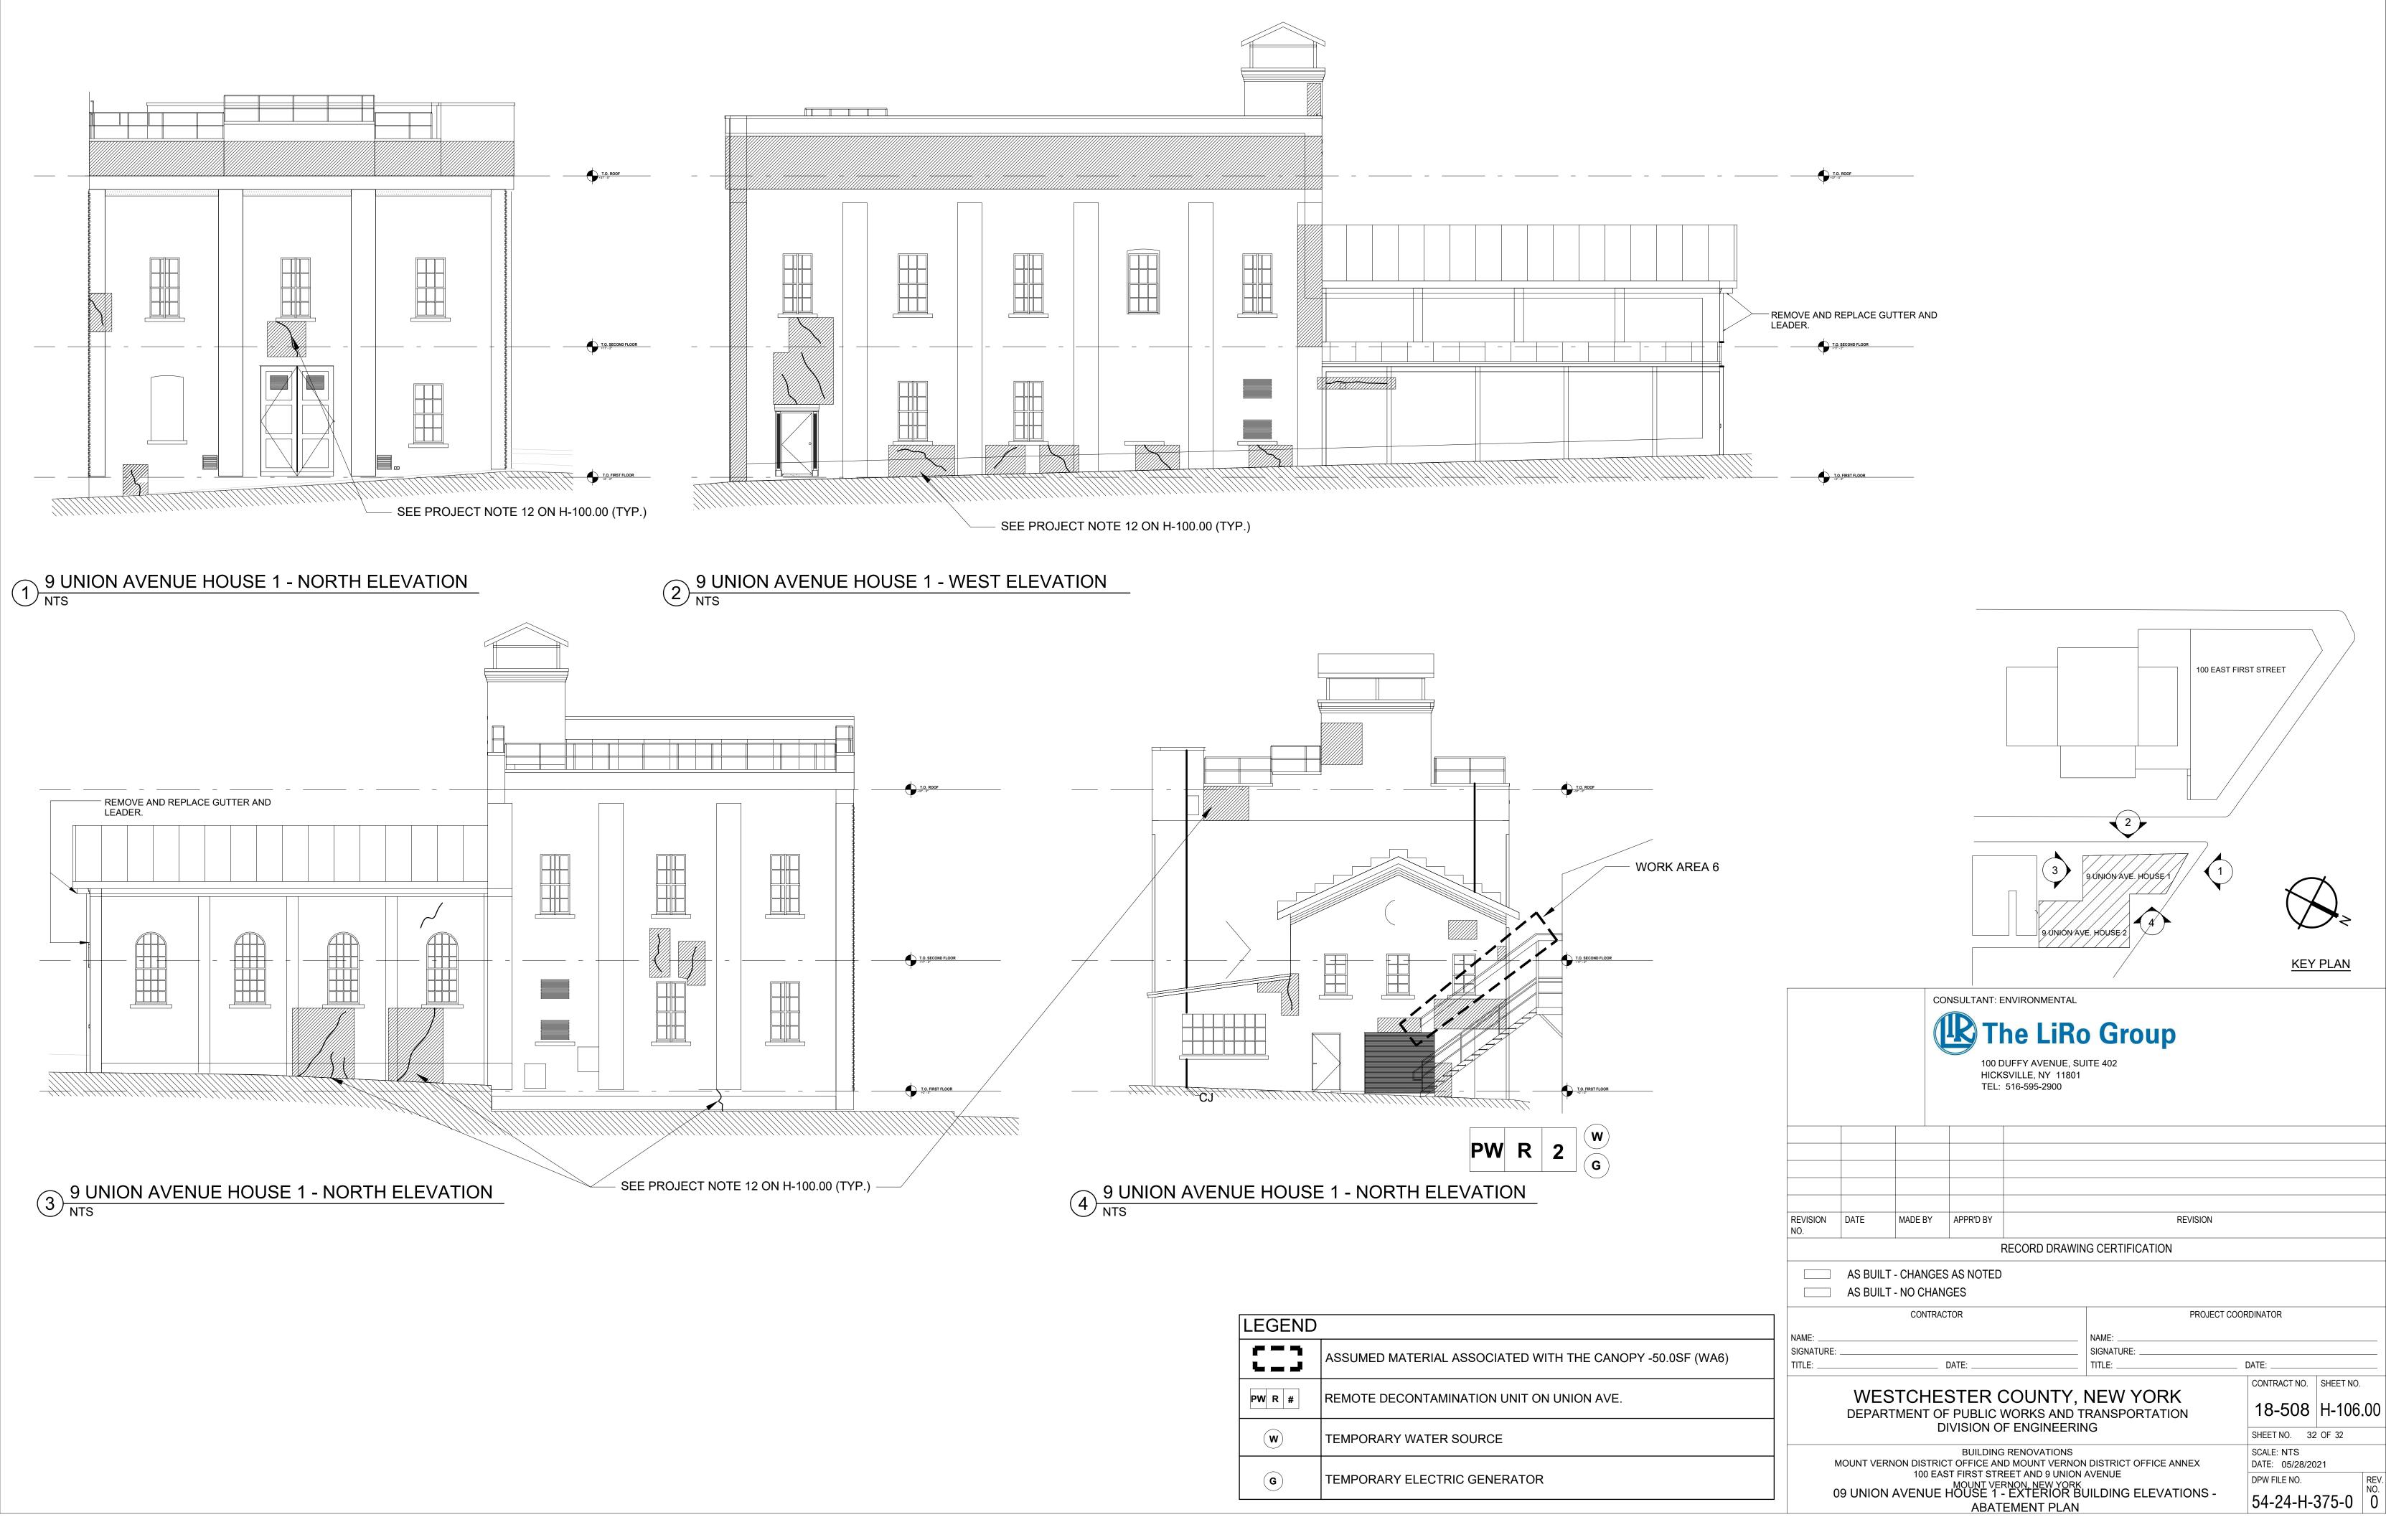

LEGEND							
::::	ASSUMED MATERIAL ASSOCIATED WITH THE CANOPY -						
PW R #	REMOTE DECONTAMINATION UNIT ON UNION AVE.						
W	TEMPORARY WATER SOURCE						
G	TEMPORARY ELECTRIC GENERATOR						