BOND PHASE 2

AT

GOLDEN HILL ELEMENTARY SCHOOL, S.S. SEWARD INSTITUTE, & S.S. SEWARD MEMORIAL

FLORIDA UNION FREE SCHOOL DISTRICT

ORANGE COUNTY, TOWN OF WARWICK, VILLAGE OF FLORIDA, NEW YORK

DISTRICT ADMINISTRATION OFFICES S.S. SEWARD MEMORIAL BUILDING 51 NORTH MAIN STREET FLORIDA NY 10921

GOLDEN HILL ELEMENTARY SCHOOL - S.E.D. # 44-21-15-02-0-004-013

S.S. SEWARD INSTITUTE - S.E.D. # 44-21-15-02-0-001-015

S.S. SEWARD MEMORIAL - S.E.D. # 44-21-15-02-0-003-010

GENERAL INFORMATION

T-0.01 TITLE SHEET

GOLDEN HILL ELEMENTARY SCHOOL (20-176A)

CIVIL

CS0.01A TOPOGRAPHIC SURVEY PLAN
CS1.01A EXISTING CONDITIONS & DEMOLITION PLAN
CS2.01A ALIGNMENT & SCHEDULE PLAN
CS4.01A GRADING & DRAINAGE PLAN
ARCHITECTURAL

A0.01 OVERALL KEYPLANS
A9.01 LIBRARY, COMPUTER ROOM and MAIN OFFICE CARPET REPLACEMENT PLANS, TOILET ROOM PARTITION REPLACEMENT PLANS
A9.02 GYMNASIUM FLOOR PLANS, PHOTOS and NOTES
FS.01 KITCHEN EQUIPMENT DEMO / PROPOSED PLAN
MECHANICAL / PLUMBING

MP1.01 DEMOLITION AND GENERAL NOTES
MP2.01 NEW MECHANICAL WORK, SCHEDULE AND DETAILS AT CAFETERIA AND BAND ROOM
ELECTRICAL

E1.01 DEMOLITION and PROPOSED PLANS

E2.02 SITE NOTES AND DETAILS

E4.01 PROPOSED GENERATOR LOADS


PARKING LOT DEMO & PROPOSED PLANS

 CS0.01B TOPOGRAPHIC SURVEY PLAN C\$1.01B
 EXISTING CONDITIONS & DEMOLITION PLAN CS2.01B ALIGNMENT & SCHEDULE PLAN C\$4.01B GRADING & DRAINAGE PLAN • CS6.01 SITE DETAILS A0.01 OVERALL KEYPLANS LOCKER ROOM DEMOLITION AND ABATEMENT PLANS LOCKER ROOM REFLECTED CEILING PLANS PARTITION TYPES A2.03 ART ROOM 205 PLAN, 6TH GRADE LOCKER REPLACEMENT PLAN, OFFICE CARPET REPLACEMENT PLANS, CEILING REPLACEMENT PLANS LOCKER ROOM FINISH SCHEDULE • A11.01 ENLARGED LOCKER ROOM PLANS AND DETAILS PTAC REPLACEMENT PLAN LOCKER ROOM MECHANICAL PLAN CAFETORIUM AIR CONDITIONING PLAN M2.04 GYM AIRHANDLER MECHANICAL PLAN M6.01 SCHEDULES, DETAILS, NOTES P1.01 PLUMBING DEMO and GENERAL NOTES NEW PLUMBING WORK and SCHEDULE LOCKER ROOMS DEMOLITION PLAN MECHANICAL DEMOLITION PLANS PROPOSED LIGHTING PLAN PROPOSED POWER PLANS

S.S. SEWARD MEMORIAL (20-176C)

ARCHITECTURAL

• A2.01 OVERALL KEY PLAN & DETAILS
• A2.02 SEWARD MEMORIAL JOINT REPAIR PLAN, SITE KEY PLAN and PHOTOS

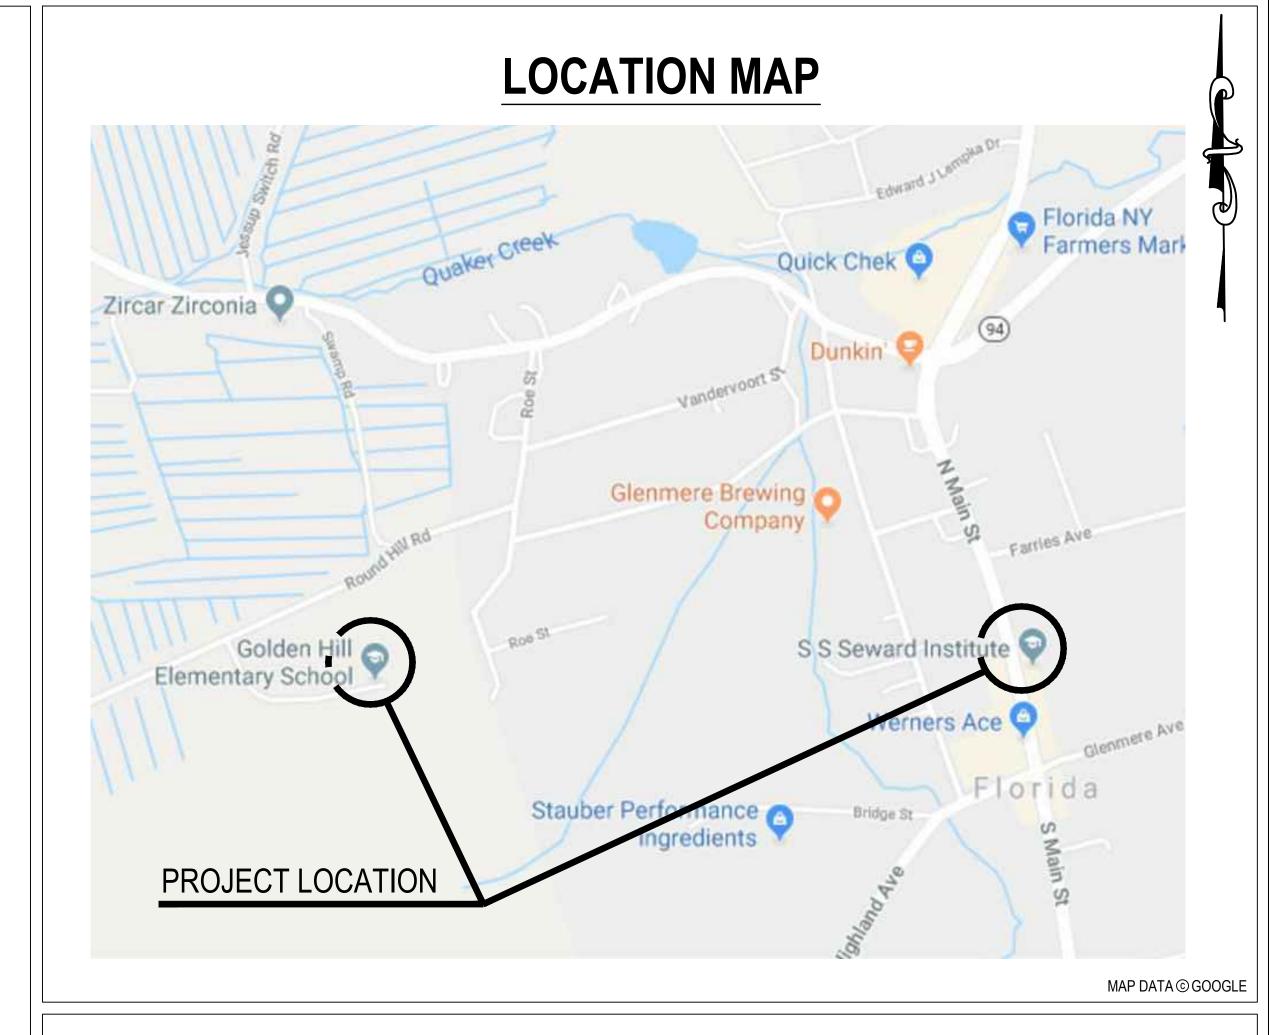

BBS ARCHITECTS
LANDSCAPE ARCHITECTS
ENGINEERS

244 EAST MAIN STREET | PATCHOGUE | NEW YORK 11772 | T. 631.475.0349 | F. 631.475.0361

244 EAST MAIN STREET | PATCHOGUE | NEW YORK 11772 | T. 631.475.0349 | F. 631.475.0361 | 187 WOLF ROAD, SUITE 205 | ALBANY | NEW YORK 12205 | T. 518.621.7650 | F. 518.621.7655

www.BBSARCHITECTURE.COM

ARCHITECTS CERTIFICATION
THE UNDERSIGNED CERTIFIES THAT TO THE BEST OF HIS KNOWLEDGE, INFORMATION, AND BELIEF, THE PLANS AND SPECIFICATIONS ARE IN ACCORDANCE WITH APPLICABLE REQUIREMENTS OF THE NEW YORK STATE UNIFORM FIRE PREVENTION AND BUILDING CODE, THE NEW YORK STATE ENERGY CONSERVATION CONSTRUCTION CODE, AND THE CONSTRUCTION STANDARDS OF THE EDUCATION DEPARTMENT.

LAWRENCE SALVESEN, A.I.A. LIC. No. 020623

BBS FILE No. 20-176A,B,C BID PICKUP DATE: March 15, 2020



COPIES OF THIS DOCUMENT WITHOUT A FACSIMILE

OF THE SIGNATURE AND AN ORIGINAL EMBOSSED SEAL OR ORIGINAL STAMP IN BLUE OR RED INK OF

THE PROFESSIONAL ENGINEER OR LAND SURVEYOR

ORIGINAL SIZE IN INCHES

THIS DOCUMENT IS PREPARED SPECIFICALLY FOR THE SHALL NOT BE CONSIDERED VALID COPIES.


CLIENT AND PROJECT DESIGNATED HEREON.

OR USE WITHOUT THE CONSENT OF TECTONIC

MODIFICATION, ALTERATION, REVISION, DUPLICATION,

ENGINEERING, PC IS PROHIBITED. COPYRIGHT 2020

TECTONIC ENGINEERING, PC. ALL RIGHTS RESERVED.

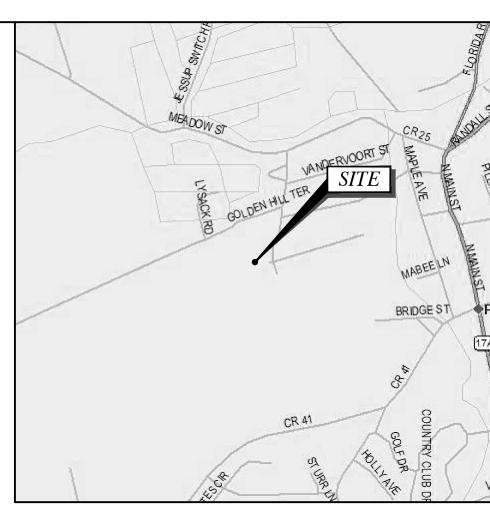

LOCATION MAP

SCALE: 1" = 2000'

GENERAL NOTES

- 1. THIS PLAN IS BASED ON A FIELD SURVEY BY TECTONIC ENGINEERING CONSULTANTS, GEOLOGISTS & LAND SURVEYORS, D.P.C. COMPLETED ON 07/27/2020.
- 2. VERTICAL DATUM: NORTH AMERICAN VERTICAL DATUM 1988.
- 3. MERIDIAN AND COORDINATES REFER TO NEW YORK STATE PLANE, NAD 83, NEW YORK EAST ZONE AND ARE BASED ON GPS OBSERVATIONS.
- 4. ANGLES OR BEARINGS SHOWN HEREON ARE FORMATTED IN DEGREES, MINUTES, AND SECONDS. DISTANCES OR ELEVATIONS SHOWN HEREON ARE IN U.S. SURVEY FEET, UNLESS NOTED OTHERWISE.
- REFERENCES:
 - (A) DEED: BOOK 1952, PAGE 85.
 - (B) MAP ENTITLED: "SUBDIVISION OF PROPERTY FOR MARJORIE L. ZAP" AS FILED IN THE ORANGE COUNTY CLERK'S OFFICE ON 09/23/1996 AS MAP #198-96.
- 6. THIS SURVEY IS SUBJECT TO A COMPLETE AND UP TO DATE ABSTRACT OF TITLE. COVENANTS, EASEMENTS, GRANTS AND RIGHTS-OF-WAY NOT VISIBLE AND NOT REFERENCED ARE NOT SHOWN. TECTONIC ENGINEERING CONSULTANTS, GEOLOGISTS & LAND SURVEYORS, D.P.C. SHALL NOT BE LIABLE FOR THE DISTURBANCE TO ANYONE'S RIGHT TO THE USE OF THE PROPERTY OR THE DISTURBANCE OF ANY UTILITIES NOT SHOWN OR REFERENCED ON THIS SURVEY
- 7. LOCATIONS OF ALL UTILITIES AND SUBSTRUCTURES ARE APPROXIMATE ONLY BASED ON SURFACE EVIDENCE AND EXISTING PLANS. THE INFORMATION GIVEN ON THE SURVEY PERTAINING TO UTILITIES AND SUBSTRUCTURES IS NOT CERTIFIED TO ACCURACY OR COMPLETENESS. CONSULT WITH THE APPROPRIATE COMPANY OR AGENCY BEFORE DESIGNING OR CONSTRUCTING IMPROVEMENTS. TECTONIC ENGINEERING CONSULTANTS, GEOLOGISTS & LAND SURVEYORS, D.P.C. WILL NOT BE RESPONSIBLE FOR ANY DAMAGE SUBSEQUENTLY CAUSED TO PERSONNEL, STRUCTURES, OR UTILITIES.
- 8. THIS SURVEY PLAT IS FOR SITE PLAN/ENGINEERING PURPOSES ONLY AND IS NOT INTENDED TO BE USED FOR THE TRANSFER OF TITLE.
- 9. THE SUBJECT PROPERTY FALLS WITHIN FLOOD ZONE "X" AS PER THE NATIONAL FLOOD INSURANCE RATE MAP FOR THE VILLAGE OF FLORIDA, ORANGE COUNTY, STATE OF NEW YORK, COMMUNITY PANEL NO # 36071C0453E, EFFECTIVE DATE OF 08/03/2009. THIS DETERMINATION IS BASED ON SCALED MAP LOCATION AND GRAPHIC PLOTTING.
- 10. UNDERGROUND UTILITY LOCATION BASED ON MARKOUT BY SOFT DIG UNDERGROUND SERVICES INC. ON 07/23/2020.

	PROPERTY LINE		STRUCTURE
	- ADJOINING PROPERTY LINE	×BC123.12 TC123.12	BOTTOM/TOP OF CURB ELEVATION
- — — — —	- EASEMENT LINE	123.12 ×	SPOT ELEVATION
	INDEX CONTOUR LINE	\sim	GUY ANCHOR
	CONTOUR LINE		UTILITY POLE CURB INLET
	TAX LOT LINE	○ CO	CLEAN OUT
	- TOWN LINE	S	MANHOLE (SAN. SEWER)
-x x x	CHAIN LINK FENCE	GV W/√	GAS VALVE
	CURB LINE	₩V 	WATER VALVE
	CURB TYPE TRANSITION	♡ 	HYDRANT SIGN
	EDGE OF CONCRETE	\$	LIGHT POST
	- EDGE OF PAVEMENT	~ □MB	MAILBOX
	PAINTED TRAFFIC LINES	□ GM	GAS METER
——— Е ————	ELECTRIC (UNDERGROUND)	⊟ EPB	ELECTRIC PULLBOX
G	GAS (UNDERGROUND)	- ф - в-#	BORING
——————————————————————————————————————	OVERHEAD WIRES	- 3	HANDICAP
s	SANITARY SEWER		
т	TELEPHONE (UNDERGROUND)		
_	GUIDE RAIL		

NYSED # 44-21-15-02-0-004-013

Released by PRACTICAL SOLUTIONS. EXCEPTIONAL SERVICE. Comment **Tectonic Engineering Consultants, Geologists** & Land Surveyors, D.P.C. Approval Phone: (845) 534-5959 70 Pleasant Hill Road

Construction

P.O. Box 37

Mountainville, NY 10953

www.tectonicengineering.com

(800) 829-6531

DOMINICK T. SANTINI, IV P.L.S. 51084 Scale


PARTIAL BOUNDARY & TOPOGRAPHIC SURVEY FLORIDA UNION SCHOOL DISTRICT GOLDEN HILL ELEMENTARY


08/18/2020


478 ROUND HILL ROAD, VILLAGE OF FLORIDA ORANGE COUNTY, NEW YORK


10537.01

SU-101

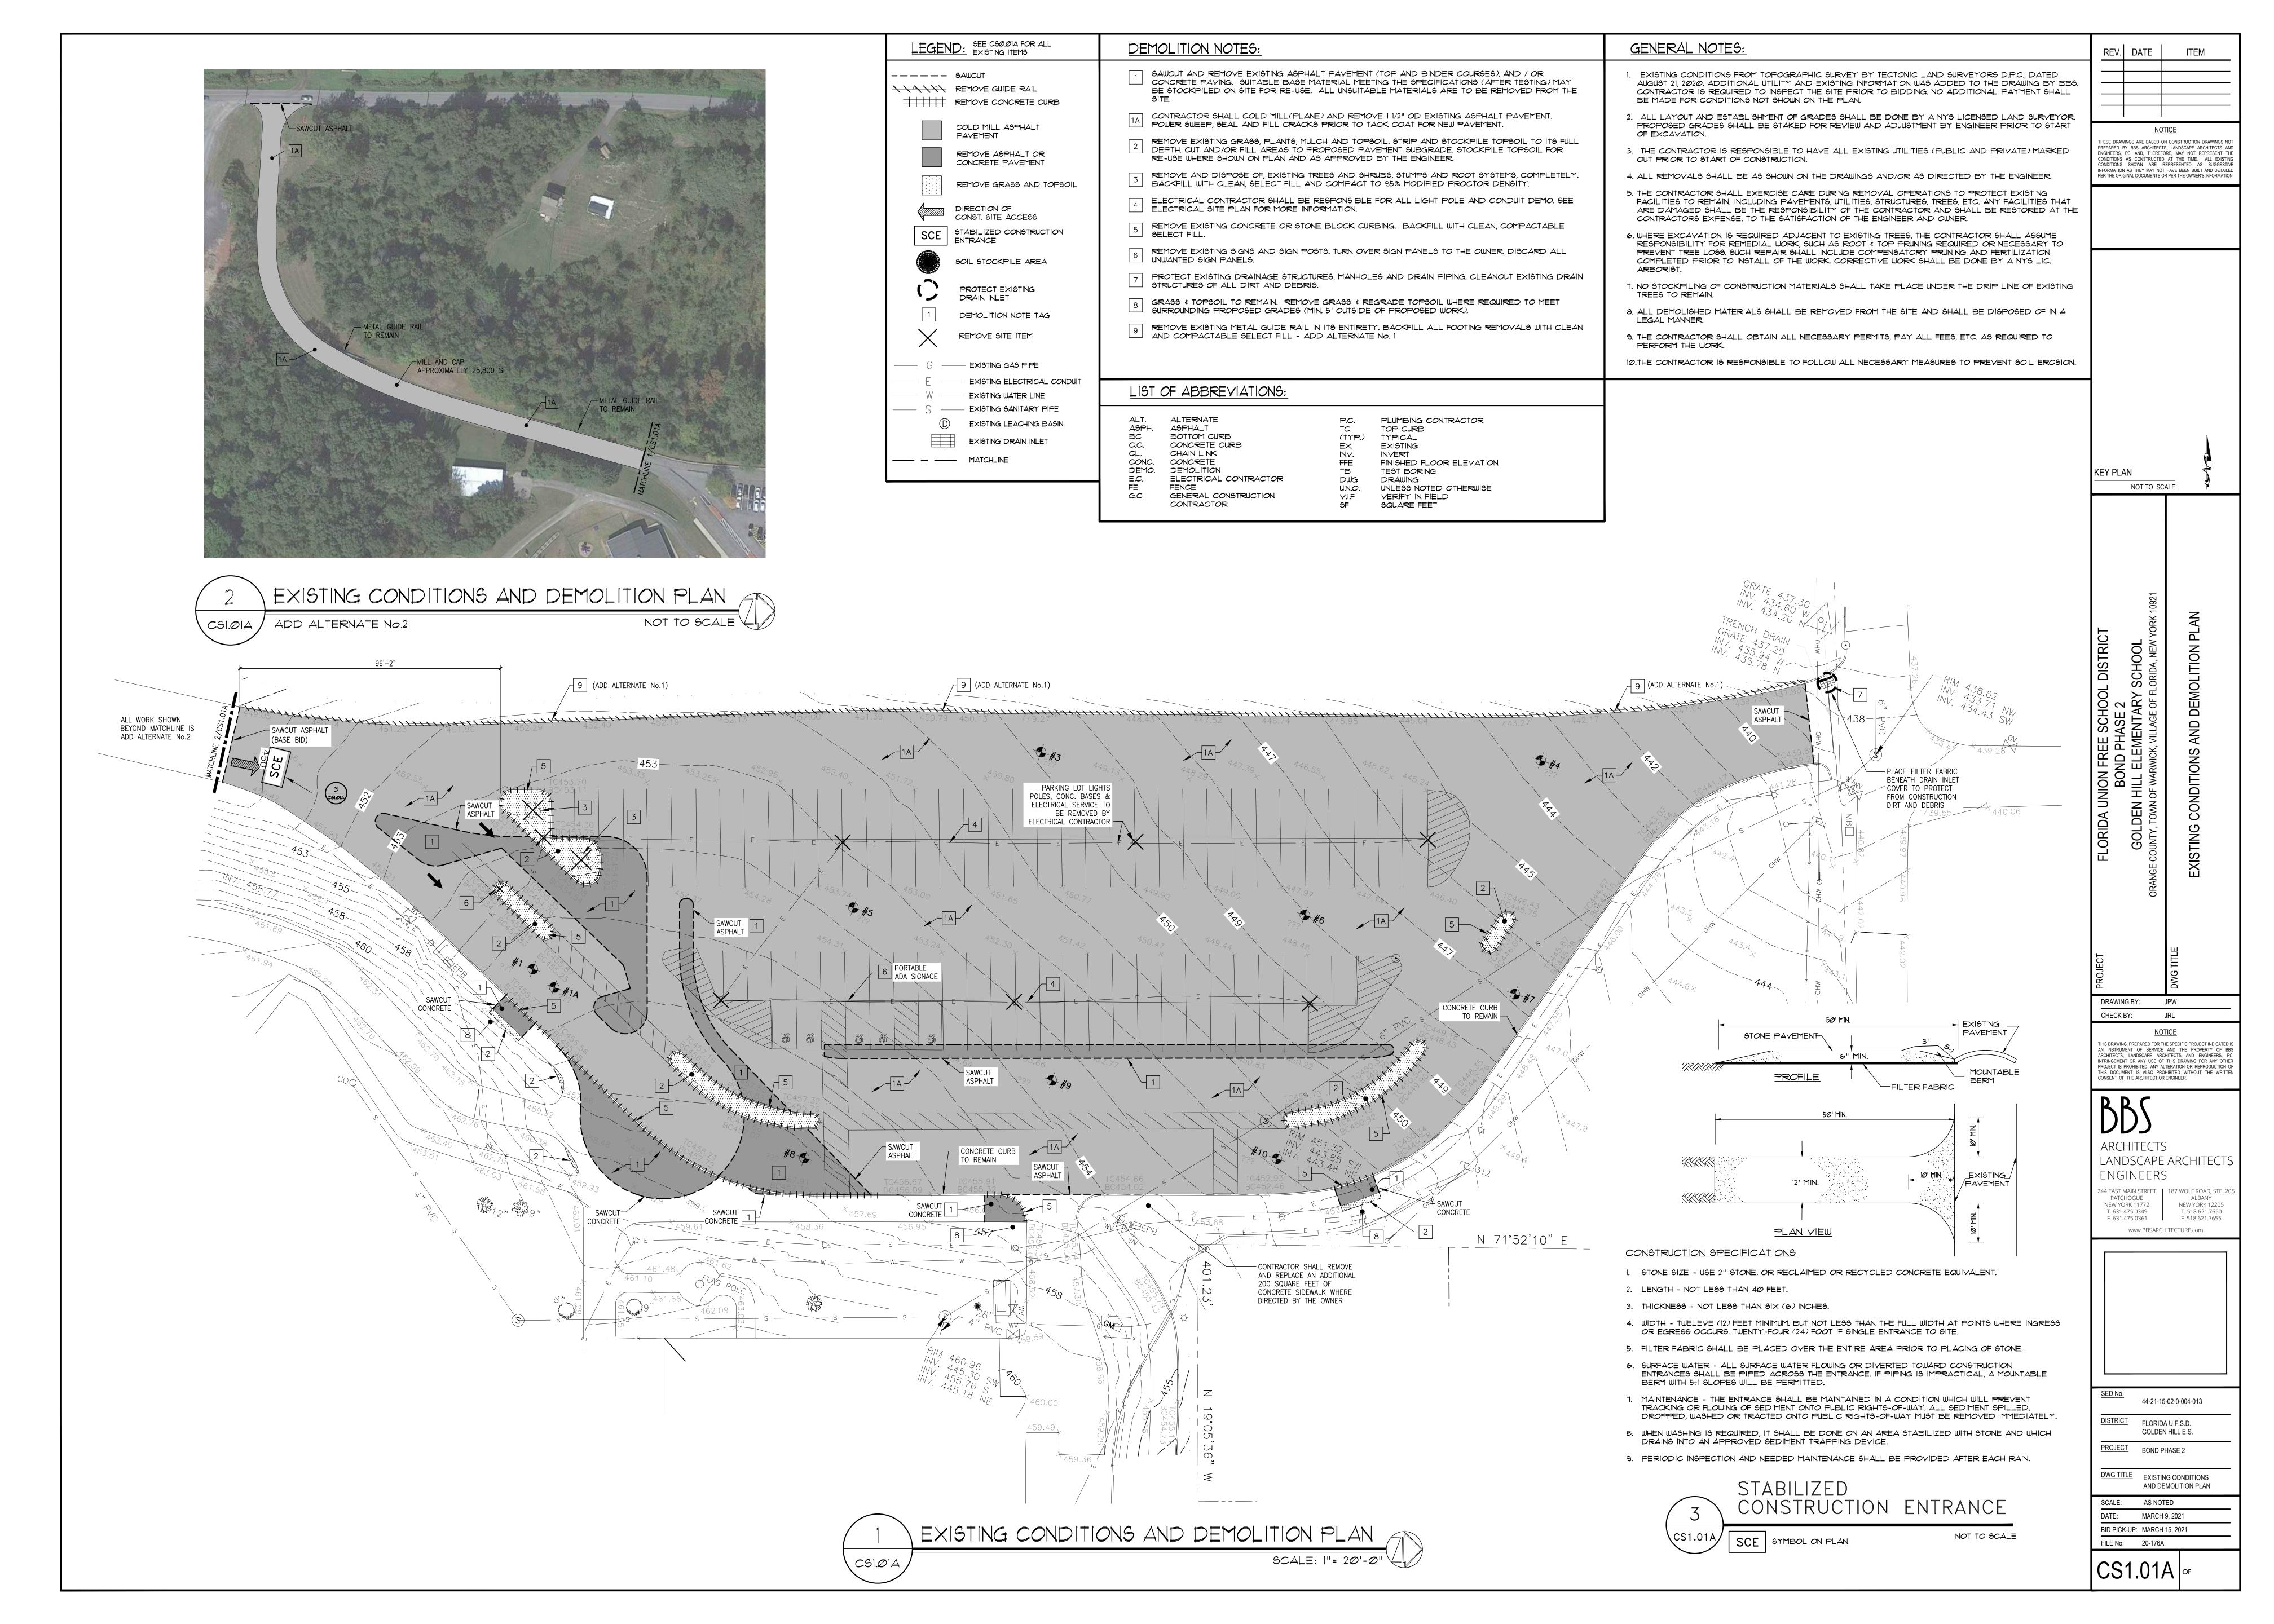

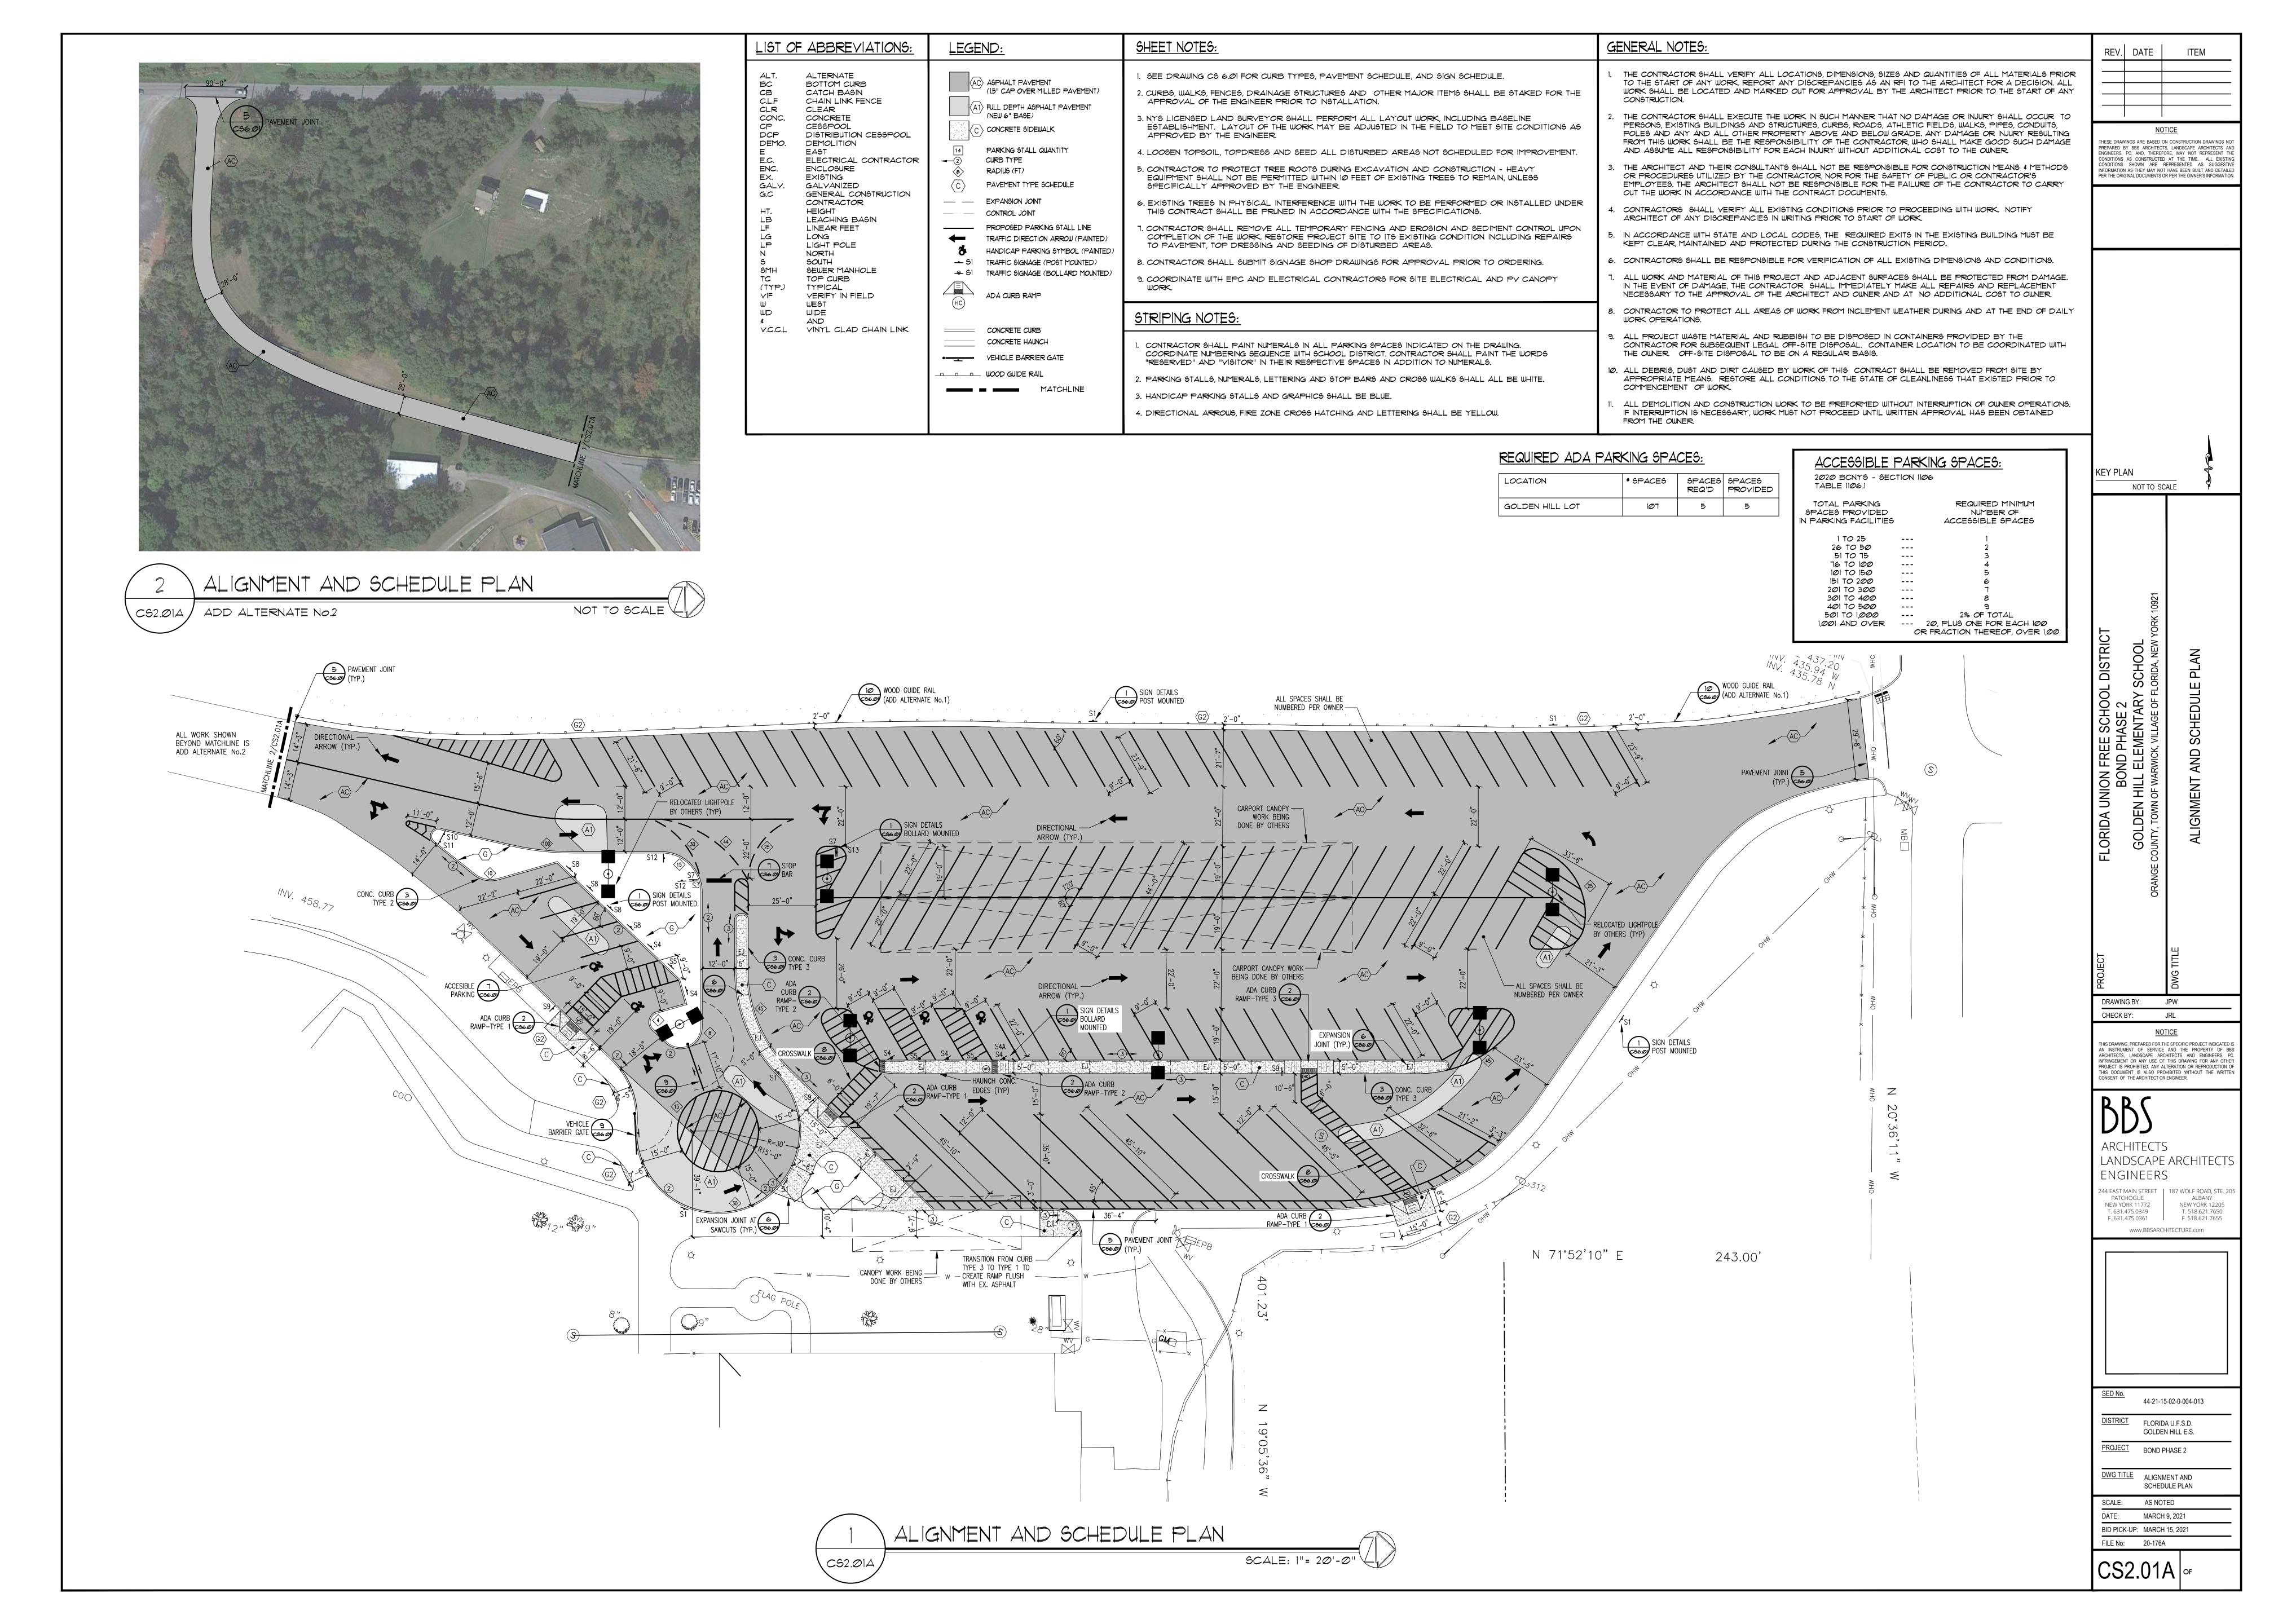

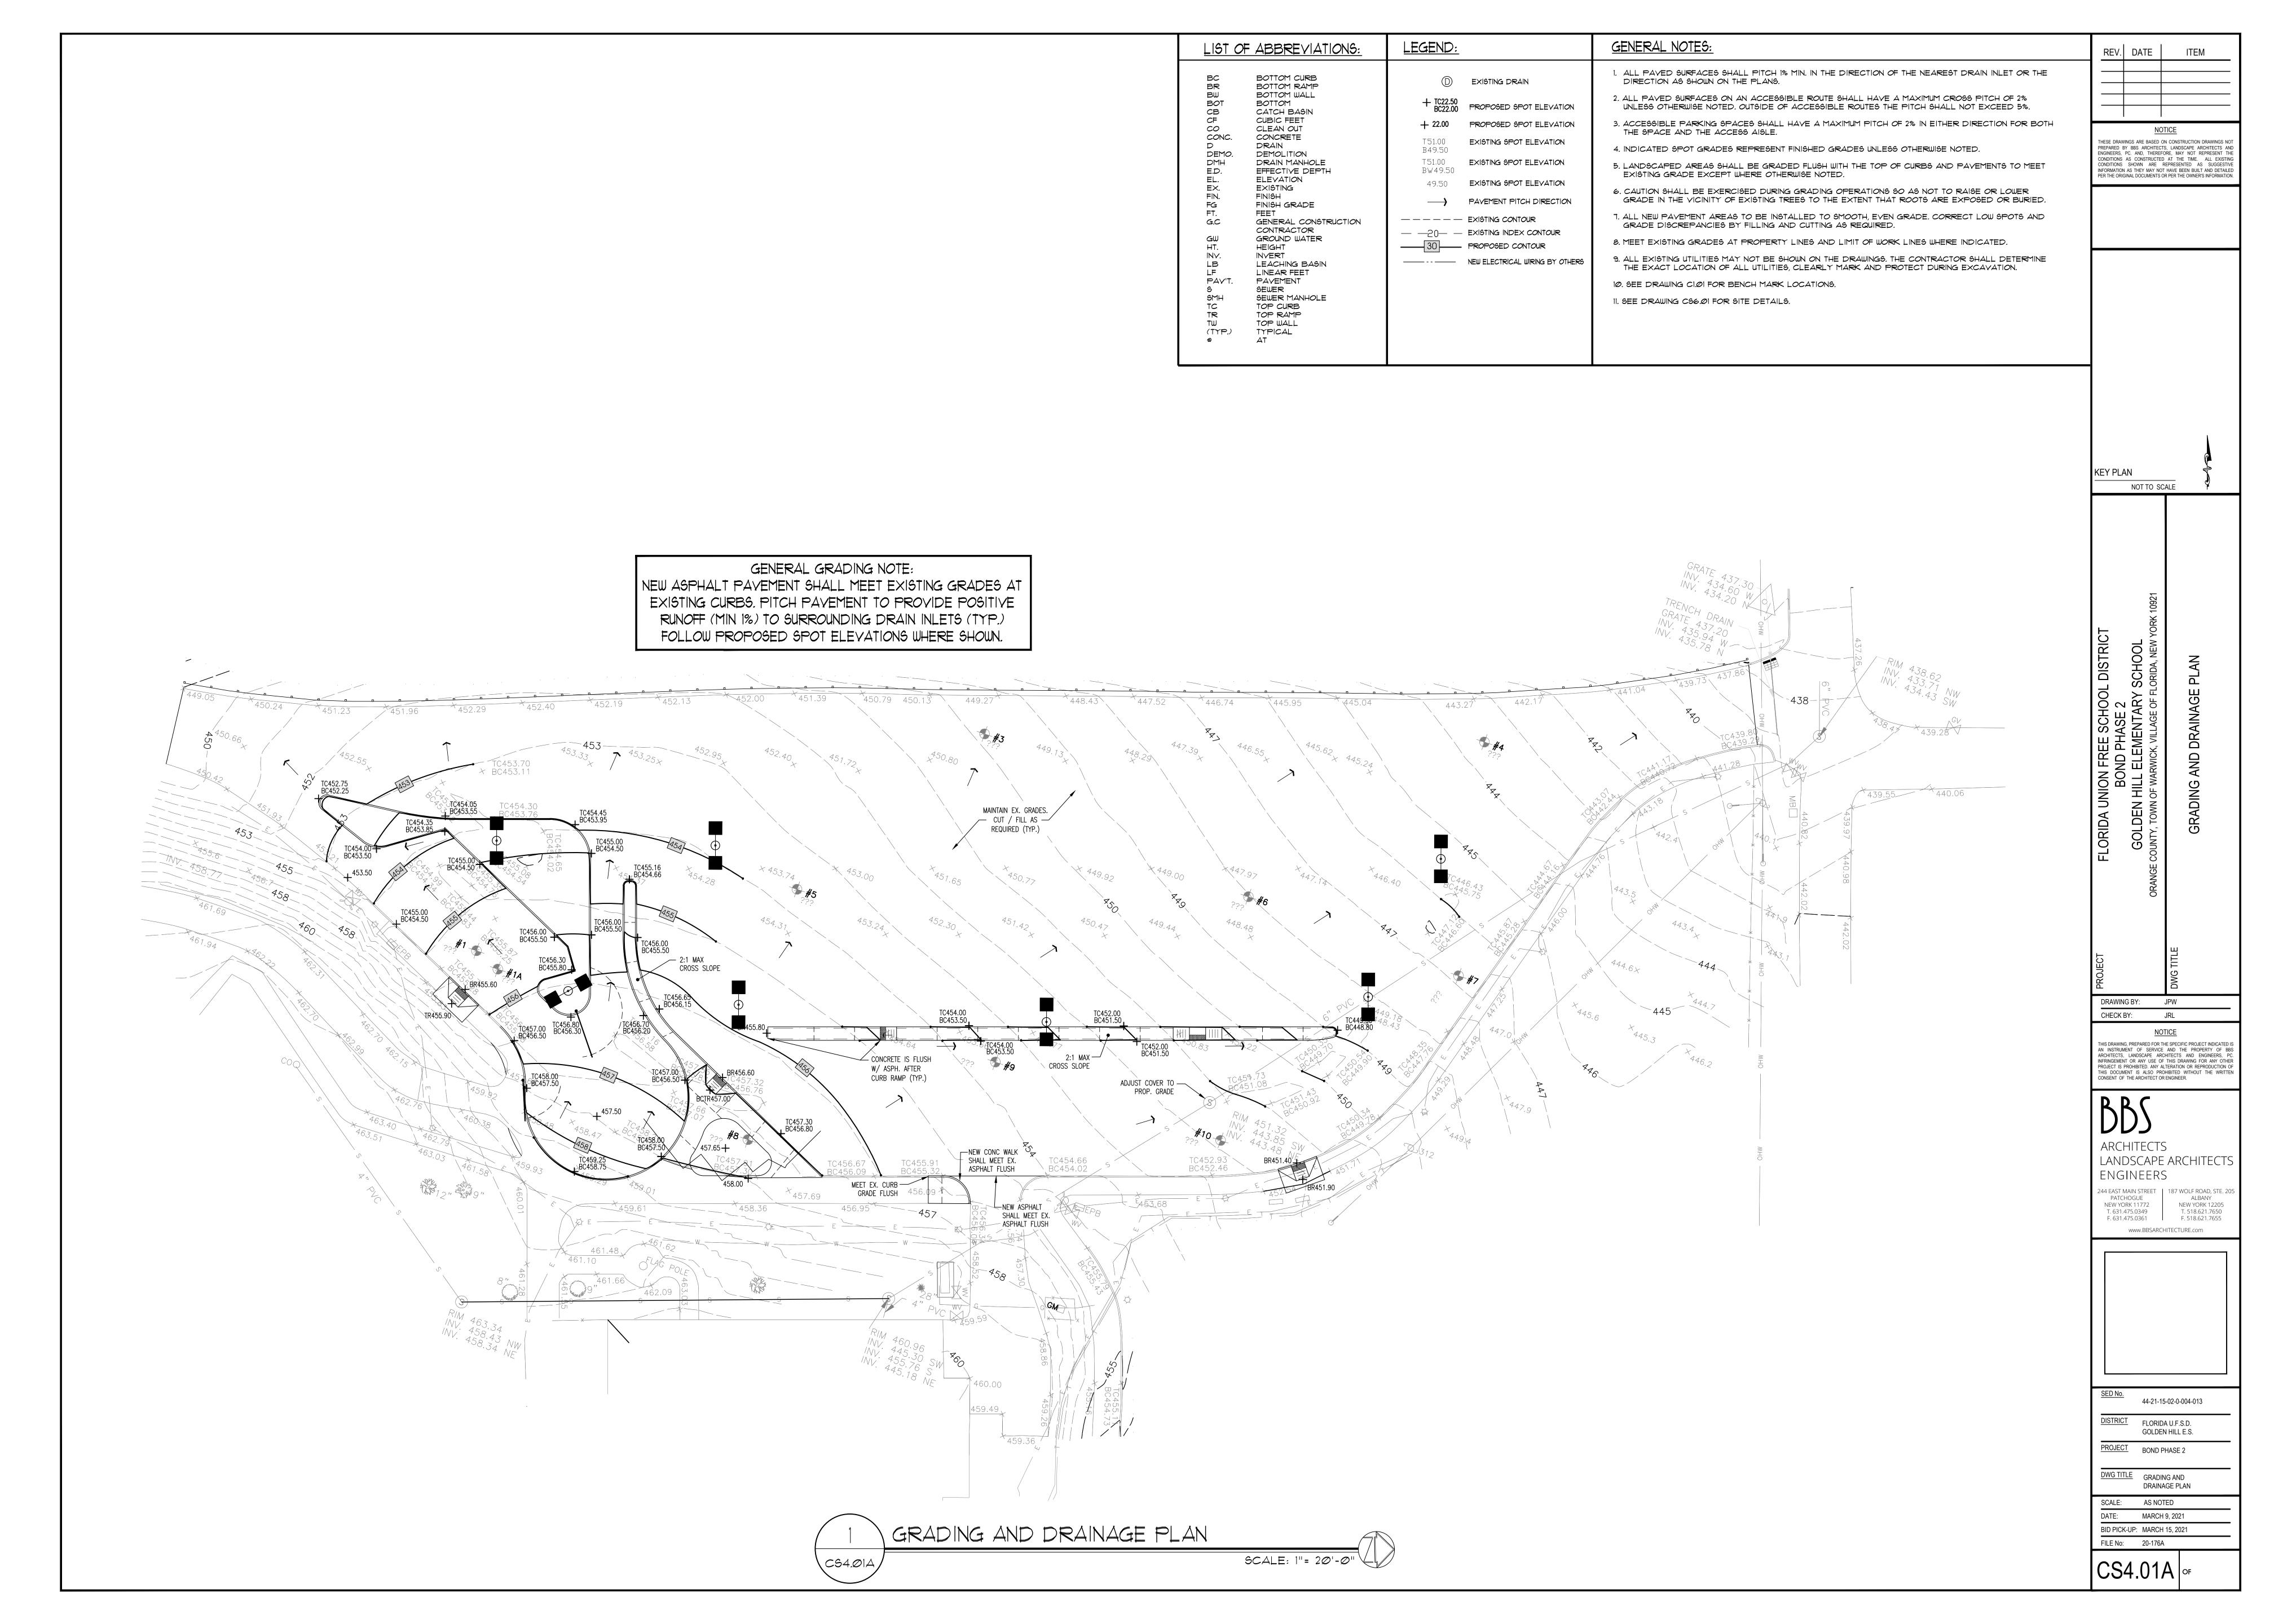

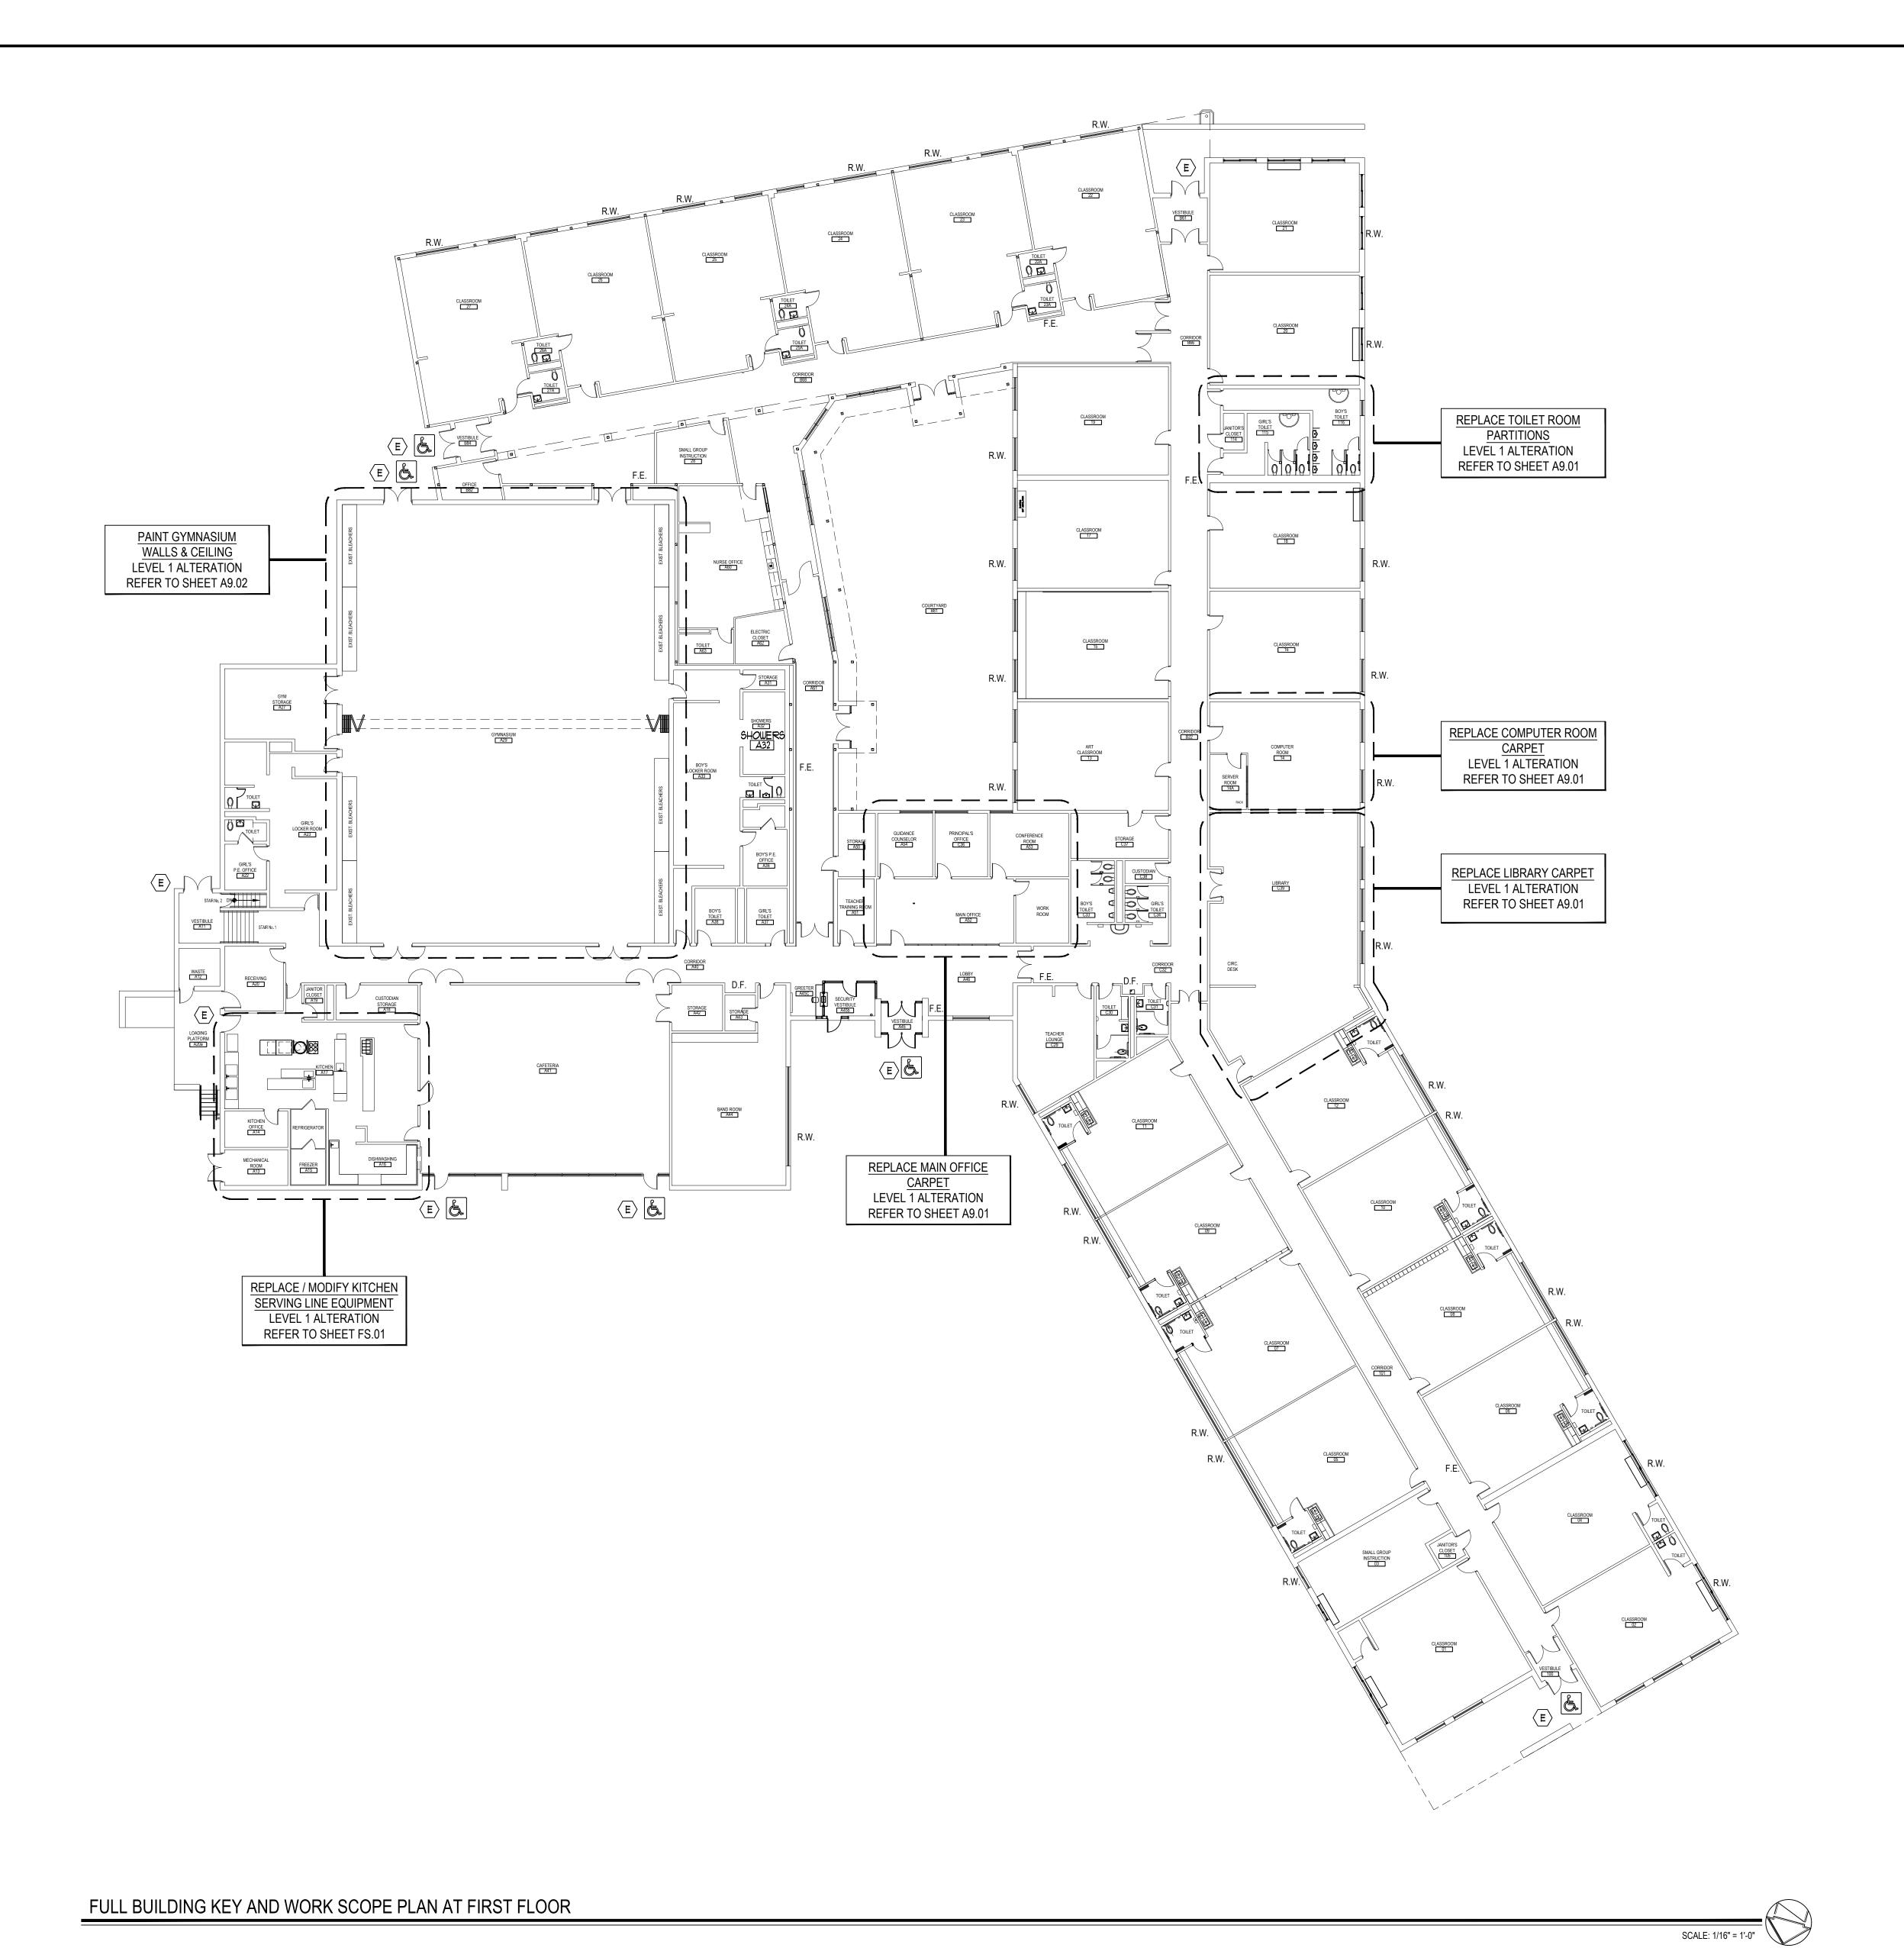

GENERAL CONSTRUCTION NOTES:

1. GENERAL CONTRACTOR SHALL VERIFY ALL EXISTING CONDITIONS PRIOR TO BIDDING & PROCEEDING WITH WORK. NOTIFY ARCHITECT OF ANY DISCREPANCIES IN WRITING PRIOR TO START OF WORK.

2. IN ACCORDANCE WITH STATE AND LOCAL CODES, THE REQUIRED EXITS IN THE EXISTING BUILDING MUST BE KEPT CLEAR, MAINTAINED AND PROTECTED DURING THE CONSTRUCTION PERIOD.

3. CONTRACTOR SHALL BE RESPONSIBLE FOR VERIFICATION OF ALL DIMENSIONS REQUIRED FOR ESTIMATING.

4. ALL WORK AND MATERIAL OF THIS PROJECT AND ADJACENT SURFACES SHALL BE PROTECTED FROM DAMAGE. IN THE EVENT OF DAMAGE, THE CONTRACTOR SHALL IMMEDIATELY MAKE ALL REPAIRS AND REPLACEMENT NECESSARY TO THE APPROVAL OF THE ARCHITECT AND OWNER AND AT NO ADDITIONAL COST TO OWNER.

5. CONTRACTOR SHALL PROTECT ALL AREAS OF WORK FROM INCLEMENT WEATHER DURING AND AT THE END OF DAILY WORK OPERATIONS.

6. ALL PROJECT WASTE MATERIAL AND RUBBISH SHALL BE DISPOSED IN CONTAINERS PROVIDED BY THE CONTRACTOR FOR SUBSEQUENT LEGAL OFF-SITE DISPOSAL. CONTAINER LOCATION TO BE COORDINATED WITH THE OWNER & CONSTRUCTION MANAGER. OFF-SITE DISPOSAL TO BE ON A REGULAR BASIS.

7. ALL INTERIOR SURFACES DISTURBED DURING CONSTRUCTION SHALL BE REPAIRED AND/OR REPLACED TO MATCH EXISTING CONDITIONS TO THE APPROVAL OF THE ARCHITECT AND OWNER.

8. ALL DEBRIS, DUST AND DIRT CAUSED BY WORK OF THIS CONTRACT SHALL BE REMOVED FROM SITE BY APPROPRIATE MEANS. RESTORE ALL CONDITIONS TO THE STATE OF CLEANLINESS THAT EXISTED PRIOR TO COMMENCEMENT OF WORK. 9. ALL DEMOLITION AND CONSTRUCTION WORK TO BE PERFORMED WITHOUT INTERRUPTION OF OWNER OPERATIONS. IF INTERRUPTION IS NECESSARY, WORK MUST NOT PROCEED UNTIL WRITTEN APPROVAL HAS BEEN OBTAINED FROM

10. ALL CONTRACTORS ARE TO COORDINATE INSTALLATION OF THEIR WORK WITH EACH OTHER AND WITH THE WORK BEING PERFORMED UNDER SEPARATE CONTRACTS BY OTHERS.

CODE COMPLIANCE NOTES:


- BUILDING OCCUPANCY CLASSIFICATION: GROUP E
- CONSTRUCTION CLASSIFICATION EXISTING: TYPE 2B
- CONSTRUCTION CLASSIFICATION NEW: TYPE 2B
- HEIGHT IN STORIES: EXISTING: 1 NEW: N.A.
- NEW FINISHES SHALL BE CLASS 'A'.

LEGEND:

- F.E. EXISTING FIRE EXTINGUISHER
- D.F. EXISTING DRINKING FOUNTAIN R.W. EXISTING RESCUE WINDOW
- ACCESSIBLE ENTRANCE / EXIT
- (E) INDICATES BUILDING EXIT

CONTRATORS NOTE

ALL CONTRACTORS SHALL REFER TO ALL DRAWINGS FOR ANY ADDITIONAL WORK SCOPE NOT INDICATED ON THIS DRAWING

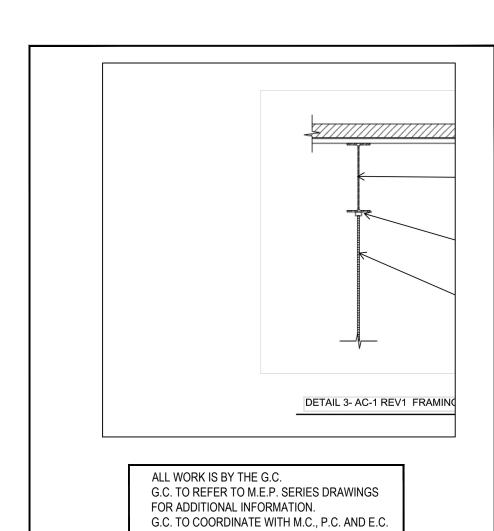

REV. DATE

<u>NOTICE</u> THESE DRAWINGS ARE BASED ON CONSTRUCTION DRAWINGS NOT PREPARED BY BBS ARCHITECTS, LANDSCAPE ARCHITECTS AND ENGINEERS, PC. AND, THEREFORE, MAY NOT REPRESENT THE CONDITIONS AS CONSTRUCTED AT THE TIME. ALL EXISTING CONDITIONS SHOWN ARE REPRESENTED AS SUGGESTIVE INFORMATION AS THEY MAY NOT HAVE BEEN BUILT AND DETAILED

KEY PLAN NOT TO SCALE

CHECK BY: KGS

THIS DRAWING, PREPARED FOR THE SPECIFIC PROJECT INDICATED IS AN INSTRUMENT OF SERVICE AND THE PROPERTY OF BBS ARCHITECTS, LANDSCAPE ARCHITECTS AND ENGINEERS, PC. INFRINGEMENT OR ANY USE OF THIS DRAWING FOR ANY OTHER PROJECT IS PROHIBITED. ANY ALTERATION OR REPRODUCTION OF THIS DOCUMENT IS ALSO PROHIBITED WITHOUT THE WRITTEN CONSENT OF THE ARCHITECT OR ENGINEER.


NEW YORK 11772

T. 631.475.0349

ARCHITECTS LANDSCAPE ARCHITECTS ENGINEERS 244 EAST MAIN STREET | 187 WOLF ROAD, STE. 20: PATCHOGUE | ALBANY

F. 631.475.0361 F. 518.621.7655 www.BBSARCHITECTURE.com

NEW YORK 12205

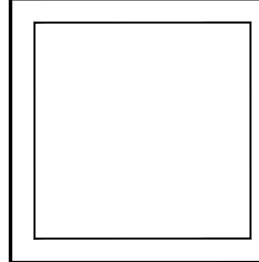

44-21-15-02-0-004-013

<u>DISTRICT</u> FLORIDA U.F.S.D. PROJECT BOND PHASE 2

DWG TITLE OVERALL KEY PLAN

SCALE: AS NOTED BID PICK-UP: March 15, 2021

A0.01



REMOVE FROM THE AREAS INDICATED BY THE HATCH PATTERN: ALL EXISTING CARPETING, COVE BASE AND ASSOCIATED MASTIC DOWN TO THE EXISTING SUBFLOOR

TYPICAL FLOOR REPLACEMENT NOTES


- EXISTING COVE BASE SHALL BE REMOVED AT ALL ROOMS SHOWN TO RECEIVE NEW FINISH FLOORING
- 2. CROSS HATCH DENOTES NEW BROADLOOM CARPETING AND FULL PERIMETER RUBBER COVE BASE. PROVIDE RUBBER TRANSITION STRIP AT ALL LOCATIONS FROM CARPET TO VCT. (COLOR AS SELECTED BY ARCHITECT, REFER TO SPECIFICATIONS

BROADLOOM AS MANUFACTURED BY MANNINGTON COMMERCIAL COLLECTION: GOOGIE

STYLE: MULTIPLEXER BACKING: INTEGRA HP

COLOR: TO BE SELECTED BY ARCHITEC


- 3. ALL LOOSE FURNISHINGS AND EQUIPMENT (EXCLUDING LIBRARY SHELVING) SHALL BE REMOVED AND/OR RELOCATED BY THE
- 4. THE DISTRICT TO REMOVE BOOKS FROM SHELVES. G.C. SHALL MOVE AND REINSTALL EXISTING LOOSE SHELVES. EXISTING FIXED SHELVES ARE TO REMAIN. G.C. TO COORDINATE WITH THE DISTRICT.

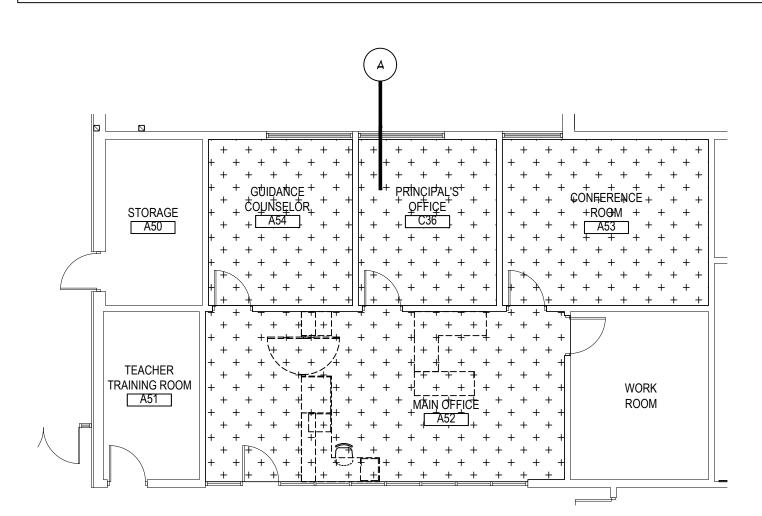

MAIN OFFICE FLOOR PLAN

ALTERNATE No.1a TO BASE BID GC-1 and ALTERNATE No.1b TO BASE BID GC-1


SCALE: 1/8" = 1'-0"

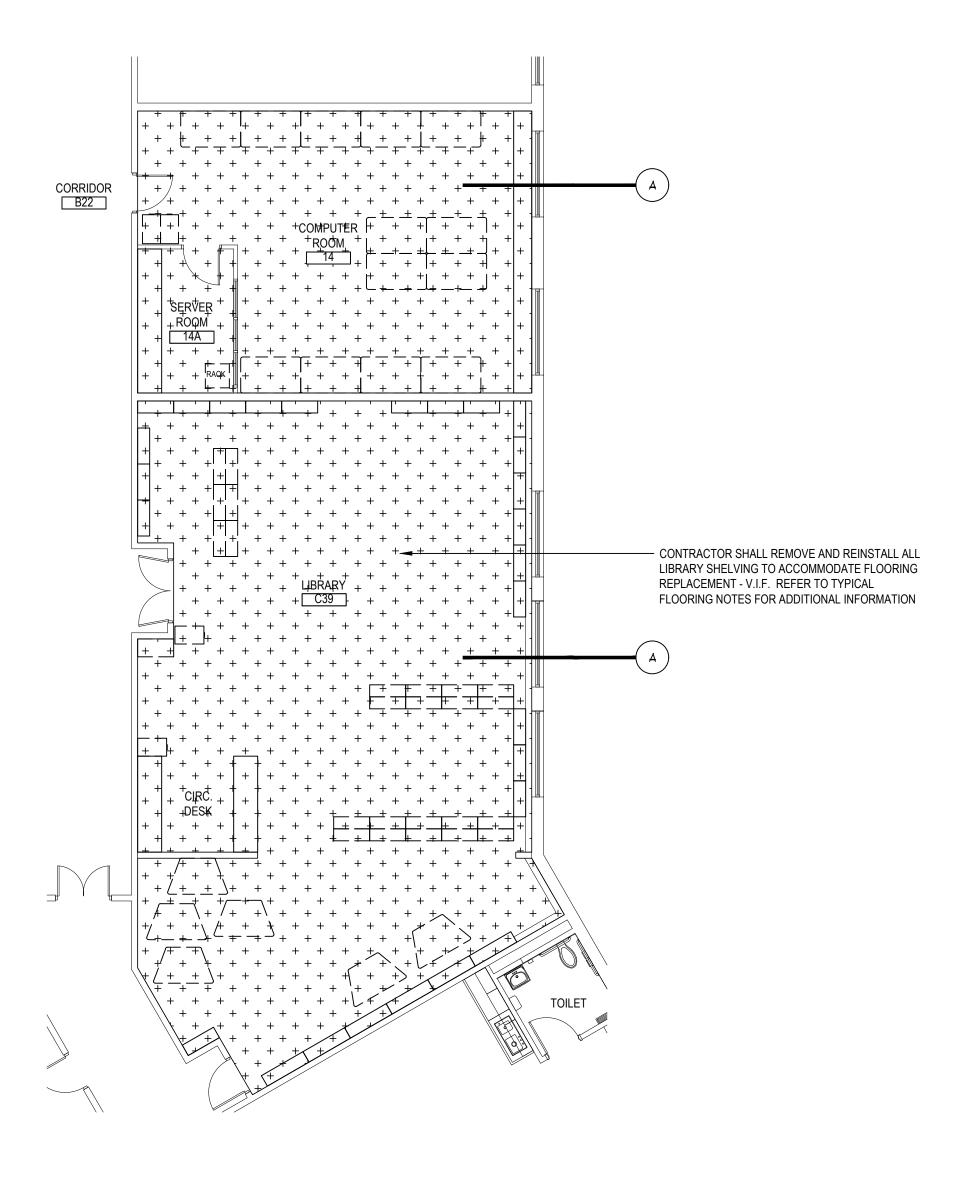


SCALE: 1/8" = 1'-0"

LIBRARY and COMPUTER CLASSROOM FLOOR PLANS

ALTERNATE No.1a TO BASE BID GC-1 and ALTERNATE No.1b TO BASE BID GC-1

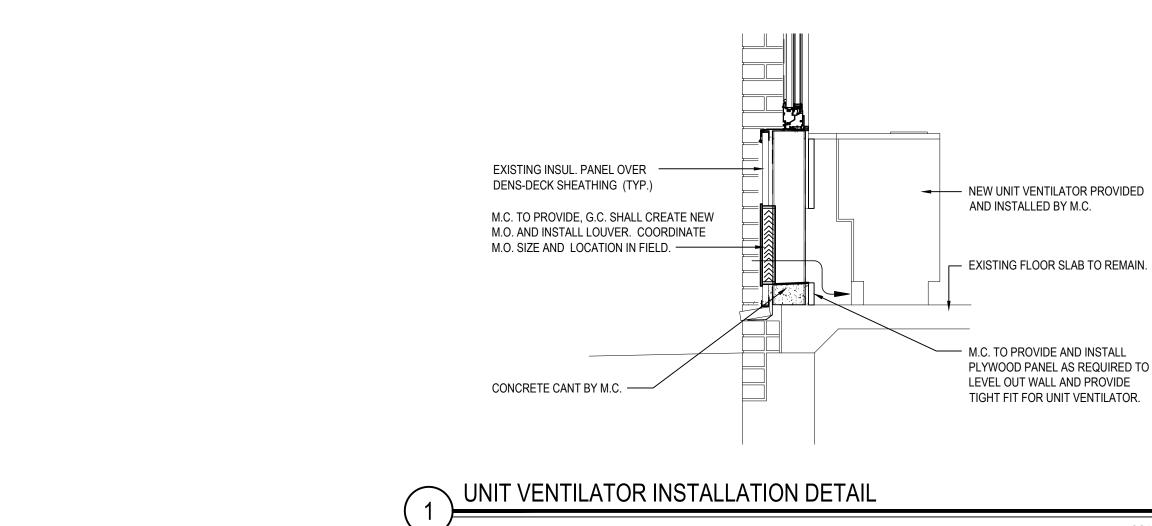

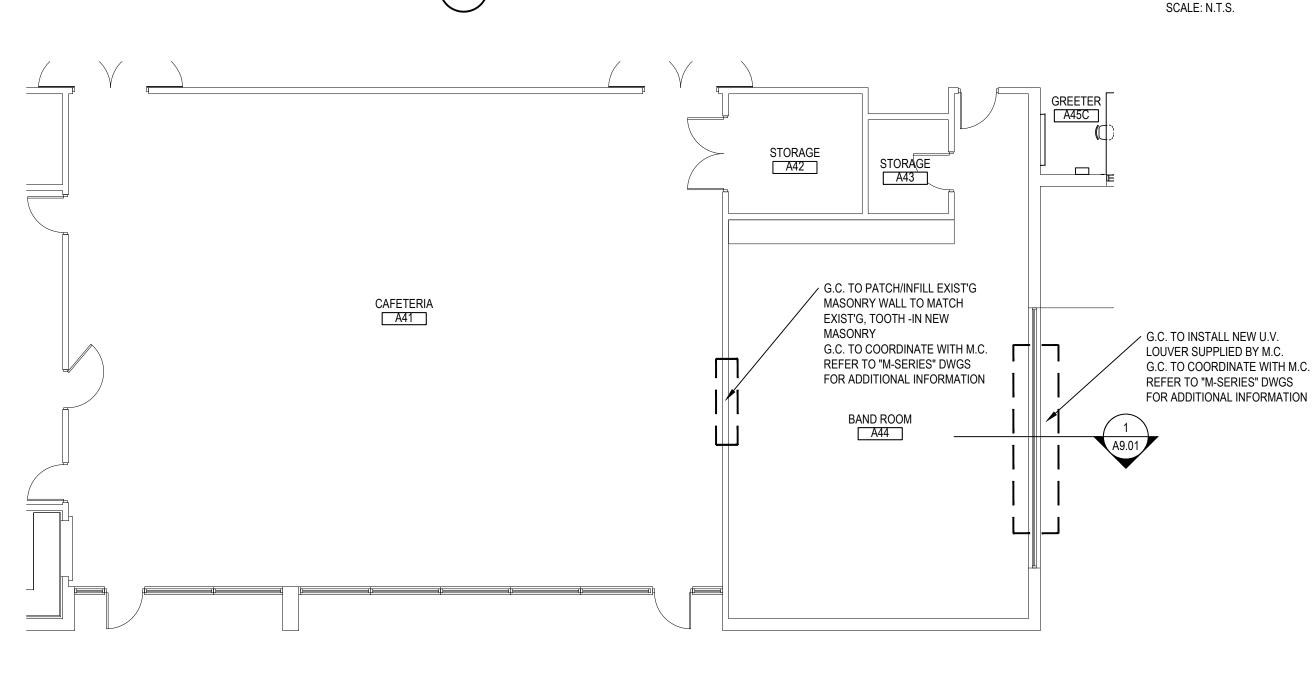

CAFETERIA and BAND ROOM FLOOR PLANS

G.C. TO REPLACE EXIST'G 6"x6" CERAMIC WALL TILES AT PREVIOUS ANCHOR HOLE LOCATIONS (TYP.) — G.C. TO REMOVE AND REPLACE EXISTING GRAB BARS WITH NEW ----G.C. TO REMOVE EXISTING TOILET PAPER DISPENSERS AND INSTALL NEW TOILET PAPER DISPENSER SUPPLIED BY DISTRICT. G.C. TO COORDINATE WITH DISTRICT —





— EXIST'G CMU WALL G.C. TO PATCH AND PAINT HOLES AT PREVIOUS ANCHOR LOCATIONS (TYP)


BOY'S TOILET ROOM PHOTOS

NO SCALE



GIRL'S TOILET ROOM PHOTOS

NO SCALE

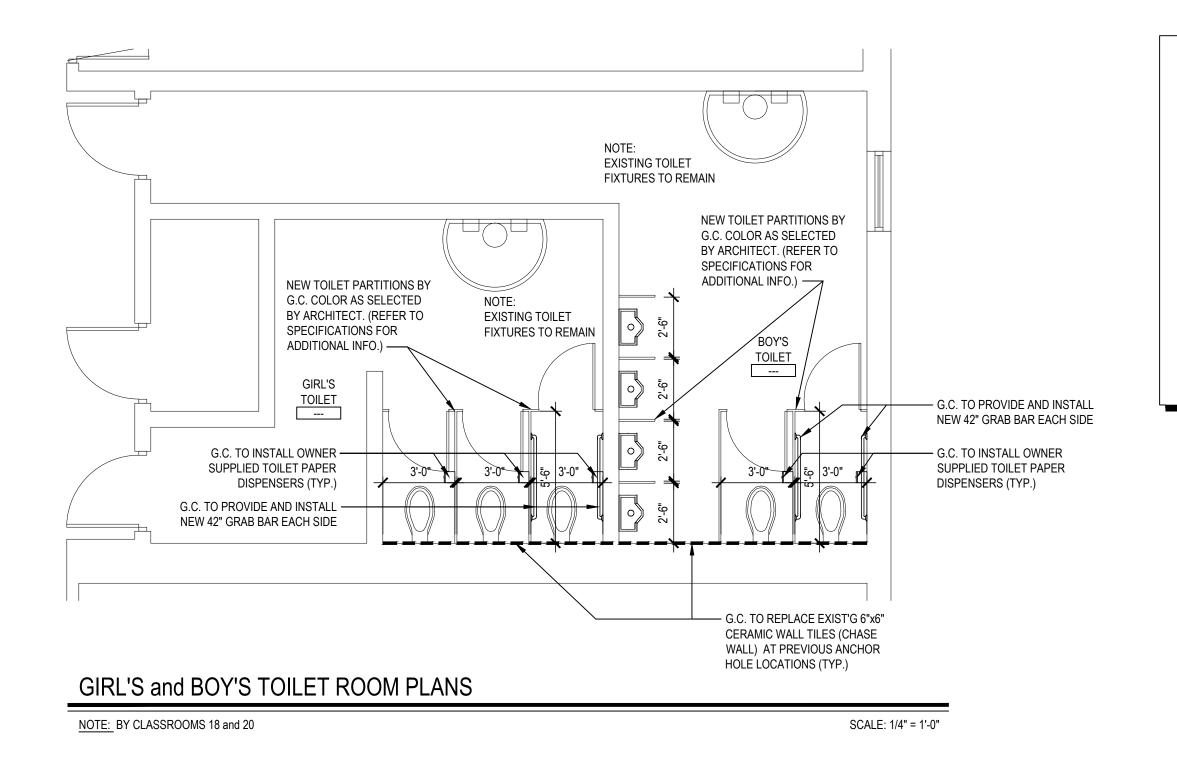

TOILET PARTITION REPLACEMENT NOTES

CONTRACTOR SHALL REMOVE AND DISPOSE OF EXISTING TOILET PARTITIONS & REPLACE WITH NEW HDPE PARTITIONS IN LOCATIONS AND CONFIGURATIONS TO MATCH EXISTING UNLESS OTHERWISE

SCALE: 1/8" = 1'-0"

- CONTRACTOR SHALL FIELD VERIFY OVERALL AND INDIVIDUAL COMPARTMENT DIMENSIONS IN FIELD. SUBMIT DETAILED SHOP DRAWINGS FOR ARCHITECTS REVIEW AND APPROVAL.
- B. CONTRACTOR SHALL REMOVE AND REPLACE ALL EXISTING GRAB BARS WITH NEW AS SHOWN ON PLANS G.C. VERIFY TYPE, QUANTITIES AND LOCATIONS IN FIELD (TYP.)
- 4. CONTRACTOR SHALL REMOVE AND REPLACE EXISTING TOILET PAPER DISPENSERS WITH NEW. THE OWNER SHALL PURCHASE G.C. TO INSTALL. G.C. TO COORDINATE WITH THE OWNER.
- 5. REFER TO SPECIFICATIONS FOR TOILET PARTITION TYPE AND COMPONENTS.
- 6. CONTRACTOR SHALL PATCH AND PAINT EXISTING CMU WALLS AT AREAS OF EXISTING ANCHOR HOLE LOCATIONS.

7. G.C. SHALL REPLACE EXISTING 6"x6" CERAMIC WALL TILE (CHASE WALL) AND FLOOR TILES AT

PREVIOUS ANCHOR HOLE LOCATIONS (TYP.)

PATCHOGUE NEW YORK 11772

KEY PLAN NOT TO SCALE DRAWING BY: CHECK BY: NOTICE THIS DRAWING, PREPARED FOR THE SPECIFIC PROJECT INDICATED IS AN INSTRUMENT OF SERVICE AND THE PROPERTY OF BBS ARCHITECTS, LANDSCAPE ARCHITECTS AND ENGINEERS, PC. INFRINGEMENT OR ANY USE OF THIS DRAWING FOR ANY OTHER PROJECT IS PROHIBITED. ANY ALTERATION OR REPRODUCTION OF THIS DOCUMENT IS ALSO PROHIBITED WITHOUT THE WRITTEN CONSENT OF THE ARCHITECT OR ENGINEER. ARCHITECTS LANDSCAPE ARCHITECTS ENGINEERS 44 EAST MAIN STREET | 187 WOLF ROAD, STE. 201 NEW YORK 12205 T. 631.475.0349 F. 631.475.0361 F. 518.621.7655 www.BBSARCHITECTURE.com

REV. DATE


NOTICE HESE DRAWINGS ARE BASED ON CONSTRUCTION DRAWINGS NO

PREPARED BY BBS ARCHITECTS, LANDSCAPE ARCHITECTS AN

CONDITIONS AS CONSTRUCTED AT THE TIME. ALL EXISTI

INFORMATION AS THEY MAY NOT HAVE BEEN BUILT AND DETAILE

PER THE ORIGINAL DOCUMENTS OR PER THE OWNER'S INFORMATION

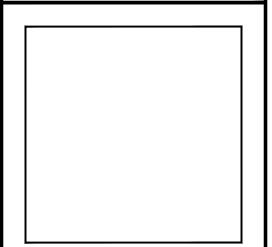



	44-21-15-02-0-004-013
DISTRICT	FLORIDA U.F.S.D. GOLDEN HILL E.S.
PROJECT	BOND PHASE 2

DWG TITLE ___

SCALE:	AS NOTED
DATE:	DECEMBER 1, 2020
BID PICK-UP:	March 15, 2021
FILE No:	20-176A

A9.01

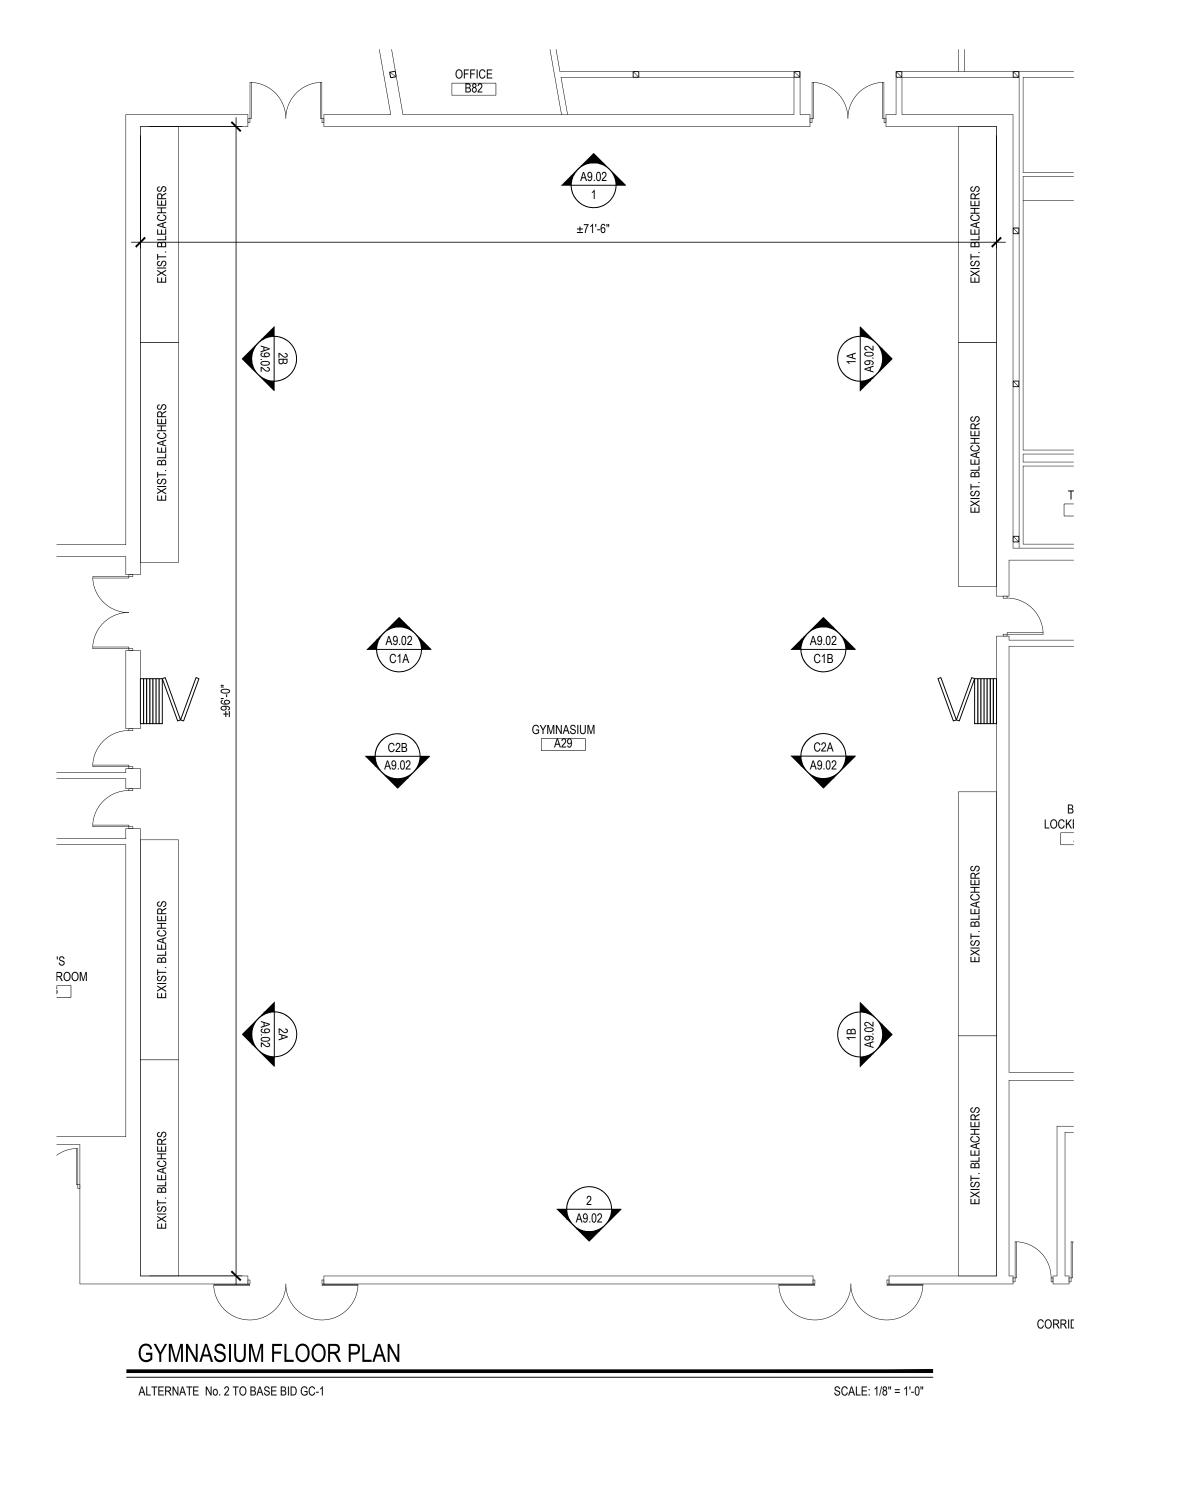

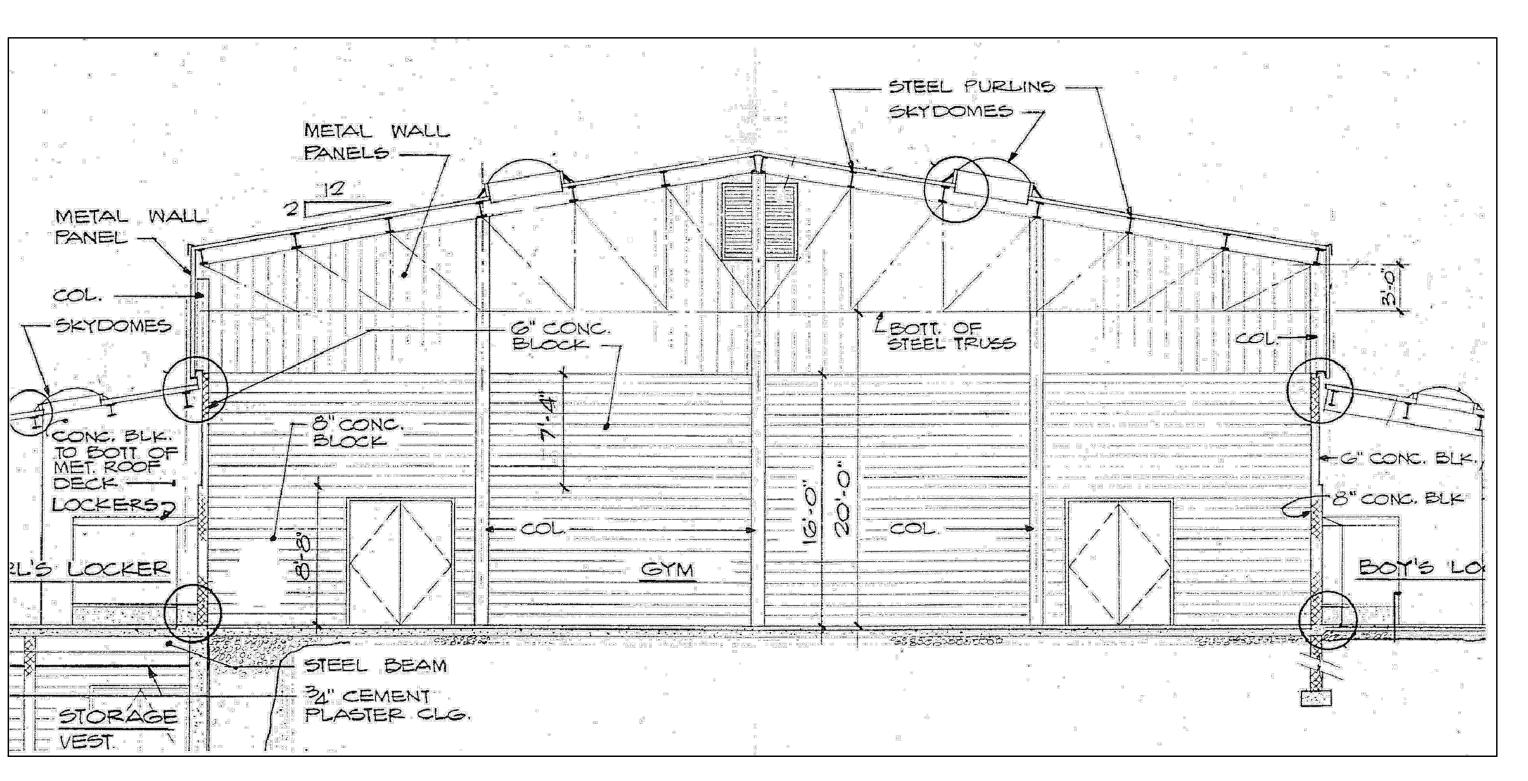

PROJECT SCOPE NOTES:

- 1. GENERAL CONTRACTOR SHALL VERIFY ALL EXISTING CONDITIONS PRIOR TO BIDDING & PROCEEDING WITH WORK. NOTIFY ARCHITECT OF ANY DISCREPANCIES IN WRITING PRIOR TO START OF WORK.
- PROJECT INCLUDES THE SCRAPING, PRIMING AND REPAINTING OF ALL THE EXISTING GYMNASIUM WALLS FROM FLOOR TO CEILING, MASONRY WALLS, METAL PANEL WALLS, EXISTING STRUCTURAL STEEL TRUSSES, MECHANICAL DUCTWORK AND UNITS, STRUCTURAL ROOF STEEL, EXPOSED CONDUITS, ROOF DECK UNDERSIDE, FOLDING PARTITION WALL SOFFIT, WALLS BEHIND EXISTING BLEACHERS, ETC.
- 3. CONTRACTOR SHALL REMOVE AND REINSTALL EXISTING WALL MATS, PROTECTIVE WIRE CAGES, FLAGS, BANNERS, ETC.
- 4. CONTRACTOR SHALL OPEN UP ALL EXISTING BLEACHERS AND PAINT WALLS BEHIND THEM AS REQUIRED
- 5. CONTRACTOR SHALL REFER TO PAINT SPECIFICATION SECTION OF PROJECT MANUAL FOR ADDITIONAL INFORMATION
- 6. CONTRACTOR SHALL PROTECT THE GYMNASIUM FLOOR, BLEACHERS, OPERABLE PARTITION, ALL ATHLETIC EQUIPMENT, SKYLIGHTS, SPEAKERS, SMOKE DETECTORS, FIRE ALARM STROBES, BELLS AND PULL STATIONS, SECURITY EQUIPMENT AND DEVICES, LIGHT FIXTURES, CEILING FANS, ETC.
- 7. CONTRACTOR SHALL PAINT EXISTING DOORS AND DOOR FRAMES
- 8. ALL FINAL COLORS BY ARCHITECT
- 9. FINISH COATS:
- Repainting Masonry Walls: Moore's Ultra Spec 500 Interior Latex Gloss N540 Underside of metal roof deck: Moore's Corotech Acrylic DTM Enamel Semi-Gloss V331 Mechanical Ductwork: Moore's Ultra Spec 500 Interior Acrylic Flat N536 Structural Steel: Moore's Ultra Spec 500 Interior Acrylic Flat N536

ALL WORK THIS DRAWING (A9.02) IS PART OF ALTERNATE No. 2 TO BASE BID GC-1



CHECK BY:

THIS DRAWING, PREPARED FOR THE SPECIFIC PROJECT INDICATED IS AN INSTRUMENT OF SERVICE AND THE PROPERTY OF BBS ARCHITECTS, LANDSCAPE ARCHITECTS AND ENGINEERS, PC. INFRINGEMENT OR ANY USE OF THIS DRAWING FOR ANY OTHER PROJECT IS PROHIBITED. ANY ALTERATION OR REPRODUCTION OF THIS DOCUMENT IS ALSO PROHIBITED WITHOUT THE WRITTEN CONSENT OF THE ARCHITECT OR ENGINEER.

LANDSCAPE ARCHITECTS

244 EAST MAIN STREET | 187 WOLF ROAD, STE. 20 PATCHOGUE | ALBANY

www.BBSARCHITECTURE.com

NEW YORK 12205

F. 518.621.7655

ENGINEERS

NEW YORK 11772

T. 631.475.0349 F. 631.475.0361

KEY PLAN

NOT TO SCALE

REV. DATE

THESE DRAWINGS ARE BASED ON CONSTRUCTION DRAWINGS NOT PREPARED BY BBS ARCHITECTS, LANDSCAPE ARCHITECTS AND ENGINEERS, PC. AND, THEREFORE, MAY NOT REPRESENT THE CONDITIONS AS CONSTRUCTED AT THE TIME. ALL EXISTING CONDITIONS SHOWN ARE REPRESENTED AS SUGGESTIVE INFORMATION AS THEY MAY NOT HAVE BEEN BUILT AND DETAILED PER THE ORIGINAL DOCUMENTS OR PER THE OWNER'S INFORMATION.












SCALE: NOT TO SCALE

GYMNASIUM END WALL ELEVATION

NOTE: FOR REFERENCE ONLY




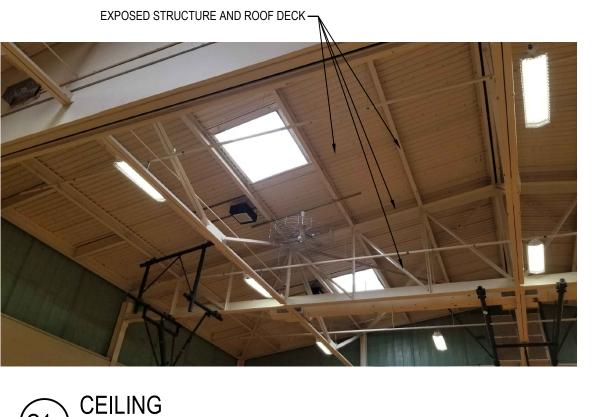









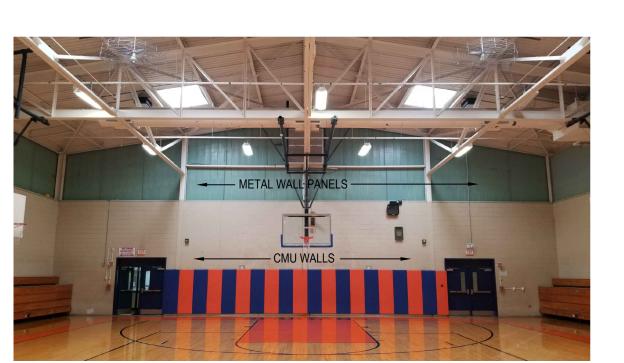

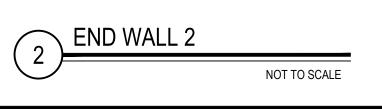






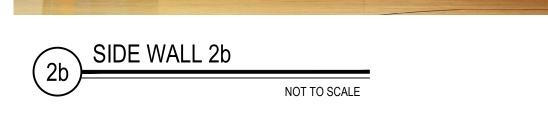



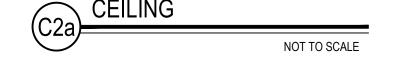





Cah	CEILING	
(020)		NOT TO SCALE

SED No.	44-21-15-02-0-004-013
DISTRICT	FLORIDA U.F.S.D. GOLDEN HILL E.S.
PROJECT	BOND PHASE 2
DWG TITLE	GYMNASIUM FLOOR PLAN PHOTOS AND NOTES

SCALE:	AS NOTED
DATE:	DECEMBER 1, 2020
BID PICK-UP:	March 15, 2021
FILE No:	20-176A

A9.02 of ---

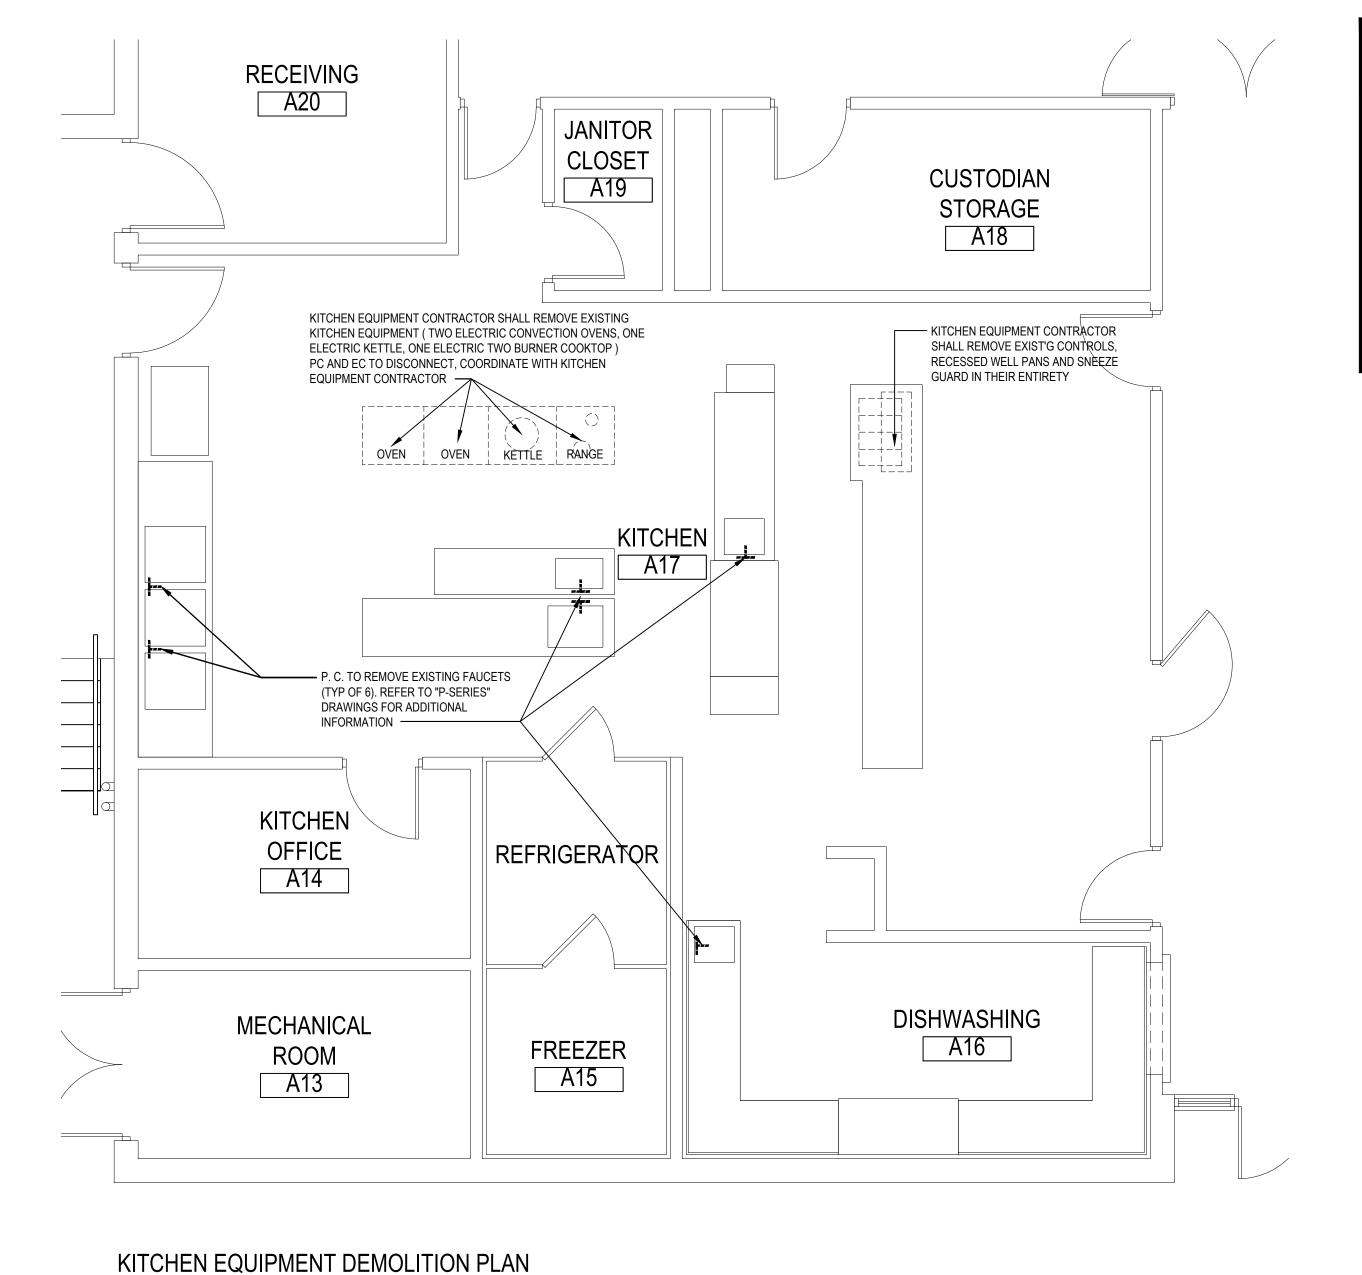

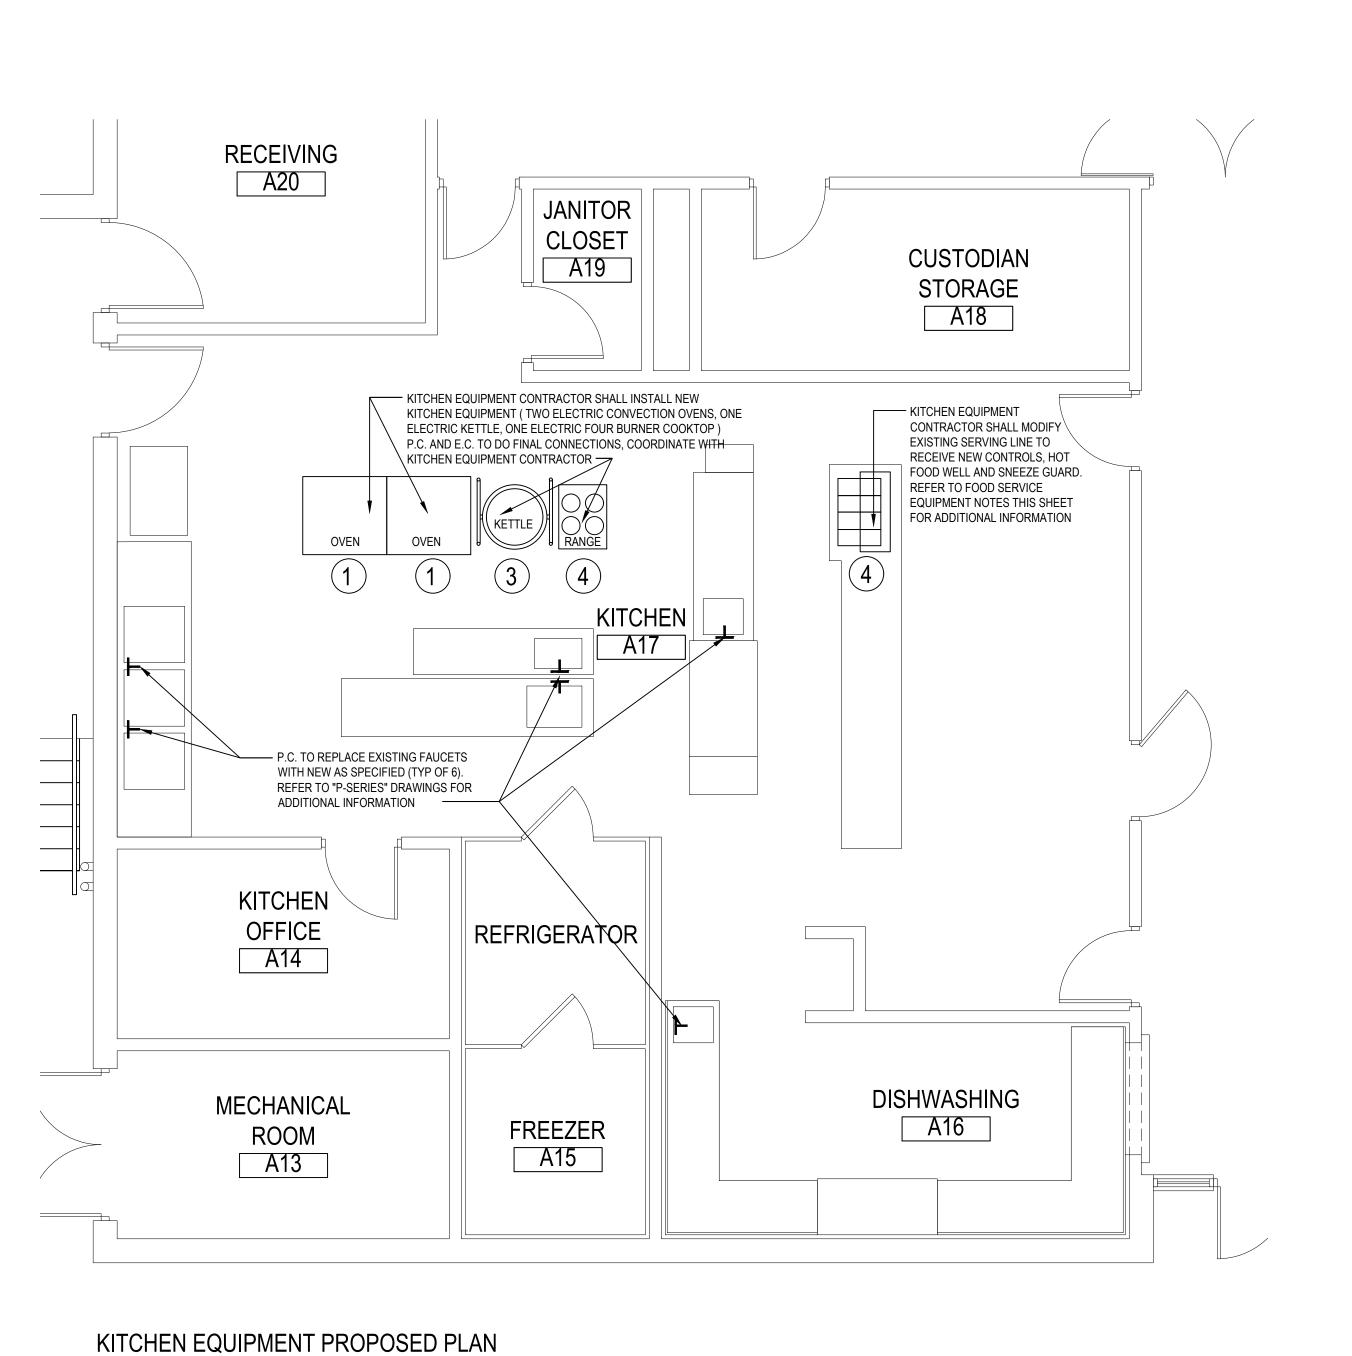

SCALE: 1/4" = 1'-0"

SCALE: 1/4" = 1'-0"

FOOD SERVICE EQUIPMENT SCHEDULE

ELECTRIC CONVECTION OVEN

ELECTRIC KETTLE

ELECTRIC HOT FOOD WELL UNIT AND FOOD SHIELD

> REFER TO PROJECT MANUAL FOR ADDITIONAL INFORMATION

ELECTRIC FOUR BURNER RANGE

FOOD SERVICE EQUIPMENT NOTES:

- . ALL FOOD SERVICE EQUIPMENT SHALL BE REMOVED and REPLACED BY KITCHEN EQUIPMENT CONTRACTOR, DISCONNECTS BY P.C. and E.C.
- . <u>SERVING LINE:</u> KITCHEN EQUIPMENT CONTRACTOR SHALL CUT, MODIFY and PATCH EXISTING STAINLESS STEEL COUNTER AND/OR CABINET TO ACCOMMODATE NEW RECESSED WELL PANS,
- CONTROL UNIT and SNEEZE GUARD 3. <u>COOKING LINE:</u> G.C. SHALL PATCH QUARRY TILE FLOOR AT ANY REQUIRED FLOOR PENETRATIONS

REV. DATE

KEY PLAN

NOT TO SCALE

SED

PJG

THIS DRAWING, PREPARED FOR THE SPECIFIC PROJECT INDICATED IS AN INSTRUMENT OF SERVICE AND THE PROPERTY OF BBS ARCHITECTS, LANDSCAPE ARCHITECTS AND ENGINEERS, PC. INFRINGEMENT OR ANY USE OF THIS DRAWING FOR ANY OTHER PROJECT IS PROHIBITED. ANY ALTERATION OR REPRODUCTION OF THIS DOCUMENT IS ALSO PROHIBITED WITHOUT THE WRITTEN CONSENT OF THE ARCHITECT OR ENGINEER.

LANDSCAPE ARCHITECTS

244 EAST MAIN STREET | 187 WOLF ROAD, STE. 20: PATCHOGUE | ALBANY

www.BBSARCHITECTURE.com

NEW YORK 12205

F. 518.621.7655

CHECK BY: KGS

ARCHITECTS

ENGINEERS

NEW YORK 11772

F. 631.475.0361

<u>NOTICE</u>

THESE DRAWINGS ARE BASED ON CONSTRUCTION DRAWINGS NOT PREPARED BY BBS ARCHITECTS, LANDSCAPE ARCHITECTS AND ENGINEERS, PC. AND, THEREFORE, MAY NOT REPRESENT THE

CONDITIONS AS CONSTRUCTED AT THE TIME. ALL EXISTIN

CONDITIONS SHOWN ARE REPRESENTED AS SUGGESTIVE INFORMATION AS THEY MAY NOT HAVE BEEN BUILT AND DETAILED

- 4. ALL STAINLESS STEEL PATCHES AND RETROFITS SHALL BE TYPE 304, 14 GAUGE
- 5. FINAL ELECTRICAL CONNECTIONS BY E.C. REFER TO E-SERIES DWGS. FOR ADDITIONAL INFORMATION. FINAL PLUMBING CONNECTIONS BY P.C. REFER TO P-SERIES DWGS. FOR ADDITIONAL INFORMATION

6. REFER TO SPECIFICATIONS FOR EQUIPMENT DETAILS, REQUIREMENTS and NOTES

FOOD SERVICE EQUIPMENT NOTE:

FOOD SERVICE EQUIPMENT IS NOT IN G.C. CONTRACT U.O.N., AND WILL BE PURCHASED BY THE OWNER UNDER A SEPARATE CONTRACT OUTSIDE OF THIS PROJECT. INFORMATION PROVIDED REGARDING SUCH ITEMS IS INCLUDED FOR COORDINATION PURPOSES ONLY AND IS SUBJECT TO CHANGE.



EXISTING HOT FOOD WELL



EXISTING OVENS and FRONT OF COOK LINE



EXISTING RANGE AND KETTLE and BACK OF COOK LINE



EXISTING KETTLE



EXISTING KITCHEN EQUIPMENT REFERENCE PHOTOS

NO SCALE

DWG TITLE KITCHEN EQUIPT. PLAN SCALE: AS NOTED DATE: DECEMBER 1, 2020 BID PICK-UP: March 15, 2021 FILE No: 20-176A

44-21-15-02-0-004-013


GOLDEN HILL E.S.


DISTRICT FLORIDA U.F.S.D.

PROJECT BOND PHASE 2

EXISTING RANGE

FS.01

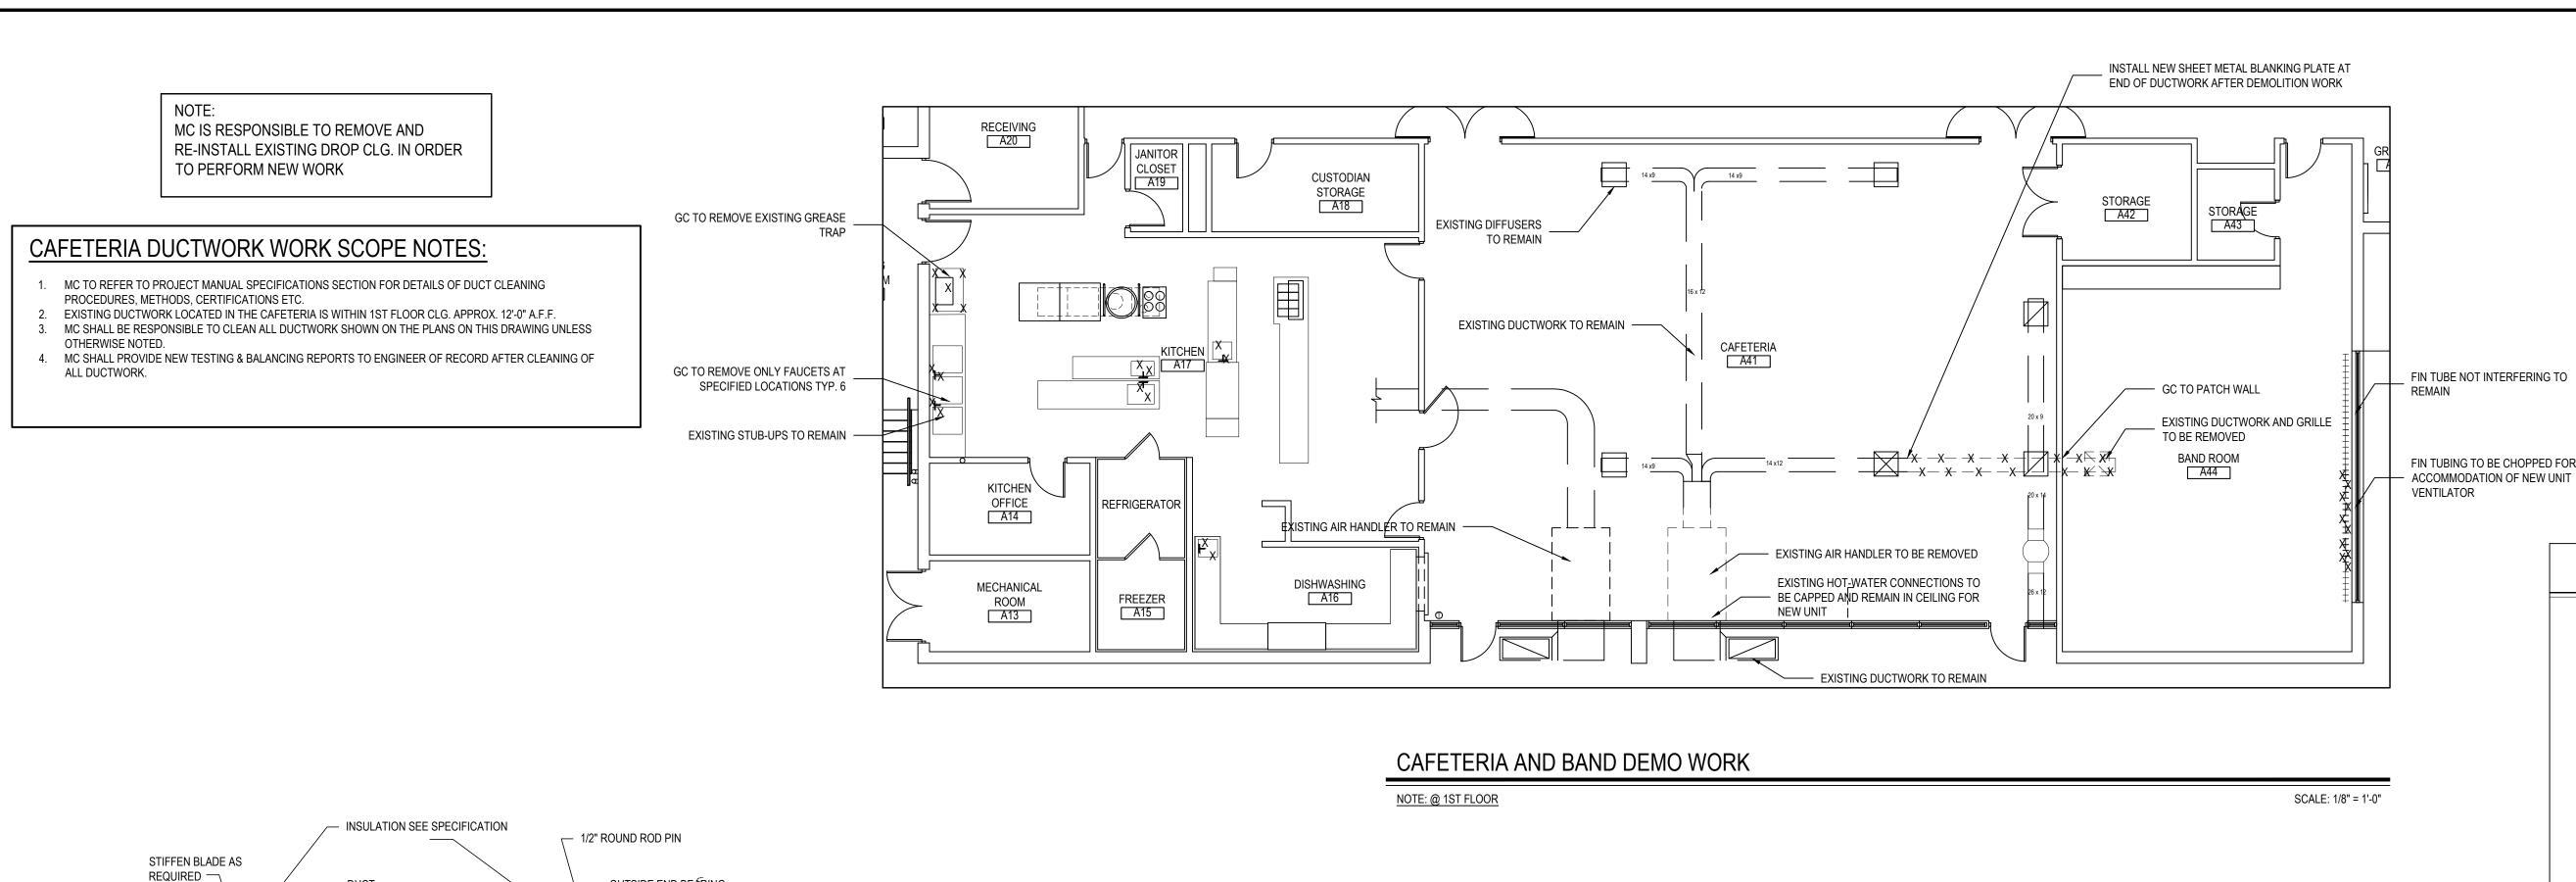

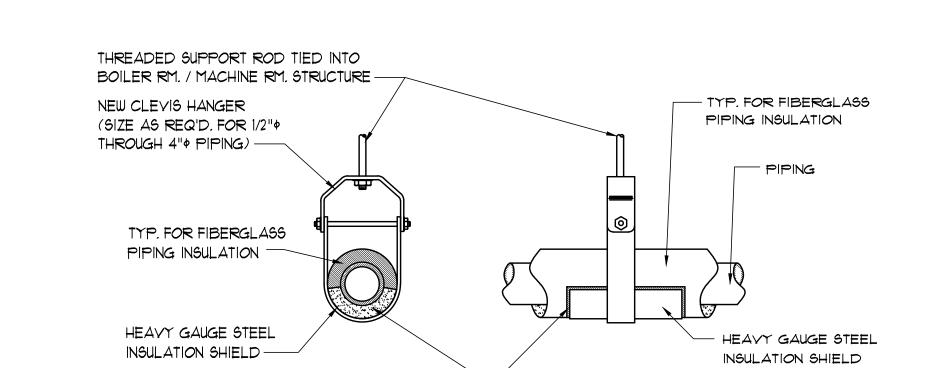


CLEVIS HANGER PIPING SUPPORT DETAIL


PROVIDE CALCIUM SILICATE

UNDER HEAVY GA. STEEL SHIELD

RIGID PIPING INSULATION

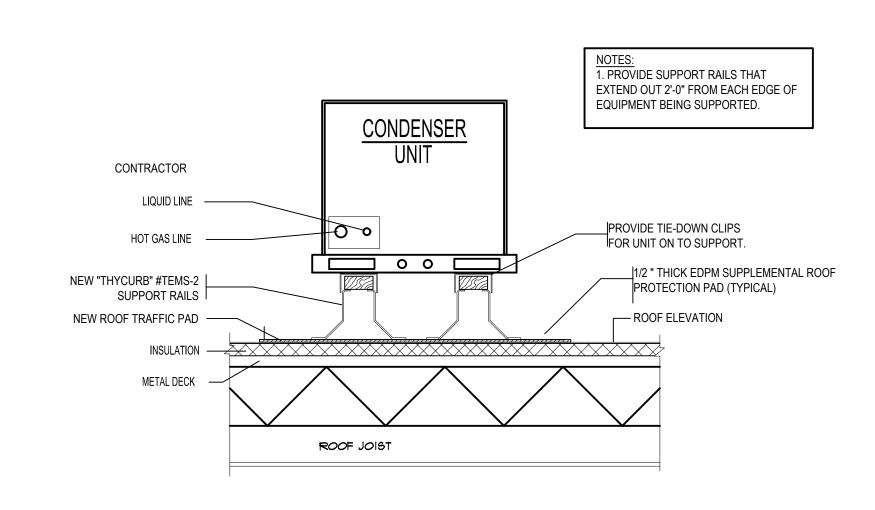

CONDENSING UNIT SUPPORT DETAIL

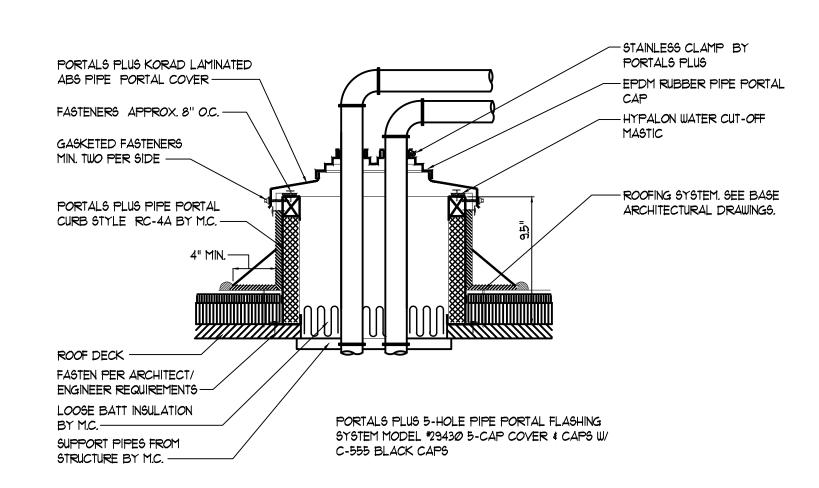

ROOF PIPING PENETRATION DETAIL

NOT TO SCALE

NOT TO SCALE

1. PLUMBING CONTRACTOR SHALL VISIT THE SITE PRIOR TO SUBMITTING HIS BID AND

PIPING SHALL BE NO HUB CAST IRON.

PLUMBING GENERAL NOTES

PERFORM ALL INVESTIGATION WORK BEFORE SUBMITTING A BID ON THE PLUMBING WORK. 2. CONNECT ALL HOT WATER, COLD WATER, VENT, AND WASTE PIPING AS REQUIRED INCLUDING PIPING, VALVES, TAPS, ESCUTCHEONS, SLEEVES, ACCESS DOORS, CLEANOUTS, PIPE HANGERS, INSULATION, ETC.

3. PROVIDE AND INSTALL PLUMBING FIXTURES INCLUDING ALL CUTTING AND PATCHING AS REQUIRED INCLUDING WASTE, VENT, AND WATER SUPPLY CONNECTIONS AND FITTINGS (ALL

4. ALL WORK SHALL BE IN ACCORDANCE WITH STATE AND LOCAL BUILDING CODES. CONTRACTOR SHALL BE RESPONSIBLE FOR OBTAINING ALL NECESSARY PERMITS AND PAYING RELATED FEES. 5. PLUMBING CONTRACTOR SHALL COORDINATE HIS WORK WITH ALL OTHER TRADES PRIOR TO CONSTRUCTION.

6. INTERIOR DOMESTIC WATER PIPING SHALL BE TYPE "L" COPPER. UNDERGROUND DOMESTIC WATER PIPING SHALL BE TYPE "K" COPPER FOR UP TO 2" AND DUCTILE IRON OVER 2". WASTE PIPING SHALL BE SERVICE WEIGHT CAST IRON SOIL PIPE, HUB AND SPIGOT UNDERGROUND, AND NO HUB INSIDE BUILDING. STORM DRAIN PIPING SHALL BE NO HUB CAST IRON SOIL PIPE INSIDE BUILDING. VENT

7. ALL WORK SHALL BE PROPERLY TESTED AND CLEANED. PROVIDE ONE YEAR WARRANTY FROM DATE OF ACCEPTED COMPLETION ON ALL PARTS AND LABOR.

8. ALL EXPOSED METALWORK ON PLUMBING FIXTURES SHALL BE CHROME PLATED. 9. PROVIDE SHUTOFF VALVE ON WATER SUPPLY BRANCH TO EACH INDIVIDUAL FIXTURE IN AN

ACCESSIBLE LOCATION. 10. ALL WORK SHALL BE IN ACCORDANCE WITH MANUFACTURER'S RECOMMENDATIONS.

11. WHERE DISSIMILAR METALS ARE CONNECTED, PROVIDE AN APPROVED MAKE OF NON-GALVANIC

ISOLATOR, DIELECTRIC UNION OR FLANGES.

12. P.C. SHALL PROVIDE AND INSTALL PIPE INSULATION ON ALL DOMESTIC COLD WATER SUPPLY, HOT WATER SUPPLY, HOT WATER SUPPLY (RECIRCULATION LINE) AND ROOF DRAIN PIPING THAT IS EXPOSED ABOVE CEILINGS OR IN CRAWL SPACE AND PIPE CHASES.

NOTE: BIDDING CONTRACTORS ARE RESPONSIBLE FOR ALL WORK SHOWN ON ALL DRAWINGS THAT ARE DESCRIBED AS WORK UNDER THEIR CONTRACT. REVIEW ALL TRADE DRAWINGS PRIOR TO SUBMITTING A BID

PLUMBING DEMO & NEW WORK NOTES

1. GENERAL CONTRACTOR SHALL DISCONNECT AND COMPLETELY REMOVE AND DISCARD EXISTING TOILETS, URINALS & LAVATORIES AS INDICATED.

2. ALL WATER SUPPLY AND SANITARY PIPING TO EXISTING PLUMBING FIXTURES SHALL BE COMPLETELY REMOVED BACK TO CHASE WALL EXCEPT AT LOCATIONS WHERE FIXTURES ARE TO BE REPLACED WITH NEW. PLUMBING CONTRACTOR SHALL BE RESPONSIBLE TO REPLACE PIPE INSULATION.

 PLUMBING CONTRACTOR SHALL PROVIDE AND INSTALL NEW FIXTURES AS SHOWN IN PLUMBING FIXTURE SCHEDULE ON THIS DWG.

CONNECT VENT PIPING TO EXISTING VENTS.

NEW FIXTURES PER SPECIFICATIONS

CONTRACTOR TO COORDINATE WITH GENERAL CONTRACTOR.

3. SEE GENERAL NOTES AND PLUMBING SPECIFICATIONS SECTION 15A FOR MORE DETAIL. 4. DEMOLITION AND RECONSTRUCTION OF PLUMBING WALLS BY GENERAL CONTRACTOR. PLUMBING

IN ALL INSTANCES WHERE NEW FIXTURES ARE PROPOSED THE GENERAL CONTRACTOR SHALL PERFORM ALL DEMOLITION REQUIRED FOR REMOVAL OF EXISTING FIXTURE CARRIERS AND INSTALL NEW FIXTURE CARRIERS. GENERAL CONTRACTOR SHALL THEN BUILD/PATCH MASONRY WALLS AS REQUIRED INCLUDING NEW TILE FINISHES. UPON COMPLETION OF MASONRY/TILE THE PLUMBING CONTRACTOR SHALL INSTALL

6. REFER TO ARCHITECTURAL DRAWINGS FOR DIMENSIONAL LOCATIONS OF NEW PLUMBING FIXTURES.

EPA 67.4 NOTE

1. THE PLUMBING CONTRACTOR SHALL PROVIDE AND INSTALL NEW AND/OR REPLACEMENT PLUMBING FIXTURES. THE RESPECTIVE FIXTURES MUST ADHERE TO THE "LEAD-FREE" DIVISION 15A SPECIFICATIONS OUTLINING THE INSTALLATION MEANS AND METHODS AS WELL AS THE FIXTURE ITSELF BEING "LEAD FREE." THE CONTRACTOR SHALL PROVIDE THE REQUIRED SUBMITTALS FOR ALL FIXTURES AND BUILDING MATERIALS PRIOR TO THE FIXTURE INSTALLATION, AND CONFIRM ON THE JOBSITE THAT THE FIXTURE ADHERES TO "LEADFREE" REGULATIONS.

AND FLUSH THE FIXTURE OF DEBRIS FROM THE SYSTEM. 2. FOLLOWING THE COMPLETION OF THE P.C. WORK SCOPE, THE OWNER SHALL HAVE THE WATER CONDITIONS

a. FOLLOWING THE POTABLE FIXTURE INSTALLATION; THE P.C. SHALL REMOVE ALL FILTERS AND STRAINERS

TESTED FOR LEAD CONTAMINANTS BY A THIRD-PARTY TESTING FIRM TO REGULATION 67.4 OF THE DEPARTMENT OF HEALTH REGULATIONS AS PART OF SECTION 1417 OF THE FEDERAL SAFE WATER ACT TO DETERMINE THEM AS "LEAD-FREE" COMPLIANT.

3. IF A FIXTURE DOES NOT COMPLY WITH SUB-PART REGULATION 67.4 OF THE DOH SECTION 1417 OF THE FEDERAL SAFE WATER ACT, THE P.C. SHALL PROVIDE A REPLACEMENT FIXTURE AT NO ADDITIONAL COST, TO THEN REPEAT THE INSTALLATION AND TESTING REQUIREMENTS. THE P.C. SHALL ABSORB THE FEE FOR THE FIRST LEAD TESTING PROCEDURE AS WELL AS THE FOLLOWING CONFIRMATION PROCEDURES AT NO ADDITIONAL COST TO THE OWNER. THERE IS AN ENERGY SERVICES CONTRACTOR (ESCO) IMPLEMENTING AN EPC THROUGHOUT THE FLORIDA UFSD. THE MECHANICAL CONTRACTOR IS RESPONSIBEL FOR COORDIANTING ALL WORK WITH THE ESCO. INCLUDED IN THE EPC IS CONTROLS WORK THE BMS WILL BE A JOHNSON FX SYSTEM. THE ESCO WILL BE TYING IN EQUIPMENT INSTALLED UNDER THIS PROJECT TO THE BMS. ALL CONTROLS PROVIDED UNDER THIS BOND PROJECT SHALL BE CAPABLE OF BEING SEEMLESSLY INTEGRATED TO THE JOHNSON SYSTEM.

General Notes

FOR SAME IN HIS BID PRICE. NO ALLOWANCE WILL BE MADE FOR FAILURE TO DO SO.

TIMES OF DAY EQUIPMENT MAY BE MOVED THROUGH THE BUILDING.

SPECIFICATION SECTION 15511 FOR FURTHER DETAILS.

 REMOVAL & RELOCATION OF CERTAIN EXISTING WORK SHALL BE NECESSARY FOR THE PERFORMANCE OF THE NEW WORK SHOWN HEREIN. ALL EXISTING CONDITIONS ARE NOT COMPLETELY DETAILED ON THE DRAWINGS. THE CONTRACTOR SHALL SURVEY THE SITE & MAKE ALL NECESSARY CHANGES BASED ON EXISTING CONDITIONS AS REQUIRED FOR PROPER DEMOLITION OF EXISTING WORK & SHALL INCLUDE ALL MATERIALS & LABOR

PRIOR TO SUBMITTING A BID, THE CONTRACTOR SHALL VISIT THE PREMISES OF THE PROPOSED WORK & SHALL CAREFULLY EXAMINE THE

ENGINEERING DRAWINGS, EXISTING CONDITIONS & LIMITATIONS THEREOF. VERIFY ACTUAL LOCATIONS WHERE THE NEW PIPING WILL BE ROUTED. COORDINATE WITH NEW & EXISTING WORK & PROVIDE CLEARANCE W/ BUILDING STRUCTURE, OTHER SERVICES, ETC.. THE CONTRACTOR SHALL INCLUDE ALL COSTS WHATSOEVER WHICH ARE INCURRED AS A RESULT OF LIMITATIONS OF THE EXISTING & NEW CONDITIONS. LATER CLAIMS FOR

EXTRA LABOR. EQUIPMENT, MATERIALS, ETC. REQUIRED DUE TO DIFFICULTIES WHICH COULD HAVE BEEN FORESEEN WILL NOT BE CONSIDERED AS

3. INSTALL WORK SO AS TO BE READILY ACCESSIBLE FOR OPERATING, MAINTENANCE & REPAIR. MINOR DEVIATIONS FROM DRAWINGS MAY BE MADE TO


ACCOMPLISH THIS, BUT CHANGES OF MAGNITUDE WHICH INVOLVE EXTRA COST SHALL NOT BE MADE WITHOUT APPROVAL

4. INVESTIGATE EACH SPACE THROUGH WHICH EQUIPMENT MUST BE MOVED. WHEN NECESSARY, EQUIPMENT SHALL BE SHIPPED FROM

<u>NOTICE</u>

REV. DATE

THESE DRAWINGS ARE BASED ON CONSTRUCTION DRAWINGS NOT PREPARED BY BBS ARCHITECTS, LANDSCAPE ARCHITECTS AND ENGINEERS, PC. AND, THEREFORE, MAY NOT REPRESENT THE CONDITIONS AS CONSTRUCTED AT THE TIME. ALL EXISTING CONDITIONS SHOWN ARE REPRESENTED AS SUGGEST NFORMATION AS THEY MAY NOT HAVE BEEN BUILT AND DETAILE ER THE ORIGINAL DOCUMENTS OR PER THE OWNER'S INFORMATI

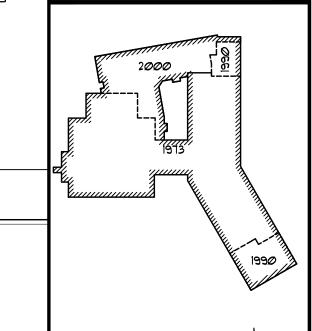

KEY PLAN NOT TO SCALE

MANUFACTURER IN CRATED SECTIONS OF SIZE SUITABLE FOR MOVING THROUGH AREAS AVAILABLE. ASCERTAIN FROM BUILDING OWNER AT WHAT COORDINATE THE EXACT SIZE & LOCATION OF NEW OPENINGS WITH EXISTING STRUCTURE. PATCH / INSULATE AS REQUIRED. CONTRACTOR SHALL FIRESTOP ALL PENETRATIONS FROM NEW PIPING, CONDUIT, DUCTWORK, ETC. THROUGH EXISTING OR NEW FIRE/ SMOKE BARRIERS. REFER TO

DISRUPTING BUILDING SYSTEMS, WIRING, PIPING OR CONTROL TUBING. ANY DAMAGE TO THESE ITEMS SHALL BE REPAIRED AT THE CONTRACTOR'S COST AS A PART OF THIS CONTRACT. 7 THE CONTRACTOR SHALL REPAIR / RESTORE TO ORIGINAL CONDITION ANY EXISTING EQUIPMENT OR MATERIALS DAMAGED IN THE PROCESS OF

IT IS THE INTENT OF THIS CONTRACT FOR REMAINING SYSTEMS TO BE LEFT IN GOOD WORKING ORDER, READY FOR OPERATION. COORDINATE ANY

WITH THE DAILY OPERATIONS OF THE BUILDING. CONTRACTOR WILL BE REQUIRED TO TAKE PROPER PRECAUTIONS AGAINST DAMAGING OR

REQUIRED SYSTEM SHUTDOWNS WITH OWNER 48 HOURS IN ADVANCE. EXISTING SYSTEM SHUTDOWNS WILL NOT BE PERMITTED IF THEY INTERFERE

INSTALLATION, OR DEMOLITION TO THE SATISFACTION OF THE OWNER'S REPRESENTATIVE. CONTRACTOR SHALL MAKE REPAIRS USING THE SAME OR EQUIVALENT MATERIALS. WORK WILL BE PERFORMED AT THE CONTRACTOR'S COST.

9. DURING THE LIFE OF THE CONTRACT PERIOD, CONTRACTOR SHALL REMOVE ALL RUBBISH / EXCESS MATERIAL ACCUMULATED AS A RESULT OF HIS OPERATIONS ON A DAILY BASIS. ALL AREAS / EQUIPMENT AFFECTED UNDER THIS CONTRACT SHALL BE KEPT CLEAN OF DUST / DEBRIS. ALL AREAS SHALL RECEIVE A FINAL CLEANING PRIOR TO FINAL ACCEPTANCE BY THE OWNER.

10. PROVIDE FOR LEGAL REMOVAL / DISPOSAL OF ALL RUBBISH / DEBRIS FROM THE BUILDING & SITE. PROTECT ALL WORK NOT SLATED FOR

11. THIS CONTRACTOR SHALL COORDINATE HIS WORK WITH ALL OTHER TRADES PRIOR TO SCHEDULING THE WORK. WORK SHALL BE PERFORMED IN PROPER SEQUENCE, AS AGREED TO BY ALL TRADES. ANY COSTS INCURRED BY THE OWNER DUE TO IMPROPER SEQUENCING OF WORK WILL BE PAID

12. CONTRACTOR SHALL OBTAIN ALL PERMITS, PAY ALL FEES, CONNECTION CHARGES, ETC. ASSOCIATED WITH THE WORK UNDER THEIR CONTRACT. 13. PAINT / TOUCH UP ALL SURFACES MARRED AS A RESULT OF THE PERFORMANCE OF THE CONTRACT WORK.

14. THE MECHANICAL CONTRACTOR SHALL REFER TO / REVIEW ALL OTHER TRADE DRAWINGS IN THE BID PACKAGE & SHALL BE RESPONSIBLE FOR / PERFORM ALL WORK INDICATED AS (M.C.) MECHANICAL WORK AS A PART OF THE BASE BID UNLESS SPECIFICALLY NOTED OTHERWISE.

15. SUBSTITUTED EQUIPMENT OF GREATER OR LARGER POWER, DIMENSIONS, CAPACITIES & RATINGS MAY BE FURNISHED PROVIDED THAT SAID EQUIPMENT IS APPROVED IN WRITING PRIOR TO ORDER. ANY CONNECTING MECHANICAL SERVICES, ELECTRICAL SERVICES, BASES, STRUCTURAL APPURTENANCES, ETC. REQUIRED TO BE INCREASED DUE TO THE USE OF SAID EQUIPMENT WILL BE PAID FOR IN FULL BY THE MECHANICAL CONTRACTOR, INCLUDING ANY ADDITIONAL REQUIRED ENGINEERING FEES.

MECHANICAL CONTRACTOR WILL BE REQUIRED TO PERFORM ALL EQUIPMENT & SYSTEM TESTING / BALANCING REQUIRED UNDER THIS CONTRACT. PROVIDE A FULL REPORT DETAILING ALL DESIGN & ACTUAL CONDITIONS FOR ALL AIR & HYDRONIC SYSTEMS SHOWN ON THE DRAWINGS. REFER TO SPECIFICATION SECTIONS 15990 & 15997 FOR FURTHER DETAILS.

UPON NOTICE OF COMPLETION OF WORK BY THE CONTRACTOR, OWNER WILL OBTAIN THE SERVICES OF AN INDEPENDENT TESTING & BALANCING CONTRACTOR TO VERIFY THE RESULTS OF THE TESTING & BALANCING REPORT SUBMISSION. INDEPENDENT TESTING AGENCY SHALL SELECT A RANDOM NUMBER OF MEASUREMENTS TO BE CHECKED. MEASUREMENTS WILL BE CHECKED IN THE SAME MANNER AS ORIGINALLY MEASURED. NUMBER OF VERIFICATION MEASUREMENTS SHALL BE APPROXIMATELY 25% OF THE TOTAL MEASUREMENTS FOR THE PROJECT.

IF MORE THAN 10% OF THE VERIFICATION TESTING SHOWS DEVIATIONS OF 10% OR MORE / SOUND LEVEL OF 2dB DIFFERENT THAN THAT READJUSTED & TESTED, NEW CERTIFIED REPORTS SUBMITTED, AND NEW VERIFICATION TESTS MADE, AT NO ADDITIONAL COST TO THE

Testing + Balancing Notes

ORIGINALLY MEASURED, THE ORIGINAL REPORT WILL BE REJECTED. ALL SYSTEMS WILL THEN BE REQUIRED TO BE COMPLETELY RE-TESTED, WITH A SECOND REPORT SUBMITTED. IN THE EVENT THAT THE ORIGINAL REPORT IS REJECTED, ALL SYSTEMS SHALL BE OWNER. THE CONTRACTOR WILL BE RESPONSIBLE FOR ALL COSTS INVOLVED WITH THE VERIFICATION TESTS.

Firestopping Notes

DETERMINE FIRE RATINGS OF ALL WALLS / PARTITIONS RELATED TO WORK UNDER THIS CONTRACT.

NOTICE HIS DRAWING, PREPARED FOR THE SPECIFIC PROJECT INDICATED ARCHITECTS, LANDSCAPE ARCHITECTS AND ENGINEERS. NFRINGEMENT OR ANY USE OF THIS DRAWING FOR ANY OTH ROJECT IS PROHIBITED. ANY ALTERATION OR REPRODUCTION THIS DOCUMENT IS ALSO PROHIBITED WITHOUT THE WRITTE CONSENT OF THE ARCHITECT OR ENGINEER.

DRAWING BY: GWT

CHECK BY:

ARCHITECTS

PATCHOGUE

NEW YORK 11772

T. 631.475.0349

LANDSCAPE ARCHITECTS **ENGINEERS** 44 EAST MAIN STREET 87 WOLF ROAD, STE. 2

NEW YORK 12205

F. 518.621.7655

T. 518.621.7650

F. 631.475.0361 RATING OF 2 HR. MECHANICAL CONTRACTOR SHALL BE RESPONSIBLE FOR A COMPLETE REVIEW OF THE ARCHITECTURAL DRAWINGS IN ORDER TO www.BBSARCHITECTURE.com MECHANICAL CONTRACTOR SHALL REVIEW THE COMPLETE ARCHITECTURAL SET OF DRAWINGS IN ORDER TO DETERMINE WHERE DUCT PENETRATIONS THROUGH RATED BARRIERS. DUCTS PENETRATING SAID RATED BARRIERS SHALL BE EQUIPPED WITH A UL LISTED FUSIBLE LINK TYPE

MECHANICAL CONTRACTOR SHALL REVIEW THE COMPLETE ARCHITECTURAL SET OF DRAWINGS IN ORDER TO DETERMINE WHERE DUCT PENETRATIONS THROUGH RATED BARRIERS OCCUR BETWEEN SEPARATE SMOKE ZONES. DUCTS PENETRATING SAID FIRE / SMOKE BARRIERS SHALL BE EQUIPPED WITH A UL LISTED COMBINATION FIRE / SMOKE DAMPER, RATED FOR SERVICE FOR WHICH IT IS BEING USED. FIRE / SMOKE DAMPERS SHALL BE PROVIDED & INSTALLED BY THE MECHANICAL CONTRACTOR, COMPLETE W/ DUCT ACCESS DOORS DIRECTLY ADJACENT TO THE DAMPER. DAMPER ACTUATOR & RELATED WIRING SHALL BE PROVIDED & INSTALLED BY THE ELECTRICAL CONTRACTOR. COORDINATE DAMPER INSTALLATIONS W/ E.C. TO VERIFY PROPER CLEARANCES TO ASSURE PROPER DAMPER OPERATION.

FIRE DAMPER, RATED FOR SERVICE FOR WHICH IT IS BEING USED. FIRE DAMPERS SHALL BE PROVIDED & INSTALLED BY THE MECHANICAL

CONTRACTOR, COMPLETE W/ DUCT ACCESS DOORS DIRECTLY ADJACENT TO THE DAMPER, POSITIONED FOR EASY REPLACEMENT OF THE LINK.

ALL PENETRATIONS RELATED TO MECHANICAL WORK THROUGH FIRE RATED WALLS, FLOORS OR OTHER STRUCTURES SHALL BE FIRE STOPPED AS

REQUIRED TO MAINTAIN THE RATING OF THE WALL BY MECHANICAL CONTRACTOR. IT IS ASSUMED THAT ALL WALLS IN THE CONSTRUCTION CARRY A

MINIMUM FIRE RATING OF 1 HR. IT SHOULD BE ASSUMED THAT ALL MACHINE ROOM WALLS / BOILER ROOM WALLS / ELECTRIC ROOM WALLS CARRY A

MECHANICAL CONTRACTOR SHALL PROVIDE A FULL SET OF AS-BUILT DRAWINGS, SHOWING EACH DAMPER LOCATION, TYPE OF DAMPER, ACCESS CONTRACTOR SHALL REFER TO SPECIFICATION SECTION 15511 FOR FURTHER DETAILS REGARDING FIRESTOPPING MATERIALS & METHODS.

CONTRACTOR SHALL SUBMIT SHOP DRAWINGS OF PRODUCTS TO BE USED. FIRESTOP MATERIALS OTHER THAN THE PRODUCTS SPECIFIED SHALL INCLUDE FULL TECHNICAL DATA WITH SHOP DRAWINGS TO DEMONSTRATE EQUALITY WITH THE SPECIFIED FIRESTOPPING MATERIALS.

General Instrumentation

1. AT A MINIMUM, PROVIDE THERMOMETERS / WELLS AT THE FOLLOWING LOCATIONS:

1. AT INLETS & OUTLET OF EACH THREE WAY VALVE (UNIT VENTILATORS / CABINET UNIT HEATER INSTALLATIONS EXCEPTED). 2. AT INLET & OUTLET OF EACH HYDRONIC BOILER, CHILLER OR COOLING TOWER.

3. AT INLET & OUTLET OF EACH HYDRONIC COIL IN AIR HANDLING UNITS & BUILT-UP CENTRAL SYSTEMS. AT A MINIMUM, PROVIDE LIQUID FILLED PRESSURE GAUGES / WELLS AT THE FOLLOWING LOCATIONS:

1. AT SUCTION & DISCHARGE OF EACH PUMP. FOR FACH MAKEUP WATER LINE.

BEFORE & AFTER ALL PRESSURE REDUCING VALVES. 4. AT ACCESSIBLE HIGH POINT OF ALL HYDRONIC PIPING SYSTEMS.

AT ALL EXPANSION / COMPRESSION TANKS.

44-21-15-02-0-004-013

DISTRICT FLORIDA U.F.S.D. GOLDEN HILL E.S. PROJECT BOND PHASE 2 DWG TITLE DEMO PLANS, NOTES &

DETAILS SCALE: AS NOTED DECEMBER 1, 2020 BID PICK-UP: BID P/U DATE FILE No: 20-176A

1/2" THICK EDPM SUPPLEMENTAL ROOF PROTECTION PAD. TYPICAL PIPING MOUNT NOTE: ROVIDE & INSTALL A "ROLLER-BEARING" PIPE SUPPORT FOR ROOF MOUNTED REFRIGERANT PIPING. SUPPORTS ARE TO BE MADE OF POLYCARBONATE AS MANUFACTURED BY 'MIRO INDUSTRIES' MODEL 3-RAH-12 PILLOW BLOCK PIPE STAND. SPACING NOT TO EXCEED 6 FEET ON CENTER. MOUNT EACH PIPE STAND ON 15-3/4" x 19-3/4" SUPPORT PAD BY MIRO INDUSTRIES. SEE DETAIL ABOVE. ROOF MTD. PIPING SUPPORT NOT TO SCALE **ROOF WORK NOTE** M.C. TO VERIFY WITH OWNER THE EXISTENCE OF EXISTING ROOF WARRANTY. M.C. TO HIRE A ROOF INSTALLER CERTIFIED TO INSTALL & PATCH THE

EXISTING ROOF SYSTEM. M.C. SHALL CONTACT THE ROOF SYSTEM MANUFACTURER AND PROVIDE A LETTER STATING THAT THE REPAIRS HAVE BEEN

MADE IN ACCORDANCE WITH MANUFACTURER REQUIREMENTS AND HAVE NOT VOIDED ANY EXISTING WARRANTIES. CONTRACTOR SHALL PROVIDE

CERTIFICATE STATING THAT THE ROOF HAS BEEN INSPECTED BY A REPRESENTATIVE OF THE WARRANTY ISSUER.

Max. 1" ABOVE TOP NUT

OUTSIDE END BEARING

OUTLET

PC TO PROVIDE NEW ZURN GREASE

TRAP GT2700-35

SECTION

INSULATION

STAND-OFF -

DAMPER BLADE

QUADRANT —

HANDLE W/ LOCKING

1/8" CLEARANCE

ALL AROUND

1. DELETE INSULATION STAND-OFF ON DUCTWORK WITHOUT EXTERIOR INSULATION.

2. DETAIL SHOWS SINGLE BLADE DAMPER. DAMPER INSTALLATION SHALL BE SIMILAR

TYPICAL VOLUME DAMPER INSTALLATION DETAIL

SCALE: NONE

FOR MULTI-BLADE DAMPERS & ROUND DAMPERS.

INSIDE END BEARING

SIDE ELEVATION

PROVIDE VENT PIPING FOR NEW GREASE

TERMINAL WITH SCREENED VENT CAP AT


SIDFWALL


FLOW RESTRICTOR WITH

VENT CONNECTION

GREASE TRAP DETAIL (GT-1)

TRAP THRU EXTERIOR SIDEWALL. PC SHALL

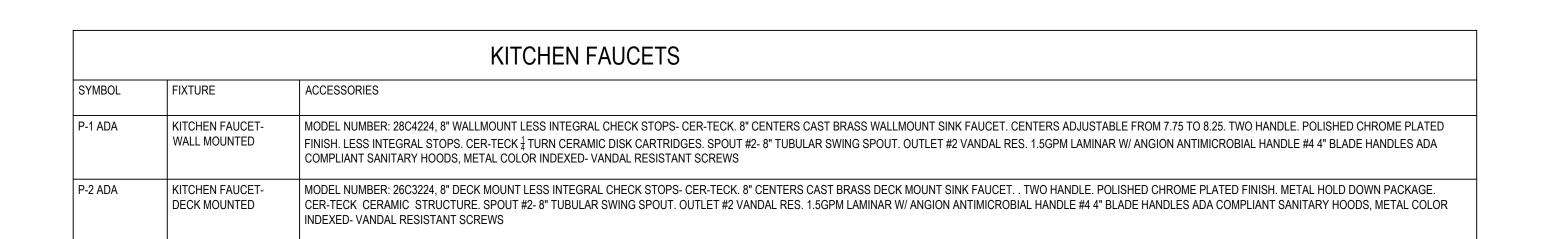

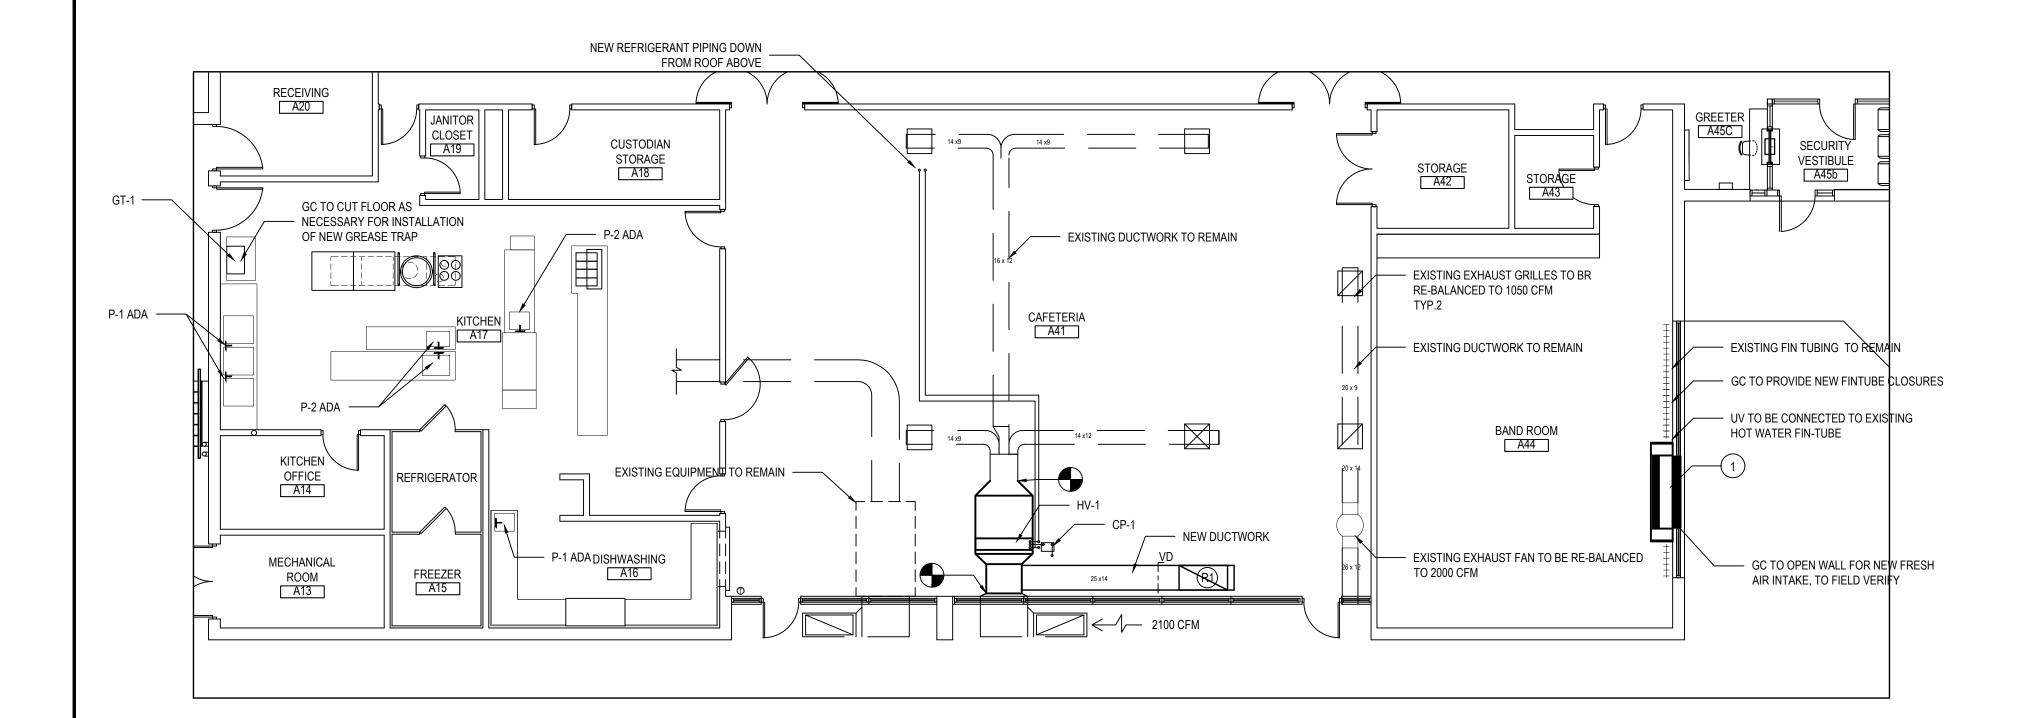

PLUMBING CONTRACTOR NOTES: -PC TO COORDINATE REMOVAL AND INSTALLATION OF EXISTING & NEW GREASE TRAP GT-1 -REFER TO SCHEDULES ON THIS DRAWING FOR ALL NEW **EQUIPMENT**


NOTE:

NOTE: @ ROOF

CAFETERIA AND BAND NEW MECHANICAL WORK

MECHANICAL CONTRACTOR NOTES: -MC IS RESPONSIBLE TO REMOVE AND RE-INSTALL EXISTING DROP CLG. IN ORDER TO PERFORM NEW WORK -PROVIDE NEW FLEX CONNECTIONS AT CONNECTIONS TO EXISTING DUCTWORK -REFER TO SCHEDULES ON THIS DRAWING FOR ALL NEW **EQUIPMENT**

SCALE: 1/8" = 1'-0"

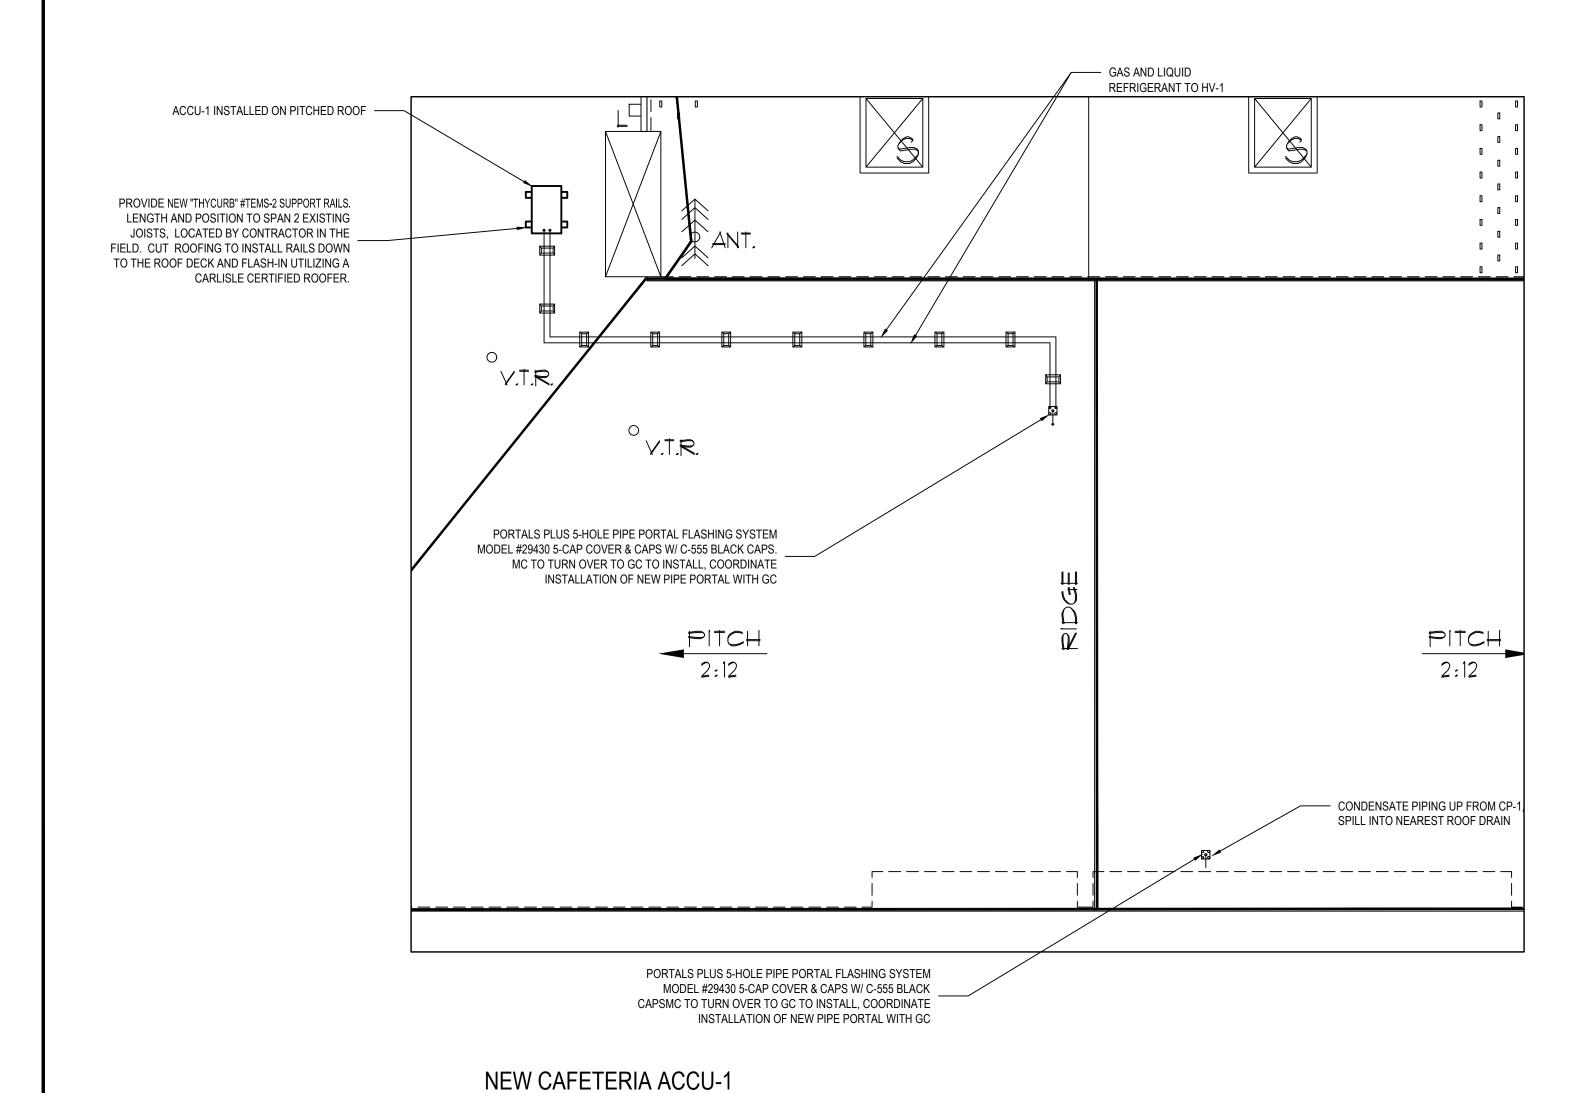


SCALE: 1/8" = 1'-0"

_					
		RETURN AIR G	RILLE SC	CHEDULE	
	SYMBOL	ANEMOSTAT MODEL NO.	MODULE SIZE	MAX. NC LEVEL	CFM
	R1)	GC 5	48"X24"	24	2000
	NOTES:				
	STEEL	CONSTRUCTION, GRID CORI	<u> </u>		

COLOR TO BE STANDARD WHITE

		CONDENS	ATE PUMP SCI	HEDULE		
TAG NO.	LITTLE GIANT	DESIGN HEAD	FLOW RATE	DIMENSIONS	ELECTRIC	CAL DATA
TAG NO.	MANUFACTURER MODEL NO.	(FEET)	GAL/HR	INCHES	VOLT /PHASE / HZ	AMPS (230V)
CP-1	VCMA-20ULS	15	80	11" x 5" x 7"	208 / 1 / 60	1.0

				UN	IIT VENTILA	ATOR SCHEDULE			
Tag No.	MFG. / Model #	CFM / S.P.	HP	Elect. Req.	Heating Coil Type	Heat Output / GPM/P.D. or Steam Pr.	Cabinet Type	Exterior Louver Type	Notes
1	MAGIC AIRE UV #MAUVF5	1500 @ .25	1/2	120V., 1 PH.	2 ROW HOT WATER	95.9 MBH @ 6 GPM, 0.4"	VERTICAL UV	72"x4 ½" W/ GRILL	

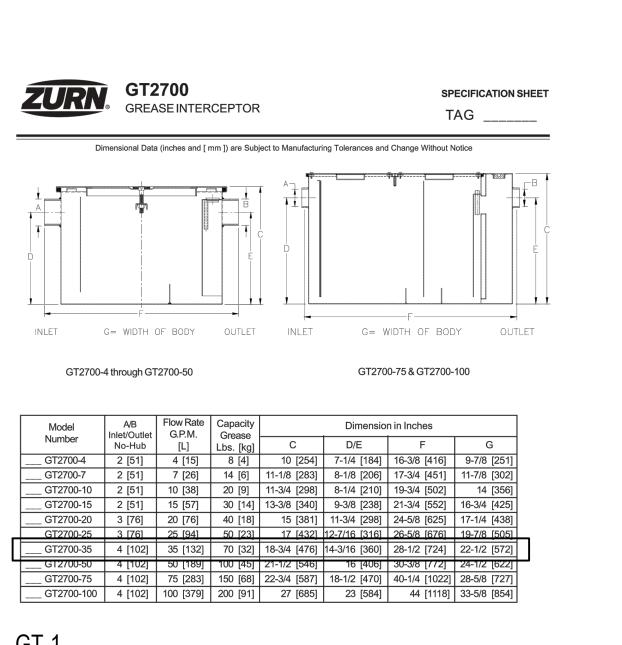




mode. Does not impact heat recovery system synchronous operating range.

ACCU-1

For continual product development, LG reserves the right to change specifications without notice.

SB_Multi
LG Electronics U.S.A., Inc., Englewood Cliffs, NJ. All rights reserved. "LG Life's Good" is a registered trademark of LG Corp. /www.lghvac.com

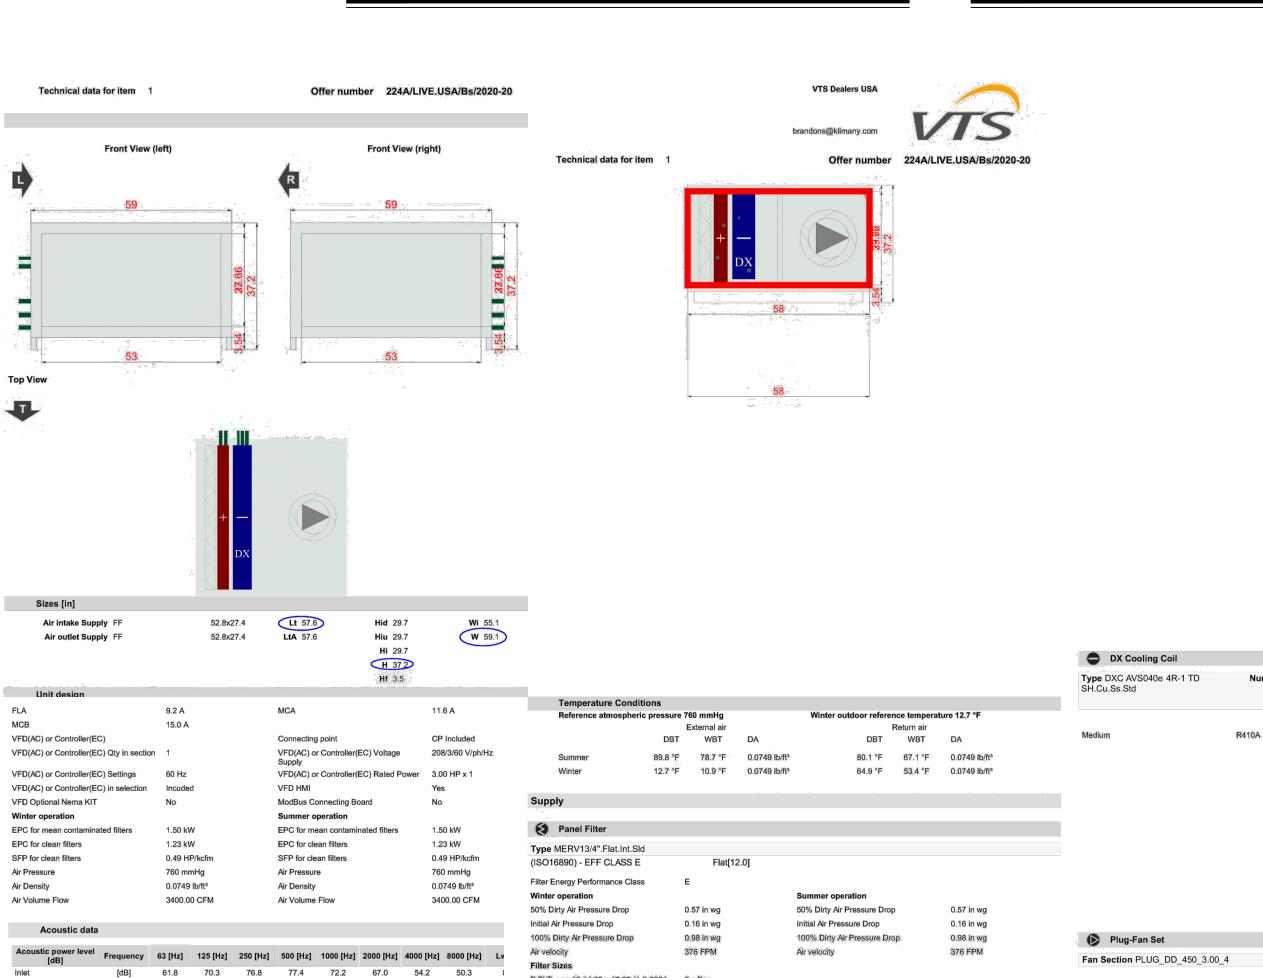

Type WCL AVS040e 2R DT SH.St.St.Std

Glycole concentration

Intake air DBT / WBT

Discharge air DBT / WBT

Pressure drop Wet / Dry Wet

Winter operation

Air velocity

Air Pressure

Air Density

Air Volume Flow

Total heating capacity

Medium temperature

Medium pressure drop

Medium flow rate

0.00 %

382 FPM

0.12 in wg

760 mmHg

3400.00 CFM

190.4 MBH

1.378 ft wg

180.0 °F/150.0 °F

28.3 °F / 25.0 °F

80.0 °F / 52.4 °F

Number of rows 2

Maximum working pressure

Maximum medium temperature

AVS040e 2R

[dB] 71.4 76.3 82.8 83.4 80.2 77.0 72.2 68.3 P.FLT merv13 14.25 x 17.35 (1-2-0301- 6 x Pcs 0.097)

Environment [dB] 49.5 64.8 69.4 69.4 66.5 63.5 42.7 29.8

Air Inlet Outlet ACCESSORIES

Inlet Outlet Holes

Control application

Functional Code

Transport Sections

Transport Sections Dims

Section splits

NOTE:


Air Inlet

Air Outlet

Controls Selection Mode: No controls

Front 52.8x27.4

Front 52.8x27.4

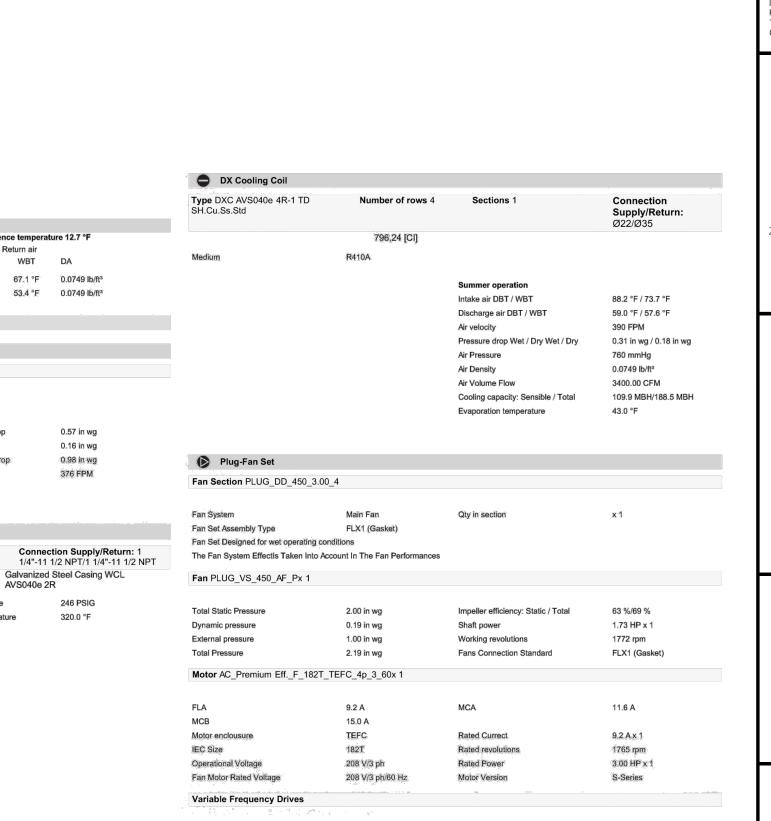



	· · ·		ТОИ	TICE	
208 / 1 / 60	1.0	PREPARED BY BE ENGINEERS, PC. CONDITIONS AS CONDITIONS SHOULD FOR MATION AS TO SHOULD BE SHOULD BE SHOULD BY	ARE BASED ON SS ARCHITECTS AND, THEREFO CONSTRUCTED DWN ARE RITHEY MAY NOT	N CONSTRUCTION DRAWINGS NOT B, LANDSCAPE ARCHITECTS AND RE, MAY NOT REPRESENT THE) :
Tag No.:	5 - 122 -22 - 61		2000	1990 1966-1-1-1-1-1-1-1-1-1-1-1-1-1-1-1-1-1-1	
°F DB) rol Indoor Units³ dB(A)	14 - 81 14 - 61 R410A EEV 32 62.0	KEY PLAN	NOT TO SC	ALE	
Brushless Digital W) le size must comply with the applicable loc at each frame. ment size, refer to the LATS Multi V tree d ratio must be between 50-130%. rvels are tested in an anechoic chamber ur on of outdoor units. able between ODU and IDUs must be 2-cor , and shielded. Ensure the communication disster ODU chassis only. Do not ground th . Wiring must comply with all applicable lo ting voltage: 187V - 253V ormance with LGRED* heat technology is in ter February 2019.	idagram. Inder ISO Standard 3745 Inductor, 18 AWG, Cable shield is properly e communication cable cal and national codes. Included in Multi V 5 ERTIFIED Inductory.org (Multi-Split AC and HP)	JNION FR BOND	GOLDEN HILL ELEMEN IARY SCHOOL ORANGE COUNTY, TOWN OF WARWICK, VILLAGE OF FLORIDA, NEW YORK 10921	NEW MECHANICAL & PLUMBING PLANS, SCHEDULES	
		PROJECT		DWG TITLE	
		DRAWING B CHECK BY:		GWT	
		AN INSTRUMENT ARCHITECTS, LAN INFRINGEMENT OR PROJECT IS PROH	OF SERVICE NDSCAPE ARCH R ANY USE OF IBITED. ANY AL' IS ALSO PROI	E SPECIFIC PROJECT INDICATED IS AND THE PROPERTY OF BBS HITECTS AND ENGINEERS, PC THIS DRAWING FOR ANY OTHER TERATION OR REPRODUCTION OF HIBITED WITHOUT THE WRITTEN	
mmer operation ake air DBT / WBT	Connection Supply/Return: Ø22/Ø35	ENGIN 244 EAST MAIN PATCHOG NEW YORK 1 T. 631.475. F. 631.475.	STREET 1772 0349 0361	ARCHITECTS 187 WOLF ROAD, STE. 20: ALBANY NEW YORK 12205 T. 518.621.7650 F. 518.621.7655	
charge air DBT / WBT velocity essure drop Wet / Dry Wet / Dry Pressure Density Volume Flow oling capacity: Sensible / Total aporation temperature	59.0 °F / 57.6 °F 390 FPM 0.31 in wg / 0.18 in wg 760 mmHg 0.0749 lb/ft³ 3400.00 CFM 109.9 MBH/188.5 MBH 43.0 °F				
		SED No.	***		
peller efficiency: Static / Total aft power orking revolutions ns Connection Standard	63 %/69 % 1.73 HP x 1 1772 rpm FLX1 (Gasket)	DISTRICT	FLORIDA	5-02-0-004-013 ————————————————————————————————————	
		PROJECT	BOND P		
cA ted Currect ted revolutions	11.6 A 9.2 A x 1 1765 rpm	DWG TITLE		ECH & PLUMBING SCHEDULES	
ted Power tor Version	3.00 HP x 1 S-Series	SCALE:	AS NOT		
		DATE: BID PICK-UP FILE No:			


SCALE: 1/8" = 1'-0"

REV. DATE

ITEM

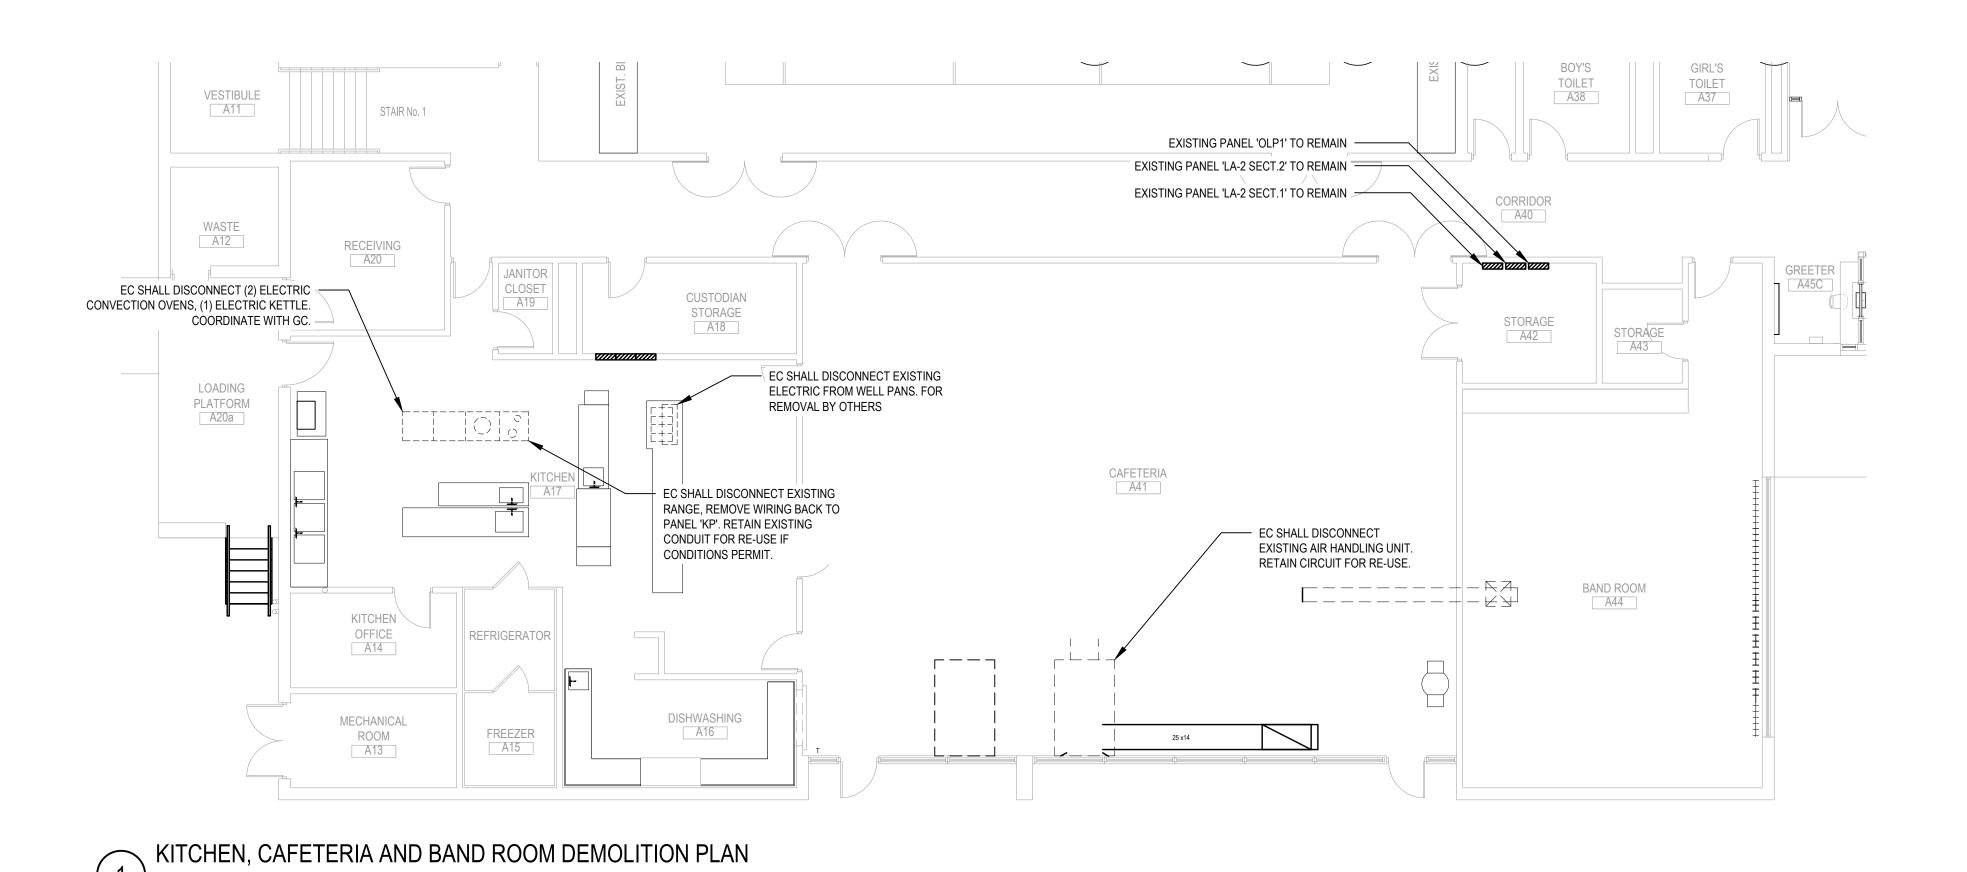

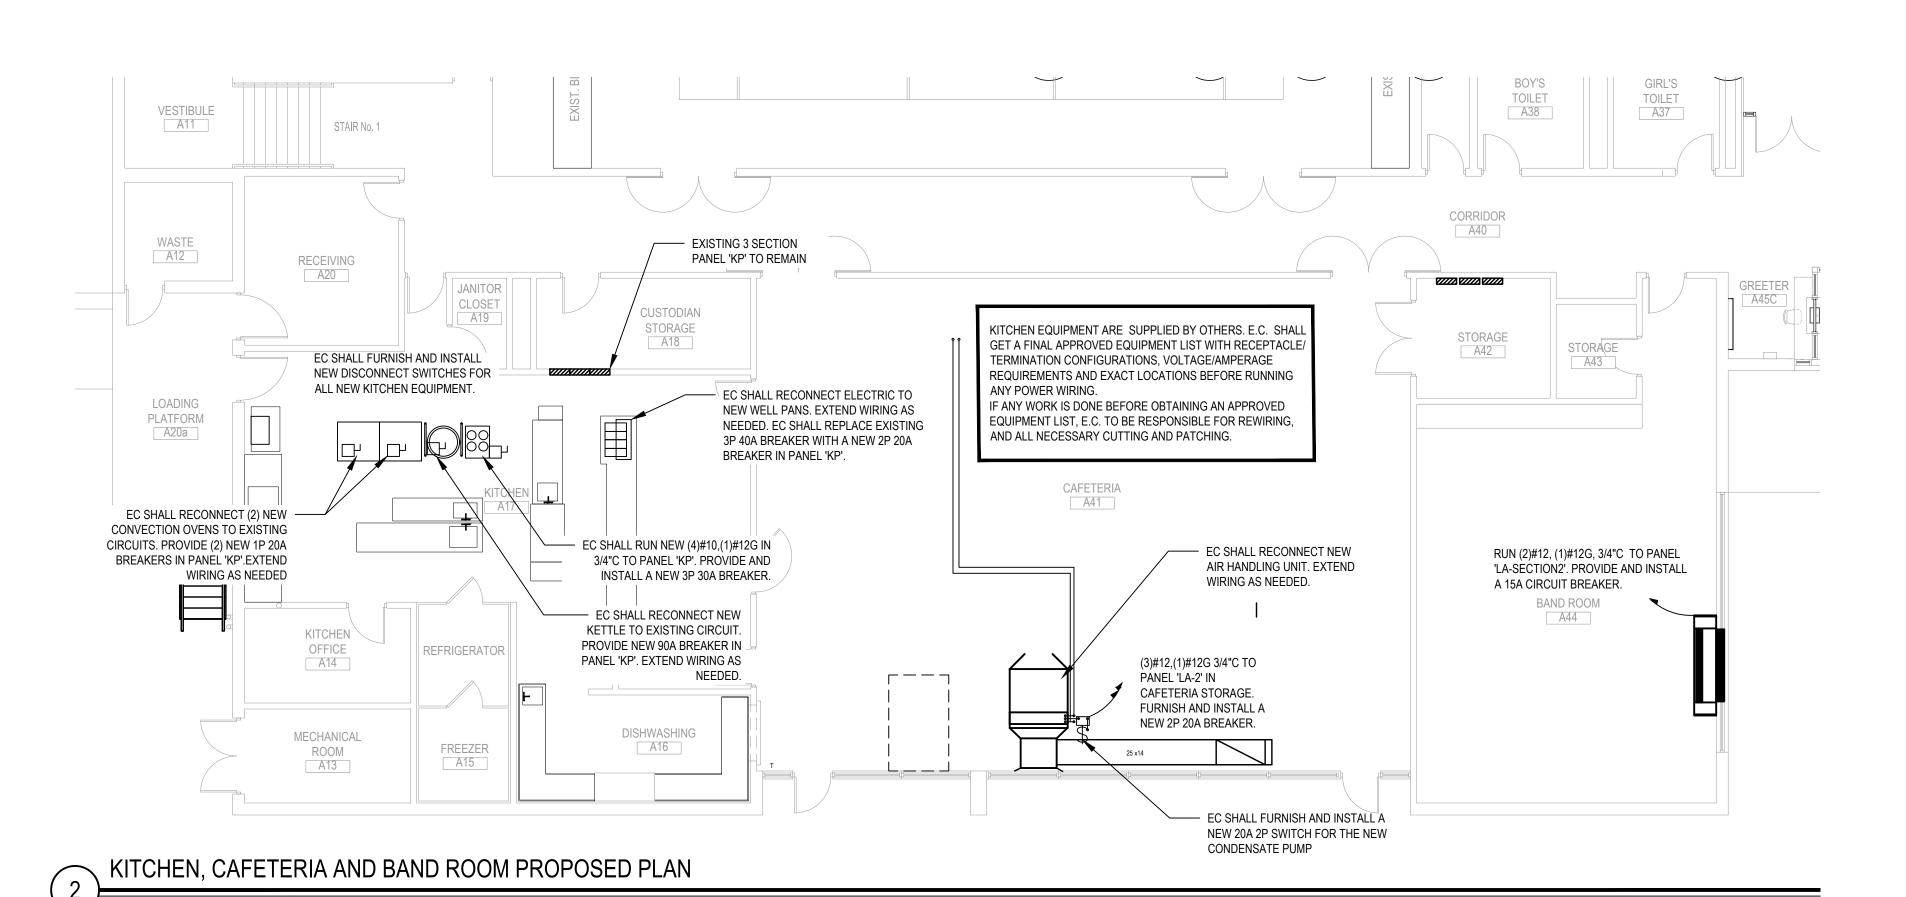

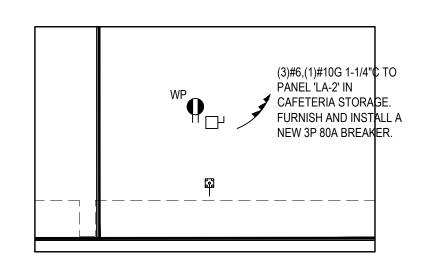



FIRE STOP NOTES

- ALL CONDUIT AND CABLE PENETRATIONS THROUGH FIRE RATED WALLS, FLOORS OR OTHER STRUCTURES SHALL BE FIRE STOPPED.
- THE FIRE STOP MATERIALS SHALL BE HILTI TYPE FS-657 FIRE BLOCK, FS-ONE SEALANT, CP-672 JOINT SPRAY, CP-601S ELASTOMERIC SEALANT, 6P-606 FLEXIBLE SEALANT, CP-643 OR CP-642 COLLAR, CP-618 PUTTY STICK, OR FS-635 TROWEL ABLE COMPOUND, AS SUITABLE.
- CONTRACTOR SHALL SUBMIT SHOP DRAWINGS OF PRODUCTS SPECIFIED OR EQUAL.
- FIRE STOP MATERIALS OTHER THAN HILTI SHALL INCLUDE FULL TECHNICAL DATA WITH SHOP DRAWINGS TO DEMONSTRATE EQUALITY WITH THE SPECIFIED FIRE STOPS AND STATEMENT FROM MANUFACTURER THAT THEY MEET OR EXCEED THE PRODUCTS SPECIFIED HERE.
- ALL SYSTEMS SHALL HAVE THEIR OWN SLEEVE THROUGH FIRE RATED WALLS. IE FIRE ALARM, PUBLIC ADDRESS, TELEPHONE, DATA, POWER AND LIGHTING.

SYMBOL	DESCRIPTION
φ	TAMPER-RESISTANT DUPLEX ELECTRICAL OUTLET FOR CONVENIENCE POWER WITH 302/304 STAINLESS STEEL FACEPLATE, NEMA 5-20R.
#	TAMPER-RESISTANT DOUBLE DUPLEX ELECTRICAL OUTLET FOR CONVENIENCE POWER WITH 302/304 STAINLESS STEEL FACEPLATE, NEM. 5-20R.
φ	TAMPER-RESISTANT GROUND FAULT INTERRUPTED DUPLEX ELECTRICAL OUTLET FOR CONVENIENCE POWER WITH 302/304 STAINLESS STEEL FACEPLATE, NEMA 5-20R.
φ	TAMPER-RESISTANT SINGLE ELECTRICAL OUTLET FOR CONVENIENCE POWER WITH 302/304 STAINLESS STEEL FACEPLATE, NEMA 5-20R.
φ	TAMPER-RESISTANT SPECIAL PURPOSE SINGLE ELECTRICAL OUTLET FOR CONVENIENCE POWER WITH 302/304 STAINLESS STEEL FACEPLATE, 250V NEMA 6-20R.
Φ	TAMPER-RESISTANT USB CHARGER DUPLEX ELECTRICAL OUTLET FOR CONVENIENCE POWER WITH 302/304 STAINLESS STEEL FACEPLATE, NEM. 5-20R.
	DATA & POWER SURFACE RACEWAY - NUMBER OF TRIANGLES INDICATES NUMBER OF DATA DROPS - PROVIDE (2) DUPLEX RECEPTACLES PER DATA DROP UNLESS OTHERWISE NOTED ON TECHNOLOGY DRAWINGS E9.XX
	POWER CORD REEL, NEMA 5-20R.
(P)	FIRE RATED POWER FEED POKE-THROUGH.
FB	FLOOR BOX.
WB	MULTIPLE SERVICE WALL BOX.
J	JUNCTION BOX, SIZE AS REQUIRE.
/HP/	MOTOR, HORSEPOWER AS INDICATED.
	UN-FUSED DISCONNECT SWITCH.
F	FUSED DISCONNECT SWITCH.
HD	HAND DRYER.
77772	PANEL.
36	TRANSFORMER.
\$	SWITCH: LOWER CASE LETTER INDICATES SWITCHING DESIGNATION UPPER CASE LETTER(S) OR NUMBER SUBSCRIPTS: (NONE) = SINGLE POLE, 20 A, HEAVY DUTY SPEC GRADE SWITCH K = KEY SWITCH D = DIMMER SWITCH 3 = THREE WAY SWITCH 4 = FOUR WAY SWITCH MC = MOMENTARY CONTACT SWITCH LV = LOW VOLTAGE BUTTON SWITCH EF = COMMERCIAL GRADE EXHAUST FAN SWITCH 2P = TWO POLE, 20A, HEAVY DUTY SPEC GRADE SWITCH
(S) (VS) (DS)	CEILING MOUNTED OCCUPANCY/ VACANCY/ DAYLIGHT SENSOR, LOW VOLTAGE, DUAL TECHNOLOGY, COMPLETE W/ POWER PACK(S) AS REQUI
(MOS) (MVS)	WALL MOUNTED OCCUPANCY/ VACANCY, LOW VOLTAGE, DUAL TECHNOLOGY, COMPLETE W/ POWER PACK(S) AS REQUIRED.
\$08	DUAL TECHNOLOGY SINGLE LEVEL OCCUPANCY SENSING WALL SWITCH.
PC	PHOTOCELL.
RC	ROOM CONTROLLER.
	SINGLE POLE CIRCUIT 2-#12, #12G, ¾"C UNLESS OTHERWISE NOTED
	∓WO POLE CIRCUIT 3-#12, #12G, ¾"C UNLESS OTHERWISE NOTED
	THREE POLE CIRCUIT 4-#12, #12G, ¾"C UNLESS OTHERWISE NOTED

SCALE: 1/8" = 1'-0"

SCALE: 1/8" = 1'-0"


ELECTRICAL CONSTRUCTION NOTES

- ALL WORK SHALL BE DONE IN ACCORDANCE WITH THE LATEST ADOPTED EDITIONS OF THE N.E.C APPLICABLE LOCAL CODES, STATE CODES, OWNER'S WORKING RULES AND SCHEDULE DIRECTIVES, AND THE ENGINEER'S SPECIFICATIONS.
- THE VOLTAGE CHARACTERISTIC OF BUILDING IS 208Y/120V, 3-PASE, 4-WIRE, GROUNDED NEUTRAL, WYE. ALL EQUIPMENT SHALL BE COMPATIBLE WITH THESE CHARACTERISTICS.
 - THE DRAWINGS SCHEMATICALLY SHOW THE APPROXIMATE LOCATION OF ALL EQUIPMENT, CONDUITS DEVICES, ETC. THE EXACT LOCATION OF WHICH SHALL BE SUBJECT TO APPROVAL BY THE ARCHITECT AND / OR OWNER WHO RESERVES THE RIGHT TO MAKE PRIOR TO INSTALLATION, ANY REASONABLE CHANGES IN LOCATION INDICATED WITHOUT EXTRA COST TO THE OWNER. CONTRACTOR SHALL VERIFY ALL INDICATED OR APPROXIMATED DIMENSIONS DRAWN OR DENOTED.
 - CONTRACTOR SHALL EXAMINE THE SITE TO VERIFY WORK TO BE PERFORMED AS SHOWN ON DRAWINGS AND SPECIFICATIONS BEFORE SUBMITTING HIS BID. ANY DISCREPANCY BETWEEN DRAWINGS AND SPECIFICATIONS AND ACTUAL FIELD CONDITIONS SHALL BE BROUGHT TO ARCHITECT / ENGINEERS ATTENTION BEFORE BID SUBMITTAL. ANY FIELD CONDITION FOUND AFTER BID APPROVAL WHICH HAMPERS AND/OR PREVENTS ANY WORK TO BE PERFORMED AS SHOWN ON DRAWINGS AND SPECIFICATIONS SHALL BE THE RESPONSIBILITY OF THE CONTRACTOR. THE CONTRACTOR SHALL BID THE HIGHER SPECIFICATION FOR ANY DISCREPANCY BETWEEN DRAWINGS AND/OR SPECIFICATIONS.
 - CONTRACTOR SHALL PROVIDE ALL LABOR, SERVICE, MATERIALS, EQUIPMENT, AND RELATED ITEMS TO COMPLETE THE WORK OF THIS DIVISION, AS REQUIRED BY THE NATIONAL ELECTRIC CODE, AND ALL STATE AND LOCAL AUTHORITIES HAVING JURISDICTION.
 - CONTRACTOR SHALL PROVIDE ALL ELECTRICAL HARDWARE SHOWN ON THESE DRAWINGS AND RELATED DETAIL MATERIALS NOT SPECIFICALLY SHOWN OR SPECIFIED.
 - CONTRACTOR SHALL PAY ANY FEES APPLICABLE TO ELECTRICAL WORK, SUCH AS, BUT NOT LIMITED TO THE POWER COMPANY, TELEPHONE COMPANY, CAT-V, AN APPROVED ELECTRICAL INSPECTION AGENCY, ALARM AND FIRE PROTECTION COMPANIES.
 - CONTRACTOR SHALL REFER TO ALL OTHER DRAWINGS IN BID PACKAGE AND PERFORM THE WORK (INCLUDE IN HIS BID) INDICATED AS ELECTRICAL CONTRACTOR (E.C.) WORK.
 - ALL WORK SHALL BE IN ACCORDANCE WITH MANUFACTURER'S RECOMMENDATIONS AND DIRECTIVES OF THE OWNER.
 - ALL WORK SHALL BE PERFORMED BY A LICENSED ELECTRICAL CONTRACTOR WHO SHALL OBTAIN AN INSPECTION CERTIFICATE AND PAY ASSOCIATED FEE. SUBMIT A PHOTOCOPY OF THIS CERTIFICATE TO THE ENGINEER WITH FINAL PAYMENT APPLICATION.
 - CONTRACTOR SHALL GUARANTEE ALL MATERIALS AND THEIR INSTALLATION TO BE FREE OF DEFECTS FOR A PERIOD AS DEFINED IN SPECIFICATION SECTION 01700 OF THE PROJECT MANUAL.
 - 12. A COMPLETE SYSTEM OF WIRING, WITH ALL FEEDERS, MAINS, AND BRANCHES AS SHOWN ON THE DRAWINGS, SHALL BE FURNISHED AND INSTALLED FROM THE MAIN DISTRIBUTION BOARD TO THE PANELS KEY PLAN OUTLETS, MOTORS, AND APPURTENANCES.
 - 3. PROVIDE IDENTIFICATION FOR ALL PANEL AND MOTOR FEEDER CABLES IN PULL BOXES AND AT TERMINATIONS. ANY CONDUCTOR VOLTAGES HIGHER THAN 240 VOLTS SHALL BE MARKED ON DEVICES AND JUNCTION BOXES.
 - 14. FURNISH AND INSTALL ALL WIRING OF ANY VOLTAGE OR PURPOSE AS SHOWN ON THE DRAWINGS.
 - 15. ALL BRANCH CIRCUITS SHALL HAVE INDIVIDUAL NEUTRALS. SHARING COMMON NEUTRALS AMONG BUNDLED CIRCUITS IS SPECIFICALLY DISALLOWED UNLESS OTHERWISE NOTED.
 - 16. PULL / JUNCTION BOXES SHALL BE PROVIDED WHERE INDICATED OR AS OTHERWISE REQUIRED TO FACILITATE THE PROPER INSTALLATION OF WIRES AND CABLES. CONDUITS MAY BE INCREASED IN SIZE FOR CONSTRUCTION CONVENIENCE.
 - 7. FURNISH AND INSTALL ALL DISCONNECT DEVICES AND SAFETY SWITCHES AS SHOWN ON THE DRAWINGS AND / OR AS REQUIRED TO CONFORM WITH CODE REQUIREMENTS.
 - 8. NEW CIRCUIT BREAKERS INSTALLED IN EXISTING PANELBOARD(S) SHALL BE LISTED/LABELED FOR USE WITH THE EXISTING PANELBOARD(S).
 - 19. CONTRACTOR SHALL REFER TO ALL FURNITURE DRAWINGS BEFORE INSTALLING RECEPTACLES. THE MOUNTING HEIGHT OF THE RECEPTACLES IS 18" ABOVE FINISHED FLOOR UNLESS INDICATED ON THE DRAWING COLOR TYPE & FINISH OF ALL RECEPTACLES. DEVICES & FACE PLATES SHALL BE AS APPROVED BY ENGINEER AND ARCHITECT. CONTRACTOR SHALL PROVIDE & WIRE WEATHERPROOF GFCI RECEPTACLES ON ALL APPLICABLE ROOFTOP UNITS AS PART OF HIS BID. SEE MECHANICAL EQUIPMENT SCHEDULES FOR UNITS WITH SERVICE RECEPTACLES FACTORY INSTALLED.
 - ALL WIRING TO BE 1 #12 + 1 #12(N) + 1 #12(G) 3/4"C, OR STEEL JACKETED MC CABLE (WHERE CODE PERMITTED), UNLESS OTHERWISE SPECIFIED ON DRAWINGS. RUN BRANCH CIRCUITS IN DROPPED CEILINGS, VOIDS, & CHASES. CONDUITS MAY BE SURFACE MOUNTED IN MECHANICAL SPACES UNLESS OTHERWISE NOTED. CONDUITS IN PUBLIC AREAS SHALL BE CONCEALED IN HUNG CEILINGS, EMBEDDED IN SLAB OR MASONRY WALLS, EXCEPT WHERE SURFACE MOUNTED RACEWAY IS SPECIFIED. ALUMINUM JACKETED MC CABLE IS NOT ACCEPTABLE.
 - 1. ALL CONNECTIONS AND / OR SPLICES SHALL BE MADE ONLY IN ACCESSIBLE JUNCTION BOXES.
 - ALL COUPLINGS AND CONNECTORS FOR USE WITH EMT SHALL BE COMPRESSION TYPE. SET SCREW TYP OR INDENT TYPE FITTINGS WILL NOT BE ACCEPTED.
 - 23. WIRING INSTALLED IN CEILINGS SHALL BE HUNG INDEPENDENT OF CEILING SYSTEM AND SECURELY TIEI
 - 24. CONDUITS SHALL BE SECURED IN PLACE AND PROTECTED WHERE NECESSARY TO PREVENT DAMAGE DURING CONSTRUCTION.
 - 5. FURNISH AND INSTALL ALL HARDWARE TO PROPERLY SUPPORT ALL CONDUITS NOT INSTALLED IN CONCRETE SLABS OR UNDERGROUND.
 - 26. ALL CONDUITS OR MC CABLE SHALL BE EQUIPPED WITH AN INSULATING/CHAFE GUARD GROMMET AT WIRE EXIT/ENTRANCE. MC CABLE SHALL USE MC STYLE BUSHINGS. BX OR OTHER BUSHINGS ARE SPECIFICALLY
 - WHERE AN EXISTING CONDUIT OR CABLE IS REQUIRED TO BE REMOVED BUT SERVES EXISTING EQUIPMENT WHICH IS TO REMAIN OPERABLE, THE ELECTRICAL CONTRACTOR SHALL REROUTE SAID CONDUIT OR CABLE OR PROVIDE A NEW SOURCE OF POWER (APPROVED BY ENGINEERING) TO THIS EQUIPMENT AS A PART OF THIS CONTRACT.
 - 8. ALL PANELS, SWITCHES, DISCONNECT STARTERS, OR OTHER ELECTRIC SYSTEM CONTROLS SHALL BE STENCILED WITH THEIR APPROPRIATE DESIGNATION/FUNCTION. ALL CIRCUIT BREAKERS SHALL BE IDENTIFIED BY A PANEL SCHEDULE OR STENCIL ADJACENT TO THE CIRCUIT BREAKER. PROVIDE PRINT PANEL SCHEDULE. HAND WRITING NOT ALLOWED.
 - ALL CIRCUIT BREAKERS POSITIONS IN ALL PANELS ARE SHOWN FOR GROUPING PURPOSES ONLY ELECTRICAL CONTRACTOR IS RESPONSIBLE FOR LOAD BALANCING.
 -). $\,$ ALL DEVICES SHALL BE $\,$ FASTENED IN PLACE SECURELY. GRID MOUNTING LIGHTING FIXTURES SHALL BI SECURED TO GRID WITH CLIPS LISTED FOR THE PURPOSE OR SUSPENDED FROM STRUCTURE PER NEC.
 - . WORK WHICH MUST BE DONE IN OCCUPIED AREAS SHALL BE DONE AT SUCH TIMES AS INDICATED IN THE PHASING OF CONSTRUCTION AND AS APPROVED BY THE SCHOOL.
 - WHERE THE CONTRACTOR IS INSTRUCTED TO PROVIDE, INSTALL AND WIRE CIRCUIT BREAKER(S) TO AN EXISTING PANEL AND THAT PANEL DOES NOT HAVE THE ROOM TO INSTALL REQUIRED CIRCUIT BREAKERS, THE CONTRACTOR SHALL REMOVE (3) ADJACENT 1P CIRCUIT BREAKERS AND PROVIDE A 3P, 60A CIRCUIT BREAKER IN THEIR PLACE FOR SUB FEED TO A SURFACE MOUNTED 100A, 3P, 4W, 24 POLE SUB PANEL AND ESTABLISH OVERFLOW CIRCUITS IN NEW SUB PANEL, EACH WITH REQUIRED CIRCUIT BREAKERS. PROVIDE (3) 1P, AMPERAGE AS BEFORE CIRCUIT BREAKERS FOR DISCONNECTED CIRCUITS IN MAIN PANEL AND RECONNECT THEM IN SUB PANEL. SUB PANEL FEED TO BE 3 #6 + 1 #6(N) + 1 #10(G) - 1"C.
 - SELECTED RECEPTACLES AS SHOWN ON DRAWINGS MAY BE GFI PROTECTED BY CONNECTING TO GFC RECEPTACLE FIRST IN CIRCUIT. ALL RECEPTACLES THAT ARE PROTECTED FROM AN UPSTREAM GFCI UNIT SHALL BE VISIBLY LABELED AS SUCH. GFCI RECEPTACLE SHALL BE SPEC GRADE AND RATED 20A, WITH OPERATING NOTIFICATION INDICATING LIGHT.
 - 34. ALL DEVICES ADDRESSED BY ADA REGULATIONS SHALL BE INSTALLED AT ADA COMPLIANT HEIGHT AND
 - REMOVAL OF ELECTRICAL ITEMS INCLUDES THEIR DISPOSAL. THE EXCEPTION WILL BE TO TURN OVER TO THE OWNER ITEMS, IF ANY, THEY SPECIFY TO BE RETAINED IN THEIR INVENTORY. PCB OR ASBESTOS BEARING MATERIAL SHALL BE DISPOSED OF IN ACCORDANCE WITH LAWS AND REGULATIONS.
- UNLESS OTHERWISE NOTED, STARTERS AND DISCONNECTS FOR MECHANICAL EQUIPMENT SHALL BE FURNISHED BY THE MECHANICAL CONTRACTOR. COORDINATE WITH THE MECHANICAL CONTRACTOR FOR ALL POWERED MECHANICAL EQUIPMENT. THE ELECTRICAL CONTRACTOR IS RESPONSIBLE TO INSTALL ALL MOTOR STARTERS AND ASSOCIATED POWER WIRING FROM SOURCE TO UNIT VIA STARTERS AND DISCONNECTS. THE LOCATIONS OF MOTOR STARTERS SHALL BE DETERMINED BY THE MECHANICAL CONTRACTOR IN THE FIELD AND SUBMITTED TO THE ENGINEER FOR APPROVAL UNLESS IT IS SPECIFIED ON THE DRAWINGS. THE ELECTRICAL CONTRACTOR SHALL REFER TO THE MECHANICAL DRAWINGS, EQUIPMENT SCHEDULES AND NOTES AND INCLUDE IN HIS BID PRICE ALL ELECTRICAL WORK ASSOCIATED WITH THEIR INSTALLATION, AND THE REMOVAL OF ANY STARTERS / DISCONNECTS NO LONGER REQUIRED.
- 37. PROVIDE PROTECTIVE DUST COVERS ON SMOKE DETECTORS IN CONSTRUCTION AREAS. REMOVE COVERS UPON COMPLETION OF WORK.
- 38. VERIFY AND MAINTAIN ALL PHASE ROTATIONS THROUGHOUT THE PROJECT.

REV.	DATE	ITEM

HESE DRAWINGS ARE BASED ON CONSTRUCTION DRAWINGS NO PREPARED BY BBS ARCHITECTS, LANDSCAPE ARCHITECTS AND ENGINEERS, PC. AND, THEREFORE, MAY NOT REPRESENT THE CONDITIONS AS CONSTRUCTED AT THE TIME. ALL EXISTIN NFORMATION AS THEY MAY NOT HAVE BEEN BUILT AND DETAILE

PER THE ORIGINAL DOCUMENTS OR PER THE OWNER'S INFORMATION

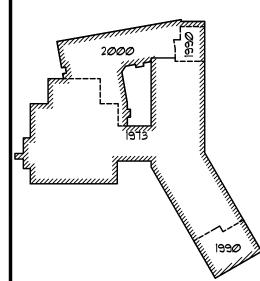

NOT TO SCALE

DRAWING BY: MG

HIS DRAWING, PREPARED FOR THE SPECIFIC PROJECT INDICATED I IN INSTRUMENT OF SERVICE AND THE PROPERTY OF BB INFRINGEMENT OR ANY USE OF THIS DRAWING FOR ANY OTHE THIS DOCUMENT IS ALSO PROHIBITED WITHOUT THE WRITTE

LANDSCAPE ARCHITECTS 4 EAST MAIN STREET | 187 WOLF ROAD, STE. 209 PATCHOGUE **NEW YORK 11772** NEW YORK 12205

F. 518.621.7655 F. 631.475.0361 www.BBSARCHITECTURE.com


44-21-15-02-0-004-013


DISTRICT FLORIDA U.F.S.D. GOLDEN HILL E.S. PROJECT BOND PHASE 2

DWG TITLE ELECTRICAL DEMO & pROP. pLANS

SCALE: AS NOTED DATE: DECEMBER 1, 2020 BID PICK-UP: BID P/U DATE FILE No: 20-176A

E1.01

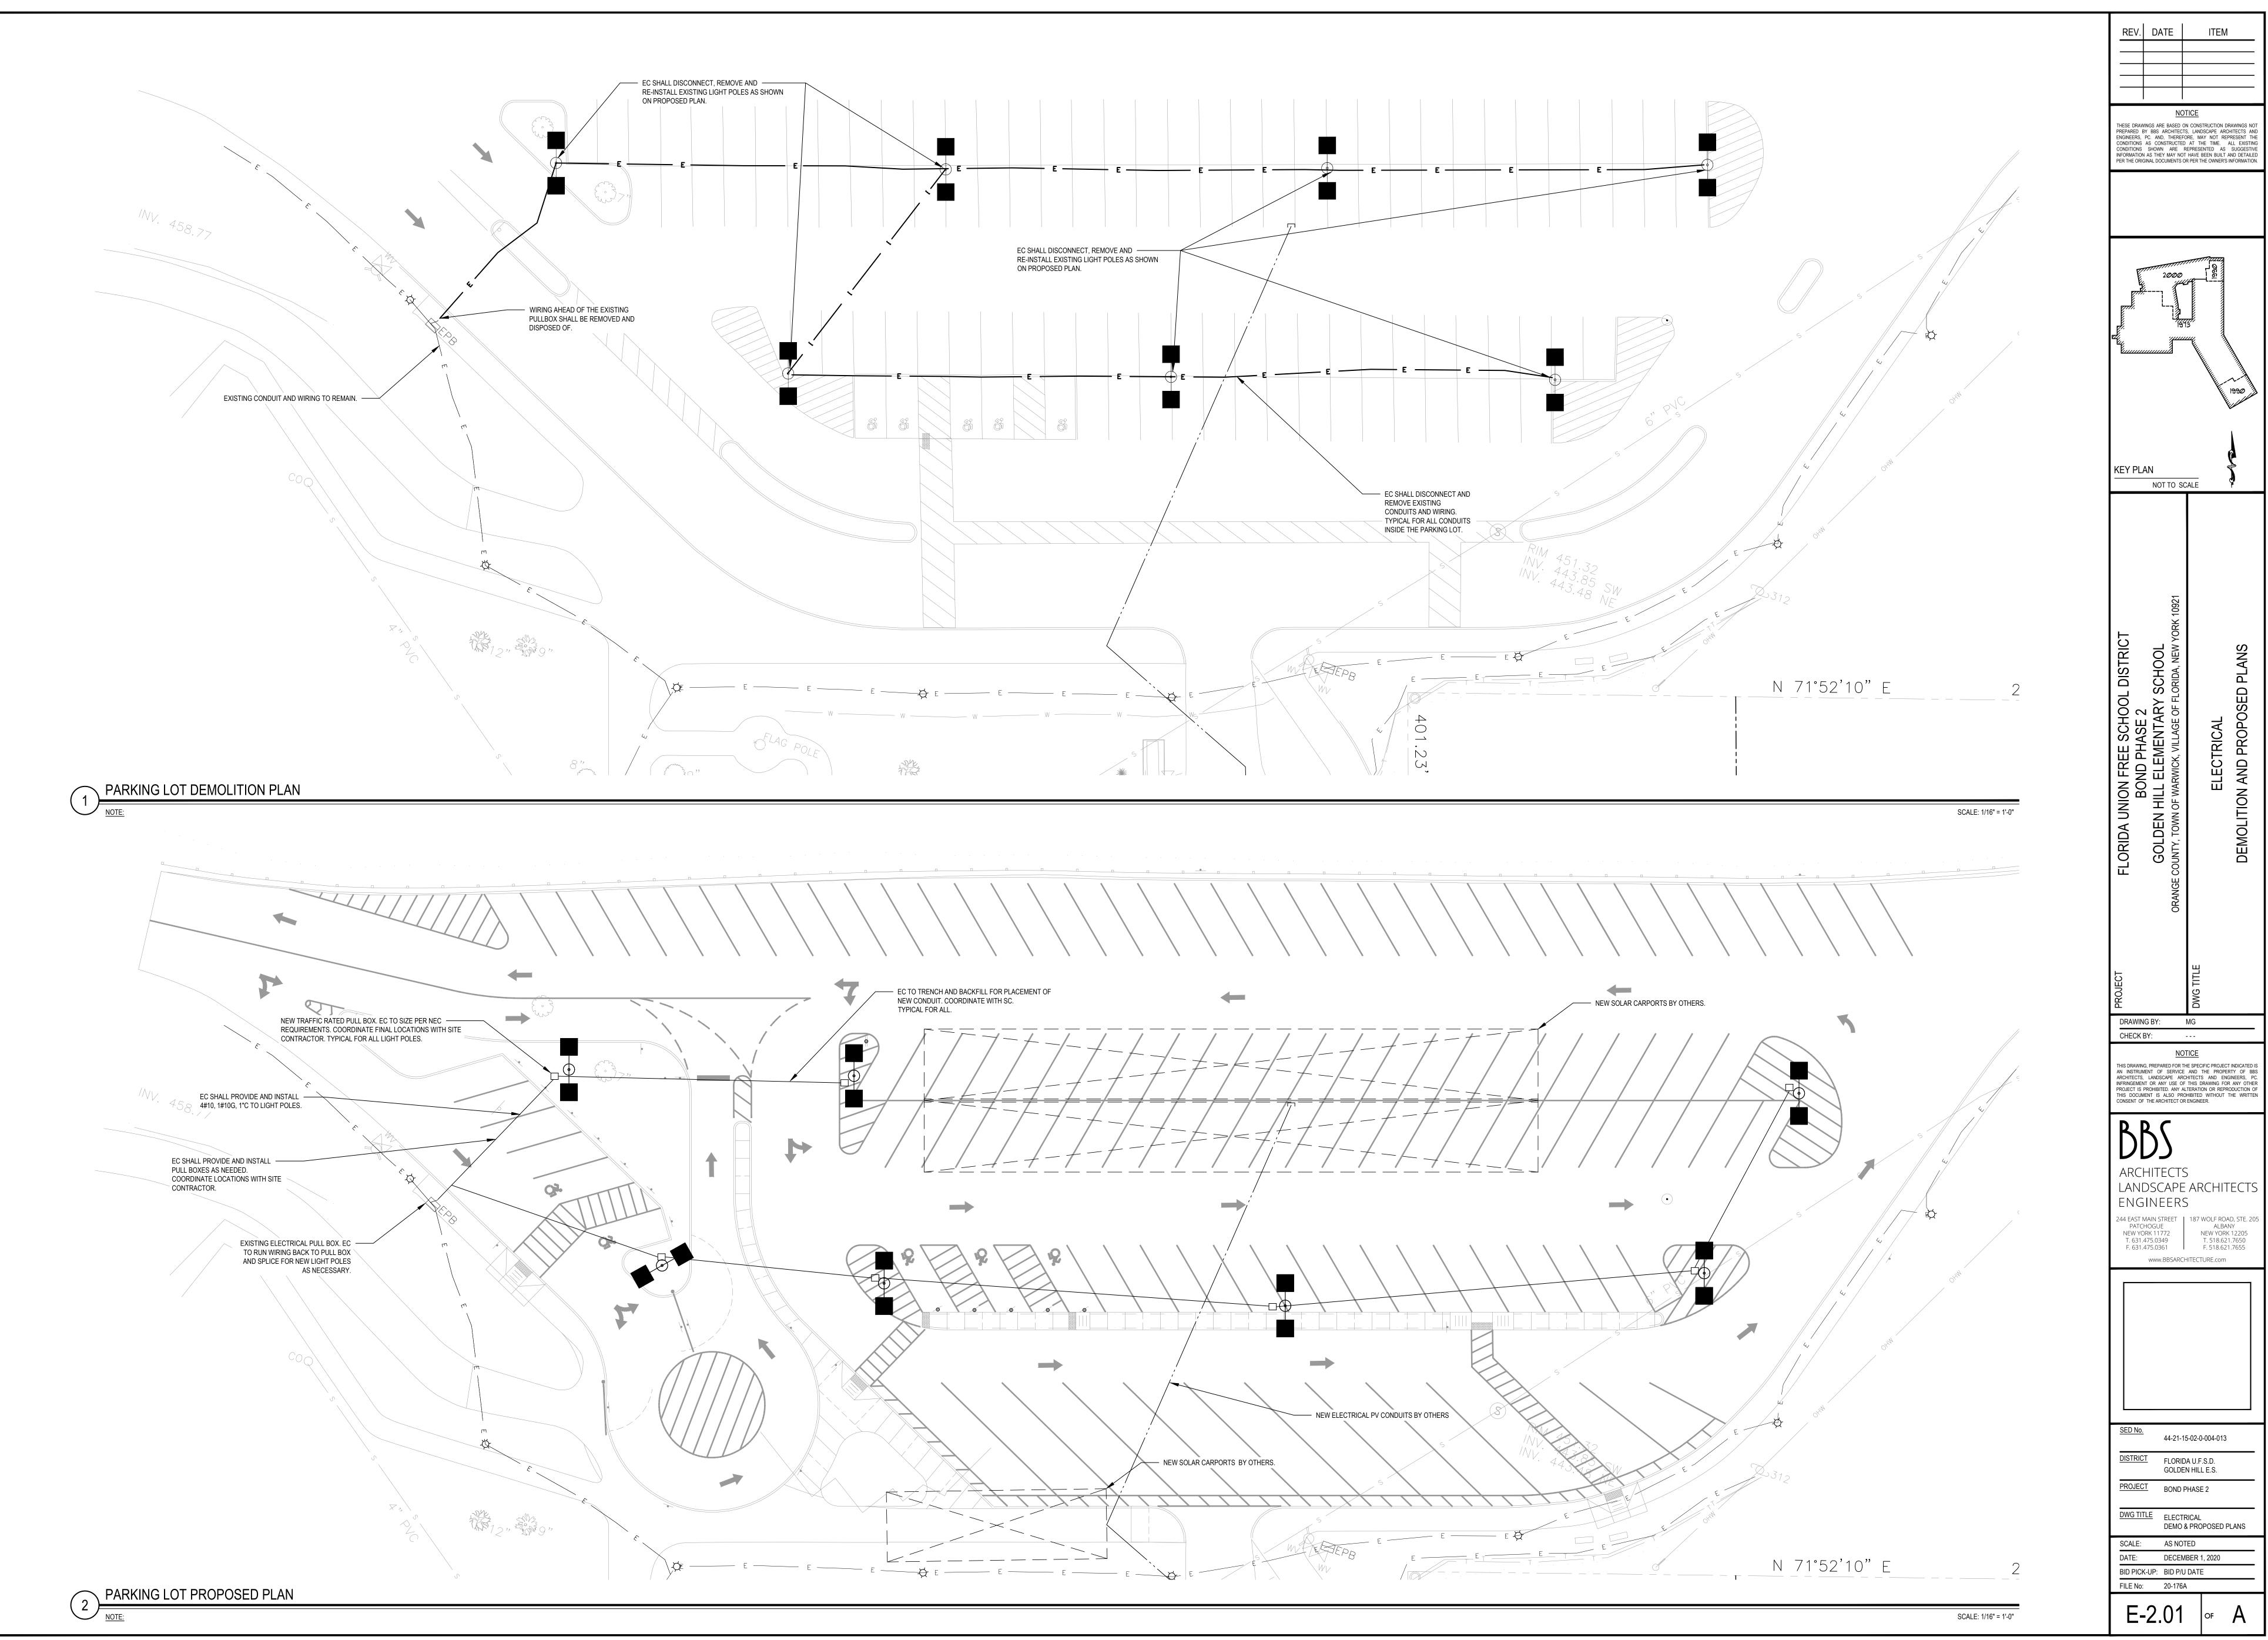


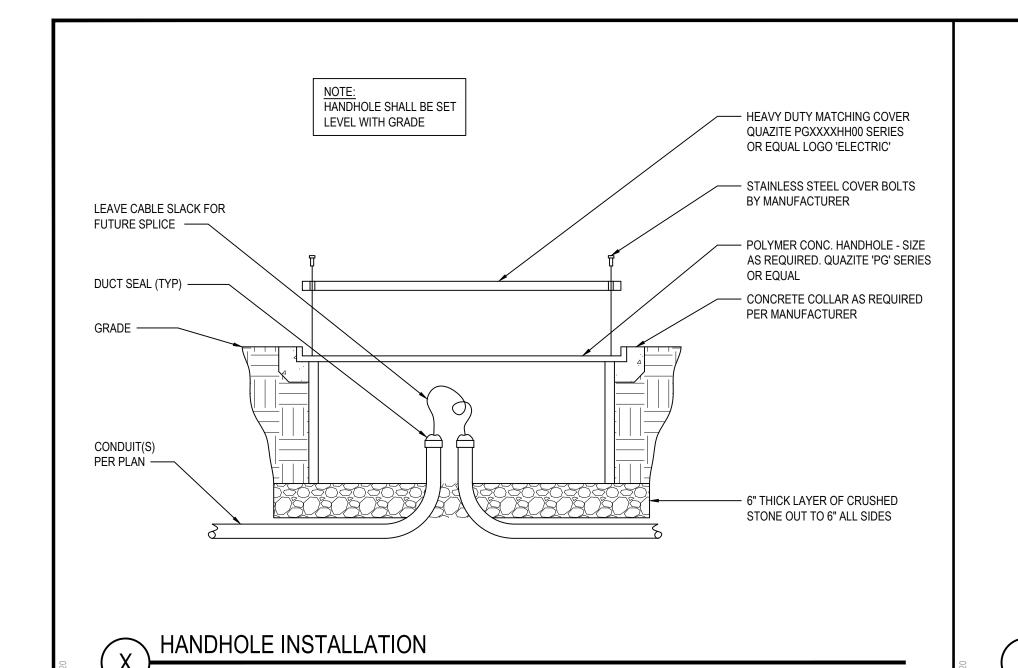


NOTE: NOT FOR USE IN AREAS


SUBJECT TO VEHICULAR TRAFFIC


SCALE: N.T.S.

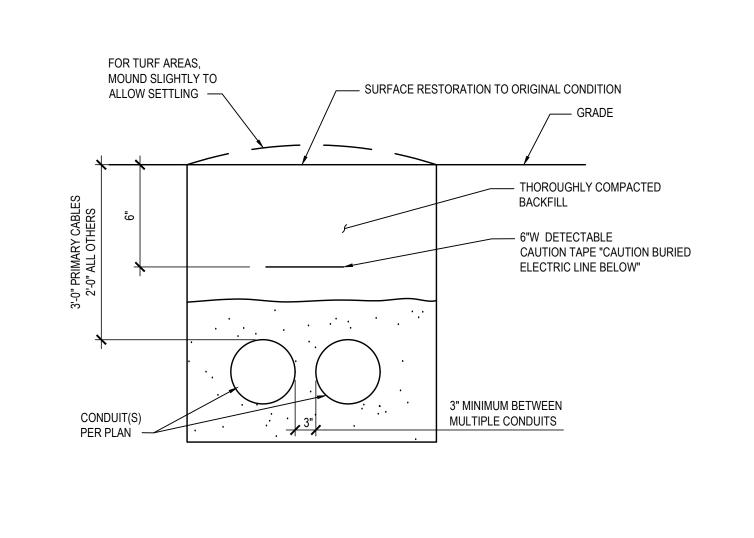

SCALE: N.T.S.

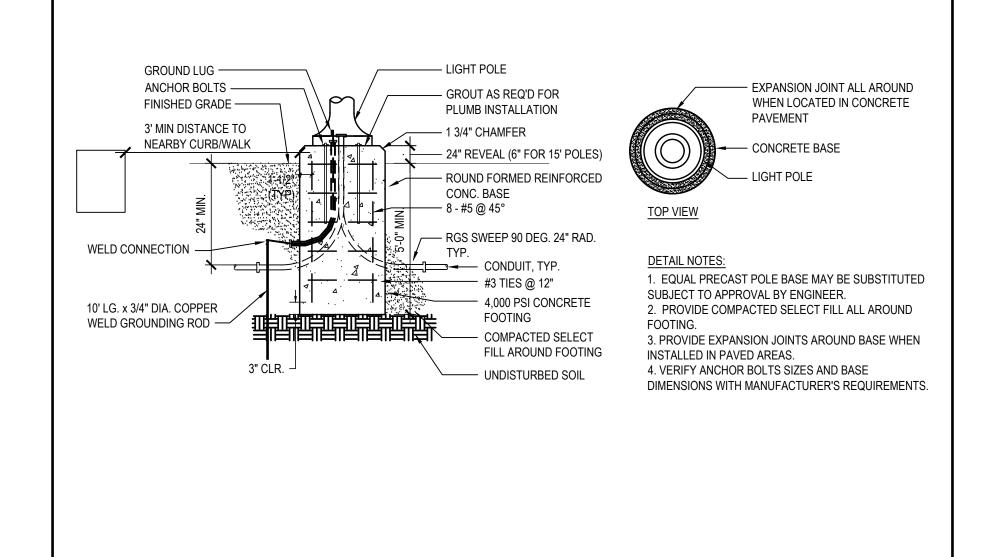

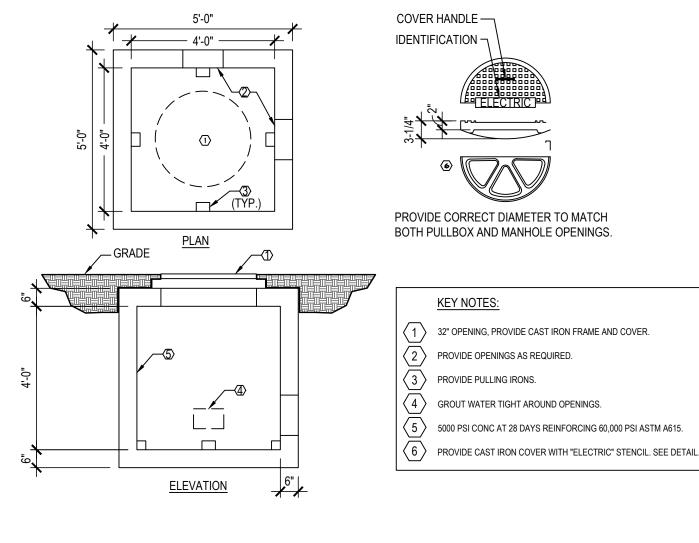

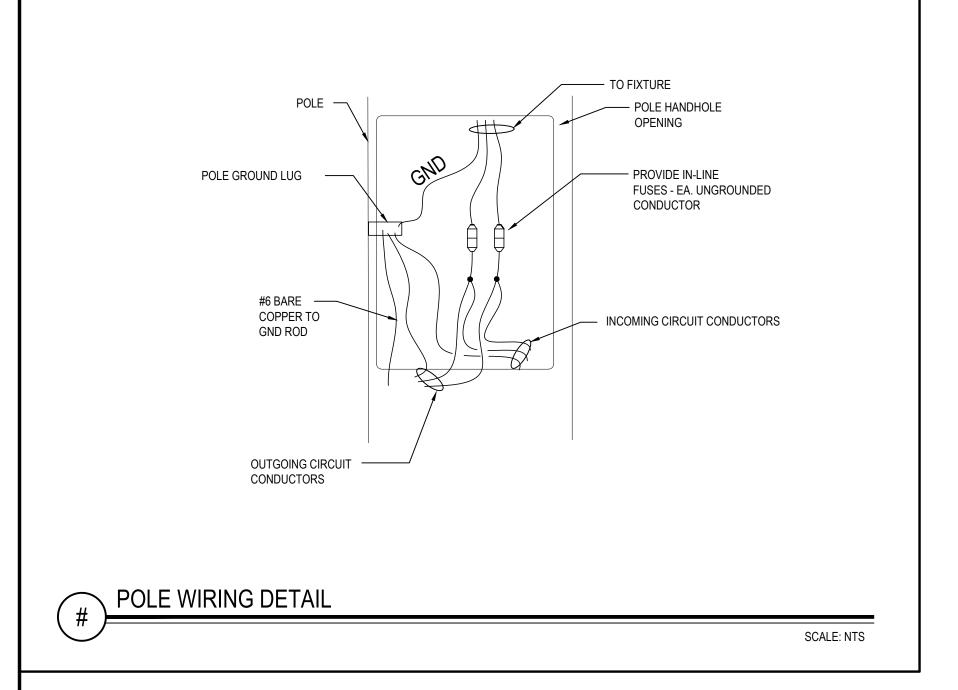

SITE WORK NOTES

SCALE: N.T.S.

- ALL MATERIALS AND METHODS OF CONSTRUCTION SHALL CONFORM TO THE STANDARDS AND SPECIFICATIONS OF THE TOWN, DEPARTMENT OF HEALTH SERVICES AND THE DEPARTMENT OF PUBLIC
- WORK WITH THE APPROPRIATE UTILITY COMPANY WHERE APPLICABLE.
- PRIOR TO THE COMMENCEMENT OF WORK, THE CONTRACTOR SHALL OBTAIN ALL PERMITS NECESSARY AND PAY ALL FEE'S FOR INSTALLATION OF THE WORK. ALL WORK SHALL BE PERFORMED IN ACCORDANCE WITH THE LATEST EDITION OF THE NEC, APPLICABLE LOCAL CODES, AND THE ENGINEER'S
- MARKER TAPE 18" ABOVE CONDUIT.
- 3. IF THE EXISTING UNDERGROUND WIRING CANNOT BE REMOVED, IT SHALL BE CADWELDED TO A GROUND ROD AT EACH END, THEN ABANDONED IN PLACE. PROVIDE GROUND RODS, 5/8"X8"L COPPER CLAD AS NECESSARY
- . ELECTRICAL CONSTRUCTION CONTRACTOR IS RESPONSIBLE TO SAFE OFF AND DISCONNECT EXISTING POWER SUPPLY TO ALL PARKING AREA LOT POLES SCHEDULED FOR DEMOLITION. GENERAL CONTRACTOR SHALL REMOVE POLES, CONCRETE BASES AND ASSOCIATED CONDUIT AND WIRE
- 5. GC TO REPAVE PARKING LOT AND IS RESPONSIBLE FOR FINAL PAVING.

- 9. ELECTRICAL CONTRACTOR SHALL DISCONNECT, REMOVE AND STORE EXISTING POLES. RE-INSTALL THE POLES AS NOTED. EC SHALL BE RESPONSIBLE FOR REMOVING EXISTING LIGHT POLE BASES AND


- THE CONTRACTOR SHALL FIELD VERIFY THE LOCATION OF ALL UTILITIES PRIOR TO COMMENCING WORK. CARE SHALL BE TAKEN NOT TO DISTURB EXISTING UTILITIES AND SERVICE CONNECTIONS (OR PORTIONS THEREOF) TO REMAIN. THE CONTRACTOR IS RESPONSIBLE FOR THE REMOVAL OF ABANDONED UTILITY SERVICE CONNECTIONS AND INSTALLATION OF NEW SERVICE CONNECTIONS AND SHALL COORDINATE
- EXISTING UTILITIES MAY EXIST IN THE WORK AREA. THESE MAY INCLUDE BUT ARE NOT LIMITED TO ELECTRIC, WATER, GAS, IRRIGATION SYSTEM, IRRIGATION MAIN, AND SANITARY. IT IS THE RESPONSIBILITY OF THE CONTRACTOR TO HAVE THE RESPECTIVE UTILITY COMPANIES AND SURVEYORS MARK ALL LOCATIONS OF UNDERGROUND UTILITIES IN THE FIELD PRIOR TO THE COMMENCEMENT OF WORK. CONTRACTOR SHALL HAND DIG TRENCH WHEN CROSSING EXISTING THE UTILITIES LINES. CONTRACTOR RESPONSIBLE FOR ANY REPAIR OR REPLACEMENT OF ANY SYSTEM DAMAGED DURING CONSTRUCTION.
- ALL DISTURBED AREAS NOT COVERED UNDER GC'S CONTRACT, TO BE TOPSOILED, FINE GRADED AND SEEDED BY EC.
- UNDERGROUND CONDUIT SHALL BE AT 36" BELOW SURFACE. INSTALL YELLOW FIBERGLASS WARNING
- THE DIVISION 16 CONTRACTOR SHALL BE RESPONSIBLE TO SAWCUT AND TRENCH ALL PAVED AREAS AS REQUIRED TO FACILITATE INSTALLATION OF WIRES AND CONDUITS. THE DIVISION 16 CONTRACTOR SHALL BE RESPONSIBLE TO BACKFILL EXCAVATION AND COMPACT TO 95% DENSITY UP TO GRADE. PATCH PAVEMENT WITH FULL DEPTH ASPHALT AND RCA BASE TO RESTORE AREAS NOT OTHERWISE BEING PAVED BY GENERAL CONTRACTOR.
- DIVISION 16 CONTRACTOR SHALL COORDINATE WORK SO THAT ALL CONDUITS TO BE RUN UNDER AREAS TO BE PAVED SHALL BE INSTALLED AFTER DEMOLITION OF ANY EXISTING PAVING AND PRIOR TO NEW PAVING. CONDUITS UNDER ROADWAYS SHALL BE SCH. 80 PVC, SIZE AS INDICATED.
- 2. ALL UNDERGROUND CONDUITS SHALL BE SCHEDULE 80 PVC UNLESS OTHERWISE NOTED.

- 16. EC TO COORDINATE WITH GC AND REFER TO CIVIL-SURVEY DRAWINGS FOR ADDITIONAL INFO.
- 7. ELECTRICAL CONTRACTOR SHALL INSTALL POLE MOUNTED FIXTURES AND BASE.
- 18. ELECTRICAL CONTRACTOR SHALL WIRE EXTERIOR POLES AS SPECIFIED ON DRAWING.

<u>NOTICE</u>	
THESE DRAWINGS ARE BASED ON CONST PREPARED BY BBS ARCHITECTS, LAND: ENGINEERS, PC. AND, THEREFORE, MA CONDITIONS AS CONSTRUCTED AT TH CONDITIONS SHOWN ARE REPRESEI INFORMATION AS THEY MAY NOT HAVE B PER THE ORIGINAL DOCUMENTS OR PER TH	SCAPE ARCHITECTS ANI Y NOT REPRESENT TH E TIME. ALL EXISTINI NTED AS SUGGESTIV EEN BUILT AND DETAILEI

SCALE: N.T.S.

REV. DATE

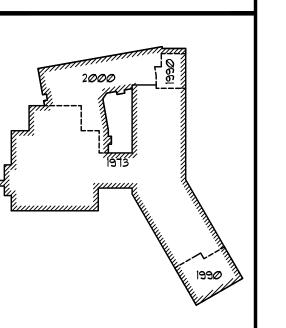


KEY PLAN NOT TO SCALE

DRAWING BY: MG CHECK BY:

THIS DRAWING, PREPARED FOR THE SPECIFIC PROJECT INDICATED IS AN INSTRUMENT OF SERVICE AND THE PROPERTY OF BBS ARCHITECTS, LANDSCAPE ARCHITECTS AND ENGINEERS, P.C. INFRINGEMENT OR ANY USE OF THIS DRAWING FOR ANY OTHER PROJECT IS PROHIBITED. ANY ALTERATION OR REPRODUCTION OF THIS DOCUMENT IS ALSO PROHIBITED WITHOUT THE WRITTEN CONSENT OF THE ARCHITECT OR ENGINEER.

> LANDSCAPE ARCHITECTS ENGINEERS 244 EAST MAIN STREET | 187 WOLF ROAD, STE. 205 PATCHOGUE

NEW YORK 11772 NEW YORK 12205 T. 631.475.0349 T. 518.621.7650 F. 631.475.0361 F. 518.621.7655 www.BBSARCHITECTURE.com

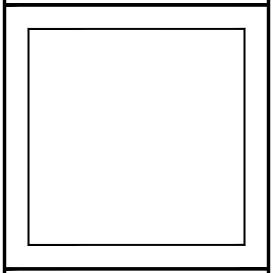


44-21-15-02-0-004-013 DISTRICT FLORIDA U.F.S.D. PROJECT BOND PHASE 2

SCALE: AS NOTED DATE: DECEMBER 1, 2020 BID PICK-UP: BID P/U DATE FILE No: 20-176A

DWG TITLE ELECTRICAL

E2.02

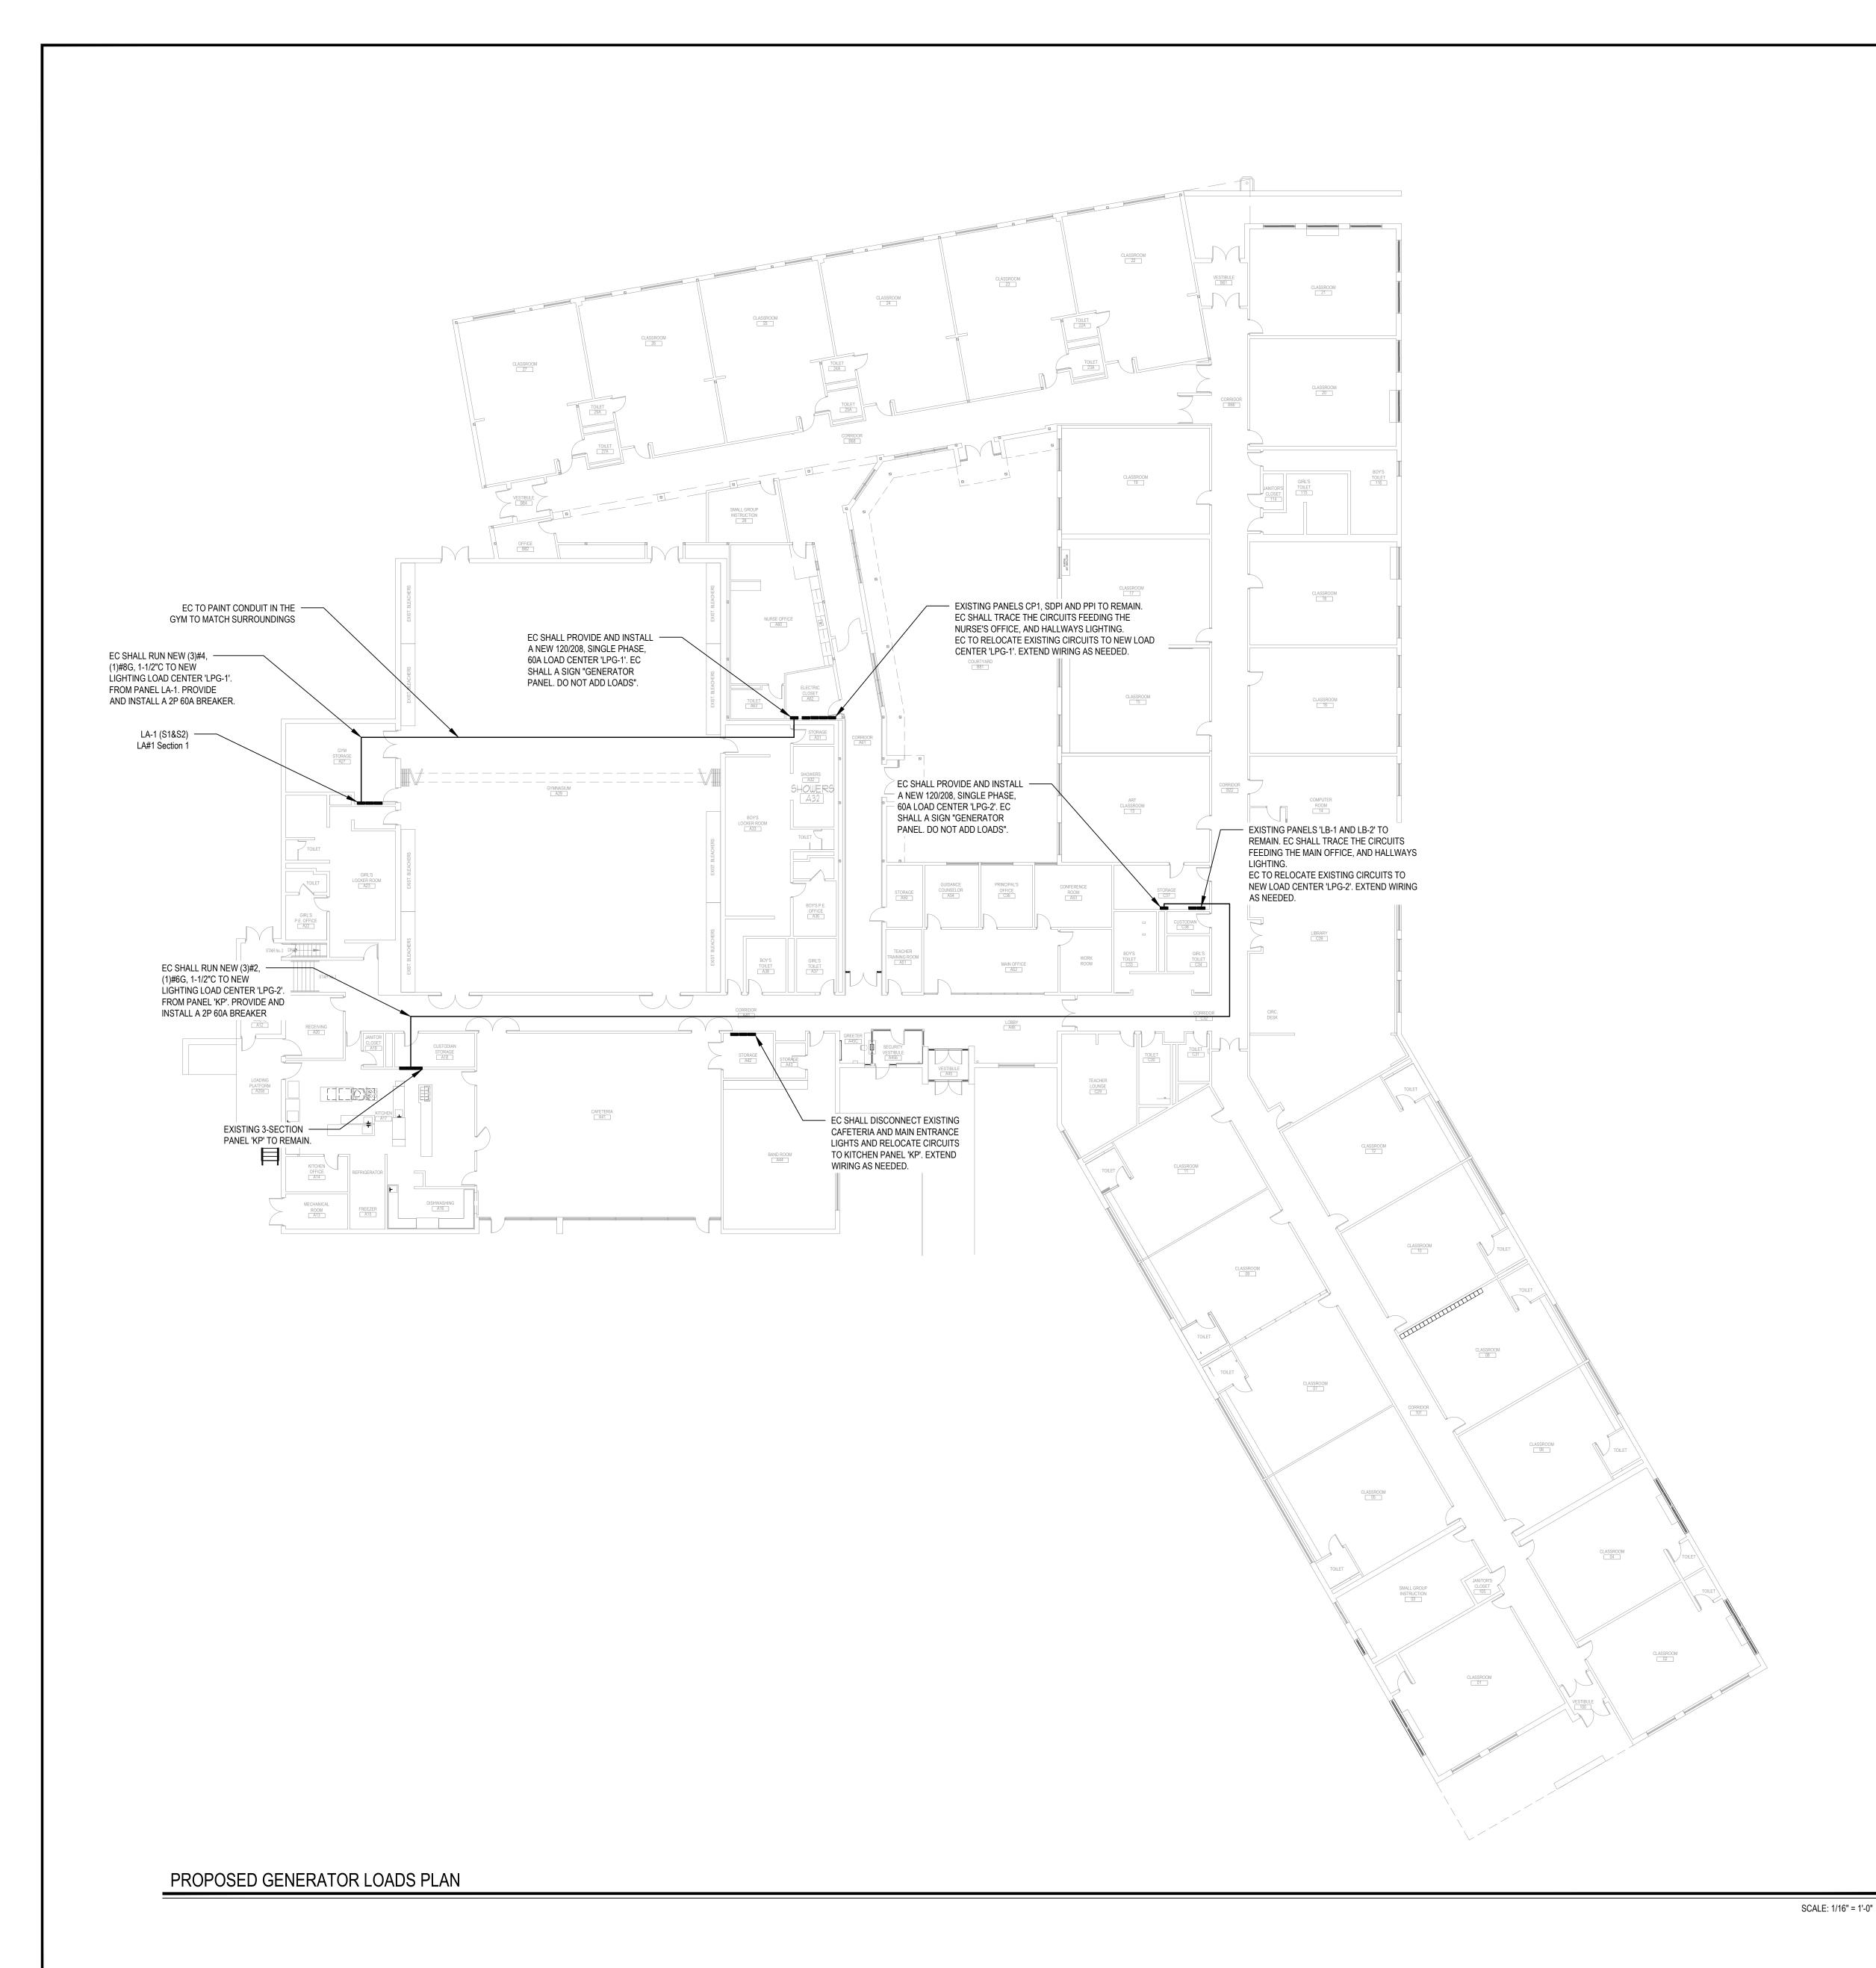

NAME: LPG-1 PANEL BOARD ELECTRICAL ROOM TYPE: ______ BRANCH BREAKER TYPE: BOLTON NO. OF POLES: BUS SIZE (A): <u>60A</u> MIN AIC RATING (KA): 22K MAIN CIRCUIT BREAKER: MLO MOUNTING: SURFACE ENCL. TYPE: NEMA 1 DOOR REQ'D: DOOR-IN-DOOR ACCESSORIES: SURGE PROTECTIVE DEVICE (SPD): \square SPD RATING(KA): $\underline{\mathsf{N/A}}$ SUB-FEED LUGS: \square FEED-THRU LUGS: \square SHUNT TRIP MAIN: \square SDLATED GROUND: \square DESIGNATION DESIGNATION 20A | 12 | MAIN OFFICE LIGHTING 1 NURSE'S ROOM A60 LIGHTING 3 CORRIDOR A61, A64 LIGHTING 20A | 12 | CORRIDOR B68 LIGHTING 20A | 12 | CORRIDOR B82, B66 LIGHTING

	PANEL BOA	ARD	NAME: _	LP(G-2			L	OCATION:	ELECTRICAL ROC	DM
TYPE	: BRANC	CH BREAKER TYPE:	BOLTO	<u> </u>		NO. OF PO	DLES:		6	BUS SIZE (A): <u>60</u> A	<u> </u>
N	MIN AIC RATING (KA):	22K	NEUTRA	L:	100A	MAI	N CIRCU	JIT BRE	AKER: <u>M</u>	LO	
MAII	N LUGS:			VOLTS:	120/208		PHA	ASE: _	<u>1P</u>	# WIRES:#2	
	MOUNT	CLIDEA	\cap E		. T.O.	$NI \perp NI \wedge 1$			00 DE0ID		
ACC		ING: <u>SURFA</u> PROTECTIVE DEVICE TRIP MAIN:		_	L. TYPE: _ TING(KA): _ <i>N/A</i>		-FEED L	.ugs: [_	DOOR-IN-DOOR IRU LUGS: D GROUND:	
ACC CKT. #	CESSORIES: SURGE SHUNT	PROTECTIVE DEVICE	(SPD):	SPD RAT	· · · · - · - · - · - · - ·	A SUB		.ugs: [FEED-TH	IRU LUGS:	CK ⁻ #
CKT.	CESSORIES: SURGE SHUNT	PROTECTIVE DEVICE	(SPD):	SPD RAT	TING(KA): N/A	A SUB ASC	O SWITE	.UGS: [CH: [WIRE	FEED-TH	RU LUGS: D GROUND: DESIGNATION	CK ^T #
CKT.	CESSORIES: SURGE SHUNT DESIGI	PROTECTIVE DEVICE TRIP MAIN:	(SPD): Size	CKT. BRKR.	TING(KA): N/A	A SUB ASC	CKT. BRKR.	.UGS: [CH: [WIRE SIZE	FEED-TH ISOLATE	RU LUGS: D GROUND: DESIGNATION	#

REV. DATE

<u>NOTICE</u> THESE DRAWINGS ARE BASED ON CONSTRUCTION DRAWINGS NOT PREPARED BY BBS ARCHITECTS, LANDSCAPE ARCHITECTS AND ENGINEERS, PC. AND, THEREFORE, MAY NOT REPRESENT THE CONDITIONS AS CONSTRUCTED AT THE TIME. ALL EXISTING CONDITIONS SHOWN ARE REPRESENTED AS SUGGESTIVE INFORMATION AS THEY MAY NOT HAVE BEEN BUILT AND DETAILED PER THE ORIGINAL DOCUMENTS OR PER THE OWNER'S INFORMATION.

KEY PLAN NOT TO SCALE

THIS DRAWING, PREPARED FOR THE SPECIFIC PROJECT INDICATED IS AN INSTRUMENT OF SERVICE AND THE PROPERTY OF BBS ARCHITECTS, LANDSCAPE ARCHITECTS AND ENGINEERS, PC. INFRINGEMENT OR ANY USE OF THIS DRAWING FOR ANY OTHER PROJECT IS PROHIBITED. ANY ALTERATION OR REPRODUCTION OF THIS DOCUMENT IS ALSO PROHIBITED WITHOUT THE WRITTEN CONSENT OF THE ARCHITECT OR ENGINEER.

MG

DRAWING BY:


CHECK BY:

LANDSCAPE ARCHITECTS ENGINEERS 244 EAST MAIN STREET | 187 WOLF ROAD, STE. 209 PATCHOGUE | ALBANY

NEW YORK 11772 T. 631.475.0349 F. 631.475.0361

NEW YORK 12205 T. 518.621.7650

F. 518.621.7655

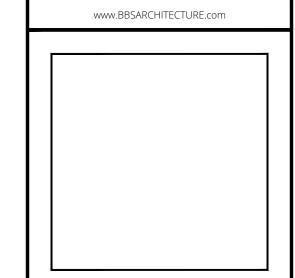

44-21-15-02-0-004-013 DISTRICT FLORIDA U.F.S.D. GOLDEN HILL E.S.

PROJECT BOND PHASE 2

DWG TITLE ELECTRICAL PROPOSED GENERATOR LOADS SCALE: AS NOTED

DATE: DECEMBER 1, 2020 BID PICK-UP: BID P/U DATE FILE No: 20-176A

E4.01

RIM 444.02 N 76°48'09" E — INV. 438.02 W -130.00**'** (40' WIDE) CONCRETE CURB INV. 440.72 RIM 441.66 INV. 436.12 N INV. 435.53 E INV. 435.45 W 5' CHAIN LINK FENCE GRATE 442.24 INV. 440.26 N/ UTILITY POST (TYP.) — A PARKING LINES (TYP.) 5' CHAIN LINK FENCE GRASS N/F WALDEN SAVINGS BANK SÉCTION 105, BLOCK 2, LOT 1 1 STORY BOOK 12975, PAGE 126 \ GARAGE S 13'19'54" E 276.51' N 13°19'51" W ASPHALT 280.50'-- N/F MARY KELDER 445.38× SÉCTION 105, BLOCK 2, LOT 2.2 BOOK 3500, PAGE 223 #5 ×446.0 NO VISIBLE INVERTS N/F JANETTA MONTUORI, TRUSTEE SECTION 105, BLOCK 2, LOT 2.1 1 STORY BOOK 14263, PAGE 1698 HOUSE - PARKING LINES (TYP.) CONCRETE WALK ×451.44 MASONRY SHED -- 6' CHAIN LINK FENCE 5' CHAIN LINK FENCE -**ASPHALT** METAL SHED -N 74°58'09" E GRASS 100.50'-N/F ORTHODOX CHURCH ST. IGNATIUS ANTIOCHIAN SECTION 105, BLOCK 2, LOT 30 BOOK 13260, PAGE 1584 N 13°38'49" W GARAGE 72.79**'**– ×455.2 ¹⁰PARKING LINES (TYP.) PAD (TYP.) GRASS N/F MEZZETTI R E LLC SECTION 105, BLOCK 2, LOT 28 BOOK 5100, PAGE 114 N 76'11'09" E LINK FENCE 161.52'-MULCH 2½ STORY MASONRY BUILDING — RIM 449.38 INV. 446.03 N INV W NOT VISABLE 1 STORY MASONRY BUILDING N/F UNION FREE SCHOOL DISTRICT 15 SECTION 105, BLOCK 2, LOT 26.2 BOOK 1501, PAGE 329 CONCRETE MASONRY WALL - CONCRETE STEPS ___ MULCH RIM 443.35 CN 1NV. 436.52 EN MASONRY WALL CONCRETE RAMP MONUMENT CONCRETE PAD (TYP.) STONE CROSSWALK N 12.53'56" W 121.49'-- CONCRETE STEPS ' CHAIN LINK FENCE 1 STORY MASONRY BUILDING — CONCRETE [∞] S 75°30'57" W CONCRETE PLANTER LOADING DOCK\\ - GRASS المنابع المنا <u>~253.47'</u> SIGN -_101.60' N/F VILLAGE OF FLORIDA SECTION 105, BLOCK 2, LOT 24 BOOK 13000, PAGE 140 TRANSFORMER ON CONCRETE PAD GENERATOR ON CONCRETE PAD - BENCH (TYP.) CONCRETE STEPS - MONUMENT - PAVERS MONUMENT N/F ANDREW ANTINORI SÉCTION 105, BLOCK 2, LOT 25 BOOK 4720, PAGE 88 UNAUTHORIZED ALTERATION OR ADDITIONS TO A Revision Approved DOCUMENT BEARING THE SEAL OF A LICENSED PROFESSIONAL ENGINEER OR LAND SURVEYOR IS A

0 08/19/20 ISSUED

VIOLATION OF SECTION 7209 SUBSECTION 2 OF THE

COPIES OF THIS DOCUMENT WITHOUT A FACSIMILE

THE PROFESSIONAL ENGINEER OR LAND SURVEYOR

ORIGINAL SIZE IN INCHES

OF THE SIGNATURE AND AN ORIGINAL EMBOSSED SEAL OR ORIGINAL STAMP IN BLUE OR RED INK OF

NEW YORK STATE EDUCATION LAW.

THIS DOCUMENT IS PREPARED SPECIFICALLY FOR THE SHALL NOT BE CONSIDERED VALID COPIES.

CLIENT AND PROJECT DESIGNATED HEREON.

OR USE WITHOUT THE CONSENT OF TECTONIC


MODIFICATION, ALTERATION, REVISION, DUPLICATION,

ENGINEERING, PC IS PROHIBITED. COPYRIGHT 2020

ECTONIC ENGINEERING, PC. ALL RIGHTS RESERVED.

GENERAL NOTES

- 1. THIS PLAN IS BASED ON A FIELD SURVEY BY TECTONIC ENGINEERING CONSULTANTS, GEOLOGISTS & LAND SURVEYORS, D.P.C. COMPLETED ON 08/21/2020.
- 2. VERTICAL DATUM: NORTH AMERICAN VERTICAL DATUM 1988.
- 3. MERIDIAN AND COORDINATES REFER TO NEW YORK STATE PLANE, NAD 83, NEW YORK EAST ZONE AND ARE BASED ON GPS OBSERVATIONS.
- 4. ANGLES OR BEARINGS SHOWN HEREON ARE FORMATTED IN DEGREES, MINUTES, AND SECONDS. DISTANCES OR ELEVATIONS SHOWN HEREON ARE IN U.S. SURVEY FEET, UNLESS NOTED OTHERWISE.
- REFERENCES:
 - (A) DEED: BOOK 1501, PAGE 329.
 - (B) MAP ENTITLED: "A MAP OF LOTS IN THE VILLAGE OF FLORIDA, NY" AS FILED IN THE ORANGE COUNTY CLERK'S OFFICE ON 01/31/1924 AS
 - (C) MAP ENTITLED: "LOT LINE ADJUSTMENT FOR LANDS OF DIANE B. KLEVENO"" AS FILED IN THE ORANGE COUNTY CLERK'S OFFICE ON 07/21/1999 AS MAP #173-99.
- 6. THIS SURVEY IS SUBJECT TO A COMPLETE AND UP TO DATE ABSTRACT OF TITLE. COVENANTS, EASEMENTS, GRANTS AND RIGHTS-OF-WAY NOT VISIBLE AND NOT REFERENCED ARE NOT SHOWN. TECTONIC ENGINEERING CONSULTANTS, GEOLOGISTS & LAND SURVEYORS, D.P.C. SHALL NOT BE LIABLE FOR THE DISTURBANCE TO ANYONE'S RIGHT TO THE USE OF THE PROPERTY OR THE DISTURBANCE OF ANY UTILITIES NOT SHOWN OR REFERENCED ON THIS SURVEY
- 7. LOCATIONS OF ALL UTILITIES AND SUBSTRUCTURES ARE APPROXIMATE ONLY BASED ON SURFACE EVIDENCE AND EXISTING PLANS. THE INFORMATION GIVEN ON THE SURVEY PERTAINING TO UTILITIES AND SUBSTRUCTURES IS NOT CERTIFIED TO ACCURACY OR COMPLETENESS. CONSULT WITH THE APPROPRIATE COMPANY OR AGENCY BEFORE DESIGNING OR CONSTRUCTING IMPROVEMENTS. TECTONIC ENGINEERING CONSULTANTS, GEOLOGISTS & LAND SURVEYORS, D.P.C. WILL NOT BE RESPONSIBLE FOR ANY DAMAGE SUBSEQUENTLY CAUSED TO PERSONNEL, STRUCTURES, OR UTILITIES.
- 8. THIS SURVEY PLAT IS FOR SITE PLAN/ENGINEERING PURPOSES ONLY AND IS NOT INTENDED TO BE USED FOR THE TRANSFER OF TITLE.
- 9. THE SUBJECT PROPERTY FALLS WITHIN FLOOD ZONE "X" AS PER THE NATIONAL FLOOD INSURANCE RATE MAP FOR THE VILLAGE OF FLORIDA, ORANGE COUNTY, STATE OF NEW YORK, COMMUNITY PANEL NO # 36071C0453E, EFFECTIVE DATE OF 08/03/2009. THIS DETERMINATION IS BASED ON SCALED MAP LOCATION AND GRAPHIC PLOTTING.
- 10. UNDERGROUND UTILITY LOCATION BASED ON MARKOUT BY SOFT DIG UNDERGROUND SERVICES INC. ON 07/23/2020.

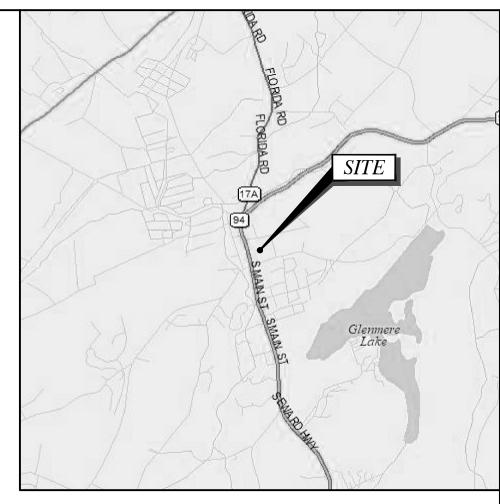

LOCATION MAP

SCALE: 1" = 2000'

LEGEND

ADJOINING PROPERTY LINE INDEX CONTOUR LINE CONTOUR LINE CHAIN LINK FENCE CURB LINE EDGE OF CONCRETE EDGE OF PAVEMENT PAINTED TRAFFIC LINES ELECTRIC (UNDERGROUND) G GAS (UNDERGROUND) S SANITARY SEWER T TELEPHONE (UNDERGROUND) WATER (UNDERGROUND) STRUCTURE BOTTOM/TOP OF CURB ELEVATION FOLIAN 12 ADDITION/TOP OF WALL ELEVATION BOTTOM/TOP OF WALL ELEVATION FOLIAN 12 ADDITION/TOP OF WALL ELEVATION MONUMENT FOUND IRON ROD FOUND IRON ROD FOUND IRON ROD FOUND C GATEPOST GUY ANCHOR C GATEPOST GUY ANCHOR C GAS VALVE MANHOLE (SAN. SEWER) MANHOLE (SAN. SEWER) MANHOLE (DRAIN) GAS VALVE WATER VALVE HYDRANT SIGN GAS VALVE HYDRANT SIGN SIGN (LARGE) C MANHOLE (LECTRIC METER GM GAS METER WM WATER METER HANDICAP		PROPERTY LINE
CONTOUR LINE CHAIN LINK FENCE CURB LINE EDGE OF CONCRETE EDGE OF PAVEMENT PAINTED TRAFFIC LINES ELECTRIC (UNDERGROUND) GAS (UNDERGROUND) SANITARY SEWER T TELEPHONE (UNDERGROUND) WATER (UNDERGROUND) STRUCTURE **PC123.12** BOTTOM/TOP OF CURB ELEVATION STRUCTURE **PC123.12** BOTTOM/TOP OF WALL ELEVATION DS12**.12** DOOR SILL ELEVATION FF12**.12** FINISHED FLOOR ELEVATION MONUMENT FOUND MONUMENT FOUND FOR GATEPOST GUY ANCHOR UTILITY POLE CURB INLET BETTOM TOP OF CURB ELEVATION TO GATEPOST COMMANDALE (SAN. SEWER) MANHOLE (SAN. SEWER) MANHOLE (SAN. SEWER) MANHOLE (DRAIN) GAS VALVE WATER METER MANIBOX EM GAS METER MANIBOX EM GAS METER MANER METER WATER METER		ADJOINING PROPERTY LINE
CHAIN LINK FENCE CURB LINE EDGE OF CONCRETE EDGE OF PAVEMENT PAINTED TRAFFIC LINES ELECTRIC (UNDERGROUND) GAS (UNDERGROUND) SANITARY SEWER T TELEPHONE (UNDERGROUND) WATER (UNDERGROUND) STRUCTURE ***PN123.12** **PN123.12** ***PN123.12** ***PN123.12** **PN123.12** ***PN123.12** ***PN123.12** **PN123.12** ***PN123.12** ***PN123.		INDEX CONTOUR LINE
CURB LINE EDGE OF CONCRETE EDGE OF PAVEMENT PAINTED TRAFFIC LINES ELECTRIC (UNDERGROUND) GAS (UNDERGROUND) SANITARY SEWER T TELEPHONE (UNDERGROUND) WATER (UNDERGROUND) STRUCTURE ** F0123-12** ** BOTTOM/TOP OF CURB ELEVATION STRUCTURE ** F0123-12** ** BOTTOM/TOP OF WALL ELEVATION DS123-12** ** DOOR SILL ELEVATION FF123-12** ** FINISHED FLOOR ELEVATION ** HON NONUMENT FOUND ** HON ROD FOUND ** BOLLARD O GATEPOST O— GUY ANCHOR UTILITY POLE CURB INLET #* FIELD INLET (SQUARE) ** MANHOLE (ELECTRIC) SMANHOLE (SAN. SEWER) MANHOLE (DRAIN) ** GAS VALVE WATER VALVE HYDRANT D— SIGN GMB MAILBOX EM GAS METER WAMMER MAILBOX EM GAS METER WATER METER		CONTOUR LINE
EDGE OF CONCRETE EDGE OF PAVEMENT PAINTED TRAFFIC LINES ELECTRIC (UNDERGROUND) S SANITARY SEWER T TELPHONE (UNDERGROUND) WATER (UNDERGROUND) STRUCTURE **C123.12** BOTTOM/TOP OF CURB ELEVATION DS123.12** DOOR SILL ELEVATION **SPOT ELEVATION **INSHED FLOOR ELEVATION **MONUMENT FOUND **OGATEPOST OGATEPOST GUY ANCHOR UTILITY POLE CURB INLET #*IFICATION **MANHOLE (ELECTRIC) **MANHOLE (SAN. SEWER) MANHOLE (DRAIN) OGAS VALVE WATER VALVE WATER VALVE WATER VALVE WATER VALVE HYDRANT SIGN OMANHOLE (MARGE) LIGHT POST MALECTRIC METER MALEOX EM GAS METER MALEOX MALECTRIC METER GAS METER WATER METER	xxx	CHAIN LINK FENCE
EDGE OF PAVEMENT PAINTED TRAFFIC LINES ELECTRIC (UNDERGROUND) GAS (UNDERGROUND) S SANITARY SEWER T TELEPHONE (UNDERGROUND) WATER (UNDERGROUND) STRUCTURE STRUCTURE STRUCTURE STRUCTURE BOTTOM/TOP OF CURB ELEVATION STRUCTURE BOTTOM/TOP OF WALL ELEVATION DS123.12 DOOR SILL ELEVATION FF123.12 F		CURB LINE
PAINTED TRAFFIC LINES E ELECTRIC (UNDERGROUND) GAS (UNDERGROUND) S SANITARY SEWER T TELEPHONE (UNDERGROUND) W WATER (UNDERGROUND) STRUCTURE *BC123.12 **RW123.12 **DOTOM/TOP OF CURB ELEVATION **SPOT ELEVATION **DOT ELEVATION **DOT ELEVATION **DOT ELEVATION **MONUMENT FOUND **MONUMENT FOUND **MONUMENT FOUND **OGATEPOST OGATEPOST OGATEPOST OGUY ANCHOR UTILITY POLE CURB INLET E CURB INLET E MANHOLE (ELECTRIC) S MANHOLE (ENAN.) OGAS VALVE W WATER VALVE HYDRANT OGAS VALVE W WATER VALVE HYDRANT SIGN OMB MAILBOX IMB MAILBOX IMB		EDGE OF CONCRETE
E ELECTRIC (UNDERGROUND) GAS (UNDERGROUND) S SANITARY SEWER T TELEPHONE (UNDERGROUND) W WATER (UNDERGROUND) STRUCTURE * DC123.12 * DS123.12 DS123.12 DOOR SILL ELEVATION FF123.12 FF123.12 FF123.12 FF123.12 MONUMENT FOUND IRON ROD FOUND IRON ROD FOUND OGATEPOST GUY ANCHOR UTILITY POLE CURB INLET FIELD INLET (SQUARE) MANHOLE (ELECTRIC) S MANHOLE (ELECTRIC) MANHOLE (DRAIN) GAS VALVE W WATER VALVE HYDRANT GIGN SIGN (LARGE) LIGHT POST MMB MAILBOX LEM GAS METER WM WATER METER		EDGE OF PAVEMENT
G GAS (UNDERGROUND) S SANITARY SEWER T TELEPHONE (UNDERGROUND) WATER (UNDERGROUND) STRUCTURE **BC123.12** **PW123.12** **PW123.12** **DS123.12** **DOOR SILL ELEVATION **POT ELEVATION **P		PAINTED TRAFFIC LINES
S SANITARY SEWER T TELEPHONE (UNDERGROUND) WATER (UNDERGROUND) STRUCTURE **BC123.12** **PW123.12** DOOR SILL ELEVATION **F123.12** **F123.12** **FINISHED FLOOR ELEVATION **MONUMENT FOUND **MONUMENT FOUND	——— Е———	ELECTRIC (UNDERGROUND)
TELEPHONE (UNDERGROUND) WATER (UNDERGROUND) STRUCTURE **BC123.12** **BW123.12** **DS123.12** **DOOR SILL ELEVATION **DOOR SILL ELEVAT	G	GAS (UNDERGROUND)
WATER (UNDERGROUND) STRUCTURE **BC123.12** **PW123.12** **PW123.12** **DOR SILL ELEVATION **BC123.12** **PW123.12** **DOR SILL ELEVATION **PW123.12** **PW123	s	SANITARY SEWER
STRUCTURE *BC123.12 *BOTTOM/TOP OF CURB ELEVATION *BV123.12 DOS123.12 DOS123.12 DOOR SILL ELEVATION FF123.12 FINISHED FLOOR ELEVATION **BOTTOM/TOP OF WALL ELEVATION FF123.12 FINISHED FLOOR ELEVATION **BOTTOM/TOP OF WALL ELEVATION **INISHED FLOOR ELEVATION **DOOR SILL ELEVATION **BOTTOM/TOP OF WALL ELEVATION **POOR SILL ELEVATION **DOOR SILL ELEVATION **POOR SILL ELEVATION **PO	тт	TELEPHONE (UNDERGROUND)
**BC123.12	w	WATER (UNDERGROUND)
BOTTOM/TOP OF WALL ELEVATION DS123.12 DS123.12 DOOR SILL ELEVATION FF123.12 FF123.12 FINISHED FLOOR ELEVATION BOULARD FRON ROD FOUND FROM ROD FROM ROD FOUND FROM ROD FROM ROD FOUND FROM ROD FROM RO		STRUCTURE
BOTTOM/TOP OF WALL ELEVATION DS123.12 DS123.12 DOOR SILL ELEVATION FF123.12 FF123.12 FINISHED FLOOR ELEVATION BOULARD FRON ROD FOUND FROM ROD FROM ROD FOUND FROM ROD FROM ROD FOUND FROM ROD FROM RO	×BC123.12 ×TC123.12	BOTTOM/TOP OF CURB ELEVATION
DS123.12 FF123.12 FINISHED FLOOR ELEVATION 123.12 SPOT ELEVATION MONUMENT FOUND IRON ROD FOUND BOLLARD GATEPOST GUY ANCHOR UTILITY POLE CURB INLET FIELD INLET (SQUARE) MANHOLE (ELECTRIC) MANHOLE (SAN. SEWER) MANHOLE (DRAIN) GAS VALVE WY WY WATER VALVE HYDRANT SIGN SIGN GAS METER GM GAS METER GM GAS METER WATER METER		BOTTOM/TOP OF WALL ELEVATION
SPOT ELEVATION MONUMENT FOUND IRON ROD FOUND BOLLARD GATEPOST GUY ANCHOR UTILITY POLE CURB INLET FIELD INLET (SQUARE) MANHOLE (ELECTRIC) MANHOLE (SAN. SEWER) MANHOLE (DRAIN) GV GAS VALVE WATER VALVE HYDRANT SIGN SIGN (LARGE) LIGHT POST MALBOX ELECTRIC METER GAS METER GAS METER WMM WATER METER		DOOR SILL ELEVATION
MONUMENT FOUND IRON ROD FOUND BOLLARD GATEPOST GUY ANCHOR UTILITY POLE CURB INLET FIELD INLET (SQUARE) MANHOLE (ELECTRIC) MANHOLE (SAN. SEWER) MANHOLE (DRAIN) GAS VALVE WATER VALVE HYDRANT SIGN SIGN SIGN (LARGE) LIGHT POST MB MAILBOX EM ELECTRIC METER GAS METER WM WATER METER	FF123.12	FINISHED FLOOR ELEVATION
● IRON ROD FOUND ● BOLLARD O GATEPOST ○ GUY ANCHOR UTILITY POLE E CURB INLET FIELD INLET (SQUARE) MANHOLE (ELECTRIC) S MANHOLE (SAN. SEWER) O MANHOLE (DRAIN) CV GAS VALVE WY WATER VALVE HYDRANT SIGN SIGN SIGN (LARGE) LIGHT POST MB MAILBOX EM ELECTRIC METER GAS METER WM WATER METER		SPOT ELEVATION
● BOLLARD O GATEPOST GUY ANCHOR UTILITY POLE CURB INLET FIELD INLET (SQUARE) MANHOLE (ELECTRIC) MANHOLE (SAN. SEWER) D MANHOLE (DRAIN) GAS VALVE WATER VALVE HYDRANT SIGN SIGN SIGN (LARGE) LIGHT POST MAB MAILBOX EM ELECTRIC METER GAS METER WM WATER METER	±	MONUMENT FOUND
O GATEPOST GUY ANCHOR UTILITY POLE CURB INLET FIELD INLET (SQUARE) MANHOLE (ELECTRIC) MANHOLE (SAN. SEWER) MANHOLE (DRAIN) GAS VALVE WATER VALVE HYDRANT SIGN SIGN SIGN (LARGE) ↓ LIGHT POST MALBOX EM ELECTRIC METER GAS METER WM WATER METER	•	IRON ROD FOUND
GUY ANCHOR UTILITY POLE CURB INLET FIELD INLET (SQUARE) MANHOLE (ELECTRIC) MANHOLE (SAN. SEWER) MANHOLE (DRAIN) GAS VALVE WATER VALVE HYDRANT SIGN SIGN (LARGE) LIGHT POST MB MAILBOX EM ELECTRIC METER GAS METER WM WATER METER	•	BOLLARD
UTILITY POLE CURB INLET FIELD INLET (SQUARE) MANHOLE (ELECTRIC) MANHOLE (SAN. SEWER) MANHOLE (DRAIN) GAS VALVE WATER VALVE HYDRANT SIGN SIGN (LARGE) LIGHT POST MB MAILBOX EM ELECTRIC METER GAS METER WMM WATER METER	0	GATEPOST
CURB INLET FIELD INLET (SQUARE) E MANHOLE (ELECTRIC) S MANHOLE (SAN. SEWER) D MANHOLE (DRAIN) GAS VALVE WATER VALVE HYDRANT SIGN SIGN (LARGE) LIGHT POST MB MAILBOX EM ELECTRIC METER GAS METER WM WM WM WM WM WM WM WM WM W	-	GUY ANCHOR
FIELD INLET (SQUARE) E MANHOLE (ELECTRIC) S MANHOLE (SAN. SEWER) D MANHOLE (DRAIN) GV WY WATER VALVE HYDRANT SIGN SIGN SIGN (LARGE) LIGHT POST MB MAILBOX EM ELECTRIC METER GM GAS METER WM WATER METER	0	UTILITY POLE
© MANHOLE (ELECTRIC) S MANHOLE (SAN. SEWER) D MANHOLE (DRAIN) GV GAS VALVE WY WATER VALVE HYDRANT SIGN SIGN (LARGE) ↓ LIGHT POST MB MAILBOX □ EM ELECTRIC METER □ GM GAS METER WM WATER METER	===	CURB INLET
MANHOLE (SAN. SEWER) D MANHOLE (DRAIN) GV GAS VALVE WATER VALVE HYDRANT SIGN SIGN (LARGE) LIGHT POST MB MAILBOX □ MB ELECTRIC METER □ GM GAS METER □ WM WATER METER	III	FIELD INLET (SQUARE)
	E	MANHOLE (ELECTRIC)
GAS VALVE WATER VALVE HYDRANT SIGN SIGN (LARGE) LIGHT POST MB MAILBOX EM ELECTRIC METER GAS METER WM WATER METER		MANHOLE (SAN. SEWER)
HYDRANT SIGN SIGN (LARGE) LIGHT POST MB MAILBOX EM ELECTRIC METER GAS METER WM WATER METER	(D)	MANHOLE (DRAIN)
HYDRANT SIGN SIGN (LARGE) LIGHT POST MB MAILBOX EM ELECTRIC METER GAS METER WM WATER METER	GV	GAS VALVE
SIGN SIGN (LARGE) LIGHT POST MB MAILBOX EM ELECTRIC METER GM GAS METER WM WATER METER	wv N	WATER VALVE
SIGN (LARGE) LIGHT POST MB MAILBOX EM ELECTRIC METER GM GAS METER WM WATER METER	8	HYDRANT
LIGHT POST MB MAILBOX EM ELECTRIC METER GM GAS METER WM WATER METER	- 0 -	SIGN
□ MB MAILBOX □ EM ELECTRIC METER □ GM GAS METER □ WM WATER METER	- 0 0	SIGN (LARGE)
□ EM ELECTRIC METER □ GM GAS METER □ WM WATER METER	\$	LIGHT POST
GAS METER WM WATER METER	ШМВ	MAILBOX
□ WM WATER METER	□ EM	ELECTRIC METER
	GM	GAS METER
HANDICAP		WATER METER
	á í	HANDICAP

TREE LEGEND

6"	CHER
6 "	MAPL
<u> </u>	OAK
% 6"	PINE
6"	ASH
<i>ç</i> .~36"	TREE

NYSED # 44-21-15-02-0-001-015



www.tectonicengineering.com

DRAWING CONTROL


urpose

Comment

Approval


Construction


Released by

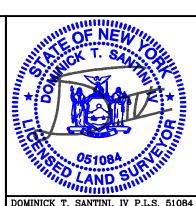



PARTIAL BOUNDARY & TOPOGRAPHIC SURVEY FLORIDA UNION SCHOOL DISTRICT SS SEWARD INSTITUTE 51 NORTH MAIN STREET, VILLAGE OF FLORIDA ORANGE COUNTY, NEW YORK


08/21/2020 10537.02 SU-101

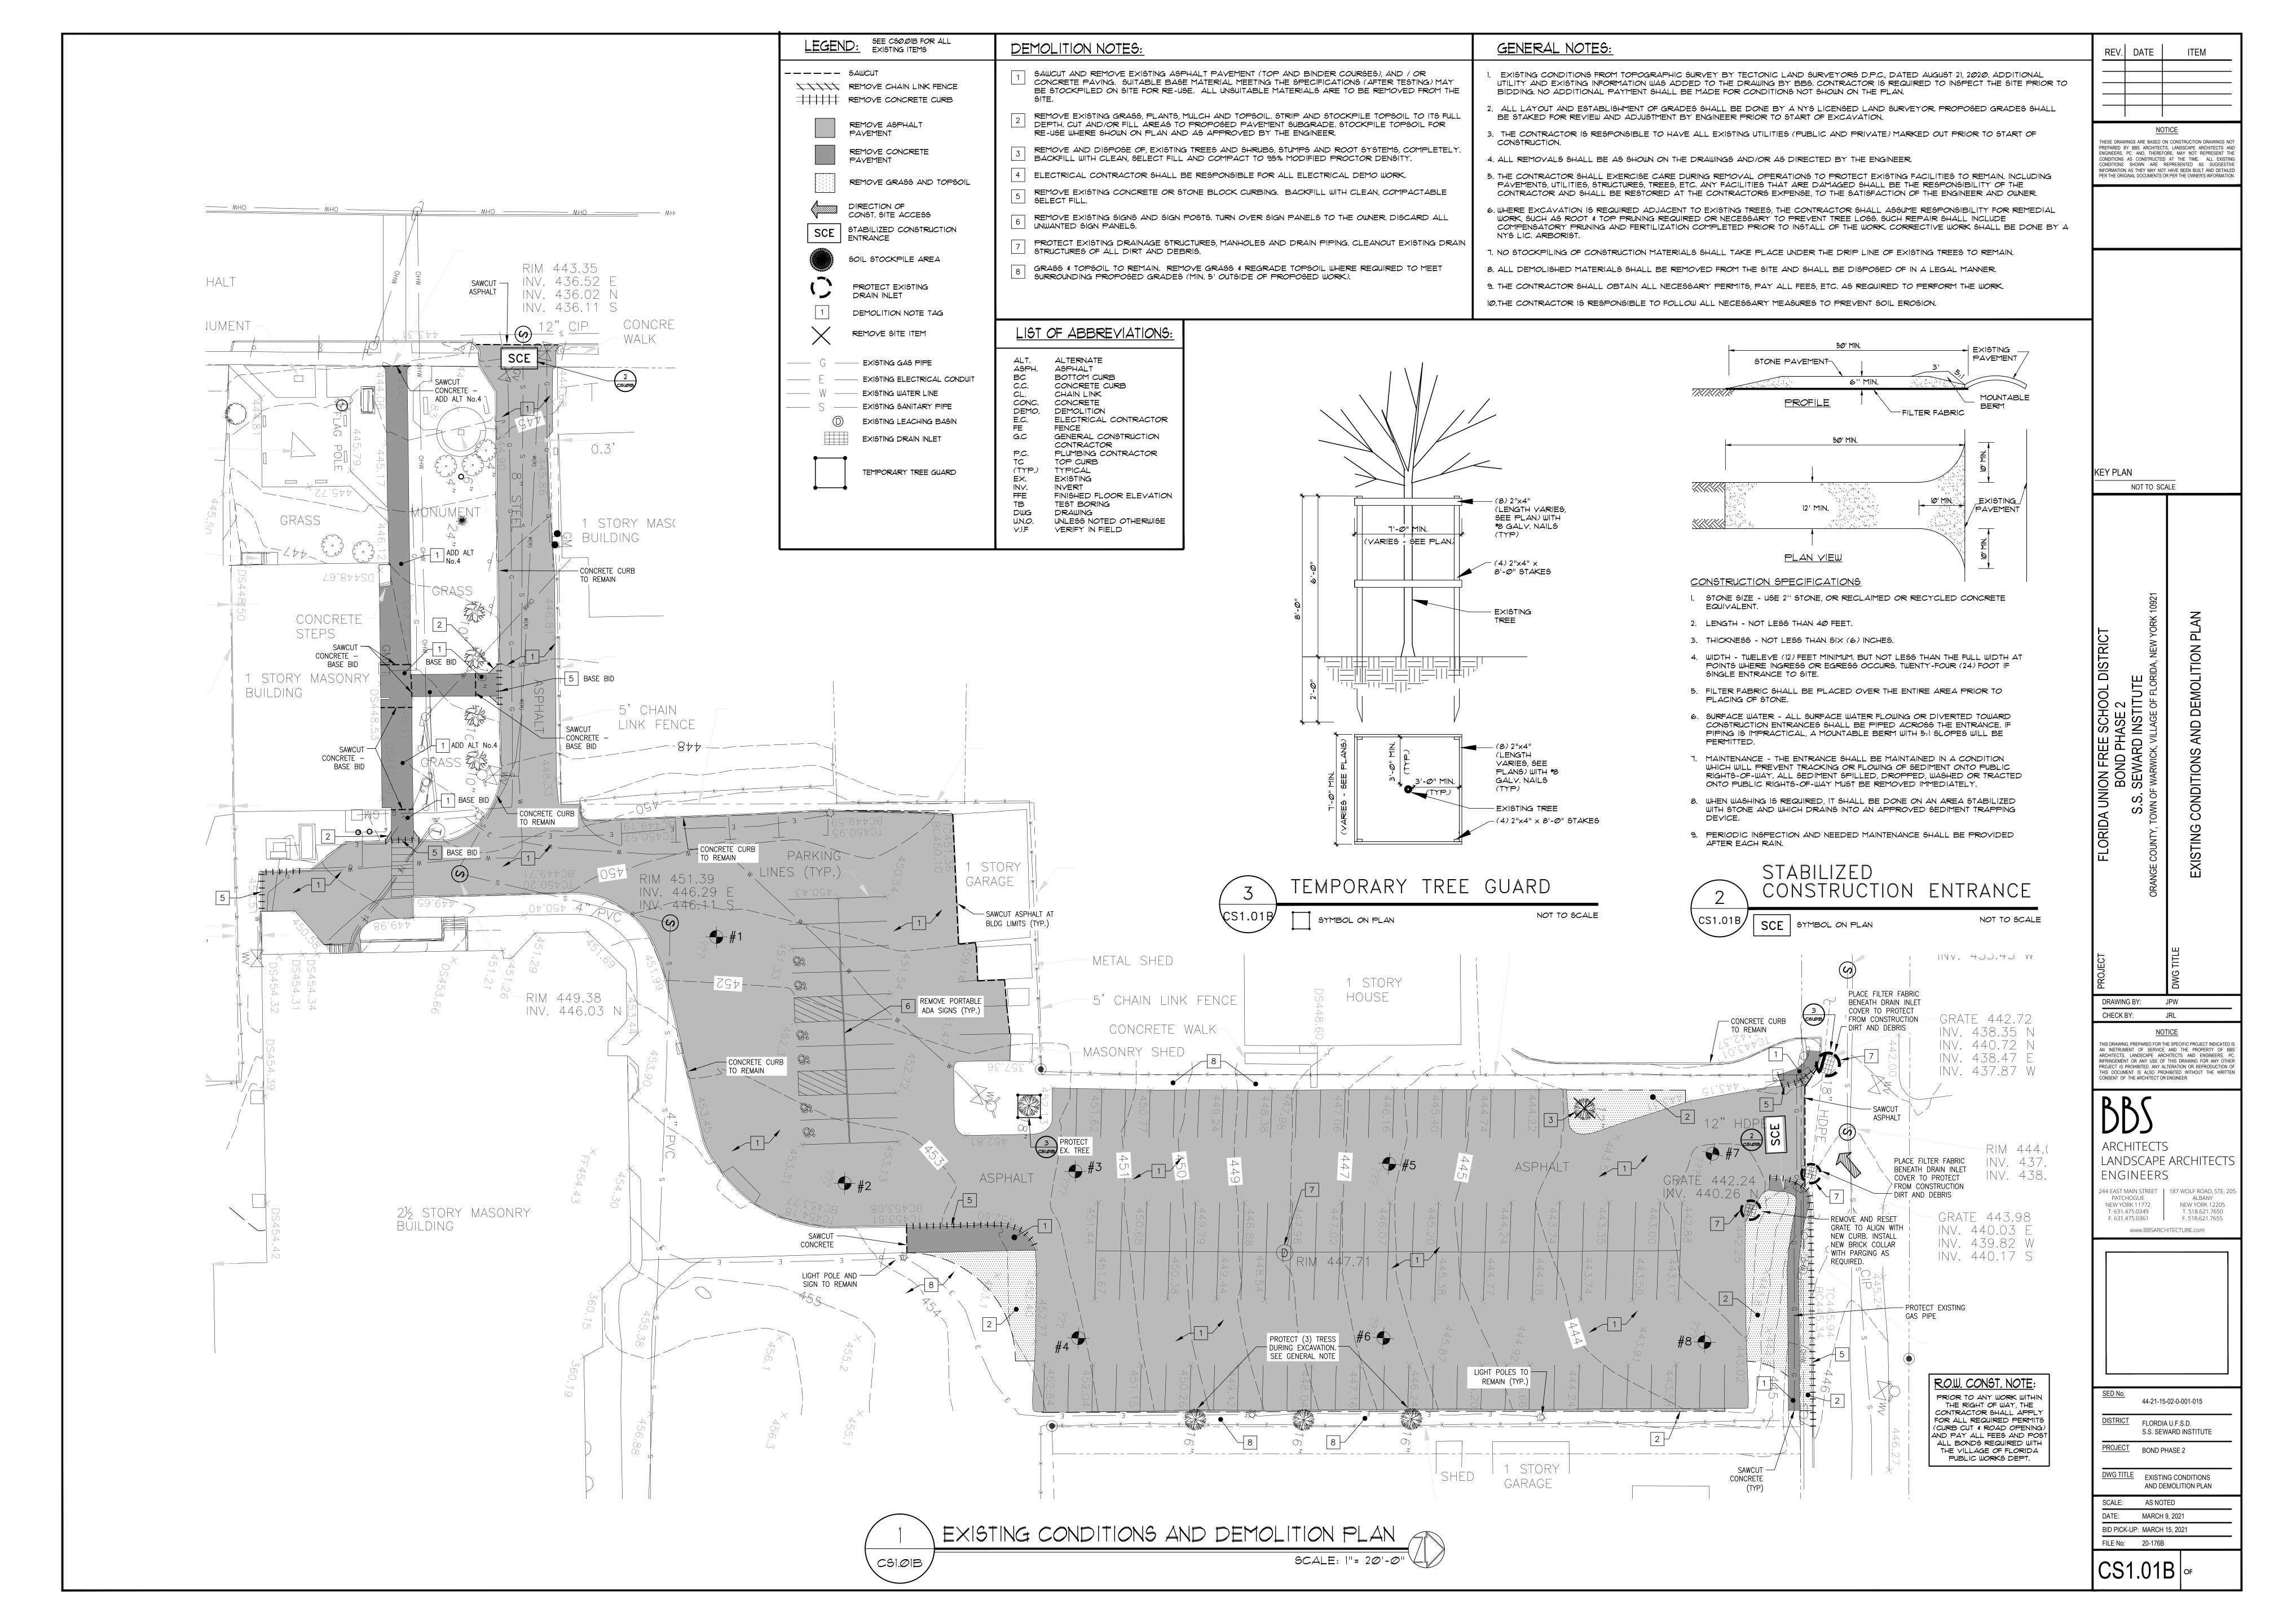

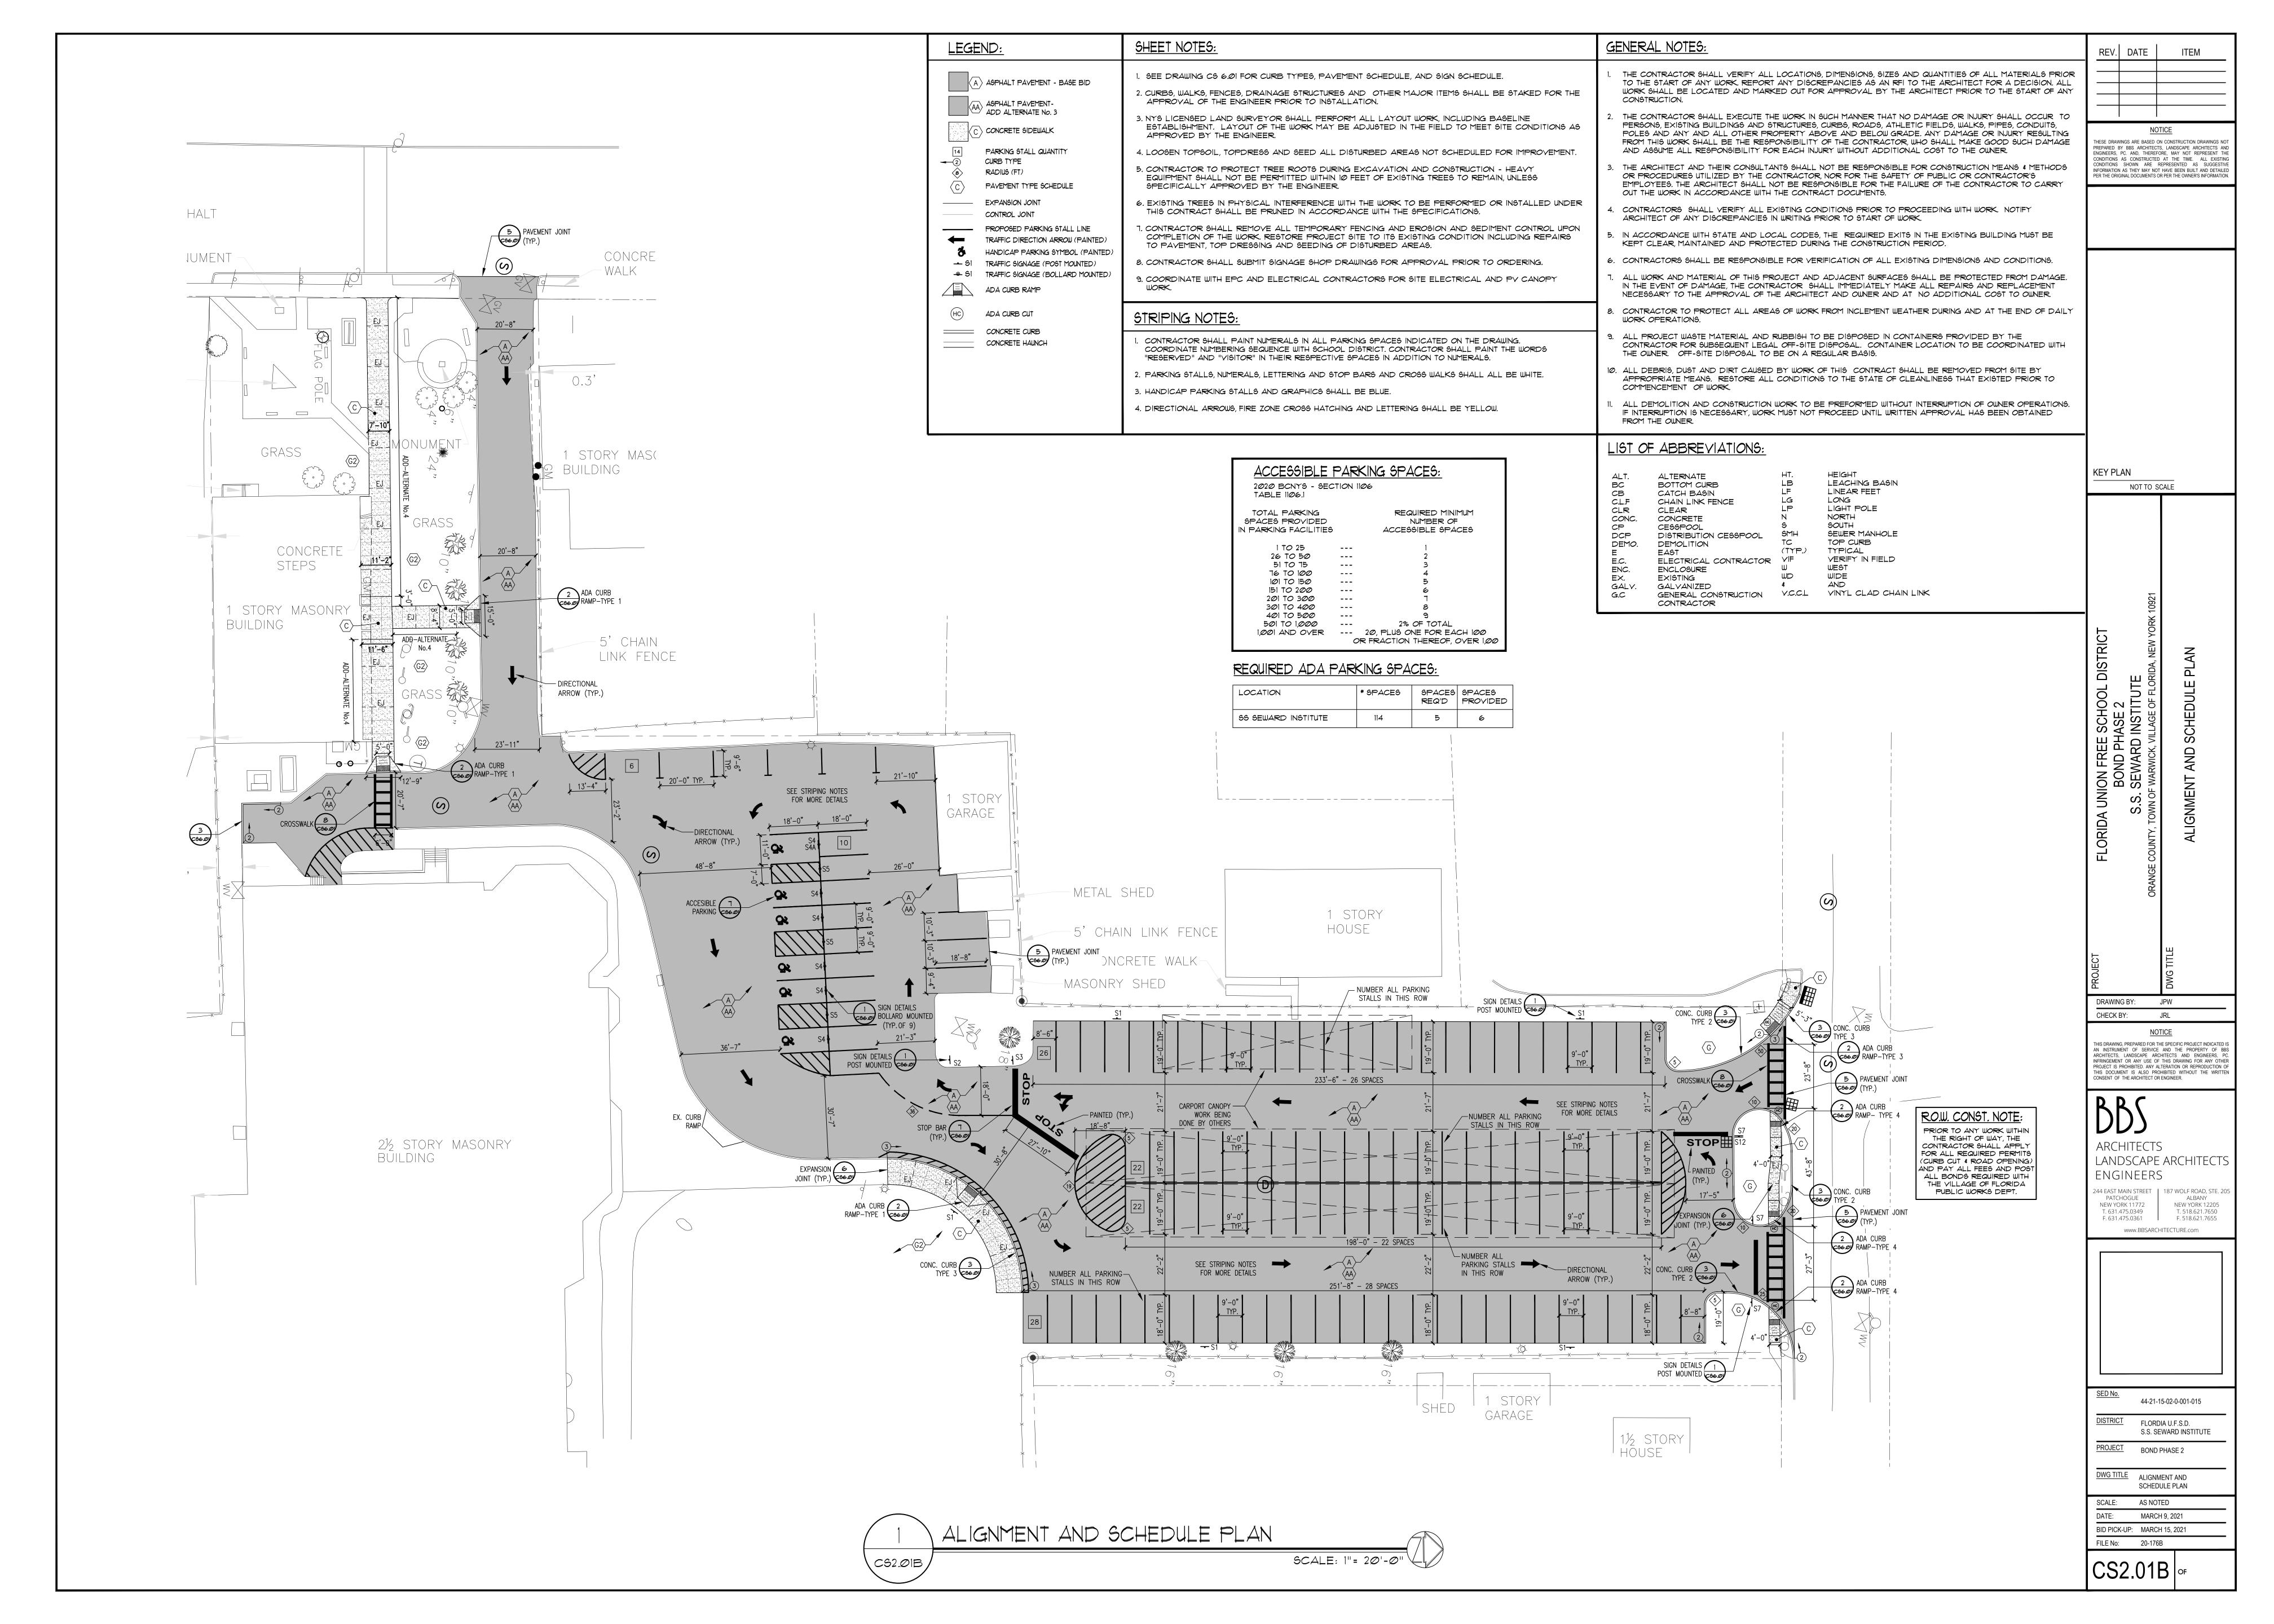

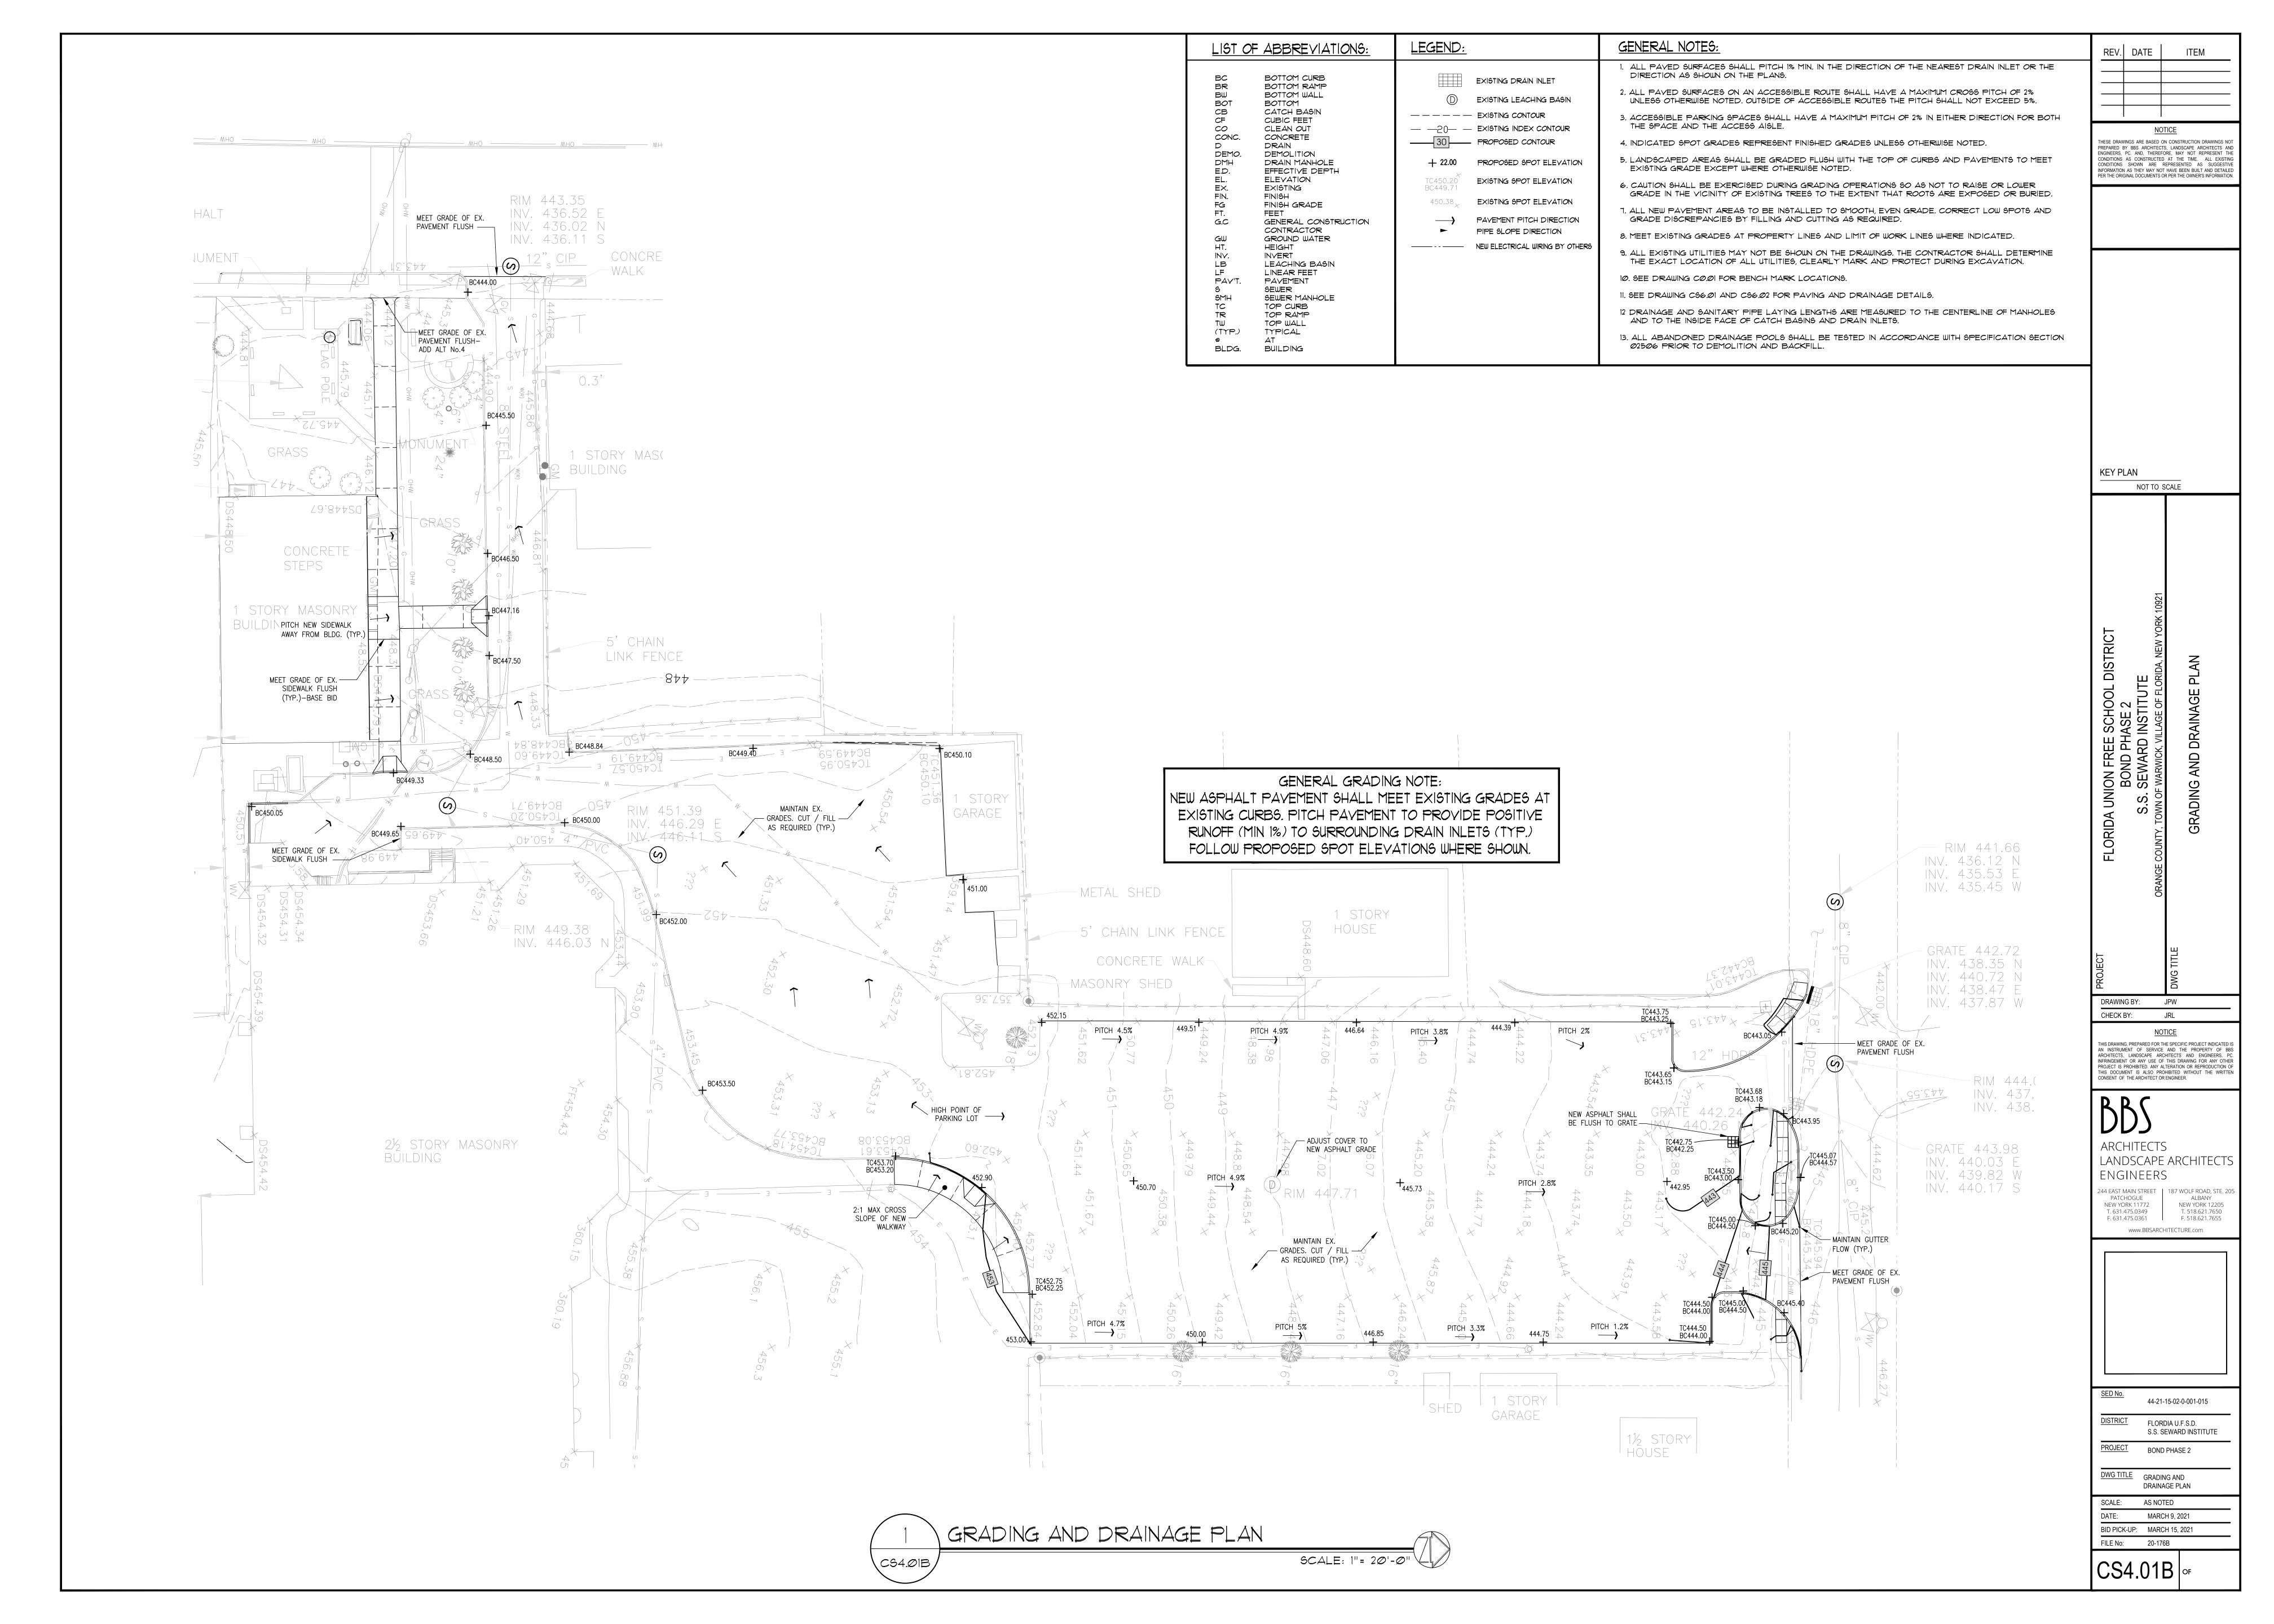


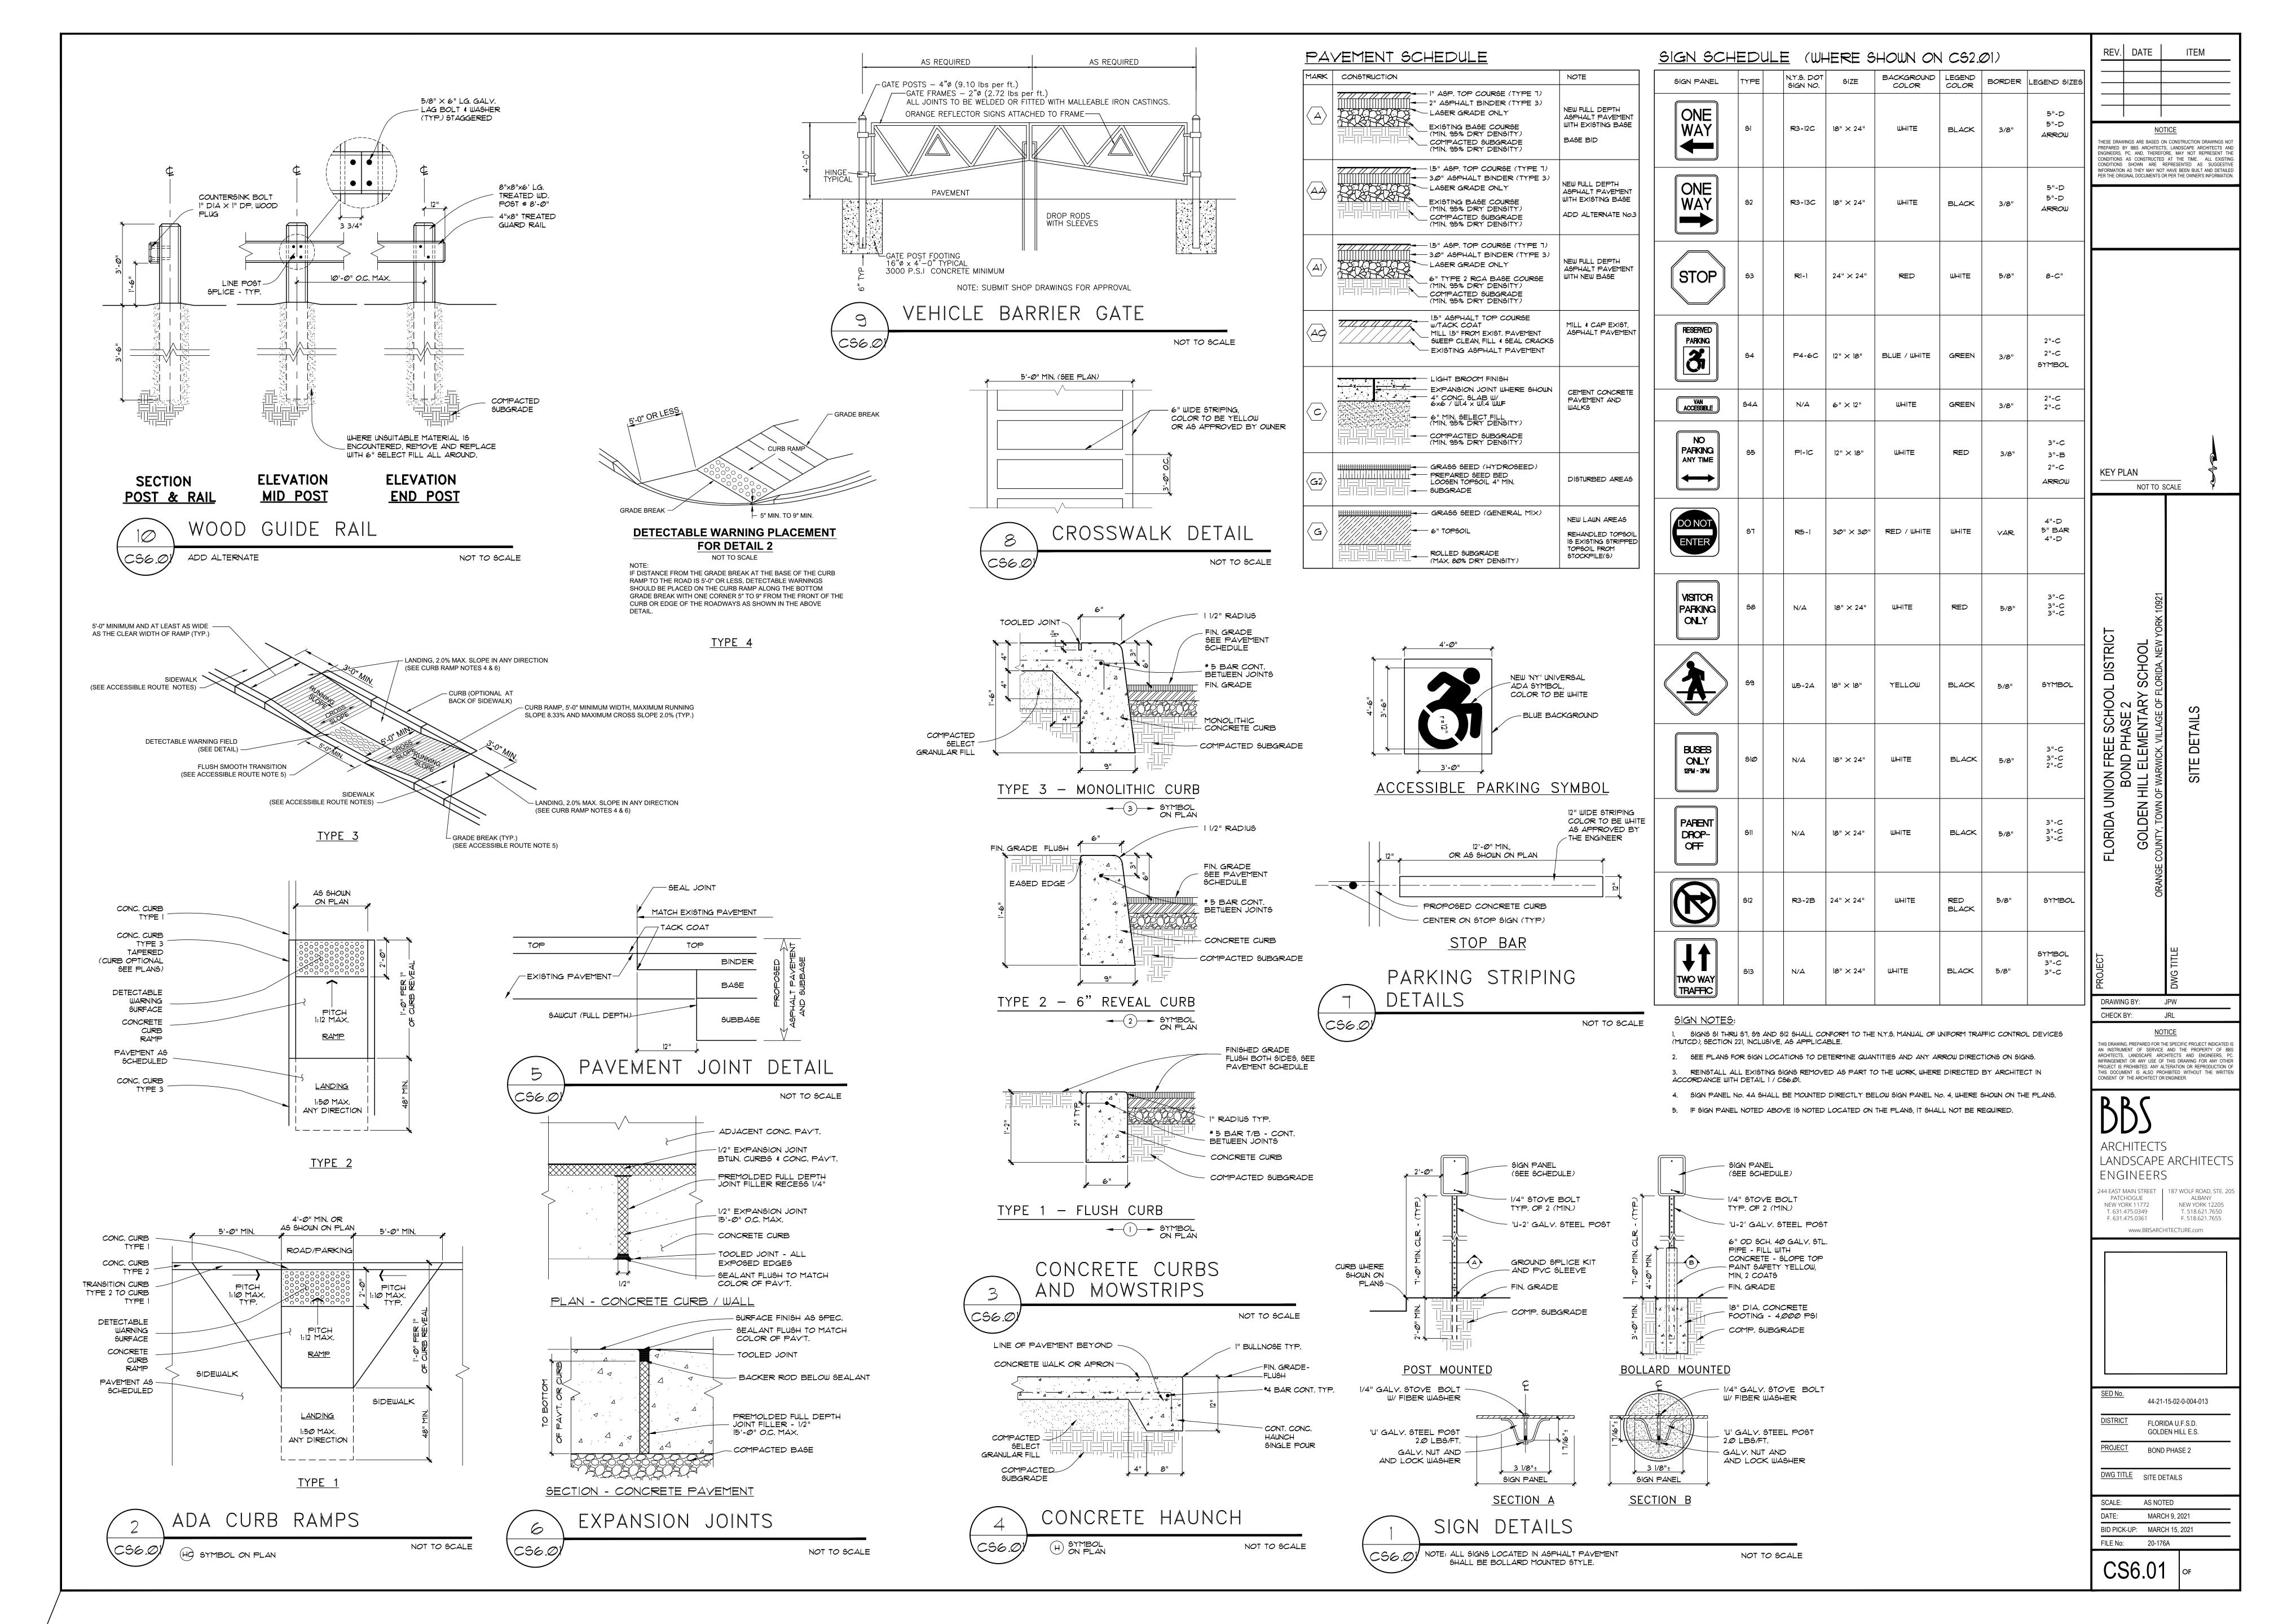

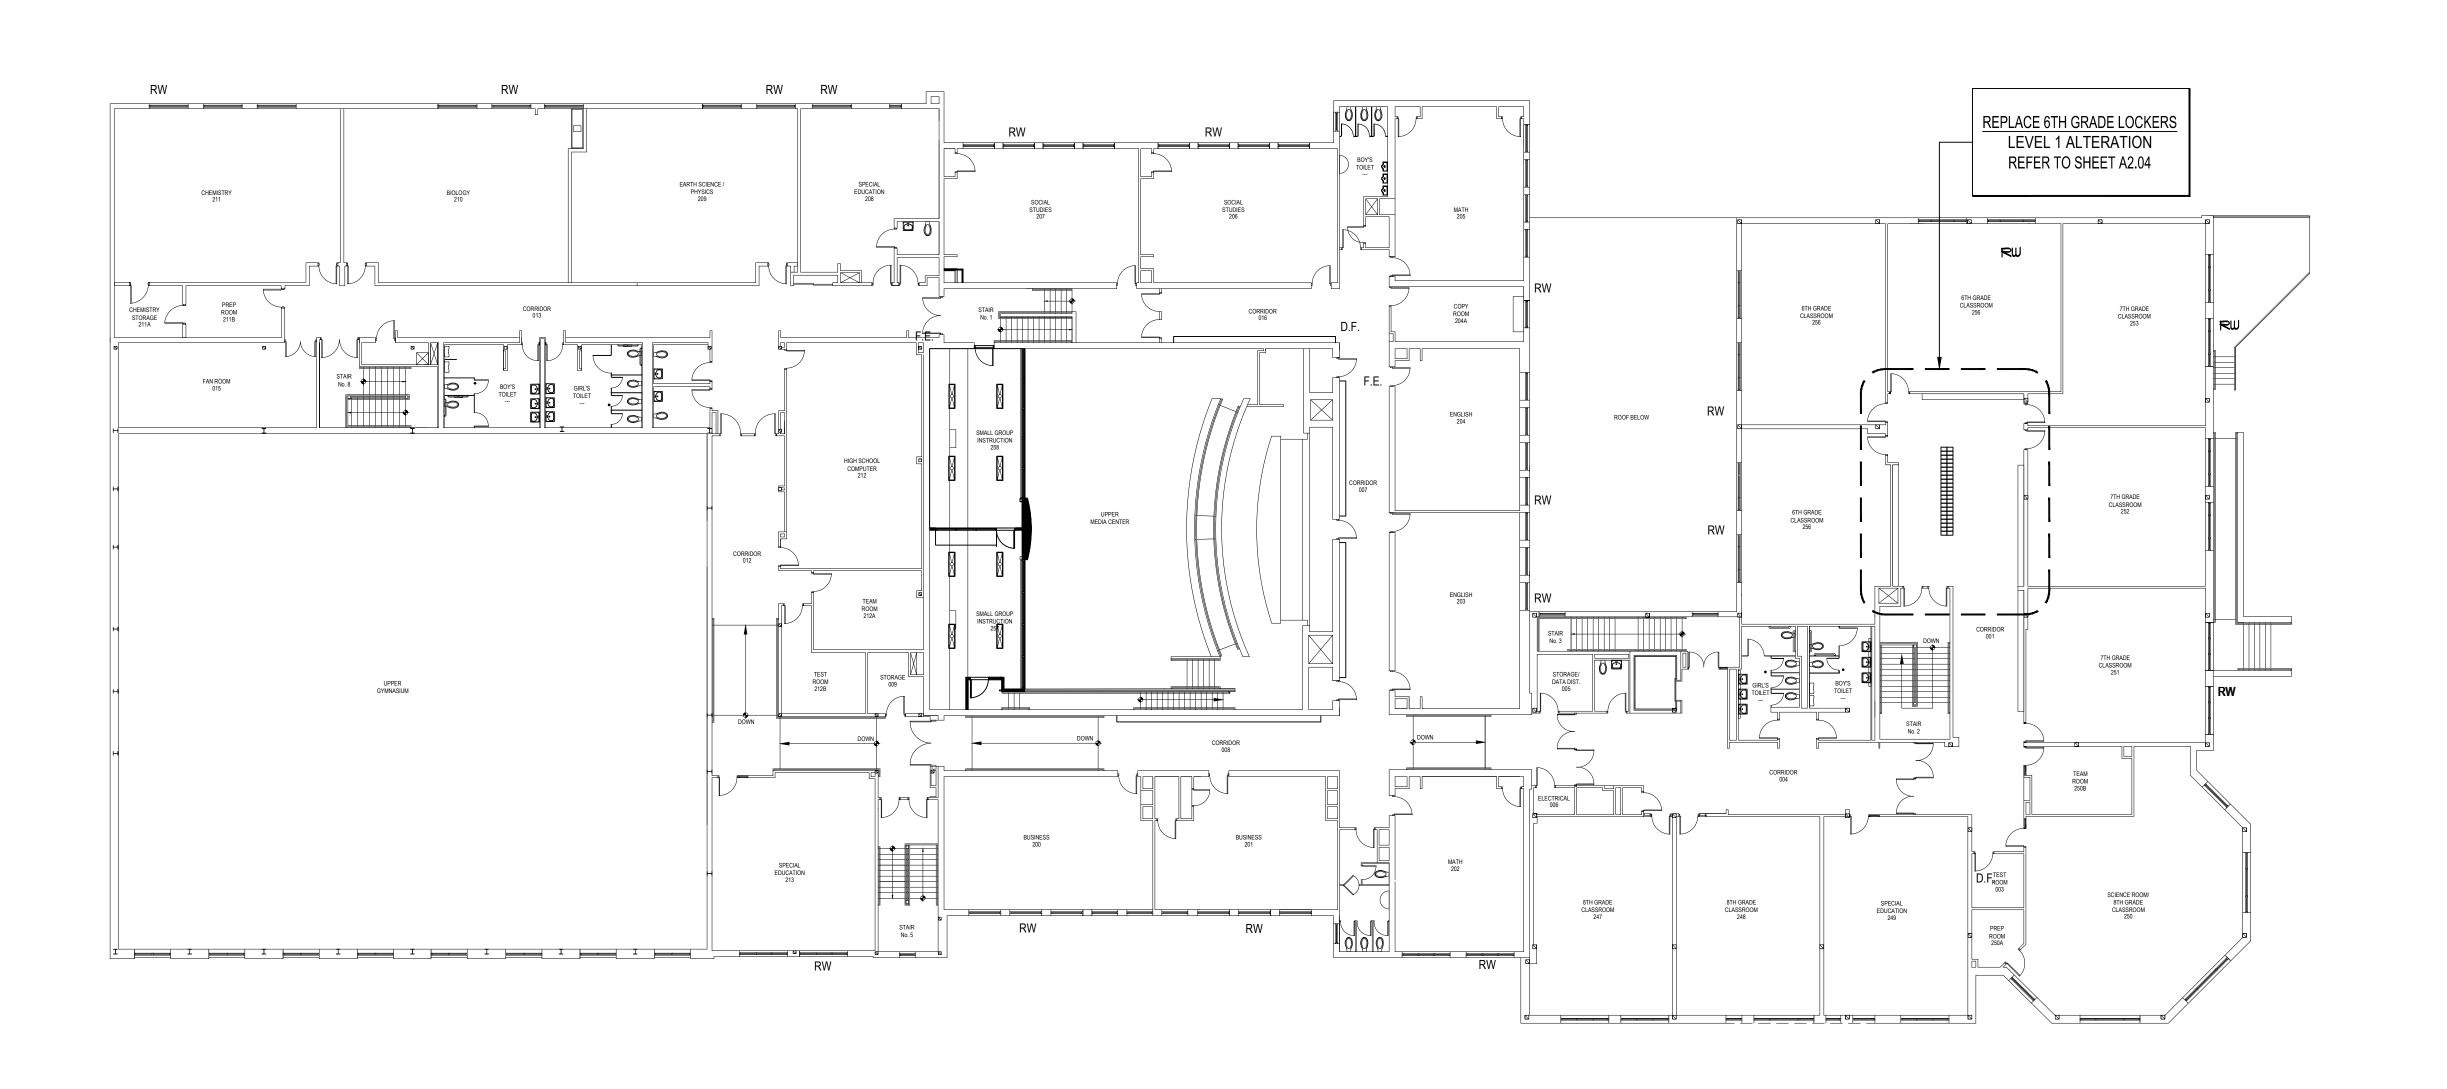

OVERALL KEY PLAN - SECOND FLOOR

SCALE: 1/16" = 1'-0"

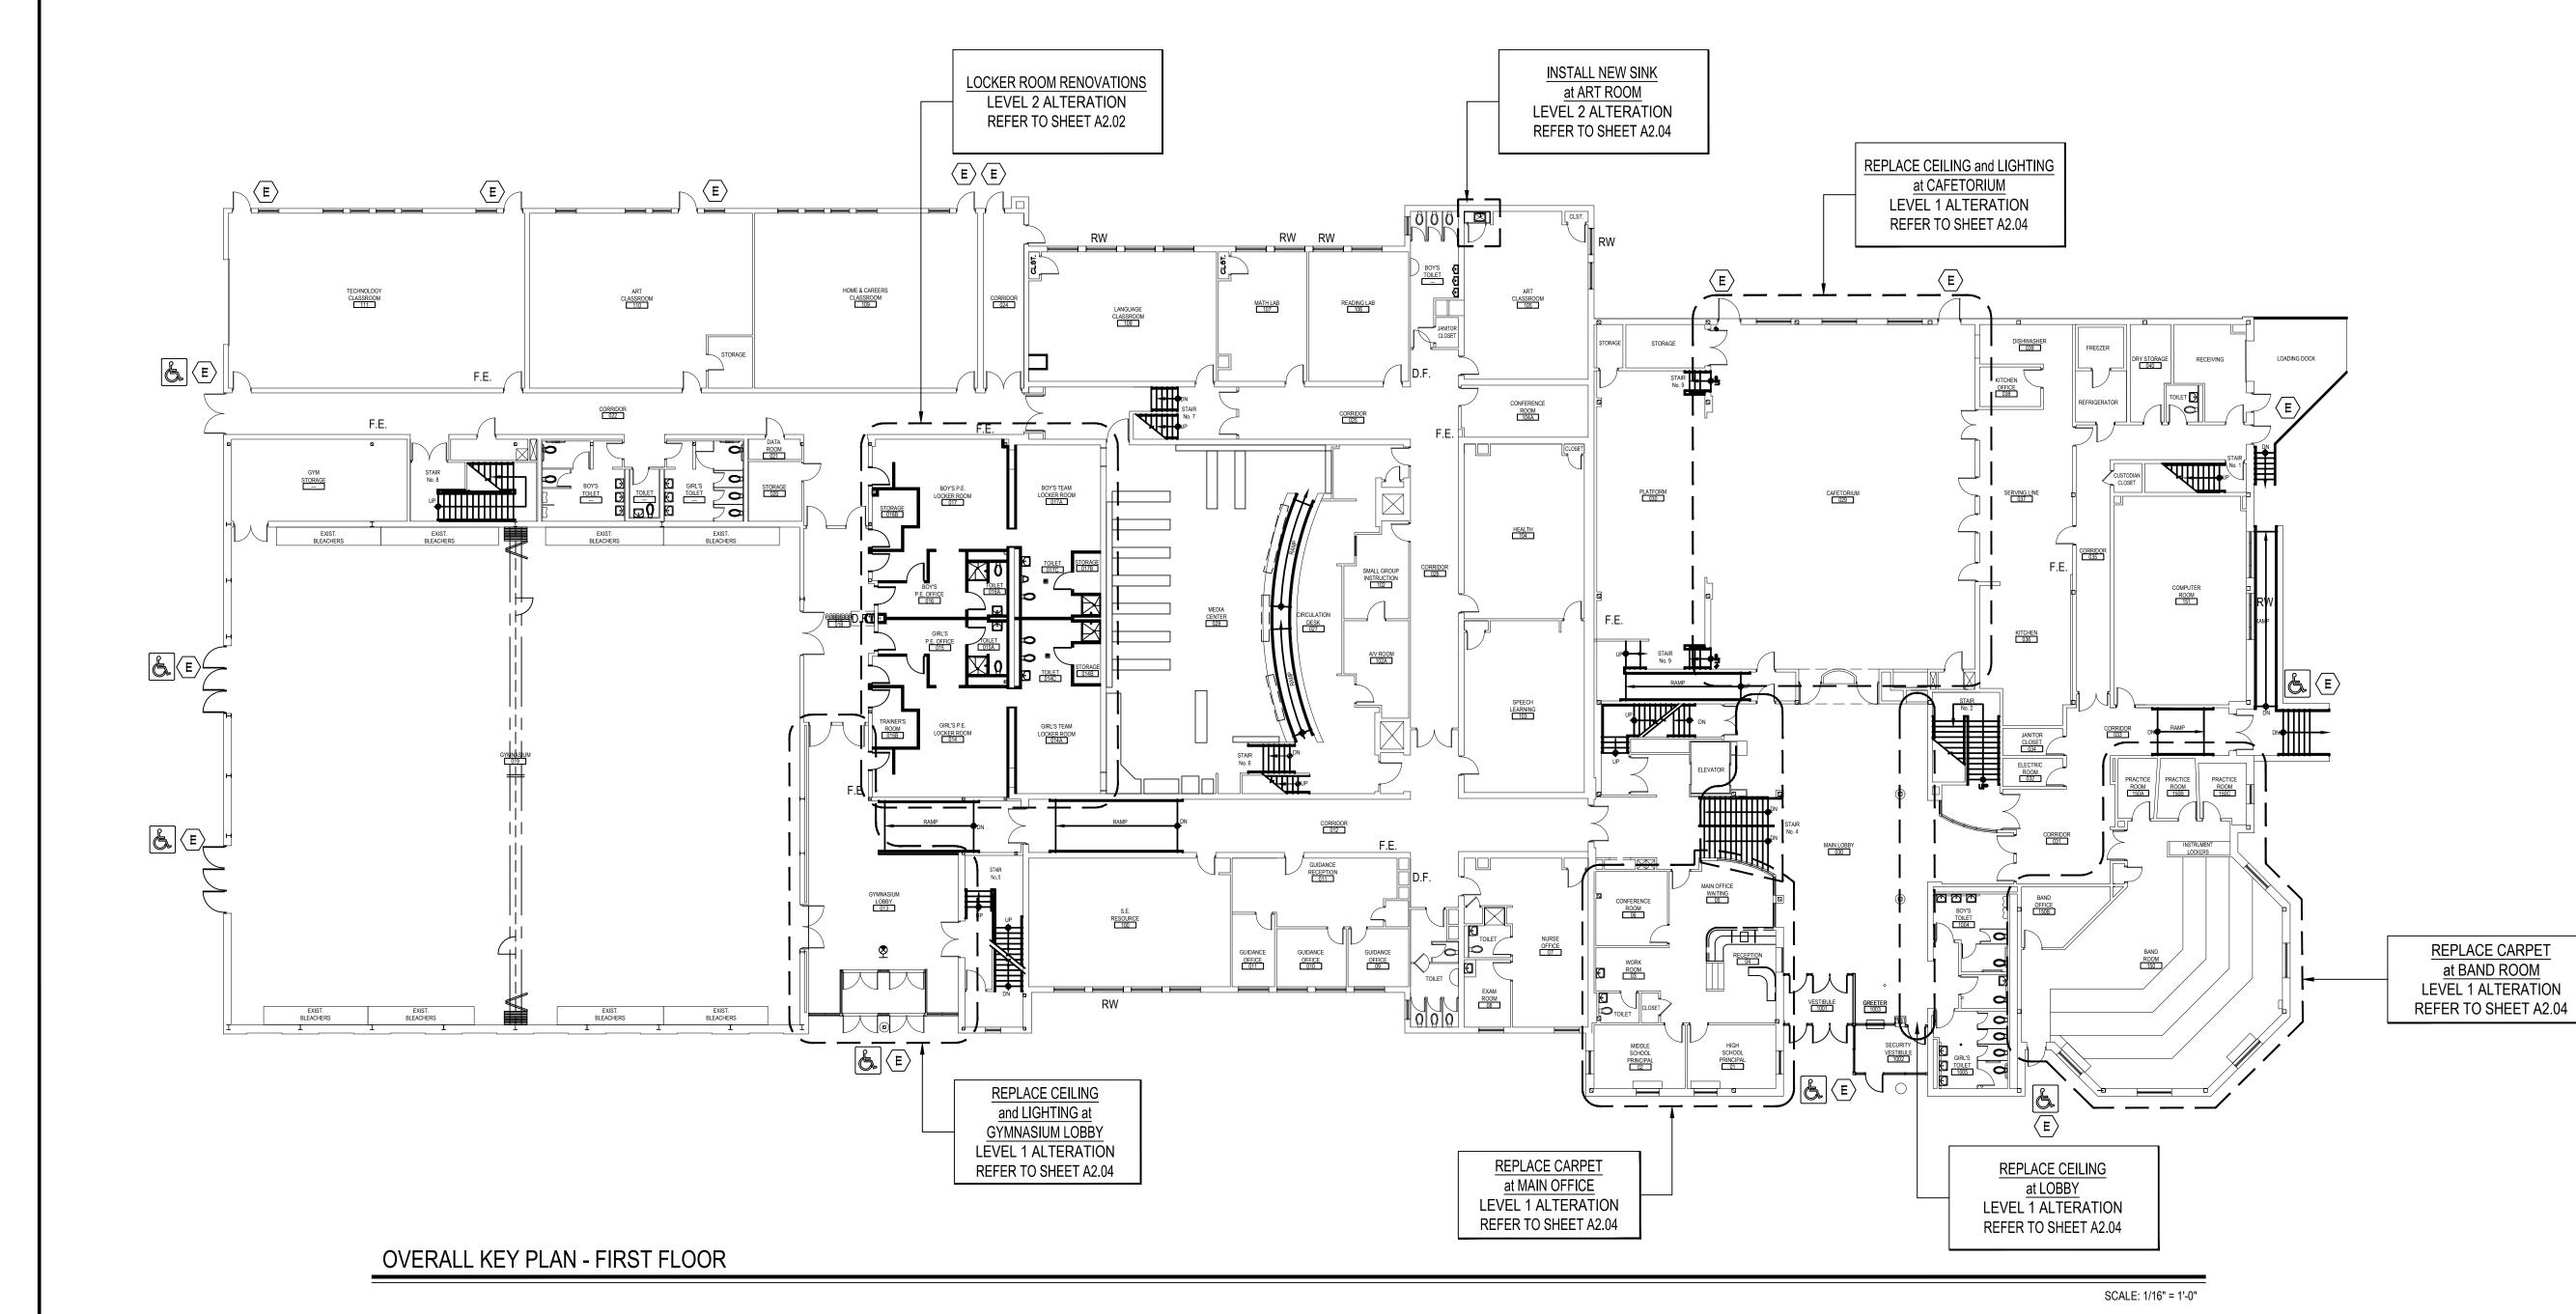

GENERAL CONSTRUCTION NOTES:

1. GENERAL CONTRACTOR SHALL VERIFY ALL EXISTING CONDITIONS PRIOR TO BIDDING & PROCEEDING WITH WORK. NOTIFY ARCHITECT OF ANY DISCREPANCIES IN WRITING PRIOR TO START OF WORK.

2. IN ACCORDANCE WITH STATE AND LOCAL CODES, THE REQUIRED EXITS IN THE EXISTING BUILDING MUST BE KEPT CLEAR, MAINTAINED AND PROTECTED DURING THE CONSTRUCTION PERIOD.

3. CONTRACTOR SHALL BE RESPONSIBLE FOR VERIFICATION OF ALL DIMENSIONS REQUIRED FOR ESTIMATING.

- 4. ALL WORK AND MATERIAL OF THIS PROJECT AND ADJACENT SURFACES SHALL BE PROTECTED FROM DAMAGE. IN THE EVENT OF DAMAGE, THE CONTRACTOR SHALL IMMEDIATELY MAKE ALL REPAIRS AND REPLACEMENT NECESSARY TO THE APPROVAL OF THE ARCHITECT AND OWNER AND AT NO ADDITIONAL COST TO OWNER.
- 5. CONTRACTOR SHALL PROTECT ALL AREAS OF WORK FROM INCLEMENT WEATHER DURING AND AT THE END OF DAILY WORK OPERATIONS.
- 6. ALL PROJECT WASTE MATERIAL AND RUBBISH SHALL BE DISPOSED IN CONTAINERS PROVIDED BY THE CONTRACTOR FOR SUBSEQUENT LEGAL OFF-SITE DISPOSAL. CONTAINER LOCATION TO BE COORDINATED WITH THE OWNER & CONSTRUCTION MANAGER. OFF-SITE DISPOSAL TO BE ON A REGULAR BASIS.
- 7. ALL INTERIOR SURFACES DISTURBED DURING CONSTRUCTION SHALL BE REPAIRED AND/OR REPLACED TO MATCH EXISTING CONDITIONS TO THE APPROVAL OF THE ARCHITECT AND OWNER.
- 8. ALL DEBRIS, DUST AND DIRT CAUSED BY WORK OF THIS CONTRACT SHALL BE REMOVED FROM SITE BY APPROPRIATE MEANS. RESTORE ALL CONDITIONS TO THE STATE OF CLEANLINESS THAT EXISTED PRIOR TO COMMENCEMENT OF WORK.9. ALL DEMOLITION AND CONSTRUCTION WORK TO BE PERFORMED WITHOUT INTERRUPTION OF OWNER OPERATIONS. IF

INTERRUPTION IS NECESSARY, WORK MUST NOT PROCEED UNTIL WRITTEN APPROVAL HAS BEEN OBTAINED FROM

10. ALL CONTRACTORS ARE TO COORDINATE INSTALLATION OF THEIR WORK WITH EACH OTHER AND WITH THE WORK BEING PERFORMED UNDER SEPARATE CONTRACTS BY OTHERS.

CODE COMPLIANCE NOTES:


- BUILDING OCCUPANCY CLASSIFICATION: GROUP E
- CONSTRUCTION CLASSIFICATION EXISTING: TYPE 3B/2B
- CONSTRUCTION CLASSIFICATION NEW: TYPE 3B/2B
- HEIGHT IN STORIES:
 EXISTING: 2
- (NO CHANGE)

NEW FINISHES SHALL BE CLASS 'A'.

LEGEND:

- F.E. EXISTING FIRE EXTINGUISHER
- D.F. EXISTING DRINKING FOUNTAIN
 R.W. EXISTING RESCUE WINDOW
- ACCESSIBLE ENTRANCE / EXIT


E INDICATES BUILDING EXIT

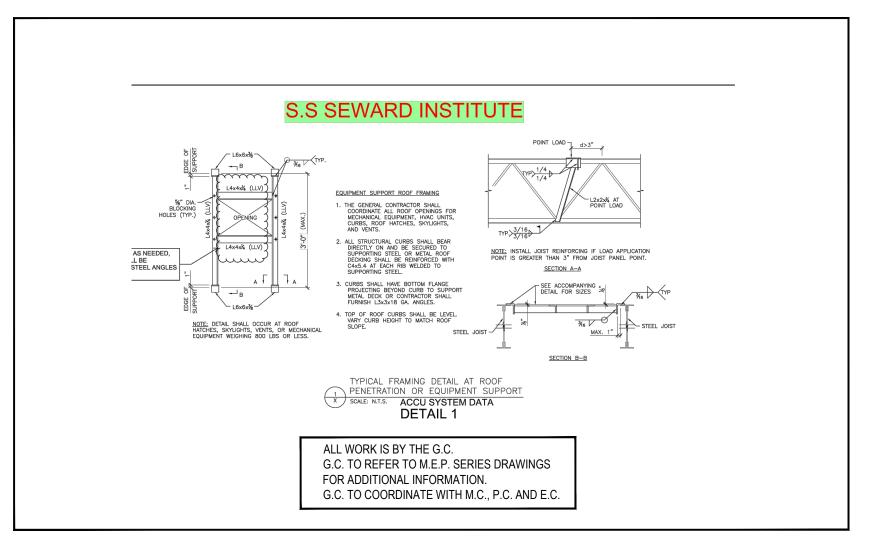

REV. DATE ITEM

NOTICE

THESE DRAWINGS ARE BASED ON CONSTRUCTION DRAWINGS NOT PREPARED BY BBS ARCHITECTS, LANDSCAPE ARCHITECTS AND ENGINEERS, PC. AND, THEREFORE, MAY NOT REPRESENT THE CONDITIONS AS CONSTRUCTED AT THE TIME. ALL EXISTING CONDITIONS SHOWN ARE REPRESENTED AS SUGGESTIVE INFORMATION AS THEY MAY NOT HAVE BEEN BUILT AND DETAILED PER THE ORIGINAL DOCUMENTS OR PER THE OWNER'S INFORMATION.

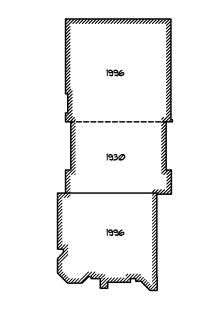

KEY PLAN

NOT TO SCALE

STRICT
A, NEW YORK 10921

INGE COUNTY, TOWN OF WARWICK, VILLAGE OF FLORIDA, NEW YOU'S AND ELANS

FIRST and SECOND FLOORS

DRAWING BY: PJG
CHECK BY: KGS

NOTICE


THIS DRAWING, PREPARED FOR THE SPECIFIC PROJECT INDICATED IS AN INSTRUMENT OF SERVICE AND THE PROPERTY OF BBS ARCHITECTS, LANDSCAPE ARCHITECTS AND ENGINEERS, PC. INFRINGEMENT OR ANY USE OF THIS DRAWING FOR ANY OTHER PROJECT IS PROHIBITED. ANY ALTERATION OR REPRODUCTION OF THIS DOCUMENT IS ALSO PROHIBITED WITHOUT THE WRITTEN CONSENT OF THE ARCHITECT OR ENGINEER.

BBS

ARCHITECTS LANDSCAPE ARCHITECTS ENGINEERS

244 EAST MAIN STREET PATCHOGUE ALBANY NEW YORK 11772 NEW YORK 12205 T. 631.475.0349 F. 631.475.0361 F. 518.621.7655

www.BBSARCHITECTURE.com

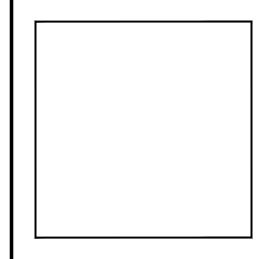

SED No. 44-21-15-02-0-001-015

DISTRICT FLORDIA U.F.S.D.

S.S. SEWARD INSTITUTE

PROJECT BOND PHASE 2

DWG TITLE OVERALL KEY PLAN FIRST & SECOND FLOOR


SCALE: AS NOTED

DATE: DECEMBER 1, 2020

BID PICK-UP: March 15, 2021

FILE No: 20-176B

A0.01 of -

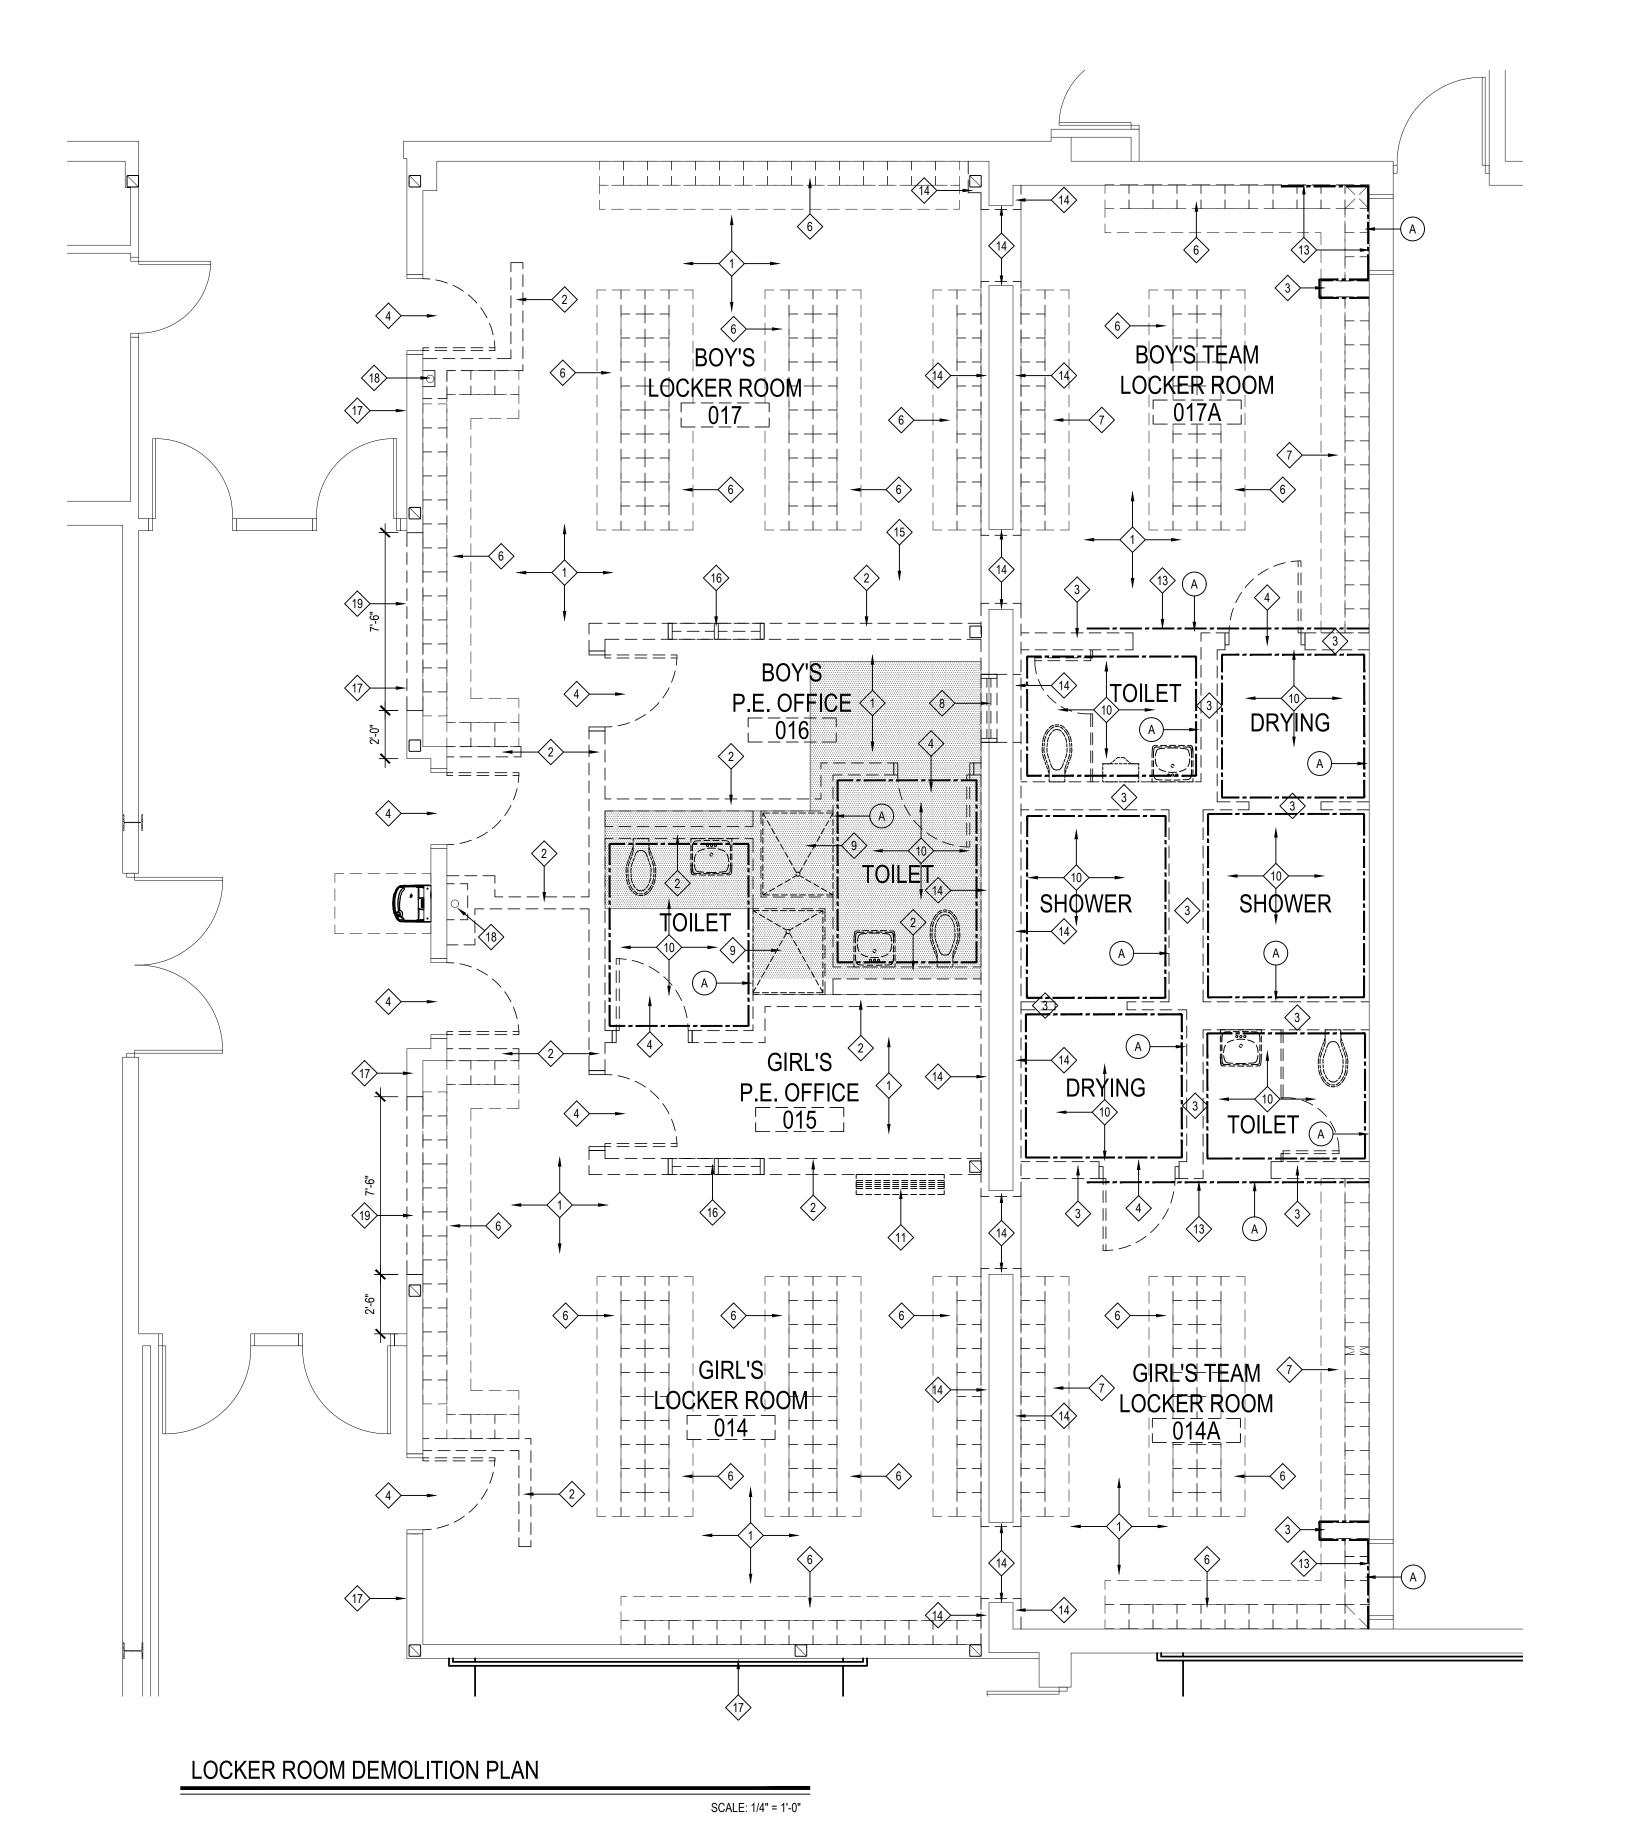

FLUORESCENT BULB NOTE

ALL EXISTING FLUORESCENT BULBS TO BE REMOVED SHALL BE CONSIDERED HAZARDOUS WASTE AND SHOULD BE HANDLED AND DISPOSED OF IN ACCORDANCE WITH THE NEW YORK STATE DEPARTMENT O ENVIRONMENTAL CONSERVATION (DEC) & UNITED STATES ENVIRONMENTAL PROTECTION AGENCY (EPA RULES, REGULATIONS & GUIDELINES.

THE GENERAL CONTRACTOR IS RESPONSIBLE FOR ALL DEMOLITION AND REMOVAL, UNLESS NOTED OTHERWISE. MECHANICAL, PLUMBING AND ELECTRICAL CONTRACTORS SHALL BE RESPONSIBLE FOR ALL DISCONNECTS. G.C. TO COORDINATE DEMOLITION WITH M.C., P.C. AND E.C. REFER TO M.E.P. SERIES DEMOLITION DRAWINGS FOR ADDITIONAL INFORMATION AND DEMOLITION SCOPE BY GENERAL CONTRACTOR NOT SHOWN THIS DWG. TYPICAL FOR ALL AREAS OF INTERIOR DEMOLITION AND/OR RECONSTRUCTION.

REV. DATE

KEY PLAN

NOT TO SCALE

NOTICE

THESE DRAWINGS ARE BASED ON CONSTRUCTION DRAWINGS NOT PREPARED BY BBS ARCHITECTS, LANDSCAPE ARCHITECTS AND INGINEERS, PC. AND, THEREFORE, MAY NOT REPRESENT THE

CONDITIONS AS CONSTRUCTED AT THE TIME. ALL EXISTI ONDITIONS SHOWN ARE REPRESENTED AS SUGGES INFORMATION AS THEY MAY NOT HAVE BEEN BUILT AND DETAILE

DEMOLITION LEGEND

_ _ _ _ _ EXISTING CONSTRUCTION TO BE REMOVED TO UNDERSIDE OF DECK U.O.N. (PATCH ALL ADJACENT SURFACES TO REMAIN TO MATCH EXISTING)

DOTTED HATCH DENOTES EXIST. CONCRETE FLOOR SLAB TO BE SAWCUT AS REQUIRED BY G.C. TO ACCOMMODATE INSTALLATION OF NEW UTILITIES AND/ OR STUB UPS INTO ROOMS. COORDINATE WITH E.C. & P.C. FLOOR SLAB INFILL BY G.C. REFER TO DETAIL #1 THIS SHEET FOR ADD'L INFO.

HAZARDOUS MATERIALS NOTES

REQUIREMENTS FOR FLOOR PREPARATION

VARIES (MIN. 24")

GC SHALL SAWCUT AND REMOVE PORTIONS OF EXISTING CONCRETE SLAB-ON-GRADE TO ACCOMMODATE INSTALLATION OF NEW UNDER-SLAB

UTILITIES BY OTHER TRADES AND PATCH SLAB AND FINISH FLOORING AS DETAILED ABOVE. SLAB SHALL BE SCANNED VIA X-RAY AND/OR OTHER

METHODS AS DEEMED APPROPRIATE BY THE GC AND MARKED-OUT FOR BURIED AND/OR EMBEDDED PIPING, DUCT BANKS, ELECTRICAL CONDUIT,

AND OTHER UTILITIES. GC SHALL EXERCISE CARE IN SLAB DEMOLITION IN THE VICINITY OF LOCATED UTILITIES AND ALTER METHODS OF SLAB DEMOLITION AS APPROPRIATE. FINAL EXTENT AND LOCATIONS OF SLAB REMOVAL TO BE COORDINATED BETWEEN TRADES IN THE FIELD. GC WILL

BE RESPONSIBLE FOR REPAIR OF ANY UTILITIES CUT OR DAMAGED BY THEIR SLAB REMOVAL WHETHER REVEALED BY SCANNING OR NOT.

EXISTING SLAB

TYPICAL SLAB SAWCUT NOTE

TO REMAIN ———

DASHED LINE DENOTES EXIST. SLAB

TO BE SAWCUT AND REMOVED BY G.C.

TYPICAL SLAB SAWCUT INFILL DETAIL

ALL CONTRACTORS SHALL BE ADVISED THAT THE FLORIDA UFSD HAS SOLICITED AN INDEPENDENT TESTING COMPANY TO INSPECT AND TEST ALL AREAS OF THE EXISTING BUILDING WHICH ARE SCHEDULED TO BE DISTURBED DURING CONSTRUCTION FOR THE PRESENCE OF ASBESTOS, LEAD AND /OR PCB CONTAINING CONSTRUCTION MATERIALS.

AFTER ALL DEMOLITION IS COMPLETE AND PIPING CORE DRILLS / SAW CUTS ARE PATCHED, ALL FLOORS IN THEIR ENTIRETY ARE TO BE SKIMCOATED WITH PLANI/PATCH PLUS BY 'MAPEI' OR APPROVED EQUAL IN

PREPARATION FOR NEW FLOORING. CONTRACTOR SHALL COORDINATE WITH FLOORING MANUFACTURER

- ALL INSPECTIONS AND TESTING HAVE BEEN PERFORMED BY: J.C. BRODERICK AND ASSOCIATES, INC. 1775 EXPRESSWAY DRIVE NORTH HAUPPAUGE, NY 11788
- RESULTS OF THE INSPECTIONS AND TESTING INDICATE THAT THE EXISTING BUILDING HAS TESTED POSITIVE FOR THE PRESENCE OF LEAD CONTAINING CONSTRUCTION MATERIALS. REFER TO PRE CONSTRUCTION SURVEY, BULK SAMPLING AND ANALYSIS OF SUSPECT LEAD CONTAINING MATERIALS (INFORMATION AVAILABLE TO BIDDERS) FOR ASSUMED CONTAINING CONSTRUCTION MATERIALS NOT IDENTIFIED BY KEYNOTES WHICH MAYBE SHOWN AS DEMOLITION OR POTENTIALLY DISTURBED AS A RESULT OF THE PROPOSED RENOVATIONS.
- ALL DISTURBANCE, REMOVAL OR DEMOLITION WORK TO THESE IDENTIFIED AREAS MUST B PERFORMED IN CONFORMANCE WITH THE GUIDELINES AS OUTLINED IN THE PROJECT MANUAL AND APPLICABLE LOCAL, STATE AND/OR FEDERAL REGULATIONS.
- ALL LEAD REMOVAL IS BY G.C. THE CONTRACTOR SHALL PERFORM A SITE INSPECTION PRIOR TO SUBMITTING A BID TO REVIEW AND QUANTIFY ALL LEAD CONTAINING CONSTRUCTION MATERIALS TO BE REMOVED OR AFFECTED BY THE PROPOSED SCOPE OF WORK.
- THE FOLLOWING KEY NOTES INDICATE THE PRESENCE OF LEAD ABATEMENT/REMOVAL REQUIRED IN THE SCOPE OF WORK:
- INDICATES LEAD CONTAINING CERAMIC WALL TILE (BEIGE). (REFER TO PROJECT MANUAL FOR ADDITIONAL INFORMATION.) SEE — - — WITHIN PLAN THIS SHEET FOR FULL LENGTH TO BE REMOVED. TILE IS FULL HEIGHT. (+/- 8'-0")

4" P.C. SLAB W/ W.W.F. OVER VAPOR BARRIER, (PROVIDE 6"

EXIST. SUB-GRADE TO BE EXCAVATED BY P.C.

OR E.C. BACKFILL AND COMPACTION BY G.C.

LONG #4 BARS AT 12" O.C. STAGGERED EACH SIDE OF TRENCH

SCALE: N.T.S.

WITH MIN. 3" EMBEDMENT AND EPOXY INTO EXIST. SLAB)

REMOVAL NOTES:

1. NOTED REMOVALS OF EXISTING LOCKERS, CONCRETE BENCHES AND BASES, ETC. HAVE BEEN IDENTIFIED. OWNER TO REMOVE ALL LOOSE FURNISHINGS AND STORED MATERIALS PRIOR TO START OF WORK.

2. G.C. SHALL REMOVE ALL LEAD CONTAINING MATERIALS AS SHOWN ON THE FIRST FLOOR DEMOLITION PLAN ON THIS DRAWING.

3. G.C. SHALL SAWCUT WALLS, FLOORS, ROOF, ETC. UNLESS OTHERWISE NOTED. REFER TO M.E.P. DRAWINGS FOR LOCATIONS, DESCRIPTIONS AND RESPONSIBILITIES. G.C. TO COORDINATE WITH E.C., P.C. AND M.C.

4. G.C. SHALL PATCH, REPLACE, OR REPAIR DAMAGE CAUSED TO EXIST'G FLOORS, WALLS, ROOF, ETC. SHOWN TO REMAIN AS A RESULT OF DEMOLITION TO PRIOR CONDITION OR MATCH ADJACENT NEW CONSTRUCTION.

5. G.C. SHALL VERIFY ALL REMOVALS W/ OWNERS REPRESENTATIVE/OWNER, AND M.C., P.C., OR E.C. PRIOR TO COMMENCEMENT.

DEMOLITION NOTES

No.	DESCRIPTION
\bigcirc 1 \bigcirc	G.C. SHALL REMOVE EXISTING VCT FLOORING, CEILING GRIDS, CEILING TILES, PLASTER CEILINGS, LIGHTING AND ALL OTHER EXISTING CEILING COMPONENTS. DISCONNECTS BY E.C., M.C. OR P.C. REFER TO M.E.P. SERIES DRAWINGS FOR ADDITIONAL INFO.
2>	G.C. SHALL REMOVE EXISTING METAL STUD AND GYPSUM WALL BOARD WALLS AND COVE BASE IN IT'S ENTIRETY. G.C. SHALL PATCH FLOOR AND WALL AS REQUIRED.
3>	G.C. SHALL REMOVE EXISTING MASONRY WALLS AND COVE BASE IN IT'S ENTIRETY. G.C. SHALL PATCH FLOOR AND WALLS AS REQUIRED.
4>	G.C. SHALL REMOVE EXISTING DOOR, HARDWARE AND FRAME IN THEIR ENTIRETY. G.C.

- AS REQUIRED. ARDWARE TO
- G.C. SHALL REMOVE ALL EXISTING LOCKERS, LOCKER BASES AND WOOD BENCHES. PATCH / REPAIR FLOORS AND WALLS AS REQUIRED
- CONCRETE BENCHES. PATCH / REPAIR FLOORS AND WALLS AS REQUIRED
- 9 G.C. SHALL REMOVE EXISTING SHOWER UNIT IN IT'S ENTIRETY. P.C., E.C. & M.C.TO
- G.C. SHALL REMOVE EXISTING PLUMBING FIXTURES, FLOOR DRAINS, TOILET ACCESSORIES, HAND DRYERS, CERAMIC FLOOR AND WALL TILES, TOILET PARTITIONS, SHOWER BASES, PLASTER CEILINGS AND LIGHTING AND ASSOCIATED PLUMBING, MECHANICAL, AND ELECTRICAL AS SCHEDULED TO BE REMOVED. DISCONNECTS BY M.C., E.C. AND P.C. REFER TO MEP DRAWINGS & FLOOR PLANS FOR ADDITIONAL INFO. PROVIDE FLOOR PREP AND SELF-LEVELING TO ACCOMMODATE INSTALLATION OF NEW
- G.C. SHALL REMOVE EXISTING MECHANICAL UNIT IN IT'S ENTIRETY. P.C., E.C. & M.C.TO DISCONNECT. REFER TO P, E AND M SERIES OF DRAWINGS FOR ADDITIONAL INFORMATION.
 - G.C. SHALL SAWCUT AND REMOVE EXISTING FLOOR SLAB IN IT'S ENTIRETY. G.C. \$\langle 12 \rangle Shall PREP NEW SLAB TO ACCOMMODATE NEW ADA SHOWER BASE INSTALLATION. ADA SHOWER BASE TO RECEIVE RECESSED SLAB. REFER TO P-SERIES DWGS FOR ADDITIONAL INFORMATION
- G.C. SHALL REMOVE EXISTING WALL TILE IN IT'S ENTIRETY. G.C. SHALL PREP NEW WALL SURFACE TO ACCOMMODATE NEW WALL FINISH. REFER TO A9-SERIES FOR ADDITIONAL INFORMATION
- EXISTING MASONRY WALLS IN THEIR ENTIRETY. G.C. SHALL PREP WALL SURFACE TO ACCOMMODATE NEW FURRED OUT GYP. BD. AND METAL STUDS. REFER TO PARTITION TYPES FOR ADDITIONAL INFORMATION.
- G.C. SHALL REMOVE EXISTING CEILING HUNG MECHANICAL UNIT IN IT'S ENTIRETY. P.C., E.C. & M.C.TO DISCONNECT. REFER TO P, E AND M SERIES OF DRAWINGS FOR ADDITIONAL INFORMATION.
- (16) G.C. SHALL REMOVE EXISTING HOLLOW METAL VISION PANEL IN IT'S ENTIRETY
- REMOVED BY THE DISTRICT PRIOR TO START OF CONSTRUCTION .
- 218 EXISTING ROOF DRAIN LEADER TO REMAIN (TYP.)
- FRAMES. REFER TO DRAWING A2.01 FOR ADDITIONAL INFORMATION.

No.	DESCRIPTION
$\langle 1 \rangle$	G.C. SHALL REMOVE EXISTING VCT FLOORING, CEILING GRIDS, CEILING TILE CEILINGS, LIGHTING AND ALL OTHER EXISTING CEILING COMPONENTS. DISC BY E.C., M.C. OR P.C. REFER TO M.E.P. SERIES DRAWINGS FOR ADDITIONAL I
$\langle 2 \rangle$	G.C. SHALL REMOVE EXISTING METAL STUD AND GYPSUM WALL BOARD WAL COVE BASE IN IT'S ENTIRETY. G.C. SHALL PATCH FLOOR AND WALL AS REQU
3>	G.C. SHALL REMOVE EXISTING MASONRY WALLS AND COVE BASE IN IT'S ENT SHALL PATCH FLOOR AND WALLS AS REQUIRED.
4	G.C. SHALL REMOVE EXISTING DOOR, HARDWARE AND FRAME IN THEIR ENT SHALL GIVE HARDWARE TO OWNER. G.C. SHALL PATCH FLOOR AND WALL AS
5	G.C. SHALL REMOVE EXISTING DOOR AND HARDWARE. G.C. SHALL GIVE HAR OWNER. EXISTING FRAME TO REMAIN.

G.C. SHALL REMOVE ALL EXISTING LOCKERS AND CONCRETE LOCKER BASES AND

8 G.C. SHALL REMOVE AND DISPOSE OF EXISTING WINDOW UNIT AND INFILL OPENING WITH MASONRY TO MATCH EXISTING.

DISCONNECT. REFER TO P, E AND M SERIES OF DRAWINGS FOR ADDITIONAL INFO.

FLOORING AS PER SCHEDULED TO ALIGN WITH EXIST. FLOOR HEIGHT.


C. SHALL REMOVE EXISTING FURRED OUT GYP. BD. AND METAL STUDS EXPOSING


17 EXISTING WALL HUNG PLAQUES AND FRAMING WITHIN THE CORRIDOR SHALL BE

G.C. SHALL REMOVE PORTION OF EXISTING GYP. BD. AND METAL STUD CORRIDOR 19> | WALLS. MODIFY EXISTING FRAMING FOR THE INSTALLATION OF NEW DOORS AND H.M.

DRAWING BY: PJG KGS THIS DRAWING, PREPARED FOR THE SPECIFIC PROJECT INDICATED IS AN INSTRUMENT OF SERVICE AND THE PROPERTY OF BBS ARCHITECTS, LANDSCAPE ARCHITECTS AND ENGINEERS, P. INFRINGEMENT OR ANY USE OF THIS DRAWING FOR ANY OTHE PROJECT IS PROHIBITED. ANY ALTERATION OR REPRODUCTION OF THIS DOCUMENT IS ALSO PROHIBITED WITHOUT THE WRITTEN CONSENT OF THE ARCHITECT OR ENGINEER. ARCHITECTS LANDSCAPE ARCHITECTS ENGINEERS 87 WOLF ROAD, STE. 205 PATCHOGUE NEW YORK 11772 NEW YORK 12205 T. 631.475.0349 F. 631.475.0361 F. 518.621.7655 www.BBSARCHITECTURE.com 44-21-15-02-0-001-015 DISTRICT FLORDIA U.F.S.D. S.S. SEWARD INSTITUTE PROJECT BOND PHASE 2 DWG TITLE LOCKER ROOM **DEMOlition PLAN** SCALE: AS NOTED DATE: DECEMBER 1, 2020 BID PICK-UP: March 15, 2021 FILE No: 20-176B

A1.01

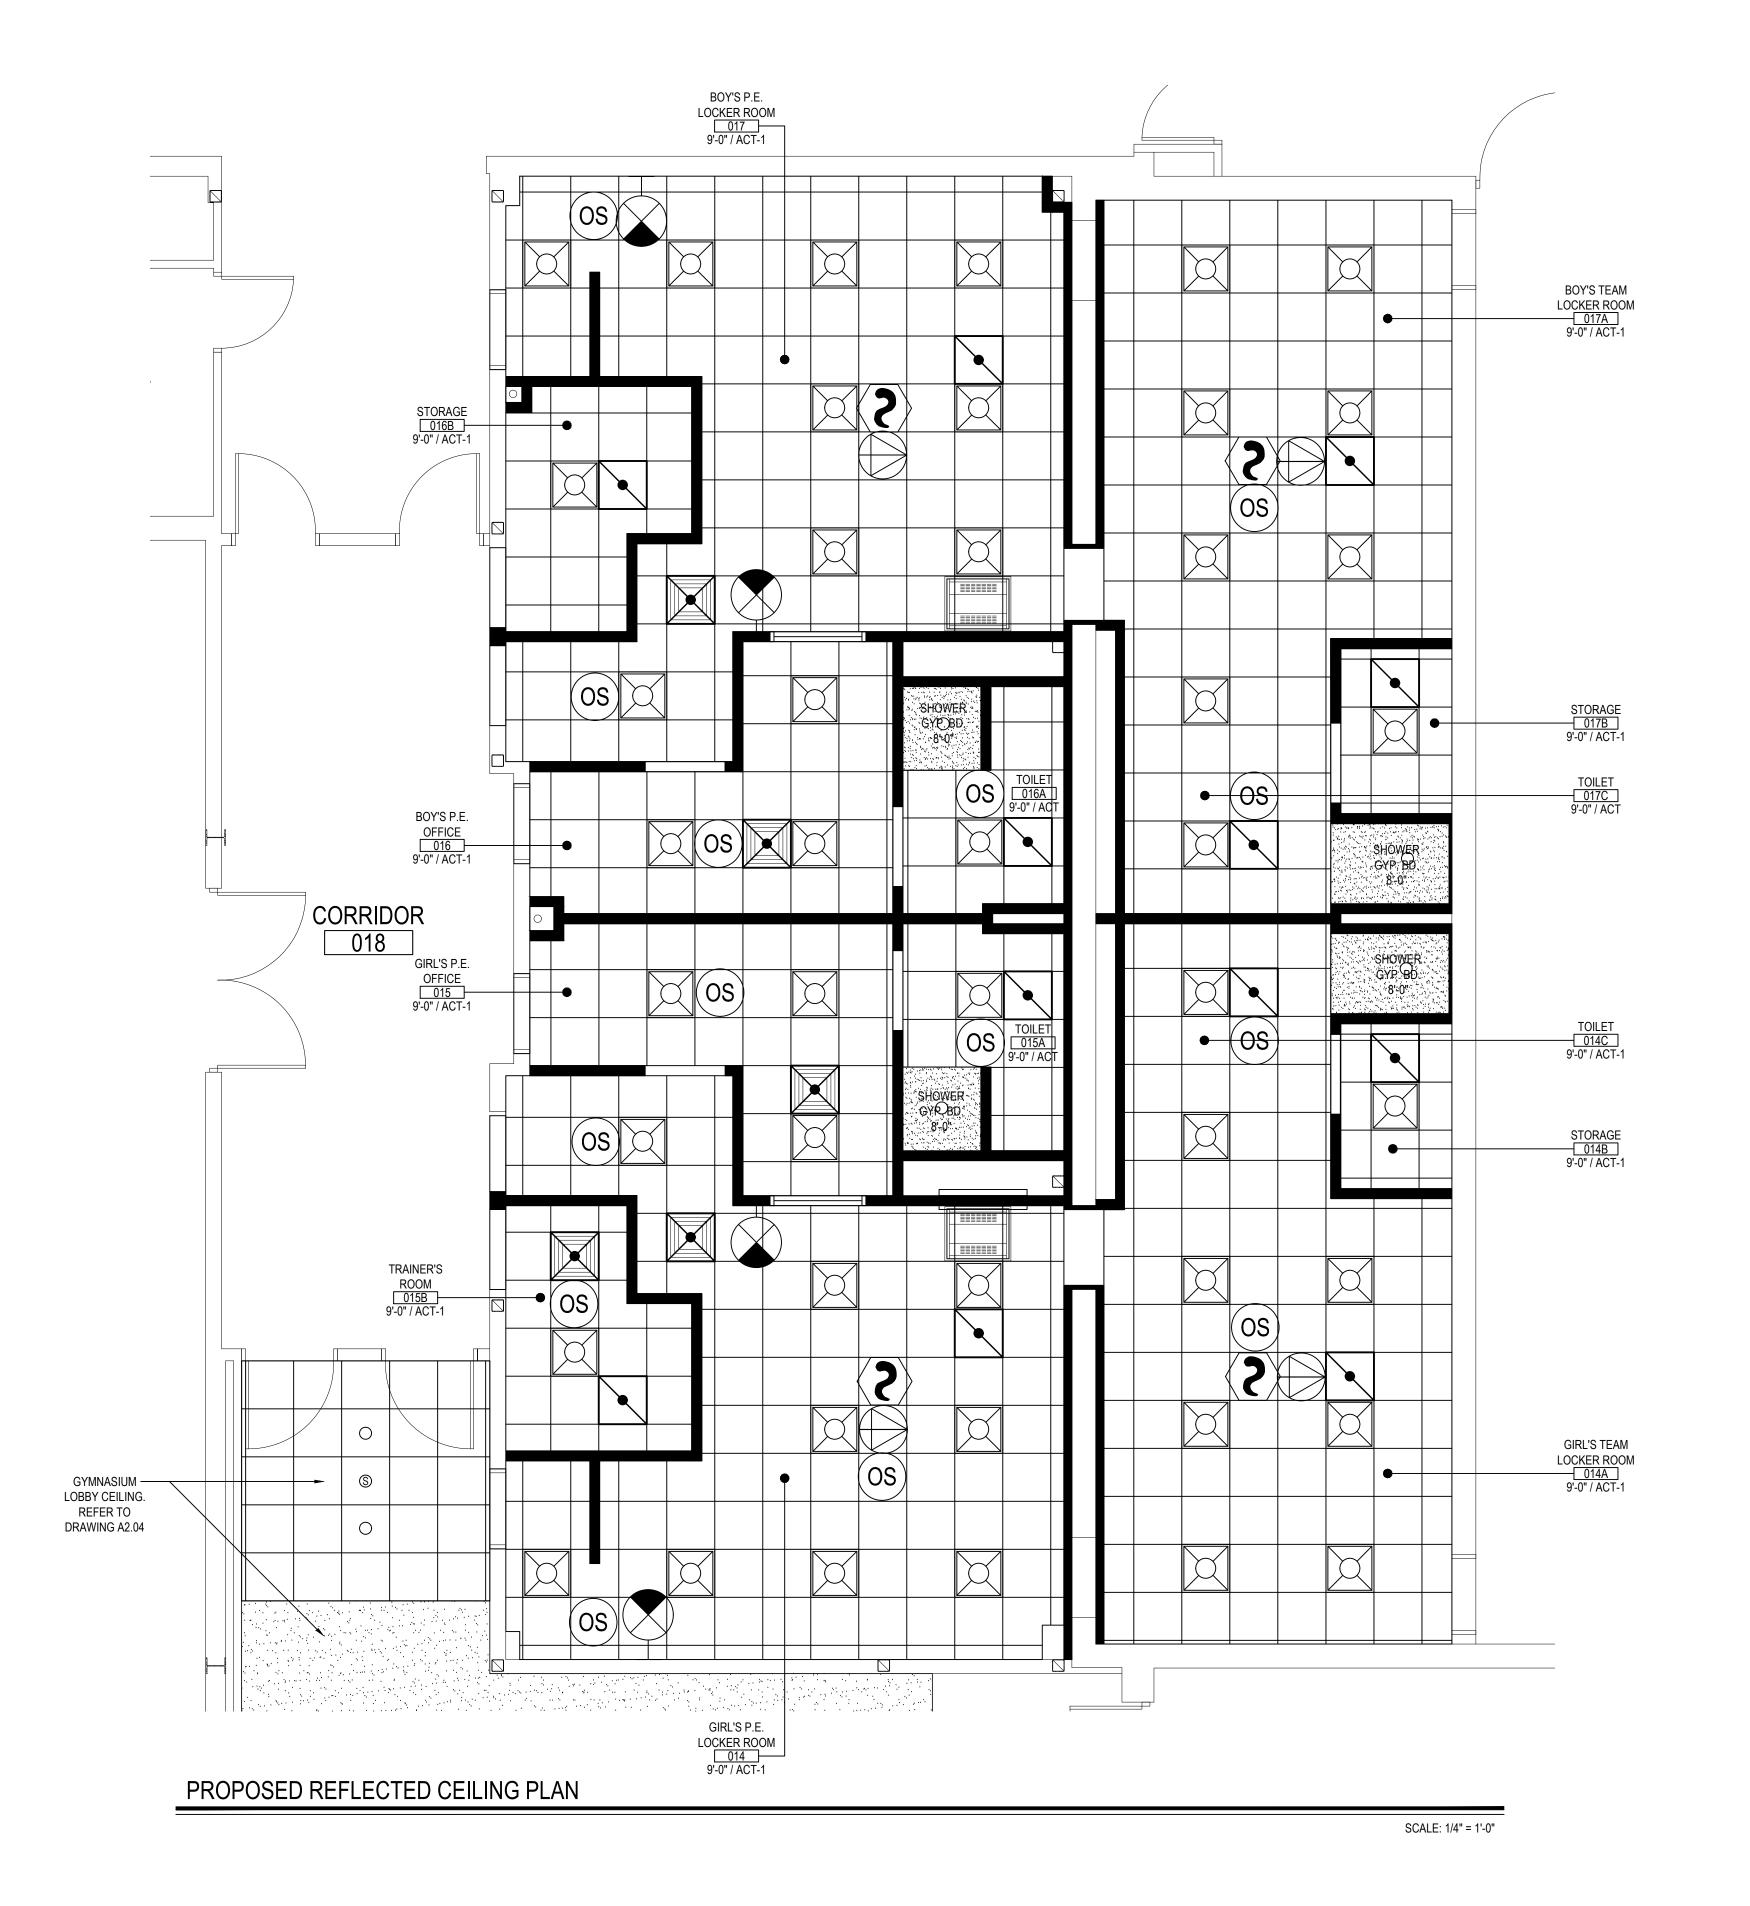

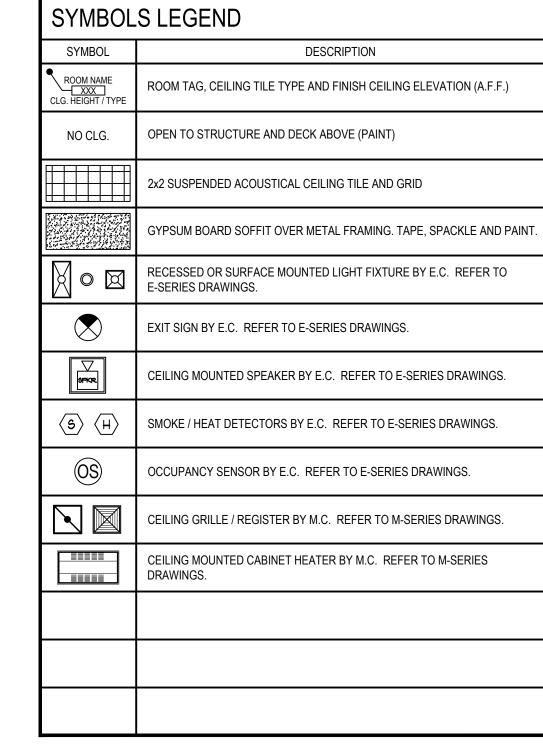

TYPICAL REFLECTED CEILING PLAN NOTES

- CEILING PLANS MAY NOT INDICATE ALL MECHANICAL AND / OR ELECTRICAL CEILING MOUNTED ITEMS. REFER TO M - SERIES AND E - SERIES DRAWINGS FOR ADDITIONAL
- CEILING GRID SHALL BE ARRANGED TO BE SPACED EQUALLY IN EACH DIRECTION WITH NO TILE LESS THAN 6" UNLESS OTHERWISE REQUIRED.
- PROVIDE CEILING EXPANSION JOINT AT ALL NEW TO EXISTING INTERSECTIONS AND WHERE INDICATED ON PLANS.
- GYP. BOARD OVER 18 GA. COLD FORMED FRAMING AT 16" O.C.
- INCLUDING BUT NOT LIMITED TO DECK, STRUCTURE, DUCTWORK, ETC.)

CEILINGS AS INDICATED IN THE REFLECTED CEILING PLAN. (ASTM E-1264)

ACOUSTICAL CEILINGS SHALL HAVE A MINIMUM NOISE REDUCTION COEFFICIENT (NRC) RATING OF 0.65.

SYMBOL	S LEGEND
SYMBOL	DESCRIPTION
ROOM NAME XXX CLG. HEIGHT / TYPE	ROOM TAG, CEILING TILE TYPE AND FINISH CEILING ELEVATION (A.F.F.)
NO CLG.	OPEN TO STRUCTURE AND DECK ABOVE (PAINT)
	2x2 SUSPENDED ACOUSTICAL CEILING TILE AND GRID
	GYPSUM BOARD SOFFIT OVER METAL FRAMING. TAPE, SPACKLE AND PAINT
	RECESSED OR SURFACE MOUNTED LIGHT FIXTURE BY E.C. REFER TO E-SERIES DRAWINGS.
lacktriangle	EXIT SIGN BY E.C. REFER TO E-SERIES DRAWINGS.
SPKR	CEILING MOUNTED SPEAKER BY E.C. REFER TO E-SERIES DRAWINGS.
(5) (H)	SMOKE / HEAT DETECTORS BY E.C. REFER TO E-SERIES DRAWINGS.
(S)	OCCUPANCY SENSOR BY E.C. REFER TO E-SERIES DRAWINGS.
	CEILING GRILLE / REGISTER BY M.C. REFER TO M-SERIES DRAWINGS.
	CEILING MOUNTED CABINET HEATER BY M.C. REFER TO M-SERIES DRAWINGS.

- UNLESS OTHERWISE NOTED, ALL SOFFITS AND WINDOW POCKETS SHALL BE ⅓" TYPE 'X'
- ALL AREAS NOTED AS 'OPEN' AND / OR 'NO CEILING (CLG.) SHALL BE PAINTED -
- 6. ACOUSTICAL CEILINGS SHALL HAVE A FLAME SPREAD OF 25 OR LESS COMPLYING WITH 'ASTM E-84'; SMOKE DEVELOPED RATING OF 50 OR LESS COMPLYING WITH PERFORMANCE REQUIREMENTS AND PHYSICAL CHARACTERISTICS OF THE SPECIFIED

LEGEND
DESCRIPTION
ROOM TAG, CEILING TILE TYPE AND FINISH CEILING ELEVATION (A.F.F.)
OPEN TO STRUCTURE AND DECK ABOVE (PAINT)
2x2 SUSPENDED ACOUSTICAL CEILING TILE AND GRID
GYPSUM BOARD SOFFIT OVER METAL FRAMING. TAPE, SPACKLE AND PAINT.
RECESSED OR SURFACE MOUNTED LIGHT FIXTURE BY E.C. REFER TO E-SERIES DRAWINGS.
EXIT SIGN BY E.C. REFER TO E-SERIES DRAWINGS.
CEILING MOUNTED SPEAKER BY E.C. REFER TO E-SERIES DRAWINGS.
SMOKE / HEAT DETECTORS BY E.C. REFER TO E-SERIES DRAWINGS.
OCCUPANCY SENSOR BY E.C. REFER TO E-SERIES DRAWINGS.
CEILING GRILLE / REGISTER BY M.C. REFER TO M-SERIES DRAWINGS.
CEILING MOUNTED CABINET HEATER BY M.C. REFER TO M-SERIES DRAWINGS.

9 LOCKER ROOM REFLECTED CEILI

REV. DATE

KEY PLAN

NOT TO SCALE

<u>NOTICE</u>


THESE DRAWINGS ARE BASED ON CONSTRUCTION DRAWINGS NOT PREPARED BY BBS ARCHITECTS, LANDSCAPE ARCHITECTS AND ENGINEERS, PC. AND, THEREFORE, MAY NOT REPRESENT THE CONDITIONS AS CONSTRUCTED AT THE TIME. ALL EXISTING CONDITIONS SHOWN ARE REPRESENTED AS SUGGESTIVE INFORMATION AS THEY MAY NOT HAVE BEEN BUILT AND DETAILED PER THE ORIGINAL DOCUMENTS OR PER THE OWNER'S INFORMATION.

DRAWING BY: PJG CHECK BY: KGS <u>NOTICE</u>

THIS DRAWING, PREPARED FOR THE SPECIFIC PROJECT INDICATED IS AN INSTRUMENT OF SERVICE AND THE PROPERTY OF BBS ARCHITECTS, LANDSCAPE ARCHITECTS AND ENGINEERS, PC. INFRINGEMENT OR ANY USE OF THIS DRAWING FOR ANY OTHER PROJECT IS PROHIBITED. ANY ALTERATION OR REPRODUCTION OF THIS DOCUMENT IS ALSO PROHIBITED WITHOUT THE WRITTEN CONSENT OF THE ARCHITECT OR ENGINEER.

LANDSCAPE ARCHITECTS ENGINEERS 244 EAST MAIN STREET | 187 WOLF ROAD, STE. 205 PATCHOGUE | ALBANY

NEW YORK 12205 T. 518.621.7650 NEW YORK 11772 F. 631.475.0361 F. 518.621.7655

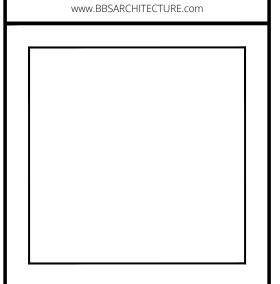


44-21-15-02-0-001-015 <u>DISTRICT</u> FLORDIA U.F.S.D. S.S. SEWARD INSTITUTE PROJECT BOND PHASE 2


DWG TITLE REFLECTED CEILING PLANS


SCALE: AS NOTED

DATE: DECEMBER 1, 2020 BID PICK-UP: March 15, 2021


A2.02

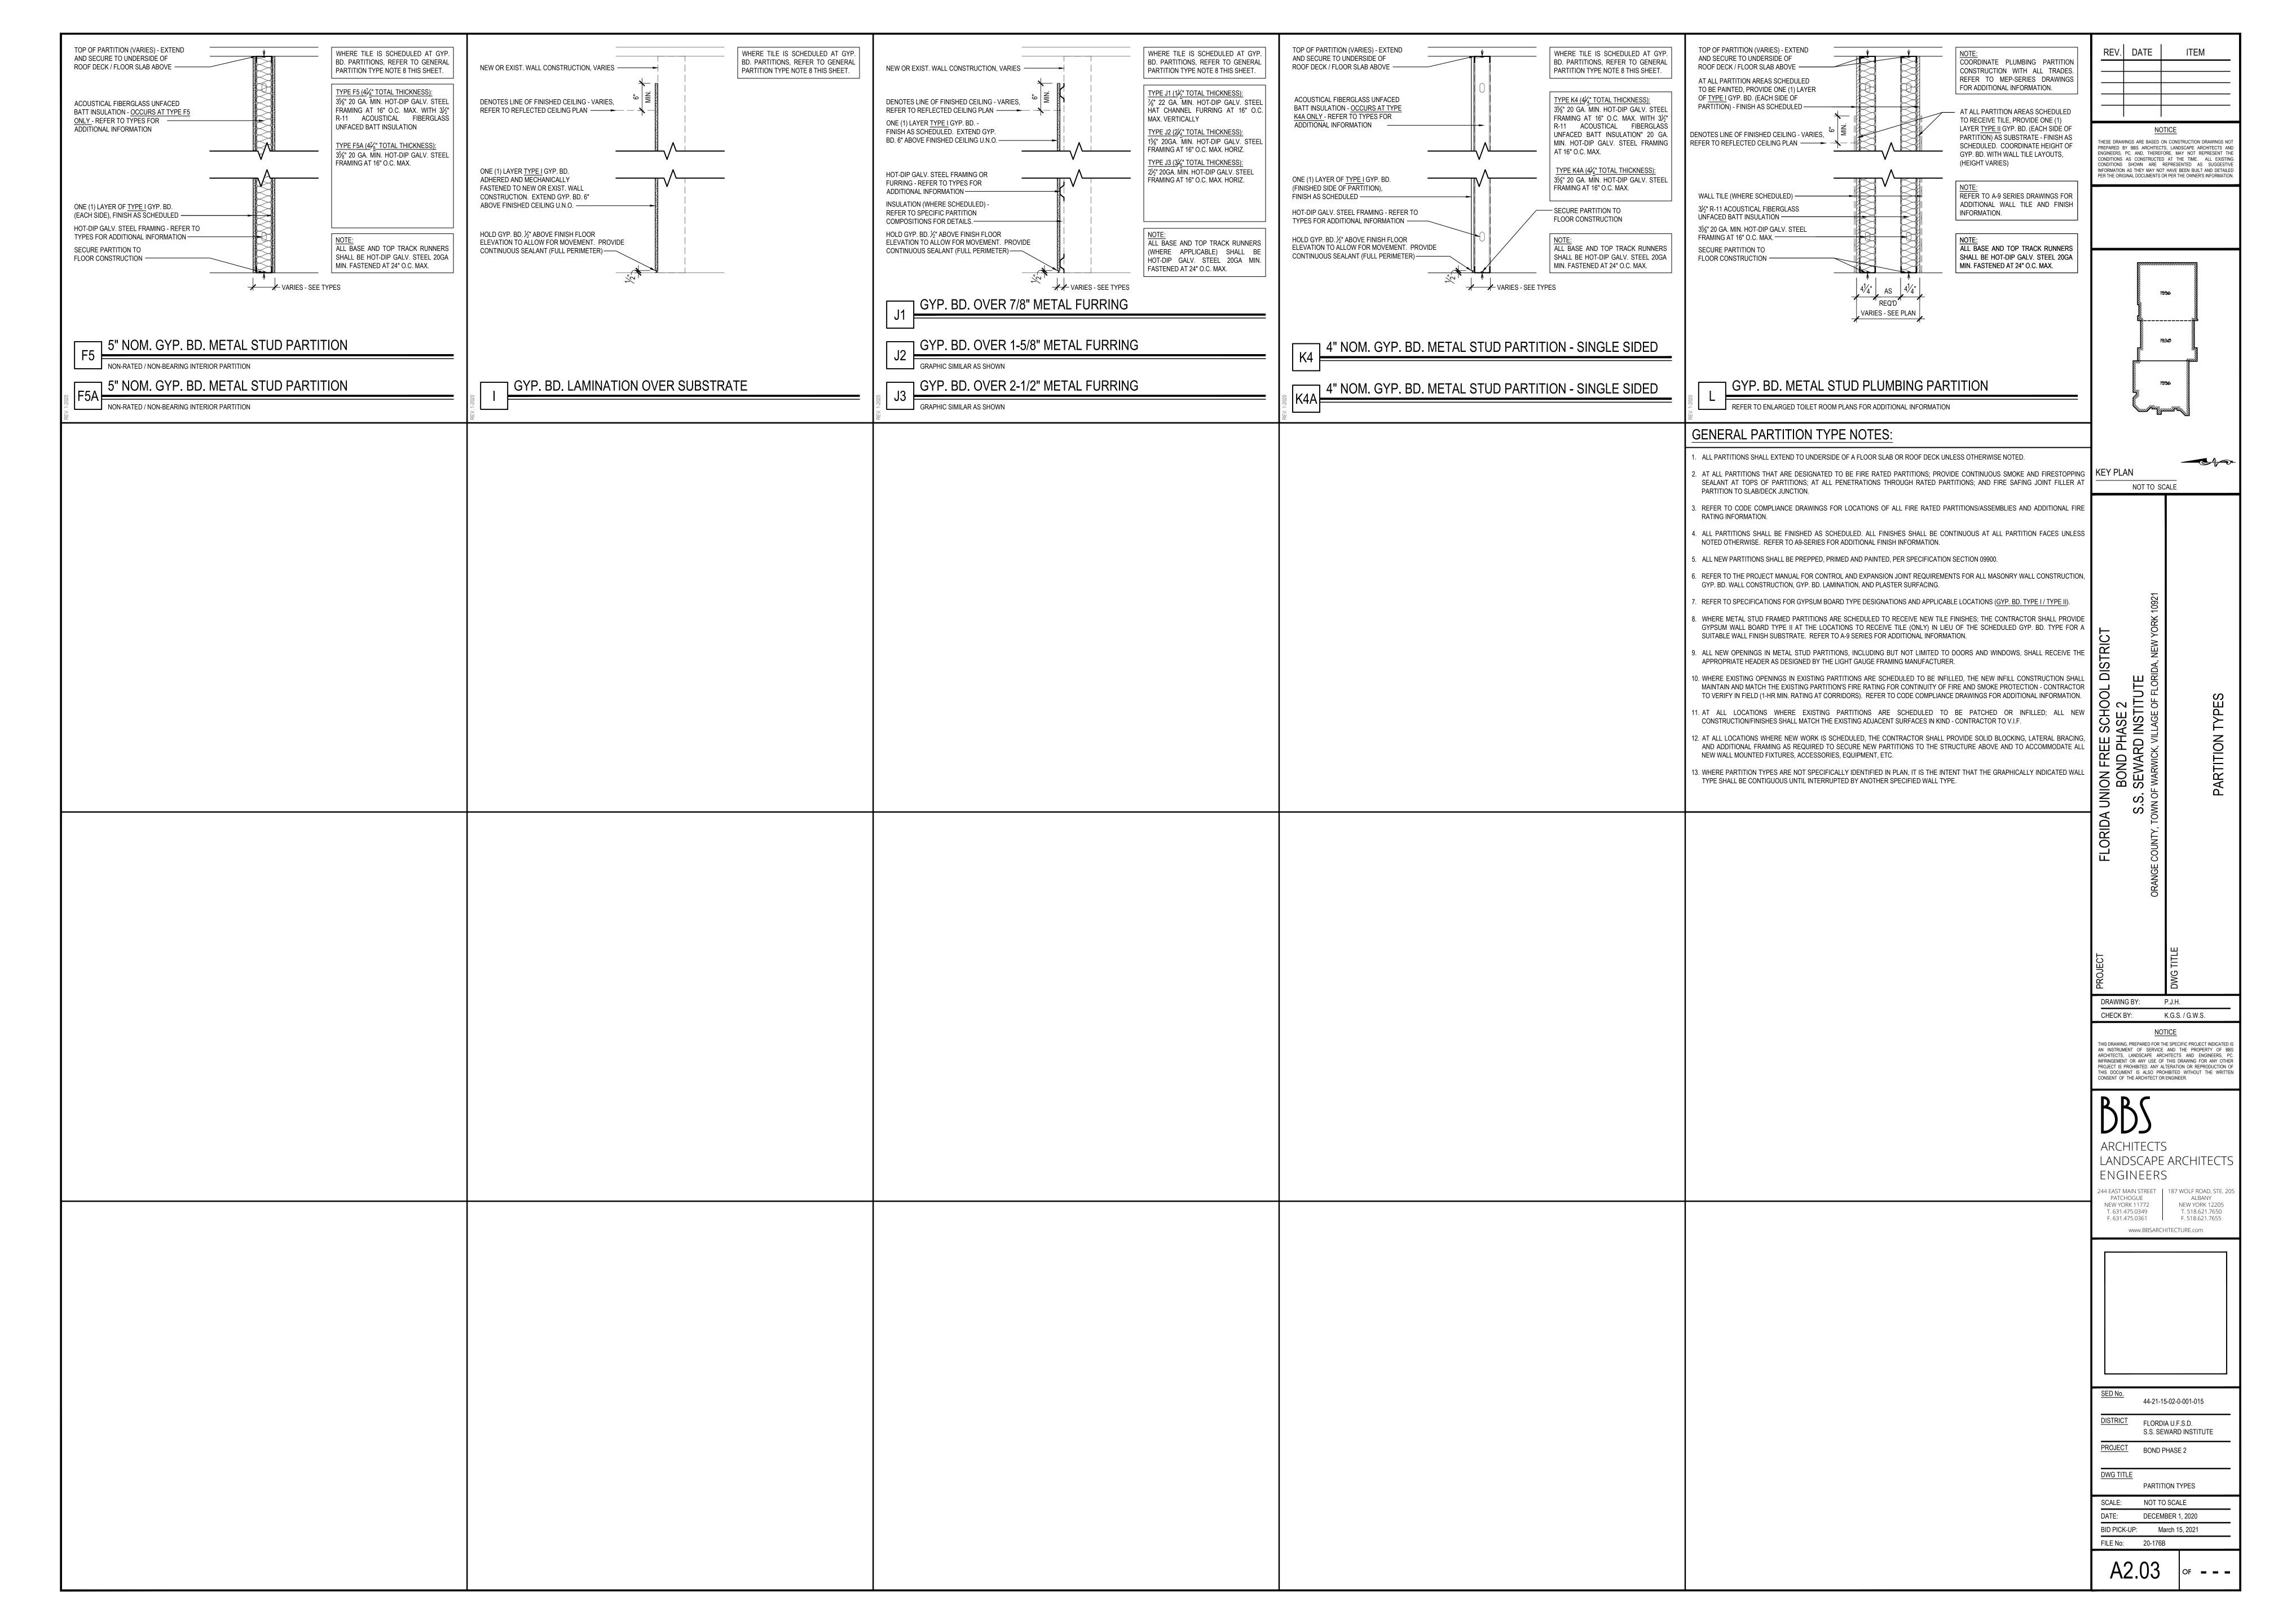

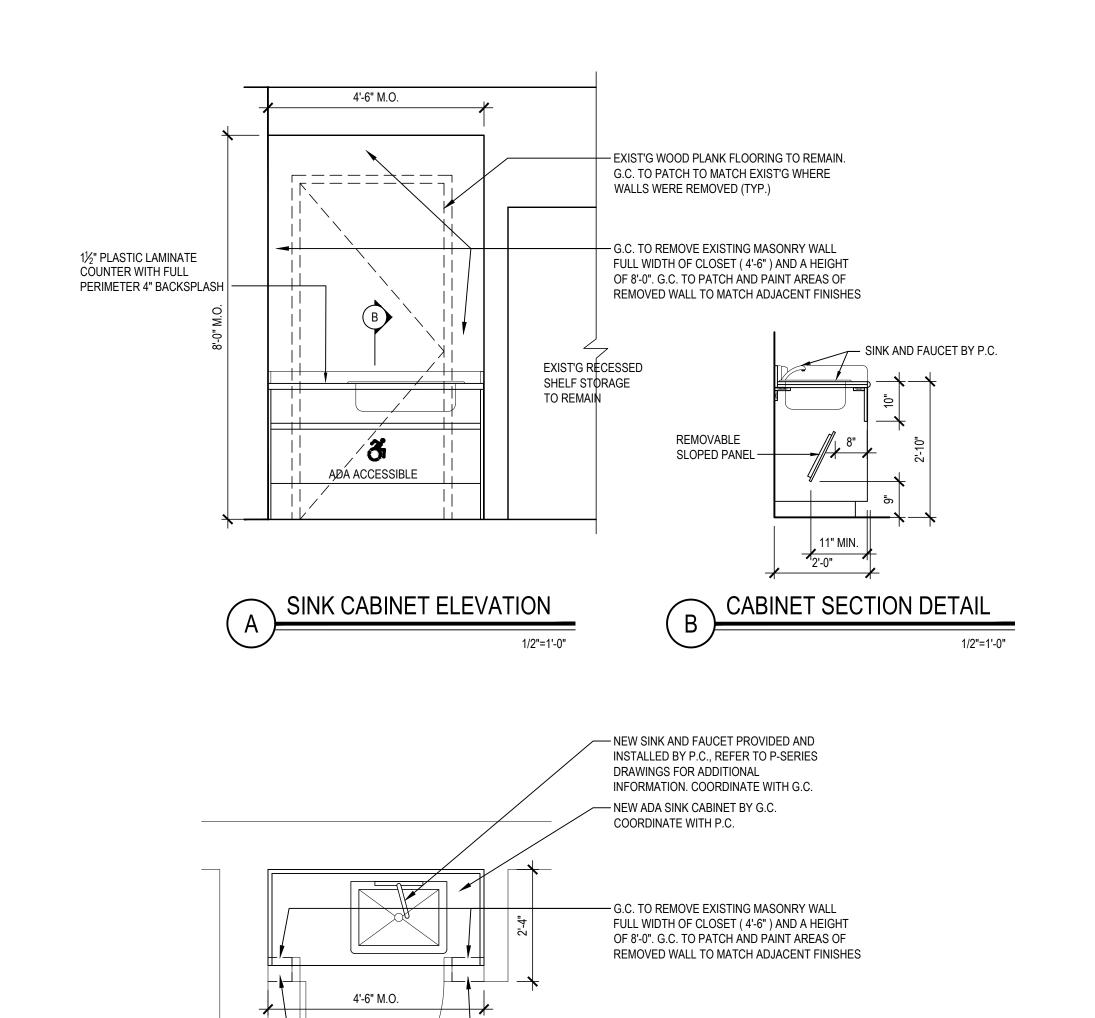

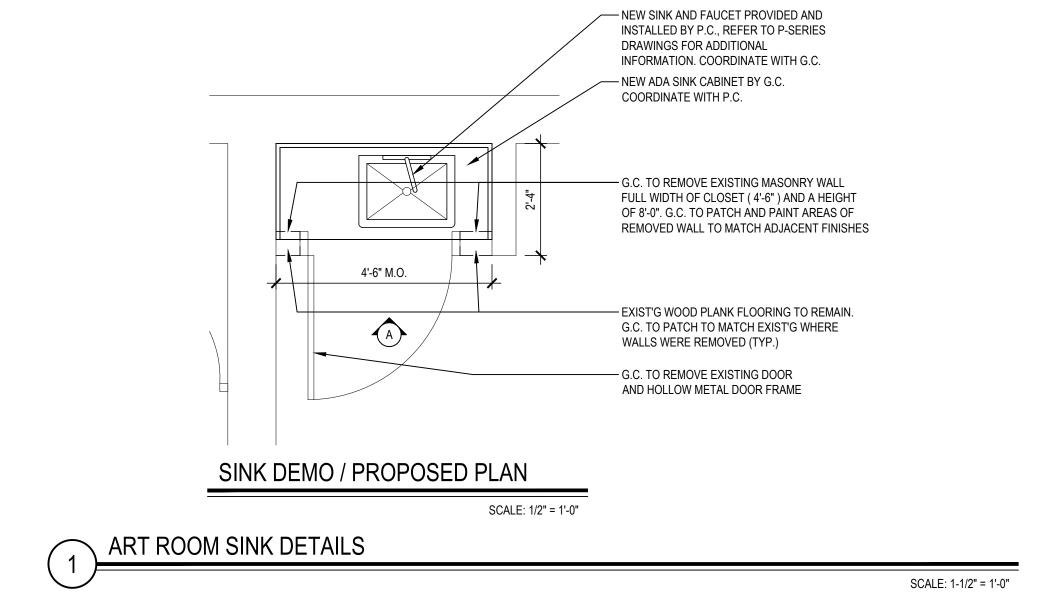

SCALE: 1/8" = 1'-0"

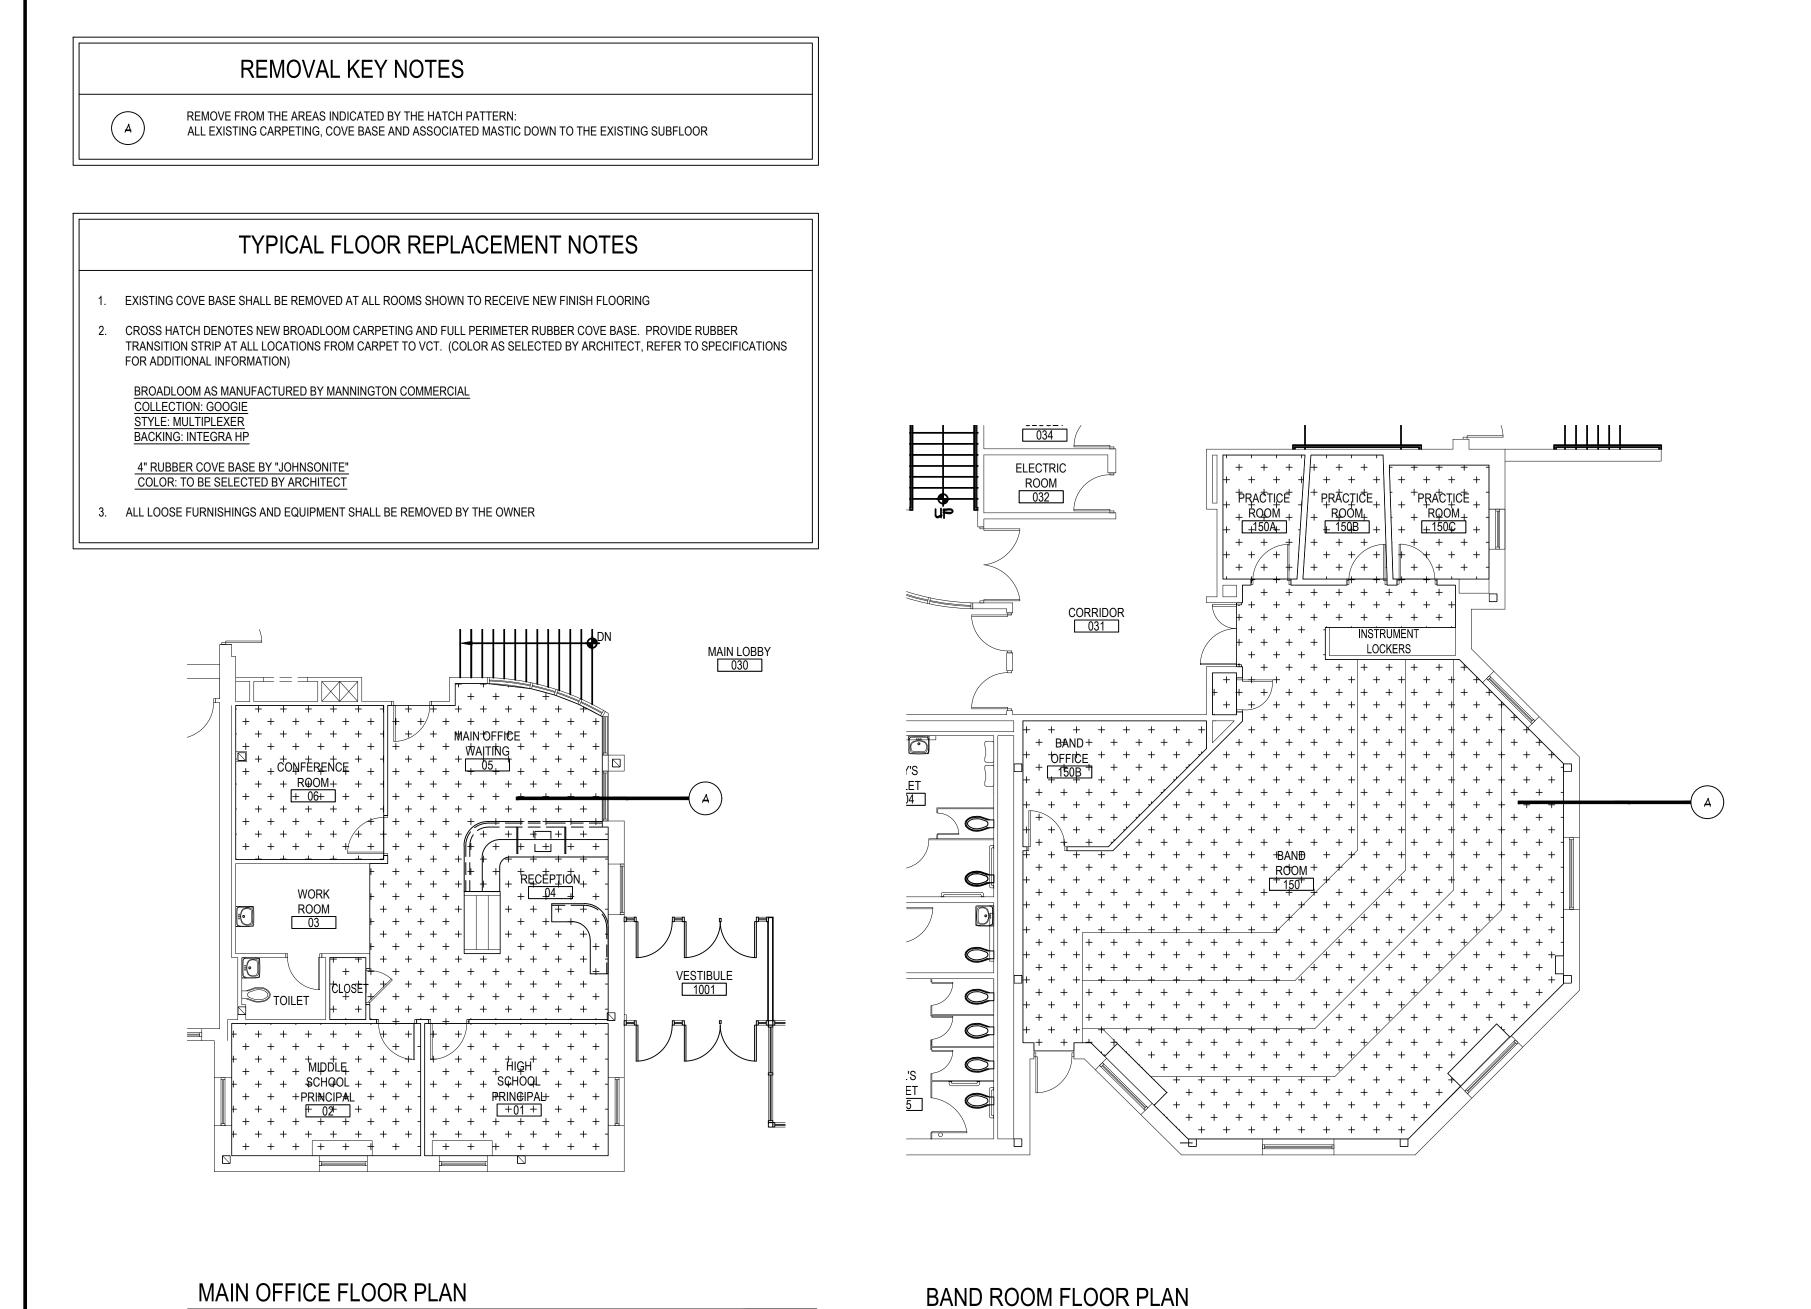

ALTERNATE NO.3a TO BASE BID GC-1 AND

ALTERNATE NO.3b TO BASE BID GC-1

SCALE: 1/8" = 1'-0"

ART ROOM SINK CABINET SCOPE NOTES:

2. G.C. SHALL REMOVE EXISTING CLOSET SHELVING

FOR NEW SINK CABINET ALCOVE (4'-6"w X 8'-0"h)

DRAWINGS FOR ADDITIONAL INFORMATION

DISPOSE OF

MATCH ADJACENT WALL

EACH END

TOILET

ART ROOM 105 FLOOR PLAN

ALTERNATE NO.3a TO BASE BID GC-1 and

ALTERNATE NO.3b TO BASE BID GC-1

1. G.C. SHALL REMOVE EXISTING DOOR AND H.M. DOOR FRAME IN ITS ENTIRETY AND

3. G.C. SHALL REMOVE PORTION OF EXISTING MASONRY WALL TO WIDEN OPENING

EXISTING CLOSET SIDE WALL TO REMAIN, CONTRACTOR TO PATCH AND FINISH TO

NEW ADA SINK CABINET BY G.C.
 REFER TO P-SERIES DRAWINGS

FOR ADDITIONAL INFORMATION

SCALE: 1/8" = 1'-0"


CLASSROOM

6. CONTRACTOR TO PROVIDE AND INSTALL 3/8" x 6"x 6" STEEL LINTEL. 6" BEARING AT

7. CONTRACTOR TO PROVIDE AND INSTALL NEW ADA COMPLIANT SINK CABINET

8. P.C. TO PROVIDE AND INSTALL NEW SINK AND FAUCET REFER TO P-SERIES

4. G.C. TO PATCH EXISTING WOOD FLOOR TO MATCH ADJACENT IN COLOR AND

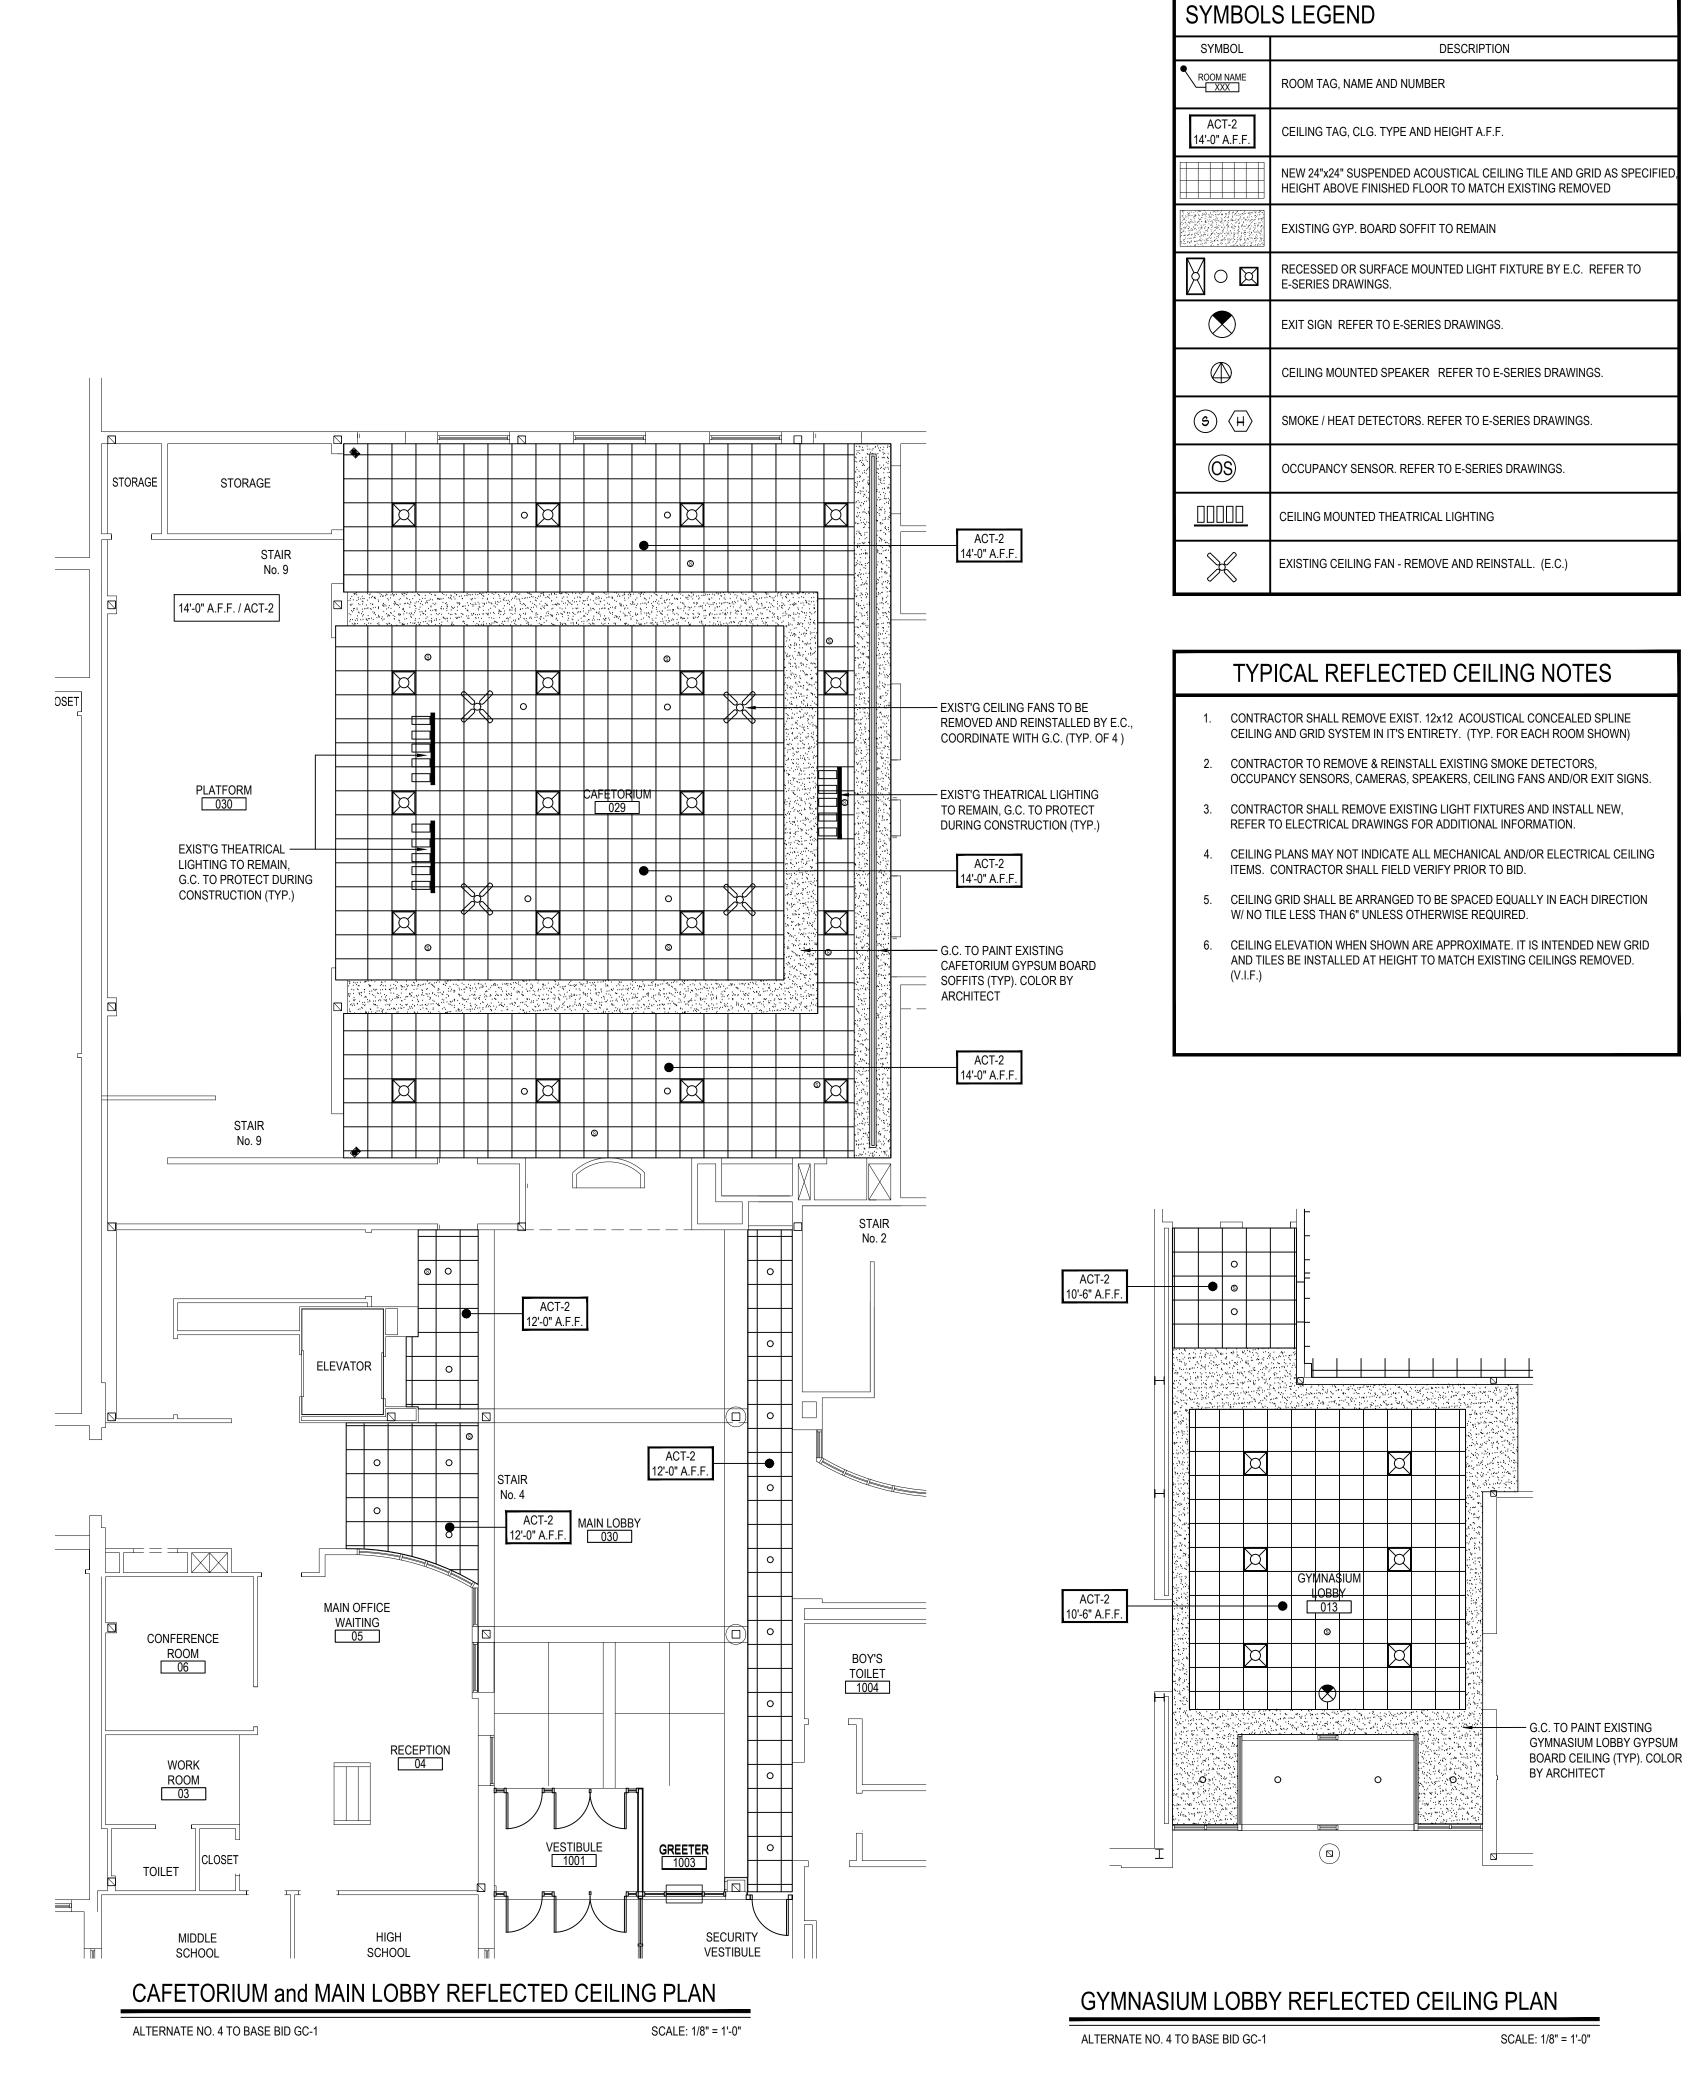

CONTRACTOR TO REMOVE EXISTING 2-TIER STUDENT LOCKERS AND GIVE TO OWNER OR

DISPOSE OF AS DIRECTED BY THE OWNER.

CONTRACTOR TO INSTALL NEW 24"x14'-8"

CONTRACTOR TO INSTALL (44) NEW SINGLE

STUDENT LOCKERS. SEE SPECIFICATION FOR

LOCKER NOTES:

APPROVAL PRIOR TO INSTALLATION.

DETERMINED ON SHOP DWGS.

LOCKER CONTRACTOR SHALL SUBMIT DETAILED SHOP DWGS FOR ARCHITECT

INSTALLATION SHALL INCLUDE ALL REQUIRED FILLER PANELS, PERIMETER TRIM,

DENOTES PROPOSED ADA LOCATION, FINAL LOCATIONS TO BE VERIFIED AND

LOCKER CONTRACTOR TO COORDINATE LOCKER NUMBER SEQUENCE W/ DISTRICT.

WOOD BLOCKING, ETC. FOR A COMPLETE AND OPERATIONAL SYSTEM.

5% OF TOTAL LOCKER QUANTITY SHALL BE ADA COMPLIANT.


CONCRETE LOCKER BASE TO

ADDITIONAL INFORMATION

SCALE: 1/8" = 1'-0"

6TH GRADE LOCKER REPLACEMENT FLOOR PLAN

ACCOMMODATE NEW LOCKERS

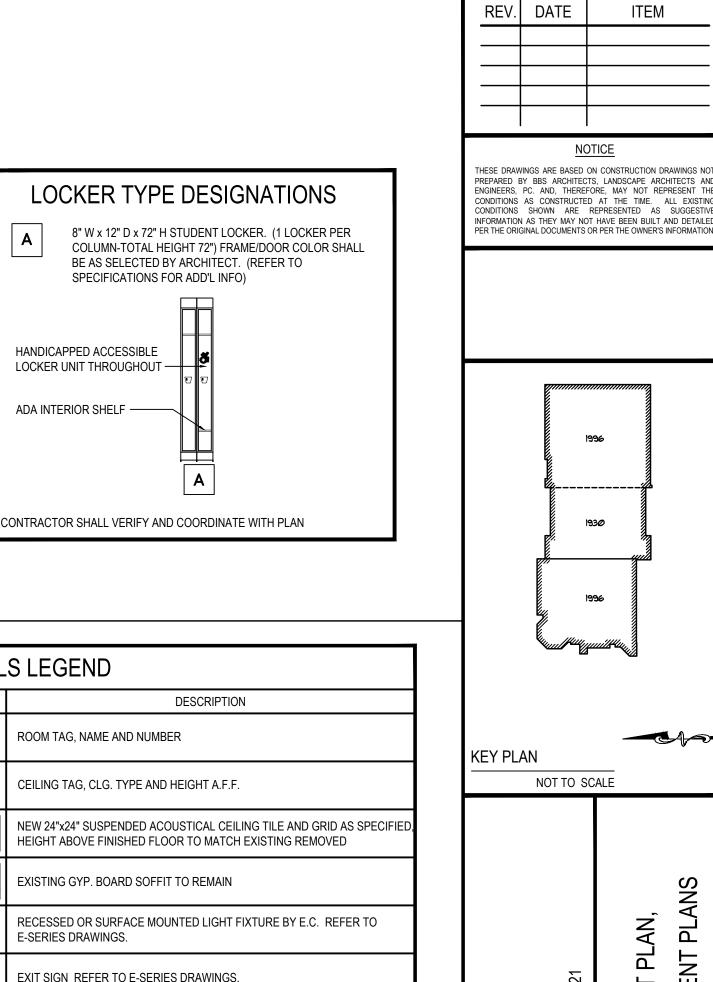

PJG

THIS DRAWING, PREPARED FOR THE SPECIFIC PROJECT INDICATED AN INSTRUMENT OF SERVICE AND THE PROPERTY OF BE

ARCHITECTS, LANDSCAPE ARCHITECTS AND ENGINEERS, FINFRINGEMENT OR ANY USE OF THIS DRAWING FOR ANY OTH

PROJECT IS PROHIBITED. ANY ALTERATION OR REPRODUCTION C THIS DOCUMENT IS ALSO PROHIBITED WITHOUT THE WRITTE

LANDSCAPE ARCHITECTS

www.BBSARCHITECTURE.com

44-21-15-02-0-001-015

S.S. SEWARD INSTITUTE

DECEMBER 1, 2020

<u>DISTRICT</u> FLORDIA U.F.S.D.

PROJECT BOND PHASE 2

DWG TITLE ...

SCALE: AS NOTED

FILE No: 20-176B

A2.04

BID PICK-UP: March 15, 2021

87 WOLF ROAD, STE. 20

NEW YORK 12205

F. 518.621.7655

CONSENT OF THE ARCHITECT OR ENGINEER.

ARCHITECTS

ENGINEERS

44 EAST MAIN STREET

PATCHOGUE NEW YORK 11772

T. 631.475.0349


F. 631.475.0361


KGS


DRAWING BY:

CHECK BY:

	DOOR SCHEDULE																			
AREA	DOOR	LOCATION	SIGNAGE	DOOR							FRAME			HARDWAR	E DETAIL		_	_	FIRE REMARKS	DOOR
	NO.	LOCATION	OIOIVAGE	LEAVES	WIDTH	HEIGHT	THICKNESS	ELEV. TYPE	MAT.	GLAZING	TYPE.	MAT.	GLAZING	SET	HEAD	JAMB	SILL	THOLD	RATING TEMATING	NO.
	001	CORRIDOR TO BOY'S LOCKER ROOM 017	В	1	3'-0"	7'-0"	1 3/4"	Α	MCOV		F1	H.M.		3A					20 MIN.	001
	002	CORRIDOR TO STORAGE 016B	В	1	3'-0"	7'-0"	1 3/4"	Α	MCOV		F1	H.M.		2	H1	J1		T1	90 MIN.	002
	003	CORRIDOR TO BOY'S LOCKER ROOM 017	В	1	3'-0"	7'-0"	1 3/4"	Α	MCOV		F1	H.M.		3					90 MIN.	003
S	004	CORRIDOR TO COACHES OFFICE 016	В	1	3'-0"	7'-0"	1 3/4"	Α	MCOV		F1	H.M.		3	H1	J1		T1	90 MIN.	004
	005	COACHES OFFICE TO BOYS LOCKER ROOM 017		1	3'-0"	7'-0"	1 3/4"	В	MCOV	TEMP.	F1	H.M.		3	H1	J1		T1	20 MIN.	005
Q	006	COACHES 016 OFFICE TO TOILET 016A		1	3'-6"	8'-0"	1 3/4"	Α	MCOV		F1	H.M.		1	H1	J1		T1	20 MIN.	006
ă	007	TOILET 017C TO STORAGE 017B	В	1	3'-0"	7'-0"	1 3/4"	Α	H.M.		F1	H.M.		2	H1	J1		T1	20 MIN.	007
8	008	TOILET 014C TO STORAGE 014B	В	1	3'-0"	7'-0"	1 3/4"	Α	H.M.		F1	H.M.		2	H1	J1		T1	20 MIN.	008
	009	COACHES OFFICE 015 TO TOILET 015A		1	3'-0"	7'-0"	1 3/4"	Α	MCOV		F1	H.M.		1	H1	J1		T1	20 MIN.	009
2	010	COACHES OFFICE 015 TO LOCKER ROOM 014		1	3'-0"	7'-0"	1 3/4"	В	MCOV	TEMP.	F1	H.M.		3	H1	J1		T1	20 MIN.	010
Ш	011	CORRIDOR TO COACHES OFFICE 015	В	1	3'-0"	7'-0"	1 3/4"	Α	MCOV		F1	H.M.		3	H1	J1		T1	90 MIN.	011
	012	CORRIDOR TO GIRL'S LOCKER ROOM 014	В	1	3'-0"	7'-0"	1 3/4"	Α	MCOV		F1	H.M.		3					90 MIN.	012
ပ	013	CORRIDOR TO TRAINERS ROOM 015B	В	1	3'-0"	7'-0"	1 3/4"	Α	MCOV		F1	H.M.		3	H1	J1		T1	90 MIN.	013
Ö	014	CORRIDOR TO GIRL'S LOCKER ROOM 014	В	1	3'-0"	7'-0"	1 3/4"	Α	MCOV		F1	H.M.		3					20 MIN.	014

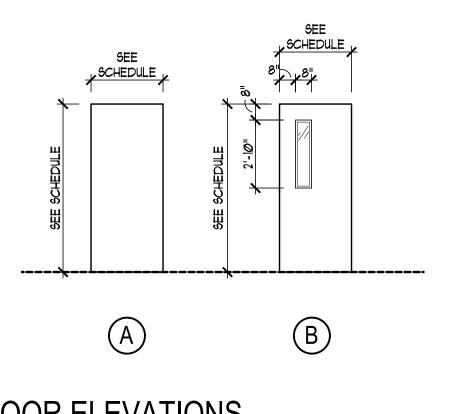

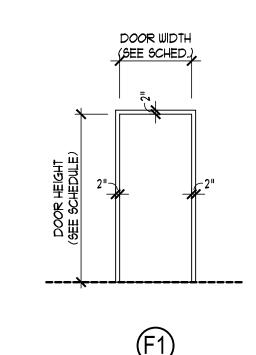


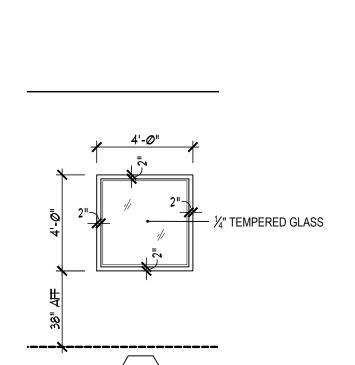







VISION PANEL FRAME ELEVATION

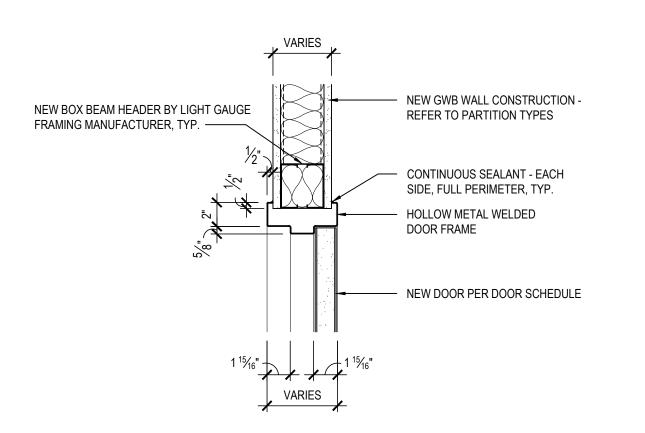

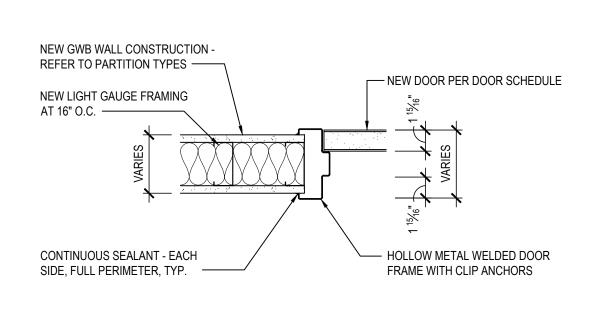

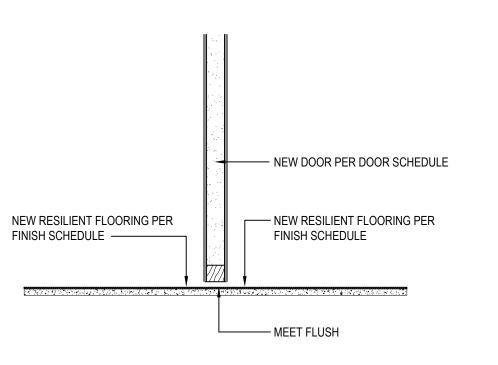

SCALE: 1-1/2" = 1'-0"

SCALE: 1-1/2" = 1'-0"

THRESHOLD DETAIL

SCALE: 1-1/2" = 1'-0"

SCALE: 1/4" = 1'-0"


ABBREVIATIONS ALUMINUM . 1/4" FIREGLASS 20 SOLID COMPOSITE LUMBER CORE OAK VENEER 5/16" FIRE-LITE PLUS MINERAL CORE OAK VENEER 1" INSULATED GLASS SOLID COMPOSITE LUMBER CORE MAPLE VENEER 1/4" TEMPERED GLASS MINERAL CORE MAPLE VENEER 1/4" SAFETY LAMINATED GLASS FIBERGLASS REINFORCED POLYESTER OBSCURE GLASS HOLLOW METAL . BULLET RESISTANT GLASS


DOOR NOTES


- . ALL DOORS, FRAMES AND HARDWARE SHALL BE PROVIDED AND INSTALLED BY GENERAL CONTRACTOR UNLESS OTHERWISE NOTED.
- 2. GENERAL CONTRACTOR SHALL COORDINATE ALL KEYING WITH OWNER.
- 3. ALL FIRE RATED WOOD DOORS SHALL HAVE SOLID MINERAL CORE, ALL OTHER WOOD DOORS SHALL HAVE SOLID COMPOSITE LUMBER CORE.
- FLUSH WOOD DOORS SHALL BE 5 PLY LAMINATED FACE SHEETS WITH 2 PLY FINISH VENEER OVER SPECIFIED CORE. AT FIRE RATED DOORS, TOP AND BOTTOM RAILS AND STILES SHALL BE FIRE RESISTANT COMPOSITION MATERIAL BONDED TO CORE. REFER TO SPECIFICATION SECTION 08211 FOR ADDITIONAL INFORMATION.
- ALL GLAZING IN DOORS SHALL BE INSTALLED IN METAL VISION KIT TO MATCH FIRE LABEL. VISION KIT COLOR SHALL BE AS SELECTED BY ARCHITECT.
- ALL NEW H.M. FRAMES SHALL BE WRAP AROUND TYPE (UNLESS OTHERWISE NOTED OR DETAILED). THROATS SHALL BE SIZED ACCORDING TO WALL THICKNESS AND FINISH, REFER TO FLOOR PLAN AND ENLARGED DETAILS FOR ADDITIONAL INFORMATION.
- GENERAL CONTRACTOR SHALL MODIFY AND PATCH EXISTING WOOD OR H.M. DOOR FRAMES (DESIGNATED TO REMAIN) TO ACCOMMODATE NEW DOOR OPERATOR, LOCKSET, LATCH, HINGES, DOOR SWING AND/OR CLOSER, ETC. AS REQUIRED FOR COMPLETE AND FUNCTIONAL OPERATION.
- GENERAL CONTRACTOR IS RESPONSIBLE FOR VERIFYING HEIGHT AND WIDTH OF PROPOSED DOORS TO BE INSTALLED IN EXISTING FRAMES (PRIOR TO SHOP DRAWING SUBMITTAL) TO ENSURE PROPER FIT AND DOOR FUNCTION.
- 10. ALL NEW HOLLOW METAL FRAMES AND HOLLOW METAL DOORS SHALL BE FINISH PAINTED. COLOR AS SELECTED BY ARCHITECT.
- . GENERAL CONTRACTOR SHALL PROVIDE AND INSTALL A.D.A. ACCESSIBLE SIGNAGE AT ALL DOORS (WHERE SPECIFIED IN DOOR SCHEDULE AND/OR SHOWN ON FLOOR PLANS) AND INSTALLED IN CONFORMANCE WITH ALL A.D.A. REQUIREMENTS.
 - ▲ WHERE DENOTED IN SCHEDULE, PROVIDE 4"x4" BRAILLE SIGNAGE INDICATING ROOM NUMBER (COORD. WITH OWNER), MODEL E-BTC43. ▲ WHERE DENOTED IN SCHEDULE, PROVIDE 4"x12" BRAILLE SIGNAGE INDICATING ROOM NAME AND NUMBER (COORD. WITH OWNER) MODEL E-BTC102.
 - WHERE DENOTED IN SCHEDULE, PROVIDE 8"x8" BRAILLE SIGNAGE INDICATING GENDER AND HANDICAP CHARACTER AT TOILET ROOMS, MODEL E-BTP85A OR E-BTP193A

MANUFACTURER: "ALLSTATE SIGN AND PLAQUE" (REFER TO DOOR SCHEDULE AND FLOOR PLANS FOR SIGN TYPE AND LOCATION). ALL SIGNAGE SHALL BE SUBMITTED TO ARCHITECT FOR REVIEW AND APPROVAL.


- 12. ALL REMOVABLE MULLIONS ARE TO BE KEYED ALIKE AND TO MATCH EXISTING BUILDING SYSTEM.
- 13. FIRE RATED GLAZING WITH SURFACE APPLIED FILMS WILL NOT BE CONSIDERED EQUIVALENT WHERE LAMINATED FILM IS SPECIFIED.

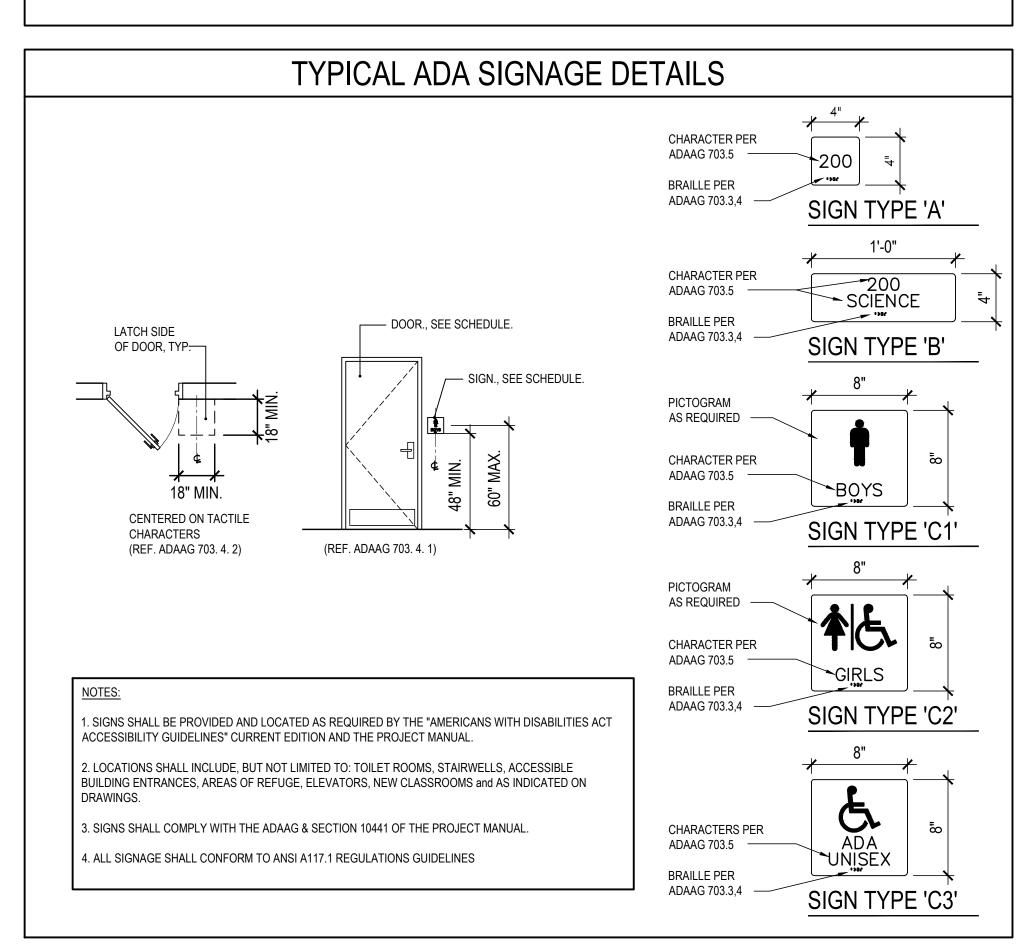


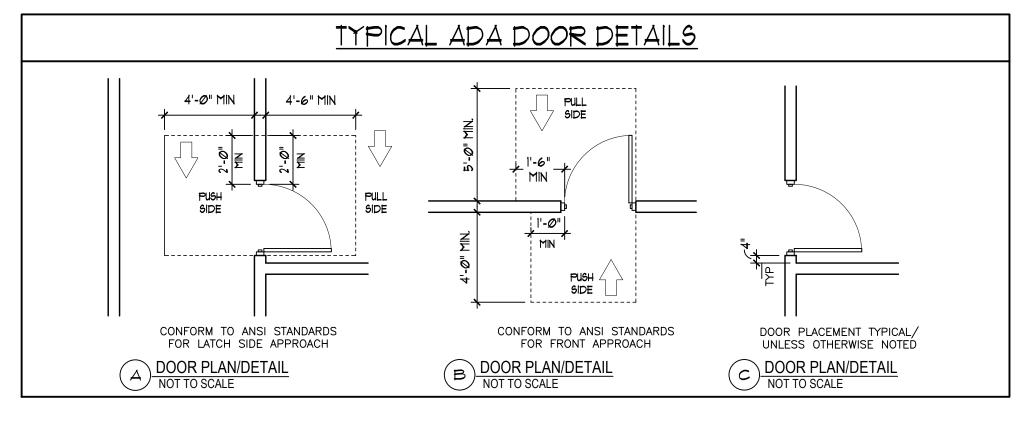


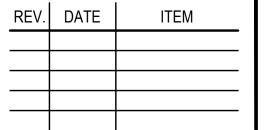

THESE DRAWINGS ARE BASED ON CONSTRUCTION DRAWINGS NOT PREPARED BY BBS ARCHITECTS, LANDSCAPE ARCHITECTS AND ENGINEERS, PC. AND, THEREFORE, MAY NOT REPRESENT THE CONDITIONS AS CONSTRUCTED AT THE TIME. ALL EXISTING CONDITIONS SHOWN ARE REPRESENTED AS SUGGESTIVE INFORMATION AS THEY MAY NOT HAVE BEEN BUILT AND DETAILED

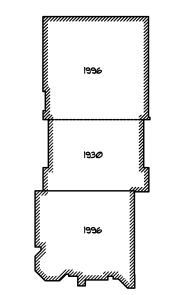

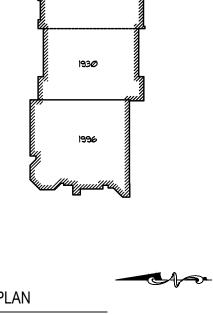


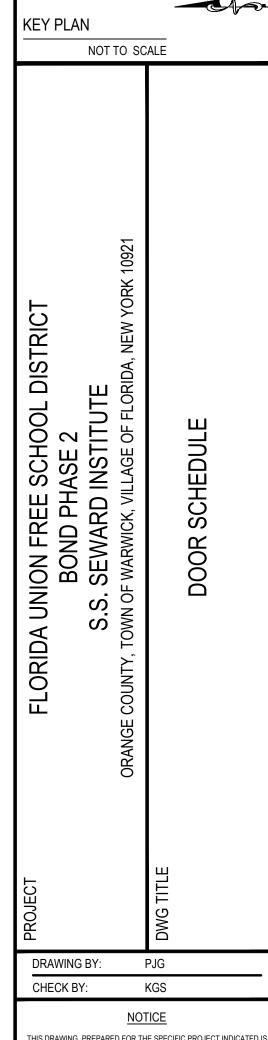

THIS DRAWING, PREPARED FOR THE SPECIFIC PROJECT INDICATED IS AN INSTRUMENT OF SERVICE AND THE PROPERTY OF BBS ARCHITECTS, LANDSCAPE ARCHITECTS AND ENGINEERS, PINFRINGEMENT OR ANY USE OF THIS DRAWING FOR ANY OTHE PROJECT IS PROHIBITED. ANY ALTERATION OR REPRODUCTION OF THIS DOCUMENT IS ALSO PROHIBITED WITHOUT THE WRITTEN CONSENT OF THE ARCHITECT OR ENGINEER.



LANDSCAPE ARCHITECTS ENGINEERS 44 EAST MAIN STREET | 187 WOLF ROAD, STE. 201 NEW YORK 11772 NEW YORK 12205

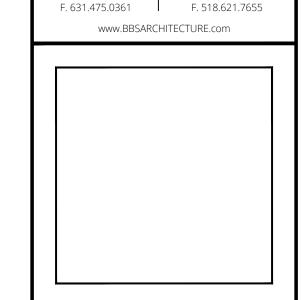



SED No.	44-21-15-02-0-001-015
DISTRICT	FLORDIA U.F.S.D. S.S. SEWARD INSTITUTE
PROJECT	BOND PHASE 2
DWG TITLE	DOOR SCHEDULE

SCALE:	AS NOTED
DATE:	DECEMBER 1, 2020
BID PICK-UP:	March 15, 2021

	FINISH SCHEDULE							
AREA	ROOM	LOCATION	FLOOR	BASE	WALL	WALL	REMARKS	ROOM
	NO.		TYPE	TYPE	TYPE	FINISH		NO.
	014	GIRLS P.E LOCKER ROOM	EP1	EP1	GYP. BD.	P1		014
	014A	GIRLS TEAM LOCKER ROOM	EP1	EP1	GYP. BD.	P1		014A
	014B	STORAGE	EP1	EP1	GYP. BD.	P1		014B
	014C	TOILET	EP1	EP1	GYP. BD.	CWT1/P1/P3		014C
	015	GIRLS P.E. OFFICE	VCT2	RCB1	GYP. BD.	P1		015
	015A	TOILET	EP1	EP1	GYP. BD.	P1		015A
	015B	TRAINERS ROOM	VCT3	RCB1	GYP. BD.	P1		015B
	016	BOYS P.E. OFFICE	VCT1	RCB1	GYP. BD.	P1		016
	016A	TOILET	EP1	EP1	GYP. BD.	P1		016A
	016B	STORAGE	VCT3	RCB1	GYP. BD.	P1		016B
	017	BOYS P.E. LOCKER ROOM	EP1	EP1	GYP. BD.	P1		017
	017A	BOYS TEAM LOCKER ROOM	EP1	EP1	GYP. BD.	P1		017A
	017B	STORAGE	EP1	EP1	GYP. BD.	P1		017B
	017C	TOILET	EP1	EP1	GYP. BD.	CWT1/P1/P3		017C

SYMBOL	DESCRIPTION
EPOXY	BROADCAST EPOXY SYSTEM OVER CONCRETE AND UP LOCKER BASE
VINYL COMPOSITE TILE	12"X12" VINYL COMPOSITION TILE
POURED CONCRETE LOCKER BASE	

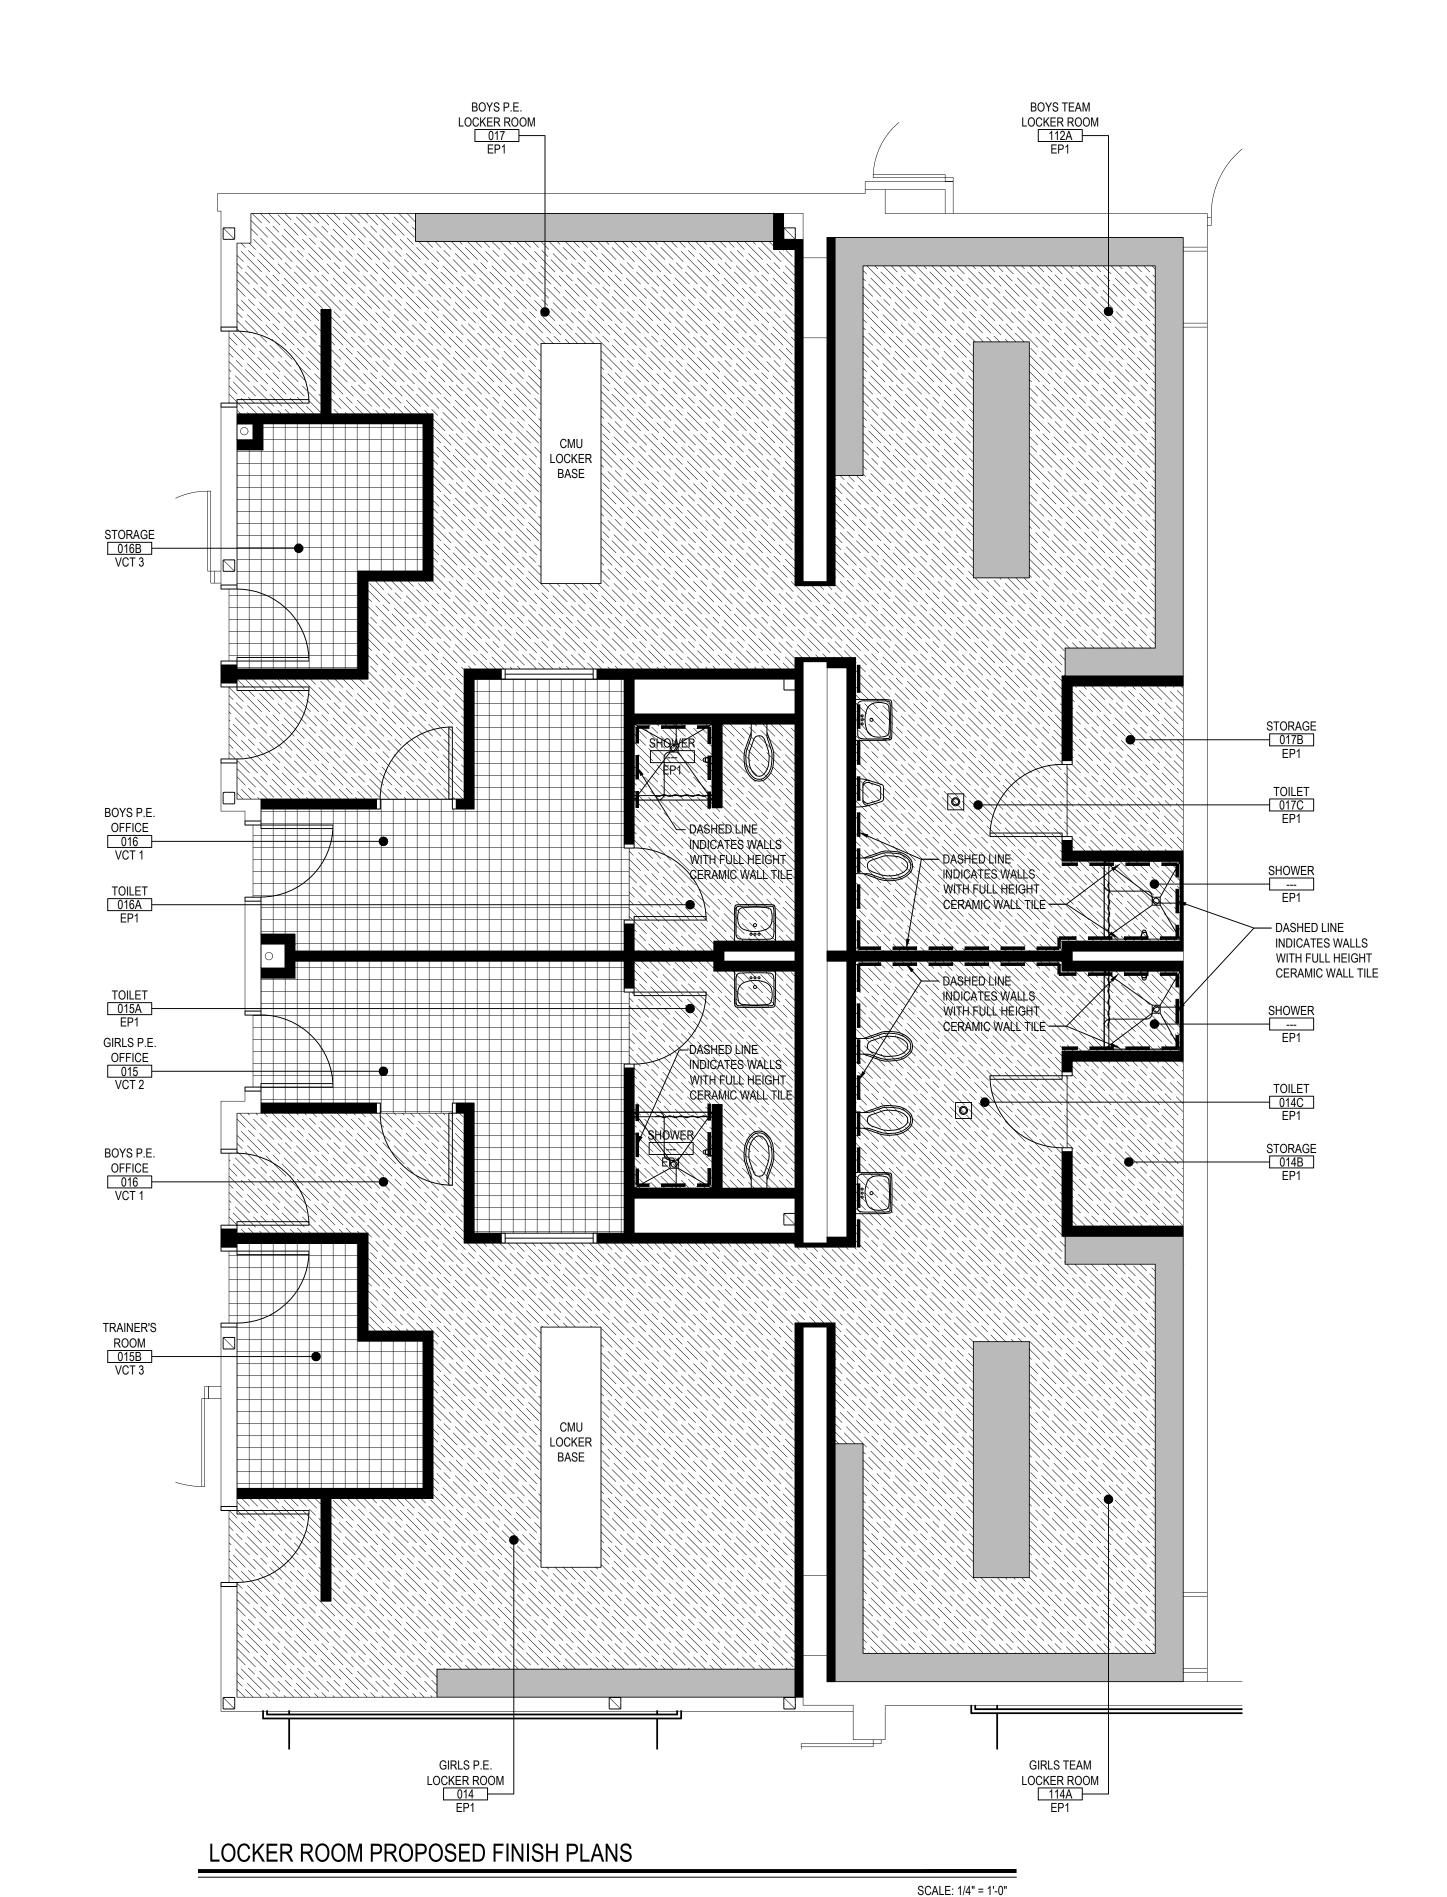

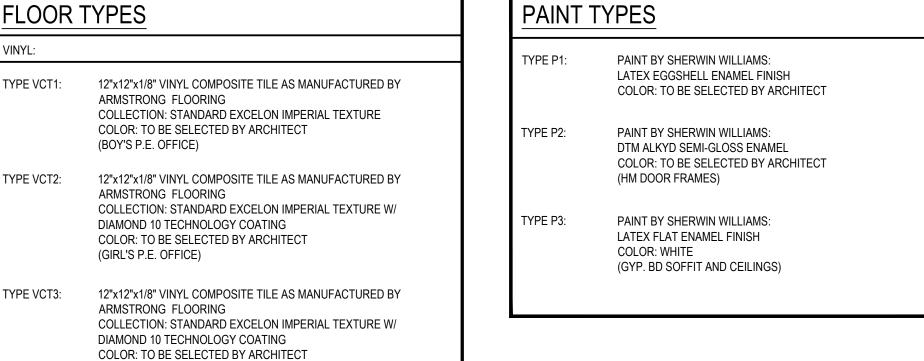

COLOR: CUSTOM MULTICOLOR PREBLEND BY ARCHITECT (BOY'S & GIRL'S LOCKER ROOMS, TOILETS, SHOWERS) **CERAMIC TILE TYPES** WALLS:

POURED DUR-A-CHIP EPOXY FLOOR SYSTEM AS

MANUFACTURED BY DURAFLEX OR EQUAL WITH INTEGRAL

(TRAINER'S ROOM, STORAGE ROOM)

(BATHROOM WALL FIELD TILE) TYPE CWT2: 6" ACCENT BAND 1" X 1" AMERICAN OLEAN COLOR APPEAL GLASS MOSAICS COLOR: TO BE SELECTED BY ARCHITECT (BATHROOM WALL ACCENT TILE)

GROUT TYPES FLOOR GROUT: AS MANUFACTURED BY LATICRETE OR MAPEI, SANDED, COLOR: TO BE SELECTED BY ARCHITECT WALL GROUT: AS MANUFACTURED BY LATICRETE OR MAPEI, UNSANDED,

TYPE CWT1: 3" X 6" CERAMIC WALL TILE BY DALTILE STYLE: CLASSIC COLOR WHEEL COLOR: TO BE SELECTED BY ARCHITECT TYPE RCB1:

COLOR: TO BE SELECTED BY ARCHITECT

NEW CERAMIC WALL TILE (CWT1) -

NEW CERAMIC WALL TILE (CWT2) ——

NEW CERAMIC WALL TILE (CWT1) ——

NEW EPOXY COVE BASE (EP 1) - TYP.

CEILING GRID BY "ARMSTRONG", 15/16" PRELUDE, U.O.N. RUBBER BASE TYPES 4" RUBBER COVE BASE BY "JOHNSONITE" COLOR: TO BE SELECTED BY ARCHITECT

SCALE: N.T.S.

PAINT TYPES

CEILING TYPES

ACOUSTIC CEILING TILE BY "ARMSTRONG" TYPE ACT1: SIZE: 24" X 24" X 3/4"

ACOUSTIC CEILING TILE BY "ARMSTRONG" SIZE: 24" X 24" X 1", NRC RATING .95 STYLE: #3250 OPTIMA SQUARE TEGULAR (CAFETORIUM, MAIN LOBBY, GYMNASIUM LOBBY)

NOTE: ALL CEILING TILE & GRID TO BE COLOR WHITE UNLESS OTHERWISE NOTED.

TYPE BOYS: COLOR: TO BE SELECTED BY ARCHITECT TYPE GIRLS: COLOR: TO BE SELECTED BY ARCHITECT

STYLE: #1910 ULTIMA SQUARE LAY-IN

TOILET PARTITIONS

AS PER SPECIFICATION SECTION, SCRANTON OR ASI GLOBAL PARTITIONS SHALL BE PROVIDED - CLASS B MIN OR NFPA RATED. COLOR AS SELECTED BY ARCHITECT FROM FULL RANGE OF COLORS.

LEVEL 5 - FOR USE WHERE GLOSS, SEMI-GLOSS, ENAMEL OR NON-TEXTURED FLAT PAINTS ARE SPECIFIED, OR WHERE SEVERE LIGHTING CONDITIONS OCCUR (IN THE OPTION OF

ABBREVIATIONS

FINISH NOTES

NOTES

GENERAL CONTRACTOR SHALL PATCH ALL AREAS OF FLOOR DAMAGED BY THE REMOVAL OF MASTIC.

OTHER SIMILAR AREAS WHERE SURFACE APPEARANCES ARE NOT OF PRIMARY CONCERN.

GENERAL CONTRACTOR SHALL FLASH PATCH ALL FLOORS IN THEIR ENTIRETY WHERE MASTIC REMOVAL HAS OCCURRED WITH (PLANI/PATCH PLUS) BY 'MAPEI' OR ARCHITECT APPROVED

B. GENERAL CONTRACTOR SHALL PERFORM A BOND TEST IN ACCORDANCE WITH MANUFACTURERS SPECIFICATIONS. PRIOR TO INSTALLATION OF NEW FLOORING.

E. LEVEL 4 - FOR USE WHERE LIGHT TEXTURE OR WALL COVERINGS ARE TO BE APPLIED, OR WHERE ECONOMY IS OF THE ARCHITECT'S CONCERN.

. ACOUSTIC CEILING TILE | VET

PORCELIAN FLOOR TILE | GYP . CONCRETE MASONRY UNIT | RUB

CERAMIC TILE COVE BASE | RCB

. ALL NEW BRICK WALLS ARE TO REMAIN NATURAL, CLEANED AND SEALED, IN ACCORDANCE WITH MANUFACTURER'S SPECIFICATIONS.

BEFORE PAINTING, CONCRETE SURFACES MUST CURE 30 DAYS, BLOCK AND PLASTER SURFACES MUST CURE FOR 30 DAYS

REFER TO REFLECTED CEILING PLANS AND FINISH FLOOR PLANS FOR ADDITIONAL INFORMATION.

SPECIFIED FOR INSTALLATION OF FINISH FLOORING AS SPECIFIED ON FINISH SCHEDULE.

12. CONTRACTOR SHALL PREP, PRIME AND PAINT SHEETROCK CEILINGS UNLESS OTHERWISE NOTED.

BID SHALL BE BASED ON THE TILE MIX AND PERCENTAGES AS INDICATED IN THE PROJECT MANUAL.

ALL FINISHES SHALL BE PROVIDED AND INSTALLED BY GENERAL CONTRACTOR UNLESS OTHERWISE NOTED.

ALL INTERIOR FINISHES IN CORRIDOR SHALL BE 'CLASS - A' RATED.

FOR APPROVAL PRIOR TO INSTALLATION.

GYPSUM BOARD FINISHING

AREAS NOT NORMALLY OPEN TO THE PUBLIC VIEW.

ARE TO BE APPLIED AS THE FINAL DECORATION.

SPECIFICATION SECTION 09250.

4. CONTRACTOR SHALL PREP, PRIME AND PAINT ALL SHEET METAL PIPE ENCLOSURES (INSTALLED BY M.C.) COLOR AS SELECTED BY ARCHITECT.

B. PATCH, REPAIR AND FINISH CEILING, WALLS, AND FLOOR AT POINTS OF DEMOLITION TO MATCH EXISTING. EXISTING FINISHES TO REMAIN.

5. REFER TO REFLECTED CEILING PLANS, TOILET ROOM TILE PLANS AND FINISHED FLOOR PLANS FOR ADDITIONAL FINISH INFORMATION.

A. LEVEL 0 - FOR USE IN TEMPORARY CONSTRUCTION, OR WHERE FINAL FINISH/DECORATION HAS NOT BEEN DETERMINED.

. CARPET TILE | LVT

ALL FINISHED TYPES (STYLE/COLOR/PATTERN) SHALL BE OFF THE STANDARD OF QUALITY INDICATED BY THE PROJECT MANUAL. FINAL STYLE / COLOR / PATTERN TO BE SELECTED BY

9. SHOULD ANY FINISH MATERIALS BE DISCONTINUED BY MANUFACTURER, THE CONTRACTOR MUST REPLACE WITH CLOSEST MATCH AT NO ADDITIONAL COST, AND SUBMIT TO ARCHITECT

. AT ROOMS HAVING EXISTING FLOOR TILE TO BE REMOVED AND / OR ABATED, CONTRACTOR SHALL PROVIDE AND INSTALL FLOOR PATCH (PLANI/PATCH PLUS) BY 'MAPEI' OR ARCHITECT

11. HOLLOW METAL DOOR FRAMES, SIDE LIGHTS AND WINDOW FRAMES SHALL BE PREPPED AND PAINTED AS PER PAINTING SPECIFICATION (ALL COLORS AS SELECTED BY ARCHITECT.)

3. REFER TO FINISH FLOOR PLANS FOR TILE PATTERNS - THE TILE PATTERNS MAY NOT REPRESENT THE FINAL PATTERNS TO BE DESIGNED, INSTALLED AND TURNED OVER TO OWNER. THE

NEW TOILET AND URINAL PARTITIONS SHALL BE 1" THICK HDPE AS MANUFACTURED BY SCRANTON, ASI GLOBAL PARTITIONS, OR APPROVED EQUAL. (COLOR AND FINISH TO BE SELECTED

. CONTRACTOR TO PROVIDE ALL REQUIRED SADDLES, THRESHOLDS, REDUCER STRIPS, TRANSITION STRIPS AND OR FLAT PLATES AS REQUIRED TO PROVIDE A FINISHED, ADA COMPLIANT

GENERAL CONTRACTOR SHALL CONFORM TO THE REQUIREMENTS OF GYPSUM ASSOCIATION TRADE PUBLICATION GA-214-96 'RECOMMENDED LEVELS OF GYPSUM BOARD FINISH' & 3.06 OF

LEVEL 1 - FOR USE AT PLENUM AREAS, ABOVE CEILING, IN ATTICS & IN AREAS WHERE THE ASSEMBLY WOULD GENERALLY BE CONCEALED OR IN BUILDING CORRIDORS & OTHER

LEVEL 2 - FOR USE AT LOCATIONS WHERE WATER-RESISTANT GYPSUM BACKING BOARD IS INSTALLED AS A TILE SUBSTRATE AND FOR USE IN GARAGES, WAREHOUSE STORAGE OR

LEVEL 3 - FOR USE IN APPEARANCE AREAS THAT ARE TO RECEIVE HEAVY OR MEDIUM TEXTURE FINISHES BEFORE FINAL PAINTING, OR WHERE HEAVY - GRADE WALL COVERINGS

TRANSITION AT NUMEROUS FLOORING TRANSITIONS AND TERMINATIONS. CONTRACTOR TO PROVIDE CUTS AND COLOR OPTIONS FOR ARCHITECTS REVIEW AND APPROVAL


18. CONTRACTOR SHALL PERFORM A BOND TEST IN ACCORDANCE WITH MANUFACTURERS SPECIFICATIONS. PRIOR TO INSTALLATION OF ALL NEW FLOORING.

APPROVED EQUAL OVER ENTIRE EXISTING SUBSTRATE AND / OR CONCRETE SLAB TO PROVIDE A FLOOR SURFACE IN ACCORDANCE WITH MANUFACTURER'S SPECIFICATIONS AND AS

2. ALL C.M.U. SURFACES SHALL BE PRIMED WITH INTERIOR & EXTERIOR BLOCK FILLER M88 INDUSTRIAL MAINTENANCE BY BENJAMIN MOORE PRIOR TO FINISH PAINT APPLICATION.

PROVIDE NEW MARBLE SADDLE AT ALL TOILET ROOM DOORS. PROVIDE BEVELED SADDLE TO MEET ADA REQUIREMENTS.

ALL NEW V.C.T. FLOORING TO BE INSTALLED THROUGHOUT ENTIRE FLOOR AREA AS SHOWN UNLESS OTHERWISE NOTED.

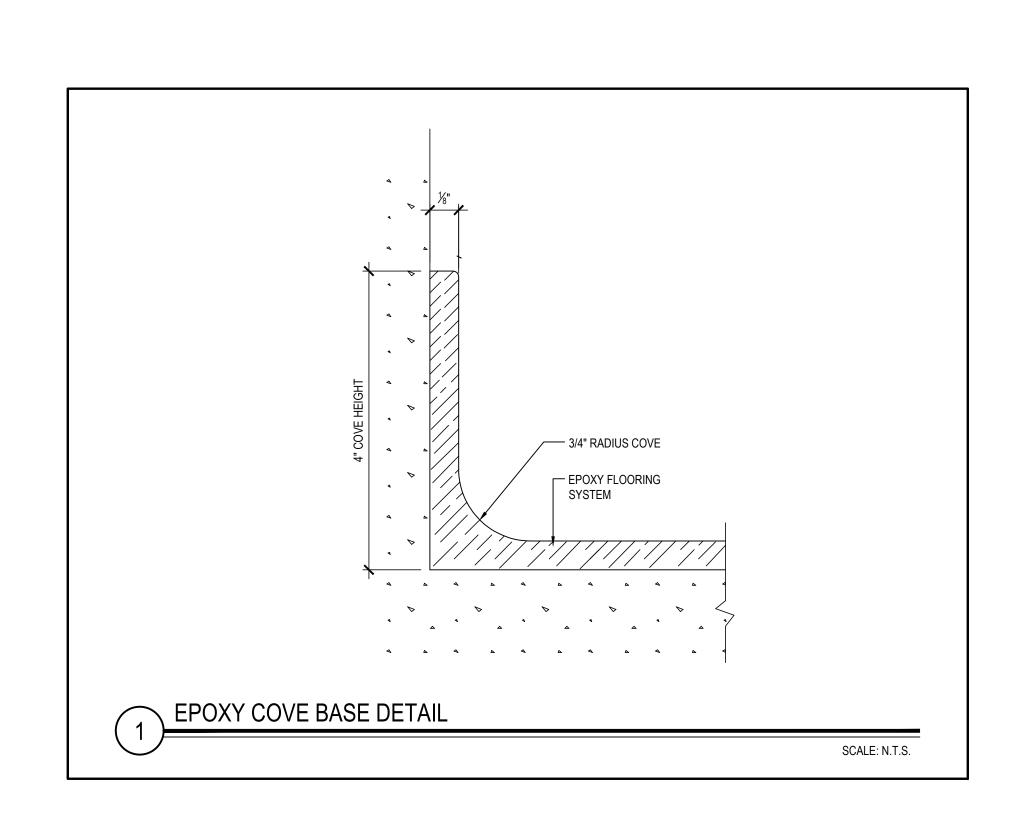




. VINYL COMPOSITION TILE

ESE DRAWINGS ARE BASED ON CONSTRUCTION DRAWINGS NOT REPARED BY BBS ARCHITECTS, LANDSCAPE ARCHITECTS AND NGINEERS, PC. AND, THEREFORE, MAY NOT REPRESENT THE INDITIONS AS CONSTRUCTED AT THE TIME. ALL EXISTII INFORMATION AS THEY MAY NOT HAVE BEEN BUILT AND DETAILE

REV. DATE

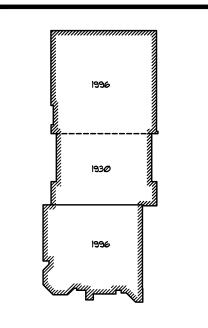

KEY PLAN NOT TO SCALE


OCKER

DRAWING BY: PJG CHECK BY: KGS

THIS DRAWING, PREPARED FOR THE SPECIFIC PROJECT INDICATED IS AN INSTRUMENT OF SERVICE AND THE PROPERTY OF BBS ARCHITECTS, LANDSCAPE ARCHITECTS AND ENGINEERS, P. INFRINGEMENT OR ANY USE OF THIS DRAWING FOR ANY OTHE PROJECT IS PROHIBITED. ANY ALTERATION OR REPRODUCTION OF THIS DOCUMENT IS ALSO PROHIBITED WITHOUT THE WRITTEN ONSENT OF THE ARCHITECT OR ENGINEER.

LANDSCAPE ARCHITECTS ENGINEERS 44 EAST MAIN STREET 87 WOLF ROAD, STE. 20 PATCHOGUE NEW YORK 11772 NEW YORK 12205

T. 631.475.0349 F. 631.475.0361 F. 518.621.7655 www.BBSARCHITECTURE.com

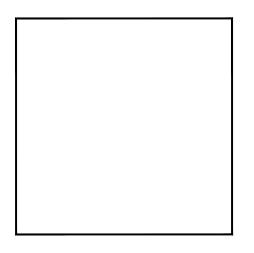


44-21-15-02-0-001-015 DISTRICT FLORDIA U.F.S.D. S.S. SEWARD INSTITUTE PROJECT BOND PHASE 2


SCALE: AS NOTED DECEMBER 1, 2020 BID PICK-UP: March 15, 2021


DWG TITLE FINISH SCHEDULE

A9.01

FILE No: 20-176B

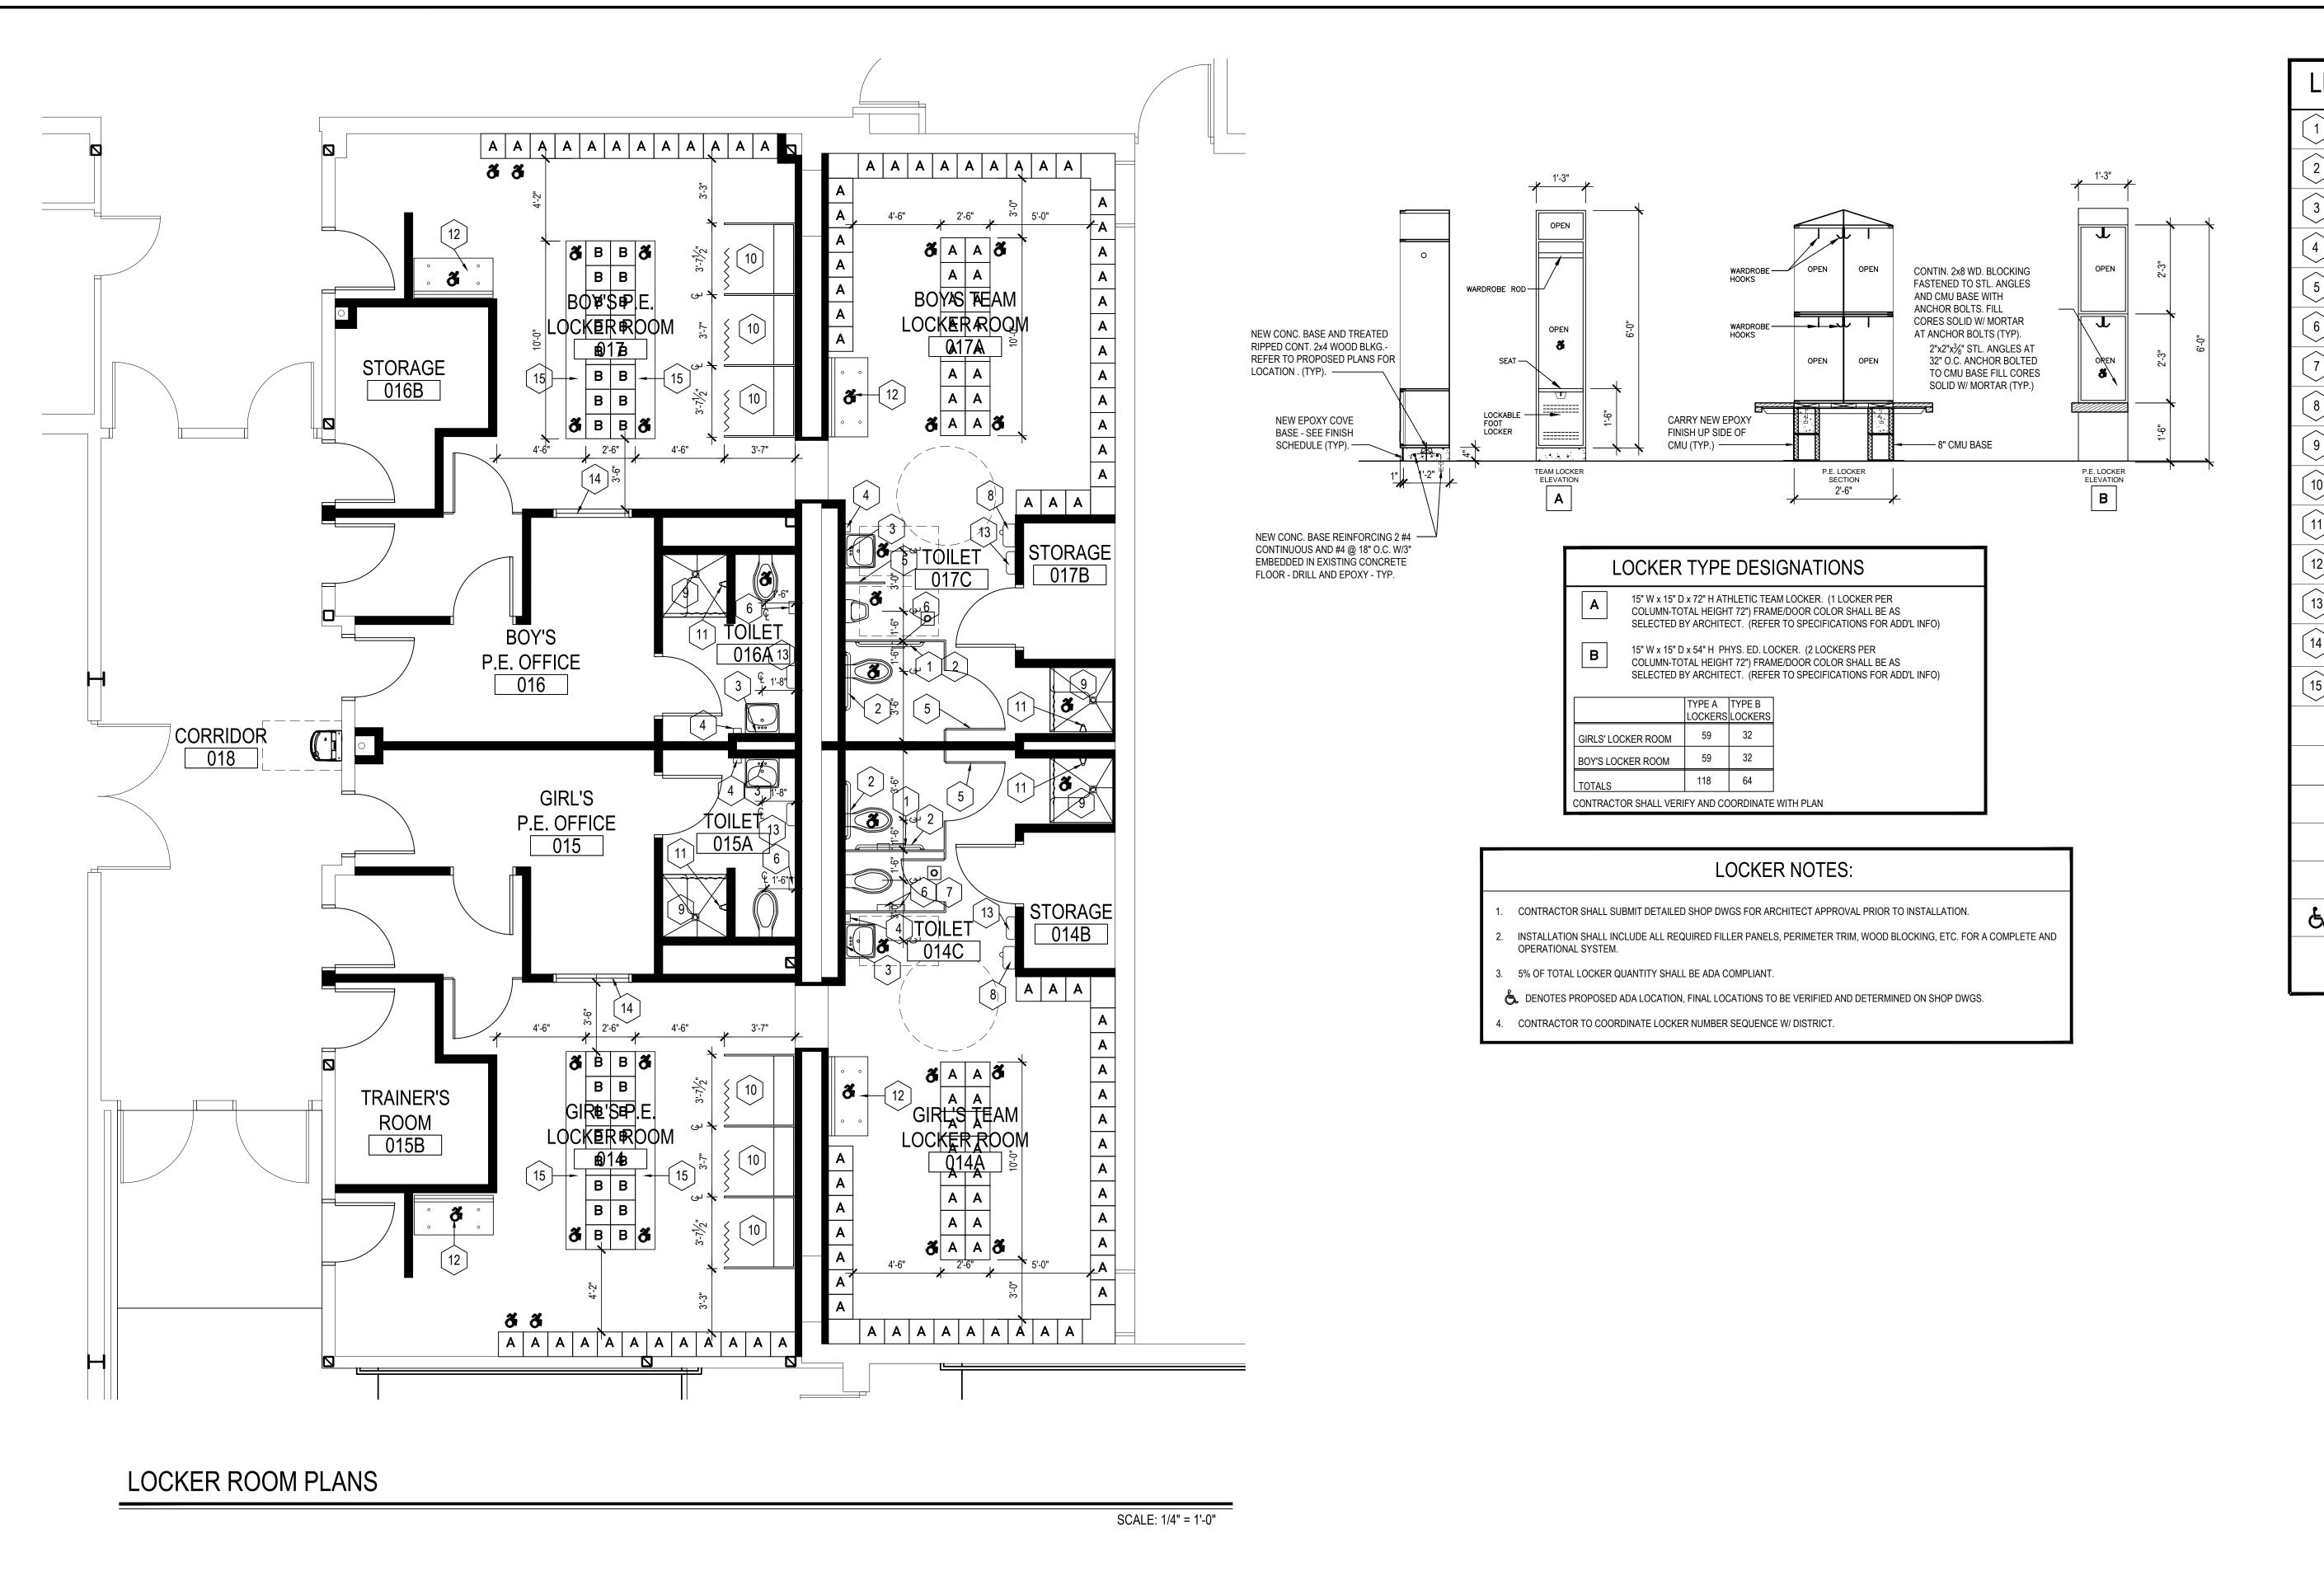

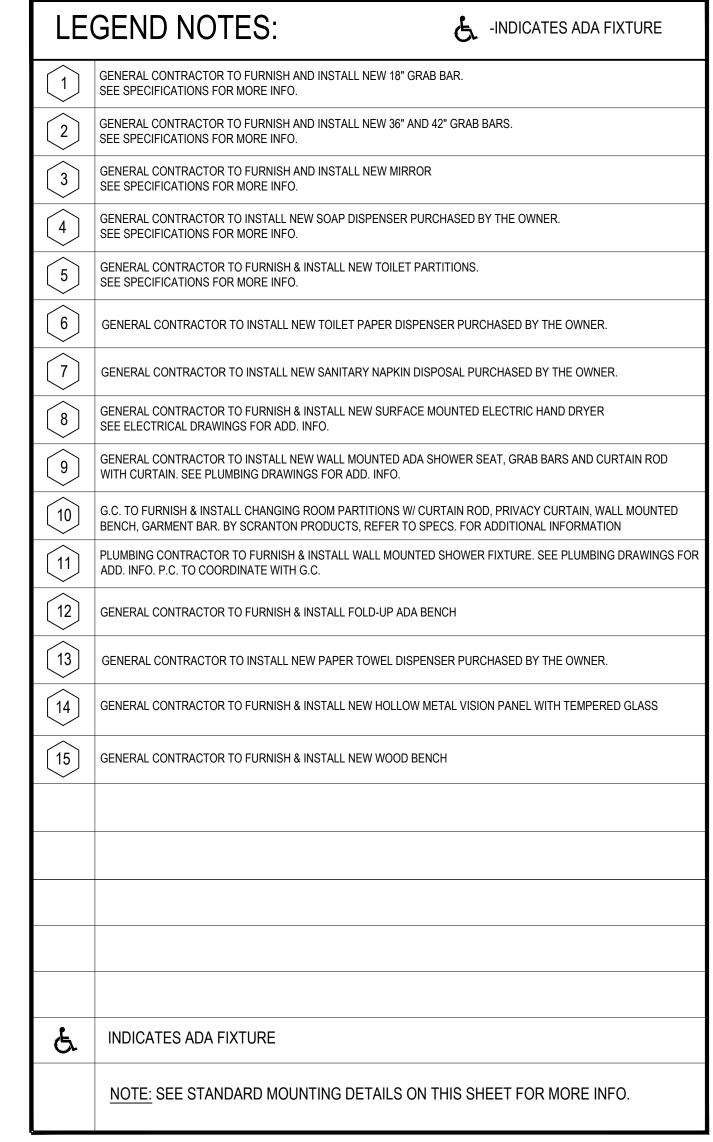

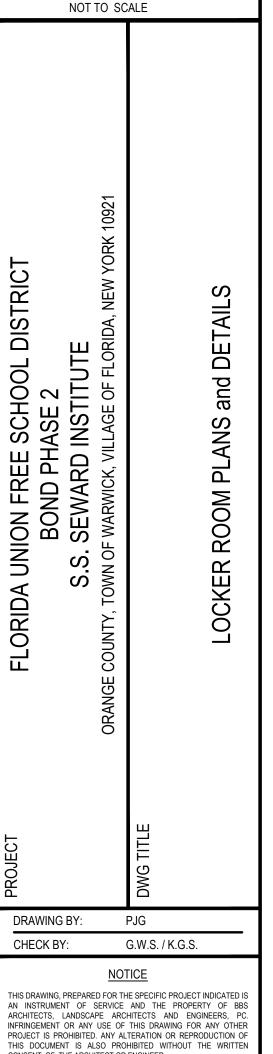

REV. DATE

KEY PLAN

HESE DRAWINGS ARE BASED ON CONSTRUCTION DRAWINGS NOT PREPARED BY BBS ARCHITECTS, LANDSCAPE ARCHITECTS AND ENGINEERS, PC. AND, THEREFORE, MAY NOT REPRESENT THE

CONDITIONS AS CONSTRUCTED AT THE TIME. ALL EXISTIN CONDITIONS SHOWN ARE REPRESENTED AS SUGGESTIN

INFORMATION AS THEY MAY NOT HAVE BEEN BUILT AND DETAILE

PROJECT IS PROHIBITED. ANY ALTERATION OR REPRODUCTION OF THIS DOCUMENT IS ALSO PROHIBITED WITHOUT THE WRITTEN CONSENT OF THE ARCHITECT OR ENGINEER. LANDSCAPE ARCHITECTS

ENGINEERS 44 EAST MAIN STREET | 187 WOLF ROAD, STE. 20 NEW YORK 12205

NEW YORK 11772 F. 631.475.0361 F. 518.621.7655

www.BBSARCHITECTURE.com


44-21-15-02-0-001-015 <u>DISTRICT</u> FLORDIA U.F.S.D. S.S. SEWARD INSTITUTE


DECEMBER 1, 2020 FILE No: 20-176B

TOILET FIXTURE MOUNTING HEIGHTS

AT ALL STUDENT OCCUPIED TOILET FACILITIES (i.e. CLASSROOM TOILET ROOMS) - ALL TOILET FIXTURES, GRAB BARS, ACCESSORIES, ETC. SHALL BE MOUNTED AT THE "CHILD" HEIGHT RANGES AS INDICATED ON THE TYPICAL TOILET ROOM MOUNTING

- THE CHILD DIMENSIONS GIVEN APPLY FOR CHILDREN BETWEEN THE AGES OF 6 AND 12 YEARS. FOR KINDERGARTEN CHILDREN -THE BOTTOM END OF THE RANGES SHOULD BE USED AS A MAXIMUM.
- AT ALL ADULT USE TOILET FACILITIES, ALL TOILET FIXTURES, GRAB BARS, ACCESSORIES, ETC. SHALL BE MOUNTED AT THE "ADULT" HEIGHT RANGES AS INDICATED ON THE TYPICAL TOILET ROOM MOUNTING DETAILS.
- THE TOP HEIGHT OF ALL GRAB BAR MUST BE THE SAME WITHIN EACH STALL/ROOM.
- THE CHILD MOUNTING HEIGHT LIMITS APPLY FOR ADA AND NON-ADA

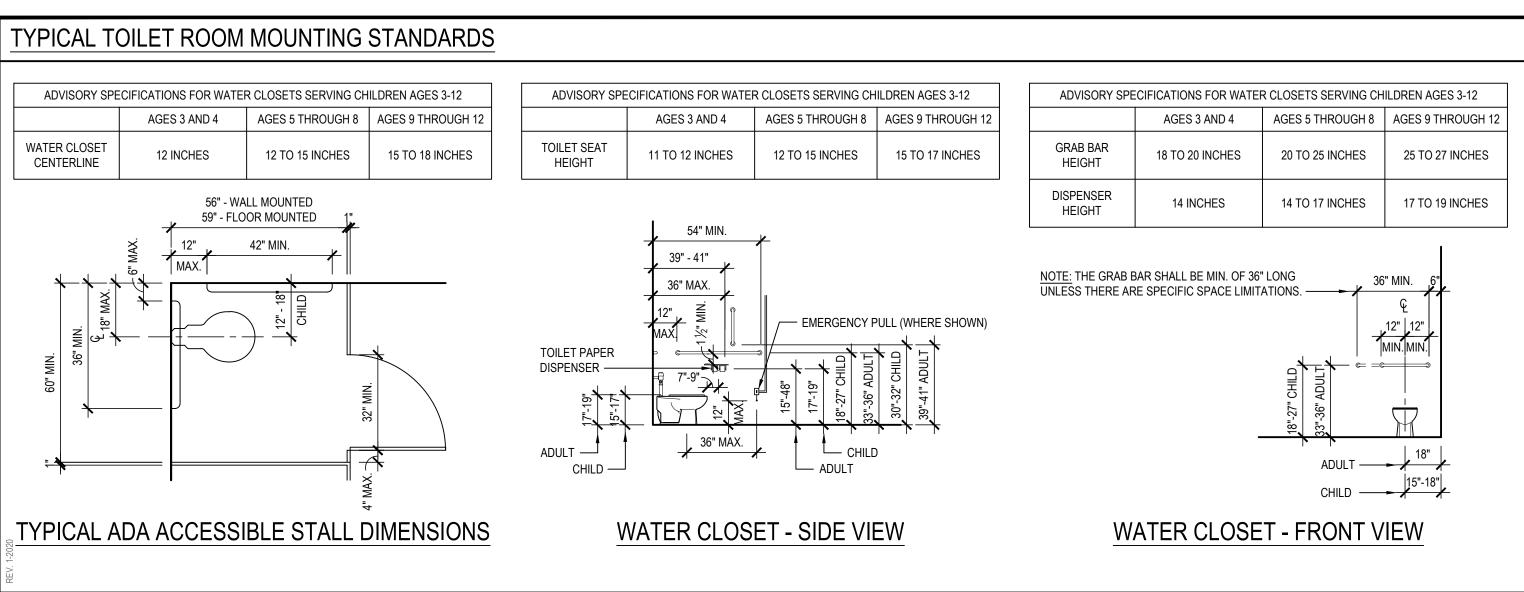

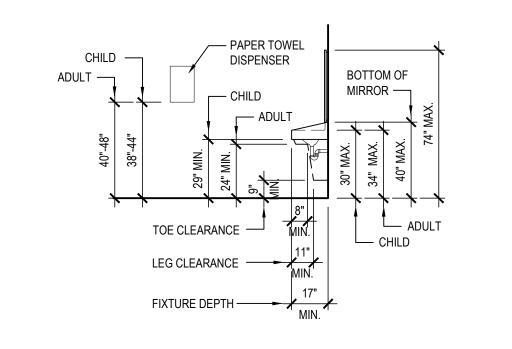

LAVATORY - SIDE VIEW

— SOAP DISPENSER ADULT — L— ADULT PROVIDE SHIELD AT ALL LAVATORIES

LAVATORY - FRONT VIEW

URINAL ADA ACCESSIBLE DIMENSIONS

30" X 48" CLEAR FLOOR SPACE

PROJECT BOND PHASE 2 DWG TITLE LOCKER ROOM

PLANS and DETAILS SCALE: AS NOTED BID PICK-UP: March 15, 2021

A11.01

GENERAL NOTES

- 1. REMOVAL AND RELOCATION OF CERTAIN EXISTING WORK SHALL BE NECESSARY FOR THE PERFORMANCE OF GENERAL WORK. ALL EXISTING CONDITIONS ARE NOT COMPLETELY DETAILED ON THE DRAWINGS. THE CONTRACTOR SHALL SURVEY THE PROPOSED WORK SCOPE AREAS AND MAKE ALL NECESSARY CHANGES REQUIRED BASED ON EXISTING CONDITIONS, FOR PROPER DEMOLITION OF EXISTING WORK AND INCLUDE ALL MATERIALS AND LABOR IN THEIR BID PRICE. NO ALLOWANCE WILL BE MADE FOR FAILURE TO DO SO.
- 2. BEFORE SUBMITTING BID, THE CONTRACTOR SHALL VISIT THE PREMISES OF THEIR PROPOSED WORK AND SHALL CAREFULLY EXAMINE THE ENGINEERING DRAWINGS, EXISTING CONDITIONS AND LIMITATIONS THEREOF. VERIFICATION SHALL BE MADE AS TO THE ACTUAL LOCATIONS WHERE THE NEW PIPING WILL BE ROUTED, COORDINATING WITH NEW AND EXISTING WORK AND PROVIDING CLEARANCES WITH STRUCTURAL MEMBERS. THE CONTRACTOR SHALL INCLUDE ALL COSTS OF ANY KIND WHATSOEVER WHICH ARE INCURRED THROUGH LIMITATIONS OF THE EXISTING AND NEW CONDITIONS. LATER CLAIMS FOR EXTRA LABOR, EQUIPMENT AND MATERIALS REQUIRED DUE TO DIFFICULTIES WHICH COULD HAVE BEEN FORESEEN WILL NOT BE CONSIDERED AS EXTRA WORK.
- 3. THE DRAWINGS SHOW THE GENERAL ARRANGEMENT OF ALL PIPING AND EQUIPMENT AND INDICATE THE REQUIRED SIZE AND POINTS OF TERMINATION OF THE PIPING AND SUGGEST PROPER ROUTING OF SAME. HOWEVER, IT IS NOT THE INTENTION OF THE DRAWINGS TO SHOW ALL NECESSARY OFFSETS, OBSTRUCTIONS OR STRUCTURAL CONDITIONS. IT SHALL BE THE RESPONSIBILITY OF THIS CONTRACTOR TO INSTALL THEIR WORK IN SUCH A MANNER THAT IT WILL CONFORM TO THE STRUCTURE, AVOID OBSTRUCTIONS, PRESERVE HEADROOM AND KEEP OPENINGS AND PASSAGEWAYS CLEAR WITHOUT FURTHER CONSTRUCTION OR COST.
- 4. INSTALL WORK SO AS TO BE READILY ACCESSIBLE FOR OPERATING, MAINTENANCE AND REPAIR. MINOR DEVIATIONS FROM DRAWINGS MAY BE MADE TO ACCOMPLISH THIS, BUT CHANGES OF MAGNITUDE WHICH INVOLVE EXTRA COST SHALL NOT BE MADE WITHOUT APPROVAL.
- 5. INVESTIGATE EACH SPACE THROUGH WHICH EQUIPMENT MUST BE MOVED. WHEN NECESSARY, EQUIPMENT SHALL BE SHIPPED FROM MANUFACTURER IN CRATED SECTIONS OF SIZE SUITABLE FOR MOVING THROUGH AREAS AVAILABLE. ASCERTAIN FROM BUILDING OWNER AT WHAT TIMES OF DAY EQUIPMENT COULD BE MOVED THROUGH THE BUILDING.
- 6. COORDINATE THE EXACT SIZE AND LOCATION OF THE NEW OPENINGS WITH EXISTING STRUCTURE. PATCH AND INSULATE AS REQUIRED. THE CONTRACTOR SHALL FIRESTOP ALL PENETRATIONS OF NEW PIPING, CONDUIT, DUCTWORK, ETC. THROUGH EXISTING FIRE/ SMOKE BARRIERS. FIRE/SMOKE STOPPING SHALL BE HILTI TYPE FS-657 FIRE BLOCK UNLESS OTHERWISE NOTED.
- 7. IT IS THE INTENT OF THIS CONTRACT TO KEEP REMAINING SYSTEMS LEFT IN GOOD WORKING ORDER, READY FOR OPERATION, INCLUDING NECESSARY LABOR AND
- 8. THE CONTRACTOR SHALL TAKE PRECAUTIONS AGAINST DAMAGING OR DISRUPTING BUILDING SYSTEMS, WIRING, PIPING OR CONTROL TUBING. ANY DAMAGE TO THESE ITEMS SHALL BE REPAIRED AT THE CONTRACTOR'S COST, WITHIN COST, WITHIN THIS CONTRACT PERIOD FOR SUBSTANTIAL COMPLETION.
- 9. THE CONTRACTOR SHALL REPAIR AND RESTORE TO ORIGINAL CONDITION ANY EXISTING EQUIPMENT OR MATERIALS DAMAGED IN THE PROCESS OF INSTALLATION, AND DEMOLITION TO THE SATISFACTION OF THE OWNER'S REPRESENTATIVE.
- 10. THE CONTRACTOR SHALL MAKE REPAIRS USING THE SAME MATERIALS, AT THE CONTRACTOR'S COST.
- 11. THE CONTRACTOR SHALL INCUR ALL COSTS AND BURDENS ASSOCIATED WITH LOST OR STOLEN EQUIPMENT AND MATERIALS.
- 12. DAILY, DURING DEMOLITION AND DURING THE CONSTRUCTION PERIOD, THE CONTRACTOR SHALL REMOVE & DISPOSE OF ALL RUBBISH AND EXCESS MATERIAL ACCUMULATED AS A RESULT OF THEIR OPERATIONS. ALL AREAS AND EQUIPMENT AFFECTED UNDER THIS CONTRACT SHALL BE CLEAN OF DUST AND DEBRIS BEFORE FINAL ACCEPTANCE BY THE OWNER.
- 13. THE CONTRACTOR SHALL PROVIDE FOR LEGAL REMOVAL AND DISPOSAL OF ALL RUBBISH AND DEBRIS FROM THE BUILDING AND SITE. PROTECT ALL WORK NOT SLATED FOR DEMOLITION.
- 14. THIS CONTRACTOR SHALL COORDINATE THEIR WORK WITH ALL OTHER TRADES.
- 15. OBTAIN ALL PERMITS, PAY ALL FEES, CONNECTION CHARGES, ETC.
- 16. PAINT AND TOUCH-UP ALL SURFACES MARRED BY PERFORMANCE OF THE WORK.
- 17. THE CONTRACTOR SHALL REFER TO ALL OTHER DRAWINGS IN THE BID PACKAGE AND PERFORM THE WORK (INCLUDE IN THEIR BID) INDICATED AS (M.C.) FOR MECHANICAL WORK AND AS (P.C.) FOR PLUMBING WORK.

FIRE STOP NOTES

- 1. ALL PENETRATIONS THROUGH FIRE RATED WALLS, FLOORS OR OTHER STRUCTURES SHALL BE FIRE STOPPED BY RESPECTIVE TRADE CONTRACTOR AFFECTING FIRE
- 2. THE FIRE STOP MATERIALS SHALL BE HILTI TYPE FS-657 FIRE BLOCK, FS-ONE SEALANT, CP-672 JOINT SPRAY, CP-601S ELASTOMERIC SEALANT, 6P-606 FLEXIBLE SEALANT, CP-643 OR CP-642 COLLAR, CP-618 PUTTY STICK, OR FS-635 TROWEL ABLE COMPOUND, AS SUITABLE.
- 3. CONTRACTOR SHALL SUBMIT SHOP DRAWINGS OF PRODUCTS TO BE USED.
- 4. FIRESTOP MATERIALS OTHER THAN HILTI SHALL INCLUDE FULL TECHNICAL DATA WITH SHOP DRAWINGS TO DEMONSTRATE EQUALITY WITH THE SPECIFIED FIRE STOPS.

GENERAL MECHANICAL NOTES:

FOR DUCTWORK.

1.DUCT SIZE DIMENSIONS ARE TO BE INTERPRETED AS 'CLEAR' INSIDE DIMENSIONS

2.ALL INTERIOR AND EXTERIOR SUPPLY AND RETURN AIR DUCTWORK SHALL INCLUDE A 1-1\2" THICK "R-6.3" DUCT LINER, 'CERTAINTEED' "TOUGHGUARD R" OR EQUAL. IN ADDITION ALL EXTERIOR SUPPLY AND RETURN AIR DUCTWORK SHALL INCLUDE A 2" THICK "R-5.0" PER INCH EXTERNAL EXTRUDED POLYSTYRENE INSULATION BOARD. 'OWENS-CORNING' "FORMULAR 250" OR EQUAL, COVERED WITH A MULTI-LAYERED INSULATION JACKET, VENTURECLAD 1579CW-E OR EQUAL.

3.DUCTWORK FIRE DAMPER NOTATION:

3.1. ALL DUCT PENETRATIONS OF 3 HOUR OR LESS FIRE RESISTANT/RATED WALLS, ROOF/CEILING, FLOORS AND DUCT SHAFT ASSEMBLIES SHALL INCLUDE UL 555

CLASSIFIED/FM APP'D. "RUSKIN" MODEL FD-35 1-1\2 HOUR RATED FIRE DAMPERS WITH 165°F FUSIBLE LINK, MINIMUM 12 INCH STEEL SLEEVE AND ACCESS DOOR

REFERENCE: NYSMC SECTION 607 AND ARCHITECTURAL 'A' DRAWINGS.

- 4.DUCTWORK BALANCING/VOLUME CONTROL DAMPER NOTATION:
 4.1. BALANCING/VOLUME CONTROL DAMPERS SHALL BE PROVIDED BETWEEN MAIN DUCT RUNS, SUBMAINS AND BRACH TAPS. THIS IS GENERALLY ACCOMPLISHED
 BY FLOW REGULATING DEVICES AT OR IN THE DIVIDED-FLOW FITTING, TAKE-OFF FITTING OR DUCT COLLAR. SQUARE/RECTANGULAR DUCTWORK DAMPERS TO
 BE "TITUS-EG-L" TYPE SINGLE-BLADE AND ROUND DUCT DAMPERS TO BE "TITUS-AG75" TYPE. ADJUSTABLE DIRECTION CHANGER (SPLITTER) DAMPERS AT SINGLE
- BRANCH/DIFFUSER TAKE-OFFS.

 5.ALL ROOMS WITH AN EXHAUST SYSTEM / WITHOUT A DUCTED RETURN SYSTEM SHALL HAVE THE ENTRY DOOR CUT 3/4" OFF THE BOTTOM.

6.CONTRACTOR SHALL FOLLOW DETAIL LOCATED ON DWG. #M6.01 FOR DUCTWORK-TO-DIFFUSER CONNECTIONS.

- 7.FOR ALL ROOFTOP UNITS:
 7.1. TYP. ALL S.A. DUCTWORK DROPS SHALL HAVE FIRE DAMPERS INSTALLED AT PENETRATION THRU THE ROOF DECK. AT THE PENETRATION THERE SHALL BE AN
- ACCESS DOOR ON THE CHASE WALL TO GET ACCESS TO THE FIRE DAMPER.
- 8.TYP. FIRE DAMPERS 'FD' SHALL BE 'RUSKIN' MODEL #FD35 1-1/2 HOUR UL LISTED FIRE DAMPER WITH 165°F FUSIBLE LINK.
 9.M.C. SHALL PROVIDE ALL ROOF CURBS & PIPE PORTALS TO G.C. FOR INSTALLATION
- 10. M.C. SHALL CREATE ALL NECESSARY CORE DRILLS IN WALLS/FLOORS FOR NEW PIPING
- 11. THE CONTRACTOR SHALL PROVIDE ALL LOUVERS, ROOF CURBS & EQUIPMENT RAILS FOR MECHANICAL EQUIPMENT. THE CONTRACTOR SHALL MARK OUT THE EXACT SIZE OF OPENINGS REQUIRED FOR LOUVERS & ROOF CURBS. THE G.C. SHALL CUT ALL WALL OPENINGS & ROOF OPENINGS AT THE LOCATIONS MARKED OUT BY THE M.C. THE G.C. SHALL INSTALL THE LOUVERS, ROOF CURBS & EQUIPMENT RAILS. THE M.C. SHALL INSTALL & SECURE ALL MECHANICAL EQUIPMENT TO ROOF CURBS & EQUIPMENT RAILS & CONNECT DUCTWORK TO LOUVERS.
- 12. THE M.C. SHALL PROVIDE & INSTALL ALL MOUNTING SUPPORTS FOR MECHANICAL EQUIPMENT LOCATED IN ATTIC SPACES SUSPENDED FROM ROOF FRAMING. ALL MOUNTING SUPPORTS SHALL BE SUFFICIENTLY SIZED & CONFIGURED TO SUPPORT THE WEIGHT OF THE EQUIPMENT.

THERE IS AN ENERGY SERVICES CONTRACTOR (ESCO) IMPLEMENTING AN EPC THROUGHOUT THE FLORIDA UFSD. THE MECHANICAL CONTRACTOR IS RESPONSIBEL FOR COORDIANTING ALL WORK WITH THE ESCO. INCLUDED IN THE EPC IS CONTROLS WORK. THE BMS WILL BE A JOHNSON FX SYSTEM. THE ESCO WILL BE TYING IN EQUIPMENT INSTALLED UNDER THIS PROJECT TO THE BMS. ALL CONTROLS PROVIDED UNDER THIS BOND PROJECT SHALL BE CAPABLE OF BEING SEEMLESSLY INTEGRATED TO THE JOHNSON SYSTEM.


		F	PTAC SC	HEDULE			
TAG	"ISLANDAIRE" MODEL NUMBER	COOLING (BTU)	HEATING (BTU)	CFM (HIGH/LOW)	ELECTRICAL VOLT-PHASE-HERTZ	AMPS (COOLING)	AMPS (HEATING)
PTAC-1	EZNYØ7A2FASI4AA	7,500				2.63	
PTAC-2	EZNYØ9A2FASI4AA	9,500	8,500	375 / 260	23Ø-1-6Ø	3.7∅	10.87
PTAC-3	EZNY16A2FA614AA	15,000				6.22	

NOTES:

-FURNISH & INSTALL NEW PTAC UNITS WITH ALL REQUIRED MOUNTING COMPONENTS AND ACCESSORIES -PROVIDE NEW ENCLOSURE, M.C. TO VERIFY SIZE IN FIELD

-PROVIDE HYDRONIC COIL ASSEMBLY #6030261

-PROVIDE HYDRONIC COIL ASSEMBLY *6030261
-PROVIDE COIL FREEZE PROTECTION THERMOSTAT *4090572
-PROVIDE TRANE DISCHARGE GRILL ASSEMBLY KIT *4082468-00

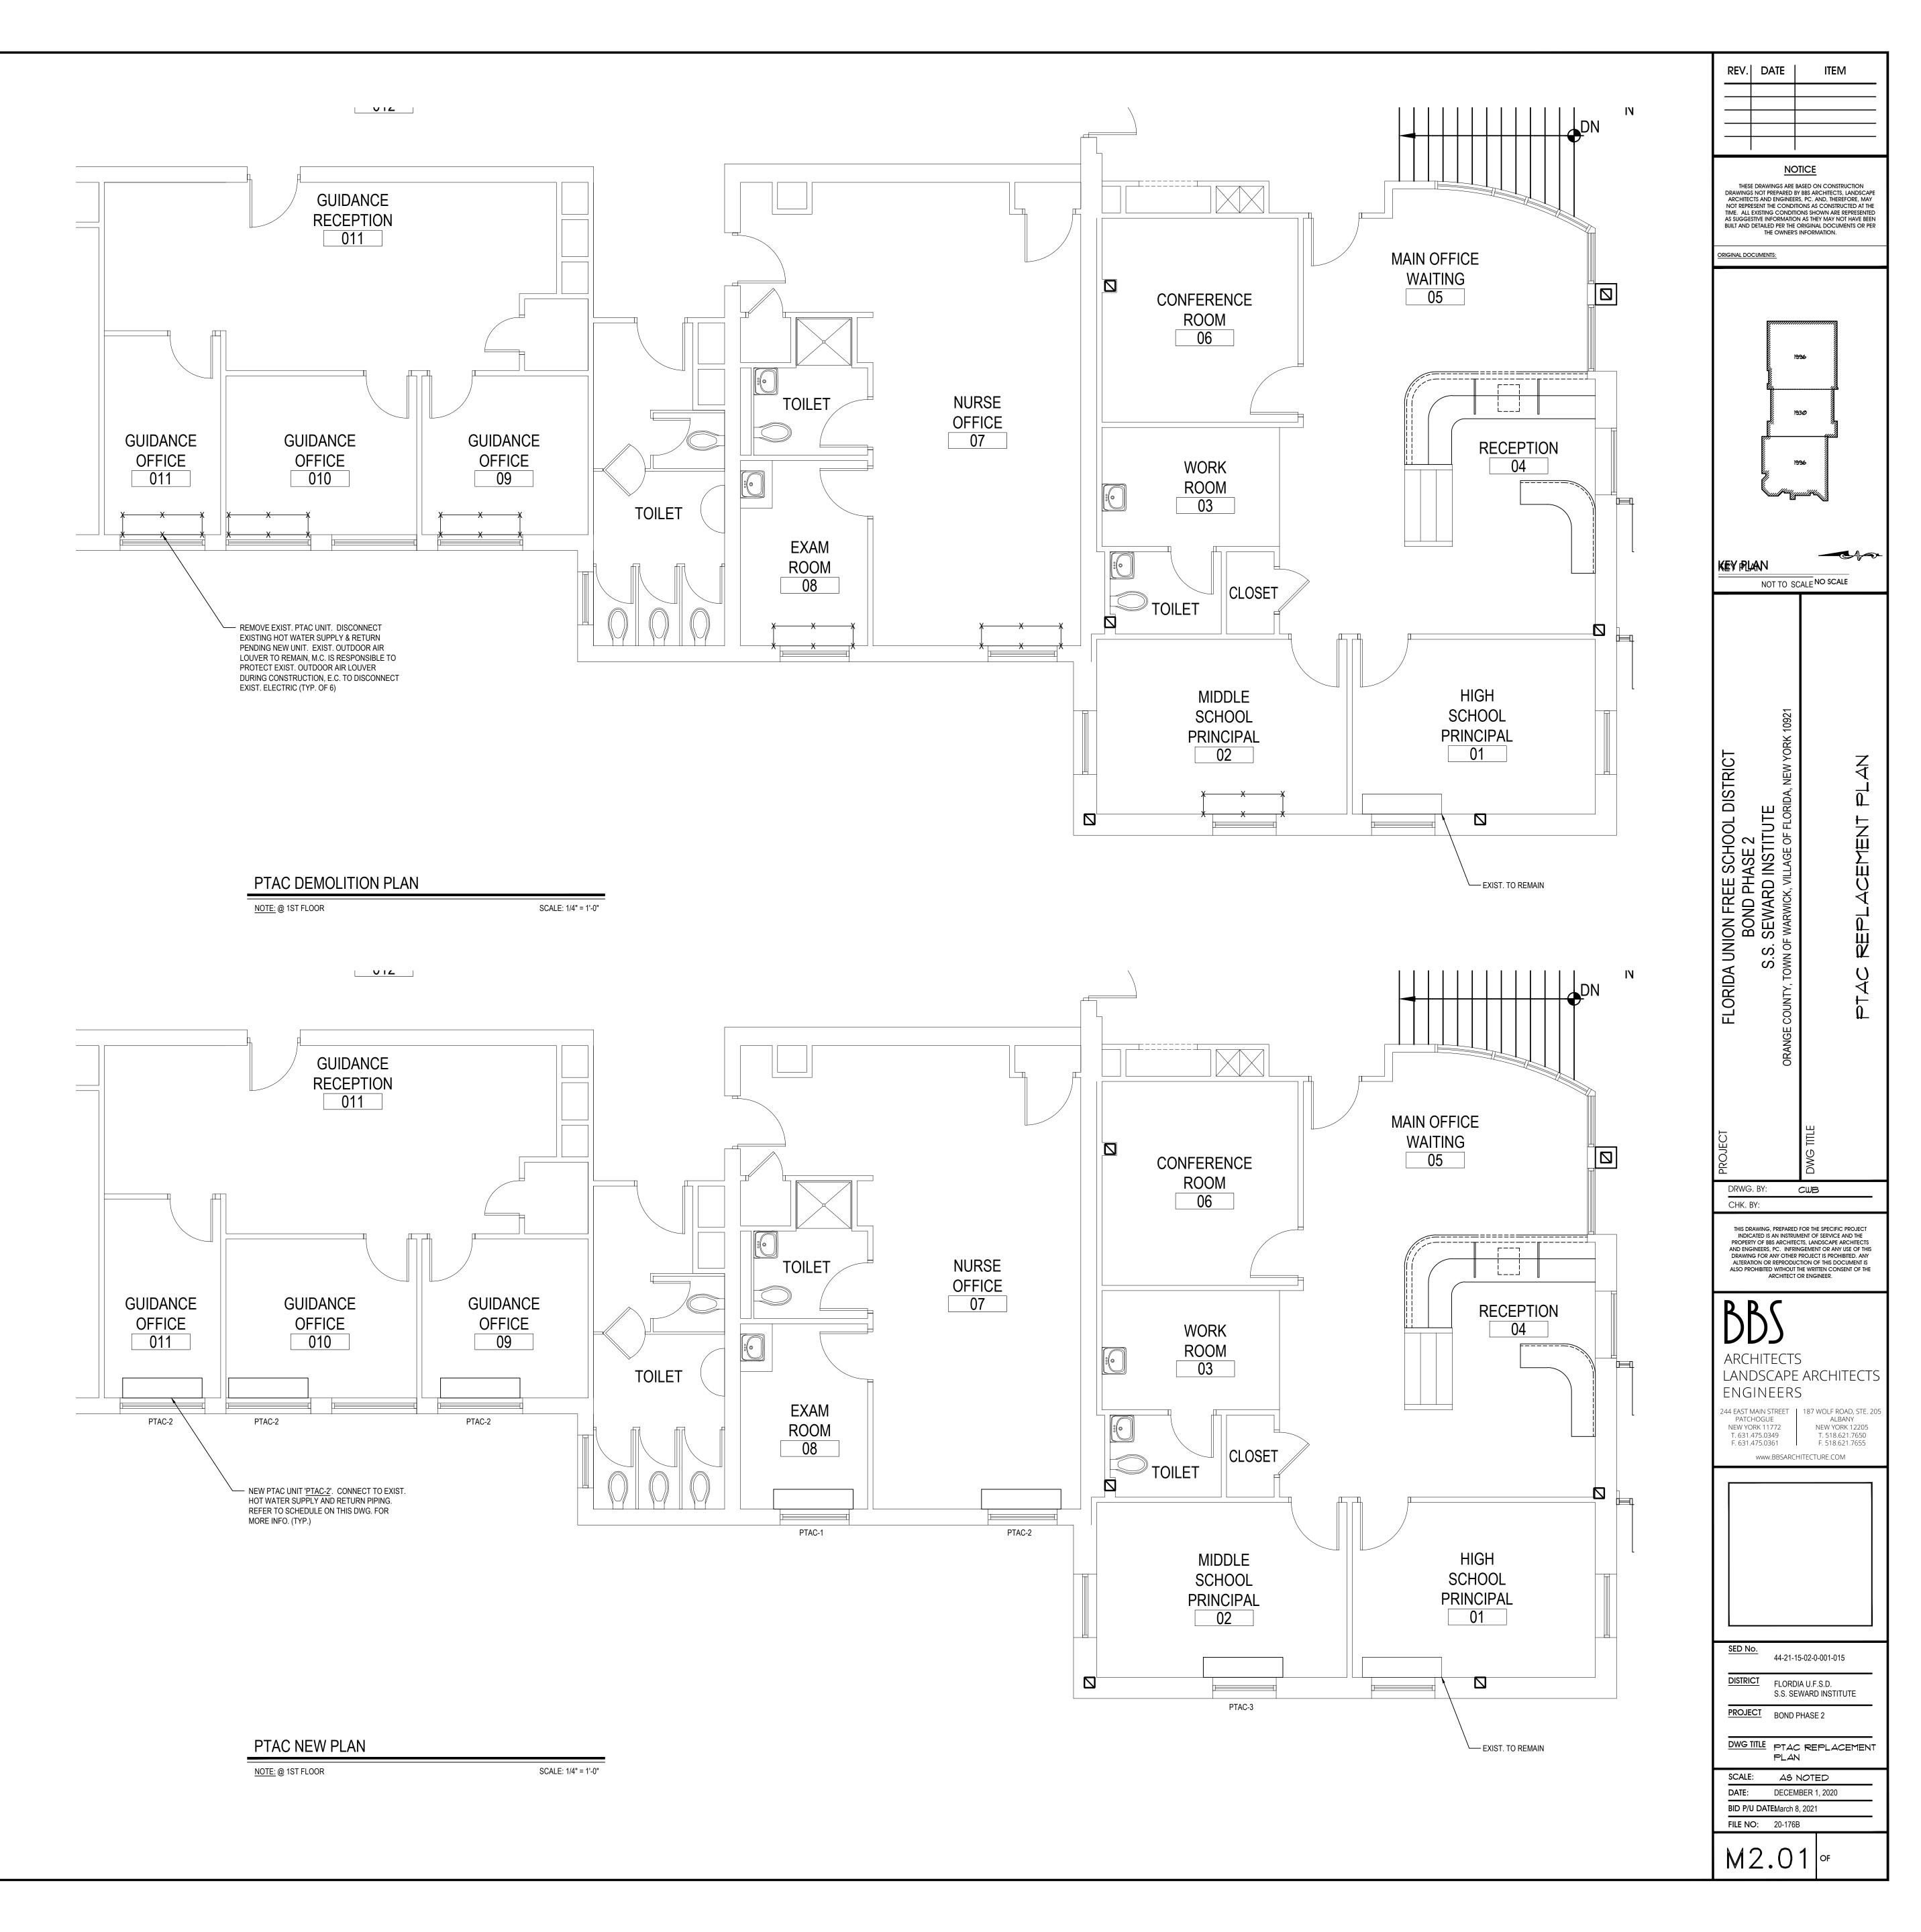

	CABINET HEATER SCHEDULE								
TAG	UNIT TYPE	"ZEHNDER RITTLING" MODEL NUMBER	WEIGH T	DIMENSIONS (L"xW"xH")	AIRFLO W (HIGH)	HEATING DATA (BTU)	GPM	FLA	CTRICAL DATA VOLT-PHASE-HE RTZ
CH-1	CEILING RECESSED CABINET UNIT HEATER	RFRC-420-02	85	382" × 24" × 1Ø"	22Ø	16,200	<i>0.</i> 7	0.6	120-1-60

-FURNISH & INSTALL CABINET UNIT HEATERS WITH ALL REQUIRED MOUNTING COMPONENTS AND ACCESSORIES -PROVIDE WALL/CEILING SEAL FOR ALL WALL/CEILING RECESSED UNITS

-PROVIDE A LINE VOLTAGE FREEZESTAT AND SERVICE DISCONNECT

22)	272FS	10"X10"	-	2Ø	UP TO 350	SURFACE MTD., DOUBLE DEFLECTION			
3	'TITUS' PXP	24"×24"	12"×12"	2Ø	UP TO 100	LAY-IN, STEEL FACE DIFFUSER			
3)	'TITUS' TDC	24"×24"	21"×21"	2Ø	UP TO 1800	LAY-IN, STEEL LOUVER FACE DIFFUSER			
2	'TITUS' 272FS	8"X8"	-	2Ø	UP TO 220	SURFACE MTD., DOUBLE DEFLECTION			
2//	RIAL SPACING UNI ESS OTHERWISE NOTED								

RETURN GRILLE SCHEDULE

28 UP TO 220 SURFACE MTD., DOUBLE DEFLECTION


 3/4" SPACING, UNLESS OTHERWISE NOTED.
 COORDINATE BORDER TYPE TO ALL AIR OUTLETS WITH CEILING. CONSTRUCTION


SYMBOL MODEL NO. FACE SIZE NECK SIZE NC LEVEL CFM RANGE

3. COLOR AS PER ARCHITECT


EXISTING LOCKEROOM DUCTWORK WORK SCOPE NOTES:

- MC TO REFER TO PROJECT MANUAL SPECIFICATIONS SECTION FOR DETAILS OF DUCT CLEANING PROCEDURES, METHODS, CERTIFICATIONS ETC.
- EXISTING DUCTWORK LOCATED IN THE LOCKERROOM IS WITHIN 1ST FLOOR CLG. MC SHALL BE RESPONSIBLE TO CLEAN ALL DUCTWORK SHOWN ON THE PLANS ON THIS DRAWING UNLESS
- OTHERWISE NOTED. MC SHALL RESET ANY TRIPPED FIRE DAMPERS LOCATED ON THE ABOVE FLOOR PLAN.
- MC SHALL PROVIDE NEW TESTING & BALANCING REPORTS TO ENGINEER OF RECORD AFTER CLEANING OF ALL DUCTWORK.

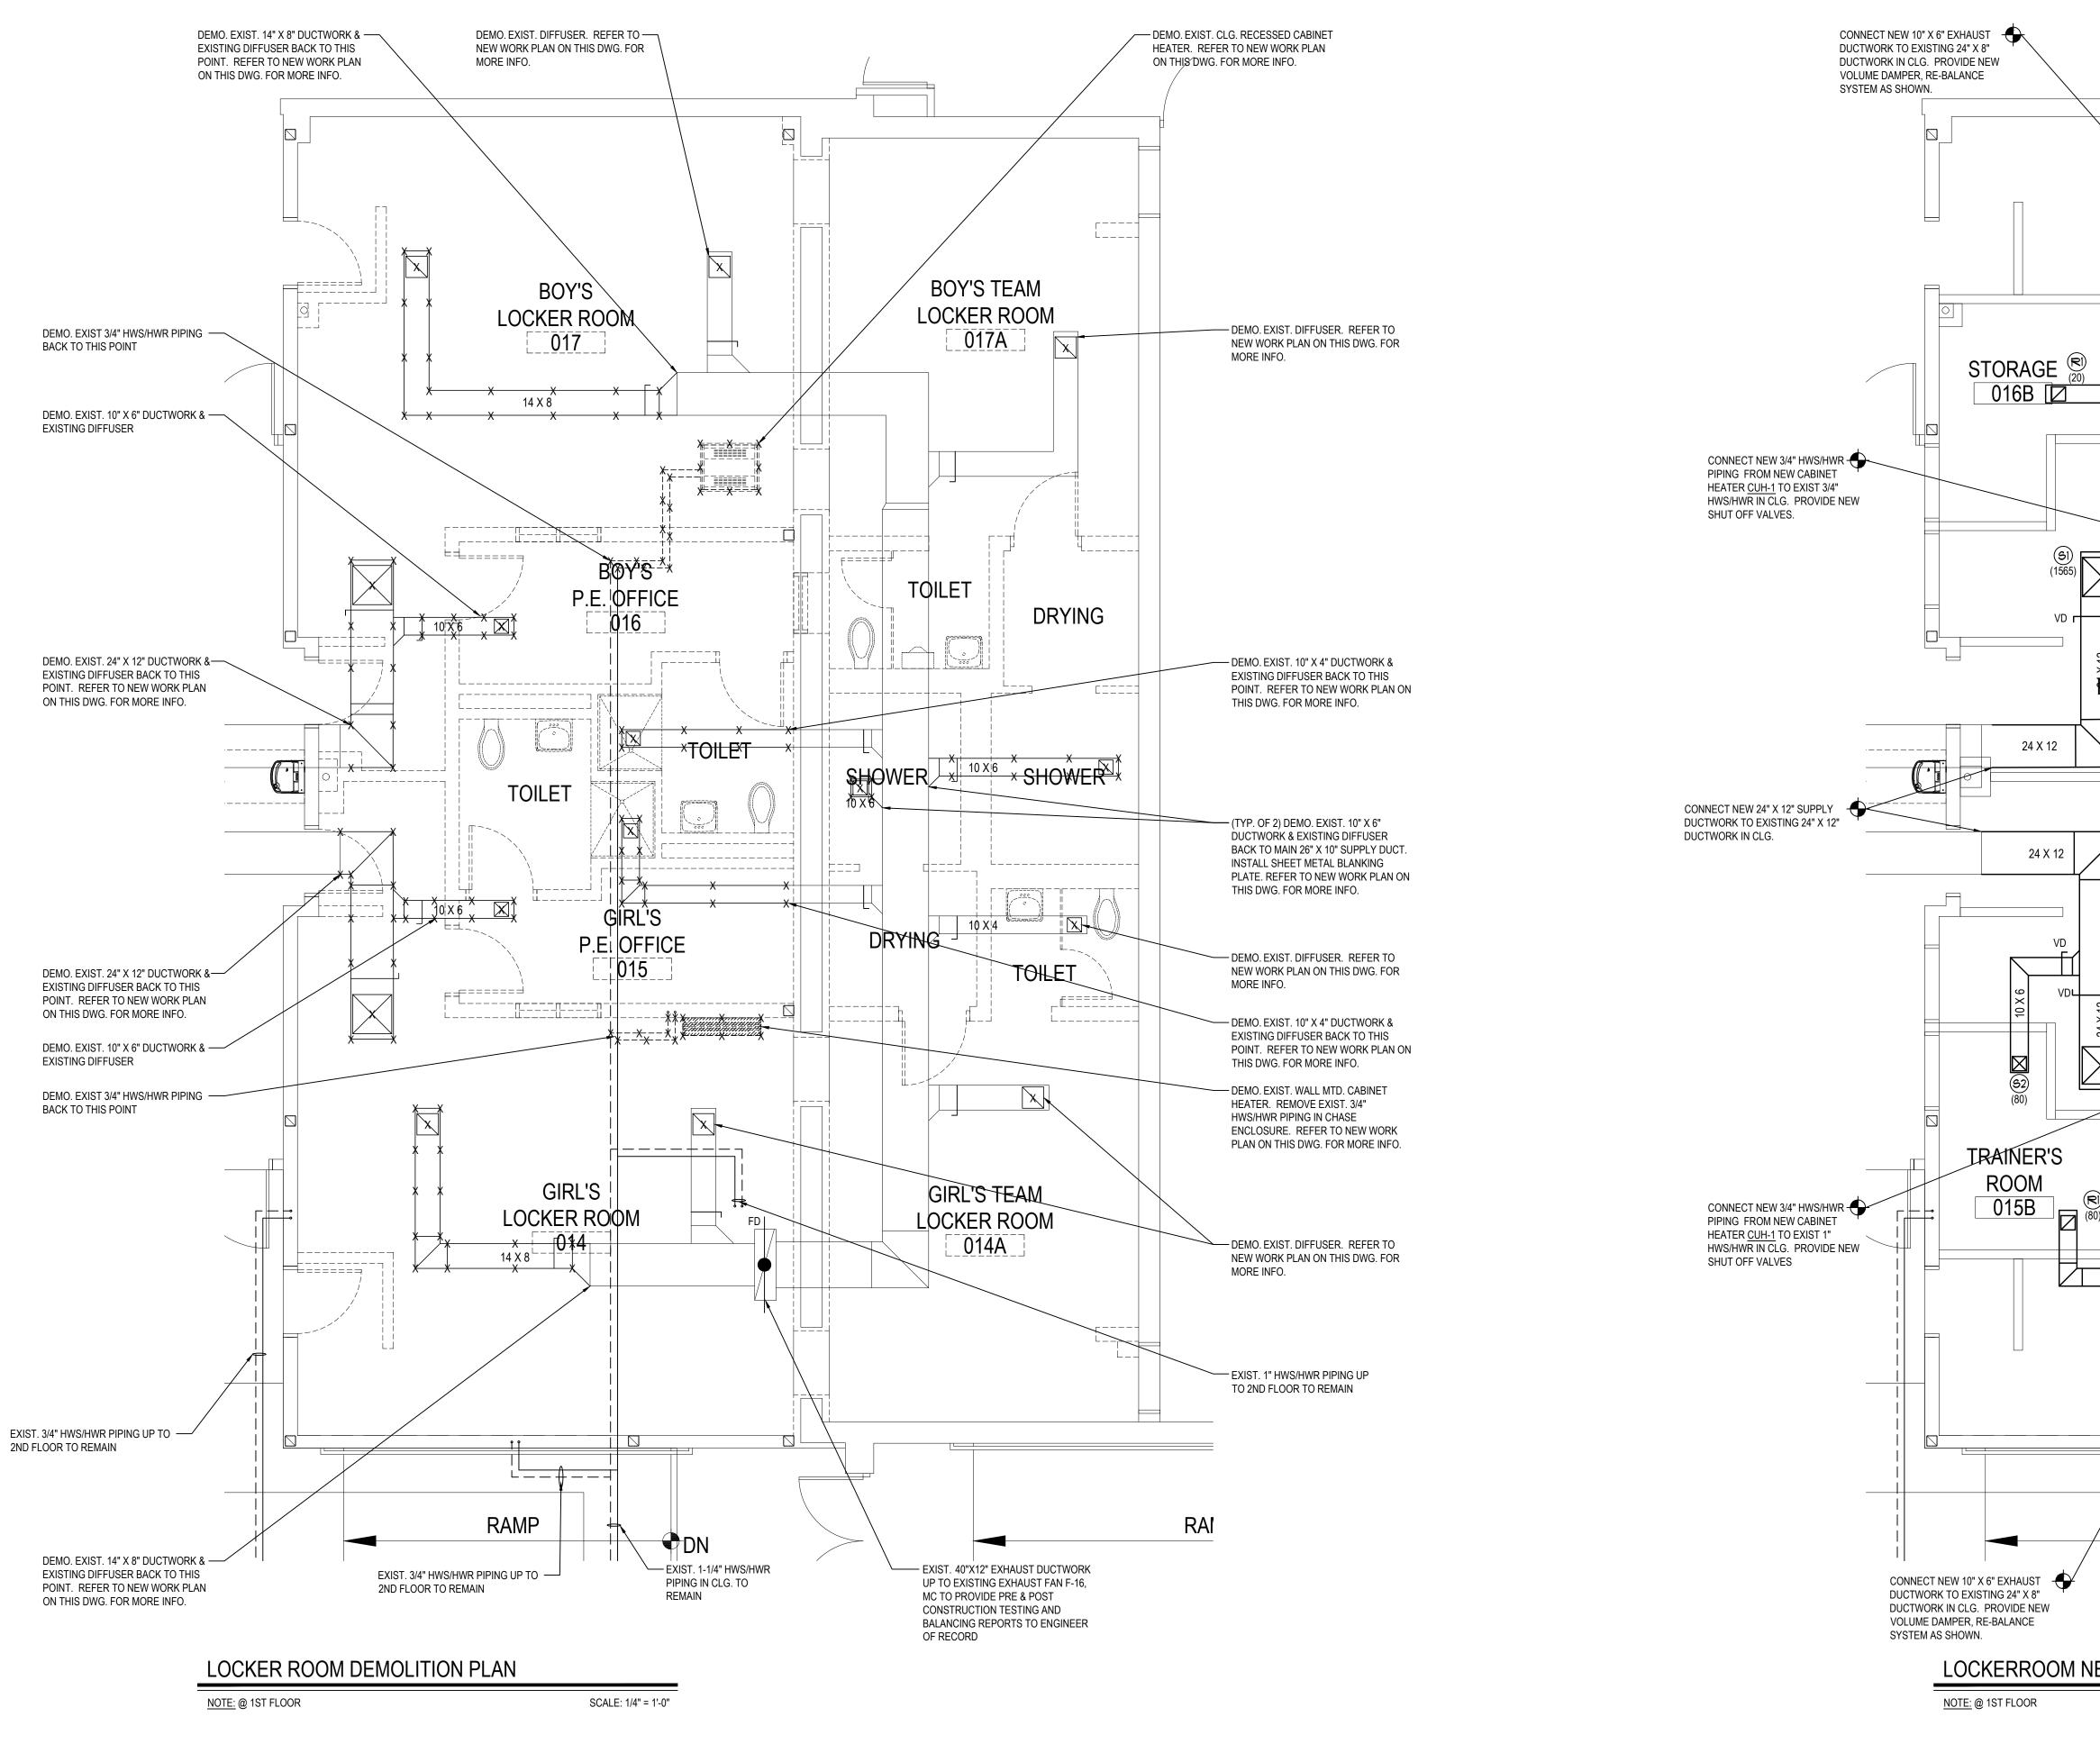

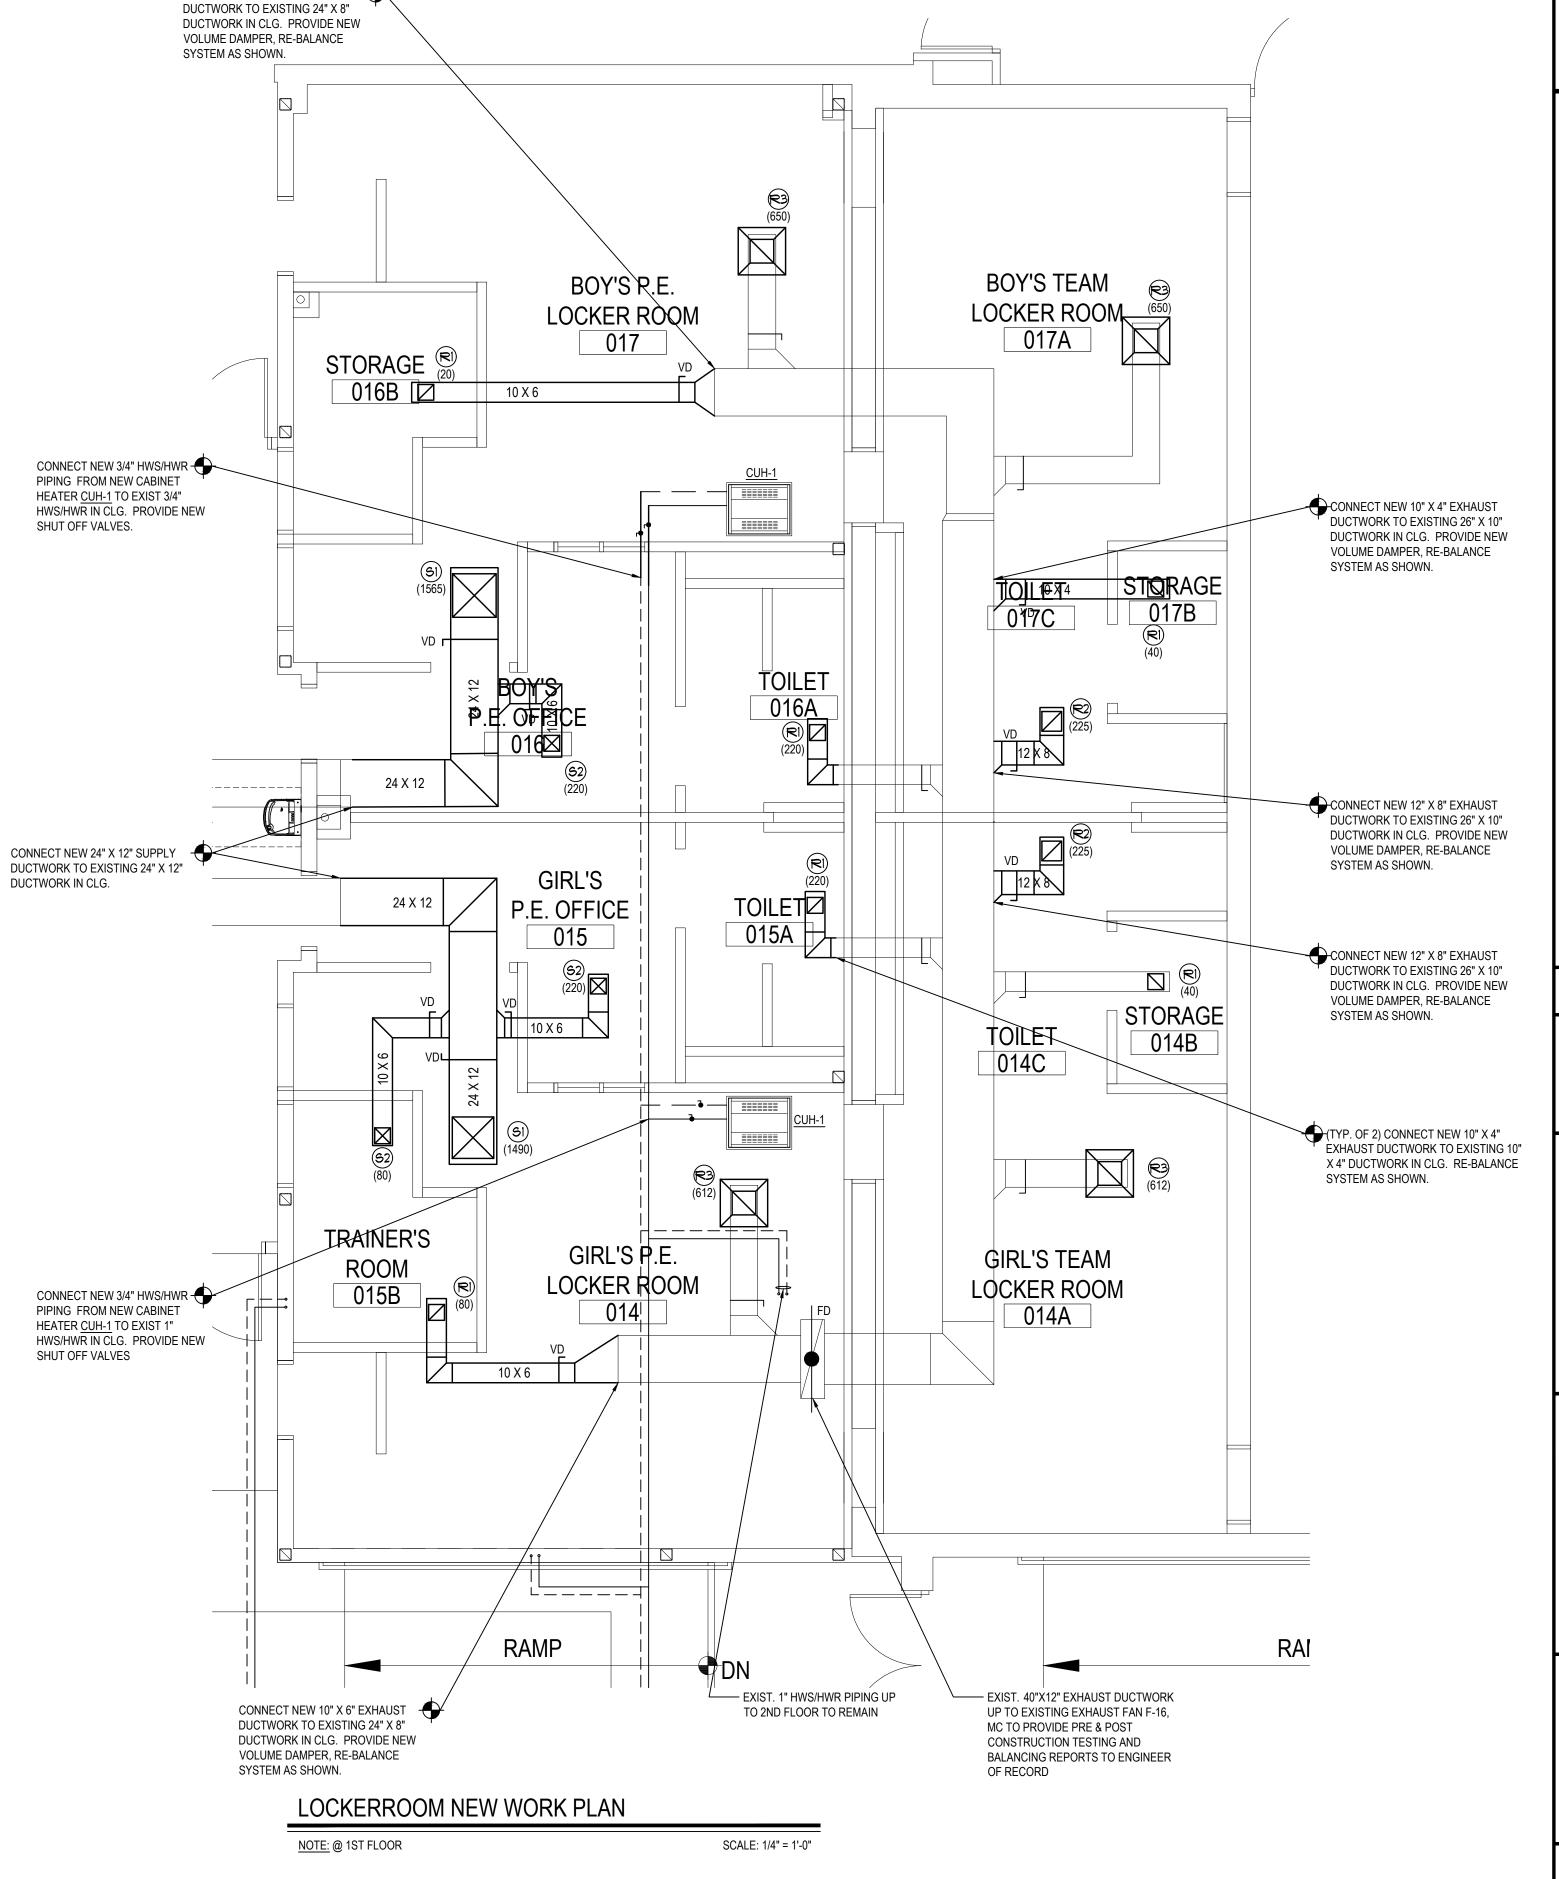





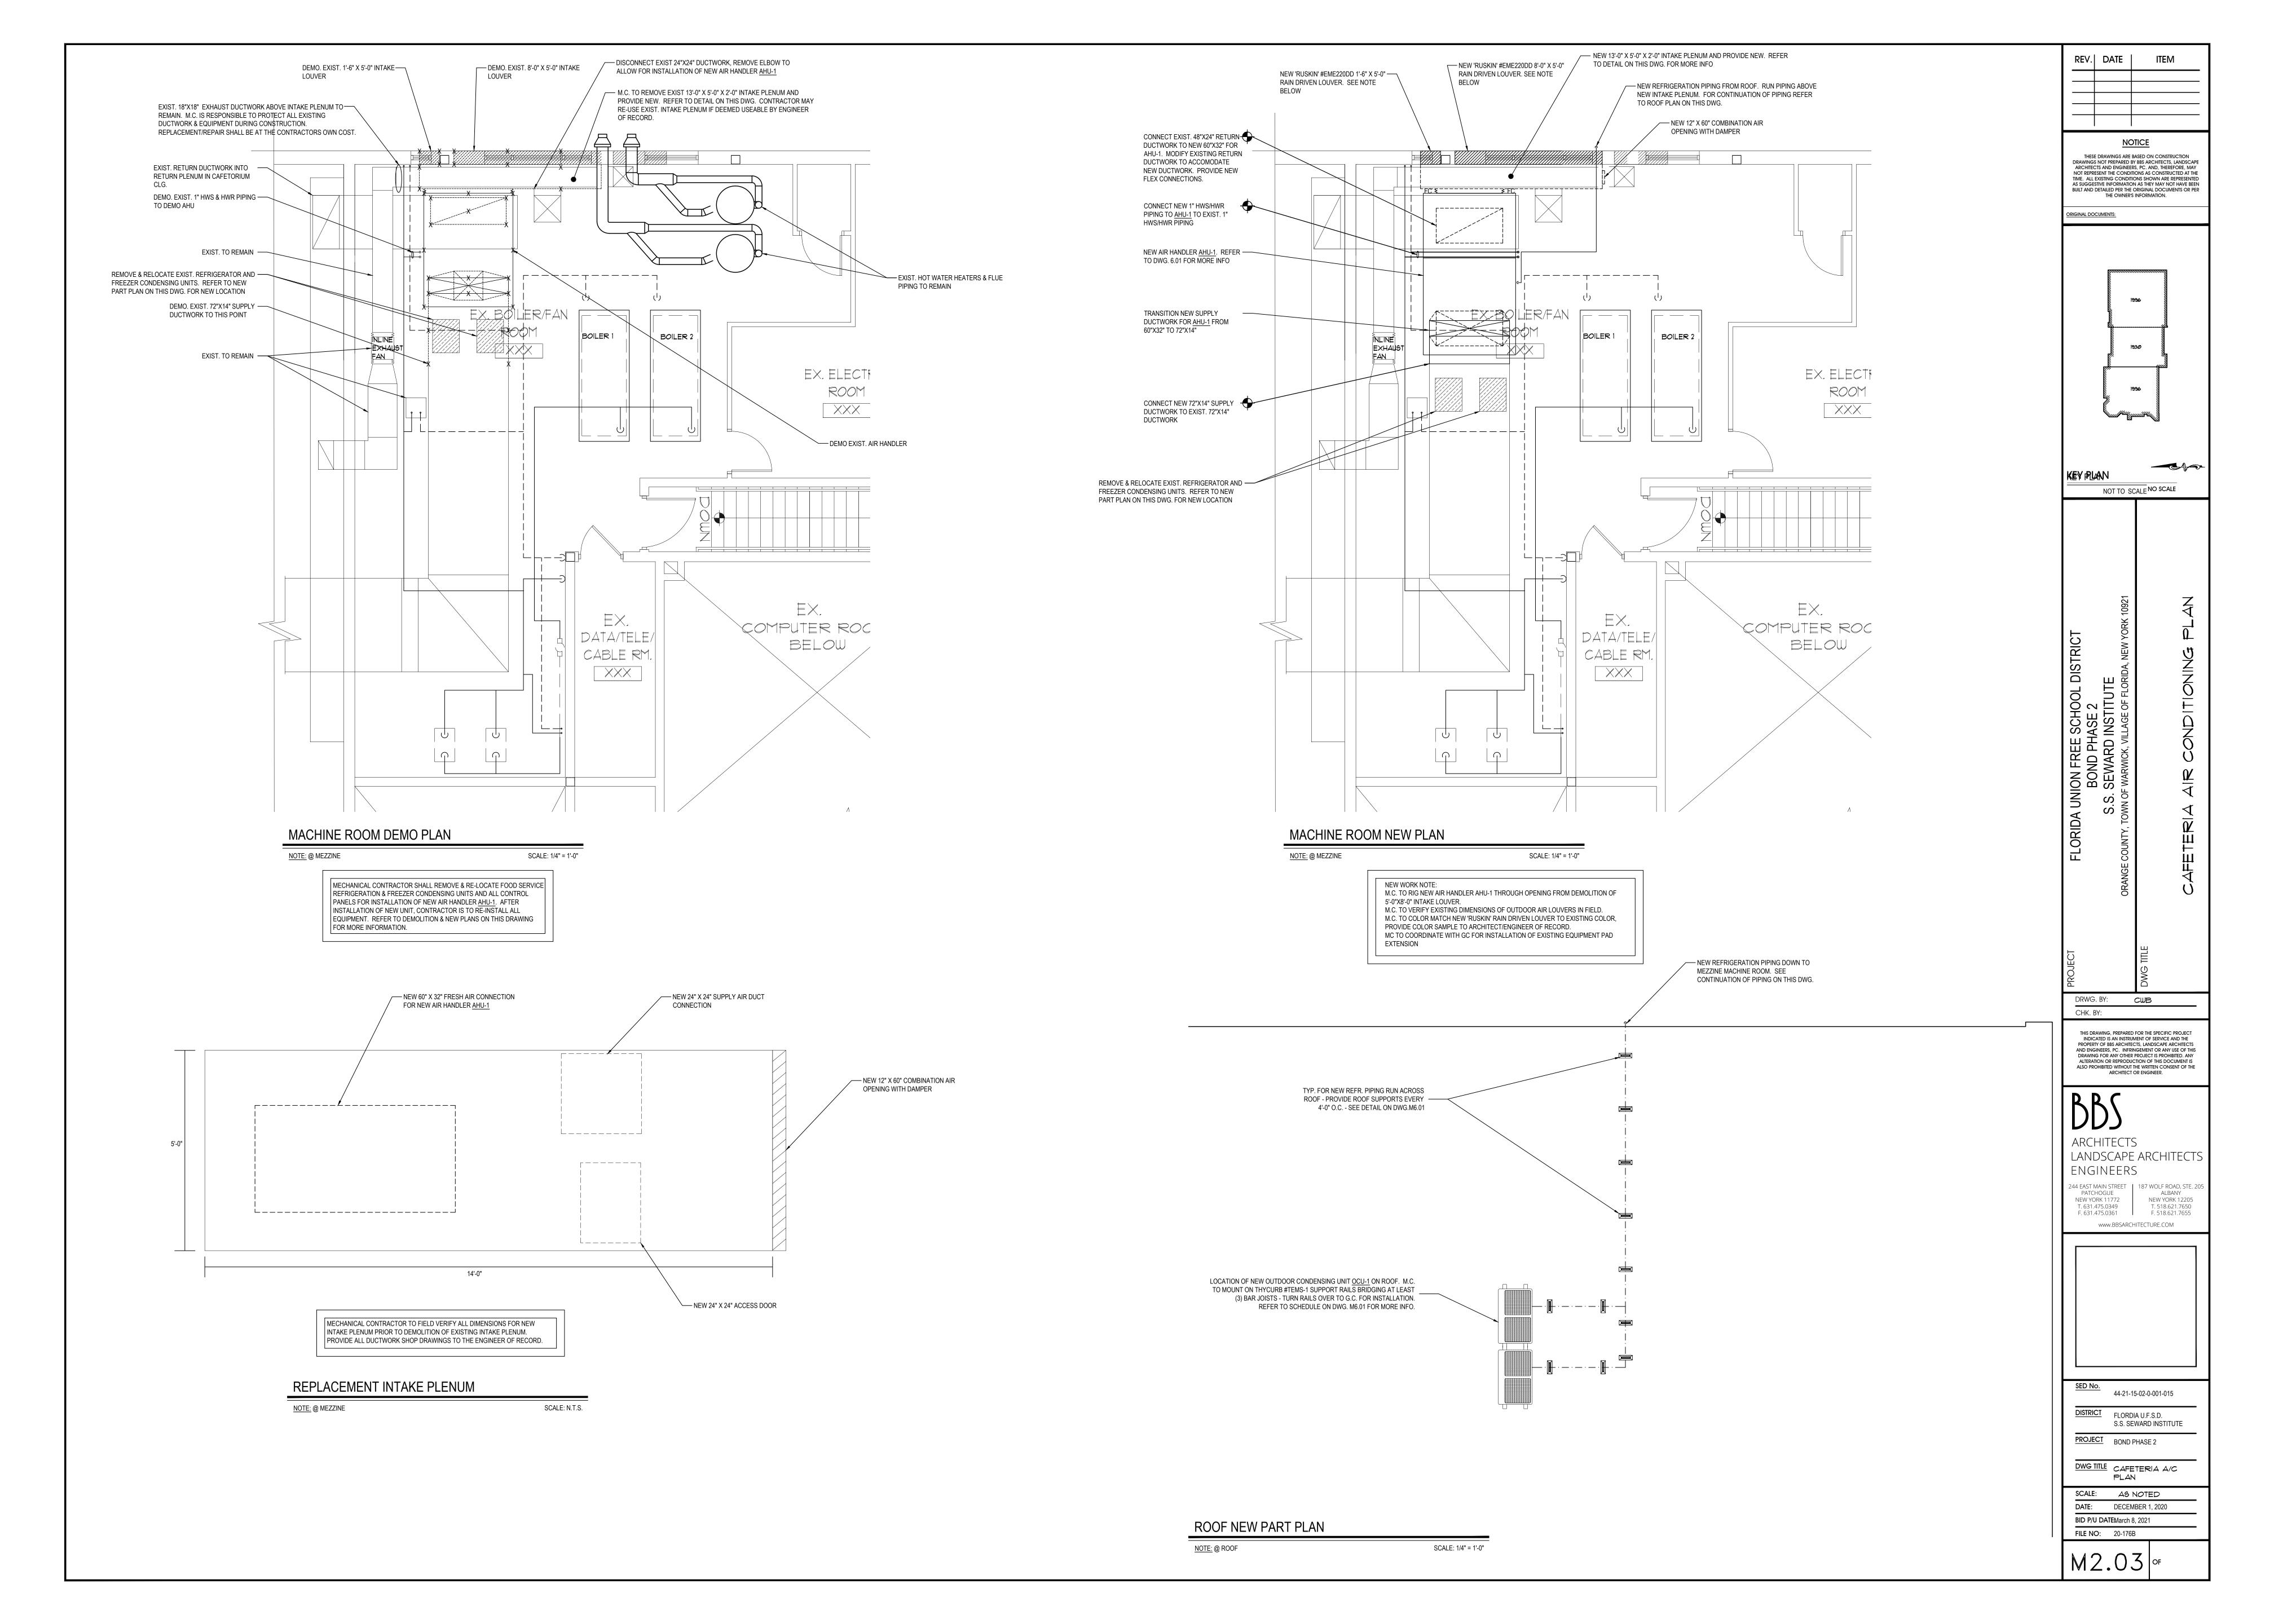


NEW MICRODRIVE FOR FAN 'F-4'

REFER TO ENLARGED PART PLAN ON THIS DWG. FOR NEW WORK IN THIS

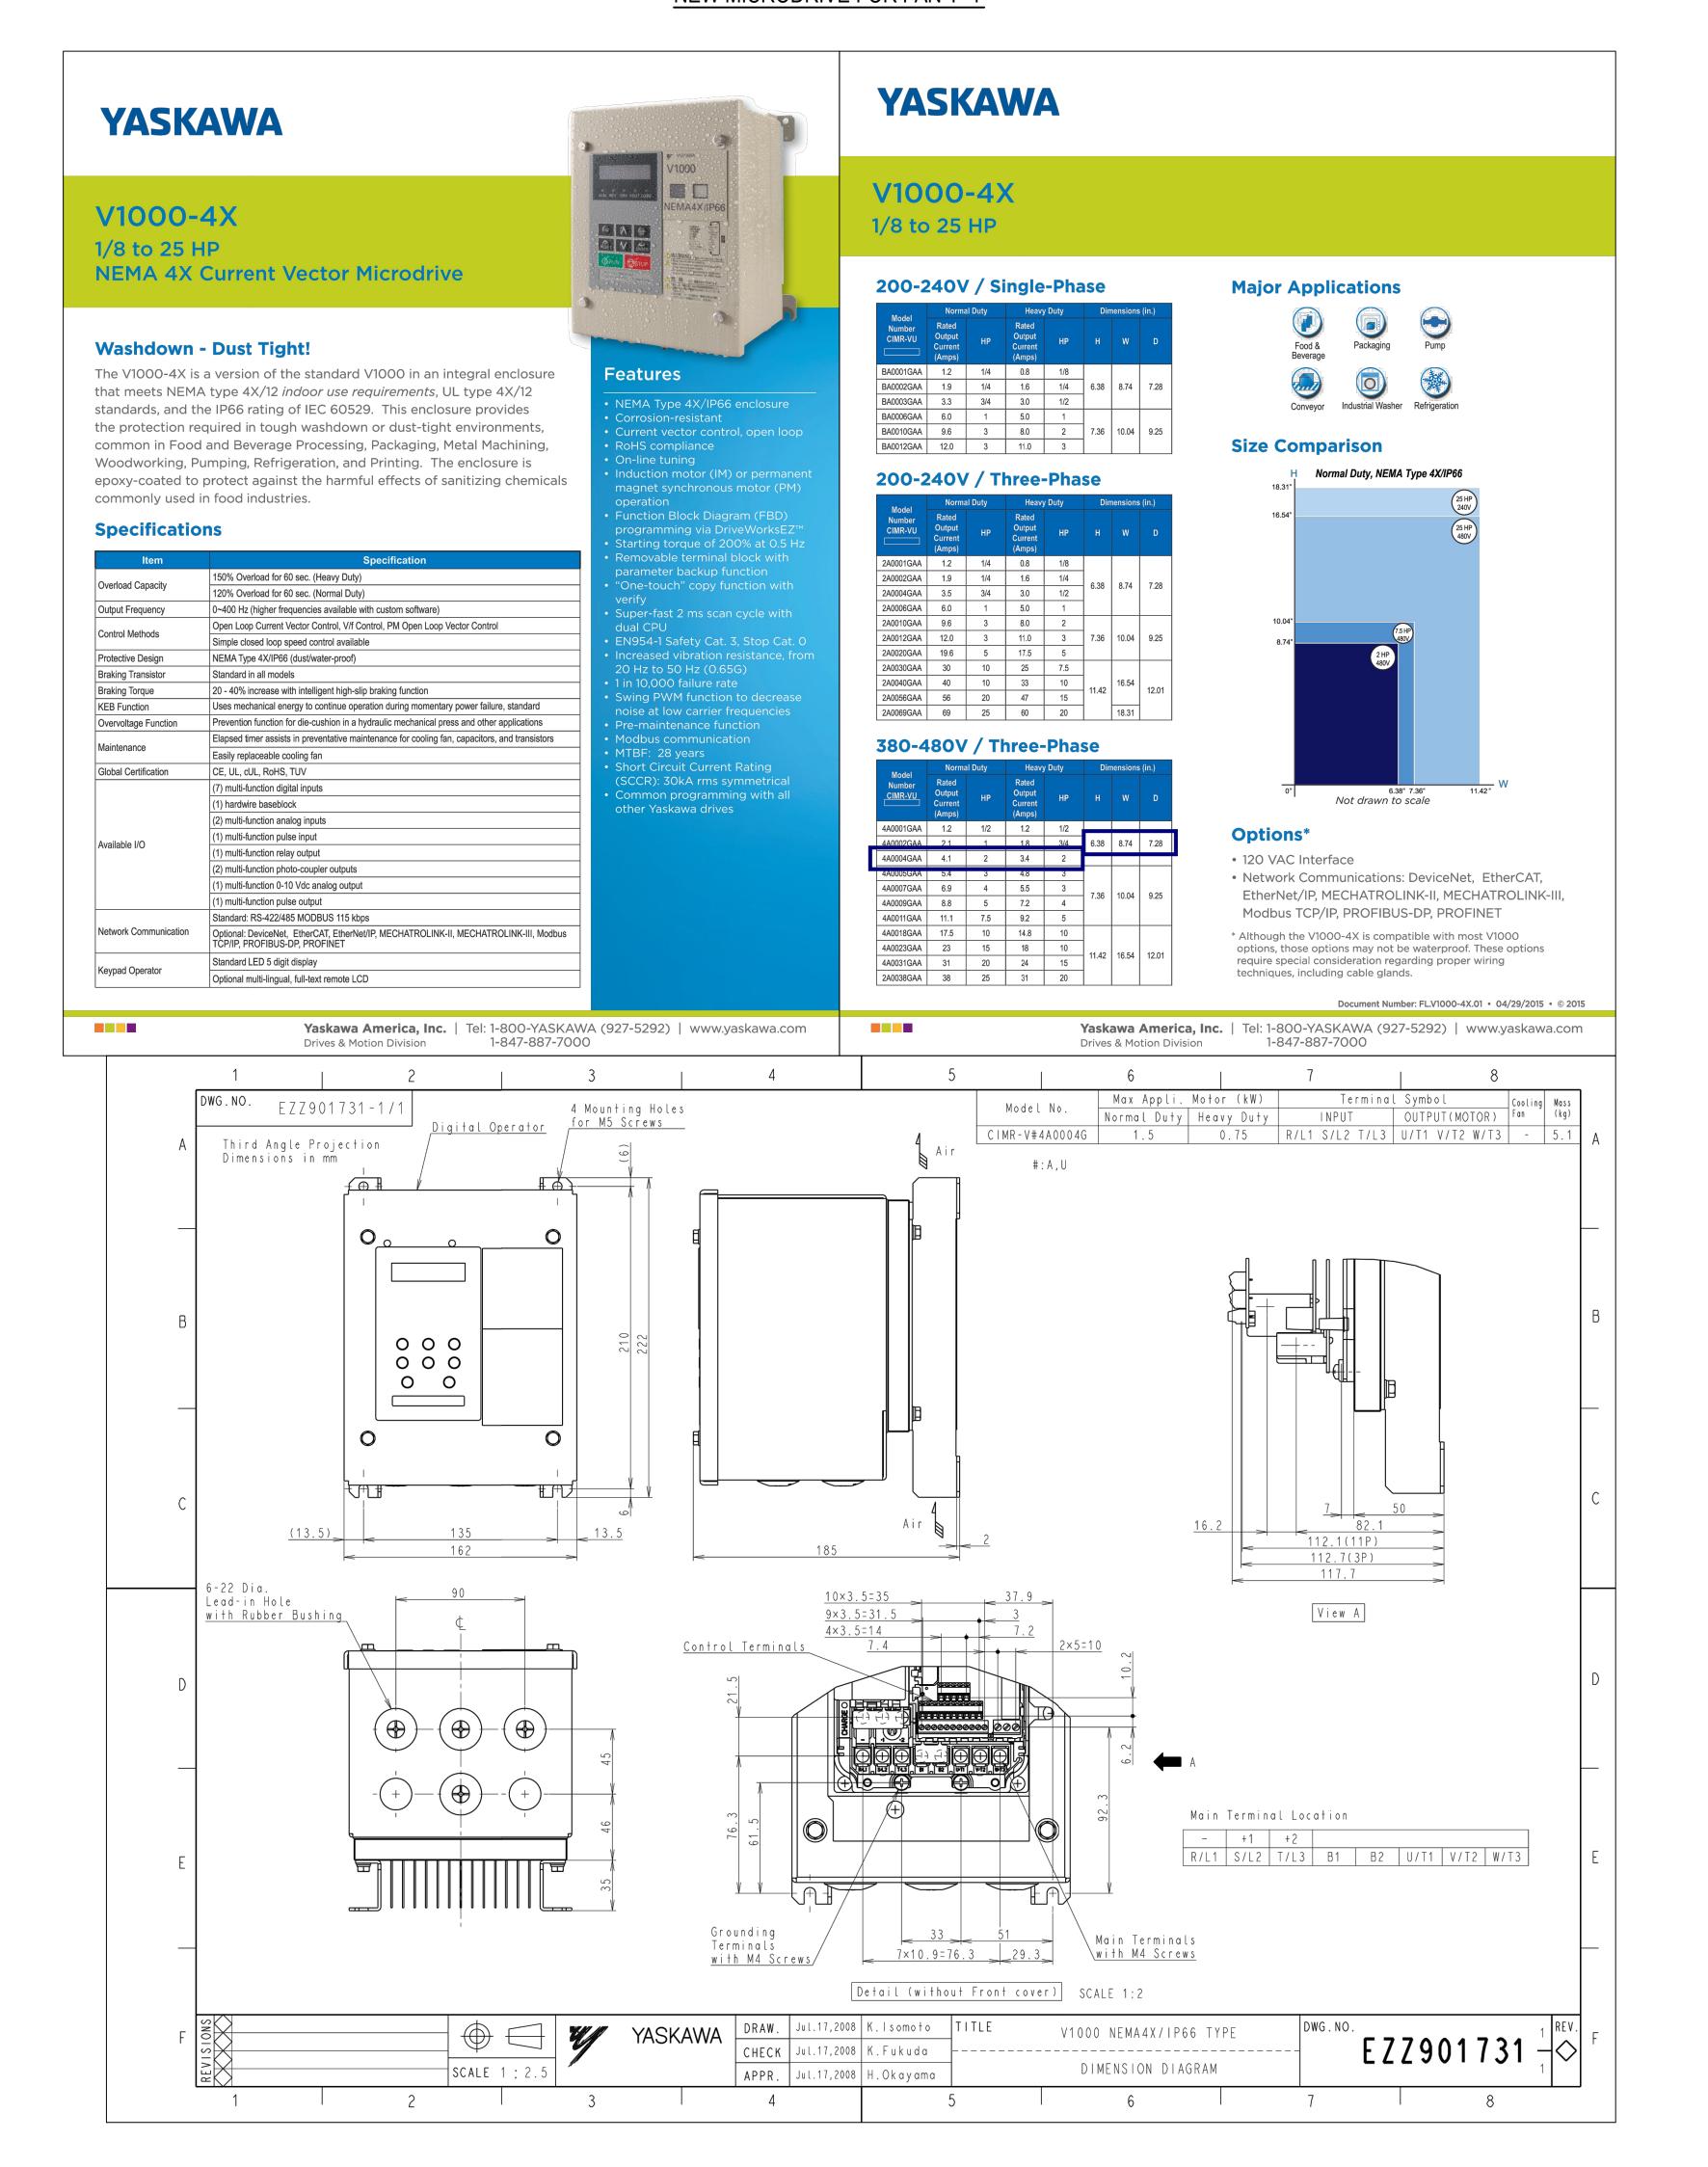

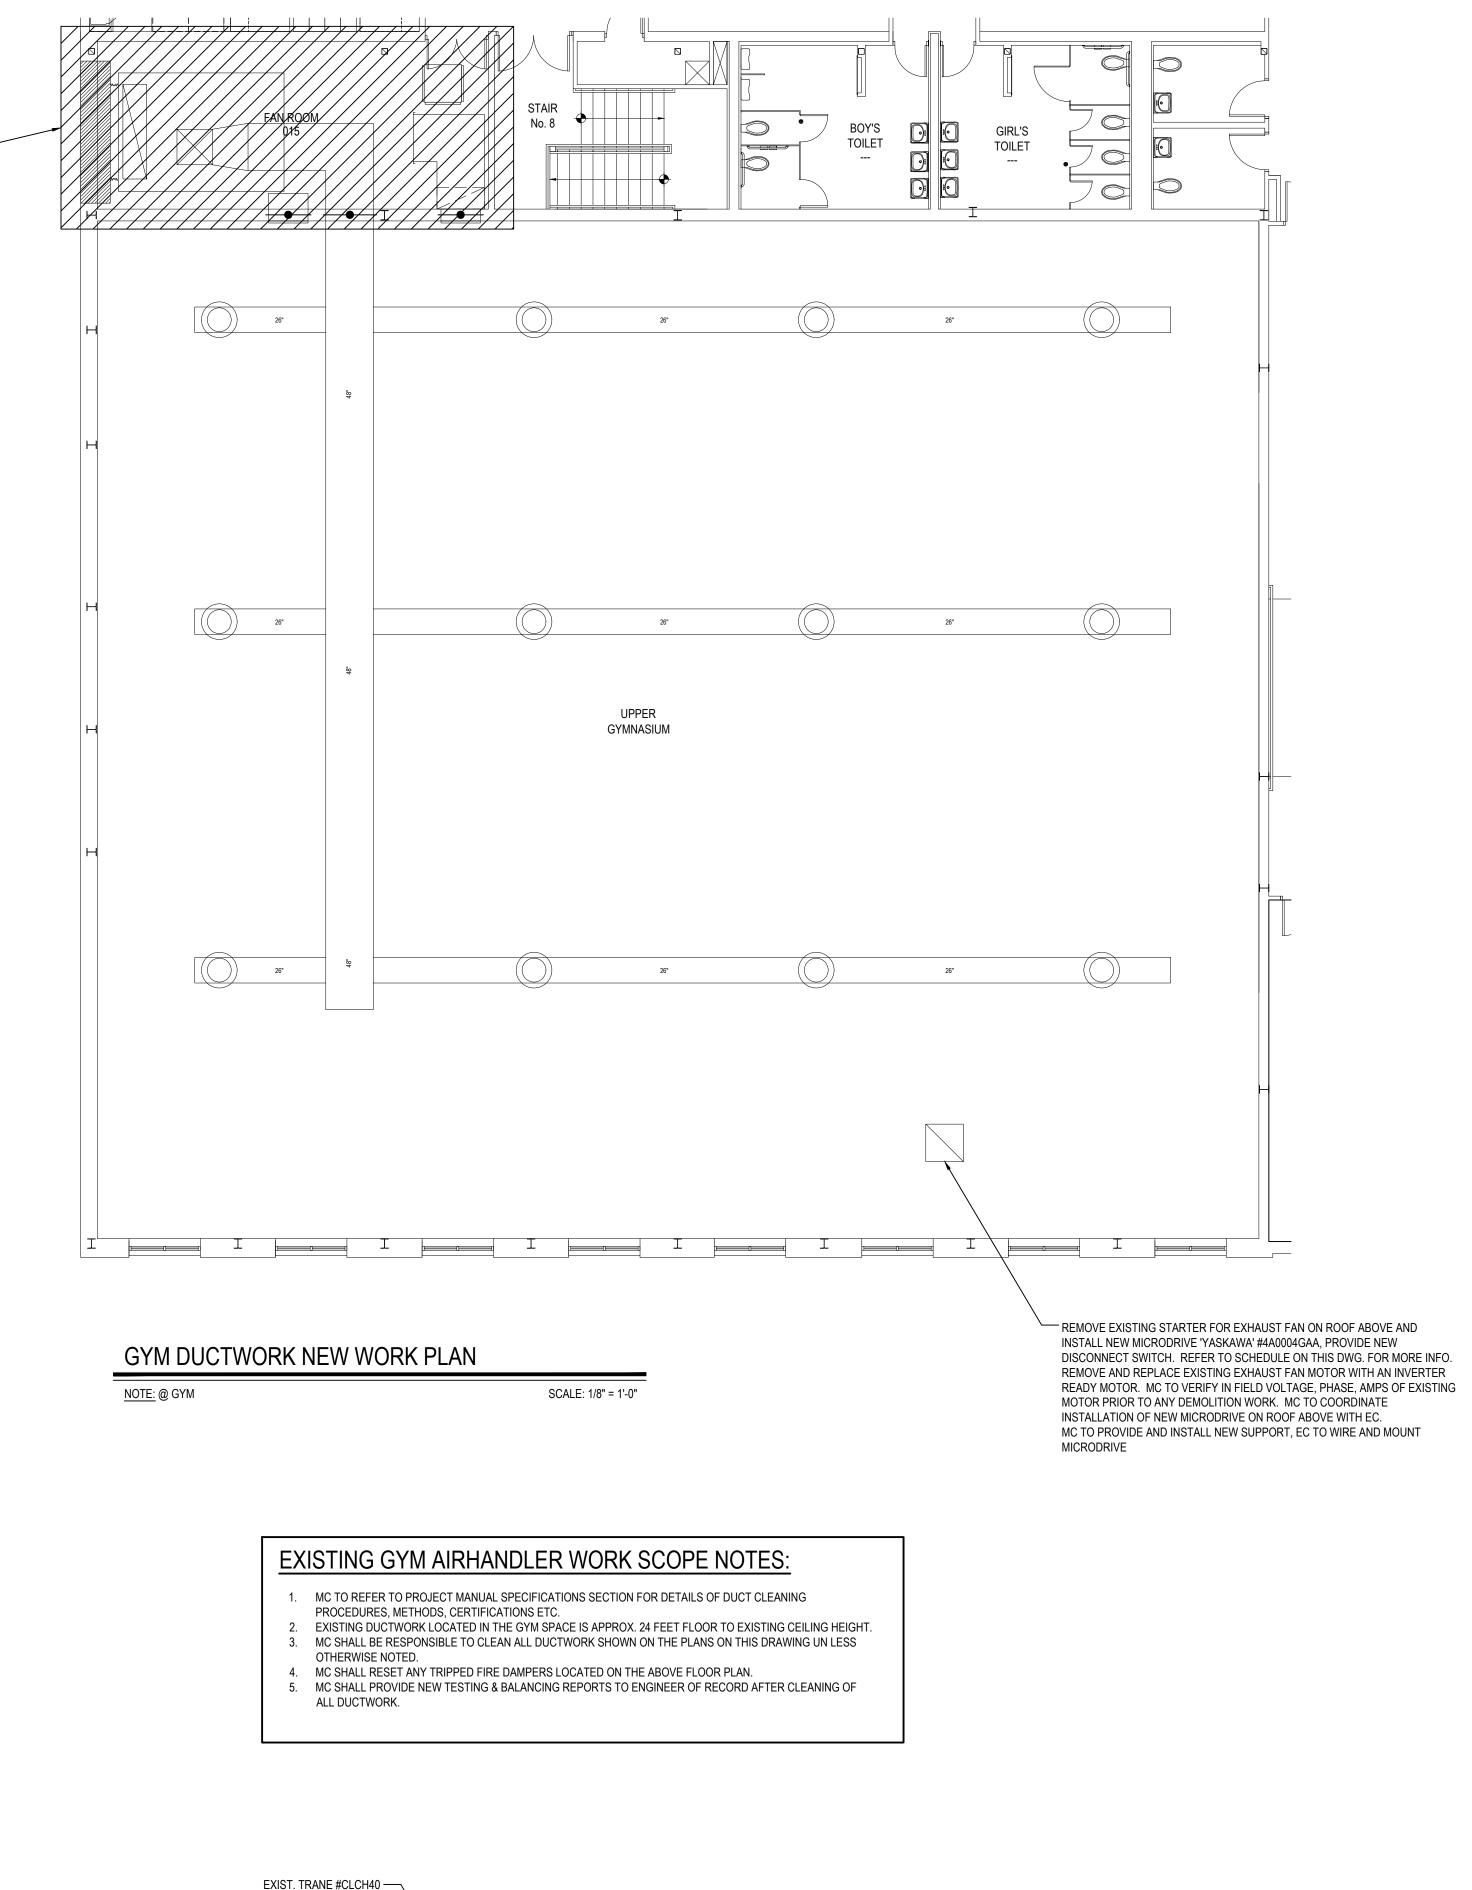

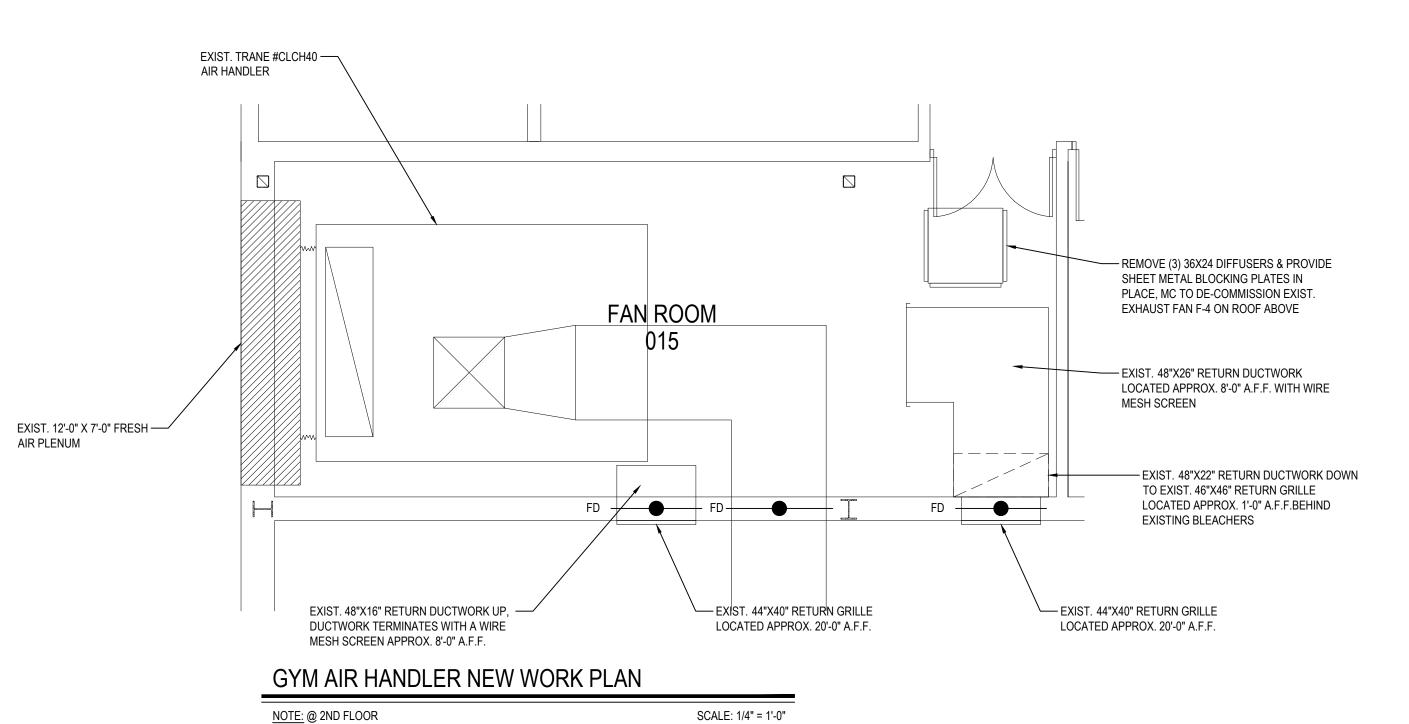

THESE DRAWINGS ARE BASED ON CONSTRUCTION DRAWINGS NOT PREPARED BY BBS ARCHITECTS, LANDSCAPE ARCHITECTS AND ENGINEERS, PC. AND, THEREFORE, MAY NOT REPRESENT THE CONDITIONS AS CONSTRUCTED AT THE TIME. ALL EXISTING CONDITIONS SHOWN ARE REPRESENTED AS SUGGESTIVE INFORMATION AS THEY MAY NOT HAVE BEEN BUILT AND DETAILED PER THE ORIGINAL DOCUMENTS OR PER THE OWNER'S INFORMATION. ORIGINAL DOCUMENTS: KEY PLAN NOT TO SCALE NO SCALE

DRWG. BY: CWB

THIS DRAWING, PREPARED FOR THE SPECIFIC PROJECT

AND ENGINEERS, PC. INFRINGEMENT OR ANY USE OF THIS DRAWING FOR ANY OTHER PROJECT IS PROHIBITED. ANY

ALTERATION OR REPRODUCTION OF THIS DOCUMENT IS ALSO PROHIBITED WITHOUT THE WRITTEN CONSENT OF THE ARCHITECT OR ENGINEER.

LANDSCAPE ARCHITECTS

244 EAST MAIN STREET | 187 WOLF ROAD, STE. 20

www.BBSARCHITECTURE.COM

44-21-15-02-0-001-015

DISTRICT FLORDIA U.F.S.D. S.S. SEWARD INSTITUTE

DWG TITLE GYM MECHANICAL PLAN

DECEMBER 1, 2020

PROJECT BOND PHASE 2

SCALE: AS NOTED

BID P/U DATEMarch 8, 2021

M2.04 of

FILE NO: 20-176B

ALBANY

NEW YORK 12205

T. 518.621.7650

F. 518.621.7655

INDICATED IS AN INSTRUMENT OF SERVICE AND THE PROPERTY OF BBS ARCHITECTS, LANDSCAPE ARCHITECTS

CHK. BY:

ARCHITECTS


ENGINEERS


PATCHOGUE


NEW YORK 11772

T. 631.475.0349

F. 631.475.0361

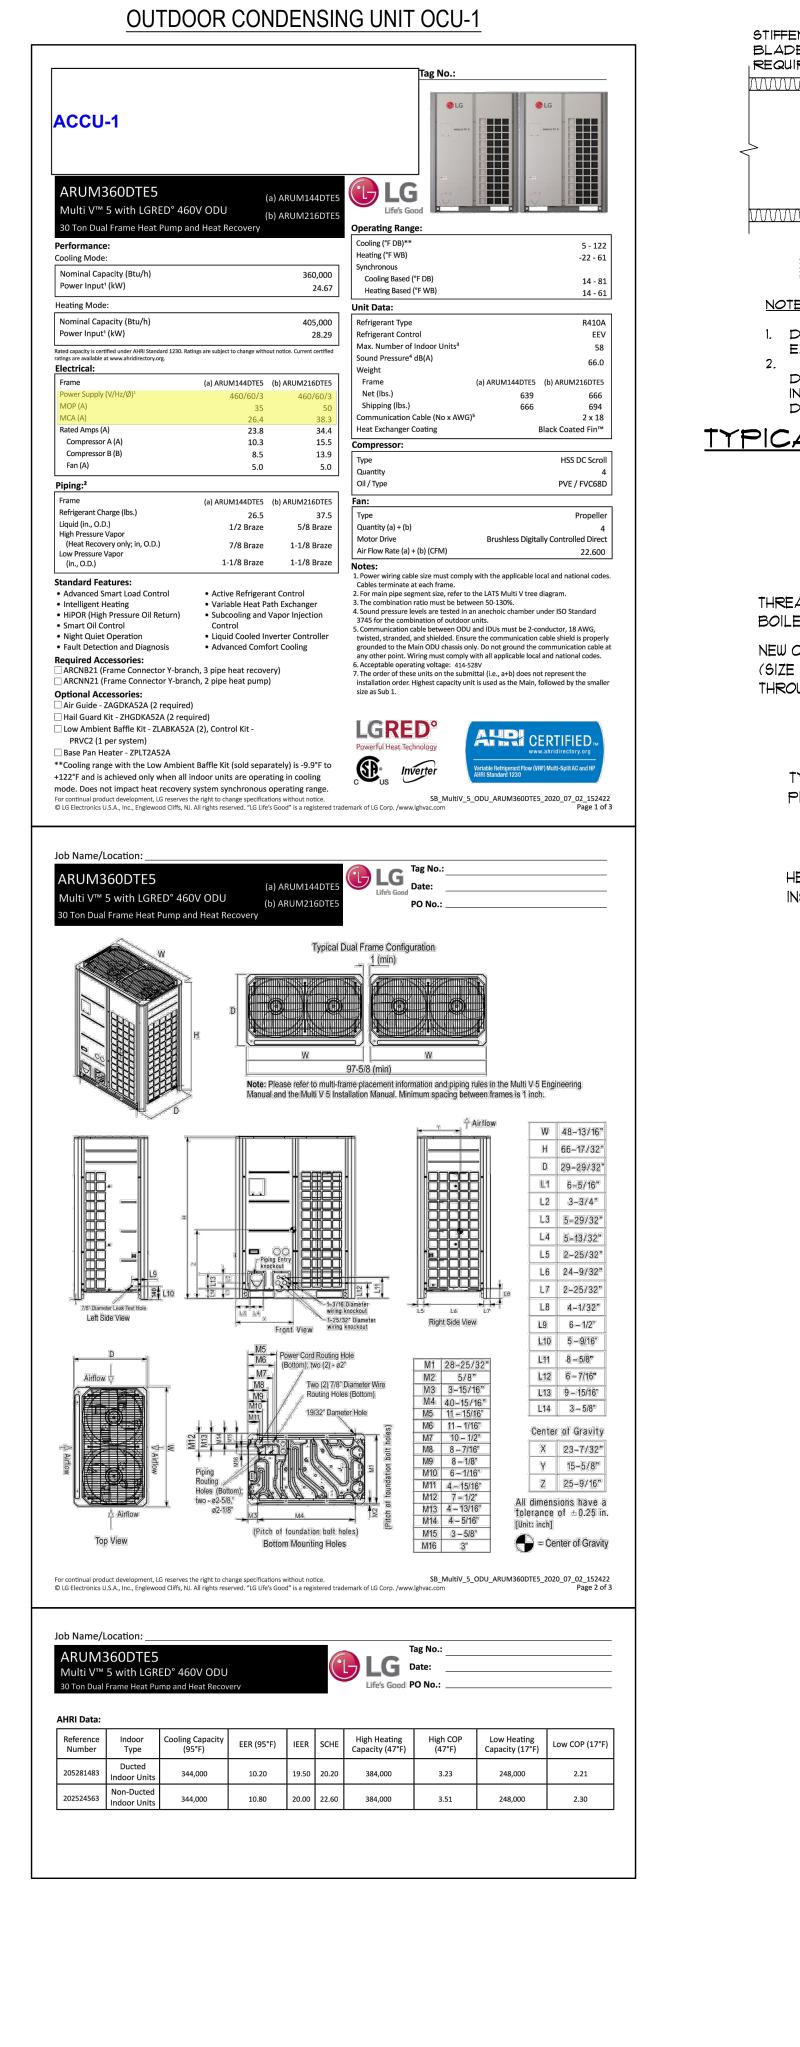

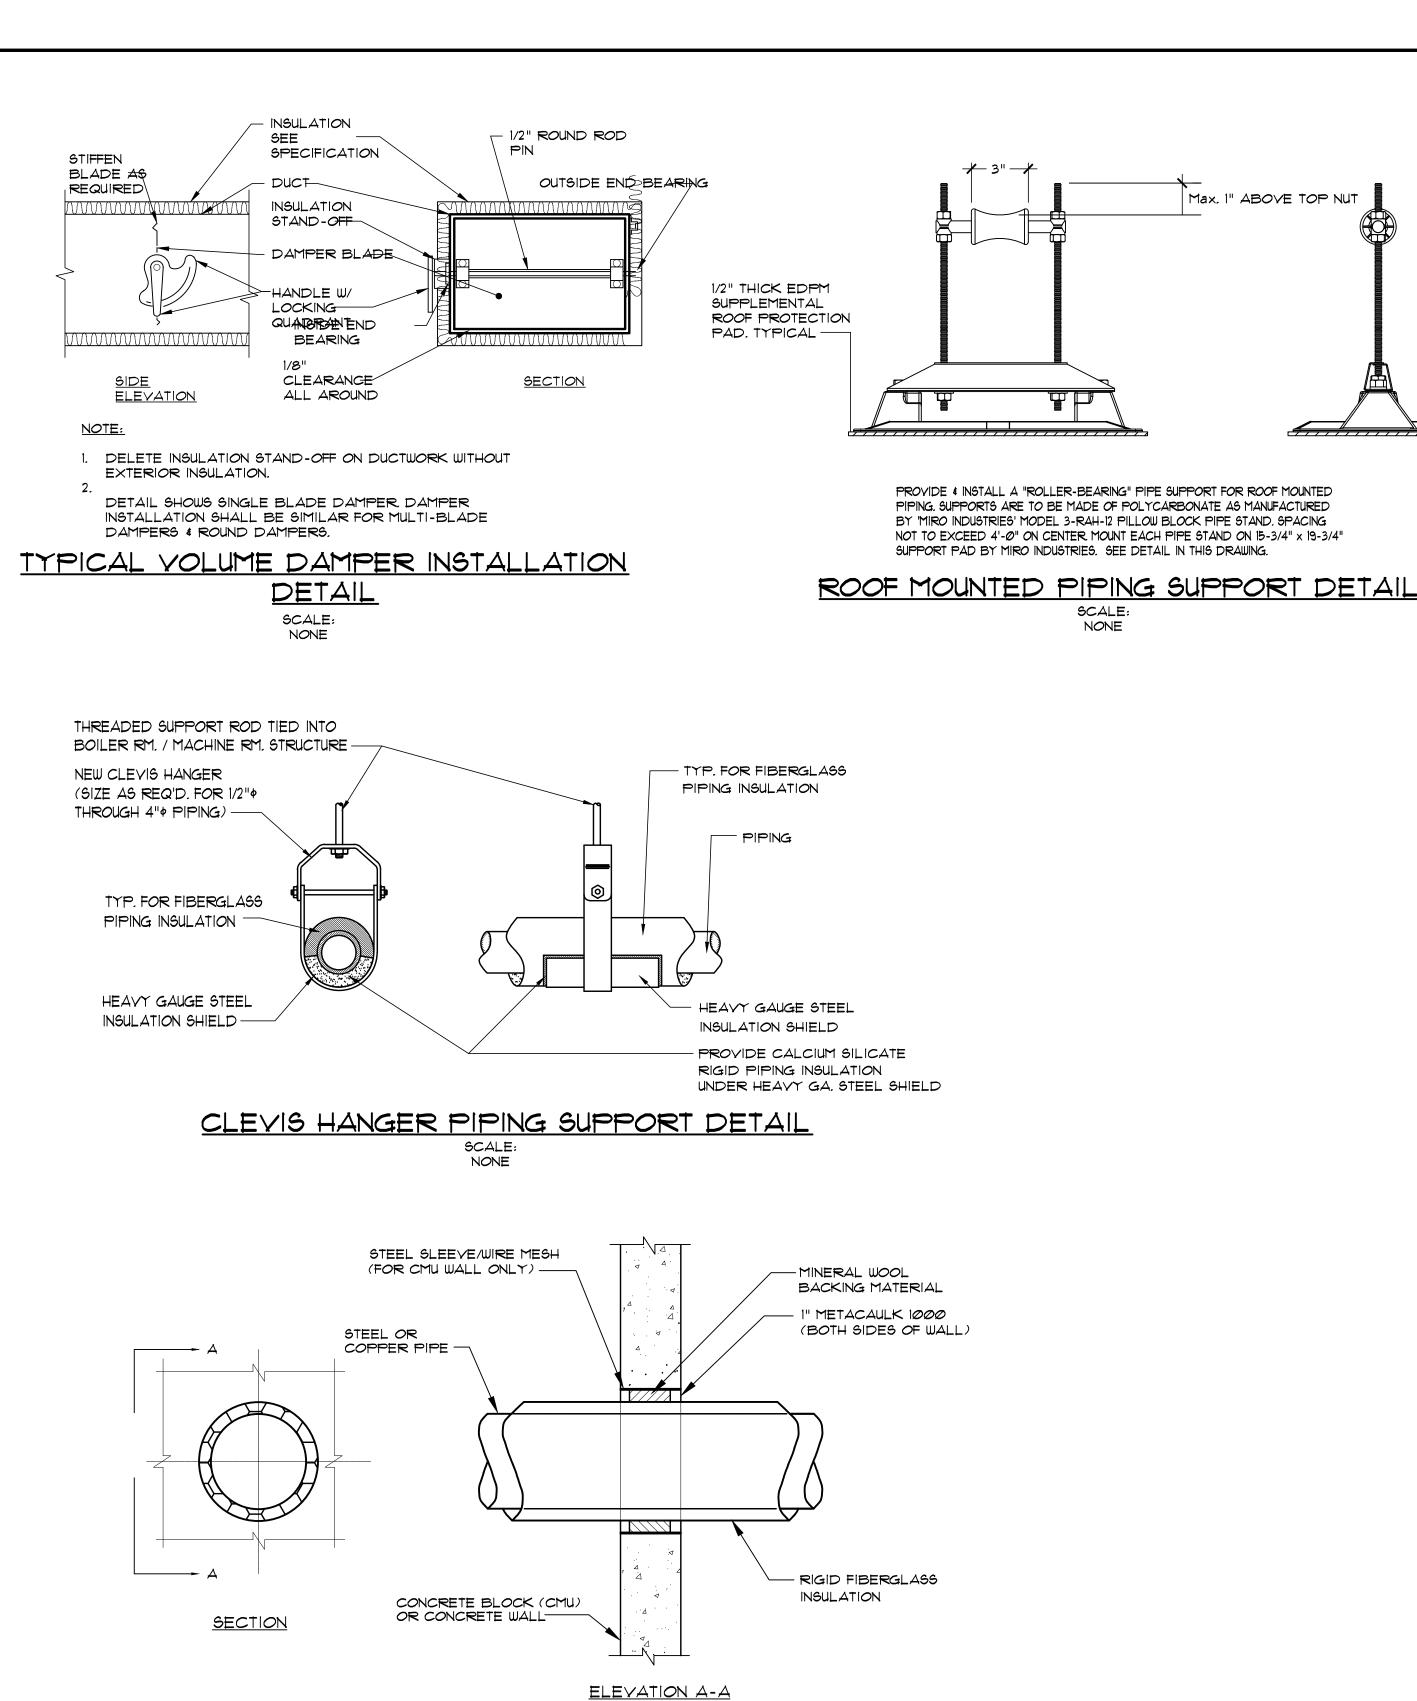

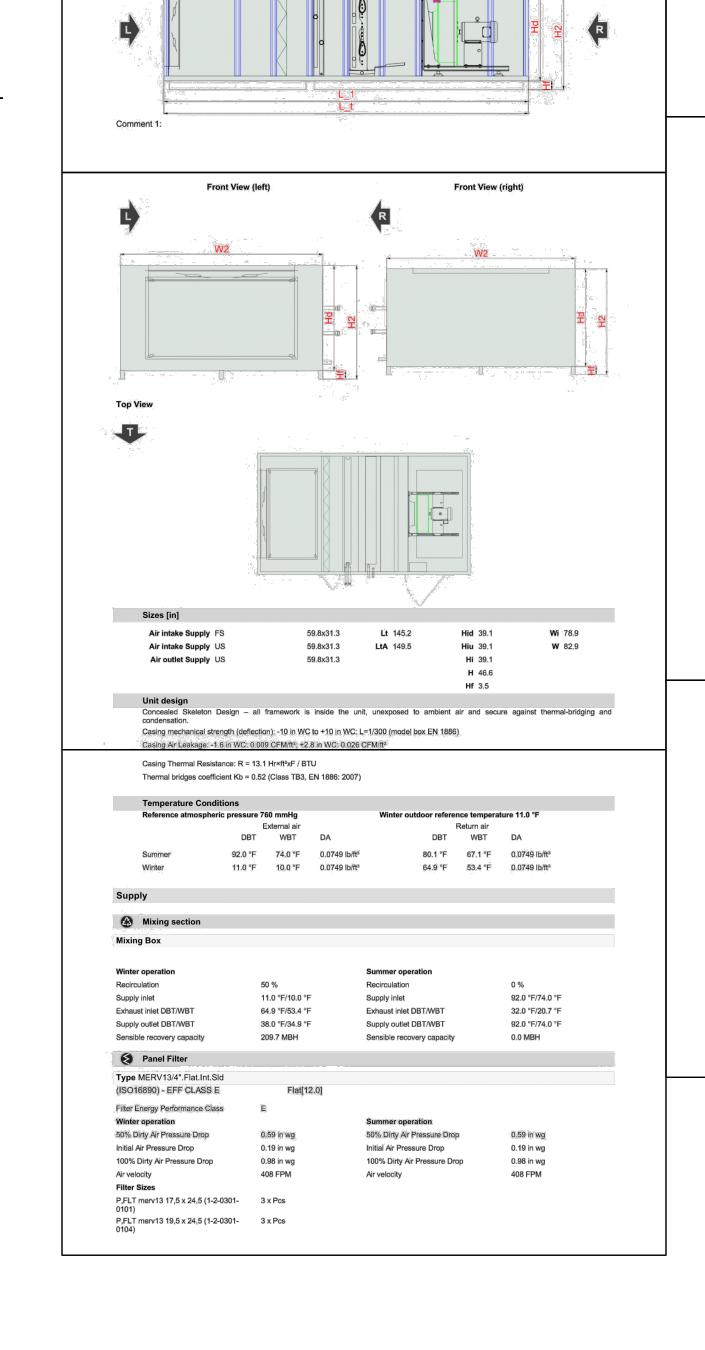

VTS Dealers USA

Offer number 226A/LIVE.USA/Bs/2020-20

Supply airflow 2 7200.00 CFM

SFP Winter 0.58 HP/kcfm

SFP Summer 0.58 HP/kcfm

External pressure 1.50 in wg

Technical data for item 1

School /1DP.UR.0018.001/

Type SingleSupply

Set AVS085-R-MFHCV

Insulation Polyurethane Foam


Application Indoor

Project Tag AHU-1

Insulation thickness 2.0 in

Weight of the set (+/- 10%)* 1515 lb

Project name Florida Steward

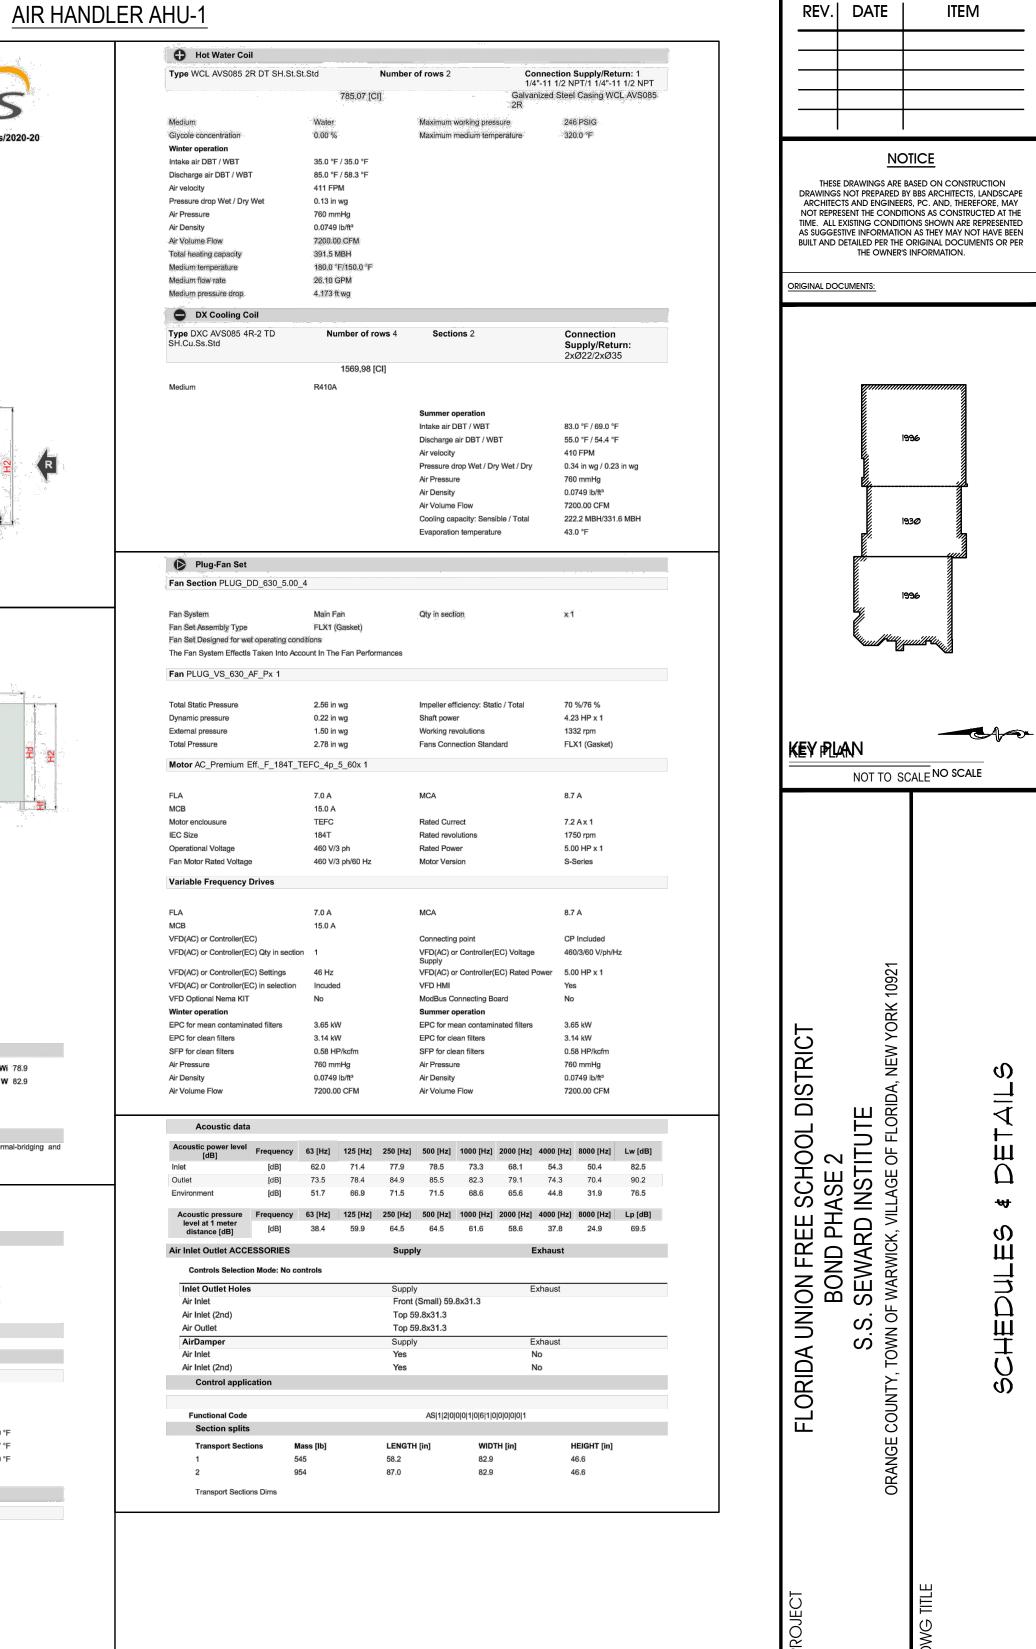

DRWG. BY:

ARCHITECTS

ENGINEERS

PATCHOGUE

NEW YORK 11772

T. 631.475.0349

F. 631.475.0361

CHK. BY:

CWB

THIS DRAWING, PREPARED FOR THE SPECIFIC PROJECT INDICATED IS AN INSTRUMENT OF SERVICE AND THE PROPERTY OF BBS ARCHITECTS, LANDSCAPE ARCHITECTS AND ENGINEERS, PC. INFRINGEMENT OR ANY USE OF THIS DRAWING FOR ANY OTHER PROJECT IS PROHIBITED. ANY ALTERATION OR REPRODUCTION OF THIS DOCUMENT IS ALSO PROHIBITED WITHOUT THE WRITTEN CONSENT OF THE ARCHITECT OR ENGINEER.

LANDSCAPE ARCHITECTS

44 EAST MAIN STREET | 187 WOLF ROAD, STE. 2

www.BBSARCHITECTURE.COM

44-21-15-02-0-001-015

S.S. SEWARD INSTITUTE

DWG TITLE SCHEDULES & DETAILS

DECEMBER 1, 2020

DISTRICT FLORDIA U.F.S.D.

PROJECT BOND PHASE 2

SCALE: AS NOTED

BID P/U DATEMarch 8, 2021
FILE NO: 20-176B


M6.01


ALBANY


NEW YORK 12205

T. 518.621.7650

F. 518.621.7655

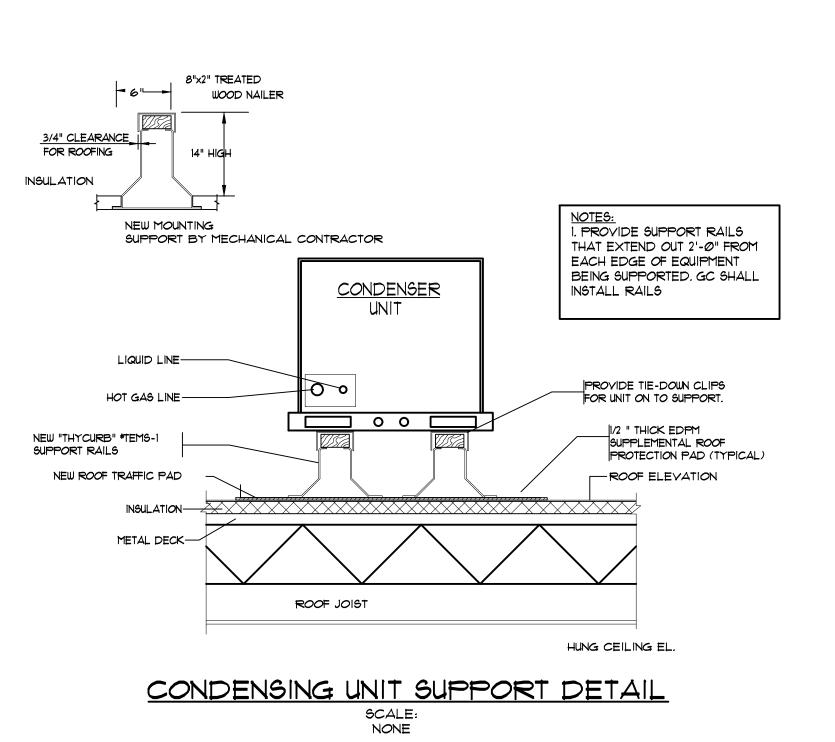


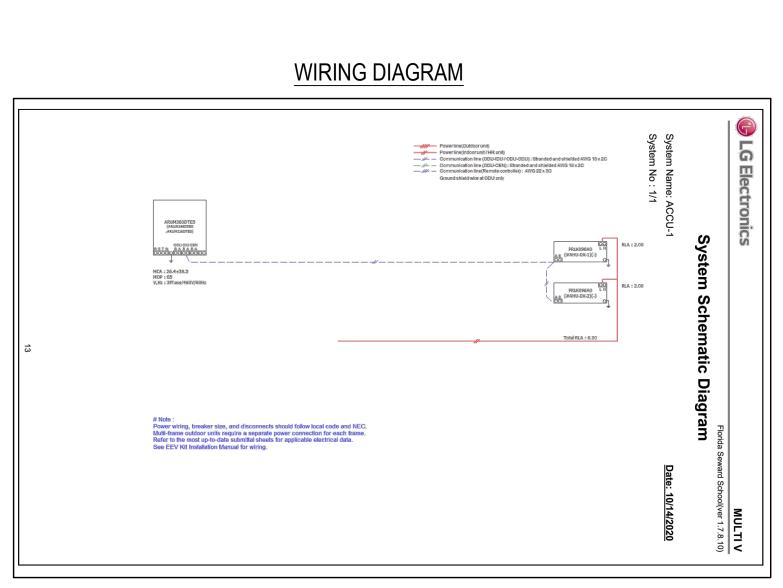

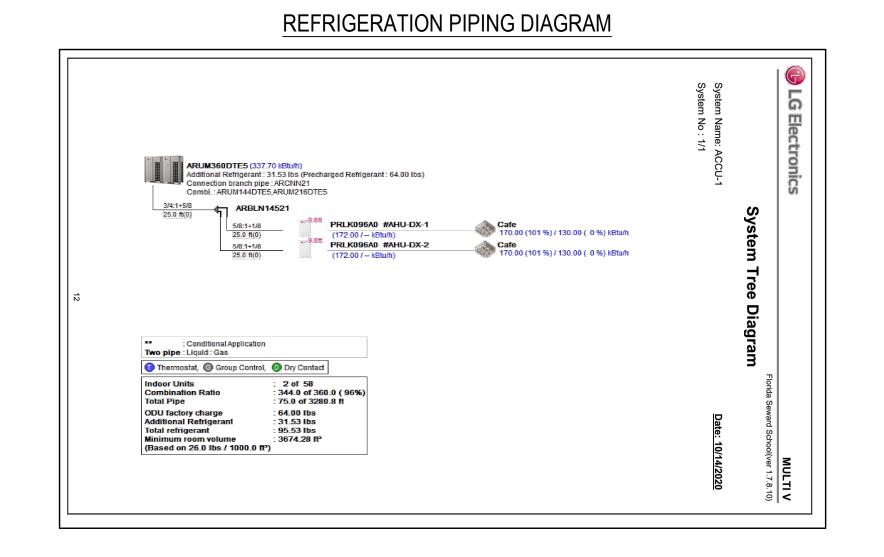

PIPING WALL PENETRATION DETAIL

SCALE: NONE

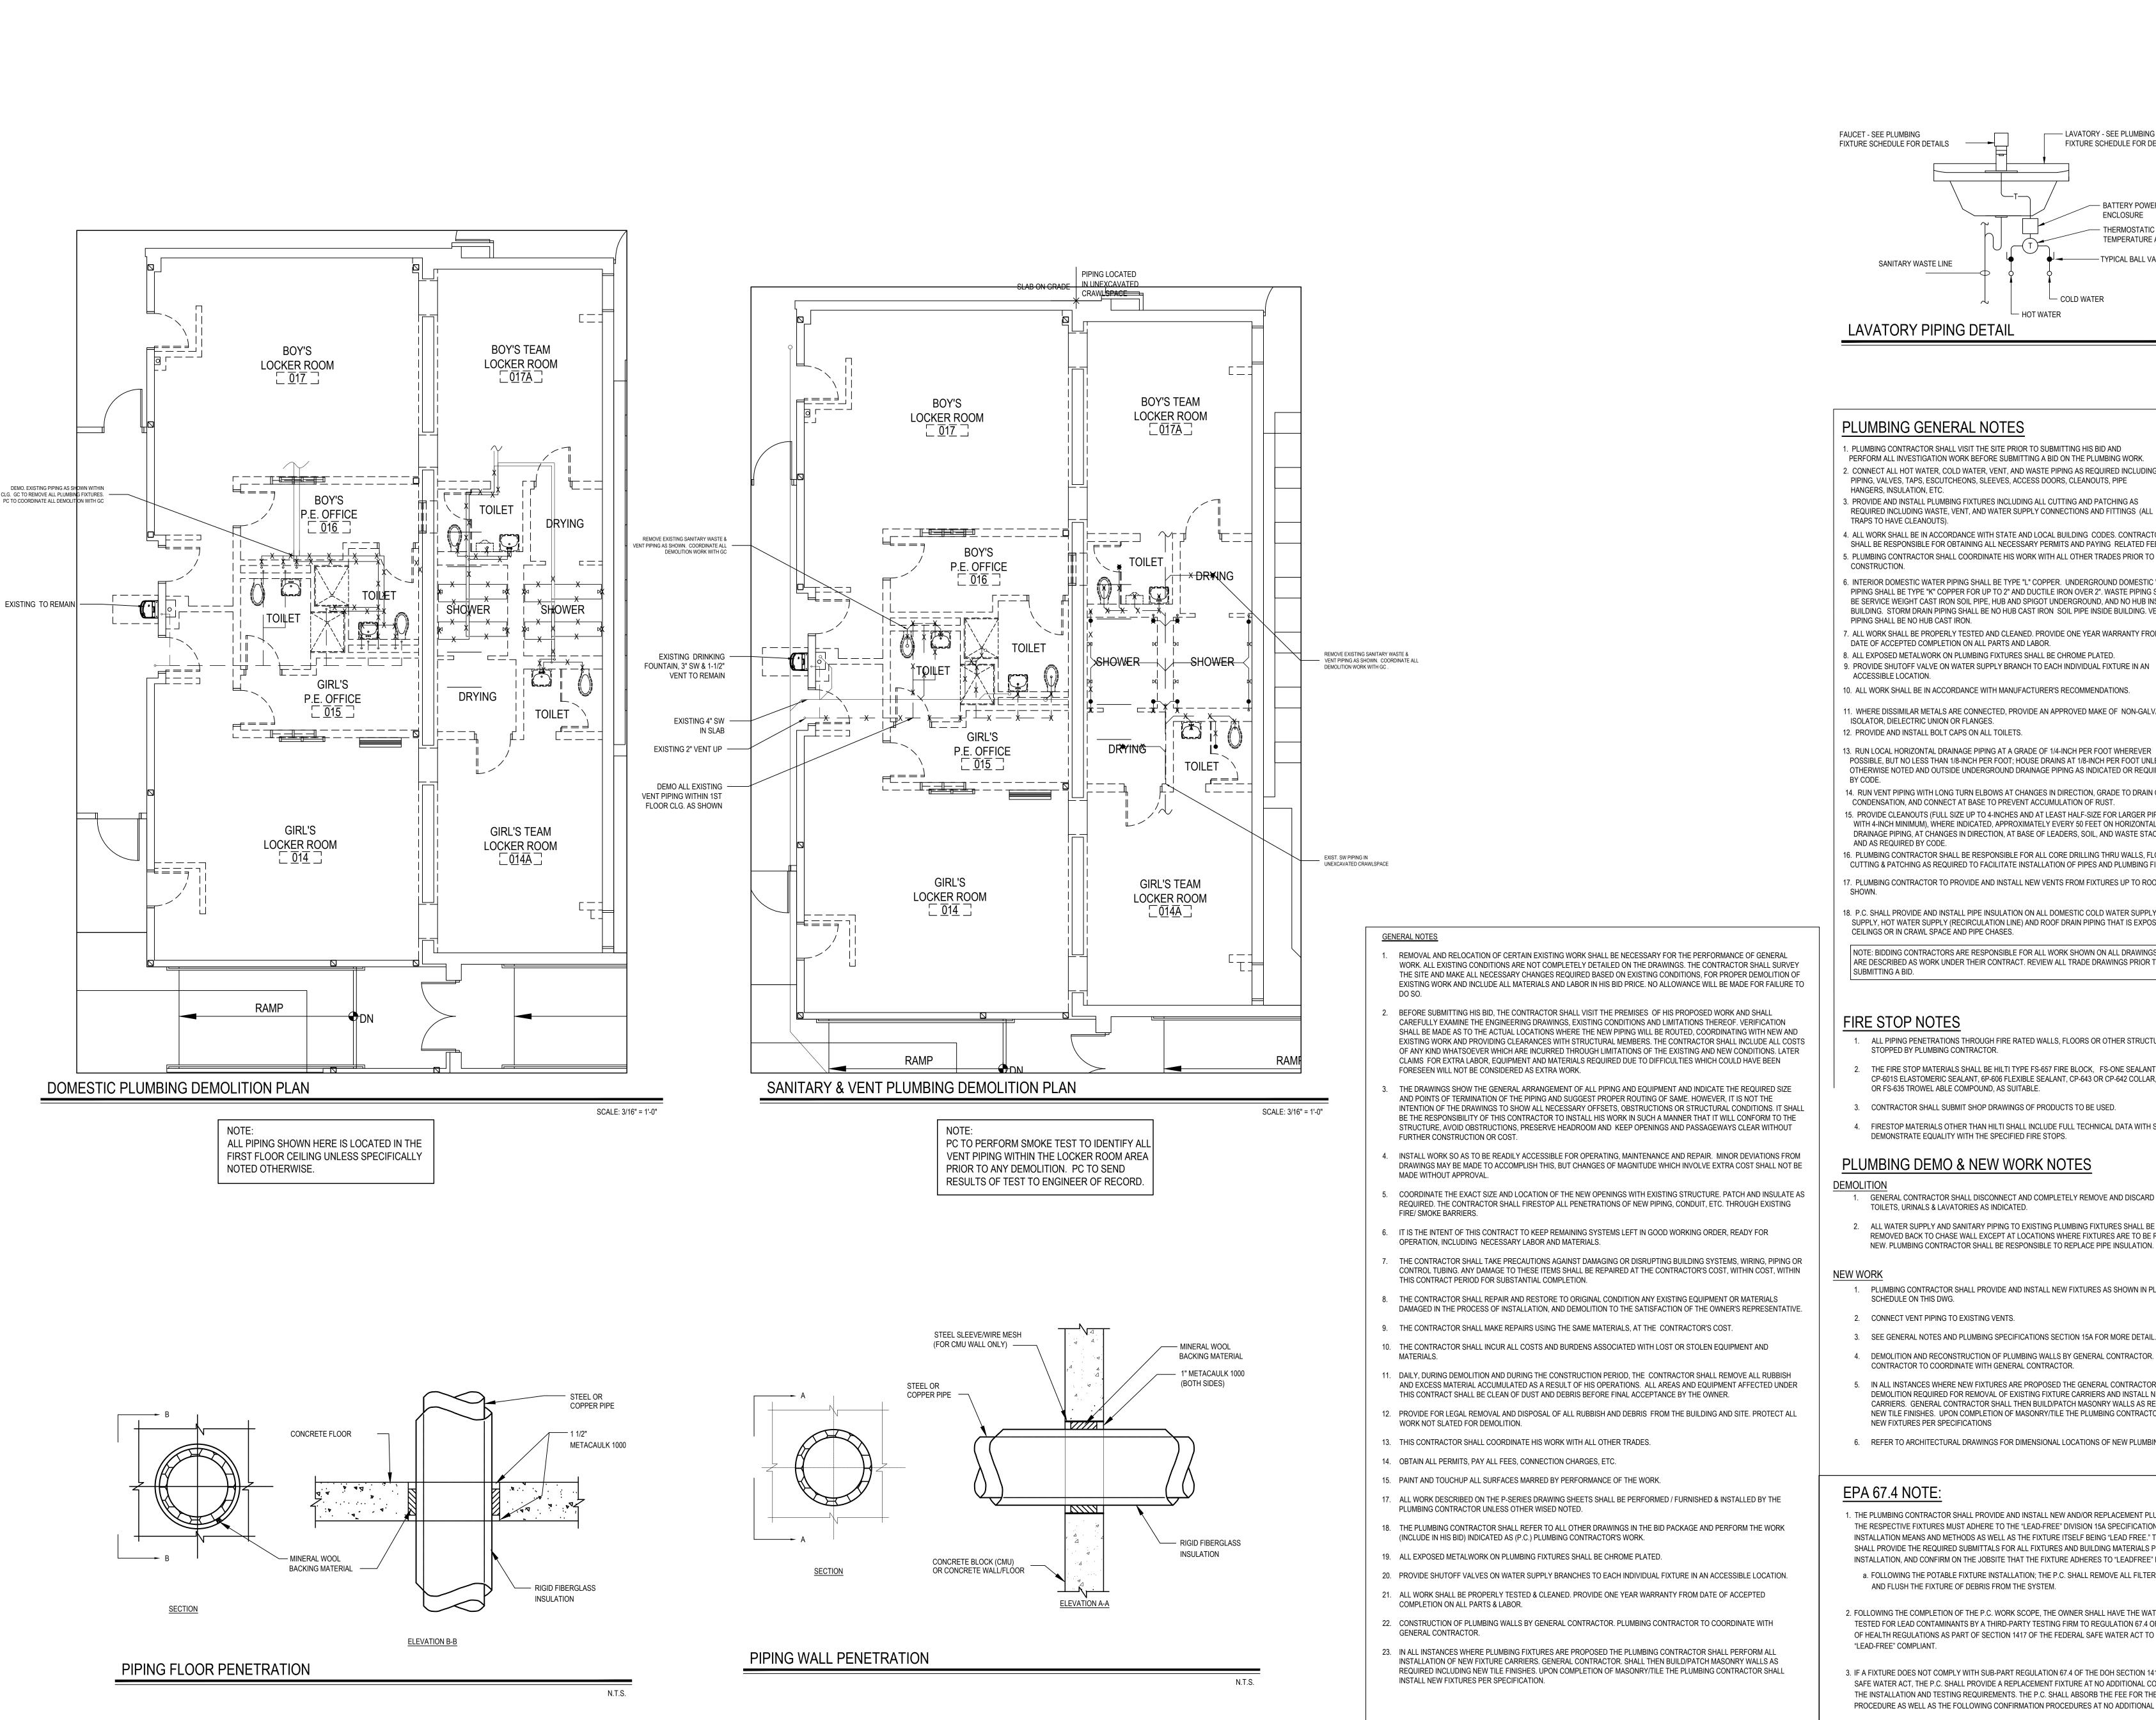

FAUCET - SEE PLUMBING — LAVATORY - SEE PLUMBING FIXTURE SCHEDULE FOR DETAILS FIXTURE SCHEDULE FOR DETAILS BATTERY POWERED SENSOR OPERATED THERMOSTATIC MIXING VALVE. SET TEMPERATURE AT 105° MAX. — TYPICAL BALL VALVES SANITARY WASTE LINE COLD WATER LAVATORY PIPING DETAIL NOT TO SCALE

PLUMBING GENERAL NOTES

- 1. PLUMBING CONTRACTOR SHALL VISIT THE SITE PRIOR TO SUBMITTING HIS BID AND
- PERFORM ALL INVESTIGATION WORK BEFORE SUBMITTING A BID ON THE PLUMBING WORK. 2. CONNECT ALL HOT WATER, COLD WATER, VENT, AND WASTE PIPING AS REQUIRED INCLUDING
- HANGERS, INSULATION, ETC. 3. PROVIDE AND INSTALL PLUMBING FIXTURES INCLUDING ALL CUTTING AND PATCHING AS
- REQUIRED INCLUDING WASTE, VENT, AND WATER SUPPLY CONNECTIONS AND FITTINGS (ALL TRAPS TO HAVE CLEANOUTS). 4. ALL WORK SHALL BE IN ACCORDANCE WITH STATE AND LOCAL BUILDING CODES. CONTRACTOR
- SHALL BE RESPONSIBLE FOR OBTAINING ALL NECESSARY PERMITS AND PAYING RELATED FEES. 5. PLUMBING CONTRACTOR SHALL COORDINATE HIS WORK WITH ALL OTHER TRADES PRIOR TO
- 6. INTERIOR DOMESTIC WATER PIPING SHALL BE TYPE "L" COPPER. UNDERGROUND DOMESTIC WATER PIPING SHALL BE TYPE "K" COPPER FOR UP TO 2" AND DUCTILE IRON OVER 2". WASTE PIPING SHALL BE SERVICE WEIGHT CAST IRON SOIL PIPE, HUB AND SPIGOT UNDERGROUND, AND NO HUB INSIDE BUILDING. STORM DRAIN PIPING SHALL BE NO HUB CAST IRON SOIL PIPE INSIDE BUILDING. VENT
- 7. ALL WORK SHALL BE PROPERLY TESTED AND CLEANED. PROVIDE ONE YEAR WARRANTY FROM
- DATE OF ACCEPTED COMPLETION ON ALL PARTS AND LABOR. 8. ALL EXPOSED METALWORK ON PLUMBING FIXTURES SHALL BE CHROME PLATED.
- 9. PROVIDE SHUTOFF VALVE ON WATER SUPPLY BRANCH TO EACH INDIVIDUAL FIXTURE IN AN ACCESSIBLE LOCATION.
- 10. ALL WORK SHALL BE IN ACCORDANCE WITH MANUFACTURER'S RECOMMENDATIONS.
- 1. WHERE DISSIMILAR METALS ARE CONNECTED, PROVIDE AN APPROVED MAKE OF NON-GALVANIC
- ISOLATOR, DIELECTRIC UNION OR FLANGES. 12. PROVIDE AND INSTALL BOLT CAPS ON ALL TOILETS.
- POSSIBLE, BUT NO LESS THAN 1/8-INCH PER FOOT; HOUSE DRAINS AT 1/8-INCH PER FOOT UNLESS OTHERWISE NOTED AND OUTSIDE UNDERGROUND DRAINAGE PIPING AS INDICATED OR REQUIRED 14. RUN VENT PIPING WITH LONG TURN ELBOWS AT CHANGES IN DIRECTION, GRADE TO DRAIN OUT
- CONDENSATION, AND CONNECT AT BASE TO PREVENT ACCUMULATION OF RUST. 15. PROVIDE CLEANOUTS (FULL SIZE UP TO 4-INCHES AND AT LEAST HALF-SIZE FOR LARGER PIPES WITH 4-INCH MINIMUM), WHERE INDICATED, APPROXIMATELY EVERY 50 FEET ON HORIZONTAL DRAINAGE PIPING, AT CHANGES IN DIRECTION, AT BASE OF LEADERS, SOIL, AND WASTE STACKS,
- AND AS REQUIRED BY CODE. 16. PLUMBING CONTRACTOR SHALL BE RESPONSIBLE FOR ALL CORE DRILLING THRU WALLS, FLOORS AND CUTTING & PATCHING AS REQUIRED TO FACILITATE INSTALLATION OF PIPES AND PLUMBING FIXTURES.
- 17. PLUMBING CONTRACTOR TO PROVIDE AND INSTALL NEW VENTS FROM FIXTURES UP TO ROOF AS
- 18. P.C. SHALL PROVIDE AND INSTALL PIPE INSULATION ON ALL DOMESTIC COLD WATER SUPPLY, HOT WATER SUPPLY, HOT WATER SUPPLY (RECIRCULATION LINE) AND ROOF DRAIN PIPING THAT IS EXPOSED ABOVE CEILINGS OR IN CRAWL SPACE AND PIPE CHASES.
- NOTE: BIDDING CONTRACTORS ARE RESPONSIBLE FOR ALL WORK SHOWN ON ALL DRAWINGS THAT ARE DESCRIBED AS WORK UNDER THEIR CONTRACT. REVIEW ALL TRADE DRAWINGS PRIOR TO

FIRE STOP NOTES

- 1. ALL PIPING PENETRATIONS THROUGH FIRE RATED WALLS, FLOORS OR OTHER STRUCTURES SHALL BE FIRE STOPPED BY PLUMBING CONTRACTOR.
- THE FIRE STOP MATERIALS SHALL BE HILTI TYPE FS-657 FIRE BLOCK, FS-ONE SEALANT, CP-672 JOINT SPRAY, CP-601S ELASTOMERIC SEALANT, 6P-606 FLEXIBLE SEALANT, CP-643 OR CP-642 COLLAR, CP-618 PUTTY STICK, OR FS-635 TROWEL ABLE COMPOUND, AS SUITABLE.
- 3. CONTRACTOR SHALL SUBMIT SHOP DRAWINGS OF PRODUCTS TO BE USED.
- 4. FIRESTOP MATERIALS OTHER THAN HILTI SHALL INCLUDE FULL TECHNICAL DATA WITH SHOP DRAWINGS TO DEMONSTRATE EQUALITY WITH THE SPECIFIED FIRE STOPS.

PLUMBING DEMO & NEW WORK NOTES

- GENERAL CONTRACTOR SHALL DISCONNECT AND COMPLETELY REMOVE AND DISCARD EXISTING TOILETS, URINALS & LAVATORIES AS INDICATED.
- ALL WATER SUPPLY AND SANITARY PIPING TO EXISTING PLUMBING FIXTURES SHALL BE COMPLETELY REMOVED BACK TO CHASE WALL EXCEPT AT LOCATIONS WHERE FIXTURES ARE TO BE REPLACED WITH NEW. PLUMBING CONTRACTOR SHALL BE RESPONSIBLE TO REPLACE PIPE INSULATION.
- 1. PLUMBING CONTRACTOR SHALL PROVIDE AND INSTALL NEW FIXTURES AS SHOWN IN PLUMBING FIXTURE SCHEDULE ON THIS DWG.
- CONNECT VENT PIPING TO EXISTING VENTS.
- 3. SEE GENERAL NOTES AND PLUMBING SPECIFICATIONS SECTION 15A FOR MORE DETAIL.
- 4. DEMOLITION AND RECONSTRUCTION OF PLUMBING WALLS BY GENERAL CONTRACTOR. PLUMBING CONTRACTOR TO COORDINATE WITH GENERAL CONTRACTOR.
- IN ALL INSTANCES WHERE NEW FIXTURES ARE PROPOSED THE GENERAL CONTRACTOR SHALL PERFORM ALL DEMOLITION REQUIRED FOR REMOVAL OF EXISTING FIXTURE CARRIERS AND INSTALL NEW FIXTURE CARRIERS. GENERAL CONTRACTOR SHALL THEN BUILD/PATCH MASONRY WALLS AS REQUIRED INCLUDING NEW TILE FINISHES. UPON COMPLETION OF MASONRY/TILE THE PLUMBING CONTRACTOR SHALL INSTALL NEW FIXTURES PER SPECIFICATIONS
- 6. REFER TO ARCHITECTURAL DRAWINGS FOR DIMENSIONAL LOCATIONS OF NEW PLUMBING FIXTURES.

EPA 67.4 NOTE:


- 1. THE PLUMBING CONTRACTOR SHALL PROVIDE AND INSTALL NEW AND/OR REPLACEMENT PLUMBING FIXTURES. THE RESPECTIVE FIXTURES MUST ADHERE TO THE "LEAD-FREE" DIVISION 15A SPECIFICATIONS OUTLINING THE INSTALLATION MEANS AND METHODS AS WELL AS THE FIXTURE ITSELF BEING "LEAD FREE." THE CONTRACTOR SHALL PROVIDE THE REQUIRED SUBMITTALS FOR ALL FIXTURES AND BUILDING MATERIALS PRIOR TO THE FIXTURE INSTALLATION, AND CONFIRM ON THE JOBSITE THAT THE FIXTURE ADHERES TO "LEADFREE" REGULATIONS. a. FOLLOWING THE POTABLE FIXTURE INSTALLATION; THE P.C. SHALL REMOVE ALL FILTERS AND STRAINERS AND FLUSH THE FIXTURE OF DEBRIS FROM THE SYSTEM.
- 2. FOLLOWING THE COMPLETION OF THE P.C. WORK SCOPE, THE OWNER SHALL HAVE THE WATER CONDITIONS TESTED FOR LEAD CONTAMINANTS BY A THIRD-PARTY TESTING FIRM TO REGULATION 67.4 OF THE DEPARTMENT OF HEALTH REGULATIONS AS PART OF SECTION 1417 OF THE FEDERAL SAFE WATER ACT TO DETERMINE THEM AS "LEAD-FREE" COMPLIANT.
- 3. IF A FIXTURE DOES NOT COMPLY WITH SUB-PART REGULATION 67.4 OF THE DOH SECTION 1417 OF THE FEDERAL SAFE WATER ACT, THE P.C. SHALL PROVIDE A REPLACEMENT FIXTURE AT NO ADDITIONAL COST, TO THEN REPEAT THE INSTALLATION AND TESTING REQUIREMENTS. THE P.C. SHALL ABSORB THE FEE FOR THE FIRST LEAD TESTING PROCEDURE AS WELL AS THE FOLLOWING CONFIRMATION PROCEDURES AT NO ADDITIONAL COST TO THE OWNER.

<u>NOTICE</u> THESE DRAWINGS ARE BASED ON CONSTRUCTION DRAWINGS NOT PREPARED BY BBS ARCHITECTS, LANDSCAPE ARCHITECTS AND ENGINEERS, PC. AND, THEREFORE, MAY NOT REPRESENT THE CONDITIONS AS CONSTRUCTED AT THE TIME. ALL EXISTING

CONDITIONS SHOWN ARE REPRESENTED AS SUGGESTIV INFORMATION AS THEY MAY NOT HAVE BEEN BUILT AND DETAILE

ER THE ORIGINAL DOCUMENTS OR PER THE OWNER'S INFORMATIC

REV. DATE

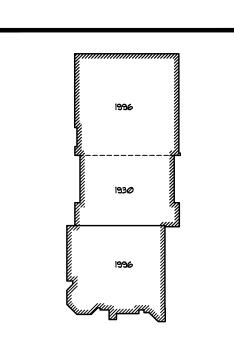

KEY PLAN NOT TO SCALE

CHECK BY: NOTICE HIS DRAWING, PREPARED FOR THE SPECIFIC PROJECT INDICATED AN INSTRUMENT OF SERVICE AND THE PROPERTY OF BE ARCHITECTS, LANDSCAPE ARCHITECTS AND ENGINEERS, PARCHITECTS AND ENGINEERS, PARCHI NFRINGEMENT OR ANY USE OF THIS DRAWING FOR ANY OTH PROJECT IS PROHIBITED. ANY ALTERATION OR REPRODUCTION C THIS DOCUMENT IS ALSO PROHIBITED WITHOUT THE WRITTEN CONSENT OF THE ARCHITECT OR ENGINEER.

DRAWING BY: GWT

ARCHITECTS LANDSCAPE ARCHITECTS


ENGINEERS 44 EAST MAIN STREET | 187 WOLF ROAD, STE. 2 PATCHOGUE NEW YORK 11772 NEW YORK 12205 T. 631.475.0349 T. 518.621.7650 F. 631.475.0361 F. 518.621.7655


www.BBSARCHITECTURE.com


44-21-15-02-0-001-015 <u>DISTRICT</u> FLORDIA U.F.S.D. S.S. SEWARD INSTITUTE PROJECT BOND PHASE 2

DWG TITLE PLUMB DEMO & NOTES SCALE: AS NOTED DECEMBER 1, 2020 BID PICK-UP: March 8, 2021


FILE No: 20-176B

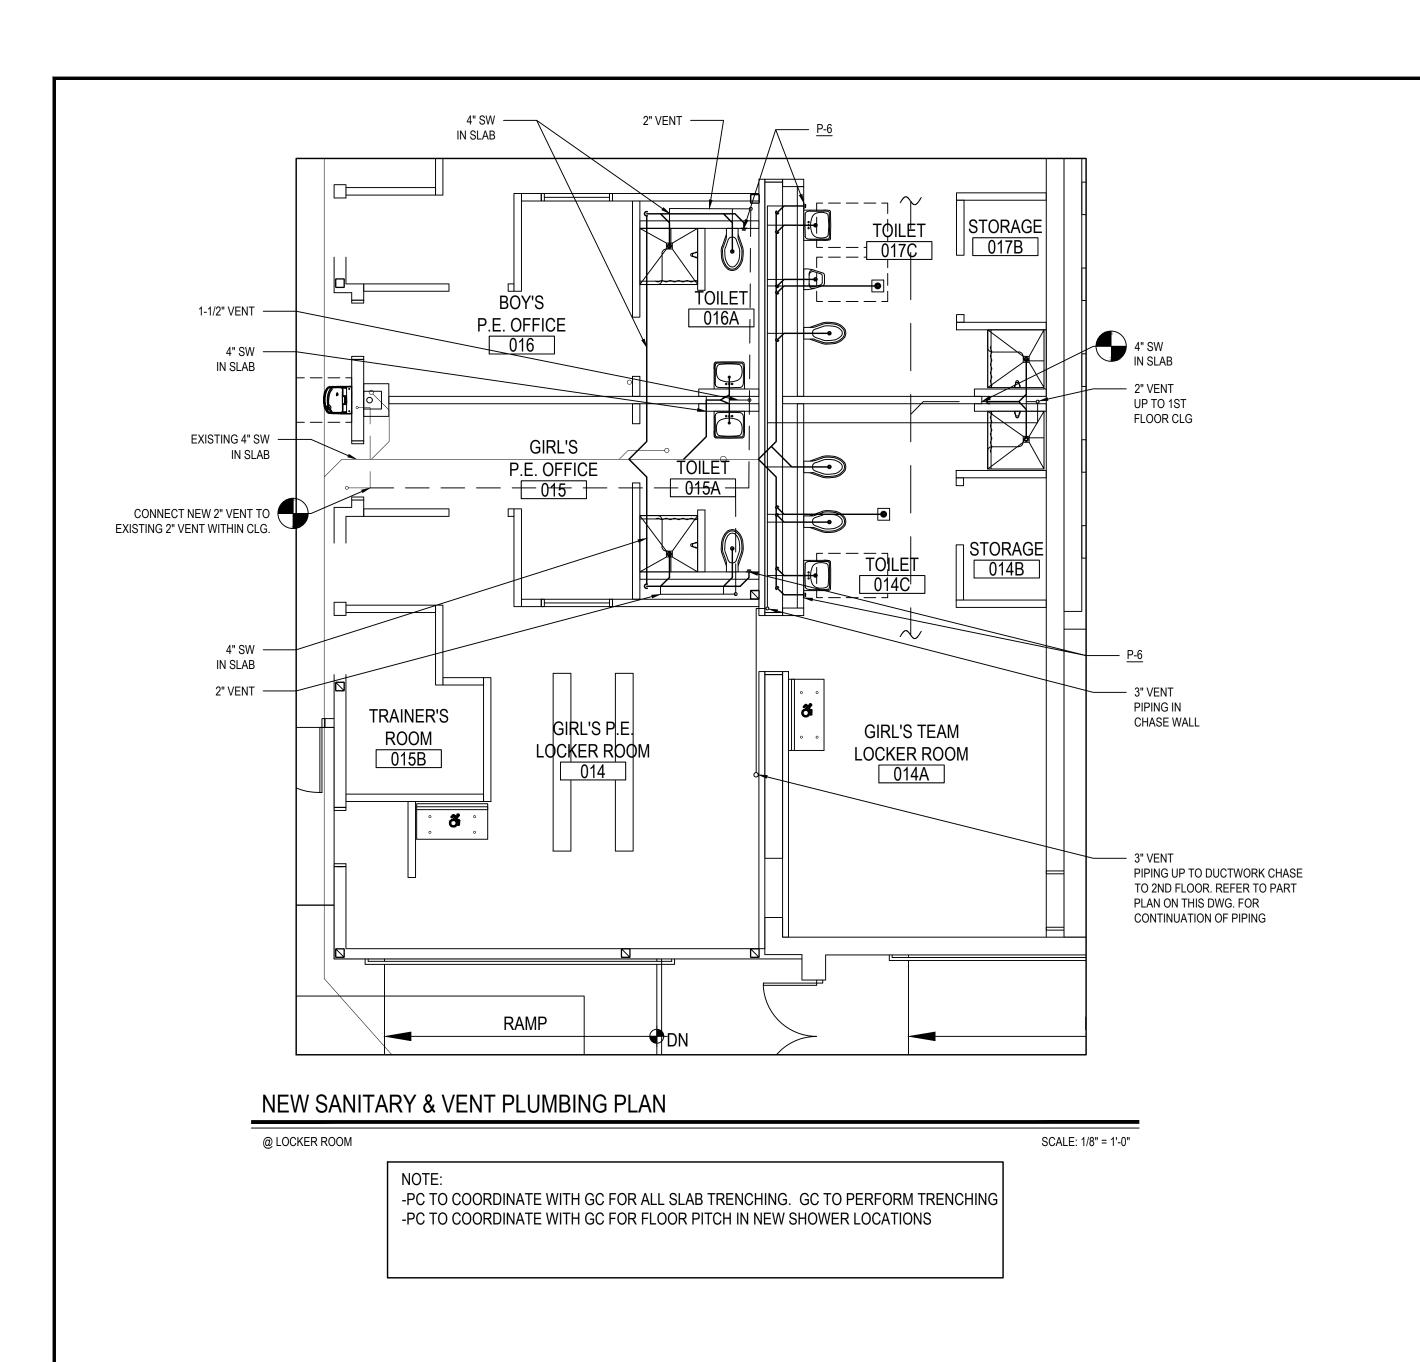

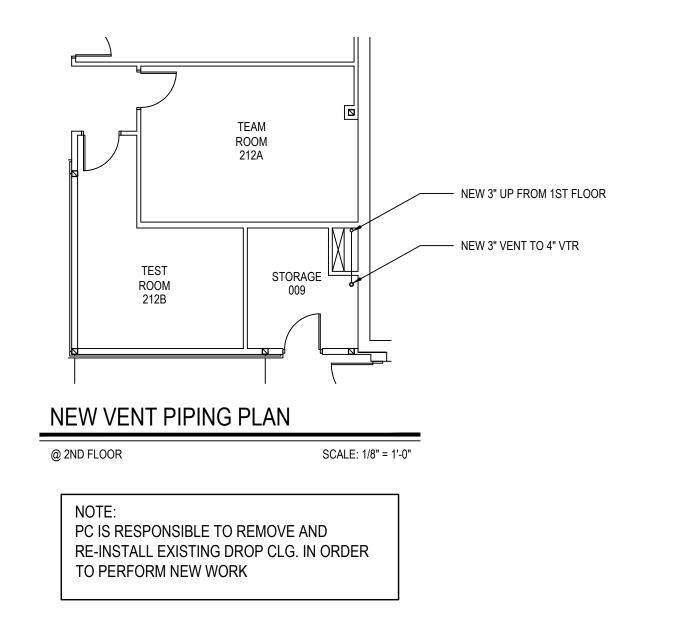

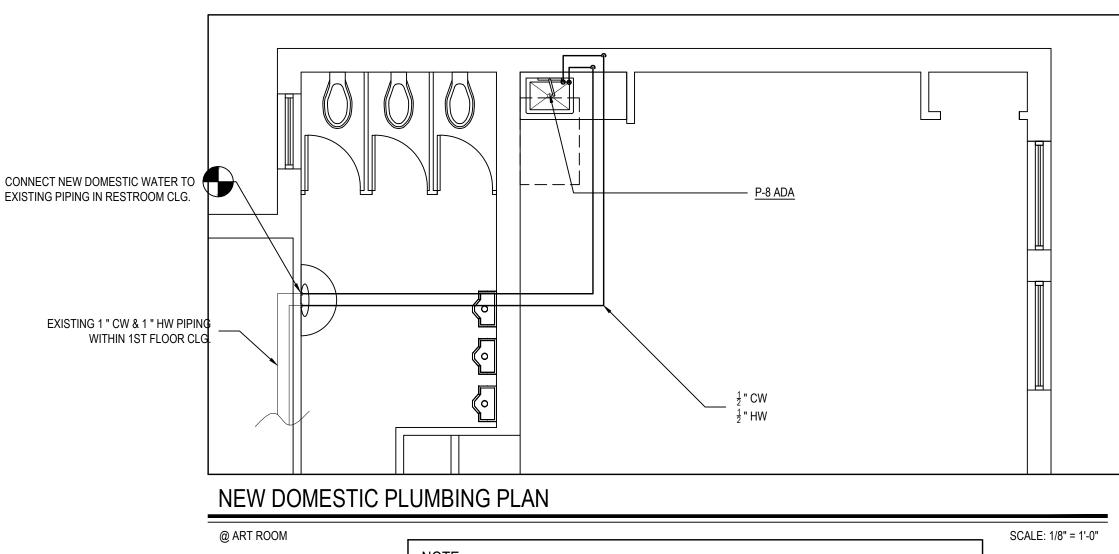

ALL PIPING SHOWN HERE IS LOCATED IN THE FIRST FLOOR CEILING UNLESS SPECIFICALLY NOTED OTHERWISE PC IS RESPONSIBLE FOR REMOVAL & RE-INSTALLATION OF EXISTING DROP CLG.

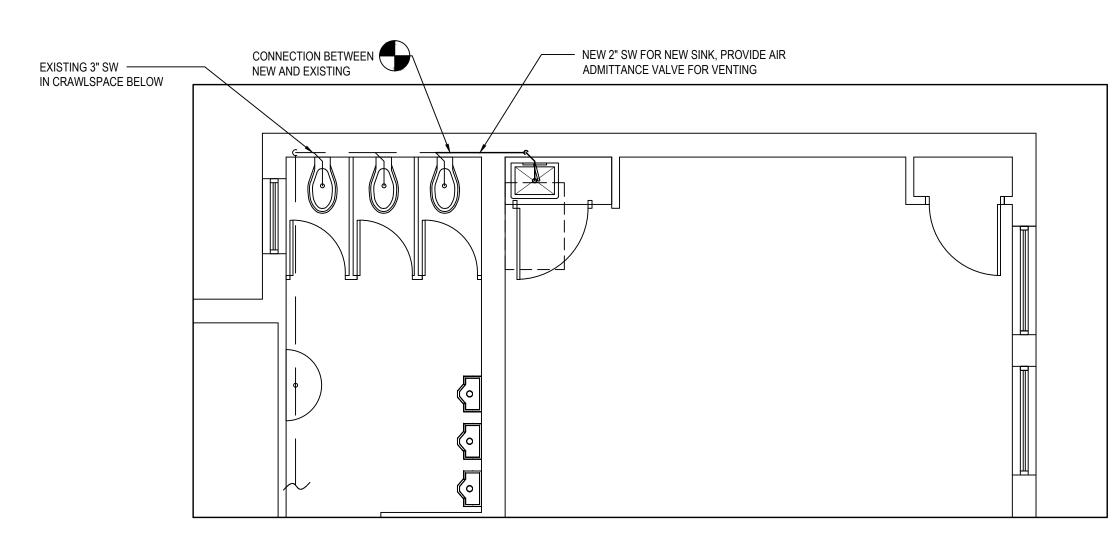

NEW SANITARY PLUMBING PLAN

SCALE: 1/8" = 1'-0" LOCKER ROOM-PLUMBING FIXTURE SCHEDULE | VENT | COLD | TEMPERED | HOT WATER | FIXTURE ACCESSORIES SYMBOL WATER WATER P-1 ADA WALL SHOWER: FURNISH & INSTALL NEW BRADLEY RECESS-MOUNTED ADA COMPLIANT WALL SHOWER MODEL HN200. ALL EXPOSED MATERIALS, EXCEPT FOR THE PHENOLIC SEAT, ARE TYPE 304 STAINLESS STEEL OR POLISHED CHROME-PLATED BRASS. SHOWER PANEL IS 16 GAUGE AND GRAB BAR IS 18 GAUGE. VALVE BODIES ARE BRASS CASTING. SUPPLY HOSES ARE 24" FLEXIBLE STAINLESS STEEL. SHOWERHEAD HEIGHT SHALL BE 6'-0" STANDARD HEIGHT. VALVE TYPE SHALL BE "TMV"-THERMOSTATIC MIXING VALVE. SHOWERHEAD TYPE SHALL BE "ES"-ECONOMY SOFT FLOW WITH BALL JOINT (FLOWRATE = 2.0 GPM / 7.6 LPM). HAND SHOWER TYPE SHALL BE "HS"-WITH 60" FLEXIBLE HOSE, WALL HOOK, VACUUM BREAKER, AND QUICK DISCONNECT. VALVE LOCATION SHALL BE "VR"-VALVE RIGHT/SEAT LEFT. BALL JOINT TYPE SHALL BE "LBJ"-LOCKABLE BALL JOINT. SLIDE BAR TYPE SHALL BE "SB"- 24" SLIDE BAR. PROVIDE L-SHAPED GRAB BAR ("GB") FABRICATED OF 18 GAUGE 1-1/2" O.D. STAINLESS STEEL TUBING WITH A 1-1/2" SAFETY STATUTE CLEARANCE. FLANGES SHALL BE 11-GAUGE AND LOAD CAPACITY SHALL BE IN EXCESS OF 300 LBS. SHOWER SEAT TYPE SHALL BE "RSS"-REVERSIBLE PHENOLIC SHOWER SEAT. CURTAIN TYPE SHALL BE "CRH"-SHOWER CURTAIN, ROD, AND HOOKS. HARDWARE TYPE SHALL BE "VS"-VANDAL RESISTANT SCREWS. SUPPLY INLETS ARE FLEXIBLE STAINLESS STEEL HOSES WITH 1/2" NPT. CONNECTIONS., P-3 ADA P.C. TO PROVIDE & INSTALL AMERICAN STANDARD MADERA FLO-WISE 16-1/2" HEIGHT ELONGATED FLUSH VALVE WHITE VITREOUS CHINA WITH EVERCLEAN TOILET MODEL NO. 3461.001 FLOOR MOUNTED WITH TOP SPUD.THE TOP | INTEGRAL, 4"~ | 2" WASTE LINE OF WATER CLOSET SHALL BE 17-5/8" ABOVE FINISHED FLOOR. FURNISH WITH AMERICAN STANDARD ELONGATED HEAVY DUTY WHITE PLASTIC SEAT, OPEN FRONT WITH EVERCLEAN SURFACE MODEL 5901.100. THE FIXTURE SHALL WATER CLOSET -ADA ALSO HAVE THE FOLLOWING FEATURES: HIGH EFFICIENCY, LOW CONSUMPTION, AND SHALL OPERATE IN THE RANGE OF 1.1 GALLONS PER FLUSH TO 1.6 GALLONS PER FLUSH, SHALL HAVE A 2-1/8" FULLY GLAZED TRAPWAY, CONDENSATION CHANNEL, POWERFUL DIRECT-FED SIPHON JET ACTION, 10"X12" WETTED SURFACE AREA, 1-1/2" INLET SPUD, 2 BOLT CAPS, AND SHALL BE 100% FACTORY FLUSH TESTED. FLUSHOMETER SPECIFICATION: PROVIDE & INSTALL SLOAN BATTERY POWERED & SENSOR OPERATED FLUSHOMETER MODEL "SLOAN 110 SMO" CONSUMPTION (1.28 GALLONS PER FLUSH) WITH POLISHED CHROME, ADA COMPLIANT, WITH DUAL FILTERED BYPASS DIAPHRAGM, 11-1/2" ROUGH IN, & ALL NECESSARY SUPPORTS & CONNECTIONS. FLUSHOMETER SHALL HAVE THE FOLLOWING FEATURES: CHROME PLATED INFRARED SENSOR HOUSING, CAN BE MOUNTED ON EITHER THE LEFT OR RIGHT SIDE OF THE VALVE, TRUE MECHANICAL OVERRIDE FLUSH BUTTON, FOUR (4) SIZE C ALKALINE BATTERIES INCLUDED, "LOW BATTERY" FLASHING LED, "USER IN VIEW" FLASHING LED, 72-HOUR SENTINEL FLUSH, INFRARED SENSOR RANGE ADJUSTMENT SCREW & RESET BUTTON, SWEAT SOLDER ADAPTOR WITH COVER TUBE & CAST WALL FLANGE WITH SET SCREW, NO EXTERNAL VOLUME ADJUSTMENT TO ENSURE WATER CONSERVATION, ADA COMPLIANT BATTERY POWERED INFRARED SENSOR FOR AUTOMATIC "HANDS-FREE" OPERATION, SPUD COUPLING & FLANGE FOR 11-1/2" TOP SPUD, INFRARED SENSOR WITH MULTIPLE-FOCUSED, LOBULAR SENSING FIELDS FOR HIGH AND LOW TARGET DETECTION, 1" I.P.S. SCREWDRIVER BAK-CHEK ANGLE STOP WITH FREE SPINNING VANDAL RESISTANT STOP CAP. P.C. SHALL FURNISH & INSTALL AMERICAN STANDARD LUCERNE WHITE VITREOUS CHINA WALL HUNG LAVATORY MODEL 0355.012 WITH FRONT OVERFLOW FAUCET LEDGE, "D" SHAPED BOWL, SELF-DRAINAGE DECK WITH P-4 ADA ADA ACCESSIBLE CONTOURED BACK & SIDE SPLASH SHIELDS& CARRIER ARM (CONCEALED ARMS SUPPORT). RIM SHALL BE 34" ABOVE FLOOR. FURNISH & INSTALL WITH AMERICAN STANDARD INNSBROOK SELECTRONIC ELECTRONIC PROXIMITY LAVATORY-ADA LAVATORY FAUCET MODEL 6055.205 BATTERY POWERED FAUCET (0.5 GPM) WITH AMERICAN STANDARD MODEL 605XTMV1070 THERMOSTATIC MIXING VALVE, GRID STRAINER MODEL 2411.015 WITH OVERFLOW AND TRUEBRO MODEL 2018-AS-L LAV SHIELD ENCLOSURE & ALL NECESSARY SUPPORTS AND CONNECTIONS. ZURN ZN1400-BZ1-VP CLEANOUT, DURA-COATED CAST IRON BODY WITH BOTTOM OUTLET, WITH GAS AND WATER TIGHT THREADED ABS TAPERED PLUG, POLISHED NICKEL BRONZE TOP AND VANDAL-PROOF SCREWS.(CLEANOUT FLOOR CLEANOUT ZURN Z1441 WALL CLEANOUT, DURA-COATED CAST IRON BODY, GAS AND WATERTIGHT ABS TAPERED THREAD PLUG, AND ROUND, SMOOTH STAINLESS STEEL ACCESS COVER WITH SECURING SCREW. ZURN MODEL# ZN415E BODY W/ "TYPE E" STRAINER. FLOOR AND SHOWER DRAIN, DURA-COATED CAST IRON BODY WITH BOTTOM OUTLET, COMBINATION INVERTIBLE MEMBRANE CLAMP AND ADJUSTABLE COLLAR WITH SEEPAGE SLOTS AND "TYPE E" POLISHED, NICKEL BRONZE STRAINER WITH 4" DIAMETER FUNNEL. P.C. TO FURNISH AND INSTALL WITH J R. SMITH #2692-04 QUAD CLOSE TRAP SEAL. P-8 ADA JUST MANUFACTURING MODEL DL ADA 1829-A-DR ADA COMPLIANT. SEAMLESS DIE DRAWN CONSTRUCTION OF TYPE 304-18STAINLESS STEEL. INTERIOR AND TOP SURFACES POLISHED TO A NONPOROUS HAND-BLENDED JUST FINISH WITH HIGHLIGHTED BOWL RIM. FULLY COATED UNDERSIDE INSULATED FOR SOUND AND SIDED COMPARTMENT WITH RADIUS CORNERS PROVIDES GREATER CAPACITY. SELF-RIMMING TOP MOUNT GRIP CHANNELS. CONFORMS TO ASME/ANSI A112.19.3M. CONFORMANCE WITH ASME A112.19.3/CSA B45.4, CANADIAN STANDARDS (CSA), UNIFORM PLUMBING CODE (UPC) AND J-35 DRAIN. PROVIDE REAR CENTER DRAIN. FAUCET SHALL JUST MANUFACTURING MODEL NUMBER JWF200 CONCEALED LEDGEMOUNT ON 8 INCH CENTERS CAST BRASS BODY HIGH RISE SWING SPOUT WITH 10-5/8" CLEARANCE REPLACEABLE SEATS BRASS QUARTER TURN STEM UNITS CHROME PLATED DIE CAST TEARDROP HANDLES EQUIPPED WITH WATER SAVING AERATOR, FINISH POLISHED CHROME PLATE, 4 INCH WRIST BLADES P.C. TO FURNISH & INSTALL AMERICAN STANDARD WASHBROOK"FLO-WISE WHITE VITREOUS CHINA URINAL MODEL 6590.525 TOP SPUD, WALL MOUNTED. INSTALL AMERICAN STANDARD BATTERY POWERED AND SENSOR OPERATED P-9 ADA SELECTRONIC FLO-WISE FLUSHOMETER MODEL 6063.013.002 LOW CONSUMPTION (1.25G.P.F.) AND ALL NECESSARY SUPPORTS AND CONNECTIONS. REFER TO ARCHITECTURAL DWGS. FOR FIXTURE MOUNTING HEIGHTS. P.C. TO FURNISH AND INSTALL WADE MODEL#400-AM11 URINAL CARRIER. UNIVERSAL HANGER PLATÉ CARRIER WITH PIPE UPRIGHTS, WELDED BASE FEET, UPPER PLATE WITH HANGER SUPPORT HARDWARE AND LOWER PLATE BEARING P-10 ADA AMERICAN STANDARD AFWALL MILLENNIUM 3351.660, 1.28 GPF EXPOSED TOP SPUD BOWL W/ SELECTRONIC FLUSH VALVE, WALL MOUNTED ELONGATED FLUSHOMETER VALVE TOILET, VITREOUS CHINA, HIGH EFFICENCY, INTEGRAL, 4"~ 2" WASTE LINE PERMANENT EVERCLEAN SURFACE INHIBITS THE GROWTH OF STAIN AND ODOR CAUSING BACTERIA, MOLD, AND MILDEW ON THE SURFACE, CONDENSATION CHANNEL, POWERFUL DIRECT-FED SIPHON JET ACTION, 1-1/2" INLET SPUD, FULLY GLAZED 2-1/8" TRAPWAY, MODEL 6065.161 ELECTRONIC FLUSH VALVE WITH SELECTRONIC PROXIMITY SYSTEM FOR "HANDS FREE" OPERATION, SELF CLEANING PISTON OPERATION HELPS PREVENT CLOGGING AND REDUCES MAINTENANCE, MECHANICAL OVERRIDE FLUSH BUTTON, LOW BATTERY INDICATOR. AMERICAN STANDARD SEAT MODEL 5905.100 EXTRA HEAVY DUTY OPEN FRONT LESS COVER. PROVIDE AND INSTALL ALL NECESSARY CONNECTIONS TO COLD WATER, SANITARY WASTE LINES, CHROME ESCUTCHEONS AND SUPPORTS. ZURN ADJUSTABLE COMMERCIAL WALL TOILET CARRIER. COLOR TO BE WHITE. REFER TO THE ARCHITECTURAL DRAWINGS FOR 1. P.C. SHALL PROVIDE AND INSTALL ALL PLUMBING FIXTURES AND ASSOCIATED ACCESSORIES. PIPING. FITTINGS ETC. AS REQUIRED FOR A COMPLETE FUNCTIONAL PLUMBING SYSTEM. 2. FOR ALL WATER PIPING SIZES GOING TO FIXTURES, PROVIDE BALL VALVES FOR LINES FOR SHUT OFF PURPOSES. 3. FOR ALL WORK WHERE P.C. IS TO TIE IN NEW WASTE LINES INTO EXISTING WASTE LINES, P.C. SHALL BE RESPONSIBLE FOR VERIFYING IN THE FIELD THE INVERT ELEVATIONS FOR ALL EXISTING WASTE LINES BEING TIED INTO. 4. PC SHALL VERIFY ALL EXISTING PIPE SIZES IN FIELD.

NEW DOMESTIC PLUMBING PLAN @ LOCKER ROOM

 $\frac{1}{2}$ " HW

 $\frac{3}{4}$ " HW

CONNECTION BETWEEN

NEW AND EXISTING

SCALE: 3/16" = 1'-0"

REFER TO ARCHITECTURAL DRAWINGS FOR

ALL PIPING SHOWN HERE IS LOCATED IN THE

FIRST FLOOR CEILING UNLESS SPECIFICALLY

ALL ADA MOUNTING HEIGHTS

NOTED OTHERWISE.

EXISTING 2¹/₂" CW

 $2\frac{1}{2}$ " CW _

2" HW

2" HW

1/2 " CW

½"HW −

P2.01

SCALE:

DATE:

NEW YORK 11772

T. 631.475.0349

F. 631.475.0361

NEW YORK 12205

T. 518.621.7650

F. 518.621.7655

www.BBSARCHITECTURE.com

44-21-15-02-0-001-015

S.S. SEWARD INSTITUTE

SCHEDULE AND DETAILS

DISTRICT FLORDIA U.F.S.D.

PROJECT BOND PHASE 2

DWG TITLE NEW MECH WORK

BID PICK-UP: March 8, 2021

FILE No: 20-176B

AS NOTED

DECEMBER 1, 2020

DRAWING BY: GWT CHECK BY: HIS DRAWING, PREPARED FOR THE SPECIFIC PROJECT INDICATED RCHITECTS, LANDSCAPE ARCHITECTS AND ENGINEERS, F NFRINGEMENT OR ANY USE OF THIS DRAWING FOR ANY OTH ROJECT IS PROHIBITED. ANY ALTERATION OR REPRODUCTION O THIS DOCUMENT IS ALSO PROHIBITED WITHOUT THE WRITTEN CONSENT OF THE ARCHITECT OR ENGINEER. ARCHITECTS LANDSCAPE ARCHITECTS ENGINEERS 44 EAST MAIN STREET | 187 WOLF ROAD, STE. 20 PATCHOGUE

REV. DATE

KEY PLAN

NOT TO SCALE

NOTICE

THESE DRAWINGS ARE BASED ON CONSTRUCTION DRAWINGS NOT PREPARED BY BBS ARCHITECTS, LANDSCAPE ARCHITECTS AND ENGINEERS, PC. AND, THEREFORE, MAY NOT REPRESENT THE CONDITIONS AS CONSTRUCTED AT THE TIME. ALL EXISTING

CONDITIONS SHOWN ARE REPRESENTED AS SUGGESTIV INFORMATION AS THEY MAY NOT HAVE BEEN BUILT AND DETAILE

ER THE ORIGINAL DOCUMENTS OR PER THE OWNER'S INFORMATIC

ELECTRICAL CONSTRUCTION NOTES

- ALL WORK SHALL BE DONE IN ACCORDANCE WITH THE LATEST ADOPTED EDITIONS OF THE N.E.C., APPLICABLE LOCAL CODES, STATE CODES, OWNER'S WORKING RULES AND SCHEDULE DIRECTIVES, AND THE ENGINEER'S SPECIFICATIONS.
- THE VOLTAGE CHARACTERISTIC OF BUILDING IS 480Y/277V, 3-PASE, 4-WIRE, GROUNDED NEUTRAL, WYE. ALL EQUIPMENT SHALL BE COMPATIBLE WITH THESE CHARACTERISTICS.
- THE DRAWINGS SCHEMATICALLY SHOW THE APPROXIMATE LOCATION OF ALL EQUIPMENT, CONDUITS DEVICES, ETC. THE EXACT LOCATION OF WHICH SHALL BE SUBJECT TO APPROVAL BY THE ARCHITECT AND / OR OWNER WHO RESERVES THE RIGHT TO MAKE PRIOR TO INSTALLATION, ANY REASONABLE CHANGES IN LOCATION INDICATED WITHOUT EXTRA COST TO THE OWNER. CONTRACTOR SHALL VERIFY ALL INDICATED OR APPROXIMATED DIMENSIONS DRAWN OR DENOTED.
- CONTRACTOR SHALL EXAMINE THE SITE TO VERIFY WORK TO BE PERFORMED AS SHOWN ON DRAWINGS AND SPECIFICATIONS BEFORE SUBMITTING HIS BID. ANY DISCREPANCY BETWEEN DRAWINGS AND SPECIFICATIONS AND ACTUAL FIELD CONDITIONS SHALL BE BROUGHT TO ARCHITECT / ENGINEERS ATTENTION BEFORE BID SUBMITTAL. ANY FIELD CONDITION FOUND AFTER BID APPROVAL WHICH HAMPERS AND/OR PREVENTS ANY WORK TO BE PERFORMED AS SHOWN ON DRAWINGS AND SPECIFICATIONS SHALL BE THE RESPONSIBILITY OF THE CONTRACTOR. THE CONTRACTOR SHALL BID THE HIGHER SPECIFICATION FOR ANY DISCREPANCY BETWEEN DRAWINGS AND/OR SPECIFICATIONS.
- CONTRACTOR SHALL PROVIDE ALL LABOR, SERVICE, MATERIALS, EQUIPMENT, AND RELATED ITEMS TO COMPLETE THE WORK OF THIS DIVISION, AS REQUIRED BY THE NATIONAL ELECTRIC CODE, AND ALL STATE AND LOCAL AUTHORITIES HAVING JURISDICTION.
- CONTRACTOR SHALL PROVIDE ALL ELECTRICAL HARDWARE SHOWN ON THESE DRAWINGS AND RELATED DETAIL MATERIALS NOT SPECIFICALLY SHOWN OR SPECIFIED.
- CONTRACTOR SHALL PAY ANY FEES APPLICABLE TO ELECTRICAL WORK, SUCH AS, BUT NOT LIMITED TO, THE POWER COMPANY, TELEPHONE COMPANY, CAT-V, AN APPROVED ELECTRICAL INSPECTION AGENCY, ALARM AND FIRE PROTECTION COMPANIES.
- CONTRACTOR SHALL REFER TO ALL OTHER DRAWINGS IN BID PACKAGE AND PERFORM THE WORK (INCLUDE IN HIS BID) INDICATED AS ELECTRICAL CONTRACTOR (E.C.) WORK.
- ALL WORK SHALL BE IN ACCORDANCE WITH MANUFACTURER'S RECOMMENDATIONS AND DIRECTIVES OF
- ALL WORK SHALL BE PERFORMED BY A LICENSED ELECTRICAL CONTRACTOR WHO SHALL OBTAIN AN INSPECTION CERTIFICATE AND PAY ASSOCIATED FEE. SUBMIT A PHOTOCOPY OF THIS CERTIFICATE TO
- THE ENGINEER WITH FINAL PAYMENT APPLICATION. CONTRACTOR SHALL GUARANTEE ALL MATERIALS AND THEIR INSTALLATION TO BE FREE OF DEFECTS FOR
- A PERIOD AS DEFINED IN SPECIFICATION SECTION 01700 OF THE PROJECT MANUAL. A COMPLETE SYSTEM OF WIRING, WITH ALL FEEDERS, MAINS, AND BRANCHES AS SHOWN ON THE

DRAWINGS, SHALL BE FURNISHED AND INSTALLED FROM THE MAIN DISTRIBUTION BOARD TO THE PANELS

- PROVIDE IDENTIFICATION FOR ALL PANEL AND MOTOR FEEDER CABLES IN PULL BOXES AND AT TERMINATIONS. ANY CONDUCTOR VOLTAGES HIGHER THAN 240 VOLTS SHALL BE MARKED ON DEVICES AND JUNCTION BOXES.
- . FURNISH AND INSTALL ALL WIRING OF ANY VOLTAGE OR PURPOSE AS SHOWN ON THE DRAWINGS.
- ALL BRANCH CIRCUITS SHALL HAVE INDIVIDUAL NEUTRALS. SHARING COMMON NEUTRALS AMONG BUNDLED CIRCUITS IS SPECIFICALLY DISALLOWED UNLESS OTHERWISE NOTED.

OUTLETS, MOTORS, AND APPURTENANCES.

- PULL / JUNCTION BOXES SHALL BE PROVIDED WHERE INDICATED OR AS OTHERWISE REQUIRED TO FACILITATE THE PROPER INSTALLATION OF WIRES AND CABLES. CONDUITS MAY BE INCREASED IN SIZE FOR CONSTRUCTION CONVENIENCE.
- FURNISH AND INSTALL ALL DISCONNECT DEVICES AND SAFETY SWITCHES AS SHOWN ON THE DRAWINGS AND / OR AS REQUIRED TO CONFORM WITH CODE REQUIREMENTS.
- FURNISH AND INSTALL ALL INDICATED LIGHTING FIXTURES COMPLETE WITH MOUNTING HARDWARE AS REQUIRED FOR A COMPLETE INSTALLATION UNLESS OTHERWISE NOTED. NOTE ALL LIGHT FIXTURES SHALL BE SUPPORTED FROM BUILDING STRUCTURE. UTILIZING CEILING FRAMING ALONE IS NOT ACCEPTABLE. NEW LIGHTING FIXTURES (OTHER THAN THEATRICAL EQUIPMENT) SHALL NOT BE DAISY CHAINED. RE-USE OF AN EXISTING LIGHTING CIRCUIT INCLUDES HOME RUN WIRING OR WIRING UP TO THE SWITCH. ANY WIRING DOWNSTREAM OF THE SWITCH IS SUBJECT TO REMOVAL/REARRANGEMENT. ELECTRICAL CONTRACTOR SHALL ALLOW FOR THIS IN THE BID PRICE.
- NEW CIRCUIT BREAKERS INSTALLED IN EXISTING PANELBOARD(S) SHALL BE LISTED/LABELED FOR USE WITH THE EXISTING PANELBOARD(S).
- CONTRACTOR SHALL REFER TO ALL FURNITURE DRAWINGS BEFORE INSTALLING RECEPTACLES. TH MOUNTING HEIGHT OF THE RECEPTACLES IS 18" ABOVE FINISHED FLOOR UNLESS INDICATED ON THE DRAWING. COLOR. TYPE & FINISH OF ALL RECEPTACLES. DEVICES & FACE PLATES SHALL BE AS APPROVED BY ENGINEER AND ARCHITECT. CONTRACTOR SHALL PROVIDE & WIRE WEATHERPROOF GFC RECEPTACLES ON ALL APPLICABLE ROOFTOP UNITS AS PART OF HIS BID. SEE MECHANICAL EQUIPMENT SCHEDULES FOR UNITS WITH SERVICE RECEPTACLES FACTORY INSTALLED.
- ALL WIRING TO BE 1 #12 + 1 #12(N) + 1 #12(G) 3/4"C, OR STEEL JACKETED MC CABLE (WHERE CODE PERMITTED), UNLESS OTHERWISE SPECIFIED ON DRAWINGS. RUN BRANCH CIRCUITS IN DROPPED CEILINGS, VOIDS, & CHASES. CONDUITS MAY BE SURFACE MOUNTED IN MECHANICAL SPACES UNLESS OTHERWISE NOTED. CONDUITS IN PUBLIC AREAS SHALL BE CONCEALED IN HUNG CEILINGS, EMBEDDED IN SLAB OR MASONRY WALLS, EXCEPT WHERE SURFACE MOUNTED RACEWAY IS SPECIFIED. ALUMINUM JACKETED MC CABLE IS NOT ACCEPTABLE.
- . ALL CONNECTIONS AND / OR SPLICES SHALL BE MADE ONLY IN ACCESSIBLE JUNCTION BOXES.
- . ALL COUPLINGS AND CONNECTORS FOR USE WITH EMT SHALL BE COMPRESSION TYPE. SET SCREW TYPE OR INDENT TYPE FITTINGS WILL NOT BE ACCEPTED.
- ALL CONNECTIONS TO CONDUIT RUN UNDERGROUND SHALL BE MADE WATERTIGHT. ALL METALLIC CONDUIT INSTALLED IN EARTH FILL, AS WELL AS UNDERGROUND, SHALL BE PAINTED WITH (2) COATS OF
- WIRING INSTALLED IN CEILINGS SHALL BE HUNG INDEPENDENT OF CEILING SYSTEM AND SECURELY TIED TO BUILDING STEEL.
- . ALL LOW VOLTAGE (FIRE ALARM, PA INTERCOM, PHONE, DATA, ETC.) WIRING INSTALLED IN OPEN AREAS SHALL BE IN METALLIC RACEWAY IN MECHANICAL AREAS, GYMNASIUMS, ART ROOMS, STOREROOMS, ETC. AND IN SURFACE MOUNTED RACEWAY IN PUBLIC AREAS. LOW VOLTAGE WIRE INSTALLED IN DROPPED CEILINGS SHALL BE BUNDLED TOGETHER AND SUPPORTED BY BUILDING STEEL. LOW VOLTAGE WIRE SHALL NOT BE SUPPORTED WITH BRANCH CIRCUITS OR FEEDER CIRCUITS AND SHALL NOT BE SUPPORTED BY CONDUIT, PIPES, ETC.. LOW VOLTAGE WIRING NOT INSTALLED IN CONDUITS, SHALL BE
- CONDUITS SHALL BE SECURED IN PLACE AND PROTECTED WHERE NECESSARY TO PREVENT DAMAGE
- FURNISH AND INSTALL ALL HARDWARE TO PROPERLY SUPPORT ALL CONDUITS NOT INSTALLED IN CONCRETE SLABS OR UNDERGROUND.
- ALL CONDUITS OR MC CABLE SHALL BE EQUIPPED WITH AN INSULATING/CHAFE GUARD GROMMET AT WIRE EXIT/ENTRANCE. MC CABLE SHALL USE MC STYLE BUSHINGS. BX OR OTHER BUSHINGS ARE SPECIFICALLY
- WHERE AN EXISTING CONDUIT OR CABLE IS REQUIRED TO BE REMOVED BUT SERVES EXISTING EQUIPMENT WHICH IS TO REMAIN OPERABLE, THE ELECTRICAL CONTRACTOR SHALL REROUTE SAID CONDUIT OR CABLE OR PROVIDE A NEW SOURCE OF POWER (APPROVED BY ENGINEERING) TO THIS EQUIPMENT AS A PART OF THIS CONTRACT.
- ALL PANELS, SWITCHES, DISCONNECT STARTERS, OR OTHER ELECTRIC SYSTEM CONTROLS SHALL BE STENCILED WITH THEIR APPROPRIATE DESIGNATION/FUNCTION. ALL CIRCUIT BREAKERS SHALL BE IDENTIFIED BY A PANEL SCHEDULE OR STENCIL ADJACENT TO THE CIRCUIT BREAKER. PROVIDE PRINT PANEL SCHEDULE. HAND WRITING NOT ALLOWED.
- ALL CIRCUIT BREAKERS POSITIONS IN ALL PANELS ARE SHOWN FOR GROUPING PURPOSES ONLY. ELECTRICAL CONTRACTOR IS RESPONSIBLE FOR LOAD BALANCING.
- ALL DEVICES SHALL BE FASTENED IN PLACE SECURELY. GRID MOUNTING LIGHTING FIXTURES SHALL BE SECURED TO GRID WITH CLIPS LISTED FOR THE PURPOSE OR SUSPENDED FROM STRUCTURE PER NEC.
- WORK WHICH MUST BE DONE IN OCCUPIED AREAS SHALL BE DONE AT SUCH TIMES AS INDICATED IN THE PHASING OF CONSTRUCTION AND AS APPROVED BY THE SCHOOL.
- WHERE THE CONTRACTOR IS INSTRUCTED TO PROVIDE, INSTALL AND WIRE CIRCUIT BREAKER(S) TO AN EXISTING PANEL AND THAT PANEL DOES NOT HAVE THE ROOM TO INSTALL REQUIRED CIRCUIT BREAKERS, THE CONTRACTOR SHALL REMOVE (3) ADJACENT 1P CIRCUIT BREAKERS AND PROVIDE A 3P. 60A CIRCUIT BREAKER IN THEIR PLACE FOR SUB FEED TO A SURFACE MOUNTED 100A, 3P, 4W, 24 POLE SUB PANEL AND ESTABLISH OVERFLOW CIRCUITS IN NEW SUB PANEL, EACH WITH REQUIRED CIRCUIT BREAKERS. PROVIDE (3) 1P, AMPERAGE AS BEFORE CIRCUIT BREAKERS FOR DISCONNECTED CIRCUITS IN MAIN PANEL AND RECONNECT THEM IN SUB PANEL. SUB PANEL FEED TO BE 3 #6 + 1 #6(N) + 1 #10(G) - 1"C.
- SELECTED RECEPTACLES AS SHOWN ON DRAWINGS MAY BE GFI PROTECTED BY CONNECTING TO GFCI RECEPTACLE FIRST IN CIRCUIT. ALL RECEPTACLES THAT ARE PROTECTED FROM AN UPSTREAM GFCI UNIT SHALL BE VISIBLY LABELED AS SUCH. GFCI RECEPTACLE SHALL BE SPEC GRADE AND RATED 20A, WITH OPERATING NOTIFICATION INDICATING LIGHT.
- ALL DEVICES ADDRESSED BY ADA REGULATIONS SHALL BE INSTALLED AT ADA COMPLIANT HEIGHT AND
- 8. ALL NEW LIGHTING OR EXISTING LIGHTING HAVING SWITCHING REARRANGEMENT SHALL BE EQUIPPED WITH CODE COMPLIANT ENERGY CONSERVATION CONTROLS. SUCH CONTROL SHALL BE SUBMITTED TO THE ENGINEER FOR APPROVAL PRIOR TO INSTALLATION.
- REMOVAL OF ELECTRICAL ITEMS INCLUDES THEIR DISPOSAL. THE EXCEPTION WILL BE TO TURN OVER TO THE OWNER ITEMS, IF ANY, THEY SPECIFY TO BE RETAINED IN THEIR INVENTORY. PCB OR ASBESTOS BEARING MATERIAL SHALL BE DISPOSED OF IN ACCORDANCE WITH LAWS AND REGULATIONS.
- UNLESS OTHERWISE NOTED. STARTERS AND DISCONNECTS FOR MECHANICAL EQUIPMENT SHALL BE FURNISHED BY THE MECHANICAL CONTRACTOR. COORDINATE WITH THE MECHANICAL CONTRACTOR FOR ALL POWERED MECHANICAL EQUIPMENT. THE ELECTRICAL CONTRACTOR IS RESPONSIBLE TO INSTALL ALL MOTOR STARTERS AND ASSOCIATED POWER WIRING FROM SOURCE TO UNIT VIA STARTERS AND DISCONNECTS. THE LOCATIONS OF MOTOR STARTERS SHALL BE DETERMINED BY THE MECHANICAL CONTRACTOR IN THE FIELD AND SUBMITTED TO THE ENGINEER FOR APPROVAL UNLESS IT IS SPECIFIED ON THE DRAWINGS. THE ELECTRICAL CONTRACTOR SHALL REFER TO THE MECHANICAL DRAWINGS EQUIPMENT SCHEDULES AND NOTES AND INCLUDE IN HIS BID PRICE ALL ELECTRICAL WORK ASSOCIATED WITH THEIR INSTALLATION, AND THE REMOVAL OF ANY STARTERS / DISCONNECTS NO LONGER REQUIRED.
- PROVIDE PROTECTIVE DUST COVERS ON SMOKE DETECTORS IN CONSTRUCTION AREAS. REMOVE COVERS UPON COMPLETION OF WORK.
- VERIFY AND MAINTAIN ALL PHASE ROTATIONS THROUGHOUT THE PROJECT.

DEMOLITION NOTES

- THE ITEMS SPECIFICALLY SHOWN ON THE DEMOLITION DRAWINGS ARE TO BE ADDRESSED BY THE ELECTRICAL CONTRACTOR. THE ITEMS ARE TO BE TREATED AS NOTED AND RANGE FROM DIRECT REMOVAL AND DISPOSAL TO REMOVAL. STORAGE AND REINSTALLATION
- MANY OTHER ELECTRIC ITEMS EXIST THAT ARE NOT SHOWN INCLUDING, BUT ARE NOT LIMITED TO, SWITCHES, RECEPTACLES, FLOOR OUTLETS, LOW VOLTAGE JACKS, LOW VOLTAGE DEVICES AND WIRING, TELEPHONE PUNCH DOWN BLOCKS, AND OUT OF SERVICE ITEMS. ALL SUCH ITEMS SHALL BE PERMANENTLY DE-ENERGIZED, DISCONNECTED, AND OTHERWISE MADE SAFE FOR DEMOLITION BY NON-ELECTRICAL CONTRACTORS. THE ELECTRICAL CONTRACTOR IS RESPONSIBLE FOR ASSURING THAT ALL ELECTRIC DEVICES SCHEDULED FOR DEMOLITION, OF ANY VOLTAGE OR FUNCTION, ARE SAFE AND
- AFTER THE ELECTRICAL CONTRACTOR HAS DISCONNECTED ELECTRIC SUPPLIES TO ITEMS TO BE DEMOLISHED, HE SHALL ADVISE THE GENERAL CONTRACTOR OF ANY ELECTRIC ITEMS TO BE RETAINED FOR FUTURE USE AND THEREFOR NOT TO BE DEMOLISHED. THE GENERAL CONTRACTOR SHALL THEN PERFORM ALL WORK ZONE DEMOLITION. THIS MATTER APPLIES TO ALL ELECTRIC ITEMS, OF ANY VOLTAGE OR PURPOSE.
- THE SPECIAL/SPECIFIC ITEMS SHOWN ON THE DRAWING FOR ELECTRICAL CONTRACTOR TO ACT ON WERE FOUND BY SURVEY. NUMEROUS LOCATIONS WERE BLOCKED BY FURNITURE, ETC. AND ADDITIONAL EQUAL TYPE ITEMS MAY BE PRESENT. THE ELECTRICAL CONTRACTOR SHALL ALLOW FOR THIS IN HIS BID PRICE AND ATTEND TO THOSE EQUAL OR SIMILAR DEVICES AS MAY BE DISCOVERED.
- REMOVAL ITEMS THAT ARE LISTED AS TO BE TURNED OVER TO OWNER'S INVENTORY SHALL BE DISCUSSED WITH THE DISTRICT BUILDINGS AND GROUNDS MANAGER. THOSE ITEMS THAT THE OWNER DECLINES SHALL THEN BE DISPOSED OF BY THE CONTRACTOR IN THE MANOR OF OTHER PERMANENT REMOVALS. ANY PCB BEARING FLUORESCENT FIXTURES SHALL BE DISPOSED OF PER REGULATIONS.
- RETAIN EXISTING RECEPTACLES IN WALLS THAT WILL NOT BE IN CONFLICT WITH NEW CONSTRUCTION. RETAIN LIGHT SWITCH LOCATIONS THAT WILL NOT BE IN CONFLICT WITH NEW CONSTRUCTION. INSTALL BLANKING PLATE COVERS OVER THE UNUSED PORTION OF GANG BOXES HAVING MORE GANG POSITIONS THAN NEEDED FOR NEW SWITCHES.
- LIGHT FIXTURES ARE TO BE REMOVED AS GENERAL, NON ELECTRIC, CONTRACTOR DEMOLITION. ELECTRICAL CONTRACTOR IS RESPONSIBLE TO SAFE OFF LIGHTING CIRCUITS FOR REMOVAL BY OTHERS. NO SPECIFIC QUANTITIES OR LOCATIONS ARE SHOWN. RETURN WHATEVER QUANTITY, IF ANY, OF THESE TO OWNER'S INVENTORY IF HE SO SPECIFIES OR THEY ARE OTHERWISE TO BE DISPOSED OF. ELECTRICAL CONTRACTOR SHALL EXAMINE FIXTURES FOR PRESENCE OF PCB'S AND SPECIAL DISPOSAL.
- THE ELECTRICAL CONTRACTOR SHALL COVER ALL BACK BOXES IN THE WALL THAT BECOME EXPOSED DUE TO DEVICE REMOVALS. THIS INSTRUCTION ALSO APPLIES TO EXPOSED ELECTRICAL BACK BOXES AS MAY EXIST AT THE SITE PRIOR TO THIS PROJECT. THE COVER SHALL BE BRUSHED ALUMINUM WITH CHAMFERED EDGES AND COVER THE HOLE COMPLETELY WITH AT LEAST 3/4" EXTRA MARGIN ON ALL SIDES. MOUNT THE COVER WITH SCREWS TO MATCH THE ORIGINAL PATTERN.
- IT IS EXPECTED THAT STRUCTURAL DEMOLITION BY THE GENERAL CONTRACTOR WILL CAUSE VARIOUS ELECTRIC SUPPLIES, OF VARIOUS VOLTAGES AND PURPOSES, TO BE CUT AND RENDER SOME DEVICES TEMPORARILY INACTIVE. IT IS THE ELECTRICAL CONTRACTOR'S RESPONSIBILITY TO RECONSTRUCT AND RECONNECT SUCH ELECTRIC SOURCES WHEN THE NEW STRUCTURE IS BUILT. NOTE THAT MOST REINSTALLED ITEMS WILL BE IN DIFFERENT LOCATIONS FROM THE REMOVAL LOCATION. THE ELECTRICAL CONTRACTOR SHALL MAKE ALL REQUIRED CIRCUIT EXTENSIONS OR MODIFICATIONS TO PROVIDE SERVICE TO A REINSTALLED ITEM AS RELOCATED. PROVIDE ALL REQUIRED CIRCUIT EXTENSIONS AS REQUIRED TO RESTORE SERVICE TO DEVICES. NOTE THAT THIS REQUIREMENT ALSO APPLIES TO THE ROOMS AND ELECTRICAL ITEMS WITHIN THAT ARE NOMINALLY NOT IN CONTRACT. SUCH RESTORATION OF SERVICE, IF NEEDED, IS SPECIFICALLY IN THE ELECTRICAL CONTRACTOR'S CONTRACT.
- . IT SHALL BE THE ELECTRICAL CONTRACTOR'S RESPONSIBILITY TO PROTECT ALL ELECTRICAL DEVICES, FROM DAMAGES DURING CONSTRUCTION, WHICH ARE EITHER INDICATED TO REMAIN, AND/OR TO BE REMOVED AND REINSTALLED THROUGHOUT ALL CONSTRUCTION AREAS. DEVICES SHALL INCLUDE BUT WILL NOT BE LIMITED TO: SMOKE DETECTORS, EMERGENCY LIGHTS, EXIT SIGNS, OCCUPANCY SENSORS, SPEAKERS, LIGHT FIXTURES, SWITCHES, RECEPTACLE, ETC. IN THE EVENT OF DAMAGES INCURRED DUE TO CONSTRUCTION ACTIVITIES, THE ELECTRICAL CONTRACTOR SHALL BE RESPONSIBLE TO REPLACE ANY DAMAGED DEVICES AT NO ADDITIONAL COST TO OWNER.
- ALL SYSTEM ASSOCIATED WITH THE DEVICES SCHEDULED TO BE REMOVED. STORED AND PROTECTED SHALL BE TESTED BY THE MANUFACTURER'S CERTIFIED TESTING VENDOR PRIOR TO ANY DEMOLITION ACTIVITY. ANY DEVICE WHICH FAILS THE TEST SHALL BE REPLACED WITH A FORM, FIT AND FUNCTION COMPONENT PER UNIT PRICES, AND SUCH DEVICES ARE NOT INCLUDED IN THIS RESPONSIBILITY STATEMENT, BUT ALSO SUCH INSTALLATION SHALL BE IN THE ELECTRICAL CONTRACTOR'S BASE BID. THE ELECTRICAL CONTRACTOR SHALL RE-TEST ALL SUCH SYSTEM COMPONENTS BY A MANUFACTURER CERTIFIED TESTING VENDOR OF SUCH SYSTEM OF ALL PREVIOUSLY TESTED SYSTEM COMPONENTS AFTER ALL WORK BY ALL TRADES HAS BEEN COMPLETED, AND ALL SYSTEM COMPONENTS HAVE BEEN INSTALLED. ANY COMPONENT WHICH FAILS SHALL BE REPLACED, AND PROGRAMMED IF NECESSARY BY THE ELECTRICAL CONTRACTOR. ALL SUCH REPLACEMENT AND PROGRAMMING COSTS SHALL BE ELECTRICAL CONTRACTOR'S RESPONSIBILITY. ALL COSTS ASSOCIATED WITH THE TESTING OF AFFECTED SYSTEM SUCH AS BUT NOT LIMITED TO FIRE ALARM, PUBLIC ADDRESS, INTERCOM, TELEPHONE, AND SECURITY SYSTEMS SHALL BE THE RESPONSIBILITY OF THE ELECTRICAL CONTRACTOR. ALL EQUIPMENT, DEVICES, WIRING AND THEIR ASSOCIATED MATERIAL SPECIFIED TO REMAIN, WHICH IS NOT STORED AND PROTECTED, SHALL BE PROTECTED DURING THE DEMOLITION ACTIVITIES, AND ALL TRADES SHALL BE INFORMED OF SUCH COMPONENTS. ANY OF SUCH COMPONENTS WHICH BECOME DAMAGED DURING DEMOLITION SHALL BE REPLACED FORM, FIT AND FUNCTION BY THE ELECTRICAL CONTRACTOR AT HIS

FIRE STOP NOTES

- ALL CONDUIT AND CABLE PENETRATIONS THROUGH FIRE RATED WALLS, FLOORS OR OTHER STRUCTURES SHALL BE FIRE STOPPED.
- THE FIRE STOP MATERIALS SHALL BE HILTI TYPE FS-657 FIRE BLOCK, FS-ONE SEALANT, CP-672 JOINT SPRAY, CP-601S ELASTOMERIC SEALANT, 6P-606 FLEXIBLE SEALANT, CP-643 OR CP-642 COLLAR, CP-618 PUTTY STICK, OR FS-635 TROWEL ABLE COMPOUND, AS SUITABLE.
- CONTRACTOR SHALL SUBMIT SHOP DRAWINGS OF PRODUCTS SPECIFIED OR EQUAL.
- FIRE STOP MATERIALS OTHER THAN HILTI SHALL INCLUDE FULL TECHNICAL DATA WITH SHOP DRAWINGS TO DEMONSTRATE EQUALITY WITH THE SPECIFIED FIRE STOPS AND STATEMENT FROM MANUFACTURER THAT THEY MEET OR EXCEED THE PRODUCTS SPECIFIED HERE.
- ALL SYSTEMS SHALL HAVE THEIR OWN SLEEVE THROUGH FIRE RATED WALLS. IE FIRE ALARM, PUBLIC ADDRESS, TELEPHONE, DATA, POWER AND LIGHTING.


UBLIC A	ADDRESS / SPEAKER SYSTEM LEGEND
SYMBOL	DESCRIPTION
S	WALL MOUNTED P.A. SPEAKER
	RECESSED CEILING MOUNTED PUBLIC ADDRESS SPEAKER

SYMBOL	DESCRIPTION
STWIDOL	DEGONI HON
	2'x4' GRID LAY-IN LED CONTEMPORARY ARCHITECTURAL TROFFER
	2'X4' GRID LAY-IN LED CONTEMPORARY ARCHITECTURAL TROFFER WITH BATTERY BACKUP
	2'X2' GRID LAY-IN LED CONTEMPORARY ARCHITECTURAL TROFFER
	2'X2' GRID LAY-IN LED CONTEMPORARY ARCHITECTURAL TROFFER WITH BATTERY BACKUP
\searrow	1'X4' GRID LAY-IN LED CONTEMPORARY ARCHITECTURAL TROFFER
	1'X4' GRID LAY-IN LED CONTEMPORARY ARCHITECTURAL TROFFER WITH BATTERY BACKUP
	2'X4' SURFACE MOUNT LED CONTEMPORARY ARCHITECTURAL TROFFER
	2'X4' SURFACE MOUNT LED CONTEMPORARY ARCHITECTURAL TROFFER WITH BATTERY BACKUP
	2'X2' SURFACE MOUNT LED CONTEMPORARY ARCHITECTURAL TROFFER
	2'X2' SURFACE MOUNT LED CONTEMPORARY ARCHITECTURAL TROFFER WITH BATTERY BACKUP
	1'X4' SURFACE MOUNT LED CONTEMPORARY ARCHITECTURAL TROFFER
	1'X4' SURFACE MOUNT LED CONTEMPORARY ARCHITECTURAL TROFFER WITH BATTERY BACKUP
•	1'X4' CABLE MOUNT LED CONTEMPORARY ARCHITECTURAL TROFFER
	1'X4' CABLE MOUNT LED CONTEMPORARY ARCHITECTURAL TROFFER WITH BATTERY BACKUP
0	LED DOWNLIGHT
Ø	LED DOWNLIGHT WITH BATTERY BACKUP
	EXTERIOR BUILDING MOUNTED WALLPACK
	EXTERIOR LIGHT POLE
EXIT	EMERGENCY LED LIGHT FIXTURE W/ 90-MINUTE BATTERY
	SUBSRIPT 'VG' - PROVIDE W/ POLYCARBONATE VANDAL GUARD
	LED EXIT LIGHT W/ 90-MINUTE EMERGENCY BATTERY. DIRECTIONAL ARRO


FIRE ALARM SYMBOL LEGEND							
SYMBOL	DESCRIPTION						
FACP	FIRE ALARM CONTROL PANEL. PROVIDE BUILDING GRAPHIC MAP WITHIN SIGHT OF PANEL.						
₹	SMOKE DETECTOR WITH BASE						
Ē	WALL MOUNT SPEAKER / STROBE NOTIFICATION DEVICE.						
∇ F	WALL MOUNT SPEAKER NOTIFICATION DEVICE.						
Ŗ	WALL MOUNT STROBE NOTIFICATION DEVICE.						
R	FIRE ALARM RELAY SHUTDOWN						

SYMBOL	DESCRIPTION
φ	TAMPER-RESISTANT DUPLEX ELECTRICAL OUTLET FOR CONVENIENCE POWER WITH 302/304 STAINLESS STEEL FACEPLATE, NEMA 5-20R.
₩	TAMPER-RESISTANT DOUBLE DUPLEX ELECTRICAL OUTLET FOR CONVENIENCE POWER WITH 302/304 STAINLESS STEEL FACEPLATE, NEMA 5-20R.
•	TAMPER-RESISTANT GROUND FAULT INTERRUPTED DUPLEX ELECTRICAL OUTLET FOR CONVENIENCE POWER WITH 302/304 STAINLESS STEEL FACEPLATE, NEMA 5-20R.
φ	TAMPER-RESISTANT SINGLE ELECTRICAL OUTLET FOR CONVENIENCE POWER WITH 302/304 STAINLESS STEEL FACEPLATE, NEMA 5-20R.
φ	TAMPER-RESISTANT SPECIAL PURPOSE SINGLE ELECTRICAL OUTLET FOR CONVENIENCE POWER WITH 302/304 STAINLESS STEEL FACEPLATE, 250V,
Φ	NEMA 6-20R. TAMPER-RESISTANT USB CHARGER DUPLEX ELECTRICAL OUTLET FOR CONVENIENCE POWER WITH 302/304 STAINLESS STEEL FACEPLATE, NEMA 5-20R.
	DATA & POWER SURFACE RACEWAY - NUMBER OF TRIANGLES INDICATES NUMBER OF DATA DROPS - PROVIDE (2) DUPLEX RECEPTACLES PER DATA DROP UNLESS OTHERWISE NOTED ON TECHNOLOGY DRAWINGS E9.XX
	POWER CORD REEL, NEMA 5-20R.
P	FIRE RATED POWER FEED POKE-THROUGH.
FB	FLOOR BOX.
WB	MULTIPLE SERVICE WALL BOX.
J	JUNCTION BOX, SIZE AS REQUIRE.
(HP)	MOTOR, HORSEPOWER AS INDICATED.
	UN-FUSED DISCONNECT SWITCH.
F	FUSED DISCONNECT SWITCH.
HD	HAND DRYER.
<i>7777</i> 2	PANEL.
36	TRANSFORMER.
\$	SWITCH: LOWER CASE LETTER INDICATES SWITCHING DESIGNATION UPPER CASE LETTER(S) OR NUMBER SUBSCRIPTS: (NONE) = SINGLE POLE, 20 A, HEAVY DUTY SPEC GRADE SWITCH K = KEY SWITCH D = DIMMER SWITCH 3 = THREE WAY SWITCH 4 = FOUR WAY SWITCH MC = MOMENTARY CONTACT SWITCH LV = LOW VOLTAGE BUTTON SWITCH EF = COMMERCIAL GRADE EXHAUST FAN SWITCH 2P = TWO POLE, 20A, HEAVY DUTY SPEC GRADE SWITCH
(3) (5) (S)	CEILING MOUNTED OCCUPANCY/ VACANCY/ DAYLIGHT SENSOR, LOW VOLTAGE, DUAL TECHNOLOGY, COMPLETE W/ POWER PACK(S) AS REQUIR
(103 (WS)	WALL MOUNTED OCCUPANCY/ VACANCY, LOW VOLTAGE, DUAL TECHNOLOGY, COMPLETE W/ POWER PACK(S) AS REQUIRED.
\$08	DUAL TECHNOLOGY SINGLE LEVEL OCCUPANCY SENSING WALL SWITCH.
PC	PHOTOCELL.
RC	ROOM CONTROLLER.
	SINGLE POLE CIRCUIT 2-#12, #12G, ¾"C UNLESS OTHERWISE NOTED
	∓WO POLE CIRCUIT 3-#12, #12G, ¾"C UNLESS OTHERWISE NOTED
	THREE POLE CIRCUIT 4-#12, #12G, ¾"C UNLESS OTHERWISE NOTED

QTY.	PART NUMBER	DESCRIPTION	MANUFACTUI
1	HBLWSC\$3A	RECESSED WALL BOX 3 GANG DRY WALL	HUBBELL
1	HBLTRIM3WI	WALL BOX TRIM RING	HUBBELL
2	IM2KIW	2 PORT KEYSTONE MODULE I UNIT	HUBBELL
4	HXJ6B/HXJ6Y	CAT 6 RJ45 CONNECTOR (2 BL DATA/2 YEL VOICE)	HUBBELL
2	HBLST3Ø16WA	DUPLEX DECORATOR FACEPLATE	HUBBELL
2	DR2ØALTR	TAMPER RESISTANT DUPLEX OUTLET	HUBBELL
1	HBLIMFSWA	3 UNIT ISTATION FACEPLATE	HUBBELL
1	IMBIW	BLANK MODULE - 1 UNIT	HUBBELL
2. COOF	R TO DRAWINGS FOR QUANTITY RDINATE HEIGHT WITH HSA DESI ILL CONDUIT AS NEEDED	/ / / // / / / /	SUSPENDED CEILII
			- COORDINATE HEIG WITH DESKTOP

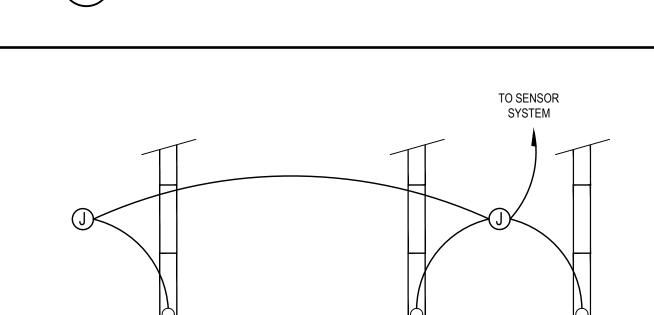

TYPICAL TANDEM FIXTURE WIRING DIAGRAM

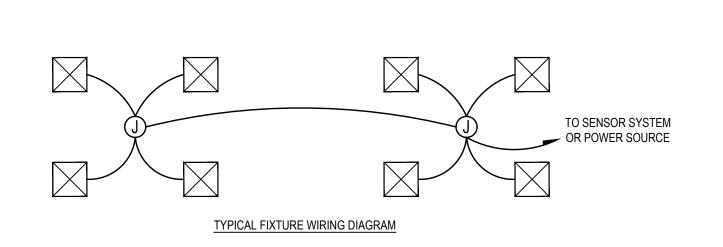


DATA & POWER WALL BOX

SETUP FOR STANDARD

SCALE: N.T.S.

SCALE: N.T.S.

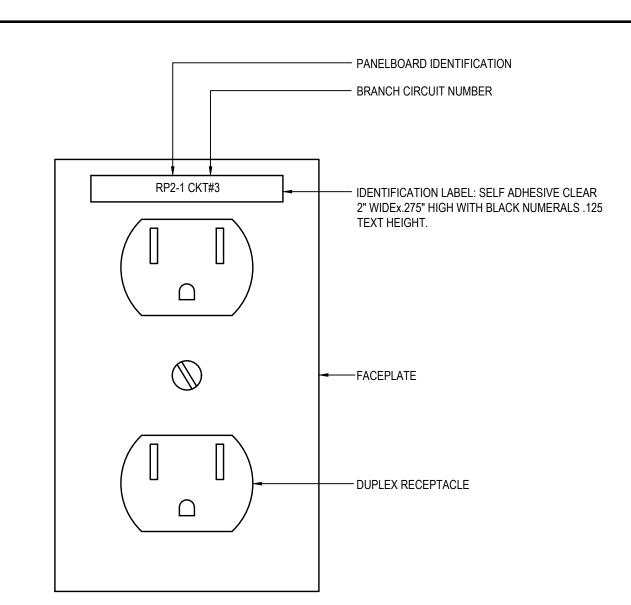

ROOFTOP CONDUIT SHALL SECURED 4" MIN. ABOVE ROOF SURFACE. SUPPORTS SHALL BE SPACED EVERY 3'-5' OR AS OTHERWISE LISTED PER NEC 352.30. IF PVC CONDUIT IS USED ON THE ROOF, IT MUST MEET UL651 FOR UV RESISTANCE & CONTINUOUS OUTDOOR USE. RIGID GALV. IS ALSO ACCEPTABLE. EC SHALL COORDINATE EXACT LOCATION FOR ALL

INSTALL EXPANSION FITTINGS THROUGHOUT ROOFTOP

CONDUIT PER NEC.

CONNECTIONS AND SWITCHES ON MECHANICAL EQUIPMENT WITH MC. DO NOT BLOCK ACCESS PANELS, REFR PIPING PORTS, ETC.

CONDUITS SIZE PER PLAN — ANY PENETRATIONS IN ROOF SURFACE SHALL BE MADE AS NOT TO VOID THE ROOFING MANUFACTURER WARRANTY. CONDUIT SUPPORTS SHALL BE SPACED EVERY 3'-5' OR AS REQUIRED CONDUITS SHALL BE SUPPORTED PER NEC. 352.30 4" MIN ABOVE THE ROOF SURFACE. —

ROOFTOP CONDUIT SUPPORT DETAIL

SCALE: NTS

ALL CONDUCTORS INSTALLED IN ROOFTOP CONDUIT SHALL BE TYPE XHHW-2 INSULATION. WIRING SIZE BASED OFF APPROXIMATE CONDUIT ROUTE SHOWN. CONTRACTOR MAY CHOOSE A DIFFERENT ROUTE IN THE FIELD, BUT ASSUMES ALL RESPONSIBILITY FOR WIRE/CONDUIT SIZING IN DOING SO.

SCALE: N.T.S.

SCALE: AS NOTED DECEMBER 1, 2020 BID PICK-UP: March 8, 2021 FILE No: 20-176B

SCALE: N.T.S.

DRAWING BY: MG CHECK BY: HIS DRAWING, PREPARED FOR THE SPECIFIC PROJECT INDICATED I AN INSTRUMENT OF SERVICE AND THE PROPERTY OF BE ARCHITECTS, LANDSCAPE ARCHITECTS AND ENGINEERS, PI

REV. DATE

THESE DRAWINGS ARE BASED ON CONSTRUCTION DRAWINGS NOT

REPARED BY BBS ARCHITECTS, LANDSCAPE ARCHITECTS AN

CONDITIONS AS CONSTRUCTED AT THE TIME. ALL EXIST

INFORMATION AS THEY MAY NOT HAVE BEEN BUILT AND DETAILE PER THE ORIGINAL DOCUMENTS OR PER THE OWNER'S INFORMATION

KEY PLAN

NOT TO SCALE

INFRINGEMENT OR ANY USE OF THIS DRAWING FOR ANY OTHI PROJECT IS PROHIBITED. ANY ALTERATION OR REPRODUCTION THIS DOCUMENT IS ALSO PROHIBITED WITHOUT THE WRITTE CONSENT OF THE ARCHITECT OR ENGINEER

LANDSCAPE ARCHITECTS

ENGINEERS 4 EAST MAIN STREET | 187 WOLF ROAD, STE. 209 PATCHOGUE NEW YORK 11772 T. 631.475.0349 F. 631.475.0361


NEW YORK 12205 F. 518.621.7655 www.BBSARCHITECTURE.com


44-21-15-02-0-001-015 DISTRICT FLORDIA U.F.S.D. S.S. SEWARD INSTITUTE PROJECT BOND PHASE 2 DWG TITLE ELECTRICAL


NOTES AND LEGENDS

NEW 3P WIRING(3#12, 1#12G, 3/4"C) —— FROM VFD TO NEW 3 PHASE MOTOR BY EC. EC SHALL REMOVE AND DISPOSE OF —— EC SHALL FURNISH AND INSTALL NEW WIRING BETWEEN EXISTING DISCONNECT 3#12, 1#12G, 3/4"C FROM DISCONNECT AND EXISTING FAN MOTOR. SWITCH TO VFD. - EC TO WIRE AND INSTALL NEW VFD FURNISHED BY MC EXISTING MOTOR TO REMAIN. -VFD SUPPORT IS FURNISHED AND INSTALLED BY MC. VFD ROOF EXISTING DISCONNECT INSIDE FAN TO REMAIN. EXISTING 480V/3P/60HZ WIRING TO DISCONNECT SWITCH TO REMAIN.

ROOM. EC TO TRACE OUT CKT TO FAN.

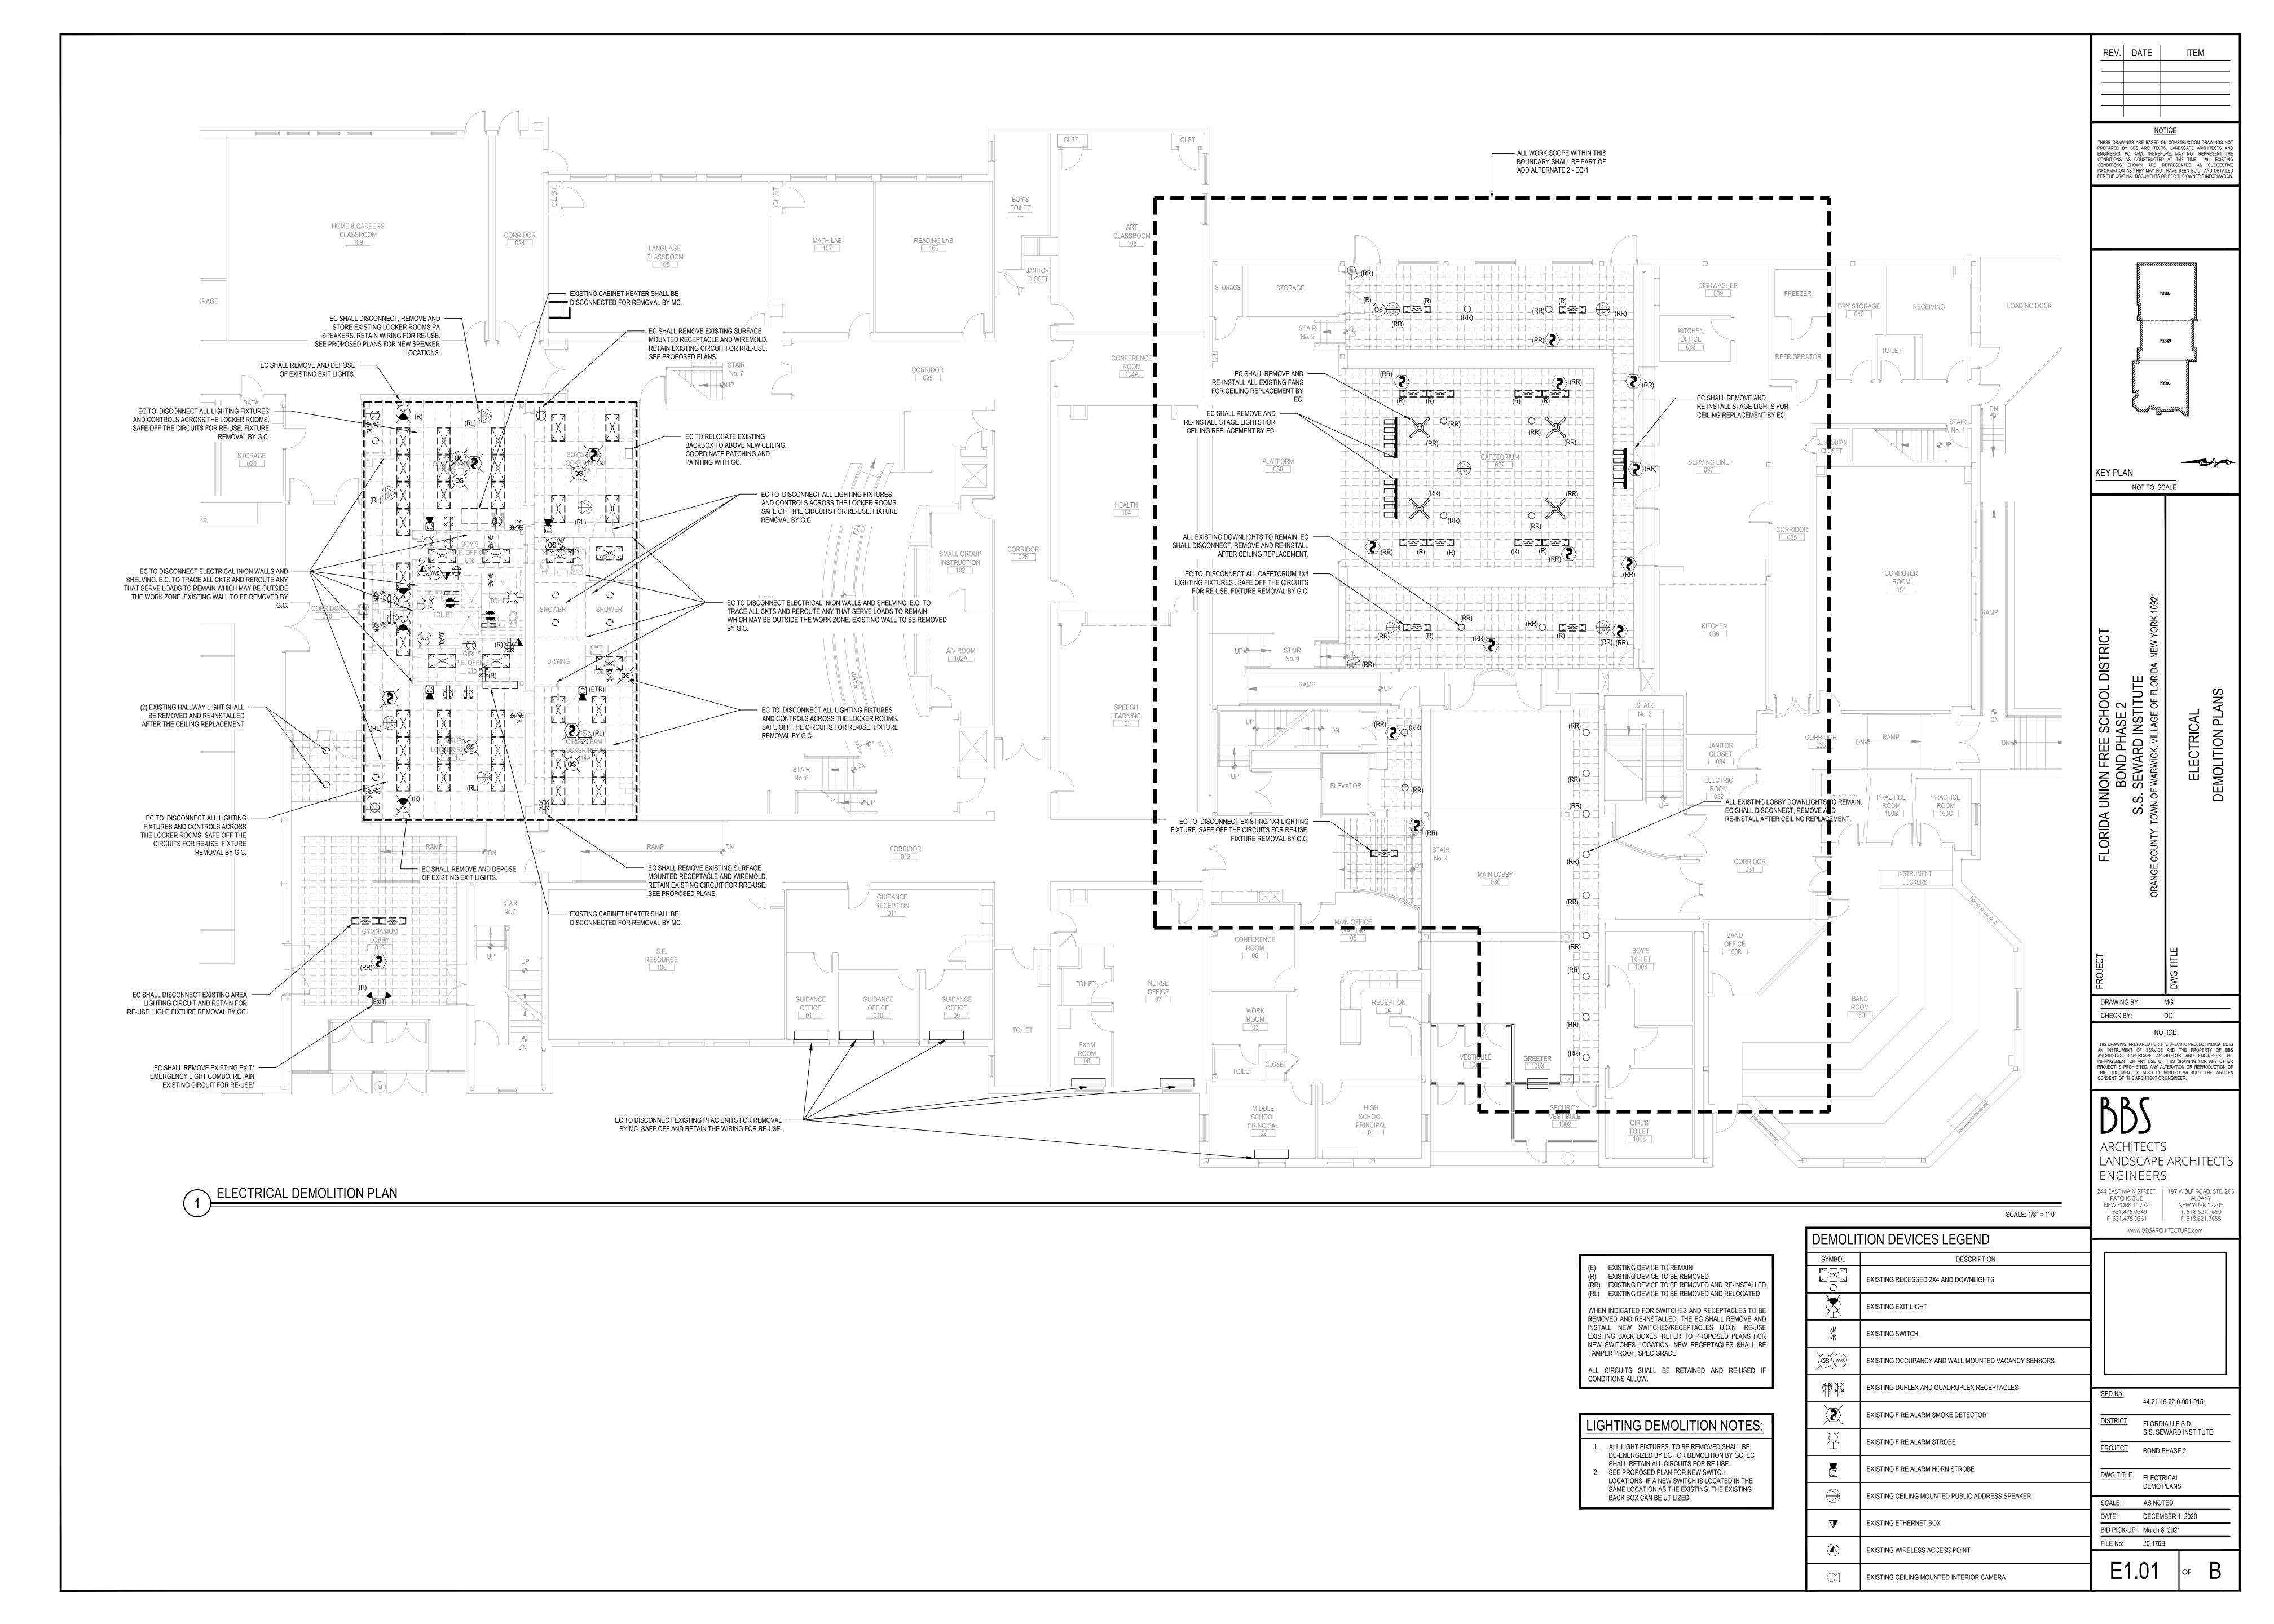

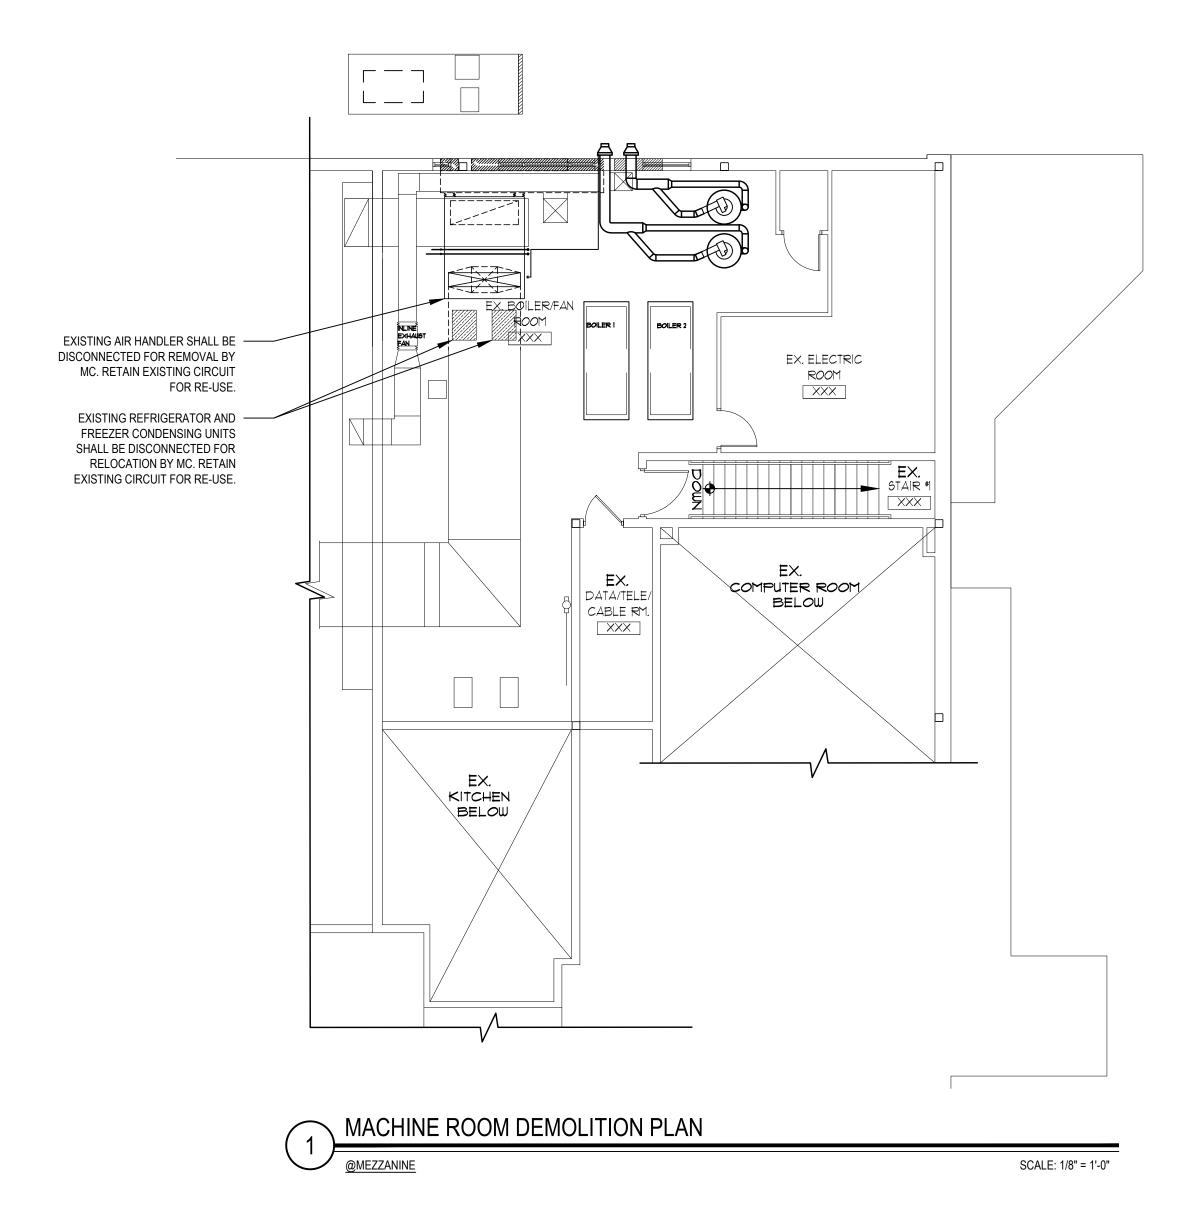

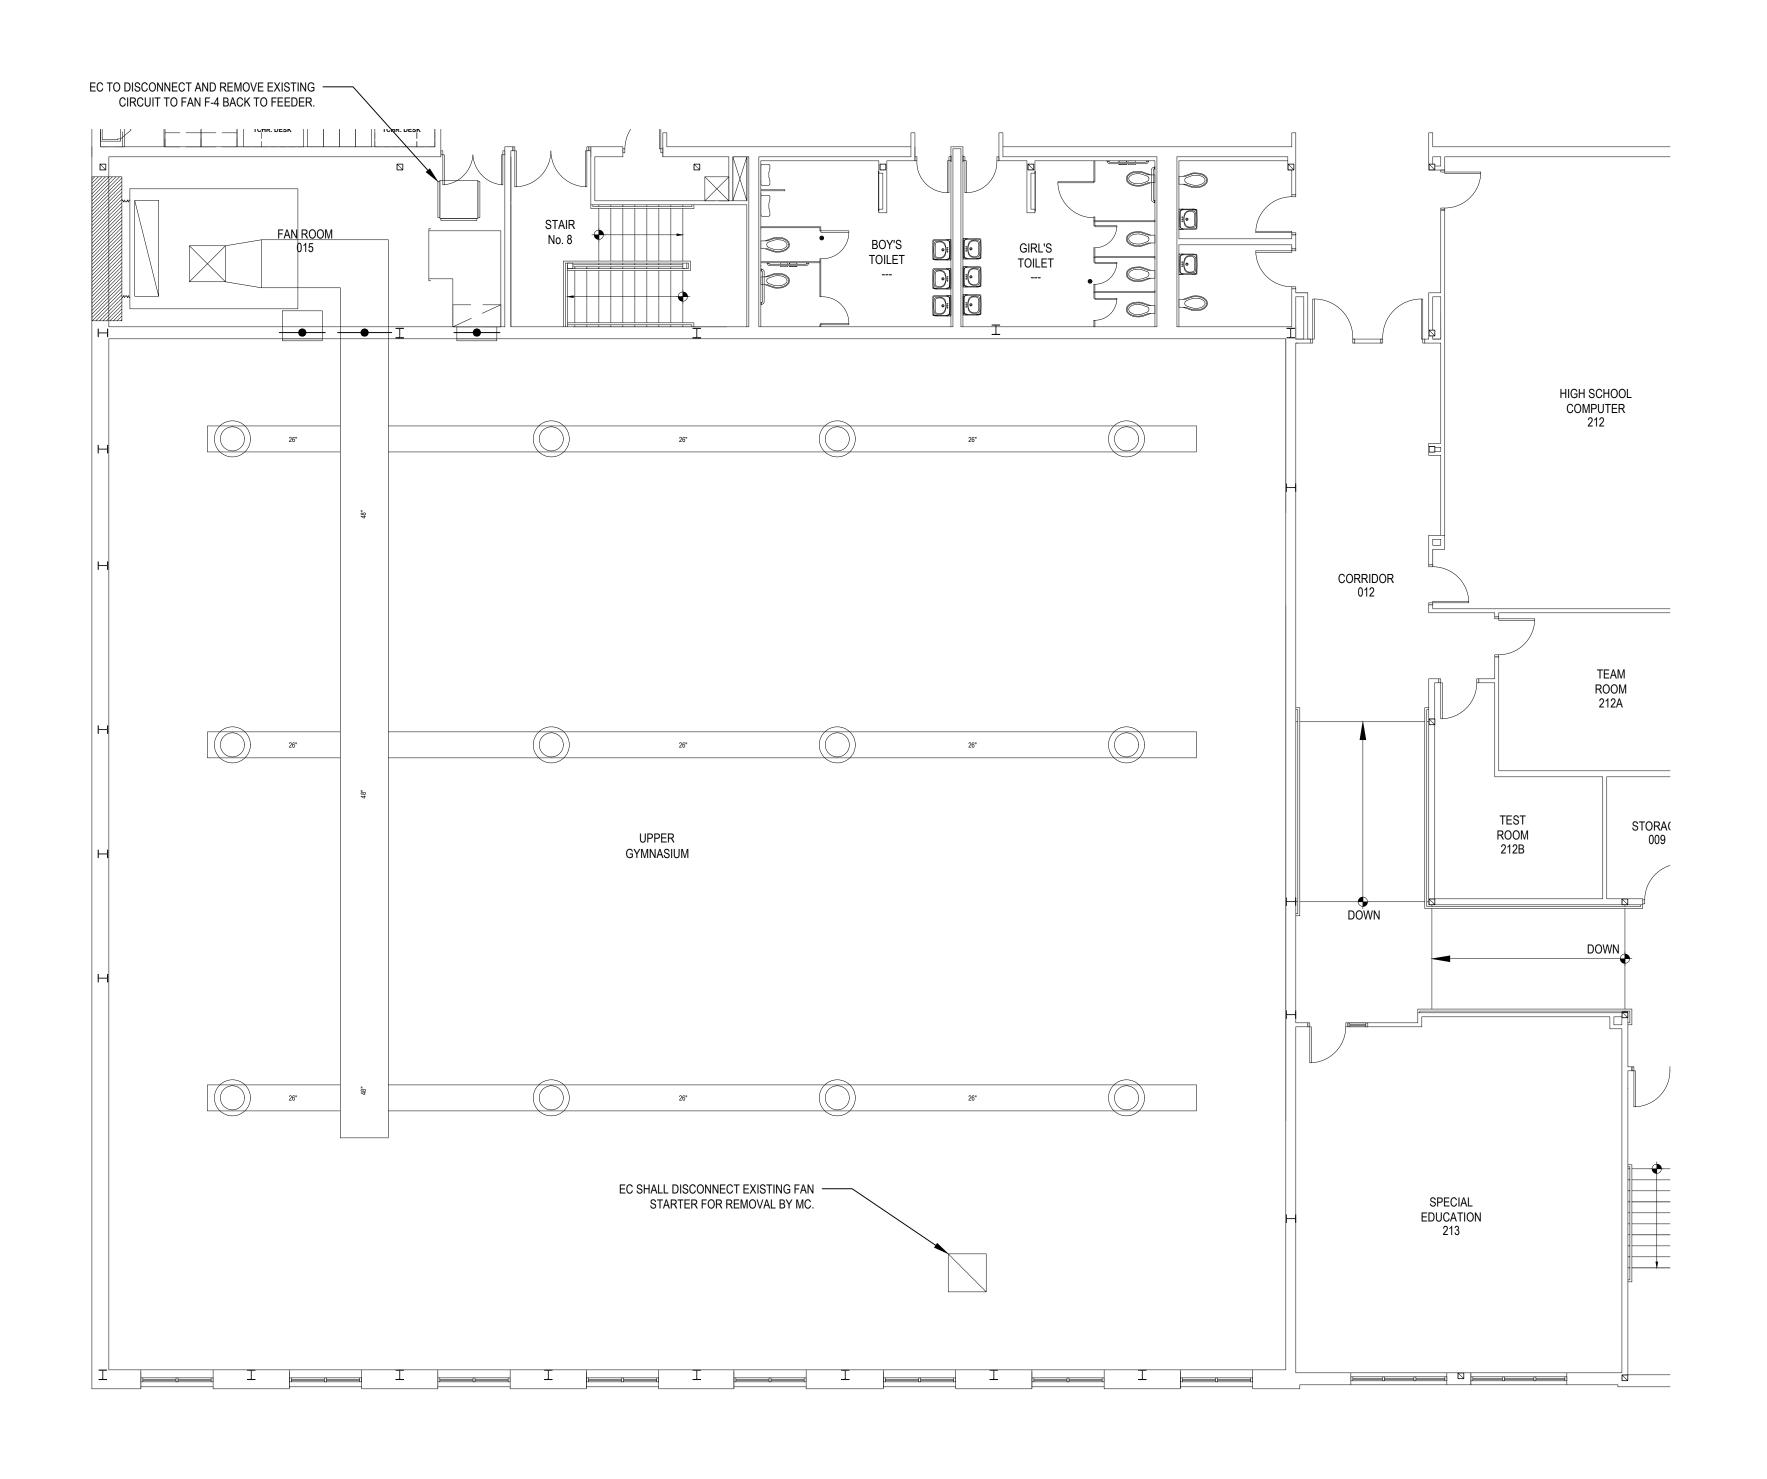

FANS DEMOLITION PLAN

@MEZZANINE

REV. DATE

<u>NOTICE</u> THESE DRAWINGS ARE BASED ON CONSTRUCTION DRAWINGS NOT PREPARED BY BBS ARCHITECTS, LANDSCAPE ARCHITECTS AND ENGINEERS, PC. AND, THEREFORE, MAY NOT REPRESENT THE CONDITIONS AS CONSTRUCTED AT THE TIME. ALL EXISTING CONDITIONS SHOWN ARE REPRESENTED AS SUGGESTIVE INFORMATION AS THEY MAY NOT HAVE BEEN BUILT AND DETAILED PER THE ORIGINAL DOCUMENTS OR PER THE OWNER'S INFORMATION.

NOT TO SCALE

KEY PLAN

DRAWING BY: MG CHECK BY: <u>NOTICE</u>

SCALE: 1/8" = 1'-0"

THIS DRAWING, PREPARED FOR THE SPECIFIC PROJECT INDICATED IS AN INSTRUMENT OF SERVICE AND THE PROPERTY OF BBS ARCHITECTS, LANDSCAPE ARCHITECTS AND ENGINEERS, PC. INFRINGEMENT OR ANY USE OF THIS DRAWING FOR ANY OTHER PROJECT IS PROHIBITED. ANY ALTERATION OR REPRODUCTION OF THIS DOCUMENT IS ALSO PROHIBITED WITHOUT THE WRITTEN CONSENT OF THE ARCHITECT OR ENGINEER.

LANDSCAPE ARCHITECTS ENGINEERS

244 EAST MAIN STREET PATCHOGUE ALBANY
NEW YORK 11772 NEW YORK 12205
T. 631.475.0349 T. 518.621.7650
F. 631.475.0361 F. 518.621.7655

www.BBSARCHITECTURE.com


44-21-15-02-0-001-015 DISTRICT FLORDIA U.F.S.D.
S.S. SEWARD INSTITUTE PROJECT BOND PHASE 2 DWG TITLE ELECTRICAL MECHANICAL POWER PLANS

SCALE: AS NOTED

DATE: DECEMBER 1, 2020 BID PICK-UP: March 8, 2021

FILE No: 20-176B

E1.02

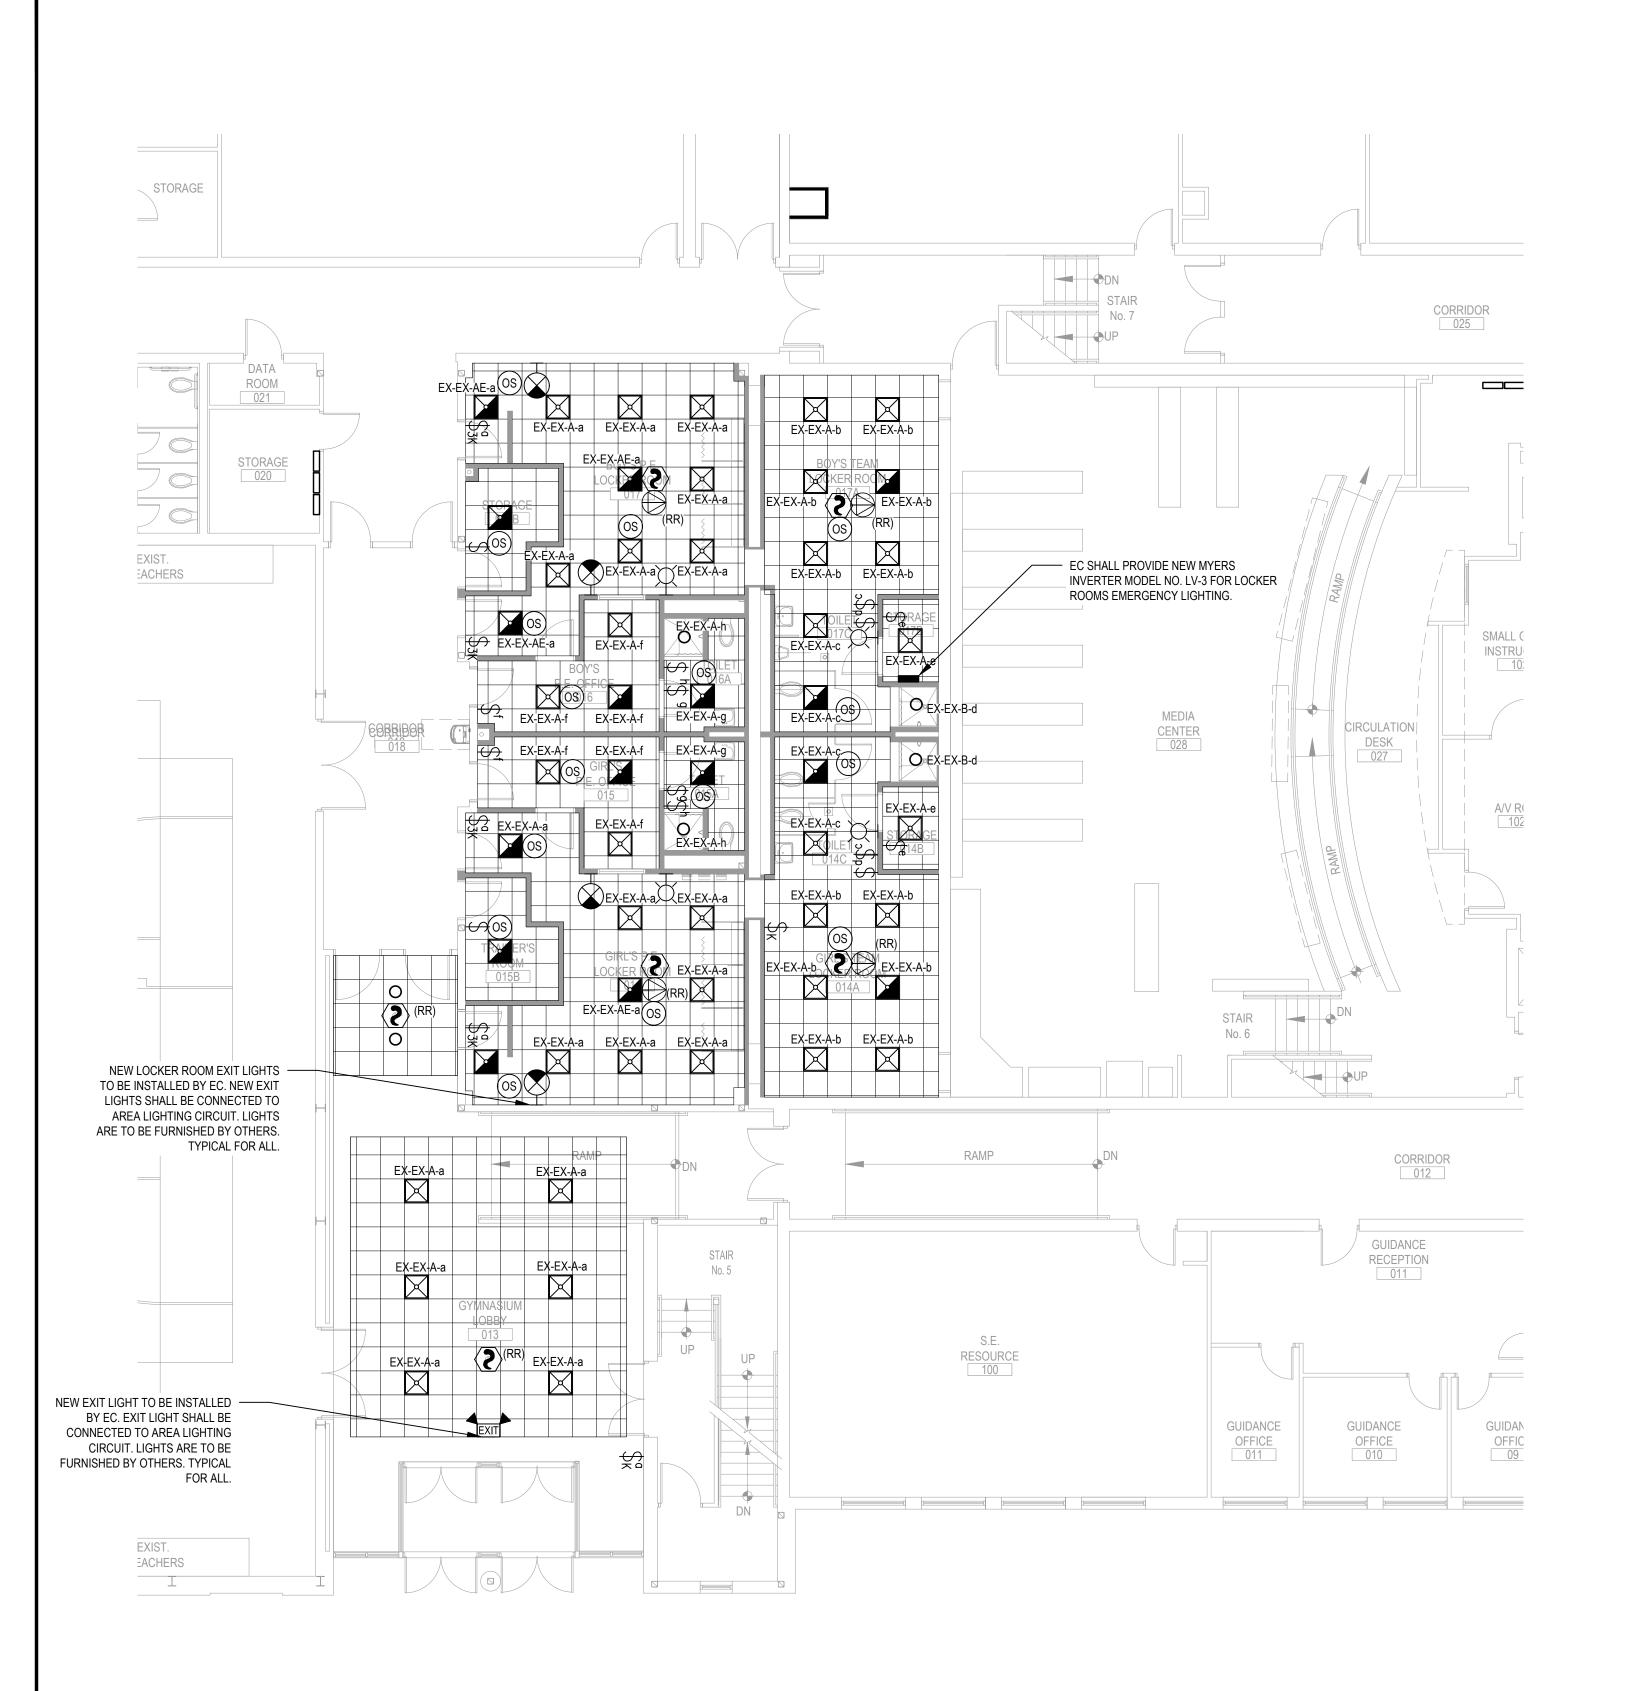

LOCKER ROOMS AND GYM LOBBY PROPOSED LIGHTING PLAN

SYMBOL

LIGHTING SCHEDULE

BE FURNISHED BY OTHERS.

NEW EXIT LIGHT. FURNISHED BY OTHERS.

NEW EMERGENCY/EXIT LIGHT. FURNISHED BY OTHERS

DESCRIPTION

2'x2' GRID LAY-IN LED CONTEMPORARY ARCHITECTURAL TROFFER BY RAB, 30

2'x2' GRID LAY-IN LED CONTEMPORARY ARCHITECTURAL TROFFER BY RAB, 30

WATTS, 0-10V DIMMING DRIVER, 3284 LUMENS, MODEL No. T34-2X2-30N-D10 TO

EC SHALL PROVIDE A COMPATIBLE INVERTER/BATTERY BACKUP.

8" LED DOWNLIGHT LITE BY RAB ,24 WATTS 0-10V DIMMING DRIVER, 2511 LUMENS. MODEL No. C8R24840UNVW. TO BE FURNISHED BY OTHERS.


8" LED DOWNLIGHT LITE/STRY BY RAB ,24 WATTS 0-10V DIMMING DRIVER, 2511 LUMENS. MODEL No. C8R24840UNVW. TO BE FURNISHED BY OTHERS.

WATTS, 0-10V DIMMING DRIVER, 3284 LUMENS, MODEL No. T34-2X2-30N-D10

(RR) EXISTING DEVICE TO BE REINSTALLED AS SHOWN ON THE PROPOSED PLAN EXTEND WIRING AS NEEDED.

EC SHALL INCLUDE HIS BID THE INSTALLATION OF ALL NEW LIGHT FIXTURES EXIT LIGHTS AND EMERGENCY LIGHTS AND ALL REQUIRED ACCESSORIES. NEW LIGHT FIXTURES, EXIT LIGHTS AND EMERGENCY LIGHTING FIXTURES WII BE FURNISHED BY OTHERS.

SCALE: 1/8" = 1'-0"

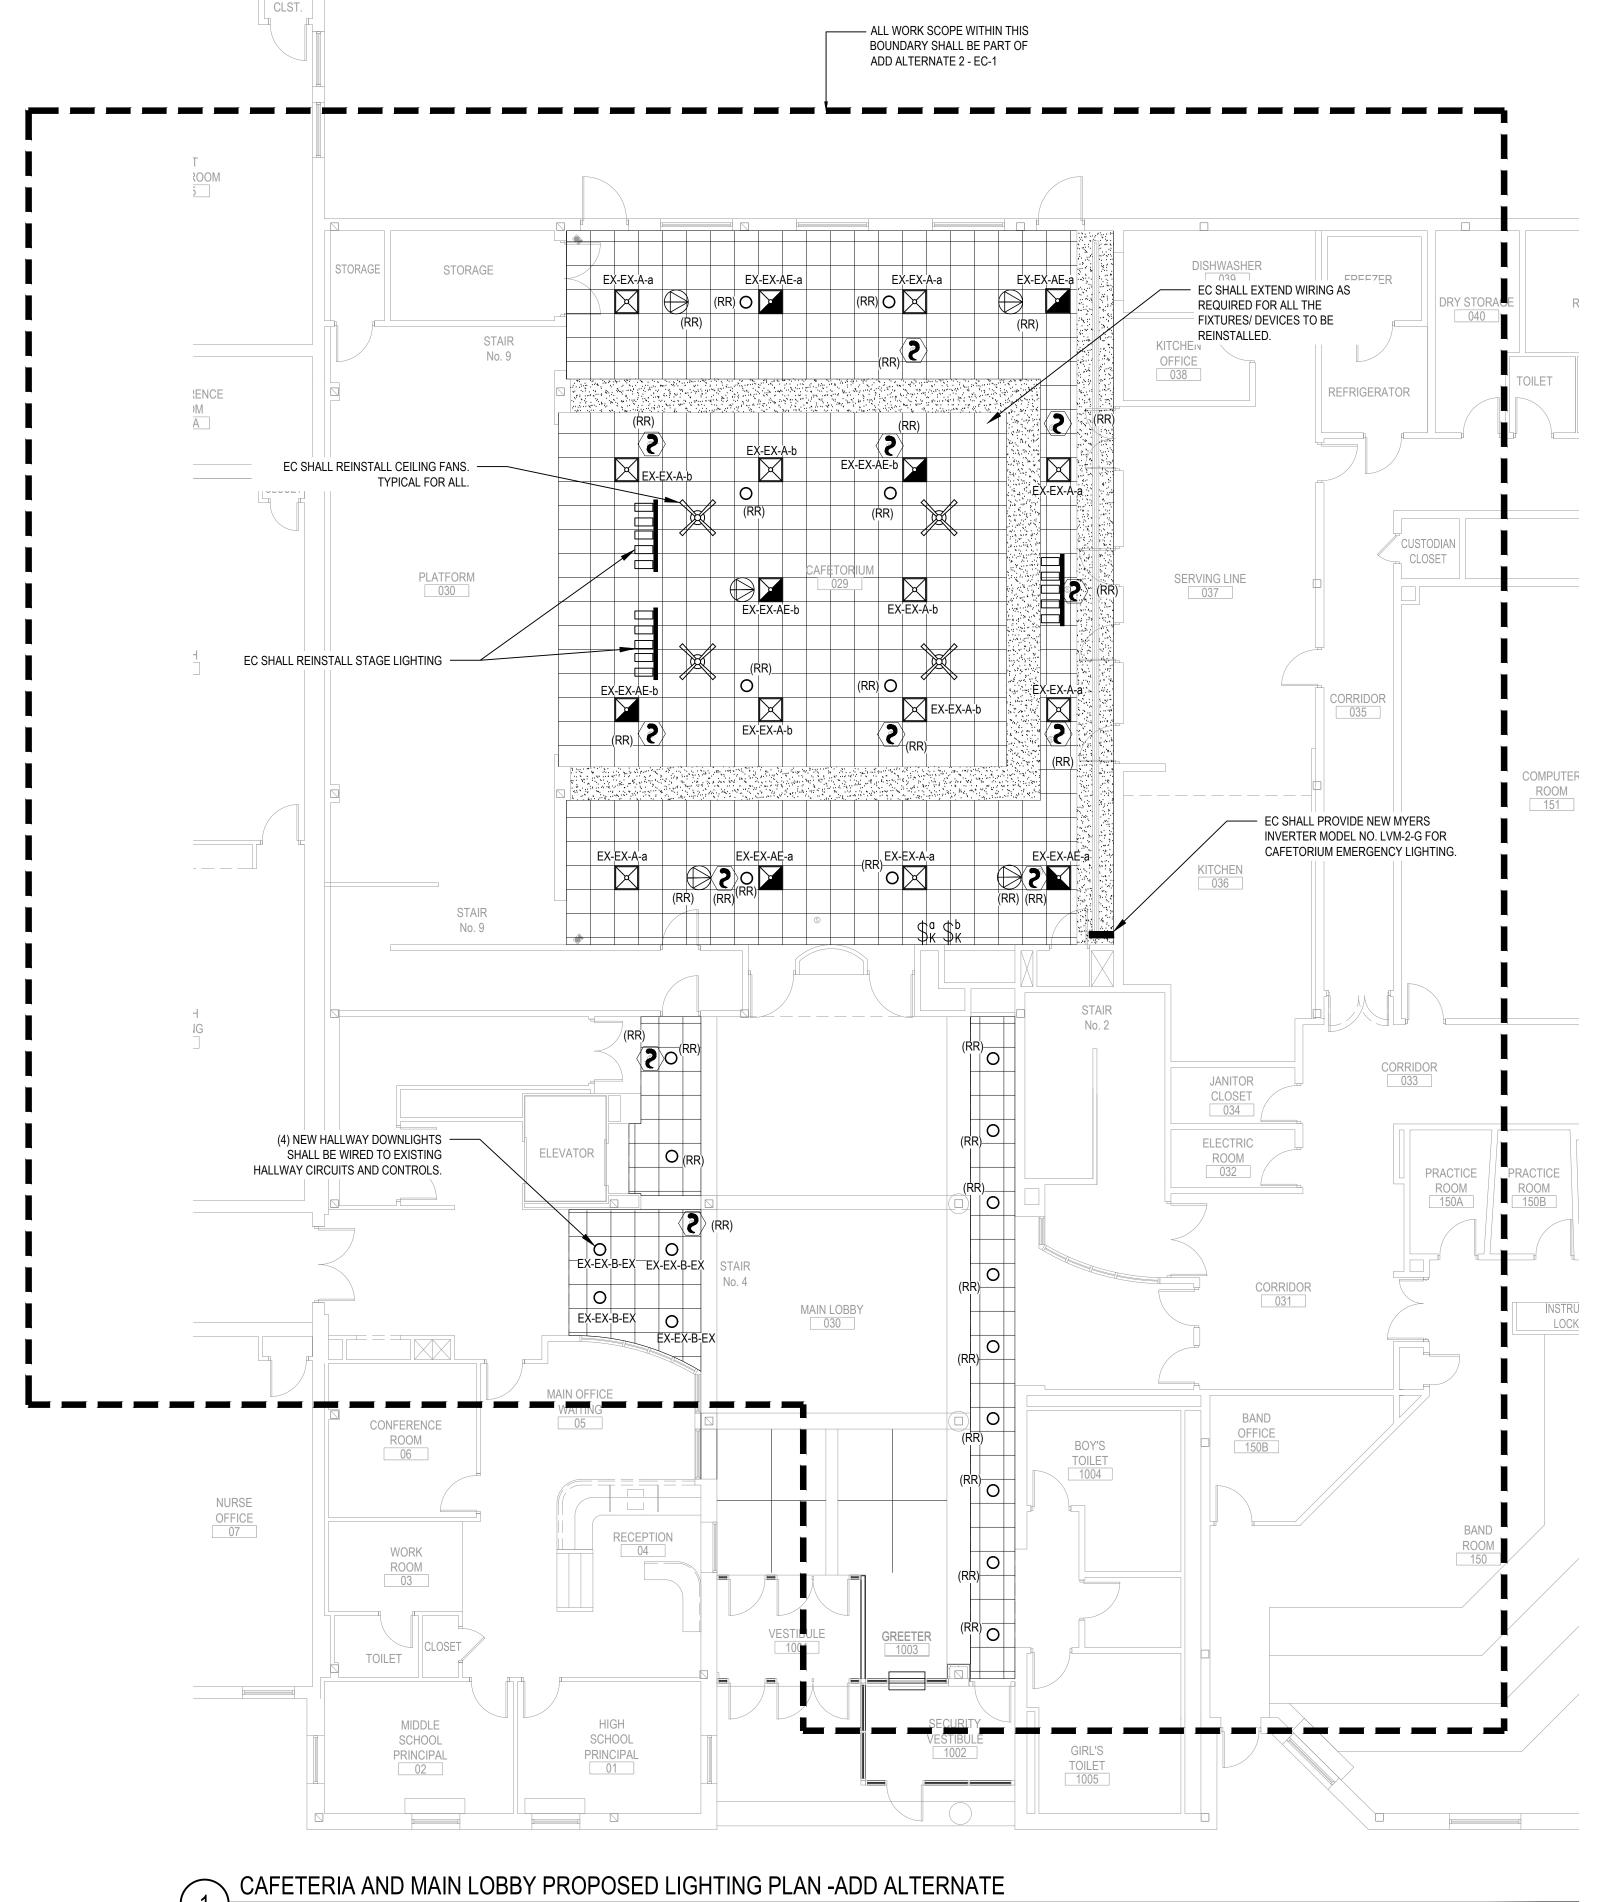

REV. DATE

<u>NOTICE</u> THESE DRAWINGS ARE BASED ON CONSTRUCTION DRAWINGS NOT PREPARED BY BBS ARCHITECTS, LANDSCAPE ARCHITECTS AND ENGINEERS, PC. AND, THEREFORE, MAY NOT REPRESENT THE CONDITIONS AS CONSTRUCTED AT THE TIME. ALL EXISTING CONDITIONS SHOWN ARE REPRESENTED AS SUGGESTIVE INFORMATION AS THEY MAY NOT HAVE BEEN BUILT AND DETAILED PER THE ORIGINAL DOCUMENTS OR PER THE OWNER'S INFORMATION.

KEY PLAN NOT TO SCALE

ELECTRICAL POSED LIGHTING F DRAWING BY: MG CHECK BY:

THIS DRAWING, PREPARED FOR THE SPECIFIC PROJECT INDICATED IS AN INSTRUMENT OF SERVICE AND THE PROPERTY OF BBS ARCHITECTS, LANDSCAPE ARCHITECTS AND ENGINEERS, PC. INFRINGEMENT OR ANY USE OF THIS DRAWING FOR ANY OTHER PROJECT IS PROHIBITED. ANY ALTERATION OR REPRODUCTION OF THIS DOCUMENT IS ALSO PROHIBITED WITHOUT THE WRITTEN CONSENT OF THE ARCHITECT OR ENCINEER. CONSENT OF THE ARCHITECT OR ENGINEER. ARCHITECTS LANDSCAPE ARCHITECTS ENGINEERS 244 EAST MAIN STREET | 187 WOLF ROAD, STE. 209 PATCHOGUE | ALBANY NEW YORK 11772 NEW YORK 12205 T. 631.475.0349 T. 518.621.7650

F. 518.621.7655

www.BBSARCHITECTURE.com


F. 631.475.0361


SCALE: 1/8" = 1'-0"

44-21-15-02-0-001-015 <u>DISTRICT</u> FLORDIA U.F.S.D. S.S. SEWARD INSTITUTE PROJECT BOND PHASE 2 DWG TITLE ELECTRICAL PROPOSED LIGHTING PLAN

SCALE: AS NOTED DATE: DECEMBER 1, 2020 BID PICK-UP: March 8, 2021

FILE No: 20-176B

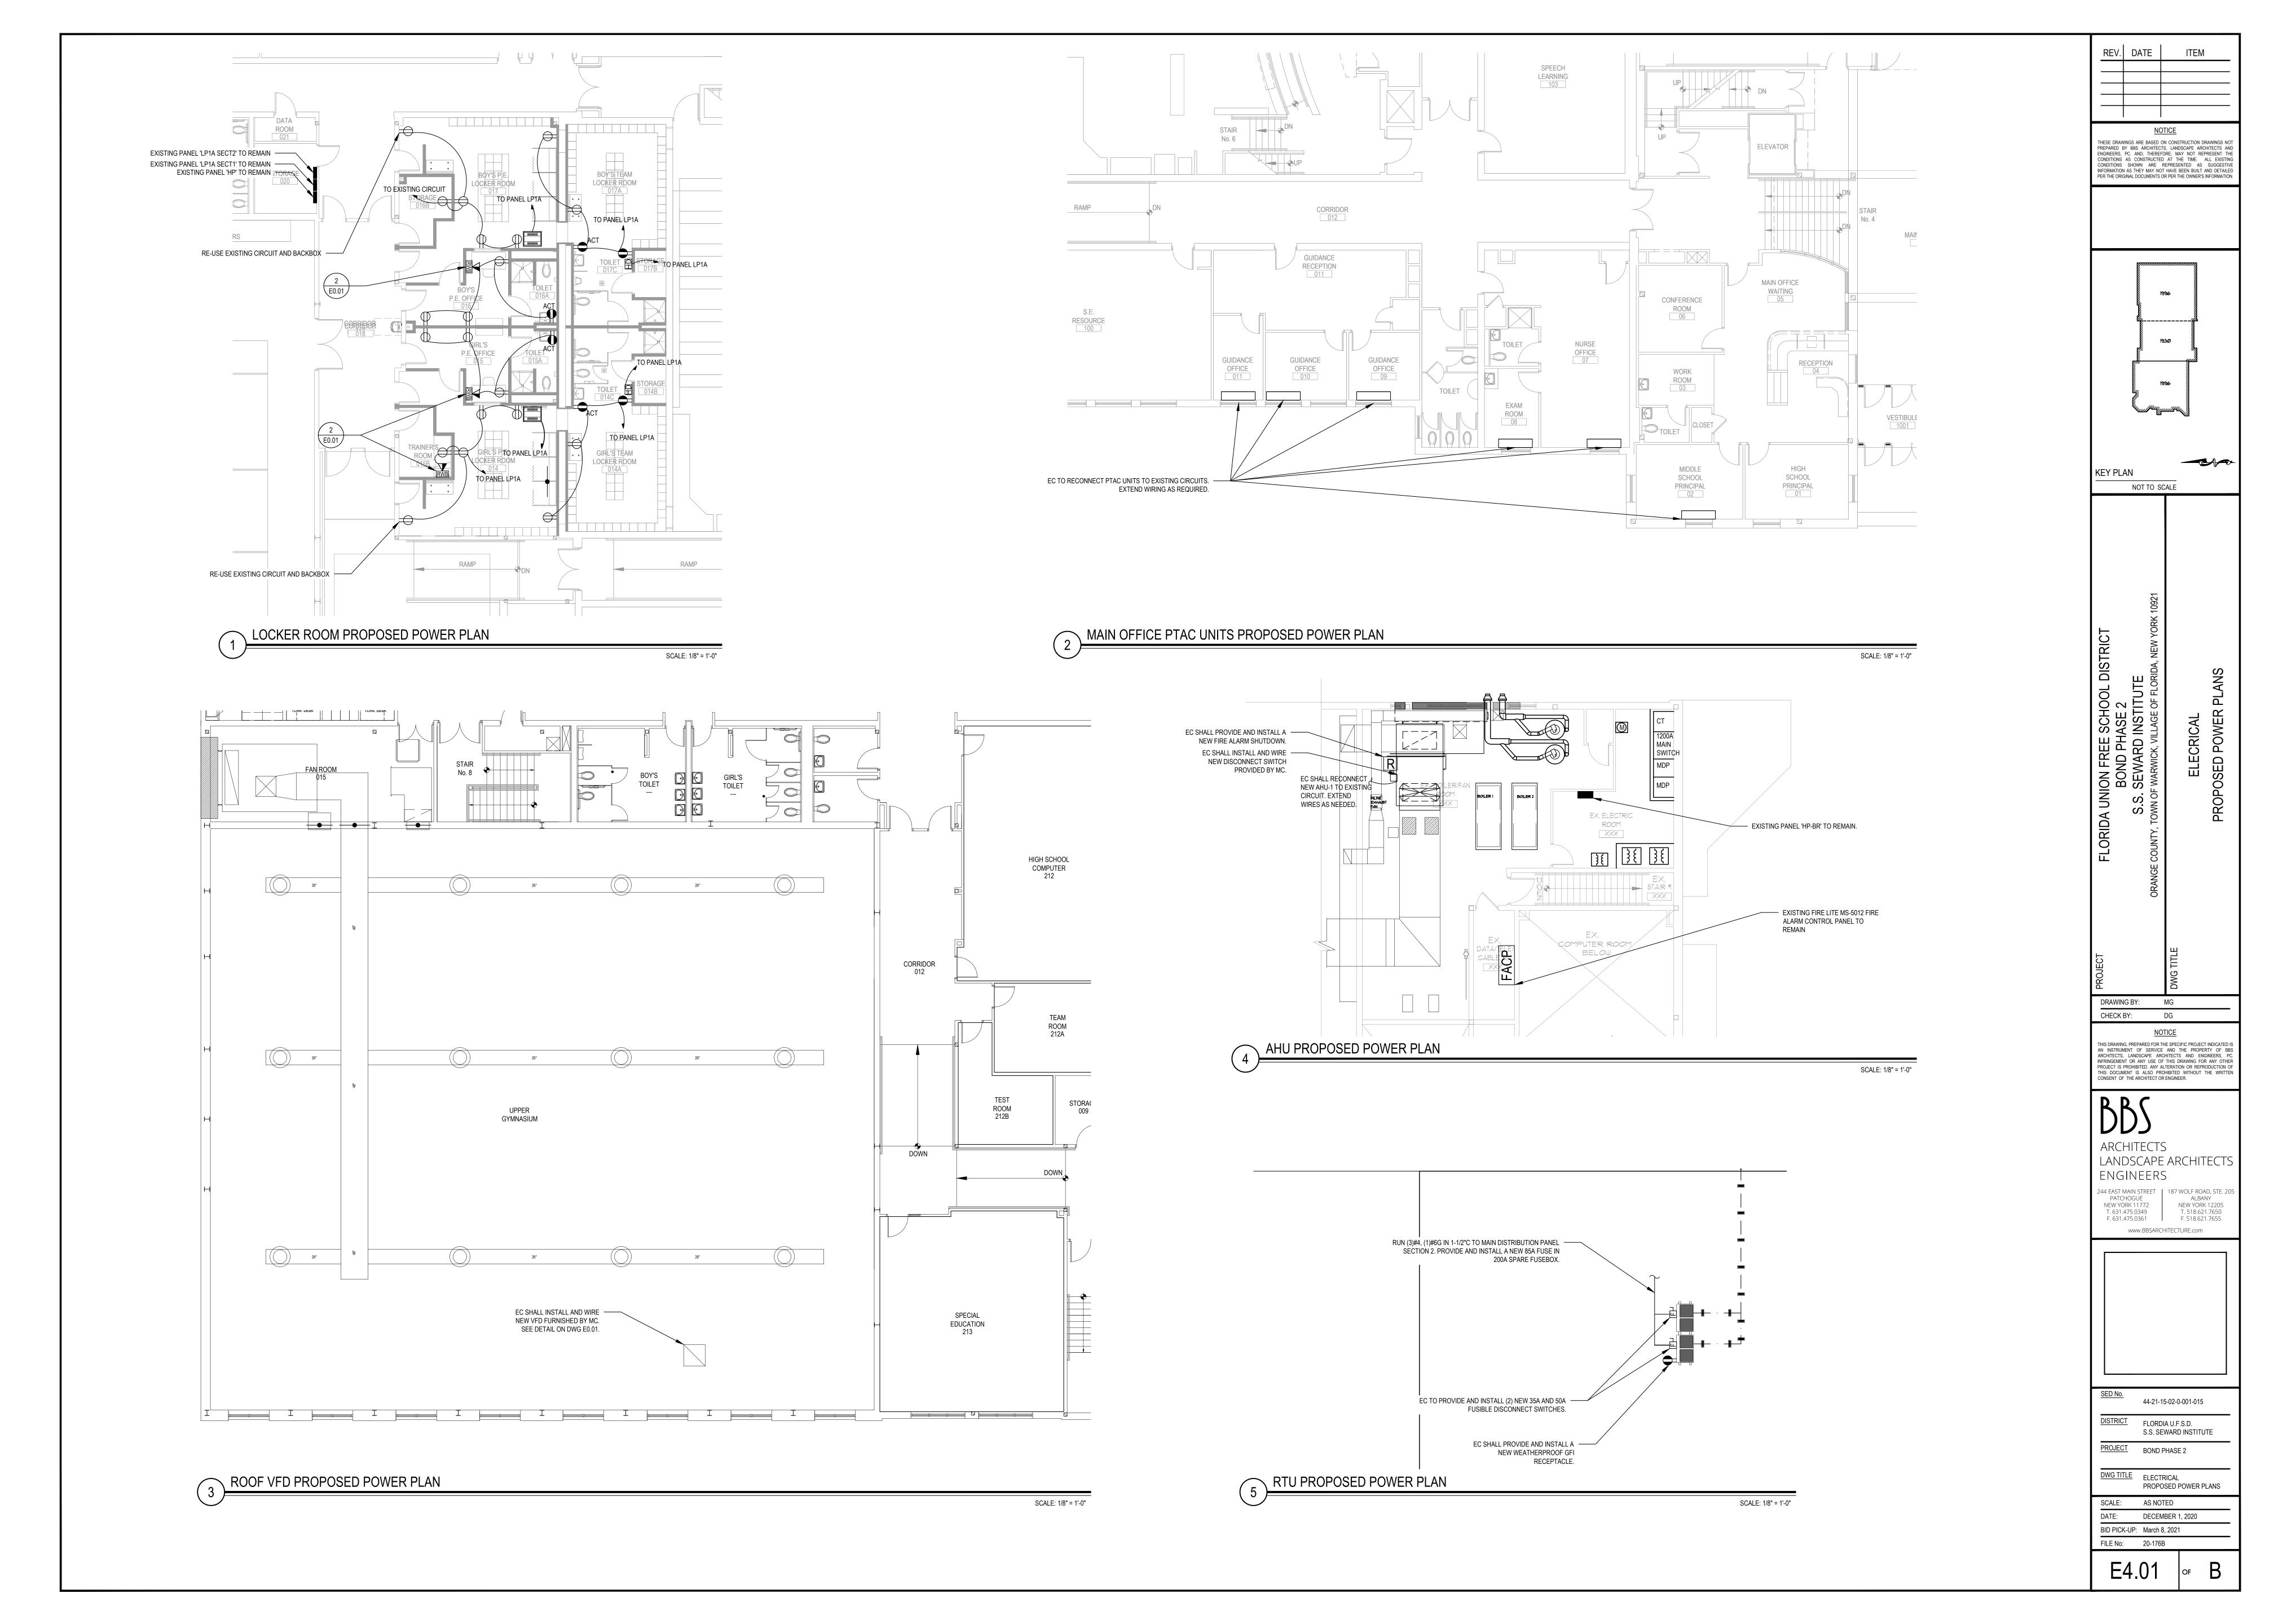

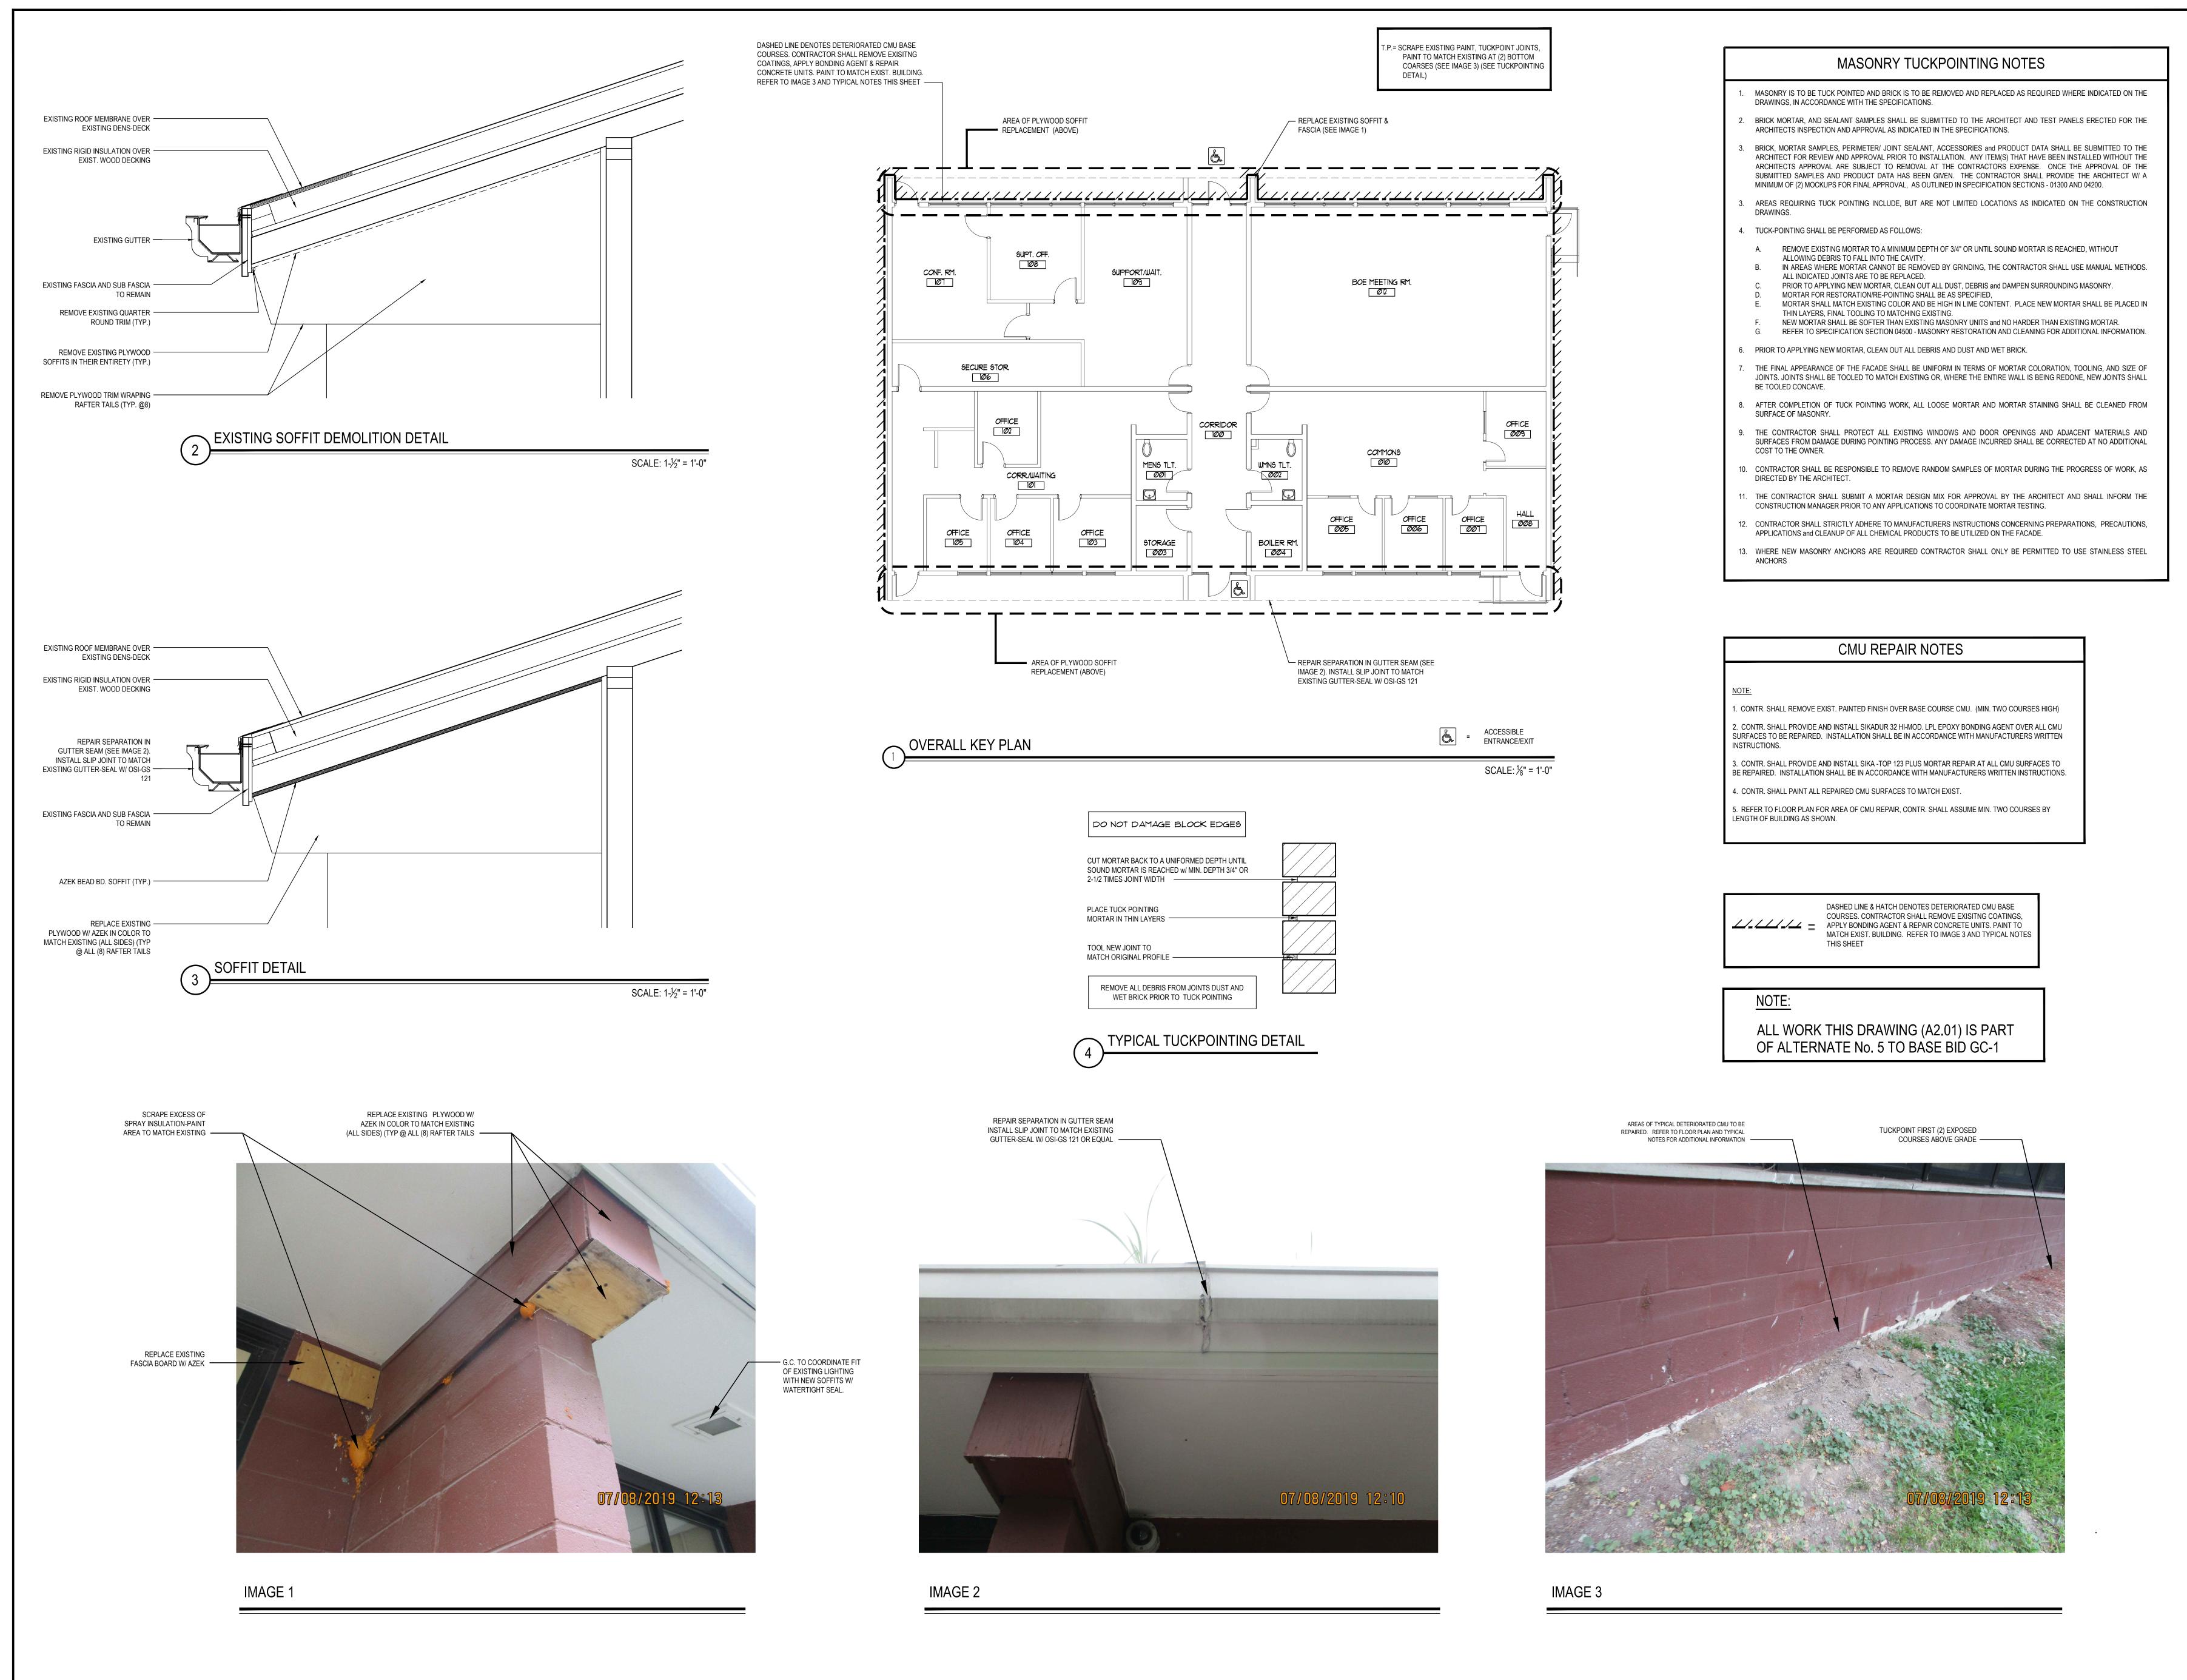

REV. DATE ITEM

NOTICE

THESE DRAWINGS ARE BASED ON CONSTRUCTION DRAWINGS NOT PREPARED BY BBS ARCHITECTS, LANDSCAPE ARCHITECTS AND ENGINEERS, PC. AND, THEREFORE, MAY NOT REPRESENT THE CONDITIONS AS CONSTRUCTED AT THE TIME. ALL EXISTING CONDITIONS SHOWN ARE REPRESENTED AS SUGGESTIVE INFORMATION AS THEY MAY NOT HAVE BEEN BUILT AND DETAILED PER THE ORIGINAL DOCUMENTS OR PER THE OWNER'S INFORMATION

NOT TO SCALE

KEY PLAN

S.S. SEWARD MEMORIAL

ORANGE COUNTY, TOWN OF WARWICK, VILLAGE OF FLORIDA, NEW YORK 10921

PROJECT IS PROHIBITED. ANY ALTERATION OR REPRODUCTION OF THIS DOCUMENT IS ALSO PROHIBITED WITHOUT THE WRITTEN CONSENT OF THE ARCHITECT OR ENGINEER.

CHECK BY:

LANDSCAPE ARCHITECTS
ENGINEERS

244 EAST MAIN STREET | 187 WOLF ROAD, STE. 201
PATCHOGUE | ALBANY

NEW YORK 12205

THIS DRAWING, PREPARED FOR THE SPECIFIC PROJECT INDICATED IS AN INSTRUMENT OF SERVICE AND THE PROPERTY OF BBS ARCHITECTS, LANDSCAPE ARCHITECTS AND ENGINEERS, PC. INFRINGEMENT OR ANY USE OF THIS DRAWING FOR ANY OTHER

T. 631.475.0349 T. 518.621.7650 F. 631.475.0361 F. 518.621.7655 www.BBSARCHITECTURE.com

NEW YORK 11772

44-21-15-02-0-004-010

DISTRICT FLORIDA U.F.S.D.
S.S. SEWARD MEMORIAL

PROJECT BOND PHASE 2

DWG TITLE OVERALL KEY PLAN DETAILS and NOTES


SCALE: AS NOTED

DATE: DECEMBER 1, 2020

BID PICK-UP: March 15, 2021

FILE No: 20-176C

A2.01 10F -

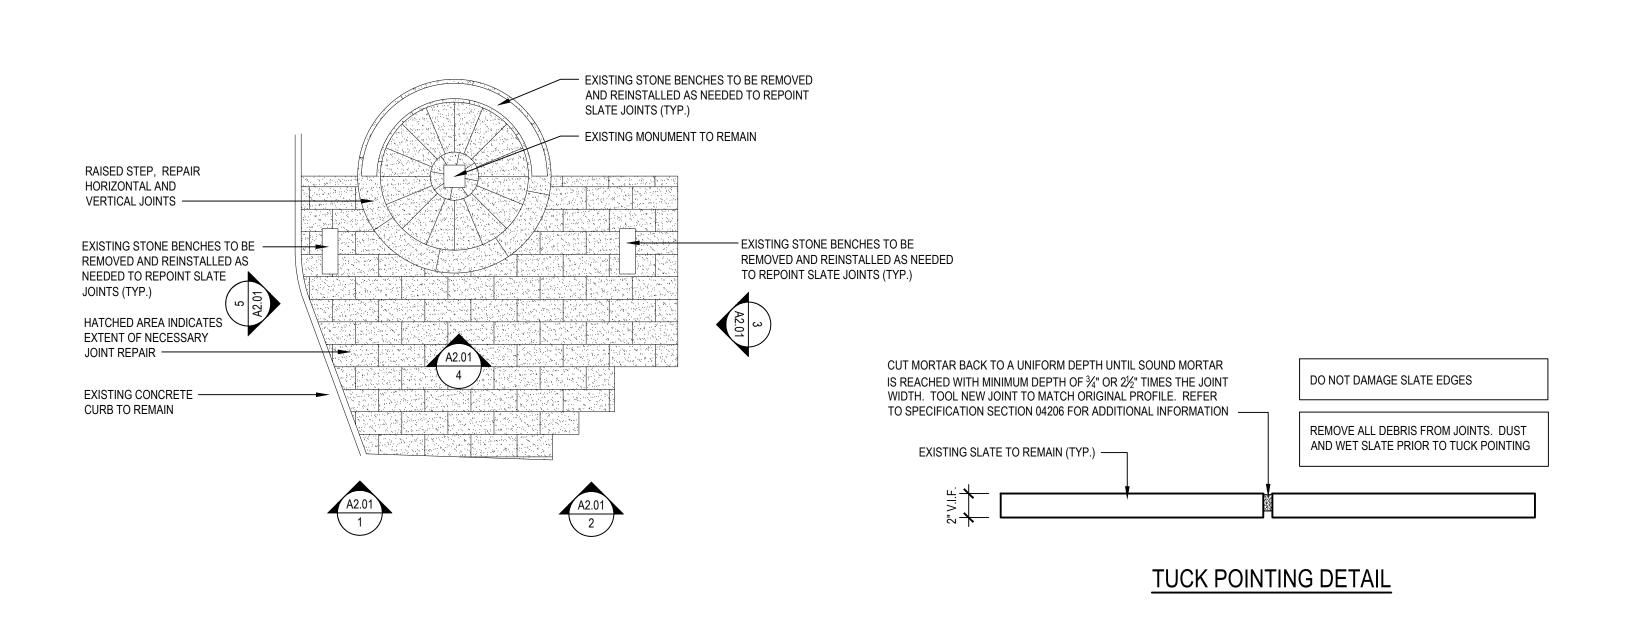

FLORIDA UFSD ADMIN. BUILDING HENRY SEWARD MONUMENT CONCRETRE WALK NORTH MAIN STREET (N.Y.S. RTE. 17A) SITE KEY PLAN

GENERAL CONSTRUCTION NOTES:

- 1. GENERAL CONTRACTOR SHALL VERIFY ALL EXISTING CONDITIONS PRIOR TO BIDDING & PROCEEDING WITH WORK. NOTIFY ARCHITECT OF ANY DISCREPANCIES IN WRITING PRIOR TO START OF WORK.
- 2. IN ACCORDANCE WITH STATE AND LOCAL CODES, THE REQUIRED EXITS IN THE EXISTING BUILDING MUST BE KEPT CLEAR, MAINTAINED AND PROTECTED DURING THE CONSTRUCTION
- 3. CONTRACTOR SHALL BE RESPONSIBLE FOR VERIFICATION OF ALL DIMENSIONS REQUIRED
- 4. ALL WORK AND MATERIAL OF THIS PROJECT AND ADJACENT SURFACES SHALL BE PROTECTED FROM DAMAGE. IN THE EVENT OF DAMAGE, THE CONTRACTOR SHALL IMMEDIATELY MAKE ALL REPAIRS AND REPLACEMENT NECESSARY TO THE APPROVAL OF THE ARCHITECT AND OWNER AND AT NO ADDITIONAL COST TO OWNER.
- 5. CONTRACTOR SHALL PROTECT ALL AREAS OF WORK FROM INCLEMENT WEATHER DURING AND AT THE END OF DAILY WORK OPERATIONS.
- 6. ALL PROJECT WASTE MATERIAL AND RUBBISH SHALL BE DISPOSED IN CONTAINERS PROVIDED BY THE CONTRACTOR FOR SUBSEQUENT LEGAL OFF-SITE DISPOSAL. CONTAINER LOCATION TO BE COORDINATED WITH THE OWNER & CONSTRUCTION MANAGER. OFF-SITE DISPOSAL TO BE ON A REGULAR BASIS.
- 7. ALL INTERIOR SURFACES DISTURBED DURING CONSTRUCTION SHALL BE REPAIRED AND/OR REPLACED TO MATCH EXISTING CONDITIONS TO THE APPROVAL OF THE ARCHITECT AND
- 8. ALL DEBRIS, DUST AND DIRT CAUSED BY WORK OF THIS CONTRACT SHALL BE REMOVED FROM SITE BY APPROPRIATE MEANS. RESTORE ALL CONDITIONS TO THE STATE OF CLEANLINESS THAT EXISTED PRIOR TO COMMENCEMENT OF WORK.
- 9. ALL DEMOLITION AND CONSTRUCTION WORK TO BE PERFORMED WITHOUT INTERRUPTION OF OWNER OPERATIONS. IF INTERRUPTION IS NECESSARY, WORK MUST NOT PROCEED UNTIL WRITTEN APPROVAL HAS BEEN OBTAINED FROM OWNER.
- 10. ALL CONTRACTORS ARE TO COORDINATE INSTALLATION OF THEIR WORK WITH EACH OTHER AND WITH THE WORK BEING PERFORMED UNDER SEPARATE CONTRACTS BY OTHERS.

FOR ESTIMATING.


ALL WORK THIS DRAWING (A2.02) IS PART OF ALTERNATE # 6 TO BASE BID GC-1



SEWARD MEMORIAL JOINT REPAIR PLAN






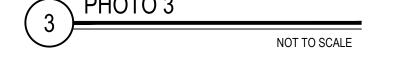



SCALE: ½" = 1'-0"

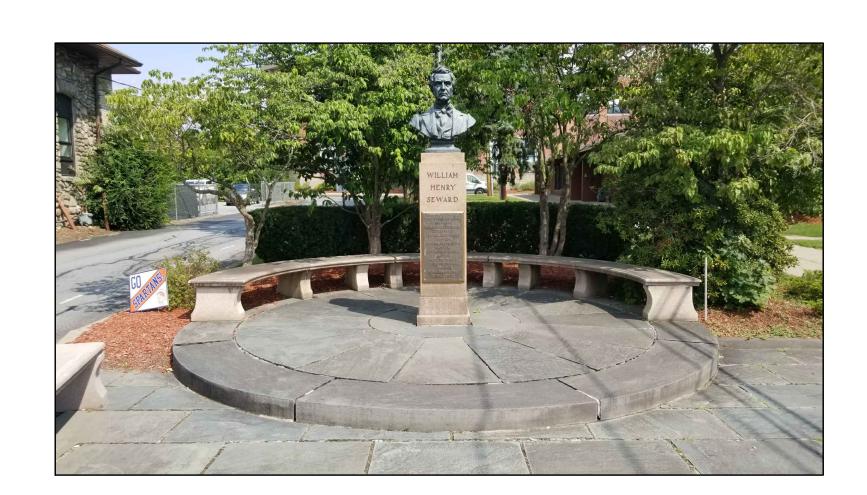





SCALE: NOT TO SCALE

PHOTO 5 NOT TO SCALE KEY PLAN NOT TO SCALE

REV. DATE

<u>NOTICE</u>

THESE DRAWINGS ARE BASED ON CONSTRUCTION DRAWINGS NOT PREPARED BY BBS ARCHITECTS, LANDSCAPE ARCHITECTS AND ENGINEERS, PC. AND, THEREFORE, MAY NOT REPRESENT THE

ENGINEERS, PC. AND, THEREFORE, MAY NOT REPRESENT THE CONDITIONS AS CONSTRUCTED AT THE TIME. ALL EXISTING CONDITIONS SHOWN ARE REPRESENTED AS SUGGESTIVE INFORMATION AS THEY MAY NOT HAVE BEEN BUILT AND DETAILED PER THE ORIGINAL DOCUMENTS OR PER THE OWNER'S INFORMATION.

ARCHITECTS

LANDSCAPE ARCHITECTS ENGINEERS 187 WOLF ROAD, STE. 20: ALBANY NEW YORK 12205 T. 518.621.7650 F. 518.621.7655

www.BBSARCHITECTURE.com

44-21-15-02-0-004-010 DISTRICT FLORIDA U.F.S.D. S.S. SEWARD MEMORIAL PROJECT BOND PHASE 2

DWG TITLE SEWARD MEMORIAL PLAN SITE KEY PLAN, PHOTOS SCALE: AS NOTED

BID PICK-UP: March 8, 2021

A2.02