



CEILING PLAN LEGEND			
2' X 4' RECESSED LIGHT FIXTURE SEE ELECTRICAL DRAWINGS FOR ADDITIONAL INFORMATION		SUPPLY AIR DIFFUSER SEE MECHANICAL PLANS FOR ADDITIONAL INFORMATION	
8' SURFACE MOUNTED LIGHT FIXTURE SEE ELECTRICAL DRAWINGS FOR ADDITIONAL INFORMATION		RETURN AIR DIFFUSER SEE MECHANICAL PLANS FOR ADDITIONAL INFORMATION	
4' SURFACE MOUNTED LIGHT FIXTURE SEE ELECTRICAL DRAWINGS FOR ADDITIONAL INFORMATION		EXHAUST FAN SEE MECHANICAL PLANS FOR ADDITIONAL INFORMATION	
EXTERIOR WALL MOUNTED LIGHT FIXTURE SEE ELECTRICAL DRAWINGS FOR ADDITIONAL INFORMATION		ELECTRIC UNIT HEATER SEE MECHANICAL PLANS FOR ADDITIONAL INFORMATION	
EXTERIOR SURFACE MOUNTED LIGHT FIXTURE SEE ELECTRICAL DRAWINGS FOR ADDITIONAL INFORMATION			


CEILING PLAN GENERAL NOTES	
1. REFER TO GENERAL NOTES OF SHEET A0.2 FOR ADDITIONAL INFORMATION. 2. HFT G.C. TO VISIT SITE AND VERIFY EXISTING CONDITIONS PRIOR TO SUBMITTING PROPOSALS AND COMMENCING WORK. 3. HFT G.C. TO NOTIFY HFT PROJECT MANAGER IMMEDIATELY AFTER DEMOLITION OR START OF CONSTRUCTION, IF PROPOSED CEILING HEIGHTS & MECHANICAL REQUIREMENTS CAN NOT BE ACHIEVED FOR ANY REASON. 4. HFT G.C. IS RESPONSIBLE FOR PATCHING & REPAIRING ALL FIREPROOFING AS REQUIRED DUE TO PRIOR TENANT CONSTRUCTION AND DUE TO ANY NEW DEMOLITION OR NEW CONSTRUCTION TO MEET BOTH LANDLORD AND BUILDING DEPARTMENT REQUIREMENTS. 5. HFT G.C. TO PROVIDE CEILING ACCESS PANELS AS REQUIRED TO ACCOMMODATE ELECTRICAL, PLUMBING, SPRINKLER AND/OR MECHANICAL SERVICES THAT PASS THROUGH THE LEASED PREMISES, IE., J-BOXES, DUCT SMOKE DETECTORS, FIRE DAMPERS, FLOW SWITCHES, UTILITY CONNECTION POINTS, ETC. 6. SUSPENSION WIRES SHALL BE INSTALLED WITH A MAXIMUM SPACING OF 48" O.C. 7. ALL LAY-IN CEILING GRIDS SHALL BE CENTERED IN ROOM U.N.O. 8. SEE FP1.0 FOR SPRINKLER INFORMATION.	
500 SERIES CEILING PLAN KEY NOTES	
500. APPROXIMATE LOCATION OF HFT LEASE LINE. 501. 2' X 4' SUSPENDED CEILING SYSTEM INSTALLED PER MANUFACTURERS SPECIFICATIONS. SEE FINISH SCHEDULE ON A1.3 FOR ADDITIONAL INFORMATION. CEILING TO BE CENTERED IN ROOM U.N.O. 502. APPROXIMATE LOCATION OF NEW HVAC ROOFTOP UNIT. G.C. TO CONTRACT WITH LANDLORD ROOFING CONTRACTOR TO MAINTAIN ALL ROOFING WARRANTIES. REFER TO DETAIL 1/A2.0, STRUCTURAL, AND MECHANICAL DRAWINGS. 503. RE-WORK EXISTING SPRINKLER SYSTEM TO WORK WITH ROOM LAYOUT. SEE FP1.0 FOR ADDITIONAL INFORMATION. 504. EXPOSED STRUCTURE. REMOVE ANY UNUSED EQUIPMENT, WIRES, HANGERS, ETC. FROM STRUCTURE AREA. PAINT ENTIRE STRUCTURE PER FINISH SCHEDULE ON SHEET A1.3. 505. NEW LIGHT FIXTURES THROUGHOUT ENTIRE HFT SPACE, UNLESS NOTED OTHERWISE. SEE ELECTRICAL DRAWINGS FOR ADDITIONAL INFORMATION. 506. SUPPLY AND RETURN AIR DIFFUSERS OCCUR AT ROOM LOCATIONS. SEE MECHANICAL DRAWINGS FOR ADDITIONAL INFORMATION. 507. MOUNT OX-BLUE CAMERAS PER DETAIL 2 THIS SHEET. 12'-0" FROM THE CORNERS OF THE SPACE AT 45° ACROSS THE SALES AND STOCK AREAS. CAMERAS ARE TO BE MOUNTED AT OPPOSITE CORNERS OF THE SPACE. COORDINATE WITH HFT PM FOR FINAL QUANTITIES AND LOCATIONS. 508. WALL MOUNTED EXTERIOR LIGHT FIXTURE. SEE ELECTRICAL DRAWINGS FOR ADDITIONAL INFORMATION. 509. LINE OF EXISTING CANOPY. SEE SHEET A3.0 FOR ADDITIONAL INFORMATION. 510. OVERHEAD COIL-UP DOOR HOUSING. SEE SHEET A5.0 FOR ADDITIONAL INFORMATION. 511. EXISTING ROOF HATCH. SEE SHEET A1.1 FOR ADDITIONAL INFORMATION. 512. GYPSUM BOARD SHELF AT 8'-0" A.F.F. TO BE PAINTED. SEE SHEET A1.3 AND DETAIL 1/A4.1 FOR ADDITIONAL INFORMATION. 513. ELECTRIC UNIT HEATER CABINET. SEE MECHANICAL DRAWINGS FOR ADDITIONAL INFORMATION. 514. EXISTING DUNNAGE TO BE ABANDONED IN PLACE. SEE MECHANICAL DRAWINGS FOR ADDITIONAL INFORMATION. 515. STEEL LINTEL. SEE STRUCTURAL DRAWINGS FOR ADDITIONAL INFORMATION. 516. GAS UNIT HEATER. SEE MECHANICAL DRAWINGS FOR ADDITIONAL INFORMATION. 517. APPROXIMATE LOCATION OF DUCTWORK. SEE MECHANICAL DRAWINGS FOR ADDITIONAL INFORMATION. 518. EXISTING CANOPY LIGHT FIXTURES TO REMAIN. SEE ELECTRICAL DRAWINGS FOR ADDITIONAL INFORMATION. 519. G.C. TO TIE BACK SUSPENDED CEILING SYSTEM TO NEW DEMISING WALL ON ALS SIDE. PATCH, REPAIR AND/OR REPLACE TILES TO MATCH EXISTING AS REQUIRED.	

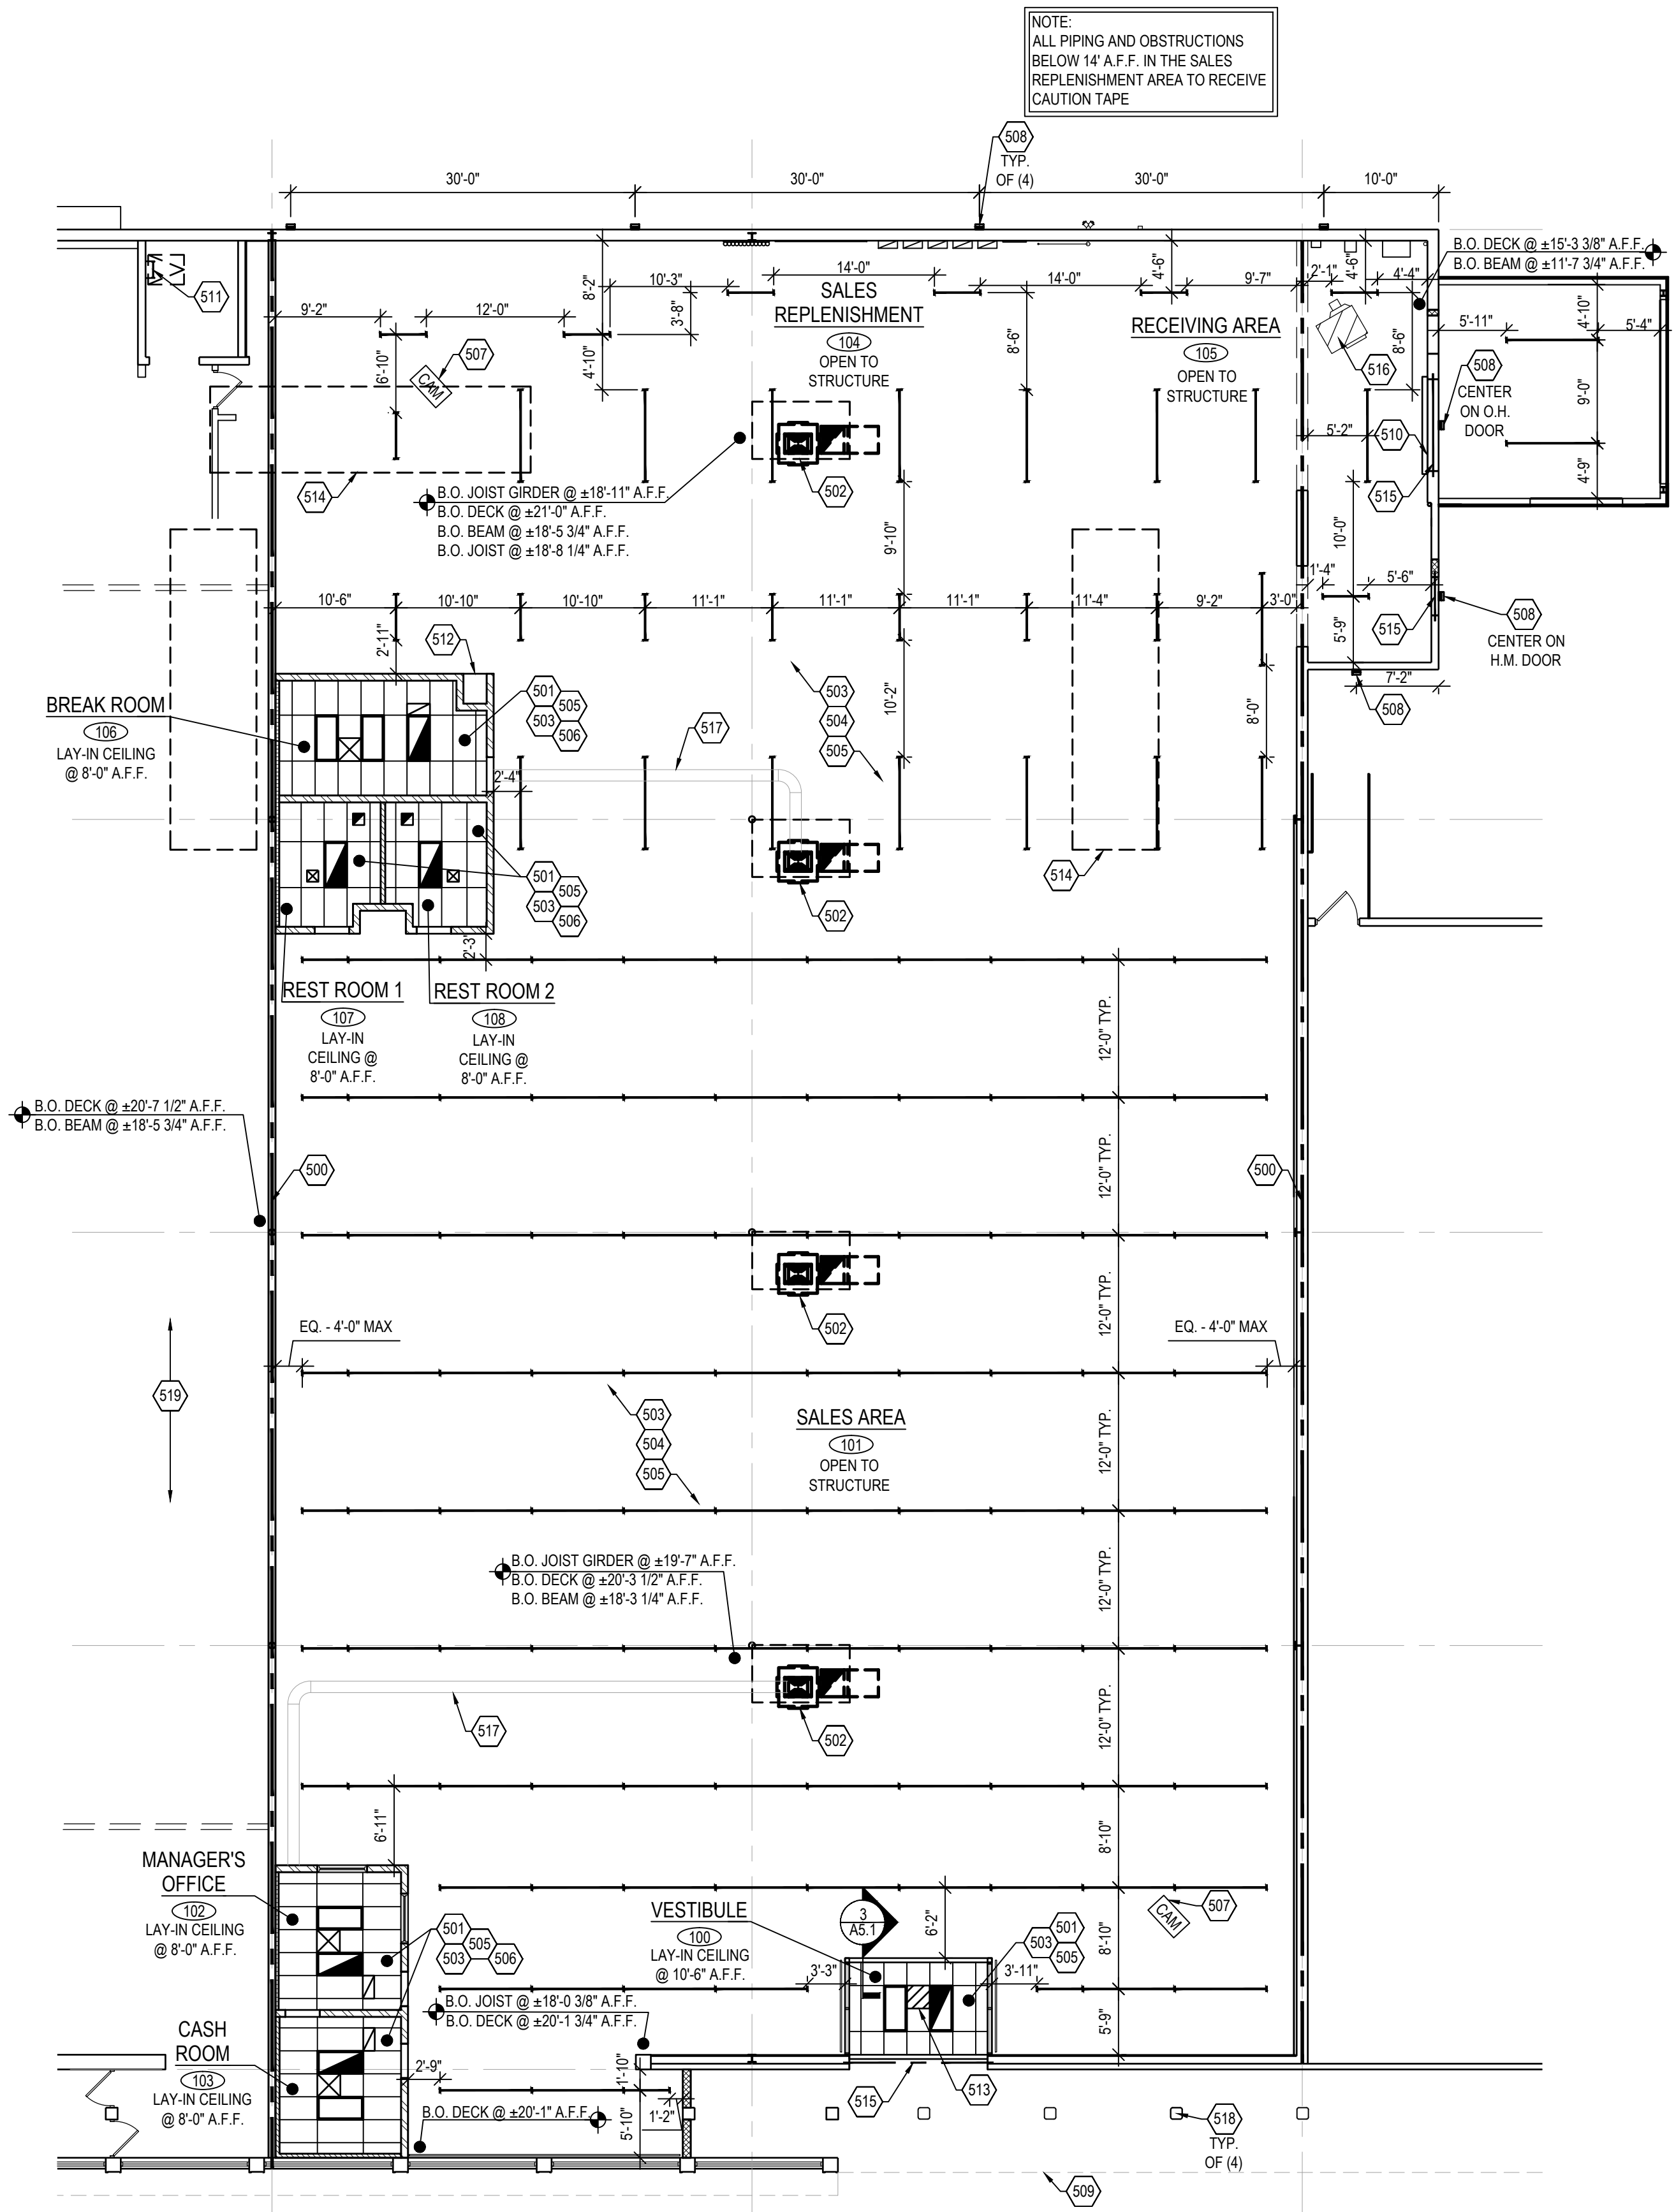

REFLECTED CEILING PLAN
SCALE 3/32" = 1'-0"

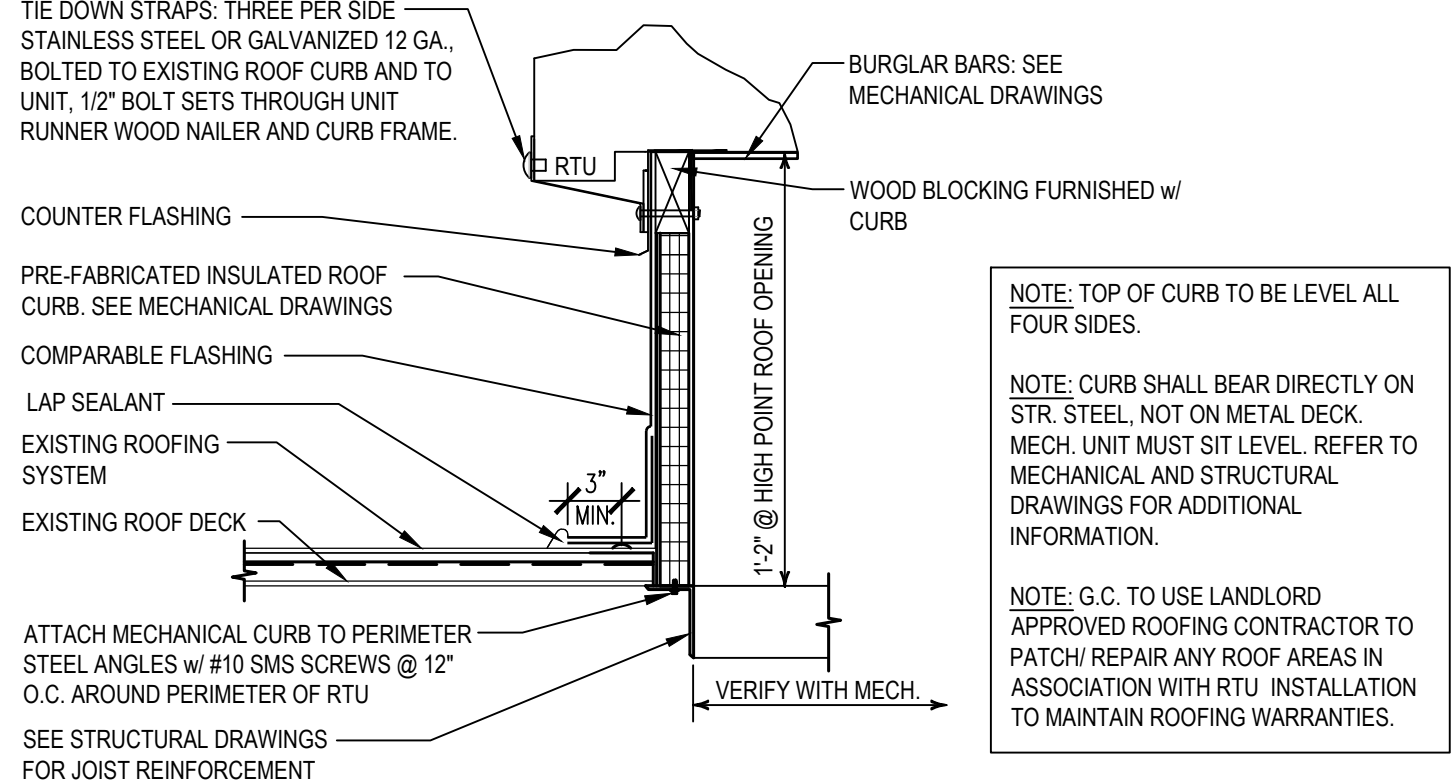

MECHANICAL ROOF CURB DETAIL
SCALE: 3/4" = 1'-0"

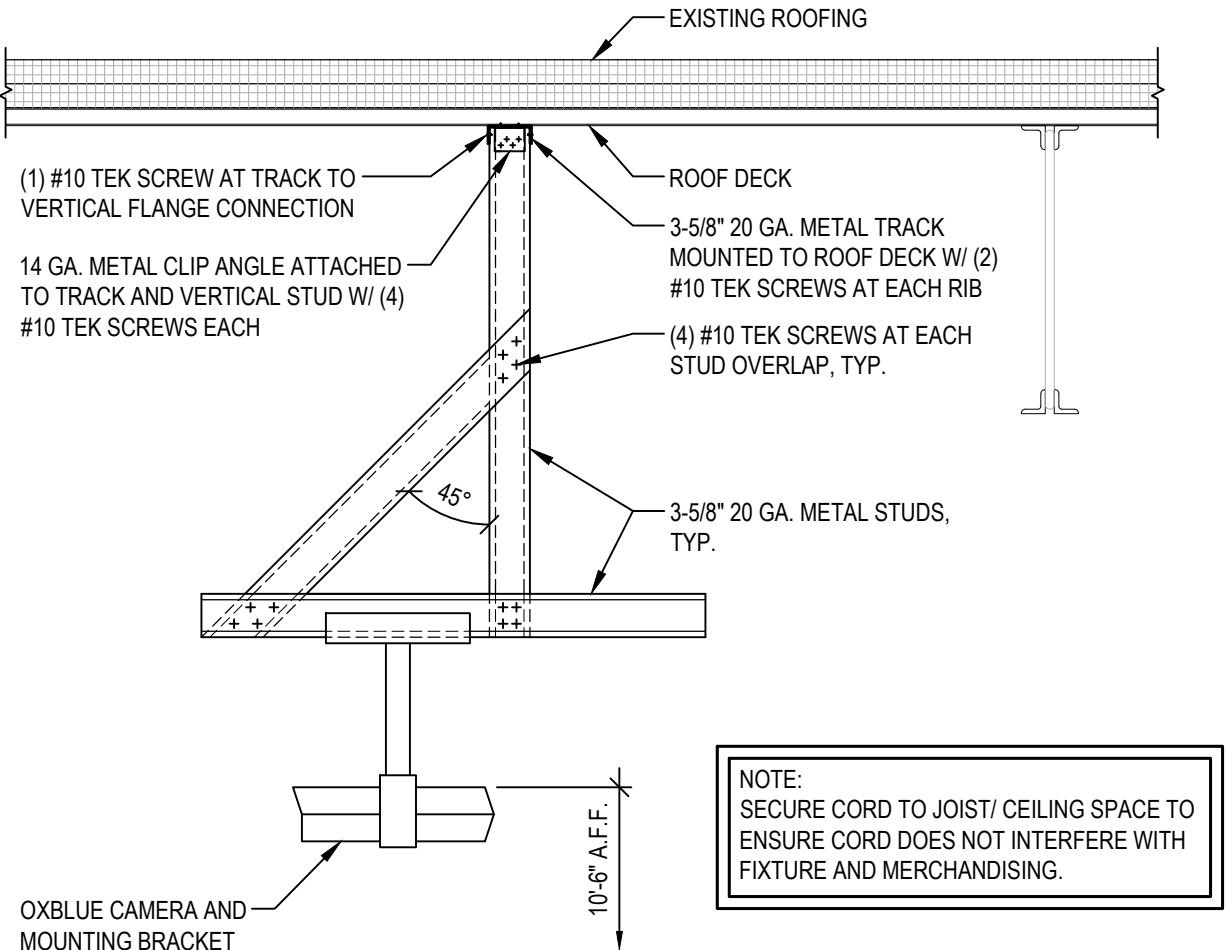

OXBLUE MOUNTING DETAIL
SCALE: 3/4" = 1'-0"

DO NOT SCALE THESE DRAWINGS

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REVISIONS	
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REFLECTED CEILING PLAN

DATE 9/22/21
JOB NO. 20420

A2.0
SHEET NO.