

## **Addendum**

Cornell Business + Technology Park 10 Brown Road Ithaca, New York 14850 Tel. (607) 277-7100 Fax (607) 277-1410

Mahopac Central School District Mahopac, New York

Reconstruction at Mahopac High School Mahopac Middle School Mahopac Falls School Bus Garage New Pump House

Tt Project No. 121111-19002

SED NO. 48-01-01-06-0-004-020 48-01-01-06-0-006-013 48-01-01-06-0-003-008 48-01-01-06-5-010-009 48-01-01-06-7-026-001

BID Addendum No. 4 to Drawings and Project Manual

March 1, 2021

To: BIDDERS

This ADDENDUM forms a part of the BIDDING AND CONTRACT DOCUMENTS and modifies the following documents: Original DRAWINGS dated August 21, 2020.

PROJECT MANUAL dated August 21, 2020, BID ADDENDUM NO. 1, dated February 12, 2021, BID ADDENDUM NO. 2, dated February 16, 2021 and BID ADDENDUM NO. 3, dated February 22, 2021.

Acknowledge receipt of the ADDENDUM in the space provided on the FORM OF PROPOSAL

This ADDENDUM consists of (9) pages and the following:

### **ATTACHMENTS**

PRE-BID REQUEST FOR INFORMATION QUESTIONS/ANSWERS

## **NEW PROJECT MANUAL SECTIONS**

SECTION 01 12 00 – SUMMARY OF PROJECT - HS SITE LOGISTICS PLAN ATTACHMENT SECTION 01 12 00 – SUMMARY OF PROJECT - MS SITE LOGISTICS PLAN ATTACHMENT SECTION 26 08 00 – COMMISSIONING OF ELECTRICAL

### **NEW DRAWINGS (8-1/2 x 11)**

AC01B Trench Drain - Section

### **REISSUED DRAWINGS (30 x 42)**

AE132 Second Floor Lighting Plan

AE600 Schedules ZC505 Site Details

## **PROJECT MANUAL MODIFICATIONS**

ITEM 4-C-1: Refer to SECTION 00 01 10 - TABLE OF CONTENTS – VOLUME 2

1. Division 26, <u>ADD</u> the following:

"26 08 00 Commissioning of Electrical"

## ITEM 4-C-2: Refer to SECTION 01 08 00 - GENERAL COMMISSIONING REQUIREMENTS

1. Part 3, <u>ADD</u> the following:

#### "3.11 STANDARD AND CORE COMPLIANCE

- A. Commissioning will be accomplished to comply with, and in accordance with the requirements of the following:
  - 1. New York State Energy Conservation Code (NYSECC)

### 3.12 SYSTEMS TO BE COMMISSIONED

- A. The following systems will be commissioned in this project. The Owner and the CxA reserves the right to amend this list at any time during the construction and acceptance process.
  - 1. HVAC Systems
  - 2. Direct Digital Control System
  - 3. Air Handling Systems
  - 4. Dedicated Outside Air System
  - 5. Direct Expansion Evaporators and associated Condensing Units
  - 6. Exhaust System and Fans
  - 7. Ducted Air Systems
  - 8. Roof Top Units
  - 9. Unit Ventilators
  - 10. Cabinet Unit Heaters
  - 11. Fan Coil Units
  - 12. Vehicle Exhaust System
  - 13. Make Up Air Units
  - 14. Variable Refrigerant Flow System
  - 15. Lighting Controls".

### ITEM 4-C-3: Refer to SECTION 01 12 00 – SUMMARY OF PROJECT

1. <u>ADD</u> HS Site Logistic and MS Site Logistics attached to this addendum to end of section.

#### PROJECT MANUAL MODIFICATIONS - ARCHITECTURAL

### ITEM 4-C-4: Refer to SECTION 08 56 53 – SLIDING SECURITY WINDOWS

- 1. Paragraph 2.2, F., 1., <u>AMEND</u> to read as follows:
  - "1. Type SCL: Clear laminated-glass security glazing:
    - a. Basis-of-Design Product: Subject to compliance with requirements, provide Laminated Technologies Inc.; SG5 by School Guard Glass, or comparable product.
    - b. Safety glazing required."

## ITEM 4-C-5: Refer to SECTION 08 71 00 – DOOR HARDWARE

- 1. Paragraph 1.6, <u>ADD</u> the following:
  - "D. Fire Rated Hardware Coordination: For doors and openings that are fire rated and require specific hardware to maintain fire ratings when tested as a component of the rated opening, provide submittals for the specific hardware items that are required to maintain the fire ratings indicated."

#### ITEM 4-C-6: Refer to SECTION 08 88 00 – GLAZING

- 1. Paragraph 2.4, <u>ADD</u> the following:
  - "C. Laminated Glass: ASTM C1172. Use materials that have a proven record of no tendency to bubble, discolor, or lose physical and mechanical properties after fabrication and installation.
    - 1. Construction: Laminate glass with polyvinyl butyral interlayer to comply with interlayer manufacturer's written instructions.
    - 2. Interlayer Thickness: Provide thickness not less than 0.060 inch and as needed to comply with requirements.
    - 3. Interlayer Color: Translucent provide samples for selection.
    - 4. Appearance: Provide laminated glass without haze and with visual clarity and transparency indistinguishable from clear fully tempered float glass.
    - 5. Type HCL: Two plies of clear heat-strengthened float glass laminated.
      - a. Manufacturers: Subject to compliance with requirements, available manufacturers offering products that may be incorporated in the Work include, but are not limited to:
        - 1) AGC Glass Company North America, Inc.
        - 2) Guardian Glass, LLC.
        - 3) Vitro Architectural Glass.
      - b. Minimum Thickness of Each Ply: 3 mm.
      - c. Safety glazing required."

- 2. Paragraph 2.5, <u>ADD</u> the following:
  - "D. Fire-Protection-Rated Laminated Ceramic Glazing: Laminated glass made from two plies of clear, ceramic glass; complying with 16 CFR 1201, Category II.
    - 1. Type FPC: Fire-protection-rated laminated ceramic glazing.
      - a. Products: Subject to compliance with requirements, available products that may be incorporated in the Work include, but are not limited to:
        - 1) Safti First Fire Rated Glazing Solutions; Pyran Platinum L.
        - 2) Technical Glass Products; FireLite Plus.
      - b. Rating: As indicated on Drawings.
      - c. Thickness: 8-9 mm.
      - d. Safety glazing required."
- 3. Paragraph 2.6, B., 1., a., 1), <u>AMEND</u> to read as follows:
  - "1) Technical Glass Products, Pilkington Pyrostop (clear or translucent intumescent interlayer where indicated on drawings)."
- 4. Paragraph 2.6, B., 1., e., <u>AMEND</u> to read as follows:
  - "e. Refer to drawings for locations of clear vs. translucent intumescent interlayer."

### **PROJECT MANUAL MODIFICATIONS - LANDSCAPE**

ITEM 4-C-7: Refer to SECTION 33 41 00 – STORM UTILITY DRAINAGE PIPING

- 1. Paragraph 2.11, A., 5., <u>AMEND</u> to read as follows:
  - "5. Basis of Design:
    - a. For 24" Clear Openings Similar to Frame "Model #V5626 and Grate "Type M3 ADA Grate" V5726-80 by East Jordan Iron Works, Inc.
    - b. For 30" Clear Openings Similar to Frame "Model #V5630 and Grate "Type M3 ADA Grate" V5630-80 by East Jordan Iron Works, Inc."
- 2. Paragraph 2.12, A., 1., <u>AMEND</u> to read as follows:
  - "... provide SC-740 and MC-3500 chamber system ..."
- 3. Paragraph 2.12, A., 2., <u>ADD</u> the following:
  - "a. Chamber dimensions and capacity:
    - 1) Small Chamber
      - a) Installed Size (L x W x H): 85.4" x 51.0" x 30.0"
      - b) Storage volume: 45.9 ft<sup>3</sup> (chamber alone)
      - c) Storage volume: 74.9 ft<sup>3</sup> (with 6" stone base)

- b. Chamber dimensions and capacity:
  - 1) Large Chamber
    - a) Installed Size (L x W x H): 86.0" x 77.0" x 45.0"
    - b) Storage volume: 109.9 ft<sup>3</sup> (chamber alone)
    - c) Storage volume: 178.9 ft<sup>3</sup> (with 9" stone base)."
- 4. Paragraph 2.14, A., ADD the following:
  - "4. Outlet Structure Frame and Cover Basis of Design Clear round opening size: 32", Similar to Frame "Model #V1610-6 and Cover "V1610-4" by East Jordan Iron Works, Inc.

## **DRAWING MODIFICATIONS - ARCHITECTURAL**

### ITEM 4-C-8: Refer to DRAWING AA100

1. Detail 5, STOR. 106D and SHOWER 106E Rooms, ADD the following note:

"ROOMS HAVE WALL TILE."

### ITEM 4-C-9: Refer to DRAWING AA104

1. Doors L101-2, L101-3 & L101-4, <u>AMEND</u> the plan to show 4" portions of Wall Type P13.3 between each of the doors in order to create 4 separate aluminum frame door openings instead of these 4 doors being contained within one frame unit.

### ITEM 4-C-10: Refer to DRAWING AA600

1. Storefront Type S1, <u>AMEND</u> the glass type to read as follows:

"SCL."

2. Storefront Type S1, <u>ADD</u> the following note:

"SLIDING SECURITY WINDOW."

3. Storefront Type S14 and S1, <u>AMEND</u> the glass type to read as follows:

"FC AND HCL."

- 4. Storefront Type S5, <u>AMEND</u> the Door to Type G2 in the elevation with the door glazing hatched gray.
- 5. Door Schedule, AMEND Doors L101-1, L101-2, L101-3 & L101-4 to each have Frame Type F2.
- 6. Door Schedule, AMEND Doors L101-1, L101-2, L101-3 & L101-4 to each be Door Type G2.
- 7. Door Schedule, <u>AMEND</u> Doors 235-1, 238-1, 239-1, 242-1, 243-1 and 244-1 to each be Door Type G2.
- 8. Note which reads, "GRAY HATCHED GLASS AREAS ARE ACID ETCHED GLASS", <u>AMEND</u> to read as follows:

"GRAY HATCHED GLASS AREAS CONTAIN A TRANSLUCENT INTERLAYER BETWEEN GLASS PLIES. REFER TO GLAZING SPEC FOR ADDITIONAL INFORMATION."

#### ITEM 4-C-11: Refer to DRAWING AA161

1. Detail 4, <u>ADD</u> Detail 17/AA750 keyed into the ceiling openings in rooms Science 234 and Physics 238. The detail applies to the entire perimeter of the ceiling openings. Lighting shown on electrical drawings will be surface mounted to the ceiling perimeter trim around the openings.

## **DRAWING MODIFICATIONS - LANDSCAPE**

### ITEM 4-C-12: Refer to DRAWING AC100

- 1. Keynote #3 indicated in sheet grid locations J-6 and J-8, <u>AMEND</u> to read as follows:
  - "Keynote #19."
- 2. Keynote #26 in sheet grid locations H-10 and I-10, <u>AMEND</u> to read as follows:
  - "Keynote #19."
- 3. Keynote Notes, <u>ADD</u> the following:
  - "45. REINSTALL EXISTING CHAIN LINK FENCE SECTION TEMPORARILY REMOVED AND STORED, TO ALLOW WATER LINK INSTALLATION WHERE INDICATED." <u>ADD</u> LABEL TO SHEET GRID LOCATION J-16 REFERENCING SECTION OF TEMPORARY FENCE REMOVAL INDICATED AS KEYNOTE 26 ON SHEET AC100."

## ITEM 4-C-13: Refer to DRAWING AC120

- 1. Detail 1, <u>AMEND</u> "PROPOSED WATER TANK" to read as follows:
  - "FACILITY GROUND-MOUNTED, POTABLE-WATER STORAGE TANK".
- 2. Detail 1, <u>AMEND</u> "PROPOSED BUILDING" to read as follows:
  - "PUMP HOUSE".
- 3. <u>DELETE</u> Site Layout Keynote #29 in its entirety. <u>DELETE</u> Site keynote labels #29 from drawing indicated at sheet grid locations G-5 and G-11.
- 4. <u>DELETE</u> Site Layout Keynote #30 in its entirety. <u>DELETE</u> Site keynote labels #30 from drawing indicated at sheet grid locations F-5 and F-11.
- 5. Site Layout Keynote #25, <u>ADD</u> the following text:
  - "TREE HEIGHT TO BE 6-8 FOOT SPECIMEN TREE. SHRUBS TO BE 2-GALLON CONTAINER SIZE."
- 6. Site Layout Keynote #26, <u>ADD</u> the following text:
  - "SHRUBS TO BE 2-GALLON CONTAINER SIZE."

7. Site Layout Keynote #33, <u>ADD</u> the following text:

"NOTE: COMPLY WITH THE LIMITS OF DISTURBANCE / RESEEDING REQUIREMENTS INDICTED ON THE DRAWINGS. REFER TO THE SPECIFIED EARTHWORK REQUIREMENTS REGARDING TOPSOIL STRIPING AND MATERIAL STOCKPILING. THE 6" TOPSOIL FOR THE SEEDING AREAS WOULD APPLY ONLY TO THOSE AREAS CLEARED AND DISTURBED FOR DEMO AND IMPROVEMENTS."

8. Site Layout Keynote #32, <u>AMEND</u> detail reference to read as follows:

"Detail 4 / ZC506".

- 9. Keynotes, ADD the following:
  - "45. REINSTALL EXISTING CHAIN LINK FENCE SECTION TEMPORARILY REMOVED AND STORED, TO ALLOW WATER LINK INSTALLATION WHERE INDICATED." <u>ADD</u> LABEL TO SHEET GRID LOCATION J-16 REFERENCING SECTION OF TEMPORARY FENCE REMOVAL INDICATED AS KEYNOTE 26 ON SHEET AC100."

### ITEM 4-C-14: Refer to DRAWING AC121

1. Detail 3, <u>AMEND</u> "PROPOSED WATER TANK" to read as follows:

"FACILITY GROUND-MOUNTED, POTABLE-WATER STORAGE TANK".

2. Detail 3, AMEND "PROPOSED BUILDING" to read as follows:

"PUMP HOUSE".

### ITEM 4-C-15: Refer to DRAWING AC130

1. Detail 1, <u>AMEND</u> "PROPOSED WATER TANK" to read as follows:

"FACILITY GROUND-MOUNTED, POTABLE-WATER STORAGE TANK".

2. Detail 1, <u>AMEND</u> "PROPOSED BUILDING" to read as follows:

"PUMP HOUSE".

### ITEM 4-C-16: Refer to DRAWING AC131

1. Detail 3, <u>AMEND</u> "PROPOSED WATER TANK" to read as follows:

"FACILITY GROUND-MOUNTED, POTABLE-WATER STORAGE TANK".

2. Detail 3, <u>AMEND</u> "PROPOSED BUILDING" to read as follows:

"PUMP HOUSE".

## ITEM 4-C-17: Refer to DRAWING AC140

1. Detail 1, <u>AMEND</u> "PROPOSED WATER TANK" to read as follows:

"FACILITY GROUND-MOUNTED, POTABLE-WATER STORAGE TANK".

2. Detail 1, <u>AMEND</u> "PROPOSED BUILDING" to read as follows:

"PUMP HOUSE".

#### ITEM 4-C-18: Refer to DRAWING AC141

1. Detail 3, AMEND "PROPOSED WATER TANK" to read as follows:

"FACILITY GROUND-MOUNTED, POTABLE-WATER STORAGE TANK".

2. Detail 3, <u>AMEND</u> "PROPOSED BUILDING" to read as follows:

"PUMP HOUSE".

## ITEM 4-C-19: Refer to DRAWING BC120

- 1. Site Layout Keynote #29, <u>AMEND</u> to read as follows:
  - "29. 8-FT TALL BLACK VINYL CLAD CHAIN LINK FENCE AT PERIMETER OF SYNTHETIC TURF FIELD AND PERIMETER CURB. SEE DETAIL 7 / ZC503 AND DETAIL 5 AND 6 / ZC501."

### ITEM 4-C-20: Refer to DRAWING ZC501

- 1. Site Detail #2, <u>DELETE</u> in its entirety.
- 2. Site Detail #3, DELETE in its entirety.
- 3. Site Detail #6, <u>ADD</u> the following notes:
  - "a. NOTE #1: WHERE INSTALLATION OF BALLSTOPPER WITH COMBINED CHAIN-LINK FENCE AND CURB (HIGH SCHOOL) PER DETAIL #4, SHEET ZC506, IS REQUIRED, NO SEPARATE PERIMETER CURBING WILL APPLY, AND SYNTHETIC TURF NAILER WILL BE INSTALLED DIRECTLY TO THE SYSTEM FOUNDATION.
  - b. NOTE #2: WHERE INSTALLATION OF CHAIN-LINK FENCE ONLY (MIDDLE SCHOOL), PER DETAIL #2, SHEET ZC501, IS REQUIRED, NO SEPARATE PERIMETER CURBING WILL APPLY, WITH SYNTHETIC TURF NAILER INSTALLED DIRECTLY TO THE CHAIN LINK FENCE FOUNDATION. NOTE THAT SYNTHETIC TURF EDGE, PER THIS DETAIL, WILL THEREFORE CREATE A CONTINUOUS LENGTH OF CURB NAILER SURFACE WHEN COMBINED WITH CHAIN LINK FENCE FOUNDATIONS."

## ITEM 4-C-21: Refer to DRAWING ZC502

1. <u>DELETE</u> Site Detail #3 in its entirety and, <u>ADD</u> new Drawing AC01B attached to this addendum.

#### ITEM 4-C-22: Refer to DRAWING ZC505

1. <u>DELETE</u> drawing in its entirety and, <u>ADD</u> new drawing attached to this addendum.

## **DRAWING MODIFICATIONS - MECHANICAL**

ITEM 4-C-23: Refer to DRAWING AM102

- 1. Note, 9, <u>AMEND</u> to read as follows:
  - "9. PROVIDE SEPARATE ¾" HWS, HWR TO EACH FTR IN ROOMS 111, 113, AND 115. FTR SHOULD BE PIPED IN PARALLEL AS OPPOSED TO IN SERIES."

## **DRAWING MODIFICATIONS - ELECTRIC**

ITEM 4-C-24: Refer to DRAWING AE132

1. <u>DELETE</u> drawing in its entirety and, <u>ADD</u> new drawing attached to this addendum.

ITEM 4-C-25: Refer to DRAWING AE600

1. <u>DELETE</u> drawing in its entirety and, <u>ADD</u> new drawing attached to this addendum.

## **END OF ADDENDUM**



## SUBMIT FORM BY EMAIL TO INE.Mahopac@tetratech.com

<b>Project No.:</b> 121111-19002		Date: 2/23/2021
<b>Project Name:</b> Reconstruction to Mahopad Garage, and New Pump House	e High School, Mahopac Middle School	ol, Mahopac Falls School, Bus
Bidder Contact Person: Stephanie Weber Bidder Company Name: Bertussi Contracting Inc Bidder Phone: 845-538-4234 Bidder Email Address: sweber@bertussis.com		
Question Pertains to: Unit Heaters		
Drawing Number: Plan Area: Room Number: Bus Garage Drawing Detail Number: Specification Section:		
Question: (Please be specific)  Who is responsible for providing the gas to the un	nit heaters in the bus garage? The HVAC or Plur	
Review by Architect/Engineers:	Responded By: <u>HR/TPG</u>	
Please refer to Spec Section 01 12 00 1.9 Co 5 - i. Provide and install new unit heate Spec Section 23 82 00 2.3 Gas Fired Unit H	ers, piping controls	C CONTRACT
Submit requests not less than 5 working day this question requires clarification or modif		



## SUBMIT FORM BY EMAIL TO INE.Mahopac@tetratech.com

<b>Project No.:</b> 121111-19002		Date: 2/16/2021
<b>Project Name:</b> Reconstruction to Mahopac Hig Garage, and New Pump House	h School, Mahopac Middle Sch	ool, Mahopac Falls School, Bus
Bidder Contact Person: Stephanie Weber Bidder Company Name: Bertussi Contracting Inc Bidder Phone: 845-538-4234 Bidder Email Address: sweber@bertussis.com		
Question Pertains to: Controls		
Drawing Number: Plan Area: Room Number: Drawing Detail Number: Specification Section:		
Question: (Please be specific)  With regard to the RFI response on the HVAC Controls, I understand it is a Joh and not the HVAC Prime. The summary of work indicates controls are a State Coordination and ancillary purposes only.	unson Controls systems, but wanted to confirm that th Contract (see attached.) Also under the HVAC summ:	e controls portion is being carried/paid by the owner ary of work it states controls is included in the HVAC contrac
Review by Architect/Engineers:	Responded By: HR/TPG	
Please refer to spec section 23 09 00 INSTRUME Also to refer to spec section 01 12 00 1.14 STA		
Submit requests not less than 5 working days pri this question requires clarification or modification be provided by formal Addendum, distributed to	on of the Bidding Documents, su	

01 12 00-3

- 13. Provide traffic control for deliveries, and equipment needed to perform the work of their own Prime Contract.
- 14. Provide protection of its own finished Work, after installation, until accepted by the Owner.
- 15. Provide fire caulking for any penetration related to the work for its own Prime Contract.
- 16. Provide final cleaning per Spec Section 01 77 00.
- 17. Provide any office and storage trailers required to complete the work of their own Prime Contract.
- 18. Provide for a thorough final cleaning of the site, building, and equipment provided under their Prime Contract immediately before the final inspection. Each Prime Contractor is responsible for cleaning and dust and debris generated from the work of their own Contract.
  - a. Maintain areas in a cleaned condition until the Owner occupies the space.
  - b. Personnel: Experienced workman or professional cleaners approved by the Construction Manager.

## 1.5 SUMMARY OF WORK

- A. The work will be constructed under multiple prime contracts. One set of contract documents is issued covering the multiple contracts. Each Prime Contract is defined as:
  - 1. CONTRACT 1 GC GENERAL CONSTRUCTION WORK
  - 2. CONTRACT 2 PC PLUMBING WORK
  - 3. CONTRACT 3 MC MECHANICAL WORK
  - 4. CONTRACT 4 EC ELECTRICAL WORK
  - 5. CONTRACT 5 AB HAZARDOUS MATERIALS WORK
  - 6. CONTRACT 6 CE CASEWORK AND LAB EQUIPMENT WORK
  - 7. CONTRACT 7 SW SITE CONSTRUCTION WORK
  - 8. STATE CONTRACT BUILDING CONTROLS (for coordination purposes)

### 1.6 WORK UNDER SEPARATE CONTRACTS

- A. The project will be constructed under a multiple-prime contracting arrangement
- B. One set of documents is issued covering all multiple prime contracts. Each prime contractor is to review ALL drawings and specifications for complete understanding and knowledge of the work.
- C. The following Contract Documents are specifically included and defined as integral to each Prime Contract.
  - 1. Bidding Requirements
  - 2. Performance and Payment Bonds
  - 3. Conditions of the Contract, including
    - a. General Conditions & Supplementary Conditions
    - b. Insurance Requirements
    - c. NYS Prevailing Wage Rates.
- D. Extent of Contract: Unless the Contract Documents contain a more specific description of the Work, names and terminology on Drawings and in Specification Sections determine which contract includes a specific element of Project.

01 12 00-12

- u. Connections below Science Casework counters (by Plumbing, Mechanical, and Electrical Contractors)
- v. Provide owner training / commissioning of equipment and controls
- 6. General Requirements, including but not limited to, additional items specifically indicated as the Work of this Contract.
- 7. Provide multiple shift work as needed to complete work as shown on milestone schedule. Schedule shows a significant amount of work to be performed second shift. "Two Work Shifts" will be required to perform the scheduled work.
- B. Section 23 09 00 Instrumentation and Control for HVAC, is included in the HVAC Contract but for coordination and ancillary work purposes only. Coordinate with the Controls Contractor during all demolition and new work. Provide ancillary controls work as stated. Extensive coordination between HVAC & Controls contractor will be required as portions of the existing building are brought on line with the new equipment. Both contractors will be responsible to ensure all systems remain active as necessary to provide adequate heat to various sections of the building and the owner must have control over both old and new systems during construction.
- C. The Work of the MECHANICAL Work Contract includes but is not limited to the Work that is specified in the Project Manual(s) and as shown on the drawings that form the contract plans. The Contractor is directed to examine all drawings since certain details and/or notes may appear anywhere therein that apply to his/her particular work. This prime contract is defined as, and includes, all Sections in the Divisions indicated by reference, and specific Sections noted:
  - 1. Division 0 Procurement and Contracting Requirement, all Sections.
  - 2. Division 1 –General Requirements all Sections, including Temporary Facilities indicated
  - 3. Section 07 84 13, Through Penetration Firestop Systems, as required for the Work of this Contract
  - 4. Section 07 92 00, Joint Sealants, as required for the Work of this Contract
  - 5. Division 23 HVAC, all Sections.

### 1.10 CONTRACT 4 - ELECTRICAL WORK CONTRACT

- A. Work of this Contract includes, but is not limited to, the following descriptions:
  - 1. Includes Electrical Distribution Service, Lighting, CATV systems, Communications, Fire Alarm, Intercom Systems, Security Systems, Emergency Lighting, and other systems traditionally recognized as Electrical work. This includes but is not limited to, all work shown on the Electrical Drawings, and applicable information shown on all other Drawings, unless noted otherwise. It also includes administrative and coordination responsibilities.
    - a. Drawings:
      - 1) All "G" series Drawings (General)
      - 2) All "AG, BG series Drawings (Code Compliance)
      - 3) All "AE, BE, FE, GE, HE" series Drawings (Electrical)
      - 4) All (Architectural) drawings as required for coordination of penetration work
  - 2. Coordination:
    - a. Coordination with the work of all of the other contractors.
  - 3. Demolition:
    - a. Removal of items as shown and/or required.
    - b. Removal and disconnections of electrical devices in walls, ceilings and floors scheduled to be removed in the portion of the building to remain.



## **INSTRUCTIONS TO BIDDERS ATTACHMENT #1:** PRE-BID REQUEST FOR INTERPRETATION FORM

## SUBMIT FORM BY EMAIL TO INE.Mahopac@tetratech.com


Date: 2/17/21
c High School, Mahopac Middle School, Mahopac Falls School, Bus
s Inc
com
et AA600) from addendum #1, doors L101-1 through L101-4 (S3's) ONFIRM.
e provided to maintain the tested Fire Rating. This includes Von Duprin s applies to S3?, S4. S5, and S6. e spec.
doors 242, 243, & 244. However, this is NOT listed in the 088000
vs. We cannot find any on the drawings. Is window type S1 pe? If not, please advise.
Responded By:Date:
te documents, Timothy Stevens 2/25/21 teptable and will

Tetra Tech INSTRUCTIONS TO BIDDERS Architects & Engineers Page ITB-8 Project No. 121111-19002



## SUBMIT FORM BY EMAIL TO INE.Mahopac@tetratech.com

<b>Project No.:</b> 121111-19002	Date: 2/18/21
<b>Project Name:</b> Reconstruction to Mahopad Garage, and New Pump House	e High School, Mahopac Middle School, Mahopac Falls School, Bus
Bidder Contact Person: Frank Grange Bidder Company Name: Darlind Associates	Inc
Bidder Phone: (845) 223-5115 Bidder Email Address: f.grange@casi-ny.co	m
Ouestion Pertains to: See Below (also see	
Ouestion: (Please be specific)	
Question from subcontractor bidder:	
Doors #L101-1,2,3,4 (also reference attached)	
Our Fire rated door/frame supplier can NOT do Also, they can NOT do the "Gun-Slot" glass in	
most important, we need to divide these into 4	s Designer doors as we are using in the other elevations. Also and separate single door/frame units. These would be separated with either e. The steel and any structural calcs if needed would be By Others.
Please advise	
Review by Architect/Engineers:	Responded By:Date:
additional information for these doors will be provided in bid addendum #4	Timothy Stevens 2/25/21
	ys prior to the specified Bid Opening date and time. In the event that ication of the Bidding Documents, such written information can only ed to all plan holders.

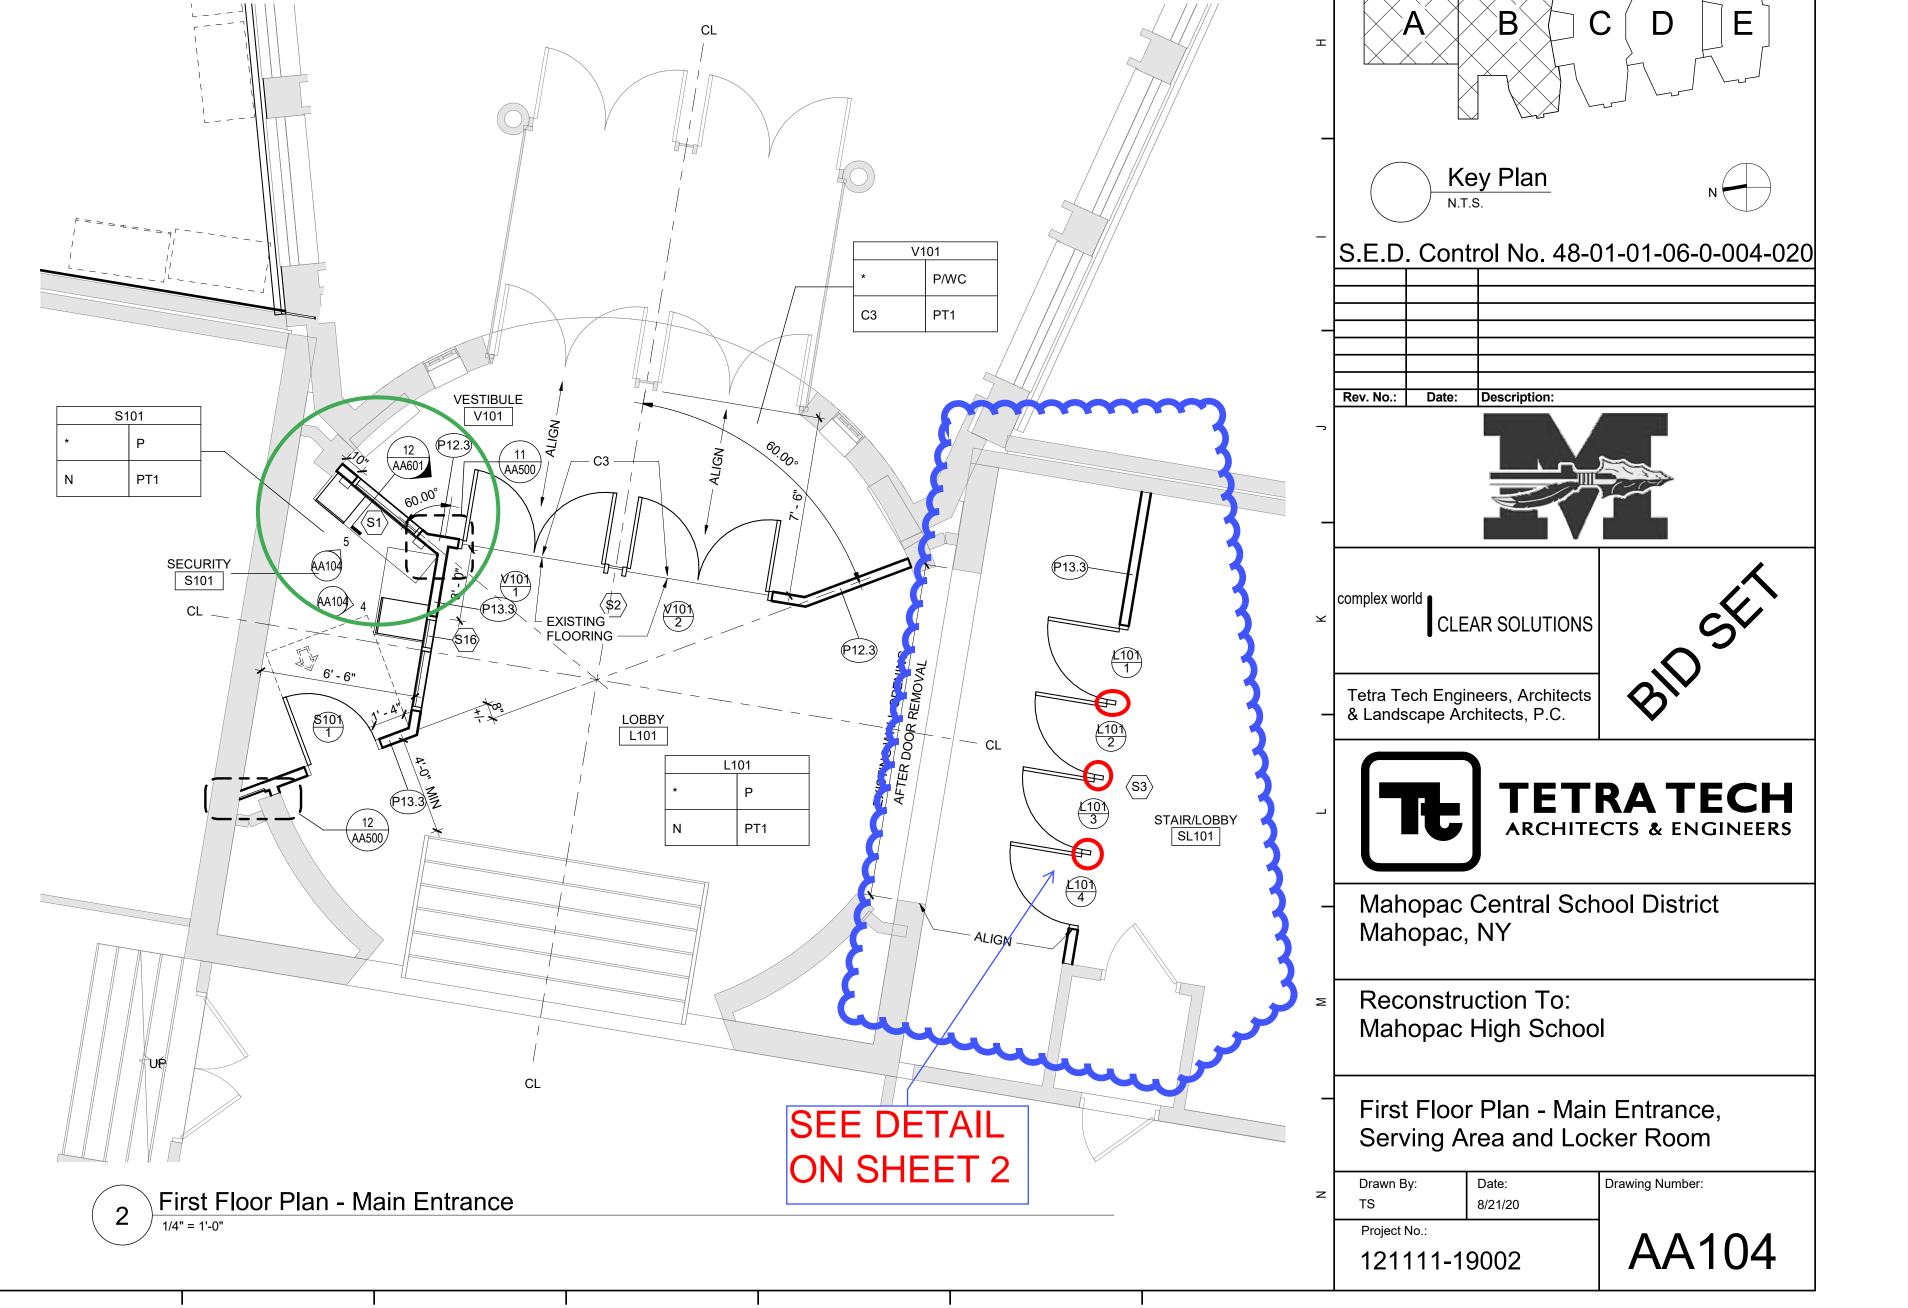





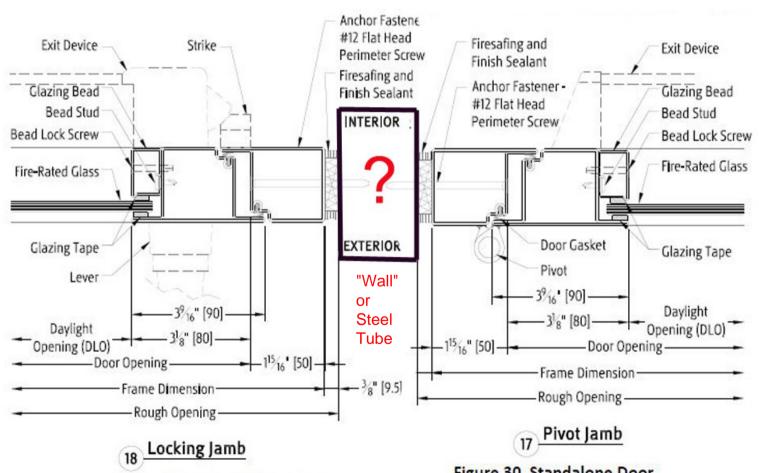


Figure 31 - Standalone Door Jamb at Lever Side

Figure 30 Standalone Door Jamb at Pivot Side



## SUBMIT FORM BY EMAIL TO INE.Mahopac@tetratech.com

Project No.: 121111-19002	Date: 02/19/2021
<b>Project Name:</b> Reconstruction to Mahopac High So Garage, and New Pump House	chool, Mahopac Middle School, Mahopac Falls School, Bus
Bidder Contact Person: Mathew DeRosa Bidder Company Name: DeRosa Sports Cons Bidder Phone: 914-341-1506 Bidder Email Address: Matt@derosasports.co	
Question Pertains to:	
Drawing Number: AE-002 Plan Area: N/A Room Number: Drawing Detail Number: Specification Section:	
Question: (Please be specific)	
Please clarify if contract #7 SW is respon foundations for scoreboard, or necessary	
Review by Architect/Engineers:	Responded By: HR/TPG Date: 02-26-2021
Spec Section 26 58 10 FOOTBALL/LAC Contract 4 - Electrical Contract	ROSSE SCOREBOARD
Submit requests not less than 5 working days prior this question requires clarification or modification of be provided by formal Addendum, distributed to all	o the specified Bid Opening date and time. In the event that of the Bidding Documents, such written information can only plan holders.

INSTRUCTIONS TO BIDDERS Page ITB-8



## SUBMIT FORM BY EMAIL TO INE.Mahopac@tetratech.com

<b>Project No.:</b> 121111-19002	Date: 02/19/2021
Garage, and New Pump House	ool, Mahopac Middle School, Mahopac Falls School, Bus
Bidder Contact Person: Mathew DeRosa Bidder Company Name: DeRosa Sports Constr Bidder Phone: 914-341-1506 Bidder Email Address: Matt@derosasports.com	
Question Pertains to:	
Drawing Number: BE-001 Plan Area: Room Number: Drawing Detail Number: Specification Section:	
Question: (Please be specific)	
Please clarify if contract #7 SW is respons pole bases or any associated work for the	
	esponded By: HR/TPG Date: 02-28-2021
Please refer to Specification Section 01 12 Division 3 – Concrete - all Sections. Please also to refer to Spec Section 03 48 02-16-2021	

Submit requests not less than 5 working days prior to the specified Bid Opening date and time. In the event that this question requires clarification or modification of the Bidding Documents, such written information can only be provided by formal Addendum, distributed to all plan holders.

Tetra Tech



## SUBMIT FORM BY EMAIL TO INE.Mahopac@tetratech.com

Project No.: 121111-19002	Date: 02/19/2021
<b>Project Name:</b> Reconstruction to Mahopac High School, Mahopac Marage, and New Pump House	Middle School, Mahopac Falls School, Bus
Bidder Contact Person: Mathew DeRosa Bidder Company Name: DeRosa Sports Construction Inc. Bidder Phone: 914-341-1506 Bidder Email Address: Matt@derosasports.com	
Question Pertains to:	
Drawing Number: BE-001 Plan Area: Room Number: Drawing Detail Number: Specification Section:	
Question: (Please be specific)	
Please clarify if contract #7 SW is responsible for light pole bases or any associated work for the lights.	pole installation, light
Review by Architect/Engineers: Responded By:	HR/TPG Date: 02-06-2021
Please refer to Specification Section 01 12 00 Contraction Electrical Contractor is responsible for Pre-cast Light Poles.	
Submit requests not less than 5 working days prior to the specified Bithis question requires clarification or modification of the Bidding Do be provided by formal Addendum, distributed to all plan holders.	id Opening date and time. In the event that

INSTRUCTIONS TO BIDDERS Page ITB-8



## SUBMIT FORM BY EMAIL TO INE.Mahopac@tetratech.com

Project No.: 121111-19002 Date: 2-16-2021

Project Name: Reconstruction to Mahopac High School, Mahopac Middle School, Mahopac Falls School, Bus

Garage, and New Pump House

.....

**Bidder Contact Person:** Chris Fracassa **Bidder Company Name:** Gianfia Corp. **Bidder Phone:** (914) 358-4601

Bidder Email Address: cfracassa@gianfiacorp.com

\_\_\_\_\_\_

Question Pertains to: Synthetic Turf

Drawing Number: AC120 & BC120

Plan Area:

Room Number: N/A

**Drawing Detail Number:** N/A **Specification Section:** 01 12 00

•

### **Question:** (Please be specific)

- #1. Could the names of both the manufacturer and installer for the synthetic turf field be provided?
- #2. Please verify with the manufacturer on whether or not the warranty for the synthetic turf field will be impacted due to the required field applied ballfield markings.

## **Review by Architect/Engineers:**

Responded By: C Glaubitz Date: 2/26/21

1. The synthetic turf contract is being bid by state contract and in process.

\_\_\_\_\_\_

Noted, will be confirmed with Turf contractor.

\_\_\_\_\_

Submit requests not less than 5 working days prior to the specified Bid Opening date and time. In the event that this question requires clarification or modification of the Bidding Documents, such written information can only be provided by formal Addendum, distributed to all plan holders.



## SUBMIT FORM BY EMAIL TO INE.Mahopac@tetratech.com

Project No.: 121111-19002 Date: 2-16-2021

Project Name: Reconstruction to Mahopac High School, Mahopac Middle School, Mahopac Falls School, Bus

Garage, and New Pump House

.....

**Bidder Contact Person:** Chris Fracassa **Bidder Company Name:** Gianfia Corp. **Bidder Phone:** (914) 358-4601

Bidder Email Address: cfracassa@gianfiacorp.com

\_\_\_\_\_\_

Question Pertains to: Synthetic Turf

Drawing Number: AC120 & BC120

Plan Area:

Room Number: N/A

**Drawing Detail Number:** N/A **Specification Section:** 01 12 00

•

### **Question:** (Please be specific)

- #1. Could the names of both the manufacturer and installer for the synthetic turf field be provided?
- #2. Please verify with the manufacturer on whether or not the warranty for the synthetic turf field will be impacted due to the required field applied ballfield markings.

## **Review by Architect/Engineers:**

Responded By: C Glaubitz Date: 2/26/21

1. The synthetic turf contract is being bid by state contract and in process.

\_\_\_\_\_\_

Noted, will be confirmed with Turf contractor.

\_\_\_\_\_

Submit requests not less than 5 working days prior to the specified Bid Opening date and time. In the event that this question requires clarification or modification of the Bidding Documents, such written information can only be provided by formal Addendum, distributed to all plan holders.



## SUBMIT FORM BY EMAIL TO INE.Mahopac@tetratech.com

Project No.: 121111-19002 Date: 2-25-2021

Project Name: Reconstruction to Mahopac High School, Mahopac Middle School, Mahopac Falls School, Bus

Garage, and New Pump House

**Bidder Contact Person:** Chris Fracassa **Bidder Company Name:** Gianfia Corp. **Bidder Phone:** (914) 358-4601

Bidder Email Address: cfracassa@gianfiacorp.com

Question Pertains to: Trench Drain

Drawing Number: ZC502

Plan Area: N/A Room Number: N/A

**Drawing Detail Number:** N/A

**Specification Section:** 33 41 00 Page 7

### **Ouestion:** (Please be specific)

#1. Trench Drain detail 3 on drawing ZC502 notates 4,000 psi reinforced concrete without showing any reinforcement in detail. If reinforcement is required, please provide type, size, and spacing of reinforcement be specified.

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## **Review by Architect/Engineers:**

Responded By: D.Bussmann Date: 03 / 01 / 2021

Refer to forthcoming Addendum #4.

\_\_\_\_\_\_

Submit requests not less than 5 working days prior to the specified Bid Opening date and time. In the event that this question requires clarification or modification of the Bidding Documents, such written information can only be provided by formal Addendum, distributed to all plan holders.



## SUBMIT FORM BY EMAIL TO INE.Mahopac@tetratech.com

<b>Project No.:</b> 121111-19002	<b>Date:</b> 2/24/21
<b>Project Name:</b> Reconstruction to Mahopac High School, M. Garage, and New Pump House	
Bidder Contact Person: Karen Panarella Bidder Company Name: Joe Lombardo Plumbing & Heat: Bidder Phone: 845-357-6537 Bidder Email Address: karen@josephlombardo.com	ing of Rockland Inc
Question Pertains to: Water Tank & Foundation  Drawing Number: AC140, Detail 2 on ZC504  Plan Area: N/A  Room Number: N/A  Drawing Detail Number: Specification Section: 221219 facility ground mounted potential	able water storage tank
Question: (Please be specific) please clarity which contractor is responsible for purchasing	
Review by Architect/Engineers: Respon  Please see Addendum 003 issued on 02-22-2021 Specifica Refer to Drawing AP600 Hydro-pneumatic Tank Schedule	ded By: HR/KC-TPGDate: 02-24-21 ution Section 22 12 19

Submit requests not less than 5 working days prior to the specified Bid Opening date and time. In the event that this question requires clarification or modification of the Bidding Documents, such written information can only be provided by formal Addendum, distributed to all plan holders.



## SUBMIT FORM BY EMAIL TO INE.Mahopac@tetratech.com

<b>Project No.:</b> 121111-19002		Date	e:
<b>Project Name:</b> Reconstruction to Mahopac Hig Garage, and New Pump House	h School, Mahopac M	Iiddle School, Mah	opac Falls School, Bus
Bidder Contact Person: Karen Panarella Bidder Company Name: Joe Lombardo Plumb Bidder Phone: 845-357-6537 Bidder Email Address: karen@joseplombardo.	oing & Heating of Roc	kland Inc	
Question Pertains to:			
Drawing Number: AM102 Plan Area: Room Number: Drawing Detail Number: Detail #9 Specification Section:			
Question: (Please be specific) As per drawing AM 102 Keynote #9 is duplicated One of the note #9 states for us to provide separation indicated in note 9 appear on same drawing area valves for existing FTR.  Note 9 appears on drawing area B, but the room Please advise	rate ¾" HWS & R line a C which has a note	es to FTR in rooms	125,129 & 131. The rooms
Review by Architect/Engineers:		DPM Date:	
Refer to forthcoming Bid Addendum No. 4			
Submit requests not less than 5 working days pri this question requires clarification or modification			



## SUBMIT FORM BY EMAIL TO INE.Mahopac@tetratech.com

Date: 2/23/2021 **Project No.:** 121111-19002 Project Name: Reconstruction to Mahopac High School, Mahopac Middle School, Mahopac Falls School, Bus Garage, and New Pump House **Bidder Contact Person: Michael Potthoff Bidder Company Name: McHugh Furnishings** Bidder Phone: 631-533-5074 Bidder Email Address: mpotthoff@mchif.com **Question Pertains to: Mahopac High School- Science Drawing Number: AA102** Plan Area: STEM and Science Labs Room Number: Rooms 111, 113, 115 and 234, 234A, 235, 238, 239, 242, 243, 244 **Drawing Detail Number: #5 Epoxy Countertop Edge** Specification Section: 123213 Manufactured Wood Veneer Faced Casework **Question:** (Please be specific) 1) Spec Section 123213- 2.3A. Please confirm lipped overlay with radius wood edges.- per spec 2) Spec Section 123213- 2.3B States White Maple, while 2.3F states Oak. Please confirm Maple, refer to addendum 3) Spec Section 123213-2.3D & 2.3E. 2.3D States continuous matching of adjacent drawer fronts with cabinets. 2.3E States grain direction as vertical on doors and horizontal on drawer fronts. Please clarify. 4) Spec Section 123213- 2.4L States solid surface window sills. We would like to supply Phenolic sills in the Science areas to match the epoxy tops. Please confirm this is an acceptable alternate. 5) Detail #5, Dwg AA102 shows bevel edge with radius corners. Please confirm this is required and is for all locations- including table tops. **Review by Architect/Engineers:** Responded By: mhhunt Date: 2-23-21 1) response - Per spec 5) refer to all details doe areas of radius corners 2)response - Refer to addendum 3) response - Per spec 4) response- not all sills are solid surface, refer to all details for correct material

Submit requests not less than 5 working days prior to the specified Bid Opening date and time. In the event that this question requires clarification or modification of the Bidding Documents, such written information can only

\_\_\_\_\_\_

be provided by formal Addendum, distributed to all plan holders.



## SUBMIT FORM BY EMAIL TO INE.Mahopac@tetratech.com

<b>Project No.:</b> 121111-19002	Date: 2/22/21
<b>Project Name:</b> Reconstruction to Mahopac High S Bus Garage, and New Pump House	School, Mahopac Middle School, Mahopac Falls School,
Bidder Contact Person: Carlos Flores Bidder Company Name: Mehl Electric Bidder Phone: 845 735 4004 Bidder Email Address: carlos@mehlnet.com	
Question Pertains to: HIGH SCHOOL	
Drawing Number: AE600 Plan Area: Room Number: Drawing Detail Number: Specification Section:	
	wer to RFI #14, are all panels listed on AE600 to be new to replace at difficulty pricing, not knowing what is new and what is existing. please
Review by Architect/Engineers:	Responded By: CREGA Date: 2/23/21
CONFIRMED, PANELS LISTED	O ARE TO BE REPLACED.
Submit requests not less than 5 working days prior	to the specified Bid Opening date and time. In the event that of the Bidding Documents, such written information can only l-plan-holders



## SUBMIT FORM BY EMAIL TO INE.Mahopac@tetratech.com

<b>Project No.:</b> 121111-19002	Date: 2/22/21
<b>Project Name:</b> Reconstruction to Mahopac High Bus Garage, and New Pump House	a School, Mahopac Middle School, Mahopac Falls School,
Bidder Contact Person: Carlos Flores Bidder Company Name: Mehl Electric Bidder Phone: 845 735 4004 Bidder Email Address: carlos@mehlnet.com	1
Question Pertains to: HIGH SCHOOL FIRE	
Drawing Number: AE200 Plan Area: Room Number: Drawing Detail Number: Specification Section:	
Question: (Please be specific) 1. In response to y	our RFI answer that the FA system is a notifier system, this does not help us.
Review by Architect/Engineers:	Responded By: CREGA Date: 2/23/21
Joe Lombardi of Doyle Sec	curity
this question requires clarification or modification	or to the specified Bid Opening date and time. In the event that on of the Bidding Documents, such written information can only all-plan-holders



## SUBMIT FORM BY EMAIL TO INE.Mahopac@tetratech.com

<b>Project No.:</b> 121111-19002	Date: 2/23/21
<b>Project Name:</b> Reconstruction to Mahopac High Bus Garage, and New Pump House	a School, Mahopac Middle School, Mahopac Falls School,
Bidder Contact Person: Carlos Flores Bidder Company Name: Mehl Electric Bidder Phone: 845 735 4004 Bidder Email Address: carlos@mehlnet.com	1
Question Pertains to: UG ELECTRIC RERO	
Drawing Number: AE001 &AE002 Plan Area: Room Number: Drawing Detail Number: Specification Section:	
Question: (Please be specific)  1. New Addend circuit, can you provide size of conduit and wire so we know who	lum 3 AE001&002 show that we are to relocate and existing underground at we need to extend and size of pullbox to provide?
Review by Architect/Engineers:	Responded By: Date:
This will have to be verified in field.	
Submit requests not less than 5 working days pricthis question requires clarification or modification	or to the specified Bid Opening date and time. In the event that on of the Bidding Documents, such written information can only eall-plan-holders
• •	•



## SUBMIT FORM BY EMAIL TO INE.Mahopac@tetratech.com

<b>Project No.:</b> 121111-19002	Date: 2/23/21
<b>Project Name:</b> Reconstruction to Muse Bus Garage, and New Pump House	Mahopac High School, Mahopac Middle School, Mahopac Falls School,
Bidder Contact Person: Carlos Fl Bidder Company Name: Mehl H Bidder Phone: 845 735 4004 Bidder Email Address: carlos@	Electric
Question Pertains to: PA and C	lock Systems
Drawing Number: AE200,201,202 Plan Area: Room Number: Drawing Detail Number: Specification Section:	2
Question: (Please be specific) 1.	Mew Addendum 3 drawings AE200,201 and 202 that previously showed clock and PA speaker scope of work seemed to have been deleted. Please confirm this scope is no longer required and that these drawings now only show Fire Alarm scope of work. If PA and Clock system is required, vendors are asking for a riser diagram and specs to price the equipment?  2. Original Set stated we were to remove FA panel and replace with new and reconnect all existing devices. Addendum 3 states to provide new devices to existing panel. Please confirm we are only providing new devices at locations shown on latest addendum3 plans and connecting to an existing panel? now new panelrequired? Can you provide an actual FA riser diagram for this system?
Review by Architect/Engineers:	Responded By: CREGA Date: 2/24/21
<ol> <li>Confirmed. Cloc</li> <li>Confirmed only</li> </ol>	cks and speakers on AE200-AE202 removed from scope. new FA devices.
this question requires clarification	rking days prior to the specified Bid Opening date and time. In the event that or modification of the Bidding Documents, such written information can only distributed to all-plan-holders.



## SUBMIT FORM BY EMAIL TO INE.Mahopac@tetratech.com

<b>Project No.:</b> 121111-19002		Date: 2/23/21
<b>Project Name:</b> Reconstruction to Mahopac High Bus Garage, and New Pump House	-	^
Bidder Contact Person: Carlos Flores Bidder Company Name: Mehl Electric Bidder Phone: 845 735 4004 Bidder Email Address: carlos@mehlnet.com		
Question Pertains to: Scoreboard		
Drawing Number: AE002 Plan Area: Room Number: Drawing Detail Number: Specification Section: 26 58 10 2.1		
Question: (Please be specific) 1 CAN WE USE a so		
-		
Review by Architect/Engineers:		
YES, IF SUBMITTED AS AN EQUA	AL.	
	CREGA	2/24/21
Submit requests not less than 5 working days prio this question requires clarification or modification be provided by formal Addendum, distributed to a	or to the specified Bion of the Bidding Doo	d Opening date and time. In the event that tuments, such written information can only



## SUBMIT FORM BY EMAIL TO INE.Mahopac@tetratech.com

<b>Project No.:</b> 121111-19002		Date: 2/24/21
<b>Project Name:</b> Reconstruction to Mahopac High School. Bus Garage, and New Pump House	, Mahopac Middle Sc	hool, Mahopac Falls School,
Bidder Contact Person: Carlos Flores Bidder Company Name: Mehl Electric Bidder Phone: 845 735 4004 Bidder Email Address: carlos@mehlnet.com		
Question Pertains to: Demolition/removal of pbc ligh	nt fixtures	
Drawing Number: AE050, Plan Area: Room Number: Drawing Detail Number: Specification Section:		
Question: (Please be specific) 1 demolition notes A-G floor plan, or can we ignore these notes?	3, where exactly doe	es this scope take place on this
Review by Architect/Engineers:		
THESE ARE GENERAL NOTES FOR AN CONDITIONS FOUND DURING CONSTR		
	CREGA	2/26/21
Submit requests not less than 5 working days prior to the this question requires clarification or modification of the only be provided by formal Addendum, distributed to all	Bidding Documents,	such written information can



## SUBMIT FORM BY EMAIL TO INE.Mahopac@tetratech.com

<b>Project No.:</b> 121111-19002	Date: 2/25/21
<b>Project Name:</b> Reconstruction to Mahopac High School, Mahopac Bus Garage, and New Pump House	Middle School, Mahopac Falls School,
Bidder Contact Person: Carlos Flores Bidder Company Name: Mehl Electric Bidder Phone: 845 735 4004 Bidder Email Address: carlos@mehlnet.com	
Question Pertains to: Scoreboard	
Drawing Number: AE002, Plan Area: Room Number: Drawing Detail Number: Specification Section:	
Question: (Please be specific)  1 Are there any borings or subs	<u> </u>

le

- 2. where will the 2ea delay of game clocks be mounted to?
- 3. Verify dimensions of beams, footings and if rebar is required for directly embedding steel columns?
- 4. Verify distance between column, schedule states 5', but a 25' L board would generally require 15' spread?

## **Review by Architect/Engineers:**

- 1. THIS NEEDS TO BE VERIFIFED BY SITE CONTRACTOR.
- 2. GAME CLOCKS ARE NOT IN SCOPE.
- 3. MANFACTURER TO PRPOVIDE SHOP DRAWINGS FOR APPROVAL.
- 4. PER MANUFACTURER RECOMMENDATIONS.

CF	REGA	2/	26	/21

Submit requests not less than 5 working days prior to the specified Bid Opening date and time. In the event that this in the street of the Bidding Documents, such written information of the Bidding Documents and the Biddin Project No. 121111-19002 Architects & Engineers onlyabelprovided by



## SUBMIT FORM BY EMAIL TO INE.Mahopac@tetratech.com

<b>Project No.:</b> 121111-19002		Date: 2/25/21
<b>Project Name:</b> Reconstruction to Mahopac High Bus Garage, and New Pump House	School, Maho	opac Middle School, Mahopac Falls School,
Bidder Contact Person: Carlos Flores Bidder Company Name: Mehl Electric Bidder Phone: 845 735 4004 Bidder Email Address: carlos@mehlnet.com	1	
Question Pertains to: MDP1		
Drawing Number: AE700 & AE600, Plan Area: Room Number: Drawing Detail Number: Specification Section:		
Question: (Please be specific) 1 AE700 show AE600 shows panel SDP to have the same ratin this meant to be a surge protection device built -	s MDP1 having and size as l	MDP1, what is the intent of panel SDP, or is
Review by Architect/Engineers:		
NO WORK REQUIRED WITH SDP.		
	CREGA	2/26/21
Submit requests not less than 5 working days price	··································	

Submit requests not less than 5 working days prior to the specified Bid Opening date and time. In the event that this requestion or squires in the event that this requestion of the Bidding Documents, such written information and time. In the event that this requestion of the Bidding Documents, such written information and time. In the event that this requestion of the Bidding Documents, such written information and time. Architects & Engineers



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<b>Project No.:</b> 121111-19002	Date: 2/25/21
<b>Project Name:</b> Reconstruction to Mahopac High Scl Bus Garage, and New Pump House	nool, Mahopac Middle School, Mahopac Falls School,
Bidder Contact Person: Carlos Flores Bidder Company Name: Mehl Electric Bidder Phone: 845 735 4004 Bidder Email Address: carlos@mehlnet.com	
Question Pertains to: Lighting	
Drawing Number: AE131 detail 3 Plan Area: Room Number: Drawing Detail Number: Specification Section:	
Question: (Please be specific) 1 Drawing 3/AE1; existing to remain, and no new type 9 fixture is re-	31 shows fixtures with letter E, please confirm this are
-	
Review by Architect/Engineers:	
CONFIRMED THESE ARE EXEMAIN.	KISTING TO
CREG	2/26/21



## SUBMIT FORM BY EMAIL TO INE.Mahopac@tetratech.com

<b>Project No.:</b> 121111-19002		Date: 2/25/21
<b>Project Name:</b> Reconstruction to Mahopac High School, I Bus Garage, and New Pump House	Mahopac Middle Sch	ool, Mahopac Falls School,
Bidder Contact Person: Carlos Flores Bidder Company Name: Mehl Electric Bidder Phone: 845 735 4004 Bidder Email Address: carlos@mehlnet.com		
Question Pertains to: Panel Schedules		
Drawing Number: AE600 Plan Area: Room Number: Drawing Detail Number: Specification Section:		
Question: (Please be specific) 1 Can you provide pand showing circuits (new/existing)?	el schedules for each	panel being replaced
Review by Architect/Engineers:		
NO,EXISTING AND REPLACEMEN CIRCUIT BREAKERS INDICATED I PANEL REPLACMENT SCHEDULE	N ·	2/26/24
	CREGA	2/26/21



### SUBMIT FORM BY EMAIL TO INE.Mahopac@tetratech.com

<b>Project No.:</b> 121111-19002		Date: 2/25/21
<b>Project Name:</b> Reconstruction to Mahopac High Sch Bus Garage, and New Pump House	nool, Mahopac	Middle School, Mahopac Falls School,
Bidder Contact Person: Carlos Flores Bidder Company Name: Mehl Electric Bidder Phone: 845 735 4004 Bidder Email Address: carlos@mehlnet.com		
Question Pertains to: Kitchen Register Data Dro		
Drawing Number: AE161 Plan Area: Room Number: Drawing Detail Number: Specification Section:		
Question: (Please be specific) 1 New note added for register and connect to rack 15, but no note 4 a where are they located?		
Review by Architect/Engineers:		
REFER TO DETAIL 2 AE161 LOCATION OF REGISTERS.	FOR	
	CREGA	2/16/21



### SUBMIT FORM BY EMAIL TO INE.Mahopac@tetratech.com

<b>Project No.:</b> 121111-19002	Date: 2/25/21
<b>Project Name:</b> Reconstruction to Mahopac High School, No. Bus Garage, and New Pump House	Mahopac Middle School, Mahopac Falls School,
Bidder Contact Person: Carlos Flores Bidder Company Name: Mehl Electric Bidder Phone: 845 735 4004 Bidder Email Address: carlos@mehlnet.com	
Question Pertains to: Security	
Drawing Number: Plan Area: Room Number: Drawing Detail Number: Specification Section:	
Question: (Please be specific) 1 Please confirm that se power where shown on plans and providing stub ups wh	curity scope is by others, EC is only bringing
<del>-</del>	
Review by Architect/Engineers:	
Please refer to specification section 01 12 00 1.10 1.10 Please clarify Drawing / Detail	CONTRACT 4 - ELECTRICAL WORK CONTRACT
HR / TPG 02-26-2021	



#### SUBMIT FORM BY EMAIL TO INE.Mahopac@tetratech.com

**Project No.:** 121111-19002 Date: 2/25/21 **Project Name:** Reconstruction to Mahopac High School, Mahopac Middle School, Mahopac Falls School, Bus Garage, and New Pump House **Bidder Contact Person: Carlos Flores Bidder Company Name: Mehl Electric** Bidder Phone: 845 735 4004 Bidder Email Address: carlos@mehlnet.com **Question Pertains to: Security Drawing Number:** Plan Area: **Room Number: Drawing Detail Number: Specification Section:** Question: (Please be specific) 1 Please confirm that security scope is by others, EC is only bringing power where shown on plans and providing stub ups where required?

#### **Review by Architect/Engineers:**

Please Refer to Spec Section 01 12 00 1.10CONTRACT 4 - ELECTRICAL WORK CONTRACT

A. Work of this Contract includes, but is not limited to, the following descriptions:

1. Includes Electrical Distribution Service, Lighting, CATV systems, Communications, Fire Alarm, Intercom Systems, Security Systems, Emergency Lighting, and other systems traditionally recognized as Electrical work. This includes but is not limited to, all work shown on the Electrical Drawings, and applicable information shown on all other Drawings, unless noted otherwise. It also includes administrative and coordination responsibilities

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### SUBMIT FORM BY EMAIL TO INE.Mahopac@tetratech.com

<b>Project No.:</b> 121111-19002		Date:	2/18/2021
<b>Project Name:</b> Reconstruction to Mahopac High Garage, and New Pump House	School, Mahopac Middle School	, Mahop	oac Falls School, Bus
Bidder Contact Person: Chris Meyer Bidder Company Name: Meyer Contracting C Bidder Phone: (845) 635-1416 Bidder Email Address: estimating@meyerco	Corporation		
Question Pertains to:			
Drawing Number: AA130 Plan Area: Music Suite Room Number: 143A Drawing Detail Number: Specification Section:			
Question: (Please be specific)			
Floor finish at room 143A calls for Terrazzo Is this correct? There is no finish schedule for		vide.	
Review by Architect/Engineers:	Responded By: MHH	Date: <u>02</u>	2/23/2021
FINISHES FOR 143A ARE PER ROOM FINISH THE ROOM FINISH BOX FOR BAND 143 IS LO UPPER RIGHT CORNER OF ROOM.		43,	
Submit requests not less than 5 working days prio this question requires clarification or modification be provided by formal Addendum, distributed to a	r to the specified Bid Opening dat n of the Bidding Documents, such	e and tin	ne. In the event that



### SUBMIT FORM BY EMAIL TO INE.Mahopac@tetratech.com

<b>Project No.:</b> 121111-19002	<b>Date:</b> 2/18/2021
<b>Project Name:</b> Reconstruction to Mahopac High School, Mahopac Barage, and New Pump House	^
Bidder Contact Person: Chris Meyer Bidder Company Name: Meyer Contracting Corporation Bidder Phone: (845) 635-1416 Bidder Email Address: estimating@meyercontracting.com	
Ouestion Pertains to:  Drawing Number: GS130 detail 2 Plan Area: Room Number: Drawing Detail Number: Specification Section:	
Question: (Please be specific)	
Who is responsible for installing the Unistrut to support the Helplease clarify Drawing there is no GS130 Please refer to spec section 23 05 29 HANGERS AND SUPPORT 01 12 00 1.9 CONTRACT 3 - MECHANICAL WORK CONTRACT framing for HVAC equipment, ie mechanical equipment curbs.	S FOR HVAC COMPONENTS; CT; 5.0; Provide support
Review by Architect/Engineers: Responded By:	HR / TPG Date: 02-28-2021
Submit requests not less than 5 working days prior to the specified B	

INSTRUCTIONS TO BIDDERS
Page ITB-8
Project No. 121111-19002
Architects & Engineers

this question requires clarification or modification of the Bidding Documents, such written information can only

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### SUBMIT FORM BY EMAIL TO INE.Mahopac@tetratech.com

<b>Project No.:</b> 121111-19002		Date:	2/18/2021
<b>Project Name:</b> Reconstruction to Mahopac Hi Garage, and New Pump House	igh School, Mahopac Middle Scho	ool, Maho	pac Falls School, Bus
Bidder Contact Person: Chris Meyer Bidder Company Name: Meyer Contractin Bidder Phone: (845) 635-1416 Bidder Email Address: estimating@meyer	g Corporation		
Question Pertains to:			
Drawing Number: GS130 detail 2 Plan Area: Room Number: Drawing Detail Number: Specification Section:			
Question: (Please be specific)			
Who is responsible for installing the Unis Please clarify Drawing there is no GS130 in		oment. C	GC or HVAC Contractor
Review by Architect/Engineers:	Responded By: HR / TPG		
Submit requests not less than 5 working days p this question requires clarification or modificat be provided by formal Addendum, distributed t	ion of the Bidding Documents, such		



### SUBMIT FORM BY EMAIL TO INE.Mahopac@tetratech.com

<b>Project No.:</b> 121111-19002		Date	February 25, 2021
<b>Project Name:</b> Reconstruction to Mahopac H. Garage, and New Pump House	igh School, Mahopac Middle	School, Mah	opac Falls School, Bus
Bidder Contact Person: Chris Meyer Bidder Company Name: Meyer Contractin Bidder Phone: (845) 635-1416 Bidder Email Address: estimating@meyer	g Corporation		
Question Pertains to:			
Drawing Number: Plan Area: Room Number: Drawing Detail Number: Specification Section: 133419			
Question: (Please be specific)			
Please confirm hot dip galvanized finish per s and end wall primary framing members, not e Please be advised that a hot dipped galvanized applies to secondary members such as purlins	nd wall secondary framing me I finish is significantly more e	embers.	•
Review by Architect/Engineers:	Responded By:		
	Timothy	Stevens	2/26/21
Please proceed as identified in the specification.			



### SUBMIT FORM BY EMAIL TO INE.Mahopac@tetratech.com

<b>Project No.:</b> 121111-19002	Date:	2/19/2021	
<b>Project Name:</b> Reconstruction to Mahopac High School, Mahopac Middle School, Garage, and New Pump House	Mahopa	c Falls School,	Bus
Bidder Contact Person: Brendan Ford Bidder Company Name: Nicky Diggs Excavation INC Bidder Phone: 914-232-1878 Bidder Email Address: office@nickydiggs.com			
Question Pertains to:			
Drawing Number: Plan Area: Room Number: Drawing Detail Number: 1/ZC500, 2/ZC500 Specification Section: 32 12 16			
Question: (Please be specific)			
Please clarify if type 3 binder and 6f top course or superpave mix should be used for asphalt paving.			
Review by Architect/Engineers: Responded By: D.Bussmann I	Date: <u>2 / 2</u>	23 / 2021	
See asphalt material requirements in paragraph 2.3.A. of the 32 12 16 Asphalt Pa	ving spec	cification.	
Submit requests not less than 5 working days prior to the specified Bid Opening date			t that
this question requires clarification or modification of the Bidding Documents, such be provided by formal Addendum, distributed to all plan holders.			



#### SUBMIT FORM BY EMAIL TO INE.Mahopac@tetratech.com

<b>Project No.:</b> 121111-19002	Date:	02/11/2021
<b>Project Name:</b> Reconstruction to Mahopac High School, Mahopac Middle School, Garage, and New Pump House	Mahopac	Falls School, Bus
Bidder Contact Person: CHRIS COLANDREA Bidder Company Name: NORTHBROOK CONTRACTING CORP Bidder Phone: 914-879-6099 Bidder Email Address: NORTHBROOKCHRIS@YAHOO.COM		
Question Pertains to:		
Drawing Number: AC-121 Plan Area: D Room Number: Drawing Detail Number: KEYNOTE # 14, 19 Specification Section:		
Question: (Please be specific)		<del></del>
KEYNOTE #14 #19 SHOWS A STRUCTURAL CONCRTE SLAB AND	FOOTING	AT THE NEW/

KEYNOTE #14, #19 SHOWS A STRUCTURAL CONCRTE SLAB AND FOOTING AT THE NEW PROPOSED BUILDING. PLEASE CLARIFY IF THIS WORK IS UNDER SITE CONTRACTOR OR GENERAL CONSTRUCTION CONTRACT AND WHICH CONTRACTOR DOES WHAT. ALSO WHICH CONTRACT COVERS ALL WORK PERTAING TO THE WATER TANK.

### Review by Architect/Engineers: Responded By: HR/TPG Date: 02-28-21

Please refer to Spec Section 01 12 00 1.7;5 New Construction -c Contract 1 GENERAL CONSTRUCTION WORK The Site Work Contractor (Contract #7) shall be responsible for the construction of all exterior concrete pads. The Site Contractor (Contract #7) shall be responsible to prepare the area to sub-grade.

1.7;5 New Construction- d. Provide shoring and bracing and excavation for all work related to new building, and all excavation for other contractors related to new building. Limit of excavation shall be within five (5) feet of building foundation.

Also Refer to Spec Section 01 12 00 1.13 Contract 7 SITE WORK CONSTRUCTION; 5. New Construction

Water Tank - Please refer to spec section 22 12 19

Submit requests not less than 5 working days prior to the specified Bid Opening date and time. In the event that this question requires clarification or modification of the Bidding Documents, such written information can only be provided by formal Addendum, distributed to all plan holders.



### **SUBMIT FORM BY EMAIL TO INE.Mahopac@tetratech.com**

<b>Project No.:</b> 121111-19002	<b>Date:</b> 2-16-21
Garage, and New Pump House	igh School, Mahopac Middle School, Mahopac Falls School, Bus
Bidder Contact Person: Rick Recine Bidder Company Name: Northbrook Bidder Phone: 914-734-5506 Bidder Email Address: rickr@northbrookcontracti	
Question Pertains to: NCC RFI#1	
Drawing Number: ZC506 Plan Area: Common site details Room Number: Drawing Detail Number: 1 & 2 Specification Section: 334100	
Question: (Please be specific)	······································
Please provide casting manufacturer abd model num	er for these OCS's
Review by Architect/Engineers:	Responded By: D.Bussmann Date: 03 / 01 / 2021
Refer to forthcoming Addendum #4. Spec	fication 33 41 00 has been revised.
Submit requests not less than 5 working days	orior to the specified Bid Opening date and time. In the event that
this question requires clarification or modification be provided by formal Addendum, distributed	tion of the Bidding Documents, such written information can only to all plan holders.



RFI #006

### SUBMIT FORM BY EMAIL TO INE.Mahopac@tetratech.com

<b>Project No.:</b> 121111-19002		Date:	2/19/2021
<b>Project Name:</b> Reconstruction to Mahopac High S Garage, and New Pump House	School, Mahopac Middle School,	Mahopa	c Falls School, Bus
Bidder Contact Person: CHRIS COLANDREA Bidder Company Name: NORTHBROOK CONTRAC Bidder Phone: 914-879-6099 Bidder Email Address: NORTHBROOKCHRIS@YAI			
Question Pertains to:			
Drawing Number: AC-140 Plan Area: A Room Number: Drawing Detail Number: DETAIL 4 ON SHEET CZ- Specification Section: 33 41 00 2.12	505		
Question: (Please be specific)  DETAIL 4 ON SHEE  A HEIGHT OF 45". WHEN REFER	T CZ-505 SHOWS THE CHAMBER ING TO THE SPEC SECTION, IT SF H. THIS MODEL IS ONLY 30" IN HE	PECIFIES	THE CHAMBER
Review by Architect/Engineers:	Responded By: D.Bussmann D	ate: 03	/ 01 / 2021
Refer to forthcoming Addendum #4. Both and the specification has been updated to		eing use	d on this project,
Submit requests not less than 5 working days prior this question requires clarification or modification or	to the specified Bid Opening date	and tim	e. In the event that

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be provided by formal Addendum, distributed to all plan holders.



#### SUBMIT FORM BY EMAIL TO INE.Mahopac@tetratech.com

**Project No.:** 121111-19002 Date: 2/19/21 Project Name: Reconstruction to Mahopac High School, Mahopac Middle School, Mahopac Falls School, Bus Garage, and New Pump House Bidder Contact Person: CHRIS COLANDREA Bidder Company Name: NORTHBROOK CONTRACTING CORP **Bidder Phone:** 914-879-6099 Bidder Email Address: NORTHBROOKCHRIS@YAHOO.COM **Question Pertains to: Drawing Number:** Plan Area: AC-140 Room Number: **Drawing Detail Number:** Specification Section ON CZ-505 **Question:** (Please be specific) DRAWING # AC-140 SHOWS THE DRAINAGE CHAMBER SYSTEMS ON WEST SIDE. IT SCALES (1" = 30') TO BE APPOX. 155 LF LONG TO INCLUDE TIE IN PIPES. DETAIL SECTION ON CZ-505 STATES THE BASE LENGTH TO BE 110.22 LF THE SAME WITH THE EASTERN DRAINAGE CHAMBER SYSTEM. THE SCALE DOESN'T MATCH THE DETAIL SHOWN LENGTH. PLEASE CLARIFY ON WHICH DIMENSION TO USE FOR BIDDING. Responded By: D. Bussmann Date: 03 / 01 / 2021 **Review by Architect/Engineers:** Refer to forthcoming Addendum #4. Storm chamber systems indicated on revised and reissued Site Detail Drawing ZC505 shall apply.

INSTRUCTIONS TO BIDDERS

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Project No. 121111-19002

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Submit requests not less than 5 working days prior to the specified Bid Opening date and time. In the event that this question requires clarification or modification of the Bidding Documents, such written information can only

be provided by formal Addendum, distributed to all plan holders.



### SUBMIT FORM BY EMAIL TO INE.Mahopac@tetratech.com

<b>Project No.:</b> 121111-19002		Date:	2.19.21	NCC RFI #8
<b>Project Name:</b> Reconstruction to Mahopac High S Garage, and New Pump House	•	•		School, Bus
Bidder Contact Person: Rick Bidder Company Name: Northbrook Bidder Phone: 914.734.5506 Bidder Email Address: rickr@northbrookcontracting.con				-
Question Pertains to:				
Drawing Number: BC 110 & ZC500 Plan Area: Erosion Control Room Number: Drawing Detail Number: 11 Specification Section: 312500				
Question: (Please be specific)				
Dwg. BC110 note #9 saysminimum entrance pad to be 30' Please provide correct dimensions				
Review by Architect/Engineers:	Responded By: D.Bussmann D			<u>?1</u>
As the stabilized construction entrance is dischar would apply per the Site Erosion and Sediment C minimum length of 50', with Note 2 also indicating therefore will be required.	Control Note #9. Detail 11 on She	et ZC5	00 indicat	tes a
Submit requests not less than 5 working days prior this question requires clarification or modification of be provided by formal Addendum, distributed to all	to the specified Bid Opening date of the Bidding Documents, such we	and tin	ne. In th	



### SUBMIT FORM BY EMAIL TO INE.Mahopac@tetratech.com

<b>Project No.:</b> 121111-19002	Date:	2.19.21	NCC RFI #009
<b>Project Name:</b> Reconstruction to Mahopac High School, Mahopac Middle Garage, and New Pump House	•		School, Bus
Bidder Contact Person: Rick Bidder Company Name: Northbrook Bidder Phone: 914.734.5506 Bidder Email Address: rickr@northbrookcontracting.com			-
Question Pertains to:			
Drawing Number: ZC500 Plan Area: Erosion Control Room Number: Drawing Detail Number: 15 Specification Section: 312500-9, 2.11, A, B, C			
Question: (Please be specific)  Dwg. ZC500 Detail shows a standard type orange fence with no stake dimensions and no noted above says2x4 vertical posts and a 2x4 top rail. Please advise which method is required.	o top rail, however, s	pec section	
Review by Architect/Engineers: Responded By: D.Bus			<u>.</u> <u>1</u>
2x4 vertical posts and 2x4 top rail only required on vegetation protection in construction fence (Detail 13). For temporary construction fence provide debetween posts as noted in Detail.			
Submit requests not less than 5 working days prior to the specified Bid Ope this question requires clarification or modification of the Bidding Documer be provided by formal Addendum, distributed to all plan holders.	ening date and tir	me. In th	



### SUBMIT FORM BY EMAIL TO INE.Mahopac@tetratech.com

<b>Project No.:</b> 121111-19002	Date:	2/22/2021
<b>Project Name:</b> Reconstruction to Mahopac High School, Mahopac Middle School Garage, and New Pump House	, Mahopac	Falls School, Bus
Bidder Contact Person: CHRIS COLANDREA Bidder Company Name: NORTHBROOK CONTRACTING CORP Bidder Phone: 914-879-6099 Bidder Email Address: NORTHBROOKCHRIS@YAHOO.COM		
Question Pertains to:		
Drawing Number: Plan Area: Room Number: Drawing Detail Number: Specification Section:8 ON ZC502		
Question: (Please be specific)		<del></del>
PLEASE SEE THE 12" DRAINAGE PIPE IN THE TURF FIELD AT BOTH THE NORT THAT SHOW "DRAIN STUB" PLEASE CLARIFY IF THERE IS A CLEAN OUT OR ELAT THESE (4) LOCATIONS.		
Review by Architect/Engineers: Responded By: D.Bussmann		
Drain stub locations indicated are the start of the run and only require an end of	ар.	
Submit requests not less than 5 working days prior to the specified Bid Opening dat this question requires clarification or modification of the Bidding Documents, such be provided by formal Addendum, distributed to all plan holders.		



#### SUBMIT FORM BY EMAIL TO INE.Mahopac@tetratech.com

Project No.: 121111-19002 Date: 2/22/2021

Project Name: Reconstruction to Mahopac High School, Mahopac Middle School, Mahopac Falls School, Bus

Garage, and New Pump House

.....

Bidder Contact Person: CHRIS COLANDREA

Bidder Company Name: NORTHBROOK CONTRACTING CORP

**Bidder Phone:** 914-879-6099

Bidder Email Address: NORTHBROOKCHRIS@YAHOO.COM

#### **Question Pertains to:**

**Drawing Number:** 

Plan Area:

Room Number: Drawing Detail Number:

**Specification Section:** 01 50 00 3.4 G

\_\_\_\_\_\_

#### **Question:** (Please be specific)

The above spec section states that a temporary perimeter enclosure fence is to be installed prior the start of excavations. Please clarify if this part of the site contract and if so, where will the fence be installed and for how long?

------

#### Review by Architect/Engineers: Responded By: <u>HR/TPG</u> Date: <u>02-28-2021</u>

Please refer to Spec Section 01 12 00; 1.13 CONTRACT 7 – SITE WORK CONSTRUCTION 5. New Construction; 1. Provide all site fencing and landscaping

Fencing Installation Locations to be Determined in the Site Logistics Plan - to be Distributed Fencing Duration; for the length of the Construction Project; Please see Project Milestone Schedule distributed in Addendum 001 02-12-2021

\_\_\_\_\_\_

Submit requests not less than 5 working days prior to the specified Bid Opening date and time. In the event that this question requires clarification or modification of the Bidding Documents, such written information can only be provided by formal Addendum, distributed to all plan holders.



### SUBMIT FORM BY EMAIL TO INE.Mahopac@tetratech.com

<b>Project No.:</b> 121111-19002		Date:	2/25/2021
<b>Project Name:</b> Reconstruction to Mahopac H Garage, and New Pump House	igh School, Mahopac Middle School	, Mahopac	Falls School, Bus
Bidder Contact Person: CHRIS COLANDREA Bidder Company Name: NORTHBROOK CON Bidder Phone: 914-879-6099 Bidder Email Address: NORTHBROOKCHRIS	TRACTING CORP @YAHOO.COM		
Question Pertains to:			
Drawing Number: Plan Areac-120 Room Number: Drawing Detail Number: Specification Seltlon6 ON ZC-501,			
Question: (Please be specific)			
AROUND THE NEW TURF FIELD. AN R BE ONLY ONE CURB WITH THE CLF A	AND DEPTH OF THE PERIMETER CURE IFI RESPONSE NOTED THAT THERE W. ND BALL STOPPER NETTING INCORP NETTING DOES NOT APPLY. DOES THE TING AT ALL?	ILL ORATED	
Review by Architect/Engineers:	Responded By: D.Bussmann I		
Refer to Addendum #3 and forthcoming Addendu requirements. Football safety netting is not in sco			
Submit requests not less than 5 working days puthis question requires clarification or modifica		e and time	. In the event that
be provided by formal Addendum, distributed		written in	iormation can only



### SUBMIT FORM BY EMAIL TO INE.Mahopac@tetratech.com

<b>Project No.:</b> 121111-19002		Date:
<b>Project Name:</b> Reconstruction to Mahopac H Garage, and New Pump House	High School, Mahopac Middle S	School, Mahopac Falls School, Bu
Bidder Contact Person: Joseph Piazz Bidder Company Name: Piazza Inc Bidder Phone: (914) 830-1344 Bidder Email Address: jd@piazzabrothe	ers.com	
Question Pertains to:		
Drawing Number: Plan Area: Room Number: Drawing Detail Number: Specification Section:		
Question: (Please be specific)  Could you please direct me to the Security Window. I see a spec sec see elevation S1 located in the s	tion for it but can't lo	ocate the drawing. I
Review by Architect/Engineers:	Responded By:	Date:
this will be addressed in bid addendum #4.	Timothy S	tevens 2/26/21
Submit requests not less than 5 working days this question requires clarification or modific be provided by formal Addendum, distributed	ation of the Bidding Documents	



### SUBMIT FORM BY EMAIL TO INE.Mahopac@tetratech.com

<b>Project No.:</b> 121111-19002		Date:	
<b>Project Name:</b> Reconstruction to Mahopa Garage, and New Pump House	nc High School, Mahopac Middle S	chool, Mahopac Fall	s School, Bus
Bidder Contact Person: Joseph Pia Bidder Company Name: Piazza Inc Bidder Phone: (914) 830-1344 Bidder Email Address: jd@piazzabrot	1		
Question Pertains to:			
Drawing Number: AA600 Plan Area: Room Number: Drawing Detail Number: S2 & S5 Specification Section: 084600 Fire Ra	ted Door Assemblies		
Question: (Please be specific)			
Fire Rated Assemblies 084600: Deshown as Flush doors with narro 084600 do not offer Flush doors L101-4, 235-1, 238-1, 239-1, 24 should proceed.	w lites; manufactures list . This occurs at doors #L1	ed in specificate of the specifi	tion 101-3, we
Review by Architect/Engineers:	Responded By:	Date:	<del></del>
these doors will be addressed in bid addendum #4	Timothy Stevens	2/26/21	
Submit requests not less than 5 working dathis question requires clarification or modibe provided by formal Addendum, distribution	fication of the Bidding Documents	•	

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Project No. 121111-19002
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### SUBMIT FORM BY EMAIL TO INE.Mahopac@tetratech.com

<b>Project No.:</b> 121111-19002		Date:
<b>Project Name:</b> Reconstruction to Mahopac Hig Garage, and New Pump House	th School, Mahopac Middle So	chool, Mahopac Falls School, Bus
Bidder Contact Person: Joseph Piazza Bidder Company Name: Piazza Inc Bidder Phone: (914) 830-1344 Bidder Email Address: jd@piazzabrothers	s.com	
Question Pertains to:		
Drawing Number: AH Drawings Plan Area: Room Number: Drawing Detail Number: Specification Section:		
Question: (Please be specific)		
Are all walls that are dashed on the contractors or only the ones indicat		<del>-</del>
Review by Architect/Engineers:	Responded By: TJT	Date: 2.25.21
The dashed lines that represent the vany abatement scope. The dashed lines walls which have corresponding abatescope.	nes located adjacent to o	r around some
Submit requests not less than 5 working days pri this question requires clarification or modification be provided by formal Addendum, distributed to	for to the specified Bid Opening on of the Bidding Documents,	g date and time. In the event that



### SUBMIT FORM BY EMAIL TO INE.Mahopac@tetratech.com

<b>Project No.:</b> 121111-19002		Da	te:
<b>Project Name:</b> Reconstruction to Mahopac High Garage, and New Pump House	School, Mahopac Middle So	chool, Ma	hopac Falls School, Bus
Bidder Contact Person: Joseph Piazza Bidder Company Name: Piazza Inc Bidder Phone: (914) 830-1344 Bidder Email Address: jd@piazzabrothers.	com		
Question Pertains to:			
Drawing Number: Plan Area: AA100 Room Number: Drawing Detail Number: Demo Note 1B Specification Section:			
Question: (Please be specific)  Currently demo note 1B is very vague finishes in it's entirety but does not you please indicate which areas have	ot tell us what the w	all fin:	ish is. Could
Review by Architect/Engineers:	Responded By:		 :
will be clarified in bid addendum #4	Timothy Ste	evens	2/26/21
Submit requests not less than 5 working days prior this question requires clarification or modification be provided by formal Addendum, distributed to a	of the Bidding Documents,		



### SUBMIT FORM BY EMAIL TO INE.Mahopac@tetratech.com

<b>Project No.:</b> 121111-1900	Date:	
<b>Project Name:</b> Reconstru Bus Garage, and New Pun	ction to Mahopac High School, Mahopac Middle School, Mahopac Falls S	School,
Bidder Contact Person: Bidder Company Name: Bidder Phone: Bidder Email Address:	PETER MADDOX RICHARDS CORPORATION 860-583-9229 pmaddox@richardscorp.com	 Ouestion
Pertains to:  Drawing Number: Plan Area: Room Number: Drawing Detail Number: Specification Section:		
(Please be specific)  1. Section 01 12 00 Summa or addenda. please clarify	ary of Project section 1.19A says a site logistics plan will be issued. I cannot find where this plan can be found.  I.a&b references "Item. #304.3 course". Please clarify what this is.	
1. A Site Logistics Plar 2. 01 50 00 , 3.3.E.4 a/d	Responded By: HR/TPG Date: 02-28-21 n will be issued in an upcoming Addendum; it has not been issued at this tire between 1804.3 course - Refers to "SUBBASE COURSE" for a general NYS DOT section 304 - Sub-base Course	
Submit requests not less the this question requires clari	nan 5 working days prior to the specified Bid Opening date and time. In the fication or modification of the Bidding Documents, such written information dendum, distributed to all plan holders.	



### SUBMIT FORM BY EMAIL TO INE.Mahopac@tetratech.com

<b>Project No.:</b> 121111-1900	2		<b>Date:</b> 2-19-2021
<b>Project Name:</b> Reconstru Garage, and New Pump H		School, Mahopac Middle School	, Mahopac Falls School, Bus
Bidder Contact Person: Bidder Company Name: Bidder Phone: Bidder Email Address:	PETER MADDOX RICHARDS CORPORATION 860-583-9229 pmaddox@richardscorp.c		
Question Pertains to:  Drawing Number: Plan Area: Room Number: Drawing Detail Number: Specification Section:	03 48 10		
Question: (Please be spec Which contractor is respon	eific)	ast concrete lighting pole bases?	
Review by Architect/Eng		Responded By: <u>HR/TPG</u> I	
Please refer to Specification Please also to refer to Specification 02-16-2021		tract 7 - Site Work 1.13 B 3. Divid in Addendum 002	ision 3 – Concrete - all Sections
Submit requests not less th	an 5 working days prior fication or modification	to the specified Bid Opening dat of the Bidding Documents, such l plan holders.	te and time. In the event that



### SUBMIT FORM BY EMAIL TO INE.Mahopac@tetratech.com

<b>Project No.:</b> 121111-1900	)2		<b>Date:</b> 2-19-2021	
<b>Project Name:</b> Reconstru- Garage, and New Pump He	1 0	School, Mahopac Middle Sc	hool, Mahopac Falls Sch	ool, Bus
Bidder Contact Person: Bidder Company Name: Bidder Phone: Bidder Email Address:	PETER MADDOX			
Question Pertains to:				
Drawing Number: ZC504 Plan Area: Room Number: Drawing Detail Number: Specification Section:				
Question: (Please be spec	<u>::ifie)</u>			
1. Which contractor is resp	onsible to place the con	crete pad below the new water	storage tank?	
2. Which contractor is resp the storage tank to the pure		nated water and 6" potable wat	er lines from	
Review by Architect/Eng		Responded By: HR/TPG		
The Site Work Contractor ( (Contract #7) shall be respo 1.7;5 New Construction- d.	Contract #7) shall be responsible to prepare the area to sub	d excavation for all work related to new b	rete pads. The Site Contractor	ner contractors related to
2. See Division 22 - Plumbing	ŗ,			
	nan 5 working days prio	or to the specified Bid Opening n of the Bidding Documents, sall plan holders.	g date and time. In the e	



### SUBMIT FORM BY EMAIL TO INE.Mahopac@tetratech.com

<b>Project No.:</b> 121111-1900	2	Date:
<b>Project Name:</b> Reconstru Garage, and New Pump He	ction to Mahopac High School, Mahopac Mide ouse	dle School, Mahopac Falls School, Bus
Bidder Contact Person: Bidder Company Name: Bidder Phone: Bidder Email Address:	PETER MADDOX RICHARDS CORPORATION 860-583-9229 jprincipi@richardscorp.com	
Question Pertains to:		
Drawing Number: AC1 Plan Area: Room Number: Drawing Detail Number: Specification Section:		
Question: (Please be spec	<b>ific)</b> of the fence removal. The existing fence is being o	
Review by Architect/Eng	ineers: Responded By: D.B	ussmann Date: 2 / 23 / 2021
Refer to issued Addendum	#3 for clarification of fence removal, temporar	y relocation, and fencing to remain.
this question requires clari	an 5 working days prior to the specified Bid O fication or modification of the Bidding Docum	



### SUBMIT FORM BY EMAIL TO INE.Mahopac@tetratech.com

<b>Project No.:</b> 121111-1900	2		Date:	2-22-2020
<b>Project Name:</b> Reconstru Garage, and New Pump H	ction to Mahopac High School, Maho buse	opac Middle Schoo	ol, Mahop	oac Falls School, Bus
Bidder Contact Person: Bidder Company Name: Bidder Phone: Bidder Email Address:	860-583-9229 pmaddox@richardscorp.com			
<b>Question Pertains to:</b>				
Drawing Number: AC100 Plan Area: Room Number: Drawing Detail Number: Specification Section:				
	sible for the demolition of the existing			
Review by Architect/Eng	ineers: Responded	By: KC/TPG		
	l be responsible for the Demo of the sonsibility to coordinate all disconnects			etor & the Plumbing
Submit requests not less the this question requires clari	an 5 working days prior to the specification or modification of the Biddin lendum, distributed to all plan holders	led Bid Opening da ag Documents, such	ate and tin	me. In the event that



### SUBMIT FORM BY EMAIL TO INE.Mahopac@tetratech.com

<b>Project No.:</b> 121111-1900	)2		Date:	2-25-2020
<b>Project Name:</b> Reconstru Garage, and New Pump H	ction to Mahopac High Schoo ouse	ol, Mahopac Middle Schoo	ol, Mahop	pac Falls School, Bus
Bidder Contact Person: Bidder Company Name: Bidder Phone: Bidder Email Address:	PETER MADDOX RICHARDS CORPORATION 860-583-9229 pmaddox@richardscorp.com			
Question Pertains to:				
Drawing Number: Plan Area: Room Number: Drawing Detail Number: Specification Section: 31	20 00 appendix - geotechinc	al borings and maps		
	cific) naps show an I-series of borings The boring logs were not provi	· ·		rough I-6, MMS I-1 through I-4,
·	ssible rock being present in the lume and location of rock remov		٠.	
Review by Architect/Eng	<u>ineers:</u> Res	ponded By: C Glaubitz	Date: 3	/1/21
Locations including "I" an locations. Rock removal is not antic	d "TS" indications are not bori ipated.	ngs. They indicate infiltrati	on test a	nd soil test

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Architects & Engineers

Submit requests not less than 5 working days prior to the specified Bid Opening date and time. In the event that this question requires clarification or modification of the Bidding Documents, such written information can only

be provided by formal Addendum, distributed to all plan holders.



### SUBMIT FORM BY EMAIL TO INE.Mahopac@tetratech.com

<b>Project No.:</b> 121111-1900	2	Date:	2-25-2020
<b>Project Name:</b> Reconstru Garage, and New Pump H			
Bidder Contact Person: Bidder Company Name: Bidder Phone: Bidder Email Address:	PETER MADDOX RICHARDS CORPORATION 860-583-9229 pmaddox@richardscorp.com		
Question Pertains to:			
Drawing Number: Plan Area: Room Number: Drawing Detail Number: Specification Section: 01	12 00, 1.13, A.3.h & 31 20 00		
Question: (Please be spec	i <u>fic)</u>		
2. If so, shall the site con	sting soil layer identified as "organic silt sand" in boring MMS ractor include its removal and replacement in the base bid? quantity as 1 boring is not sufficient to determine a volume.	3 AB-20 r€	epresents "unsuitable fill
Review by Architect/Eng	neers: Responded By: C Glaubitz I	Date: 3	/1/21
The soil in question has	not been determined to be unsuitable fill.		
Submit requests not less th	an 5 working days prior to the specified Bid Opening dat	e and tin	ne. In the event that
	endum, distributed to all plan holders.	.,,,,,,,,,,,,,,,,,,,,,,,,,,,,,,,,,,,,,,	and the control of th



#### SUBMIT FORM BY EMAIL TO INE.Mahopac@tetratech.com

Project No.: 121111-19002 Date: 2-25-2020

Project Name: Reconstruction to Mahopac High School, Mahopac Middle School, Mahopac Falls School, Bus

Garage, and New Pump House

.....

**Bidder Contact Person:** PETER MADDOX

Bidder Company Name: RICHARDS CORPORATION

**Bidder Phone:** 860-583-9229

Bidder Email Address: pmaddox@richardscorp.com

\_\_\_\_\_

#### **Question Pertains to:**

**Drawing Number:** 

Plan Area:

**Room Number:** 

**Drawing Detail Number:** 

Specification Section: 31 20 00, 2.1.D.1 and 2.1.E.1 and 2.1.F.1

•

#### **Question:** (Please be specific)

- 1. Detail 8/ZC504 calls for "structural fill" to backfill pipes below paved areas. Specification section 31 20 00,2.1.D.1 says "granular fill" is required below pavements and synthetic fields. Please clarify which material is required as these have different definitions.
- 2. Please confirm the onsite soils will not be allowed for filling to subgrade below the paved areas and synthetic fields. If not, please clarify which, "granular fill" or "structural fill" is required.

#### Review by Architect/Engineers: Responded By: D.Bussmann Date: 2/26/2021

Refer to specification 31 00 00 Earth Moving 3.18.B. section for soil fill requirements, including areas under walks, pavements and exterior slabs, under steps and ramps, under building slabs, and under synthetic turf fields. Regarding backfill for pipes below paved areas and synthetic turf, use structural fill up to the subbase layer, where granular fill (or as specified for synthetic turf) will apply.

\_\_\_\_\_

Submit requests not less than 5 working days prior to the specified Bid Opening date and time. In the event that this question requires clarification or modification of the Bidding Documents, such written information can only be provided by formal Addendum, distributed to all plan holders.



### SUBMIT FORM BY EMAIL TO INE.Mahopac@tetratech.com

<b>Project No.:</b> 121111-19002		Date:	2/25/21
<b>Project Name:</b> Reconstruction to Mahopac High Garage, and New Pump House	•		
Bidder Contact Person: Jim Sass III Bidder Company Name: J&J Sass Electric Inc Bidder Phone: 845-331-8666 Bidder Email Address: jimsass3@jjsass.com			
Question Pertains to:			·
Drawing Number: AE003 Plan Area: Room Number: Drawing Detail Number: Specification Section:			
Question: (Please be specific)  Please clarify the location of the MDP i is to panel PH-1. Also clarify where the clarify the scale on the drawing as well.	(2) 2" spare conduits are going i		
Review by Architect/Engineers:	Responded By: CREGA	Date:	2/26/21
MDP AND CONDUITS AS INDICAT BUILDING AS SHOWN ON DRAWI PROVIDED ON DRAWING.			
Submit requests not less than 5 working days prio this question requires clarification or modification	or to the specified Bid Opening da	ate and tin	me. In the event that

INSTRUCTIONS TO BIDDERS
Page ITB-8
Project No. 121111-19002
Architects & Engineers

be provided by formal Addendum, distributed to all plan holders.



### SUBMIT FORM BY EMAIL TO INE.Mahopac@tetratech.com

Project No.: 121111-19002	Date:	February 25, 2021
<b>Project Name:</b> Reconstruction to Mahopac High School, Mahopac Middle School, Garage, and New Pump House	Mahop	ac Falls School, Bus
Bidder Contact Person: Adam Horton Bidder Company Name: Turco Golf, Inc. Bidder Phone: Cell: 607-437-4672 Office: 845-357-9300 Bidder Email Address: ahorton@grasskeepers.net		
Question Pertains to: Ref. Contract 7 SW - Site Construction Work		
Drawing Number: Sheet ZC 504 Plan Area: N/A Room Number: N/A Drawing Detail Number: Detail 2 - Water Storage Tank & Detail 9 - Well Modificat Specification Section:	tion	
Question: (Please be specific)		
Please confirm which contract includes the proposed water storage tank installation and on plan sheet ZC 504.	well moo	dification shown
Review by Architect/Engineers: Responded By: HR/TPG D		
Please refer to Spec Section 22 12 19 Facility Ground-Mounted, Potable V Also see Spec Section 01 12 00 1.13 CONTRACT 7 – SITE WORK CONS		•
Submit requests not less than 5 working days prior to the specified Bid Opening date this question requires clarification or modification of the Bidding Documents, such the provided by formal Addendum, distributed to all plan holders.	and tin	ne. In the event that





#### SECTION 26 08 00 - COMMISSIONING OF ELECTRICAL

#### PART 1 - GENERAL

#### 1.1 RELATED DOCUMENTS

- A. Drawings and general provisions of the Contract, including General Conditions and other Division 01 Specification Sections, apply to this Section.
  - 1. See especially Section 01 08 00, "General Commissioning Requirements" for general commissioning process requirements and Commissioning Coordinator responsibilities.

#### 1.2 INCLUDED SYSTEMS AND EQUIPMENT

- A. The following is a list of the equipment and system test requirements included in this section:
  - 1. Interior Occupancy Lighting Controls
  - 2. Exterior Motion/Photo and Timeclock Controls

#### 1.3 DESCRIPTION

- A. This section specifies the example functional testing requirements for Division 23 systems and equipment. From these examples, the Commissioning Authority (CxA) shall develop step-by-step procedures to be executed by the Subs or the Commissioning Authority. The general functional testing process, requirements and test method definitions are described in Section 01 9113. The test requirements for each piece of equipment or system contain the following:
  - 1. The contractors responsible to execute the tests, under the direction of the CxA.
  - 2. A list of the integral components being tested.
  - 3. Prefunctional checklists associated with the components.
  - 4. Functions and modes to be tested.
  - 5. Required conditions of the test for each mode.
  - 6. Special procedures.
  - 7. Required methods of testing.
  - 8. Required monitoring.
  - 9. Acceptance criteria.

#### 1.4 MONITORING

- A. Monitoring is a method of testing as a stand-alone method or to augment manual testing.
- B. All points listed in the required monitoring section of the test requirements which are control system monitored points shall be trended by the controls contractor. Other points shall be monitored by the CxA using dataloggers. At the option of the CxA, some control system monitoring may be replaced with datalogger monitoring. At the CxA's request, the controls contractor shall trend up to 20% more points than listed herein at no extra charge.

- C. Hard copies of monitored data must be in columnar format with time down the left column and at least 5 columns of point values on the same page.
- D. Graphical output is desirable, and will be required for all output, if the system can produce it.

#### PART 2 - PRODUCTS (Not Used)

#### **PART 3 - EXECUTION**

#### 3.1 **TESTING PREPARATION**

- A. Certify that Lighting Control systems have been installed, calibrated, and started and are operating according to the Contract Documents.
- B. Testing Instrumentation: Install measuring instruments and logging devices to record test data as directed by the CxA.

#### 3.2 GENERAL TESTING REQUIREMENTS

A. The CxA in cooperation with the Electrical Contractor shall prepare detailed testing plans, procedures, and checklists for Lighting control systems.


#### 3.3 LIGHTING CONTROL SYSTEMS FUNCTIONAL TESTING PROCEDURES

- A. Parties Responsible to Execute Functional Test
  - Controls contractor: operate the controls to activate the equipment if BAS controlled 1.
  - 2. Electrical contractor or vendor: assist in testing sequences.
  - 3. CxA: to witness, direct and document testing.
- B. Integral Components or Related Equipment Being Tested
  - 1. Lighting Controls (Occupancy, Vacancy, Daylighting, Dimming, Timeclocks)
- C. Prerequisites The commissioning agent will spot-check misc. items and calibrations on the prefunctional checklists previously completed by the installer, prior to beginning functional testing
- D. Functions / Modes Required to be Tested, Test Methods and Seasonal Test Requirements
- E. The following testing requirements are in addition to and do not replace any testing requirements elsewhere in this Division.


	Function / Mode	Test Method Manual and/or Monitoring
1.	GENERAL All specified functions and features are set up, debugged and full operable	Verbal discussion of features
2.	Power failure and battery backup and power-up restart functions	Demonstration
3.	Occupant override functions and duration settings	Demonstration
	SWITCHING FUNCTIONS	
4.	Test the sequence of operation for all features and modes	Manual
5.	Verify that off delays are set and functioning so that the change of light fixture operation is judged non-bothersome to occupants	Manual
6.	Verify that the controls and sensors are not easily overridden or disabled by unauthorized occupants	Visual inspection
7.	Verify control strategies, schedules and setpoints to be reasonable and appropriate	Manual

- F. Special Procedures (other equipment to test with, etc.; reference to function ID)
  - 1. Daylight/photo sensors controls to be confirmed at multiple ambient light levels if necessary.
- G. Acceptance Criteria (referenced by function or mode ID)
  - 1. For the conditions, sequences and modes tested as shown above, the lighting controls, integral components and related equipment respond to changing conditions and parameters appropriately as expected, as specified and according to acceptable operating practice.
- H. Sampling Strategy for Identical Units
  - 1. A representative sample of units will be tested by the CxA.
  - 2. For identical units, test a minimum of three before sampling.

END OF SECTION 26 08 00

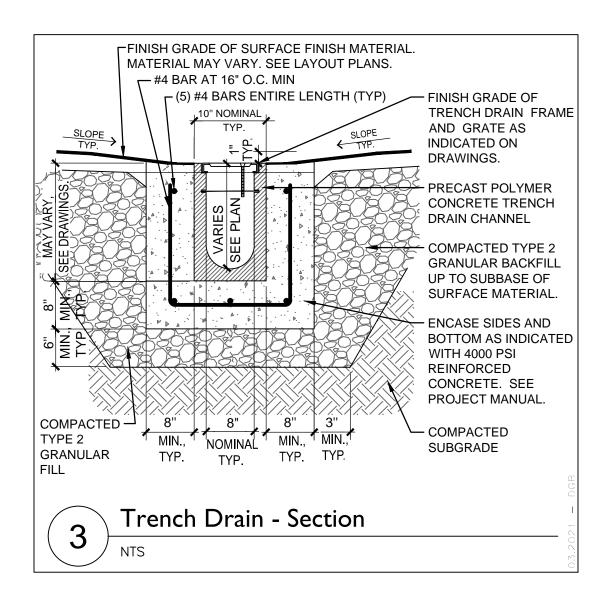

			Proj. No.: 121111-19002	
TETRATECH ARCHITECTS & ENGINEERS			Date: 2021-03-01	
Tetra Tech Engineers, Architects & Landscape Architects, P.C.	Rev.:	Date:	Drawn By: DGB	
Mahopac Central School District	Drawing No.:			
Reconstruction to Mahopac HS and	1 A CO4 D			
Trench Drain - Section (Revised Pe	AC01B			

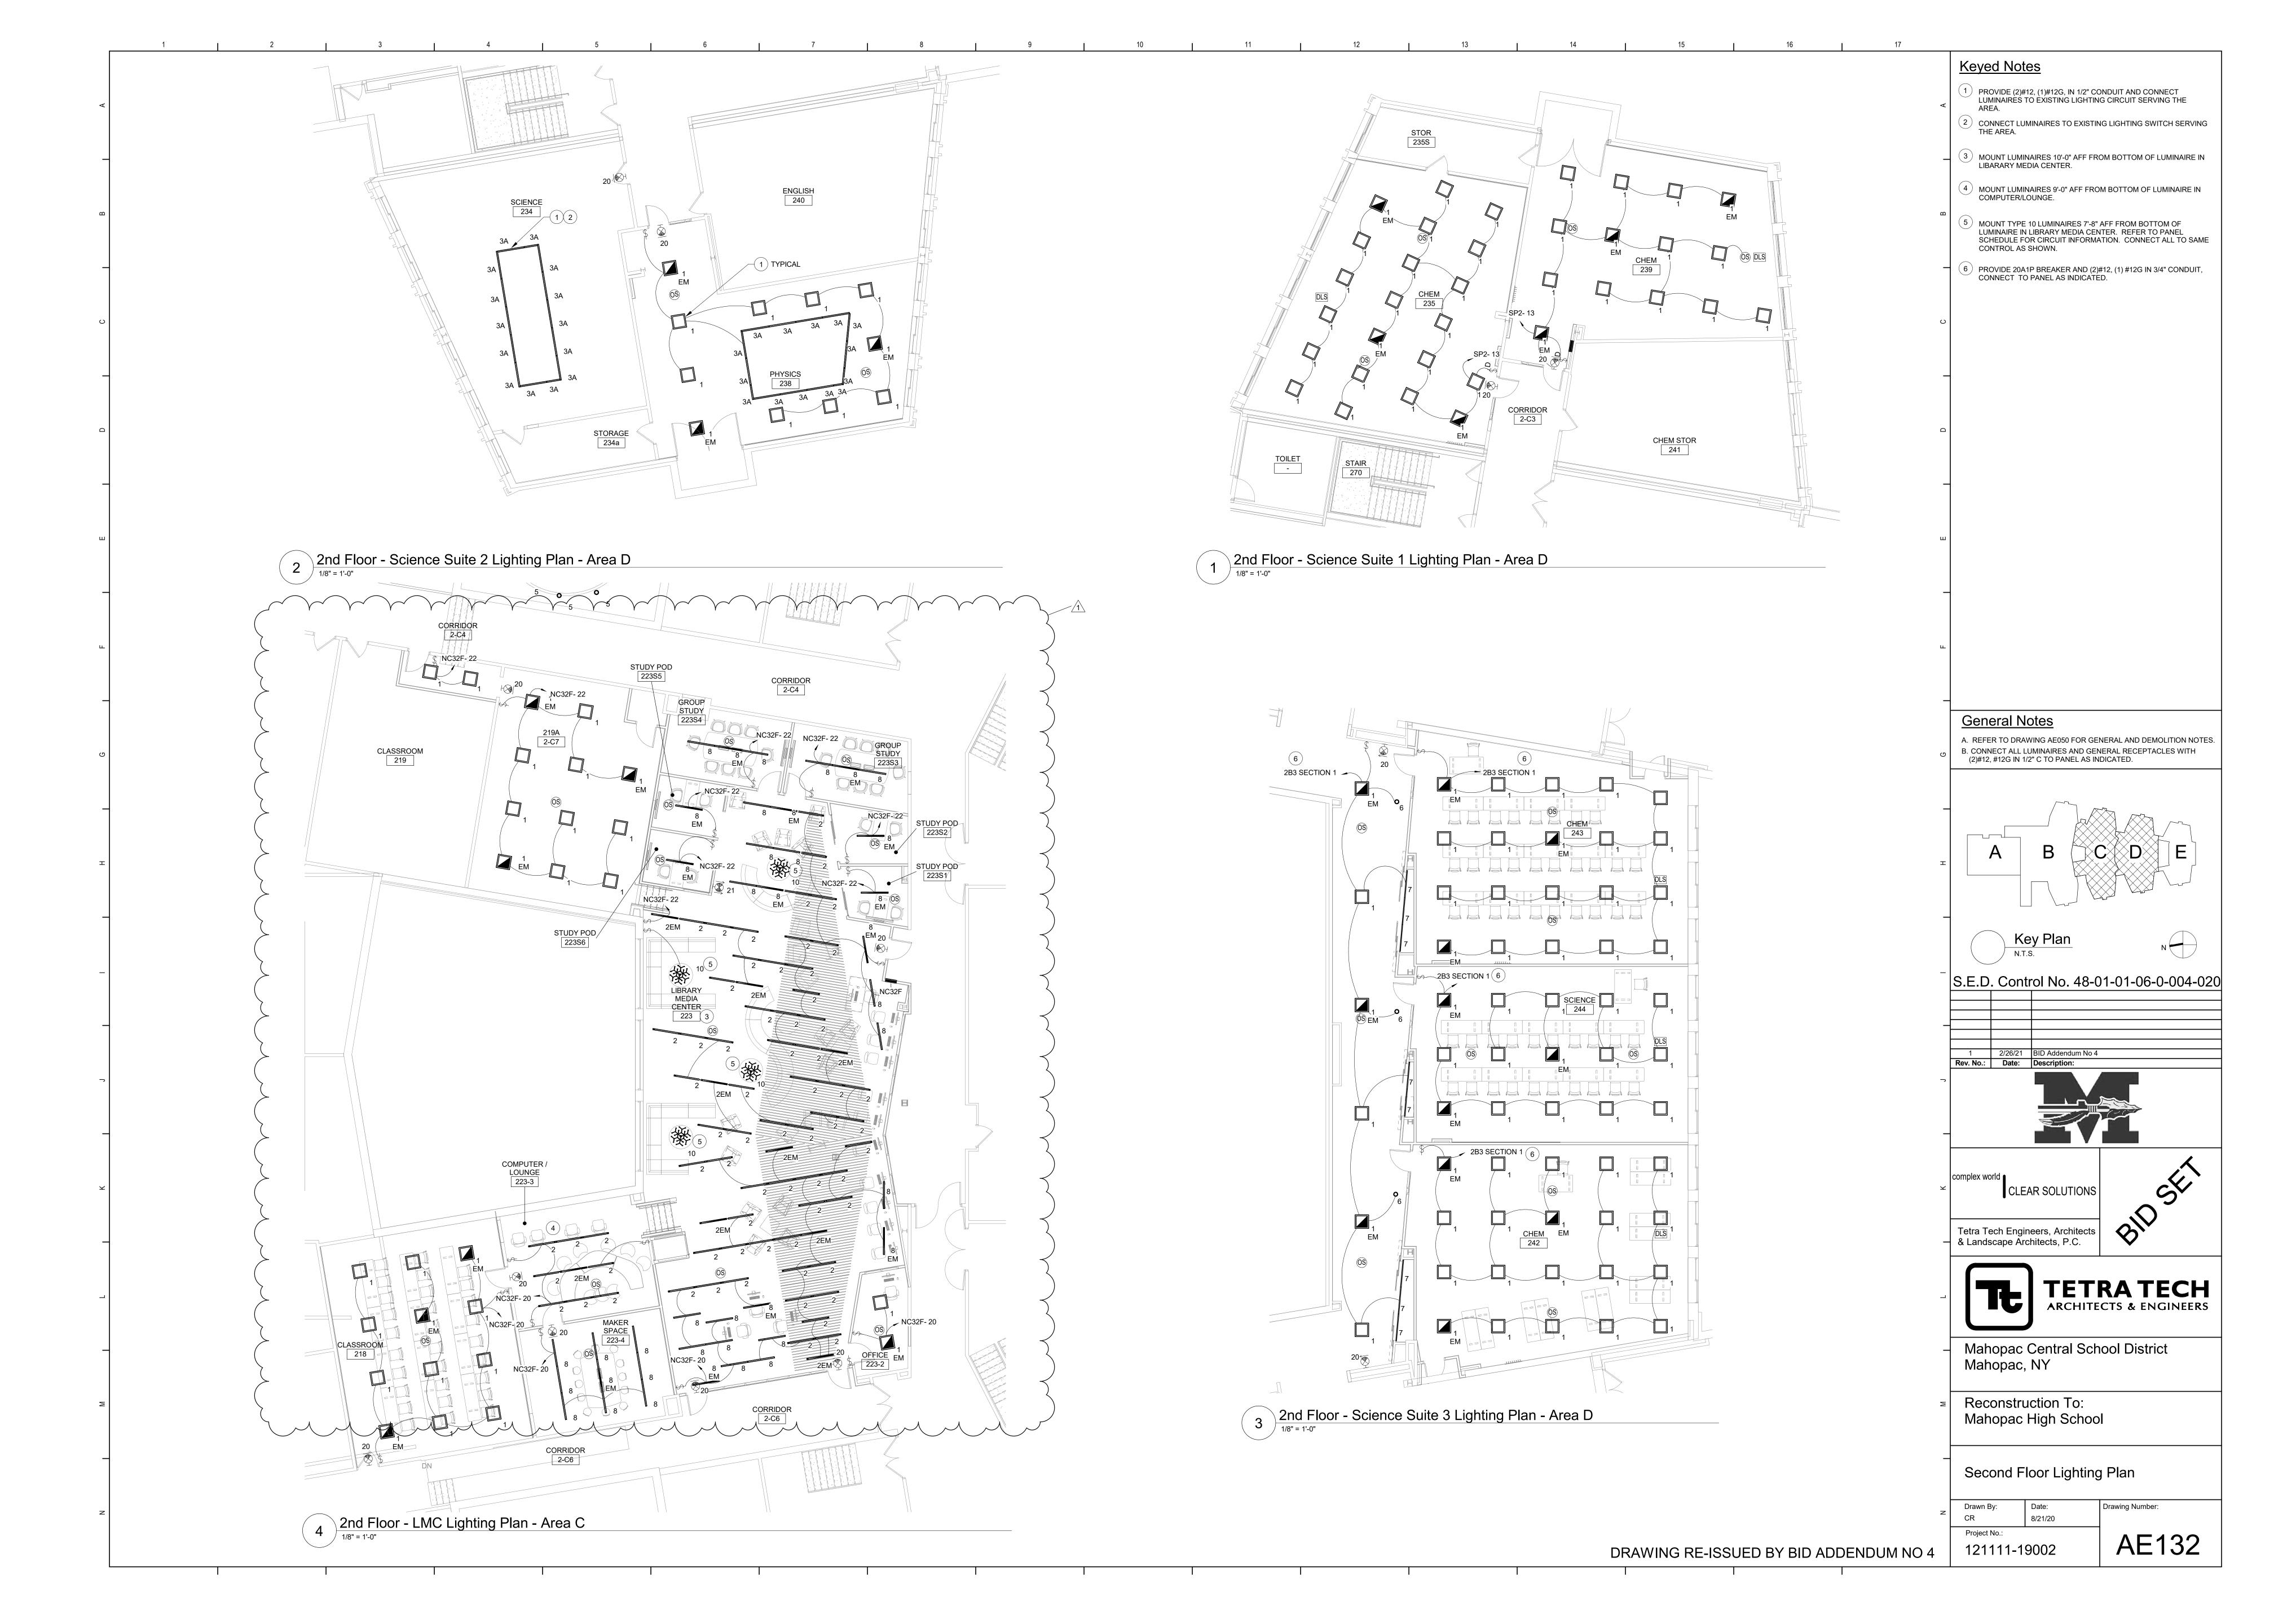

NAME	5 <u>N. 9</u>	6	D N I	XG NUM OF SPACES	REPLACEMENT NUM OF SPACES	GE /	L RATING (A)	NG NG	MAIN CIRCUIT BREAKER REQUIRED (RATING)	AIC		0 GFCI	0	0 0			11	00	20 0		12	0			00	50		25	14 05	00	20	00	15
PANEL	AREA IN BUILDING	ROOM	MOUN	EXG NI SPA(	REPLA NU SP/	VOLTAGE	PANEL (	PANEL LUG RATING	MAIN C BRE/ REQU	PANEL	1P15	1P20 1P20	1P30	1P50 2P15	2P20	2P50	2P60	2P100	3P15 3P20	3P30	3P40 3P50	3P60	3P70	3890	3P100	3P150 3P175	3P200	3P225	3P250	3P300	3P350	3P3000	
OL EX	Basement Basement	Custodial Storage 019	Surface	24 12	24 12	120/208/3P 120/208/3P	100A 100A	100A 100A	-	10K 10K	7 :	22		2					1														
GB1 KP SECTION 1	Basement Basement	Teacher's Work Rm03	0 Surface Recessed	42 36	42 42	120/208/3P 120/208/3P	225A 400A	225A 400A	-	10K 10K	3 3	25 5			2	2			2 1	2		1	1										
KP SECTION 2	Basement	Kitchen 007	Recessed	42	42	120/208/3P	400A	400A	-	10K	9 1	18			1				1 1	2	2												
SH1 SECTION 1 SH1 SECTION 2	Basement Basement	Tech Room 024 Tech Room 024	Surface Surface	24	24	120/208/3P 120/208/3P	225A 225A	- 225A	225A -	10K 10K		6							8									1					
SH1 SECTION 3	Basement	Tech Room 024	Surface	42	42	120/208/3P	225A	225A	-	10K	!	9 9			1	1		;	3	1	1												
SH2 SECTION 1 SH2 SECTION 2	Basement Basement	Serving Serving	Recessed Recessed	7	7 42	120/208/3P 120/208/3P	250A 400A	- 400A	250A -	10K 10K		6							2		1							1	_				
SH2 SECTION 3	Basement	Serving	Recessed	42	42	120/208/3P	400A	400A	-	10K	1 1	17 8	4		2 2			- + '	3 1		2												
SH3 SECTION 1	Basement	Cafeteria	Recessed	1	7	120/208/3P	225A	-	225A	10K	(	6																1					
SH3 SECTION 2	Basement Basement	Cafeteria  Meter Room 131	Recessed	9	9	120/208/3P 120/208/3P	225A 3000A	225A -	2500A	10K 10K		8									1							+				1	
GBB	Basement			15	15	120/208/3P	200A	200A	-	10K					1				1	2					1								
BP MDP4	TBD Basement	TBD  Meter Room 131	Surface Floor	30 Switchboard	30	120/208/3P d 120/208/3P	100A 3000A	100A	60A 2500A	10K 65K								_				3			4		8					1	**PROVIDE (6)30A 3P BREAKE
MDP1 MDP2	1st Floor	Storage 186		1	+	d 120/208/3P d 120/208/3P	800A	800A	800A	10K												4			4		6					5	
AP	1st Floor	Gym Storage 117	Surface	36	36	120/208/3P		225A	-	10K					6					8													
1A1 1A2	1st Floor	Janitor Closet 129  Corridor 131	Recessed Recessed		30	120/208/3P 120/208/3P		225A 225A	-	10K 10K	+	39 14		1	1 1				1														
1A3		Outside 120 Janitor CL		36	36	120/208/3P		225A	-	10K	3	36																					
1A4	1st Floor	+	Surface	18	18 42	120/208/3P 120/208/3P		100A 400A	-	10K 10K	<del>                                     </del>	17 36							1		1							-					
1B1 1B2		Stairway across 186 Rr Corridor across 184 Rr	_	42	42	120/208/3P		400A 400A	-	10K	+	39							1		'												
1B3		Corridor outside 189 Rr		-	54	120/208/3P		400A	-	10K	+	36	2		2	2		1	2														
1B4 SP	1st Floor	Corridor outside 199 Rr	m Recessed Recessed	1	54 42	120/208/3P 120/208/3P		225A 400A	-	10K 10K	+	15 34			2			_	1														
2A1 SECTION 1		Corridor outside 218 Rr		24	24	120/208/3P		225A	-	10K	+	14	4						2														
2A1 SECTION 2		Corridor outside 218 Rr		+	24	120/208/3P		225A	-	10K	+-+	24	1						1														
2A2 2B1		Corridor across 201 Rr Corridor outside 242 Rr	-	+	42 36	120/208/3P 120/208/3P		225A 400A	-	10K 10K	+ ' + '	33	1						1														
2B2		Corridor outside 268 Rr		+	30	120/208/3P		400A	-	10K	+-+	22			1			:	2														
2B3 SECTION 1 2B3 SECTION 2		Corridor outside 253 Rr Corridor outside 253 Rr		30	42	120/208/3P 120/208/3P	200A 200A	-	200A 200A	10K 10K	+	38 36	2			1			1														
2B4		Corridor outside 260 Rr	-	-	42	120/208/3P		225A	-	10K	3	31	2						1	2	2												
LPSC1 LPSC2	2nd Floor 2nd Floor	+	Surface Surface	24 18	24	120/208/3P 120/208/3P		60A 100A	-	10K 10K	<del> </del>	22 23		1				_															
Panel F	Replacem	nent Schedul	le													*	MANUE	ACTUR	RER AND	MODEL													
						LUMIN ***AL		RES ARE 120								N	IUMBER	ARE P	PROVIDEI GN ONLY	D TO SHO	)W												
ITEM	SYMBOL		ITEM			LUM	ENS \	LAMPS WATTAGE	TYPE		NAME	ANUFACT		OR EQU ODEL OR				NOT	E														
1		2' X	( 2' RECESSEI	D TROFFER	₹	45	00	42	LED	\$	SIGNIFY		2FXP-4	15L-835-2-	DS-UNV-D	IM																	
1EM		2' X 2' RECE	ESSED TROFF BATTERY BA		ITEGRAL	45	00	42	LED	\$	SIGNIFY		2FXP-4	-5L-835-2-I EMLE	DS-UNV-DI :D	M-																	
2			PERATURE W JSITIC SUSPE			16	55	4.6	LED	F	INELITE	HP-2	2-B-P-D-	-4'-835-F-S	SC-FC-10%	-C4-FE																	
2EM		2.25" APERAT SUSPENDED LINE				UP 16	55	4.6	LED	F	INELITE	HP-2	-B-P-D-	4'-835-F-S BSL310	SC-FC-10% DLP	-C4-FE-																	
3 1		DIFFUSE	' APERATURE ER SURFACE	MOUNT LIN	NEAR	14	86	4.6	LED	F	INELITE	HP-		0-4-B-835-F C-10%-C4	RG-D-120-8 I-FE	SC-						/ .	<u>^2</u>										
3EM I		2.25" X 4 DIFFUSER INTE	' APERATURE SURFACE ME EGRAL BATTE	E 1" REGRES DUNT LINEA ERY BACKUI	SSED AR/WITH P	14.	86	4.6	LED~		INELITE	HR-	2-SM-D FC-10%	0-4-B-835-F %-C4-FE-B	RG-D-120-8 3SL310LP	3C-		\ <u></u>	$\sim$		<u> </u>	$\prec$											
3A I			RECESSED		DIFFUSER	14	86	4.6	LED	F	INELITE	HP-		0-2-B-835-F C-10%-C4	RG-D-120-8 I-FE	SC-	REFER		ANS FOR	R LENGTH S	I AND	, ,											
4		2.25" X 4" APEF					36	4.6	LED		WELITE	HP-2	2-B-P-0	0-4'-83 <del>5-F-</del>	SCFC-10%	€4-FE																	
4EM		2.25" X 4' APERAT	TURE WITH SI EGRAL BATTE			14		4.6	LED		INELITE	HP-2	2-B-P-D-	-4'-835-F-S BSL310	SCFC-10%- DLP	C4-FE-																	
5	<u> </u>	3.5" DIAM	IETER 12" CYL	LINDER PEN	NDANT	95		18	LED	L	NTENSE GHTING		MXPRE	D-TW2-2-D	)10V1-WF-I	-R																	
6			ETER RECESS			10		20	LED	L	NTENSE GHTING	4-R	R-N-Z4R		5-W-O-CD-2	Z10-U																	
7			4" DISPLAY TA			418		4.1	LED	L	VODE GHTING			707-Z1-			REFE	ER TO	PLANS F	OR LENG	TH												
8		2.25	5"X 4' RECESS	SED LINEAR	₹	16	92	4.6	LED	F	INELITE	HP-2	2-R-D-4'	-B-835-F-S	SC-FC-10%	-C4-FE																	

FINELITE HP-2-R-D-4'-B-835-F-SC-FC-10%-C4-FE-BSL310LP

4-R-N-Z4RDL-10-835-W-O-CD-Z10-U

4-R-N-Z4RDL-10-835-W-O-CD-Z10-U-EM

CRO HOW 52

ER46L-1-W-R

ER46L-2-W-R

CLUN-W

SEE PLANS FOR DIRECTIONAL INDICATORS

SEE PLANS FOR DIRECTIONAL INDICATORS

SIGNIFY (LIGHTOLIER)

SIGNIFY (LIGHTOLIER)

NEMO LIGHTING

SIGNIFY (CHLORIDE)

SIGNIFY (CHLORIDE)

SIGNIFY

LED

LED

LED

LED

LED

LED

2.25"X 4' RECESSED LINEAR WITH INTEGRAL

BATTERY BACKUP

4" DIAMETER RECESSED SHOWER DOWNLIGHT

4" DIAMETER RECESSED SHOWER DOWNLIGHT WITH INTEGRAL BATTERY BACKUP

48" X 46" X 38" CABLE MOUNTED ALUMINIUM/GLASS CHANDELIER

EXIT SIGN (SINGLE FACE)

EXIT SIGN (DOUBLE FACE)

BATTERY PACK EMERGENCY LIGHT

9EM

1000

1000

2.5

.027

**General Notes** A. REFER TO DRAWING AE050 FOR GENERAL AND DEMOLITION NOTES. S.E.D. Control No. 48-01-01-06-0-004-020 2 2/26/21 BID Addendum No 4 1 02/11/2021 BID Addendum No 1

Rev. No.: Date: Description: CLEAR SOLUTIONS Tetra Tech Engineers, Architects & Landscape Architects, P.C. TETRATECH
ARCHITECTS & ENGINEERS Mahopac Central School District Mahopac, NY Reconstruction To: Mahopac High School Schedules Drawing Number: Drawn By: 8/21/20 CR Project No.: AE600 121111-19002

DRAWING RE-ISSUED BY BID ADDENDUM NO 4

