PLUMBING SYMBOLS					
SYMBOL	DESCRIPTION				
	ACCESS PANEL				
E	PIPE CAP				
COI	CLEANOUT				
\times	EXISTING PIPING TO BE REMOVED				
NPCW	NON-POTABLE COLD WATER PIPING				
>	PIPE BREAK				
- 3	PIPE CONNECTION, BOTTOM				
C	PIPE DROP OR DOWN				
0	PIPE RISE OR UP				
•	POINT OF DISCONNECTION				
•	POINT OF RECONNECTION				
<u> </u>	VALVE IN VERTICAL				
	WATERTIGHT PIPE SLEEVE, WALL PENETRATION				
	CTOPM LEADED				
X	STORM LEADER STORM LEADER NUMBER				
	DIRECTION OF VIEW(S)				
1-	SECTION IDENTIFICATION				
P-100					
	REFERENCE DRAWING NUMBER				
1 - P-100	PLAN OR DETAIL IDENTIFICATION				
	REFERENCE DRAWING NUMBER				

NOTES

1) THE KEY OF SYMBOLS INDICATED IS FOR CONVENIENCE ONLY AND ITEMS INDICATED ARE NOT NECESSARILY WITHIN THE SCOPE OF THE WORK.

BBREVIATION	DESCRIPTION
AB	ABOVE
AFF	ABOVE FINISH FLOOR
AP	ACCESS PANEL
BLDG	BUILDING
CFM	CUBIC FEET PER MINUTE
CMU	CONCRETE MASONRY UNIT
СО	CLEANOUT
CONN	CONNECTION
DIM	DIMENSION
DN	DOWN
DWG	DRAWING
EA	EACH
ETC	ET CETERA
EXIST	EXISTING
FL	FLOOR
HZ	HERTZ
KW	KILOWATT
NPCW	NON-POTABLE COLD WATER
NTS	NOT TO SCALE
RPM	REVOLUTIONS PER MINUTE
SST	STAINLESS STEEL
SQ. FT.	SQUARE FEET
TYP	TYPICAL
UON	UNLESS OTHERWISE NOTED
VIF	VERIFY IN FIELD
V	VOLT
W	WATT

GENERAL NOTES

- 1. ALL PLUMBING WORK SHALL MEET THE REQUIREMENTS OF THE 2020 NEW YORK STATE PLUMBING CODE.
- 2. THE DRAWINGS SHOW THE GENERAL ARRANGEMENT OF ALL PIPING AND EQUIPMENT AND INDICATE REQUIRED SIZE AND POINTS OF TERMINATION OF THE PIPING AND SUGGEST PROPER ROUTES OF PIPING. HOWEVER, IT IS NOT THE INTENTION OF THE DRAWINGS TO SHOW ALL NECESSARY OFFSETS, OBSTRUCTIONS OR STRUCTURAL CONDITIONS. IT SHALL BE THE RESPONSIBILITY OF THIS CONTRACTOR TO INSTALL HIS WORK IN SUCH A MANNER THAT IT WILL CONFORM TO THE STRUCTURE, AVOID OBSTRUCTIONS, AND KEEP OPENINGS CLEAR WITHOUT FURTHER CONSTRUCTION OR COST.
- 3. THIS CONTRACTOR SHALL VISIT THE PREMISES OF HIS PROPOSED WORK AND SHALL CAREFULLY EXAMINE THE EXISTING CONDITIONS AND LIMITATIONS THEREOF. VERIFICATION SHALL BE MADE AS TO THE ACTUAL LOCATIONS WHERE PIPE RUNS WILL TIE INTO EXISTING WORK AND CLEARANCES WITH STRUCTURAL MEMBERS. THE CONTRACTOR SHALL INCLUDE ALL COSTS OF ANY KIND WHATSOEVER WHICH ARE INCURRED THROUGH LIMITATIONS OF THE EXISTING CONDITIONS.
- 4. THE DRAWINGS ON THESE PLANS ARE DIAGRAMMATIC. THIS CONTRACTOR SHALL BE RESPONSIBLE FOR COORDINATING HIS WORK WITH OTHER TRADES AND STRUCTURE. NO EXTRA PAYMENTS WILL BE AUTHORIZED FOR REROUTING OR REMOVAL OF INSTALLED WORK DUE TO LACK OF COORDINATION.
- 5. COORDINATE ALL WORK WITH AUTHORITIES HAVING JURISDICTION AND LOCAL UTILITY COMPANIES, INCLUDING BUT NOT LIMITED TO APPLICATIONS, PERMITS, FEES, APPROVALS, AND SIGN OFFS.
- 6. FOR WATER WELL DECOMMISSIONING, CONTRACTOR TO FOLLOW GUIDELINES AND RECOMMENDATIONS FROM DEC DOCUMENT TITLED "WATER SUPPLY WELL DECOMMISSIONING RECOMMENDATIONS DIVISION OF WATER."
- 7. FOR WATER WELL TESTING, CONTRACTOR TO FOLLOW GUIDELINES AND RECOMMENDATIONS FROM WESTCHESTER COUNTY DOCUMENT TITLED "WESTCHESTER COUNTY HEALTH DEPARTMENT RULES & REGULATIONS FOR PRIVATE WATER WELL TESTING IN WESTCHESTER COUNTY, NEW YORK.

PROPOSED WORK NOTES

- PROVIDE SUPPORTS, RISER CLAMPS, HANGERS TO SUPPORT PIPES EQUIPMENT AND ACCESSORIES FROM THE STRUCTURE AND GROUND. CONTRACTOR SHALL PROVIDE REQUIRED SUPPLEMENTAL STEEL TO ACCOMPLISH A SAFE AND SOUND INSTALLATION.
- 2. THE CONTRACTOR SHALL SUBMIT SHOP DRAWINGS SIGNED AND SEALED BY A PROFESSIONAL ENGINEER LICENSED IN THE STATE OF NEW YORK TO THE ENGINEERS FOR APPROVAL, PRIOR TO INSTALLATION, COMPLETE LAYOUT DRAWINGS INDICATING ALL PIPING SIZING AND ELEVATIONS.

	SUBMERSIBLE WELL PUMP SCHEDULE								
PUMP#	PUMP CAPACITY (GPM)			DISCH. SIZE	MOTORDATA				ADDTIONAL
POIVIP#			(INCHES)	RPM	HP	PHASE	CYCLE	VOLTS	INFORMATION
P-1	18	300	3/4"	1200	2	1	60	230	VFD

DESIGNED
B.F.

DRAWN
M.C.

CHECKED
J.Y.

APPROVED

IT IS A VIOLATION OF LAW FOR ANY PERSON TO ALTER A DOCUMENT IN ANY WAY, UNLESS ACTING UNDER THE DIRECTION OF A LICENSED PROFESSIONAL ENGINEER OR REGISTERED ARCHITECT. IF THIS DOCUMENT BEARING THE SEAL OF AN ENGINEER/ARCHITECT IS ALTERED, THE ALTERING ENGINEER/ARCHITECT SHALL AFFIX TO THE DOCUMENT THEIR SEAL AND THE NOTATION "ALTERED BY" FOLLOWED BY THEIR SIGNATURE AND THE DATE OF SUCH ALTERATION, AND A SPECIFIC DESCRIPTION OF THE ALTERATION.

		CONFORMED				
NO.	DATE		DRWN	CHKD	APPVD	
REVISIONS						





UPPER HARLEM PARKING IMPROVEMENTS
AT CROTON FALLS
PACKAGE 2 SURFACE PARKING LOT

PLUMBING NOTES, ABBREVIATIONS, AND LEGEND

 CONTRACT NO.

 142486

 SCALE
 DATE


 N.T.S.
 08-21-2020

PL-001

SHEET 84 OF 105

DRAWING NO.

 $C: \ \ Construction \ \ \ Construction \ \ \ Construction \ \ \ Construction \ \ \ Construction \ \ \ Construction \ \ \ Construction \ \ Construction \ \ Construction \ \ Construction \ \ \ Construction \ \ Construction \ \ Construction \ \ \ Construction \ \ \ Construction \ \ \ Construction \ \ \ \ \ \ \ \$

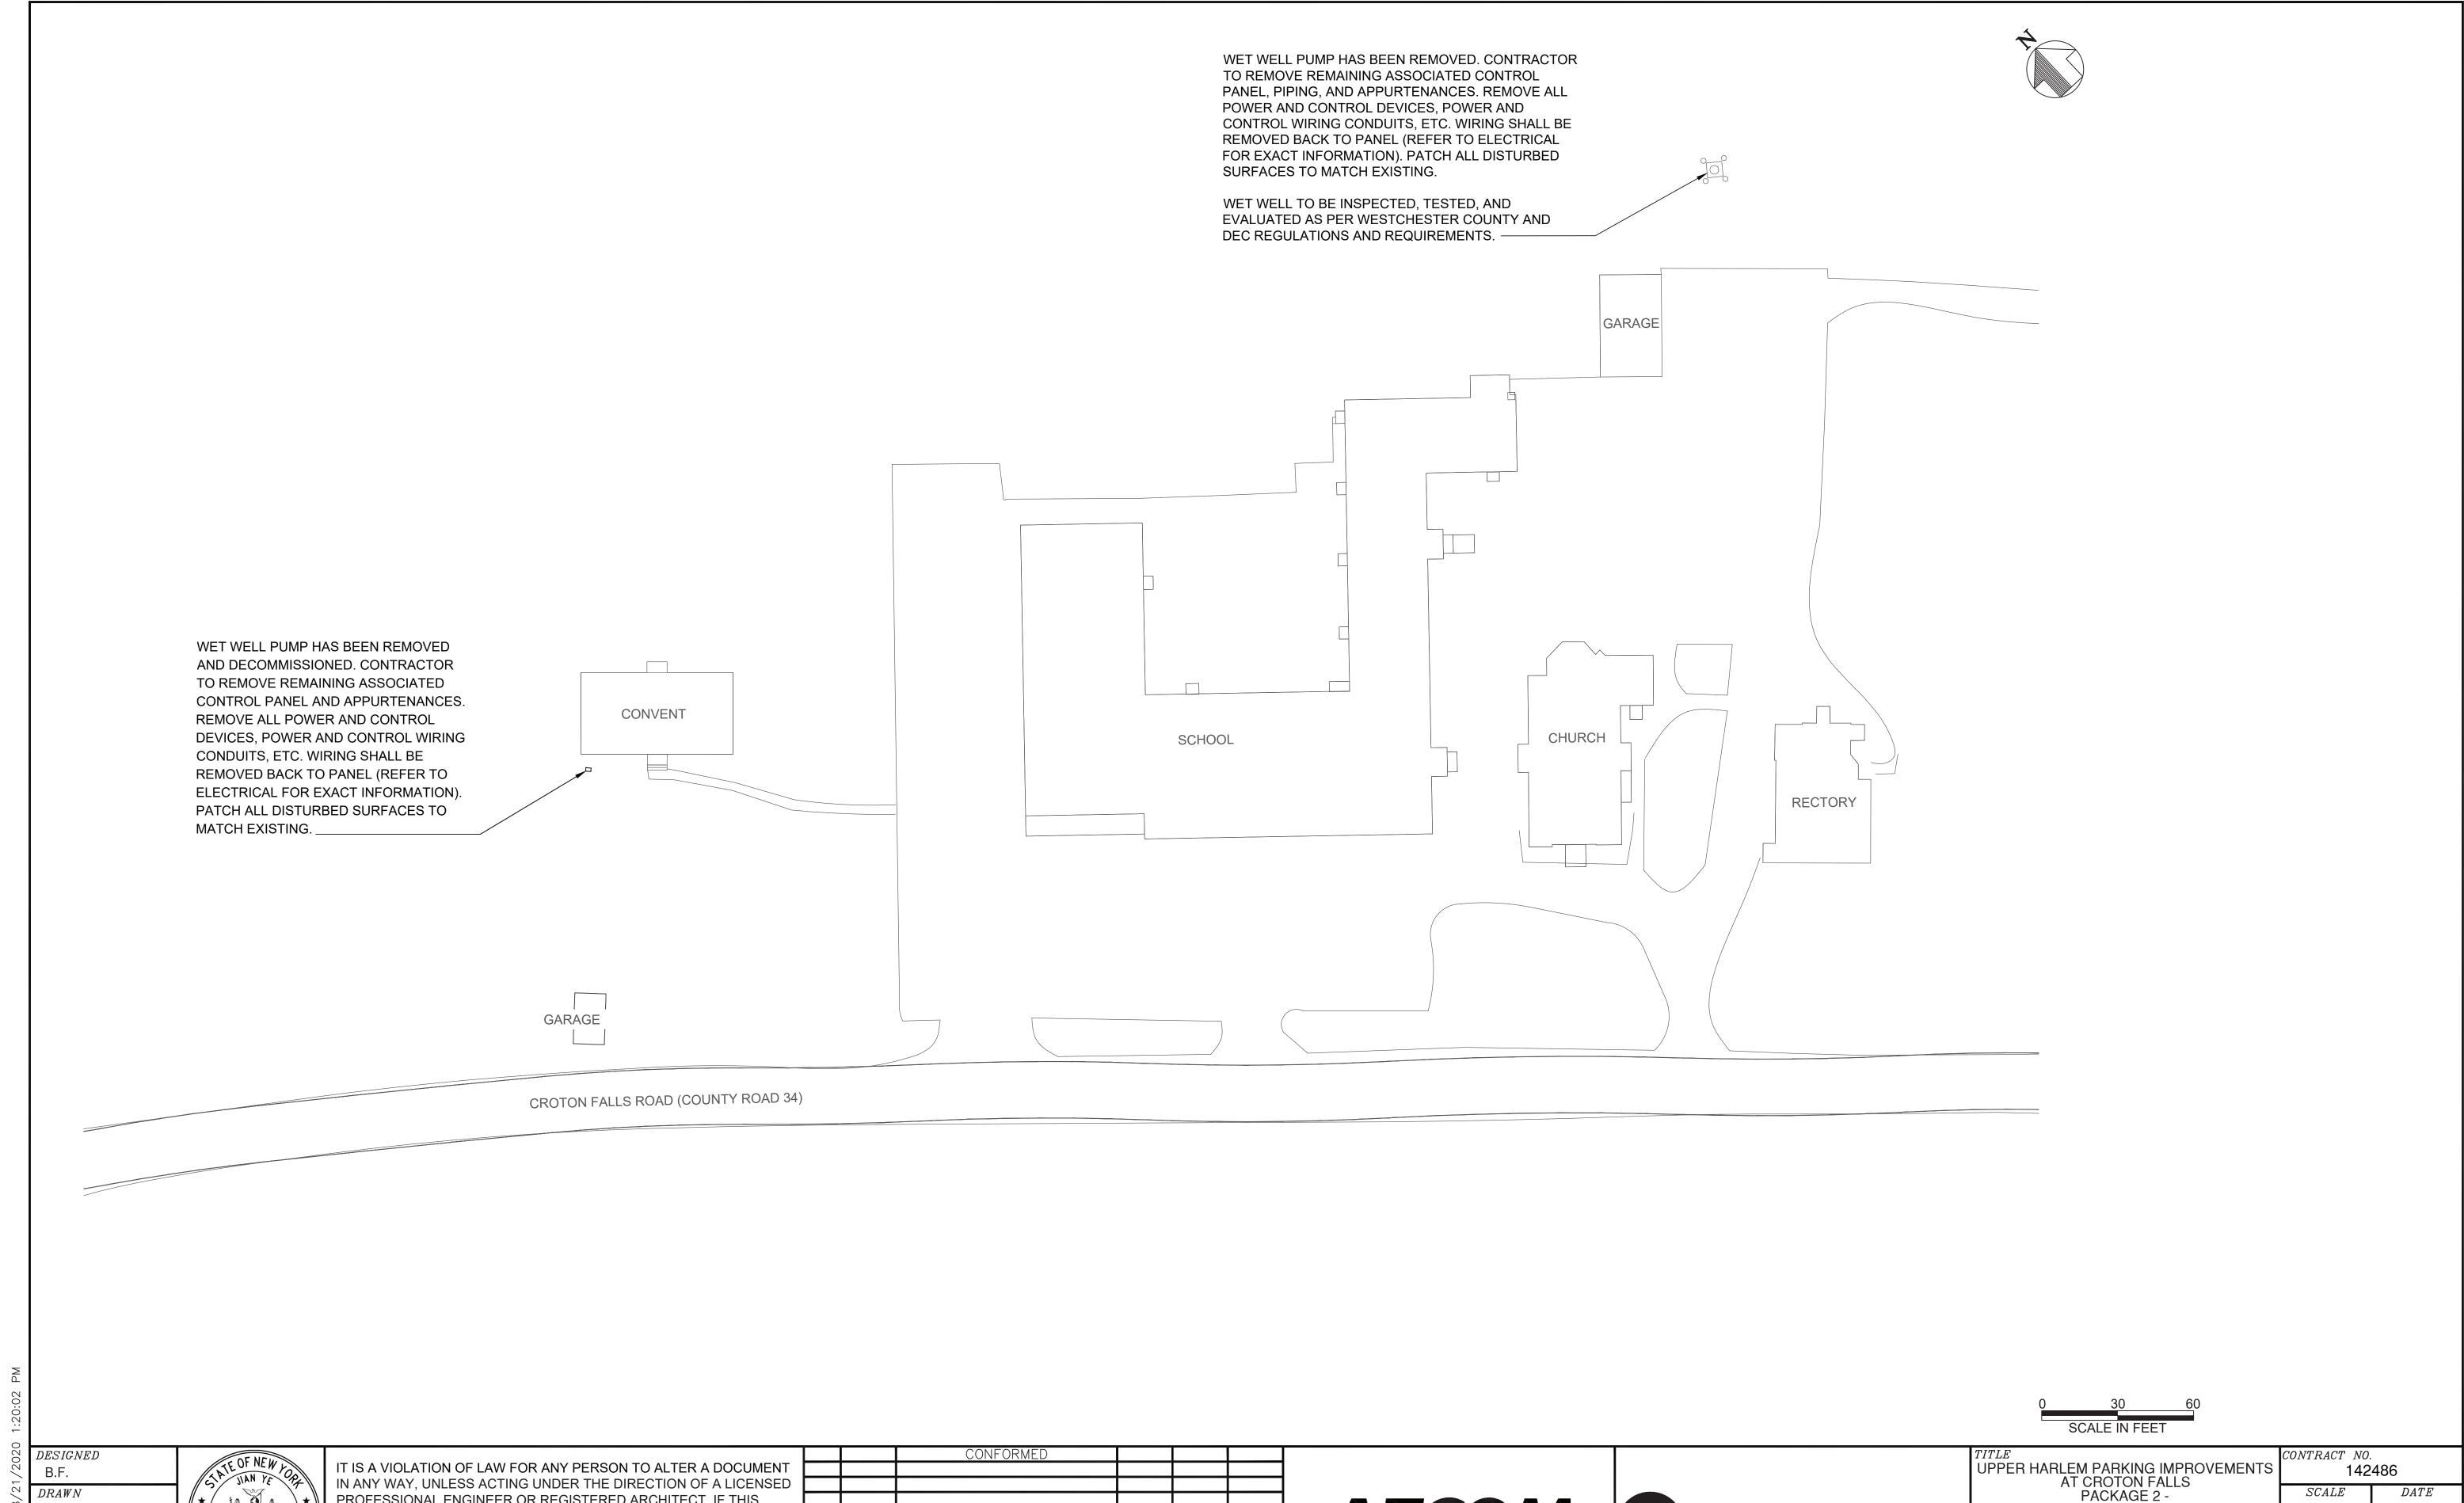

CHECKEDAPPROVED



PROFESSIONAL ENGINEER OR REGISTERED ARCHITECT. IF THIS DOCUMENT BEARING THE SEAL OF AN ENGINEER/ARCHITECT IS ALTERED, THE ALTERING ENGINEER/ARCHITECT SHALL AFFIX TO THE DOCUMENT THEIR SEAL AND THE NOTATION "ALTERED BY" FOLLOWED BY THEIR SIGNATURE AND THE DATE OF SUCH ALTERATION, AND A SPECIFIC DESCRIPTION OF THE ALTERATION.

		CONFORMED			
NO.	DATE		DRWN	CHKD	APPVD
		REVISIONS			



UPPER HARLEM PARKING IMPROVEMENTS
AT CROTON FALLS
PACKAGE 2 SURFACE PARKING LOT

PLUMBING REMOVAL PLAN

1" = 30' 08-21-2020

DRAWING NO. PL-101 SHEET 85 OF 105



INSTALL WET WELL PUMP (P-1), CONTROLLER, AND ALL ASSOCIATED PIPING AND APPURTENANCES. SEE DRAWING PL-501 FOR MORE INFORMATION.

REFER TO DRAWING S-100 FOR CONCRETE PAD DETAILS.
CONCRETE PAD SIZE SHALL BE DETERMINED PENDING FINAL PUMP SELECTION.

CASING SIZE AND SELECT THE PUMP PER THE SCHEDULE ON

PL-001. SEE DRAWING PL-501 FOR MORE INFORMATION.

- PROVIDE BLADDER TANK WITH DURAFOLD MODEL DF8FEH HOT BOX ENCLOSURE, REFER TO ELECTRICAL AND STRUCTURAL DRAWINGS.

PL-501 REFER TO DRAWING PL-501 FOR CONNECTIONS AND PIPING SIZES

WATER PIPING (TYPICAL). SEE DRAWING PL-501 FOR MORE INFORMATION.

WOODFORD MODEL Y-2 $\frac{3}{4}$ " FREEZELESS YARD HYDRANT. SEE DRAWING PL-501 FOR MORE INFORMATION.

0 30

DESIGNED
B.F.
DRAWN

M.C.

CHECKED

J.Y.

APPROVED

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		CONFORMED				
NO.	DATE		DRWN	CHKD	APPVD	
REVISIONS						

AECOM



UPPER HARLEM PARKING IMPROVEMENTS
AT CROTON FALLS
PACKAGE 2 SURFACE PARKING LOT

PLUMBING PROPOSED PLAN


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 & 142486 \\
\hline
SCALE & DATE \\
1" = 30' & 08-21-2020
\end{array}$

CONTRACT NO.


DRAWING NO.

PL-201 SHEET 86 OF 105

C:\Users\michael.cervini\AECOM Directory\MNR Croton Falls — Documents\General\900_CAD_GIS\910_CAD\20—SHEETS\Plumbing\PL—201 — Plumbing Proposed Plan.dwg

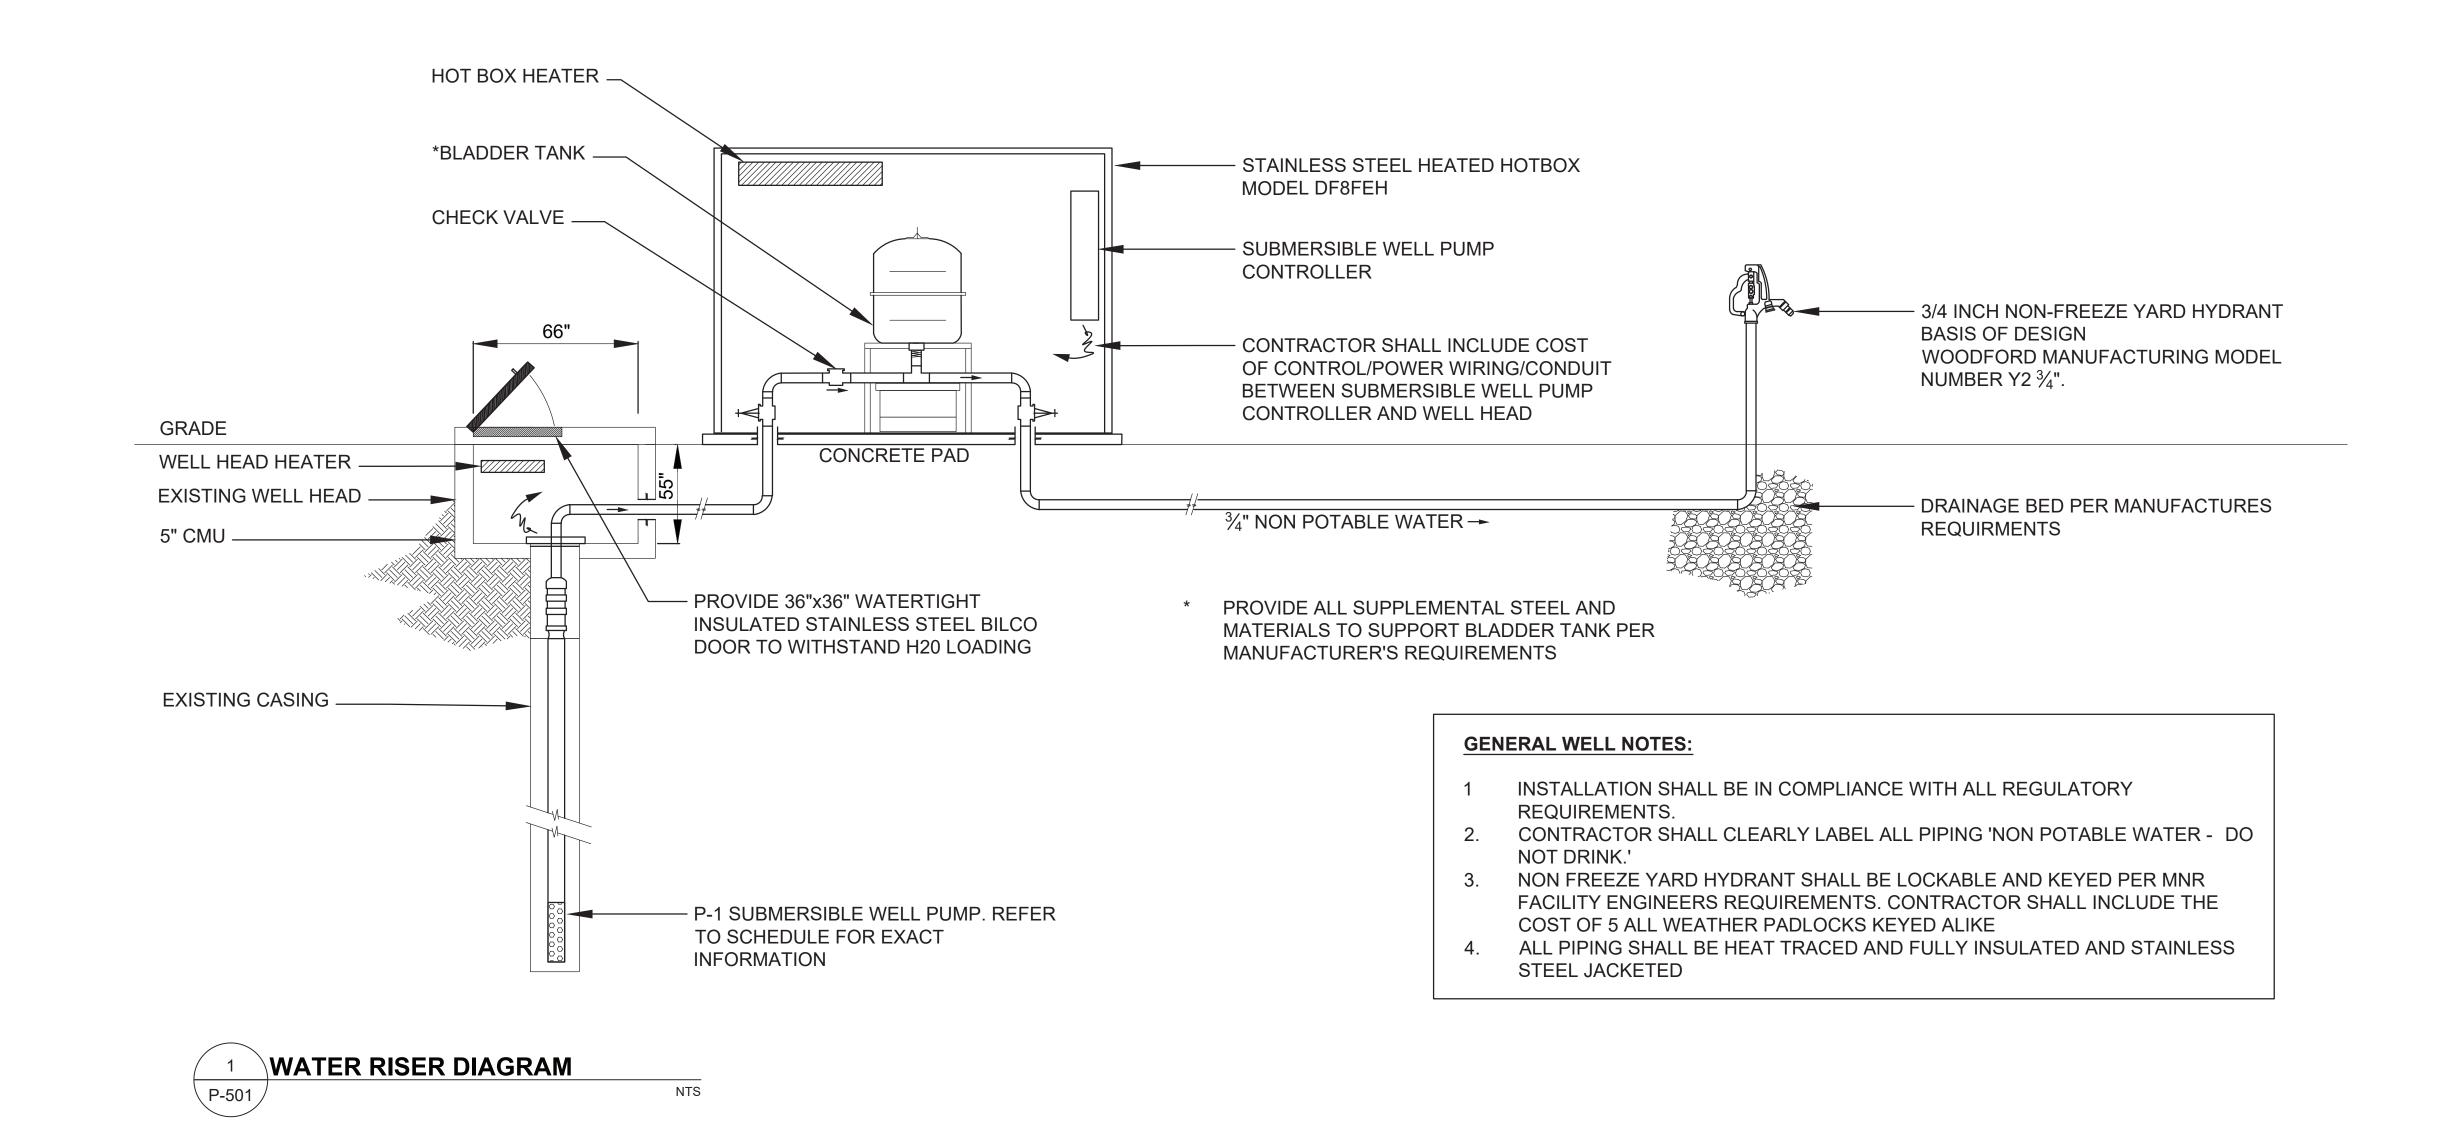

DESIGNED
B.F.
DRAWN
M.C.
CHECKED
J.Y.
APPROVED
F.B.

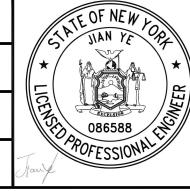

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		CONFORMED					
NO.	DATE		DRWN	CHKD	APPVD		
REVISIONS							

AECOM



UPPER HARLEM PARKING IMPROVEMENTS
AT CROTON FALLS
PACKAGE 2 SURFACE PARKING LOT

PLUMBING DETAILS PL-501
SHEET 87 OF 105