

ABBREVIATIONS

A/C	AIR CONDITIONING	LAM.	LAMINATE
ABV.	ABOVE	LOC.	LOCATION
ACC.	ACCESSORIES	LVR	LOUVER
APC / ACT	ACOUSTICAL PANEL CEILING	MANUF.	MANUFACTURER
A.D.	AREA DRAIN	MAS.	MASONRY
ADJ.	ADJACENT	MATL	MATERIAL
A.F.F.	ABOVE FINISHED FLOOR	MAX	MAXIMUM
A.H.U.	AIR HANDLING UNIT	M.D.F.	MEDIUM DENSITY FIBER BOARD
ALT.	ALTERNATE	MECH.	MECHANICAL
ALUM.	ALUMINIUM	MEP	MECHANICAL, ELECTRICAL, PLUMBING
ANOD.	ANODIZED		
ARCH.	ARCHITECTURAL	MTL.	METAL
APPROX.	APPROXIMATELY	MIN.	MINIMUM
BOT	BIO-BASED TILE	MISC.	MISCELLANEOUS
B.C.	BRICK COURSE	M.O.	MASONRY OPENING
BN	BETWEEN	MTD.	MOUNTED
BLDG.	BUILDING	N.I.C.	NOT IN CONTRACT
BLKG.	BLOCKING	NOM.	NOMINAL
BM	BEAM	NSMF	NON-STRUCTURAL METAL
B.O. -	BOTTOM OF -		
BRGL	BEARING	N.T.S.	NOT TO SCALE
CAB.	CABINET	O.C.	ON CENTER
C.I.	CAST IRON	O.D.	OUTSIDE DIAMETER
C.I.P.	CAST IN PLACE	O.F.C.I.	OWNER FURNISHED, CONTRACTOR INSTALLED
C.L	CENTER LINE	OH	OVERHEAD
CFMF	COLD FORMED METAL FRAMING	OPP	OPPOSITE
C.J.	CONTROL JOINT	OPNG	OPENING
CLG.	CEILING	PERF.	PERFORATED
CLR.	CLEAR	PL	PLATE
CMU	CONCRETE MASONRY UNIT	P.LAM	PLASTIC LAMINATE
C.O.	CLEAN OUT	PLYWD.	PLYWOOD
COL	COLUMN	PNL	PANEL
CONC.	CONCRETE	POLY.	POLYETHYLENE
CONT.	CONTINUOUS	PR	PAIR
COORD.	COORDINATE	PTD.	PAINTED
CPT	CARPET	P.T.	PRESSURE TREATED
C.T.	CERAMIC TILE	Q.T.	QUARRY TILE
CTR	CENTER	QTY.	QUANTITY
DBL	DOUBLE	R	RISER / RADIUS
DEMO.	DEMOLITION	R.C.P.	REFLECTED CEILING PLAN
D.F.	DRINKING FOUNTAIN	R.D.	ROOF DRAIN
DIA.	DIAMETER	REFL.	REFLECTED
DM	DIMENSION(S)	REINF.	REINFORCING, REINFORCED
DISP.	DISPENSER	REOD.	REQUIRED
D.M.B.	DAVE MATTHEWS BAND	REV.	REVISION
DN	DOWN	REG.	ROOFING
DOC.	DOCUMENT(S)	R.O.	ROUGH OPENING
DR	DOOR	R.O.W.	RIGHT OF WAY
D.S.	DOWNSPOUT	RH.	ROOM
DTL	DETAIL	S.A.T.M.	SELF-ADHERED TRANSITION
DW.	DISHWASHER		
DWG.	DRAWING	S.C.	SOLID CORE
EA	EACH	S.F.	SQUARE FEET / STOREFRONT
E.B	EXPANSION BOLT	SFI / AB	SPRAY FOAM INSULATION / AIR BARRIER
E.J	EXPANSION JOINT	SFRM	SPRAYED FIRE-RESISTIVE MATERIAL
ELEC.	ELECTRICAL	SHT.	SHEET
ELEV.	ELEVATION	SIM	SIMILAR
EMER.	EMERGENCY	S.O.G.	SLAB ON GRADE
ENCL	ENCLOSURE	SPEC	SPECIFICATION
E.O.P.	EDGE OF PAVEMENT	SQ	SQUARE
E.P	ELECTRICAL PANEL	SQ.FT.	SQUARE FOOT
EPDM	ETHYLENE PROPYLENE	STD.	STANDARD
	DIENE MONOMER	STL	STEEL
EQ.	EQUAL	STRUCT.	STRUCTURAL
EX. EXIST.	EXISTING	SS	STAINLESS STEEL
E.T.R.	EXISTING TO REMAIN	SUSP.	SUSPENDED
EXP.	EXPANSION	T&G	TONGUE AND GROOVE
EXPD	EXPOSED	TEMP	TEMPORARY
EXT.	EXTERIOR	THK.	THICK
F.E.C.	FIRE EXTINGUISHER CABINET	T.O. -	TOP OF -
F.D.	FLOOR DRAIN	T.O.S.	TOP OF SLAB, TOP OF SLAB (AS APPLICABLE)
F.F.	FINISHED FLOOR	TYP.	TYPICAL
FIN.	FINISH, FINISHED	T.O.W.	TOP OF WALL
F.O. -	FACE OF -	T.W.F.	THROUGH WALL FLASHING
FLR	FLOOR	U.N.O.	UNLESS NOTED OTHERWISE
F.R.T.W.	FIRE RETARDANT TREATED WOOD	U.G.	UNDER GROUND
F.S.	FRAME SIZE		
FT.	FOOT, FEET	VP	VAPOR BARRIER
FTG.	FOOTING	VERT.	VERTICAL
G	ING (SUFFIX)	V.I.F.	VERIFY IN FIELD
GALV.	GALVANIZED	V.T.R.	VENT THROUGH ROOF
G.C.	GENERAL CONTRACTOR	W	WITH
GL	GRID LINE	W/O	WITHOUT
GYP.	GYPSUM	W.C.	WATER CLOSET
GWB	GYPSUM WALL BOARD	WO	WOOD
HDWD.	HARDWOOD	W.H.	WATER HEATER
HDWR.	HARDWARE	WK.PT.	WORK POINT
H.M.	HOLLOW METAL	WP	WATERPROOF
HORIZ.	HORIZONTAL	WT.	WEIGHT
HR	HOUR	W.W.F.	WELED WIRE FABRIC
HVAC	HEATING / VENTILATION / AIR CONDITIONING		
	INCLUDE (I), (ING)		
INFO	INFORMATION		
INSUL.	INSULATION		
INT.	INTERIOR		
JAN.	JANITOR		
J.C.	JANITOR CLOSET		
JT.	JOINT		

GENERAL NOTES

1. COMPLY WITH ALL APPLICABLE CODES AND ORDINANCES.
2. VERIFY GRADES/ELEVATIONS SHOWN ON DRAWINGS.
3. CONTRACTOR IS RESPONSIBLE FOR ALL DIMENSIONS AND FOR VERIFICATION OF DIMENSIONS SHOWN ON DRAWINGS. ANY DISCREPANCIES IN DRAWINGS SHALL BE REPORTED TO THE ARCHITECT IMMEDIATELY.
4. DO NOT SCALE DRAWINGS.
5. VERIFY AND PROVIDE ALL ROUGH-IN DIMENSIONS FOR EQUIPMENT PROVIDED IN THE CONTRACT OR IN OTHERS.
6. REPETITIVE FEATURES MAY BE DRAWN ONLY ONCE AND SHALL BE COMPLETELY PROVIDED AS IF DRAWN IN FULL.

SYMBOL LEGEND

	DRAWING BREAK LINE
	DRAWING MATCH LINE
	SPOT ELEVATION
	LEVEL ELEVATION
	BUILDING SECTION KEY
	WALL SECTION KEY
	SECTION DETAIL KEY
	PLAN DETAIL KEY
	INTERIOR ELEVATION KEY
	BUILDING ELEVATION KEY
	GRID LINE (NUMERICAL DESIGNATION @ VERT. COL. LINES)
	GRID LINE (ALPHABETICAL DESIGNATION @ HORIZ. COL. LINES)
	DOOR TYPE INDICATOR
	PARTITION TYPE INDICATOR SEE PLAN VIEWS
	FIRE RATED PARTITION TYPE INDICATOR SEE PLAN VIEWS
	EXTERIOR ASSEMBLY TYPE INDICATOR SEE SECTION VIEWS
	ROOF TYPE INDICATOR SEE SECTION VIEWS
	CURTAINWALL / STOREFRONT / WINDOW TYPE INDICATOR. SEE ELEVATION VIEWS FOR CURTAINWALL AND WINDOW, SEE PLAN VIEWS AND INTERIOR ELEVATION VIEWS FOR STOREFRONT
	EXISTING WALLS
	DEMOLISHED WALLS
	NEW WALLS
	TEMPORARY OR ALTERNATE LOCATION WALLS
	NORTH ARROW: BOLD = PROJECT NORTH DASHED = TRUE NORTH
	INTERIOR RAILING ELEVATION KEY

SHEET ORGANIZATION DIAGRAM

SHEET BORDER	01	02	03	04	05
SHEET GRID	06	07	08	09	10
DRAWING CELL	11	12	13	14	15
DRAWING NUMBER	16	17	18	19	20



New City Library

New City Library Addition & Renovation

220 North Main Street  
New City, NY 10956

Client Project Number  
VMDO Project Number

1301

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Drawn By


Checker  
Author

ISSUES AND REVISIONS		
NO.	SUBMITTAL	DATE
	SCHEMATIC DESIGN	03.05.2021
	DESIGN DEVELOPMENT	07.09.2021

ABBREVIATIONS & NOTES




NON-RATED STL FRAMED PARTITIONS

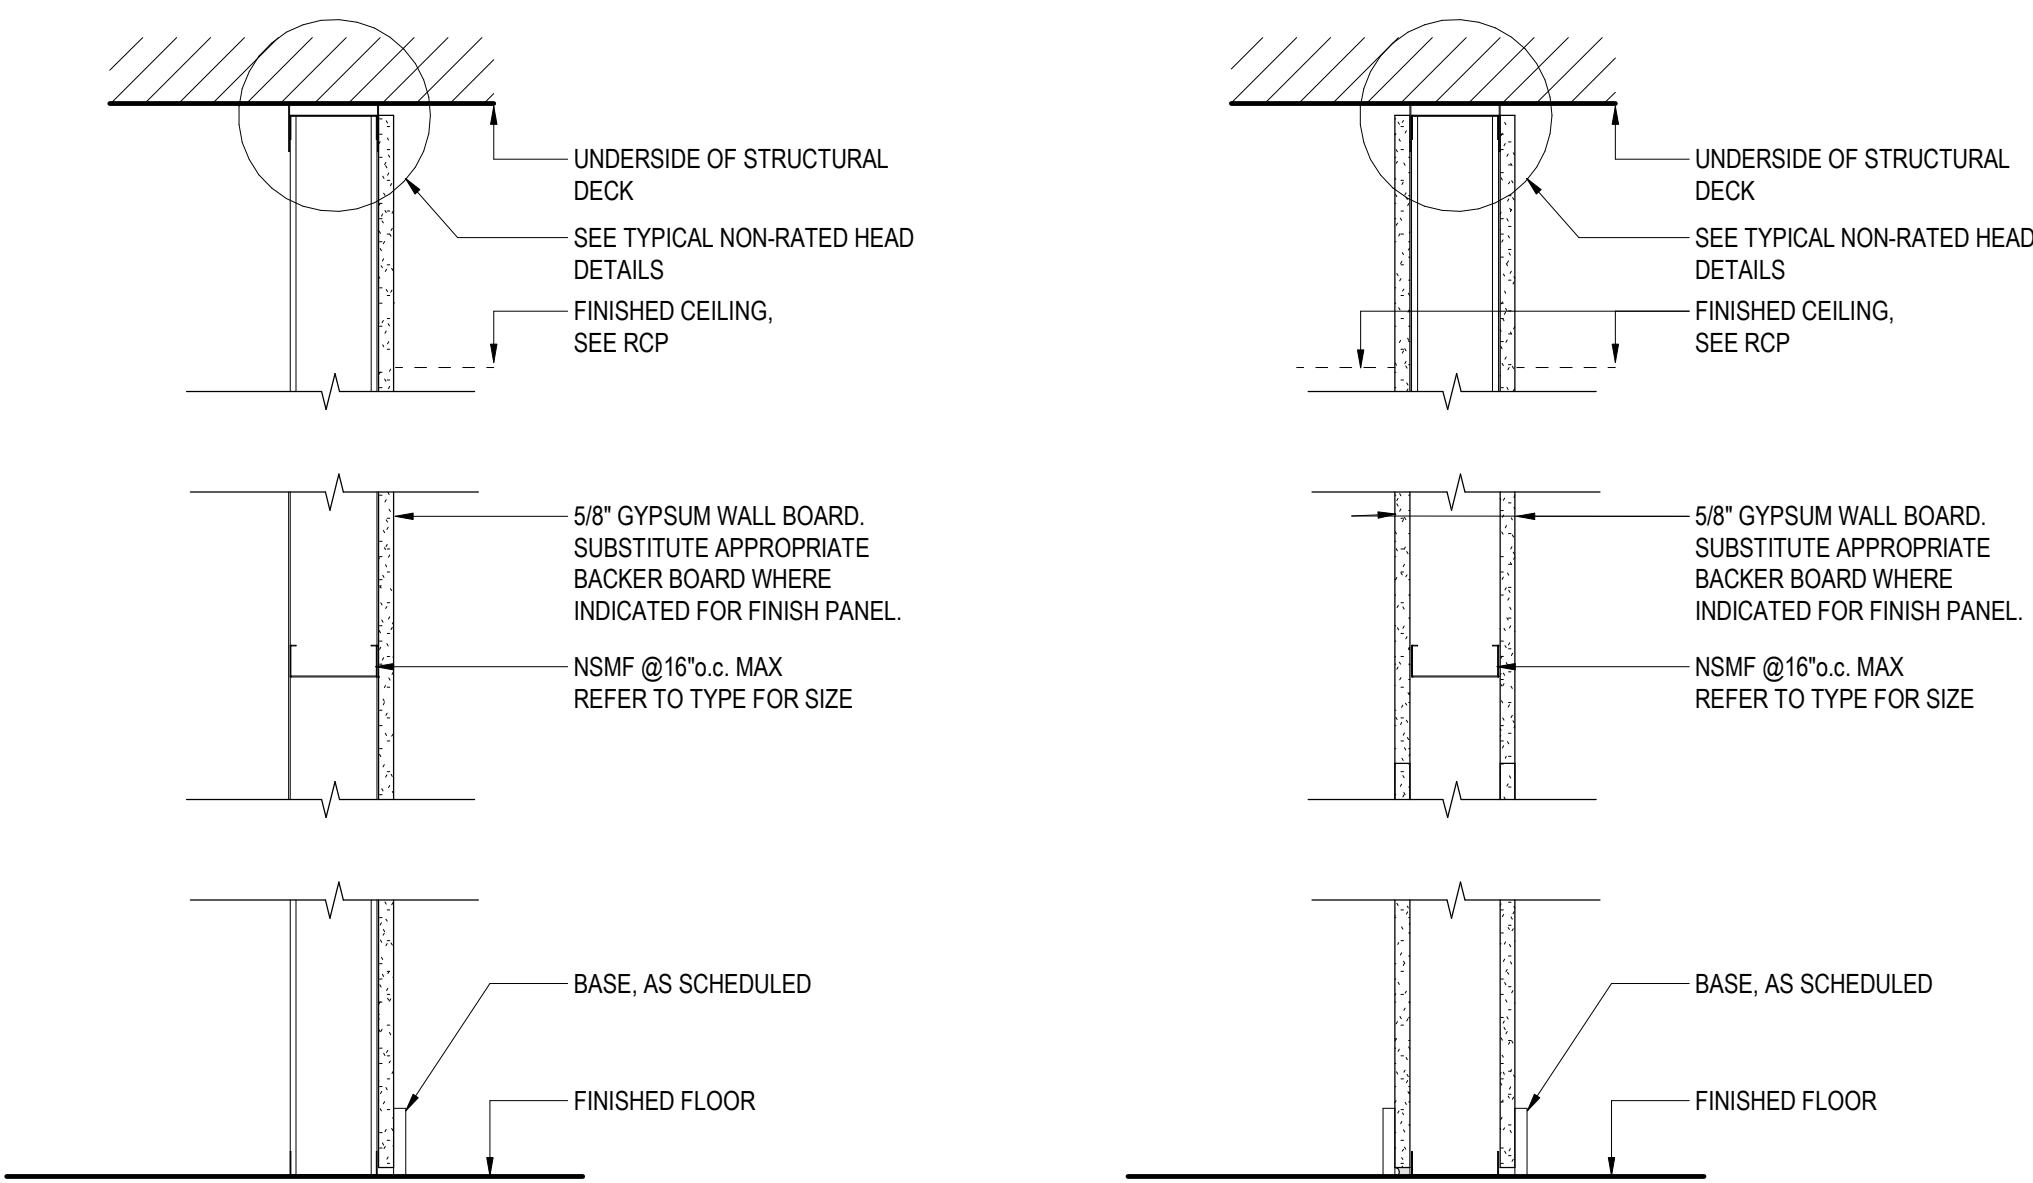


N1B	1.5/8" NSMF	N1A	1.5/8" NSMF
N2B	2.1/2" NSMF	N2A	2.1/2" NSMF
N3B	3.5/8" NSMF	N3A	3.5/8" NSMF
N6B	6" NSMF	N6A	6" NSMF

NON-RATED STL FRAMED SOUND ATTENUATED PARTITIONS

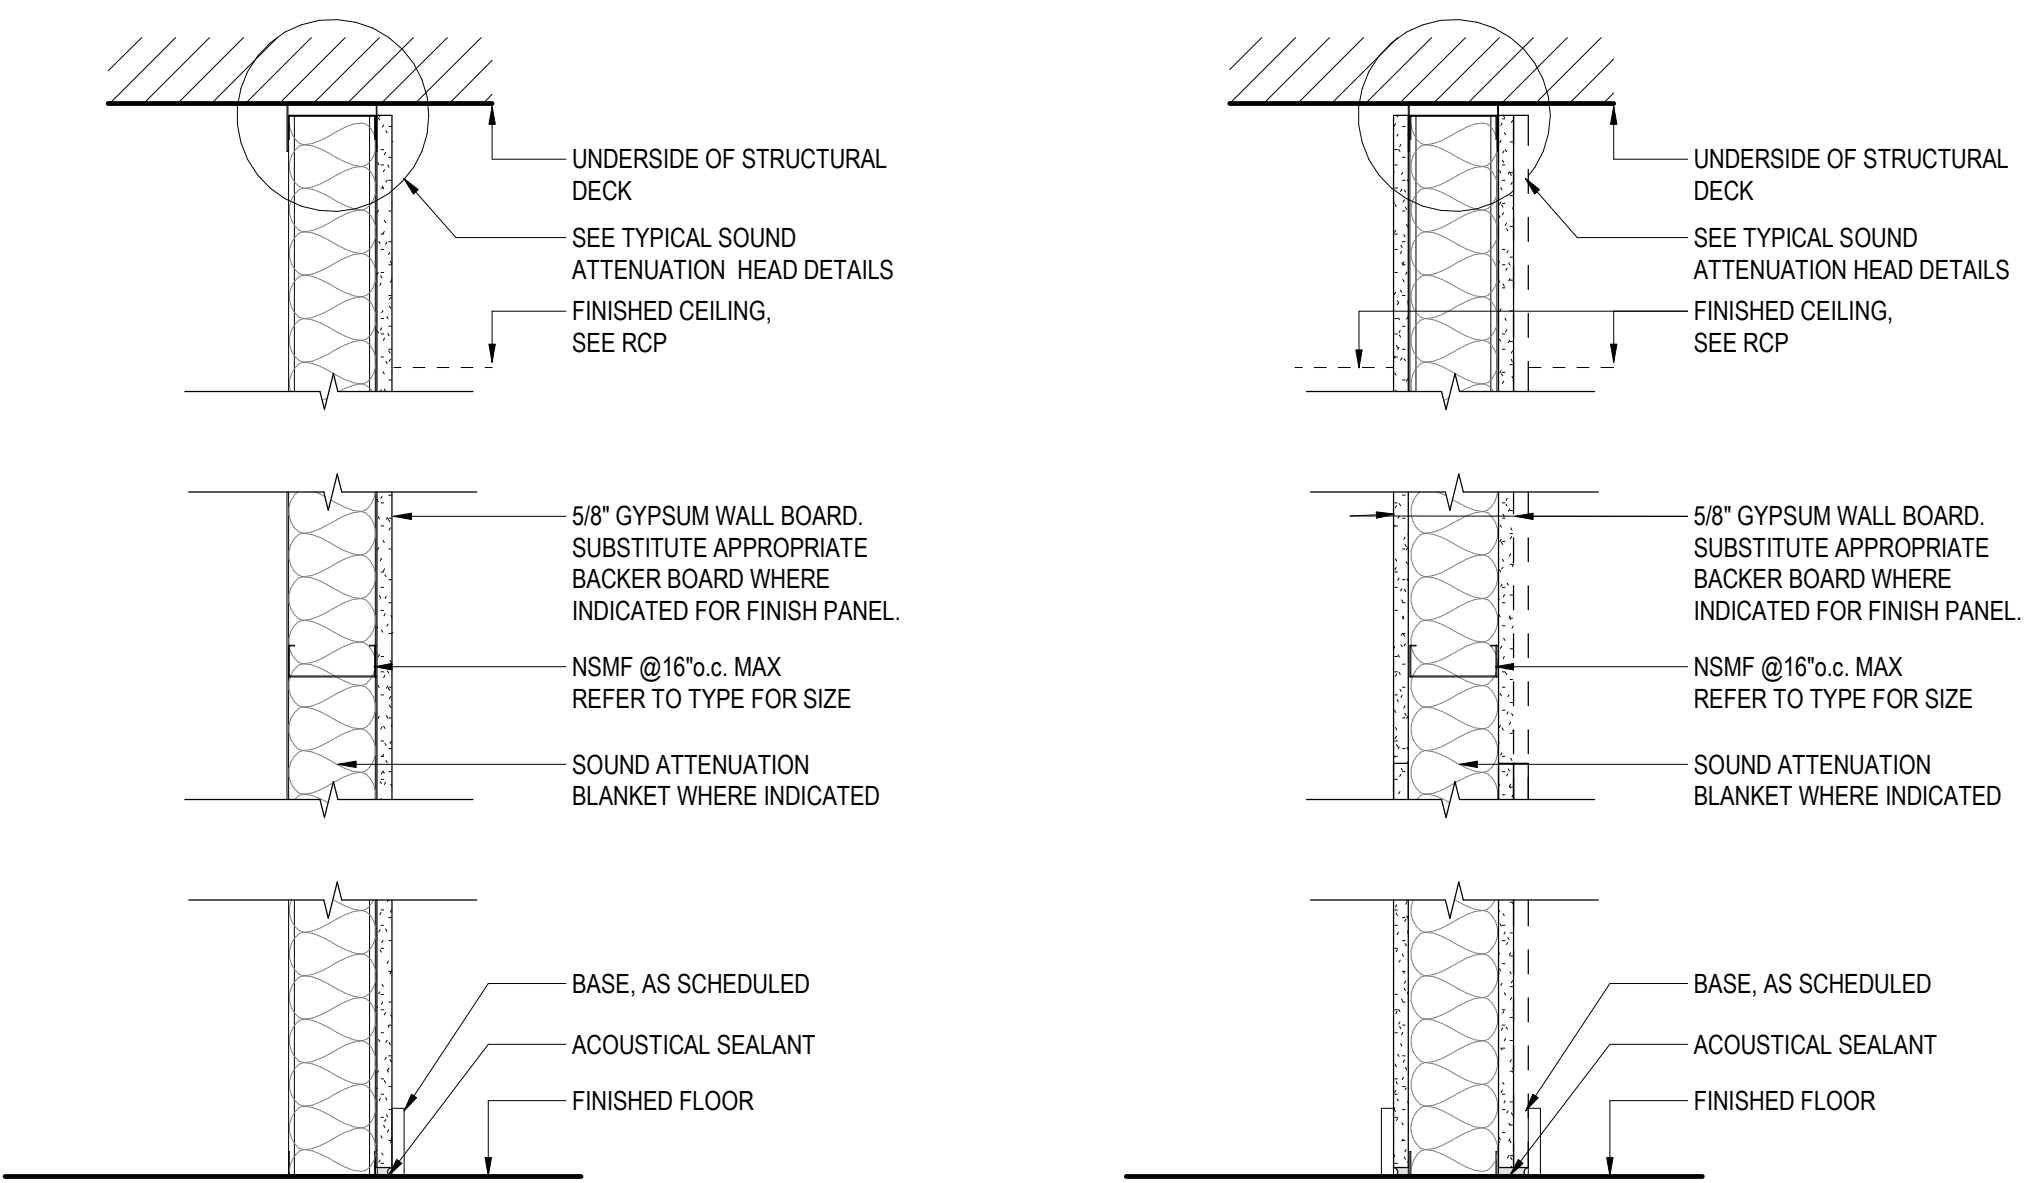

N3H	3.5/8" NSMF GWBX W/ SOUND ATTENUATION BLANKET	N3G	3.5/8" NSMF GWBX ON BOTH SIDES
N3L	3.5/8" NSMF 2 LAYERS GWBX W/ SOUND ATTENUATION BLANKET	N3J	3.5/8" NSMF 2 LAYERS GWBX ON BOTH SIDES
N5H	6" NSMF GWBX W/ SOUND ATTENUATION BLANKET	N3K	3.5/8" NSMF 2 LAYERS GWBX ON ONE SIDE, 1 LAYER GWBX ON OPPOSITE SIDE
N6L	6" NSMF 2 LAYERS GWBX W/ SOUND ATTENUATION BLANKET	N6G	6" NSMF GWBX ON BOTH SIDES
		N6J	6" NSMF 2 LAYERS GWBX ON BOTH SIDES

SHAFT WALL

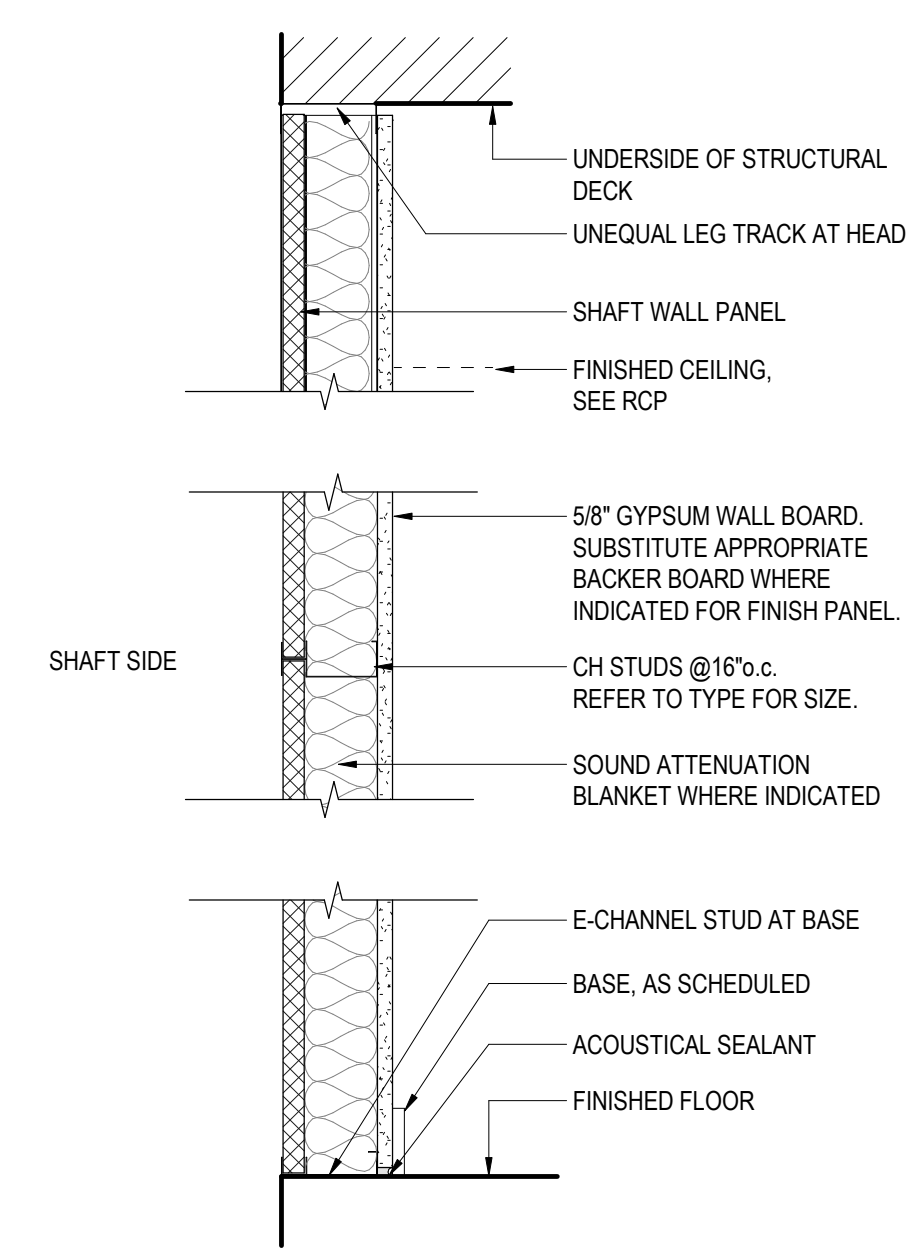

S4G	4" C-H STUD GWBX W/ SOUND ATTENUATION BLANKET
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INTERIOR PARTITION TYPES  
GENERAL NOTES

- REFER TO STRUCTURAL DRAWINGS FOR GROUTING &/OR REINFORCING REQUIRED AT ALL MASONRY PARTITIONS.
- REFER TO FIRE PROTECTION PLANS FOR FIRE RESISTANCE RATINGS OF BUILDINGS' ELEMENTS.
- REFER TO WALL SECTIONS FOR ADDITIONAL DIMENSIONS BETWEEN GRID LINES, CENTER LINES OF STRUCTURE, SHEATHING & EXTERIOR FINISH FACE.
- PARTITION STRUCTURE DESCRIBES CORE CONSTRUCTION ONLY. SUBSTRATE MATERIAL SHALL BE DETERMINED BY FINISH. SEE A810 SUMMARY OF FINISHES / MATERIALS FOR FINISH DESCRIPTIONS.

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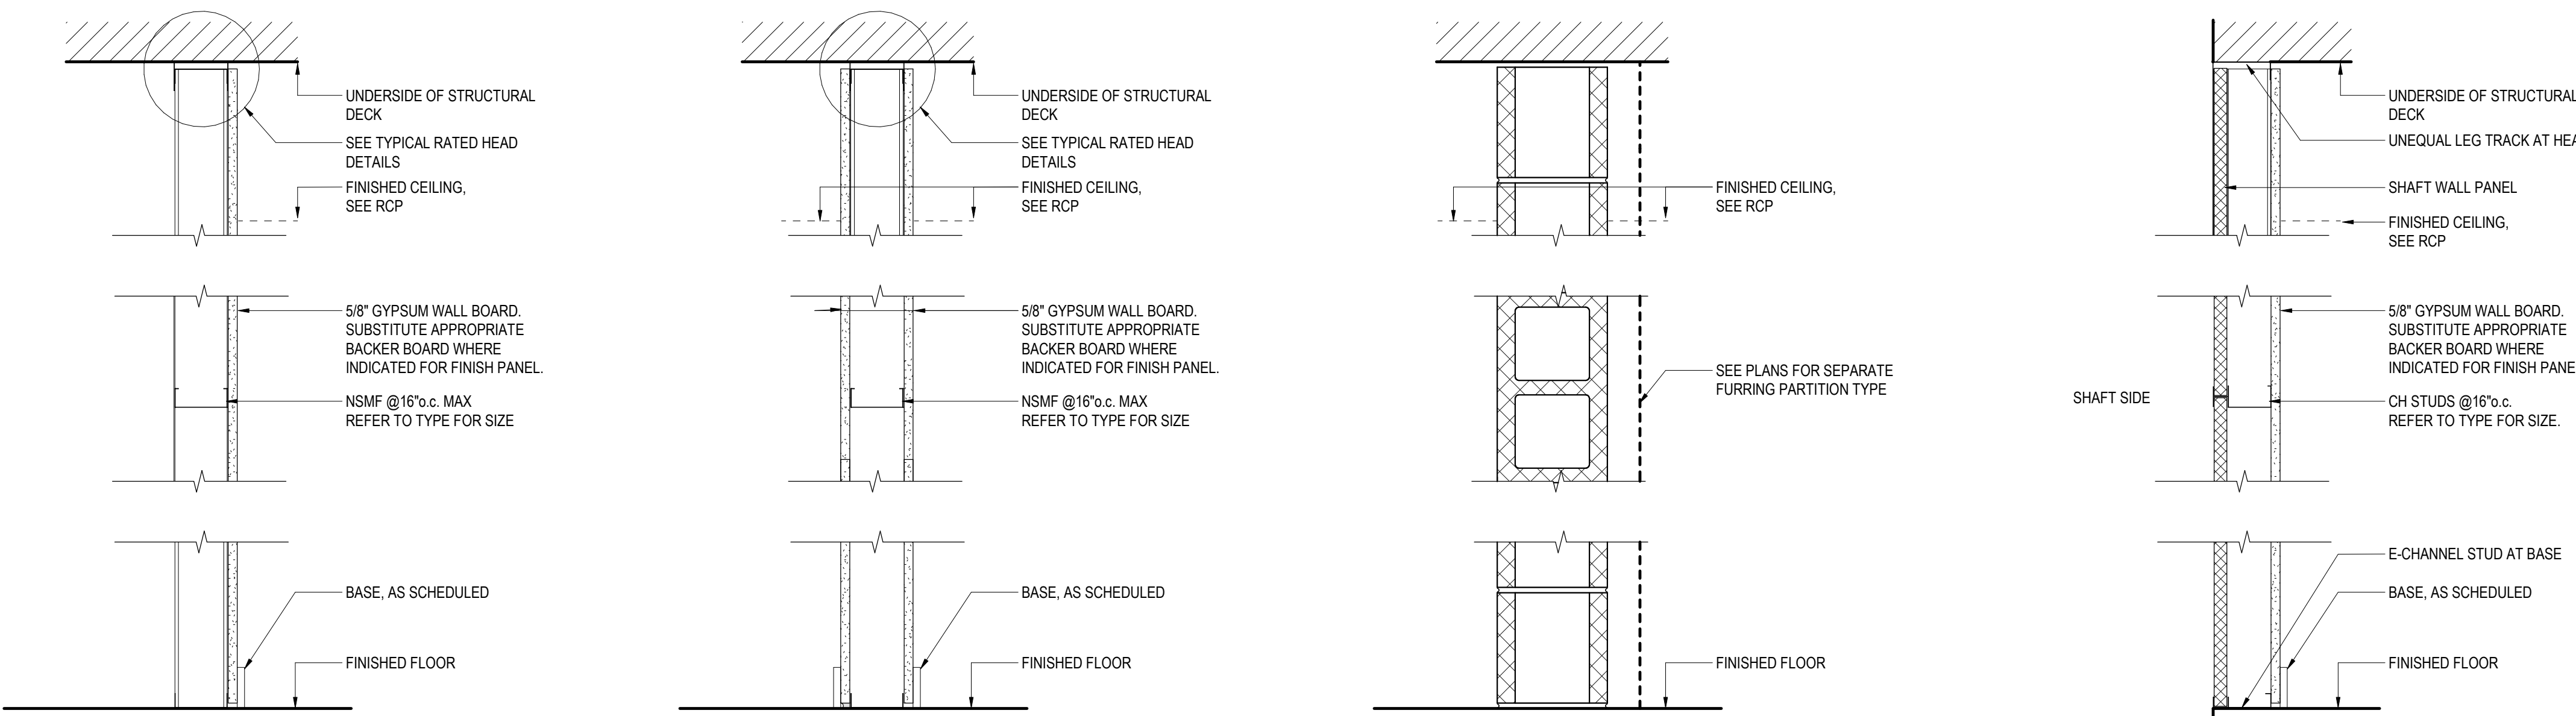
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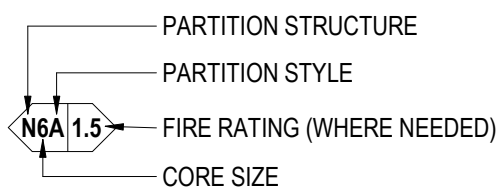
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RATED PARTITIONS




DRYWALL FURRING PARTITION	STANDARD DRYWALL PARTITION	MASONRY PARTITION	SHAFT WALL
N1B 0.5 1.5/8" NSMF - GWBX	N1A 0.5 1.5/8" NSMF - GWBX	M4 1.0 4" MASONRY	S2B 1.0 2.1/2" C-H STUD - GWBX
N1B 1.0 1.5/8" NSMF - GWBX	N1A 1.0 1.5/8" NSMF - GWBX	M6 1.0 6" MASONRY	S2E 2.0 2.1/2" C-H STUD - 2 LAYERS GWBX
N1E 2.0 1.5/8" NSMF - 2 LAYERS GWBX	N1D 2.0 1.5/8" NSMF - 2 LAYERS GWBX	M8 1.0 8" MASONRY	S4B 1.0 4" C-H STUD - GWBX
N2B 0.5 2.1/2" NSMF - GWBX	N2A 0.5 2.1/2" NSMF - GWBX		S4E 2.0 4" C-H STUD - 2 LAYERS GWBX
N2B 1.0 2.1/2" NSMF - GWBX	N2A 1.0 2.1/2" NSMF - GWBX		S6B 1.0 6" C-H STUD - GWBX
N2E 2.0 2.1/2" NSMF - 2 LAYERS GWBX	N2D 2.0 2.1/2" NSMF - 2 LAYERS GWBX		S6E 2.0 6" C-H STUD - 2 LAYERS GWBX
N3B 0.5 3.5/8" NSMF - GWBX	N3A 0.5 3.5/8" NSMF - GWBX		
N3B 1.0 3.5/8" NSMF - GWBX	N3A 1.0 3.5/8" NSMF - GWBX		
N3E 2.0 3.5/8" NSMF - 2 LAYERS GWBX	N3D 2.0 3.5/8" NSMF - 2 LAYERS GWBX		
N6B 0.5 6" NSMF - 2 LAYERS GWBX	N6A 0.5 6" NSMF - GWBX		
N6B 1.0 6" NSMF - 2 LAYERS GWBX	N6A 1.0 6" NSMF - GWBX		
N6E 2.0 6" NSMF - 2 LAYERS GWBX	N6D 2.0 6" NSMF - 2 LAYERS GWBX		

PARTITION TAG DIAGRAM



PARTITION STRUCTURE:  
N. NON-STRUCTURAL METAL FRAMING (NSMF)  
M. CONCRETE MASONRY  
S. SHAFT WALL

CORE SIZE:  
0 = 0.7/8"  
1 = 1.5/8"  
2 = 2.1/2"  
3 = 3.5/8"  
4 = 4"  
5 = 5.1/2"  
6 = 6" (NOM. @ MASONRY)  
8 = 8" (NOM. @ MASONRY)

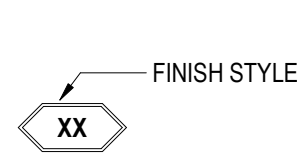

FINISH STYLE:  
CT CERAMIC TILE  
WD WOOD PANELING  
WC WALL COVERING  
AP ACOUSTIC PANEL

FIRE RATING:  
30 = 30 MIN.  
45 = 45 MIN.  
60 = 60 MIN.  
90 = 90 MIN.  
2 = 2 HOUR

PARTITION STYLE:  
A. (1) SUBSTRATE + CORE + (1) SUBSTRATE  
B. (1) SUBSTRATE + CORE  
C. CORE ONLY  
D. (2) SUBSTRATE + CORE + (2) SUBSTRATE  
E. (2) SUBSTRATE + CORE + (1) SUBSTRATE  
F. (2) SUBSTRATE + CORE  
G. (1) SUBSTRATE + CORE W/ SOUND ATTENUATION + (1) SUBSTRATE  
H. (1) SUBSTRATE + CORE W/ SOUND ATTENUATION  
J. (2) SUBSTRATE + CORE W/ SOUND ATTENUATION + (2) SUBSTRATE  
K. (2) SUBSTRATE + CORE W/ SOUND ATTENUATION + (1) SUBSTRATE  
L. (2) SUBSTRATE + CORE W/ SOUND ATTENUATION

DRAWING NOT FOR  
CONSTRUCTION


ISSUES AND REVISIONS	DATE
NO. SUBMITTAL	03.05.2021
SCHEMATIC DESIGN	07.09.2021
DESIGN DEVELOPMENT	

PARTITION & FLOOR  
TYPES


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DESIGN DEVELOPMENT  
07.09.2021




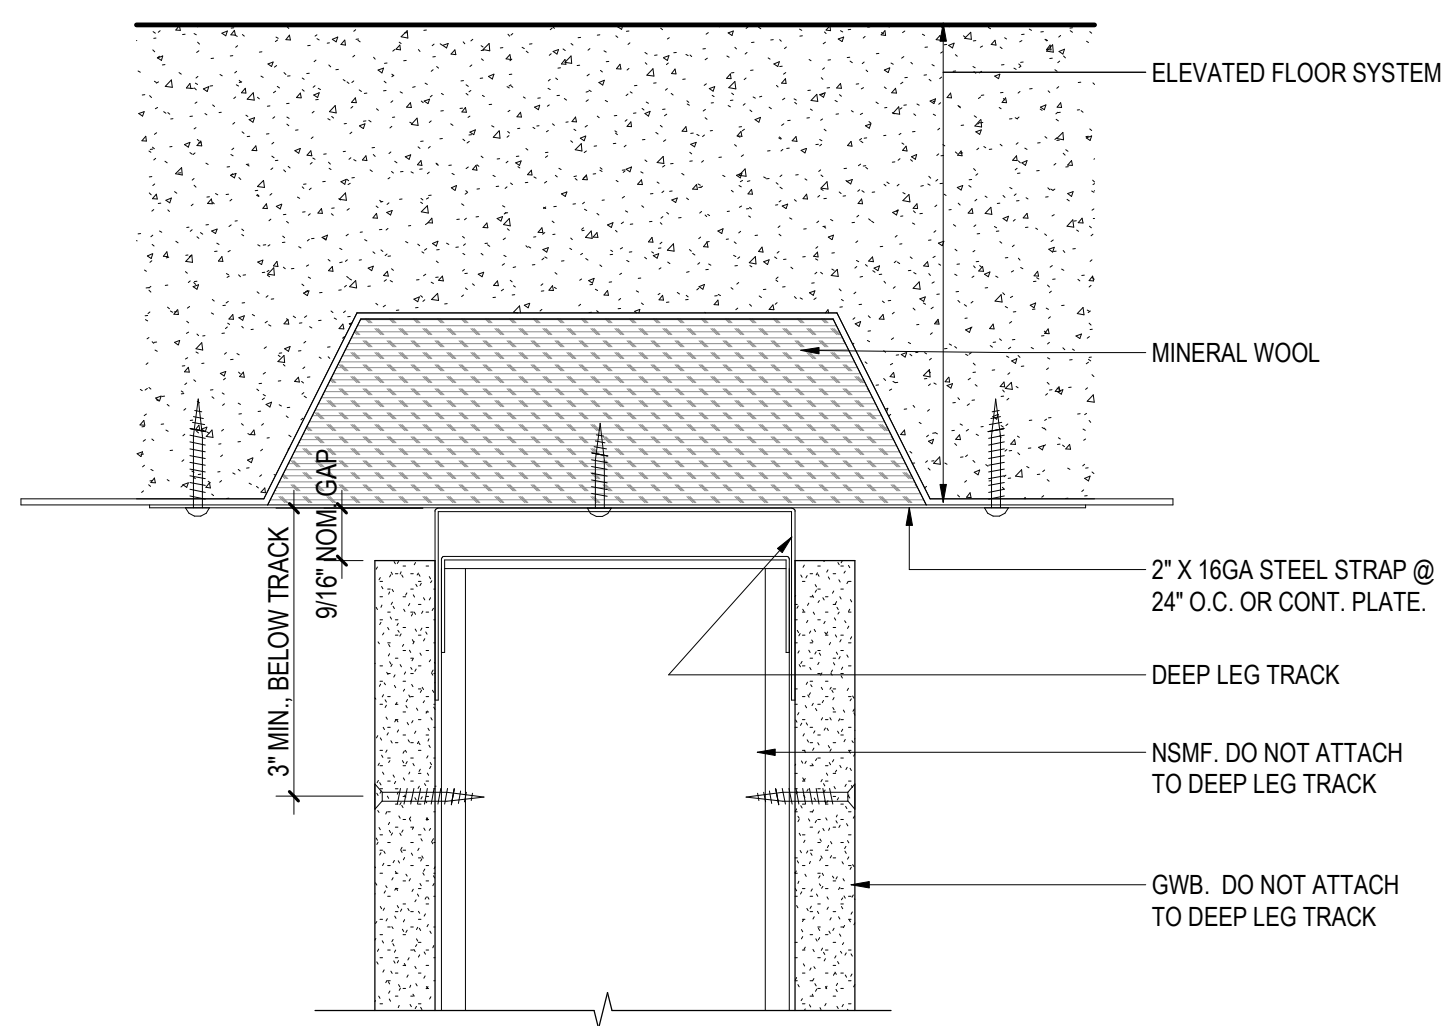


2 TYP. FIRE RATED DETAIL - HEAD (FLUTES PARALLEL)  
A003 N.T.S.



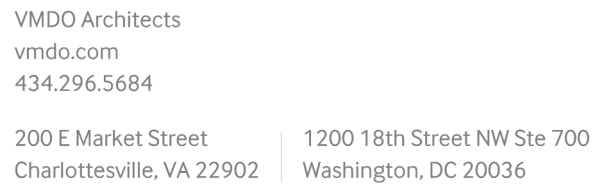


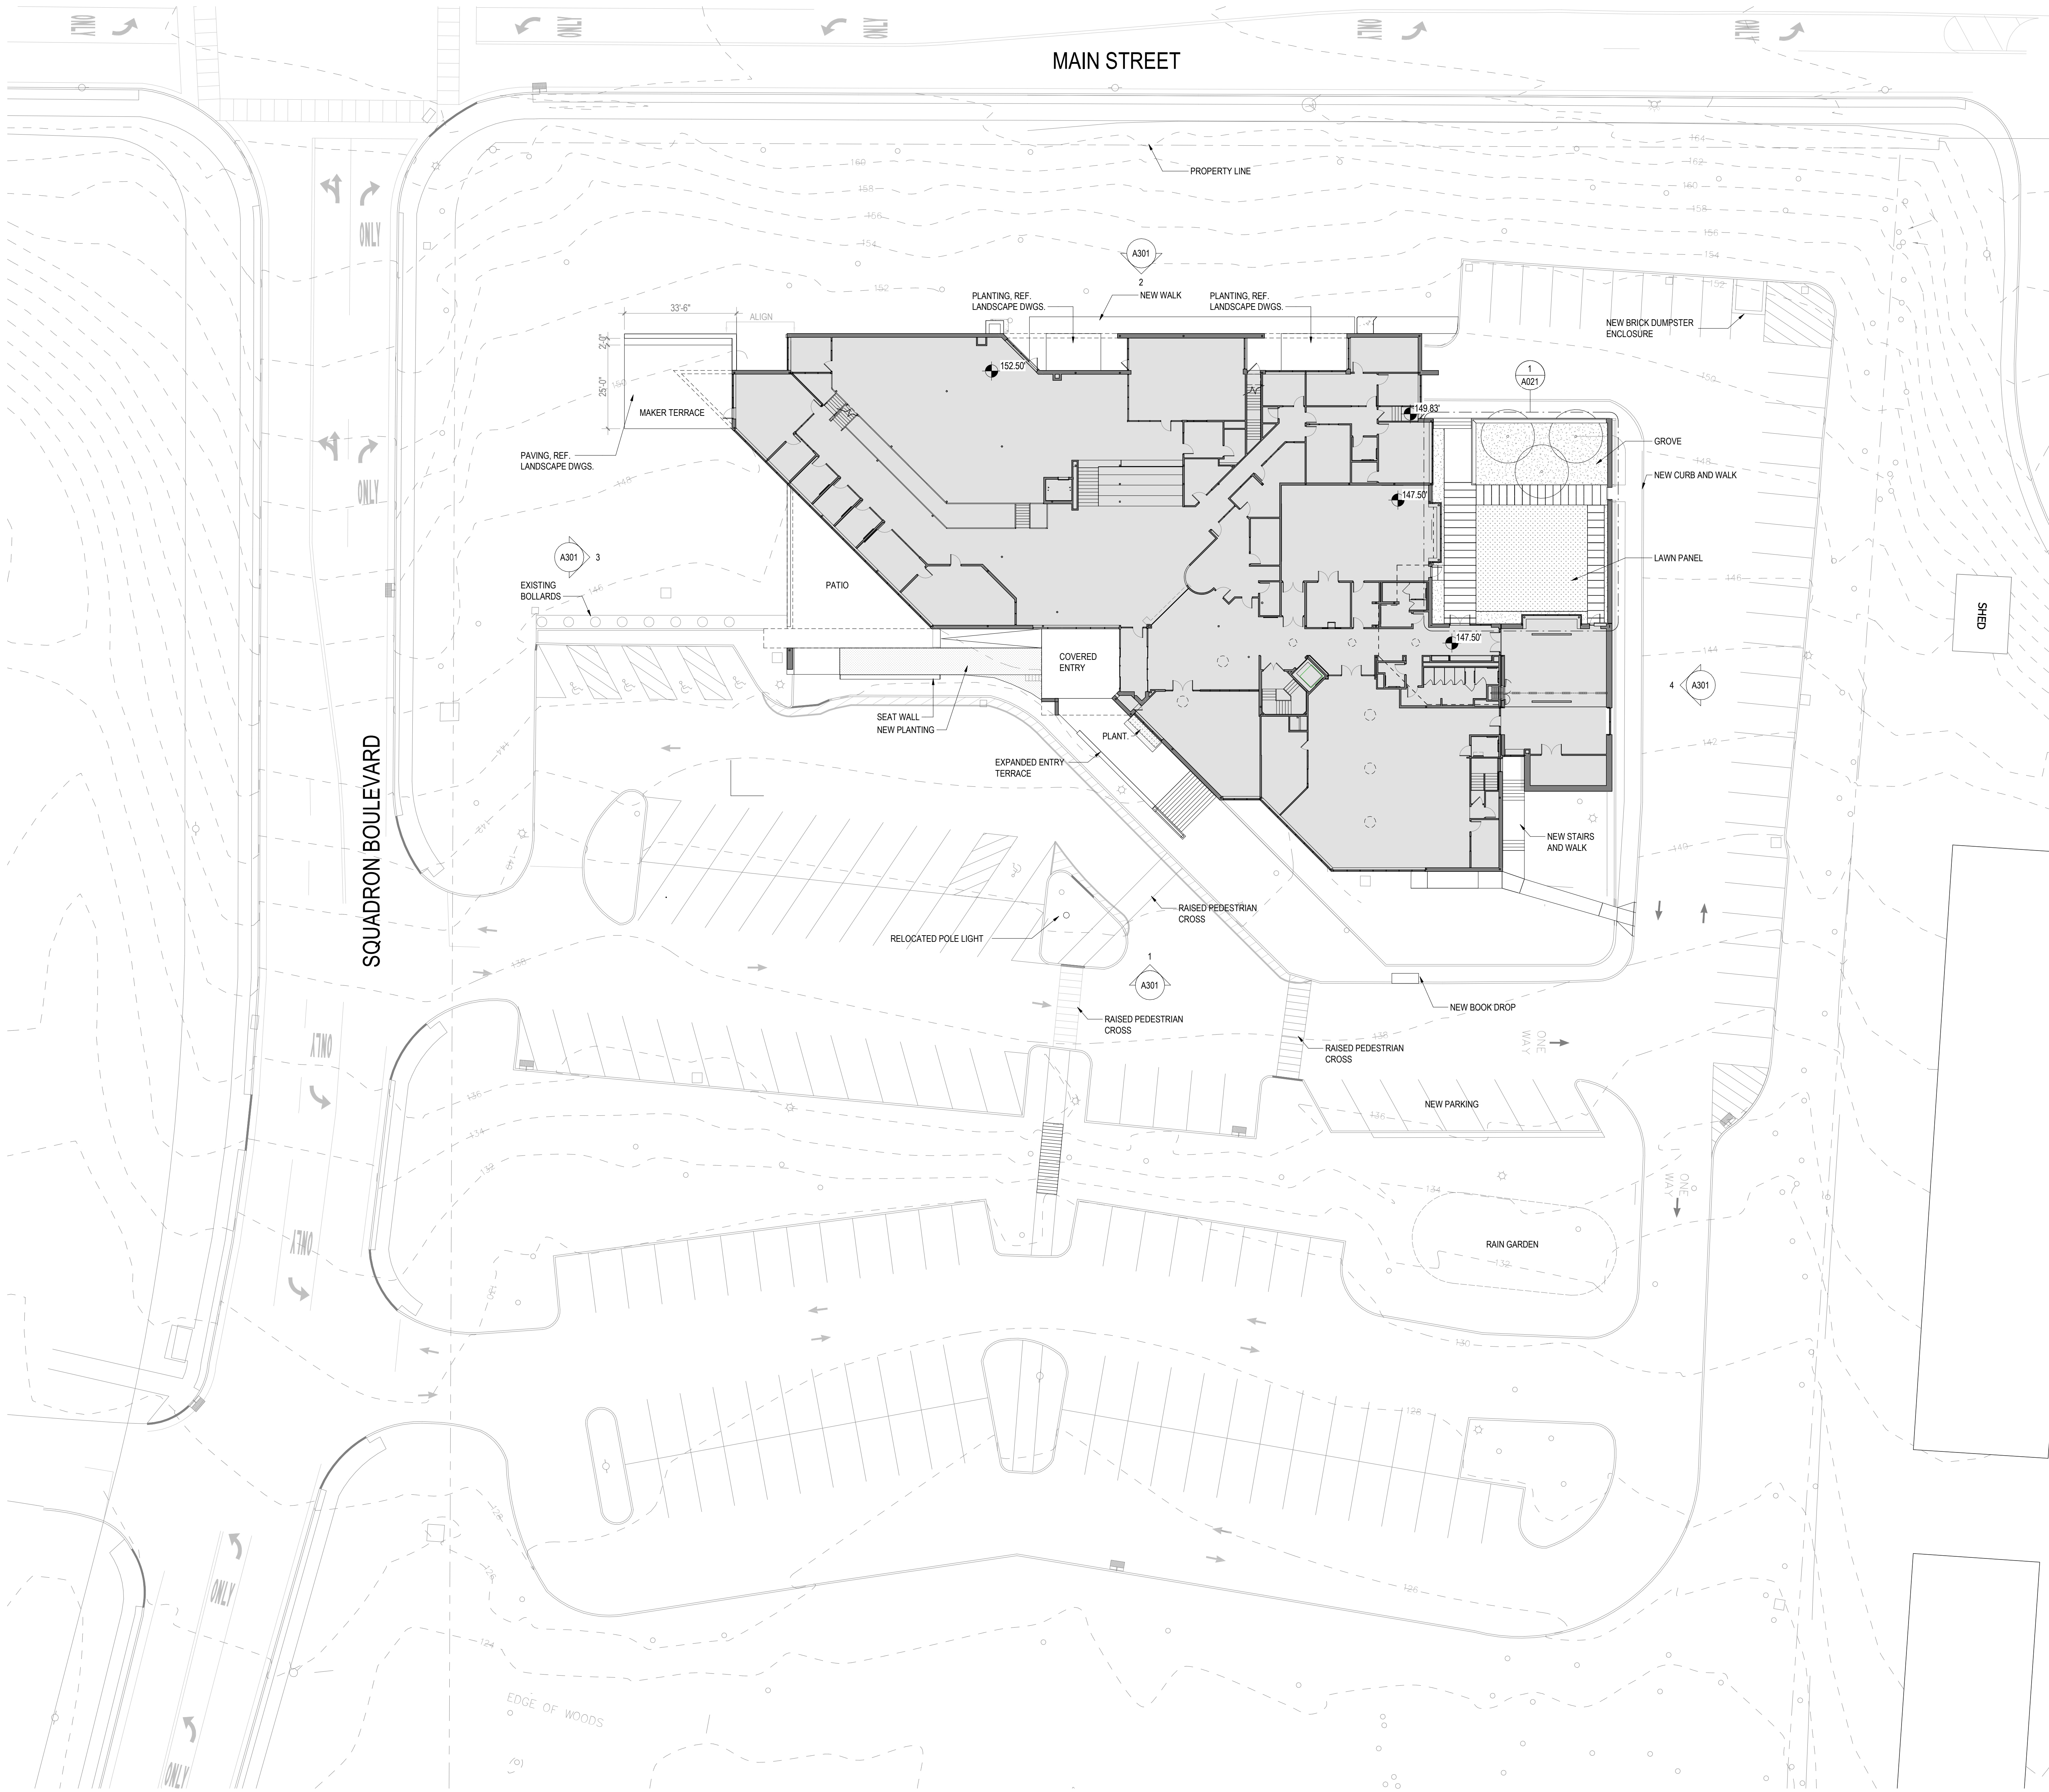



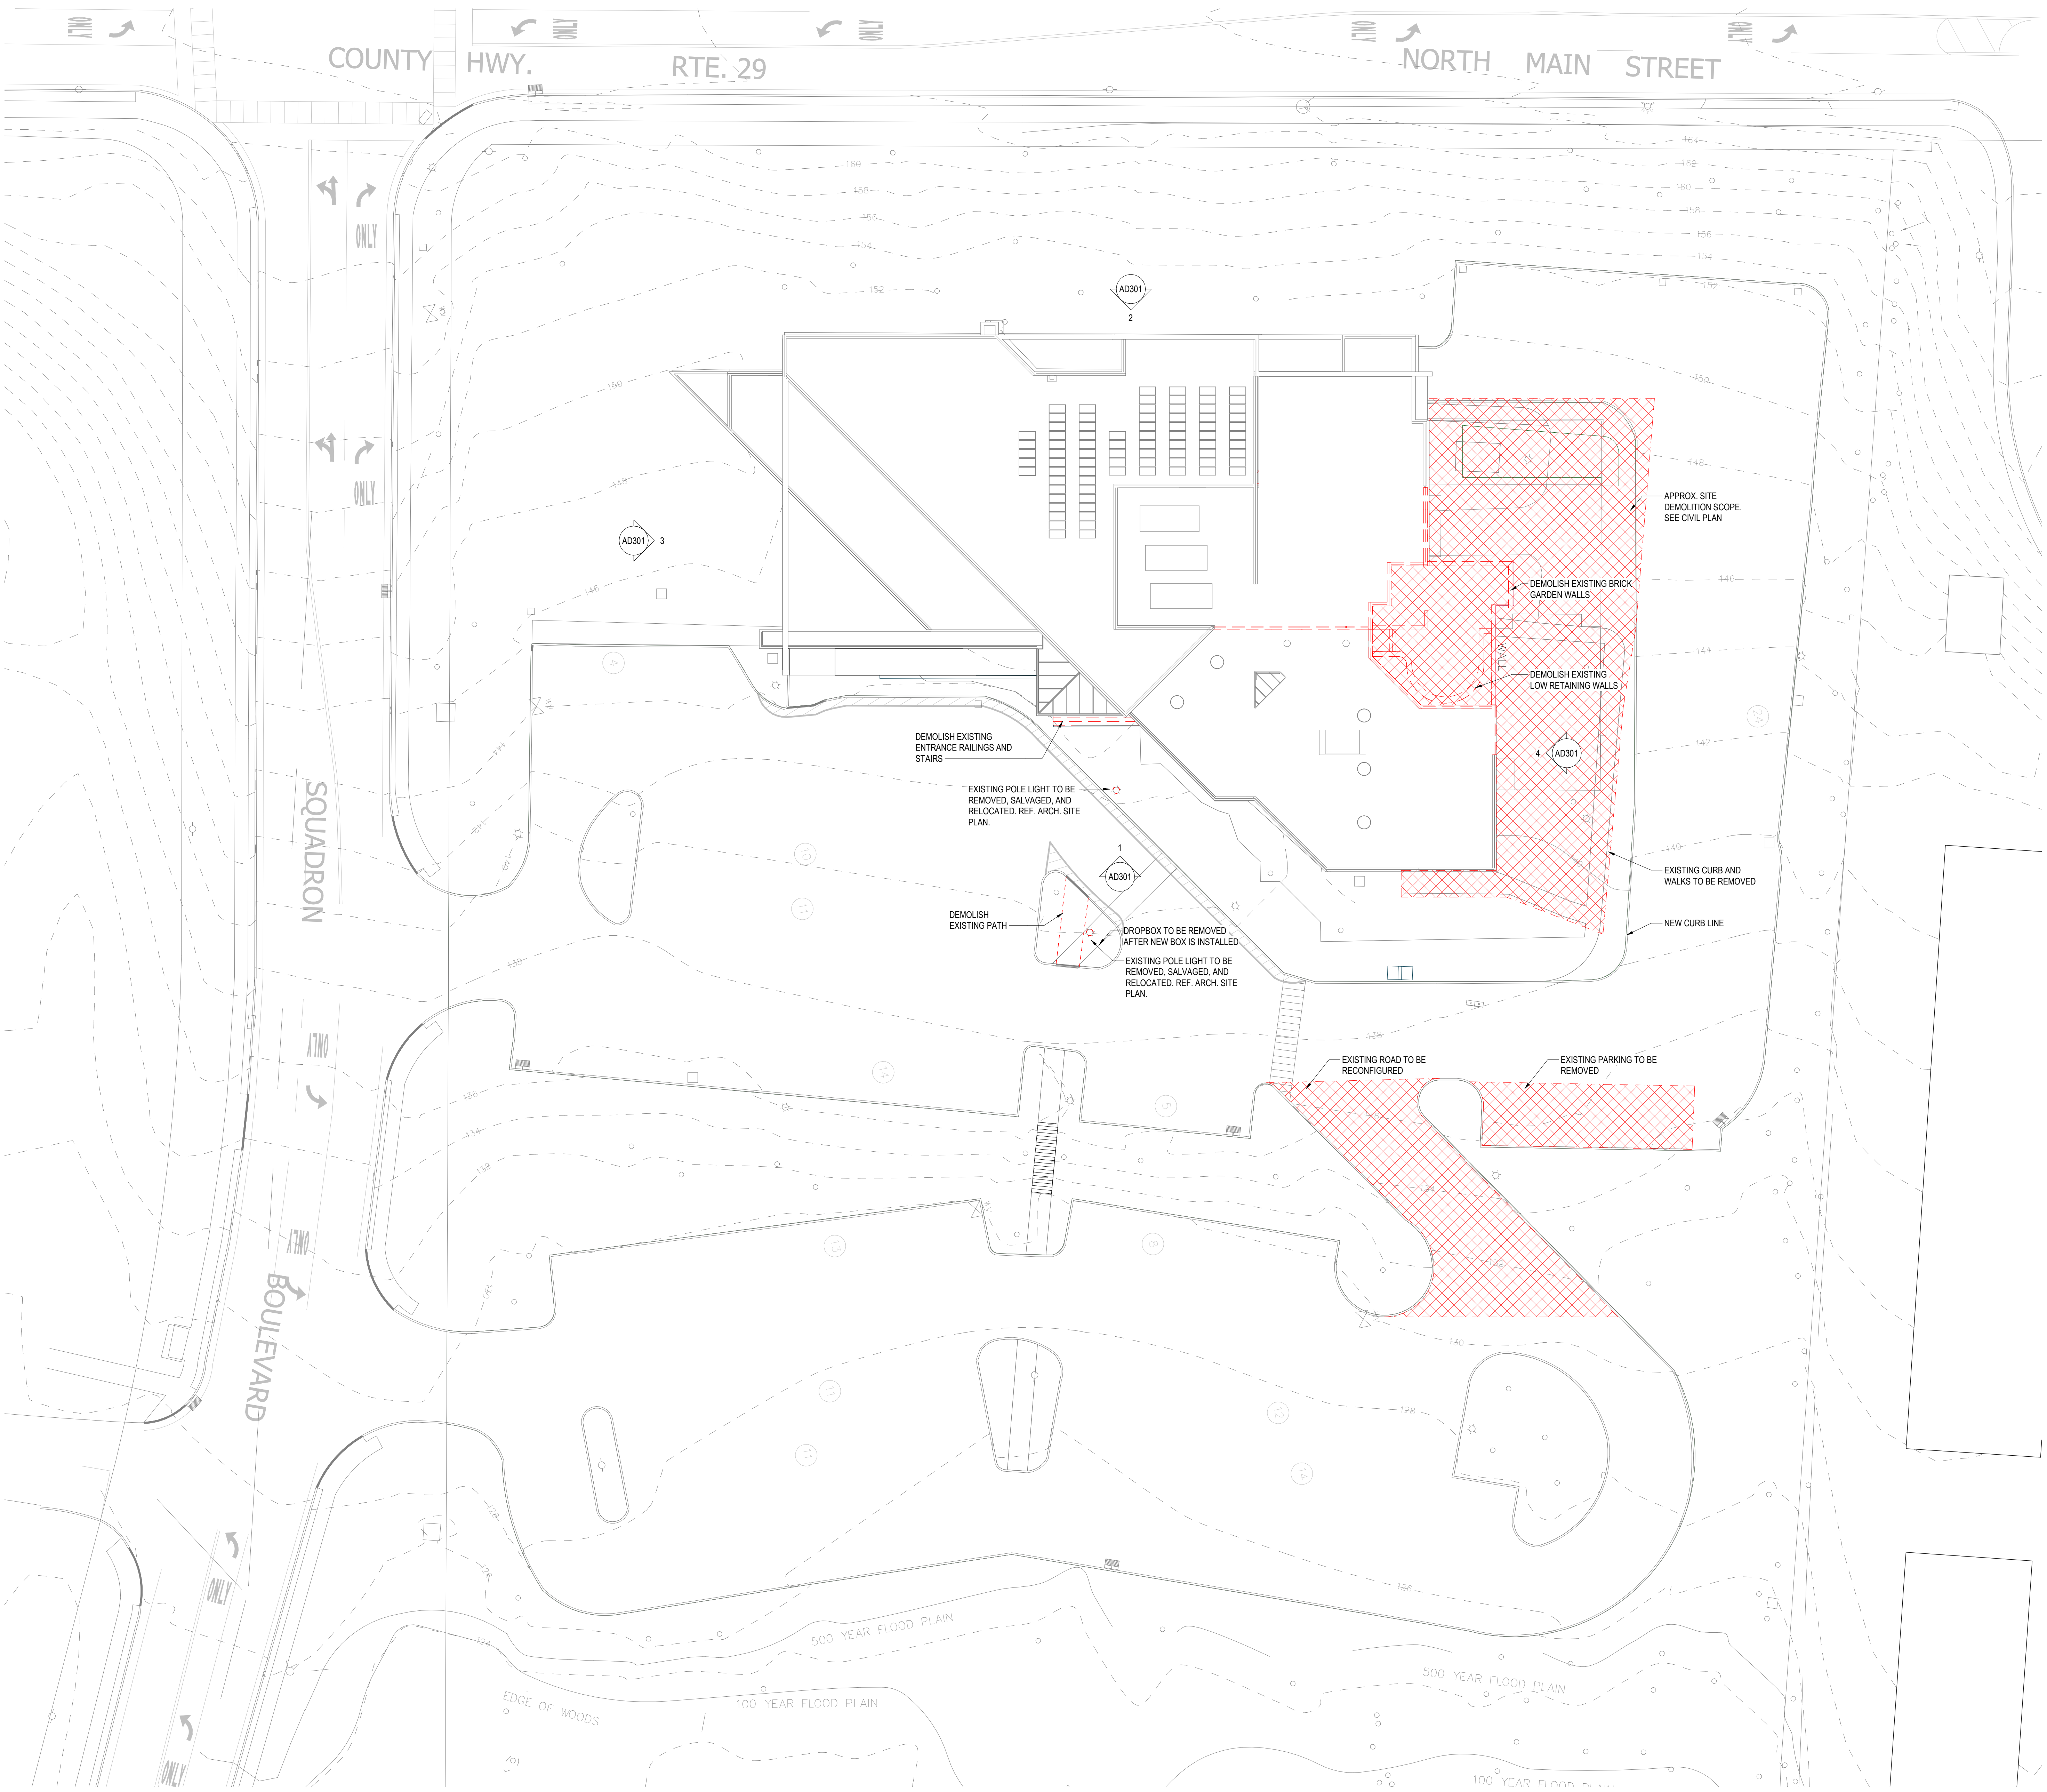



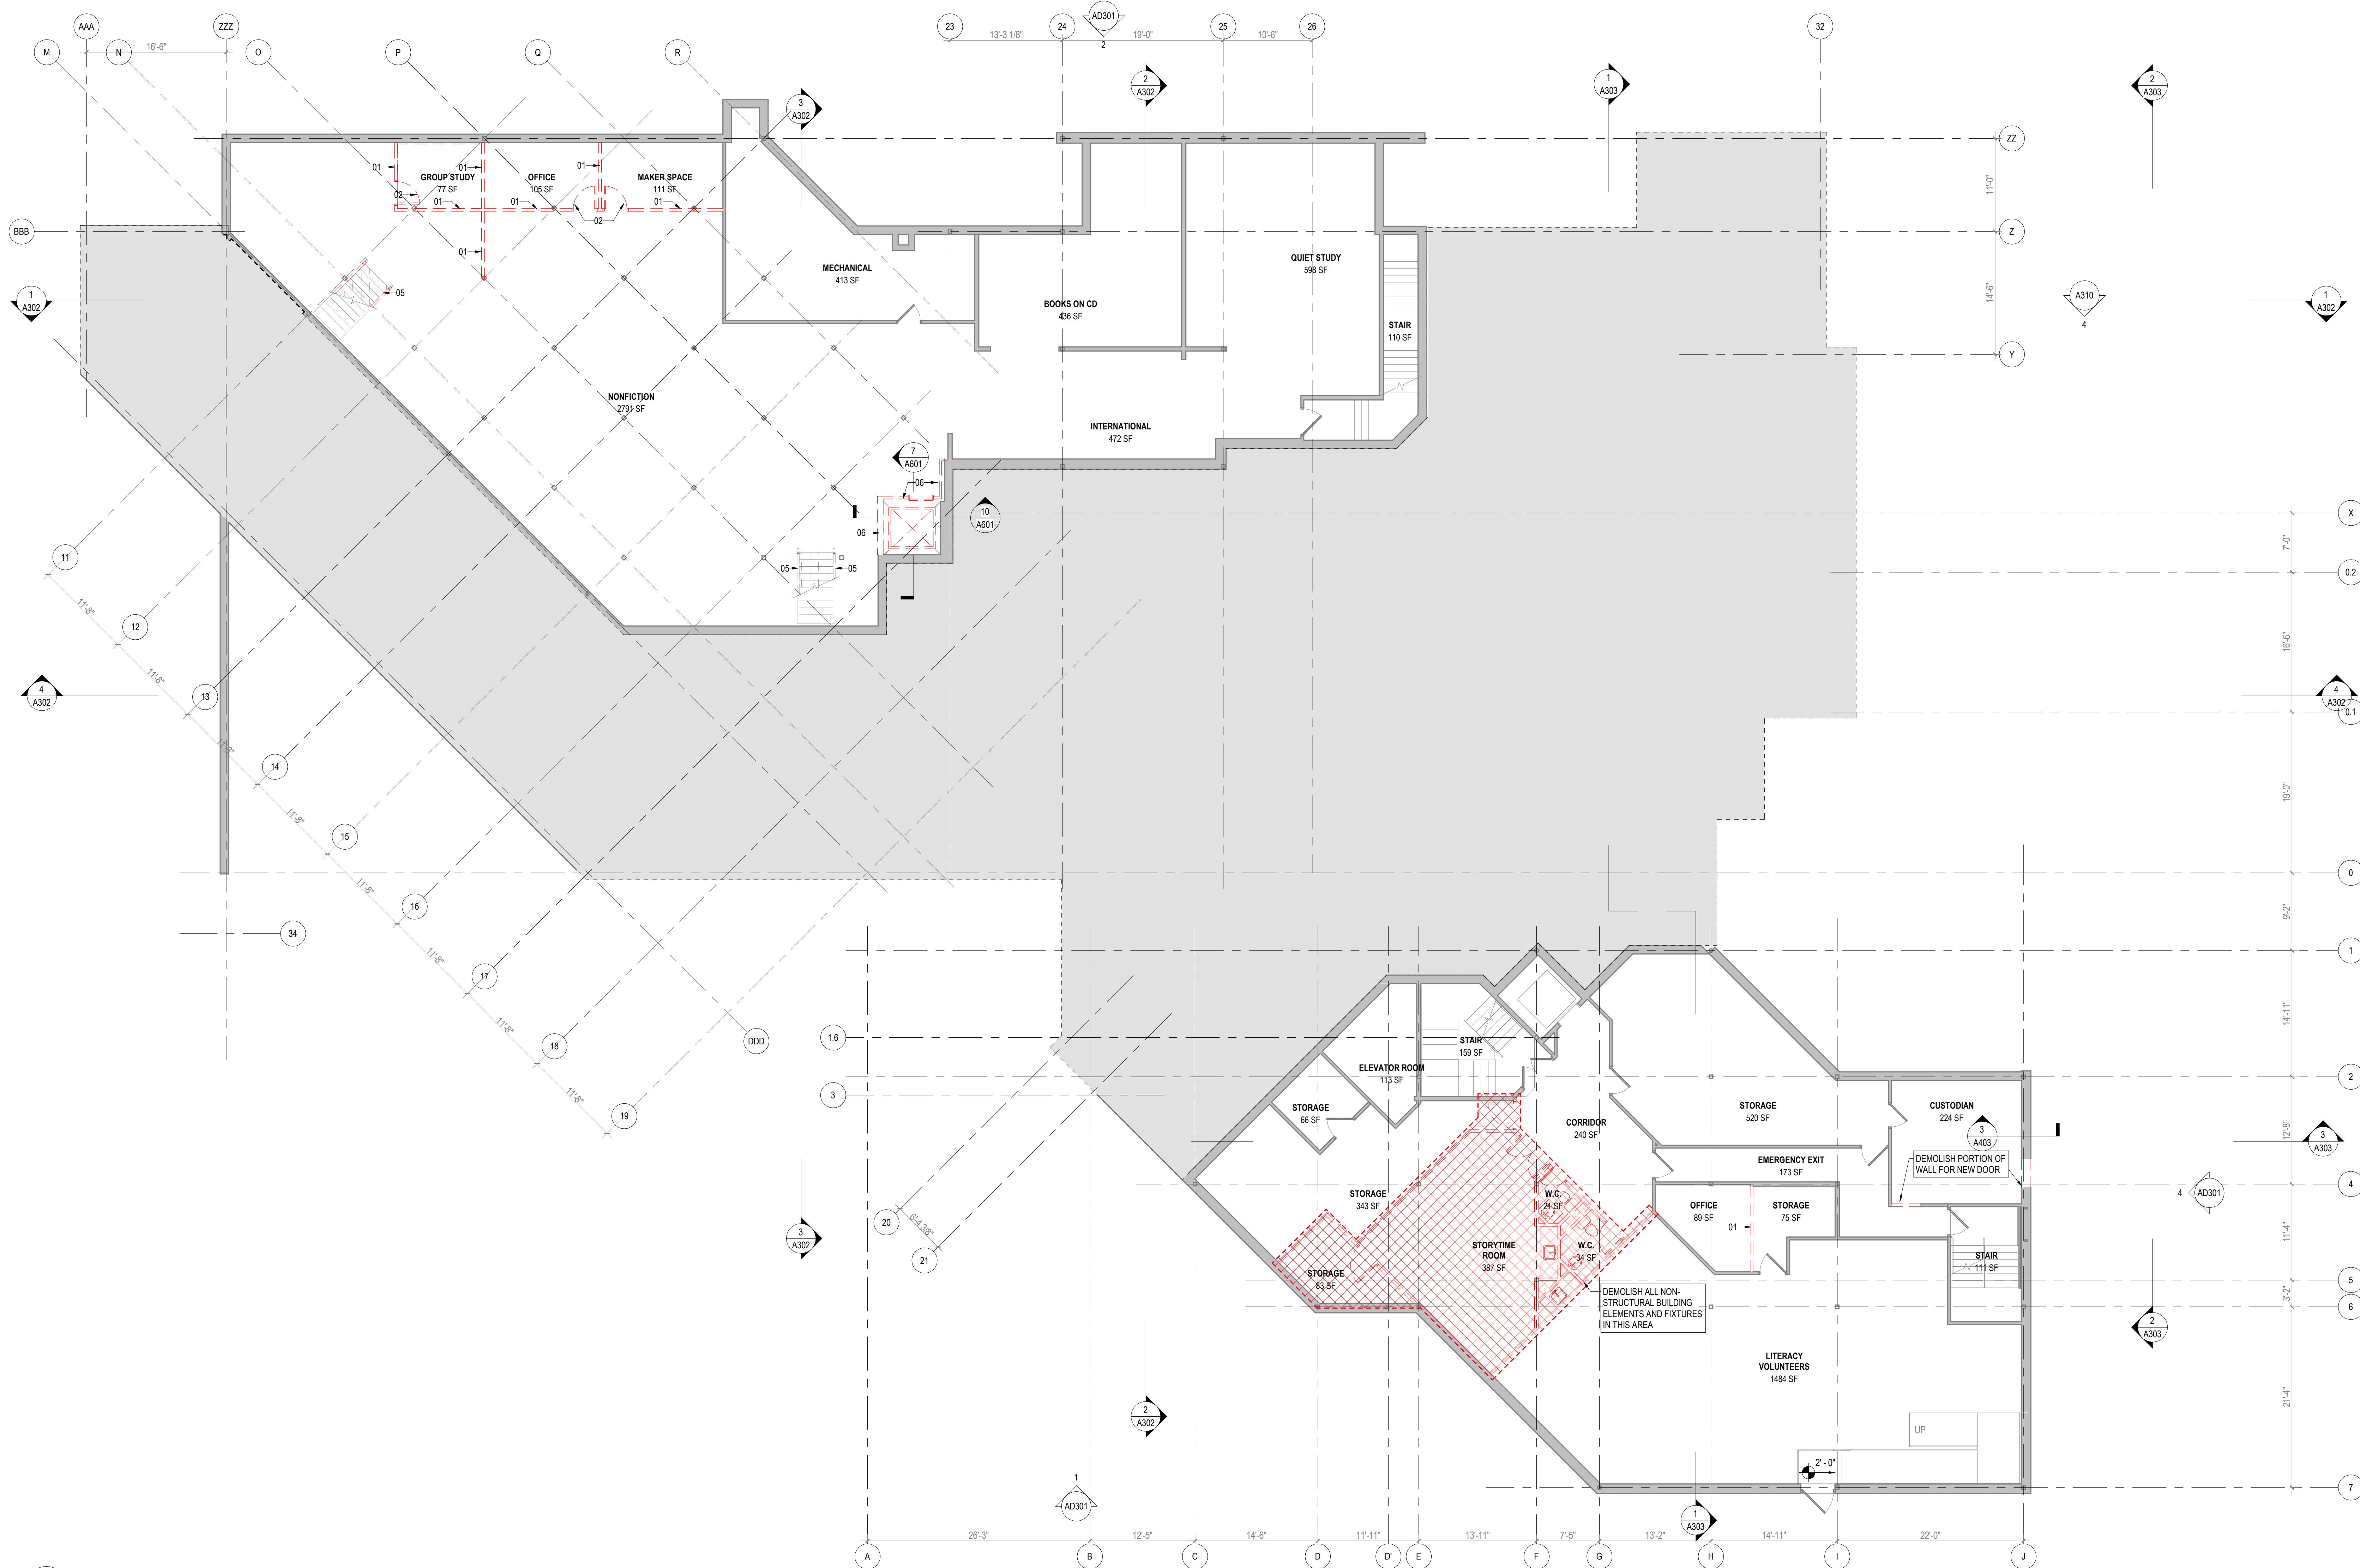

1 LOWER LEVEL DEMO PLANS  
A301/AD101 1/8" = 1'-0"

## GENERAL DEMOLITION NOTES:

- BOOK SHELVES NOT SHOWN FOR CLARITY. ALL BOOK SHELVES ARE TO BE MOVED AND STORED IN A DESIGNATED AREA TBD


## DEMOLITION NOTES

- DEMOLISH COMPLETE EXISTING INTERIOR WALL AND/OR STOREFRONT. DEMOLISH ASSOCIATED DOORS AND FRAMES
- DEMOLISH EXISTING HM DOOR AND FRAME
- DEMOLISH EXISTING INTERIOR STOREFRONT. SURROUNDING WALL CONSTRUCTION TO REMAIN
- DEMOLISH EXISTING INTERIOR BRICK WALL. BACKUP WALL TO REMAIN WHERE INDICATED
- DEMOLISH AND/OR REPLACE RAILINGS AS INDICATED
- PARTIALLY DEMOLISH EXISTING ELEVATOR SHAFT. SEE DETAILS AND STRUCTURAL DRAWINGS FOR FULL DEMO SCOPE
- DEMOLISH EXISTING COLUMN. SEE STRUCTURAL DRAWINGS FOR FULL DEMO AND SHORING DETAILS
- DEMOLISH ALL NON-STRUCTURAL ELEMENTS OF EXISTING EXTERIOR WALL
- DEMOLISH EXISTING EXTERIOR BRICK WALL AND STOREFRONT WINDOW
- DEMOLISH EXISTING EXTERIOR STOREFRONT FRAME AND DOOR
- DEMOLISH EXISTING LIGHT FIXTURE
- DEMOLISH EXISTING ACOUSTIC PANEL CEILING
- DEMOLISH EXISTING PLASTER CEILING

## DEMOLITION LEGEND

- AREA OF FULL INTERIOR DEMOLITION. FLOOR SLAB AND STRUCTURE TO REMAIN U.N.O.
- ELEMENTS TO BE DEMOLISHED
- EXISTING WALLS & STRUCTURE TO REMAIN
- EXISTING DOORS TO REMAIN
- DOORS & FIXTURES TO BE DEMOLISHED



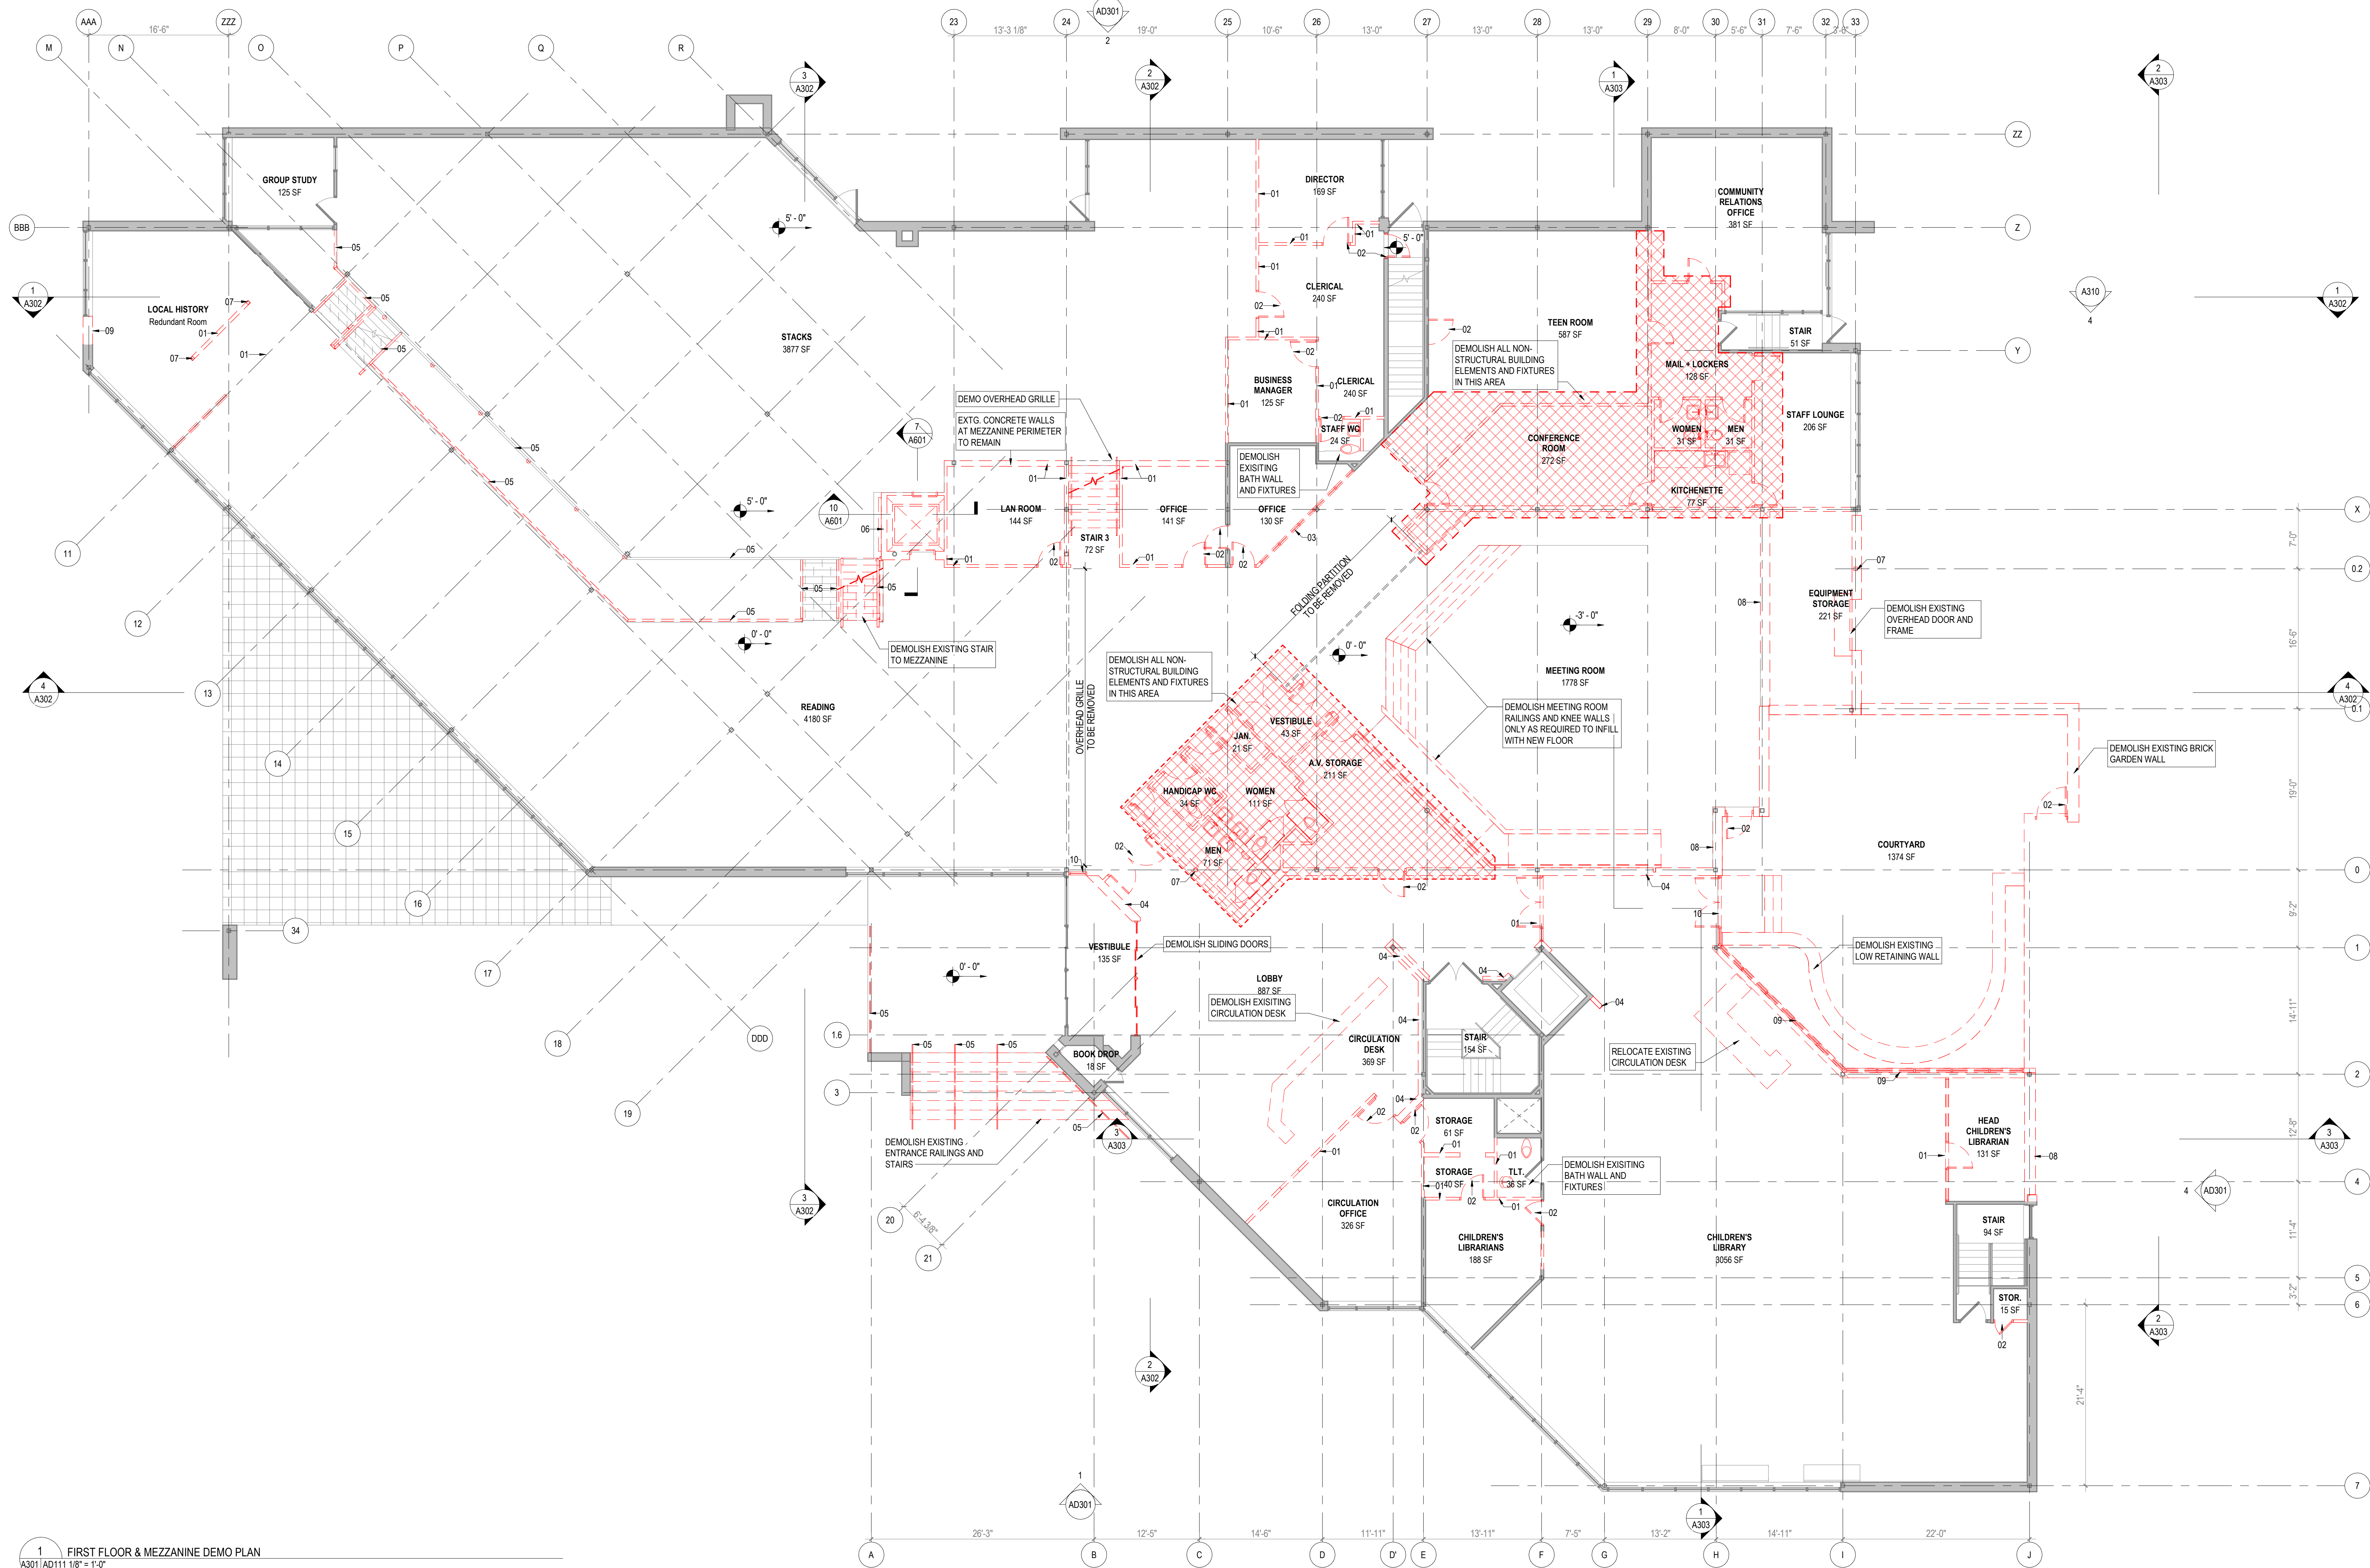

1 FIRST FLOOR & MEZZANINE DEMO PLAN  
A301 AD111 1/8" = 1'-0"

## GENERAL DEMOLITION NOTES:

- BOOK SHELVES NOT SHOWN FOR CLARITY. ALL BOOK SHELVES ARE TO BE MOVED AND STORED IN A DESIGNATED AREA TBD

## DEMOLITION NOTES

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## DEMOLITION LEGEND

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- ELEMENTS TO BE DEMOLISHED
- EXISTING WALLS & STRUCTURE TO REMAIN
- EXISTING DOORS TO REMAIN
- DOORS & FIXTURES TO BE DEMOLISHED

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New City Library

## New City Library Addition & Renovation


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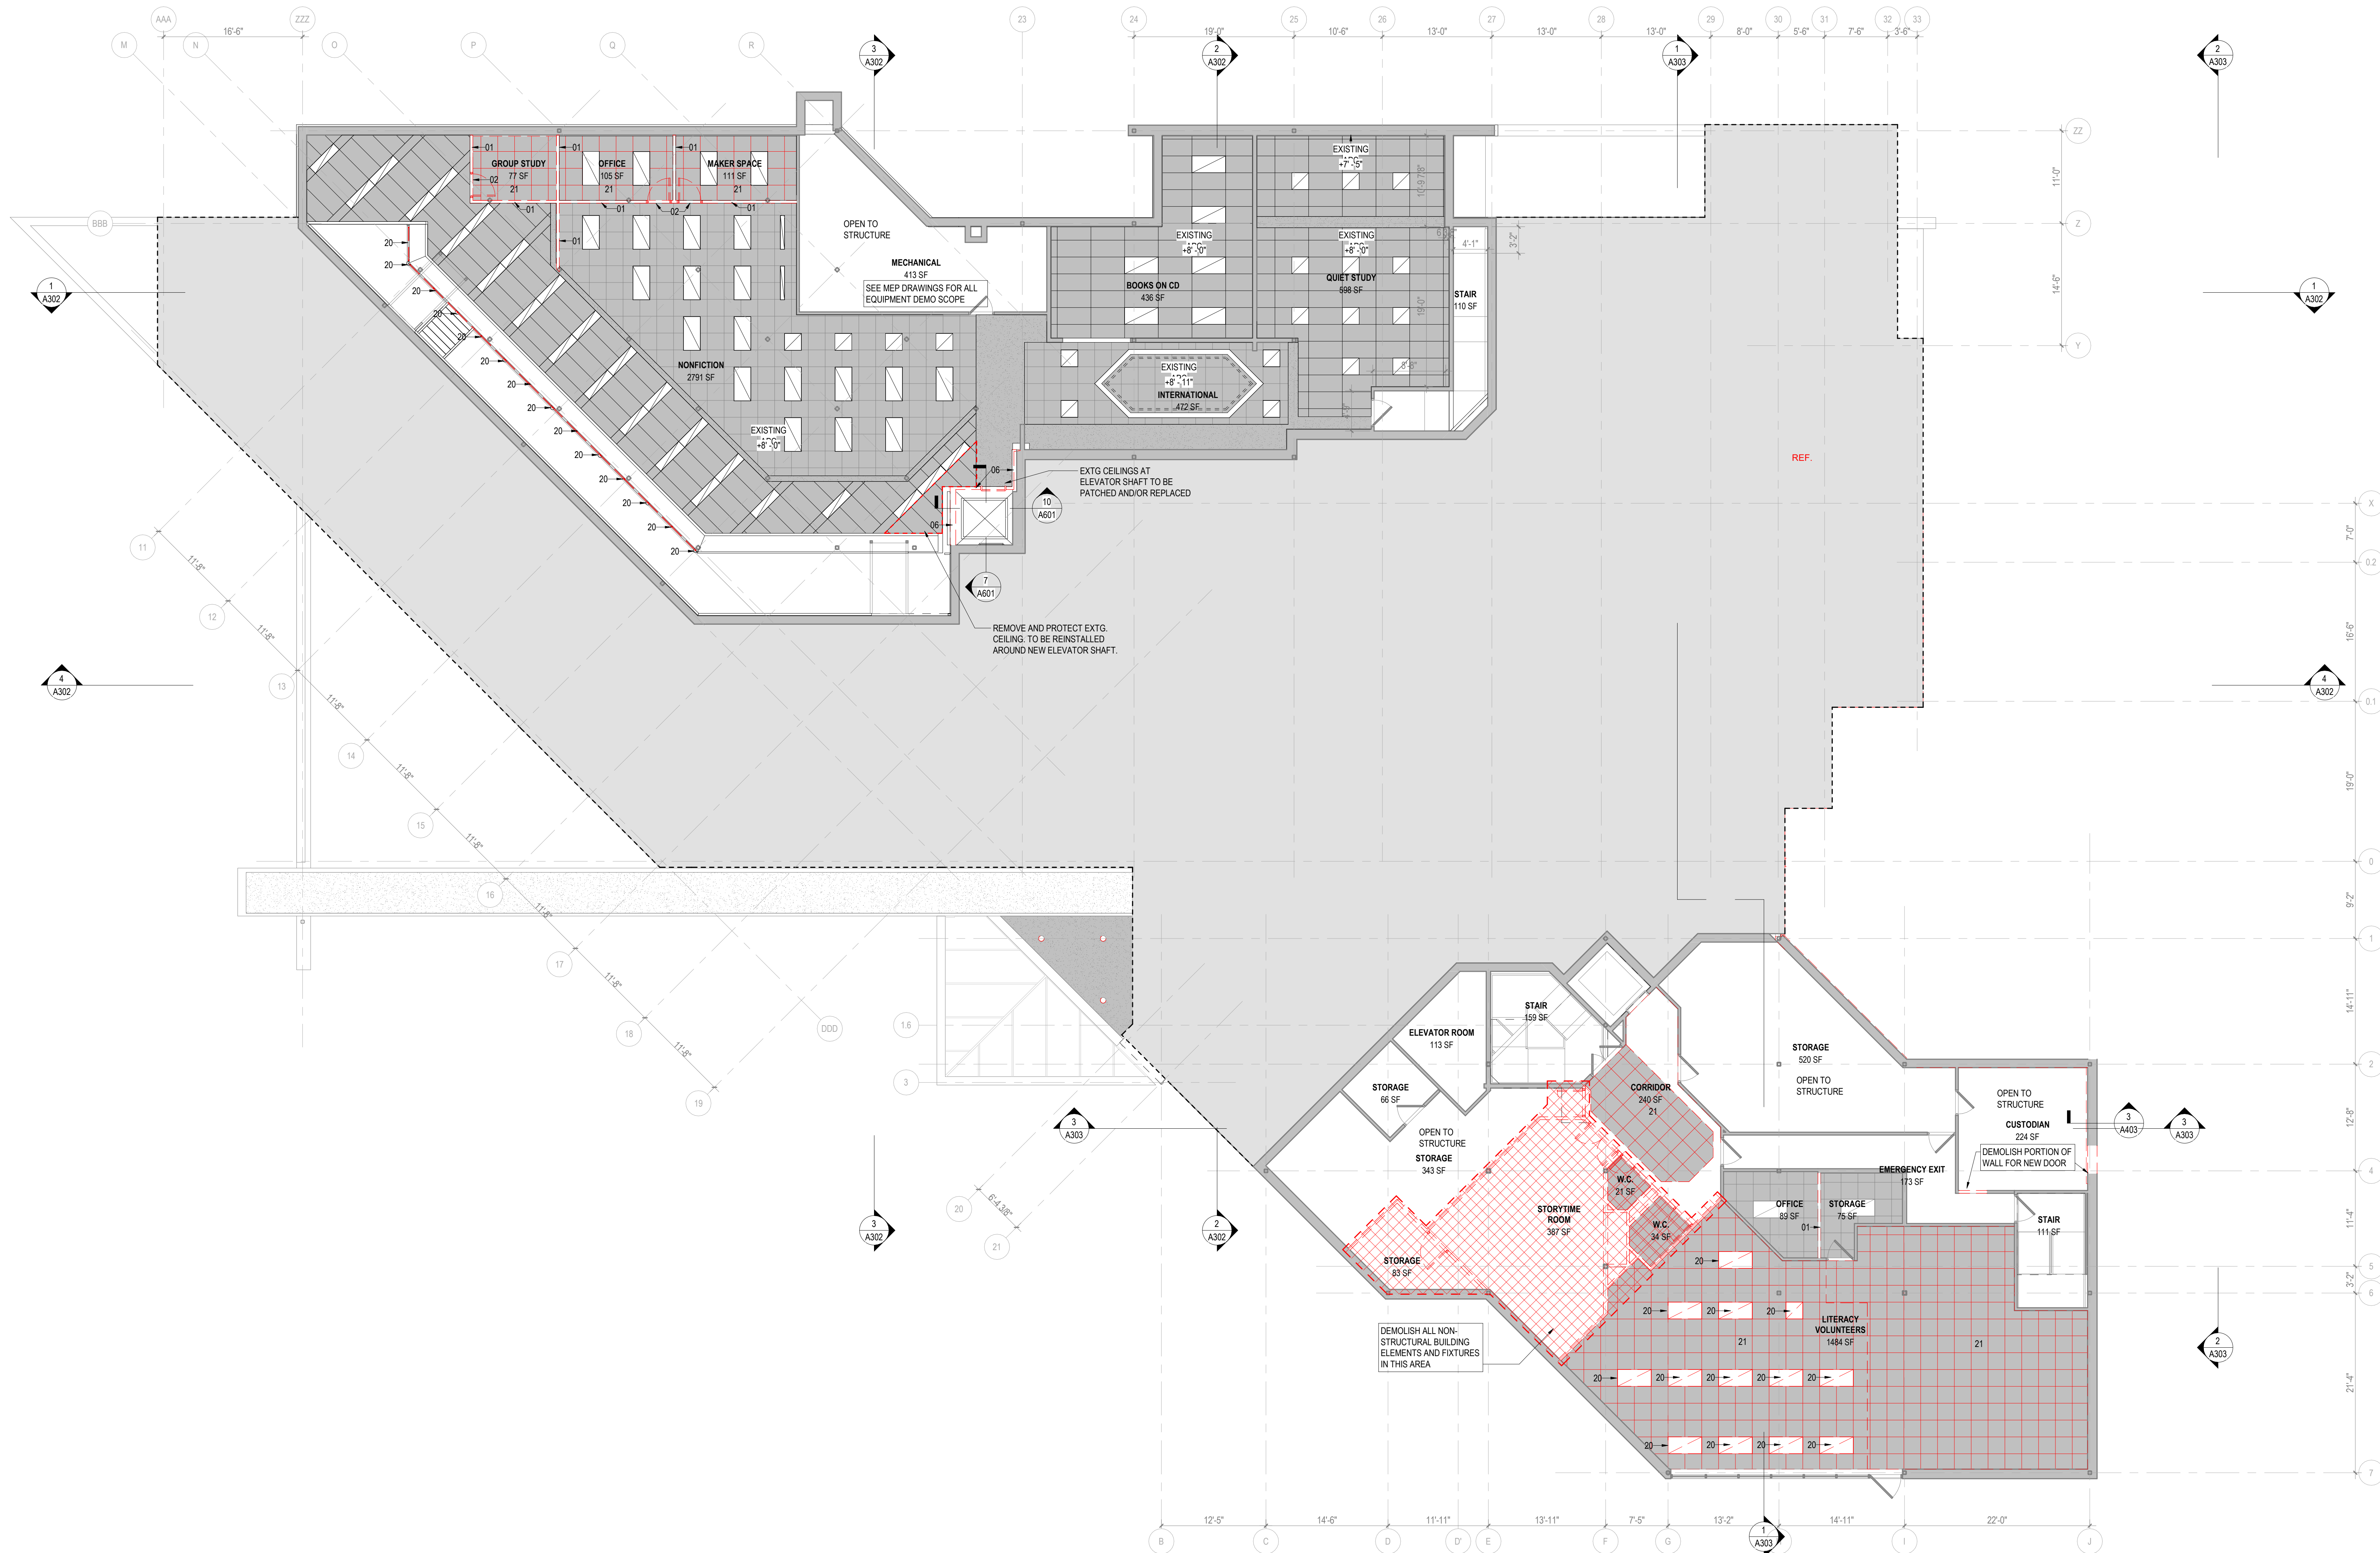


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	SCHEMATIC DESIGN	03.05.2021

## DEMOLITION PLAN - FIRST FLOOR & MEZZANINE

AD111  
DESIGN DEVELOPMENT  
07.09.2021



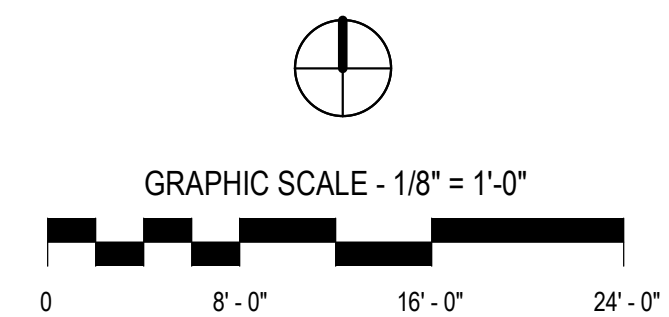

1 EXISTING RCP LOWER LEVELS DEMO  
A301 AD201 1/8" = 1'-0"

## REFLECTED CEILING PLAN GENERAL NOTES

1. CEILING HEIGHTS ARE MEASURED FROM FINISHED FLOOR.
2. REFER TO REFLECTED CEILING PLANS FOR GRID LAYOUTS AND FIXTURE LOCATIONS & COORDINATE WITH MEP. IN CASE OF CONFLICT, CONSULT ARCHITECT. SEE ELECTRICAL FOR SPECIFIC LIGHT FIXTURE TYPE DESIGNATION.
3. PAINT ALL STRUCTURE AND INFRASTRUCTURE COMPONENTS AND SURFACES AT OPEN OR EXPOSED CEILINGS.
4. SPRINKLERS, WHERE SHOWN, INDICATE PREFERRED RELATIONSHIP TO ADJACENT BUILDING ELEMENTS ONLY. ALL SPRINKLER PIPING IS TO BE CONCEALED IN WALL OR CEILING CAVITIES. CONSULT WITH ARCHITECT ON CONFLICTS.
5. ALL SUSPENDED ACOUSTICAL TILE CEILINGS SHALL BE CENTERED IN EACH ROOM PER THE REFLECTED CEILING PLAN U.N.O.
6. CENTER SPRINKLER HEADS, MECHANICAL AIR DEVICES, LIGHT FIXTURES AND OTHER ELECTRICAL DEVICES IN ACOUSTICAL CEILING PANELS, U.N.O.
7. LOCATE M.E.P. COMPONENTS REQUIRING ACCESS AT ACCESSIBLE CEILING AREAS TO THE GREATEST EXTENT POSSIBLE. WHERE CEILINGS ARE INACCESSIBLE, PROVIDE ACCESS PANELS.
8. SOME M.E.P. COMPONENTS, ELECTRICAL DEVICES AND PLUMBING DEVICES MAY NOT BE SHOWN. REFER TO M.E.P. DRAWINGS.
9. PROVIDE VERTICAL GYP. BD. AT ALL CEILING HEIGHT TRANSITIONS, U.N.O.

## DEMOLITION NOTES

01. DEMOLISH COMPLETE EXISTING INTERIOR WALL AND/OR STOREFRONT. DEMOLISH ASSOCIATED DOORS AND FRAMES
02. DEMOLISH EXISTING HM DOOR AND FRAME
03. DEMOLISH EXISTING INTERIOR STOREFRONT. SURROUNDING WALL CONSTRUCTION TO REMAIN
04. DEMOLISH EXISTING INTERIOR BRICK WALL. BACKUP WALL TO REMAIN WHERE INDICATED
05. DEMOLISH AND/OR REPLACE RAILINGS AS INDICATED
06. PARTIALLY DEMOLISH EXISTING ELEVATOR SHAFT. SEE DETAILS AND STRUCTURAL DRAWINGS FOR FULL DEMO SCOPE
07. DEMOLISH EXISTING COLUMN. SEE STRUCTURAL DRAWINGS FOR FULL DEMO AND SHORING DETAILS
08. DEMOLISH ALL NON-STRUCTURAL ELEMENTS OF EXISTING EXTERIOR WALL
09. DEMOLISH EXISTING EXTERIOR BRICK WALL AND STOREFRONT WINDOW
10. DEMOLISH EXISTING EXTERIOR STOREFRONT FRAME AND DOOR
20. DEMOLISH EXISTING LIGHT FIXTURE
21. DEMOLISH EXISTING ACOUSTIC PANEL CEILING
22. DEMOLISH EXISTING PLASTER CEILING






## New City Library Addition & Renovation

220 North Main Street  
New City, NY 10956

VMDO Project Number 1301

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Drawn By	Autho

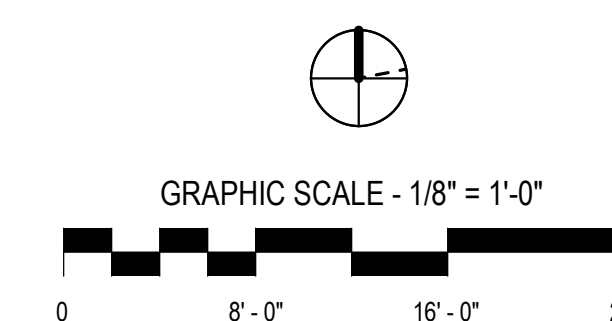


DRAWING NOT FOR  
CONSTRUCTION

ISSUES AND REVISIONS	
NO. SUBMITTAL	DATE
1	11/11/2014
2	12/11/2014
3	1/14/2015
4	2/11/2015
5	3/11/2015
6	4/11/2015
7	5/11/2015
8	6/11/2015
9	7/11/2015
10	8/11/2015
11	9/11/2015
12	10/11/2015
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128	6/11/2025
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130	8/11/2025
131	9/11/2025
132	10/11/2025
133	1

DEMOLITION RCP -  
FIRST FLOOR &  
MEZZANINE

AD202  
DESIGN DEVELOPMENT  
07.09.2021

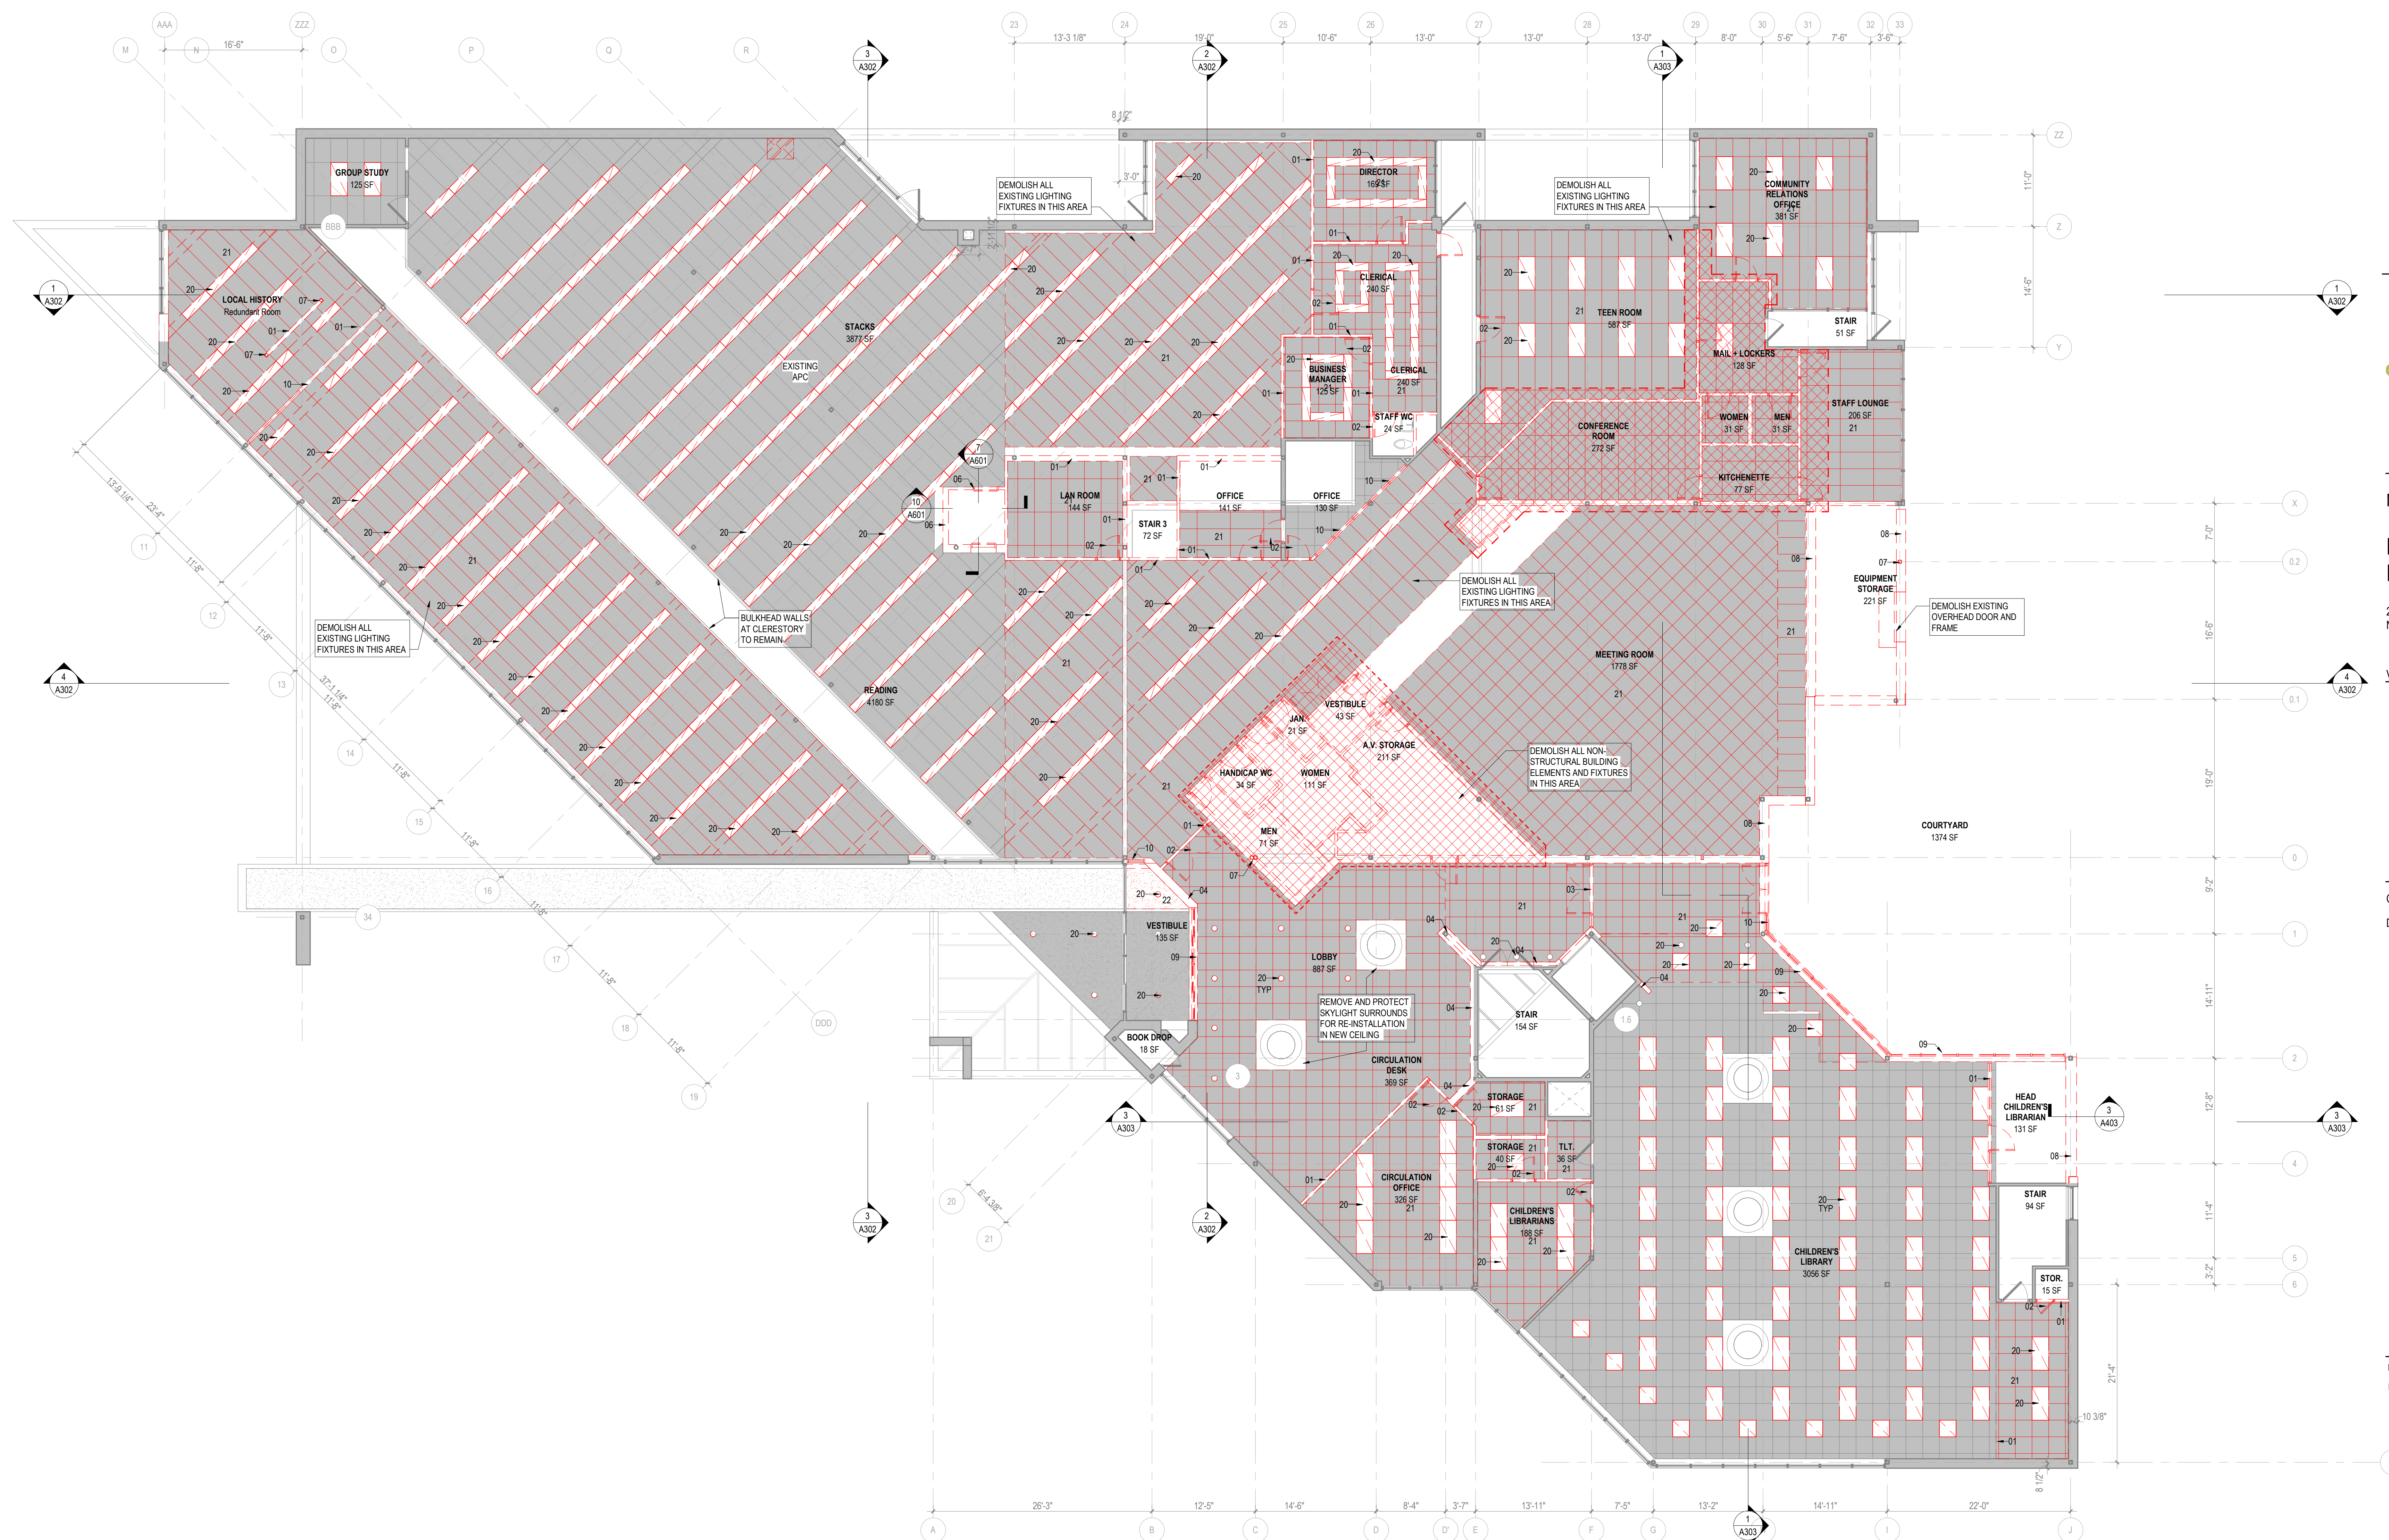

1	EXISTING RCP FIRST FLOOR AND MEZZANINE DEMO
A301	AD202 1/8" = 1'-0"


REFLECTED CEILING PLAN  
GENERAL NOTES

1. CEILING HEIGHTS ARE MEASURED FROM FINISHED FLOOR.
2. REFER TO REFLECTED CEILING PLANS FOR GRID LAYOUTS AND FIXTURE LOCATIONS & COORDINATE WITH MEP IN ORDER TO PREVENT CONFLICTS. PROVIDE SPECIFIC LIGHT FIXTURE TYPE DESIGNATION.
3. PAINT ALL STRUCTURAL AND MECHANICAL COMPONENTS AND SURFACES OPEN OR EXPOSED ELEMENTS, SPRINKLERS, REFER TO SHOWN, INDICATE PREFERRED RELATIONSHIP TO ADJACENT BUILDING TYPE ELEMENTS. ONLY ALL PAINTS ARE FINISHING 4. PROVIDE SPECIFIC LIGHT FIXTURE TYPE DESIGNATION.
5. ALL SUSPENDED ACOUSTICAL TILE CEILINGS SHALL BE CENTERED IN EACH ROOM PER THE REFLECTED CEILING PLAN U.N.O.
6. PROVIDE SPRINKLER HEADS, MECHANICAL AIR DEVICES, LIGHT FIXTURES AND OTHER ELECTRICAL DEVICES IN ACOUSTICAL CEILING PANELS, U.N.O.
7. LOCATE M.E.P. COMPONENTS REQUIRING ACCESS AT ACCESSIBLE CEILING PANELS TO THE GREATEST EXTENT POSSIBLE, WHERE CEILING PANELS ARE NONACCESSIBLE, E. PROVIDE ACCESS PANELS.
8. SOME M.E.P. COMPONENTS, ELECTRICAL DEVICES AND PLUMBING DEVICES MAY NOT BE EXPOSED. REFER TO M.E.P. DRAWINGS.
9. PROVIDE VERTICAL GYP. BD AT ALL CEILING HEIGHT TRANSITIONS U.N.O.


## DEMOLITION NOTES

- |    |   |
|----|---|
| 01 | DEMOLISH COMPLETE EXISTING INTERIOR WALL AND/OR STOREFRONT. DEMOLISH ASSOCIATED DOORS AND FRAMES    |
| 02 | DEMOLISH EXISTING HM DOOR AND FRAME   |
| 03 | DEMOLISH EXISTING INTERIOR STOREFRONT. SURROUNDING WALL CONSTRUCTION TO REMAIN                      |
| 04 | DEMOLISH EXISTING INTERIOR BRICK WALL. BACKUP WALL TO REMAIN WHERE INDICATED                        |
| 05 | DEMOLISH AND/OR REPLACE RAILINGS AS INDICATED   |
| 06 | PARTIALLY DEMOLISH EXISTING ELEVATOR SHAFT. SEE DETAILS AND STRUCTURAL DRAWINGS FOR FULL DEMO SCOPE |
| 07 | DEMOLISH EXISTING COLUMN. SEE STRUCTURAL DRAWINGS FOR FULL DEMO AND SHORING DETAILS                 |
| 08 | DEMOLISH ALL NON-STRUCTURAL ELEMENTS OF EXISTING EXTERIOR WALL                                      |
| 09 | DEMOLISH EXISTING EXTERIOR BRICK WALL AND STOREFRONT WINDOW   |
| 10 | DEMOLISH EXISTING EXTERIOR STOREFRONT FRAME AND DOOR  |
| 20 | DEMOLISH EXISTING LIGHT FIXTURE   |
| 21 | DEMOLISH EXISTING ACOUSTIC PANEL CEILING  |
| 22 | DEMOLISH EXISTING PLASTER CEILING   |




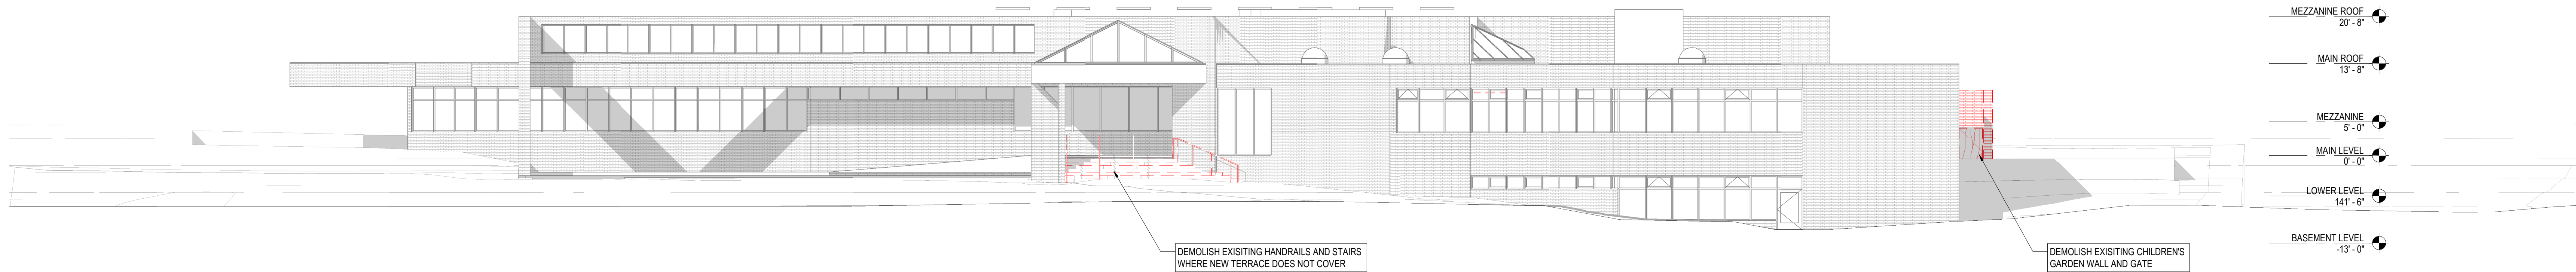

1 OVERALL SOUTH ELEVATION - DEMOLITION  
AD001 | AD301 3/32" = 1'-0"

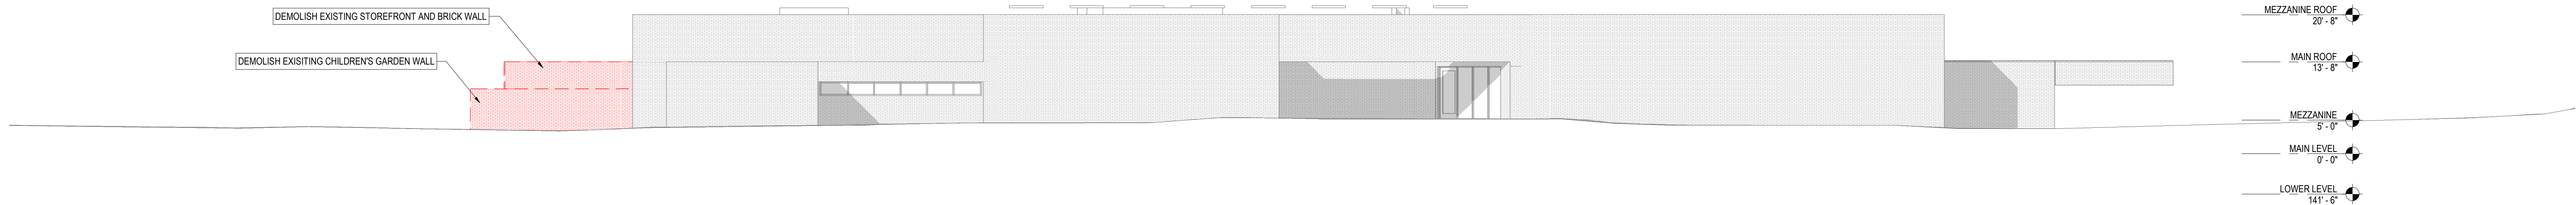

2 OVERALL NORTH ELEVATION - DEMOLITION  
AD001 | AD301 3/32" = 1'-0"

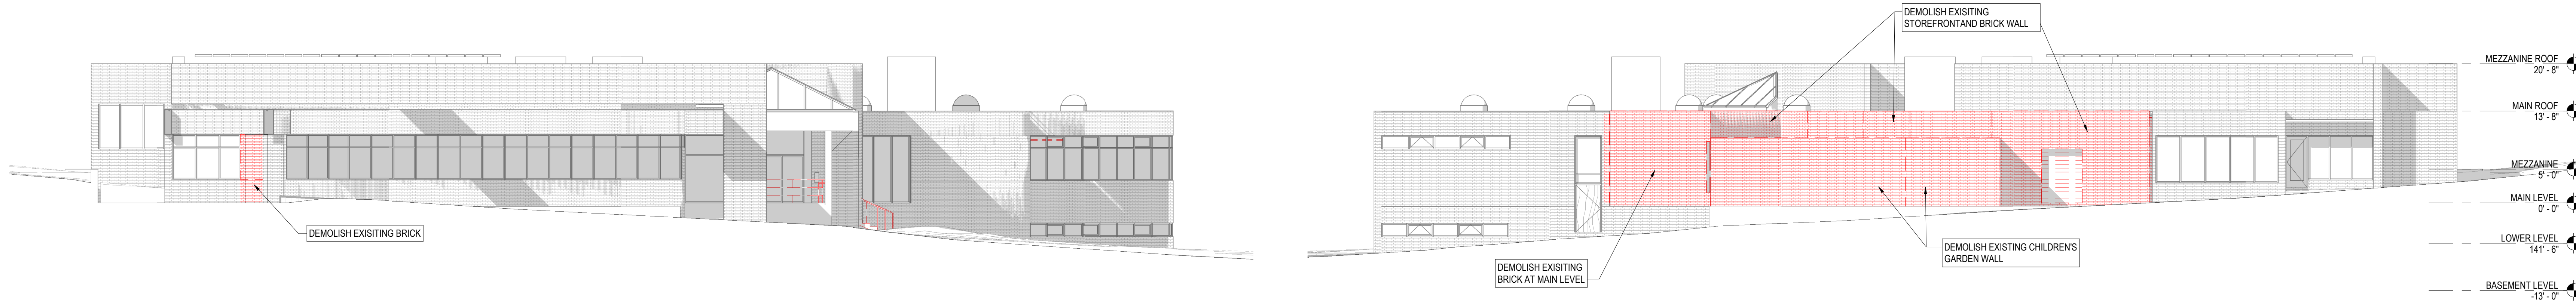

3 OVERALL EAST ELEVATION - DEMOLITION  
AD001 | AD301 3/32" = 1'-0"

4 OVERALL WEST ELEVATION - DEMOLITION  
AD001 | AD301 3/32" = 1'-0"

GENERAL DEMOLITION NOTES:


1. BOOK SHELVES NOT SHOWN FOR CLARITY. ALL BOOK SHELVES ARE TO BE MOVED AND STORED IN A DESIGNATED AREA TBD

DEMOLITION LEGEND

- AREA OF FULL INTERIOR DEMOLITION. FLOOR SLAB AND STRUCTURE TO REMAIN U.N.O.  
ELEMENTS TO BE DEMOLISHED  
EXISTING WALLS & STRUCTURE TO REMAIN  
EXISTING DOORS TO REMAIN  
DOORS & FIXTURES TO BE DEMOLISHED

KEY DEMOLITION ELEVATIONS



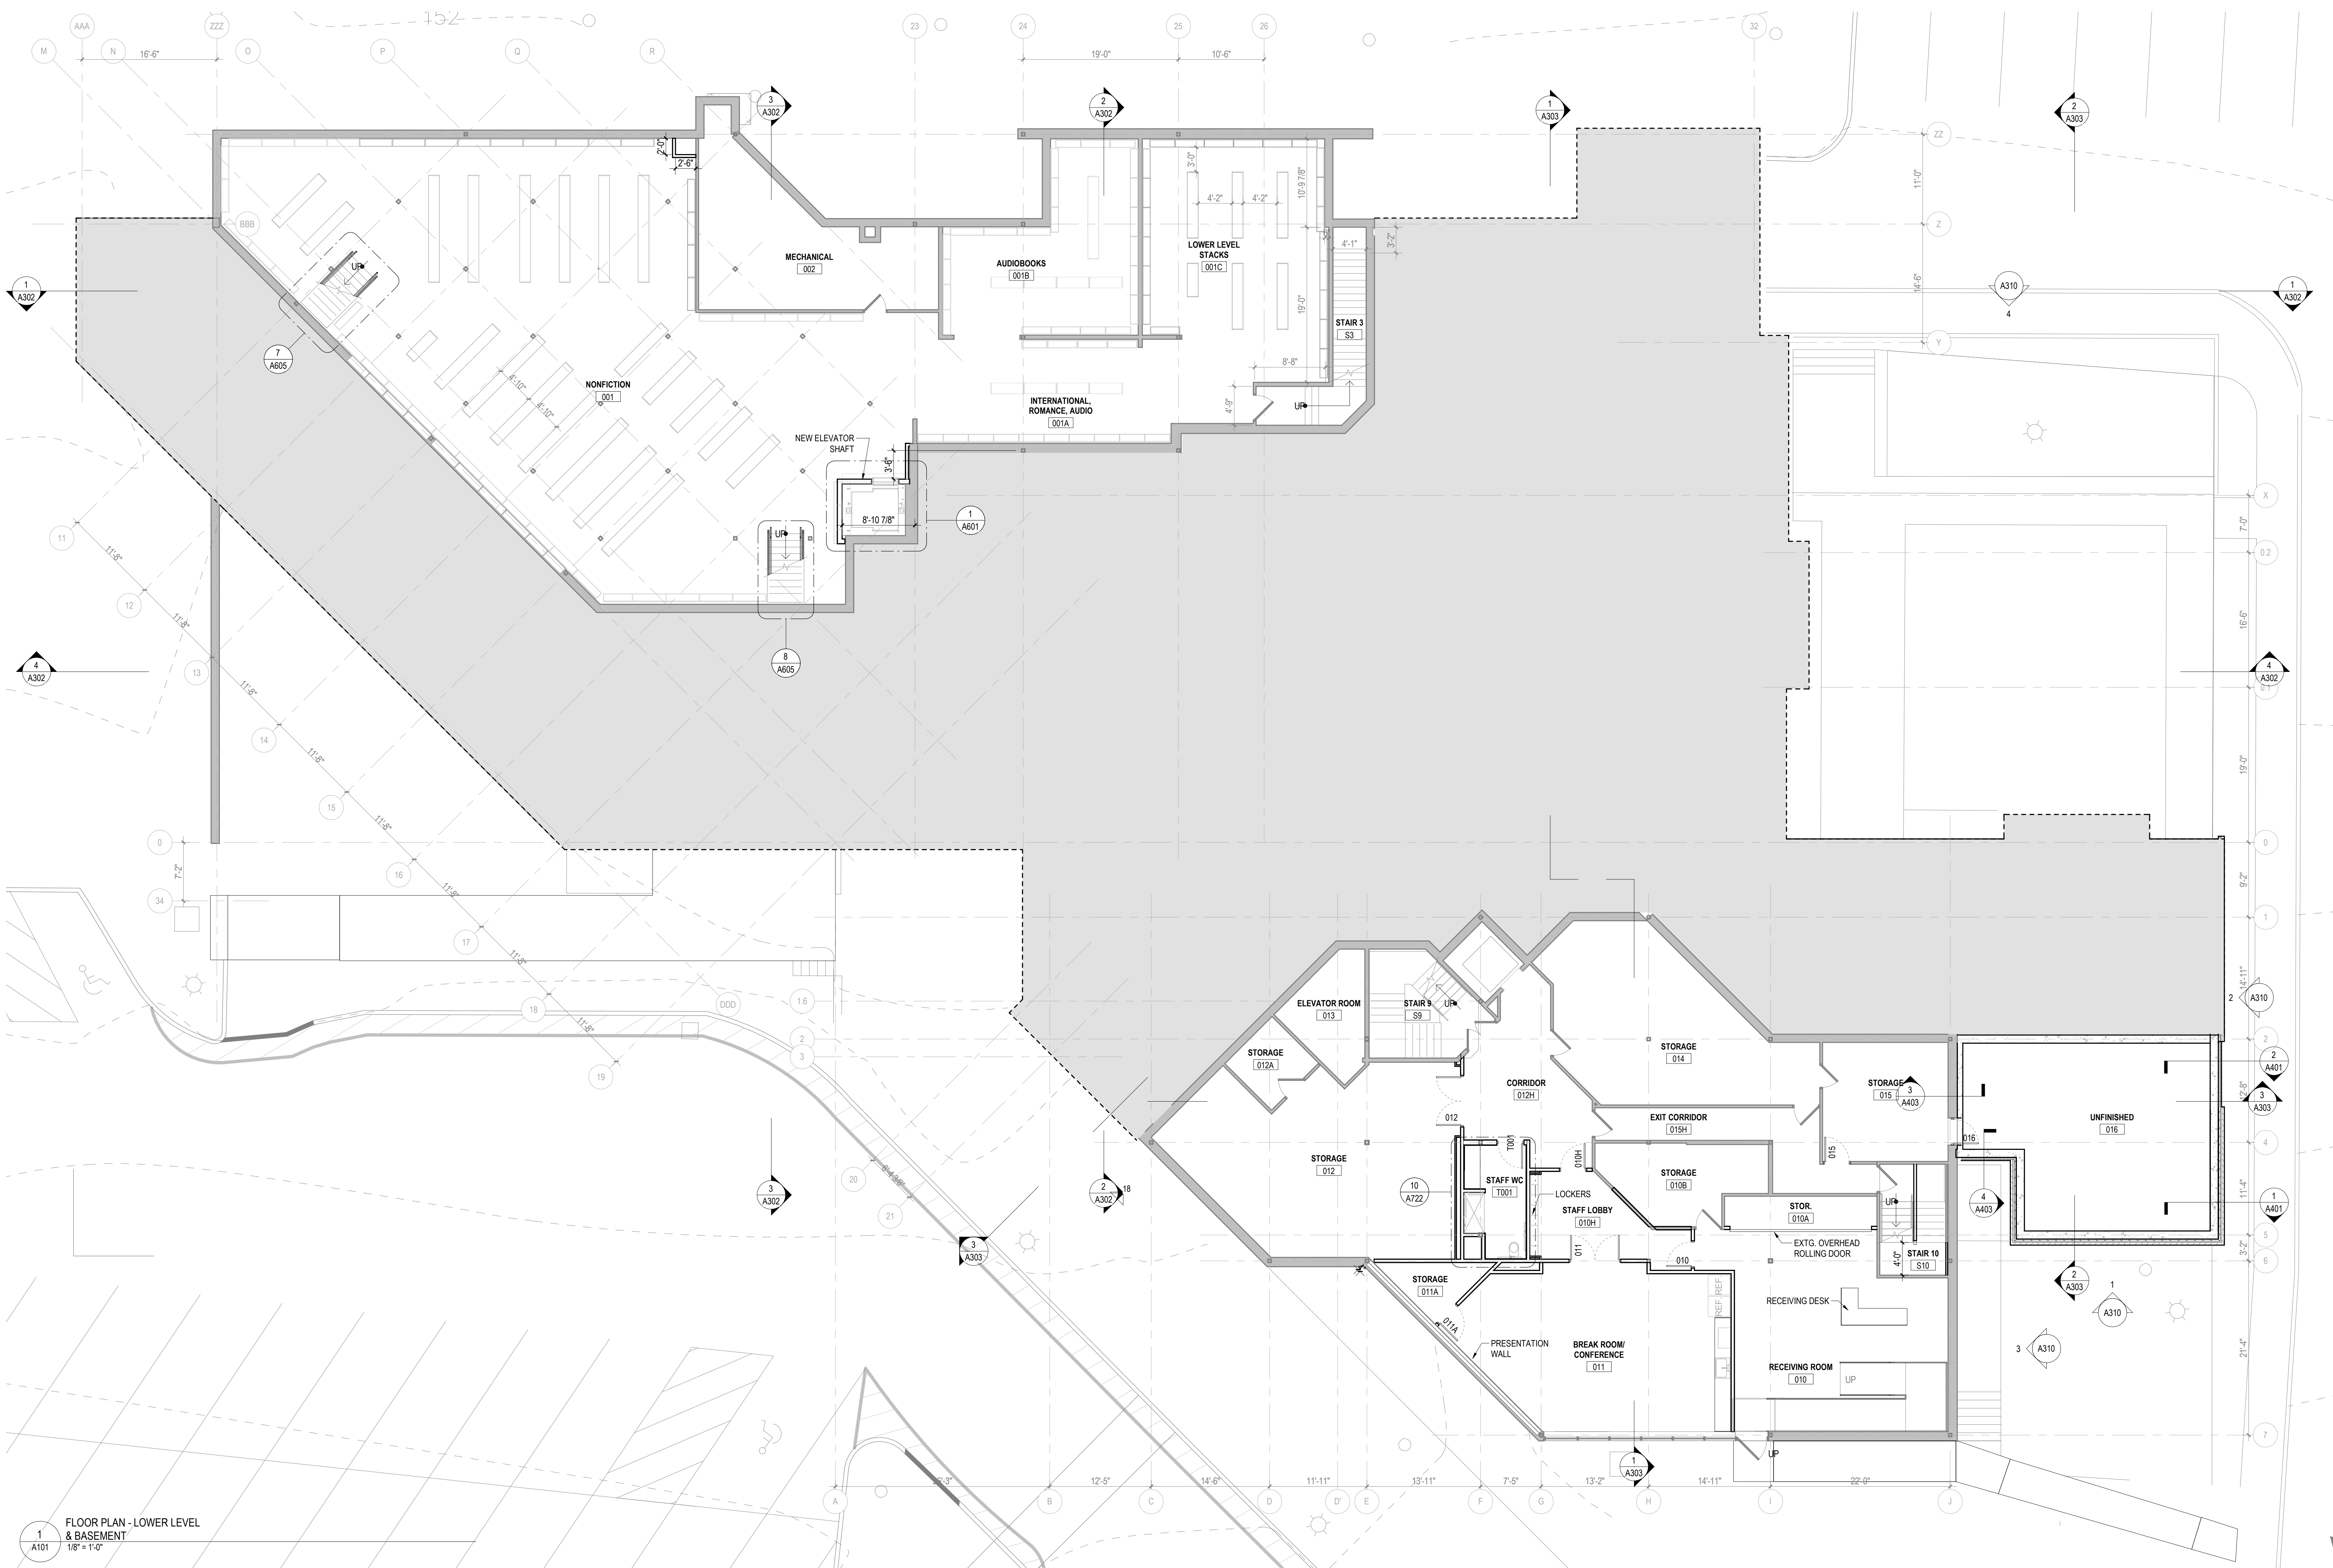

**FLOOR PLAN - LOWER LEVEL & BASEMENT**  
1/8" = 1'-0"

**FLOOR PLAN GENERAL NOTES**

- SEE LANDSCAPE DRAWINGS FOR HARDSCAPE ELEMENTS, PAVING AND SITE WALL ADJACENT TO THE BUILDING.
- LOCATE ROUGH OPENINGS FOR DOORS 4" FROM INSIDE FACE OF INTERSECTING WALL UNLESS OTHERWISE NOTED.
- REFER TO LIFE SAFETY PLANS FOR ADDITIONAL RATED CONSTRUCTION INFORMATION.
- ALL DIMENSIONS ARE TO FINISH FACE OF WALL, MASONRY OPENING, AND OUTSIDE EDGE OF DOOR FRAME (NOMINAL), U.N.O.
- PROVIDE ACCESS PANELS / DOORS IN PARTITIONS AT ALL LOCATIONS REQUIRING ACCESS. PANELS SHALL MAINTAIN FIRE RATING.
- PROVIDE WOOD BLOCKING OR 16 GAUGE METAL STRAPPING BEHIND G.W.B. WHERE REQUIRED TO SUPPORT FIXTURES OR EQUIPMENT PROVIDED IN THE CONTRACT OR BY OTHERS.
- WHERE METAL FRAMING REQUIRES SUPPORT AT COLUMNS & BEAMS, PROVIDE METAL STAND-OFFS PRIOR TO APPLYING FIREPROOFING.
- ALL M.E.P. AND I.T. SYSTEMS ARE TO BE CONCEALED WITHIN WALL OR CEILING CAVITY, U.N.O.
- ALL INTERIOR PARTITIONS ARE TYPE N3A U.N.O. SEE T002 FOR PARTITION TYPES.

- SEE SHEET A002 FOR PARTITION TYPES.
- DIMENSIONS ARE TO FINISHED FACE OF PARTITION TYPE AS DEFINED ON SHEET A002. FINISH TYPES (TILE, WOOD PANELING, WAINSCOT, WALL COVERINGS, ETC.) ARE NOT INCLUDED.
- SEE ELEVATION SHEETS A300 FOR EXTERIOR FRAME TYPE TAGS. SEE A800 SERIES FOR FRAMES TYPES.
- SEE PLANS & INTERIOR ELEVATION SHEETS A700s FOR INTERIOR FRAME TYPE TAGS. SEE A800 SHEETS FOR FRAME TYPES.

**PARTITION TAG DIAGRAM**

**PARTITION STRUCTURE:**

N. NON-STRUCTURAL METAL FRAMING (NSMF)  
M. CONCRETE MASONRY  
S. SHAFT WALL

**CORE SIZE:**

0 = 0'7/8"    4 = 4"  
1 = 1'5/8"    5 = 5'1/2"  
2 = 2'1/2"    6 = 6" (NOM. @ MASONRY)  
3 = 3'5/8"    8 = 8" (NOM. @ MASONRY)

**PARTITION STYLE:**

CT. CERAMIC TILE  
WD. WOOD PANELING  
WC. WALL COVERING  
AP. ACOUSTIC PANEL

**FIRE RATING:**

30 = 30 MIN.  
45 = 45 MIN.  
60 = 60 MIN.  
90 = 90 MIN.  
2 = 2 HOUR

**FINISH STYLE:**

XX


**PARTITION STYLE:**

A. (1) SUBSTRATE + CORE + (1) SUBSTRATE  
B. (1) SUBSTRATE + CORE  
C. CORE ONLY  
D. (2) SUBSTRATE + CORE + (2) SUBSTRATE  
E. (2) SUBSTRATE + CORE + (1) SUBSTRATE  
F. (2) SUBSTRATE + CORE  
G. (1) SUBSTRATE + CORE W/ SOUND ATTENUATION + (1) SUBSTRATE  
H. (1) SUBSTRATE + CORE W/ SOUND ATTENUATION  
I. NOT USED  
J. (2) SUBSTRATE + CORE W/ SOUND ATTENUATION + (2) SUBSTRATE  
K. (2) SUBSTRATE + CORE W/ SOUND ATTENUATION + (1) SUBSTRATE  
L. (2) SUBSTRATE + CORE W/ SOUND ATTENUATION



New City Library  
**New City Library Addition & Renovation**  
220 North Main Street  
New City, NY 10956  
VMDO Project Number **1301**

Checked By  
Drawn By  
Checker  
Author

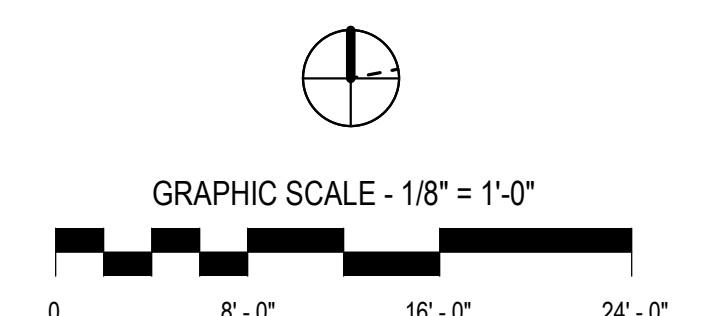


**DRAWING NOT FOR CONSTRUCTION**

ISSUES AND REVISIONS		
NO.	SUBMITTAL	DATE
	SCHEMATIC DESIGN	03.05.2021

**FLOOR PLAN - LOWER LEVEL & BASEMENT**

**A101**  
DESIGN DEVELOPMENT  
07.09.2021



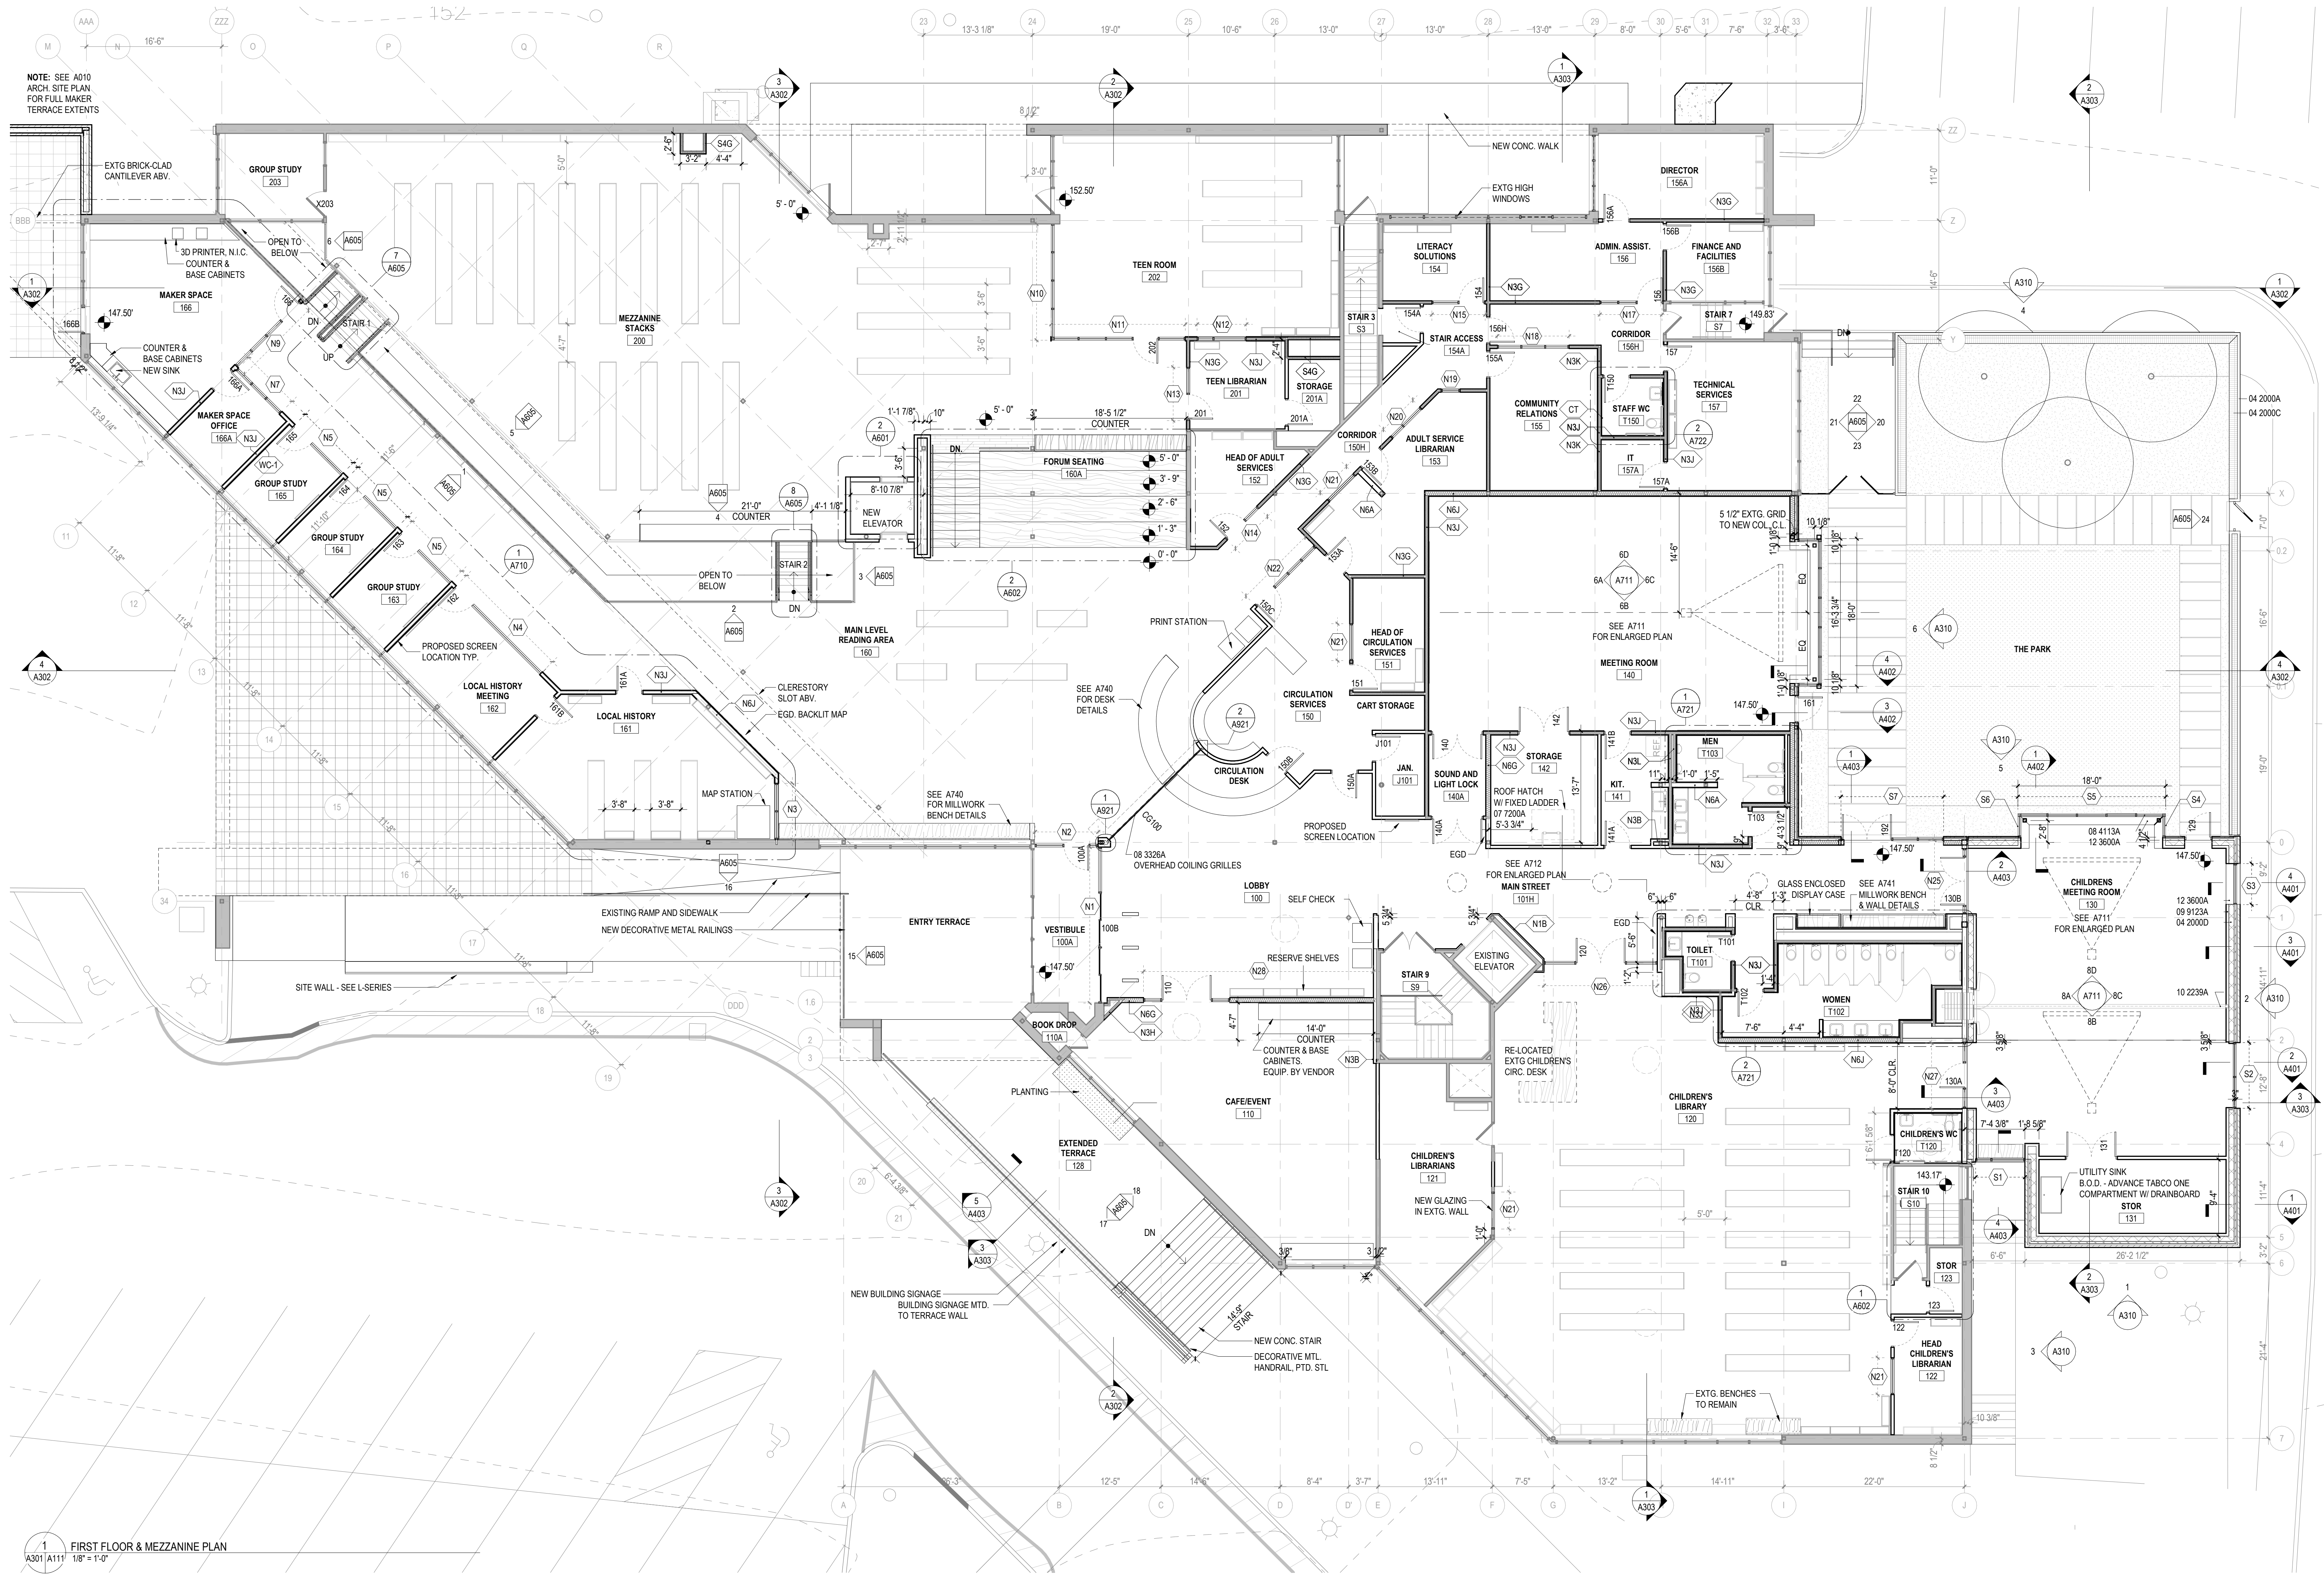

FLOOR PLAN GENERAL NOTES

- SEE LANDSCAPE DRAWINGS FOR HARDSCAPE ELEMENTS, PAVING AND SITE WALL ADJACENT TO THE BUILDING.
- LOCATE ROUGH OPENINGS FOR DOORS 4" FROM INSIDE FACE OF INTERSECTING WALL UNLESS OTHERWISE NOTED.
- REFER TO LIFE SAFETY PLANS FOR ADDITIONAL RATED CONSTRUCTION INFORMATION.
- ALL DIMENSIONS ARE TO FINISH FACE OF WALL, MASONRY OPENING, AND OUTSIDE EDGE OF DOOR FRAME (NOMINAL), U.N.O.
- PROVIDE ACCESS PANELS / DOORS IN PARTITIONS AT ALL LOCATIONS REQUIRING ACCESS. PANELS SHALL MAINTAIN FIRE RATING.
- PROVIDE WOOD BLOCKING OR 18 GAUGE METAL STRAPPING BEHIND C.W.B. WHERE REQUIRED TO SUPPORT FIXTURES OR EQUIPMENT PROVIDED IN THE CONTRACT OR BY OTHERS.
- WHERE METAL FRAMING REQUIRES SUPPORT AT COLUMNS & BEAMS, PROVIDE METAL STAND-OFFS PRIOR TO APPLYING FIREPROOFING.
- ALL M.E.P. AND I.T. SYSTEMS ARE TO BE CONCEALED WITHIN WALL OR CEILING CAVITY, U.N.O.
- ALL INTERIOR PARTITIONS ARE TYPE N3A U.N.O. SEE T002 FOR PARTITION TYPES.
- SEE SHEET A002 FOR PARTITION TYPES.
- DIMENSIONS ARE TO FINISHED FACE OF PARTITION TYPE AS DEFINED ON SHEET A002. FINISH TYPES (TILE, WOOD PANELING, WAINSCOT, WALL COVERINGS, ETC.) ARE NOT INCLUDED.
- SEE ELEVATION SHEETS A300 FOR EXTERIOR FRAME TYPE TAGS. SEE A800 SERIES FOR FRAME TYPES.
- SEE PLANS & INTERIOR ELEVATION SHEETS A700'S FOR INTERIOR FRAME TYPE TAGS. SEE A800 SHEETS FOR FRAME TYPES.

PARTITION TAG DIAGRAM

**PARTITION STRUCTURE:**

N. NON-STRUCTURAL METAL FRAMING (NSMF)  
WD. CONCRETE MASONRY  
S. SHAFT WALL

**CORE SIZE:**

0 = 0/8"  
1 = 1/8"  
2 = 2/12"  
3 = 3/8"

**FINISH STYLE:**


CT. CERAMIC TILE  
WD. WOOD PANELING  
WC. WALL COVERING  
AP. ACOUSTIC PANEL

**FIRE RATING:**

30 = 30 MIN.  
45 = 45 MIN.  
60 = 60 MIN.  
90 = 90 MIN.  
2 = 2 HOUR

**PARTITION STYLE:**

A. (1) SUBSTRATE + CORE = (1) SUBSTRATE  
B. (1) SUBSTRATE + CORE  
C. CORE ONLY  
D. (2) SUBSTRATE + CORE + (2) SUBSTRATE  
E. (2) SUBSTRATE + CORE + (1) SUBSTRATE  
F. (2) SUBSTRATE + CORE  
G. (1) SUBSTRATE + CORE W/ SOUND ATTENUATION + (1) SUBSTRATE  
H. (1) SUBSTRATE + CORE W/ SOUND ATTENUATION  
I. NOT USED  
J. (2) SUBSTRATE + CORE W/ SOUND ATTENUATION + (2) SUBSTRATE  
K. (2) SUBSTRATE + CORE W/ SOUND ATTENUATION + (1) SUBSTRATE  
L. (2) SUBSTRATE + CORE W/ SOUND ATTENUATION

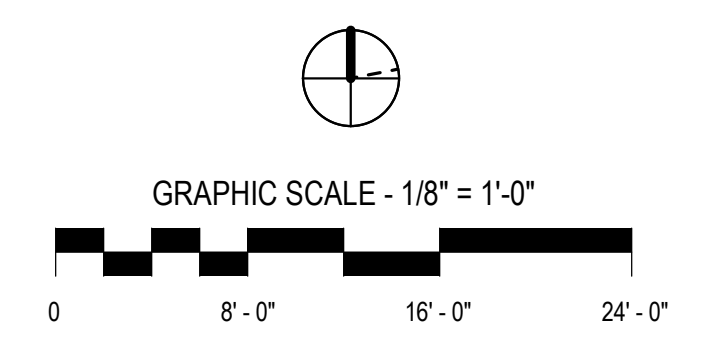


DRAWING NOT FOR CONSTRUCTION

ISSUES AND REVISIONS		
NO.	SUBMITTAL	DATE
1	SCHEMATIC DESIGN	03.05.2021
2	DESIGN DEVELOPMENT	07.09.2021

FLOOR PLAN - FIRST FLOOR & MEZZANINE



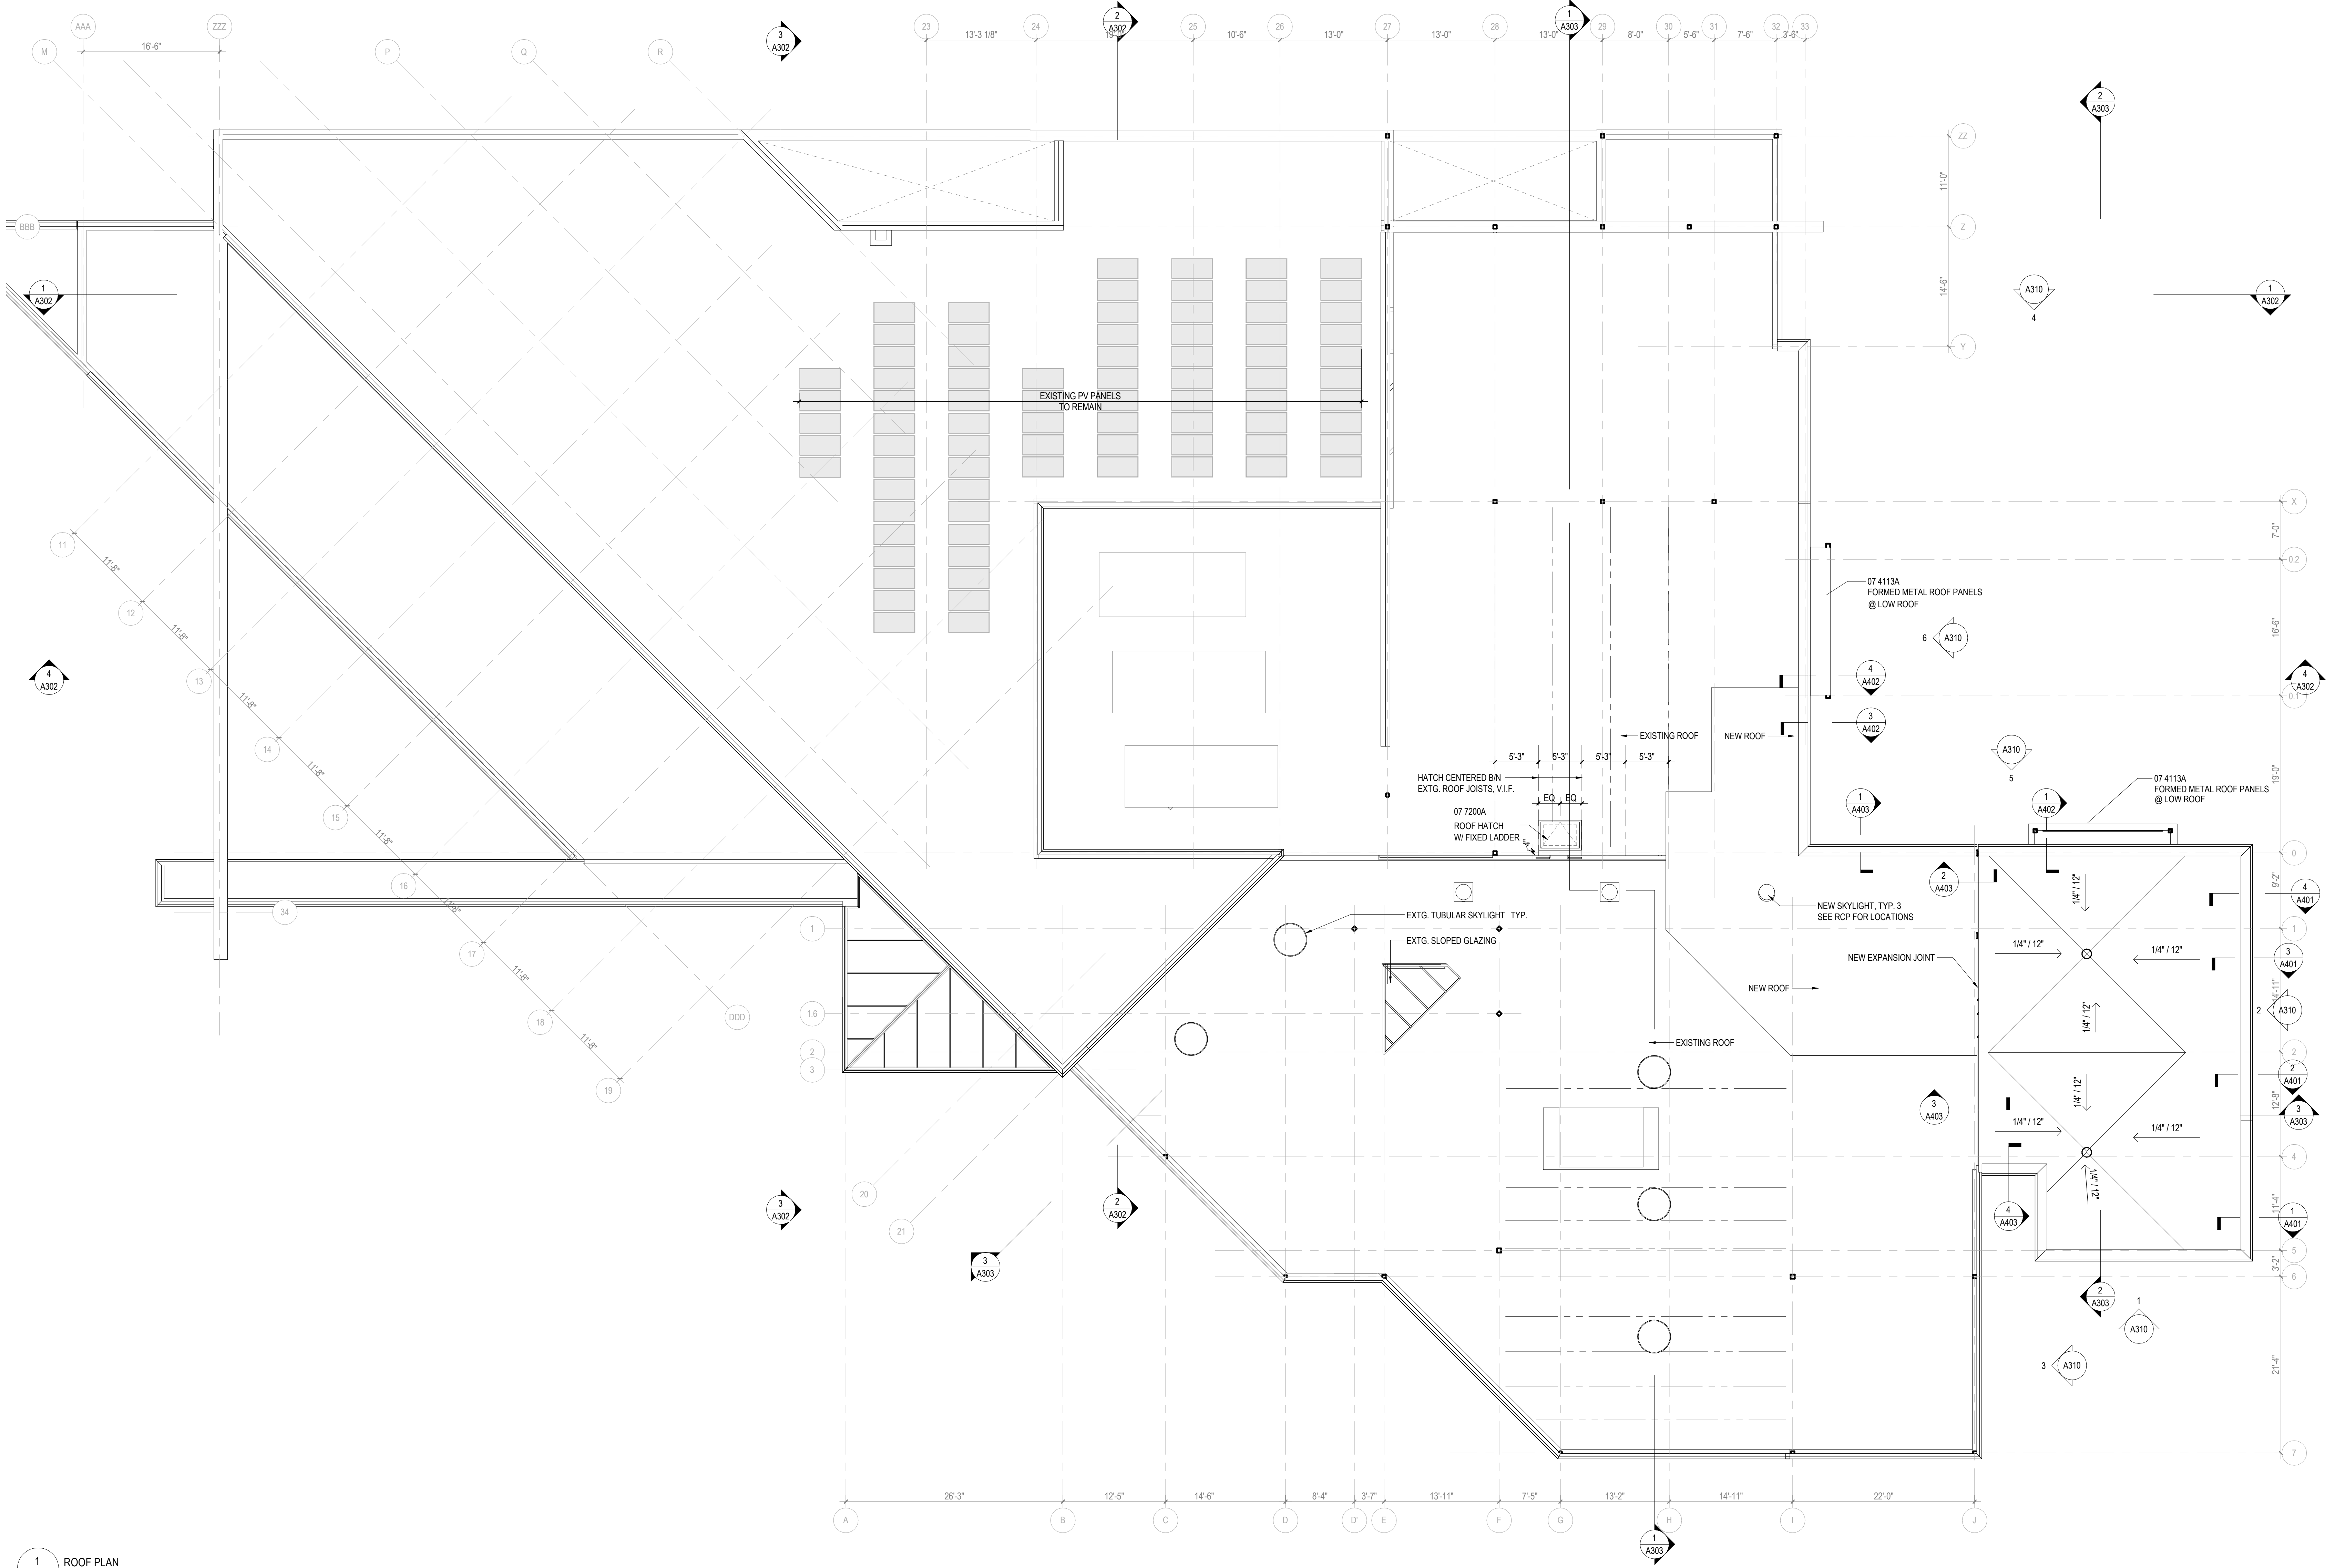

1 ROOF PLAN  
A301 A131 1/8" = 1'-0"

ROOF PLAN GENERAL NOTES

- ALL TAPERED ROOFING INSULATION SHALL HAVE A MINIMUM DEPTH OF 4" AT DRAINS & SLOPE TO DRAIN AT 1/4" PER FOOT, TYPICAL.
- PROVIDE CRICKETS AT ALL OBSTRUCTIONS TO MAINTAIN POSITIVE DRAINAGE.
- ALL BLOCKING SHALL BE PRESSURE TREATED. PROVIDE FLEXIBLE FLASHING THAT IS COMPATIBLE WITH SPECIFIED ROOF MEMBRANE AS A SEPARATION FROM STEEL DECKING.
- ALL ROOF-MOUNTED MECHANICAL EQUIPMENT THAT REQUIRES SERVICE SHALL BE LOCATED MORE THAN 10 FEET FROM EDGE OF ROOF. IF ANY MECHANICAL EQUIPMENT REQUIRING SERVICE CANNOT BE LOCATED 10 FEET FROM EDGE OF ROOF, CONTRACTOR SHALL NOTIFY ARCHITECT BEFORE PROCEEDING.
- PROVIDE WALKWAY PADS AT ALL ROOF ACCESS POINTS AND TO ALL ROOFTOP MOUNTED MECHANICAL UNITS.
- COORDINATE ALL ROOF PENETRATIONS W/ MECH., PLUMB., ELEC. AND STRUCTURAL DRAWINGS. SEE M.E.P. DRAWINGS FOR ADDITIONAL ROOF PENETRATIONS NOT SHOWN.
- FLASH & SEAL ALL PENETRATIONS & CURBS PER ROOFING MANUFACTURER'S RECOMMENDED DETAILS AND APPLICABLE NRCA PLATES.
- PROVIDE CONTINUOUS ROOF MEMBRANE OVER ALL CURBS AND EQUIPMENT PADS. PAD & CURB SIZES ARE TO BE DETERMINED BY EQUIPMENT REQUIREMENTS.
- ROOF EXPANSION JOINTS TO BE COORDINATED W/ CEILING, WALL & FLOOR EXPANSION JOINTS.
- PROVIDE CONTINUOUS FLASHING & COUNTER FLASHING AT ALL ROOF TO WALL CONDITIONS & PARAPET CONDITIONS.
- REFER TO ROOFING MANUFACTURER'S REQUIREMENTS FOR CAP SHEET FLASHING, BASE TIE-INS AND SEALANT BEADS.
- REFER TO APPLICABLE FACTORY MUTUAL LISTING FOR FASTENING METHODS AND SPACING.
- REFER TO TYPICAL ROOF ASSEMBLIES FOR TYPICAL ROOF TYPES.
- SLOPE ALL COPINGS TOWARD ROOF U.N.O.

KEYNOTES

- 07 4113A FORMED METAL ROOF PANELS  
07 7200A ROOF ACCESSORIES




New City Library

New City Library Addition & Renovation

220 North Main Street  
New City, NY 10956

VMDO Project Number 1301

Checked By  
Drawn By  
Checker  
Author

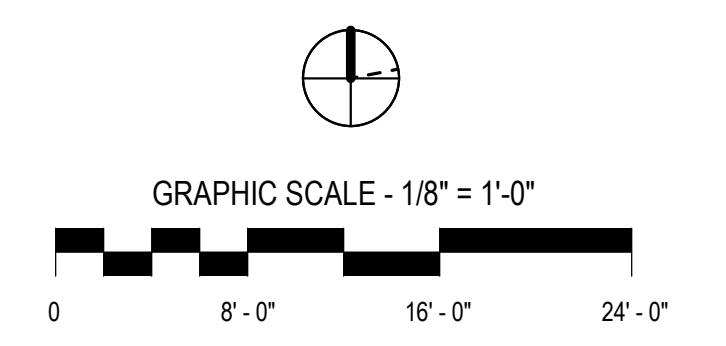


DRAWING NOT FOR  
CONSTRUCTION

ISSUES AND REVISIONS		
NO.	SUBMITTAL	DATE
1	SCHEMATIC DESIGN	07.09.2021

ROOF PLAN

**A131**  
DESIGN DEVELOPMENT  
07.09.2021



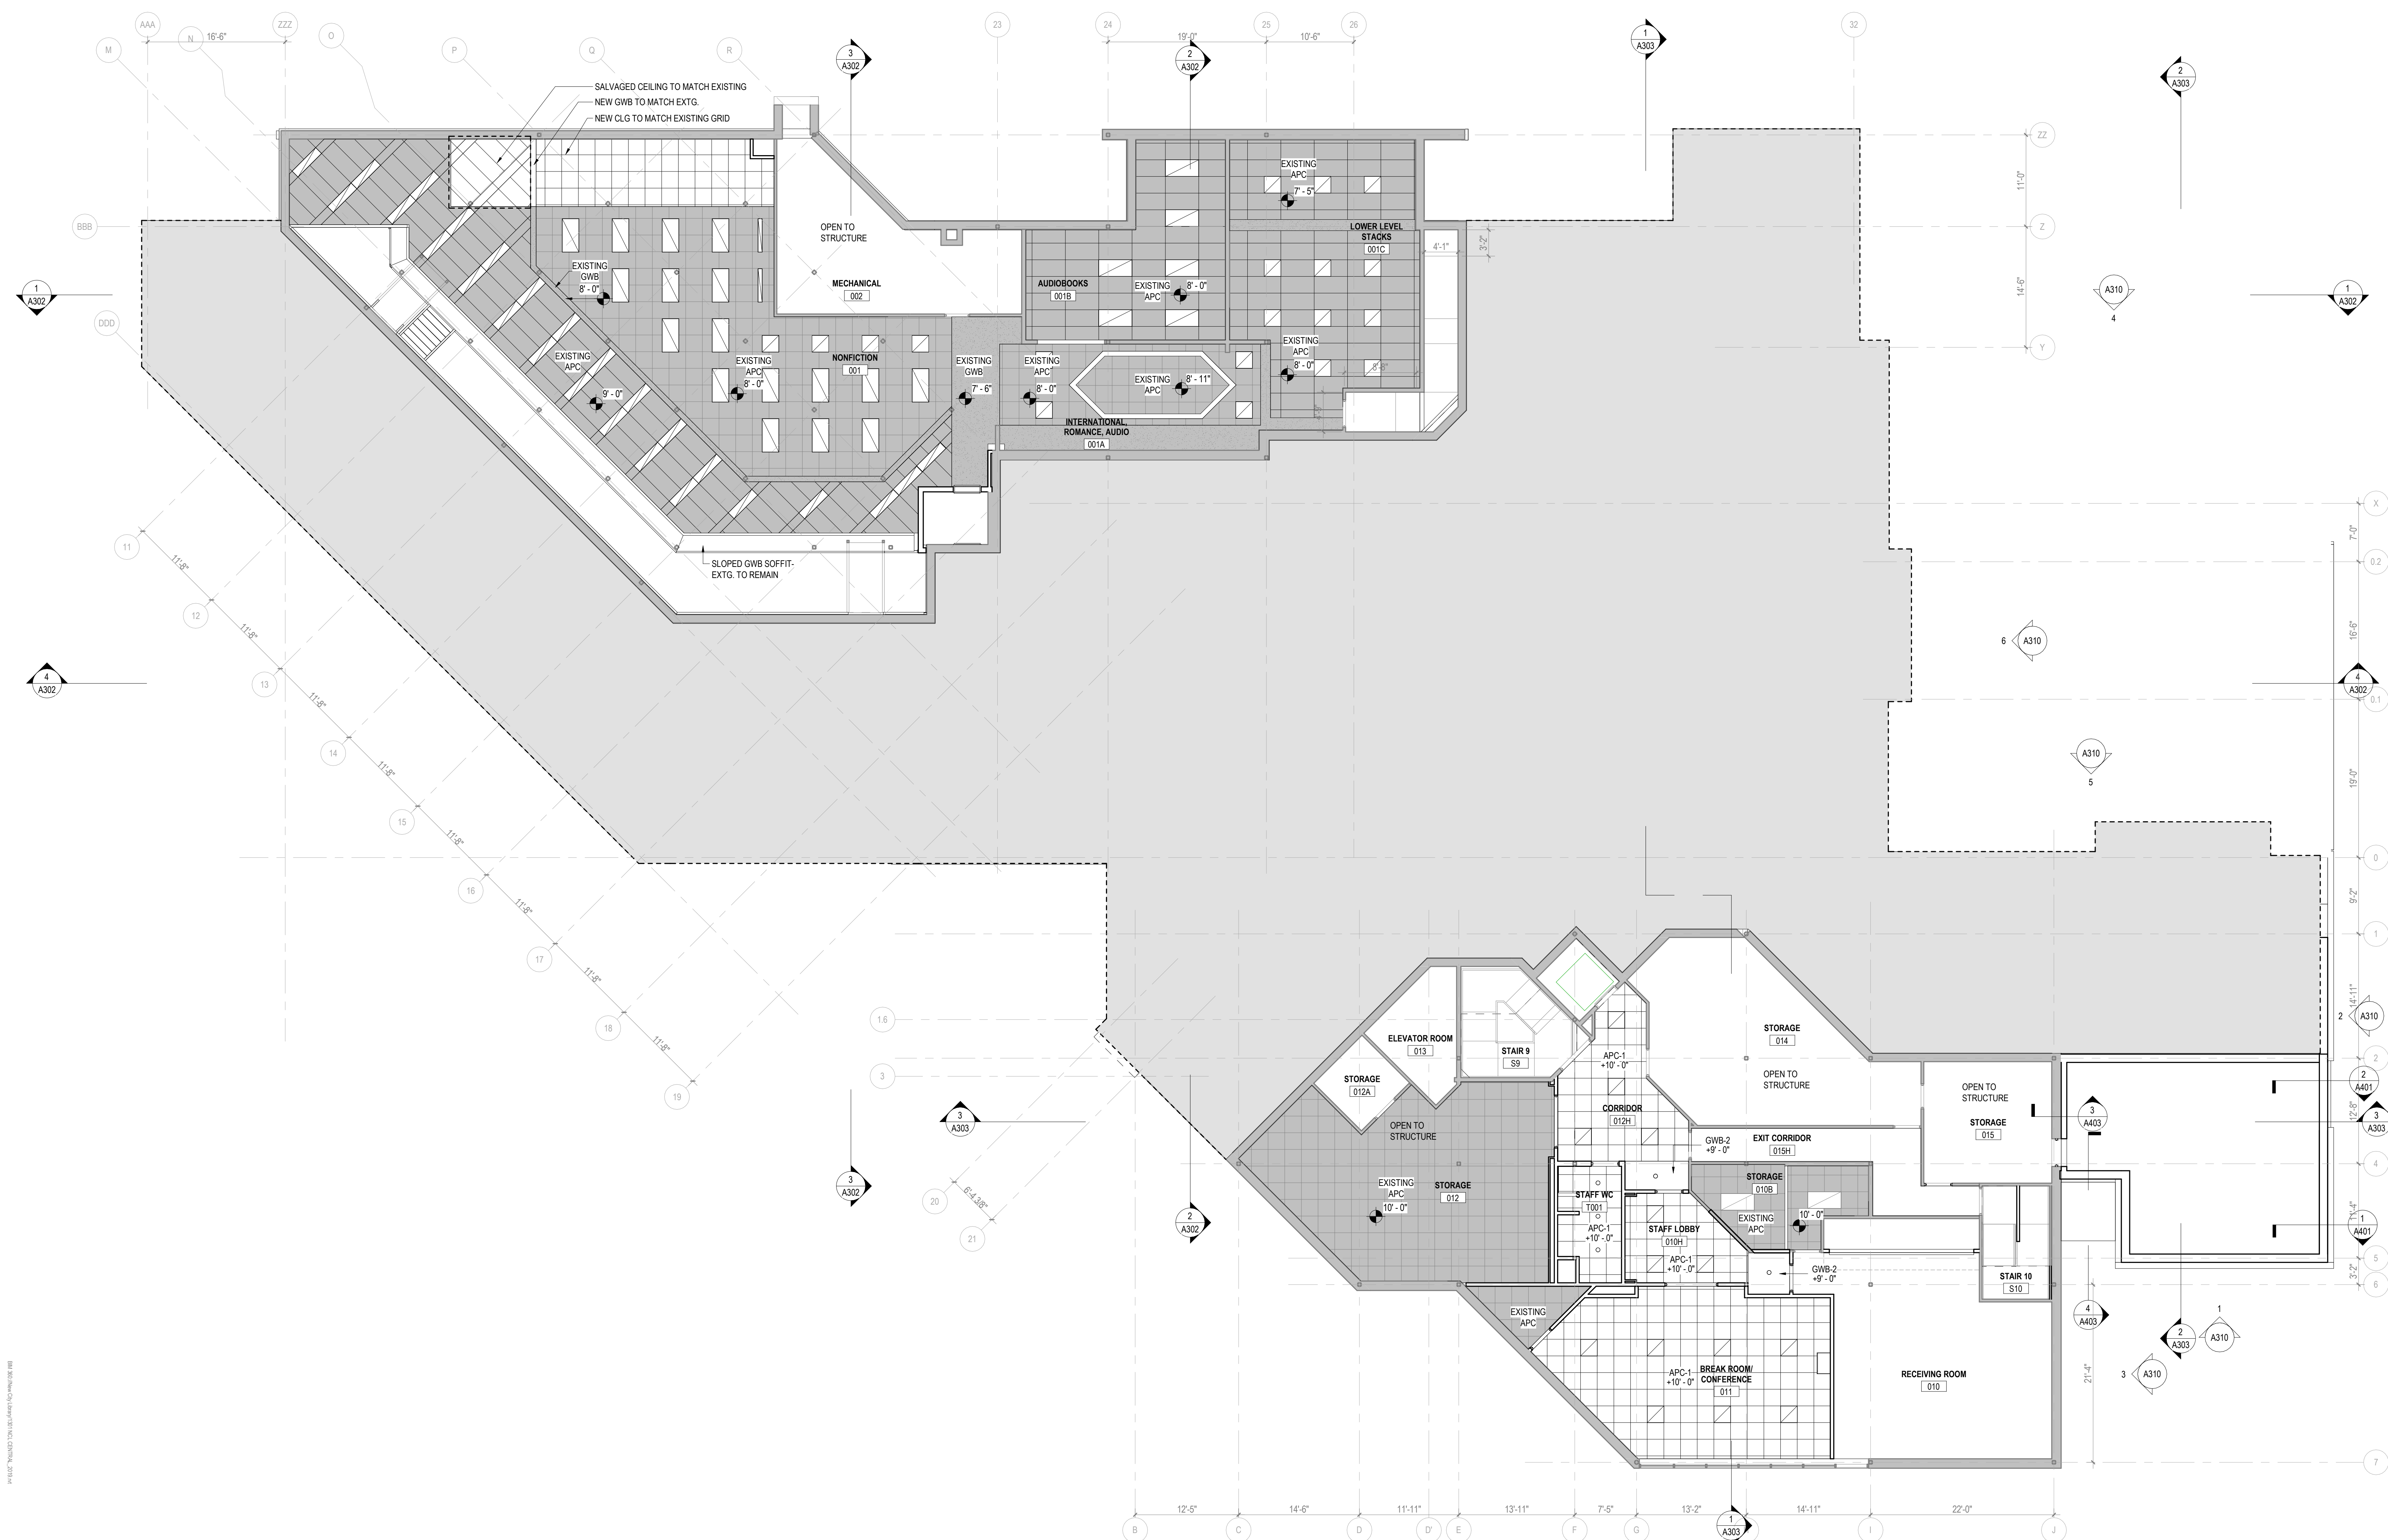

1 RCP LOWER LEVELS  
A301 A301 1/8" = 1'-0"

## REFLECTED CEILING PLAN GENERAL NOTES

- CEILING HEIGHTS ARE MEASURED FROM FINISHED FLOOR.
- REFER TO REFLECTED CEILING PLANS FOR GRID LAYOUTS AND FIXTURE LOCATIONS & COORDINATE WITH MEP. IN CASE OF CONFLICT, CONSULT ARCHITECT. SEE ELECTRICAL FOR SPECIFIC LIGHT FIXTURE TYPE DESIGNATION.
- PAINT ALL STRUCTURE AND INFRASTRUCTURE COMPONENTS AND SURFACES AT OPEN OR EXPOSED CEILINGS.
- SPRINKLERS, WHERE SHOWN, INDICATE PREFERRED RELATIONSHIP TO ADJACENT BUILDING ELEMENTS ONLY. ALL SPRINKLER PIPING IS TO BE CONCEALED IN WALL OR CEILING CAVITIES. CONSULT WITH ARCHITECT ON CONFLICTS.
- ALL SUSPENDED ACOUSTICAL TILE CEILINGS SHALL BE CENTERED IN EACH ROOM PER THE REFLECTED CEILING PLAN U.N.O.
- CENTER SPRINKLER HEADS, MECHANICAL AIR DEVICES, LIGHT FIXTURES AND OTHER ELECTRICAL DEVICES IN ACOUSTICAL CEILING PANELS, U.N.O.
- LOCATE M.E.P. COMPONENTS REQUIRING ACCESS AT ACCESSIBLE CEILING AREAS TO THE GREATEST EXTENT POSSIBLE. WHERE CEILINGS ARE INACCESSIBLE, PROVIDE ACCESS PANELS.
- SOME M.E.P. COMPONENTS, ELECTRICAL DEVICES AND PLUMBING DEVICES MAY NOT BE SHOWN. REFER TO M.E.P. DRAWINGS.
- PROVIDE VERTICAL GYP. BD. AT ALL CEILING HEIGHT TRANSITIONS, U.N.O.


## LEGEND - CEILING TYPE

	<b>GWP-01</b> 5/8" GYP. BOARD ON SUSPENSION SYSTEM		<b>SDG-01</b> SUSPENDED LINEAR WOOD CEILING
	<b>GWP-02</b> 5/8" GYP. BOARD ON STRUCTURE		<b>WD-01</b> WOOD PANEL CEILING
	<b>APC-01</b> 2' x 2' ACOUSTIC PANEL CEILING		EXISTING ACOUSTIC PANEL CEILING TO REMAIN WHERE INDICATED
	<b>APC-02</b> 2' x 4' ACOUSTIC PANEL CEILING		
	<b>APC-03</b> SUSPENDED TECTUM BAFFLE CEILING		

## LEGEND - LIGHTING & CEILING DEVICES

	6" SQUARE LED DOWNLIGHT		2x4 LED LAY-IN FIXTURE		LINEAR LED RECESSED ACCENT FIXTURE
	6" RECESSED LED CAN DOWNLIGHT		LINEAR LED RECESSED FIXTURE (RULON CEILING)		TUBULAR SKYLIGHT
	(SM) DECORATIVE PENDANT		LINEAR LED RECESSED FIXTURE (GWB CEILING)		8" SUSPENDED LED PENDANT
	(M) DECORATIVE PENDANT		LINEAR LED DIRECT-IN-DIRECT LED SUSPENDED FIXTURE		(L) DECORATIVE PENDANT
	RING DECORATIVE PENDANT, SIZES VARY.				
	2x2 LED LAY-IN FIXTURE				
	EMERGENCY EXIT SIGN				
	LED COVE LIGHT (CIRCULATION SERVICES)				



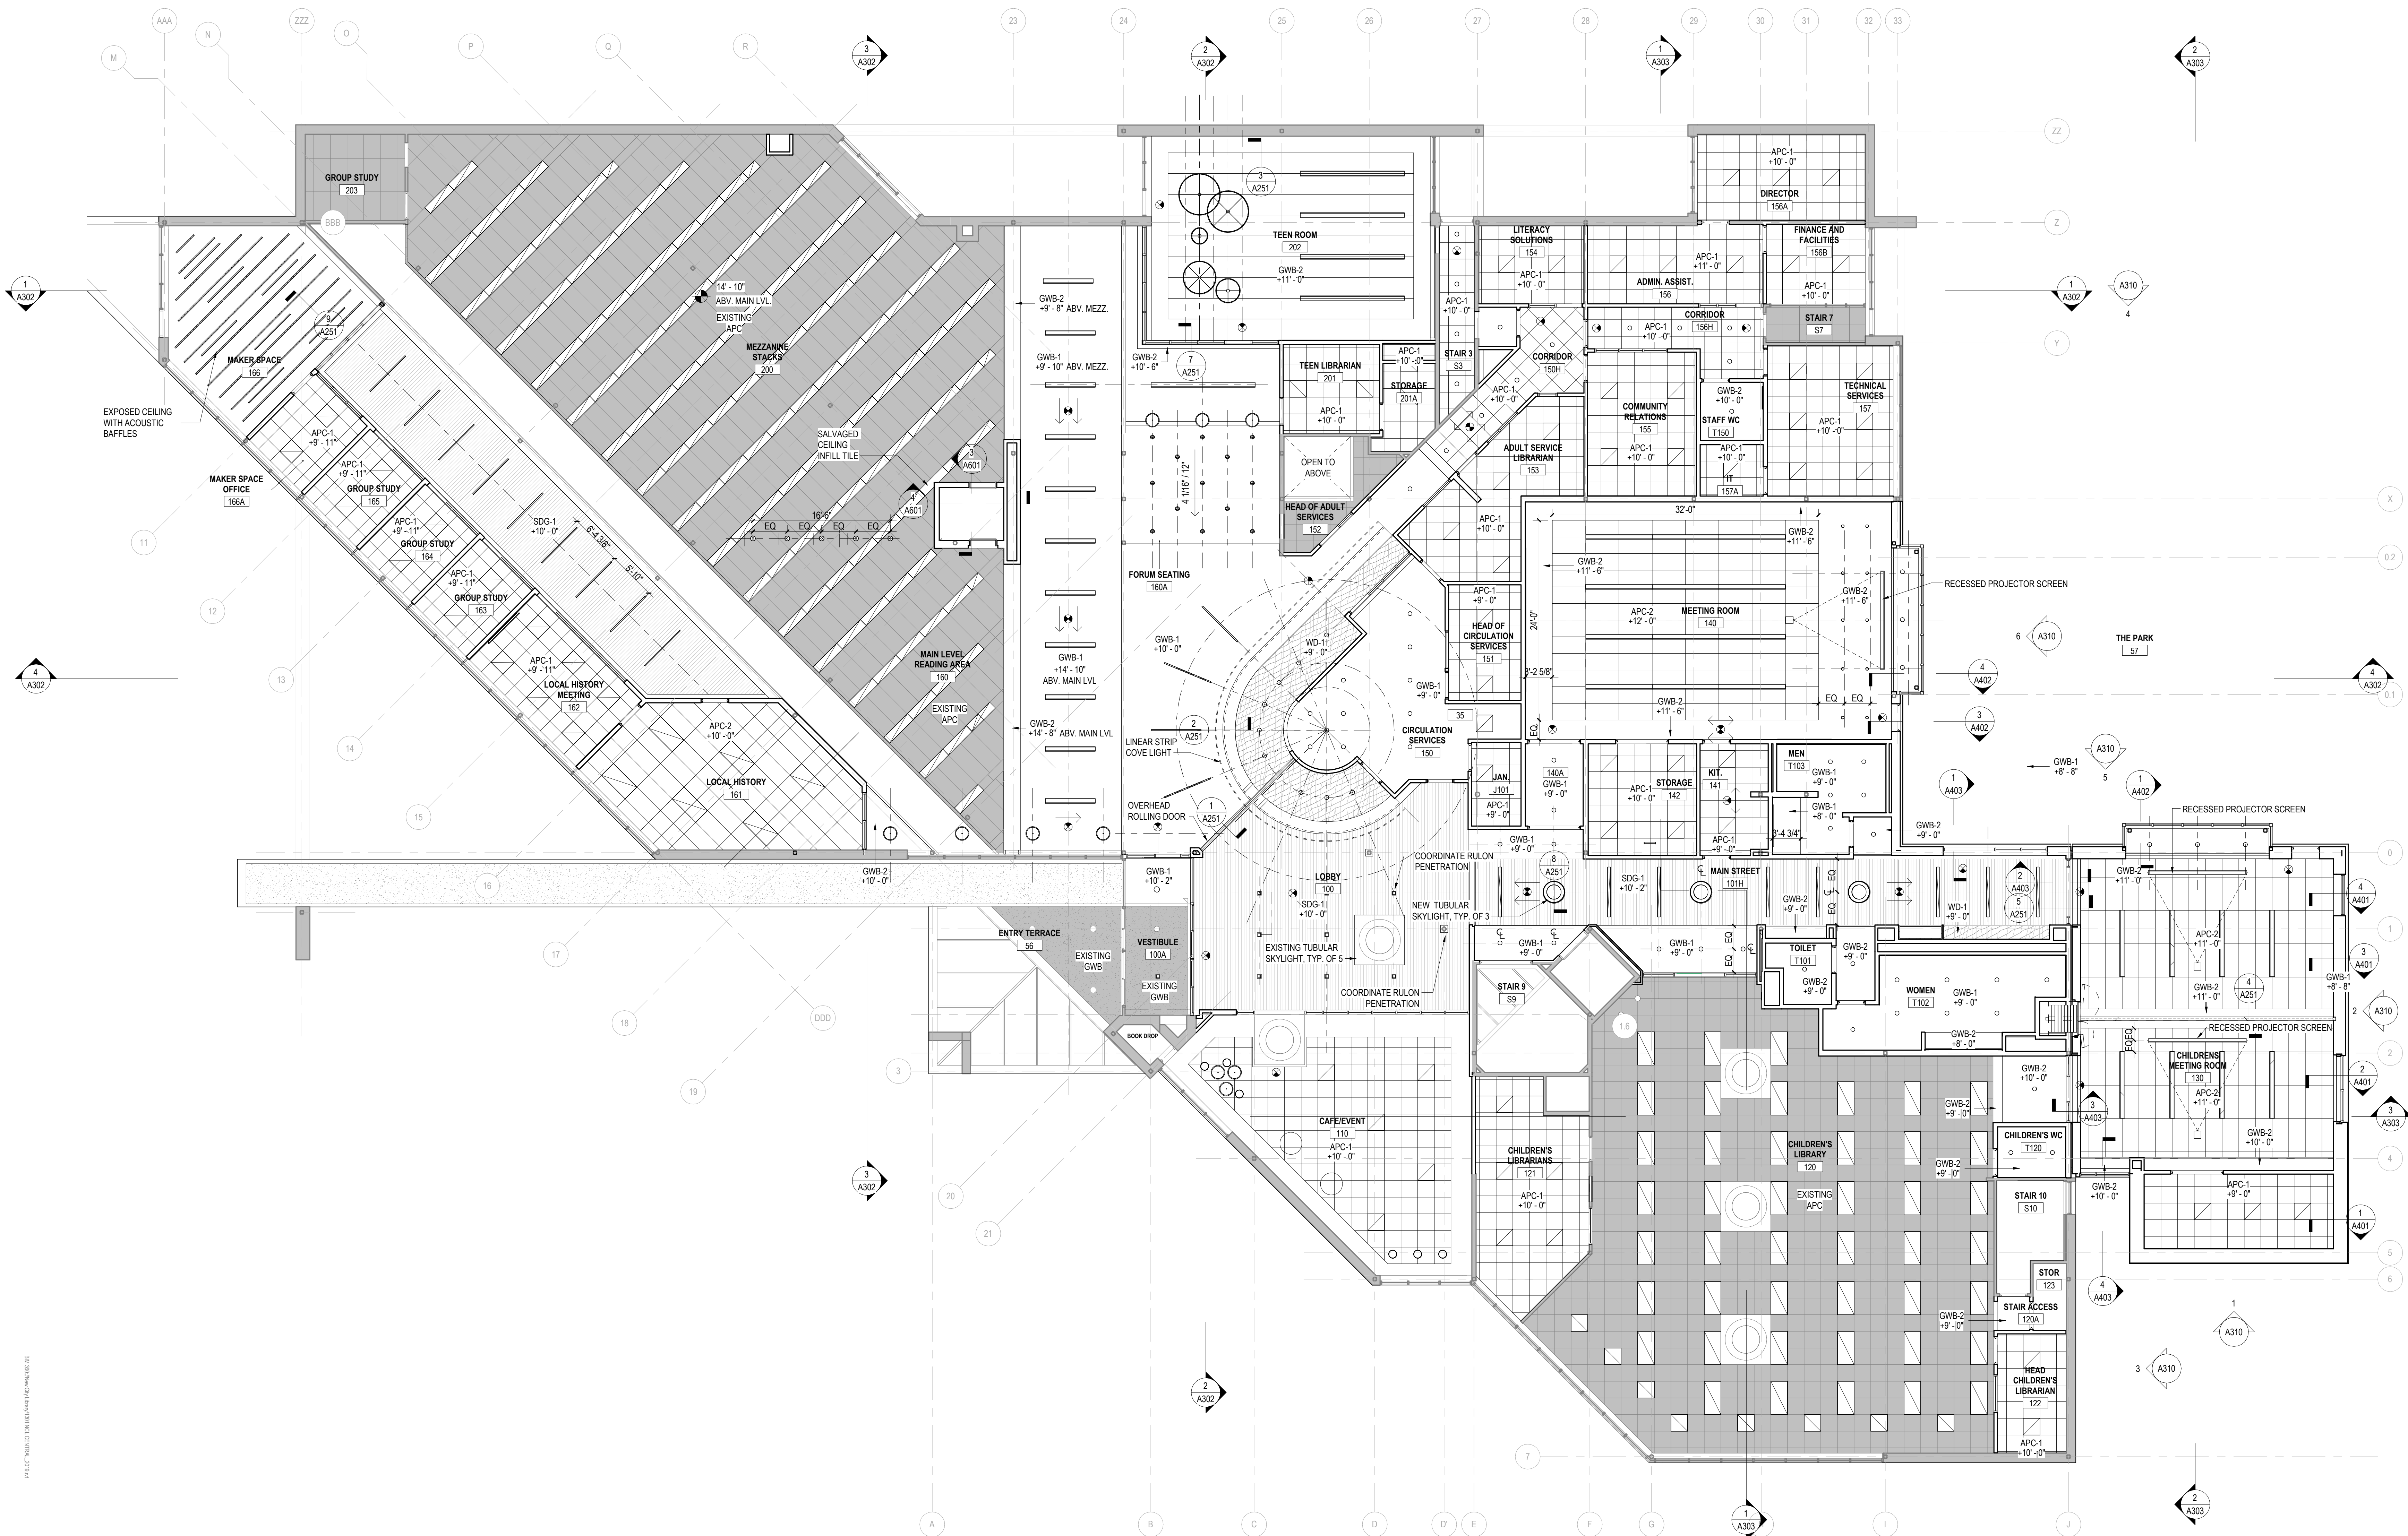

1 RCP FIRST FLOOR AND MEZZANINE  
A301/A211 1/8" = 1'-0"

## REFLECTED CEILING PLAN GENERAL NOTES

- CEILING HEIGHTS ARE MEASURED FROM FINISHED FLOOR.
- REFER TO REFLECTED CEILING PLANS FOR GRID LAYOUTS AND FIXTURE LOCATIONS & COORDINATE WITH MEP. IN CASE OF CONFLICT, CONSULT ARCHITECT. SEE ELECTRICAL FOR SPECIFIC LIGHT FIXTURE TYPE DESIGNATION.
- PAIN ALL STRUCTURE AND INFRASTRUCTURE COMPONENTS AND SURFACES AT OPEN OR EXPOSED CEILINGS.
- SPRINKLERS, WHERE SHOWN, INDICATE PREFERRED RELATIONSHIP TO ADJACENT BUILDING ELEMENTS ONLY. ALL SPRINKLER PIPING IS TO BE CONCEALED IN WALL OR CEILING CAVITIES. CONSULT WITH ARCHITECT ON CONFLICTS.
- ALL SUSPENDED ACOUSTICAL TILE CEILINGS SHALL BE CENTERED IN EACH ROOM PER THE REFLECTED CEILING PLAN U.N.O.
- CENTER SPRINKLER HEADS, MECHANICAL AIR DEVICES, LIGHT FIXTURES AND OTHER ELECTRICAL DEVICES IN ACOUSTICAL CEILING PANELS U.N.O.
- LOCATE M.E.P. COMPONENTS REQUIRING ACCESS AT ACCESSIBLE CEILING AREAS TO THE GREATEST EXTENT POSSIBLE. WHERE CEILINGS ARE INACCESSIBLE, PROVIDE ACCESS PANELS.
- SOME M.E.P. COMPONENTS, ELECTRICAL DEVICES AND PLUMBING DEVICES MAY NOT BE SHOWN. REFER TO M.E.P. DRAWINGS.
- PROVIDE VERTICAL GYP. BD. AT ALL CEILING HEIGHT TRANSITIONS, U.N.O.


## LEGEND - CEILING TYPE

	<b>GWB-01</b>	5/8" GYP. BOARD ON SUSPENSION SYSTEM		<b>SDG-01</b>	SUSPENDED LINEAR WOOD CEILING
	<b>GWB-02</b>	5/8" GYP. BOARD ON STRUCTURE		<b>WD-01</b>	WOOD PANEL CEILING
	<b>APC-01</b>	2' x 2' ACOUSTIC PANEL CEILING			EXISTING ACOUSTIC PANEL CEILING TO REMAIN WHERE INDICATED
	<b>APC-02</b>	2' x 4' ACOUSTIC PANEL CEILING			
	<b>APC-03</b>	SUSPENDED TECTUM BAFFLE CEILING			


## LEGEND - LIGHTING & CEILING DEVICES

	6\"/>		
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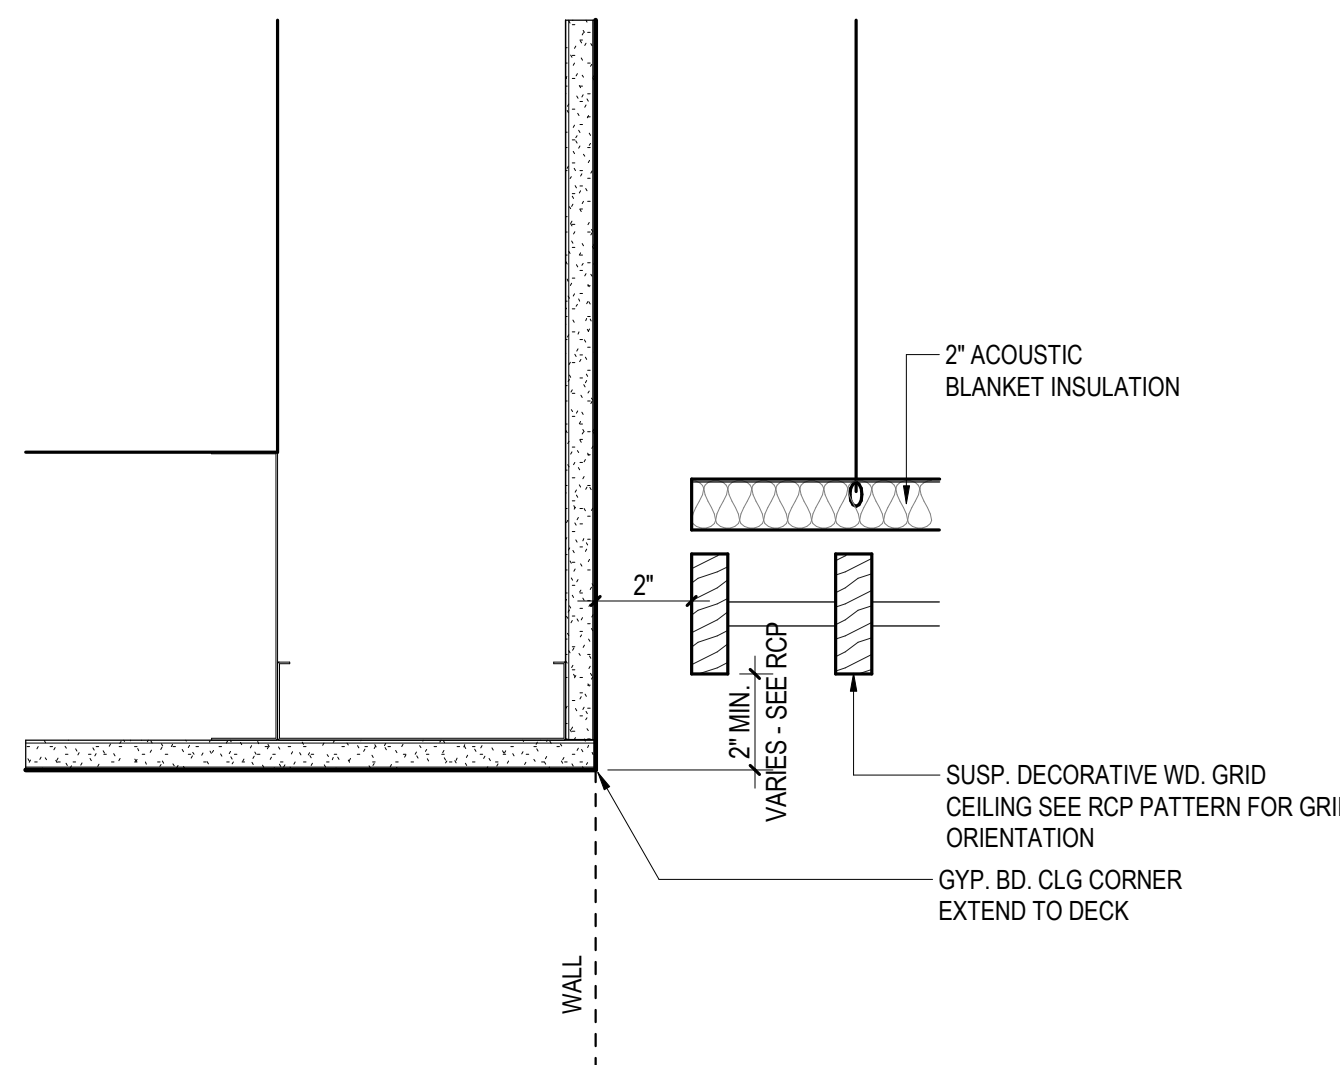


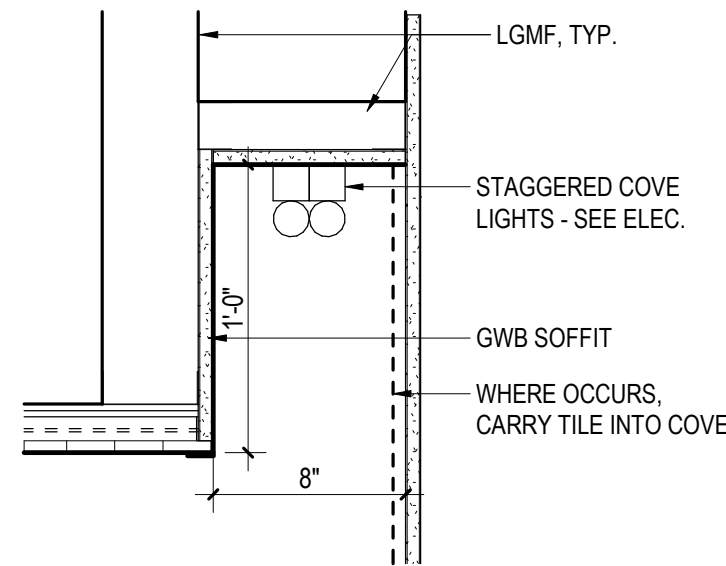


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CLG.  
A250 N.T.S.

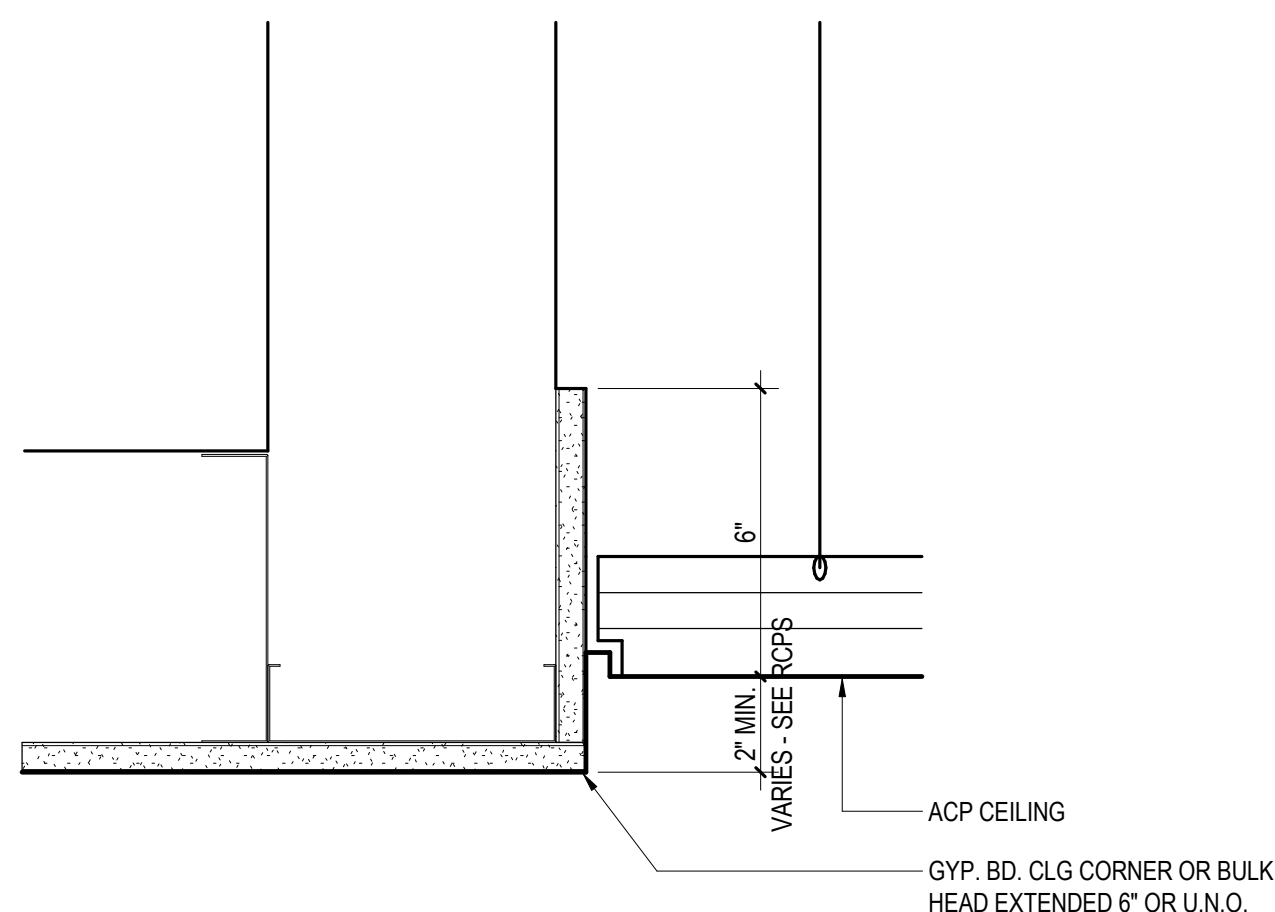


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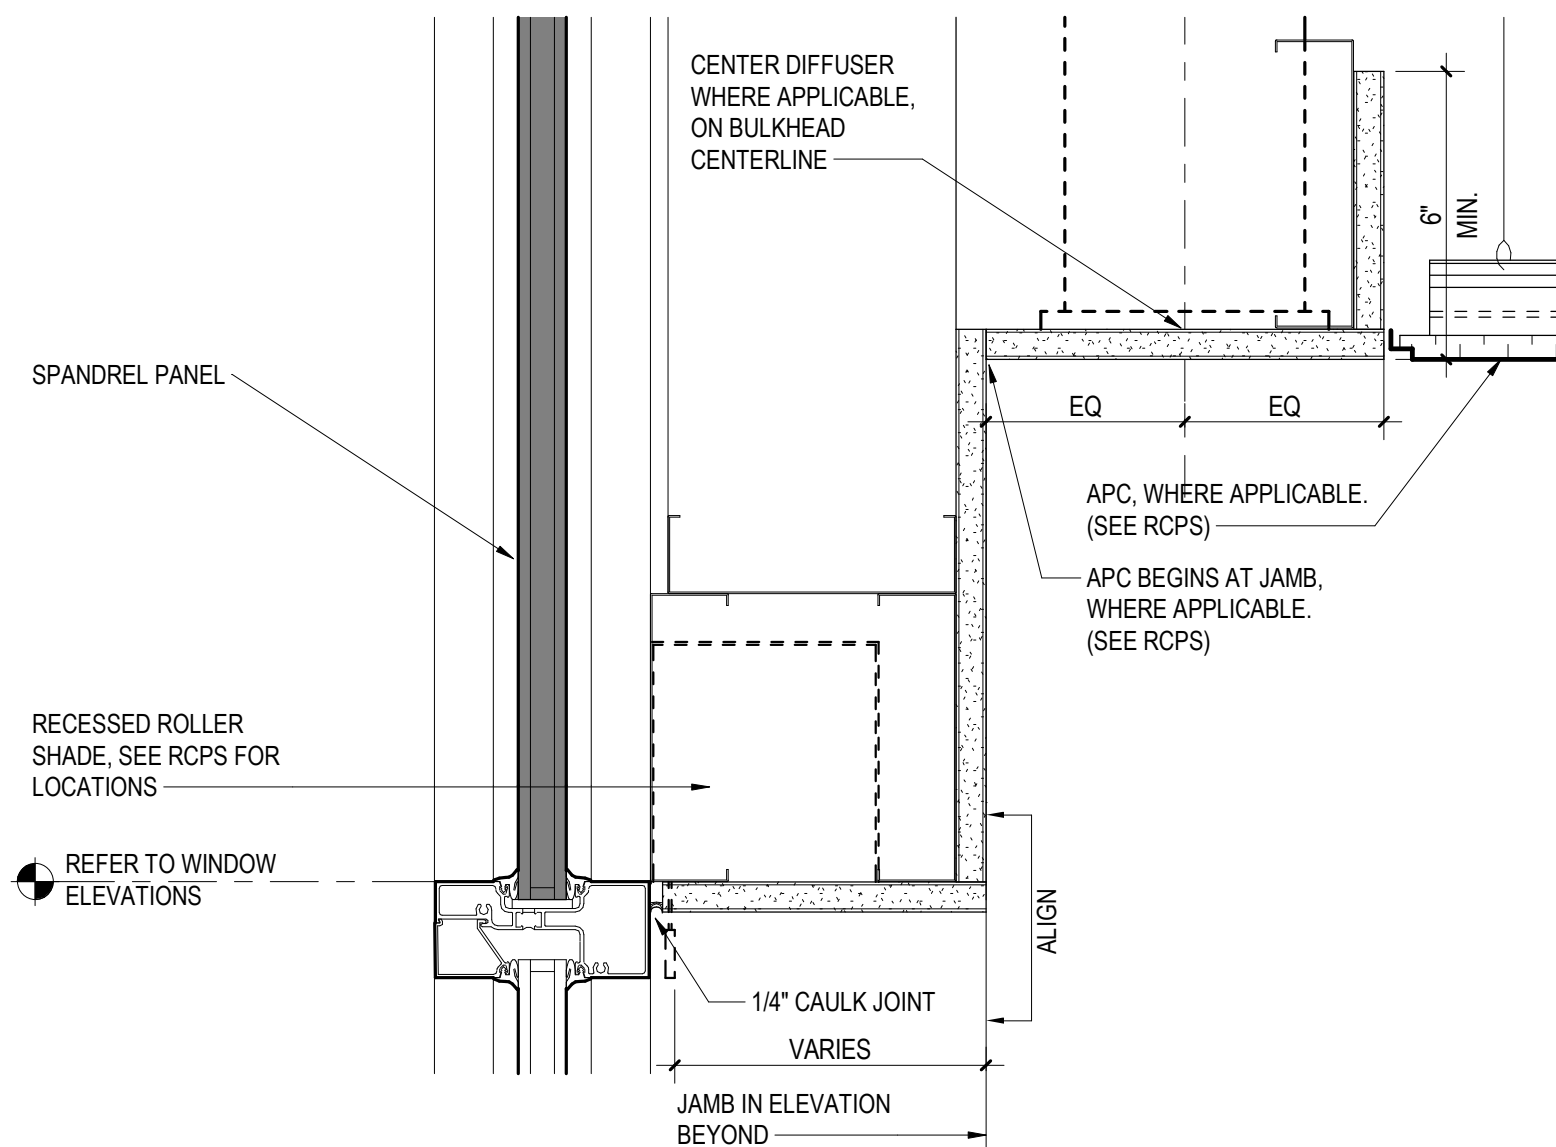
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A250 N.T.S.




4 TYP. CLG. DTL. SECTION - TRANSITION GWB TO FINISHED WALL  
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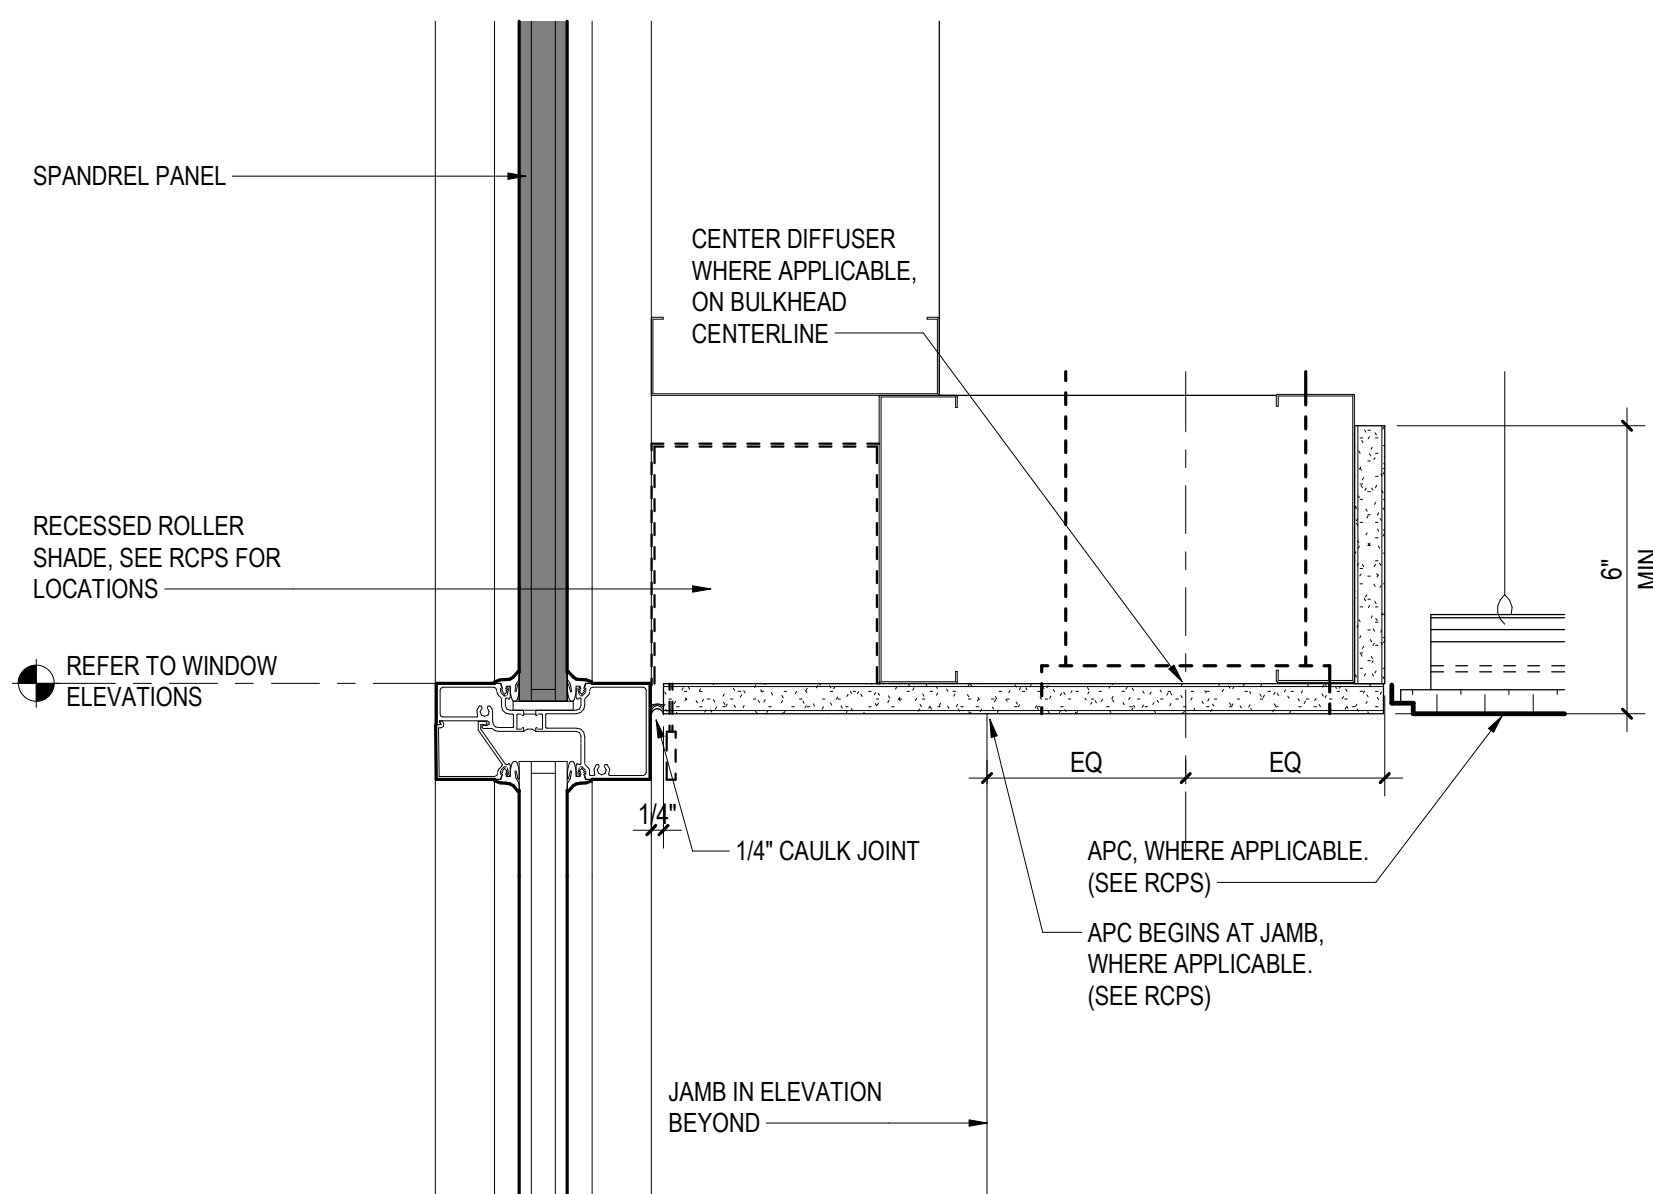
5 TYP. CLG. DTL. SECTION - @ DECOR. WD. GRID & CLG. FIXTURE  
A250 N.T.S.

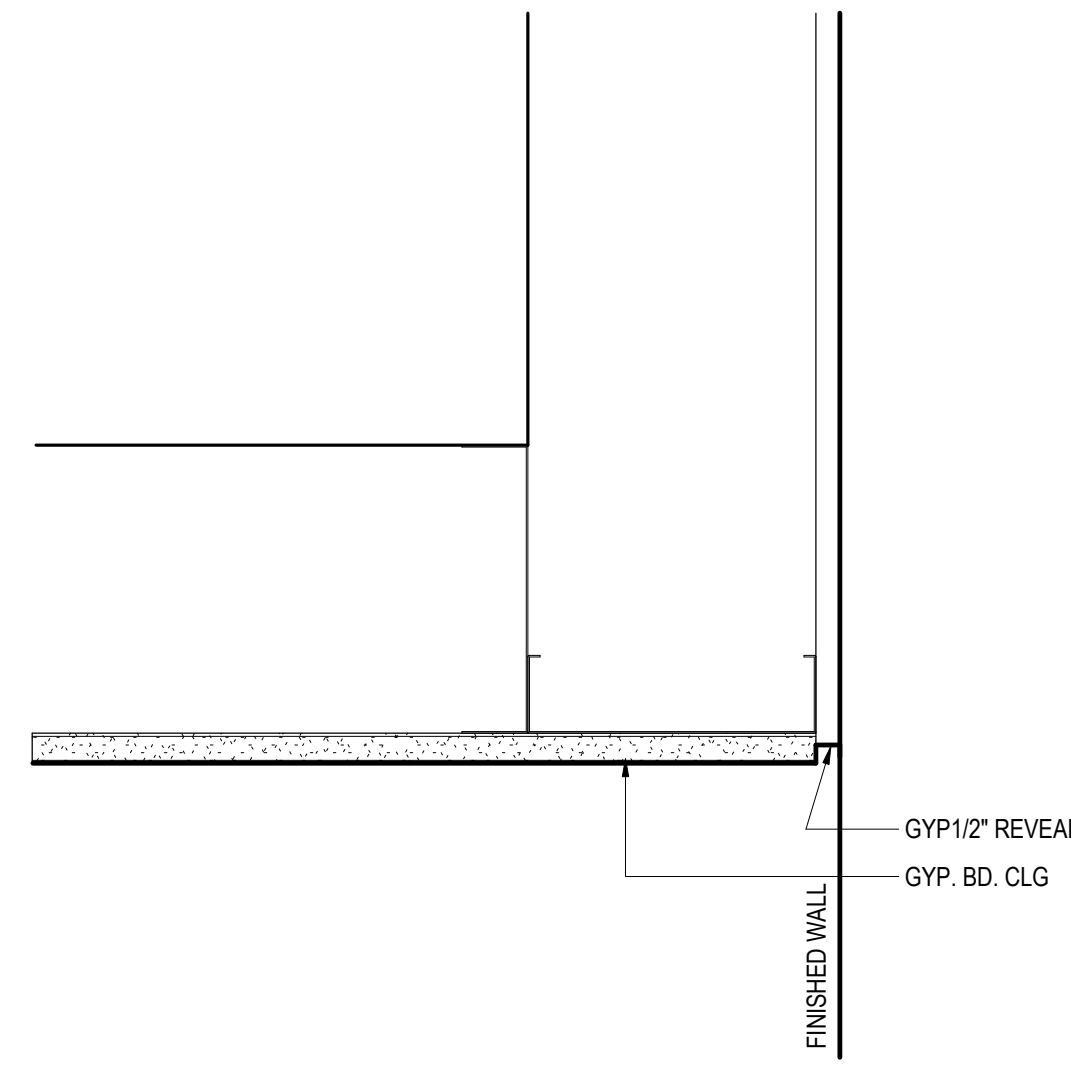


6 TYP. CLG. DTL. SECTION - @ SPANDREL - LOW BULKHEAD  
A250 N.T.S.

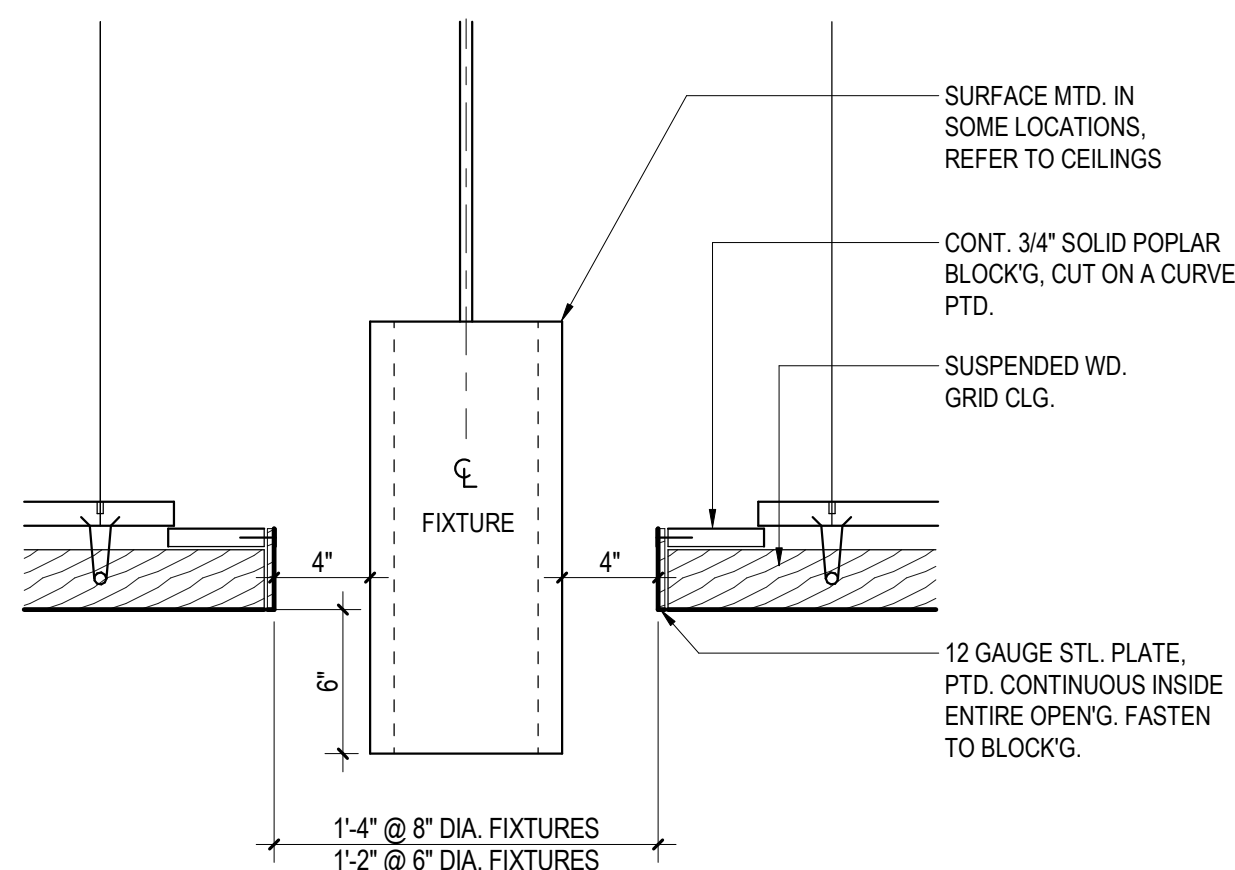

7 TYP. CLG. DTL. SECTION - @ SPANDREL - HIGH POCKET  
A250 N.T.S.

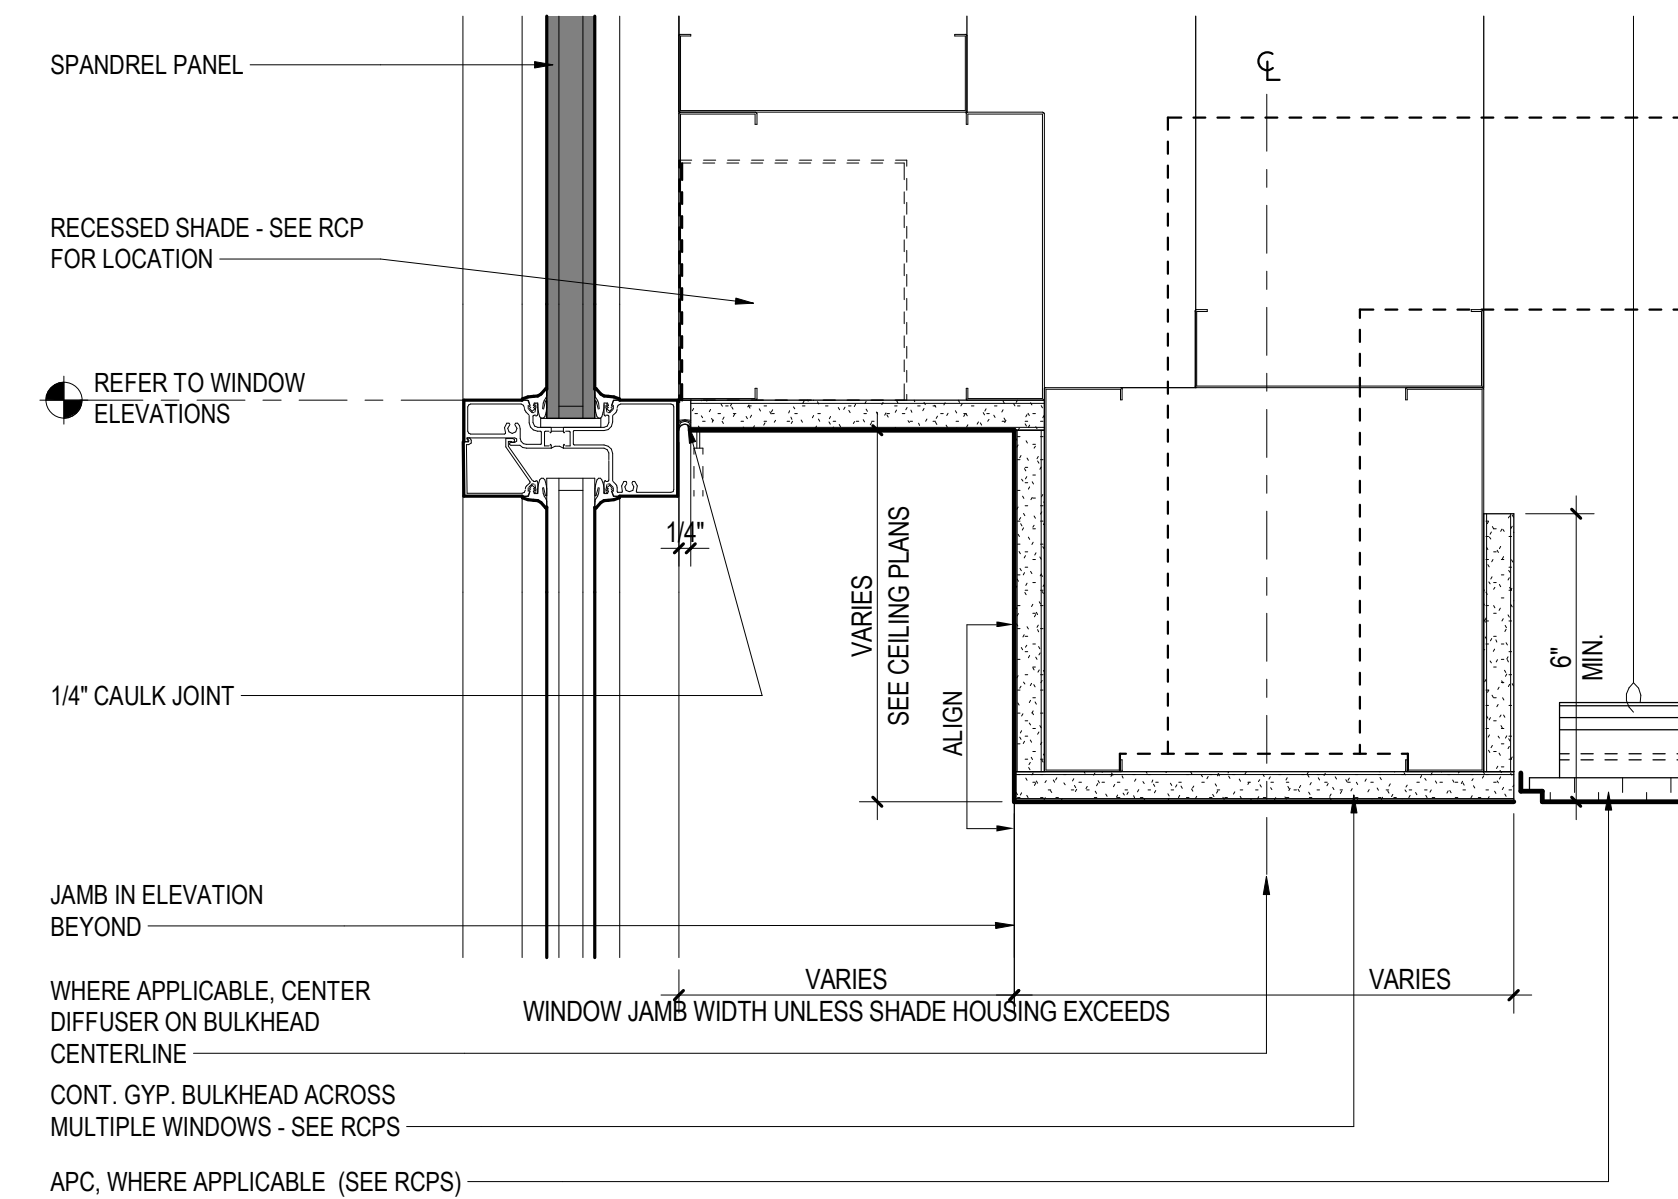

9 TYP. CLG. DTL. SECTION - @ SPANDREL - FLUSH  
A250 N.T.S.

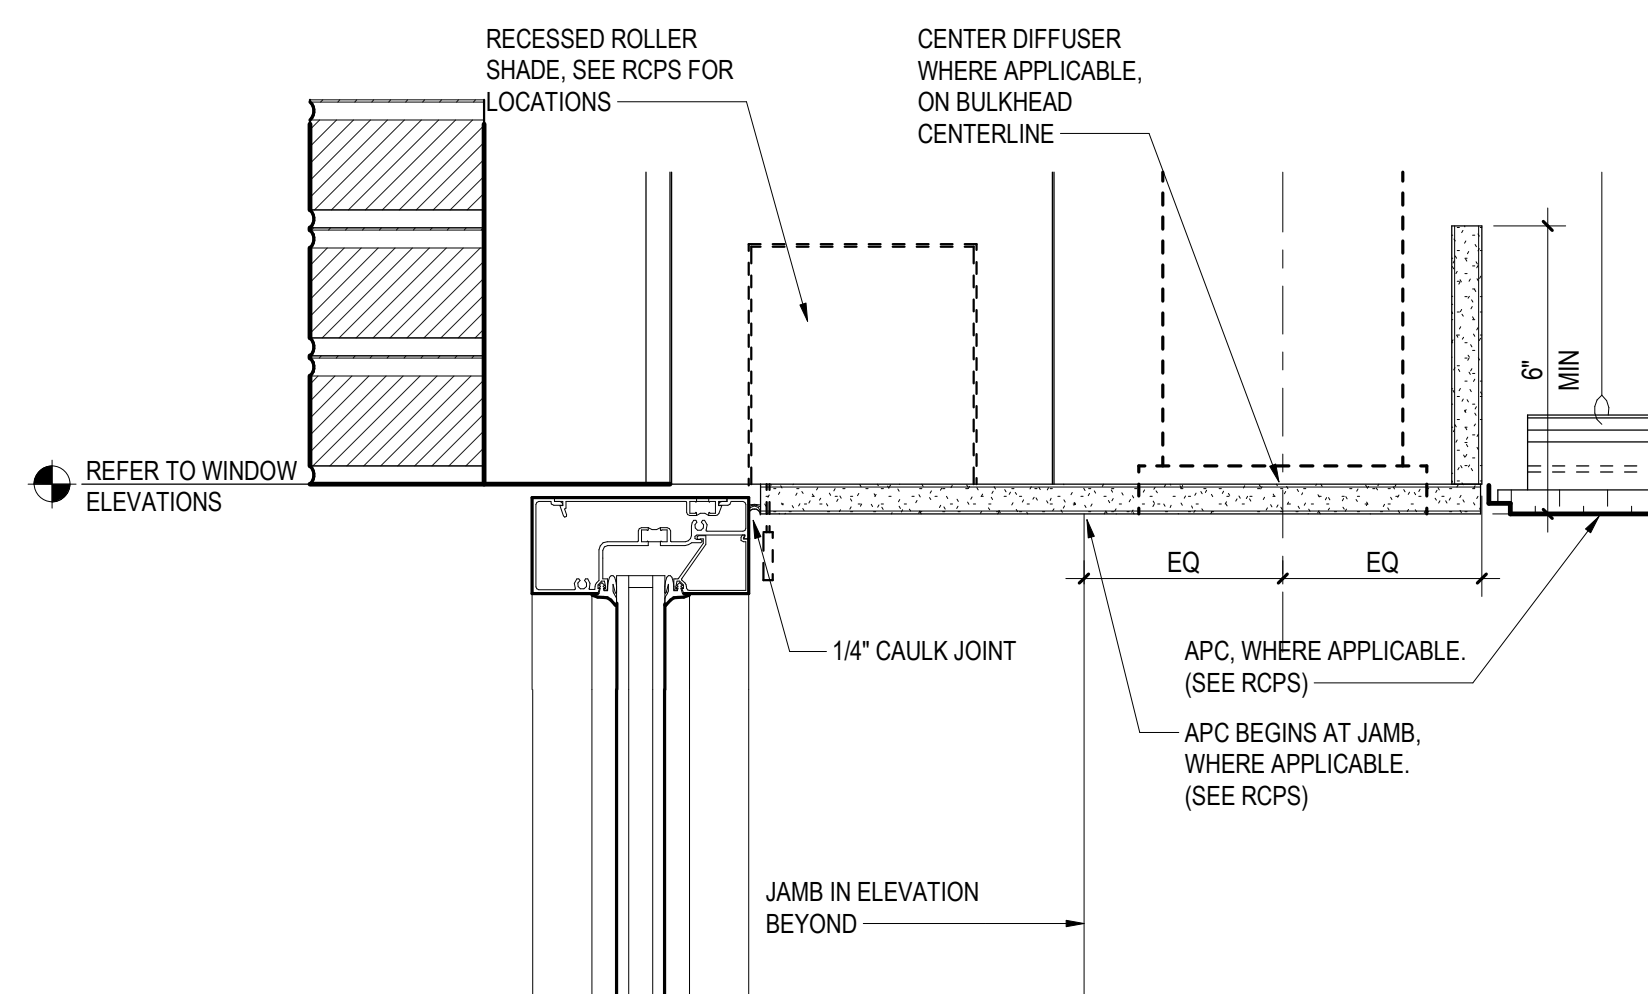

8 TYP. CLG. DTL. SECTION - @ WINDOW HEAD  
A250 N.T.S.






220 North Main Street  
New City, NY 10956

Client Project Number  
VMDO Project Number

1301

Checked By \_\_\_\_\_  
Drawn By \_\_\_\_\_

Checker  
Author

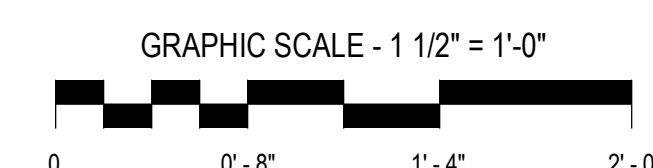


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## ISSUES AND REVISIONS





NO. SUBMITTAL	DATE
SCHEMATIC DESIGN	03.05.202

## CEILING DETAILS

**A251**  
DESIGN DEVELOPMENT  
07.09.2021




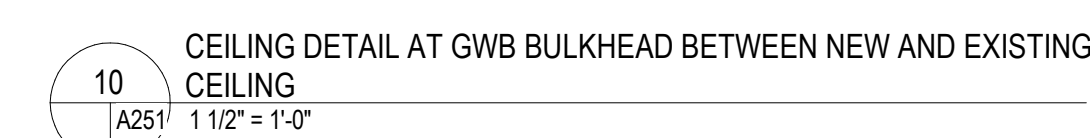

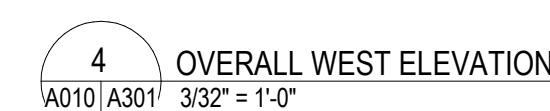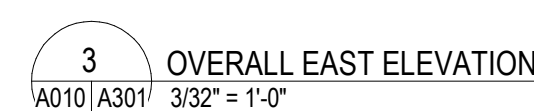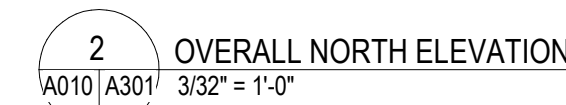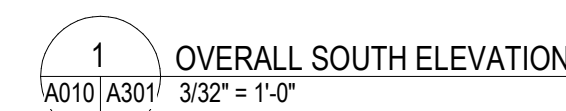


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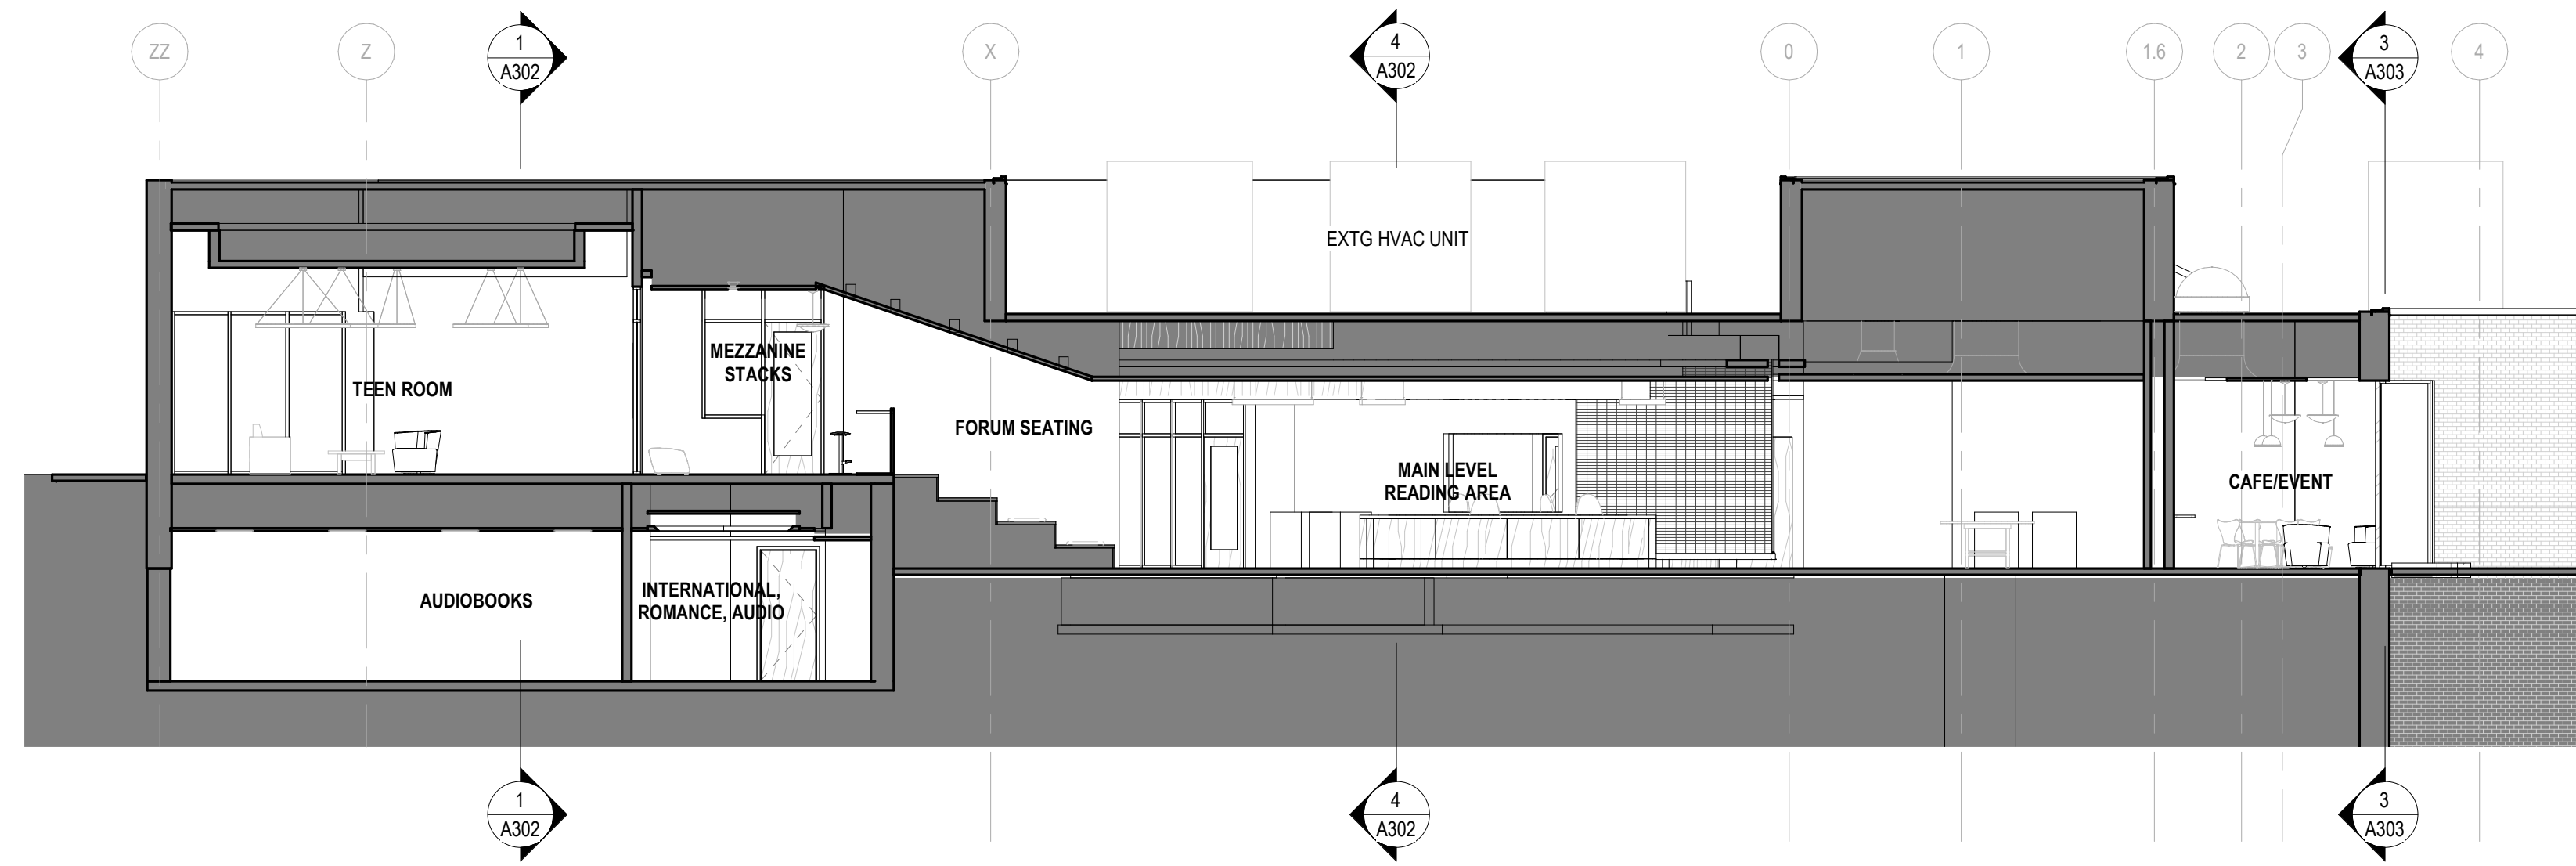


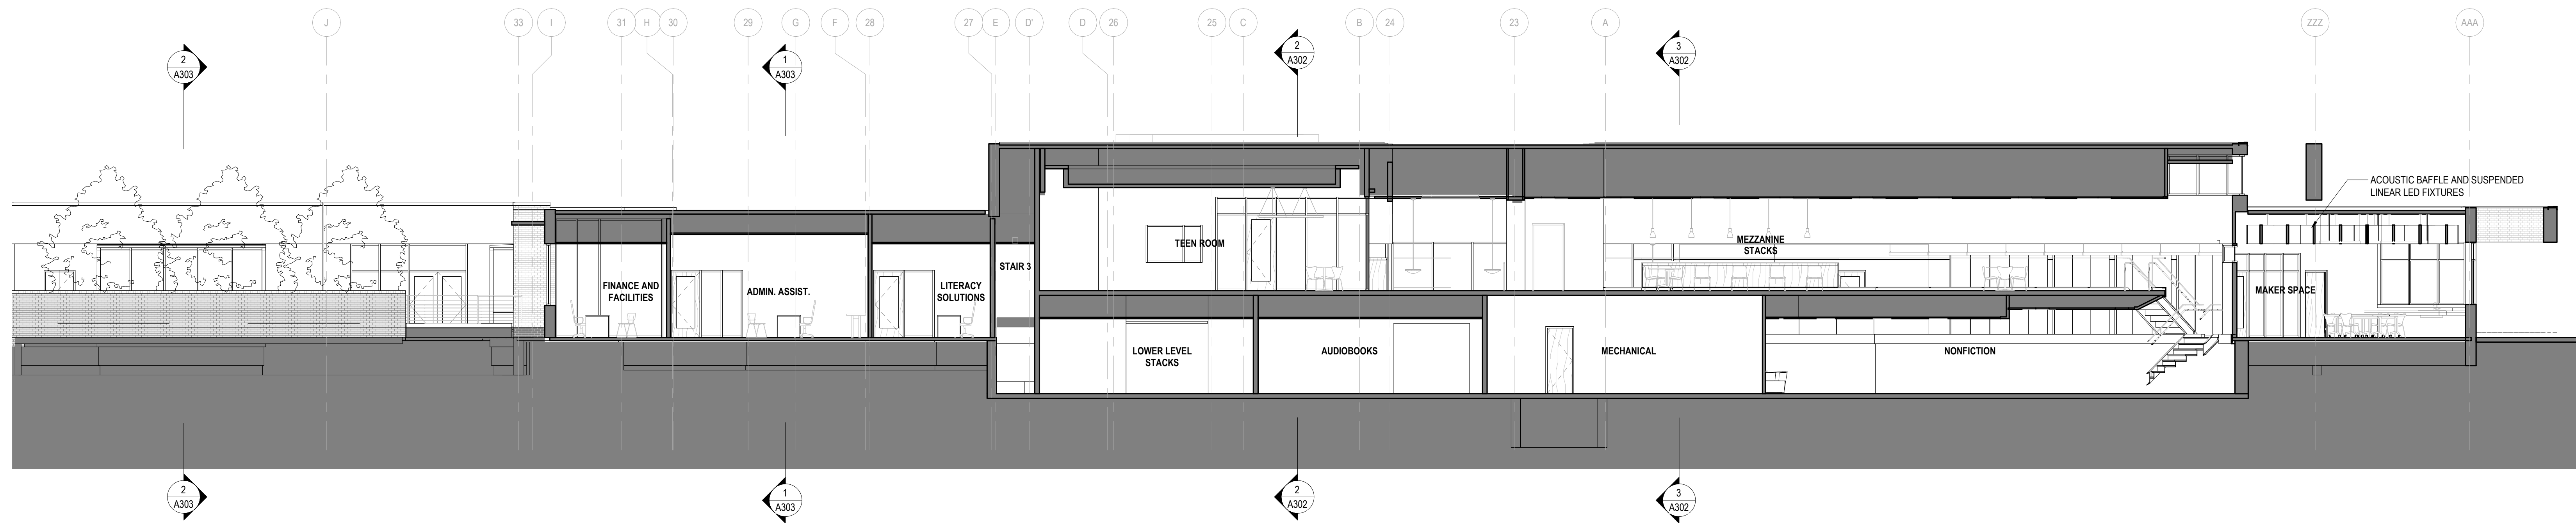


1 BUILDING SECTION THROUGH MEZZANINE - NS  
A101 A302 1/8" = 1'-0"

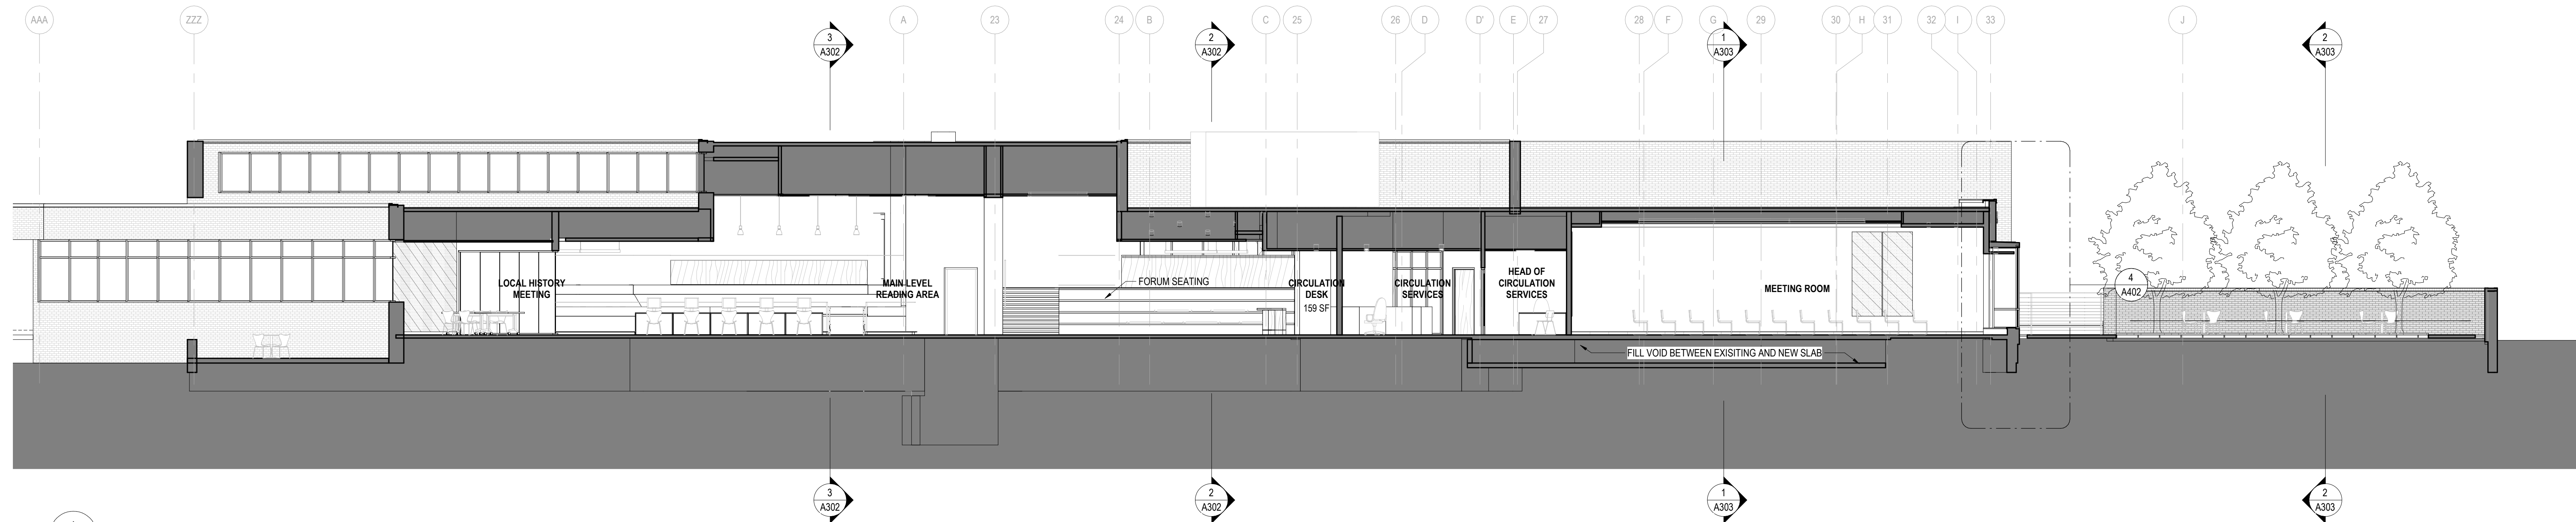




4 BUILDING SECTION THROUGH EVENT SPACE - NS  
A101 A302 1/8" = 1'-0"



2 BUILDING SECTION THROUGH FORUM SEATING - EW  
A101 A302 1/8" = 1'-0"

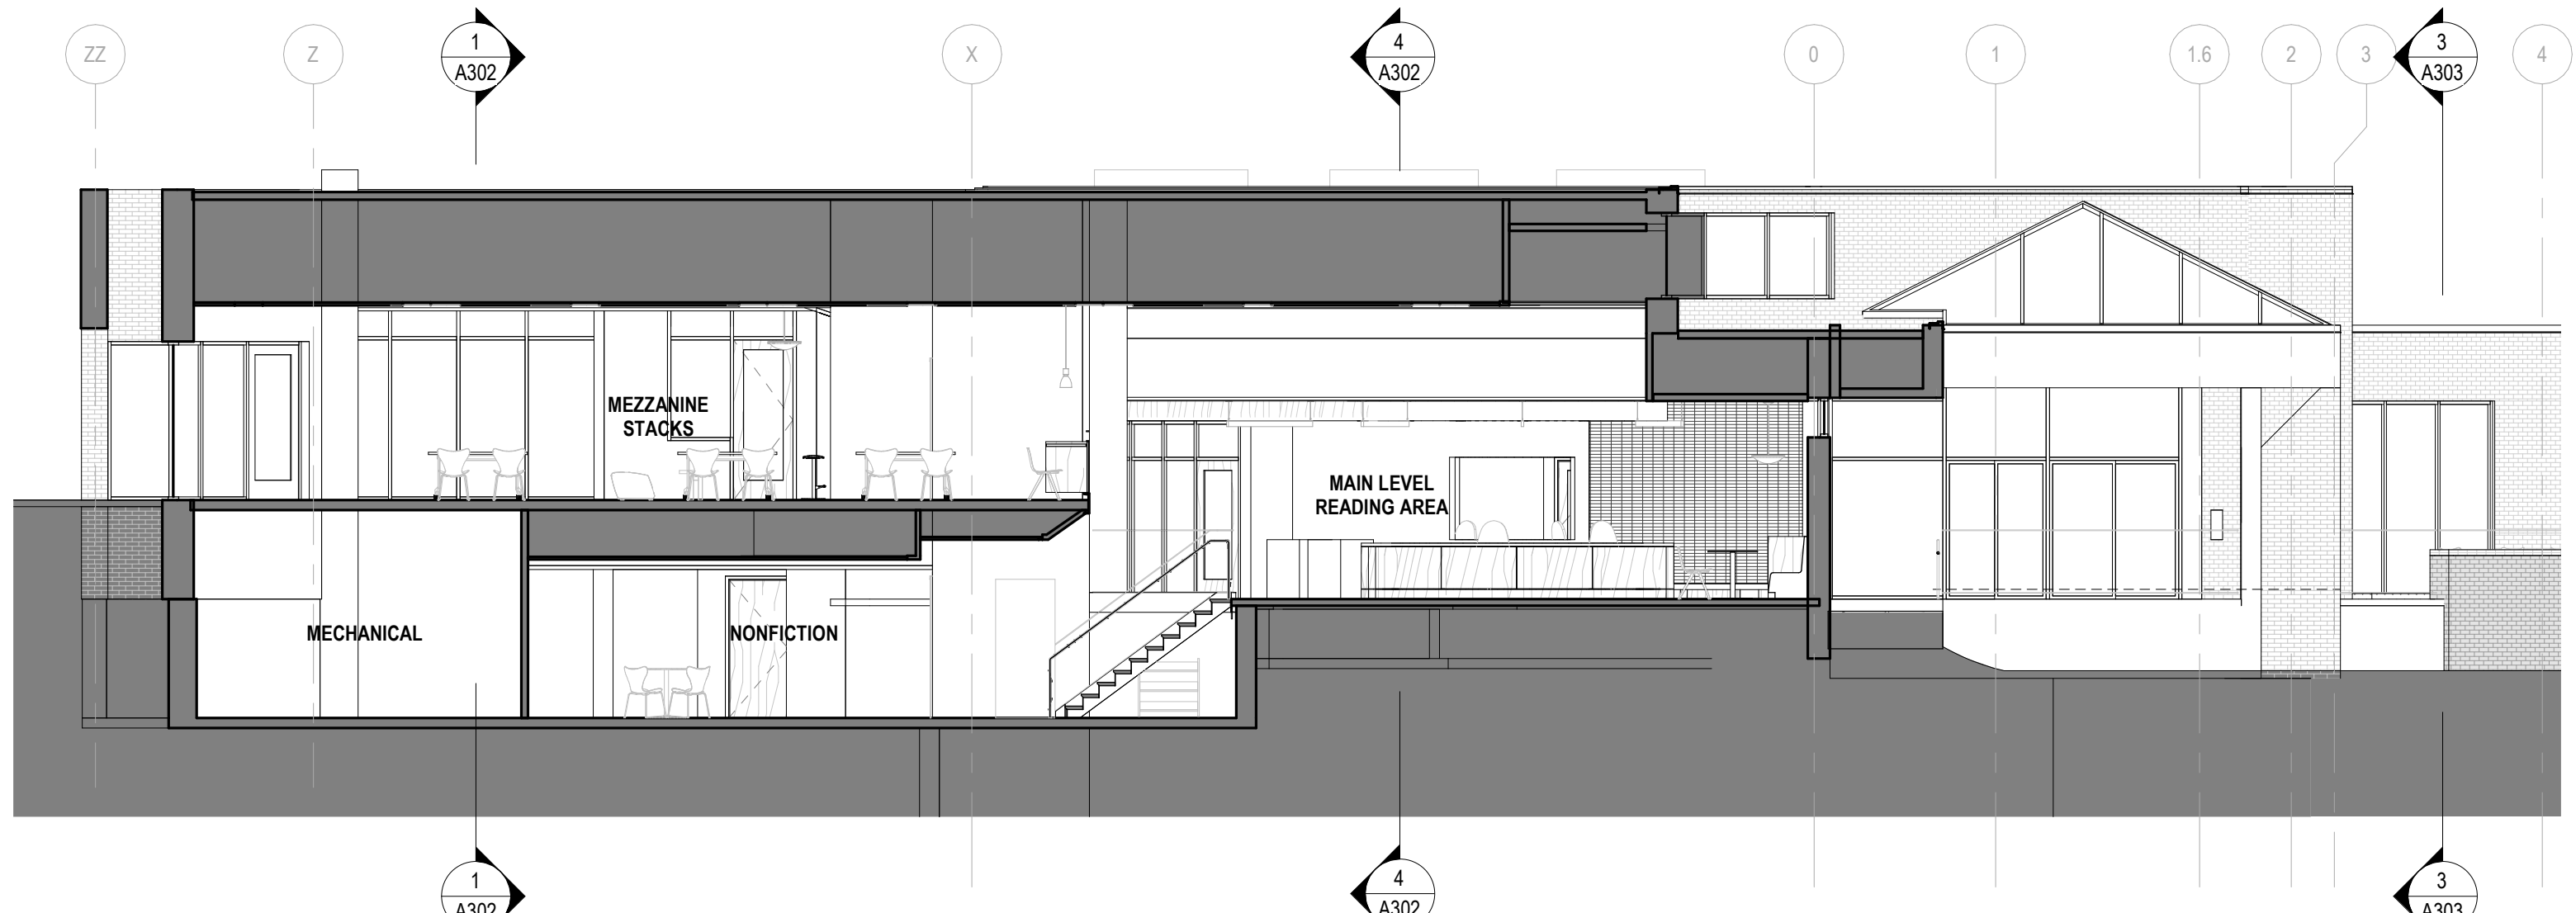

3 BUILDING SECTION THROUGH MEZZANINE - EW  
A101 A302 1/8" = 1'-0"

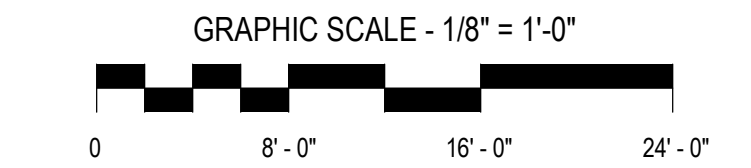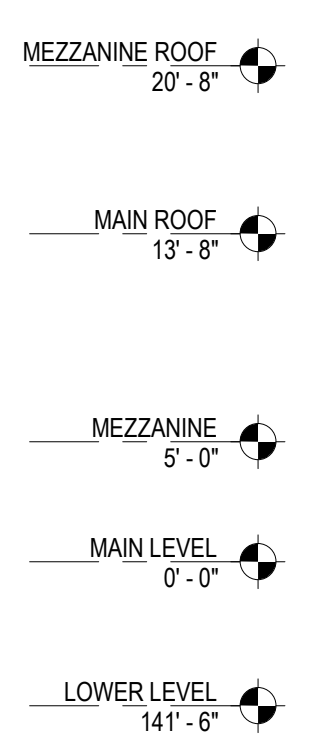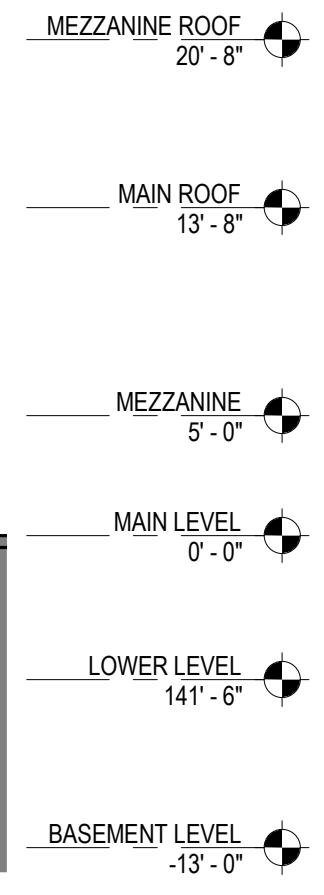


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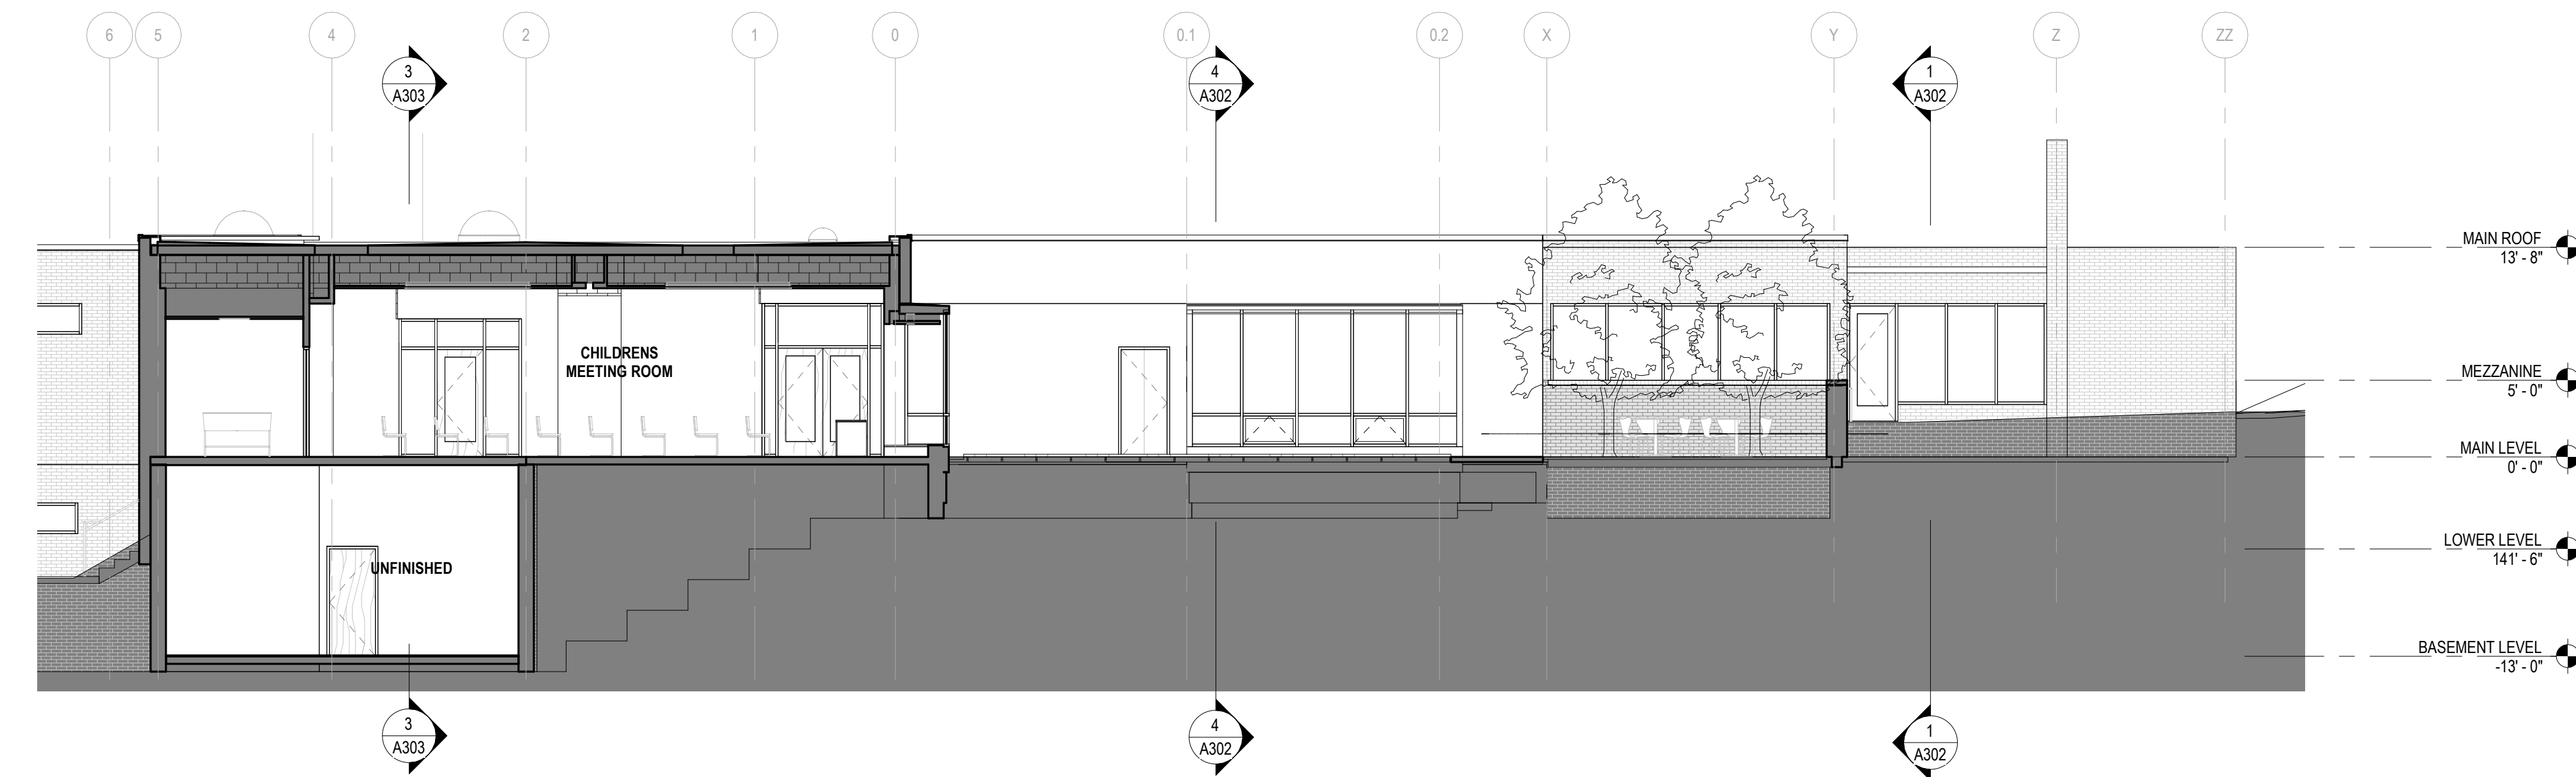
ISSUES AND REVISIONS		DATE
NO.	SUBMITTAL	03.05.2021
SCHEMATIC DESIGN		

**KEY BUILDING SECTIONS**




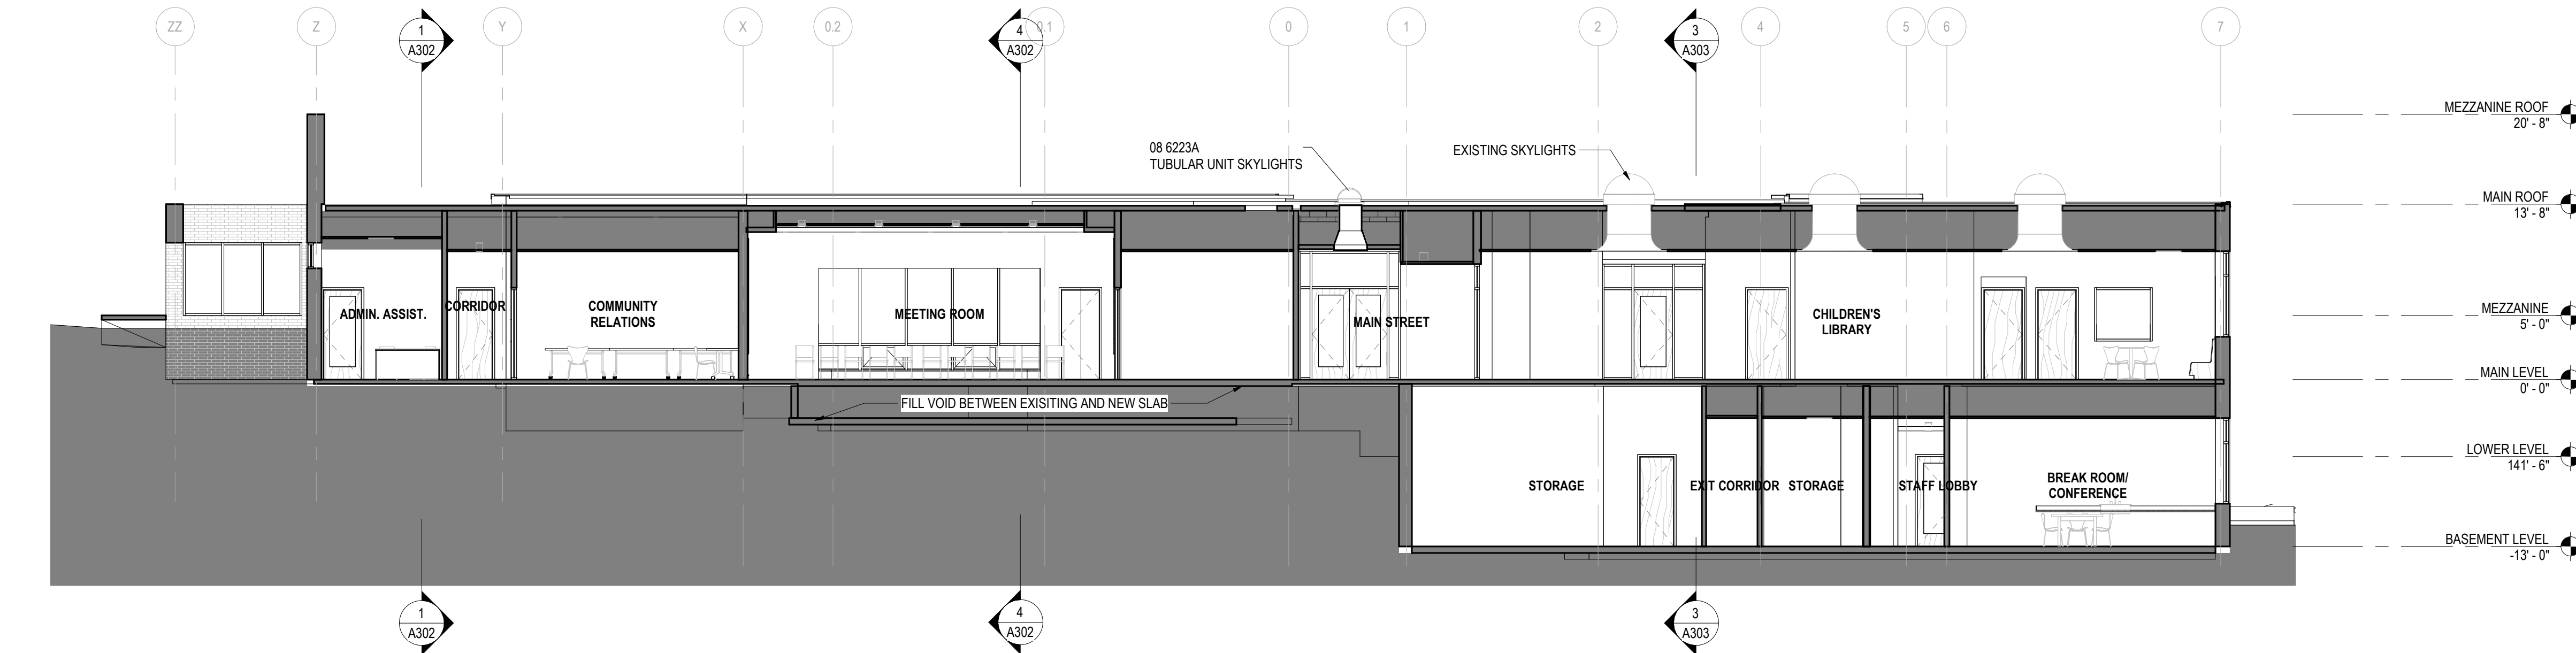

1 BUILDING SECTION THROUGH CHILDREN'S LIBRARY - EW  
A101/A303 1/8" = 1'-0"




2 BUILDING SECTION THROUGH ADDITION - EW  
A101/A303 1/8" = 1'-0"

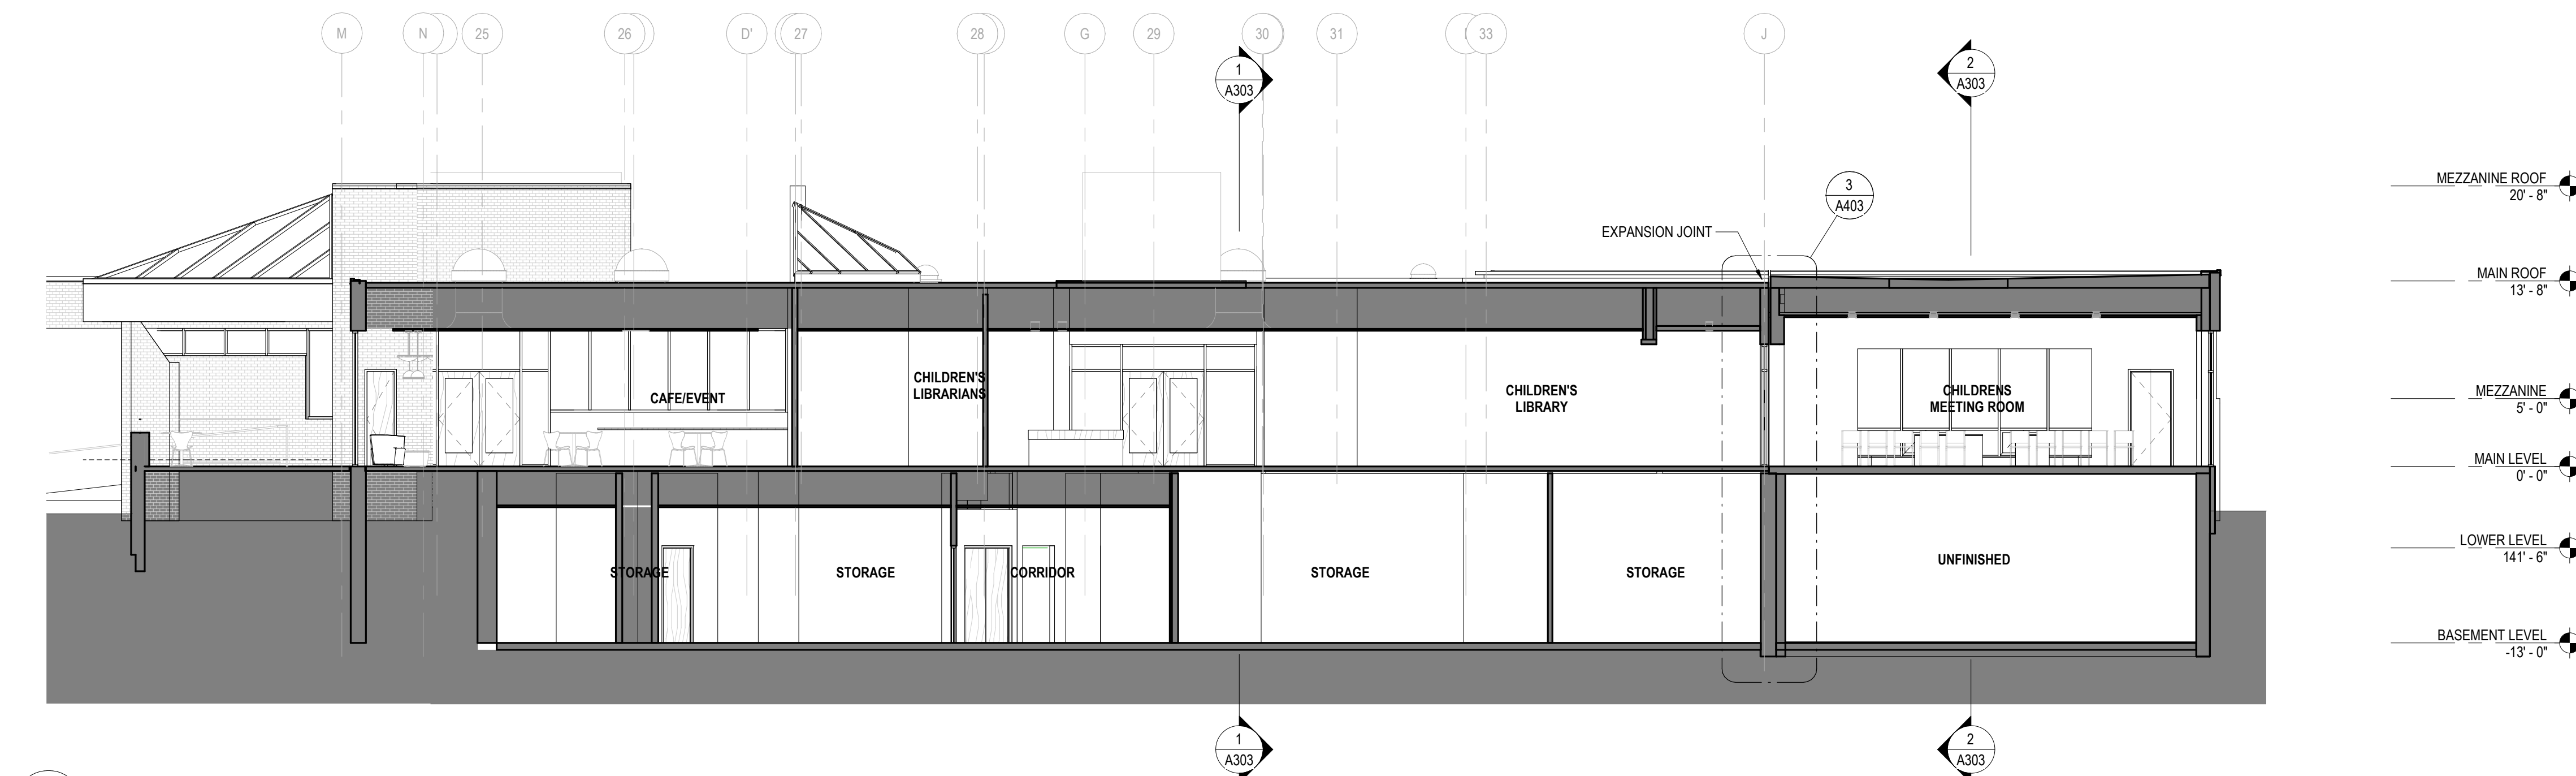

3 BUILDING SECTION THROUGH ADDITION - NS  
A101/A303 1/8" = 1'-0"



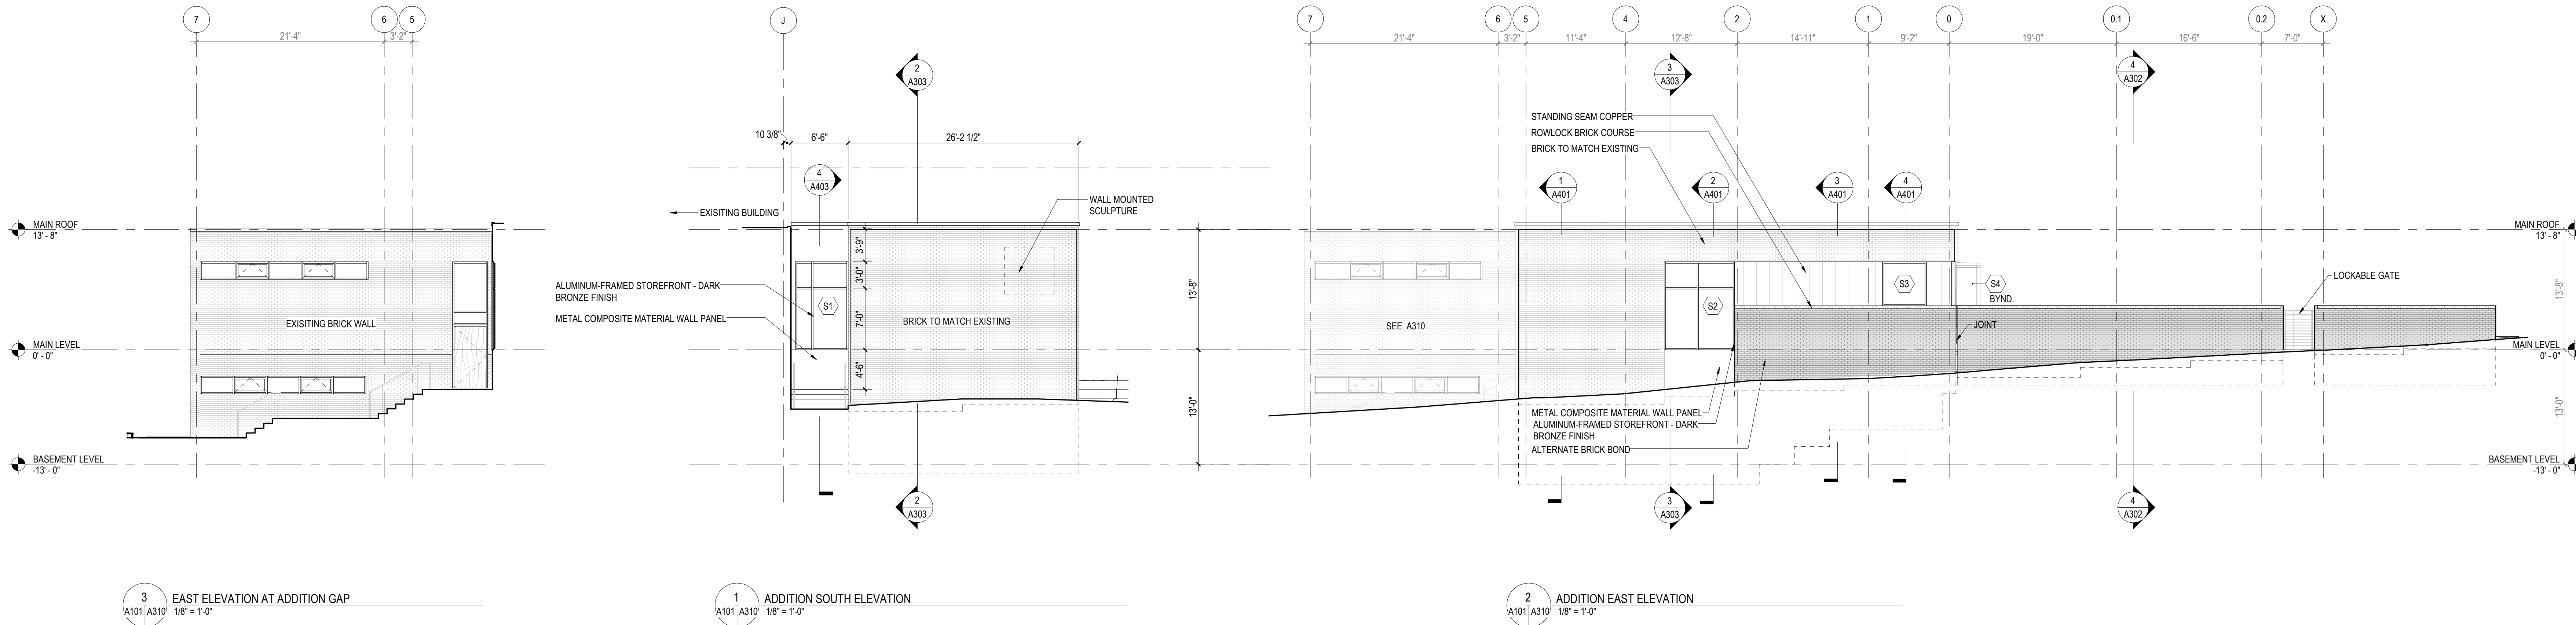


KEYNOTES


ELEVATION / BUILDING  
SECTION GENERAL NOTES

1. ON SYMMETRICAL DRAWINGS, ALL NOTES AND DIMENSIONS SHOWN ON ONE-HALF OF DRAWING SHALL APPLY TO BOTH HALVES OF DRAWINGS.
2. PROVIDE HIGH PERFORMANCE COATINGS AT ALL EXTERIOR FERROUS METALS (STRUCTURAL AND DECORATIVE).
3. INTERIOR VIEWS IN BUILDING SECTIONS ARE TYPICALLY SIMPLIFIED FOR CLARITY. REFER TO LARGER SCALED INTERIOR ELEVATIONS FOR ADDITIONAL INFORMATION.
4. FOOTINGS AND FOUNDATIONS ARE SHOWN FOR ILLUSTRATION ONLY. REFER TO STRUCTURAL DRAWINGS FOR EXTENT OF WORK.
5. ALL DOWNSPOUTS ARE TO BE 6" TYPICAL, U.N.O.
6. REFERENCE MEP & CIVIL DRAWINGS FOR FULL SCOPE OF M.E.P. AND CIVIL WORK.
7. PROVIDE CAST IRON BOOTS AT ALL DOWNSPOUTS AT GRADE, U.N.O.




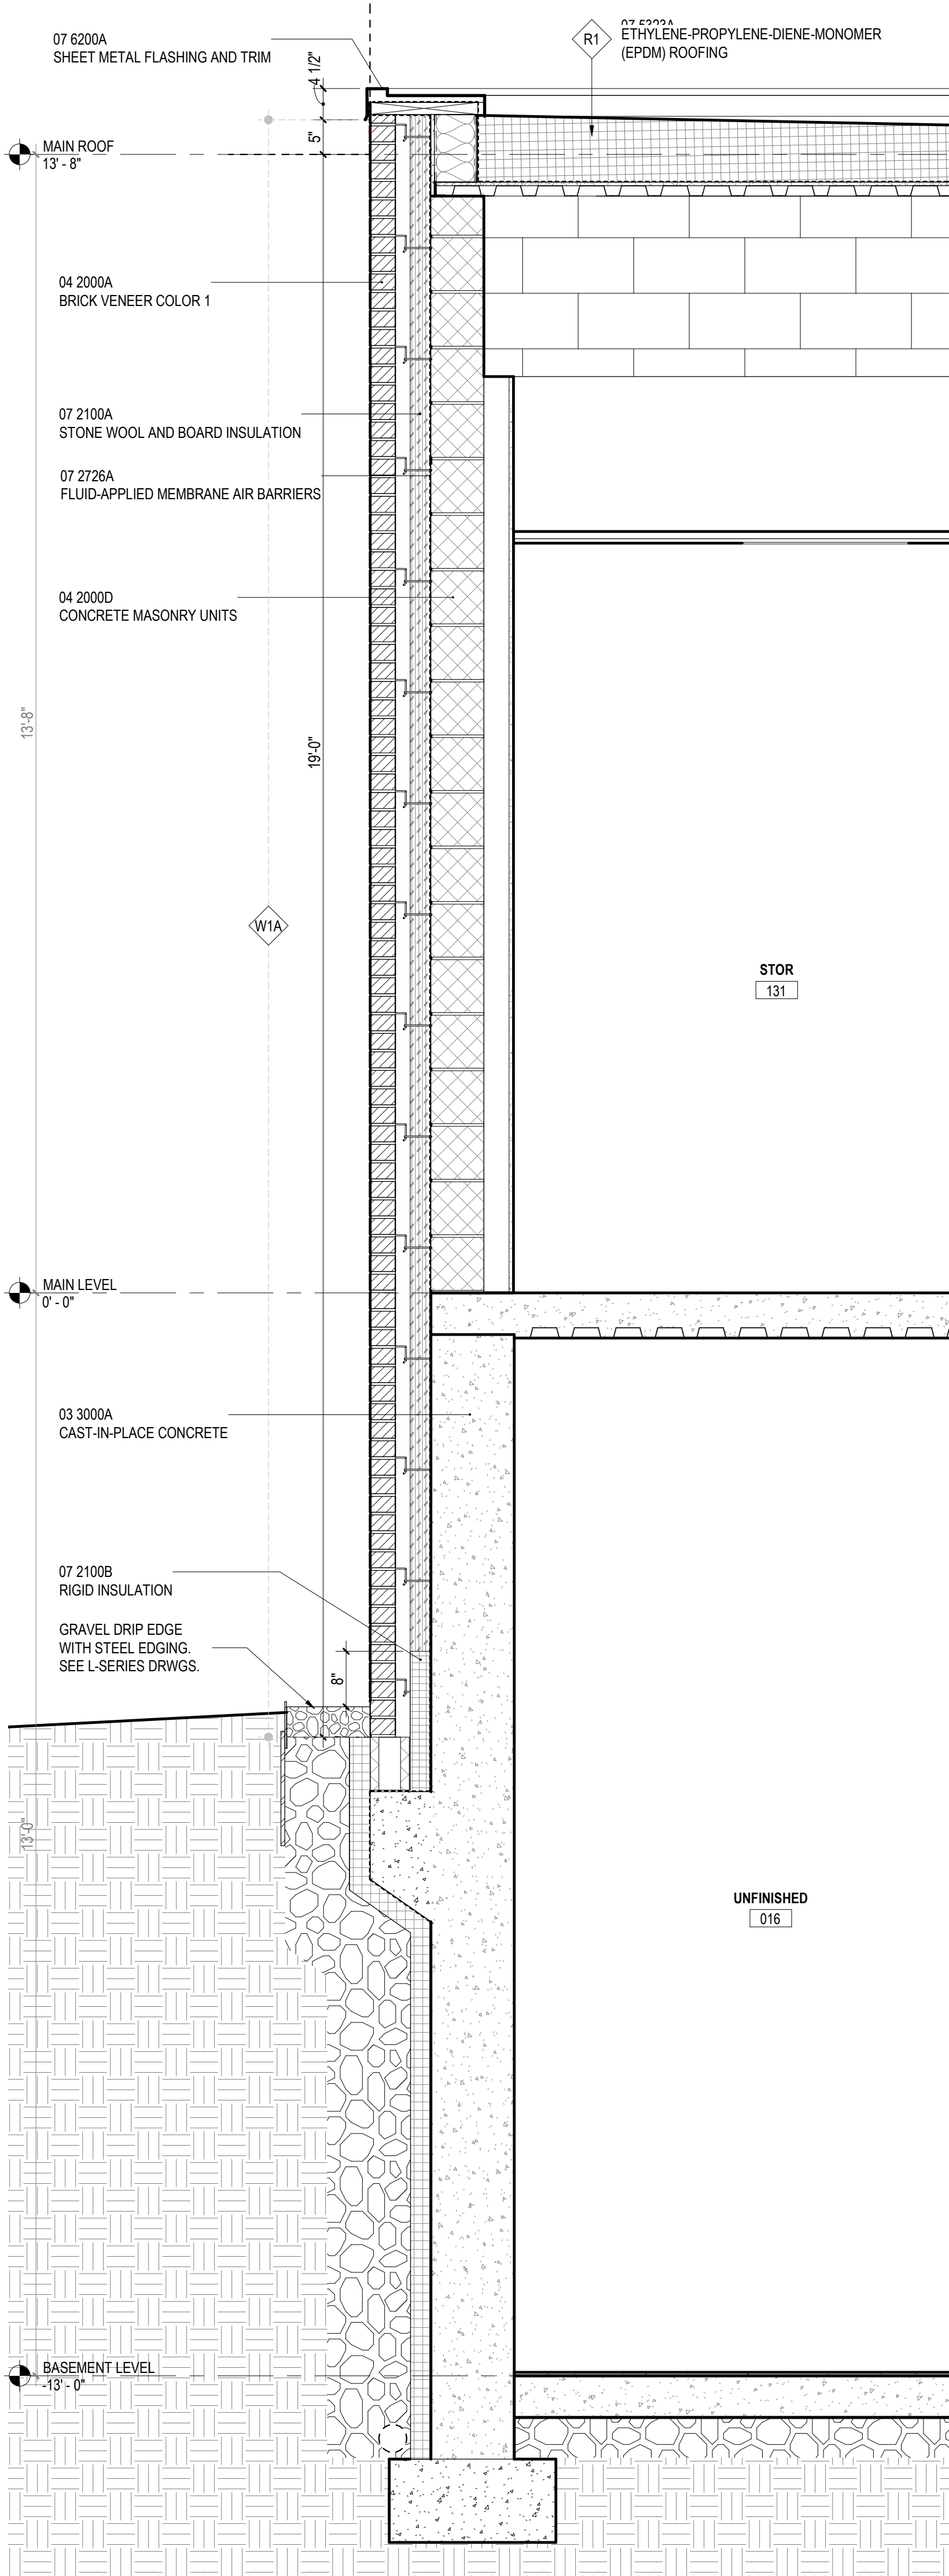


1 WALL SECTION AT ADDITION MASONRY WALL  
A101 | A401 3/4" = 1'-0"

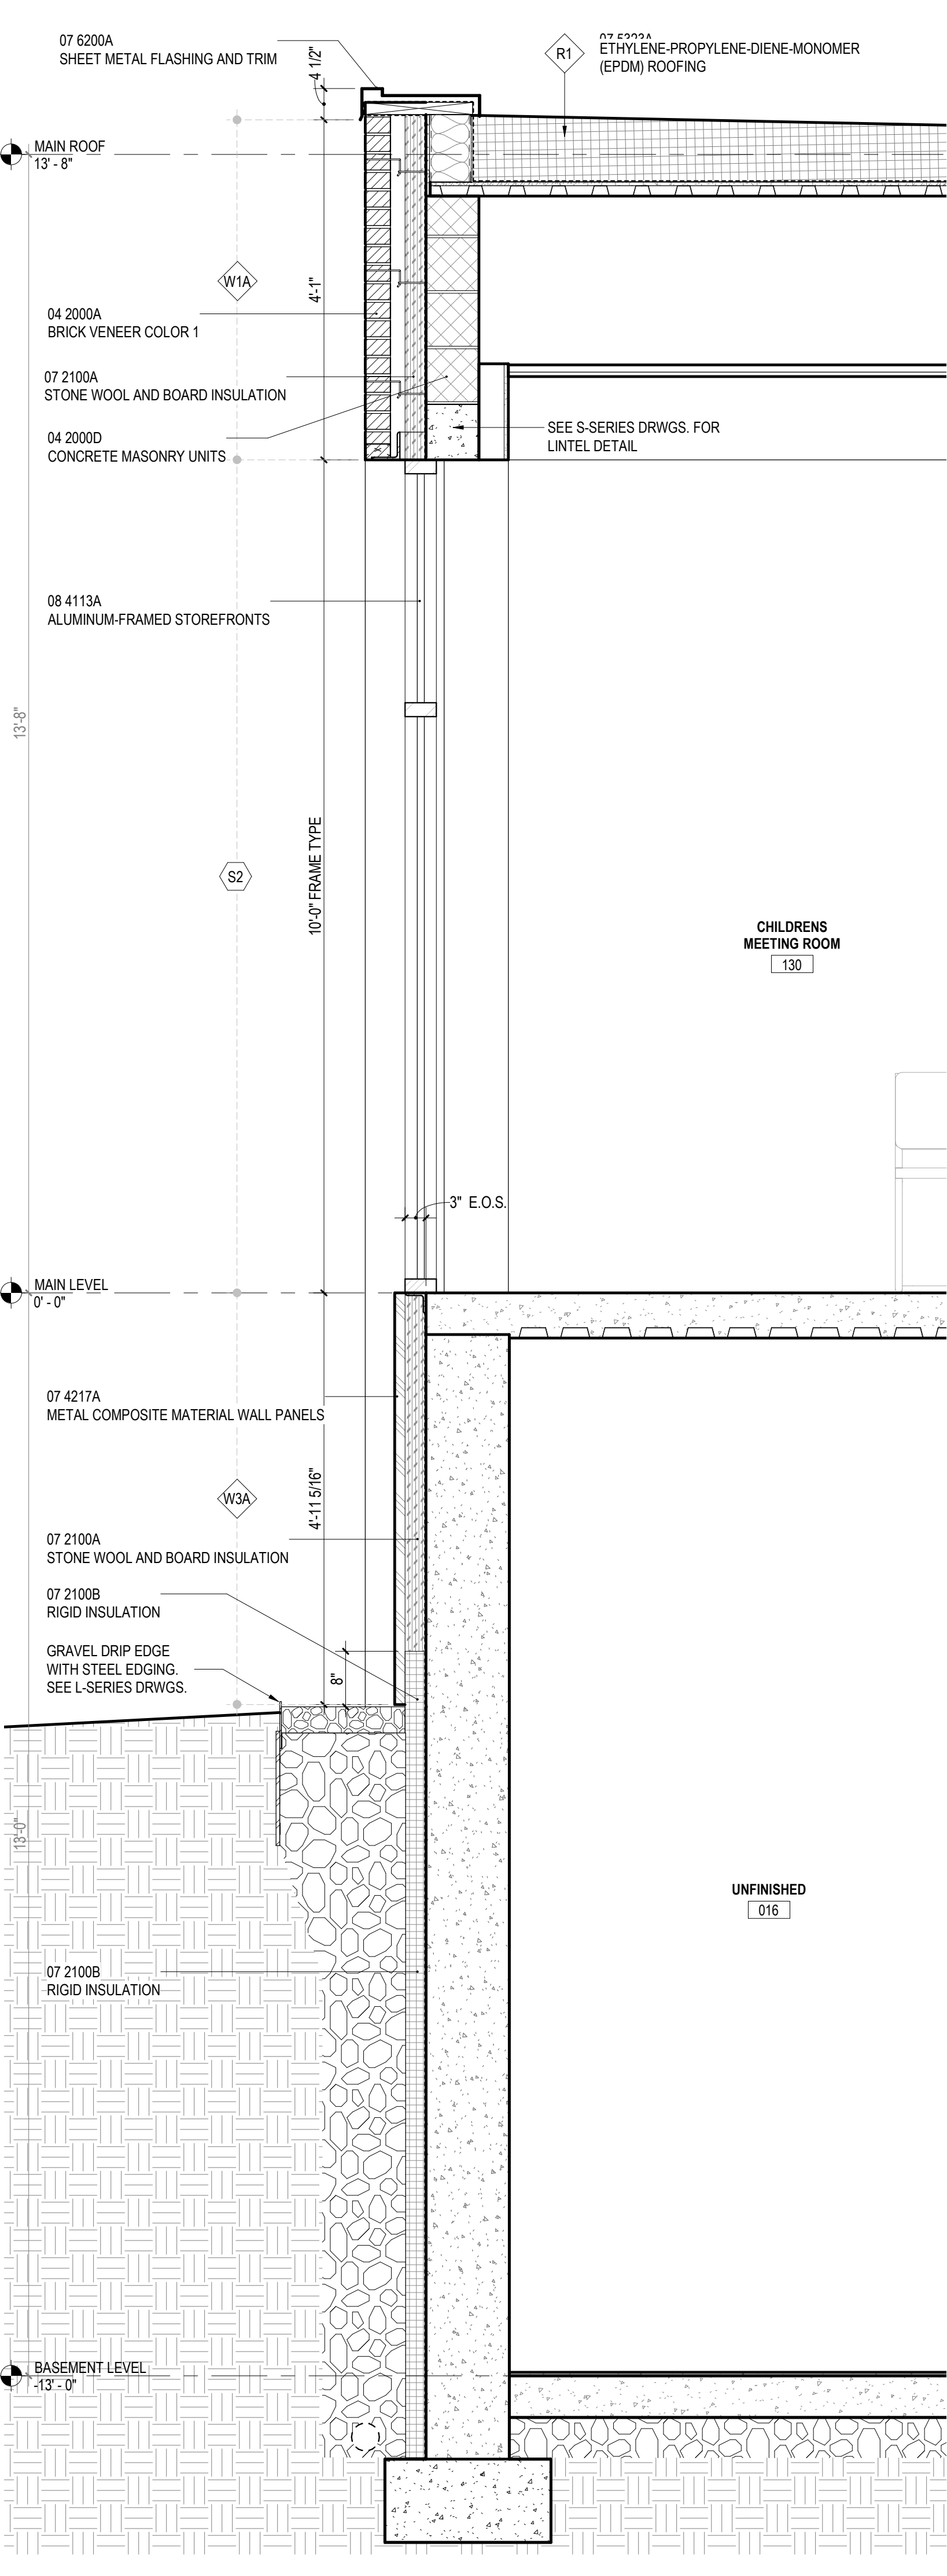

2 WALL SECTION AT ADDITION GLAZING  
A101 | A401 3/4" = 1'-0"

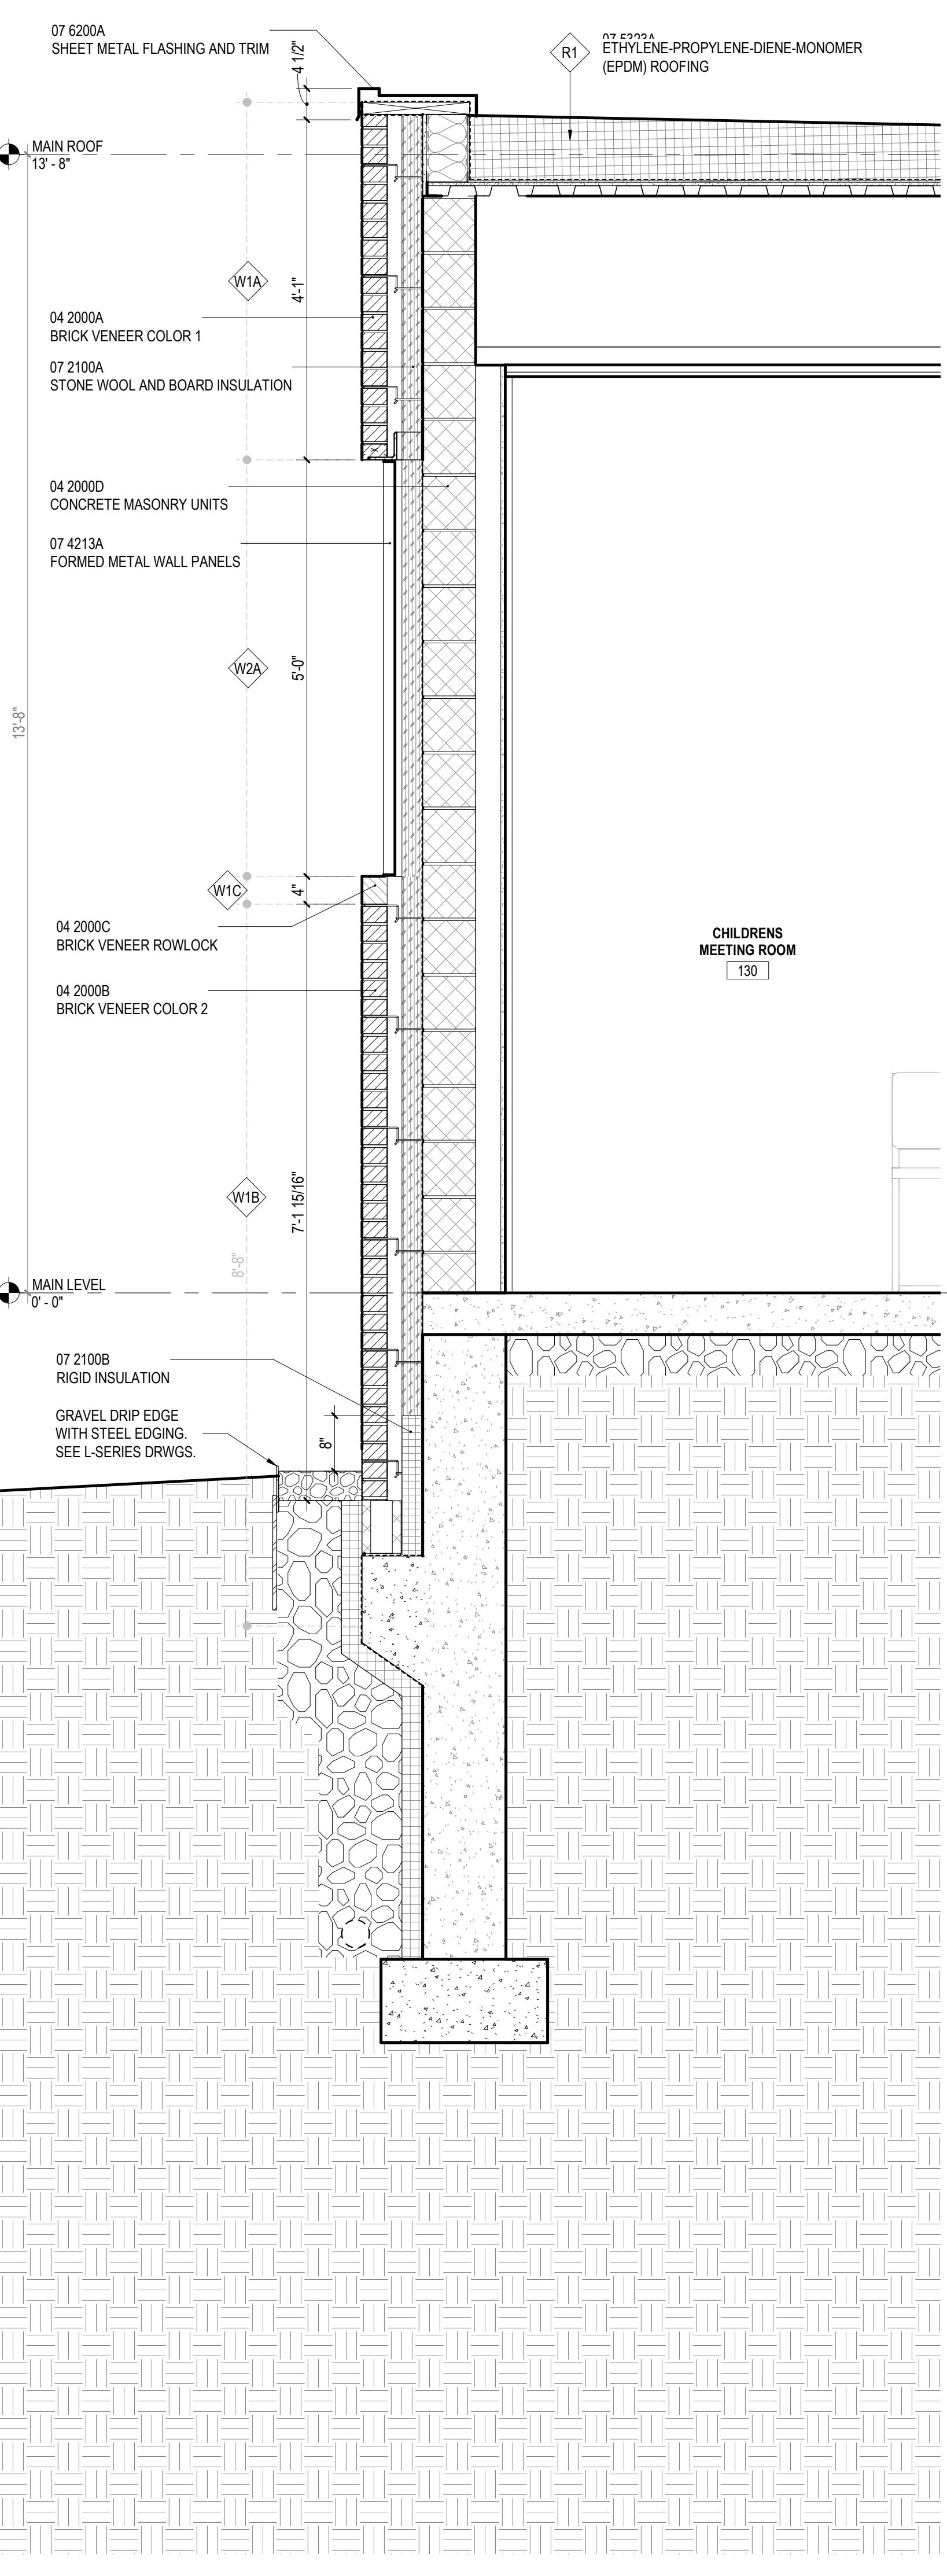

3 WALL SECTION AT ADDITION MASONRY AND METAL PANELING  
A111 | A401 3/4" = 1'-0"

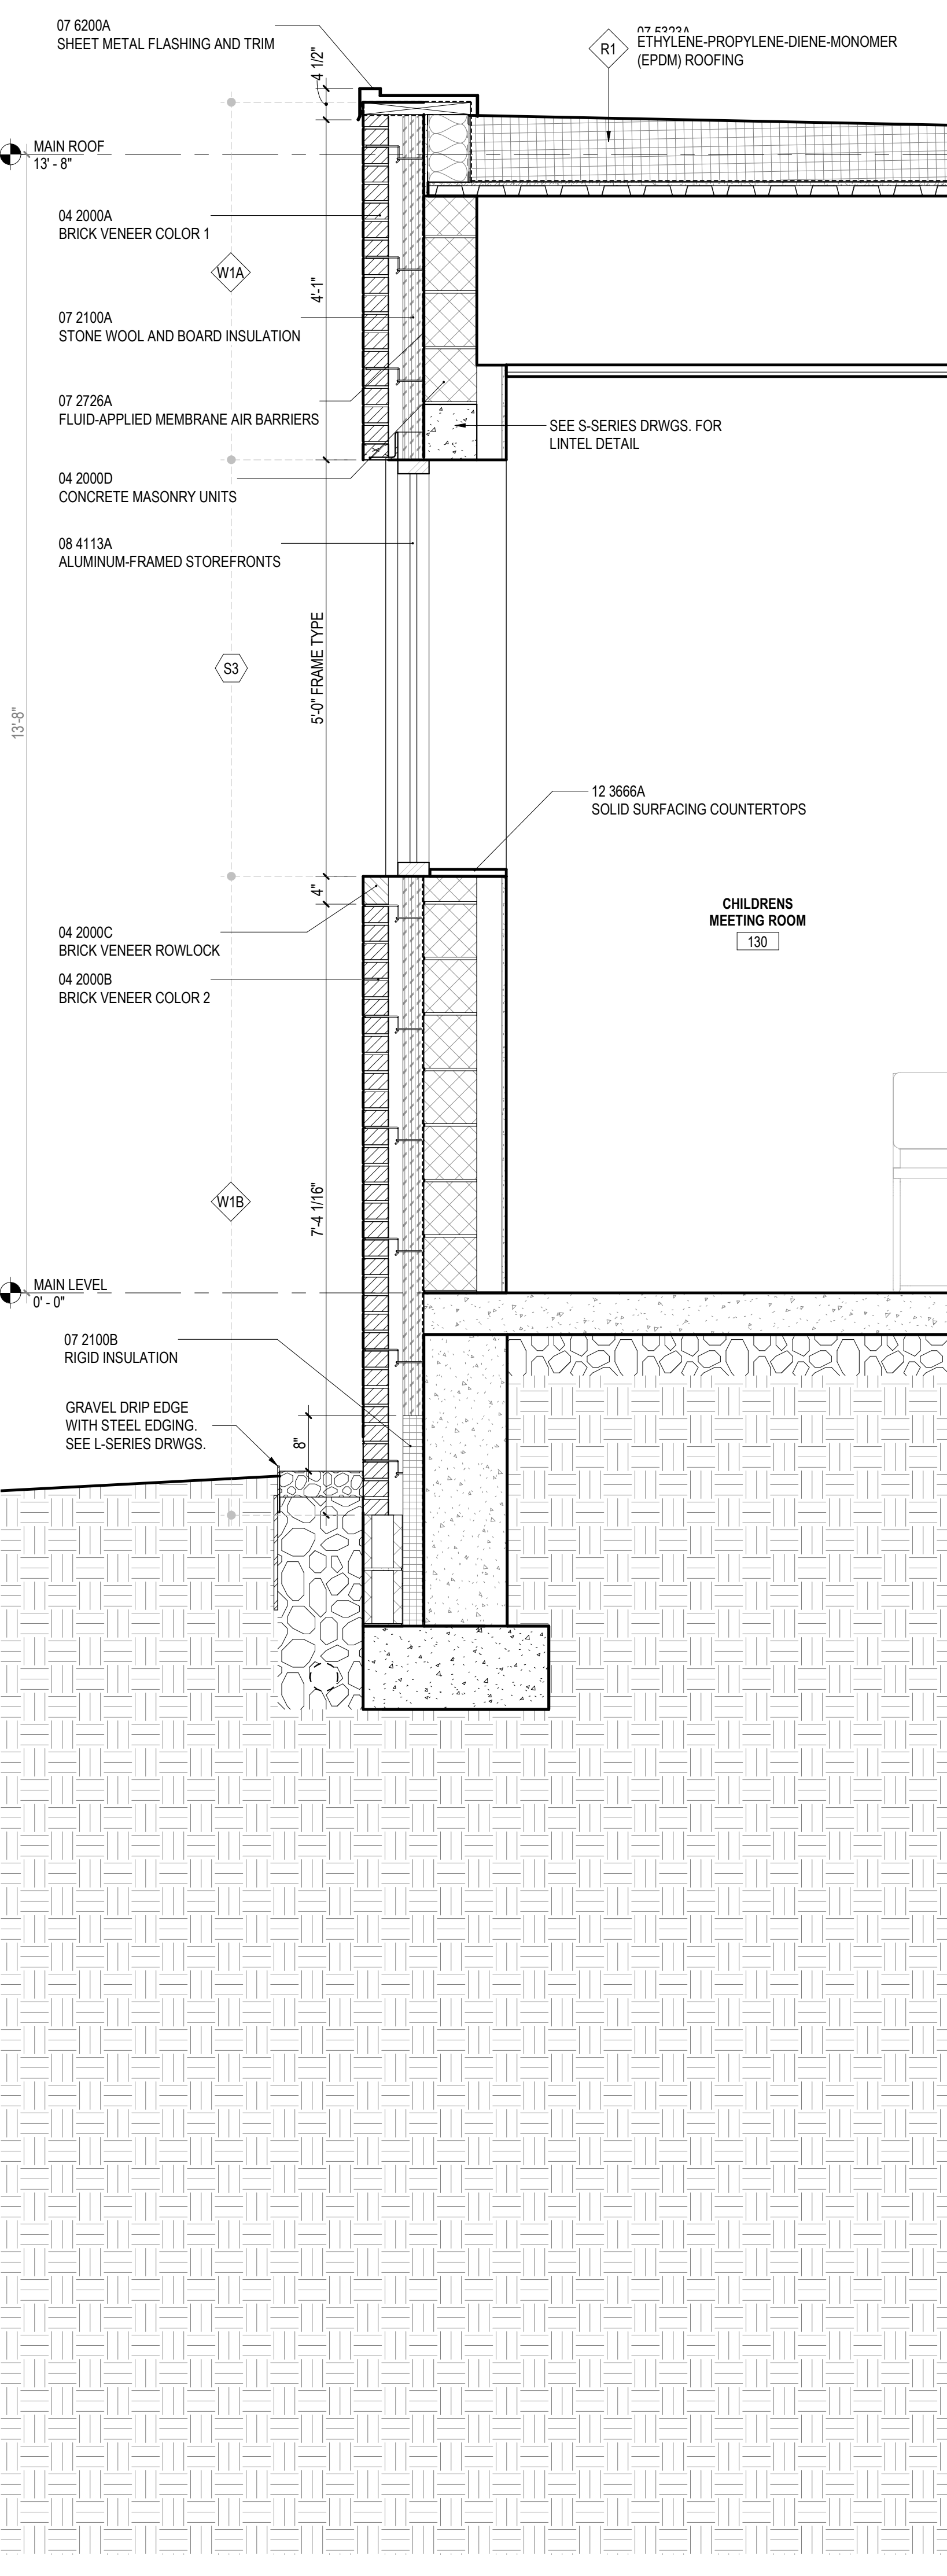

4 WALL SECTION AT ADDITION PUNCHED OPENING  
A111 | A401 3/4" = 1'-0"

## WALL SECTION GENERAL NOTES

- SEE STRUCTURAL DRAWINGS FOR LOCATION, SIZE, REINFORCING AND DETAILS OF FOOTINGS, FOUNDATIONS AND STRUCTURAL FRAMING.
- MASONRY UNITS ARE SIZED NOMINALLY. CONCRETE MASONRY ON ARCHITECTURAL PLANS AND SECTIONS IS SHOWN DIAGRAMMATICALLY. SEE STRUCTURAL DRAWINGS FOR CMU BOND BEAMS, REINFORCING, AND GROUTING REQUIREMENTS.
- WHERE WATERPROOFING SYSTEMS ARE NOT CALLED FOR, PROVIDE DAMPPROOFING SYSTEM AT ALL MASONRY AND CONCRETE WALLS IN CONTACT WITH EARTH OR OTHER FILL.
- PROVIDE CONTINUOUS AIR BARRIER SYSTEM FROM FOUNDATION TO ROOF.
- REFER TO FIRE PROTECTION PLANS FOR FULL EXTENT OF RATED CONSTRUCTION.
- AT SUSPENDED CEILING SYSTEMS, HANGER WIRE IS TYPICALLY OMITTED FOR CLARITY.
- PROVIDE HIGH PERFORMANCE COATINGS AT ALL EXTERIOR FERROUS METALS (STRUCTURAL AND DECORATIVE).
- COLD FORMED METAL FRAMING KICKERS MAY NOT BE SHOWN IN ALL WALL SECTIONS. PROVIDE KICKERS AND BRACING AS REQ'D.
- WHERE METAL FRAMING REQUIRES SUPPORT AT COLUMNS & BEAMS, PROVIDE METAL STAND-OFFS PRIOR TO APPLYING FIREPROOFING.
- ALL STEEL FRAMING REQUIRED TO BE RATED IS TO RECEIVE SPRAY APPLIED FIRE PROOFING, U.N.O. SEE FIRE PROTECTION PLANS FOR FULL EXTENT OF RATED CONSTRUCTION.
- PROVIDE 12" HIGH CAVITY DRAINAGE MATERIAL AT ALL CAVITY WALL THROUGH WALL FLASHING, FULL DEPTH OF CAVITY.
- PROVIDE COLD FORMED METAL FRAMING AND 1/2" SHEATHING WHERE CMU BACKUP IS INTERRUPTED BY STEEL BEAMS, COLUMNS, AND BRACING, U.N.O.
- SEE INTERIOR ELEVATIONS & FINISH SCHEDULE FOR INTERIOR FINISHES.

## KEYNOTES

- |          |   |
|----------|---|
| 03 3000A | CAST-IN-PLACE CONCRETE                          |
| 04 2000A | BRICK VENEER COLOR 1                            |
| 04 2000B | BRICK VENEER COLOR 2                            |
| 04 2000C | BRICK VENEER ROWLOCK                            |
| 04 2000D | CONCRETE MASONRY UNITS                          |
| 07 2100A | STONE WOOL AND BOARD INSULATION                 |
| 07 2100B | RIGID INSULATION                                |
| 07 2726A | FLUID-APPLIED MEMBRANE AIR BARRIERS             |
| 07 4213A | FORMED METAL WALL PANELS                        |
| 07 4217A | METAL COMPOSITE MATERIAL WALL PANELS            |
| 07 5323A | ETHYLENE-PROPYLENE-DIENE-MONOMER (EPDM) ROOFING |
| 07 6200A | SHEET METAL FLASHING AND TRIM                   |
| 08 4113A | ALUMINUM-FRAMED STOREFRONTS                     |
| 12 3666A | SOLID SURFACING COUNTERTOPS                     |

VMDO

VMDO Architects  
vmdo.com  
434.296.5684  
200 E Market Street  
Charlottesville, VA 22902  
1200 18th Street NW Ste 700  
Washington, DC 20036




New City Library

## New City Library Addition & Renovation

220 North Main Street  
New City, NY 10956

VMDO Project Number 1301

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Drawn By  
Checker  
HJO

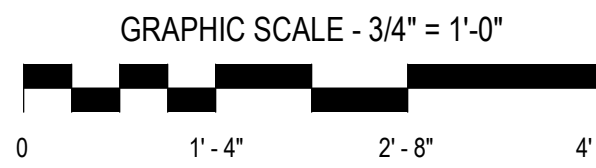

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CONSTRUCTION





ISSUES AND REVISIONS		
NO.	SUBMITTAL	DATE
1	SCHEMATIC DESIGN	03.05.2021

## WALL SECTIONS

A401

DESIGN DEVELOPMENT  
07.09.2021



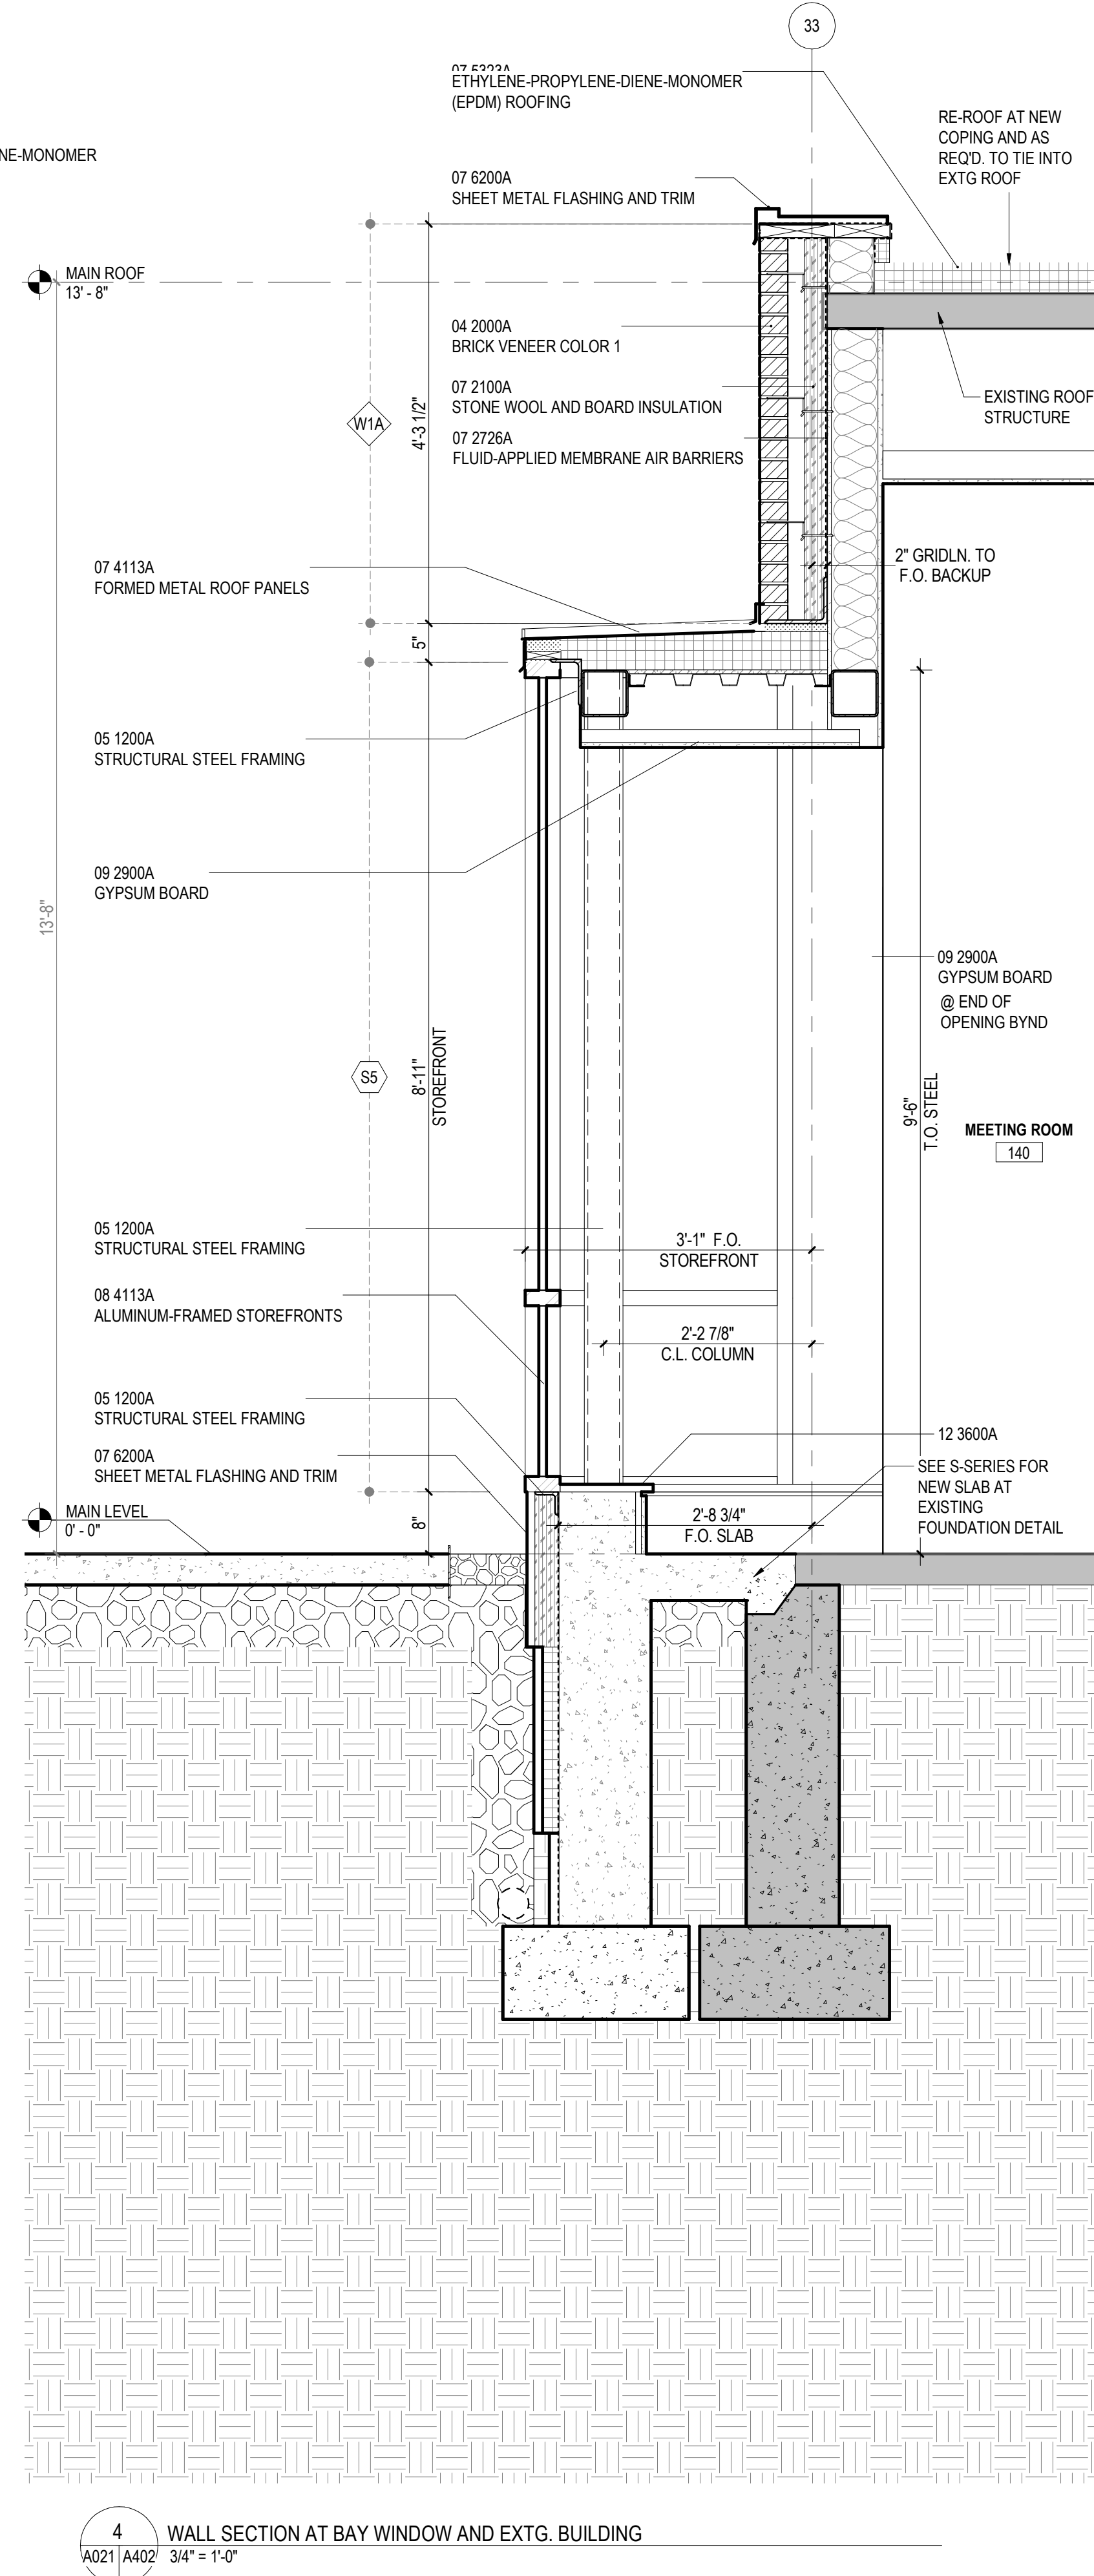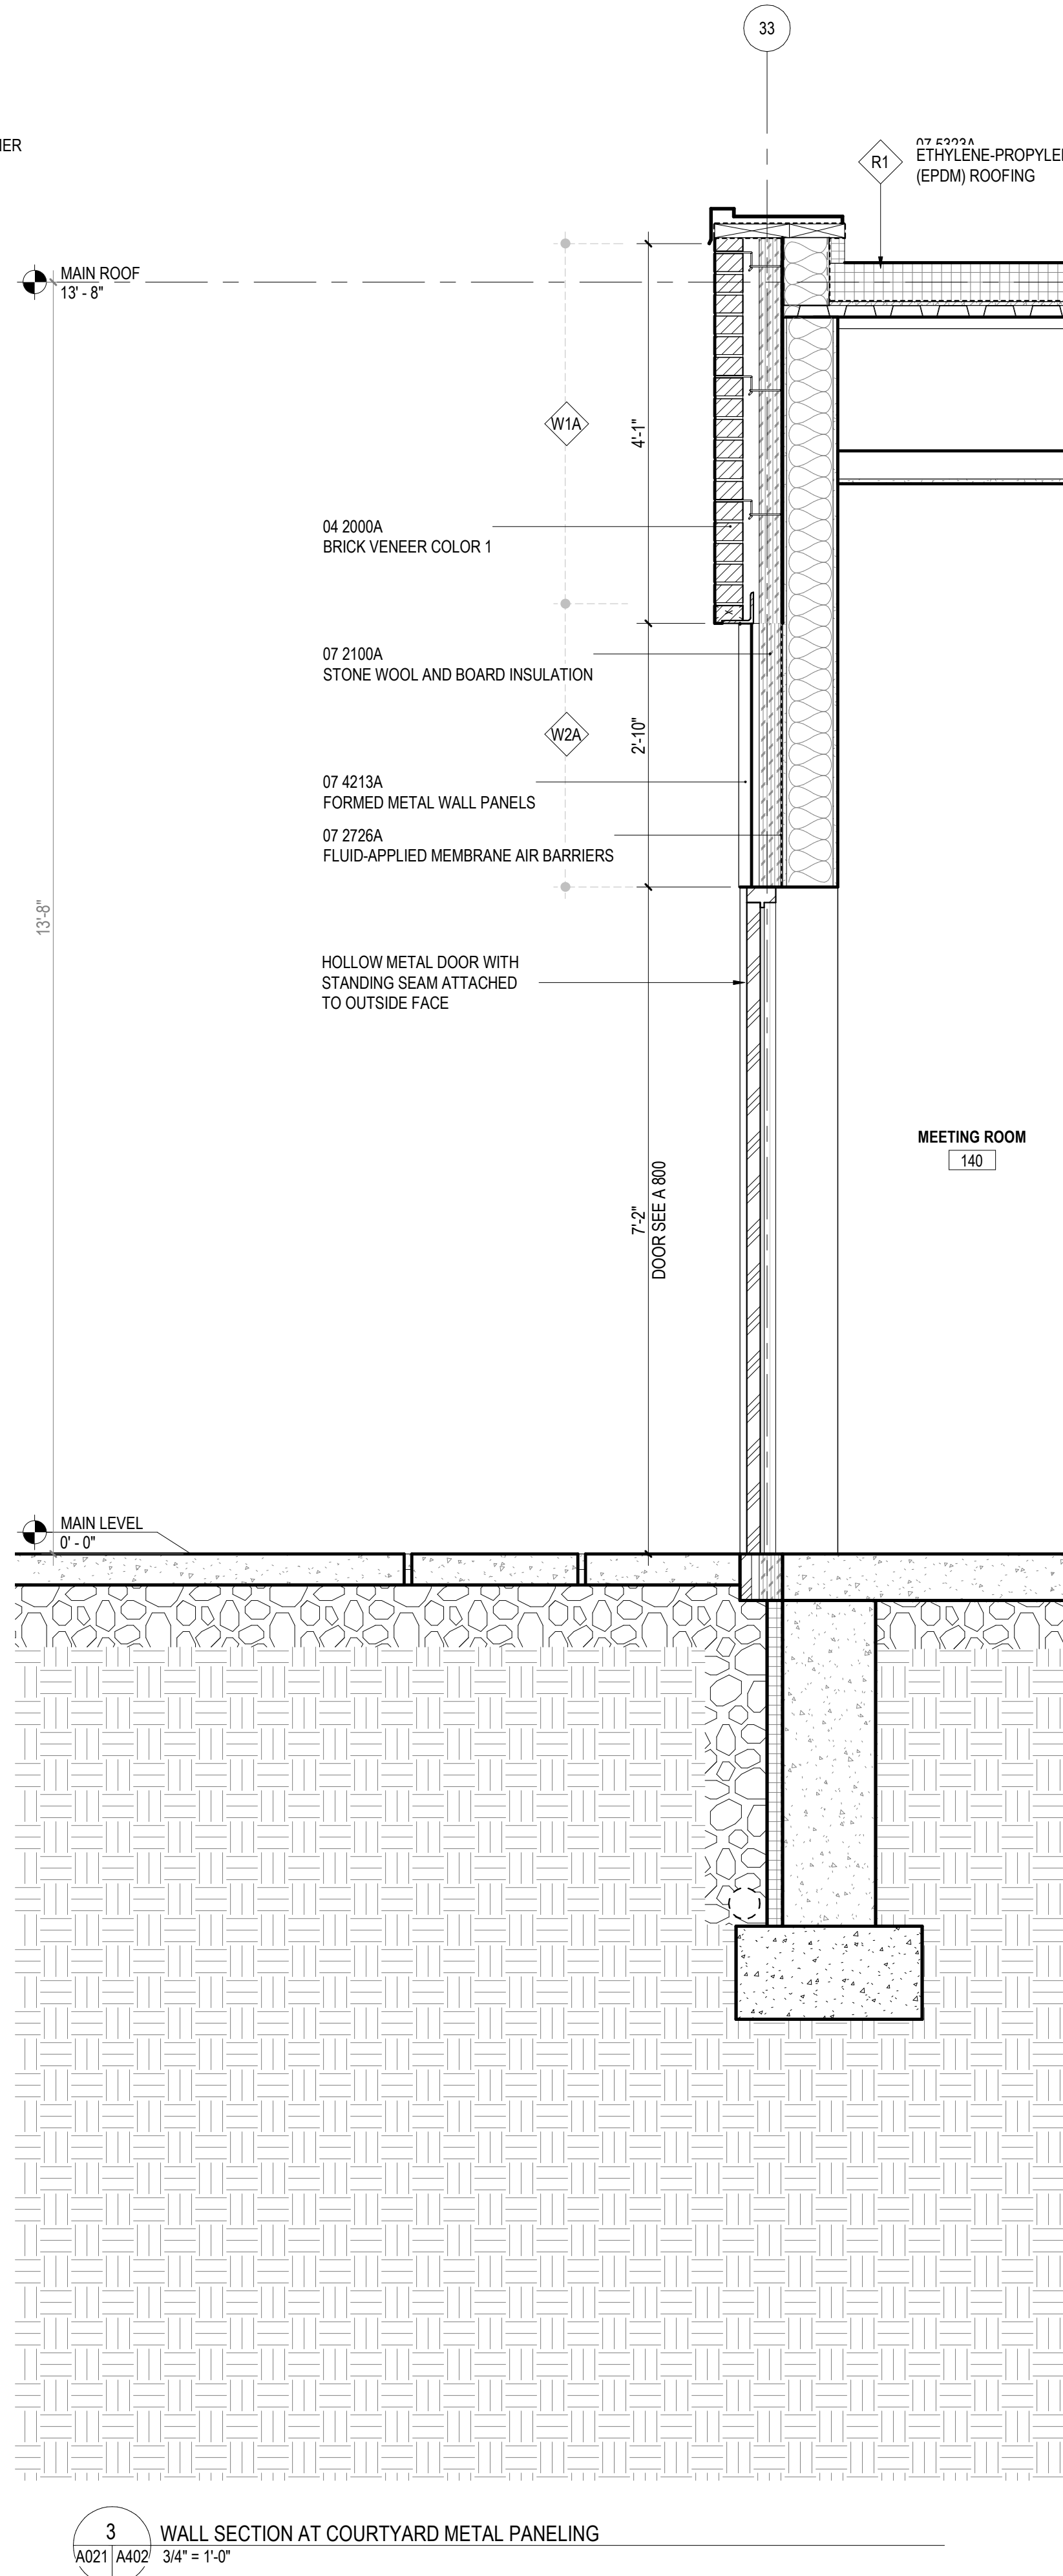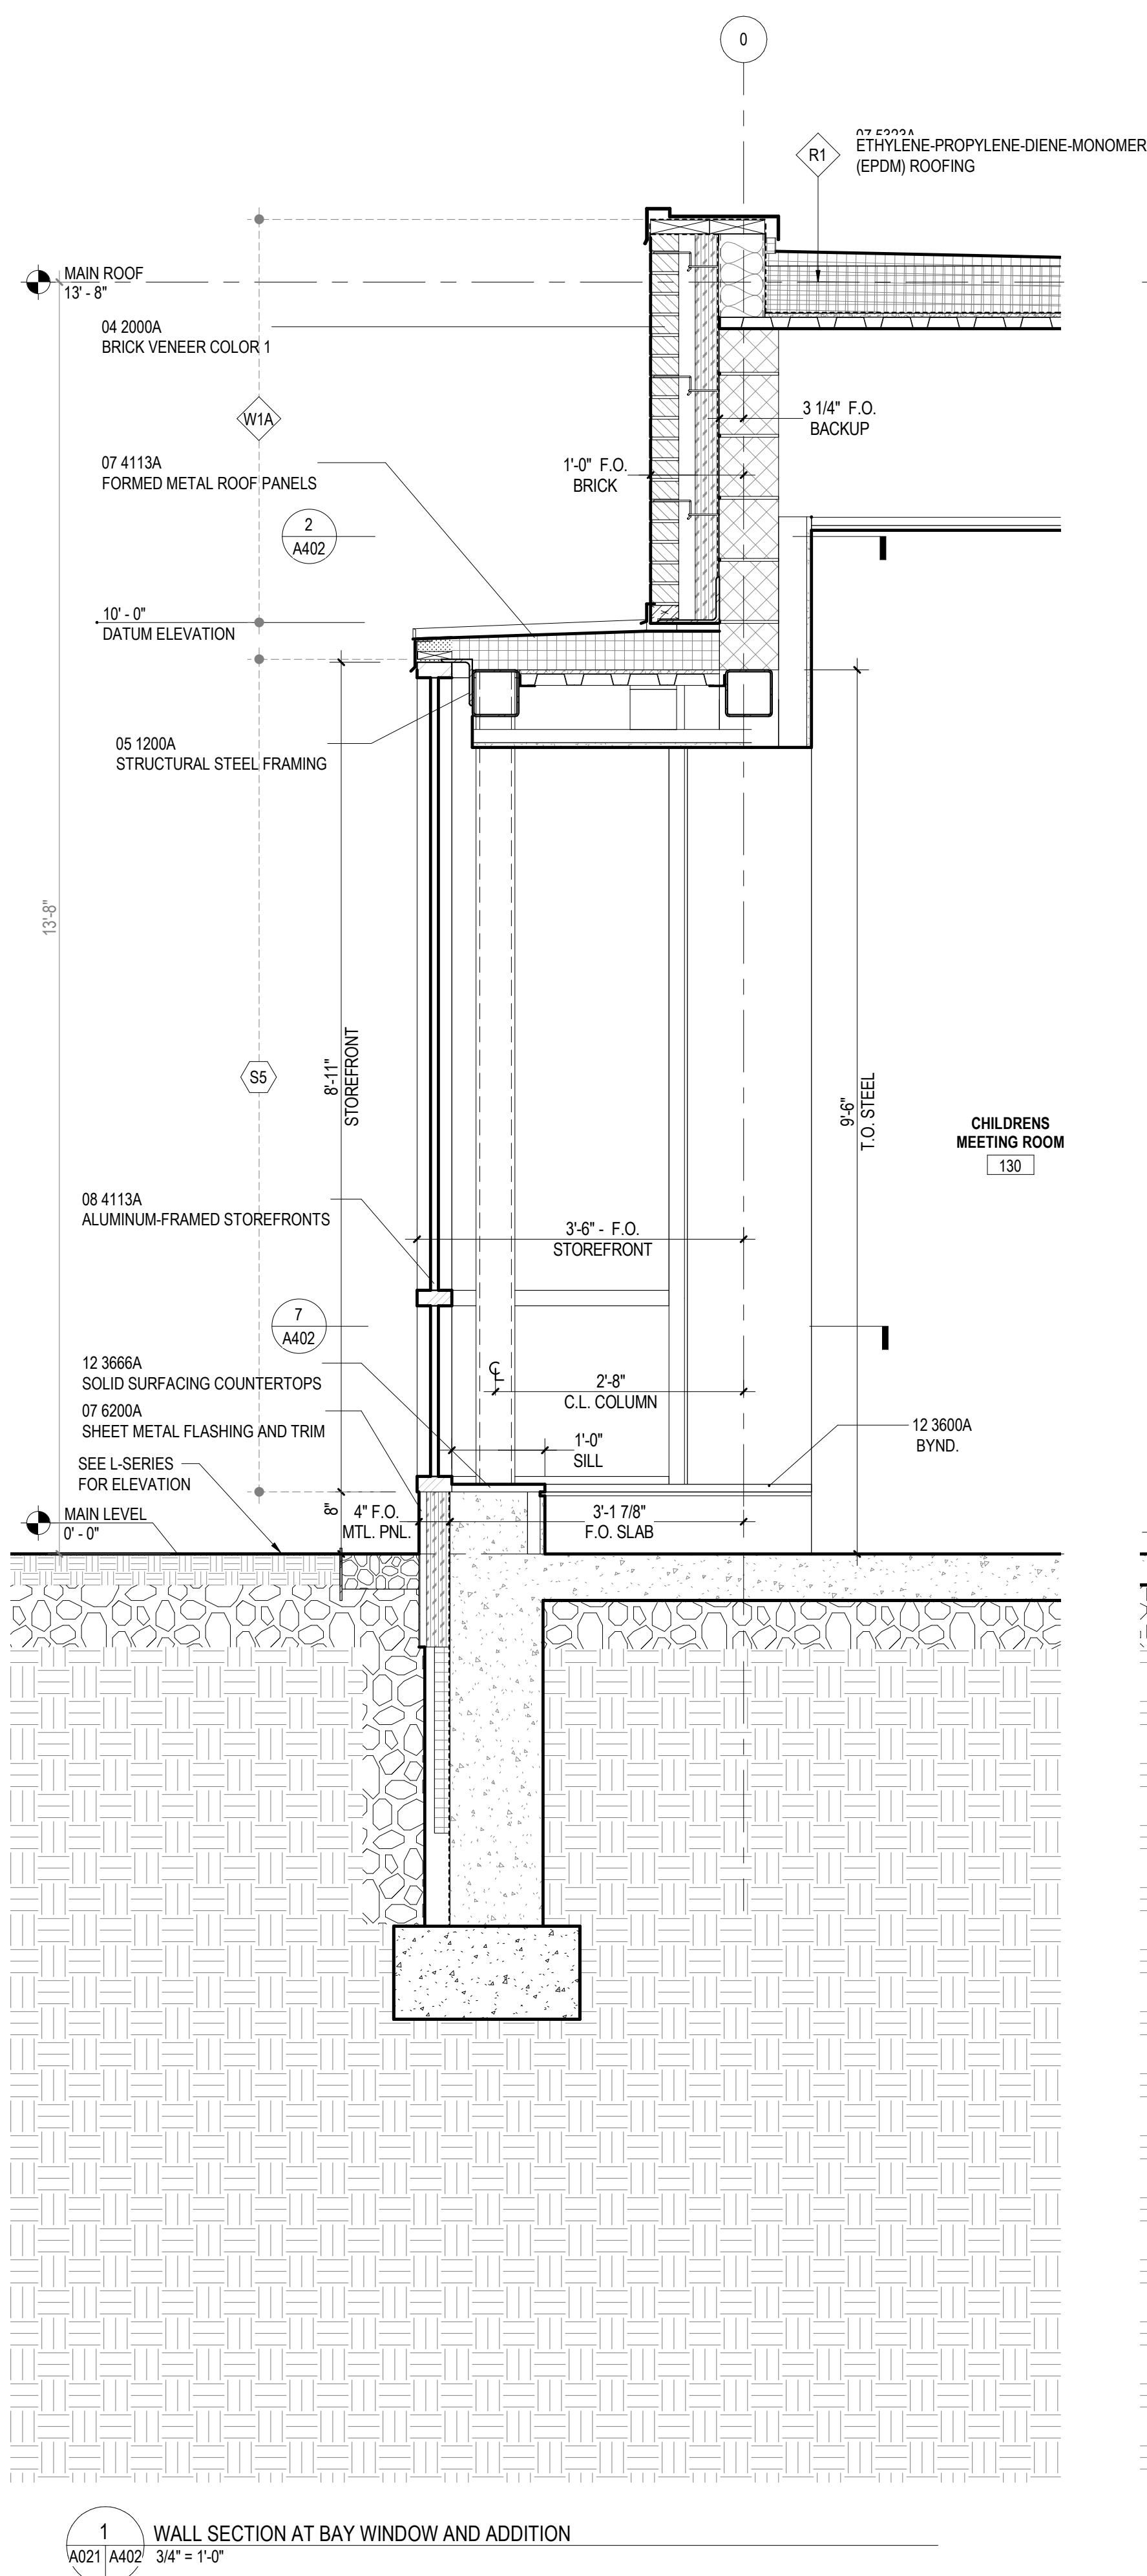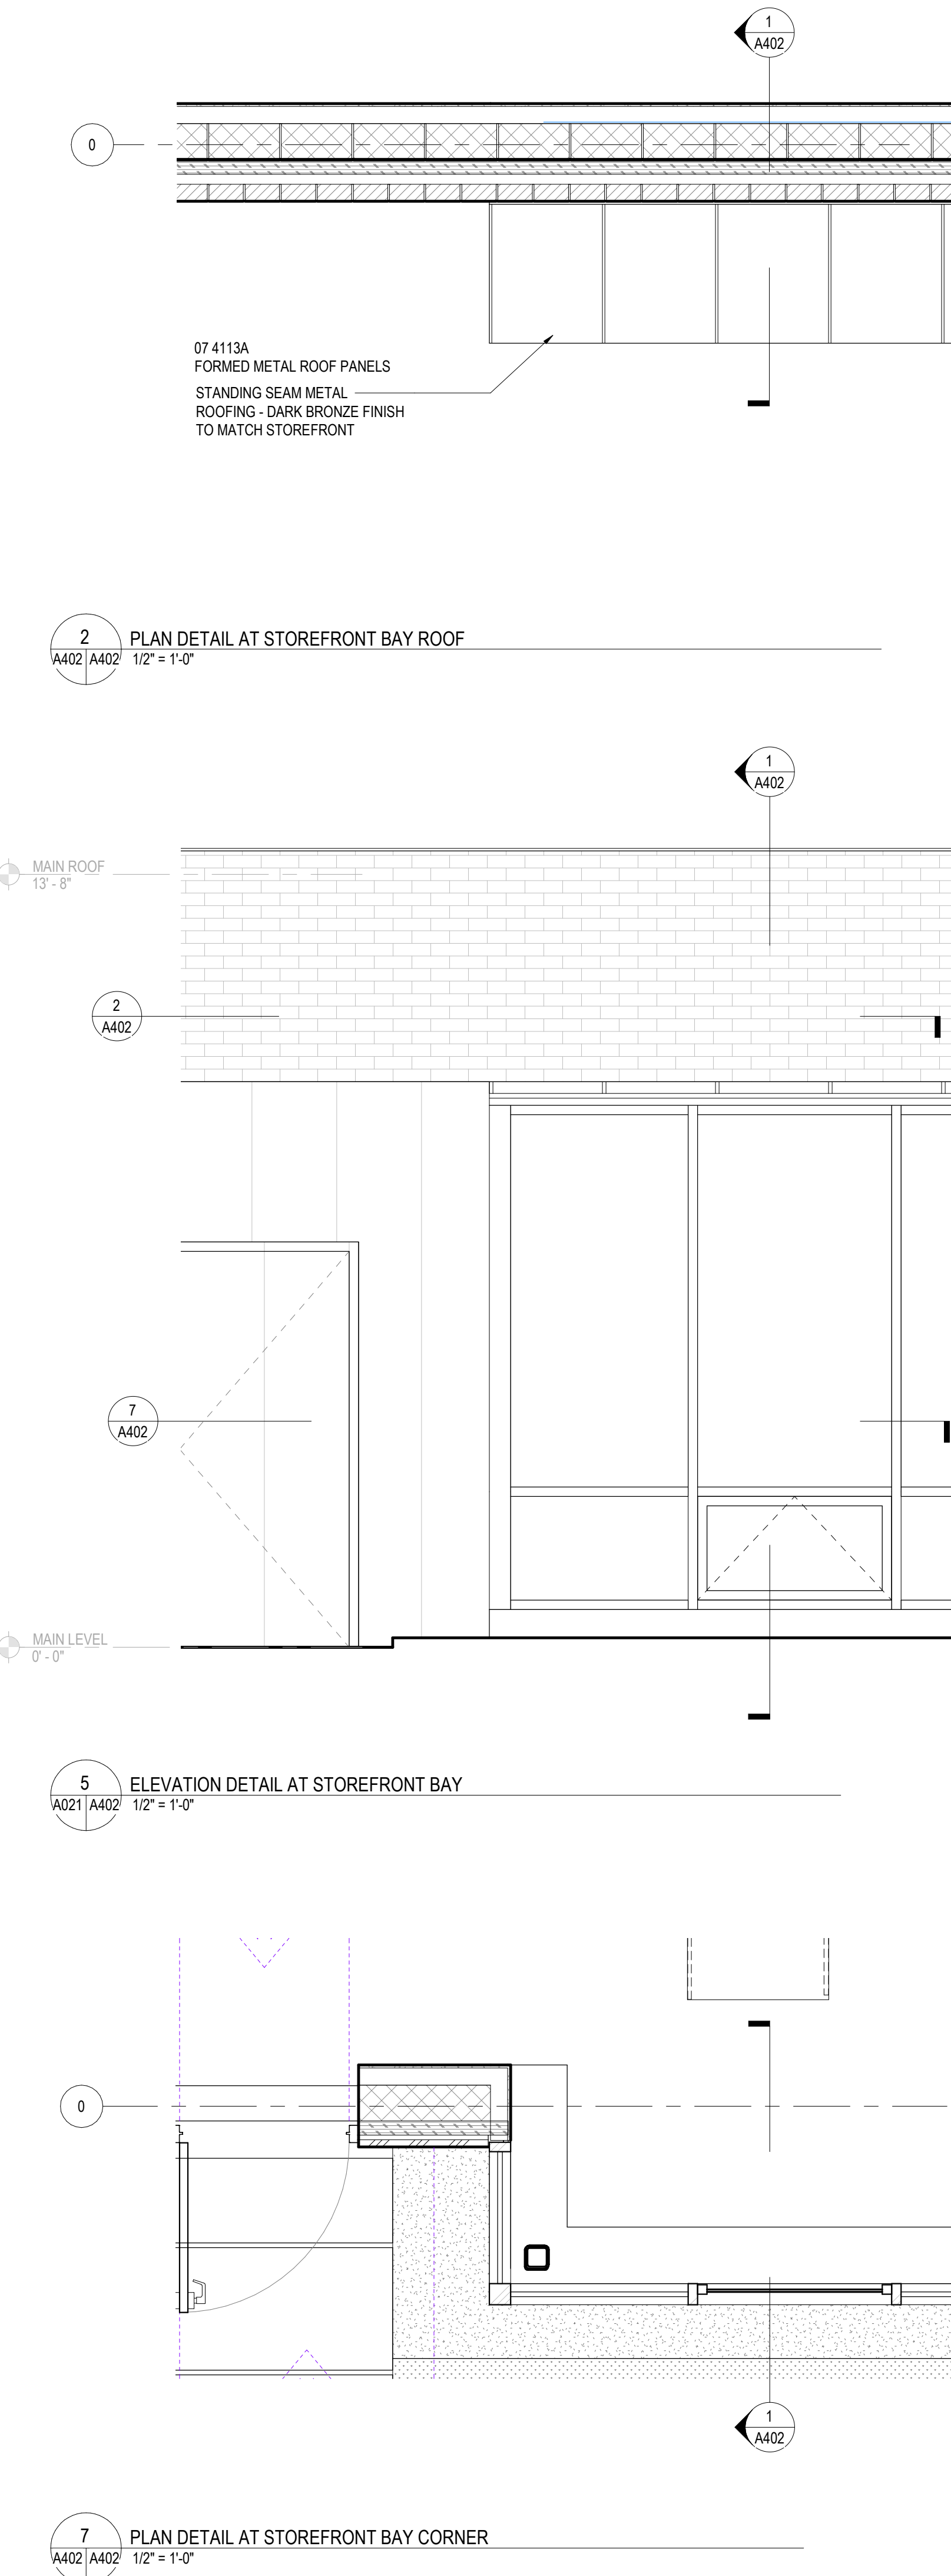

## WALL SECTION GENERAL NOTES

- SEE STRUCTURAL DRAWINGS FOR LOCATION, SIZE, REINFORCING AND DETAILS OF FOOTINGS, FOUNDATIONS AND STRUCTURAL FRAMING.
- MASONRY UNITS ARE SIZED NOMINALLY. CONCRETE MASONRY ON ARCHITECTURAL PLANS AND SECTIONS IS SHOWN DIAGRAMMATICALLY. SEE STRUCTURAL DRAWINGS FOR CMU BOND BEAMS, REINFORCING, AND GROUTING REQUIREMENTS.
- WHERE WATERPROOFING SYSTEMS ARE NOT CALLED FOR, PROVIDE DAMPROOFING SYSTEM AT ALL MASONRY AND CONCRETE WALLS IN CONTACT WITH EARTH OR OTHER FILL.
- PROVIDE CONTINUOUS AIR BARRIER SYSTEM FROM FOUNDATION TO ROOF.
- REFER TO FIRE PROTECTION PLANS FOR FULL EXTENT OF RATED CONSTRUCTION.
- AT SUSPENDED CEILING SYSTEMS, HANGER WIRE IS TYPICALLY OMITTED FOR CLARITY.
- PROVIDE HIGH PERFORMANCE COATINGS AT ALL EXTERIOR FERROUS METALS (STRUCTURAL AND DECORATIVE).
- COLD FORMED METAL FRAMING KICKERS MAY NOT BE SHOWN IN ALL WALL SECTIONS. PROVIDE KICKERS AND BRACING AS REQD.
- WHERE METAL FRAMING REQUIRES SUPPORT AT COLUMNS & BEAMS, PROVIDE METAL STAND-OFFS PRIOR TO APPLYING FIREPROOFING.
- ALL STEEL FRAMING REQUIRED TO BE RATED IS TO RECEIVE SPRAY APPLIED FIRE PROOFING, U.N.O. SEE FIRE PROTECTION PLANS FOR FULL EXTENT OF RATED CONSTRUCTION.
- PROVIDE 12" HIGH CAVITY DRAINAGE MATERIAL AT ALL CAVITY WALL THROUGH WALL FLASHING, FULL DEPTH OF CAVITY.
- PROVIDE COLD FORMED METAL FRAMING AND 1/2" SHEATHING WHERE CMU BACKUP IS INTERRUPTED BY STEEL BEAMS, COLUMNS, AND BRACING, U.N.O.
- SEE INTERIOR ELEVATIONS & FINISH SCHEDULE FOR INTERIOR FINISHES.

## KEYNOTES

- |          |   |
|----------|---|
| 04 2000A | BRICK VENEER COLOR 1                            |
| 05 1200A | STRUCTURAL STEEL FRAMING                        |
| 07 2100A | STONE WOOL AND BOARD INSULATION                 |
| 07 2726A | FLUID-APPLIED MEMBRANE AIR BARRIERS             |
| 07 4113A | FORMED METAL ROOF PANELS                        |
| 07 4213A | FORMED METAL WALL PANELS                        |
| 07 5323A | ETHYLENE-PROPYLENE-DIENE-MONOMER (EPDM) ROOFING |
| 07 6200A | SHEET METAL FLASHING AND TRIM                   |
| 08 4113A | ALUMINUM-FRAMED STOREFRONTS                     |
| 09 2900A | GYPSUM BOARD                                    |
| 12 3666A | SOLID SURFACING COUNTERTOPS                     |


## WALL SECTIONS

# A402


## DESIGN DEVELOPMENT

07.09.2021




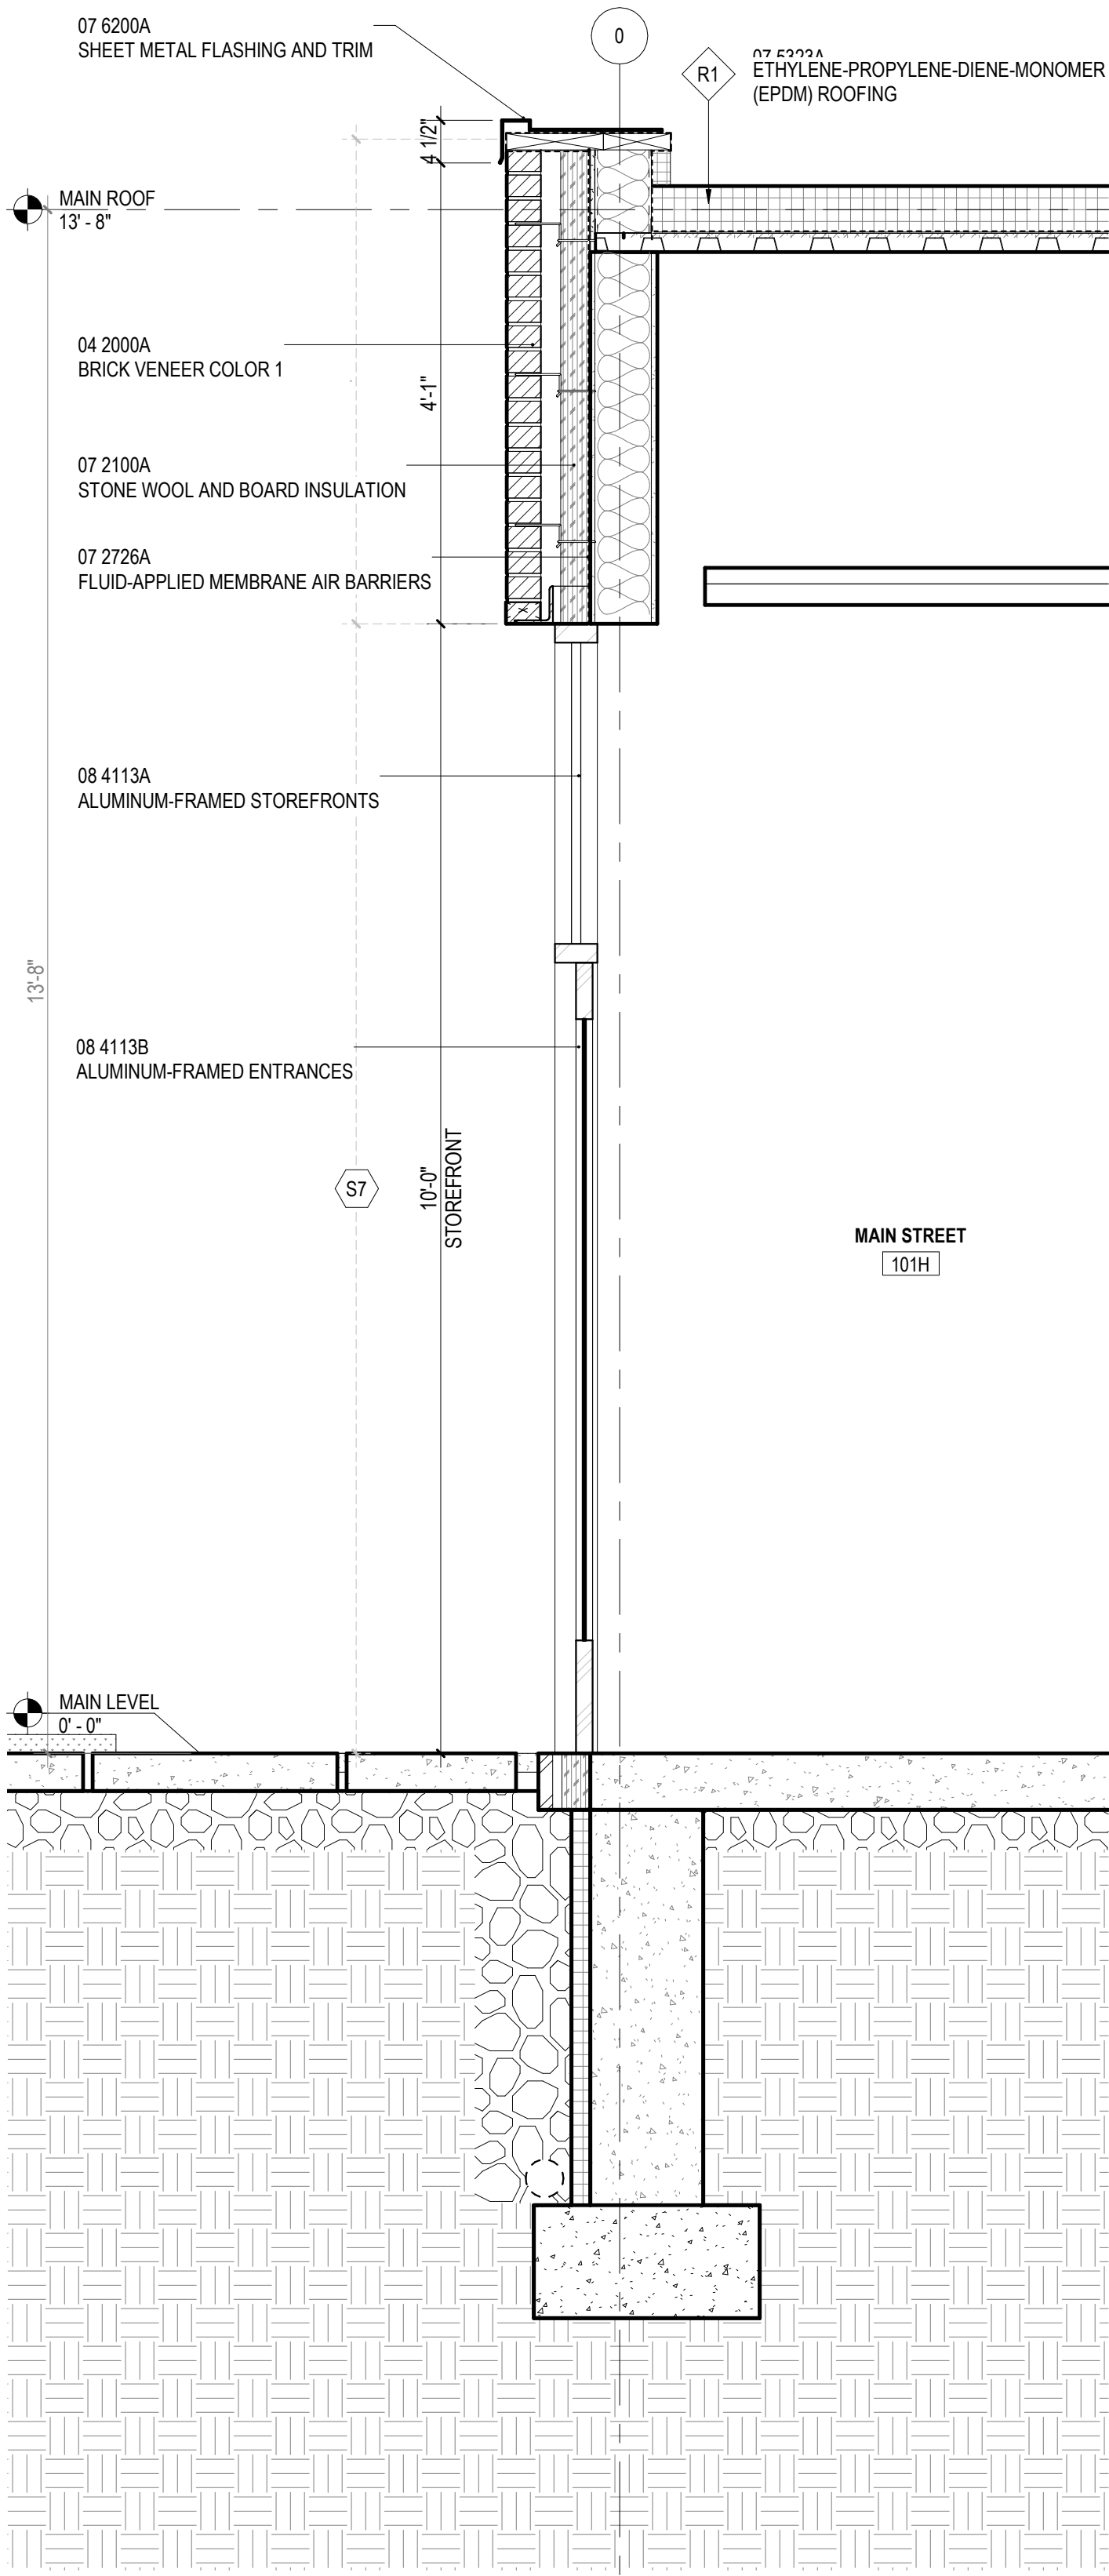


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A4021/A403 3/4" = 1'-0"

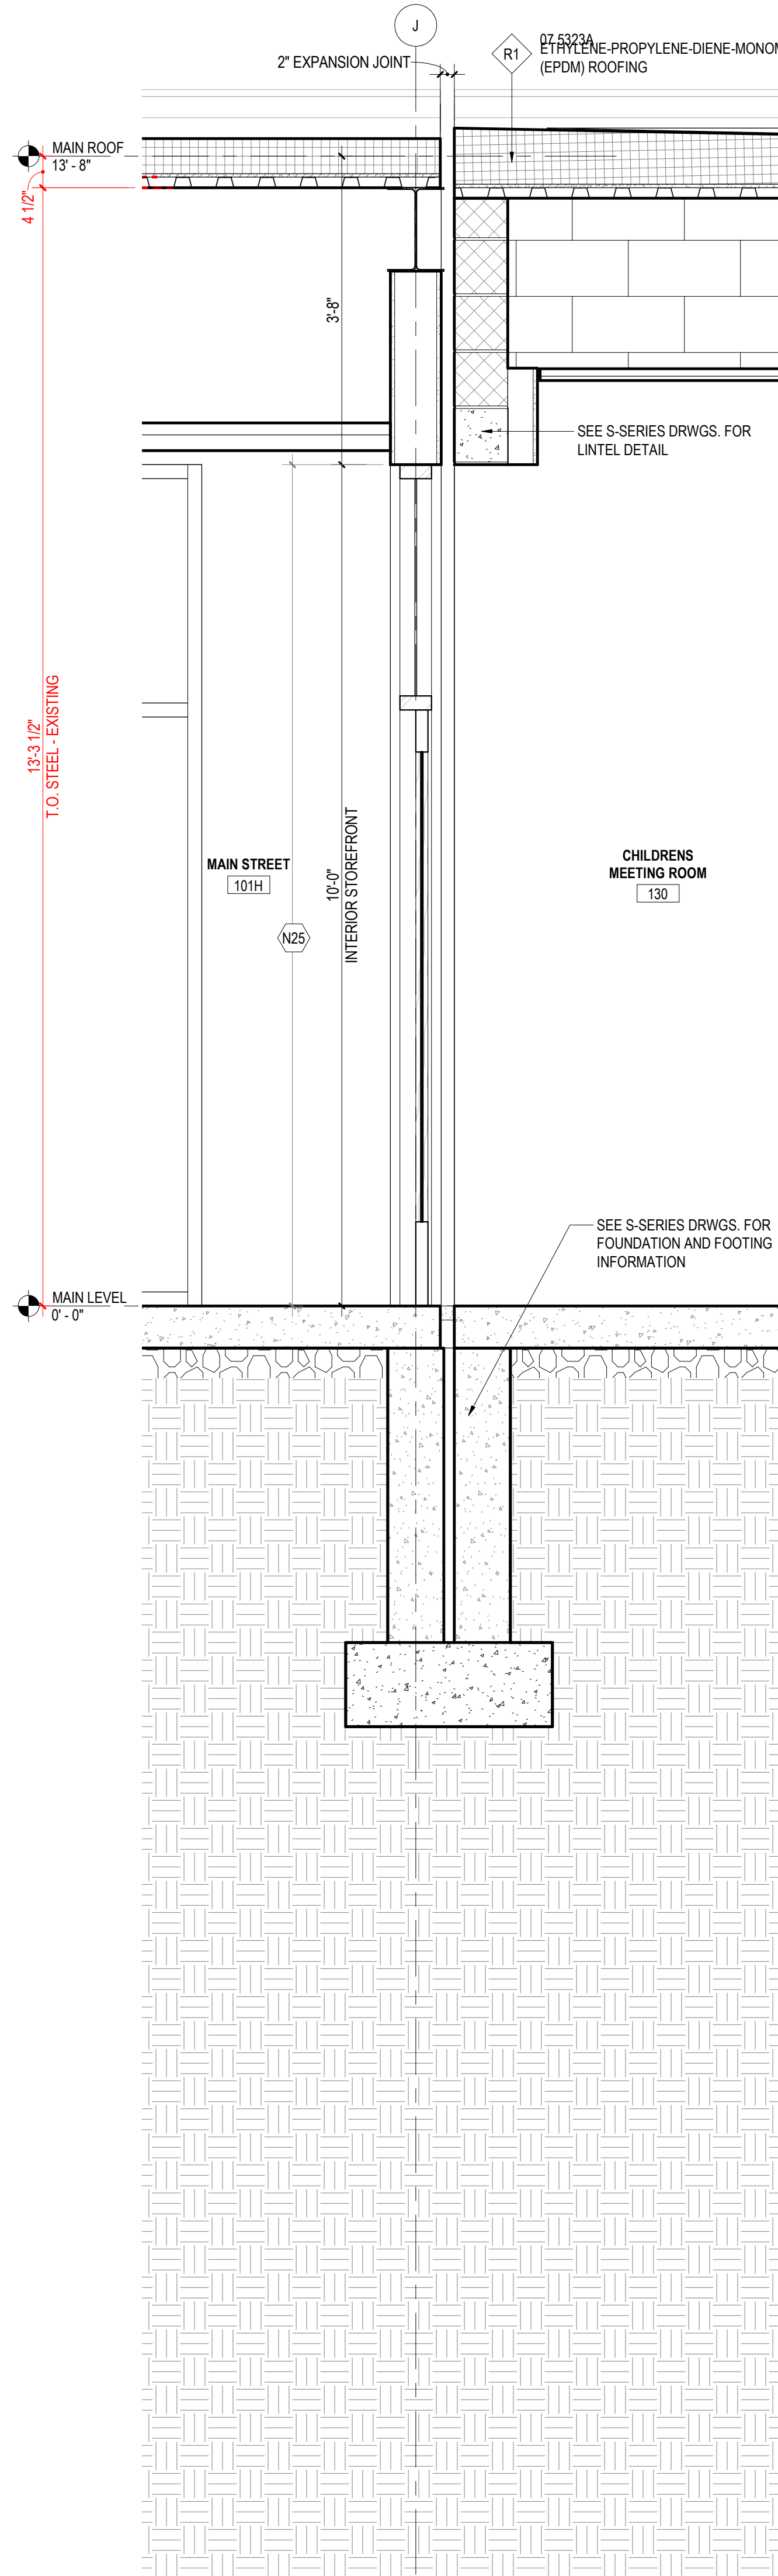


2 WALL SECTION AT EJ B/N NEW INFILL AND ADDITION  
A4111/A403 3/4" = 1'-0"

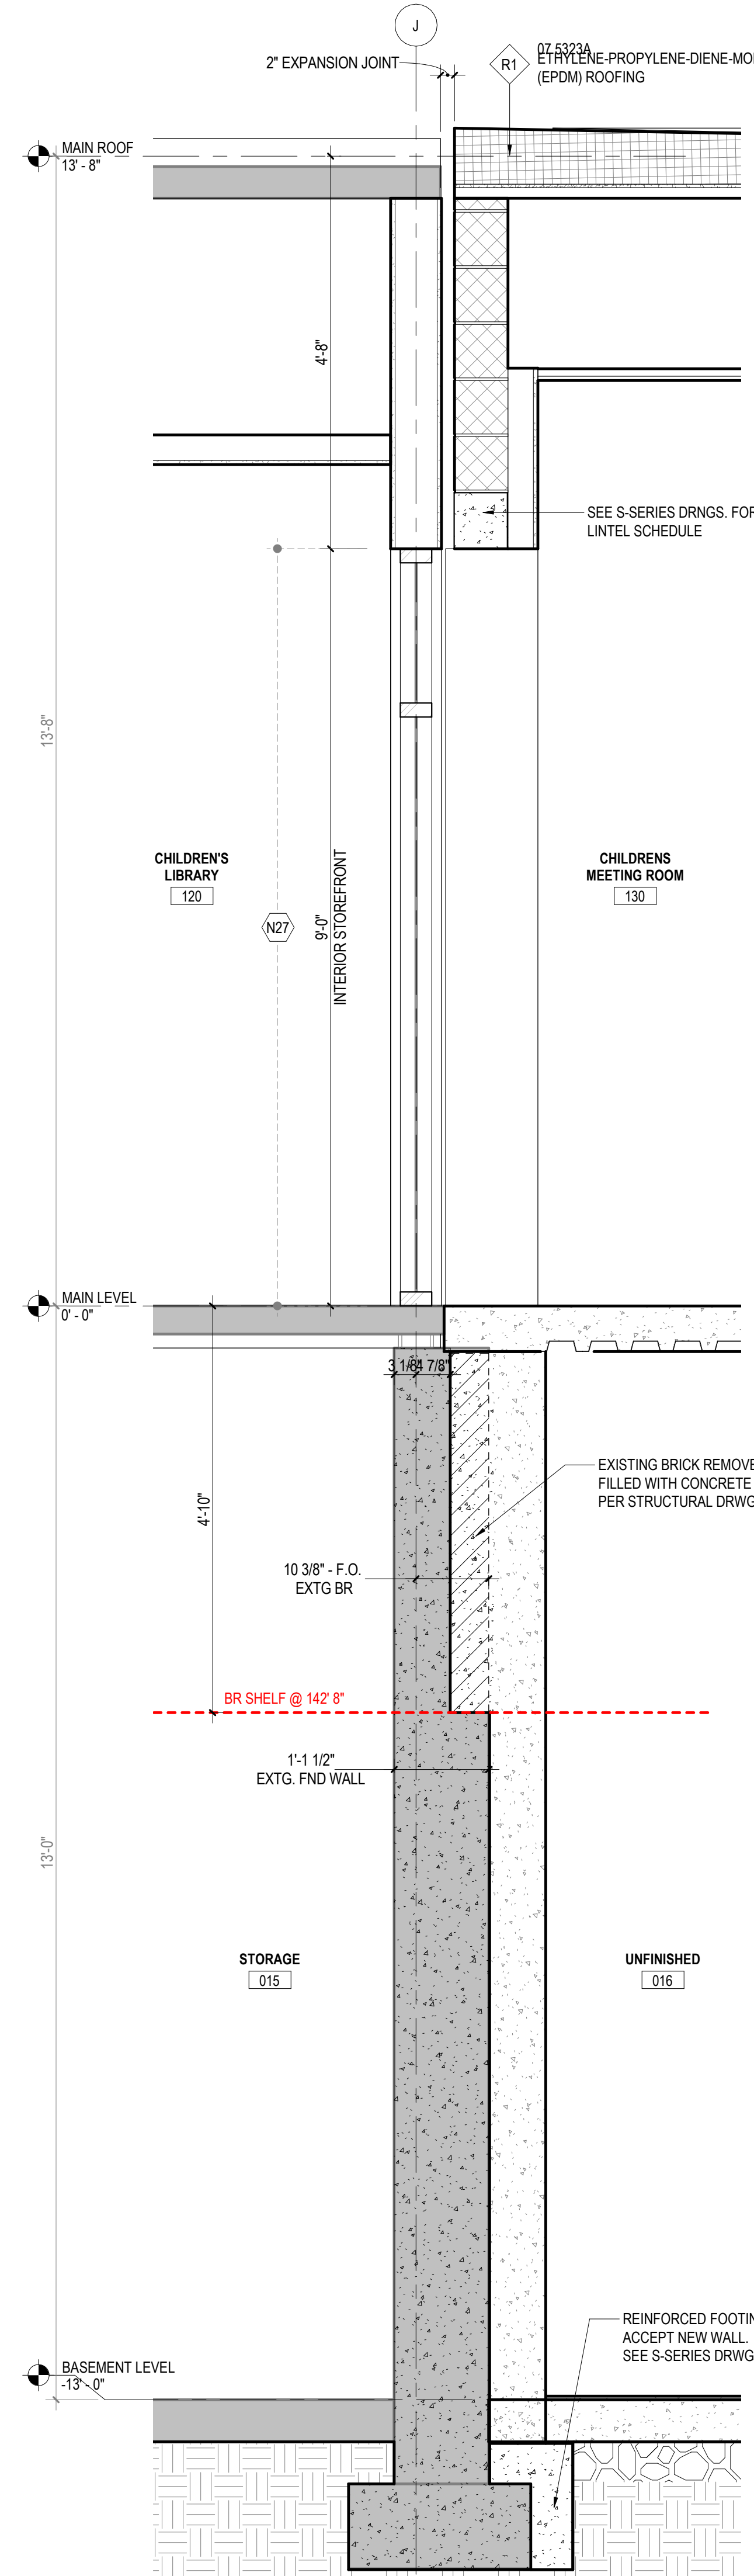

3 WALL SECTION AT EJ B/N EXTG AND ADDITION  
A4101/A403 3/4" = 1'-0"

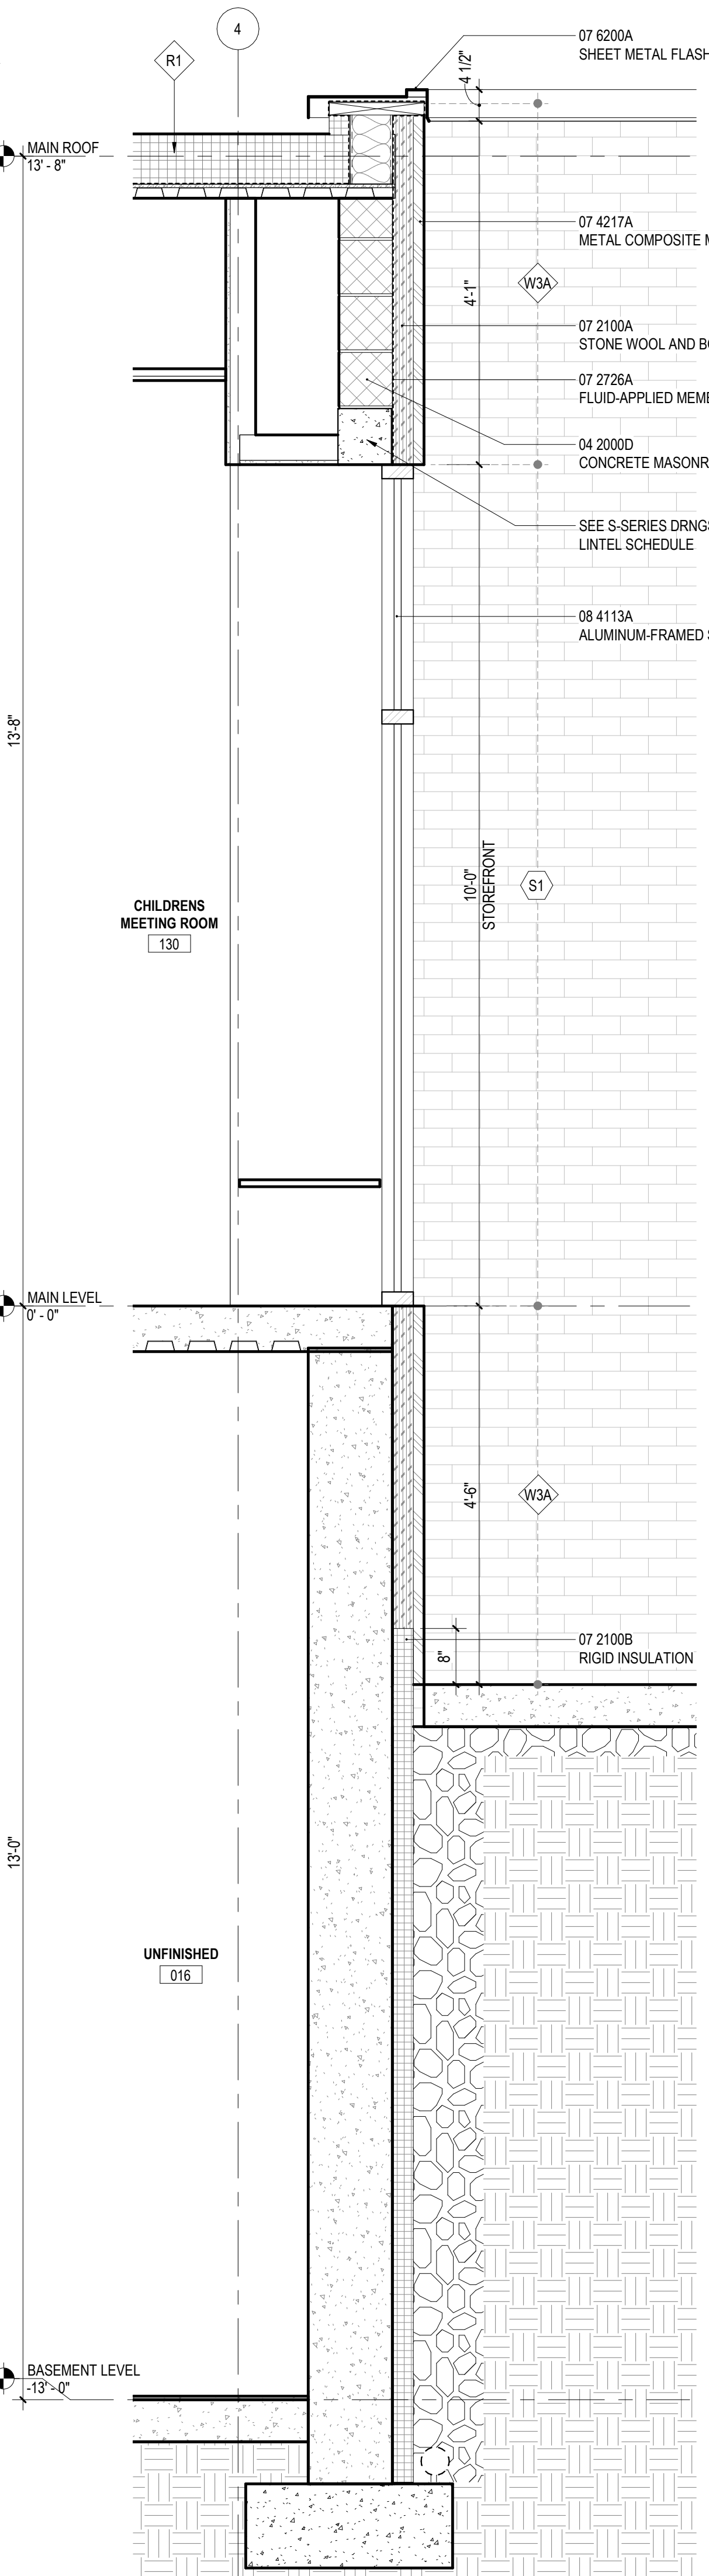

4 WALL SECTION AND ELEVATION AT WEST ADDITION SLOT  
A4101/A403 3/4" = 1'-0"

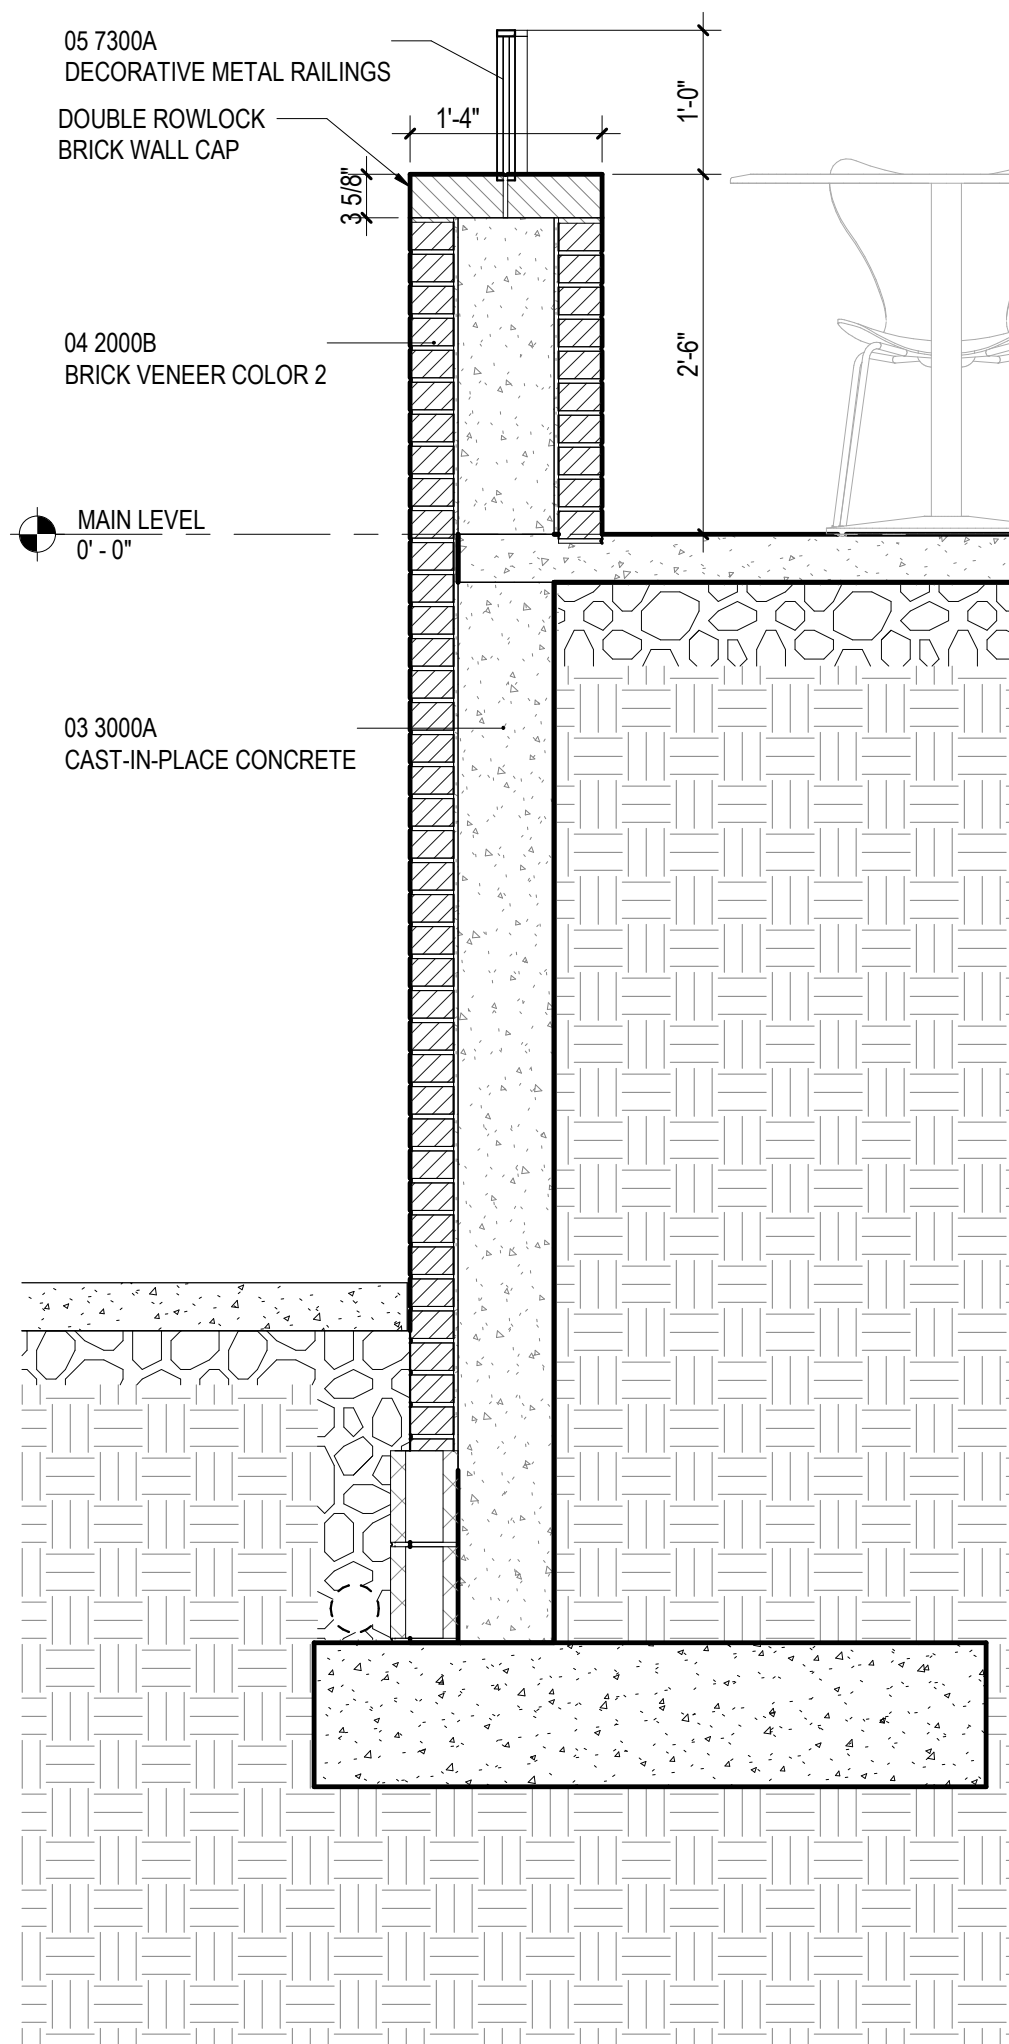

5 WALL SECTION AT ENTRY TERRACE  
A4111/A403 3/4" = 1'-0"

## WALL SECTION GENERAL NOTES

- SEE STRUCTURAL DRAWINGS FOR LOCATION, SIZE, REINFORCING AND DETAILS OF FOOTINGS, FOUNDATIONS AND STRUCTURAL FRAMING.
- MASONRY UNITS ARE SIZED NOMINALLY. CONCRETE MASONRY ON ARCHITECTURAL PLANS AND SECTIONS IS SHOWN DIAGRAMMATICALLY. SEE STRUCTURAL DRAWINGS FOR CMU BOND BEAMS, REINFORCING, AND GROUTING REQUIREMENTS.
- WHERE WATERPROOFING SYSTEMS ARE NOT CALLED FOR, PROVIDE DAMPROOFING SYSTEM AT ALL MASONRY AND CONCRETE WALLS IN CONTACT WITH EARTH OR OTHER FILL.
- PROVIDE CONTINUOUS AIR BARRIER SYSTEM FROM FOUNDATION TO ROOF.
- REFER TO FIRE PROTECTION PLANS FOR FULL EXTENT OF RATED CONSTRUCTION.
- AT SUSPENDED CEILING SYSTEMS, HANGER WIRE IS TYPICALLY OMITTED FOR CLARITY.
- PROVIDE HIGH PERFORMANCE COATINGS AT ALL EXTERIOR FERROUS METALS (STRUCTURAL AND DECORATIVE).
- COLD FORMED METAL FRAMING KICKERS MAY NOT BE SHOWN IN ALL WALL SECTIONS. PROVIDE KICKERS AND BRACING AS REQ'D.
- WHERE METAL FRAMING REQUIRES SUPPORT AT COLUMNS & BEAMS, PROVIDE METAL STAND-OFFS PRIOR TO APPLYING FIREPROOFING.
- ALL STEEL FRAMING REQUIRED TO BE RATED IS TO RECEIVE SPRAY APPLIED FIRE PROOFING, U.N.O. SEE FIRE PROTECTION PLANS FOR FULL EXTENT OF RATED CONSTRUCTION.
- PROVIDE 12" HIGH CAVITY DRAINAGE MATERIAL AT ALL CAVITY WALL THROUGH WALL FLASHING, FULL DEPTH OF CAVITY.
- PROVIDE COLD FORMED METAL FRAMING AND 1/2" SHEATHING WHERE CMU BACKUP IS INTERRUPTED BY STEEL BEAMS, COLUMNS, AND BRACING, U.N.O.
- SEE INTERIOR ELEVATIONS & FINISH SCHEDULE FOR INTERIOR FINISHES.

## KEYNOTES

- |          |   |
|----------|---|
| 03 3000A | CAST-IN-PLACE CONCRETE                          |
| 04 2000A | BRICK VENEER COLOR 1                            |
| 04 2000B | BRICK VENEER COLOR 2                            |
| 04 2000D | CONCRETE MASONRY UNITS                          |
| 05 7300A | DECORATIVE METAL RAILINGS                       |
| 07 2100A | STONE WOOL AND BOARD INSULATION                 |
| 07 2100B | RIGID INSULATION                                |
| 07 2726A | FLUID-APPLIED MEMBRANE AIR BARRIERS             |
| 07 4217A | METAL COMPOSITE MATERIAL WALL PANELS            |
| 07 5323A | ETHYLENE-PROPYLENE-DIENE-MONOMER (EPDM) ROOFING |
| 07 6200A | SHEET METAL FLASHING AND TRIM                   |
| 08 4113A | ALUMINUM-FRAMED STOREFRONTS                     |
| 08 4113B | ALUMINUM-FRAMED ENTRANCES                       |


## New City Library Addition & Renovation

220 North Main Street  
New City, NY 10956

VMDO Project Number 1301

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Drawn By

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HJO

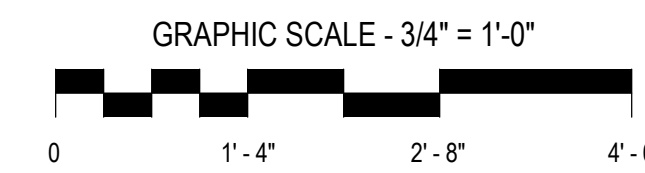


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ISSUES AND REVISIONS  
NO. SUBMITTAL DATE

## WALL SECTIONS




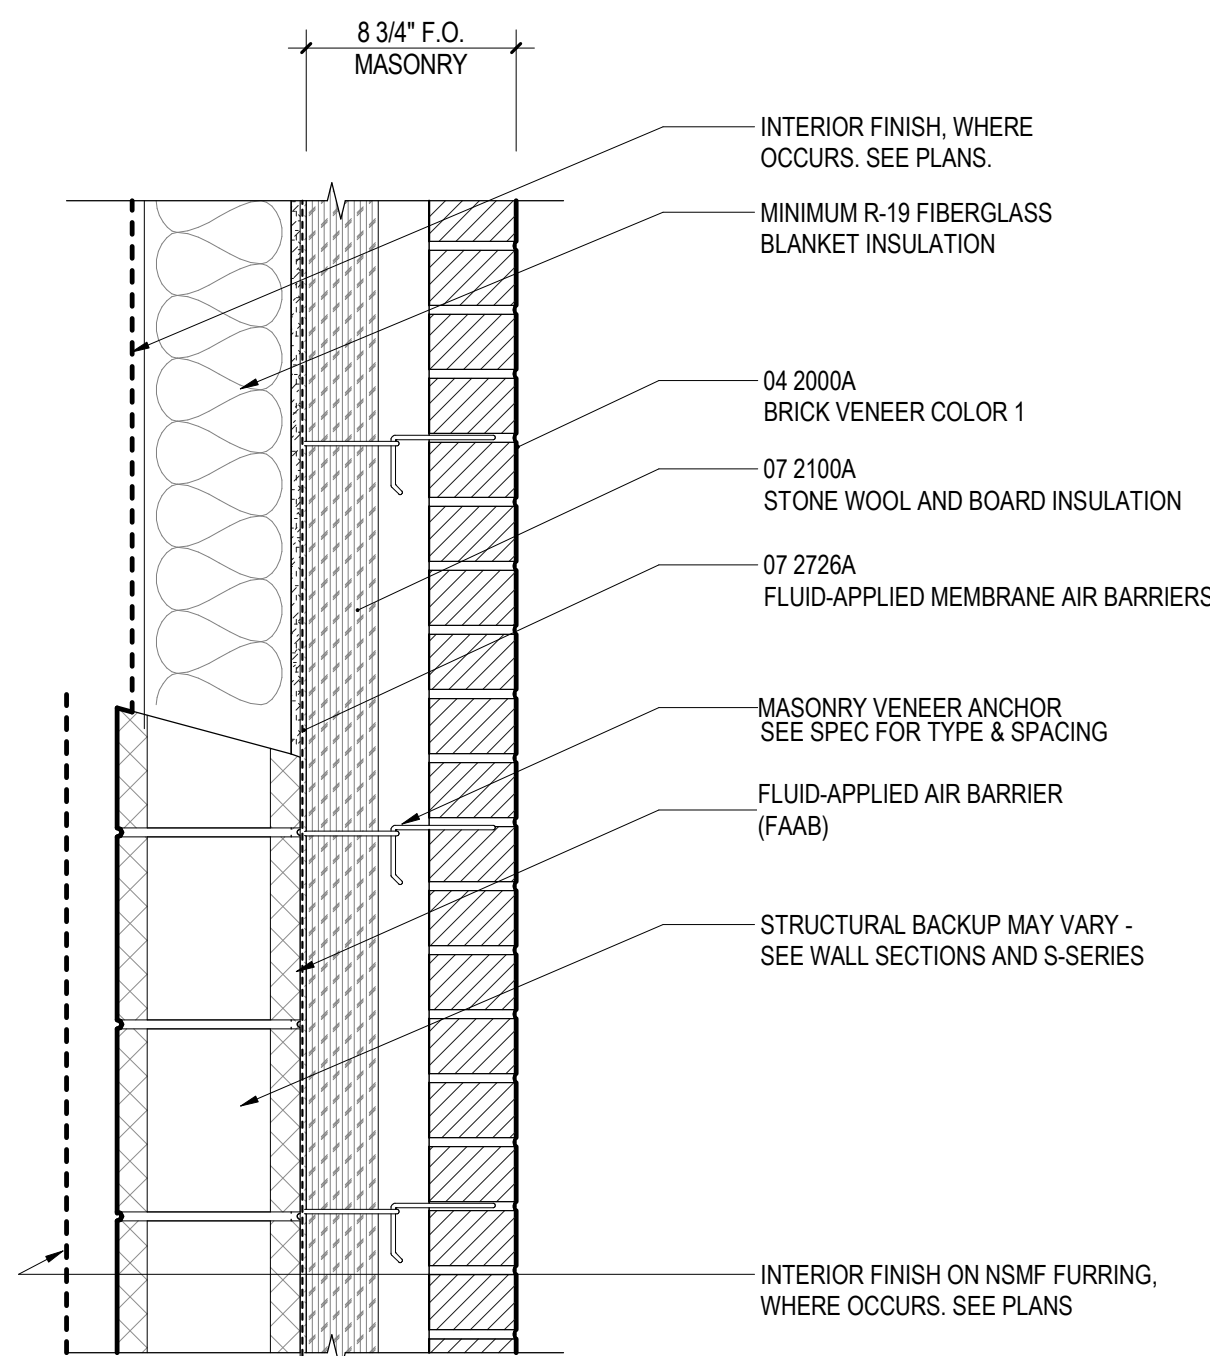

WALL TYPE W1A

WALL ASSEMBLY U-VALUE ACCORDING TO  
TABLE A3.3 OF ASHRAE 90.1  
U - 0.047

WALL ASSEMBLY U-VALUE ACCORDING TO  
ASHRAE 90.1 - APP. A  
U - 0.068

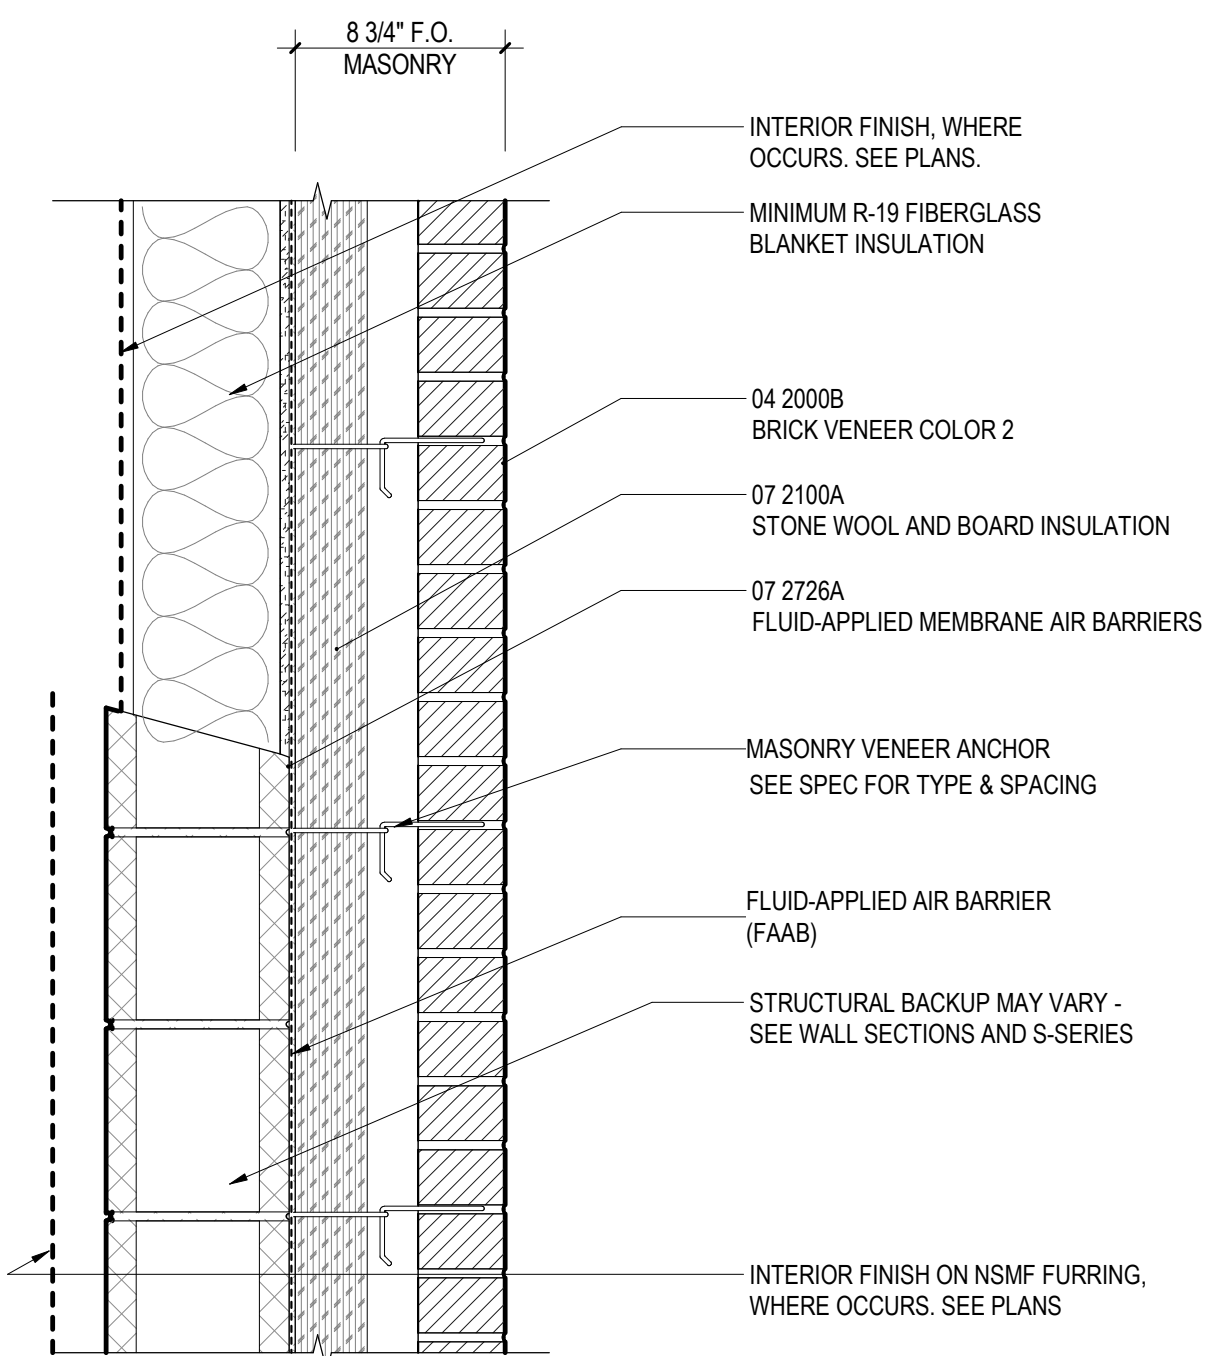


WALL TYPE W1B

- DECORATIVE COURSING

WALL ASSEMBLY U-VALUE ACCORDING TO  
TABLE A3.3 OF ASHRAE 90.1  
U - 0.047


WALL ASSEMBLY U-VALUE ACCORDING TO  
ASHRAE 90.1 - APP. A  
U - 0.068

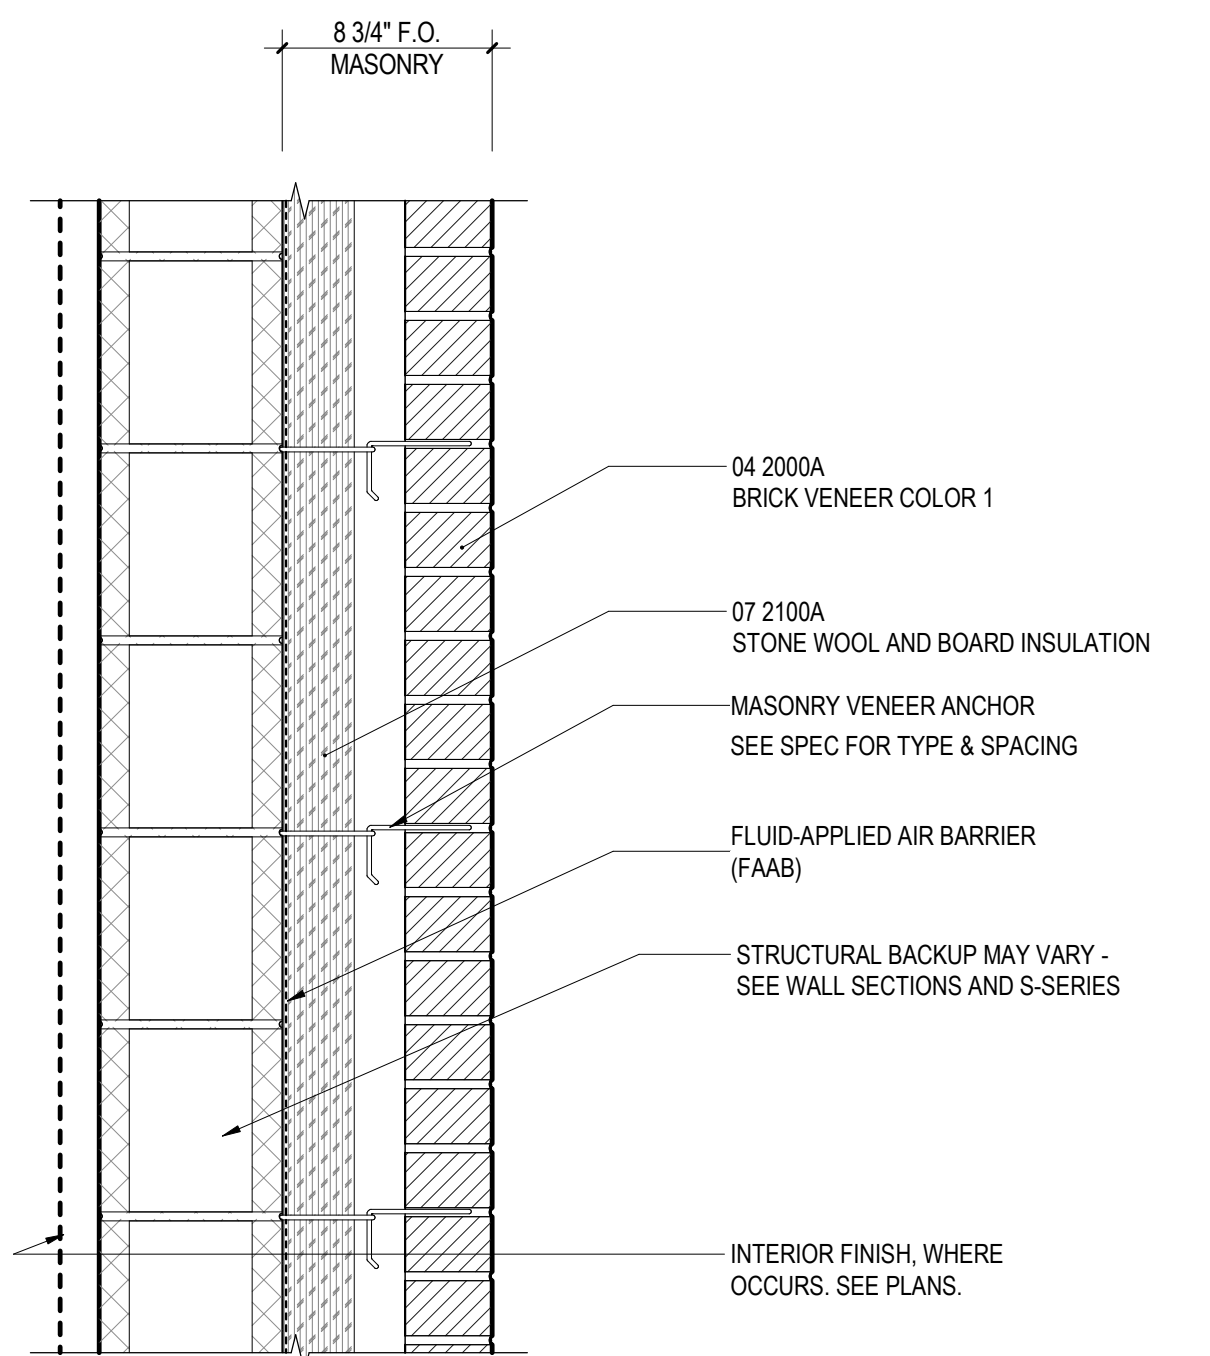

WALL TYPE W1C


- ROWLOCK COURSING

WALL ASSEMBLY U-VALUE ACCORDING TO  
TABLE A3.3 OF ASHRAE 90.1  
U - 0.047

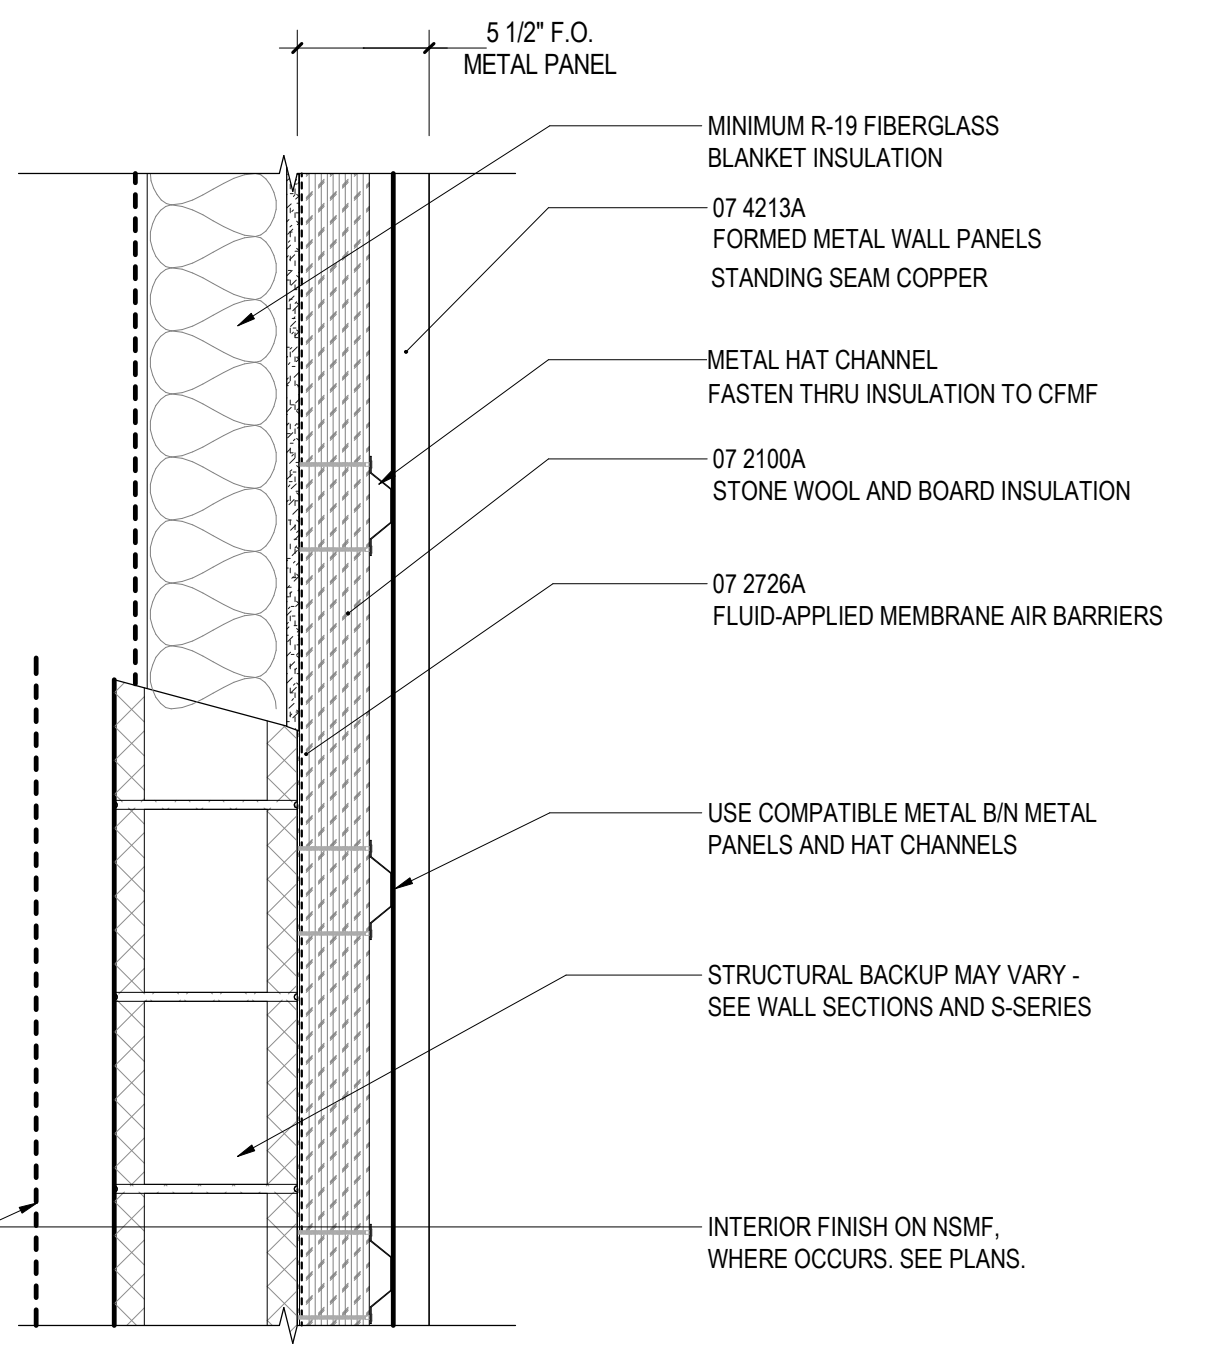


WALL TYPE W2A

WALL ASSEMBLY U-VALUE ACCORDING TO  
TABLE A3.3 OF ASHRAE 90.1  
U - 0.047

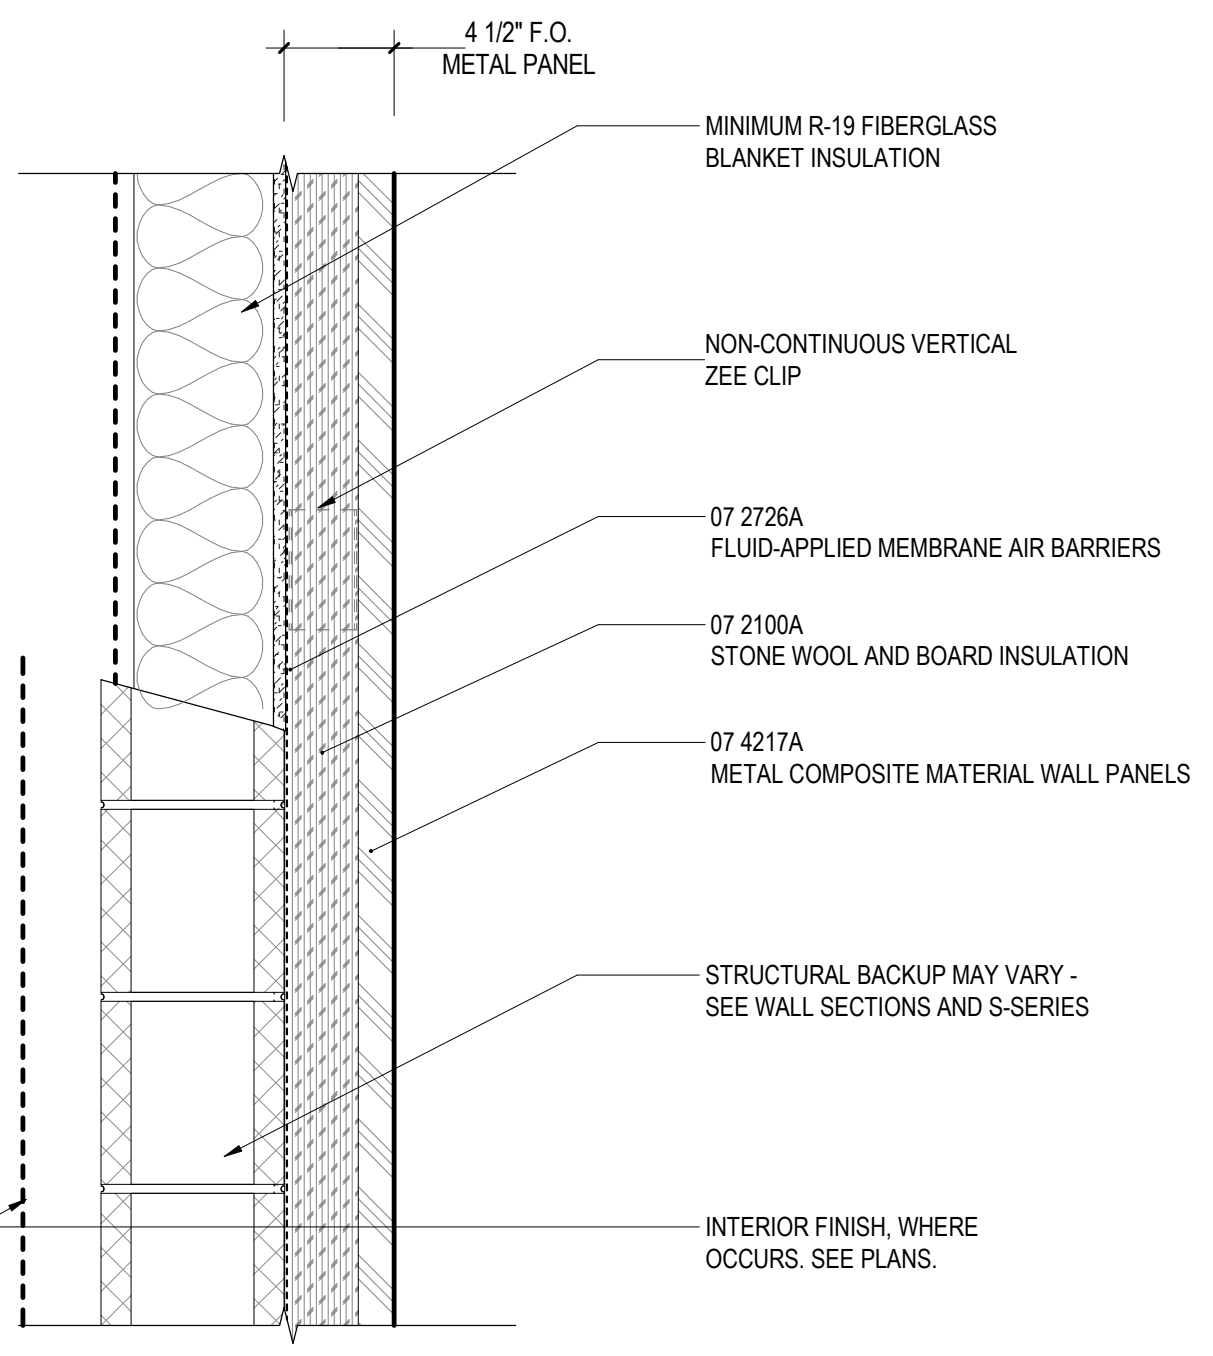


WALL TYPE W3A

WALL ASSEMBLY U-VALUE ACCORDING TO  
TABLE A3.3 OF ASHRAE 90.1  
U - 0.047

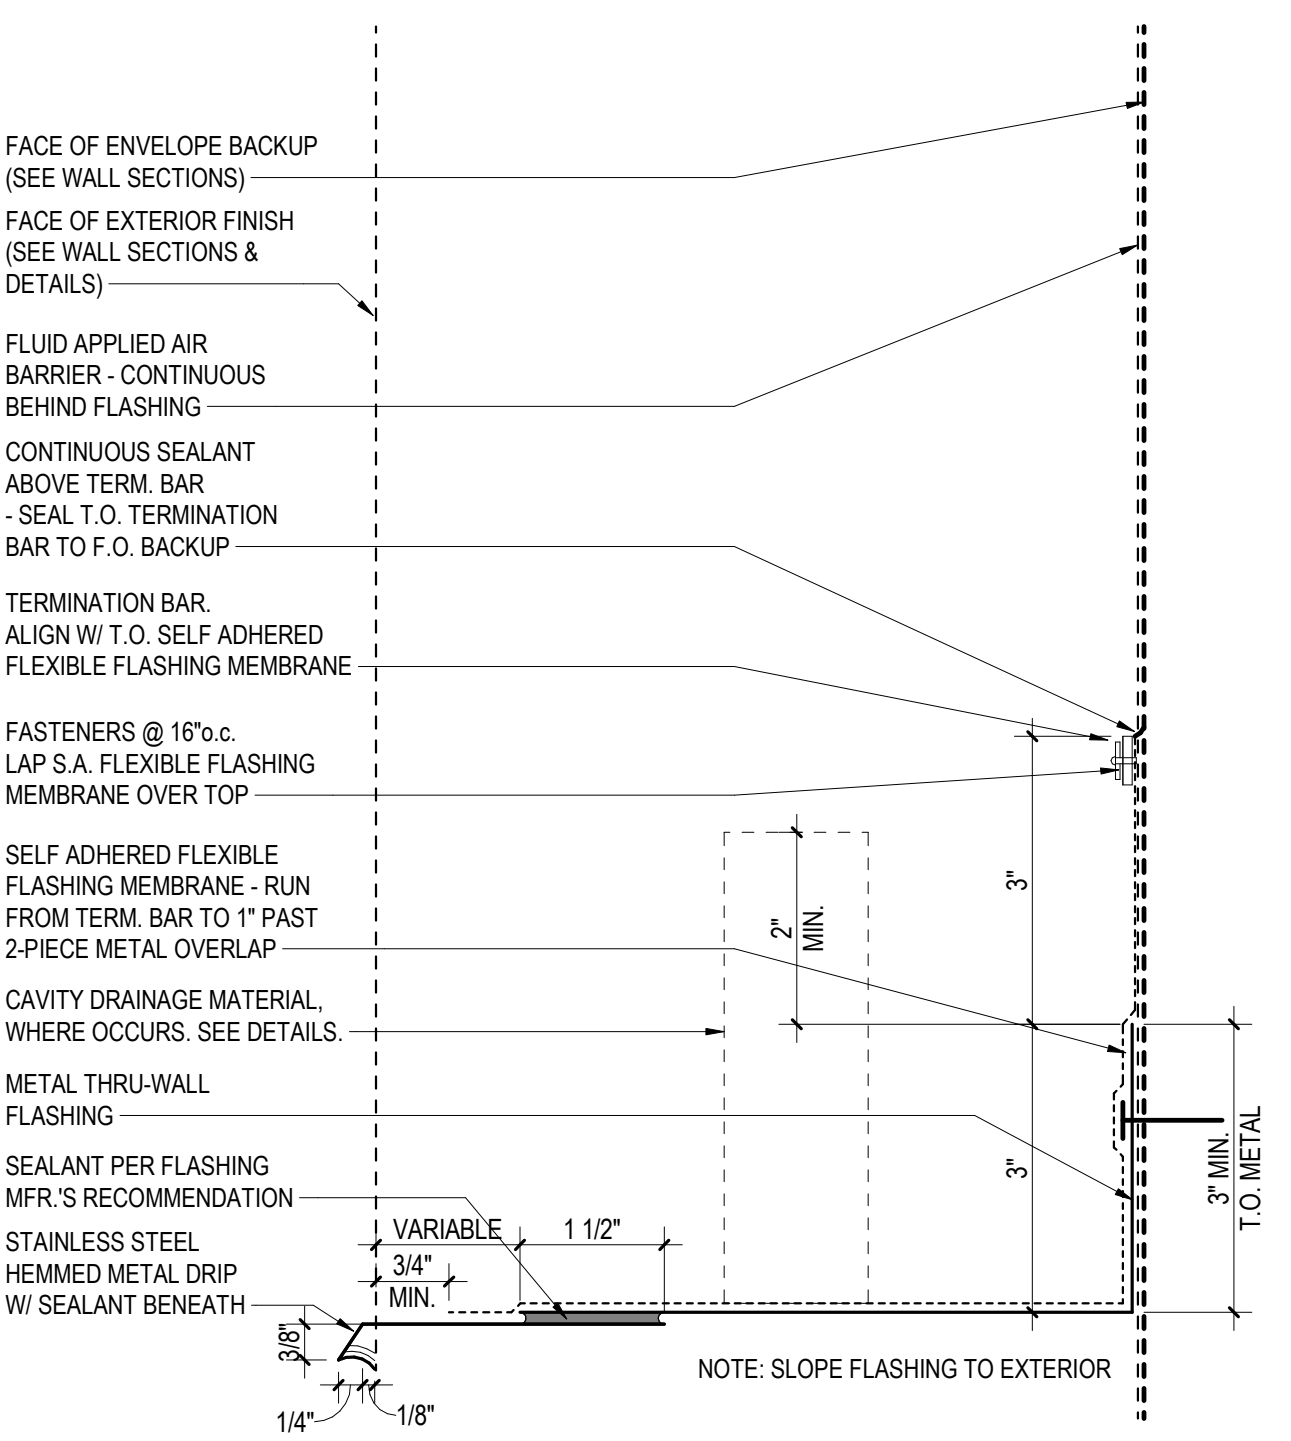

NOTE: AT SUPPORTED LOCATIONS, 2 PIECE METAL FLASHING MAY BE REDUCED  
TO 1 PIECE METAL DRIP W/ FLEXIBLE FLASHING - ALL DIMENSIONS ABOVE STILL  
APPLY TO 1 PIECE METAL FLASHING

ROOF TYPES:

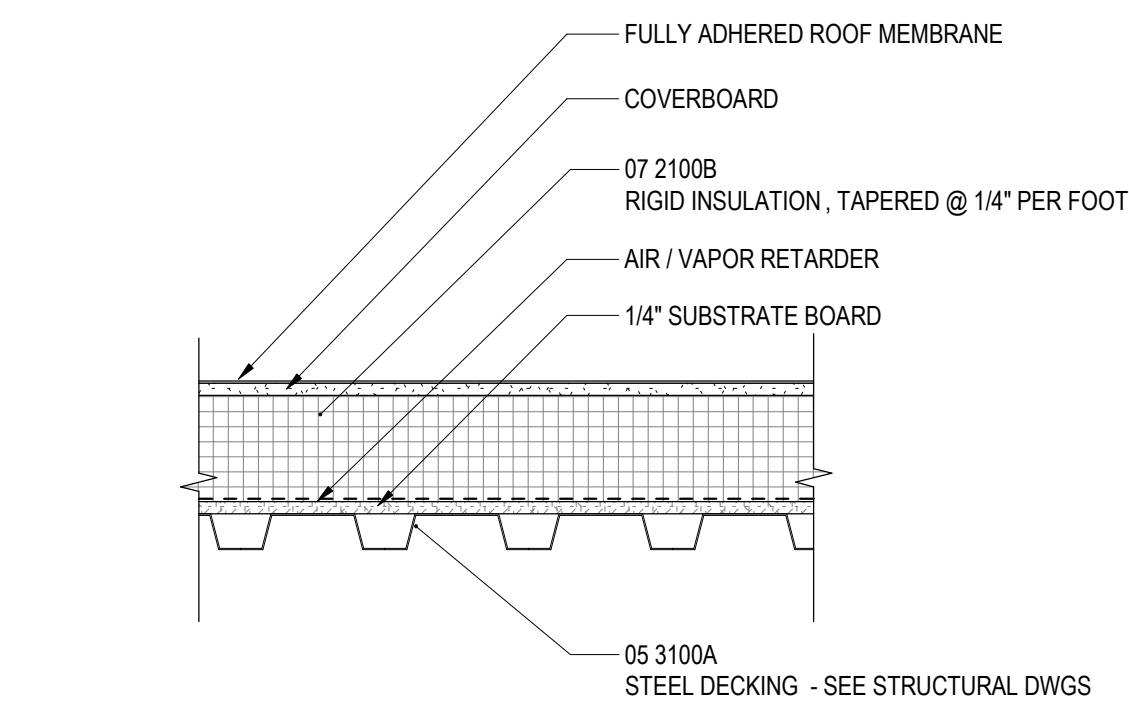

ROOF TYPE R1  
07 0700A  
ETHYLENE-PROPYLENE-DIENE-MONOMER  
(EPDM) ROOFING

EXTERIOR WALL TYPES  
GENERAL NOTES

1. SEE STRUCTURAL DRAWINGS FOR LOCATION, SIZE, REINFORCING AND DETAILS OF FOOTINGS, FOUNDATIONS AND STRUCTURAL FRAMING.
2. MASONRY UNITS ARE SIZED NOMINALLY. CONCRETE MASONRY ON ARCHITECTURAL PLANS AND SECTIONS IS SHOWN DIAGRAMMATICALLY. SEE STRUCTURAL DRAWINGS FOR CMU BOND BEAMS, REINFORCING, AND GROUTING REQUIREMENTS.
3. REFER TO FIRE PROTECTION PLANS FOR FULL EXTENT OF RATED CONSTRUCTION.
4. WHERE METAL FRAMING REQUIRES SUPPORT AT COLUMNS & BEAMS, PROVIDE METAL STAND-OFFS PRIOR TO APPLYING FIREPROOFING.
5. ALL STEEL FRAMING REQUIRED TO BE RATED IS TO RECEIVE SPRAY APPLIED FIRE PROOFING, U.N.O. SEE FIRE PROTECTION PLANS FOR FULL EXTENT OF RATED CONSTRUCTION.
6. SEE INTERIOR ELEVATIONS & FINISH SCHEDULE FOR INTERIOR FINISHES.

VMDO

VMDO Architects  
vmdo.com  
434.296.5684  
200 E Market Street  
Charlottesville, VA 22902  
1200 18th Street NW Ste 700  
Washington, DC 20036




New City Library

New City Library Addition &  
Renovation


220 North Main Street  
New City, NY 10956

VMDO Project Number 1301

FLOOR TYPES:

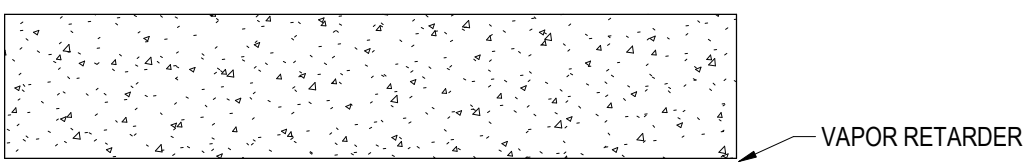

TYPE F6A  
VMDO STR 'F6A' CONCRETE SLAB ON GRADE 06"

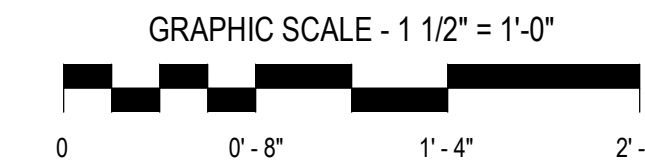


DRAWING NOT FOR  
CONSTRUCTION

ISSUES AND REVISIONS  
NO. SUBMITTAL DATE  
SCHEMATIC DESIGN 03.05.2021


EXTERIOR ASSEMBLY  
TYPES

A500  
DESIGN DEVELOPMENT  
07.09.2021




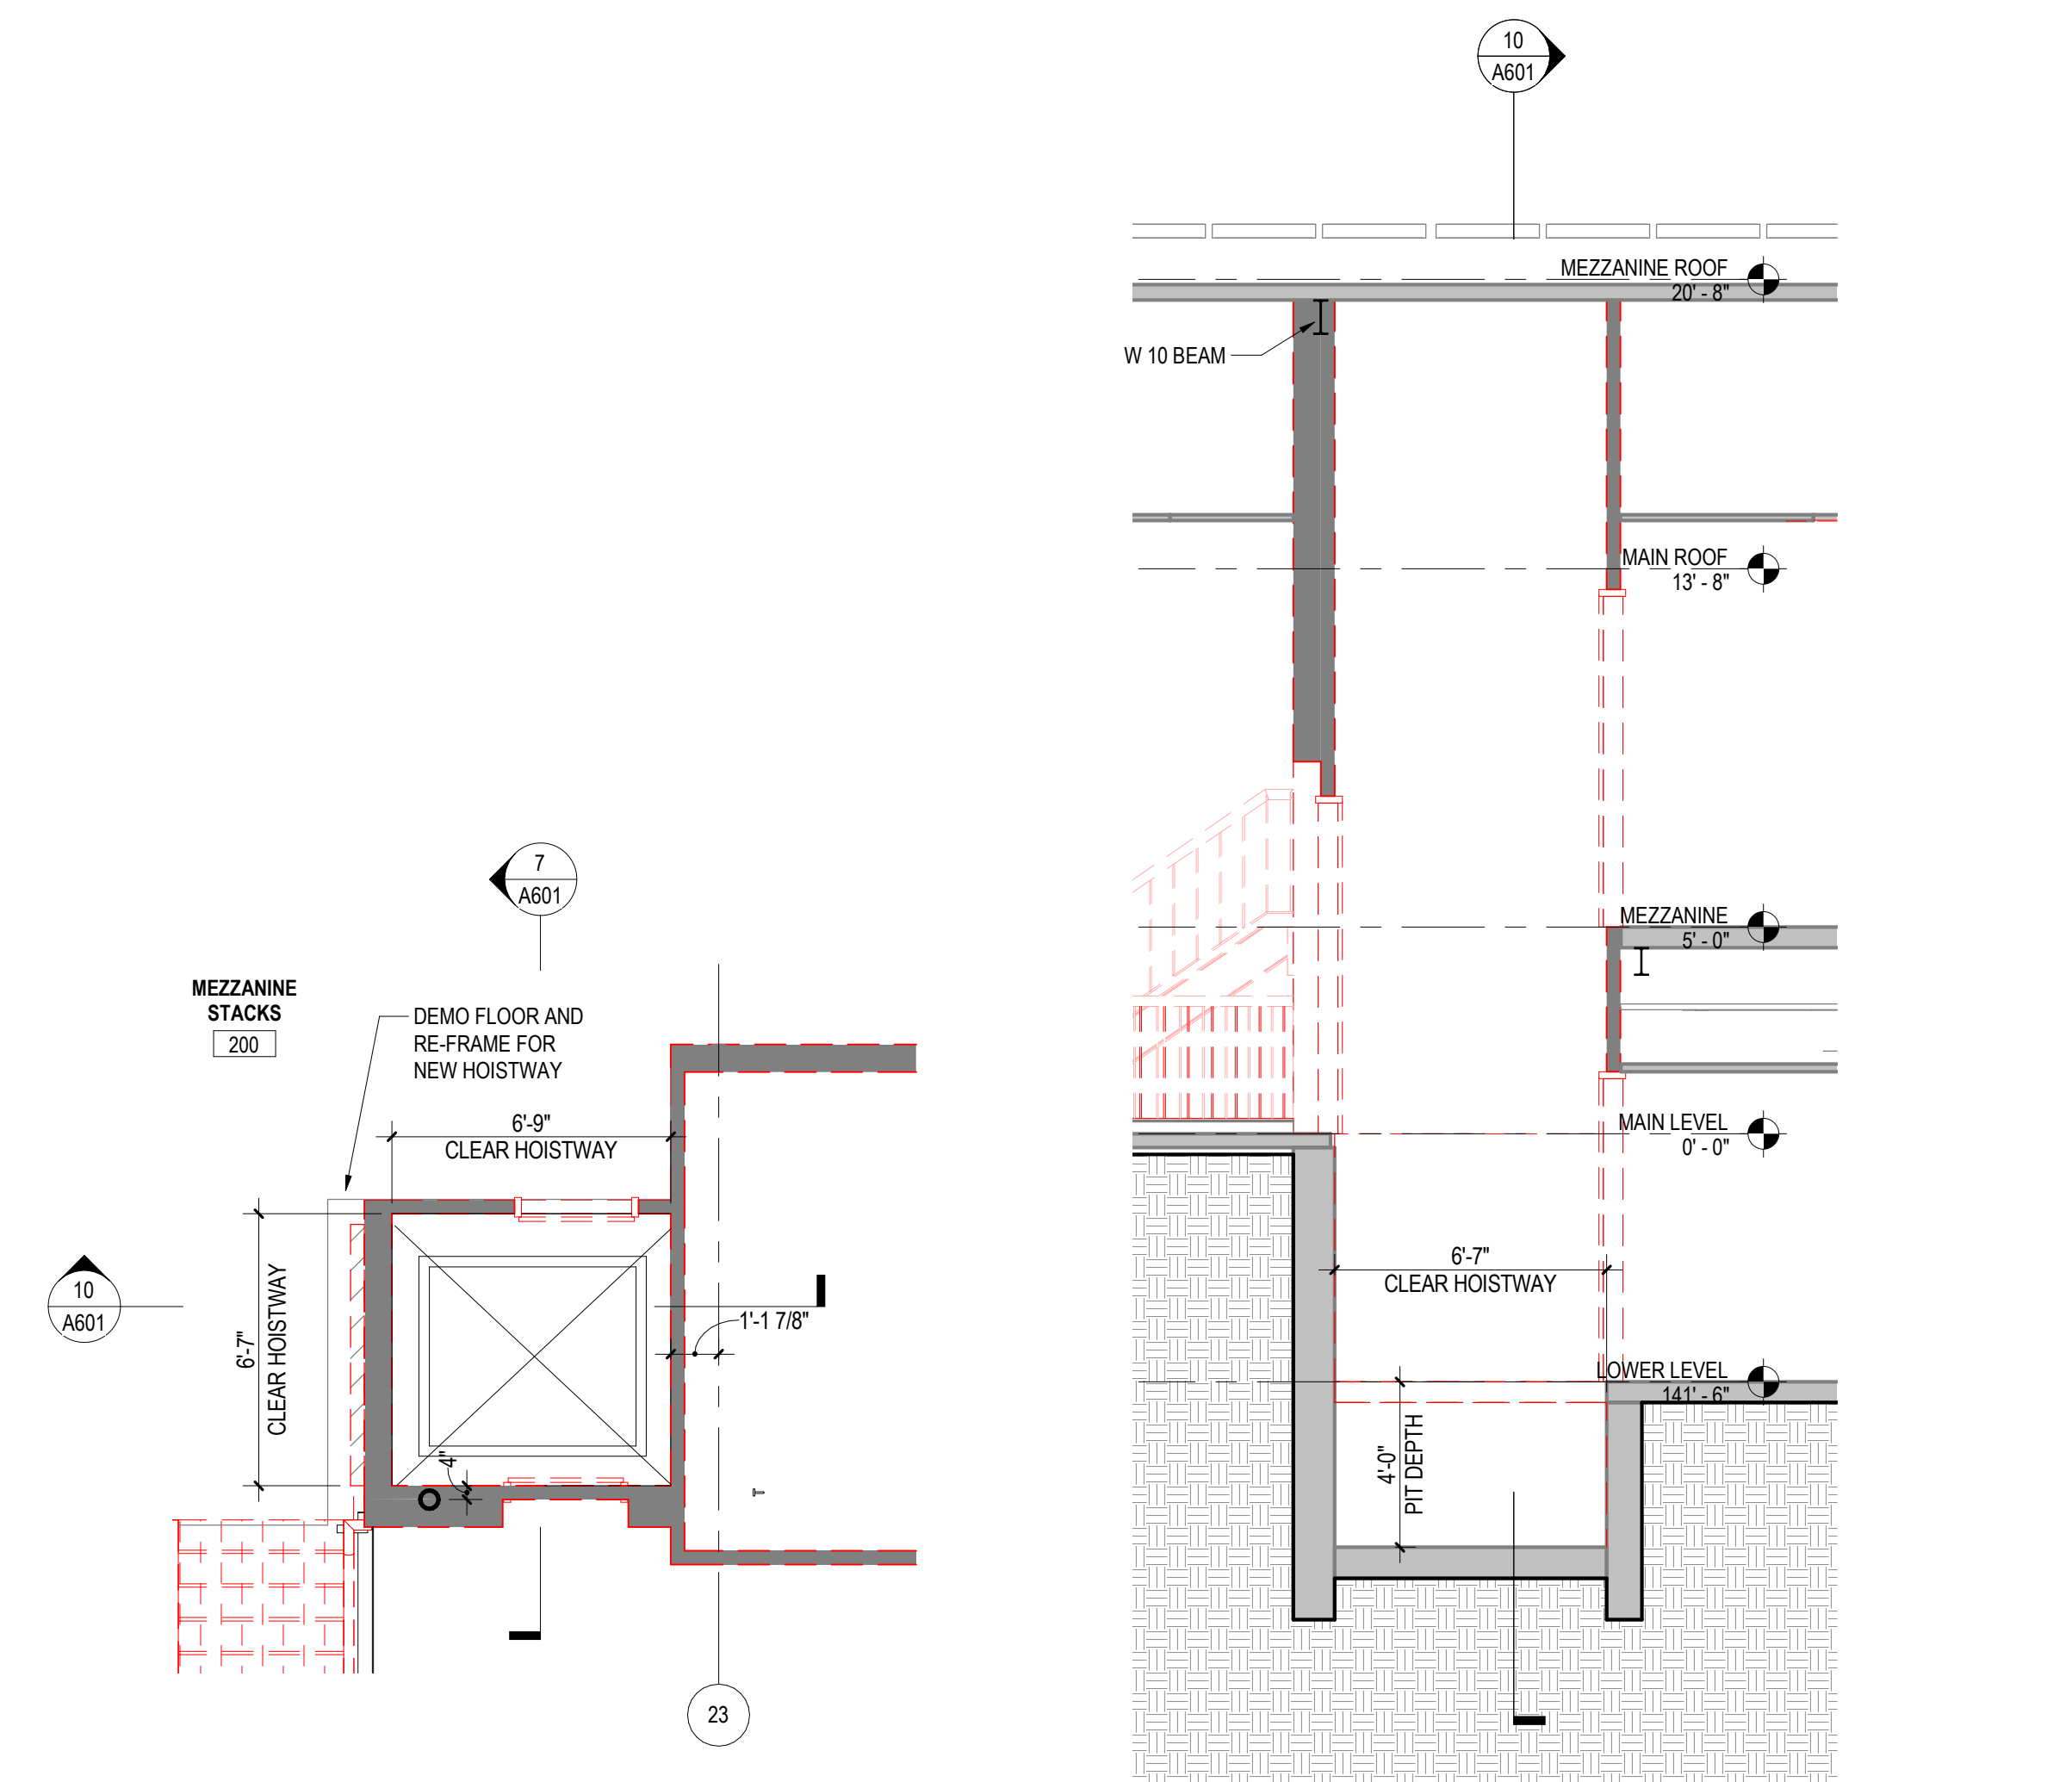


8 ELEVATOR PLAN - MEZZANINE EXISTING  
A601 1/4" = 1'-0"

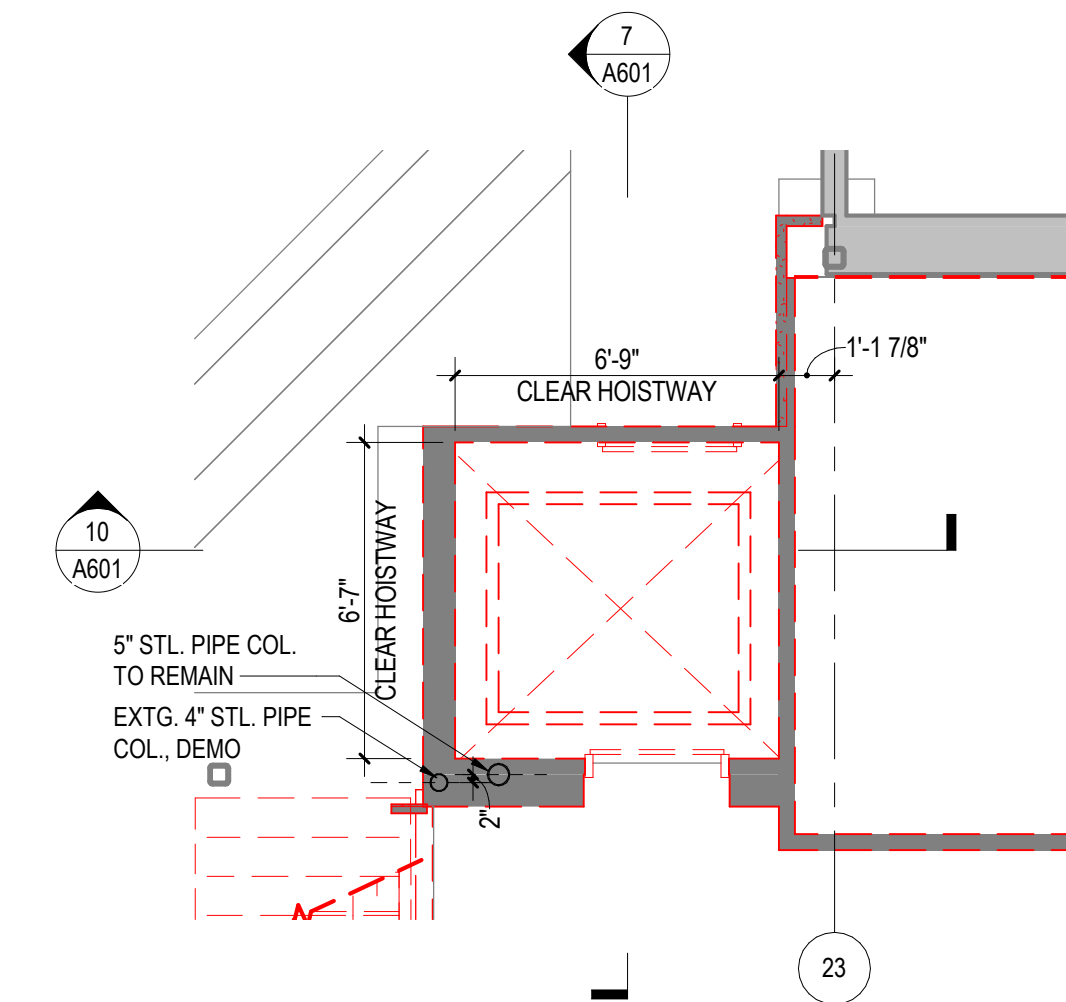


6 ELEVATOR PLAN - MAIN LEVEL EXISTING  
A601 1/4" = 1'-0"

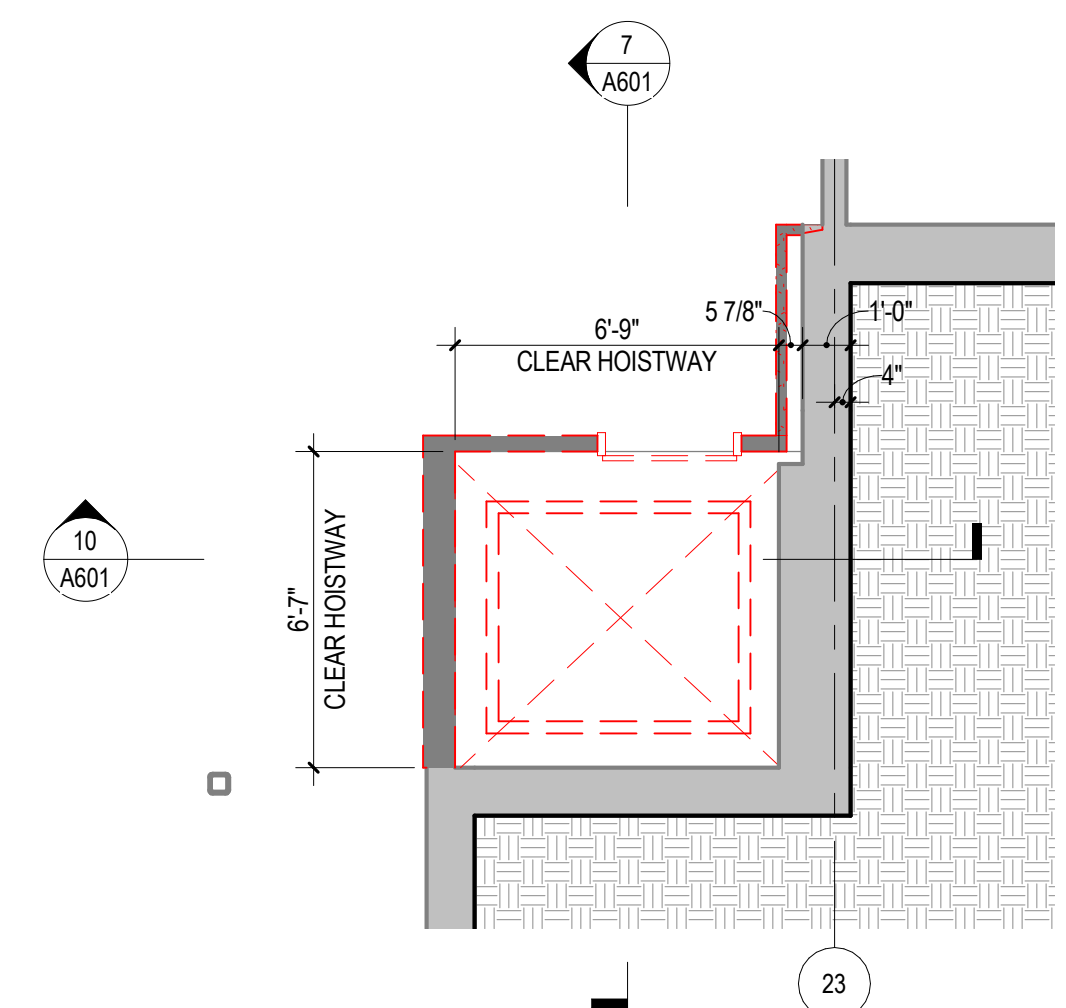


5 ELEVATOR PLAN - LOWER LEVEL EXISTING  
A601 1/4" = 1'-0"

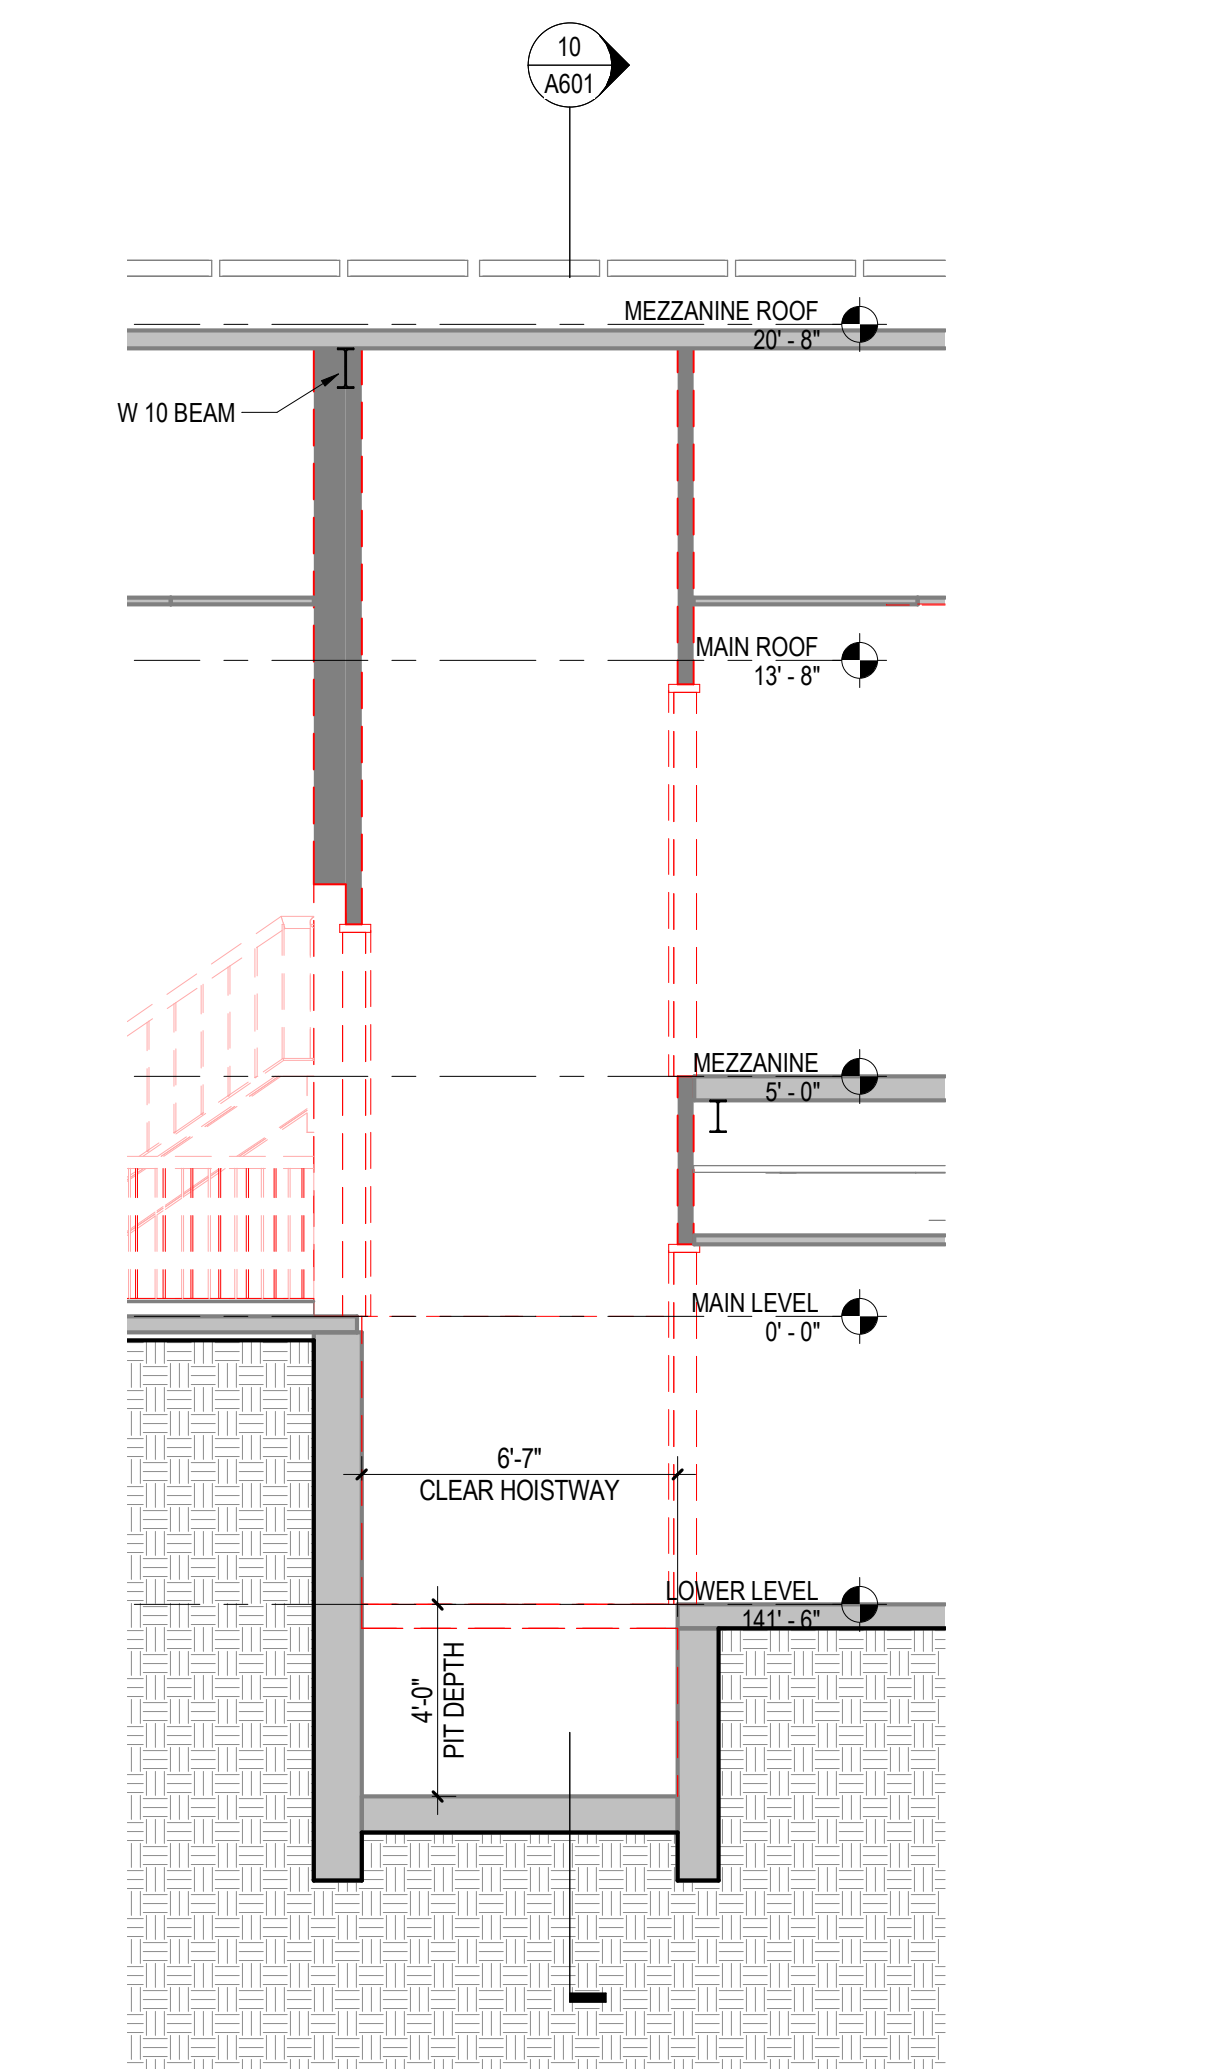


7 ELEVATOR SECTION AT DOORS - EXISTING  
A601 1/4" = 1'-0"

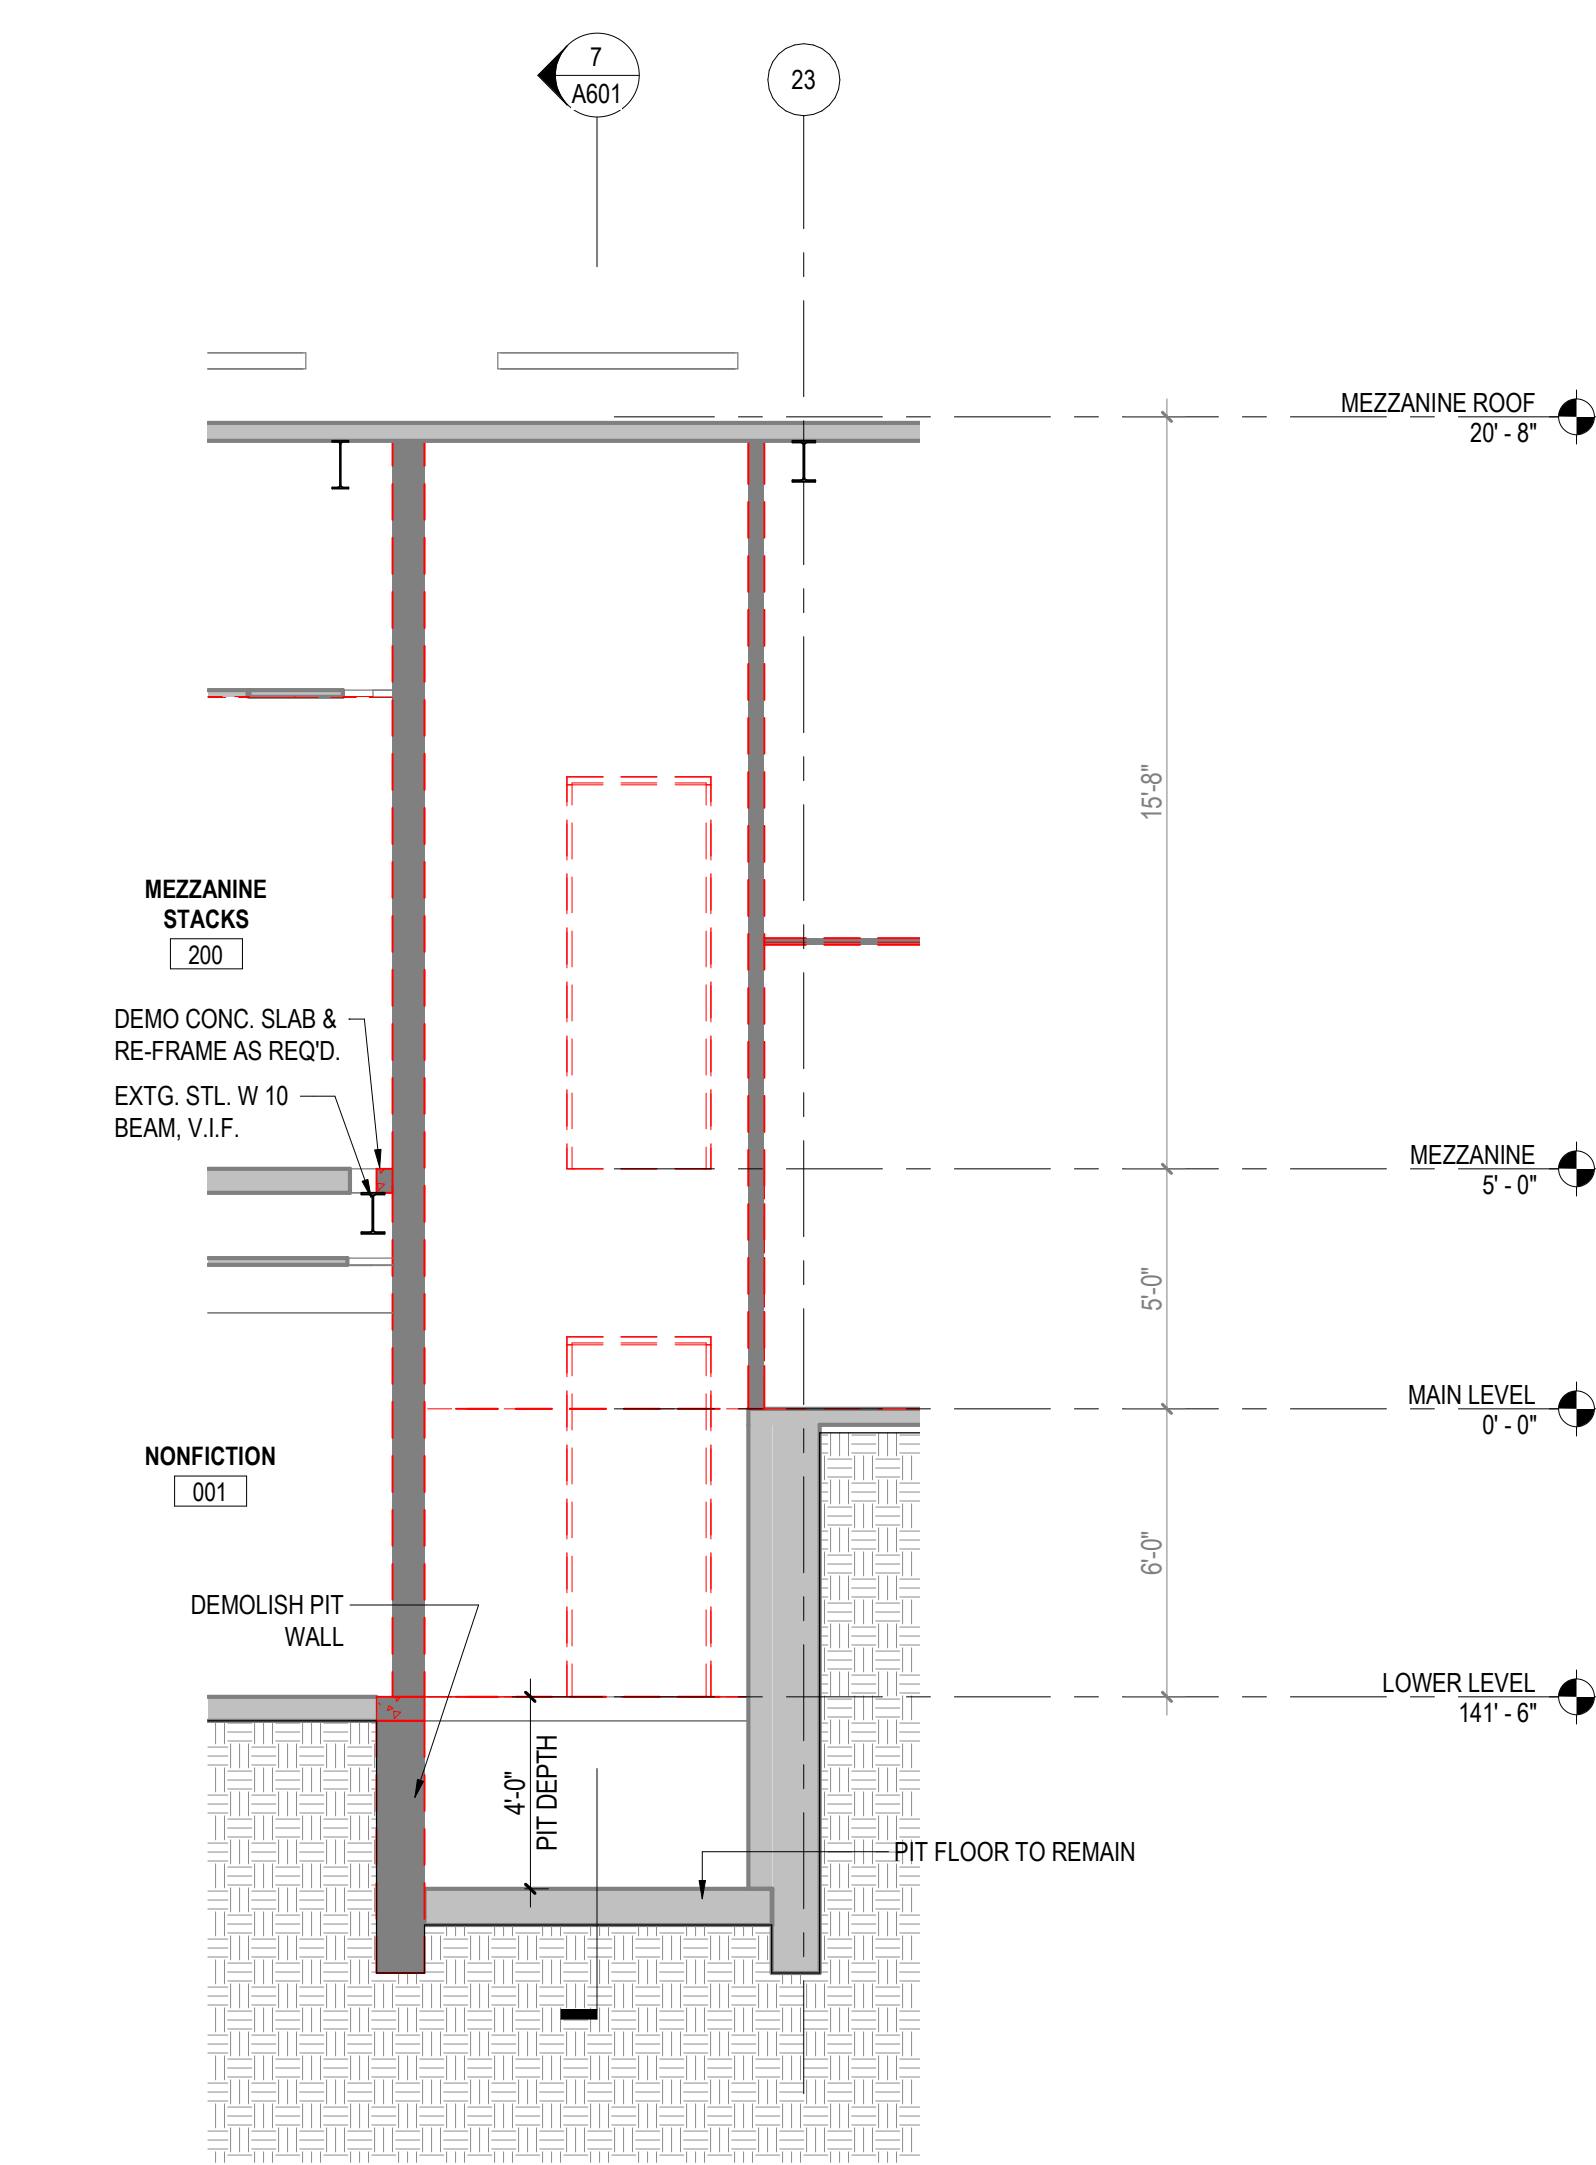


10 ELEVATOR CROSS SECTION - EXISTING  
A601 1/4" = 1'-0"

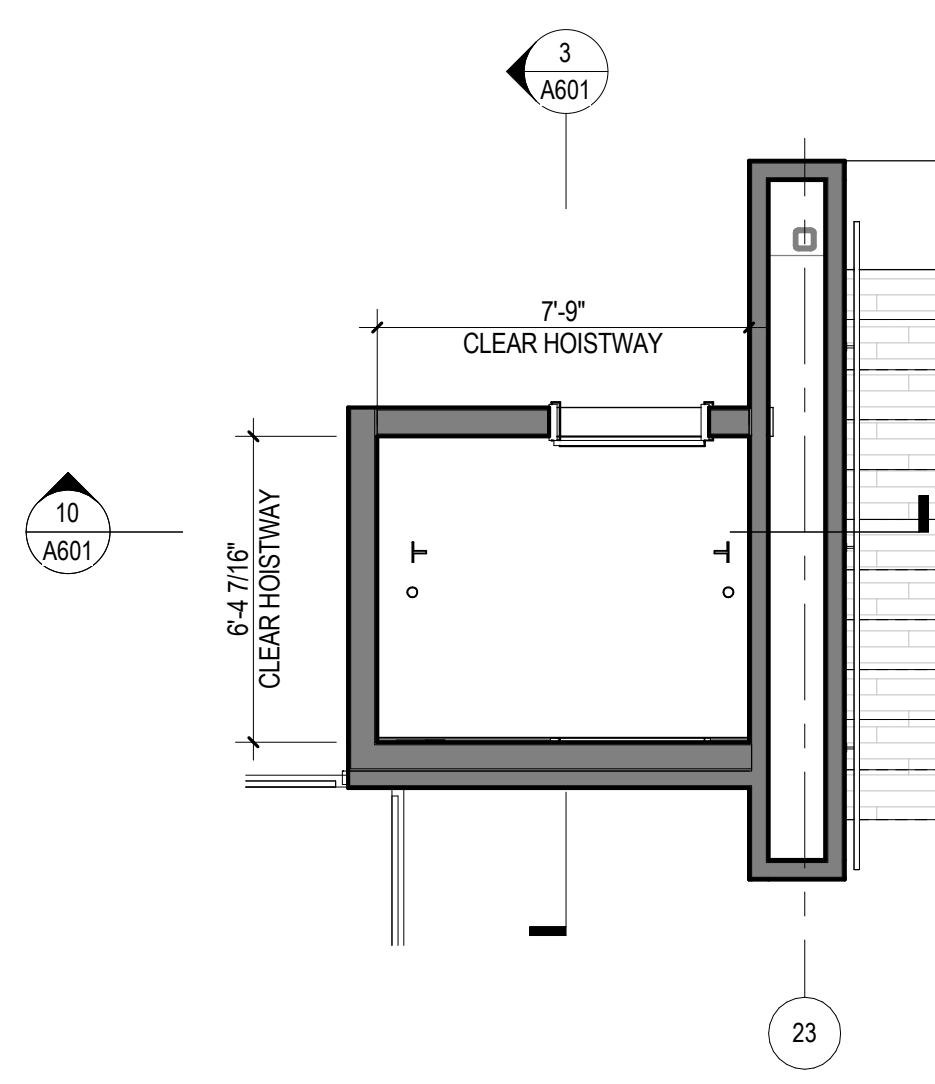


9 ELEVATOR PLAN - MEZZANINE  
A601 1/4" = 1'-0"

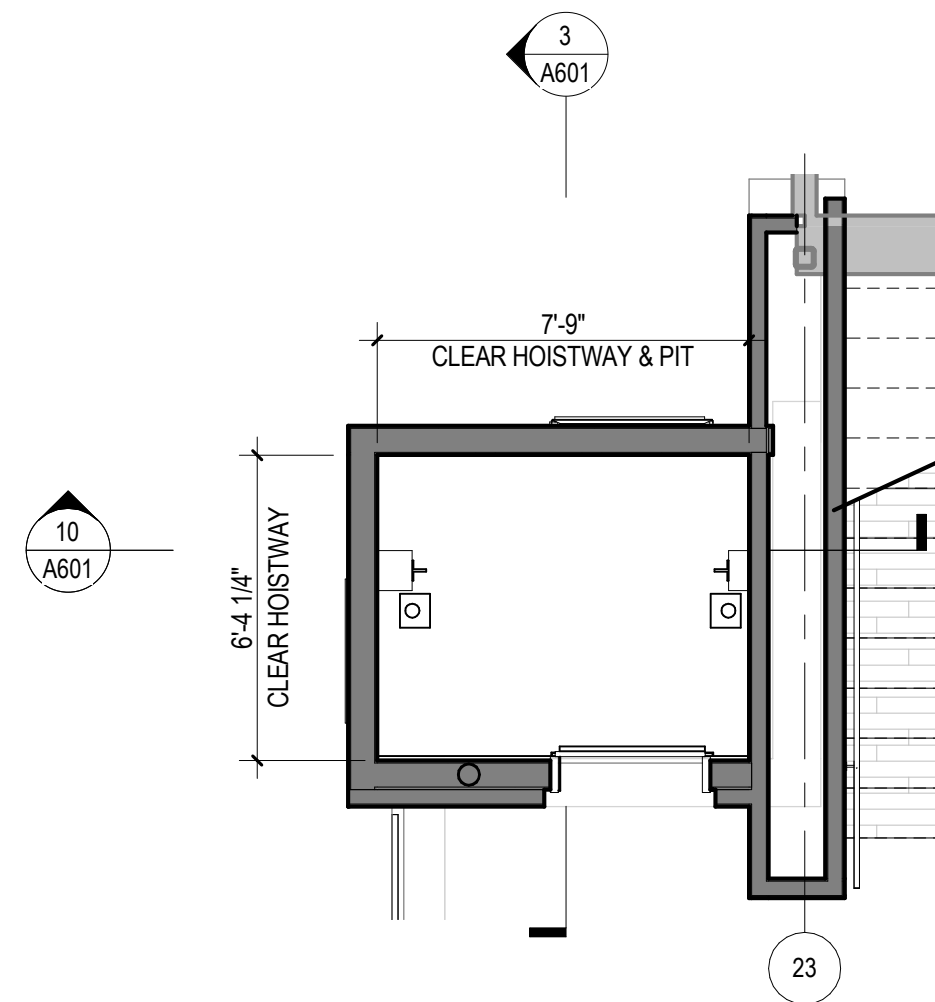


2 ELEVATOR PLAN - MAIN LEVEL  
A111 A601 1/4" = 1'-0"

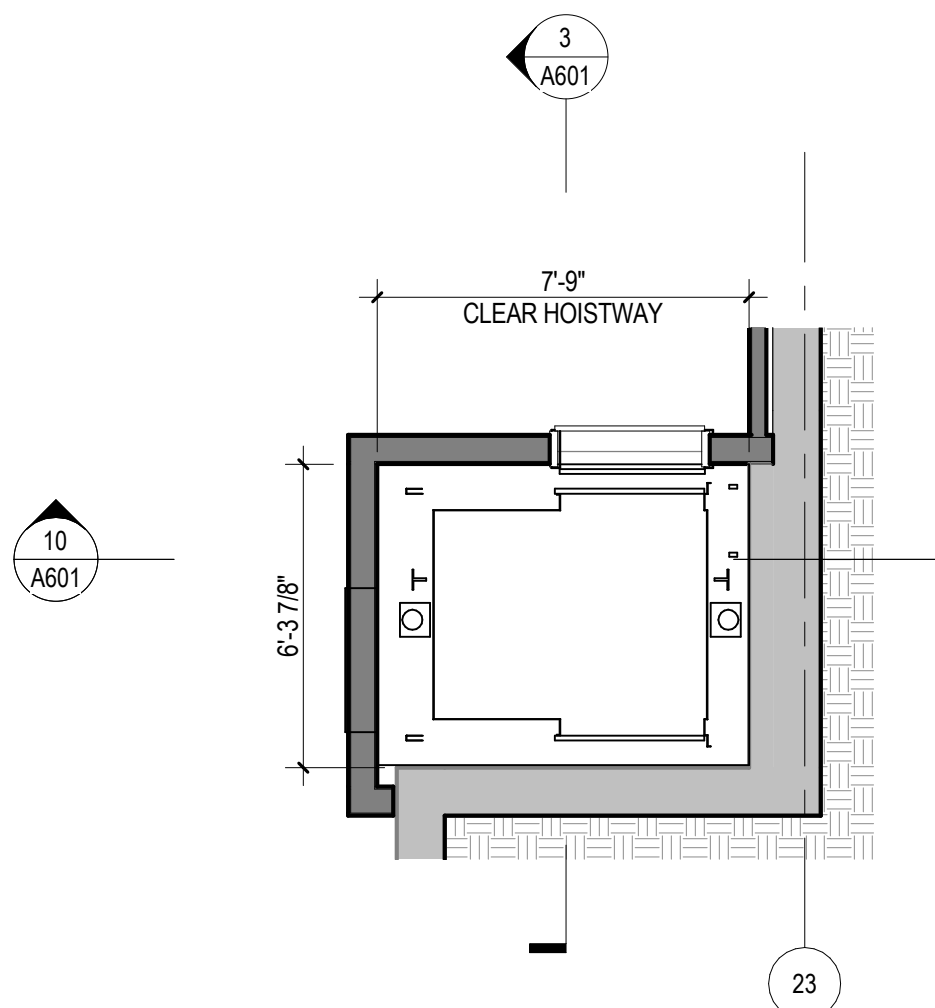

1 ELEVATOR PLAN - LOWER LEVEL  
A101 A601 1/4" = 1'-0"

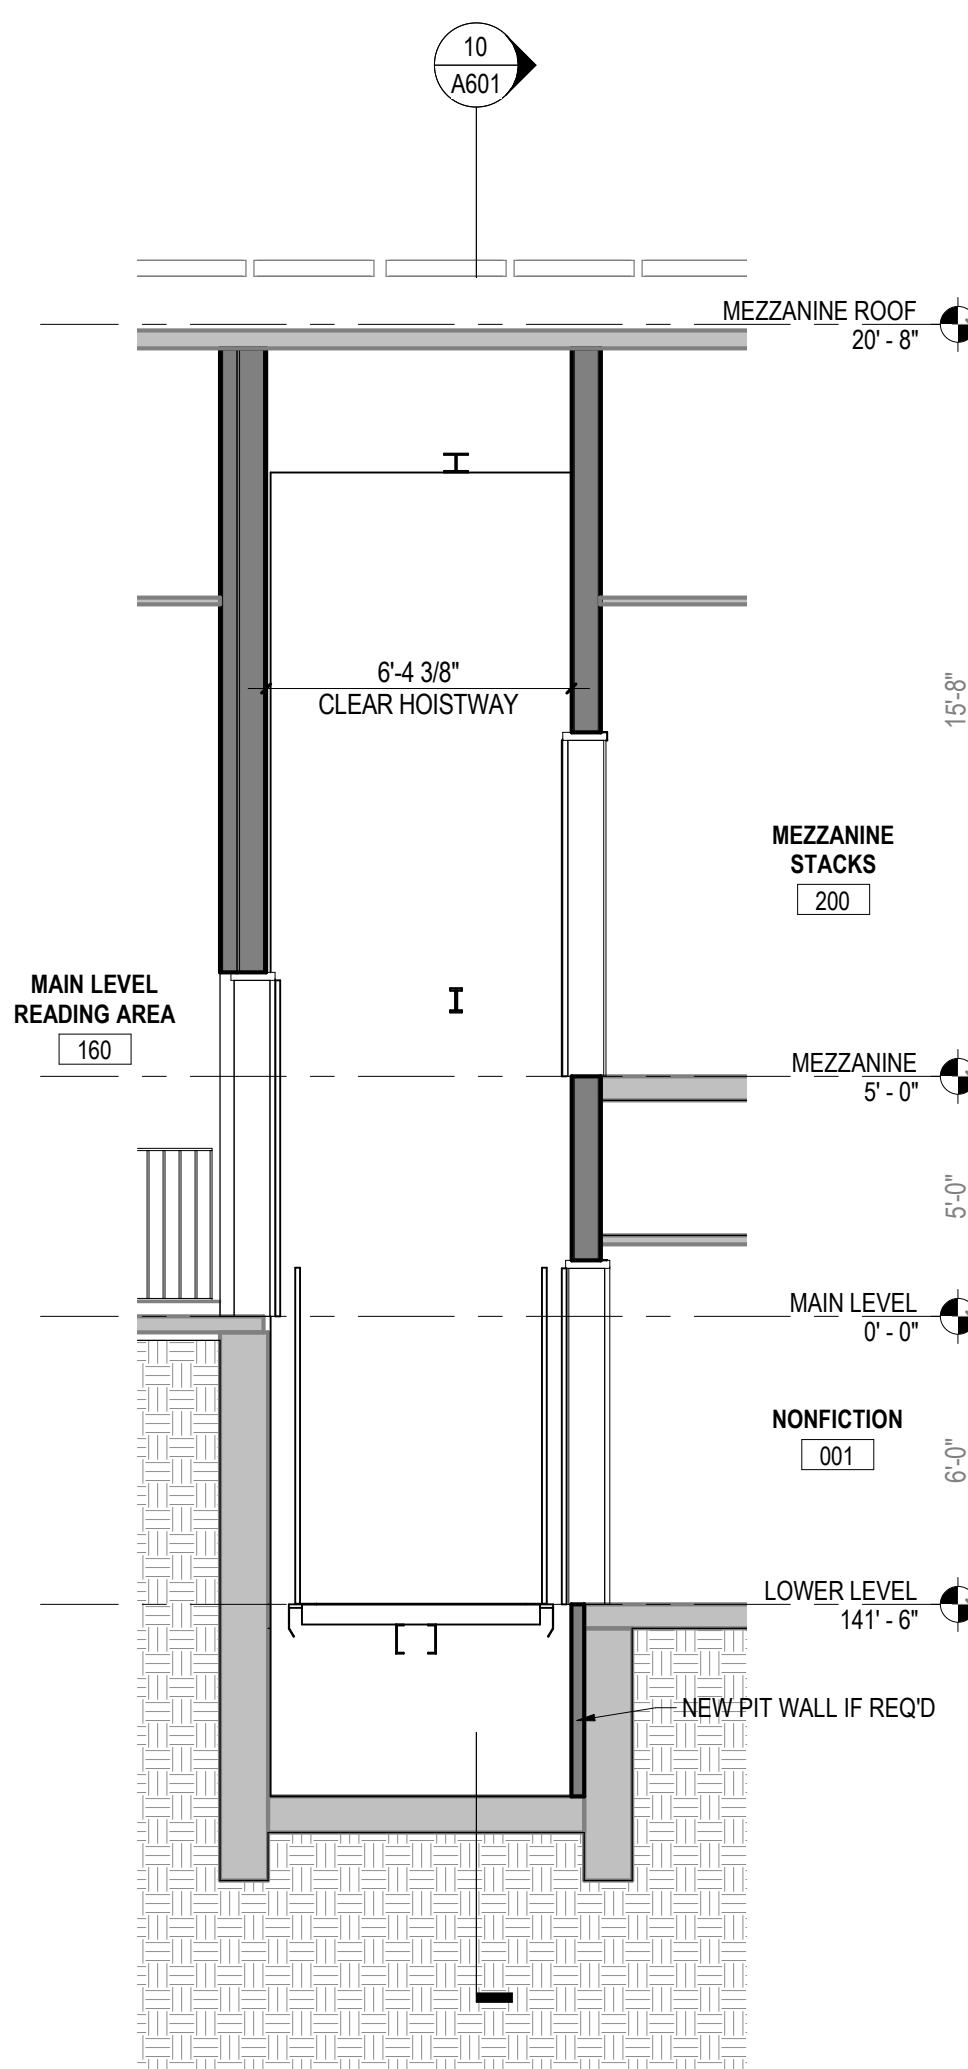


3 ELEVATOR SECTION AT DOORS  
A211 A601 1/4" = 1'-0"

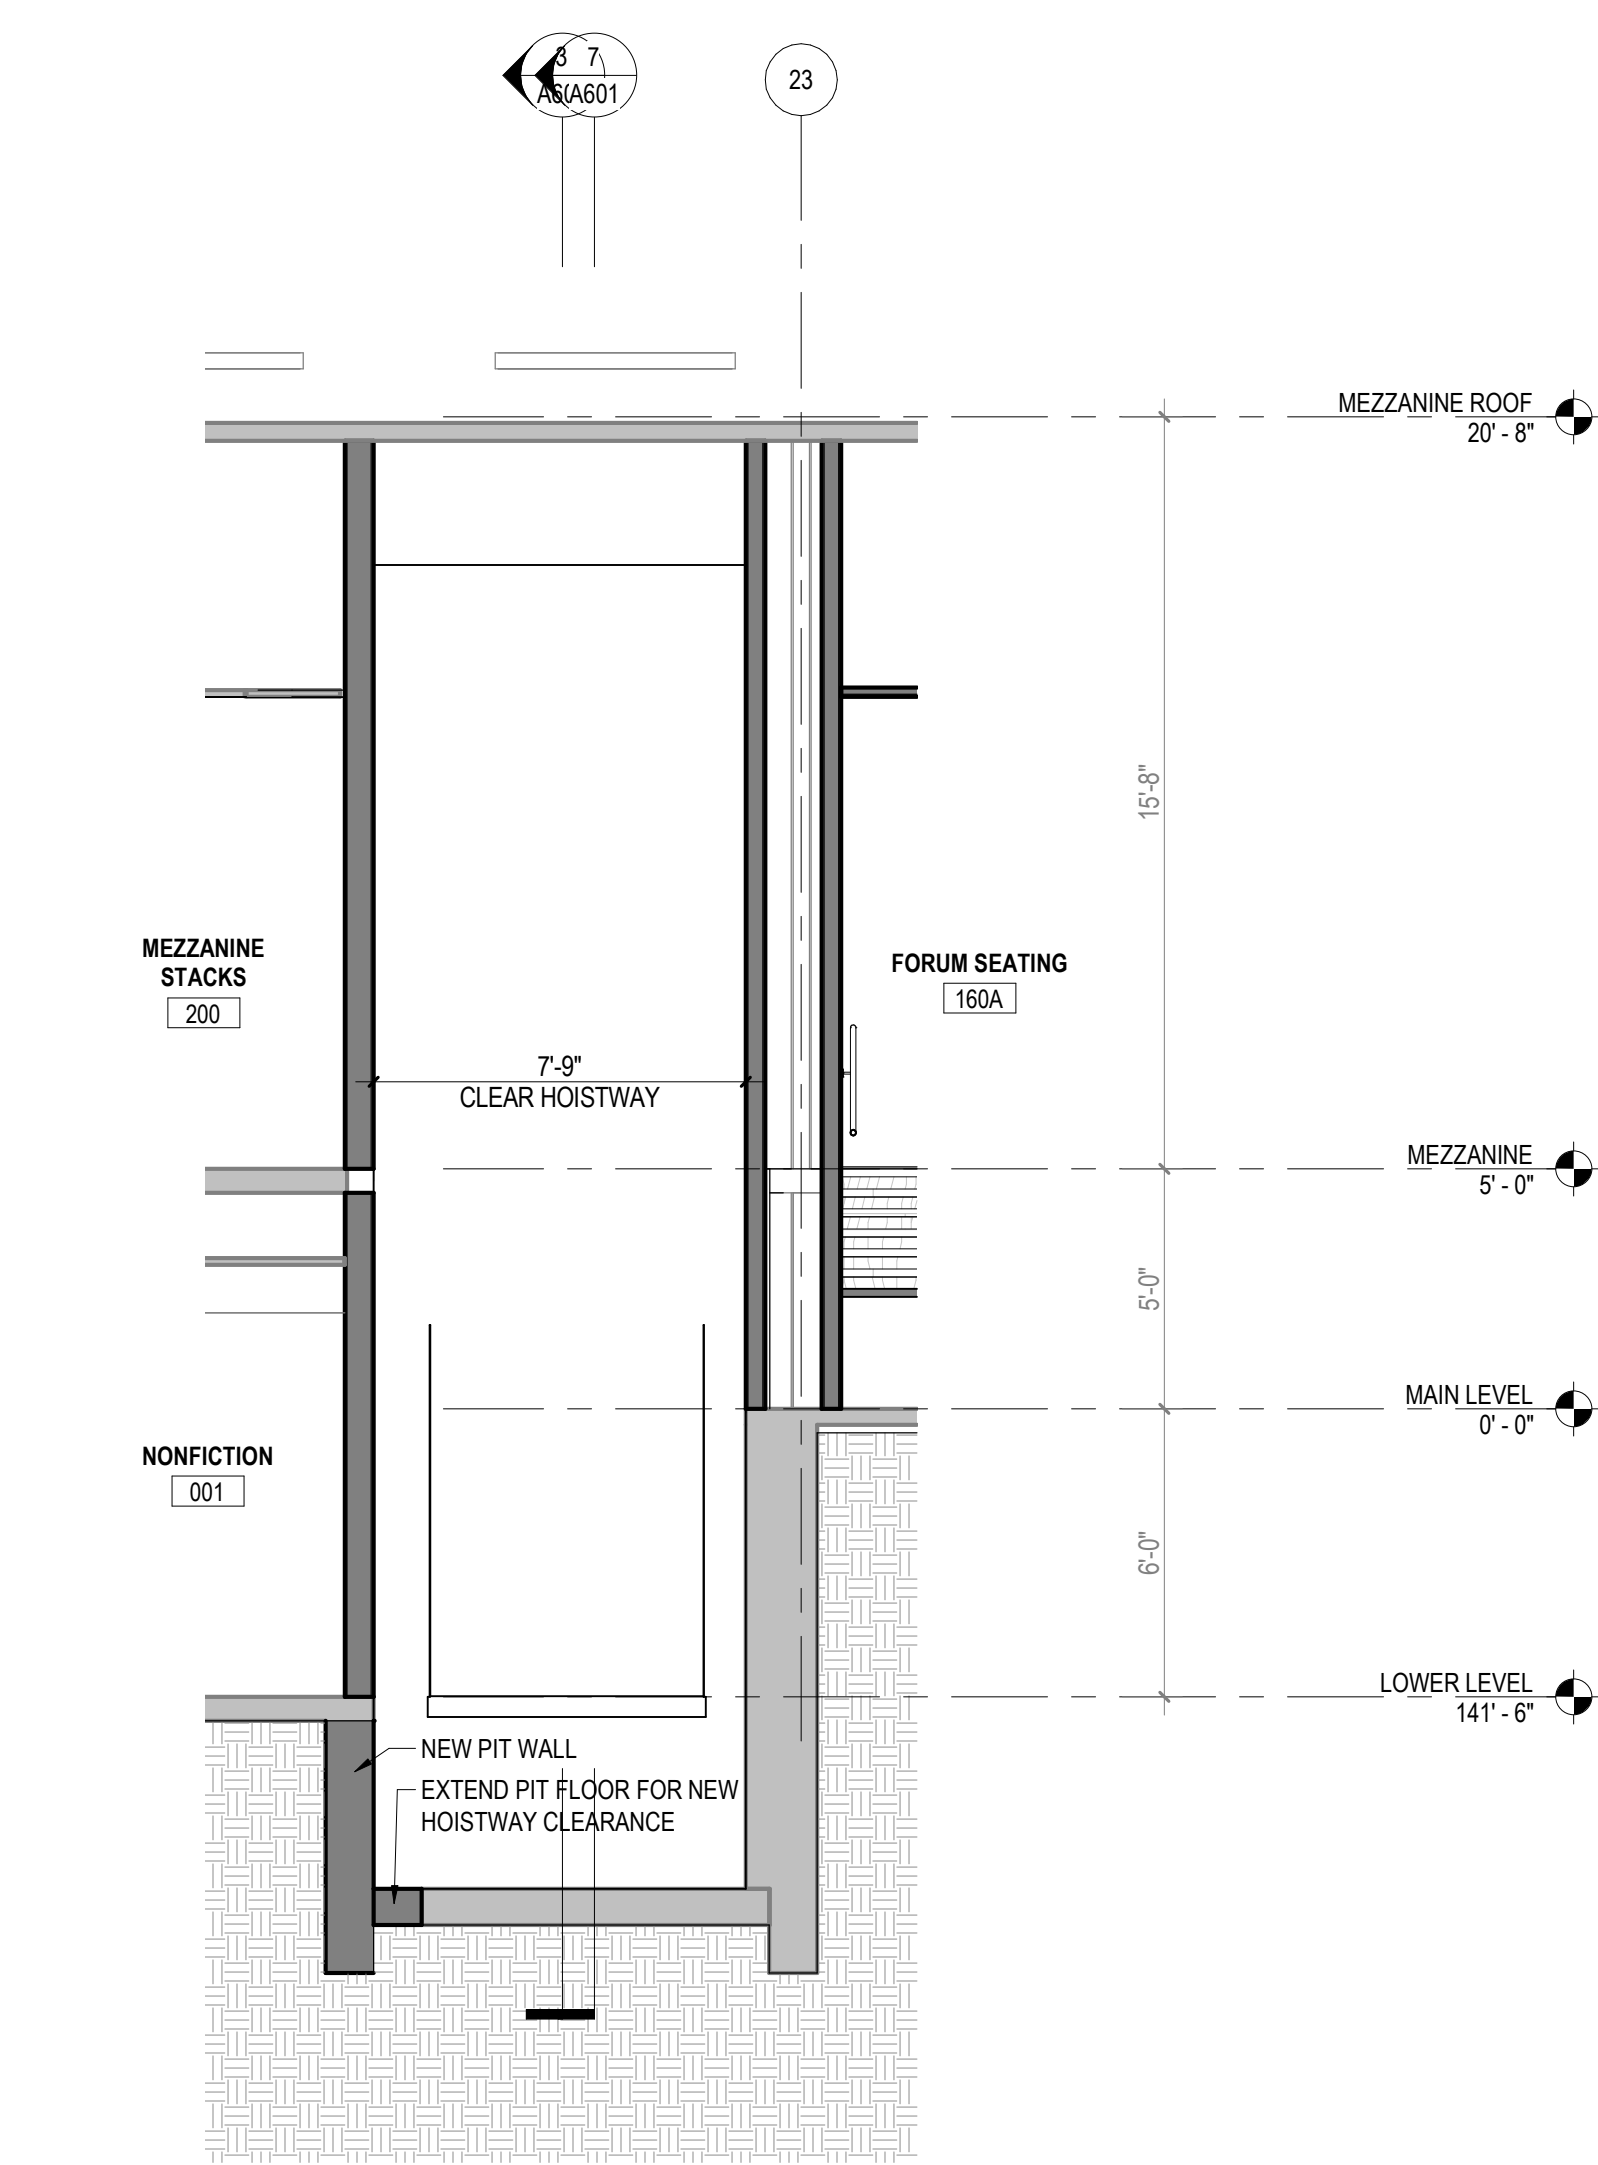


4 ELEVATOR CROSS SECTION  
A211 A601 1/4" = 1'-0"



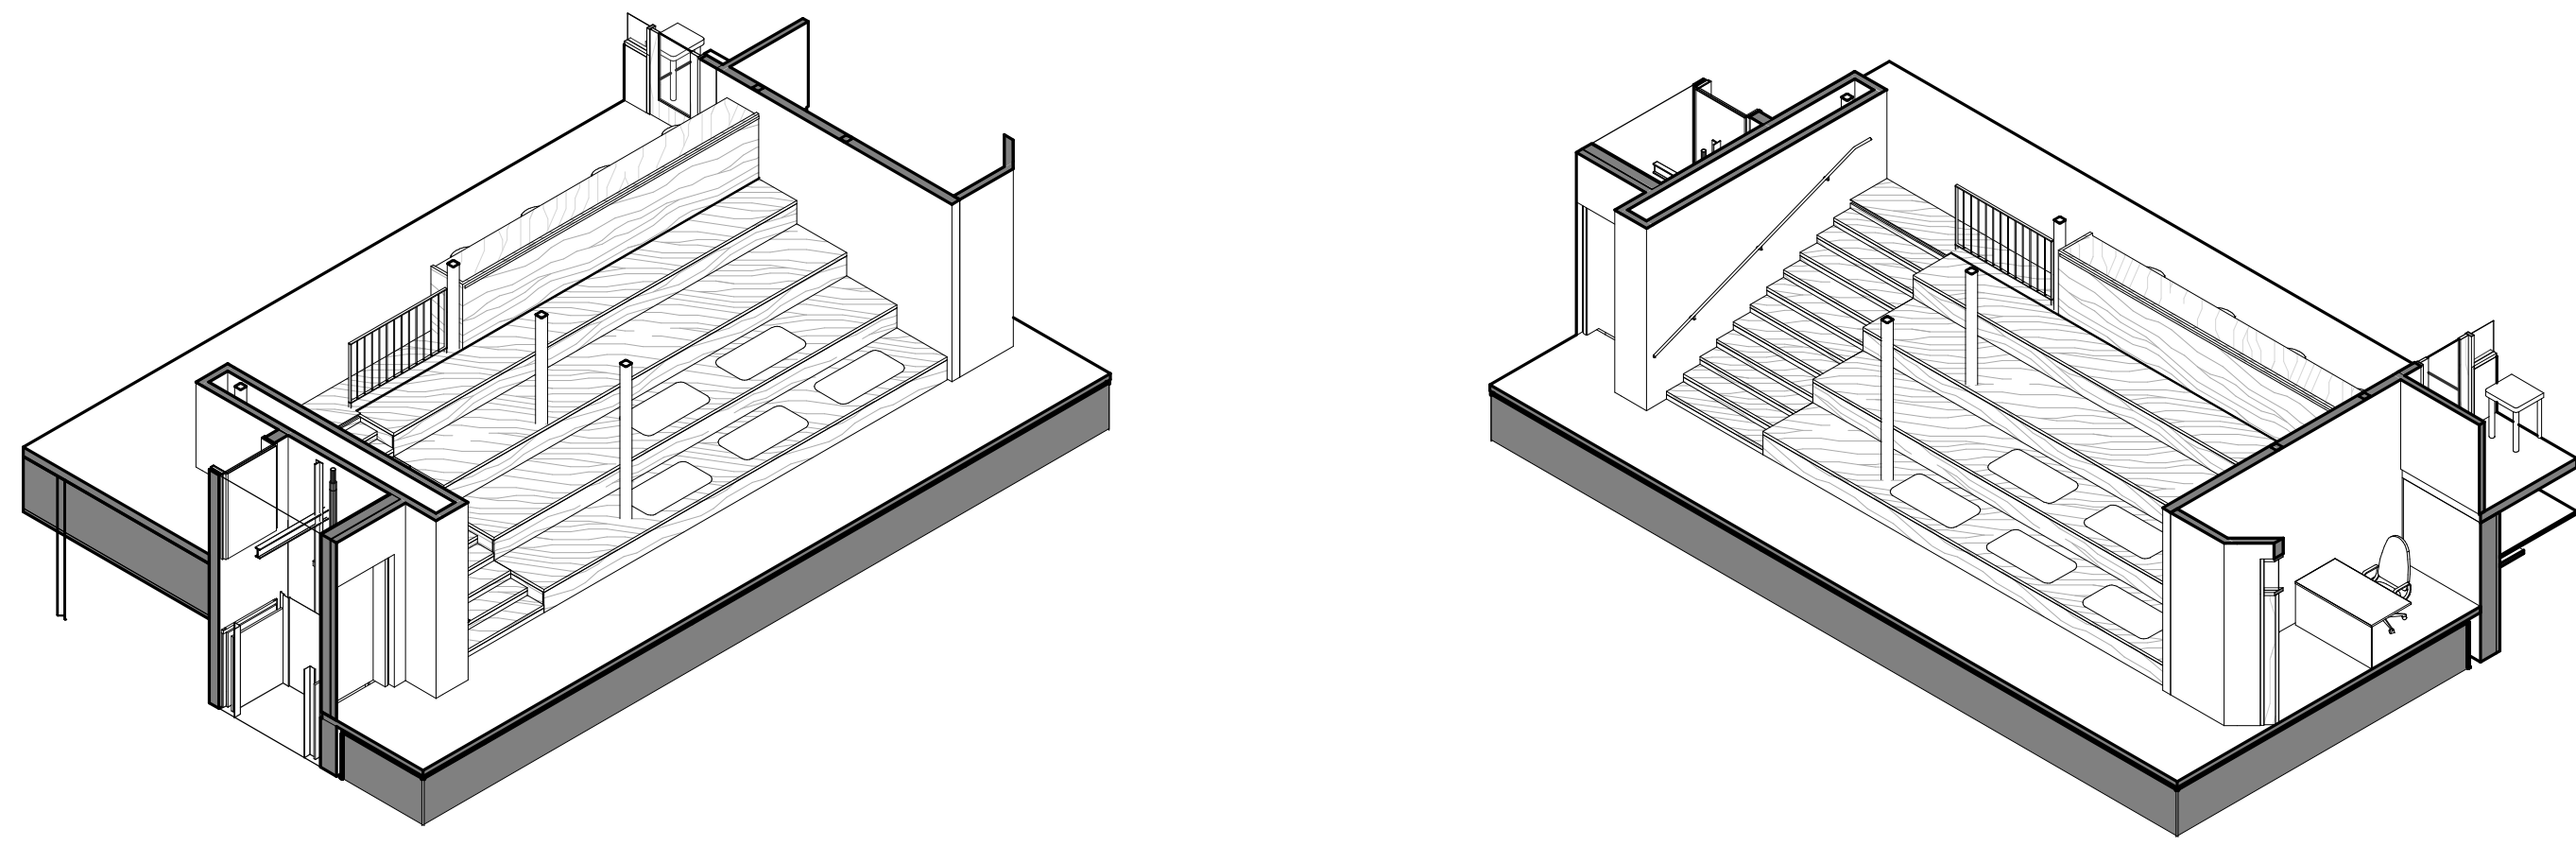


5 STAIR AXON - FORUM SEATING, VIEW 1  
A602

6 STAIR AXON - FORUM SEATING, VIEW 2  
A602

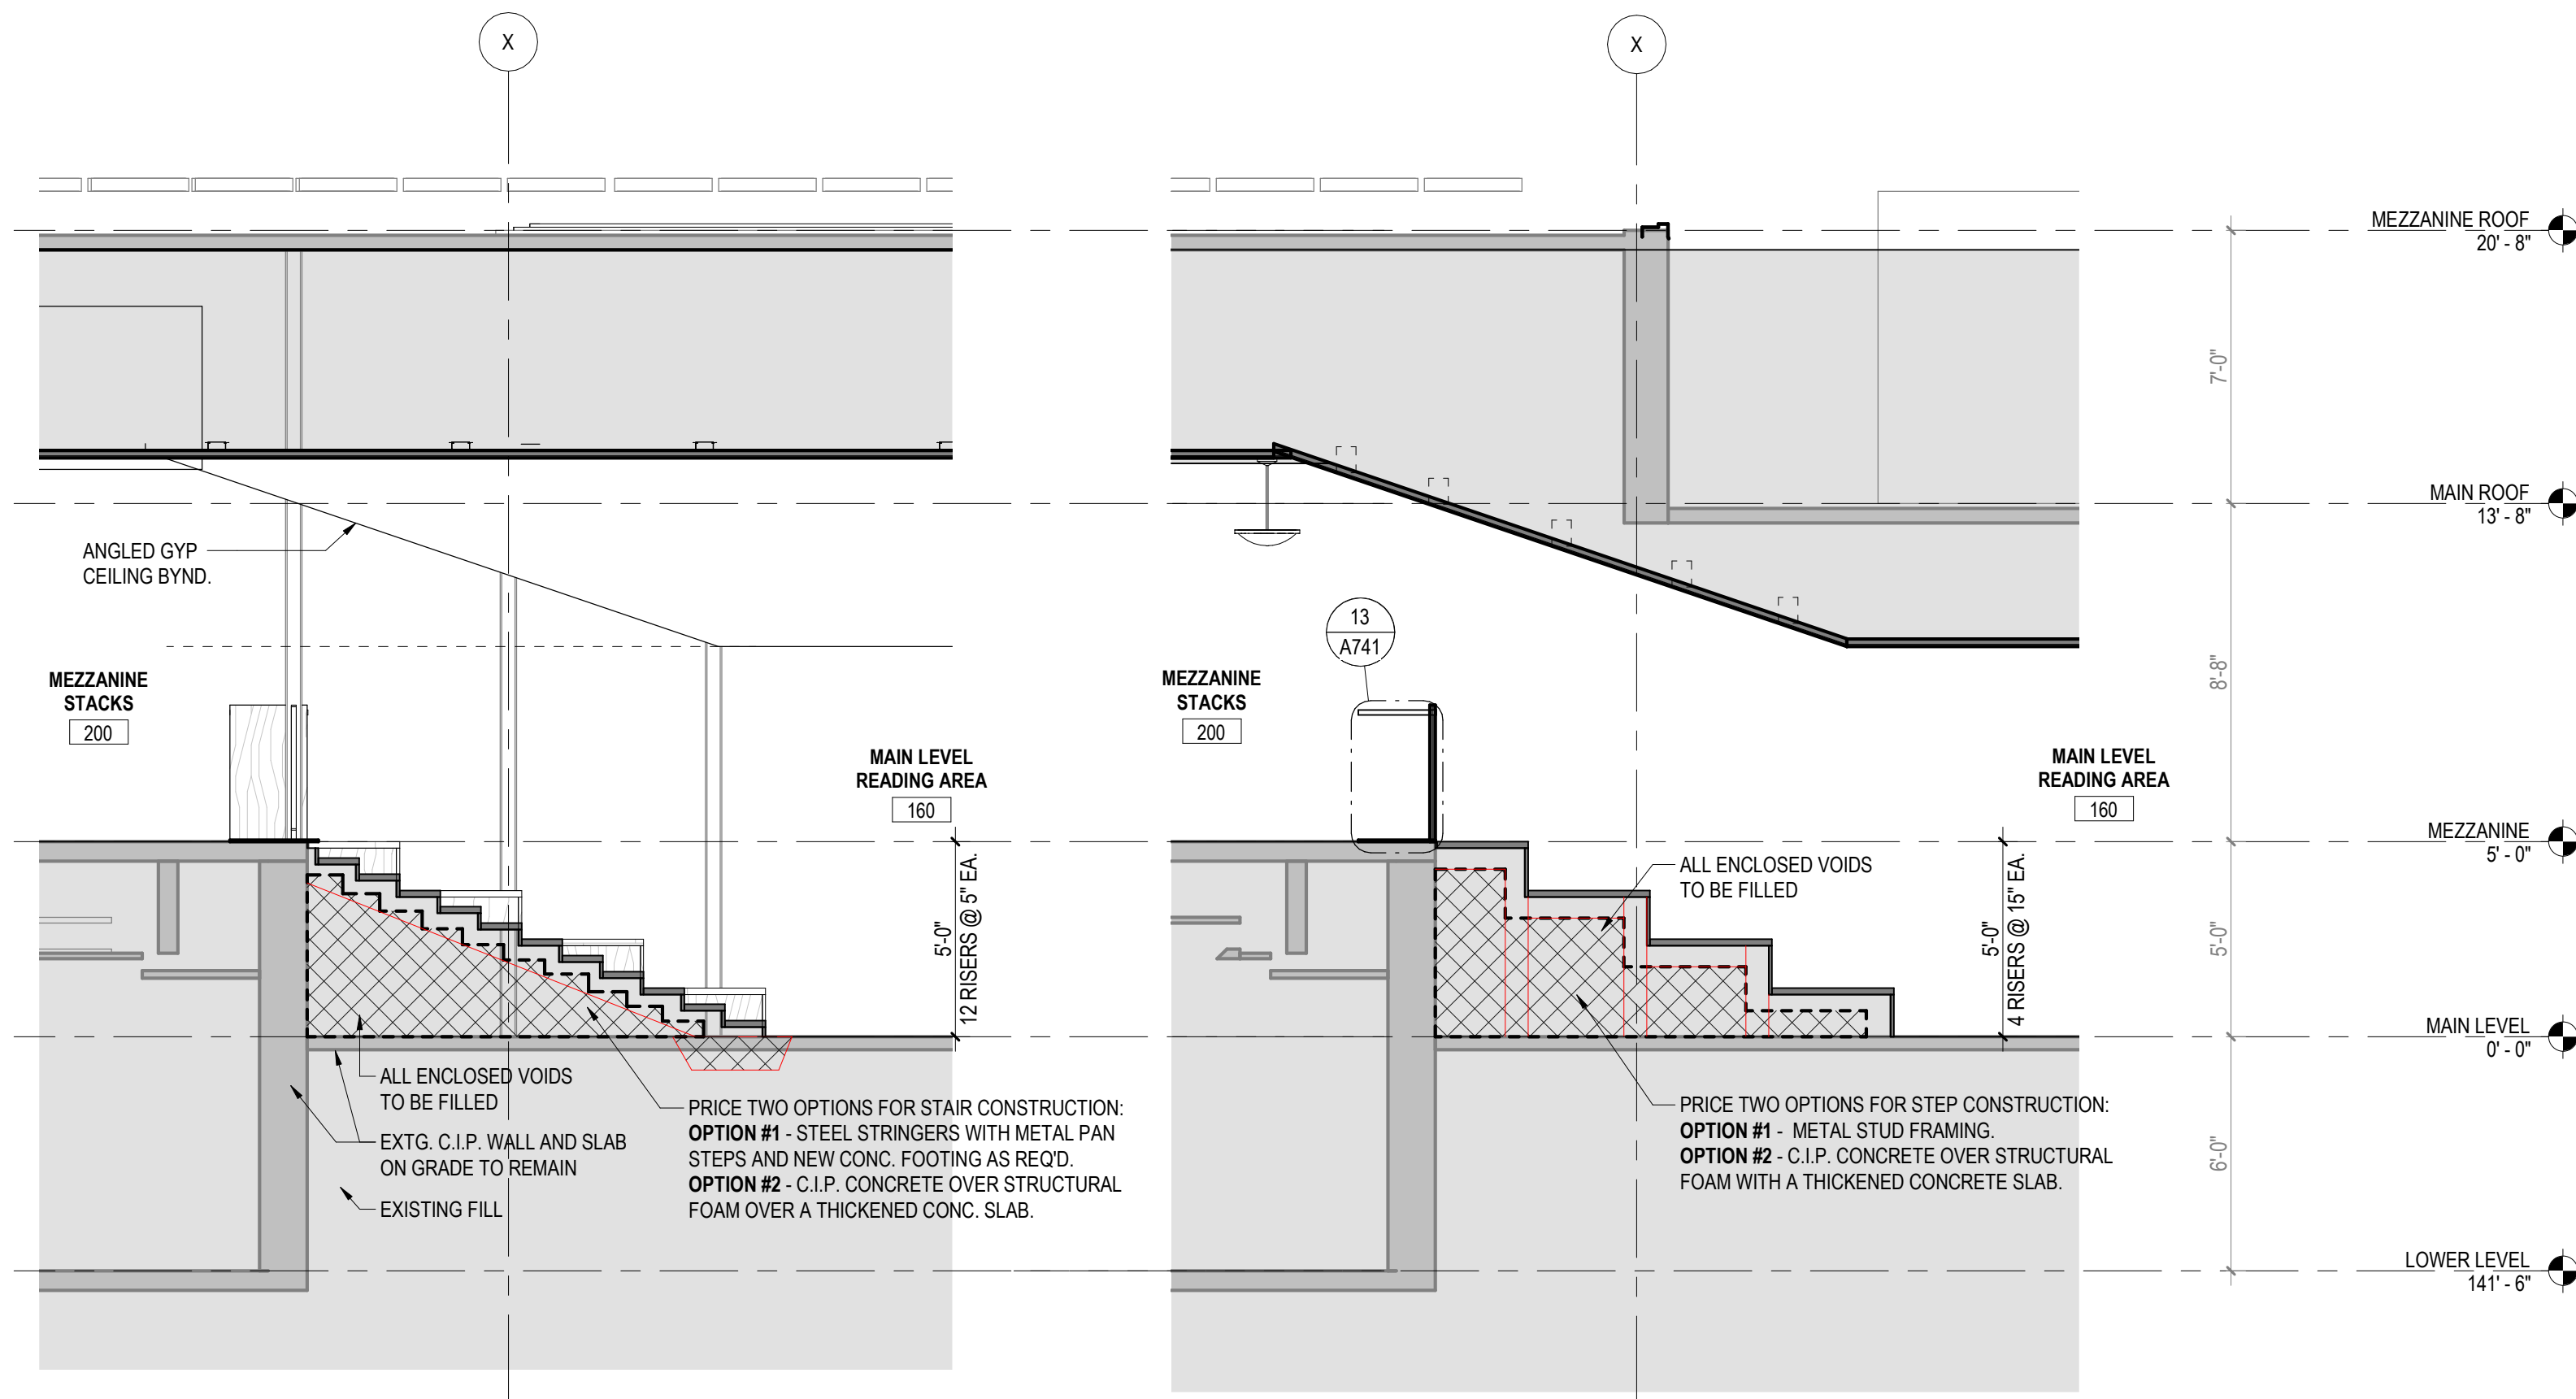


3 SECTION AT FORUM SEATING STAIR RUN  
A602 A602 1/4" = 1'-0"


4 SECTION AT FORUM SEATING  
A602 A602 1/4" = 1'-0"

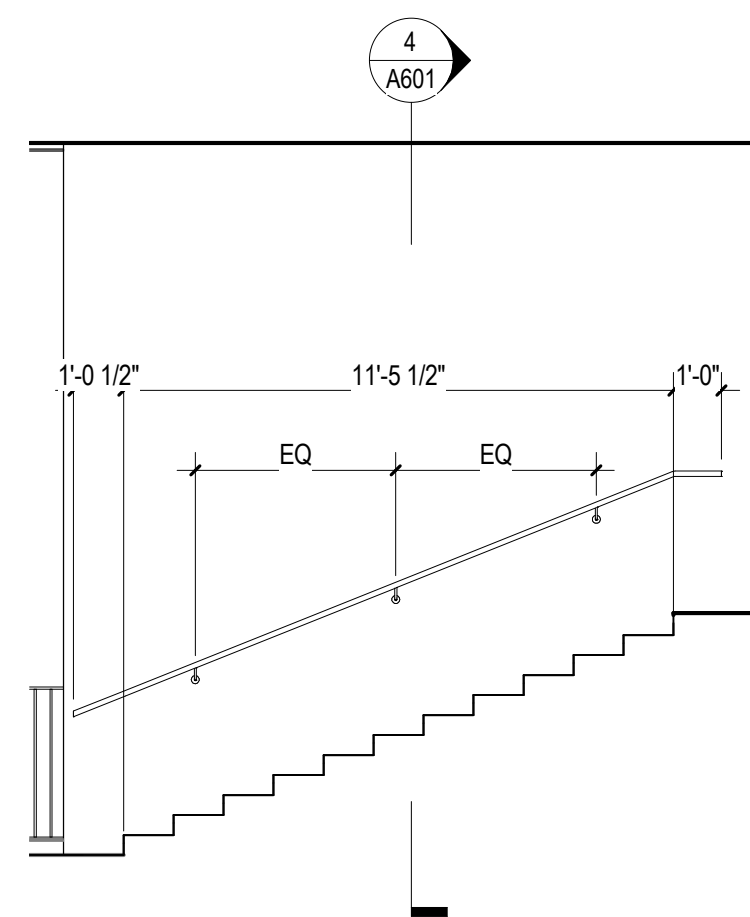


7 FORUM STAIR RAILING ELEVATION  
A602 1/4" = 1'-0"

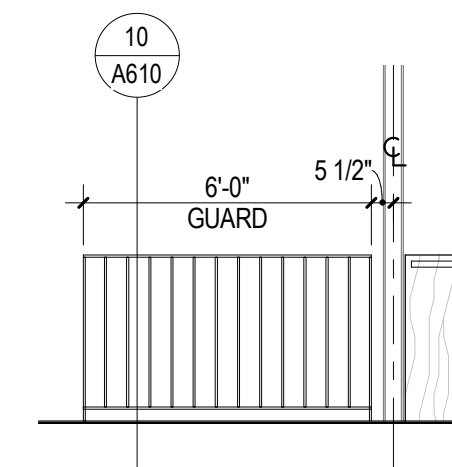


8 FORUM STAIR AT MEZZANINE GUARDRAIL ELEVATION  
A741 A602 1/4" = 1'-0"

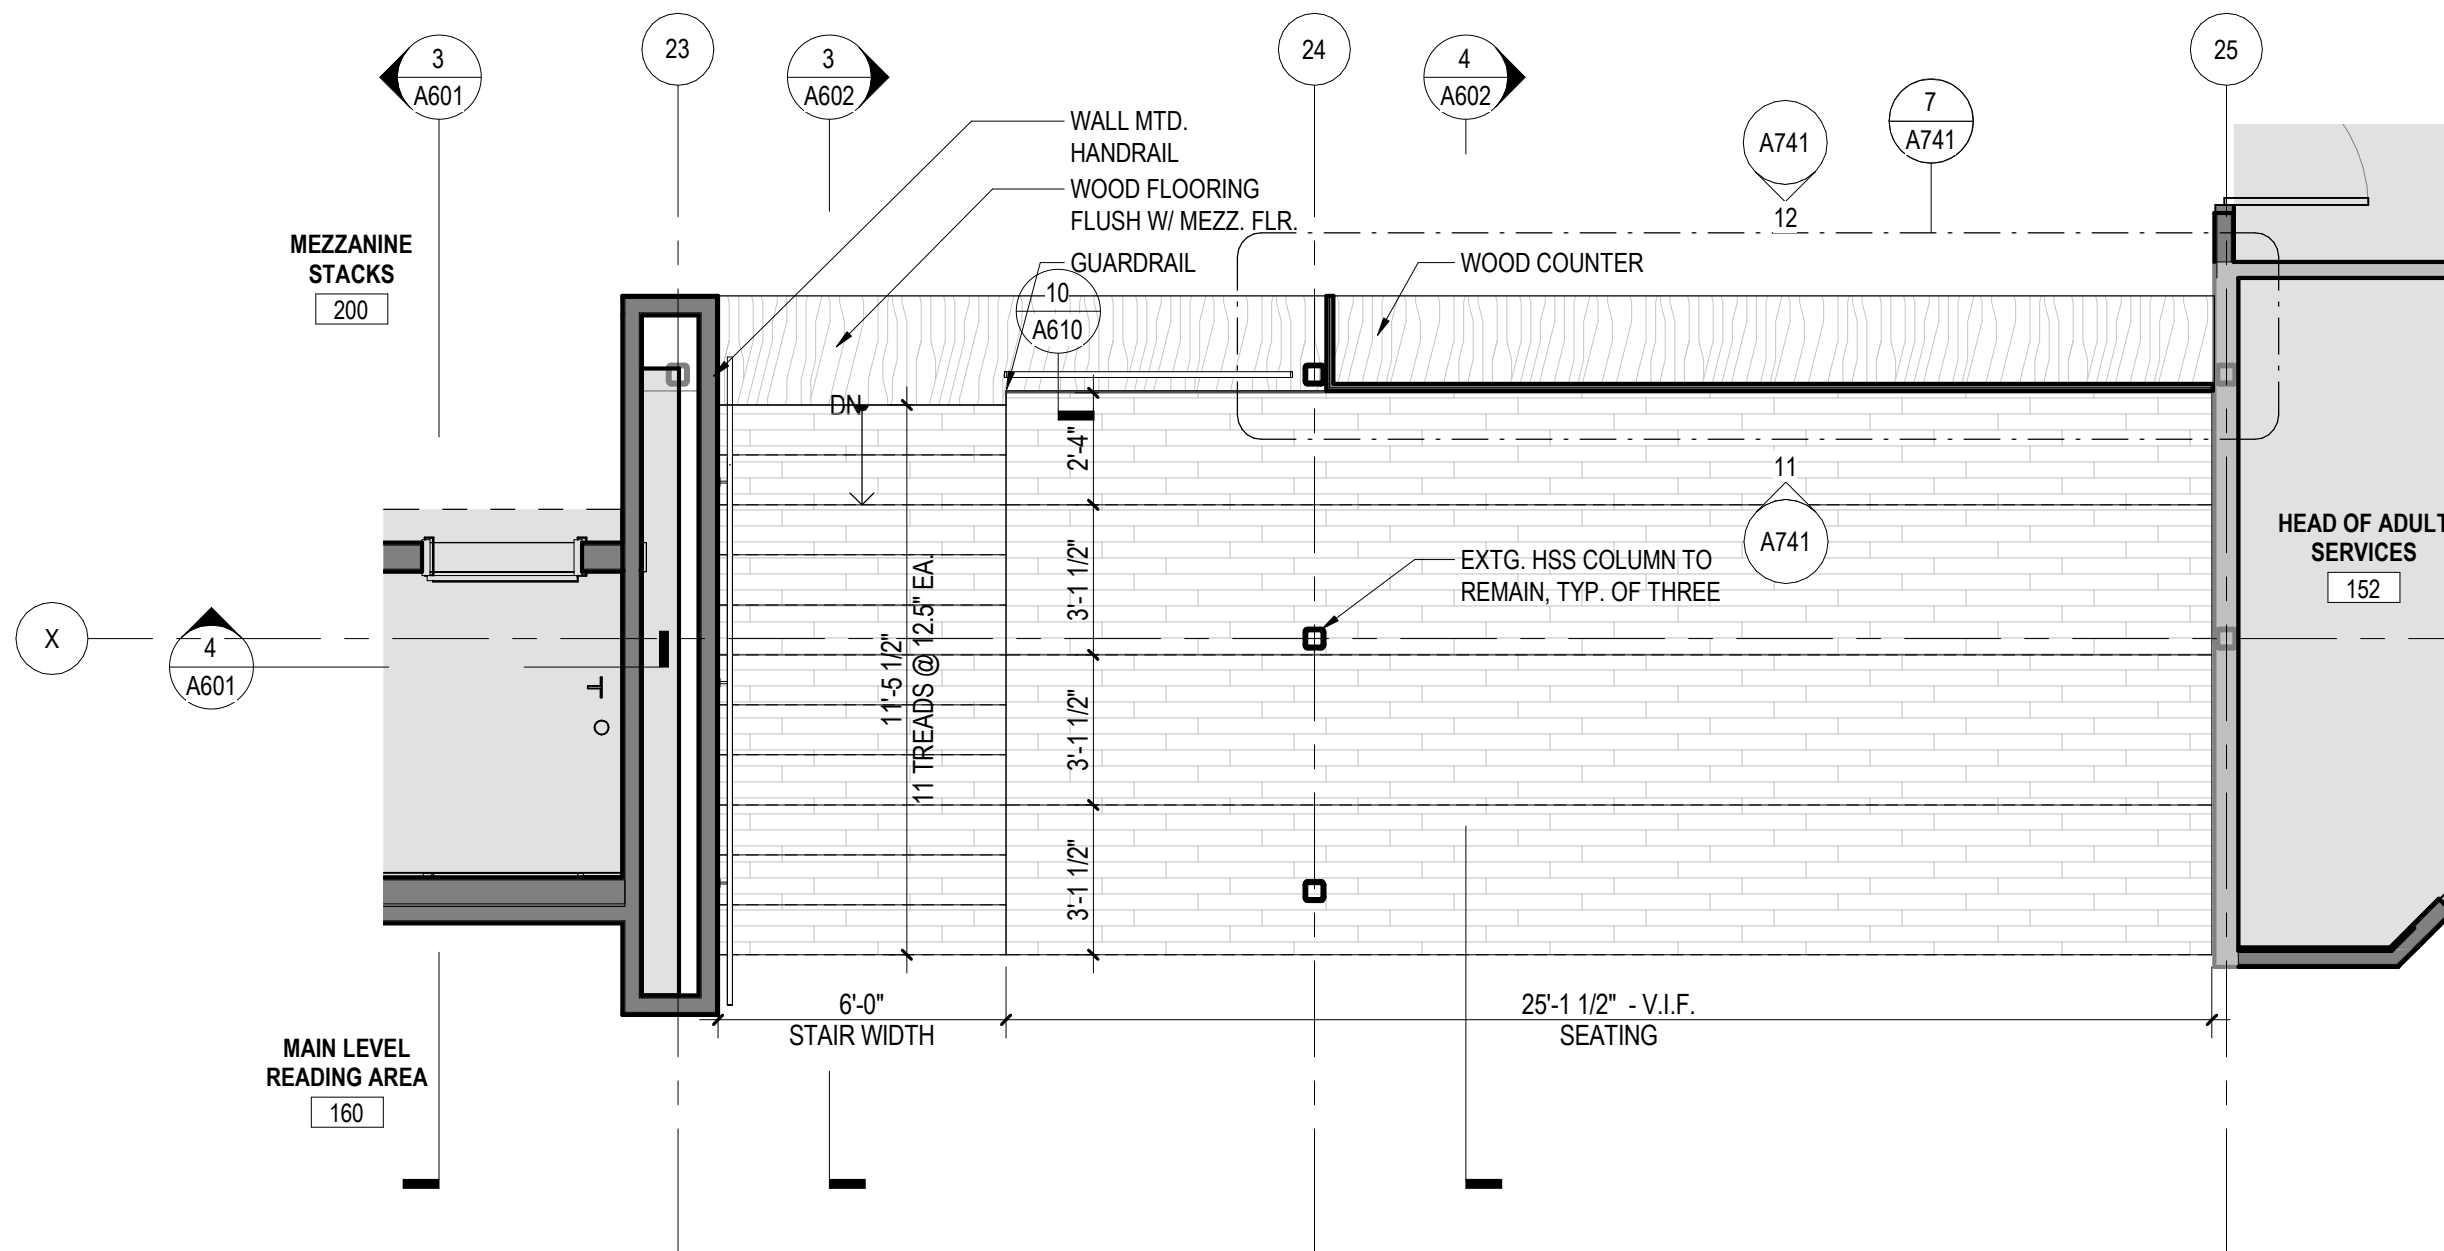


2 FORUM SEATING STEPS - PLAN  
A111 A602 1/4" = 1'-0"

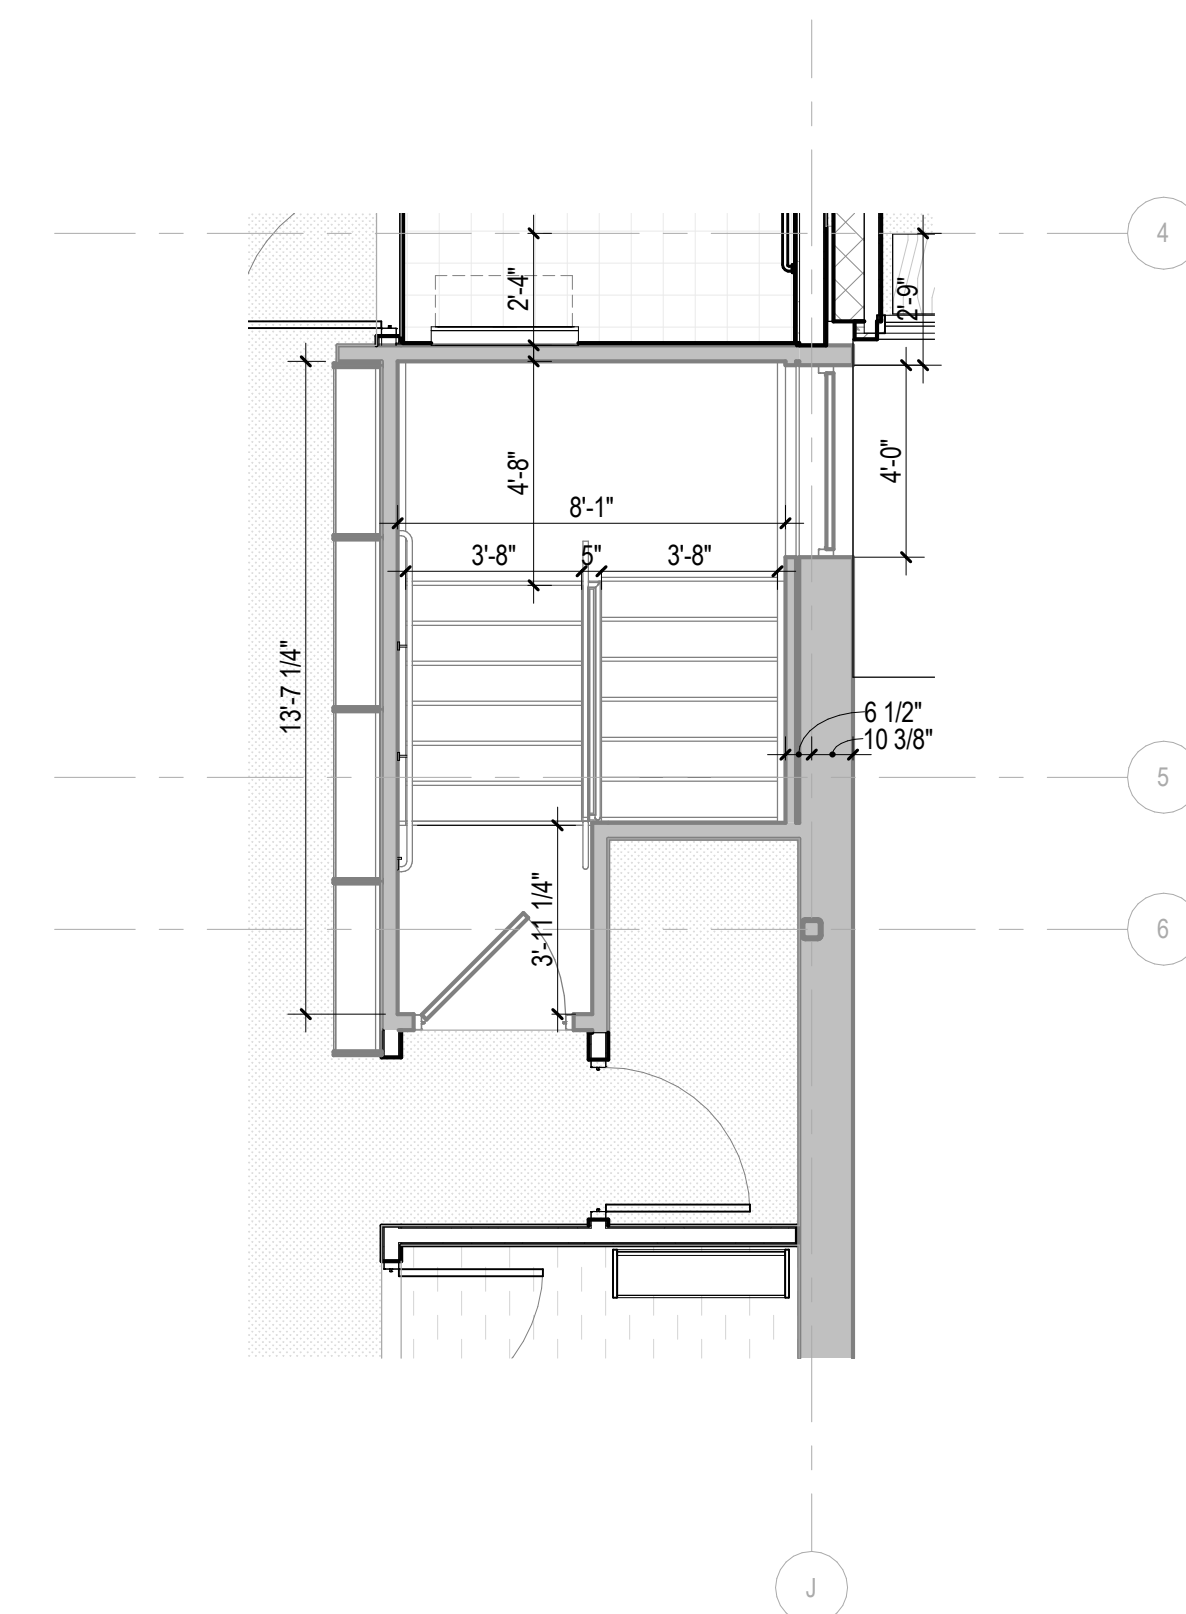


1 STAIR 10 - MAIN LEVEL PLAN  
A111 A602 1/4" = 1'-0"

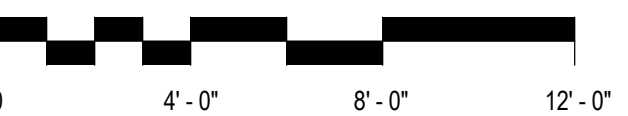




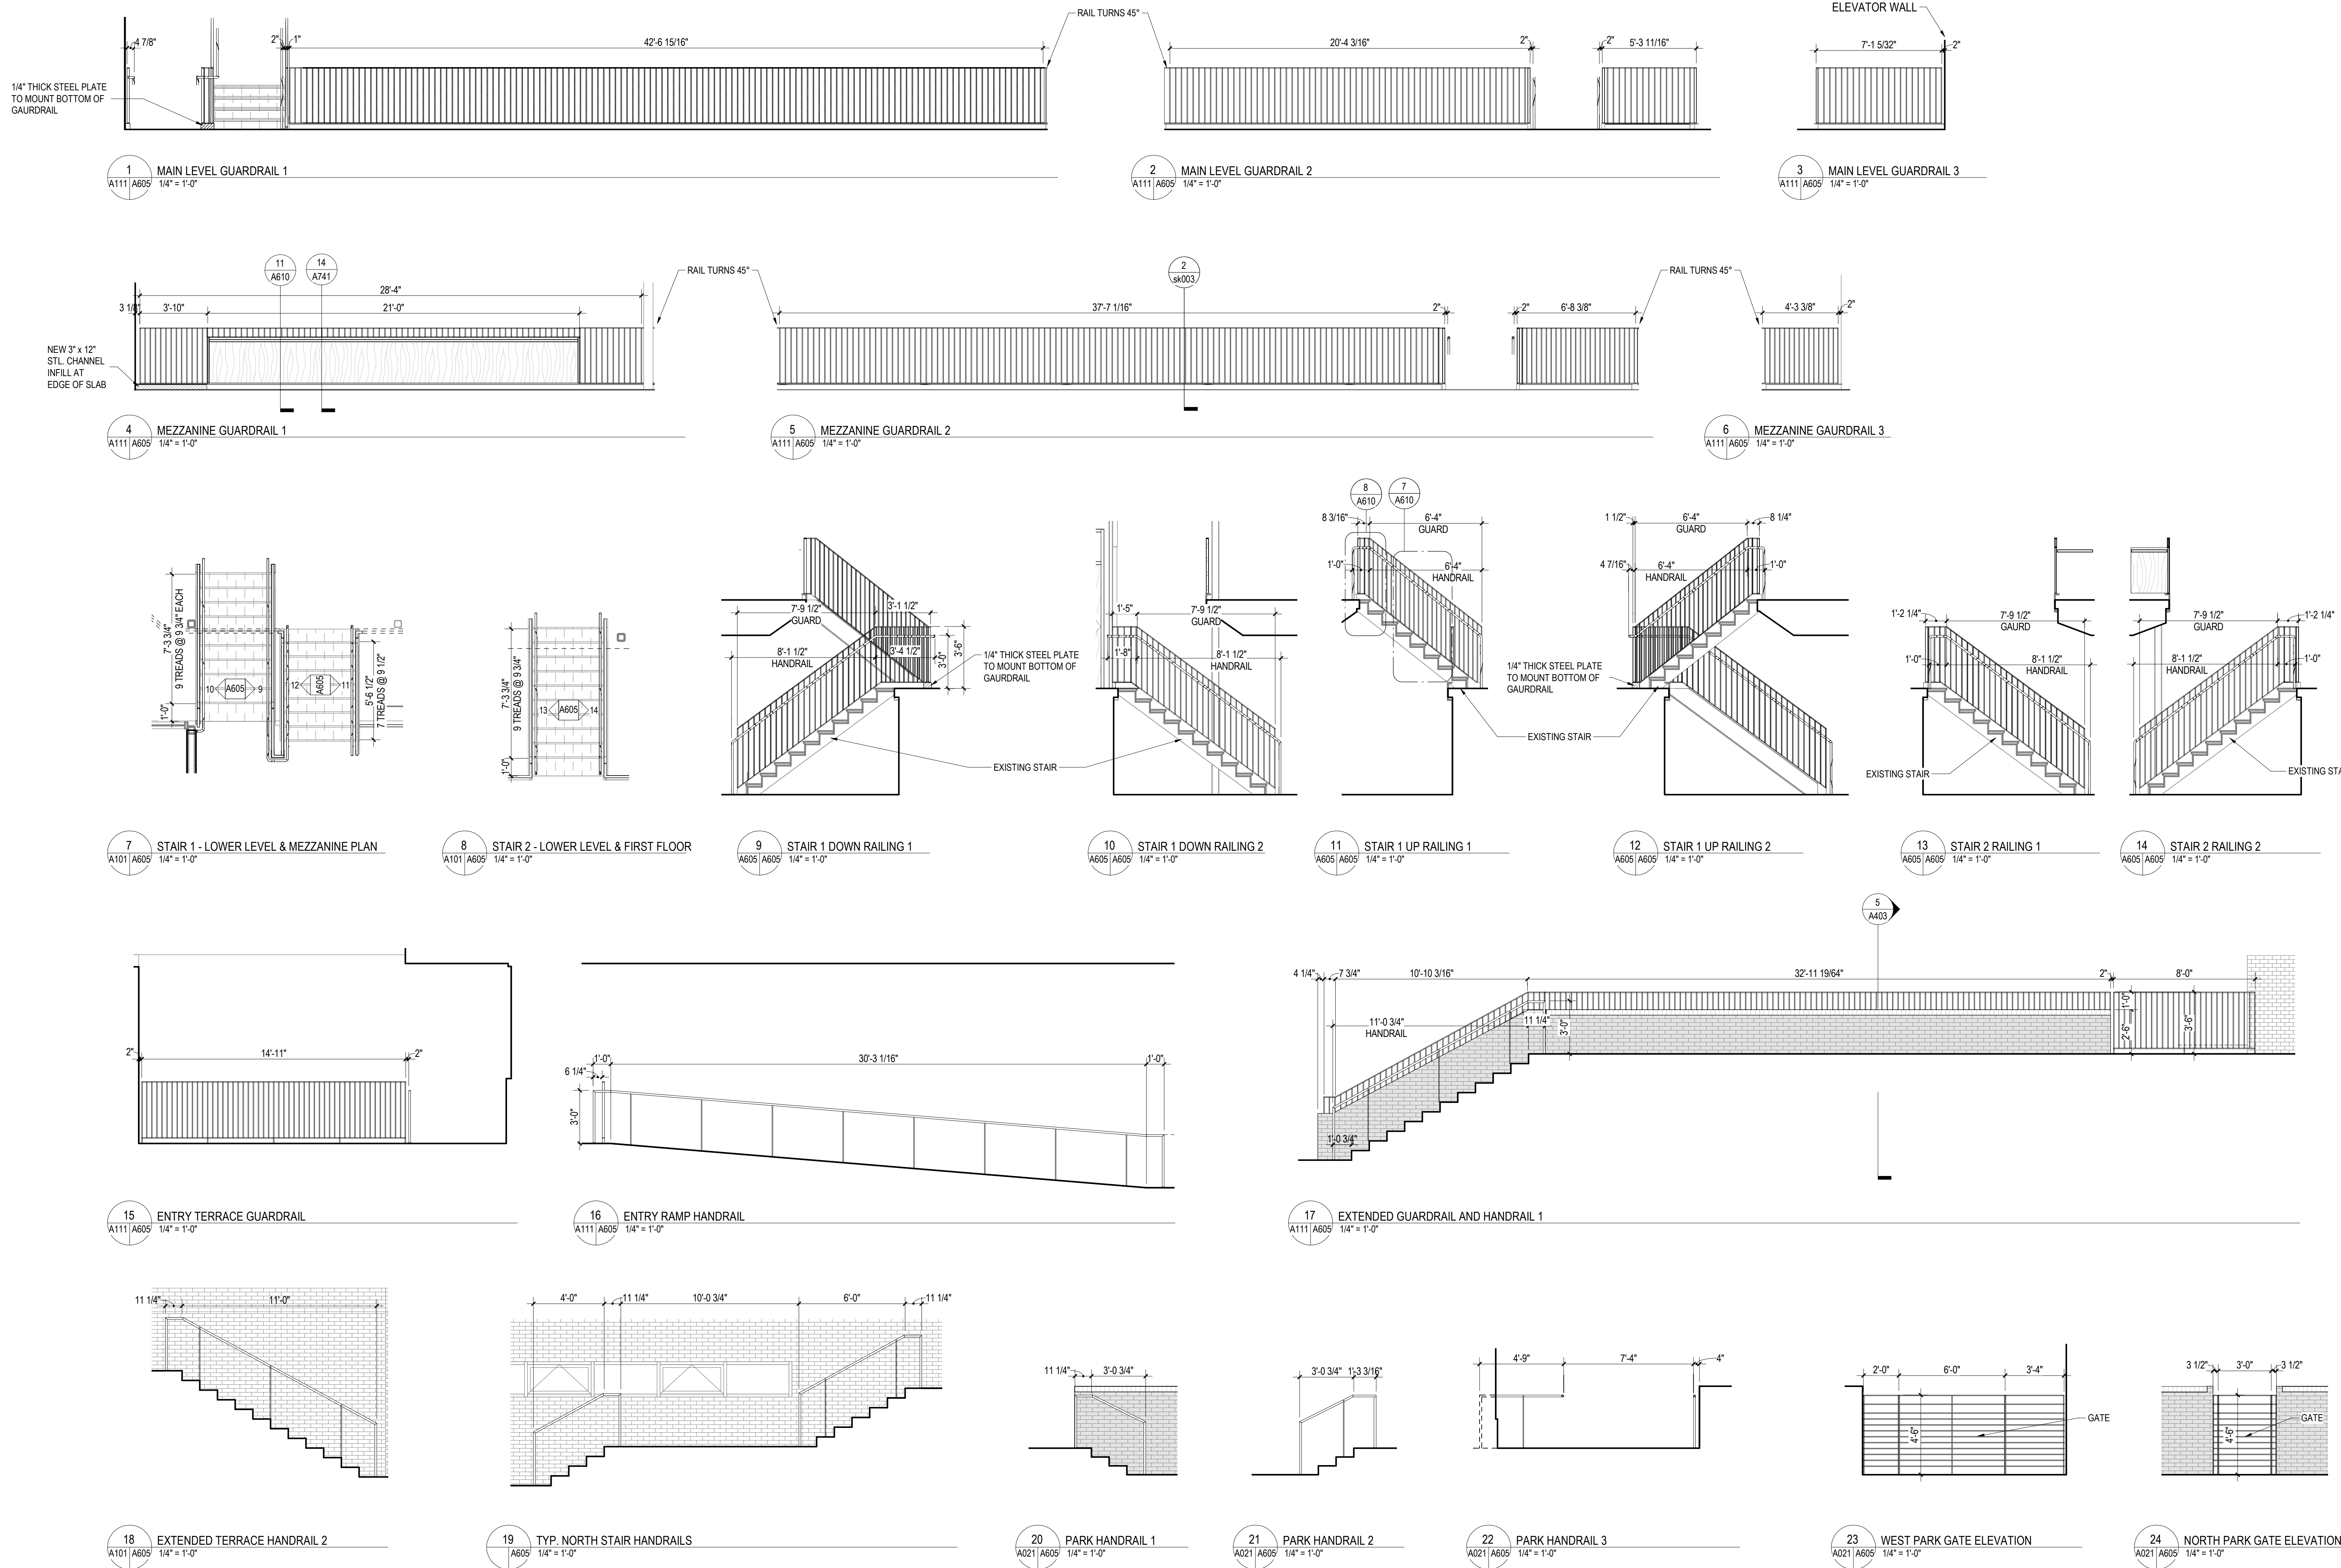




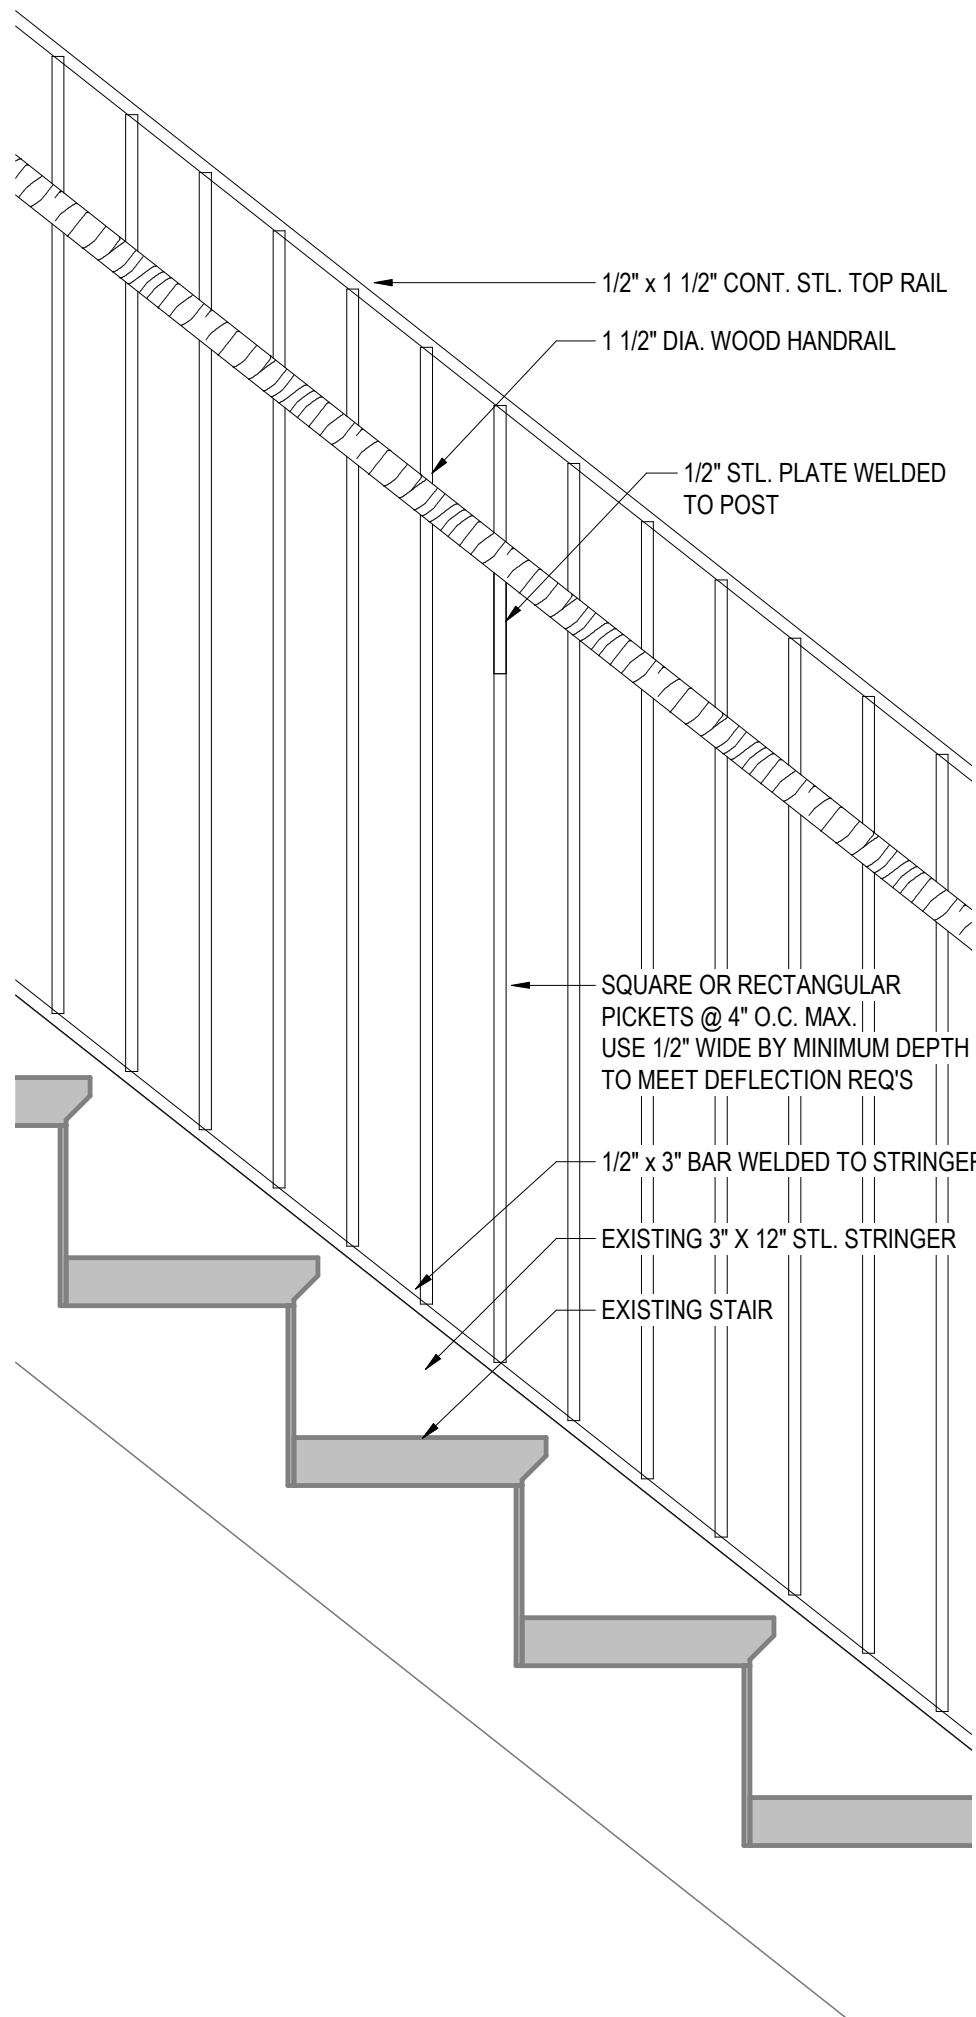


7 TYP. SEC./ELEV. @ EXISTING STAIR  
A605 A610 1 1/2" = 1'-0"

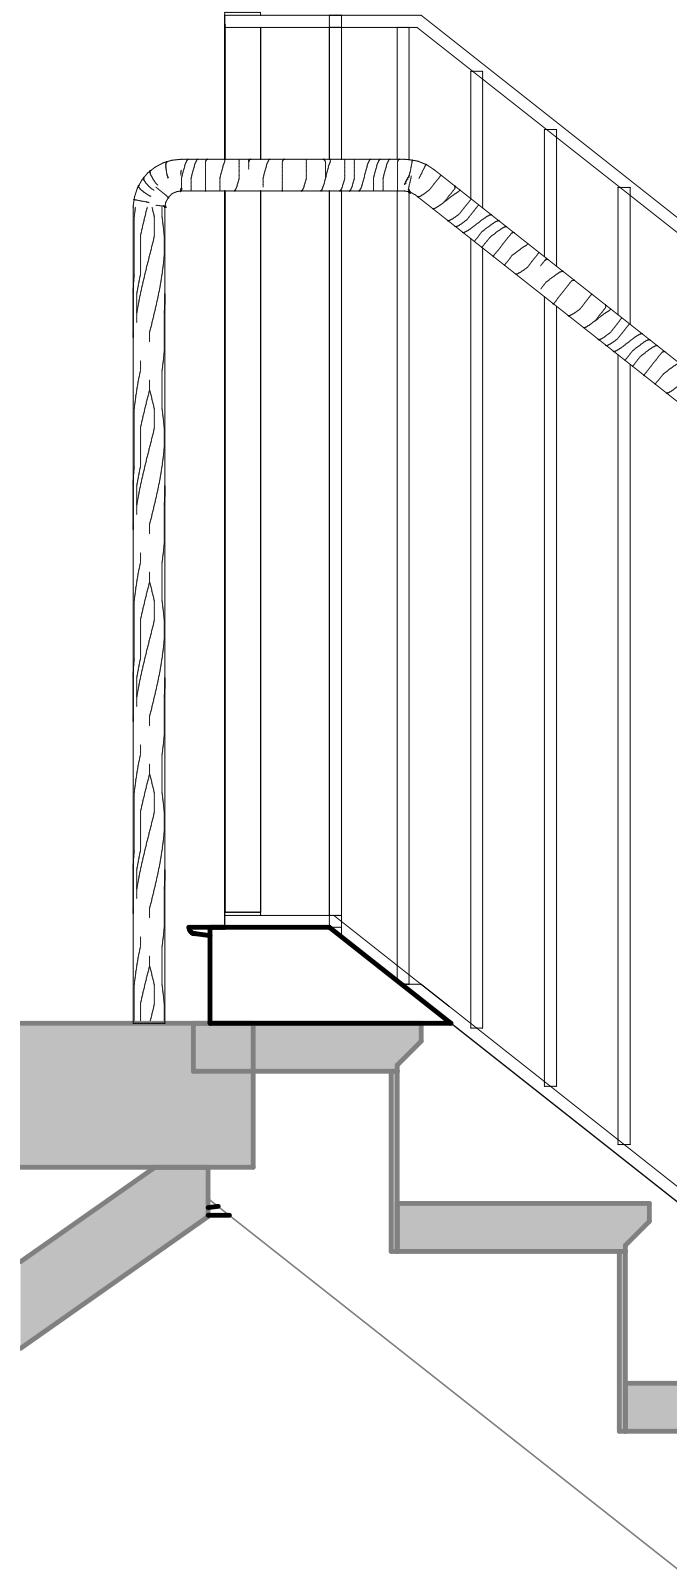

8 TYP. SEC./ELEV. TOP TREAD @ EXISTING STAIR  
A605 A610 1 1/2" = 1'-0"

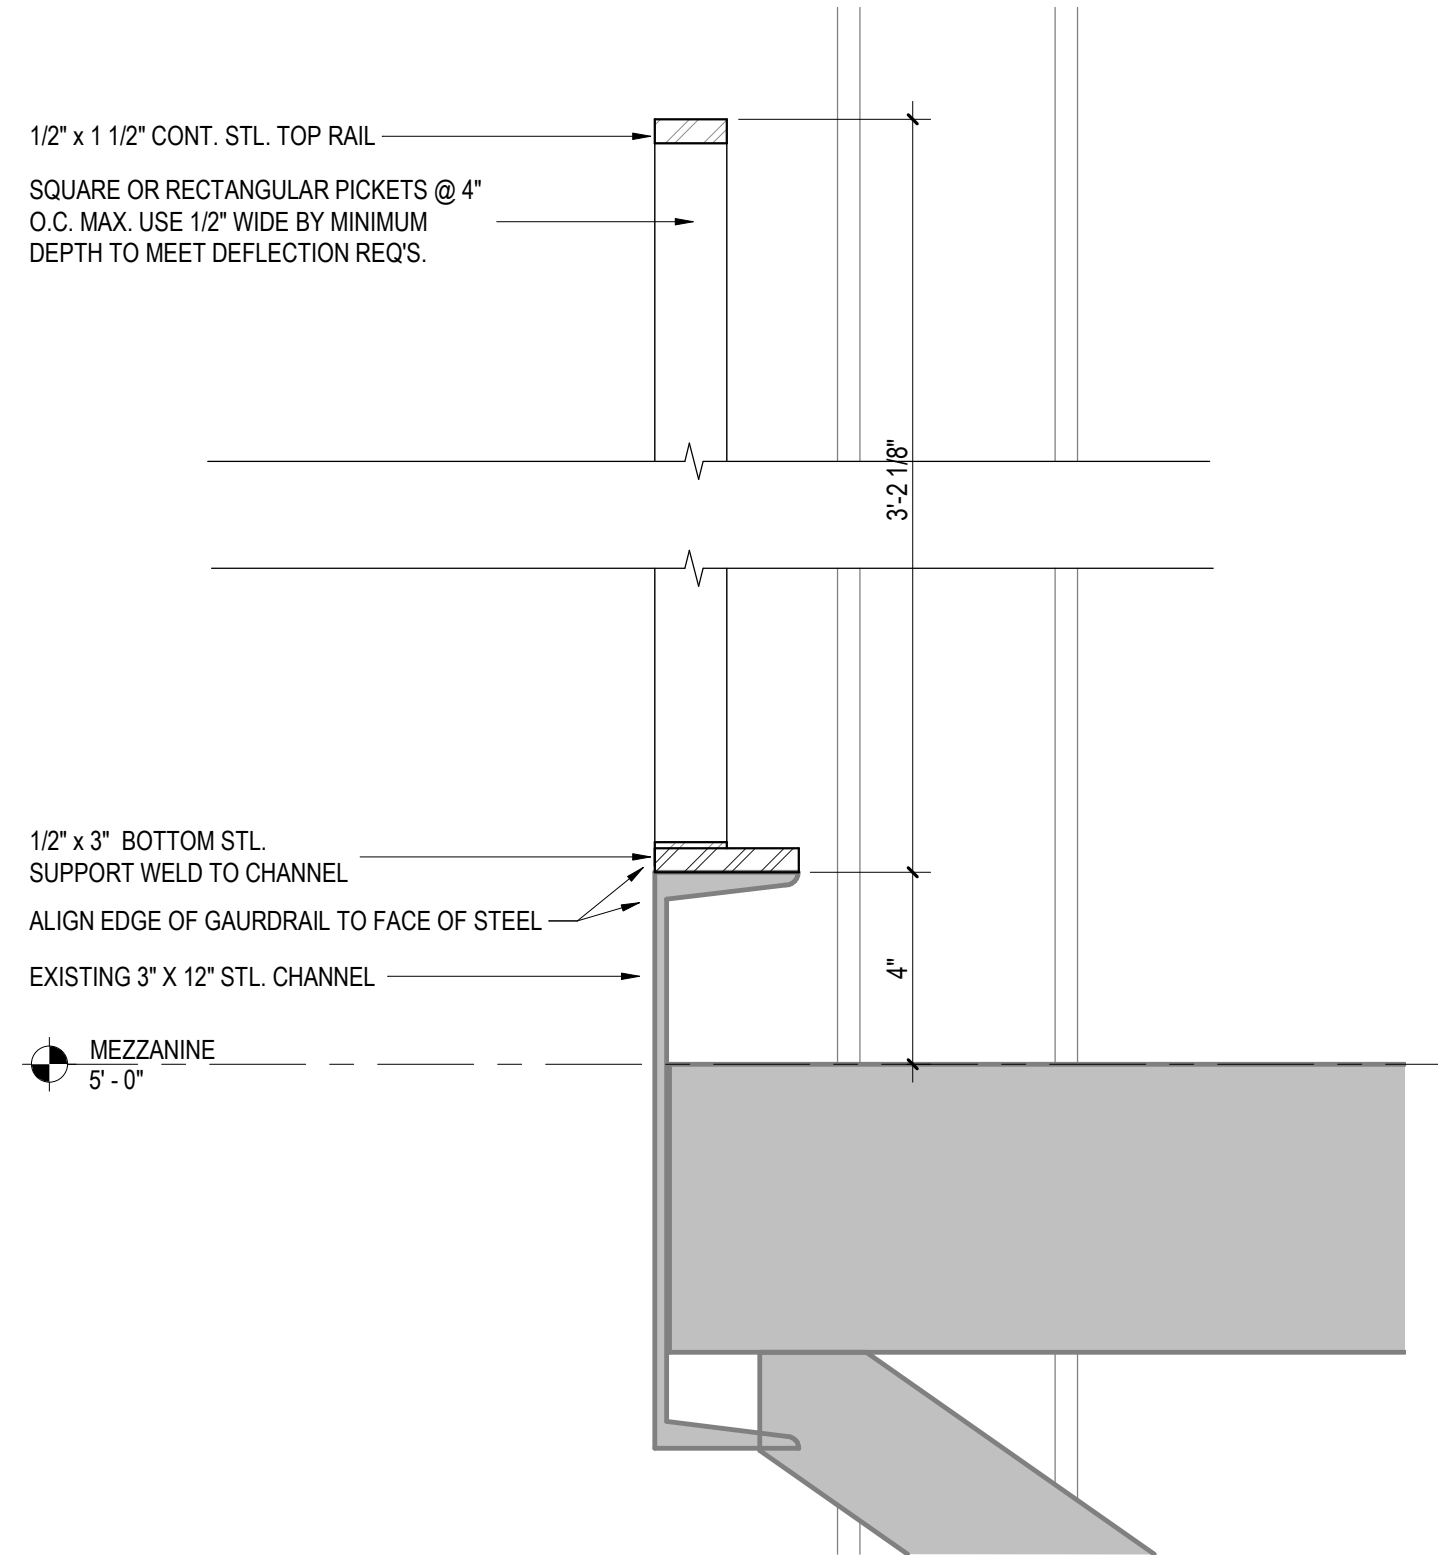


9 TYP. GUARDRAIL AT EXISTING SLAB EDGE  
A605 A610 3" = 1'-0"

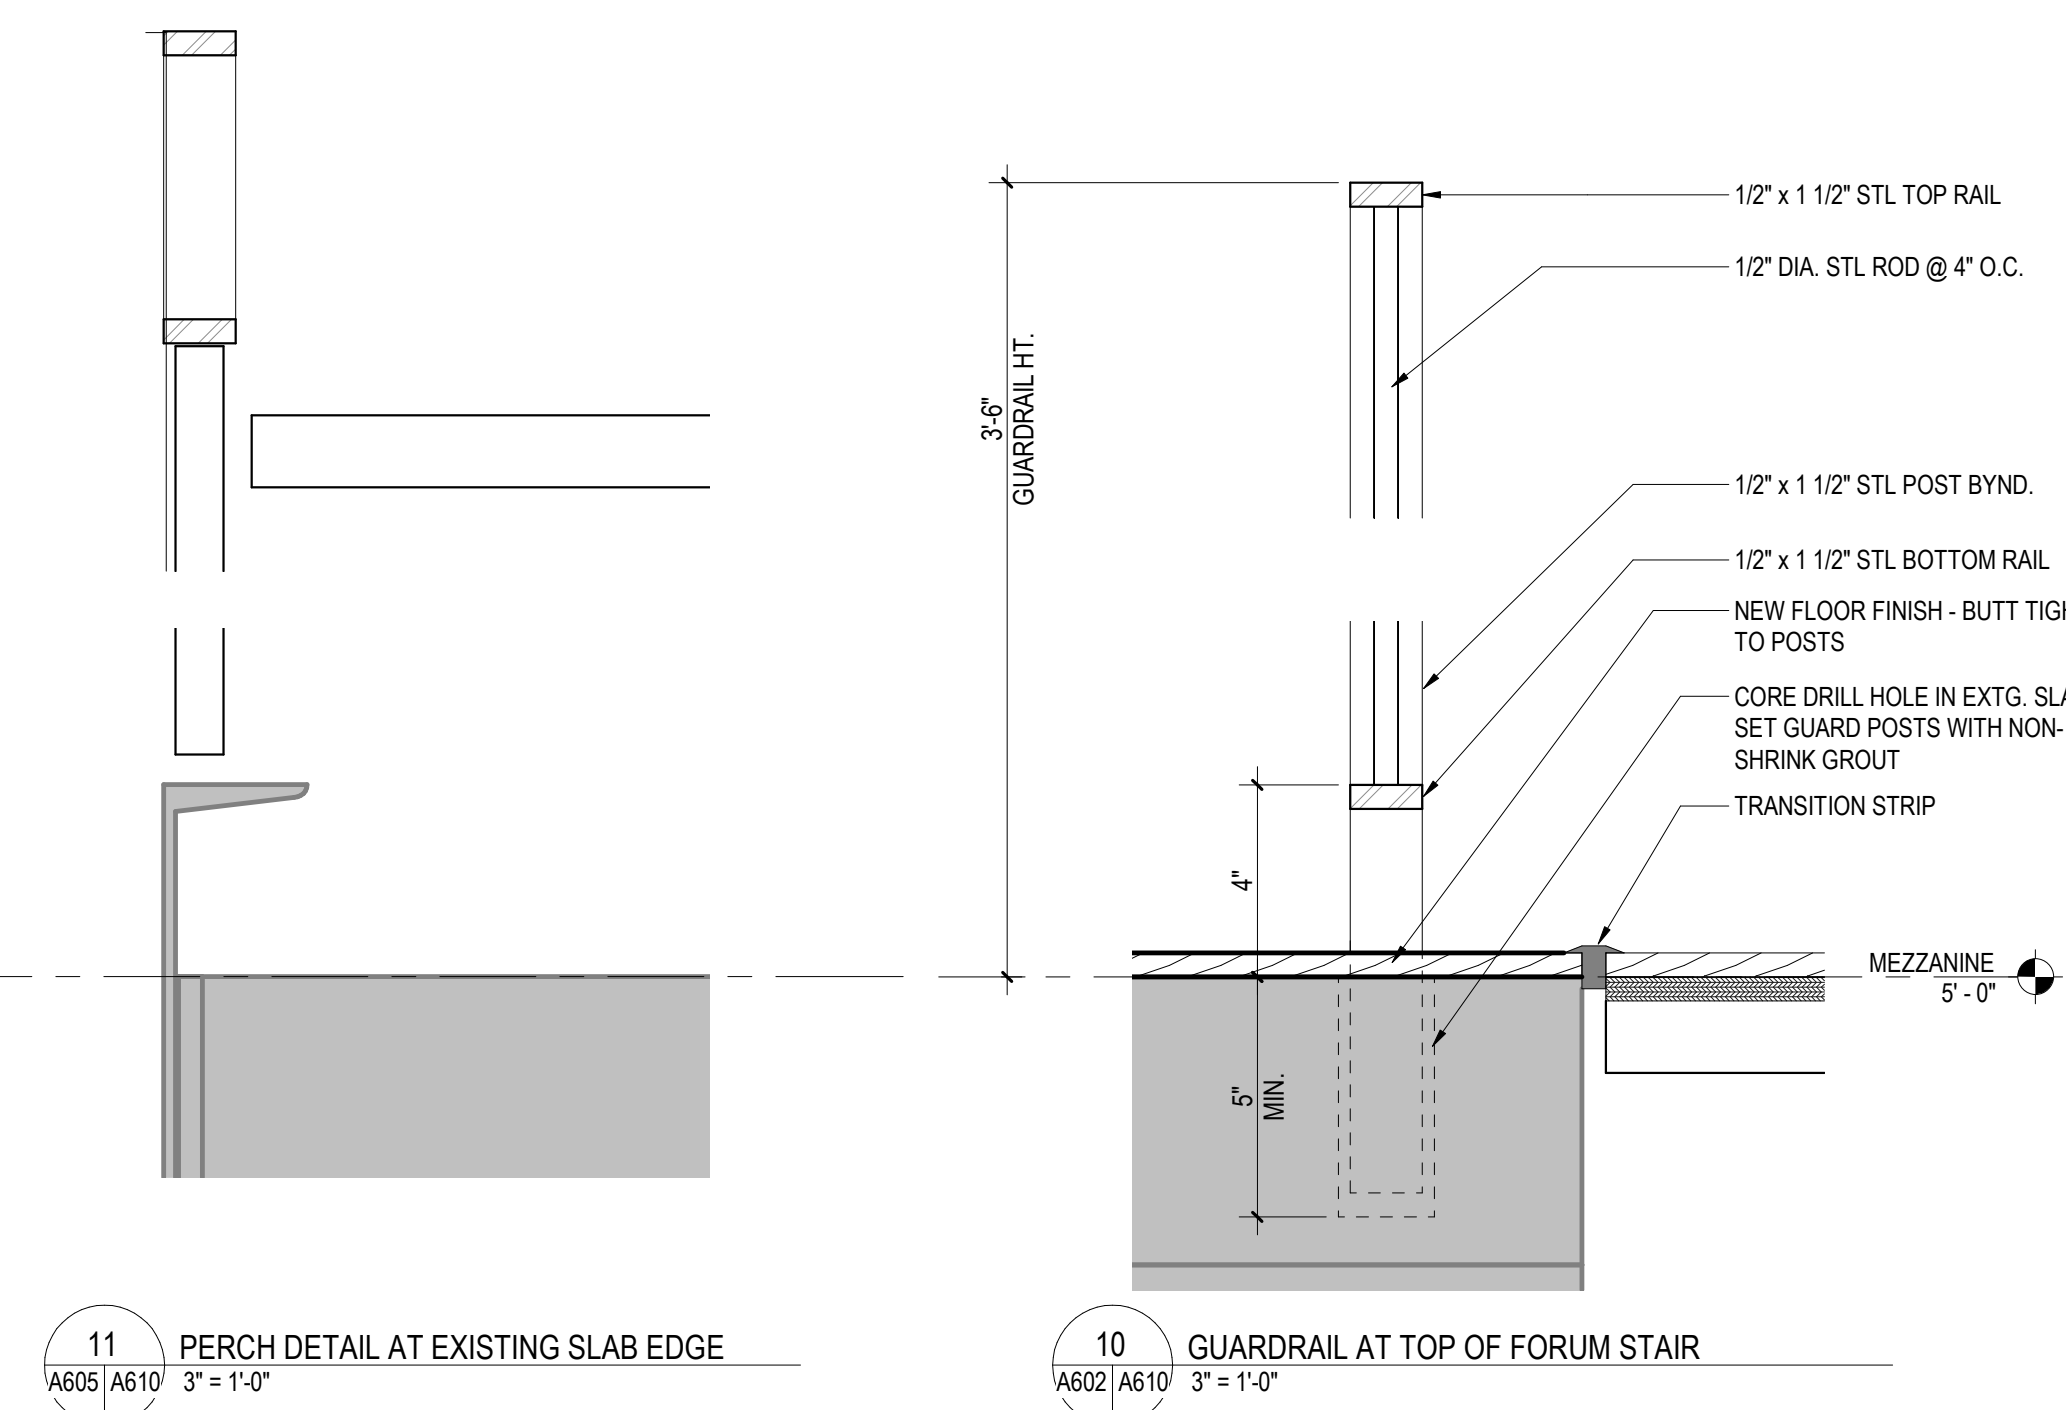


11 PERCH DETAIL AT EXISTING SLAB EDGE  
A605 A610 3" = 1'-0"


10 GUARDRAIL AT TOP OF FORUM STAIR  
A602 A610 3" = 1'-0"

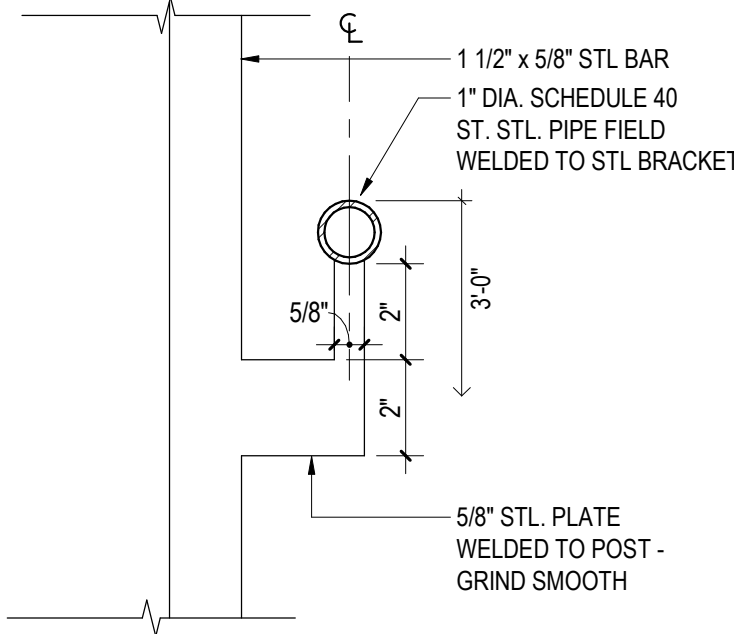

4 TYP. HANDRAIL @ STAIR GUARD  
A610 N.T.S.

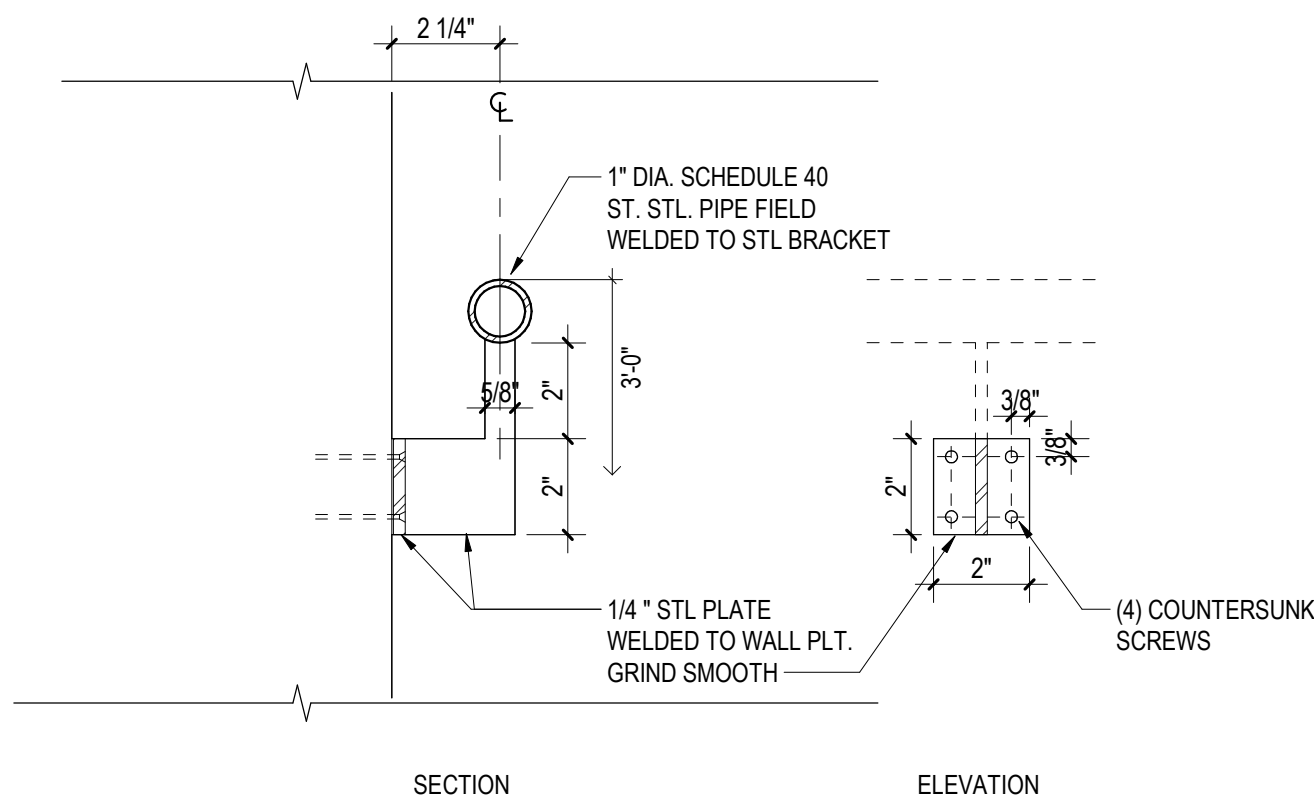

5 TYP. STL. PIPE HANDRAIL @ WALL  
A610 N.T.S.

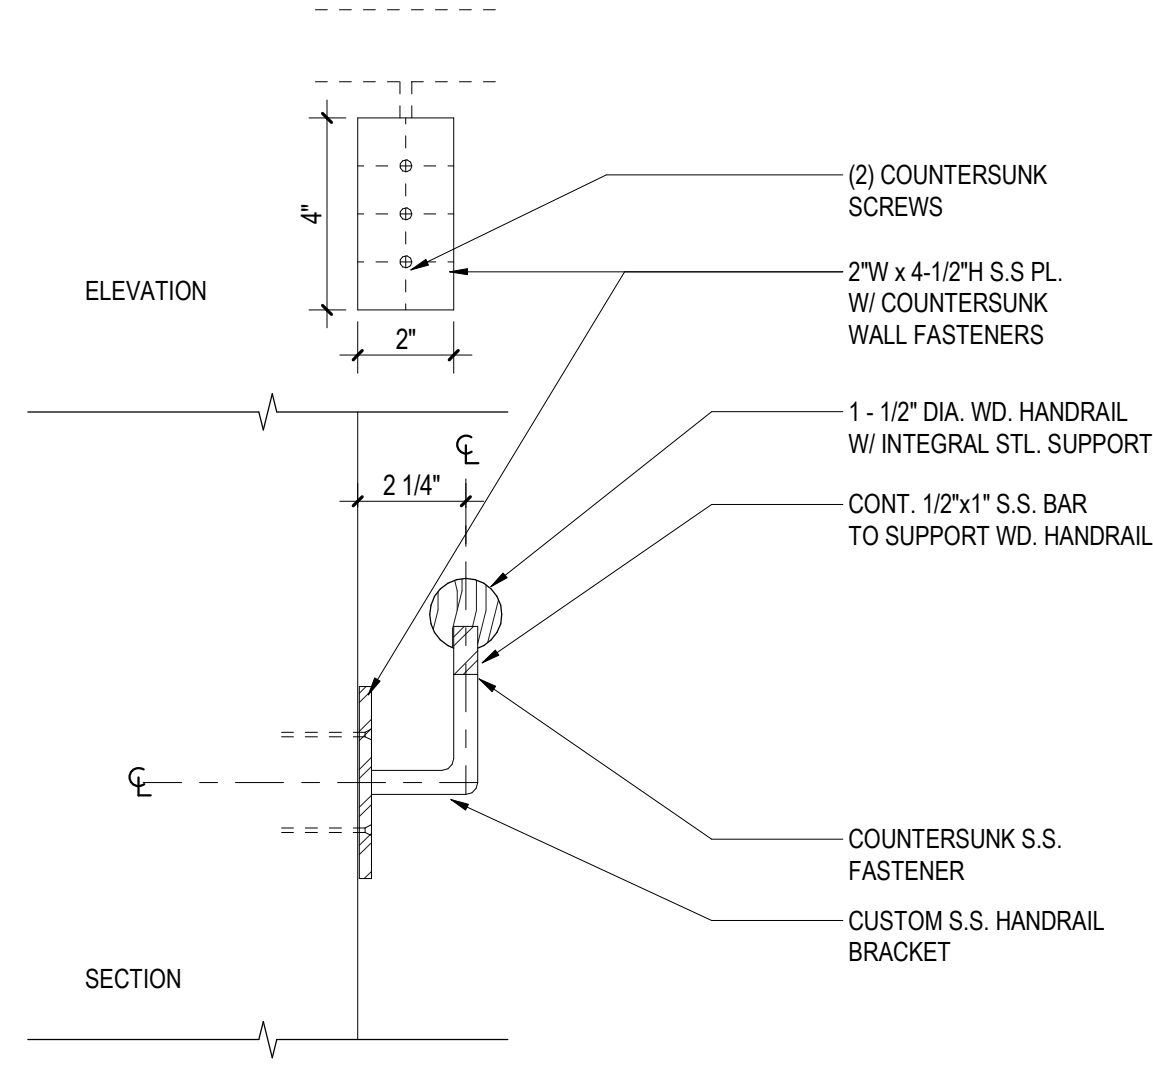

6 TYP. SWD. HANDRAIL @ WALL  
A610 N.T.S.



## New City Library Addition & Renovation


220 North Main Street  
New City, NY 10956

Client Project Number  
VMDO Project Number

130

Checked By \_\_\_\_\_  
Drawn By \_\_\_\_\_

Checked  
Author

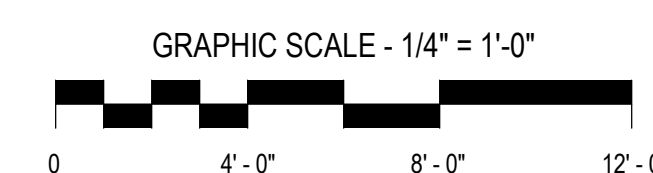


ISSUES AND REVISIONS

NO.	SUBMITTAL	DATE
	SCHEMATIC DESIGN	03.05.20

## ENLARGED PLANS & INTERIOR ELEVATIONS

A710

DESIGN DEVELOPMENT

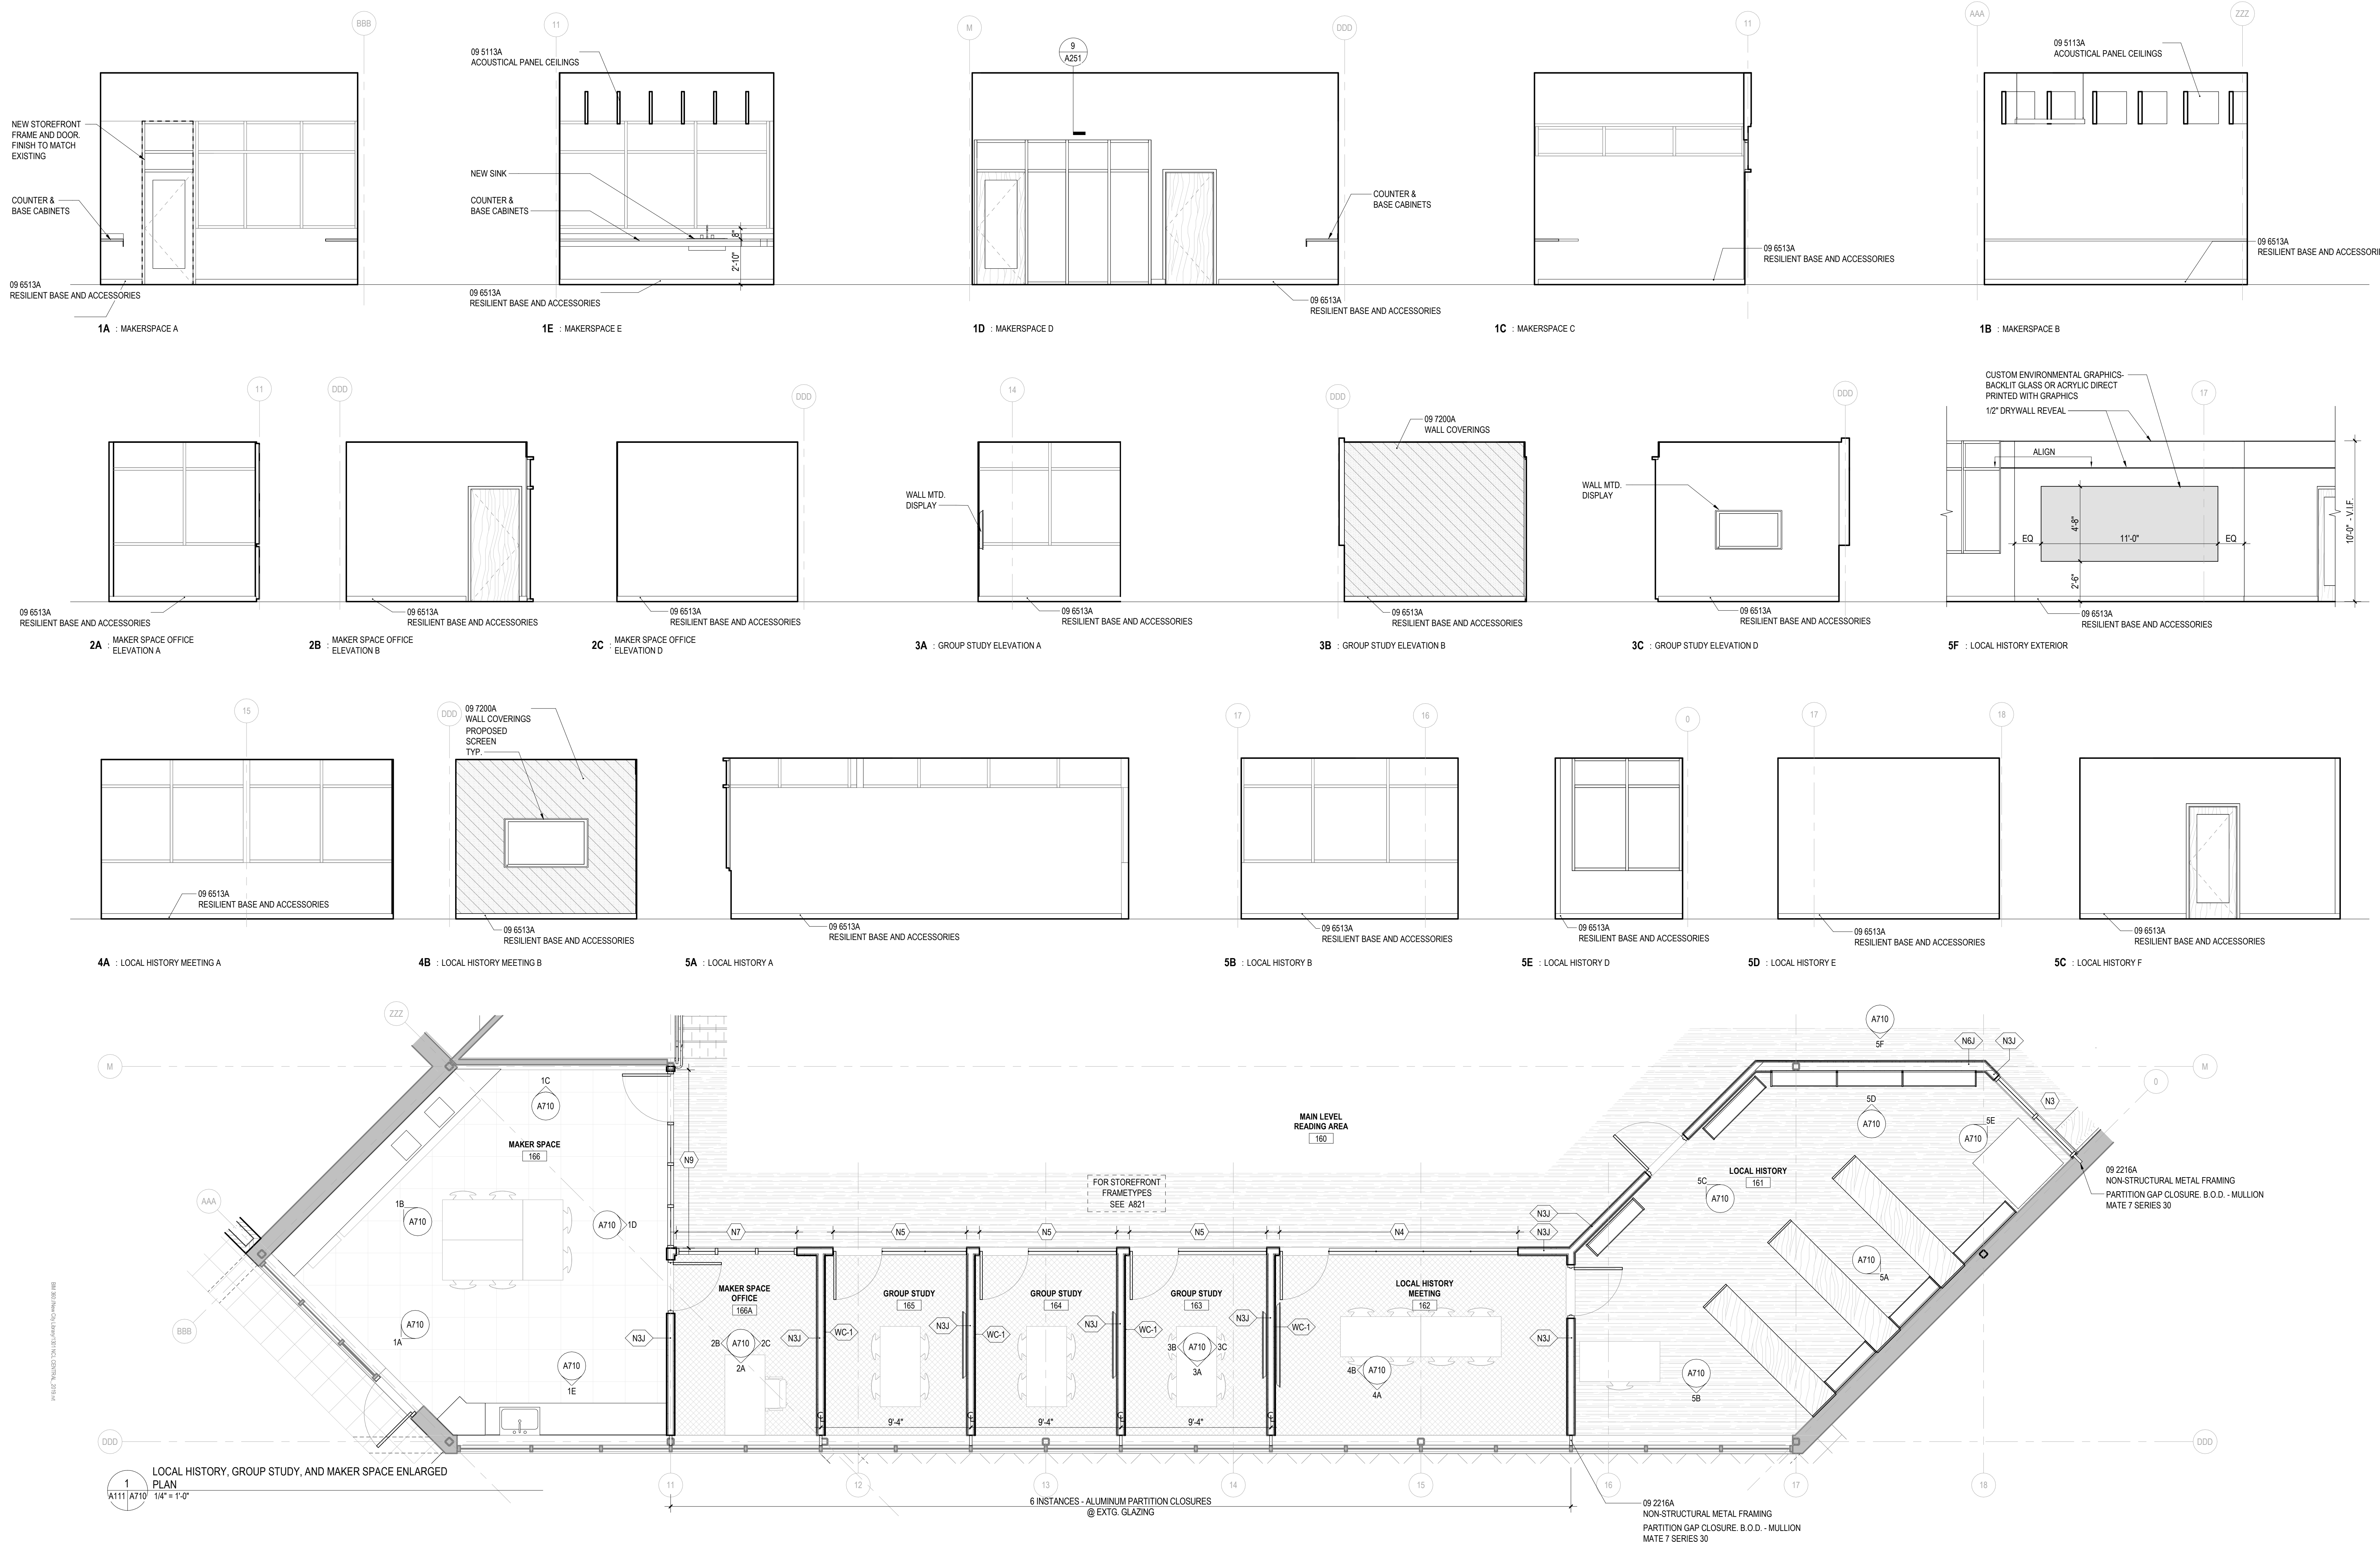

### FLOOR PLAN GENERAL NOTES

1. SEE LANDSCAPE DRAWINGS FOR HARDSCAPE ELEMENTS, PAVING AND SITE WALL ADJACENT TO THE BUILDING.
2. LOCATE ROOF OPENINGS FOR DOORS 4' FROM INSIDE FACE OF INTERSECTING WALL UNLESS OTHERWISE NOTED.
3. REFER TO LIFE SAFETY PLAN FOR ADDITIONAL, RELATED CONSTRUCTION INFORMATION.
4. ALL DIMENSIONS ARE TO FINISH FACE OF WALL, MASONRY OPENING, AND FINISH FACE OF DOOR.
5. PROVIDE ACCESS PANELS / DOORS IN PARTITIONS AT ALL LOCATIONS REQUIRING ACCESS. PANELS SHALL MAINTAIN FIRE RATING.
6. PROVIDE WOOD BLOCKING OR 3/4" GAUGE METAL STRAPPING BEHIND 2" W/4" MIN. STAND-OFFS TO PROVIDE FOR DOOR OR EQUIPMENT PROVIDED IN THE CONTRACT OR BY OTHERS.
7. WHERE METAL TRAILING REQUIRES SUPPORT AT COLUMNS & BEAMS, PROVIDE 2" W/4" MIN. STAND-OFFS TO PROVIDE FOR DOOR OR EQUIPMENT PROVIDED IN THE CONTRACT OR BY OTHERS.
8. ALL M.E.P. AND IT SYSTEMS ARE TO BE CONCEALED WITHIN WALL OR CEILING CAVITY, U.N.O.
9. ALL INTERIOR PARTITIONS ARE TYPE **NSA** U.N.O. SEE 1002 FOR PARTITION TYPES.

INTERIOR ELEVATION  
GENERAL NOTES

11. SEE SHEET A002 FOR PARTITION TYPES.
12. DIMENSIONS ARE TO FINISHED FACE OF PARTITION TYPE AS DEFINED ON SHEET A002. FINISH TYPES (TILE, WOOD PANELING, WAINSCOT, WALL COVERINGS, ETC.) ARE NOT INCLUDED.
13. SEE ELEVATION SHEETS A300 FOR EXTERIOR FRAME TYPE TAGS. SEE A800 SERIES FOR FRAME TYPES.
14. SEE PLANS & INTERIOR ELEVATION SHEETS A700s FOR INTERIOR FRAME TYPE TAGS. SEE A800 SHEETS FOR FRAME TYPES.

## KEYNOTES

1. CERTAIN ELEMENTS MAY NOT BE SHOWN IN INTERIOR ELEVATIONS. REFER TO COMPLETE DOCUMENT SET FOR INFORMATION ON MECHANICAL, ELECTRICAL & PLUMBING ITEMS, ETC.
2. FOR INFORMATION ON FINISHES SEE A900s.

09 2216A	NON-STRUCTURAL METAL FRAMING
09 5113A	ACOUSTICAL PANEL CEILINGS
09 6513A	RESILIENT BASE AND ACCESSORIES
09 7200A	WALL COVERINGS

## ENLARGED PLANS & INTERIOR ELEVATIONS




220 North Main Street  
New City, NY 10956

Client Project Number  
VMDO Project Number

1301

Checked By \_\_\_\_\_  
Drawn By \_\_\_\_\_

Checker  
Author

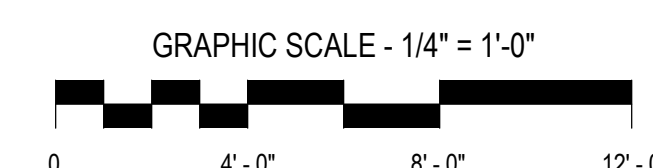

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ISSUES AND REVISIONSNO. SUBMITTAL  
SCHEMATIC DESIGN

DATE  
03.05.2021

## ENLARGED PLANS & INTERIOR ELEVATIONS

A711

DESIGN DEVELOPMENT



1. SEE LANDSCAPE DRAWINGS FOR HARDSCAPE ELEMENTS, PAVING AND SITE WALL ADJACENT TO THE BUILDING.
2. LOCATE ROOF OPENINGS FOR DOORS 4" FROM INSIDE FACE OF INTERSECTING WALL UNLESS OTHERWISE NOTED.
3. REFLECT TO LIFE SAFETY PLAN FOR ADDITIONAL TRAIL CREST OBSTRUCTION INFORMATION.
4. ALL DIMENSIONS ARE TO FINISH FACE OF WALL, MASONRY OPENING, AND TOP OF ROOF OR FINISH FLOOR.
5. PROVIDE ACCESS PANELS/ DOORS IN PARTITIONS AT ALL LOCATIONS REQUIRING ACCESS. PANELS SHALL MAINTAIN FIRE RATING.
6. PROVIDE WOOD BLOCKING OR 1/8 GAUGE METAL STRAPPING BETWEEN WALLS WHERE REQUIRED FOR THE PROTECTION OF UTILITIES OR EQUIPMENT PROVIDED IN THE CONTRACT OR BY OTHERS.
7. WHERE METAL FRAMING REQUIRES SUPPORT AT COLUMNS & BEAMS, PROVIDE A STANDARD 4" X 8" POST TO AVOIDING PREPARED FOR.
8. ALL M.E.P. AND I.T. SYSTEMS ARE TO BE CONCEALED WITHIN WALL OR CEILING CAVITY. U.O.U.
9. ALL INTERIOR PARTITIONS ARE TYPE: **N3A** U.O.U. SEE 1000 FOR PARTITION

1. CERTAIN ELEMENTS MAY NOT BE SHOWN IN INTERIOR ELEVATIONS. REFER TO COMPLETE DOCUMENT SET FOR INFORMATION ON MECHANICAL, ELECTRICAL & PLUMBING ITEMS, ETC.
2. FOR INFORMATION ON FINISHES SEE A900s

11. SEE SHEET A002 FOR PARTITION TYPES.
12. DIMENSIONS ARE TO FINISHED FACE OF PARTITION TYPE AS DEFINED ON SHEET A002. FINISH TYPES (TILE, WOOD PANELING, WAINSCOT, WALL COVERINGS, ETC.) ARE NOT INCLUDED.
13. SEE ELEVATION SHEETS A300 FOR EXTERIOR FRAME TYPE TAGS. SEE A800 SERIES FOR FRAMES TYPES.
14. SEE PLANS & INTERIOR ELEVATION SHEETS A700'S FOR INTERIOR FRAME TYPE TAGS. SEE A800 SHEETS FOR FRAME TYPES.

06 2023A	INTERIOR FINISH CARPENTRY
08 4113A	ALUMINUM-FRAMED STOREFRONTS
09 6513A	RESILIENT BASE AND ACCESSORIES
09 8430A	SOUND-ABSORBING PANELS
12 3666A	SOLID SURFACING COUNTERTOPS





New City Library

## New City Library Addition & Renovation


220 North Main Street  
New City, NY 10956

Client Project Number  
VMDO Project Number




1301

Checked By  
Drawn By

Checker  
Author

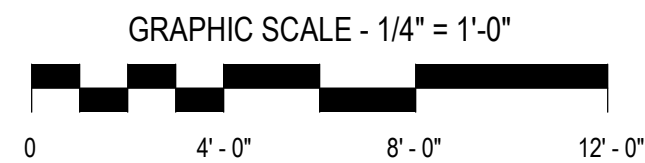

ISSUES AND REVISIONS		DATE
NO.	SUBMITTAL	

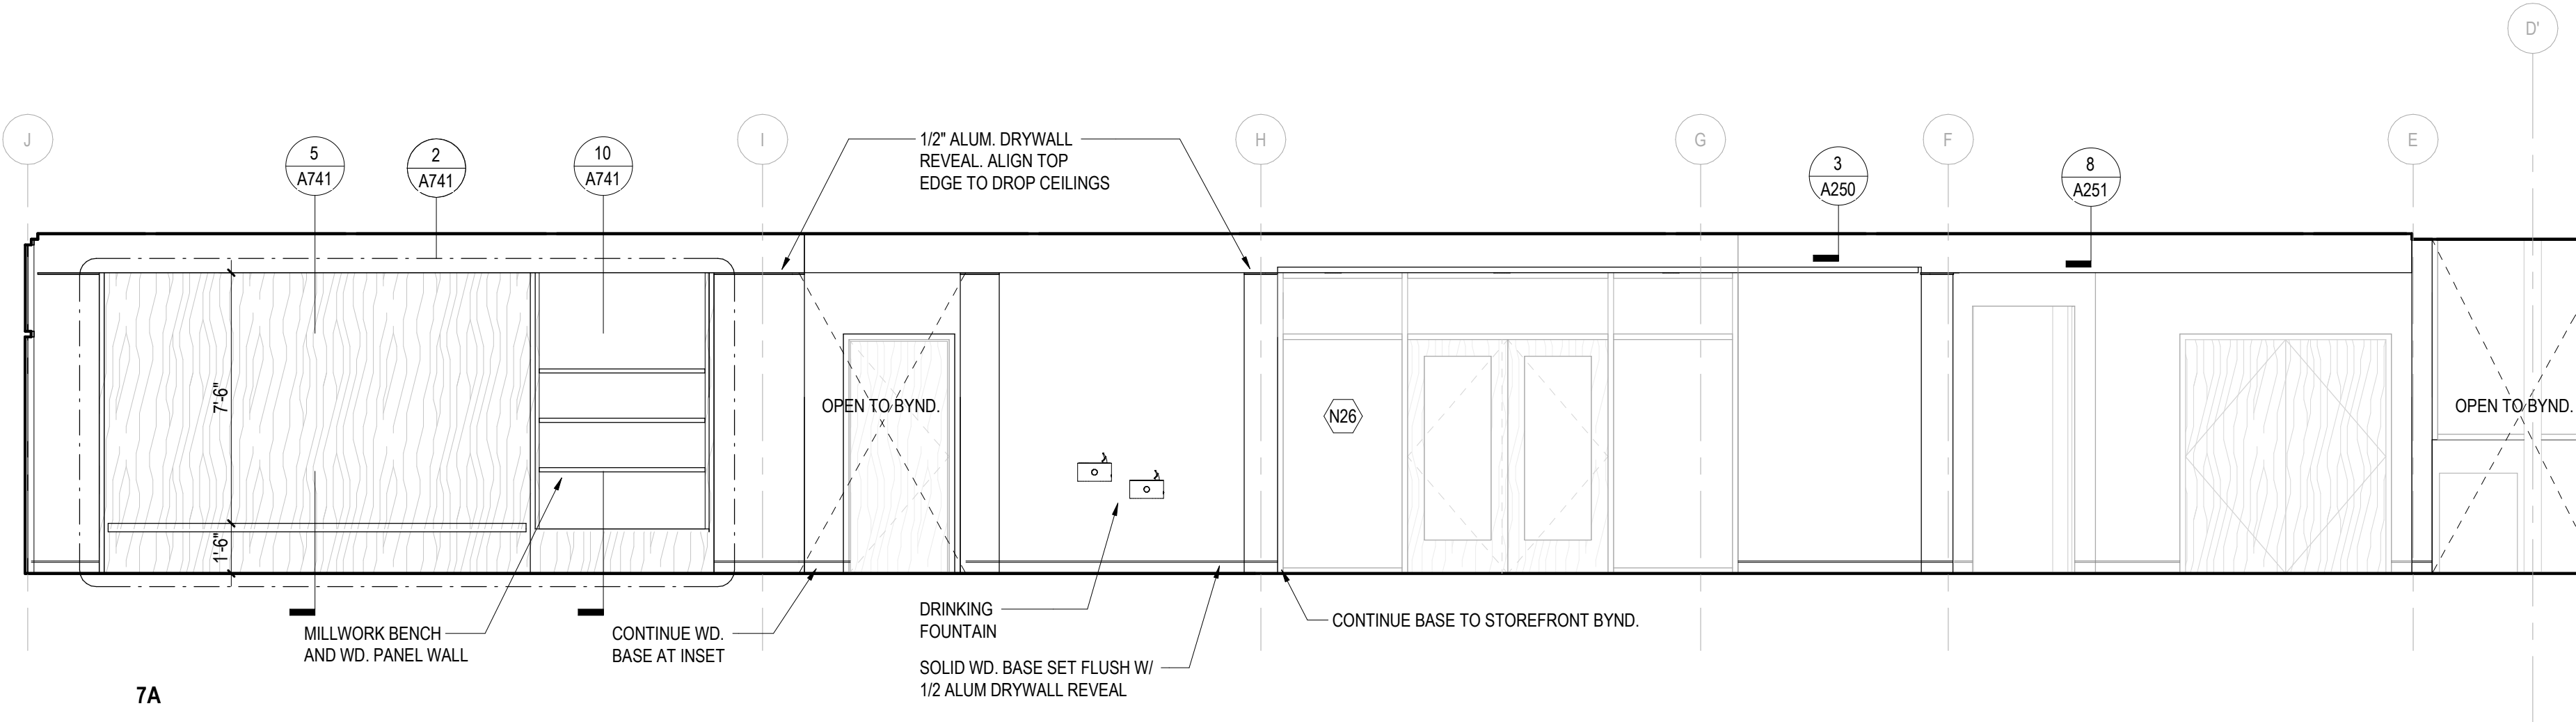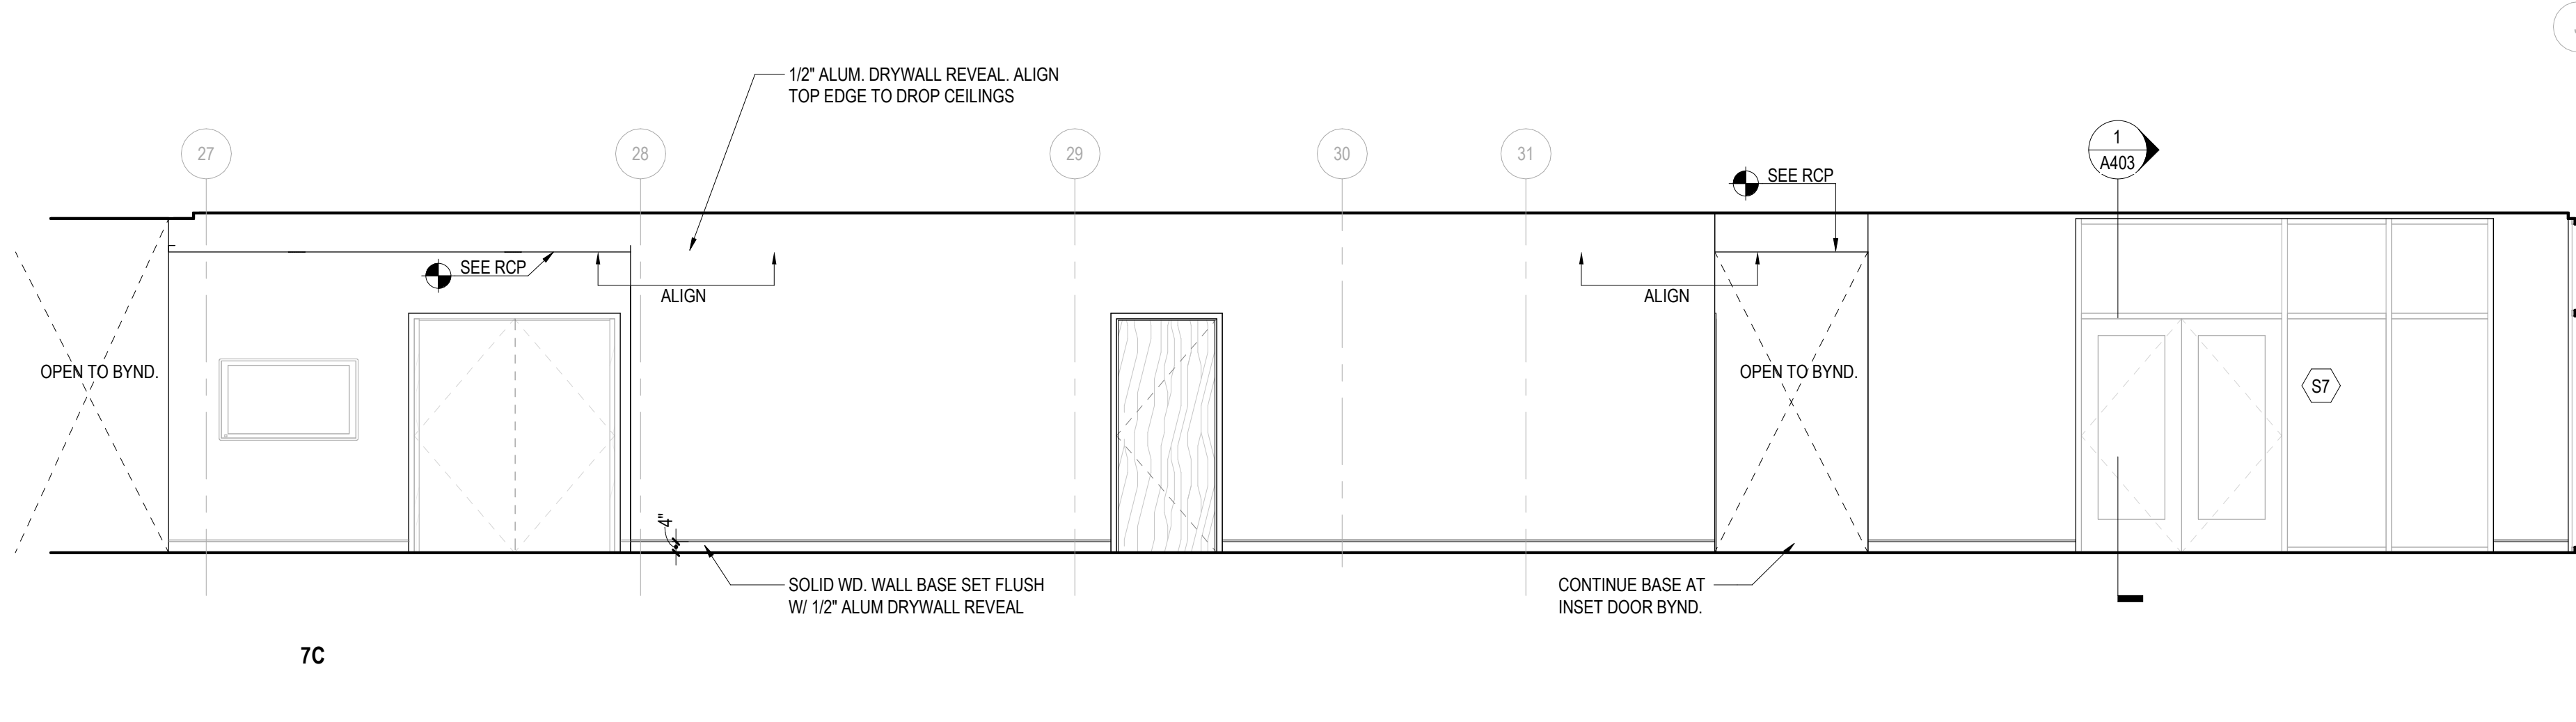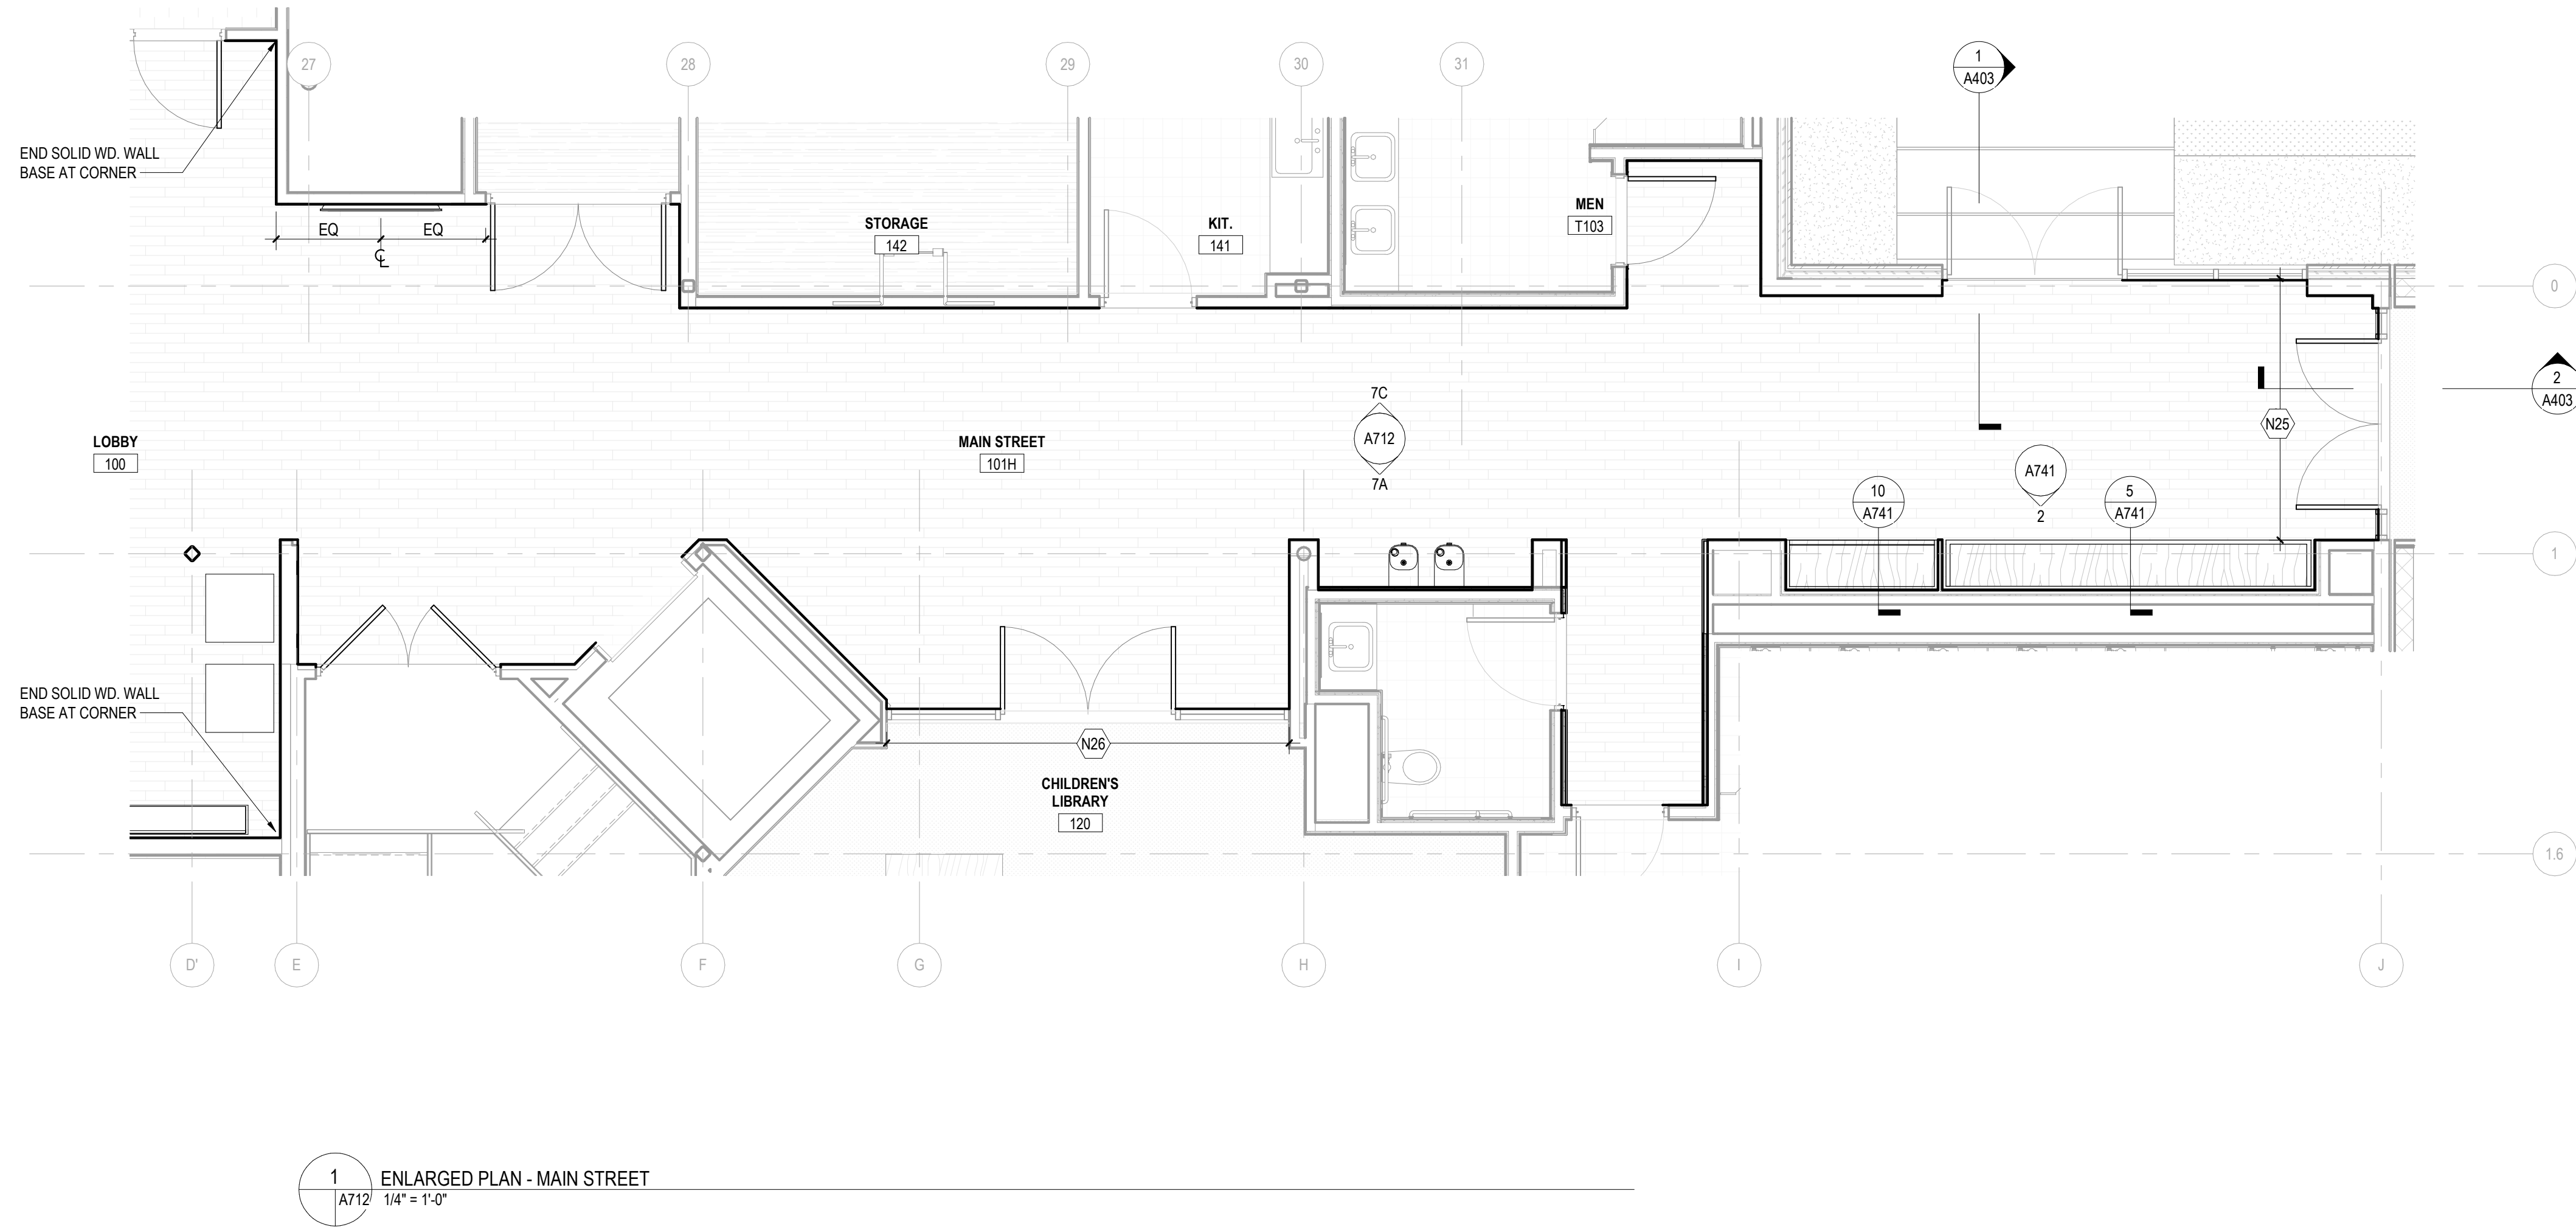

### FLOOR PLAN GENERAL NOTES

- SEE LANDSCAPE DRAWINGS FOR HARDSCAPE ELEMENTS, PAVING AND SITE WALL ADJACENT TO THE BUILDING.
- LOCATE ROUGH OPENINGS FOR DOORS 4" FROM INSIDE FACE OF INTERSECTING WALL UNLESS OTHERWISE NOTED.
- REFER TO LIFE SAFETY PLANS FOR ADDITIONAL RATED CONSTRUCTION INFORMATION.
- ALL DIMENSIONS ARE TO FINISH FACE OF WALL, MASONRY OPENING, AND OUTSIDE EDGE OF DOOR FRAME (NOMINAL), U.N.O.
- PROVIDE ACCESS PANELS / DOORS IN PARTITIONS AT ALL LOCATIONS REQUIRING ACCESS. PANELS SHALL MAINTAIN FIRE RATING.
- PROVIDE WOOD BLOCKING OR 18 GAUGE METAL STRAPPING BEHIND G.W.B. WHERE REQUIRED TO SUPPORT FIXTURES OR EQUIPMENT PROVIDED IN THE CONTRACT OR BY OTHERS.
- WHERE METAL FRAMING REQUIRES SUPPORT AT COLUMNS & BEAMS, PROVIDE METAL STAND-OFFS PRIOR TO APPLYING FIREPROOFING.
- ALL M.E.P. AND I.T. SYSTEMS ARE TO BE CONCEALED WITHIN WALL OR CEILING CAVITY, U.N.O.
- ALL INTERIOR PARTITIONS ARE TYPE NSA U.N.O. SEE T002 FOR PARTITION TYPES.

- SEE SHEET A002 FOR PARTITION TYPES.
- DIMENSIONS ARE TO FINISHED FACE OF PARTITION TYPE AS DEFINED ON SHEET A002. FINISH TYPES (TILE, WOOD PANELING, WAINSCOT, WALL COVERINGS, ETC.) ARE NOT INCLUDED.
- SEE ELEVATION SHEETS A000 FOR EXTERIOR FRAME TYPE TAGS. SEE A800 SERIES FOR FRAMES TYPES.
- SEE PLANS & INTERIOR ELEVATION SHEETS A700s FOR INTERIOR FRAME TYPE TAGS. SEE A800 SHEETS FOR FRAME TYPES.

### INTERIOR ELEVATION GENERAL NOTES




- CERTAIN ELEMENTS MAY NOT BE SHOWN IN INTERIOR ELEVATIONS. REFER TO COMPLETE DOCUMENT SET FOR INFORMATION ON MECHANICAL, ELECTRICAL & PLUMBING ITEMS, ETC.
- FOR INFORMATION ON FINISHES SEE A800s.

### KEYNOTES

### ENLARGED PLANS & INTERIOR ELEVATIONS

A712  
DESIGN DEVELOPMENT  
07.09.2021



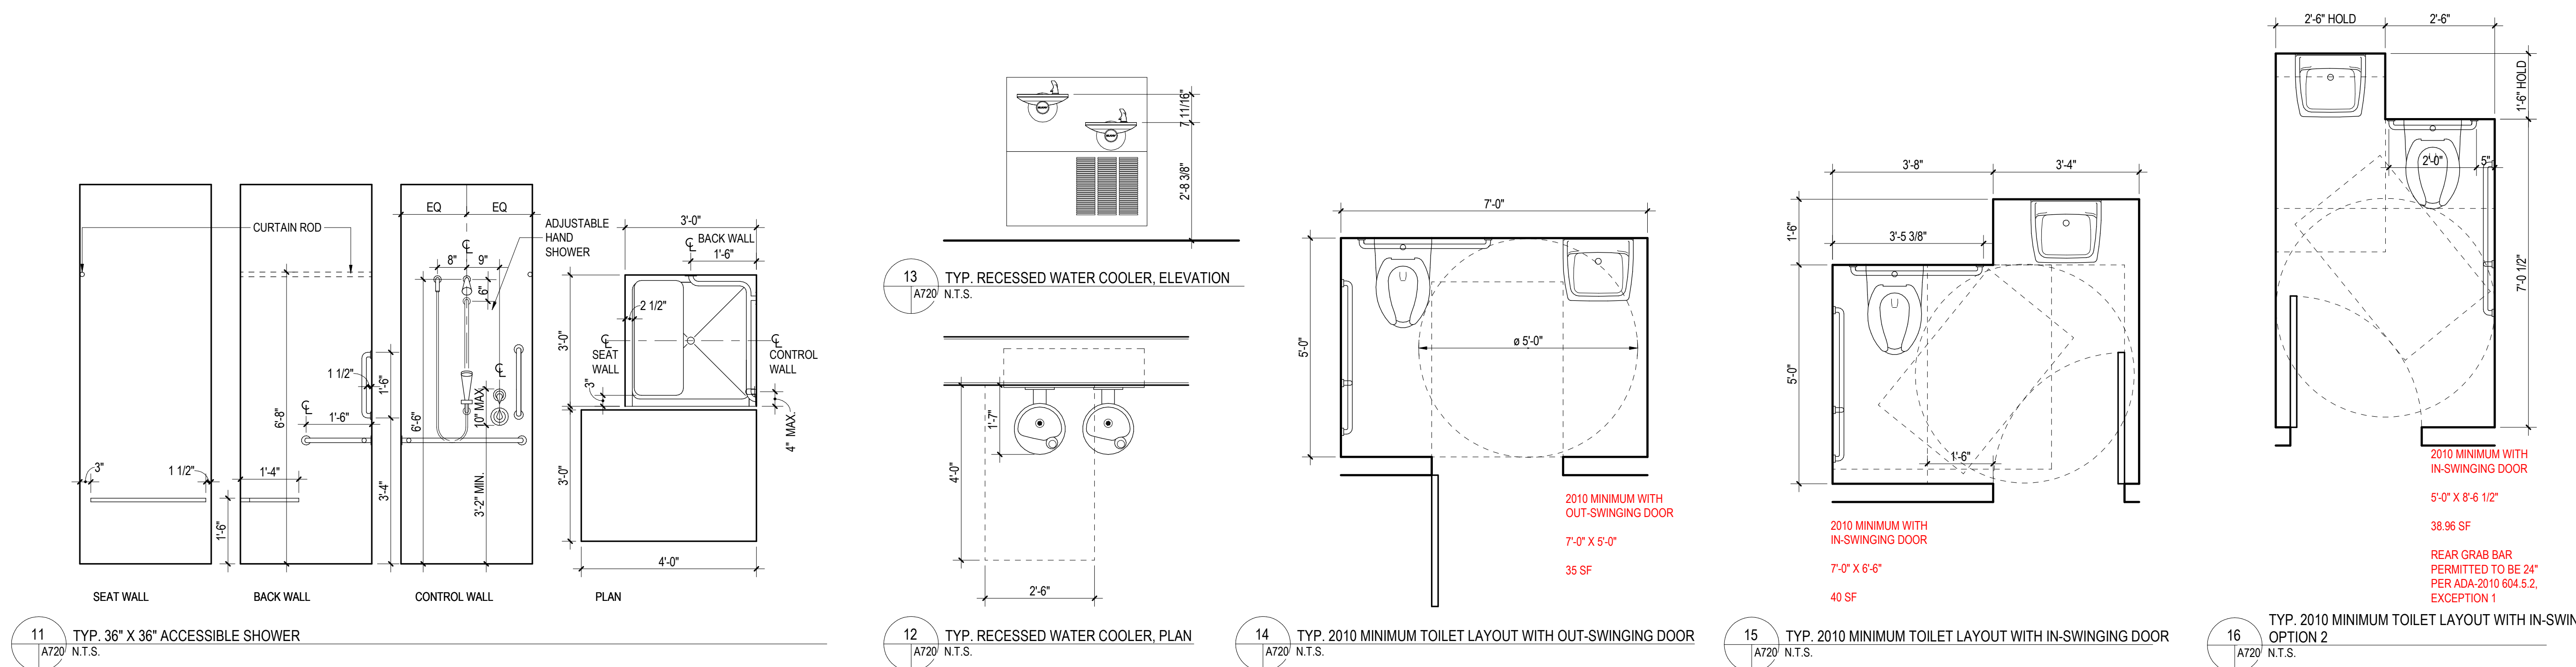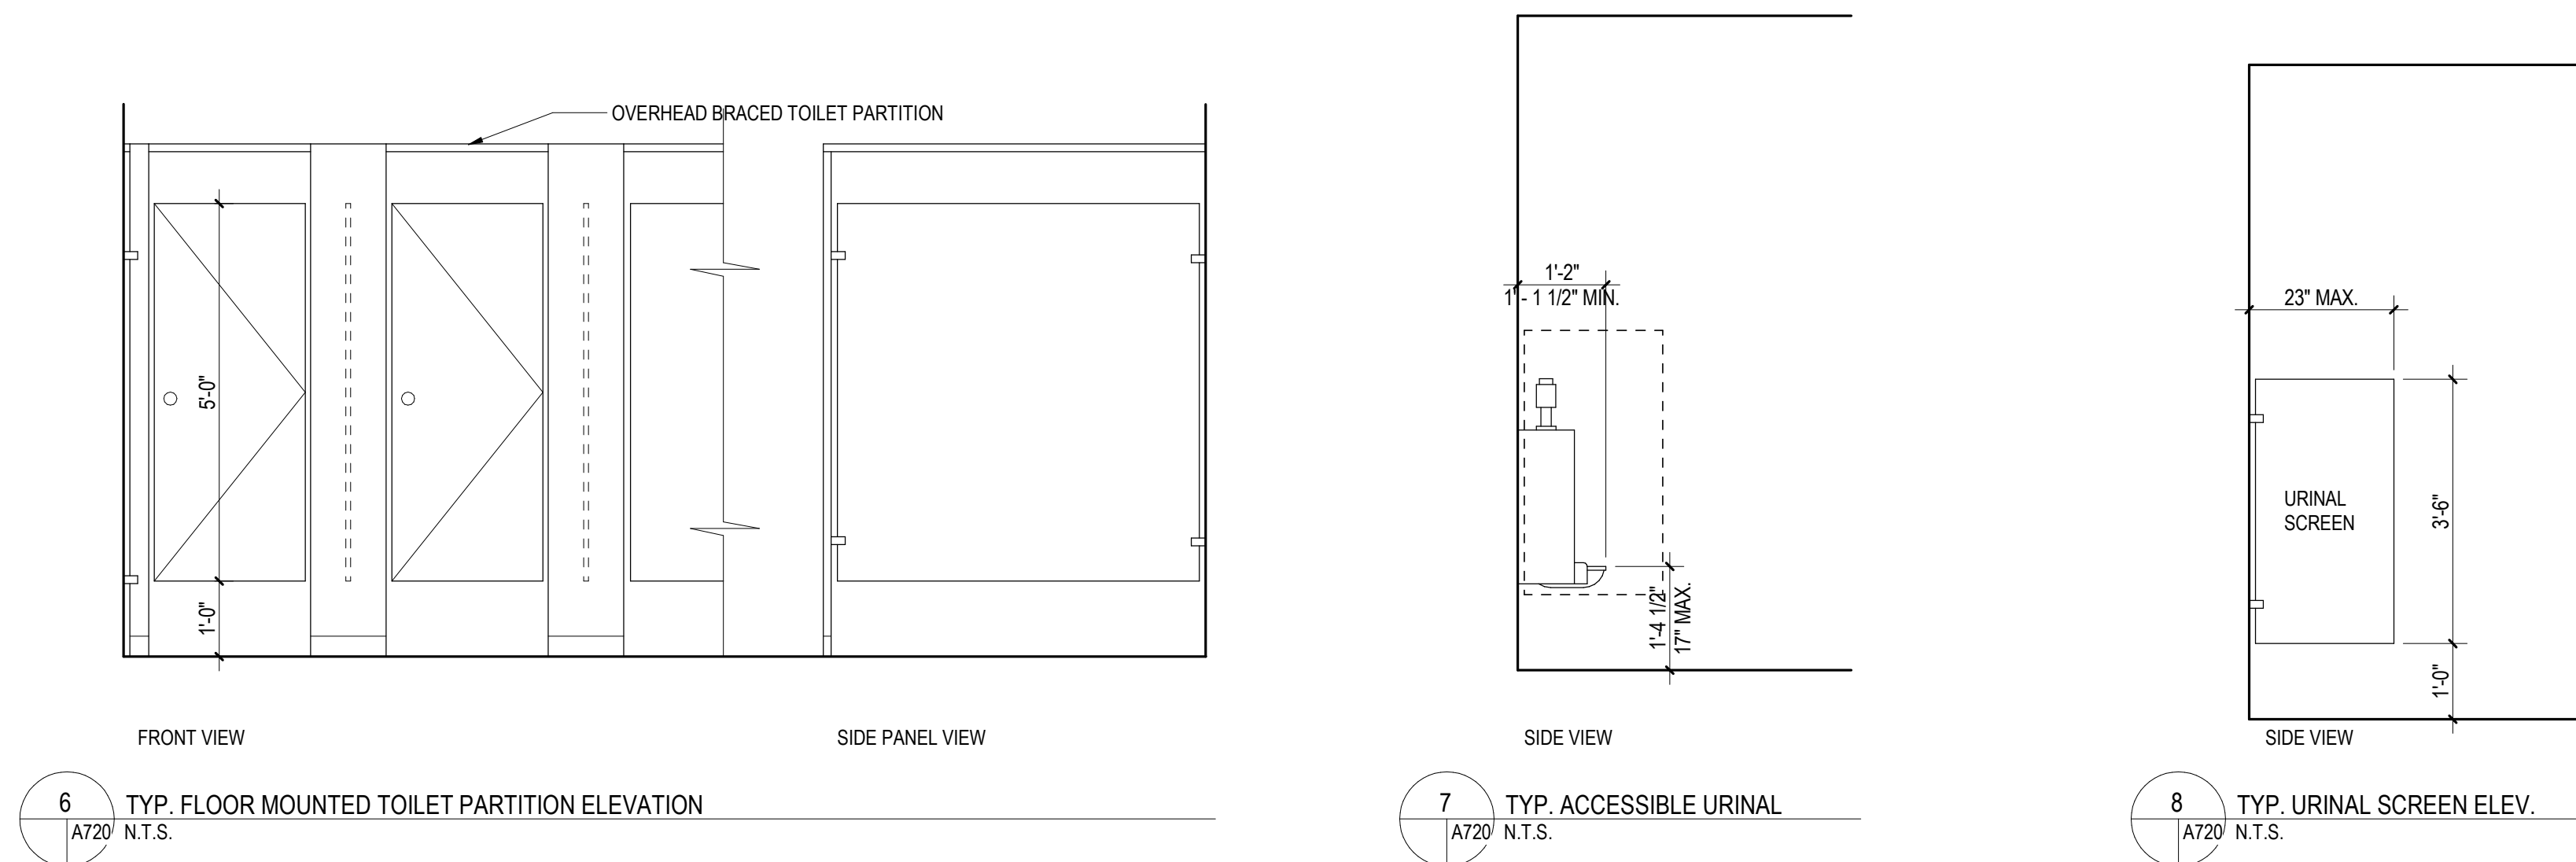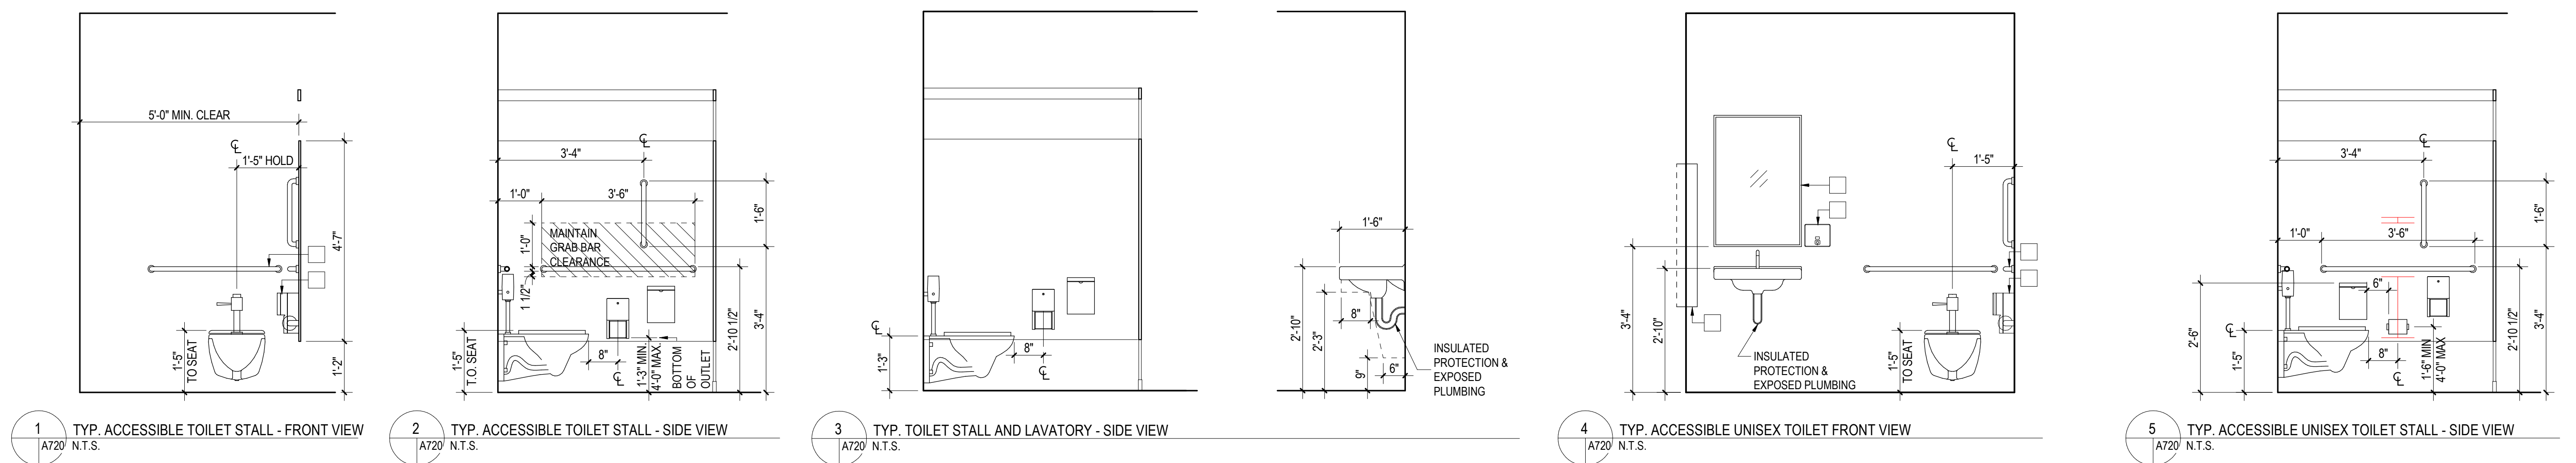

ACCESSORY LEGEND


A TOILET TISSUE DISPENSER	H SANITARY NAPKIN DISPOSAL UNIT	Q SOAP DISH
B PAPER TOWEL DISPENSER	J SEAT COVER DISPENSER	R TOWEL BAR
C WASTE RECEPTACLE	K FOLD-DOWN PURSE SHELF	S MEDICINE CABINET
D COMBINATION TOWEL DISPENSER/WASTE RECEPTACLE	L MIRROR UNIT	T ROBE HOOK
E LIQUID-SOAP DISPENSER	M SHOWER CURTAIN ROD	U WARM AIR DRYERS
F1 TOILET COMPARTMENT GRAB BARS	N SHOWER CURTAIN AND HOOKS	V DIAPER CHANGING STATION
F2 SHOWER GRAB BAR	O FOLDING SHOWER SEAT	W UTILITY SHELF
G VENDORS	P SHOWER SHELF	X MOP AND BROOM HOLDER

ACCESSORY GENERAL NOTES:


- DIMENSIONS INDICATE AVERAGE MOUNTING HEIGHT FROM FINISHED FLOOR FOR CONDITIONS GENERALLY ENCOUNTERED IN PUBLIC WASHROOMS. MOUNTING HEIGHTS SHALL BE IN COMPLIANCE WITH ADA 2010.
- THIS SCHEDULE REPRESENTS GENERAL INSTALLATION FOR TYPICAL ACCESSORIES. ACCESSORY APPEARANCE IN THIS SCHEDULE DOES NOT AN INDICATION OF INCLUSION IN THIS PROJECT.
- REFER TO ACCESSORIES SPECIFICATION FOR ADDITIONAL DESCRIPTION AND DIMENSIONAL INFORMATION.

USERS NOTE:


- THE TAGGING INFORMATION SHOWN HERE IS COORDINATED WITH ROBERT'S ORGANIZATION OF THE TOILET ACCESSORY SPECIFICATION. REORDERING AND RETAGGING IS NOT RECOMMENDED. COORDINATE WITH ROBERT FOR ANY NECESSARY CHANGES, ADDITIONS, OR ELIMINATIONS.
- DIMENSIONS PROVIDED HERE ALLEVIATE THE NEED FOR DIMENSIONS IN SPECIFIC ROOM ELEVATIONS. AVOID REPEATING INFORMATION.
- DELETE THIS NOTE BEFORE PRINTING OR ELECTRONICALLY PUBLISHING THIS DOCUMENT.

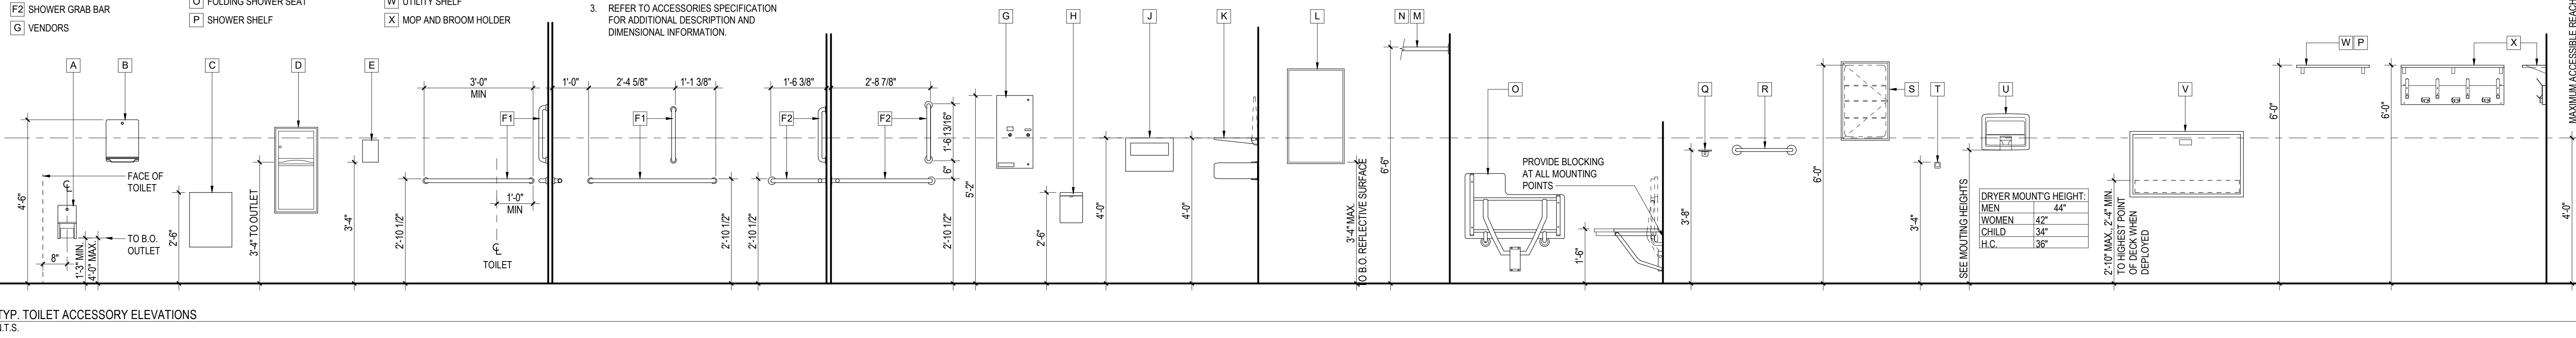




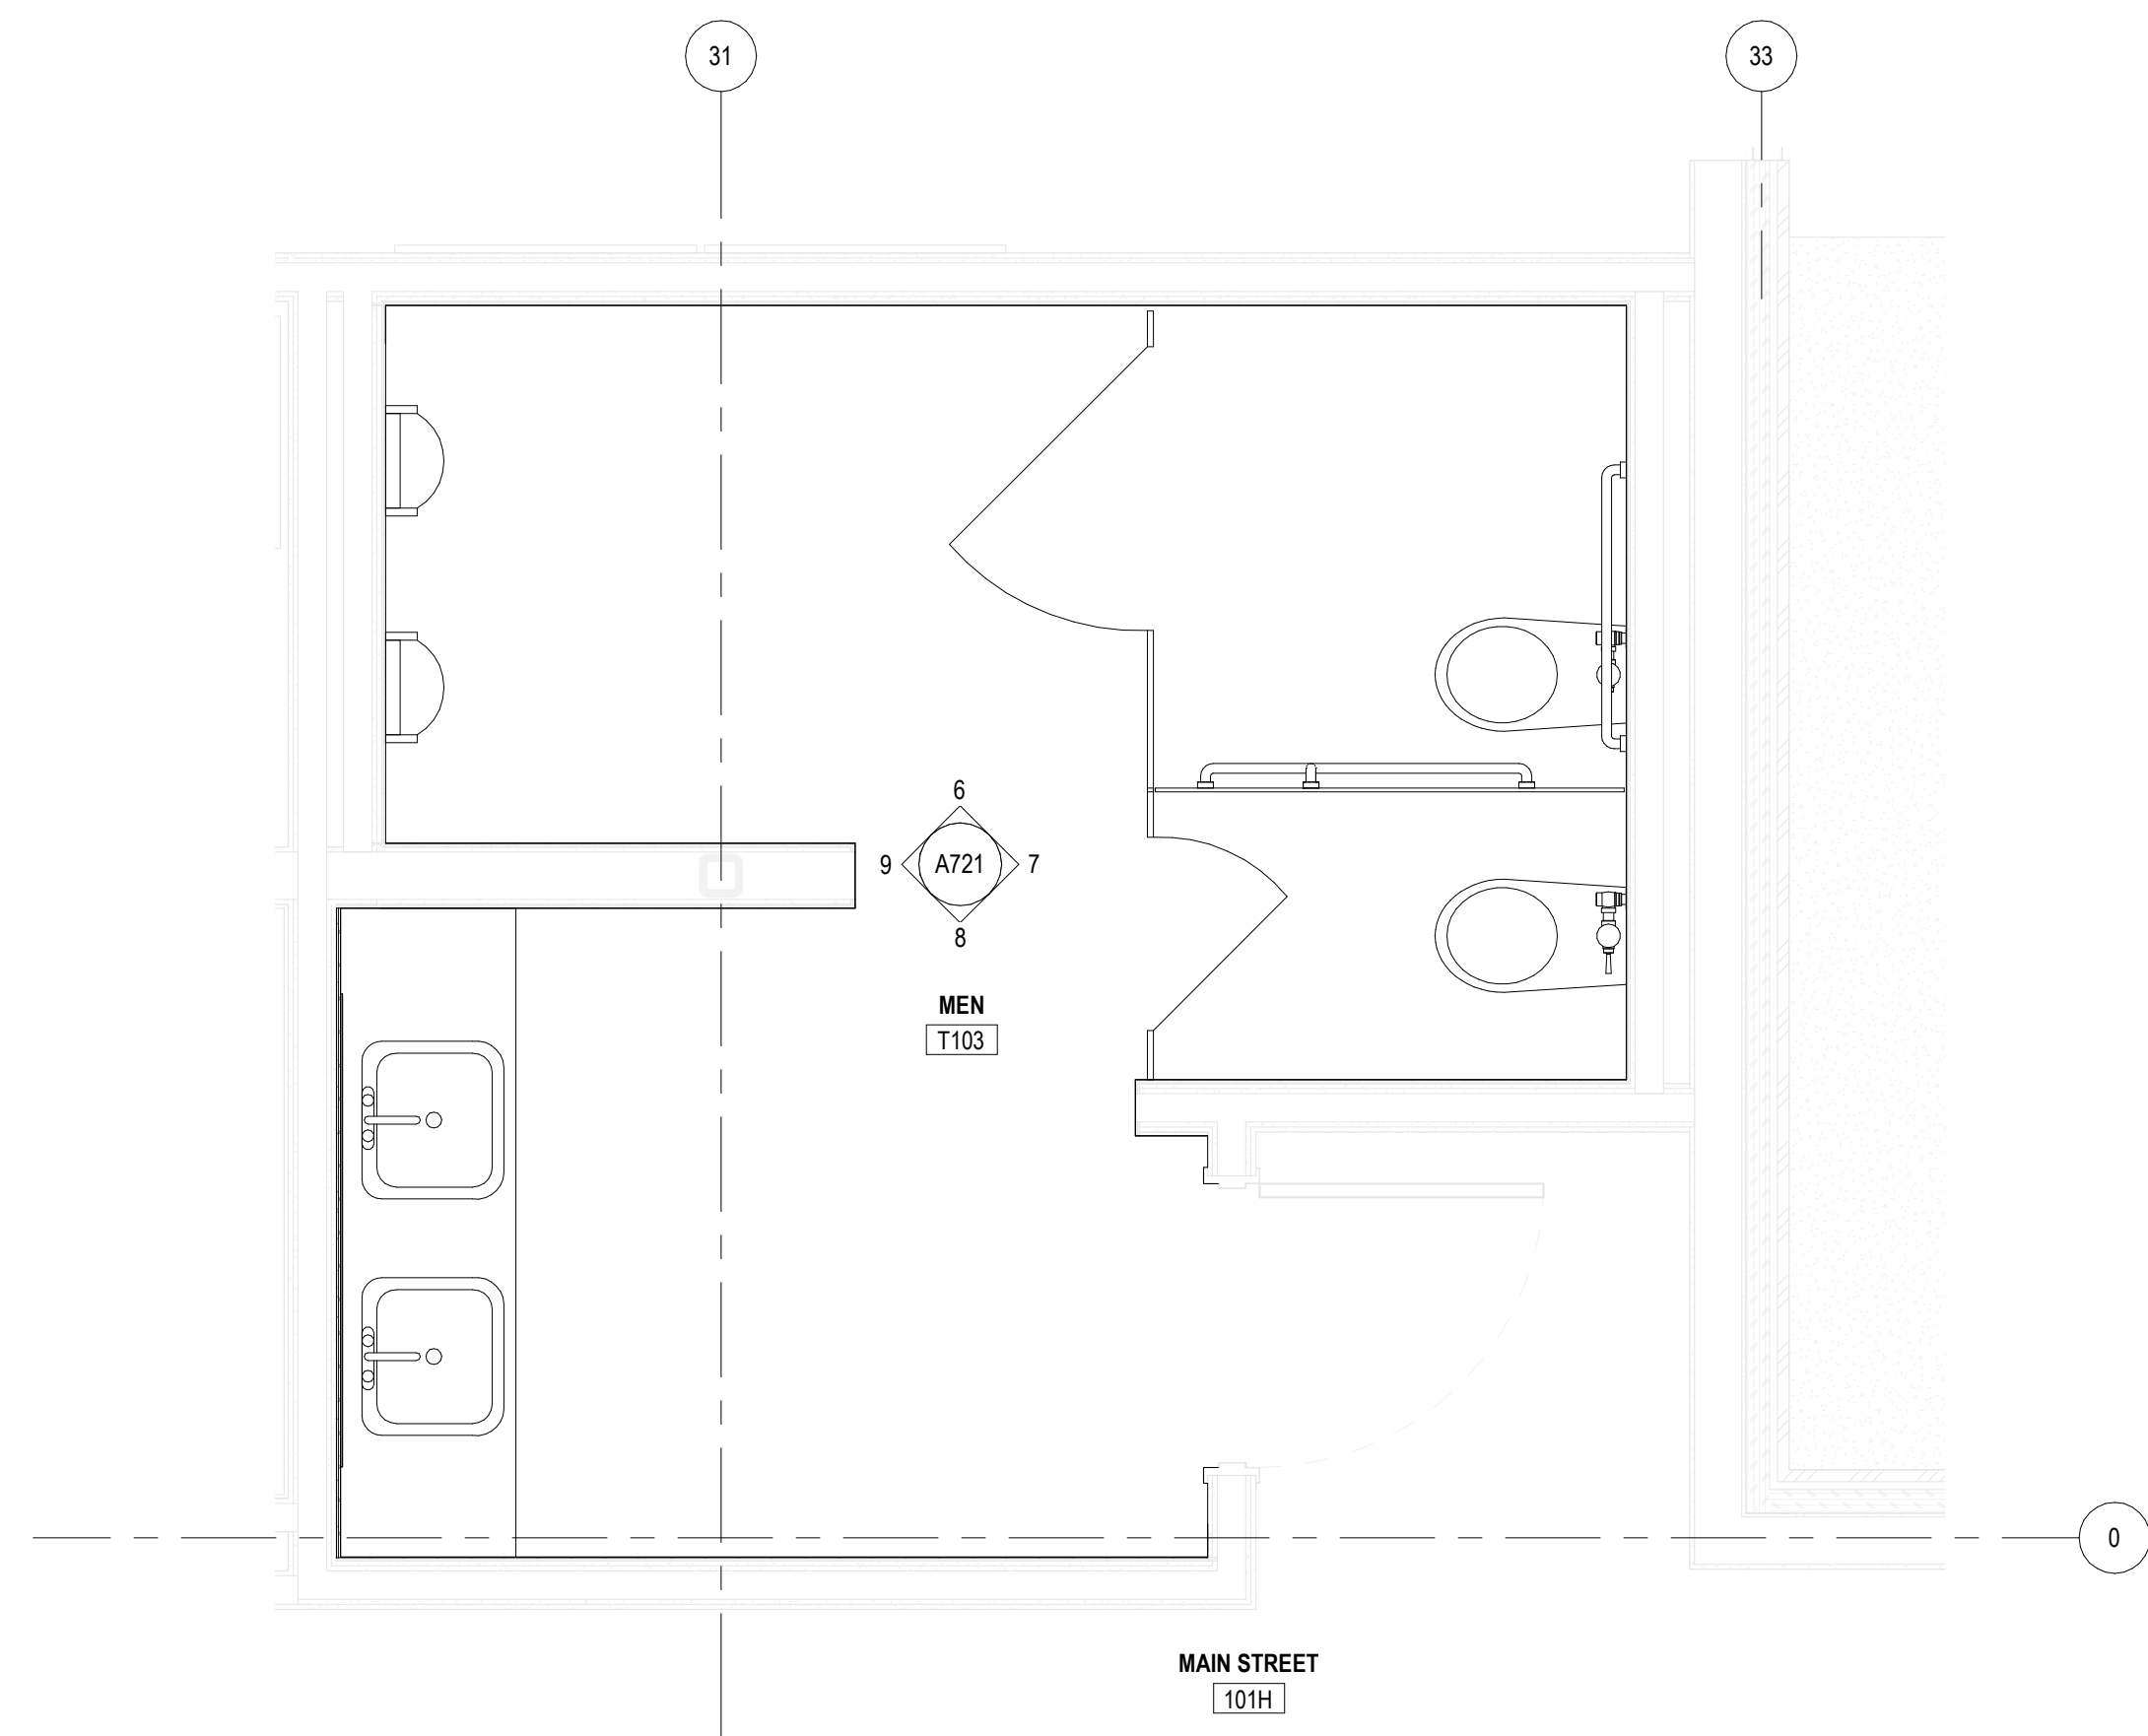


1 ENLARGED PLAN - MENS RESTROOM  
A111 | A721 | 1/2" = 1'-0"

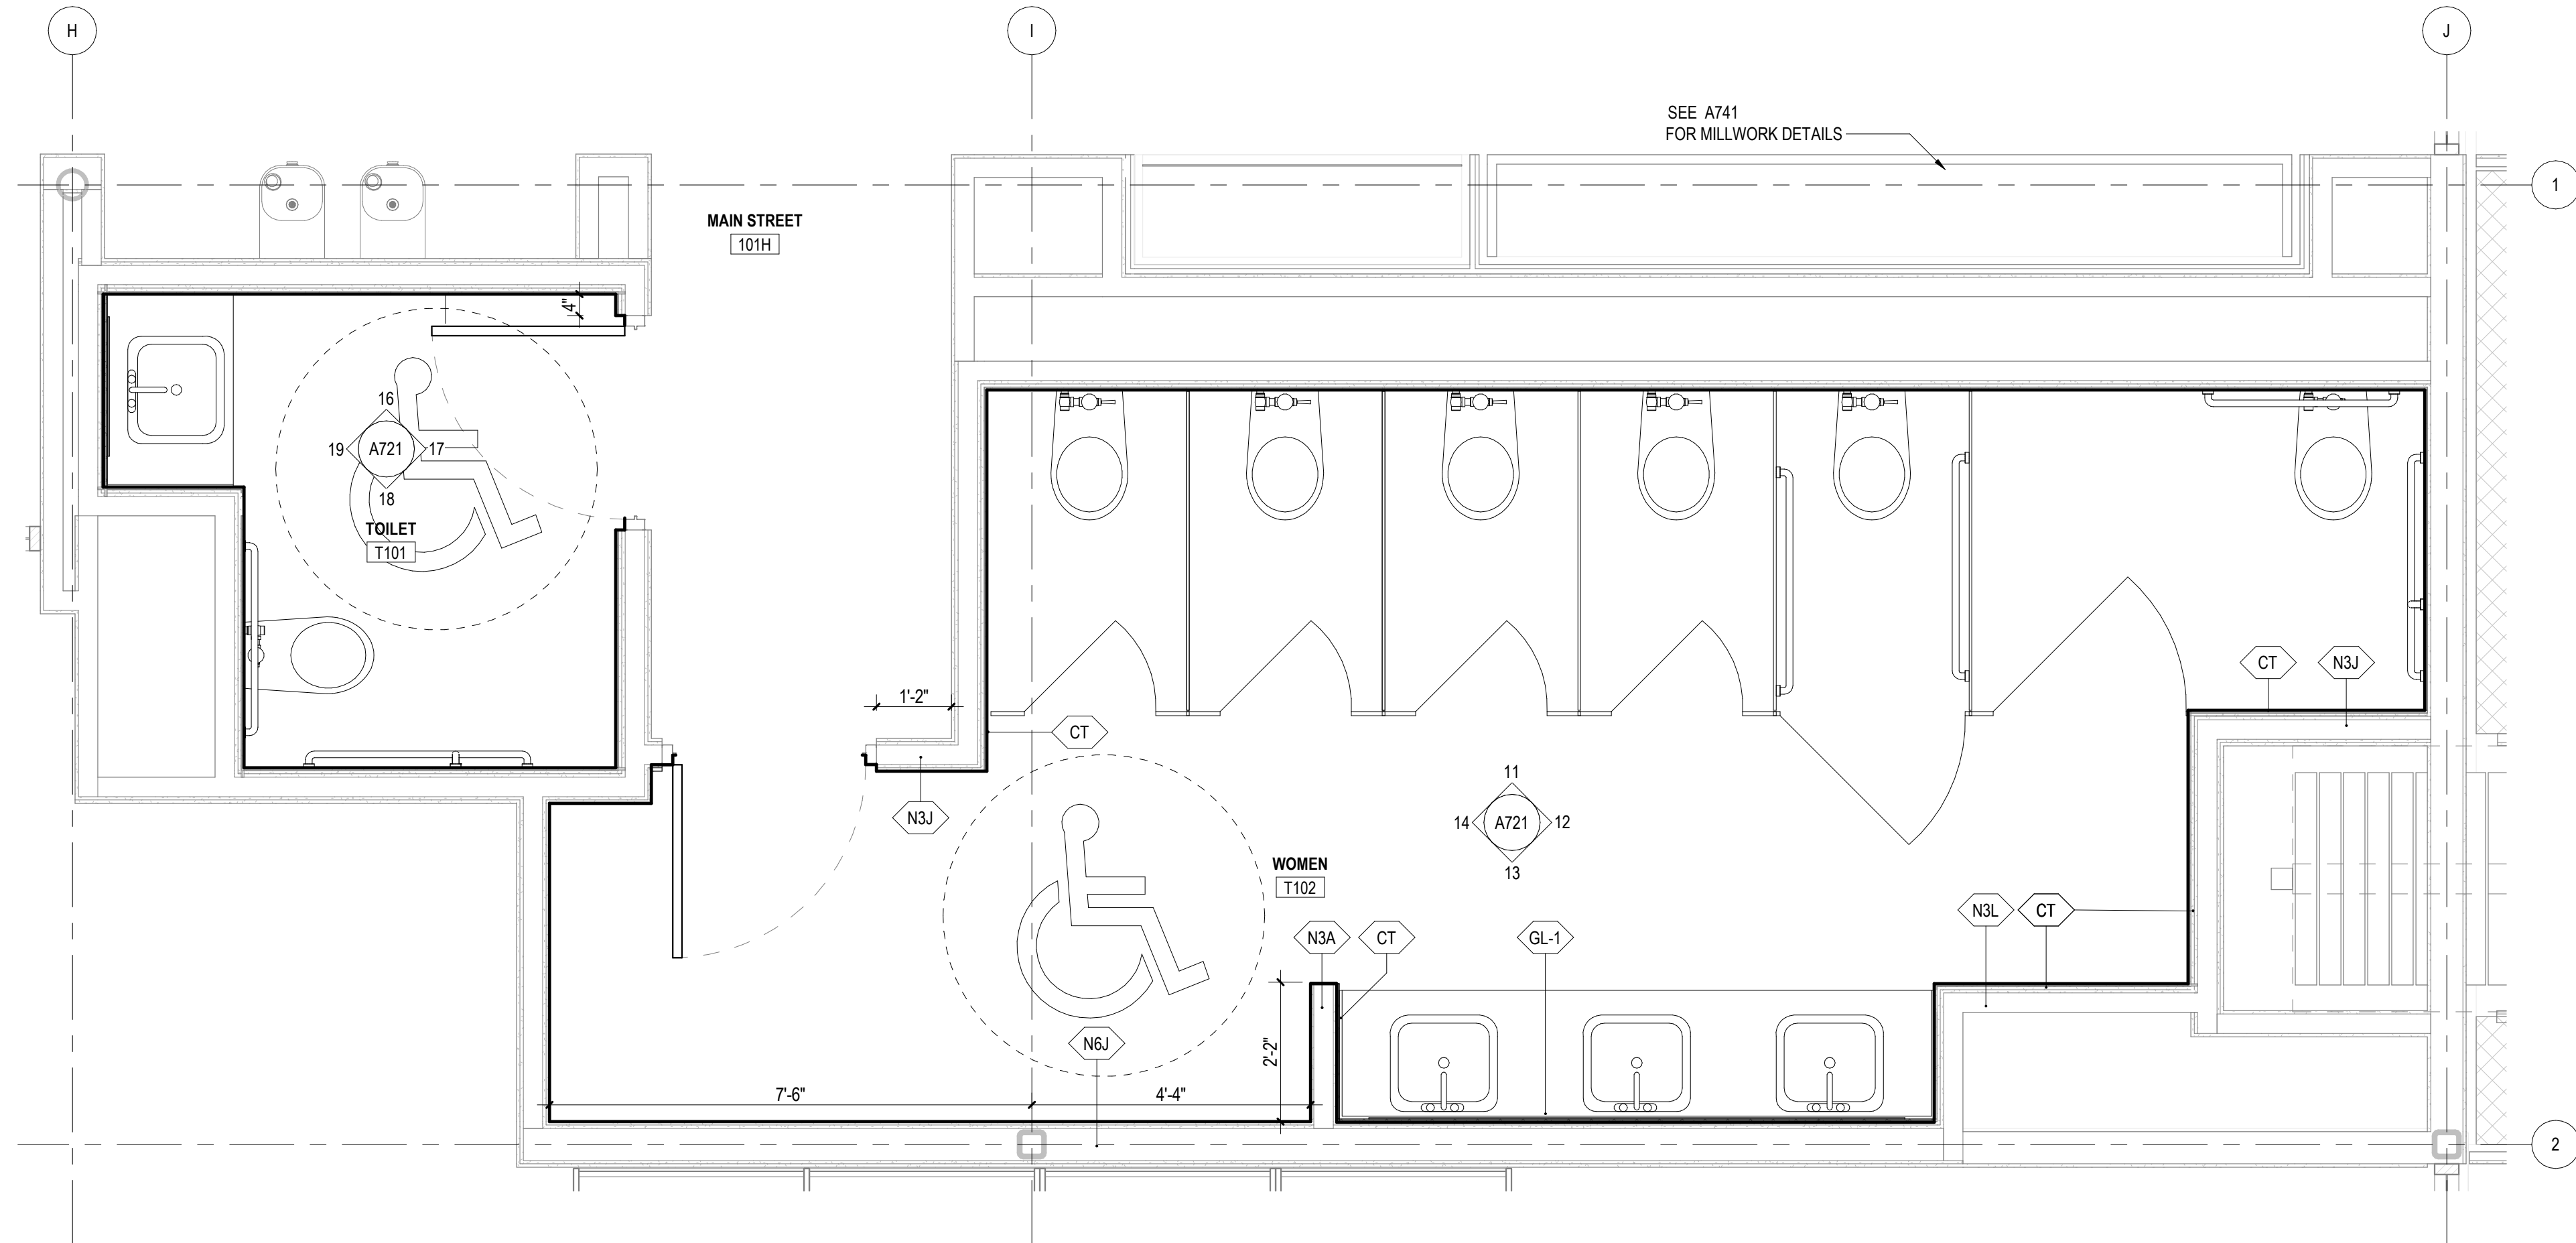


2 ENLARGED PLAN - WOMENS & GEN NEUTRAL RESTROOM  
A111 | A721 | 1/2" = 1'-0"

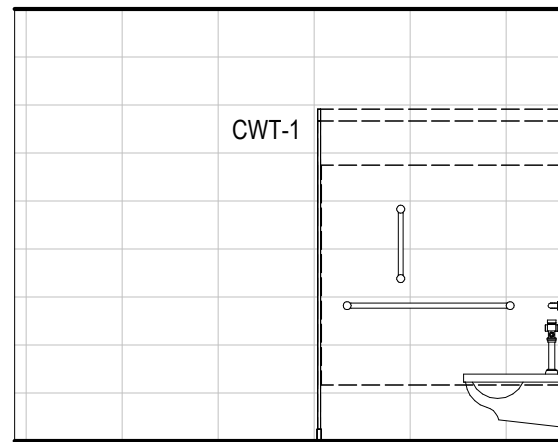


6 WEST ELEVATION - MENS RESTROOM  
A721 | A721 | 1/4" = 1'-0"

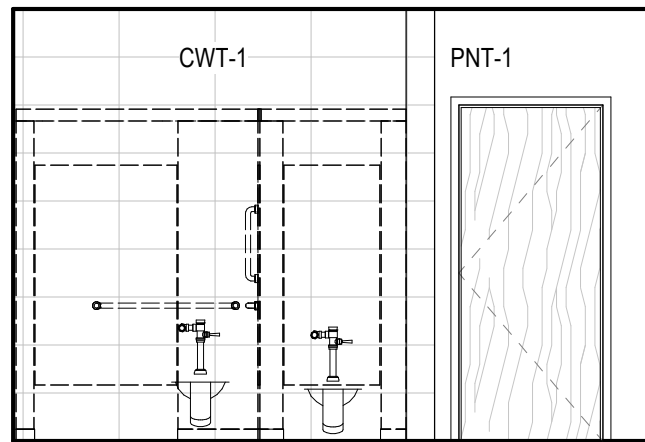


7 NORTH ELEVATION - MENS RESTROOM  
A711 | A721 | 1/4" = 1'-0"

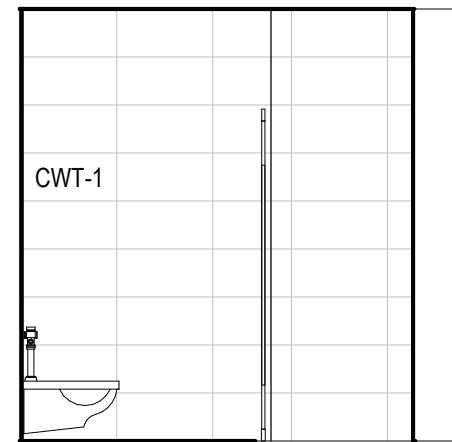


8 EAST ELEVATION - MENS RESTROOM  
A721 | A721 | 1/4" = 1'-0"

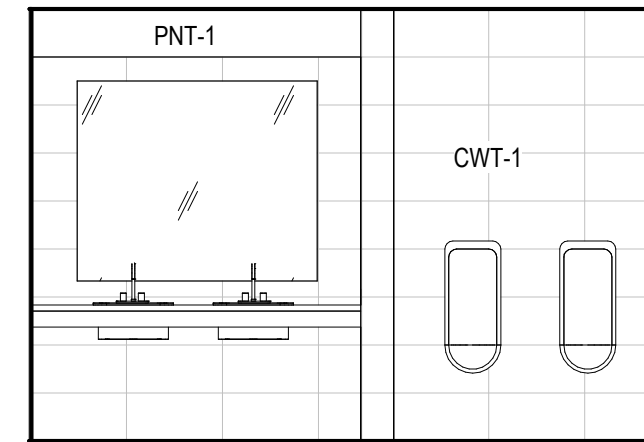


9 SOUTH ELEVATION - MENS RESTROOM  
A711 | A721 | 1/4" = 1'-0"

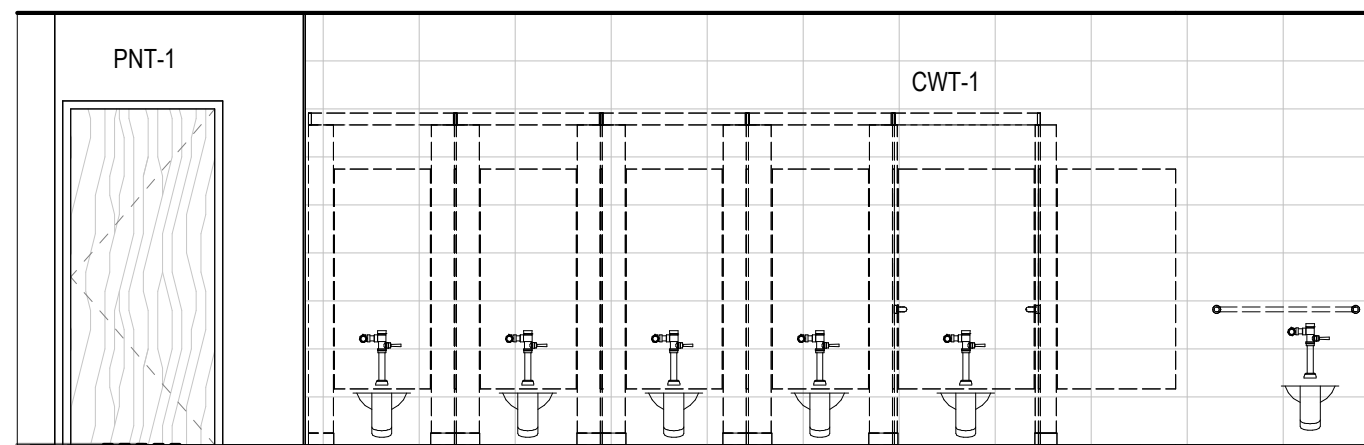

11 WEST ELEVATION - WOMENS RESTROOM  
A711 | A721 | 1/4" = 1'-0"

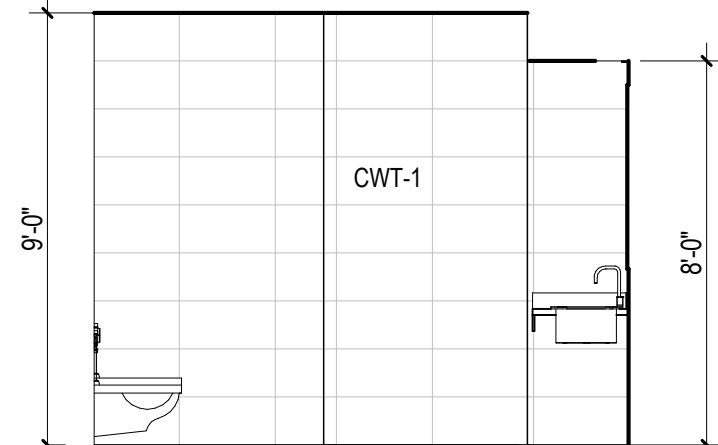


12 NORTH ELEVATION - WOMENS RESTROOM  
A721 | A721 | 1/4" = 1'-0"

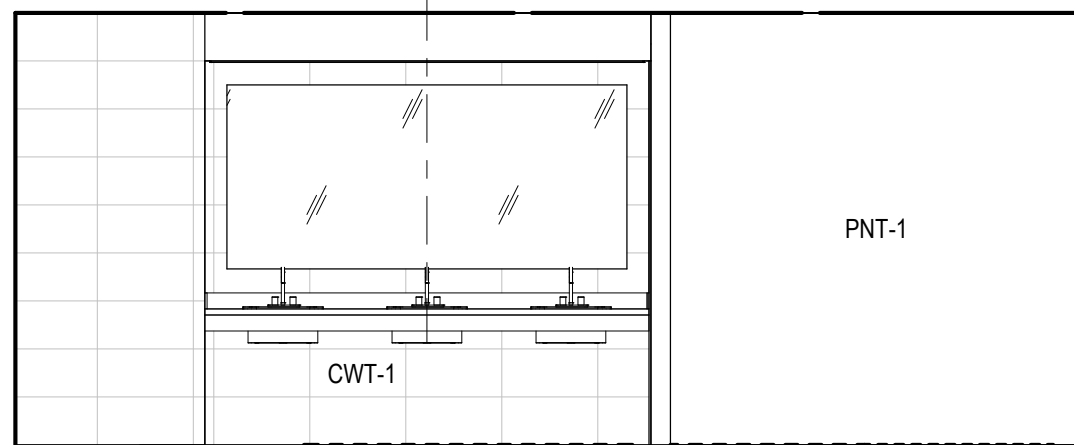


13 EAST ELEVATION - WOMENS RESTROOM  
A711 | A721 | 1/4" = 1'-0"




14 SOUTH ELEVATION - WOMENS RESTROOM  
A711 | A721 | 1/4" = 1'-0"

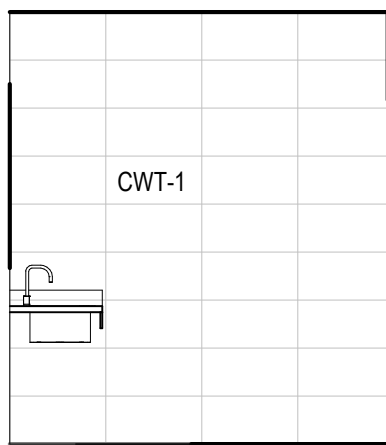


16 WEST ELEVATION - ALL GENDER RESTROOM  
A721 | A721 | 1/4" = 1'-0"

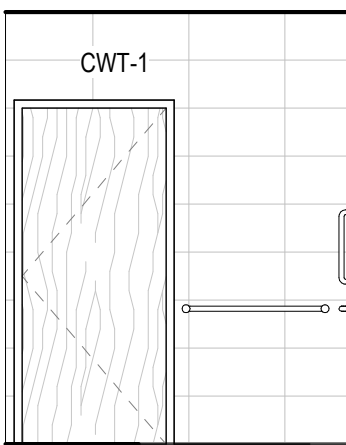

17 NORTH ELEVATION - ALL GENDER RESTROOM  
A721 | A721 | 1/4" = 1'-0"

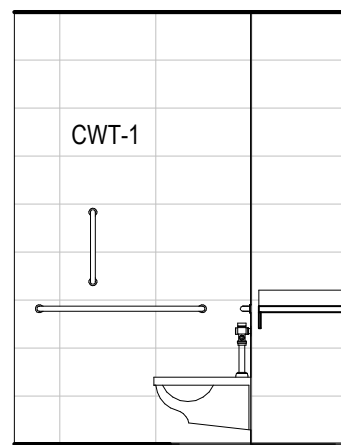

18 EAST ELEVATION - ALL GENDER RESTROOM  
A721 | A721 | 1/4" = 1'-0"

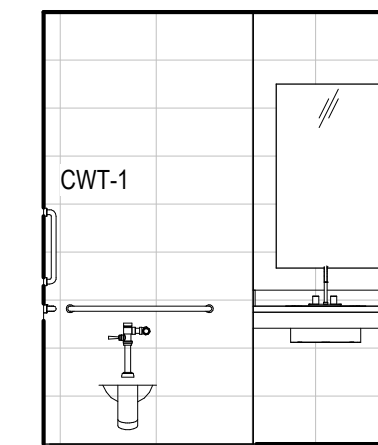



19 SOUTH ELEVATION - ALL GENDER RESTROOM  
A721 | A721 | 1/4" = 1'-0"

## FLOOR PLAN GENERAL NOTES


- SEE LANDSCAPE DRAWINGS FOR HARDSCAPE ELEMENTS, PAVING AND SITE WALL ADJACENT TO THE BUILDING.
- LOCATE ROUGH OPENINGS FOR DOORS 4" FROM INSIDE FACE OF INTERSECTING WALL UNLESS OTHERWISE NOTED.
- REFER TO LIFE SAFETY PLANS FOR ADDITIONAL RATED CONSTRUCTION INFORMATION.
- ALL DIMENSIONS ARE TO FINISH FACE OF WALL, MASONRY OPENINGS, AND OUTSIDE EDGE OF DOOR FRAME (NOMINAL), U.N.O.
- PROVIDE ACCESS PANELS / DOORS IN PARTITIONS AT ALL LOCATIONS REQUIRING ACCESS. PANELS SHALL MAINTAIN FIRE RATING.
- PROVIDE WOOD BLOCKING OR 18 GAUGE METAL STRAPPING BEHIND G.W.B. WHERE REQUIRED TO SUPPORT FIXTURES OR EQUIPMENT PROVIDED IN THE CONTRACT OR BY OTHERS.
- WHERE METAL FRAMING REQUIRES SUPPORT AT COLUMNS & BEAMS, PROVIDE METAL STAND-OFFS PRIOR TO APPLYING FIREPROOFING.
- ALL M.E.P. AND I.T. SYSTEMS ARE TO BE CONCEALED WITHIN WALL OR CEILING CAVITY, U.N.O.
- ALL INTERIOR PARTITIONS ARE TYPE N3A U.N.O. SEE T002 FOR PARTITION TYPES.

- SEE SHEET A002 FOR PARTITION TYPES.
- DIMENSIONS ARE TO FINISHED FACE OF PARTITION TYPE AS DEFINED ON SHEET A002. FINISH TYPES (TILE, WOOD PANELING, WAINSCOT, WALL COVERINGS, ETC.) ARE NOT INCLUDED.
- SEE ELEVATION SHEETS A300 FOR EXTERIOR FRAME TYPE TAGS. SEE A800 SERIES FOR FRAMES TYPES.
- SEE PLANS & INTERIOR ELEVATION SHEETS A700'S FOR INTERIOR FRAME TYPE TAGS. SEE A800 SHEETS FOR FRAME TYPES.




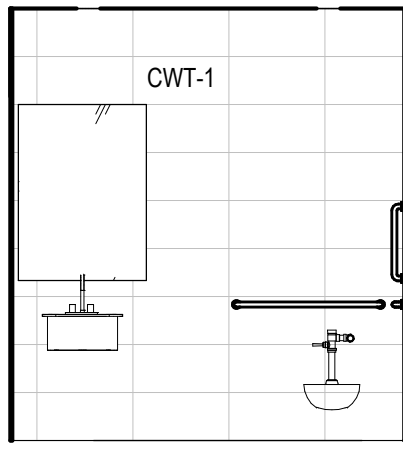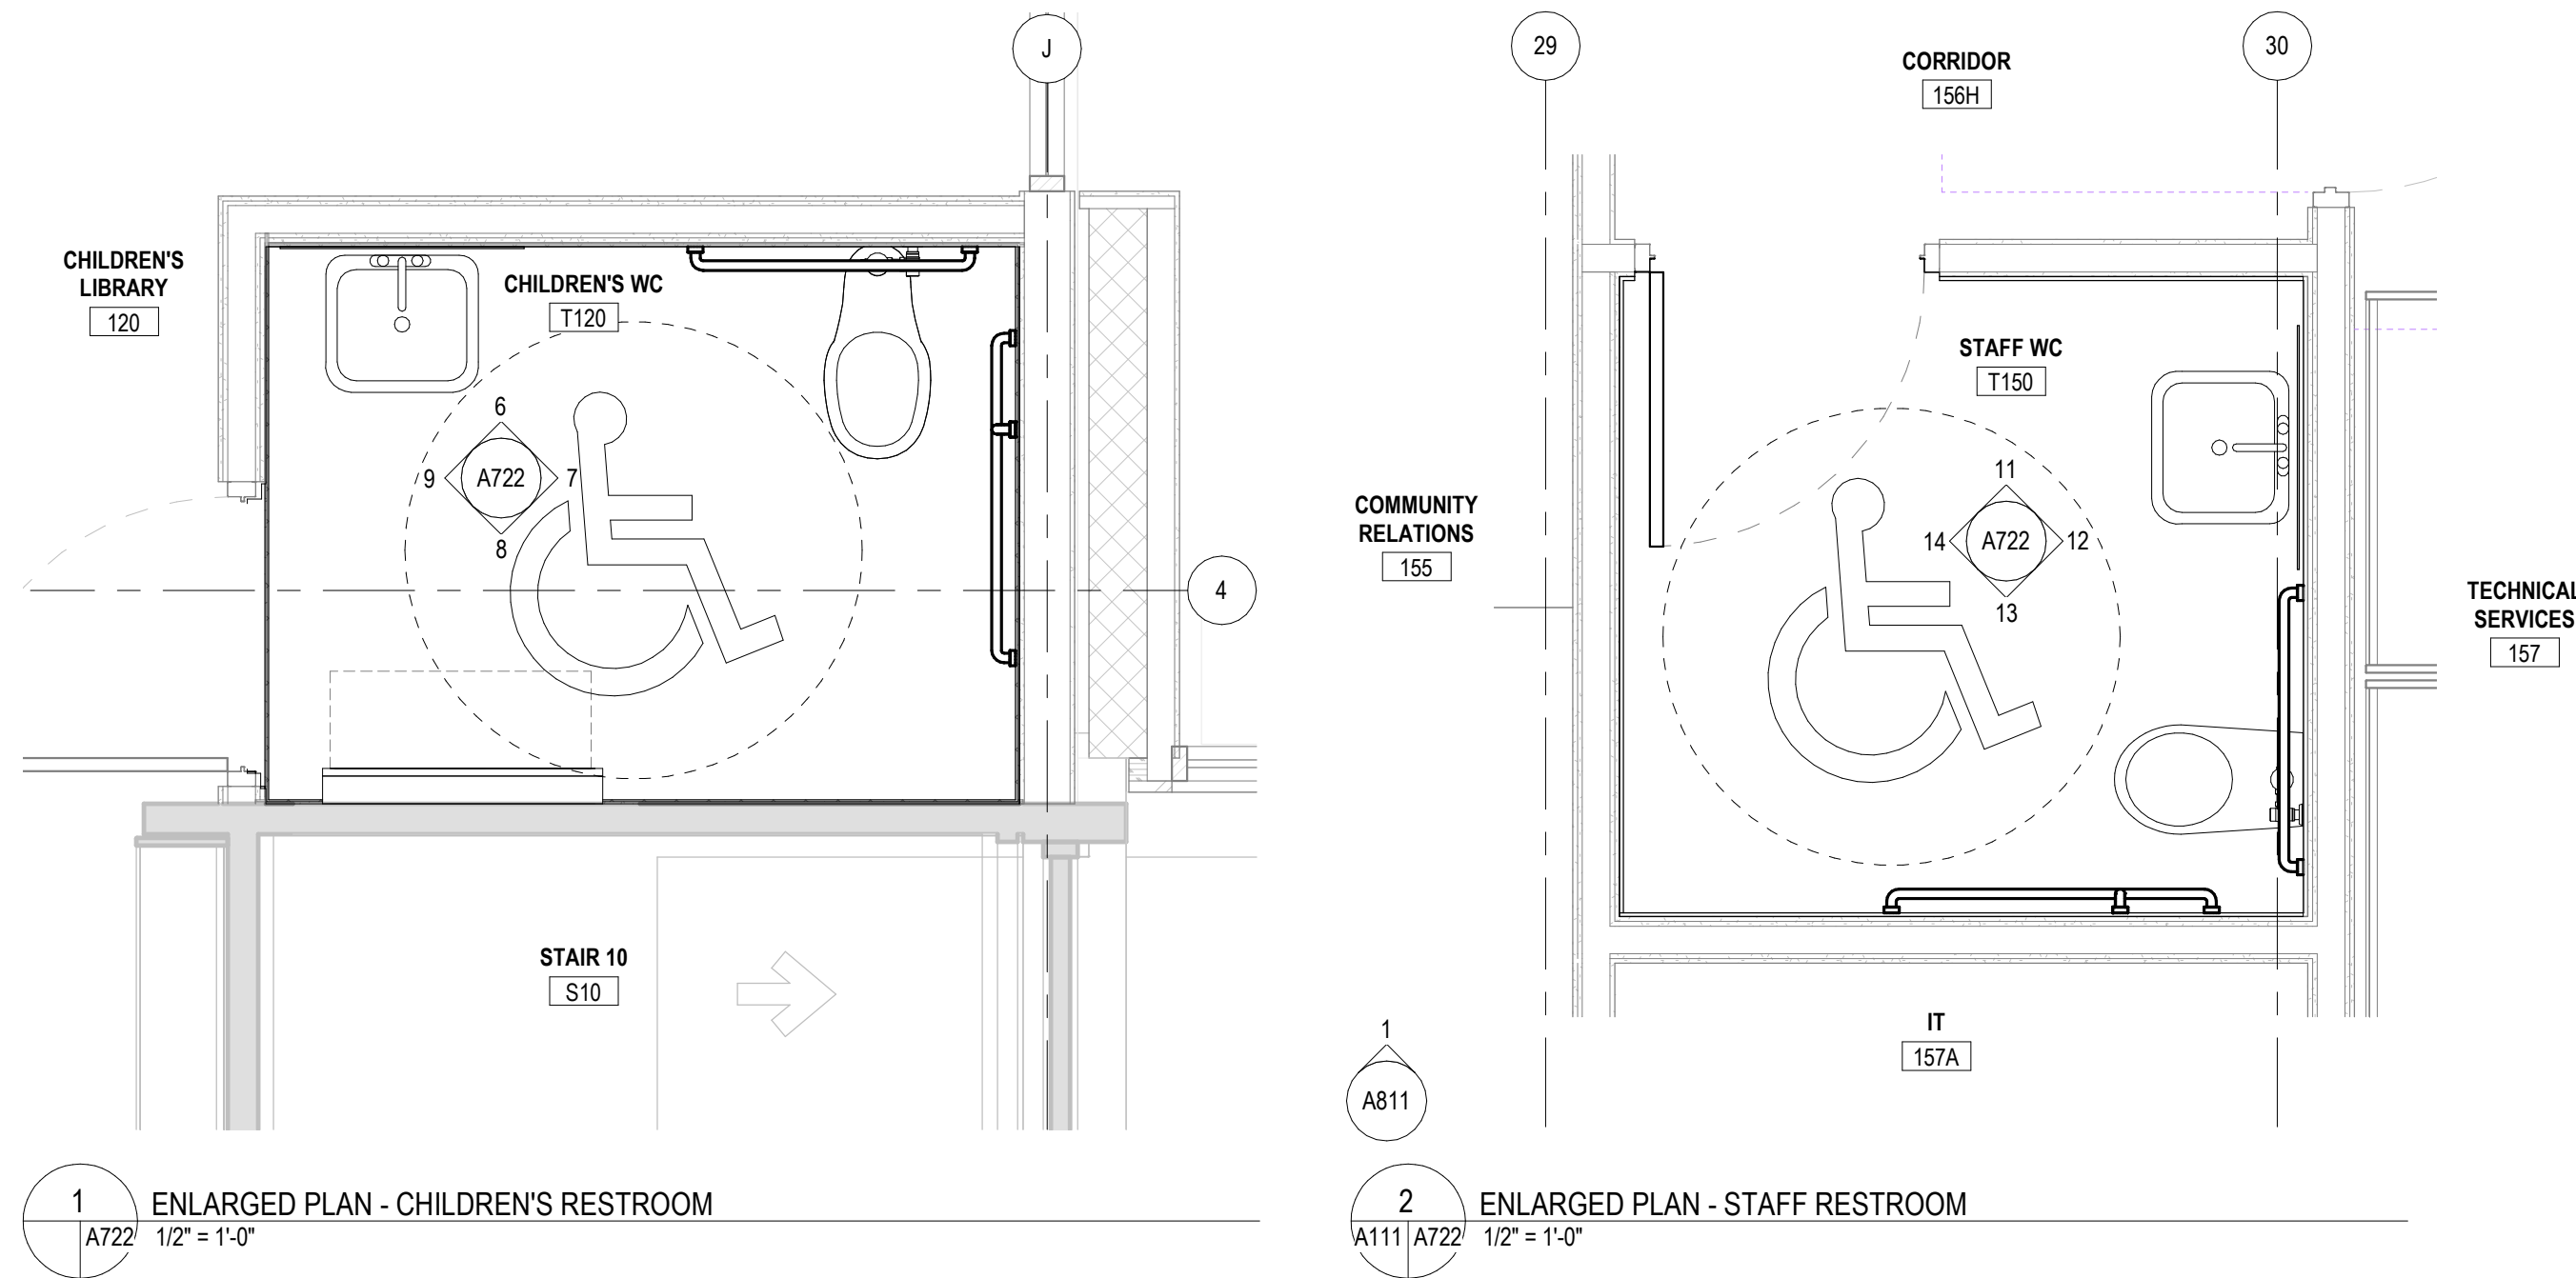


6 WEST ELEVATION - CHILDREN'S RESTROOM  
A722 A722 1/4" = 1'-0"

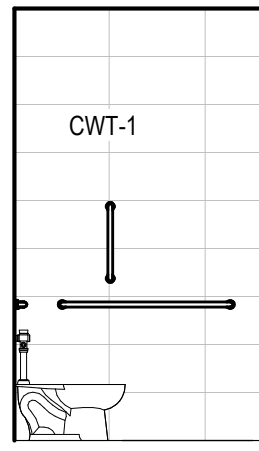



7 NORTH ELEVATION - CHILDREN'S RESTROOM  
A722 A722 1/4" = 1'-0"

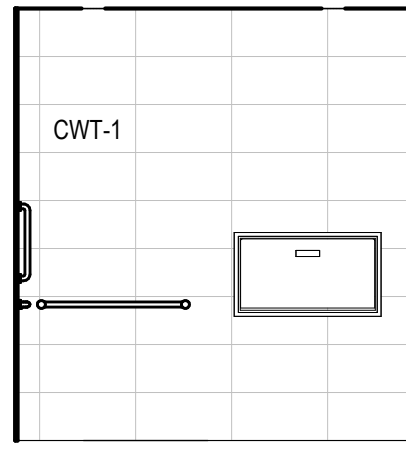


8 EAST ELEVATION - CHILDREN'S RESTROOM  
A722 A722 1/4" = 1'-0"

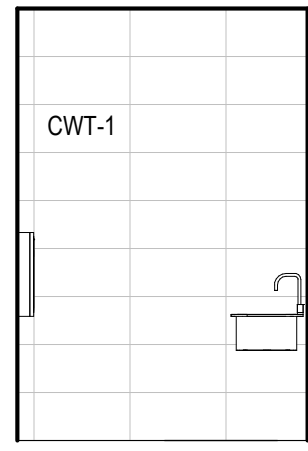


9 SOUTH ELEVATION - CHILDREN'S RESTROOM  
A722 A722 1/4" = 1'-0"

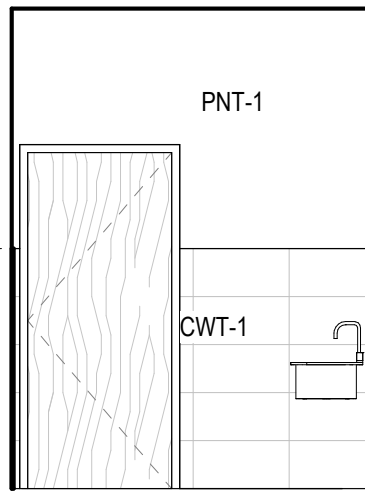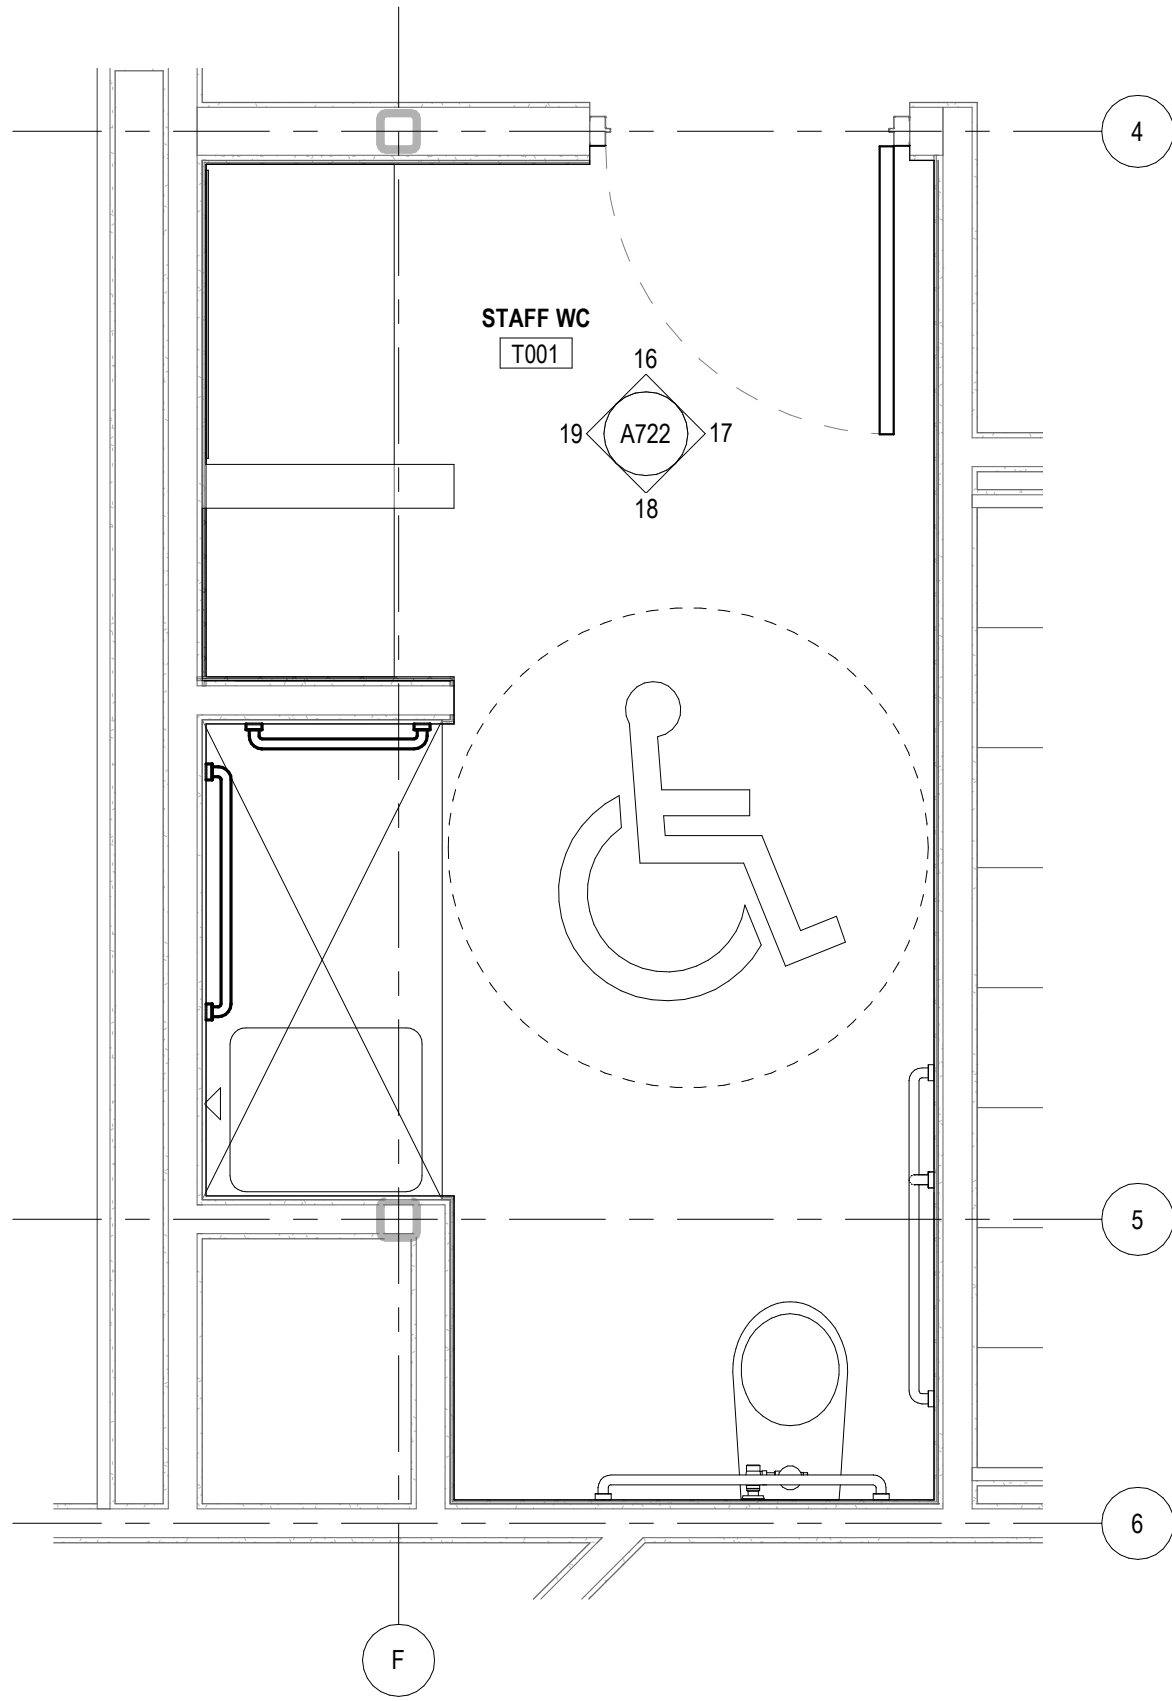


11 WEST ELEVATION - STAFF RESTROOM  
A722 A722 1/4" = 1'-0"

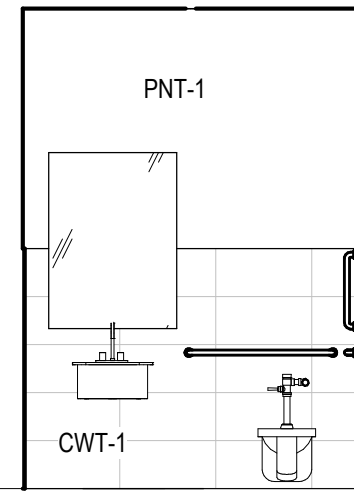


12 NORTH ELEVATION - STAFF RESTROOM  
A722 A722 1/4" = 1'-0"

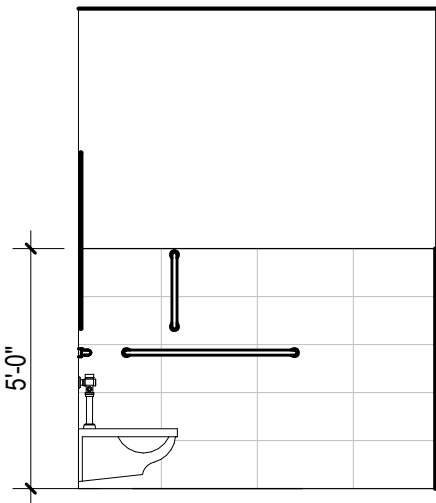


13 EAST ELEVATION - STAFF RESTROOM  
A722 A722 1/4" = 1'-0"

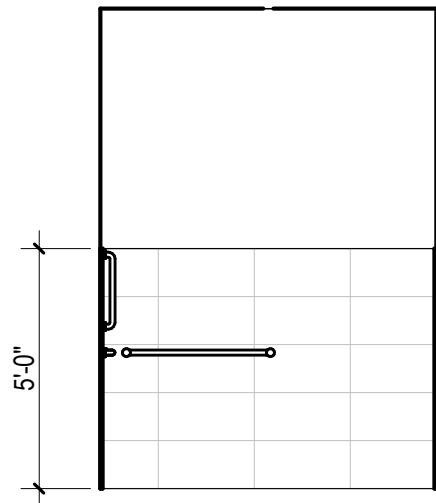


14 SOUTH ELEVATION - STAFF RESTROOM  
A722 A722 1/4" = 1'-0"

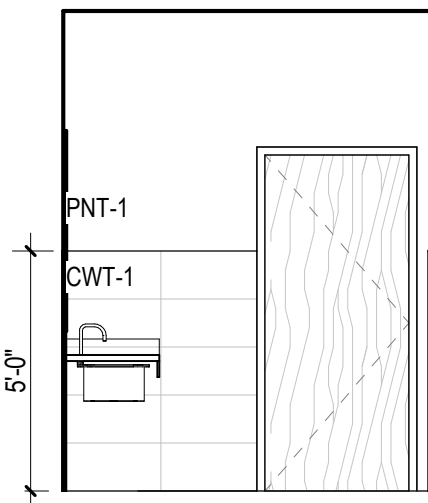


16 WEST ELEVATION - LOWER LEVEL STAFF WC  
A722 A722 1/4" = 1'-0"

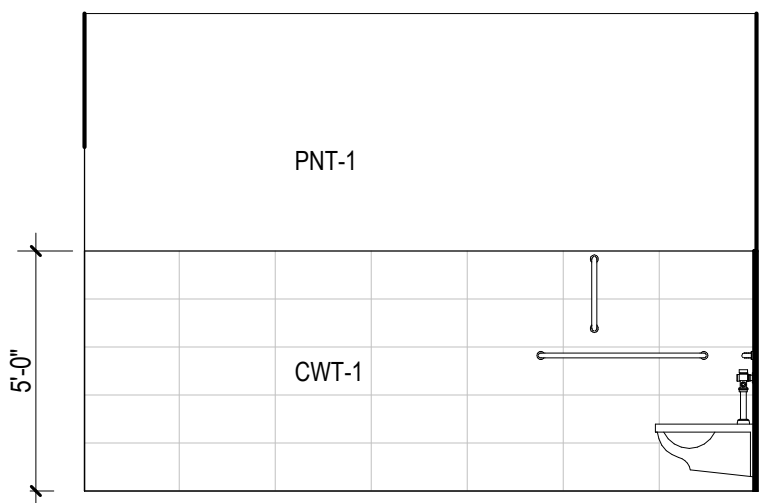

17 NORTH ELEVATION - LOWER LEVEL STAFF WC  
A722 A722 1/4" = 1'-0"

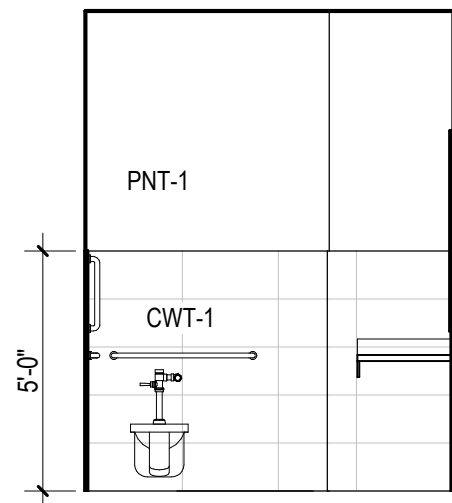

18 EAST ELEVATION - LOWER LEVEL STAFF WC  
A722 A722 1/4" = 1'-0"

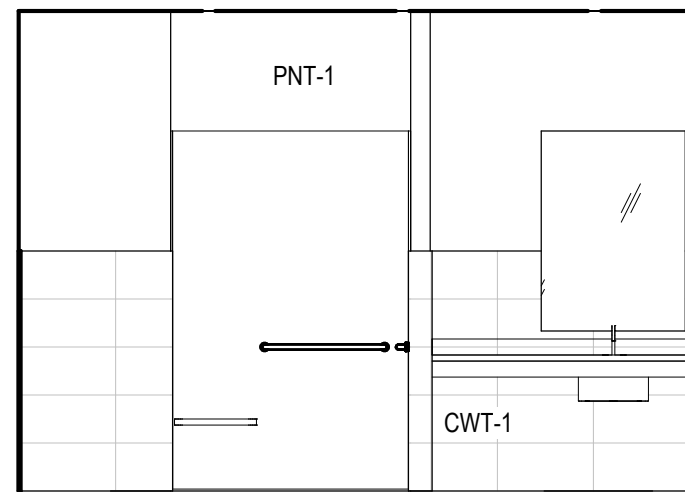

19 SOUTH ELEVATION - LOWER LEVEL STAFF WC  
A722 A722 1/4" = 1'-0"

## FLOOR PLAN GENERAL NOTES

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- SEE PLANS & INTERIOR ELEVATION SHEETS A700'S FOR INTERIOR FRAME TYPE TAGS. SEE A800 SHEETS FOR FRAME TYPES.

VMDO

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200 E Market Street  
Charlottesville, VA 22902  
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Washington, DC 20036



New City Library

## New City Library Addition & Renovation


220 North Main Street  
New City, NY 10956

Client Project Number  
VMDO Project Number

1301

Checked By  
Drawn By

Checker  
Author

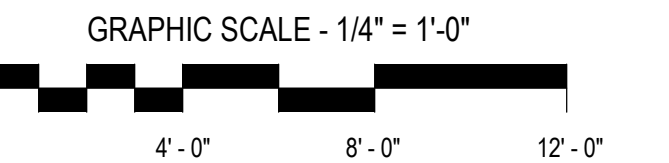


ISSUES AND REVISIONS		
NO.	SUBMITTAL	DATE
	SCHEMATIC DESIGN	03.05.2021

## ENLARGED TOILET PLANS & ELEVATIONS


A722

DESIGN DEVELOPMENT  
07.09.2021




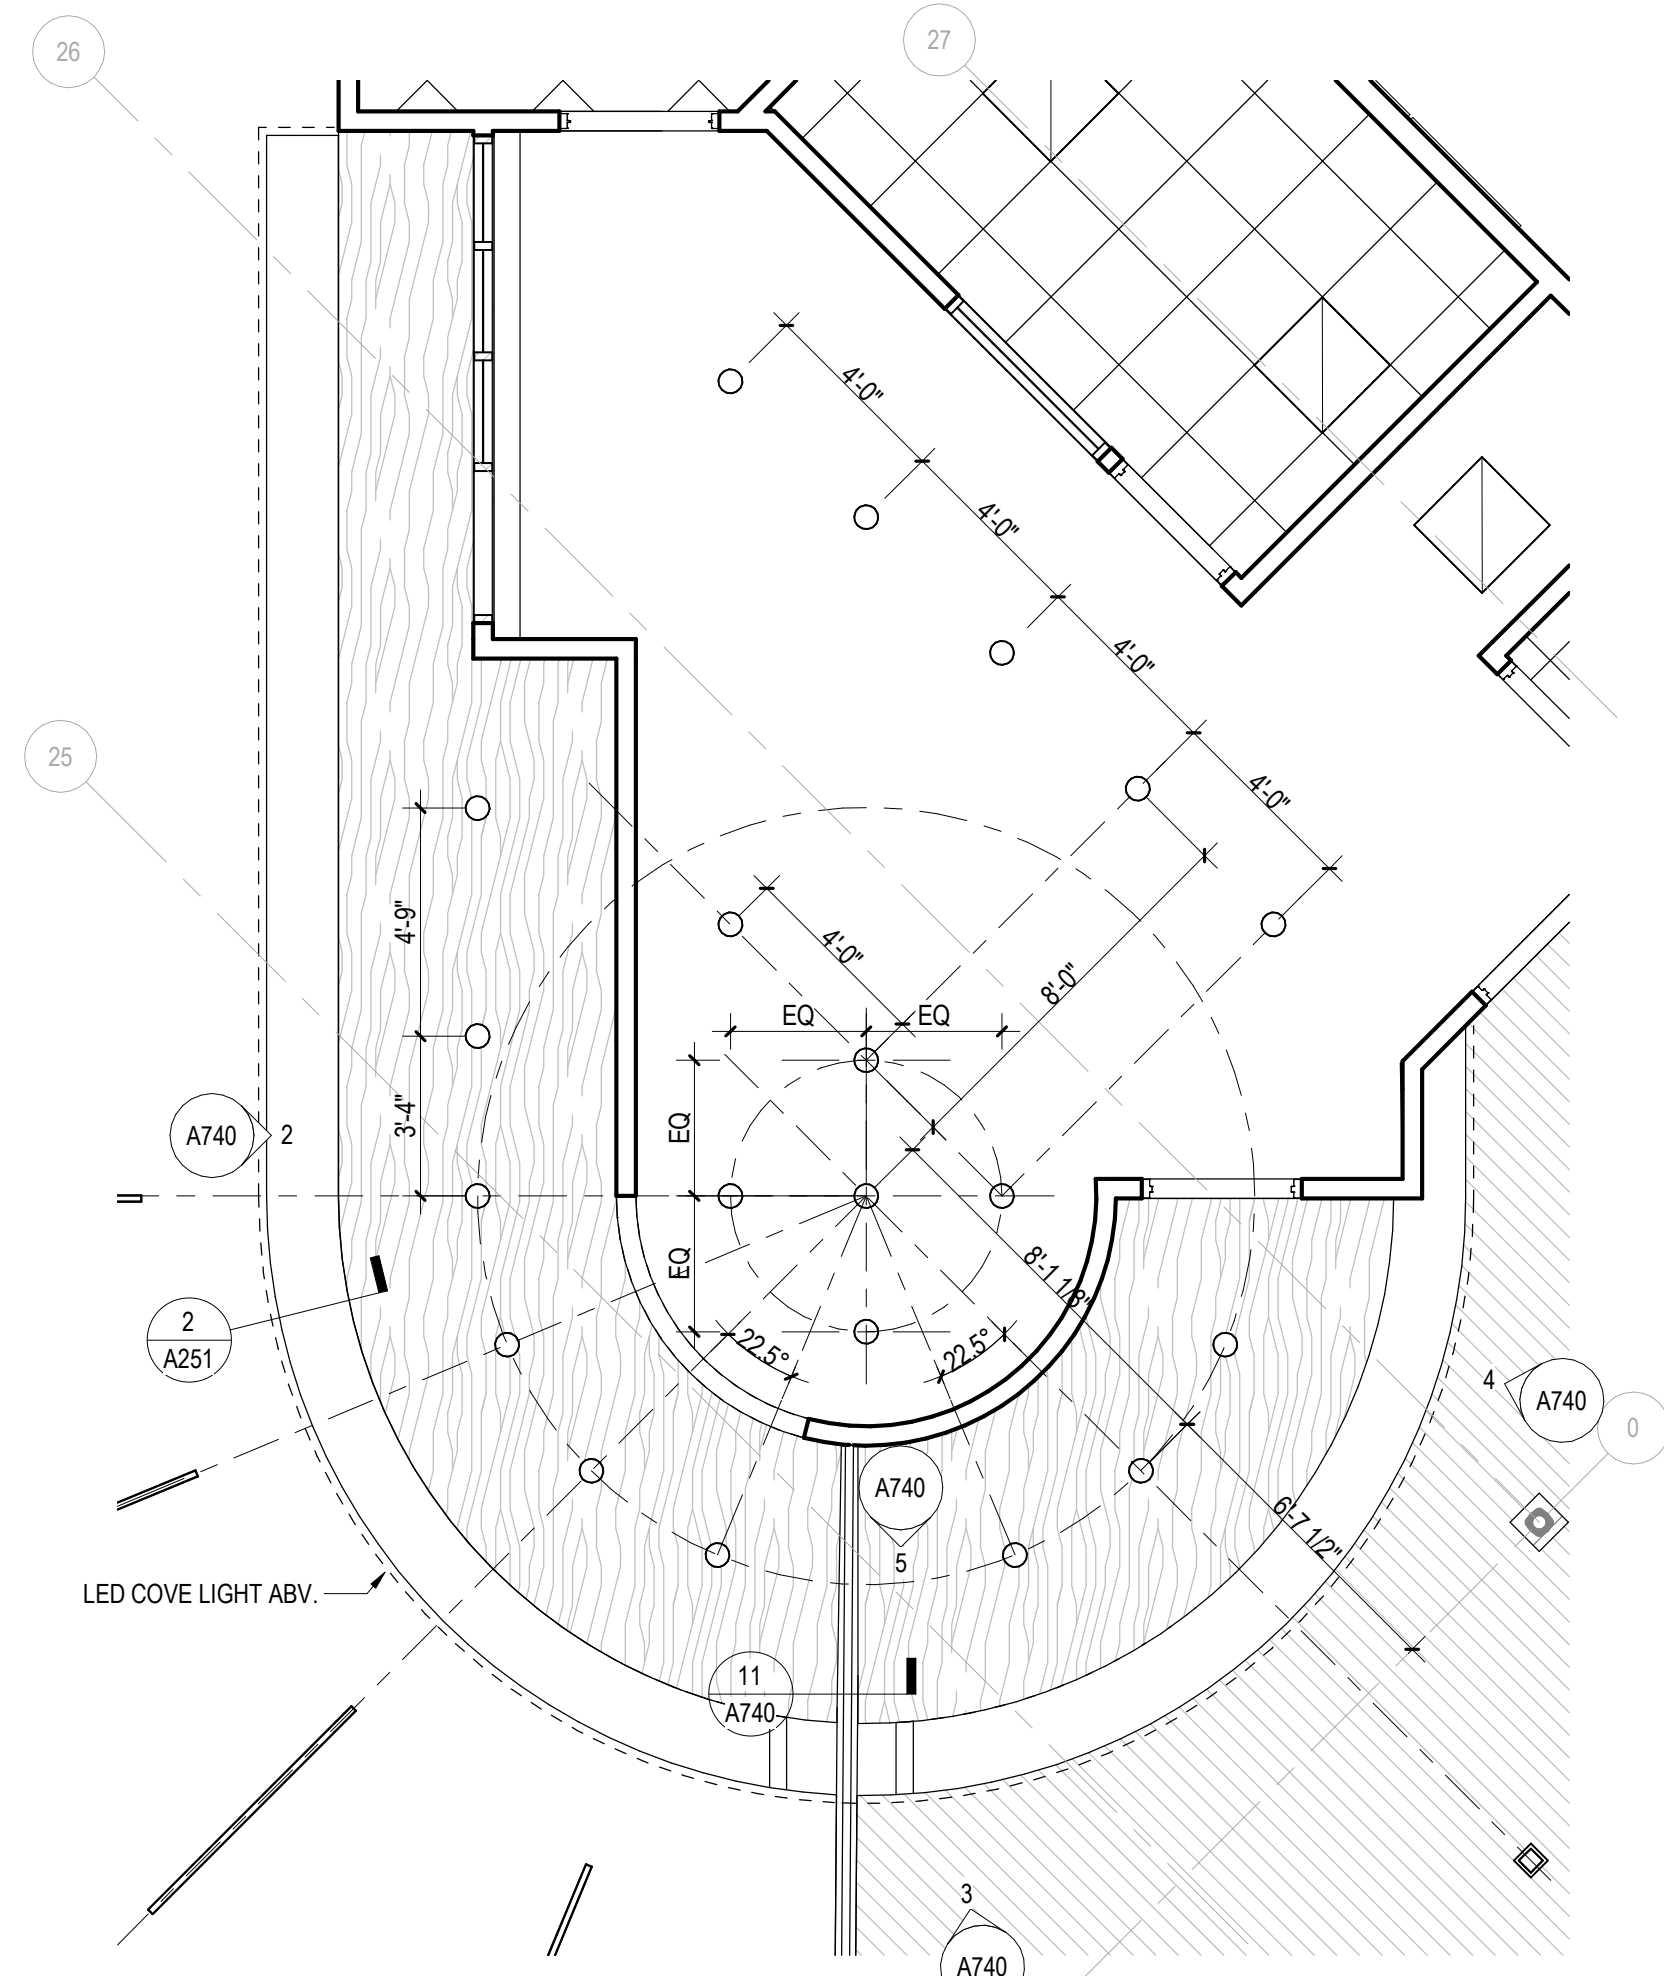


6 CIRCULATION DESK - ENLARGED RCP  
A740 1/4" = 1'-0"

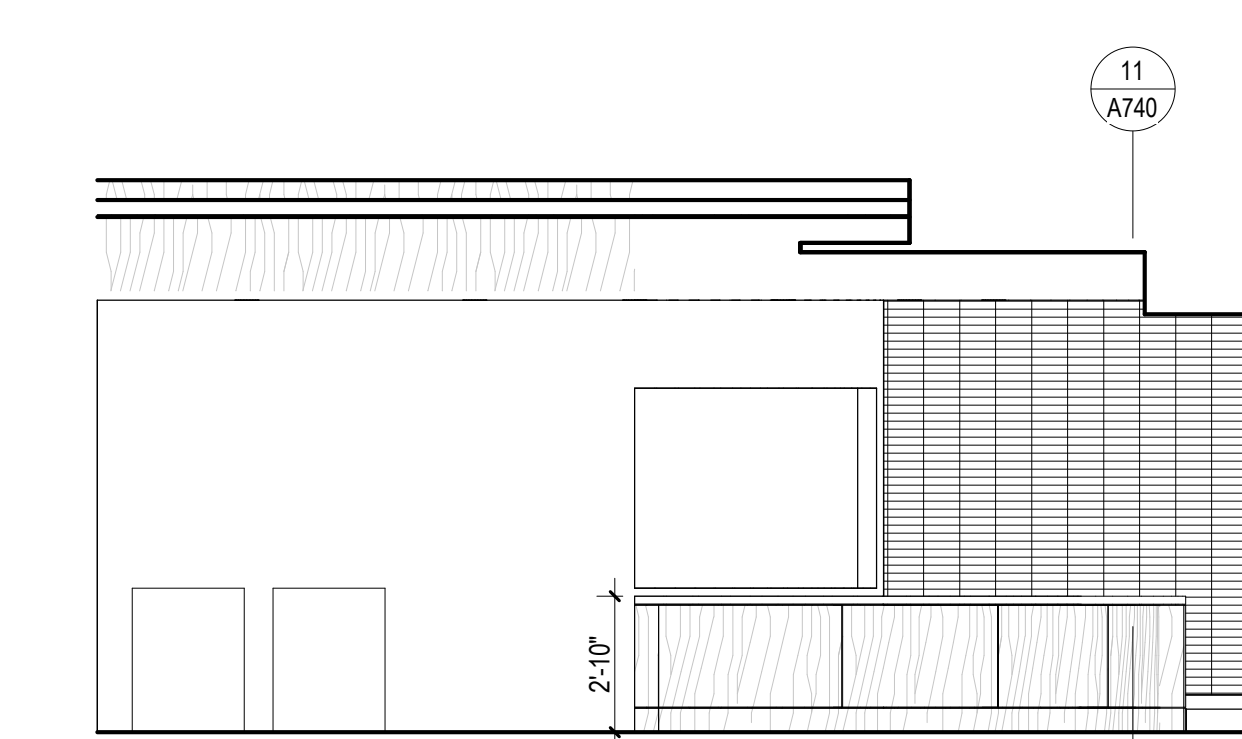


2 NORTH ELEVATION - CIRCULATION DESK CASEWORK  
A740 A740 1/4" = 1'-0"

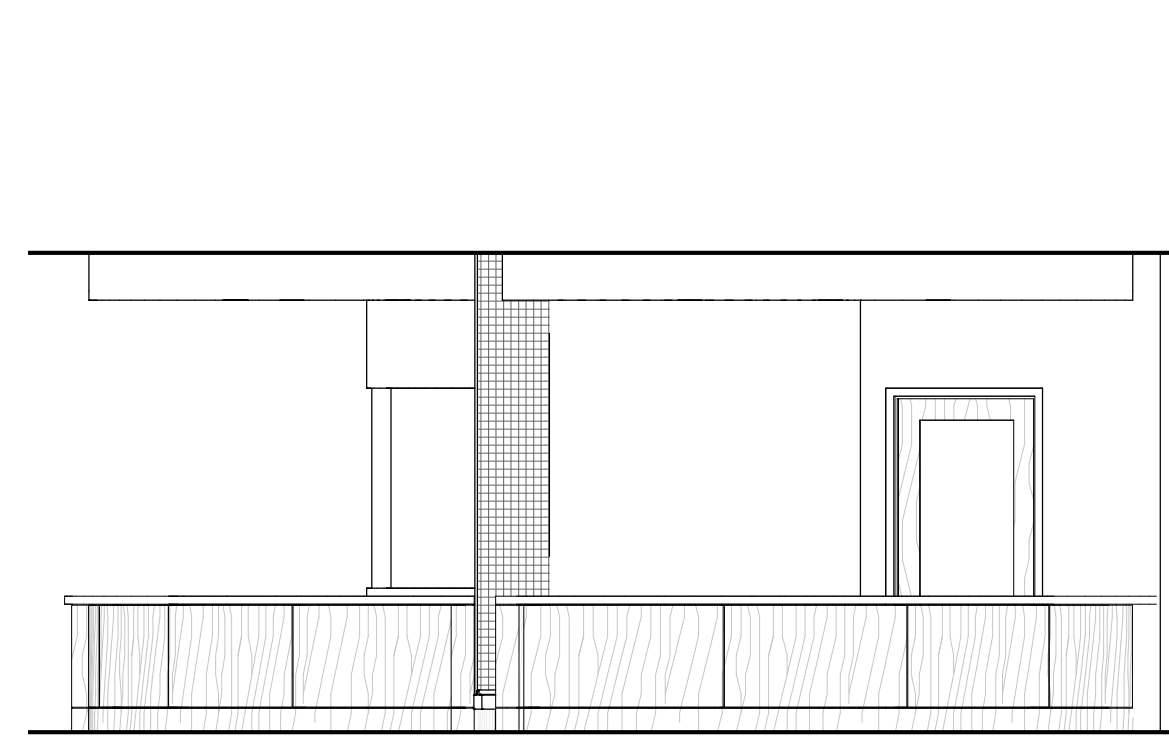


3 WEST ELEVATION - CIRCULATION DESK CASEWORK  
A740 A740 1/4" = 1'-0"

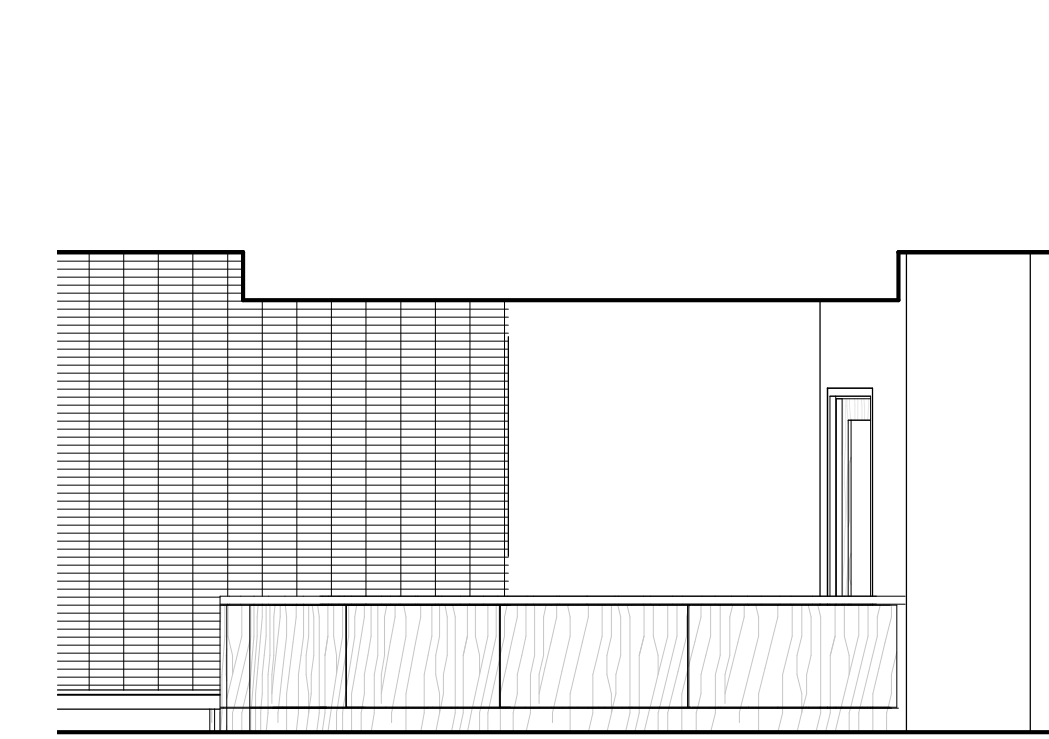


4 SOUTH ELEVATION - CIRCULATION DESK CASEWORK  
A740 A740 1/4" = 1'-0"

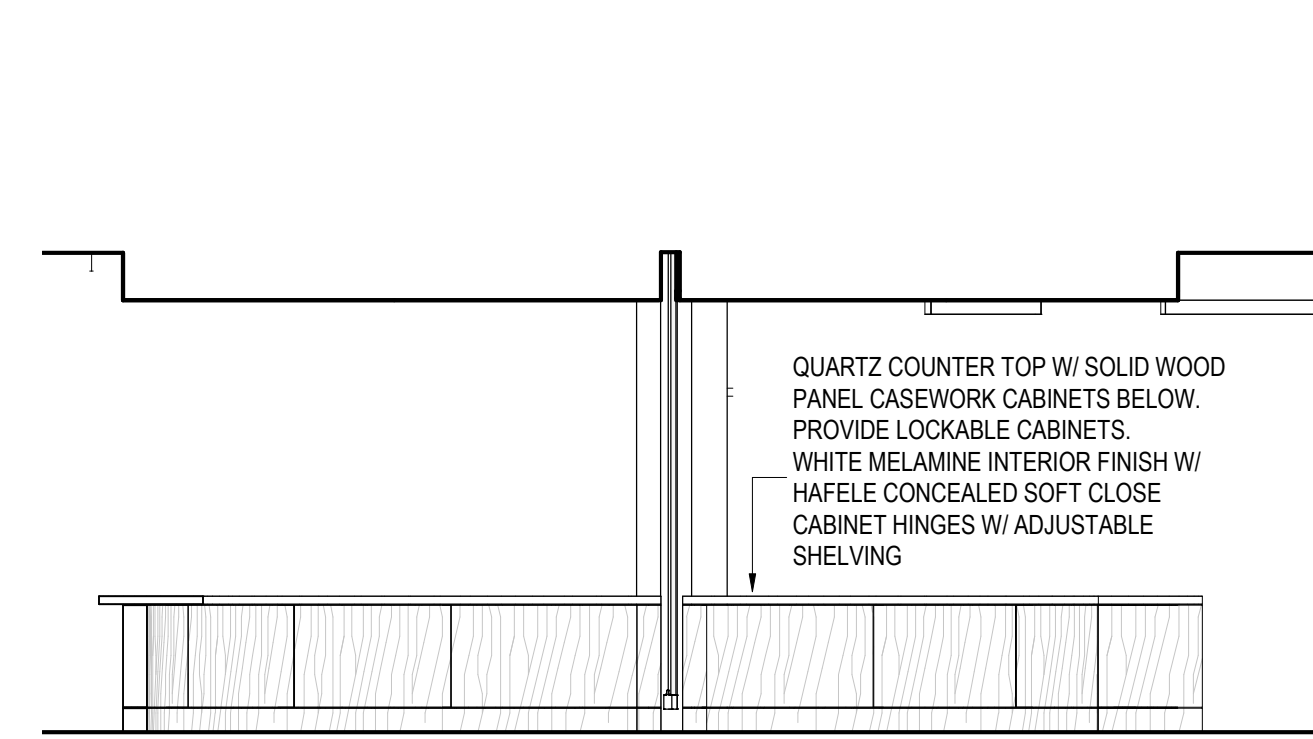


5 EAST ELEVATION - CIRCULATION DESK CASEWORK  
A740 A740 1/4" = 1'-0"

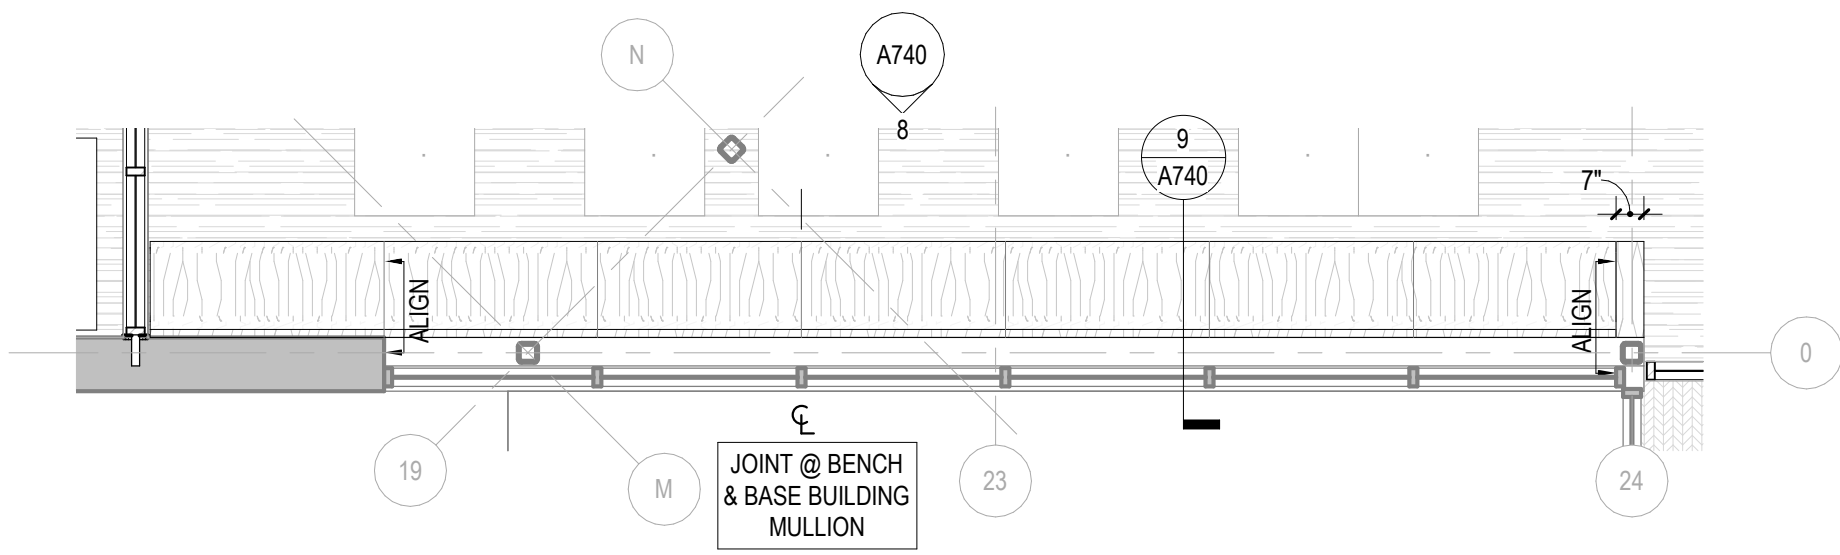


7 ENLARGED PLAN - MAIN LEVEL BENCH  
A740 1/4" = 1'-0"

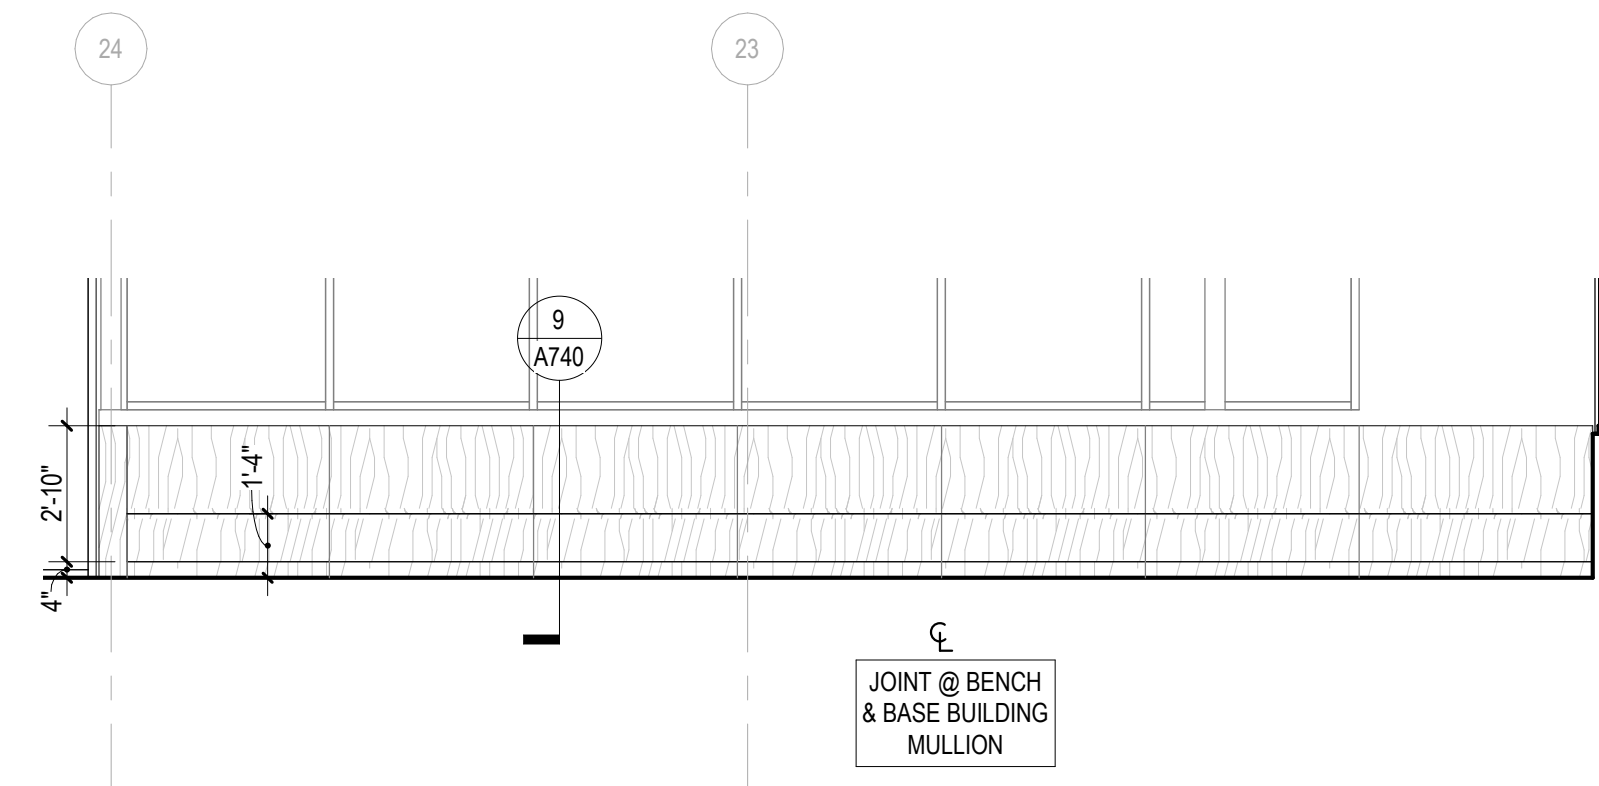


8 EAST ELEVATION - MAIN LEVEL BENCH  
A740 A740 1/4" = 1'-0"

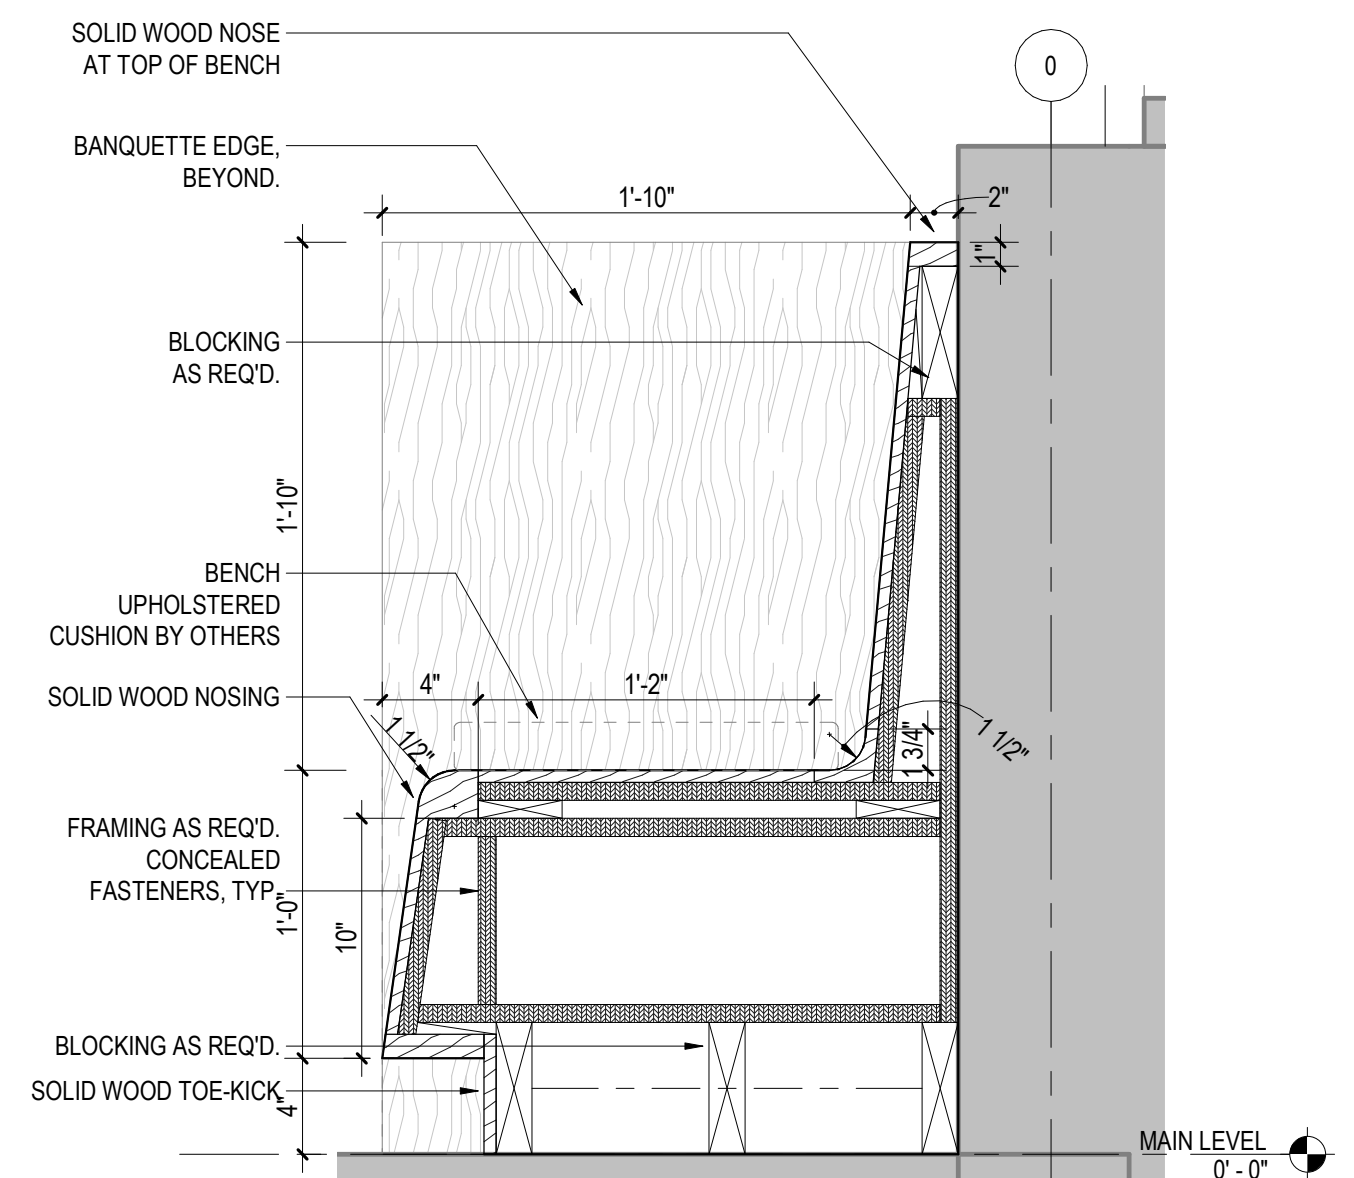


9 SECTION @ MAIN LEVEL BENCH  
A740 A740 1 1/2" = 1'-0"

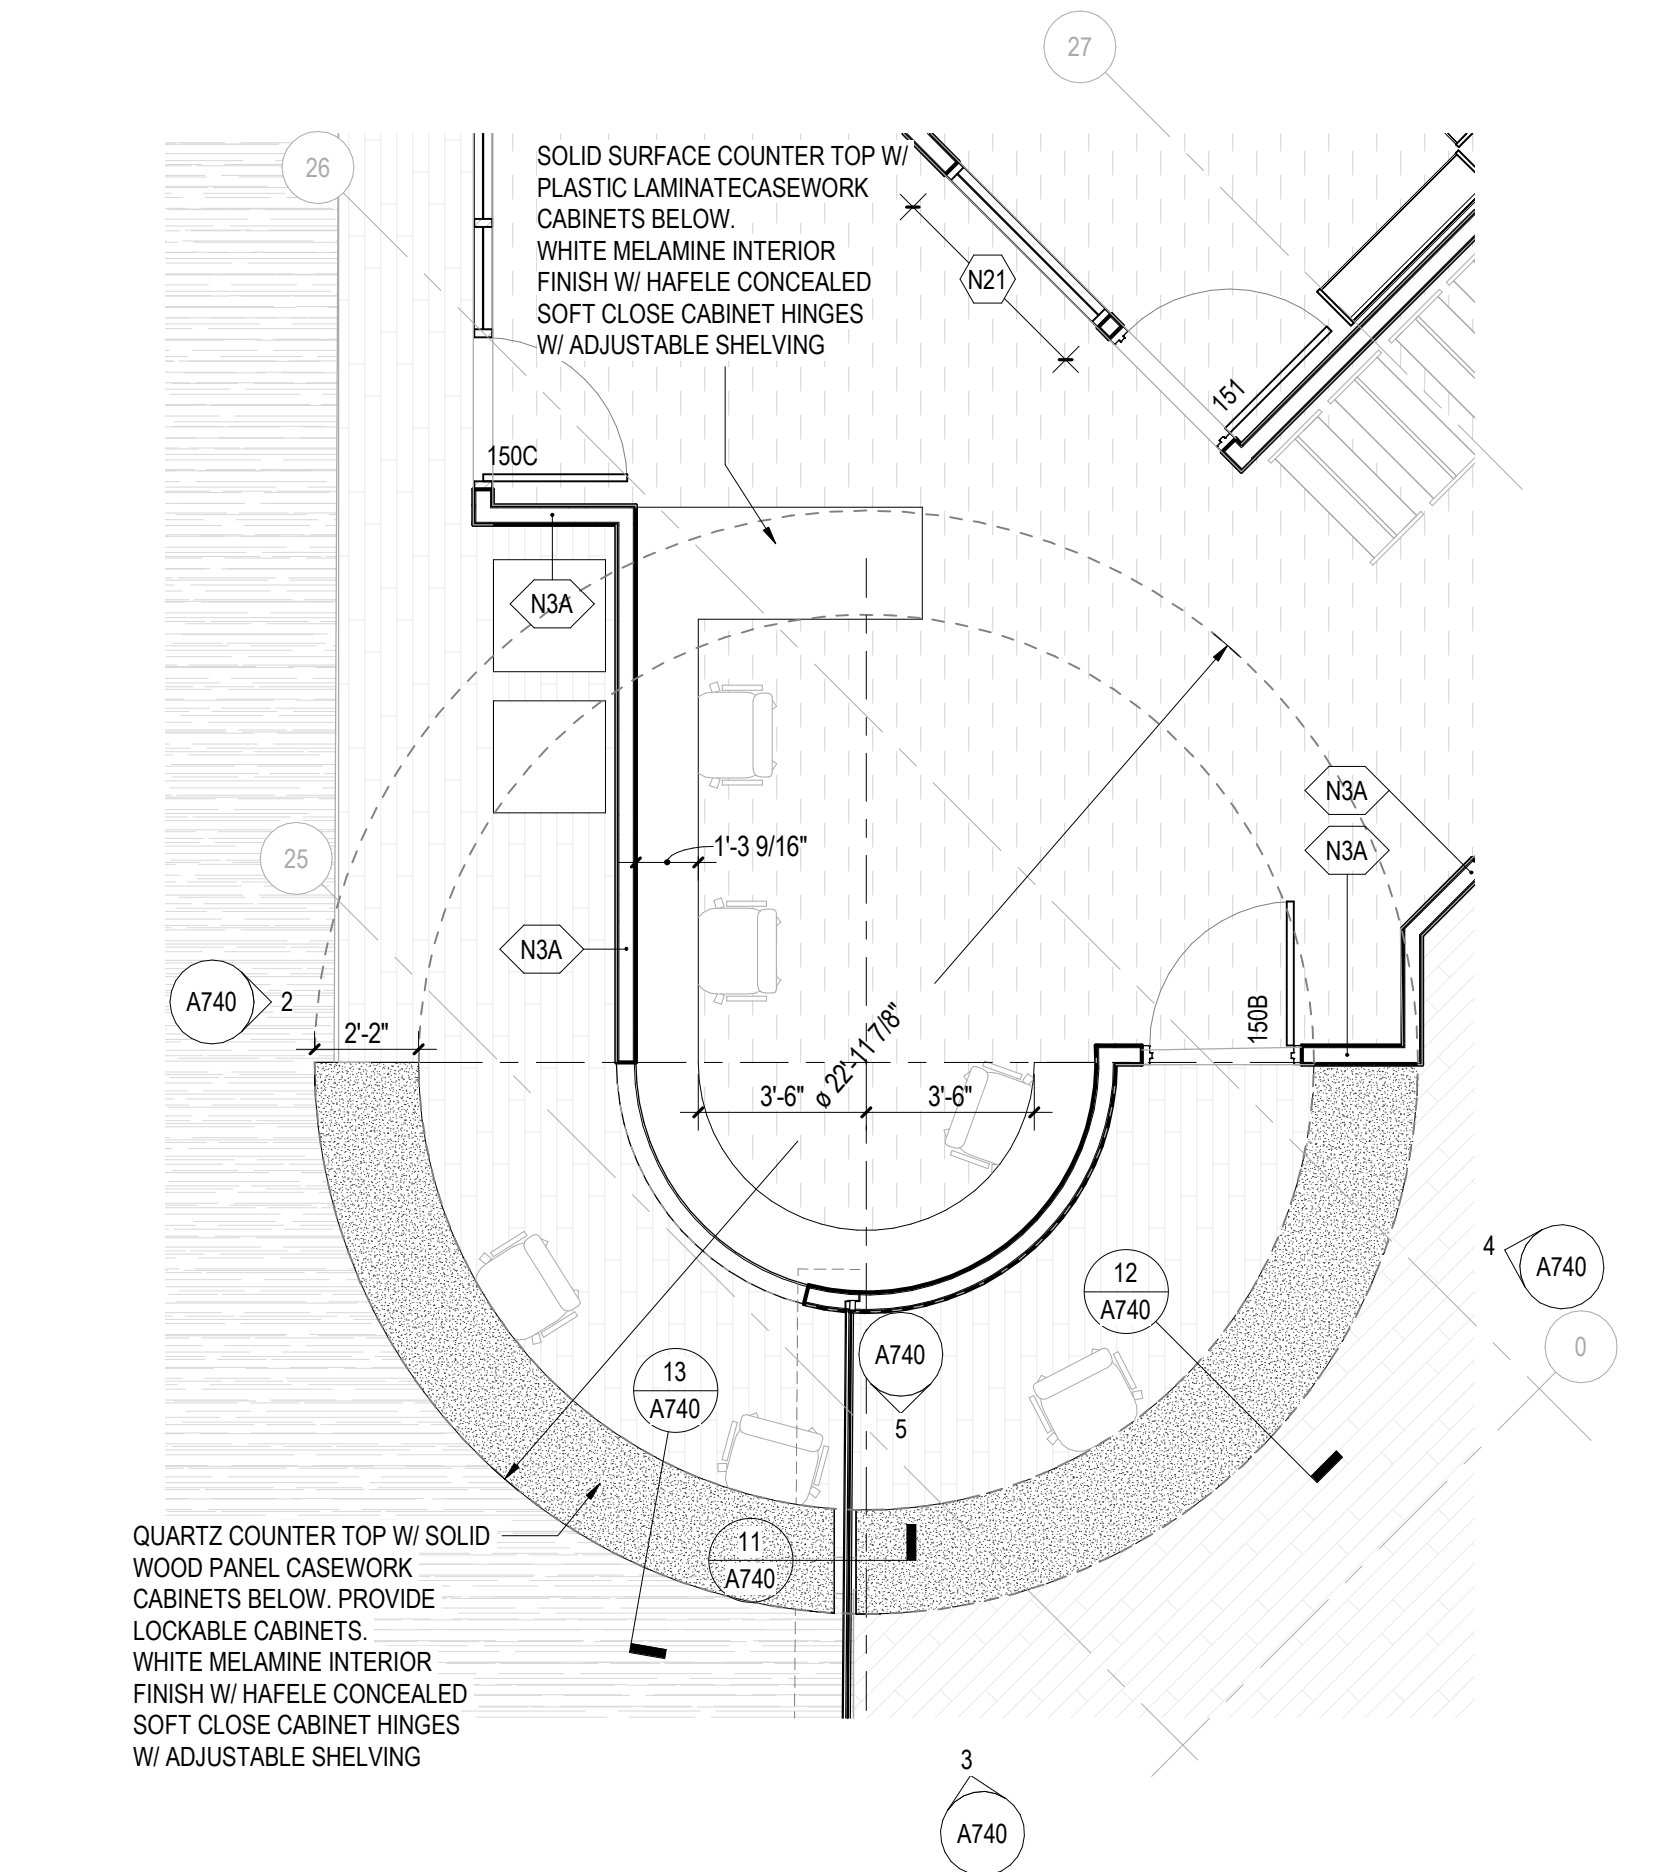

10 CIRCULATION DESK - ENLARGED PLAN  
A740 1/4" = 1'-0"

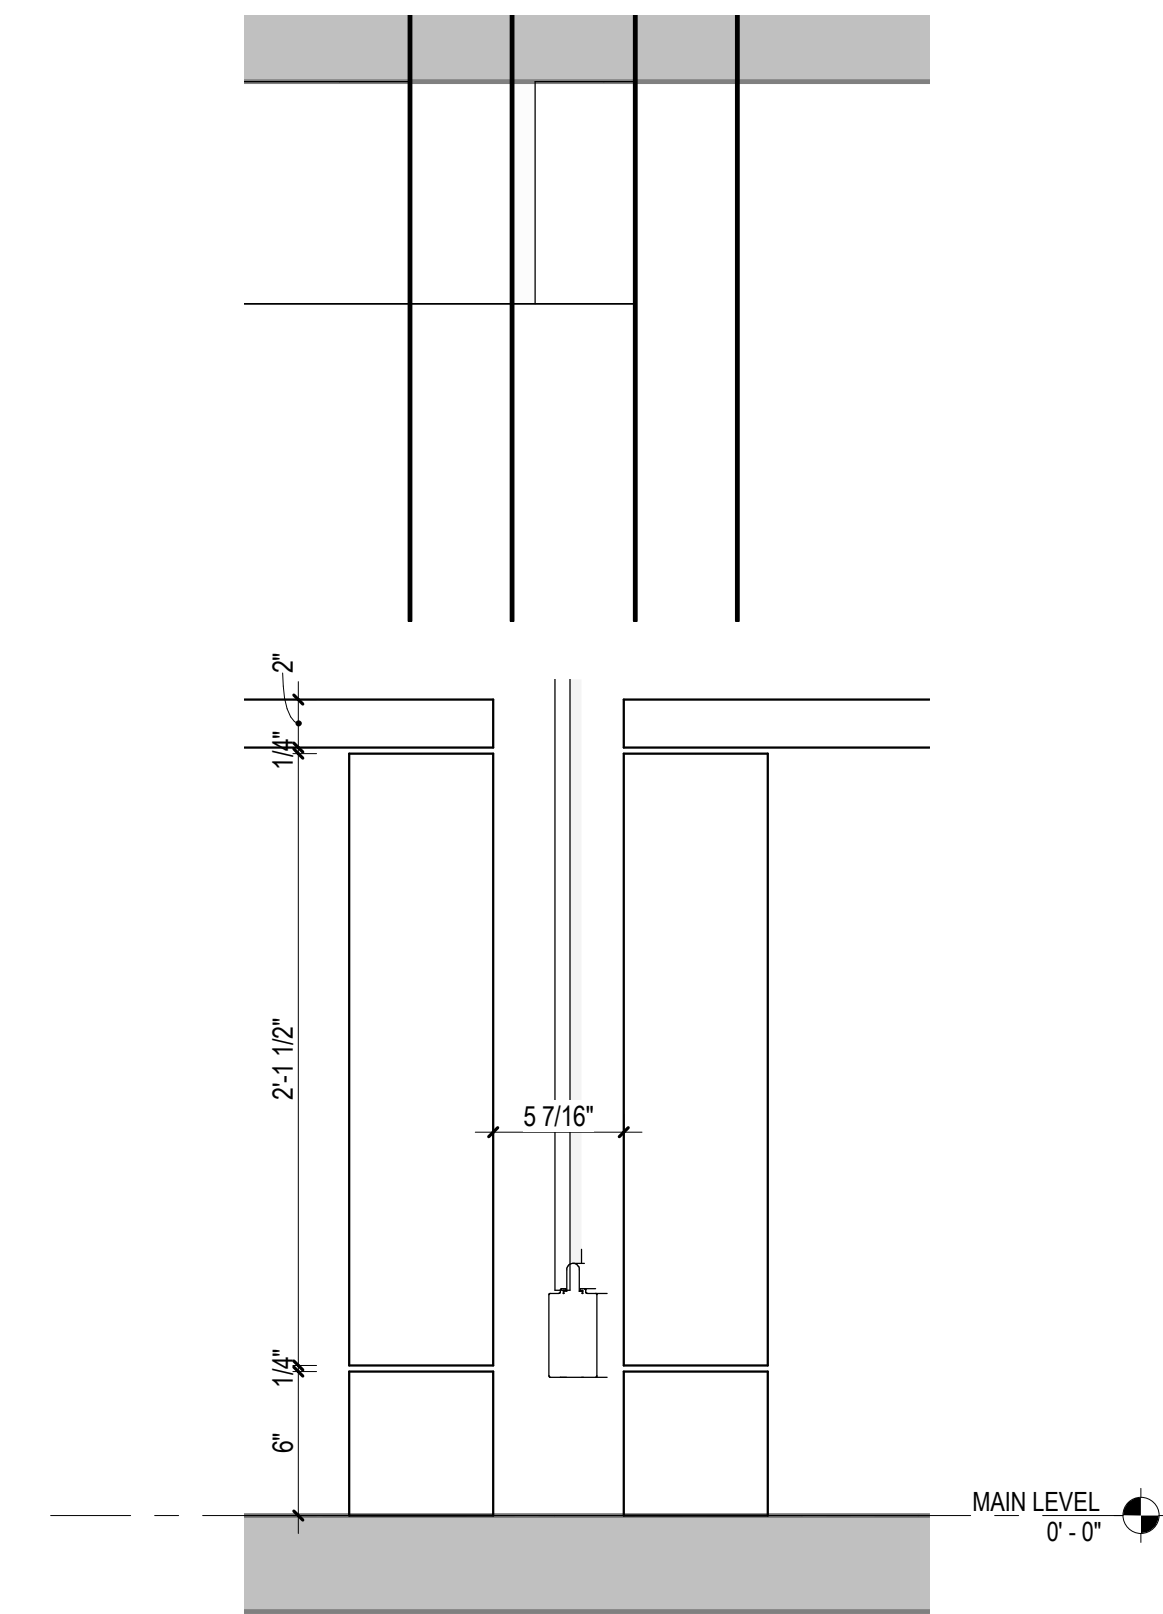

11 SECTION @ CIRCULATION DESK OVERHEAD GATE  
A740 A740 1 1/2" = 1'-0"

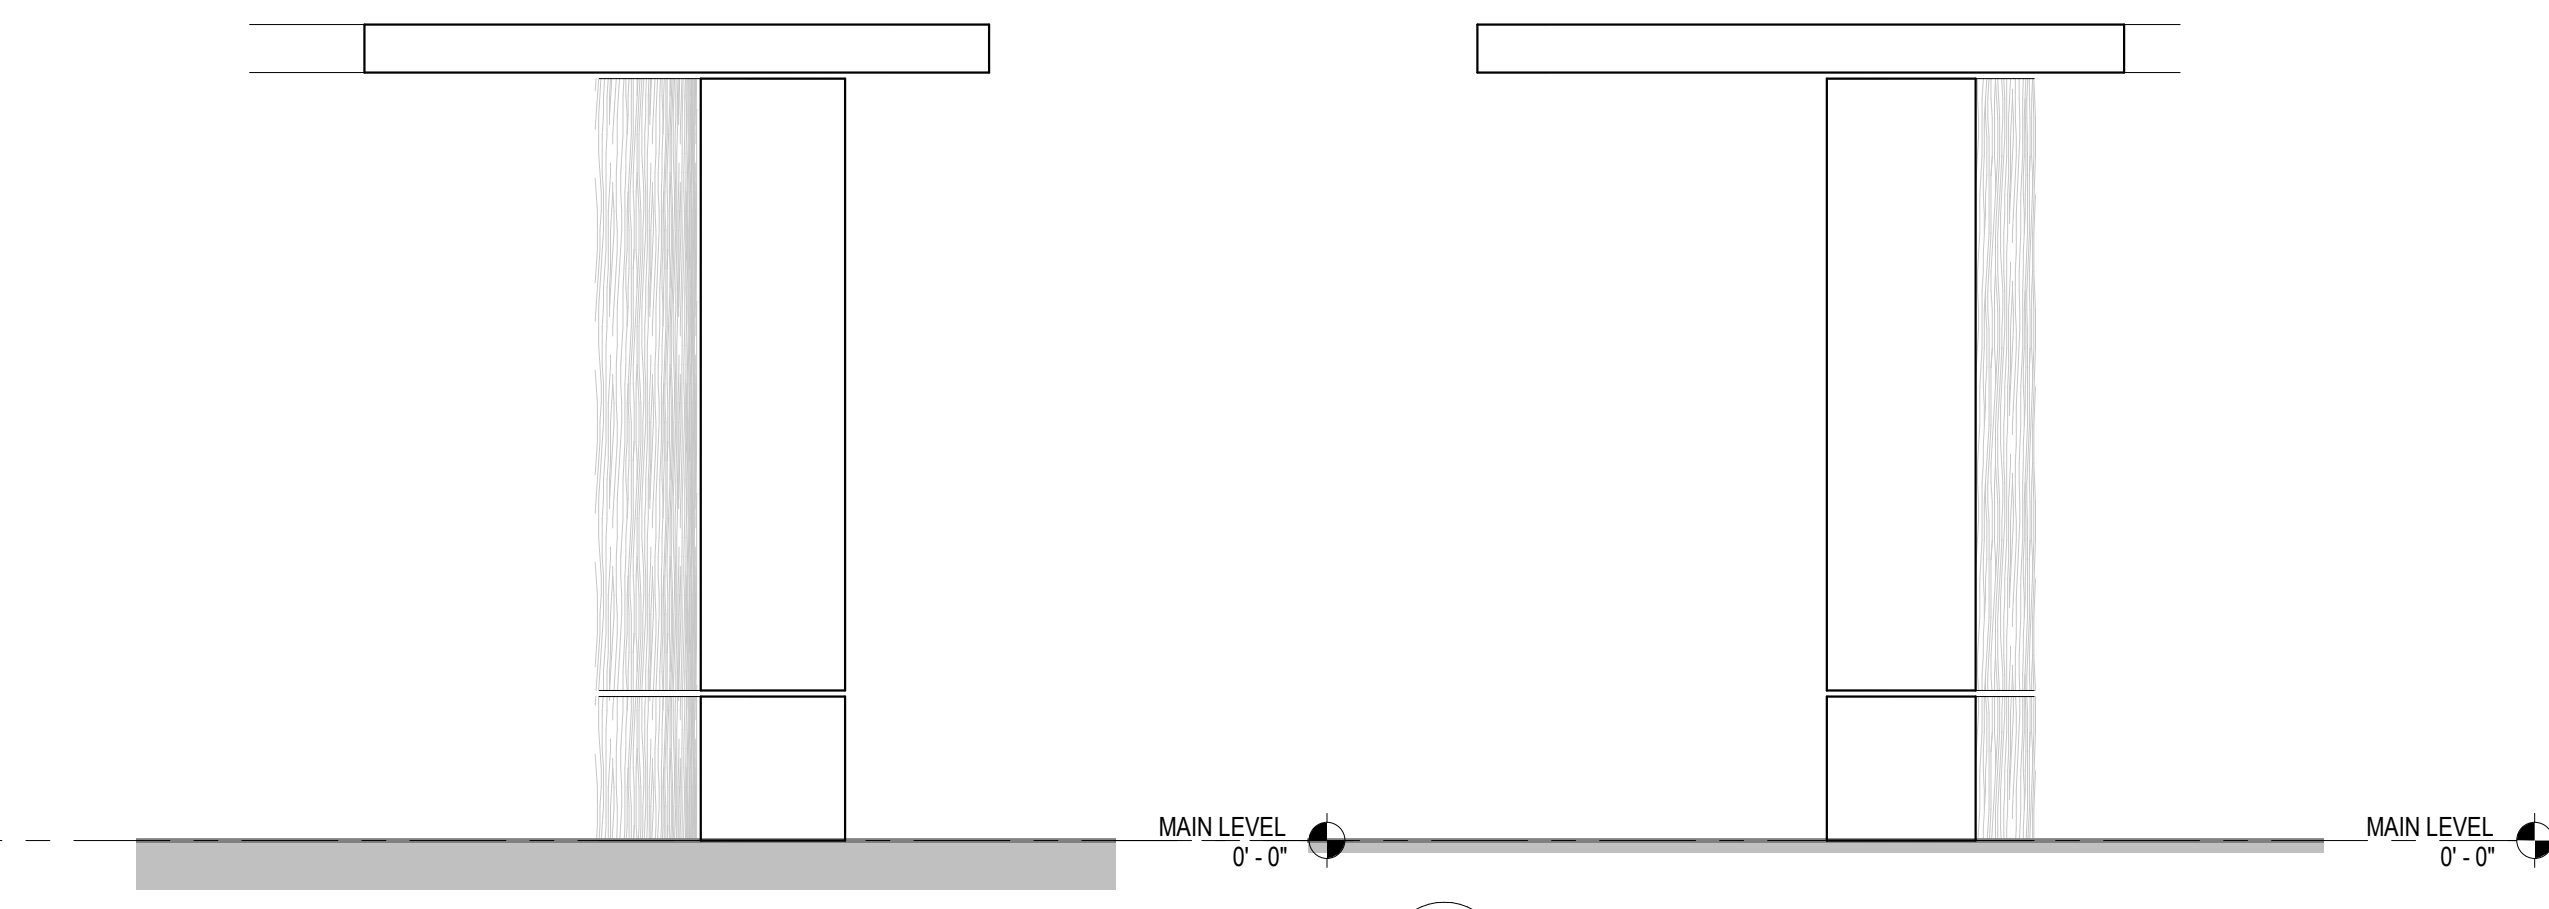

12 SECTION @ CIRCULATION DESK CASEWORK  
A740 A740 1 1/2" = 1'-0"

13 SECTION @ CIRCULATION DESK CASEWORK / GATE  
A740 A740 1 1/2" = 1'-0"

KEYNOTES

VMDO

VMDO Architects  
vmdo.com  
434.296.5684  
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Charlottesville, VA 22902  
1200 18th Street NW Ste 700  
Washington, DC 20036




New City Library

New City Library Addition & Renovation

220 North Main Street  
New City, NY 10956

Client Project Number  
VMDO Project Number 1301

Checked By  
Drawn By  
Checker  
Author

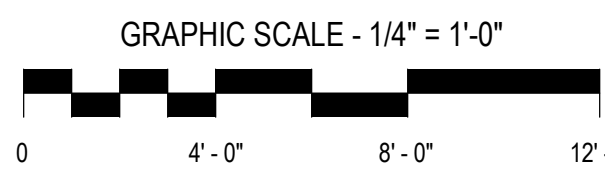


ISSUES AND REVISIONS		
NO.	SUBMITTAL	DATE
	SCHEMATIC DESIGN	03.05.2021


MILLWORK ENLARGED  
PLANS & INTERIOR  
ELEVATIONS

A740  
DESIGN DEVELOPMENT  
07.09.2021




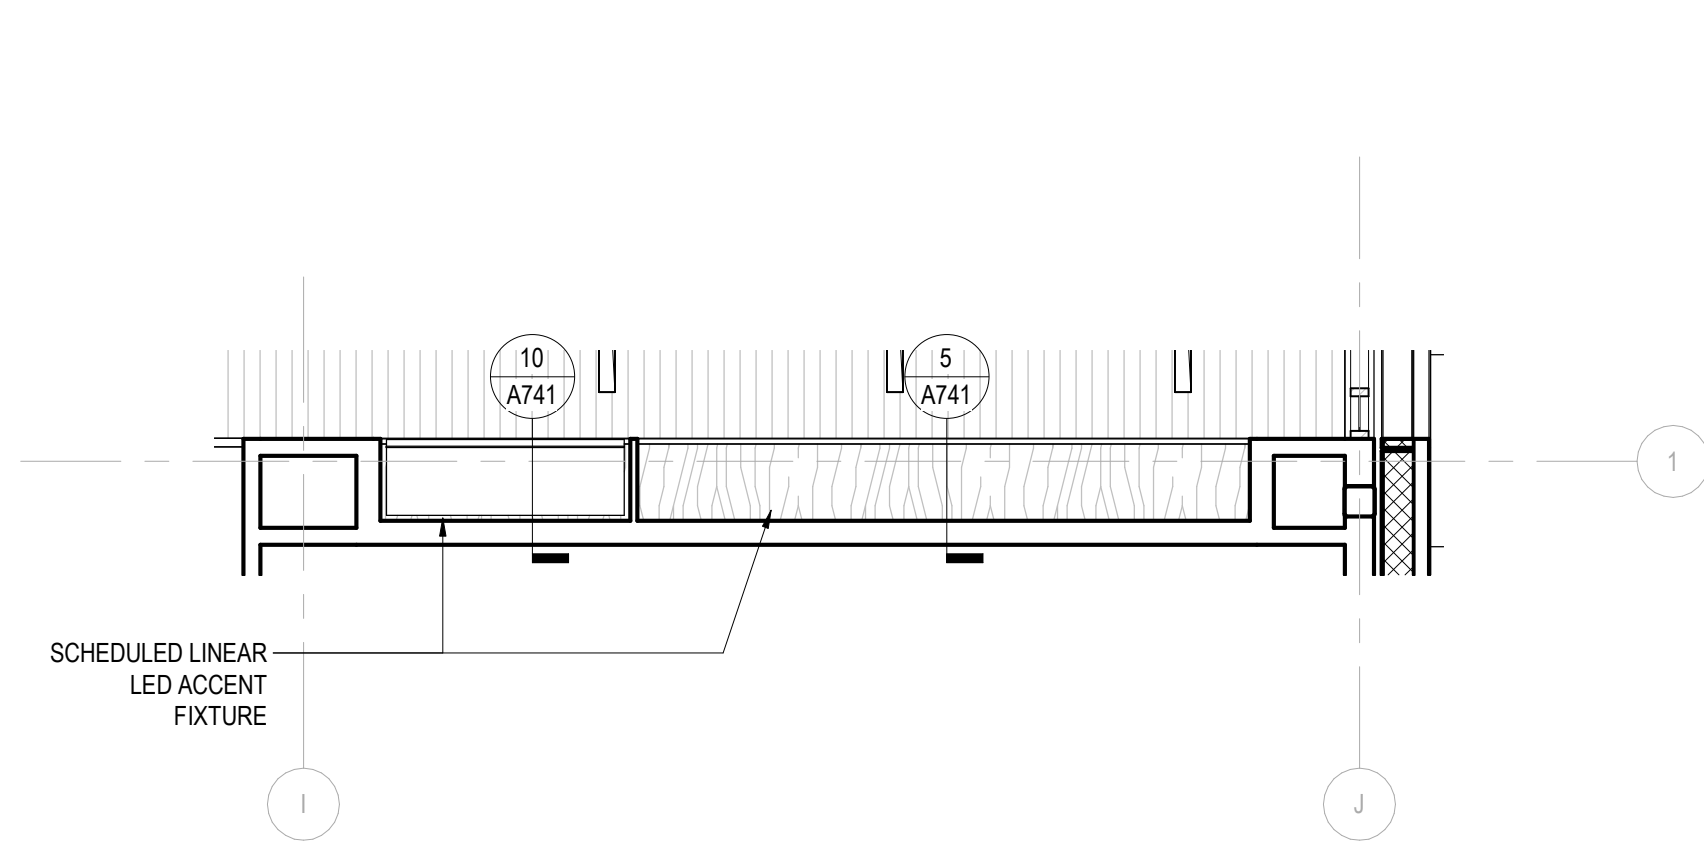


1 ENLARGED RCP - MILLWORK BENCH AT MAIN STREET  
A741 1/4" = 1'-0"

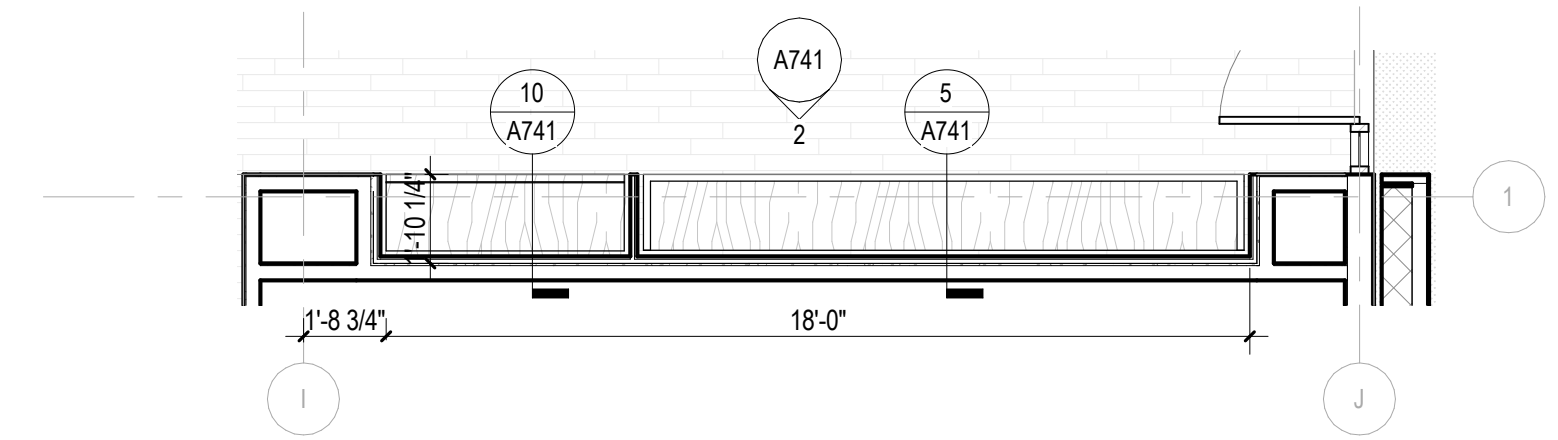


3 ENLARGED PLAN - MILLWORK BENCH AT MAIN STREET  
A741 1/4" = 1'-0"

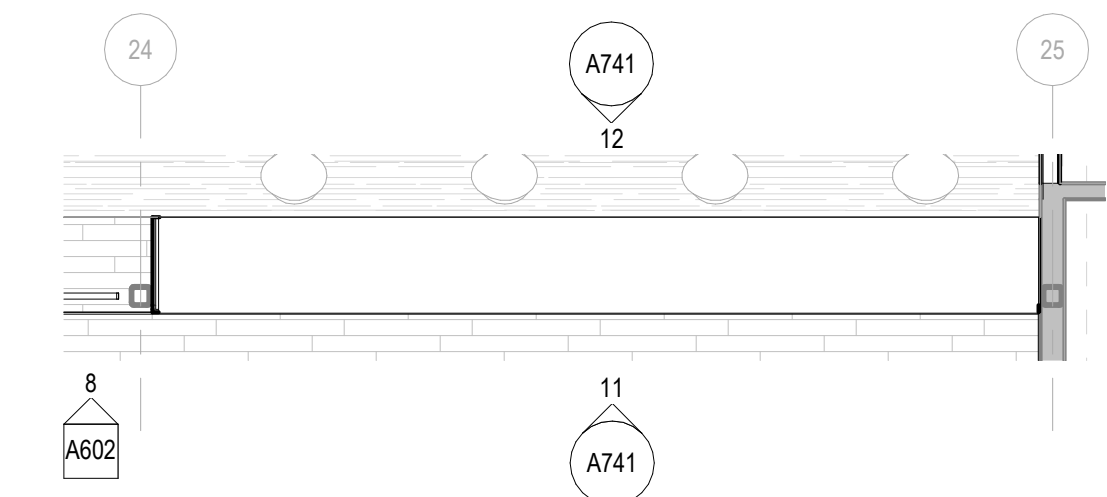


7 ENLARGED PLAN - FORUM COUNTER  
A602 A741 1/4" = 1'-0"

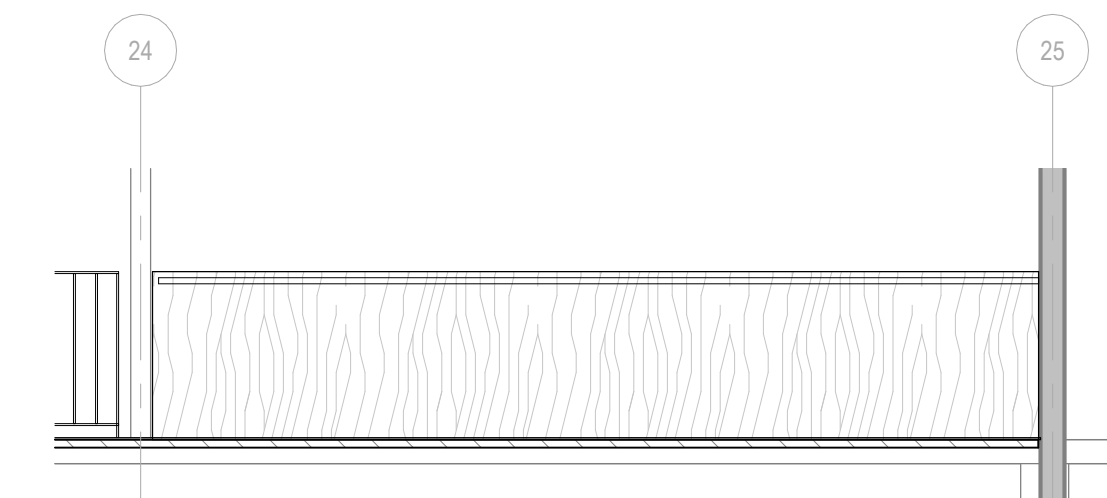


11 FRONT ELEVATION - FORUM COUNTER  
A602 A741 1/4" = 1'-0"

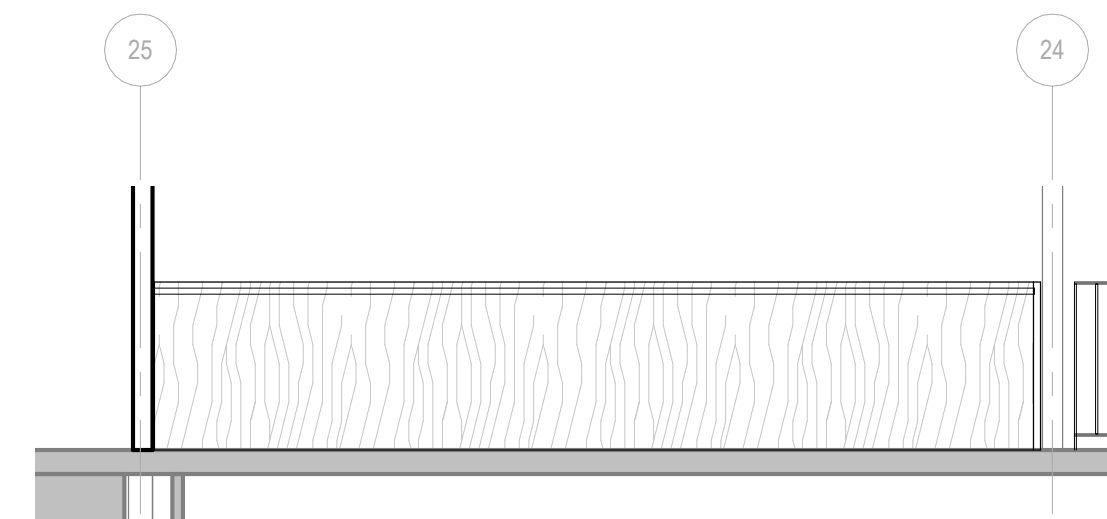



12 BACK ELEVATION - FORUM COUNTER  
A602 A741 1/4" = 1'-0"

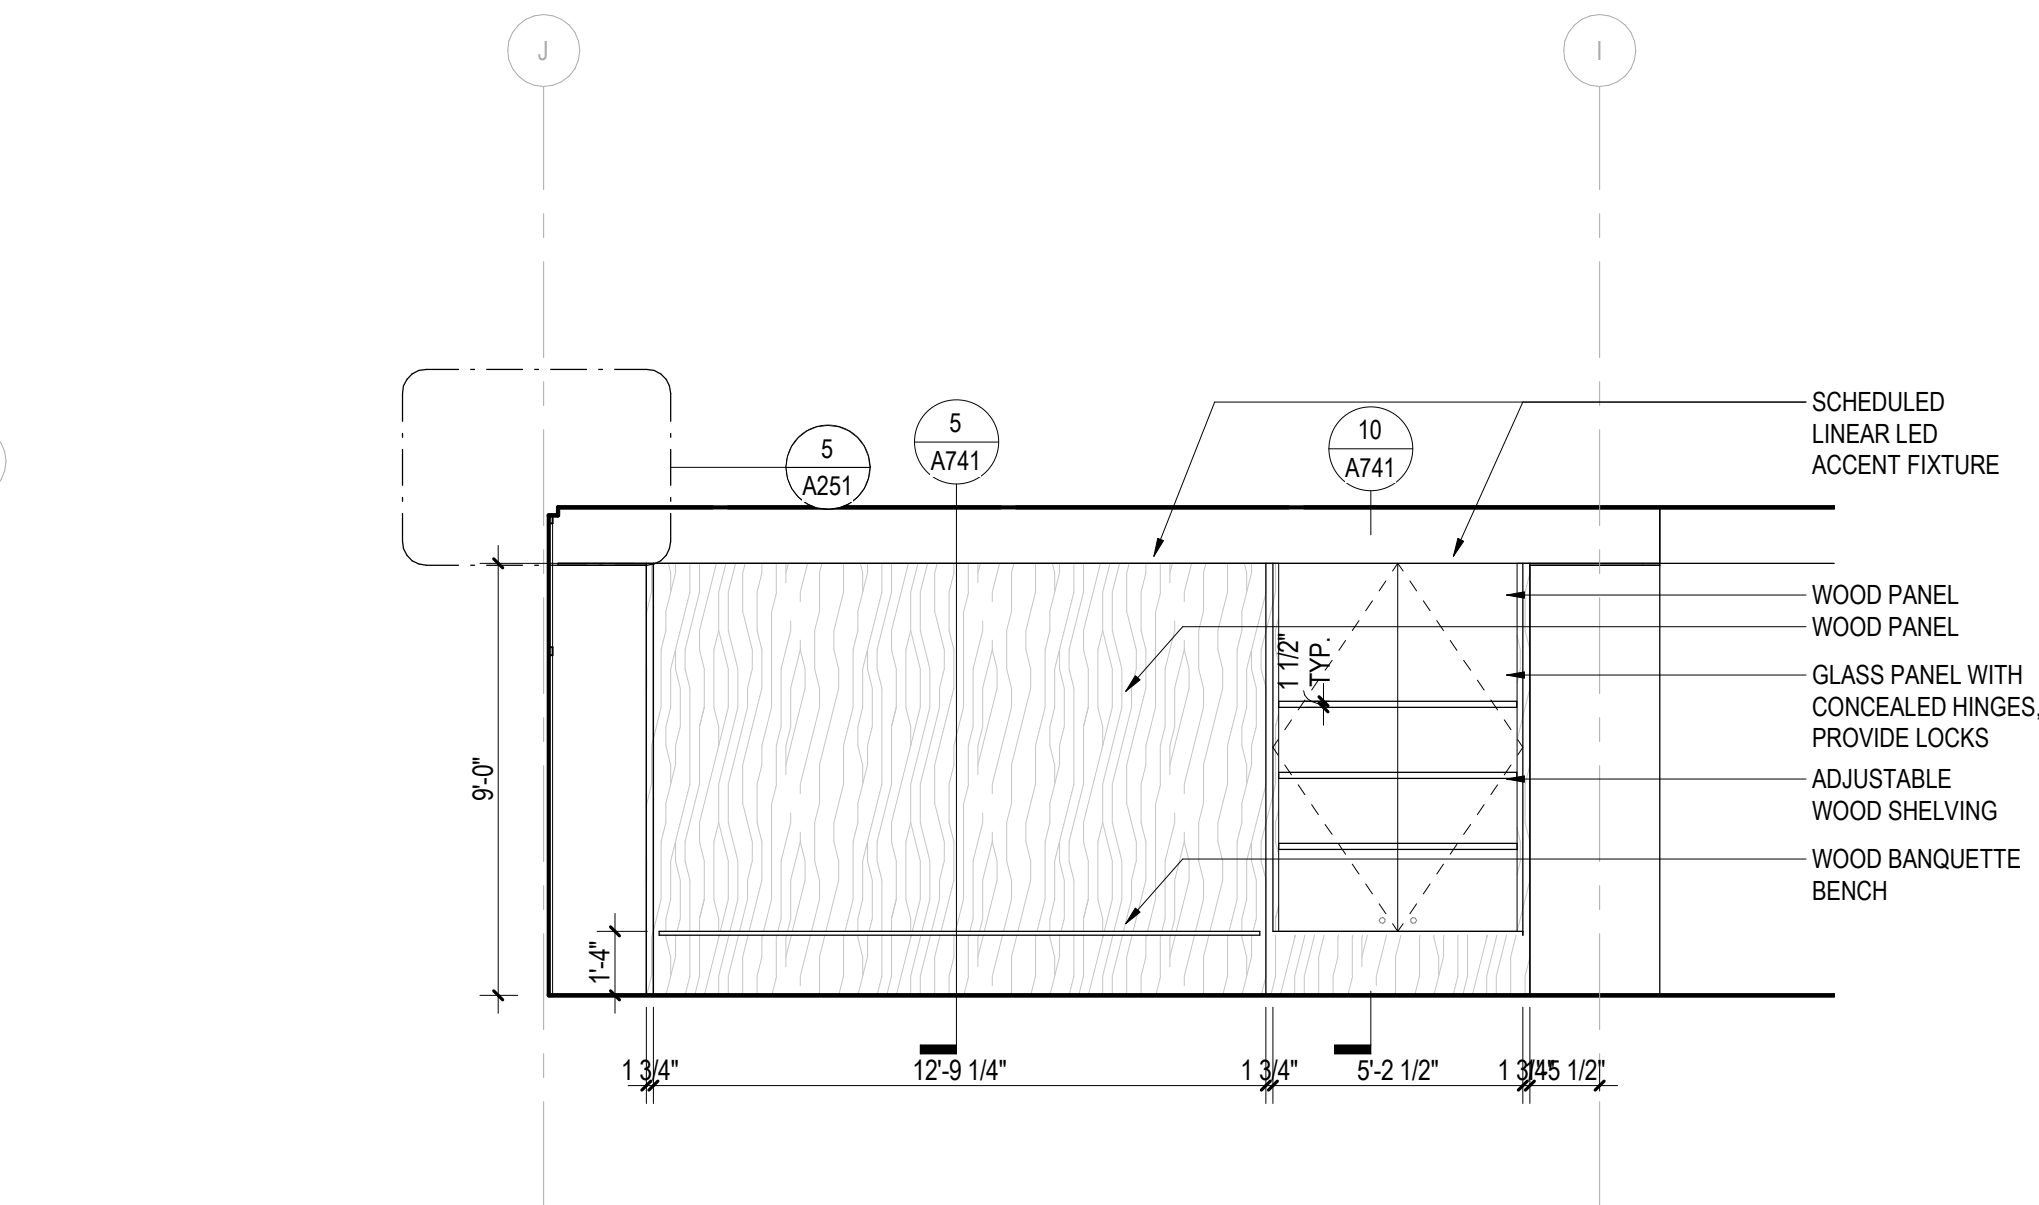


2 EAST ELEVATION - MILLWORK BENCH AT MAINSTREET  
A711 A741 1/4" = 1'-0"

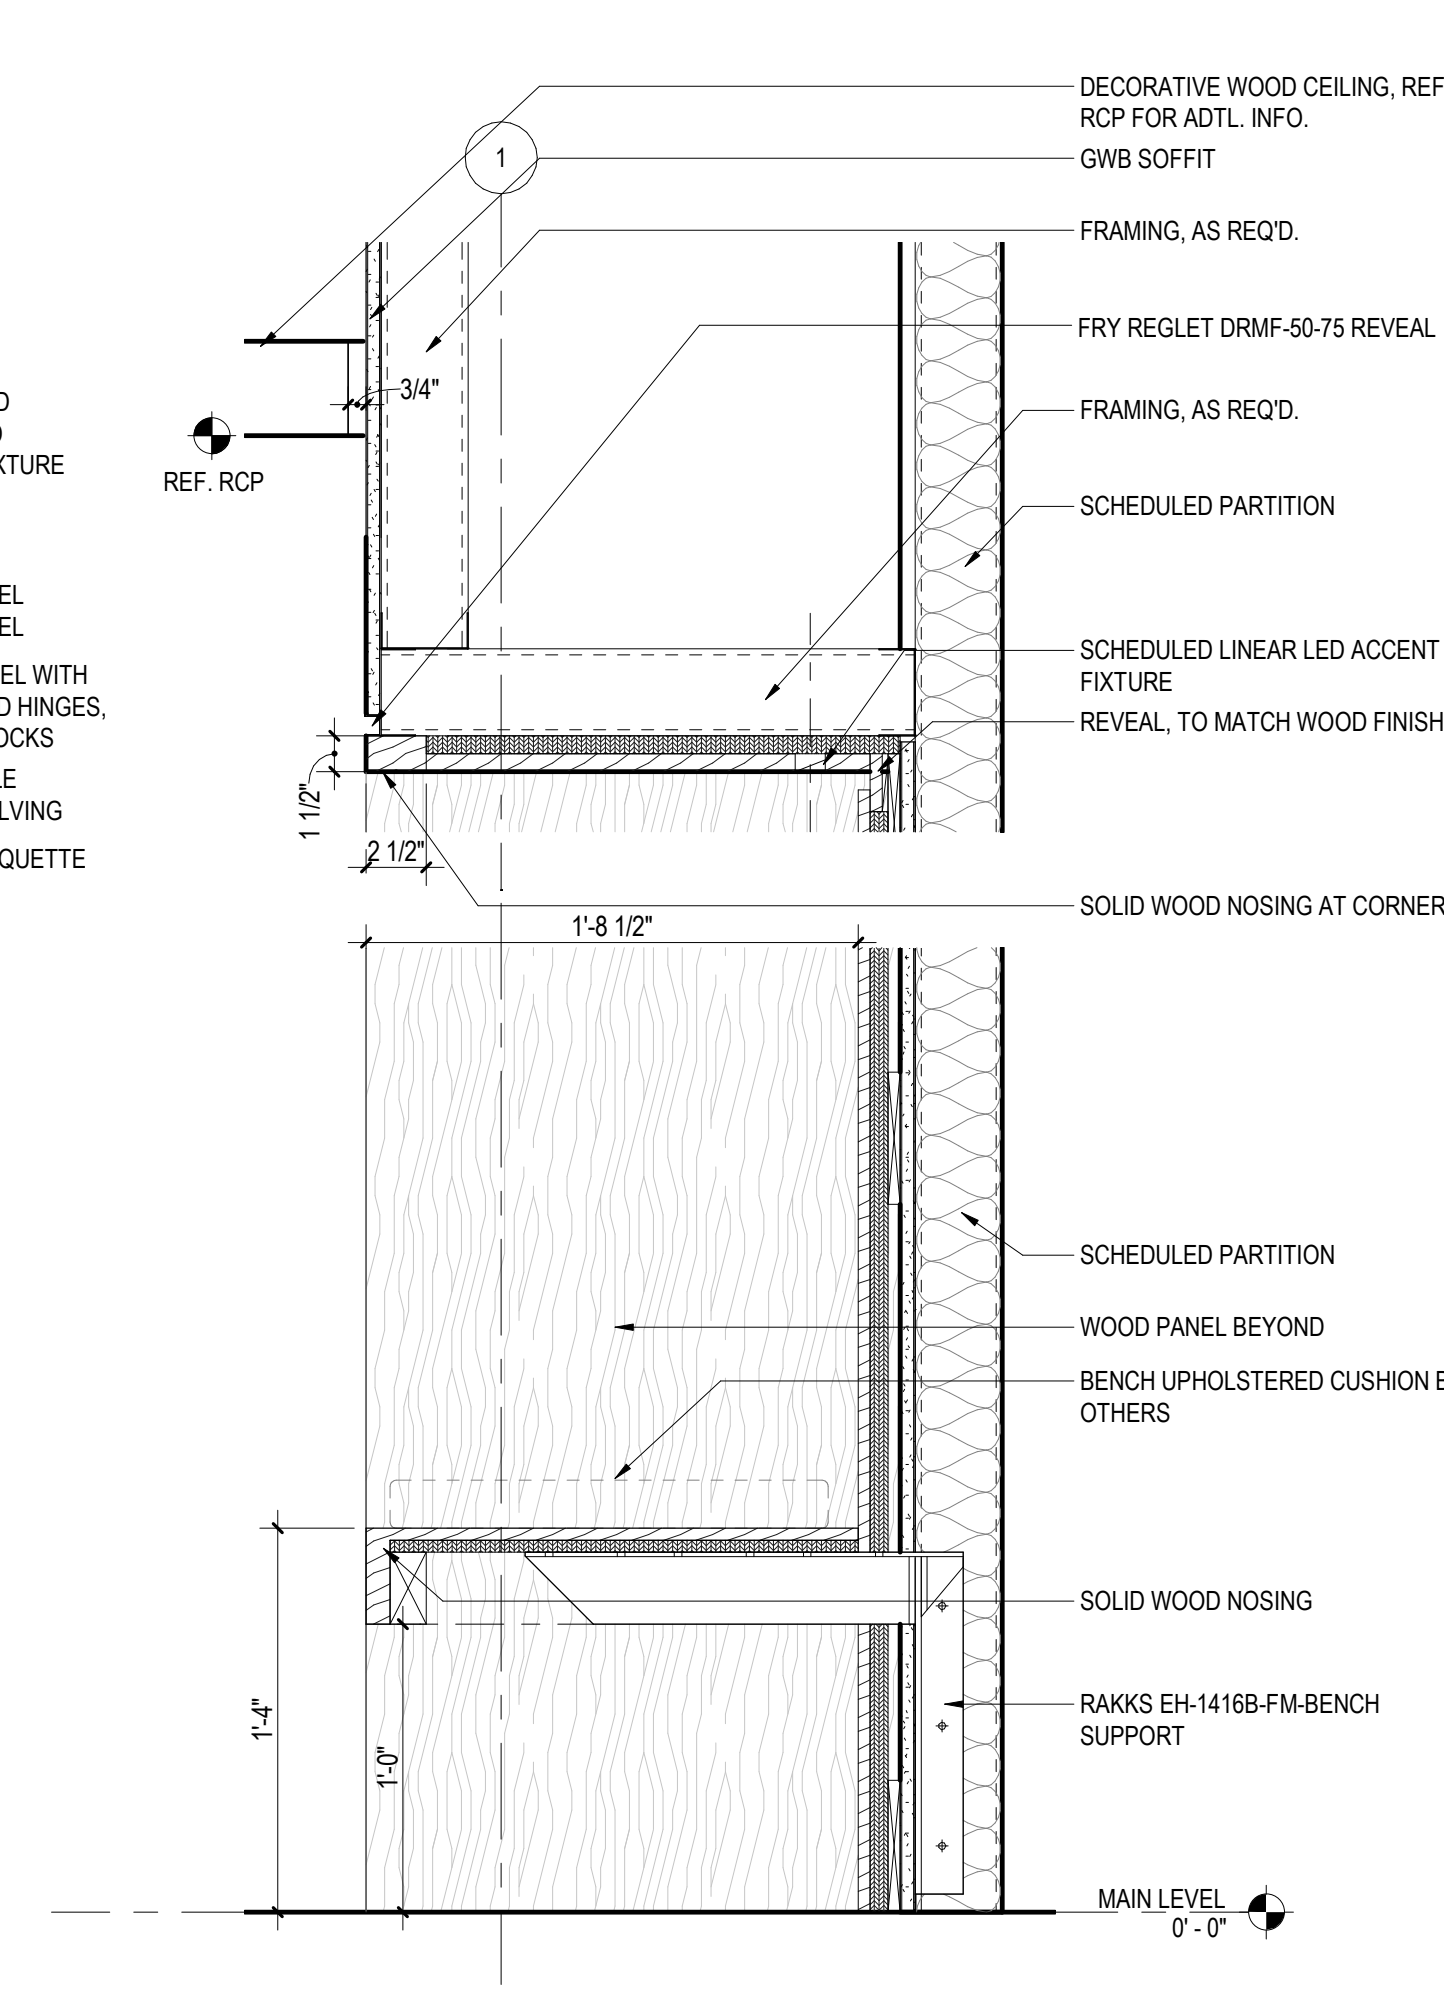


5 MILLWORK BENCH SECTION AT MAINSTREET  
A712 A741 1 1/2" = 1'-0"

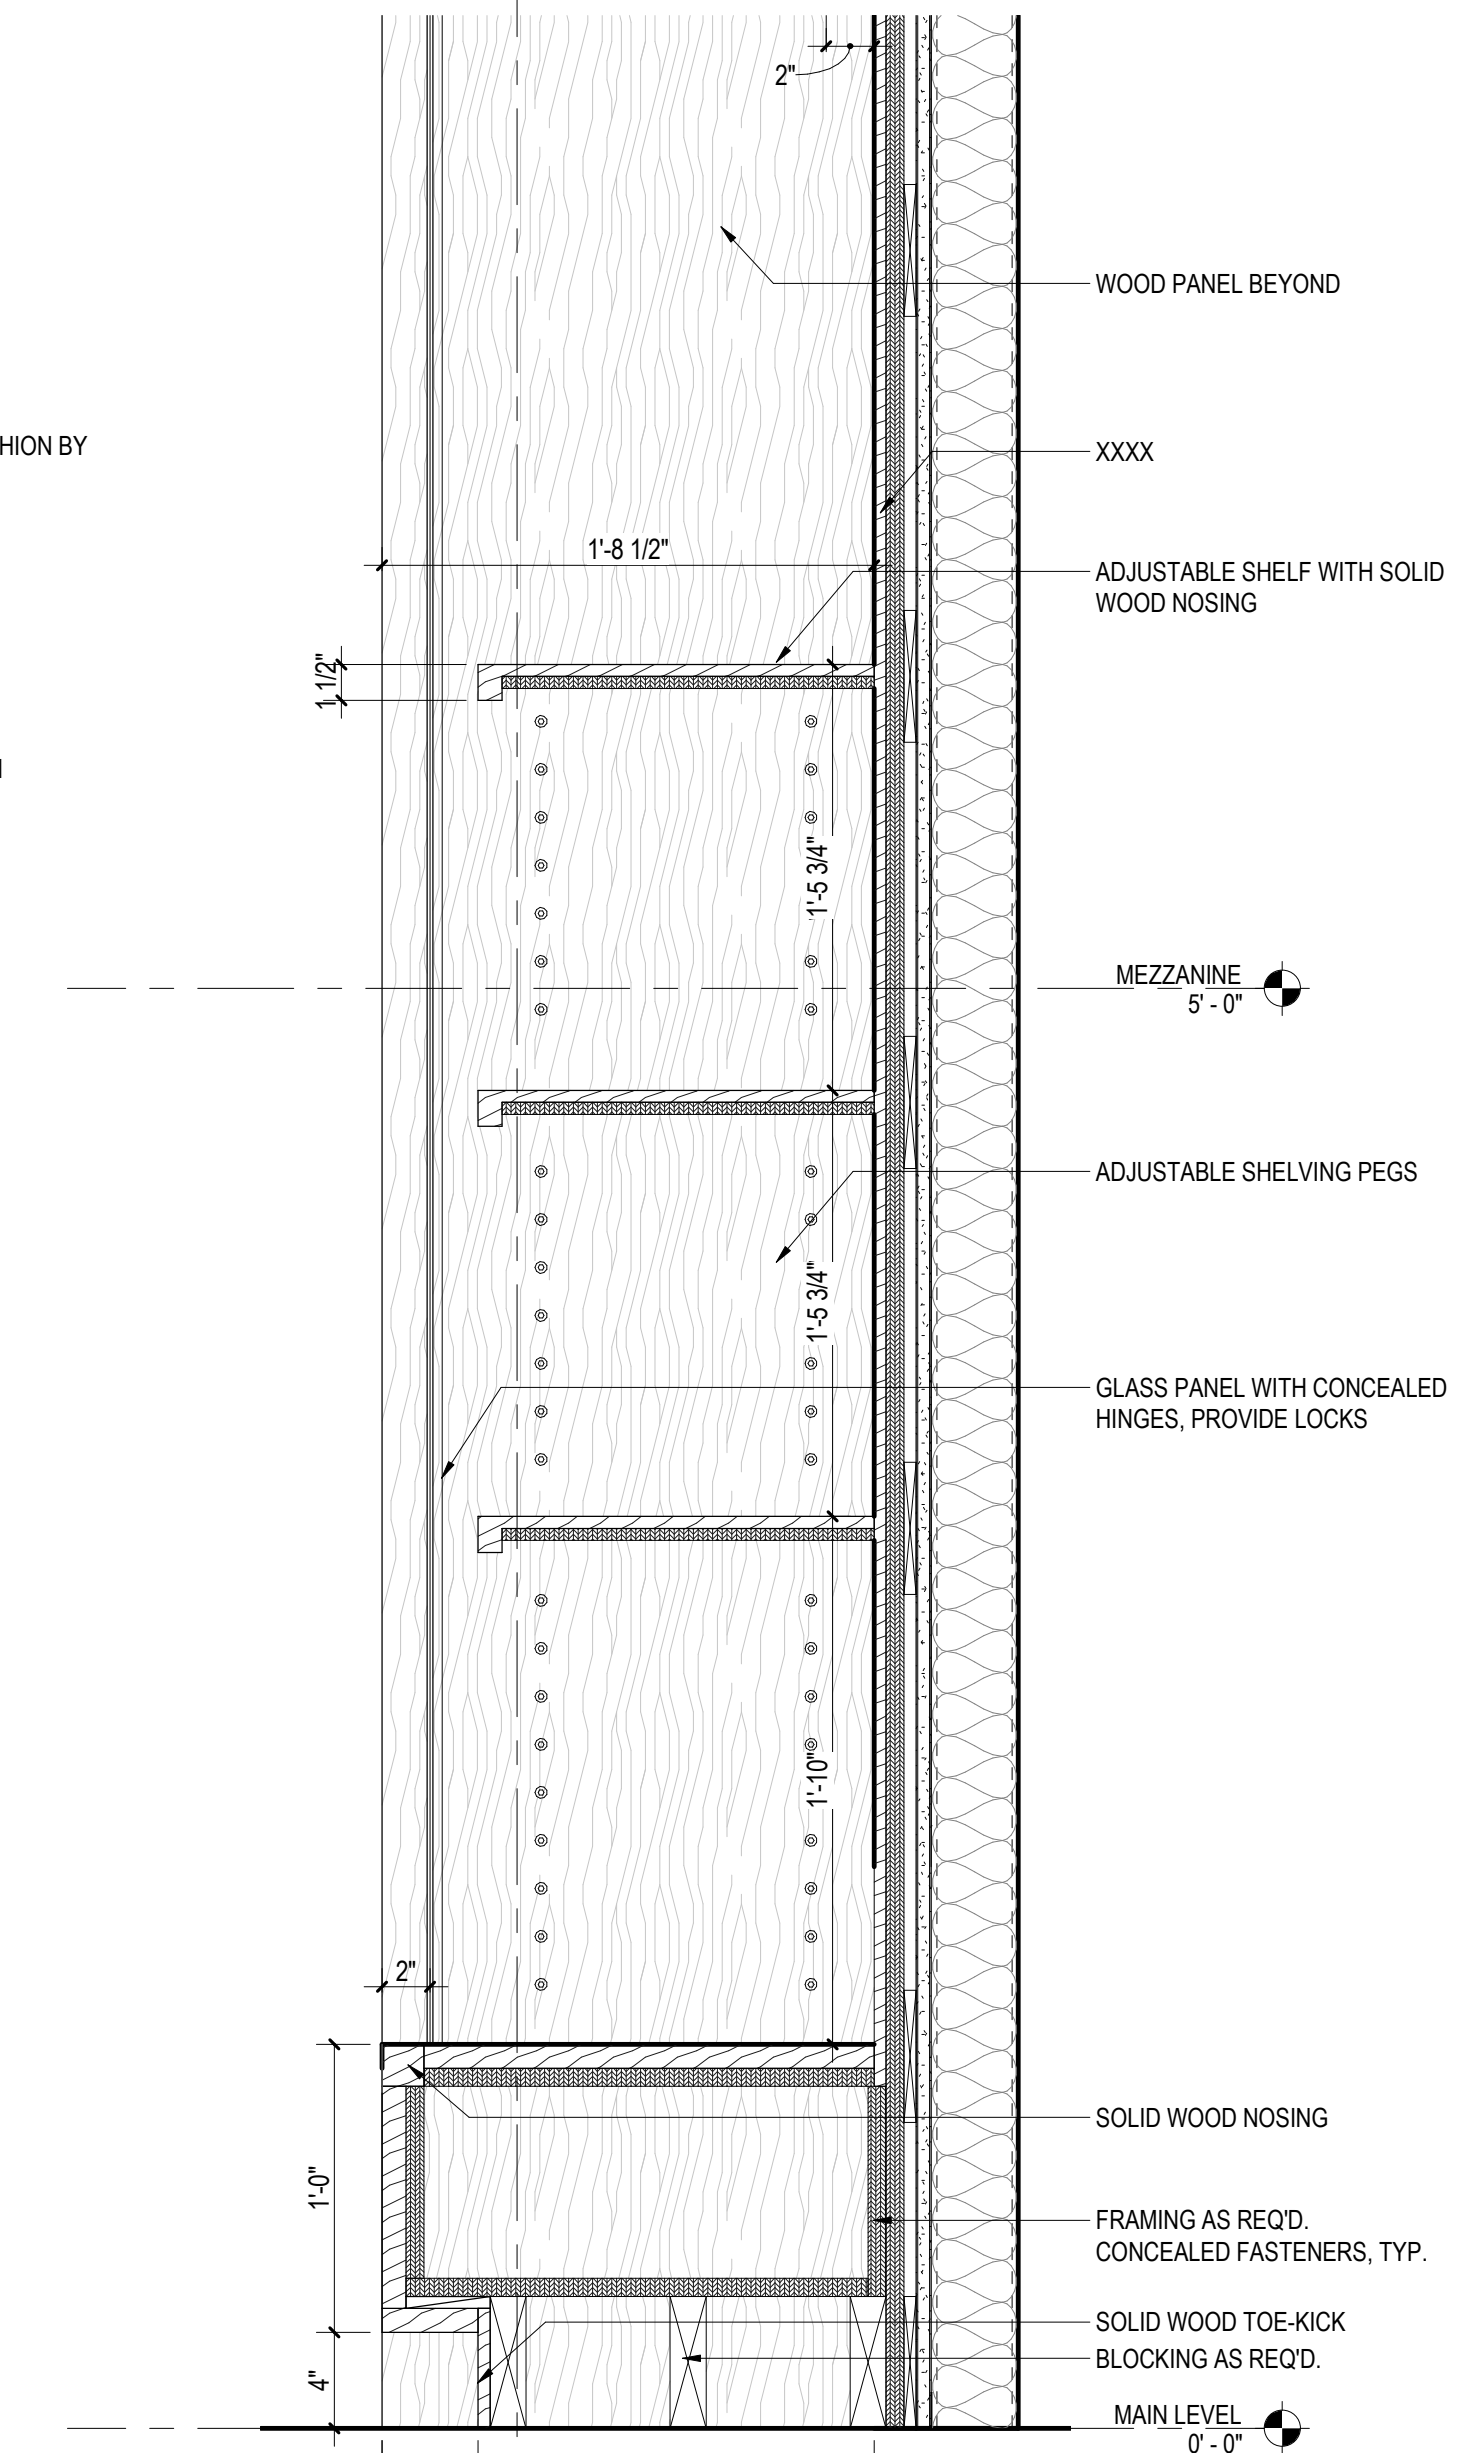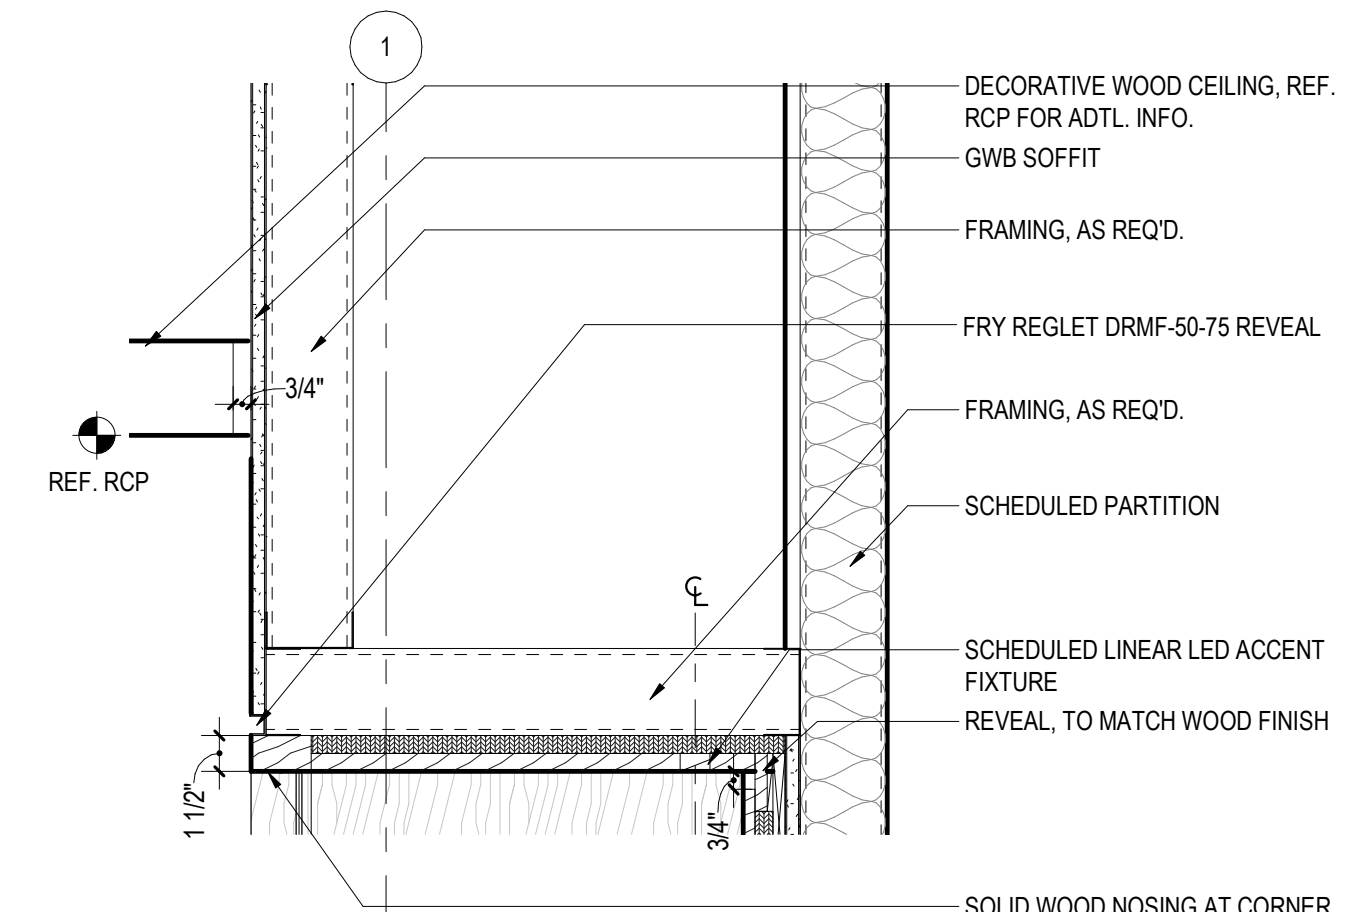

10 MILLWORK SHELVING SECTION AT MAINSTREET  
A712 A741 1 1/2" = 1'-0"

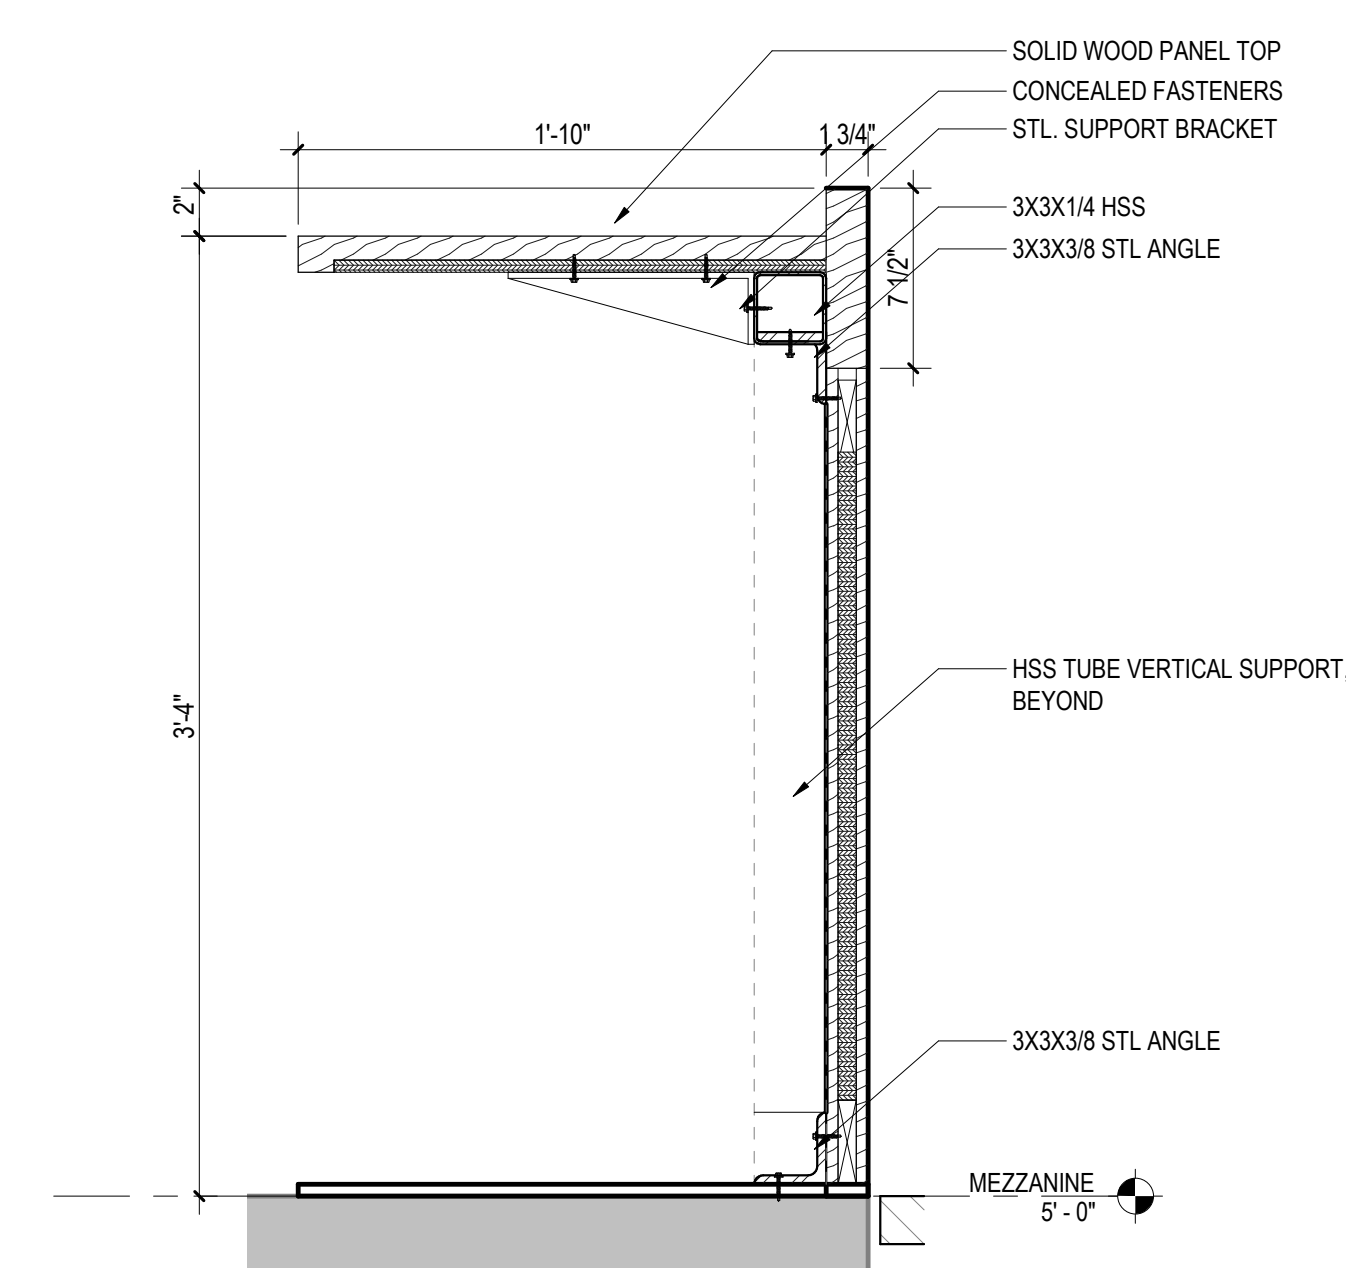

13 SECTION DETAIL AT FORUM COUNTER  
A602 A741 1 1/2" = 1'-0"

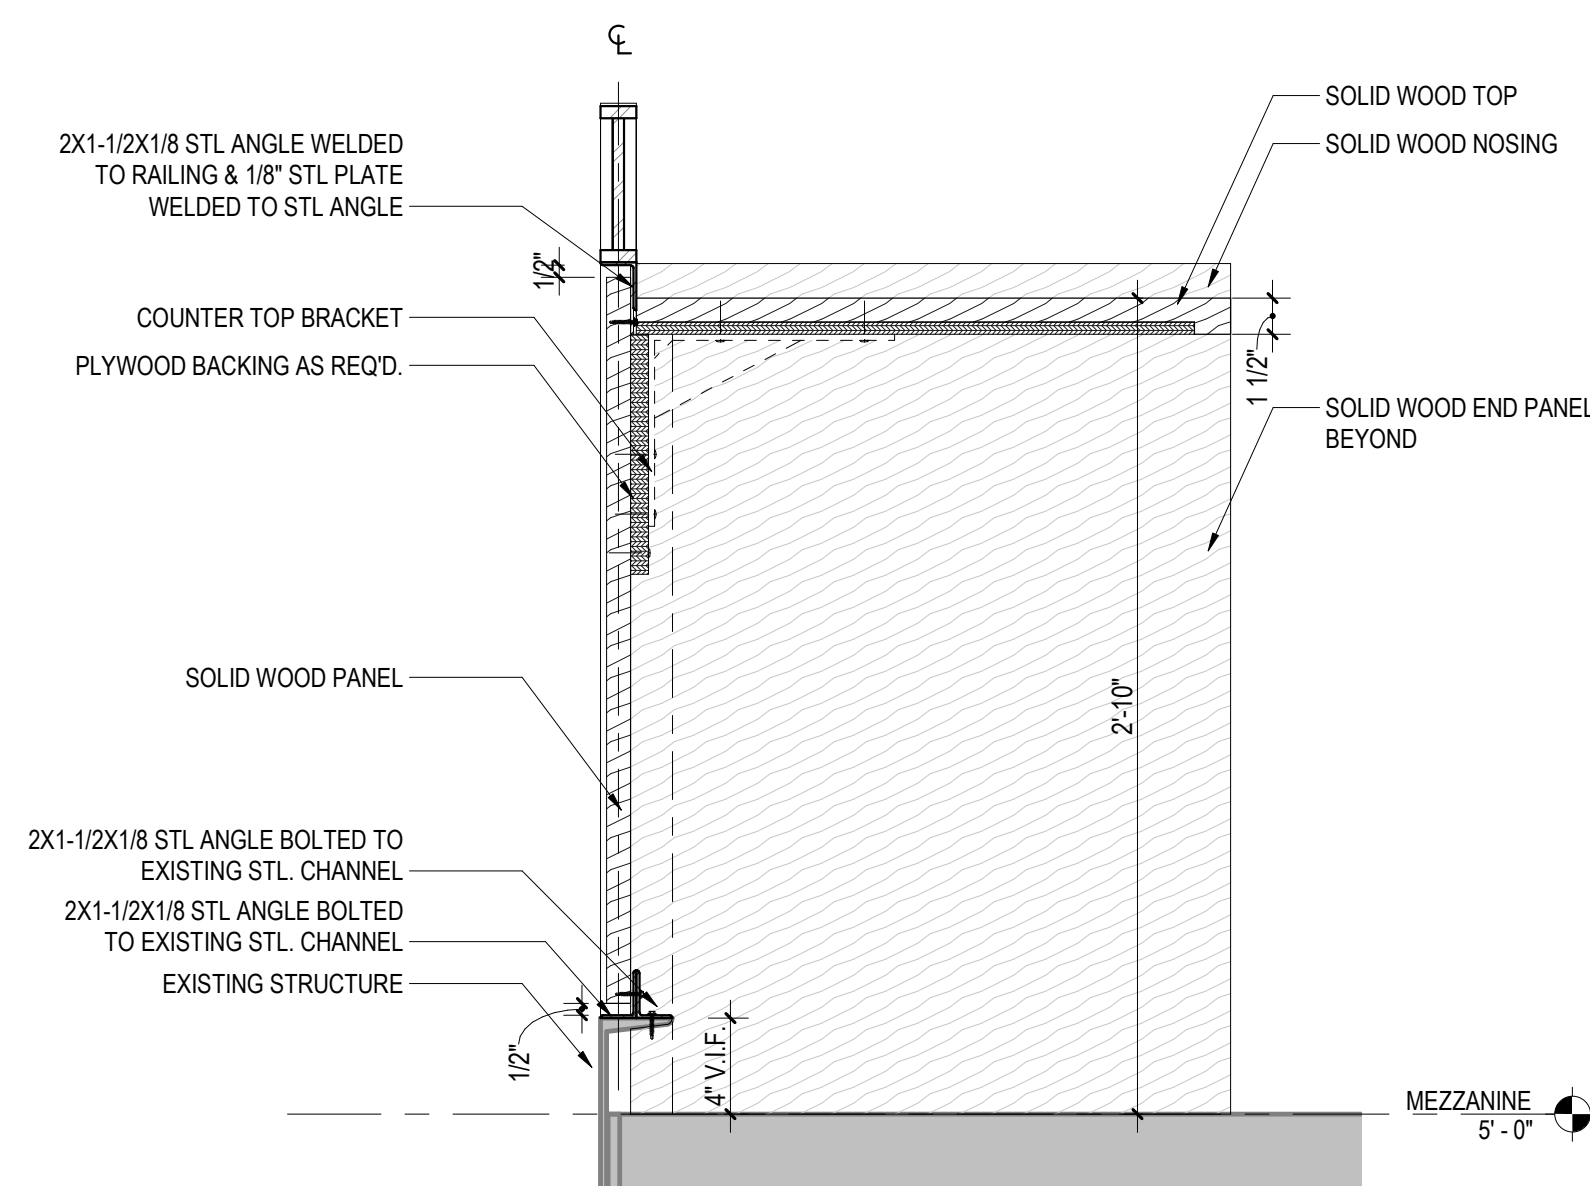

14 SECTION DETAIL AT MEZZ. COUNTER  
A605 A741 1 1/2" = 1'-0"



DOOR SCHEDULE  
GENERAL NOTES

- ALL DOORS SHALL BE 1-3/4" THICK UNLESS NOTED OTHERWISE.
- ALL INTERIOR DOORS SHALL BE UNDERCUT 3/4" A.F.F. UNLESS NOTED OTHERWISE.
- ALL HOLLOW METAL DOOR FRAMES IN MASONRY SHALL BE GROUTED SOLID.
- REFER TO THE FLOOR PLANS FOR EXACT LOCATIONS OF DOORS AND DIRECTION OF DOOR SWINGS.
- SEE EXTERIOR ELEVATIONS FOR EXTERIOR FRAME TYPES.
- VERIFY ALL DIMENSIONS IN FIELD PRIOR TO FABRICATION.
- DIMENSIONS SHOWN ARE NOMINAL AND/OR ROUGH OPENINGS, CONTRACTOR TO ACCOUNT FOR JOINTS, SHIMS, SEALANT, ETC.
- ALL INTERIOR DOORS TO BE GLAZED WITH TEMPERED GLASS U.N.O.
- ALL EXTERIOR DOORS TO BE GLAZED WITH INSULATED TEMPERED GLASS U.N.O.

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Washington, DC 20036



New City Library

New City Library Addition & Renovation

220 North Main Street  
New City, NY 10956

Client Project Number

VMDO Project Number 1301

Checked By

Drawn By

Checker

Author

ISSUES AND REVISIONS

NO. SUBMITTAL DATE  
SCHEMATIC DESIGN 03.05.2021

DOOR SCHEDULE &  
HARDWARE SCHEDULE


A800

DESIGN DEVELOPMENT  
07.09.2021

DOOR SCHEDULE


DR. NO.	OPENING			DOOR			FRAME			ASSEMBLY	REMARKS/NOTES
	QNTY.	WIDTH	HEIGHT	ELEV.	MATERIAL	FINISH	ELEV.	MATERIAL	FINISH		
010		3'-0"	7'-0"	FL	WD	CLR	I	HM	PNTD.		
010H		3'-0"	7'-0"	FL	WD	CLR	I	HM	PNTD.		
011	(2)	3'-0"	7'-0"	FP	WD	CLR	I	HM	PNTD.		
011A		3'-0"	7'-0"	DL	WD	CLR	I	HM	PNTD.		
012	(2)	3'-0"	7'-0"	FP	WD	CLR	I	HM	PNTD.		
015		3'-0"	7'-0"	FP	WD	CLR	I	HM	PNTD.		
016		3'-0"	7'-0"	FP	WD	CLR	I	HM	PNTD.		
100A		3'-0"	7'-0"	FL	AL	SEE SPEC.	SEE ELEV.	AL	CLR. ANOD.		
100B	(2)	3'-3 1/8"	7'-0"	SEE ELEV.	SEE SPEC.	SEE SPEC.	SEE ELEV.	SEE SPEC.	SEE SPEC.		AUTOMATIC SLIDING DOOR
100C	(2)	3'-3 1/8"	7'-0"	SEE ELEV.	SEE SPEC.	SEE SPEC.	SEE ELEV.	SEE SPEC.	SEE SPEC.		AUTOMATIC SLIDING DOOR
110	(2)	3'-0"	7'-0"	FL	WD	CLR	SEE ELEV.	AL	CLR. ANOD.		
120	(2)	3'-0"	7'-0"	FL	WD	CLR	SEE ELEV.	AL	CLR. ANOD.		
122		3'-0"	7'-0"	FP	WD	CLR	I	HM	PNTD.		
123		3'-0"	7'-0"	FP	WD	CLR	I	HM	PNTD.		
129		3'-0"	7'-0"	FP	HM	PNTD.	I	HM	PNTD.		
130A		3'-0"	7'-0"	FL	WD	CLR	SEE ELEV.	AL	CLR. ANOD.		ACOUSTIC GASKETING
130B	(2)	2'-11"	7'-1"	FL	WD	CLR	SEE ELEV.	AL	CLR. ANOD.		ACOUSTIC GASKETING
131	(2)	3'-0"	7'-0"	FP	WD	CLR	I	HM	PNTD.		
140	(2)	3'-0"	7'-0"	FP	WD	CLR	I	HM	PNTD.		
140A	(2)	3'-0"	7'-0"	FP	WD	CLR	I	HM	PNTD.		ACOUSTIC GASKETING
141A		3'-0"	7'-0"	FP	WD	CLR	I	HM	PNTD.		
141B		3'-0"	7'-0"	FP	WD	CLR	I	HM	PNTD.		ACOUSTIC GASKETING
142	(2)	3'-0"	7'-0"	FP	WD	CLR	I	HM	PNTD.		
150A		3'-0"	7'-0"	FL	WD	CLR	I	HM	PNTD.		
150B		3'-0"	7'-0"	FL	WD	CLR	I	HM	PNTD.		
150C		3'-0"	7'-0"	FL	WD	CLR	SEE ELEV.	AL	CLR. ANOD.		
151		3'-0"	7'-0"	FL	WD	CLR	I	HM	PNTD.		ACOUSTIC GASKETING
152		3'-0"	7'-0"	FP	WD	CLR	SEE ELEV.	AL	CLR. ANOD.		
153A		3'-0"	7'-0"	FP	WD	CLR	I	HM	PNTD.		ACOUSTIC GASKETING
153B		3'-0"	7'-0"	FL	WD	CLR	I	HM	PNTD.		ACOUSTIC GASKETING
154		3'-0"	7'-0"	FL	WD	CLR	SEE ELEV.	AL	CLR. ANOD.		ACOUSTIC GASKETING
154A		3'-0"	7'-0"	FP	WD	CLR	I	HM	PNTD.	90 MIN.	
155A		3'-0"	7'-0"	FL	WD	CLR	I	HM	PNTD.		ACOUSTIC GASKETING
156		3'-0"	7'-0"	FL	WD	CLR	SEE ELEV.	AL	CLR. ANOD.		ACOUSTIC GASKETING
156A		3'-0"	7'-0"	FL	WD	CLR	I	HM	PNTD.		ACOUSTIC GASKETING
156B		3'-0"	7'-0"	FL	WD	CLR	I	HM	PNTD.		ACOUSTIC GASKETING
156H		3'-0"	7'-0"	FL	WD	CLR	I	HM	PNTD.		
157		3'-0"	7'-0"	FL	WD	CLR	I	HM	PNTD.		ACOUSTIC GASKETING
157A		3'-0"	7'-0"	FP	WD	CLR	I	HM	PNTD.		
161		3'-0"	7'-0"	FP	HM	PNTD.	I	HM	PNTD.		
161A		3'-0"	7'-0"	FL	WD	CLR	I	HM	PNTD.		
161B		3'-0"	7'-0"	FL	WD	CLR	I	HM	PNTD.		
162		3'-0 1/16"	8'-10"	AG	WD	CLR	SEE ELEV.	AL	CLR. ANOD.		
163		3'-0"	8'-10"	AG	WD	CLR	SEE ELEV.	AL	CLR. ANOD.		
164		3'-0"	8'-10"	AG	WD	CLR	SEE ELEV.	AL	CLR. ANOD.		
165		3'-0"	8'-10"	AG	WD	CLR	SEE ELEV.	AL	CLR. ANOD.		
166		3'-0"	7'-0"	FL	WD	CLR	SEE ELEV.	AL	CLR. ANOD.		
166A		3'-0"	7'-0"	FP	WD	CLR	I	HM	PNTD.		
166B		3'-0"	7'-0"	FL	AL	SEE SPEC.	SEE ELEV.	AL	CLR. ANOD.		
192	(2)	3'-0"	7'-0"	FL	AL	SEE SPEC.	SEE ELEV.	AL	CLR. ANOD.		
201		3'-0"	8'-1"	FL	WD	CLR	SEE ELEV.	AL	CLR. ANOD.		ACOUSTIC GASKETING
201A		3'-0"	7'-0"	FL	WD	CLR	I	HM	PNTD.		
202		3'-0"	8'-1"	FL	WD	CLR	SEE ELEV.	AL	CLR. ANOD.		
CG100	(2)	8'-3"	10'-3"	-	SEE SPEC.	SEE SPEC.	-	SEE SPEC.	SEE SPEC.		OVERHEAD COILING GRILLE
J101		3'-0"	7'-0"	FL	WD	CLR	I	HM	PNTD.		
T001		3'-0"	7'-0"	FP	WD	CLR	I	HM	PNTD.		
T101		3'-0"	7'-0"	FP	WD	CLR	I	HM	PNTD.		
T102		3'-0"	7'-0"	FP	WD	CLR	I	HM	PNTD.		
T103		3'-0"	7'-0"	FP	WD	CLR	I	HM	PNTD.		
T120		3'-0"	7'-0"	FP	WD	CLR	I	HM	PNTD.		ACOUSTIC GASKETING
T150		3'-0"	7'-0"	FP	WD	CLR	I	HM	PNTD.		ACOUSTIC GASKETING

DOOR TYPE ELEVATIONS

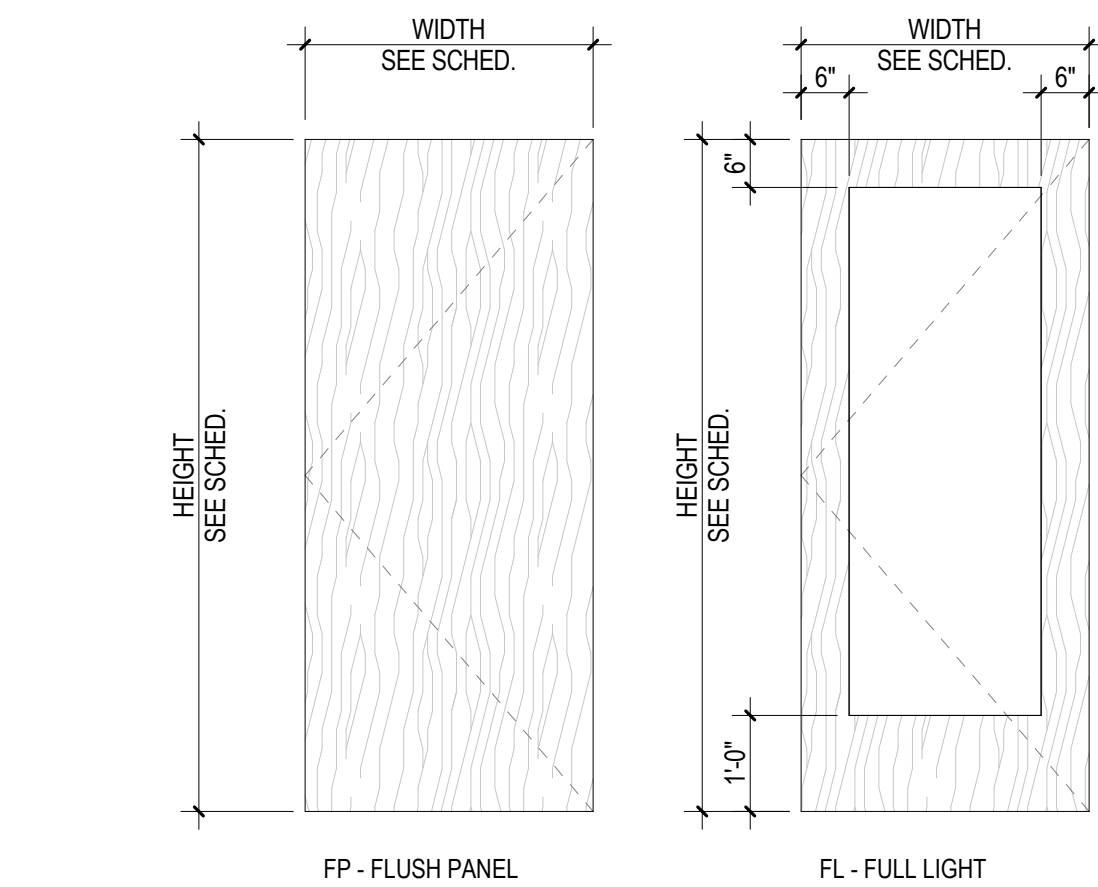

TYPES - DOOR ELEVATIONS  
1/2" = 1'-0"

INTERIOR FRAME TYPE ELEVATIONS

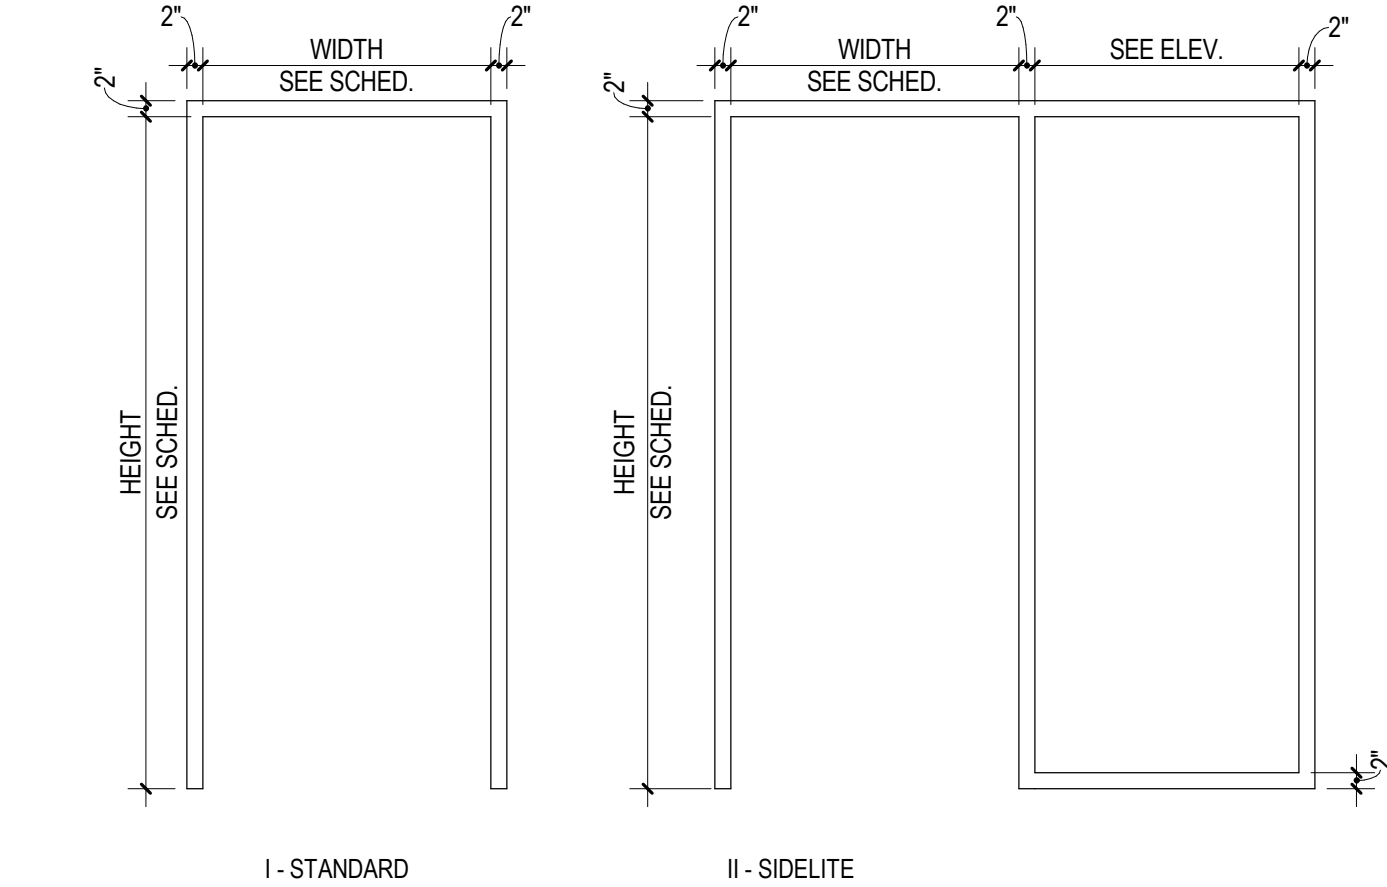

TYPES - INTERIOR FRAME ELEVATIONS  
1/2" = 1'-0"






New City Library

## New City Library Addition & Renovation

220 North Main Street  
New City, NY 10956

Client Project Number  
VMDO Project Number 1301

Checked By  
Drawn By  
Checker  
Author

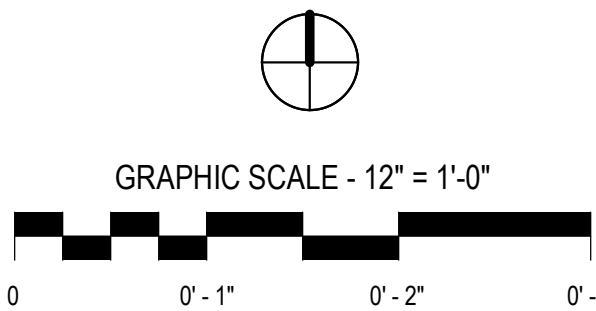


ISSUES AND REVISIONS		
NO.	SUBMITTAL	DATE
	SCHEMATIC DESIGN	03.05.2021

DOOR TYPES & HOLLOW  
METAL FRAME TYPES


A801  
DESIGN DEVELOPMENT  
07.09.2021

### DOOR TYPE ELEVATIONS

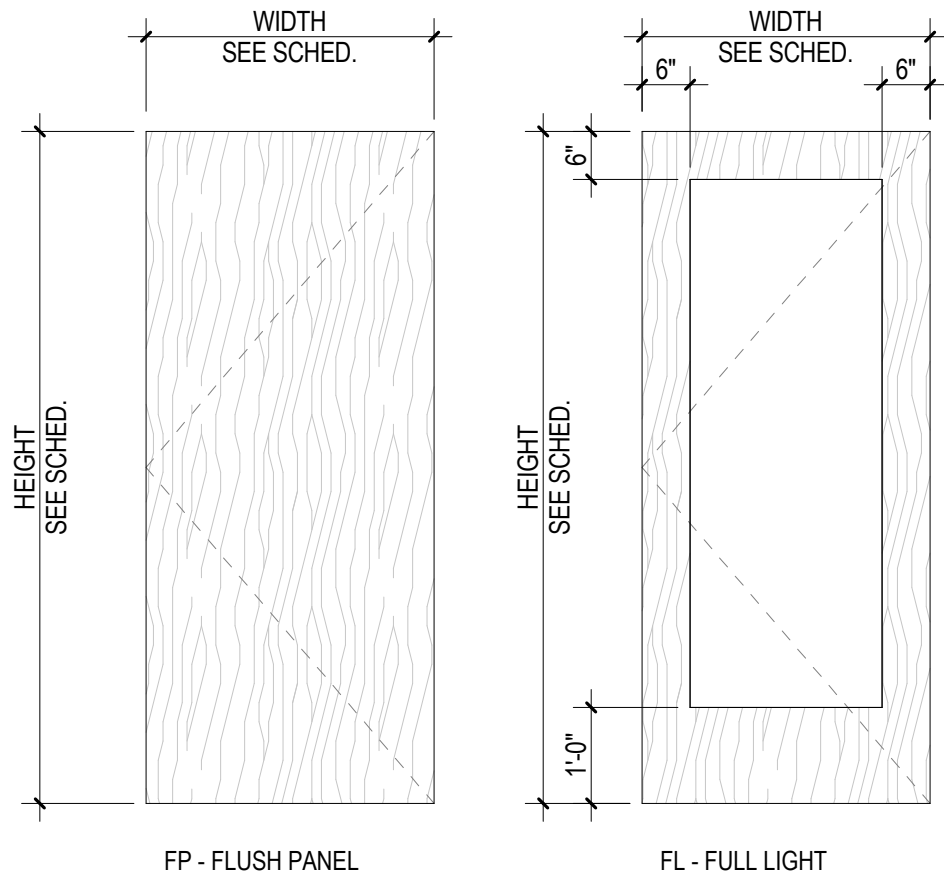

TYPES - DOOR ELEVATIONS  
1/2" = 1'-0"

### INTERIOR FRAME TYPE ELEVATIONS

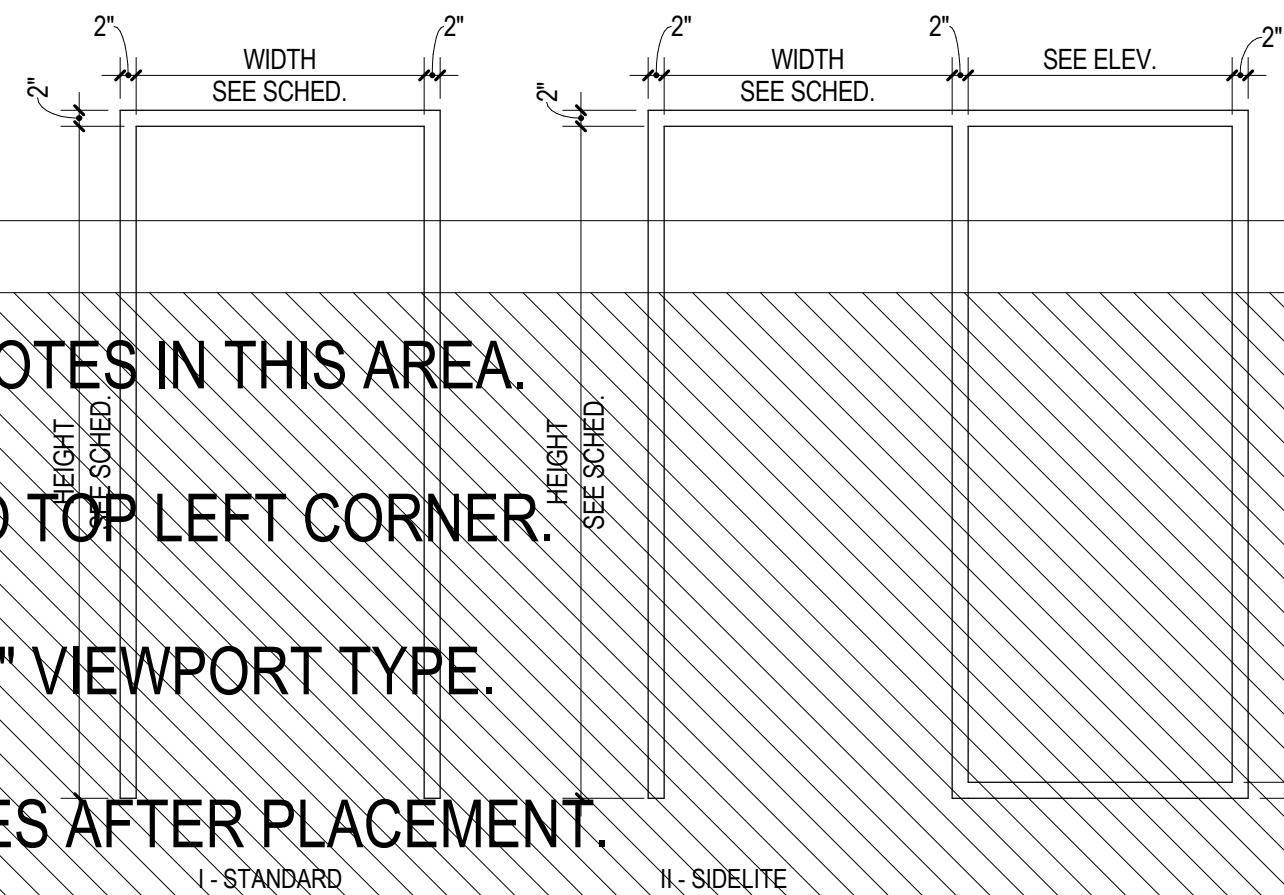

TYPES - INTERIOR FRAME ELEVATIONS  
1/2" = 1'-0"

PLACE GENERAL NOTES IN THIS AREA.

VISUALLY ALIGN TO TOP LEFT CORNER.

USE THE "NO TITLE" VIEWPORT TYPE.

PIN GENERAL NOTES AFTER PLACEMENT.

PLACE KEYNOTES IN THIS AREA.

ALIGN TEXT BOX TO TOP LEFT CORNER.

PIN KEYNOTES AFTER PLACEMENT.

FILTER KEYNOTES BY SHEET.


PLACE LEGENDS IN THIS AREA.

ALIGN TO TOP LEFT CORNER.

USE THE "NO TITLE" VIEWPORT TYPE.

PIN LEGENDS AFTER PLACEMENT.



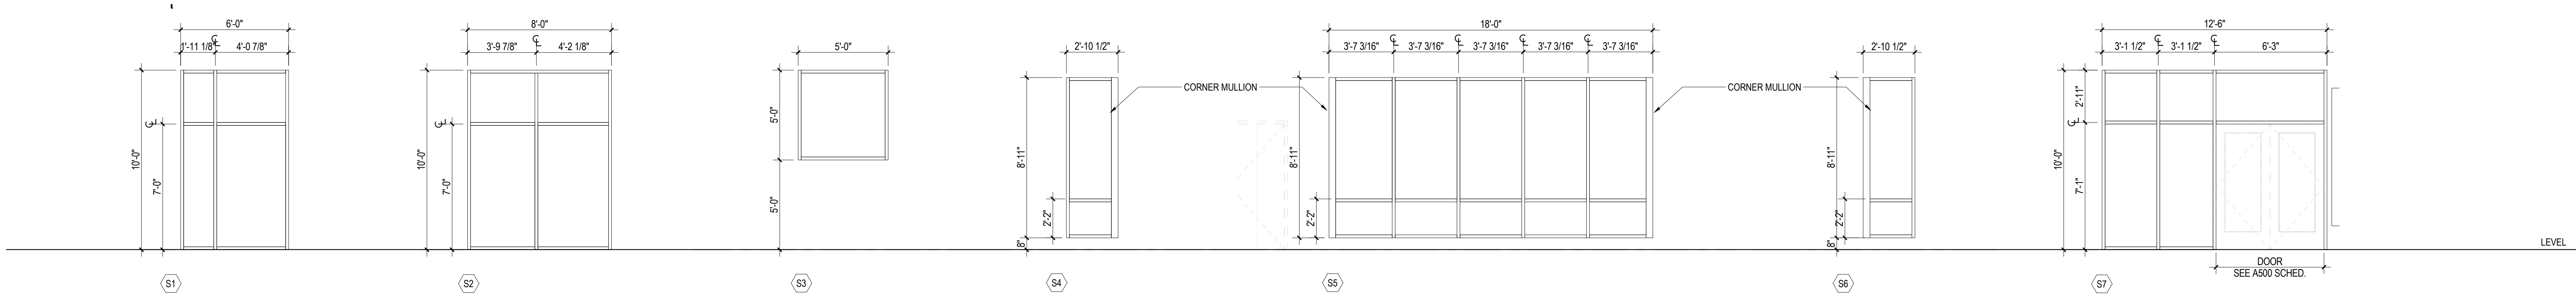


New City Library

New City Library Addition & Renovation

220 North Main Street  
New City, NY 10956

Client Project Number  
VMDO Project Number 1301

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Drawn By  
Checker  
HJO

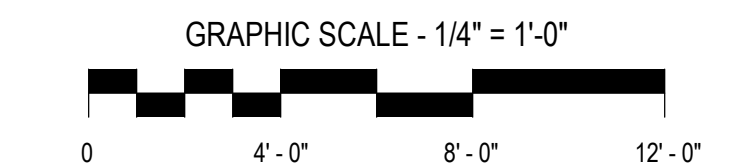

ISSUES AND REVISIONS		
NO.	SUBMITTAL	DATE
	SCHEMATIC DESIGN	03.05.2021

FRAME TYPE GENERAL NOTES

1. VERIFY ALL DIMENSIONS IN FIELD PRIOR TO FABRICATION.
2. DIMENSIONS SHOWN ARE NOMINAL AND/OR ROUGH OPENINGS. CONTRACTOR TO ACCOUNT FOR JOINTS, SHIMS, SEALANT, ETC.
3. CONTRACTOR RESPONSIBLE TO COORDINATE ALL ALUMINUM FRAMES WITH ALL RELEVANT DETAILS DEPICTED THROUGHOUT DRAWINGS.
4. COORDINATE ALL ALUMINUM FRAMES WITH SPECIFICATION REQUIREMENTS, INCLUDING BUT NOT LIMITED TO PROVIDING ENGINEERING TO VERIFY REQUIRED WIND LOADING CRITERIA IS MET IN ALL CASES.
5. ALUMINUM FRAME DRAWINGS REPRESENT DESIGN INTENT. SHOP DRAWINGS ARE REQUIRED PRIOR TO FABRICATION.
6. SOME FRAME TYPES ARE REPEATED AS SIMILAR OR OPPOSITE. SEE ELEVATIONS FOR QUANTITIES, LOCATIONS, AND INSTALLATION.
7. COORDINATE ALL HARDWARE WITH DOOR SCHEDULE AND SPECIFICATIONS.
8. SEE DOOR SCHEDULE FOR TYPICAL DOOR TYPES, WHICH INCLUDE ALUMINUM DOORS INSTALLED IN ALUMINUM FRAMES.

SAFETY GLAZING NOTES

REFER TO THE BUILDING CODE OF NEW YORK STATE (BCNYS 2020, CHAPTER 24) FOR DEFINITION OF "HAZARDOUS LOCATIONS" AND LIST OF LOCATIONS WHERE SAFETY GLAZING IS REQUIRED.

FOR WINDOWS AND DOORS SCHEDULED ON THIS PROJECT, SAFETY GLAZING IS REQUIRED IN HAZARDOUS LOCATIONS THAT MEET ALL OF THE FOLLOWING CRITERIA:

1. THE EXPOSED AREA OF AN INDIVIDUAL PANE IS GREATER THAN 9 SQ. FT.
2. THE EXPOSED BOTTOM EDGE IS LESS THAN 18" ABOVE THE FLOOR.
3. THE TOP EDGE IS GREATER THAN 36" ABOVE WALKING SURFACE, AND
4. ONE OR MORE WALKING SURFACE(S) ARE WITHIN 36" HORIZONTALLY OF THE PANE OF GLAZING. (EXCEPTION: THE OUTBOARD PANE OF INSULATED GLASS UNITS WHERE THE BOTTOM EDGE OF GLASS IS 25' OR MORE ABOVE GRADE, ROOF OR WALKING SURFACE OR OTHER HORIZONTAL OR SLOPED SURFACE.)

EXTERIOR FRAME TYPES





1. VERIFY ALL DIMENSIONS IN FIELD PRIOR TO FABRICATION.
2. ALL EXTERIOR GLASS IS TYPE GL-0.5 U.O.N. & ALL INTERIOR GLASS IS TYPE GL-0.1 U.O.N. SEE SPECIFICATIONS FOR GLASS TYPE DESCRIPTIONS.
3. DIMS SHOW REINFORCING ANCHOR RODS FOR OPENINGS. CONTRACTOR TO ACQUIRE FOR JOINTS, SHIMS, SEALANT, ETC.
4. CONTRACTOR RESPONSIBLE TO COORDINATE ALL ALUMINUM FRAMES WITH ALL RELEVANT DETAILS.
5. COORDINATE ALL ALUMINUM FRAMES WITH SPECIFICATION REQUIREMENTS, INCLUDING BUT NOT LIMITED TO PROVIDING ENGINEERING TO VERIFY WIND LOADING CRITERIA ARE MET IN ALL CASES. SEE STRUCTURAL DRAWINGS.
6. ALUMINUM FRAME DRAWINGS REPRESENT DESIGN INTENT. SHOP DRAWINGS ARE REQUIRED PRIOR TO FABRICATION.
7. SOME FRAME TYPES MAY BE REPEATED AS SIMILAR OR OPPOSITE HAND. SEE ELEVATIONS FOR QUANTITIES, LOCATIONS, AND INSTALLATION.
8. COORDINATE ALL HARDWARE WITH DOOR SCHEDULE AND SPECIFICATIONS.
9. SEE FRAME SCHEDULE FOR TYPICAL DOOR TYPES, WHICH INCLUDE ALUMINUM DOORS INSTALLED IN ALUMINUM FRAMES.
10. FRAMES ARE SET AT MIN. X OFFSET FROM BACKUP. PROVIDE STRAP ATTACHMENTS AND COORDINATE WITH DETAILING FOR ANCHOR BOLT ATTACHMENT LOCATIONS.
11. SEE RCPs FOR ROLLER SHADE SCHEME.

REFER TO THE BUILDING CODE OF NEW YORK STATE (BCNYS 2020, CHAPTER 24 FOR DEFINITION OF "HAZARDOUS LOCATIONS" AND LIST OF LOCATIONS WHERE SAFETY GLAZING IS REQUIRED.

FOR WINDOWS AND DOORS SCHEDULED ON THIS PROJECT, SAFETY GLAZING IS REQUIRED IN HAZARDOUS LOCATIONS THAT MEET ALL OF THE FOLLOWING CRITERIA:

1. THE EXPOSED AREA OF AN INDIVIDUAL PANE IS GREATER THAN 9 SQ. FT.
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4. ONE OR MORE WALKING SURFACE(S) ARE WITHIN 36" HORIZONTALLY OF THE PANE OF GLAZING. EXCEPTION: THE OUTBOARD PANE OF INSULATED GLAZING UNITS WHERE THE BOTTOM EDGE OF GLASS IS 25" OR MORE ABOVE GRADE, ROOF OR WALKING SURFACE OR OTHER HORIZONTAL OR SLOPED SURFACE.)





New City Library

New City Library Addition & Renovation

220 North Main Street  
New City, NY 10956

Client Project Number  
VMDO Project Number

1301

Checked By  
Drawn By

Checker  
Author

ISSUES AND REVISIONS

NO.	SUBMITTAL	DATE
	SCHEMATIC DESIGN	03.05.2021

FINISH SCHEDULE

B.O.D. MATERIAL SCHEDULE							
KEY	KEYNOTE	MANUFACTURER	PRODUCT	FINISH	SIZE	COMMENTS	HYPERLINK
CEILING							
APC-1	09 5113A	Armstrong	Optima Lay-In		24" x 24"		<a href="https://www.armstrongceilings.com/commercial/en/commercial-ceilings-walls/optima-lay-in-and-regular-ceilin-g-iles.html">https://www.armstrongceilings.com/commercial/en/commercial-ceilings-walls/optima-lay-in-and-regular-ceilin-g-iles.html</a>
APC-2	09 5113B	Armstrong	Optima Lay-In		24" x 48"		<a href="https://www.armstrongceilings.com/commercial/en/commercial-ceilings-walls/optima-lay-in-and-regular-ceilin-g-iles.html">https://www.armstrongceilings.com/commercial/en/commercial-ceilings-walls/optima-lay-in-and-regular-ceilin-g-iles.html</a>
SDG-1	09 5436A	Rulon	Panel Grille	Match WD-1 Floor			<a href="https://ulonco.com/products/panel-grille/">https://ulonco.com/products/panel-grille/</a>
FABRIC WRAPPED PANELS							
AWP-1		Armstrong	Soundsaak	TBD	SEE ELEV.		<a href="https://www.armstrongceilings.com/commercial/en/commercial-ceilings-walls/acoustic-wall-panels/soundsaak-wall-panels.html#bbbh=%7B%22selectedItem%22%3A%7B%22name%22%3A%22browse%22%2C%22temIndex%22%3Anull%7D%7D">https://www.armstrongceilings.com/commercial/en/commercial-ceilings-walls/acoustic-wall-panels/soundsaak-wall-panels.html#bbbh=%7B%22selectedItem%22%3A%7B%22name%22%3A%22browse%22%2C%22temIndex%22%3Anull%7D%7D</a>
FLOORING							
CPT-1	09 3000B	Daltile	Linden Point	Grigio	2" x 2"	Straight Joint	<a href="https://www.daltile.com/product/Linden-Point?color=Grigio&amp;shape=Straight%20Joint">https://www.daltile.com/product/Linden-Point?color=Grigio&amp;shape=Straight%20Joint</a>
CPT-1	09 6813A	Tarkett	2nd Power	Ironsand	9" x 36"		<a href="https://commercial.tarkett.com/en_US/collection-0001002-2ndpower?backing=ethos%2CAE%20Modular%20with%20Omnicat%20Technology%E2%84%A2">https://commercial.tarkett.com/en_US/collection-0001002-2ndpower?backing=ethos%2CAE%20Modular%20with%20Omnicat%20Technology%E2%84%A2</a>
CPT-2	09 6813B	Tarkett	Aggregate	Urban Shadow	24" x 24"		<a href="https://commercial.tarkett.com/en_US/collection-0000783-aggregate?backing=ethos%2CAE%20Modular%20with%20Omnicat%20Technology%E2%84%A2">https://commercial.tarkett.com/en_US/collection-0000783-aggregate?backing=ethos%2CAE%20Modular%20with%20Omnicat%20Technology%E2%84%A2</a>
CPT-3	09 6813C	Tarket	Glacial Striae	Coastal Shelf	24" x 24"		<a href="https://commercial.tarkett.com/en_US/collection-0000634-glacial-striae?backing=ethos%2CAE%20Modular%20with%20Omnicat%20Technology%E2%84%A2">https://commercial.tarkett.com/en_US/collection-0000634-glacial-striae?backing=ethos%2CAE%20Modular%20with%20Omnicat%20Technology%E2%84%A2</a>
CPT-4	09 6813D	Tarkett	Resonate	Bay View	9" x 36"		<a href="https://commercial.tarkett.com/en_US/collection-0001589-resonate?backing=ethos%2CAE%20Modular%20with%20Omnicat%20Technology%E2%84%A2">https://commercial.tarkett.com/en_US/collection-0001589-resonate?backing=ethos%2CAE%20Modular%20with%20Omnicat%20Technology%E2%84%A2</a>
CPT-5	09 6813E	Tarkett	Abrasive Action	Asphalt	Roll		<a href="https://commercial.tarkett.com/en_US/collection-0000580-abrasive-action-4?backing=ethos%2CAE%20Modular%20with%20Omnicat%20Technology%E2%84%A2">https://commercial.tarkett.com/en_US/collection-0000580-abrasive-action-4?backing=ethos%2CAE%20Modular%20with%20Omnicat%20Technology%E2%84%A2</a>
CPT-6	09 6813F	J+J Flooring	Kinetix	Timber	12" x 48"		<a href="https://www.jjflooringgroup.com/product/timber-demi-plank/">https://www.jjflooringgroup.com/product/timber-demi-plank/</a>
RES-1	09 6543A	Forbo	Marmoleum Modular Tiles	White wash	39.4" x 9.8"		<a href="https://www.forbo.com/flooring/en-us/products/marmoleum-modular-tiles/marmoleum-modular-b-dcmw">https://www.forbo.com/flooring/en-us/products/marmoleum-modular-tiles/marmoleum-modular-b-dcmw</a>
SC-1	03 3000A					Sealed Concrete	
WD-1	09 6400A	Armstrong	Rigid Core	Oasis	9" x 60"	Engineered wood flooring	<a href="https://www.armstrongflooring.com/commercial/en-us/products/rigid-core/rest-refuge/item/ARR01.html">https://www.armstrongflooring.com/commercial/en-us/products/rigid-core/rest-refuge/item/ARR01.html</a>
PAINT							
PNT-1	09 9123A	Sherwin Williams		Field Color - TBD			
PNT-2	09 9123B	Sherwin Williams		Accent Color - TBD			
PNT-3	09 9123A	Sherwin Williams		Accent Color - TBD			
SOLID SURFACE							
SS-1	12 3600A	Corian		White (TBD)		Solid Surface for window stools	<a href="https://www.corian.com/?src=globalnav">https://www.corian.com/?src=globalnav</a>
SS-2	12 3600B	Corian		Rain Streak		Solid Surface for toilet room countertops and sinks	<a href="https://www.corian.com/?src=globalnav">https://www.corian.com/?src=globalnav</a>
SS-3	12 3600C	Wilsonart	Quartz	Telaro		Quartz agglomerate countertop	<a href="https://www.wilsonart.com/telaro-q4025">https://www.wilsonart.com/telaro-q4025</a>
WALL BASE							
RUB-1	09 9123A	Nora		TBD			
WALL COVERING							
WC-1	09 7200A	Knoll	Alias II Backed	Greyhound			<a href="https://www.knoll.com/knolltextileproductdetail/alias-ii-lh-backed">https://www.knoll.com/knolltextileproductdetail/alias-ii-lh-backed</a>
WALL TILE							
CWT-1	09 3000A	Daltile	Linden Point	Grigio	12" x 24"		<a href="https://www.daltile.com/product/Linden-Point?color=Grigio&amp;shape=Straight%20Joint">https://www.daltile.com/product/Linden-Point?color=Grigio&amp;shape=Straight%20Joint</a>

FINISH SCHEDULE

RM. NO.	ROOM NAME	FLOOR	BASE	WALL FINISH	CEILING FINISH	Comments
001	NONFICTION	CPT-1	RUB-1	PNT-1, PNT-3	APC-2	
001A	INTERNATIONAL ROMANCE, AUDIO	CPT-1	RUB-1	PNT-1, PNT-3	APC-2	
001B	AUDIOBOOKS	CPT-1	RUB-1	PNT-1, PNT-3	APC-2	
001C	LOWER LEVEL STACKS	CPT-1	RUB-1	PNT-1, PNT-3	APC-2	
002	MECHANICAL	ETR	ETR	ETR	ETR	
010	RECEIVING ROOM	CPT-1	RUB-1	PNT-1	APC-1	
010A	STOR.	CPT-1	RUB-1	PNT-1	APC-1	
010B	STORAGE	CPT-1	RUB-1	PNT-1	APC-1	
010H	STAFF LOBBY	RES-1	RUB-1	PNT-1	APC-1	
011	BREAK ROOM/ CONFERENCE	RES-1	RUB-1	PNT-1, PNT-3	APC-1	
011A	STORAGE	RES-1	RUB-1	PNT-1	APC-1	
012	STORAGE	ETR	ETR	ETR	ETR	
012A	STORAGE	ETR	ETR	ETR	ETR	
012H	CORRIDOR	RES-1	RUB-1	PNT-1	APC-1	
013	ELEVATOR ROOM	ETR	ETR	ETR	ETR	
014	STORAGE	ETR	ETR	ETR	ETR	
015	STORAGE	ETR	ETR	ETR	ETR	
015H	EXIT CORRIDOR	ETR	ETR	ETR	ETR	
016	UNFINISHED	UNFINISHED	UNFINISHED	UNFINISHED	UNFINISHED	
100	LOBBY	WD-1	RUB-1	PNT-1, PNT-3	SDG-1	
100A	VESTIBULE	CPT-6	RUB-1	PNT-1	GWB	
100B	CIRCULATION DESK	WD-1	RUB-1	PNT-3	GWB, WD	
101H	MAIN STREET	WD-1	RUB-1	PNT-1, PNT-3	SDG-1	
110	CAFE/EVENT	RES-1	RUB-1	PNT-1, PNT-3	APC-1	
110A	BOOK DROP	ETR	ETR	ETR	ETR	
120	CHILDRENS LIBRARY	CPT-6	RUB-1	PNT-1, PNT-2	APC-1	
120A	STAIR ACCESS	CPT-6	RUB-1	PNT-1, PNT-2	APC-1	
121	CHILDRENS LIBRARIANS	CPT-2	RUB-1	PNT-1	APC-1	
122	HEAD CHILDRENS LIBRARIAN	CPT-2	RUB-1	PNT-1	APC-1	
123	STOR	CPT-6	RUB-1	PNT-1, PNT-2	APC-1	
130	CHILDRENS MEETING ROOM	CPT-6	RUB-1	PNT-1, PNT-2	APC-1	
131	STOR	RES-1	RUB-1	PNT-1	APC-1	
140	MEETING ROOM	CPT-3	RUB-1	WC-1	APC-1	
140A	SOUND AND LIGHT LOCK	CPT-3	RUB-1	WC-1	APC-1	
141	KIT.	CFT-1	CFT-1	PNT-1	APC-1	
142	STORAGE	CPT-3	RUB-1	WC-1	APC-1	
150	CIRCULATION SERVICES	CPT-2	RUB-1	PNT-1	APC-1	
150H	CORRIDOR	CPT-1	RUB-1	PNT-1	APC-1	
151	HEAD OF CIRCULATION SERVICES	CPT-2	RUB-1	PNT-1	APC-1	
152	HEAD OF ADULT SERVICES	CPT-2	RUB-1	PNT-1	APC-1	
153	ADULT SERVICE LIBRARIAN	CPT-2	RUB-1	PNT-1	APC-1	
154	LITERACY SOLUTIONS	CPT-2	RUB-1	PNT-1	APC-1	
154A	STAIR ACCESS	RES-1	RUB-1	PNT-1	APC-1	
155	COMMUNITY RELATIONS	CPT-2	RUB-1	PNT-1	APC-1	
156	ADMIN. ASSIST.	CPT-2	RUB-1	PNT-1	APC-1	
156A	DIRECTOR	CPT-2	RUB-1	PNT-1	APC-1	
156B	FINANCE AND FACILITIES	CPT-2	RUB-1	PNT-1	APC-1	
159H	CORRIDOR	CPT-1	RUB-1	PNT-1	APC-1	
157	TECHNICAL SERVICES	CPT-2	RUB-1	PNT-1	APC-1	
157A	IT	CPT-2	RUB-1	PNT-1	APC-1	
160	MAIN LEVEL READING AREA	CPT-1	RUB-1	PNT-1, PNT-2	ETR, GWB, SDG-1	
161	LOCAL HISTORY	CPT-1	RUB-1	PNT-1, PNT-3	APC-2	
162	LOCAL HISTORY MEETING	CPT-3	RUB-1	WC-1	APC-1	
163	GROUP STUDY	CPT-3	RUB-1	WC-1	APC-1	
164	GROUP STUDY	CPT-3	RUB-1	WC-1	APC-1	
165	GROUP STUDY	CPT-3	RUB-1	WC-1	APC-1	
166	MAKER SPACE	RES-1	RUB-1	PNT-1, PNT-3	APC-1	
166A	MAKER SPACE OFFICE	CPT-3	RUB-1	WC-1	APC-1	
200	MEZZANINE STACKS	CPT-1	RUB-1	PNT-1, PNT-3	APC-2	
201	TEEN LIBRARIAN	CPT-2	RUB-1	PNT-1	APC-1	
201A	STORAGE	CPT-2	RUB-1	PNT-1	APC-1	
202	TEEN ROOM	CPT-4	RUB-1	PNT-1, PNT-2	APC-1	
203	GROUP STUDY	CPT-3	RUB-1	WC-1	APC-1	
T101	JAN.	SC	RUB-1	PNT-1	GWB, WD	
S3	STAIR 3	ETR	ETR	ETR	ETR	
S3	STAIR 3	ETR	ETR	ETR	ETR	
S7	STAIR 7	ETR	ETR	ETR	ETR	
S9	STAIR 9	ETR	ETR	ETR	ETR	
S9	STAIR 9	ETR	ETR	ETR	ETR	
S10	STAIR 10	ETR	ETR	ETR	ETR	
S10	STAIR 10	ETR	ETR	ETR	ETR	
T101	STAFF WC	CFT-1	CFT-1	CWT-1, PNT-1	GWB	
T101	TOILET	CFT-1	CFT-1	CWT-1	GWB	
T102	WOMEN	CFT-1	CFT-1	CWT-1	GWB	
T103	MEN	CFT-1	CFT-1	CWT-1	GWB	
T120	CHILDRENS WC	CFT-1	CFT-1	CWT-1	GWB	
T150	STAFF WC	CFT-1	CFT-1	CWT-1, PNT-1	GWB	





New City Library


## New City Library Addition & Renovation

220 North Main Street  
New City, NY 10956

VMDO Project Number 1301

Checked By  
Drawn By

Checker  
Author

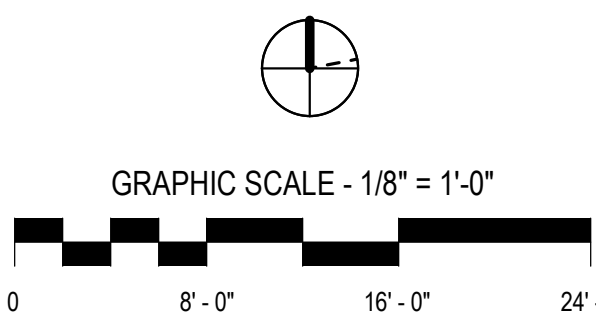


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CONSTRUCTION

ISSUES AND REVISIONS  
NO. SUBMITTAL  
SCHEMATIC DESIGN  
DATE  
03.05.2021


FINISH PLAN - LOWER  
LEVEL & BASEMENT

A911

DESIGN DEVELOPMENT  
07.09.2021

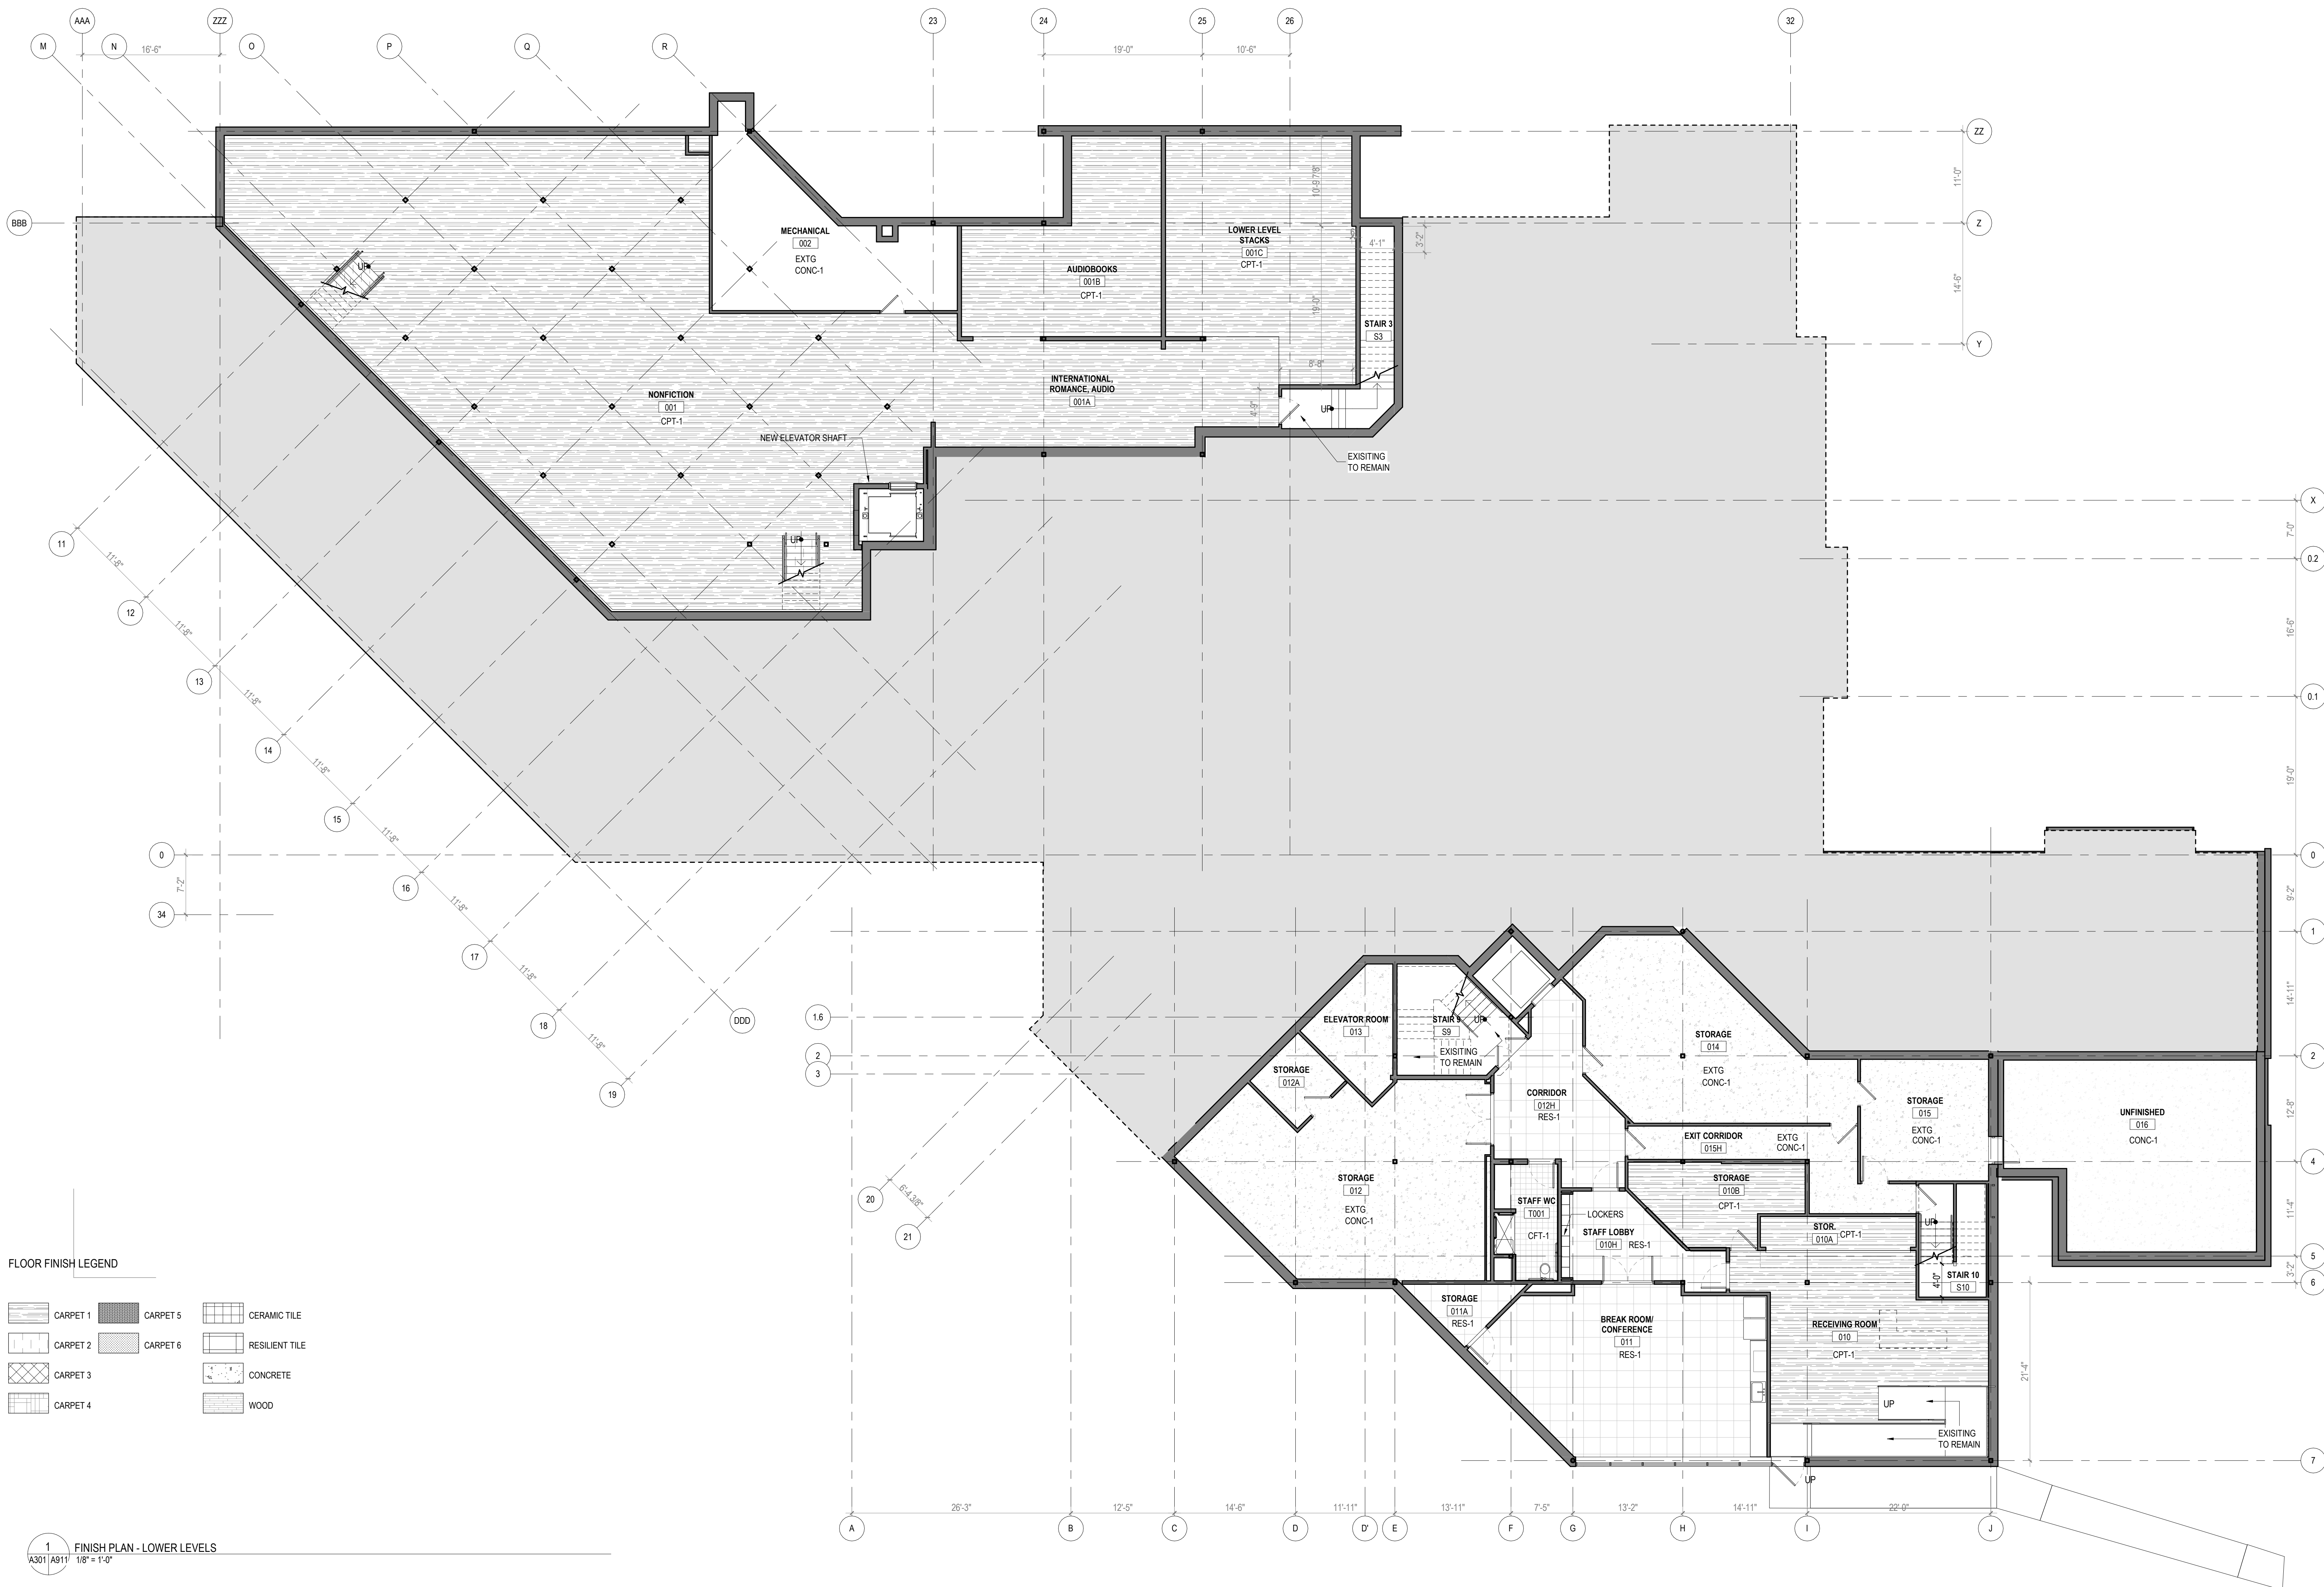

### FLOOR FINISH LEGEND

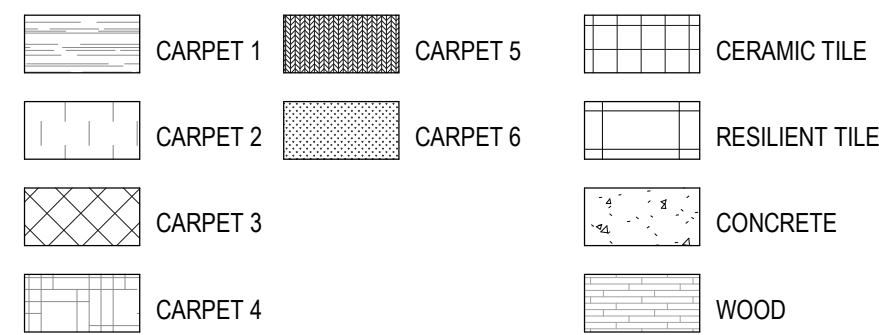

1 FINISH PLAN - LOWER LEVELS  
A301/A911 1/8" = 1'-0"

### FINISH SCHEDULE GENERAL NOTES

- FOR ADDITIONAL INFORMATION ON INTERIOR FINISHES, SEE REMAINDER OF DRAWINGS INCLUDING FLOOR PLANS, REFLECTED CEILING PLANS & INTERIOR ELEVATIONS.
- PROVIDE STONE THRESHOLDS AT DOORS OR OPENINGS TO TOILET ROOMS AND BATHROOMS AT TRANSITION BETWEEN CERAMIC TILE AND ADJACENT (OTHER) FLOOR FINISH.
- ALL FLOORS SCHEDULED TO RECEIVE A SEALED CONCRETE FINISH SHALL HAVE TWO (2) COATS OF SEALER. THE SECOND COAT OF SEALER SHALL BE APPLIED AT THE TIME OF SUBSTANTIAL COMPLETION.
- REFER TO "FP" SHEETS FOR FIRE RESISTANCE RATINGS OF WALL AND FLOOR ASSEMBLIES.
- ALL M.E.P. SYSTEMS SHALL BE CONCEALED WITHIN WALL OR CEILING CAVITY, U.N.O.
- PAINT ALL STRUCTURE AND INFRASTRUCTURE COMPONENTS AND SURFACES AT OPEN OR EXPOSED CEILINGS.





New City Library


## New City Library Addition & Renovation

220 North Main Street  
New City, NY 10956

VMDO Project Number 1301


Checked By  
Drawn By

Checker  
Author

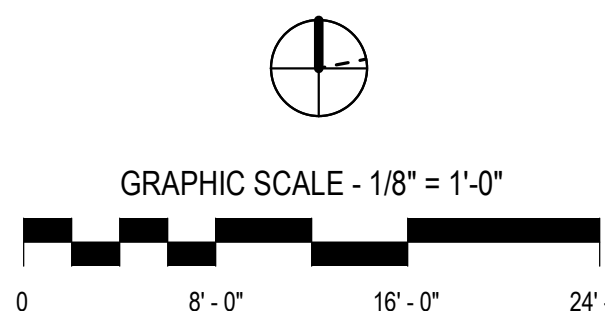

DRAWING NOT FOR  
CONSTRUCTION

ISSUES AND REVISIONS  
NO. SUBMITTAL DATE

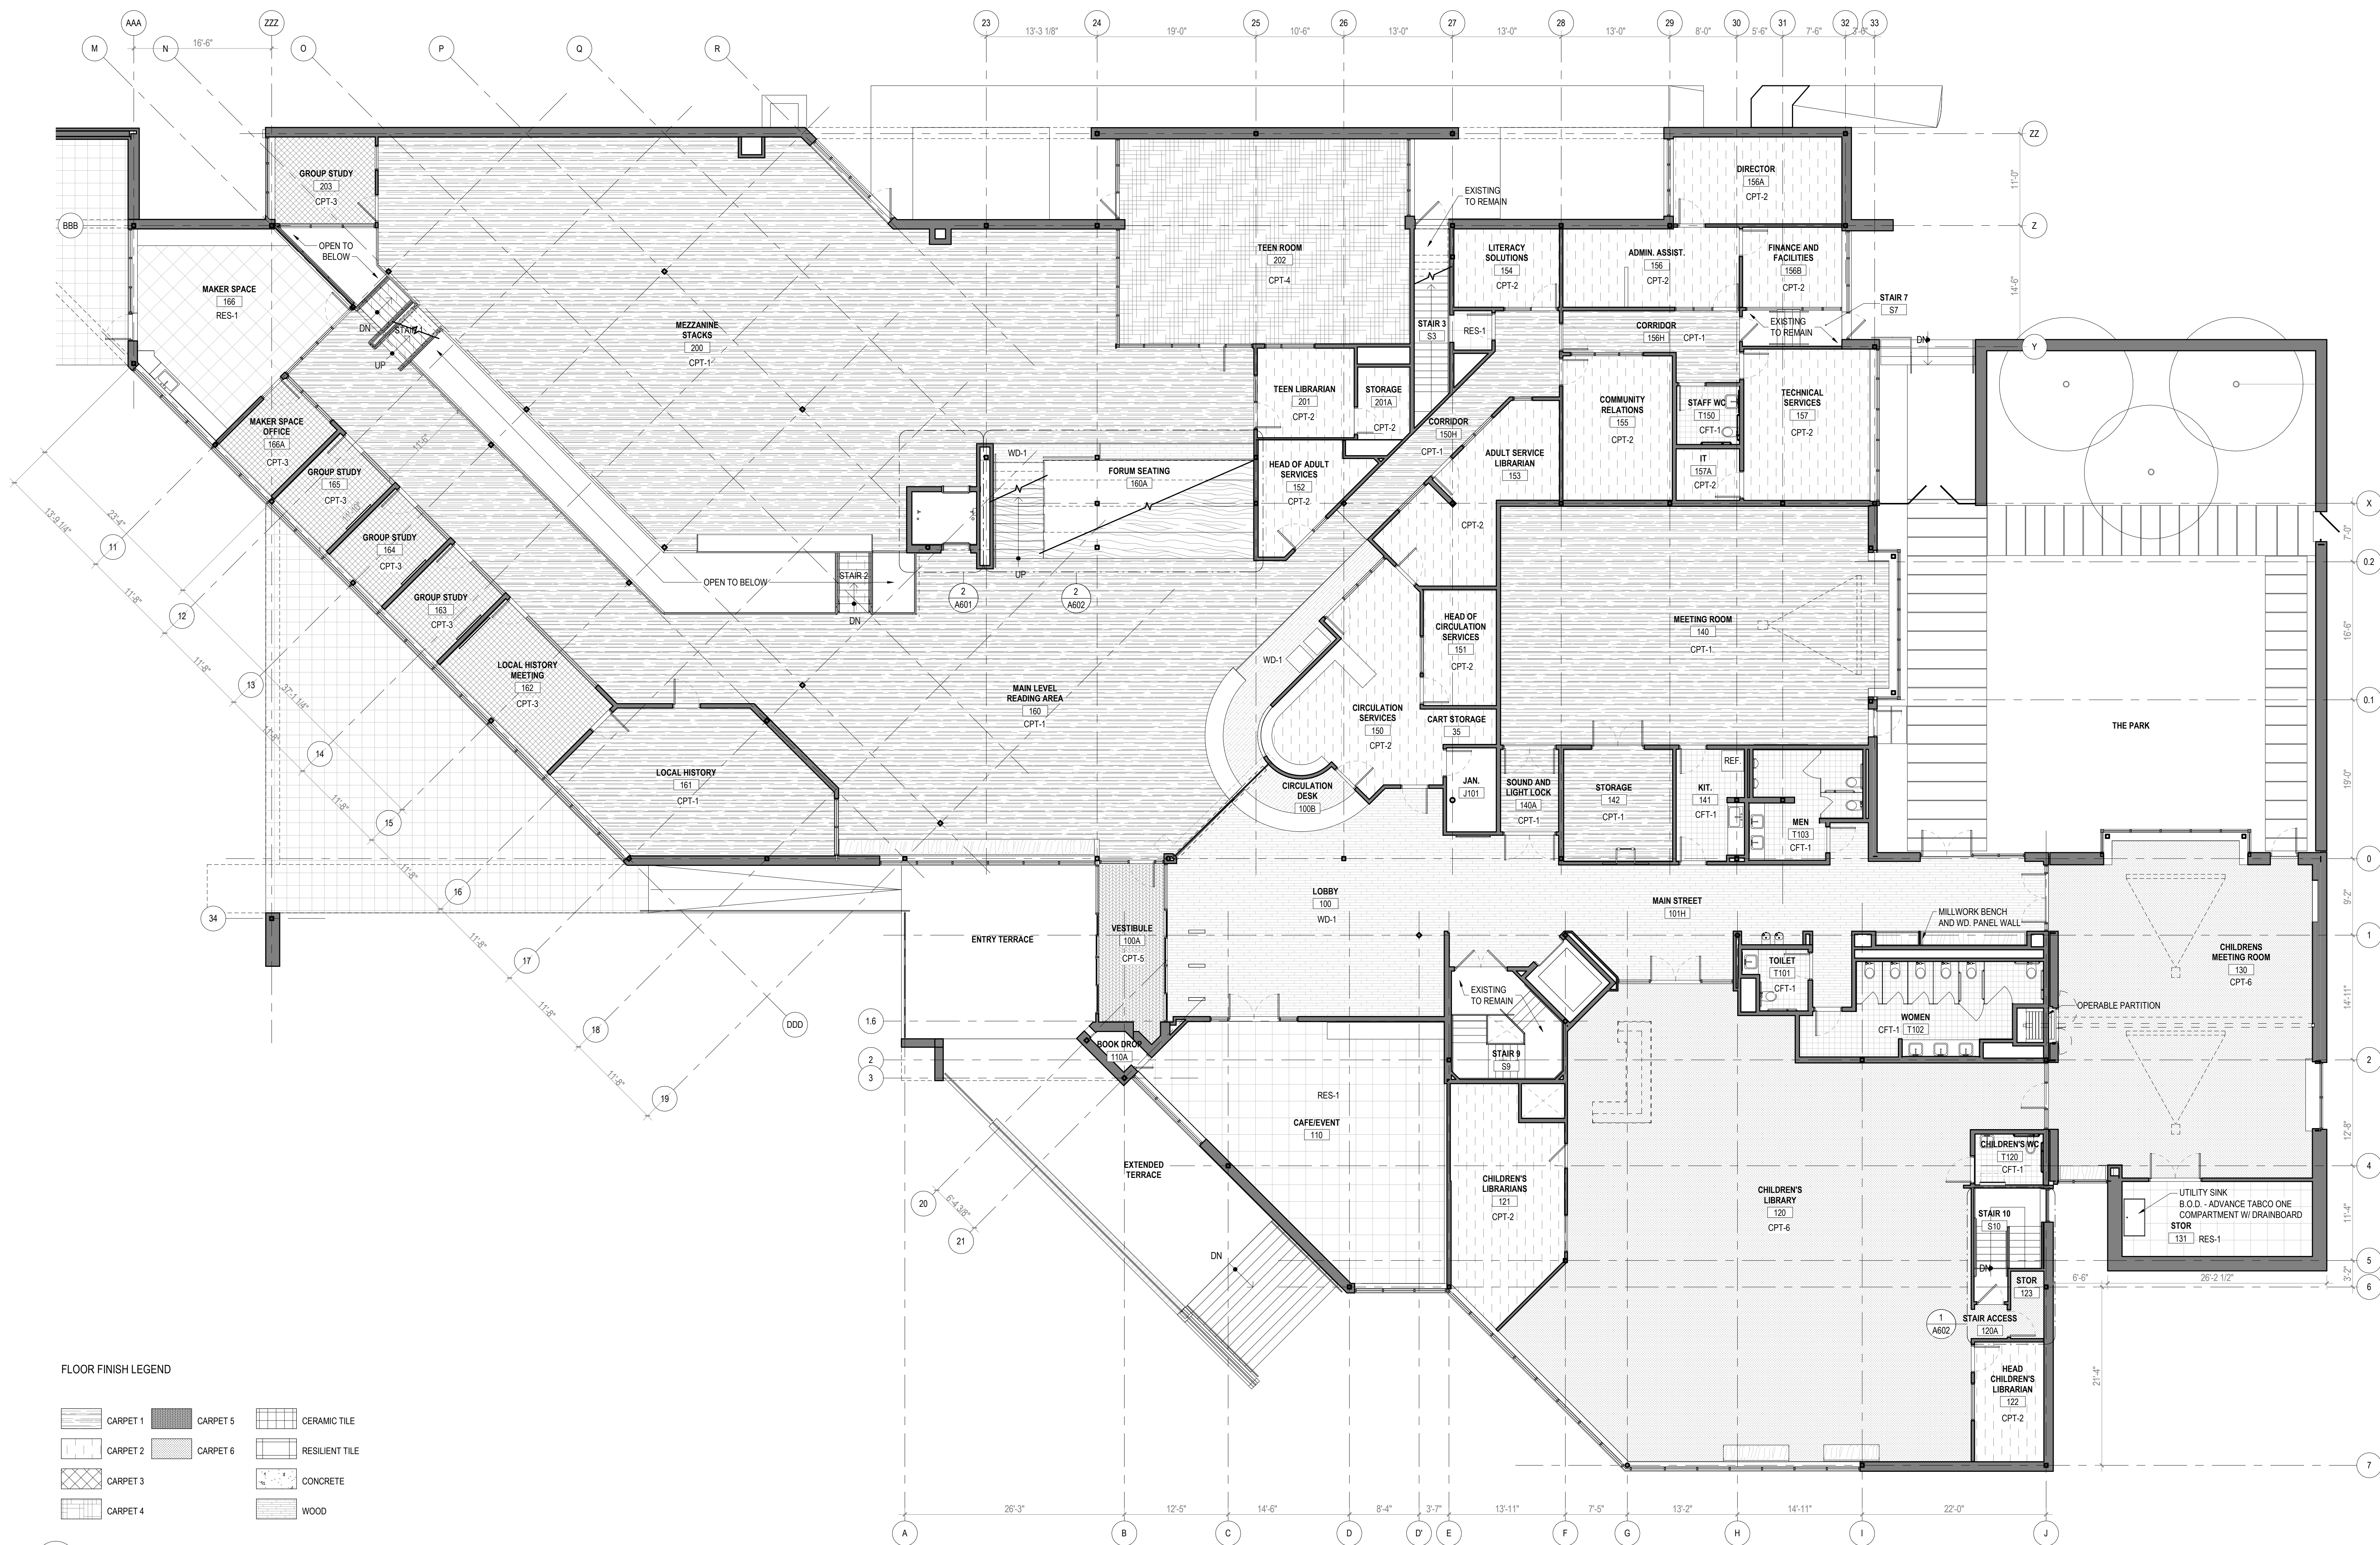

### FLOOR FINISH LEGEND

CARPET 1	CARPET 5	CERAMIC TILE
CARPET 2	CARPET 6	RESILIENT TILE
CARPET 3		CONCRETE
CARPET 4		WOOD

1 FINISH PLAN - FIRST FLOOR & MEZZANINE  
A301 A912 1/8" = 1'-0"

### FINISH SCHEDULE GENERAL NOTES


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FINISH PLAN - FIRST  
FLOOR & MEZZANINE

A912

DESIGN DEVELOPMENT  
07.09.2021



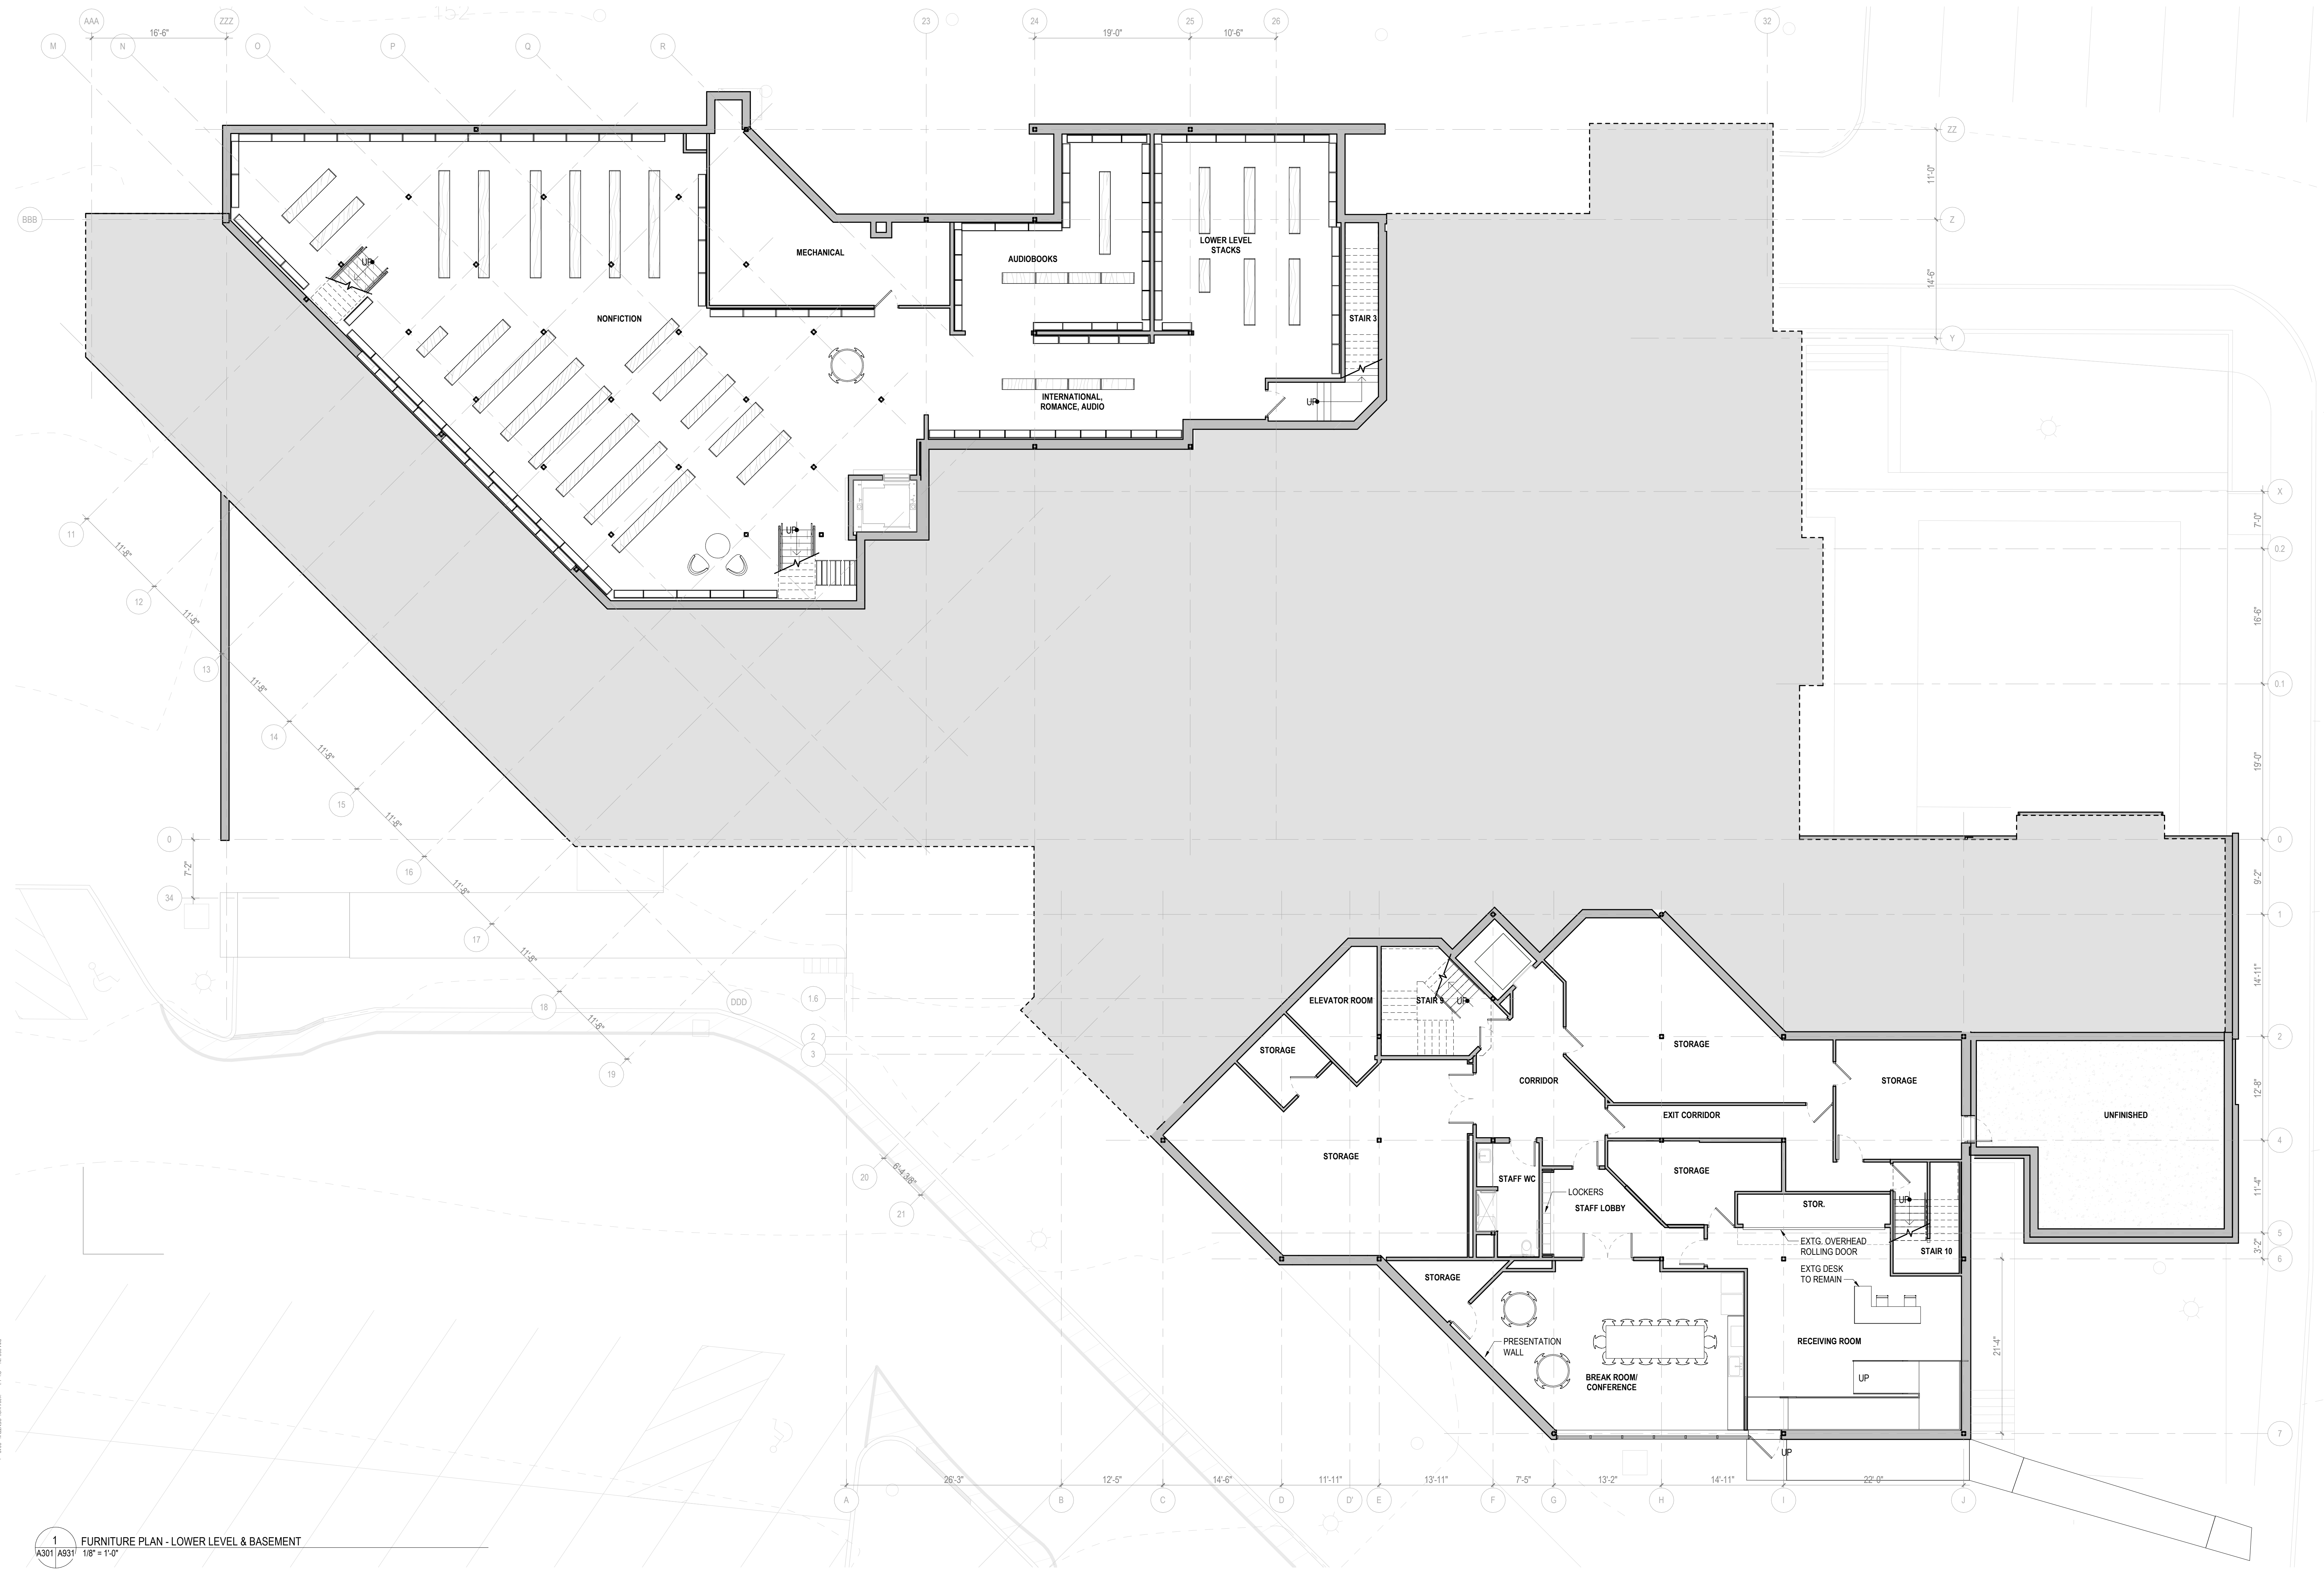


1 FURNITURE PLAN - LOWER LEVEL & BASEMENT  
A301/A931 1/8" = 1'-0"

### KEYNOTES



New City Library  
**New City Library Addition & Renovation**  
220 North Main Street  
New City, NY 10956  
VMDO Project Number **1301**

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Drawn By \_\_\_\_\_ Author

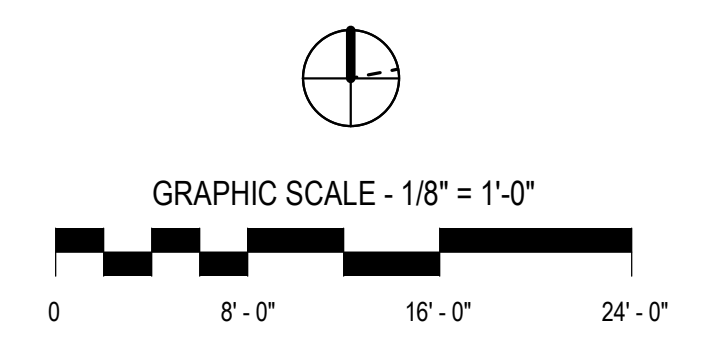


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ISSUES AND REVISIONS		DATE
NO.	SUBMITTAL	

FURNITURE PLAN -  
LOWER LEVEL &  
BASEMENT



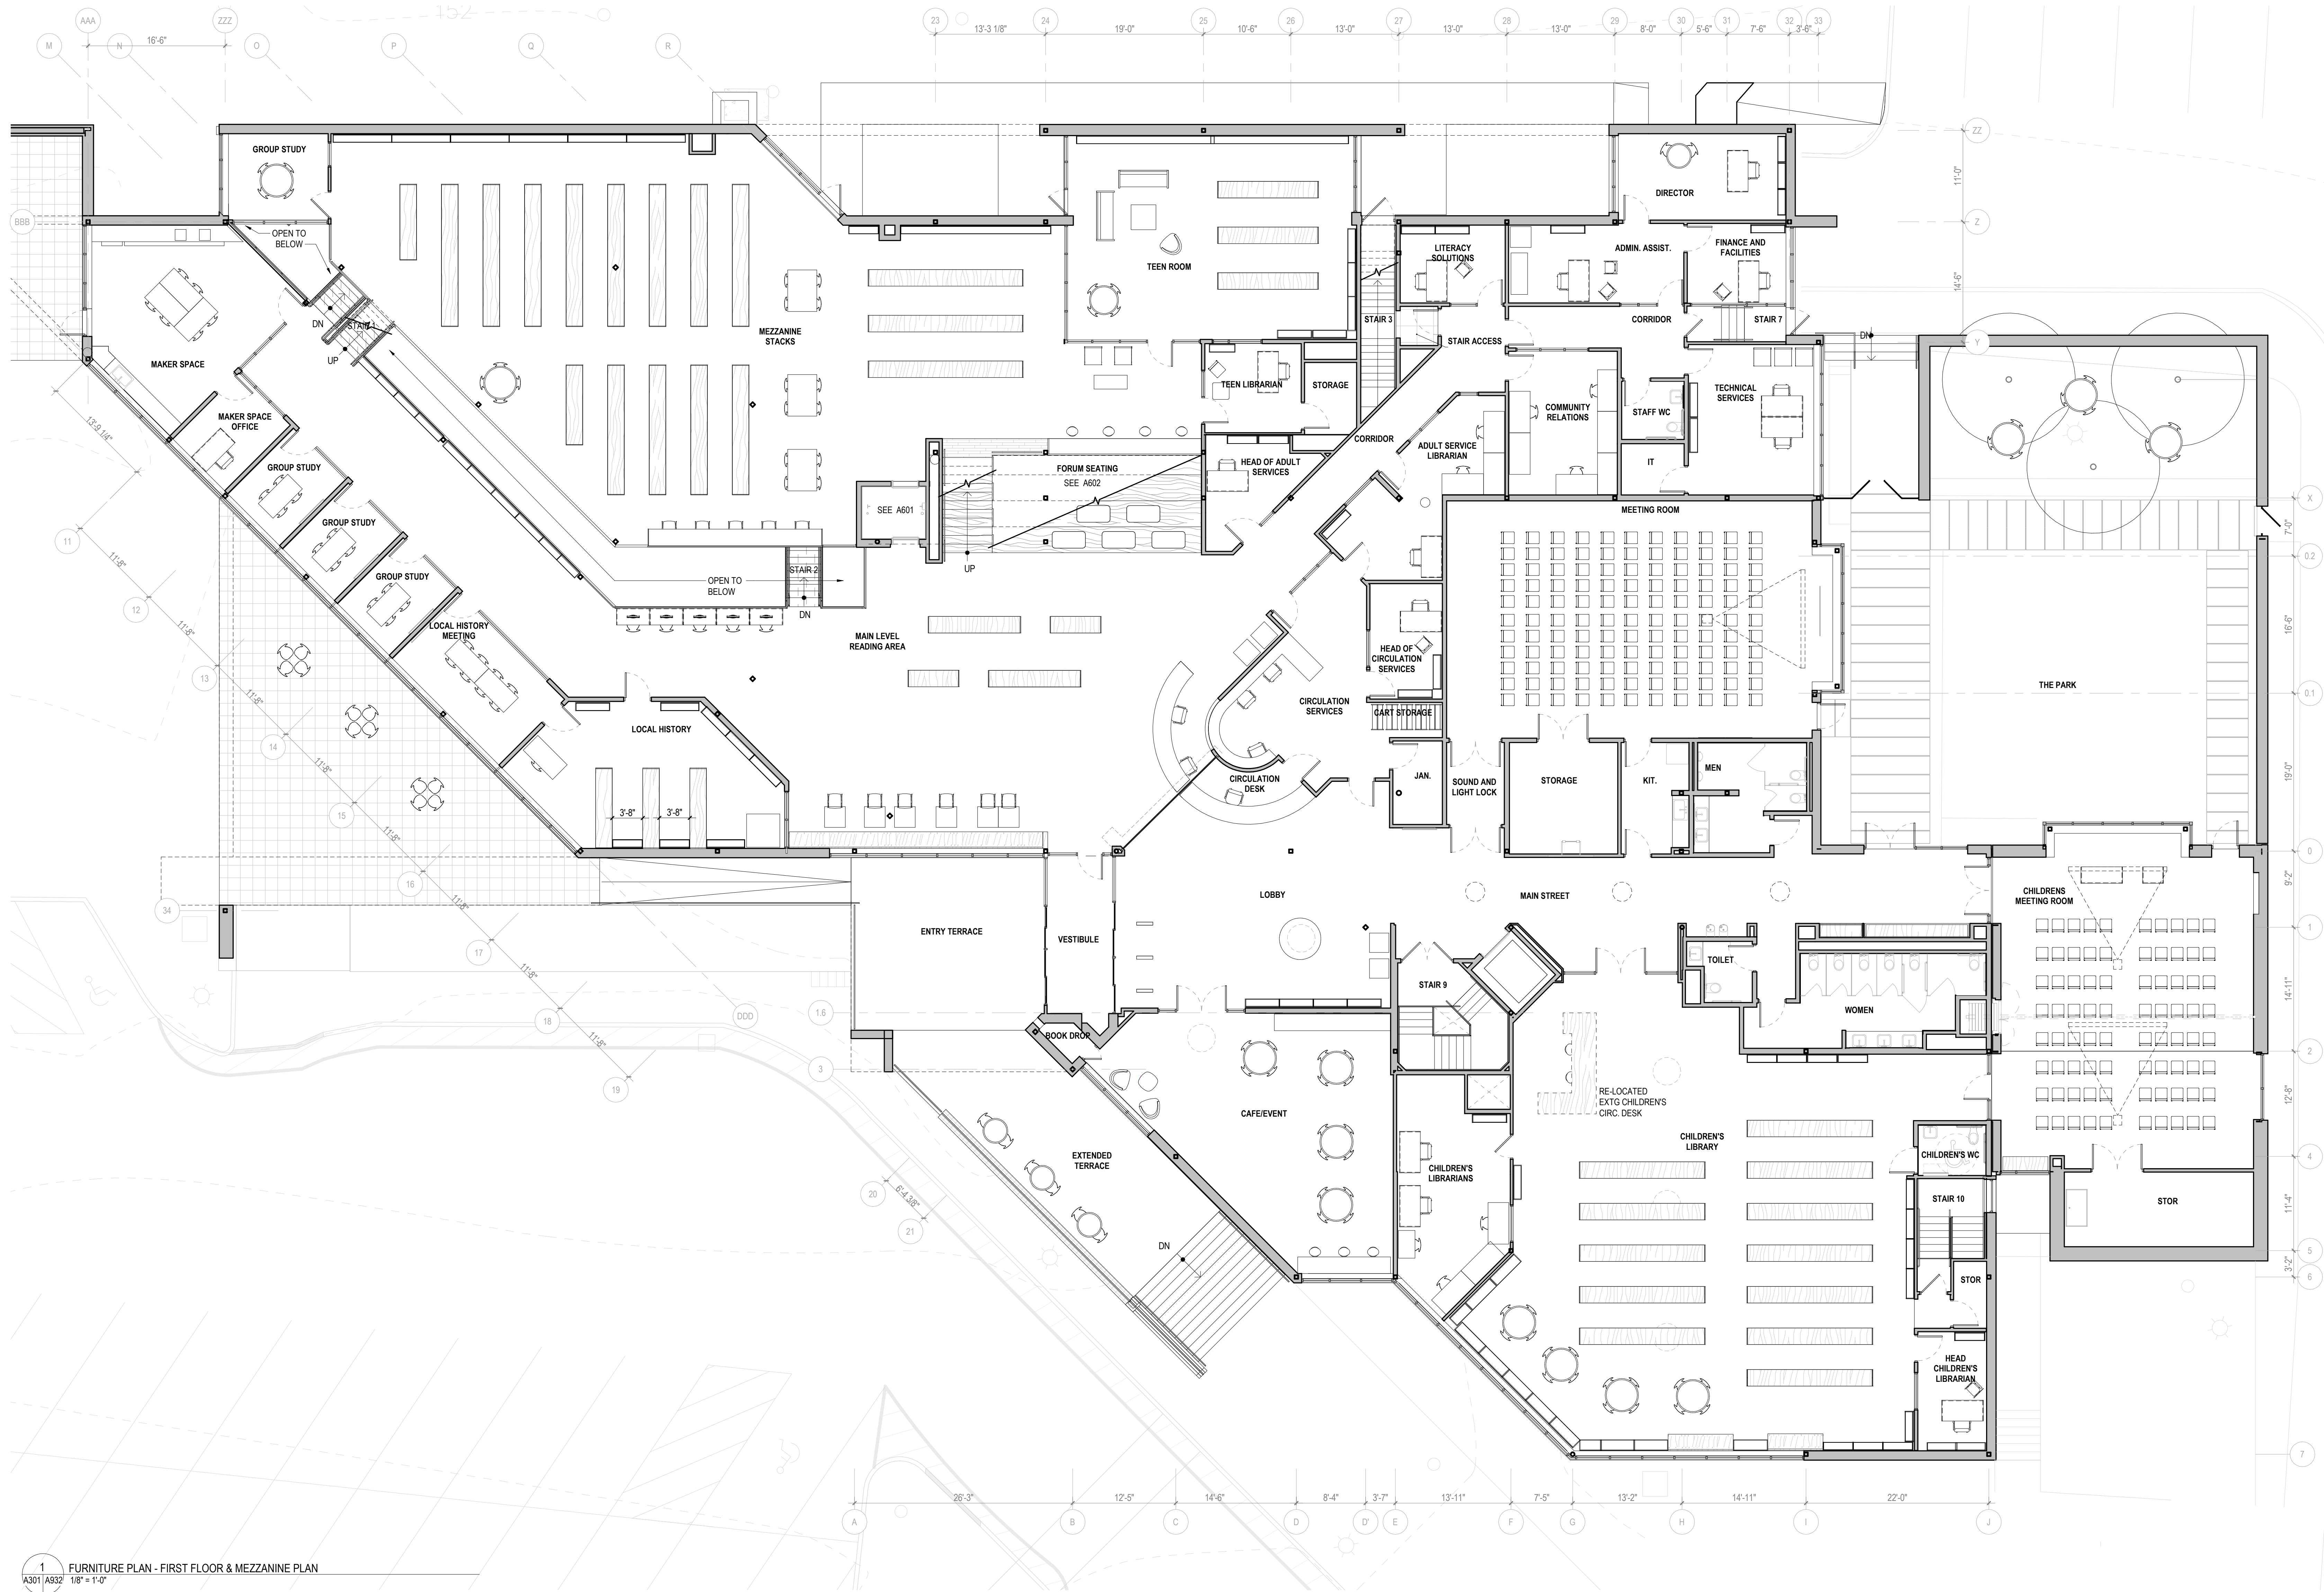

1 FURNITURE PLAN - FIRST FLOOR & MEZZANINE PLAN  
A301/A932 1/8" = 1'-0"

KEYNOTES

VMDO

VMDO Architects  
vmdo.com  
434.296.5684  
200 E Market Street  
Charlottesville, VA 22902  
1200 18th Street NW Ste 700  
Washington, DC 20036




New City Library

New City Library Addition & Renovation

220 North Main Street  
New City, NY 10956

VMDO Project Number 1301

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Author

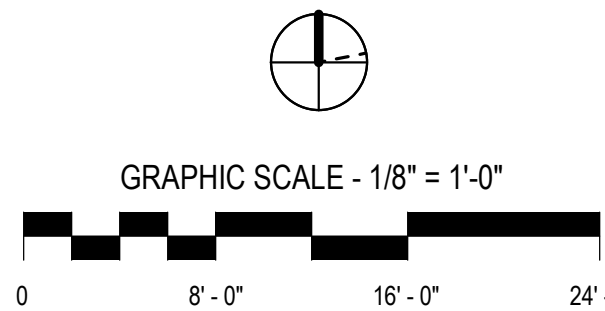

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ISSUES AND REVISIONS  
NO. SUBMITTAL DATE

FURNITURE PLAN -  
FIRST FLOOR &  
MEZZANINE

A932

DESIGN DEVELOPMENT  
07.09.2021