


DEMOLITION GENERAL NOTES

ASBESTOS ABATEMENT GENERAL NOTES

- 1. IT IS THE CONTRACTORS RESPONSIBILITY TO FAMILIARIZE THEMSELVES WITH ALL DETAILS INVOLVED IN THE DEMOLITION CONTRACT. SPECIFIC INSTRUCTION ON EACH ITEM WILL NOT BE GIVEN.
 - 2. GC IS RESPONSIBLE FOR KEEPING BUILDING WEATHERTIGHT DURING DEMOLITION
 - 3. GC IS TO PROVIDE DUST CONTROL BARRIERS AT ALL AREAS OF CONSTRUCTION.
- 4. GC WILL SALVAGE ANY ITEMS PER OWNERS LIST (TBD). 5. PC = PLUMBING CONTRACTOR, EC = ELECTRICAL CONTRACTOR, MC = MECHANICAL
- CONTRACTOR 6. PATCH WALLS, FLOORS AND CEILINGS AT ALL WALL REMOVALS, TO MATCH
- SCHEDULED FINISHES. 7. WORK AREAS SHALL BE MAINTAINED AND LEFT BROOM CLEANED AT END OF EACH
- 8. EXISTING BUILDING AND STRUCTURE TO REMAIN EXCEPT AS NOTED.

DEMOLITION KEY NOTES

- REMOVE EXISTING ACOUSTIC CEILING TILES, GRID, AND SUSPENSION SYSTEM IN ITS
- REMOVE EXISTING METAL STUD, GYPSUM WALL BOARD SOFFIT AND ALL
- ASSOCIATED COMPONENTS IN ITS ENTIRETY.
- REMOVE AND SALVAGE 24X24 OR 24X48 ACOUSTIC CEILING TILE. STORE PANELS (C4) SAFELY FOR REINSTALLATION IN NEW WORK. REFER TO RCPS. EXISTING GRID AND
- SUSPENSION SYSTEM TO REMAIN. REMOVE PORTION OF EXISTING CEILING TILES, GRID, AND SUSPENSIONS SYSTEM (C5) AT SHADED AREAS INDICATED ON DRAWINGS. SALVAGE EXISTING CEILING TILES
- REMOVE EXISTING HOLLOW METAL DOOR, FRAME, AND ALL ASSOCIATED
- REMOVE EXISTING VCT FLOORING, RUBBER BASE, AND ALL ASSOCIATED TRIM IN (F1) ITS ENTIRETY FULL EXTENT OF ROOM. PREPARE SUBSTRATE FOR INSTALLATION OF
- REMOVE EXISTING CONCRETE RAMP, RAILING, AND ALL ASSOCIATED MOUNTING HARDWARE IN ITS ENTIRETY.
- REMOVE EXISTING CONCRETE STAIR, RAILING, AND ALL ASSOCIATED MOUNTING HARDWARE IN ITS ENTIRETY.
- REMOVE EXISTING 4" THICK CONCRETE SLAB, FINISHES, AND ALL ASSOCIATED (F4) TRIM IN ITS ENTIRETY. EXCAVATE DOWN TO REQUIRED ELEVATION FOR NEW
- (F5) REMOVE EXISTING SAFETY PADDING. PREPARE SUBTRATE FOR NEW FINISHES.
- (F6) REMOVED DAMAGED STAIR TREAD.
- SAW CUT AND REMOVE PORTION OF EXISITNG SLAB ON GRADE AND EXCAVATE AS REQUIRED FOR NEW WORK. COORDINATE WORK WITH ALL TRADES.
- REMOVE EXISTING QUARRY TIL AND MUDSETE TO EXTENT SHOWN IN SHADED AREA.
- REMOVE EXISTING RUBBER BASE. PREPARE SURFACE FOR INSTALLATION OF NEW FINISHES.
- REMOVE RUBBER STAIR TREAD/RISER AND ALL ASSOCIATED TRIM. PREPARE SUBSTRATE FOR NEW FINISHES.
- SAW CUT AND REMOVE EXISTING FLOOR SLAB. PROVIDE OPENING SUPPORT PER
- (M1) REMOVE EXISTING GYPSUM COLUMN WRAP AND ALL ASSOCIATED
- COMPONENTS, PREPARE FOR NEW FINISHES
- MC TO REMOVE EXISTING UNIT VENTILATORS. GC TO PATCH INTAKE OPENING AND FINISHES @ WALL/FLOOR PER DETAIL ON A801.
- (M3) REMOVE EXISTING RAILING.
- REMOVE EXISTING BALLASTED ROOF SYSTEM DOWN TO DECKING. REMOVE EXISTING FLASHING AS NECESSARY FOR INSTALLATION OF NEW ROOF SYSTEM.
- $\stackrel{\textstyle \frown}{}$ PC TO REMOVE EXISTING DRINKING FOUNTAIN. PATCH WALL AFFECTED BY
- (M6) REMOVE PAPER TOWEL DISPENSER AND TURN OVER TO OWNER.
- (M7) REMOVE AND SALVAGE FOR RE-REINSTALLATION EXISTING STEEL WORK SURFACE.
- REMOVE AND REINSTALL STAINLESS STEEL TRAY SURFACE AS NECESSARY FOR
- (M9) REMOVE FLOOR MOUNTED SLEEVES. PATCH HOLE IN CONCRETE FLOOR.
- MC TO REMOVE EXISTING UNIT VENTILATORS. GC TO MODIFY CASEWORK AS NEEDED TO FASCILITATE INSTALLATION OF NEW UNIT.
- REMOVE EXISTING EPDM ROOF MEMBRANE, COVER BOARD, ROOF INSULATION, AND SUBSTRATE BOARD REQUIRED TO INSTALL NEW ROOF CURB. COORDINATE
- INSTALLATION OF ROOF CURBS WITH MECHANICAL CONTRACTOR.
- REMOVE PORTION OF EXISTING CMU WALL PER DETAIL ON A401. SUPPORT
- REMAINING EXISITNG WALL AS REQUIRED. PREPARE AREA FOR NEW WORK.
- REMOVE PORTION OF EXISTING WALL AS REQUIRED. PREPARE AREA FOR NEW WORK
- REMOVE EXISTING 6" CMU WALL IN ITS ENTIRETY. PATCH AND PREP. FOR NEW WORK.
- REMOVE EXISTING CHASE WALL IN ITS ENTIRETY. PATCH ALL ADJACENT SURFACES AFFECTED BY DEMOLITION.
- REMOVE PORTION OF EXISTING 8" CMU WALL. PREPARE ADJACENT SURFACES FOR NEW WORK.

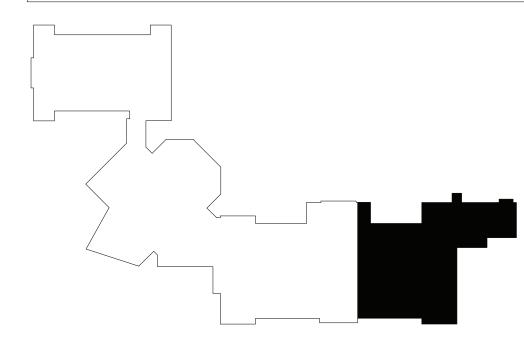



CPL | Architecture Engineering Planning 50 FRONT ST. SUITE 202

NEWBURGH, NY 12550

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PROJECT INFORMATION

Project Number 13940.18

NEWBURGH ENLARGED CITY SCHOOL DISTRICT

PHASE 3: HERITAGE MIDDLE SCHOOL 2019 CAPITAL **IMPROVEMENT PROJECT**

405 Union Avenue, New Windsor, NY 12553

SED Number 44-16-00-01-0-039-011

PROJECT ISSUE SCHEDULE


1 09/27/21 BID ADDENDA 2

IT IS A VIOLATION OF THE NEW YORK STATE EDUCATION LAW UNLESS ACTING UNDER THE DIRECTION OF A LICENSED ARCHITECT, ENGINEER OR LAND SURVEYOR, TO ALTER AN ITEM ENGINEER OR SURVEYOR IS ALTERED, THE ALTERING PARTY SHALL AFFIX TO THE ITEM THEIR SEAL AND THE NOTATION "ALTERED BY" FOLLOWED BY THEIR SIGNATURE AND THE DATE OF SUCH ALTERATION, AND A SPECIFIC DESCRIPTION OF THE

SHEET INFORMATION

Issued 9/9/2021 As indicated Project Status CONSTRUCTION DOCUMENTS

CPL CPL THIRD FLOOR AREA D -DEMOLITION PLAN

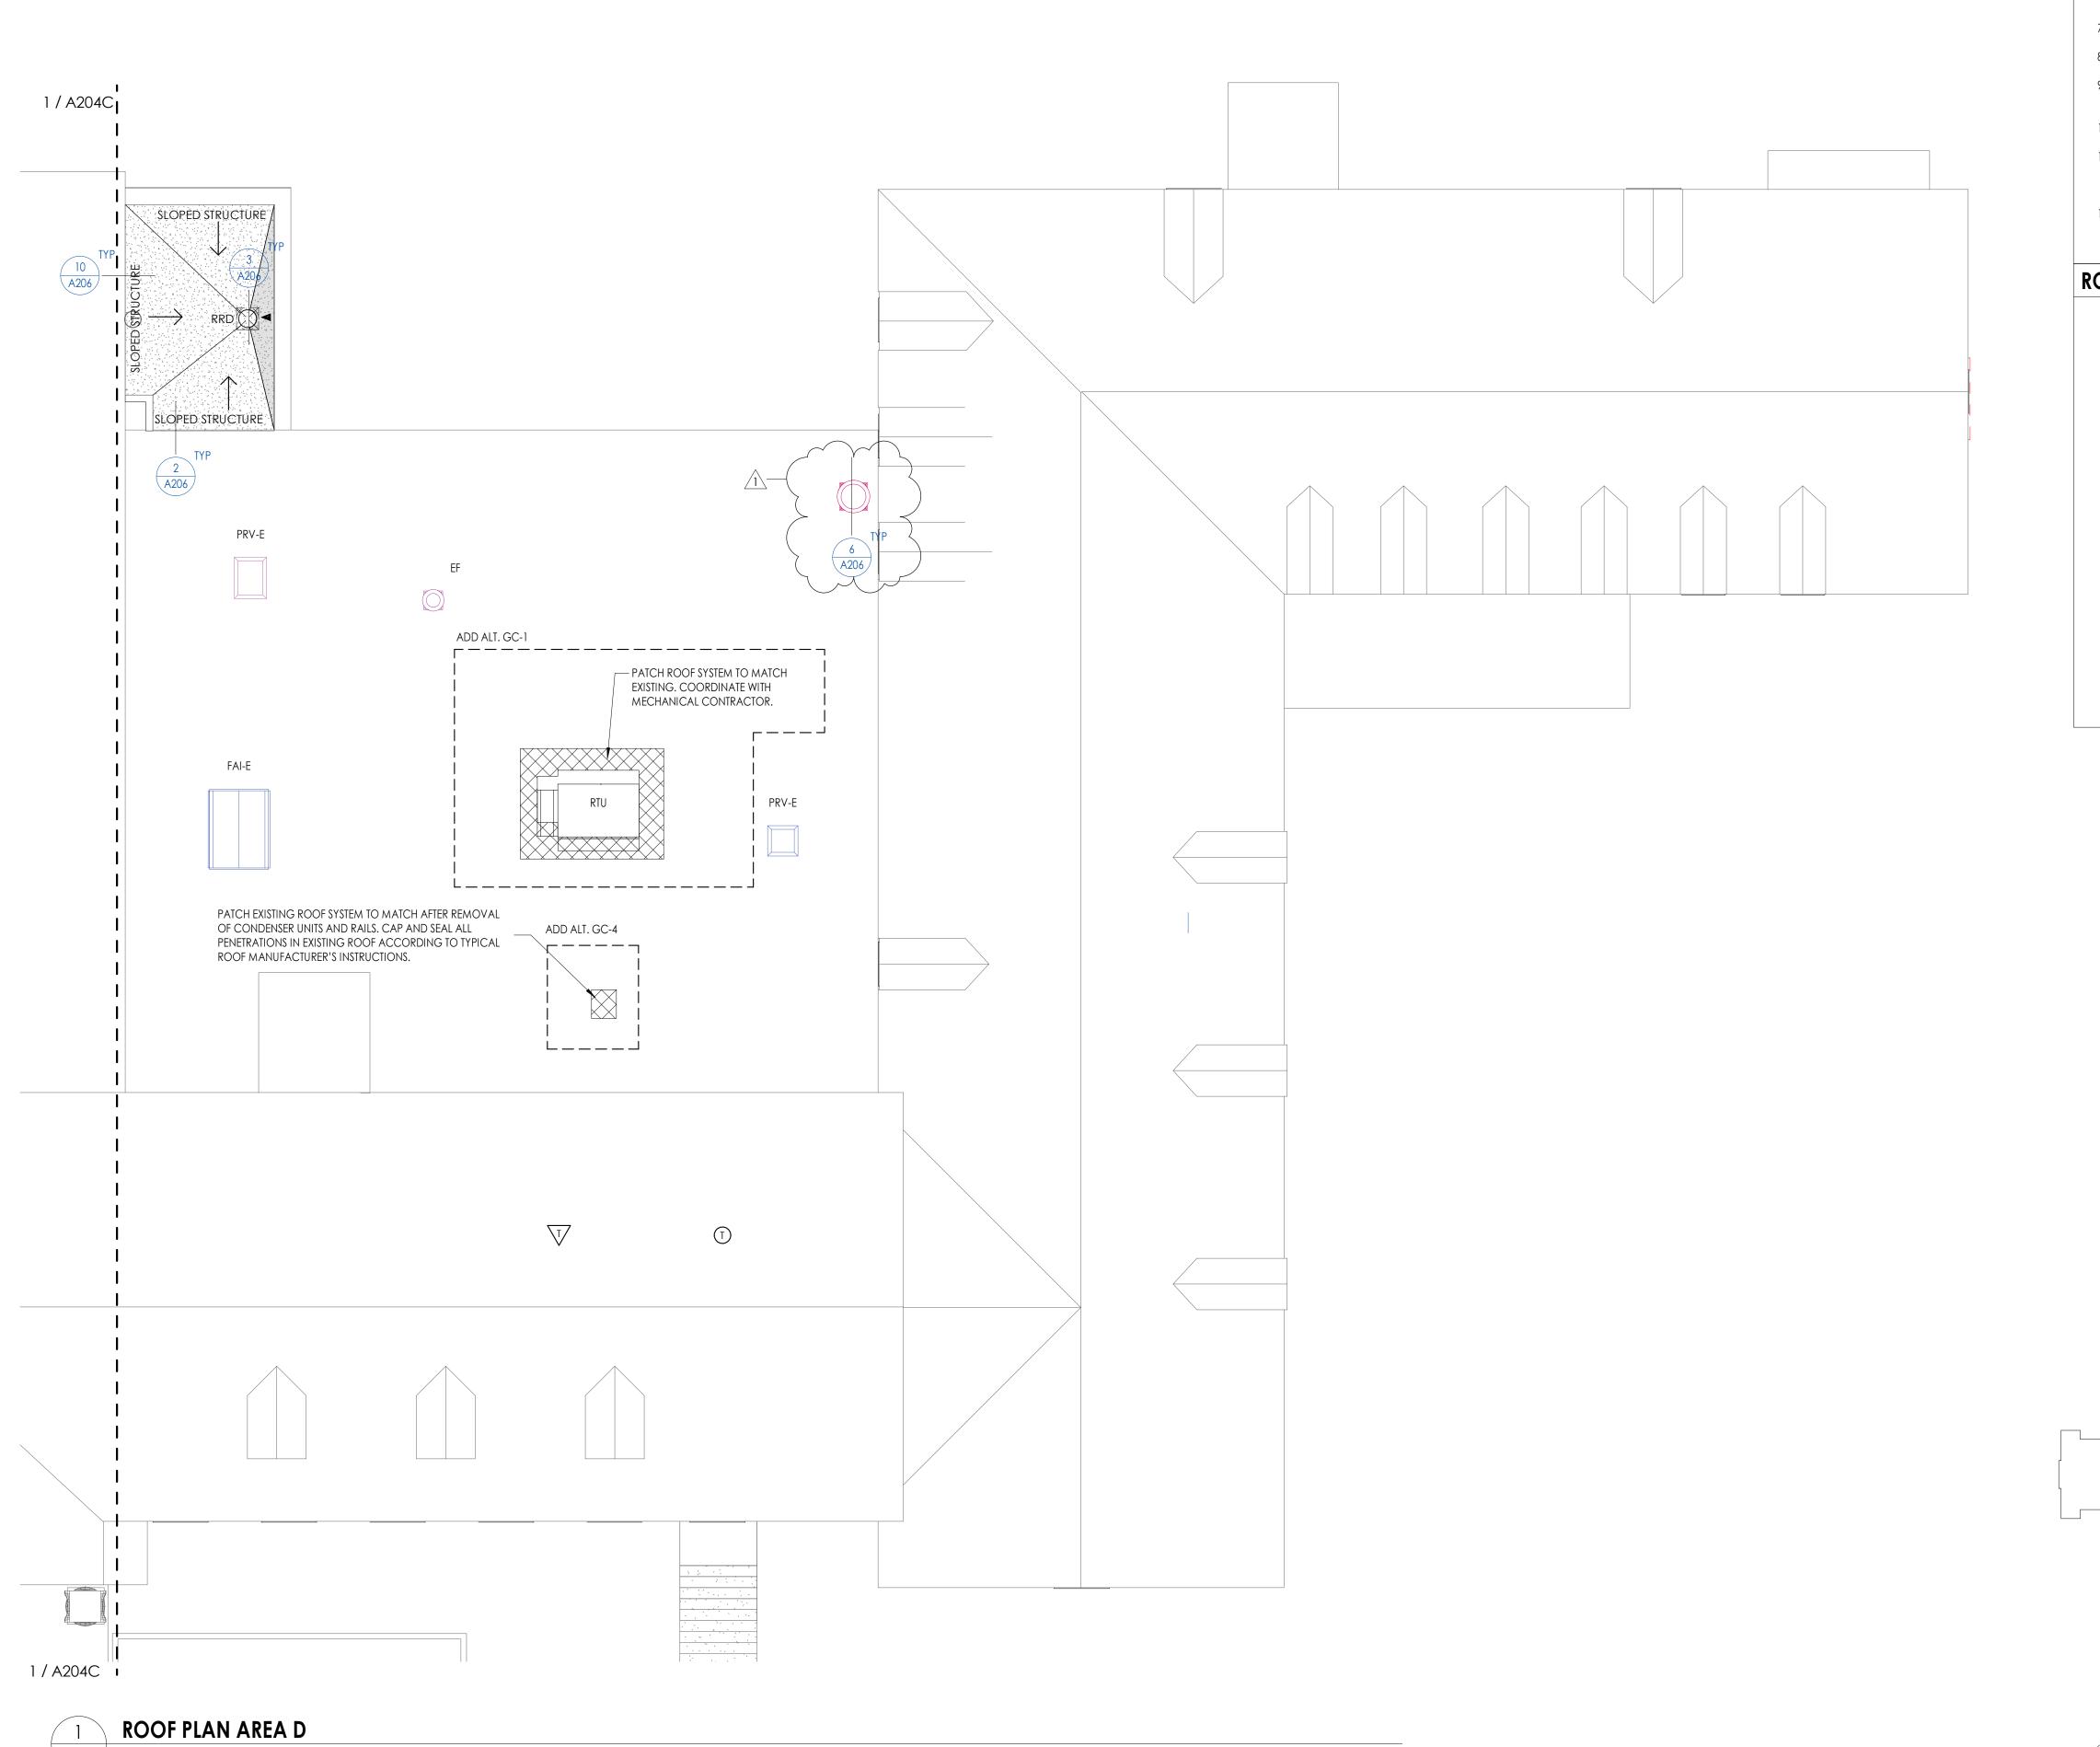

ROOF PLAN GENERAL NOTES

- 1. ALL DRAWINGS ARE GRAPHIC REPRESENTATIONS OF APPROXIMATE LOCATIONS OF MATERIALS. IT IS THE CONTRACTORS RESPONSIBILITY TO FIELD VERIFY ALL CONDITITONS PRIOR TO THE COMMENCEMENT OF WORK.
- 2. REFER TO ALL DRAWINGS IN THE SET FOR LOCATIONS OF ALL ROOF PENETRATIONS.

 PROVIDE FRAMING AS REQUIRED.
- 3. CONTRACTOR SHALL PAINT ALL ROOF FASTENERS EXPOSED TO VIEW AT UNDERSIDE OF DECK TO MATCH.
- OF DECK TO MATCH.

 4. WORK AREAS SHALL BE MAINTAINED AND ALL WORK AREAS SHALL BE BROOM
- CLEAN AT THE END OF EACH DAY.
- 5. ALL WOOD BLOCKING USED SHALL BE PRESSURE TREATED.
 6. THE CONTRACTOR SHALL BE RESPONSIBLE FOR INSTALLING ALL ROOF DRAINS AND CUTTING THE HOLES IN THE DECK FOR ANY DRAINS AND PROVIDING STRUCTURAL
- SUPPORTS.

 7. THE ROOF ELEVATIONS SHOWN ON THE PLAN ARE SHOWN TO ESTABLISH RELATIVE
- HEIGHTS OF THE INDIVIDUAL ROOFS.

 8. NO WEEP HOLES SHALL BE COVERED OR PLUGGED AS A RESULT OF THE ROOFING
- WORK, UNLESS OTHERWISE DIRECTED.

 9. THE CONTRACTOR SHALL BE RESPONSIBLE TO MAINTAIN WATER TIGHTNESS AND PROVIDE PROTECTION AT ANY/ALL OPENINGS IN THE ROOF LEFT AT THE END OF EACH DAY.
- 10. PROVIDE CRICKETS FOR WATER DIVERSION AT ALL CURBS, RAILS, ETC. WHICH RUN PERPENDICULAR TO THE SLOPE OF THE INSULATION/SLOPED STRUCTURE.
- 11. ALL ROOF TOP UNITS SHALL BE MOUNTED ON 16" MIN. INSULATED METAL CURBS. PROVIDE TAPERED INSULATION CRICKETS AS REQUIRED TO SHED WATER. WOOD BLOCKING SHALL BE PROVIDED SO CURBS ARE 8" ABOVE FINISHED ROOF SURFACE.
- 12. THE MINIMUM INSULATION THICKNESS SHALL BE 5.5". SLOPE OF TAPERED INSULATION TO BE A MINIMUM OF 1/4" PER FOOT FOR NEW CONSTRUCTION AND 1/8" PER FOOT OVER EXISTING STRUCTURE.

ROOF PLAN LEGEND

RD ROO

ROOF DRAIN W/ SECONDARY

H.P. XX" SLOPED INSULATION HIGH POINT (MIN. 5 1/2")

SLOPED INSULATION ROOF CRICKET.



MECH. CURB (W/ CRICKET), PROVIDE FLASHING PER ROOF MANUFACTURER'S DETAILS

PROVIDE 1/2"/ 1'-0" POSITIVE DRAINAGE

1/4" / 1'-0"

ROOF SLOPE

2'-0" x 2'-0" ROOF MEMBRANE WALKWAY SYSTEM

OOI SLOI L

NEW EPDM ROOF SYSTEM AS SPECIFIED Project Number 13940.18

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NEWBURGH ENLARGED CITY SCHOOL DISTRICT

CPL | Architecture Engineering Planning

50 FRONT ST. SUITE 202

NEWBURGH, NY 12550

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SCHOOL 2019 CAPITAL
IMPROVEMENT PROJECT

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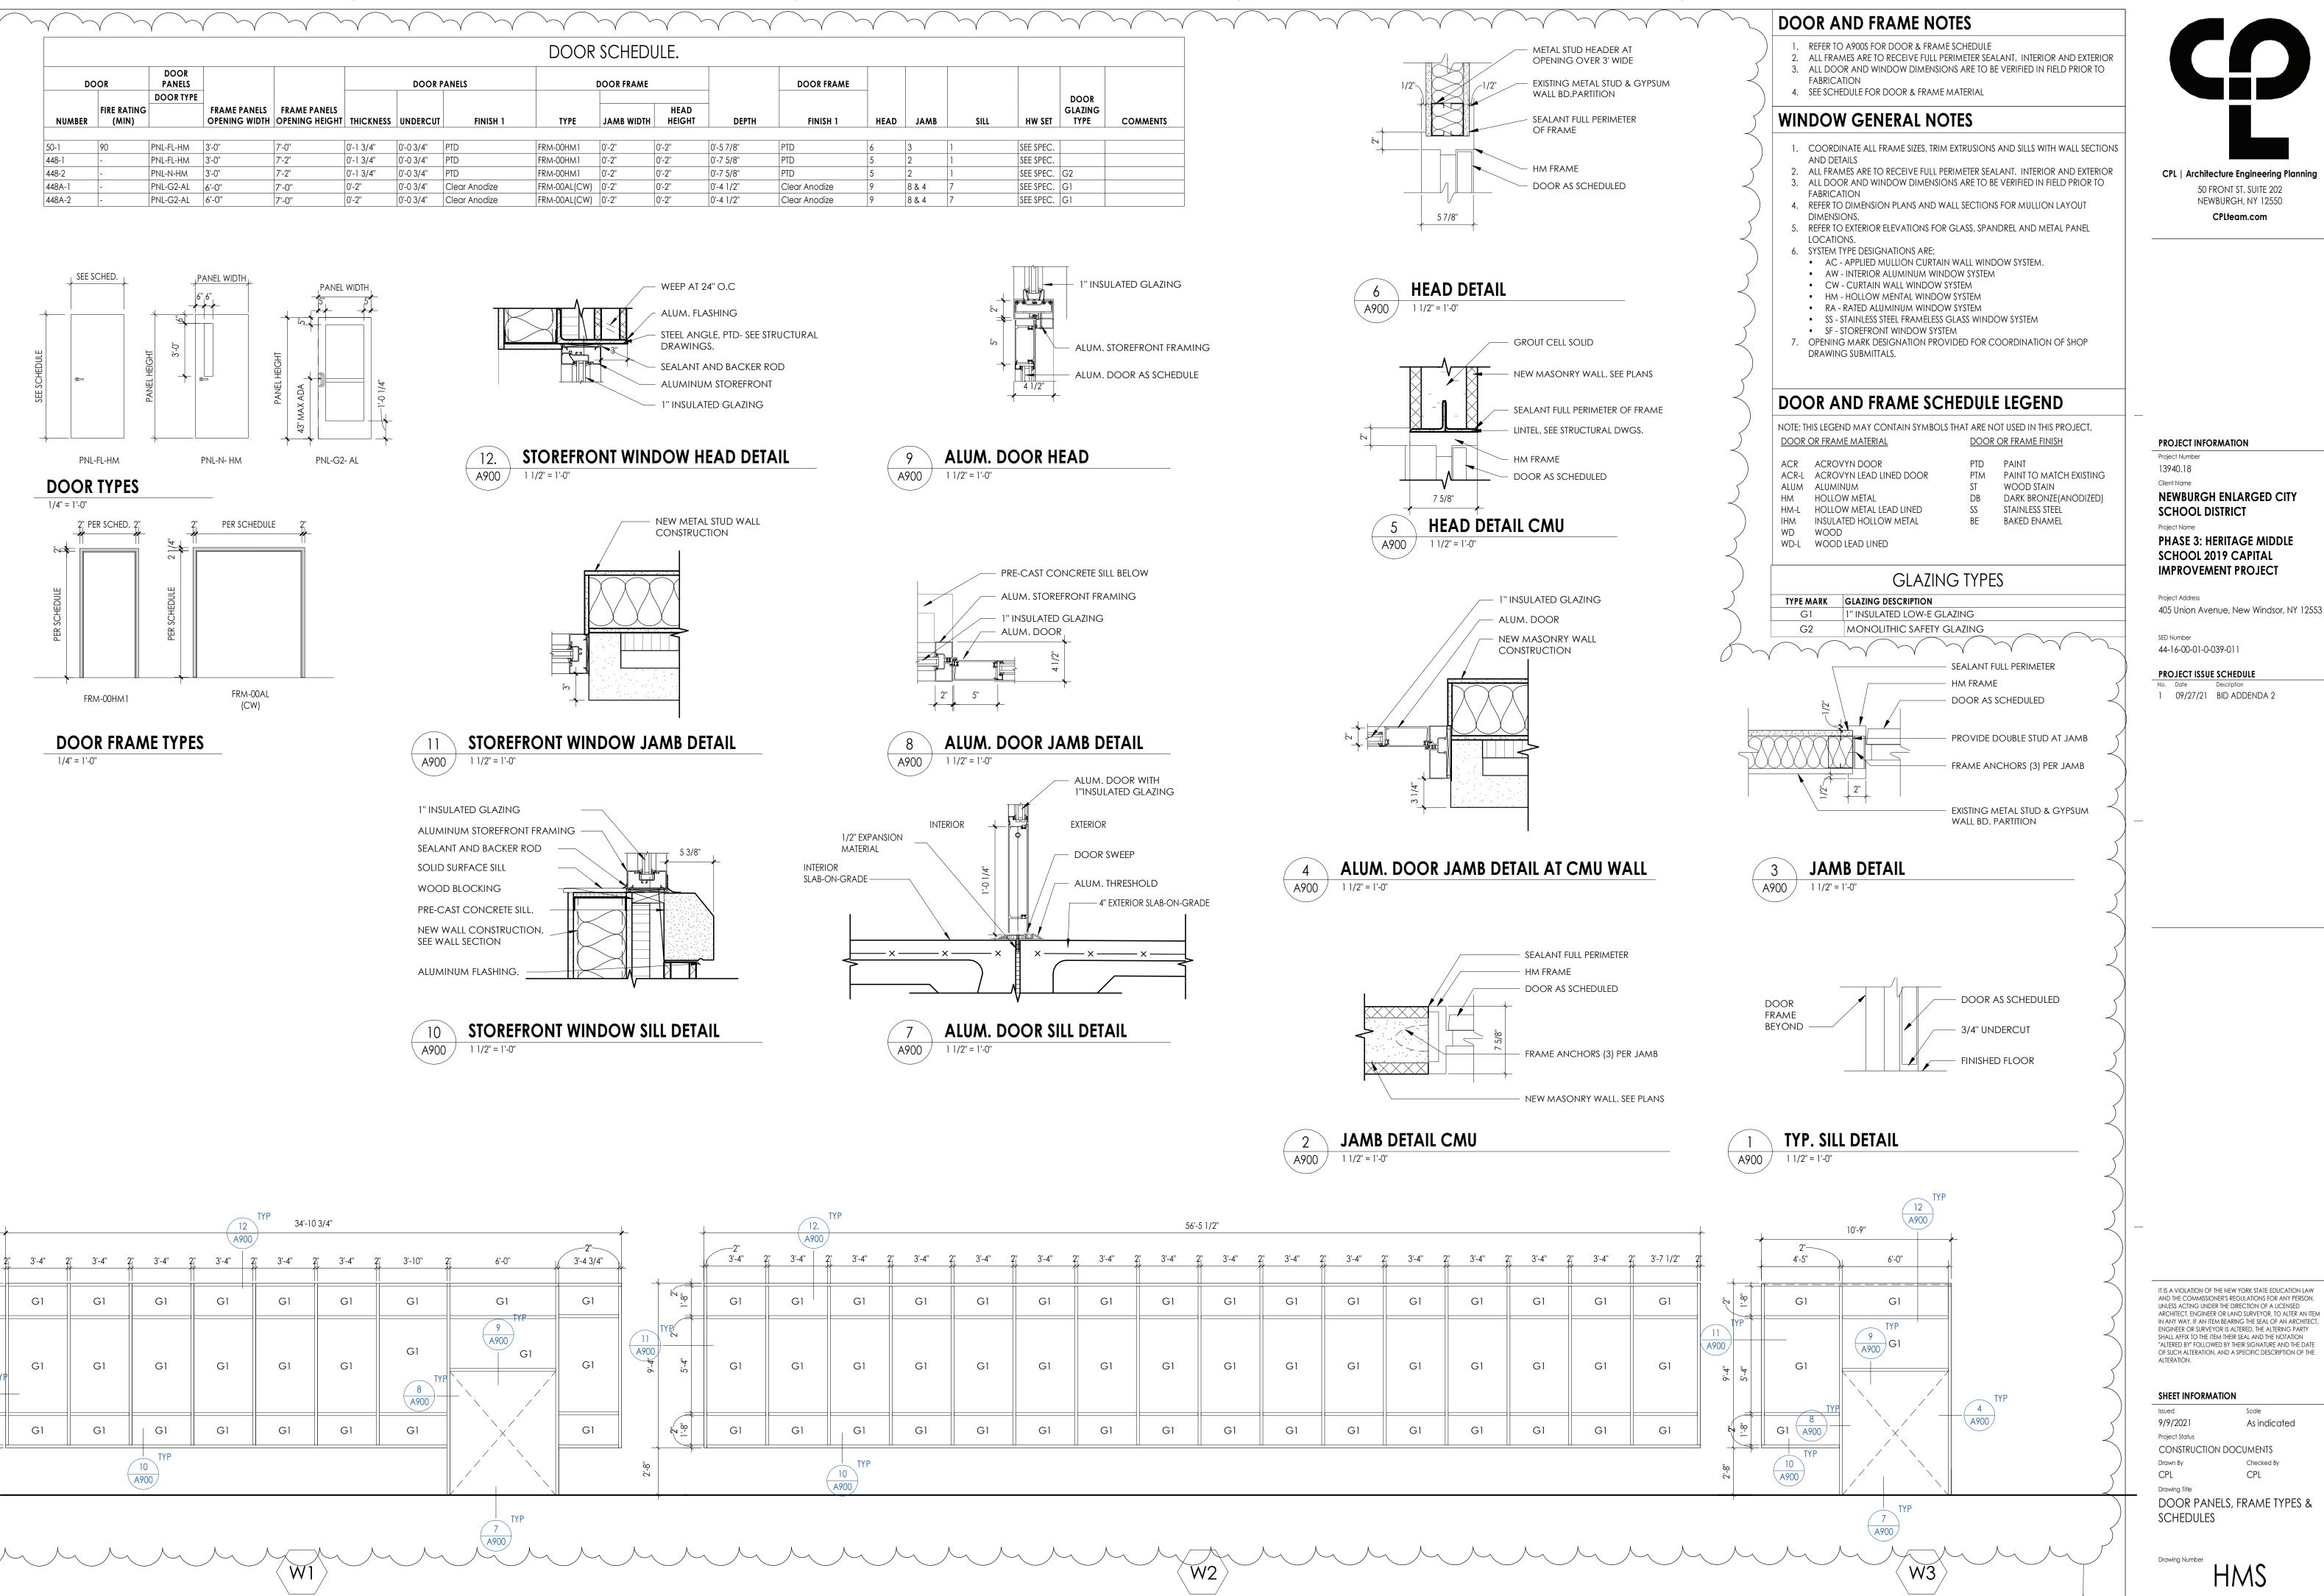
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COLUMENTS

CPL CPL
Drawing Title
ROOF PLAN AREA D

Drawing Number HMS

KEYPLAN AREA D
NTS



A900

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PROJECT INFORMATION

13940.18

Client Name NEWBURGH ENLARGED CITY

Project Name PHASE 3: HERITAGE MIDDLE SCHOOL 2019 CAPITAL

IMPROVEMENT PROJECT Project Address

44-16-00-01-0-039-011

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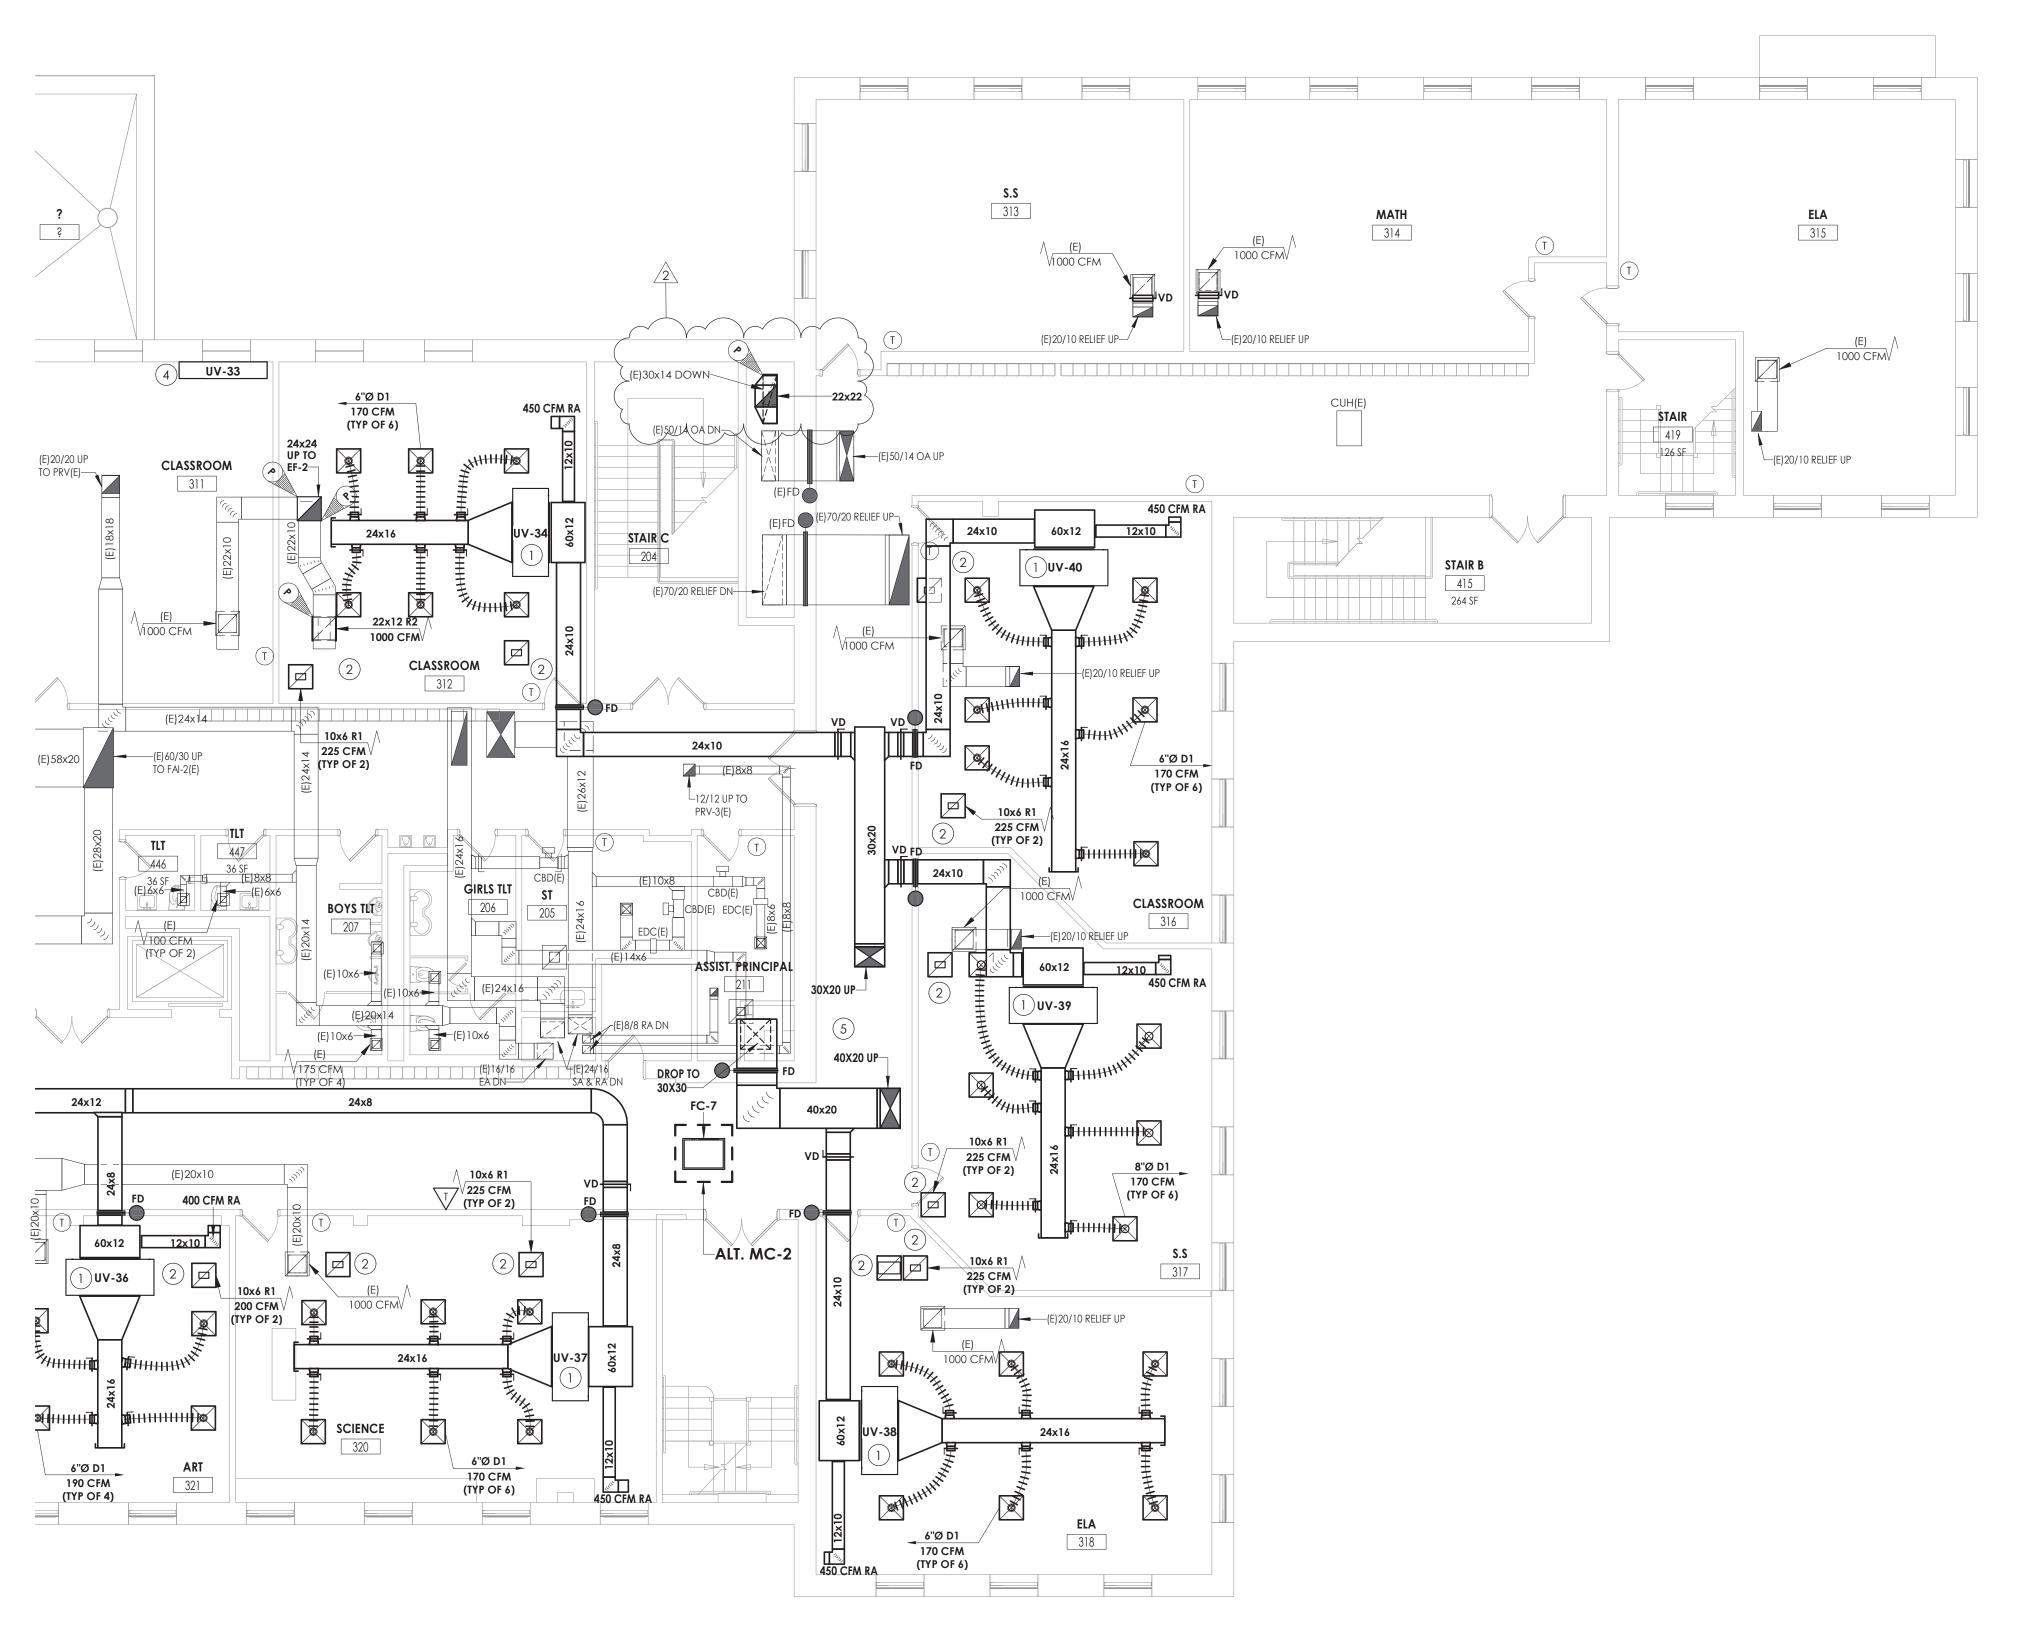
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> SHEET INFORMATION Issued

As indicated Project Status CONSTRUCTION DOCUMENTS CPL

Drawing Title DOOR PANELS, FRAME TYPES & SCHEDULES

A900



KEY NOTES

- MOUNT UNIT VENTILATOR ABOVE CEILING. COORDINATE WITH ANY CEILING UTILITIES. MAINTAIN ACCESS FOR FILTER CHANGES. ALL SUPPLY AND RETURN DUCTWORK SHALL BE LINED. EXTEND EXISTING CONTROLS TO NEW UNIT LOCATION.
- 2 PLENUM RETURN.
- (3) DUCTWORK LOCATED IN ATTIC SPACE.
- PROVIDE NEW UNIT VENTILATOR IN EXISTING LOCATION. EXTEND EXISTING UTILITIES TO NEW UNIT. COORDINATE NEW INSTALLATION WITH EXISTING CABINETS.
- (5) REROUTE EXISTING DUCTWORK AS NEEDED TO ACCOMMODATE NEW INSTALLATION.



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2 9/23/21 BID ADDENDUM #2

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Drawn By Checked By

NRH JJM

Drawing Title

SECOND FLOOR HVAC


DUCTWORK PLAN - AREA D

Drawing Number

HMS H202D

SECOND FLOOR HVAC DUCTWORK PLAN - AREA D

1/8" = 1'-0"

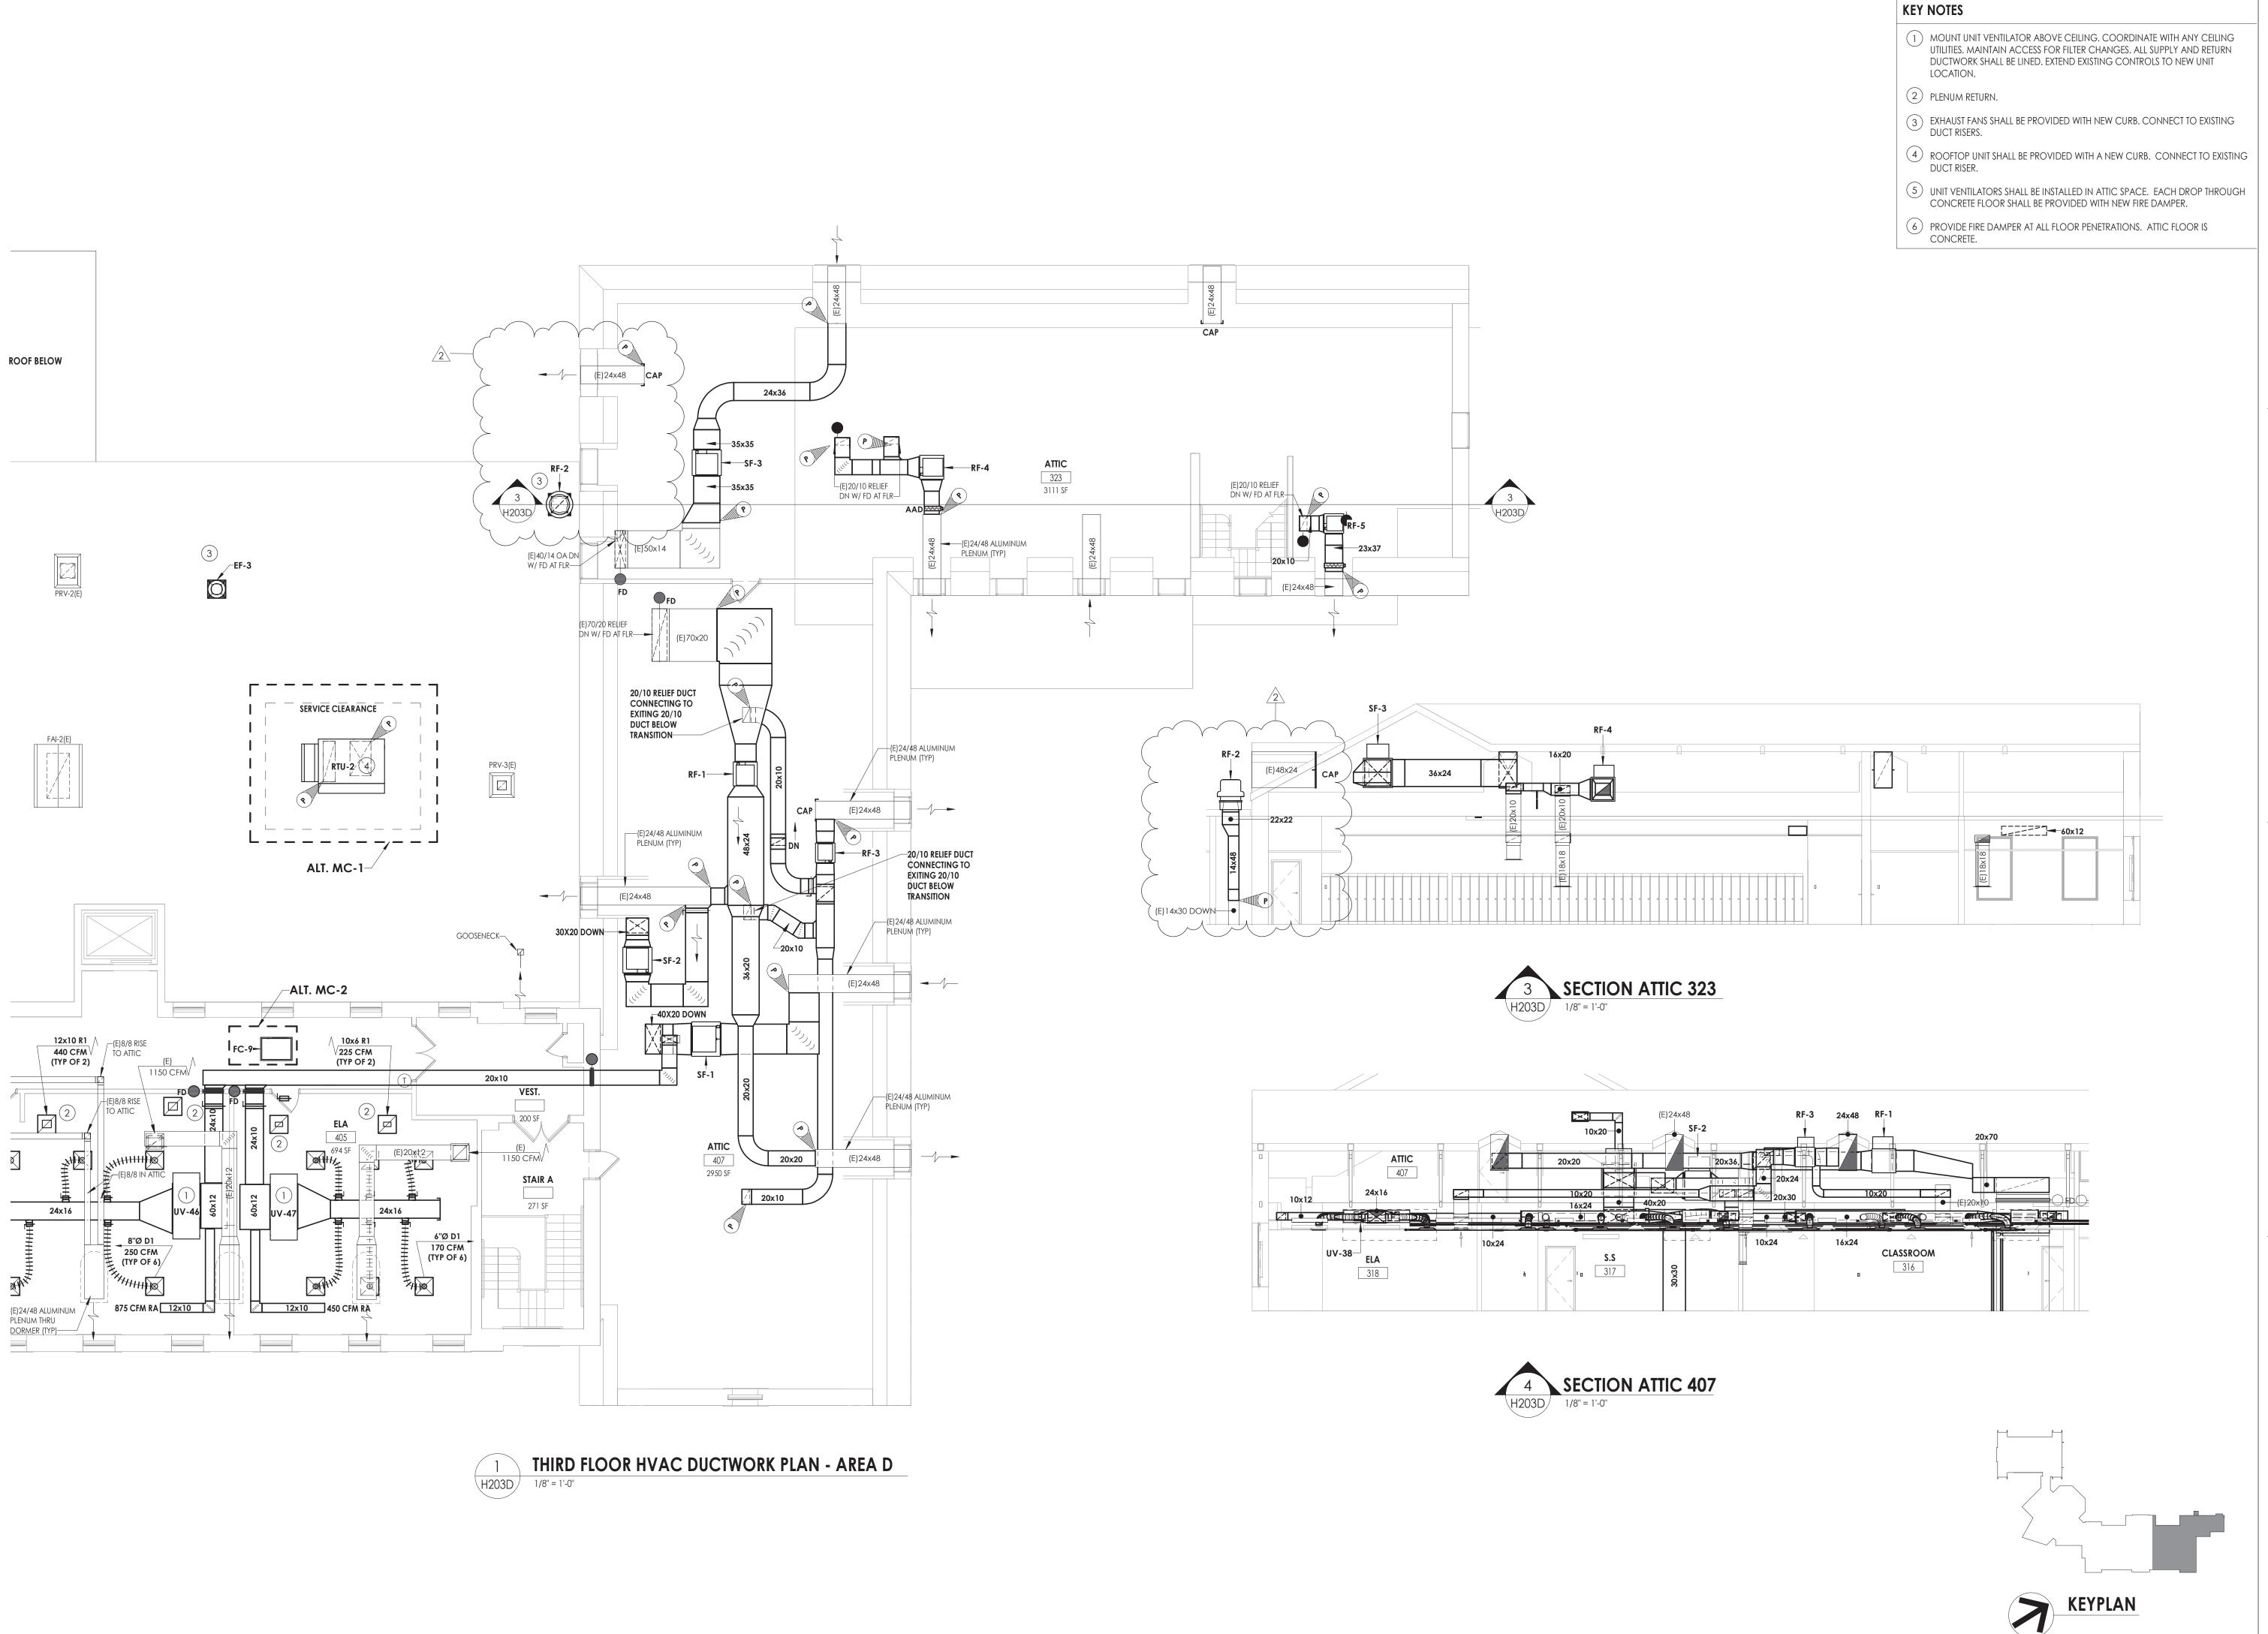



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Drawn By Checker
NRH JJM
Drawing Title

THIRD FLOOR HVAC DUCTWORK PLAN - AREA D

HMS H203D

													ROO	F TOP	ENE	RGY RE	COVER	Y UNI	Γ										
			0.4	F.A.	Б.4		С	OOLING CO	IL			SL	JPPLY FAN				E)	HAUST FAN			TOTAL MOULON/FD	TOTAL MOULONVED	OPERATING			LECTRICAL		TVDIOAL LINIT MEO	
MARK	LOCATION	AREA SERVED	SA (CFM)	EA (CFM)	RA (CFM)	TOTAL MBH	SENS MBH	EAT	LAT	AMB	FAN TYPE	E.S.P. (IN. WC)	RPM	BHP	HP	FAN TYPE	E.S.P. (IN. WC)	RPM	BHP	HP	TOTAL MBH SAVED SUMMER	TOTAL MBH SAVED WINTER	OPERATING WEIGHT (LBS)	FILTERS	V/Ø/HZ	LECTRICAL QUIREMENTS FLA	S	TYPICAL UNIT MFG & MODEL NO.	REMARKS:
RTU-4	CAFÉ ROOF	CAFETERIA	9100	6000	6000	486	320	79.7	54.07	75	PLENUM	1	1760	11.89	15	PLENUM	0.5	1760	9.39	10	183	511	3780	MERV 13	208/360	195	207	AAON RN-025-8-0- EB09-EJK	1,2,3,4
REMARKS:		OUNTED AND WIRED								SWITCH,		,		'		'		'							<u>'</u>	'			·

2. ECM CONDENSER FAN, HEAT PRESSURE CONTROL WITH SIGHT GLASS. REMOTE SAFETY SHUTDOWN TERMINAL.

3. TERMINAL STRIP FOR BMS CONTROL OF FAN AND DAMPERS. COMPATIBLE WITH JOHNSON CONTROLS FACILITY EXPLORER.	
4. DOUBLE WALL, R-13 FOAM INSULATION. STAINLESS STEEL DRAIN PAN.	

	•	All	R SEP	ARATO	R SCH	EDULE		
MARK	LOCATION	SERVED	GPM	WEIGHT (LBS)	DIA. (IN)	LNG. (IN)	STRAINER SQ. IN. FA	TYRICAL UNIT WIFE & MODEL NO.
AS-1	CHILLER PUMP ROOM	CHILLED WATER	300	579	18	44	6	B&G R-6F
REMARKS:	1. 30% PROPYLENE GI	YCOL.						~

				PUM	P SCI	HE	DULE)
MARK	LOCATION	SERVICE	GPM	HD		ELÈ	CTRICAL DA	TA	TYPICAL UNIT MFG	REMARKS:
IVIAIXIX	LOCATION	SLITVICE	GFIVI	(FT.)	HP) VOLTS	PH	& MODEL NO.	TLIVIAITIO.
P-1	STORAGE	CHILLED	300	80 /	15	\prec	208	3 >	B&G E-1510 3BD ~	1,2,3
1 -1	423	WATER	300		10	2	200		Dag E-1010 0BB	1,2,0
P-2	STORAGE	CHILLED	300	80	> 15		208	3 (B&G E-1510 3BD	1,2,3
F-2	423	WATER	300	00) 200	\ \ \	B&G L-1310 3BD) 1,2,3
REMARKS:	1. 30% PROP	YLENE GLYC	OL.		7	7				7
1	2. SUCTION D	DIFFUSER.					1	7		
	3. WALL MOU	INTED VFD UI	NIT DISCONN	ECT.						1

MARK	TOTAL AIRFLOW CFM	NOM.HEATING CAPACITY BTU/HR	NOM.COOLING CAPACITY BTU/HR	WEIGHT (LBS)	POWER (Ø/V/HZ)	AMPS	TYPICAL UNIT MFG & MODEL NO.	REMARKS
SSI-1	1500	27000	24000	47	1 / 208 / 60	0.28	SAMSUNG - AM024KN4DCH/AA	1,2,3,4,5
SSI-2	1500	27000	24000	47	1 / 208 / 60	0.28	SAMSUNG - AM024KN4DCH/AA	1,2,3,4,5
SSI-3	1500	27000	24000	47	1 / 208 / 60	0.28	SAMSUNG - AM024KN4DCH/AA	1,2,3,4,5
SSI-4	1500	27000	24000	47	1 / 208 / 60	- 0.28	SAMSUNG - AM024KN4DCH/AA	1,2,3,4,5
SSI-5	1500	27000	24000	47	1 / 208 / 60	0.28	SAMSUNG - AM024KN4DCH/AA	1,2,3,4,5
SSI-6	1500	27000	24000	47	1 / 208 / 60	0.28	SAMSUNG - AM024KN4DCH/AA	1,2,3,4,5
SSI-7	1500	27000	24000	47	1 / 208 / 60	0.28	SAMSUNG - AM024KN4DCH/AA	1,2,3,4,5
SSI-8	1500	27000	24000	47	1 / 208 / 60	0.28	SAMSUNG - AM024KN4DCH/AA	1,2,3,4,5
SSI-9	250-430	21500	15000	23.4	1 / 208 / 60	1	SAMSUNG - AR12TSFABWKNCV	1,2,3,4,5
REMARKS:	1. UNIT MOUNTED	AND WIRED DISCON	NECT.					
	2. BAC NET INTER	RGRATION TO BMS, JC	HNSON CONTROLS FA	CILITY EXPLORE	₹.			

		EXPA	NSION	TANK	SCHED	ULE		
MARK	LOCATION	SERVED	ACCEPT. GAL.	DIA (IN.)	HEIGHT (IN.)	WEIGHT FULL (LBS.)	TYPICAL UNIT MFG & MODEL NO.	REMARKS:
ET-1	CHILLER PUMP ROOM	CHILLED WATER	79	20	58	992	TACO CA-300	1,2
REMARKS:	1. REMOVABLE BLADE	DER TYPE			•			
	2. CHARGE TO 12PSI.							
	3. 30% PROPYLENE GL	YCOL.						

				F	IN TUI	BE SCI	HEDUL	E			
MARK	BTU/FT.	GPM	TUBE	FINS /	EWT	EAT		ENCLOSUR	RE .	TYPICAL UNIT MFG	REMARKS:
IVIARK	BIU/FI.	GPIVI	SIZE (IN.)	FT.	(°F)	(°F)	H (IN.)	D (IN.)	STYLE	& MODEL NO.	REWARKS
FT-1	720	5	3/4	40	180	65	10-3/4	6-1/16	PEDESTAL	STERLING JVB	1,2,3,4
REMARKS:	1. CONTROL	VALVES AB	OVE THE CEI	LING.							
	2. COLOR B	Y ARCHITEC	Т.								
	3. ELEMENT	LENGTH LIS	STED ON PLAN	NS. CAT - 662	89C RETURN						
		<u> </u>									

	4. COORDINA	ATE HEIGHT \	WITH ELECT	RICAL DEVICE	S.										
						(CHILLE	R SCH	EDULE						
	NOMINAL	% PROP		CI	HILLED WATE	R		REFRIG	ERANT	EL	ECTRICAL D	ATA	WEIGHT	TYPICAL UNIT MFG	
MARK	CAPACITY (TONS)	GLYCOL	FLOW (GPM)	DELTA P (FT)	IPLV	EWT (°F)	LWT (°F)	REF. TYPE.	CHARGE (LB)	VOLTS/Ø	MCA	MOP	(LBS)	& MODEL NO.	REMARKS
CH-1	180	30	270	17.42	20.516	56.97	42.00	134A	420.00	230/3	654	800	15700	TRANE-ACRB1805B	1,2,3,4

REMARKS: 1. FACTORY MOUNTED AND WIRED DISCONNECT. 2. THE SCHEDULED REFRIGERANT CHARGE IS A MANUFACTURERS ESTIMATE, COORDINATE THE CORRECT CHARGE BASED ON FIELD CONDITIONS.

FIVE YEAR COMPRESSOR WARRANTY. 4. HEAT TRACED EVAPORATOR BARREL AND EXTERIOR PIPING. HEAT TRACE SHALL BE ON SEPARATE 120V/20AMP CIRCUIT.

TYPE DUCTED CEILING	LOCATION 159 CUSTODIAN	MAX CFM	MBH	COOLING											
DUCTED		IVIAX CFIVI	MDLI					HEATING		14/55	ELE	CTRICAL DA	TA	TYPICAL UNIT MFG	DEMARKS.
CEILING	159 CUSTODIAN		IVIDIT	GPM	WPD	MBH	EWT (°F)	WATER ∆T	GPM	WPD FT WC	WATTS	VOLTS	PHASE	& MODEL NO.	REMARKS:
		1020	20	5	3.1	42	180	160	4.5	5.6	150	115	60	AIRTHERM 101-1	1,2,3,4,5
RECESSED	GROUND FLOOR HALL	1020	20	5	3.1	42	180	160	4.5	5.6	150	115	60	AIRTHERM 101-1	1,2,3,4
CEILING RECESSED	GROUND FLOOR HALL	1020	20	5	3.1	42	180	160	4.5	5.6	150	115	60	AIRTHERM 101-1	1,2,3,4,5
CEILING RECESSED	1ST FLOOR HALL	1020	20	5	3.1	42	180	160	4.5	5.6	150	115	60	AIRTHERM 101-1	1,2,3,4,5
CEILING RECESSED	1ST FLOOR HALL	1020	20	5	3.1	42	180	160	4.5	5.6	150	115	60	AIRTHERM 101-1	1,2,3,4,5
CEILING RECESSED	2ND FLOOR HALL	1020	20	5	3.1	42	180	160	4.5	5.6	150	115	60	AIRTHERM 101-1	1,2,3,4,5
CEILING RECESSED	2ND FLOOR HALL	1020	20	5	3.1	42	180	160	4.5	5.6	150	115	60	AIRTHERM 101-1	1,2,3,4,5
CEILING RECESSED	1ST FLOOR HALL	1020	20	5	3.1	42	180	160	4.5	5.6	150	115	60	AIRTHERM 101-1	1,2,3,4,5
CEILING RECESSED	3RD FLOOR HALL	1020	20	5	3.1	42	180	160	4.5	5.6	150	115	60	AIRTHERM 101-1	1,2,3,4,5
DUCTED	105B SCHOOL PYCHOLOGIST	1020	20	5	3.1	42	180	160	4.5	5.6	150	115	60	AIRTHERM 101-1	1,2,3,4
CEILING RECESSED	3RD FLOOR HALL	1020	20	5	3.1	42	180	160	4.5	5.6	150	115	60	AIRTHERM 101-1	1,2,3,4,5
	CEILING ECESSED	ECESSED CEILING ECESSED 1ST FLOOR HALL CEILING ECESSED 2ND FLOOR HALL CEILING ECESSED 2ND FLOOR HALL CEILING ECESSED 1ST FLOOR HALL CEILING ECESSED 3RD FLOOR HALL CEILING ECESSED 105B SCHOOL PYCHOLOGIST CEILING CEILIN	1020 1020	1020 20 20 20 20 20 20 2	1020 20 5	1020 20 5 3.1	1020 20 5 3.1 42	CECESSED 1020 20 5 3.1 42 180	1020 20 5 3.1 42 180 160	1020 20 5 3.1 42 180 160 4.5	1020 20 5 3.1 42 180 160 4.5 5.6	The color of the	DEILING COESSED 1020 20 5 3.1 42 180 160 4.5 5.6 150 115 CEILING COESSED 1ST FLOOR HALL 1020 20 5 3.1 42 180 160 4.5 5.6 150 115 CEILING COESSED 2ND FLOOR HALL 1020 20 5 3.1 42 180 160 4.5 5.6 150 115 CEILING COESSED 2ND FLOOR HALL 1020 20 5 3.1 42 180 160 4.5 5.6 150 115 CEILING COESSED 2ND FLOOR HALL 1020 20 5 3.1 42 180 160 4.5 5.6 150 115 CEILING COESSED 1ST FLOOR HALL 1020 20 5 3.1 42 180 160 4.5 5.6 150 115 CEILING COESSED 3RD FLOOR HALL 1020 20 5 3.1 42 180 160 4.5 5.6 150 115 CEILING COESSED 1ST FLOOR HALL 1020 20 5 3.1 42 180 160 4.5 5.6 150 115 CEILING COESSED 3RD FLOOR HALL 1020 20 5 3.1 42 180 160 4.5 5.6 150 115 CEILING COESSED 3RD FLOOR HALL 1020 20 5 3.1 42 180 160 4.5 5.6 150 115 CEILING COESSED 3RD FLOOR HALL 1020 20 5 3.1 42 180 160 4.5 5.6 150 115 COESSED 105B SCHOOL PYCHOLOGIST 1020 20 5 3.1 42 180 160 4.5 5.6 150 115 CEILING COESSED 3RD FLOOR HALL 1020 20 5 3.1 42 180 160 4.5 5.6 150 115 CEILING COESSED 3RD FLOOR HALL 1020 20 5 3.1 42 180 160 4.5 5.6 150 115 CEILING COESSED 3RD FLOOR HALL 1020 20 5 3.1 42 180 160 4.5 5.6 150 115 CEILING COESSED 3RD FLOOR HALL 1020 20 5 3.1 42 180 160 4.5 5.6 150 115 CEILING COESSED 3RD FLOOR HALL 1020 20 5 3.1 42 180 160 4.5 5.6 150 115 CEILING COESSED 3RD FLOOR HALL 1020 20 5 3.1 42 180 160 4.5 5.6 150 115 CEILING COESSED 3RD FLOOR HALL 1020 20 5 3.1 42 180 160 4.5 5.6 150 115 CEILING COESSED 3RD FLOOR HALL 1020 20 5 3.1 42 180 160 4.5 5.6 150 115 CEILING COESSED 3RD FLOOR HALL 1020 20 5 3.1 42 180 160 4.5 5.6 150 115 CEILING COESSED 3RD FLOOR HALL 1020 20 5 3.1 42 180 160 4.5 5.6 150 115 CEILING COESSED 3RD FLOOR HALL 1020 20 5 3.1 42 180 160 4.5 5.6 150 115 CEILING COESSED 3RD FLOOR HALL 1020 20 5 3.1 42 180 160 4.5 5.6 150 115 CEILING COESSED 3RD FLOOR HALL 1020 20 5 3.1 42 180 160 4.5 5.6 150 115 CEILING COESSED 3RD FLOOR HALL 1020 20 5 3.1 42 180 160 4.5 5.6 150 115 CEILING COESSED 3RD FLOOR HALL 1020 20 5 3.1 42 180 160 4.5 5.6 150 115 CEILING COESSED 3RD FLOOR HALL 1020 20 5 3.1 42 180 160 4.5 5.6 150 TITLE TORD TORD TORD TORD TORD TORD TORD TORD	CELLING STEP COUNTY CO	DELING STEP STEP

								AIR	HAND	ING	UNIT S	SCHEE	ULE				-				
							COOLING	MBH				HOT WA	TER HEATING	G COIL DATA			SUPPLY	FAN MO	TOR DATA		
MARK	ROOM SERVED	CFM	MIN. OA CFM	EXT. SP W.C.	TOTAL	SENS	ROWS	EAT °F DB/WB	LAT °F DB/WB	МВН	EWT	LWT	EAT °F	LAT °F	GPM	WPD FT-W.C.	BHP/HP	RPM	VOLTS/Θ	TYPICAL UNIT MFG & MODEL NO.	REMARKS:
AHU-1	GYM	3500	750	1.5	145	102	4	83.2/68.8	57.9/56	204	180	138	58.7/55.6	111.5/72.7	10	0.7	3.3/4	1935	208/3/60	AAON: H3-DRB-8-0-162D-12F	1,2,3,4,5
AHU-2	GYM	3500	750	1.5	145	102	4	83.2/68.8	57.9/56	204	180	138	58.7/55.6	111.5/72.7	10	0.7	3.3/4	1935	208/3/60	AAON: H3-DRB-8-0-162D-12F	1,2,3,4,5
AHU-3	GYM	3500	750	1.5	145	102	4	83.2/68.8	57.9/56	204	180	138	58.7/55.6	111.5/72.7	10	0.7	3.3/4	1935	208/3/60	AAON: H3-DRB-8-0-162D-12F	1,2,3,4
AHU-4	GYM	3500	750	1.5	145	102	4	83.2/68.8	57.9/56	204	180	138	58.7/55.6	111.5/72.7	10	0.7	3.3/4	1935	208/3/60	AAON: H3-DRB-8-0-162D-12F	1,2,3,4
AHU-5	KITCHEN	2600	500	1	98.3	70.57	6	80/67	56.1/44.7	128.7	180	127	60.4/56.6	105.4/71.3	5	0.3	1.68/4	1552	208/3/60	AAON:H3-CRB-8-0-162C-12F	1,2,3,4,5
AHU-6	MUSIC	4200	1500	1.2	185.6	129.7	6	85.4/70.2	57.8/56.3	266.4	180	122.3	47.9/47.9	104.2/68.5	9.5	0.7	3.12/4	1901	208/3/60	AAON: H3-DRB-8-0-162C-12F	1,2,3,4,5
REMARKS:	1. FACTORY MOUNTED	AND WIRE	D DISCONNEC	T. ALL UNITS	SHALL BE	SINGLE POINT	CONNECTI	ON.	1					•							

2. DAMPER ACTUATORS BY MANUFACTURER. FULLY MODULATING ACCUATORS. MERV 13 FILTERS. MAGNEHELIC HAUGE CLOG FILTER SWITCH. THERMAL EXPANSION VALVES.

3. CONNECT TO EXISTING JOHNSON CONTROLS, FACILITY EXPLORER.

4. PROVIDE WITH SLOPPED CURBS.

4. VIBRATION ISOLATION.

REGISTERS, GRILLES, AND DIFFUSERS

FINISH

WHITE

TYPE

LAY-IN

STEEL DUCT GRILLE WHITE

STEEL DUCT GRILLE WHITE

LAY-IN

WALL GRILLE WHITE

APPLICATION MATERIAL

RETURN/EA

RETURN/EA

CONCEALED MOUNTING.

4. INSULATED BACK PAN.

REMARKS: 1. OPPOSED BLADE DAMPER.

STEEL

STEEL

STEEL

3. SINGLE DEFLECTION, BLADES PARALLEL TO LENGTH.

D1

D2

S1

5. CONTROLS RELOCATED BY OTHERS FROM EXISTING UNIT.

DESIGN EQUIP.

PRICE SPD

PRICE SDG

PRICE HCD

PRICE PDR

PRICE 90

REMARKS

4

1,3

2,3

						HOT	WATE	R COIL	SCHE	DULE				
				AIR DATA				WATER	R DATA		MEO 0175		TVDIOAL LINUT MEO	
MARK S	SERVICE	TEMP (°F) MAX APD N			MIN.	GPM	TEMI	P (°F)	MAX APD	MFG SIZE HXL (IN.)	ROWS	TYPICAL UNIT MFG & MODEL NO.	REMARKS:	
		CFIVI	ENT	LVG	(IN. WC)	MBH	GPIVI	ENT	LVG	(IN. WC)	TIXE (IIV.)		a MODEL NO.	
HC-1	SF-9	2250	-2	70	0.76	174,960	18.8	180	160	3.8	15X22	2	CAPITAL COIL W8-2215-12B-HCA-R	1,2
HC-2	RTU-4	9100	-2	70	0.56	707,616	70.8	180	160	4.5	46X30	4	CAPITAL COIL	1
REMARKS: 1.	TUBE OD 0.	625, FUBE S	SPACING 1.50	X1.299										

					FAN	SCHE	DULE					
MARK	LOCATION	SERVICE	TYPE	CFM	SP IN W.G.	RPM	HP	ELECTRICA VOLTS	AL DATA PHASE	AMPS	TYPICAL UNIT MFG & MODEL NO.	REMARKS
EF-1	GYM	LOCKER ROOM EXHAUST	CENTRIFUGAL	1500	0.75	1457	.25	115	1	3.8	GREENHECK G-100-VG	1,2,4
EF-2	GYM	LOCKER ROOM EXHAUST	CENTRIFUGAL	1500	0.75	1457	.25	115	1	3.8	GREENHECK G-100-VG	1,2,4
EF-3	ROOF	CLASSROOM EXHAUST	CENTRIFUGAL	2000	0.5	948	1/2	208	1	5.4	GREENHECK GB-161	1,2
EF-4	ROOF	MUSIC ROOM	CENTRIFUGAL	1400	1	1725	1/2	208	1	5.4	GREENHECK G-123-A	1,2
EF-5	ROOF	CLASSROOM EXHAUST	CENTRIFUGAL	1250	1	1725	1/2	208	1	4.9	GREENHECK G-123-1	1,2
EF-6	ROOF	CLASSROOM EXHAUST	CENTRIFUGAL	4500	1	1102	2	208	1	12	GREENHECK G-200	1,2
SF-1	ATTIC	CLASSROOM OA	INLINE	10000	1.5	824	5	208	3	16.7	GREENHECK BSQ-300	1
SF-2	ATTIC	CLASSROOM OA	INLINE	3750	0.4	539	1/2	208	3	2.4	GREENHECK BSQ-240	1
SF-3	ATTIC	CLASSROOM OA	INLINE	8750	1.5	1147	5	208	3	16.7	GREENHECK BSQ-240	1
SF-4	-	-	-	-	-	-	-	-	-	-	NOT USED	-
SF-5	-	-	-	-	-	-	-	-	-	-	NOT USED	-
SF-6	ATTIC	CLASSROOM OA	INLINE	7000	0.75	875	2	208	3	7.5	GREENHECK BSQ-240	1
SF-7	ATTIC	CLASSROOM OA	INLINE	7500	1	964	3	208	3	10.6	GREENHECK BSQ-240	1
SF-8	ATTIC	CLASSROOM OA	INLINE	6750	1.5	1012	5	208	3	16.7	GREENHECK BSQ-240	1
SF-9	TECH	CLASSROOM OA	INLINE	2250	0.5	992	1/2	208	1	5.4	GREENHECK BSQ-160	1,3
RF-1	ATTIC	CLASSROOM EA	INLINE	13750	1.25	675	7-1/2	208	3	24.2	GREENHECK BSQ-360	1
RF-2	ATTIC	CLASSROOM EA	CENTRIFUGAL	3750	0.8	738	1	208	3	4.6	GREENHECK GB-220	1,2
RF-3	ATTIC	CLASSROOM EA	INLINE	3750	0.4	539	1/2	208	3	2.4	GREENHECK BSQ-240	1
RF-4	ATTIC	CLASSROOM EA	INLINE	2500	0.25	585	1/3	208	3	2.4	GREENHECK BSQ-200	1
RF-5	ATTIC	CLASSROOM EA	INLINE	1250	0.25	623	1/4	208	3	2.4	GREENHECK BSQ-160	1
RF-6	ATTIC	CLASSROOM EA	INLINE	6250	0.75	816	2	208	3	7.5	GREENHECK BSQ-240	1
RF-7	ATTIC	CLASSROOM EA	INLINE	4000	1	1038	1-1/2	208	3	6.6	GREENHECK BSQ-200	1
RF-8	ATTIC	CLASSROOM EA	INLINE	7250	1	945	3	208	3	10.6	GREENHECK BSQ-240	1

	MARK	LOCATION	SERVES	NOMINAL TONS	ELECTRICAL DATA						OPERATING	TVDICAL LINUT MEC	
					FAN		COMPRESSOR		VOLT/Ø	MCA	WEIGHT	TYPICAL UNIT MFG & MODEL NO.	REMARKS:
					NO.	HP	QTY	RLA	VOLI/Ø	IVICA	(LBS.)		
	ACC-1	GYM	AHU-1	13	2	.75	2	20.4	208/3	59	1141	AAON CFA-013-B-A-8-DC00K	1,3
	ACC-2	GYM	AHU-2	13	2	.75	2	20.4	208/3	59	1141	AAON CFA-013-B-A-8-DC00K	1,3
	ACC-3	GYM	AHU-3	13	2	.75	2	20.4	208/3	59	1141	AAON CFA-013-B-A-8-DC00K	1,3
	ACC-4	GYM	AHU-4	13	2	.75	2	20.4	208/3	59	1141	AAON CFA-013-B-A-8-DC00K	1,3
	ACC-5	KITCHEN ROOF	AHU-5	8	2	1/3	2	16.1	208/3	39	1078	AAON CFA-009-B-A-8-DC00K	1,3,4
	ACC-6	KITCHEN ROOF	AHU-6	15	2	.75	2	25	208/3	66	1143	AAON CFA-015-B-A-8-DC00K	1,3,4
	ACC-7	KITCHEM ROOF	SSI-4 THRU 8	16	2	620W	2	28	208/3	73~	763	SAMSUNG AM 92HXVAFH2AA	1,2,3,4
	SSO-9	KITCHEN ROOF	SSI-9	1 _人	1	40W	1 . \lambda	9.2	208/1	12.5	70.8	SAMSUNG AR12TSFABWKXCV	1,2
	<u>REMARKS:</u>	1. FACTORY	MOUNTED AND WIRE	D DISCONNE	CT AND	HAILGU	ARDS.						
		2. LOW AMBI	ENT KIT.										

CPL | Architecture Engineering Planning 50 FRONT ST. SUITE 202

NEWBURGH, NY 12550 CPLteam.com

PROJECT INFORMATION

Project Number 13940.18

Client Name NEWBURGH ENLARGED CITY SCHOOL DISTRICT

Project Name PHASE 3: HERITAGE MIDDLE SCHOOL 2019 CAPITAL IMPROVEMENT PROJECT

405 Union Avenue, New Windsor, NY 12553

SED Number 44-16-00-01-0-039-011

Project Address

PROJECT ISSUE SCHEDULE

1 9/17/21 BID ADDENDUM #1

2 9/23/21 BID ADDENDUM #2


IT IS A VIOLATION OF THE NEW YORK STATE EDUCATION LAW AND THE COMMISSIONER'S REGULATIONS FOR ANY PERSON, UNLESS ACTING UNDER THE DIRECTION OF A LICENSED ARCHITECT, ENGINEER OR LAND SURVEYOR, TO ALTER AN ITEM ARCHITECT, ENGINEER OR LAND SURVEYOR, TO ALTER AN ITEM IN ANY WAY. IF AN ITEM BEARING THE SEAL OF AN ARCHITECT, ENGINEER OR SURVEYOR IS ALTERED, THE ALTERING PARTY SHALL AFFIX TO THE ITEM THEIR SEAL AND THE NOTATION "ALTERED BY" FOLLOWED BY THEIR SIGNATURE AND THE DATE OF SUCH ALTERATION, AND A SPECIFIC DESCRIPTION OF THE ALTERATION.

SHEET INFORMATION Issued 09/09/2021 12" = 1'-0" Project Status

CONSTRUCTION DOCUMENTS Drawn By NRH Drawing Title HVAC SCHEDULES

2. PROVIDE WITH 1" MERV 7 FILTERS 3. 30% PROPYLENE GLYCOL COOLING COIL.

CONDENSATE PUMP. 5. ALTERNATE NO. MC-2

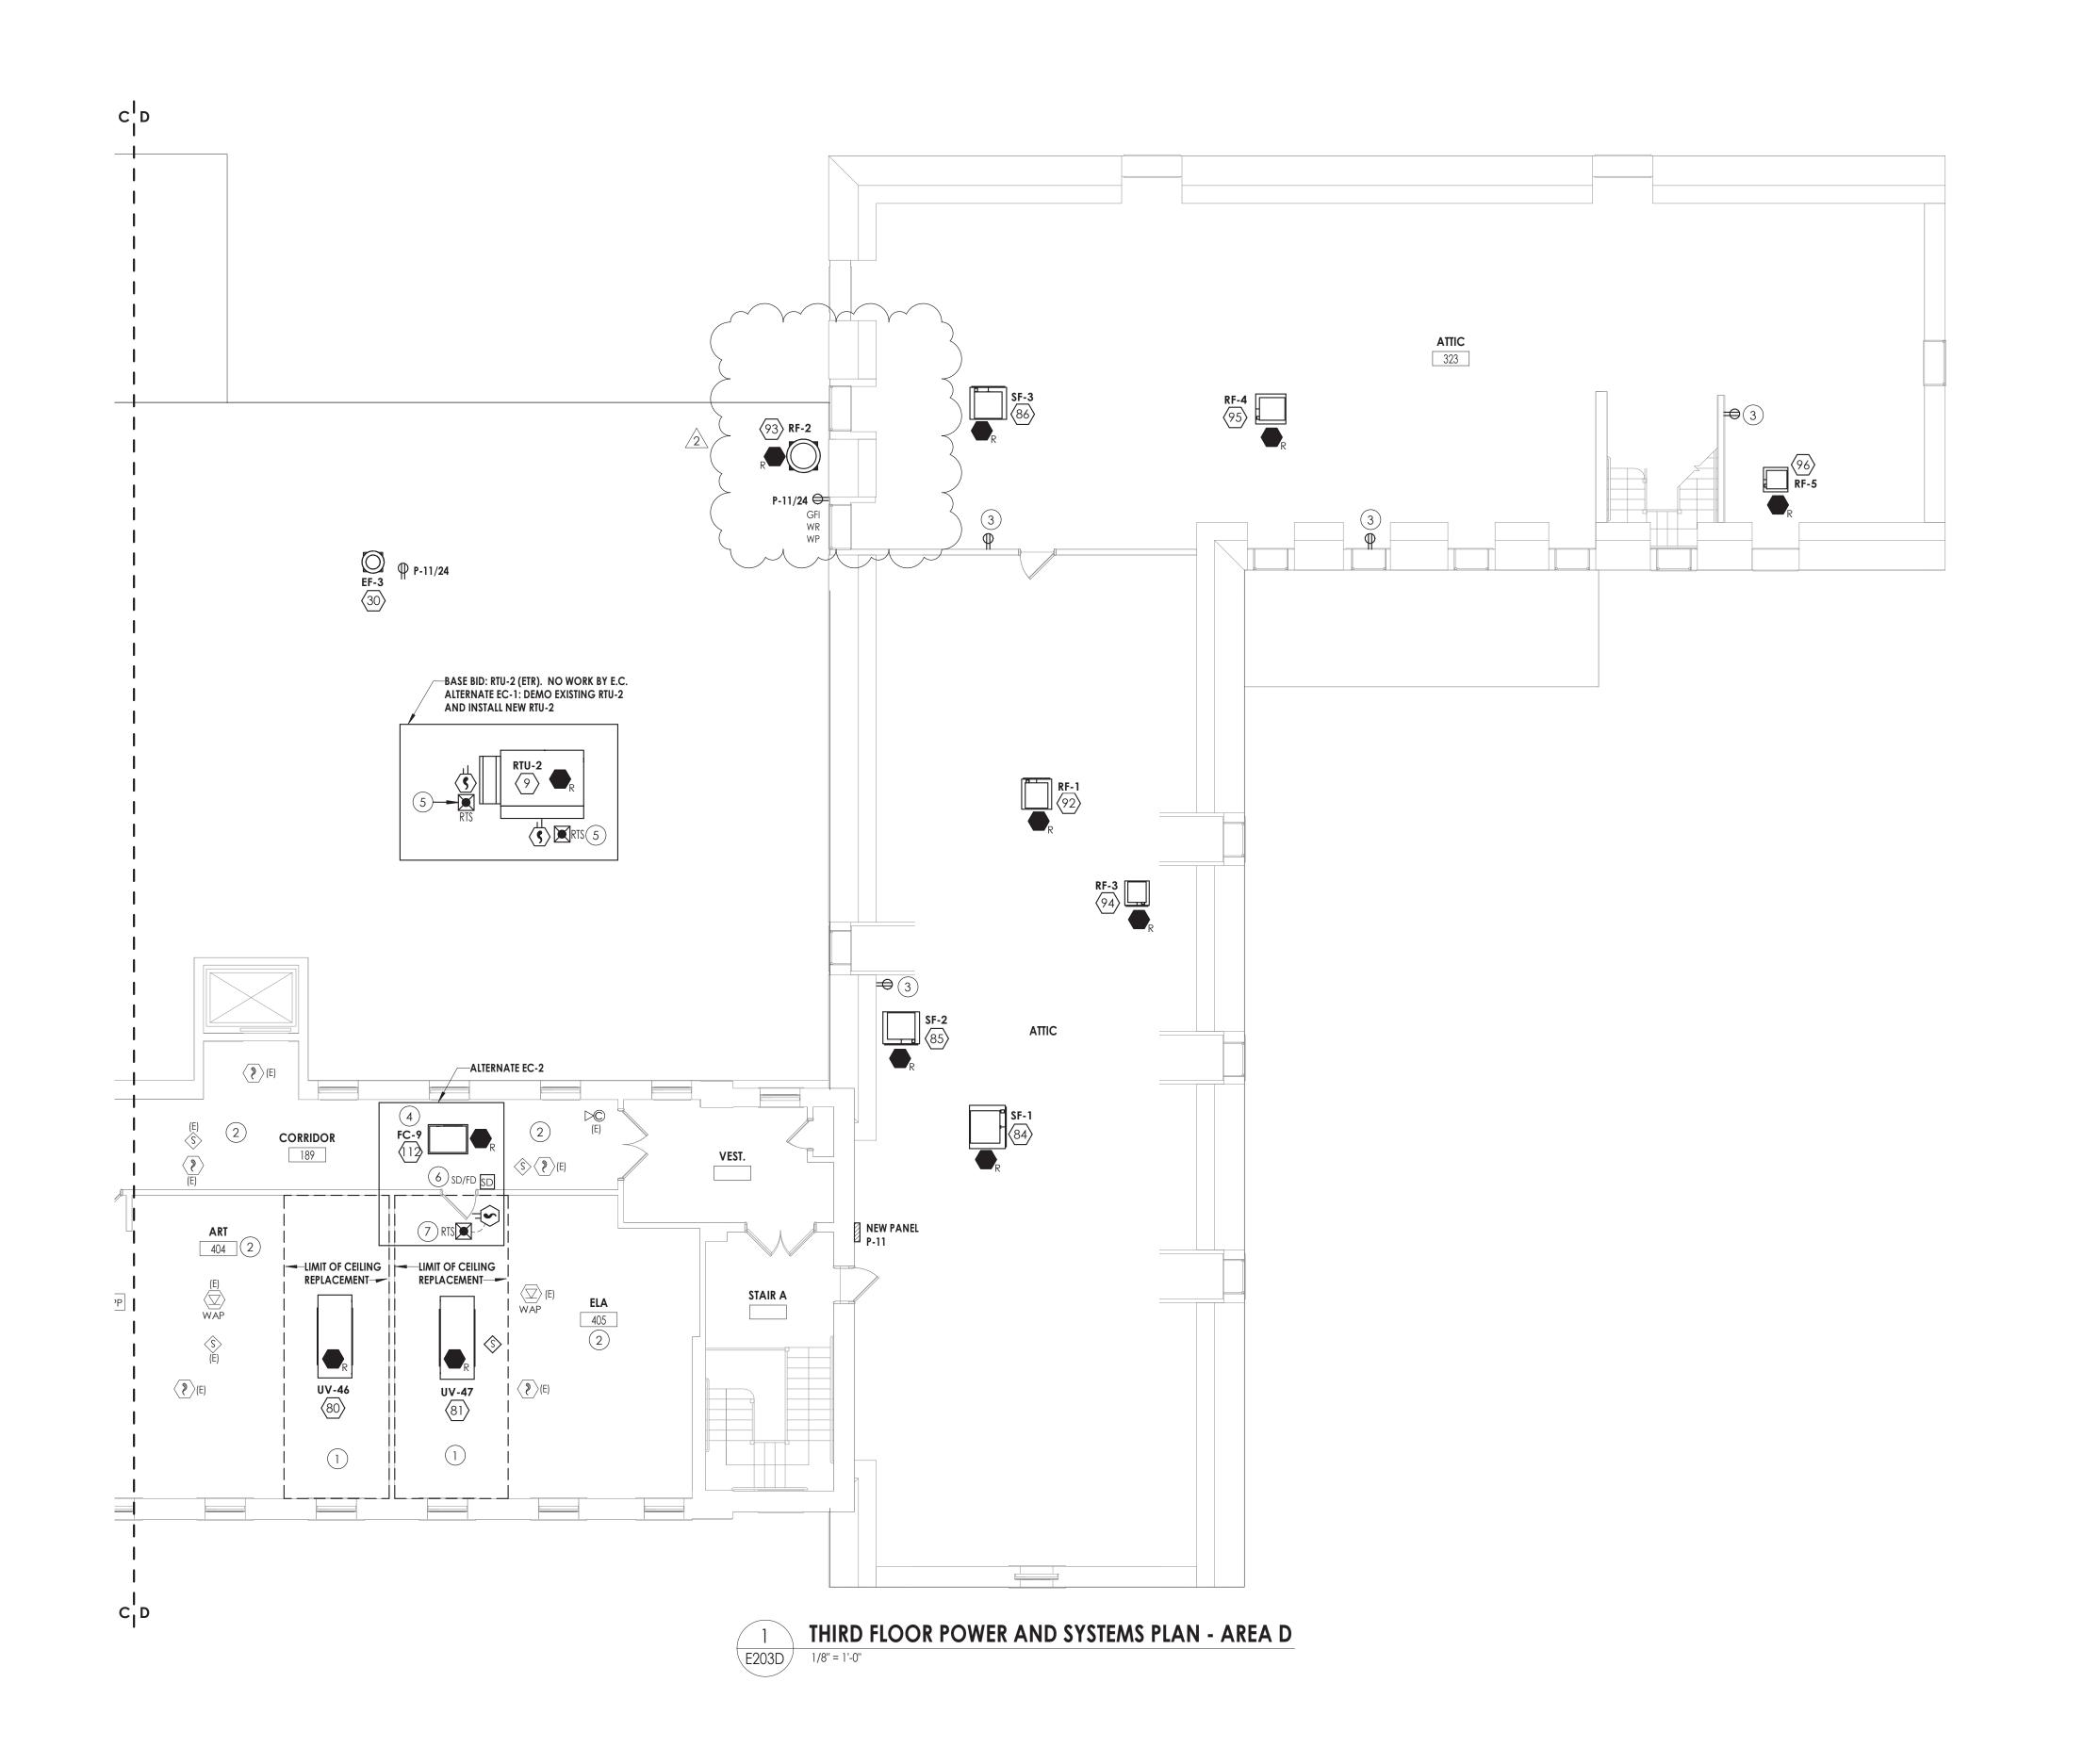


GENERAL NOTES:

- A. FIXTURES, DEVICES, AND EQUIPMENT LABELED AS "(E)" ARE EXISTING AND ARE SHOWN FOR REFERENCE ONLY. ALL OF THESE DEVICES SHALL REMAIN OPERATIONAL FOLLOWING CONSTRUCTION.
- B. EQUIPMENT DESIGNATED WITH A NUMBER INSIDE OF A HEXAGON ARE SCHEDULED ON DRAWING E900. REFER TO EQUIPMENT WIRING SCHEDULE FOR BREAKER AND CIRCUITING INFORMATION.
- C. DISCONNECT SWITCHES AND STARTER DEVICES ASSOCIATED WITH HVAC EQUIPMENT SHALL BE FURNISHED AND INSTALLED BY THE MECHANICAL CONTRACTOR, AND WIRED BY THE ELECTRICAL CONTRACTOR. INCLUDE AN ADDITIONAL 10' OF CIRCUITING IN PRICING FOR INSTANCES WHERE A DISCONNECT MAY NOT BE MOUNTED DIRECTLY ON UNIT. E.C. IS RSPONSIBLE TO WIRE BOTH LINE AND LOAD SIDES OF DISCONNECT.
- D. UPDATE PANELBOARD DIRECTORIES TO REFLECT CHANGES MADE TO CIRCUITS WITH LOAD(S) AND ROOM(S) SERVED. LABEL ANY UNUSED BREAKER AS SPARE AND TURN TO OFF POSITION.
- E. FIRE ALARM SCOPE OF THIS PROJECT INCLUDES INSTALLING A NEW SIMPLEX 4100ES PANEL TO SERVE NEW AND RENOVATED AREAS WHILE MAINTAINING EXISTING SIMPLEX 4020 PANEL. ALL EXISTING DEVICES REMOVED IN THE DEMOLITION PHASE OF THE PROJECT SHALL BE REMOVED FROM THE SYSTEM PROGRAMMING OF THE 4020 PANEL. NEW INITIATION AND NOTIFICATION DEVICES SHOWN SHALL BE CONNECTED TO AND COMPATIBLE WITH THE NEW SIMPLEX 4100ES FIRE ALARM CONTROL PANEL LOCATED IN CUSTODIAN ROOM 50. PROVIDE NEW NOTIFICATION APPLIANCE CIRCUIT PANELS (WITH SMOKE DETECTOR WITHIN 5') WITH BATTERIES WHERE REQUIRED TO ACCOMMODATE NEW NOTIFICATION DEVICES. LOCATE SAID NAC PANEL IN A STORAGE OR ELEC/MECH ROOM, AND WIRE TO NEAREST AVAILABLE PANELBOARD WITH (2) #12, #12 GND. IN 3/4" CONDUIT. FOR PRICING PURPOSES, ASSUME 150' PER CIRCUIT. PROVIDE 20/1 CIRCUIT BREAKER AS REQUIRED.
- F. FIRE ALARM SPACING SHALL COMPLY WITH NFPA 72 REQUIREMENTS. ALL FIRE ALARM INITATION DEVICES SHOWN SHALL NOT BE LOCATED IN DIRECT AIRFLOW PATH OR CLOSER THAN 3' OF AN AIR SUPPLY DIFFUSER OR RETURN AIR OPENING.
- G. THE OPERABLE PART OF PULL STATIONS SHALL BE MOUNTED MORE THAN 3'-6" BUT LESS THAN 4'-0" ABOVE FINISHED FLOOR.
- H. FOR PUBLIC MODE, WALL MOUNTED VISUALS AND AUDIBLE/VISUALS SHALL BE MOUNTED SUCH THAT THE ENTIRE LENS IS NOT LESS THAN 80" AND NOT GREATER THAN 96" ABOVE FINISHED FLOOR.
- I. THE MINIMUM REQUIRED CANDELA LEVEL IS INDICATED ADJACENT TO NEW VISUAL DEVICES. IF NOT INDICATED, MINIMUM ALLOWABLE SETTING IS 15 CANDELA.
- J. ACTIVATION OF BUILDING FIRE ALARM SYSTEM SHALL AUTOMATICALLY SHUT DOWN ALL FANS ASSOCIATED WITH HVAC UNITS IN THE BUILDING AS REQUIRED BY LOCAL, STATE, AND NATIONAL CODES. PROVIDE FIRE ALARM SHUT DOWN RELAYS IN EACH UNIT.
- K. FINAL TESTING OF FIRE ALARM SYSTEM SHALL COMPLY WITH ALL NFPA 72 REQUIREMENTS. ANY ALTERED CIRCUIT(S) SHALL HAVE ALL FIRE ALARM INITIATION DEVICES TESTED IN THEIR ENTIRETY AND 10% OF NEIGHBORING ZONE/LOOP DEVICES.
- L. PROVIDE 8" ROUND, FLUSH MOUNTED, WHITE CEILING SPEAKERS WHERE SHOWN. NEW SPEAKERS SHALL BE CONNECTED TO AND COMPATIBLE WITH EXISTING BUILDING PUBLIC ADDRESS SYSTEM. EXPAND EXISTING SYSTEM WITH ADDITIONAL AMPLIFIERS AS REQUIRED AT HEAD END LOCATION FOR A COMPLETE OPERATIONAL SYSTEM. COORDINATE EXACT REQUIREMENTS WITH OWNER.
- M. ALL CABLING ABOVE ACCESSIBLE CEILINGS SHALL BE SUPPORTED VIA J-HOOK, J-HOOKS SHALL NOT EXCEED 5'-0" SPACING. ALL CABLING ABOVE INACCESSIBLE SPACES AND CEILINGS OPEN TO STRUCTURE SHALL BE IN CONDUIT.
- N. ALL EXPOSED RACEWAY SHALL BE PAINTED TO MATCH CEILING/WALL FINISH. CONTRACTOR SHALL USE APPROVED PAINT COLOR/TYPE.
- O. NEW CARBON MONOXIDE DETECTORS SHALL BE ADDRESSABLE AND BE CONNECTED TO THE BUILDING FIRE ALARM SYSTEM.

KEY NOTES:

- IN DESIGNATED CEILING REPLACEMENT AREA, ELECTRICAL CONTRACTOR SHALL REINSTALL SALVAGED CEILING MOUNTED ELECTRICAL DEVICES SHOWN.
 RECONNECT EXISTING CABLING AND BRANCH CIRCUIT WIRING LEFT FROM DEMOLITION.
- 2 EXISTING CEILING MOUNTED SYSTEM AND POWER DEVICES SHOWN IN THIS AREA ARE SHOWN FOR REFERENCE PURPOSES ONLY. SHOULD CEILING TILE BE REQUIRED TO BE REMOVED AS NOTED IN DEMOLITION DRAWING KEY NOTES, THE ELECTRICAL CONTRACTOR SHALL BE RESPONSIBLE TO TEMPORARILY SUPPORT OR REMOVE/REINSTALL THE EQUIPMENT.
- (3) INSTALL SERVICE RECEPTACLE FOR NEW HVAC EQUIPMENT. COORDINATE EXACT LOCATION IN FIELD TO MEET NEC 210.63. WIRE RECEPTACLES TOGETHER WITH (2) #12, #12 G. IN 1/2" CONDUIT AND WIRE TO PANEL P-11, CIRCUIT 26.
- WIRE NEW FAN COIL UNIT TO BRANCH CIRCUIT WIRING LEFT FROM DEMOLITION OF HVAC UNIT. SPLICE AND EXTEND EXISTING CIRCUIT AS REQUIRED WITH (2)# 12, #12 GND. IN 1/2" CONDUIT TO REACH TERMINATION POINT OF NEW UNIT.
- (5) LOCATE REMOTE TEST SWITCHES FOR ROOFTOP UNIT DUCT SMOKE DETECTOR IN ACCESSIBLE SPACE BELOW UNIT. RECESS MOUNT IN DROP CEILING TILE OR WALL MOUNT IN JANITOR CLOSET/STORAGE ROOM TYPE SPACE. LABEL SWITCHES WITH UNIT NAME AND SUPPLY/RETURN DESIGNATION.
- 6 PROVIDE DUCT SMOKE DETECTOR AND FIRE ALARM RELAY TO SIGNAL MECHANICAL SMOKE DAMPER. PROVIDE 120V BRANCH CIRCUIT TO DAMPER ACTUATOR FROM NEAREST 120V RECEPTACLE CIRCUIT. WIRE WITH (2) #12, #12 GND. IN 1/2" CONDUIT.
- 7 LOCATE REMOTE TEST SWITCH FOR DUCT SMOKE DETECTOR BELOW UNIT, RECESSED IN CEILING TILE.

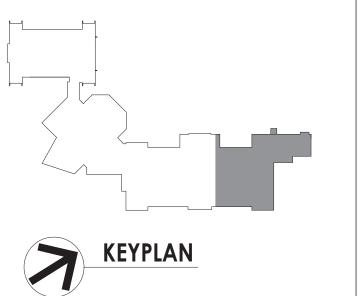



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PROJECT INFORMATION

13940.18

Project Number

NEWBURGH ENLARGED CITY
SCHOOL DISTRICT

PHASE 3: HERITAGE MIDDLE SCHOOL 2019 CAPITAL IMPROVEMENT PROJECT

Project Address
405 Union Avenue, New Windsor, NY 12553

SED Number

PROJECT ISSUE SCHEDULE

No. Date Description
2 9/23/21 BID ADDENDUM #2

AND THE COMMISSIONER'S REGULATIONS FOR ANY PERSON, UNLESS ACTING UNDER THE DIRECTION OF A LICENSED ARCHITECT, ENGINEER OR LAND SURVEYOR, TO ALTER AN ITEM IN ANY WAY. IF AN ITEM BEARING THE SEAL OF AN ARCHITECT, ENGINEER OR SURVEYOR IS ALTERED, THE ALTERING PARTY SHALL AFFIX TO THE ITEM THEIR SEAL AND THE NOTATION "ALTERED BY" FOLLOWED BY THEIR SIGNATURE AND THE DATE OF SUCH ALTERATION, AND A SPECIFIC DESCRIPTION OF THE ALTERATION.

IT IS A VIOLATION OF THE NEW YORK STATE EDUCATION LAW

SHEET INFORMATION Issued

09/06/2021 As indicated
Project Status

CONSTRUCTION DOCUMENTS

Drawn By Checked By

RJD ARM

THIRD FLOOR POWER AND SYSTEMS PLAN - AREA D

Drawing Number HMS