

### ADDENDUM NO. 02

PROJECT:	Newburgh Enlarged City School District 2019 Capital Improvements Project – Phase 3				
CPL PROJECT NO.	13940.18				
SED PROJECT NO.	Heritage Middle School	SED # 44-16-00-01-0-039-011			

DATE:	September 27, 2021	

Include this Addendum as part of the Contract Documents. It supplements portions of the original specifications and drawings, the extent of which shall remain, except as revised herein:

#### **CLARIFICATIONS**

- 1.1 See the attached Pre-Bid Walkthrough Sign in Sheet.
- 1.2 Regarding the existing lightning protection system, it is unknown if there is an existing ground loop to connect to. New work should include main conductor from last aerial terminal shown and include new ground rods.
- 1.3 The existing ceiling tile is Armstrong 933.

#### CHANGES TO THE PROJECT MANUAL:

- 2.1 Section 000550: Replace the construction schedule with the attached revised construction schedule
- 2.2 Section 004010: Replace with the attached revised Section 004010.
- 2.3 Section 004040: Replace with the attached revised Section 004040.
- 2.4 Section 011200:
  - 2.4.1 Part 1.7.B: Add the following:

50 Front Street, Suite 202 Newburgh, NY 12550 cplteam.com 845.567.6700 TEL 845.567.9614 FAX

itage					
ct Lead: TPG					2021 2022 2023 2024
					Sep Nov Nov Nov Nov Nar Apr Nay Jul Jul Jul Jul Jul Jul Jul Jul Jul Jul
Task Name	Start	Finish	Duration	RESPONSIBILTY LOCATION	0       2       0       3       1       2       3       4       5       5       4       0       0       2       0       3       1       2       4       2       5       5       4       0       0       2       0       0       1
Out to bid	Mon 06-Sep-21	Tue 05-Oct-21	22		Out to bid
Bid Contractor Walkthrough	Wed 22-Sep-21	Wed 22-Sep-21	1		Bid Contractor Walkthrough
Bid Opening	Tue 05-Oct-21	Tue 05-Oct-21	1		Bid Opening
Contractor qualification	Thu 07-Oct-21	Mon 11-Oct-21	3		Contractor qualification
Award contracts	Tue 12-Oct-21	Wed 13-Oct-21	2		Award contracts
Front end submittals	Thu 14-Oct-21	Fri 29-Oct-21	12		Front end submittals
Product submittals	Thu 14-Oct-21	Wed 15-Dec-21	45		Product submittals
Substantial Completeion	Thu 01-Sep-22	Thu 01-Sep-22	1		Substantial Completeion
C of O Inspection	Tue 23-Aug-22	Tue 23-Aug-22	1		C of O Inspection
Startup and balancing	Tue 24-May-22	Mon 05-Dec-22	140		Startup and balancing
Closeout	Tue 06-Sep-22	Mon 10-Oct-22	25		Closeout
Demobilize	Tue 06-Sep-22	Mon 10-Oct-22	25		Demobilize
New Addition Construction	Thu 14-Oct-21	Mon 15-Aug-22	218		New Addition Construction
	Thu 14-Oct-21	Wed 03-Nov-21	15		Mobilization / Site fence
Under ground utility re-route	Thu 04-Nov-21	Wed 24-Nov-21	15		Under ground utility re-route
Phase one site prep	Thu 25-Nov-21	Wed 01-Dec-21	5		Phase one site prep
Survey stakeout	Thu 02-Dec-21	Thu 02-Dec-21	1		Survey stakeout
Phase two site/pad prep	Fri 03-Dec-21	Mon 06-Dec-21	2		Phase two site/pad prep
Excavation footings	Tue 07-Dec-21	Thu 09-Dec-21	3		Excavation footings
Footing rebar	Fri 10-Dec-21	Tue 21-Dec-21	8		Footing rebar
Form and pour footings	Wed 22-Dec-21	Tue 28-Dec-21	5		Form and pour footings
Strip footings	Wed 29-Dec-21	Thu 30-Dec-21	2		Strip footings
Rebar FO walls / set sleeves	Fri 31-Dec-21	Mon 10-Jan-22	7		Rebar FO walls / set sleeves
Install anchor bolts	Tue 11-Jan-22	Tue 11-Jan-22	1		Install anchor bolts
Form and Pour FO walls	Wed 12-Jan-22	Wed 19-Jan-22	6		Form and Pour FO walls
Strip walls	Thu 20-Jan-22	Fri 21-Jan-22	2		Strip walls
•	Mon 24-Jan-22	Tue 25-Jan-22	2		Waterproof FO Walls
·	Wed 26-Jan-22	Fri 28-Jan-22	3		Backfill FO Walls
	Mon 31-Jan-22	Thu 03-Feb-22	4		Prep SOG
•	Fri 04-Feb-22	Wed 09-Feb-22	4		Stone for SOG
	Thu 10-Feb-22	Wed 16-Feb-22	5		Underground MEP / outlets
-	Thu 17-Feb-22	Mon 21-Feb-22	3		Waterproof SOG
·		Tue 01-Mar-22	6		Rebar SOG
	Wed 02-Mar-22	Tue 15-Mar-22			Pour SOG + cure time
	Wed 16-Mar-22	Tue 29-Mar-22			Set structural steel framing
-					Set roof deck
		-			Install temp roof
·	·	-			Set Storefront
	-	-			interior framing
Mechanical rough / duct work	Thu 07-Apr-22	Wed 27-Apr-22	15		Mechanical rough / duct work
	itage ct Lead: TPG Task Name Out to bid Bid Contractor Walkthrough Bid Opening Contractor qualification Award contracts Front end submittals Product submittals Product submittals Substantial Completeion C of O Inspection Startup and balancing Closeout Demobilize <b>New Addition Construction</b> Mobilization / Site fence Under ground utility re-route Phase one site prep Survey stakeout Phase two site/pad prep Excavation footings Footing rebar Form and pour footings Strip footings Rebar FO walls / set sleeves Install anchor bolts Form and Pour FO walls Strip walls Waterproof FO Walls Backfill FO Walls Backfill FO Walls Backfill FO Walls Prep SOG Stone for SOG Underground MEP / outlets Waterproof SOG Rebar SOG Pour SOG + cure time Set structural steel framing Set roof deck Install temp roof Set Storefront interior framing	Task NameStartOut to bidMon 06-Sep-21Bid Contractor WalkthroughWed 22-Sep-21Bid Contractor qualificationThu 07-Oct-21Award contractsTue 12-Oct-21Front end submittalsThu 14-Oct-21Product submittalsThu 14-Oct-21Substantial CompleteionTue 23-Aug-22Startup and balancingTue 24-May-22CloseoutTue 06-Sep-22DemobilizeTue 07-Dec-21Stroen of SoligeTue 21-Sep-22Form and pour footingsWed 22-Dec-21Strip footingsWed 22-Dec-21<	Task NameStartFinishOut to bidMon 06-Sep-21Tue 05-Oct-21Bid Contractor WalkthroughWed 22-Sep-21Wed 22-Sep-21Bid OpeningTue 05-Oct-21Tue 05-Oct-21Contractor qualificationThu 07-Oct-21Mon 11-Oct-21Award contractsTue 12-Oct-21Wed 13-Oct-21Front end submittalsThu 14-Oct-21Wed 15-Dec-21Substantial CompleteionTue 23-Aug-22Tue 23-Aug-22Col O InspectionTue 06-Sep-22Mon 05-Dec-22CloseoutTue 06-Sep-22Mon 01-Oct-22DemobilizeTue 06-Sep-22Mon 01-Oct-22Mobilization / Site fenceThu 14-Oct-21Wed 03-Nov-21Under ground utility re-routeThu 04-Nov-21Wed 04-Nov-21Phase one site prepThu 02-Dec-21Thu 02-Dec-21Surve stakeoutThu 02-Dec-21Thu 02-Dec-21Phase two site/pad prepFri 10-Dec-21Thu 02-Dec-21Froit ong site prepThu 14-Oct-21Mon 06-Dec-21Surve stakeoutThu 02-Dec-21Thu 03-Dec-21Phase two site/pad prepFri 10-Dec-21Thu 03-Dec-21Footing rebarFri 10-Dec-21Thu 03-Dec-21Footing siteTue 01-Dec-21Thu 03-Dec-21Strip footingsWed 22-Dec-21Thu 03-Dec-21Footing rebarFri 10-Dec-21Thu 03-Dec-21Footing rebarFri 10-Dec-21Thu 03-Dec-21Strip footingsWed 22-Dec-21Thu 03-Dec-21Strip footingsWed 22-Dec-21Thu 03-Dec-21St	Task Name       Start       Finish       Duration         Out to bid       Mon 06-Sep-21       Tue 05-Oct-21       22         Bid Contractor Walkthrough       Wed 22-Sep-21       Wed 22-Sep-21       12         Bid Opening       Tue 05-Oct-21       Tue 05-Oct-21       12         Contractor qualification       Thu 07-Oct-21       Wed 13-Oct-21       22         Front end submittals       Thu 14-Oct-21       Fri 29-Oct-21       12         Product submittals       Thu 14-Oct-21       Wed 13-Oct-22       14         Substantial Completeion       Thu 24-May-22       Tue 23-Aug-22       12         Cof O Inspection       Tue 24-May-22       Mon 10-Oct-22       25         Demobilize       Tue 05-Sep-22       Mon 10-Oct-22       25         New Addition Construction       Thu 14-Oct-21       Wed 33-Nov-21       15         Under ground utility re-route       Thu 04-Nov-21       Wed 33-Nov-21       15         Under ground utility re-route       Thu 02-Dec-21       Thu 02-Dec-21       11         Phase one site prep       Fri 10-Dec-21       Mon 06-Dec-22       22         Exavation footings       Wed 22-Dec-21       Thu 02-Dec-21       12         Phase one site prep       Fri 10-Dec-21       Thu 02-D	Task Name         Start         Finish         Duration         RESPONSIBILIY         LOCATION           Out to bid         Mon 06-Sep-21         Tue 05-Oct-21         Z2             Bid Contractor Walkthrough         Wed 22-Sep-21         Med 2-Sep-21         1             Bid Gontractor Walkthrough         Tue 12-Oct-21         Med 2-Sep-21         1             Ward Contracts         Tue 12-Oct-21         Med 13-Oct-21         2             Ward Contracts         Tue 12-Oct-21         Wed 13-Oct-21         45             Substantial Completeion         Tue 23-Aug-22         Tue 03-Sep-22         1             Colo Onspecton         Tue 23-Aug-22         Mon 05-Oct-22         25             Substantial Completeion         Tue 23-Aug-22         Mon 01-Oct-22         25             Closout         Tue 06-Sep-22         Mon 10-Oct-22         25              Mobilization / Site fence         Thu 14-Oct-21         Mon 15-Aug-22         218             Under ground Multily re-route         Thu 04-Nov-21         Wed 24-Nov-21

41	Electrical rough	Wed 11-May-22	Tue 31-May-22	15	Electrical rough
42	Plumbig rough	Wed 11-May-22	Mon 30-May-22	14	Plumbig rough
43	exterior finish	Wed 04-May-22	Tue 31-May-22	20	exterior finish
44	finish roofing / tie in	Wed 30-Mar-22	Tue 26-Apr-22	20	finish roofing / tie in
45	Exterior concrete Sidewalks	Sat 28-May-22	Fri 24-Jun-22	20	Exterior concrete Sidewalks
46	Sheet rock / tapingc/ Paint	Tue 07-Jun-22	Mon 18-Jul-22	30	Sheet rock / tapingc/ Paint
47	Ceilings	Tue 19-Jul-22	Mon 08-Aug-22	15	Ceilings
48	Architechtural finishes	Tue 19-Jul-22	Mon 08-Aug-22	15	Architechtural finishes
49	MEP finishes	Tue 19-Jul-22	Mon 15-Aug-22	20	MEP finishes
50	Final Cleaning / training / turnover	Tue 16-Aug-22	Mon 05-Sep-22	15	Final Cleaning / training / turnover
51	C of O Inspection	Tue 23-Aug-22	Tue 23-Aug-22	1	C of O Inspection
52	startup and balancing	Tue 16-Aug-22	Mon 05-Dec-22	80	startup and balancing
53	Existing Cafeteria Renovation	Tue 28-Jun-22	Tue 06-Sep-22	51	Existing Cafeteria Renovation SUmmer 202
54	Demo Space/MEPS	Tue 28-Jun-22	Thu 07-Jul-22	8	Demo Space/MEPS
55	New Mechanical / MEP rough	Fri 08-Jul-22	Thu 04-Aug-22	20	New Mechanical / MEP rough
56	Framing	Fri 05-Aug-22	Tue 16-Aug-22	8	Framing
57	Sheetrock	Fri 12-Aug-22	Mon 29-Aug-22	12	Sheetrock
58	Paint / finishes	Tue 30-Aug-22	Tue 06-Sep-22	6	Paint / finishes
59	Mechanical Startup and balancing	Wed 07-Sep-22	Fri 09-Dec-22	68	Mechanical Startup and balancing
60	GYM MEP Second Shift work	Thu 16-Dec-21	Mon 15-Aug-22	173	GYM MEP Second Shift work
61	New unit install	Tue 01-Feb-22	Mon 04-Apr-22	45	New unit install
62	Duct work install	Tue 05-Apr-22	Mon 09-May-22	25	Duct work install
63	Copper runs	Tue 05-Apr-22	Mon 09-May-22	25	Copper runs
64	Diffusers and grills	Tue 10-May-22	Mon 23-May-22	10	Diffusers and grills
65	Demo Existing Mechanical	Tue 28-Jun-22	Mon 29-Aug-22	45	Demo Existing Mechanical
66	Mechanical Startup and balancing	Tue 24-May-22	Fri 09-Dec-22	144	Mechanical Startup and balancing
67	Existing BLDG MEP / ceilings Second	Thu 16-Dec-21	Mon 15-Aug-22	173	Existing BLDG MEP / ceilings Second shif
68	Relocate existing fresh air intake at	Mon 27-Dec-21	Fri 07-Jan-22	10	Relocate existing fresh air intake at ca
69	Chiller line / ceiling removal	Thu 16-Dec-21	Wed 23-Mar-22	70	Chiller line / ceiling removal
70	New Ceiling unit install	Tue 28-Jun-22	Mon 19-Sep-22	60	New Ceiling unit install
71	New Copper runs / condensate	Thu 16-Dec-21	Wed 23-Mar-22	70	New Copper runs / condensate
72	Electrical tie ins	Tue 28-Jun-22	Mon 29-Aug-22	45	Electrical tie ins
73	New ceilings	Tue 12-Jul-22	Mon 29-Aug-22	35	New ceilings
74	Demo Existing Mechanical	Tue 28-Jun-22	Mon 08-Aug-22	30	Demo Existing Mechanical
75	New units tie ins	Mon 04-Jul-22	Thu 01-Sep-22	44	New units tie ins
76	Floor / finishes repair	Tue 05-Jul-22	Mon 15-Aug-22	30	Floor / finishes repair
77	Mechanical Start up And balancing	Tue 16-Aug-22	Fri 09-Dec-22	84	Mechanical Start up And balancing
78	Site work summer 2022	Tue 28-Jun-22	Thu 01-Sep-22	48	Site work summer 2022
79	Concrete sidewalk demo	Tue 28-Jun-22	Mon 22-Aug-22	40	Concrete sidewalk demo
80	New conc. Sidewalk forms	Tue 05-Jul-22	Mon 08-Aug-22	25	New conc. Sidewalk forms
81	New Conc. Sidewalk pour	Tue 19-Jul-22	Mon 29-Aug-22	30	New Conc. Sidewalk pour
82	New Asphalt at entrance + stripeing	Tue 05-Jul-22	Wed 03-Aug-22	22	New Asphalt at entrance + stripeing
83	Soil and seeding	Thu 04-Aug-22	Wed 24-Aug-22	15	Soil and seeding
84	Submittals Long Leed Submission	Thu 14-Oct-21	Wed 10-Nov-21	20	Submittals Long Leed Submission
85	Casework / Shop drawings	Thu 14-Oct-21	Wed 27-Oct-21	10	Casework / Shop drawings

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86 Windo	lows / Shop Drawings	Thu 14-Oct-21	Wed 27-Oct-21	10	Windows / Shop Drawings
87 Mecha	nanical units	Thu 14-Oct-21	Wed 27-Oct-21	10	Mechanical units
88 Doors	s	Thu 14-Oct-21	Wed 27-Oct-21	10	Doors
89 Steel /	/ rebar / Shop Drawings	Thu 14-Oct-21	Wed 27-Oct-21	10	Steel / rebar / Shop Drawings
90 Main e	electrical Equipment	Thu 14-Oct-21	Wed 27-Oct-21	10	Main electrical Equipment
91 Gym E	Equipment	Thu 14-Oct-21	Wed 27-Oct-21	10	Gym Equipment
92 Lightir	ing fixtures	Thu 14-Oct-21	Wed 27-Oct-21	10	Lighting fixtures
93 Roof in	insulation	Thu 14-Oct-21	Wed 27-Oct-21	10	Roof insulation
94 Brick		Thu 14-Oct-21	Wed 27-Oct-21	10	Brick
95 Drinki	king fountains	Thu 14-Oct-21	Wed 27-Oct-21	10	Drinking fountains
96 Coord	dination drawings	Thu 14-Oct-21	Wed 27-Oct-21	10	Coordination drawings
97 Site w	work catch basins / vaults	Thu 14-Oct-21	Wed 27-Oct-21	10	Site work catch basins / vaults
Type h	here to add a new task				

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### SECTION 004010

### FORM OF PROPOSAL GENERAL CONSTRUCTION

#### PART 1 GENERAL

#### 01. SUMMARY

Fill in information: Date:

> TO: Newburgh Enlarged City School District: 124 Grand Street

Newburgh, New York 12550

FROM:

BIDDER NAME & ADDRESS

#### 02. GENERAL

Pursuant to, and in compliance with, the Procurement and Contracting Requirements, Conditions of the Contract, relative thereto and all of the Contract Documents, including any Addenda issued by the Architect and mailed or delivered to the undersigned prior to the opening of Bids, whether received by the undersigned or not, we,

 having visited the site and being familiar with all conditions and requirements of the Work, hereby propose to furnish all plant, labor, supplies, materials and equipment incidental to GENERAL CONSTRUCTION WORK as required by and in strict accord with the applicable provisions of the Drawings and Specifications entitled (Insert project title Here)all to the satisfaction and approval of the Architect and the Owner in accordance with the terms and conditions of the Contract Documents for the following sum:

DOLLARS		
(\$	)	
BASE BID		

#### **03. BID GUARANTEE**

The undersigned Bidder agrees to execute a contract for this Work in the above amount and to furnish surety as specified within [10] days after a written Notice of Award, if offered within 45 days after receipt of bids, and on failure to do so agrees to forfeit to Owner the attached cash, cashier's check, certified check, U.S. money order, or bid bond, as liquidated damages for such failure, in the following amount constituting five percent (5%) of the Base Bid.

1) In the event Owner does not offer Notice of Award within the time limits stated above, Owner will return to the undersigned the cash, cashier's check, certified check, U.S. money order, or bid bond.

#### 04. TIME OF COMPLETION

It is agreed by the undersigned that after receipt of a Notice of Award and a consummation of a Contract Agreement in accord with the terms of the Contract Documents, he will start work within 10 (or Insert number) consecutive calendar days of this notice to

NEWI	BURGH ECS			Phase 3: 2019 Capital Improvement Project		
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)5.	ALLOWA Specified A	NCES (REFEREN	d above.	ON SECTIO	•	
)6.		•	CE SPECIFICATIO section 012700. (Unit		<b>012700)</b> sed in anticipation that ther	
		ract documents.) Unit Price No. G	ities of materials and C-1: (Ceiling Replac er		ressly indicated on the	
7.	ALTERNA	ATES (REFEREN	CE SPECIFICATIO	ON SECTIO	N 012300)	
	assur be as	med. Do not leave ssumed the Bidder ease, in Contract Pr Alternate No. GC	will provide that Alter ice.	t blank. If an rnate for no c	DEDUCT" will be y amount is blank, it will hange, neither increase nor ociated with Roof Top Uni	
		Replacement: ADD/DEDUCT	(\$		)	
			( •		DOLLARS	
	2)	Alternate No. GC	2-2: General Construc	tion work as	sociated with Fan Coil Unit	
	,	ADD/DEDUCT	(\$		) DOLLARS	
	3)	Alternate No. GC Ventilator Replac	2-3; General Construc cement:	tion work ass	sociated with Unit	
		ADD/DEDUCT	(\$		)	
					DOLLARS	
	4)	Unit Removal:		tion work ass	sociated with Condensing	
		ADD/DEDUCT	(\$			
	5)		2-5; General Construc	tion work as	DOLLARS sociated with Cafeteria	
		Stage Removal:	( ¢		``````````````````````````````````````	
		ADD/DEDUCT	(\$		) DOLLARS	
	6)	Alternate No. GC Stage Floor:	2-6;General Construct	ion work ass	ociated with Gymnasium	
		ADD/DEDUCT	(\$		)	
					DOLLARS	
	7)	Alternate No. GC Material:	2-7; General Construc	tion work ass	sociated with Floor	

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			DOLLARS	

8) Alternate No. GC-8; Motorized Window Shades: ADD/DEDUCT (\$

DOLLARS

)

9) Alternate No. GC-9; Painting walls at mechanical equipment removals: ADD/DEDUCT (\$)
DOLLARS

#### **08. BID SECURITY**

Bid Security in the form of a Certified or Cashier's Check or a Bid Bond in the form required by the Contract Documents is attached to and made a part of this Proposal.

#### 09. IRAN DIVESTMENT ACT CERTIFICATION

Contractor to submit with the bid, Iran Divestment Act Certification which hereto is made a part of this Form of Proposal and is attached at the end of this Form of Proposal.

#### 10. **REPRESENTATIONS**

By submitting this Proposal the Bidder represents and certifies to the Owner and the Architect that

- 1) It has examined the Contract Documents, the site of the proposed Work, is familiar with the local conditions at the place where the Work is to be performed and fully comprehends the requirements and intent of the plans and specifications for this Project in accordance with the drawings, specifications and other Contract Documents prepared by CPL the Owners Consultant, for this Project.
- 2) It has examined and reviewed, where applicable, all information and data in the Contract Documents related to existing underground facilities at or contiguous to the site. Bidder shall require of the Owner or Architect no further investigations, explorations, tests or reports with respect to such underground facilities in order for the Bidder to perform the Work of the Proposal within the Contract Time and in accordance with the Contract Documents.
- 3) It has given notice to the Architect, as required by the Contract Documents of any and all discrepancies it has discovered and accepts the resolution of those discrepancies offered by the Architect.
- 4) Pursuant to New York State General Municipal Law section 103-d, by submission of this bid, each bidder and each person signing on behalf of any bidder certifies, and in the case of a joint bid each party thereto certifies as to its own organization, under penalty of perjury, that to the best of knowledge and belief:
  - a) The prices in this bid have been arrived at independently without collusion, communication, or agreement, for the purpose of restricting competition, as to any matter relating to such prices with any other bidder or with any competitor;
  - b) Unless otherwise required by law, the prices which have been quoted in this bid have not been knowingly disclosed by the bidder and will not be knowingly disclosed by the bidder prior to opening, directly or indirectly, to any other bidder or competitor; and
  - c) No attempt has been made or will be made by bidder to induce any other person, partnership or corporation to submit or not to submit a bid for

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the purpose of restricting competition.

d) The proposal is based upon the materials, equipment and systems required by the Contract Documents, without exception, unless otherwise set forth in this Proposal in detail.

#### 11. CHANGE ORDERS

We propose and agree that the above lump sum shall be adjusted for changes in the Contract Work not included in unit prices by addition of the following costs:

1) Profit and overhead as permitted in the General Conditions.

#### 12. NON-COLLUSIVE BIDDING CERTIFICATION

By submission of this bid, each bidder and each person signing on behalf of any bidder certifies, and in the case of a joint bid each party thereto certifies as to its own organization, under penalty of perjury, that to the best of knowledge and belief:

- 1) The prices in this bid have been arrived at independently without collusion, consultation, communication, or agreement, for the purpose of restricting competition, as to any matter relating to such prices with any other bidder or with any competitor;
- 2) Unless otherwise required by law, the prices which have been quoted in this bid have not been knowingly disclosed by the bidder and will not knowingly be disclosed by the bidder prior to opening, directly or indirectly, to any other bidder or to any competitor; and
- 3) No attempt has been made or will be made by the bidder to induce any other person, partnership or corporation to submit or not to submit a bid for the purpose of restricting competition.

#### **13. ACCEPTANCE**

When this Proposal is accepted, the undersigned agrees to enter into a Contract with the Owner as provided in the Form of Agreement.

#### 14. AFFIRMS

The undersigned affirms and agrees that this Proposal is a firm one which remains in effect and will be irrevocable for a period of forty-five (45) days after opening of Bids.

#### **15. TYPE OF BUSINESS**

The undersigned hereby represents that it is a (select with circle):

- 1) Corporation, Partnership, Individual.
- 2) If a Corporation, then the undersigned further represents that it is duly qualified as a Corporation under the laws of New York State and it is authorized to do business in this State.

#### 16. PLACE OF BUSINESS

The following is the name and address of the person to whom all notices required in connection with this Proposal may be telephoned, mailed, or delivered.

Name of Contact Person:		
Name of Business or Firm:		
Address:		
Address:		
Telephone:	Fax	
Email Address:		
FEIN: Federal Employer Identification No.:		

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#### **17. EXECUTION OF CONTRACT**

When written Notice of Acceptance of the Proposal is mailed or delivered to the undersigned within forty-five (45) days after the opening of Bids, or anytime thereafter should the Proposal not be withdrawn, the undersigned, within ten (10) days, will execute the Form of Agreement with the Owner.

#### 18. ADDENDA

Any addenda issued by the Architect and mailed or delivered to the undersigned prior to the Bid opening date shall become part of the Contract Documents. The Bidder shall enter on this list any addenda issued after this Form of Proposal has been received and shall fill in the addenda number and date.

Addendum #	Dated:
Addendum #	Dated:
Addendum #	Dated:
Addendum #	Dated:

#### **19. ASBESTOS**

The bidder certifies that no asbestos or asbestos-containing materials will be incorporated into the Work of this Contract.

#### 20. AUTHORIZED SIGNATURES FOR PROPOSALS

	r Legal Name of	-		
-	Representative o	f Firm or Corpo	oration:	
Printed Nam	ne and Title:			
Date:				
If Corporation	on – provide Seal	:		
1				

By submission of this bid, (DL & AV Equip 1315), or by assuming the responsibility of a Contract awarded hereunder, each bidder and each person signing on behalf of any bidders, certifies, and in the case of a joint bid each party thereto certifies as to its own organization, under penalty of perjury, that to the best of its knowledge and belief:

 That each bidder/contractor/assignee is not on the "Entities Determined To Be Non-Responsive Bidders/Offerers Pursuant to The New York State Iran Divestment Act of 2012" list created pursuant to paragraph (b) subdivision 3 of section 165-a of the New York State Finance Law and posted on the OGS website at http://www.ogs.ny.gov/about/regs/docs/ListofEntities.pdf and

21.

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	further certifies that it will t	not utilize on such	Contract any subcontractor that		
			Additionally, Bidder/Contractor is		
			a Contract awarded in response		
		itation, it must provide the same certification at the time the			
			e in the Instructions to Bidders.)		
	Individual or Legal N				
	Mailing Address:				
	Signature of Represe	ntative of Firm or	Corporation:		
	<b>e i</b>	inted Name and Title:			
	Date:	Date:			
	SWORN to before m	WORN to before me this date:			
	Notary Public Signat	ary Public Signature and Stamp:			
22. S	SEXUAL HARASSMENT POLICY/TRAINING AFFIRMATION				
By submission of this bid, each bidder and each person signing on behalf of any bidder certifies, and in the case of a joint bid each party thereto certifies as to its own organization, under penalty of perjury, that the bidder has and has implemented a written policy addressing sexual harassment prevention in the workplace and provides annual sexual harassment prevention training to all its employees.					
	Name of Contractor:				
	Name of Business or Firm:				
	Address:				
	Telephone:		Fax		
	Email Address:				
	Signature and Title of Contractor:				

Date:

**END OF SECTION 004010** 004010

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#### SECTION 004040 FORM OF PROPOSAL ELECTRICAL CONSTRUCTION

#### PART 1 GENERAL

#### 1.01 SUMMARY

A. Fill in information:

Date:
TO:
Newburgh Enlarged City School District
124 Grand Street
Newburgh, New York
FROM:
BIDDER NAME & ADDRESS

#### 1.02 GENERAL

- A. Pursuant to, and in compliance with, the Procurement and Contracting Requirements, Conditions of the Contract, relative thereto and all of the Contract Documents, including any Addenda issued by the Architect and mailed or delivered to the undersigned prior to the opening of Bids, whether received by the undersigned or not,
  - we,\_
  - 1. having visited the site and being familiar with all conditions and requirements of the Work, hereby propose to furnish all plant, labor, supplies, materials and equipment incidental to ELECTRICAL CONSTRUCTION WORK as required by and in strict accord with the applicable provisions of the Drawings and Specifications entitled (Insert project title Here)all to the satisfaction and approval of the Architect and the Owner in accordance with the terms and conditions of the Contract Documents for the following sum:

		DOLLARS
(\$	)	
BASE BID		

#### 1.03 BID GUARANTEE

- A. The undersigned Bidder agrees to execute a contract for this Work in the above amount and to furnish surety as specified within 10 days after a written Notice of Award, if offered within 45 days after receipt of bids, and on failure to do so agrees to forfeit to Owner the attached cash, cashier's check, certified check, U.S. money order, or bid bond, as liquidated damages for such failure, in the following amount constituting five percent (5%) of the Base Bid.
  - 1. In the event Owner does not offer Notice of Award within the time limits stated above, Owner will return to the undersigned the cash, cashier's check, certified check, U.S. money order, or bid bond.

#### 1.04 TIME OF COMPLETION

A. It is agreed by the undersigned that after receipt of a Notice of Award and a consummation of a Contract Agreement in accord with the terms of the Contract Documents, he will start work within 10 consecutive calendar days of this notice to proceed and fully complete the work as indicated in the project schedule.

#### 1.05 ALLOWANCES (REFERENCE SPECIFICATION SECTION 012100)

- A. Specified Allowance as indicated in Specification Section 012100. This amount is to be included in the Base Bid above.
  - 1. Allowance Amount:
    - \$ (Insert Amount)

NEWBURGH ECSD		Phase 3: 2019 Capital Improvement Project
13940.18		OF PROPOSAL 004040 - 2
	"DEDUCT" for each Alterna	<b>CATION SECTION 012300.)</b> <sup>•</sup> it is zero (\$ 0), for each Alternate. Circle "ADD" or f neither is circled, "DEDUCT" will be assumed. Do not f any amount is blank, it will be assumed the Bidder wil

2.	Alternate No. EC	-2; Electrical Work Associated with the Fan Coi	l Unit:
	ADD/DEDUCT	(\$	)
			DOLLARS

3. Alternate No. EC-3;Electrical work associated with the Unit Ventilator Replacement: ADD/DEDUCT (\$)

DOLLARS

DOLLARS

4.	Alternate No. EC-4; Electrical work associated with the Condensing Unit Removal:			
	ADD/DEDUCT	(\$		)
				DOLLARS

5. Alternate No. EC-5;Electrical work associated with the Dust Collector Replacement: ADD/DEDUCT (\$)

		DOLLARS
6.	Alternate No. EC-6;Cafeteria Stage Removal:	
	ADD/DEDUCT (\$	)
		DOLLARS

#### 1.07 BID SECURITY

A. Bid Security in the form of a Certified or Cashier's Check or a Bid Bond in the form required by the Contract Documents is attached to and made a part of this Proposal.

#### **1.08 IRAN DIVESTMENT ACT CERTIFICATION**

A. Contractor to submit with the bid, Iran Divestment Act Certification which hereto is made a part of this Form of Proposal and is attached at the end of this Form of Proposal.

#### **1.09 REPRESENTATIONS**

- A. By submitting this Proposal the Bidder represents and certifies to the Owner and the Architect that
  - 1. It has examined the Contract Documents, the site of the proposed Work, is familiar with the local conditions at the place where the Work is to be performed and fully comprehends the requirements and intent of the plans and specifications for this Project in accordance with the drawings, specifications and other Contract Documents prepared by CPL the Owners Consultant, for this Project.
  - 2. It has examined and reviewed, where applicable, all information and data in the Contract Documents related to existing underground facilities at or contiguous to the site. Bidder shall require of the Owner or Architect no further investigations, explorations, tests or reports with respect to such underground facilities in order for the Bidder to perform the Work of the Proposal within the Contract Time and in accordance with the Contract Documents.
  - 3. It has given notice to the Architect, as required by the Contract Documents of any and all discrepancies it has discovered and accepts the resolution of those discrepancies offered by the Architect.
  - 4. Pursuant to New York State General Municipal Law section 103-d, by submission of this bid, each bidder and each person signing on behalf of any bidder certifies, and in the case of a joint bid each party thereto certifies as to its own organization, under penalty of perjury, that to the best of knowledge and belief:

NEWBURGH ECSD	Phase 3	: 2019 Capital Improvement Project
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- a. The prices in this bid have been arrived at independently without collusion, communication, or agreement, for the purpose of restricting competition, as to any matter relating to such prices with any other bidder or with any competitor;
- b. Unless otherwise required by law, the prices which have been quoted in this bid have not been knowingly disclosed by the bidder and will not be knowingly disclosed by the bidder prior to opening, directly or indirectly, to any other bidder or competitor; and
- c. No attempt has been made or will be made by bidder to induce any other person, partnership or corporation to submit or not to submit a bid for the purpose of restricting competition.
- d. The proposal is based upon the materials, equipment and systems required by the Contract Documents, without exception, unless otherwise set forth in this Proposal in detail.

#### 1.10 NON-COLLUSIVE BIDDING CERTIFICATION

- A. By submission of this bid, each bidder and each person signing on behalf of any bidder certifies, and in the case of a joint bid each party thereto certifies as to its own organization, under penalty of perjury, that to the best of knowledge and belief:
  - 1. The prices in this bid have been arrived at independently without collusion, consultation, communication, or agreement, for the purpose of restricting competition, as to any matter relating to such prices with any other bidder or with any competitor;
  - 2. Unless otherwise required by law, the prices which have been quoted in this bid have not been knowingly disclosed by the bidder and will not knowingly be disclosed by the bidder prior to opening, directly or indirectly, to any other bidder or to any competitor; and
  - 3. No attempt has been made or will be made by the bidder to induce any other person, partnership or corporation to submit or not to submit a bid for the purpose of restricting competition.

#### 1.11 ACCEPTANCE

A. When this Proposal is accepted, the undersigned agrees to enter into a Contract with the Owner as provided in the Form of Agreement.

#### 1.12 AFFIRMS

A. The undersigned affirms and agrees that this Proposal is a firm one which remains in effect and will be irrevocable for a period of forty-five (45) days after opening of Bids.

#### 1.13 TYPE OF BUSINESS

- A. The undersigned hereby represents that it is a (select with circle):
  - 1. Corporation, Partnership, Individual.
  - 2. If a Corporation, then the undersigned further represents that it is duly qualified as a Corporation under the laws of New York State and it is authorized to do business in this State.

#### 1.14 PLACE OF BUSINESS

A. The following is the name and address of the person to whom all notices required in connection with this Proposal may be telephoned, mailed, or delivered.

Name of Contact Person.	
Name of Business or Firm:	
Address:	
Address:	
Telephone:	Fax
Email Address:	
FEIN: Federal Employer Identification No.:	

#### 1.15 EXECUTION OF CONTRACT

A. When written Notice of Acceptance of the Proposal is mailed or delivered to the undersigned within forty-five (45) days after the opening of Bids, or anytime thereafter should the Proposal not be withdrawn, the undersigned, within ten (10) days, will execute

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the Form of Agreement with the Owner.

#### 1.16 ADDENDA

A. Any addenda issued by the Architect and mailed or delivered to the undersigned prior to the Bid opening date shall become part of the Contract Documents. The Bidder shall enter on this list any addenda issued after this Form of Proposal has been received and shall fill in the addenda number and date.

Addendum #	Dated:
Addendum #	Dated:
Addendum #	Dated:
Addendum #	Dated:

#### 1.17 ASBESTOS

A. The bidder certifies that no asbestos or asbestos-containing materials will be incorporated into the Work of this Contract.

#### 1.18 AUTHORIZED SIGNATURES FOR PROPOSALS

Individual or Legal Name of Firm or Corporation:
Signature of Representative of Firm or Corporation:
Printed Name and Title:
Date:
If Corporation – provide Seal:

#### 1.19 IRAN DIVESTMENT ACT CERTIFICATION

- A. By submission of this bid, (DL & AV Equip 1315), or by assuming the responsibility of a Contract awarded hereunder, each bidder and each person signing on behalf of any bidders, certifies, and in the case of a joint bid each party thereto certifies as to its own organization, under penalty of perjury, that to the best of its knowledge and belief:
  - That each bidder/contractor/assignee is not on the "Entities Determined To Be Non-Responsive Bidders/Offerers Pursuant to The New York State Iran Divestment Act of 2012" list created pursuant to paragraph (b) subdivision 3 of section 165-a of the New York State Finance Law and posted on the OGS website at http://www.ogs.ny.gov/about/regs/docs/ListofEntities.pdf and further certifies that it will not utilize on such Contract any subcontractor that is identified on the Prohibited Entities List. Additionally, Bidder/Contractor is advised that should it seek to renew or extend a Contract awarded in response to the solicitation, it must provide the same certification at the time the Contract is renewed or extended. (See Article in the Instructions to Bidders.)
     Individual or Legal Name of Firm or Corporation:

Individual or Legal Name of Firm or Corporation:	
Mailing Address:	
Signature of Representative of Firm or Corporation:	
Printed Name and Title:	
Date:	
SWORN to before me this date:	

NEWBURGH ECSD		Phase 3: 2	019 Capital Improvement Project
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Notary Public Signature and Stamp:


### 1.20 SEXUAL HARASSMENT POLICY/TRAINING AFFIRMATION

A.	By submission of this bid, each bidder and ea certifies, and in the case of a joint bid each pa under penalty of perjury, that the bidder has a addressing sexual harassment prevention in t harassment prevention training to all its emplo	arty thereto certifies as to its own organization, and has implemented a written policy he workplace and provides annual sexual						
	Name of Contractor:							
	Name of Business or Firm:							
	Address:							
	Telephone:	Fax						
	Email Address:							
	Signature and Title of Contractor:							
	Date:							

#### END OF SECTION 004040

NEWBURGH ECSD		Phase 3: 2019 Capital Improvement Project			
13940.18	FORM OF F ELECTRICAL CO		004040 - 1		

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# ASBESTOS ABATEMENT GENERAL NOTES

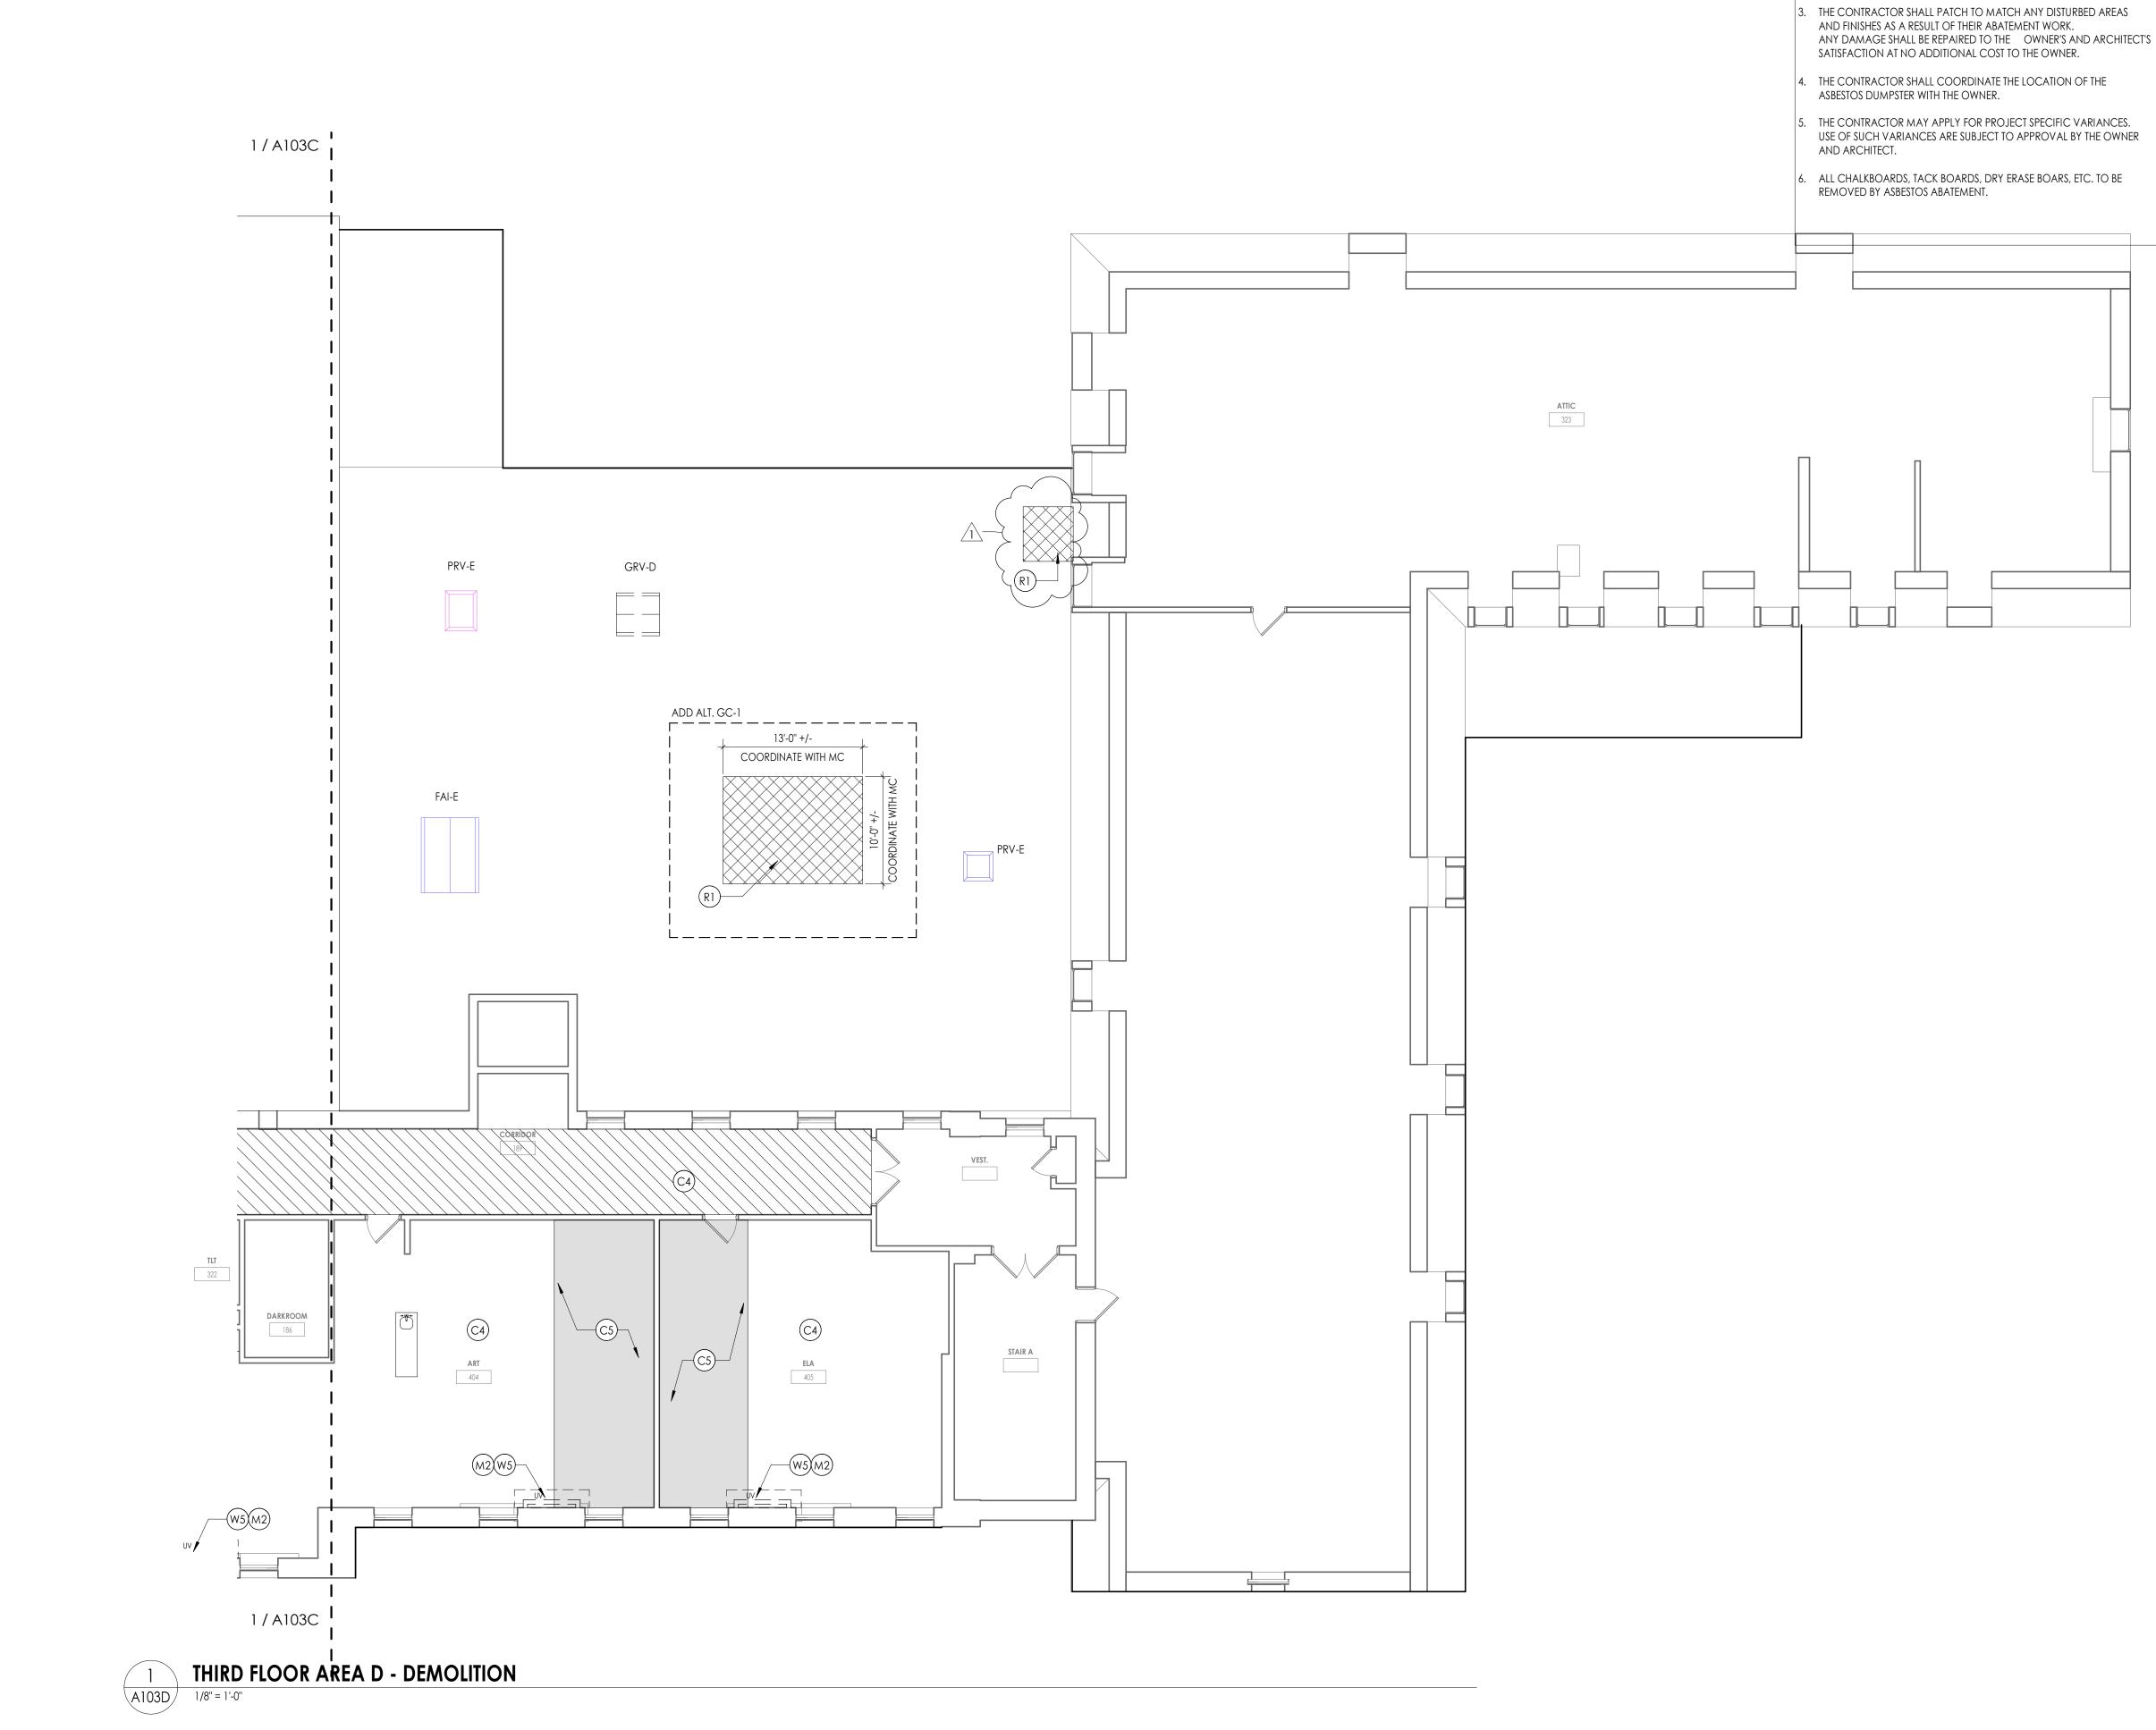
- ALL DRAWINGS ARE A GRAPHIC REPRESENTATION OF APPROXIMATE LOCATIONS OF MATERIALS TO BE ABATED. IF THERE ARE ANY DISCREPANCIES WITH WHAT EXISTS TO WHAT IS INDICATED ON THE CONTRACT DOCUMENTS, THE CONTRACTOR SHALL REPORT SAID DISCREPANCIES TO THE ARCHITECT PRIOR TO SUBMITTING A BID. THE INTENT OF THIS PROJECT IS TO COMPLETELY REMOVE ASBESTOS CONTAINING MATERIALS INDICATED AND TO PROVIDE A CLEAN ACM FREE WORK AREA POST ABATEMENT.
- ALL ABATEMENT PROCEDURES TO BE IN ACCORDANCE WITH STANDARDS SET FORTH BY NEW YORK STATE DEPARTMENT OF LABOR INDUSTRIAL CODE RULE 56 AND ALL APPLICABLE REGULATIONS.

# DEMOLITION GENERAL NOTES

- 1. IT IS THE CONTRACTORS RESPONSIBILITY TO FAMILIARIZE THEMSELVES WITH ALL DETAILS INVOLVED IN THE DEMOLITION CONTRACT. SPECIFIC INSTRUCTION ON EACH ITEM WILL NOT BE GIVEN.
- 2. GC IS RESPONSIBLE FOR KEEPING BUILDING WEATHERTIGHT DURING DEMOLITION
- WORK. 3. GC IS TO PROVIDE DUST CONTROL BARRIERS AT ALL AREAS OF CONSTRUCTION.
- 4. GC WILL SALVAGE ANY ITEMS PER OWNERS LIST (TBD). 5. PC = PLUMBING CONTRACTOR, EC = ELECTRICAL CONTRACTOR, MC = MECHANICAL CONTRACTOR
- 6. PATCH WALLS, FLOORS AND CEILINGS AT ALL WALL REMOVALS, TO MATCH
- SCHEDULED FINISHES. 7. WORK AREAS SHALL BE MAINTAINED AND LEFT BROOM CLEANED AT END OF EACH
- DAY 8. EXISTING BUILDING AND STRUCTURE TO REMAIN EXCEPT AS NOTED.

# **DEMOLITION KEY NOTES**

- REMOVE EXISTING ACOUSTIC CEILING TILES, GRID, AND SUSPENSION SYSTEM IN ITS ENTIRETY FULL EXTENT OF ROOM. PATCH WALLS AFFECTED BY DEMOLITION.
- REMOVE EXISTING METAL STUD, GYPSUM WALL BOARD SOFFIT AND ALL ASSOCIATED COMPONENTS IN ITS ENTIRETY.
- C3 REMOVE EXISTING GYPSUM BOARD CEILING AND ALL ASSOCIATED FRAMING IN ITS ENTIRETY.
- REMOVE AND SALVAGE 24X24 OR 24X48 ACOUSTIC CEILING TILE. STORE PANELS (C4) SAFELY FOR REINSTALLATION IN NEW WORK. REFER TO RCPS. EXISTING GRID AND SUSPENSION SYSTEM TO REMAIN.
- REMOVE PORTION OF EXISTING CEILING TILES, GRID, AND SUSPENSIONS SYSTEM (C5) AT SHADED AREAS INDICATED ON DRAWINGS. SALVAGE EXISTING CEILING TILES FOR REINSTALLATION. PATCH WALLS AFFECTED BY DEMOLITION.
- REMOVE EXISTING HOLLOW METAL DOOR, FRAME, AND ALL ASSOCIATED HARDWARE IN ITS ENTIRETY.
- REMOVE EXISTING VCT FLOORING, RUBBER BASE, AND ALL ASSOCIATED TRIM IN (F1) ITS ENTIRETY FULL EXTENT OF ROOM. PREPARE SUBSTRATE FOR INSTALLATION OF NEW FINISHES.
- REMOVE EXISTING CONCRETE RAMP, RAILING, AND ALL ASSOCIATED MOUNTING HARDWARE IN ITS ENTIRETY.
- (F3) REMOVE EXISTING CONCRETE STAIR, RAILING, AND ALL ASSOCIATED MOUNTING HARDWARE IN ITS ENTIRETY.
- REMOVE EXISTING 4" THICK CONCRETE SLAB, FINISHES, AND ALL ASSOCIATED (F4) TRIM IN ITS ENTIRETY. EXCAVATE DOWN TO REQUIRED ELEVATION FOR NEW WORK.
- (F5) REMOVE EXISTING SAFETY PADDING. PREPARE SUBTRATE FOR NEW FINISHES. (F6) REMOVED DAMAGED STAIR TREAD.
- SAW CUT AND REMOVE PORTION OF EXISITING SLAB ON GRADE AND EXCAVATE
- AS REQUIRED FOR NEW WORK. COORDINATE WORK WITH ALL TRADES. F8 REMOVE EXISTING QUARRY TIL AND MUDSETE TO EXTENT SHOWN IN SHADED AREA.
- (F9) REMOVE EXISTING RUBBER BASE. PREPARE SURFACE FOR INSTALLATION OF NEW FINISHES.
- (F10) REMOVE RUBBER STAIR TREAD/RISER AND ALL ASSOCIATED TRIM. PREPARE SUBSTRATE FOR NEW FINISHES.
- SAW CUT AND REMOVE EXISTING FLOOR SLAB. PROVIDE OPENING SUPPORT PER STRUCTURAL DWGS.
- (M1) REMOVE EXISTING GYPSUM COLUMN WRAP AND ALL ASSOCIATED COMPONENTS, PREPARE FOR NEW FINISHES
- MC TO REMOVE EXISTING UNIT VENTILATORS. GC TO PATCH INTAKE OPENING AND FINISHES @ WALL/FLOOR PER DETAIL ON A801.
- (M3) REMOVE EXISTING RAILING.
- REMOVE EXISTING BALLASTED ROOF SYSTEM DOWN TO DECKING. REMOVE EXISTING FLASHING AS NECESSARY FOR INSTALLATION OF NEW ROOF SYSTEM.
- (M5) PC TO REMOVE EXISTING DRINKING FOUNTAIN. PATCH WALL AFFECTED BY
- (M6) REMOVE PAPER TOWEL DISPENSER AND TURN OVER TO OWNER.
- (M7) REMOVE AND SALVAGE FOR RE-REINSTALLATION EXISTING STEEL WORK SURFACE. REMOVE AND REINSTALL STAINLESS STEEL TRAY SURFACE AS NECESSARY FOR
- (M9) REMOVE FLOOR MOUNTED SLEEVES. PATCH HOLE IN CONCRETE FLOOR.
- MC TO REMOVE EXISTING UNIT VENTILATORS. GC TO MODIFY CASEWORK AS NEEDED TO FASCILITATE INSTALLATION OF NEW UNIT.
- REMOVE EXISTING EPDM ROOF MEMBRANE, COVER BOARD, ROOF INSULATION, AND SUBSTRATE BOARD REQUIRED TO INSTALL NEW ROOF CURB. COORDINATE V ROOF DECK REMOVAL WITH STRUCTURAL DRAWINGS. COORDINATE
- INSTALLATION OF ROOF CURBS WITH MECHANICAL CONTRACTOR.
- (S1) REMOVE EXISTING COLUMN. REFER TO STRUCTURAL DWGS.
- (W1) REMOVE PORTION OF EXISTING CMU WALL PER DETAIL ON A401. SUPPORT REMAINING EXISITNG WALL AS REQUIRED. PREPARE AREA FOR NEW WORK.
- W2 REMOVE PORTION OF EXISTING WALL AS REQUIRED. PREPARE AREA FOR NEW WORK
- W3 REMOVE EXISTING ALUMINUM STOREFRONT SYSTEM AND ALL RELATED MOUNTING HARDWARE.
- W4 REMOVE EXISTING 6" CMU WALL IN ITS ENTIRETY. PATCH AND PREP. FOR NEW WORK.
- W5 REMOVE EXISTING CHASE WALL IN ITS ENTIRETY. PATCH ALL ADJACENT SURFACES AFFECTED BY DEMOLITION.
- REMOVE PORTION OF EXISTING 8" CMU WALL. PREPARE ADJACENT SURFACES FOR NEW WORK.

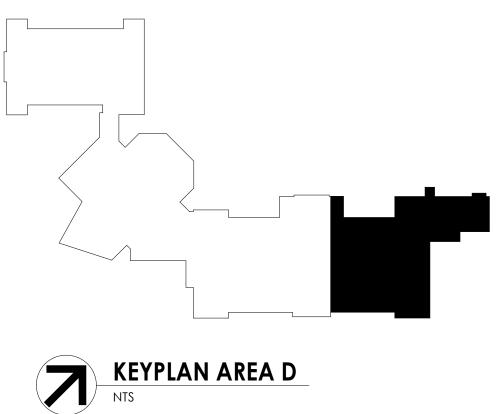






50 FRONT ST. SUITE 202 NEWBURGH, NY 12550 CPLteam.com

Project Number 13940.18 Client Name NEWBURGH ENLARGED CITY SCHOOL DISTRICT Project Name PHASE 3: HERITAGE MIDDLE SCHOOL 2019 CAPITAL **IMPROVEMENT PROJECT** 

Project Address 405 Union Avenue, New Windsor, NY 12553

SED Number 44-16-00-01-0-039-011

PROJECT ISSUE SCHEDULE No. Date Descriptio 1 09/27/21 BID ADDENDA 2

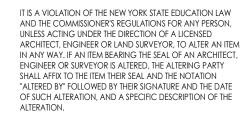


### SHEET INFORMATION

Issued	Scale					
9/9/2021	As indicated					
Project Status						
CONSTRUCTION DOC	CUMENTS					
Drawn By	Checked By					
CPL	CPL					
Drawing Title						
THIRD FLOOR AREA D -						
DEMOLITION PL/	۹N					



PROJECT INFORMATION

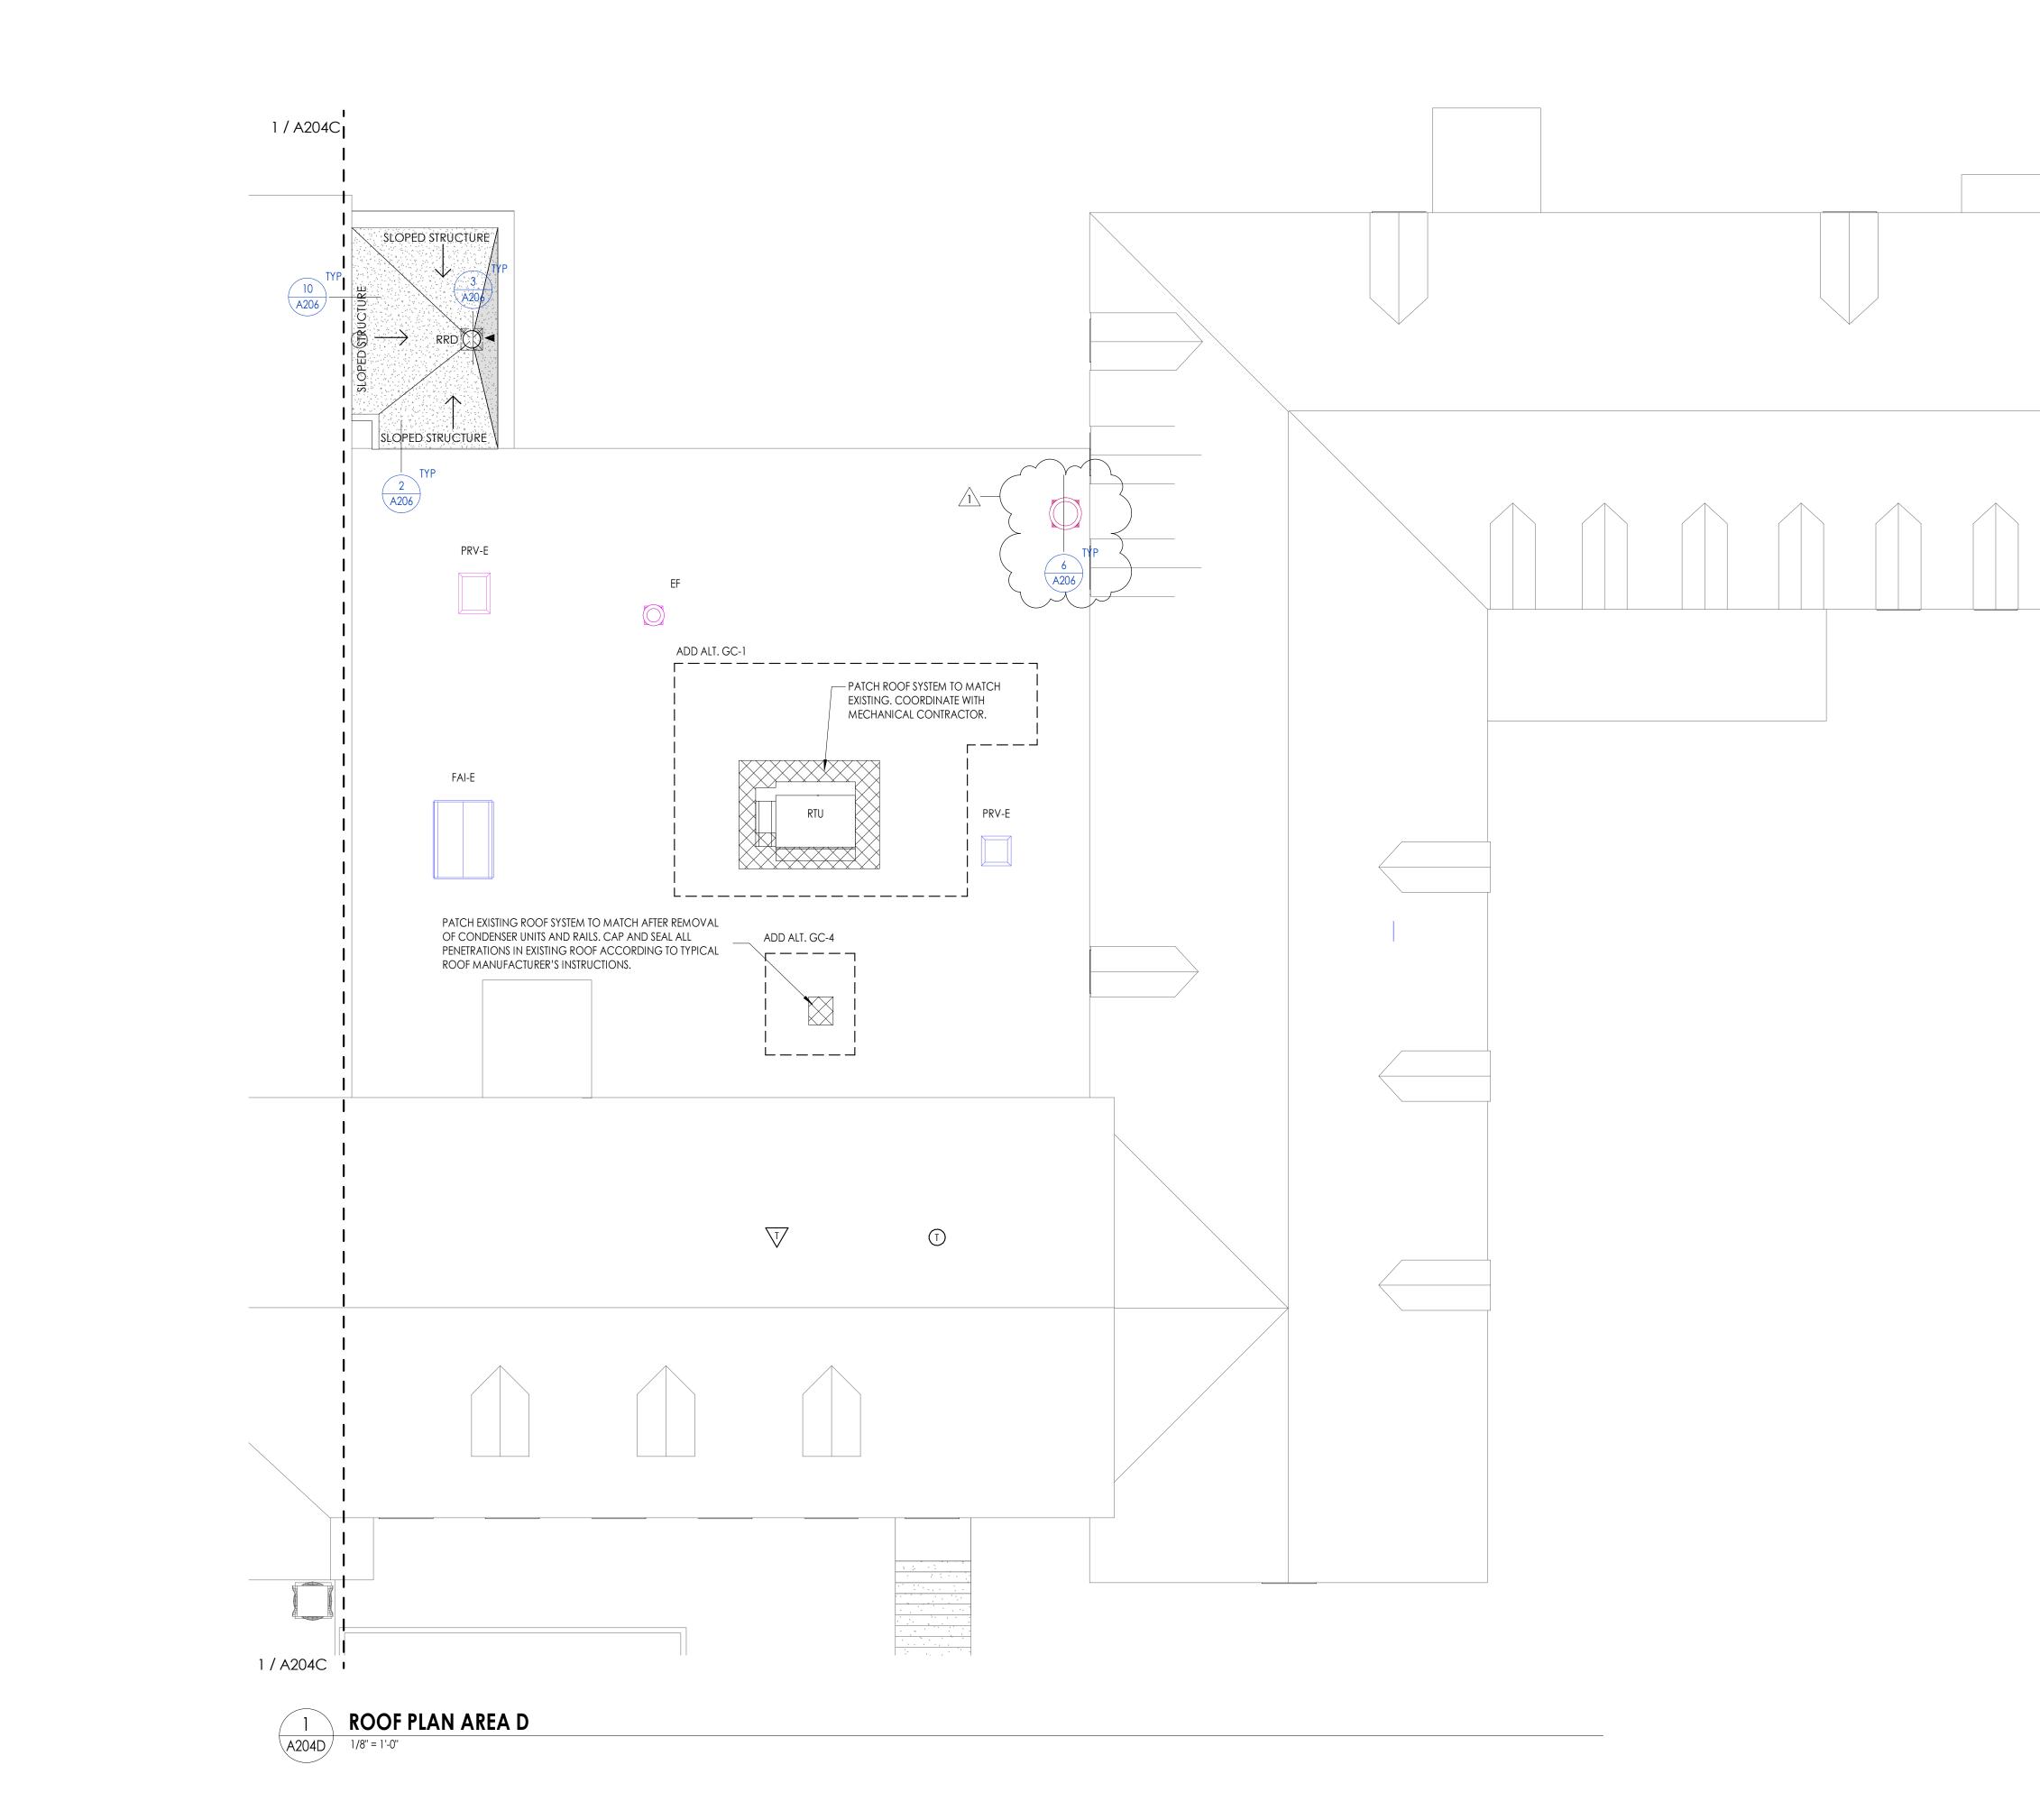


# **ROOF PLAN GENERAL NOTES**

- 1. ALL DRAWINGS ARE GRAPHIC REPRESENTATIONS OF APPROXIMATE LOCATIONS OF MATERIALS. IT IS THE CONTRACTORS RESPONSIBILITY TO FIELD VERIFY ALL CONDITITONS PRIOR TO THE COMMENCEMENT OF WORK.
- 2. REFER TO ALL DRAWINGS IN THE SET FOR LOCATIONS OF ALL ROOF PENETRATIONS.
- PROVIDE FRAMING AS REQUIRED. 3. CONTRACTOR SHALL PAINT ALL ROOF FASTENERS EXPOSED TO VIEW AT UNDERSIDE
- OF DECK TO MATCH. 4. WORK AREAS SHALL BE MAINTAINED AND ALL WORK AREAS SHALL BE BROOM
- CLEAN AT THE END OF EACH DAY. 5. ALL WOOD BLOCKING USED SHALL BE PRESSURE TREATED.
- 6. THE CONTRACTOR SHALL BE RESPONSIBLE FOR INSTALLING ALL ROOF DRAINS AND CUTTING THE HOLES IN THE DECK FOR ANY DRAINS AND PROVIDING STRUCTURAL SUPPORTS.
- 7. THE ROOF ELEVATIONS SHOWN ON THE PLAN ARE SHOWN TO ESTABLISH RELATIVE HEIGHTS OF THE INDIVIDUAL ROOFS.
- 8. NO WEEP HOLES SHALL BE COVERED OR PLUGGED AS A RESULT OF THE ROOFING WORK, UNLESS OTHERWISE DIRECTED. 9. THE CONTRACTOR SHALL BE RESPONSIBLE TO MAINTAIN WATER TIGHTNESS AND
- PROVIDE PROTECTION AT ANY/ALL OPENINGS IN THE ROOF LEFT AT THE END OF EACH DAY.
- 10. PROVIDE CRICKETS FOR WATER DIVERSION AT ALL CURBS, RAILS, ETC. WHICH RUN PERPENDICULAR TO THE SLOPE OF THE INSULATION/SLOPED STRUCTURE. 11. ALL ROOF TOP UNITS SHALL BE MOUNTED ON 16" MIN. INSULATED METAL CURBS.
- PROVIDE TAPERED INSULATION CRICKETS AS REQUIRED TO SHED WATER. WOOD BLOCKING SHALL BE PROVIDED SO CURBS ARE 8" ABOVE FINISHED ROOF surface.
- 12. THE MINIMUM INSULATION THICKNESS SHALL BE 5.5". SLOPE OF TAPERED INSULATION TO BE A MINIMUM OF 1/4" PER FOOT FOR NEW CONSTRUCTION AND 1/8" PER FOOT OVER EXISTING STRUCTURE.

# **ROOF PLAN LEGEND**

	JLND
	ROOF DRAIN W/ SECONDARY
H.P. XX"	SLOPED INSULATION HIGH POINT (MIN. 5 1/2")
	SLOPED INSULATION ROOF CRICKET. PROVIDE 1/2"/ 1'-0" POSITIVE DRAINAGE
	MECH. CURB (W/ CRICKET), PROVIDE FLASHING PER ROOF MANUFACTURER'S DETAILS
1/4" / 1'-0"	ROOF SLOPE
	2'-0'' x 2'-0'' ROOF MEMBRANE WALKWAY SYSTEM
	NEW EPDM ROOF SYSTEM AS SPECIFIED

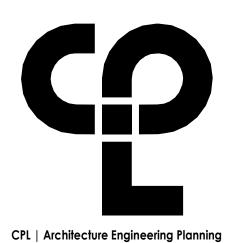


50 FRONT ST. SUITE 202 NEWBURGH, NY 12550 CPLteam.com

PROJECT INFORMATION Project Number 13940.18 Client Name NEWBURGH ENLARGED CITY SCHOOL DISTRICT Project Name PHASE 3: HERITAGE MIDDLE SCHOOL 2019 CAPITAL IMPROVEMENT PROJECT

Project Address 405 Union Avenue, New Windsor, NY 12553

SED Number 44-16-00-01-0-039-011

PROJECT ISSUE SCHEDULE No. Date Description 1 09/27/21 BID ADDENDA 2

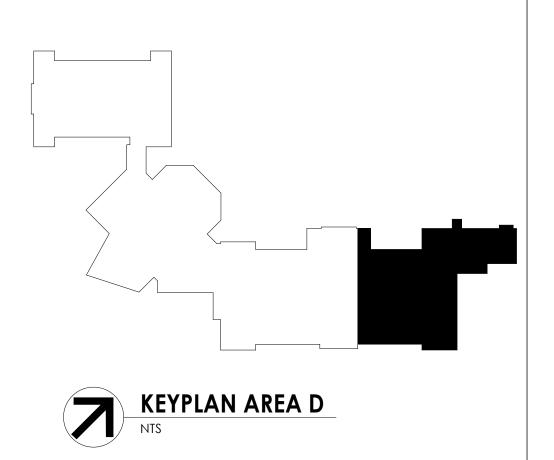



#### IT IS A VIOLATION OF THE NEW YORK STATE EDUCATION LAW AND THE COMMISSIONER'S REGULATIONS FOR ANY PERSON, UNLESS ACTING UNDER THE DIRECTION OF A LICENSED ARCHITECT, ENGINEER OR LAND SURVEYOR, TO ALTER AN ITEM IN ANY WAY. IF AN ITEM BEARING THE SEAL OF AN ARCHITECT, ENGINEER OR SURVEYOR IS ALTERED, THE ALTERING PARTY SHALL AFFIX TO THE ITEM THEIR SEAL AND THE NOTATION "ALTERED BY" FOLLOWED BY THEIR SIGNATURE AND THE DATE OF SUCH ALTERATION, AND A SPECIFIC DESCRIPTION OF THE ALTERATION.

# SHEET INFORMATION


Issued	Scale					
9/9/2021	As indicated					
Project Status						
CONSTRUCTION DOCUMENTS						
Drawn By	Checked By					
CPL	CPL					
Drawing Title						
ROOF PLAN AREA D						

Drawing Number HMS A204D

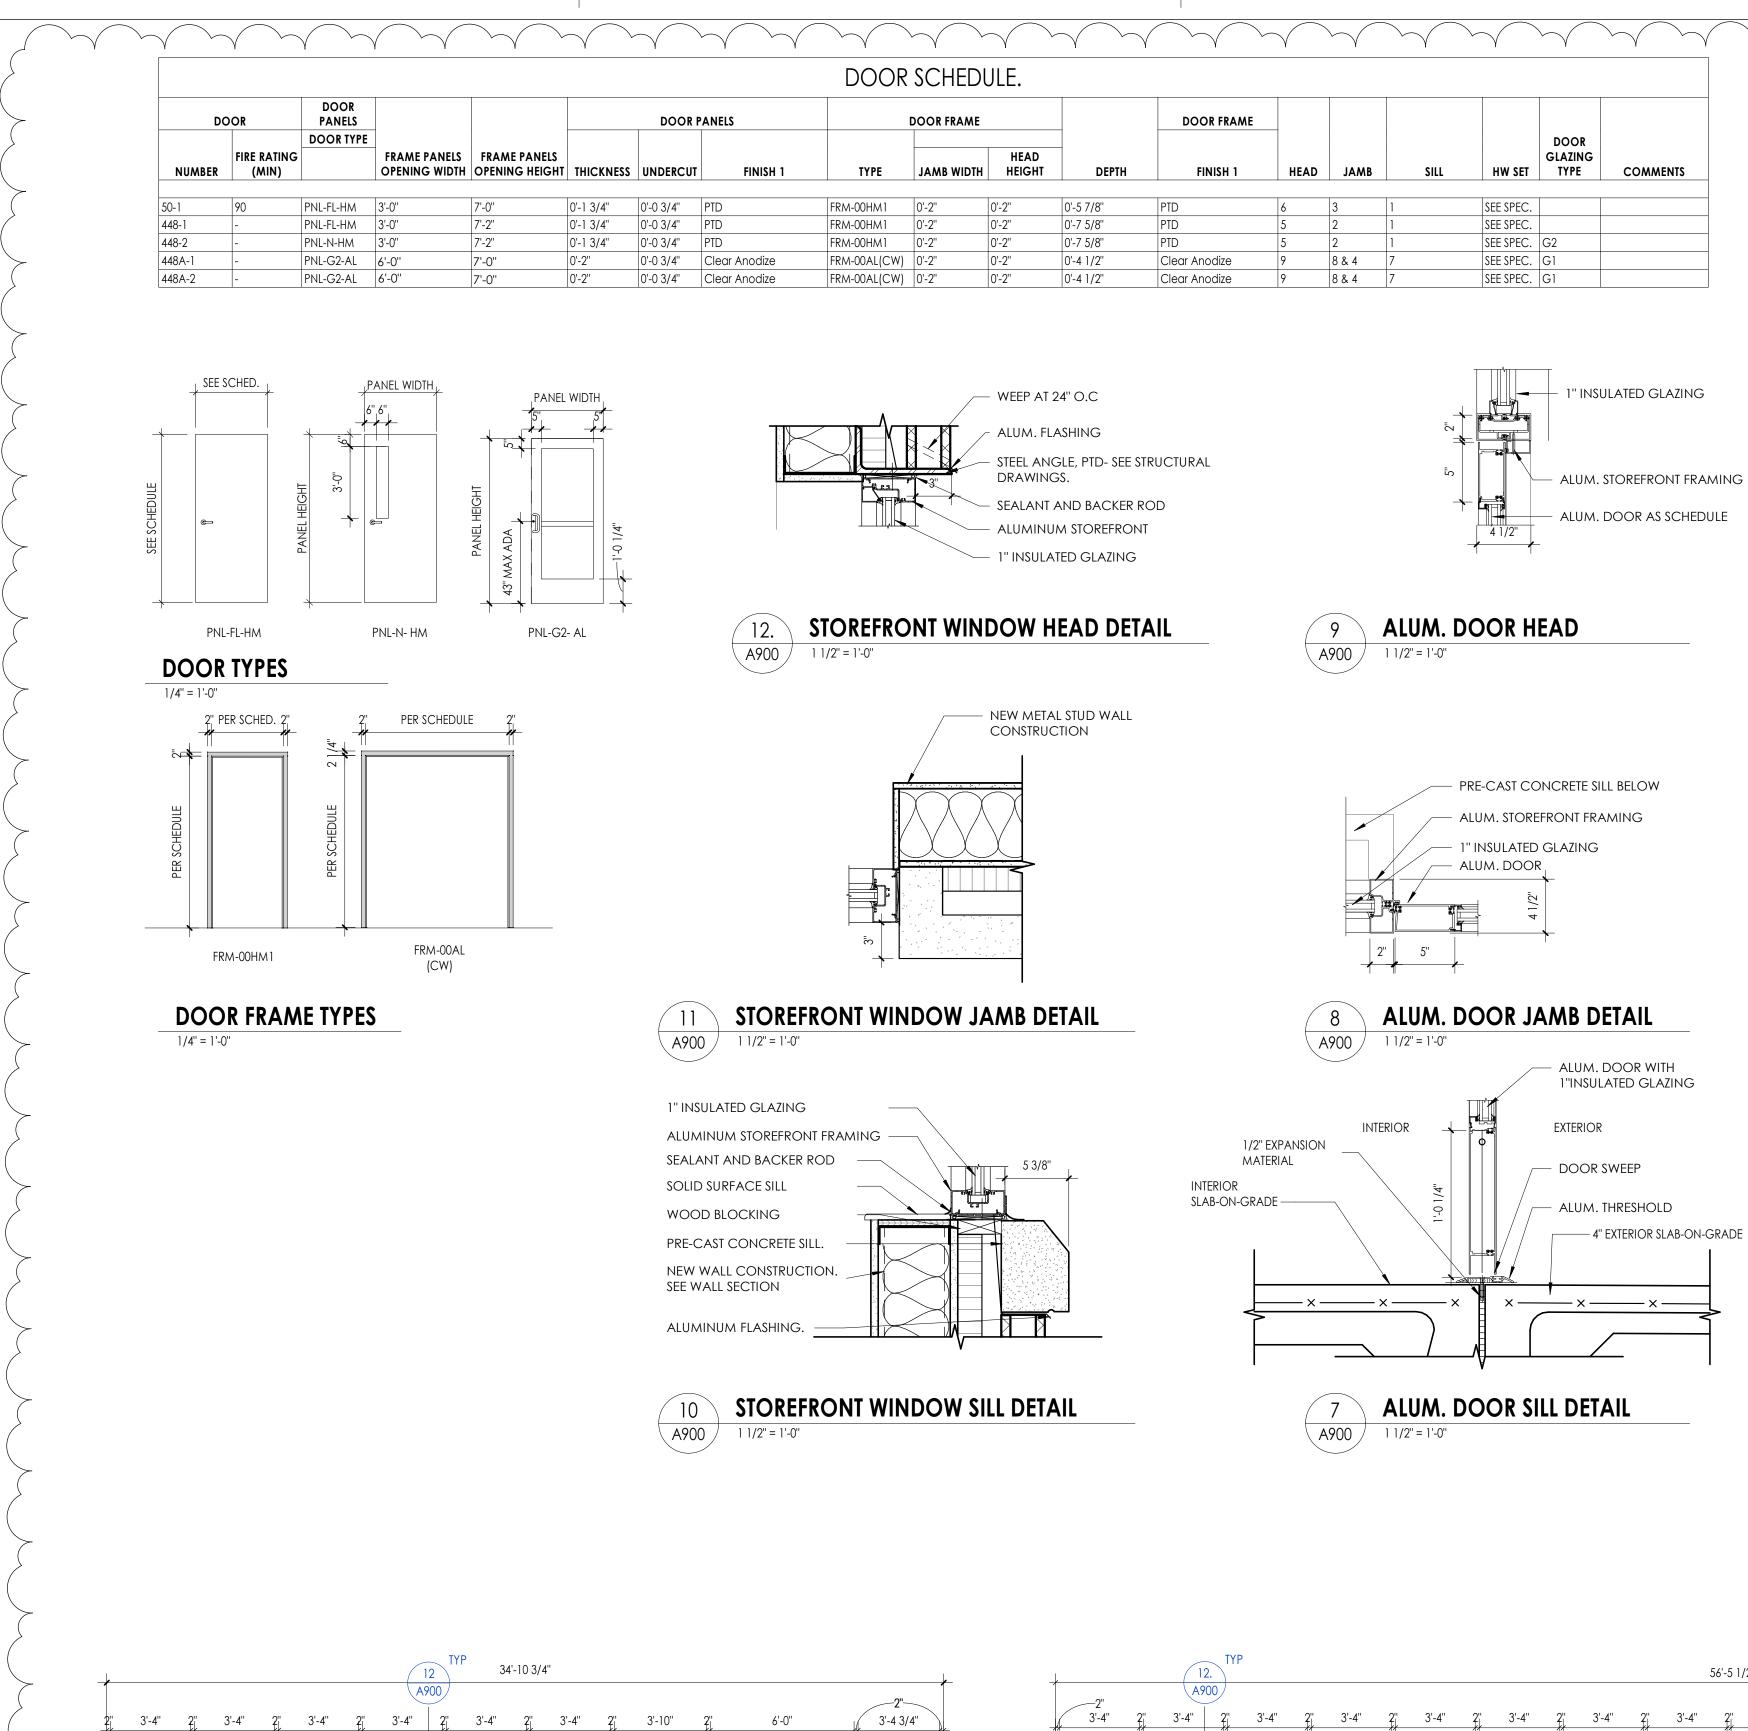

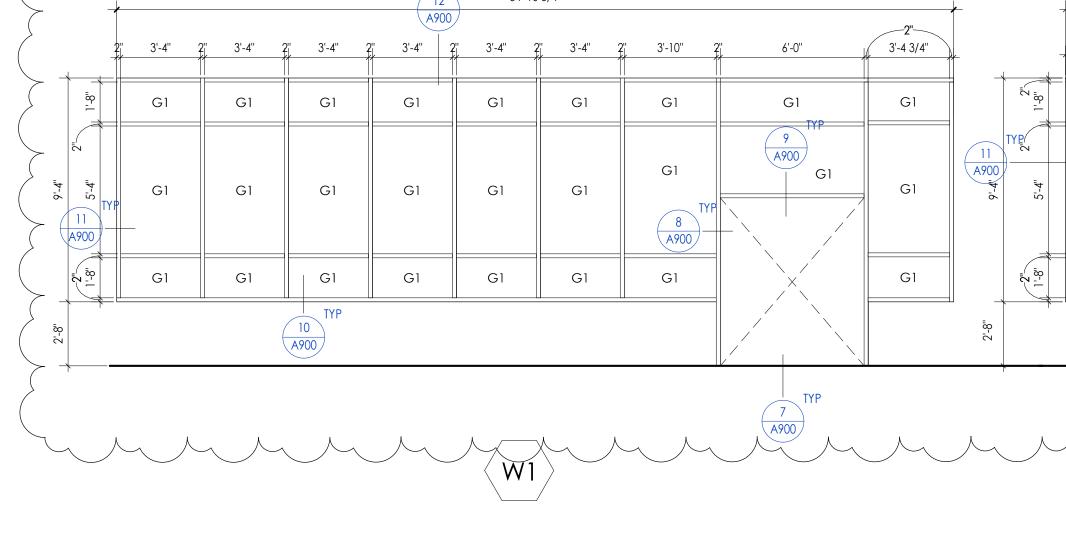


	DOOR FRAME						
 DEPTH	FINISH 1	HEAD	JAMB	SILL	HW SET	DOOR GLAZING TYPE	COMMENTS
0'-5 7/8''	PTD	6	3	1	SEE SPEC.		
0'-7 5/8"	PTD	5	2	1	SEE SPEC.		
0'-7 5/8"	PTD	5	2	1	SEE SPEC.	G2	
0'-4 1/2"	Clear Anodize	9	8 & 4	7	SEE SPEC.	G1	
0'-4 1/2"	Clear Anodize	9	8 & 4	7	SEE SPEC.	G1	

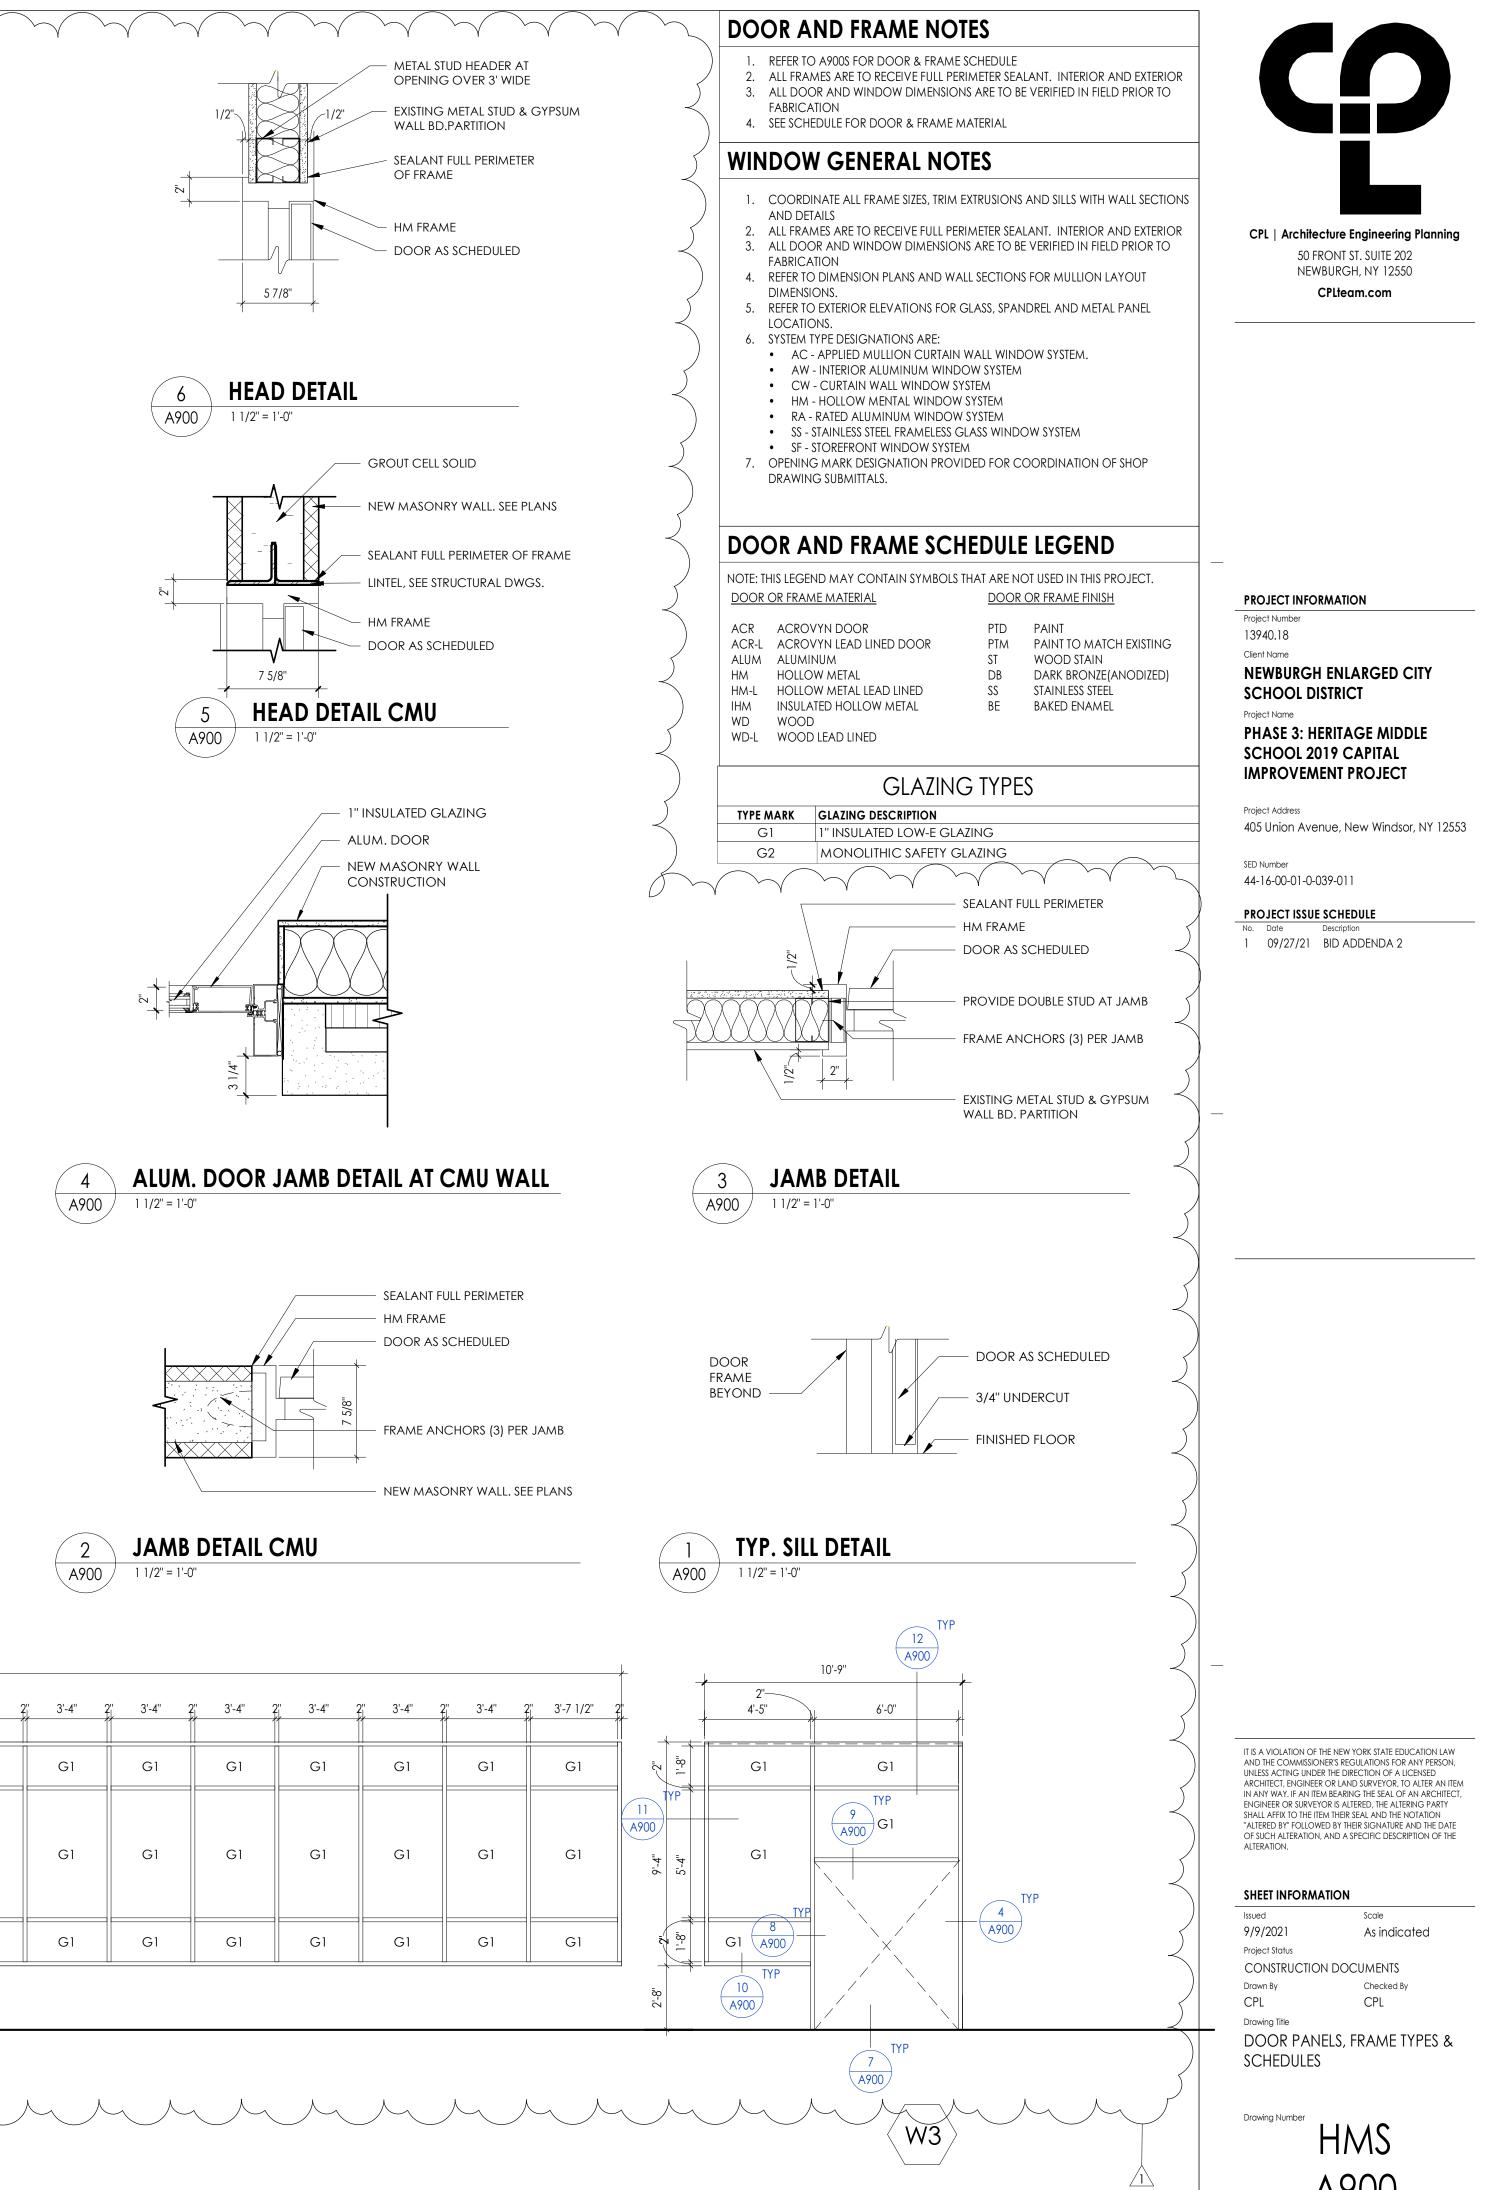



+	0"	12. A900	TYP	56'-5 1/2"											
	2" 3'-4" 2	2" 3'-4"	2" 3'-4"	2" 3'-4"	2" 3'-4" 2	2" 3'-4" 2	2" 3'-4" 2	" 3'-4" 2	"3'-4"	2" 3'-4" 2	2"3'-4"	2" 3'-4"	2" 3'-4" 2	2" 3'-4" 2	)" 
=															
	G1	G1	Gl	G1	Gl	G1	Gl	G1	Gl	G1	G1	G1	G1	Gl	
	– G1	Gl	Gl	G1	G1	G1	Gl	G1	Gl	G1	G1	Gl	G1	Gl	
	G1	G1	G1	G1	G1	G1	G1	G1	Gl	G1	G1	G1	G1	Gl	
_ ⊔			TYP (10 (A900)												

W2

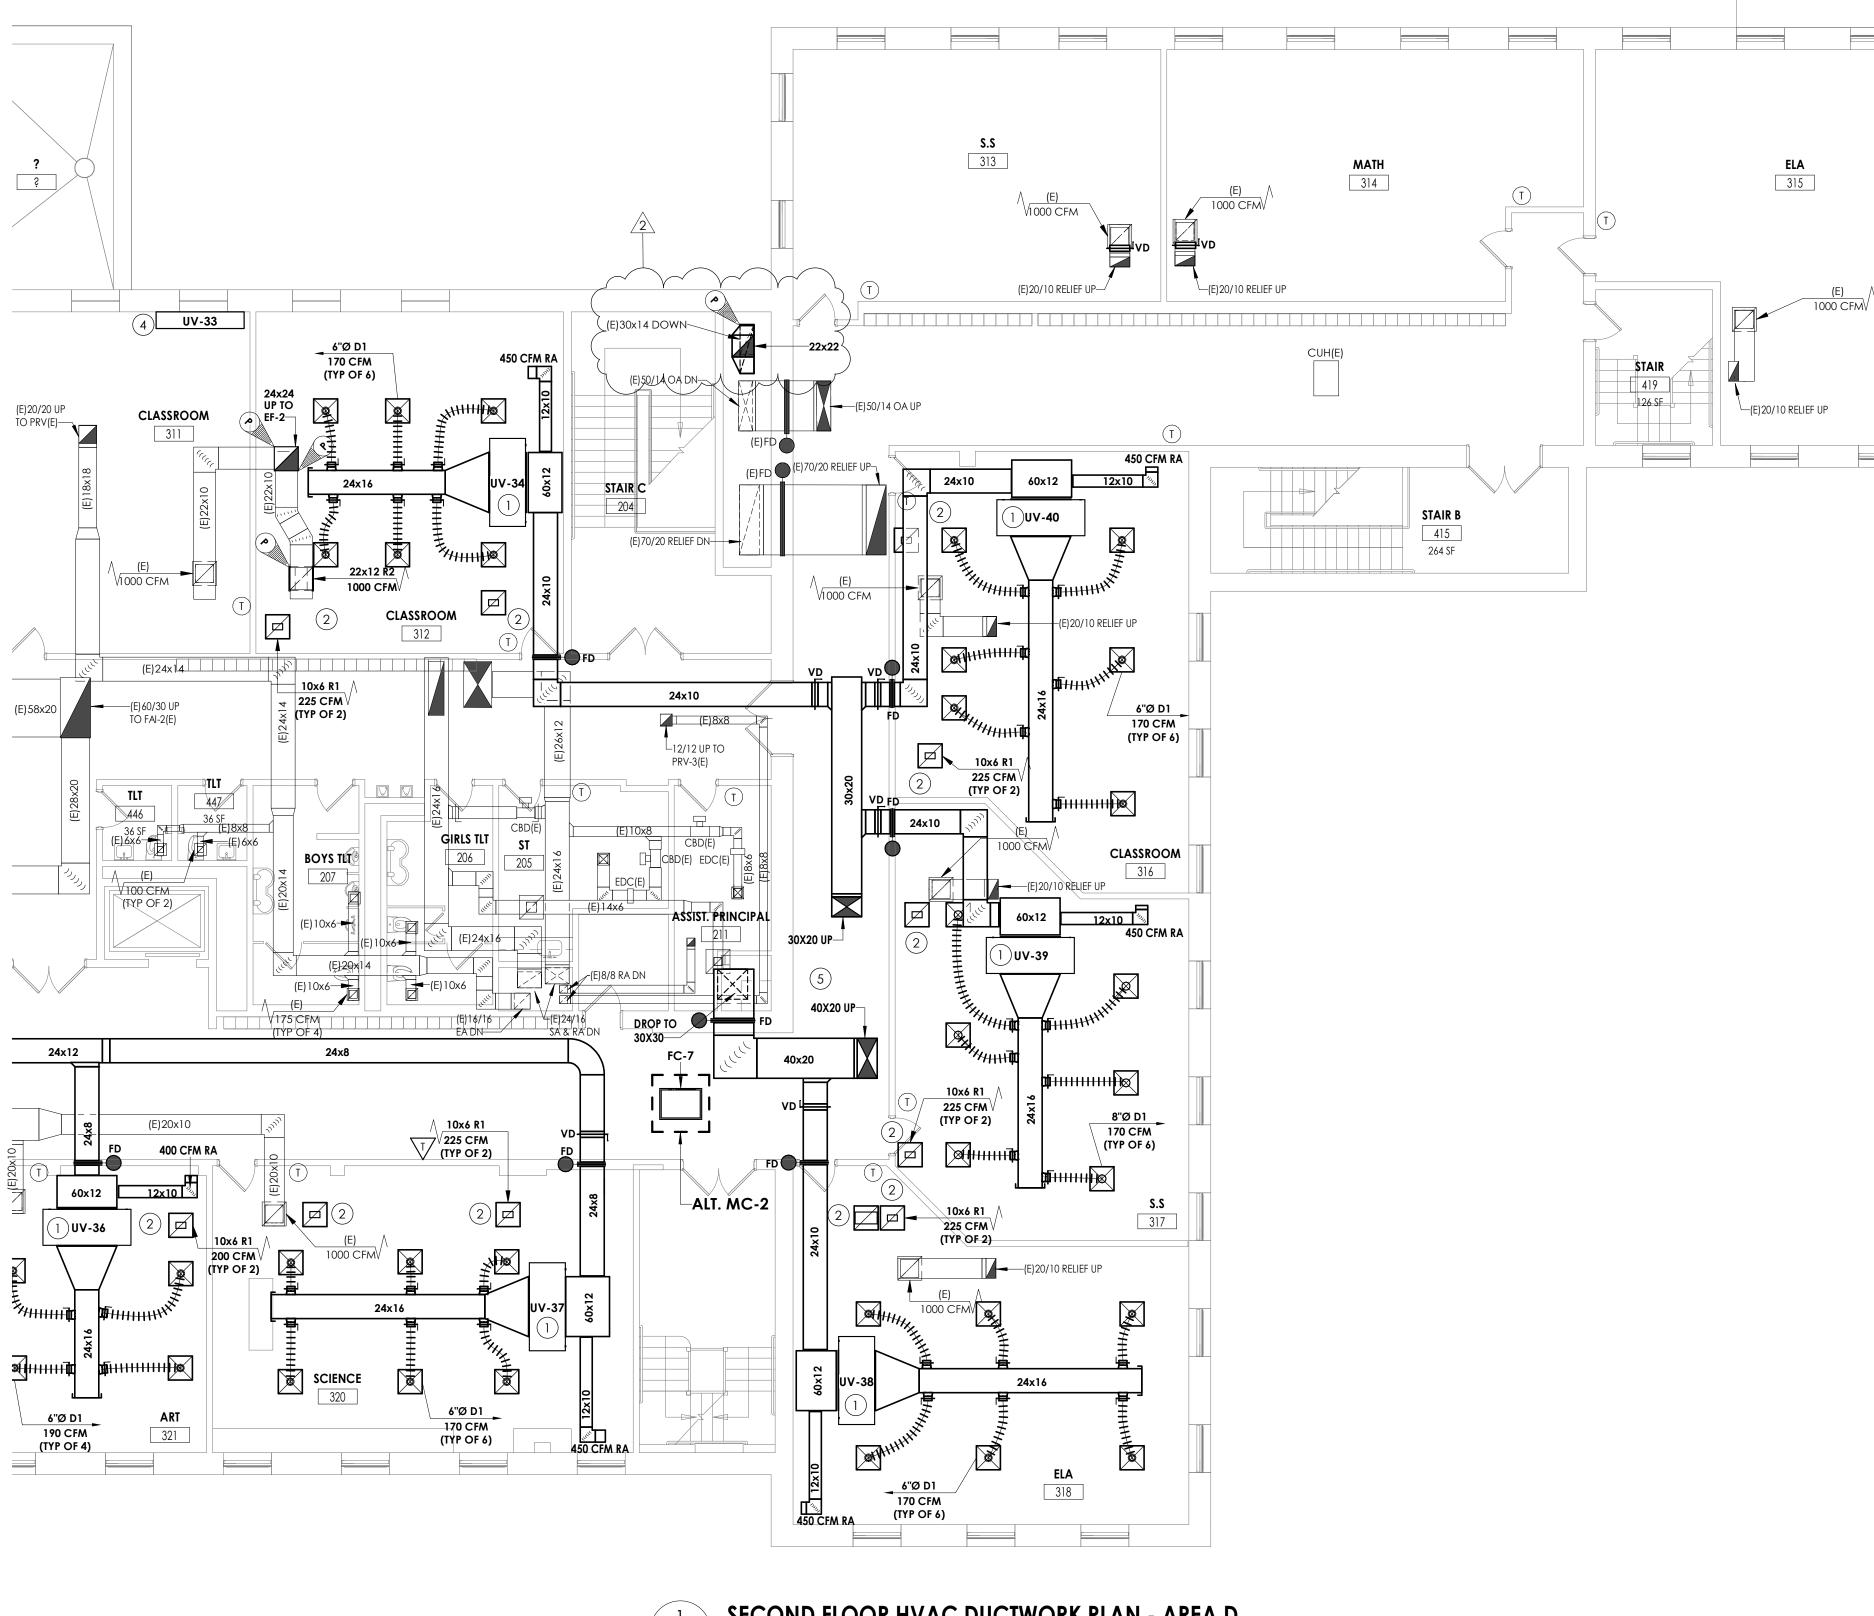


SECOND FLOOR HVAC DUCTWORK PLAN - AREA D H202D 1/8" = 1'-0"



\_\_\_\_\_

- (1) MOUNT UNIT VENTILATOR ABOVE CEILING. COORDINATE WITH ANY CEILING UTILITIES. MAINTAIN ACCESS FOR FILTER CHANGES. ALL SUPPLY AND RETURN DUCTWORK SHALL BE LINED. EXTEND EXISTING CONTROLS TO NEW UNIT LOCATION.
- 2 PLENUM RETURN.
- (3) DUCTWORK LOCATED IN ATTIC SPACE.
- 4 PROVIDE NEW UNIT VENTILATOR IN EXISTING LOCATION. EXTEND EXISTING UTILITIES TO NEW UNIT. COORDINATE NEW INSTALLATION WITH EXISTING CABINETS.
- (5) REROUTE EXISTING DUCTWORK AS NEEDED TO ACCOMMODATE NEW INSTALLATION.

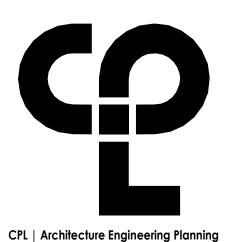

50 FRONT ST. SUITE 202

NEWBURGH, NY 12550

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PROJECT INFORMATION Project Number 13940.18 Client Name


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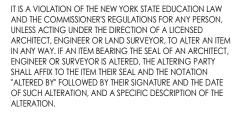
### NEWBURGH ENLARGED CITY SCHOOL DISTRICT Project Name PHASE 3: HERITAGE MIDDLE SCHOOL 2019 CAPITAL IMPROVEMENT PROJECT

Project Address 405 Union Avenue, New Windsor, NY 12553

SED Number 44-16-00-01-0-039-011

PROJECT ISSUE SCHEDULE No. Date Description 2 9/23/21 BID ADDENDUM #2




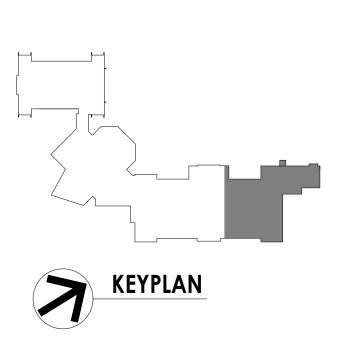

#### SHEET INFORMATION Issued


Issued	Scale
09/09/2021	As indicated
Project Status	
CONSTRUCTION DOCL	JMENTS
Drawn By	Checked By
NRH	JJM
Drawing Title	
SECOND FLOOR I	HVAC
DUCTWORK PLAN	I - AREA D

Drawing Number HMS H202D

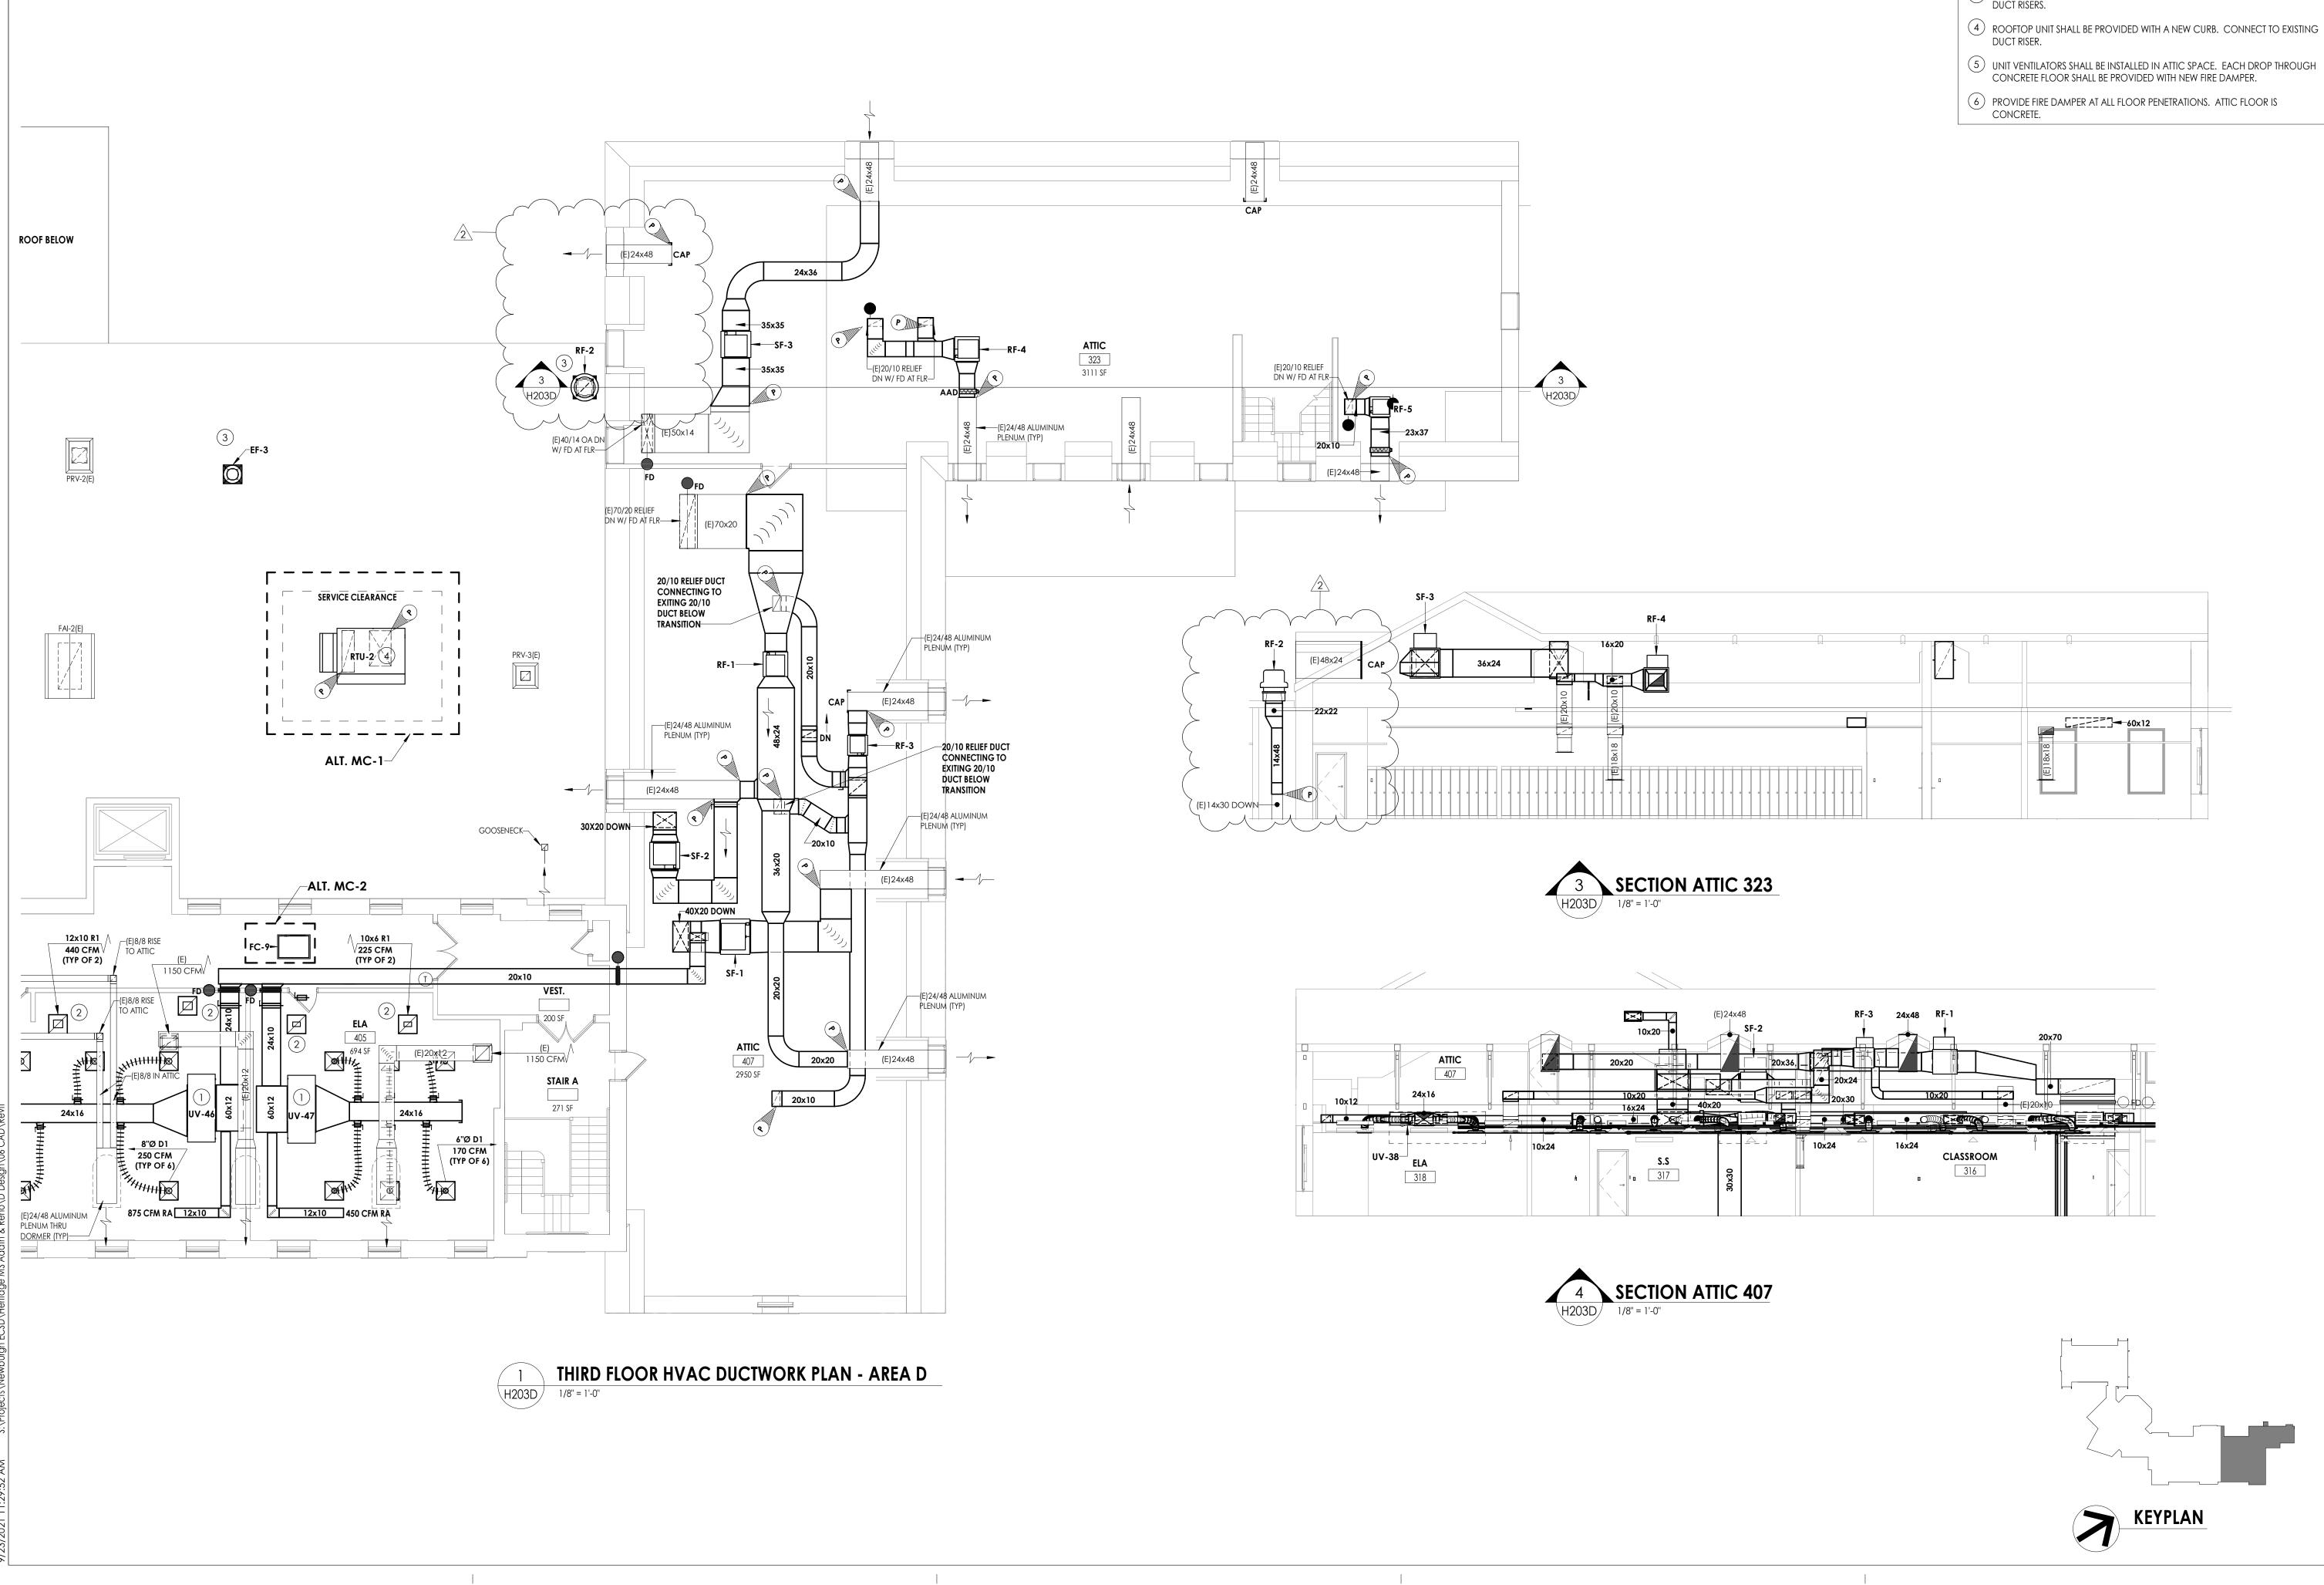

# **KEY NOTES**

- 1 MOUNT UNIT VENTILATOR ABOVE CEILING. COORDINATE WITH ANY CEILING UTILITIES. MAINTAIN ACCESS FOR FILTER CHANGES. ALL SUPPLY AND RETURN DUCTWORK SHALL BE LINED. EXTEND EXISTING CONTROLS TO NEW UNIT LOCATION.
- 2 PLENUM RETURN.
- (3) EXHAUST FANS SHALL BE PROVIDED WITH NEW CURB. CONNECT TO EXISTING DUCT RISERS.

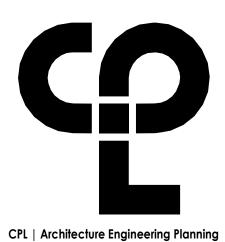

50 FRONT ST. SUITE 202 NEWBURGH, NY 12550 CPLteam.com

PROJECT INFORMATION Project Number 13940.18 Client Name

NEWBURGH ENLARGED CITY SCHOOL DISTRICT Project Name PHASE 3: HERITAGE MIDDLE SCHOOL 2019 CAPITAL

IMPROVEMENT PROJECT

Project Address 405 Union Avenue, New Windsor, NY 12553

SED Number 44-16-00-01-0-039-011

PROJECT ISSUE SCHEDULE No. Date Description 2 9/23/21 BID ADDENDUM #2

IT IS A VIOLATION OF THE NEW YORK STATE EDUCATION LAW AND THE COMMISSIONER'S REGULATIONS FOR ANY PERSON, UNLESS ACTING UNDER THE DIRECTION OF A LICENSED ARCHITECT, ENGINEER OR LAND SURVEYOR, TO ALTER AN ITEM IN ANY WAY, IF AN ITEM BEARING THE SEAL OF AN ARCHITECT, ENGINEER OR SURVEYOR IS ALTERED, THE ALTERING PARTY SHALL AFFIX TO THE ITEM THEIR SEAL AND THE NOTATION "ALTERED BY" FOLLOWED BY THEIR SIGNATURE AND THE DATE OF SUCH ALTERATION, AND A SPECIFIC DESCRIPTION OF THE ALTERATION.

## SHEET INFORMATION

Issued	Scale
09/09/2021	As indicated
Project Status	
CONSTRUCTION DOC	UMENTS
Drawn By	Checked By
NRH	JJW
Drawing Title	
THIRD FLOOR HV. PLAN - AREA D	AC DUCTWORK

Drawing Number HMS H203D

												ROO	F TOP	ENE	RGY RE	COVEF	RY UNI	T										
							COOLING	COIL			SI	UPPLY FAN				E	XHAUST FAI	N				OPERATING						
MARK	LOCATION	AREA SERVED	SA (CFM)	EA (CFM)	RA (CFM)	TOTAL MBH SEN	МВН ЕАТ	LAT	AMB	FAN TYPE	E.S.P. (IN. WC)	RPM	BHP	HP	FAN TYPE	E.S.P. (IN. WC)	RPM	BHP	HP	TOTAL MBH SAVED SUMMER	TOTAL MBH SAVED WINTER	WEIGHT (LBS)	FILTERS	V/Ø/HZ	ELECTRICAL EQUIREMENTS FLA	MCA	TYPICAL UNIT MFG & MODEL NO.	REMARK
RTU-4	CAFÉ ROOF	CAFETERIA	9100	6000	6000	486 3	0 79.7	54.07	75	PLENUM	1	1760	11.89	15	PLENUM	0.5	1760	9.39	10	183	511	3780	MERV 13	208/360	195	207	AAON RN-025-8-0- EB09-EJK	1,2,3,4
<u>EMARKS:</u>	2. ECM CONDE 3. TERMINAL S	OUNTED AND WIRE NSER FAN, HEAT PF STRIP FOR BMS CON ALL, R-13 FOAM INSU	RESSURE CO ITROL OF FA	NTROL WIT	H SIGHT GL/ PERS. COM	ASS. REMOTE SAF	TY SHUTDOW	N TERMINAL.								·												-

		AI	R SEP	ARATO	R SCH	EDULE		
MARK	LOCATION	SERVED	GPM	WEIGHT (LBS)	DIA. (IN)	LNG. (IN)	STRAINER SQ. IN. FA	TYRICAL UNIT MFG & MODEL NO.
AS-1	CHILLER PUMP ROOM	CHILLED WATER	300	579	18	44	6	B&G R-6F
<u>REMARKS:</u>	1. 30% PROPYLENE GL	YCOL.						

								$\frown$							
	PUMP SCHEDULE														
MARK	LOCATION	SERVICE	GPM	HD (FT.)	ELÉ HP	CTRICAL DA	TA	TYPICAL UNIT MFG & MODEL NO.	REMARKS:						
P-1	STORAGE 423	CHILLED WATER	300	80	15	208	3	- B&G E-1510 3BD	1,2,3						
P-2	STORAGE 423	CHILLED WATER	300	80	15	208	3	B&G E-1510 3BD	1,2,3						
<u>REMARKS:</u>	1. 30% PROP 2. SUCTION E 3. WALL MOU			ECT											

			VRF FA	N COIL U	NITS	$\frown$	)	
MARK	TOTAL AIRFLOW CFM	NOM.HEATING CAPACITY BTU/HR	NOM.COOLING CAPACITY BTU/HR	WEIGHT (LBS)	POWER (Ø/V/HZ)	AMPS	TYPICAL UNIT MFG & MODEL NO.	REMARKS:
SSI-1	1500	27000	24000	47	1 / 208 / 60	0.28	SAMSUNG - AM024KN4DCH/AA	1,2,3,4,5
SSI-2	1500	27000	24000	47	1 / 208 / 60	0.28	SAMSUNG - AM024KN4DCH/AA	1,2,3,4,5
SSI-3	1500	27000	24000	47	1 / 208 / 60	0.28	SAMSUNG - AM024KN4DCH/AA	1,2,3,4,5
SSI-4	1500	27000	24000	47	1 / 208 / 60	- 0.28	SAMSUNG - AM024KN4DCH/AA	1,2,3,4,5
SSI-5	1500	27000	24000	47	1 / 208 / 60	0.28	SAMSUNG - AM024KN4DCH/AA	1,2,3,4,5
SSI-6	1500	27000	24000	47	1 / 208 / 60	0.28	SAMSUNG - AM024KN4DCH/AA	1,2,3,4,5
SSI-7	1500	27000	24000	47	1 / 208 / 60	0.28	SAMSUNG - AM024KN4DCH/AA	1,2,3,4,5
SSI-8	1500	27000	24000	47	1 / 208 / 60	0.28	SAMSUNG - AM024KN4DCH/AA	1,2,3,4,5
SSI-9	250-430	21500	15000	23.4	1 / 208 / 60		SAMSUNG - AR12TSFABWKNCV	1,2,3,4,5
REMARKS:	1. UNIT MOUNTER	D AND WIRED DISCON	NECT.					
	2. BAC NET INTER	RGRATION TO BMS, JC	HNSON CONTROLS FA	CILITY EXPLORE	२.			
	3. COLOR WHITE	$\checkmark$ $\land$ $\land$				$\wedge$		
	4. BRAIN PANYLEY	ř.	/					
	5. CONDENSATE I	PUMP.						

	EXPANSION TANK SCHEDULE													
MARK	LOCATION	SERVED	ACCEPT. GAL.	DIA (IN.)	HEIGHT (IN.)	WEIGHT FULL (LBS.)	TYPICAL UNIT MFG & MODEL NO.	REMARKS:						
ET-1	CHILLER PUMP ROOM	CHILLED WATER	79	20	58	992	TACO CA-300	1,2						
REMARKS:	1. REMOVABLE BLADD	ER TYPE												
	2. CHARGE TO 12PSI.													
	3. 30% PROPYLENE GL	YCOL.												

	FIN TUBE SCHEDULE													
MARK	BTU/FT.	GPM	TUBE	FINS /	EWT	EAT		ENCLOSUR	E	TYPICAL UNIT MFG	REMARKS:			
WARK	BIU/FI.	GPIVI	SIZE (IN.)	FT.	(°F)	(°F)	H (IN.)	D (IN.)	STYLE	& MODEL NO.	REIVIARNO.			
FT-1	720	5	3/4	40	180	65	10-3/4	6-1/16	PEDESTAL	STERLING JVB	1,2,3,4			
REMARKS:	1. CONTROL	VALVES AB	OVE THE CEIL	ING.			1				1			
	2. COLOR B	Y ARCHITEC	Т.											
	3. ELEMENT	LENGTH LIS	TED ON PLAN	IS. CAT - 662	89C RETURN									
	4. COORDIN	ATE HEIGHT	WITH ELECT	RICAL DEVIC	ES.									

	CHILLER SCHEDULE														
	NOMINAL			CI	HILLED WATE	R		REFRIG	ERANT	EL	ECTRICAL DA	ATA	MEIGUT		
MARK	CAPACITY (TONS)	% PROP GLYCOL	FLOW (GPM)	DELTA P (FT)	IPLV	EWT (°F)	LWT (°F)	REF. TYPE.	CHARGE (LB)	VOLTS/Ø	MCA	MOP	WEIGHT (LBS)	TYPICAL UNIT MFG & MODEL NO.	REMARKS
CH-1	180	30	270	17.42	20.516	56.97	42.00	134A	420.00	230/3	654	800	15700	TRANE-ACRB1805B	1,2,3,4
<u>REMARKS:</u>		EDULED RE	FRIGERANT			TURERS ES	TIMATE, CC	ORDINATE TH	IE CORREC	T CHARGE B	ASED ON FI	ELD CONDIT	FIONS.		

4. HEAT TRACED EVAPORATOR BARREL AND EXTERIOR PIPING. HEAT TRACE SHALL BE ON SEPARATE 120V/20AMP CIRCUIT.

	T) (D.E.				COOLING				HEATING			EL	ECTRICAL DA	ATA	TYPICAL UNIT MFG	DEMAD
MARK	TYPE	LOCATION	MAX CFM	MBH	GPM	WPD	MBH	EWT (°F)	WATER $\Delta T$	GPM	FT WC	WATTS	VOLTS	PHASE	& MODEL NO.	REMAR
FC-1	DUCTED	159 CUSTODIAN	1020	20	5	3.1	42	180	160	4.5	5.6	150	115	60	AIRTHERM 101-1	1,2,3,4
FC-2	CEILING RECESSED	GROUND FLOOR HALL	1020	20	5	3.1	42	180	160	4.5	5.6	150	115	60	AIRTHERM 101-1	1,2,3,
FC-3	CEILING RECESSED	GROUND FLOOR HALL	1020	20	5	3.1	42	180	160	4.5	5.6	150	115	60	AIRTHERM 101-1	1,2,3,4
FC-4	CEILING RECESSED	1ST FLOOR HALL	1020	20	5	3.1	42	180	160	4.5	5.6	150	115	60	AIRTHERM 101-1	1,2,3,4
FC-5	CEILING RECESSED	1ST FLOOR HALL	1020	20	5	3.1	42	180	160	4.5	5.6	150	115	60	AIRTHERM 101-1	1,2,3,4
FC-6	CEILING RECESSED	2ND FLOOR HALL	1020	20	5	3.1	42	180	160	4.5	5.6	150	115	60	AIRTHERM 101-1	1,2,3,4
FC-7	CEILING RECESSED	2ND FLOOR HALL	1020	20	5	3.1	42	180	160	4.5	5.6	150	115	60	AIRTHERM 101-1	1,2,3,4
FC-8	CEILING RECESSED	1ST FLOOR HALL	1020	20	5	3.1	42	180	160	4.5	5.6	150	115	60	AIRTHERM 101-1	1,2,3,4
FC-9	CEILING RECESSED	3RD FLOOR HALL	1020	20	5	3.1	42	180	160	4.5	5.6	150	115	60	AIRTHERM 101-1	1,2,3,4
FC-10	DUCTED	105B SCHOOL PYCHOLOGIST	1020	20	5	3.1	42	180	160	4.5	5.6	150	115	60	AIRTHERM 101-1	1,2,3
FC-11	CEILING RECESSED	3RD FLOOR HALL	1020	20	5	3.1	42	180	160	4.5	5.6	150	115	60	AIRTHERM 101-1	1,2,3,4
<u>EMARKS:</u>	2. PROVIDE WITH	UNTED AND WIRED DISCO 1 1" MERV 7 FILTERS NE GLYCOL COOLING CO														

							· · · ·	AIR	HAND	ING	UNIT S	SCHED	ULE		-		-				
							COOLING N	ИВН				HOT WA	TER HEATIN	G COIL DATA			SUPPLY	FAN MOT	OR DATA		
MARK	ROOM SERVED	CFM	MIN. OA CFM	EXT. SP W.C.	TOTAL	SENS	ROWS	EAT °F DB/WB	LAT °F DB/WB	MBH	EWT	LWT	EAT °F	LAT °F	GPM	WPD FT-W.C.	BHP/HP	RPM	VOLTS/Ø	TYPICAL UNIT MFG & MODEL NO.	REMARKS:
AHU-1	GYM	3500	750	1.5	145	102	4	83.2/68.8	57.9/56	204	180	138	58.7/55.6	111.5/72.7	10	0.7	3.3/4	1935	208/3/60	AAON: H3-DRB-8-0-162D-12F	1,2,3,4,5
AHU-2	GYM	3500	750	1.5	145	102	4	83.2/68.8	57.9/56	204	180	138	58.7/55.6	111.5/72.7	10	0.7	3.3/4	1935	208/3/60	AAON: H3-DRB-8-0-162D-12F	1,2,3,4,5
AHU-3	GYM	3500	750	1.5	145	102	4	83.2/68.8	57.9/56	204	180	138	58.7/55.6	111.5/72.7	10	0.7	3.3/4	1935	208/3/60	AAON: H3-DRB-8-0-162D-12F	1,2,3,4
AHU-4	GYM	3500	750	1.5	145	102	4	83.2/68.8	57.9/56	204	180	138	58.7/55.6	111.5/72.7	10	0.7	3.3/4	1935	208/3/60	AAON: H3-DRB-8-0-162D-12F	1,2,3,4
AHU-5	KITCHEN	2600	500	1	98.3	70.57	6	80/67	56.1/44.7	128.7	180	127	60.4/56.6	105.4/71.3	5	0.3	1.68/4	1552	208/3/60	AAON:H3-CRB-8-0-162C-12F	1,2,3,4,5
AHU-6	MUSIC	4200	1500	1.2	185.6	129.7	6	85.4/70.2	57.8/56.3	266.4	180	122.3	47.9/47.9	104.2/68.5	9.5	0.7	3.12/4	1901	208/3/60	AAON: H3-DRB-8-0-162C-12F	1,2,3,4,5
REMARKS:	1. FACTORY MOUNTED	AND WIRE	D DISCONNEC	T. ALL UNITS	SHALL BE S	SINGLE POINT (	CONNECTIO	ON.													

2. DAMPER ACTUATORS BY MANUFACTURER. FULLY MODULATING ACCUATORS. MERV 13 FILTERS. MAGNEHELIC HAUGE CLOG FILTER SWITCH. THERMAL EXPANSION VALVES. 3. CONNECT TO EXISTING JOHNSON CONTROLS, FACILITY EXPLORER. 4. VIBRATION ISOLATION.


5. CONTROLS RELOCATED BY OTHERS FROM EXISTING UNIT.

						НОТ	WA1
				AIR DATA			
MARK	SERVICE	0514	TEM	P (°F)	MAX APD	MIN.	0.014
		CFM	ENT	LVG	(IN. WC)	MBH	GPM
HC-1	SF-9	2250	-2	70	0.76	174,960	18.8
HC-2	RTU-4	9100	-2	70	0.56	707,616	70.8
REMARKS:	1. TUBE OD	0.625, FUBE	SPACING 1.50	X1.299		•	
6	2. ALTERNA	ТЕ <sup>Ү</sup> МС-05. <sup>\</sup>	)				
<u> </u>		ı r	$\lambda$				
		$\checkmark$ $\nearrow$	/1				

REGISTERS, GRILLES, AND DIFFUSERS									
MARK	APPLICATION	MATERIAL	TYPE	FINISH	DESIGN EQUIP.	REMARKS			
D1	SUPPLY	STEEL	LAY-IN	WHITE	PRICE SPD	4			
D2	SUPPLY	STEEL	DUCT GRILLE	WHITE	PRICE SDG	1,3			
S1	SUPPLY	STEEL	DUCT GRILLE	WHITE	PRICE HCD	1			
R1	RETURN/EA	STEEL	LAY-IN	WHITE	PRICE PDR	4			
R2	RETURN/EA	STEEL	WALL GRILLE	WHITE	PRICE 90	2,3			
REMARKS:       1. OPPOSED BLADE DAMPER.         2. CONCEALED MOUNTING.         3. SINGLE DEFLECTION, BLADES PARALLEL TO LENGTH.         4. INSULATED BACK PAN.									

						FAN	SCHE	DULE					
-	MARK	LOCATION	SERVICE	TYPE	CFM	SP IN W.G.	RPM	HP	ELECTRIC, VOLTS	AL DATA PHASE	AMPS	TYPICAL UNIT MFG & MODEL NO.	REMARK
-	EF-1	GYM	LOCKER ROOM EXHAUST	CENTRIFUGAL	1500	0.75	1457	.25	115	1	3.8	GREENHECK G-100-VG	1,2,4
-	EF-2	GYM	LOCKER ROOM EXHAUST	CENTRIFUGAL	1500	0.75	1457	.25	115	1	3.8	GREENHECK G-100-VG	1,2,4
-	EF-3	ROOF	CLASSROOM EXHAUST	CENTRIFUGAL	2000	0.5	948	1/2	208	1	5.4	GREENHECK GB-161	1,2
-	EF-4	ROOF	MUSIC ROOM	CENTRIFUGAL	1400	1	1725	1/2	208	1	5.4	GREENHECK G-123-A	1,2
-	EF-5	ROOF	CLASSROOM EXHAUST	CENTRIFUGAL	1250	1	1725	1/2	208	1	4.9	GREENHECK G-123-1	1,2
-	EF-6	ROOF	CLASSROOM EXHAUST	CENTRIFUGAL	4500	1	1102	2	208	1	12	GREENHECK G-200	1,2
-	SF-1	ATTIC	CLASSROOM OA	INLINE	10000	1.5	824	5	208	3	16.7	GREENHECK BSQ-300	1
-	SF-2	ATTIC	CLASSROOM OA	INLINE	3750	0.4	539	1/2	208	3	2.4	GREENHECK BSQ-240	1
	SF-3	ATTIC	CLASSROOM OA	INLINE	8750	1.5	1147	5	208	3	16.7	GREENHECK BSQ-240	1
	SF-4	-	-	-	-	-	-	-	-	-	-	NOT USED	-
	SF-5	-	-	-	-	-	-	-	-	-	-	NOT USED	-
	SF-6	ATTIC	CLASSROOM OA	INLINE	7000	0.75	875	2	208	3	7.5	GREENHECK BSQ-240	1
	SF-7	ATTIC	CLASSROOM OA	INLINE	7500	1	964	3	208	3	10.6	GREENHECK BSQ-240	1
	SF-8	ATTIC	CLASSROOM OA	INLINE	6750	1.5	1012	5	208	3	16.7	GREENHECK BSQ-240	1
	SF-9	TECH	CLASSROOM OA	INLINE	2250	0.5	992	1/2	208	1	5.4	GREENHECK BSQ-160	1,3
	RF-1	ATTIC	CLASSROOM EA	INLINE	13750	1.25	675	7-1/2	208	3	24.2	GREENHECK BSQ-360	1 A
-(	RF-2	ATTIC	CLASSROOM EA	CENTRIFUGAL	3750	0.8	738	1	208	3	4.6	GREENHECK GB-220	1,2
	RF-3	ATTIC	CLASSROOM EA	INLINE	3750	0.4	539	1/2	208	3	2.4	GREENHECK BSQ-240	1
-	RF-4	ATTIC	CLASSROOM EA	INLINE	2500	0.25	585	1/3	208	3	2.4	GREENHECK BSQ-200	1
-	RF-5	ATTIC	CLASSROOM EA	INLINE	1250	0.25	623	1/4	208	3	2.4	GREENHECK BSQ-160	1
F	RF-6	ATTIC	CLASSROOM EA	INLINE	6250	0.75	816	2	208	3	7.5	GREENHECK BSQ-240	1
-	RF-7	ATTIC	CLASSROOM EA	INLINE	4000	1	1038	1-1/2	208	3	6.6	GREENHECK BSQ-200	1
	RF-8	ATTIC	CLASSROOM EA	INLINE	7250	1	945	3	208	3	10.6	GREENHECK BSQ-240	1

4. PROVIDE WITH SLOPPED CURBS.

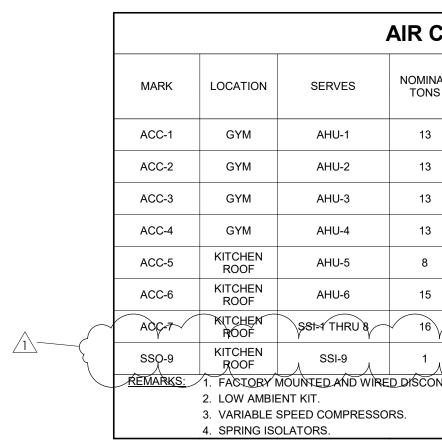

HOT WATER COIL SCHEDULE										
		WATER	R DATA							
MIN.	MIN. GPM	TEMP (°F)			MFG SIZE HXL (IN.)	ROWS	TYPICAL UNIT MFG & MODEL NO.	REMARKS:		
MBH	GPM	ENT	LVG	(IN. WC)						
174,960	18.8	180	160	3.8	15X22	2	CAPITAL COIL W8-2215-12B-HCA-R	1,2		
707,616	70.8	180	160	4.5	46X30	4	CAPITAL COIL	1		

			ELECT	RICAL DATA			OPERATING		
NAL IS	FA	AN	COMF	PRESSOR			WEIGHT	TYPICAL UNIT MFG & MODEL NO.	REMARKS:
0	NO.	HP	QTY	RLA	VOLT/Ø	MCA	(LBS.)	a mobel no.	
	2	.75	2	20.4	208/3	59	1141	AAON CFA-013-B-A-8-DC00K	1,3
	2	.75	2	20.4	208/3	59	1141	AAON CFA-013-B-A-8-DC00K	1,3
	2	.75	2	20.4	208/3	59	1141	AAON CFA-013-B-A-8-DC00K	1,3
	2	.75	2	20.4	208/3	59	1141	AAON CFA-013-B-A-8-DC00K	1,3
	2	1/3	2	16.1	208/3	39	1078	AAON CFA-009-B-A-8-DC00K	1,3,4
	2	.75	2	25	208/3	66	1143	AAON CFA-015-B-A-8-DC00K	1,3,4
$\bigvee$	2	620W	2	28	208/3	73√	763	SAMSUNG AM192HXVAFH2AA	1,2,3,4
٨	1	40W	1	9.2	208/1	,12.5	70.8	SAMSUNG AR12TSFABWKXÇV	1,,2

CPL | Architecture Engineering Planning 50 FRONT ST. SUITE 202 NEWBURGH, NY 12550 CPLteam.com

PROJECT INFORMATION Project Number 13940.18 Client Name NEWBURGH ENLARGED CITY SCHOOL DISTRICT Project Name PHASE 3: HERITAGE MIDDLE SCHOOL 2019 CAPITAL IMPROVEMENT PROJECT

Project Address 405 Union Avenue, New Windsor, NY 12553

SED Number 44-16-00-01-0-039-011

# No. Date Description 1 9/17/21 BID ADDENDUM #1 2 9/23/21 BID ADDENDUM #2


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## SHEET INFORMATION

Scale						
12" = 1'-0"						
JMENTS						
Checked By						
JJW						
hvac schedules						

Drawing Number HMS H900

4/2021 2:51:14 PM S:\Projects\Newburgh ECSD\Heritage MS Addtn & Reno\D Design\06 CAD\

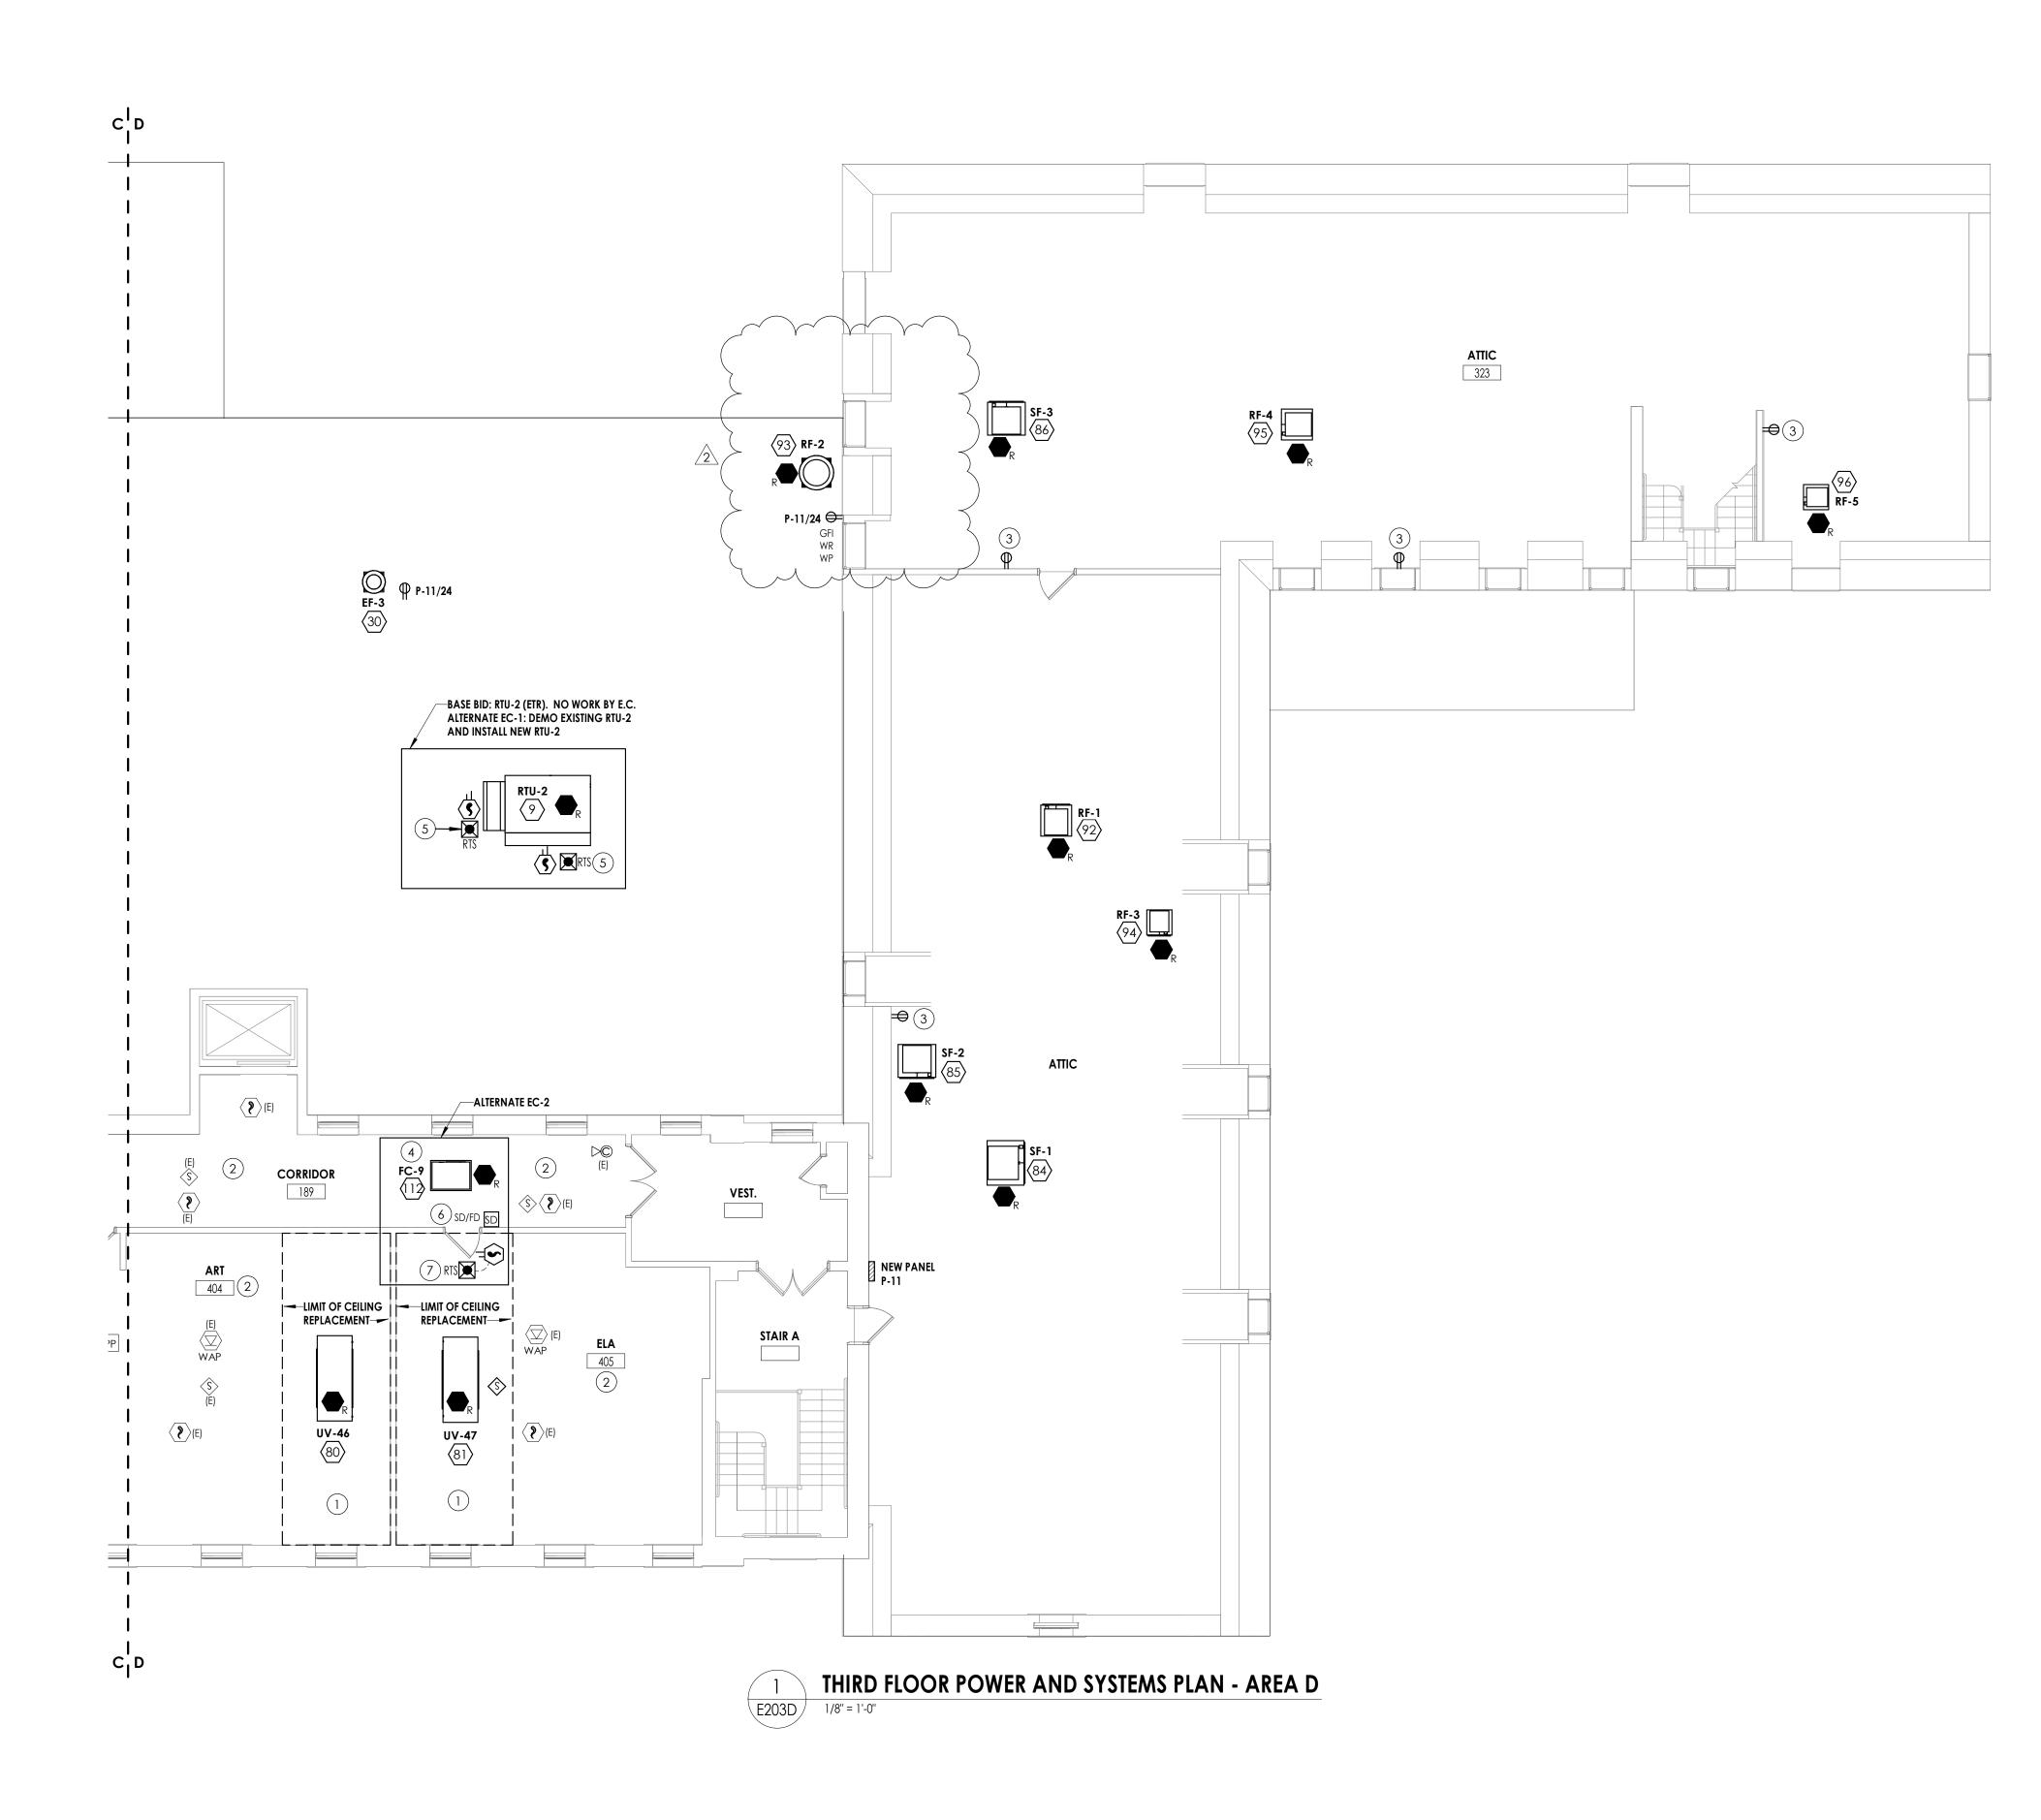



### **GENERAL NOTES:**

- A. FIXTURES, DEVICES, AND EQUIPMENT LABELED AS "(E)" ARE EXISTING AND ARE SHOWN FOR REFERENCE ONLY. ALL OF THESE DEVICES SHALL REMAIN OPERATIONAL FOLLOWING CONSTRUCTION.
- B. EQUIPMENT DESIGNATED WITH A NUMBER INSIDE OF A HEXAGON ARE SCHEDULED ON DRAWING E900. REFER TO EQUIPMENT WIRING SCHEDULE FOR BREAKER AND CIRCUITING INFORMATION.
- C. DISCONNECT SWITCHES AND STARTER DEVICES ASSOCIATED WITH HVAC EQUIPMENT SHALL BE FURNISHED AND INSTALLED BY THE MECHANICAL CONTRACTOR, AND WIRED BY THE ELECTRICAL CONTRACTOR. INCLUDE AN ADDITIONAL 10' OF CIRCUITING IN PRICING FOR INSTANCES WHERE A DISCONNECT MAY NOT BE MOUNTED DIRECTLY ON UNIT. E.C. IS RSPONSIBLE TO WIRE BOTH LINE AND LOAD SIDES OF DISCONNECT.
- D. UPDATE PANELBOARD DIRECTORIES TO REFLECT CHANGES MADE TO CIRCUITS WITH LOAD(S) AND ROOM(S) SERVED. LABEL ANY UNUSED BREAKER AS SPARE AND TURN TO OFF POSITION.
- E. FIRE ALARM SCOPE OF THIS PROJECT INCLUDES INSTALLING A NEW SIMPLEX 4100ES PANEL TO SERVE NEW AND RENOVATED AREAS WHILE MAINTAINING EXISTING SIMPLEX 4020 PANEL. ALL EXISTING DEVICES REMOVED IN THE DEMOLITION PHASE OF THE PROJECT SHALL BE REMOVED FROM THE SYSTEM PROGRAMMING OF THE 4020 PANEL. NEW INITIATION AND NOTIFICATION DEVICES SHOWN SHALL BE CONNECTED TO AND COMPATIBLE WITH THE NEW SIMPLEX 4100ES FIRE ALARM CONTROL PANEL LOCATED IN CUSTODIAN ROOM 50. PROVIDE NEW NOTIFICATION APPLIANCE CIRCUIT PANELS (WITH SMOKE DETECTOR WITHIN 5') WITH BATTERIES WHERE REQUIRED TO ACCOMMODATE NEW NOTIFICATION DEVICES. LOCATE SAID NAC PANEL IN A STORAGE OR ELEC/MECH ROOM, AND WIRE TO NEAREST AVAILABLE PANELBOARD WITH (2)#12, #12 GND. IN 3/4" CONDUIT. FOR PRICING PURPOSES, ASSUME 150' PER CIRCUIT. PROVIDE 20/1 CIRCUIT BREAKER AS REQUIRED.
- F. FIRE ALARM SPACING SHALL COMPLY WITH NFPA 72 REQUIREMENTS. ALL FIRE ALARM INITATION DEVICES SHOWN SHALL NOT BE LOCATED IN DIRECT AIRFLOW PATH OR CLOSER THAN 3' OF AN AIR SUPPLY DIFFUSER OR RETURN AIR OPENING.
- G. THE OPERABLE PART OF PULL STATIONS SHALL BE MOUNTED MORE THAN 3'-6" BUT LESS THAN 4'-0" ABOVE FINISHED FLOOR.
- H. FOR PUBLIC MODE, WALL MOUNTED VISUALS AND AUDIBLE/VISUALS SHALL BE MOUNTED SUCH THAT THE ENTIRE LENS IS NOT LESS THAN 80" AND NOT GREATER THAN 96" ABOVE FINISHED FLOOR.
- I. THE MINIMUM REQUIRED CANDELA LEVEL IS INDICATED ADJACENT TO NEW VISUAL DEVICES. IF NOT INDICATED, MINIMUM ALLOWABLE SETTING IS 15 CANDELA.
- J. ACTIVATION OF BUILDING FIRE ALARM SYSTEM SHALL AUTOMATICALLY SHUT DOWN ALL FANS ASSOCIATED WITH HVAC UNITS IN THE BUILDING AS REQUIRED BY LOCAL, STATE, AND NATIONAL CODES. PROVIDE FIRE ALARM SHUT DOWN RELAYS IN EACH UNIT.
- K. FINAL TESTING OF FIRE ALARM SYSTEM SHALL COMPLY WITH ALL NFPA 72 REQUIREMENTS. ANY ALTERED CIRCUIT(S) SHALL HAVE ALL FIRE ALARM INITIATION DEVICES TESTED IN THEIR ENTIRETY AND 10% OF NEIGHBORING ZONE/LOOP DEVICES.
- L. PROVIDE 8" ROUND, FLUSH MOUNTED, WHITE CEILING SPEAKERS WHERE SHOWN. NEW SPEAKERS SHALL BE CONNECTED TO AND COMPATIBLE WITH EXISTING BUILDING PUBLIC ADDRESS SYSTEM. EXPAND EXISTING SYSTEM WITH ADDITIONAL AMPLIFIERS AS REQUIRED AT HEAD END LOCATION FOR A COMPLETE OPERATIONAL SYSTEM. COORDINATE EXACT REQUIREMENTS WITH OWNER.
- M. ALL CABLING ABOVE ACCESSIBLE CEILINGS SHALL BE SUPPORTED VIA J-HOOK. J-HOOKS SHALL NOT EXCEED 5'-0" SPACING. ALL CABLING ABOVE INACCESSIBLE SPACES AND CEILINGS OPEN TO STRUCTURE SHALL BE IN CONDUIT.
- N. ALL EXPOSED RACEWAY SHALL BE PAINTED TO MATCH CEILING/WALL FINISH. CONTRACTOR SHALL USE APPROVED PAINT COLOR/TYPE.
- O. NEW CARBON MONOXIDE DETECTORS SHALL BE ADDRESSABLE AND BE CONNECTED TO THE BUILDING FIRE ALARM SYSTEM.

### **KEY NOTES:**

- 1 IN DESIGNATED CEILING REPLACEMENT AREA, ELECTRICAL CONTRACTOR SHALL REINSTALL SALVAGED CEILING MOUNTED ELECTRICAL DEVICES SHOWN. RECONNECT EXISTING CABLING AND BRANCH CIRCUIT WIRING LEFT FROM DEMOLITION.
- 2 EXISTING CEILING MOUNTED SYSTEM AND POWER DEVICES SHOWN IN THIS AREA ARE SHOWN FOR REFERENCE PURPOSES ONLY. SHOULD CEILING TILE BE REQUIRED TO BE REMOVED AS NOTED IN DEMOLITION DRAWING KEY NOTES, THE ELECTRICAL CONTRACTOR SHALL BE RESPONSIBLE TO TEMPORARILY SUPPORT OR REMOVE/REINSTALL THE EQUIPMENT.
- (3) INSTALL SERVICE RECEPTACLE FOR NEW HVAC EQUIPMENT. COORDINATE EXACT LOCATION IN FIELD TO MEET NEC 210.63. WIRE RECEPTACLES TOGETHER WITH (2) #12, #12 G. IN 1/2" CONDUIT AND WIRE TO PANEL P-11, CIRCUIT 26.
- WIRE NEW FAN COIL UNIT TO BRANCH CIRCUIT WIRING LEFT FROM DEMOLITION OF HVAC UNIT. SPLICE AND EXTEND EXISTING CIRCUIT AS REQUIRED WITH (2)# 12, #12 GND. IN 1/2" CONDUIT TO REACH TERMINATION POINT OF NEW UNIT.
- (5) LOCATE REMOTE TEST SWITCHES FOR ROOFTOP UNIT DUCT SMOKE DETECTOR IN ACCESSIBLE SPACE BELOW UNIT. RECESS MOUNT IN DROP CEILING TILE OR WALL MOUNT IN JANITOR CLOSET/STORAGE ROOM TYPE SPACE. LABEL SWITCHES WITH UNIT NAME AND SUPPLY/RETURN DESIGNATION.
- (6) PROVIDE DUCT SMOKE DETECTOR AND FIRE ALARM RELAY TO SIGNAL MECHANICAL SMOKE DAMPER. PROVIDE 120V BRANCH CIRCUIT TO DAMPER ACTUATOR FROM NEAREST 120V RECEPTACLE CIRCUIT. WIRE WITH (2) #12, #12 GND. IN 1/2" CONDUIT.
- 7 LOCATE REMOTE TEST SWITCH FOR DUCT SMOKE DETECTOR BELOW UNIT, RECESSED IN CEILING TILE.

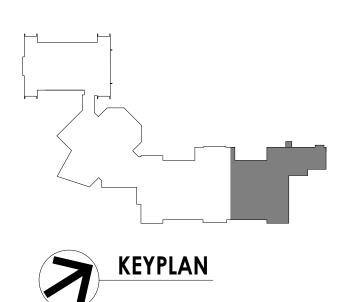

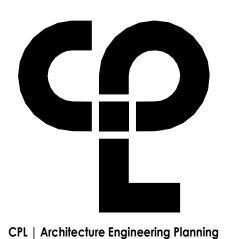

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PROJECT INFORMATION
Project Number
13940.18
Client Name
NEWBURGH ENLARGED CITY
SCHOOL DISTRICT
Project Name
PHASE 3: HERITAGE MIDDLE
SCHOOL 2019 CAPITAL

SCHOOL 2019 CAPITAL IMPROVEMENT PROJECT

Project Address 405 Union Avenue, New Windsor, NY 12553


SED Number

 PROJECT ISSUE SCHEDULE

 No.
 Date

 2
 9/23/21

 BID ADDENDUM #2

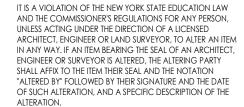

### SHEET INFORMATION

Issued	Scale
09/06/2021	As indicated
Project Status	
CONSTRUCTION DOCL	JMENTS
Drawn By	Checked By
RJD	ARM
Drawing Title	
THIRD FLOOR PO SYSTEMS PLAN - A	

HMS E203D



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"g. All "TR" Drawings (Theatrical Rigging)

2.4.2 Part 1.7.H: Add the following:

"q) Division 19 - Section 193000-Theatrical Stage Rigging and curtains"

2.4.3 Part 1.9.A.a: Add the following:

"7) All "TL" Drawings (Theatrical Lighting)8) All "TS" Drawings (Theatrical Sound)"

- 2.5 Section 012300:
  - 2.5.1 Part 3.01.A: Add the following:
    - "8. Alternate No. GC-8: Motorized Window Shades
      - a. Description: Provide and install motorized window shades as specified in the Cafeteria."
    - "9. Alternate No. GC-9: Painting walls at mechanical equipment removals a. Description: Paint wall surface per keynote 7 on drawings."
  - 2.5.2 Part 3.01.C: Add the following:
    - "6. Alternate No. EC-6: Cafeteria Stage Removal
      - a. Description: Provide Electrical work associated with the removal of the existing stage and the installation of a new concrete slab on grade."
- 2.6 Section 084313, Part 2.02.A: Revise "Front-Set Style..." to read; "Center Set Style..."

#### CHANGES TO THE DRAWINGS:

- 3.1 Drawing HMS C100: Revise note, "Concrete sidewalk and subbase to be removed and disposed (~1,960 LF measured along the pavement side)" to read, "Concrete sidewalk and subbase to be removed and disposed (~290 LF measured along the pavement side)"
- 3.2 Drawing HMS C101:
  - 3.2.1 Revise note, "Contractor to establish temporary additional..." to read "Contractor to maintain temporary additional parking area."
  - 3.2.2 Revise note, "Contractor to establish temporary access..." to read "Contractor to maintain temporary access..."



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- 3.2.3 Remove note, "Provide stone subbase for contractor staging area"
- 3.2.4 Revise note, "Contractor to install construction entrance..." to read, "Contractor to maintain construction entrance. Contractor will be responsible for keeping erosion and debris on site"
- 3.2.5 Remove note, "Contractor to establish temporary additional parking area (~30 spaces) using 6" of compacted crushed stone (see detail)."
- 3.2.6 Remove note, "Contractor to replace curb when restoring area"
- 3.2.7 Remove note, "Temporary tree protection..."
- 3.2.8 Remove note, "After construction, contractor to remove..."
- 3.3 Drawing HMS A103D: Replace with the attached revised HMS A103D.
- 3.4 A200 Series Drawings: Revise Keynote 7 to read, "Base Bid: Patch existing wall. Coordinate work with MC. Refer to A801 for details. Alternate GC-9: Paint surface corner to corner and floor to ceiling to match existing color."
- 3.5 Drawing HMS A204D: Replace with the attached revised HMS A204D.
- 3.6 Drawing HMS A800, Detail 3: After note, "Motorized window shades" add the words, "per Alternate GC-8"
- 3.7 Drawing HMS A900: Replace sheet with attached HMS A900.
- 3.8 Drawing HMS I000: At WT-1 Notes, revise "By Owner" to read, "Alternate GC-8"
- 3.9 Drawing HMS H202D: Replace with the attached revised drawing HMS H202D.
- 3.10 Drawing HMS H203D: Replace with the attached revised drawing HMS H203D.
- 3.11 Drawing HMS H900: Replace with the attached revised drawing HMS H900.
- 3.12 Drawing HMS E203D: Replace with the attached revised HMS E203D.

#### END OF ADDENDUM NO. 02