#### **ADDENDUM NO. 01**

PROJECT: Ossining Union Free School District

**Ossining High School** 

**Guidance Office Renovations** 

SED PROJECT NO: 66-14-01-03-0-003-039

DATE: **December 22, 2020** 

CPL PROJECT NO: **14428.12** 

Include this Addendum as part of the Contract Documents. It supplements portions of the original Specifications and Drawings, the extent of which shall remain, except as revised herein:

#### **CLARIFICATIONS / RESPONSE TO BIDDER QUESTIONS:**

- 1.1 Attached, for reference, is a copy of the Pre-bid meeting/walk-thru sign-in sheet.
- 1.2 Clarification: The existing fire alarm system is Simplex 4100ES.
- 1.3 Clarification: The existing public address (PA) system is Rauland Borg, the 'head-end' is located in the High School Main Office.
- 1.4 Clarification: All new PA speakers to be tied into existing speaker wiring.
- 1.5 Clarification: The existing clock system is Primex (Wireless). Clocks are battery powered.
- 1.6 Clarification: Owner will remove furniture, etc. from the work areas.
- 1.7 Clarification: The Owner will make the building available on weekends and after hours as needed so the Contractor can complete the project per the Schedule. Contractor shall notify Owner at least 24 hours in advance of working said extended hours. See Section 01 1125, Paragraph 1.4 for additional information.
- 1.8 Question: AA102: Are we replacing roofing after abatement work? Are there roof drawings the Contractor can go by?

Answer: Roofing removed due to abatement operations shall be replaced maintaining all existing warranties. See Details 1/H101 and 1/H201.

1.9 Question: AA102: Are we replacing the tile after we remove the MJP's?

Answer: It is the assumption that the question refers to the 'square' hatching used to show work area. Scope of work is to remove MJP's and debris in attic. See Section 02 0800, Paragraph 3.17.1. Note that reinsulating all piping where insulation was removed is part of the work. See H301, H302.

Ossining Union Free School District Ossining High School Guidance Office Renovations Addendum No. 01

**1.10** Question: AA100: Are we replacing the tile that is getting removed?

Answer: It is the assumption that the question refers to the 'square' hatching used to show work area. Scope of work is to remove MJP's in the basement. See Section 02 0800, Paragraph 3.17.1. Note that reinsulating all piping where insulation was removed is part of the work. See H301, H302.

- 1.11 Question: How much reinsulation of piping do we need to figure after abatement? Note that H302 says to replace 200 LF, but note H301 says to replace 135 LF.

  Answer: 335 LF.
- 1.12 Question: Is the current roofing under warranty, and who is the manufacturer?

  Answer: Roofing reported to be manufactured by Carlisle Syntec Systems, accepted 10/2012, 20 year warranty.

#### **CHANGES TO THE PROJECT MANUAL:**

- 1.13 Section 00 0110 Table of Contents:
  - A. Division 00: add the text "00 3113 CONSTRUCTION SCHEDULE".
- 1.14 Section 00 3113 Construction Schedule:
  - A. Add the attached Section 00 3113.
- 1.15 Section 00 4010 Form of Proposal Guidance Office Renovations:
  - A. Replace Section 00 4010 with the attached Section 00 4010.
- **1.16** Section 01 1000 Summary:
  - A. Delete Paragraph 1.7.D.
- 1.17 Section 02 0800 Asbestos Abatement:
  - A. In paragraph 3.17.2: replace text '200 SF' to read '30 SF'.

#### **CHANGES TO THE DRAWINGS**

- **1.18 Drawing OHS/A200:** 
  - A. Replace Drawing with Drawing OHS/A200, attached to this addendum.
- **1.19 Drawing OHS/A600:** 
  - A. Replace Drawing with Drawing OHS/A600, attached to this addendum.
- **1.20 Drawing OHS/A900:** 
  - A. Replace Drawing with Drawing OHS/A900, attached to this addendum.
- **1.21 Drawing OHS/H101:** 
  - A. Replace Drawing with Drawing OHS/H101, attached to this addendum.
- **1.22 Drawing OHS/H201:** 
  - A. Replace Drawing with Drawing OHS/H201, attached to this addendum.

Ossining Union Free School District Ossining High School Guidance Office Renovations Addendum No. 01

#### **1.23 Drawing OHS/H301:**

A. Replace Drawing with Drawing OHS/H301, attached to this addendum.

#### **1.24 Drawing OHS/H800:**

A. Replace Drawing with Drawing OHS/H800, attached to this addendum.

#### 1.25 Drawing OHS/E100:

A. Replace Drawing with Drawing OHS/E100, attached to this addendum.

## **1.26 Drawing OHS/E101:**

A. Replace Drawing with Drawing OHS/E101, attached to this addendum.

#### **1.27 Drawing OHS/E201:**

A. Replace Drawing with Drawing OHS/E201, attached to this addendum.

#### **1.28 Drawing OHS/E900:**

A. PP1 Panel Schedule PP1: Location: Change text "Generator Room (Basement)" to read "Storage 103L".

### PREVIOUSLY ISSUED ADDENDA

A. None.

#### END OF ADDENDUM NO. 01

Ossining Union Free School District Ossining High School Guidance Office Renovations

Pre-Bid Meeting December 16, 2020

Attendee Sign-in Sheet

Name	Firm	Phone Number	E-mail Address
Alas Oranis	1 HD	718.690.53 43	lighthousedesigns gmail. co.
John News	Renu	732,3,6,0469	Sneed Oran y, con
MARK MACISZEWSKI	DELTA EUCCTRIC	914-376-5911	mmalise delto electricisc spet
CARREN Jantely	JENNES	914 381 530	giernings a gernings sire co
CHESS WATERS	Januar !	914 381 5300	
Bas Camillia.	Toter A Comillio Sexter	कुर्य – या ५	Feter.comill: everizor Het
UNCOM TOOCO	GRACE CONTRACTING	844 242-5629	estimuting@ qcdny.com

Attendee Sign-in Sheet (continued)

Name	Firm	Phone Number	E-mail Address
Flor Cordero	Upper Restration	646-4062735	Flora oupper restoration co

# SECTION 00 3113 – CONSTRUCTION SCHEDULE

### PART 1 - GENERAL

### 1.1 CONSTRUCTION SCHEDULE

A. Contractor shall complete work of their Contract per the following Schedule:

Work	Start Date (Date listed or earlier if permitted by Owner)	Completion Date
Submittals:	Submittals to begin upon award of Contract.	
Construction:	June 28, 2021	August 27, 2021.

PART 2 - PRODUCTS (Not Used)

PART 3 - EXECUTION (Not Used)

END OF SECTION 00 3113

# SECTION 00 4010 - FORM OF PROPOSAL CONTRACT 1 – GUIDANCE OFFICE RENOVATIONS

#### 1.1 GENERAL

<b>4</b> .	Pursuant to, and in compliance with, the Advertisement for Bids and the Instructions to Bids relative thereto, and all of the Contract Documents, including any and all Addenda issued by Architect and mailed or delivered to the Undersigned prior to the opening of Bids, when	the
	received by the Undersigned or not, we,	
	hereby propose to furnish all plant, labor, supplies, mater	ials
	and equipment incidental to GUIDANCE OFFICE RENOVATIONS as required by, and strict accord with, the applicable provisions of the Drawings and Specifications entitled Ossin	
	Union Free School District, Ossining High School, Guidance Office Renovations to satisfaction and approval of the Architect and the Owner in accordance with the terms conditions of the Contract Documents for the following sum:	
	BASE BID:	
	Total: (\$)	
	Dollars	

#### 1.2 TIME OF COMPLETION

- A. The Undersigned agrees, after receipt of a Notice of Award and a consummation of a Contract Agreement in accord with the terms of the Contract Documents, to start work within ten (10) consecutive calendar days of said Notice of Award and will fully complete the work per Section 00 3113 Construction Schedule.
- B. Liquidated Damages: Ossining Union Free School District (Owner) and CONTRACTOR recognize that time is of the essence of this Agreement and that Owner will suffer financial loss if the Work is not completed by the date specified in Paragraph 1.2.A above, plus any extensions thereof allowed in accordance with the General Conditions. They also recognize the delays, expense and difficulties involved in proving in a legal or arbitration proceeding the actual loss suffered by Owner if the Work is not completed on time. Accordingly, instead of requiring any such proof, Owner and CONTRACTOR agree that as Liquidated Damages for delay (but not as a penalty) CONTRACTOR shall pay Owner, **Five Hundred Dollars (\$500)** for each day that expires after the date specified in Paragraph 1.2.A above

#### 1.3 SCHEDULE OF WORK

- A. Scheduling of all work shall be coordinated through the District's needs. Representative. Contractor shall coordinate their work around the District's needs.
- B. It is the District's intent to work with the Contractor and make the building available for the work to be performed within the time frame allowed.

#### 1.4 ATTACHMENTS

- A. The Undersigned has attached the following documents to this Bid:
  - 1. Bid Bond/Certified Check in the amount of five percent (5%) of the Base Bid.
  - 2. Contractor's Qualification Statement (AIA Document A305).
  - 3. Iran Divestment Act Certifications (see Section 00 4951).
  - 4. Bid Proposal Certifications (see Section 00 4960).
  - 5. Hold Harmless Agreement (see Section 00 4970).
  - 6. Prevailing Wage Agreement (see Section 00 7343).

#### 1.5 CHANGE ORDERS

- A. We propose and agree that the Contract Sum shall be adjusted for changes in the Contract Work, not included in unit prices, by addition of the following costs:
  - 1. Profit and overhead as permitted in the GENERAL CONDITIONS.

## 1.6 ALLOWANCES: (Reference Specification Section 01 2100).

A. The Bidder acknowledges that the Allowance applicable to this Contract is included in the Base Bid.

#### 1.7 UNIT PRICE SCHEDULE (Reference Specification Section 01 2200):

In addition to the Work provided within the above Base Bid, the Undersigned agrees to provide the following work in accordance with the Drawings and Specifications:

1. Insulate steam and condensate piping, NPS 3.5" diameter and smaller where insulation was removed due to hazardous material abatement work beyond the amounts included in the Base Bid (see Drawings H201 & H301).

Per lineal foot.

Unit price to be used as an add or deduct value from base bid quantities and allocation of bid allowances.

 Insulate steam and condensate piping, NPS 4" diameter and larger where removed due to hazardous material abatement work beyond the amounts included in the Base Bid (see Drawings H201 & H301).

Per lineal foot.

Unit price to be used as an add or deduct value from base bid quantities and allocation of bid allowances.

#### 1.8 NON-COLLUSIVE BIDDING CERTIFICATION (See Specification Section 00 4960 also).

- A. By submission of this bid, the bidder, and each person signing on behalf of the bidder, certifies, and in the case of a joint bid each party thereto certifies as to its own organization, under penalty of perjury, that to the best of knowledge and belief:
  - 1. The prices in this bid have been arrived at independently without collusion, consultation, communication, or agreement, for the purpose of restricting competition, as to any matter relating to such prices with any other bidder or with any competitor;

- 2. Unless otherwise required by law, the prices which have been quoted in this bid have not been knowingly disclosed by the bidder and will not knowingly be disclosed by the bidder prior to opening, directly or indirectly, to any other bidder or to any competitor; and,
- 3. No attempt has been made, or will be made, by the bidder to induce any other person, partnership or corporation to submit, or not to submit, a bid for the purpose of restricting competition.
- B. The person signing this bid or proposal certifies that he/she has fully informed himself/herself regarding the accuracy of the statements contained in this certification, and under the penalties or perjury, affirms the truth thereof, such penalties being applicable to the bidder as well as the person signing in its behalf;

corporate bidder. Resolved that			
(Na	me of Individi	ual)	
be authorized to sign and submit the			•
Union Free School District, Ossin			
to include in such bid or proposal one Hundred Three (d) ((103d)) of			
such corporation, and for any in			
corporate bidder shall be liable und			
1			
-	0.1		
The foregoing is a true and correct	copy of the res	solution by:	
The foregoing is a true and correct		•	_ Corporation at a
The foregoing is a true and correct of meeting of its Board of Directors he		•	_ Corporation at a
The foregoing is a true and correct		•	_ Corporation at a
The foregoing is a true and correct of meeting of its Board of Directors he		•	_ Corporation at a
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The foregoing is a true and correct of meeting of its Board of Directors he		•	_ Corporation at a
The foregoing is a true and correct of meeting of its Board of Directors he		•	_ Corporation at a

#### 1.9 ACCEPTANCE

A. When this Proposal is accepted, the Undersigned agrees to enter into a Contract with the Owner as provided in the Form of Agreement.

Secretary

(SEAL OF THE CORPORATION)

#### 1.10 AFFIRMS

- A. The Undersigned affirms and agrees that this Proposal is a firm one which shall remain in effect and will be irrevocable for a period of forty-five (45) days after opening of Bids.
- B. The Undersigned acknowledges the receipt of the prevailing wage rates for the Contract which are incorporated into the Contract Documents.

- C. The Undersigned understands that the Owner reserves the right to accept or reject any or all Proposals and to waive any informalities in the bidding.
- D. By submission of this bid, each bidder and each person signing on behalf of any bidder certifies, and in the case of a joint bid, each party thereto certifies as to its own organization, under penalty of perjury, that the bidder has and has implemented a written policy addressing sexual harassment prevention in the workplace and provides annual sexual harassment prevention training to all of its employees. Such policy shall, at a minimum, meet the requirements of Section 201-G of the New York State Labor Law.

1.11	<b>TYPE</b>	OF B	USINESS
------	-------------	------	---------

A.	The Undersigned hereby represents that it is a (check one) $\square$ Corporation, $\square$ Partnership, $\square$
	Individual. If a Corporation, then the Undersigned further represents that it is duly qualified as a
	Corporation under the laws of New York State and it is authorized to do business in this State.

1.12	PLACE OF BUSINESS	
A.	The following is the name ar with this Proposal may be tele	nd address of the person to whom all notices required in connection ephoned, mailed, or delivered:
	Name of Contact Person:	
	Name of Business or Firm:	
	Address:	
	Federal ID No. or Social Security Number:	
	Telephone:	Fax:
	E-mail:	Mobile Phone:

#### 1.13 EXECUTION OF CONTRACT

A. When written Notice of Acceptance of the Proposal is mailed or delivered to the Undersigned within forty-five (45) days after the opening of Bids, or anytime thereafter should the Proposal not be withdrawn, the Undersigned, within ten (10) days, will execute the Form of Agreement with the Owner.

#### 1.14 ADDENDA

A. The Undersigned acknowledges the receipt of the following Addenda, but agrees that it is bound by all Addenda whether or not listed herein:

Addendum Number	Date of Addendum	Remarks	
	-		

### 1.15 ASBESTOS

1.16


A. The bidder certifies that no asbestos or asbestos-containing materials will be incorporated into the Work of this Contract.

Signature:	
Name:	
	(Typed or Printed)
Title:	
Firm:	
	(Legal Name of Person, Single Proprietorship, Partnership, or Corporation)
Date:	

(if Corporation, provide seal above)

**AUTHORIZED SIGNATURE FOR PROPOSAL** 

END OF SECTION 00 4010

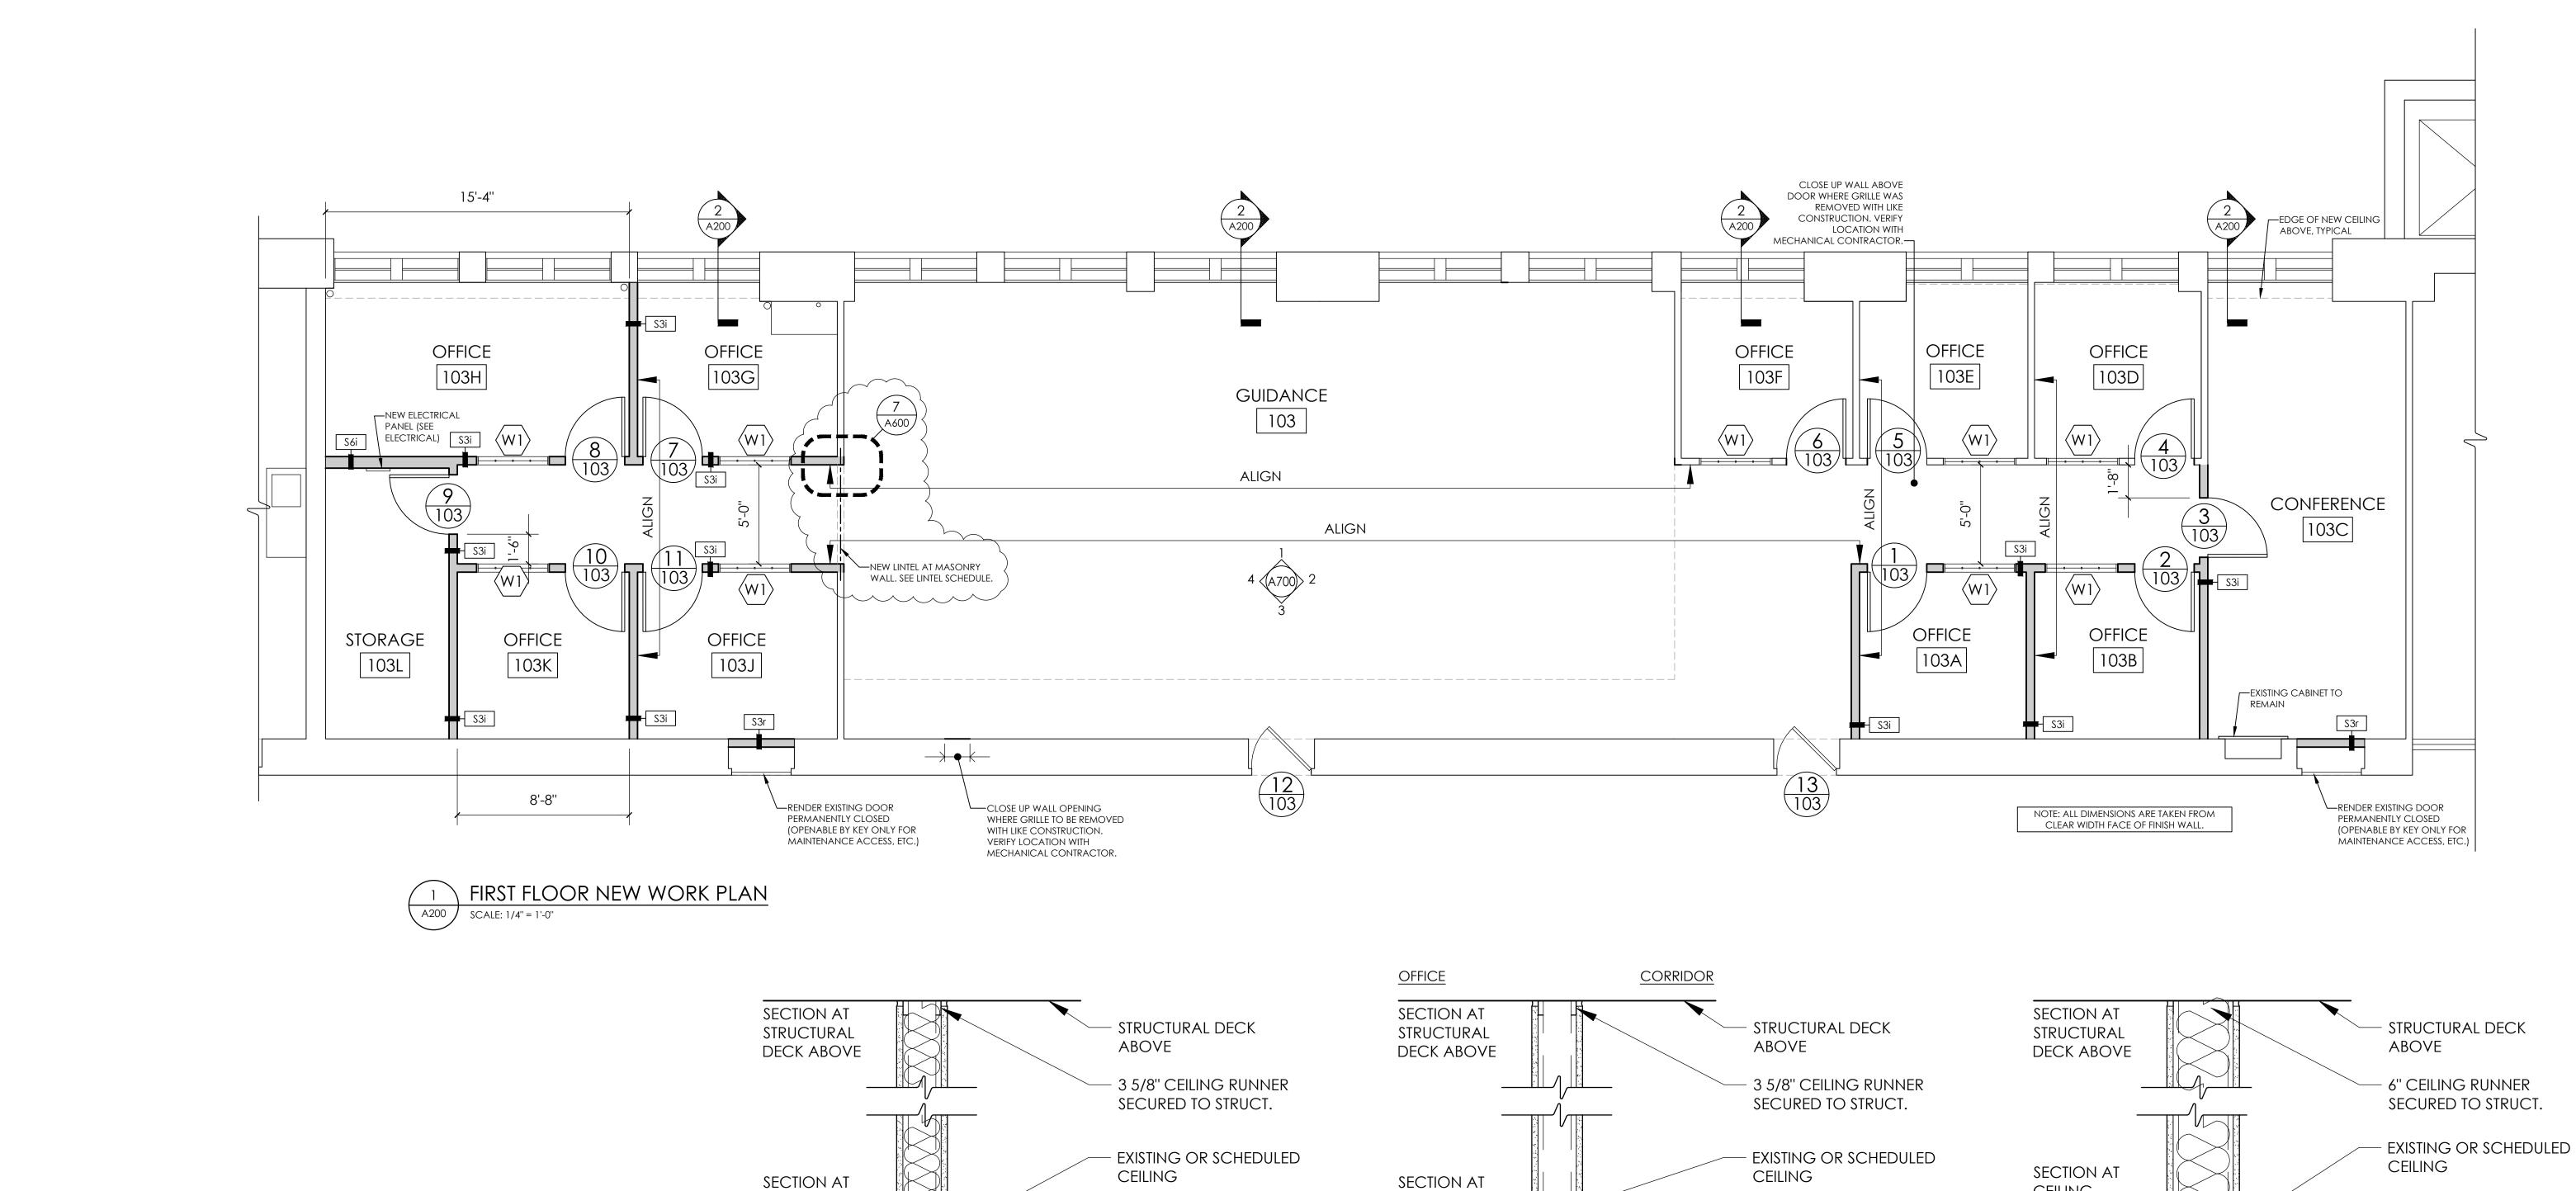

5/8" TYPE X

SHEATHING -

SCHEDULED

2 EXTERIOR INFILL WALL DETAIL
A200 SCALE: 1" = 1'-0"

FLOORING & BASE -

EXISTING EXTERIOR LOUVER TO REMAIN

5/8" GYPSUM SHEATHING

INSTALLED TO WINTER -

COLD SIDE. SHEATHING TO BE ONE CONTINUOUS

SHEET WITH NO SEAMS.

- EXISTING CONSTRUCTION

3 WALL TYPES
A200 SCALE: NTS

6" STEEL STUDS


@16" O.C.


GYPSUM BOARD —

SEALANT AT FULL PERIMETER OF

6" FIBERGLASS BATT

INSULATION WITH VAPOR
BARRIER INSTALLED ON
WINTER - WARM SIDE

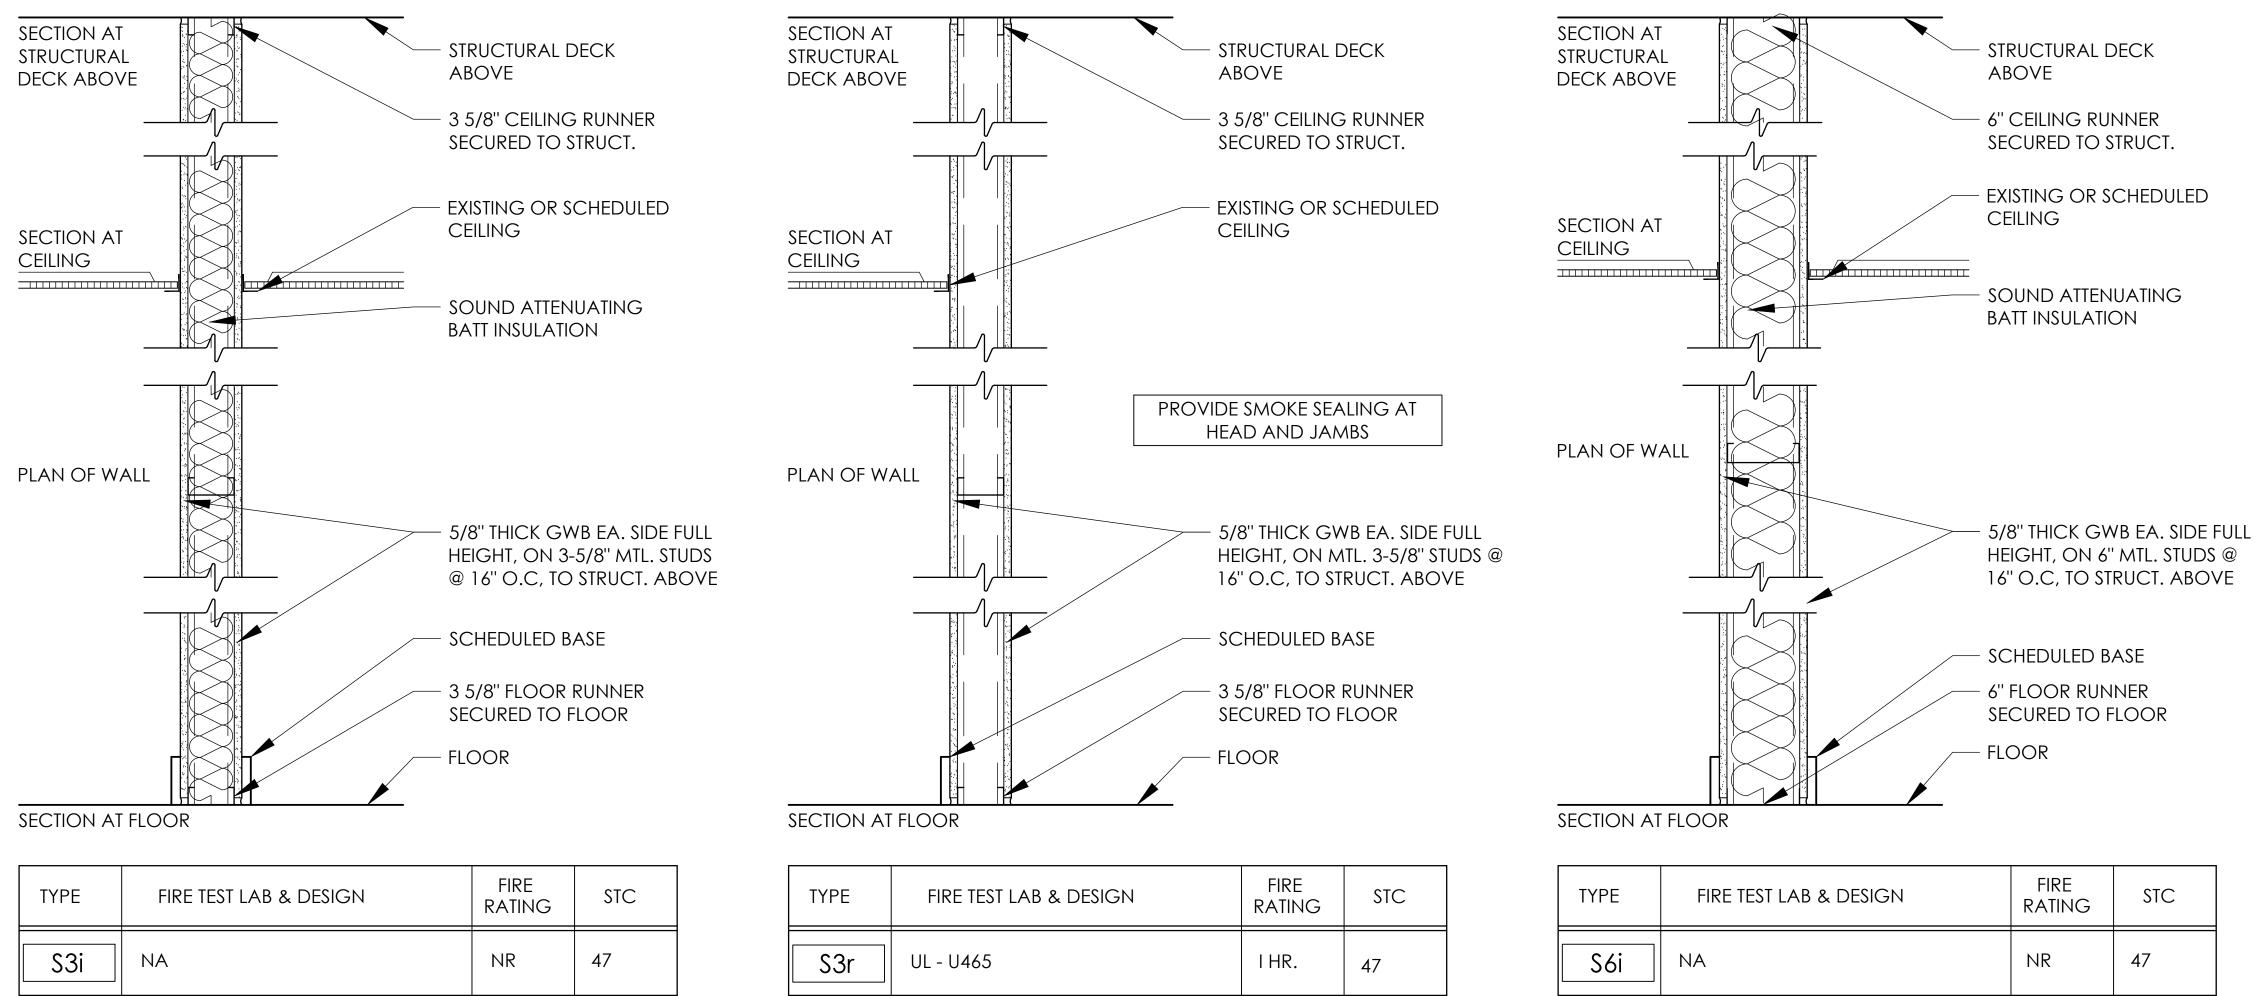

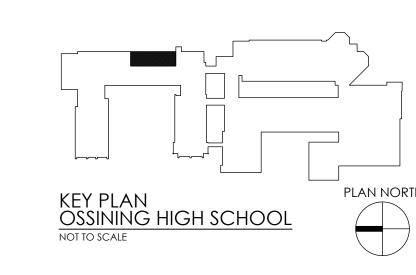

CPLteam.com
ARCHITECTURE - ENGINEERING - PLANNING

50 FRONT STREET, SUITE 202
NEWBURGH, NEW YORK 12550
TEL (800) 274-9000

FAX (845) 567-9614

E DESCRIPTION
2020 BID ADDENDUM 1

SSINING UNION FREE SCHOOL DISTRICT

OSSINING HIGH SCHOOL

GUIDANCE OFFICE RENOVATIONS

SED #66-14-01-03-0-003-039

DATE DRAWN CHECKED

08/31/2020 NH MJ

SCALE AS NOTED

SHEET TITLE

NEW WORK FLOOR

PLAN & WALL TYPES


PROJECT NUMBER

14428.12

OHS

A200

DRAWING NUMBER

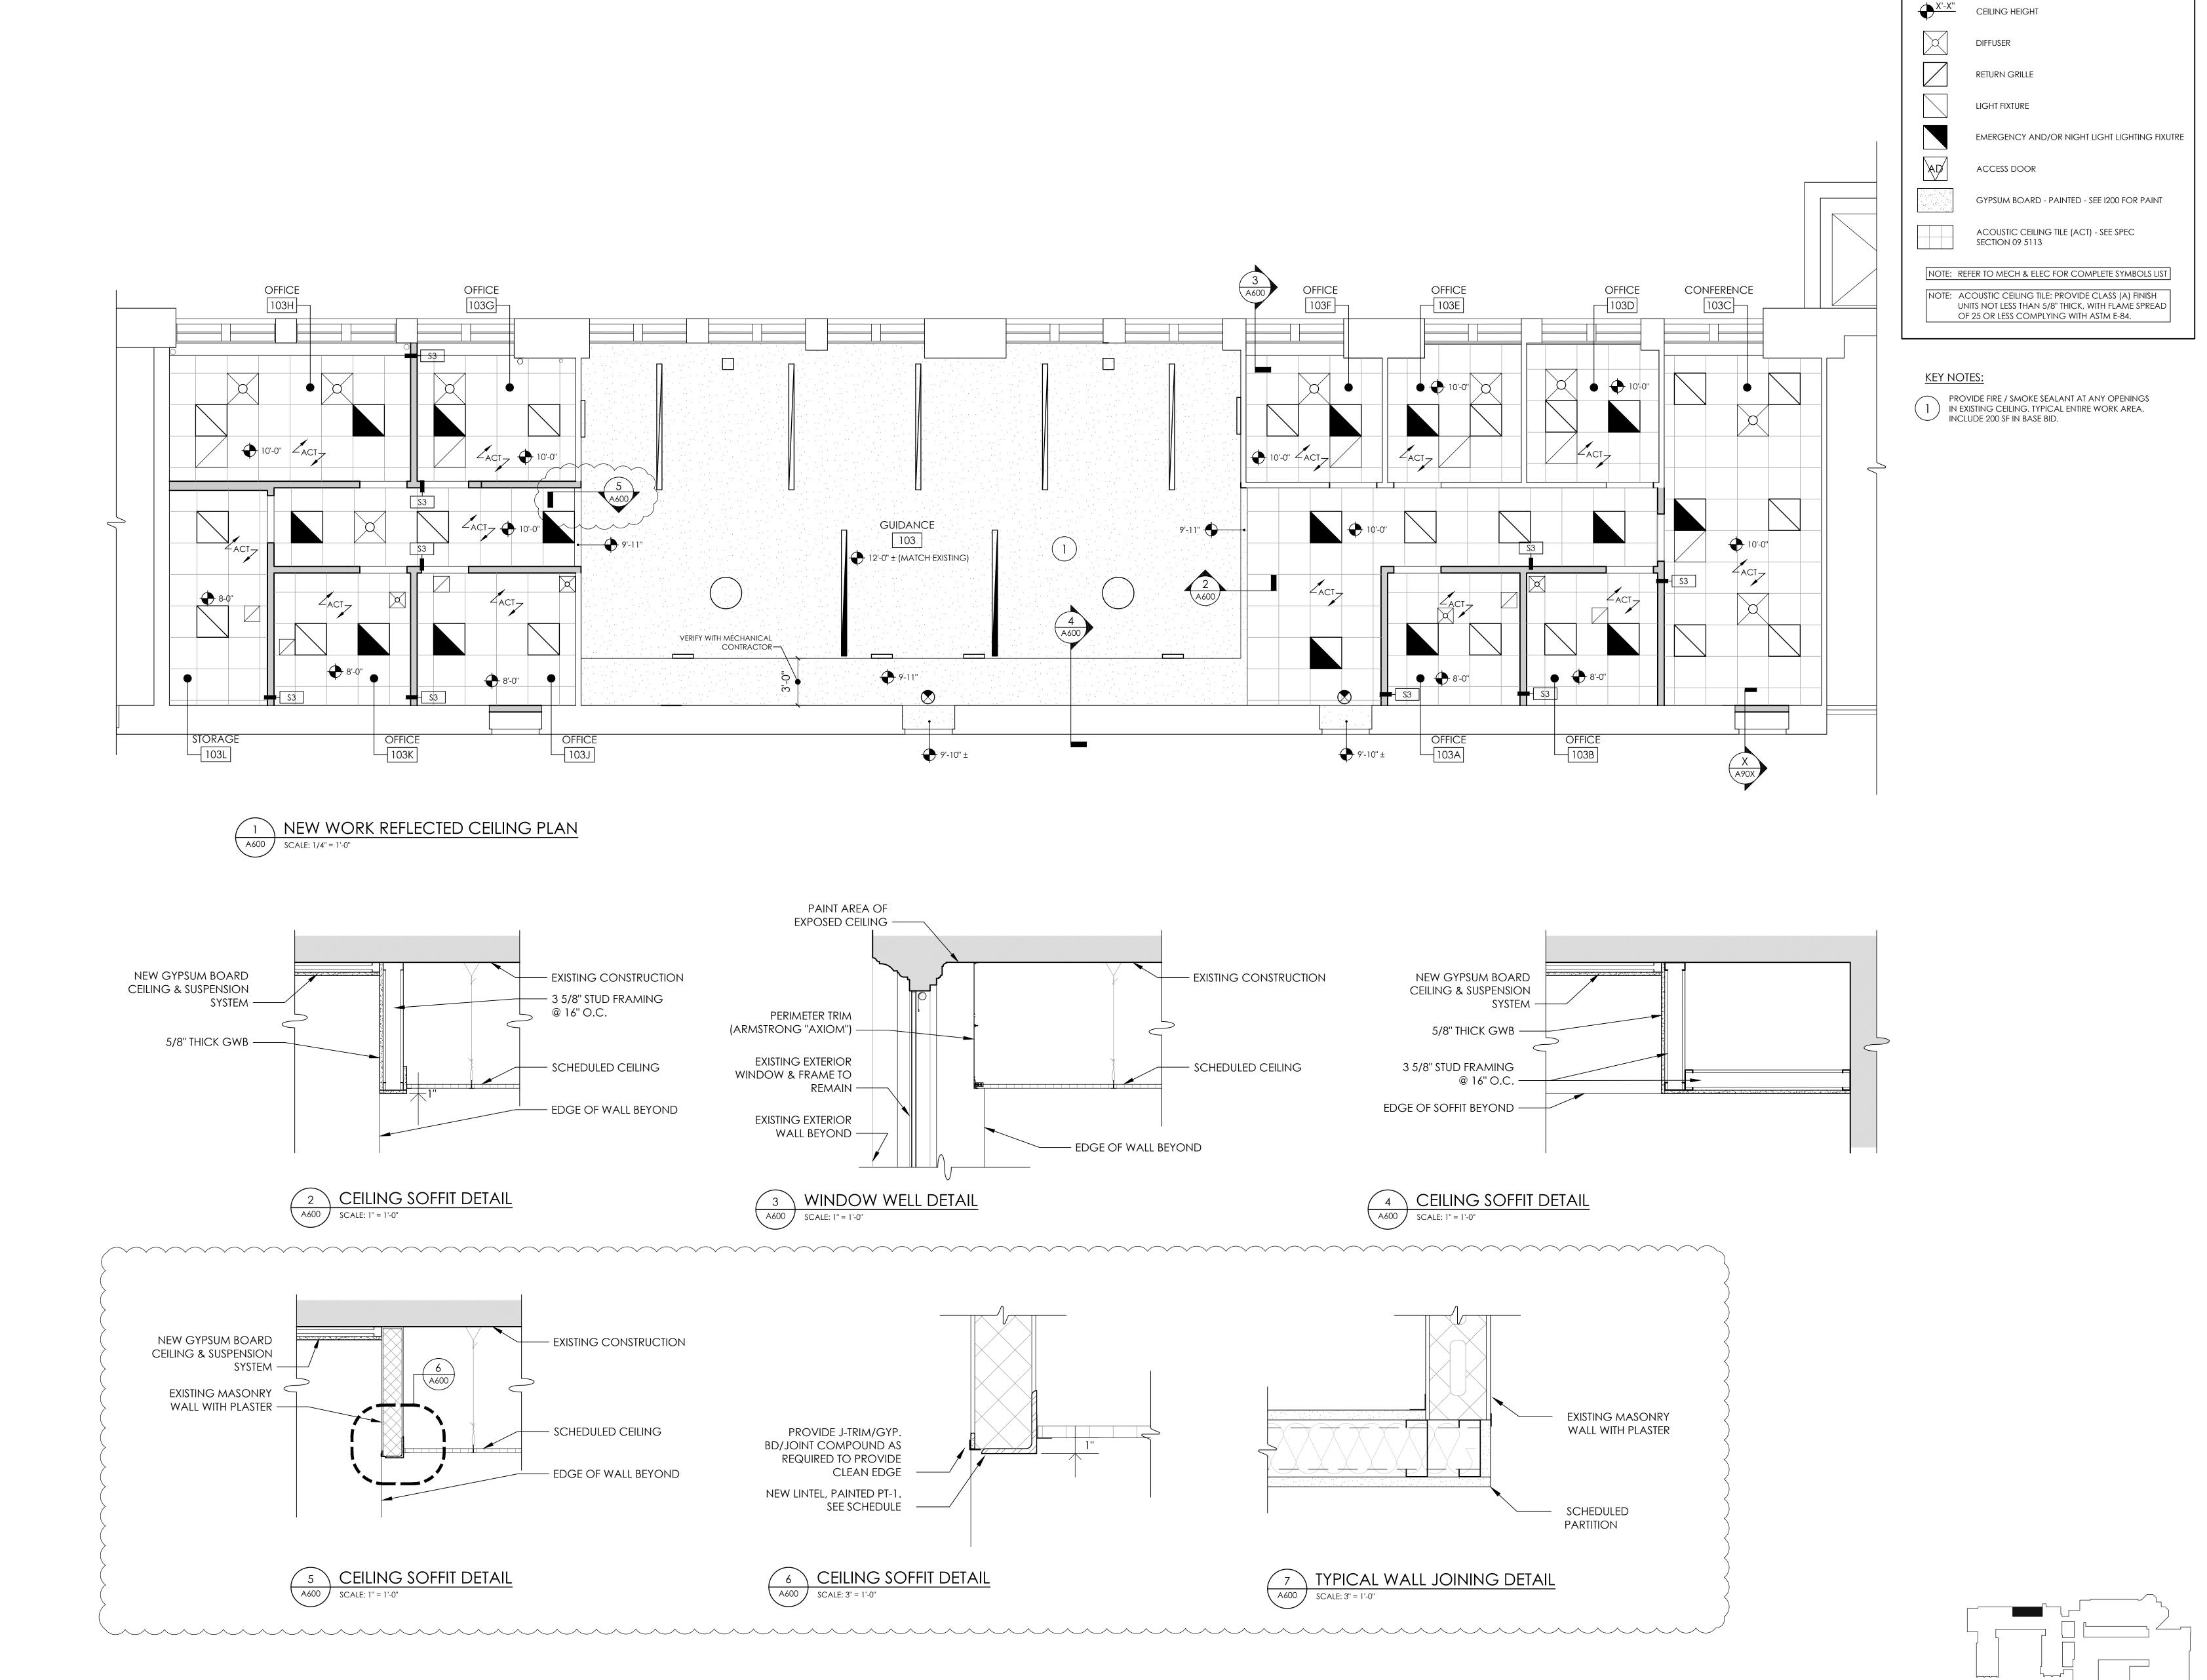

ARCHITECTURE - ENGINEERING - PLANNING

<u>LEGEND:</u>

50 FRONT STREET, SUITE 202 NEWBURGH, NEW YORK 12550 TEL (800) 274-9000

FAX (845) 567-9614

DISTRIC OSSINING UNION OSSINING GUIDANCE O


DATE DRAWN CHECKED 08/31/2020 NH MJ SCALE AS NOTED SHEET TITLE

NEW WORK REFLECTED CEILING PLAN & WALL DETAILS

PLAN NORTH

PROJECT NUMBER 14428.12 OHS A600 DRAWING NUMBER


											DO	OR SCHE	DULE				
		DOC	ORS									FRAMES					
5005		SIZE			AAATEDIAL /	CUT			OVERALL SIZ	Έ		A A A TEDIA I	LALAD	LIEAD	CILI		
DOOR NO.	WIDTH	HEIGHT	TH.	TYPE	material / Finish	UNDERG	FIRE RATING	WIDTH	HEIGHT	DEPTH	TYPE	MATERIAL / FINISH	JAMB DETAIL	HEAD DETAIL	SILL DETAIL	HARDWARE SET NO.	REMARKS (SEE NOTES BELOW ALSO)
1-103	3'-0"	7'-0''	1 3/4"	Α	WD/ST	-	-	3'-4"	7'-2"	5 1/8"	1	HM/PT	2/A900	2/A900	2/A900	SEE SPEC. SECTION 087100	
2-103	3'-0''	7'-0''	1 3/4"	Α	WD/ST	-	-	3'-4"	7'-2''	5 7/8"	1	HM/PT	2/A900	2/A900	2/A900	SEE SPEC. SECTION 087100	
3-103	3'-0''	7'-0''	1 3/4"	Α	WD/ST	-	-	3'-4"	7'-2''	5 7/8"	1	HM/PT	2/A900	2/A900	2/A900	SEE SPEC. SECTION 087100	
4-103	3'-0''	7'-0''	1 3/4"	Α	WD/ST	-	-	3'-4"	7'-2"	5 7/8"	1	HM/PT	2/A900	2/A900	2/A900	SEE SPEC. SECTION 087100	
5-103	3'-0''	7'-0''	1 3/4"	Α	WD/ST	-	-	3'-4"	7'-2"	5 7/8"	1	HM/PT	2/A900	2/A900	2/A900	SEE SPEC. SECTION 087100	
6-103	3'-0''	7'-0''	1 3/4"	Α	WD/ST	-	-	3'-4"	7'-2''	5 7/8"	1	HM/PT	2/A900	2/A900	2/A900	SEE SPEC. SECTION 087100	
7-103	3'-0''	7'-0''	1 3/4"	Α	WD/ST	-	-	3'-4"	7'-2"	5 7/8"	1	HM/PT	2/A900	2/A900	2/A900	SEE SPEC. SECTION 087100	
8-103	3'-0''	7'-0''	1 3/4"	Α	WD/ST	-	-	3'-4"	7'-2"	5 7/8"	1	HM/PT	2/A900	2/A900	2/A900	SEE SPEC. SECTION 087100	
9-103	3'-0''	7'-0''	1 3/4"	Α	WD/ST	-	-	3'-4"	7'-2"	5 1/8"	1	HM/PT	2/A900	2/A900	2/A900	SEE SPEC. SECTION 087100	
10-103	3'-0''	7'-0''	1 3/4"	Α	WD/ST	-	-	3'-4"	7'-2"	5 1/8"	1	HM/PT	2/A900	2/A900	2/A900	SEE SPEC. SECTION 087100	
11-103	3'-0''	7'-0''	1 3/4"	Α	WD/ST	-	-	3'-4"	7'-2"	5 1/8"	1	HM/PT	2/A900	2/A900	2/A900	SEE SPEC. SECTION 087100	
12-103		•	EX	( I S	TING	D	0 O R	&	F R	A M E		T O R E	EMAIN		•	SEE SPEC. SECTION 087100	
13-103			ΕX	( I S	TING	D	0 O R	&	F R	A M E		T O R E	EMAIN			SEE SPEC. SECTION 087100	

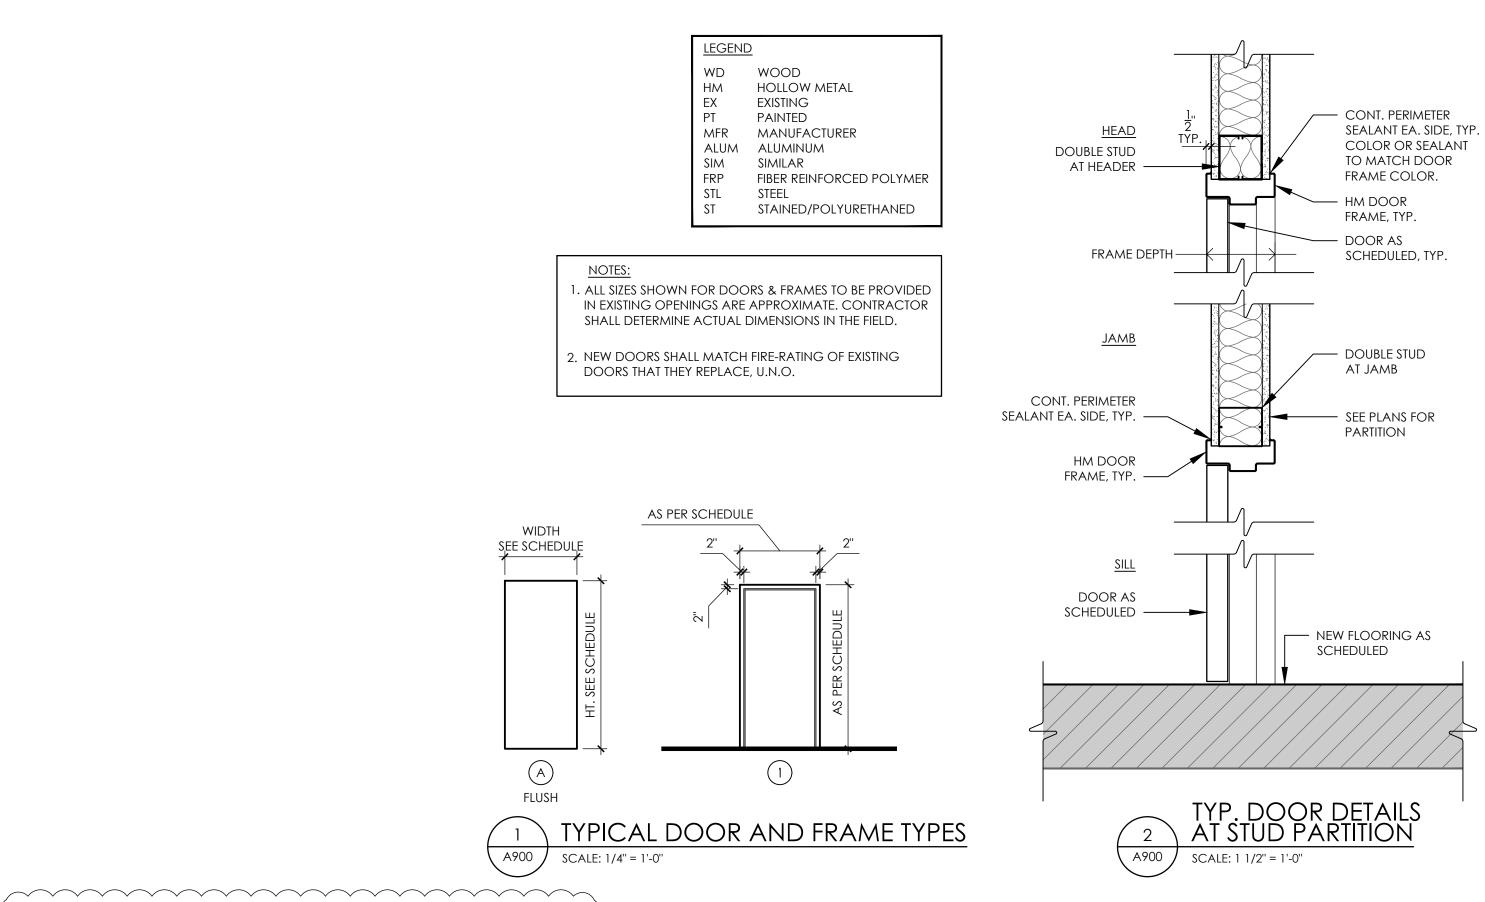


WALL TYPE	SPAN	LINTEL
	1'-4" to 4'-6"	L 4 x 3 1/2 x 5/16 (L.L.V.)
4" MASONRY	4'-7" to 5'-6"	L 4 x 3 1/2 x 5/16 (L.L.V.)
/ VENEER	5'-7" to 6'-6"	L 5 x 3 1/2 x 5/16 (L.L.V.)
	6'-7" to 7'-6"	L 6 x 3 1/2 x 5/16 (L.L.V.)
	1'-4" to 4'-6"	WT 4 x 9
	4'-7" to 5'-6"	WT 4 x 10.5
6" BLOCK	5'-7" to 6'-6"	WT 5 x 13
	6'-7" to 7'-6"	WT 5 x 13
	7'-7" to 9'-0"	W8 x 10 + 5 1/2 x 5/16 PL.
	1'-4" to 4'-6"	(2) - L4 x 3 1/2 x 5/16 (L.L.V.)
	4'-7" to 5'-6"	(2) - L4 x 3 1/2 x 5/16 (L.L.V.)
8" BLOCK	5'-7" to 6'-6"	(2) - L5 x 3 1/2 x 5/16 (L.L.V.)
	6'-7" to 7'-6"	(2) - L6 x 3 1/2 x 5/16 (L.L.V.)
	7'-7" to 9'-0"	WT 9 x 25
4" BRICK &	1'-4" to 4'-6"	(3) - L4 x 3 1/2 x 5/16 (L.L.V.)
8" BLOCK	4'-7" to 5'-6"	(3) - L4 x 3 1/2 x 5/16 (L.L.V.)
OR	5'-7" to 6'-6"	(3) - L5 x 3 1/2 x 5/16 (L.L.V.
12" BLOCK	6'-7" to 7'-6"	(3) - L6 x 3 1/2 x 5/16 (L.L.V.

- INDICATED ON THE DRAWINGS.
- 2. MINIMUM BEARING FOR ALL LINTELS SHALL BE 8" EACH END.
- BLOCK WALLS SHALL BE GROUTED SOLID 3 COURSES BELOW BEARING POINT FOR A WIDTH OF 16" UNLESS NOTED OTHERWISE ON STRUCTURAL FRAMING PLANS.
- 4. SEE ARCH., HVAC, & PLUMBING DRAWINGS FOR SIZE AND LOCATION OF ALL WALL OPENINGS.
- 5. CONTRACTOR SHALL PROVIDE AN ADDITIONAL 50 FT. OF ANGLE  $5 \times 3 \ 1/2 \times 5/16$  OR THE EQUIVALENT. 6. FOR LINTEL SPANS GRATER THAN 6'-0", BOLT ASSEMBLIES
- TOGETHER AT 1/3 POINTS. 7. WHERE LINTELS REQUIRE 3 ANGLES, PROVIDE A 3/16" PLATE EQUAL TO WALL WIDTH ACROSS SPAN, ATTACHED TO BOTTOM OF THE LINTEL.

_											
		WINDOW SCHEDULE									
		unit size (	NOMINAL)		GLA	zing					
	TYPE	WIDTH	HEIGHT	MATERIAL	TYPE	THICKNESS	REMARKS				
Γ	W1	3'-8"	4'-0''	НМ	TG-1	1/4"					

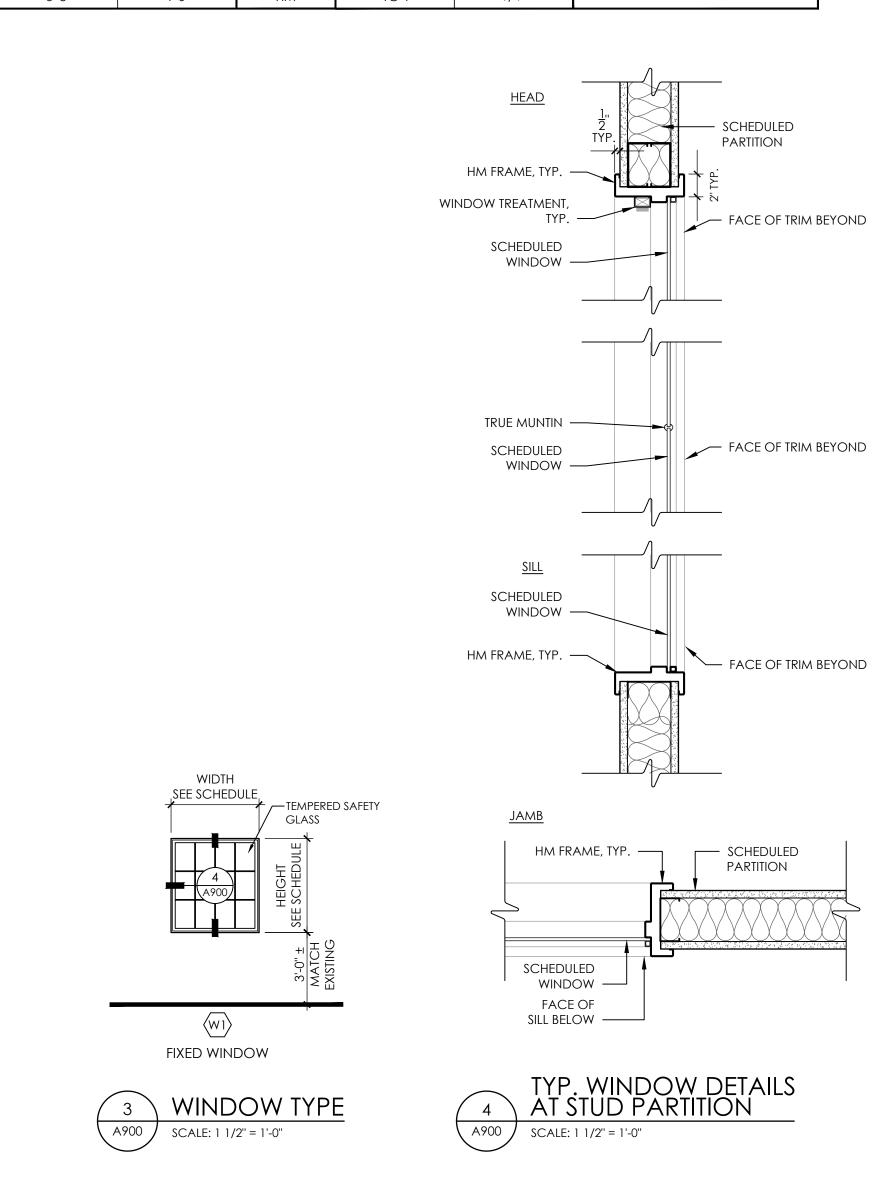



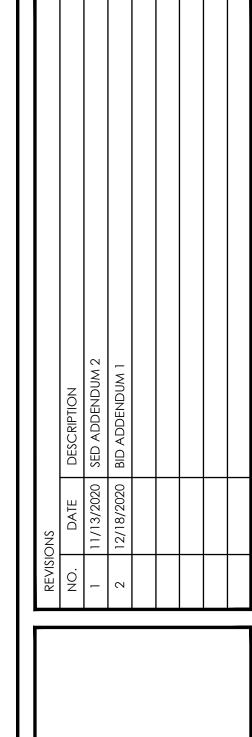

08/31/2020 NH MJ SE SCALE AS NOTED SHEET TITLE DOOR & WINDOW SCHEDULES & DETAILS

> PROJECT NUMBER 14428.12 OHS DRAWING NUMBER

**KEY NOTES:** 

(1) REMOVE EXISTING GRILLE, ABANDON DUCTWORK. COORDINATE WALL

2 REMOVE EXISTING GRILLE, PREPARE FOR NEW WORK.

REMOVE EXISTING DUCTWORK FROM ROOF PENETRATION BACK TO MAIN. PREPARE FOR NEW WORK.

REMOVE EXISTING STEAM RADIATOR AND PIPING BACK TO FLOOR. PREPARE FOR NEW WORK.

5 REMOVE EXISTING UNIT VENTILATOR AND PIPING BACK TO FLOOR. COORDINATE SEALING AND INSULATING PENETRATION AT INTERIOR OF BUILDING WITH G.C. PREPARE FOR NEW WORK.

REMOVE EXISTING FAN COIL UNIT AND ALL ASSOCIATED DUCTWORK, PIPING AND CONTROLS. REMOVE PIPING UP TO CONDENSER ON ROOF. PREPARE FOR NEW WORK.

(7) REMOVE EXISTING CONDENSING UNIT AND ALL ASSOCIATED PIPING, WIRING AND SUPPORTS. PREPARE FOR NEW WORK.

# **GENERAL NOTES:**

1. ALL CONTROLS WORK SHALL BE DONE USING THE EXISTING BUILDING MANAGEMENT SYSTEM, CONTACT AUTOMATED CONTROL LOGIC, INC. (AGL) FOR ALL CONTROLS WORK

2. MODIFY AND PATCH ROOFING AND DECK AS NECESSARY TO ACCOMMODATE MECHANICAL WORK SCOPE. COORDINATE WITH OWNER AND THE EXISTING ROOFING MANUFACTURER TO MAINTAIN THE EXISTING ROOF WARRANTY. ALL ROOFING WORK SHALL BE PER THE ROOFING MANUFACTURER'S AND NRCA REQUIREMENTS AND RECOMMENDATIONS.

3. PRIOR TO CLOSEOUT, SUBMIT ROOFING MANUFACTURER'S WRITTEN APPROVAL OF ALL ROOFING WORK.

ARCHITECTURE - ENGINEERING - PLANNING

50 FRONT STREET, SUITE 202

NEWBURGH, NEW YORK 12550

TEL (800) 274-9000

FAX (845) 567-9614

DATE DRAWN CHECKED BOOK AJS

SCALE AS SHOWN

SHEET TITLE


MECHANICAL DEMOLITION PLANS

> PROJECT NUMBER 14428.12

KEY PLAN OSSINING HIGH SCHOOL NOT TO SCALE

OHS H101

FIRST FLOOR DEMOLITION PLAN
SCALE: 1/4" = 1'-0"

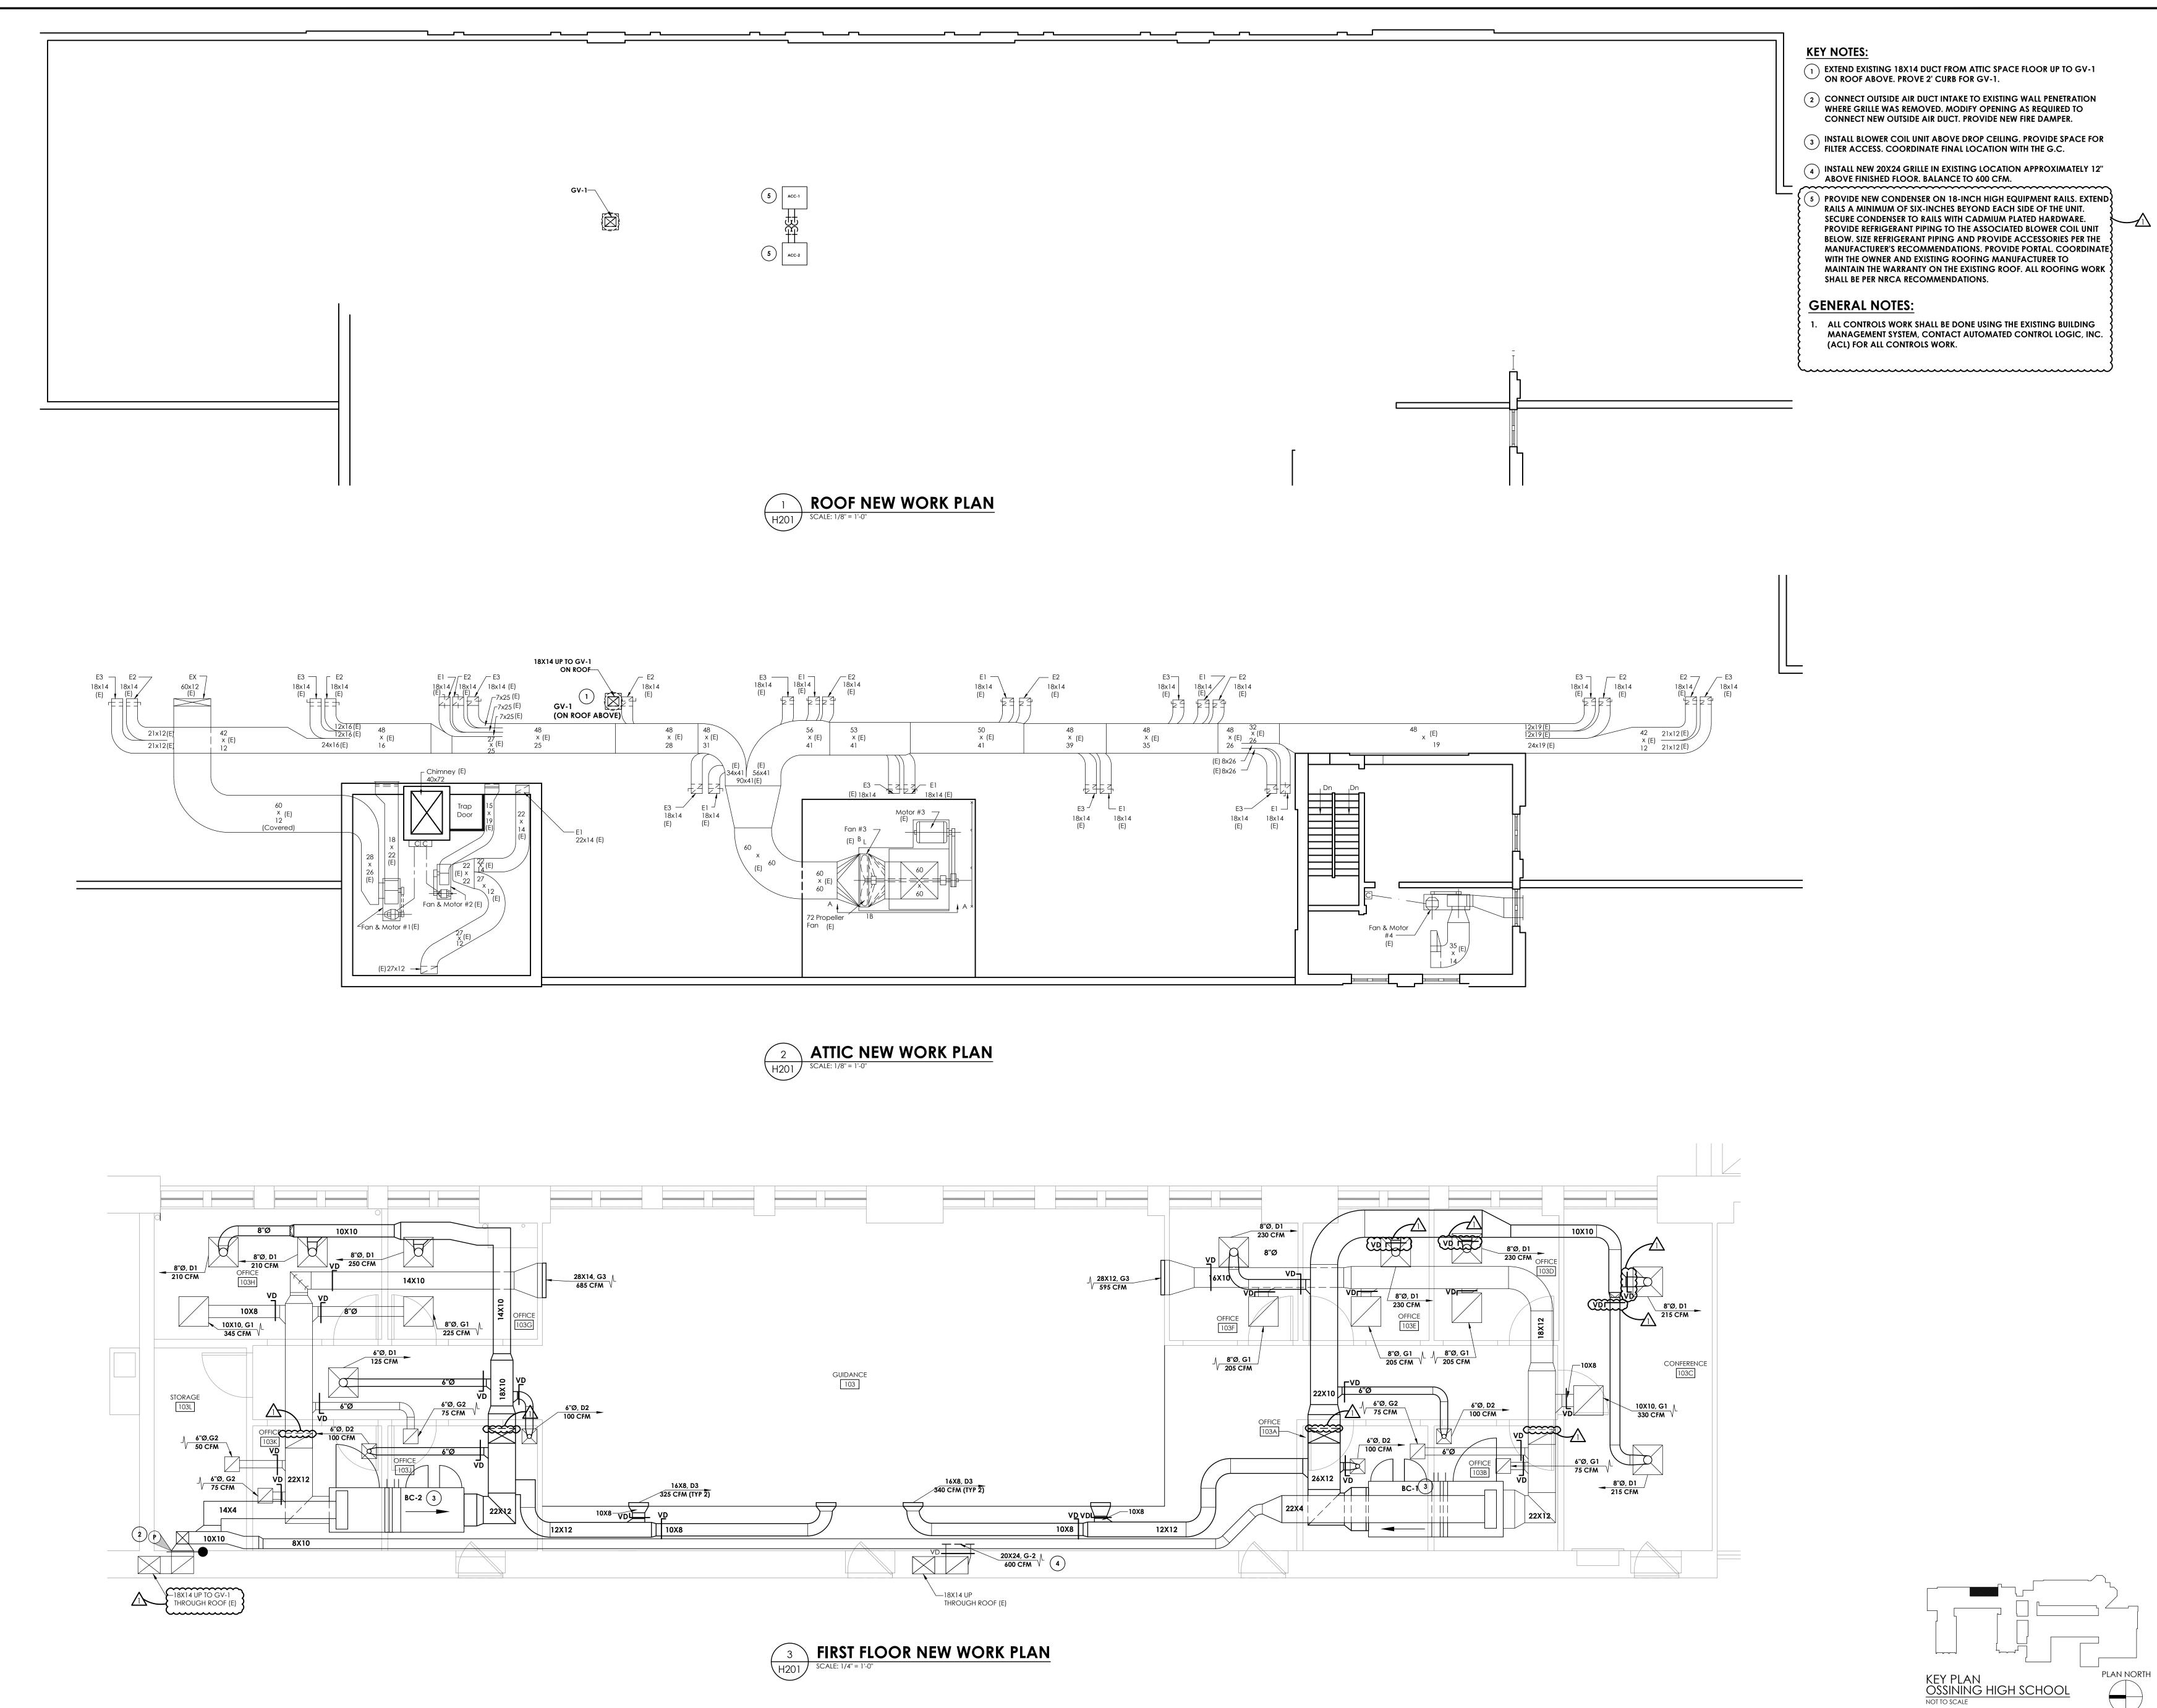

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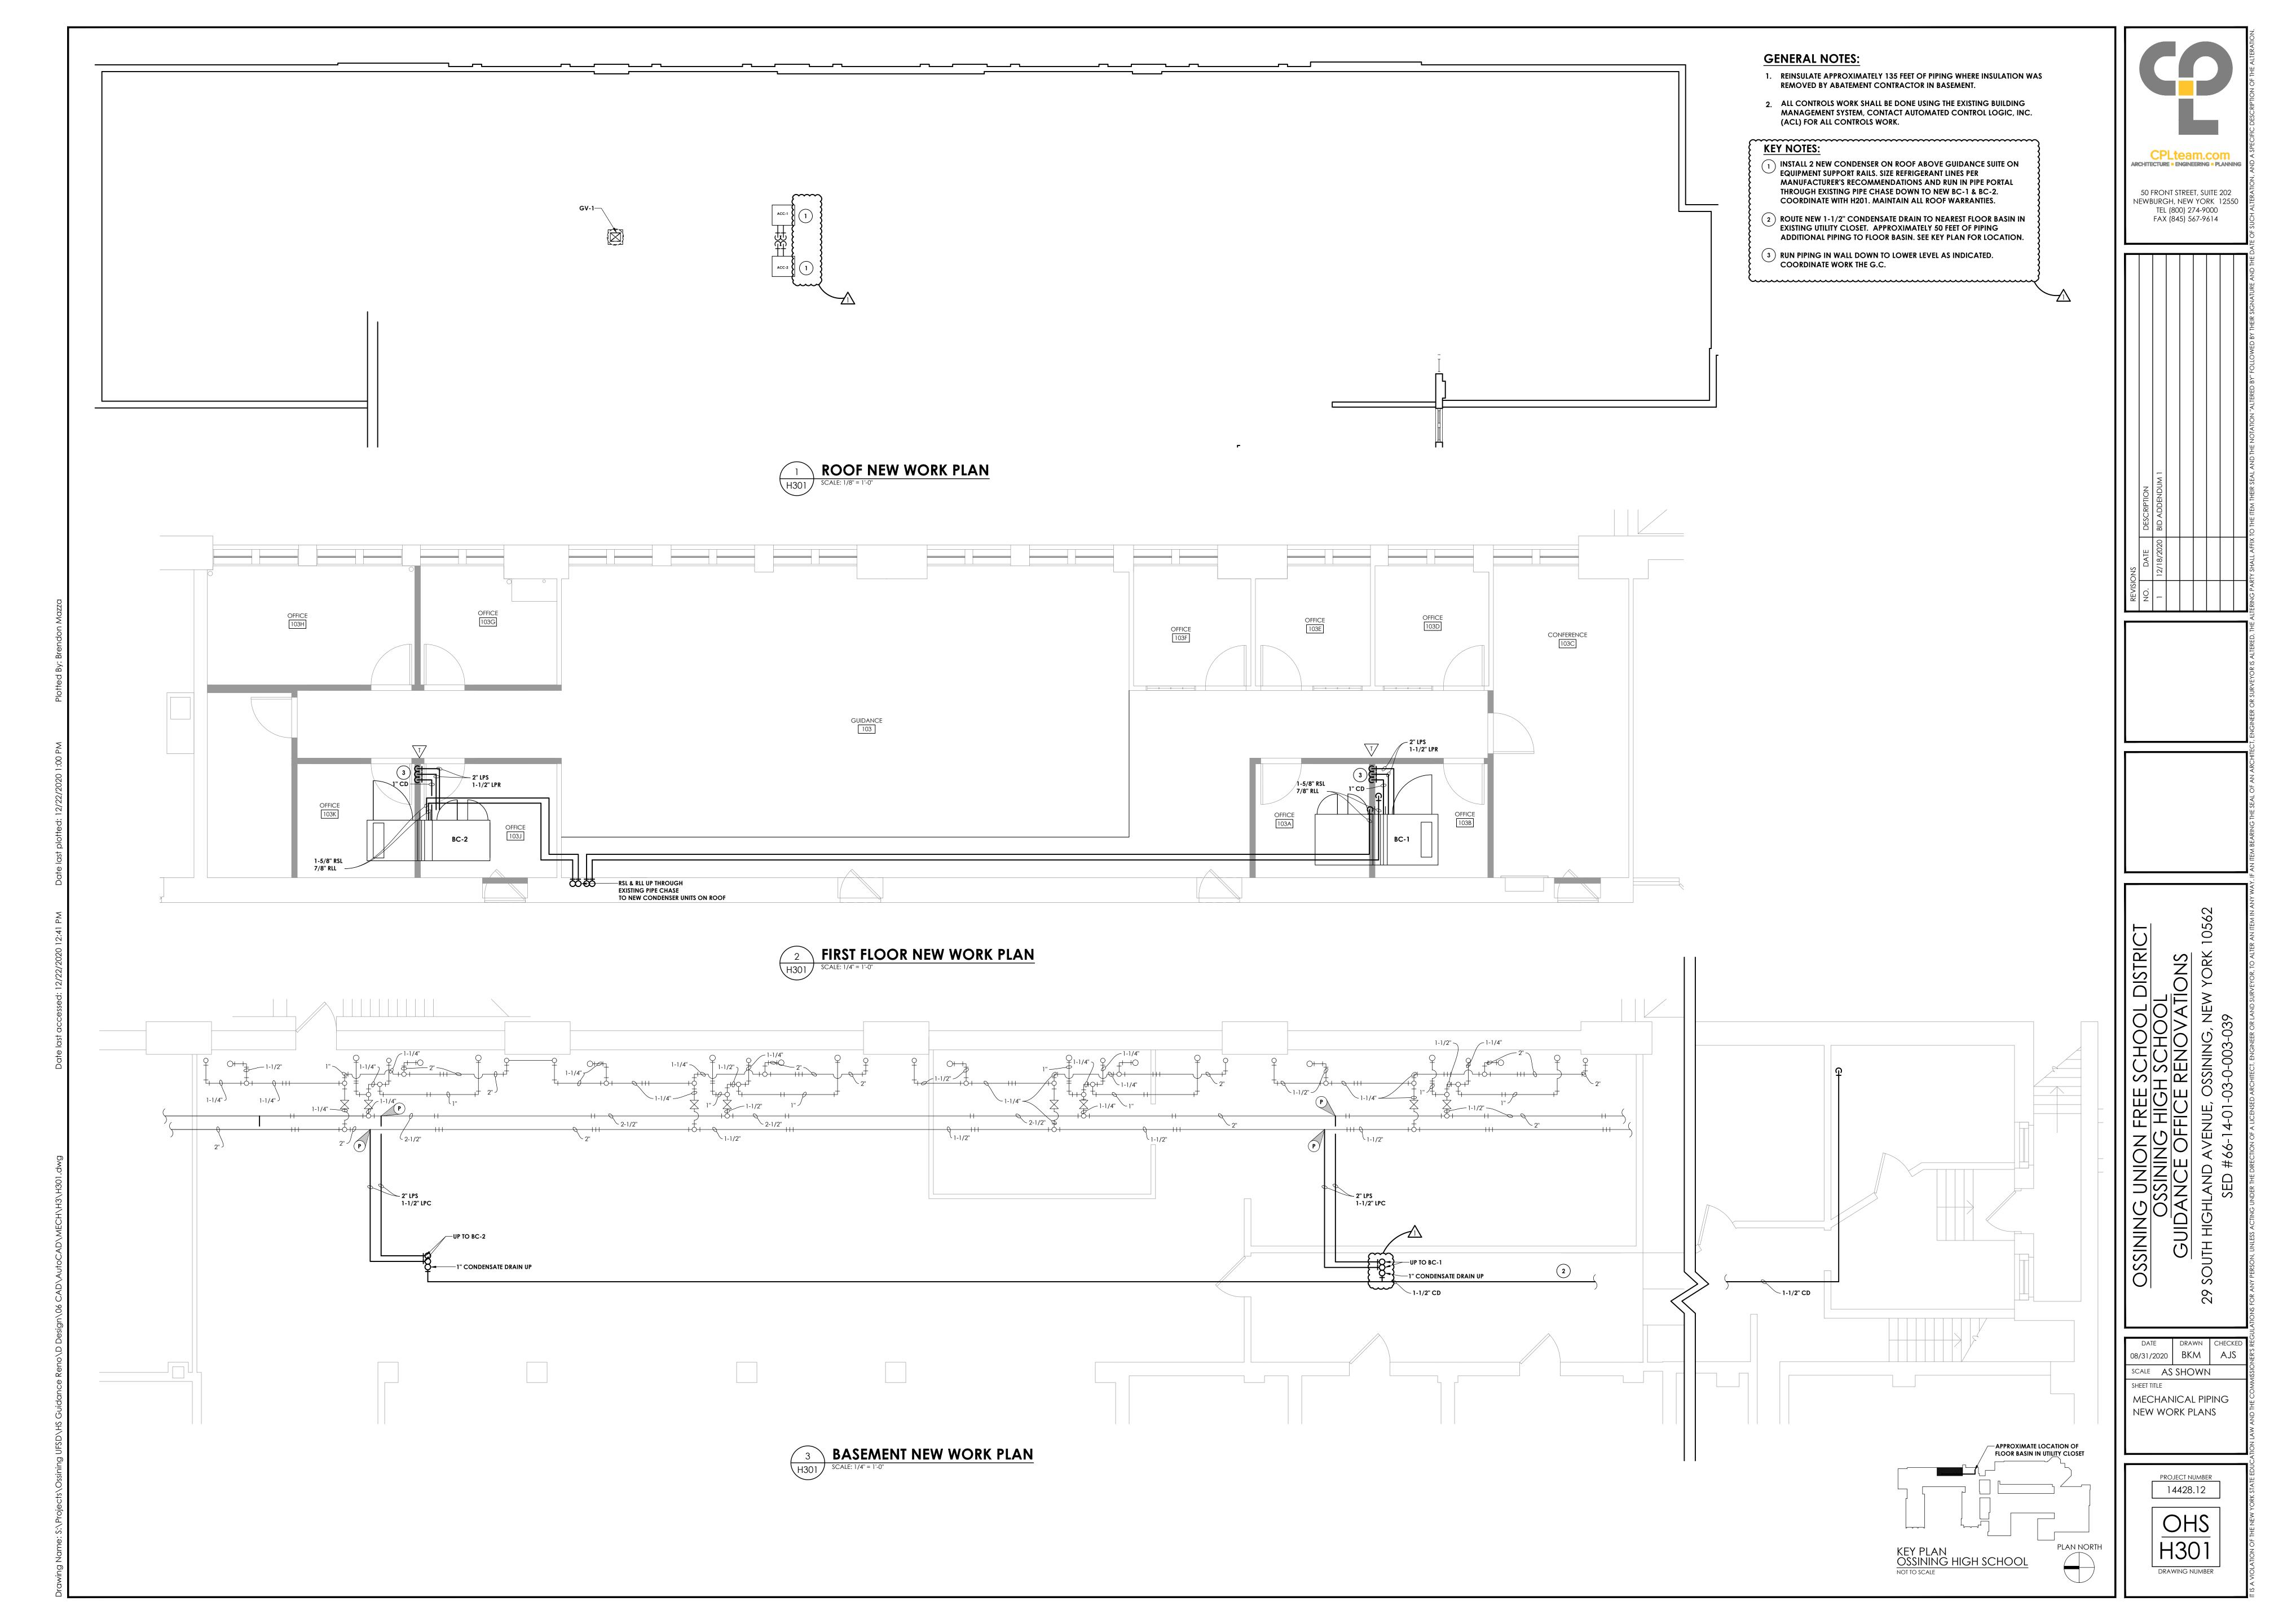
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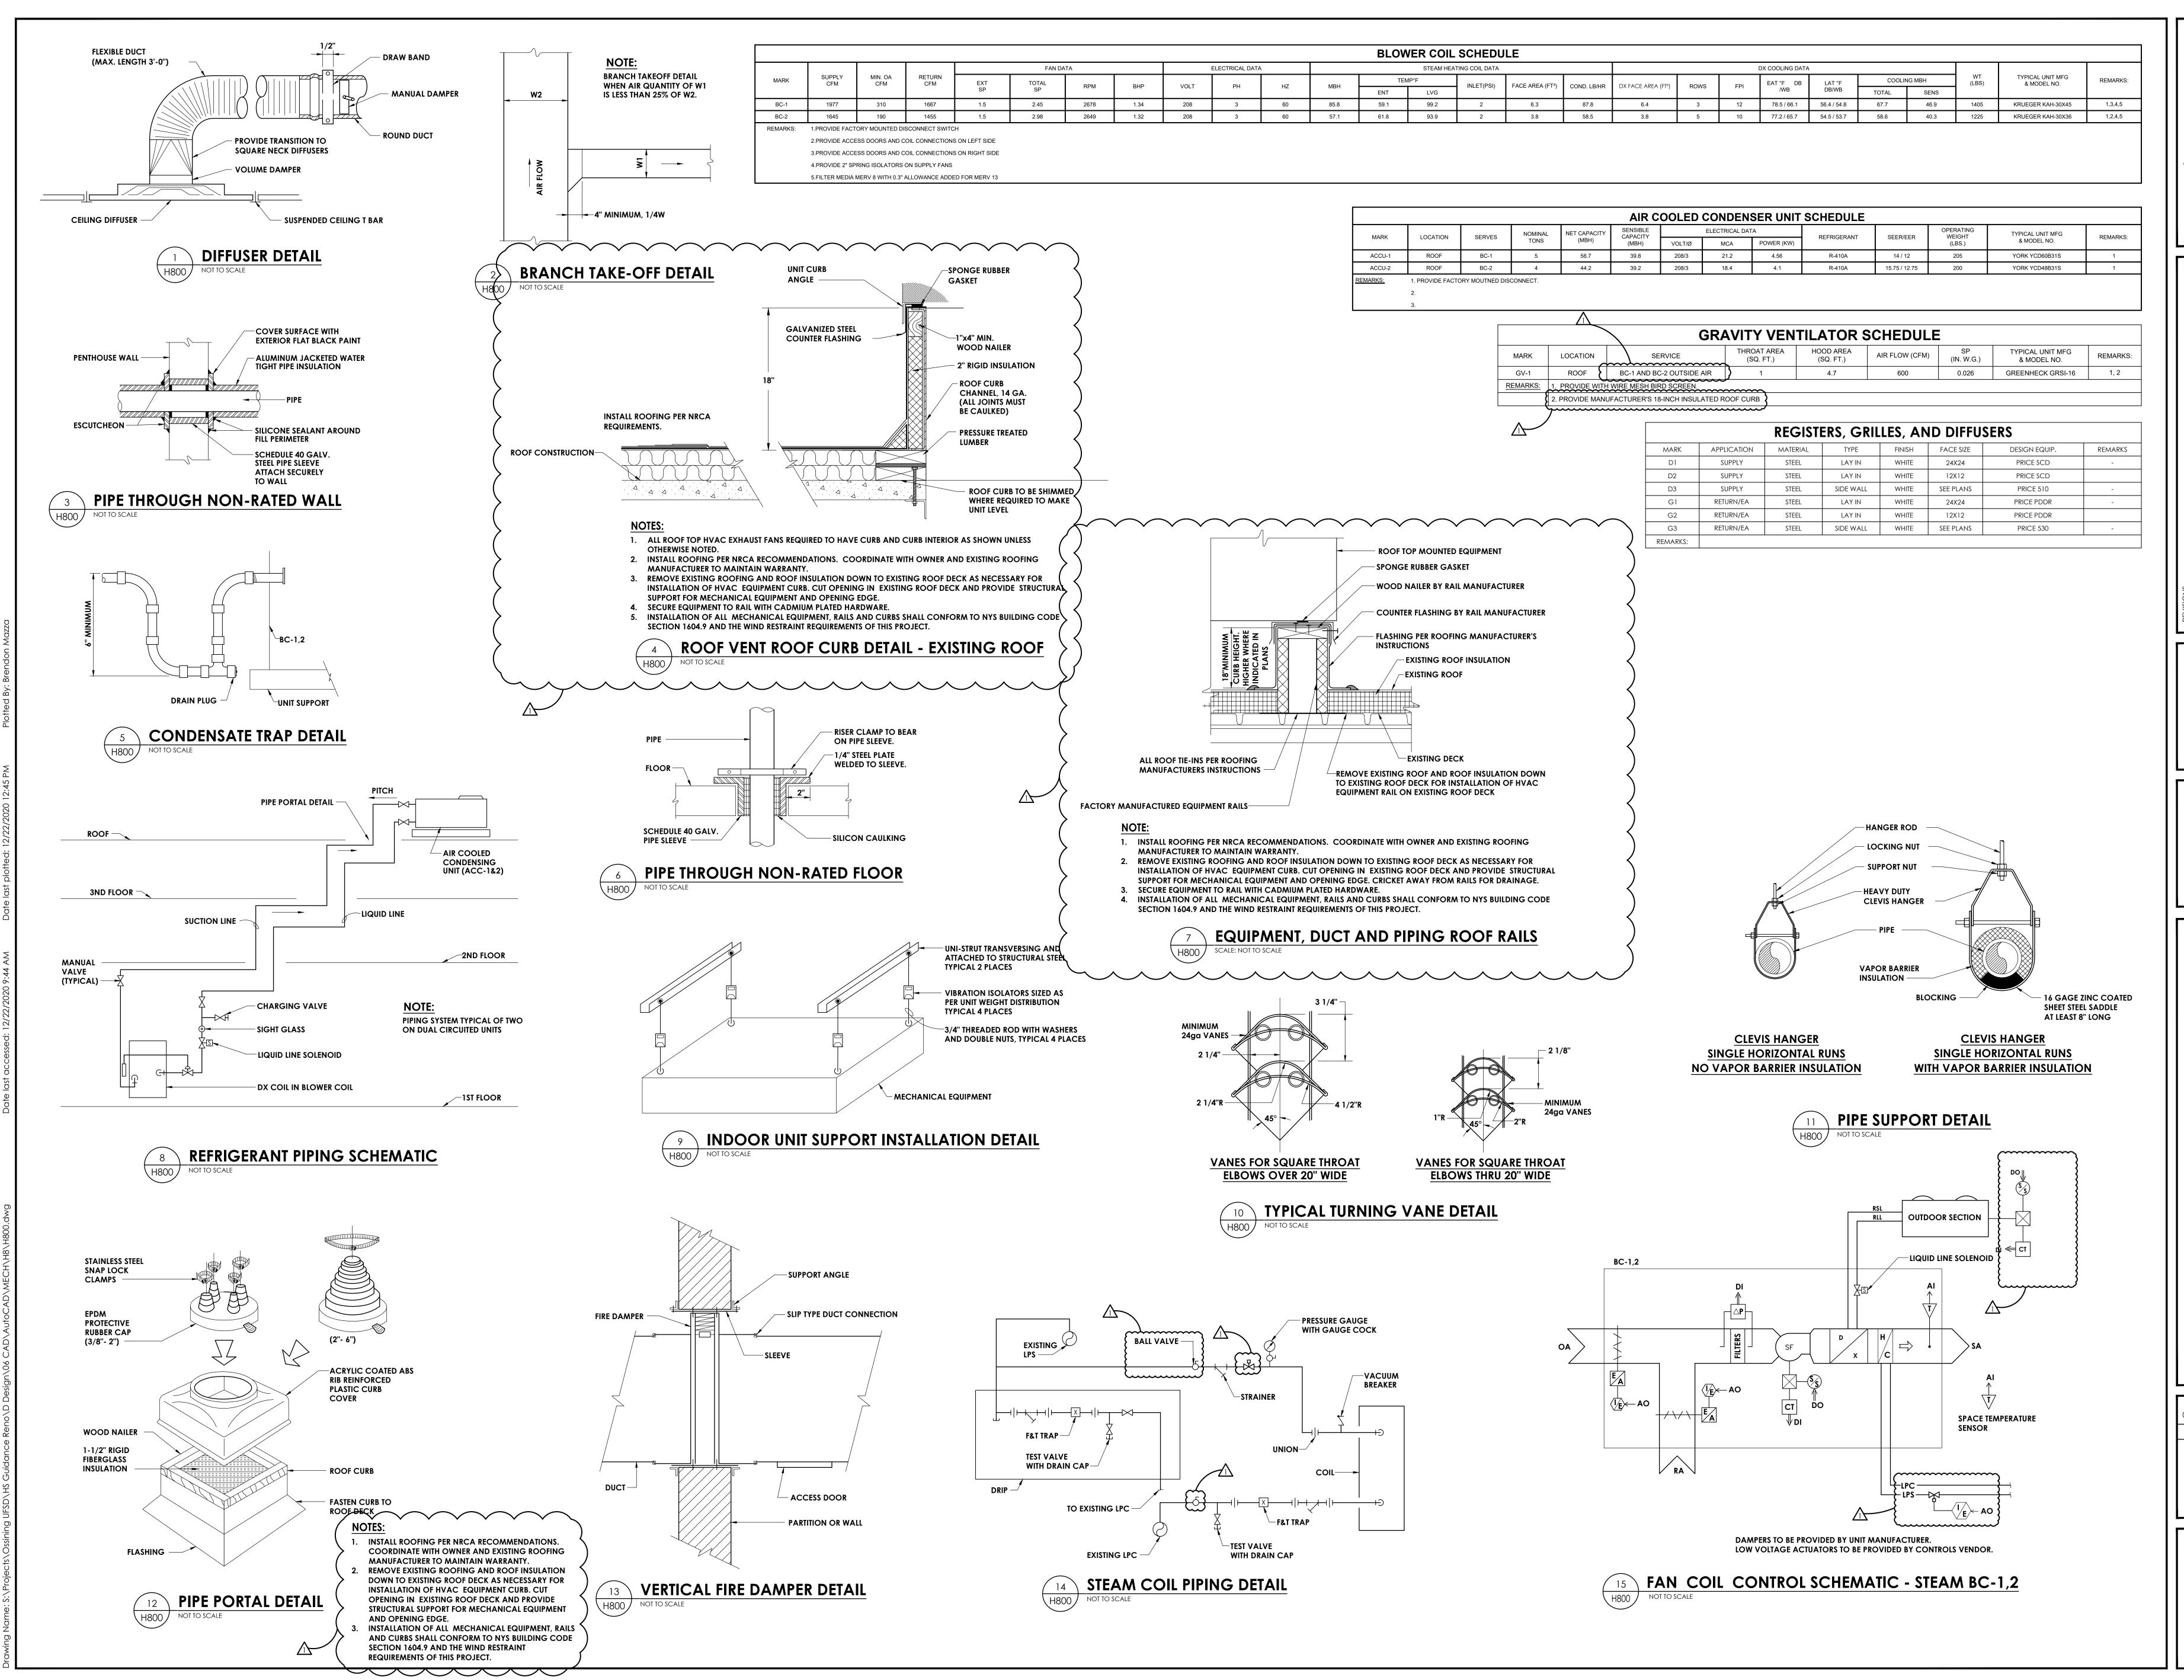
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PROJECT NUMBER

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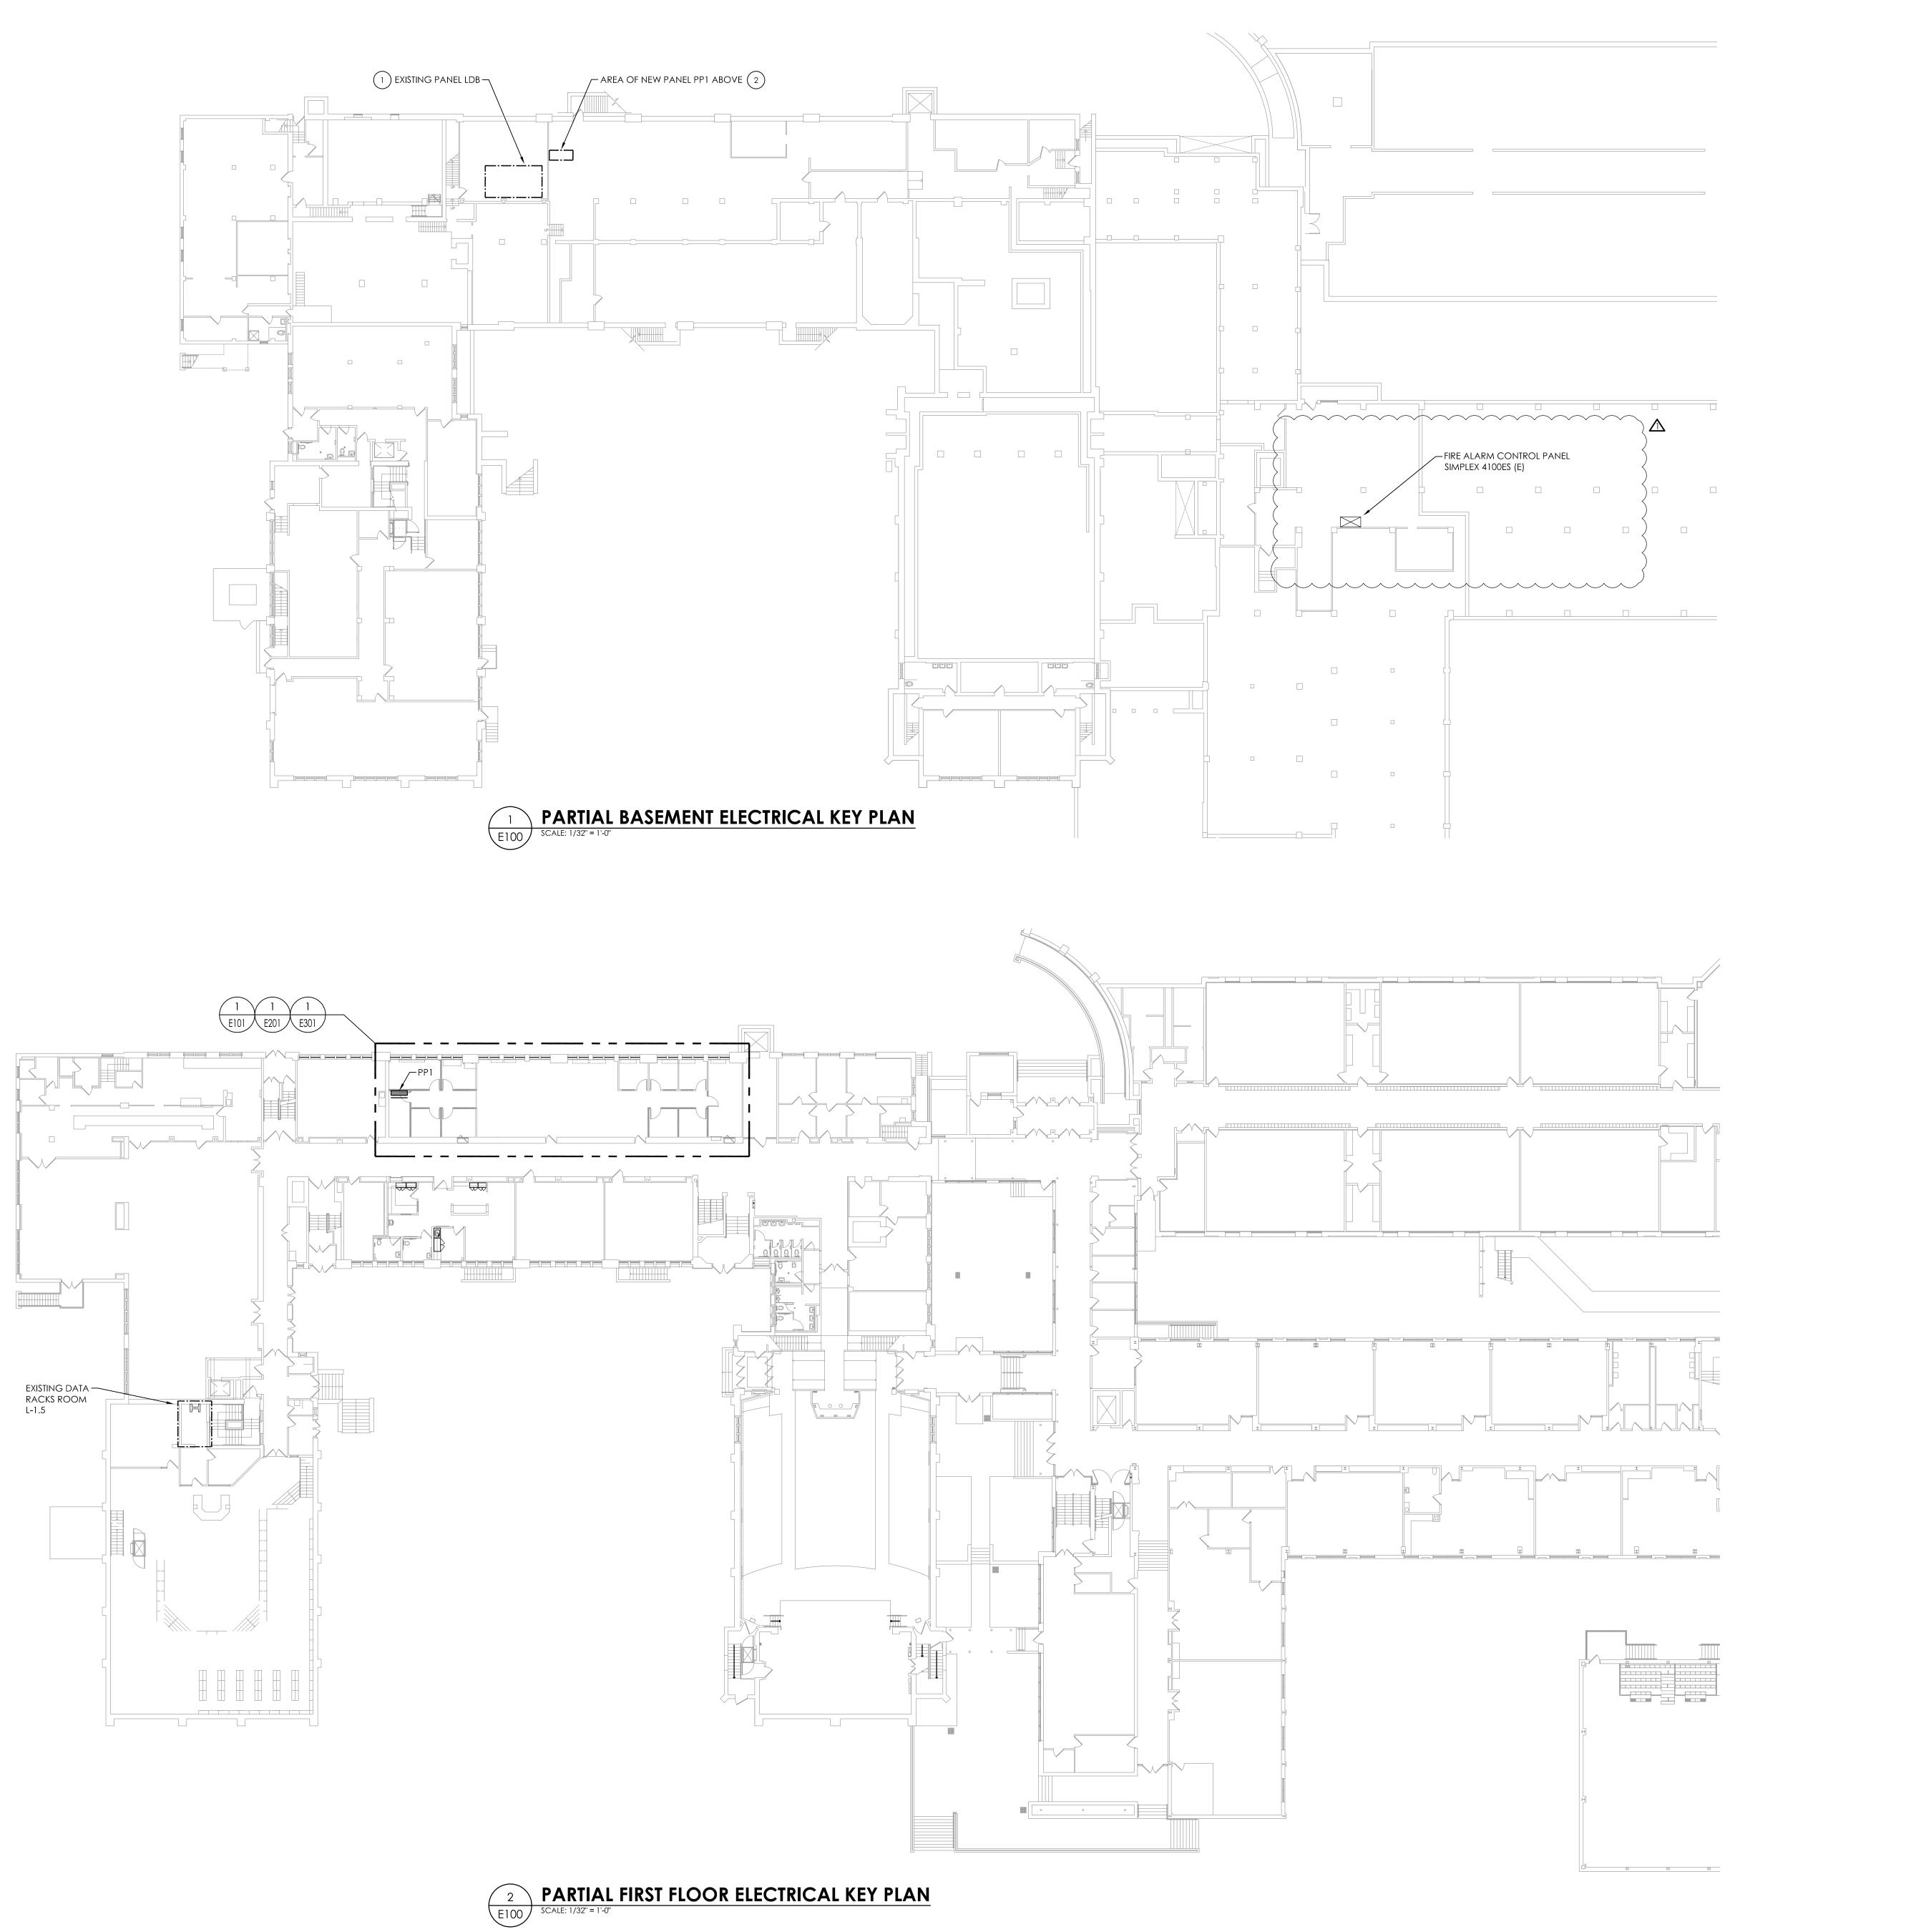
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MECHANICAL
SCHEDULES AND DETAILS

PROJECT NUMBER
14428.12

OHS H800



KEY NOTES:

UTILIZE EXISTING 100-AMP, 3-POLE CIRCUIT BREAKER IN EXISTING PANEL LDB TO FEED NEW PANEL PP1. LABEL BREAKER ACCORDINGLY.

AREA OF PANEL PP1 ABOVE IN GUIDANCE SUITE ROOM STORAGE 103L.
PROVIDE (4) #2, (1) #6 GND IN 2" CONDUIT FROM PANEL LDB TO NEW
PANEL PP1, ALL CONDUIT AND WIRING TO BE RUN TIGHT TO CEILING THEN
UP INTO NEW PANEL.

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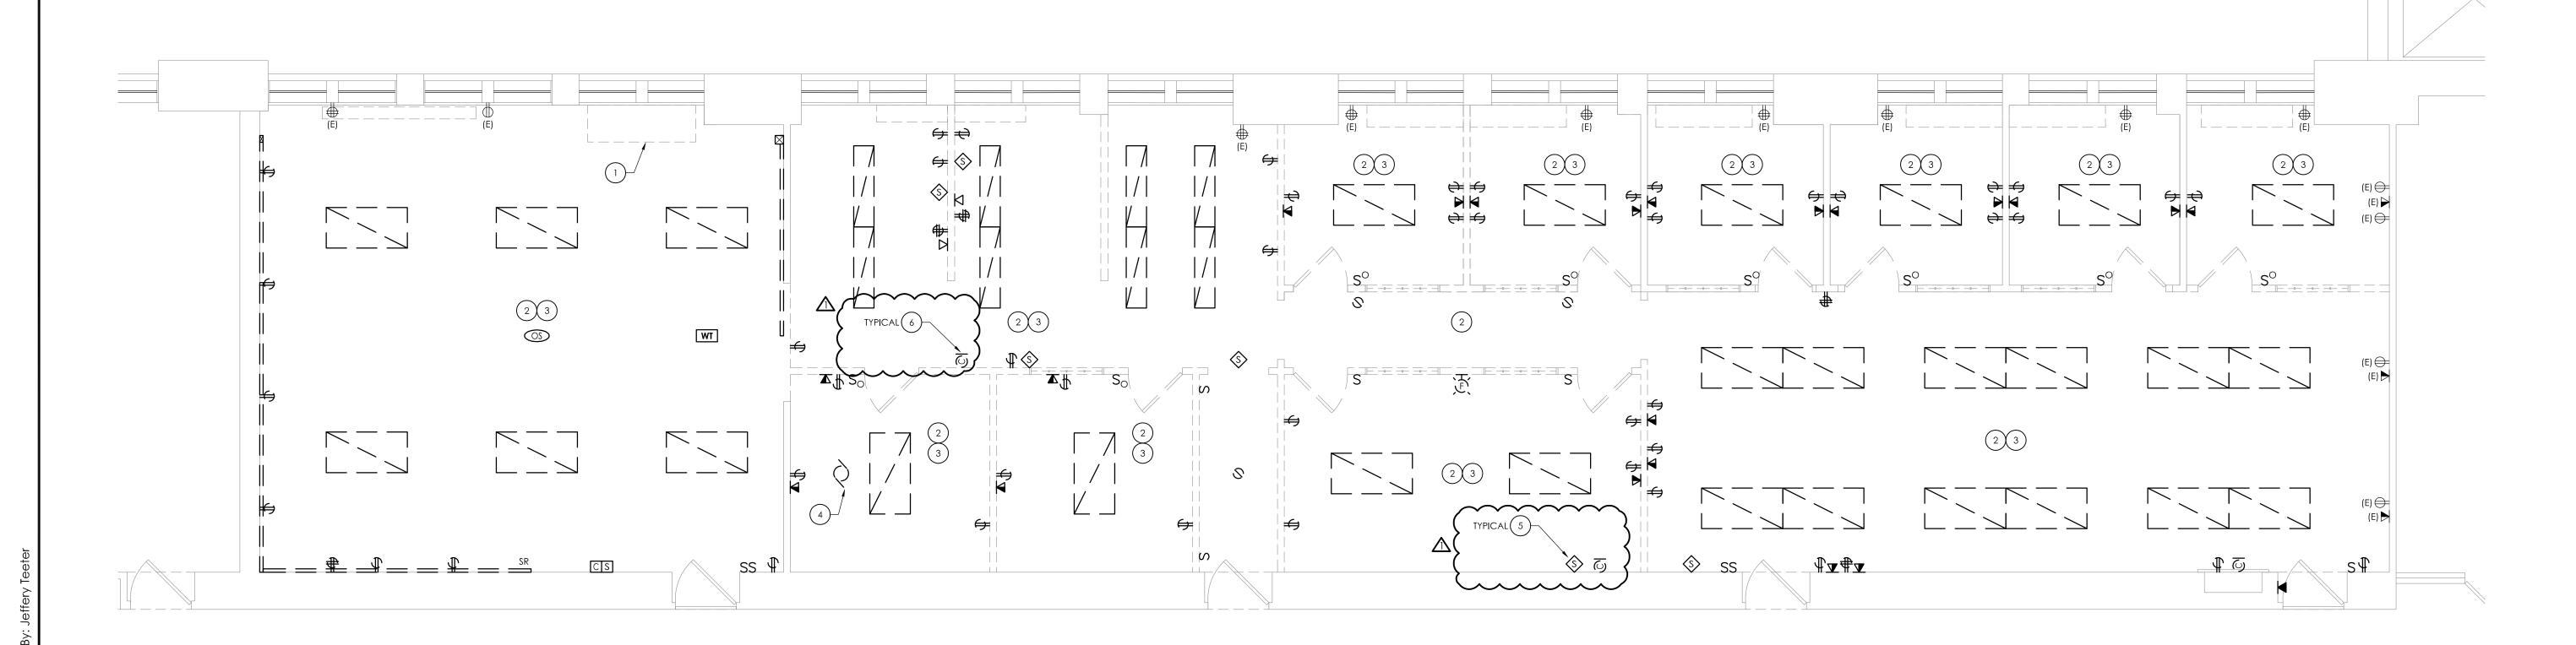
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PARTIAL BASEMENT AND FIRST FLOOR ELECTRICAL KEY PLANS

PROJECT NUMBE

OHS E100 DRAWING NUMBER



FIRST FLOOR ELECTRICAL DEMOLITION PLAN

SCALE: 1/4" = 1'-0"

# **GENERAL NOTES:**

- A. ALL ITEMS SHOWN ARE TO BE REMOVED UNLESS LABELED AS (E) EXISTING TO REMAIN. ANY DEVICE, AS WELL AS ITS ASSOCIATED CIRCUITING, AND CONDUIT, LABELED "(E)" SHALL REMAIN, UNLESS OTHERWISE NOTED.
- B. INFORMATION ON DRAWINGS WAS OBTAINED THROUGH FIELD OBSERVATION AND AS-BUILT DOCUMENTATION. THE CONTRACTOR IS RESPONSIBLE FOR THE REMOVAL AND REPLACEMENT OF ANY DEVICES AND CABLING THAT MAY NOT BE SHOWN ON DRAWING AT NO ADDITIONAL COST TO OWNER.
- C. DRAWINGS ARE GRAPHICAL REPRESENTATIONS OF APPROXIMATE EQUIPMENT AND DEVICE LOCATIONS. CONTRACTOR SHALL VISIT THE SITE TO DETERMINE THE EXACT EXTENT OF ELECTRICAL WORK REQUIRED TO COMPLETE THE PROJECT. EXISTING CONDITIONS ARE TAKEN FROM FIELD OBSERVATION AND EXISTING BUILDING DOCUMENTS. OTHER ELECTRICAL ITEMS MAY EXIST FOR WHICH THE CONTRACTOR IS RESPONSIBLE AT NO ADDITIONAL COST.
- D. THE CONTRACTOR SHALL REMOVE THE EXISTING ELECTRIC IN AREAS OF NEW RENOVATIONS TO ACCOMMODATE NEW CONSTRUCTION. REROUTING OF EXISTING MAY BE REQUIRED AT NEW OPENINGS IN EXISTING CONSTRUCTION OR INTERFERENCE WITH OTHER NEW WORK AS NOTED IN THE FOLLOWING NOTES.
- E. DRAWINGS INDICATE SPECIFIC ITEMS TO BE REMOVED AND/OR RELOCATED IN ORDER TO INDICATE GENERAL SCOPE. ADDITIONAL ITEMS NOT INDICATED, BUT NECESSARY FOR PROJECT RENOVATIONS, SHALL BE REMOVED, RELOCATED AND/OR REROUTED AS REQUIRED TO ACCOMMODATE THE NEW CONSTRUCTION. AT NO ADDITIONAL COST TO OWNER.
- F. COORDINATE DEMOLITION OF EQUIPMENT, DEVICES, ETC. WITH OTHER DISCIPLINES AS APPLICABLE.
- G. ALL ITEMS (DEVICES, FIXTURES, ETC.) SHOWN ARE TO BE REMOVED UNLESS LABELED AS EXISTING TO REMAIN (E). THESE ITEMS AND THEIR RELATED WIRING/CONDUIT SHALL BE REMOVED BACK TO THE SOURCE CONTROL PANEL/PANELBOARD UNLESS OTHERWISE NOTED. ON CIRCUITS WHERE OTHER DEVICES, FIXTURES, ETC. ARE FOUND THAT MUST REMAIN, MAINTAIN CIRCUIT CONTINUITY BY PROVIDING ADDITIONAL WIRING, TO FEED THROUGH TO THESE REMAINING ITEMS. RELOCATE ANY CIRCUITS THAT REMAIN, TO AVOID CONFLICT WITH NEW CONSTRUCTION AS REQUIRED. PROPERLY TERMINATE ALL WIRING.
- H. CONTRACTOR SHALL PROPERLY DISPOSE OF ALL ITEMS AND/OR EQUIPMENT BEING REMOVED AS PART OF THE PROJECT. THE OWNER SHALL HAVE THE RIGHT OF RETAINING ANY ITEMS BEING REMOVED.
- I. CONTRACTOR SHALL PROVIDE NEW COVERPLATES ON ALL UNUSED FLUSH MOUNT DEVICE BOXES UPON COMPLETION OF PROJECT.
- J. FIREPROOFING AND/OR FIRE STOP MATERIALS REMOVED FROM FIRE RATED WALLS AND CEILINGS AS A RESULT OF DEMOLITION SHALL BE REPLACED USING AN APPROVED METHOD AS DESCRIBED IN ASSOCIATED PROJECT SPECIFICATIONS.

# KEY NOTES:

- 1) DISCONNECT AND REMOVE ALL CONDUIT AND WIRING TO UNIT VENTILATOR BACK TO SOURCE.
- 2 DISCONNECT AND REMOVE EXISTING LIGHT FIXTURES. TAG EXISTING CIRCUITRY FOR RE-USE WITH NEW LIGHTING.
- 3) DISCONNECT AND REMOVE EXISTING DATA DEVICES. COIL AND TAGE EXISTING DATA WIRING FOR RE-USE WITH NEW DATA DEVICES.
- DISCONNECT AND REMOVE ALL CONDUIT AND WIRING TO FAN COIL BACK TO SOURCE.

  5 DISCONNECT AND REMOVE EXISTING SPEAKERS. PULL WIRING BACK
- 6) REMOVE EXISTING WIRELESS CLOCK AND STORE FOR RE-LOCATION.

AND TAG FOR RE-USE.

REFER TO DRAWING OHS-E201 FOR NEW LOCATIONS.

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SCALE AS SHOWN
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FIRST FLOOR ELECTRICAL
DEMOLITION PLAN

PROJECT NUMBER
14428.12

OHS E101 DRAWING NUMBER 1 FIRST FLOOR ELECTRICAL NEW WORK PLAN
SCALE: 1/4" = 1'-0"

# GENERAL NOTES:

- A. FOR ALL 120V DEVICES SHOWN, WIRE WITH (2)#12, #12G IN 3/4"C AND CONNECT TO 20A/1P CIRCUIT BREAKER IN PANEL PP1 OF CIRCUIT INDICATED ADJACENT TO DEVICE.
- B. FOR ALL WALL MOUNT VOICE/DATA DROPS SHOWN, PROVIDE FLUSH MOUNT 2-GANG BOX WITH SINGLE GANG DEVICE RING. PROVIDE (2) CATEGORY 6 UTP CABLES IN 1-1/4" CONDUIT ABOVE FINISHED CEILING SPACE TO DATA RACK IN WORK ROOM L-1.5. REFER TO DRAWING E100 FOR DATA RACK LOCATION. PROVIDE ASSOCIATED 2-PORT FACEPLATE, (2) RJ45 JACKS, ETC. AT DROP LOCATION. PROVIDE NEW 48-PORT PATCH PANEL AND ALL CABLING TERMINATIONS AND TESTING. PROVIDE PATCH CABLES IN DATA RACK FROM NETWORK SWITCH TO PATCH PANEL FOR EACH DATA
- C. AT EACH SYMBOL INDICATES, REFER TO ELECTRICAL EQUIPMENT WIRING SCHEDULE ON DRAWING E900.
- F. THE CONTRACTOR SHALL PROVIDE NEW NOTIFICATION APPLIANCE (NAC) PANEL ON EACH FLOOR TO ACCOMMODATE NEW NOTIFICATION DEVICES. PANELS SHALL BE LOCATED IN ACCESSIBLE CLOSET SPACE ON ASSOCIATED FLOOR, COORDINATE EXACT PANEL LOCATION WITH OWNER PRIOR TO INSTALLATION. SERVE NEW NAC PANEL FROM NEAREST AVAILABLE 120VAC PANELBOARD SOURCE WITH (2) #12, #12 G IN 1/2" EMT CONDUIT. CIRCUIT LENGTHS EXCEEDING 100' SHALL BE WITH #10 AWG. PROVIDE 20/1 CIRCUIT BREAKER IN AVAILABLE PANEL SPACE AND ASSOCIATED "BREAKER ON" LOCK. NEW CIRCUIT BREAKER SHALL BE U.L. LISTED AND MATCH EXISTING PANEL INTERRUPTING RATING.
- G. THE CONTRACTOR SHALL INCLUDE MATERIAL AND LABOR COSTS ASSOCIATED WITH THE REPLACEMENT OF ADDITIONAL SMOKE DUCT DETECTORS, REMOTE TEST STATIONS AND FAN SHUTDOWN RELAYS AS INDICATED IN DIV 28 SPECIFICATION. THIS SHALL COVER DEVICES ASSOCIATED WITH HVAC EQUIPMENT NOT ACCESSIBLE OR VISIBLE DURING FIELD INVESTIGATION.
- H. INITIATION DEVICES SHOWN SHALL NOT BE LOCATED IN A DIRECT AIRFLOW PATH OR CLOSER THAN 3' OF AN AIR SUPPLY DIFFUSER OR RETURN AIR GRILLE.
- I. FIRE ALARM CABLING RUN EXPOSED IN UNFINISHED AREAS SHALL BE INSTALLED IN EMT CONDUIT AND PAINTED TO MATCH EXISTING WALL/CEILING FINISH. HORIZONTAL RUNS THROUGH WALLS AND VERTICAL RUNS THROUGH FLOORS SHALL BE SLEEVED IN EMT CONDUIT AND FIRE CAULKED. ALL FIRE ALARM CABLING RUN EXPOSED IN FINISHED SPACES SHALL BE INSTALLED IN 500 SERIES STEEL WIREMOLD. IVORY IN COLOR.
- J. MOUNT SMOKE DETECTORS WITHIN 5 FEET OF DOORS THAT CLOSE ON A FIRE ALARM ACTIVATION. REFER TO NFPA 72 FOR THE MINIMUM DISTANCE A SMOKE DETECTOR CAN BE FROM DOOR.
- K. FOR PUBLIC MODE, WALL MOUNTED VISUALS OR AUDIBLE/VISUALS SHALL BE MOUNTED SUCH THAT THE ENTIRE LENS IS NOT LESS THAN 80" AND NOT GREATER THAN 96" ABOVE FINISHED FLOOR. REFER TO NFPA 72 FOR CEILING MOUNTED VISUALS. REFER TO NFPA FOR SPACING OF STROBES. WHERE CEILING HEIGHTS ALLOW, WALL MOUNTED AUDIBLE ONLY APPLIANCES SHALL HAVE THEIR TOPS ABOVE FINISHED FLOOR AT HEIGHTS OF NOT LESS THAN 90".
- L. THE OPERABLE PART OF PULL STATIONS SHALL BE MOUNTED MORE THAN 3-1/2 FEET BUT LESS THAN 4-1/2 FEET ABOVE THE FLOOR. REFER TO NFPA FOR SPACING OF DEVICES.
- M. REFER TO MANUFACTURER INSTALLATION GUIDELINES FOR DUCT SMOKE DETECTOR INSTALLATION.
- N. ADDRESSABLE DEVICES SHOULD ONLY BE INSTALLED IN AREAS WHERE AMBIENT TEMPERATURE IS BETWEEN 32° AND 100° F.
- O. CIRCUIT DISCONNECT MEANS (BREAKER IN PANELBOARD) FOR THE FACP SHALL HAVE A RED MARKING AND SHALL BE IDENTIFIED AS "FIRE ALARM CIRCUIT CONTROL". CIRCUIT DISCONNECT LOCATION SHALL BE PERMANENTLY IDENTIFIED AT THE FACP ON AN ENGRAVED LABEL. EXISTING CIRCUIT IS CURRENTLY SERVED VIA NORMAL BRANCH POWER FROM PANELBOARD LOCATED IN MAIN ELECTRICAL ROOM.
- P. EACH MANUAL FIRE ALARM PULL STATION SHALL BE PROVIDED WITH PULL STATION COVER WITH HORN.

# KEY NOTES:

- AT NEW DATA DEVICES, CONNECT TO EXISTING DATA CABLING TAGGED FOR RE-USE. WHERE DATA CABLING IS NOT AVAILABLE PROVIDED NEW DATA CABLING AS INDICATED IN THE GENERAL NOTES.
- 2 PROVIDE PUBLIC ADDRESS SPEAKER, BOGEN MODEL S86T725PG8WVK AT EACH LOCATION SHOWN. CONNECT SPEAKERS TO EXISTING TAGGED SPEAKER WIRING. REWORK/EXTEND WIRING AS NECESSARY TO ACCOMMODATE NEW SPEAKER LOCATIONS.

PROVIDE PRIMEX WIRELESS CLOCK MODEL B1004Z155 AT LOCATIONS SHOWN.

- 4 AT EACH WIRELESS TRANSMITTER INDICATED PROVIDE (2) CATEGORY 6 UTP CABLES AND (2) RJ45 JACKS ABOVE CEILING. COIL 20' OF EXTRA CABLING AT LOCATION.
- 5 PROVIDE NEW RECESSED 200-AMP, 120/208V, 3-PHASE, 4-WIRE, 10K AIC, 30 CIRCUIT PANEL BOARD AT LOCATION SHOWN. NEW PANEL TO BE FED FROM PANEL LDB. REFER TO DRAWING HS-E100 FOR PANEL LOCATION.
- PROVIDE 120-VOLT CONNECTION TO POWERED DOOR OPERATORS AS NOTED. OPERATORS TO BE WIRED BACK TO PANEL PP1, CIRCUIT 27. WIRE OPERATORS WITH (2) #12, (1) #12GND IN 3/4" CONDUIT. COORDINATE ALL WORK WITH DOOR HARDWARE INSTALLER.
- PROVIDE 120-VOLT CONNECTION TO ELECTRIC STRIKE POWER SUPPLY.
  ELECTRIC STRIKE POWER SUPPLY TO BE WIRED BACK TO PANEL PP1,
  CIRCUIT 28. WIRE WITH (2) #12, (1) #12GND IN 3/4" CONDUIT.
  COORDINATE ALL WORK WITH DOOR HARDWARE INSTALLER.

8 RELOCATE EXISTING WIRELESS CLOCKS TO LOCATIONS INDICATED.

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SCALE AS SHOWN

SHEET TITLE

FIRST FLOOR ELECTRICAL

NEW WORK PLAN

14428.12

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