NOVEMBER 19, 2021

CONSTRUCTION DOCUMENTS

OWNER

Putnam Valley CSD

Putnam Valley Middle School 142 Peekskill Hollow Road Putnam Valley, NY 10579 District Phone: 845.528.8143

2018 CAPITAL PROJECTS PHASE 3

PUTNAM VALLEY MIDDLE SCHOOL TOILET ROOM ALTERATIONS

142 PEEKSKILL HOLLOW RD, PUTNAM VALLEY, NY 10579



LIST OF DRAWINGS

HAZARDOUS MATERIALS

ASBESTOS ABATEMENT 1ST AND 2ND FLOOR PLAN

<u>ARCHITECTURAL</u>

DEMOLITION PLANS FLOOR PLANS INTERIOR ELEVATIONS & SCHEDULES REFLECTED CEILING PLANS

FIRST AND SECOND FLOOR REMOVAL PLANS

FIRST AND SECOND FLOOR PLANS H301 SCHEDULES AND DETAILS

ELECTRICAL

LEGEND, NOTES & ABBREVIATIONS E001 E101 FIRST AND SECOND FLOOR REMOVAL PLANS E201 FIRST AND SECOND FLOOR LIGHTING PLANS E301 FIRST AND SECOND FLOOR POWER PLANS E501 POWER AND FA RISER ELECTRICAL SCHEDULES

ARCHITECT

KG+D Architects

Kaeyer Garment & Davidson Architects, PC 285 Main Street Mt. Kisco, NY 10549 phone: 914.666.5900 fax: 914.666.0051

MECHANICAL ENGINEER

Barile Gallagher
Barile Gallagher & Associates
Consulting Engineers 39 Marble Ave, Pleasantville, NY 10570 phone: 914.328.6060 fax: 914.328.9304

ABATEMENT CONSULTANTS WSP

Environmental Consultant 96 Morton Street, 8th Floor New York, NY 10014 phone: 914.789.3710 fax: 914.592.1734

KG+D Project No. 2021-1067a

NY SED Project No. 48-05-03-04-0-004-016

JOBSITE RULES SIGN DETAIL

ATTENTION!

AUTHORIZED PERSONNEL ONLY

SAFETY STARTS HERE

JOBSITE REQUIREMENTS: ALL VISITORS MUST CHECK IN AT THE PROJECT OFFICE


ALL ACCIDENTS MUST BE REPORTED TO THE CONSTRUCTION MANAGER IMMEDIATELY MATERIAL SAFETY DATA SHEETS ARE REQUIRED FOR ALL MATERIALS BROUGHT ONTO THE JOBSITE.

POSSESSING AND OR WORKING UNDER THE INFLUENCE OF DRUGS AND OR ALCOHOL IS PROHIBITED NO FIREARMS OR WEAPONS OF ANY KIND ARE PERMITTED ON SITE. HARD HATS MUST BE WORN AT ALL TIMES PROTECTIVE EYE WEAR IS REQUIRED. NO SMOKING NO LOITERING ALL TRADE PERSONS MUST WEAR SHIRTS

WITH SLEEVES, LONG PANTS, AND PROPER

ANY PERSONS FOUND IN VIOLATION OF THESE REQUIREMENTS WILL BE REMOVED FROM THE JOBSITE AT THE DISCRETION OF THE CONSTRUCTION MANAGER.

FOOTWEAR

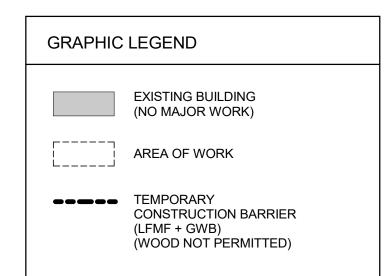

ALL TEMPORARY CONSTRUCTION MATERIALS MUST BE NON-COMBUSTIBLE


ALL CONSTRUCTION MUST COMPLY WITH PART 155.5

ALL TEMPORARY EXITING & SEPARATION OF WORK ZONES MUST BE IN-PLACE PRIOR TO COMMENCEMENT OF WORK


FIRE ACCESS ROAD NOTES: 1. EXISTING EMERGENCY VEHICLE ACCESS ROAD TO BE MAINTAINED FREE & CLEAR THROUGHOUT ENTIRE PROJECT. 2. IF EMERGENCY VEHICLE ACCESS ROAD NEEDS TO BE BLOCKED, AN EQUAL OR GREATER WIDTH AND LENGTH OF TEMPORARY FIRE ACCESS ROAD MUST BE PROVIDED. 3. MAINTAIN FULL AND SAFE 24/7 **EMERGENCY VEHICLE ACCESS TO THE**

ENTIRE PERIMETER OF BUILDING DURING

ALL PHASES OF CONSTRUCTION.

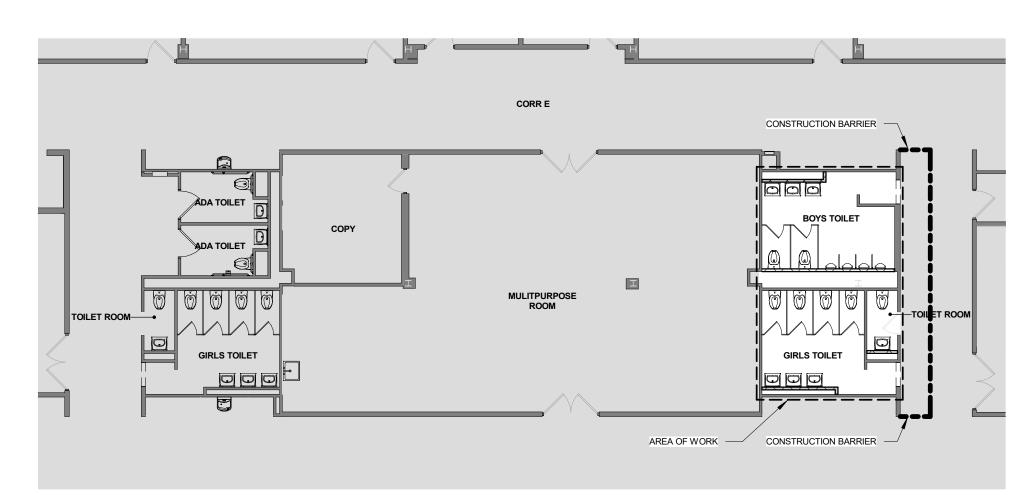

2nd FLOOR PLAN - TEMPORARY CONSTRUCTION

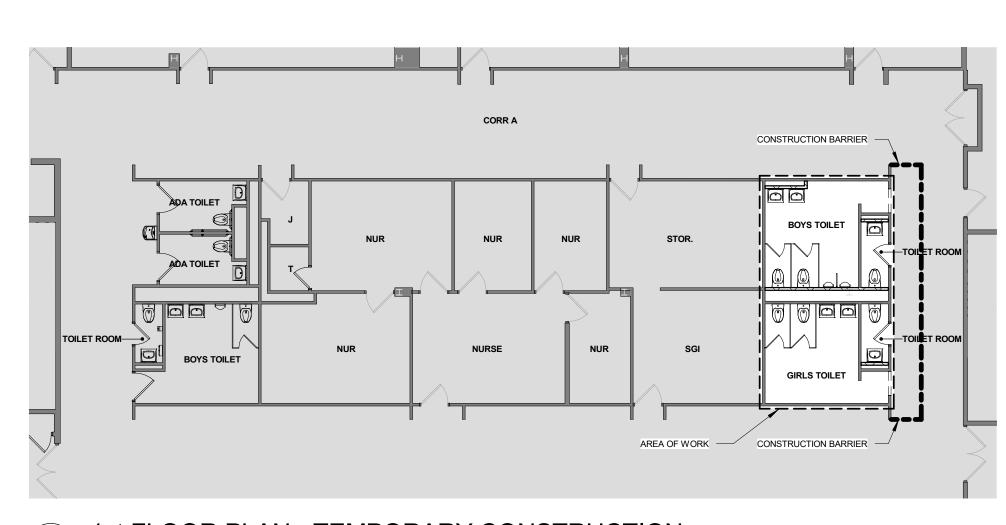

1st FLOOR PLAN - TEMPORARY CONSTRUCTION

ABBREVIATIONS

AFF		GALV	GALVANIZED	QT	QUARRY TILE
ACM			GROUND FACE BLOCK	QTB	QUARRY TILE BASE
ACPI ACT		GFRG GL	GLASS FIBER REINFORCED GYPSUM GLASS	QTY	QUANTITY
ADJ		GOG	GOGGLE	RCP	REFLECTED CEILING PLAN
AC	AIR CONDITIONING	GWB	GYPSUM WALLBOARD	REFL	REFLECTED
AES	S ARCHITECTURAL EXPOSED ST	RUCTURAL STEEL		REQD	REQUIRED
AHAI		Н	HEIGHT AFF	RB	RUBBER BASE
ALUN		HDW	HARDWARE	RTN	RETURN
AMP	P ACRYLIC MODIFIED POLYESTE PROX APPROXIMATE	R HDWD HD	HARDWOOD HEAD	RA REV	RETURN AIR REVISED/REVISION
AFFI	NOX AFFROMINATE	HDR	HEADER	RFI	REQUEST FOR INFORMATION
BEP	O BROADCAST EPOXY	HVAC	HEATING, VENTILATING, AIR CONDITIONING		ROUGH OPENING
BTW		HR	HOUR	RT	RUBBER TREATD/TILE
BLK		HT	HEIGHT	RTB	RUBBER TREAD BASE
BOT BLD(HM HMFR	HOLLOW METAL HOLLOW METAL FRAME	RTT RW	RESILIENT TERRAZZO TILE RESCUE WINDOW
BLD	BUILDING LINE	HORIZ	HORIZONTAL	KVV	RESCUE WINDOW
DL	BOILDING LINE	HC	HANDICAP	S	SAFETY GLZING/SEE SPEC
CAB				SCHED	SCHEDULE/SCHEDULED
CB	CEMENT BOARD	IF	INSIDE FACE	SECT	SECTION
CI	CAST IRON	IN INC.	INCH/INCHES	SFB	SPLIT FACE BLOCK
CLG CL	G CEILING CENTER LINE	INCL INFO	INCLUDE/INCLUSIVE INFORMATION	SH SIM	SHELVING/SHELF/SHELVES SIMILAR
CMU		INSUL	INSULATION	SL	SLATE
COL		INT	INTERIOR	STC	SOUND TRANSMISSION CLASS
CON	NC CONCRETE			SPEC	SPECIFICATION
CON		JC	JANITOR'S CLOSET	SQFT	SQUARE FOOT
CON		JT	JOINT	SS	SAND, STAIN, SEAL
CON		KPL	KICK PLATE	STSTL STL	STAINLESS STEEL STEEL
CPT		KD	KNOCKDOWN	STR	STRUCTURAL/STRUCTURE
CT	CERAMIC TILE	КО	KNOCKOUT	SUSP	SUSPENDED/SUSPENSION
СТВ					
		LAM	LAMINATED	T	TOP
DA	DEVICE ARRANGEMENT	LAMGL	LAMINATED GLASS	TB	TACKBOARD
DET DF	DETAIL DRINKING FOUNTAIN	LT LTG	LIGHT LIGHTING	TBD TERR	TO BE DETERMINED TERRAZZO
DIM		LWC	LIGHT WEIGHT CONCRETE	TFF	TOP FINISHED FLOOR
DR	DOOR	LIN	LINOLEUM	TMP GL	TEMPERED GLASS
DN	DOWN			THERMO	THERMOSTAT
DWG	G DRAWING	MAINT	MAINTAIN/MAINTENANCE	T&B	TOP AND BOTTOM
EE	EACH END	MAX MFG	MAXIMUM MANUFACTURER	TO TOS	TOP OF TOP OF STEEL
EIFS			MASONRY	TOSS	TOP OF STEEL TOP OF STRUCTURAL SLAB
EJ	EXPANSION JOINT	MO	MASONRY OPENING	TOES	TOP OF EXISTING SLAB
ELEC		MATL	MATERIAL	TRT	TERRAZZO RESILIENT TILE
	ELEV ELEVATION	MECH	MECHANICAL	TYP	TYPICAL
ENC		MTL	METAL COMPOSITE BANGI	LINITINI	LINEINIOLIED
EOD EOS		MCP MCB	METAL COMPOSITE PANEL METAL CORNER BEAD	UNFIN UNO	UNFINISHED UNLESS NOTED OTHERWISE
EPO		MS	METAL STUD	UR	UNRINAL
EPS		MLWK	MILL WORK	UTIL	UTILITY
EQ		MIN	MINIMUM		
ES	EACH SIDE	MISC	MISCELLANEOUS	VAT	VINYL ASBESTOS TILE
EXS		MLDG MTC	MOLDING	VCT	VINYL COMPOSITE TILE
ETR ETRI		MTG	MOUNTING	VEN VERT	VENEER VERTICAL
EXP		NIC	NOT IN CONTRACT	VET	VINYL ENHANCED TILE
EXT		NTS	NOT TO SCALE	VIF	VERIFY IN FIELD
EW	EACH WAY	NO	NUMBER	VRS	VINYL REDUCER STRIP
EAD	FARRIC	00	ON OFNITED	VT	VINYL TILE
FAB FTF		OC OPNG	ON CENTER OPENING	VWC	VINYL WALL COVERING
FIN		OPP	OPPOSITE	WB	WHITEBOARD
FA	FIRE ALARM	OH	OPPOSITE HAND	WC	WATER CLOSET
FD	FLOOR DRAIN	OTS	OPEN TO STRUCTURE	WF	WATER FOUNTAIN
FDM		OUT	OUTLET	WGL	WIRE GLASS
FE	FIRE EXTINGUISHER	OD	OUTSIDE DIAMETER	W/	WITH
FEC FF		OF	OUTSIDE FACE	W/C W/O	WHEEL CHAIR WITHOUT
FHC		Р	PAINTED	WOM	WALK OFF MAT
FHV		PT	PORCELAIN TILE	WD	WOOD
FR	FIRE RATED	PTB	PORCELAIN TILE BASE	WD BLKG	WOOD BLOCKING
FRD		PR	PAIR	WD DR	WOOD DOOR
FFS(PANEL	WP	WATERPROOFING
FRTI FIX		PTN PL	PARTITION PROPERTY LINE	WR WW	WARDROBE WINDOW WALL
FIX FL/FI		PL PLAM	PLASTIC LAMINATE	V V V V	VVIINDOVV VVALL
FLUC		PLMB	PLUMBING	YD	YARD
FL M	ITD FLUSH MOUNTED	PLYWD	PLYWOOD	YCO	YARD CLEANOUT
FT FDN	FOOT/FEET	PTWD	PRESERVATIVE TREATED WOOD	7CC	ZINC COATED COPPER
F1 11/1				21.1	, 1131 1 14 E 1 1 1 1 1 1 1 1

UNIFORM SAFETY STANDARDS FOR SCHOOL CONSTRUCTION AND MAINTENANCE PROJECTS PER COMMISSIONERS REGULATIONS PART 155.5

ZINC COATED COPPER

THE OCCUPIED PORTION OF THE EXISTING SCHOOL BUILDING SHALL ALWAYS COMPLY WITH THE MINIMUM REQUIREMENTS NECESSARY TO MAINTAIN A CERTIFICATE OF OCCUPANCY.

ALL SCHOOL AREAS TO BE DISTURBED DURING RENOVATION OR DEMOLITION HAVE BEEN OR WILL BE TESTED FOR LEAD AND ASBESTOS.

GENERAL SAFETY AND SECURITY STANDARDS FOR CONSTRUCTION PROJECTS:

ALL CONSTRUCTION MATERIALS SHALL BE STORED IN A SAFE AND SECURE MANNER.

FENCES AROUND CONSTRUCTION SUPPLIES OR DEBRIS SHALL BE MAINTAINED. GATES SHALL ALWAYS BE LOCKED UNLESS A WORKER IS IN ATTENDANCE TO PREVENT UNAUTHORIZED ENTRY

(D) DURING EXTERIOR RENOVATION WORK, OVERHEAD PROTECTION SHALL BE PROVIDED FOR ANY SIDEWALKS OR AREAS IMMEDIATELY BENEATH THE WORK SITE OR SUCH AREAS SHALL BE FENCED OFF AND PROVIDED WITH WARNING SIGNS TO PREVENT

WORKERS SHALL BE REQUIRED TO WEAR PHOTO-IDENTIFICATION BADGES AT ALL TIMES FOR IDENTIFICATION AND SECURITY PURPOSES WHILE WORKING AT OCCUPIED SITES.

SEPARATION OF CONSTRUCTION AREAS FROM OCCUPIED SPACES:

FOUNDATION

FRITZ FLOOR (RTT) TILE

FRITZ

CONSTRUCTION AREAS WHICH ARE UNDER THE CONTROL OF A CONTRACTOR AND THEREFORE NOT OCCUPIED BY DISTRICT STAFF OR STUDENTS SHALL BE SEPARATED FROM OCCUPIED AREAS. PROVISIONS SHALL BE MADE TO PREVENT THE PASSAGE OF DUST AND CONTAMINANTS INTO OCCUPIED PARTS OF THE BUILDING. PERIODIC INSPECTION AND REPAIRS OF THE CONTAINMENT BARRIERS MUST BE MADE TO PREVENT EXPOSURE TO DUST OR CONTAMINANTS. GYPSUM BOARD MUST BE USED IN EXIT WAYS OR OTHER AREAS THAT REQUIRE FIRE RATED SEPARATION. HEAVY DUTY PLASTIC SHEETING MAY BE USED ONLY FOR A VAPOR, FINE DUST OR AIR INFILTRATION BARRIER, AND SHALL NOT BE USED TO SEPARATE OCCUPIED SPACES FROM CONSTRUCTION AREAS.

- (A) A SPECIFIC STAIRWELL AND/OR ELEVATOR SHOULD BE ASSIGNED FOR CONSTRUCTION WORKER USE DURING WORK HOURS. IN GENERAL, WORKERS MAY NOT USE CORRIDORS, STAIRS OR ELEVATORS DESIGNATED FOR STUDENTS OR SCHOOL STAFF.
- (B) LARGE AMOUNTS OF DEBRIS MUST BE REMOVED BY USING ENCLOSED CHUTES OR A SIMILAR SEALED SYSTEM. THERE SHALL BE NO MOVEMENT OF DEBRIS THROUGH HALLS OF OCCUPIED SPACES OF THE BUILDING. NO MATERIAL SHALL BE DROPPED OR THROWN OUTSIDE THE WALLS OF THE BUILDING.
- (C) ALL OCCUPIED PARTS OF THE BUILDING AFFECTED BY RENOVATION ACTIVITY SHALL BE CLEANED AT THE CLOSE OF EACH WORKDAY SCHOOL BUILDINGS OCCUPIED DURING A CONSTRUCTION PROJECT SHALL MAINTAIN REQUIRED HEALTH, SAFETY AND EDUCATIONAL CAPABILITIES AT ALL TIMES THAT CLASSES ARE IN SESSION.

A PLAN DETAILING HOW EXITING REQUIRED BY THE APPLICABLE BUILDING CODE WILL BE MAINTAINED.

A PLAN DETAILING HOW ADEQUATE VENTILATION WILL BE MAINTAINED DURING CONSTRUCTION.

CONSTRUCTION AND MAINTENANCE OPERATIONS SHALL NOT PRODUCE NOISE IN EXCESS OF 60 DBA IN OCCUPIED SPACES OR SHALL BE SCHEDULED FOR TIMES WHEN THE BUILDING OR AFFECTED BUILDING SPACES ARE NOT OCCUPIED OR ACOUSTICAL ABATEMENT MEASURES SHALL BE TAKEN.

THE CONTRACTOR SHALL BE RESPONSIBLE FOR THE CONTROL OF CHEMICAL FUMES, GASES, AND OTHER CONTAMINATES PRODUCED BY WELDING, GASOLINE OR DIESEL ENGINES, ROOFING, PAVING, PAINTING, ETC. TO ENSURE THEY DO NOT ENTER OCCUPIED PORTIONS OF THE BUILDING OR AIR


THE CONTRACTOR SHALL BE RESPONSIBLE TO ENSURE THAT ACTIVITIES AND MATERIALS WHICH RESULT IN "OFF-GASSING" OF VOLATILE ORGANIC COMPOUNDS SUCH AS GLUES, PAINTS, FURNITURE, CARPETING, WALL COVERING, DRAPERY, ETC. ARE SCHEDULED, CURED OR VENTILATED IN ACCORDANCE WITH MANUFACTURERS RECOMMENDATIONS BEFORE A SPACE CAN BE OCCUPIED.


LARGE AND SMALL ASBESTOS ABATEMENT PROJECTS AS DEFINED BY 12NYCRR56 SHALL NOT BE PERFORMED WHILE THE BUILDING IS OCCUPIED". NOTE, IT IS OUR INTERPRETATION THAT THE TERM "BUILDING", AS REFERENCED IN THIS SECTION, MEANS A WING OR MAJOR SECTION OF A BUILDING THAT CAN BE COMPLETELY ISOLATED FROM THE REST OF THE BUILDING WITH SEALED NON COMBUSTIBLE CONSTRUCTION. THE ISOLATED PORTION OF THE BUILDING MUST CONTAIN EXITS THAT DO NOT PASS THROUGH THE OCCUPIED PORTION AND VENTILATION SYSTEMS MUST BE PHYSICALLY SEPARATED AND SEALED AT THE ISOLATION BARRIER.

EXTERIOR WORK SUCH AS ROOFING, FLASHING, SIDING, OR SOFFIT WORK MAY BE PERFORMED ON OCCUPIED BUILDINGS PROVIDED PROPER VARIANCES ARE IN PLACE AS REQUIRED, AND COMPLETE ISOLATION OF VENTILATION SYSTEMS AND AT WINDOWS IS PROVIDED. CARE MUST BE TAKEN TO SCHEDULE WORK SO THAT CLASSES ARE NOT DISRUPTED BY NOISE OR VISUAL DISTRACTION.

SURFACES THAT WILL BE DISTURBED BY RECONSTRUCTION MUST HAVE A DETERMINATION MADE AS TO THE PRESENCE OF LEAD. PROJECTS WHICH DISTURB SURFACES THAT CONTAIN LEAD SHALL HAVE IN THE SPECIFICATIONS A PLAN PREPARED BY A CERTIFIED LEAD RISK ASSESSOR OR SUPERVISOR WHICH DETAILS PROVISIONS FOR OCCUPANT PROTECTION, WORKSITE PREPARATION, WORK METHODS, CLEANING AND CLEARANCE TESTING WHICH ARE IN GENERAL ACCORDANCE WITH THE HUD GUIDELINES.

SYMBOLS LEGEND

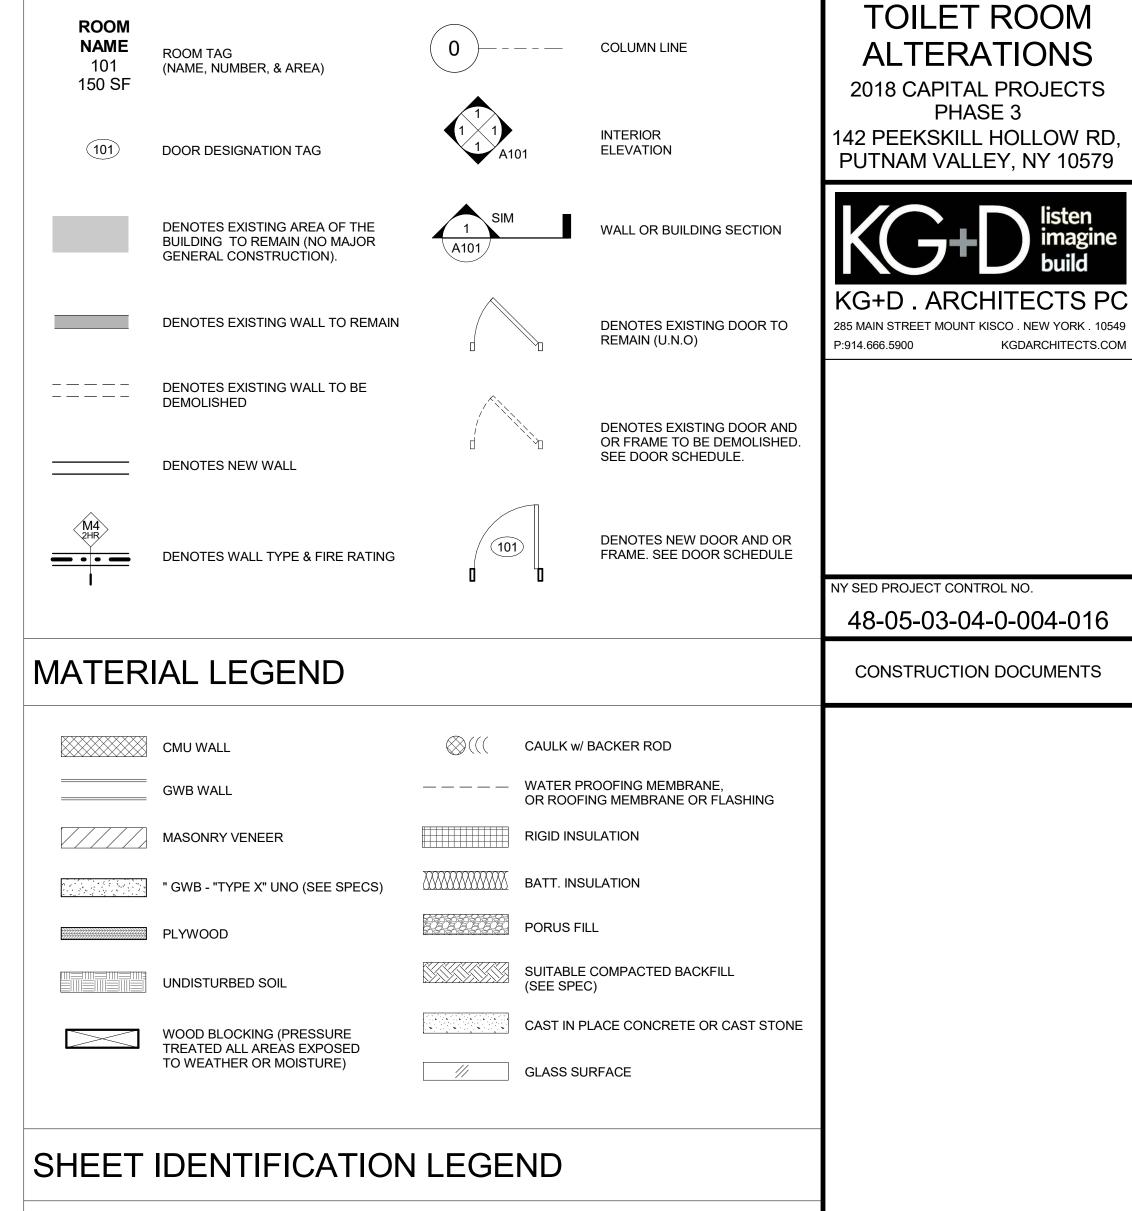

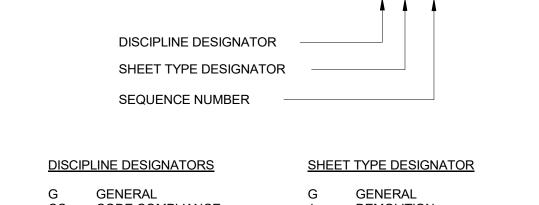

CODE COMPLIANCE HAZARDOUS MATERIAL ABATEMEN⁻ LANDSCAPE STRUCTURAL **ARCHITECTURA** FIRE PROTECTION PLUMBING

MECHANICAL

DEMOLITION **EXTERIOR ELEVATIONS & BUILDING SECTIONS ENLARGED PLANS & INTERIOR** ELEVATIONS FINISHES REFLECTED CEILING PLANS

A10²

VERTICAL CIRCULATION WALL SECTIONS & ENLARGED DETAILS TYPICAL DETAILS

PROJECT INFORMATION

OWNER PUTNAM VALLEY CENTRAL SCHOOL DISTRICT 171 OSCAWANA LAKE ROAD PUTNAM VALLEY, NEW YORK 10579

WWW.PVCSD.ORG

CONTACT: DAVID SPITTAL DIRECTOR OF FACILITIES & TRANSPORTATION

845.528.8143 (DISTRICT'S OFFICE)

BUILDING LOCATION

TYPE OF PROJECT ALTERATIONS NYSED NUMBER 48-05-03-04-0-004-016 PROJECT COMMENCEMENT SPRING 2022

PROJECT COMPLETION APPLICABLE CODES

2015 NEW YORK STATE UNIFORM FIRE PREVENTION

SUMMER 2022

PUTNAM VALLEY MIDDLE SCHOOL

PUTNAM VALLEY, NEW YORK 10579

142 PEEKSKILL HOLLOW ROAD

- AND BUILDING CODE CONSISTS OF THE FOLLOWING: INTERNATIONAL BUILDING CODE 2015 WITH AMENDMENTS INTERNATIONAL EXISTING BUILDING CODE WITH AMENDMENTS INTERNATIONAL FIRE CODE 2015 WITH AMENDMENTS INTERNATIONAL ENERGY CONSERVATION CODE WITH
- INTERNATIONAL PLUMBING CODE WITH AMENDMENTS INTERNATIONAL MECHANICAL CODE WITH AMENDMENTS INTERNATIONAL FUEL GAS CODE WITH AMENDMENTS

MANUAL OF PLANNING STANDARDS, THE UNIVERSITY OF THE STATE OF NEW YORK, THE STATE EDUCATION DEPARTMENT

CONDITIONS ON THE JOB AND THE ARCHITECT MUST BE NOTIFIED OF A ITECT WHOSE PROFESSIONAL SEAL IS AFFIXED HERETO IS A VIOL TITLE VII, SECT. 69.5 (b) OF NEW YORK STATE LAW. Professional Seal

KEY PLAN

USE ON THIS PROJECT, NONE OF SUCH IDEAS, DESIGNS, ARRANGEME

PUTNAM VALLEY

MIDDLE SCHOOL


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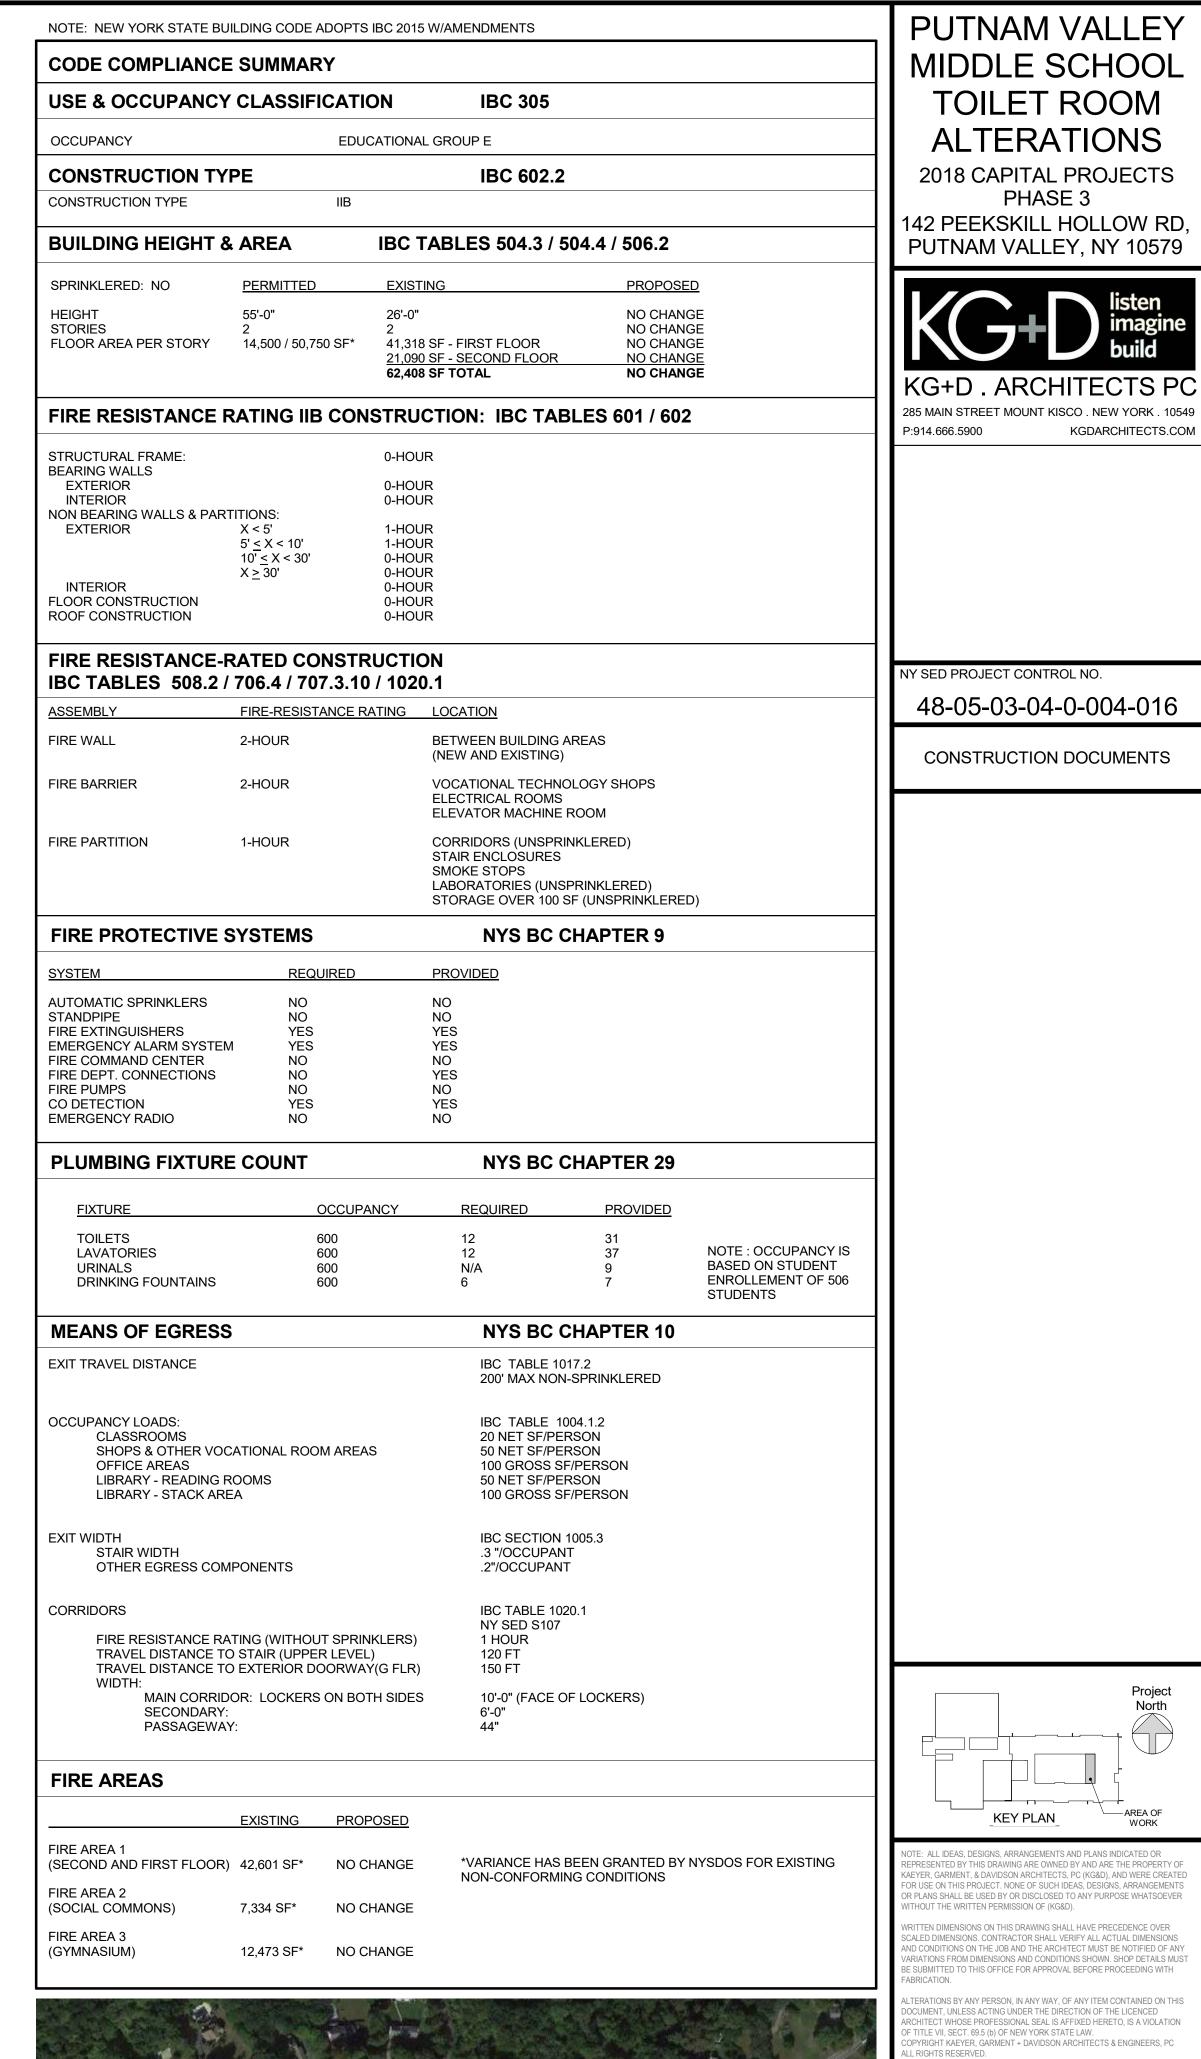
11/19/21 CONSTRUCTION DOCUMENTS P **GENERAL**

INFORMATION

01/14/2021 Drawn / Checked AS NOTED Sheet Number

G001



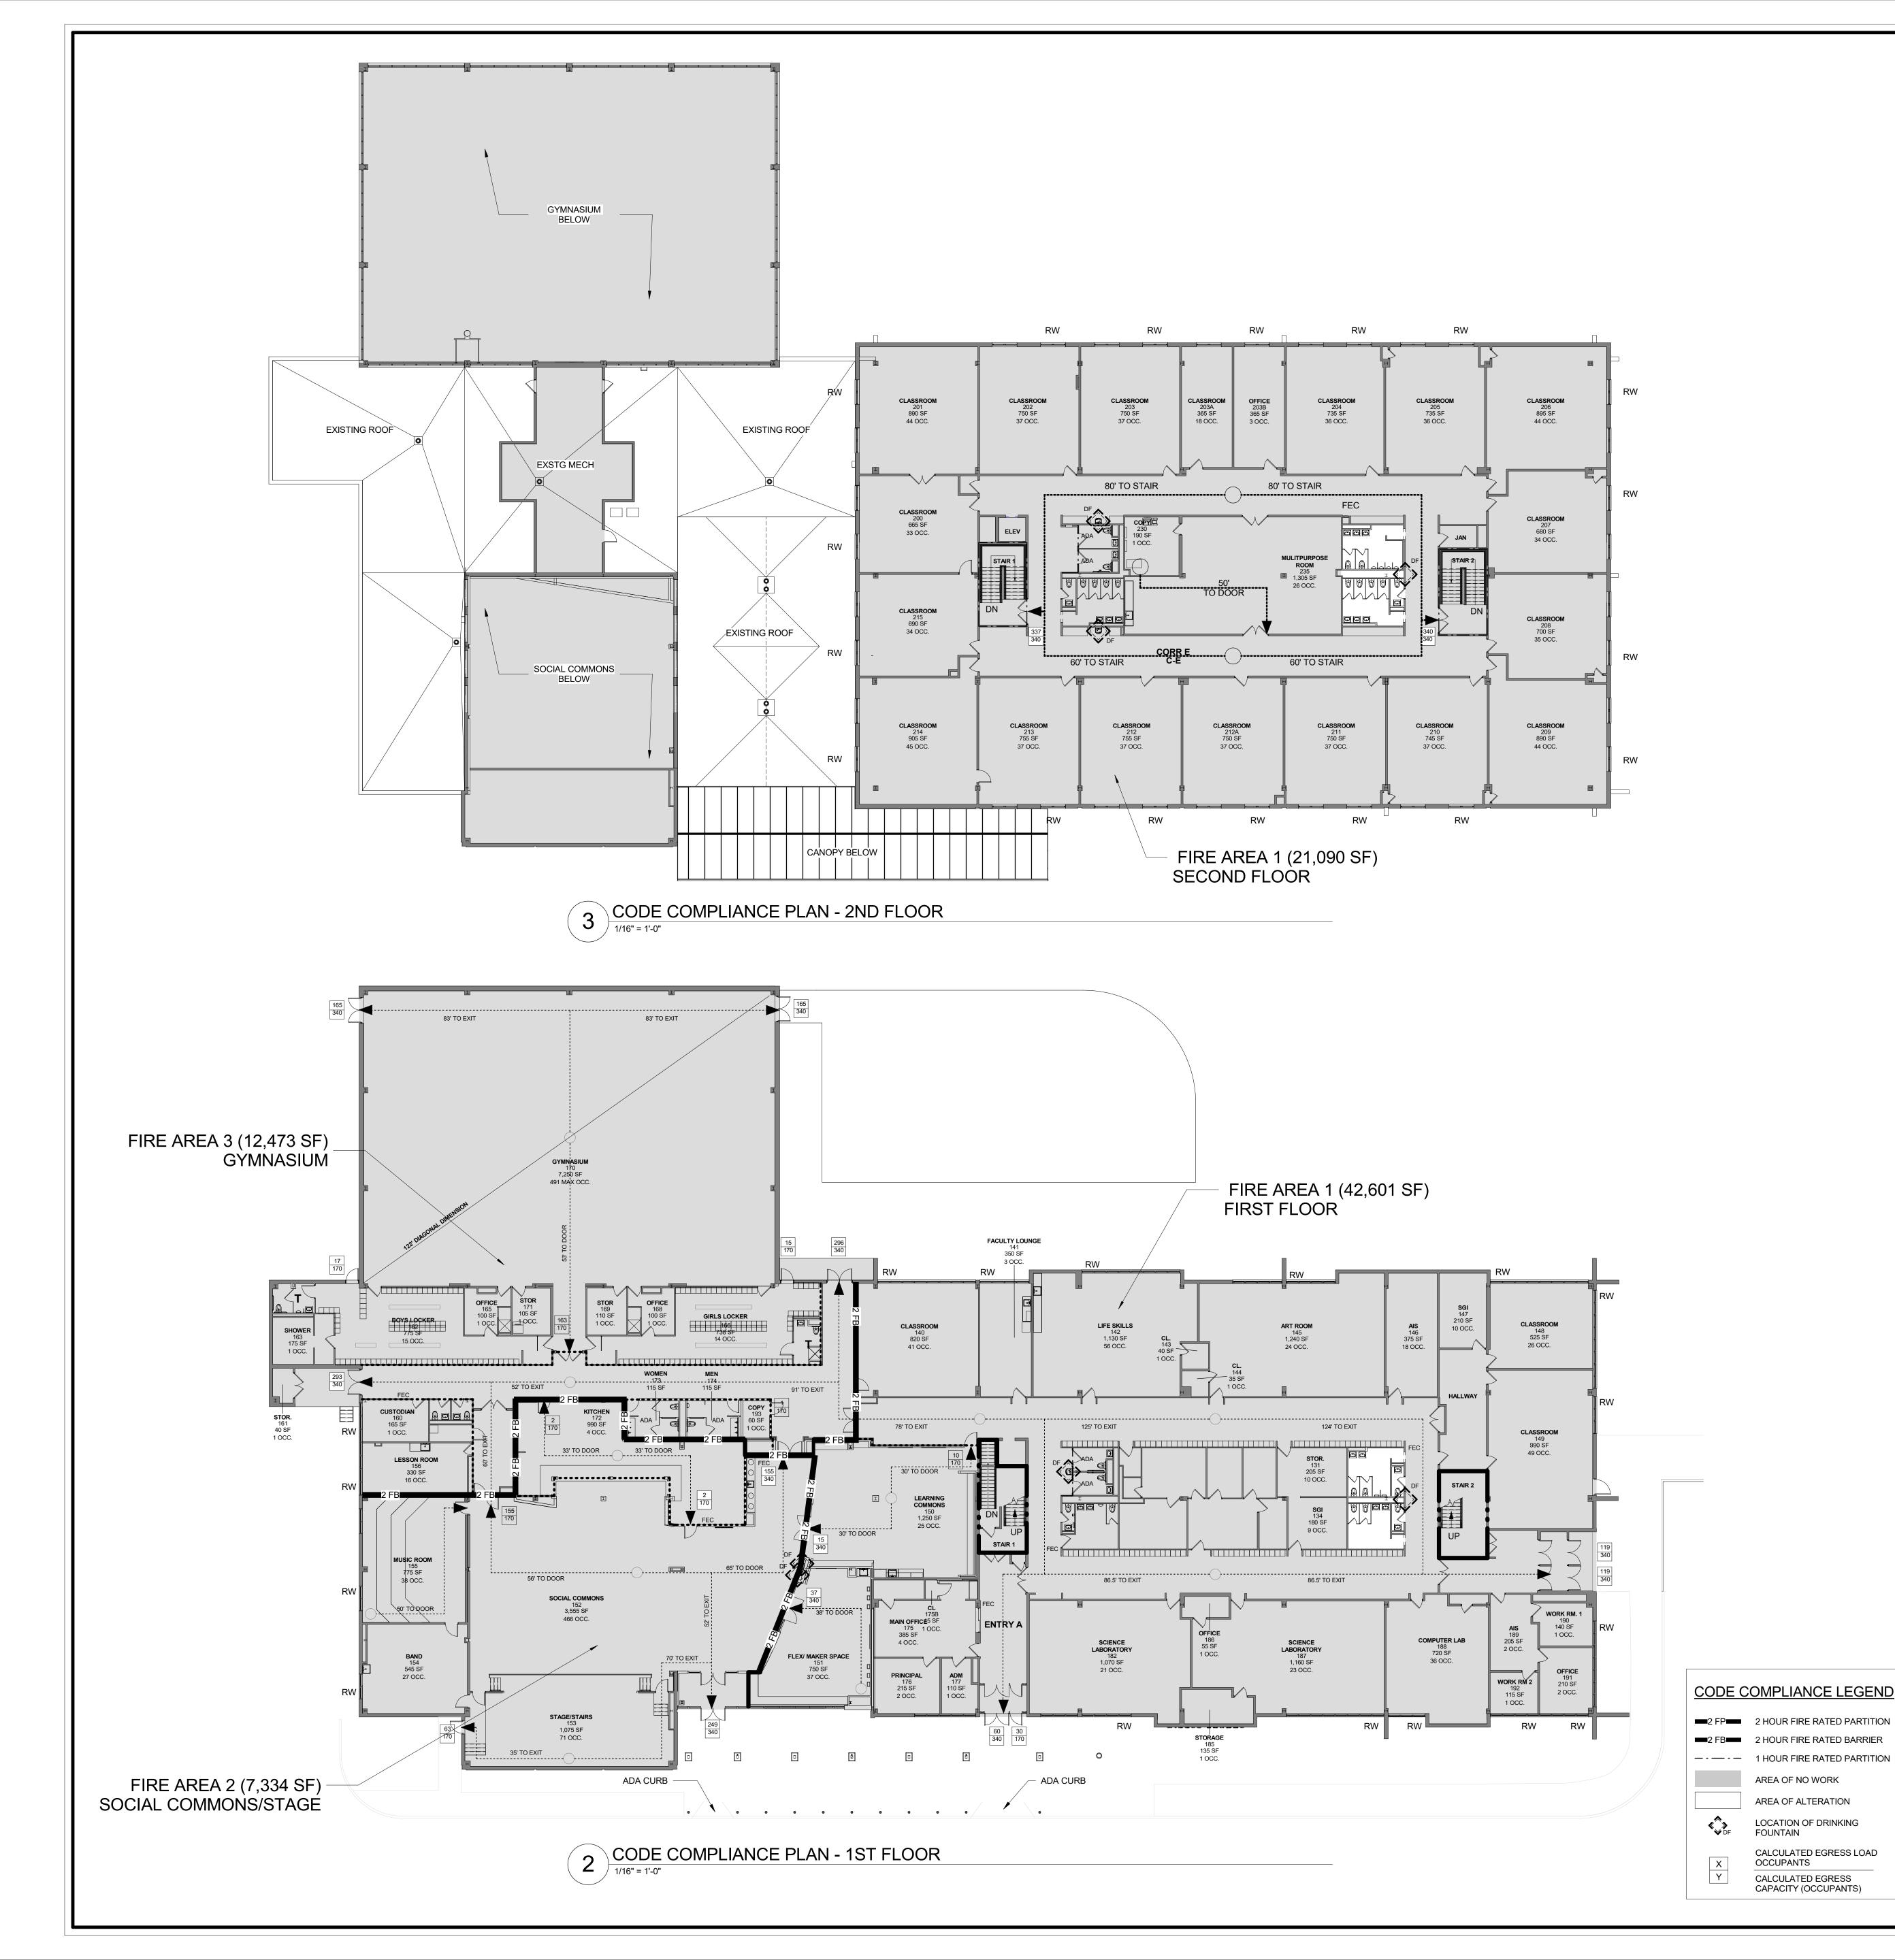



AERIAL PHOTO - SITE LOCATION PLAN

PUTNAM VALLEY MIDDLE SCHOOL **TOILET ROOM ALTERATIONS**

2018 CAPITAL PROJECTS PHASE 3 142 PEEKSKILL HOLLOW RD, PUTNAM VALLEY, NY 10579




KGDARCHITECTS.COM

NY SED PROJECT CONTROL NO.

48-05-03-04-0-004-016

CONSTRUCTION DOCUMENTS

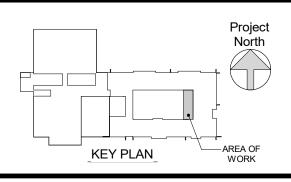

TE: ALL IDEAS DESIGNS ARRANGEMENTS AND PLANS INDICATED OR SENTED BY THIS DRAWING ARE OWNED BY AND ARE THE PROPERTY ER, GARMENT, & DAVIDSON ARCHITECTS, PC (KG&D), AND WERE CREA R USE ON THIS PROJECT. NONE OF SUCH IDEAS, DESIGNS, ARRANGEMEN PLANS SHALL BE USED BY OR DISCLOSED TO ANY PURPOSE WHATSOEVE THOUT THE WRITTEN PERMISSION OF (KG&D).

ALED DIMENSIONS. CONTRACTOR SHALL VERIFY ALL ACTUAL DIMENSIONS D CONDITIONS ON THE JOB AND THE ARCHITECT MUST BE NOTIFIED OF AN

SUBMITTED TO THIS OFFICE FOR APPROVAL BEFORE PROCEEDING WITH HITECT WHOSE PROFESSIONAL SEAL IS AFFIXED HERETO, IS A VIOLATION

TITLE VII, SECT. 69.5 (b) OF NEW YORK STATE LAW. YRIGHT KAEYER, GARMENT + DAVIDSON ARCHITECTS & ENGINEERS, P

Professional Seal

11/19/21 | CONSTRUCTION DOCUMENTS P

CODE COMPLIANCE INFORMATION

11/19/2021 2021-1067a Drawn / Checked AS NOTED Sheet Number

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ASBESTOS ABATEMENT GENERAL NOTES

PVMS TOILET ROOM ALTERATIONS

CAPITAL PROJECTS PHASE 2

142 PEEKSKILL HOLLOW RD
PUTNAM VALLEY, NY 10579



ENVIRONMENTAL CONSULTANT

WSP USA SOLUTIONS, INC.
500 Summit Lake Drive, Suite 450
Valhalla, NY 10595
TEL. 914.742.1120

NY SED PROJECT CONTROL NO.

48-05-03-04-0-004-016

SED SUBMISSION

PRE-ABATEMENT WORK NOTES

1. THE HAZARDOUS MATERIALS, CONFIGURATIONS, AND LOCATIONS SHOWN IN THESE DRAWINGS ARE BASED ON THE HAZARDOUS MATERIALS TESTING REPORT COMPLETED BY LOUIS BERGER A WSP COMPANY, DATED NOVEMBER 19, 2019.

2. THE CONTRACTOR SHALL DETERMINE EXACT FINAL LOCATIONS OF PERSONAL AND WASTE DECONTAMINATION ENCLOSURES, PICK UP AREA FOR REFUSE AND ASBESTOS DEBRIS. THESE LOCATIONS SHALL BE REVIEWED AND PROPERLY APPROVED BY THE DISTRICT PRIOR TO COMMENCEMENT OF WORK. THE CONTRACTOR SHALL ESTABLISH, LABEL AND AND MAINTAIN PROPER EXITS AND WAYS OF DEPARTURE WITHIN EACH WORK AREA FOR NORMAL AND EMERGENCY USE BY WORKERS DURING ALL ABATEMENT.

POST-ABATEMENT WORK NOTES

1. THE CONTRACTOR SHALL, UPON COMPLETION OF REMOVALS, PROVIDE WRITTEN DOCUMENTATION THAT THE PROJECT WORK AREAS ARE COMPLETELY FREE OF ALL HAZARDOUS MATERIALS.

2. THE CONTRACTOR SHALL PROVIDE RECORDS OF ALL HAZARDOUS MATERIALS REMOVED FROM THE SITE.

- SED ADDENDUM # 1 02/26/21

PROJECT DESIGNER: VINCENT E. RICEVUTO NYS 02-06290

DRAWING DRAWING NAME

H-001.00 ASBESTOS ABATEMENT LOCATIONS - GENERAL NOTES

H-002.00 ASBESTOS ABATEMENT LOCATIONS - 1ST AND 2ND FLOOR PLAN

GENERAL NOTES:

1. ALL ASBESTOS REMOVAL SHALL BE PERFORMED IN ACCORDANCE WITH ALL APPLICABLE FEDERAL, STATE AND LOCAL LAWS, GUIDELINES, REGULATIONS, ORDERS AND DIRECTIVES, INCLUDING WITHOUT LIMITATIONS, THE U.S. ENVIRONMENTAL PROTECTION AGENCY (EPA), AND U.S. DEPARTMENT OF LABOR, OCCUPATIONAL SAFETY AND HEALTH ADMINISTRATION (OSHA), NATIONAL INSTITUTE FOR OCCUPATIONAL SAFETY AND HEALTH (NIOSH), AND NEW YOK STATE DEPARTMENT OF LABOR (NYSDOL).

2. CONTRACTOR SHALL FURNISH ALL LABOR, MATERIAL, EQUIPMENT, SERVICES, ETC., NECESSARY TO PERFORM THE WORK REQUIRED FOR ASBESTOS ABATEMENT IN ACCORDANCE WITH CONTRACT DOCUMENTS AND ALL APPLICABLE FEDERAL, STATE AND LOCAL REGULATIONS.

3. CONTRACTOR SHALL DEVELOP AND IMPLEMENT A WRITTEN STANDARD PROCEDURE FOR ABATEMENT WORK TO ENSURE MAXIMUM PROTECTION AND SAFEGUARD FROM ASBESTOS EXPOSURE OF THE WORKERS, VISITORS, EMPLOYEES, GENERAL PUBLIC, AND THE ENVIRONMENT.

4. CONTRACTOR SHALL PROVIDE SIGNS, LABELS, WARNINGS, AND POST INSTRUCTIONS THAT ARE NECESSARY TO PROTECT, INFORM AND WARN PEOPLE OF THE HAZARD FROM ASBESTOS EXPOSURE. POST IN A PROMINENT AND CONVENIENT PLACE FOR THE WORKERS A COPY OF THE LATEST APPLICABLE REGULATIONS FROM OSHA, EPA, NIOSH AND NYSDOL.

5. ALL WORK SHALL BE PERFORMED IN ACCORDANCE WITH THE SPECIFICATION.

6. THE CONTRACTOR SHALL RELOCATE ALL FURNITURE, LOCKERS, DESKS AND OTHER MISC. ITEMS IN AND OUT OF THE WORK AREAS TO ACCOMODATE ASBESTOS ACTIVITIES.

7. THE CONTRACTOR SHALL PROVIDE ALL ELECTRICAL, WATER, AND WASTE CONNECTIONS, TIE-INS, EXTENSIONS, CONSTRUCTION MATERIALS, SUPPLIES, ETC. AS REQUIRED TO FACILITATE ASBESTOS REMOVAL.

8. CONTRACTOR SHALL PROVIDE TEMPORARY ELECTRIC AND LIGHT THROUGHOUT THE WORK AREA(S) AS REQUIRED IN ACCORDANCE WITH ALL APPLICABLE REGULATIONS AND CODES.

9. THE CONTRACTOR SHALL ESTABLISH CRITICAL BARRIERS OVER ALL OPENINGS LOCATED INSIDE THE PARTICULAR WORK AREA AS WELL AS INSIDE THE SCHOOL.

10. CONTRACTOR SHALL PROPERLY PROTECT ALL CONTROLS, TUBING, ELECTRICAL PANELS, EQUIPMENT, ETC. WITHIN THE WORK AREA.

11. THE CONTRACTOR SHALL BE REQUIRED TO ISSUE NON-WHITE WORK COVERALLS FOR ALL ABATEMENT WORKERS.

12. CONTRACTOR SHALL EXERCISE EXTREME CARE AND CAUTION DURING ANY AND ALL DEMOLITION AND ABATEMENT OPERATIONS. CONTRACTOR SHALL CONDUCT REMOVAL OF ALL MATERIALS FROM THE SITE WITH MINIMUM DISTURBANCE; PROVIDE PROPER PROTECTION AND REGULAR MAINTENANCE OF ALL BUILDING PREMISES DIRECTLY OR INDIRECTLY ASSOCIATED WITH ABATEMENT OPERATIONS.

13. CONTRACTOR SHALL LOCATE AND SEAL ALL PENETRATIONS THROUGH WALLS BETWEEN THE WORK AREA AND ADJACENT AREAS, INCLUDING, BUT NOT LIMITED TO PIPE, DUCT, CONDUIT, CHASES, AND OPENINGS IN FIRE WALLS OR DECKS BETWEEN FLOORS AS REQUIRED BY THE FIELD CONDITION.

14. THE CONTRACTOR SHALL USE A WATER SPRAYER TO WET ASBESTOS—CONTAINING MATERIALS INSIDE THE WORK AREA.

15. CONTRACTOR SHALL CONSTRUCT A PERSONAL/WASTE DECONTAMINATION ENCLOSURE SYSTEM (P./W.D.E.S.) AS INDICATED. IT SHALL BE OF SUFFICIENT SIZE TO ACCOMMODATE STORAGE OF MATERIALS, EQUIPMENT, ETC. .

16. SHOWER AND WASTEWATER MUST BE FILTERED AND DISPOSED OF IN THE BUILDING'S SANITARY SYSTEM. REFER TO CONTRACT SPECIFICATIONS.

17. IF WATER IS NOT AVAILABLE, THE CONTRACTOR SHALL PROVIDE A 55-GALLON WATER TANK FOR THE DECONTAMINATION UNIT.

18. THE CONTRACTOR SHALL UTILIZE GFCI PANEL CONNECTIONS AT THE SOURCE OUTLET WHEN ACCESSING TEMPORARY POWER.

19. CONTRACTOR SHALL SUPPLY ALL NECESSARY CONNECTIONS, FASTENERS, FLEXIBLE DUCTS, MANIFOLDS, SUPPORTS, ETC. ANY AND ALL INSTALLATIONS SHALL COMPLY WITH CONTRACT DOCUMENTS AND MANUFACTURER'S REQUIREMENTS.

20. THE CONTRACTOR SHALL VERIFY THE LOCATION OF THE TEMPORARY WATER AND POWER SOURCES PRIOR TO ABATEMENT ACTIVITIES.

21. DEBRIS RESULTING FROM ANY DEMOLITION AND/OR ASBESTOS ABATEMENT ACTIVITIES SHALL BE DISPOSED OF AS ASBESTOS CONTAMINATED WASTE.

22. NO WASTE SHALL BE STORED ON SITE OR INSIDE THE DECONTAMINATION UNIT BETWEEN SHIFTS. WASTE SHALL BE DOUBLE BAGGED BEFORE PROCEEDING TO THE CONTAINER AND/OR DECON. BAGS WILL BE MOVED FROM WORK AREAS TO THE WASTE DECON AND SUBSEQUENTLY TO THE CONTAINER IN COVERED CARTS. BAGS WILL BE CARRIED BY HAND ONLY WHEN NECESSARY. ALL WASTE SHALL BE CONTAINERIZED AT THE END OF EACH WORK SHIFT BEFORE RELINQUISHING TO WASTE HAULER.


23. CONTRACTOR IS RESPONSIBLE TO COORDINATE AND CONFIRM THE EXACT SCOPE OF WORK FOR EACH PHASE OF ABATEMENT WITH THE GENERAL CONTRACTOR AND OTHER TRADES.

24. CONTRACTOR SHALL PROVIDE ALL EQUIPMENT, TOOLS, TRANSPORTATION AND ANY OTHER EQUIPMENT REQUIRED AND/OR NECESSARY TO COMPLETE ALL WORK DESCRIBED IN THE CONTRACT DOCUMENTS.

25. THE LOCATION OF THE PERSONAL/WASTE DECONTAMINATION UNITS, AIRLOCKS, ETC. IS SHOWN FOR REFERENCE PURPOSES. EXACT LOCATIONS SHALL BE DETERMINED IN THE FIELD.

26. ASBESTOS ABATEMENT INDICATED IN THE DRAWING #HOO2.00 WILL BE DONE IN ACCORDANCE WITH 12 NYCRR PART 56 AND SHALL BE PERFORMED BY A NYS STATE DEPARTMENT OF LABOR LICENSED ASBESTOS CONTRACTOR.

— SED ADDENDUM # 1 02/26/21

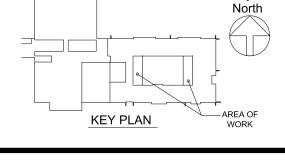

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02/26/21 SED ADDENDUM # 1 02/01/21 SED SUBMISSION

ASBESTOS
ABATEMENT
GENERAL
NOTES

 Job No.
 Date


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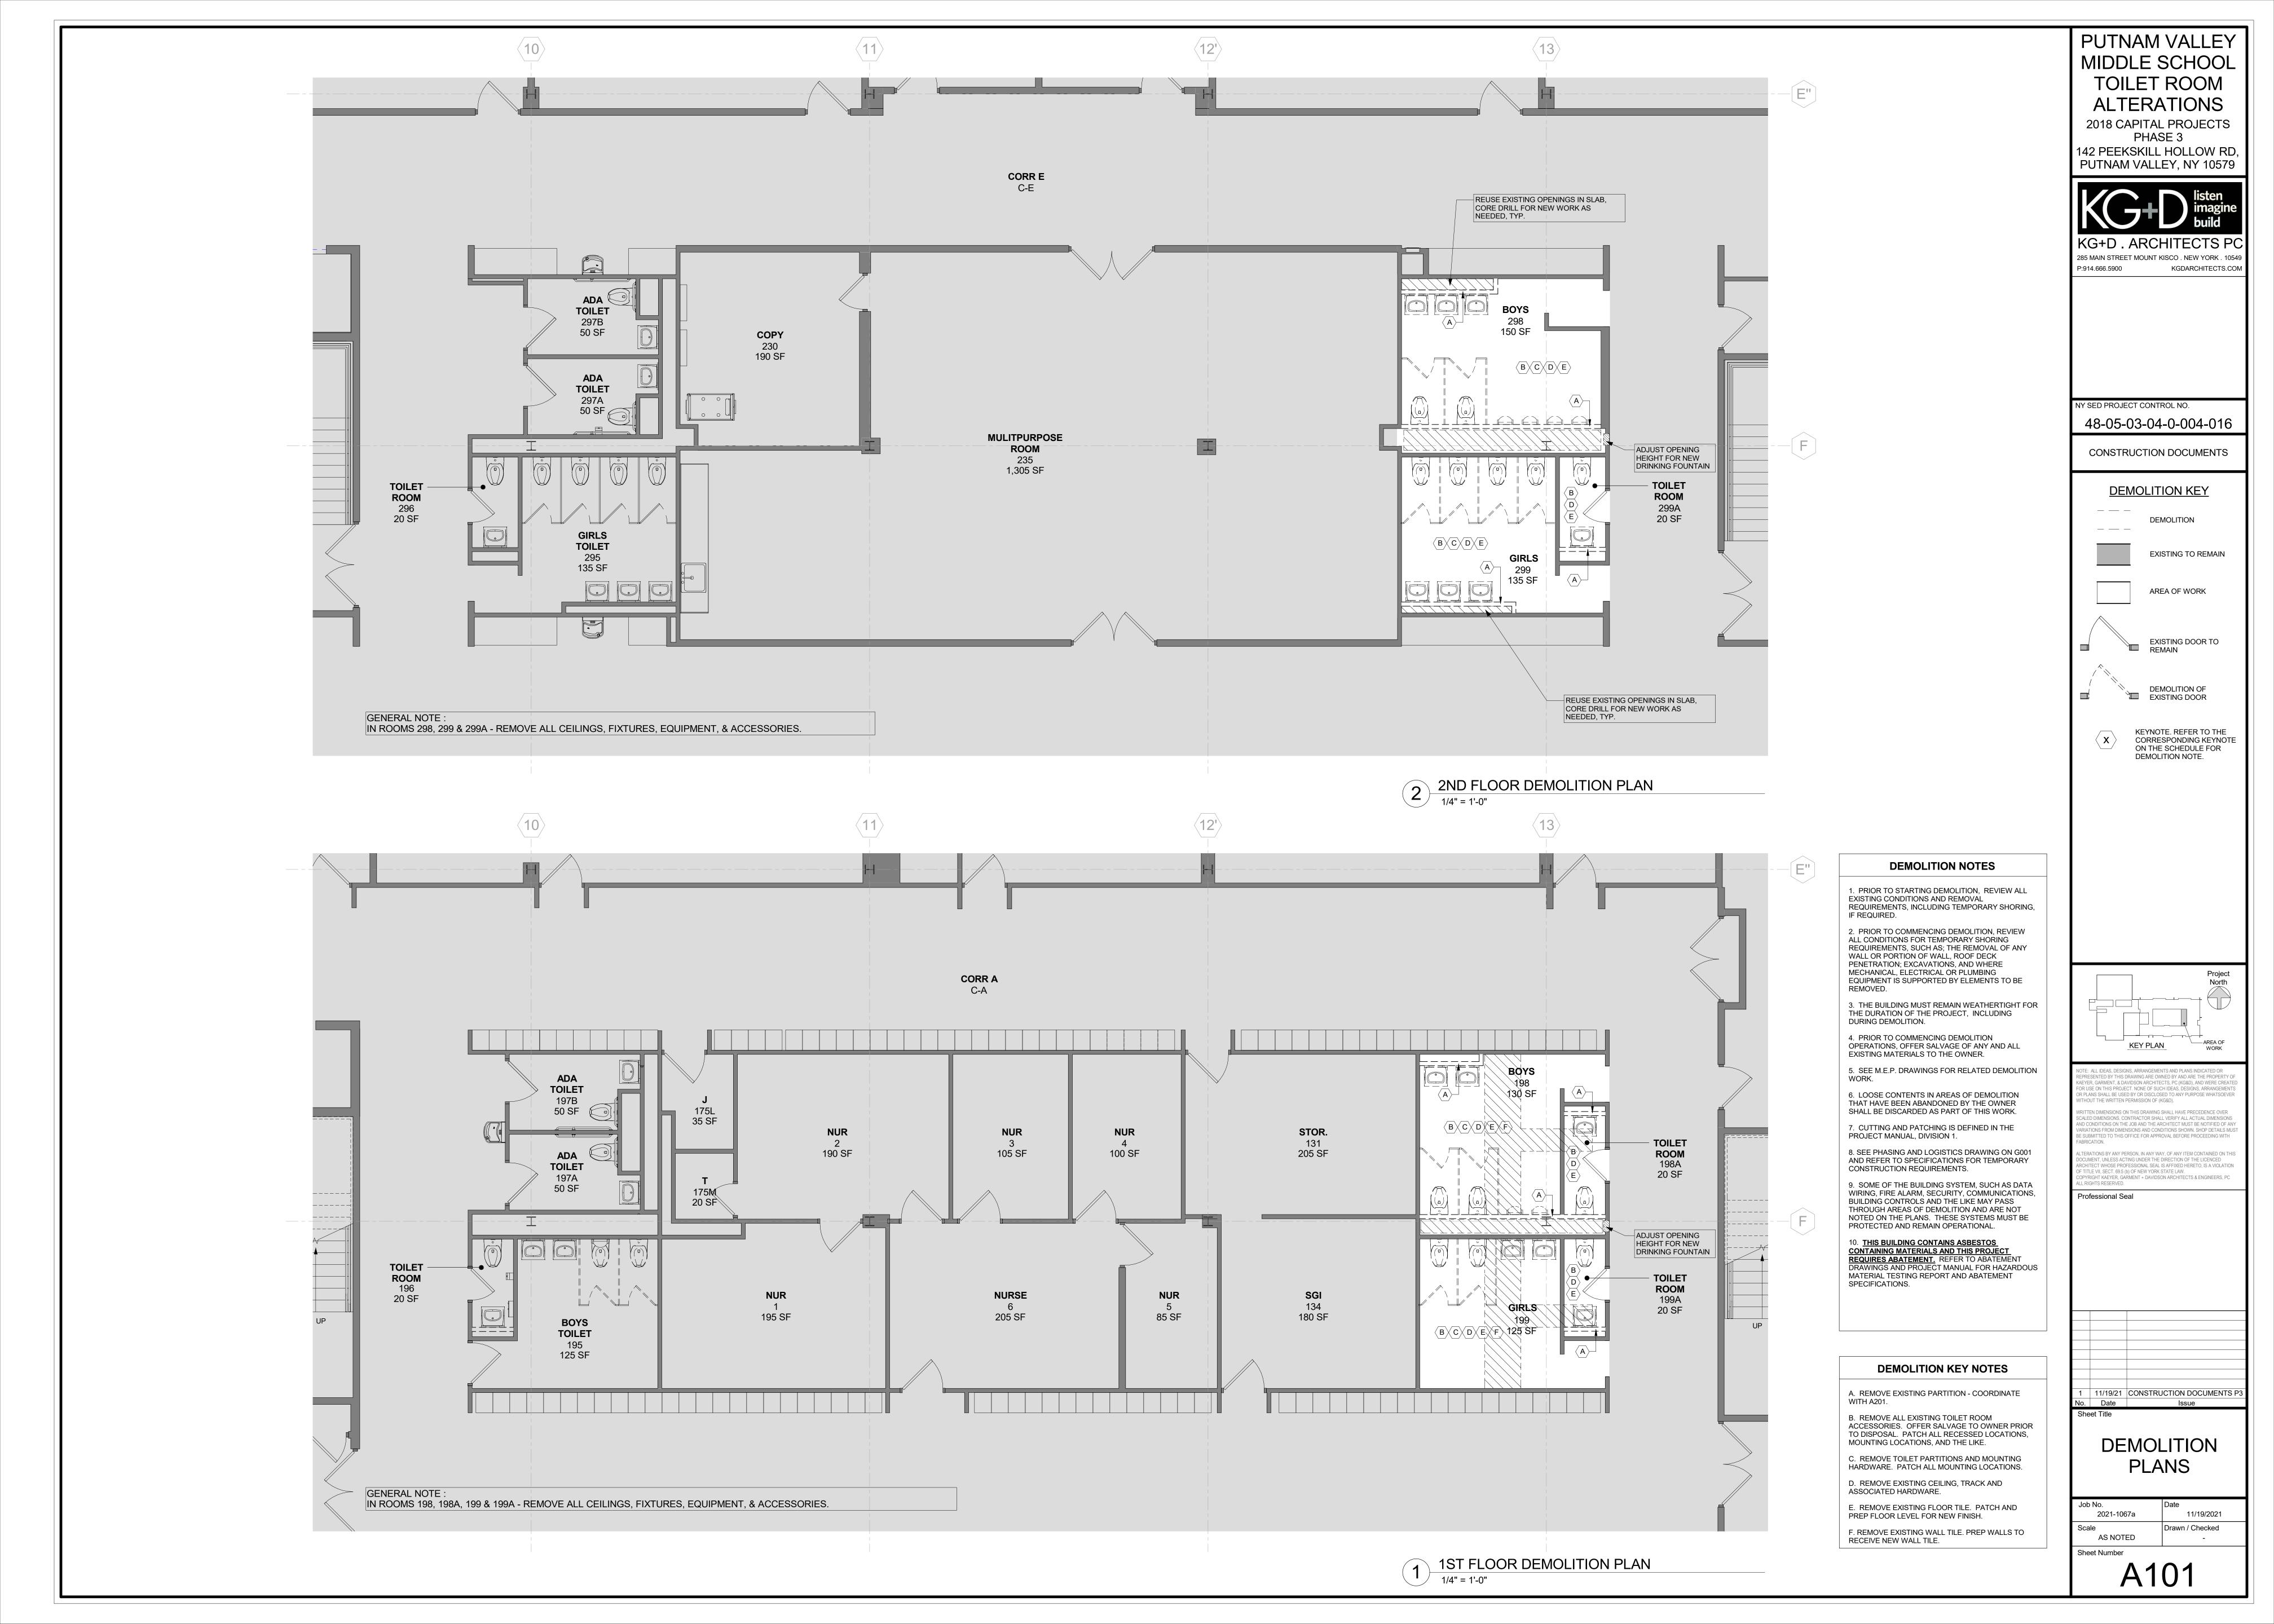
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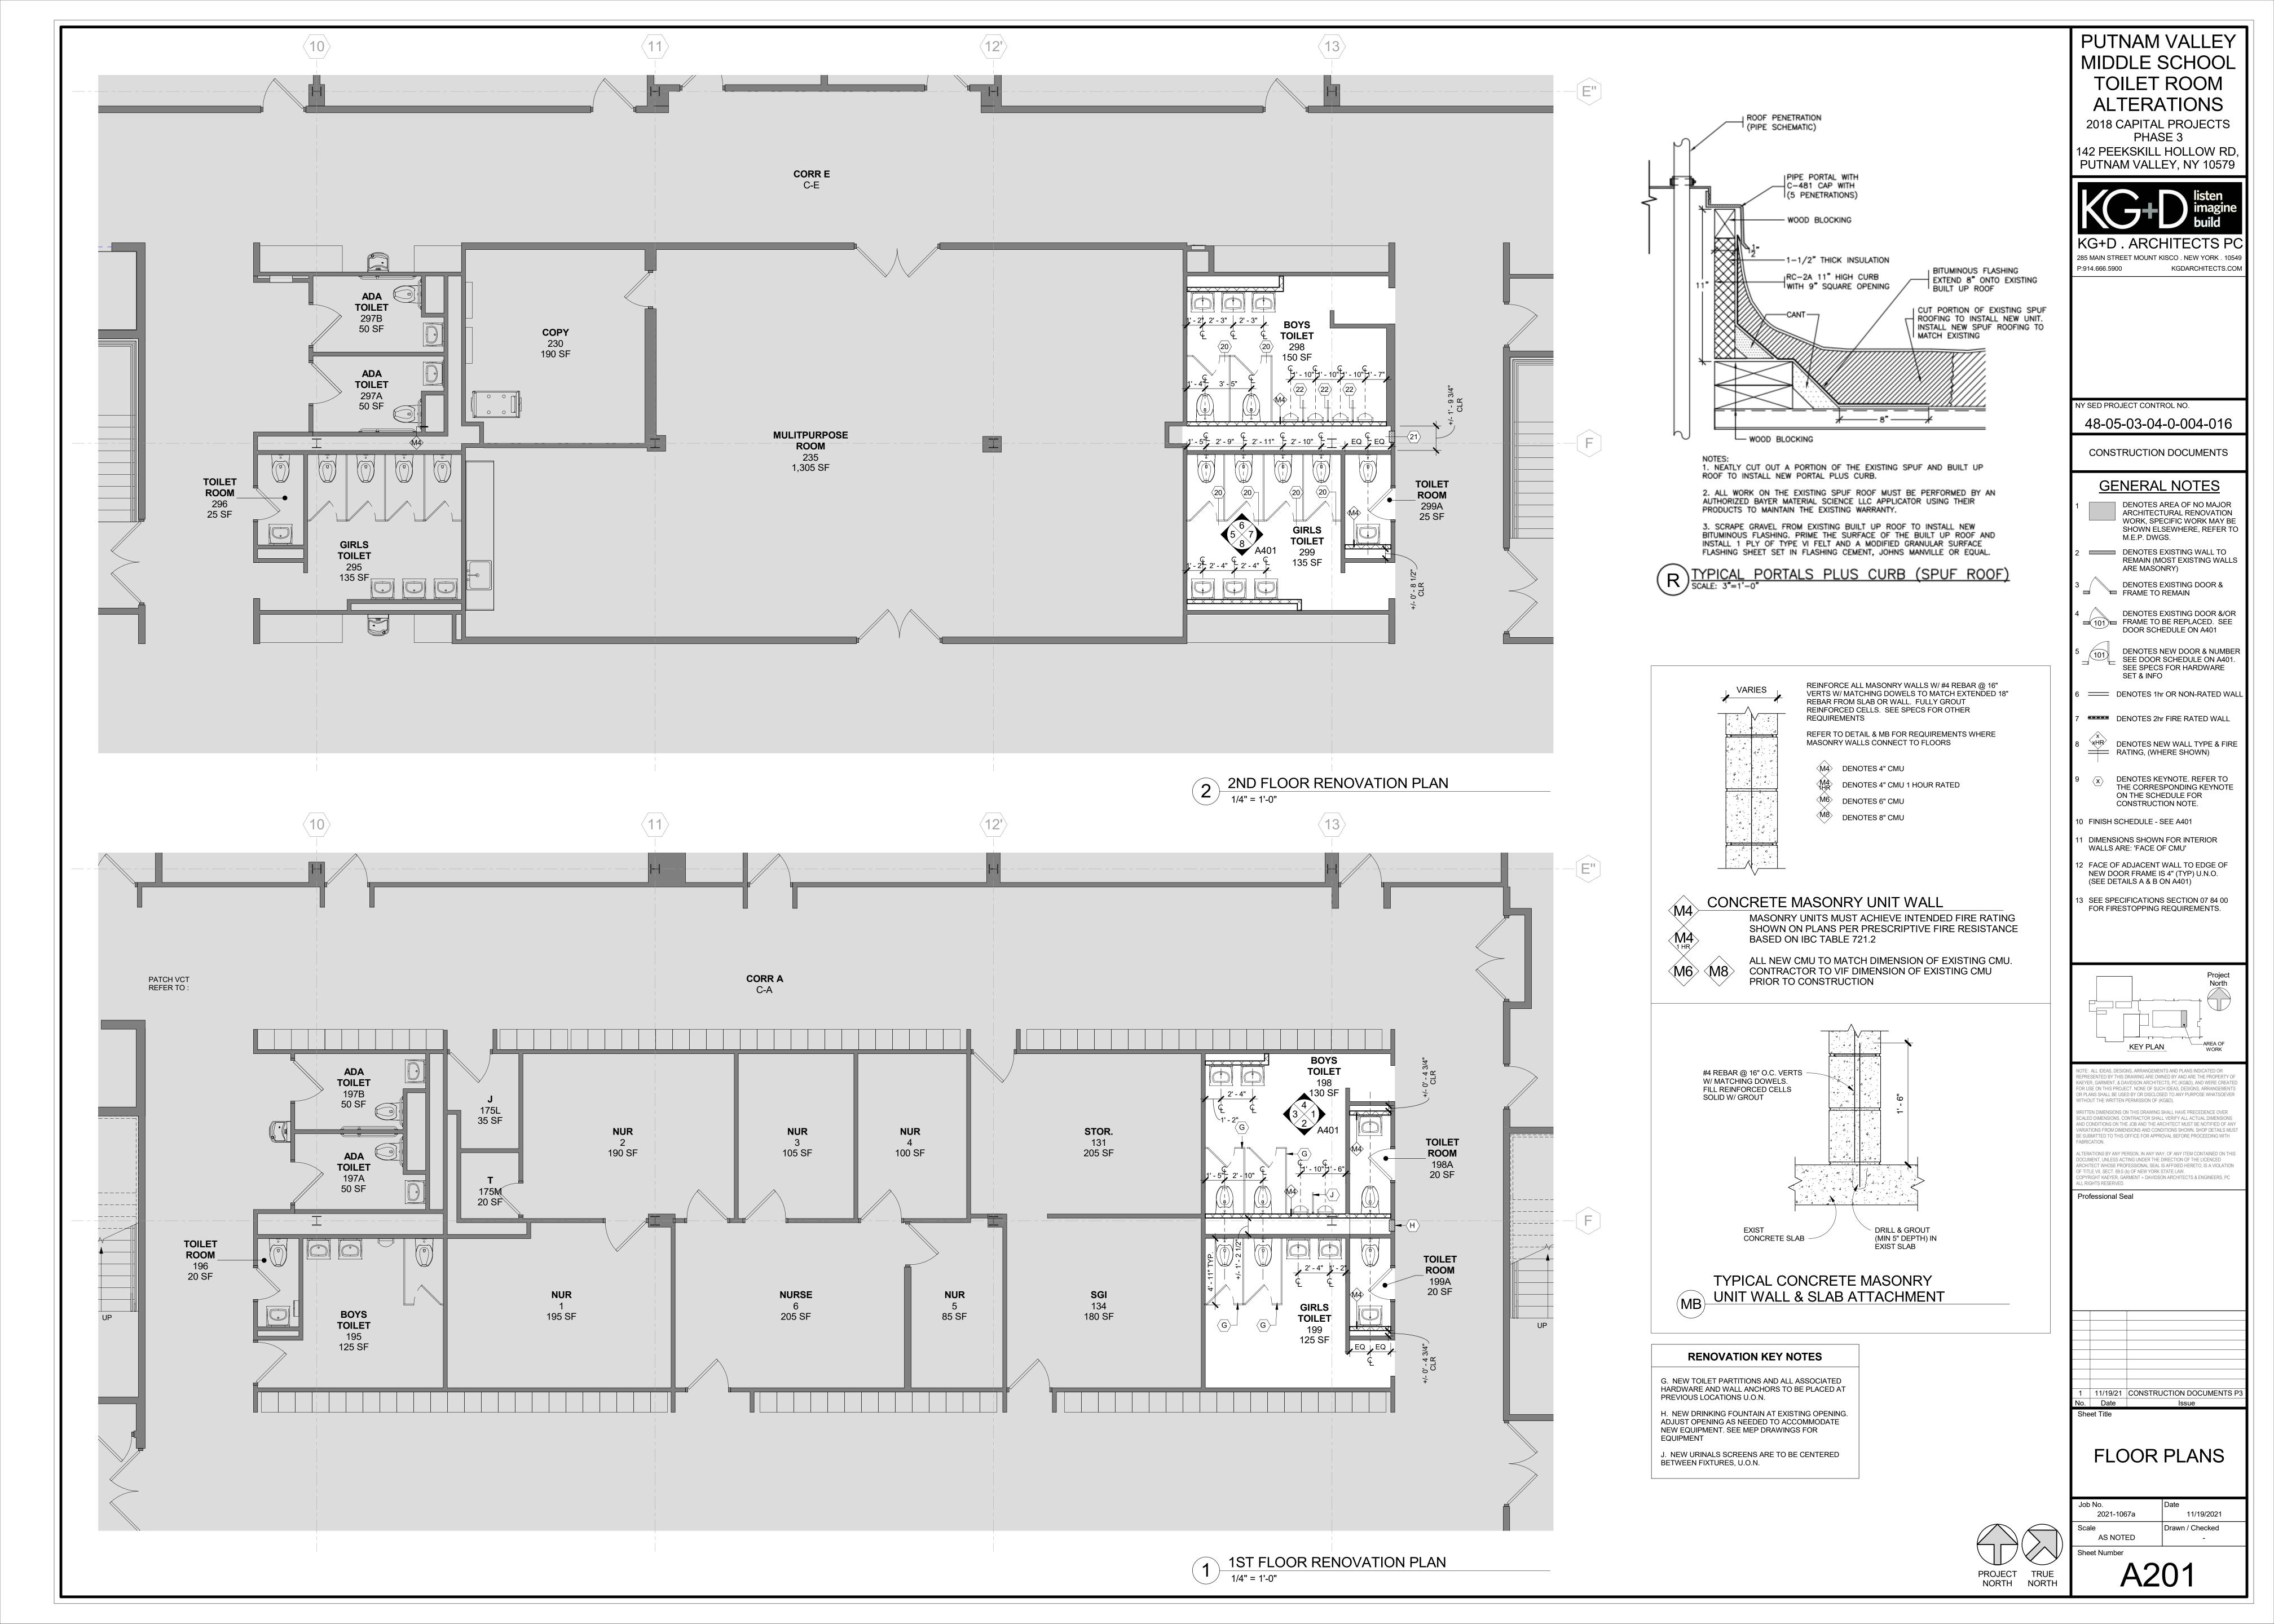
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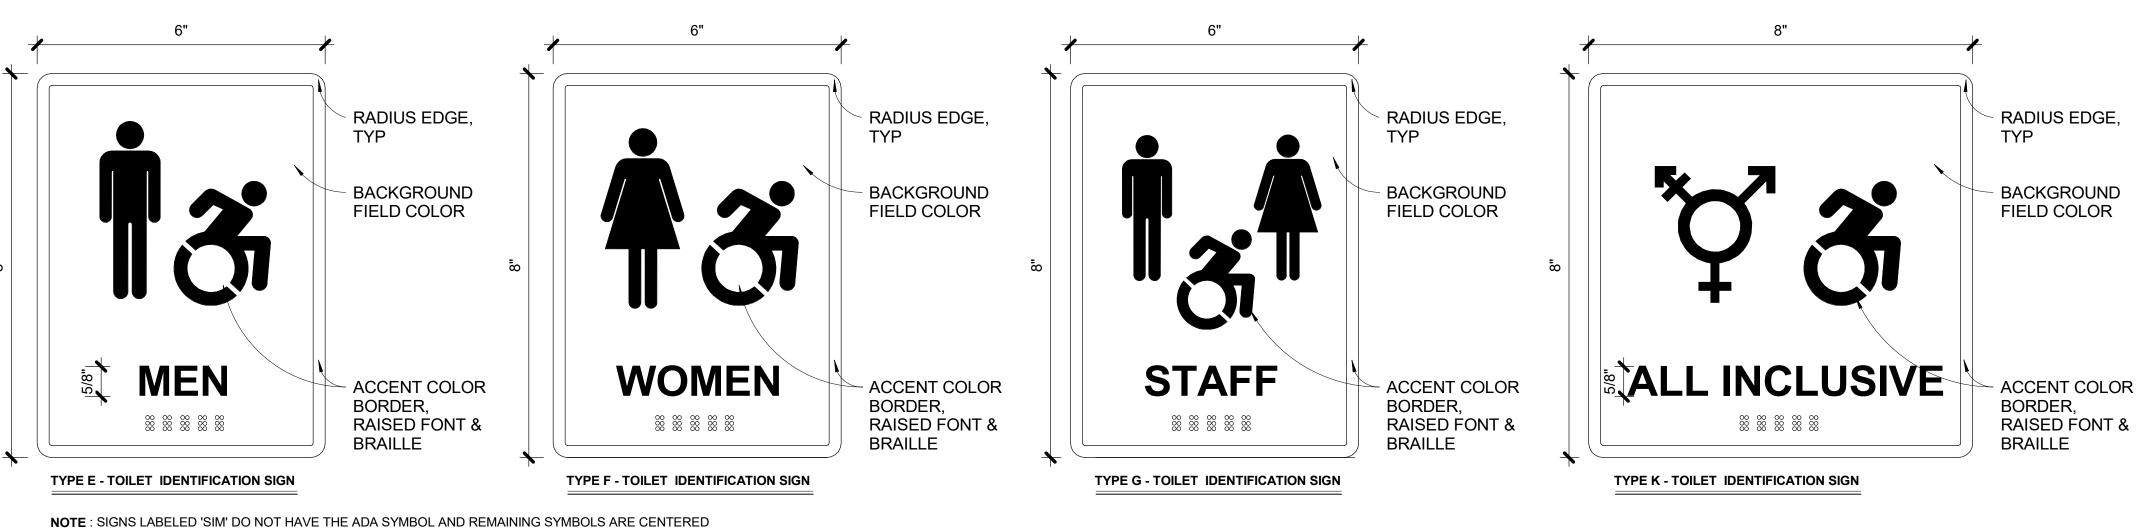




NY SED PROJECT CONTROL NO. 48-05-03-04-0-004-016

CONSTRUCTION DOCUMENTS



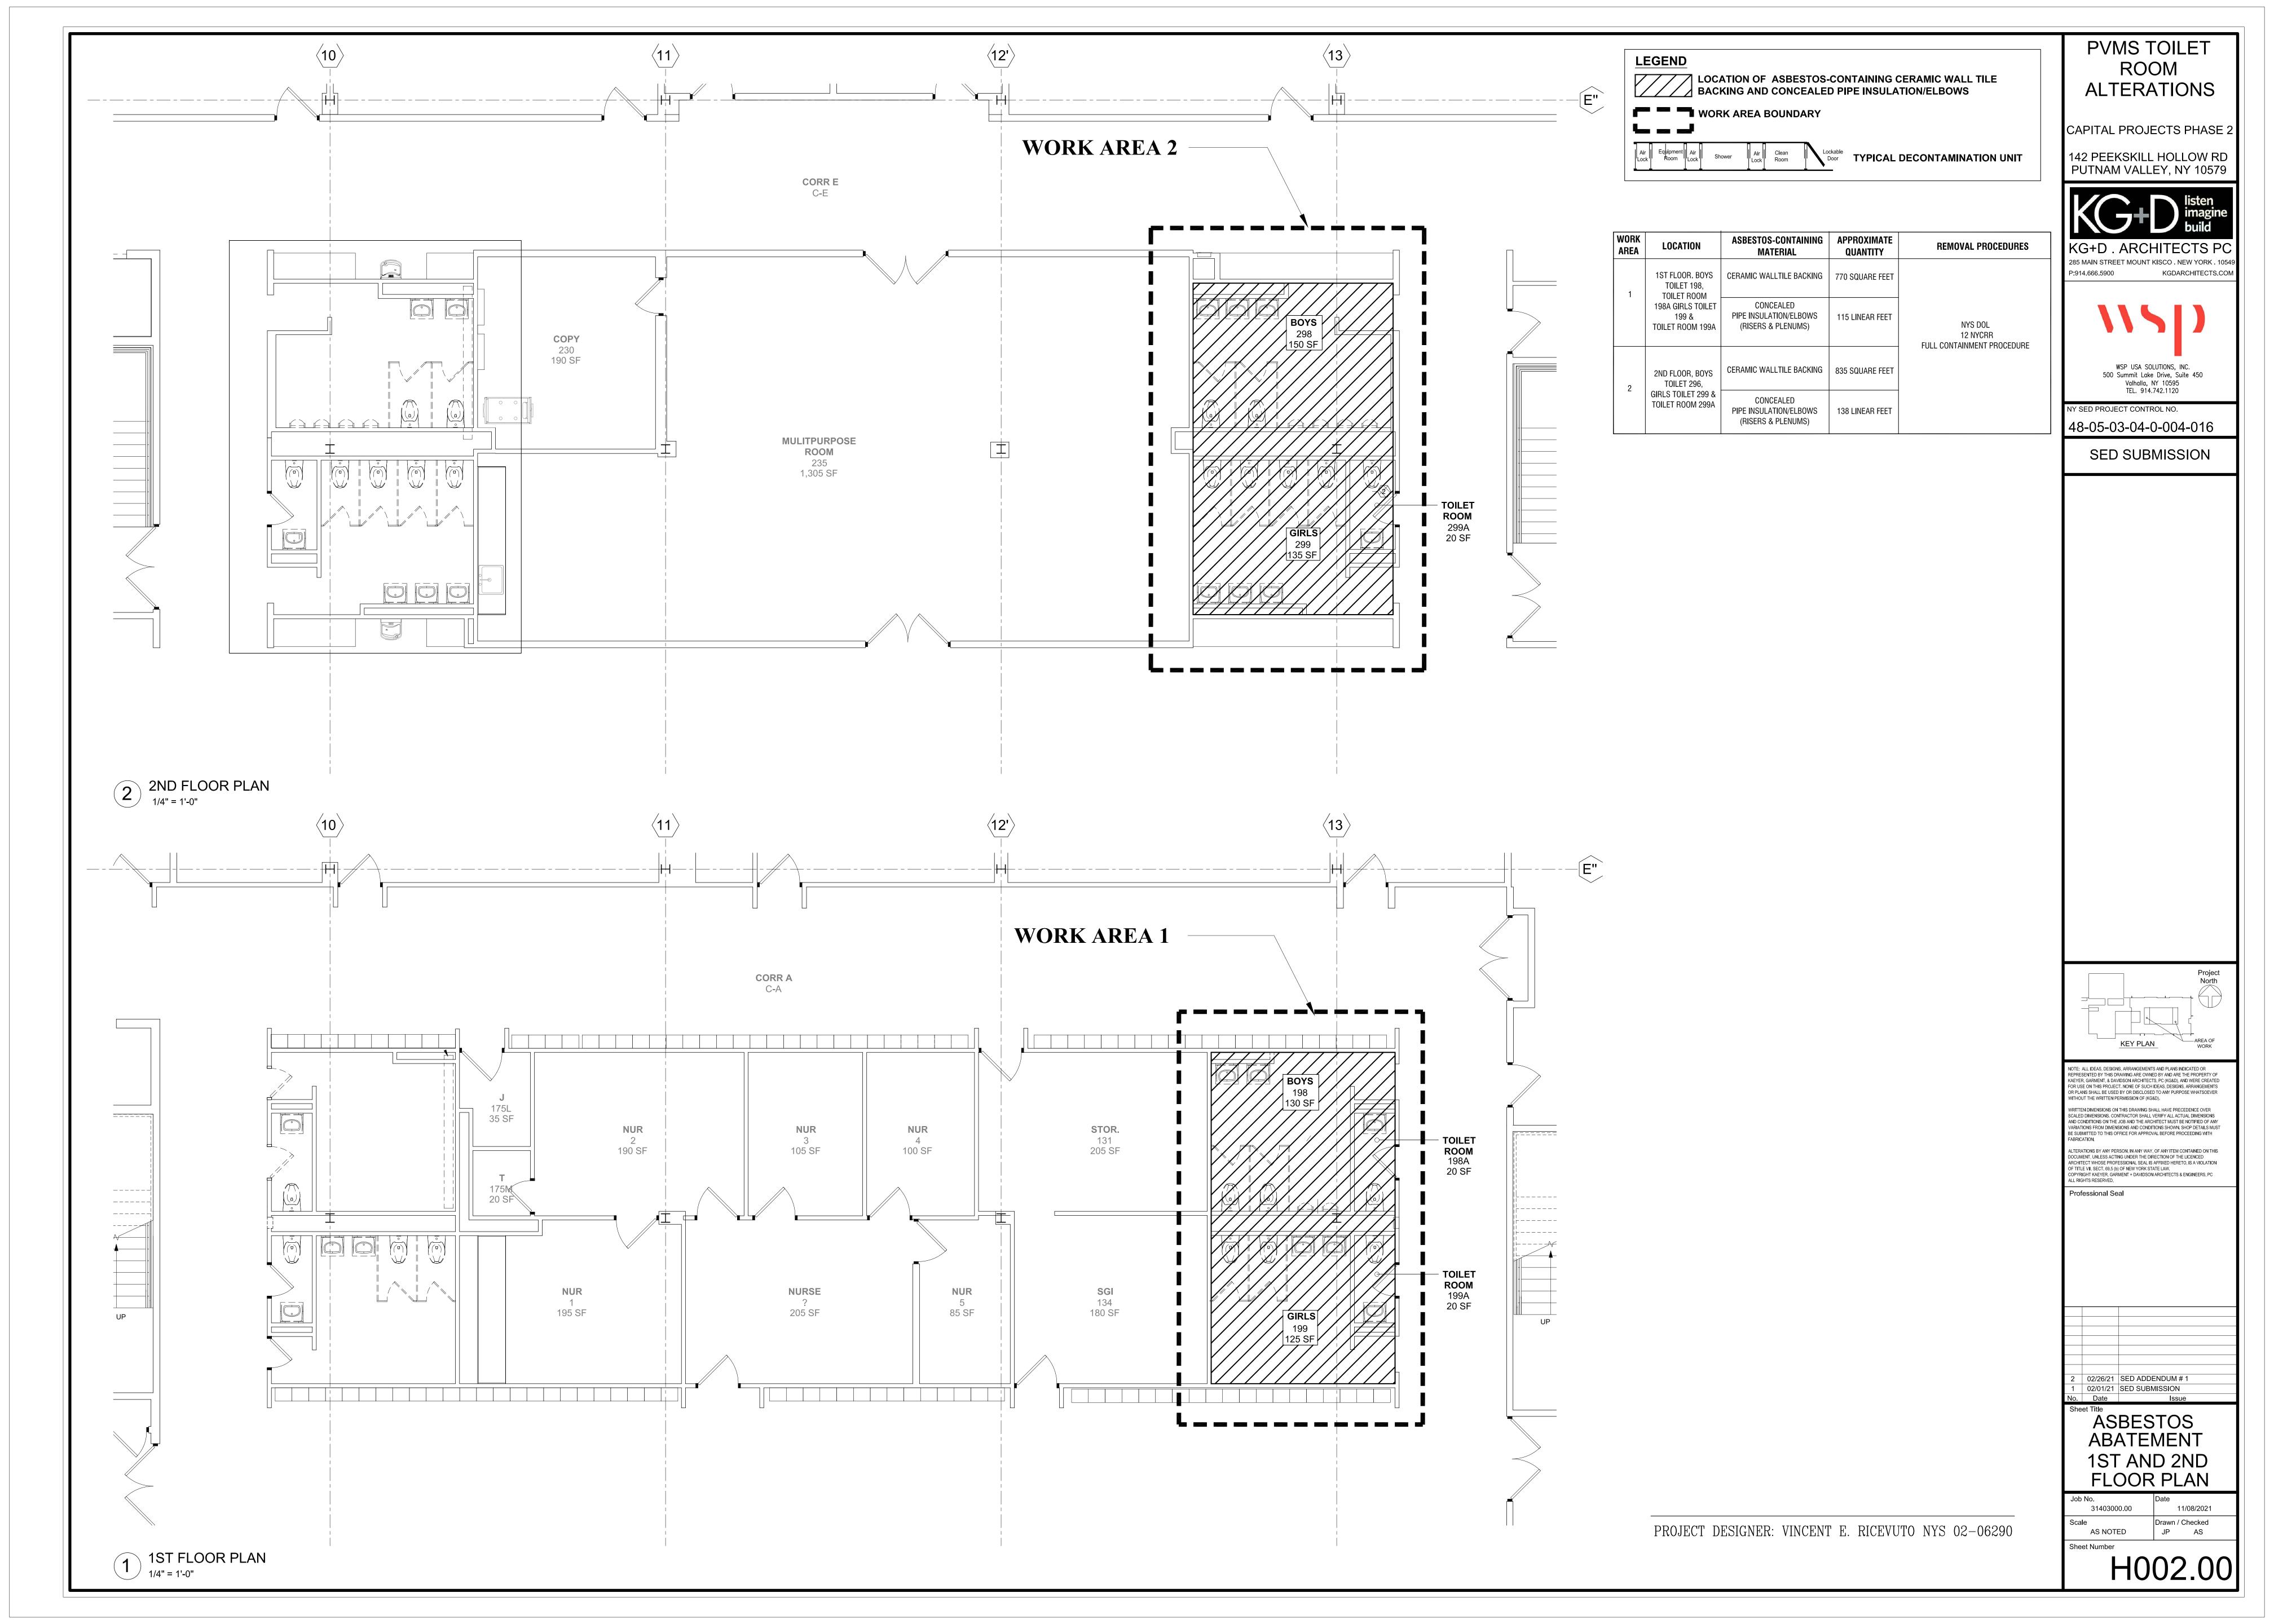



							FINIS	SH S	CHED	ULE					
		FLO	OOR	NORTI	H WALL	EAST	WALL	SOUT	H WALL	WEST	WALL				
													CEILING		
ROOM#	ROOM NAME	FIN	BASE	MAT	FIN	MAT	FIN	MAT	FIN	MAT	FIN	MAT	FIN	HT	Comments
T/ 1st FLOC)R														
198	BOYS TOILET	PT1	CT1	EXIST CMU	CT3/CT4	EXIST CMU	CT3	CMU	CT3	EXIST CMU	СТ3	ACT	FF	8'-0"	SCHLUTER EDGE BETWEEN CT3 & CT4
198A	TOILET ROOM	PT1	CT2	EXIST CMU	EPO	EXIST CMU	EPO	CMU	EPO	EXIST CMU	EPO	ACT	FF	8'-0"	
199	GIRLS TOILET	PT1	CT1	EXIST CMU	CT3/CT4	EXIST CMU	CT3	EXIST CMU	СТЗ	EXIST CMU	СТЗ	ACT	FF	8'-0"	SCHLUTER EDGE BETWEEN CT3 & CT4
199A	TOILET ROOM	PT1	CT2	EXIST CMU	EPO	EXIST CMU	EPO	EXIST CMU	EPO	EXIST CMU	EPO	ACT	FF	8'-0"	
T/ 2nd FLO	OR			1											
298	BOYS TOILET	PT1	CT1	EXIST CMU	CT3/CT4	EXIST CMU	CT3	CMU	СТ3	EXIST CMU	CT3	ACT	FF	8'-0"	SCHLUTER EDGE BETWEEN CT3 & CT4
299	GIRLS TOILET	PT1	CT1	EXIST CMU	СТЗ	EXIST CMU	CT3	EXIST CMU	CT3/CT4	EXIST CMU	CT3	ACT	FF	8'-0"	SCHLUTER EDGE BETWEEN CT3 & CT4
299A	TOILET ROOM	PT1	CT2	EXIST CMU	EPO	EXIST CMU	EPO	EXIST CMU	EPO	EXIST CMU	EPO	ACT	FF	8'-0"	


FINISH SCHEDULE ABBREVIATIONS LIST


CERAMIC TILE BASE PAINT STM = STEAMED CLEANED ACOUSTIC CEILING PANEL PORCELAIN TILE VCT = VINYL COMPOSITION TILE CONCRETE MASONRY BLOCK **EPOXY PAINT** CONC = PORCELAIN TILE BASE EXIST= **EXISTING** CONCRETE WD =CT = GYPSUM WALL BOARD RUBBER BASE CERAMIC TILE GWB =

NOTE: ALL TOILET ROOMS WHERE TILES HAVE BEEN REMOVED FROM WALLS AND FLOORS MUST BE NOTE: PT1 TO BE LAID LONG SIDE PARALLEL TO DOOR SADDLE, TYP. COVERED WITH A NEW NON-ABSORBANT IMPERVIOUS FINISH, WHICH SHOULD FACILITATE CLEANING.

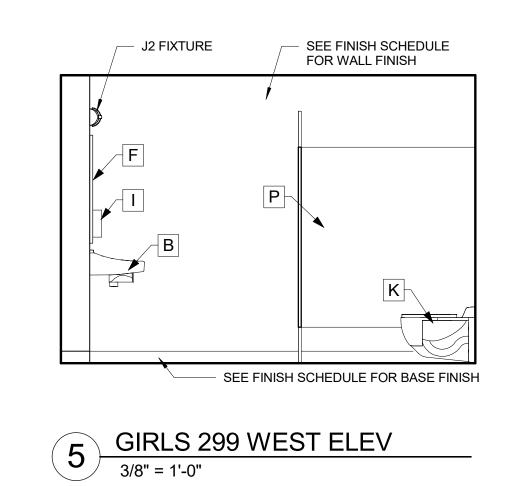


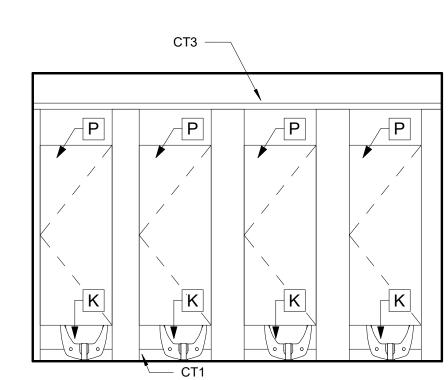


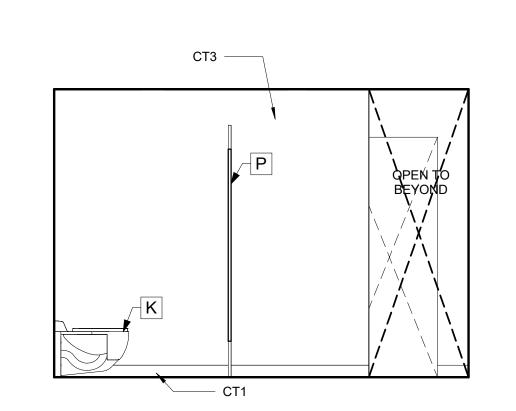

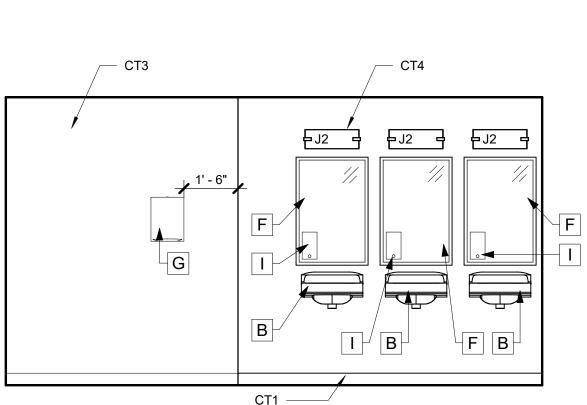


ADA WALL- HUNG TOILET	E SIDE TOILET VERTICAL GRAB BAR	HAND DRYER, XLERATOReco XL- G SB-ECO, 110v, OR EQ.	K STANDARD WALL-HUNG TOILET	O COAT HOOK
LAVATORY	F WALL MIRROR w/ FRAME	H TOILET PAPER ROLL DISPENSER	L STANDARD WALL-HUNG URINAL	P FLOOR MOUNTED OVERHEAD
REAR TOILET GRAB BAR	G2 SURFACE MOUNTED C-FOLD	I LIQUID SOAP DISPENSER	M URINAL SCREEN	BRACED TOILET PARTITION
SIDE TOILET GRAB BAR	PAPER TOWEL DISPENSER & WASTER RECEPTACLE	J SANITARY DISPOSAL	N ADA/CHILD WALL-HUNG URINAL	Q WALL-HUNG DRINKING FOUNTAIN

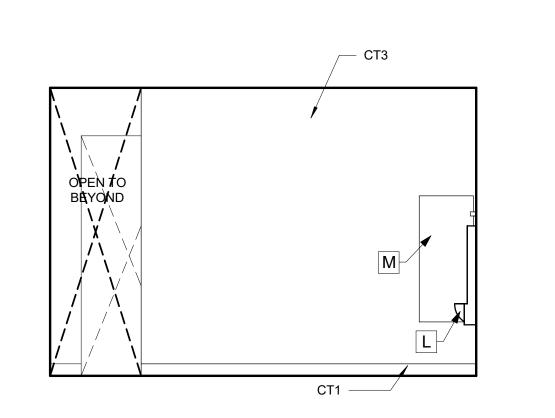


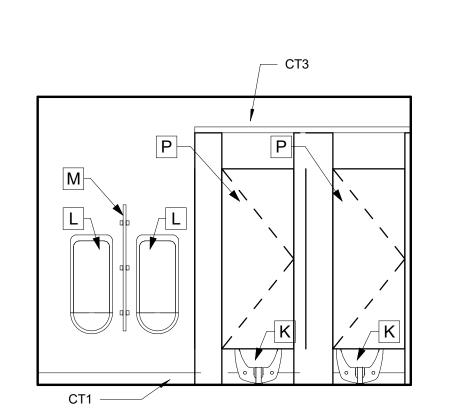

6 GIRLS 299 NORTH ELEV
3/8" = 1'-0"

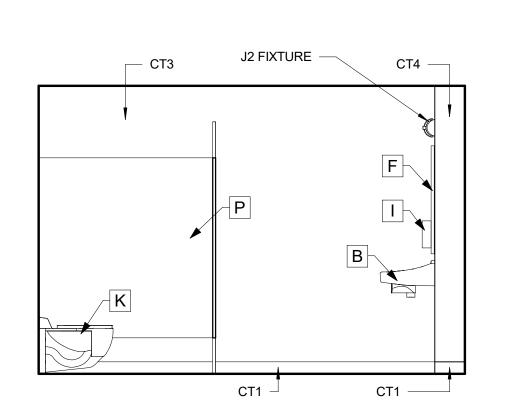

7 GIRLS 299 EAST ELEV
3/8" = 1'-0"

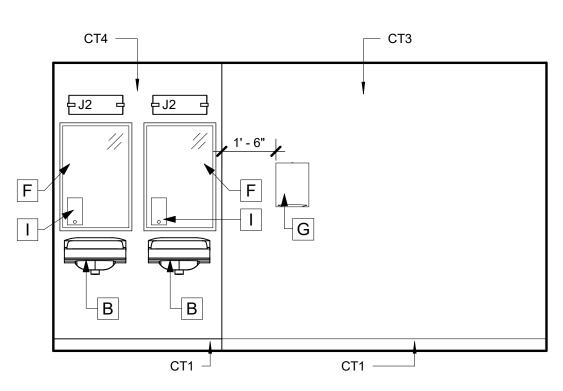

8 GIRLS 299 SOUTH ELEV
3/8" = 1'-0"

USE TEMPERED GLASS	
2' - 0 ".	0
CLEAR 1' - 0" EQ 6" 4' - 0" D	STALL
3	3'-6" AT ADA -0" AT ADA
K L M N B F C A H J	G G2 I P Q Q

ALL MIRRORS SHALL

TOILET ROOM MOUNTING HEIGHTS

1/4" = 1'-0"

ACCESSORIES H, I & J ARE SUPPLIED BY OWNER, INSTALLED BY GC.

D SIDE TOILET GRAB BAR

1 BOYS 198 EAST ELEV
3/8" = 1'-0"

2 BOYS 198 SOUTH ELEV
3/8" = 1'-0"

3 BOYS 198 WEST ELEV
3/8" = 1'-0"

BOYS 198 NORTH ELEV
3/8" = 1'-0"

ROOM 298 HAS SIMILAR FINISHES AND FIXTURES

ROOM 199 HAS SIMILAR FINISHES AND FIXTURES

RCHITECT WHOSE PROFESSIONAL SEAL IS AFFIXED HERETO, IS A VIOLATIC OF TITLE VII, SECT. 69.5 (b) OF NEW YORK STATE LAW. RIGHTS RESERVED. Professional Seal INTERIOR **ELEVATIONS &**

KEY PLAN


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CONDITIONS ON THE JOB AND THE ARCHITECT MUST BE NOTIFIED OF A SUBMITTED TO THIS OFFICE FOR APPROVAL BEFORE PROCEEDING WITH

11/19/2021 Drawn / Checked AS NOTED Sheet Number

SCHEDULES

A401

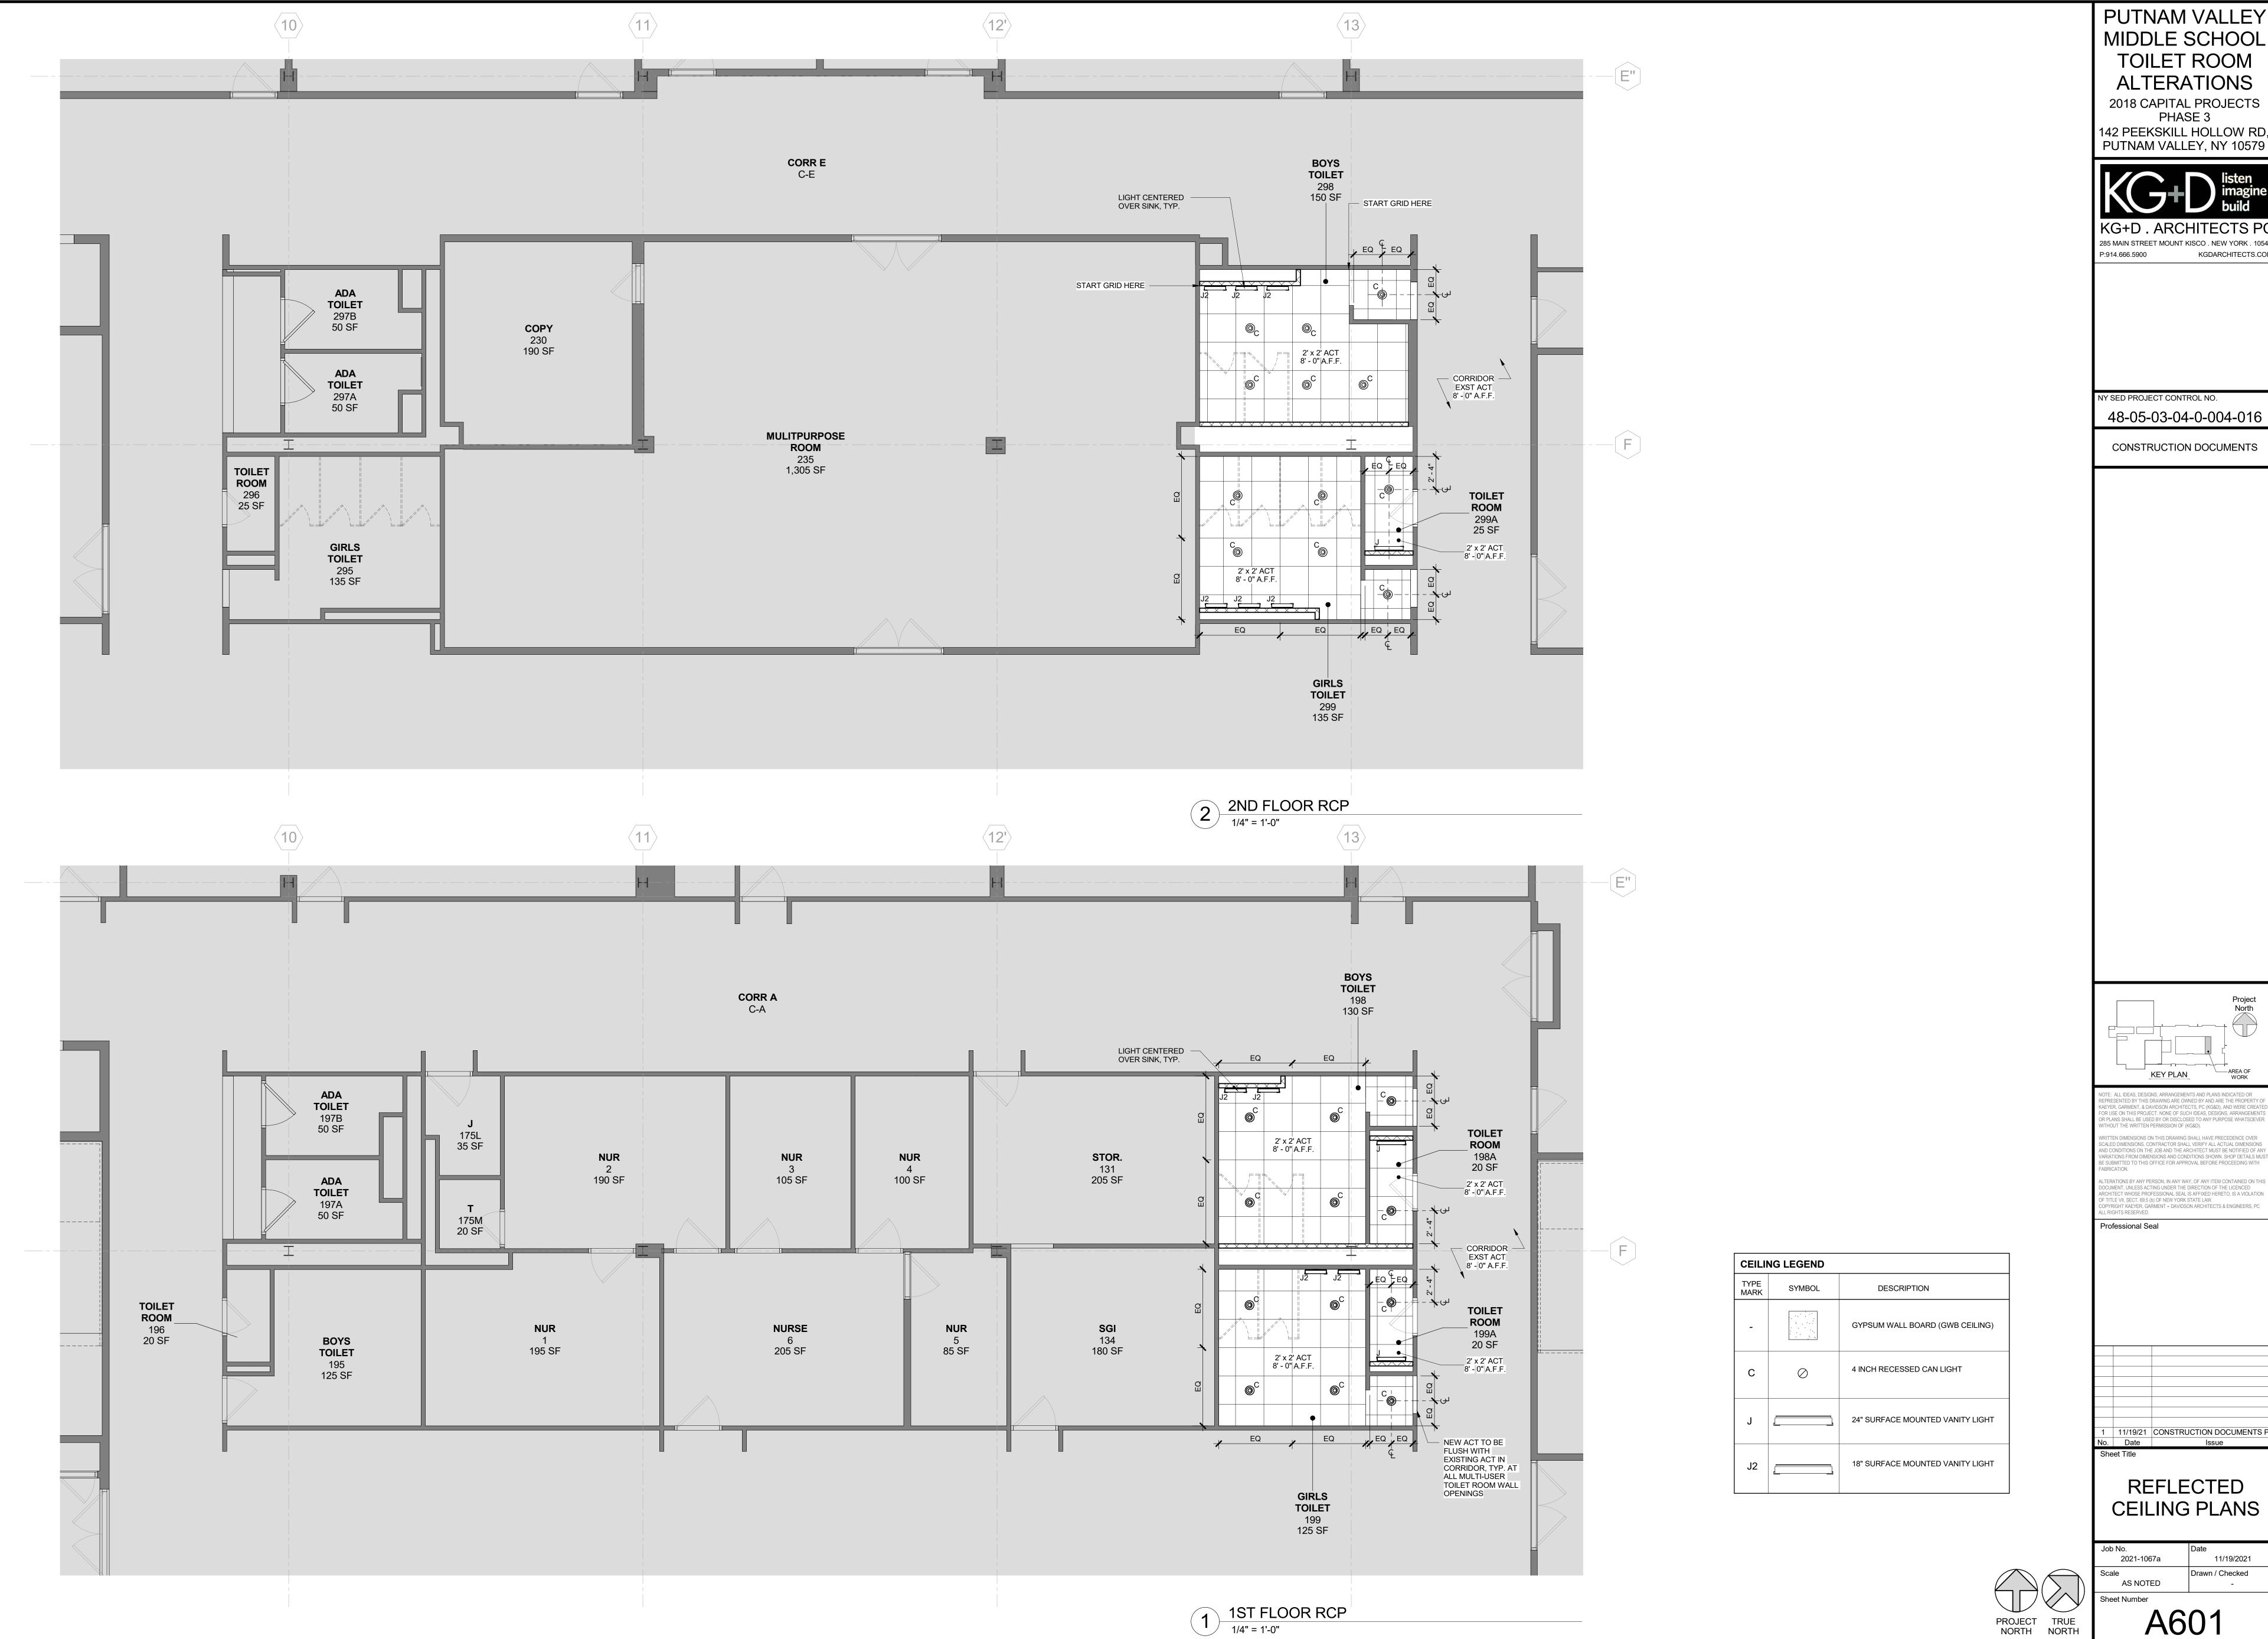

PUTNAM VALLEY MIDDLE SCHOOL **TOILET ROOM** ALTERATIONS


2018 CAPITAL PROJECTS PHASE 3 142 PEEKSKILL HOLLOW RD, PUTNAM VALLEY, NY 10579



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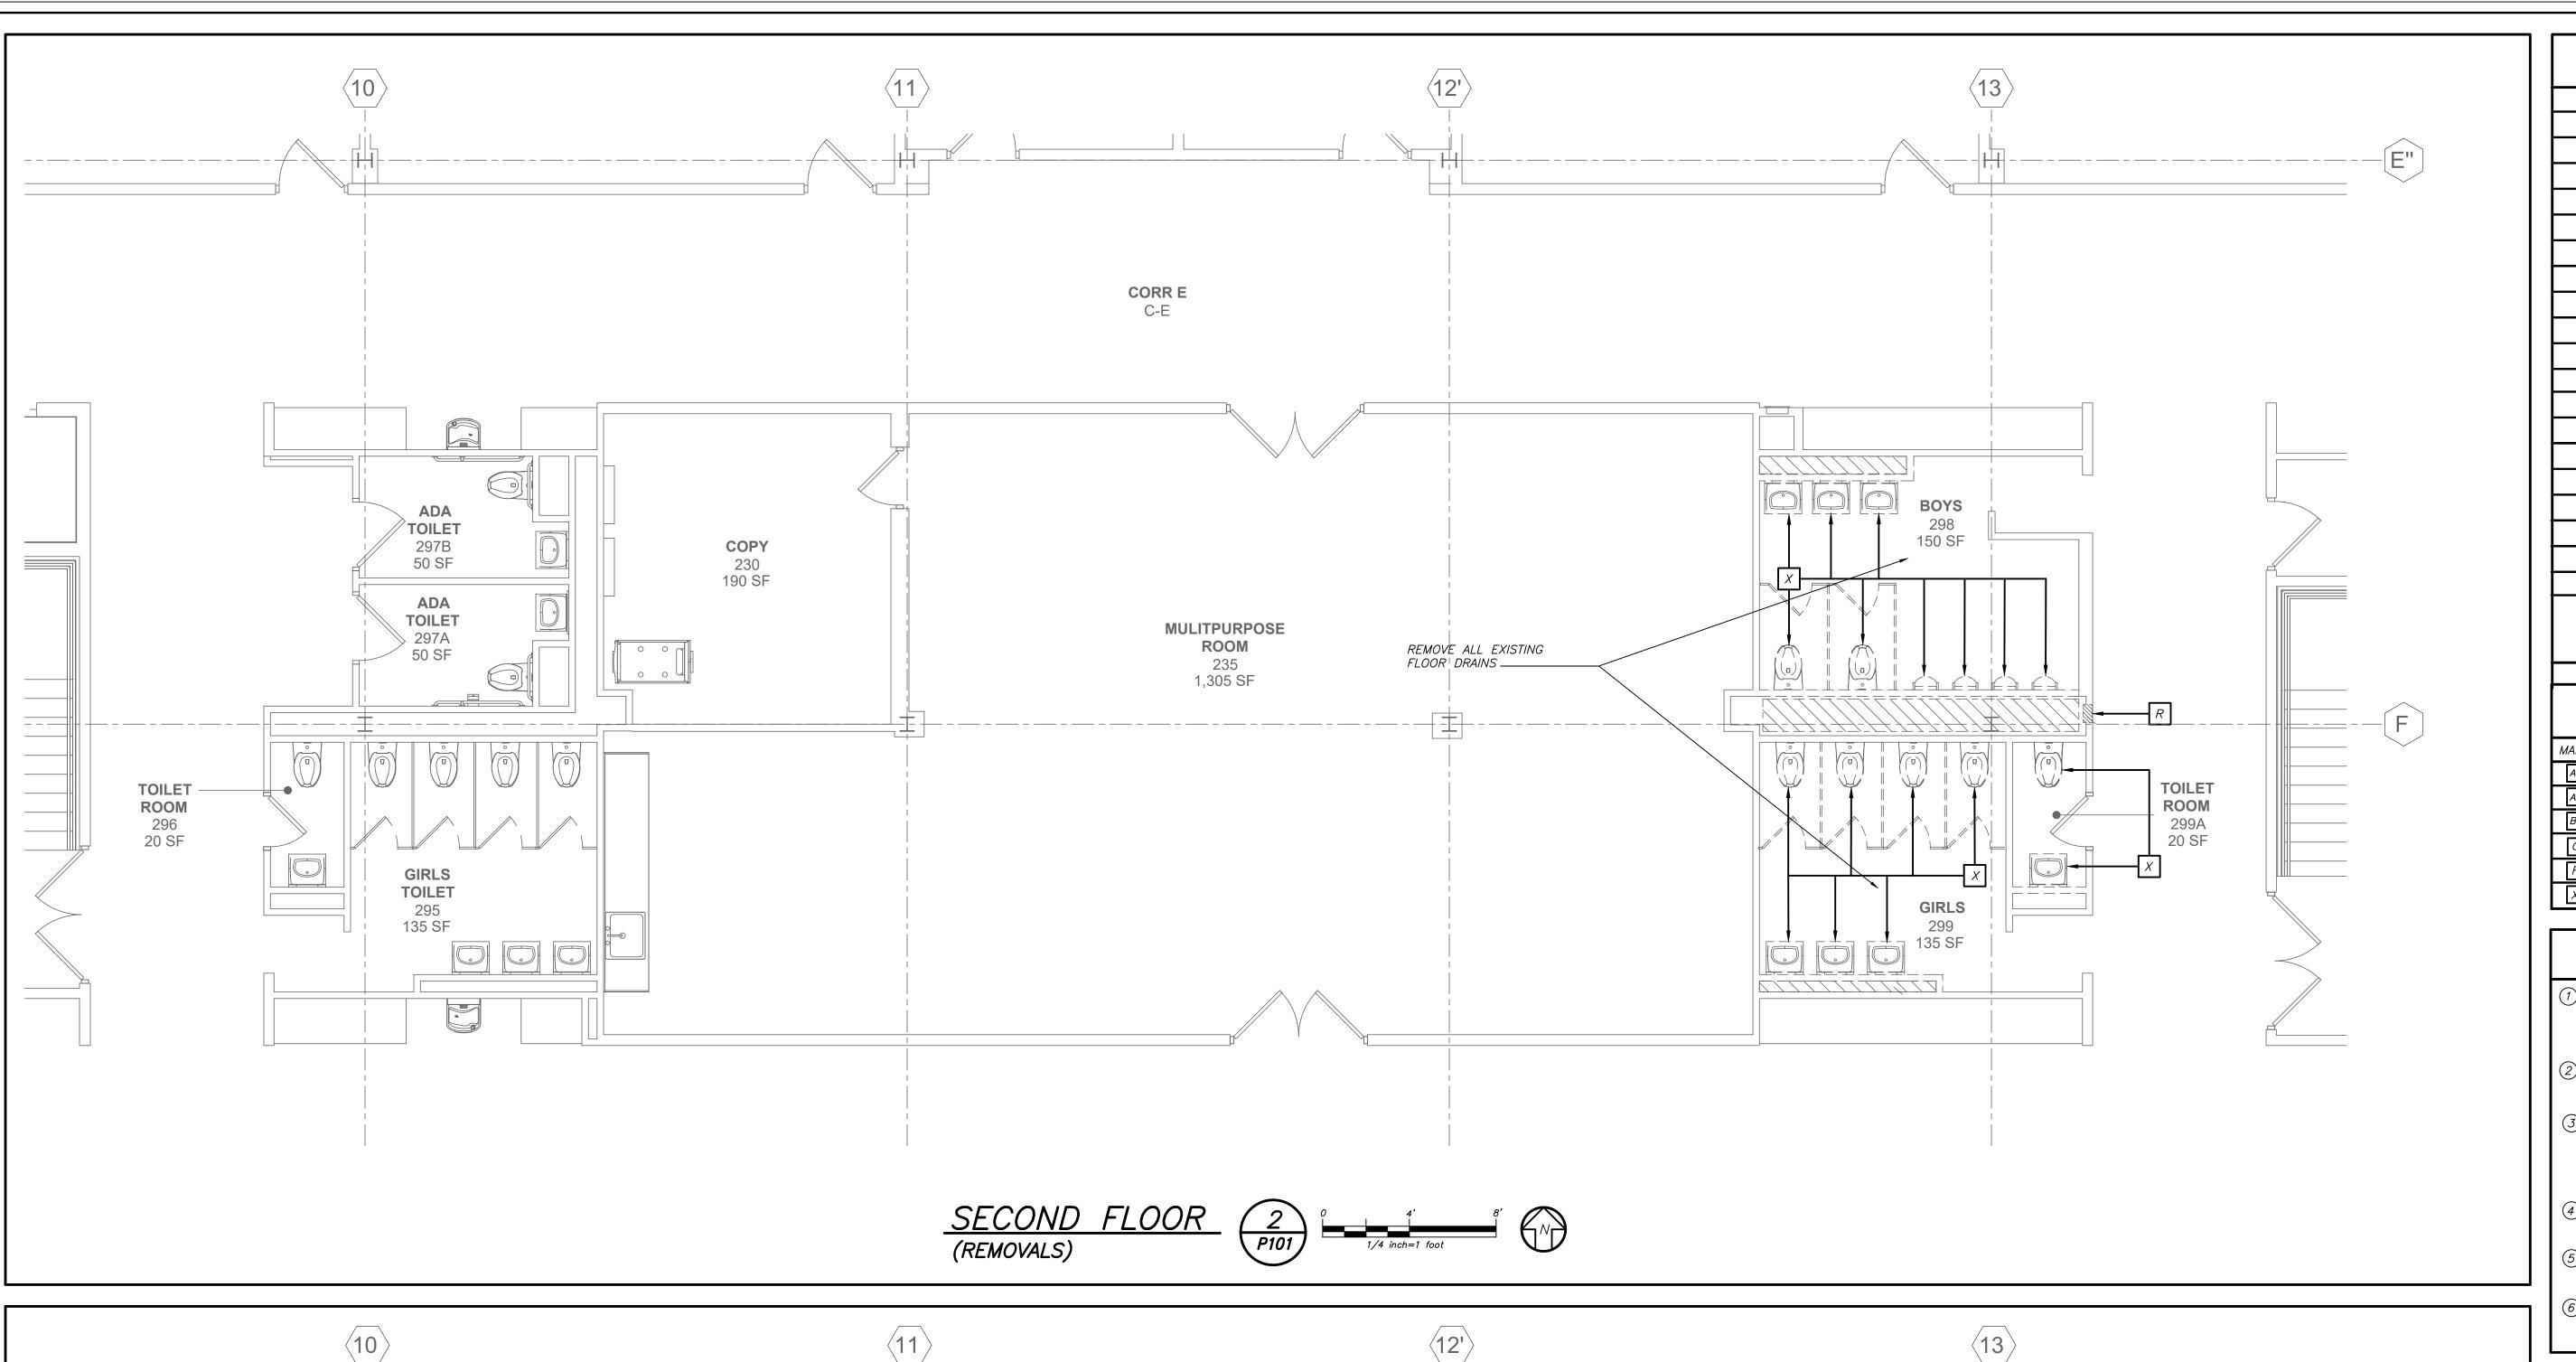
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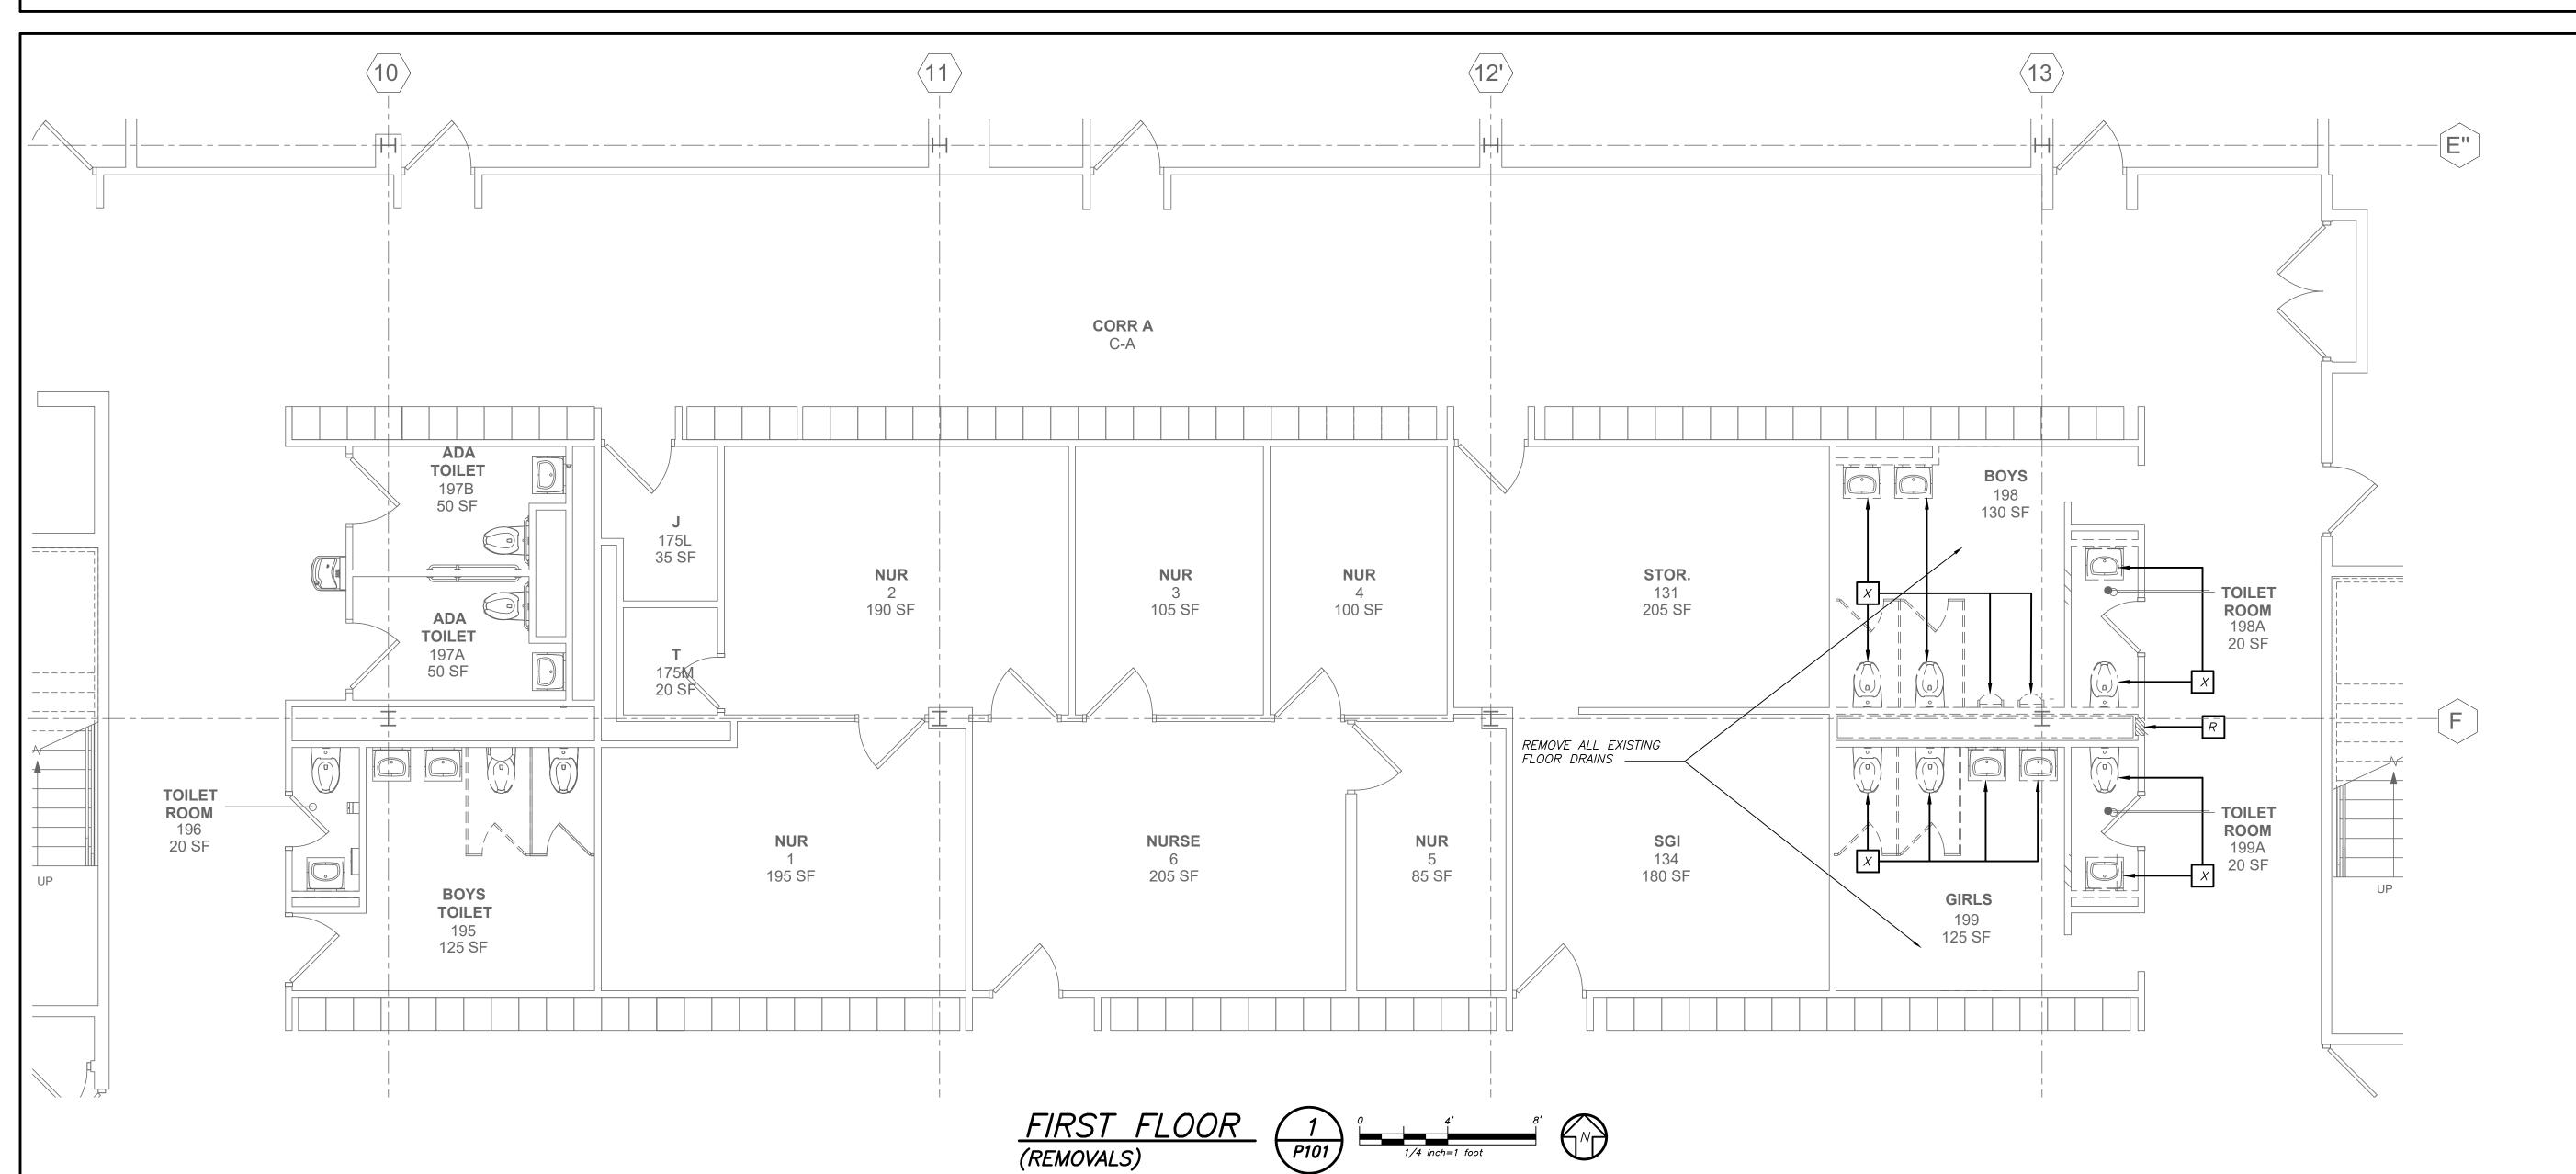
11/19/21 CONSTRUCTION DOCUMENTS P

REFLECTED

11/19/2021

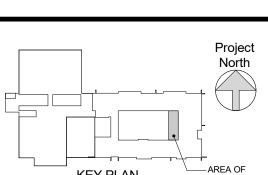Drawn / Checked A601






	LEGEND
	EXISTING PIPING, FIXTURES, ETC. TO REMAIN
	NEW PIPING, FIXTURES, ETC.
—• —	COLD WATER PIPING
••	HOT WATER PIPING
-•••	HOT WATER RETURN PIPING
	PLUMBING VENT PIPING
= SAN =	SANITARY PIPING (UNDERGROUND)
=ESAN=	EXISTING SANITARY PIPING (UNDERGROUND)
—ESAN—	EXISTING SANITARY PIPING
-	FLOW DIRECTION WITHIN PIPE
	CLEANOUT
<u> </u>	CLEANOUT DECK PLATE
₩	SHUT-OFF VALVE
- ₩	COMBINATION BALANCING & SHUT-OFF VALVE
\$ -\$-\$-\$	PIPE CONNS. (BOTTOM; TOP 45 OR 90; PIPE UP)
*	PLUMBING FIXTURE IDENTIFICATION
VTR	VENT THRU ROOF
FD	FLOOR DRAIN
COWP	CLEAN OUT WALL PLATE
•	POINT OF CONNECTION
	PART PLAN, DETAIL, SECTION NUMBER DRAWING NUMBER SECTION IDENTIFICATION

PLUMBING FIXTURE SCHEDULE

MARK	DESCRIPTION	BRANCH SIZE							
WAKK	DESCIVII TIOIV	W	V	Н	С				
A 1	WALL MOUNTED WATER CLOSET	4"	2"	_	1 "				
A2	WALL MOUNTED WATER CLOSET (HANDICAPPED)	4"	2"	-	1 "				
B1	WALL MOUNTED LAVATORY (HANDICAPPED)	1-1/2"	1-1/2"	1/2"	1/2'				
S	URINAL — WALL MOUNTED	3"	2"	_	1/2'				
R	EXISTING FIXTURE TO REMAIN	_	_	_	_				
X	EXISTING FIXTURE TO BE REMOVED	_	_	_	-				

REMOVAL NOTES

- SCOPE OF REMOVAL SHOWN IS DIAGRAMMATIC ONLY AND INDICATES THE INTENT OF THE WORK TO BE PERFORMED AND NOT THE COMPLETE SCOPE OF DEMOLITION AND/OR REMOVAL WORK TO BE TENTORMED AND NOT THE COMPLETE SCOTE OF DEMOCITION AND/OR REMOVA
 WORK. IT SHALL BE THE RESPONSIBILITY OF THIS CONTRACTOR TO REMOVE ANY RELATED
 MECHANICAL DEVICES EVEN IF NOT SPECIFICALLY INDICATED TO BE REMOVED IN ORDER TO
 ACCOMMODATE NEW WORK.
- (2) REMOVE ALL PLUMBING EQUIPMENT, SPECIALTIES, DRAINS, CONTROLS, HANGERS, BASES, SUPPORTS, PIPING, VALVES, TUBING AND PLUMBING ACCESSORIES THAT ARE NOT INCORPORATED IN THE NEW LAYOUT.
- 3) WHERE REMOVAL IS INDICATED OR IMPLIED OR NOT INCORPORATED IN THE NEW LAYOUT, THE ITEM ITSELF IS TO BE REMOVED COMPLETELY TOGETHER WITH ALL CONNECTING PIPING, SPECIALTIES, SUPPORTS, CONTROLS, ETC. CONNECTING PIPING IS TO BE REMOVED BACK TO MAINS WHERE THE ARE TO BE CAPPED OR DISCONNECTED. THIS INCLUDES ALL GAS, SANITARY, VENT, WATER, AND PUMP DISCHARGE PIPING. REFER TO DIVISION I OF SPECIFICATION FOR CUTTING AND PATCHING REQUIREMENTS.
- (4) WHERE EXISTING PIPING ENTERS INACCESSIBLE TRENCHES, TUNNELS, SHAFTS, WALLS AND CEILINGS INSIDE THE EXISTING BUILDING, IT SHALL BE CUT BACK AT LEAST 2" INTO SUCH INACCESSIBLE SPACES AND SHALL BE SUITABLY CAPPED AND SEALED BY THE CONTRACTOR.
- 5) THE CONTRACTOR SHALL EXERCISE NORMAL CAUTION TO PREVENT UNNECESSARY CUTTING AND DAMAGE TO THE EXISTING BUILDING. ANY EXCESSIVE DAMAGE AS DETERMINED BY THE OWNER SHALL BE REPAIRED AND PAID FOR BY THE CONTRACTOR CAUSING THE DAMAGE.
- (S) all demolished equipment etc. except those items specifically requested by the OWNER SHALL BECOME THE CONTRACTORS PROPERTY, SHALL BE REMOVED FROM THE PREMISES, AND DISPOSED OF LEGALLY.

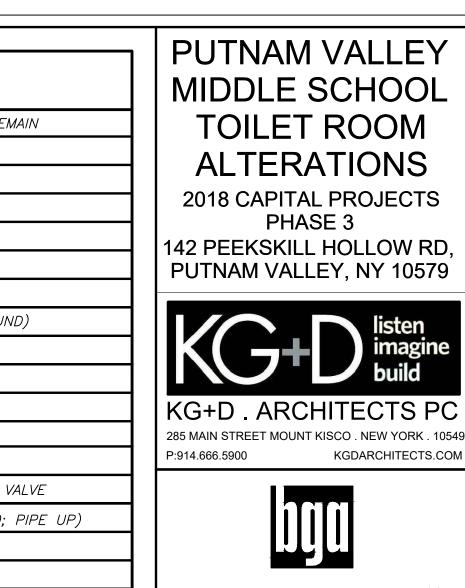


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48-05-03-04-0-004-016

CONSTRUCTION DOCUMENTS




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FIRST AND SECOND FLOOR REMOVAL PLANS

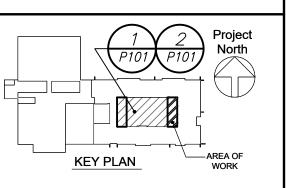Job No.	Date
2020-1051	01/14/2021
Scale	Drawn / Checked
AS NOTED	BGA/BGA

P101


PROJECT TRUE NORTH

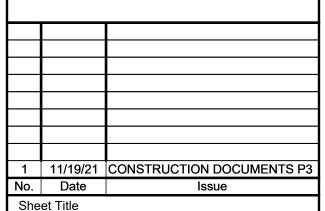
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BEFORE FABRICATION THIS CONTRACTOR SHALL VERIFY ALL MEASUREMENTS AND CONDITIONS ON

OF ALL OTHER CONTRACTORS

JOB AND COORDINATE HIS WORK WITH THE WORK



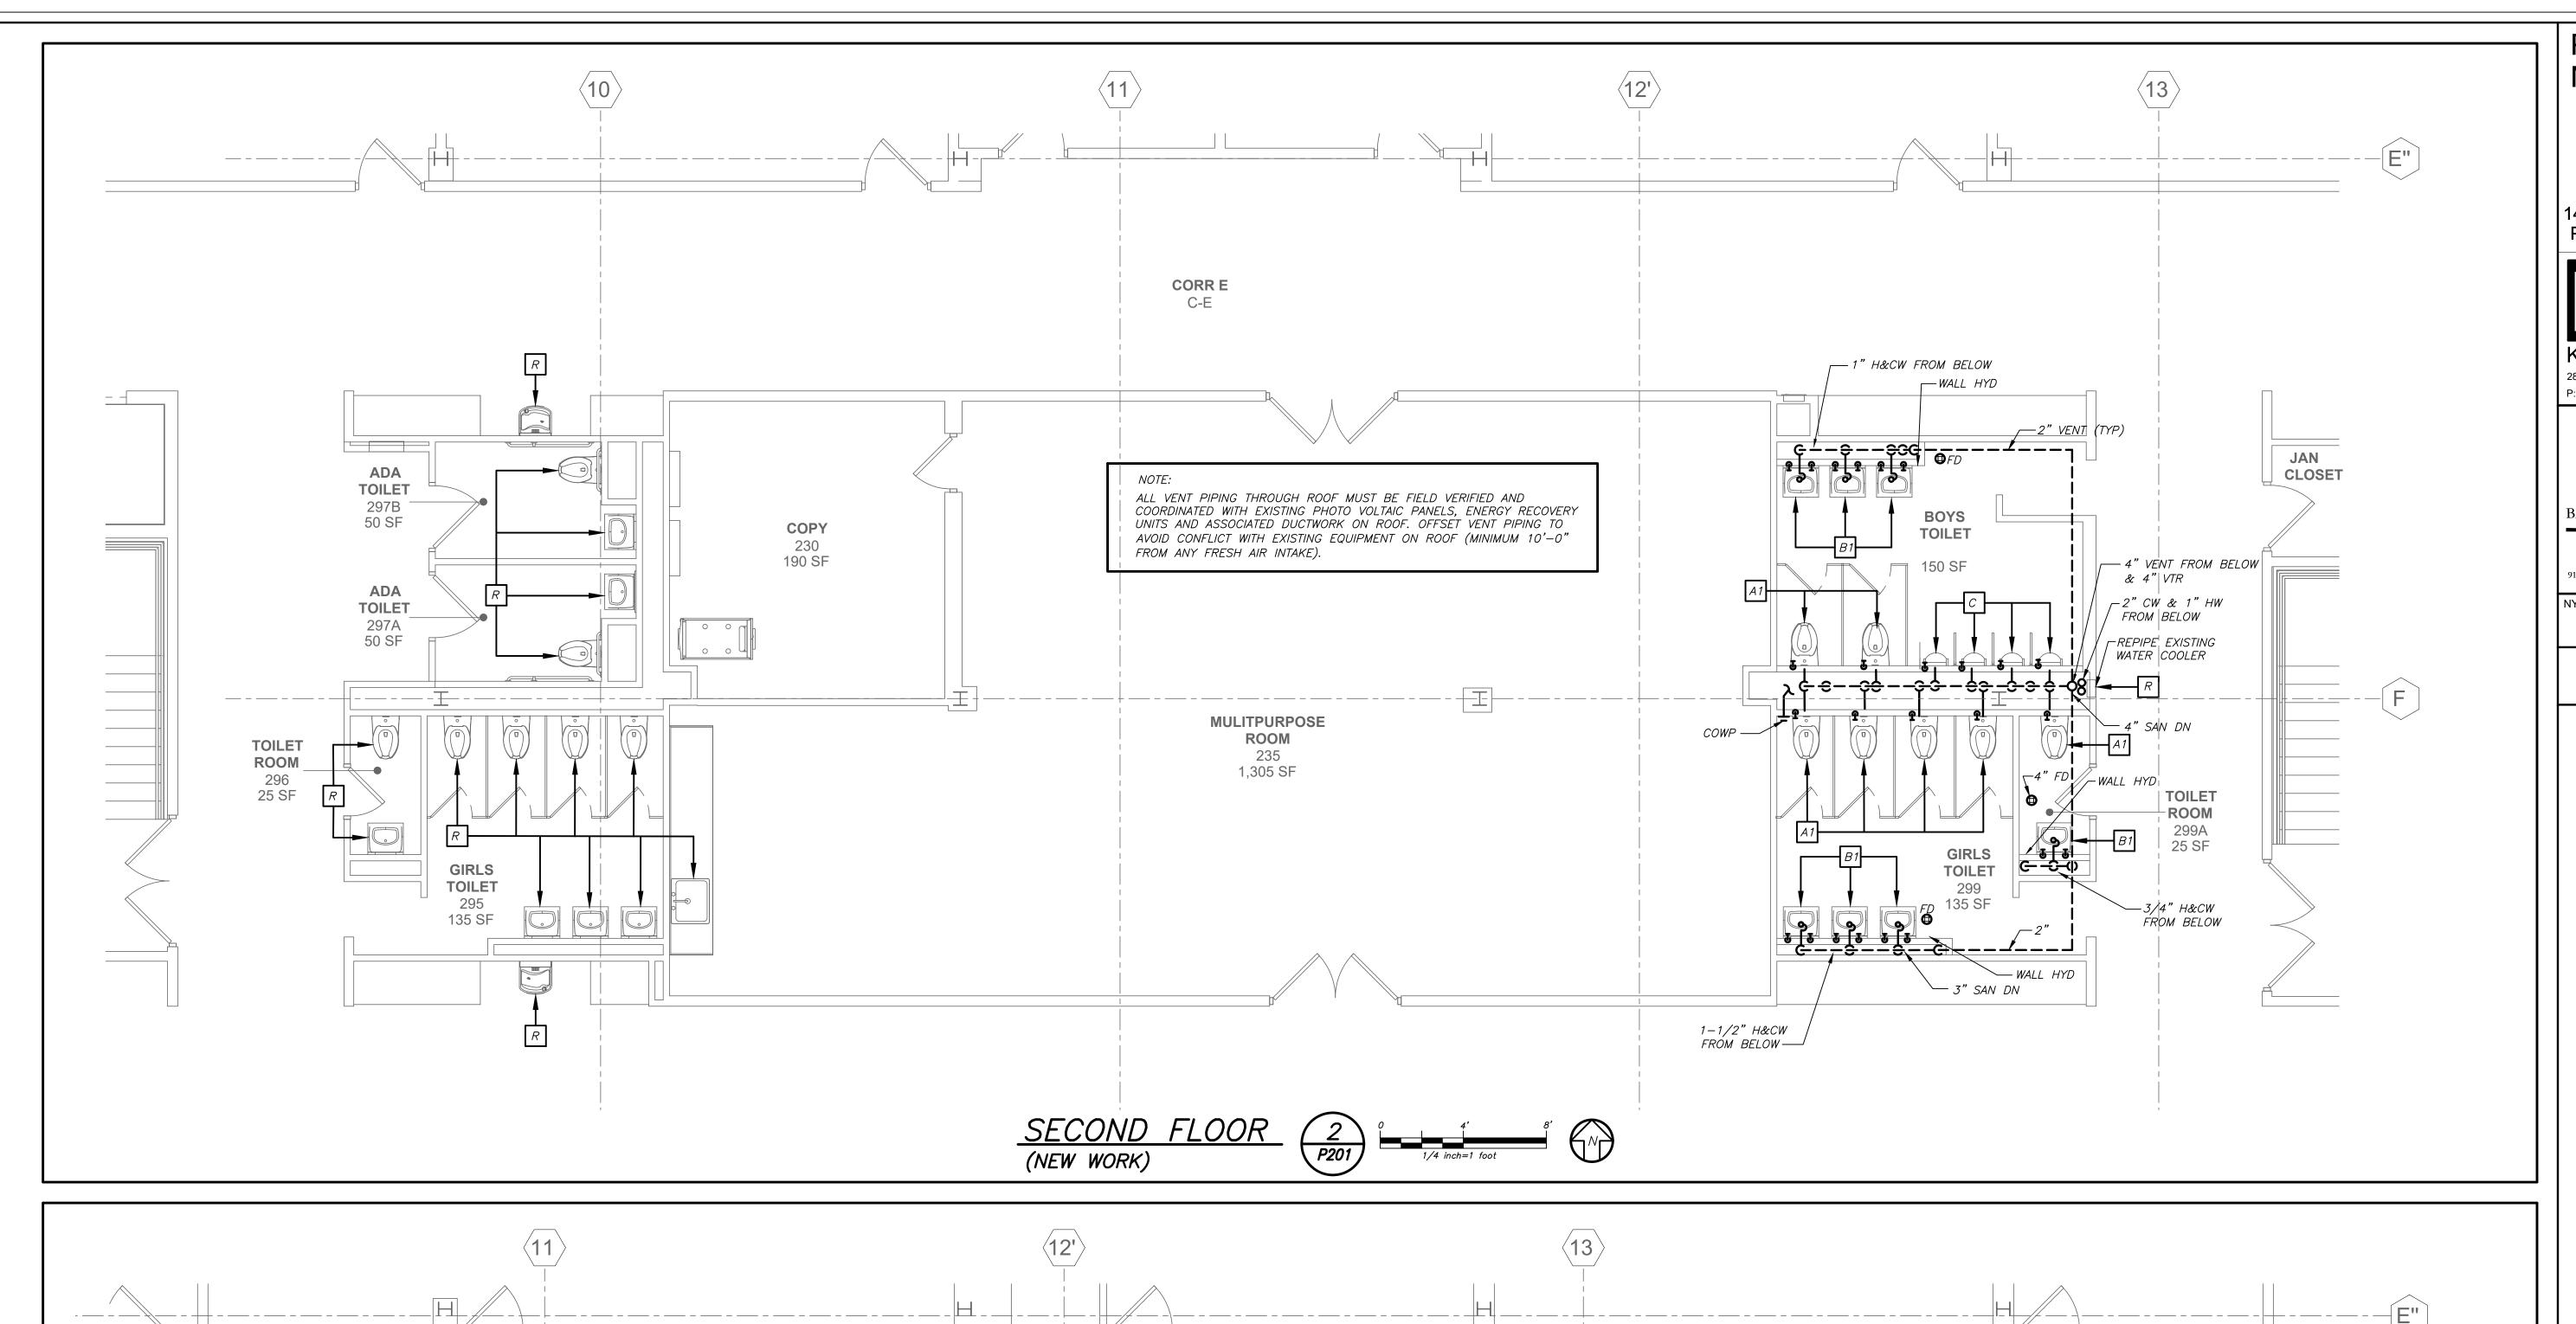

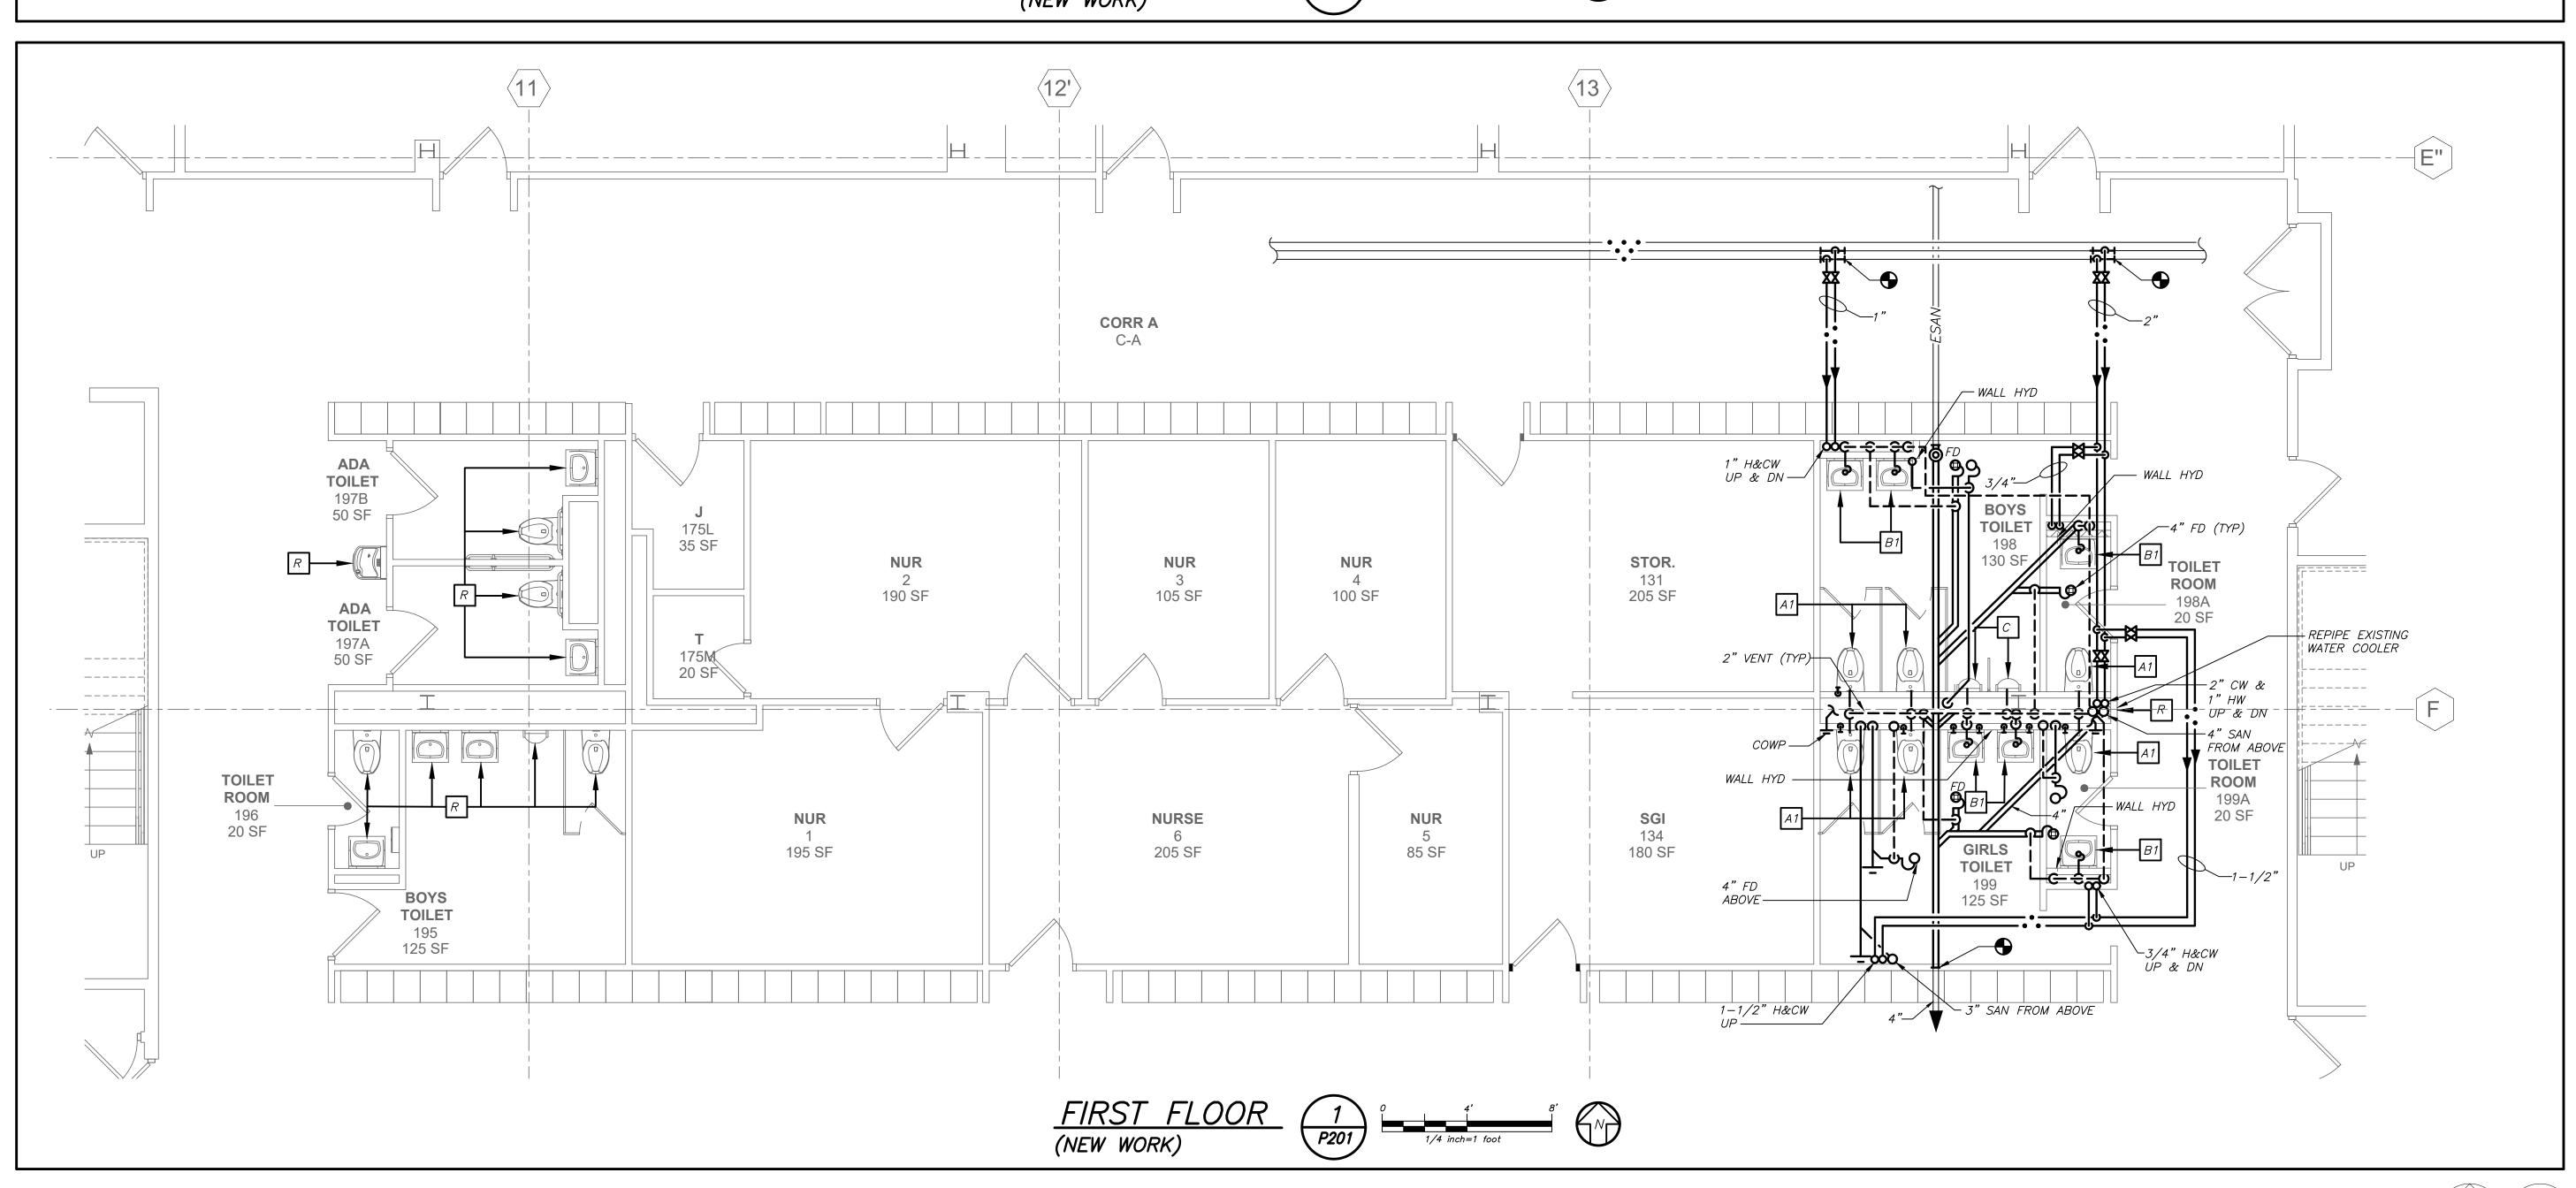PUTNAM VALLEY
MIDDLE SCHOOL
TOILET ROOM
ALTERATIONS

2018 CAPITAL PROJECTS
PHASE 3
142 PEEKSKILL HOLLOW RD,
PUTNAM VALLEY, NY 10579



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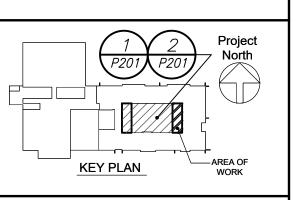


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1 11/19/21 CONSTRUCTION DOCUMENTS P3
No. Date Issue

FIRST AND SECOND FLOOR PLANS

 Job No.
 Date

 2020-1051
 01/14/2021


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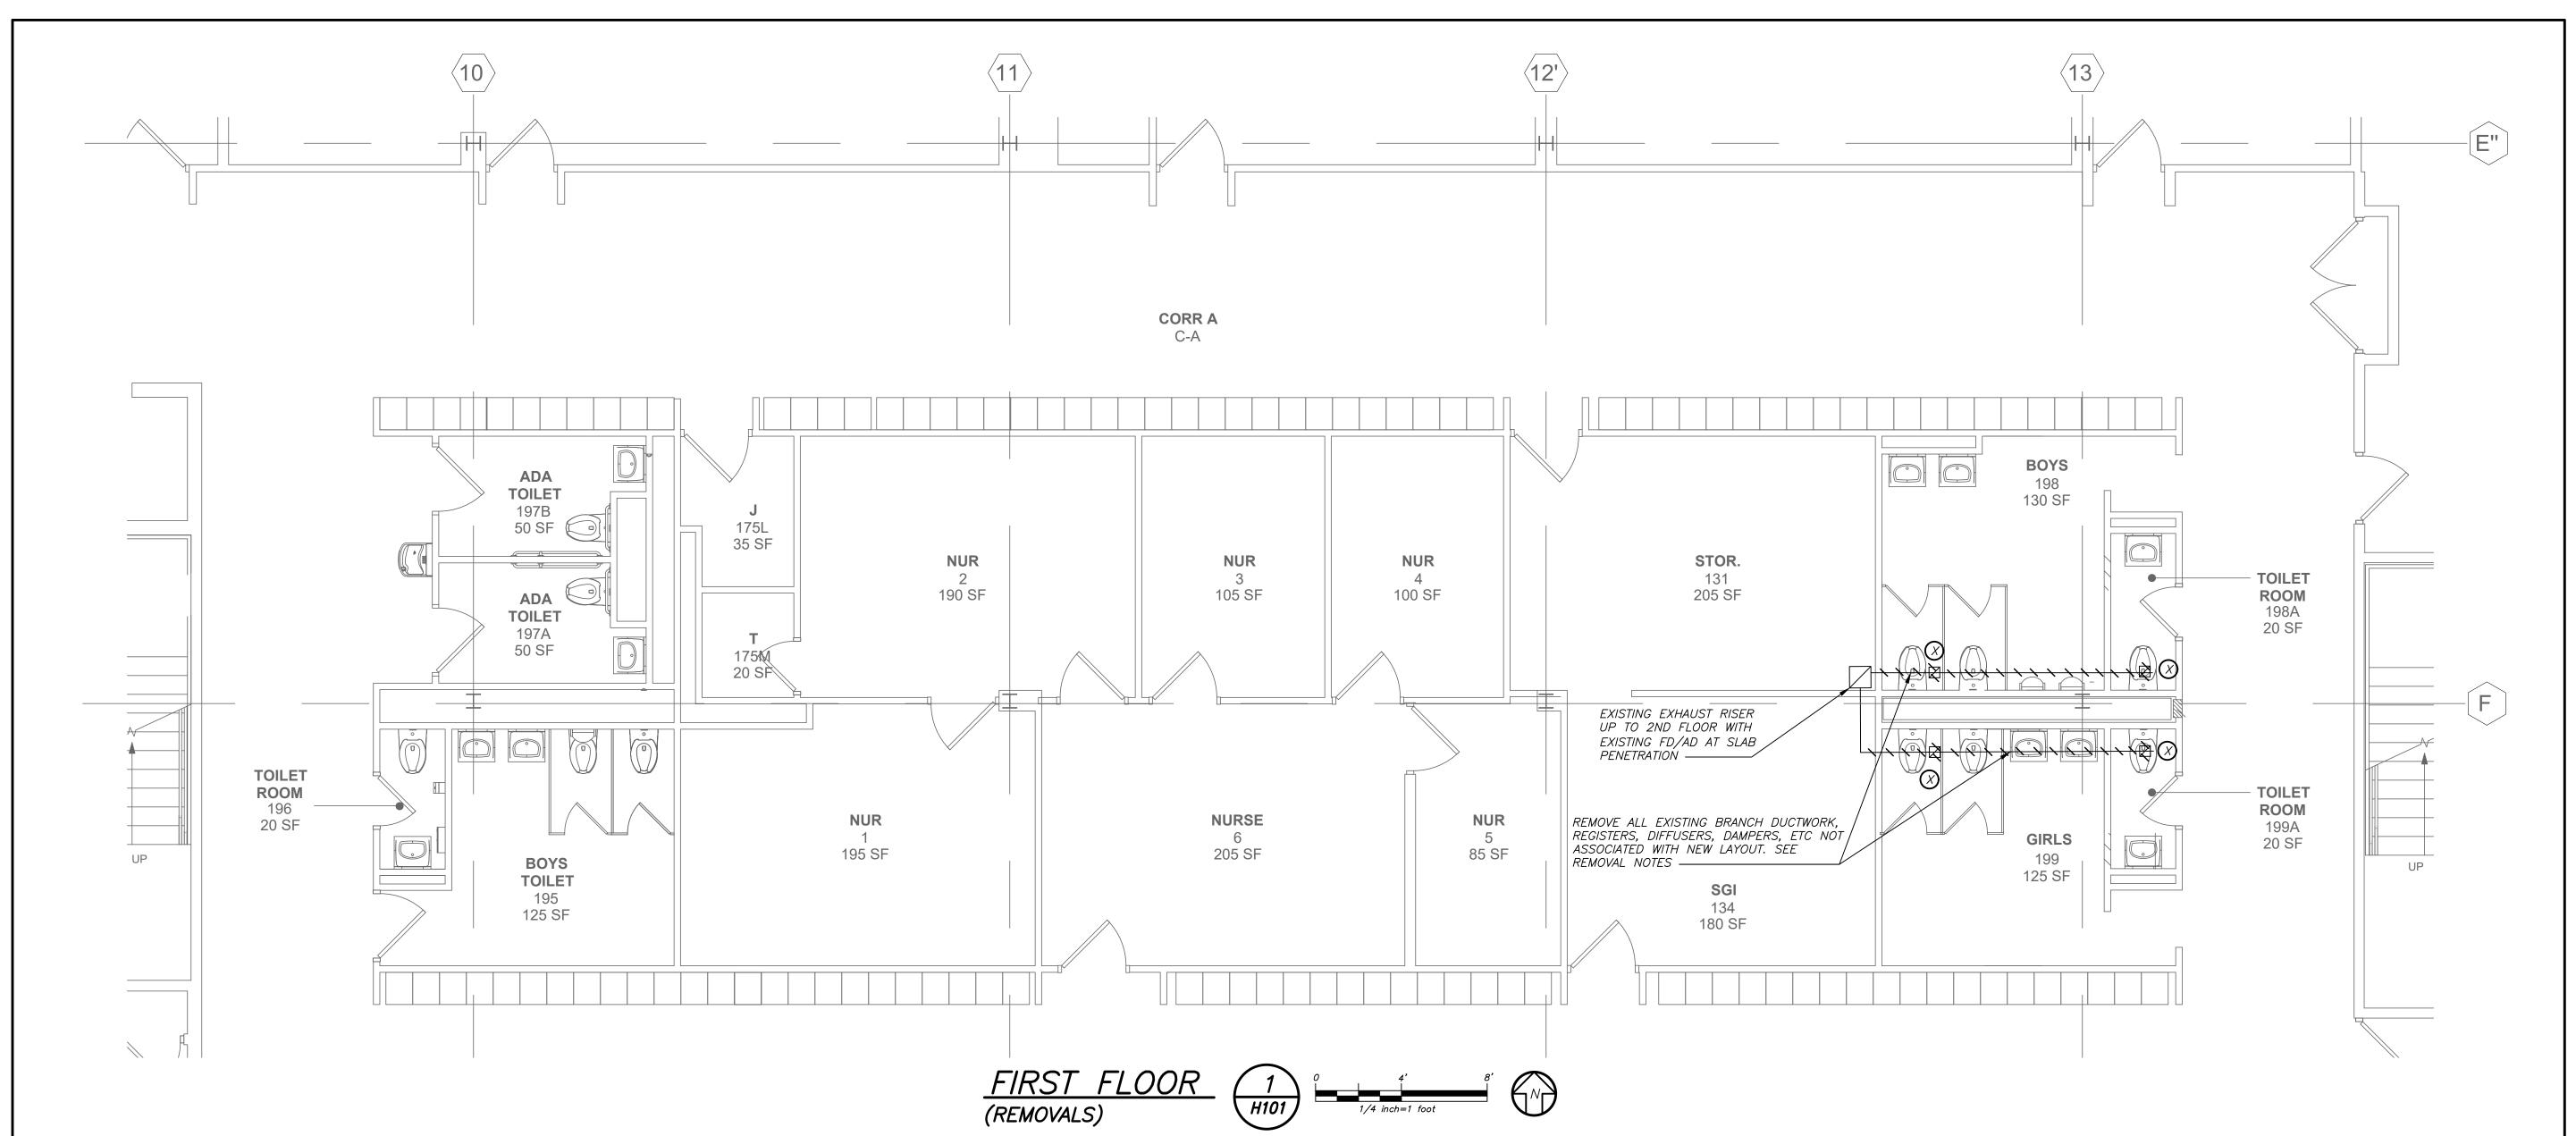
 AS NOTED
 BGA/BGA


Sheet Number

PROJECT TRUE NORTH

P201



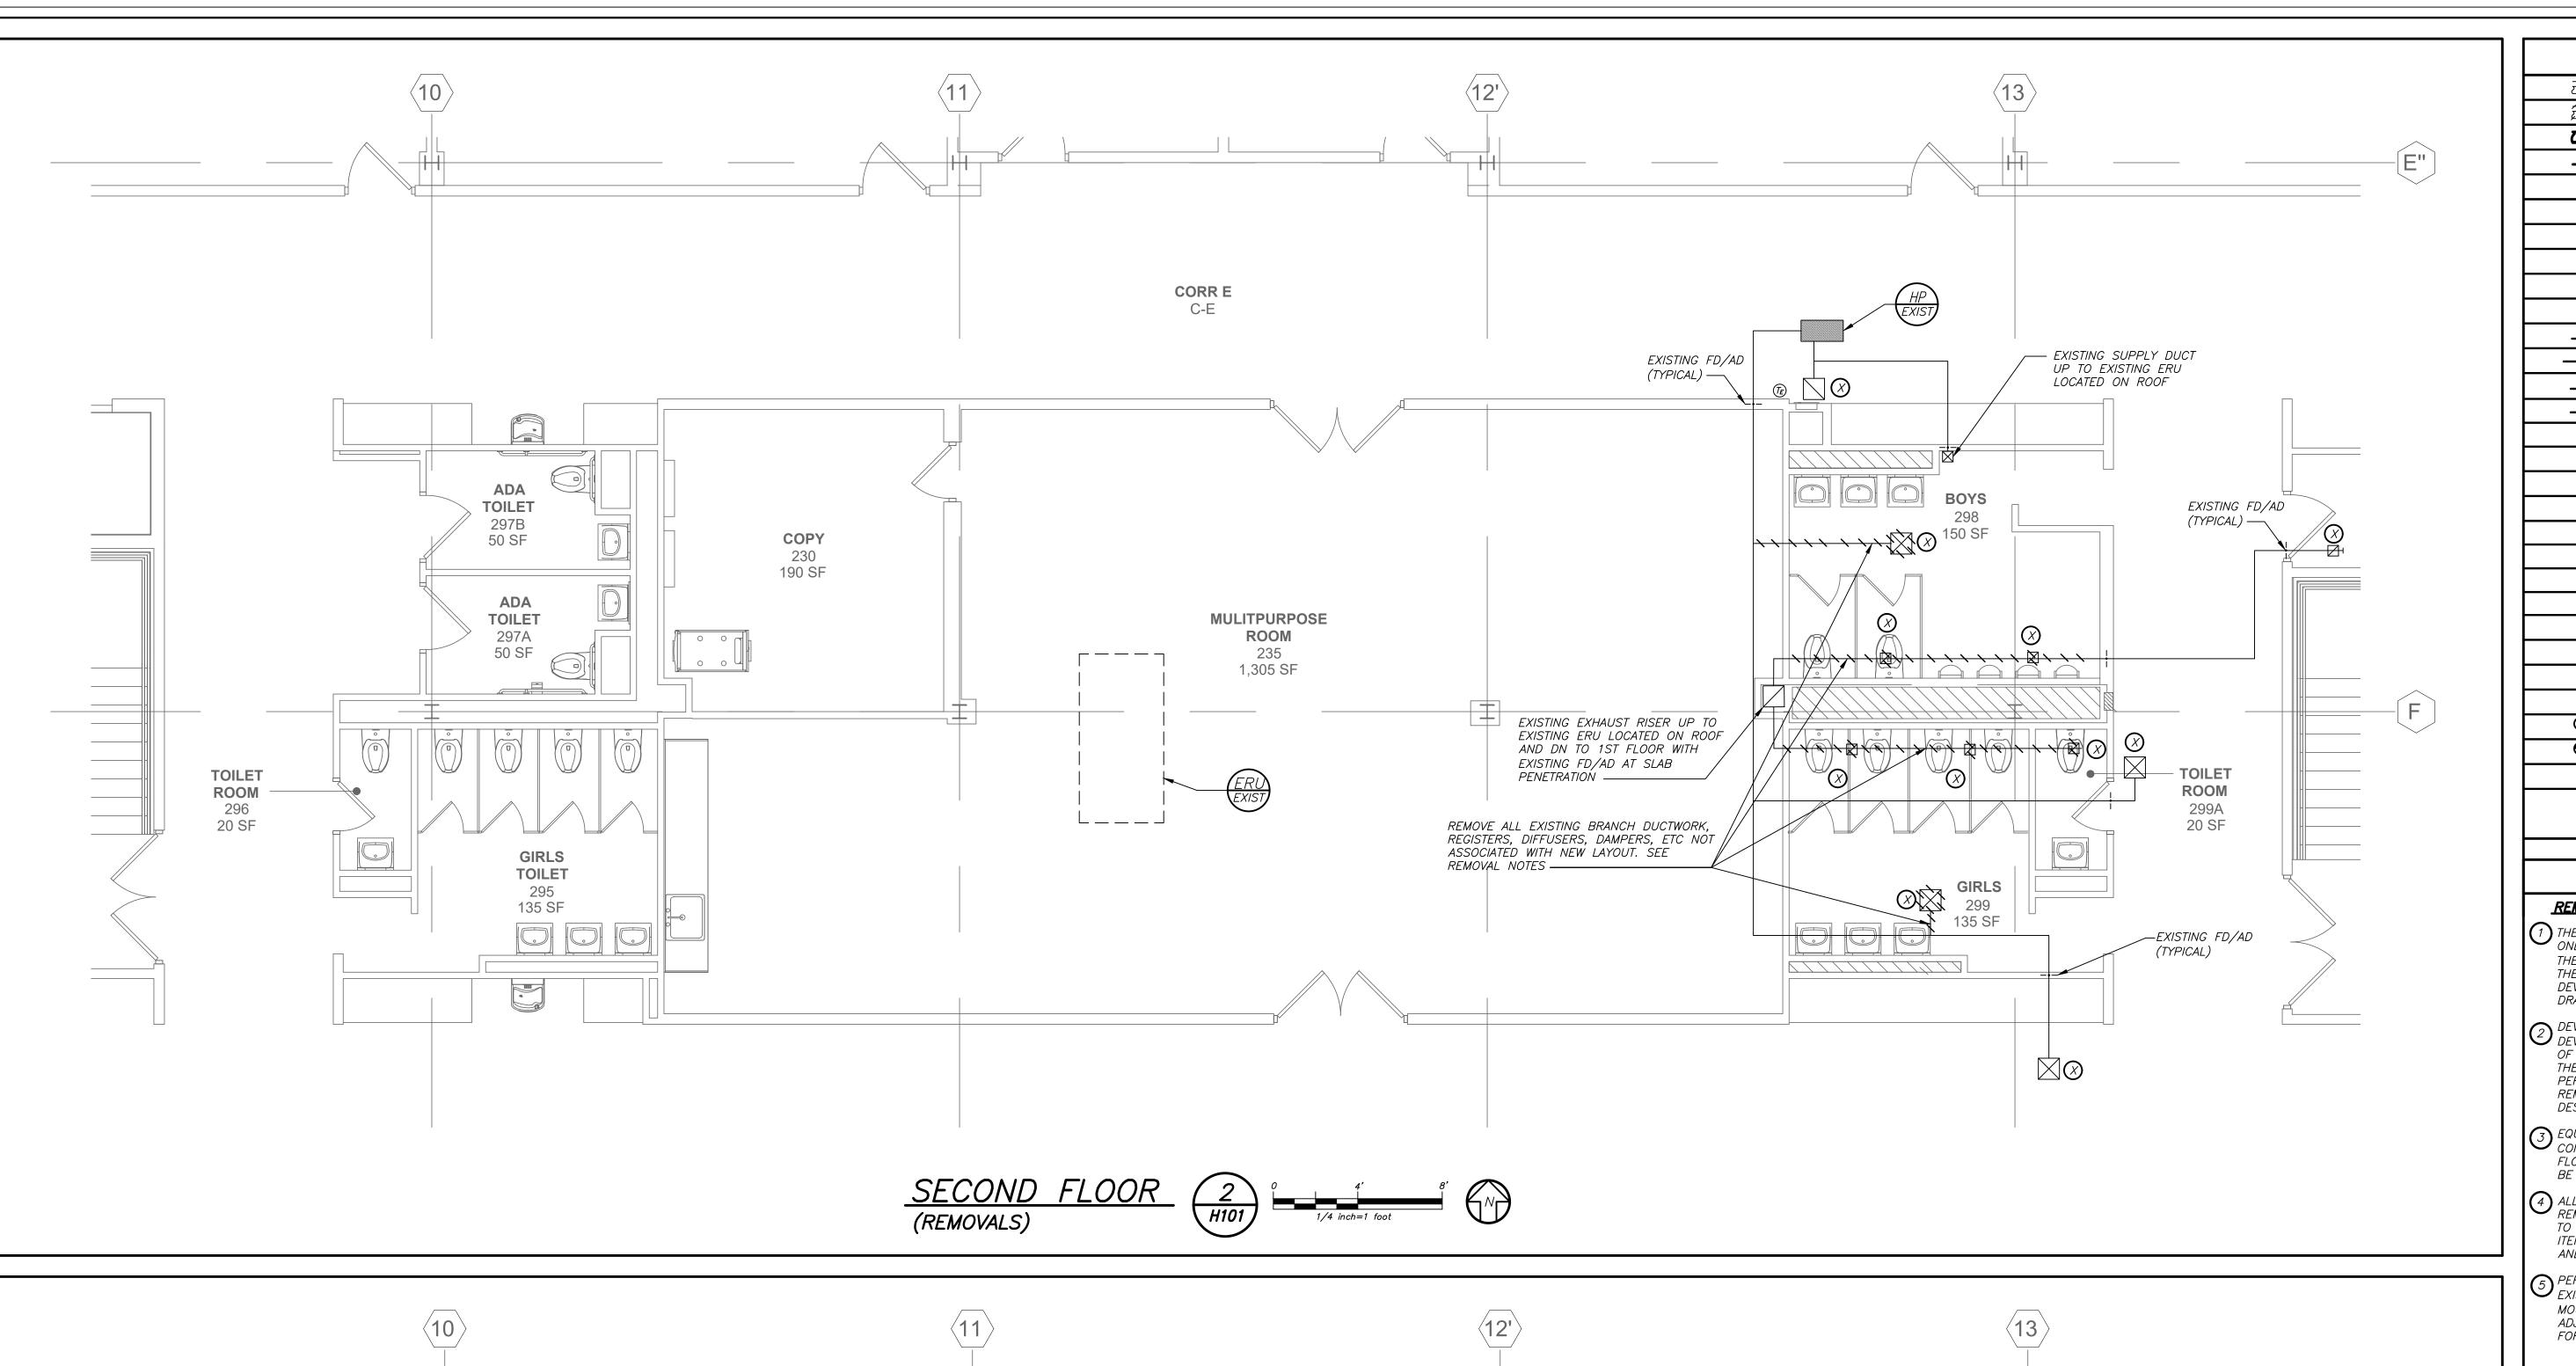

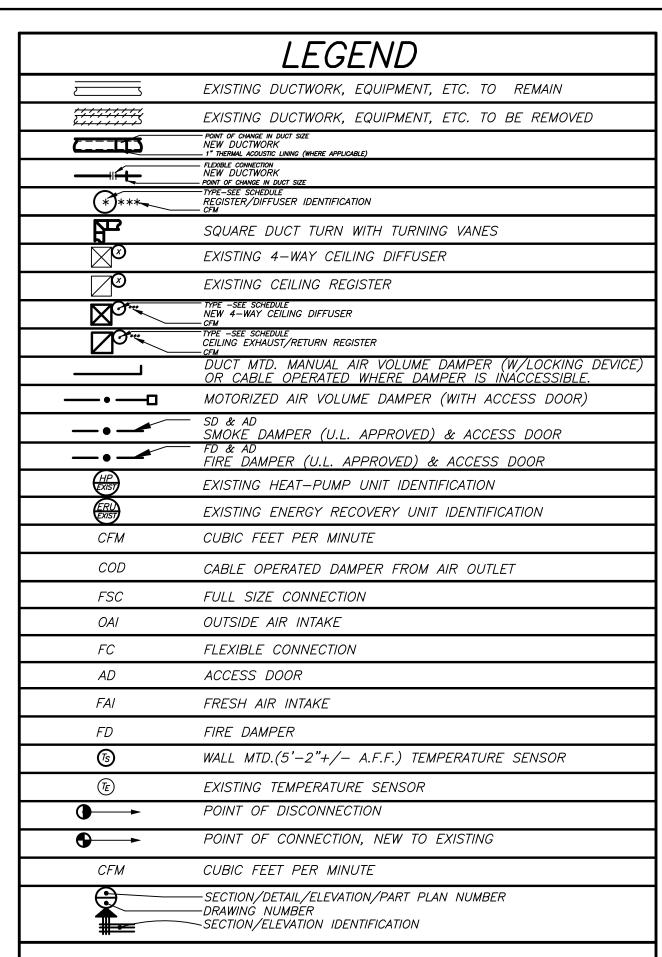

REMOVAL NOTES

REMOVAL NOTES:

(1) THE SCOPE OF REMOVAL SHOWN ON "REMOVALS" DRAWINGS IS DIAGRAMMATIC ONLY AND INDICATES THE INTENT OF THE WORK TO BE PERFORMED AND NOT THE COMPLETE SCOPE OF DEMOLITION AND/OR REMOVAL WORK. IT SHALL BE THE RESPONSIBILITY OF THIS CONTRACTOR TO REMOVE ANY RELATED MECHANICAL DEVICES EVEN IF NOT SPECIFICALLY INDICATED TO BE REMOVED ON THESE DRAWINGS IN ORDER TO ACCOMMODATE NEW WORK.

DEVICES SHOWN CROSS HATCHED ON DRAWINGS ARE ITEMS TO BE REMOVED. ANY DEVICES REMOVED SHALL INCLUDE (BUT SHALL NOT BE LIMITED TO) THE REMOVAL OF ALL ASSOCIATED PIPING, CONTROLS, ETC. THAT ARE NOT INCORPORATED IN THE NEW LAYOUT, UNTIL SUCH REMOVAL IS COMPLETE. THIS CONTRACTOR SHALL PERFORM ALL WORK REQUIRED TO INSURE CONTINUITY OF SERVICE TO EXISTING REMAINING EQUIPMENT. NO EXTRAS RELATING TO THE SCOPE OF WORK DESCRIBED WILL BE ALLOWED.

3 EQUIPMENT, PIPING, ETC., REQUIRED TO RECONNECT SHALL BE INSTALLED CONCEALED WITHIN THE NEW SUSPENDED CEILINGS, PARTITIONS AND/OR WALLS, FLOORS, NO SURFACE MOUNTED OR EXPOSED EQUIPMENT, PIPING, ETC., SHALL BE PERMITTED, UNLESS SPECIFICALLY INDICATED.

ALL ITEMS TO BE REMOVED SHALL BE REVIEWED WITH THE OWNER PRIOR TO REMOVAL. OWNER SHALL HAVE FIRST SALVAGE RIGHTS. ITEMS THE OWNER WISHES TO KEEP SHALL BE REMOVED WITH CARE AND STORED AS DIRECTED BY OWNER. ITEMS THE OWNER DOES NOT WISH TO KEEP SHALL BE REMOVED FROM THE SITE AND DISPOSED OF PROPERLY.

PERFORM INITIAL AIR BALANCING REPORT AND UNIT SERVICE REPORT FOR THE EXISTING ROOF MOUNTED ENERGY RECOVERY UNIT (ERU) AND THE CEILING MOUNTED HEAT PUMP UNITS (HP=1&2) SERVING THE TOILET ROOMS AND ADJACENT CORRIDORS. SUBMIT A DETAILED REPORT WITH ANY UNIT DEFICIENCIES FOR REVIEW AND COURSE OF ACTION BY OWNER.

PUTNAM VALLEY
MIDDLE SCHOOL
TOILET ROOM
ALTERATIONS
2018 CAPITAL PROJECTS
PHASE 3

142 PEEKSKILL HOLLOW RD, PUTNAM VALLEY, NY 10579






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NY SED PROJECT CONTROL NO.

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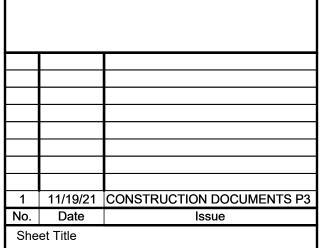
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FIRST AND SECOND FLOOR REMOVAL PLANS

 Job No.
 Date

 2020-1051
 01/14/2021

 Scale
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 AS NOTED
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 Sheet Number

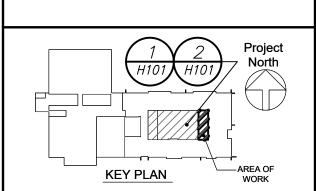
H101

PROJECT TRUE NORTH

BEFORE FABRICATION THIS CONTRACTOR SHALL

OF ALL OTHER CONTRACTORS

VERIFY ALL MEASUREMENTS AND CONDITIONS ON JOB AND COORDINATE HIS WORK WITH THE WORK

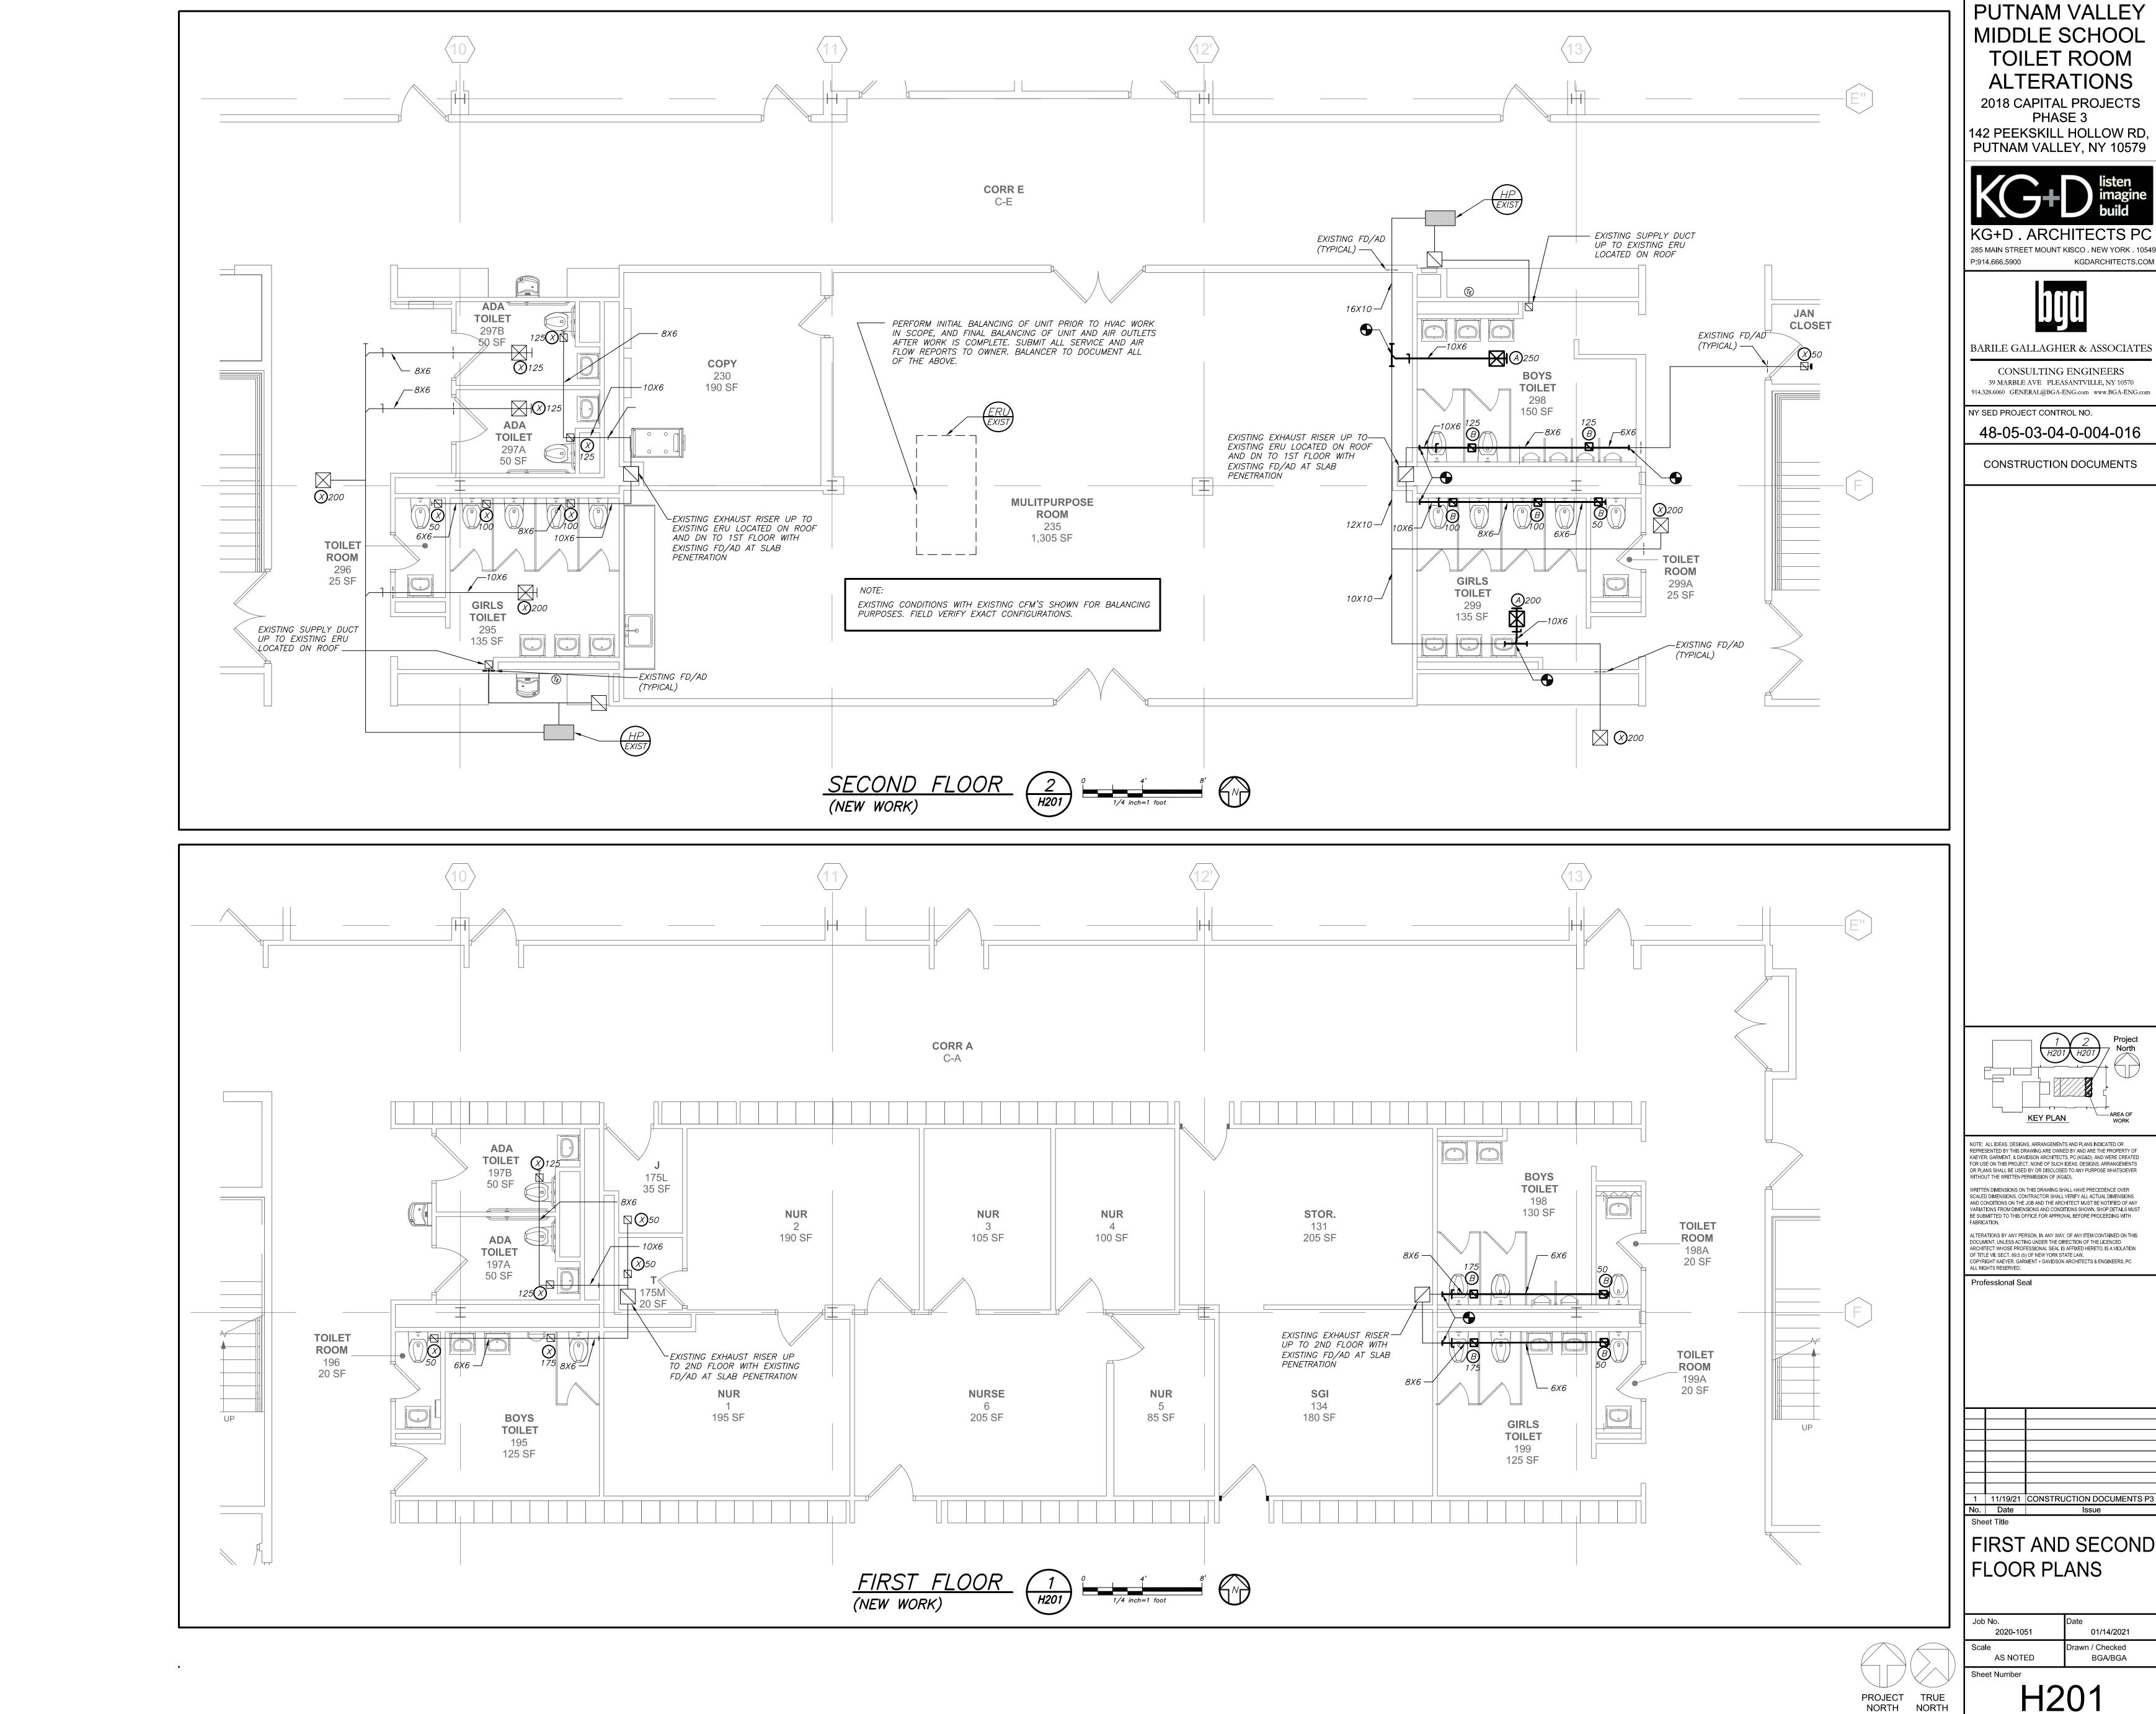

FIRST AND SECOND

H201

BEFORE FABRICATION THIS CONTRACTOR SHALL VERIFY ALL MEASUREMENTS AND CONDITIONS ON

OF ALL OTHER CONTRACTORS

JOB AND COORDINATE HIS WORK WITH THE WORK

	SCHEL	ULE	OF	EXIS	STING	WA	TER	SOL	<i>YRCI</i>	E HEA	TP	UM	P UN	VITS
MARK	MODEL No. 🛈	TYPE	LOCATION	SUPPLY CFM	O.A. CFM	EXT. S.P.	WATER GPM	COOLI TOTAL CAP. (MBH)	NG 2 SENSIBLE (MBH)	HEATING 2 TOTAL CAP. (MBH)	ELE(MCA	CTRICAL MOCP	DATA ELECTRIC SERVICE	REMARKS
HP EXIST	_	HORIZONTAL	CEILING	850	350	0.4	4.5	24.8	18.3	20.0	13.0	20	208/1/60	3

PERFORMANCE BASED ON 20% ENVIRONOL 200 GLYCOL SOURCE FLUID.

	SCHEDULE OF EXISTING ENERGY RECOVERY UNITS												
	GENERAL				SUPPLY FAN DATA			RETURN—EXHAUST FAN			ELECTRICAL DATA		DEMARKS
MARK	SERVICE	LOCATION	OUTSIDE AIR CFM MIN/MAX	MODEL No. 🚺	CFM	EXT. S.P. IN WG	MOTOR HP	CFM MIN/MAX	EXT. S.P. IN WG	MOTOR HP	MCA	ELECTRIC SERVICE	REMARKS
ERU EXIST	TOILETS/ CORRIDORS	ROOF	2000	-	2000	0.4	1.5	2000	0.4	1.5	23	208/3/60	34
N O 10 MANUFACTURED BY "MENUAR"													

N (1) AS MANUFACTURED BY "VENMAR"

DESIGN AIR CONDITIONS: SUMMER OA (95°F/75°F)
RA (75°F/63°F)

BASED ON A.R.I. CERTIFIED COIL SELECTIONS.

S BASED ON HOT WATER SUPPLY TEMPERATURE OF 160°F AND RETURN TEMPERATURE OF 140°F.

WINTER OA (6°F) RA (70°F/53°F)

SCHEDULE OF REGISTERS AND DIFFUSERS											
MARK	TYPE	SERVICE	MODEL No.	DIRECTION DISCHARGE	DAMPER TYPE	FINISH	REMARKS				
A	CEILING DIFFUSER	SUPPLY	EPL/E-1	4-WAY	OPPOSED BLADE	PER ARCH.	REFER TO 2456				
B	CEILING REGISTER	RETURN	<i>30/S/45</i>	-	↓	↓	REFER TO 23457				
\bigcirc	EXISTING OUTLET										

N 1 AS MANUFACTURED BY "ANEMOSTAT."

O 2 INSTALL PER MANUFACTURERS RECOMMENDATIONS.


T 3 45 DEGREES DEFLECTION TOWARD WALL/FLOOR.

S 4 PROVIDE CABLE OPERATED DAMPER
WHERE NOT ACCESSIBLE PROVIDE BLANK-OFF BAFFLES, VOLUME DAMPER,
EQUALIZING GRID AND MOLDED INSULATION BLANKET

SUPPLY NECK SIZE PER CFM RANGE (NOT TO EXCEED 500 fpm) RETURN NECK SIZE PER CFM RANGE (NOT TO EXCEED 675 fpm)

SCHEDULE OF MINIMUM VENTILATION ROOM FLOW RATES - Middle School - First Floor

		Α	В	С	D	E	F	G	Н	1	
ROOM NAME/NUMBER	OCCUPANCY CATEGORY	ROOM AREA (SQ.FT.)	PEOPLE DENSITY (#P/1000 SQ.FT.)	PEOPLE OUTDOOR AIR FLOW RATE (CFM/PERSON)	AREA OUTDOOR AIR FLOW RATE IN BREATHING ZONE (CFM/SQ.FT.)	EXHASUT AIR FLOW RATE (CFM/SQ.FT.)	NUMBER OF PEOPLE (A×B)÷1000=#P	OUTDOOR AIR FLOW RATE WITHOUT ZONE EFFECTIVENESS FACTOR (F×C)+(A×D)=CFM	ZONE AIR DISTRIBUTION EFFECTIVENESS FACTOR	MINIMUM ROOM VENTILATION AIR FLOW RATE G÷H=CFM	MINIMUM EXHAUST AIR FLOW RATE A×E=CFM
Boys Toilet/198	BATHROOM	130	_		-		-	_	_	_	150
Toilet/198A	BATHROOM	20	-	-	-	-	-	-	-	-	50
Girls Toilet/199	BATHROOM	125	-	-	-	-	-	-	-	-	150
Toilet/199A	BATHROOM	20	-	-	-	-	-	-	-	-	50
Boys Toilet/298	BATHROOM	150	-	-	-	-	-	-	-	-	200
Girls Toilet/299	BATHROOM	135	-	-	-	-	-	-	-	-	150
Toilet/299A	BATHROOM	20	-	-	-	-	-	-	-	-	50

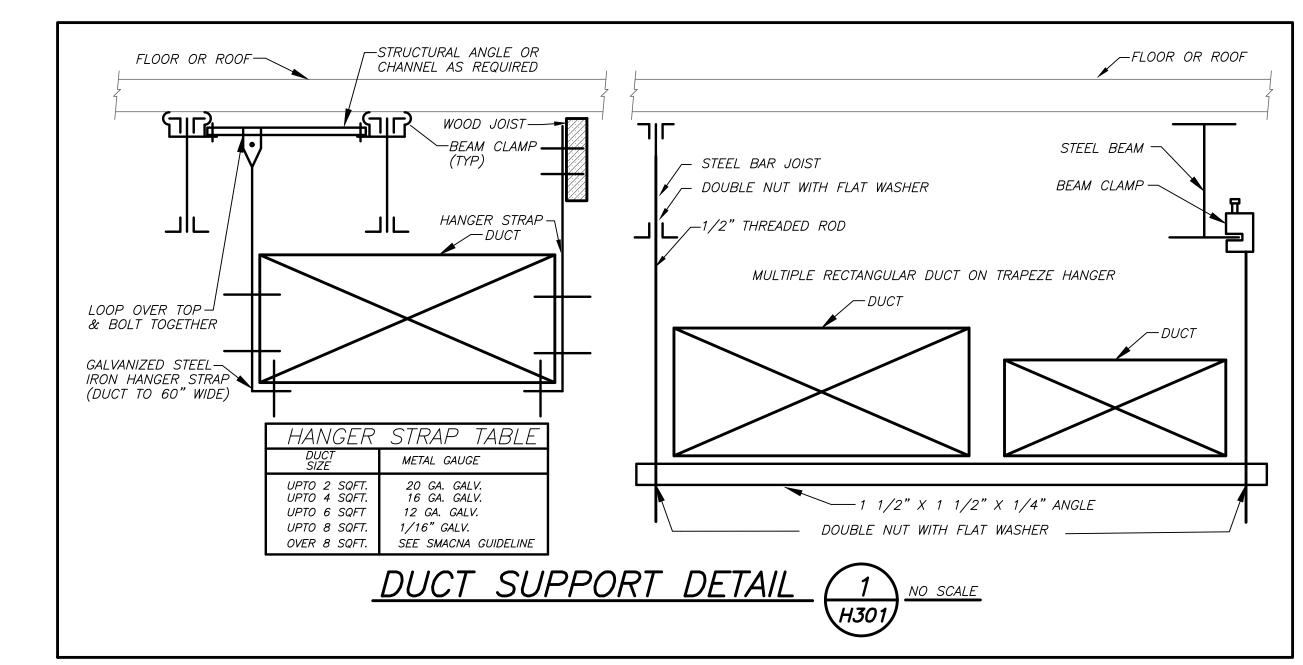



PHASE 3

142 PEEKSKILL HOLLOW RD, PUTNAM VALLEY, NY 10579

285 MAIN STREET MOUNT KISCO . NEW YORK . 10549 P:914.666.5900 KGDARCHITECTS.COM

BARILE GALLAGHER & ASSOCIATES

CONSULTING ENGINEERS 39 MARBLE AVE PLEASANTVILLE, NY 10570 914.328.6060 GENERAL@BGA-ENG.com www.BGA-ENG.com

48-05-03-04-0-004-016

CONSTRUCTION DOCUMENTS

NY SED PROJECT CONTROL NO.

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1	11/19/21	CONSTRUCTION DOCUMENTS P3
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SCHEDULES AND DETAILS

2020-1051 01/14/2021 Drawn / Checked AS NOTED BGA/BGA

PROJECT TRUE NORTH

Sheet Number H301

BEFORE FABRICATION THIS CONTRACTOR SHALL VERIFY ALL MEASUREMENTS AND CONDITIONS ON JOB AND COORDINATE HIS WORK WITH THE WORK OF ALL OTHER CONTRACTORS

GENERAL NOTES

- DRAWINGS ARE DIAGRAMMATIC AND INDICATE THE GENERAL ARRANGEMENT OF SYSTEMS AND WORK. CONTRACTOR SHALL FURNISH ALL NECESSARY OUTLETS, SUPPORTS, FITTINGS AND ACCESSORIES TO FULFILL APPLICABLE CODES, REGULATIONS, BUILDING STANDARDS AND THE BEST PRACTICES OF THE TRADE FOR FIRST CLASS ELECTRICAL INSTALLATION.
- 2. THE DRAWINGS INDICATE SIZE AND GENERAL LOCATION OF WORK. SCALED DIMENSIONS SHALL NOT BE USED. THE EXACT LOCATION AND ELEVATION OF ALL ELECTRICAL EQUIPMENT SHALL BE COORDINATED IN FIELD WITH RESPECTIVE CONTRACTOR/OWNER.
- 3. THE CONTRACTOR SHALL COORDINATE WITH THE OWNER PRIOR TO SUBMISSION OF BID TO DETERMINE WHAT WORK MUST BE PERFORMED AFTER NORMAL BUSINESS HOURS. UNLESS OTHERWISE DIRECTED ANY NOISY WORK (CHOPPING, CORE DRILLING, HAMMERING, ETC.) AND BUILDING POWER INTERRUPTIONS SHALL BE PERFORMED OUTSIDE OF NORMAL BUSINESS HOURS. CONFIRM NORMAL BUSINESS HOURS WITH BUILDING OWNER. NO ADDITIONAL COST WILL BE CHARGED TO OWNER FOR WORK PERFORMED OUTSIDE NORMAL

4. BUSINESS HOURS.


- ALL WORK WHERE SHOWN WITH DARK/SOLID LINES ON THE DRAWINGS IS NEW UNLESS OTHERWISE NOTED. WHERE SHOWN WITH DASHED LINES WITH LETTER (E) IS EXISTING TO REMAIN, WITH LETTER (R) IS EXISTING TO BE REMOVED, WITH LETTER (ER) IS EXISTING RELOCATED, WITH LETTER (RN) IS EXISTING TO BE REPLACED WITH NEW AND WITH LETTER (RR) IS EXISTING TO BE REMOVED AND RELOCATED.
- FEEDERS AND BRANCH CIRCUITRY SHALL BE RUN IN MINIMUM 3/4" CONDUIT UNLESS OTHERWISE NOTED. FINAL CONNECTIONS TO MOTORS MAY BE MADE WITH FLEXIBLE METALLIC CONDUIT (NO LONGER THAN 18"). IN UNFINISHED AREAS CONDUIT SHALL BE RUN EXPOSED AND IN FINISHED AREAS CONDUIT SHALL BE RUN CONCEALED.
- ALL CONDUCTORS SHALL BE COPPER, TYPE THHN/THWN INSULATED. ALL CONDUCTORS SHALL HAVE 600 VOLT RATED INSULATION UNLESS OTHERWISE NOTED.
- REFER TO ARCHITECT'S REFLECTED CEILING PLAN FOR EXACT LOCATION OF ALL CEILING MOUNTED LIGHTING FIXTURES AND OTHER CEILING INSTALLED ITEMS.
- 7. THE USE OF FLEXIBLE CONDUIT FROM LIGHTING FIXTURES TO JUNCTION BOX IS PERMITTED ONLY WHEN A SEPARATE GROUND WIRE IS INSTALLED WITH THE CONDUCTORS INSIDE FLEXIBLE CONDUIT. THE GROUND WIRE MUST BOND THE FIXTURE HOUSING TO THE JUNCTION BOX. MAXIMUM LENGTH 6'-0".
- 8. EXACT LOCATION AND MOUNTING HEIGHTS OF ALL DEVICES SHALL BE COORDINATED WITH THE ARCHITECT PRIOR TO THE INSTALLATION.
- 9. CONDUIT RUNS SHALL BE PARALLEL WITH OR AT RIGHT ANGLES TO WALLS AND CEILINGS. CONDUIT SHALL BE SUPPORTED BY APPROVED MEANS. SUPPORTS FOR HORIZONTAL RUNS OF CONDUIT SHALL NOT EXCEED SEVEN FEET ON CENTERS.
- 10. PROVIDE PULL BOXES, JUNCTION BOXES, CONDUIT ELBOWS AND OFFSETS TO SUIT FIELD CONDITIONS AND THE NATIONAL ELECTRICAL CODE.
- 11. CONTRACTOR SHALL COORDINATE WITH THE FIRE DEPARTMENT AND F.A. VENDOR BEFORE PROCEEDING WITH WORK INVOLVING FIRE ALARM SYSTEM.
- 12. THE MINIMUM WIRE SIZE FOR 120 VOLT BRANCH CIRCUITS SHALL BE NO. 12 AWG, EXCEPT OVER 100' IN LENGTH SHALL BE NO. 10 AWG.
- 13. PROVIDE ALL REQUIRED AND NECESSARY ACCESSORIES (EX. CONNECTORS, ADAPTERS, BUSHINGS, CLAMPS, ETC.) TO FACILITATE COMPLETE INSTALLATION.
- 14. ALL JUNCTION OR OUTLET BOXES SHALL BE INSTALLED SO AS TO ALLOW ACCESS TO COVER. PROVIDE ARCHITECT APPROVED ACCESS DOORS OR PLATES AS REQUIRED IN AREAS WHERE UNOBSTRUCTED ACCESS TO BOX OR OUTLET IS NOT POSSIBLE.
- 15. PRIOR TO ANY CHASING, CHOPPING OR CORE DRILLING BEING PERFORMED, THE CONTRACTOR SHALL FIELD INVESTIGATE CONDITIONS AND COORDINATE ALL WORK TO ENSURE THAT IT WILL BE IN HARMONY AND NOT AFFECT ANY EXISTING BUILDING SYSTEMS. THIS WORK MUST BE APPROVED BY BUILDING OWNER PRIOR TO PROCEEDING.
- 16. OPENINGS AROUND ELECTRICAL PENETRATIONS THROUGH FIRE RESISTANCE RATED WALLS, PARTITIONS, FLOORS OR CEILINGS SHALL BE FIRE STOPPED USING APPROVED METHODS. ALL SLEEVES MUST HAVE BUSHINGS. SEALANT SHALL BE 3 HOUR FIRE BARRIER #CP-25 (NO LESS THAN 3" THICK BACKED UP WITH MINERAL WOOL).
- 17. PREPARE 'AS-BUILT' DRAWINGS THAT REFLECT ACTUAL CONSTRUCTION AND SHOW DEVIATIONS FROM DESIGN DRAWINGS.

GENERAL REMOVAL NOTES

- BEFORE COMMENCING WORK, EXAMINE ALL ADJOINING AREAS THAT MAY BE AFFECTED BY REMOVAL. REPORT TO THE CONSTRUCTION MANAGER ANY CONDITION THAT PREVENTS PERFORMANCE OF THE WORK.
- 2. BECOME THOROUGHLY FAMILIAR WITH EXISTING CONDITIONS WHERE CONNECTIONS MUST BE MADE, CHANGED OR ALTERED. THE INTENT OF THE WORK IS SHOWN ON THE DRAWINGS AND DESCRIBED HEREINAFTER AND NO CONSIDERATION WILL BE GRANTED BY REASON OF LACK OF FAMILIARITY ON THE PART OF THE CONTRACTOR WITH ACTUAL PHYSICAL CONDITIONS AT THE SITE. INSPECT EACH AND EVERY AREA AFFECTED BY THE ALTERATION OF THE SPACE BEFORE SUBMITTAL OF BID.
- ALL CONDUCTORS AND CONDUIT ASSOCIATED WITH THE ELECTRICAL EQUIPMENT SHALL BE REMOVED COMPLETELY BACK TO ITS SOURCE OF POWER AND DISCONNECTED UNLESS OTHERWISE NOTED.
- ALL POWER CONDUCTORS, CONTROL WIRING AND CONDUIT ASSOCIATED WITH MECHANICAL EQUIPMENT SUCH AS FANS. AIR CONDITIONING UNITS. PUMPS. ETC. DESIGNATED FOR REMOVAL ON THE HVAC AND PLUMBING REMOVAL DRAWINGS SHALL BE REMOVED CLEAR BACK TO THE SOURCE OF POWER AND DISCONNECTED. ALL MOTOR STARTERS, DISCONNECT SWITCHES, CONTROL DEVICES, ETC. SHALL BE REMOVED. REFER TO MECHANICAL AND PLUMBING DRAWINGS FOR ADDITIONAL INFORMATION.
- ELECTRICAL CONTRACTOR SHALL BE RESPONSIBLE FOR SECURING ALL EXISTING DATA WIRING AS CEILINGS AND WALLS ARE BEING REMOVED. ANY DAMAGED WIRING IS TO BE REPLACED
- FOR ALL LOCATIONS WHERE DEVICES (RECEPTACLES, SWITCHES, FIRE ALARM DEVICES, P.A. DEVICES, CLOCKS, ETC.) ARE REMOVED AND EXISTING BACKBOXES AND JUNCTION BOXES ARE REQUIRED TO REMAIN ON WALL AND CAN NOT BE PATCHED. PROVIDE BLANK STAINLESS STEEL COVER PLATE SIZED AS REQUIRED TO PROPERLY COVER OPENING.

3/**3** VS 2,(4,6) ____ * - *

	LEGEND	MIDDLE SCHOOL
A a	2'x4' CEILING MOUNTED LIGHT FIXTURE. UPPER CASE LETTER DENOTES TYPE, LOWER CASE LETTER DENOTES SWITCH CONTROL. FIXTURE SCHEDULE DENOTES TYPE.	TOILET ROOM
EM Emál	2'x4' CEILING LIGHT FIXTURE FOR EMERGENCY OPERATION. 'EM' INDICATES SWITCHED EMERGENCY FIXTURE, 'EM/NL'—UNSWITCHED EMERGENCY/NIGHT FIXTURE (TYP.).	ALTERATIONS
)	CEILING/WALL MOUNTED EXIT LIGHT WITH OUTLET BOX, DIRECTIONAL ARROWS SHADED PORTION INDICATES ILLUMINATED FACE. SCHEDULE DENOTES TYPE.	2018 CAPITAL PROJECTS PHASE 3
	FLUSH WALL MOUNTED LIGHTING CONTROL SWITCH CONTROLLING OUTLET "a". 'K' WHERE USED INDICATES KEY SWITCH.	142 PEEKSKILL HOLLOW RD, PUTNAM VALLEY, NY 10579
	WALL RECESS MOUNTED DUAL TECHNOLOGY VACANCY SENSOR, SIMILAR TO WATTSTOPPER MODEL# DSW-100. MANUAL ON, AUTO OFF.	
	CEILING MOUNTED LOW VOLTAGE, DUAL TECHNOLOGY SENSOR, SIMILAR TO WATTSTOPPER MODEL# DT-300, MANUAL ON, AUTO OFF, WORK WITH LOCAL LOW VOLTAGE MOMENTARY CONTACT WALL SWITCH (LVSW-100). INCLUDE POWER PACKS.	listen imagine build
-	CONDUCTORS IN CONDUIT CONCEALED BY WALL OR CEILING.	KG+D . ARCHITECTS PC
•	HOMERUN TO DESIGNATED PANEL, ARROWHEAD INDICATES SINGLE POLE CIRCUIT. HOMERUN SHALL CONSIST OF $2\#12-3/4$ C U.O.N.	285 MAIN STREET MOUNT KISCO . NEW YORK . 10549 P:914.666.5900 KGDARCHITECTS.COM
6) \	HOMERUN TO DESIGNATED PANEL, NUMBERS IN PARENTHESIS INDICATE MULTIPLE CIRCUIT, I.E. 3—HOTS AND 1—GROUND U.O.N.	nnn
_	EXISTING TO REMAIN	
-	EXISTING TO BE REMOVED	BARILE GALLAGHER & ASSOCIATES
_	NEW	
	125V-2P-3W-20A GROUNDED TYPE, SPECIFICATION GRADE WALL MOUNTED DUPLEX RECEPTACLE HUBBELL #5362.	CONSULTING ENGINEERS 39 MARBLE AVE PLEASANTVILLE, NY 10570 914.328.6060 GENERAL@BGA-ENG.com www.BGA-ENG.com
	20A FLUSH WALL MOUNTED GROUND FAULT INTERRUPTING TYPE DUPLEX RECEPTACLE HUBBELL #GF5362.	NY SED PROJECT CONTROL NO.
	EXISTING ELECTRICAL PANELBOARD.	48-05-03-04-0-004-016
	WALL MOUNTED COMBINATION FIRE ALARM HORN/STROBE DEVICE.	CONSTRUCTION DOCUMENTS
	CEILING MOUNTED IONIZATION TYPE SMOKE DETECTOR	
	WALL MOUNTED FIRE ALARM STROBE LIGHT.	
	CEILING MOUNTED PA SPEAKERS. PROVIDE CAT6 CABLE FROM DEVICE TO NEAREST IDF CLOSET AND TERMINATE INTO PATCH PANEL	
	TAG SYMBOL. NUMERAL DENOTES REFERENCE TO A WORK NOTE.	
נ	SURFACE MOUNTED WIREMOLD V700 FOR RECEPTACLE AND/OR COMMUNICATION WIRING. REFER TO DRAWINGS FOR ADDITIONAL INFORMATION.	
	MECHANICAL EQUIPMENT IDENTIFICATION:	
	——————————————————————————————————————	
	DETAIL/PART PLAN NUMBER IDENTIFICATION:	
/ /	DETAIL/PART PLAN NUMBER DRAWING NUMBER	

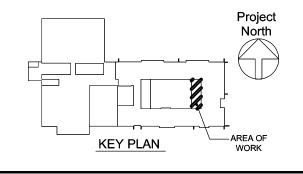

PUTNAM VALLEY

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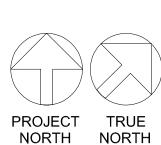
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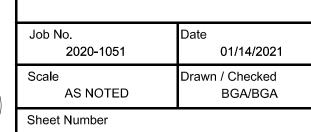
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1	11/19/21	CONSTRUCTION DOCUMENTS P		
No.	Date	Issue		
Sheet Title				


LEGEND, NOTES, **ABBREVIATIONS**






E001

OF ALL OTHER CONTRACTORS

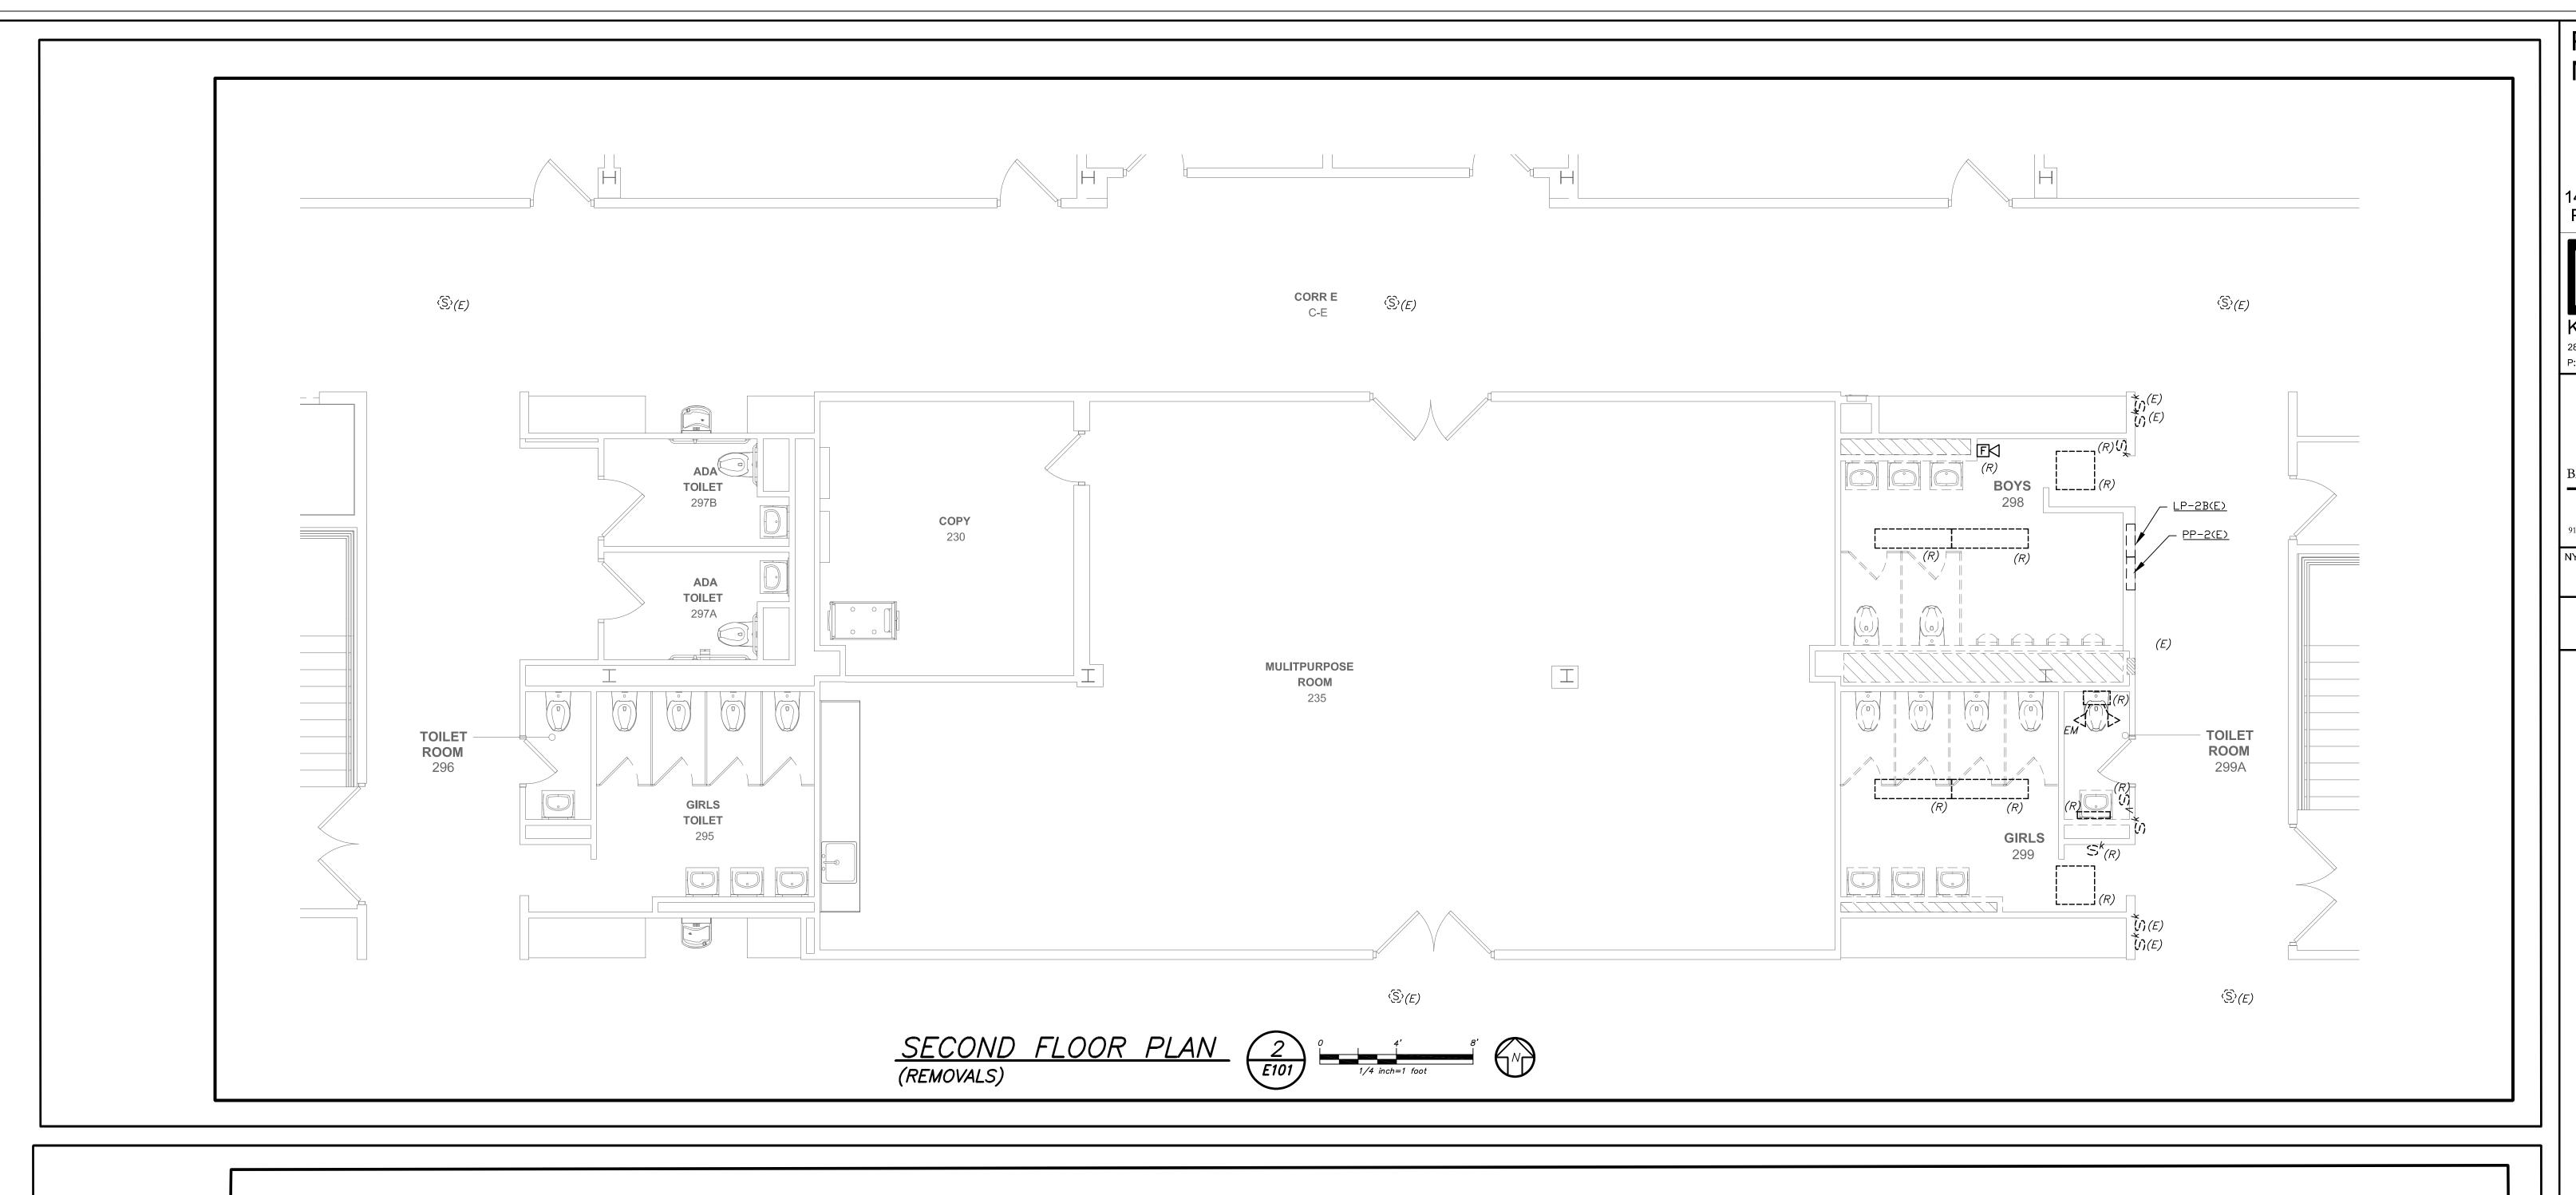

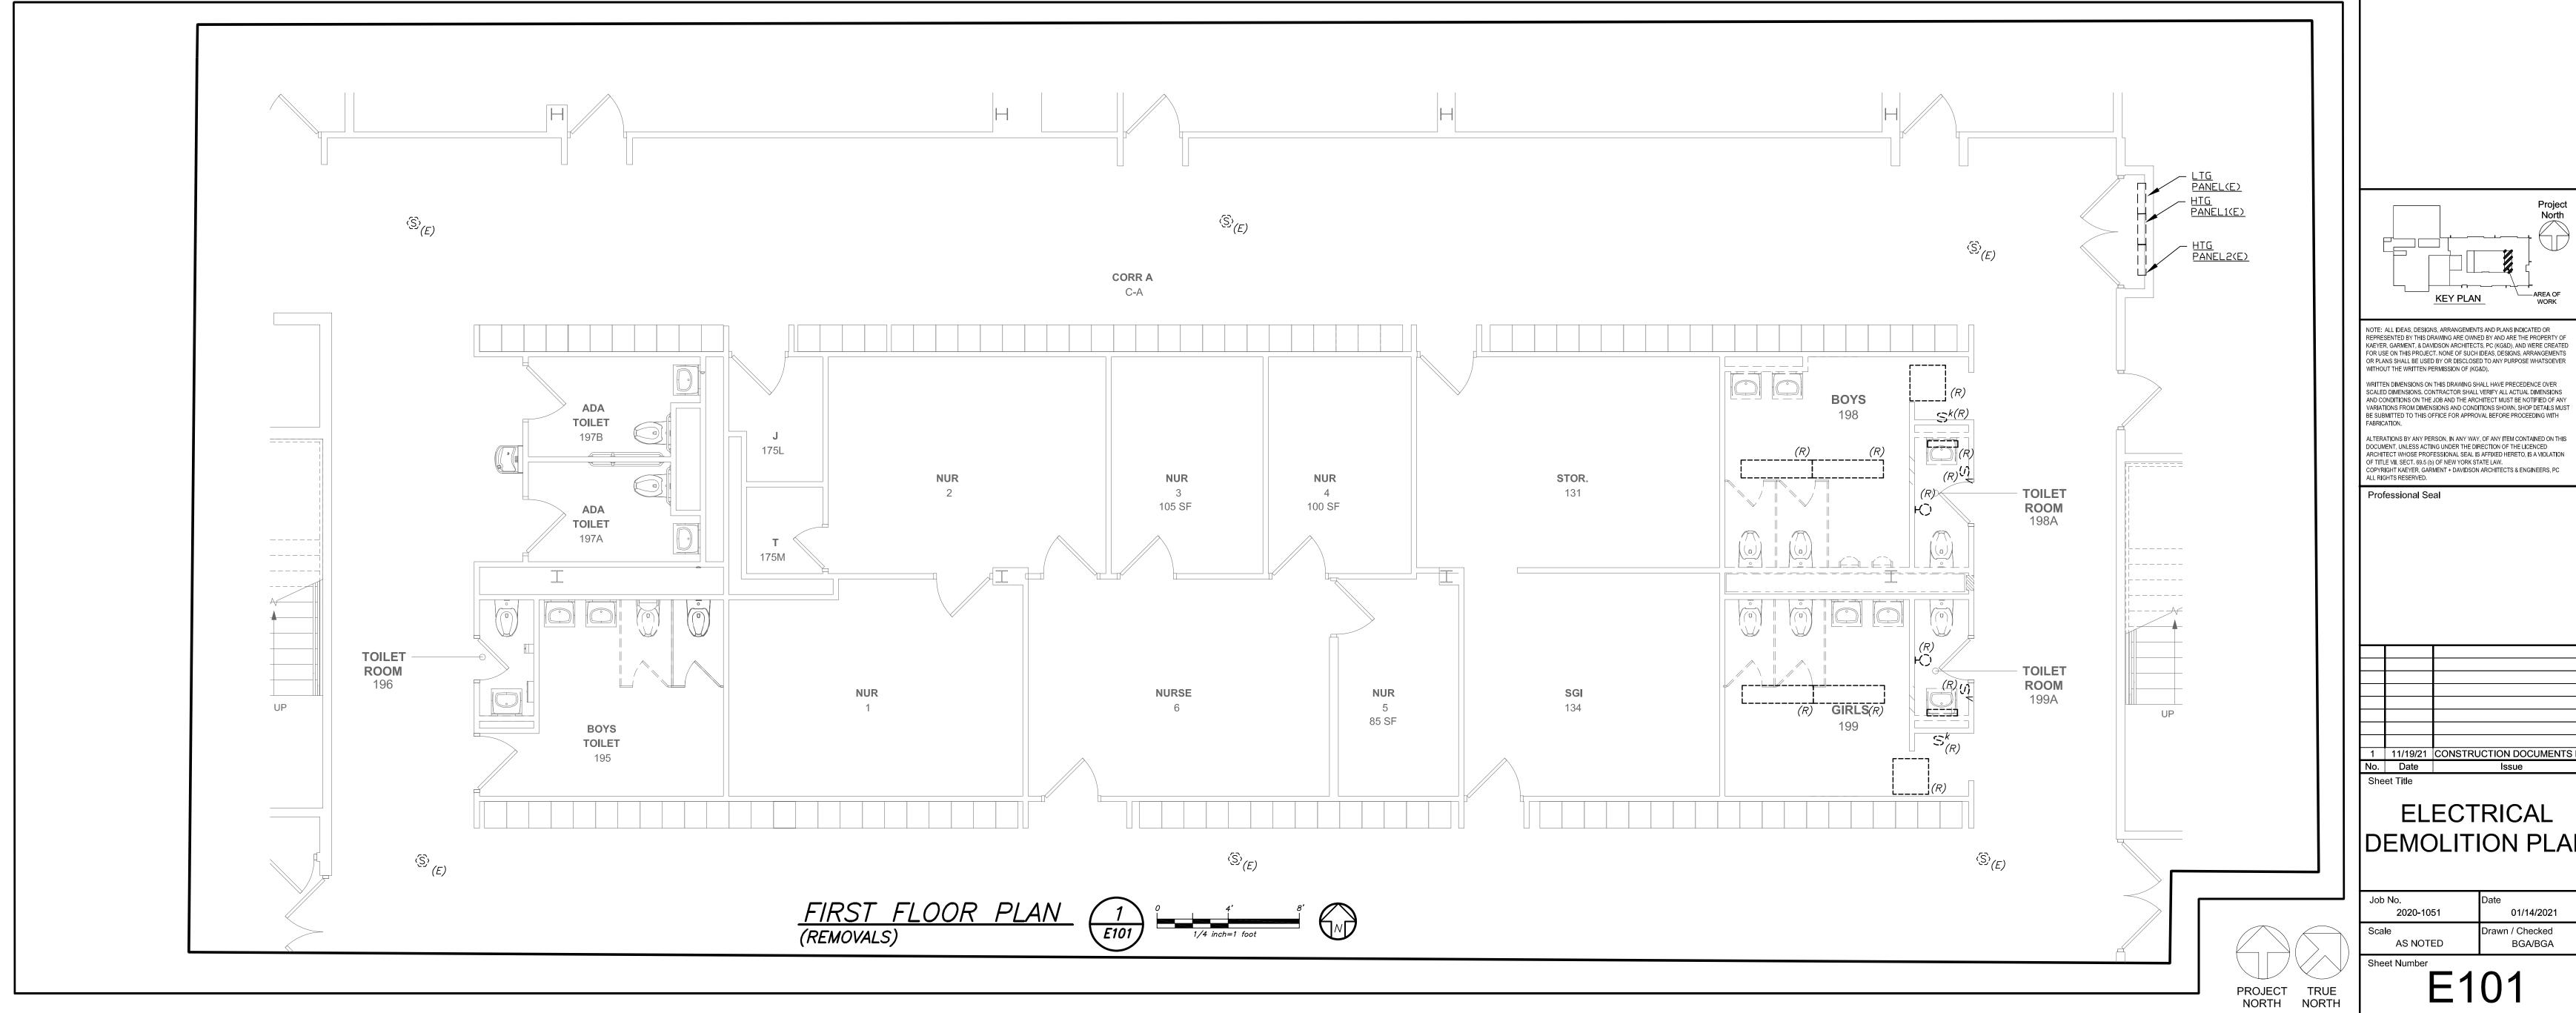

BEFORE FABRICATION THIS CONTRACTOR SHALL VERIFY ALL MEASUREMENTS AND CONDITIONS ON JOB AND COORDINATE HIS WORK WITH THE WORK OF ALL OTHER CONTRACTORS

PUTNAM VALLEY MIDDLE SCHOOL TOILET ROOM **ALTERATIONS**

2018 CAPITAL PROJECTS PHASE 3 142 PEEKSKILL HOLLOW RD, PUTNAM VALLEY, NY 10579



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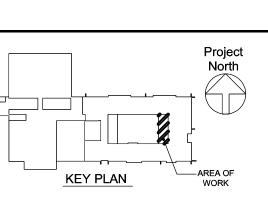


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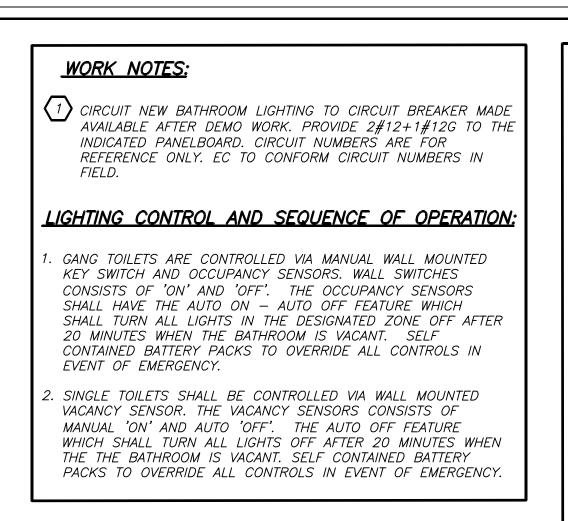
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ELECTRICAL DEMOLITION PLAN


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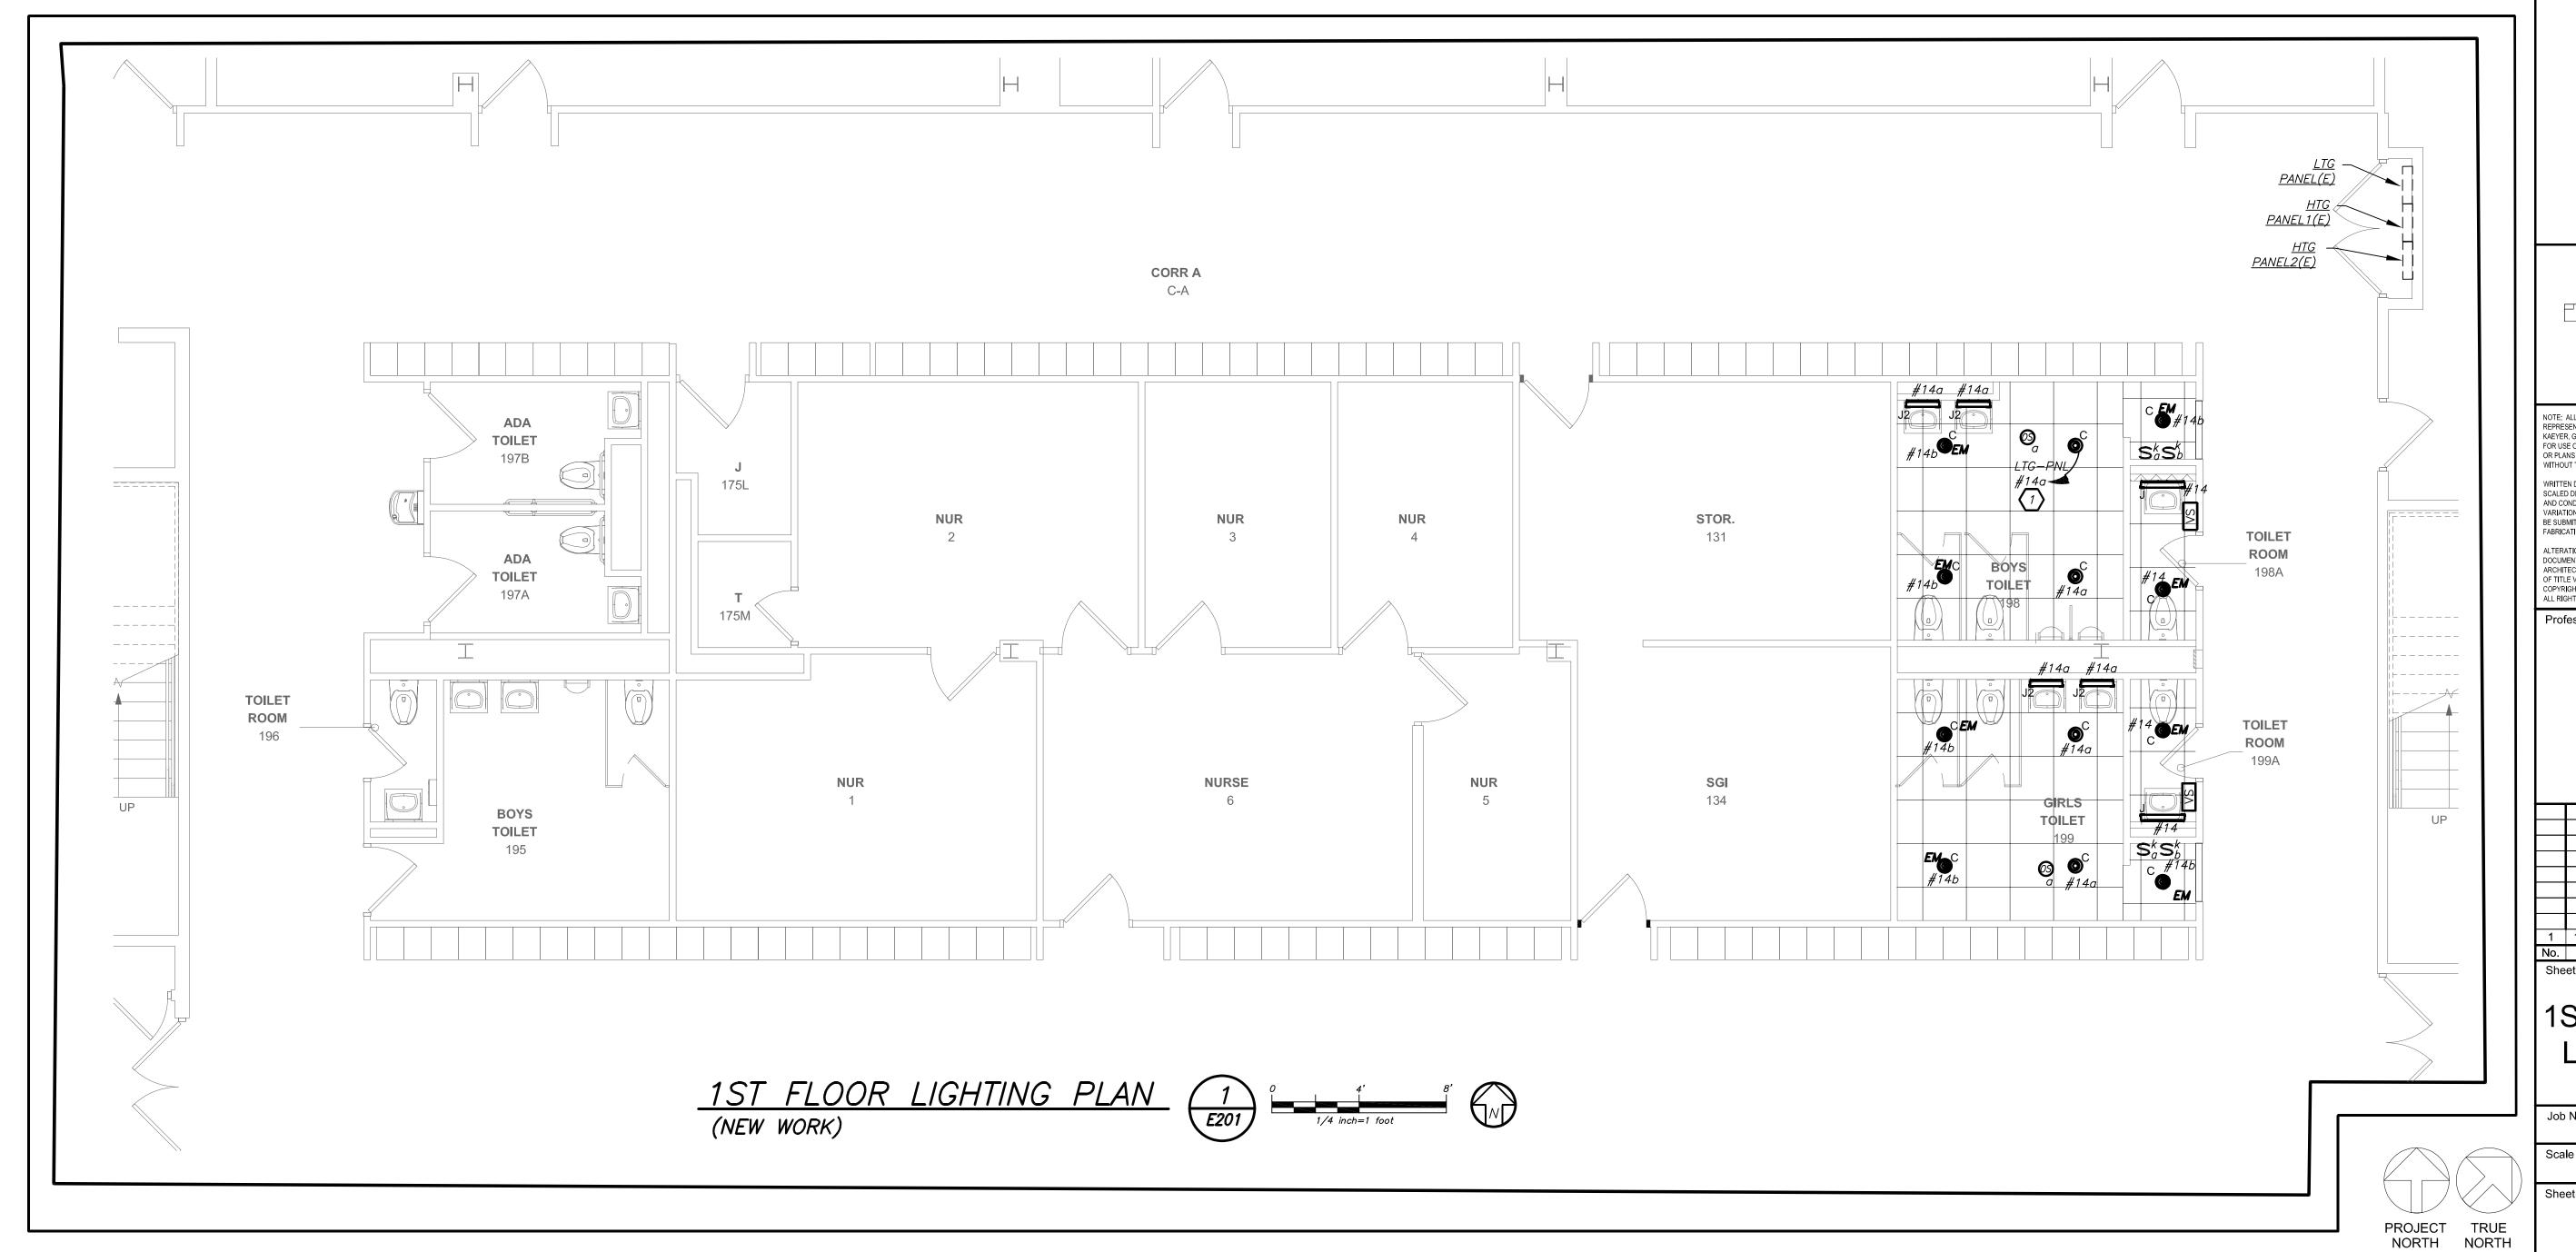
E101



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PUTNAM VALLEY
MIDDLE SCHOOL
TOILET ROOM
ALTERATIONS
2018 CAPITAL PROJECTS

142 PEEKSKILL HOLLOW RD, PUTNAM VALLEY, NY 10579 listen imagine



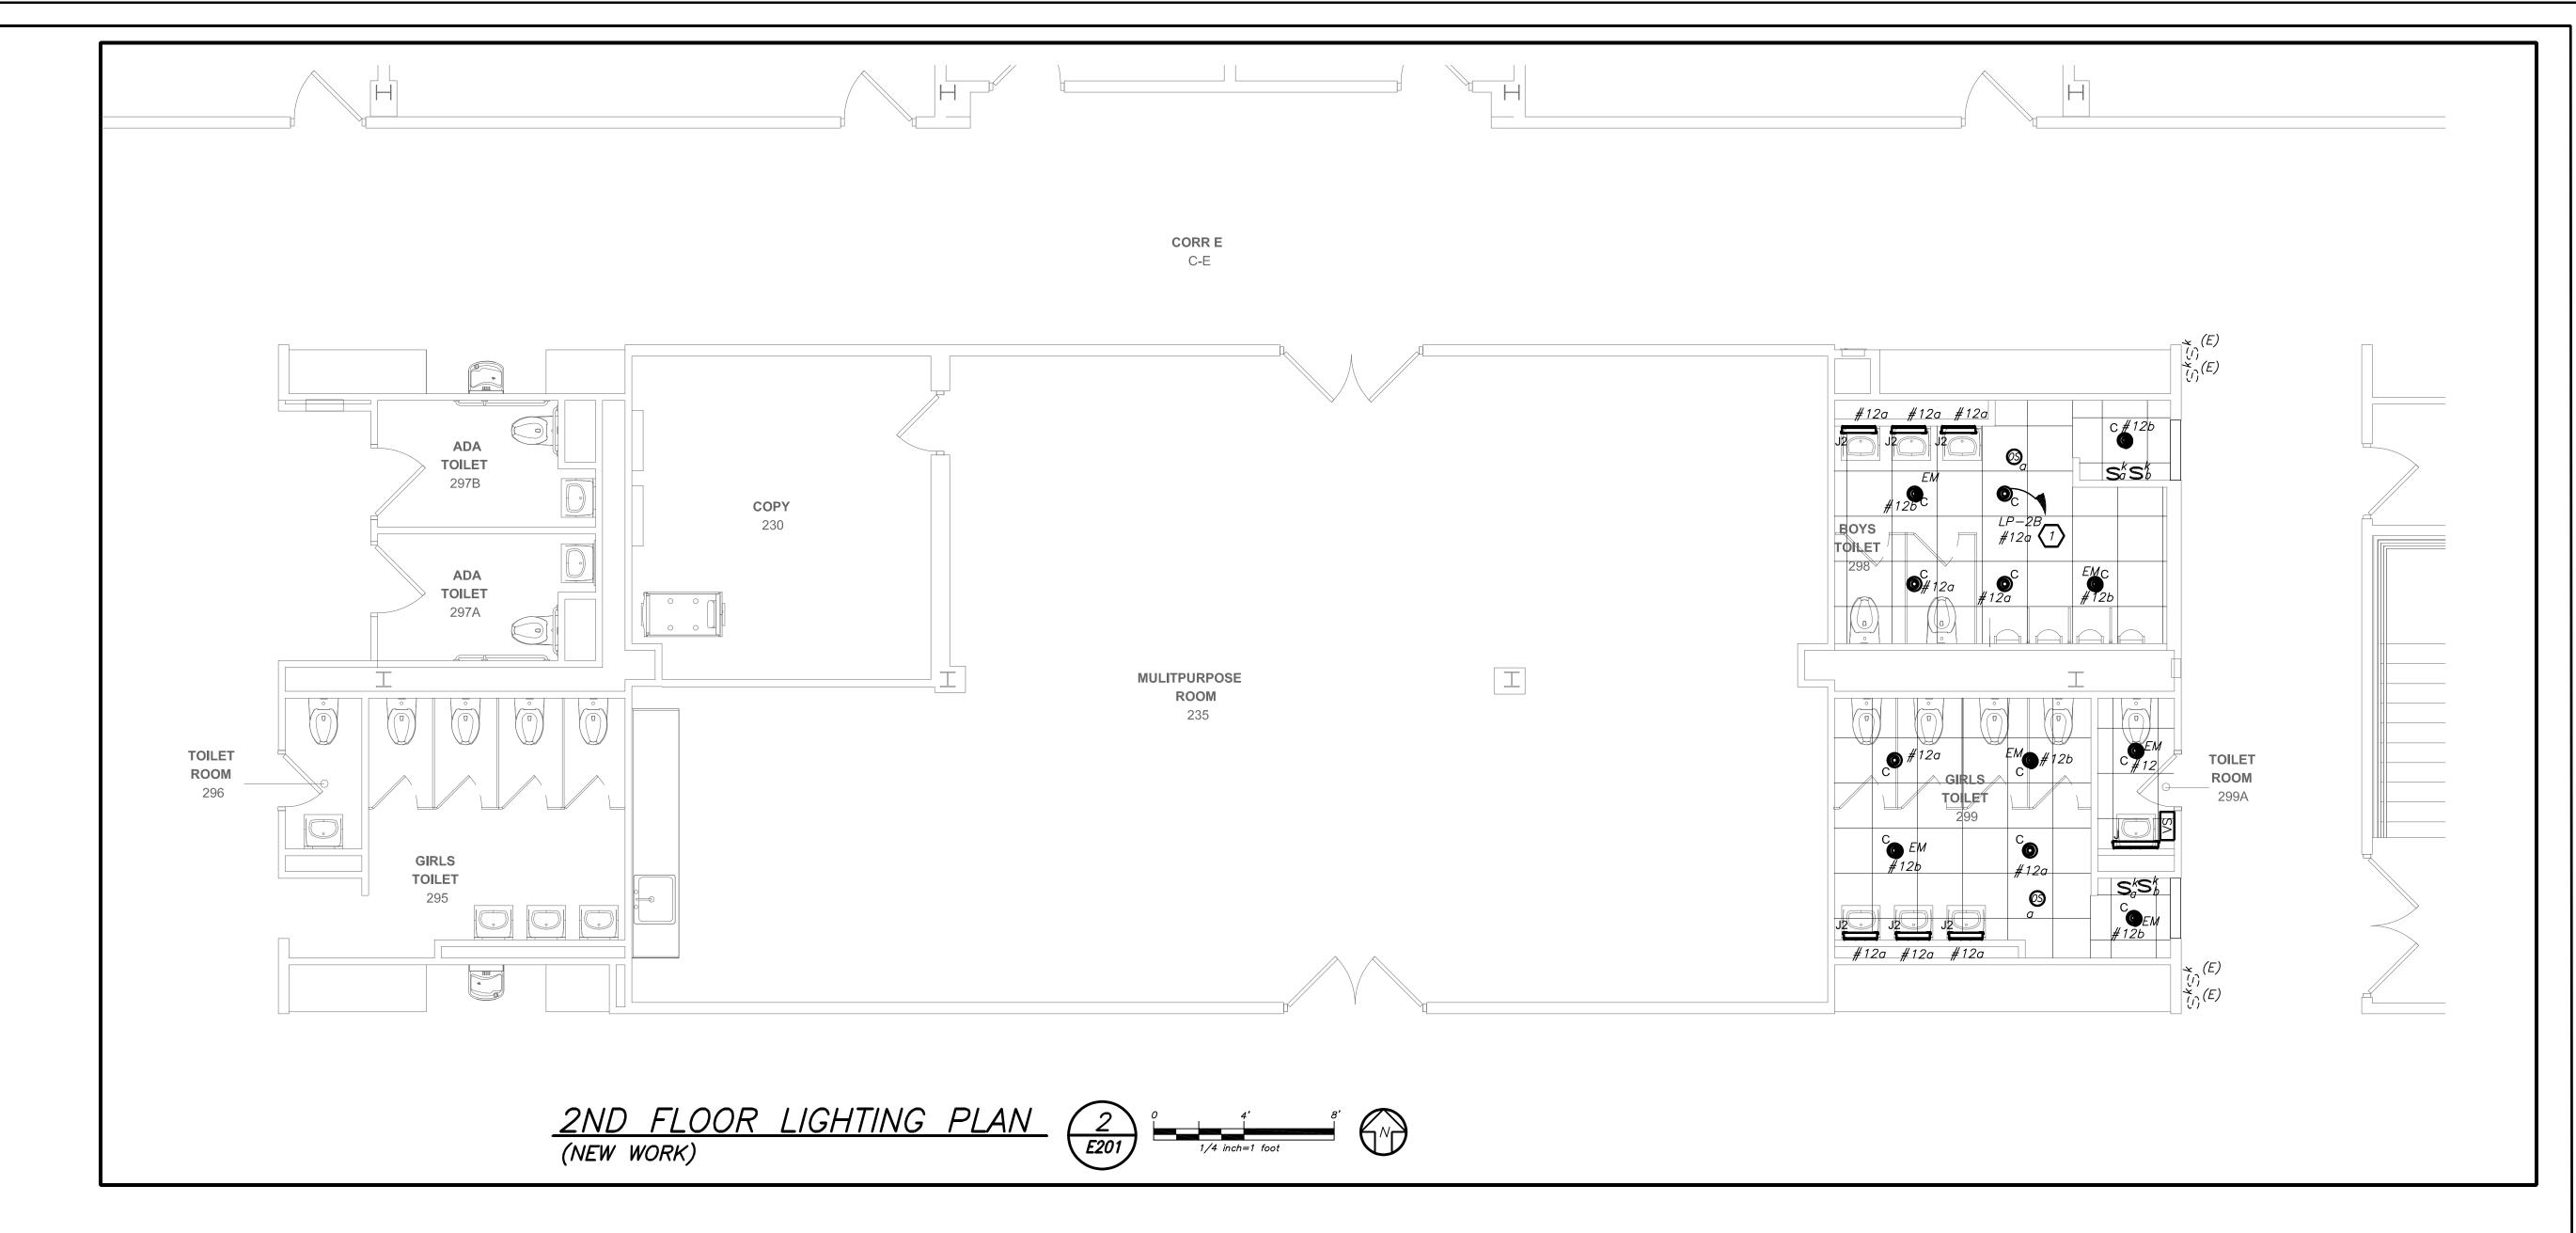


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1 11/19/21 CONSTRUCTION DOCUMENTS P3
No. Date Issue

1ST & 2ND FLOOR LIGHTING PLAN

Job No.

2020-1051

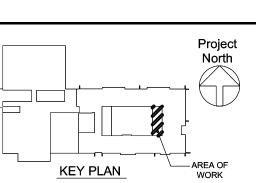Scale

AS NOTED


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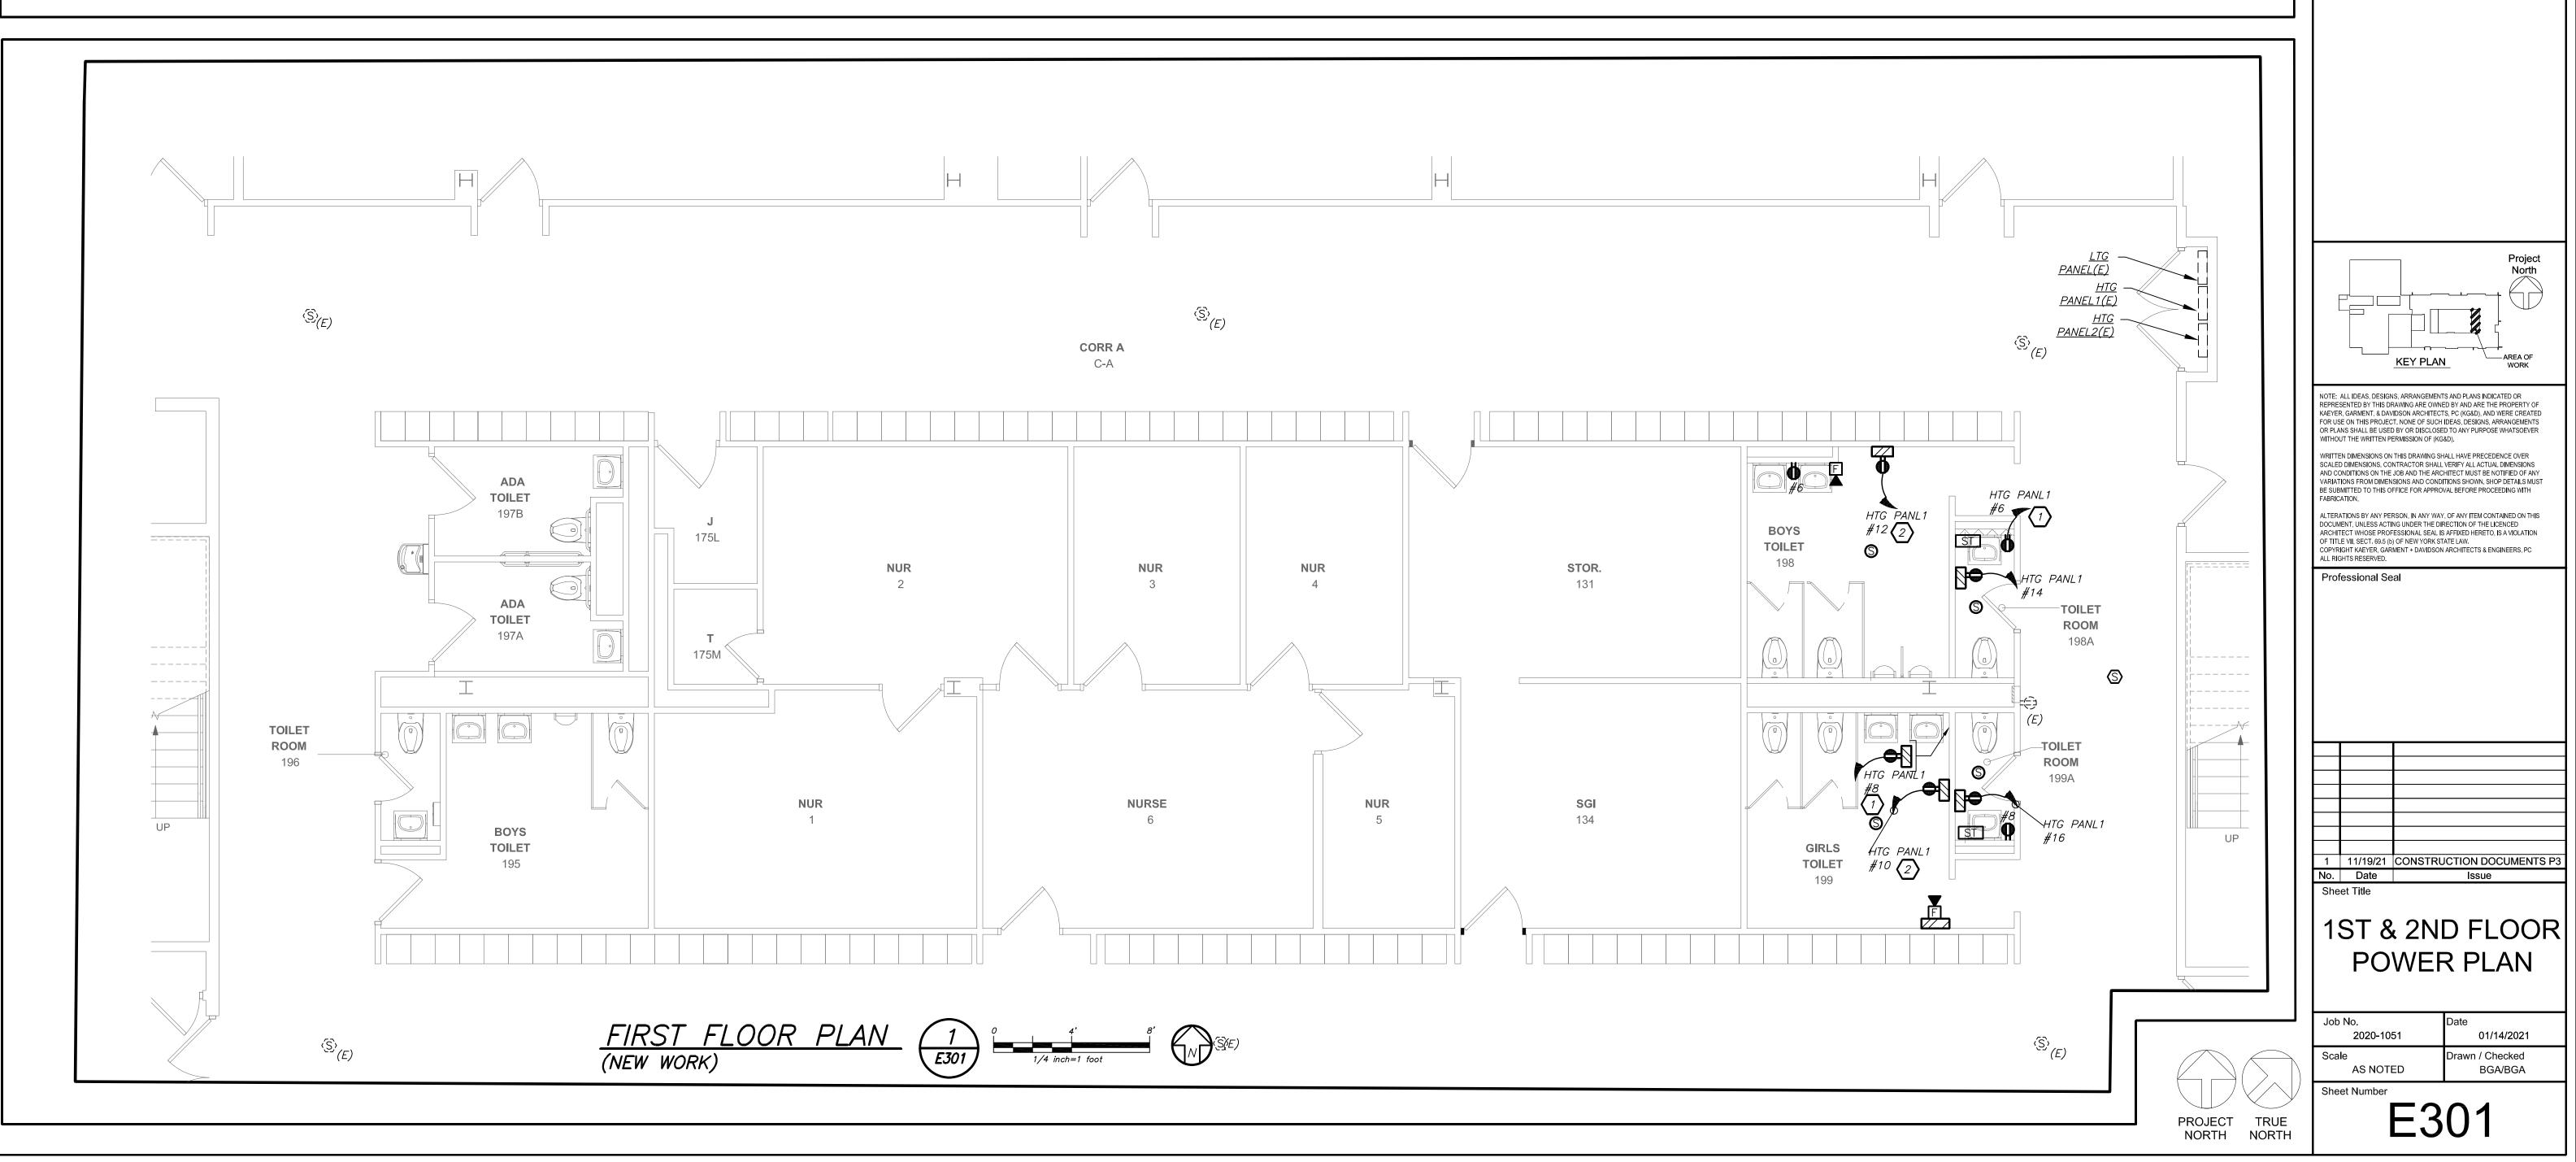


WORK NOTES:

START OF ANY WORK

BEFORE FABRICATION THIS CONTRACTOR SHALL VERIFY ALL MEASUREMENTS AND CONDITIONS ON JOB AND COORDINATE HIS WORK WITH THE WORK OF ALL OTHER CONTRACTORS

2) CIRCUIT FOR ELECTRIC HAND DRYER. PROVIDE

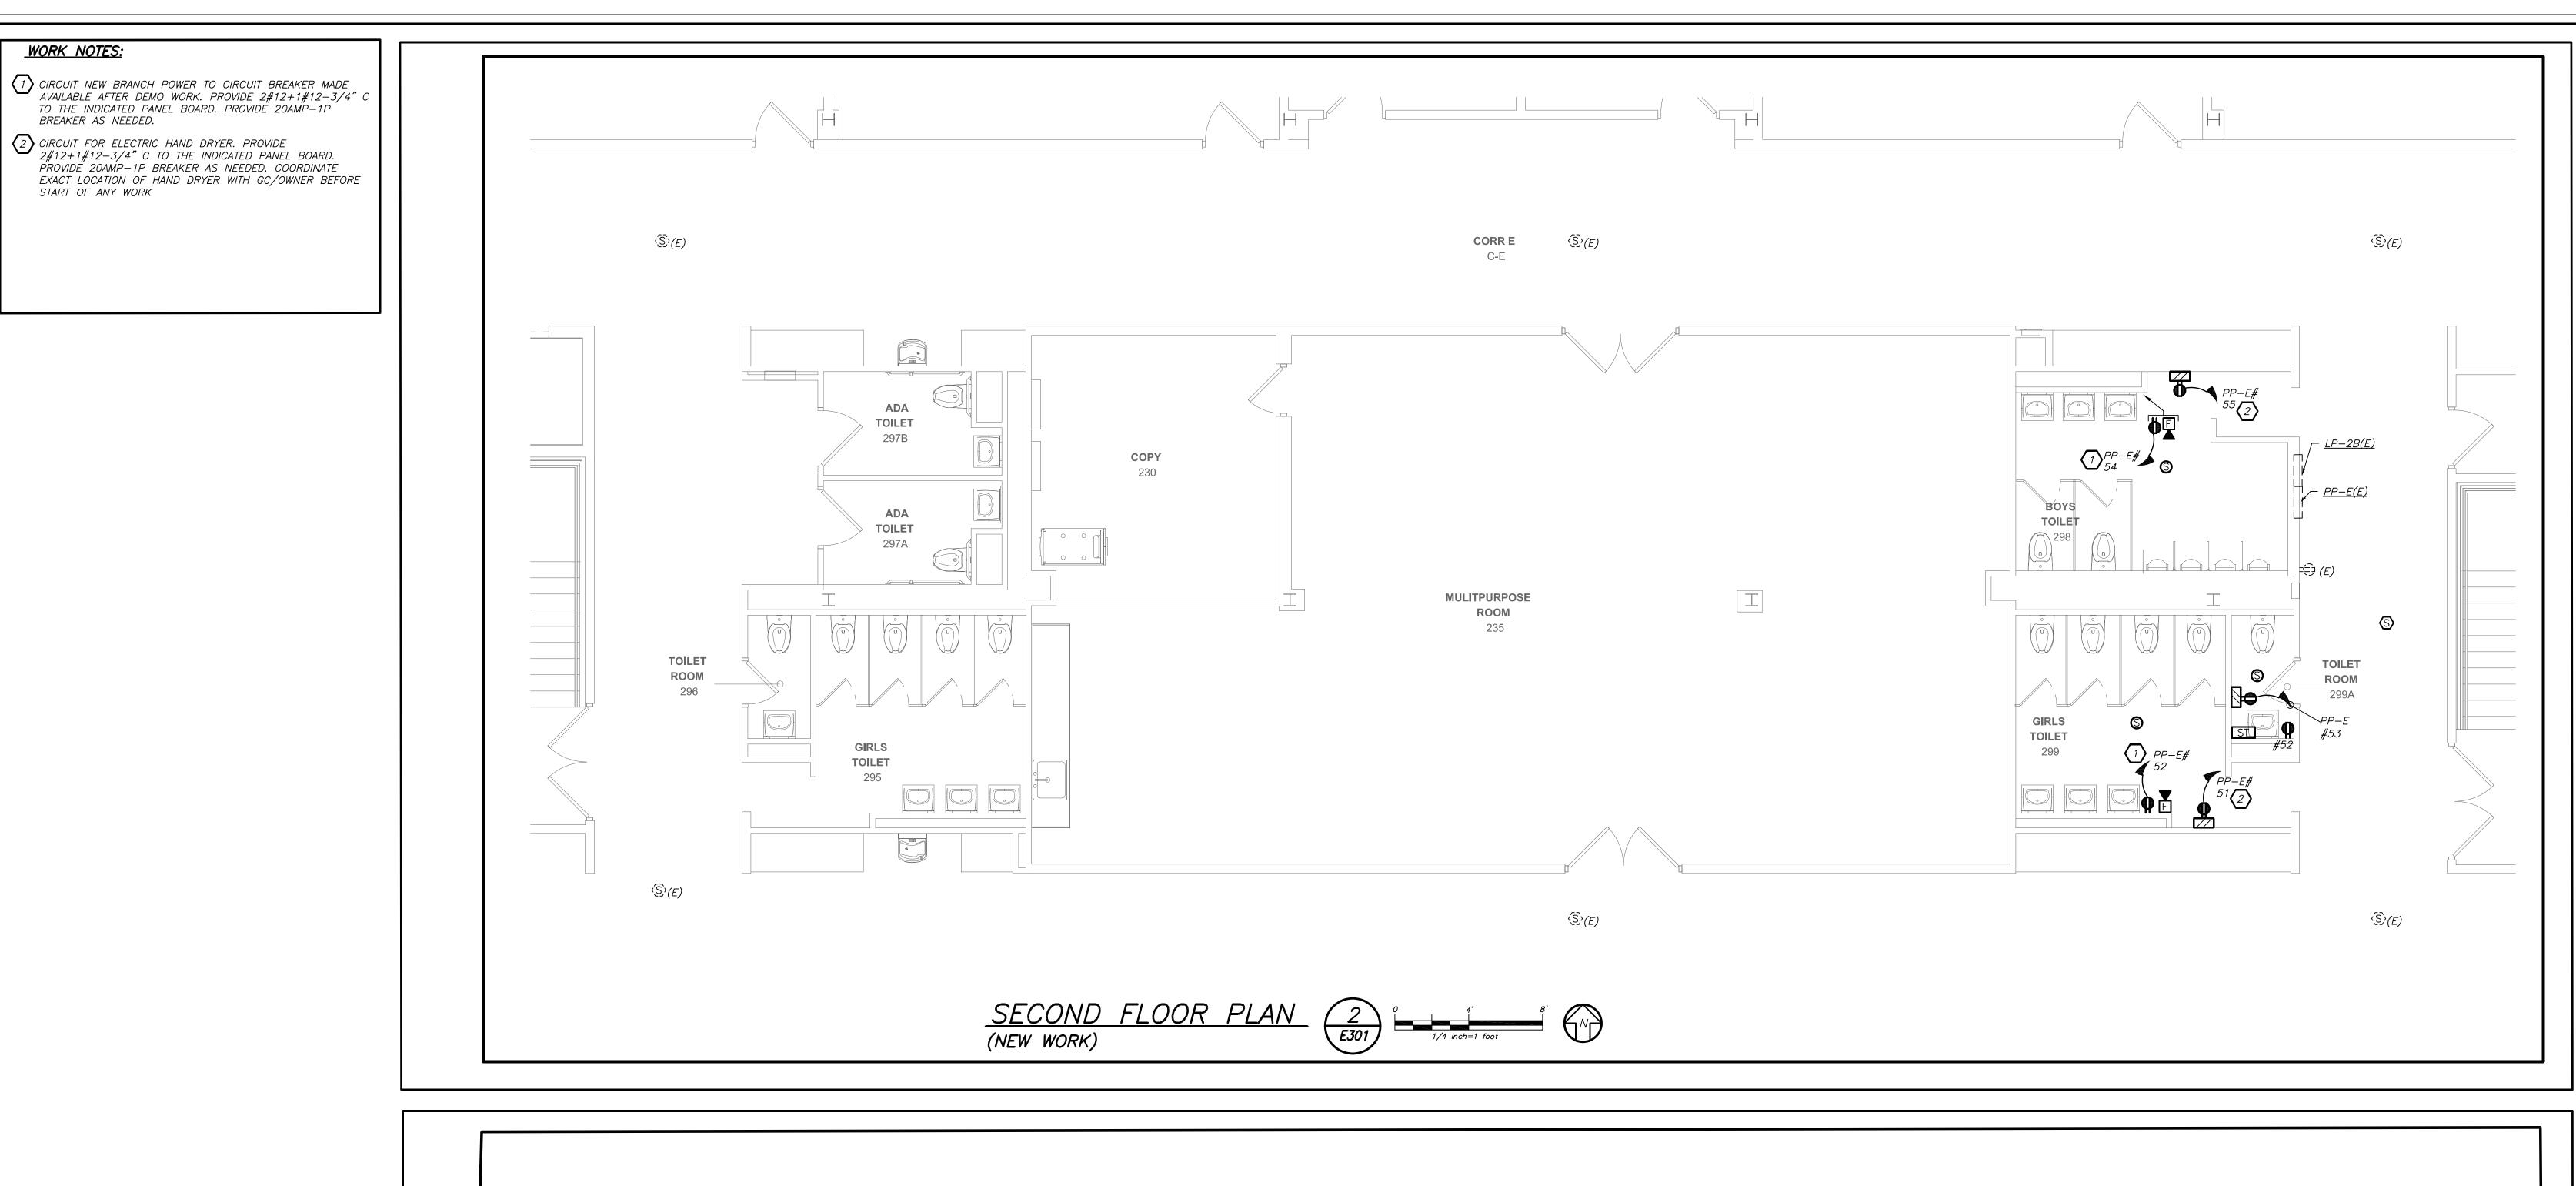

PUTNAM VALLEY MIDDLE SCHOOL **TOILET ROOM** ALTERATIONS

2018 CAPITAL PROJECTS PHASE 3 142 PEEKSKILL HOLLOW RD,

PUTNAM VALLEY, NY 10579





BARILE GALLAGHER & ASSOCIATES

CONSULTING ENGINEERS 39 MARBLE AVE PLEASANTVILLE, NY 10570 914.328.6060 GENERAL@BGA-ENG.com www.BGA-ENG.com

48-05-03-04-0-004-016

NY SED PROJECT CONTROL NO.

CONSTRUCTION DOCUMENTS

FIRE ALARM RISER GENERAL NOTES:


- 1. FIRE ALARM WIRING DIAGRAMS SHOWN ARE FOR GENERAL ARRANGEMENT ONLY. ELECTRICAL CONTRACTOR SHALL VERIFY AND OBTAIN POINT TO POINT WIRING DIAGRAM PRIOR TO INSTALLATION FROM MANUFACTURER.
- 2. PERMITS AND APPROVALS NECESSARY FOR INSTALLATION OF THE WORK SHALL BE OBTAINED PRIOR TO THE COMMENCEMENT OF THE WORK. ALL PERMIT COSTS AND INSPECTION FEES SHALL BE INCLUDED AS PART OF
- 3. IN AREAS WHERE DUST AND DIRT WILL BE AIRBORNE DURING DEMOLITION AND CONSTRUCTION THE CONTRACTOR SHALL PROVIDE PLASTIC WRAP OVER SMOKE DETECTORS AND THEN REMOVE ONCE SPACE IS CLEAN.
- 4. UNLESS DIRECTED OTHERWISE BY FIRE ALARM SYSTEM MANUFACTURER FIRE ALARM DEVICE WIRING SHALL BE AS FOLLOWS (FOR BIDDING PURPOSES ONLY):

HORN WIRING - #16 AWG TWISTED STROBE WIRING - "#14 AWG TWISTED SIGNAL WIRING — #14 AWG TWISTED/SHIELDED

THE WIRING SHALL HAVE THE FOLLOWING CHARACTERISTICS: A. A MINIMUM TEMPERATURE RATING OF 150 C

THE COLOR OF THE CABLE SHALL BE RED

- B. A MINIMUM AVERAGE INSULATION THICKNESS OF 15 MILS A MINIMUM AVERAGE JACKET THICKNESS OF 25 MILS
- E. THE CABLE SHALL BE A TYPE FPLP (PLENUM TYPE) WHEN CONDUIT IS USED. SEE NOTE 5 FOR ADDITIONAL CLARIFICATION. F. THE CABLE SHALL BE VISIBLY MARKED EXTERNALLY THAT IT MEETS THE ABOVE REQUIREMENTS AND IS LISTED BY UL.
- CONFIRM WIRING TYPE AND QUANTITY WITH FIRE ALARM SYSTEM MANUFACTURER PRIOR TO PURCHASING.
- PROVIDE MC FIRE ALARM CABLE WITH RED STRIPE AS MANUFACTURED BY AFC SERIES 1800 WHEN CABLE IS CONCEALED OR ABOVE HUNG CEILING. WHEN FIRE ALARM CABLE IS RUN EXPOSED IN FINISHED AREAS, CABLE SHALL RUN IN WIREMOLD V-700. WHEN FIRE ALARM CABLE IS RUN EXPOSED IN UNFINISHED AREAS, PROVIDE PLENUM RATED CABLE IN MIN. 3/4" CONDUIT.
- 6. STROBES SHALL HAVE A MINIMUM LIGHT OUTPUT OF 75 CANDELA AND A FLASH RATE OF 1−3 HZ.
- 7. WALL MOUNTED HORN/STROBE UNITS SHALL NOT HAVE ANY OTHER DEVICES OR APPURTENANCES WITHIN 5 FEET OF THE DEVICE. THEY SHALL BE A MAXIMUM OF 80 INCHES ABOVE FLOOR OR 6" BELOW THE CEILING, WHICHEVER IS LOWER. DEVICES SHALL BE FLUSH MOUNTED IN ALL FINISHED AREAS. PROVIDE DOUBLE DEEP DEVICE BOX IN WALL.
- 8. SHUTDOWN OF HVAC SYSTEM EQUIPMENT WITH SUPPLY AIR OF 2000 CFM OR GREATER, SEND SIGNAL TO BUILDING AUTOMATED TEMPERATURE CONTROL SYSTEM (ATC) INDICATING SHUTDOWN HAS OCCURRED. EQUIPMENT RESTART SHALL BE BY BUILDING 'ATC' SYSTEM UPON
- FIRE ALARM RESET TO NORMAL MODE. RESTART OF EQUIPMENT SHALL BE SEQUENTIAL. 9. AFTER THE SYSTEM IS COMPLETE, TEST ALL COMPONENTS IN ACCORDANCE WITH SEQUENCE OF OPERATION PRIOR TO FIRE DEPARTMENT INSPECTION.
- 10. ALL PULL STATIONS SHALL BE MOUNTED 48" AFF AND PROVIDED WITH CLEAR PROTECTIVE LEXAN COVER. COVER SHALL BE AS MANUFACTURED BY SAFETY TECHNOLOGY INTERNATIONAL INC. CAT.#STI 1100 STOPPER II.
- 11. ALL DEVICES SHALL BE SUPERVISED AS PER N.F.P.A. 72. PROVIDE END OF LINE RESISTORS AS REQUIRED PER INDIVIDUAL MANUFACTURER. PROVIDE LOAD RELAYS AS REQUIRED FOR PROPER OPERATION OF EQUIPMENT.
- 12. VERIFY EXACT QUANTITY OF DEVICES WITH PLANS. COORDINATE F.A WORK WITH F.A VENDOR.

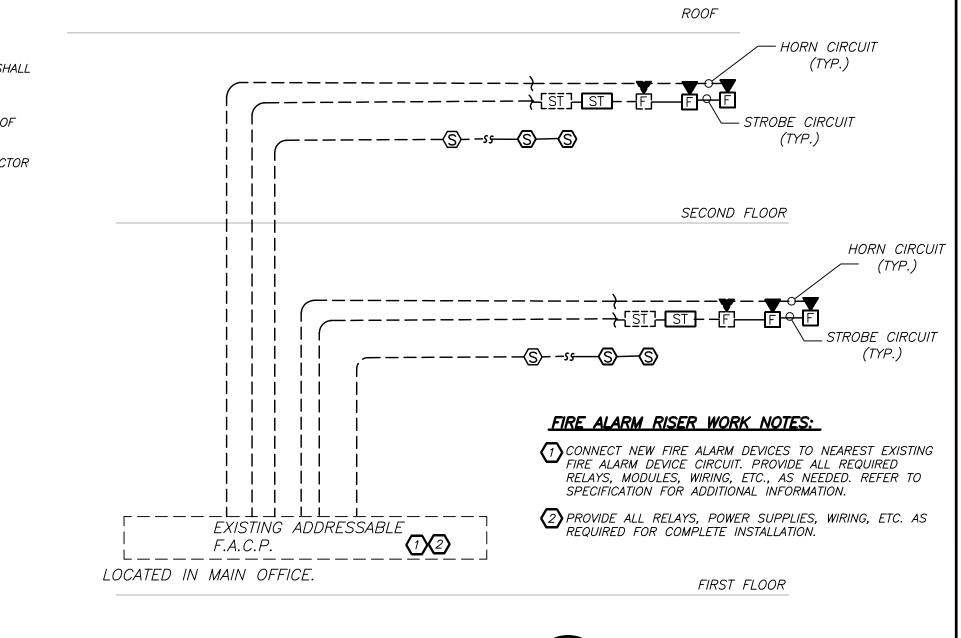



TYPE MOUNTING LAMPS

RECESSED

RECESSED

SURFACE

MOUNTED

SURFACE

MOUNTED

MOUNTED

●EM

19 WATTS

120V

3.4 WATTS

8.4 WATTS

LED 120V

BATTERY PACK.

MOUNTED

LIGHTING FIXTURE SCHEDULE

DESCRIPTION

4" ROUND DOWNLIGHT. 1500 LUMEN OUTPUT,3500K

COLOR TEMP WIDE DISTRIBUTION, SEMI SPECULAR

SAME AS FIXTURE "C" EXCEPT WITH EMERGENCY

24" HORIZONTAL WALL MOUNTED WET LOCATION LED

18" HORIZONTAL WALL MOUNTED WET LOCATION LED

1181 LUMENS, 3500K COLOR TEMP OPAL ACRYLIC

1181 LUMENS, 3500K COLOR TEMP OPAL ACRYLIC

DIFFUSER WITH SATIN PEWTER FINISH. CUSTOM

DIFFUSER WITH SATIN PEWTER FINISH.

MANUFACTURER & CAT.#

LTR-4RD-T-SL-35K-8-WD-SS-WT

LTR-4RD-H-SL15L-DM1-120-EM

LTR-4RD-T-SL-35K-8-WD-SS-WT

MOD 9131-24HM-SP-OA-02-3500K

MOD 9131-18HM-SP-OA-02-3500K


MANUFACTURER: PRESCOLITE

LTR-4RD-H-SL15L-DM1-120


MANUFACTURER: PRESCOLITE


MANUFACTURER: ULTRALIGHT


MANUFACTURER: ULTRALIGHT

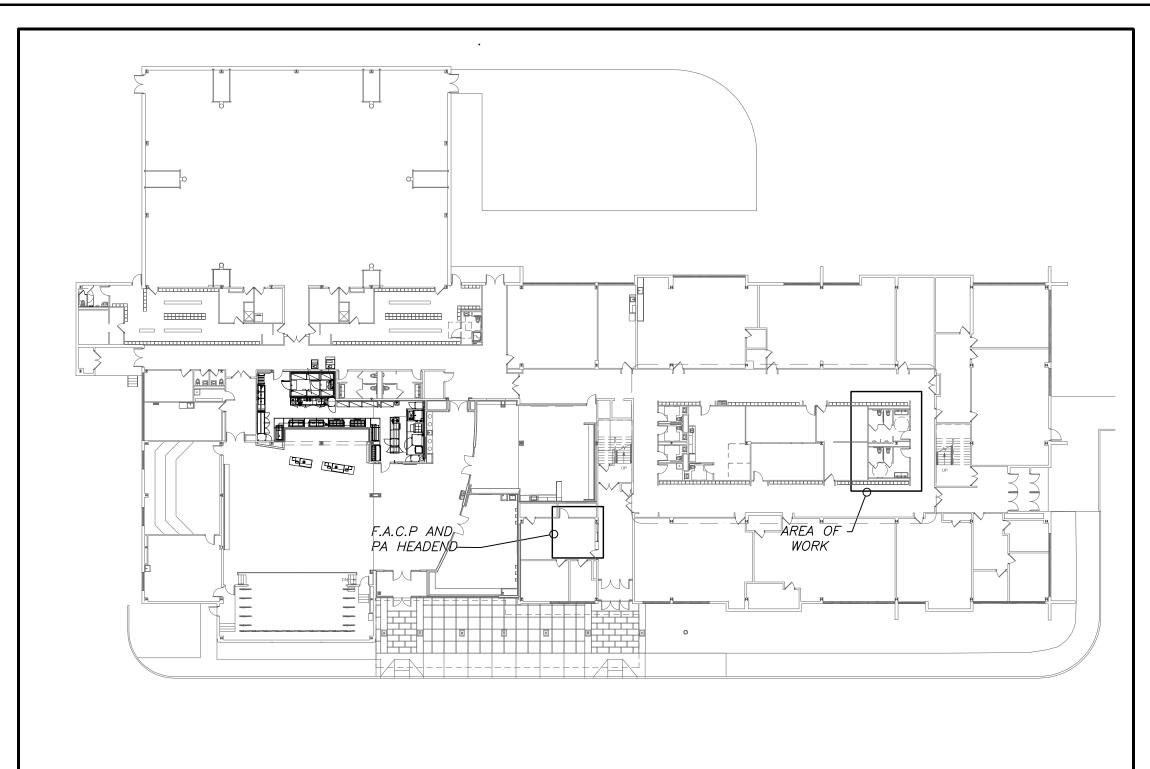





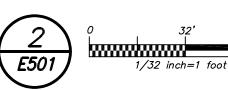

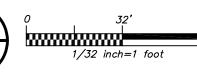


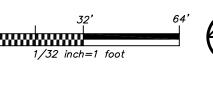

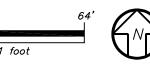

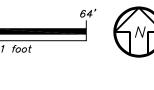



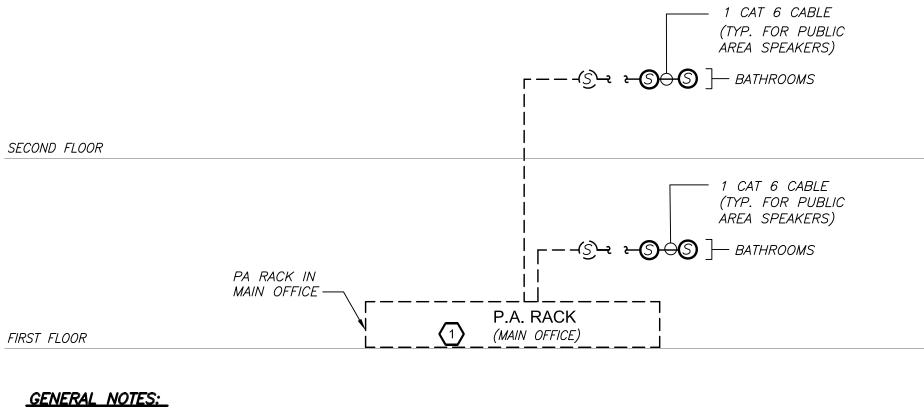



- 1. VERIFY EXACT QUANTITY AND LOCATION OF DEVICES ON PLAN DRAWINGS.
- 2. WIRING TYPES ARE SHOWN FOR REFERENCE ONLY. VERIFY EXACT WIRING REQUIREMENTS WITH MANUFACTURER.
- 3. ALL PROGRAMMING AND FINAL CONNECTIONS TO P.A. SYSTEM RACK SHALL BE BY SYSTEM MAINTENANCE CONTRACTOR. ALL COSTS ASSOCIATED WITH THIS SHALL BE BY ELECTRICAL CONTRACTOR.
- 4. SPEAKERS SHALL MATCH EXISTING TYPE. VERIFY WATTAGE TAP REQUIREMENTS IN FIELD.

WORK NOTES:

PROVIDE NEW ZONE CARD, AMPLIFIER, ETC. AS REQUIRED FOR COMPLETE INSTALLATION. EXISTING SYSTEM IS BOGAN AND IS LOCATED IN THE MAIN OFFICE 138.

PUBLIC ADDRESS SYSTEM RISER

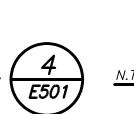

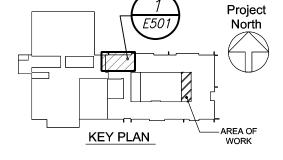

PUTNAM VALLEY

MIDDLE SCHOOL

TOILET ROOM

ALTERATIONS

2018 CAPITAL PROJECTS

142 PEEKSKILL HOLLOW RD,

285 MAIN STREET MOUNT KISCO . NEW YORK . 10549

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CONSTRUCTION DOCUMENTS

NY SED PROJECT CONTROL NO.

KGDARCHITECTS.COM

PUTNAM VALLEY. NY 10579

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RISERS AND LIGHTING SCHEDULE

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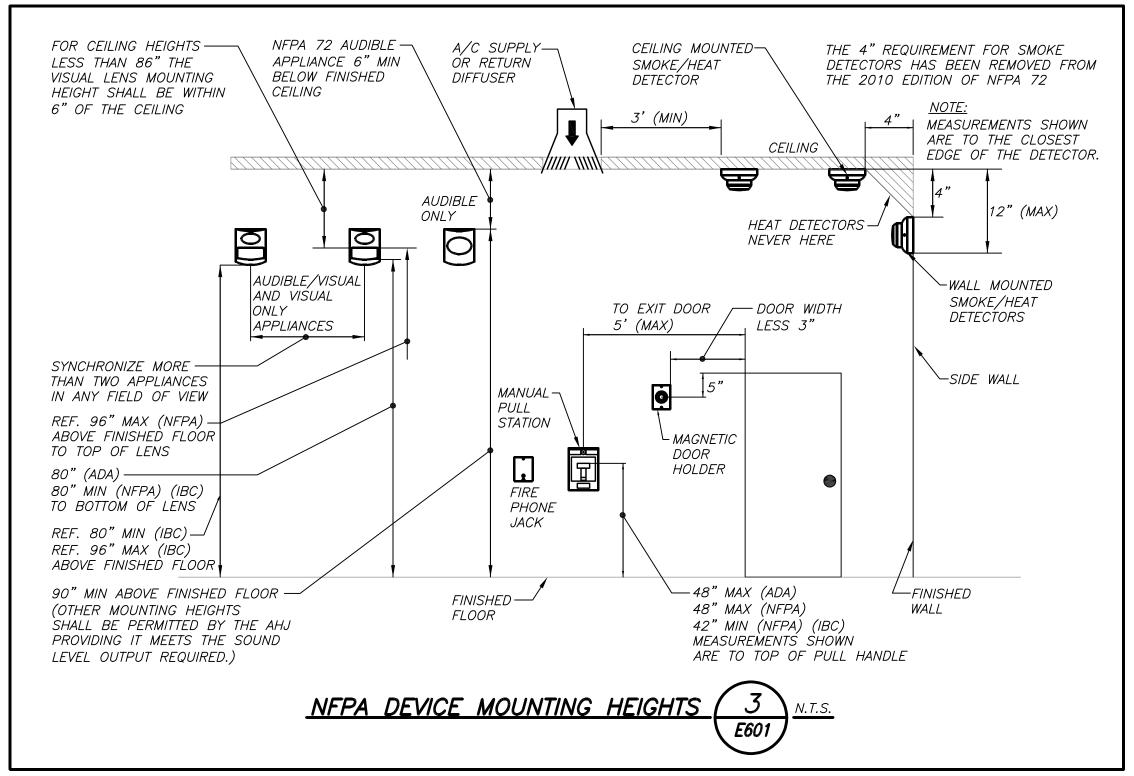
PROJECT TRUE


NORTH


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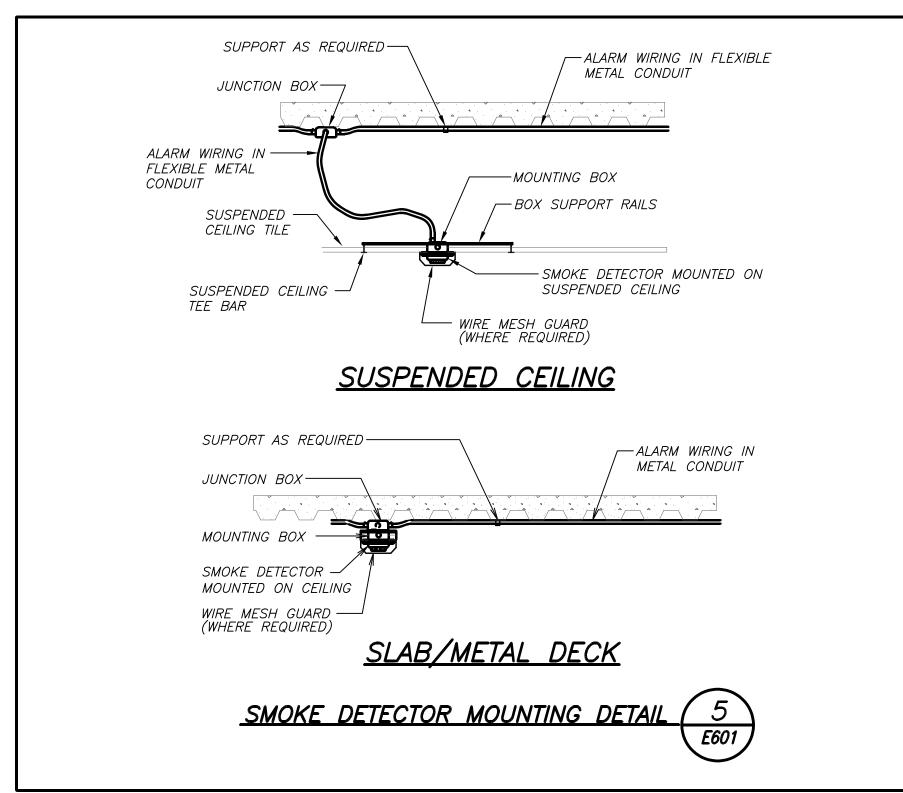
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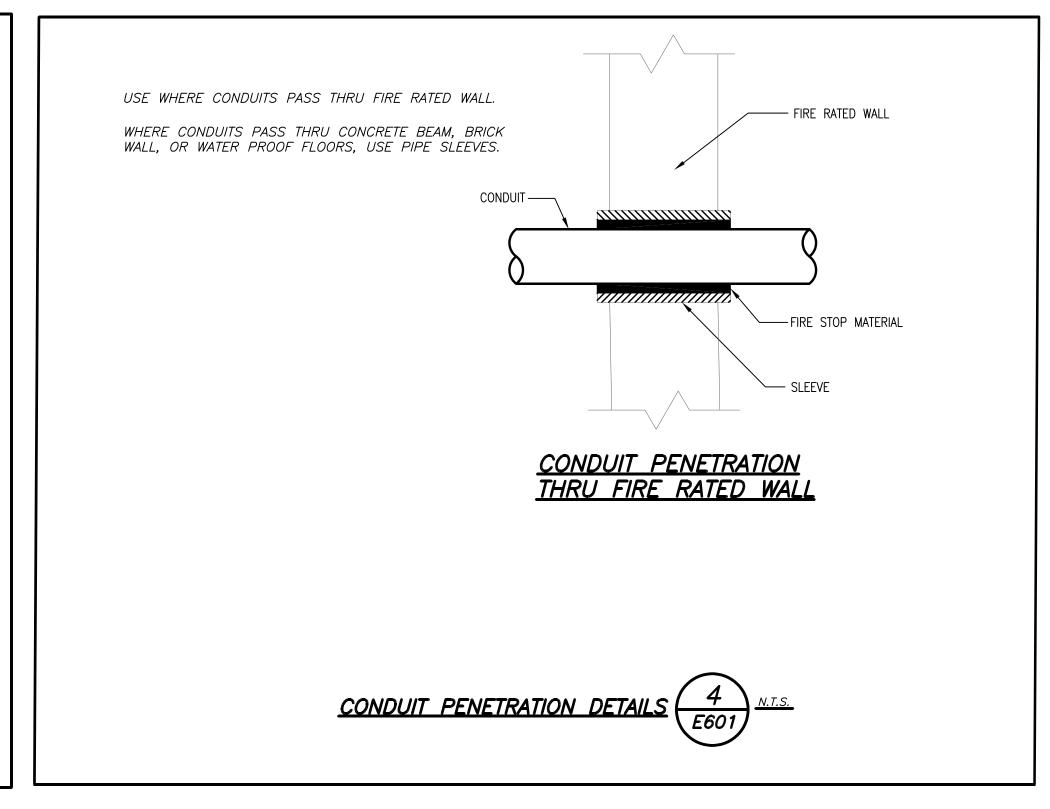
BEFORE FABRICATION THIS CONTRACTOR SHALL VERIFY ALL MEASUREMENTS AND CONDITIONS ON JOB AND COORDINATE HIS WORK WITH THE WORK OF ALL OTHER CONTRACTORS







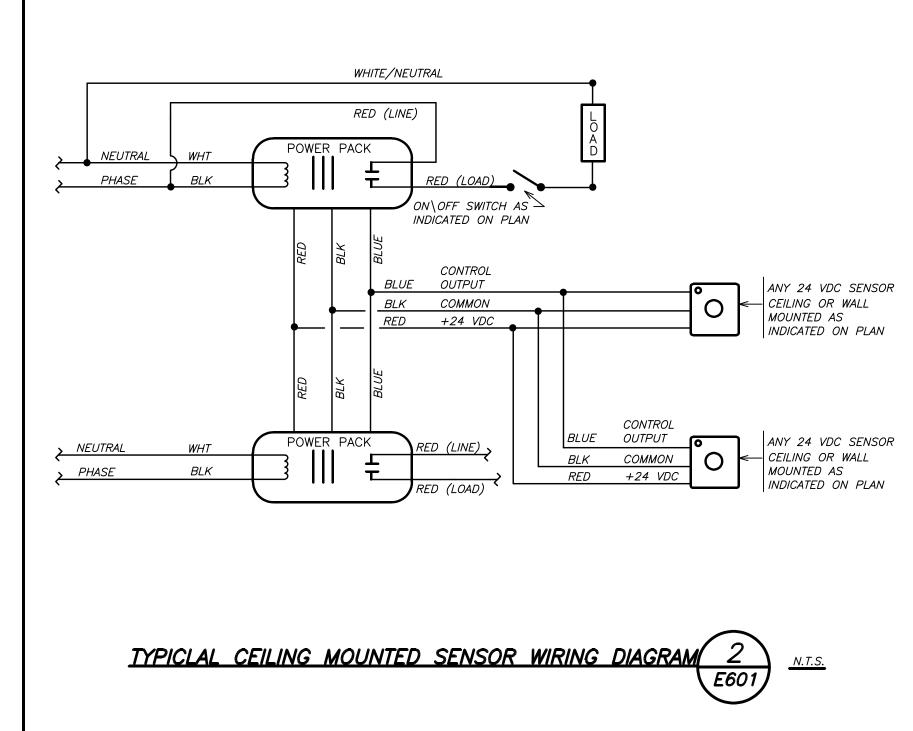

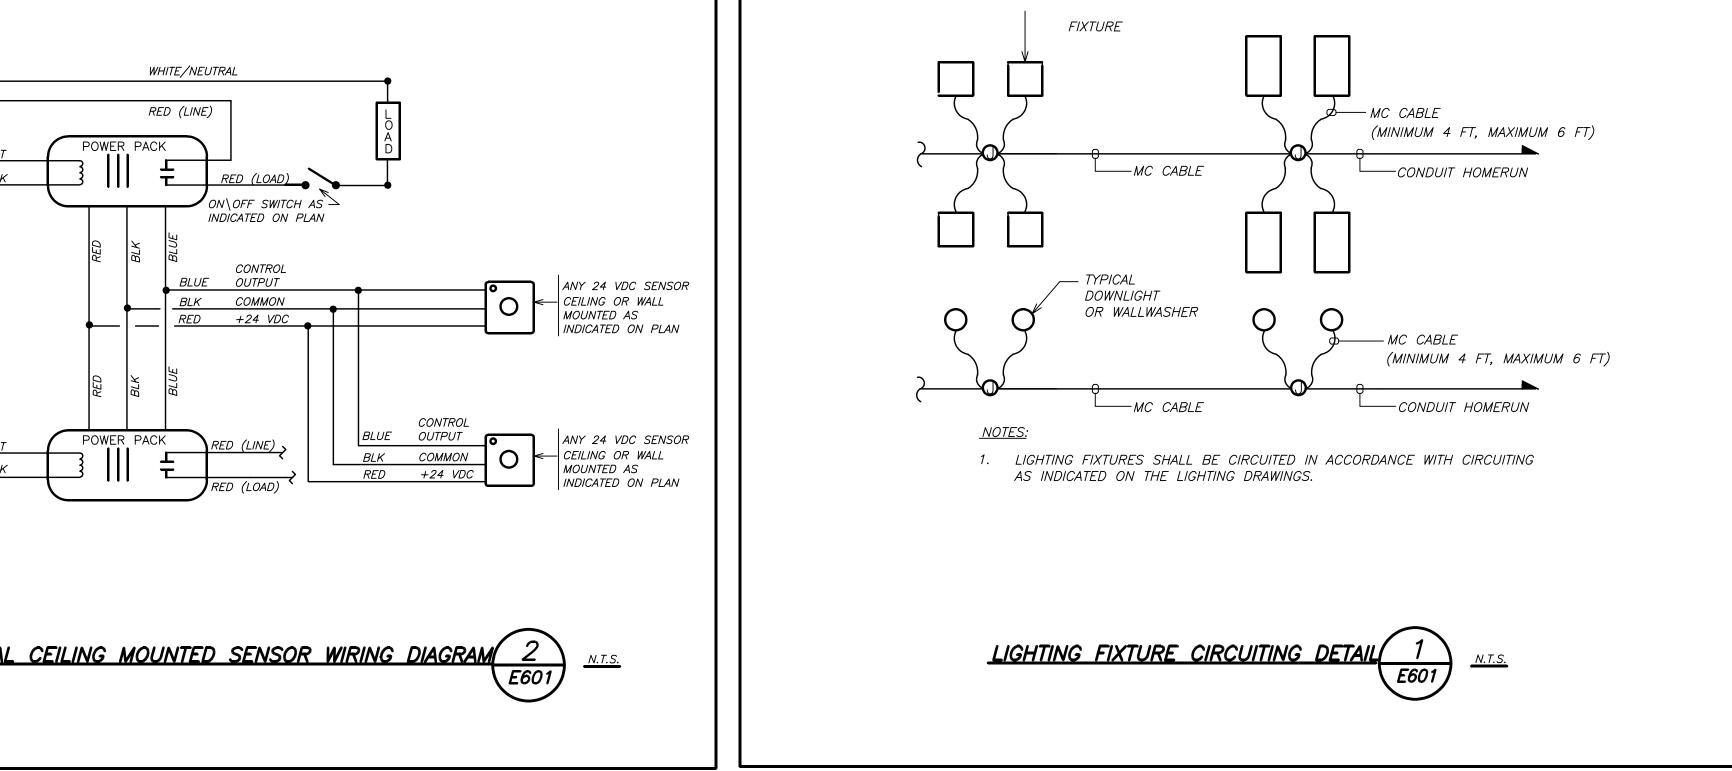



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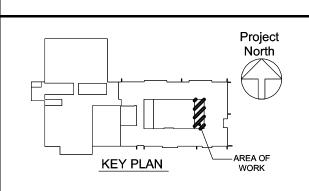


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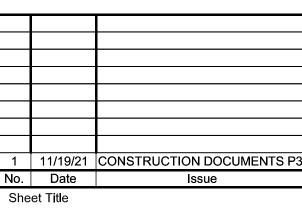


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SCHEDULES AND **DETAILS**

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