




WESTCHESTER COUNTY, NEW YORK DEPARTMENT OF PUBLIC WORKS AND TRANSPORTATION DIVISION OF ENGINEERING

CONTRACT No. 21-514 BOILER REPLACEMENT AND ASSOCIATED WORK VERNON PLAZA FAMILY CENTER 17 SOUTH SECOND AVE MOUNT VERNON, NEW YORK

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JAI PUNNOOSE, P.E. JAI PUNNOOSE, P.E. VINCENT LEONE, P.E.

IN CHARGE OF

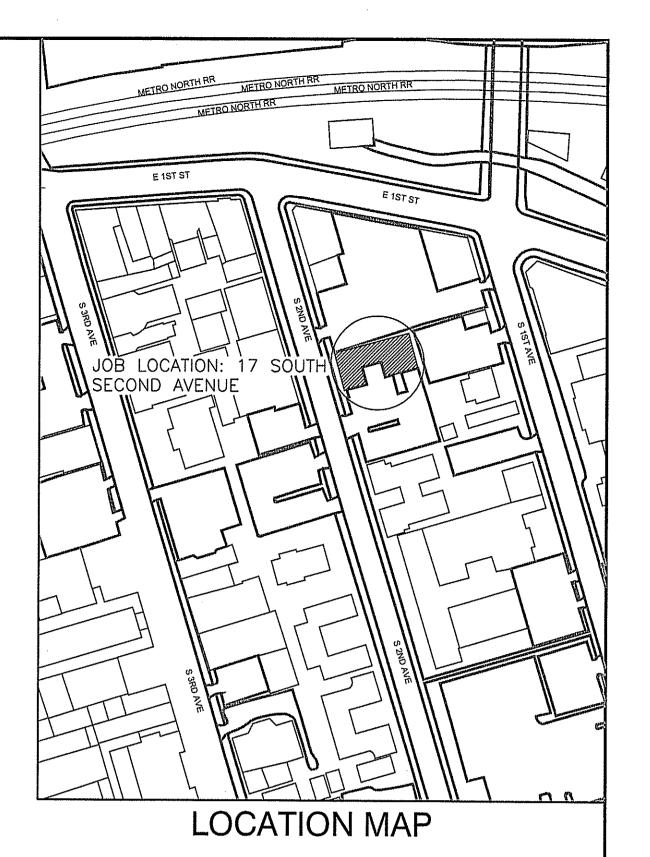CHECKED BY

MADE BY

RECOMMENDED FOR CONSTRUCTION GAYLE M. KATZMAN, P.E. FIRST DEPUTY COMMISSIONER

AND TRANSPORTATION

9 see Gh

DEPARTMENT OF PUBLIC WORKS

E-1

6.4.2021

BOILER ROOM POWER AND LIGHTING PLAN

LEONARD G. TOWNES COMMISSIONER DEPARTMENT OF SOCIAL SERVICES

APPROVED FOR CONSTRUCTION

HUGH J. GREECHAN, JR., P.E. COMMISSIONER DEPARTMENT OF PUBLIC WORKS AND TRANSPORTATION


54-29-E-55

MADE APP'D DATE REVISION RECORD DRAWING CERTIFICATION AS BUILT - CHANGES AS NOTED AS BUILT - NO CHANGES CONTRACTOR PROJECT COORDINATOR NAME _ SIGNATURE DATE ONTRACT APEROVED FOR CONSTRUCTION DATE 21-514 DEPARTMENT OF PUBLIC WORKS AND TRANSPORTATION DIVISION OF ENGINEERING SHEET NO.1 OF SCALE: AS SHOWN BOILER REPLACEMENT AND ASSOCIATED WORK DATE: 06/04/21 VERNON PLAZA FAMILY CENTER DPW FILE NO. 17 SOUTH SECOND AVENUE, VALHALLA CAMPUS, VALHALLA, NEW YORK TITLE SHEET 54-29-T-47


RECOMMENDED FOR DESIGN JAI PUNNOOSE, P.E. ASSOCIATE ENGINEER


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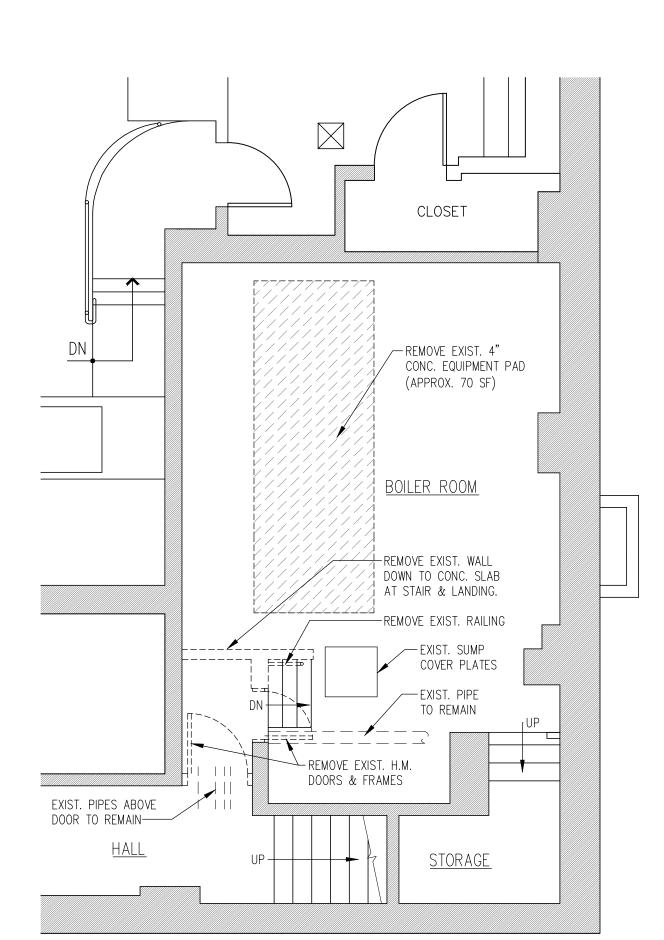


DOOR JAMB DETAIL

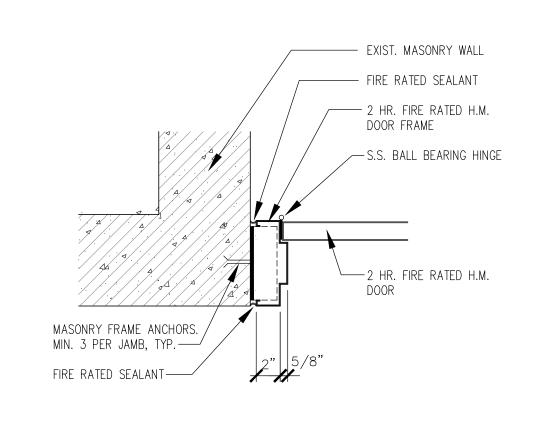


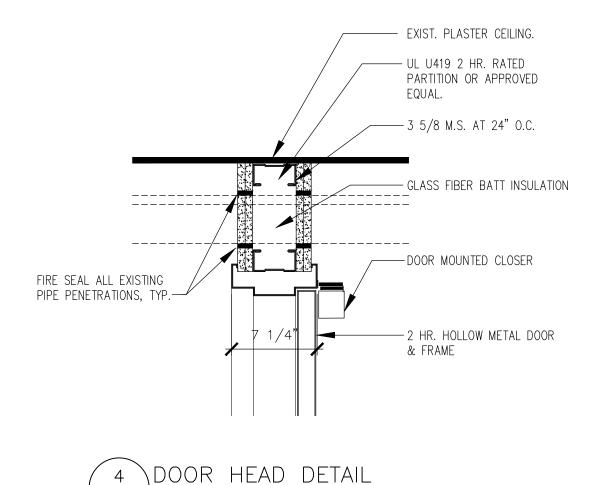


\CONCRETE EQUIPMENT PAD DETAIL

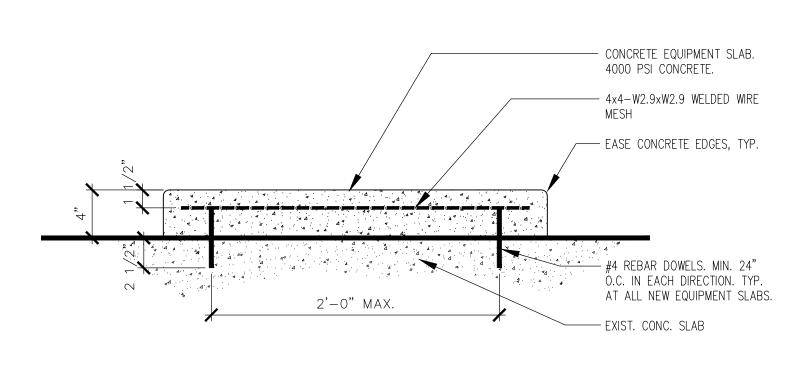




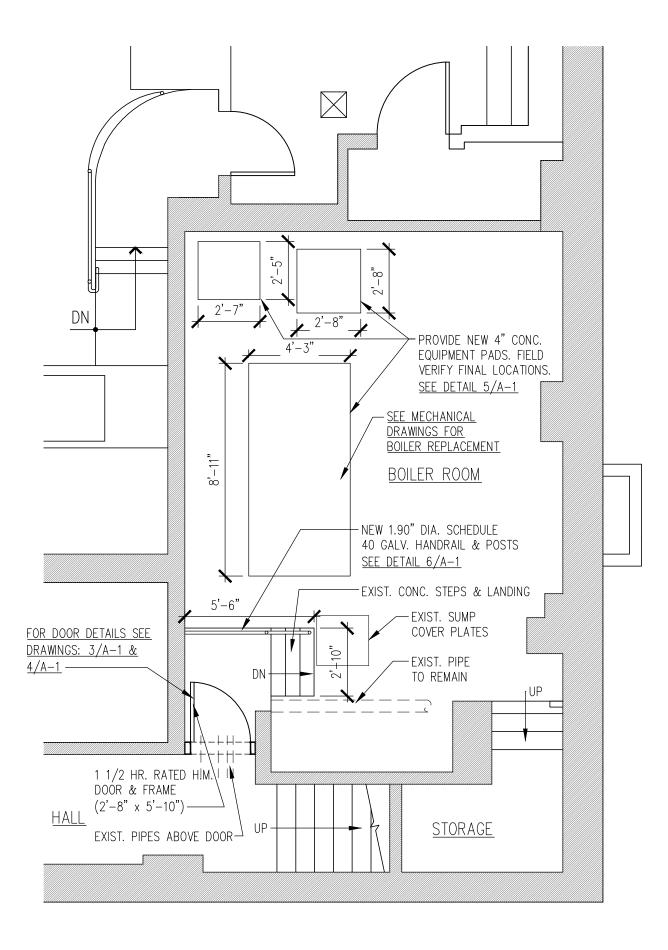

BOILER ROOM PLAN

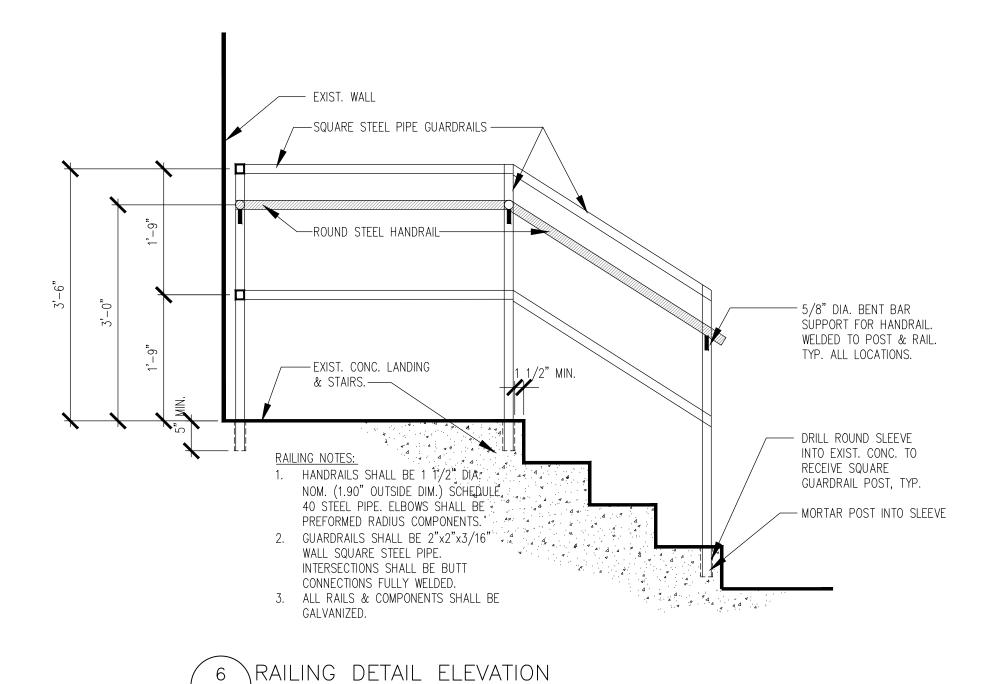



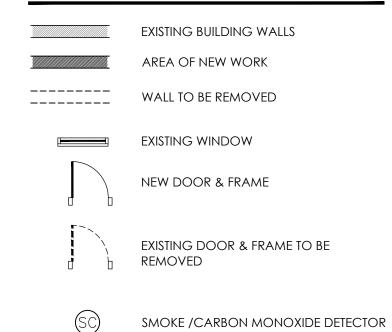

DOOR NOTES

1. DOOR LOCK: SCHLAGE L9080 STOREROOM LOCK; M82 LEVER & ROSE; 626 SATIN CHROME FINISH; KEYED AS DIRECTED BY COUNTY. 2. DOOR CLOSER: LCN 4040XP SERIES CLOSER

PAINTING NOTES

- 1. PREPARE & PAINT MECHANICAL ROOM WALLS & FLOORS INCLUDING EQUIPMENT PADS WITH PRIMER AND EPOXY COATING, COLORS TO BE SELECTED. FLOOR: 340 SF; WALLS: 640 SF
- 2. PAINT NEW DOOR & FRAME WITH EPOXY PAINT. 3. USE BENJAMIN MOORE COROTECH FAST DRY POLYAMIDE EPOXY COATINGS OR APPROVED EQUAL. APPLY PER MANUFACTURERS

GENERAL NOTES

- 1. THE INFORMATION GIVEN ON THIS PLAN IS FOR BID PURPOSES ONLY.THE SUCCESSFUL CONTRACTOR SHALL MAKE HIS OWN FIELD MEASUREMENTS AND FIELD VERIFY ALL GIVEN INFORMATION BEFORE ORDERING MATERIALS.
- 2. ALL REGULATIONS, RULES, ETC., OF ALL STATE, COUNTY AND LOCAL GOVERNMENTS, AND ALL UTILITY AGENCIES SHALL BE FOLLOWED BY THE CONTRACTOR.
- 3. DO NOT SCALE THE DRAWINGS. USE WRITTEN DIMENSIONS ONLY. 4. THE CONTRACTOR IS RESPONSIBLE FOR FIELD VERIFYING ALL CONDITIONS AND DIMENSIONS PRIOR TO SUBMITTING SHOP
- DRAWINGS OR COMMENCING ANY WORK. 5. ALL QUESTIONS AND/OR DISCREPANCIES SHALL BE IMMEDIATELY
- BROUGHT TO THE ATTENTION OF THE ARCHITECT. CONTRACTOR SHALL NOT COMMENCE WORK WITHOUT THE ARCHITECT'S DIRECTION.
- 6. CONTRACTOR IS RESPONSIBLE TO PROVIDE FOR THE SAFETY OF ITS WORKERS, AND THE PUBLIC AS PER ALL LOCAL, STATE, AND NATIONAL CODES AND REGULATIONS.
- 7. ALL DEMOLITION AND CONSTRUCTION MATERIAL DISPOSAL MUST BE IN ACCORDANCE WITH LOCAL, STATE AND FEDERAL REGULATIONS. 8. ALL DEMO AND CONSTRUCTION DEBRIS SHALL BE LEGALLY DISPOSED
- OF OFF THE PROPERTY. 9. THE DEMOLITION AND DISPOSAL OF ANY HAZARDOUS MATERIALS IF ANY MUST BE IN ACCORDANCE WITH LOCAL, STATE AND FEDERAL
- REGULATIONS. 10. PATCH ALL ALTERED SURFACES. RESTORE ALL EXISTING AREAS DISTURBED BY CONSTRUCTION TO MATCH EXISTING SURFACES
- WITHOUT NOTICEABLE CRACKS, JOINTS OR BULGES.
- 11. GENERAL CONTRACTOR SHALL COORDINATE ALL WORK WITH OTHER TRADES AS REQUIRED.

CONTRAC NUMBER WESTCHESTER COUNTY, NEW YORK DEPARTMENT OF PUBLIC WORKS AND TRANSPORTATION DIVISION OF ENGINEERING

BOILER REPLACEMENT AND ASSOCIATED WORK VERNON PLAZA FAMILY CENTER 17 SOUTH SECOND AVENUE, MOUNT VERNON, NEW YORK

DEMOLITION AND NEW WORK PLAN, CELLAR LEVEL


SCALE: AS SHOWN DATE: 06/18/21DPW FILE NO. 54-29-A-48-0

SHEET NO. 2 OF 5

21-514

SHEET NUMBER

IN CHARGE OF ADAM KAPLINSKI, RA KENT JOHNSSON, RA KENT JOHNSSON, RA

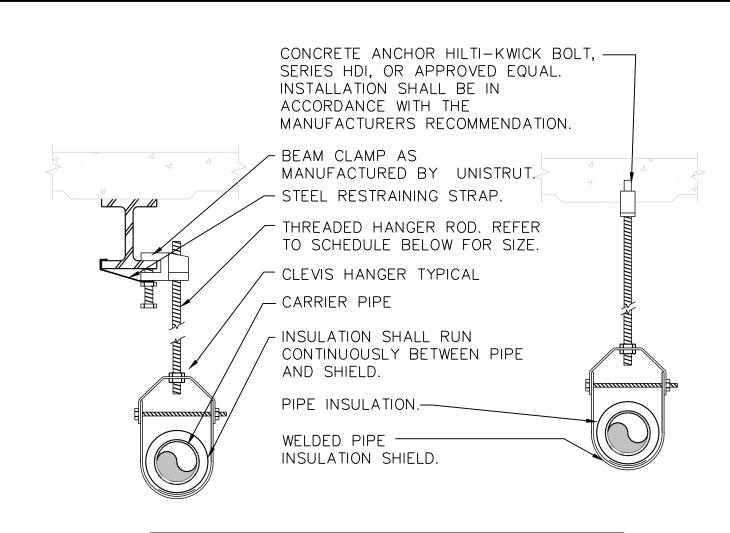


PIPE	HAN	GER S	SCHE	DULI	E
PIPE DIA.	3/4"-2"	2 1/2"-3"	4"-5"	6"	8"-12"
HANGER DIA.	3/8"	1/2"	5/8"	3/4"	7/8"

- 1. CLEVIS HANGERS WITH WELDED INSULATION SHEILDS SIMILAR TO RAUCH FIG. 100SH ON ALL PIPES LARGER THAN 1".
- 2. FOR PIPES 1" OR SMALLER, A BAND HANGER WITH INSULATION SHEILD MAY BE USED SIMILAR TO RAUCH FIG. NO. 1ASH. 3. FOR NONINSULATED PIPE, INSULATION SHEILDS MAY BE OMITTED.
- BLACK WITH ENAMEL. 5. FOR NON FERROUS PIPING WITHOUT INSULATION, ALL HANGERS SHALL BE COPPER PLATED OR FURNISHED WITH A DI-ELECTRIC BETWEEN PIPE AND HANGERS.


4. ALL PIPE HANGERS SHALL BE GALVANIZED STEEL OR FACTORY PAINTED



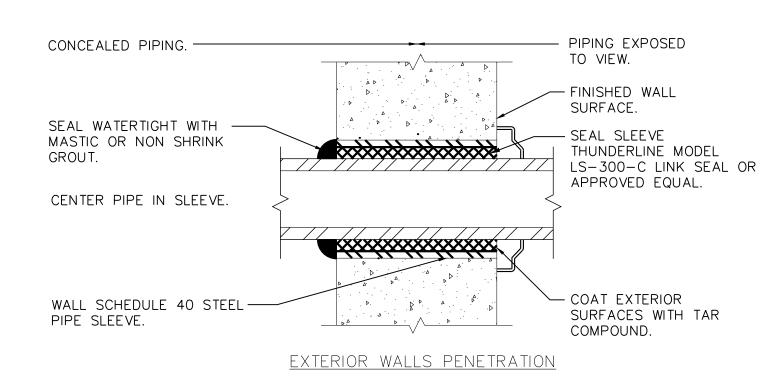

WALL PENETRATION DETAIL /SCALE: NONE

1. PIPE SLEEVE FOR EXTERIOR WALL ABOVE OR BELOW GRADE. 2. FOR GAS SERVICE EXTEND SLEEVE 1" PAST INSIDE FACE OF WALL & 4" PAST OUTSIDE FACE OF WALL.

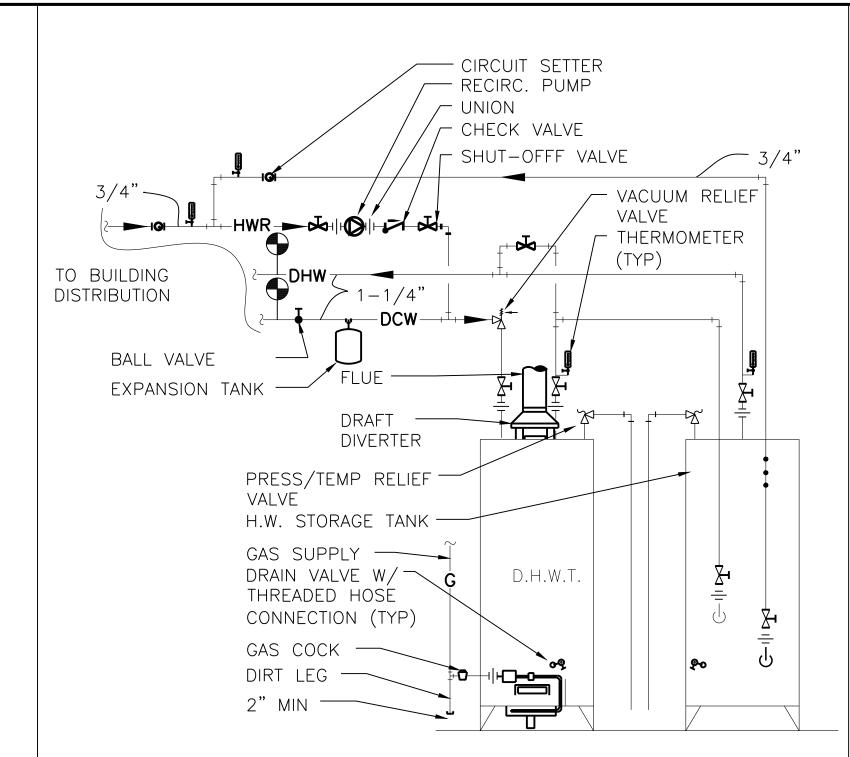

1. PROVIDE ALL NEW PIPING & PIPING SPECIALTIES AS REQUIRED.



GAS SERVICE INSTALLATION GENERAL NOTES

- CONTRACTOR IS RESPONSIBLE FOR OBTAINING ALL NECESSARY PERMITS AND PAYING FEE ASSOCIATED WITH THIS WORK.
- ALL GAS PIPING WORK SHALL BE PERFORMED BY WESTCHESTER COUNTY LICENSED MASTER PLUMBER, AUTHORIZED FOR CON-EDISON WORK.

TEST PRESSURE AND DURATION

THE TEST PRESSURE AND DURATION SHALL BE AS FOLLOWS: (FOR NEW PIPING ONLY) ISOLATE NEW PIPING SECTION AS REQUIRED.

MAXIMUM PRESSURE UTILIZATION	TEST PRESSURE	TEST DURATION
LESS THAN 125 PSIG	90 PSIG OR ONE AND A HALF TIMES THE MAXIMUM OPERATING PRESSURE OR WHICHEVER IS GREATER	2—INCHES AND SMALLER: 15 MINUTES > 2" — 30 MINUTES.
GREATER THAN 125 PSIG	90 PSIG OR ONE AND A HALF TIMES OPERATING PRESSURE, WHICHEVER IS GREATER	2-INCHES AND SMALLER: 2 HOURS

NOTE: THE ABOVE CHARTS DO NOT REPRESENT TEST PRESSURE FOR DISTRIBUTION PIPING AFTER THE METER, WHICH IS NOT UNDER OUR JURISDICTION BUT THAT OF THE GOVERNING AUTHORITIES/CODES

(**** DO NOT INCLUDE PRESSURE REGULATOR IN PIPE PRESSURE TEST ****) NOTE: ALL PIPING VALVES, AND RELATED EQUIPMENT SHALL BE INSTALLED PER CURRENT PUBLISHED STANDARDS AND REQUIREMENTS OF CON EDISON INC.

- 1. CONNECTION BETWEEN THE NEW PIPING AND THE EXISTING PIPING SHALL BE TESTED WITH A NONCORROSIVE LEAK-DETECTING FLUID OR APPROVED LEAK DETECTING METHODS.
- 2. EXISTING PIPING AFFECTED BY NEW INSTALLATION SHALL BE PRESSURE TESTED BY A TEST PRESSURE 1-1/2 TIMES THE PROPOSED MAXIMUM WORKING PRESSURE, BUT NOT LESS THAN 3 PSI. IRRESPECTIVE OF DESIGN PRESSURE.

WELDING:

- 1. ALL WELDERS WORKING ON GAS SERVICE, METER, AND DISTRIBUTION PIPING MUST BE QUALIFIED IN ACCORDANCE WITH THE REQUIREMENTS OF LOCAL AUTHORITIES AND CONED PROCEDURES.
- 2. WELDERS ARE REQUIRED TO FOLLOW THE NEW YORK STATE FUEL AND GAS CODE FOR WELDING DISTRIBUTION PIPING.
- 3. LICENSED PLUMBING CONTRACTOR MUST SUBMIT A "WELDING AFFIDAVIT" SHOWING COMPLIANCE WITH THE LOCAL BUILDING CODES IN THE MUNICIPALITY WHERE WORK WAS PERFORMED:

EQUIPMENT NOTES

-) DOMESTIC HOT WATER STORAGE TANK: BASED ON AO SMITH MODEL T-200 STD OR APPROVED EQUAL 200 GALLON CAPACITY, 30"øX72", WITH 2-1/2" THREADED CONNECTIONS. VERTICAL INSTALLATION USING 2-1/2" THREADED LEG SOCKETS.
- 2) DOMESTIC HOT WATER CIRCULATOR PUMP: BASED ON BELL & GOSSETT MODEL ECOCIRC XL 20-35, LEAD FREE BRONZE BODY PUMP OR APPROVED EQUAL. ELECTRICAL CHARACTERISTICS SHALL BE 115/1/60, 1/12 HP, HIGH EFFICIENT, WET ROTOR PUMP WITH ELECTRONICALLY COMMUTATED MOTOR (ECM)
- 3) <u>DOMESTIC HOT WATER EXPANSION TANK</u>: BASED ON BELL & GOSSETT MODEL HFT-60 DIAPHRAGM-TYPE EXPANSION TANK OR EQUAL. EXPANSION TANK SHALL BE CARBON STEEL SHELL AND HD BUTYL RUBBER

DIAPHRAGM; 7.6 GAL TANK VOLUME, 2.5 GAL ACCEPTANCE. MAXIMUM DESIGN PRESSURE /TEMP: 100 PSI /

- 4) <u>BACKFLOW PREVENTER</u>: BASED ON 3/4" WATTS MODEL LF909QT BONZE RPZ ASSEMBLY OR APPROVED EQUAL
- 5) WATER METER: BASED ON 3/4" SENSUS MODEL SR II OR APPROVED EQUAL, TIE INTO BMS FOR EMERGENCY ALARM. PROVIDE CONNECTIONS TO BMS FOR STATUS/GPM READING.
- 6) <u>PRESSURE REDUCING VALVE (PRV)</u>: BASED ON 3/4" WATTS MODEL-LF223 OR APPROVED EQUAL. ALL WETTED PARTS SHALL BE LEAD FREE BRASS.
- 7) <u>angle sillcock valve</u>: based on nibco model# 763-cl-ls or approved equal.

PLUMBING PIPING MATERIAL

- WATER PIPING: TYPE "K" COPPER AND WROUGHT COPPER FITTINGS, 95-5 LEADLESS SOLDER.
- 2. WASTE AND VENT: SERVICE WT. CAST IRON OR COPPER DWV WITH PUSH-ON RUBBER GASKETS OR NO-HUB PIPE WITH HUSKY HEAVY COUPLINGS FOR ABOVE GRADE PIPING.

GAS PIPING MATERIALS

SERVICE	SIZE (IN.)	MATERIAL	TYPE/ WEIGHT	STANDARD
GAS	ALL	BLACK	ERW/ SCH. 40	ASTM A53
			THREADED	

GAS PIPE FITTINGS

-				
SERVICE	SIZE	MATERIAL	TYPE/	STANDARD
	(INI)		WEIGHT	

ABOVEGROUND AND PIPE CHASE

THRU 4

MALLEABLE SCREWED/ ANSI B16.3 150 PSI

GAS VALVE SCHEDULE

MISCELLANEOUS SERVICE MANUFACTURER GAS VALVES/ ROCKWELL CO./FLOWSERVE NORDSTROM #142 PLUG VALVES

PROVIDE LUBRICANT AND WRENCH FOR EACH GAS VALVE

VALVE SCHEDULE

GATE VALVES	2-1/2" AND SMALLER	STOCKHAM B-105 THREADED, RISING STEM
BALL VALVES	3" AND SMALLER	STOCKHAM S-206-BRI-R-T WITH EXTENSION STEM FOR INSULATED PIPE
HOSE END DRAIN VALVES	1" AND SMALLER	WOODFORD COMPANY, MODEL #24P, POLISHED CHROME IN FINSHED AREAS

EXCEPT WHERE SPECIFICALLY STATED TO CONTRARY, ALTERNATE MANUFACTURERS FOR VALVES ARE AS FOLLOWS:

CRANE COMPANY

LUNKENHEIMER CO.

 JENKINS BROTHERS - NIBCO, INC.

- HAMMOND VALVE CORP. (SERIES IB,IR) KENNEDY VALVE MFG. CO., INC. - STOCKHAM VALVE AND FITTINGS

THE CONTRACTOR SHALL PROVIDE THE VALVES SPECIFIED, OR THE EQUIVALENT AS PRODUCED BY ONE OF THE ABOVE LISTED MANUFACTUERES.

VACUUM BREAKER PLUMBING NOTES

T&P RELIEF VALVE

SYMBOL & ABBREVIATIONS

DESCRIPTION

ABOVE FINISHED FLOOR

GALLONS PER MINUTE

HOT WATER SUPPLY

HOT WATER RETURN

TRIPLE DUTY VALVE

FLOW CONTROL VALVE

2-WAY VALVE

GATE VALVE

GLOBE VALVE

STRAINER

OS&Y GATE VALVE

BUTTERFLY VALVE

CIRCUIT SETTER

AUTO AIR VENT

PRESSURE GAGE

THERMOMETER

CHECK VALVE

WATER METER

FLOW DIRECTION

NEW WORK

MOTORIZED DAMPER

EXISTING TO REMAIN

EXISTING TO BE REMOVED

POINT OF CONNECTION OR DISCONNECTION

UNION

BALL VALVE

MANUAL AIR VENT

PRIMARY HOT WATER SUPPLY/RTEURN

DOMESTIC COLD WATER SUPPLY

DOMESTIC HOT WATER SUPPLY

SECONDARY HOT WATER SUPPLY/RETURN

DOMESTIC WATER

ABBREVIATION

AFF

GPM

HWS

HWR

CW

PHWS/R

SHWS/R

DCWS

DHWS

EX.

NEW

DEM.

SYMBOL

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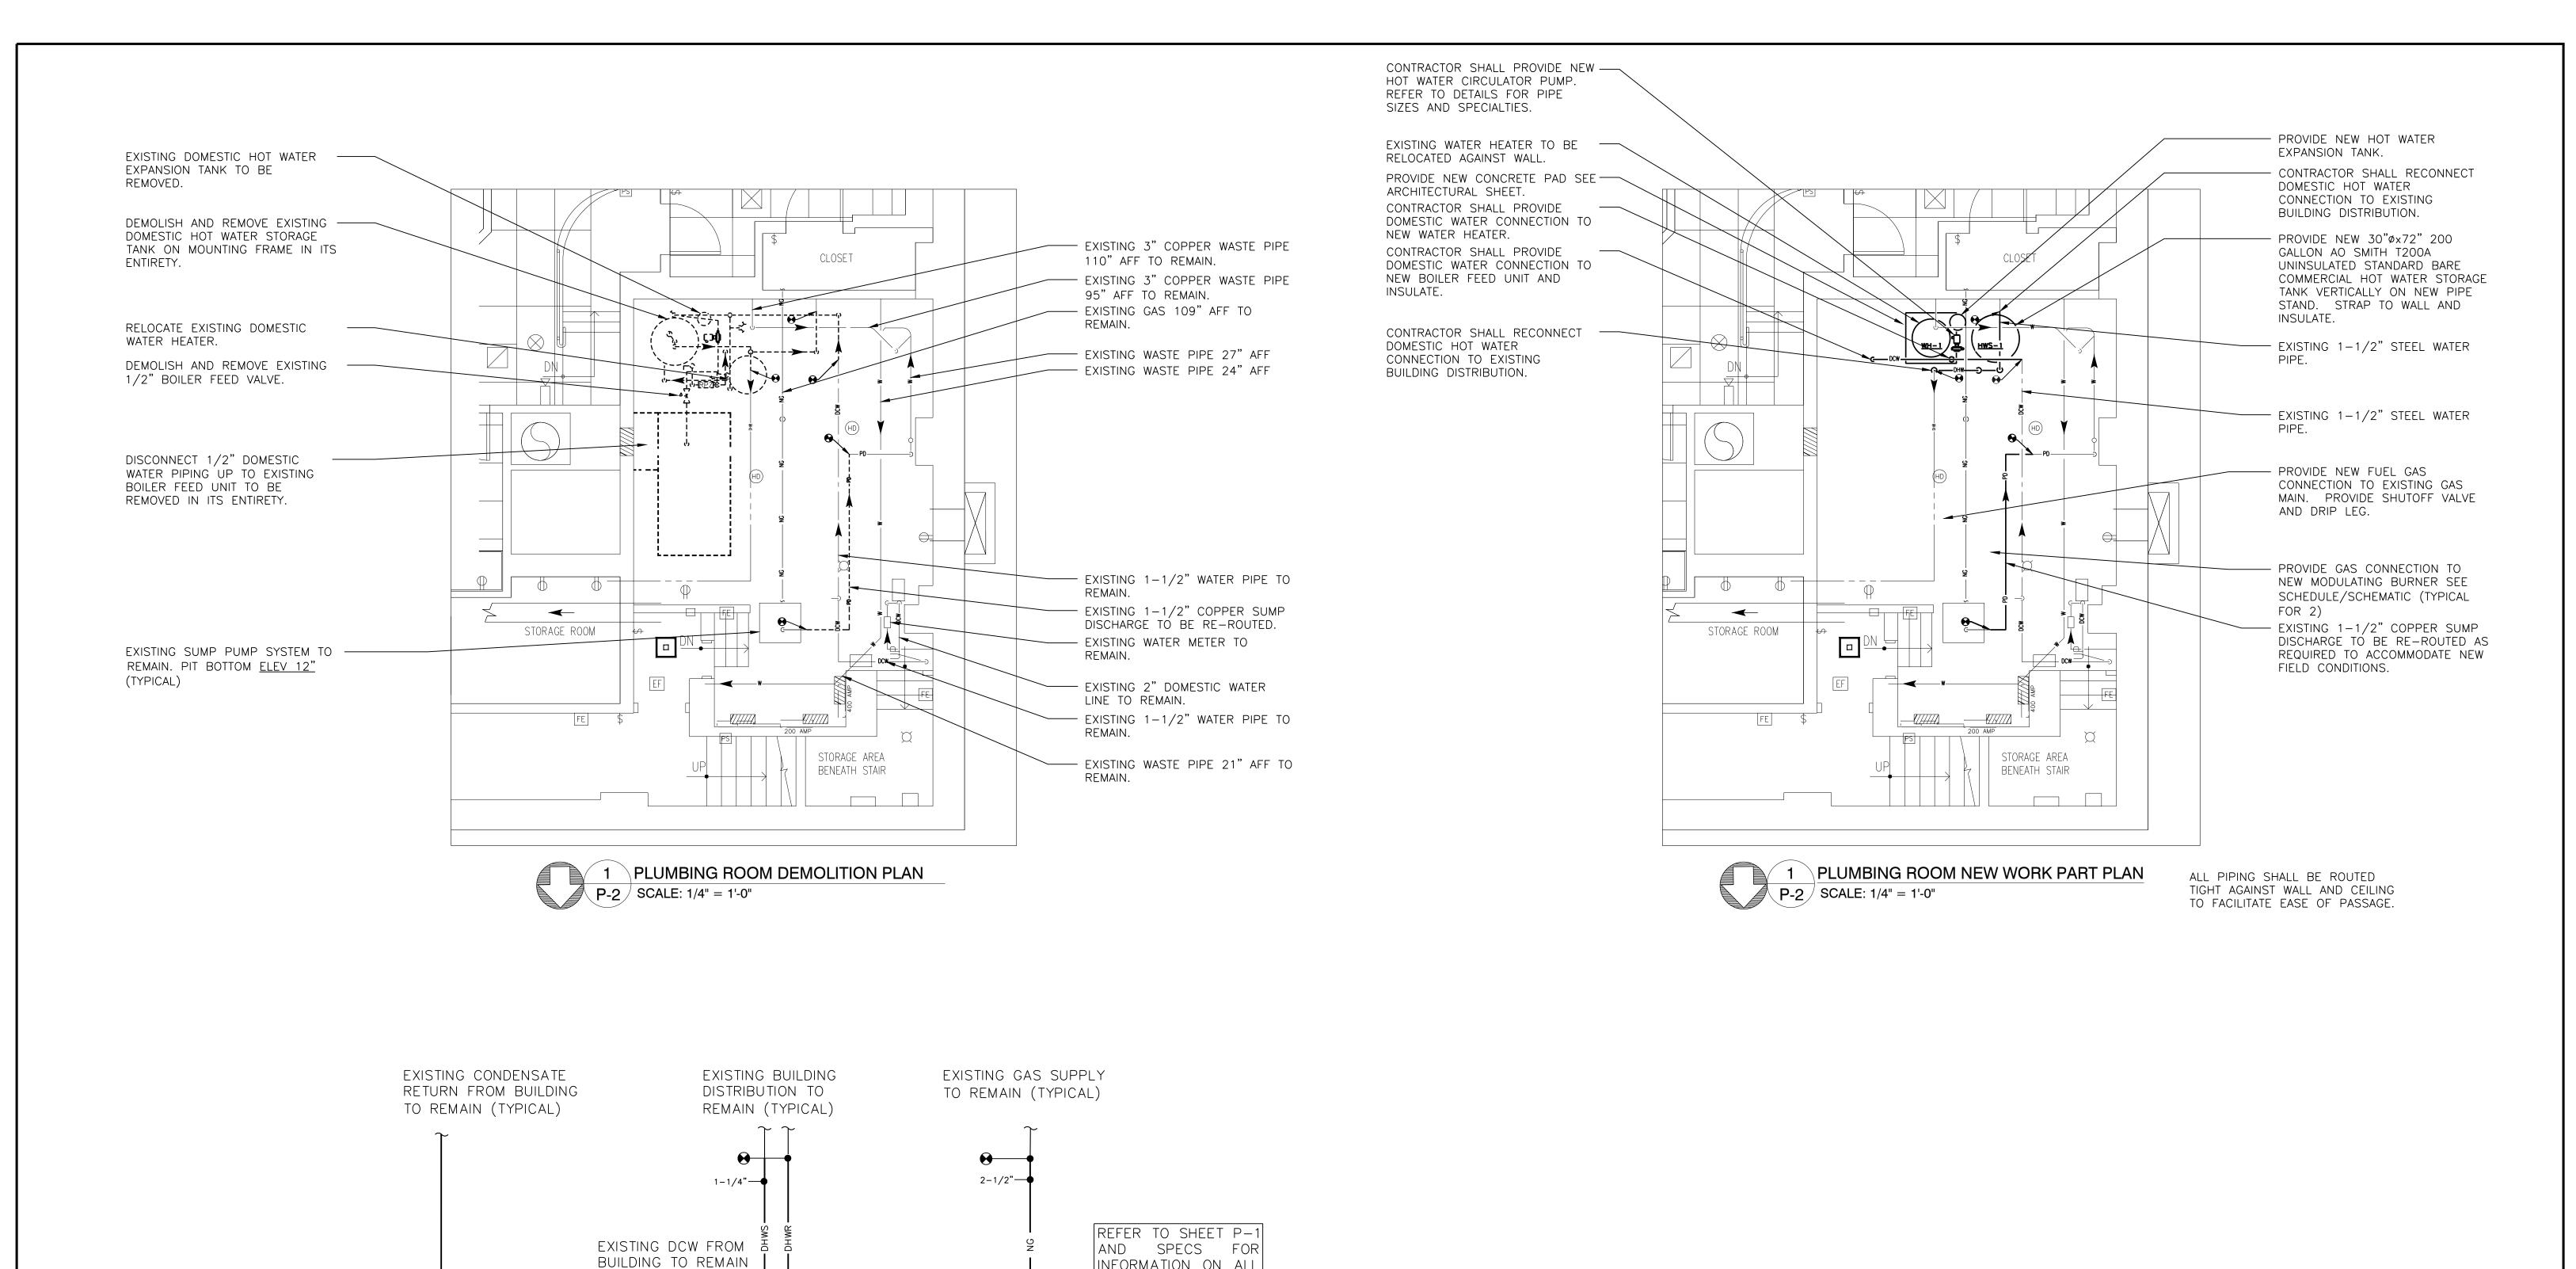
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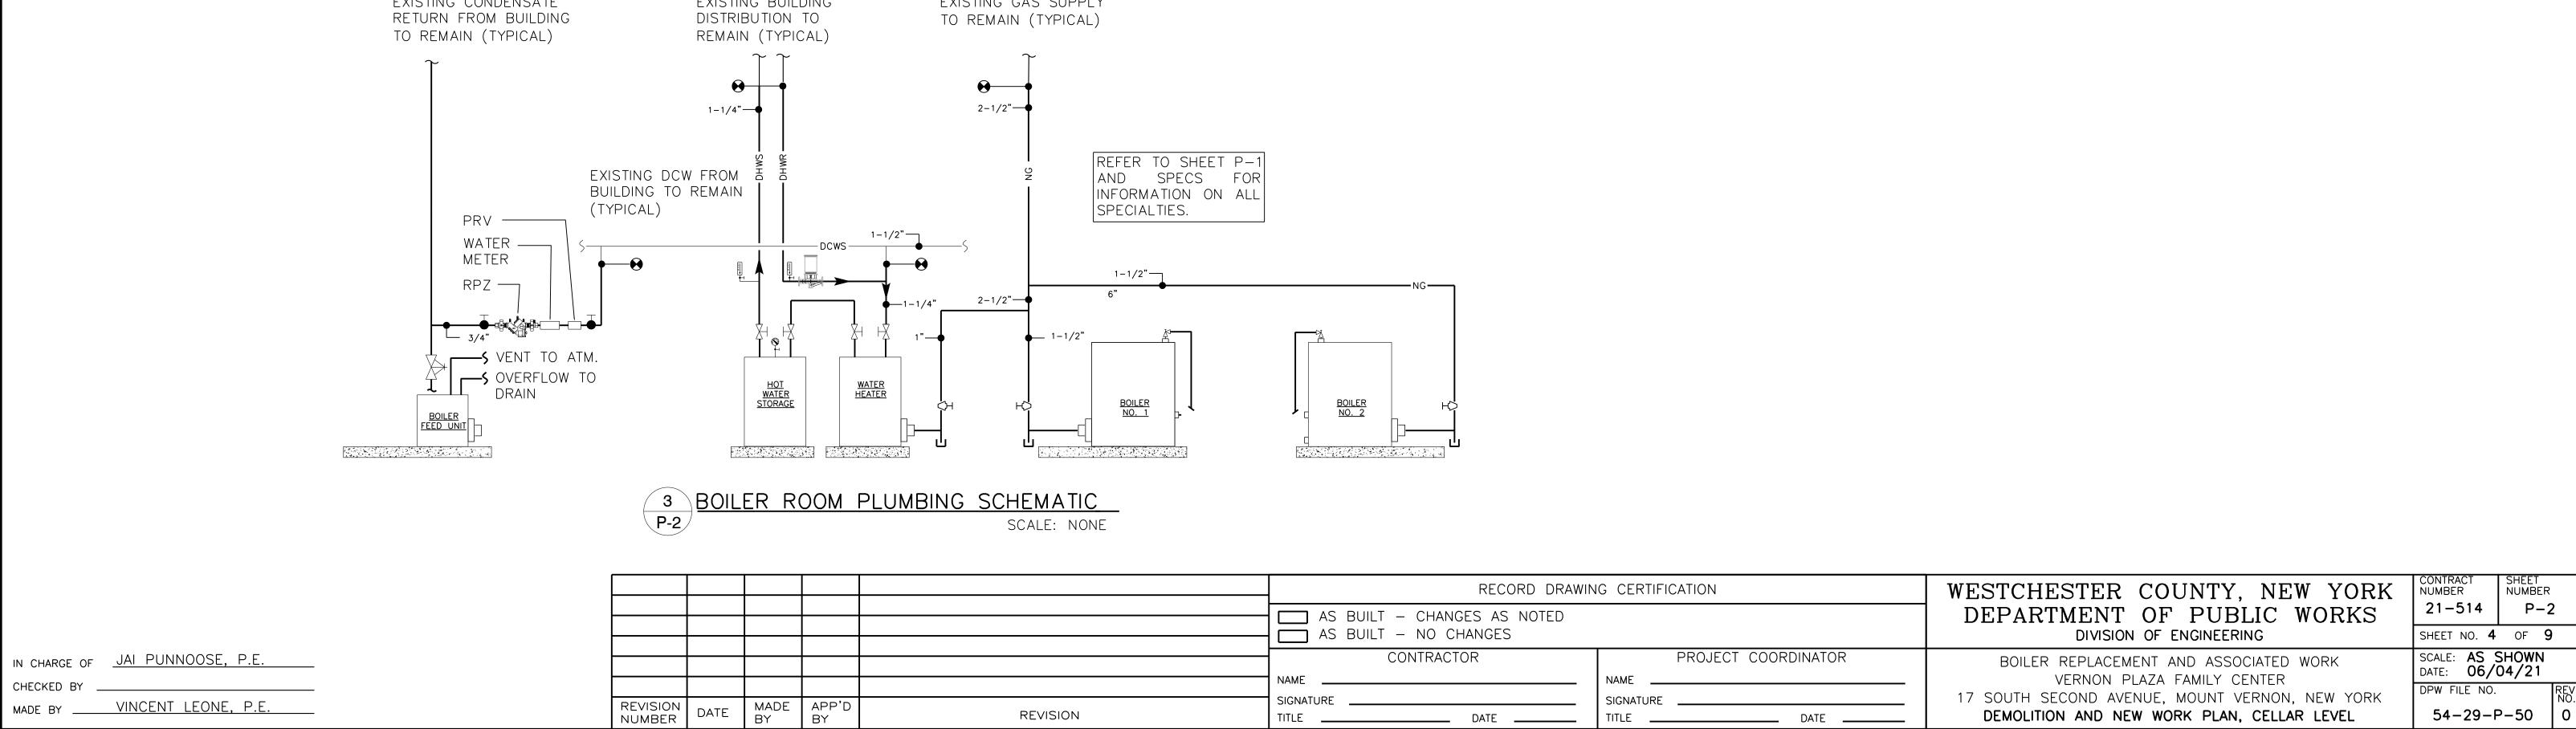
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- 2. THE CONTRACTOR SHALL PROVIDE ALL PLUMBING EQUIPMENT, PIPING, VALVES, AND ACCESSORY ITEMS AS SPECIFIED AND AS REQUIRED FOR A COMPLETE INSTALLATION, INCLUDING HOT WATER AND COLD WATER ISOLATION VALVES FOR ALL EQUIPMENT.
- 3. REMOVE ABANDONED PIPING BACK TO MAIN OR RISER AND CAP. CAPPING AND PLUGGING OF PIPING SHALL BE DONE USING THE SAME MATERIAL AS THE PIPING.
- 4. EXACT LOCATIONS OF PIPING IN FLOORS, WALLS, CEILINGS, AND CHASES SHALL BE COORDINATED WITH THE EXISTING CONDITIONS IN THE FIELD. CONTRACTOR SHALL BE RESPONSIBLE FOR VERIFYING SIZE AND LOCATION OF ALL EXISTING PIPING IN FIELD.
- 5. ALL WORK SHALL BE DONE IN COMPLIANCE WITH NFPA, THE N.Y. STATE AND THE LOCAL PLUMBING
- 6. ALL PLUMBING WORK SHALL BE PERFORMED BY A PLUMBER LICENSED BY THE COUNTY OF WESTCHESTER. A COPY OF THE LICENSE SHALL BE SUBMITTED TO OWNER AND ALL FEES PAID.
- 7. PROVIDE SUFFICIENT CLEVIS TYPE HANGERS, SUPPORTS, RODS, BRACES, ETC. TO PROPERLY SUPPORT PIPING. INSTALL HANGERS OVER INSULATION.
- 8. ALL WORK SHALL BE PROPERLY TESTED, BALANCED, AND CLEANED. DISINFECT ALL WATER PIPING WITH HTL TABLETS FOR 24 HOURS, FLUSH AFTERWARDS.
- 9. COORDINATE ROUTING OF PIPING WITH WORK OF OTHER TRADES. VERIFY ELEVATIONS OF NEW PIPING PRIOR TO INSTALLATION. NOTIFY ENGINEER IMMEDIATELY IF ANY POSSIBLE CONFLICTS WITH LIGHTS, DUCTWORK, ETC. COULD OCCUR.
- 10. PROVIDE ALL PIPE OPENINGS THROUGH PARTITIONS WITH PIPE SLEEVES. FOR PIPES PENETRATING FIRE RATED PARTITIONS, THE SPACE BETWEEN THE PIPE AND THE SLEEVE SHALL BE SEALED WITH FIRE STOPPING MATERIAL.
- 11. CONTRACTOR SHALL COORDINATE NEW FIXTURES LOCATIONS WITH DRAWINGS.
- 12. ALL CORE DRILLING, SAW CUTTING AND PATCHING BY THIS CONTRACTOR. ALL PIPING SHALL BE NEW UNLESS OTHERWISE SPECIFIED.
- 13. CONTRACTOR SHALL PRESSURE TEST ALL NEW PIPING AFTER THE METER ACCORDING TO THE CODES AND REGULATIONS UNDER THE JURISDICTION OF THE GOVERNING AUTHORITIES OR LOCAL MUNICIPALITY


WESTCHESTER COUNTY, NEW YORK RECORD DRAWING CERTIFICATION NUMBER NUMBER 21-514 P-1 DEPARTMENT OF PUBLIC WORKS AS BUILT - CHANGES AS NOTED AS BUILT - NO CHANGES DIVISION OF ENGINEERING SHEET NO. 3 OF 9CONTRACTOR PROJECT COORDINATOR SCALE: AS SHOWN BOILER REPLACEMENT AND ASSOCIATED WORK DATE: 06/04/21 VERNON PLAZA FAMILY CENTER NAME NAME DPW FILE NO. 17 SOUTH SECOND AVENUE, MOUNT VERNON, NEW YORK SIGNATURE SIGNATURE MADE | APP'D DATE REVISION DETAILS, SYMBOL LEGEND AND NOTES 54-29-P-49 | 0 ____ DATE ____ BY BY ___ DATE ___ NUMBER

IN CHARGE OF JAI PUNNOOSE, P.E. CHECKED BY _____ MADE BY VINCENT LEONE, P.E.






SYMBOL	ABBREVIATION	DESCRIPTION	SYMBOL	ABBREVIATION	DESCRIPTION
_	AD	ACCESS DOOR	<u>⊠</u>	_	ANGLE GLOBE VALVE
	AFF	ABOVE FINISHED FLOOR	<u>Z</u>	_	ANGLE GATE VALVE
<u> </u>	AHC	ABOVE HUNG CEILING	Z.	_	T&P RELIEF VALVE
	AP	ACCESS PANEL	4	_	VACUUM BREAKER
				_	FILTER DRYER
	BDD	BACKDRAFT DAMPER		_	FILTER
-	BHP	BRAKE HORSEPOWER	⊗	_	FLOAT AND THERMOSTATIC TRAP
_	BTU	BRITISH THERMAL UNIT	F	_	FLOAT TRAP
_	CFM	CUBIC FEET PER MINUTE	•		BALL VALVE
_	<u> </u>	CENTERLINE	Ø +		PRESSURE GAGE
	DIA. OR Ø	DIAMETER	†	_	TERMOMETER
	EL	ELEVATION	<u>+</u>	_	CHECK VALVE
_	EWT	ENTERING WATER TEMPERATURE		_	UNION
_	FPM	FEET PER MINUTE	1 1	_	
_	FPS	FEET PER SECOND		EX.	EXISTING TO REMAIN
_	GPM	GALLONS PER MINUTE		REL.	REMOVE AND RELOCATE
-	HP	HORSE POWER		NEW	NEW WORK
_	LF	LINEAR FEET		DEM.	EXISTING TO BE REMOVED
-	LWT	LEAVING WATER TEMPERATURE	—— CA ——	_	COMPRESSED AIR
_	мвн	1000 BRITISH THERMAL UNITS PER HOUR	— D —	_	DRAIN
_	NC	NORMALLY CLOSED	v	_	VACUUM LINE
_	NIC	NOT IN CONTRACT	—— FOS ——	_	FUEL OIL SUPPLY
_	NO	NORMALLY OPEN	FOR	_	FUEL OIL RETURN
_	OAI	OUTSIDE AIR INTAKE	FOV	-	FUEL OIL VENT
_	PSI	POUNDS PER SQUARE INCH	HWS	-	HOT WATER SUPPLY
_	RPM	REVOLUTIONS PER MINUTE	HWR	_	HOT WATER RETURN
_	TDH	TOTAL DYNAMIC HEAD	—— LPS ——	_	LOW PRESSURE STEAM
_	TYP.	TYPICAL	LPC	_	LOW PRESSURE CONDENSATE
_	U.O.N.	UNLESS OTHERWISE NOTED	— PC —	_	PUMPED CONDENSATE
_	WMS	WIRE MESH SCREEN	M	_	MOTORIZED DAMPER
_	WG	INCHES OF WATER GAUGE	(S)	_	SMOKE DETECTOR
	_	3-WAY VALVE	+	_	DOOR LOUVER
	_	FLEXIBLE CONNECTION	← √-	_	AIR INTO REGISTER
\mathbb{A}	_	2-WAY VALVE	Θ	_	POINT OF CONNECTION DISCONNECTION
	_	PLUG VALVE		P-1	PUMP
<u> </u>	_	LOCK SHIELD VALVE		_	SUPPLY DUCT UP
		GATE VALVE		_	SUPPLY DUCT DOWN
	_	GLOBE VALVE		_	RETURN DUCT UP
		TEE DOWN		_	RETURN DUCT DOWN
<u> </u>			<u> </u>		TRANSITION FROM SQUARE TO
		ELBOW DOWN			ROUND DUCT TRANSITION
	_	TEE UP	<u>{</u>	_	
<u> </u>		ELBOW UP		_	DUCT DROP
	_	CONCENTRIC REDUCER	{ R → }	_	DUCT RISE
	_	ECCENTRIC REDUCER		_	DUCT RISE
<u> </u>	_	OS&Y GATE VALVE		_	DUCT DROP
		PIPE GUIDE		_	DUCT TRANSITION
×	_	PIPE ANCHOR	6x8	_	DUCT SIZE — 1ST FIGURE IS SIDE SHOWN
⊢ X l	_	STRAINER	SECT# DWG#	1	SECTION CALLOUT
U	_	BASKET STRAINER	<u>L</u>	_	LOUVER
, , , , , , , , , , , , , , , , , , ,	_	PRESSURE REDUCING VALVE	P 1	_	PUMP
-	_	FLOW ARROW			
Ó	_	BUTTERFLY VALVE			
101	_	BALANCING VALVE			
Ĥ	_	MANUAL AIR VENT			
	_	SOLENOID VALVE			
<u>M</u>	_	MOTORIZED VALVE			
~	1	.			
HARGE OF JAI F	PUNNOOSE, P.E				
CKED BY VINCENT LEONE					

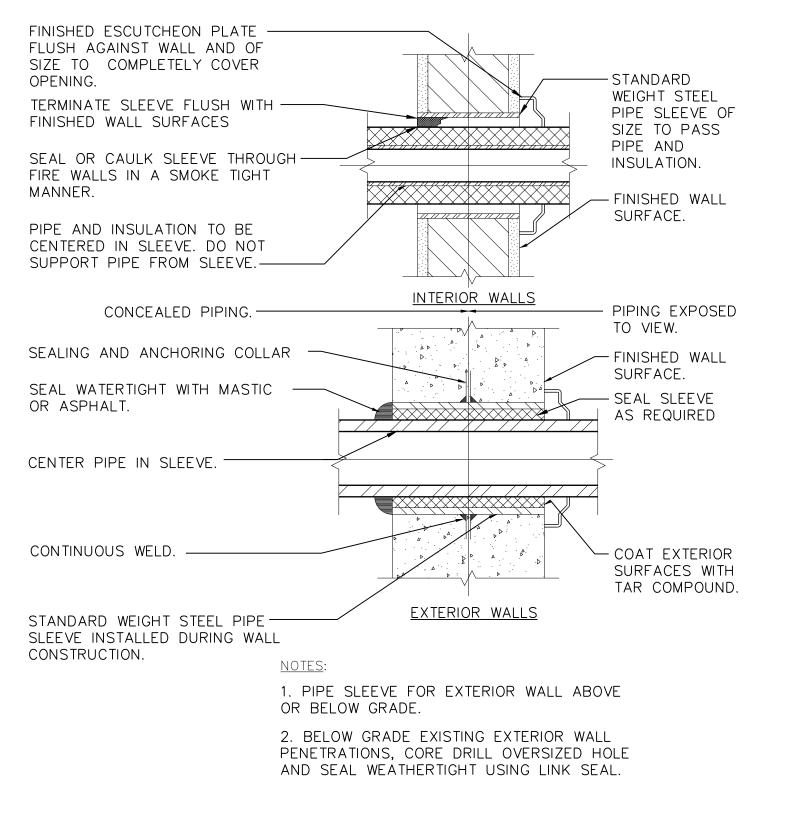

4 PIPE PENETRATION DETAIL

\ HV-3 /SCALE: NONE

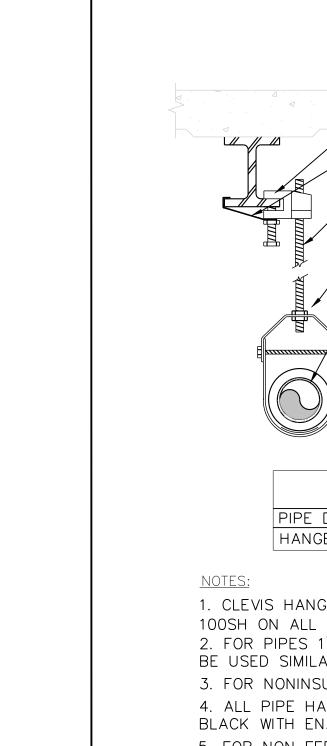

CONCRETE ANCHOR HILTI-KWICK BOLT, -SERIES HDI, OR APPROVED EQUAL. INSTALLATION SHALL BE IN ACCORDANCE WITH THE MANUFACTURERS RECOMMENDATION. -BEAM CLAMP AS MANUFACTURED BY UNISTRUT. - STEEL RESTRAINING STRAP. THREADED HANGER ROD. REFER TO SCHEDULE BELOW FOR SIZE. — CLEVIS HANGER TYPICAL - CARRIER PIPE - INSULATION SHALL RUN CONTINUOUSLY BETWEEN PIPE AND SHIELD. PIPE INSULATION.-WELDED PIPE -INSULATION SHIELD.


PIPE	HAN	GER S	CHE	DUL	
PIPE DIA.	3/4"-2"	2 1/2"-3"	4"-5"	6"	8"-12"
HANGER DIA.	3/8"	1/2"	5/8"	3/4"	7/8"

- 1. CLEVIS HANGERS WITH WELDED INSULATION SHEILDS SIMILAR TO RAUCH FIG. 100SH ON ALL PIPES LARGER THAN 1".
- 2. FOR PIPES 1" OR SMALLER, A BAND HANGER WITH INSULATION SHEILD MAY BE USED SIMILAR TO RAUCH FIG. NO. 1ASH.
- 3. FOR NONINSULATED PIPE, INSULATION SHEILDS MAY BE OMITTED.
- 4. ALL PIPE HANGERS SHALL BE GALVANIZED STEEL OR FACTORY PAINTED BLACK WITH ENAMEL.
- 5. FOR NON FERROUS PIPING WITHOUT INSULATION, ALL HANGERS SHALL BE COPPER PLATED OR FURNISHED WITH A DI-ELECTRIC BETWEEN PIPE AND HANGERS.



EQUIPMENT NOTES

1) MOTORIZED BOILER FEED VALVE: BASED ON BELIMO FULL PORT BALL OPEN/CLOSE MOTORIZED WITH AUXILIARY END SWITCH HARD-WIRED BETWEEN BOILER LEVEL CONTROLLER AND BOILER FEED PUMP.

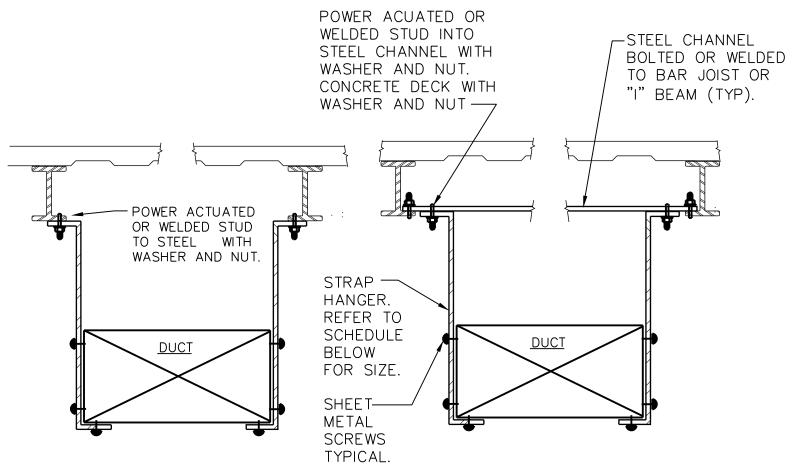

NOTES:

1. FOR DUCTS OVER 49" WIDE, THE STRAP HANGER SHALL BE TURNED UNDER THE BOTTOM OF THE DUCT.

2. CONTRACTOR SHALL SUBMIT DUCT HANGER DETAIL TYPICAL ARRANGEMENT OF TRUSS AND ARRANGEMENT ENCOUNTERED AT JOB SITE

HANGER S	TRAP SCH	EDULE
DUCT SIZE	HANGER SIZE	MAXIMUM SPACING
UP TO 2 SQ.FT.	1" X 1/16"	8'-0"
2 SQ. FT. TO 4 SQ.FT.	1" X 1/8"	8'-0"
4 SQ.FT. TO 10 SQ.FT.	1" X 1/8"	6'-0"
OVER 10 SQ.FT.	1" X 1/8"	4'-0"



REVISION NUMBER	DATE	MADE BY	APP'D BY	REVISION
			RECO	RD DRAWING CERTIFICATION
AS	BUILT -	- CHAN	GES AS	NOTED

AS BUILT - NO CHANGES

CONTRACTOR
NAME
SIGNATURE
TITLE
DATE

VESTCHESTER COUNTY. NEW YORK

CONTRACT
NUMBER

PROJECT COORDINATOR
NAME
SIGNATURE
TITLE
DATE

CONTRACT
NUMBER
NUMBER

WESTCHESTER COUNTY, NEW YORK
DEPARTMENT OF PUBLIC WORKS
DIVISION OF ENGINEERING

BOILER REPLACEMENT AND ASSOCIATED WORK

VERNON PLAZA FAMILY CENTER

17 SOUTH SECOND AVENUE, MOUNT VERNON, NEW YORK

DETAILS AND SYMBOL LEGEND

SHEET NO. 5 OF 9

SCALE: AS SHOWN
DATE: 06/04/21

DPW FILE NO. REV
NO. 54-29-HV-51 0

HV-1

21-514

BUILDING OCCUPANCY NOTES

- 1. VERNON PLAZA FAMILY CENTER WILL BE OCCUPIED DURING TRANSITION WORK OF BOILERS.
- 2. BUILDILNG INTERUPTIONS.
- 2.1. DAYTIME: NO INTERRUPTIONS WILL BE ALLOWED
- 2.2. <u>NIGHT TIME:</u> WILL BE ALLOWED TO PERFORM TEMPORARY PIPING MODIFICATION ON EXISTING PIPING IN THE BOILER ROOM FOR TIE—IN OF RENTAL BOILER/DOMESTIC HOT WATER HEATER.
- 3. ALL INTERRUPTIONS SHALL BE COORDINATED WITH THE PROJECT MANAGER A MINIMUM OF ONE (1) WEEK PRIOR TO THE ANTICIPATED INTERRUPTION.
- 4. ANY WORK THAT REQUIRES INTERRUPTION TO THE DOMESTIC WATER OR SPACE HEATING SYSTEMS FOR MORE THAN 4 HOURS WILL NOT BE ALLOWED.
- 5. CONTRACTOR SHALL PLAN ALL <u>TEMPORARY PIPING MODIFICATION WORK TO BE PERFORMED IN 4 HOUR WINDOWS</u> DURING NIGHTTIME, AS APPROVED BY CONSTRUCTION MANAGER. EXISTING SPACE HEATING SYSTEM/DOMESTIC HOT WATER SYSTEM SHALL BE PUT BACK IN SERVICE AND FULLY FUNCTIONAL/OPERATIONAL AT THE END OF EACH WORK WINDOW ALLOWED.

PHASING NOTES:

- 1. VERNON PLAZA FAMILY CENTER WILL BE FULLY OCCUPIED DURING CONSTRUCTION.
- 2. CURRENTLY, THE BUILDING IS SET UP FOR BUILDING HEAT PROVIDED BY AN ALREADY-INSTALLED TEMPORARY BOILER. CONTRACTOR SHALL COORDINATE WITH BUILDING SERVICE COMPANY FOR CHANGEOVER TO NEW BOILER AFTER WORK IS COMPLETED. ANY WORK REQUIRED TO TEMPORARILY HEAT BUILDING SHALL BE BY BUILDING SERVICE COMPANY. CONTRACTOR SHALL COORDINATE WITH BUILDING SERVICE COMPANY FOR CHANGEOVER TO NEW SYSTEM FROM TEMPORARY.
- 3. DOMESTIC WATER SYSTEM HAS A SEPARATE GAS SUPPLY FROM, BUT COMMON BREECHING TO, BOILER. CONTRACTOR SHALL COORDINATE WITH BUILDING SERVICE COMPANY TO PROVIDE TEMPORARY DOMESTIC WATER SERVICE DURING PERIOD OFTIME THE OPERATION OF BUILDING BREECHING IS INTERUPTED. PAYMENT TO BUILDING SERVICE COMPANY SHALL BE THROUGH AN ALLOWANCE INCLUDED IN CONTRACT.
- 4. CONTRACTOR SHALL PHASE WORK, SO AS NOT TO CREATE ANY INTERRUPTIONS TO BUILDING STEAM/DOMESTIC HOT WATER SUPPLY SYSTEMS OUTSIDE OF THOSE DESCRIBED ELSEWHERE IN THE BID DOCUMENTS. IN CASE OF ANY UNANTICIPATED OR ACCIDENTAL INTERRUPTION TO BUILDING HEATING OR DOMESTIC WATER SERVICE, CONTRACTOR SHALL RESPOND ON 24 HOUR, 7 DAY EMERGENCY RESPONSE TO RESTORE SERVICES.
- 5. CONTRACTOR SHALL SUBMIT A DETAILED PHASING PLAN TO THE COUNTY, SHOWING METHODS EMPLOYED, ORDER OF WORK TO BE PERFORMED, ETC, THAT ENSURES UNINTERRUPTED SERVICE OF SPACE HEATING AND DOMESTIC HOT WATER SERVICES TO THE BUILDING DURING CONSTRUCTION, FOR APPROVAL BY THE COUNTY, PRIOR TO START OF ANY CONSTRUCTION WORK.

GENERAL MECHANICAL NOTES

- THE INFORMATION GIVEN ON THIS PLAN IS FOR BID PURPOSES ONLY. THE SUCCESSFUL CONTRACTOR SHALL FIELD VERIFY ALL EXISTING CONDITIONS PRIOR TO THE BEGINNING OF WORK AND SHALL PROVIDE COMPOSITE SHOP DRAWINGS FULLY COORDINATED WITH ALL OTHER TRADES FOR REVIEW, MARK-UP AND COORDINATION INDICATING DUCTWORK, PLUMBING, SMOKE DETECTORS, LIGHTS, CONDUITS, SMOKE DETECTORS, DIFFUSERS, GRILLES, ETC. CONTRACTOR SHALL MAKE HIS OWN FIELD MEASUREMENTS AND VERIFY ALL GIVEN INFORMATION BEFORE ORDERING MATERIALS.
- 2. CONTRACT DRAWINGS, AS FAR AS THEY RELATE TO THE GENERAL ARRANGEMENT AND LOCATION OF EQUIPMENT, SHEET METAL, AND PIPING, SHALL BE UNDERSTOOD AS DIAGRAMMATIC. ANY CHANGES TO EQUIPMENT, SHEET METAL, AND PIPING LOCATIONS NECESSARY TO AVOID INTERFERENCE WITH OTHER TRADES SHALL BE MADE AT NO EXTRA COST, AND MUST BE APPROVED BY THE ENGINEER.
- 3. COORDINATE LOCATIONS OF NEW BOILERS, COMBUSTION AIR INTAKE FAN, ETC. WITH OTHER TRADES AND WITH EXISTING CONDITIONS.
- 4. THIS PROJECT SHALL BE EXECUTED IN AN ORDERLY AND CAREFUL MANNER WITH DUE CONSIDERATION FOR THE PROTECTION OF ADJACENT ACTIVITIES, GENERAL PUBLIC AND THE BUILDING TENANTS. ALL WORK AREA SHALL BE BARRICADED OR FENCED, TO PREVENT ACCESS BY GENERAL PUBLIC OR BUILDING TENANTS. ANY DUST PRODUCING DEMOLITION SHALL BE ISOLATED WITH PROPER PRECAUTIONS.
- 5. CONTRACTOR SHALL VERIFY ALL DEMOLITION WORK WITHIN THE AREA AND SHALL REMOVE OR RELOCATE ANY EXISTING DUCTWORK, PIPING OR ELECTRICAL WIRING/CONDUIT AS REQUIRED OR AS INSTRUCTED BY THE COUNTY REPRESENTATIVE.
- 6. CONTRACTOR SHALL FURNISH AND INSTALL NEW EQUIPMENT AS SHOWN ON THE CONTRACT DOCUMENTS INCLUDING ALL REQUIRED RIGGING, FIELD—ASSEMBLY, INSTALLATION ETC. FOR A COMPLETE INSTALLATION OF HEATING SYSTEM. CONTRACTOR SHALL FURNISH AND INSTALL CONTROL PANELS, ELECTRICAL POWER HOOK UP, ETC TO EACH PIECE OF EQUIPMENT AS REQUIRED.
- 7. CONTRACTOR SHALL PROVIDE COORDINATION SHOP DRAWINGS OF ALL WORK FOR REVIEW, MARK-UP AND COORDINATION WITH OTHER TRADES.
- 8. ALL WORK, MATERIALS, REGULATIONS, RULES, PERMITS, ETC., OF ALL STATE, COUNTY AND LOCAL GOVERNMENTS, AND ALL UTILITY AGENCIES SHALL BE FOLLOWED BY THE CONTRACTOR.
- PRIOR TO THE INSTALLATION OF ANY WORK AND PROCUREMENT OF EQUIPMENT THE CONTRACTOR SHALL PROVIDE COUNTY REPRESENTATIVE (6) SIX COMPLETE SET OF MANUFACTURER'S DATA OR SHOP DRAWINGS OF THE FOLLOWING APPARATUS GIVING FULL INFORMATION AS TO DIMENSIONS, MATERIALS, PERFORMANCE, AND SEQUENCE OF OPERATION FOR REVIEW:
- A) BOILER/BURNER CONTROLS INSTALLATION DETAIL
- B) BOILER FEED UNIT
- D) PIPING, VALVES, FITTINGS, ACCESSORIES, AND ROUTING LAYOUT
- E) COMBUSTION AIR INTAKE SYSTEM
- F) SUPPORT & HANGER DETAILS
- G) TEMPERATURE CONTROLS, SENSORS, RELAYS, ETC.
- H) CHIMNEY LINER AND BREECHING
- 10. ALL WORK DESIGNATED FOR DEMOLITION SHALL BE REMOVED OF SITE AND DISPOSED OF LEGALLY.
- 11. CONTRACTOR SHALL PROVIDE ALL POWER, CONTROL WIRING, AND CONDUIT AS PART OF A COMPLETE BOILER CONTROL SYSTEM.
- 12. CONTRACTOR SHALL PROVIDE ALL CONDUIT AND WIRE AS REQUIRED BETWEEN BURNER, BOILER CONTROLS, SAFETY INTERLOCKS, LIMITS, ETC.
- 13. CONTRACTOR SHALL ONLY BE PERMITTED TO WORK IN AREAS AS AUTHORIZED.
- 14. PROVIDE ALL PIPE OPENINGS THROUGH PARTITIONS WITH PIPE SLEEVES. FOR PIPES PENETRATING FIRE RATED PARTITIONS, THE SPACE BETWEEN THE PIPE AND THE SLEEVE SHALL BE SEALED WITH FIRE STOPPING MATERIAL. PENETRATIONS FOR PIPING SHALL BE MADE BY CORE DRILLING WHENEVER POSSIBLE.
- 15. ALL VSDs, MOTOR STARTERS, AND DISCONNECT SWITCHES FOR HVAC EQUIPMENT SHALL BE FURNISHED AND INSTALLED BY THE CONTRACTOR UNLESS OTHERWISE NOTED. DISCONNECT SWITCHES FURNISHED BY THE CONTRACTOR FOR HVAC EQUIPMENT SHALL BE HEAVY DUTY TYPE.
- 16. DUCT DIMENSIONS SHOWN ON MECHANICAL DRAWINGS REFER TO INSIDE CLEAR DUCT DIMENSIONS.
- 17. ALL WORK SHALL COMPLY WITH NEW YORK STATE BUILDING CODE, LOCAL BUILDING CODE, AND ENERGY CODE REQUIREMENTS. IN CASE OF CONFLICT BETWEEN THE CONTRACT DOCUMENTS AND A GOVERNING CODE OR ORDINANCE, THE MORE STRINGENT STANDARD SHALL APPLY.
- 18. THE CONTRACTOR SHALL BE RESPONSIBLE FOR PROVIDING TEMPORARY VENTILATION AND EXHAUST AIR WHEN WELDING OR SOLDERING OPERATIONS ARE PERFORMED, AS REQUIRED BY OSHA.

GENERAL MECHANICAL NOTES (CONT.)

- 19. WHERE EXISTING BUILDING STRUCTURAL COMPONENTS HAVE FIREPROOF MATERIAL, ANY AREA THAT IS DISTURBED OR DAMAGED AS A RESULT OF MECHANICAL WORK, INCLUDING THE INSTALLATION OF HANGERS FOR PIPING, DUCTWORK, OR EQUIPMENT, SHALL BE PATCHED WITH UL AND FM APPROVED FIREPROOFING.
- 20. THE MECHANICAL CONTRACTOR SHALL PROVIDE ALL CUTTING, PATCHING, CORE DRILLING, ACCESS PANELS, PAINTING, AND FINAL RESTORATION REQUIRED TO FACILITATE THE INSTALLATION OF DUCTWORK, CONTROL CONDUITS, AND PIPING, INCLUDING ABOVE CEILINGS AND IN SHAFTS THAT WILL NOT BE REPLACED OR OPENED UNDER ANY OTHER SCOPE OF WORK RELATED TO THIS PROJECT. CONTRACTOR TO REMOVE AND REPLACE CEILINGS, AND OPEN AND PATCH SHAFTS AND WALLS, AS REQUIRED TO EXECUTE THE MECHANICAL WORK.

PAYMENT ITEM B

THIS CONTRACTOR SHALL BE ENTITLED TO THE BUILDING SERVICE COMPANY'S (JCI) COST PLUS 10 PERCENT. BEFORE ANY PAYMENT WILL BE MADE, THIS CONTRACTOR MUST PROVIDE THE BUILDING SERVICE COMPANY'S ITEMIZED INVOICE.

BUILDING SERVICE COMPANY INFORMATION
SCOTT BENNETT
(914)589-4339
SCOTT.BENNETT@JCI.COM
JOHNSON CONTROLS, INC.
8 SKYLINE DRIVE

HAWTHORNE, NY 10532

WESTCHESTER COUNTY, NEW YORK DEPARTMENT OF PUBLIC WORKS

NOTES

BOILER REPLACEMENT AND ASSOCIATED WORK
VERNON PLAZA FAMILY CENTER

17 SOUTH SECOND AVENUE, MOUNT VERNON, NEW YORK

SHEET NO. 6 OF 9

SCALE: AS SHOWN
DATE: 06/04/21

DPW FILE NO. REV. NO. NO. S4-29-HV-52 0

SHEET NUMBER

HV-2


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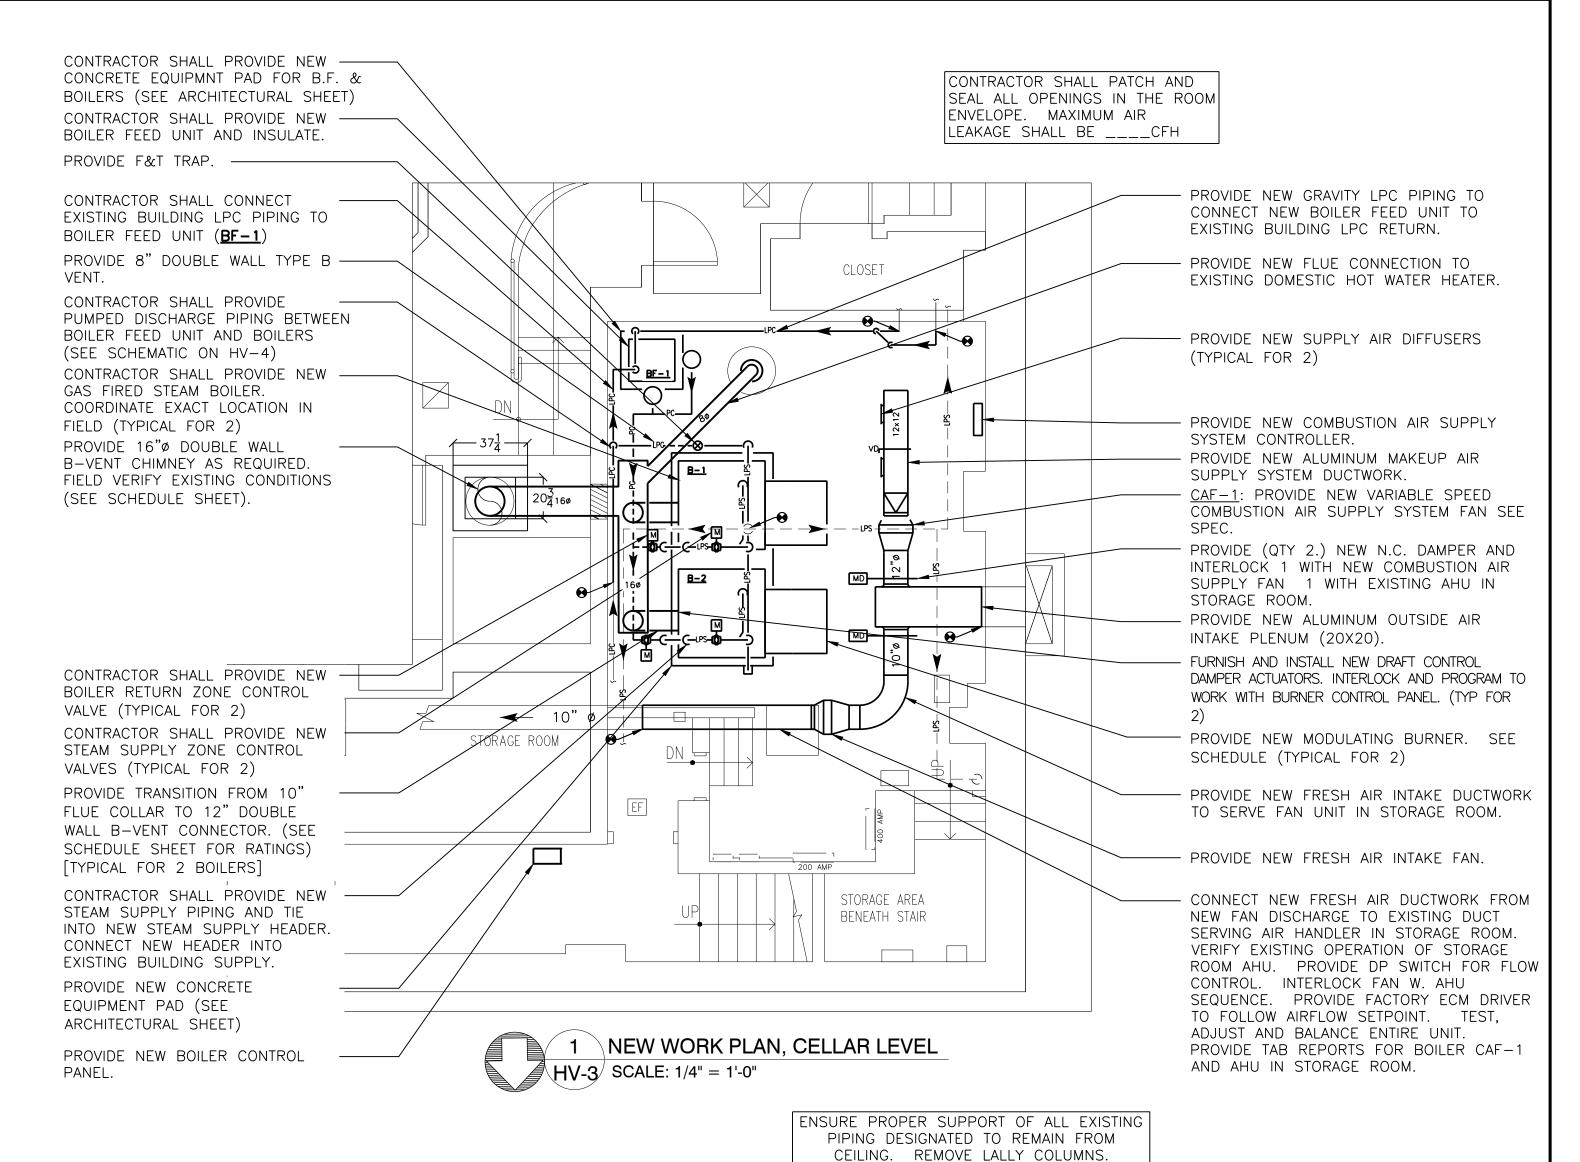
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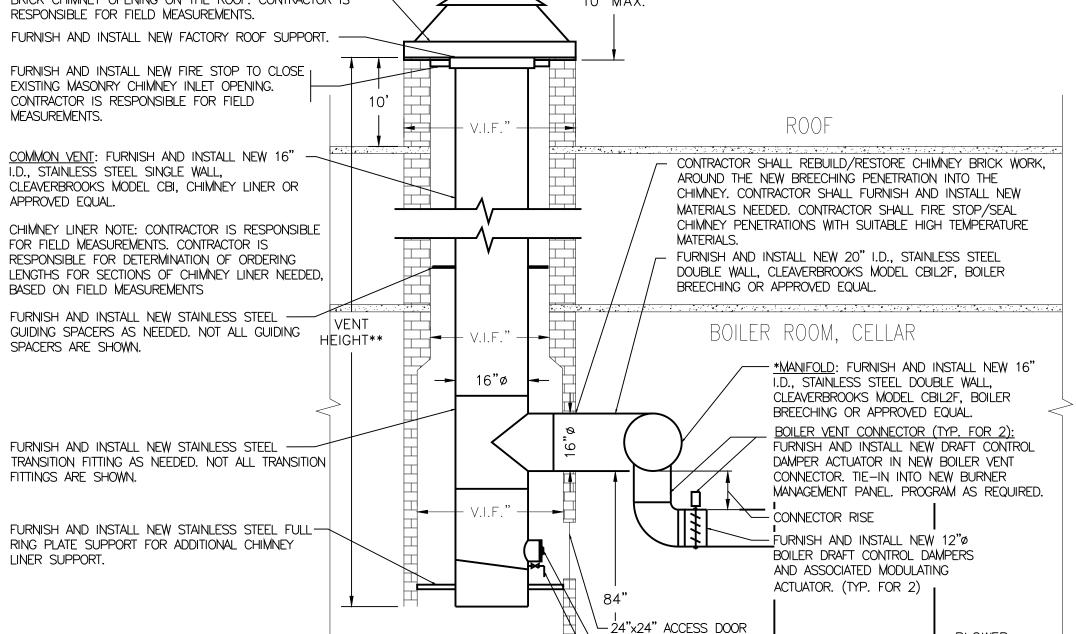
IN CHARGE OF <u>JAI PUNNOOSE, P.E.</u>

CHECKED BY _____

MADE BY VINCENT LEONE, P.E.





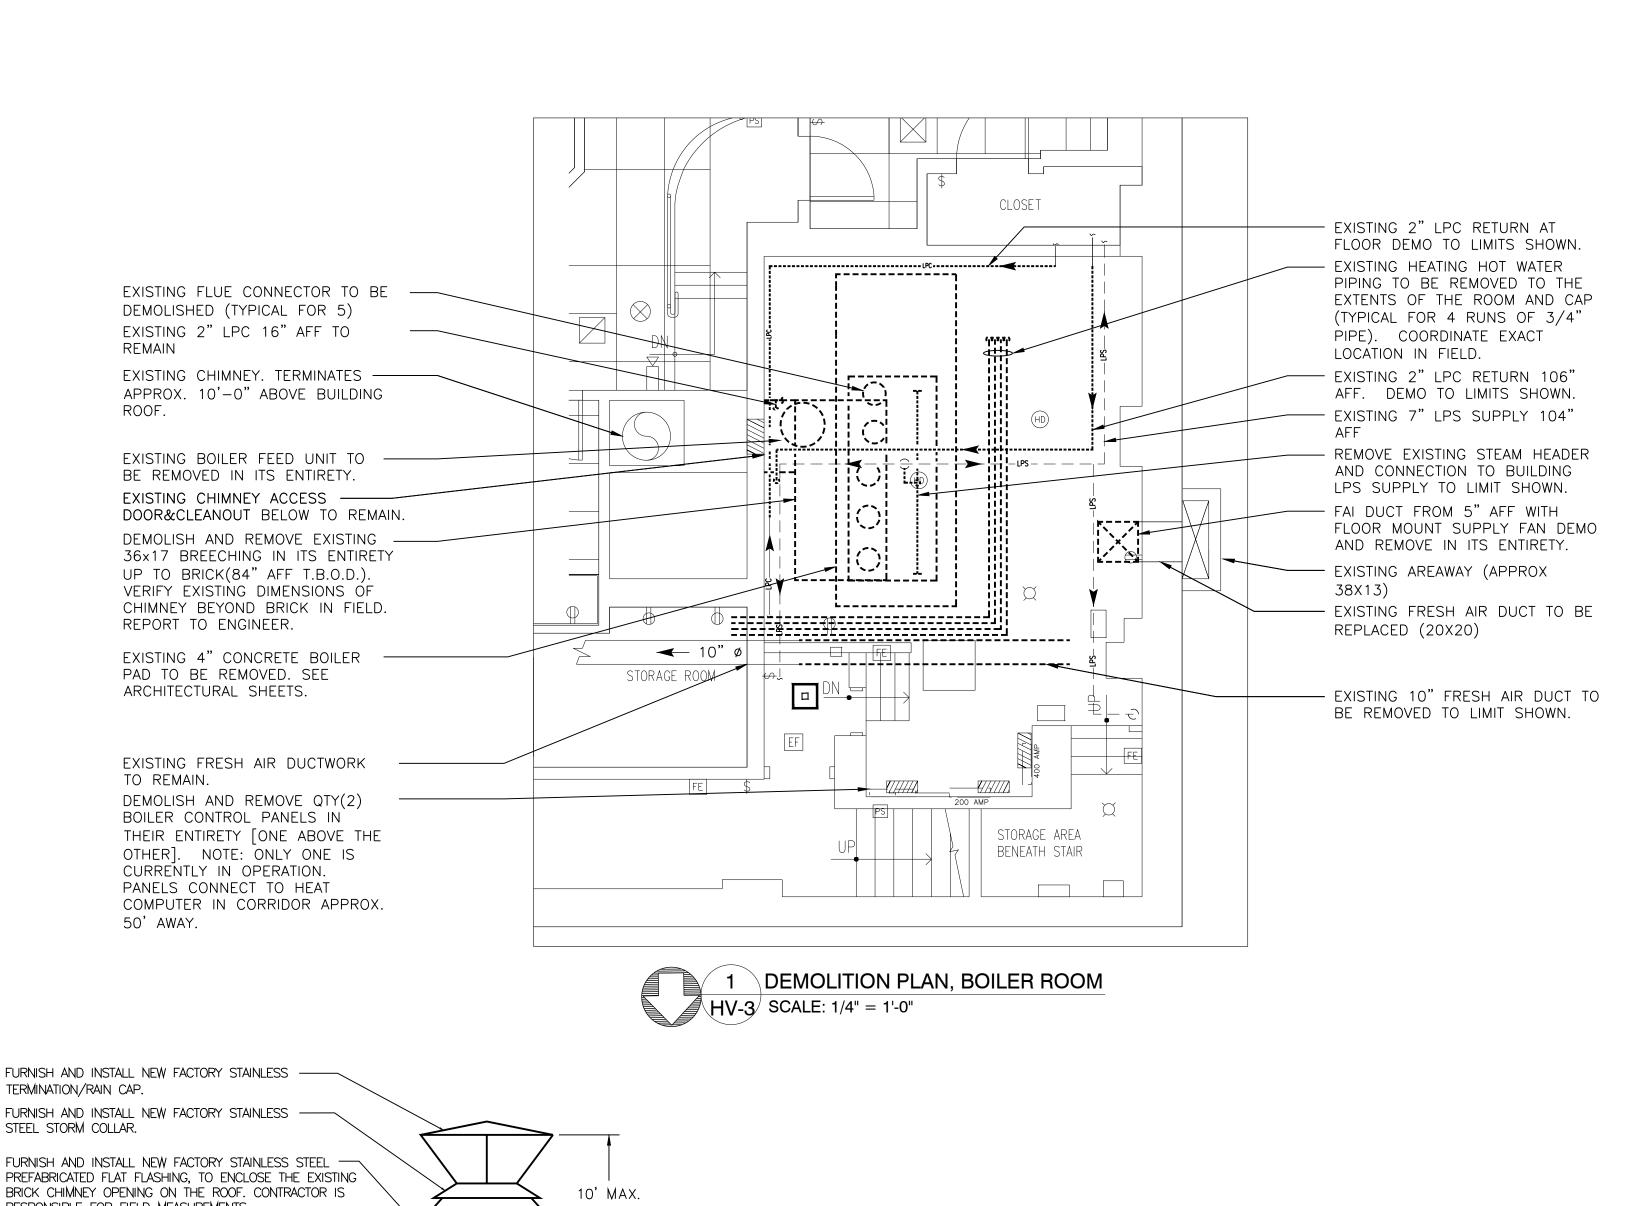

- NEW CLEAN OUT

DRAIN VALVE.

2 BOILER ROOM/ROOF MECHANICAL NEW WORK VENTING SKETCH

VERTICAL VENT TO THE NEAREST APPLIANCE

SHOULD NOT EXCEED 10 FEET OR 50% OF

THE TOTAL VENT HEIGHT, WHICHEVER IS

**APPROX 50' (VERIFY IN FIELD)

GREATEST.

HV-3/SCALE: N.T.S

JAI PUNNOOSE, P.E.

VINCENT LEONE, P.E.

CHECKED BY

-NEW DRAIN PIPE WITH

*MANIFOLD LENGTH FROM THE BASE OF THE REFER. TABLE 504.3 2018 IFGC

WAICK HEAICK			
VENT CONNECTOR PARAMETER		VALUE	
VENT HEIGHT		50	
CONNECTOR RISE (FT)		3	
TYPE B DOUBLE WALL VENT Ø(INCHES)		8	
APPLIANCE INPUT RATING LIMIT (MBH) FAN _{min} / FAN _{MAX} / NAT _{MAX}	103	3 / 661 / <u>343</u>	
BOILER			
VENT CONNECTOR PARAMETER		VALUE	
VENT HEIGHT	50		
CONNECTOR RISE (FT)	2		
TYPE B DOUBLE WALL VENT Ø(INCHES)		12	
APPLIANCE INPUT RATING LIMIT (MBH) FAN _{min} / FAN _{MAX} / NAT _{MAX}	206	206 / 1479 / 689	
COMMON VENT PARAMETER		VALUE	
VENT HEIGHT		50	
TYPE B DOUBLE WALL VENT Ø(INCHES)		16	
COMBINED APPLIANCE INPUT RATING (MI FAN + NAT	3H)	3,183	

WATER HEATER

BLOWER

NOTE: EXISTING WATER HEATER IS IN AFT GROUND AND

NOT SHOWN HERE FOR CLARITY. CONNECT NATURAL

DRAFT HOOD TO END OF MANIFOLD WITH 8" VENT

DOUBLE WALL VENT CONNECTOR (SEE PLAN VIEW).

CHIMNEY NOTES: CONTRACTOR TO VERIFY THE FOLLOWING AND REPORT BACK TO ENGINEER: ACTUAL VENT HEIGHT OF EXISTING CHIMNEY. ACTUAL VENT DIAMETER OF EXISTING CHIMNEY/LINER AND CONDITION.

FAN MBH (MIN/MAX) (450/1,356) BOILER 2(NOT SHOWN): FAN MBH (MIN/MAX) (450/1,356) WATER HEATER(NOT SHOWN): NATURAL DRAFT (300MBH)

EXISTING BRICK CHIMNEY NOTES:

- CONTRACTOR SHALL CHECK FOR CRACKS. MISSING BRICKS/MORTAR OR ANY OTHER LOOSE WATERIALS THAT COULD INHIBIT NEW LINER INSTALLATION AND CORRECTING PROBLEMS. PRIOR TO INSTALLATION
- . CONTRACTOR SHALL PERFORM VIDEO INSPECTION, THE ENTIRE LENGTH OF EXISTING CHIMNEY, SUBMIT REPORT TO COUNTY 3. CONTRACTOR IS RESPONSIBLE FOR INTERIOR CLEANING AND NEUTRALIZATION OF EXISTING MASONRY CHIMNEY.
- 4. CONTRACTOR SHALL CLEAN WITH A WATER JET ALL INTERIOR SURFACES OF EXISTING MASONRY CHIMNEY TO REMOVE ANY COMBUSTION 5. CONTRACTOR SHALL WASH WITH CLEAN WATER ON AIR PRESSURE WITH A MIXTURE OF 10% POTASSIUM CARBONATE TO NEUTRALIZE
- ACCUMULATED ACID INSIDE THE CHIMNEY, AND LET IT ACT FOR A MINIMUM OF 12 HOURS PRIOR TO RINSING WITH CLEAN WATER ON AIR PRESSURE.
- 6. CONTRACTOR SHALL OPEN UP THE EXISTING BRICK CHIMNEY, AT THE BASE, AS NEEDED, INSIDE THE BOILER ROOM, TO PERFORM CHIMNEY LINER COMPONENTS ASSEMBLY WORK OR STRUCTURAL SUPPORT WORK ETC. CONTRACTOR SHALL PROVIDE TEMPORARY STRUCTURAL SUPPORTS TO EXISTING BRICK CHIMNEY DURING LINER INSTALLATION WORK. CONTRACTOR SHALL REBUILD/ RESTORE CHIMNEY BRICK WORK AFTER LINER WORK IS COMPLETED. CONTRACTOR IS RESPONSIBLE FOR MATERIALS AND LABOR NEEDED FOR REBUILDING CHIMNEY. CONTRACTOR SHALL FIRE STOP, FIRE/WATER SEAL CHIMNEY.

BREECHING DEMOLITION NOTES:

- 1. AS PART OF DEMOLITION WORK, CONTRACTOR SHALL DISCONNECT EXISTING BREECHING FROM THE BOILERS AND
- CHIMNEY, PRIOR TO CUTTING INTO SMALLER SECTIONS AND REMOVAL FROM THE BOILER ROOM. 2. CONTRACTOR SHALL CLEAN EXISTING BREECHING INSIDE FOR SOOT REMOVAL, PRIOR TO CUTTING INTO SMALLER
- PIECES FOR DISPOSAL OFFSITE. 3. CONTRACTOR IS RESPONSIBLE FOR LEGAL OFFSITE DISPOSAL OF EXISTING BOILER BREECHING.
- 4. CONTRACTOR IS RESPONSIBLE FOR CUTTING AND PATCHING. 5. CONTRACTOR IS RESPONSIBLE FOR ANY REPAIR WORK NEEDED TO EXISTING BRICK CHIMNEY.
- 6. ANY CUTTING, GRINDING, TORCH WORK SHALL FOLLOW HOT WORK SAFETY PROCEDURES.
- 7. ALL WORK AREAS SHALL BE EXHAUST VENTILATED TO THE OUTDOORS OR CHIMNEY TO PREVENT ODORS/FUMES WITH-IN THE BUILDING.

NEW CHIMNEY LINER INSTALLATION NOTES:

AND ALL COSTS, LICENSES ASSOCIATED

- 1. CONTRACTOR SHALL FURNISH AND INSTALL NEW 20" I.D., 20 GAGE, STAINLESS STEEL, CLEAVERBROOKS MODEL CBI CHIMNEY LINER OR APPROVED EQUAL.
- 2. CONTRACTOR SHALL FURNISH AND INSTALL NEW STAINLESS STEEL PREFABRICATED FLAT FLASHING, TO ENCLOSE THE EXISTING BRICK CHIMNEY OPENING ON THE ROOF. CONTRACTOR IS RESPONSIBLE FOR FIELD MEASUREMENTS.
- 3. CONTRACTOR IS RESPONSIBLE FOR FIELD MEASUREMENTS PRIOR TO FINALIZING LINER LENGTHS NEEDED AND ORDERING NEW LINER
- 4. CONTRACTOR IS RESPONSIBLE FOR ALL LABOR REQUIRED FOR TRANSPORTING/ DELIVERING SECTIONS OF THE NEW LINER MATERIAL TO 8TH FLOOR ROOF OF THE BUILDING. 5. CONTRACTOR IS RESPONSIBLE FOR ALL HOISTING, LIFTING, GUIDING, RIGGING PERMITS AND SAFE OPERATION REQUIREMENTS ETC. NEEDED
- 6. CONTRACTOR IS RESPONSIBLE FOR STRUCTURAL SUPPORTS, FIRE/WATER STOPPING OF EXISTING BRICK CHIMNEY/NEW CHIMNEY LINER. CONTRACTOR IS RESPONSIBLE FOR CUTTING AND PATCHING. 8. CONTRACTOR IS RESPONSIBLE FOR ALL REPAIRS NEEDED ON EXISTING BRICK CHIMNEY TO ACCOMMODATE INSTALLATION OF NEW CHIMNEY
- 9. CONTRACTOR IS RESPONSIBLE FOR COMPLETE ASSEMBLY NEW CHIMNEY LINER SECTIONS FOR SUCCESSFUL INSTALLATION. 10.CONTRACTOR IS RESPONSIBLE FOR TESTING FOR LEAKS, FIXING LEAKS AND PUTTING NEW CHIMNEY IN OPERATION.

DEMOLITION NOTES:

- 1. CONTRACTOR IS RESPONSIBLE FOR ALL PIPING/WIRING DISCONNECTIONS NEEDED, PRIOR TO DEMOLITION OF EXISTING BOILER AND ASSOCIATED FLOOR MOUNTED CONTROL PANELS.
- 2. CONTRACTOR IS RESPONSIBLE FOR FIELD VERIFICATION OF EXISTING PIPING CONNECTIONS/ROUTING AND WIRING CONNECTIONS THROUGHOUT BOILER/CONTROL PANELS.
- 3. CONTRACTOR IS RESPONSIBLE TO DEMOLISH AND REMOVE EXISTING NATURAL GAS PIPING. NG PIPING SHOWN ON THE DRAWING IS FOR BID PURPOSES ONLY. CONTRACTOR IS RESPONSIBLE FOR FIELD VERIFICATION OF PIPING LENGTHS, ROUTING,
- 4. CONTRACTOR IS RESPONSIBLE FOR TRANSPORTATION AND LEGAL OFFSITE DISPOSAL OF ALL MATERIAL CALLED OUT TO BE
- DEMOLISHED AND REMOVED. 5. CONTRACTOR IS RESPONSIBLE FOR CUTTING AND PATCHING. CONTRACTOR IS RESPONSIBLE FOR RESTORING ANY BUILDING
- SURFACES DAMAGED DURING DEMOLITION WORK 6. CONTRACTOR IS RESPONSIBLE FOR ALL REPAIRS NEEDED TO EXISTING CONCRETE FLOORS, BRICK WALLS AND BUILDING STRUCTURE DAMAGED DURING DEMOLITION PROCESS.
- 7. DEMOLISH EXISTING BOILER COMPLETE. CUT 6"LPS PIPING TO LPS HEADER, 2"LPC PIPING TO LPC HEADER, AND BREECHING
- AS INDICATED ON DEMOLITION FLOOR PLAN. 8. DEMOLISH EXISTING STEEL FLOOR SUPPORTS, BURNER, BURNER CONTROLS, CONTROL CABINET, CONDUITS, WIRING, PIPE
- VALVES, & SPECIALTIES COMPLETE.

NEW WORK NOTES:

- 1. CONTRACTOR IS RESPONSIBLE FOR COMPLETE INSTALLATION OF NEW MODULATING GAS BURNERS AND ALL ASSOCIATED EQUIPMENT.
- 2. CONTRACTOR IS RESPONSIBLE FOR INSTALLATION OF CONTROLS PANEL AND ASSOCIATED EQUIPMENT.
- 3. CONTRACTOR IS RESPONSIBLE FOR INSTALLATION OF DRAFT CONTROL ACTUATORS AND ASSOCIATED CONTROLS DISPLAY PANELS. 4. CONTRACTOR IS RESPONSIBLE FOR COMPLETE INSTALLATIONS OF ALL EQUIPMENT.
- 5. CONTRACTOR IS RESPONSIBLE FOR NEW ELECTRICAL/CONTROLS WIRING AND CONDUIT NEEDED. CONTRACTOR IS RESPONSIBLE FOR WIRING TERMINATIONS.
- 6. NEW GAS BURNERS ASSOCIATED FIELD DEVICES OR ELECTRICAL/CONTROLS WIRING DETAILS NOT SHOWN ON THE DRAWINGS. 7. CONTRACTOR IS RESPONSIBLE TO COORDINATE WITH VENDORS TO OBTAIN ADDITIONAL INFO OR DRAWINGS.
- 8. CONTRACTOR SHALL PROVIDE NEW MOUNTING HARDWARE NEEDED FOR MOUNTING THE NEW CONTROL PANELS AND ASSOCIATED
- FIELD DEVICES. 9. CONTRACTOR IS RESPONSIBLE FOR CUTTING/PATCHING.
- 10. CONTRACTOR IS RESPONSIBLE FOR ALL MODIFICATIONS, REPAIRS, RESTORATION, ETC NEEDED ON EXISTING CONCRETE FLOORS, BRICK WALLS, ETC INSIDE THE BOILER ROOM AS NEEDED FOR NEW INSTALLATION WORK.
- 11. CONTRACTOR IS RESPONSIBLE FOR ALL WORK RELATED TO SWITCHING OVER THE BUILDING FROM RENTAL BOILERS TO NEW MODULATING GAS FIRED BURNERS. SEE BID ITEM B ON HV-2.
- 12. CONTRACTOR IS RESPONSIBLE FOR TESTING AND PUTTING NEW MODULATING GAS FIRED BOILERS IN SERVICE. 13. CONTRACTOR IS RESPONSIBLE FOR TROUBLE SHOOTING NEW GAS BOILERS AND ASSOCIATED EQUIPMENT FOR PROPER
- OPERATION. ANY BOILER PROBLEMS SHALL BE BOUGHT TO THE ATTENTION OF THE ENGINEERS. 14. CONTRACTOR IS RESPONSIBLE FOR PROVIDING FACTORY AUTHORIZED TRAINING PERSONNEL FOR A MINIMUM OF 20 HRS, TO TRAIN BUILDING OPERATIONS PERSONNEL, ON NEW SYSTEMS.

WESTCHESTER COUNTY, NEW YORK DEPARTMENT OF PUBLIC WORKS	CONTRACT SHEET NUMBER 21-514 HV-3
DIVISION OF ENGINEERING	SHEET NO. 7 OF 9
BOILER REPLACEMENT AND ASSOCIATED WORK VERNON PLAZA FAMILY CENTER	SCALE: AS SHOWN DATE: 06/04/21
17 SOUTH SECOND AVENUE, MOUNT VERNON, NEW YORK	DPW FILE NO. REV NO.
DEMOLITION AND NEW WORK PLAN, CELLAR LEVEL	54-29-HV-53 0

BOILER SCHEDULE


- BOILER(B-1 & B-2) SHALL BE WEIL MCLAIN BG-588-S CAST IRON SECTIONAL OR APPROVED EQUAL. BOILER SHALL BE GAS FIRED, 33.6 BHP, ,1356INPUT , 1,1260UTPUT MBH WITH THERMAL EFFICIENCY OF 83.1%, FORCED DRAFT TYPE, WITH 10" FLUE OUTLET; 44-1/4"W x 65"H x 42-3/4" L; DRY WEIGHT OF 3210 LBS.
- BURNER SHALL BE POWER FLAME CR1-G-12 ATI OR EQUAL. BURNER INPUT SHALL BE 1356 MBH (845 MBH I=B=R RATING), 1/3HP BLOWER, 1-1/4" GAS TRAIN SIZE, 4" WC MIN, 14" WC MAX GAS INLET PRESSURE; 10-1 MODULATING; 115V/1/60.
- PROVIDE INTERLOCKS FOR THE BREAK GLASS STATIONS, FRESH AIR DAMPERS, GAS DETECTION.
- 4. INCLUDE BURNER MOUNTED BURNER PANELS, AND FSG CONTROL.
- INCLUDE GAS TRAIN FIELD PIPED AND WIRED.
- THE CONTRACTOR SHALL FURNISH AND INSTALL UL APPROVED POWER FLAME MODEL SYNC-MATIC HMI PROGRAMMABLE CONTROLLER BASED LEAD-LAG SYSTEM. SEE BOILER CONTROLS SYSTEM DETAILS ON THIS SHEET.

BOILER FEED UNIT SCHEDULE

- BOILER FEED UNIT SHALL BE BELL & GOSSETT DOMESTIC PUMP MODEL 61.5CM DUPLEX OR APPROVED EQUAL. UNIT SHALL INCORPORATE 2 PUMPS OPERATING AT 1/3 HP 115/1/60HZ & 7.9 FLA EACH @ 1750 RPM; 6 GPM @ 15PSI WITH 2"INLET, ¾" OUTLET, 6-3/16"IMPELLER; 632 LBS., 21"W x 13" H x 23" L AND 2" OVERFLOW AND VENT CONNECTIONS.
- NEMA 2 TYPE CONTROL PANEL, UNIT MOUTNED & WIRED; LIQUID TIGHT CONDUIT; MAGNETIC STARTERS WITH FUSED DISCONNECT W/ FUSES; SELECTOR SWITCHES -BOILER/PUMP; POWER CONTROL SWITCHING RELAY; SINGLE POWER POINT CONNECTION; UL LISTING.
- 3. 3-VALVE BYPASS AROUND MAKEUP VALVE; AIR GAP FITTING ON MAKEUP ASSEMBLY; LOW LEVEL FLOAT AND LOW WATER CUTOFF WIRED TO TERMINAL FOR REMOTE ANNUNCIATION; GAUGE GLASS; DIAL THERMOMETER; DISCHARGE PRESSURE GAUGE; LIFTING EYES; BUTTERFLY SUCTION VALVE; 1-CONTROL RELAY

BOILER FEED UNIT CONTROL NOTES:

- 1. BOILER FEED UNIT CONTROL SHALL CONSIST OF THE FOLLOWING:
- 2 COMBINATION MAGNETIC STARTERS (3 OVERLOAD RELAYS) WITH FUSED DISCONNECTS AND COVER INTERLOCKS.
- 2 "OFF-HAND-LEAD-LAG" PUMP SELECTOR SWITCHES
- 2 PUMP RUNNING PILOT LIGHTS.
- 1 NUMBERED TERMINAL BLOCK • 1 FUSED CONTROL CIRCUIT TRANSFORMER WHEN THE MOTOR EXCEEDS 130 V
- 1 CONTROL CIRCUIT RELAY
- 1 CONTROL POWER RELAY.
- 2. CONTROL CABINET SHALL CONTAIN U.L. LISTED OR RECOGNIZED COMPONENTS.
- 3. CONTROL COMPONENTS SHALL BE PROVIDED BY THE UNIT MANUFACTURER, FOR OPERATION AS FOLLOWS:
- 3.1. AS THE LEVEL IN THE BOILER RECEDES, THE PUMP CONTROL SWITCH WILL CLOSE OPENING THE FEED VALVE AND STARTING ONE PUMP (THROUGH THE END SWITCH). AS THE LEVEL IS RESTORED, THE SWITCH WILL OPEN, CLOSE THE VALVE, AND STOP THE PUMP. SHOULD THE LEVEL CONTINUE TO RISE, THE LOWER CONTACTS WILL CLOSE AND START THE REMAINING PUMP. EACH PUMP SELECTOR SWITCH SHALL PROVIDE "OFF-HAND-LEAD-LAG" POSITIONS.
- 4. MANUAL SEQUENCE CONTROL SHALL PROVIDE FOR MANUAL SELECTION OF THE ACTIVE OR LEAD PUMP, SIMULTANEOUS OPERATION OF BOTH PUMPS UNDER ABNORMAL LOAD CONDITIONS AND AUTOMATIC OPERATION OF THE LAG PUMP IF THE LEAD PUMP OR ITS CONTROL FAILS.
- 5. THE UNIT MANUFACTURER SHALL FURNISH (1) MCDONALD MILLER PUMP CONTROL: NO.150S RATED TO 150 PSI FOR BOILERS WITH SEPARATE WATER COLUMNS
- 6. THE INSTALLING CONTRACTOR, IN ADDITION TO THE ABOVE NOTED PUMP CONTROL, SHALL PROVIDE AND INSTALL A LOW WATER CUTOFF SWITCH, A LOW WATER BOILER
- ALARM SWITCH AND ASSOCIATED CIRCUITS IN ACCORDANCE WITH LOCAL CODES. 7. THE UNIT SHALL BE FACTORY TESTED AS A COMPLETE UNIT WITH A CERTIFIED TEST REPORT OF PUMP CHARACTERISTICS SHALL BE SUBMITTED PRIOR TO SHIPMENT. THE UNIT MANUFACTURER SHALL FURNISH COMPLETE ELEMENTARY AND CONNECTION WIRING DIAGRAMS (2dw408), PIPING DIAGRAMS (1 DPD08-A), INSTALLATION AND OPERATION
- 8. MANUFACTURER SHALL BE BELL & GOSSETT DOMESTIC PUMP, MORTON GROVE, IL OR EQUAL,

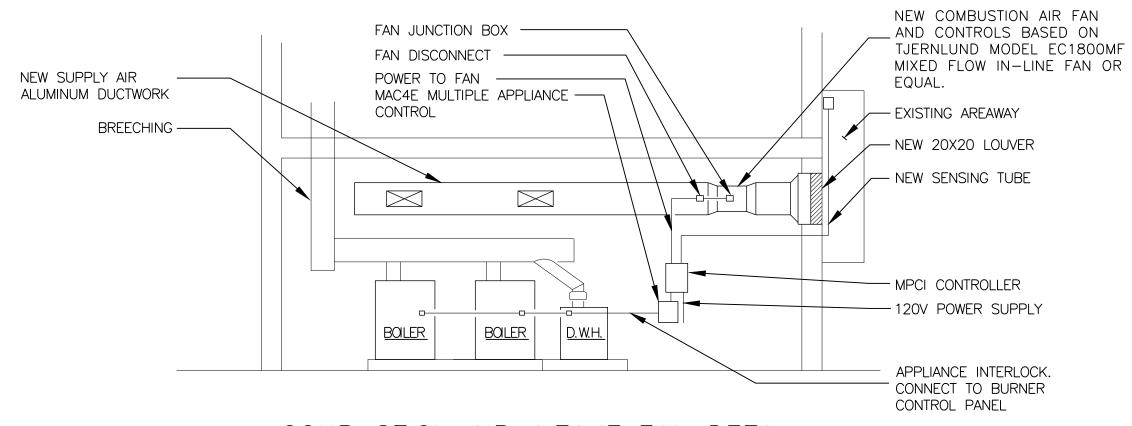

COMBUSTION AIR INTAKE FAN DETAIL

SCALE: NONE

CONTRACTOR SHALL PROVIDE MPCI MODULATING PRESSURE CONTROLLER WITH UC1 BURNER CIRCUIT INTERLOCK BY TJERNLUND OR EQUAL FOR BOILER BURNER CONTROL AND COMBUSTION AIR FAN SPEED CONTROL.

PROGRAM OPTION	FACTORY PRESETS	ADJUSTMENT RANGE
EXHAUST PRESSURE	-0.10" W.C.	-0.01" TO -0.40" W.C.
SUPPLY PRESSURE	+.00" W.C.	+0.01" TO +0.40" W.C.
ALARM CIRCUIT TIME	10 SEC.	1 SEC. TP 15 MIN
ACCELERATION RATE	50	SCALEE OF 1 TO 999
POWER REQUIREMENTS	120 VAC, 7AMPS	

ELECTRICAL ENCLOSURE SHALL BE 18-GAUGE GALVANIZED STEEL WITH HINGED ACCESS DOOR.

ETL C/US TO UL508 AND CSA C22.2 LISTINGS

WARRANTY: 1 YEAR

REQUIRED OPTIONS: MAC4E MULTIPLE APPLIANCE CONTROL; IPS-1 INDOOR PRESSURE SENSOR WITH DECORATIVE COVER TO

BE MOUNTED IN CORRIDOR.

IN CHARGE OF JAI PUNNOOSE, P.E.

<u>VINCENT LE</u>ONE, P.E.

CHECKED BY

MAINTAINS PRESSURE IN BOILER ROOM EQUAL TO PRESSURE IN REFERENCE SPACE.

COMBUSTION AIR FAN

CONTRACTOR SHALL PROVIDE EC1800MF MIXED FLOW IN-LINE FAN BY TJERNLUND OR EQUAL FOR COMBUSTION AIR VOLUME CONTROL. HOUSING SHALL BE GALVANIZED SHEET METAL WITH FOLDED SEEM AIR TIGHT CASING, 1" CONNECTION COLLAR, MIXED FLOW IMPELLER, EXTERNAL ROTOR EC-MOTOR. INPUT SIGNAL SHALL BE 0-10V DC FROM MPC-SERIES. FFP-1 FREEZE AND FIRE PROTECTION SWITCH. WEIGHT: 39 LBS

MOTOR SHLL BE ECM 120/1/60 VAC, 366 WATTS

UL/ULC LISTINGS

<u>COMBUSTION AIR INTAKE SYSTEM</u> $\left(HV - 4 \right)$

BOILER CONTROL SYSTEM DETAILS

THE CONTRACTOR SHALL FURNISH AND INSTALL A UL APPROVED POWER FLAME MODEL SYNC-MATIC HMI PROGRAMMABLE CONTROLLER BASED LEAD-LAG SYSTEM. THE LEAD-LAG FUNCTION SHALL BE BY THE PROGRAMMABLE CONTROLLER AND SHALL SERVICE 2 BOILER/BURNER UNITS. A 5.7" MINIMUM HMI OPERATOR TOUCH SCREEN SHALL BE STANDARD EQUIPMENT. THE HMI SHALL ALLOW THE OPERATOR TO INPUT SYSTEM OPERATING PARAMETERS AS WELL AS PROVIDE VISUAL INDICATION OF EACH BURNER'S OPERATION STATUS. FIRING RATE, OPERATING SET POINT, AS WELL AS THE PRESSURE OF THE COMMON HEADER. MODBUS COMMUNICATIONS SHALL BE STANDARD.


THE LEAD-LAG CONTROL PANEL SHALL INCLUDE THE FOLLOWING FEATURES:

- DIRECT ENTRY OF SYSTEM SET POINT THROUGH THE HMI.
- PID CONTROLLED AUTOMATIC MODULATION WITH BASELOAD OR PARALLEL MODULATION RESPONSE 4-20 mA SIGNAL).

MANUAL MODULATION INPUT FOR SYSTEM TESTING AND

- ADJUSTMENTS. • INDICATING LAMPS TO INDICATE BURNER ONLINE OR BURNER
- FAILED.
- LEAD LAG/ BACKUP SELECTOR SWITCH TO ALLOW CONTROL FUNCTION TO BE SWITCHED TO
- THE PROGRAMMABLE CONTROLLER:
- •• THE INDIVIDUAL BOILER-MOUNTED OPERATING AND MODULATION CONTROLLERS.
- ADJUSTABLE LEAD AND LAG BURNER ON AND OFF DELAY TIMERS, ACCESSIBLE THROUGH THE HMI.
- BOILER CYCLE AND BOILER HOUR COUNTERS.
- MULTIPLE LEAD SELECTION MODES: MANUAL, TIME ALTERNATE, TIME EQUALIZE, CYCLE ALTERNATE, CYCLE EQUALIZE, AND DAY OF WEEK.
- NIGHT AND/OR WEEKEND SETBACK SETTINGS ALLOW FOR REDUCED SET POINTS AT NON- PEAK TIMES TO REDUCE

- FUEL USAGE.
- FAILURE TRANSFER AUTOMATICALLY TRANSFERS FAILED BURNER'S SETTINGS TO THE NEXT AVAILABLE BURNER.
- THE SEQUENCE OF OPERATION SHALL BE AS FOLLOWS:
 - UPON START UP, BURNERS SHALL ALWAYS START IN THE LOW FIRE POSITION. UPON RELEASE OF THE COMBUSTION CONTROL SYSTEM, THE BURNERS SHALL MODULATE VIA THE PROGRAMMABLE CONTROLLER.
 - AS THE PRESSURE/TEMPERATURE INCREASES, THE HEADER MOUNTED TRANSDUCER WILL SIGNAL THE PROGRAMMABLE CONTROLLER. IN TURN, THE CONTROLLER SHALL SEQUENCE THE PID FIRING RATE CIRCUITS OF EACH ACTIVE MODULATING BURNER IN AN APPROPRIATE LEAD-LAG SEQUENCE.
 - UPON STILL FURTHER INCREASE IN PRESSURE/TEMPERATURE. THE PROGRAMMABLE CONTROLLER WILL DE-ENERGIZE THE LAG BURNER(S) THEN THE LEAD BURNER IN THE APPROPRIATE SEQUENCE. THIS FUNCTION WILL EITHER TAKE PLACE IMMEDIATELY OR AFTER A TIME DELAY BASED ON THE VARIANCE FROM SETPOINT. THE BURNERS WILL BE IN THE LOW FIRE POSITION BEFORE DE-ENERGIZING.
- WITH A DROP IN PRESSURE/TEMPERATURE, THE PROGRAMMABLE CONTROLLER WILL REVERSE THE SEQUENCE TO CALL THE BURNERS TO FIRE AND TO MODULATE THE BURNERS IN AN APPROPRIATE LEAD-LAG SEQUENCE.
- IN THE EVENT THAT ANY BURNER FAILS TO OPERATE, THE PROGRAMMABLE CONTROLLER SHALL AUTOMATICALLY TRANSFER CONTROL TO THE NEXT AVAILABLE BURNER.
- AN APPROPRIATE PRESSURE/TEMPERATURE TRANSDUCER SHALL BE SUPPLIED WITH EACH SYSTEM. THE TRANSDUCER SHALL BE INSTALLED IN THE MAIN STEAM/WATER HEADER.
- 3. OPTIONS:
 - OUTDOOR RESET: RAISES THE WATER PRESSURE SET POINT AS OUTSIDE TEMPERATURE INCREASES.

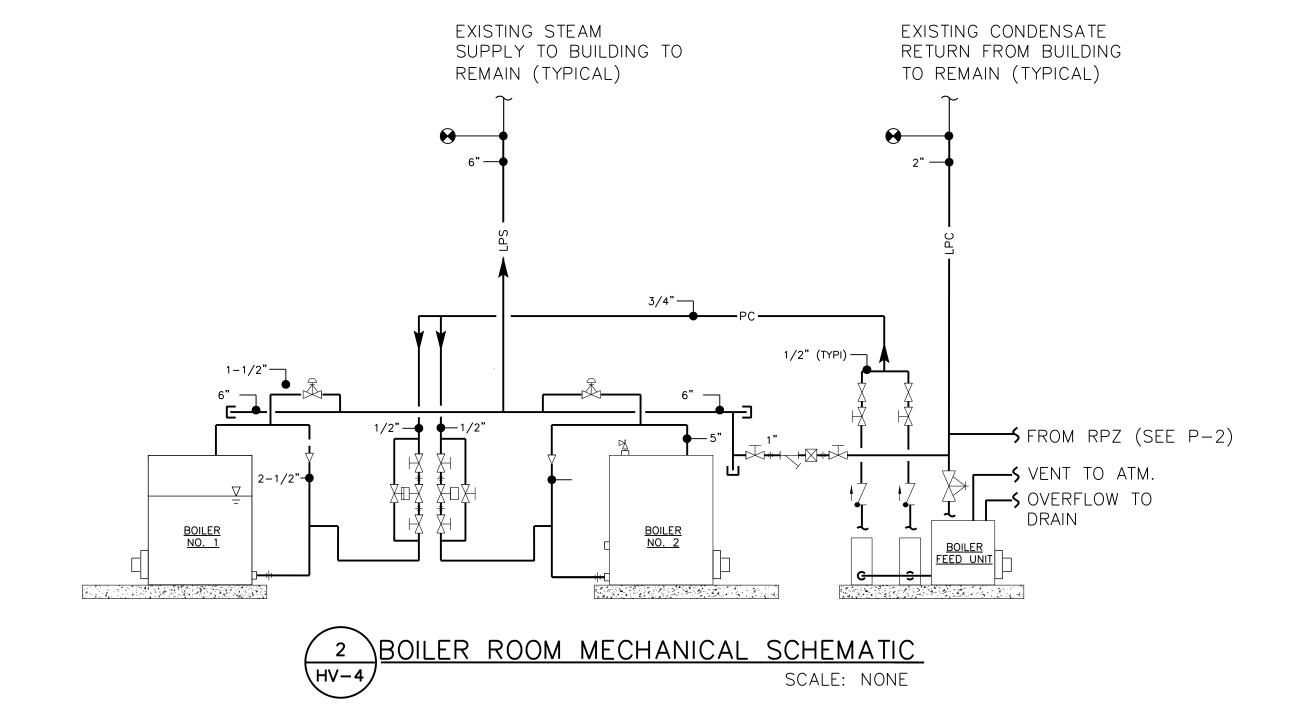

CONTRAC' NUMBER WESTCHESTER COUNTY, NEW YORK 21-514 DEPARTMENT OF PUBLIC WORKS DIVISION OF ENGINEERING SHEET NO. 8 OF 9 SCALE: AS SHOWN BOILER REPLACEMENT AND ASSOCIATED WORK DATE: 06/04/21 VERNON PLAZA FAMILY CENTER

17 SOUTH SECOND AVENUE, MOUNT VERNON, NEW YORK

SCHEDULE AND SCHEMATICS

SHEET NUMBER


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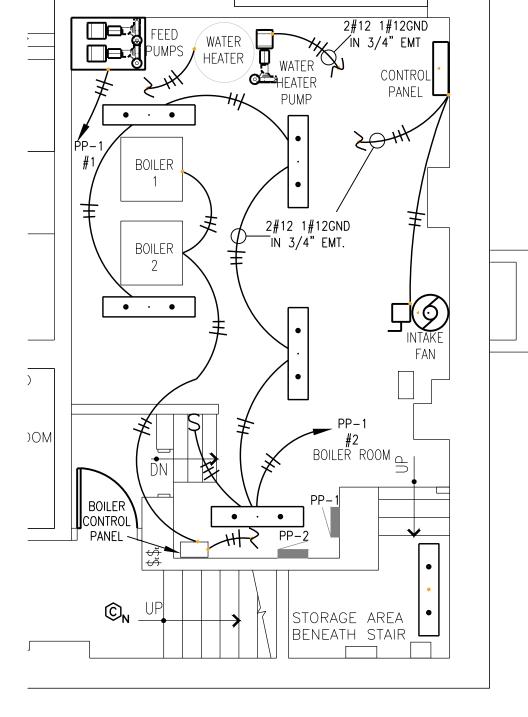
HV-4

OFFICE #2 OFFICE #1 ROOM VESTIBULE MAIN LOBBY BOILER ROOM BELOW THIS AREA. LAUNDRY SEE CELLAR PLAN PARTIAL 1ST FLOOR

E-1 SCALE: 1/4"=1'-0" FACP LOCATED IN SECURITY OFFICE




E-1 /SCALE: 1/4"=1'-0" EXISTING BOILER ELECTRICAL

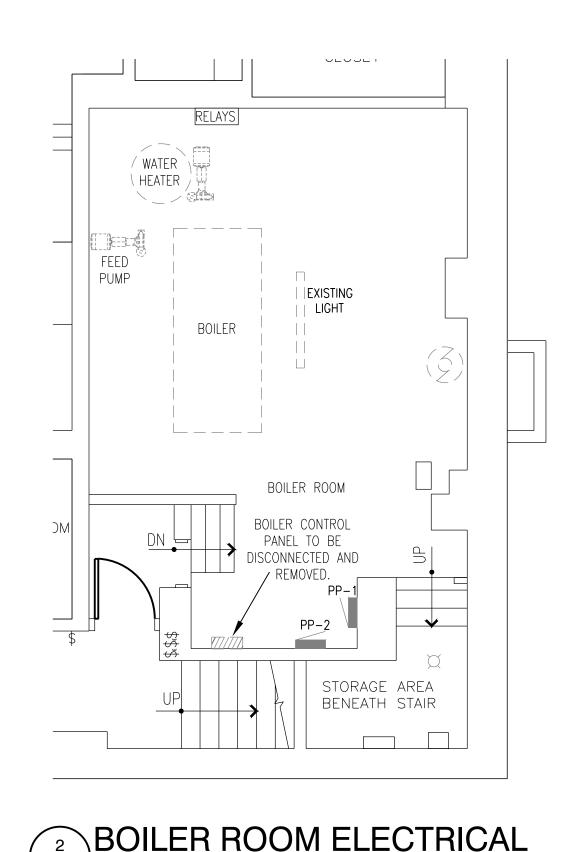


CLOSET



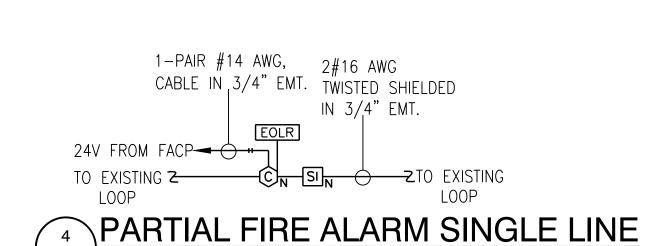

E-1 SCALE: NONE

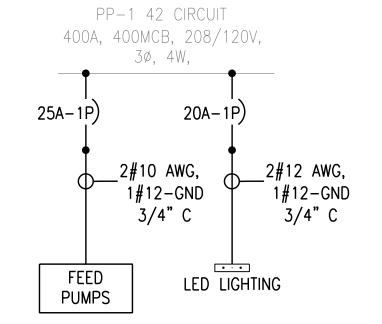

5 PARTIAL PP-1 SINGLE LINE
E-1 SCALE: NONE

IN CHARGE OF GARRY LYNCH CHECKED BY GARRY LYNCH MADE BY MICHAEL DEFONCE

SYMBOLS LIST

- EXISTING POWER PANEL SURFACE MOUNTED.
- BRANCH CIRCUITRY. # OF TICKS INDICATES # OF CONDUCTORS. #12 AWG MINIMUM.
- BRANCH CIRCUITRY. # OF TICKS INDICATES # OF CONDUCTORS. #12 AWG MINIMUM. TO EXISTING CIRCUIT AND EXTEND IF NEEDED.
- BRANCH CIRCUIT HOMERUN. #OF ARROW HEADS INDICATES # OF SEPARATE HOMERUNS. # OF TICKS INDICATES # OF CONDUCTORS. #12 AWG MINIMUM.
 - S 125/277 VOLT, 20AMP TOGGLE SWITCH ASSEMBLY.
 - ©_N CO DETECTOR. EDWARDS: #260 CO DETECTOR
 - SIN TRI-S SINGLE INPUT MONITOR MODULE.
 - FACE EXISTING FIRE ALARM CONTROL PANEL.
 - 42 WATT LED LUMINAIRE FOR MECHANICAL ROOM AS MANUFACTURED BY H.E. WILLIAMS LIGHTING MODEL #82-4-L64-840 L24-DRV-UVN. TO BE CHAIN HUNG.

NOTES:

- 1. CONTRACTOR SHALL DISCONNECT EXISTING WIRING FROM EXISTING BOILER AND EXTEND TO NEW BOILERS AND CONTROL PANEL. CONTRACTOR SHALL DISCONNECT AND REMOVE ALL BOILER ASSOCIATE WIRING AND EQUIPMENT/DEVICES NOT NEEDED FOR NEW BOILERS.
- 2. CONTRACTOR SHALL FURNISH AND INSTALL ALL MATERIAL AND LABOR NEEDED TO INSTALL BOILER ROOM ELECTRICAL.
- 3. CONTRACTOR SHALL COORDINATED ALL POWER SHUTDOWNS WITH COUNTY CONSTRUCTION COORDINATOR AND BUILDING MANAGER PRIOR TO ANY SHUTDOWNS.
- 4. CONTRACTOR SHALL FURNISH AND INSTALL A CO DETECTOR WITH ALL ASSOCIATED CABLE AND WIRING NEEDED TO INSTALL THE CO DETECTOR. THE CO DETECTOR SHALL BE FULLY COMPATIBLE WITH THE EXISTING FIRE ALARM SYSTEM.
- 5. CONTRACTOR SHALL BE RESPONSIBLE FOR THE TESTING AND REPROGRAMMING OF THE EXISTING FIRE ALARM SYSTEM AFTER INSTALLING CO DETECTOR.
- 6. THE CONTRACTOR SHALL COORDINATE ALL FIRE ALARM WORK WITH THE COUNTY FIRE ALARM SERVICE CONTRACTOR (OPEN SYSTEMS METRO INC, MIKE TIANO, (914)241-0057. CONTRACTOR SHALL INCLUDE ALL COSTS IN HIS BID.
- 7. CONTRACTOR SHALL BE RESPONSIBLE TO TRACE OUT ALL CIRCUITS HE IS WORKING ON AND UPDATE PANELBOARD SCHEDULES.
- 8. CONTRACTOR SHALL PERFORM ALL WIRE/CABLE TERMINATIONS AND LABEL WIRE/CABLES ON BOTH ENDS.
- 9. ALL WORK SHALL COMPLY WITH 2020 NEC AND NFPA 72 CODES.

REVISION NUMBER	DATE	MADE BY	APP'D BY	REVISION				
RECORD DRAWING CERTIFICATION								
AS BUILT - CHANGES AS NOTED AS BUILT - NO CHANGES								
CONTRACTOR					PROJECT COORDINATOR			
NAME SIGNATURE					NAMESIGNATURE			
TITLE DATE TITLE				DATE				
WESTCHESTER COUNTY, NOT DEPARTMENT OF PUBLIC WORKS AND T						CONTRACT NUMBER 21-514	SHEET NUMBER E – 1	
DIVISION OF ENGINEERING					SHEET NO. 9	OF 9		
BOILER REPLACEMENT AND ASSOCIATED WORK VERNON PLAZA FAMILY CENTER					SCALE: AS SHOWN DATE: 6/11/21			
17 SOUTH SECOND AVENUE MOUNT VERNON NEW YORK						DPW FILE NO.	REV.	

BOILER ROOM POWER AND LIGHTING PLAN

54-29-E-55 0