


MARCH 15, 2021

CONSTRUCTION DOCUMENTS

OWNER
Putnam Valley CSD

Putnam Valley Middle School
142 Peekskill Hollow Road
Putnam Valley, NY 10579
District Phone: 845.528.8143

2018 CAPITAL PROJECTS - PHASE 2
PUTNAM VALLEY MIDDLE SCHOOL TOILET ROOM ALTERATIONS
142 PEEKSKILL HOLLOW RD, PUTNAM VALLEY, NY 10579

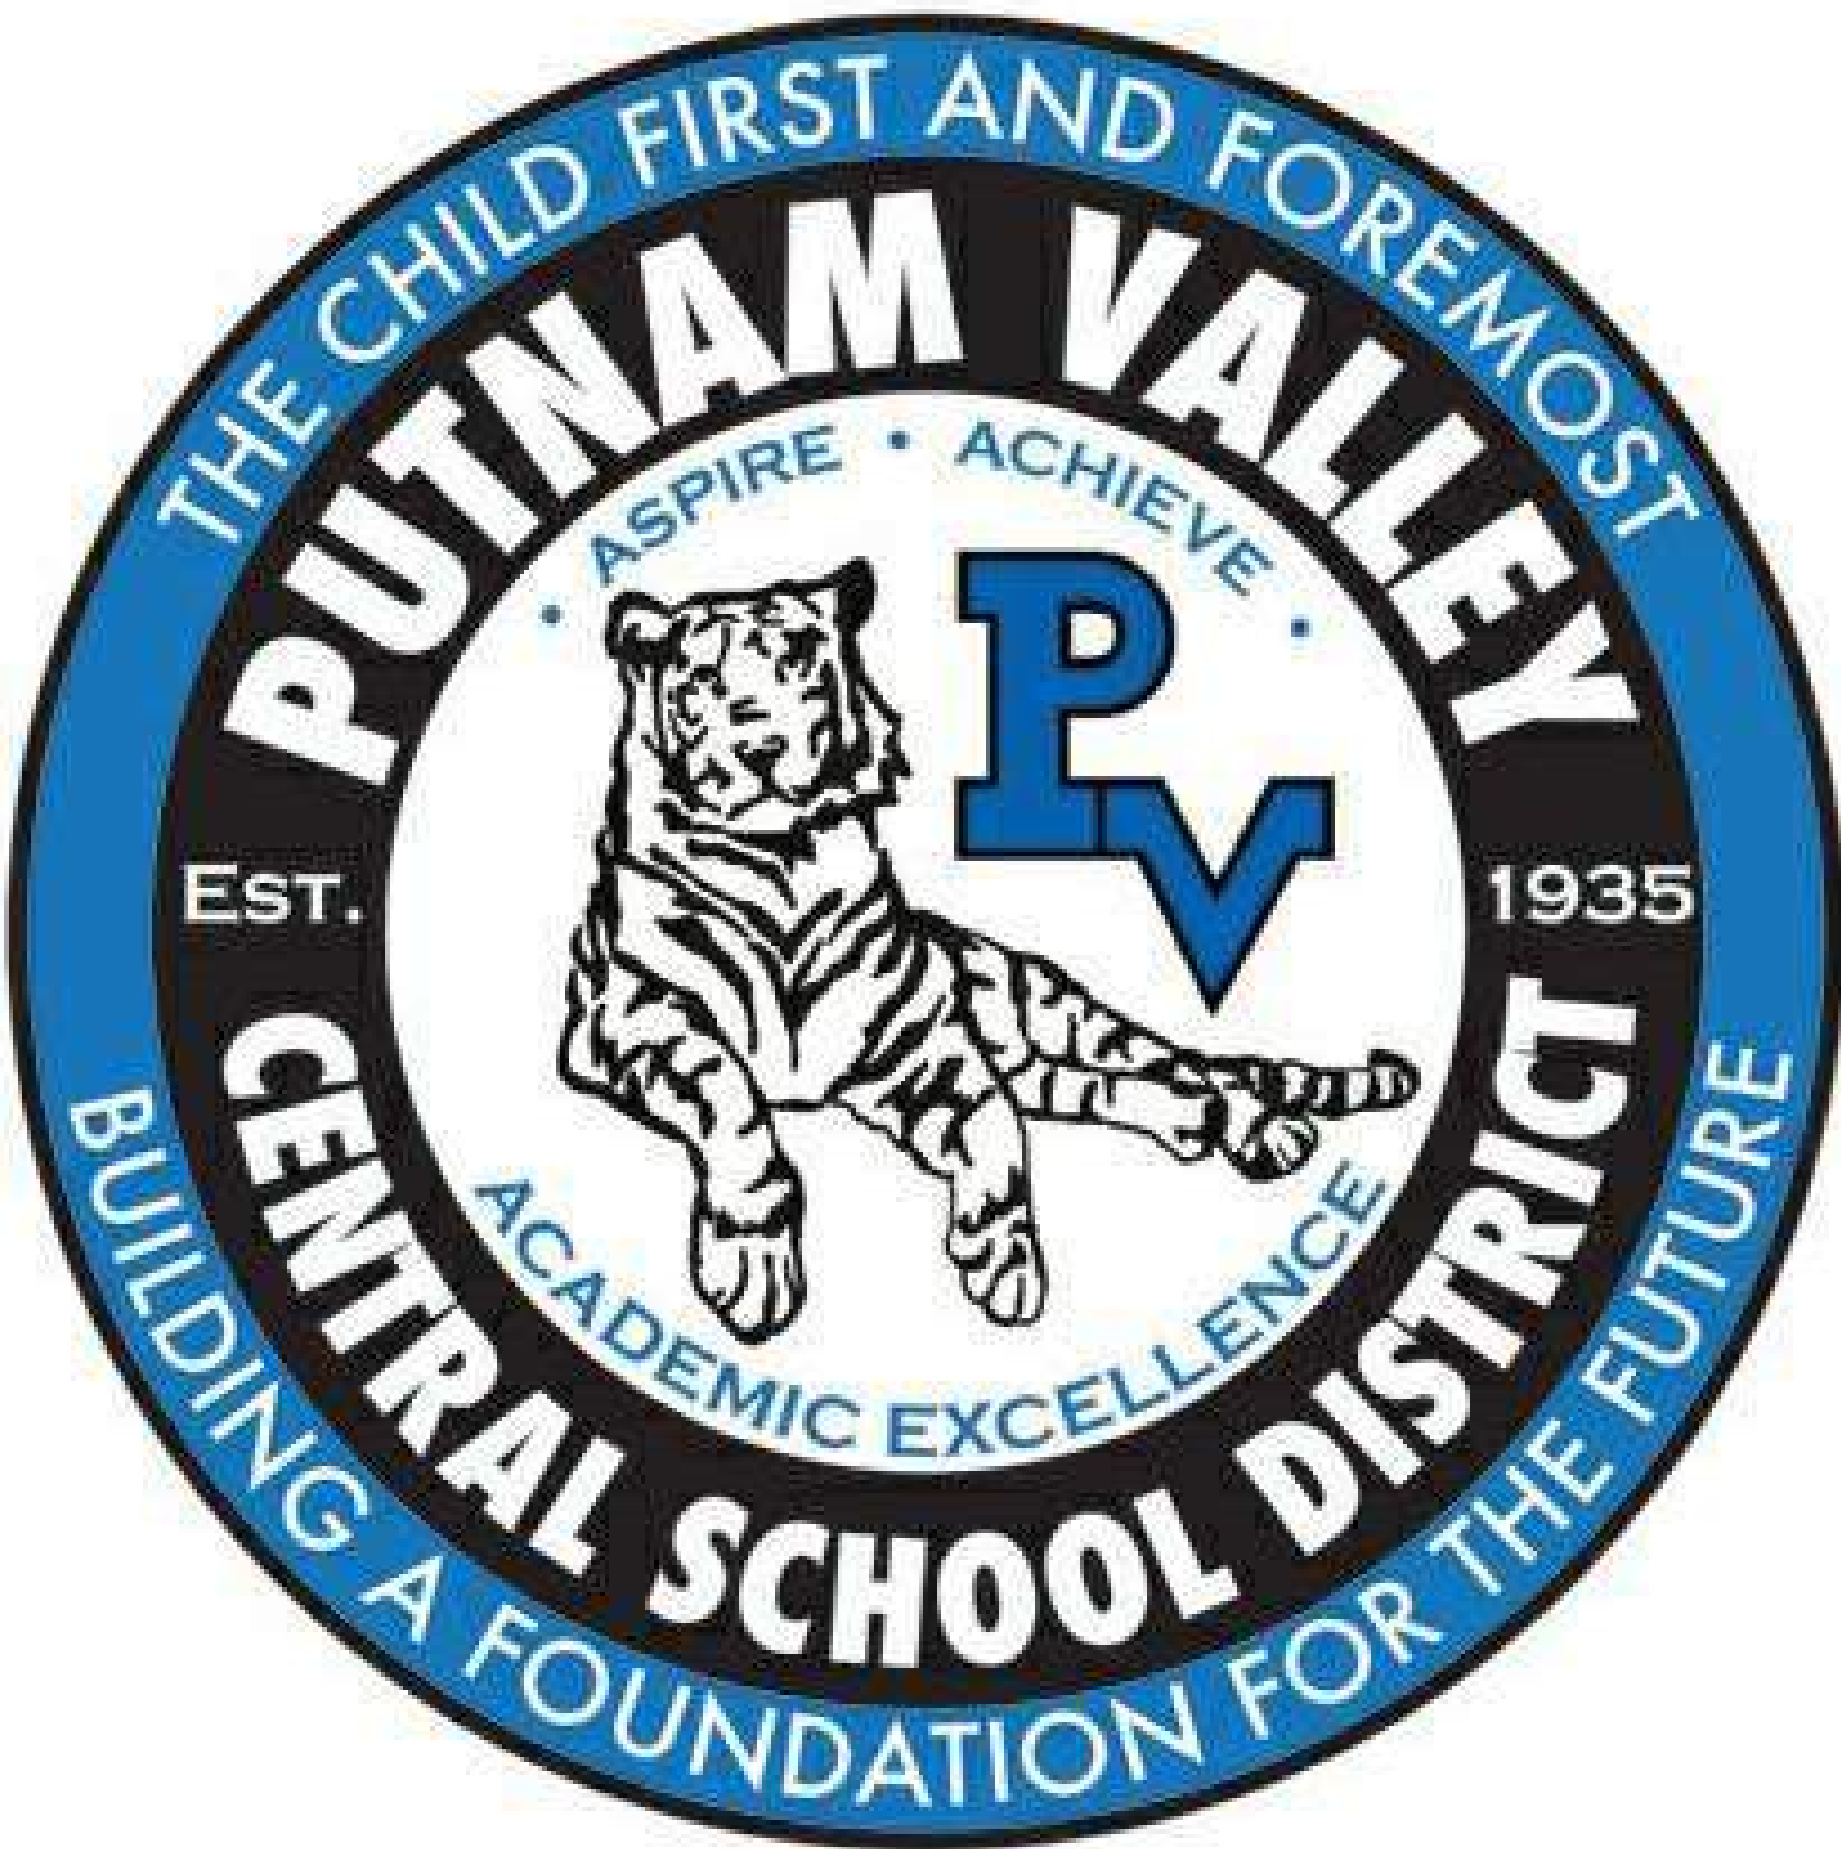

ARCHITECT
KG+D Architects
Kaeyer Garment & Davidson Architects, PC
285 Main Street Mt. Kisco, NY 10549
phone: 914.666.5900 fax: 914.666.0051

MECHANICAL ENGINEER
Barile Gallagher
Barile Gallagher & Associates
Consulting Engineers
39 Marble Ave, Pleasantville, NY 10570
phone: 914.328.6060 fax: 914.328.9304

ABATEMENT CONSULTANTS
WSP
Environmental Consultant
96 Morton Street, 8th Floor
New York, NY 10014
phone: 914.789.3710 fax: 914.592.1734

LIST OF DRAWINGS

<u>GENERAL INFORMATION</u>		<u>PLUMBING</u>	
G001	GENERAL INFORMATION	P101	FIRST AND SECOND FLOOR REMOVAL PLANS
CC-1	CODE COMPLIANCE INFORMATION	P201	FIRST AND SECOND FLOOR PLANS
<u>HAZARDOUS MATERIALS</u>		<u>MECHANICAL</u>	
H-001.00	ASBESTOS ABATEMENT GENERAL NOTES	H101	FIRST AND SECOND FLOOR REMOVAL PLANS
H-002.00	ASBESTOS ABATEMENT 1ST AND 2ND FLOOR PLAN	H201	FIRST AND SECOND FLOOR PLANS
<u>ARCHITECTURAL</u>		H301	SCHEDULES AND DETAILS
A101	DEMOLITION PLANS	<u>ELECTRICAL</u>	
A201	FLOOR PLANS	E001	LEGEND, NOTES & ABBREVIATIONS
A401	INT. FINISHES, DOOR SCHEDULE, SIGNAGE & ROOF DETLS.	E101	FIRST AND SECOND FLOOR REMOVAL PLANS
A402	INTERIOR ELEVATIONS	E201	FIRST AND SECOND FLOOR LIGHTING PLANS
A601	REFLECTED CEILING PLANS	E301	FIRST AND SECOND FLOOR POWER PLANS
		E501	POWER AND FA RISER
		E601	ELECTRICAL SCHEDULES
		Grand total: 20	

KG+D Project No.
2020-1051

NY SED Project No.
48-05-03-04-0-004-016

PUTNAM VALLEY
MIDDLE SCHOOL
TOILET ROOM
ALTERATIONS
2018 CAPITAL PROJECTS -
PHASE 2
142 PEEKSKILL HOLLOW RD,
PUTNAM VALLEY, NY 10579



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48-05-03-04-0-004-016

CONSTRUCTION
DOCUMENTS

NOTE: NEW YORK STATE BUILDING CODE ADOPTS IBC 2015 W/AMENDMENTS

CODE COMPLIANCE SUMMARY			
USE & OCCUPANCY CLASSIFICATION		IBC 305	
OCCUPANCY		EDUCATIONAL GROUP E	
CONSTRUCTION TYPE		IBC 602.2	
CONSTRUCTION TYPE		IIB	
BUILDING HEIGHT & AREA		IBC TABLES 504.3 / 504.4 / 506.2	
SPRINKLERED: NO		PERMITTED	EXISTING
HEIGHT		55'-0"	26'-0"
STORIES		2	2
FLOOR AREA PER STORY		14,500 / 50,750 SF*	41,318 SF - FIRST FLOOR 21,090 SF - SECOND FLOOR 62,408 SF TOTAL
			NO CHANGE NO CHANGE NO CHANGE NO CHANGE

FIRE RESISTANCE RATING IIB CONSTRUCTION: IBC TABLES 601 / 602	
STRUCTURAL FRAME:	0-HOUR
BEARING WALLS	
EXTERIOR	0-HOUR
INTERIOR	0-HOUR
NON BEARING WALLS & PARTITIONS:	
EXTERIOR	X < 5' 1-HOUR 5' ≤ X < 10' 1-HOUR 10' ≤ X < 30' 0-HOUR X ≥ 30' 0-HOUR
INTERIOR	0-HOUR
FLOOR CONSTRUCTION	0-HOUR
ROOF CONSTRUCTION	0-HOUR

FIRE RESISTANCE-RATED CONSTRUCTION IBC TABLES 508.2 / 706.4 / 707.3.10 / 1020.1		
ASSEMBLY	FIRE-RESISTANCE RATING	LOCATION
FIRE WALL	2-HOUR	BETWEEN BUILDING AREAS (NEW AND EXISTING)
FIRE BARRIER	2-HOUR	VOCATIONAL TECHNOLOGY SHOPS ELECTRICAL ROOMS ELEVATOR MACHINE ROOM
FIRE PARTITION	1-HOUR	CORRIDORS (UNSPRINKLERED) STAIR ENCLOSURES SMOKE STOPS LABORATORIES (UNSPRINKLERED) STORAGE OVER 100 SF (UNSPRINKLERED)


FIRE PROTECTIVE SYSTEMS NYS BC CHAPTER 9		
SYSTEM	REQUIRED	PROVIDED
AUTOMATIC SPRINKLERS	NO	NO
STANDPIPE	NO	NO
FIRE EXTINGUISHERS	YES	YES
EMERGENCY ALARM SYSTEM	YES	YES
FIRE COMMAND CENTER	NO	NO
FIRE DEPT. CONNECTIONS	NO	YES
FIRE PUMPS	NO	NO
CO DETECTION	YES	YES
EMERGENCY RADIO	NO	NO

PLUMBING FIXTURE COUNT NYS BC CHAPTER 29			
FIXTURE	OCCUPANCY	REQUIRED	PROVIDED
TOILETS	600	12	31
LAVATORIES	600	12	37
URINALS	600	N/A	9
DRINKING FOUNTAINS	600	6	7

NOTE: OCCUPANCY IS
BASED ON STUDENT
ENROLLMENT OF 506
STUDENTS

MEANS OF EGRESS NYS BC CHAPTER 10	
EXIT TRAVEL DISTANCE	IBC TABLE 1017.2 200' MAX NON-SPRINKLERED
OCCUPANCY LOADS:	IBC TABLE 1004.1.2
CLASSROOMS	20 NET SF/PERSON
SHOPS & OTHER VOCATIONAL ROOM AREAS	50 NET SF/PERSON
OFFICE AREAS	100 GROSS SF/PERSON
LIBRARY - READING ROOMS	50 NET SF/PERSON
LIBRARY - STACK AREA	100 GROSS SF/PERSON
EXIT WIDTH	IBC SECTION 1005.3
STAIR WIDTH	.3"/OCCUPANT
OTHER EGRESS COMPONENTS	.2"/OCCUPANT
CORRIDORS	IBC TABLE 1020.1
FIRE RESISTANCE RATING (WITHOUT SPRINKLERS)	NY SED §107
TRAVEL DISTANCE TO STAIR (UPPER LEVEL)	1 HOUR
TRAVEL DISTANCE TO EXTERIOR DOORWAY(G FLR)	120 FT
WIDTH:	150 FT
MAIN CORRIDOR: LOCKERS ON BOTH SIDES	10'-0" (FACE OF LOCKERS)
SECONDARY:	6'-0"
PASSAGEWAY:	44"

FIRE AREAS			
	EXISTING	PROPOSED	
FIRE AREA 1 (SECOND AND FIRST FLOOR)	42,601 SF*	NO CHANGE	*VARIANCE HAS BEEN GRANTED BY NYSDO FOR EXISTING NON-CONFORMING CONDITIONS
FIRE AREA 2 (SOCIAL COMMONS)	7,334 SF*	NO CHANGE	
FIRE AREA 3 (GYMNASIUM)	12,473 SF*	NO CHANGE	

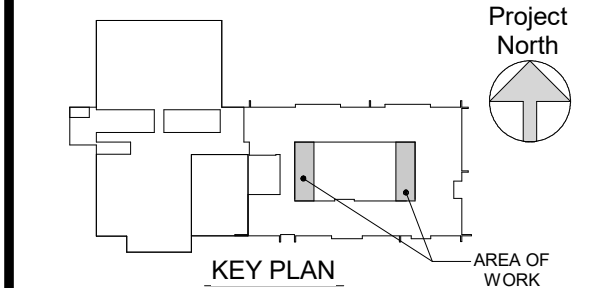

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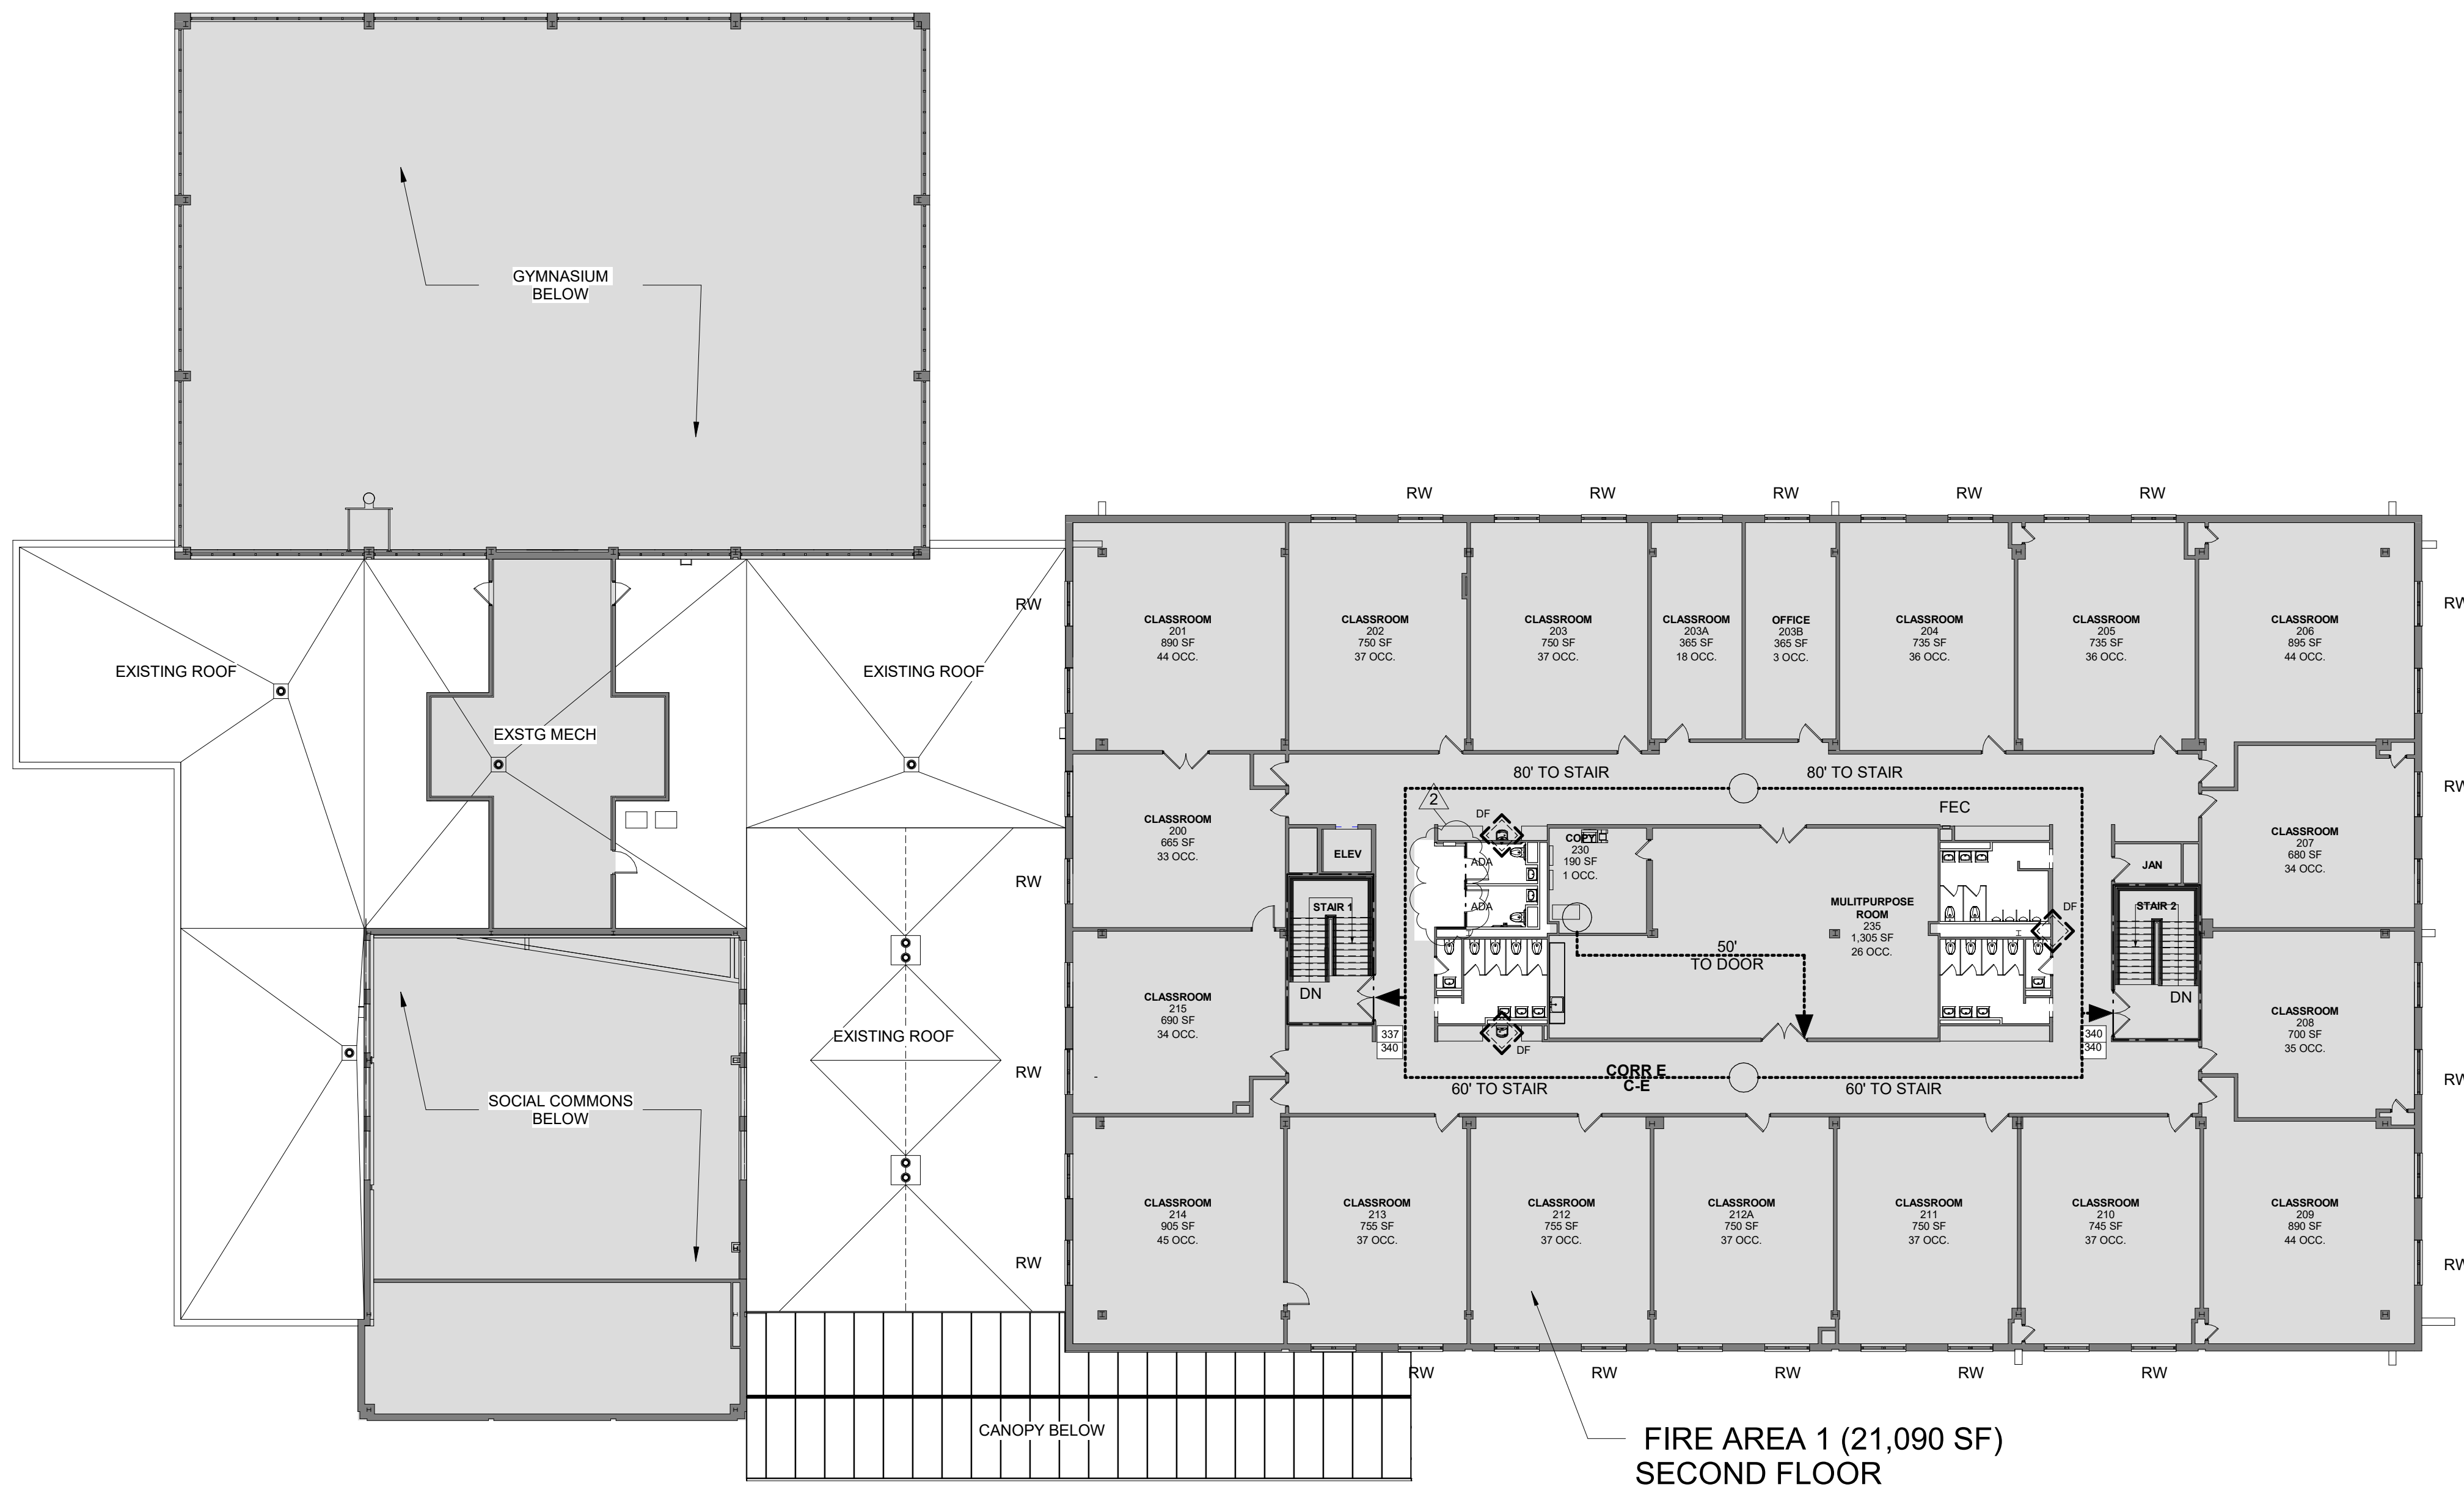
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3	03/15/21	CONSTRUCTION DOCUMENTS
2	02/26/21	SED ADDENDUM 1
1	02/01/21	CONSTRUCTION DOCUMENTS
No.	Date	Issue
Sheet Title		

CODE
COMPLIANCE
INFORMATION

Job No. 2020-1051 Date 01/14/2021
Scale AS NOTED Drawn / Checked

Sheet Number
CC-1




3 CODE COMPLIANCE PLAN - 2ND FLOOR
1/16" = 1'-0"

FIRE AREA 3 (12,473 SF)
GYMNASIUM

FIRE AREA 1 (42,601 SF)
FIRST FLOOR


FIRE AREA 2 (7,334 SF)
SOCIAL COMMONS/STAGE

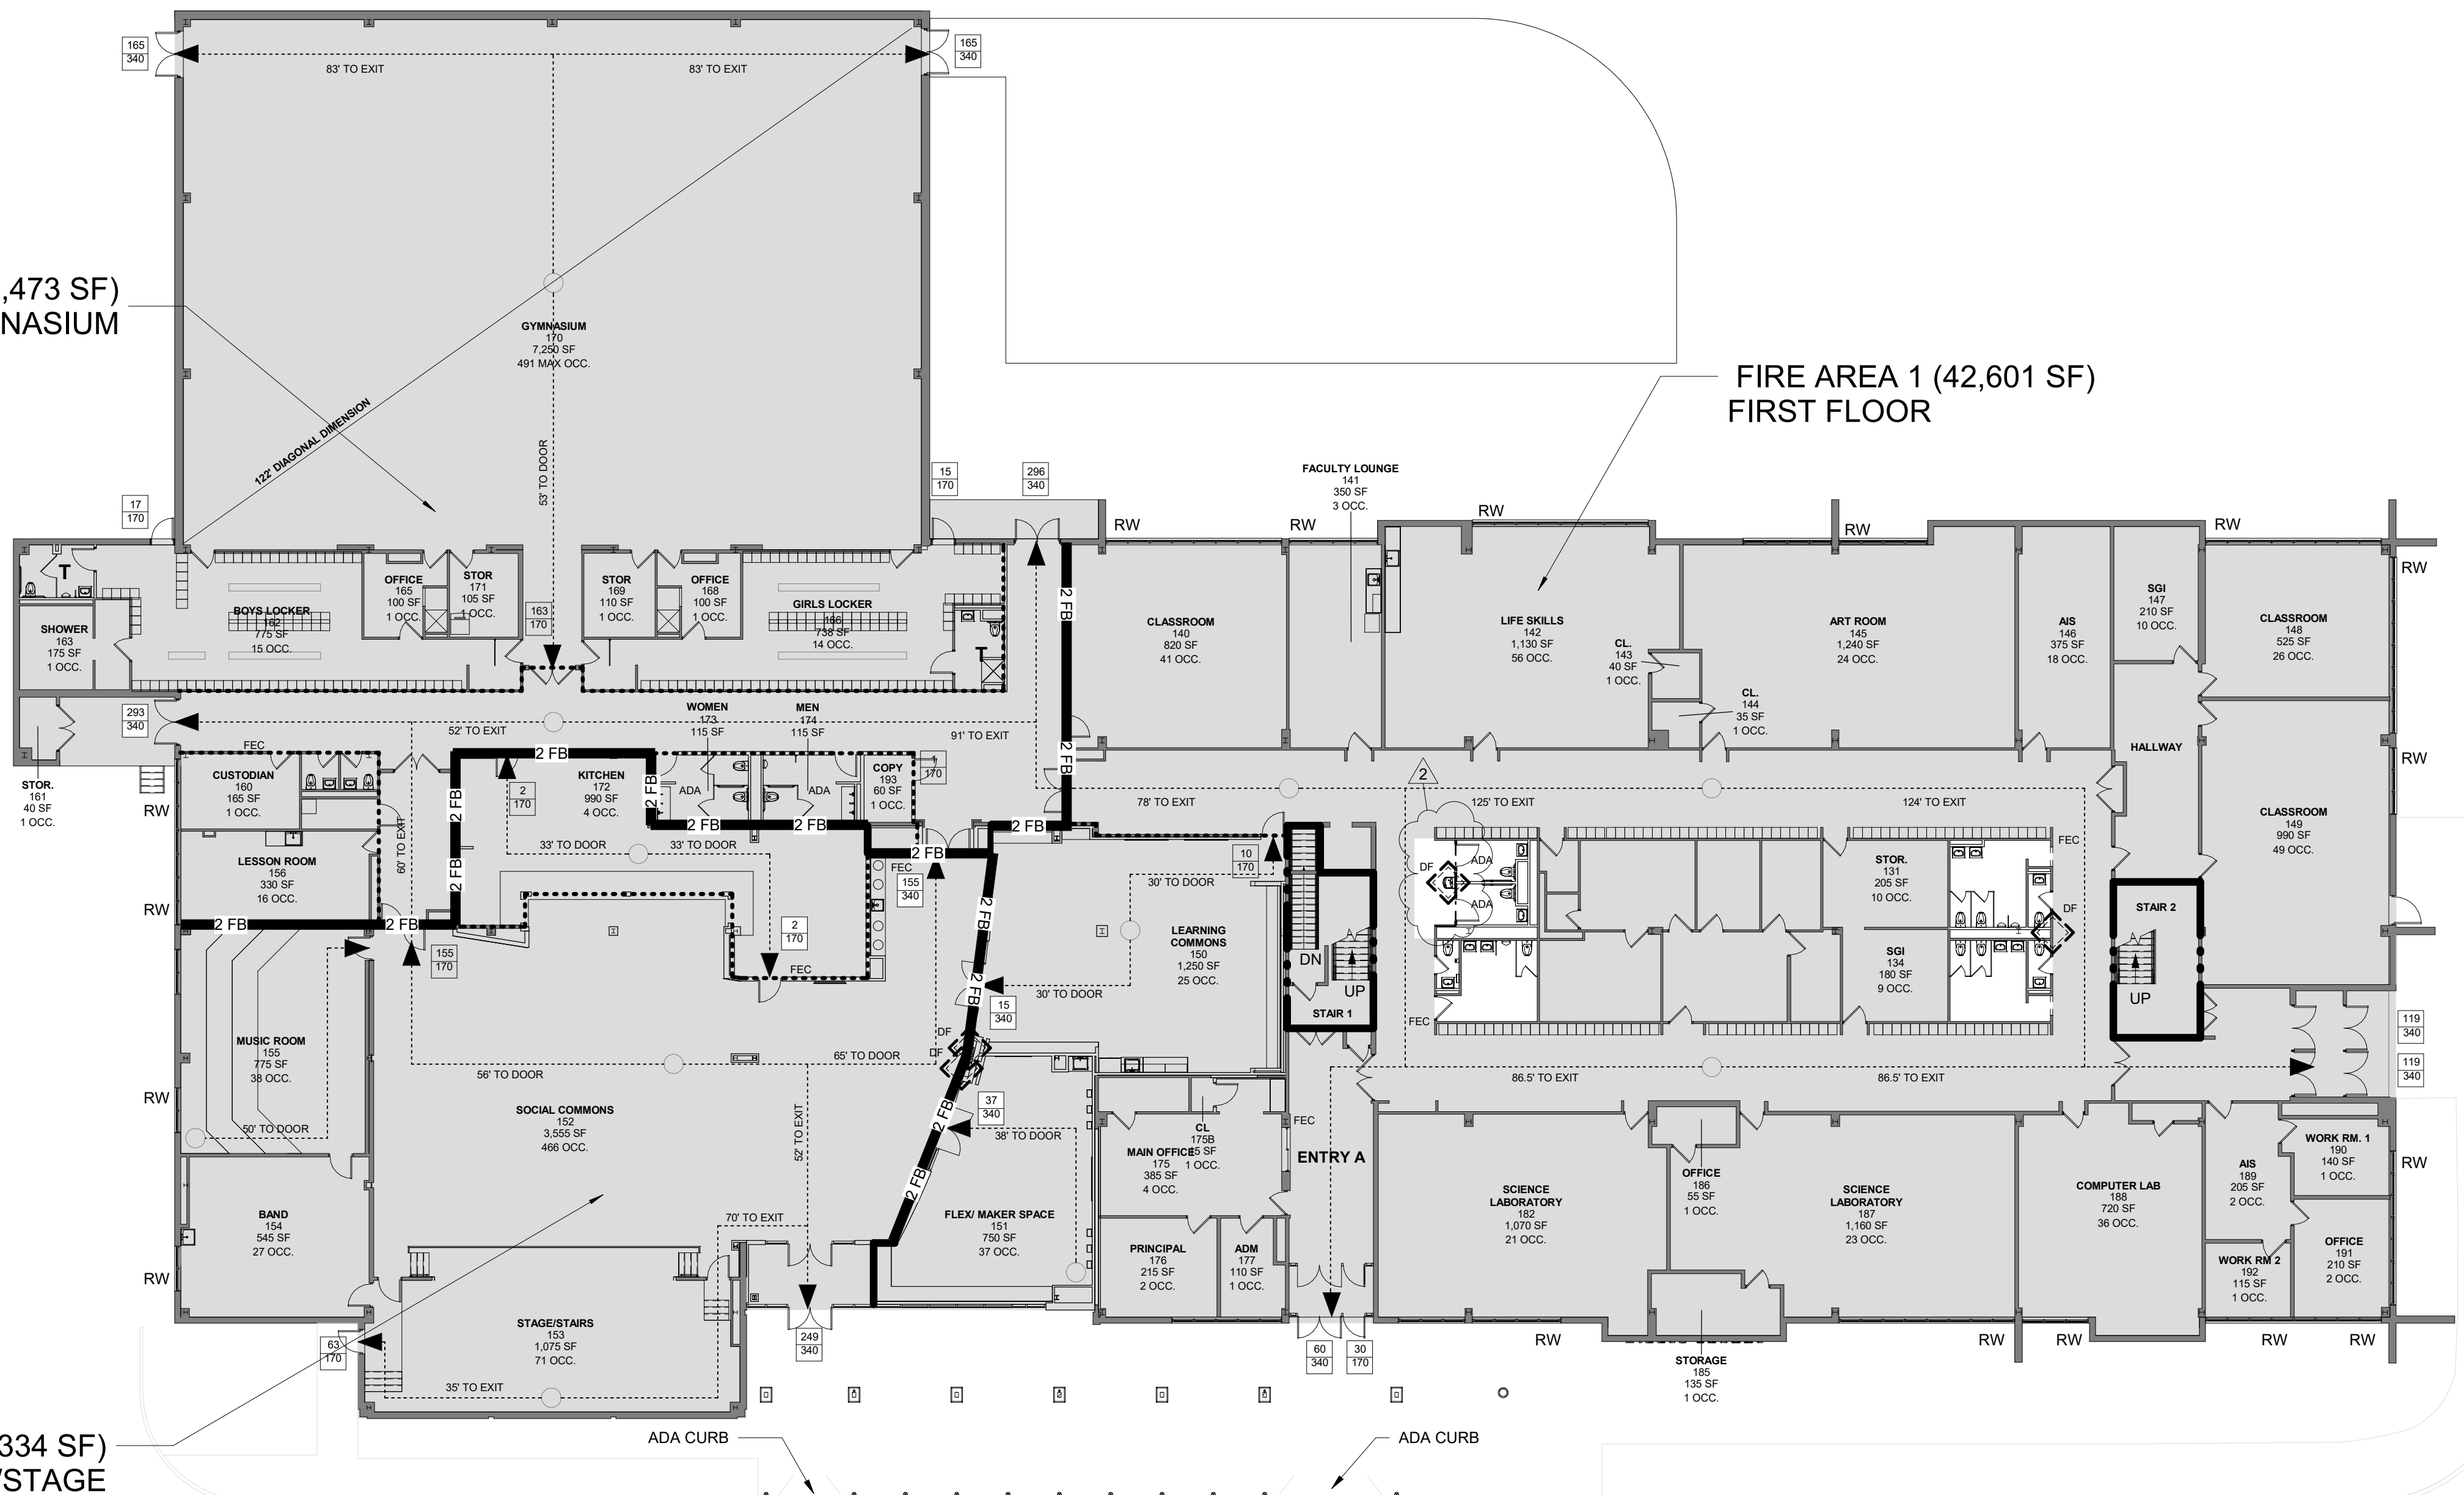

2 CODE COMPLIANCE PLAN - 1ST FLOOR
1/16" = 1'-0"

CODE COMPLIANCE LEGEND	
2 FP	2 HOUR FIRE RATED PARTITION
2 FB	2 HOUR FIRE RATED BARRIER
1 FP	1 HOUR FIRE RATED PARTITION
	AREA OF NO WORK
	AREA OF ALTERATION
	LOCATION OF DRINKING FOUNTAIN
X	CALCULATED EGRESS LOAD OCCUPANTS
Y	CALCULATED EGRESS CAPACITY (OCCUPANTS)

1 AERIAL PHOTO - SITE LOCATION PLAN
NOT TO SCALE

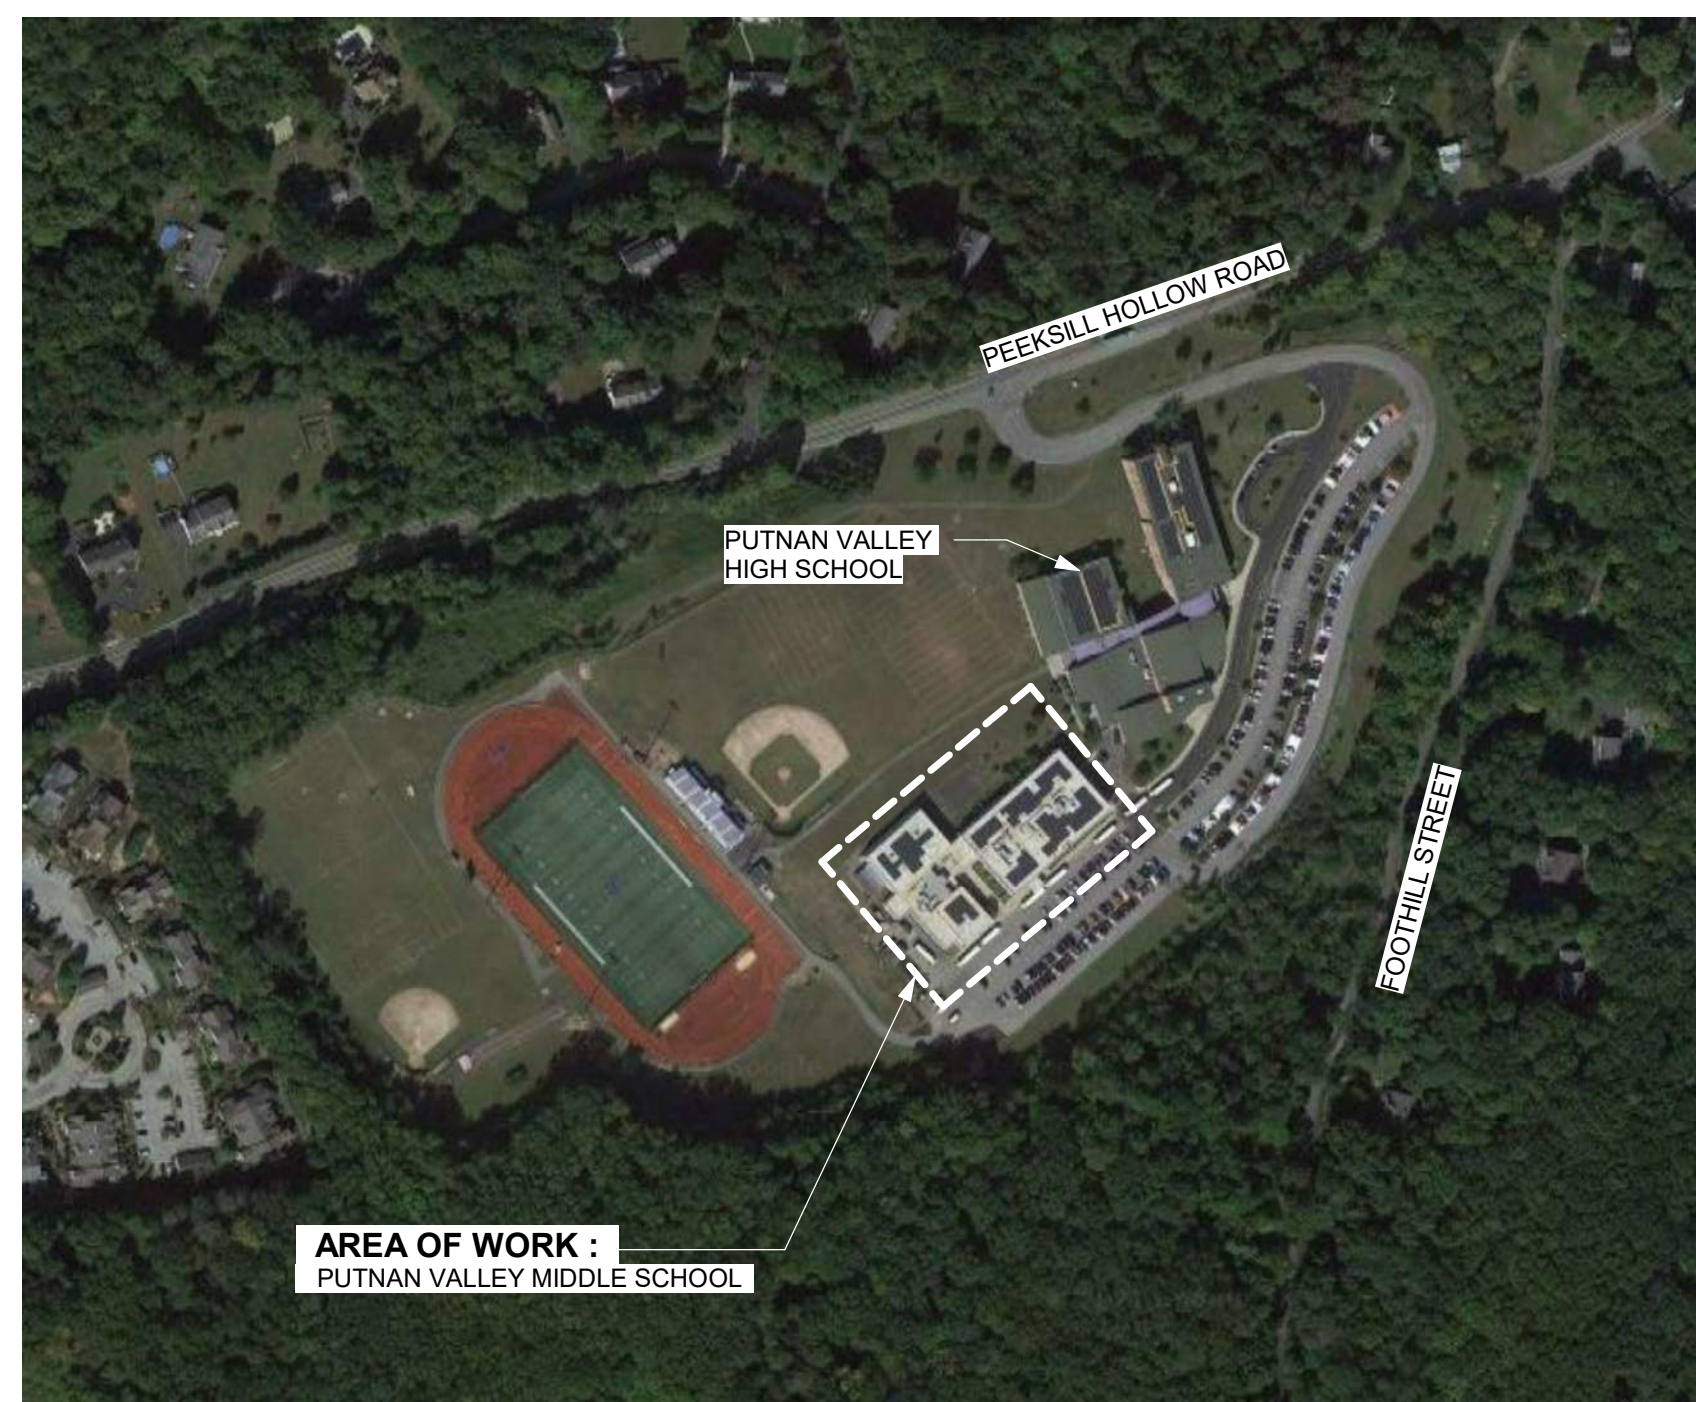

ASBESTOS ABATEMENT GENERAL NOTES

PVMS TOILET ROOM ALTERATIONS

CAPITAL PROJECTS PHASE 2

142 PEEKSKILL HOLLOW RD
PUTNAM VALLEY, NY 10579



ENVIRONMENTAL CONSULTANT



WSP USA SOLUTIONS, INC.
500 Summit Lake Drive, Suite 450
Valhalla, NY 10595
TEL. 914.742.1120

NY SED PROJECT CONTROL NO

48-05-03-04-0-004-016

SED SUBMISSION

DRAWING	DRAWING NAME
H-001.00	ASBESTOS ABATEMENT LOCATIONS - GENERAL NOTES
H-002.00	ASBESTOS ABATEMENT LOCATIONS - 1ST AND 2ND FLOOR PLAN

- SED ADDENDUM # 1 02/26/21

- SED ADDENDUM # 1 02/26/21



PROJECT DESIGNER: VINCENT E. RICEVUTO NYS 02-06290

KEY PLAN

Project North

AREA OF WORK

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2	02/26/21	SED ADDENDUM # 1
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Sheet Title

ASBESTOS ABATEMENT GENERAL NOTES

Job No. 31403000.000	Date 02/26/2021
Scale AS NOTED	Drawn / Checked JP AS

Sheet Number

H001.00

PUTNAM VALLEY
MIDDLE SCHOOL
TOILET ROOM
ALTERATIONS
2018 CAPITAL PROJECTS -
PHASE 2
142 PEEKSKILL HOLLOW RD,
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CONSTRUCTION
DOCUMENTS

DEMOLITION KEY


- DEMOLITION
--- EXISTING TO REMAIN
--- AREA OF WORK
--- EXISTING DOOR TO REMAIN
--- DEMOLITION OF EXISTING DOOR
X KEYNOTE. REFER TO THE CORRESPONDING KEYNOTE ON THE SCHEDULE FOR DEMOLITION NOTE.

DEMOLITION NOTES


1. PRIOR TO STARTING DEMOLITION, REVIEW ALL EXISTING CONDITIONS AND REMOVAL REQUIREMENTS, INCLUDING TEMPORARY SHORING, IF REQUIRED.
2. PRIOR TO COMMENCING DEMOLITION, REVIEW ALL CONDITIONS FOR TEMPORARY SHORING REQUIREMENTS, SUCH AS: THE REMOVAL OF ANY WALL OR PORTION OF WALL, ROOF DECK PENETRATION, EXCAVATIONS, AND WHERE MECHANICAL, ELECTRICAL OR PLUMBING EQUIPMENT IS SUPPORTED BY ELEMENTS TO BE REMOVED.
3. THE BUILDING MUST REMAIN WEATHERTIGHT FOR THE DURATION OF THE PROJECT, INCLUDING DURING DEMOLITION.
4. PRIOR TO COMMENCING DEMOLITION OPERATIONS, OFFER SALVAGE OF ANY AND ALL EXISTING MATERIALS TO THE OWNER.
5. SEE M.E.P. DRAWINGS FOR RELATED DEMOLITION WORK.
6. LOOSE CONTENTS IN AREAS OF DEMOLITION THAT HAVE BEEN ABANDONED BY THE OWNER SHALL BE DISCARDED AS PART OF THIS WORK.
7. CUTTING AND PATCHING IS DEFINED IN THE PROJECT MANUAL, DIVISION 1.
8. SEE PHASING AND LOGISTICS DRAWING ON G001 AND REFER TO SPECIFICATIONS FOR TEMPORARY CONSTRUCTION REQUIREMENTS.
9. SOME OF THE BUILDING SYSTEM, SUCH AS DATA WIRING, FIRE ALARM, SECURITY, COMMUNICATIONS, BUILDING CONTROLS AND THE LIKE MAY PASS THROUGH AREAS OF DEMOLITION AND ARE NOT NOTED ON THE PLANS. THESE SYSTEMS MUST BE PROTECTED AND REMAIN OPERATIONAL.
10. **THIS BUILDING CONTAINS ASBESTOS. CONTAINING MATERIALS AND THIS PROJECT REQUIRES ABATEMENT.** REFER TO ABATEMENT DRAWINGS AND PROJECT MANUAL FOR HAZARDOUS MATERIAL TESTING REPORT AND ABATEMENT SPECIFICATIONS.
11. GO TO SALVAGE EXISTING WALL TILE AND FLOOR TILE IN BOYS ROOM 297 TO PATCH EXISTING WALL AND FLOOR IN AREAS OF WORK.

DEMOLITION KEYNOTES


- 1 REMOVE EXISTING PARTITION - COORD. W/ A201.
- 2 REMOVE EXISTING DOOR, FRAME AND ALL ASSOCIATED HARDWARE - COORD. W/ RENOVATION DRAWINGS.
- 3 REMOVE ALL EXISTING TOILET ROOM ACCESSORIES: MIRROR, PAPER TOWEL DISPENSORS, TOILET PAPER DISPENSORS, ETC - THIS INCLUDES ALL RECESSED ACCESSORIES. UPON REMOVAL OF THE RECESSED ACCESSORIES, PATCH AND FILL.
- 4 REMOVE TOILET PARTITIONS AND ALL ASSOCIATED HARDWARE AND WALL ANCHORS.
- 5 REMOVE EXISTING CEILING ACOUSTIC TILES, TRACK, AND ASSOCIATED HARDWARE.
- 6 REMOVE EXISTING WALL TILE. SEE HAZARDOUS MATERIAL DRAWINGS AND SPECIFICATIONS.
- 7 REMOVE EXISTING FLOOR TILE.

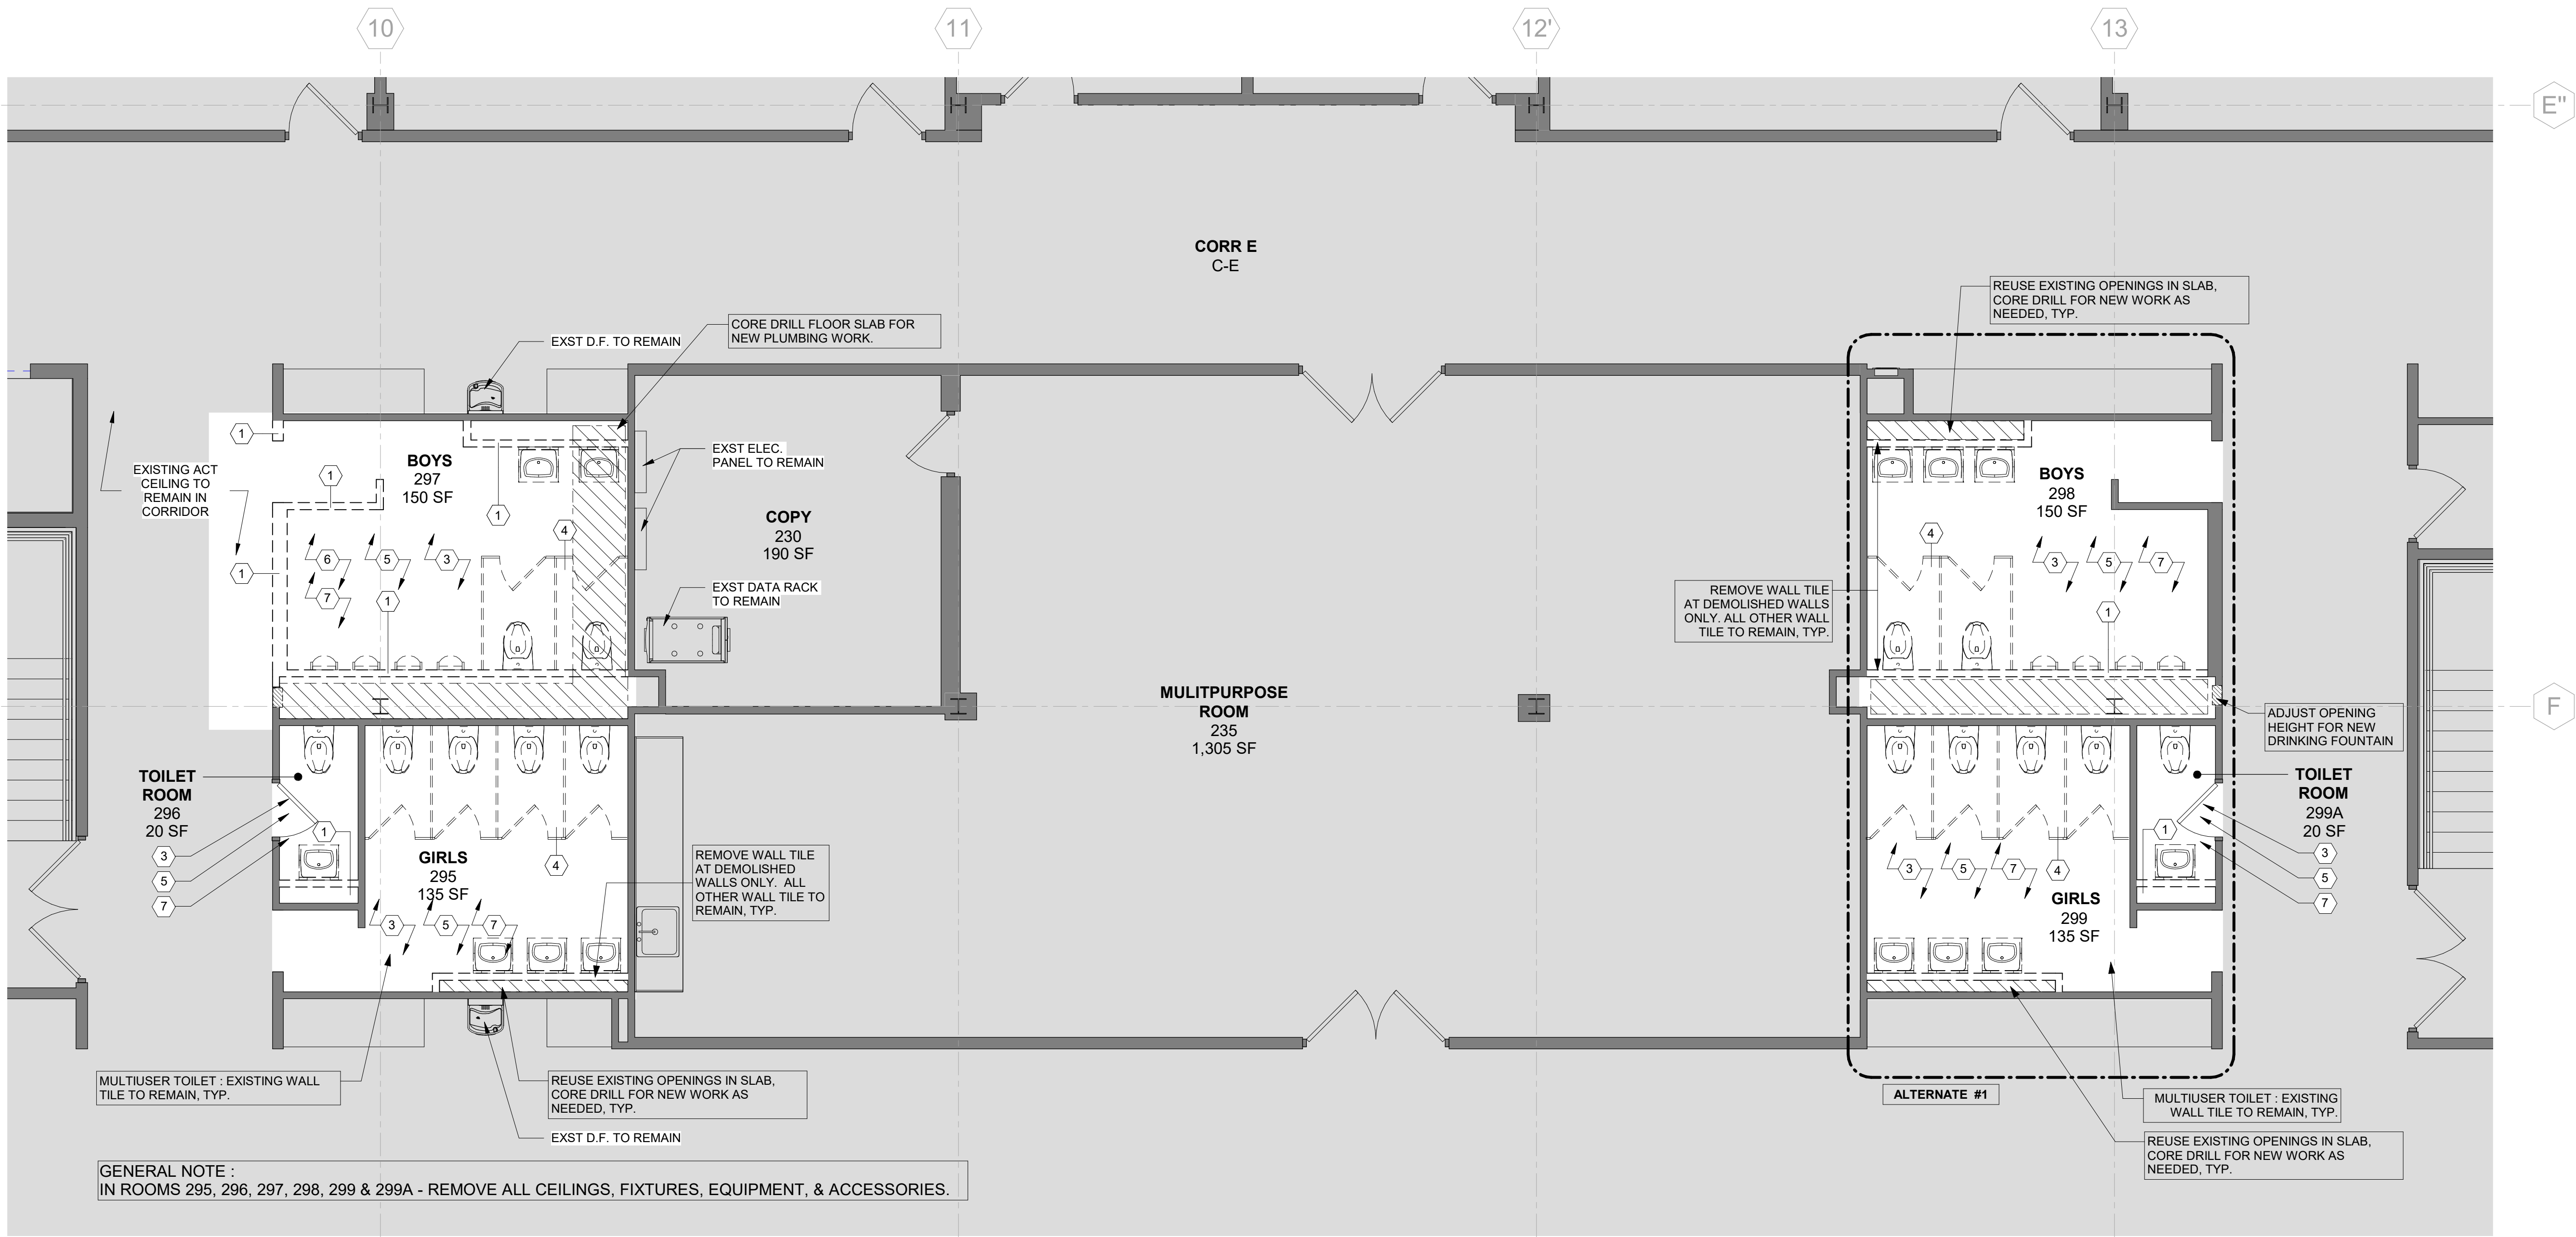

2 2ND FLOOR DEMOLITION PLAN
1/4" = 1'-0"

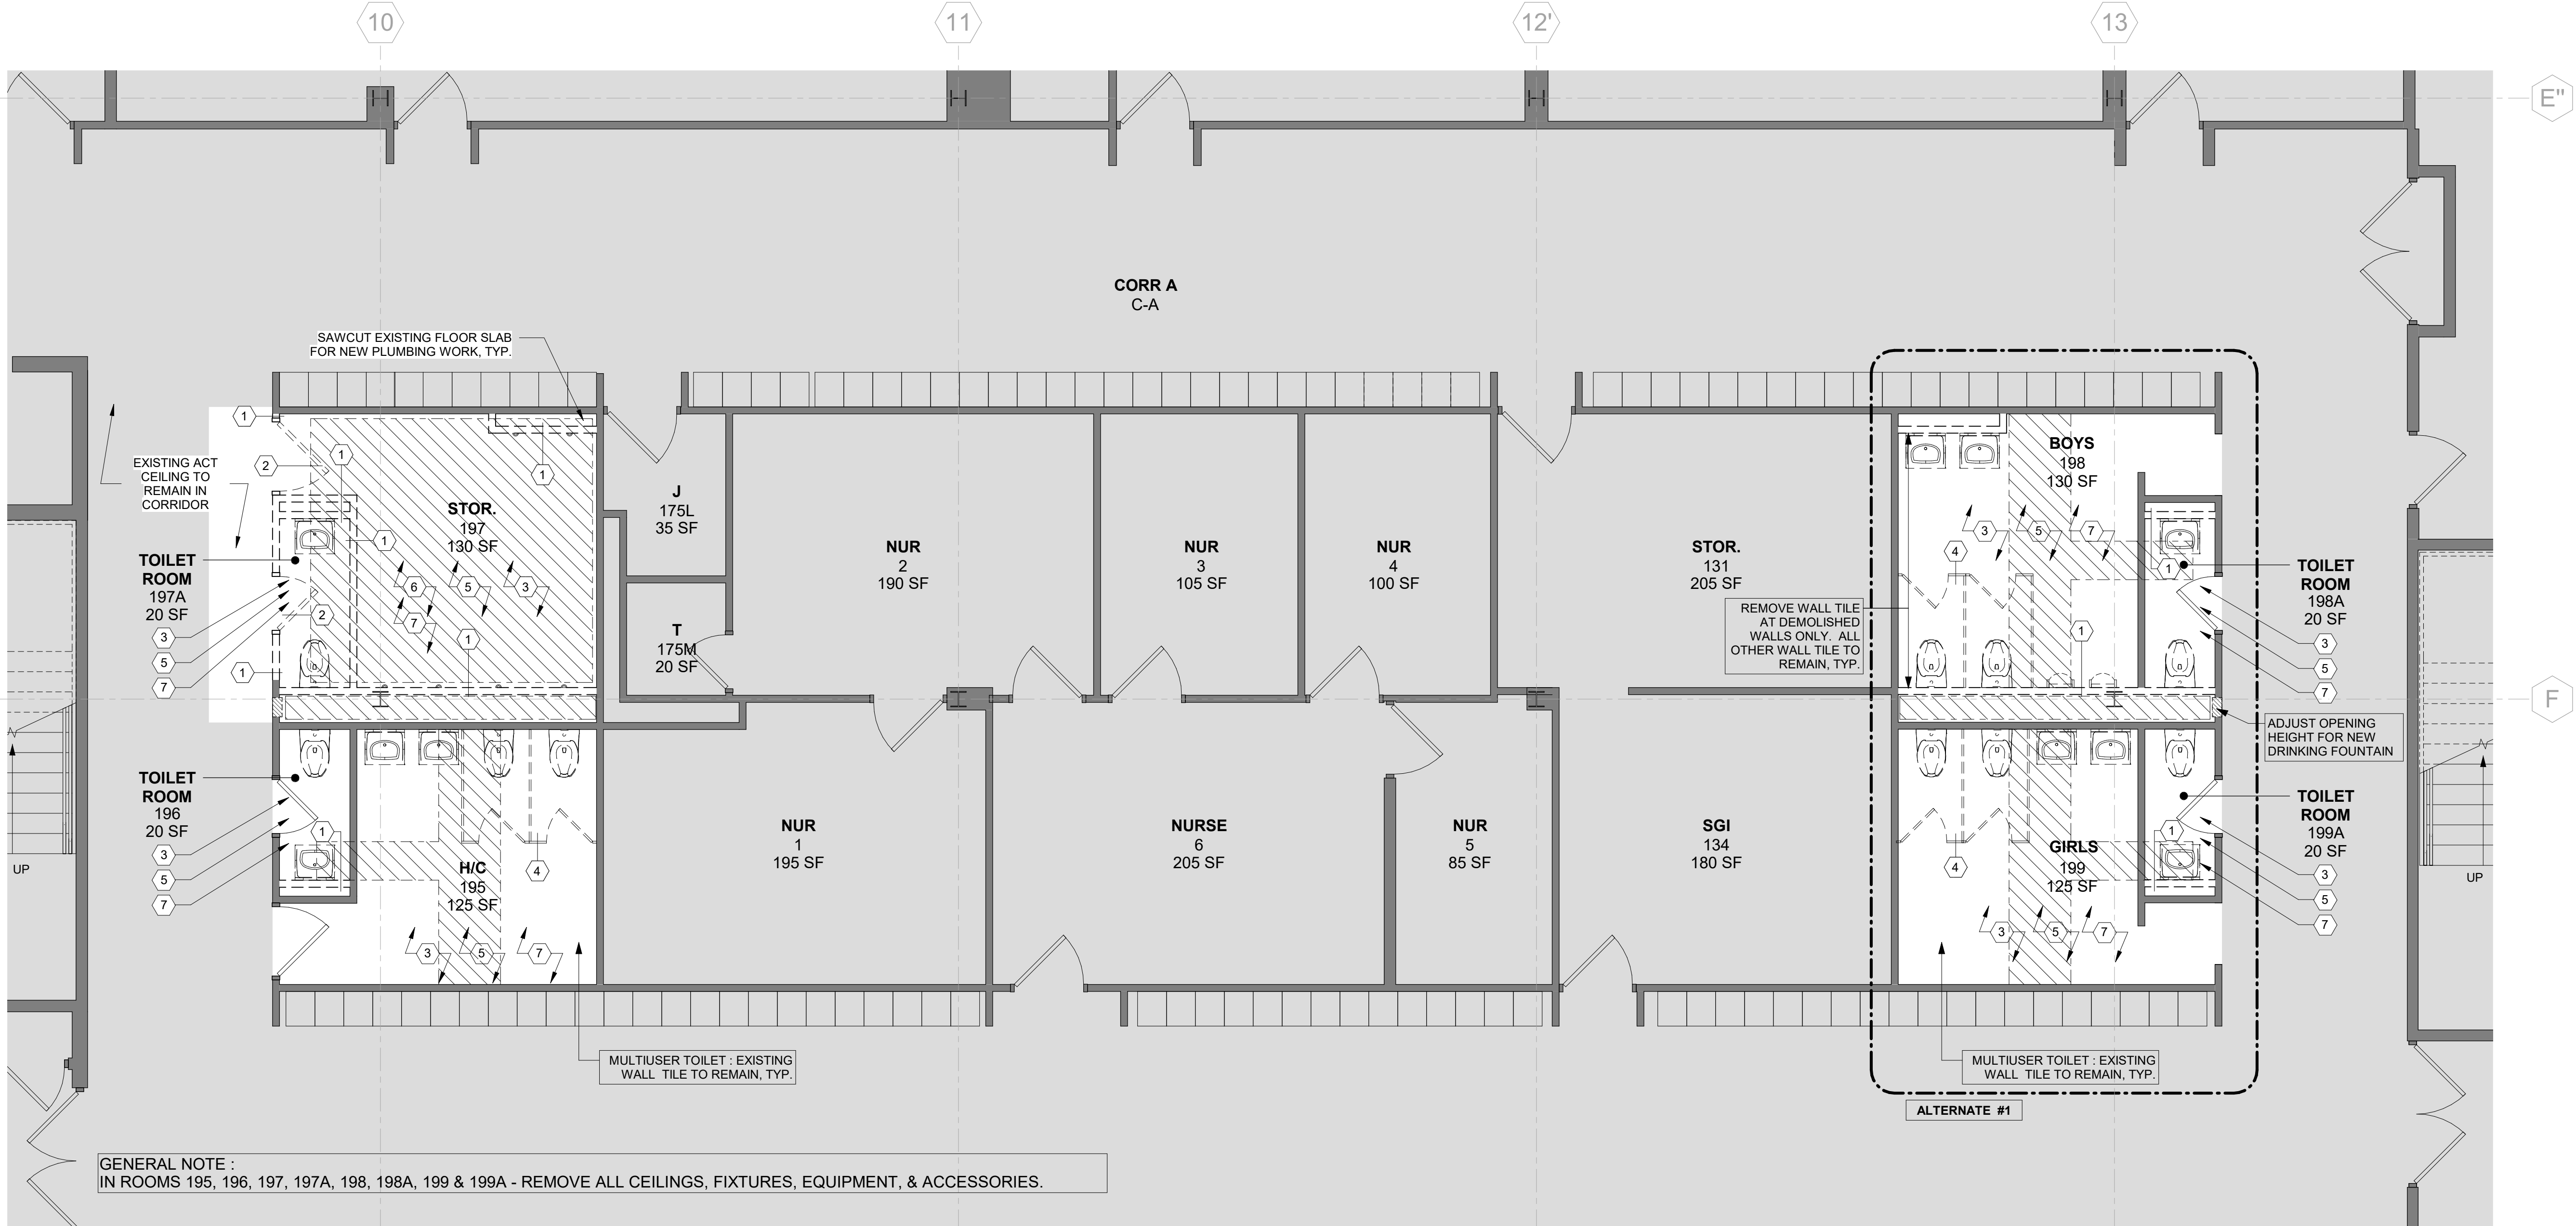

1 1ST FLOOR DEMOLITION PLAN
1/4" = 1'-0"

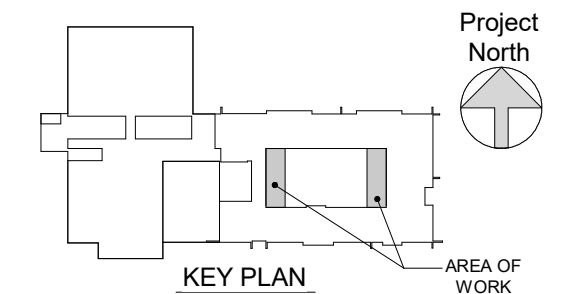

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1 02/01/21 CONSTRUCTION DOCUMENTS

No. Date Issue

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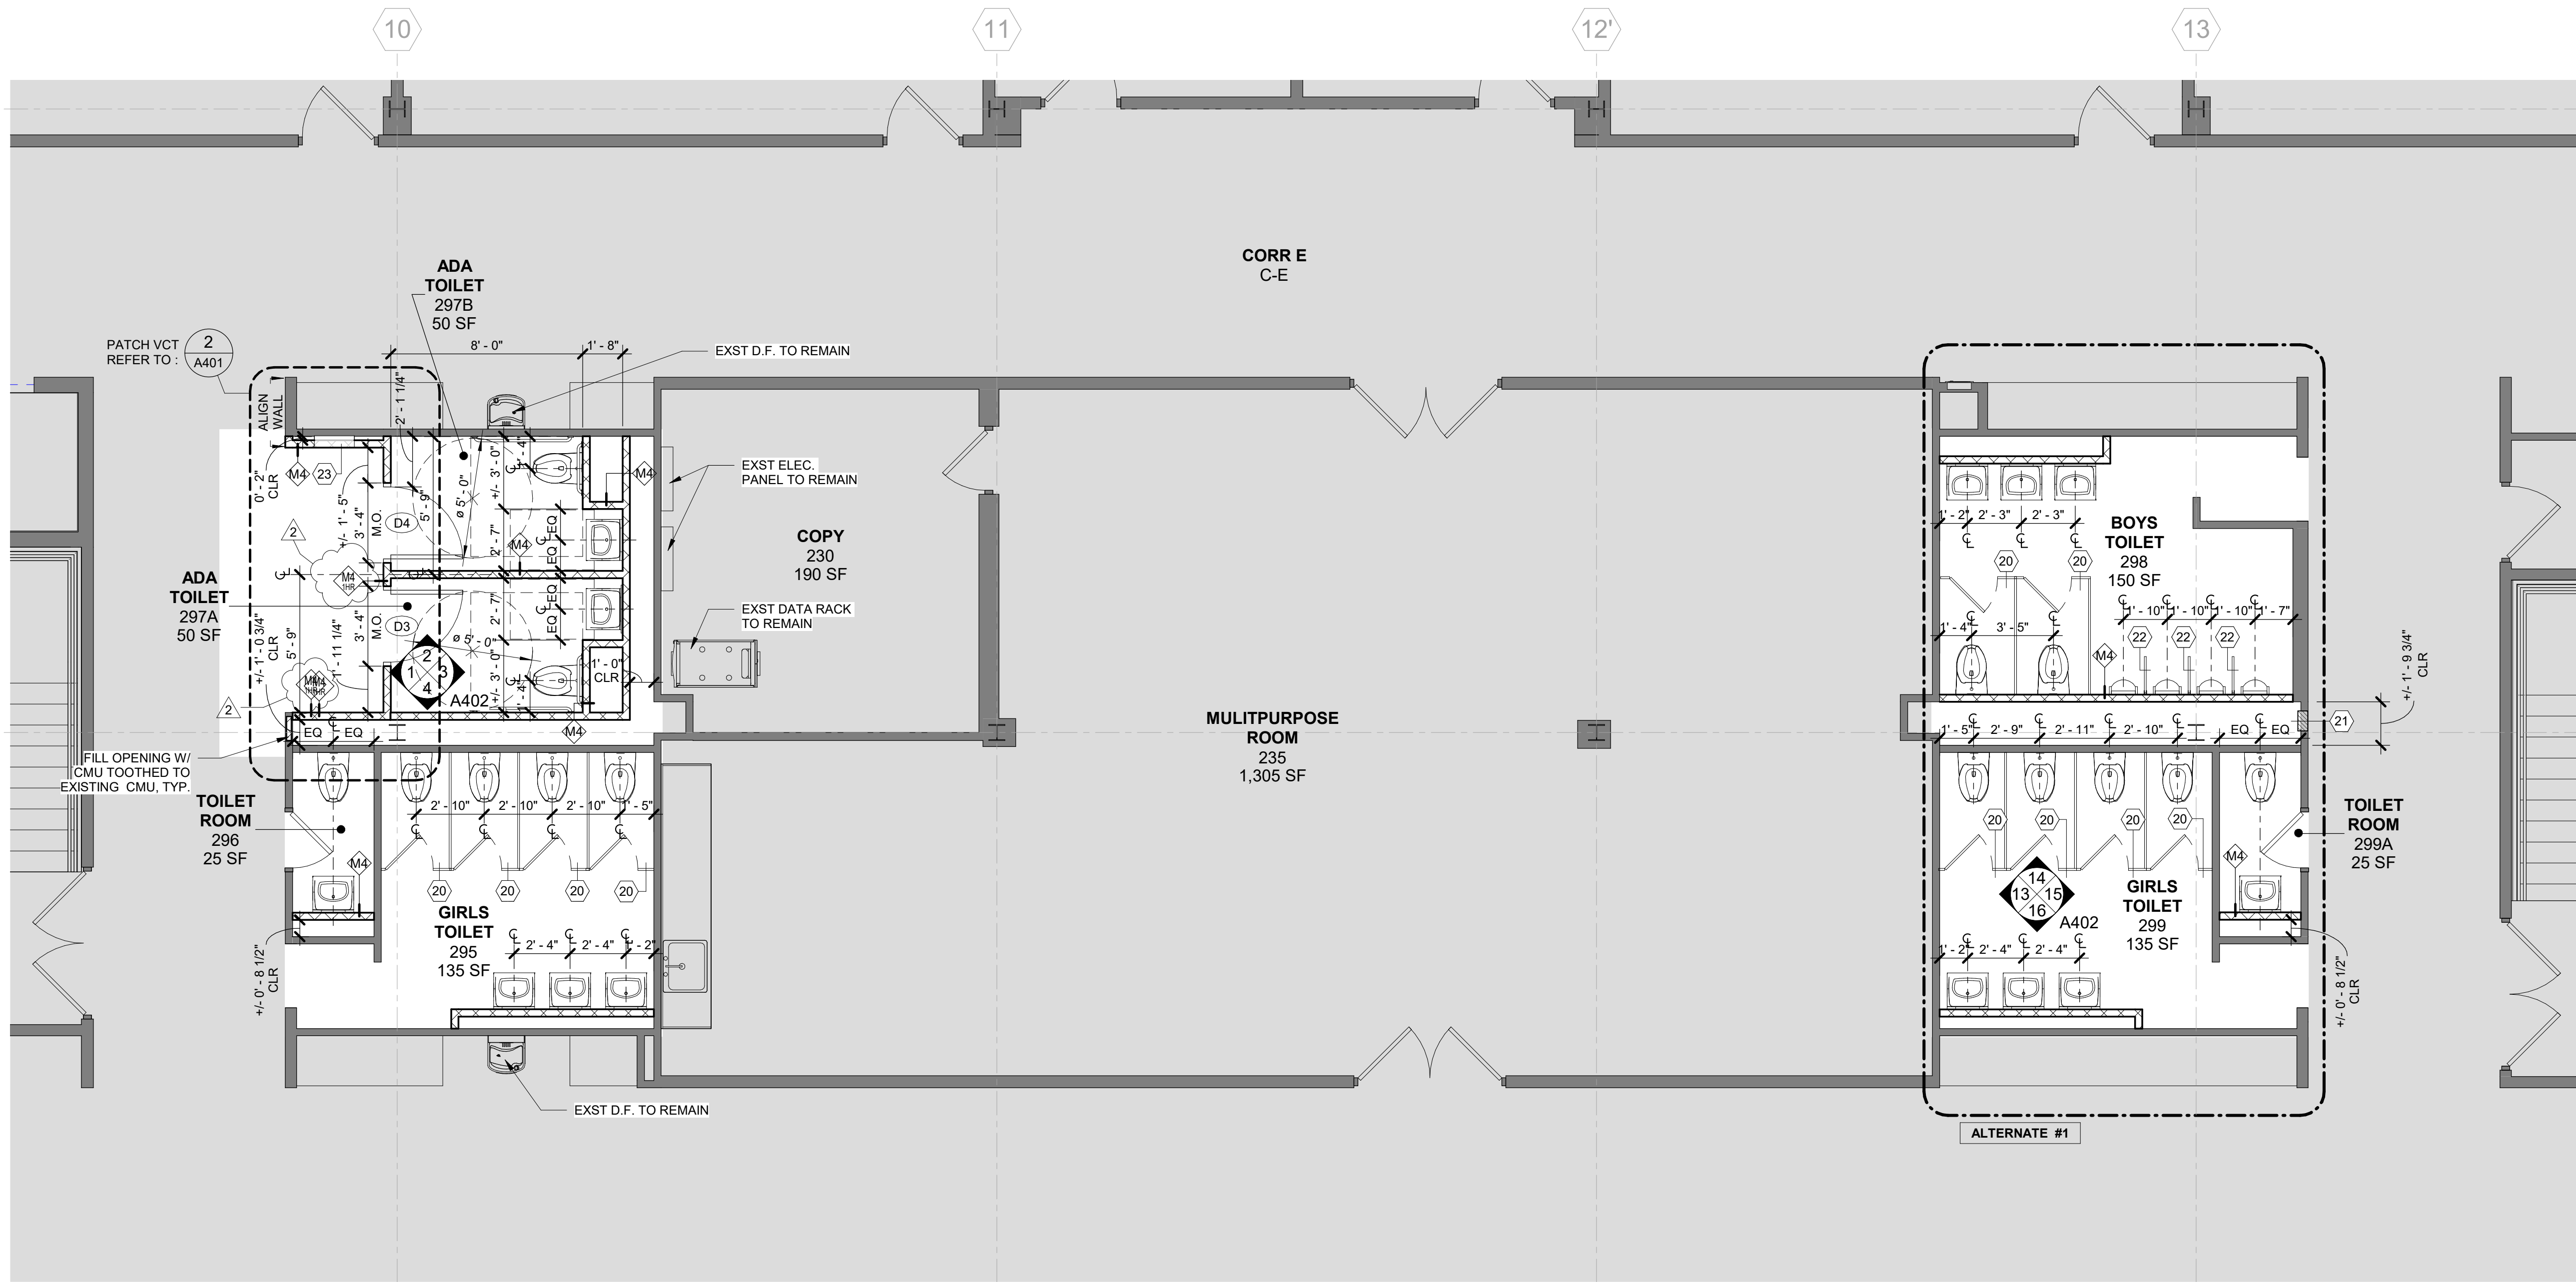
DEMOLITION
PLANS

Job No. 2020-1051 Date 01/14/2021


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A101



2 2ND FLOOR RENOVATION PLAN
1/4" = 1'-0"



1 1ST FLOOR RENOVATION PLAN
1/4" = 1'-0"

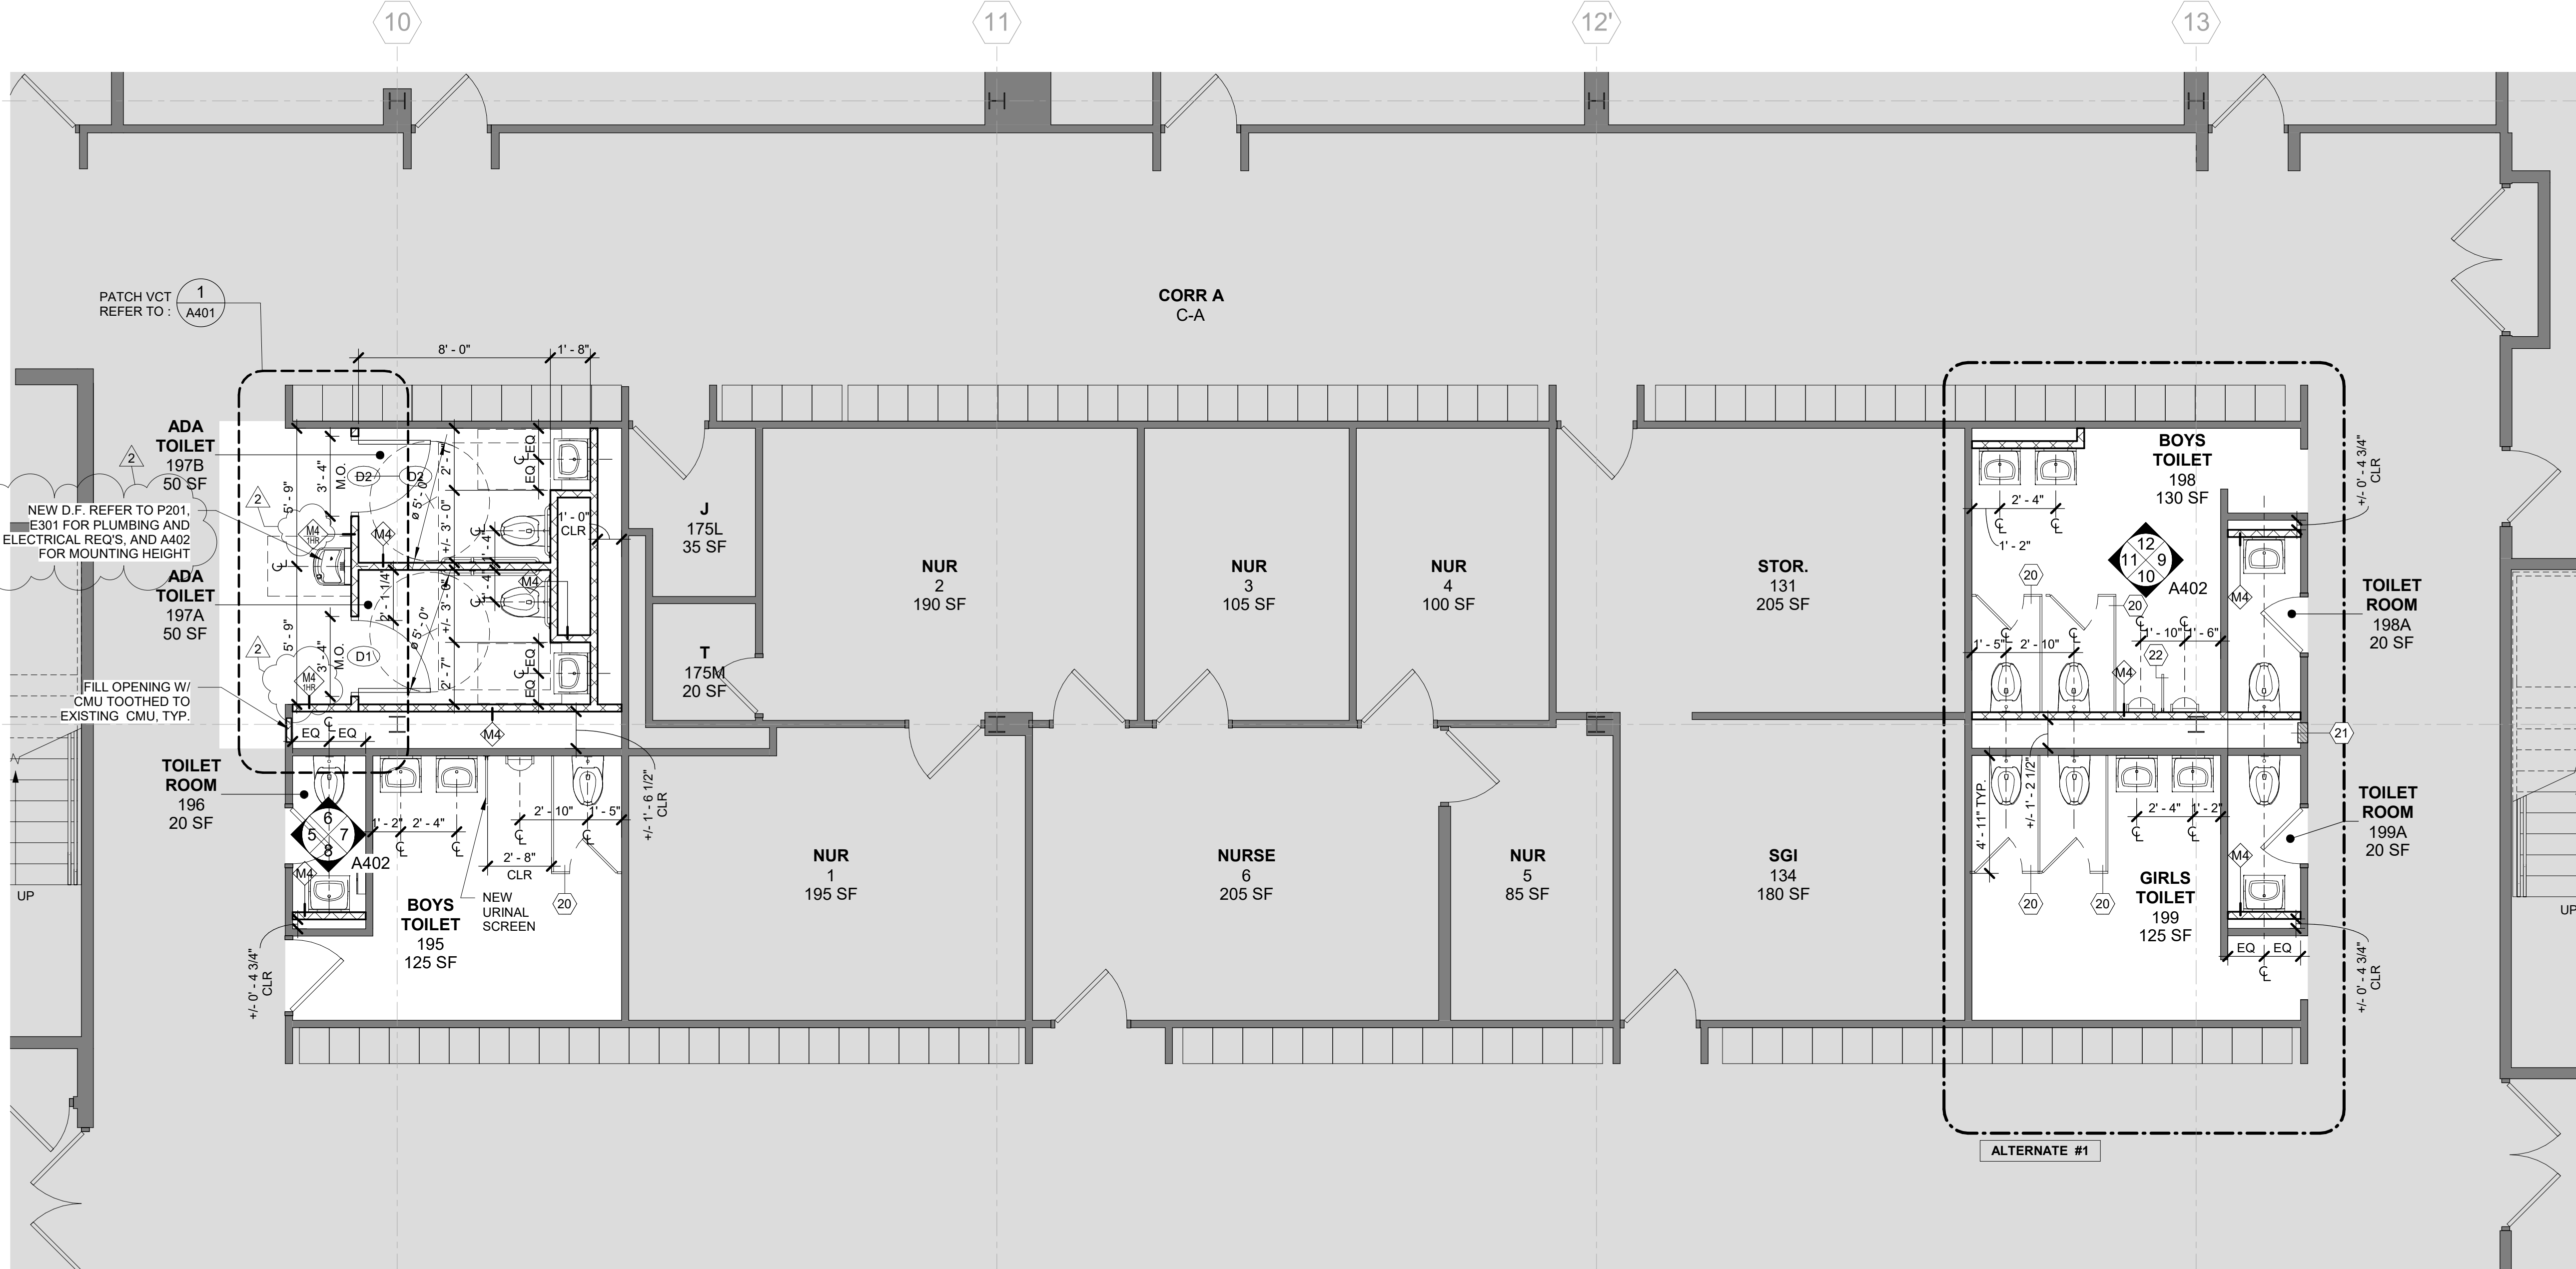REINFORCE ALL MASONRY WALLS W/ #4 REBAR @ 16"
VERTS W/ MATCHING DOWELS TO MATCH EXTENDED 18"
REBAR FROM SLAB OR WALL. FULLY GROUT
REINFORCED CELLS. SEE SPECS FOR OTHER
REQUIREMENTS


REFER TO DETAIL & MB FOR REQUIREMENTS WHERE
MASONRY WALLS CONNECT TO FLOORS

M4 DENOTES 4" CMU
 M4 HR DENOTES 4" CMU 1 HOUR RATED
 M6 DENOTES 6" CMU
 M8 DENOTES 8" CMU

CONCRETE MASONRY UNIT WALL

MASONRY UNITS MUST ACHIEVE INTENDED FIRE RATING
SHOWN ON PLANS PER PRESCRIPTIVE FIRE RESISTANCE
BASED ON IBC TABLE 721.2

ALL NEW CMU TO MATCH DIMENSION OF EXISTING CMU.
CONTRACTOR TO VIF DIMENSION OF EXISTING CMU
PRIOR TO CONSTRUCTION

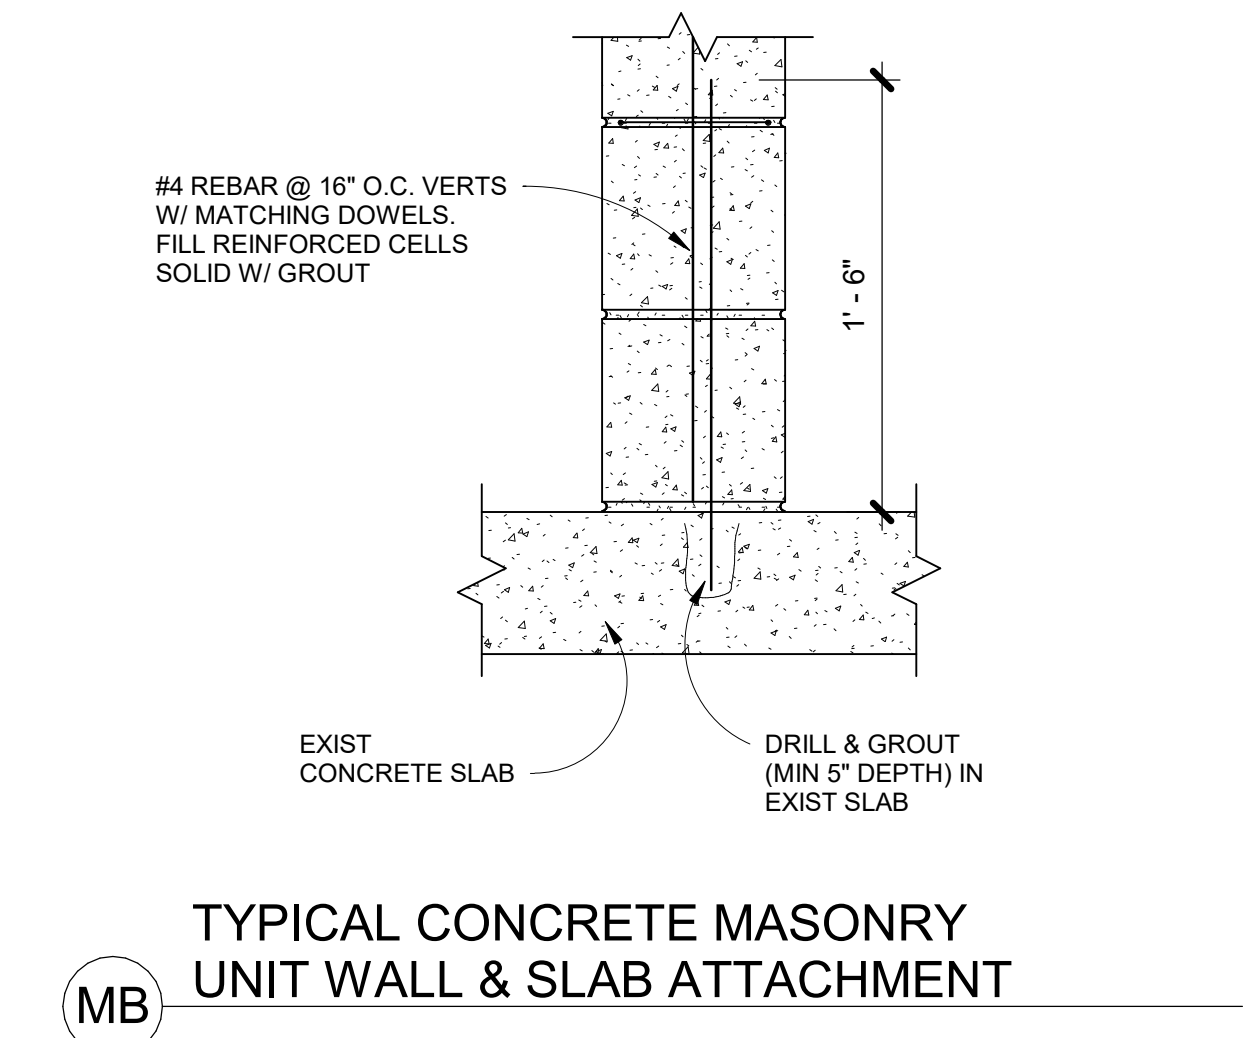

RENOVATION KEYNOTES	
20	NEW TOILET PARTITIONS AND ALL ASSOCIATED HARDWARE AND WALL ANCHORS TO BE PLACED AT PREVIOUS LOCATIONS U.O.N.
21	NEW DRINKING FOUNTAIN AT EXISTING OPENING. ADJUST OPENING AS NEEDED TO ACCOMMODATE NEW EQUIPMENT. SEE MEP DRAWINGS FOR EQUIPMENT SIZE.
22	NEW URINALS SCREENS ARE TO BE CENTERED BETWEEN FIXTURES, U.O.N.
23	NEW/RELOCATED ELECTRICAL PANEL.

**PUTNAM VALLEY
MIDDLE SCHOOL
TOILET ROOM
ALTERATIONS**

2018 CAPITAL PROJECTS -
PHASE 2

142 PEEKSKILL HOLLOW RD,
PUTNAM VALLEY, NY 10579

KG+D listen
imagine
build


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48-05-03-04-0-004-016

**CONSTRUCTION
DOCUMENTS**

GENERAL NOTES

- DENOTES AREA OF NO MAJOR ARCHITECTURAL RENOVATION WORK. SPECIFIC WORK MAY BE SHOWN ELSEWHERE. REFER TO M.E.P. DWGS.
- DENOTES EXISTING WALL TO REMAIN (MOST EXISTING WALLS ARE MASONRY)
- DENOTES EXISTING DOOR & FRAME TO REMAIN
- DENOTES EXISTING DOOR &/OR FRAME TO BE REPLACED. SEE DOOR SCHEDULE ON A401
- DENOTES NEW DOOR & NUMBER. SEE DOOR SCHEDULE ON A401. SEE SPECS FOR HARDWARE SET & INFO
- DENOTES 1hr OR NON-RATED WALL
- DENOTES 2hr FIRE RATED WALL
- DENOTES NEW WALL TYPE & FIRE RATING. (WHERE SHOWN)
- DENOTES KEYNOTE. REFER TO THE CORRESPONDING KEYNOTE ON THE SCHEDULE FOR CONSTRUCTION NOTE.
- FINISH SCHEDULE - SEE A401
- DIMENSIONS SHOWN FOR INTERIOR WALLS ARE: FACE OF CMU
- FACE OF ADJACENT WALL TO EDGE OF NEW DOOR FRAME IS 4" (TYP) U.O.N. (SEE DETAILS A & B ON A401)
- SEE SPECIFICATIONS SECTION 07 84 00 FOR FIRESTOPPING REQUIREMENTS.

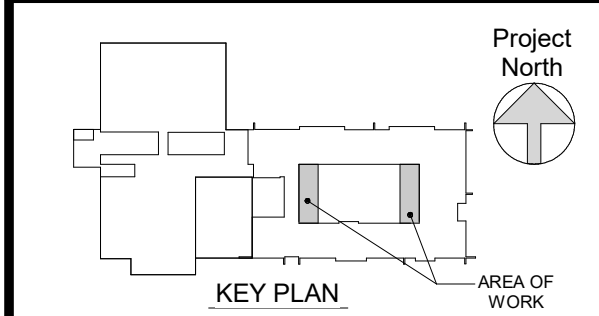

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2	02/26/21	SED ADDENDUM 1
1	02/01/21	CONSTRUCTION DOCUMENTS
No.	Date	Issue

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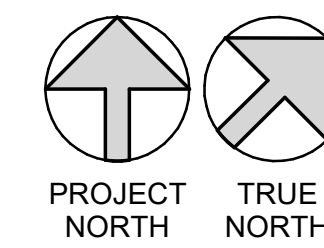
FLOOR PLANS

Job No. 2020-1051 Date 01/14/2021

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Sheet Number

A201




PUTNAM VALLEY
MIDDLE SCHOOL
TOILET ROOM
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2018 CAPITAL PROJECTS -
PHASE 2
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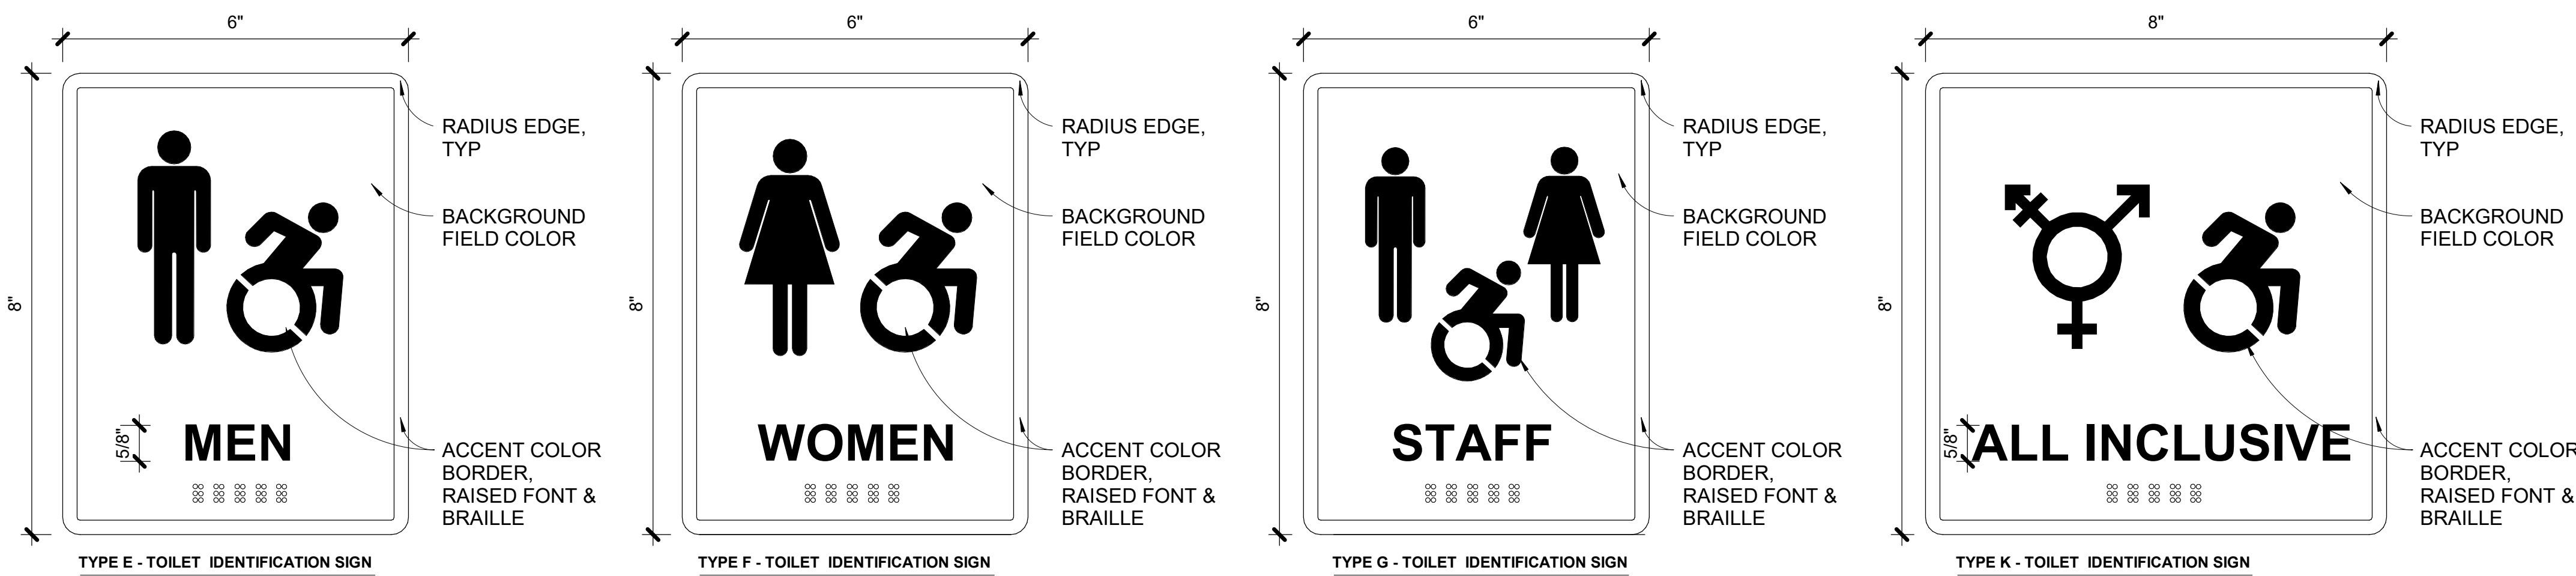
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CONSTRUCTION
DOCUMENTS




- NOTES:
1. NEATLY CUT OUT A PORTION OF THE EXISTING SPUF AND BUILT UP ROOF TO INSTALL NEW PORTAL PLUS CURB.
 2. ALL WORK ON THE EXISTING SPUF ROOF MUST BE PERFORMED BY AN AUTHORIZED BAYER MATERIAL SCIENCE LLC APPLICATOR USING THEIR PRODUCTS TO MAINTAIN THE EXISTING WARRANTY.
 3. SCRAPE GRAVEL FROM EXISTING BUILT UP ROOF TO INSTALL NEW BITUMINOUS FLASHING. PRIME THE SURFACE OF THE BUILT UP ROOF AND INSTALL 1 PLY OF TYPE VI FELT AND A MODIFIED GRANULAR SURFACE FLASHING SHEET SET IN FLASHING CEMENT, JOHNS MANVILLE OR EQUAL.

3 TYPICAL PORTALS PLUS CURB (SPUF ROOF)
SCALE: 3"=1'-0"

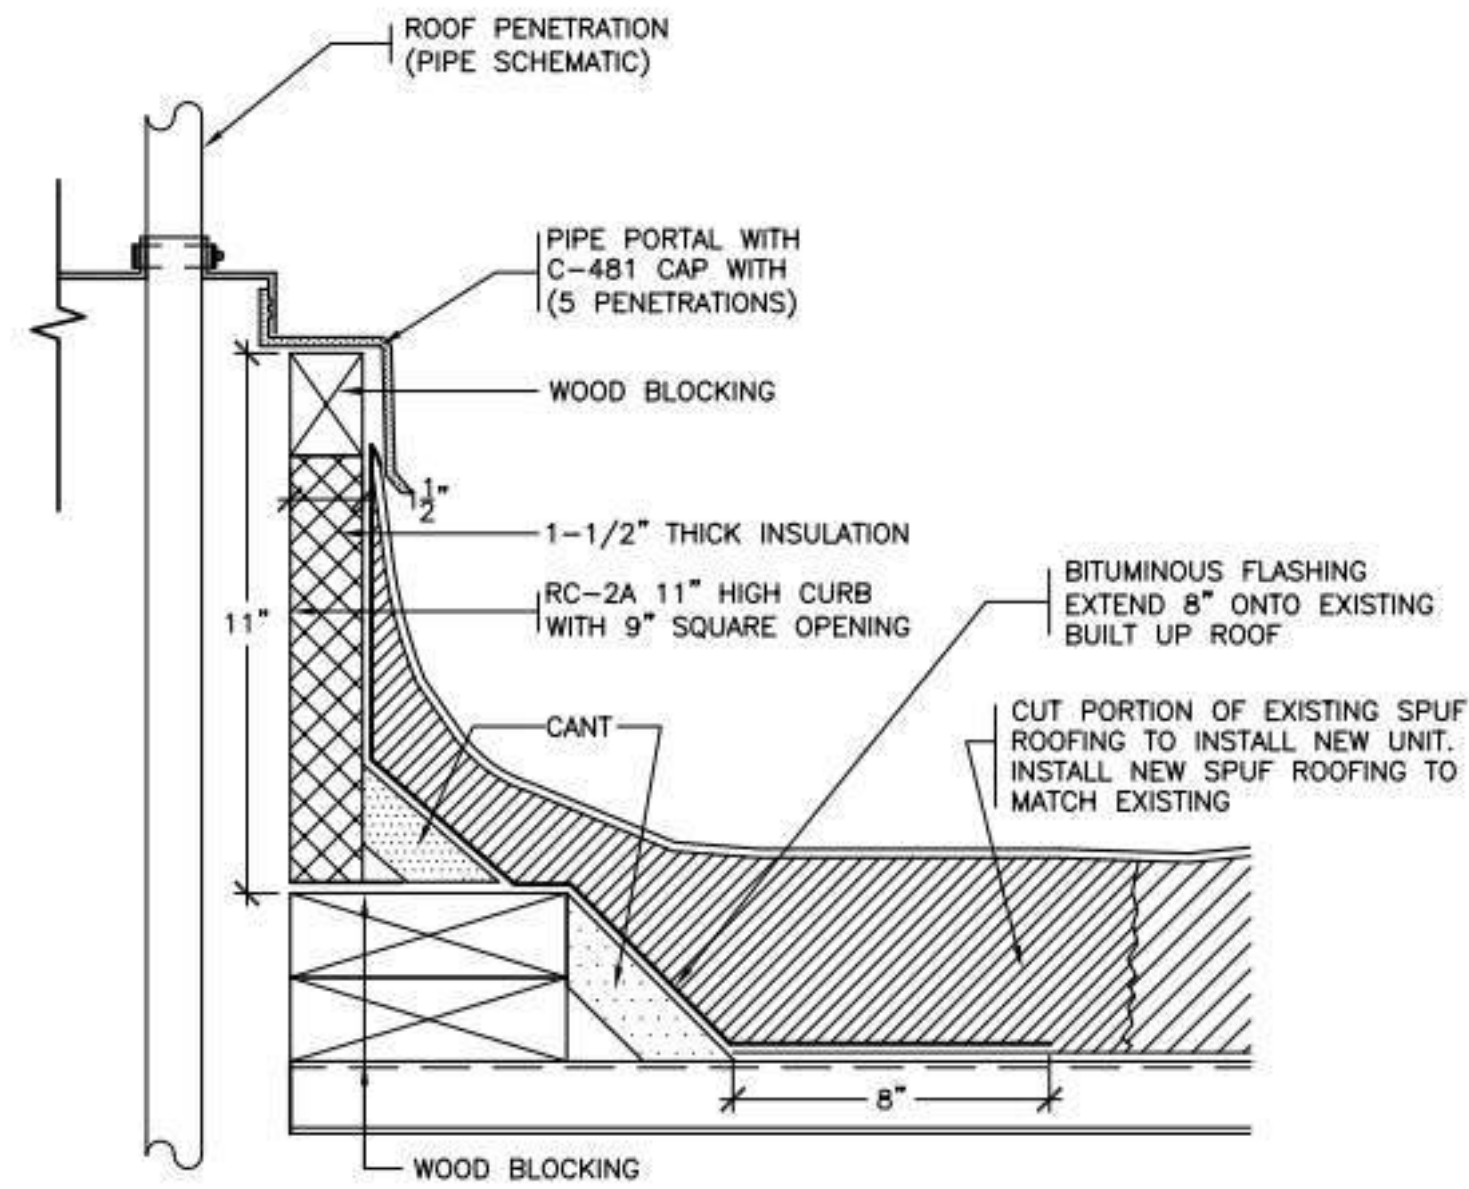


SIGNAGE SCHEDULE				
ROOM NO.	LOCATION	SIGN TYPE	SIGN TEXT (TEXT TO BE CONFIRMED WITH OWNER)	QTY
T/ 1st FLOOR				
195	BOYS TOILET	E (SIM)	BOYS	1
196	TOILET ROOM	K (SIM)	ALL INCLUSIVE	1
197A	ADA TOILET	K	ALL INCLUSIVE	1
197B	ADA TOILET	G	FACULTY TOILET	1
198	BOYS TOILET	E (SIM)	BOYS	1
198A	TOILET ROOM	G (SIM)	FACULTY TOILET	1
199	GIRLS TOILET	F (SIM)	GIRLS	1
199A	TOILET ROOM	G (SIM)	FACULTY TOILET	1
T/ 2nd FLOOR				
295	GIRLS TOILET	F (SIM)	GIRLS	1
296	TOILET ROOM	K (SIM)	ALL INCLUSIVE	1
297A	ADA TOILET	K	ALL INCLUSIVE	1
297B	ADA TOILET	G	FACULTY TOILET	1
298	BOYS TOILET	E (SIM)	BOYS	1
299	GIRLS TOILET	F (SIM)	GIRLS	1
299A	TOILET ROOM	G (SIM)	FACULTY TOILET	1

NOTE : SIGNS LABELED 'SIM' DO NOT HAVE THE ADA SYMBOL AND REMAINING SYMBOLS ARE CENTERED

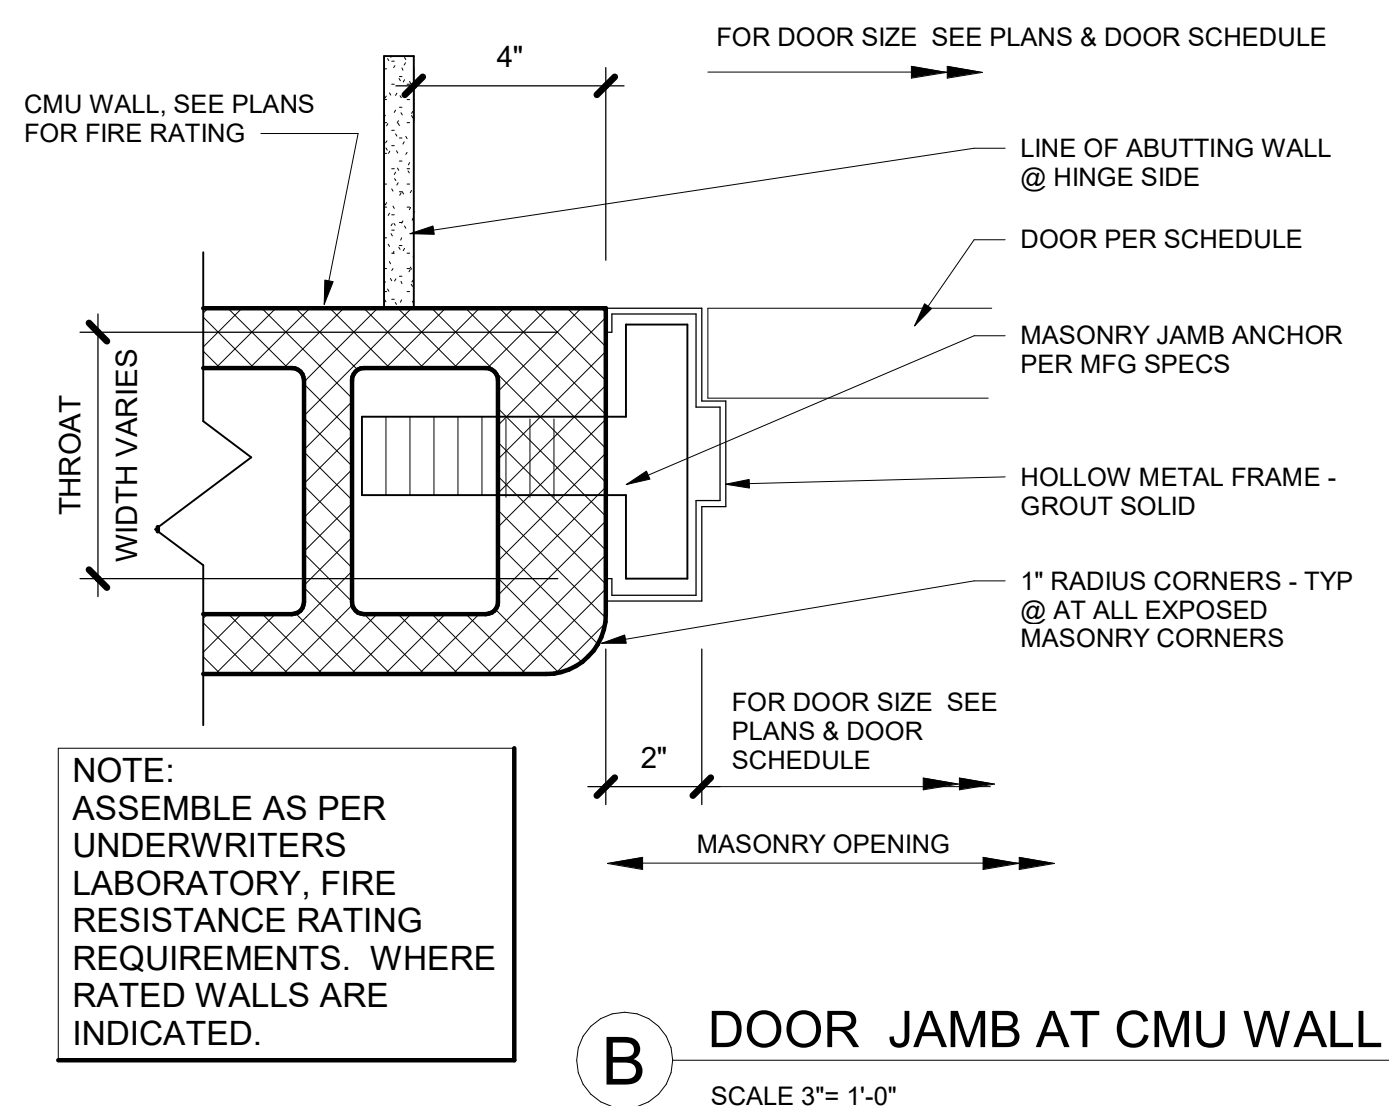

A DOOR JAMB AT CMU WALL
SCALE 3"= 1'-0"

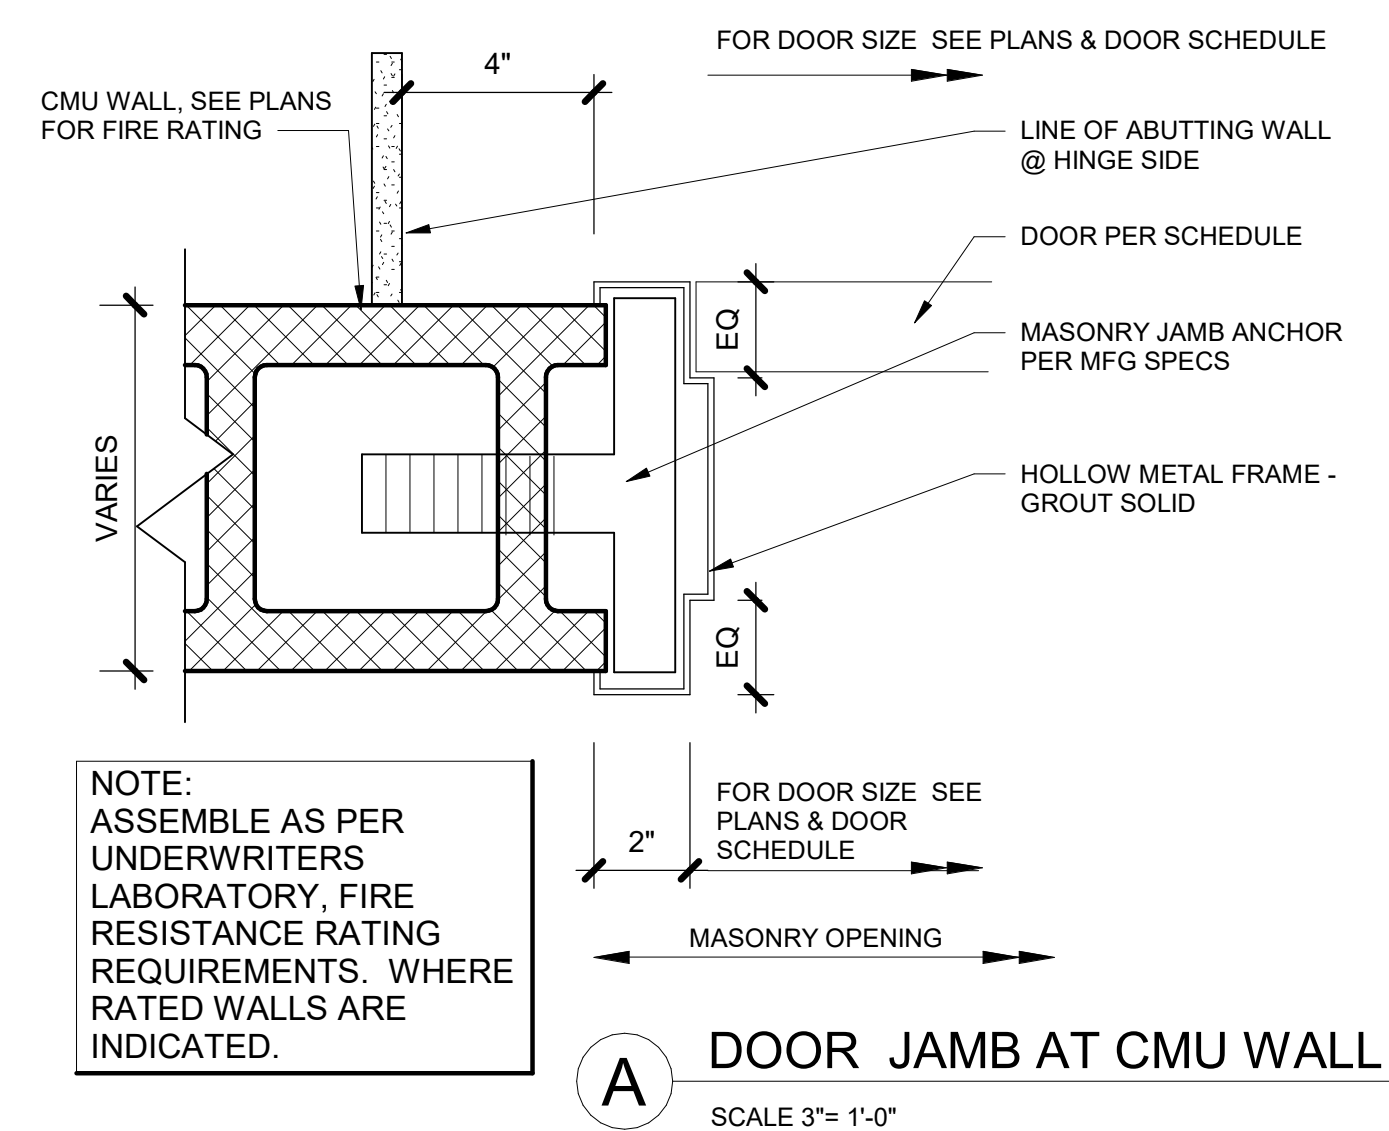

B DOOR JAMB AT CMU WALL
SCALE 3"= 1'-0"

FINISH SCHEDULE															
ROOM #	ROOM NAME	FLOOR		NORTH WALL		EAST WALL		SOUTH WALL		WEST WALL		CEILING			Comments
		FIN	BASE	MAT	FIN	MAT	FIN	MAT	FIN	MAT	FIN	MAT	FIN	HT	
T/ 1st FLOOR															
195	BOYS TOILET	PT1	CT1	EXIST TILE	CT3/CT4	EXIST TILE	CT3	EXIST TILE	CT3	EXIST TILE	CT3	ACT	FF	8'-0"	
196	TOILET ROOM	PT1	CT2	EXIST CMU	EPO	EXIST CMU	EPO	EXIST CMU	EPO	EXIST CMU	EPO	ACT	FF	8'-0"	
197A	ADA TOILET	PT1	CT2	CMU	EPO	CMU	EPO	CMU	EPO	CMU	EPO	ACT	FF	8'-0"	
197B	ADA TOILET	PT1	CT2	EXIST CMU	EPO	CMU	EPO	CMU	EPO	CMU	EPO	ACT	FF	8'-0"	
198	BOYS TOILET	PT1	CT1	EXIST TILE	CT3/CT4	EXIST TILE	CT3	CMU	CT3	EXIST TILE	CT3	ACT	FF	8'-0"	
198A	TOILET ROOM	PT1	CT2	EXIST CMU	EPO	EXIST CMU	EPO	CMU	EPO	EXIST CMU	EPO	ACT	FF	8'-0"	
199	GIRLS TOILET	PT1	CT1	EXIST TILE	CT3/CT4	EXIST TILE	CT3	EXIST TILE	CT3	EXIST TILE	CT3	ACT	FF	8'-0"	
199A	TOILET ROOM	PT1	CT2	EXIST CMU	EPO	EXIST CMU	EPO	EXIST CMU	EPO	EXIST CMU	EPO	ACT	FF	8'-0"	
C-A	CORR A	VCT1,VCT2	RB	EXIST	PTD	CMU	PTD	EXIST	PTD	-	-	EXIST	ACT	FF	8'-0"
T/ 2nd FLOOR															
295	GIRLS TOILET	PT1	CT1	EXIST TILE	CT3	EXIST TILE	CT3	EXIST TILE	CT3/CT4	EXIST TILE	CT3	ACT	FF	8'-0"	
296	TOILET ROOM	PT1	CT2	EXIST CMU	EPO	EXIST CMU	EPO	EXIST CMU	EPO	EXIST CMU	EPO	ACT	FF	8'-0"	
297A	ADA TOILET	PT1	CT2	CMU	EPO	CMU	EPO	CMU	EPO	CMU	EPO	ACT	FF	8'-0"	
297B	ADA TOILET	PT1	CT2	EXIST CMU	EPO	CMU	EPO	CMU	EPO	CMU	EPO	ACT	FF	8'-0"	
298	BOYS TOILET	PT1	CT1	EXIST TILE	CT3/CT4	EXIST TILE	CT3	CMU	CT3	EXIST TILE	CT3	ACT	FF	8'-0"	
299	GIRLS TOILET	PT1	CT1	EXIST TILE	CT3	EXIST TILE	CT3	EXIST TILE	CT3/CT4	EXIST TILE	CT3	ACT	FF	8'-0"	
299A	TOILET ROOM	PT1	CT2	EXIST CMU	EPO	EXIST CMU	EPO	EXIST CMU	EPO	EXIST CMU	EPO	ACT	FF	8'-0"	
C-E	CORR E	VCT1,VCT2	RB	EXIST	PTD	CMU	PTD	EXIST	PTD	-	-	EXIST	ACT	FF	8'-0"

INTERIOR FINISH ABBREVIATIONS LIST

ACT =
CMU =
CCT =
ACUSTIC CEILING PANEL
CONCRETE MASONRY BLOCK
CONCRETE
CERAMIC TILE


CTB =
EPO =
EXIST =
GWB =
CERAMIC TILE BASE
EPOXY PAINT
EXISTING
GYPSUM WALL BOARD

PTD =
PT =
PTB =
RB =
PAINT
PORCELAIN TILE
PORCELAIN TILE BASE
RUBBER BASE

STM =
VCT =
WD =
STEAMED CLEANED
VINYL COMPOSITION TILE
WOOD

NOTE: ALL TOILET ROOMS WHERE TILES HAVE BEEN REMOVED FROM WALLS AND FLOORS MUST BE COVERED WITH A NEW NON-ABSORBANT IMPERVIOUS FINISH, WHICH SHOULD FACILITATE CLEANING.

NOTE: PT-1 TO BE LAID LONG SIDE PARALLEL TO DOOR SADDLE, TYP.

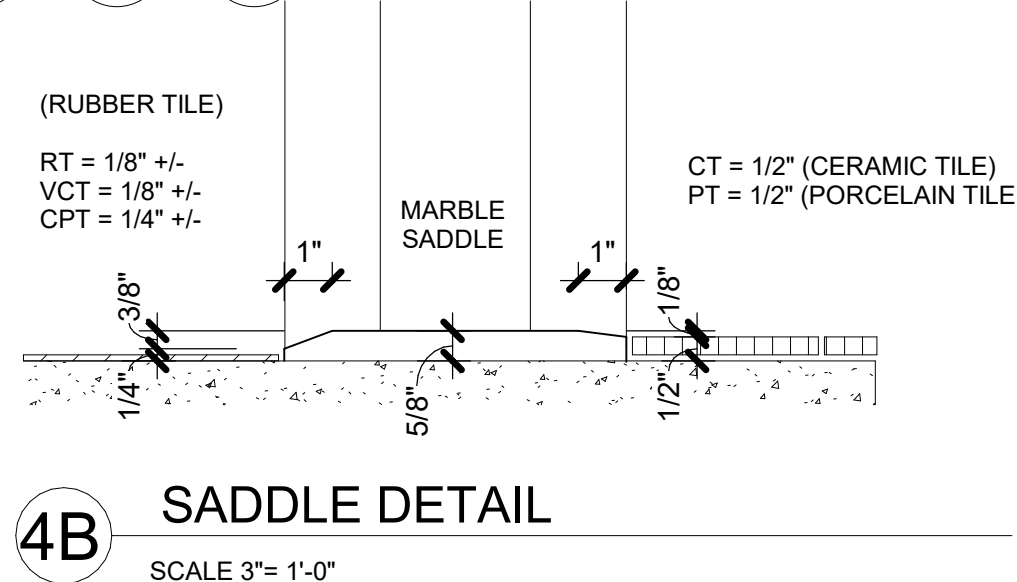

4B SADDLE DETAIL
SCALE 3"= 1'-0"

DOOR SCHEDULE														
MARK	FROM	TO	LEAFS	WIDTH	HEIGHT	ELEV	DOOR	DOOR FINISH	FRAME	FRAME FINISH	FIRE RATING (MIN.)	SADDLE	HOWE SET	COMMENTS
D1	CORR A	ADA TOILET	1	3'-0"	7'-0"	F	WD	SS	HM	P	20	4B	1.0	1M DOOR TRIM TYPE
D2	CORR A	ADA TOILET	1	3'-0"	7'-0"	F	WD	SS	HM	P	20	4B	1.0	1M DOOR TRIM TYPE
D3	CORR E	ADA TOILET	1	3'-0"	7'-0"	F	WD	SS	HM	P	20	4B	1.0	1M DOOR TRIM TYPE
D4	CORR E	ADA TOILET	1	3'-0"	7'-0"	F	WD	SS	HM	P	20	4B	1.0	1M DOOR TRIM TYPE

NOTE : PROVIDE 3 1/2" x 4" x 5/16" (LLV) LOOSE LINTEL FOR MAX MASONRY OPENING 3' - 6" W/ MIN 6" BEARING AT EACH END AT NEW MASONRY OPENINGS.


ABBREVIATIONS
HM HOLLOW METAL
P PAINTED
SS STAINLESS STEEL
WD WOOD

VCT LEGEND :	
	EXIST. VCT TO REMAIN
	EXIST. VCT1 TO REMAIN
	EXIST. VCT2 TO REMAIN
	NEW VCT1 : EMBLEM BLUE
	NEW VCT2 : HAIL
TYPICAL VCT SIZE = 12" x 12"	



2 2ND FLOOR CORRIDOR FLOOR FINISH
1/2" = 1'-0"

1 1ST FLOOR CORRIDOR FLOOR FINISH
1/2" = 1'-0"

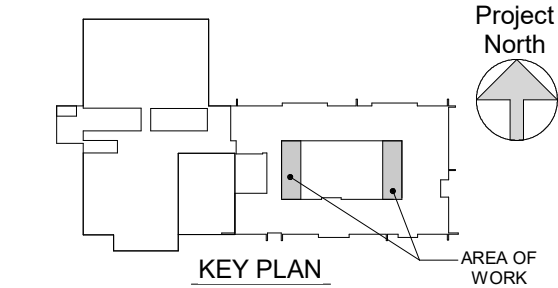

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Professional Seal

3	03/15/21	CONSTRUCTION DOCUMENTS
2	02/26/21	SED ADDENDUM 1
1	02/01/21	CONSTRUCTION DOCUMENTS

Sheet Title

INT. FINISHES,
DOOR SCHEDULE,
SIGNAGE & ROOF
DETLS.

Job No. 2020-1051 Date 01/19/21

Scale AS NOTED Drawn / Checked

Sheet Number

A401

PUTNAM VALLEY
MIDDLE SCHOOL
TOILET ROOM
ALTERATIONS
2018 CAPITAL PROJECTS -
PHASE 2
142 PEEKSKILL HOLLOW RD,
PUTNAM VALLEY, NY 10579

KG+D listen
imagine
build
KG+D . ARCHITECTS PC
385 MAIN STREET MOUNT KISCO, NEW YORK, 10549
P:914.666.5900 KGDARCHITECTS.COM

NY SED PROJECT CONTROL NO.
48-05-03-04-0-004-016
CONSTRUCTION
DOCUMENTS



A ADA WALL-HUNG TOILET
B LAVATORY
C REAR TOILET GRAB BAR
D SIDE TOILET GRAB BAR

E SIDE TOILET VERTICAL GRAB BAR
F WALL MIRROR w/ FRAME
G2 SURFACE MOUNTED C-FOLD
PAPER TOWEL DISPENSER &
WASTER RECEPTACLE


NOTE:
ACCESSORIES G, H, I & J
ARE SUPPLIED BY
OWNER, INSTALLED BY
GC.
H TOILET PAPER ROLL DISPENSER
I LIQUID SOAP DISPENSER
J SANITARY DISPOSAL
G SURFACE MOUNTED PAPER
TOWEL DISPENSER

K STANDARD WALL-HUNG TOILET
L STANDARD WALL-HUNG URINAL
M URINAL SCREEN
N ADA/CHILD WALL-HUNG URINAL


O COAT HOOK
P FLOOR MOUNTED OVERHEAD
BRAZED TOILET PARTITION
Q WALL-HUNG DRINKING
FOUNTAIN

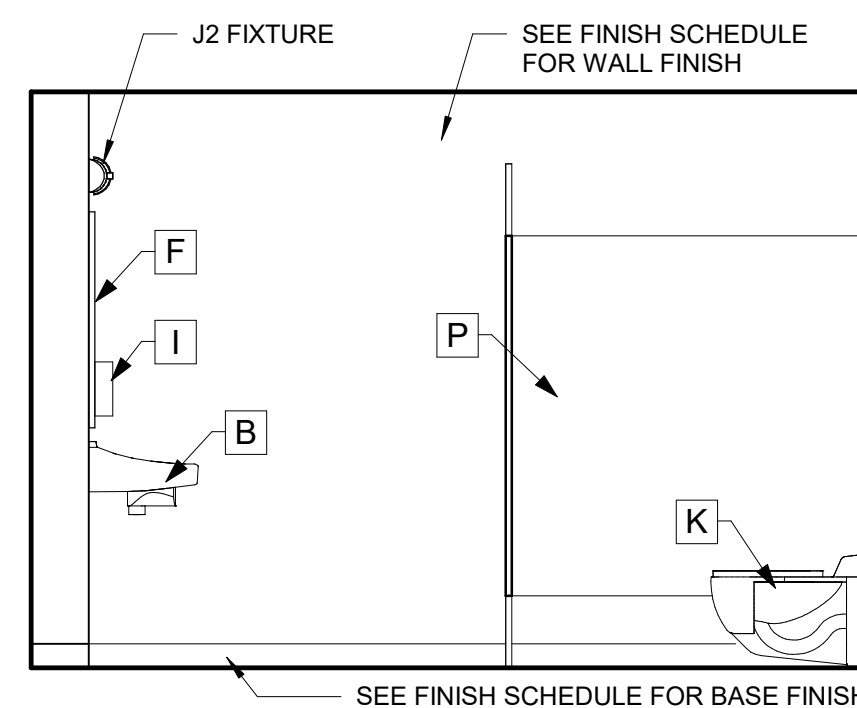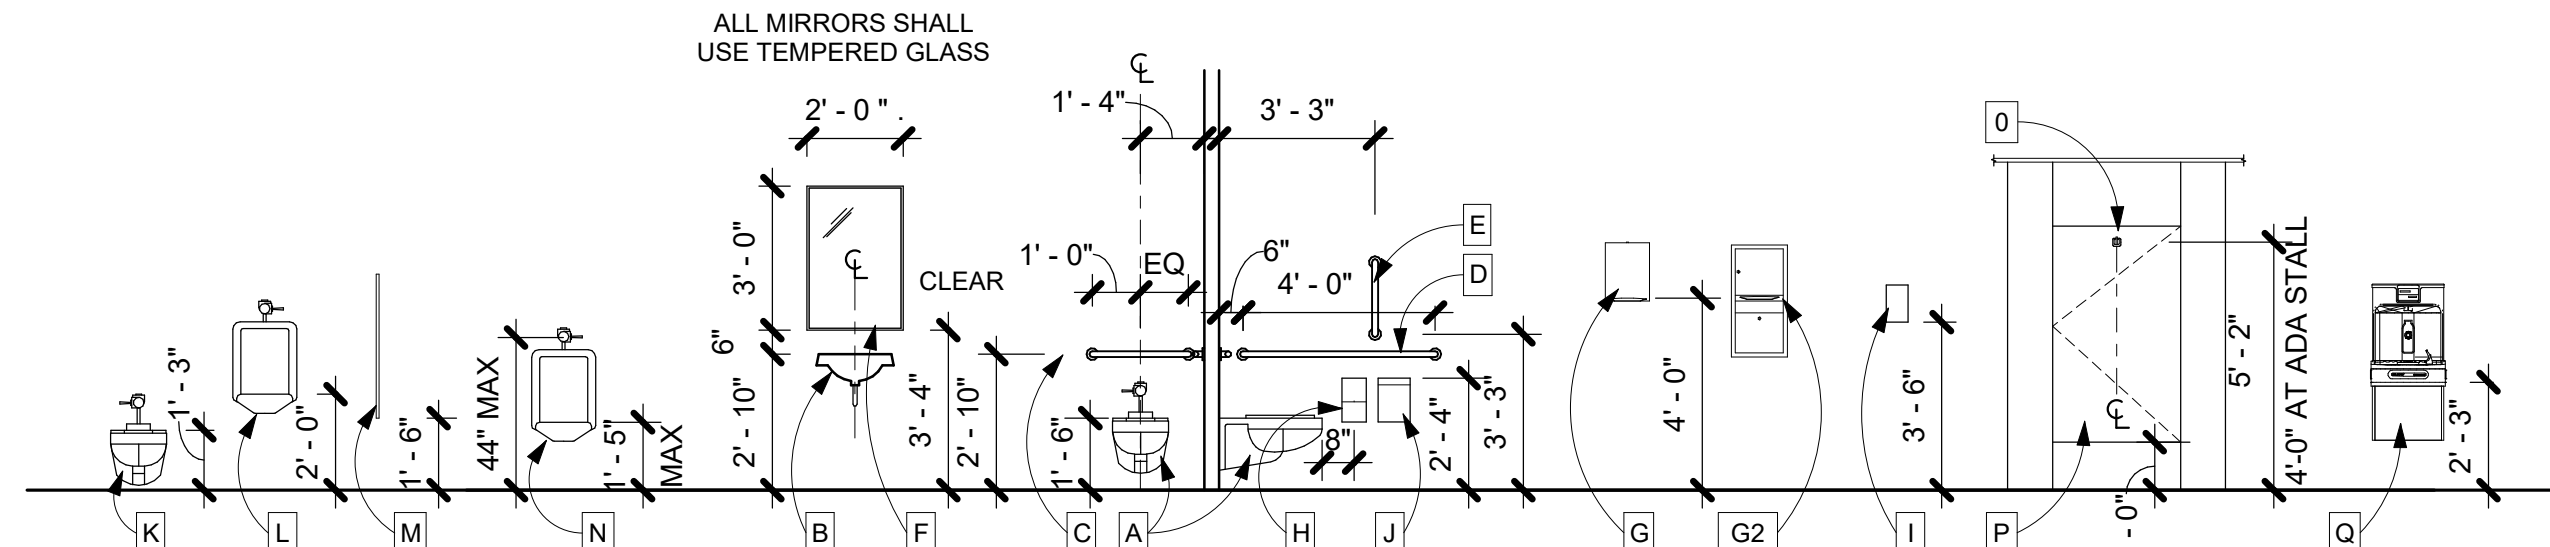


13 GIRLS 299 WEST ELEV
3/8" = 1'-0" ROOMS 199 & 295 HAVE SIMILAR FINISHES AND
FIXTURES TO ROOM 299

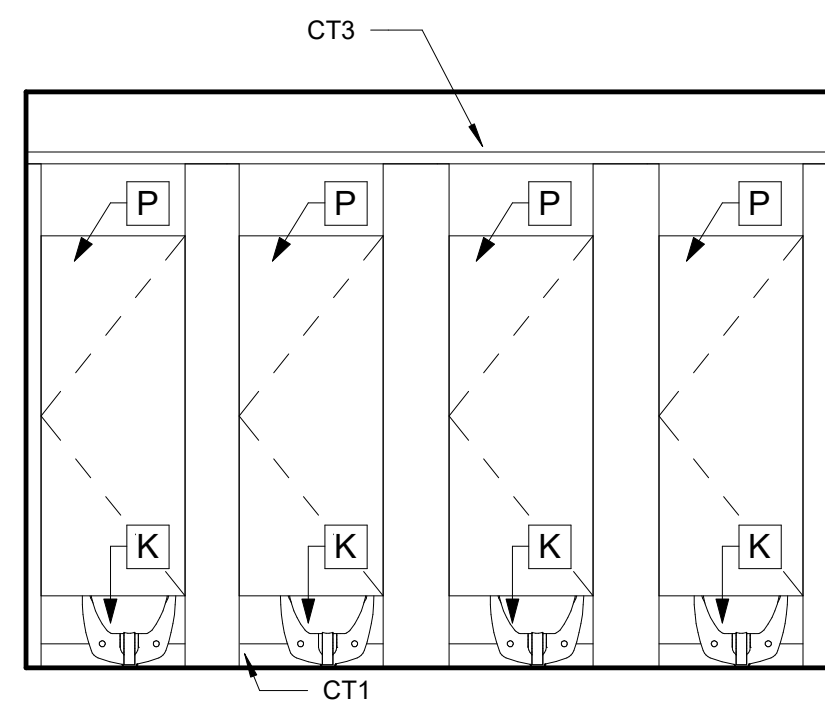


14 GIRLS 299 NORTH ELEV
3/8" = 1'-0" ROOMS 199 & 295 HAVE SIMILAR FINISHES AND
FIXTURES TO ROOM 299

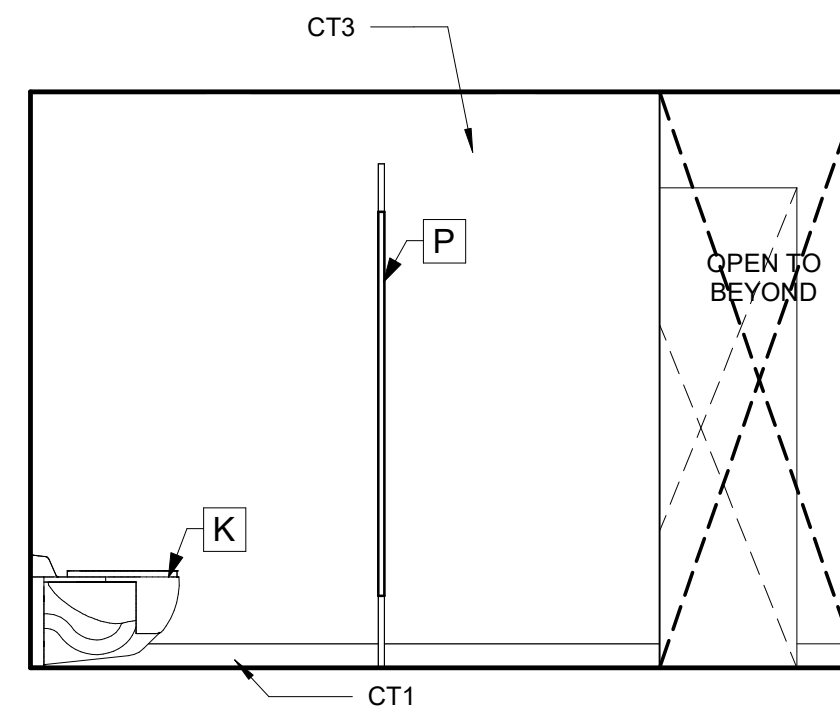


15 GIRLS 299 EAST ELEV
3/8" = 1'-0" ROOMS 199 & 295 HAVE SIMILAR FINISHES AND
FIXTURES TO ROOM 299

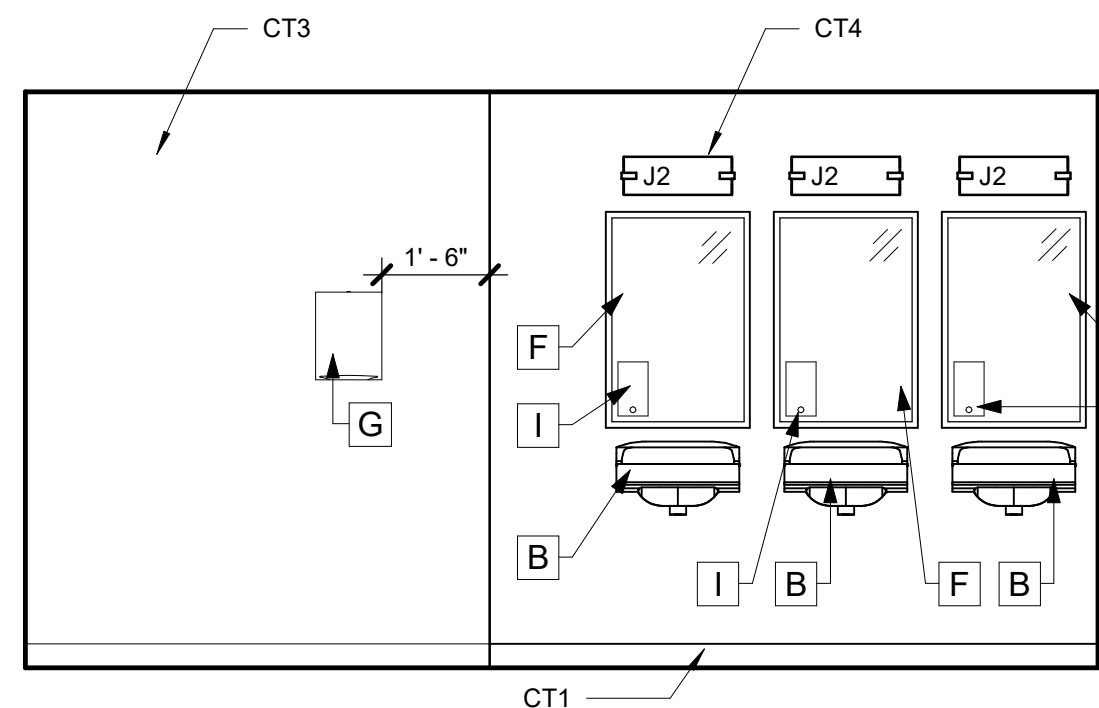


16 GIRLS 299 SOUTH ELEV
3/8" = 1'-0" ROOMS 199 & 295 HAVE SIMILAR FINISHES AND
FIXTURES TO ROOM 299
ROOM 199 - APPLY CT4 BEHIND SINKS +/- 4'-8"
WIDE, APPLY SCHLUTER EDGE AT TRANSITION
FROM CT3 TO CT4

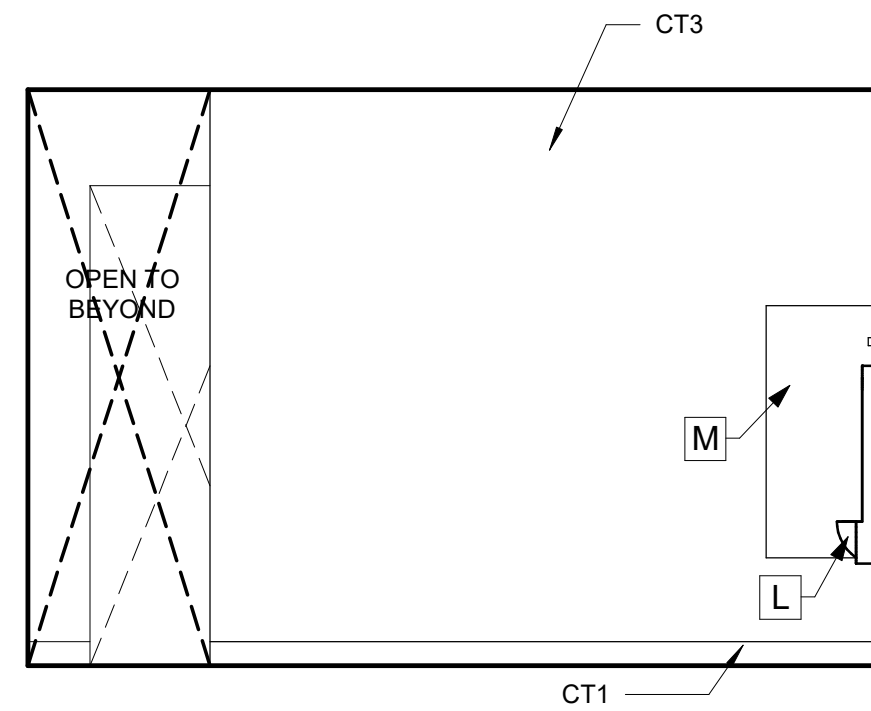


9 BOYS 198 EAST ELEV
3/8" = 1'-0" ROOMS 195 & 298 HAVE SIMILAR FINISHES AND
FIXTURES TO ROOM 198

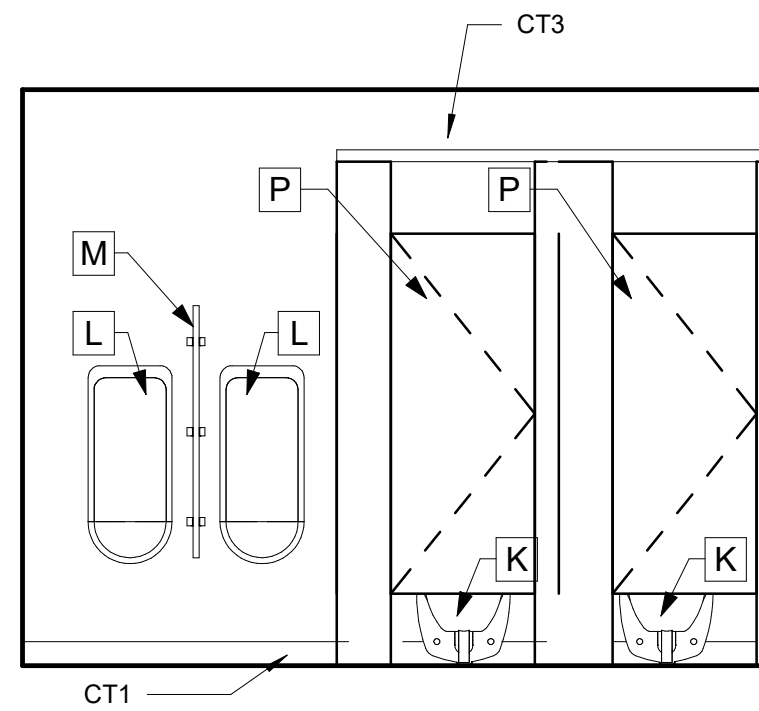


10 BOYS 198 SOUTH ELEV
3/8" = 1'-0" ROOMS 195 & 298 HAVE SIMILAR FINISHES AND
FIXTURES TO ROOM 198

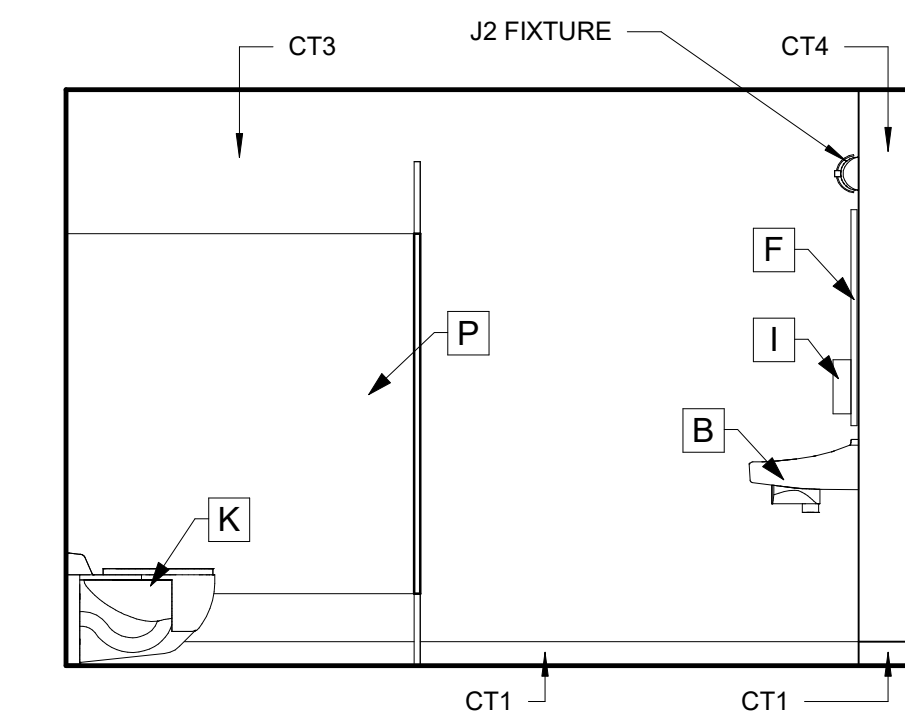


11 BOYS 198 WEST ELEV
3/8" = 1'-0" ROOMS 195 & 298 HAVE SIMILAR FINISHES AND
FIXTURES TO ROOM 198

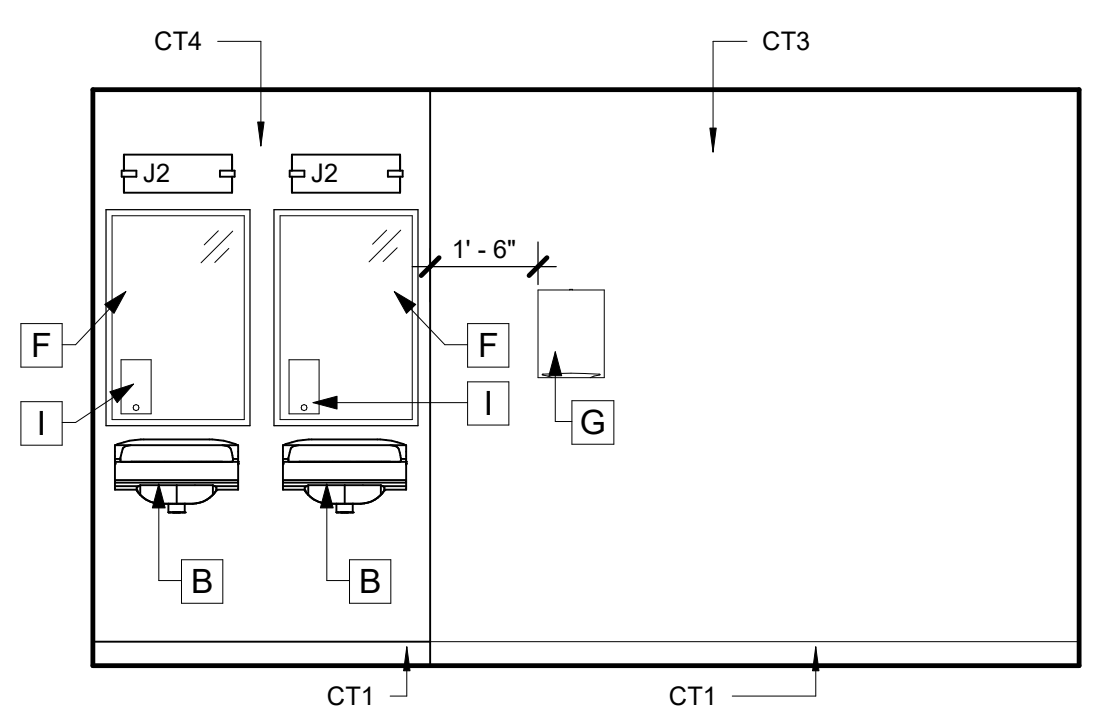


12 BOYS 198 NORTH ELEV
3/8" = 1'-0" ROOMS 195 & 298 HAVE SIMILAR FINISHES AND
FIXTURES TO ROOM 198
ROOM 195 - APPLY CT4 BEHIND SINKS +/- 4'-8"
WIDE, APPLY SCHLUTER EDGE AT TRANSITION
FROM CT3 TO CT4

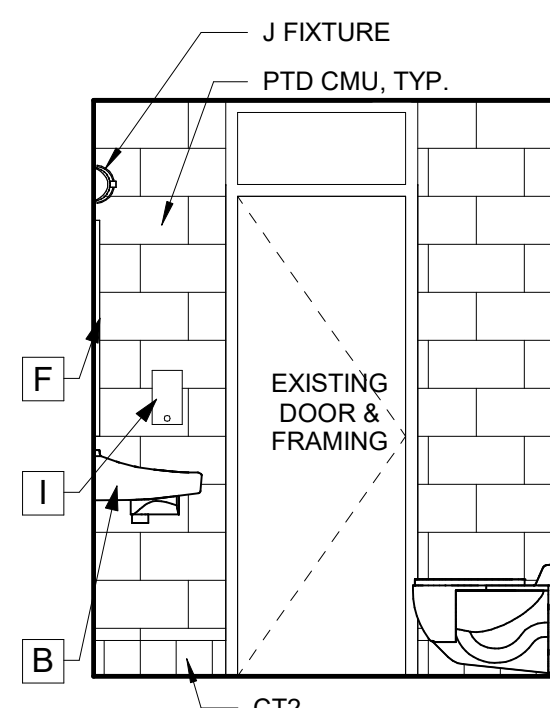


5 SINGLE USER
196 WEST ELEV
3/8" = 1'-0" ROOM 198A & 296 IS SIMILAR TO 196
ROOMS 199A & 299A IS SIM. OPP TO 297A

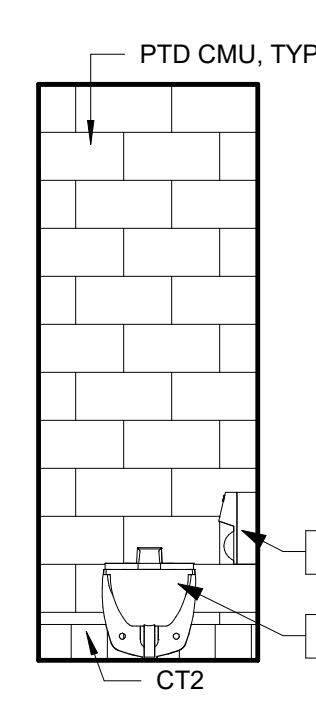


6 SINGLE USER
196 NORTH ELEV
3/8" = 1'-0" ROOM 198A & 296 IS SIMILAR TO 196
ROOMS 199A & 299A IS SIM. OPP TO 297A

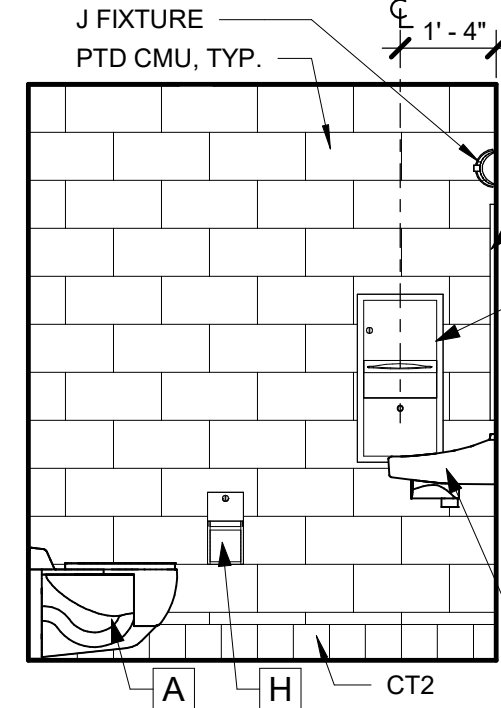


7 SINGLE USER
196 EAST ELEV
3/8" = 1'-0" ROOM 198A & 296 IS SIMILAR TO 196
ROOMS 199A & 299A IS SIM. OPP TO 297A

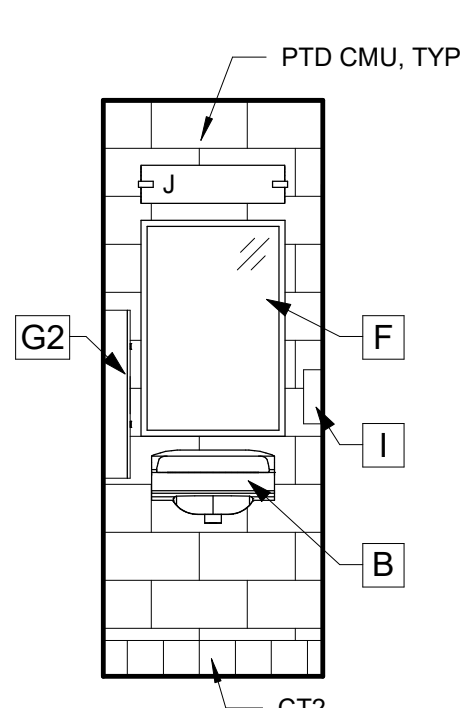


8 SINGLE USER
196 SOUTH ELEV
3/8" = 1'-0" ROOM 198A & 296 IS SIMILAR TO 196
ROOMS 199A & 299A IS SIM. OPP TO 297A

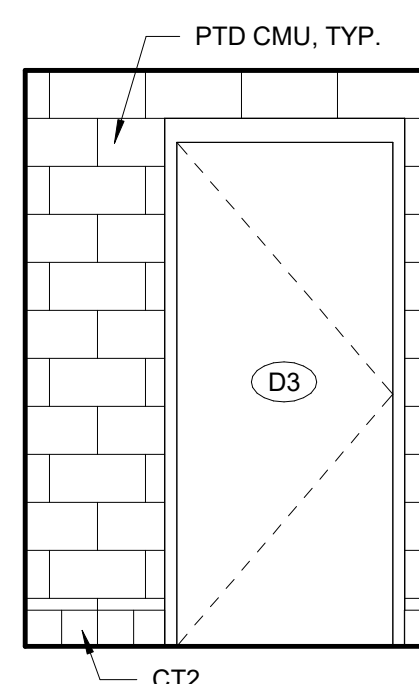


1 ADA 297A WEST ELEV
3/8" = 1'-0" ROOM 197B IS SIMILAR TO 297A
ROOMS 297B & 197A IS SIM. OPP TO 297A

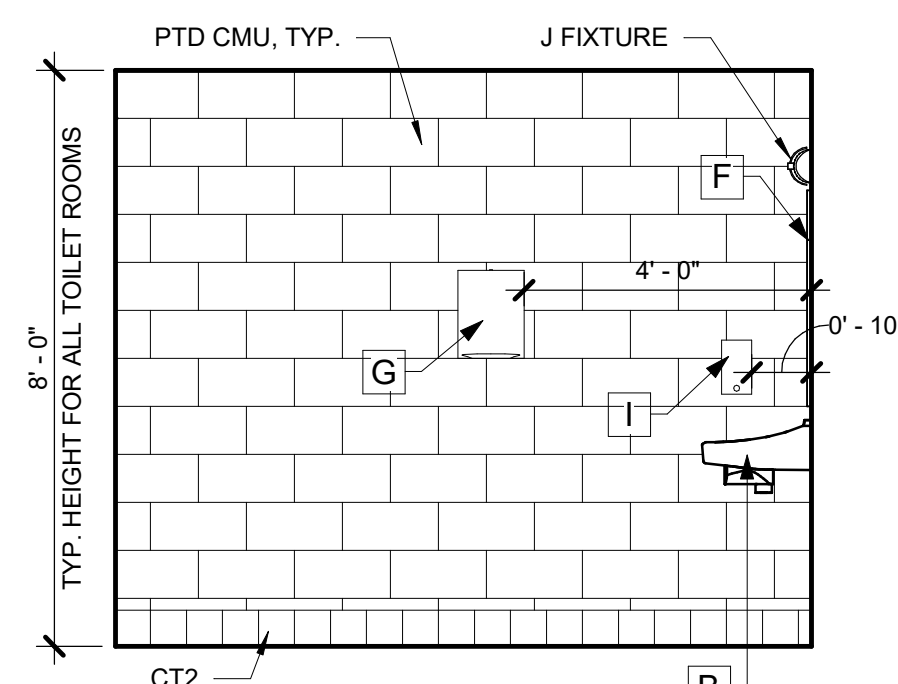


2 ADA 297A NORTH ELEV
3/8" = 1'-0" ROOM 197B IS SIMILAR TO 297A
ROOMS 297B & 197A IS SIM. OPP TO 297A

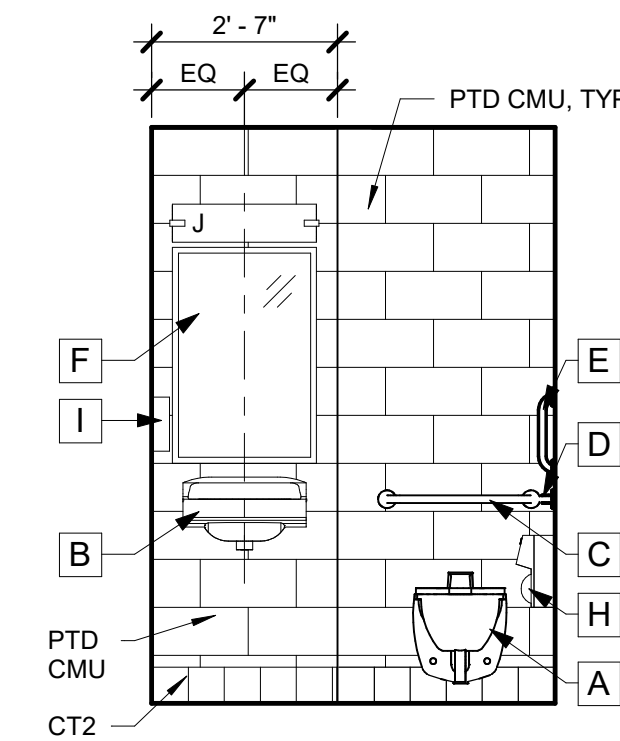

3 ADA 297A EAST ELEV
3/8" = 1'-0" ROOM 197B IS SIMILAR TO 297A
ROOMS 297B & 197A IS SIM. OPP TO 297A

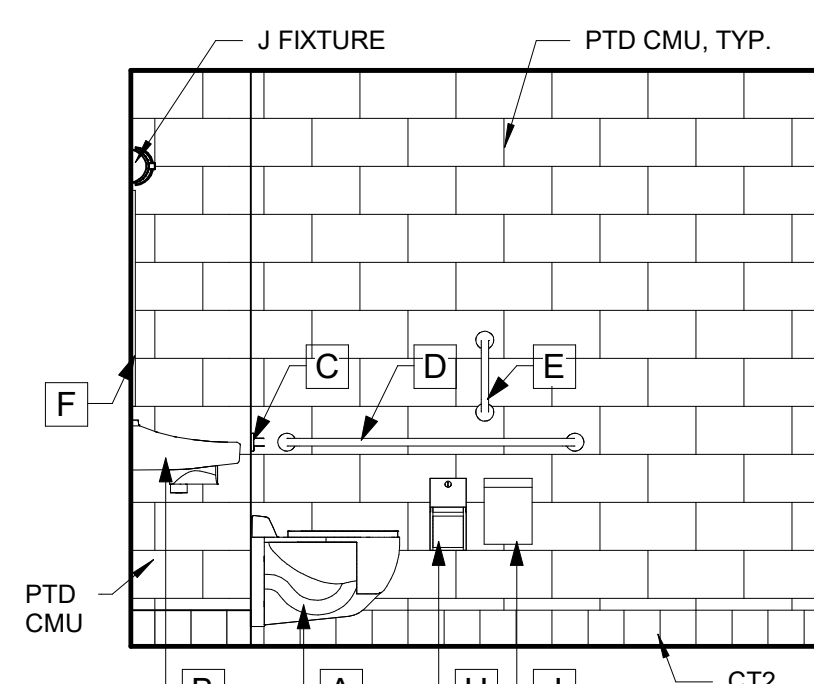

4 ADA 297A SOUTH ELEV
3/8" = 1'-0" ROOM 197B IS SIMILAR TO 297A
ROOMS 297B & 197A IS SIM. OPP TO 297A

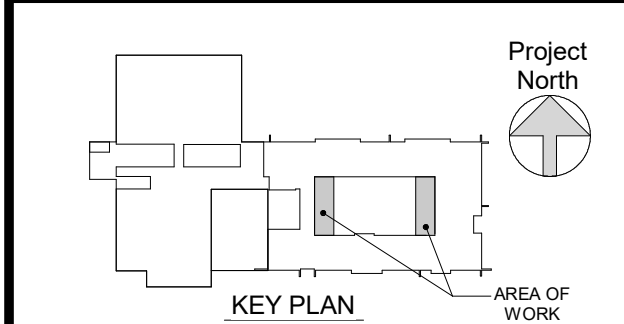

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3 03/15/21 CONSTRUCTION DOCUMENTS
1 02/01/21 CONSTRUCTION DOCUMENTS
No Date Issue

Sheet Title

INTERIOR
ELEVATIONS

Job No. 2020-1051 Date 01/18/2021
Scale AS NOTED Drawn / Checked

Sheet Number

A402


PUTNAM VALLEY
MIDDLE SCHOOL
TOILET ROOM
ALTERATIONS
2018 CAPITAL PROJECTS -
PHASE 2
142 PEEKSKILL HOLLOW RD,
PUTNAM VALLEY, NY 10579




KG+D . ARCHITECTS PC
385 MAIN STREET MOUNT KISCO, NEW YORK, 10549
P:914.666.5900 KGDARCHITECTS.COM

NY SED PROJECT CONTROL NO.
48-05-03-04-0-004-016

CONSTRUCTION
DOCUMENTS

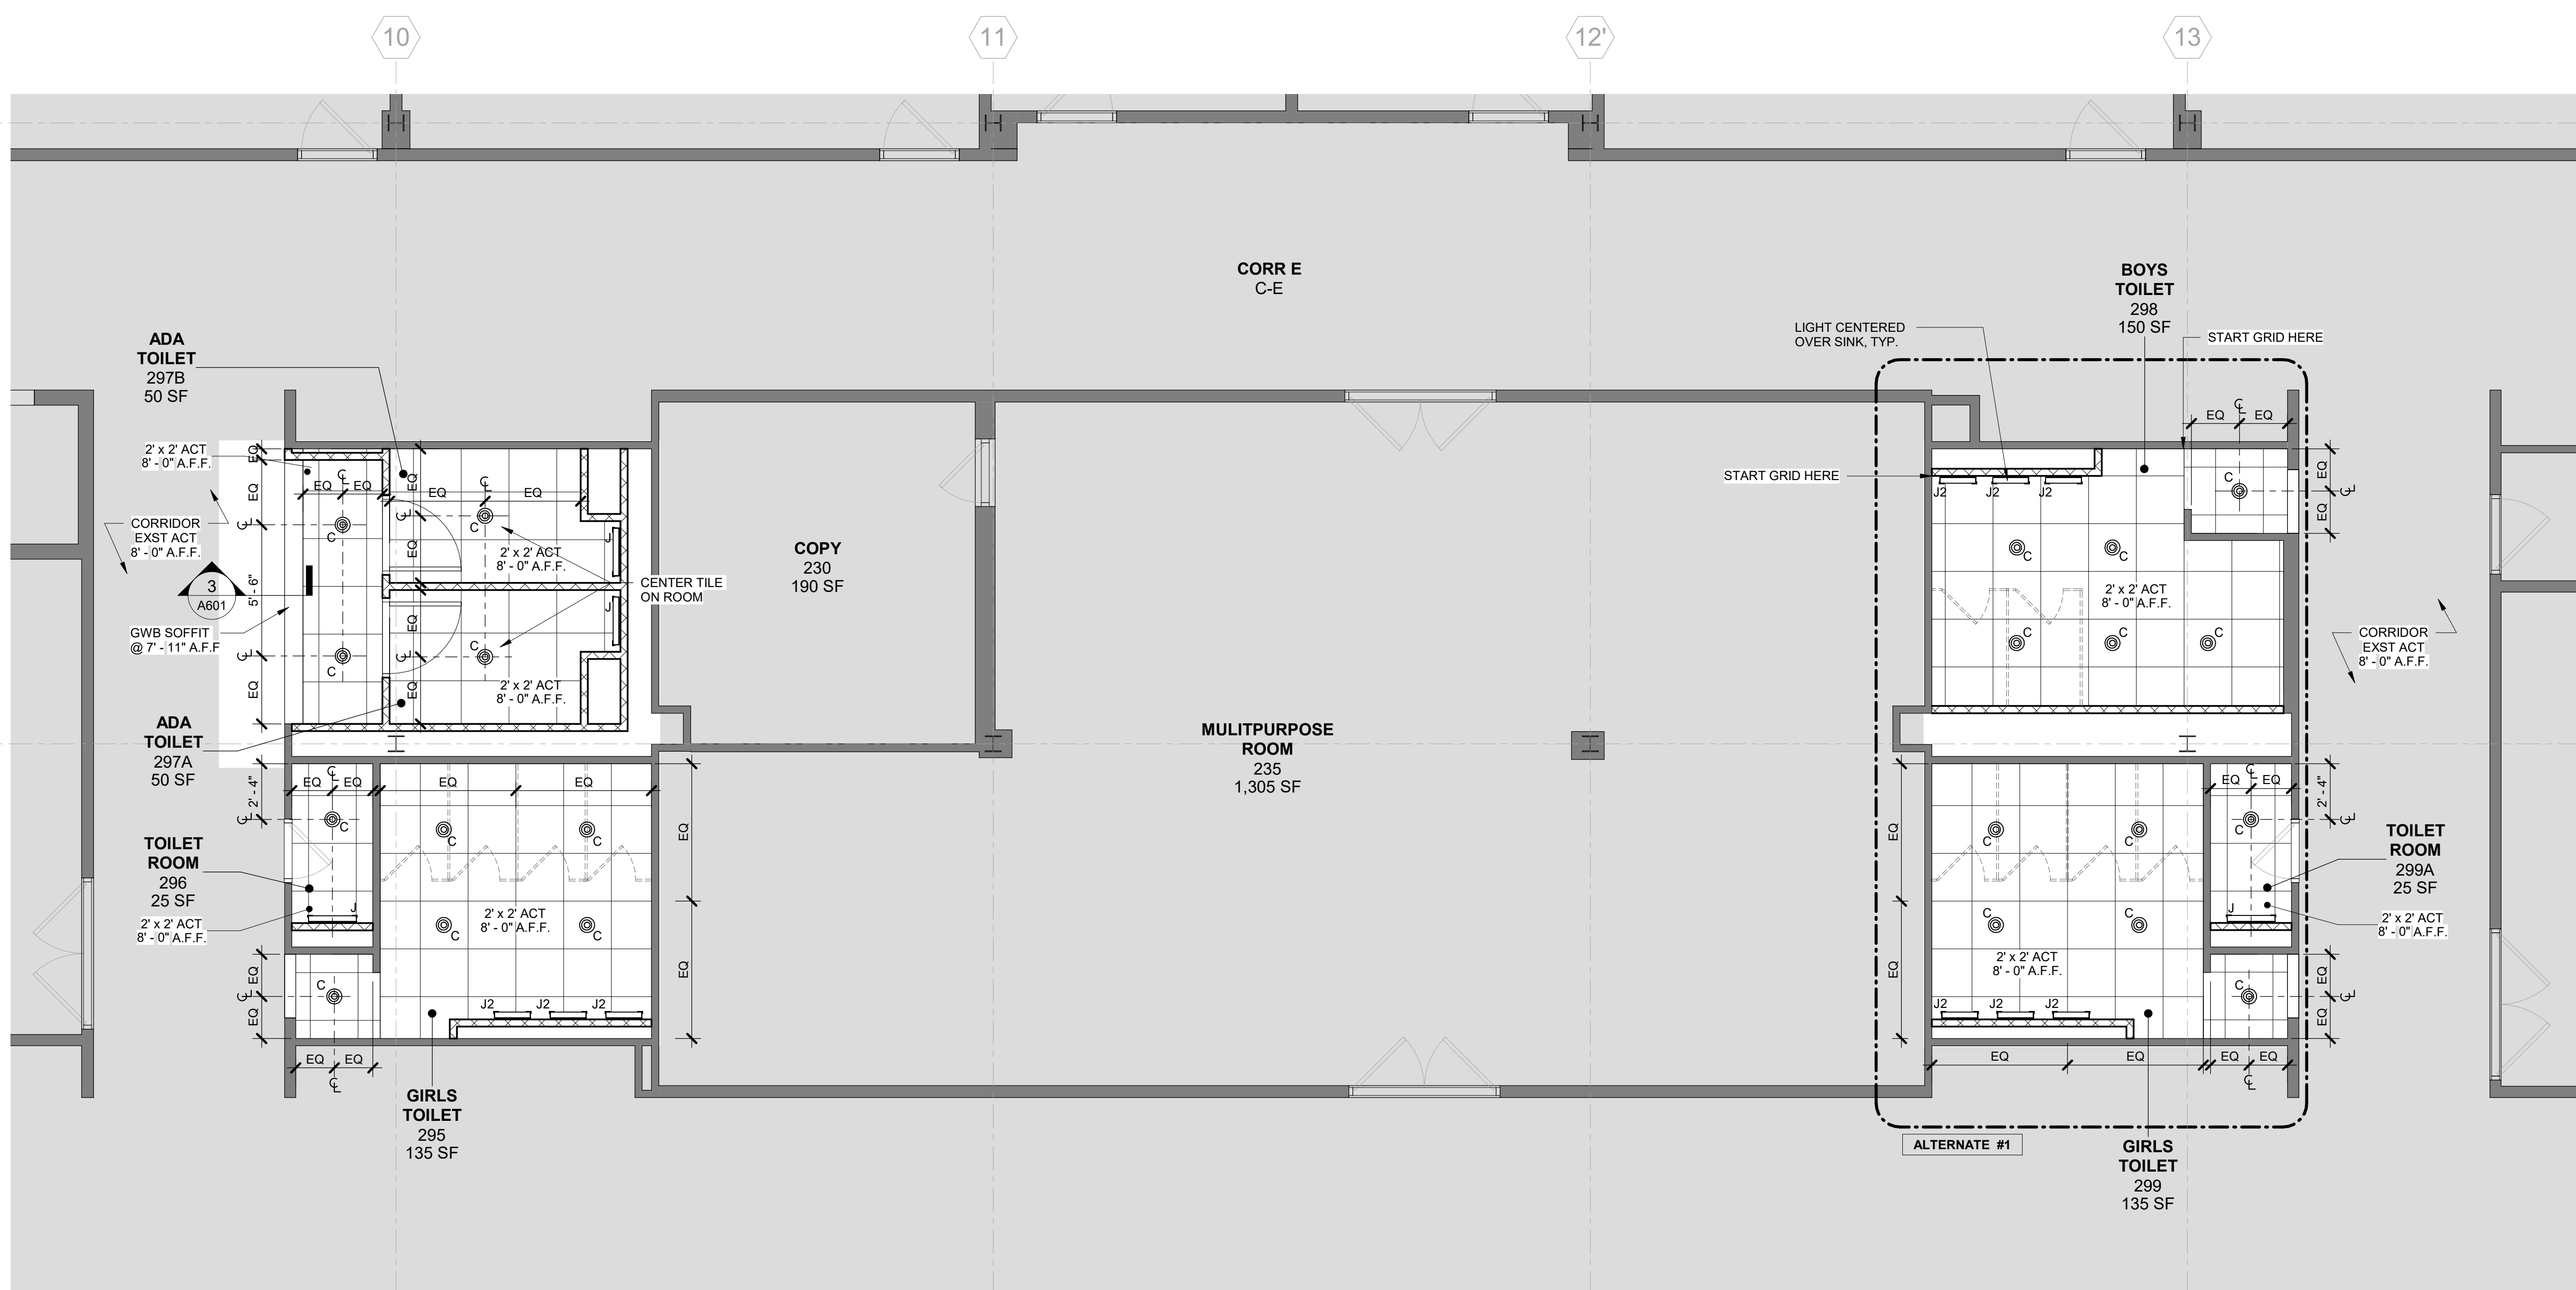


2 2ND FLOOR RCP
1/4" = 1'-0"

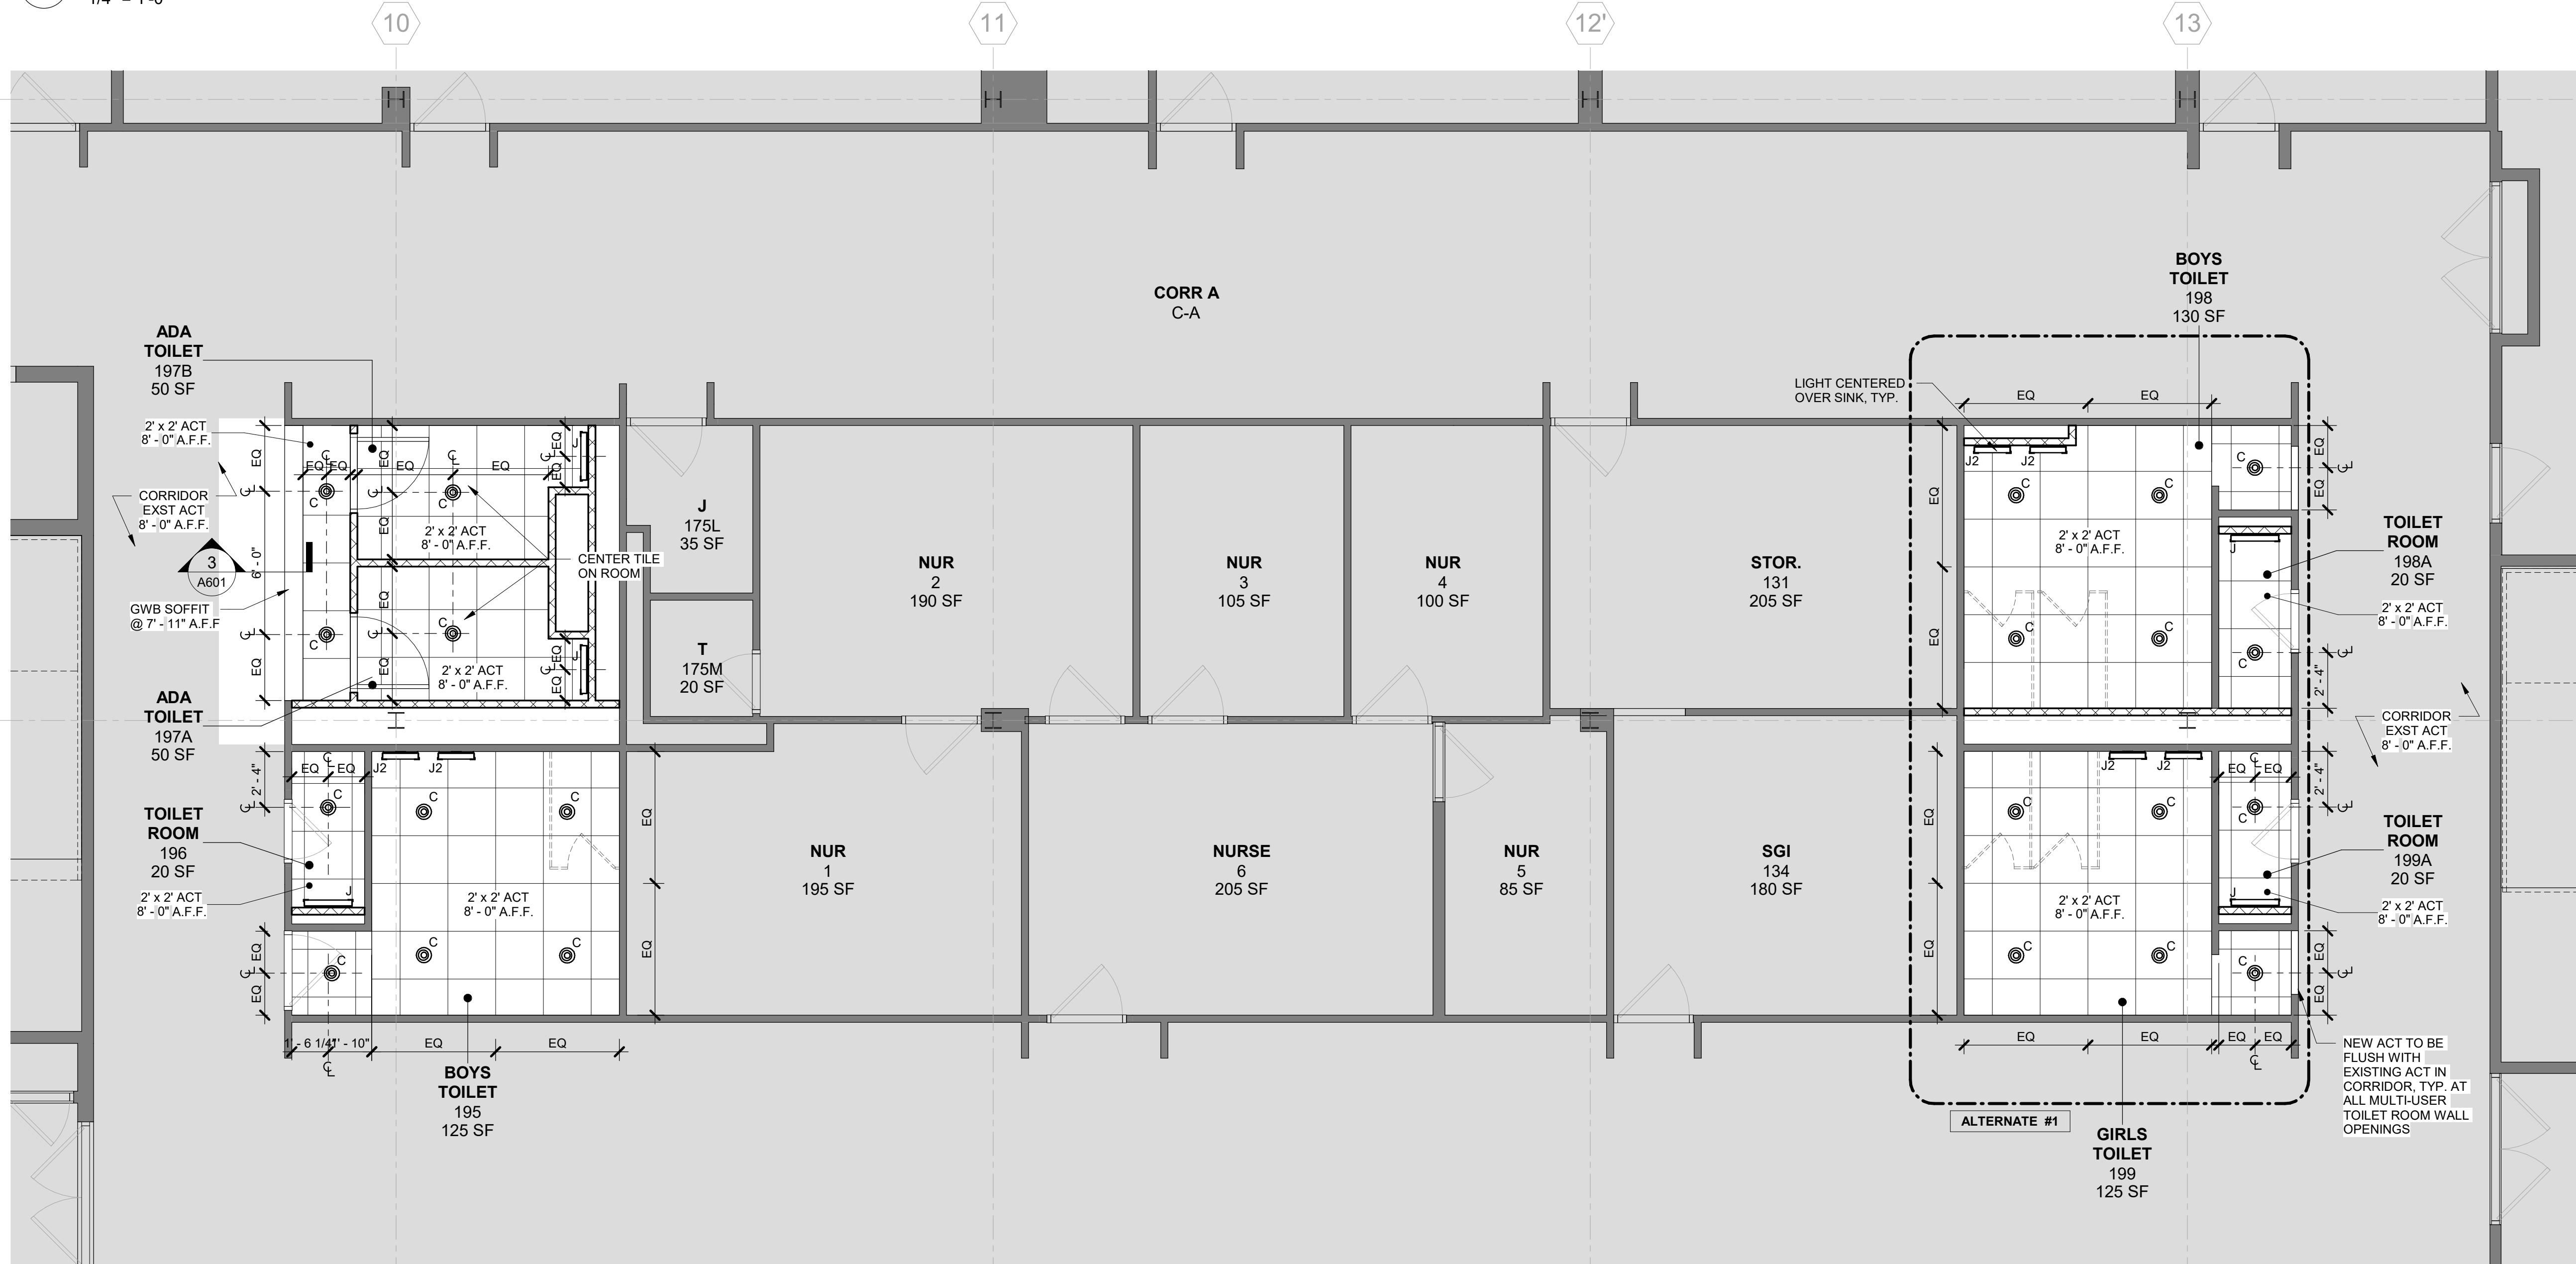


1 1ST FLOOR RCP
1/4" = 1'-0"

NOTE: ALL TOILET ROOM CEILING MUST BE COVERED WITH A NON-ABSORBANT IMPERVIOUS COATING WHICH SHALL FACILITATE CLEANING

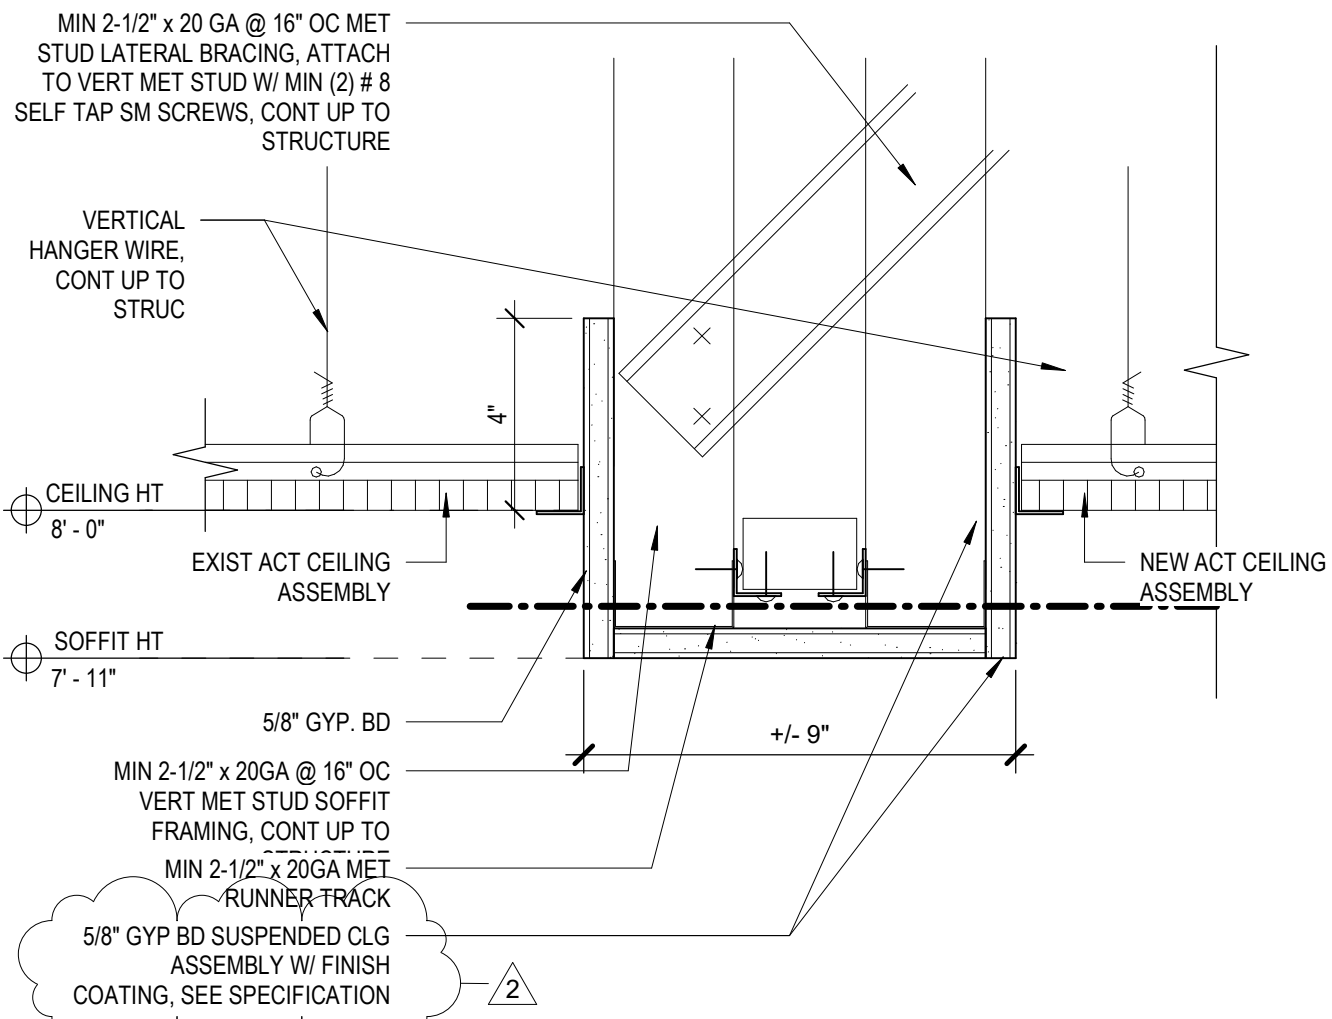

3 SOFFIT CEILING DETAIL
3" = 1'-0"

CEILING LEGEND		
TYPE MARK	SYMBOL	DESCRIPTION
-		GWB
C		4INCH RECESSED CAN LIGHT
J		24" VANITY LIGHT
J2		18" VANITY LIGHT

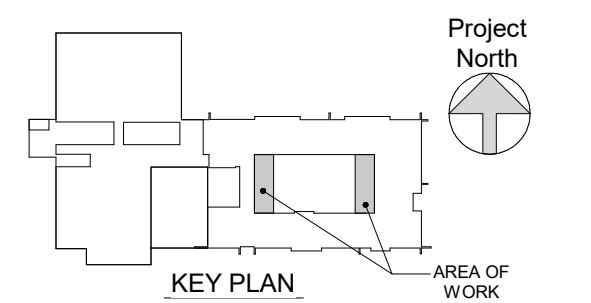

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3 03/15/21 CONSTRUCTION DOCUMENTS
2 02/26/21 SED ADDENDUM 1
1 02/01/21 CONSTRUCTION DOCUMENTS

No. Date Issue

Sheet Title


REFLECTED
CEILING PLANS



Job No. 2020-1051 Date 01/14/2021

Scale AS NOTED Drawn / Checked

Sheet Number

A601

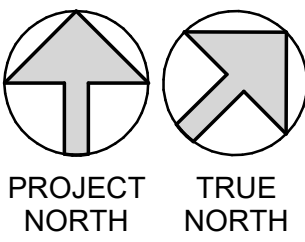

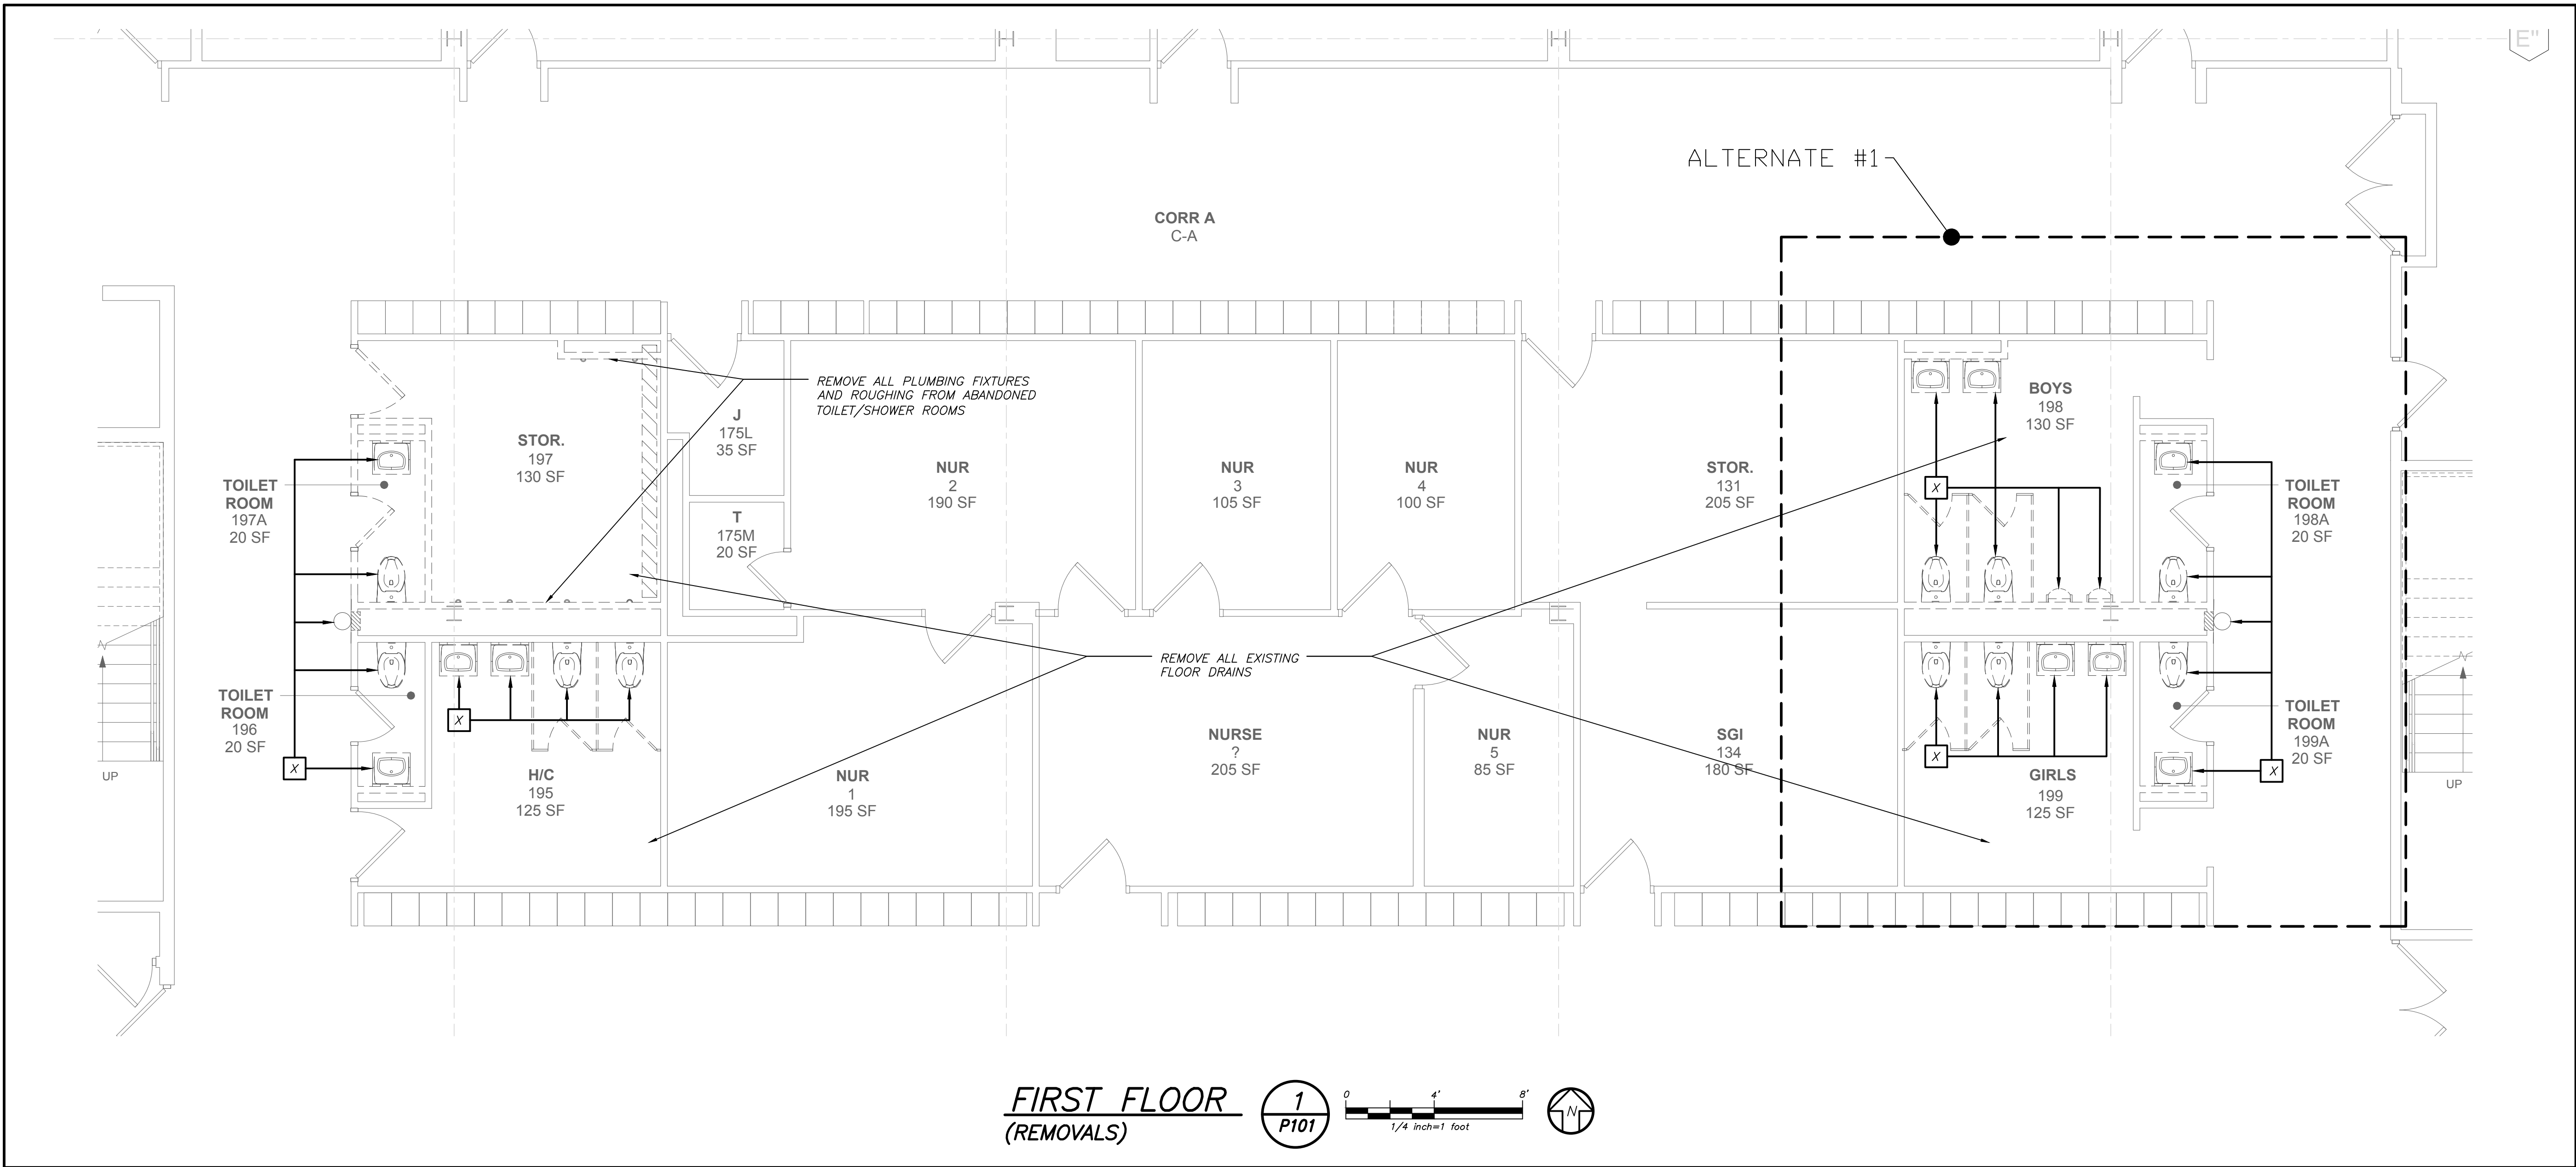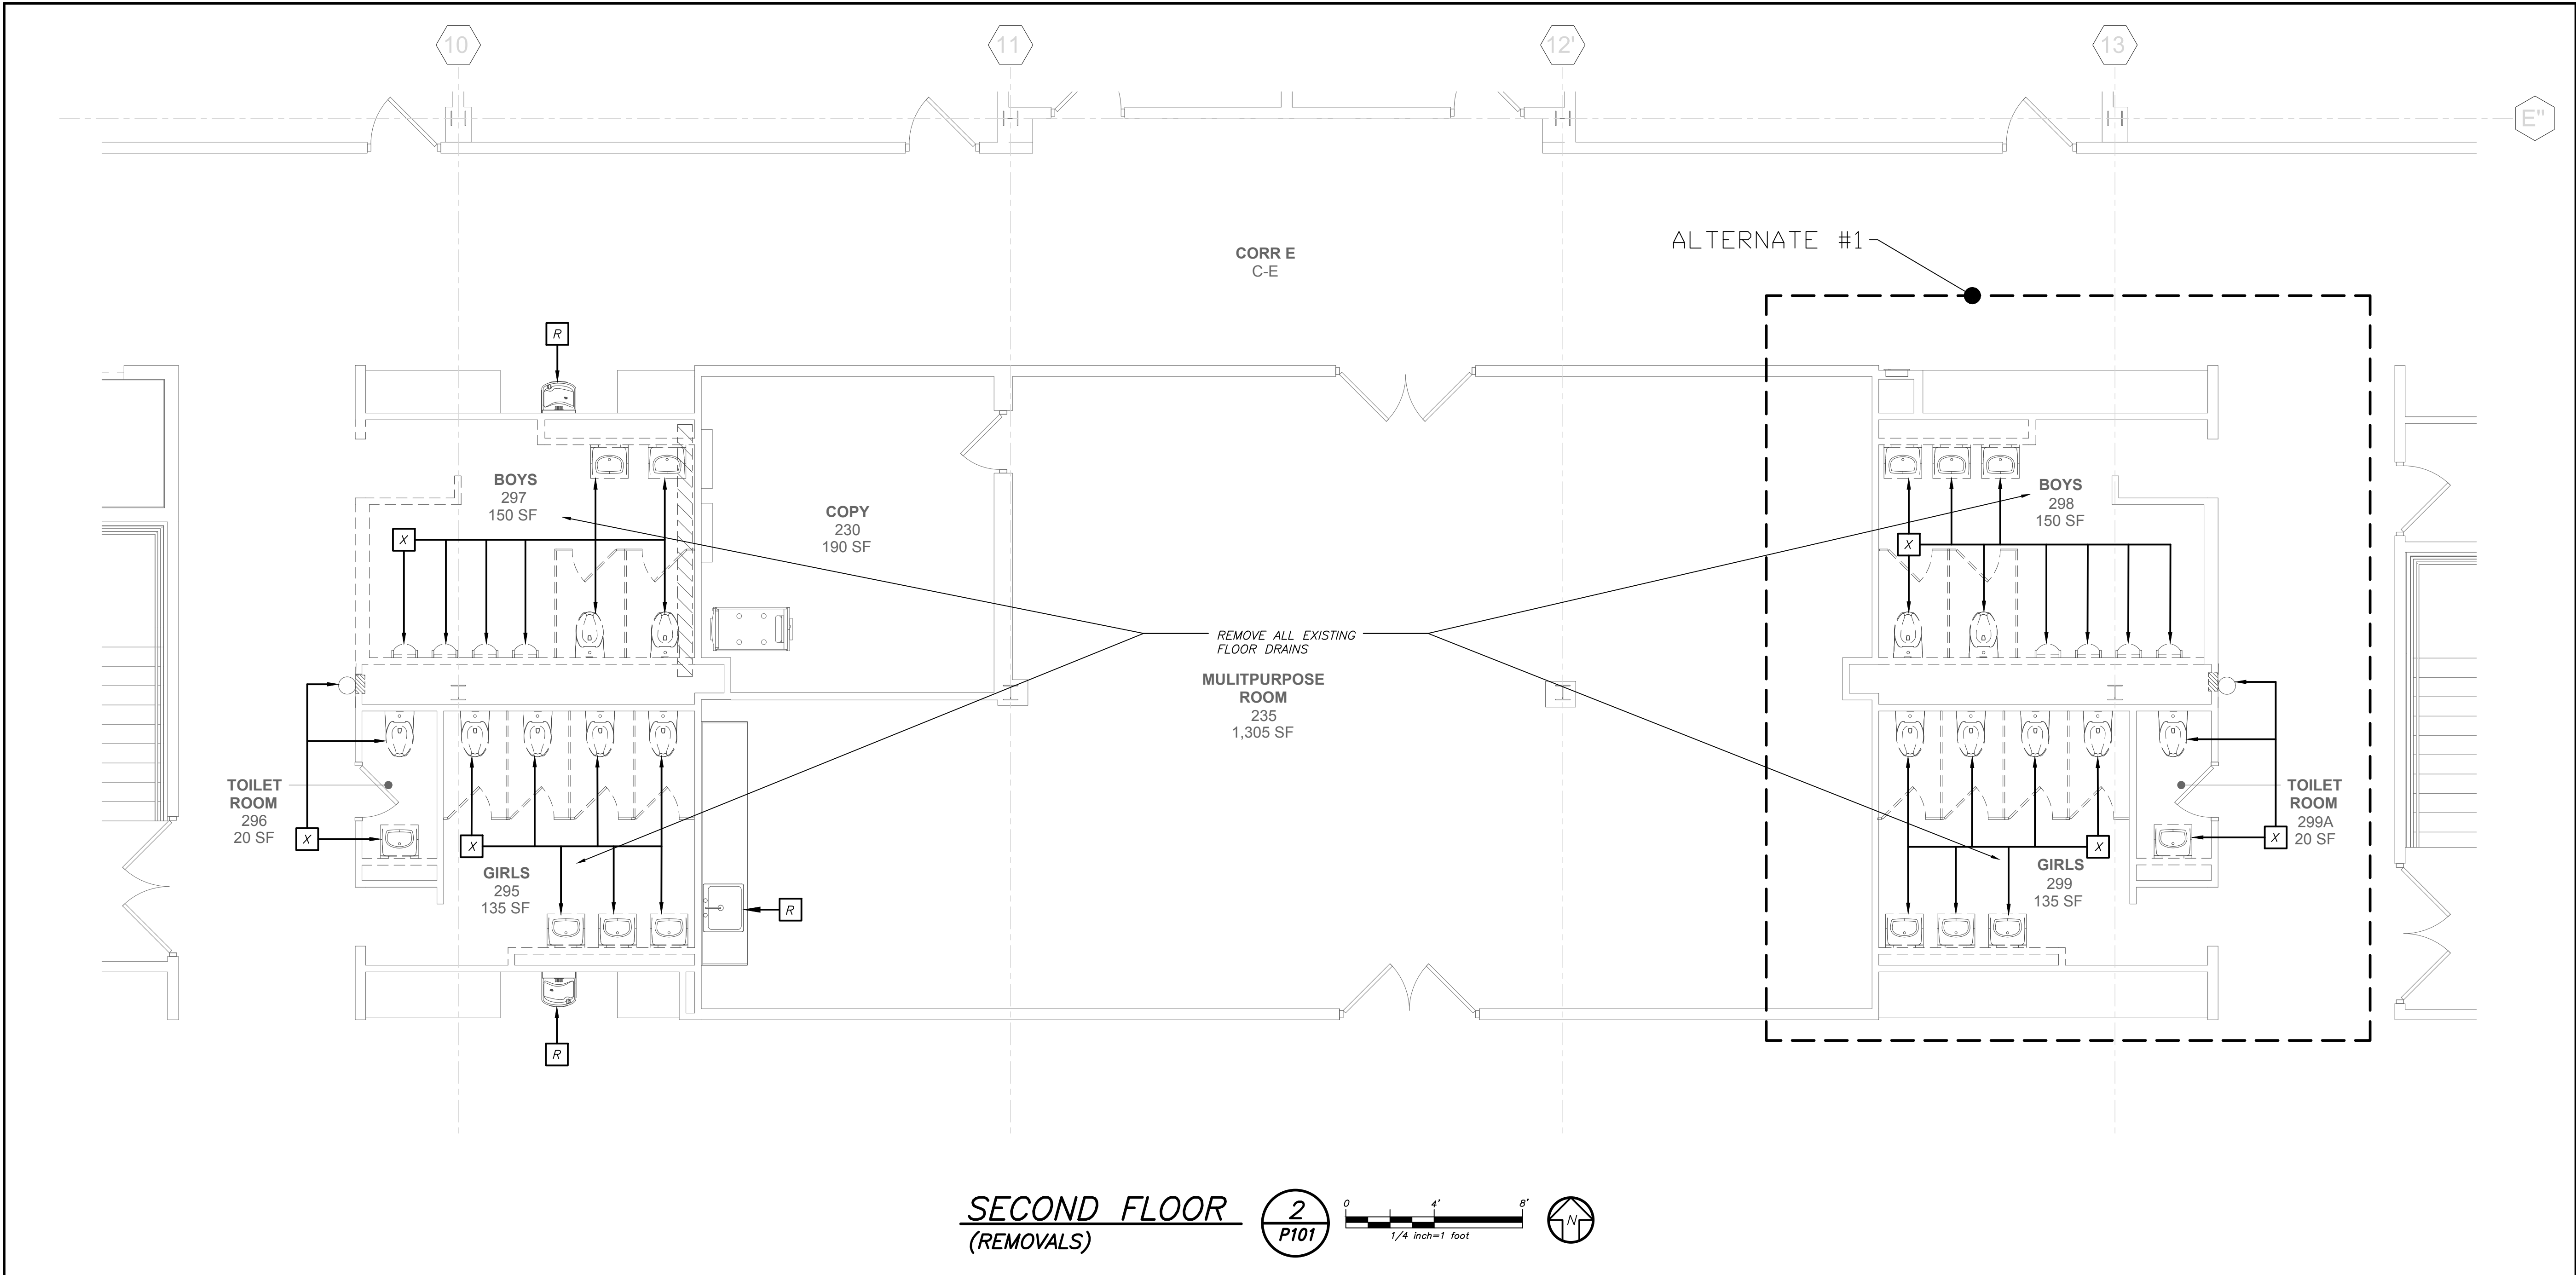

LEGEND	
	EXISTING PIPING, FIXTURES, ETC. TO REMAIN
	NEW PIPING, FIXTURES, ETC.
	COLD WATER PIPING
	HOT WATER PIPING
	HOT WATER RETURN PIPING
	PLUMBING VENT PIPING
	SANITARY PIPING (UNDERGROUND)
	EXISTING SANITARY PIPING (UNDERGROUND)
	EXISTING SANITARY PIPING
	FLOW DIRECTION WITHIN PIPE
	CLEANOUT
	CLEANOUT DECK PLATE
	SHUT-OFF VALVE
	COMBINATION BALANCING & SHUT-OFF VALVE
	PIPE CONNS. (BOTTOM; TOP 45 OR 90; PIPE UP)
	PLUMBING FIXTURE IDENTIFICATION
	VENT THRU ROOF
	FLOOR DRAIN
	CLEAN OUT WALL PLATE
	POINT OF CONNECTION
	PART PLAN, DETAIL, SECTION NUMBER
	SECTION IDENTIFICATION

PLUMBING FIXTURE SCHEDULE					
MARK	DESCRIPTION	BRANCH SIZE			
		W	V	H	C
A1	WALL MOUNTED WATER CLOSET	4"	2"	-	1"
A2	WALL MOUNTED WATER CLOSET (HANDICAPPED)	4"	2"	-	1"
B1	WALL MOUNTED LAVATORY (HANDICAPPED)	1-1/2"	1-1/2"	1/2"	1/2"
C	URINAL - WALL MOUNTED	3"	2"	-	1/2"
D1	WATER COOLER - RECESSED	2"	1-1/2"	-	1/2"
D2	WATER COOLER	2"	1-1/2"	-	1/2"
R	EXISTING FIXTURE TO REMAIN	-	-	-	-
X	EXISTING FIXTURE TO BE REMOVED	-	-	-	-

- ### REMOVAL NOTES
- THE SCOPE OF REMOVAL SHOWN IS DIAGRAMMATIC ONLY AND INDICATES THE INTENT OF THE WORK TO BE PERFORMED AND NOT THE COMPLETE SCOPE OF DEMOLITION AND/OR REMOVAL WORK. IT SHALL BE THE RESPONSIBILITY OF THIS CONTRACTOR TO REMOVE ANY RELATED MECHANICAL DEVICES EVEN IF NOT SPECIFICALLY INDICATED TO BE REMOVED IN ORDER TO ACCOMMODATE NEW WORK.
 - REMOVE ALL PLUMBING EQUIPMENT, SPECIALTIES, DRAINS, CONTROLS, HANGERS, BASES, SUPPORTS, PIPING, VALVES, TUBING AND PLUMBING ACCESSORIES THAT ARE NOT INCORPORATED IN THE NEW LAYOUT.
 - WHERE REMOVAL IS INDICATED OR IMPLIED OR NOT INCORPORATED IN THE NEW LAYOUT, THE ITEM ITSELF IS TO BE REMOVED COMPLETELY TOGETHER WITH ALL CONNECTING PIPING, SPECIALTIES, SUPPORTS, CONTROLS, ETC. CONNECTING PIPING IS TO BE REMOVED BACK TO MAINS WHERE THE ARE TO BE CAPPED OR DISCONNECTED. THIS INCLUDES ALL GAS, SANITARY, VENT, WATER, AND PUMP DISCHARGE PIPING. REFER TO DIVISION 1 OF SPECIFICATION FOR CUTTING AND PATCHING REQUIREMENTS.
 - WHERE EXISTING PIPING ENTERS INACCESSIBLE TRENCHES, TUNNELS, SHAFTS, WALLS AND CEILINGS INSIDE THE EXISTING BUILDING, IT SHALL BE CUT BACK AT LEAST 2" INTO SUCH INACCESSIBLE SPACES AND SHALL BE SUITABLY CAPPED AND SEALED BY THE CONTRACTOR.
 - THE CONTRACTOR SHALL EXERCISE NORMAL CAUTION TO PREVENT UNNECESSARY CUTTING AND DAMAGE TO THE EXISTING BUILDING. ANY EXCESSIVE DAMAGE AS DETERMINED BY THE OWNER SHALL BE REPAIRED AND PAID FOR BY THE CONTRACTOR CAUSING THE DAMAGE.
 - ALL DEMOLISHED EQUIPMENT ETC. EXCEPT THOSE ITEMS SPECIFICALLY REQUESTED BY THE OWNER SHALL BECOME THE CONTRACTORS PROPERTY, SHALL BE REMOVED FROM THE PREMISES, AND DISPOSED OF LEGALLY.

PVMS TOILET ROOM ALTERATIONS

CAPITAL PROJECTS PHASE 2

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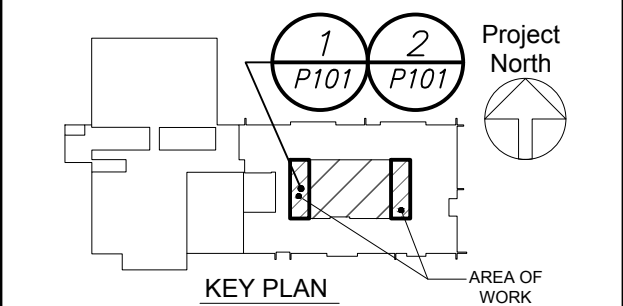
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NY SED PROJECT CONTROL NO.

48-05-03-04-0-004-016

CONSTRUCTION DOCUMENTS

MARK	DESCRIPTION	W	BRANCH SIZE	H	C
A1	WALL MOUNTED WATER CLOSET	4"	2"	-	1"
A2	WALL MOUNTED WATER CLOSET (HANDICAPPED)	4"	2"	-	1"
B1	WALL MOUNTED LAVATORY (HANDICAPPED)	1-1/2"	1-1/2"	1/2"	1/2"
C	URINAL - WALL MOUNTED	3"	2"	-	1/2"
D1	WATER COOLER - RECESSED	2"	1-1/2"	-	1/2"
D2	WATER COOLER	2"	1-1/2"	-	1/2"
R	EXISTING FIXTURE TO REMAIN	-	-	-	-
X	EXISTING FIXTURE TO BE REMOVED	-	-	-	-



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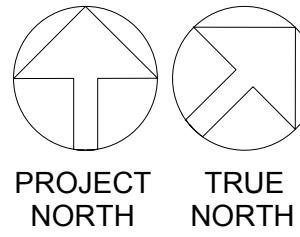
No.	Date	Issue
3	03/15/21	CONSTRUCTION DOCUMENTS
1	02/01/21	SED SUBMISSION

FIRST AND SECOND FLOOR REMOVAL PLANS



Job No.	2020-1051	Date	01/14/2021
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Sheet Number

P101



BEFORE FABRICATION THIS CONTRACTOR SHALL VERIFY ALL MEASUREMENTS AND CONDITIONS ON JOB AND COORDINATE HIS WORK WITH THE WORK OF ALL OTHER CONTRACTORS

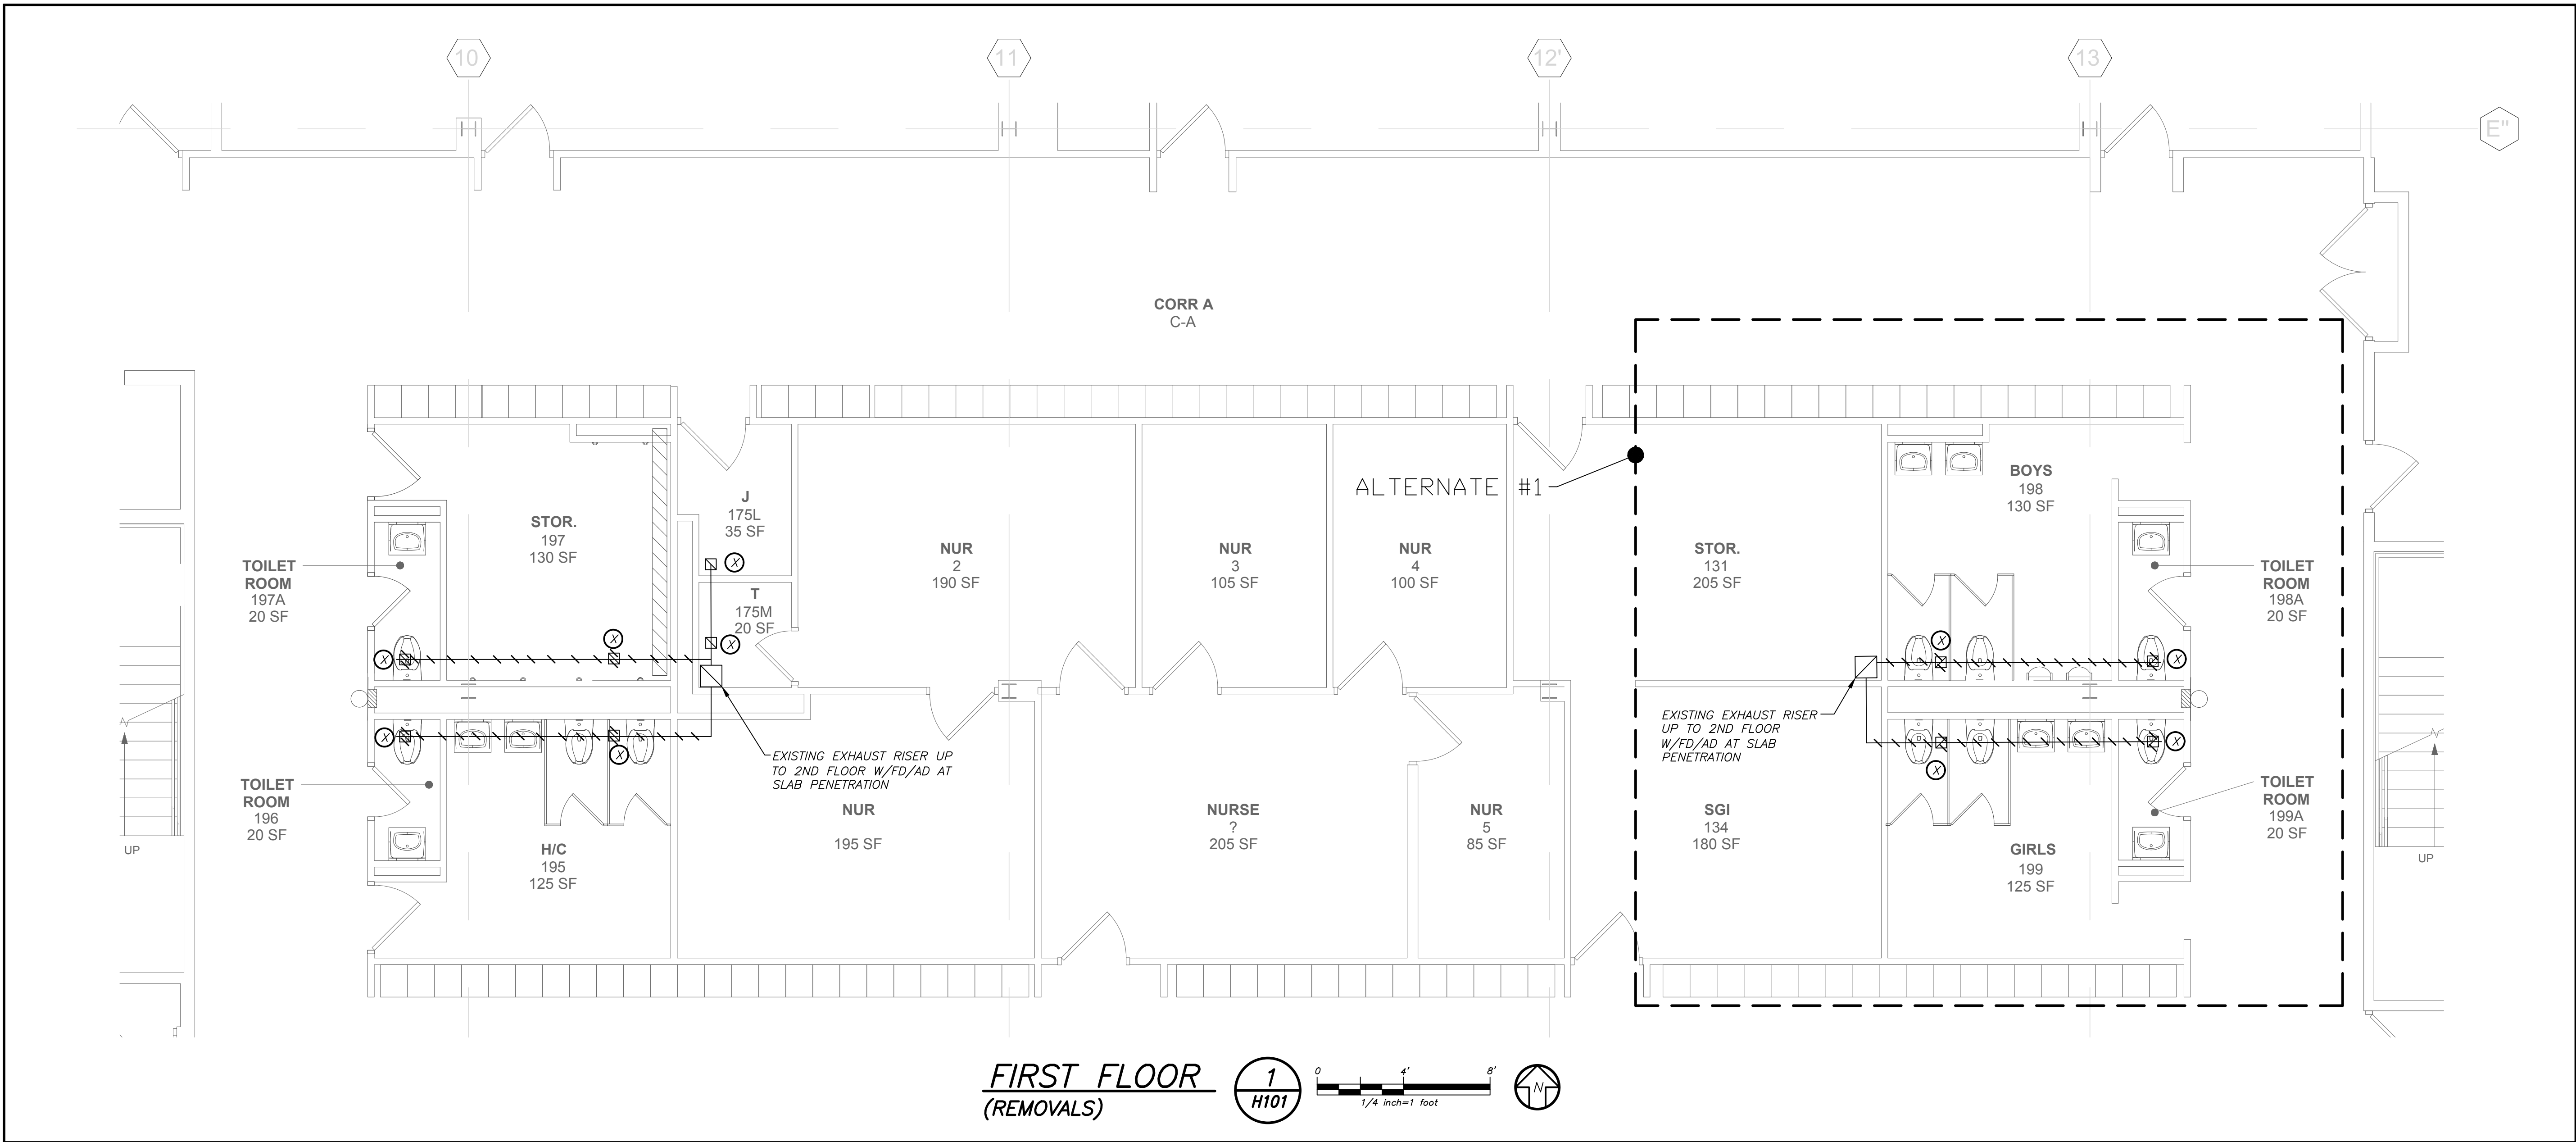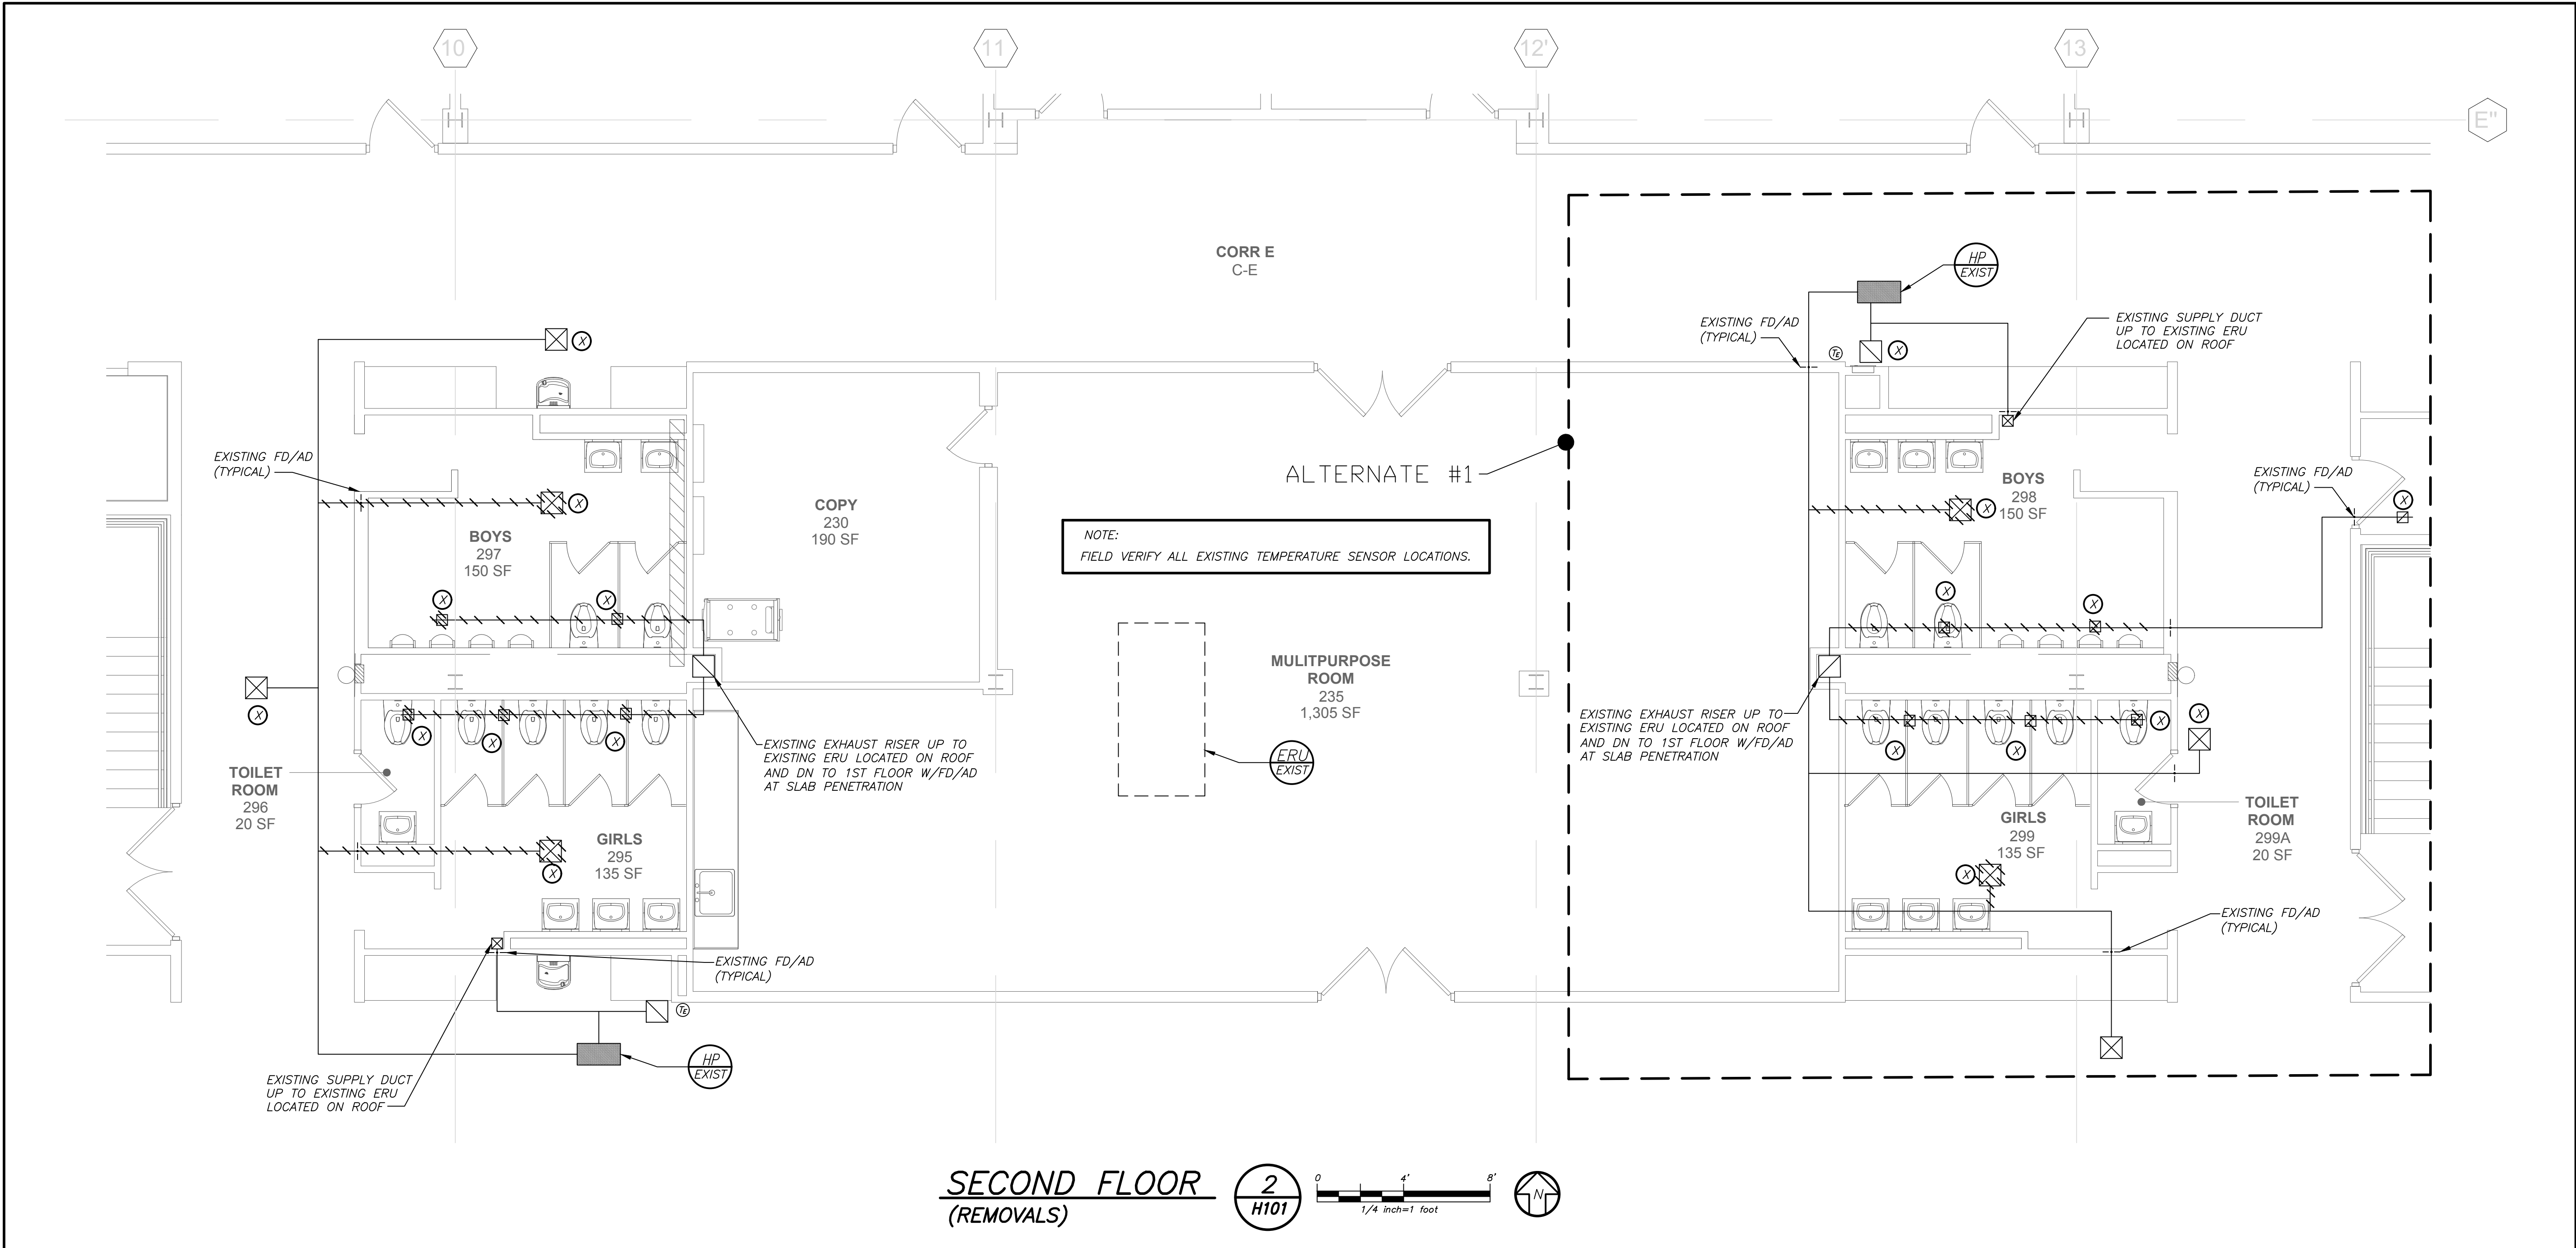

LEGEND	
	EXISTING DUCTWORK, EQUIPMENT, ETC. TO REMAIN
	EXISTING DUCTWORK, EQUIPMENT, ETC. TO BE REMOVED
	NEW DUCTWORK
	NEW EQUIPMENT
	NEW SUPPLY REGISTER
	NEW RETURN REGISTER
	EXISTING CEILING REGISTER
	EXISTING 4-WAY CEILING DIFFUSER
	EXISTING CEILING EXHAUST/RETURN REGISTER
	DUCT MTD. MANUAL AIR VOLUME DAMPER (W/LOCKING DEVICE) OR CABLE OPERATED WHERE DAMPER IS INACCESSIBLE
	MOTORIZED AIR VOLUME DAMPER (WITH ACCESS DOOR)
	SMOKE DAMPER (U.L. APPROVED) & ACCESS DOOR
	FIRE DAMPER (U.L. APPROVED) & ACCESS DOOR
	EXISTING HEAT-PUMP UNIT IDENTIFICATION
	EXISTING ENERGY RECOVERY UNIT IDENTIFICATION
	CFM CUBIC FEET PER MINUTE
	COD CABLE OPERATED DAMPER FROM AIR OUTLET
	FSC FULL SIZE CONNECTION
	OAI OUTSIDE AIR INTAKE
	FC FLEXIBLE CONNECTION
	AD ACCESS DOOR
	FAI FRESH AIR INTAKE
	FD FIRE DAMPER
	WALL MTD.(5'-2"+/- A.F.F.) TEMPERATURE SENSOR
	EXISTING TEMPERATURE SENSOR
	POINT OF DISCONNECTION
	POINT OF CONNECTION, NEW TO EXISTING
	CFM CUBIC FEET PER MINUTE
	SECTION/DETAIL/ELEVATION/PART NUMBER
	DRAWING NUMBER
	SECTION/ELEVATION IDENTIFICATION

- REMOVAL NOTES:**
- THE SCOPE OF REMOVAL SHOWN ON "REMOVALS" DRAWINGS IS DIAGRAMMATIC ONLY AND INDICATES THE INTENT OF THE WORK TO BE PERFORMED AND NOT THE COMPLETE SCOPE OF DEMOLITION AND/OR REMOVAL WORK. IT SHALL BE THE RESPONSIBILITY OF THIS CONTRACTOR TO REMOVE ANY RELATED MECHANICAL DEVICES EVEN IF NOT SPECIFICALLY INDICATED TO BE REMOVED ON THESE DRAWINGS IN ORDER TO ACCOMMODATE NEW WORK.
 - DEVICES SHOWN CROSS HATCHED ON DRAWINGS ARE ITEMS TO BE REMOVED. ANY DEVICES REMOVED SHALL INCLUDE (BUT SHALL NOT BE LIMITED TO) THE REMOVAL OF ALL ASSOCIATED PIPING, CONTROLS, ETC. THAT ARE NOT INCORPORATED IN THE NEW LAYOUT. UNTIL SUCH REMOVAL IS COMPLETE, THIS CONTRACTOR SHALL PERFORM ALL WORK REQUIRED TO INSURE CONTINUITY OF SERVICE TO EXISTING REMAINING EQUIPMENT. NO EXTRAS RELATING TO THE SCOPE OF WORK DESCRIBED WILL BE ALLOWED.
 - EQUIPMENT, PIPING, ETC., REQUIRED TO RECONNECT SHALL BE INSTALLED CONCEALED WITHIN THE NEW SUSPENDED CEILINGS, PARTITIONS AND/OR WALLS, FLOORS. NO SURFACE MOUNTED OR EXPOSED EQUIPMENT, PIPING, ETC., SHALL BE PERMITTED, UNLESS SPECIFICALLY INDICATED.
 - ALL ITEMS TO BE REMOVED SHALL BE REVIEWED WITH THE OWNER PRIOR TO REMOVAL. OWNER SHALL HAVE FIRST SALVAGE RIGHTS. ITEMS THE OWNER WISHES TO KEEP SHALL BE REMOVED WITH CARE AND STORED AS DIRECTED BY OWNER. ITEMS THE OWNER DOES NOT WISH TO KEEP SHALL BE REMOVED FROM THE SITE AND DISPOSED OF PROPERLY.
 - PERFORM INITIAL AIR BALANCING REPORT AND UNIT SERVICE REPORT FOR THE EXISTING ROOF MOUNTED ENERGY RECOVERY UNIT (ERU) AND THE CEILING MOUNTED HEAT PUMP UNITS (HP=1&2) SERVING THE TOILET ROOMS AND ADJACENT CORRIDORS. SUBMIT A DETAILED REPORT WITH ANY UNIT DEFICIENCIES FOR REVIEW AND COURSE OF ACTION BY OWNER.

PVMS TOILET ROOM ALTERATIONS

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NY SED PROJECT CONTROL NO.
48-05-03-04-0-004-016

CONSTRUCTION DOCUMENTS

Project North

KEY PLAN

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3 03/15/21 CONSTRUCTION DOCUMENTS
1 02/01/21 SED SUBMISSION

Sheet Title

FIRST AND SECOND FLOOR REMOVAL PLANS

Job No. 2020-1051 Date 01/14/2021



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Sheet Number

H101

PROJECT NORTH

TRUE NORTH

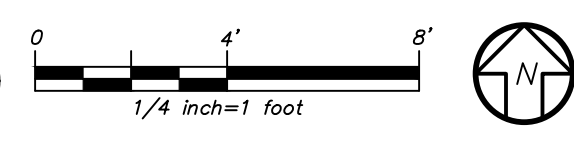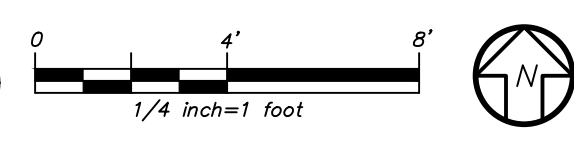

H201

BEFORE FABRICATION THIS CONTRACTOR SHALL VERIFY ALL MEASUREMENTS AND CONDITIONS ON JOB AND COORDINATE HIS WORK WITH THE WORK OF ALL OTHER CONTRACTORS

SCHEDULE OF EXISTING WATER SOURCE HEAT PUMP UNITS															
MARK	MODEL No. ①	TYPE	LOCATION	SUPPLY CFM	O.A. CFM	EXT. S.P.	WATER GPM	COOLING ②		HEATING ②		ELECTRICAL DATA			REMARKS
								TOTAL CAP. (MBH)	SENSIBLE (MBH)	TOTAL CAP. (MBH)	MCA	MOCP	ELECTRIC SERVICE		
(H301) (EXIST)	-	HORIZONTAL	CEILING	850	350	0.4	4.5	24.8	18.3	20.0	13.0	20	208/1/60	③	
NOTES	① AS MANUFACTURED BY "WATER FURNACE";														
	② SCHEDULED EER'S AND COP'S ARE AT THE CONDITIONS INDICATED (I.E. 80°F EWT SUMMER AND 30°F EWT WINTER).														
	③ PERFORMANCE BASED ON 20% ENVIRONOL 200 GLYCOL SOURCE FLUID.														

SCHEDULE OF EXISTING ENERGY RECOVERY UNITS													
GENERAL DATA					SUPPLY FAN DATA			RETURN-EXHAUST FAN			ELECTRICAL DATA		REMARKS
MARK	SERVICE	LOCATION	OUTSIDE AIR CFM MIN/MAX	MODEL No. ①	CFM	EXT. S.P. IN WG	MOTOR HP	CFM MIN/MAX	EXT. S.P. IN WG	MOTOR HP	MCA	ELECTRIC SERVICE	
(H301) (EXIST)	TOILETS/CORRIDORS	ROOF	2000	-	2000	0.4	1.5	2000	0.4	1.5	23	208/3/60	②③
NOTES ① AS MANUFACTURED BY "VENMAR" ② DESIGN AIR CONDITIONS: SUMMER OA (95°F/75°F) RA (75°F/63°F) ③ BASED ON A.R.I. CERTIFIED COIL SELECTIONS. ④ BASED ON HOT WATER SUPPLY TEMPERATURE OF 160°F AND RETURN TEMPERATURE OF 140°F. WINTER OA (6°F) RA (70°F/53°F)													

SCHEDULE OF REGISTERS AND DIFFUSERS							
MARK	TYPE	SERVICE	MODEL No. ①	DIRECTION DISCHARGE	DAMPER TYPE	FINISH	REMARKS
(A)	CEILING DIFFUSER	SUPPLY	EPL/E-1	4-WAY	OPPOSED BLADE	PER ARCH.	REFER TO ②④⑤⑥
(B)	CEILING REGISTER	RETURN	30/S/45	-	↓	↓	REFER TO ②③④⑤⑦
(X)	EXISTING OUTLET						
NOTES	① AS MANUFACTURED BY "ANEMOSTAT."						
	② INSTALL PER MANUFACTURERS RECOMMENDATIONS.						
	③ 45 DEGREES DEFLECTION TOWARD WALL/FLOOR.						
	④ PROVIDE CABLE OPERATED DAMPER WHERE NOT ACCESSIBLE.						
	⑤ PROVIDE BLANK-OFF BAFFLES, VOLUME DAMPER, EQUALIZING GRID AND MOLDED INSULATION BLANKET						
	⑥ SUPPLY NECK SIZE PER CFM RANGE (NOT TO EXCEED 500 fpm)				⑦ RETURN NECK SIZE PER CFM RANGE (NOT TO EXCEED 675 fpm)		
	50 100 150 200 250 300 350 400 450 500				50 100 150 200 250 300 350 400 450 500		
	600 800 1000 1200 1400 1600 1800 2000 2200 2400				600 800 1000 1200 1400 1600 1800 2000 2200 2400		
	2500 2800 3000 3200 3500 3800 4000 4200 4500 4800				2500 2800 3000 3200 3500 3800 4000 4200 4500 4800		
	5000 5500 6000 6500 7000 7500 8000 8500 9000 9500				5000 5500 6000 6500 7000 7500 8000 8500 9000 9500		

1. DRAWINGS ARE DIAMMATIC AND INDICATE THE GENERAL ARRANGEMENT OF SYSTEMS AND WORK. CONTRACTOR SHALL FURNISH ALL NECESSARY OUTLETS, SUPPORTS, FITTINGS AND ACCESSORIES TO FULFILL APPLICABLE CODES, REGULATIONS, BUILDING STANDARDS AND THE BEST PRACTICES OF THE TRADE FOR FIRST CLASS ELECTRICAL INSTALLATION.
2. THE DRAWINGS INDICATE SIZE AND GENERAL LOCATION OF WORK. SCALED DIMENSIONS SHALL NOT BE USED. THE EXACT LOCATION AND ELEVATION OF ALL ELECTRICAL EQUIPMENT SHALL BE COORDINATED IN FIELD WITH RESPECTIVE CONTRACTOR/OWNER.
3. WHERE PANELBOARDS, SWITCHES, CIRCUIT BREAKERS, ETC. ARE EXISTING AND TO BE REUSED THE CONTRACTOR SHALL CLEAN AND REFURBISH THE EQUIPMENT. THIS SHALL INCLUDE TIGHTENING ALL CONNECTIONS, REPLACING DEFECTIVE MECHANISMS AND PROVIDING ALL REQUIRED AND NECESSARY MISCELLANEOUS COMPONENTS SO THAT THE EQUIPMENT SHALL BE IN PERFECT WORKING ORDER.
4. THE CONTRACTOR SHALL COORDINATE WITH THE OWNER PRIOR TO SUBMISSION OF BID TO DETERMINE WHAT WORK MUST BE PERFORMED AFTER NORMAL BUSINESS HOURS. UNLESS OTHERWISE DIRECTED ANY NOISY WORK (CHOPPING, CORE DRILLING, HAMMERING, ETC.) AND BUILDING POWER INTERRUPTIONS SHALL BE PERFORMED OUTSIDE OF NORMAL BUSINESS HOURS. CONFIRM NORMAL BUSINESS HOURS WITH BUILDING OWNER. NO ADDITIONAL COST WILL BE CHARGED TO OWNER FOR WORK PERFORMED OUTSIDE NORMAL BUSINESS HOURS.
5. ALL WORK WHERE SHOWN WITH DARK/SOLID LINES ON THE DRAWINGS IS NEW UNLESS OTHERWISE NOTED. WHERE SHOWN WITH DASHED LINES WITH LETTER (E) IS EXISTING TO REMAIN, WITH LETTER (R) IS EXISTING TO BE REMOVED, WITH LETTER (ER) IS EXISTING RELOCATED, WITH LETTER (RN) IS EXISTING TO BE REPLACED WITH NEW AND WITH LETTER (RR) IS EXISTING TO BE REMOVED AND RELOCATED.
6. CIRCUIT NUMBERS TO EXISTING PANELS ARE SHOWN FOR INTENT ONLY. ACTUAL CIRCUIT NUMBERS TO BE USED SHALL BE AS PER FIELD CONDITIONS BY UTILIZING SPARE CIRCUITS, BREAKERS OR SPACES IN EXISTING PANEL. SIZE AS INDICATED ON THE PLANS. THE ELECTRICAL CONTRACTOR SHALL BALANCE LOAD OF CIRCUITS EVENLY ON ALL PHASES.
7. FEEDERS AND BRANCH CIRCUITRY SHALL BE RUN IN MINIMUM 3/4" CONDUIT UNLESS OTHERWISE NOTED. FINAL CONNECTIONS TO MOTORS MAY BE MADE WITH FLEXIBLE METALLIC CONDUIT (NO LONGER THAN 18"). IN UNFINISHED AREAS CONDUIT SHALL BE RUN EXPOSED AND IN FINISHED AREAS CONDUIT SHALL BE RUN CONCEALED.
8. PROVIDE PANEL NAME PLATE MADE OF BLACK LAMINATED PLASTIC WITH WHITE ENGRAVED LETTERING AND TYPE WRITTEN DIRECTORY FOR ALL NEW AND EXISTING PANELS BEING USED FOR THIS PROJECT.
9. ALL CONDUCTORS SHALL BE COPPER, TYPE THHN/THWN INSULATED. ALL CONDUCTORS SHALL HAVE 600 VOLT RATED INSULATION UNLESS OTHERWISE NOTED.
10. REFER TO ARCHITECT'S REFLECTED CEILING PLAN FOR EXACT LOCATION OF ALL CEILING MOUNTED LIGHTING FIXTURES AND OTHER CEILING INSTALLED ITEMS.
11. THE USE OF FLEXIBLE CONDUIT FROM LIGHTING FIXTURES TO JUNCTION BOX IS PERMITTED ONLY WHEN A SEPARATE GROUND WIRE IS INSTALLED WITH THE CONDUCTORS INSIDE FLEXIBLE CONDUIT. THE GROUND WIRE MUST BOND THE FIXTURE HOUSING TO THE JUNCTION BOX. MAXIMUM LENGTH 6'-0".
12. EXACT LOCATION AND MOUNTING HEIGHTS OF ALL DEVICES SHALL BE COORDINATED WITH THE ARCHITECT PRIOR TO THE INSTALLATION.
13. WALL MOUNTED EQUIPMENT (SWITCHES, RECEPTACLES, ETC.) SHALL BE SURFACE MOUNTED IN UNFINISHED AREAS AND ON EXISTING CONCRETE BLOCK WALLS AND FLUSH MOUNTED IN NEW WALLS/PARTITIONS.
14. CONDUIT RUNS SHALL BE PARALLEL WITH OR AT RIGHT ANGLES TO WALLS AND CEILINGS. CONDUIT SHALL BE SUPPORTED BY APPROVED MEANS. SUPPORTS FOR HORIZONTAL RUNS OF CONDUIT SHALL NOT EXCEED SEVEN FEET ON CENTERS.
15. PROVIDE PULL BOXES, JUNCTION BOXES, CONDUIT ELBOWS AND OFFSETS TO SUIT FIELD CONDITIONS AND THE NATIONAL ELECTRICAL CODE.
16. CONTRACTOR SHALL COORDINATE WITH THE FIRE DEPARTMENT AND F.A. VENDOR BEFORE PROCEEDING WITH WORK INVOLVING FIRE ALARM SYSTEM.
17. THE MINIMUM WIRE SIZE FOR 120 VOLT BRANCH CIRCUITS SHALL BE NO. 12 AWG, EXCEPT OVER 100' IN LENGTH SHALL BE NO. 10 AWG.
18. PROVIDE ALL REQUIRED AND NECESSARY ACCESSORIES (EX. CONNECTORS, ADAPTERS, BUSHINGS, CLAMPS, ETC.) TO FACILITATE COMPLETE INSTALLATION.
19. ALL JUNCTION OR OUTLET BOXES SHALL BE INSTALLED SO AS TO ALLOW ACCESS TO COVER. PROVIDE ARCHITECT APPROVED ACCESS DOORS OR PLATES AS REQUIRED IN AREAS WHERE UNOBSTRUCTED ACCESS TO BOX OR OUTLET IS NOT POSSIBLE.
20. PRIOR TO ORDERING LIGHTING FIXTURES, COORDINATE WITH ARCHITECTURAL DRAWINGS AND SPECIFICATIONS. IF DISCREPANCIES EXIST BETWEEN ARCHITECTURAL AND ENGINEERING INFORMATION OBTAIN CLARIFICATION PRIOR TO PROCEEDING.
21. MULTIPLE SWITCHES SHOWN IN SAME LOCATION SHALL BE GANGED TOGETHER WITH A COMMON FACEPLATE.
22. ALL LIGHTING FIXTURES CONTROLLED BY DIMMER SWITCHES SHALL BE PROVIDED WITH A DEDICATED NEUTRAL CONDUCTOR.
23. ALL EMERGENCY LIGHT FIXTURES DESIGNATED 'EM' SHALL BE SWITCHED UNLESS DESIGNATED WITH 'EM/NL' WHICH INDICATES FIXTURE TO SERVE AS NITE LIGHT AND SHALL NOT BE SWITCHED. PROVIDE UNSWITCHED HOT LEG FOR BATTERY CHARGER REGARDLESS OF FUNCTION. ALL EMERGENCY AND EMERGENCY/NITE LIGHT FIXTURES SHALL REVERT TO BATTERY OPERATION UPON INTERRUPTION OF NORMAL POWER AND ILLUMINATE REGARDLESS OF LIGHT SWITCH POSITION.
24. WIRING FOR P.A. SYSTEMS SHALL BE IN ACCORDANCE WITH APPROVED MANUFACTURER'S REQUIREMENTS, WRITING INDICATED ON DRAWINGS IS FOR REFERENCE ONLY. WIRING FOR P.A. SYSTEM AND CLOCKS SHALL BE PLENUM RATED AND RUN EXPOSED ABOVE ACCESSIBLE CEILINGS. IT SHALL BE RUN IN EMT CONDUIT WHERE EXPOSED, EXCEPT FOR CORRIDORS, CLASSROOMS AND OFFICES IT SHALL BE RUN IN STEEL SURFACE RACEWAY (SIMILAR TO WIREMOLD V-500 AND/OR V-700).
25. PRIOR TO ANY CHASING, CHOPPING OR CORE DRILLING BEING PERFORMED, THE CONTRACTOR SHALL FIELD INVESTIGATE CONDITIONS AND COORDINATE ALL WORK TO ENSURE THAT IT WILL BE IN HARMONY AND NOT AFFECT ANY EXISTING BUILDING SYSTEMS. THIS WORK MUST BE APPROVED BY BUILDING OWNER PRIOR TO PROCEEDING.
26. OPENINGS AROUND ELECTRICAL PENETRATIONS THROUGH FIRE RESISTANCE RATED WALLS, PARTITIONS AND CEILINGS SHALL BE FIRE STOPPED USING APPROVED METHODS. ALL SLEEVES MUST HAVE BUSHINGS. SEALANT SHALL BE 3 HOUR FIRE BARRIER #CP-25 (NO LESS THAN 3" THICK BACKED UP WITH MINERAL WOOL).
27. ALL PANELBOARD COVERS SHALL BE INSTALLED IN PLACE AT THE COMPLETION OF EACH DAYS WORK.
28. PREPARE "AS-BUILT" DRAWINGS THAT REFLECT ACTUAL CONSTRUCTION AND SHOW DEVIATIONS FROM DESIGN DRAWINGS.
29. LIGHT FIXTURES SHALL BE CONSTRUCTED TO SUIT PARTICULAR TYPE OF CEILING AND WALL CONSTRUCTION AND SHALL BE PROVIDED WITH APPROPRIATE TRIMS, MOUNTING FRAMES AND ADAPTERS AS REQUIRED.
30. ALL NEW CIRCUIT BREAKERS INSTALLED INTO EXISTING PANELBOARDS SHALL BE UL LISTED FOR USE IN THE PANEL.

1. BEFORE COMMENCING WORK, EXAMINE ALL ADJOINING AREAS THAT MAY BE AFFECTED BY REMOVAL OF THE EQUIPMENT. REPORT TO CONSTRUCTION MANAGER ANY CONDITION THAT PREVENTS PERFORMANCE OF THE WORK.
2. BECOME THOROUGHLY FAMILIAR WITH EXISTING CONDITIONS WHERE CONNECTIONS MUST BE MADE, CHANGED OR ALTERED. THE INTENT OF THE WORK IS SHOWN ON THE DRAWINGS AND DESCRIBED HEREINAFTER AND NO CONSIDERATION WILL BE GRANTED BY REASON OF OMISSION OF THE MATERIAL PART OF THE CONTRACTOR WITH ACTUAL PHYSICAL CONDITIONS AT THE SITE. INSPECT EACH AND EVERY AREA AFFECTED BY THE ALTERATION OF THE SPACE BEFORE SUBMITTAL OF BID.
3. ALL ELECTRICAL EQUIPMENT DESIGNATED WITH (R) IS EXISTING TO BE REMOVED UNLESS OTHERWISE NOTED. THIS SHALL INCLUDE BUT NOT BE LIMITED TO THE FOLLOWING:
 - A. LIGHTING FIXTURES AND SWITCHES.
 - B. CIRCUIT BREAKERS AND DISCONNECT SWITCHES.
 - C. RECEPTACLES, OUTLETS AND DEVICES.
 - D. FIRE ALARM EQUIPMENT AND DEVICES.
 - E. PANELBOARDS.
 - F. PUBLIC ADDRESS DEVICES.
4. ALL CONDUCTORS AND CONDUIT ASSOCIATED WITH THE ELECTRICAL EQUIPMENT SHALL BE REMOVED COMPLETELY BACK TO ITS SOURCE OF POWER AND DISCONNECTED UNLESS OTHERWISE NOTED.
5. ALL POWER CONDUCTORS, CONTROL WIRING AND CONDUIT ASSOCIATED WITH MECHANICAL EQUIPMENT SUCH AS FANS, AIR CONDITIONING UNITS, PUMPS, ETC., DESIGNATED FOR REMOVAL ON THE HVAC AND PLUMBING REMOVAL DRAWINGS SHALL BE REMOVED CLEAR BACK TO THE SOURCE OF POWER AND DISCONNECTED. ALL MOTOR STARTERS, DISCONNECT SWITCHES, CONTROL WIRING DEVICES, ETC. BE REMOVED. REFER TO MECHANICAL AND PLUMBING DRAWINGS FOR ADDITIONAL INFORMATION.
6. CIRCUIT BREAKERS AND/OR SWITCHES IN PANELBOARD(S) OR DISTRIBUTION BOARD(S) MADE SPARE DUE TO REMOVAL SHALL BE DESIGNATED AS SUCH ON THE EQUIPMENT SCHEDULE.
7. THE ELECTRICAL CONTRACTOR SHALL BE RESPONSIBLE TO TRACE AND RELOCATE ALL EXISTING FEEDERS AND BRANCH CIRCUIT WIRING WHICH PASSES THROUGH THE REMOVAL AREA THAT SERVE EXISTING OCCUPIED SPACES TO REMAIN. COORDINATE WITH CONSTRUCTION MANAGER PRIOR TO ANY SHUTDOWNS OR DISRUPTIONS THAT MAY BE REQUIRED TO ACCOMPLISH THIS WORK.
8. DISPOSE OF ALL REMOVED EQUIPMENT, WHICH IS NOT INTENDED TO BE REUSED. PRIOR TO DISPOSAL, CONTACT CONSTRUCTION MANAGER TO DETERMINE IF ANY REMOVED EQUIPMENT IS DESIRED FOR STOCK.
9. ELECTRICAL CONTRACTOR SHALL MAINTAIN CONTINUITY OF CIRCUIT FOR EXISTING EQUIPMENT AND DEVICES THAT ARE TO REMAIN. WHERE OUTLETS ARE REMOVED AND NOT AT THE CIRCUIT BREAKER, ATTENTION MUST BE GIVEN TO THE REMOVAL OF THE OUTLET. WHERE A WIRING DEVICE IS TO BE REMOVED AND WALL OR CEILING IS TO REMAIN, THE ELECTRICAL CONTRACTOR SHALL REMOVE BRANCH CIRCUITRY FROM ITS SOURCE AND FILL IN OUTLET BOX. BLANK PLATES WILL BE PERMITTED.
10. EXISTING CIRCUIT BREAKERS IN PANEL(S) ARE TO BE RE-USED. ELECTRICAL CONTRACTOR TO PATCH AND REPAIR CIRCUIT BREAKERS BE PATCHED WITH CARE TO ENSURE AGAINST DAMAGE. THIS CONTRACTOR SHALL PROVIDE NEW CIRCUIT BREAKERS AS REQUIRED.
11. CONTRACTOR SHALL BE RESPONSIBLE FOR THE REMOVAL OF ADDITIONAL DEVICES NOT IDENTIFIED ON THIS DRAWING DUE TO FURNITURE AND/OR EQUIPMENT CONCEALMENT.
12. EXTEND EXISTING CIRCUITRY TO THOSE DEVICES THAT ARE TO BE RELOCATED. MATCH EXISTING TYPE AND SIZE. RELOCATION OF EXISTING EQUIPMENT SHALL BE PERFORMED ONLY UPON CONSTRUCTION MANAGERS ACCEPTANCE OF EXISTING EQUIPMENT.
13. ELECTRICAL CONTRACTOR SHALL BE RESPONSIBLE FOR SECURING ALL EXISTING DATA WIRING AS CEILINGS AND WALLS ARE BEING REMOVED. ANY DAMAGED WIRING IS TO BE REPLACED IN KIND.
14. FOR ALL LOCATIONS WHERE DEVICES (RECEPTACLES, SWITCHES, FIRE ALARM DEVICES, P.A. DEVICES, CLOCKS, ETC.) ARE REMOVED AND EXISTING BACKBOXES AND JUNCTION BOXES ARE REMOVED, CONTRACTOR SHALL REMOVE AND PATCHED, PROVIDE BLANK STAINLESS STEEL COVER PLATE SIZED AS REQUIRED TO PROPERLY COVER OPENING.

ABBV.	DESCRIPTION
A	AMP/AMPERE
A.F.F.	ABOVE FINISHED FLOOR
C.B.	CIRCUIT BREAKER
CKT	CIRCUIT
(E)	EXISTING TO REMAIN
E.C.	ELECTRICAL CONTRACTOR
EM	EMERGENCY
FA	FIRE ALARM
F.A.C.P.	FIRE ALARM CONTROL PANEL
G.GRD	GROUND
GFI	GROUND FAULT INTERRUPTER
KVA	KILOVOLT AMPERE
KW	KILOWATT
LTC	LIGHTING
MCB	MAIN CIRCUIT BREAKER
MDP	MAIN DISTRIBUTION PANEL
MTD	MOUNTED
N	NEUTRAL
NTS	NOT TO SCALE
P.A.	PUBLIC ADDRESS
PNL	PANEL
(R)	REMOVE EXISTING
RCPT	RECEPTACLE
W	WATT

	2'x4' CEILING MOUNTED LIGHT FIXTURE. UPPER CASE LETTER DENOTES TYPE, LOWER CASE LETTER DENOTES SWITCH CONTROL. FIXTURE SCHEDULE DENOTES TYPE.
	CEILING/WALL MOUNTED EXIT LIGHT WITH OUTLET BOX, DIRECTIONAL ARROWS SHADED PORTION INDICATES ILLUMINATED FACE. SCHEDULE DENOTES TYPE.
	FLUSH WALL MOUNTED LIGHTING CONTROL SWITCH CONTROLLING OUTLET "a". "k" WHERE USED INDICATES KEY SWITCH.
	WALL RECESS MOUNTED DUAL TECHNOLOGY VACANCY SENSOR, SIMILAR TO WATTSTOPPER MODEL D5W-100. MANUAL ON, AUTO OFF.
	CEILING MOUNTED LOW VOLTAGE, DUAL TECHNOLOGY SENSOR, SIMILAR TO WATTSTOPPER MODEL DT-30G, MANUAL ON, AUTO OFF, WORK WITH LOCAL LOW VOLTAGE MOMENTARY CONTACT WALL SWITCH (L5W-100). INCLUDE POWER PACKS.
	CONDUCTORS IN CONDUIT CONCEALED BY WALL OR CEILING.
	HOMERUN TO DESIGNATED PANEL, ARROWHEAD INDICATES SINGLE POLE CIRCUIT. HOMERUN SHALL CONSIST OF 2#12-3/4" U.O.N.
	HOMERUN TO DESIGNATED PANEL, NUMBERS IN PARENTHESIS INDICATE MULTIPLE CIRCUIT, I.E. 3-HOTS AND 1-GROUND U.O.N.
	EXISTING TO REMAIN
	TO BE REMOVED
	NEW
	125V-2P-3W-20A GROUNDED TYPE, SPECIFICATION GRADE WALL MOUNTED DUPLEX RECEPTACLE HUBBELL #5362.
	20A FLUSH WALL MOUNTED GROUND FAULT INTERRUPTING TYPE DUPLEX RECEPTACLE HUBBELL #Gf5362.
	SURFACE MOUNTED NEW ELECTRICAL PANELBOARD.
	WALL MOUNTED COMBINATION FIRE ALARM HORN/STROBE DEVICE.
	CEILING MOUNTED IONIZATION TYPE SMOKE DETECTOR
	WALL MOUNTED FIRE ALARM STROBE LIGHT.
	CEILING MOUNTED PA SPEAKERS, PROVIDE CAT6 CABLE FROM DEVICE TO NEAREST IDF CLOSET AND TERMINATE INTO PATCH PANEL
	TAG SYMBOL, NUMERAL DENOTES REFERENCE TO A WORK NOTE.
	SURFACE MOUNTED WIREMOLD W700 FOR RECEPTACLE AND/OR COMMUNICATION WIRING. REFER TO DRAWINGS FOR ADDITIONAL INFORMATION.
	MECHANICAL EQUIPMENT IDENTIFICATION: <div> </div>
	DETAIL/PART PLAN NUMBER IDENTIFICATION: <div> </div>

CAPITAL PROJECTS PHASE 2











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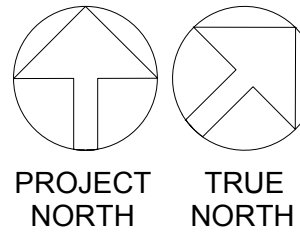
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860 GENERAL@BGA-ENG.com www.BGA-ENG.com

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JOB AND COORDINATE HIS WORK WITH THE WORK
OF ALL OTHER CONTRACTORS



PVMS TOILET ROOM ALTERATIONS

CAPITAL PROJECTS PHASE 2
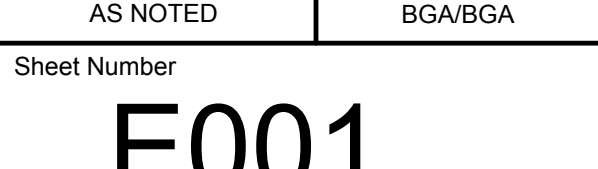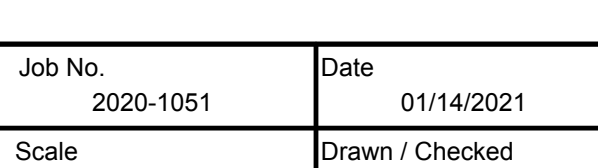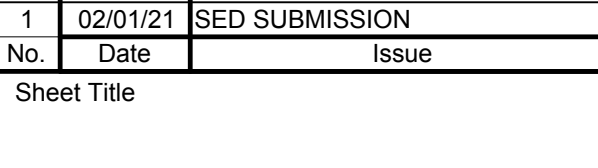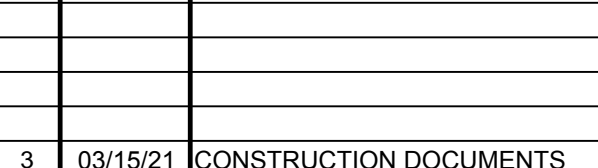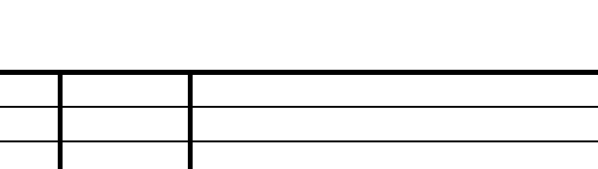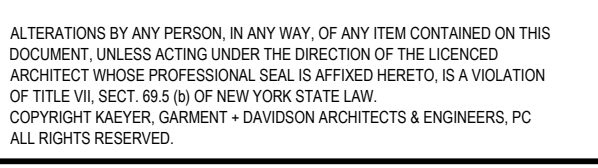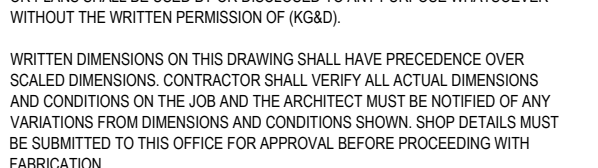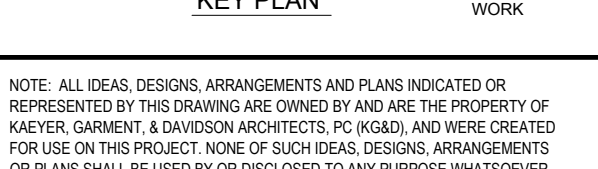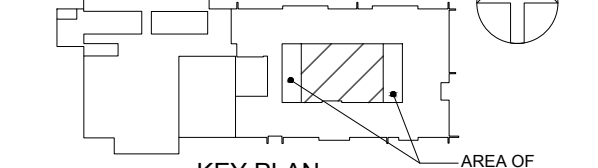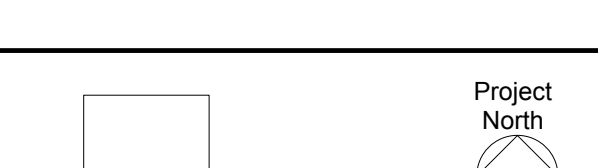
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KG+D

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imagine
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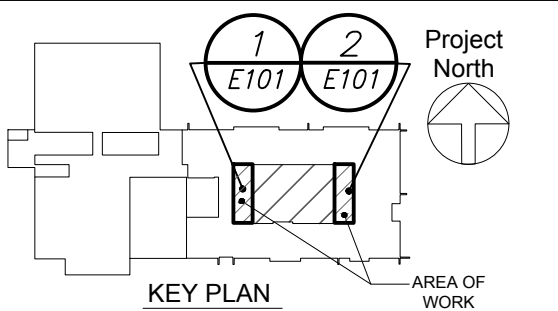
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3	03/15/21	CONSTRUCTION DOCUMENTS
1	02/01/21	SED SUBMISSION
No.	Date	Issue


Sheet Title

FIRST AND SECOND DEMOLITION PLANS

Job No.	2020-1051	Date	01/14/2021
Scale	AS NOTED	Drawn / Checked	BGA/BGA

Sheet Number

E101


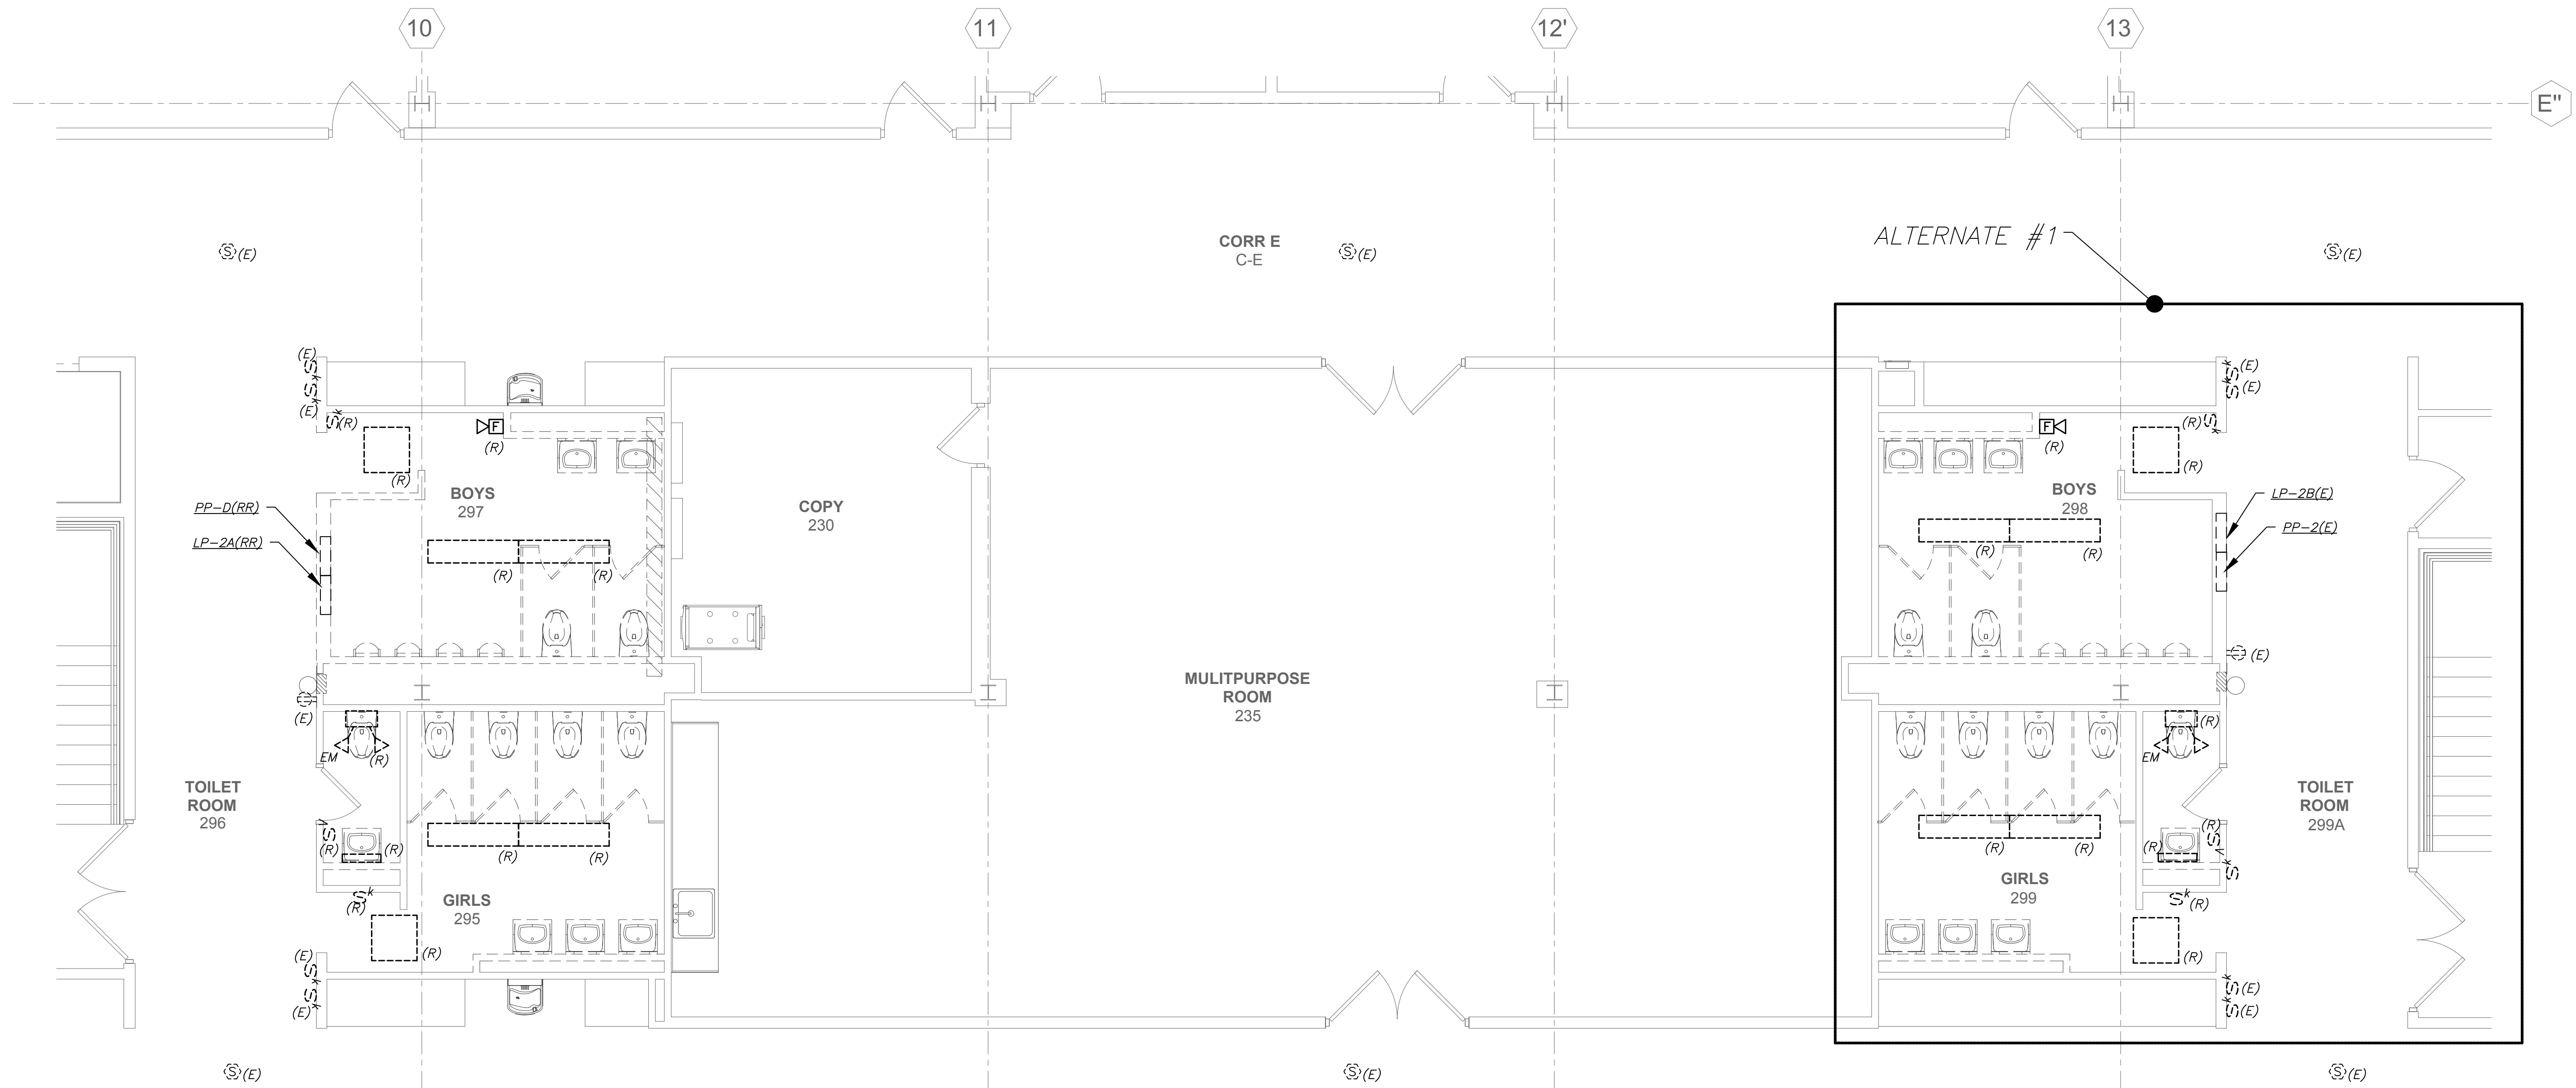


SECOND FLOOR PLAN
(REMOVALS)



FIRST FLOOR PLAN
(REMOVALS)

BEFORE FABRICATION THIS CONTRACTOR SHALL VERIFY ALL MEASUREMENTS AND CONDITIONS ON JOB AND COORDINATE HIS WORK WITH THE WORK OF ALL OTHER CONTRACTORS

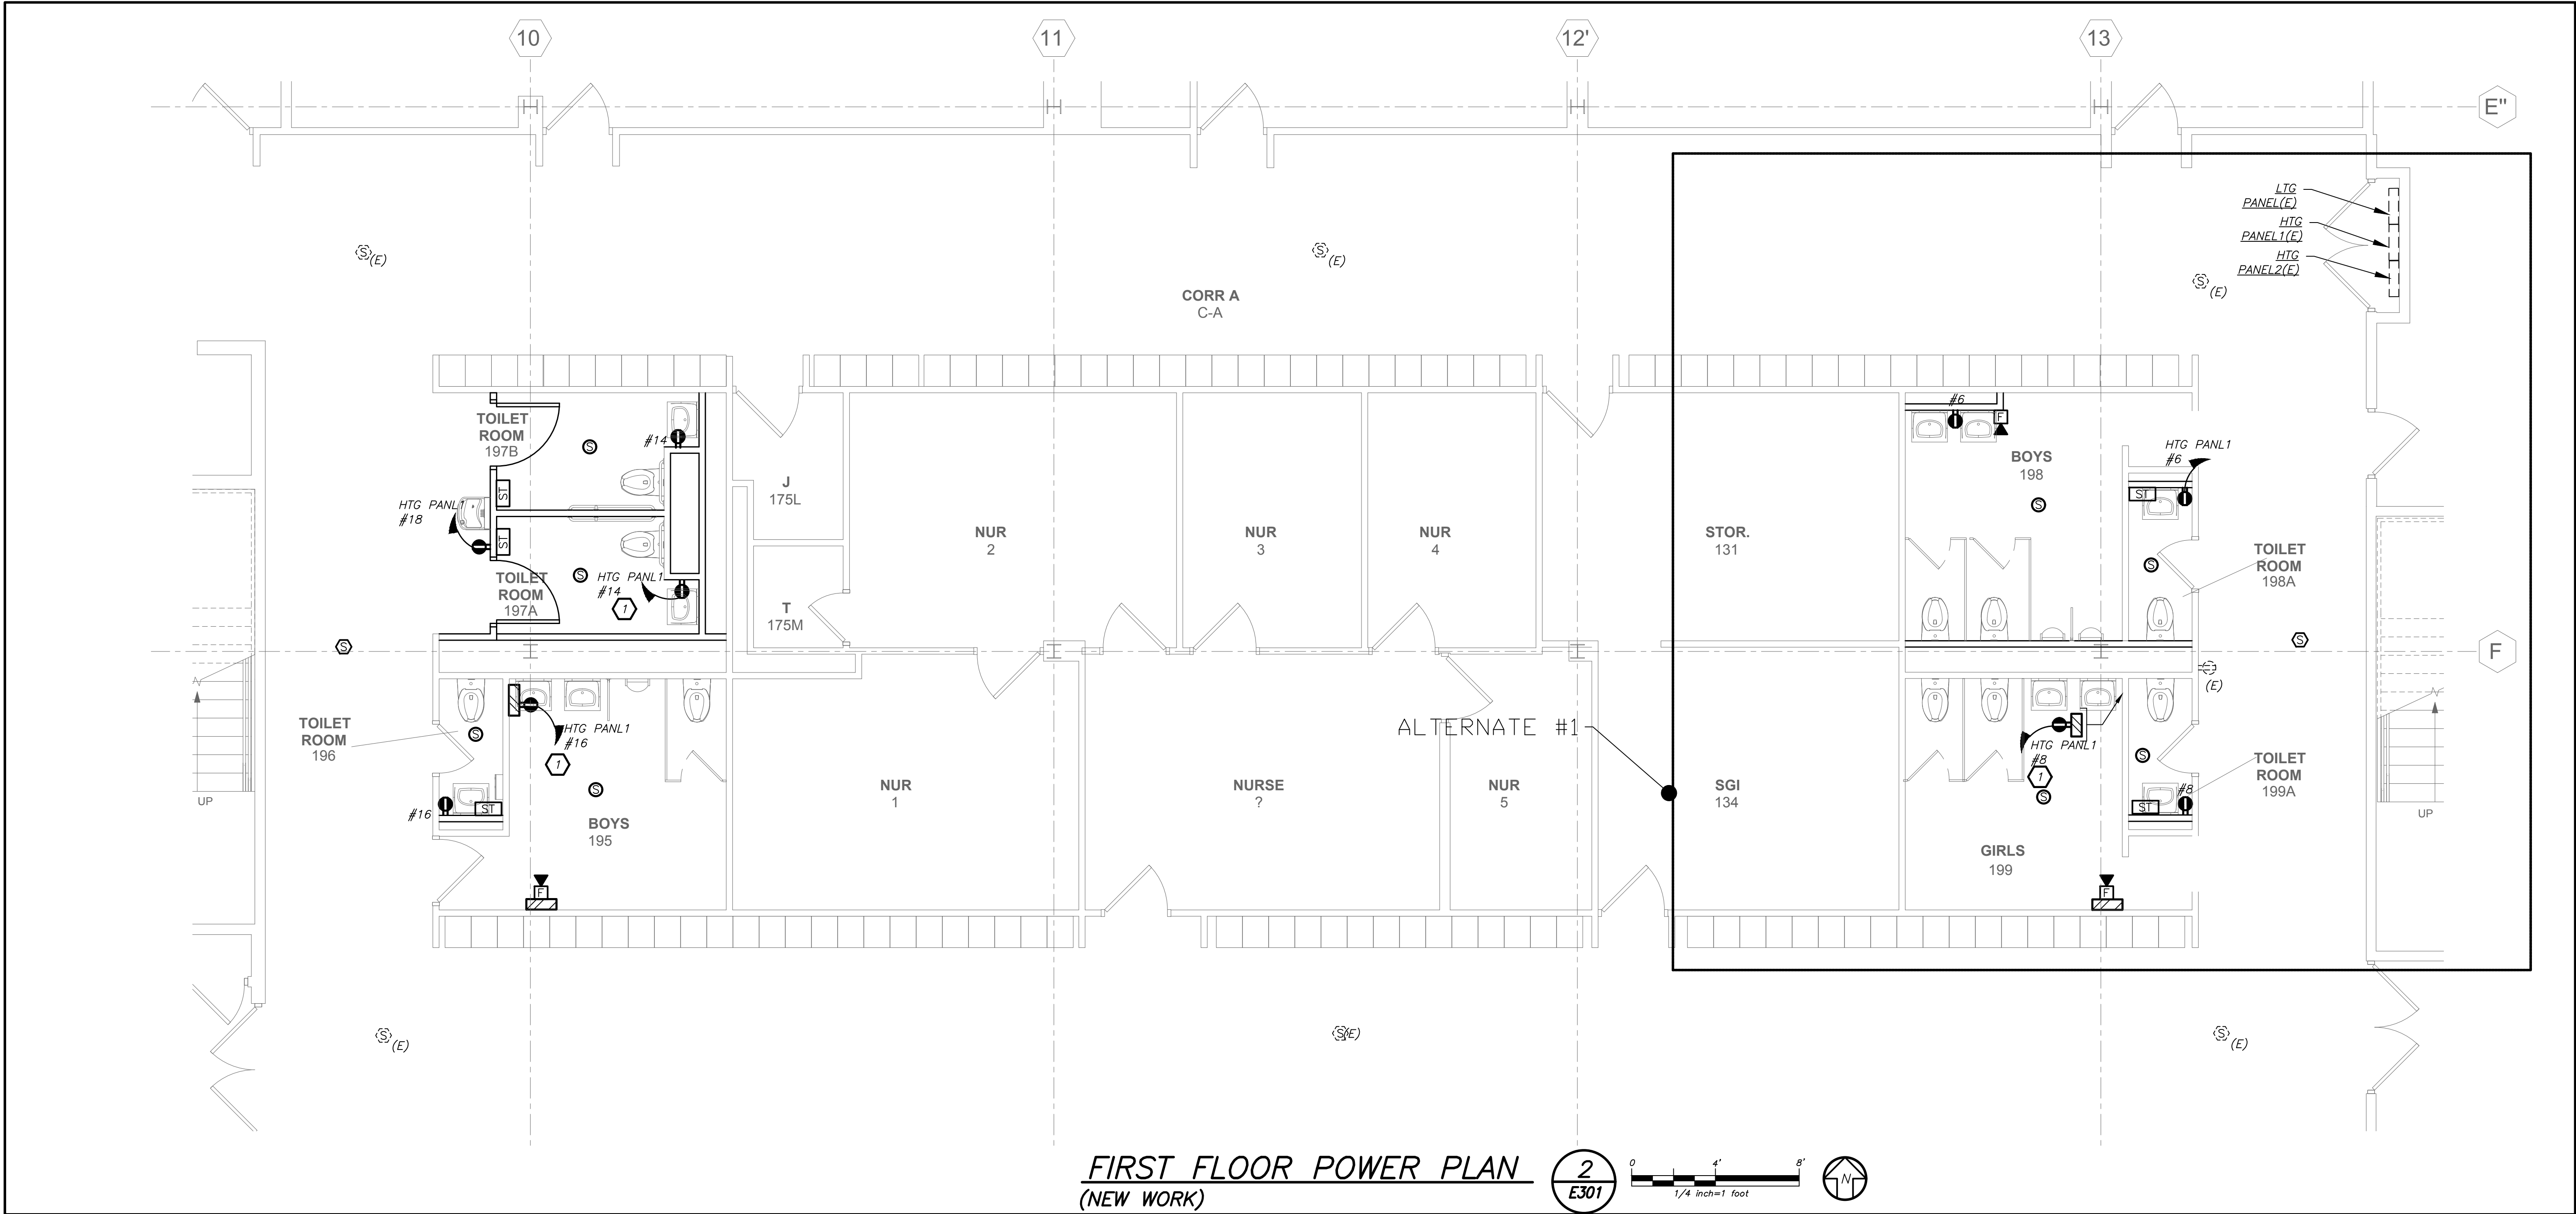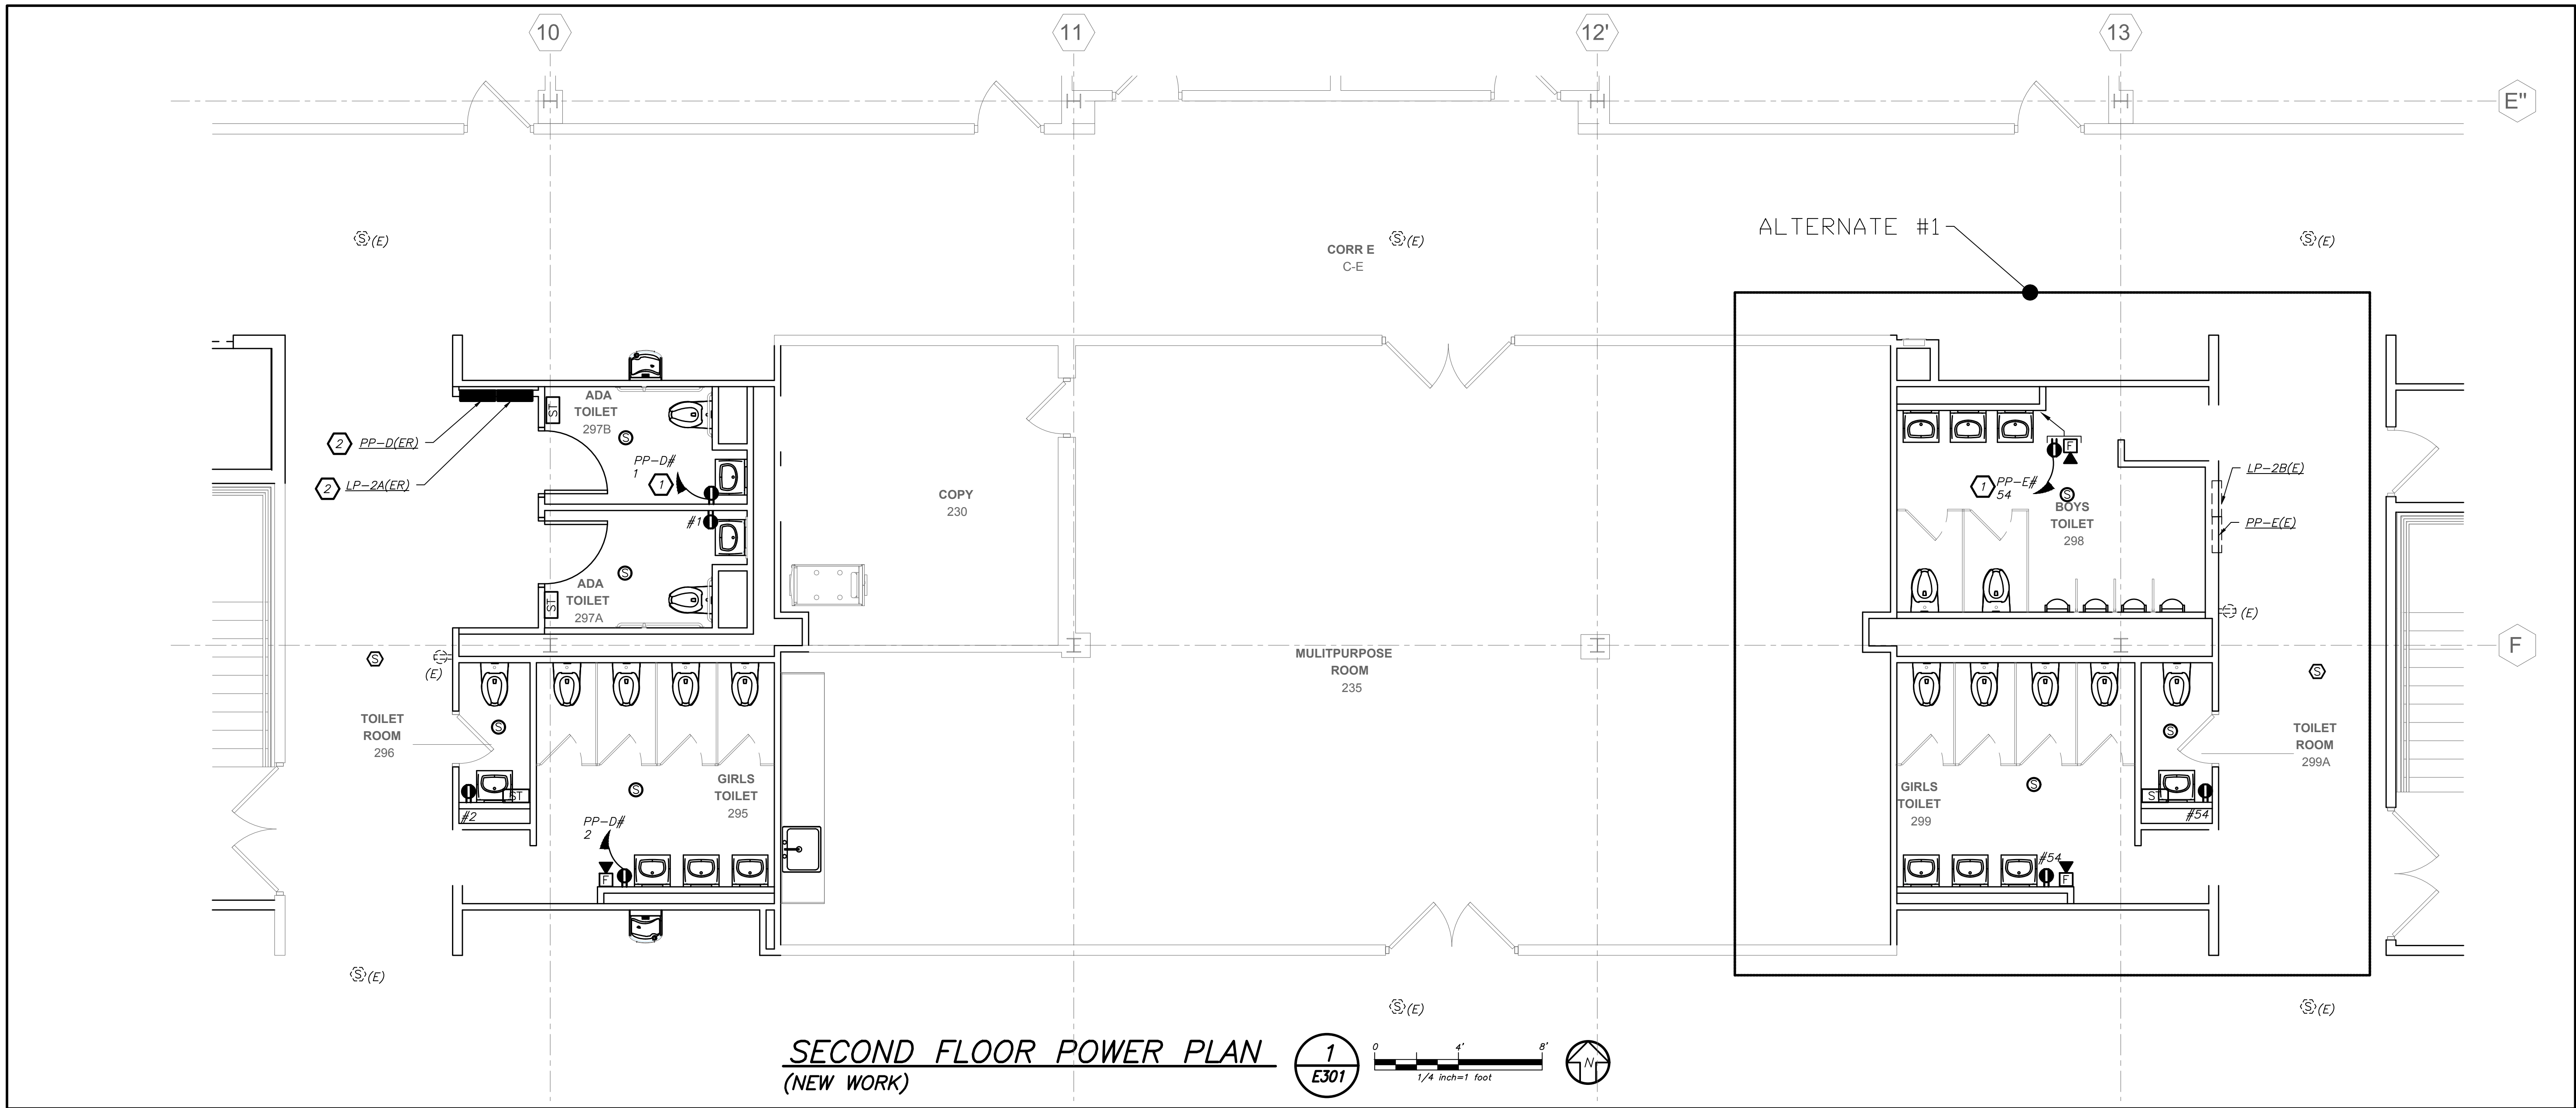

BEFORE FABRICATION THIS CONTRACTOR SHALL VERIFY ALL MEASUREMENTS AND CONDITIONS ON JOB AND COORDINATE HIS WORK WITH THE WORK OF ALL OTHER CONTRACTORS

- WORK NOTES:**
- CIRCUIT NEW BRANCH POWER TO CIRCUIT BREAKER MADE AVAILABLE AFTER DEMO WORK. PROVIDE 2#12+1#12-3/4" C TO THE INDICATED PANEL BOARD.
 - RELOCATE EXISTING PANELBOARD TO NEW LOCATION. EC TO UTILIZE EXISTING BREAKERS INTO THE NEW PANELBOARD. EXTEND ALL BRANCH POWER TO NEW LOCATION. PROVIDE ALL REQUIRED ACCESSORIES AS NEEDED FOR COMPLETE OPERATIONAL PANELBOARD.

PVMS TOILET ROOM ALTERATIONS

CAPITAL PROJECTS PHASE 2

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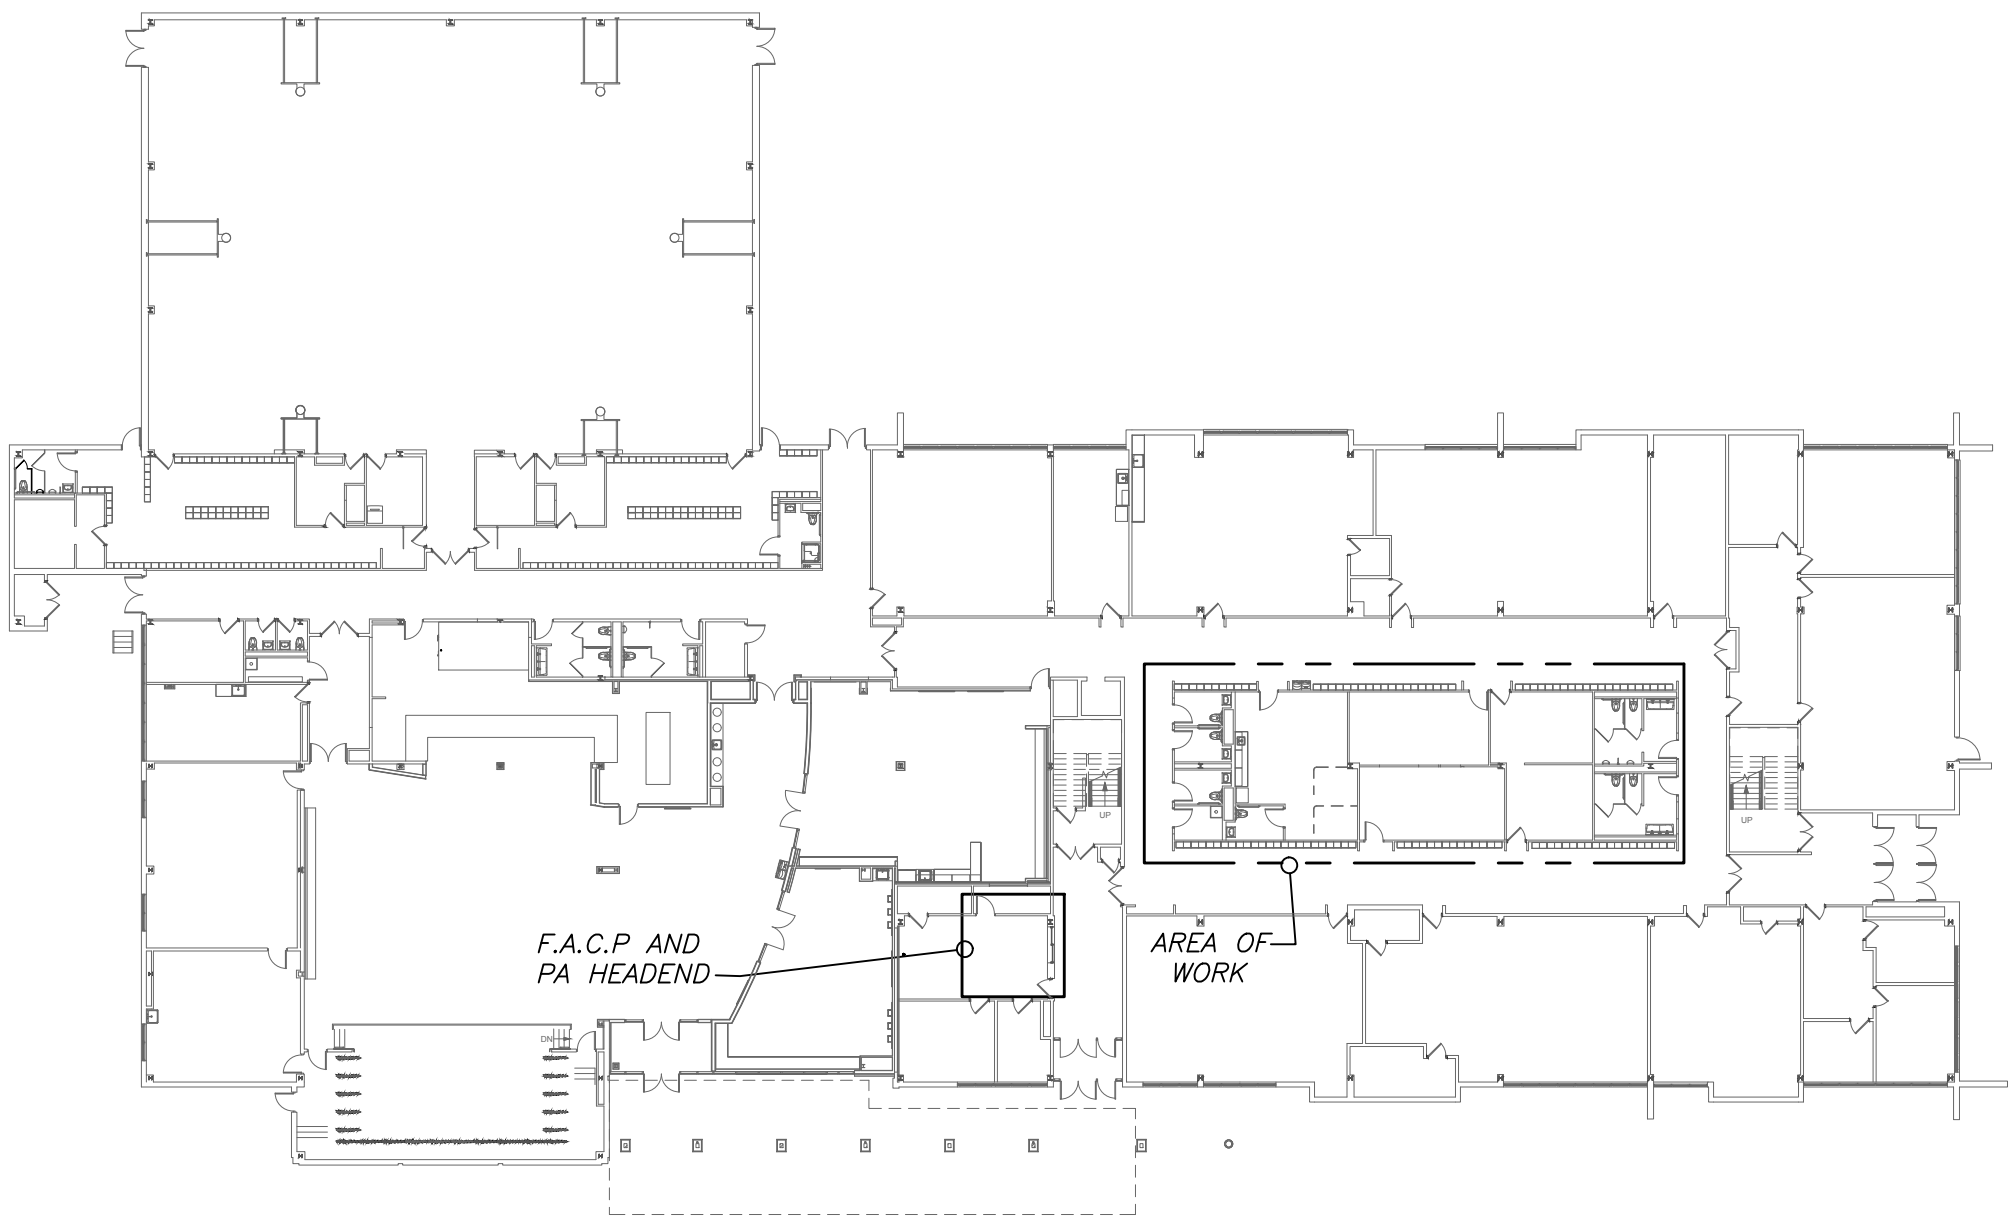
3	03/15/21	CONSTRUCTION DOCUMENTS
1	02/01/21	SED SUBMISSION
No.	Date	Issue

Sheet Title


FIRST AND SECOND FLOOR POWER PLANS

Job No.	2020-1051	Date	01/14/2021
Scale	AS NOTED	Drawn / Checked	BGA/BGA
Sheet Number	E301		


LIGHTING FIXTURE SCHEDULE				
TYPE	MOUNTING	LAMPS	DESCRIPTION	MANUFACTURER & CAT.#
C	CEILING RECESSED MOUNTED	19 WATTS LED 120V	4" ROUND DOWNLIGHT, 1500 LUMEN OUTPUT, 3500K COLOR TEMP WIDE DISTRIBUTION, SEMI SPECULAR FINISH	MANUFACTURER: PRESCOLITE LTR-4RD-H-SL15L-DM1-120 LTR-4RD-T-SL-35K-8-WD-SS-WT
C-EM	CEILING RECESSED MOUNTED	19 WATTS LED 120V	SAME AS FIXTURE "C" EXCEPT WITH EMERGENCY BATTERY PACK.	MANUFACTURER: PRESCOLITE LTR-4RD-H-SL15L-DM1-120-EM LTR-4RD-T-SL-35K-8-WD-SS-WT
J	WALL SURFACE MOUNTED	8.4 WATTS LED 120V	24" HORIZONTAL WALL MOUNTED WET LOCATION LED 1181 LUMENS, 3500K COLOR TEMP OPAL ACRYLIC DIFFUSER WITH SATIN PEWTER FINISH. CUSTOM LENGHT	MANUFACTURER: ULTRALIGHT MOD 9131-24HM-SP-OA-02-3500K
J2	WALL SURFACE MOUNTED	8.4 WATTS LED 120V	18" HORIZONTAL WALL MOUNTED WET LOCATION LED 1181 LUMENS, 3500K COLOR TEMP OPAL ACRYLIC DIFFUSER WITH SATIN PEWTER FINISH.	MANUFACTURER: ULTRALIGHT MOD 9131-18HM-SP-OA-02-3500K



FIRST FLOOR PLAN (EXISTING) 2 E501

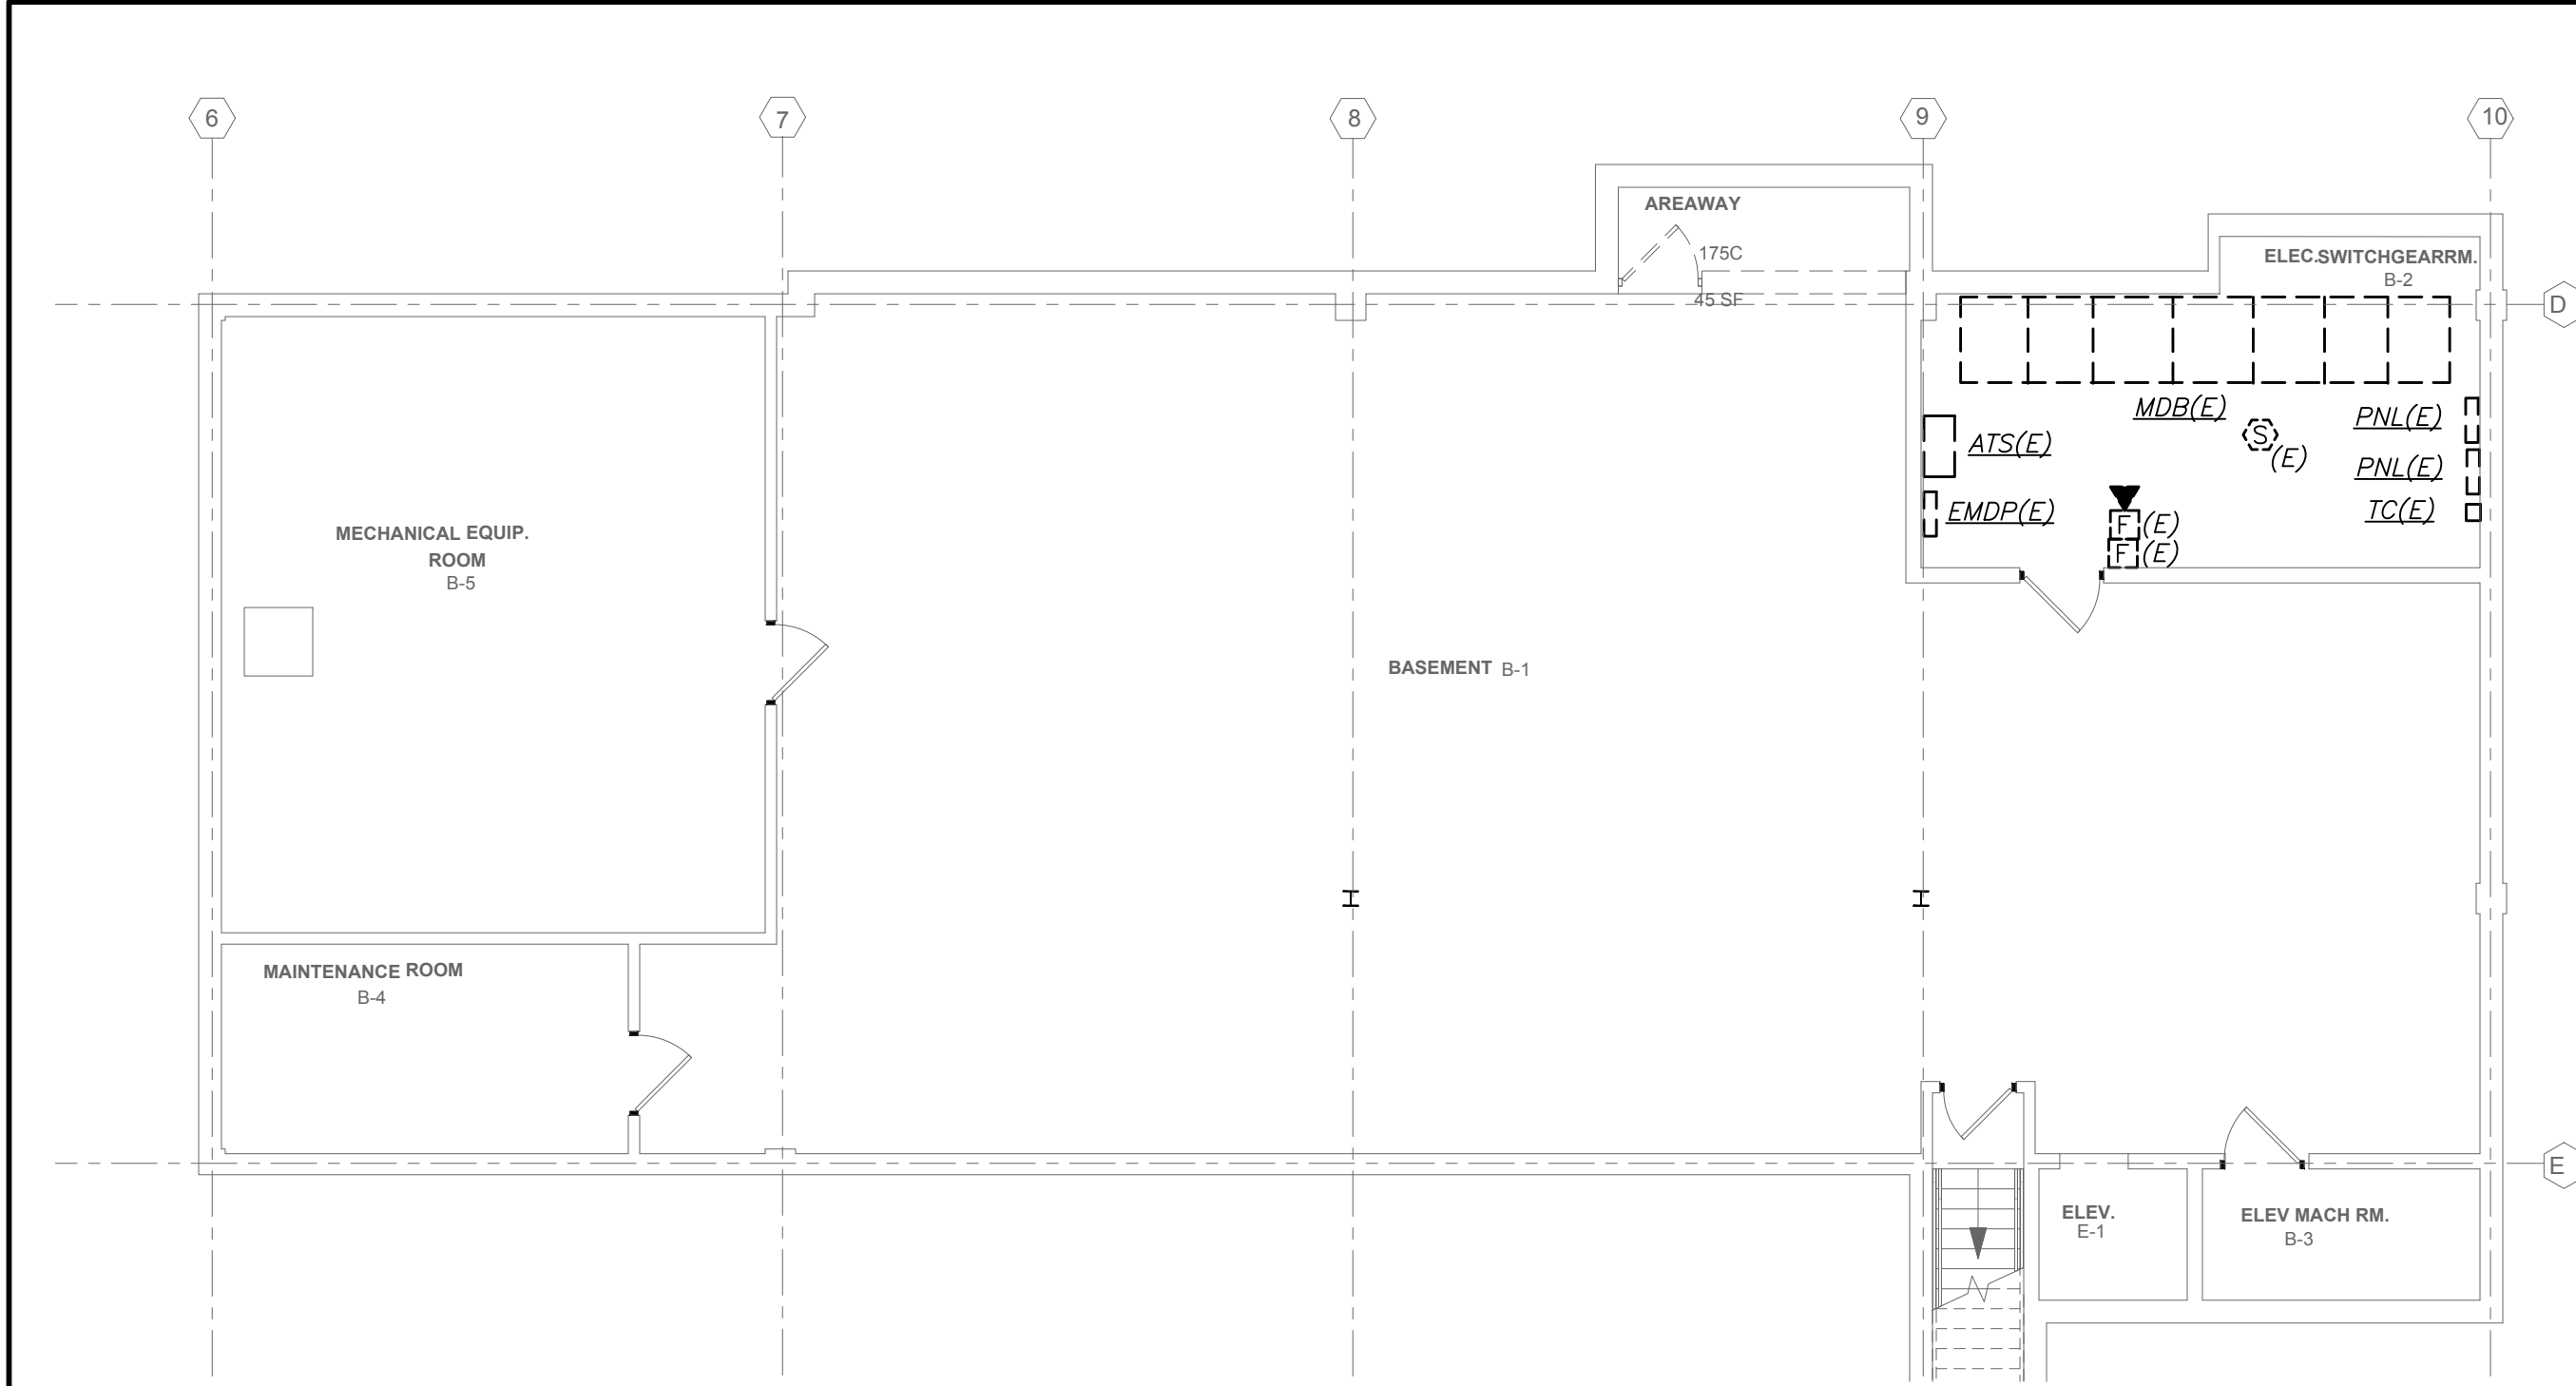

BASEMENT PLAN (EXISTING) 1 E501

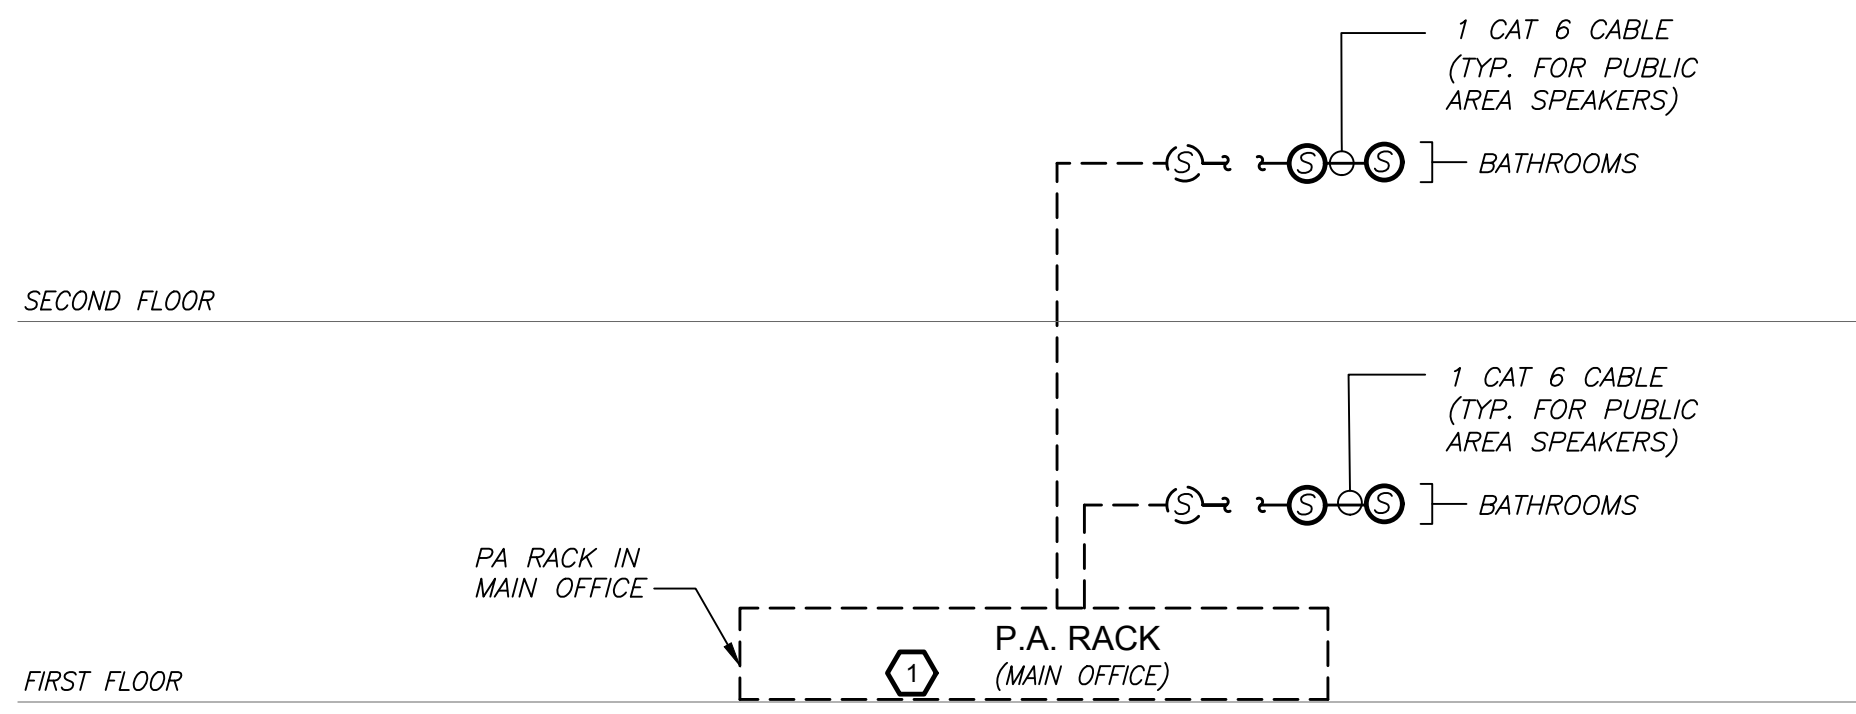


- GENERAL NOTES:**
- VERIFY EXACT QUANTITY AND LOCATION OF DEVICES ON PLAN DRAWINGS.
 - WIRING TYPES ARE SHOWN FOR REFERENCE ONLY. VERIFY EXACT WIRING REQUIREMENTS WITH MANUFACTURER.
 - ALL PROGRAMMING AND FINAL CONNECTIONS TO P.A. SYSTEM RACK SHALL BE BY SYSTEM MAINTENANCE CONTRACTOR. ALL COSTS ASSOCIATED WITH THIS SHALL BE BY ELECTRICAL CONTRACTOR.
 - SPEAKERS SHALL MATCH EXISTING TYPE. VERIFY WATTAGE TAP REQUIREMENTS IN FIELD.

- WORK NOTES:**
- PROVIDE NEW ZONE CARD, AMPLIFIER, ETC. AS REQUIRED FOR COMPLETE INSTALLATION. EXISTING SYSTEM IS BOGAN AND IS LOCATED IN THE MAIN OFFICE 138.

PUBLIC ADDRESS SYSTEM RISER 4 E501 N.T.S.


- WORK NOTES.**
- EXISTING 120/208V, 5000 AMP, 3 PHASE, 4 WIRE DISTRIBUTION BOARD RATED FOR 100,000 AIC.
 - RELOCATE EXISTING PANELBOARD TO NEW LOCATION AS SHOWN ON E301. EC TO PROVIDE ALL NEW INTERNAL COMPONENTS, NEW BACKBOX AND NEW COVER TO MATCH EXISTING. REFER TO PANEL SCHEDULES ON E601 FOR ADDITIONAL INFORMATION.
 - EC TO REMOVE EXISTING FEEDERS BACK TO ITS SOURCE IN THE MAIN DISTRIBUTION BOARD. RE-USE SAME CIRCUIT BREAKER TO FEED THE RELOCATED PANELBOARD.
 - PROVIDE NEW WIRING AND CONDUIT TO THE RELOCATED PANELBOARDS. PROVIDE ALL ACCESSORIES, PULLBOXES ETC AS NEEDED FOR THE COMPLETE FUNCTIONAL INSTALLATION.

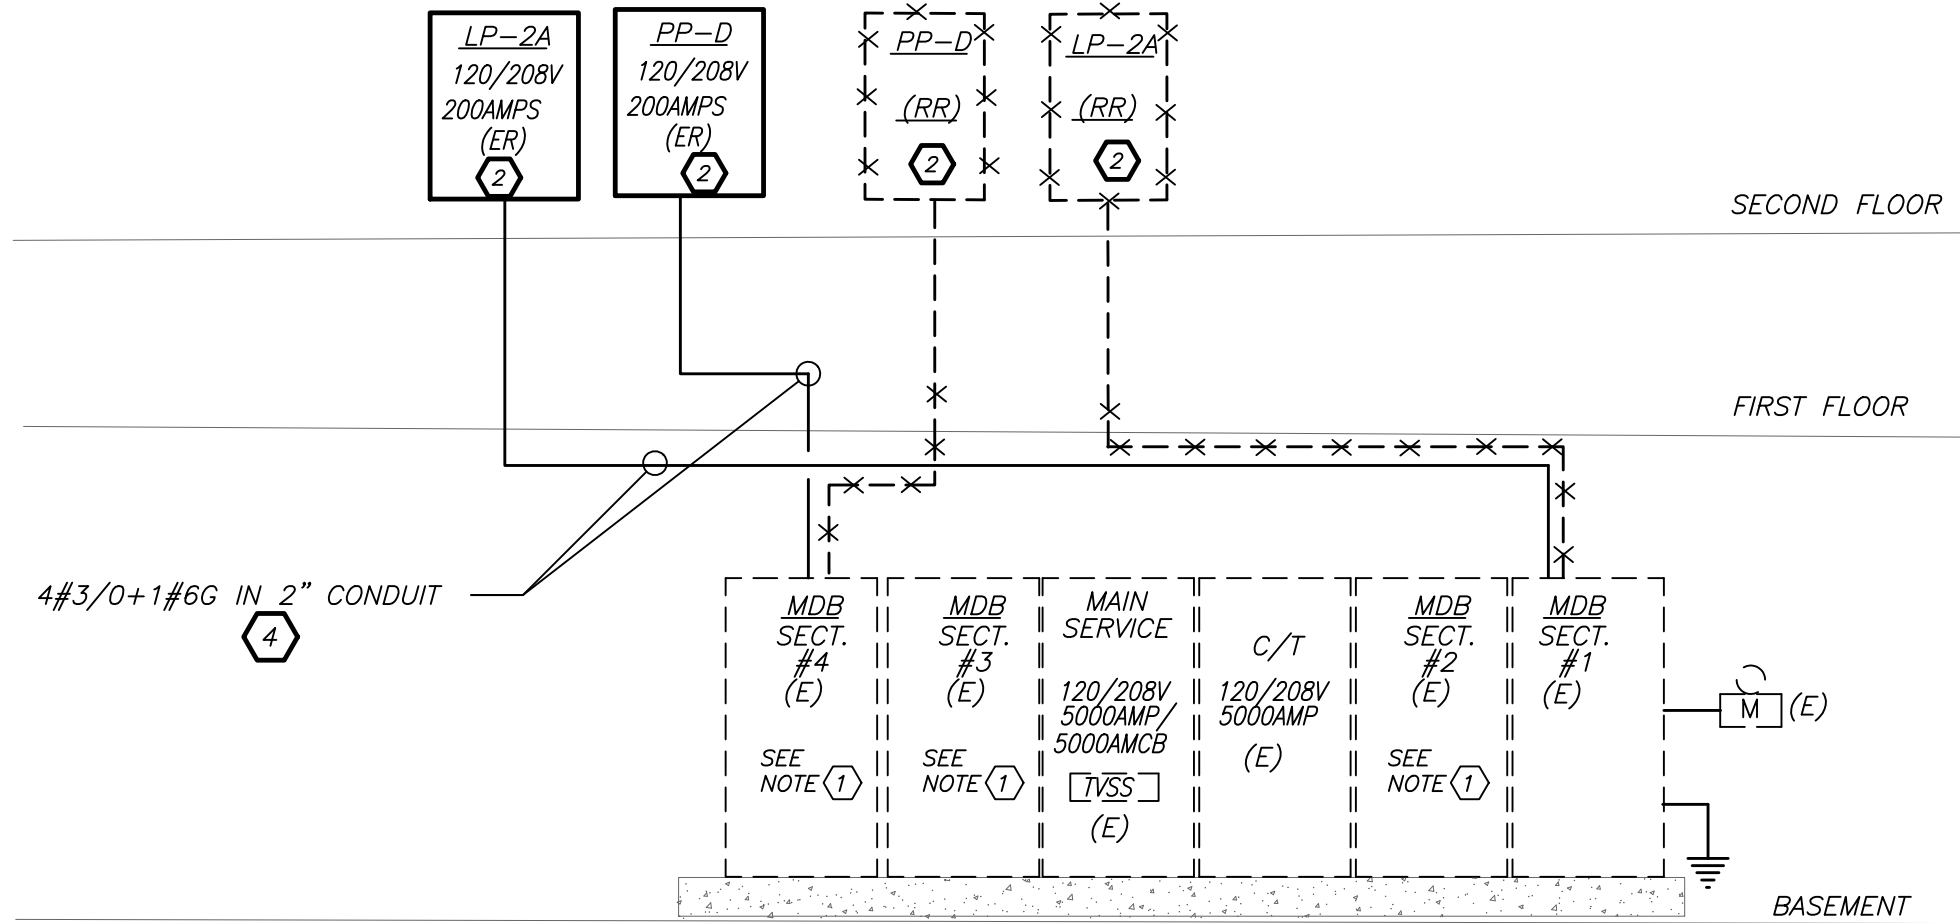

PARTIAL POWER RISER DIAGRAM 3 E501 N.T.S.

FIRE ALARM RISER GENERAL NOTES:

- FIRE ALARM WIRING DIAGRAMS SHOWN ARE FOR GENERAL ARRANGEMENT ONLY. ELECTRICAL CONTRACTOR SHALL VERIFY AND OBTAIN POINT TO POINT WIRING DIAGRAM PRIOR TO INSTALLATION FROM MANUFACTURER.
- PERMITS AND APPROVALS NECESSARY FOR INSTALLATION OF THE WORK SHALL BE OBTAINED PRIOR TO THE COMMENCEMENT OF THE WORK. ALL PERMIT COSTS AND INSPECTION FEES SHALL BE INCLUDED AS PART OF THIS CONTRACT.
- IN AREAS WHERE DUST AND DIRT WILL BE AIRBORNE DURING DEMOLITION AND CONSTRUCTION THE CONTRACTOR SHALL PROVIDE PLASTIC WRAP OVER SMOKE DETECTORS AND THEN REMOVE ONCE SPACE IS CLEAN.
- UNLESS DIRECTED OTHERWISE BY FIRE ALARM SYSTEM MANUFACTURER FIRE ALARM DEVICE WIRING SHALL BE AS FOLLOWS (FOR BIDDING PURPOSES ONLY):
 - HORN WIRING - #16 AWG TWISTED
 - STROBE WIRING - #14 AWG TWISTED
 - SIGNAL WIRING - #14 AWG TWISTED/SHELDTHE WIRING SHALL HAVE THE FOLLOWING CHARACTERISTICS:
 - A. A MINIMUM TEMPERATURE RATING OF 150 C
 - B. A MINIMUM AVERAGE INSULATION THICKNESS OF 15 MILS
 - C. A MINIMUM AVERAGE JACKET THICKNESS OF 25 MILS
 - D. THE COLOR OF THE CABLE SHALL BE RED
 - E. THE CABLE SHALL BE A TYPE PLP (PLENUM TYPE) WHEN CONDUIT IS USED.
 - F. THE CABLE SHALL BE VISIBLY MARKED EXTERNALLY THAT IT MEETS THE ABOVE REQUIREMENTS AND IS LISTED BY UL.CONFIRM WIRING TYPE AND QUANTITY WITH FIRE ALARM SYSTEM MANUFACTURER PRIOR TO PURCHASING.
- PROVIDE MC FIRE ALARM CABLE WITH RED STRIPE AS MANUFACTURED BY AFC SERIES 1800 WHEN CABLE IS CONCEALED OR ABOVE HUNG CEILING. WHEN FIRE ALARM CABLE IS RUN EXPOSED IN FINISHED AREAS, CABLE SHALL RUN IN WIREMOLD V-700. WHEN FIRE ALARM CABLE IS RUN EXPOSED IN UNFINISHED AREAS, PROVIDE PLENUM RATED CABLE IN MIN. 3/4" CONDUIT.
- STROBES SHALL HAVE A MINIMUM LIGHT OUTPUT OF 75 CANDELA AND A FLASH RATE OF 1-3 HZ.
- WALL MOUNTED HORN/STROBE UNITS SHALL NOT HAVE ANY OTHER DEVICES OR APPURTENANCES WITHIN 5 FEET OF THE DEVICE. THEY SHALL BE A MAXIMUM OF 80 INCHES ABOVE FLOOR OR 6" BELOW THE CEILING, WHICHEVER IS LOWER. DEVICES SHALL BE FLUSH MOUNTED IN ALL FINISHED AREAS. PROVIDE DOUBLE DEEP DEVICE BOX IN WALL.
- SHUTDOWN OF HVAC SYSTEM EQUIPMENT WITH SUPPLY AIR OF 2000 CFM OR GREATER, SEND SIGNAL TO BUILDING AUTOMATED TEMPERATURE CONTROL SYSTEM (ATC) INDICATING SHUTDOWN HAS OCCURRED. EQUIPMENT RESTART SHALL BE BY BUILDING ATC SYSTEM UPON FIRE ALARM RESET TO NORMAL MODE. RESTART OF EQUIPMENT SHALL BE SEQUENTIAL.
- AFTER THE SYSTEM IS COMPLETE, TEST ALL COMPONENTS IN ACCORDANCE WITH SEQUENCE OF OPERATION PRIOR TO FIRE DEPARTMENT INSPECTION.
- ALL PULL STATIONS SHALL BE MOUNTED 48" AFF AND PROVIDED WITH CLEAR PROTECTIVE LEXAN COVER. COVER SHALL BE AS MANUFACTURED BY SAFETY TECHNOLOGY INTERNATIONAL INC. CAT.#STI 1100 STOPPER II.
- ALL DEVICES SHALL BE SUPERVISED AS PER N.F.P.A. 72. PROVIDE END OF LINE RESISTORS AS REQUIRED PER INDIVIDUAL MANUFACTURER. PROVIDE LOAD RELAYS AS REQUIRED FOR PROPER OPERATION OF EQUIPMENT.
- VERIFY EXACT QUANTITY OF DEVICES WITH PLANS. COORDINATE F.A WORK WITH F.A VENDOR.

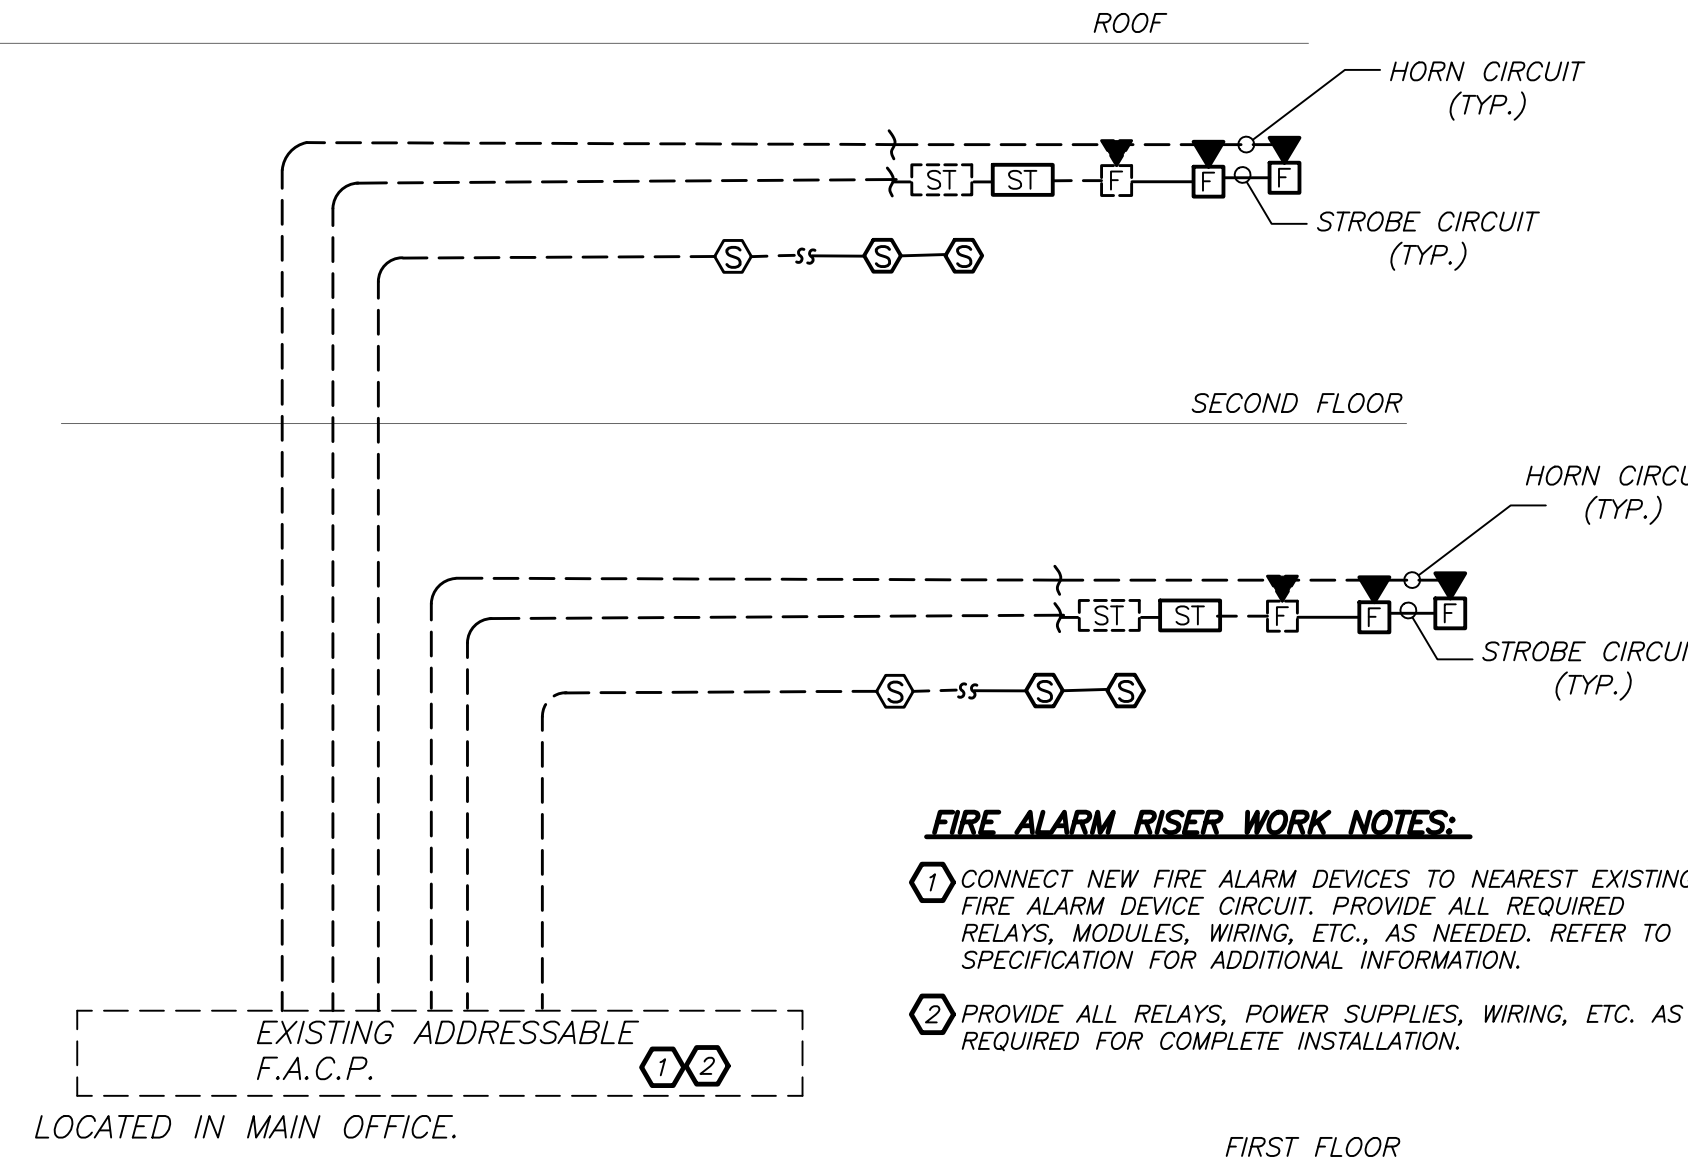

- FIRE ALARM RISER WORK NOTES:**
- CONNECT NEW FIRE ALARM DEVICES TO NEAREST EXISTING FIRE ALARM DEVICE CIRCUIT. PROVIDE ALL REQUIRED RELAYS, MODULES, WIRING, ETC., AS NEEDED. REFER TO SPECIFICATION FOR ADDITIONAL INFORMATION.
 - PROVIDE ALL RELAYS, POWER SUPPLIES, WIRING, ETC. AS REQUIRED FOR COMPLETE INSTALLATION.

PART FIRE ALARM RISER 5 E501

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PVMS TOILET ROOM ALTERATIONS

CAPITAL PROJECTS PHASE 2


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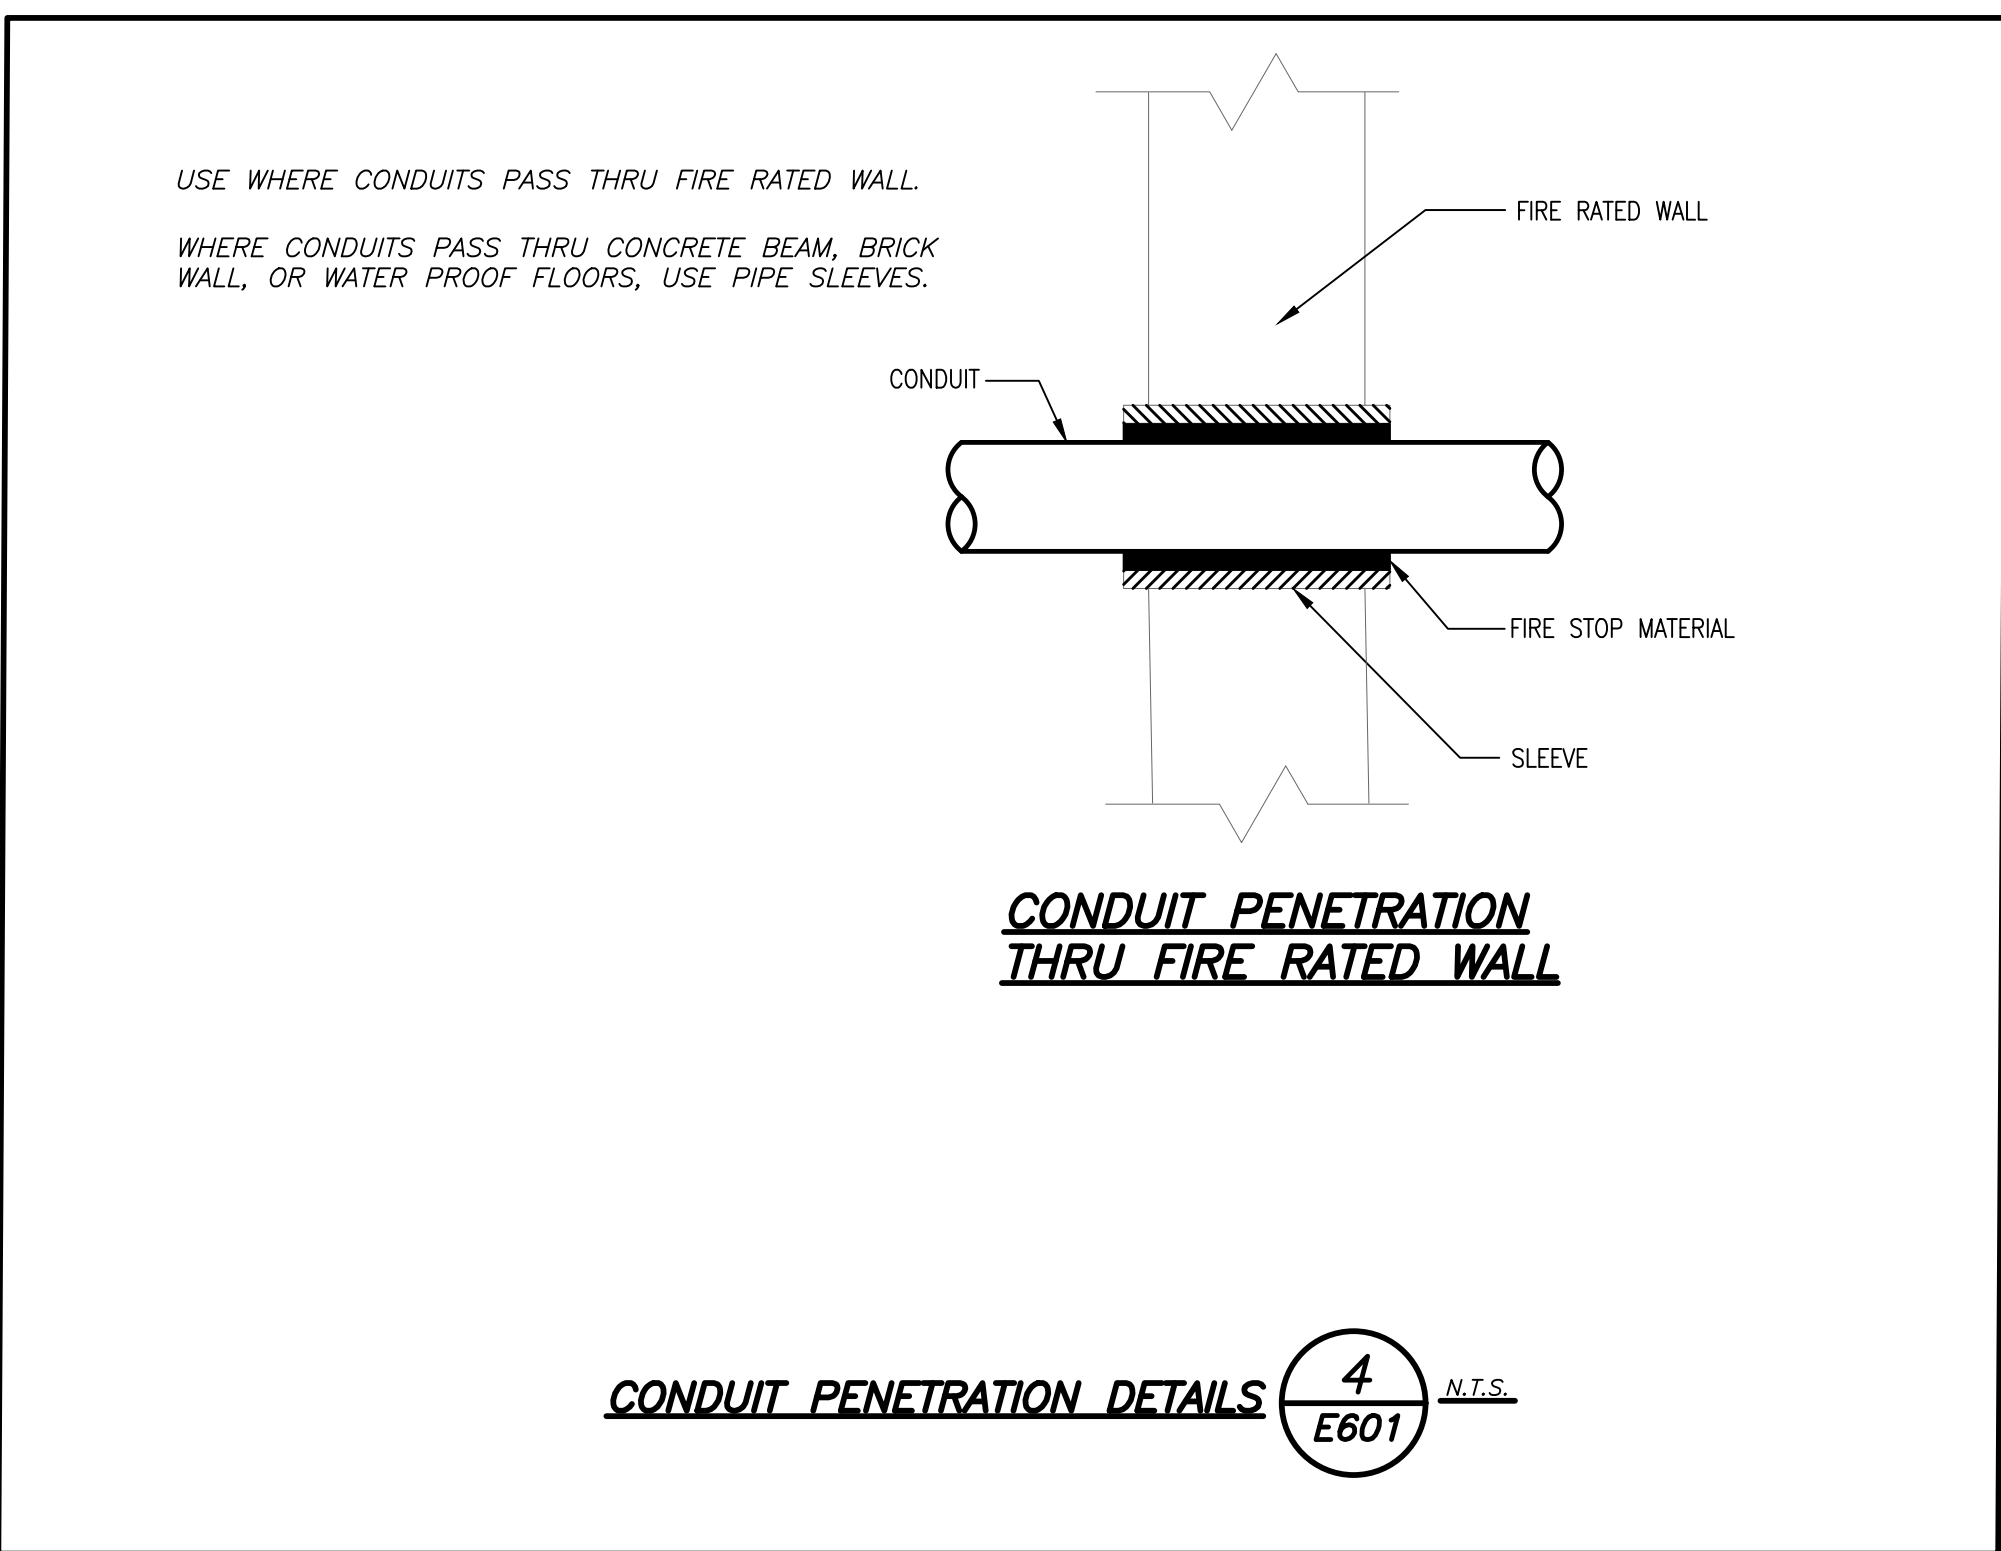
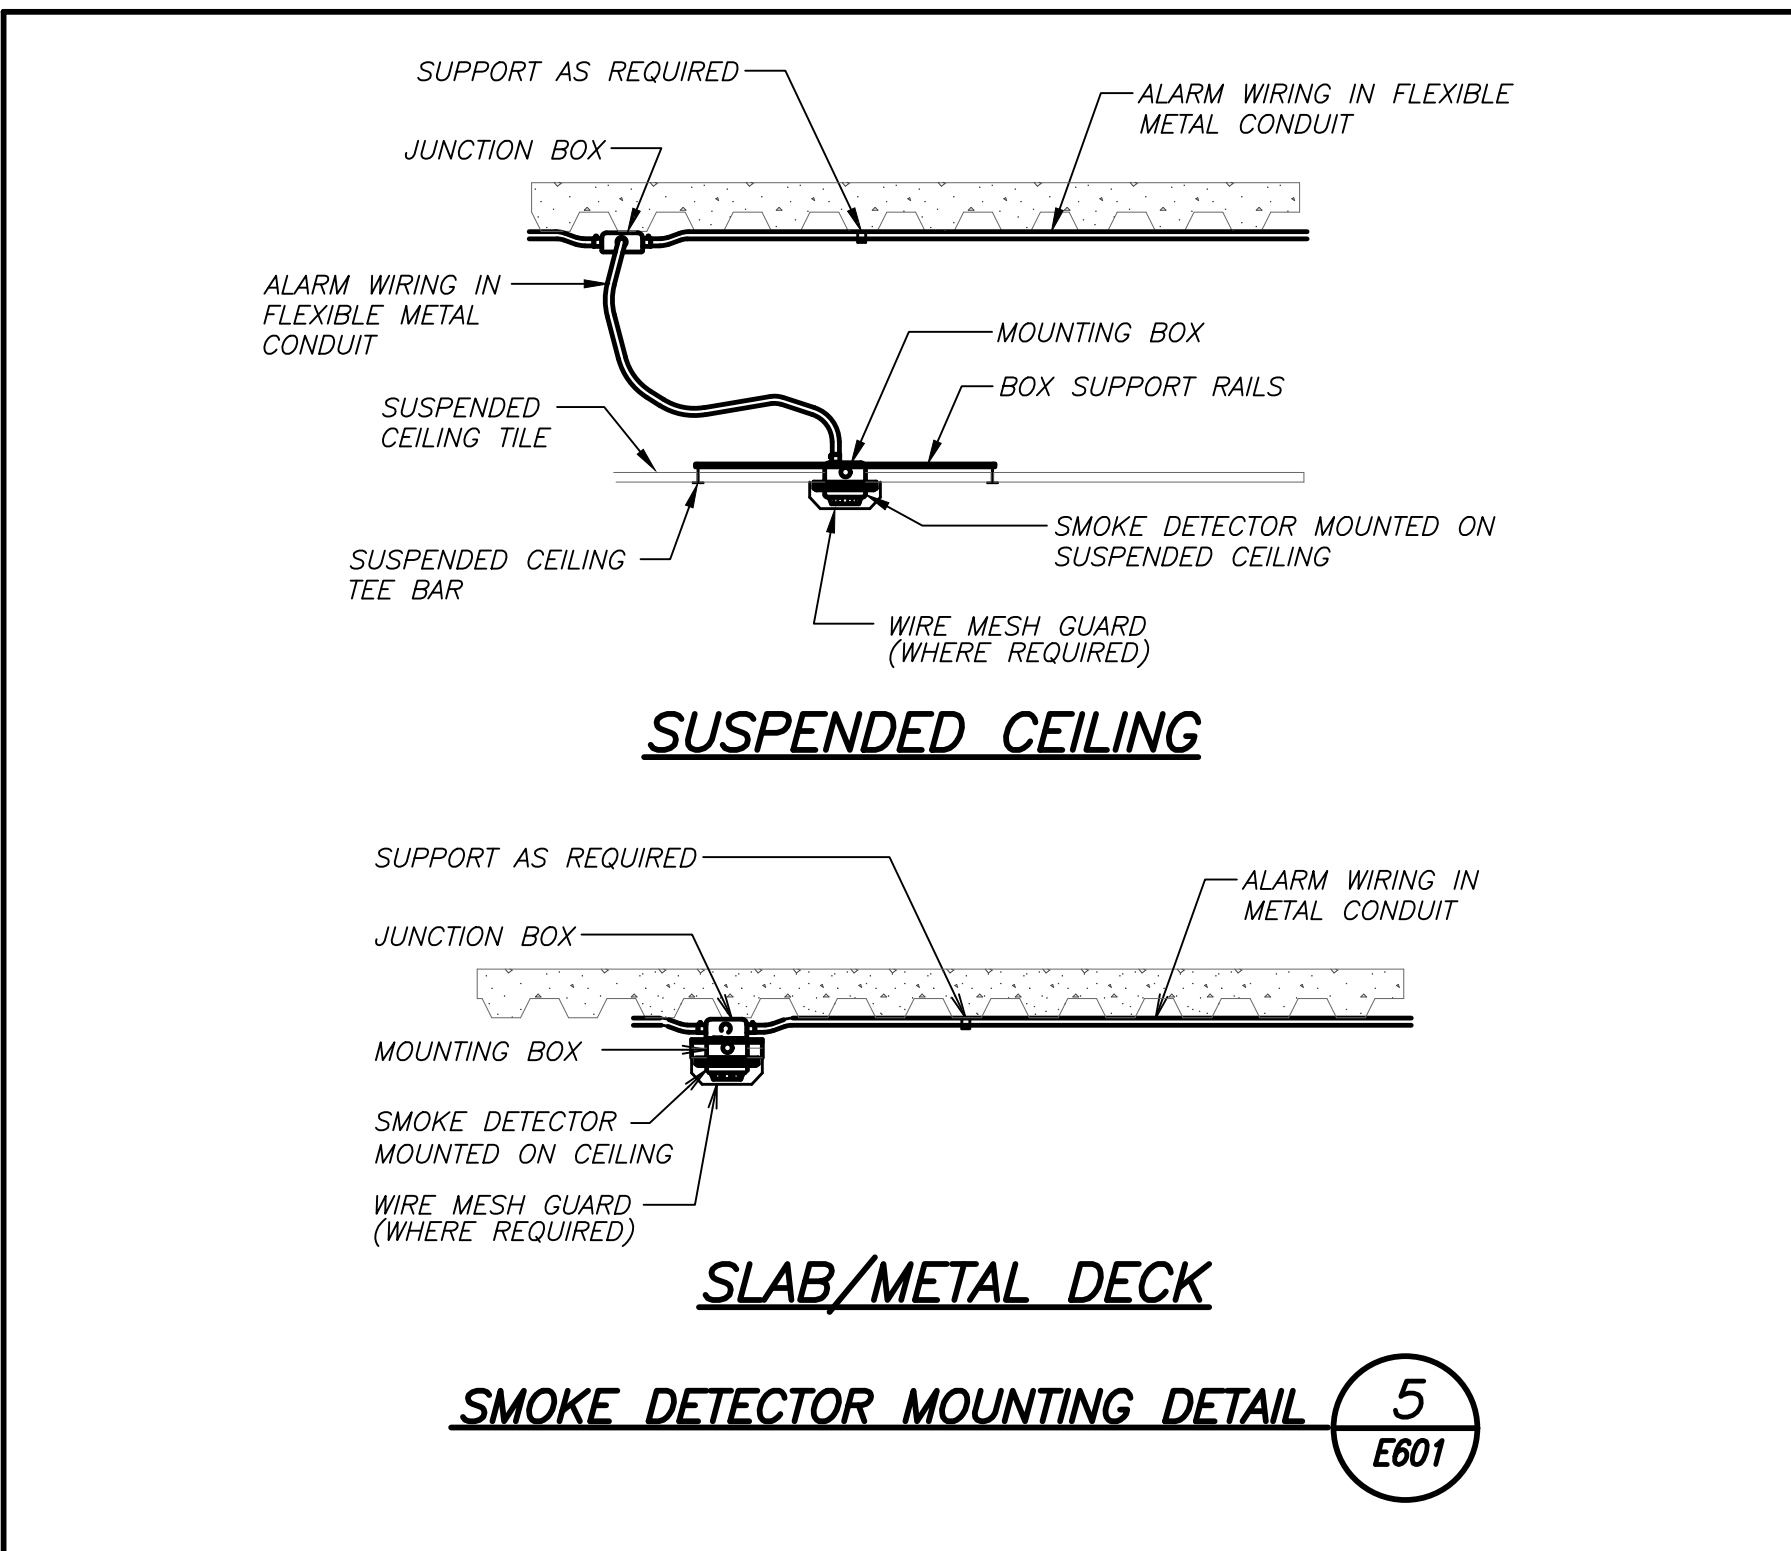
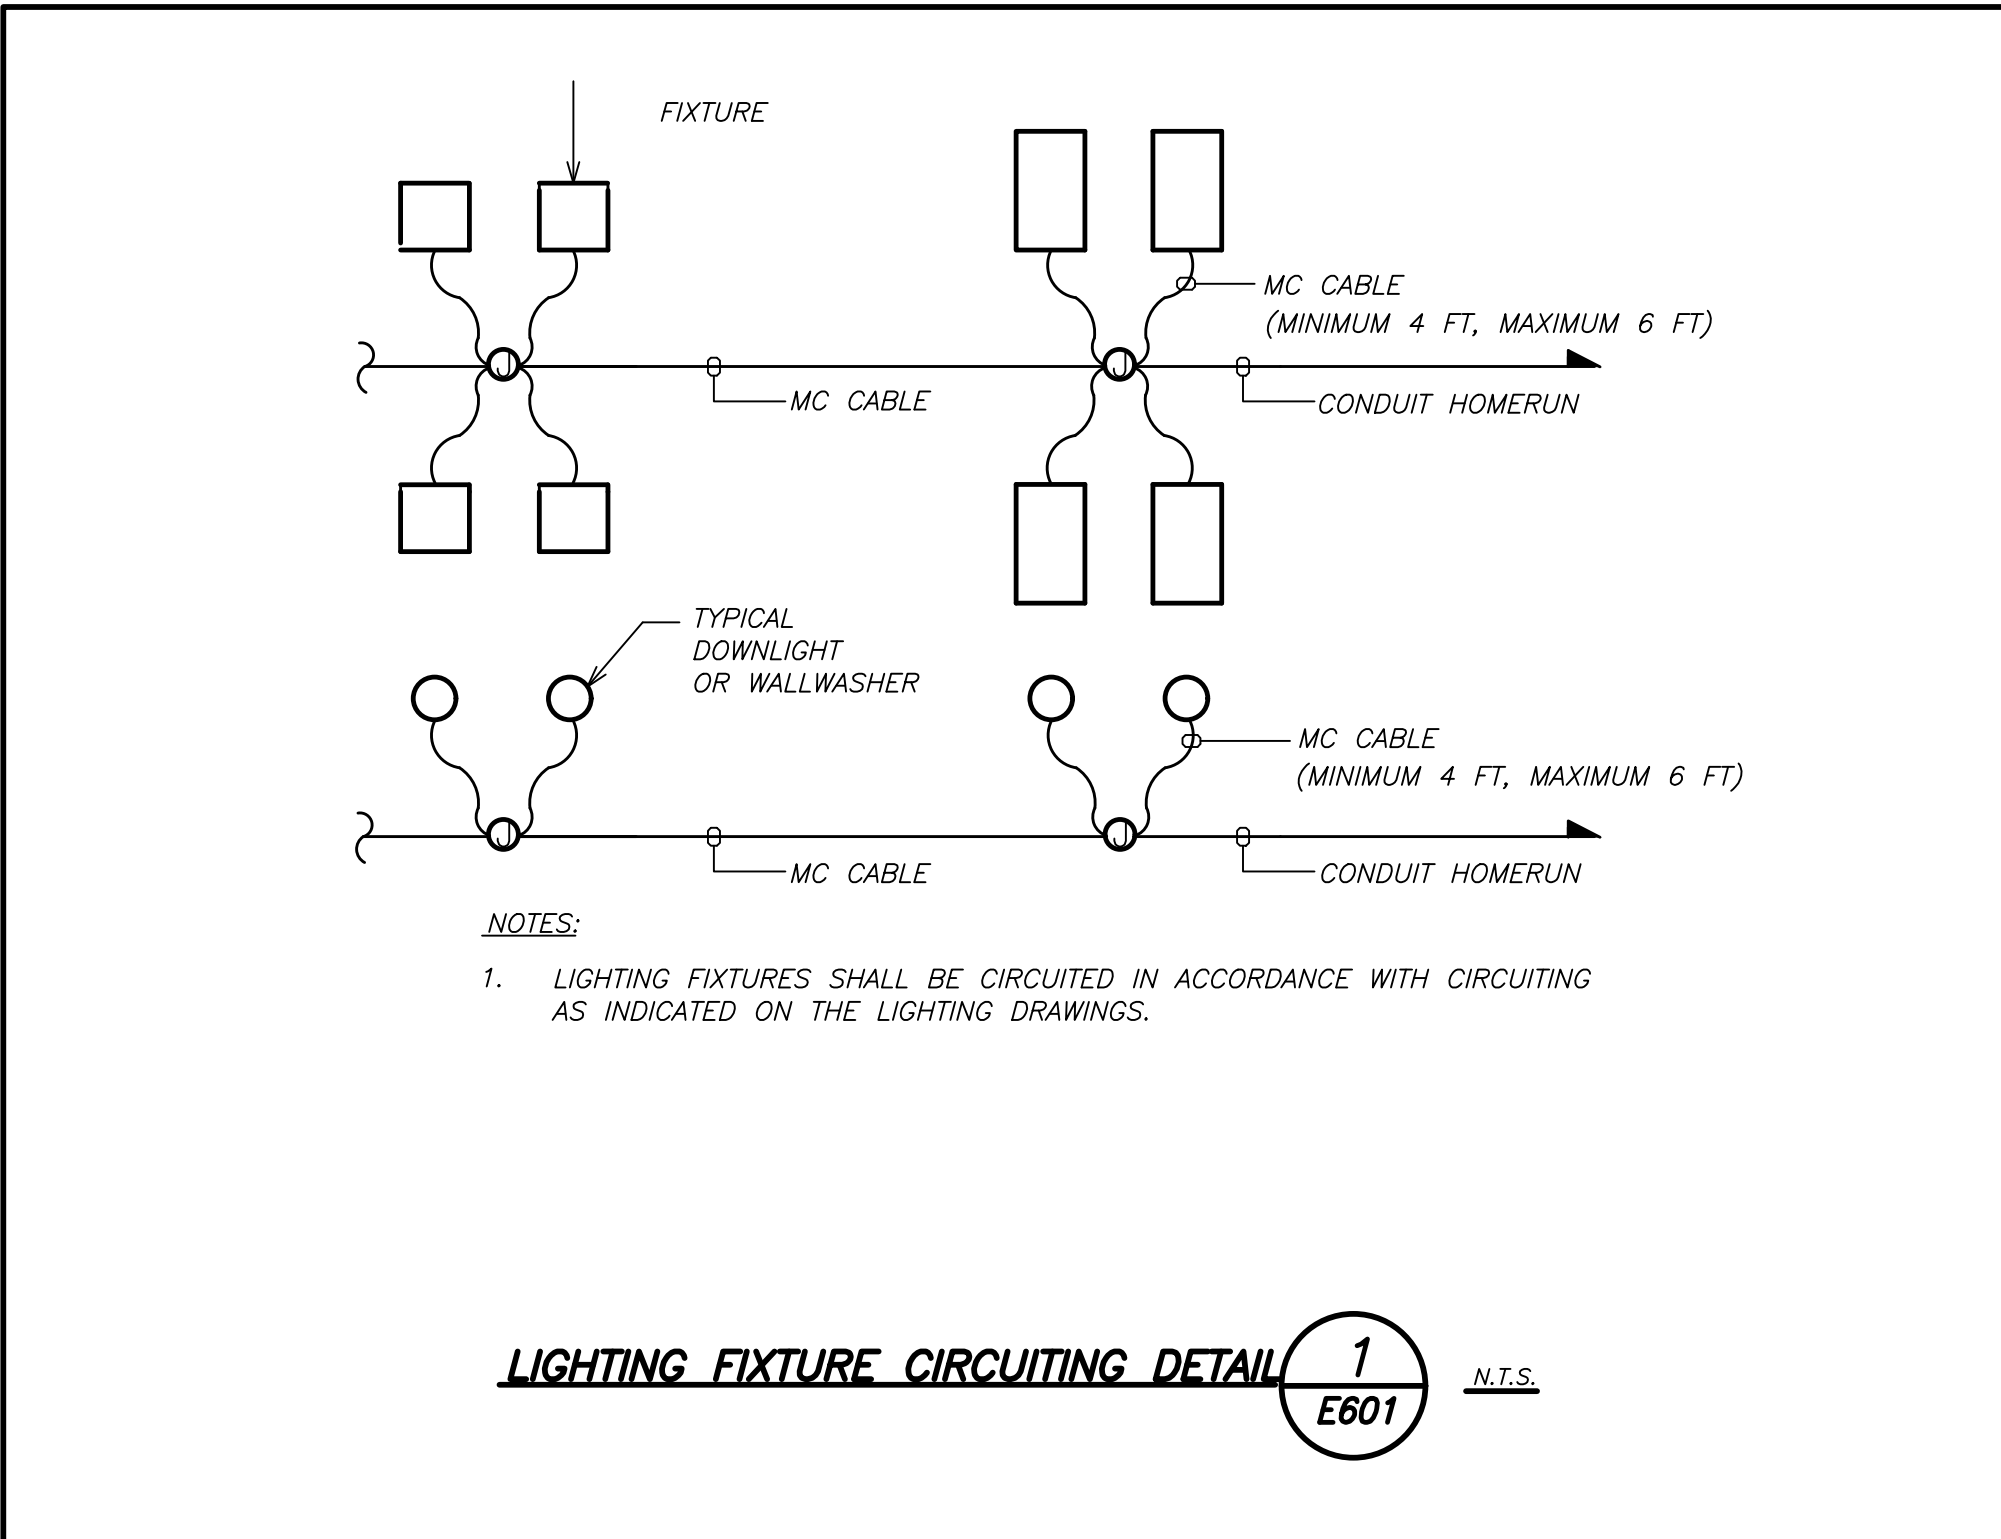
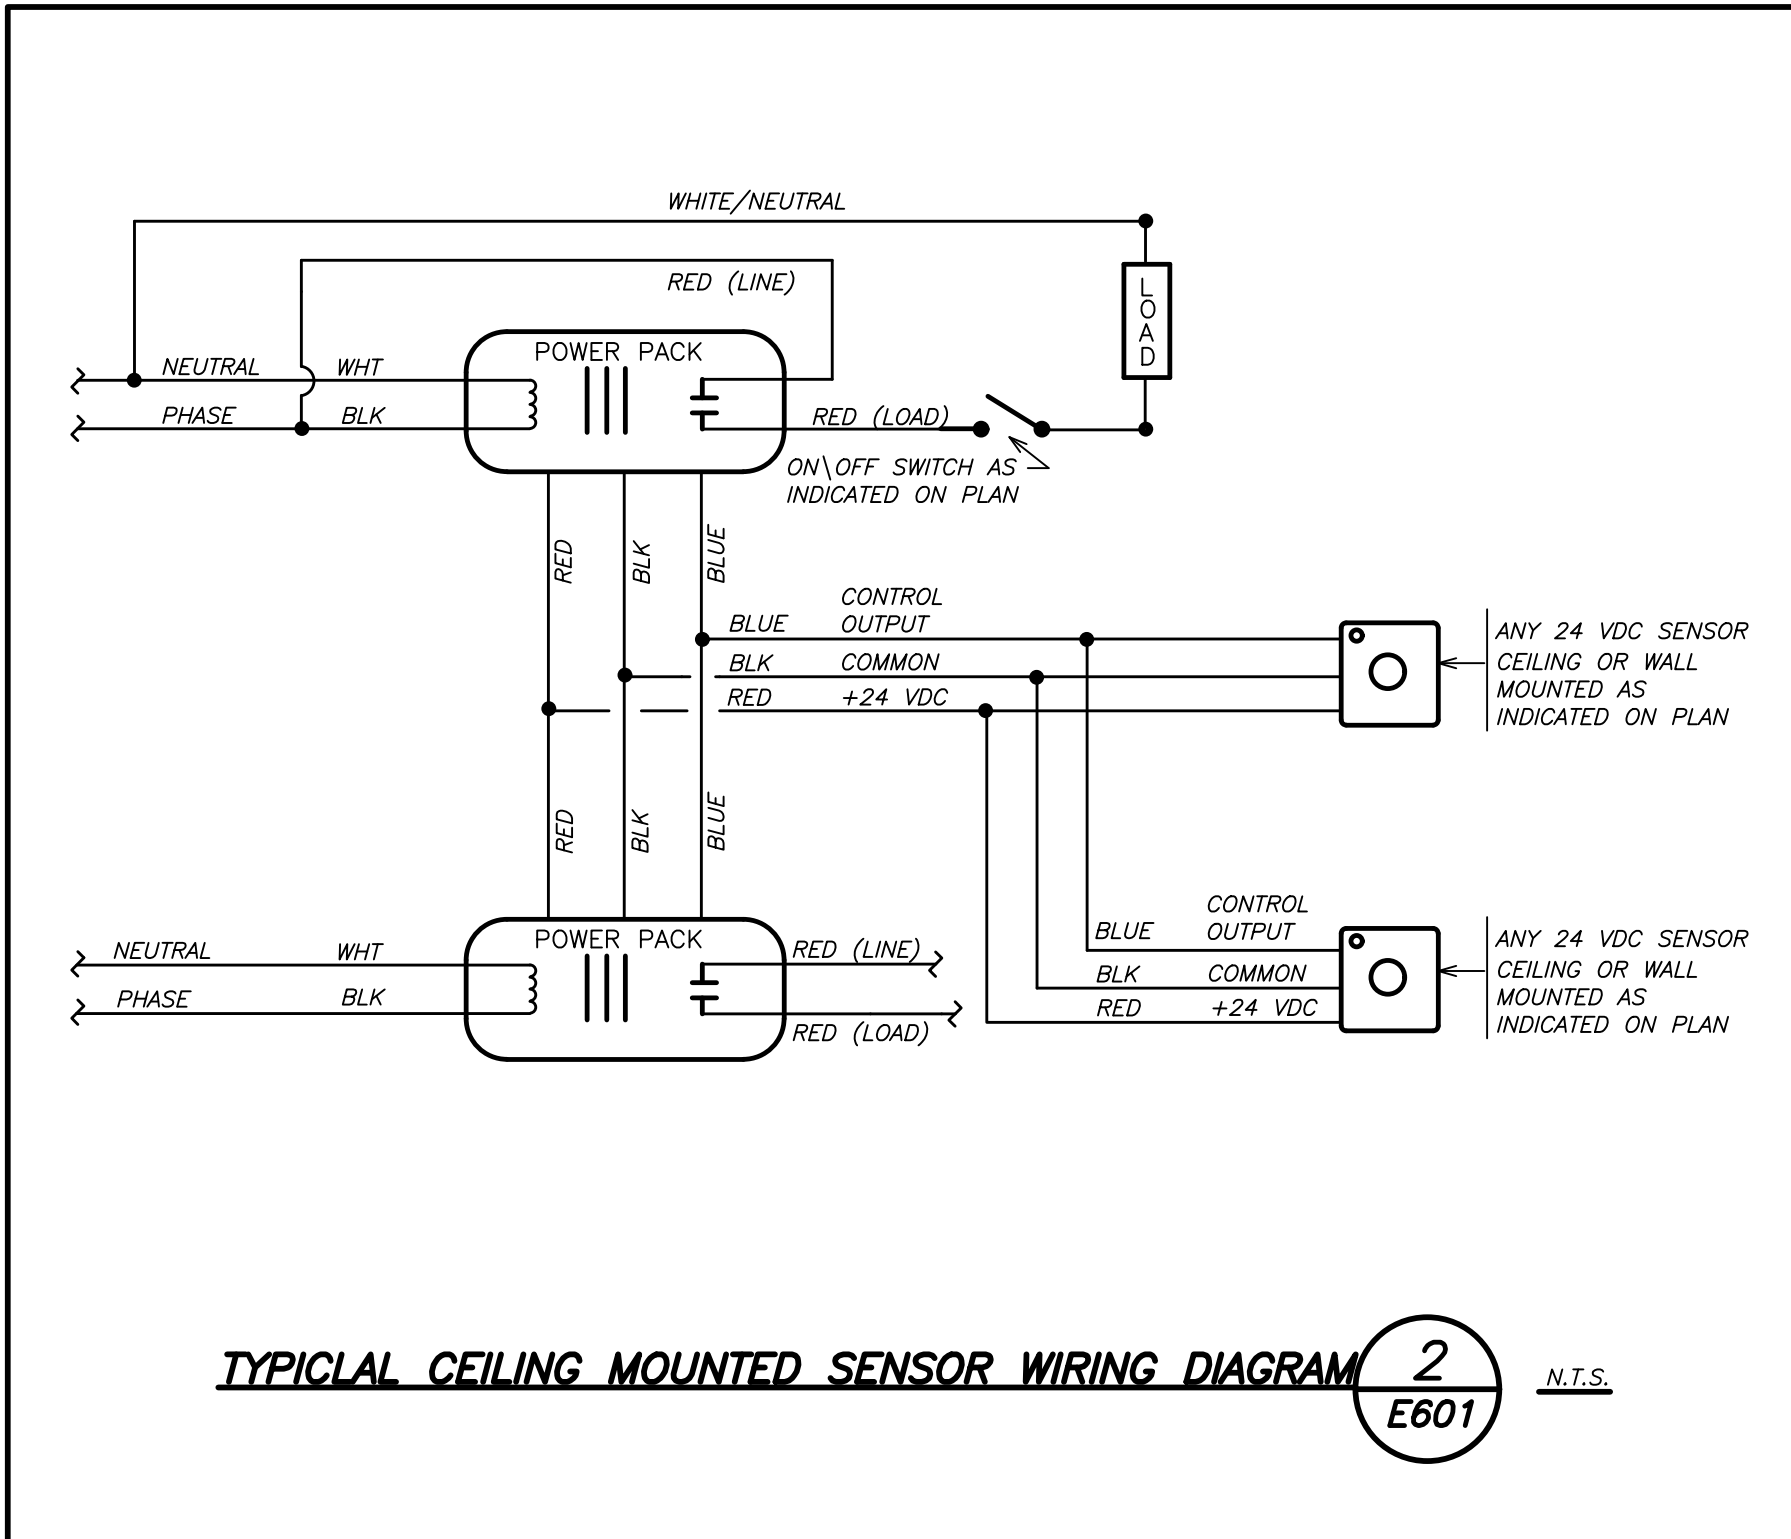
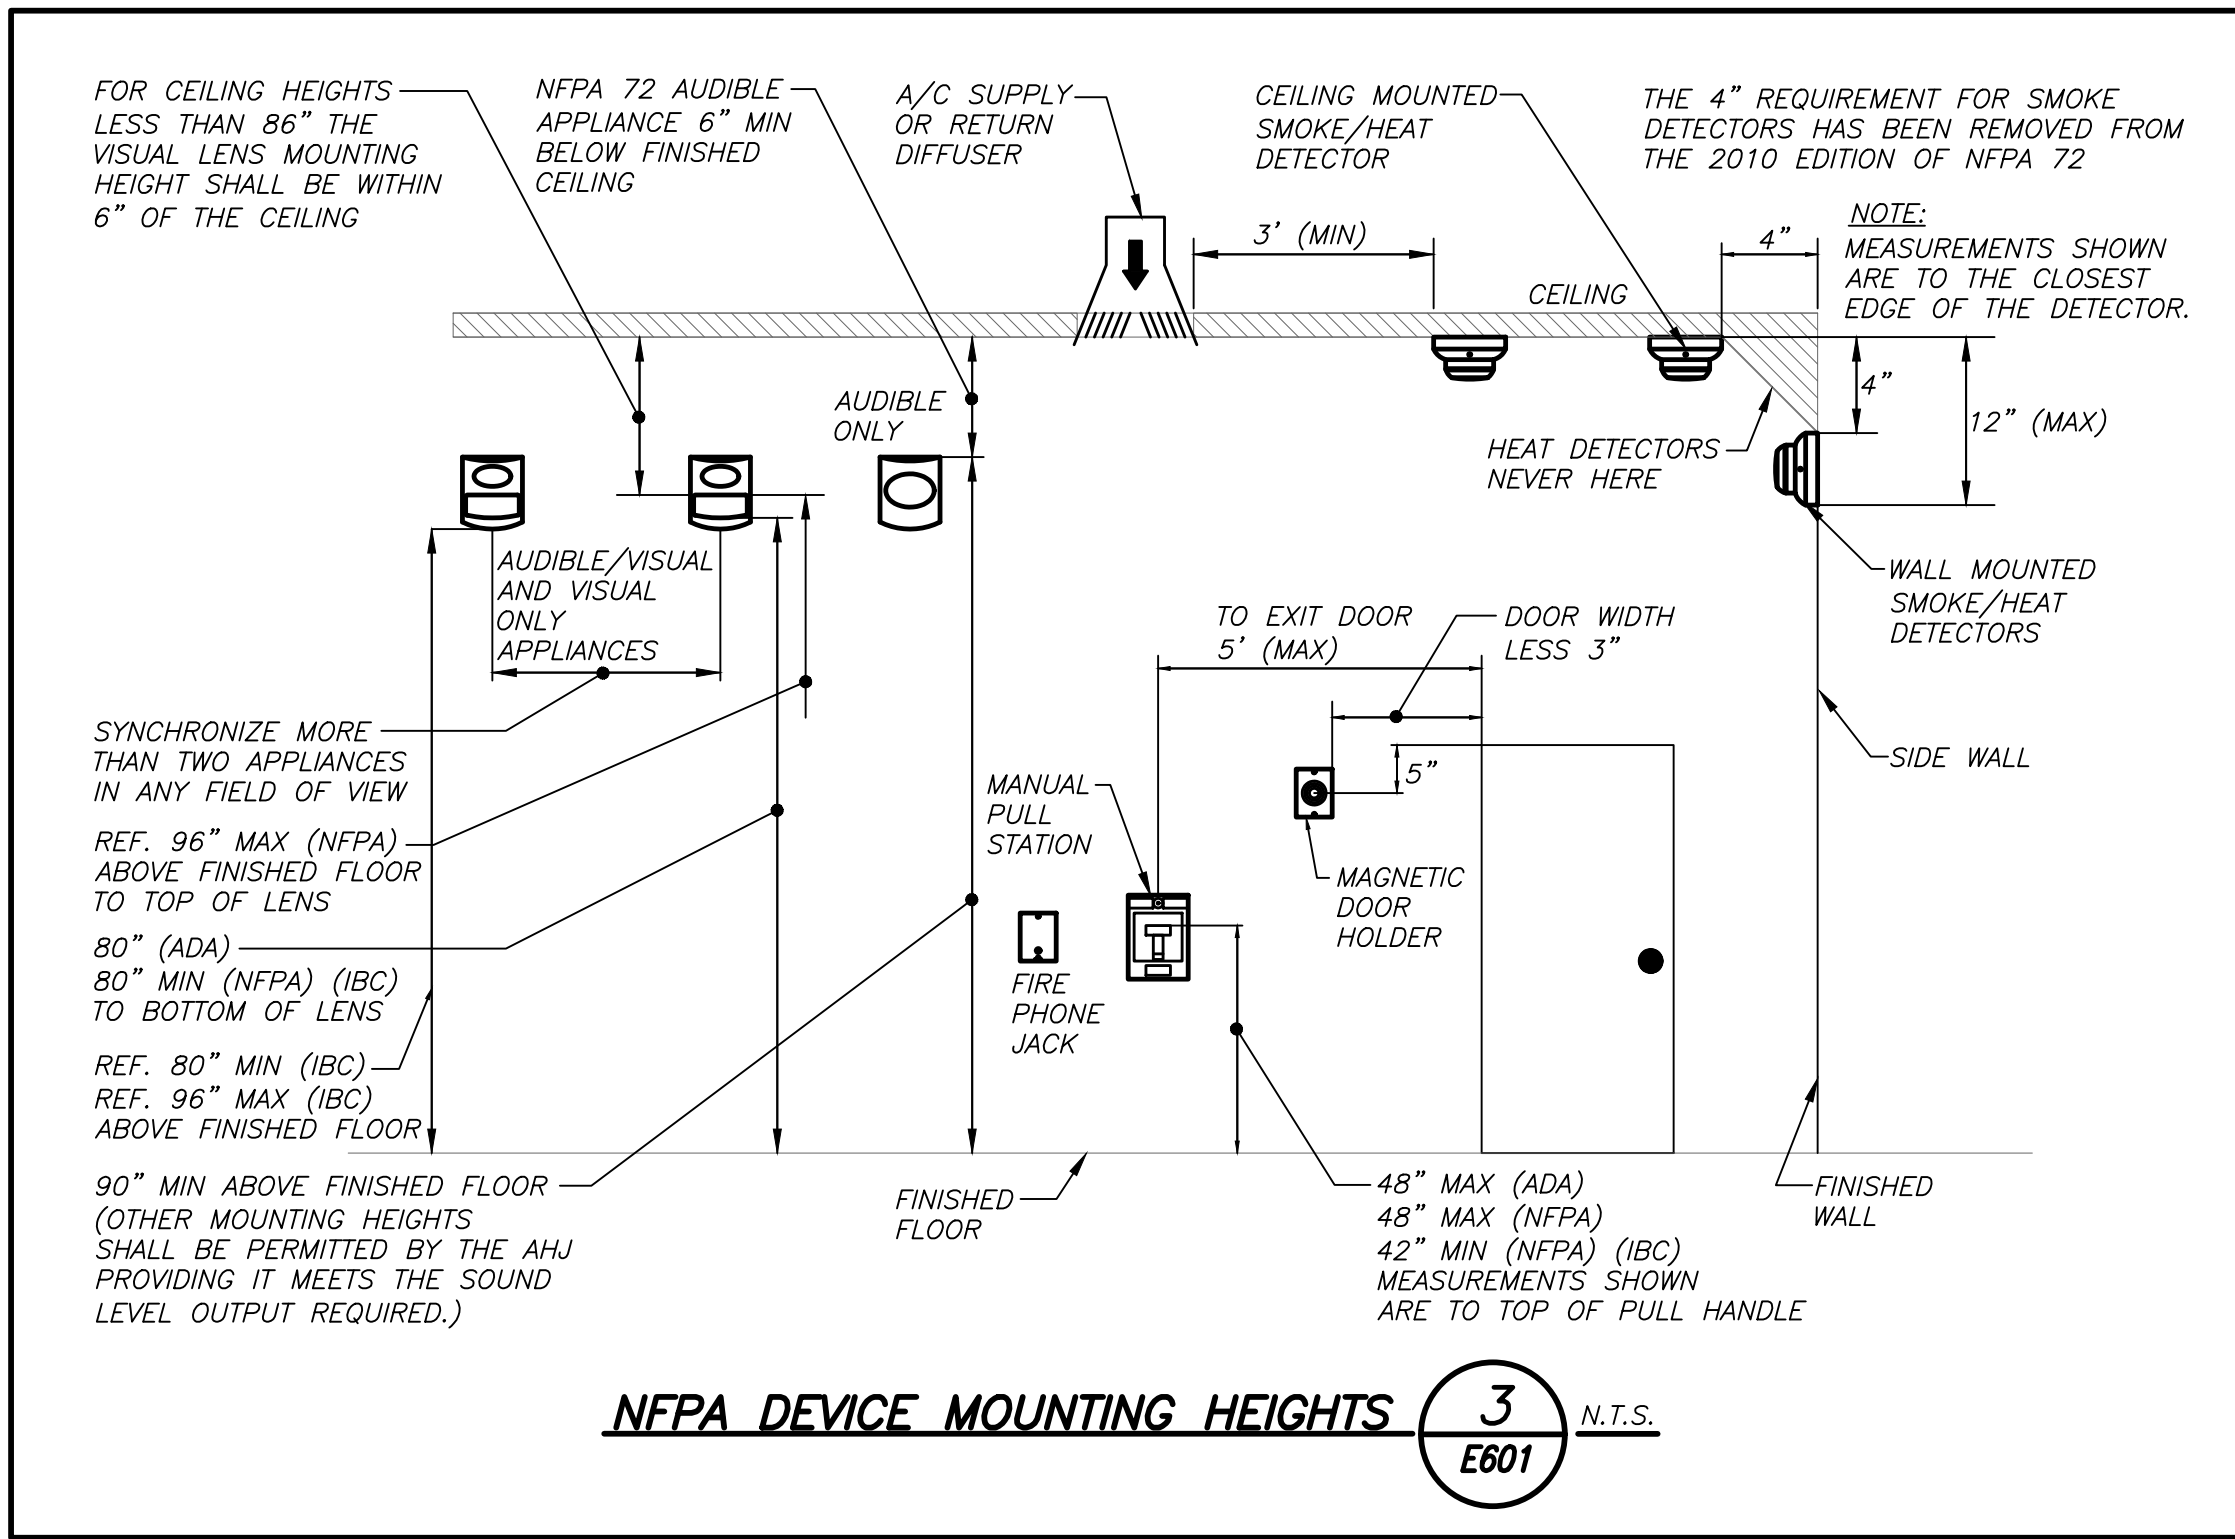
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No.	Date	Issue
3	03/15/21	CONSTRUCTION DOCUMENTS
1	02/01/21	SED SUBMISSION

Sheet Title
RISERS AND LIGHTING SCHEDULE

Job No. 2020-1051 Date 01/14/2021
Scale AS NOTED Drawn / Checked BGA/BGA

Sheet Number
E501

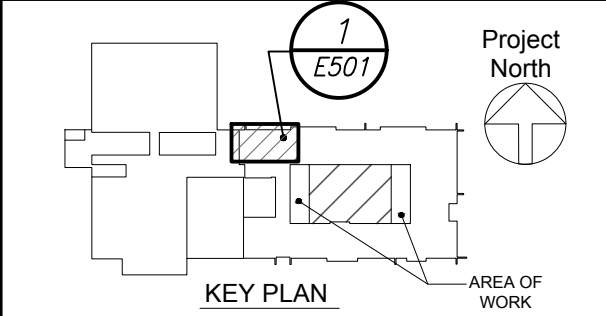

RELOCATED ELECTRICAL PANEL SCHEDULE																
PNL: PP-D (ER)				MOUNTING: SURFACE		X		MAIN LUGS ONLY		X		MAIN C BKR-		X		
208Y/120, 3 PHASE, 4 WIRE				(NEMA 1)		FLUSH		DOUBLE LUGS				ISOLATED GROUND BUS:				
22 .000MIN A.I.C. SYM						IN MCC		FEED THRU LUG		X		MAIN BUS -		TVSS:		
NEUTRAL: 100%								SHUNT TRIP MAIN		200A				NUMBER OF POLES: 54		
CKT No.	TRIP (AMP)	LOAD	WIRE	CND. (IN.)	KVA / PHASE			KVA / PHASE			CND. (IN.)	WIRE	LOAD	TRIP (AMP)	CKT No.	
1	20	GFI	2#12*1#12G	3/4	0.50						-	EXIST	EXISTING LOAD	30	2	
3	20	GFI	2#12*1#12G	3/4	0.50						-	EXIST	EXISTING LOAD	30	4	
5	20	SPARE	-	-							-	EXIST	EXISTING LOAD	30	6	
7	20	SPARE	-	-							-	EXIST	EXISTING LOAD	30	8	
9	-		-								-	EXIST	EXISTING LOAD	30	10	
11	3		-	-							-	EXIST	EXISTING LOAD	30	12	
13	20	EXISTING LOAD	-	-							-	EXIST	EXISTING LOAD	30	14	
15	20	EXISTING LOAD	-	-							-	EXIST	EXISTING LOAD	30	16	
17	20	EXISTING LOAD	-	-							-	EXIST	EXISTING LOAD	30	18	
19	15	EXISTING LOAD	EXIST	-							-	EXIST	EXISTING LOAD	30	20	
21	15	EXISTING LOAD	EXIST	-							-	EXIST	EXISTING LOAD	30	22	
23	15	EXISTING LOAD	EXIST	-							-	EXIST	EXISTING LOAD	30	24	
25	15	EXISTING LOAD	EXIST	-							-	EXIST	EXISTING LOAD	30	26	
27	15	SPARE	-	-							-	EXIST	EXISTING LOAD	30	28	
29	15	SPARE	-	-							-	EXIST	EXISTING LOAD	30	30	
31	30	EXISTING LOAD	-	-							-	EXIST	EXISTING LOAD	30	32	
33	3		EXIST	-	-							-	EXIST	EXISTING LOAD	30	34
35	3		-	-	-							-	EXIST	EXISTING LOAD	30	36
37	20	EXISTING LOAD	-	-							-	EXIST	EXISTING LOAD	30	38	
39	20	SPARE	-	-							-	EXIST	EXISTING LOAD	30	40	
41	20	SPARE	-	-							-	EXIST	EXISTING LOAD	30	42	
43	-	SPACE	-	-							-	EXIST	EXISTING LOAD	30	44	
45	-	SPACE	-	-							-	EXIST	EXISTING LOAD	30	46	
47	-	SPACE	-	-							-	EXIST	EXISTING LOAD	30	48	
49	-	SPACE	-	-							-	EXIST	EXISTING LOAD	30	50	
51	-	SPACE	-	-							-	EXIST	EXISTING LOAD	30	52	
53	-	SPACE	-	-							-	EXIST	EXISTING LOAD	30	54	
SUBTOTALS					0.50	0.50	0.00	0.00			0.00	0.00	SUBTOTALS			
TOTAL LOADS					0.5	KVA PHASE A			LIGHTING:			0.00 KVA				
					0.5	KVA PHASE B			RECEPTACLE:			0.00 KVA				
					0.0	KVA PHASE C			KITCHEN:			0.00 KVA				
TOTAL CONN. LOAD					1.0	KVA 3.0 A			MOTOR:			0.00 KVA				
TOTAL DEMAND LOAD					1.0	KVA 3.0 A			POWER:			1.00 KVA				
									TOTAL:			1.00 KVA				

RELOCATED ELECTRICAL PANEL SCHEDULE																							
PNL: LP-2A(ER)			MOUNTING: SURFACE			X		MAIN LUGS ONLY			X		MAIN C BKR:		GROUND BUS:		X						
208Y/120, 3 PHASE, 4 WIRE			(NEMA 1)			FLUSH			DOUBLE LUGS						ISOLATED GROUND BUS:								
22 .000MIN A.I.C. SYM						IN MCC			FEED THRU LUG			X		MAIN BUS -			TVSS:						
NEUTRAL: 100%									SHUNT TRIP MAIN			200A			NUMBER OF POLES:			42					
CKT No.		TRIP (AMP)		LOAD		WIRE		CND.		KVA / PHASE		KVA / PHASE		CND.		WIRE		LOAD		TRIP (AMP)		CKT No.	
								(IN.)		A		B		(IN.)									
1	20	EXIST LOAD		EXIST		-								-		-		SPARE		20		2	
3	20	LIGHTING		2#12+1#12G		3/4				0.80						-		EXIST		EXIST LOAD		20 4	
5	20	EXIST LOAD		EXIST		-										-		EXIST		EXIST LOAD		20 6	
7	20	EXIST LOAD		EXIST		-										-		EXIST		EXIST LOAD		20 8	
9	20	EXIST LOAD		EXIST		-										-		EXIST		EXIST LOAD		20 10	
11	20	EXIST LOAD		EXIST		-										-		EXIST		EXIST LOAD		20 12	
13	20	EXIST LOAD		EXIST		-										-		EXIST		EXIST LOAD		20 14	
15	20	EXIST LOAD		EXIST		-										-		EXIST		EXIST LOAD		20 16	
17	20	EXIST LOAD		EXIST		-										-		EXIST		EXIST LOAD		20 18	
19	20	EXIST LOAD		EXIST		-										-		EXIST		EXIST LOAD		20 20	
21	20	EXIST LOAD		EXIST		-										-		EXIST		EXIST LOAD		20 22	
23	20	EXIST LOAD		EXIST		-										-		EXIST		EXIST LOAD		20 24	
25	20	EXIST LOAD		EXIST		-										-		EXIST		EXIST LOAD		20 26	
27	20	EXIST LOAD		EXIST		-										-		EXIST		EXIST LOAD		20 28	
29	20	EXIST LOAD		EXIST		-										-		EXIST		EXIST LOAD		20 30	
31	20	EXIST LOAD		EXIST		-										-		EXIST		EXIST LOAD		20 32	
33	20	EXIST LOAD		EXIST		-										-		EXIST		EXIST LOAD		20 34	
35	20	EXIST LOAD		EXIST		-										-		EXIST		EXIST LOAD		20 36	
37	20	EXIST LOAD		EXIST		-										-		EXIST		EXIST LOAD		20 38	
39	20	EXIST LOAD		EXIST		-										-		EXIST		EXIST LOAD		20 40	
41	20	EXIST LOAD		EXIST		-										-		EXIST		EXIST LOAD		20 42	
SUBTOTALS								0.00		0.80		0.00		0.00				SUBTOTALS					
TOTAL LOADS				0.0		KVA		PHASE A								LIGHTING:		0.80 KVA					
				0.8		KVA		PHASE B								RECEPTACLE:		0.00 KVA					
				0.0		KVA		PHASE C								KITCHEN:		0.00 KVA					
TOTAL CONN. LOAD				0.8		KVA		2.0		A						MOTOR:		0.00 KVA					
TOTAL DEMAND LOAD				0.8		KVA		2.0		A						POWER:		0.00 KVA					
																TOTAL:		0.80 KVA					

BEFORE FABRICATION THIS CONTRACTOR SHALL VERIFY ALL MEASUREMENTS AND CONDITIONS ON JOB AND COORDINATE HIS WORK WITH THE WORK OF ALL OTHER CONTRACTORS

PVMS TOILET ROOM ALTERATIONS

CAPITAL PROJECTS PHASE 2

142 PEEKSKILL HOLLOW RD

PUTNAM VALLEY, NY 10579

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KG+D . ARCHITECTS PC

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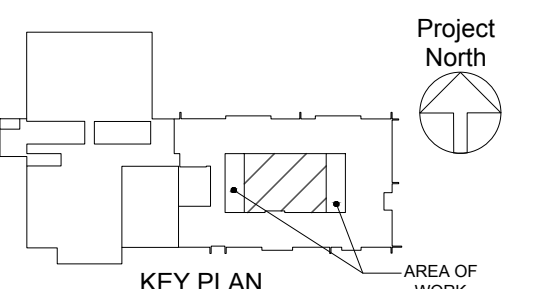
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NY SED PROJECT CONTROL NO.

48-05-03-04-0-004-016

CONSTRUCTION DOCUMENTS



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Professional Seal

3 03/15/21 CONSTRUCTION DOCUMENTS

1 02/01/21 SED SUBMISSION

No. Date Issue

Sheet Title

SCHEDULES AND DETAILS

Job No. 2020-1051 Date 01/14/2021

Scale AS NOTED Drawn / Checked BGA/BGA

Sheet Number

E601