




Architect: **Hamlin Design Group**

915 Broadway, Suite 101A Albany, New York 12207 Tel: 518.724.5159 Fax: 518.320.8633 Web: hamlindesigngroup.com

Hazardous Material Consultant:



MEP Engineer:

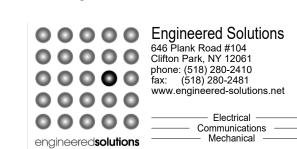



1031 Elm St. Peekskill, NY 10566

Peekskill City School District

Peekskill Reconstruction

SED Project: 66-15-00-01-0-005-020 HDG Project: 201 **Oakside Elementary**

200 Decatur Ave., Peekskill, NY 10566

SED Project: 66-15-00-01-0-008-017 HDG Project: 203

Woodside Elementary 612 Depew St., Peekskill, NY 10566

Woodside Elementary - Basement Floor Plan

SEE MECHANICAL AND DRAWINGS (NO ARCHITECTURAL SCOPE) —

LEGEND

EXISTING WALL CONST. TO REMAIN

> EXISTING DOOR AND FRAME TO REMAIN



AREA OF WORK (SEE ELECTRICAL & MECHANICAL FOR ADDITIONAL DETAILS)



REFERENCE PHOTO

GENERAL REMOVAL NOTES

W-A.100 SCALE: NTS

- ALL WALL, FLOORING, & CLG. SURFACES TO REMAIN WHICH ARE DAMAGED DURING REMOVALS SHALL BE REPAIRED TO MATCH SURROUNDING MATERIALS & PREPARED READY FOR APPLICATION OF REQ'D FINISHES. PROVIDE MATERIALS TO MATCH EXIST. MATERIALS & SURFACES "IN-KIND". THIS INCLUDES BUT NOT LIMITED TO REPLACEMENT OF FINISH MAT'LS, DRYWALL CONST., MASONRY, & MASONRY REPAIRS, TAPING, SANDING, & PAINTING ETC.
- DIMENSIONED REMOVALS ARE FOR GENERAL INFORMATIONAL PURPOSES ONLY. COORDINATE
- EXACT EXTENT OF ALL REMOVALS AND MODIFICATIONS W/ CONST. WHERE REMOVALS OF MASONRY OCCURS, TOOTH IN MASONRY TO MATCH EXIST. COURSING &

CONST. MATCH EXIST. MASONRY MAT'LS, USE SALVAGED MASONRY FOR PATCHING & REPAIR.

- R4. AT ALL MASONRY OPENINGS OF REMOVALS PROVIDE TEMPORARY SHORINGS TO MAINTAIN STRUCTURAL INTEGRITY OF EXISTING CONST.
- SEE MECHANICAL, ELECTRICAL, AND PLUMBING FOR ADDITIONAL REMOVALS.
- CONTRACTOR SHALL PROVIDE PROTECTION OVER EXISTING FLOORING SYSTEMS AT ALL TIMES UNLESS FLOORING IS SCHEDULED FOR REMOVAL.
- HAZARDOUS MATERIAL SHALL BE REMEDIATED BY CERTIFIED HAZARDOUS MATERIAL CONTRACTOR. COORDINATE ALL WORK WITH HAZARDOUS MATERIAL DOCUMENTS.

KEYED REMOVAL NOTES

REMOVE EXISTING VINYL TILE FINISH FLOORING & CONCEALED FLOORING MATERIALS COMPLETE, INCLUDING BUT NOT LIMITED TO ADHESIVES, AS REQUIRED FOR INSTALLATION OF NEW UNIT VENT.

SEE MECHANICAL AND DRAWINGS (NO ARCHITECTURAL SCOPE)

- REMOVE WALL CONST. AS REQUIRED FOR INSTALLATION OF NEW UNIT VENT AND LOUVER. SEE MECHANICAL DRAWINGS.
- REMOVE EXISTING CEILING SYSTEM COMPLETE. INCLUDING SUSPENSION WIRES, ANCHORS, CLIPS, FASTENERS, CHANNELS, ETC. (V.I.F.) SALVAGE EXISTING CEILING TILES, LIGHT FIXTURES, SMOKE DETECTORS, SECURITY CAMERAS, AND SPEAKERS.
- REMOVE AND SALVAGE EXISTING WINDOW SASH AS REQUIRED FOR INSTALLATION OF NEW UNIT VENT. SEE MECHANICAL DRAWINGS.
- REMOVE AIR CONDITIONER WINDOW UNIT AND PANEL. RETURN TO OWNER

GENERAL PLAN NOTES

- G1. ALL DIMENSIONS ARE TO FINISH FACE AT EXISTING CONST. AND UNIT MASONRY CONSTRUCTION AND TO FACE OF FRAMING AT DRYWALL CONSTRUCTION UNLESS OTHERWISE NOTED.
- G2. ± NOTATIONS ARE USED IN DIMENSION STRINGS TO ACCOUNT FOR VARIATIONS BETWEEN DRAWINGS AND FIELD CONDITIONS. CONTRACTOR SHALL VERIFY ALL ± DIMENSION DURING LAYOUT AND INFORM ARCHITECT OF ANY DISCREPANCIES OR NECESSARY MODIFICATIONS PRIOR TO PROCEEDING WITH CONSTRUCTION.
- G3. CLEAN PATCH & REPAIR EXISTING WALLS AS REQ'D TO RESTORE TO LIKE NEW CONDITION. FINISH SURFACES TO BE SMOOTH AND FLUSH WITH ADJACENT SURFACES AND READY TO RECEIVE PAINT.

KEYED PLAN NOTES

- INSTALL NEW FLOORING TO MATCH EXIST WHERE DAMAGED DURING REMOVAL / INSTALLATION.
- PATCH & REPAIR EXTERIOR WALL CONST. AS REQUIRED FOR NEW UNIT VENT INSTALLATION.
- INSTALL NEW 2'X2' SUSPENDED ACOUSTICAL CEILING SYSTEM IN EXISTING LOCATION USING SALVAGED CEILING TILES.
- PAINT ENTIRE WALL BELOW WINDOW UNITS TO MATCH EXISTING ROOM COLOR AND FINISH.



DESCRIPTION Basement Plan


DRAWN BY:

W-A.100.00 (ALTERNATE NO. 1)

ISSUE: 03/19/2021

PLOT DATE: 3/18/2021 FILE LOCATION: /Users/TimG/Desktop/Enter_copied/PRJ/PRJ_203 PCSD Woodside ES/03 Design/04 Construction Docs/01 Plot USER: TimG

Sheets/W-A.100.00.dwg

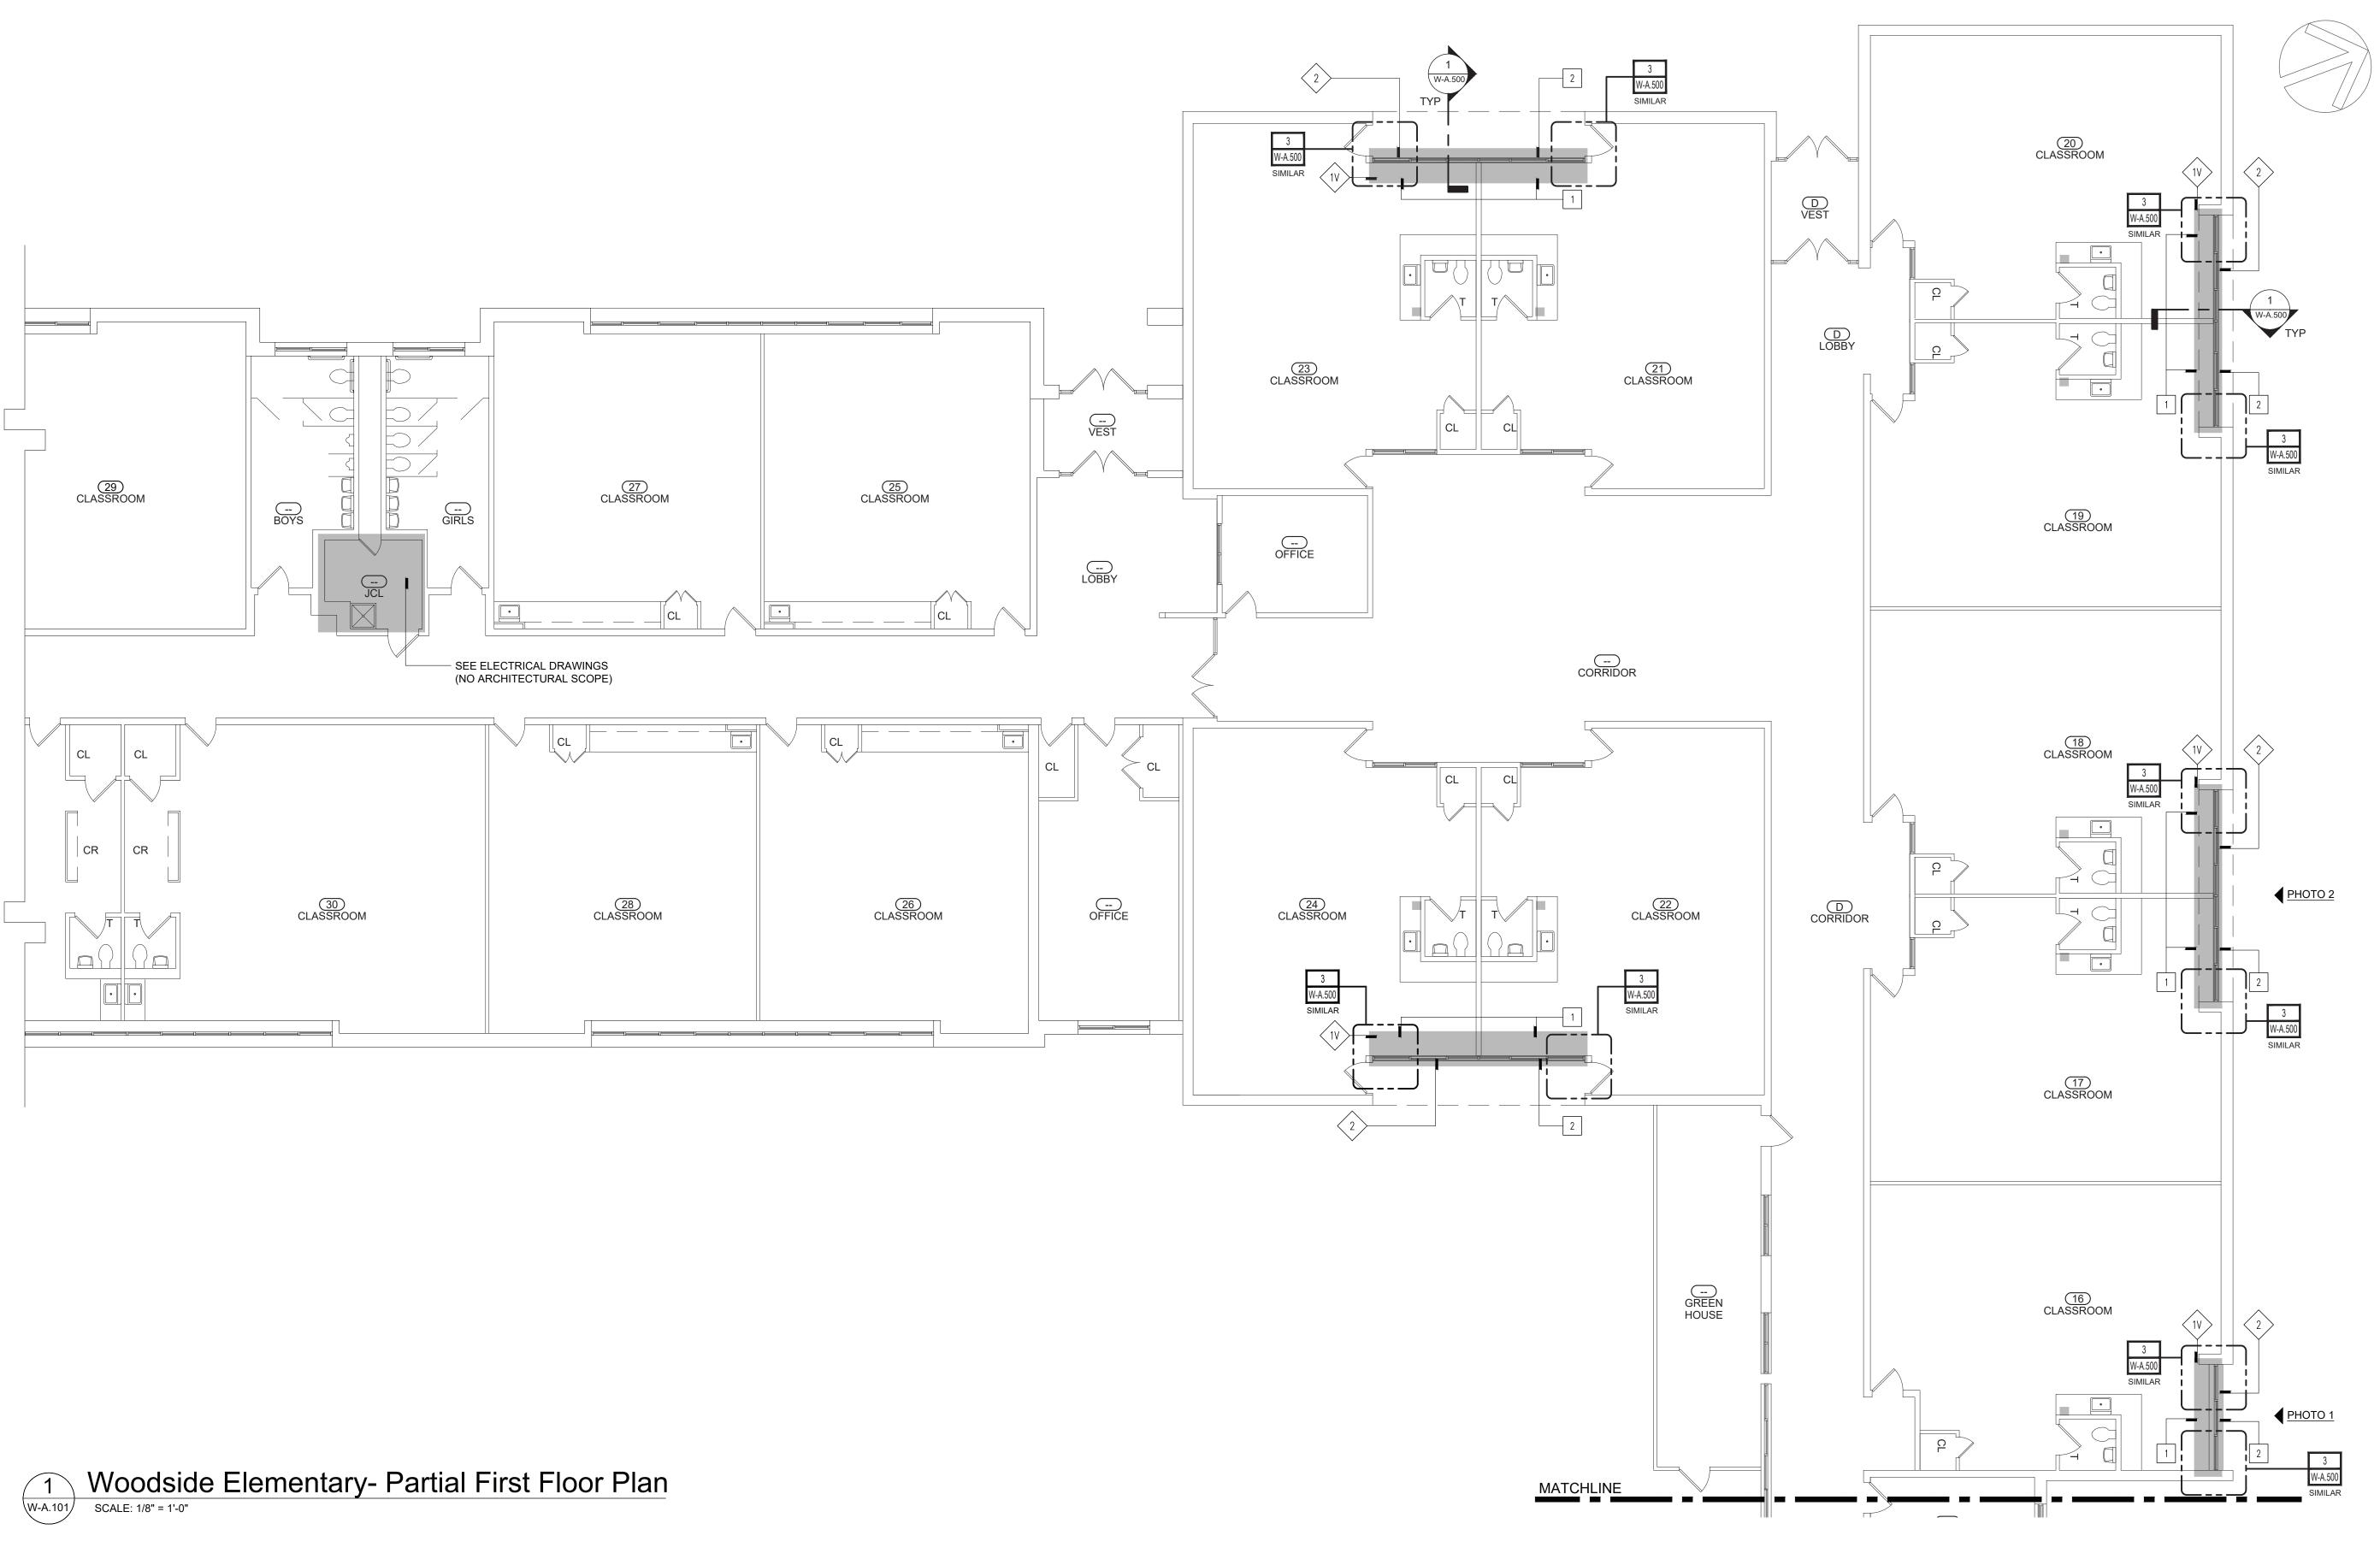

LEGEND

EXISTING WALL CONST. TO REMAIN

EXISTING DOOR AND FRAME TO REMAIN

AREA OF WORK (SEE ELECTRICAL & MECHANICAL FOR

ADDITIONAL DETAILS) REFERENCE PHOTO

FILE LOCATION: /Volumes/hdglogin.com/enter/PRJ/PRJ_203 PCSD Woodside ES/03 Design/04 Construction Docs/01 Plot Sheets/W-A.101.00.dwg

GENERAL REMOVAL NOTES

- ALL WALL, FLOORING, & CLG. SURFACES TO REMAIN WHICH ARE DAMAGED DURING REMOVALS SHALL BE REPAIRED TO MATCH SURROUNDING MATERIALS & PREPARED READY FOR APPLICATION OF REQ'D FINISHES. PROVIDE MATERIALS TO MATCH EXIST. MATERIALS & SURFACES "IN-KIND". THIS INCLUDES BUT NOT LIMITED TO REPLACEMENT OF FINISH MAT'LS, DRYWALL CONST., MASONRY, & MASONRY REPAIRS, TAPING, SANDING, & PAINTING ETC.
- DIMENSIONED REMOVALS ARE FOR GENERAL INFORMATIONAL PURPOSES ONLY. COORDINATE
- EXACT EXTENT OF ALL REMOVALS AND MODIFICATIONS W/ CONST.

WHERE REMOVALS OF MASONRY OCCURS, TOOTH IN MASONRY TO MATCH EXIST. COURSING &

CONST. MATCH EXIST. MASONRY MAT'LS, USE SALVAGED MASONRY FOR PATCHING & REPAIR.

PLOT DATE: 3/16/2021

- R4. AT ALL MASONRY OPENINGS OF REMOVALS PROVIDE TEMPORARY SHORINGS TO MAINTAIN
- STRUCTURAL INTEGRITY OF EXISTING CONST.
- CONTRACTOR SHALL PROVIDE PROTECTION OVER EXISTING FLOORING SYSTEMS AT ALL TIMES UNLESS FLOORING IS SCHEDULED FOR REMOVAL.
- HAZARDOUS MATERIAL SHALL BE REMEDIATED BY CERTIFIED HAZARDOUS MATERIAL CONTRACTOR. COORDINATE ALL WORK WITH HAZARDOUS MATERIAL DOCUMENTS.

SEE MECHANICAL, ELECTRICAL, AND PLUMBING FOR ADDITIONAL REMOVALS.

KEYED REMOVAL NOTES

- REMOVE EXISTING VINYL TILE FINISH FLOORING & CONCEALED FLOORING MATERIALS COMPLETE, INCLUDING BUT NOT LIMITED TO ADHESIVES, AS REQUIRED FOR INSTALLATION OF NEW UNIT VENT.
- REMOVE WALL CONST. AS REQUIRED FOR INSTALLATION OF NEW UNIT VENT AND LOUVER. SEE MECHANICAL DRAWINGS.
- REMOVE EXISTING CEILING SYSTEM COMPLETE. INCLUDING SUSPENSION WIRES, ANCHORS, CLIPS, FASTENERS, CHANNELS, ETC. (V.I.F.) SALVAGE EXISTING CEILING TILES, LIGHT FIXTURES, SMOKE DETECTORS, SECURITY CAMERAS, AND SPEAKERS.
- REMOVE AND SALVAGE EXISTING WINDOW SASH AS REQUIRED FOR INSTALLATION OF NEW UNIT VENT. SEE MECHANICAL DRAWINGS.
- REMOVE AIR CONDITIONER WINDOW UNIT AND PANEL. RETURN TO OWNER

GENERAL PLAN NOTES

- G1. ALL DIMENSIONS ARE TO FINISH FACE AT EXISTING CONST. AND UNIT MASONRY CONSTRUCTION AND TO FACE OF FRAMING AT DRYWALL CONSTRUCTION UNLESS OTHERWISE NOTED.
- G2. ± NOTATIONS ARE USED IN DIMENSION STRINGS TO ACCOUNT FOR VARIATIONS BETWEEN DRAWINGS AND FIELD CONDITIONS. CONTRACTOR SHALL VERIFY ALL ± DIMENSION DURING LAYOUT AND INFORM ARCHITECT OF ANY DISCREPANCIES OR NECESSARY MODIFICATIONS PRIOR TO PROCEEDING WITH CONSTRUCTION.
- CLEAN PATCH & REPAIR EXISTING WALLS AS REQ'D TO RESTORE TO LIKE NEW CONDITION. FINISH SURFACES TO BE SMOOTH AND FLUSH WITH ADJACENT SURFACES AND READY TO RECEIVE PAINT.

KEYED PLAN NOTES

- INSTALL NEW FLOORING TO MATCH EXIST WHERE DAMAGED DURING REMOVAL / INSTALLATION.
- PATCH & REPAIR EXTERIOR WALL CONST. AS REQUIRED FOR NEW UNIT VENT INSTALLATION.
- INSTALL NEW 2'X2' SUSPENDED ACOUSTICAL CEILING SYSTEM IN EXISTING LOCATION USING SALVAGED CEILING TILES.

PAINT ENTIRE WALL BELOW WINDOW UNITS TO MATCH EXISTING ROOM COLOR AND FINISH.



Architect: **Hamlin Design Group**

915 Broadway, Suite 101A Albany, New York 12207 Tel: 518.724.5159 Fax: 518.320.8633 Web: hamlindesigngroup.com

Hazardous Material Consultant:



MEP Engineer:

engineered**solutions**

Engineered Solutions
646 Plank Road #104
Clifton Park, NY 12061
phone: (518) 280-2410
fax: (518) 280-2481
www.engineered-solutions net www.engineered-solutions.net 00000



1031 Elm St. Peekskill, NY 10566

Peekskill City School District

Peekskill Reconstruction

SED Project: 66-15-00-01-0-005-020 HDG Project: 201 **Oakside Elementary**

200 Decatur Ave., Peekskill, NY 10566

SED Project: 66-15-00-01-0-008-017 HDG Project: 203

Woodside Elementary 612 Depew St., Peekskill, NY 10566

DRAWN BY:


ISSUE: 03/19/2021



DESCRIPTION Partial First Floor Plan

W-A.101.00



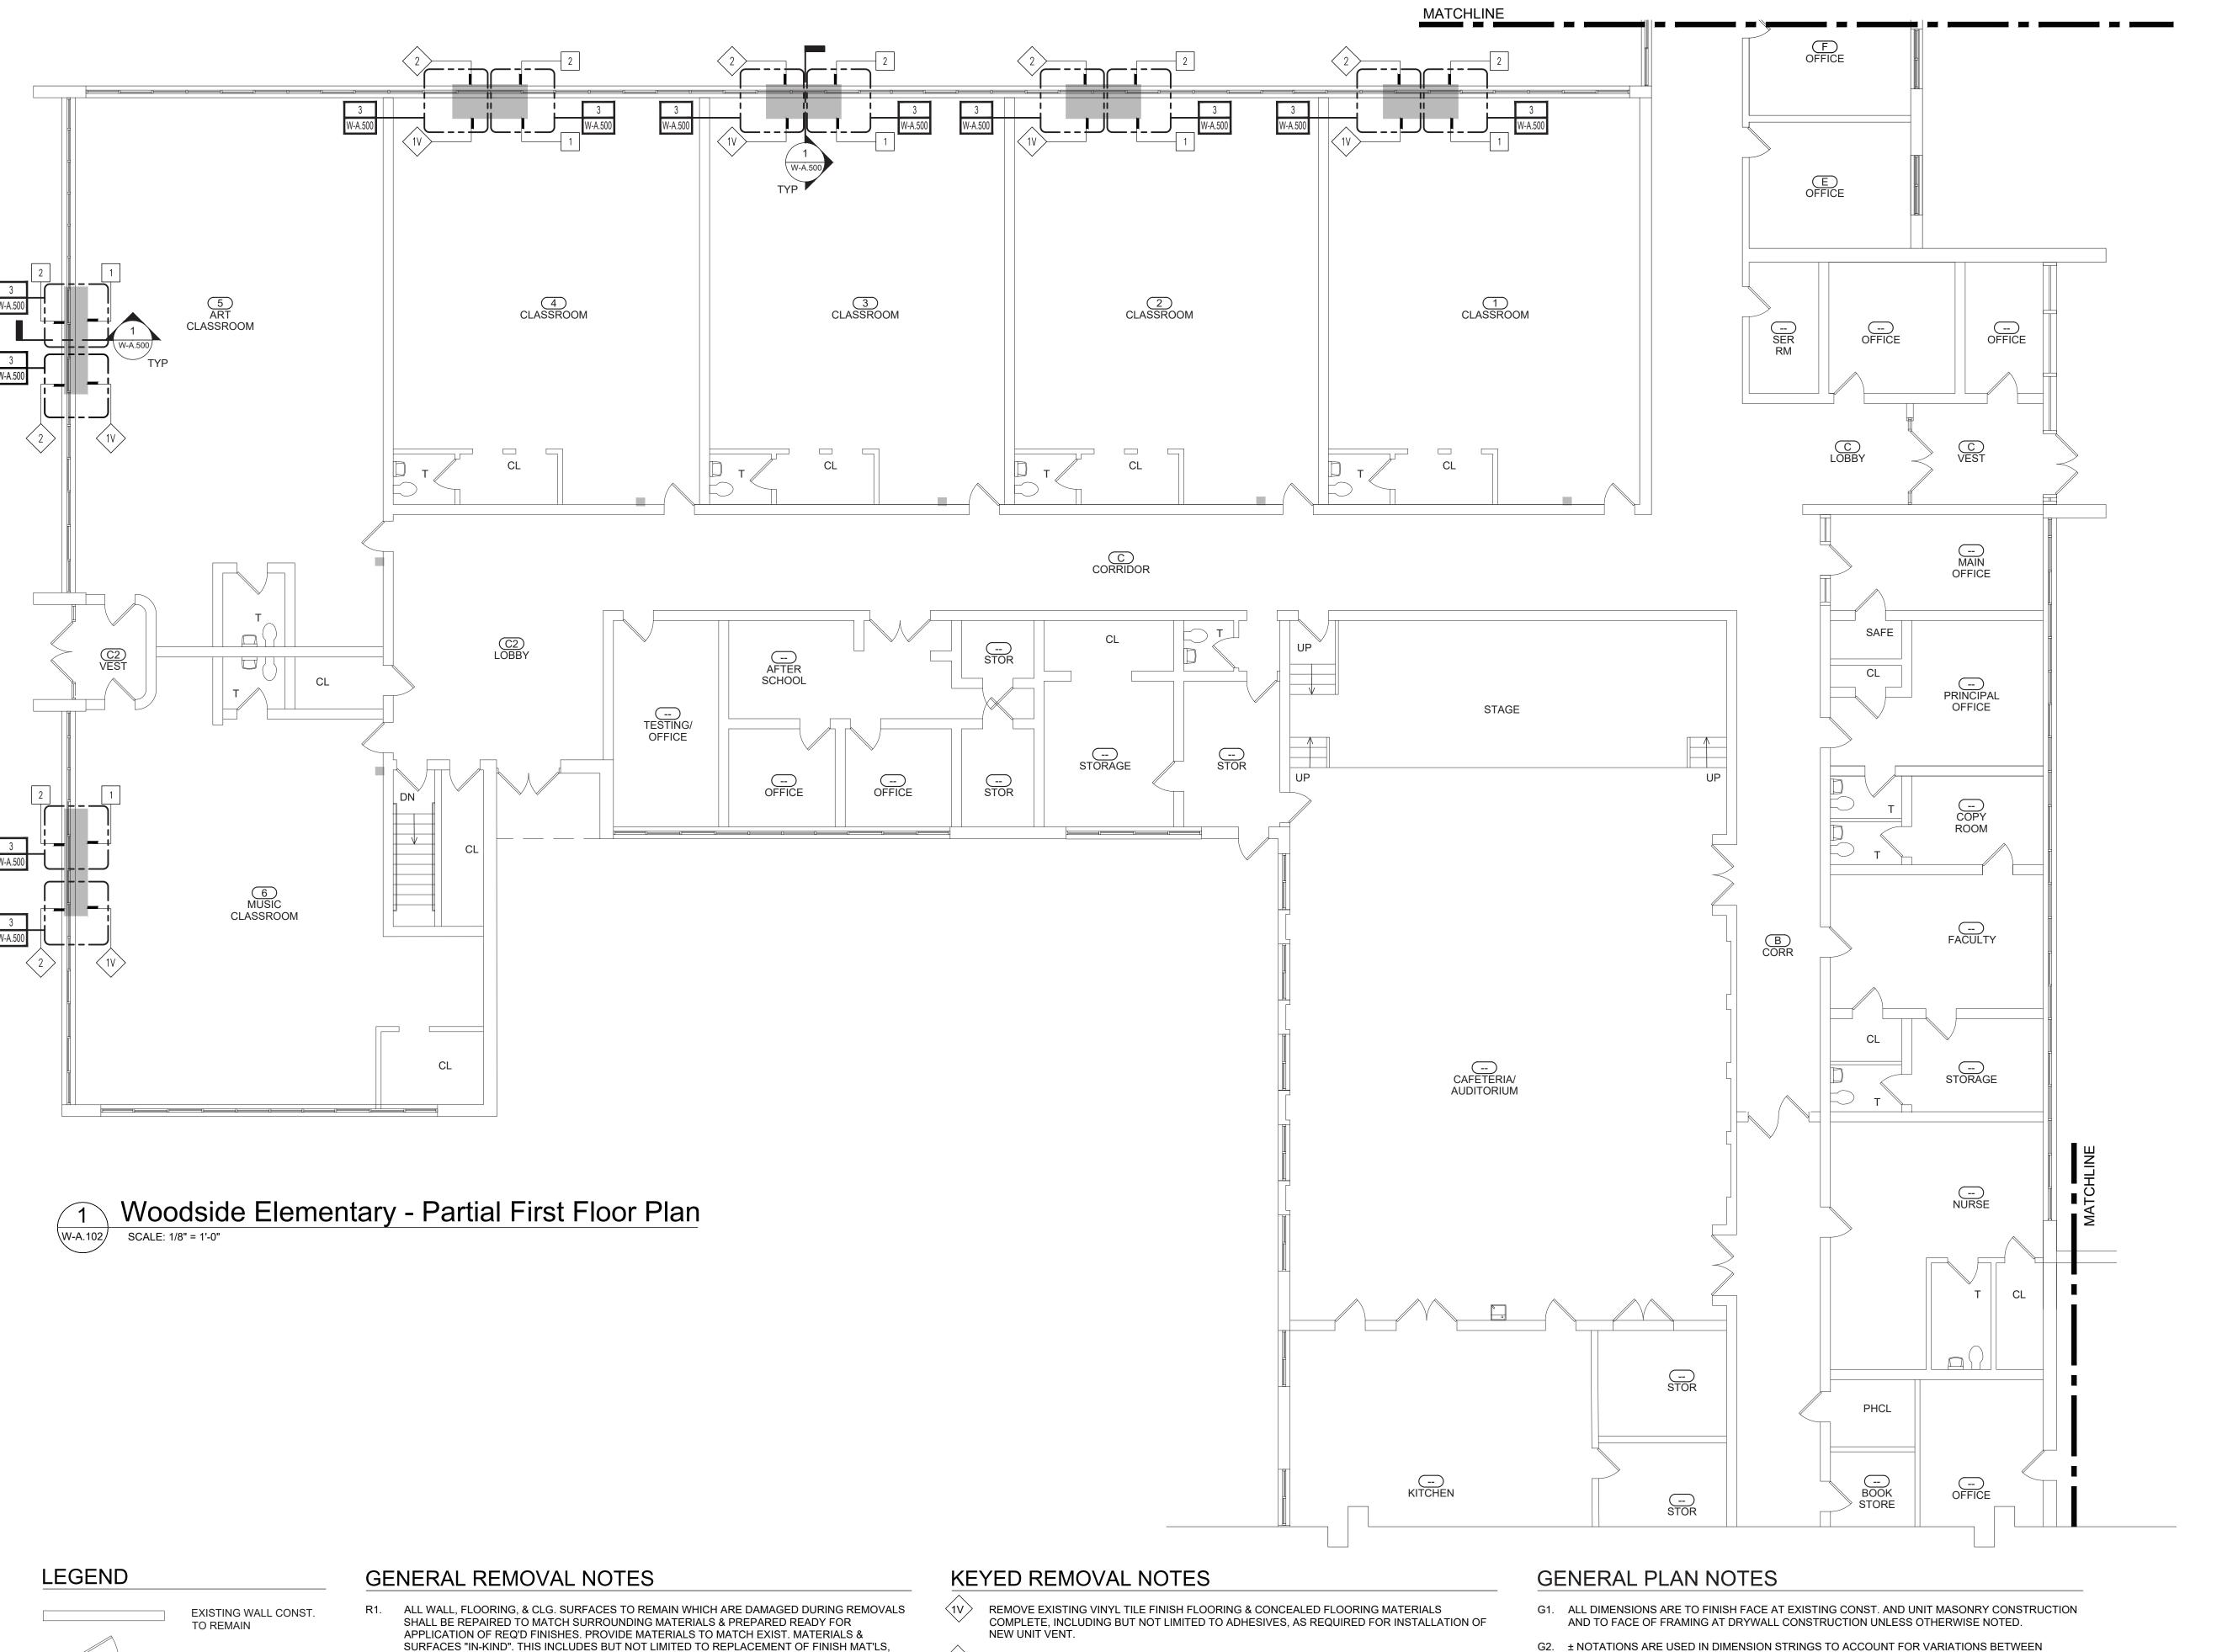

- REMOVE WALL CONST. AS REQUIRED FOR INSTALLATION OF NEW UNIT VENT AND LOUVER. SEE MECHANICAL DRAWINGS.
- REMOVE EXISTING CEILING SYSTEM COMPLETE. INCLUDING SUSPENSION WIRES, ANCHORS, CLIPS, FASTENERS, CHANNELS, ETC. (V.I.F.) SALVAGE EXISTING CEILING TILES, LIGHT FIXTURES, SMOKE DETECTORS, SECURITY CAMERAS, AND SPEAKERS.
- CONST. MATCH EXIST. MASONRY MAT'LS, USE SALVAGED MASONRY FOR PATCHING & REPAIR. REMOVE AND SALVAGE EXISTING WINDOW SASH AS REQUIRED FOR INSTALLATION OF NEW R4. AT ALL MASONRY OPENINGS OF REMOVALS PROVIDE TEMPORARY SHORINGS TO MAINTAIN UNIT VENT. SEE MECHANICAL DRAWINGS. STRUCTURAL INTEGRITY OF EXISTING CONST.
 - REMOVE AIR CONDITIONER WINDOW UNIT AND PANEL. RETURN TO OWNER SEE MECHANICAL, ELECTRICAL, AND PLUMBING FOR ADDITIONAL REMOVALS.
- CONTRACTOR SHALL PROVIDE PROTECTION OVER EXISTING FLOORING SYSTEMS AT ALL TIMES UNLESS FLOORING IS SCHEDULED FOR REMOVAL.

DRYWALL CONST., MASONRY, & MASONRY REPAIRS, TAPING, SANDING, & PAINTING ETC.

EXACT EXTENT OF ALL REMOVALS AND MODIFICATIONS W/ CONST.

DIMENSIONED REMOVALS ARE FOR GENERAL INFORMATIONAL PURPOSES ONLY. COORDINATE

WHERE REMOVALS OF MASONRY OCCURS, TOOTH IN MASONRY TO MATCH EXIST. COURSING &

EXISTING DOOR AND

FRAME TO REMAIN

AREA OF WORK

(SEE ELECTRICAL &

REFERENCE PHOTO

ADDITIONAL DETAILS)

MECHANICAL FOR

- HAZARDOUS MATERIAL SHALL BE REMEDIATED BY CERTIFIED HAZARDOUS MATERIAL CONTRACTOR. COORDINATE ALL WORK WITH HAZARDOUS MATERIAL DOCUMENTS.

KEYED PLAN NOTES INSTALL NEW FLOORING TO MATCH EXIST WHERE DAMAGED DURING REMOVAL / INSTALLATION.

PRIOR TO PROCEEDING WITH CONSTRUCTION.

PATCH & REPAIR EXTERIOR WALL CONST. AS REQUIRED FOR NEW UNIT VENT INSTALLATION.

DRAWINGS AND FIELD CONDITIONS. CONTRACTOR SHALL VERIFY ALL ± DIMENSION DURING


LAYOUT AND INFORM ARCHITECT OF ANY DISCREPANCIES OR NECESSARY MODIFICATIONS

CLEAN PATCH & REPAIR EXISTING WALLS AS REQ'D TO RESTORE TO LIKE NEW CONDITION. FINISH

SURFACES TO BE SMOOTH AND FLUSH WITH ADJACENT SURFACES AND READY TO RECEIVE PAINT.

- INSTALL NEW 2'X2' SUSPENDED ACOUSTICAL CEILING SYSTEM IN EXISTING LOCATION USING
- SALVAGED CEILING TILES. PAINT ENTIRE WALL BELOW WINDOW UNITS TO MATCH EXISTING ROOM COLOR AND FINISH.

Depew St WOODSIDE KEY PLAN

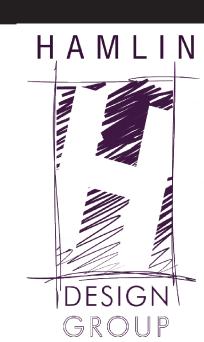

Architect: **Hamlin Design Group**

915 Broadway, Suite 101A Albany, New York 12207 Tel: 518.724.5159 Fax: 518.320.8633 Web: hamlindesigngroup.com

Hazardous Material Consultant:



engineered**solutions**

NYS/NJS Certified WBE & SBA EDWOSB & DBE

MEP Engineer:

Engineered Solutions
646 Plank Road #104
Clifton Park, NY 12061
phone: (518) 280-2410
fax: (518) 280-2481
www.engineered-solutions net www.engineered-solutions.net 00000



1031 Elm St. Peekskill, NY 10566

Peekskill City School District

Peekskill Reconstruction

SED Project: 66-15-00-01-0-005-020 HDG Project: 201 **Oakside Elementary**

200 Decatur Ave., Peekskill, NY 10566

Peekskill, NY 10566

SED Project: 66-15-00-01-0-008-017 HDG Project: 203

Woodside Elementary 612 Depew St.,

DRAWN BY:

ISSUE: 03/19/2021




DESCRIPTION Partial First Floor Plan

> W-A.102.00 (ALTERNATE NO. 2)

FILE LOCATION: /Users/TimG/Desktop/Enter_copied/PRJ/PRJ_203 PCSD Woodside ES/03 Design/04 Construction Docs/01 Plot Sheets/W-A.102.00.dwg USER: TimG

PLOT DATE: 3/18/2021

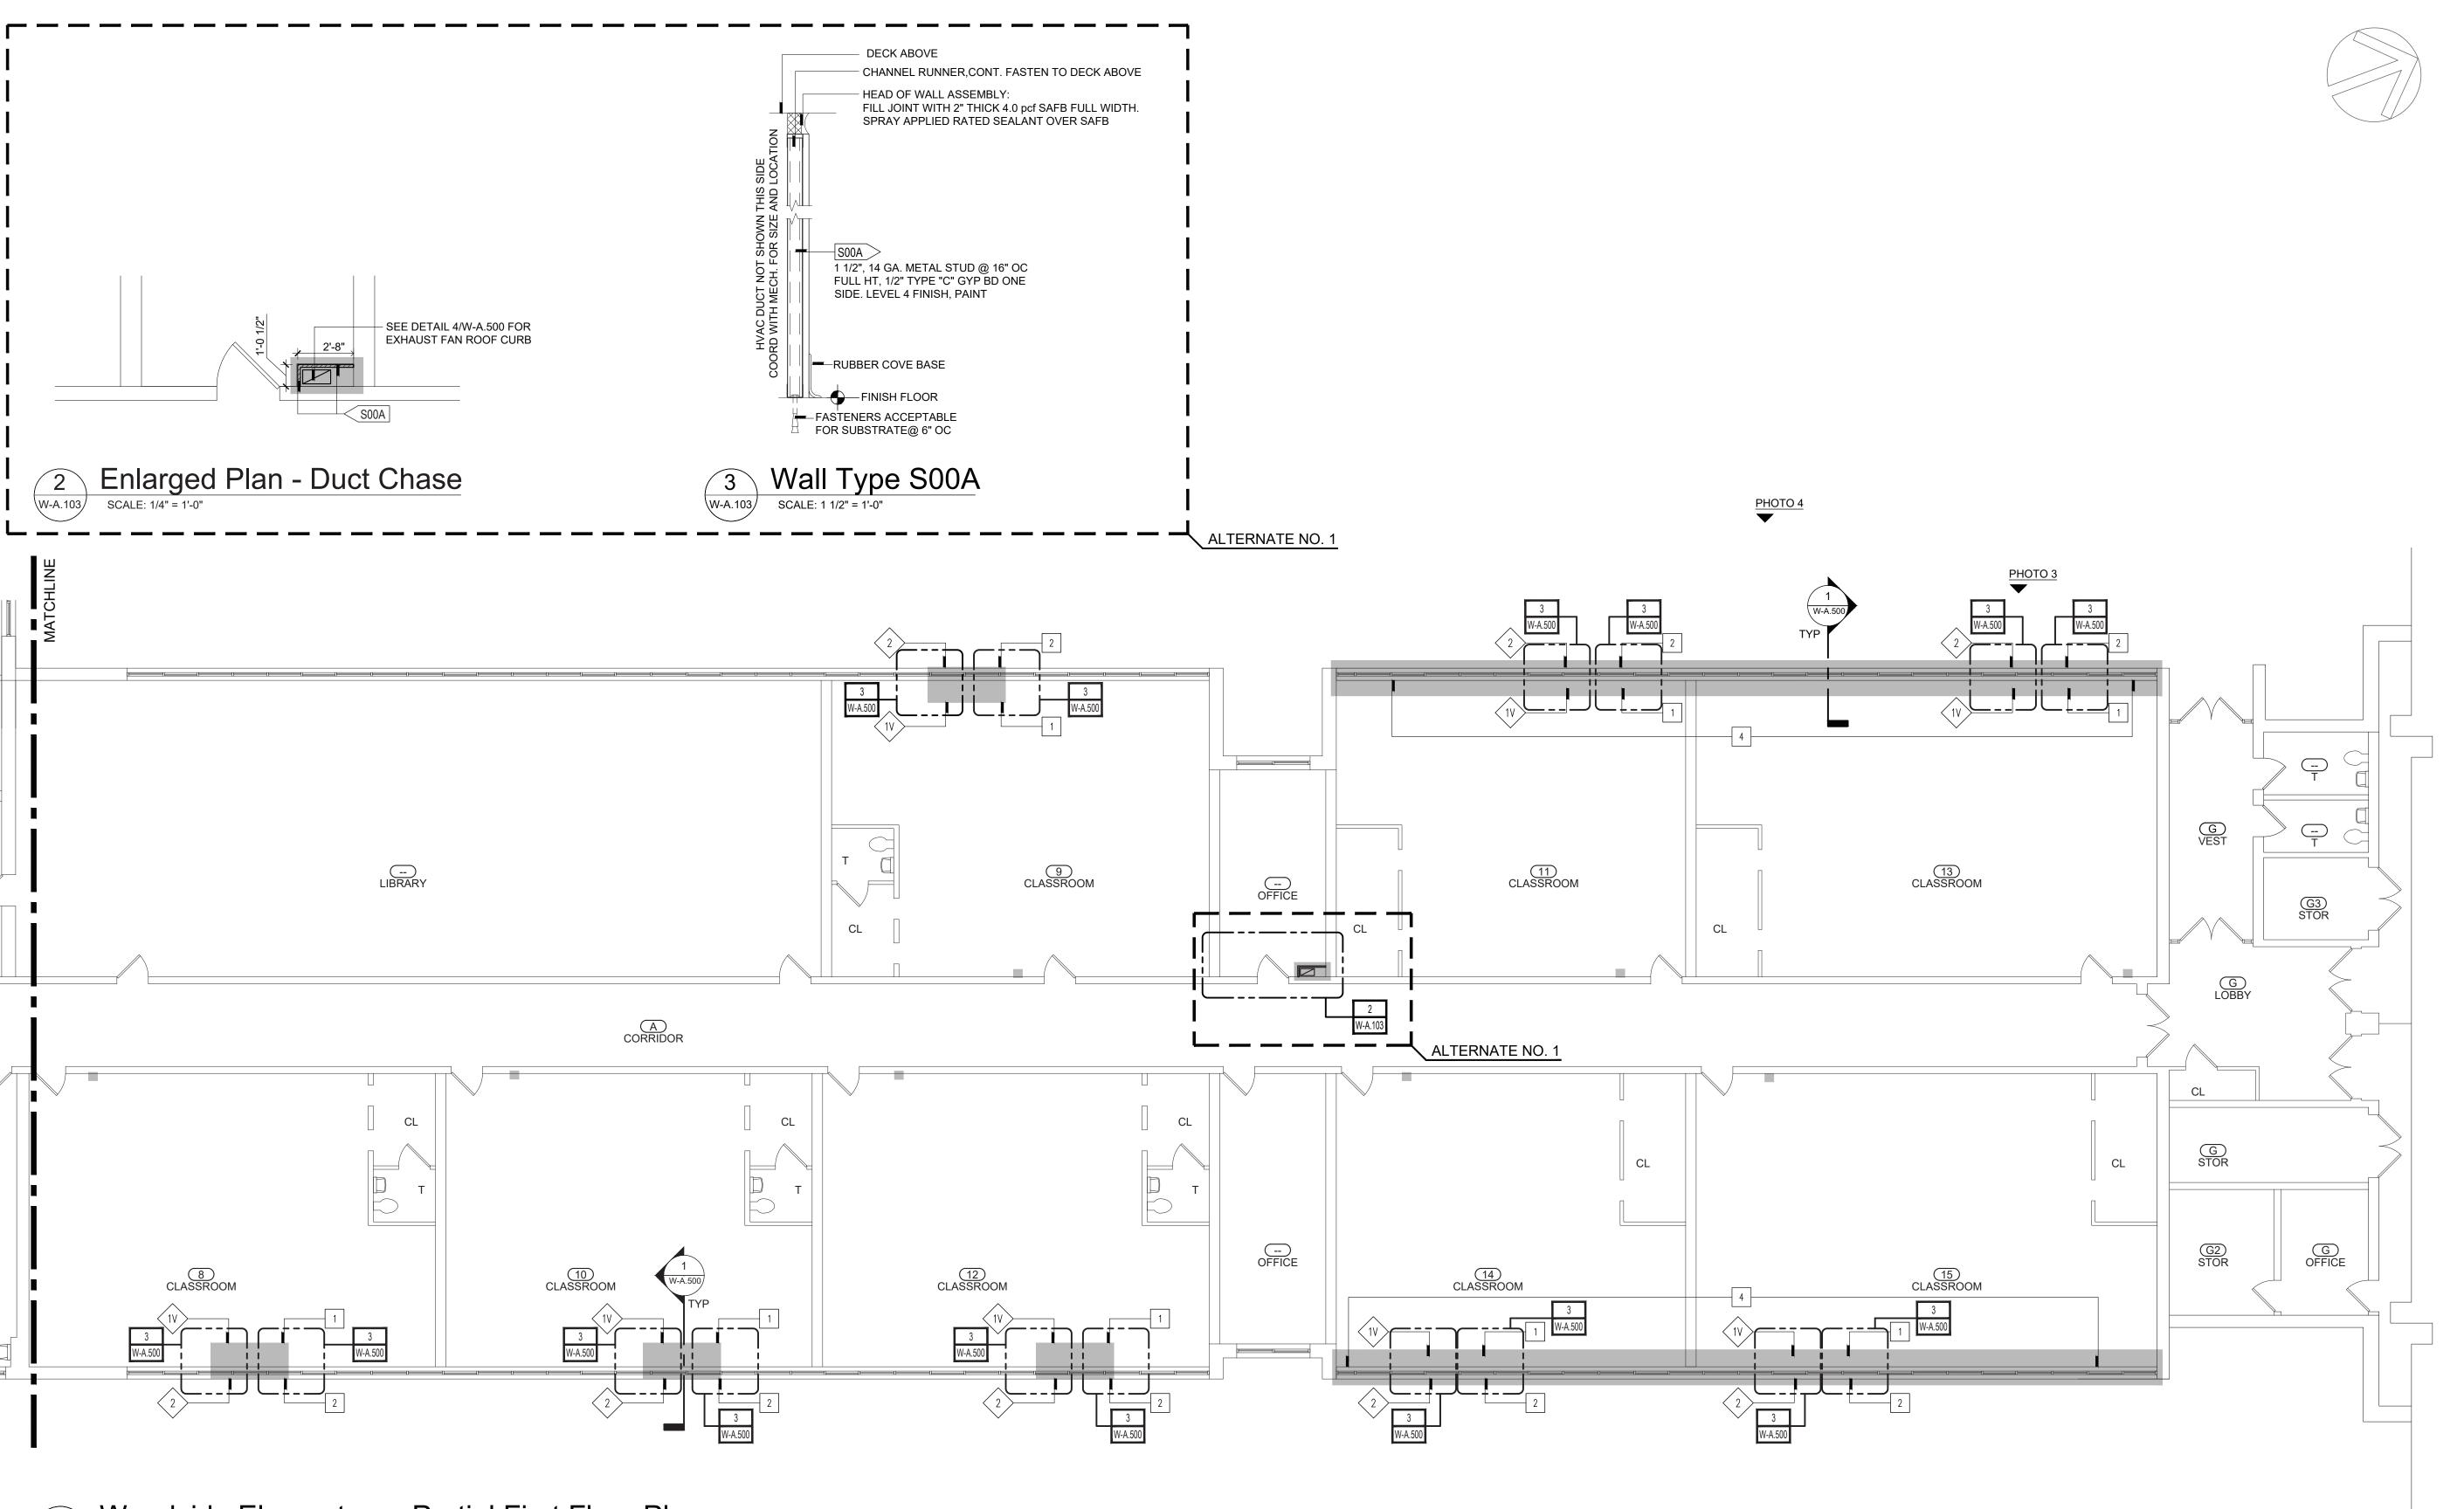

1 Woodside Elementary - Partial First Floor Plan

EXISTING WALL CONST. TO REMAIN EXISTING DOOR AND FRAME TO REMAIN AREA OF WORK

(SEE ELECTRICAL &

REFERENCE PHOTO

ADDITIONAL DETAILS)

MECHANICAL FOR

GENERAL REMOVAL NOTES

- R1. ALL WALL, FLOORING, & CLG. SURFACES TO REMAIN WHICH ARE DAMAGED DURING REMOVALS SHALL BE REPAIRED TO MATCH SURROUNDING MATERIALS & PREPARED READY FOR APPLICATION OF REQ'D FINISHES. PROVIDE MATERIALS TO MATCH EXIST. MATERIALS & SURFACES "IN-KIND". THIS INCLUDES BUT NOT LIMITED TO REPLACEMENT OF FINISH MAT'LS, DRYWALL CONST., MASONRY, & MASONRY REPAIRS, TAPING, SANDING, & PAINTING ETC.
- R2. DIMENSIONED REMOVALS ARE FOR GENERAL INFORMATIONAL PURPOSES ONLY. COORDINATE EXACT EXTENT OF ALL REMOVALS AND MODIFICATIONS W/ CONST.
- R3. WHERE REMOVALS OF MASONRY OCCURS, TOOTH IN MASONRY TO MATCH EXIST. COURSING &

CONST. MATCH EXIST. MASONRY MAT'LS, USE SALVAGED MASONRY FOR PATCHING & REPAIR.

- R4. AT ALL MASONRY OPENINGS OF REMOVALS PROVIDE TEMPORARY SHORINGS TO MAINTAIN
- STRUCTURAL INTEGRITY OF EXISTING CONST.
- R5. SEE MECHANICAL, ELECTRICAL, AND PLUMBING FOR ADDITIONAL REMOVALS.
- R6. CONTRACTOR SHALL PROVIDE PROTECTION OVER EXISTING FLOORING SYSTEMS AT ALL TIMES UNLESS FLOORING IS SCHEDULED FOR REMOVAL.
- R7. HAZARDOUS MATERIAL SHALL BE REMEDIATED BY CERTIFIED HAZARDOUS MATERIAL CONTRACTOR. COORDINATE ALL WORK WITH HAZARDOUS MATERIAL DOCUMENTS.

KEYED REMOVAL NOTES


- REMOVE EXISTING VINYL TILE FINISH FLOORING & CONCEALED FLOORING MATERIALS COMPLETE, INCLUDING BUT NOT LIMITED TO ADHESIVES, AS REQUIRED FOR INSTALLATION OF NEW UNIT VENT.
- REMOVE WALL CONST. AS REQUIRED FOR INSTALLATION OF NEW UNIT VENT AND LOUVER. SEE MECHANICAL DRAWINGS.
- REMOVE EXISTING CEILING SYSTEM COMPLETE. INCLUDING SUSPENSION WIRES, ANCHORS, CLIPS, FASTENERS, CHANNELS, ETC. (V.I.F.) SALVAGE EXISTING CEILING TILES, LIGHT FIXTURES, SMOKE DETECTORS, SECURITY CAMERAS, AND SPEAKERS.
- REMOVE AND SALVAGE EXISTING WINDOW SASH AS REQUIRED FOR INSTALLATION OF NEW UNIT VENT. SEE MECHANICAL DRAWINGS.
- REMOVE AIR CONDITIONER WINDOW UNIT AND PANEL. RETURN TO OWNER

GENERAL PLAN NOTES


- G1. ALL DIMENSIONS ARE TO FINISH FACE AT EXISTING CONST. AND UNIT MASONRY CONSTRUCTION AND TO FACE OF FRAMING AT DRYWALL CONSTRUCTION UNLESS OTHERWISE NOTED.
- G2. ± NOTATIONS ARE USED IN DIMENSION STRINGS TO ACCOUNT FOR VARIATIONS BETWEEN DRAWINGS AND FIELD CONDITIONS. CONTRACTOR SHALL VERIFY ALL ± DIMENSION DURING LAYOUT AND INFORM ARCHITECT OF ANY DISCREPANCIES OR NECESSARY MODIFICATIONS PRIOR TO PROCEEDING WITH CONSTRUCTION.
- G3. CLEAN PATCH & REPAIR EXISTING WALLS AS REQ'D TO RESTORE TO LIKE NEW CONDITION. FINISH SURFACES TO BE SMOOTH AND FLUSH WITH ADJACENT SURFACES AND READY TO RECEIVE PAINT.

KEYED PLAN NOTES

- 1 INSTALL NEW FLOORING TO MATCH EXIST WHERE DAMAGED DURING REMOVAL / INSTALLATION.
- 2 PATCH & REPAIR EXTERIOR WALL CONST. AS REQUIRED FOR NEW UNIT VENT INSTALLATION.
- INSTALL NEW 2'X2' SUSPENDED ACOUSTICAL CEILING SYSTEM IN EXISTING LOCATION USING SALVAGED CEILING TILES.
- 4 PAINT ENTIRE WALL BELOW WINDOW UNITS TO MATCH EXISTING ROOM COLOR AND FINISH.

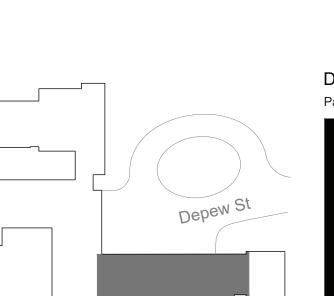

WOODSIDE KEY PLAN

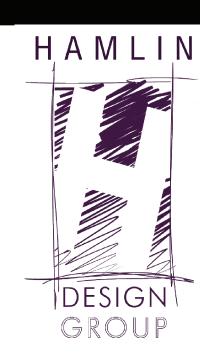

Architect: Hamlin Design Group

915 Broadway, Suite 101A Albany, New York 12207 Tel: 518.724.5159 Fax: 518.320.8633 Web: hamlindesigngroup.com

Hazardous Material Consultant:



MEP Engineer:

Engineered Solutions
646 Plank Road #104
Clifton Park, NY 12061
phone: (518) 280-2410
fax: (518) 280-2481
www.engineered-solutions.net

— Electrical
— Communications

engineered**solutions**

OI: - -- 4



1031 Elm St. Peekskill, NY 10566

Peekskill City School District

Peekskill Reconstruction

SED Project: 66-15-00-01-0-005-020 HDG Project: 201 Oakside Elementary 200 Decatur Ave.,

Peekskill, NY 10566 SED Project: 66-15-00-01-0-008-017

HDG Project: 203
Woodside Elementary
612 Depew St.,
Peekskill, NY 10566

DRAWN BY:

ISSUE: 03/19/2021




DESCRIPTION
Partial First Floor Plan



FILE LOCATION: /Users/TimG/Desktop/Enter_copied/PRJ/PRJ_203 PCSD Woodside ES/03 Design/04 Construction Docs/01 Plot

USER: TimG
Sheets/W-A.103.00.dwg

USER: TimG PLOT DATE: 3/18/2021

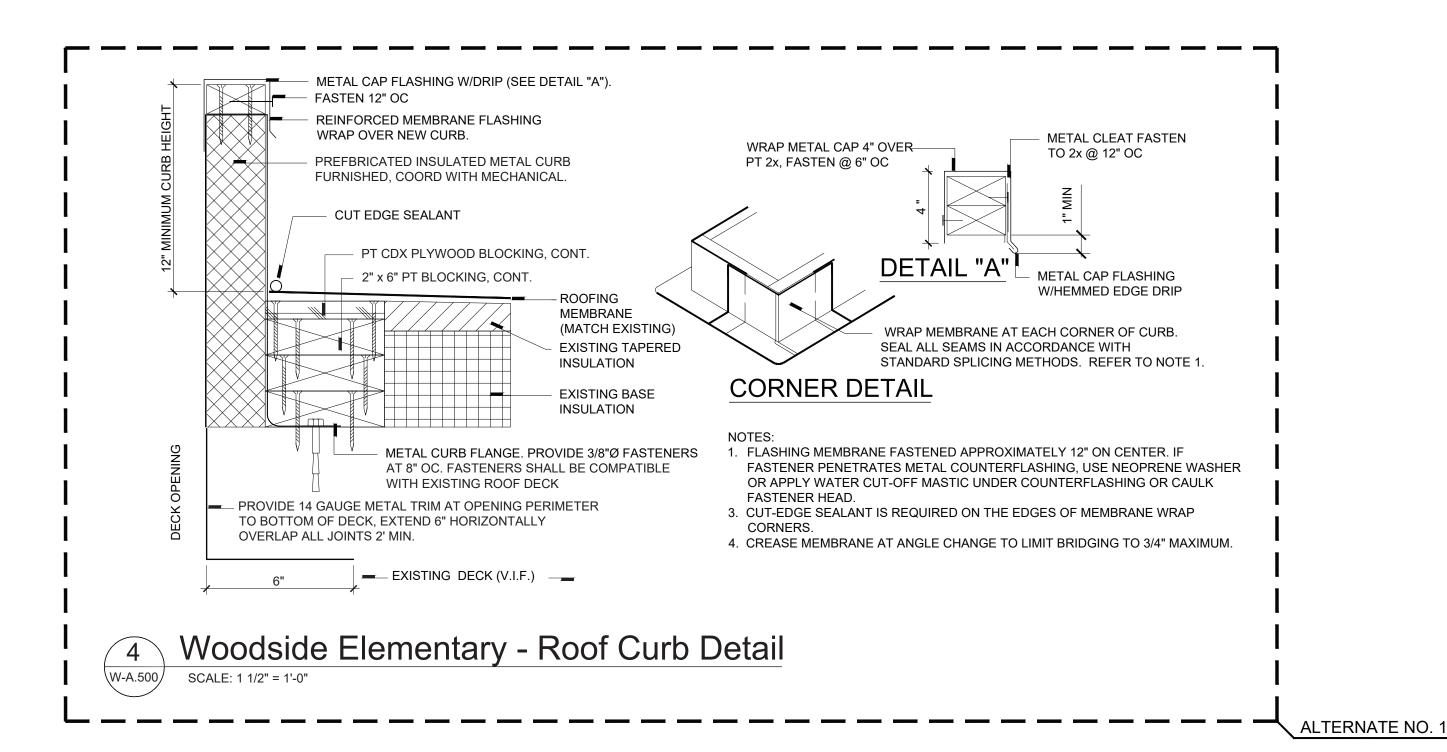

РНОТО 3





NEW 108"X28" LOUVER. MATCH COLOR AND — PROFILE OF EXISTING (DARK ANODIZED). PROVIDE LINTEL FOR NEW OPENING.

NEW LOUVER TO EXTEND ENTIRE

MATCH COLOR AND PROFILE OF

EXISTING (DARK ANODIZED).

LENGTH OF EXISTING WINDOW UNIT.


PHOTO 4 PROVIDE LINTEL FOR NEW OPENING. -




EXISTING (DARK ANODIZED).

NEW 108"X28" LOUVER. MATCH COLOR AND PROFILE OF EXISTING (DARK ANODIZED).



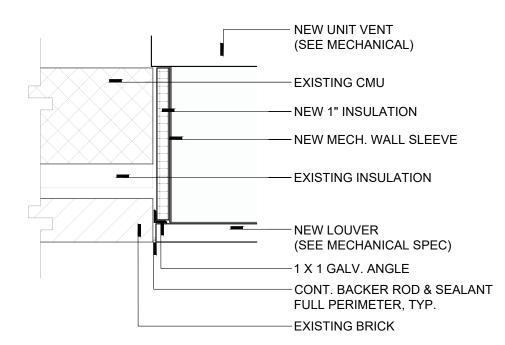

Woodside Elementary - Typical Jamb Detail at Unit Vent SCALE: 1 1/2" = 1'-0"

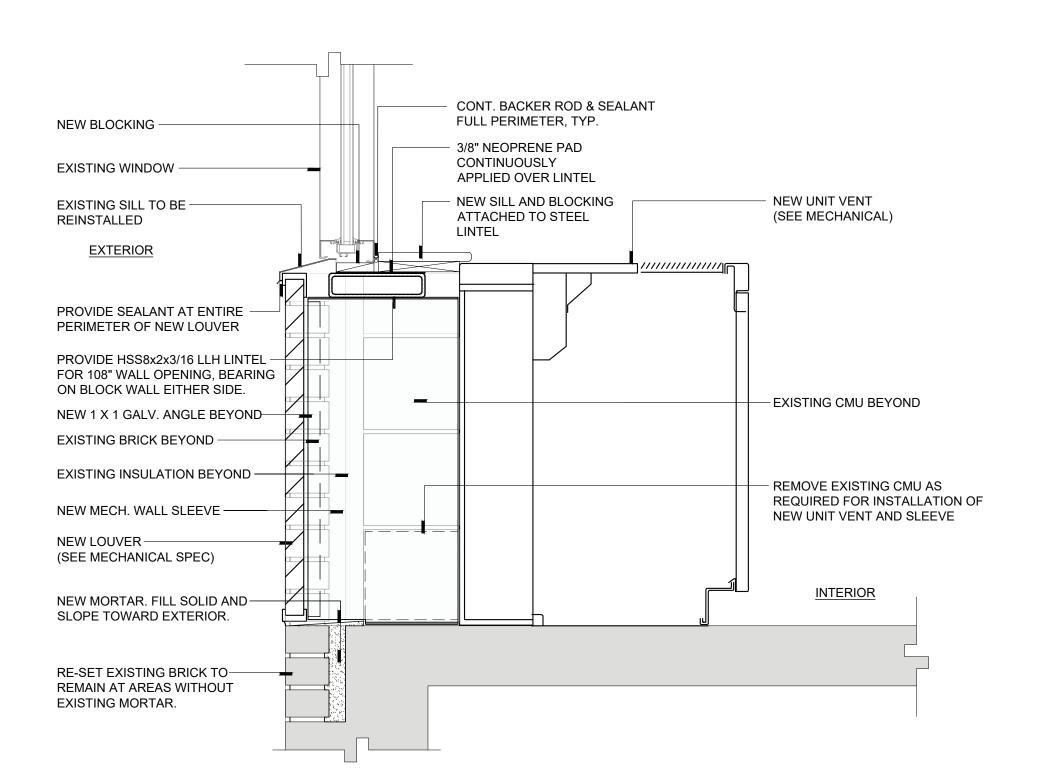


Woodside Elementary - Typical Wall Detail at Unit Vent SCALE: 1 1/2" = 1'-0"

LINTEL NOTES

- 1. COORDINATE WALL OPENINGS WITH ELECTRICAL, MECHANICAL, AND PLUMBING DRAWINGS.
- FOR OPENINGS NOT OTHERWISE DETAILED OR SCHEDULED, INCLUDING MECHANICAL OPENINGS, MINIMUM LINTELS SHALL BE (FOR EACH 4 INCHES OF MASONRY WIDTH) ONE L3 1/2x3 1/2x5/16 FOR SPANS UP TO 4 FEET; ONE L4x3 1/2x5/16 (LLV) FOR SPANS UP TO 6 FEET; ONE L5x3 1/2x5/16 (LLV) FOR SPANS UP TO 9 FEET. FOR SPANS LESS THAN 2 FEET, PROVIDE A 5/16 INCH PLATE.

FOR 8-INCH MASONRY WALLS, USE TWO L3 1/2x3 1/2x5/16 (LLV) FOR SPANS UP TO 4 FEET AND A BUILT-UP PLATE SECTION FOR SPANS UP TO 9 FEET. BUILT-UP SECTION SHALL CONSIST OF A HORIZONTAL PLATE 5/16 INCH BY 7 INCHES AND A VERTICAL PLATE 1/2 INCH BY 5 INCHES WELDED TOGETHER WITH 3/16-INCH FILLET WELDS, 3 INCHES LONG AND 6 INCHES ON CENTER ON EACH SIDE OF THE VERTICAL PLATE, TO FORM AN INVERTED TEE.

- 3. FOR OPENINGS NOT OTHERWISE DETAILED OR SCHEDULED IN 4-INCH-THICK VENEER, INCLUDING MECHANICAL OPENINGS, MINIMUM LINTELS SHALL BE ONE L4x4x5/16 FOR SPANS UP TO 6 FEET AND ONE L6x4x5/16 (LLV) FOR SPANS UP TO 9 FEET. FOR SPANS LESS THAN 2 FEET, PROVIDE A 5/16-INCH PLATE.
- 4. WELD TOGETHER BACK-TO-BACK LINTELS. MAXIMUM WELD SPACING SHALL NOT EXCEED 18 INCHES ON CENTER.
- BEAR LINTELS A MINIMUM OF 8 INCHES EACH END UNLESS NOTED OTHERWISE
- 6. HOT-DIP GALVANIZE LINTELS IN EXTERIOR WALLS.

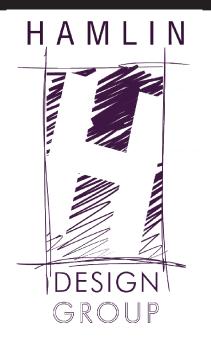

Architect: **Hamlin Design Group**

915 Broadway, Suite 101A Albany, New York 12207 Tel: 518.724.5159 Fax: 518.320.8633 Web: hamlindesigngroup.com

Hazardous Material Consultant:



MEP Engineer:

Engineered Solutions 646 Plank Road #104 Clifton Park, NY 12061 phone: (518) 280-2410 fax: (518) 280-2481 www.engineered-solutions.net 00000

engineered**solutions**



1031 Elm St. Peekskill, NY 10566

Peekskill City School District

Peekskill Reconstruction

SED Project: 66-15-00-01-0-005-020 HDG Project: 201

Oakside Elementary 200 Decatur Ave.,

Peekskill, NY 10566

Peekskill, NY 10566 SED Project: 66-15-00-01-0-008-017 HDG Project: 203

Woodside Elementary 612 Depew St.,


DRAWN BY:

ISSUE: 03/19/2021



DESCRIPTION



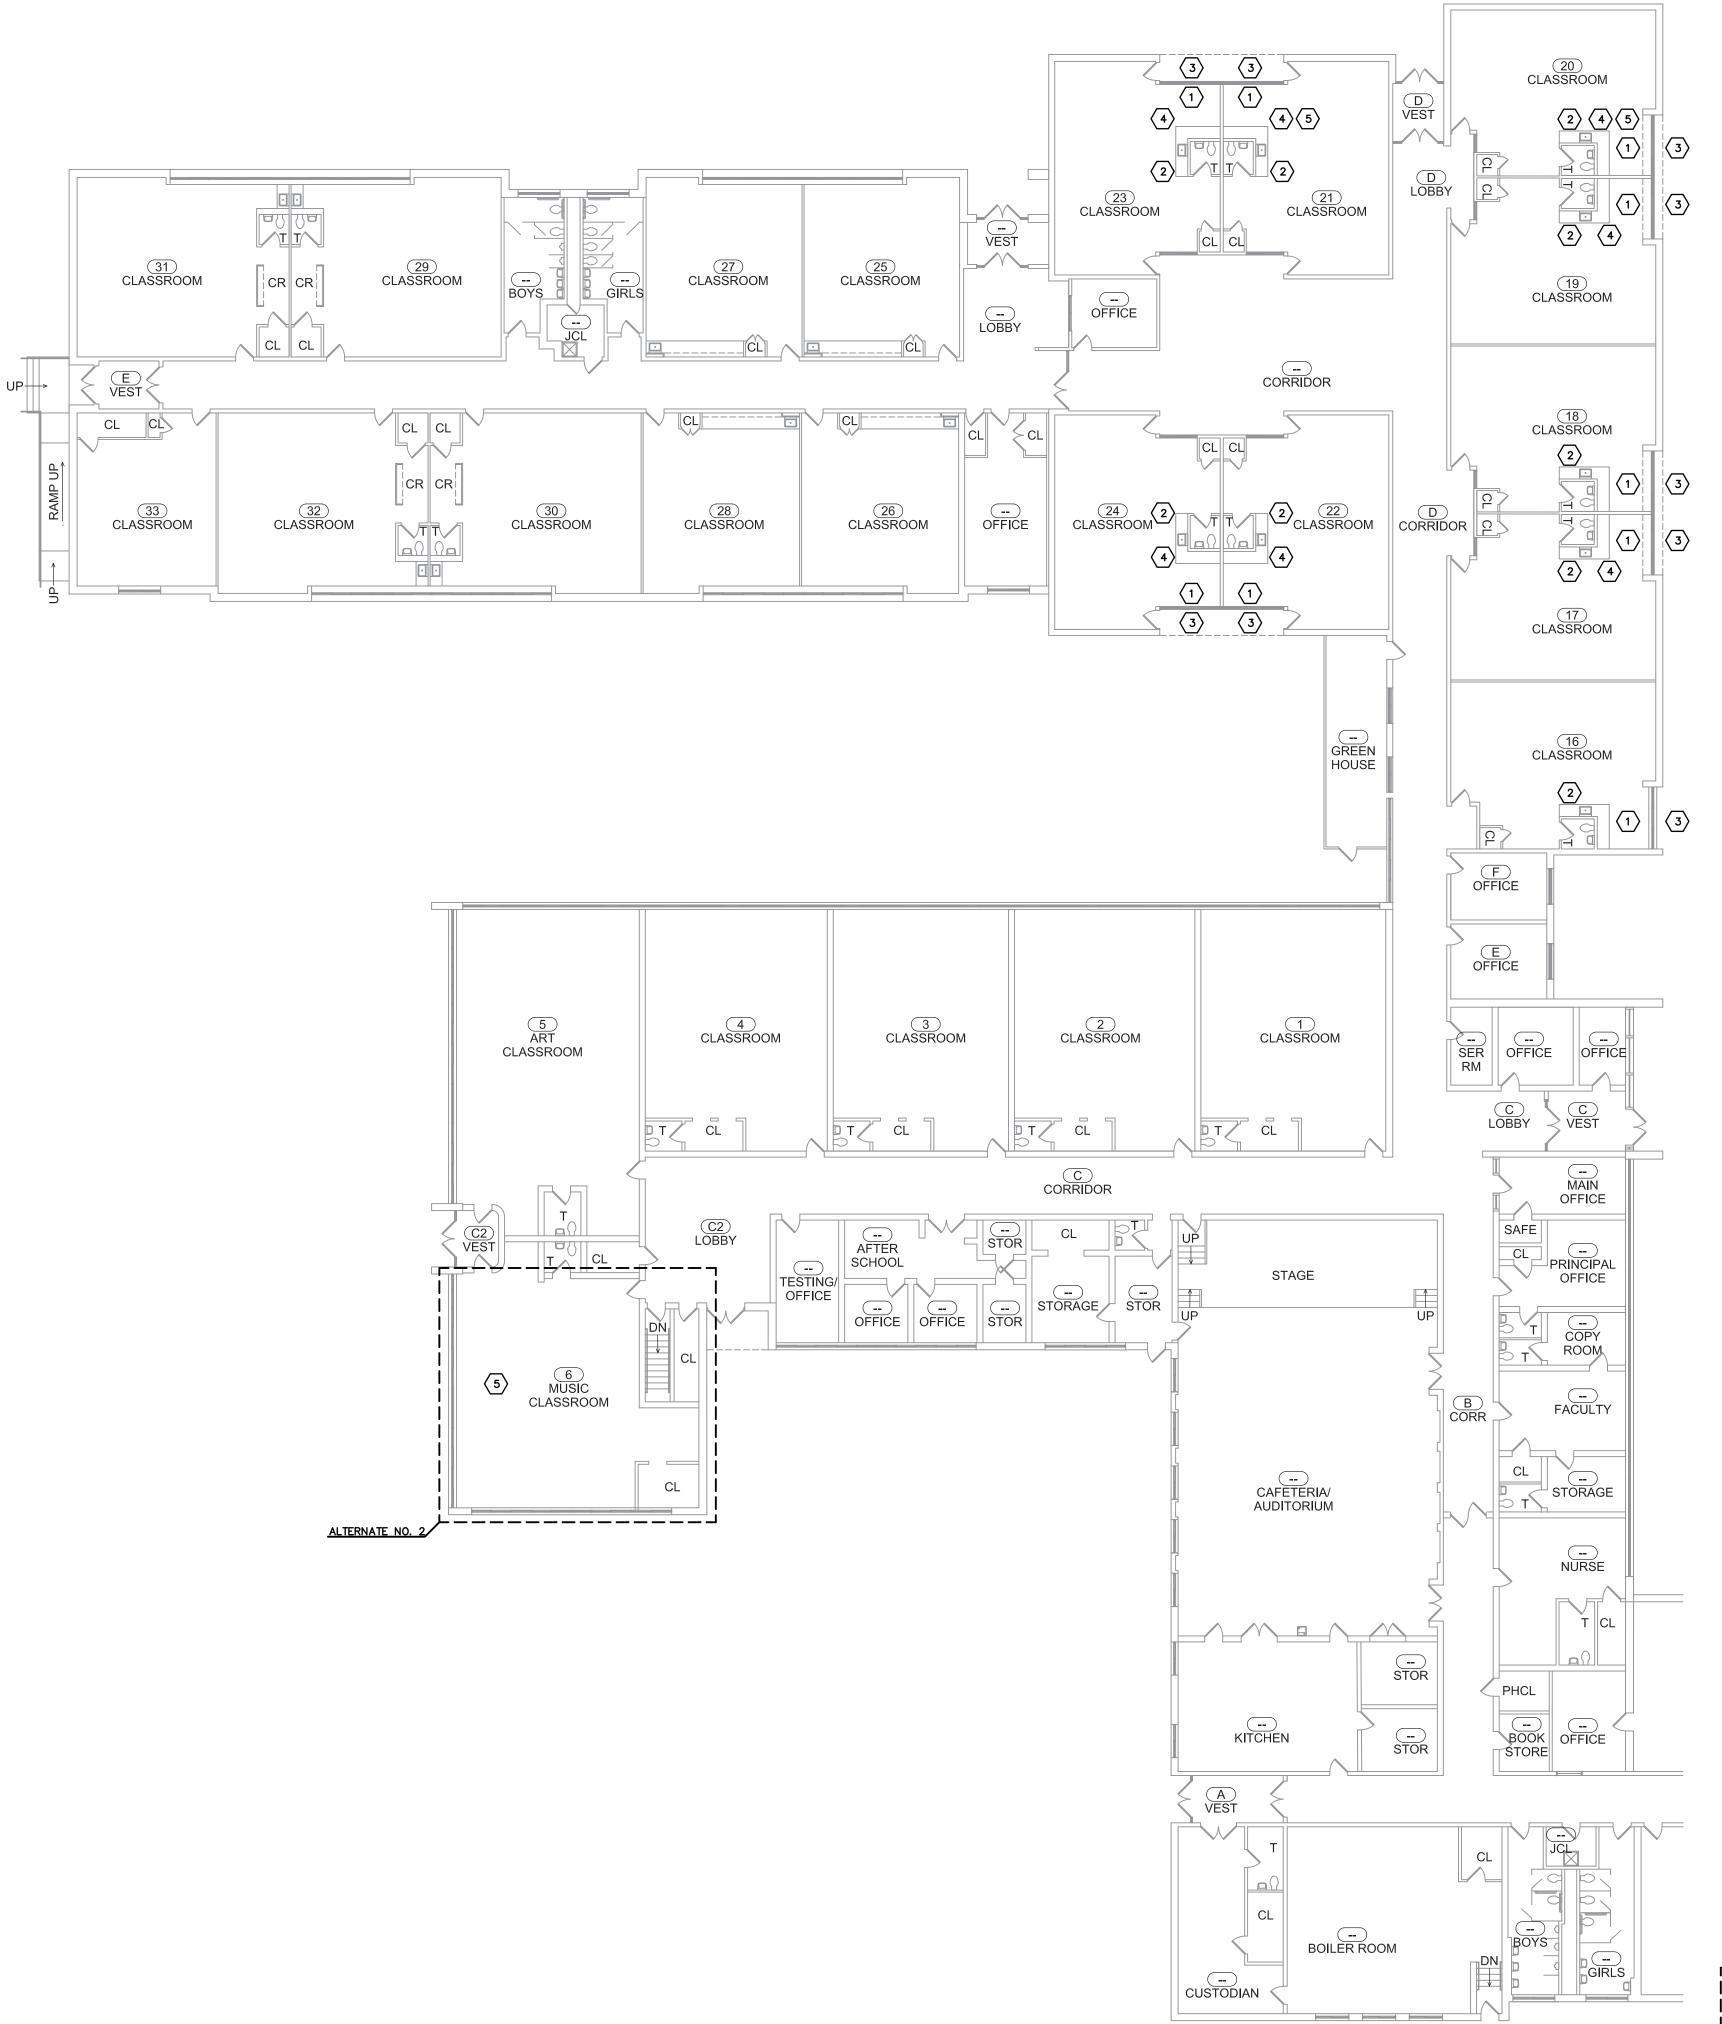

GENERAL REMOVAL NOTES

- THE CONTRACTOR SHALL BE SOLELY RESPONSIBLE FOR ALL MEANS, METHODS, TECHNIQUES, SEQUENCES AND PROCEDURES, AND FOR COORDINATING THE COMPLETION OF ALL PORTIONS OF THE SCOPE OF WORK WITHIN THE SPECIFIED CONSTRUCTION SCHEDULE AND AS DEFINED IN THE CONTRACT DOCUMENTS.
- 2. ALL ASBESTOS ABATEMENT SHALL BE PERFORMED IN ACCORDANCE WITH ALL FEDERAL, STATE, LOCAL REGULATIONS, AND THE TERMS OF THE CONTRACT. ALL ABATEMENT ACTIVITY WITHIN THE BUILDING SHALL BE PERFORMED INSIDE A CONTAINED WORK AREA THAT MEETS THE REQUIREMENTS OF OSHA 1926.1101, THE ASBESTOS HAZARD EMERGENCY RESPONSE ACT AND NEW YORK STATE DEPARTMENT OF LABOR CODE RULE 56.
- 3. ALL ABATEMENT ACTIVITY ON THE EXTERIOR OF THE BUILDING SHALL BE PERFORMED WITHIN THE REQUIREMENTS OF OSHA 1926.1101, THE ASBESTOS HAZARD EMERGENCY RESPONSE ACT AND NEW YORK STATE DEPARTMENT OF LABOR CODE RULE 56. ALL EXTERIOR ABATEMENT ACTIVITY THAT DISTURBS FRIABLE ASBESTOS MATERIALS OR RESULTS IN NON-FRIABLE ASBESTOS MATERIALS BEING MADE FRIABLE SHALL BE PERFORMED UNDER NEGATIVE PRESSURE WITHIN AN ISOLATED WORK AREA.
- 4. THE HAZARDOUS MATERIALS DRAWINGS ASSOCIATED WITH THIS PROJECT WERE PRODUCED FROM AVAILABLE FLOOR PLANS. ACCORDINGLY, VARIATIONS WITHIN THE DEMARCATED WORK AREAS ARE EXPECTED AND SHALL HAVE NO IMPACT ON THE CONTRACT PRICE OR SCHEDULE.
- 5. THE HAZARDOUS MATERIALS DRAWINGS DO NOT SHOW EXISTING MECHANICAL, ELECTRICAL, PLUMBING, COMMUNICATION, SECURITY SYSTEMS OR CASEWORK PRESENT WITHIN OR IN THE PROXIMITY OF THE BUILDING. REFER TO THE ARCHITECTURAL, PLUMBING, MECHANICAL AND ELECTRICAL REMOVAL AND NEW WORK DRAWINGS FOR COORDINATION. ALL LOW VOLTAGE WIRING, INCLUDING BUT NOT LIMITED TO, SPEAKER WIRING, ALARM SYSTEM WIRING, TELEPHONE, DATA AND/OR TELEVISION CABLES SHALL BE PROTECTED IN PLACE DURING ASBESTOS ABATEMENT ACTIVITIES. MATERIALS SPECIFIED FOR REMOVAL ARE QUANTIFIED IN THE MATERIALS SCHEDULE IN DOCUMENT 028213.
- 6. PLACEMENT OF PERSONAL AND WASTE DECONTAMINATION UNITS WILL BE COORDINATED WITH AND APPROVED BY THE OWNER'S REPRESENTATIVE.
- 7. ASBESTOS CONTAINING MATERIALS (ACM) HAVE BEEN IDENTIFIED IN THE AREAS INDICATED ON DRAWINGS W-H.101.00 AND W-H.102.00 AND INCLUDE JOINT COMPOUND, EXTERIOR WINDOW/LOUVER CAULK, PIPE INSULATION AND MUDDED FITTING INSULATION AND FLOOR TILE MASTICS. ASBESTOS ABATEMENT WORK SHALL BE PERFORMED AS SPECIFIED IN SECTION 028213.
- 8. THE CONTRACTOR IS RESPONSIBLE FOR THE REMOVAL OF EXISTING NON-ASBESTOS MATERIALS INCLUDING, BUT NOT LIMITED TO, PIPE INSULATION, CEILING TILES AND WALL PLASTER AND/OR OTHER WALL CONSTRUCTION AS REQUIRED TO ACCESS PIPE INSULATION AND/OR MUDDED FITTING INSULATION PRESENT WITHIN THE SCHEDULED REGULATED WORK AREAS. THE CONTRACTOR SHALL VERIFY FIELD CONDITIONS, MEASUREMENTS AND QUANTITIES. REPORT ANY DISCREPANCIES TO THE CONSTRUCTION MANAGER IN WRITING.
- 9. THE CONTRACTOR IS RESPONSIBLE FOR CONFIRMING THE LOCATIONS, TIMING AND EXTENTS OF REMOVALS AND INSTALLATIONS WITH THE APPROPRIATE CONTRACTOR.
- 10. THE ASBESTOS ABATEMENT CONTRACTOR IS RESPONSIBLE FOR THE REMOVAL AND LEGAL DISPOSAL OF ASBESTOS-CONTAINING AND ASBESTOS-CONTAMINATED MATERIALS AS INDICATED IN THE PROJECT SPECIFICATIONS AND DRAWINGS.
- 11. THE ASBESTOS ABATEMENT CONTRACTOR IS RESPONSIBLE FOR THE REMOVAL OF ALL WALL MOUNTED ITEMS FROM DRYWALL WITH ASBESTOS CONTAINING JOINT COMPOUND INCLUDING BUT NOT LIMITED TO CLASSROOM UNIT VENTILATORS, MOLDINGS, TRIM, THERMOSTATS, WIRING, AND BACKER PLATES. ALL PATCHING OF DRYWALL SHALL BE PERFORMED BY THE ASBESTOS ABATEMENT CONTYRACTOR. INSTALL NEW UNIT VENTILATOR WALL ANCHORS, BACKER PLATES FOR TEMPERATURE SENSORS OR OTHER COMPONENTS IDENTIFIED FOR INSTALLATION ON OR IN DRYWALL AS SHOWN ON THE ARCHITECTURAL AND MECHANICAL DRAWINGS.
- 12. THE ASBESTOS ABATEMENT CONTRACTOR IS TO NOTIFY THE ARCHITECT IN WRITING OF ANY DISCREPANCIES BETWEEN THE CONTRACT DOCUMENTS AND FIELD CONDITIONS PRIOR TO THE START OF WORK.
- 13. THE ASBESTOS ABATEMENT CONTRACTOR IS RESPONSIBLE FOR REVIEWING AND UNDERSTANDING THE ASSUMPTIONS AND LIMITATIONS INCLUDED IN THE ENVIRONMENTAL SERVICES REPORT INCLUDED IN THE SPECIFICATION.

KEYED REMOVAL NOTES

- EXISTING UNIT VENTILATOR TO BE REMOVED AND REPLACED. THE EXISTING DRYWALL JOINT COMPOUND CONTAINS ASBESTOS. THE ABATEMENT CONTRACTOR SHALL REMOVE ALL ATTACHMENTS TO THE DRYWALL INCLUDING BUT NOT LIMITED TO UNIT VENTILATOR ANCHORS, MOLDINGS AND TRIM PIECES AND PATCH THE WALL. ABATEMENT CONTRACTOR SHALL INSTALL ALL NEW ATTACHMENTS TO DRYWALL. COORDINATE WITH THE MECHANICAL CONTRACTOR.
- EXISTING THERMOSTAT AND WIRING TO BE REMOVED AND REPLACED. THE EXISTING DRYWALL JOINT COMPOUND CONTAINS ASBESTOS. THE ABATEMENT CONTRACTOR SHALL REMOVE THE THERMOSTAT AND BACKER PLATE AND PATCH THE WALL. ABATEMENT CONTRACTOR SHALL INSTALL NEW BACKER PLATE AND PROVIDE ANY NECESSARY PENETRATIONS IN THE DRYWALL. COORDINATE WITH THE MECHANICAL CONTRACTOR.
- THE EXISTING WINDOW/LOUVER CAULK CONTAINS ASBESTOS. WHERE THE LOUVERS ARE SHOWN TO BE REMOVED AND REPLACED ON THE MECHANICAL DRAWINGS, THE ABATEMENT CONTRACTOR SHALL REMOVE ALL CAULK AND CLEAN AND DISPOSE OF THE LOUVERS IN ACCORDANCE WITH SPECIFICATION SECTIONS 028213 AND 028433.
- ASBESTOS CONTAINING PIPE AND FITTING INSULATION IS PRESENT ABOVE THE CEILING. IT IS NOT ANTICIPATED THAT REMOVAL OF THE INSULATION IS NECESSARY FOR THE REPLACEMENT OF THE UNIT VENTILATORS. CONTRACTORS MUST BE AWARE OF ITS PRESENCE AND USE CAUTION WHEN REMOVING CEILING TILES AND WORKING ABOVE THE CEILING.
- ASBESTOS CONTAINING FLOOR TILE MASTIC IS PRESENT IN THIS ROOM. ABATEMENT CONTRACTOR SHALL REMOVE 12X12 FLOOR TILE AND MASTIC AROUND AND UNDER THE UNIT VENTILATOR TO ALLOW FOR THE REPLACEMENT OF THE UNIT VENTILATOR. COORDINATE ALL WORK WITH THE APPROPRIATE CONTRACTORS.







Architect:
Hamlin Design Group

915 Broadway, Suite 101A Albany, New York 12207 Tel: 518.724.5159 Fax: 518.320.8633 Web: hamlindesigngroup.com

Hazardous Material Consultant:



MEP Engineer:

Engineered Solutions
646 Plank Road #104
Clifton Park, NY 12061
phone: (518) 280-2410
fax: (518) 280-2481
www.engineered-solutions.net

Electrical
Communications
engineeredsolutions

Cliont



Peekskill City School District 1031 Elm St. Peekskill, NY 10566

Peekskill Reconstruction

SED Project: 66-15-00-01-0-005-020 HDG Project: 201 Oakside Elementary

200 Decatur Ave., Peekskill, NY 10566

SED Project: 66-15-00-01-0-008-017 HDG Project: 203

Woodside Elementary 612 Depew St., Peekskill, NY 10566

DRAWN BY:

KJ

WOODSIDE KEY

PLAN

ISSUE: 03/19/2021

DESCRIPTION

Existing First Floor Hazardous Materials Plan



Wh.101.00 Woodside Elementary - Partial Existing First Floor Plan

SCALE: 1/16" = 1'-0"

GENERAL REMOVAL NOTES


- 1. THE CONTRACTOR SHALL BE SOLELY RESPONSIBLE FOR ALL MEANS, METHODS, TECHNIQUES, SEQUENCES AND PROCEDURES, AND FOR COORDINATING THE COMPLETION OF ALL PORTIONS OF THE SCOPE OF WORK WITHIN THE SPECIFIED CONSTRUCTION SCHEDULE AND AS DEFINED IN THE CONTRACT DOCUMENTS.
- 2. ALL ASBESTOS ABATEMENT SHALL BE PERFORMED IN ACCORDANCE WITH ALL FEDERAL, STATE, LOCAL REGULATIONS, AND THE TERMS OF THE CONTRACT. ALL ABATEMENT ACTIVITY WITHIN THE BUILDING SHALL BE PERFORMED INSIDE A CONTAINED WORK AREA THAT MEETS THE REQUIREMENTS OF OSHA 1926.1101, THE ASBESTOS HAZARD EMERGENCY RESPONSE ACT AND NEW YORK STATE DEPARTMENT OF LABOR CODE RULE 56.
- 3. ALL ABATEMENT ACTIVITY ON THE EXTERIOR OF THE BUILDING SHALL BE PERFORMED WITHIN THE REQUIREMENTS OF OSHA 1926.1101, THE ASBESTOS HAZARD EMERGENCY RESPONSE ACT AND NEW YORK STATE DEPARTMENT OF LABOR CODE RULE 56. ALL EXTERIOR ABATEMENT ACTIVITY THAT DISTURBS FRIABLE ASBESTOS MATERIALS OR RESULTS IN NON-FRIABLE ASBESTOS MATERIALS BEING MADE FRIABLE SHALL BE PERFORMED UNDER NEGATIVE PRESSURE WITHIN AN ISOLATED WORK AREA.
- 4. THE HAZARDOUS MATERIALS DRAWINGS ASSOCIATED WITH THIS PROJECT WERE PRODUCED FROM AVAILABLE FLOOR PLANS. ACCORDINGLY, VARIATIONS WITHIN THE DEMARCATED WORK AREAS ARE EXPECTED AND SHALL HAVE NO IMPACT ON THE CONTRACT PRICE OR SCHEDULE.
- 5. THE HAZARDOUS MATERIALS DRAWINGS DO NOT SHOW EXISTING MECHANICAL, ELECTRICAL, PLUMBING, COMMUNICATION, SECURITY SYSTEMS OR CASEWORK PRESENT WITHIN OR IN THE PROXIMITY OF THE BUILDING. REFER TO THE ARCHITECTURAL, PLUMBING, MECHANICAL AND ELECTRICAL REMOVAL AND NEW WORK DRAWINGS FOR COORDINATION. ALL LOW VOLTAGE WIRING, INCLUDING BUT NOT LIMITED TO, SPEAKER WIRING, ALARM SYSTEM WIRING, TELEPHONE, DATA AND/OR TELEVISION CABLES SHALL BE PROTECTED IN PLACE DURING ASBESTOS ABATEMENT ACTIVITIES. MATERIALS SPECIFIED FOR REMOVAL ARE QUANTIFIED IN THE MATERIALS SCHEDULE IN DOCUMENT 028213.
- 6. PLACEMENT OF PERSONAL AND WASTE DECONTAMINATION UNITS WILL BE COORDINATED WITH AND APPROVED BY THE OWNER'S REPRESENTATIVE.
- 7. ASBESTOS CONTAINING MATERIALS (ACM) HAVE BEEN IDENTIFIED IN THE AREAS INDICATED ON DRAWINGS W-H.101.00 AND W-H.102.00 AND INCLUDE JOINT COMPOUND, EXTERIOR WINDOW/LOUVER CAULK, PIPE INSULATION AND MUDDED FITTING INSULATION AND FLOOR TILE MASTICS. ASBESTOS ABATEMENT WORK SHALL BE PERFORMED AS SPECIFIED IN SECTION 028213.
- 8. THE CONTRACTOR IS RESPONSIBLE FOR THE REMOVAL OF EXISTING NON-ASBESTOS MATERIALS INCLUDING, BUT NOT LIMITED TO, PIPE INSULATION, CEILING TILES AND WALL PLASTER AND/OR OTHER WALL CONSTRUCTION AS REQUIRED TO ACCESS PIPE INSULATION AND/OR MUDDED FITTING INSULATION PRESENT WITHIN THE SCHEDULED REGULATED WORK AREAS. THE CONTRACTOR SHALL VERIFY FIELD CONDITIONS, MEASUREMENTS AND QUANTITIES. REPORT ANY DISCREPANCIES TO THE CONSTRUCTION MANAGER IN WRITING.
- 9. THE CONTRACTOR IS RESPONSIBLE FOR CONFIRMING THE LOCATIONS, TIMING AND EXTENTS OF REMOVALS AND INSTALLATIONS WITH THE APPROPRIATE CONTRACTOR.
- 10. THE ASBESTOS ABATEMENT CONTRACTOR IS RESPONSIBLE FOR THE REMOVAL AND LEGAL DISPOSAL OF ASBESTOS-CONTAINING AND ASBESTOS-CONTAMINATED MATERIALS AS INDICATED IN THE PROJECT SPECIFICATIONS AND DRAWINGS.
- 11. THE ASBESTOS ABATEMENT CONTRACTOR IS RESPONSIBLE FOR THE REMOVAL OF ALL WALL MOUNTED ITEMS FROM DRYWALL WITH ASBESTOS CONTAINING JOINT COMPOUND INCLUDING BUT NOT LIMITED TO CLASSROOM UNIT VENTILATORS, MOLDINGS, TRIM, THERMOSTATS, WIRING, AND BACKER PLATES. ALL PATCHING OF DRYWALL SHALL BE PERFORMED BY THE ASBESTOS ABATEMENT CONTYRACTOR. INSTALL NEW UNIT VENTILATOR WALL ANCHORS, BACKER PLATES FOR TEMPERATURE SENSORS OR OTHER COMPONENTS IDENTIFIED FOR INSTALLATION ON OR IN DRYWALL AS SHOWN ON THE ARCHITECTURAL AND MECHANICAL DRAWINGS.
- 12. THE ASBESTOS ABATEMENT CONTRACTOR IS TO NOTIFY THE ARCHITECT IN WRITING OF ANY DISCREPANCIES BETWEEN THE CONTRACT DOCUMENTS AND FIELD CONDITIONS PRIOR TO THE START OF WORK.
- 13. THE ASBESTOS ABATEMENT CONTRACTOR IS RESPONSIBLE FOR REVIEWING AND UNDERSTANDING THE ASSUMPTIONS AND LIMITATIONS INCLUDED IN THE ENVIRONMENTAL SERVICES REPORT INCLUDED IN THE SPECIFICATION.

KEYED REMOVAL NOTES

- EXISTING UNIT VENTILATOR TO BE REMOVED AND REPLACED. THE EXISTING DRYWALL JOINT COMPOUND CONTAINS ASBESTOS. THE ABATEMENT CONTRACTOR SHALL REMOVE ALL ATTACHMENTS TO THE DRYWALL INCLUDING BUT NOT LIMITED TO UNIT VENTILATOR ANCHORS, MOLDINGS AND TRIM PIECES AND PATCH THE WALL. ABATEMENT CONTRACTOR SHALL INSTALL ALL NEW ATTACHMENTS TO DRYWALL. COORDINATE WITH THE MECHANICAL CONTRACTOR.
- 2 EXISTING THERMOSTAT AND WIRING TO BE REMOVED AND REPLACED. THE EXISTING DRYWALL JOINT COMPOUND CONTAINS ASBESTOS. THE ABATEMENT CONTRACTOR SHALL REMOVE THE THERMOSTAT AND BACKER PLATE AND PATCH THE WALL. ABATEMENT CONTRACTOR SHALL INSTALL NEW BACKER PLATE AND PROVIDE ANY NECESSARY PENETRATIONS IN THE DRYWALL. COORDINATE WITH THE MECHANICAL CONTRACTOR.
- THE EXISTING WINDOW/LOUVER CAULK CONTAINS ASBESTOS. WHERE THE LOUVERS ARE SHOWN TO BE REMOVED AND REPLACED ON THE MECHANICAL DRAWINGS, THE ABATEMENT CONTRACTOR SHALL REMOVE ALL CAULK AND CLEAN AND DISPOSE OF THE LOUVERS IN ACCORDANCE WITH SPECIFICATION SECTIONS 028213 AND 028433.
- ASBESTOS CONTAINING PIPE AND FITTING INSULATION IS PRESENT ABOVE THE CEILING. IT IS NOT ANTICIPATED THAT REMOVAL OF THE INSULATION IS NECESSARY FOR THE REPLACEMENT OF THE UNIT VENTILATORS. CONTRACTORS MUST BE AWARE OF ITS PRESENCE AND USE CAUTION WHEN REMOVING CEILING TILES AND WORKING ABOVE THE CEILING.
- ASBESTOS CONTAINING FLOOR TILE MASTIC IS PRESENT IN THIS ROOM. ABATEMENT CONTRACTOR SHALL REMOVE 12X12 FLOOR TILE AND MASTIC AROUND AND UNDER THE UNIT VENTILATOR TO ALLOW FOR THE REPLACEMENT OF THE UNIT VENTILATOR. COORDINATE ALL WORK WITH THE APPROPRIATE CONTRACTORS.

THE BUILT-UP ROOFING IS ASSUMED TO CONTAIN ASBESTOS. THE ABATEMENT CONTRACTOR SHALL REMOVE THE BUILT-UP ROOFING SYSTEM AS REQUIRED FOR THE INSTALLATION OF NEW EXHAUST FAN SHOWN ON DRAWING W-M.405.00. ALL MATERIALS SHALL BE REMOVED DOWN TO ROOF DECK. ALL NEW PENETRATIONS THROUGH THE EXISTING ROOF DECK SHALL BE MADE BY THE ABATEMENT CONTRACTOR. ALL FASTENERS INTO THE EXISTING ROOF DECK FOR WORK BY OTHER TRADES SHALL BE MADE BY THE ABATEMENT CONTRACTOR. STABILIZE EXISTING ROOFING FOR PATCHING BY ROOFING SUBCONTRACTOR. COORDINATE ALL WORK WITH THE APPROPRIATE CONTRACTORS.



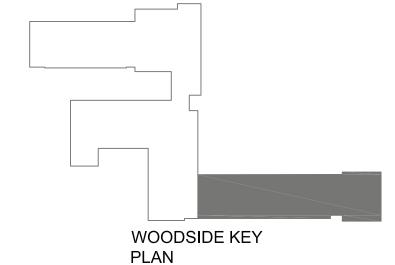





Architect:

Hamlin Design Group 915 Broadway, Suite 101A Albany, New York 12207 Tel: 518.724.5159 Fax: 518.320.8633 Web: hamlindesigngroup.com

Hazardous Material Consultant:



MEP Engineer:

Client



1031 Elm St. Peekskill, NY 10566

Peekskill City School District

Peekskill Reconstruction
SED Project: 66-15-00-01-0-005-020

HDG Project: 201

Oakside Elementary

200 Decatur Ave., Peekskill, NY 10566

SED Project: 66-15-00-01-0-008-017 HDG Project: 203

Woodside Elementary 612 Depew St., Peekskill, NY 10566

DRAWN BY:

KJ

ISSUE: 03/19/2021

DESCRIPTION

W-H.102.00

(PARTIAL ALTERNATE NO. 1)

Woodside Elementary - Partial Existing First Floor Plan


SCALE: 1/16" = 1'-0"

GENERAL NOTES - POWER DISTRIBUTION

- A. PROVIDE (2)-#10, (1)-#10 EG WIRING FOR 120V, 20A BRANCH CIRCUITS EXCEEDING 100 FEET.
- B. THE DRAWINGS SHOW GENERAL LOCATION OF DEVICES AND CONTROL EQUIPMENT. THE CONTRACTOR SHALL INSTALL ALL DEVICES AND CONTROLS TO MEET ALL NEC REQUIREMENTS. COORDINATE THE EXACT LOCATION IN THE FIELD.
- C. THE ELECTRICAL CONTRACTOR SHALL COORDINATE ALL ELECTRICAL CONNECTIONS TO ELECTRICAL EQUIPMENT PROVIDED BY OTHERS PRIOR TO ROUGH-IN.
- D. PROVIDE DEDICATED NEUTRALS FOR ALL 120V, 20A, SINGLE PHASE BRANCH CIRCUITS.
- E. DO NOT INSTALL NORMAL AND EMERGENCY POWER IN THE SAME RACEWAY, JUNCTION BOX, OR OUTLET BOX. PROVIDE SEPARATE OR SEGREGATED RACEWAY SYSTEMS.
- F. WHERE BREAKERS ARE INSTALLED IN EXISTING PANELBOARDS. THE BREAKERS SHALL BE LISTED/LABELED FOR USE IN THE EXISTING PANEL AND THE KAIC RATING SHALL MATCH THE KAIC RATING OF THE EXISTING PANEL.

<u>NOTES</u>

- A. PANELBOARDS SUPPLIED BY A FEEDER SHALL BE MARKED TO INDICATE WHERE THE POWER SUPPLY ORIGINATES PER NEC
- B. PROVIDE FLASH PROTECTION LABEL PER NEC SECTION 110.16
- C. REFER TO ELECTRICAL IDENTIFICATION SECTION 260195 FOR ADDITIONAL INFORMATION.
- D. PROVIDE IDENTIFICATION FOR ALL PANELBOARD INSTALLATIONS.

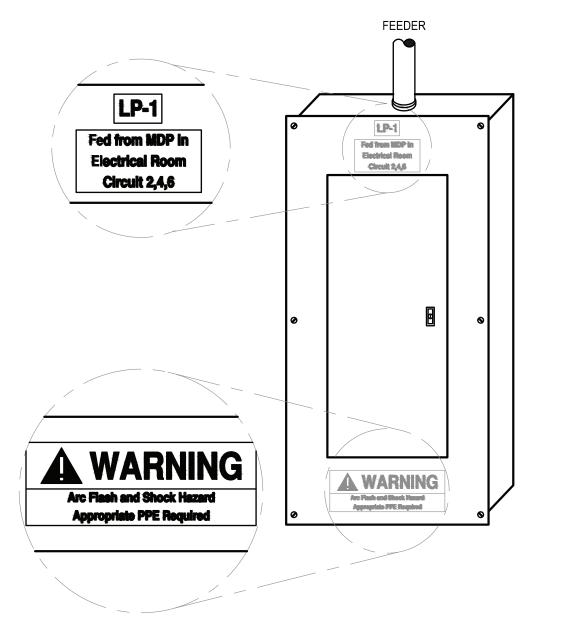

Panelboard Identification Detail

GENERAL NOTES - REMOVALS

- A. THIS INFORMATION REPRESENTS EXISTING CONDITIONS BASED ON ORIGINAL DRAWINGS AND OBSERVED SITE CONDITIONS. NOT ALL CONDUIT, WIRE, FIXTURES AND DEVICES ARE SHOWN. FIELD VERIFY THE EXACT REQUIREMENTS IN ALL REMOVAL AREAS. DISCONNECT AND REMOVE ALL ELECTRICAL WORK THAT IS SHOWN DASHED ON REMOVAL PLANS AND ALL ELECTRIC WORK IN RENOVATION AREAS THAT IS NOT BEING REUSED, REMOVE ALL BRANCH CIRCUITING, LOW VOLTAGE CABLING, SUPPORTING DEVICES. RACEWAY, AND ASSOCIATED TERMINATION HARDWARE.
- "ERL" ADJACENT TO A DEVICE, FIXTURE OR PIECE OF EQUIPMENT INDICATES AN EXISTING ITEM TO BE RELOCATED. DISCONNECT AND REMOVE THE ITEM. REMOVE ALL UNNECESSARY RACEWAY AND WIRING. REINSTALL AND RECONNECT THE ITEM AS REQUIRED.
- C. "EXR" ADJACENT TO A DEVICE FIXTURE OR PIECE OF EQUIPMENT INDICATES AN EXISTING ITEM TO REMAIN. MAINTAIN EXISTING CONNECTIONS TO EQUIPMENT UNLESS NOTED OTHERWISE.
- PROVIDE FIRE STOPPING CUTTING, PATCHING AND PAINTING AS REQUIRED TO REPAIR HOLES OR OTHER PHYSICAL DEFECTS CAUSED BY THE REMOVAL OR INSTALLATION OF EQUIPMENT AND DEVICES. THE CONTRACTOR SHALL PROVIDE A QUALIFIED TRADES PERSON TO RESTORE FINISHED WALLS TO ORIGINAL CONDITIONS AND PAINT TO MATCH
- PROVIDE STAINLESS STEEL BLANK COVER PLATES ON ALL UNUSED ELECTRICAL BOXES AFTER DEMOLITION AND INSTALLATION WORK IS COMPLETE.
- WHERE EXISTING DEVICES ARE BEING REMOVED AND THE REMOVAL BREAKS AN EXISTING BRANCH CIRCUIT TO DOWNSTREAM DEVICE THE CONTRACTOR SHALL PROVIDE ALL WIRING TO PERMANENTLY RECONNECT THE REMAINING DEVICE EQUIPMENT OR FIXTURE.
- G. THE CONSTRUCTION MANAGER OR GENERAL CONTRACTOR WILL SCHEDULE ALL REMOVAL WORK. PRIOR TO BEGINNING REMOVAL WORK PROVIDE AN EXISTING CONDITION REPORT WITH PICTURES AND SUBMIT TO THE CONSTRUCTION MANAGER. ANY DAMAGES OR EXISTING CONDITIONS THAT ARE NOT DOCUMENTED WILL BE CORRECTED BY THE CONTRACTOR PRIOR TO FINAL COMPLETION.
- H. LEGALLY DISPOSE OF ALL ELECTRICAL WIRING, DEVICES, BALLAST, LAMPS ETC. FOLLOW ALL LOCAL, STATE AND FEDERAL REGULATIONS REGARDING DISPOSAL OF HAZARDOUS WASTE.

GENERAL NOTES - INSTALLATION

- A. COORDINATE DEVICE LOCATIONS WITH ARCHITECTURAL ELEVATIONS PRIOR TO ROUGH-IN, VERIFY DEVICE LOCATIONS ABOVE MILLWORK TO ENSURE CLEARANCE ABOVE THE COUNTER-TOP AND BACKSPLASH, DEVICES THAT INTERFERE WITH NEW CASEWORK, MILLWORK OR EQUIPMENT SHALL BE RELOCATED AT NO ADDITIONAL COST TO THE CONTRACT.
- WHERE DEVICES ARE SCHEDULED TO BE INSTALLED IN CASEWORK AND MILLWORK SUPPLIED BY THE GENERAL CONTRACTOR, OBTAIN A SHOP DRAWING FROM THE GENERAL CONTRACTOR PRIOR TO ROUGHING. WHERE REQUIRED, CUT OPENINGS IN MILLWORK OR COORDINATE OPENINGS WITH THE GENERAL CONTRACTOR.
- C. COORDINATE ALL CONDUIT RUNS WITH OTHER TRADES PRIOR TO ROUGH-IN. RELOCATE ANY CONDUITS AS NECESSARY TO PERMIT INSTALLATION OF DUCTWORK OR PIPING.
- D. INSTALL ALL CIRCUITING CONCEALED INSIDE WALL CAVITY WHERE EVER POSSIBLE, PROVIDE SURFACE MOUNTED BACKBOXES AND RACEWAY FOR WIRING DEVICES LOCATED ON EXISTING SOLID WALL CONSTRUCTION. PROVIDE SHALLOW TYPE BACKBOXES FOR SURFACE MOUNTED POWER AND SWITCHING APPLICATIONS. REFER TO ARCHITECTURAL PLANS FOR WALL TYPES.
- FIRESTOP ALL LOW VOLTAGE SLEEVES AND PENETRATIONS AFTER INSTALLATION OF CABLE
- PROVIDE OPEN TOP CABLE HANGERS 4' ON CENTER SUPPORTED TO SUPPORT ALL LOW VOLTAGE CABLING ABOVE ACCESSIBLE CEILINGS. PROVIDE SEPARATE CABLE HANGERS FOR BACKBONE CABLING, HORIZONTAL CABLING, PUBLIC ADDRESS & SECURITY CABLING, AND FIRE ALARM CABLING. INSTALL ALL EXPOSED CABLES IN EMT CONDUIT OR SURFACE RACEWAY IN FINISHED AREAS.
- G. ALL LOW VOLTAGE CABLING SHALL BE PLENUM RATED.
- OBTAIN WIRING AND INSTALLATION DIAGRAMS FOR ALL ELECTRICAL CONNECTIONS TO EQUIPMENT PROVIDED BY THE GENERAL, MECHANICAL OR PLUMBING CONTRACTORS PRIOR TO ROUGHING. WORK THAT IS NOT PROPERLY COORDINATED WILL BE RELOCATED AT NO COST TO THE OWNER.
- PROVIDE HORIZONTAL AND VERTICAL RACEWAY AS REQUIRED TO TRANSITION FROM UNIT VENTILATORS TO ACCESSIBLE CEILINGS, CONTRACTOR IS TO ASSUME VERTICAL RISE IS IN THE FURTHEST CORNER AWAY FROM EQUIPMENT CONNECTION POINT AS INDICATED IN PLANS. REFER TO PLANS FOR CEILING TYPES.

ELECTRIC EQUIPMENT AND CONTROL SCHEDULE SUPPLY DISCONNECT CONTROLS **EQUIPMENT** NOTES PANEL OR CONTROL WIRING FROM PANEL TO WIRING FROM CONTROL MOTOR STARTER/ CONTROLLER NEMA NEMA CIRCUIT BREAKER NAME ROOM LOCATION AMPS | FUSE SIZE | CONTROL UNIT UNIT TO EQUIPMENT RATING CONTROLLER NOTES LOCATION RATING CENTER CLASSROOM 1 LP-2 40A/3P 3)-#8, (1)-#10 EGC IN 3/4"C UV-1 CLASSROOM 2 LP-2 40A/3P (3)-#8, (1)-#10 EGC IN 3/4"C UV-2 - | 3 | 208 4 CLASSROOM 3 - | 3 | 208 (3)-#8, (1)-#10 EGC IN 3/4"C UV-3 LP-2 40A /3P 4 (3)-#8, (1)-#10 EGC IN 3/4"C CLASSROOM 4 UV-4 LP-2 40A/3P 4 CLASSROOM 5 (3)-#8, (1)-#10 EGC IN 3/4"C UV-5 - | 3 | 208 LP-2 40A/3P 4 CLASSROOM 6 LP-2 (3)-#8, (1)-#10 EGC IN 3/4"C 40A/3P UV-6 4 (3)-#8, (1)-#10 EGC IN 3/4"C UV-8 CLASSROOM 8 MP-1 40A/3P CLASSROOM 9 MP-1 (3)-#8, (1)-#10 EGC IN 3/4"C UV-9 - | 3 | 208 40A/3P 1 CLASSROOM 10 MP-1 3)-#8, (1)-#10 EGC IN 3/4"C UV-10 40A/3P (3)-#8, (1)-#10 EGC IN 3/4°C CLASSROOM 11 MP-1 40A/3P UV-11 1 3 1208 1 (3)-#8, (1)-#10 EGC IN $3/4^{\circ}$ C UV-12 CLASSROOM 12 - | 3 | 208 MP-1 40A/3P UV-13 CLASSROOM 13 MP-1 40A/3P (3)-#8, (1)-#10 EGC IN 3/4"C (3)-#8, (1)-#10 EGC IN 3/4"C CLASSROOM 14 MP-1 UV-14 - | 3 | 208 40A/3P 14 **|** CLASSROOM 15 - | 3 | 208 MP-1 40A/3P (3)-#8, (1)-#10 EGC IN 3/4"C 2. 7 UV-15 15 CLASSROOM 16 - | 3 | 208 (3)-#8, (1)-#10 EGC IN 3/4"C UV-16 MP-2 40A/3P (3)-#8, (1)-#10 EGC IN $\overline{3/4^{\circ}C}$ 16 UV-17 CLASSROOM 17 - | 3 | 208 MP-2 40A/3P 17 **|** CLASSROOM 18 - | 3 | 208 (3)-#8, (1)-#10 EGC IN 3/4"C UV-18 MP-2 40A/3P UV-19 CLASSROOM 19 MP-2 40A/3P (3)-#8, (1)-#10 EGC IN 3/4"C 19 UV-20 CLASSROOM 20 - | 3 | 208 MP-2 40A/3P (3)-#8, (1)-#10 EGC IN 3/4"C CLASSROOM 21 (3)-#8, (1)-#10 EGC IN 3/4"C UV-21 MP-2 CLASSROOM 22 (3)-#8, (1)-#10 EGC IN 3/4"C UV-22 - | 3 | 208 PPA40A/3P CLASSROOM 23 22 UV-23 - | 3 | 208 MP-2 40A/3P (3)-#8, (1)-#10 EGC IN 3/4"C (3)-#8, (1)-#10 EGC IN 3/4"C UV-24 CLASSROOM 24 MD1 40A/3P CRAWL SPACE (2)-#8, (1)-#10 EGC IN 3/4"C (2)-#8, (1)-#10 EGC IN 3/4"C DHU-1 LP-2 40A/2P 24 - | 1 | 208 60 | NF 5, 6 (2)-#8, (1)-#10 EGC IN 3/4"C DHU-2 CRAWL SPACE MP-2 40A/2P (2)-#8, (1)-#10 EGC IN 3/4"C 60 NF 3, 5 EF-1 ROOF |1/4| - | 1 |120| MP-1 15A/1P (2)-#12, (1)-#12 EGC IN 3/4°C

ELECTRIC EQUIPMENT AND CONTROL SCHEDULE GENERAL NOTES:

- A. ALL CONTROL EQUIPMENT PROVIDED BY THE DIVISION 26 CONTRACTOR UNLESS OTHERWISE NOTED.
- B. ITEM NUMBER INDICATES EQUIPMENT NUMBER. C. ALL CONTROL DEVICES TO BE SURFACE MOUNTED UNLESS OTHERWISE NOTED.
- D. PROVIDE OVERLOADS, SIZE AS REQUIRED BY DIVISION 23 CONTRACTOR. E. "AU" INDICATES CONTROL DEVICE LOCATED AT UNIT.

O-E.001.00

- F. "NF" INDICATES NON-FUSED.
- G. WHERE CONTROLS ARE LOCATED REMOTE FROM MOTOR PROVIDE DISCONNECT IN ADDITION TO CONTROLS. H. WHERE DISCONNECT SIZES ARE INDICATED PROVIDE DISCONNECT.

NOTES:

- 1. PROVIDE 40A, 3-POLE BRANCH CIRCUIT BREAKER "EATON PRL1A" SERIES.
- 2. REMOVE 3-20A, 1-POLE BRANCH CIRCUIT BREAKERS AND PROVIDE 40A, 3-POLE BRANCH CIRCUIT BREAKER "EATON PRL1A" SERIES. 3. REMOVE 2-20A, 1-POLE BRANCH CIRCUIT BREAKERS AND PROVIDE 40A, 2-POLE BRANCH CIRCUIT BREAKER "EATON PRL1A" SERIES.
- 4. ALTERNATE NO. 2.
- 5. ALTERNATE NO. 1 6. IN LIEU OF ALTERNATE NO. 2 NOT BEING ACCEPTED CIRCUIT DUH-1 TO MDP. PROVIDE 3-#6, 1-#8 EGC IN 1"C AND 40A, 2-POLE BREAKER.
- 7. REMOVE & RE-WORK EXISTING 20A, 1-POLE BRANCH CIRCUIT AS REQUIRED TO ACCOMMODATE 3-POLE BRANCH CIRCUIT BREAKERS. 8. PROVIDE 15A, 1-POLE BRANCH CIRCUIT BREAKER "EATON PRL1A" SERIES.

MOTOR STARTER/CONTROLLER NOTES:

- MOTOR RATED SWITCH.
- 2. MANUAL MOTOR STARTER. 3. MANUAL MOTOR STARTER WITH RELAY.
- 4. MAGNETIC STARTER.
- 5. COMBINATION MAGNETIC STARTER.
- 6. VARIABLE FREQUENCY DRIVE. FURNISHED BY MC, INSTALLED BY EC. 7. COMBINATION TWO SPEED MAGNETIC STARTER.
- 8. COMBINATION REDUCED VOLTAGE MAGNETIC STARTER
- 9. DUPLEX CONTROLLER WITH ALTERNATION CIRCUIT.
- 10. PACKAGED CONTROL UNIT.
- 11. H-O-A SELECTOR SWITCH IN COVER.
- 12. PILOT LIGHT IN COVER. 13. START-STOP PUSHBUTTON.
- 14. DUPLEX RECEPTACLE.
- LINE-VOLTAGE THERMOSTAT. 16. PROVIDE FAN SHUTDOWN RELAY AND CONNECT TO FACP FOR SHUTDOWN ON BUILDING ALARM.

POWER

- MOTOR CONNECTION NUMBER INDICATES ITEM REFER TO ELECTRIC EQUIPMENT AND CONTROL SCHEDULE
- NON-FUSED DISCONNECT NUMBER INDICATES ITEM REFER TO ELECTRIC EQUIPMENT AND CONTROL SCHEDULE
- FUSED DISCONNECT
- ECB ENCLOSED CIRCUIT BREAKER
- EXISTING SURFACE MOUNTED 208Y/120V BRANCH CIRCUIT PANELBOARD
- SURFACE MOUNTED 208Y/120V BRANCH CIRCUIT PANELBOARD INDICATES HOMERUN TO PANEL
- CKT# PANEL NAME AND CKT NUMBERS INDICATED PROVIDE (2) #12 AWG, (1) #12 AWG EGC IN 3/4"C UNLESS OTHERWISE NOTED

GENERAL

- 7777 OFFSET FOR CLARITY

UNLESS OTHERWISE NOTED, MOUNT DEVICES AND EQUIPMENT AT HEIGHTS MEASURED FROM FINISHED FLOOR TO DEVICE/ EQUIPMENT CENTERLINE AS

COORDINATE DEVICE LOCATIONS WITH ARCHITECTURAL ELEVATIONS PRIOR TO ROUGH-IN. WHERE STRUCTURAL OR OTHER INTERFERENCE'S PREVENT COMPLIANCE WITH MOUNTING HEIGHTS LISTED BELOW, CONSULT OWNER'S REPRESENTATIVE FOR APPROVAL TO CHANGE

LOCATION BEFORE INSTALLATION. TOGGLE SWITCHES RECEPTACLE OUTLETS

OR STEAM BASEBOARD HEATERS	3
RECEPTACLE OUTLETS, HAZARDOUS LOCATIONS	4
RECEPTACLE OUTLETS, WEATHER PROOF, ABOVE GRADE	2
CLOCKS, CLOCK	9
BRANCH CIRCUIT PANELBOARDS.	

ABBREVIATIONS

	AC AFF AFG AFCI AIC AL ASYM ATS AUX AWG	ABOVE COUNTER ABOVE FINISHED FLOOR ABOVE FINISHED GRADE ARC FAULT CIRCUIT INTERRUPTER AMPERES INTERRUPTING CAPACITY ALUMINUM ASYMMETRICAL AUTOMATIC TRANSFER SWITCH AUXILLARY CONTACTS AMERICAN WIRE GAUGE	
	BD BR	BUS DUCT BRANCH	
	C CB	CONDUIT CIRCUIT BREAKER	
	CD CH	CANDELA CABINET HEATER	
)	CKT CT CU	CIRCUIT CURRENT TRANSFORMER COPPER	
)	CATV CCTV CLG	CABLE TELEVISION CLOSED CIRCUIT TELEVISION CEILING	

CTRICAL CONTRACTOR

QUIPMENT GROUND CONDUCTOR

THYLENE PROPYLENE RUBBER

EXISTING TO BE RELOCATED

LECTRIC METALLIC TUBING

FIRE ALARM CONTROL PANEL

FULL CAPACITY ABOVE NORMAL

FULL CAPACITY BELOW NORMAL

ULL VOLTAGE, NON-REVERSING

GROUND FAULT CIRCUIT INTERRUPTER

LONG TIME-SHORT TIME-INSTANTANEOUS-GROUND FAULT

FULL VOLTAGE, REVERSING

GENERAL CONTRACTOR

GALVANIZED RIGID STEEL

HAND-OFF-AUTOMATIC

HIGH PRESSURE SODIUM

INTERMEDIATE METAL CONDUIT

THOUSAND AMPERE INTERRUPTING CAPACITY

FIRE ALARM REMOTE ANNUNCIATOR PANEL

QUIPMENT GROUND

EXPLOSION PROOF

XPLOSION PROOF

EXISTING

FIRE ALARM

OTCANDLE

LUORESCENT

GENERATOR

GROUND FAULT

HOSPITAL GRADE

HORSEPOWER

HIGH VOLTAGE HERTZ

JUNCTION BOX

KILOVOLT-AMPERE

KILO (THOUSAND)

LOW VOLTAGE

MEGA (MILLION)

THOUŠAND CIRCULAR MILS THOUSAND CIRCULAR MILS

MASTER ANTENNA TELEVISION

MECHANICAL CONTRACTOR

NATIONAL ELECTRICAL CODE

OVER CURRENT PROTECTION DEVICE

REDUCED VOLTAGE, NON-REVERSING

MAIN CIRCUIT BREAKER

MULTI MODE FIBER

NORMALLY CLOSED

NORMALLY OPEN

NOT IN CONTRACT

PLUMBING CONTRACTOR POWER FACTOR

POTENTIAL TRANSFORMER POLYVINYL CHLORIDE

ROOT MEAN SQUARED

SURGE SURPRESSION SOLID-STATE TRIP DEVICE

ROOF TOP UNIT

SWITCHBOARD SYMMETRICAL

TELEVISION

UNIT HEATER

VOLT-AMPERE

VAPORPROOF

WIRE GUARD

WEATHERPROOF

EXPLOSION PROOF

WYE CONNECTED

UNDERGROUND

UNIVERSAL SERIAL BUS

TAMPER RESISTANT

TIME DELAY RELAY

TEMPERATURE CONTROL PANEL

CROSS LINKED POLYETHYLENE

NOT TO SCALE

NIGHT LIGHT

NEUTRAL

OCPD

RVNR

TSTAT

NONFUSED

OVERHEAD OVERLOAD

PULL BOX

PILOT LIGHT

PLUGMOLD POWER PANEL

POWER

MEDIUM VOLTAGE MEGAVOLT-AMPERE

MOTOR CONTROL CENTER

KILOWATT

INTERCOM ISOLATED GROUND INCANDESCENT

FULL LOAD AMPERES

EPR EQUIP

FARAP

FLUOR

- # REMOVAL NOTE
- # INSTALLATION NOTE

MOUNTING HEIGHTS

LISTED BELOW.

RECEPTACLE OUTLETS ABOVE HOT WATER

ON STEAM DASEDOAND HEATENS	
RECEPTACLE OUTLETS, HAZARDOUS LOCATIONS	4
RECEPTACLE OUTLETS, WEATHER PROOF, ABOVE GRADE	2
CLOCKS, CLOCK	9
BRANCH CIRCUIT PANELBOARDS, TO THE TOP OF THE BACKBOX	7

DISCONNECT SWITCHES, MOTOR STARTERS,

ENCLOSED CIRCUIT BREAKERS

CONTACTOR CONTROL PANEL DELTA CONNECTED DISCONNECT DRINKING FOUNTAIN DOUBLE POLE, SINGLE THROW DOUBLE POLE, DOUBLE THROW LECTRIC BASEBOARD

Tel: 518.724.5159 Fax: 518.320.8633 Web: hamlindesigngroup.com

Architect:

Hazardous Material Consultant:

Hamlin Design Group

915 Broadway, Suite 101A

Albany, New York 12207



& SBA EDWOSB & DBE

MEP Engineer

	Engineered Soluti 646 Plank Road #104 Clifton Park, NY 12061 phone: (518) 280-2410 fax: (518) 280-2481 www.engineered-solution
00000	— Electrical — Communication

——— ES # 19071 ———

engineered**solutions**



1031 Elm St. Peekskill, NY 10566

Peekskill City School District

Peekskill Reconstruction

SED Project: 66-15-00-01-0-005-020 HDG Project: 201 Oakside Elementary

200 Decatur Ave. Peekskill, NY 10566 SED Project: 66-15-00-01-0-008-017

Woodside Elementary 612 Depew St., Peekskill, NY 10566

HDG Project: 203


DRAWN BY: SDK

ISSUE: 03/19/2021




DESCRIPTION Legend, General Notes, Schedules and Details

W-E.001.00

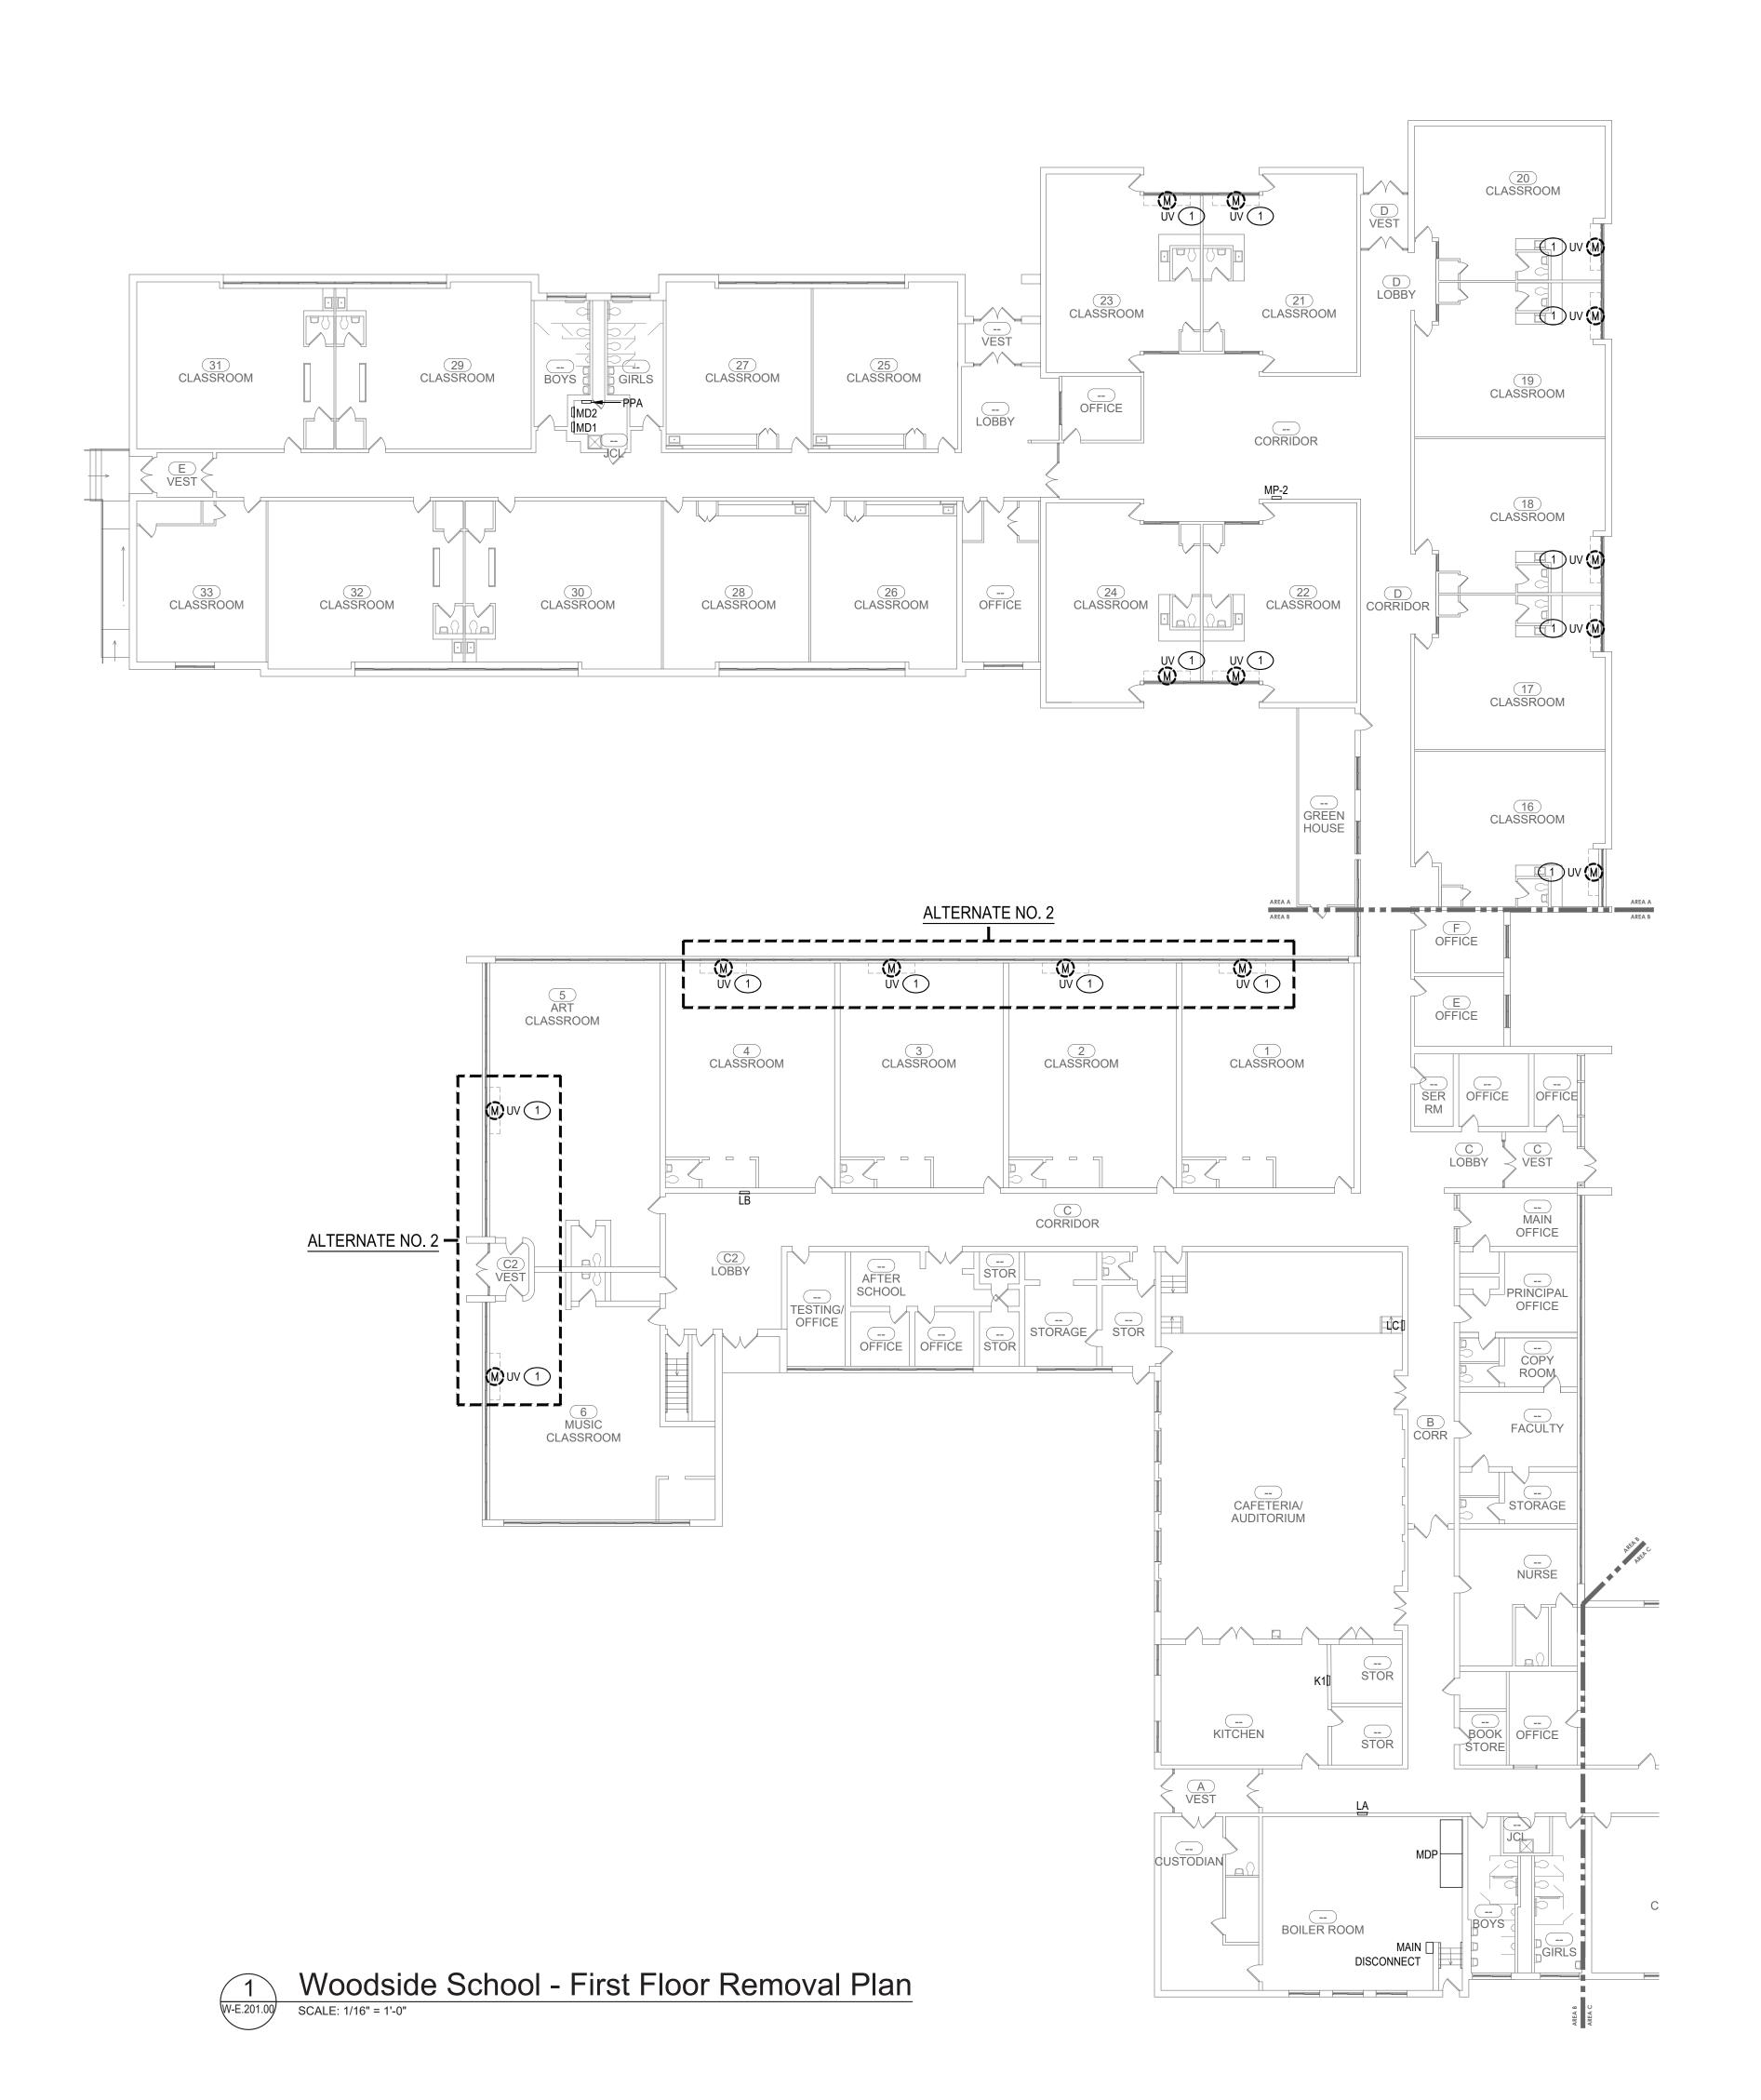



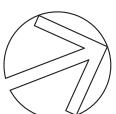

DISCONNECT & REMOVE HVAC BRANCH CIRCUIT IN ITS ENTIRETY

HAMLIN



Architect:

Hamlin Design Group

915 Broadway, Suite 101A Albany, New York 12207 Tel: 518.724.5159 Fax: 518.320.8633 Web: hamlindesigngroup.com

Hazardous Material Consultant:



AMDIENT ENVIRONMENTAL, INC Comprehensive Building Science solution NYS/NJS Certified WBE & SBA EDWOSB & DBE

MEP Engineer:

64 Cl ph fa.	ngineered Solutions 16 Plank Road #104 ifton Park, NY 12061 ione: (518) 280-2410 ix: (518) 280-2481 iww.engineered-solutions.net Electrical Communications Mechanical ES # 19071
-----------------------	--

Client:



1031 Elm St. Peekskill, NY 10566

Peekskill City School District

Peekskill Reconstruction

SED Project: 66-15-00-01-0-005-020 HDG Project: 201 Oakside Elementary

200 Decatur Ave.,

Peekskill, NY 10566 SED Project: 66-15-00-01-0-008-017 HDG Project: 203 Woodside Elementary

Woodside Elementary 612 Depew St., Peekskill, NY 10566


DRAWN BY: SDK


ISSUE: 03/19/2021



DESCRIPTION
First Floor Removal Plan



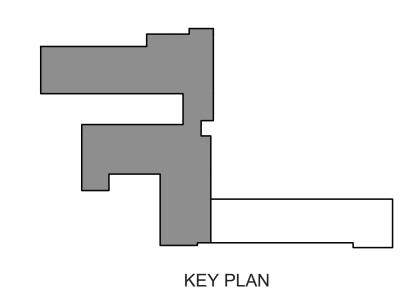

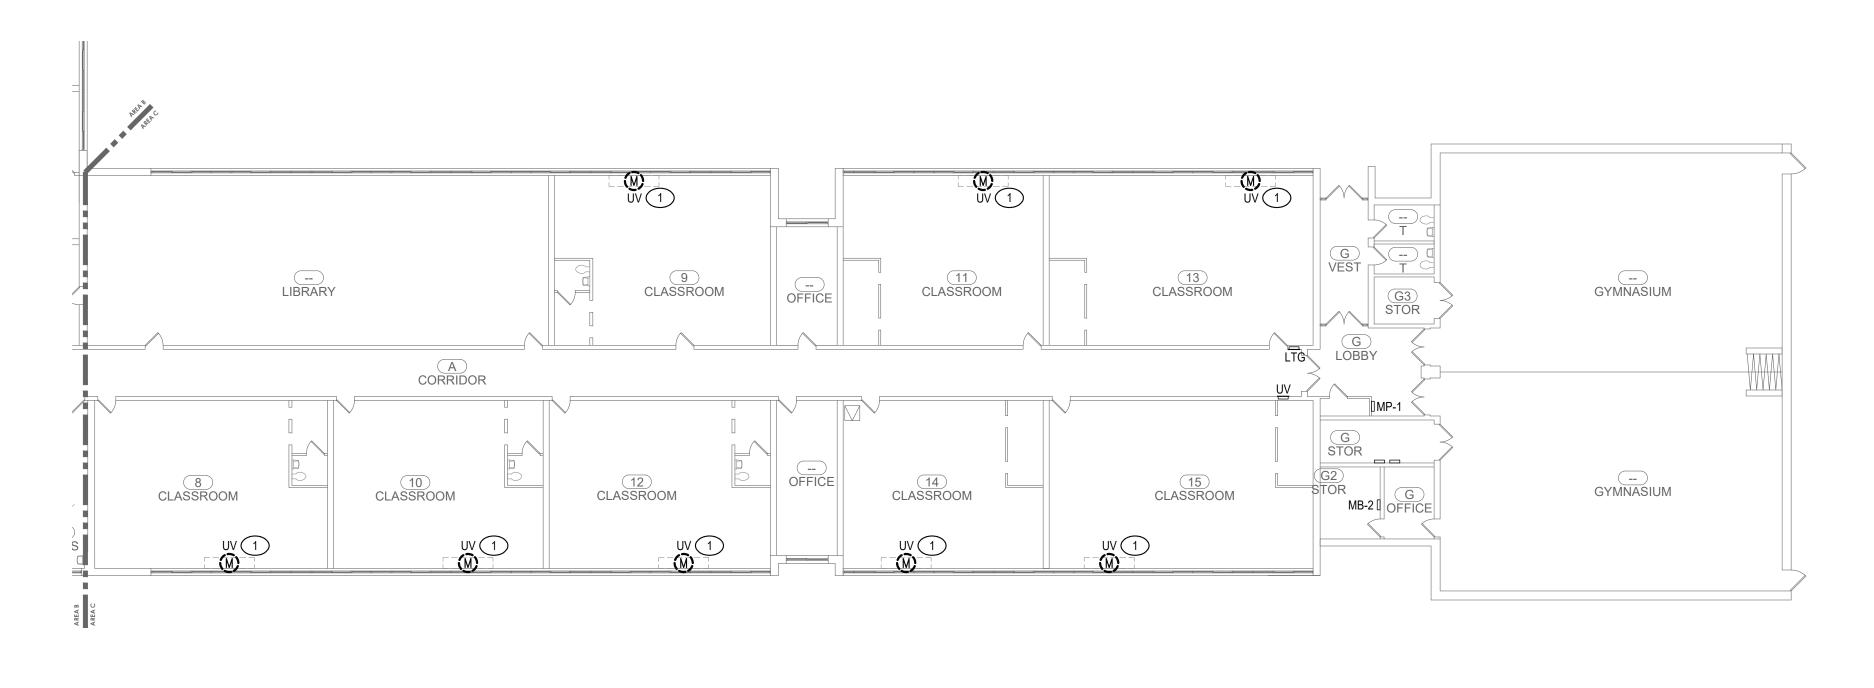



REMOVAL NOTES:

1. DISCONNECT & REMOVE HVAC BRANCH CIRCUIT IN ITS





Architect:

Hamlin Design Group

915 Broadway, Suite 101A Albany, New York 12207 Tel: 518.724.5159 Fax: 518.320.8633 Web: hamlindesigngroup.com

Hazardous Material Consultant:



Ambient Environmental, Inc.
Comprehensive Building Science solutions
NYS/NJS Certified WBE
& SBA EDWOSB & DBE

MEP Engineer:

64 CI ph fa	Ingineered Solutions 16 Plank Road #104 16ton Park, NY 12061 16none: (518) 280-2410 17 x: (518) 280-2481 18 ww.engineered-solutions.net 18 Electrical
----------------------	--



1031 Elm St. Peekskill, NY 10566

Peekskill City School District

Peekskill Reconstruction

SED Project: 66-15-00-01-0-005-020 HDG Project: 201 **Oakside Elementary** 200 Decatur Ave., Peekskill, NY 10566

SED Project: 66-15-00-01-0-008-017 HDG Project: 203 **Woodside Elementary** 612 Depew St., Peekskill, NY 10566


DRAWN BY: SDK


ISSUE: 03/19/2021



DESCRIPTION First Floor Removal Plans



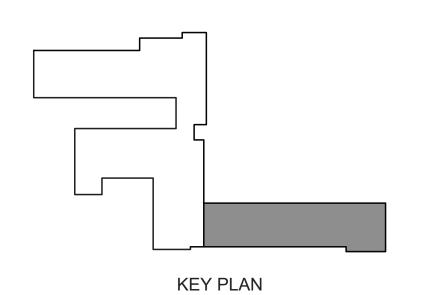

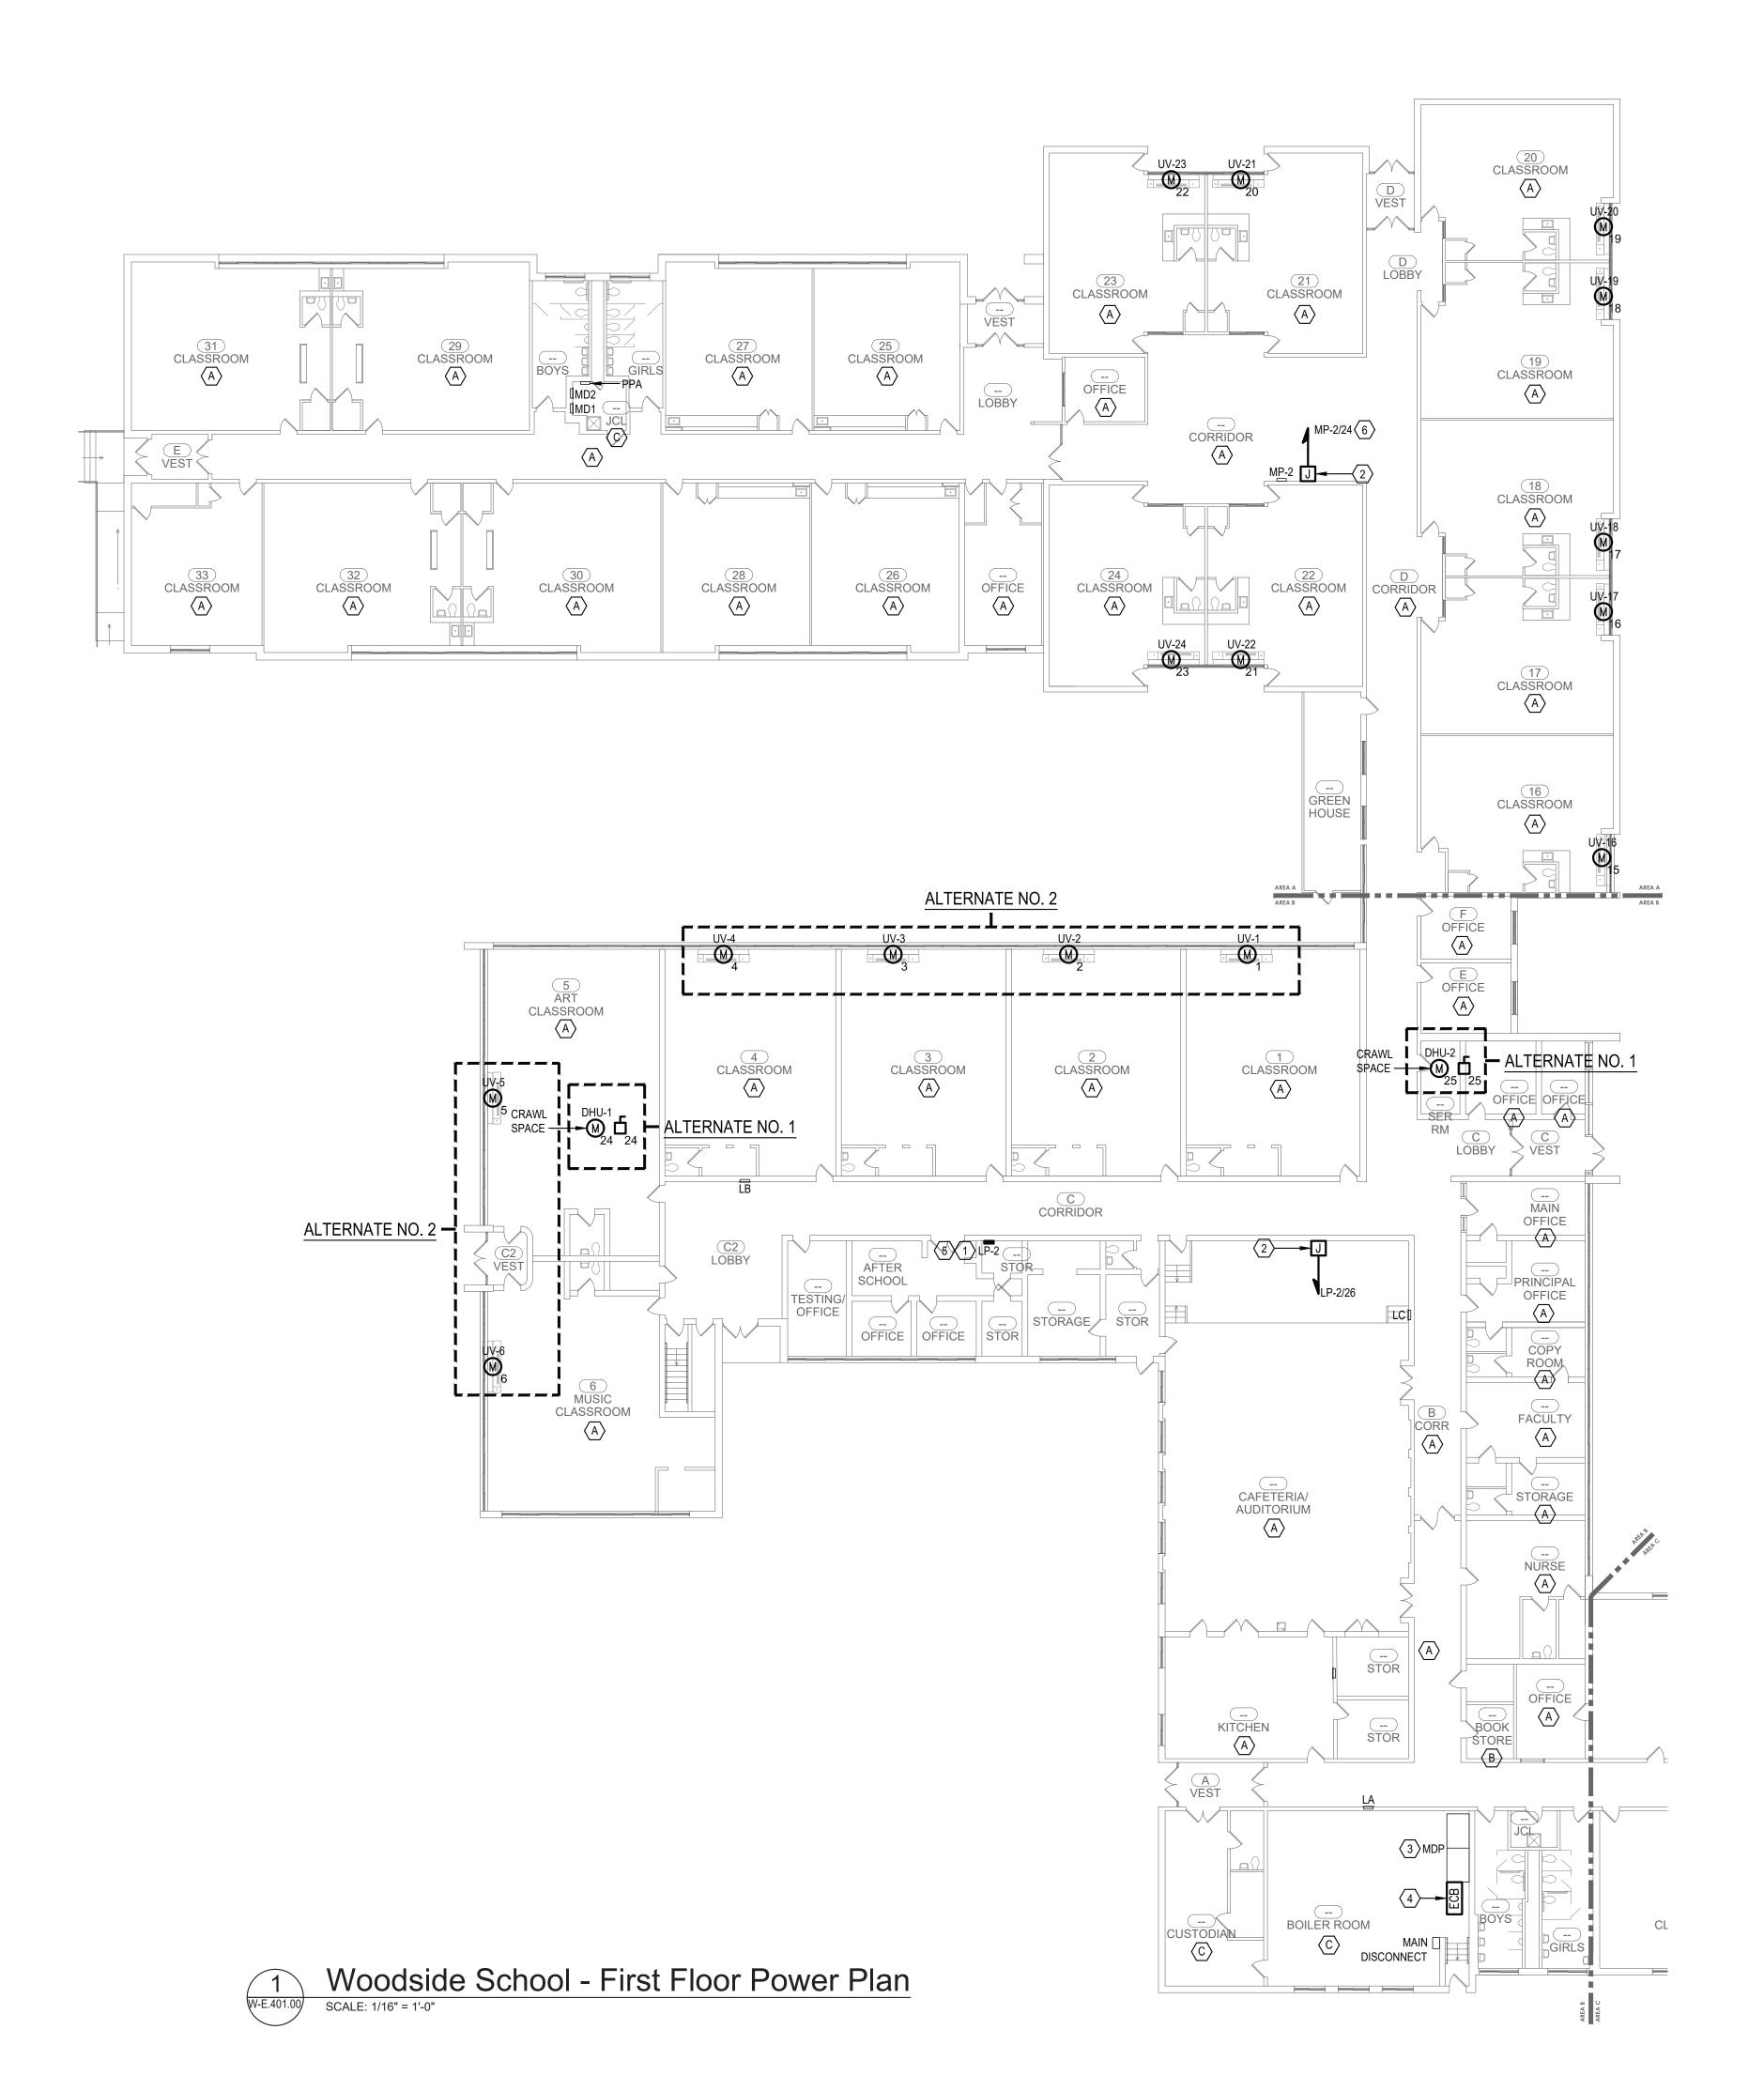



DRAWING NOTES: \bigcirc

- ALTERNATE NO. 2: COORDINATE FINAL LOCATIONS WITH
 OWNER PRIOR TO ROUGH-IN OF FEEDERS AND PANELBOARDS.
- 2. ALTERNATE NO. 2: PROVIDE 120V BRANCH CIRCUIT FOR TEMPERATURE CONTROLS CONTRACTOR (TC). TC TO PROVIDE POWER FROM THIS LOCATION TO THEIR EQUIPMENT, COORDINATE FINAL LOCATION WITH TC.
- 3. <u>ALTERNATE NO. 2</u>: EXISTING 208Y/120V, 1,200A MLO, 3-PHASE, 4-WIRE DISTRIBUTION PANELBOARD. PROVIDE BUS TAP AND LUGS FOR PANELBOARD LP2 ENCLOSED CIRCUIT BREAKER
- 4. <u>ALTERNATE NO. 2</u>: PROVIDE 600V, 3-POLE, 225A ENCLOSED CIRCUIT BREAKER AND (4)-#4/0 AWG, (1)-#4 AWG EGC IN 2-1/2"C FROM MDP FOR PANELBOARD LP2.
- 5. <u>ALTERNATE NO. 2</u>: PROVIDE (4)-#4/0 AWG, (1)-#4 AWG EGC IN 2-1/2"C FROM ECB FOR PANELBOARD LP-2.
- 6. CONNECT TO SPARE 20A, 1-POLE BRANCH CIRCUIT BREAKER.

CEILING SCHEDULE												
DESIGNATION	DESCRIPTION											
A	ACCESSIBLE CEILING											
B	INACCESSIBLE CEILING											
C	EXPOSED STRUCTURE											

HAMLIN



Architect:

Hamlin Design Group

915 Broadway, Suite 101A Albany, New York 12207 Tel: 518.724.5159 Fax: 518.320.8633 Web: hamlindesigngroup.com

Hazardous Material Consultant:



NYS/NJS Certified WBE & SBA EDWOSB & DBE

MEP Engineer:

1031 Elm St.



Peekskill, NY 10566

Peekskill City School District

Peekskill Reconstruction

SED Project: 66-15-00-01-0-005-020 HDG Project: 201

Oakside Elementary 200 Decatur Ave.,

Peekskill, NY 10566

SED Project: 66-15-00-01-0-008-017 HDG Project: 203 **Woodside Elementary** 612 Depew St.,

Peekskill, NY 10566


DRAWN BY: SDK

ISSUE: 03/19/2021



DESCRIPTION



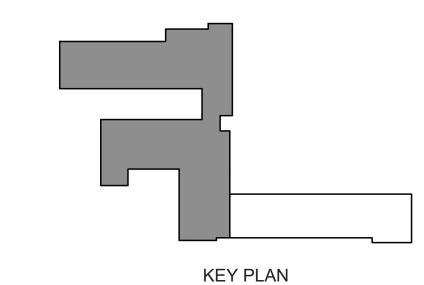

	TION - STORAGE			E - EC					TING - S				SE RATED FEED-THRU LUGS			
	NG (AMPS) - 225A MLO				.08Y/120				:/WIRE -		SE/4-WIF	RE	HINGED TRIM ☑ SUB FEED LUGS COMPUTER GRADE ☐ SUB-FEED BREAKER			
KAIC	- 10		DESIGN	MAKE	(SQUAR	E D) - N			RATING	- 1					ATED GND BUS	
скт	DESCRIPTION	RRF	AKER					LOAD				BREAKI	FR	R DESCRIPTION		
OIX.1	DESCRIPTION		-/ ((\	LTG	RCPT	MOTOR	HTG	HTG	HTG MOTOR	RCPT	LTG	BINE/IINEIN		DESCRIPTION	Cł	
1																
3	UV-1	40A/3P				8.7			8.7			40A/3	3P	UV-2	<u> </u>	
5																
7		١.,	. /==									/=		1		
9	UV-3	40/	A/3P			8.7			8.7			40A/3	5P	P UV-4		
11															1	
13 15	UV-5	1 40.	A/3P			8.7			8.7			40A/3	_{zD}	UV-6	1	
17	04-3	40/	A/3P			0.7			0.7			40A/3		´ UV-0		
19		+			-										1 2	
21	UV-16	1 40	A /3D			8.7			8.7			40A/3	3P UV-17		2	
23	0 1 10	40A/3P				0.7			0.7			10// 0	"	0 1 7	2	
25		+										20A/1	IP I	TC	2	
27	DHU-1	40/	A/2P			4.5						20A/1		SPARE	2	
29	SPARE	20/	A/1P									20A/1	$\overline{}$	SPARE	3	
31	SPARE		A/1P									20A/1	$\overline{}$	SPARE	3	
33	SPARE		A/1P									20A/1	IP	SPARE	3	
35	SPARE	20/	A/1P									20A/1	IP	SPARE	3	
37	SPARE	20/	A/1P									20A/1	IP	SPARE	3	
39	SPARE	20/	A/1P									20A/1	IΡ	SPARE	4	
41	SPARE	20/	A/1P									20A/1	IΡ	SPARE	4	
43	SPARE	20/	A/1P									20A/1	IP	SPARE	4	
45	SPARE		A/1P									20A/1		SPARE	4	
47	SPARE	20	A/1P									20A/1	_	SPARE	4	
	SIDE SUB-TOTAL			-	-	39	-	-	35	-	-	RIGHT	SIDE	SUB-TOTAL		
	NECTED SUB-TOTAL			- 1.0	<u> </u>	74	-									
	MAND FACTOR				10+1/2		.8									
SOB-	TOTAL	-		59	-											





TOTAL AMPS

DRAWING NOTES: (

- PROVIDE 120V BRANCH CIRCUIT FOR TEMPERATURE CONTROLS CONTRACTOR (TC). TC TO PROVIDE POWER FROM THIS LOCATION TO THEIR EQUIPMENT, COORDINATE FINAL LOCATION WITH TC.
- 2. PROVIDE 20A, 1-POLE BRANCH CIRCUIT BREAKER "EATON PRL1A" SERIES.

CEILING SCHEDULE												
DESIGNATION	DESCRIPTION											
A	ACCESSIBLE CEILING											
B	INACCESSIBLE CEILING											
C	EXPOSED STRUCTURE											

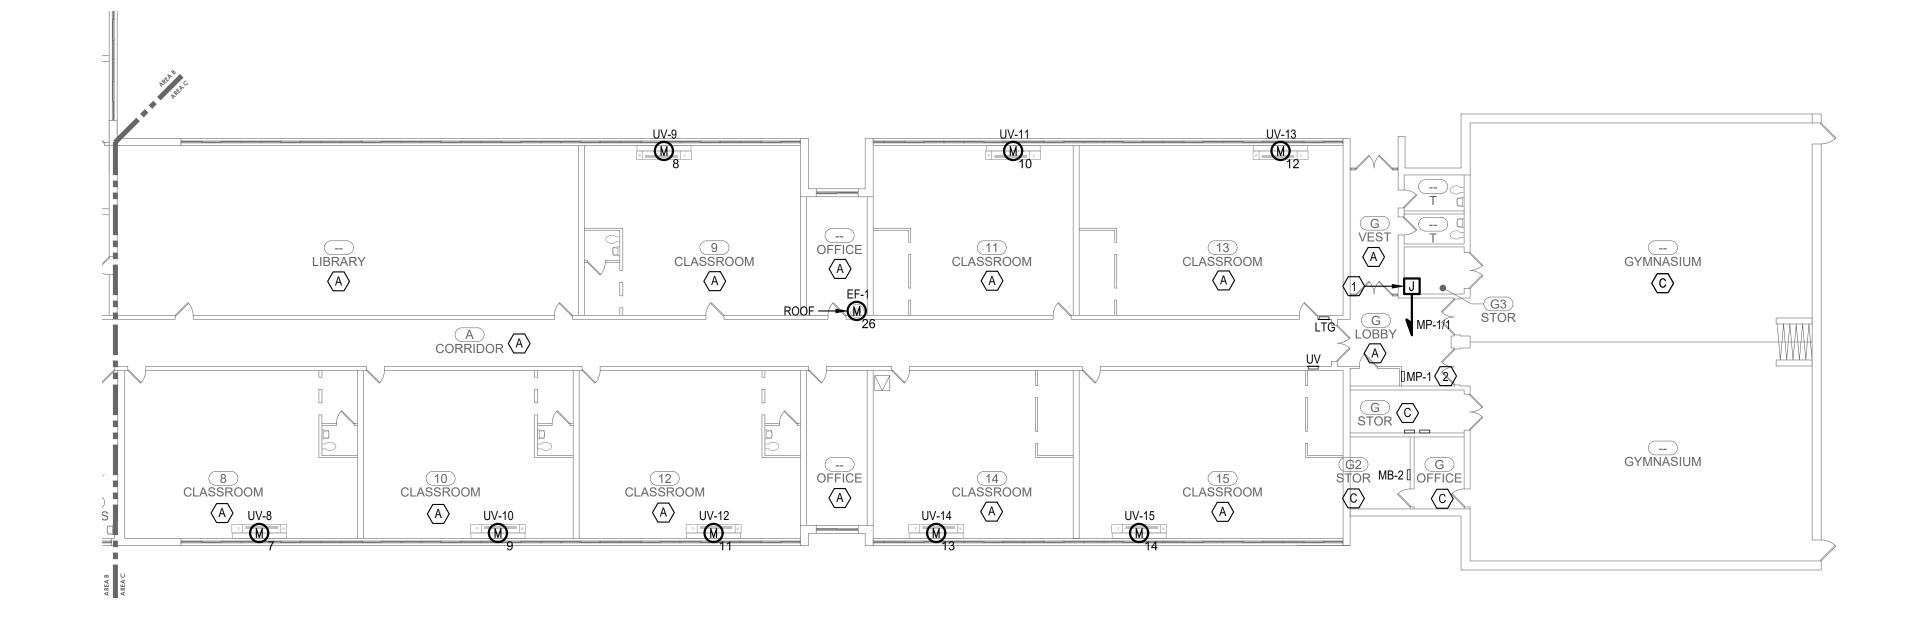

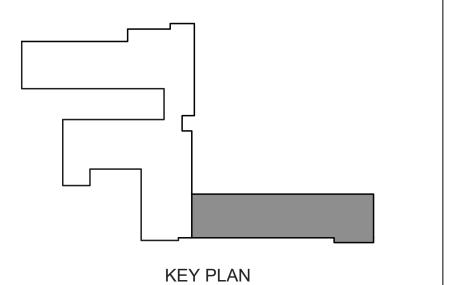



Architect:

Hamlin Design Group

915 Broadway, Suite 101A Albany, New York 12207 Tel: 518.724.5159 Fax: 518.320.8633 Web: hamlindesigngroup.com

Hazardous Material Consultant:



MEP Engineer:

Engineered Solutions
646 Plank Road #104
Clifton Park, NY 12061
phone: (518) 280-2410
fax: (518) 280-2481

www.engineered-solutions.net

Electrical



1031 Elm St. Peekskill, NY 10566

Peekskill City School District

Peekskill Reconstruction

SED Project: 66-15-00-01-0-005-020 HDG Project: 201 **Oakside Elementary**

200 Decatur Ave., Peekskill, NY 10566

SED Project: 66-15-00-01-0-008-017
HDG Project: 203
Woodside Elementary
612 Depew St.,
Peekskill, NY 10566

DRAWN BY: SDK



ISSUE: 03/19/2021

DESCRIPTION

W-E.402.00 (PARTIAL ALTERNATE NO. 2)

First Floor Power Plan and Panelboard Schedules

W-E.402.00 SCALE: 1/16" = 1'-0"

Woodside School - First Floor Power Plan (con't)

	UNIT VENTILATOR SCHEDULE																									
	LOCATION		AIRSIE	DE PERFOR	RMANCE			HYDRONIC PERFORMANCE								COOLING PERFORMANCE										
TAG		TYPE	FAN SPEED SETTING	SUPPLY (CFM)	MIN. O.A. (CFM)	CAPACITY (MBH)	E.A.T. (°F)	L.A.T. (°F)	E.W.T. (*F)	L.W.T. (°F)	FLOW RATE (GPM)	W.P.D. (FT.)	FLUID	ROWS	TOTAL MBH	SENSIBLE MBH	EAT (DB/WB)	LAT (DB/WB)) COIL TYPE	REFRIGERANT	VOLT	PHASE	MCA	MAX FUSE	MANUFACTURER & MODEL NO.	NOTES
UV-11-W	CLASSROOM	FLOOR	HIGH	1500	448	81	49	100	180	125.8	3.0	3.5	HW	3	42	37	80/67	55/54	DX	R-410A	208	3	30.1	45	DAIKIN — AZQ 054	1,2,3,4,5,6,7,8
UV-13-W	CLASSROOM	FLOOR	HIGH	1500	797	104	35	100	180	127.8	4.0	3.5	HW	3	48	32	80/67	55/54	DX	R-410A	208	3	30.1	45	DAIKIN — AZQ 054	1,2,3,4,5,6,7,8
UV-14-W	CLASSROOM	FLOOR	HIGH	1500	445	81	49	100	180	139.4	3.0	3.5	HW	3	42	37	80/67	55/54	DX	R-410A	208	3	30.1	45	DAIKIN — AZQ 054	1,2,3,4,5,6,7,8
UV-15-W	CLASSROOM	FLOOR	HIGH	1500	797	104	35	100	180	127.8	4.0	3.5	HW	3	48	32	80/67	55/54	DX	R-410A	208	3	30.1	45	DAIKIN — AZQ 054	1,2,3,4,5,6,7,8
UV-16-W	CLASSROOM	FLOOR	HIGH	1350	440	75	48	100	180	104.4	2.0	3.5	HW	3	42	37	80/67	55/54	DX	R-410A	208	3	30.1	45	DAIKIN — AZQ 054	1,2,3,4,5,6,7,8
UV-17-W	CLASSROOM	FLOOR	HIGH	1350	443	75	48	100	180	104.4	2.0	3.5	HW	3	42	37	80/67	55/54	DX	R-410A	208	3	30.1	45	DAIKIN — AZQ 054	1,2,3,4,5,6,7,8
UV-18-W	CLASSROOM	FLOOR	HIGH	1350	440	75	48	100	180	104.4	2.0	3.5	HW	3	42	37	80/67	55/54	DX	R-410A	208	3	30.1	45	DAIKIN — AZQ 054	1,2,3,4,5,6,7,8
UV-19-W	CLASSROOM	FLOOR	HIGH	1350	441	75	48	100	180	104.4	2.0	3.5	HW	3	42	37	80/67	55/54	DX	R-410A	208	3	30.1	45	DAIKIN — AZQ 054	1,2,3,4,5,6,7,8
UV-20-W	CLASSROOM	FLOOR	HIGH	1500	441	75	48	100	180	104.4	2.0	3.5	HW	3	42	37	80/67	55/54	DX	R-410A	208	3	30.1	45	DAIKIN — AZQ 054	1,2,3,4,5,6,7,8
UV-21-W	CLASSROOM	FLOOR	HIGH	1350	439	75	48	100	180	104.4	2.0	3.5	HW	3	42	37	80/67	55/54	DX	R-410A	208	3	30.1	45	DAIKIN — AZQ 054	1,2,3,4,5,6,7,8
UV-22-W	CLASSROOM	FLOOR	HIGH	1350	440	75	48	100	180	104.4	2.0	3.5	HW	3	42	37	80/67	55/54	DX	R-410A	208	3	30.1	45	DAIKIN — AZQ 054	1,2,3,4,5,6,7,8
UV-23-W	CLASSROOM	FLOOR	HIGH	1500	440	75	48	100	180	104.4	2.0	3.5	HW	3	42	37	80/67	55/54	DX	R-410A	208	3	30.1	45	DAIKIN — AZQ 054	1,2,3,4,5,6,7,8
UV-24-W	CLASSROOM	FLOOR	HIGH	1350	441	75	48	100	180	104.4	2.0	3.5	HW	3	42	37	80/67	55/54	DX	R-410A	208	3	30.1	45	DAIKIN — AZQ 054	1,2,3,4,5,6,7,8

- REMARKS:

 1. PROVIDE MANUFACTURERS DISCONNECT, FACTORY MOUNTED AND WIRED.

 2. PROVIDE UNIT WITH MANUFACTURERS THREE SPEED SWITCH SET TO AIRFLOW INDICATED.

 3. PROVIDE UNIT WITH FACE AND BYPASS.

 4. REQUIDE ANTIQUE LYORY COLOR.

- 5. UNIT TO COME WITH FACTORY MICROTECH CONTROLLER.
 6. PROVIDE BASIC WALL MOUNTED ROOM SENSOR, PT # 910247450.
- 7. PROVIDE SS DRAIN PAN.
- 8. PROVIDE MANUFACTURERS WALL SLEEVE.

	STEAM UNIT VENTILATOR SCHEDULE																					
			AIRSIE	E PERFOR	RMANCE		STEAM P	ANCE				COOLING	PERFORMA	NCE								
TAG	LOCATION	TYPE	FAN SPEED SETTING	SUPPLY (CFM)	MIN. O.A. (CFM)	CAPACITY (MBH)	STEAM PRESSURE (PSI)	E.A.T. (*F)	L.A.T. (*F)	ROWS	TOTAL MBH	SENSIBLE MBH	EAT (DB/WB)	LAT (DB/WB)	COIL TYPE	REFRIGERANT	VOLT	PHASE	MCA	MAX FUSE	MANUFACTURER & MODEL NO.	NOTES
UV-1-W	CLASSROOM	FLOOR	HIGH	1500	787	101	2	32	95	3	48	32	80/67	55/54	DX	R-410A	208	3	30.1	45	DAIKIN — AZQ 054	1,2,3,4,5,6,7,8
UV-2-W	CLASSROOM	FLOOR	HIGH	1500	770	101	2	32	95	3	48	32	80/67	55/54	DX	R-410A	208	3	30.1	45	DAIKIN — AZQ 054	1,2,3,4,5,6,7,8
UV-3-W	CLASSROOM	FLOOR	HIGH	1500	743	101	2	32	95	3	48	32	80/67	55/54	DX	R-410A	208	3	30.1	45	DAIKIN — AZQ 054	1,2,3,4,5,6,7,8
UV-4-W	CLASSROOM	FLOOR	HIGH	1500	784	101	2	32	95	3	48	32	80/67	55/54	DX	R-410A	208	3	30.1	45	DAIKIN — AZQ 054	1,2,3,4,5,6,7,8
UV-5-W	CLASSROOM	FLOOR	HIGH	1500	1061	121	2	19	95	3	48	32	80/67	55/54	DX	R-410A	208	3	30.1	45	DAIKIN — AZQ 054	1,2,3,4,5,6,7,8
UV-6-W	CLASSROOM	FLOOR	HIGH	1500	881	108	2	28	95	3	48	32	80/67	55/54	DX	R-410A	208	3	30.1	45	DAIKIN — AZQ 054	1,2,3,4,5,6,7,8
UV-8-W	CLASSROOM	FLOOR	HIGH	1500	465	77	2	46	95	3	48	32	80/67	55/54	DX	R-410A	208	3	30.1	45	DAIKIN — AZQ 054	1,2,3,4,5,6,7,8
UV-9-W	CLASSROOM	FLOOR	HIGH	1500	454	77	2	43	95	3	42	37	80/67	55/54	DX	R-410A	208	3	30.1	45	DAIKIN — AZQ 054	1,2,3,4,5,6,7,8
UV-10-W	CLASSROOM	FLOOR	HIGH	1500	450	77	2	43	95	3	42	37	80/67	55/54	DX	R-410A	208	3	30.1	45	DAIKIN — AZQ 054	1,2,3,4,5,6,7,8
UV-12-W	CLASSROOM	FLOOR	HIGH	1500	458	77	2	43	95	3	42	37	80/67	55/54	DX	R-410A	208	3	30.1	45	DAIKIN — AZQ 054	1,2,3,4,5,6,7,8

- REMARKS:

 1. PROVIDE MANUFACTURERS DISCONNECT, FACTORY MOUNTED AND WIRED.

 2. PROVIDE UNIT WITH MANUFACTURERS THREE SPEED SWITCH SET TO AIRFLOW INDICATED.
- 3. PROVIDE UNIT WITH STEAM CONTROL VALVE.
 4. PROVIDE ANTIQUE IVORY COLOR.
- 5. UNIT TO COME WITH FACTORY MICROTECH CONTROLLER.
- 6. PROVIDE BASIC WALL MOUNTED ROOM SENSOR, PT # 910247450. 7. PROVIDE SS DRAIN PAN.
- 8. PROVIDE MANUFACTURERS WALL SLEEVE.

	DEHUMIDIFICATION UNIT SCHEDULE																			
		SUPPLY	MOISTURE	EXTERNAL	OUTDOOR AIR			COOLING	G			ELE	ECTRICA	AL DATA	٨		MAXIMUM	MAXIMUM		
TAG	SERVICE	AIRFLOW (CFM)	REMOVAL	STATIC PRESSURE	(RH BELOW 50%)	TOTAL CAPACITY (MBH)	SENSIBLE CAPACITY (MBH)	REHEAT CAPACITY (MBH)	EER	REFRIGERANT	VOLTS	PHASE	HZ	FLA	MCA	МОР	WEIGHT (LBS.)	DIMENSIONS LxWxH (IN.)	MANUFACTURER & MODEL NO.	REMARKS
DHU-1	BASEMENT	1500	6.5	0.5	450	30.3	18.4	38.4	11.7	R-410A	208	1	60	22.8	28	45	400	46x32x21	DECTRON DRY-O-TRON DS-015	1,2,3,4,5
DHU-2	BASEMENT	1000	6.5	0.5	0	30.3	18.4	38.4	11.7	R-410A	208	1	60	22.8	28	45	400	46x32x21	DECTRON DRY-O-TRON DS-015	1,2,3,4,5

- REMARKS:

 1. MOTOR TO BE PREMIUM EFFICIENCY, ODP.

 2. UNIT TO FIT THROUGH STANDARD 3FT DOOR.
- PROVIDE MANUFACTURER'S HUMIDITY SENSOR.
 E.C. TO PROVIDE UNIT DISCONNECT.
 PROVIDE BACNET INTERFACE.

	FAN SCHEDULE															
				AIRFLOW	E.S.P.			DRIVE			FA	N MOTOR	DATA			
TAG	LOCATION	SERVICE	TYPE	(CFM)	(IN. W.G.)	RPM	SONES	DRIVE TYPE	MOTOR TYPE	HP	W	VOLTS	PHASE	HZ	MANUFACTURER & MODEL NO.	NOTES
EF-1-W	ROOF	CRAWLSPACE	DOWNBLAST	600	0.5	1534	9.1	DIRECT	ECM	1/6	_	120	1	60	GREENHECK G-095-VG	1,2,3,4,5

- NOTE:

 1. PROVIDE ECM MOTOR (NO MOTOR STARTER).

 2. PROVIDE ME-1/D-1 DAMPER WITH ACTUATOR.

 3. PROVIDE NEMA-1 TOGGLE SWITCH FACTORY MOUNTED AND WIRED.


 4. PROVIDE EC MOTOR WITH INPUTS FOR 0-10V SIGNAL BY TC TO VARY THE SPEED OF THE FAN.

 5. PROVIDE CURB.

	DIFFUSER, REGISTERS, AND GRILLES													
TAG	MODEL	MOUNTING	FRAME TYPE	MAX CFM	BLOW PATTERN	FACE SIZE	NECK SIZE	VELOCITY (FPM.)	THROW (FT.)	PD	SOUND LEVEL	MATERIAL	MANUFACTURER	REMARKS
SD-1	61DH	DUCT	FLANGED	252	1-WAY	14x8	12x6	600	15	.022	17	STEEL	NAILOR	

	FIN TUBE SCHEDULE									
TAG	CABINET STYLE	CABINET HEIGHT	HEAT CAPACITY BTU/FT	HEAT MEDIUM	AVG WATER TEMP	TUBE SIZE(#TIERS)	FIN SIZE (FIN/IN)	FIN LENGTH	MANUFACTURER & MODEL NO.	REMARKS
FTR-1	SLOPE TOP	24	1190	WATER	170	3/4"(1)	4 ¹ / ₄ × 3 ⁵ / ₈ (50)	SEE DRAWINGS	STERLING JVB-S20	1,2,3

REMARKS:
1. CONCEAL ALL PIPING BELOW COVER.
2. FIN ENCLOSURE SHALL BE SLOPE TOP.
3. MOUNT FIN 4" A.F.F.

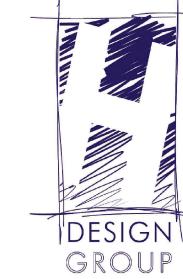

Architect:

Hamlin Design Group

915 Broadway, Suite 101A Albany, New York 12207 Tel: 518.724.5159 Fax: 518.320.8633 Web: hamlindesigngroup.com

Hazardous Material Consultant:



Ambient Environmental, Inc.
Comprehensive Building Science solutions
NYS/NJS Certified WRF
& SBA EDWOCT

MEP Engineer:





1031 Elm St. Peekskill, NY 10566

Peekskill City School District

Peekskill Reconstruction SED Project: 66-15-00-01-0-005-020

HDG Project: 201 Oakside Elementary 200 Decatur Ave.,

Peekskill, NY 10566 SED Project: 66-15-00-01-0-008-017 HDG Project: 203

Woodside Elementary 612 Depew St., Peekskill, NY 10566


DRAWN BY: MLB

ISSUE: 03/19/2021



DESCRIPTION **HVAC Schedules**

W-M.002.00

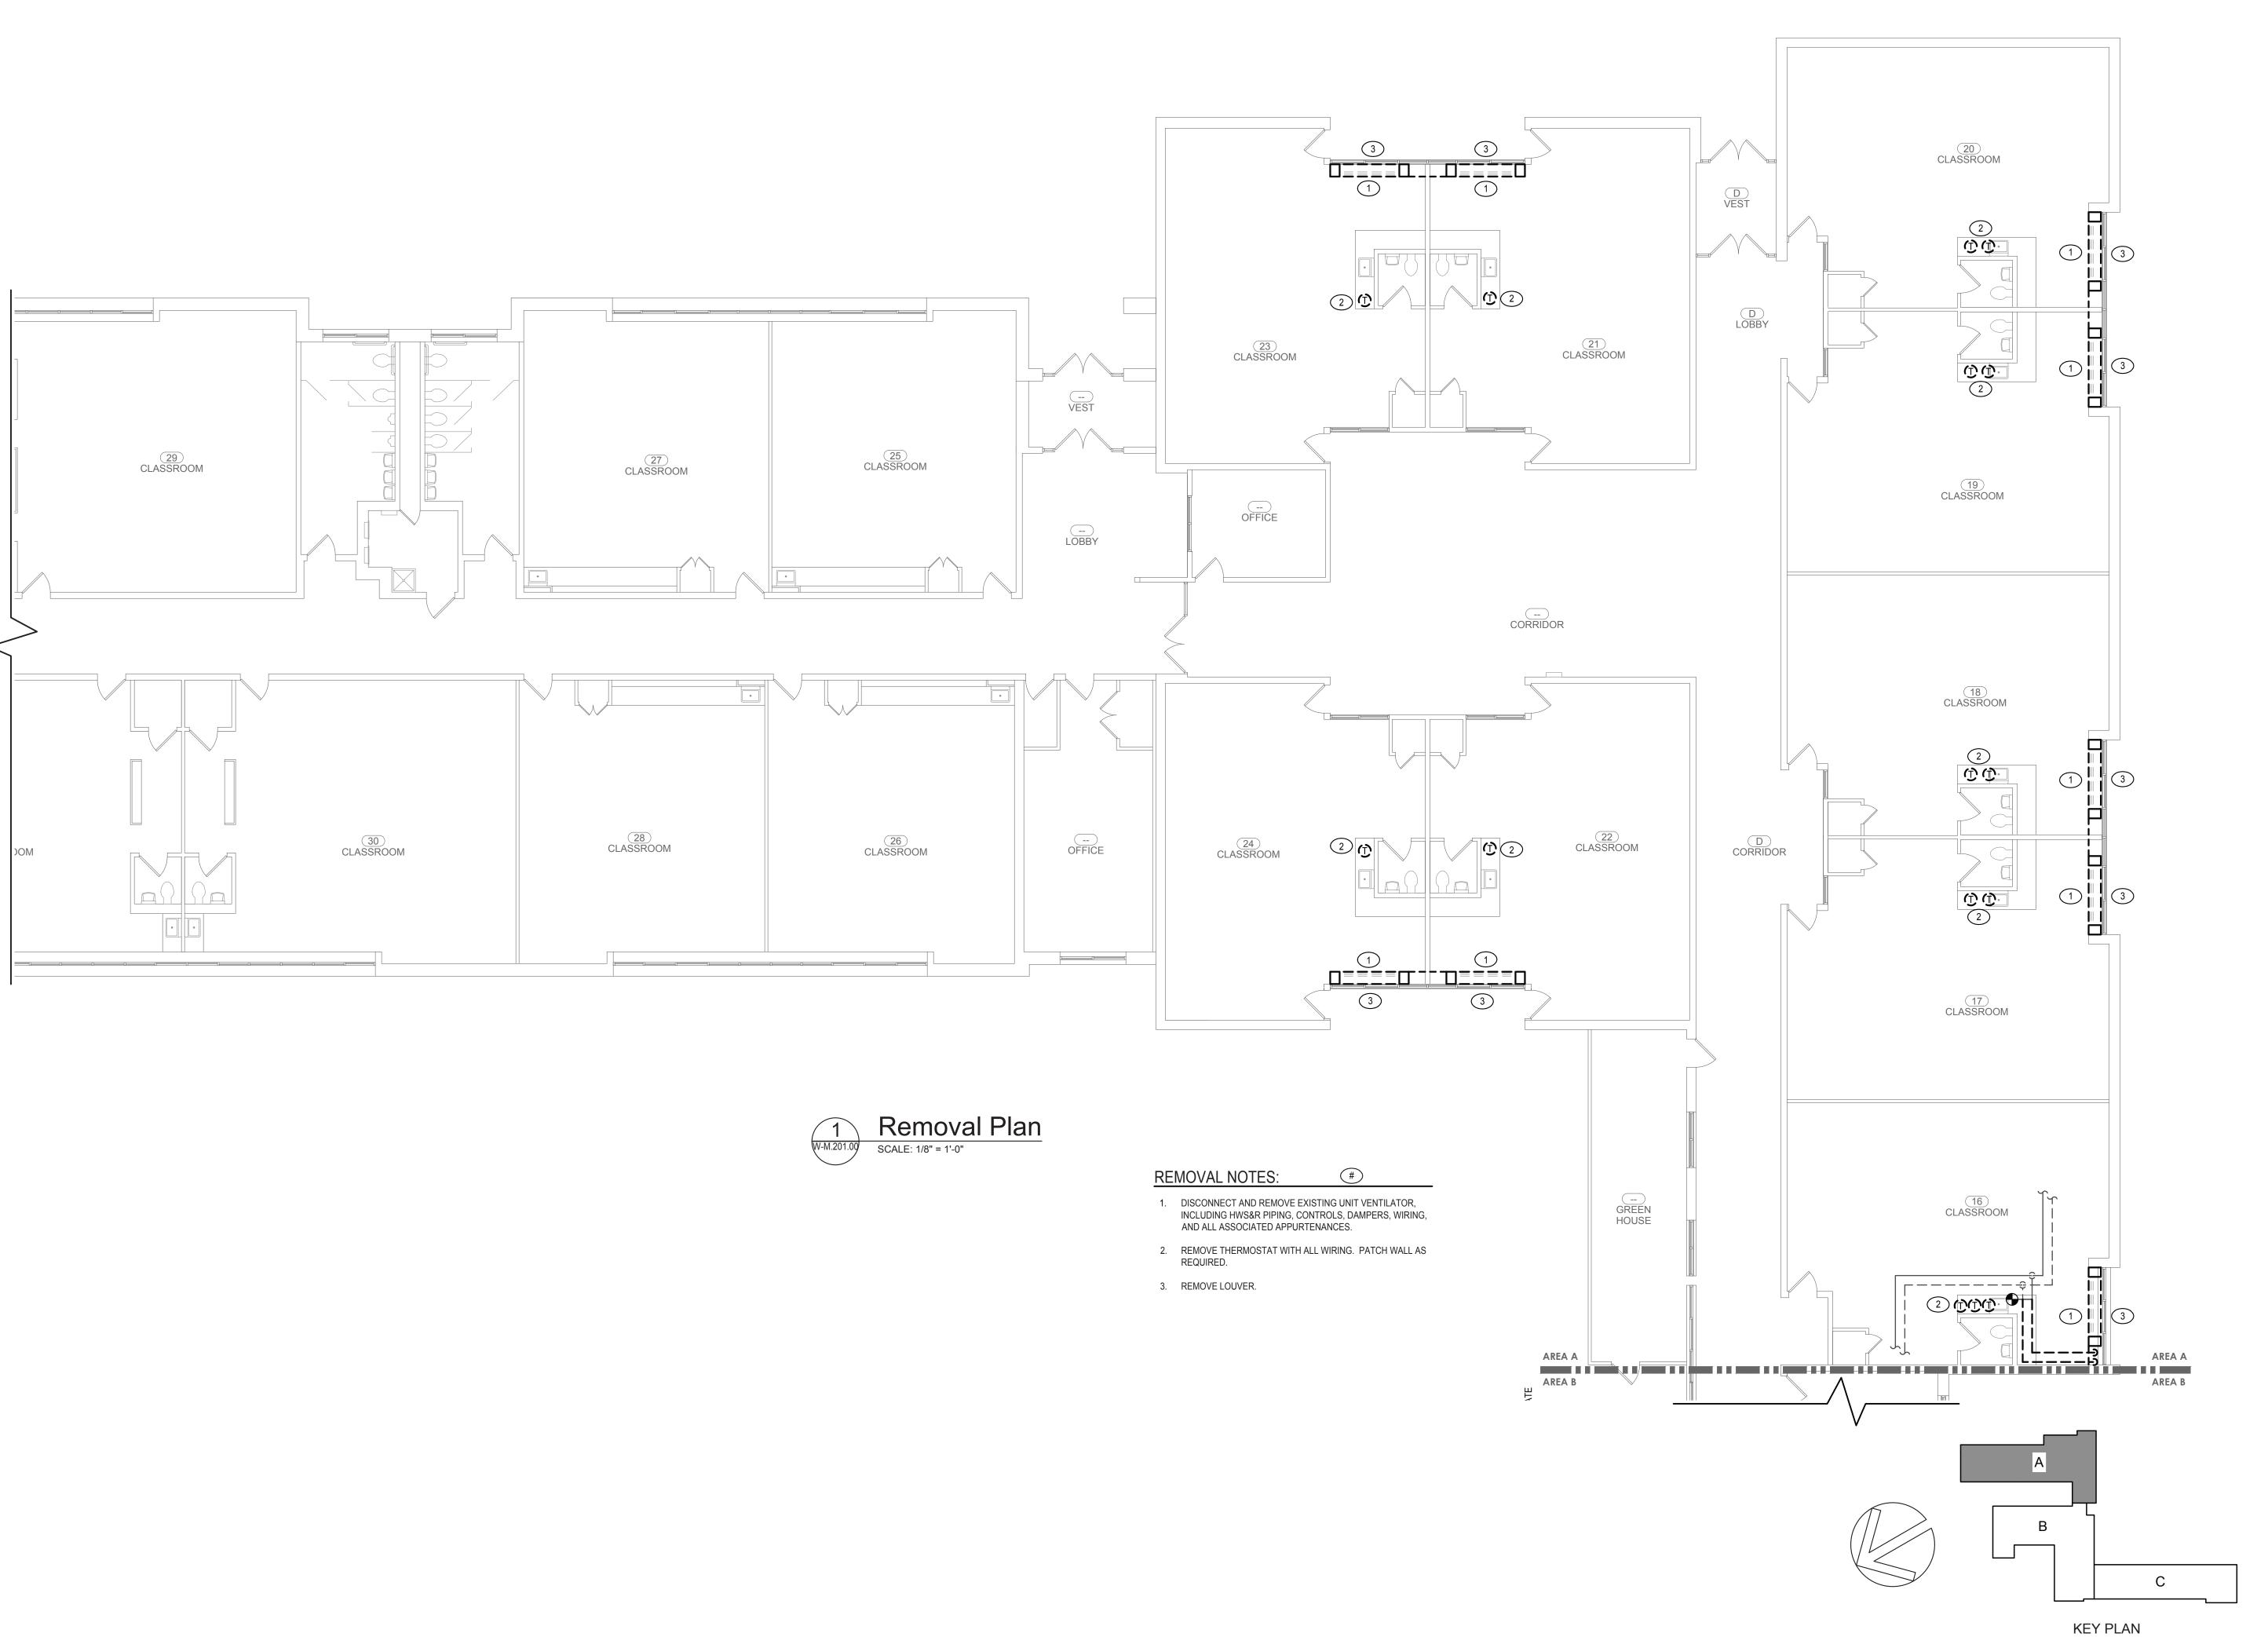

HAMLIN



Architect:

Hamlin Design Group
915 Broadway, Suite 101A
Albany, New York 12207
Tel: 518.724.5159
Fax: 518.320.8633 Web: hamlindesigngroup.com

Hazardous Material Consultant:



MEP Engineer:

engineeredsolutions	Engineered Solutions 646 Plank Road #104 Clifton Park, NY 12061 phone: (518) 280-2410 fax: (518) 280-2481 www.engineered-solutions.net Electrical Communications Mechanical ES # 19071
---------------------	---



Peekskill City School District 1031 Elm St. Peekskill, NY 10566

Peekskill Reconstruction

SED Project: 66-15-00-01-0-005-020 HDG Project: 201 Oakside Elementary

200 Decatur Ave., Peekskill, NY 10566

SED Project: 66-15-00-01-0-008-017 HDG Project: 203 Woodside Elementary

612 Depew St., Peekskill, NY 10566


DRAWN BY: MLB

ISSUE: 03/19/2021



DESCRIPTION Removal Plan - Area A

W-M.201.00

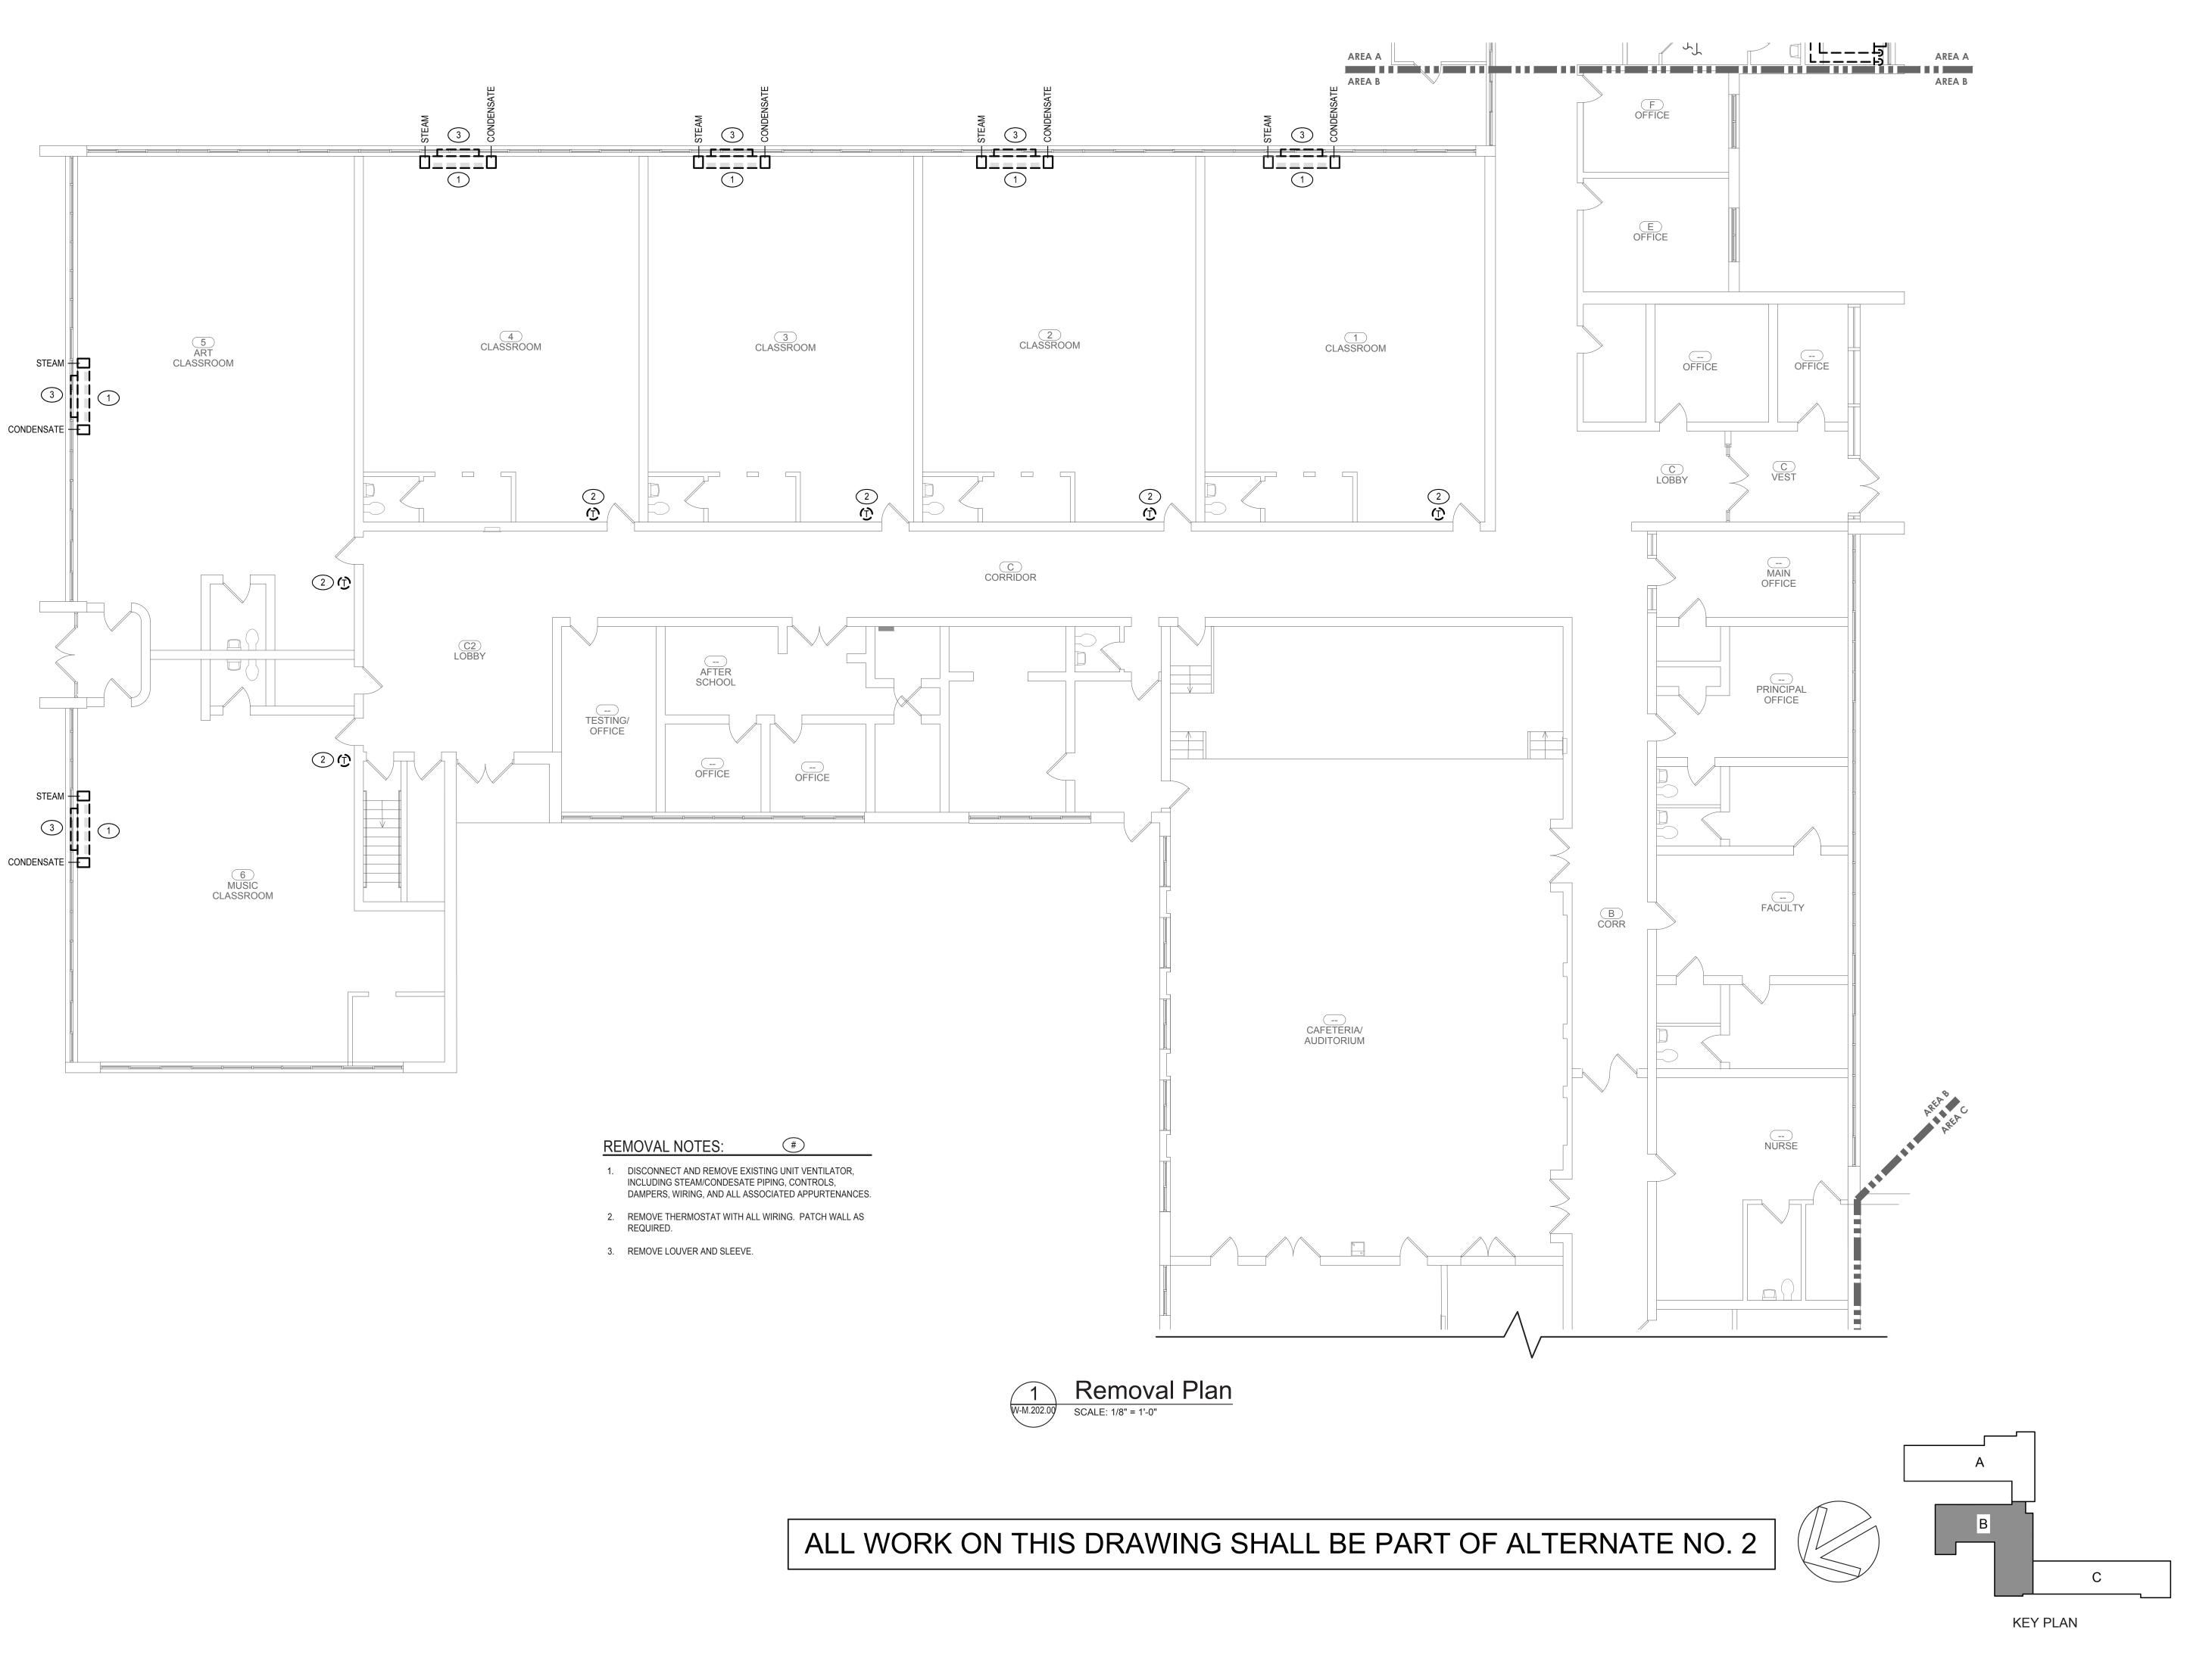

HAMLIN



Architect: **Hamlin Design Group**

915 Broadway, Suite 101A Albany, New York 12207 Tel: 518.724.5159 Fax: 518.320.8633 Web: hamlindesigngroup.com

Hazardous Material Consultant:



Ambient Environmental, Inc.
Comprehensive Building Science solutions
NYS/NJS Certified WBE
& SBA EDWOSB & DBE

MEP Engineer:

Engineered Solutions
646 Plank Road #104
Clifton Park, NY 12061
phone: (518) 280-2410
fax: (518) 280-2481
www.engineered-solutions.net
Electrical



1031 Elm St. Peekskill, NY 10566 Peekskill Reconstruction

Peekskill City School District

SED Project: 66-15-00-01-0-005-020

HDG Project: 201

Oakside Elementary

200 Decatur Ave., Peekskill, NY 10566

SED Project: 66-15-00-01-0-008-017 HDG Project: 203 Woodside Elementary

612 Depew St., Peekskill, NY 10566

DRAWN BY: MLB


ISSUE: 03/19/2021



DESCRIPTION Removal Plan - Area B

W-M.202.00

(ALTERNATE NO. 2)

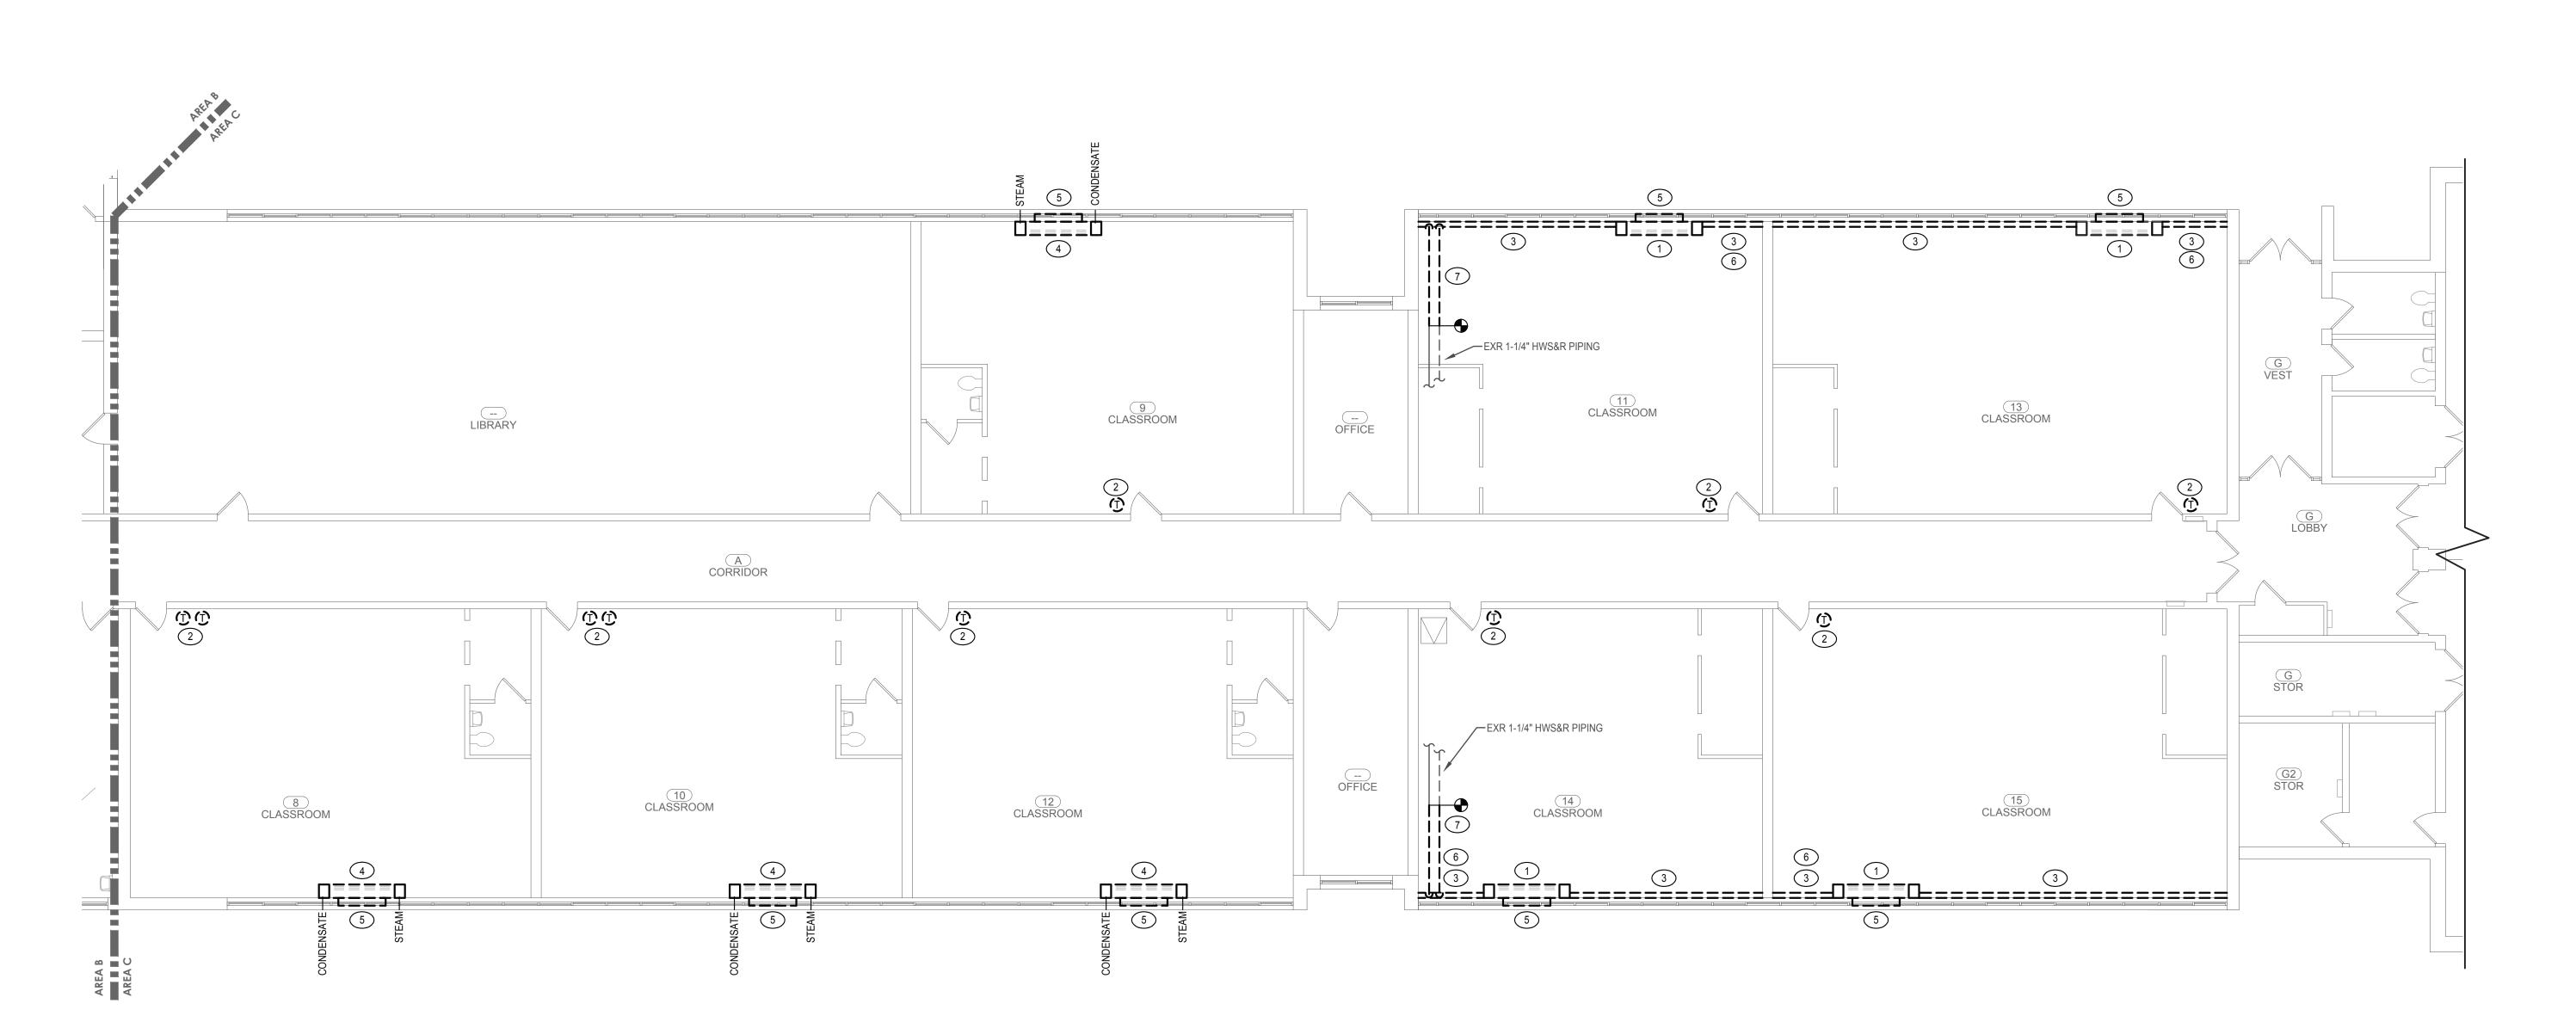

Removal Plan
SCALE: 1/8" = 1'-0"

REMOVAL NOTES:

1. DISCONNECT AND REMOVE EXISTING UNIT VENTILATOR, INCLUDING HWS&R PIPING, CONTROLS, DAMPERS, WIRING, AND ALL ASSOCIATED APPURTENANCES.

- 2. REMOVE THERMOSTAT WITH ALL WIRING. PATCH WALL AS
- 3. REMOVE FIN TUBE WITH ENCLOSURE, WALL MOUNTING BRACKETS. REMOVE PIPING AS REQUIRED FOR NEW WORK.
- 4. DISCONNECT AND REMOVE EXISTING UNIT VENTILATOR, INCLUDING STEAM AND CONDESATE PIPING, CONTROLS, DAMPERS, WIRING, AND ALL ASSOCIATED APPURTENANCES.
- 5. REMOVE LOVER AND SLEEVE.

REQUIRED.

- 6. PATCH WALL TO MATCH EXISTING.
- 7. REMOVE PIPING WITH ALL SUPPORTS AND HANGERS.



Architect: Hamlin Design Group

915 Broadway, Suite 101A Albany, New York 12207 Tel: 518.724.5159 Fax: 518.320.8633 Web: hamlindesigngroup.com

Hazardous Material Consultant:



MEP Engineer:

	Engineered Solutions 646 Plank Road #104 Clifton Park, NY 12061 phone: (518) 280-2410 fax: (518) 280-2481 www.engineered-solutions.net
	Electrical — Communications —
00000	— Mechanical —
engineered solutions	——————————————————————————————————————



1031 Elm St. Peekskill, NY 10566

Peekskill City School District

Peekskill Reconstruction

SED Project: 66-15-00-01-0-005-020 HDG Project: 201 **Oakside Elementary** 200 Decatur Ave., Peekskill, NY 10566


SED Project: 66-15-00-01-0-008-017
HDG Project: 203
Woodside Elementary
612 Depew St.,
Peekskill, NY 10566

DRAWN BY: MLB


ISSUE: 03/19/2021



DESCRIPTION Removal Plan - Area C

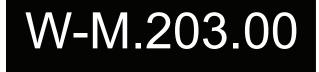

KEY PLAN

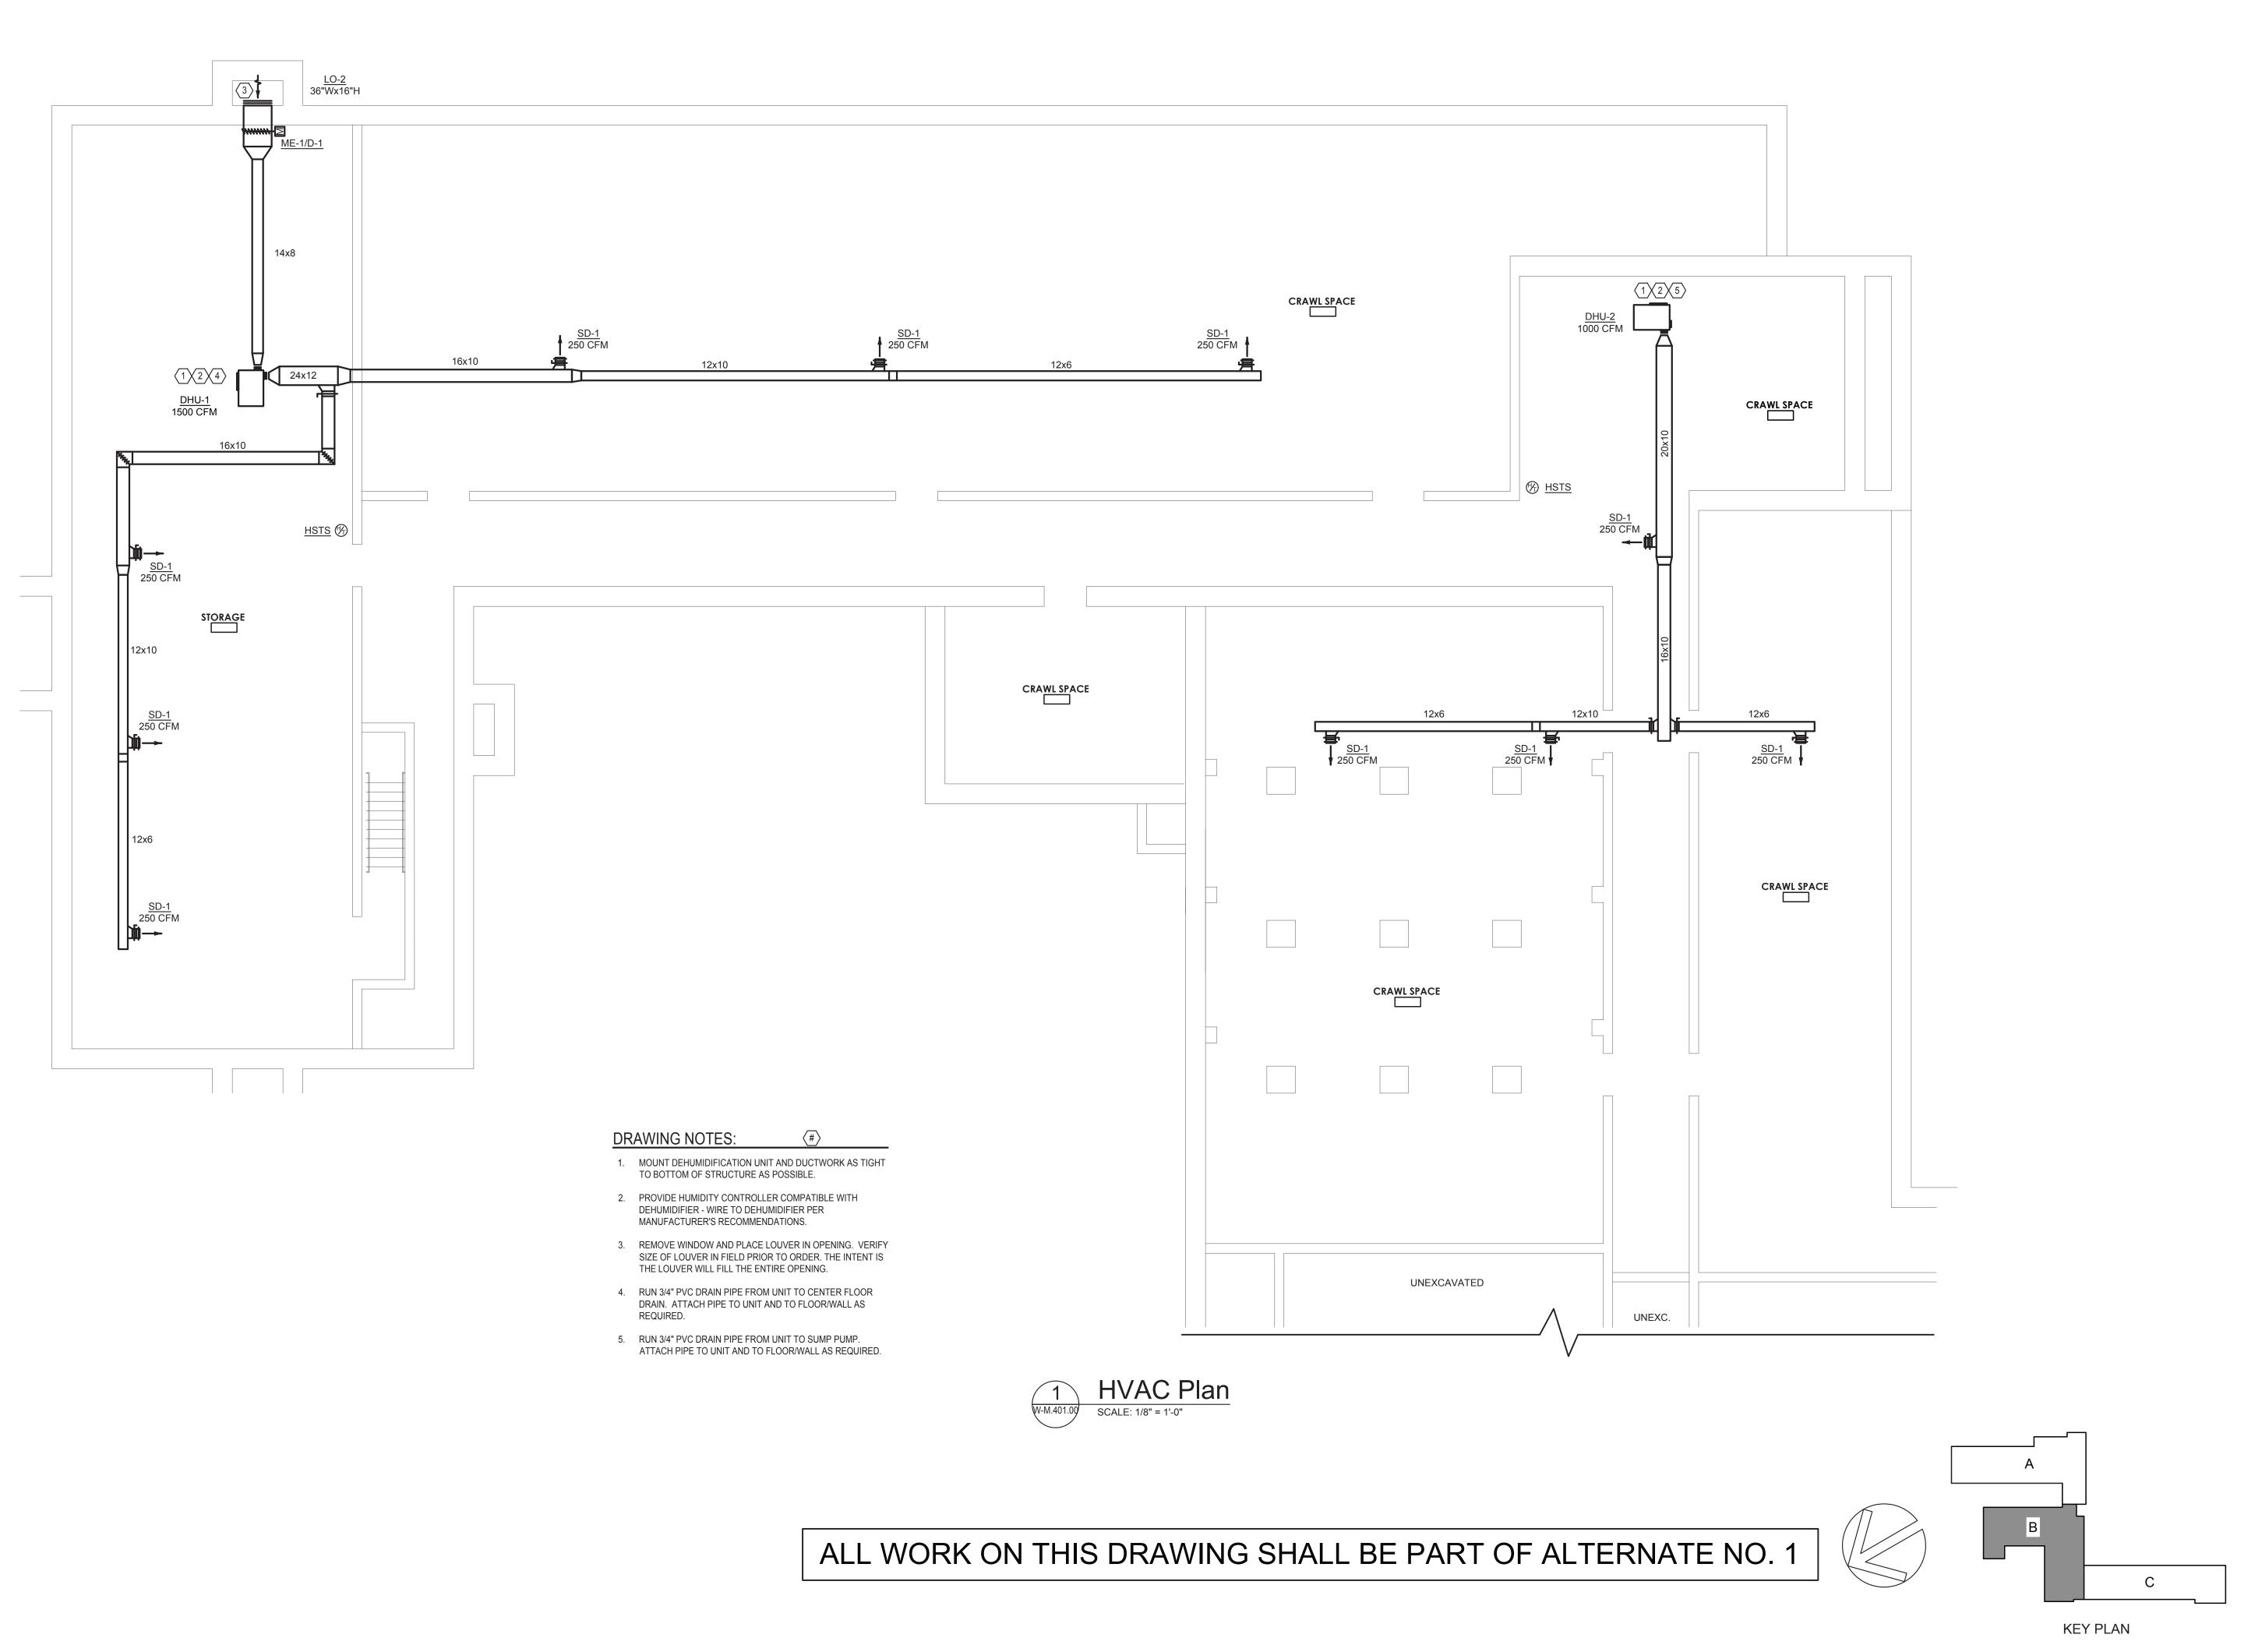



Architect: **Hamlin Design Group**

915 Broadway, Suite 101A Albany, New York 12207 Tel: 518.724.5159 Fax: 518.320.8633 Web: hamlindesigngroup.com

Hazardous Material Consultant:



Ambient Environmental, Inc.
Comprehensive Building Science solutions
NYS/NJS Certified WBE
& SBA EDWOSB & DBE

MEP Engineer:

Engineered Solutions
646 Plank Road #104
Clifton Park, NY 12061
phone: (518) 280-2410
fax: (518) 280-2481
www.engineered-solutions.net
Electrical



Peekskill City School District 1031 Elm St. Peekskill, NY 10566

Peekskill Reconstruction

SED Project: 66-15-00-01-0-005-020 HDG Project: 201

Oakside Elementary

200 Decatur Ave., Peekskill, NY 10566

SED Project: 66-15-00-01-0-008-017 HDG Project: 203

Woodside Elementary 612 Depew St.,

Peekskill, NY 10566

DRAWN BY:

ISSUE: 03/19/2021



DESCRIPTION Basement HVAC Plan - Area B

W-M.401.00

(ALTERNATE NO. 1)

- 1. PROVIDE OPEN ENDED DUCT, WITH 1/4" GALVANIZED MESH SCREEN ON OPEN END.
- 2. PROVIDE 16x8 DUCT UP TO <u>EF-1-W</u> ON ROOF.



Architect: Hamlin Design Group

915 Broadway, Suite 101A Albany, New York 12207 Tel: 518.724.5159 Fax: 518.320.8633 Web: hamlindesigngroup.com

Hazardous Material Consultant:



MEP Engineer:



1031 Elm St. Peekskill, NY 10566

Peekskill City School District

Peekskill Reconstruction

SED Project: 66-15-00-01-0-005-020 HDG Project: 201 Oakside Elementary

200 Decatur Ave., Peekskill, NY 10566

SED Project: 66-15-00-01-0-008-017
HDG Project: 203
Woodside Elementary

612 Depew St., Peekskill, NY 10566


DRAWN BY:

ISSUE: 03/19/2021




DESCRIPTION Basement HVAC Plan - Area C




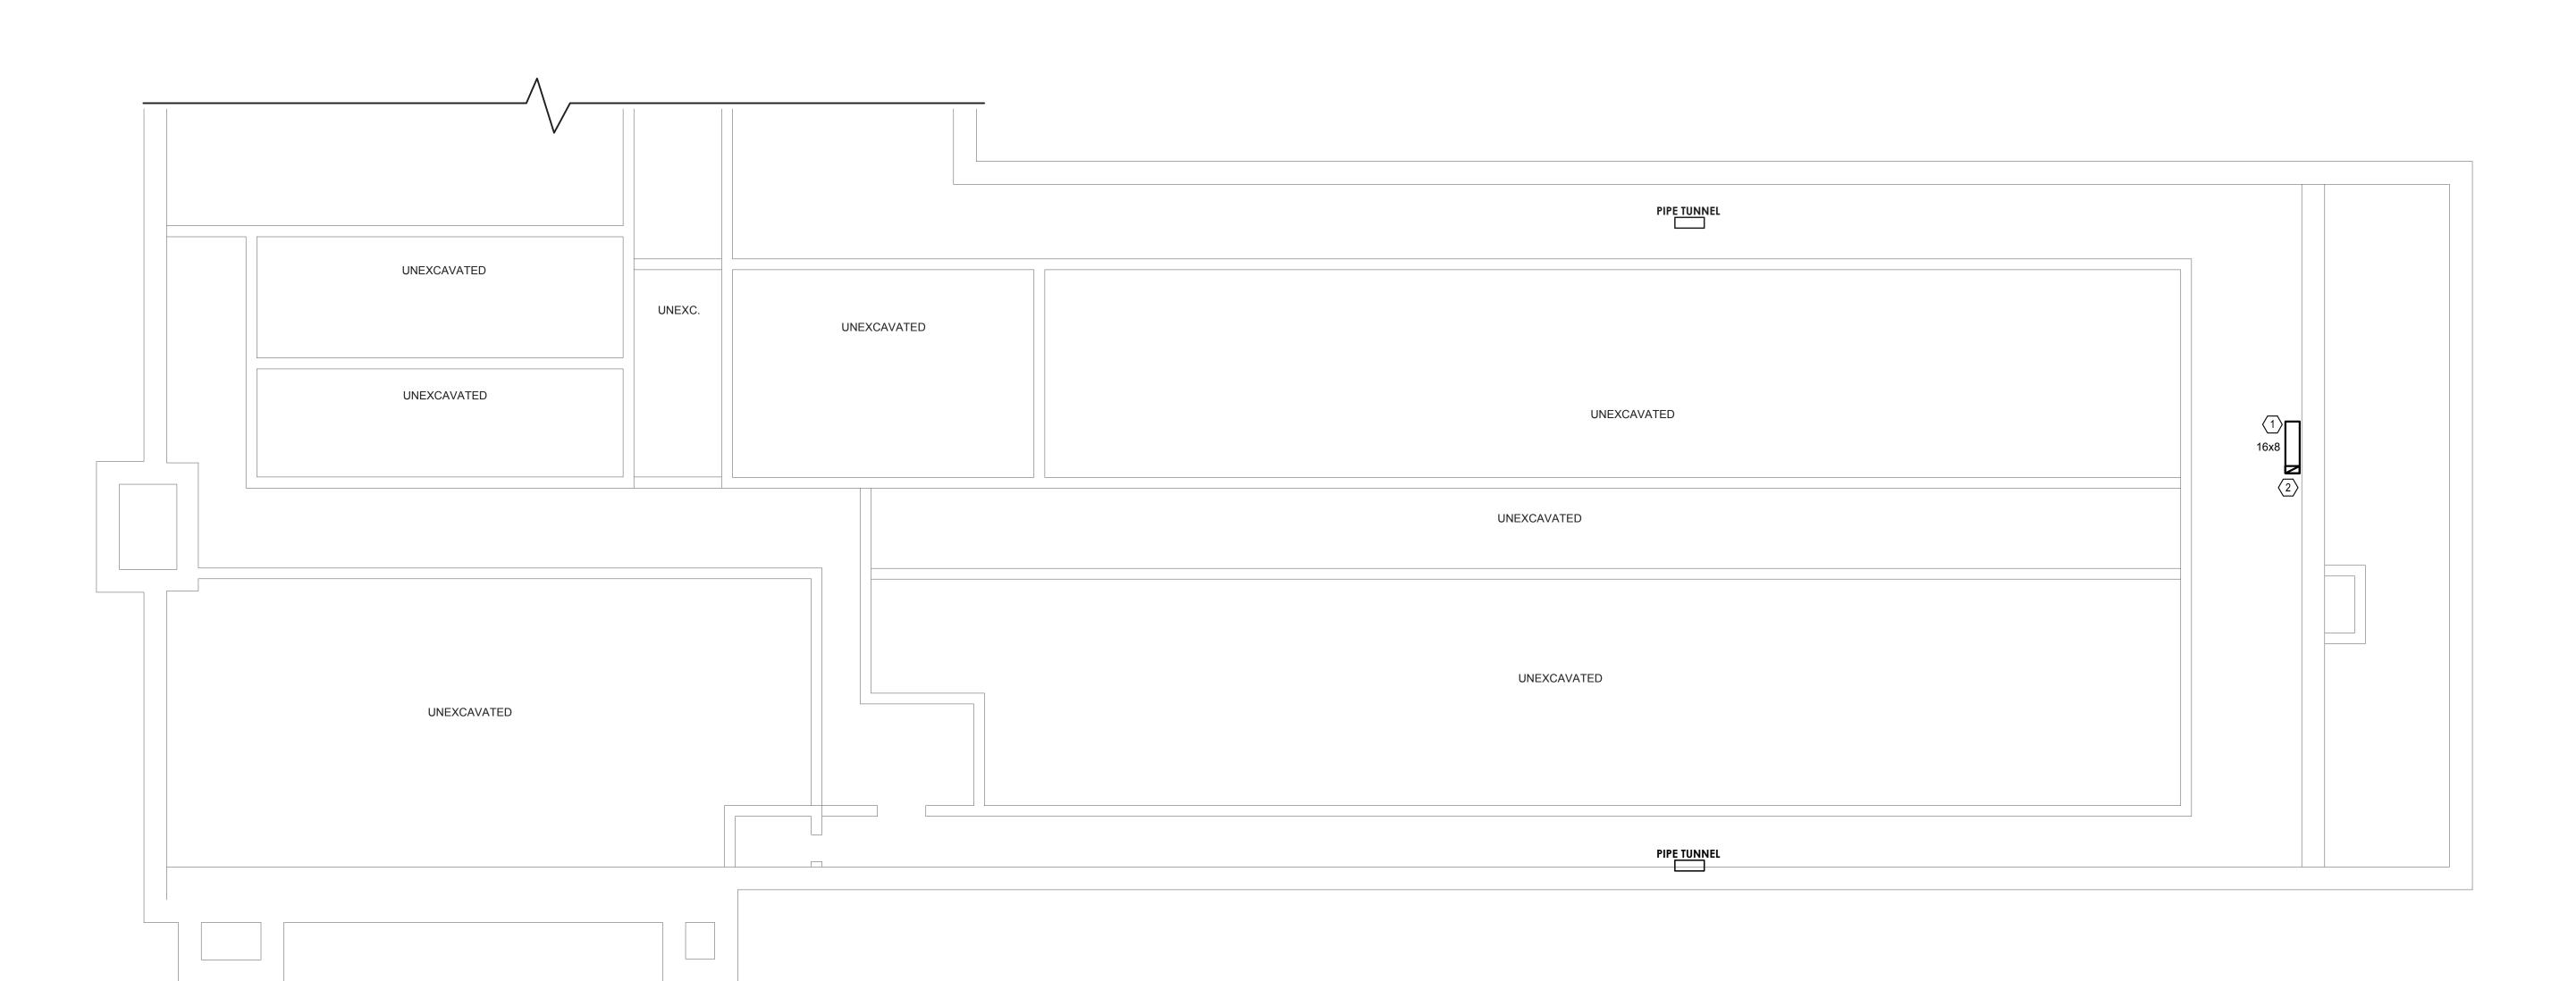



ALL WORK ON THIS DRAWING SHALL BE PART OF ALTERNATE NO. 1

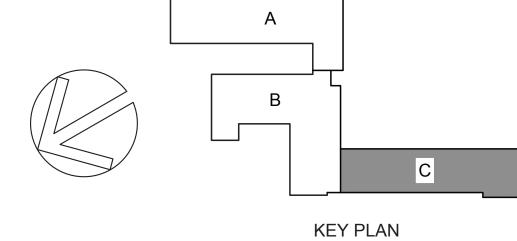

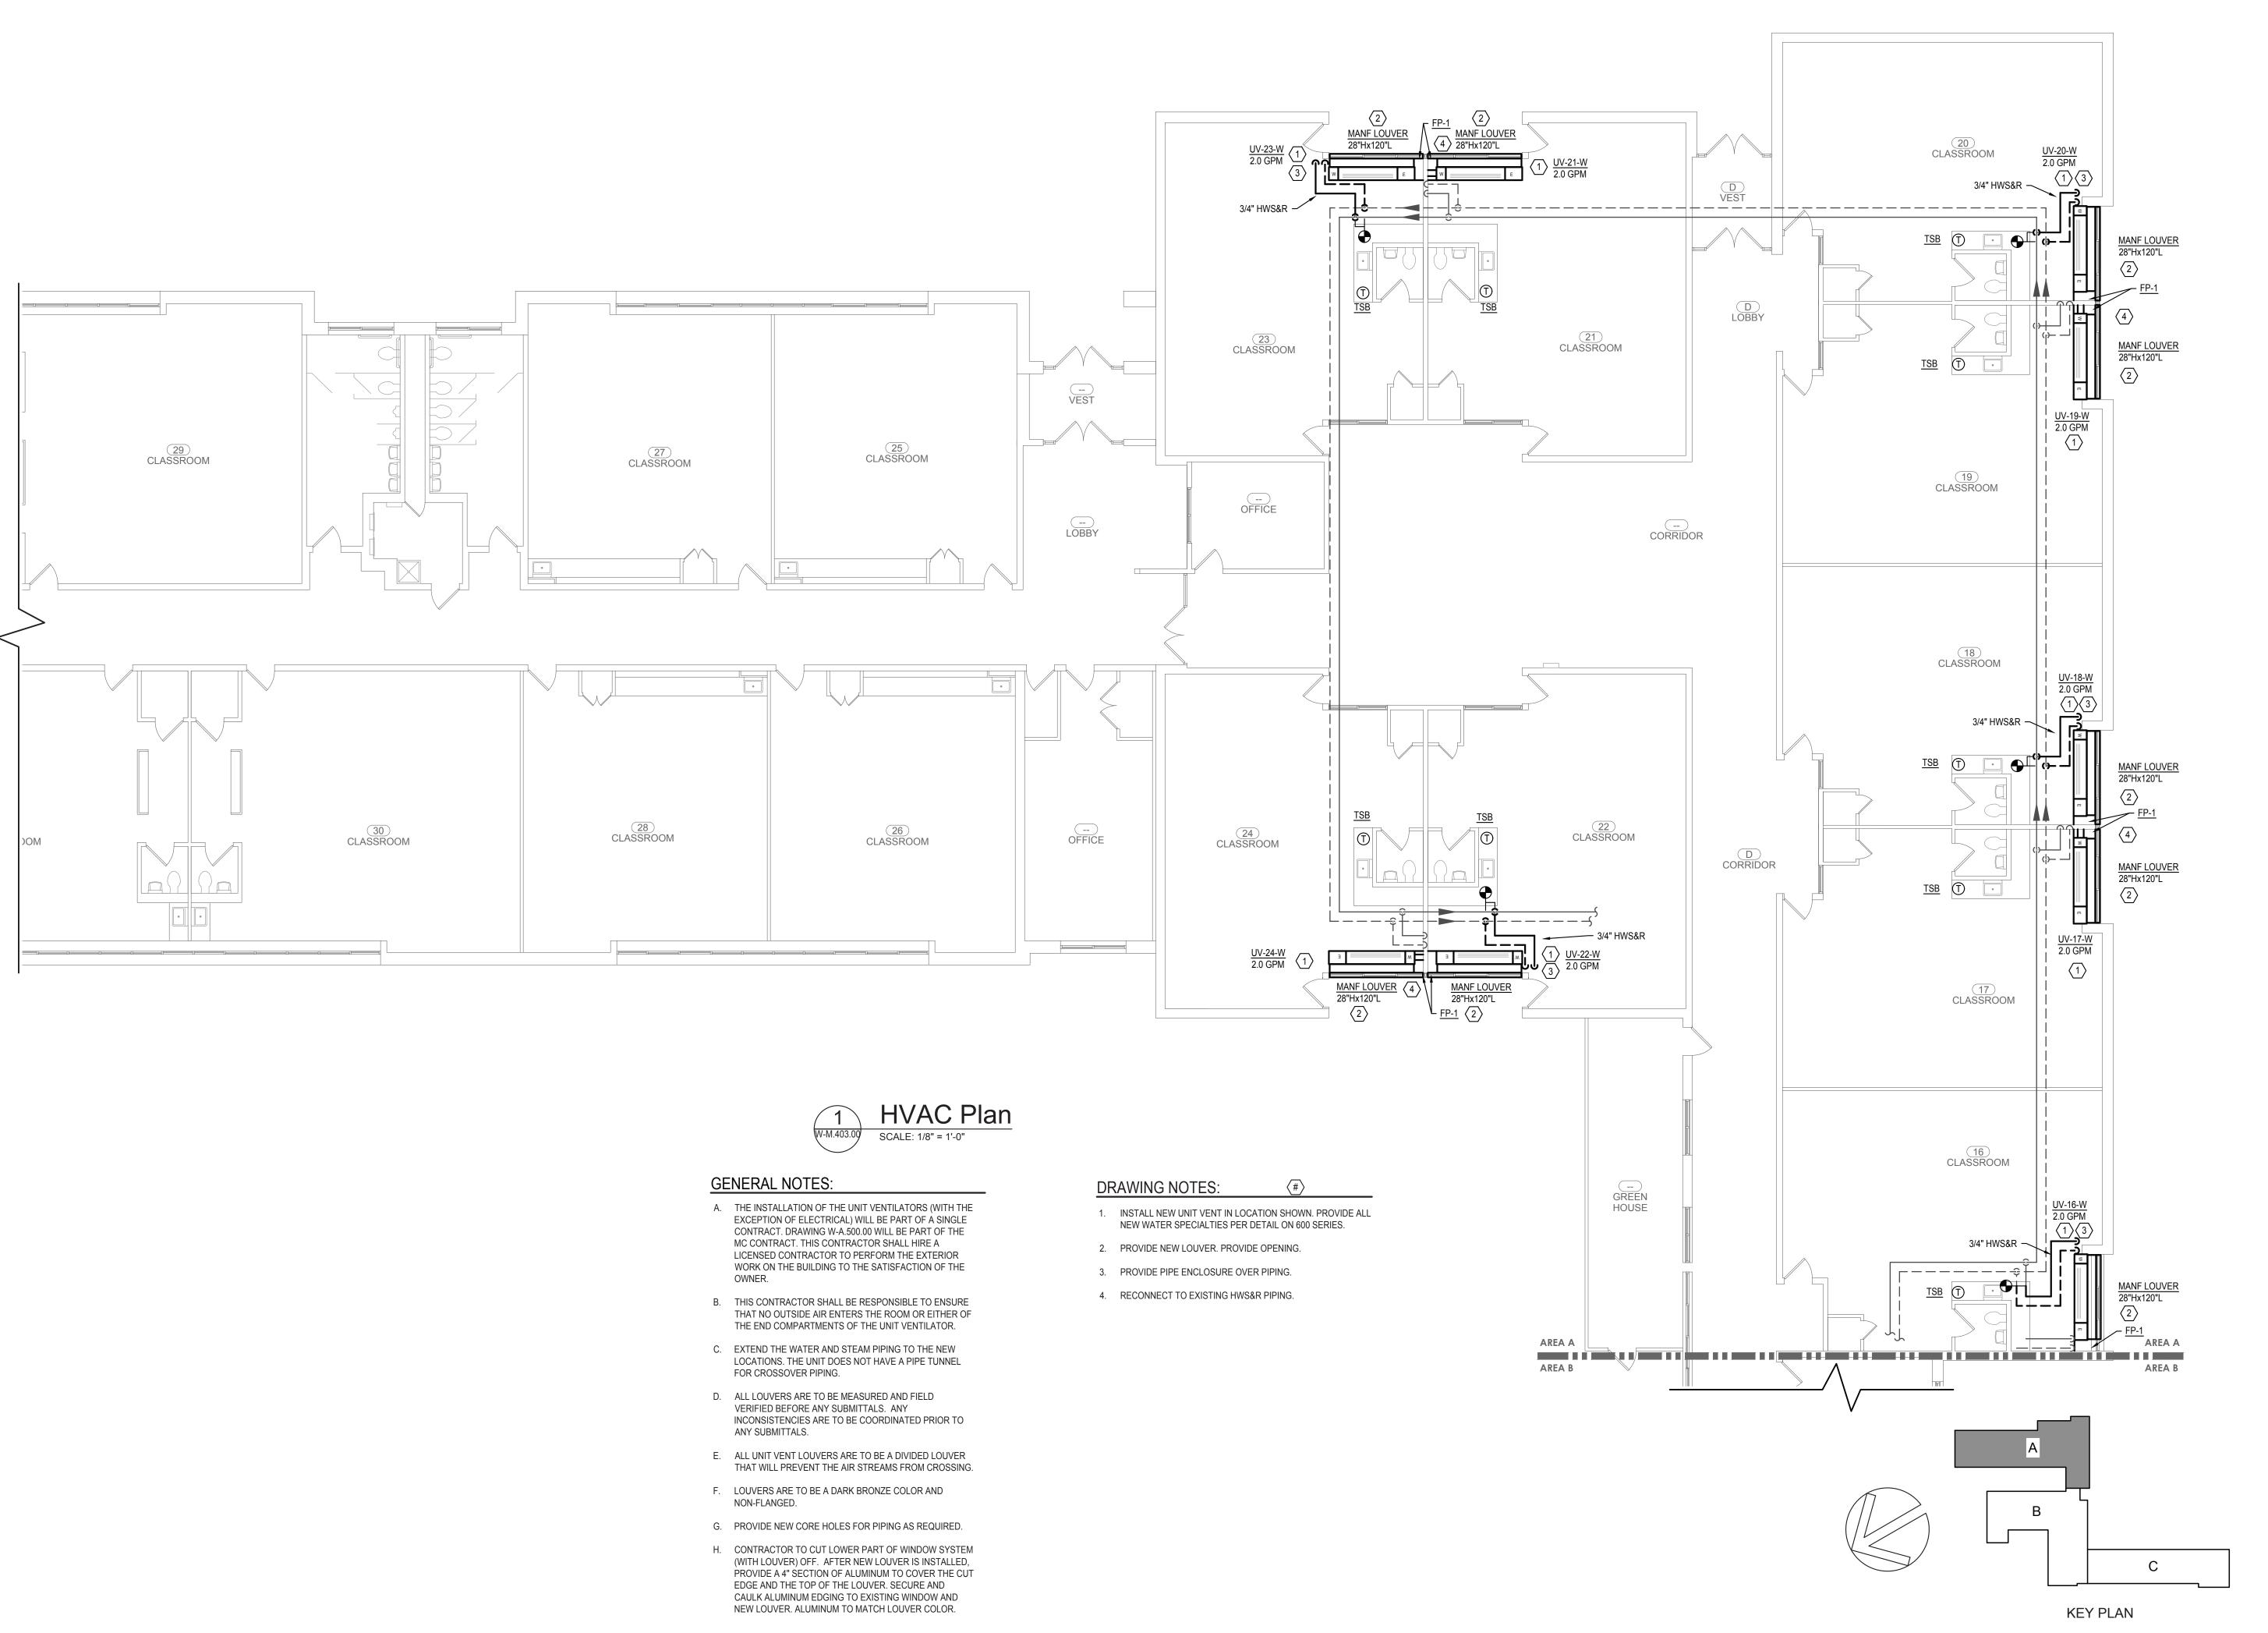

HAMLIN



Architect:

Hamlin Design Group
915 Broadway, Suite 101A
Albany, New York 12207
Tel: 518.724.5159
Fax: 518.320.8633 Web: hamlindesigngroup.com

Hazardous Material Consultant:



Ambient Environmental, Inc.
Comprehensive Building Science solutions
NYS/NJS Certified WBE
& SBA EDWOSB & DBE

MEP Engineer:

00000	Engineered Solutions 646 Plank Road #104 Clifton Park, NY 12061 chone: (518) 280-2410 fax: (518) 280-2481 www.engineered-solutions.net — Electrical — Communications — Mechanical — ES # 19071
-------	---



Peekskill City School District 1031 Elm St. Peekskill, NY 10566

Peekskill Reconstruction

SED Project: 66-15-00-01-0-005-020 HDG Project: 201

Oakside Elementary 200 Decatur Ave.,

Peekskill, NY 10566 SED Project: 66-15-00-01-0-008-017

HDG Project: 203 **Woodside Elementary**


612 Depew St., Peekskill, NY 10566


DRAWN BY: MLB

ISSUE: 03/19/2021



DESCRIPTION First Floor HVAC Plan - Area A

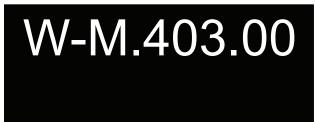

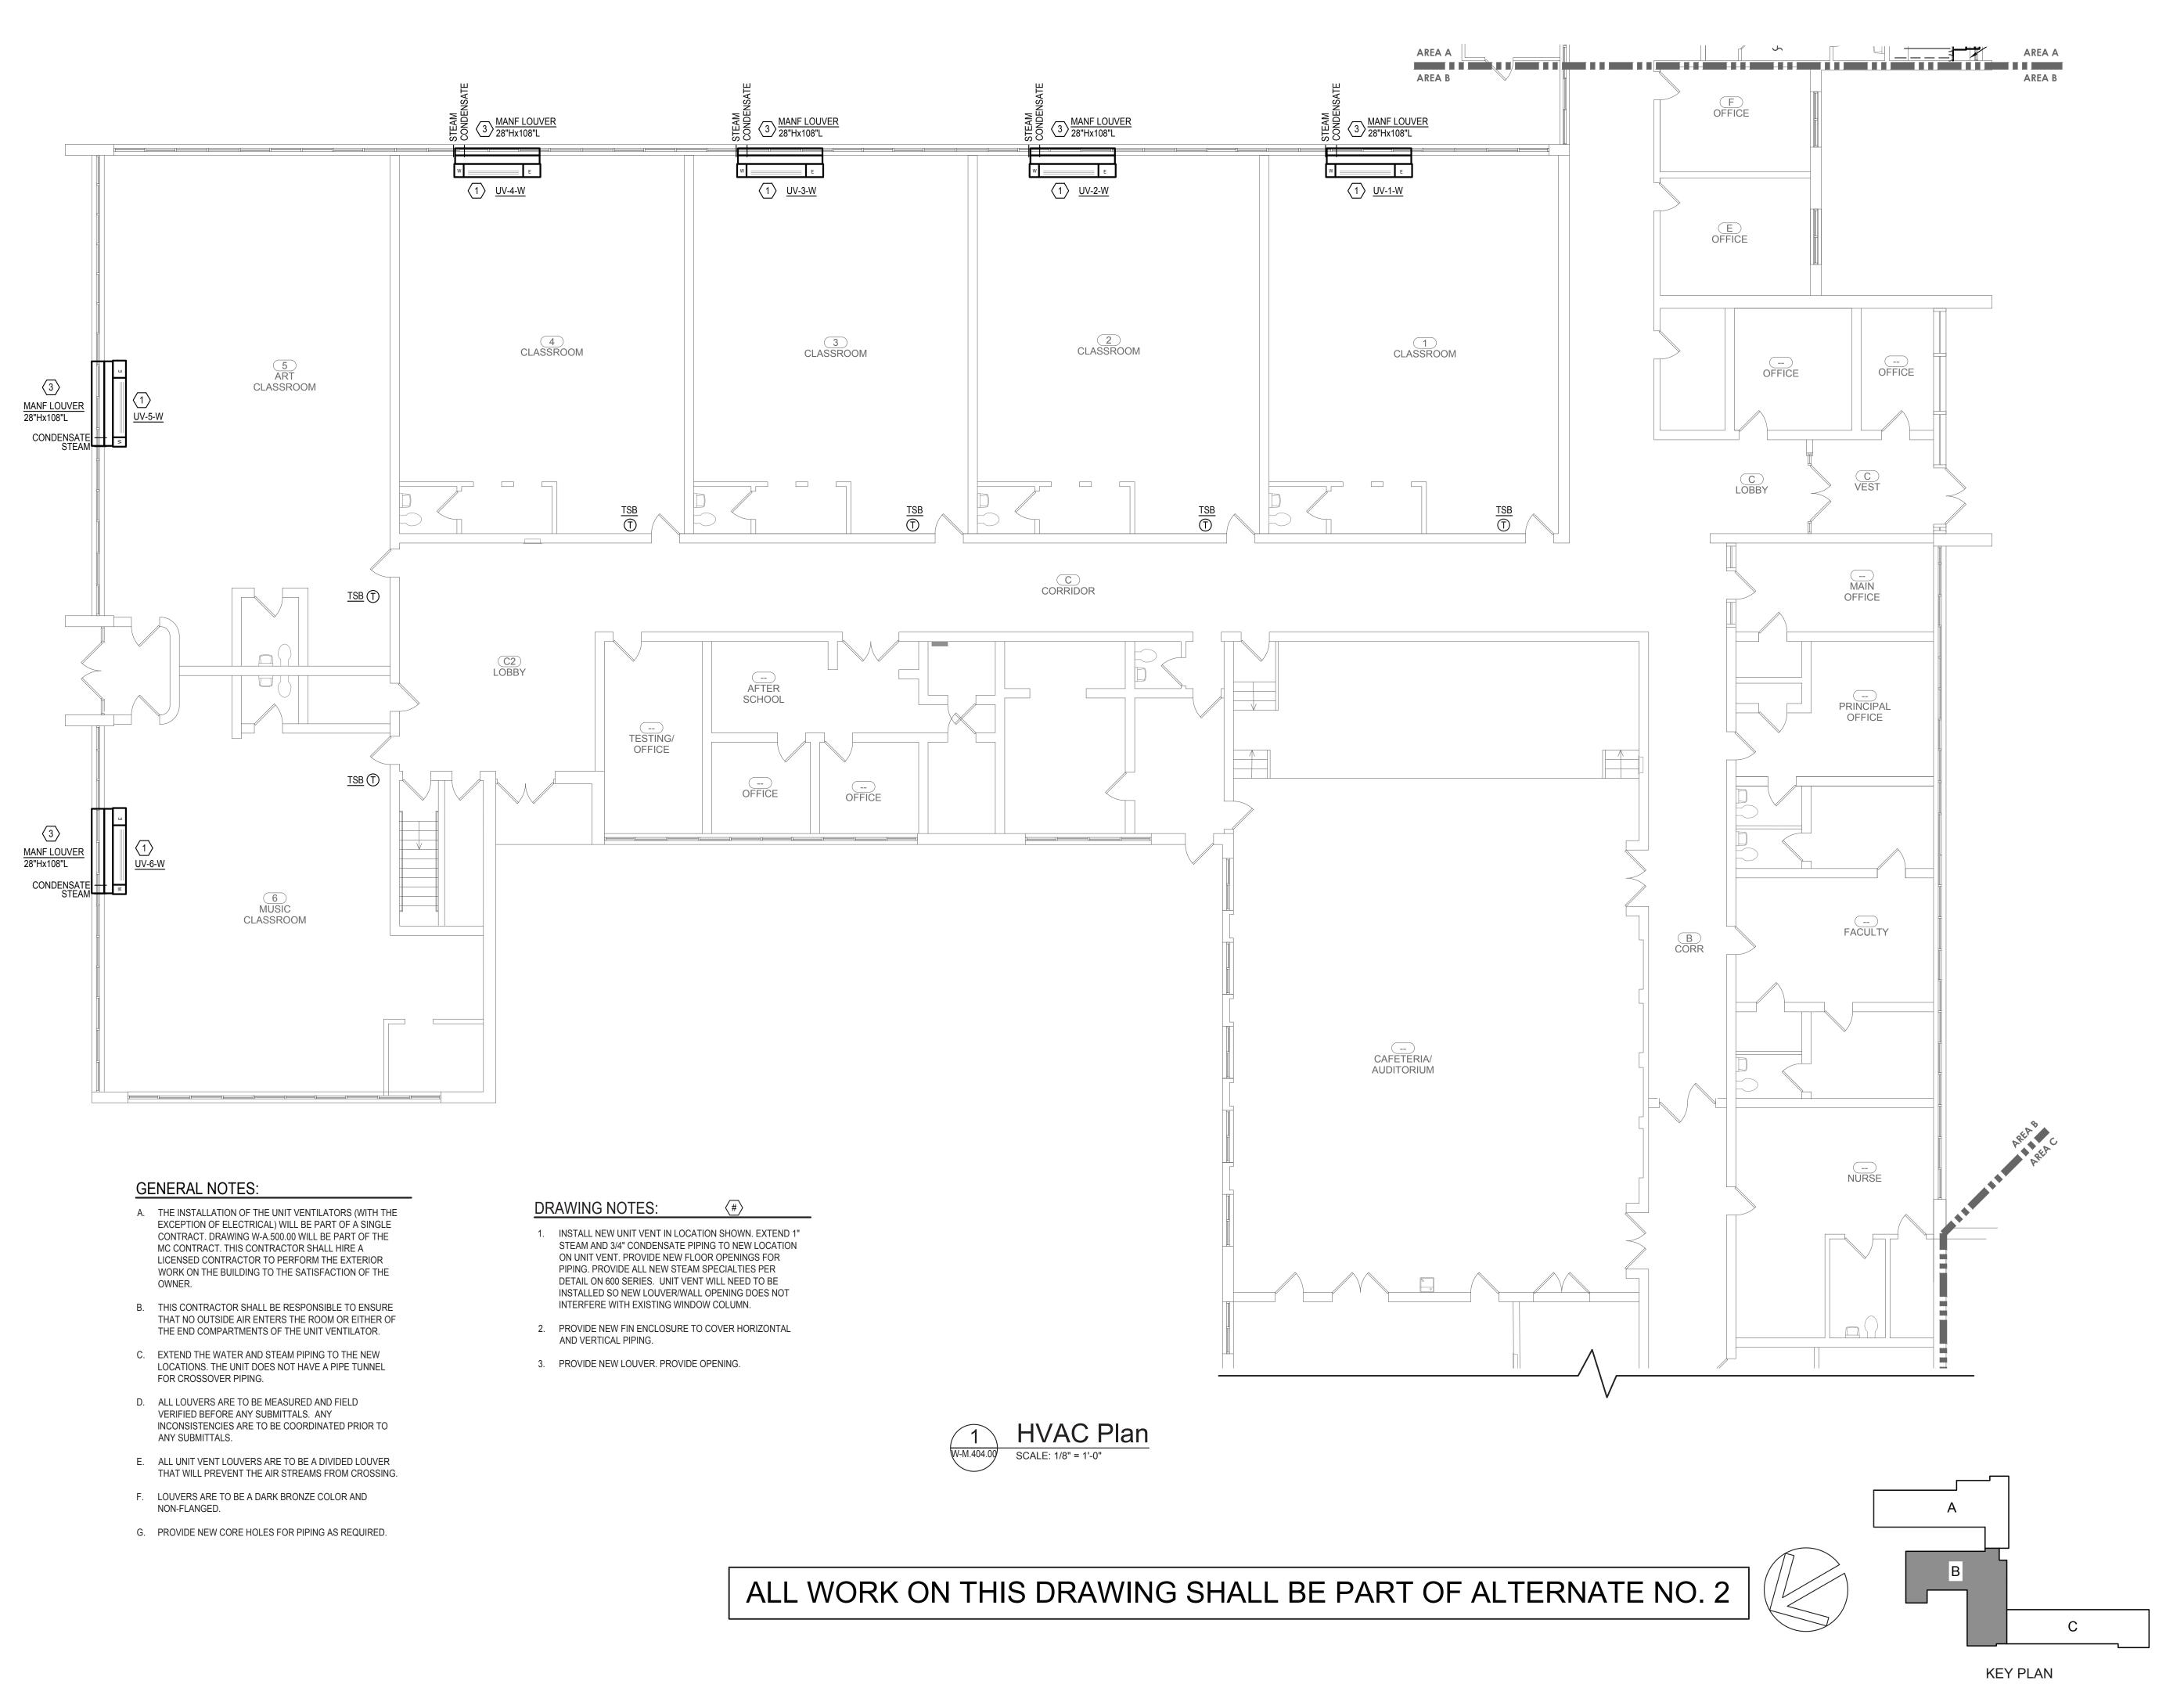

HAMLIN



Architect: **Hamlin Design Group**

915 Broadway, Suite 101A Albany, New York 12207 Tel: 518.724.5159 Fax: 518.320.8633 Web: hamlindesigngroup.com

Hazardous Material Consultant:



Ambient Environmental, Inc.
Comprehensive Building Science solutions
NYS/NJS Certified WBE
& SBA EDWOSB & DBE

MEP Engineer:

Engineered Soluti 646 Plank Road #104 Clifton Park, NY 12061 phone: (518) 280-2410 fax: (518) 280-2481 www.engineered-solution ————————————————————————————————————	s.net
---	-------



Peekskill, NY 10566 Peekskill Reconstruction

Peekskill City School District 1031 Elm St.

SED Project: 66-15-00-01-0-005-020

HDG Project: 201

Oakside Elementary

200 Decatur Ave., Peekskill, NY 10566 SED Project: 66-15-00-01-0-008-017 HDG Project: 203

Woodside Elementary

612 Depew St., Peekskill, NY 10566

DRAWN BY: MLB

ISSUE: 03/19/2021



DESCRIPTION First Floor HVAC Plan - Area B



GENERAL NOTES:

- A. THE INSTALLATION OF THE UNIT VENTILATORS (WITH THE EXCEPTION OF ELECTRICAL) WILL BE PART OF A SINGLE CONTRACT. DRAWING W-A.500.00 WILL BE PART OF THE MC CONTRACT. THIS CONTRACTOR SHALL HIRE A LICENSED CONTRACTOR TO PERFORM THE EXTERIOR WORK ON THE BUILDING TO THE SATISFACTION OF THE
- B. THIS CONTRACTOR SHALL BE RESPONSIBLE TO ENSURE THAT NO OUTSIDE AIR ENTERS THE ROOM OR EITHER OF THE END COMPARTMENTS OF THE UNIT VENTILATOR.
- C. EXTEND THE WATER AND STEAM PIPING TO THE NEW LOCATIONS. THE UNIT DOES NOT HAVE A PIPE TUNNEL FOR CROSSOVER PIPING.
- D. ALL LOUVERS ARE TO BE MEASURED AND FIELD VERIFIED BEFORE ANY SUBMITTALS. ANY INCONSISTENCIES ARE TO BE COORDINATED PRIOR TO ANY SUBMITTALS.
- E. ALL UNIT VENT LOUVERS ARE TO BE A DIVIDED LOUVER THAT WILL PREVENT THE AIR STREAMS FROM CROSSING.
- F. LOUVERS ARE TO BE A DARK BRONZE COLOR AND NON-FLANGED.
- G. PROVIDE NEW CORE HOLES FOR PIPING AS REQUIRED.
- H. CONTRACTOR TO CUT WINDOW SIL FLUSH WITH EXISTING WALL. THIS WOULD BE FOR ALL ROOMS THIS AREA.

DRAWING NOTES:

- 1. INSTALL NEW UNIT VENT IN LOCATION SHOWN. CONNECT TO EXISTING HWS&R PIPING. PROVIDE ALL NEW WATER SPECIALTIES PER DETAIL ON 600 SERIES.
- 2. PROVIDE STERLING FTR HORIZONTAL PIPE ENCLOSURE (NO LOUVERS) TO COVER PIPES STACKED ON WALL.
- 3. INSTALL NEW UNIT VENT IN LOCATION SHOWN. EXTEND 1" STEAM AND 3/4" CONDENSATE PIPING TO NEW LOCATION ON UNIT VENT. PROVIDE NEW FLOOR OPENINGS FOR PIPING. PROVIDE ALL NEW STEAM SPECIALTIES PER DETAIL ON 600 SERIES. UNIT VENT WILL NEED TO BE INSTALLED SO NEW LOUVER/WALL OPENING DOES NOT INTERFERE WITH EXISTING WINDOW COLUMN.
- 4. PROVIDE NEW LOUVER. PROVIDE OPENING.
- 5. PROVIDE NEW EXHAUST FAN ON ROOF AND RUN 16x8 DUCT DOWN TO BASEMENT. PROVIDE CHASE. PROVIDE FIRE DAMPER (FRD-B) AT FLOOR LINE WITH ACCESS DOOR IN DUCT AND IN CHASE.
- 6. FIN ENCLOSURE TO RUN FROM UNIT TO WALL.
- 7. PROVIDE PIPE ENCLOSURE OVER VERTICAL PIPING.
- 8. PROVIDE AIR VENT AT TOP OF PIPING, SUPPLY AND RETURN.

Ambient Environmental, Inc. NYS/NJS Certified WBE & SBA EDWOSB & DBE

Hamlin Design Group

Web: hamlindesigngroup.com

Hazardous Material Consultant:

915 Broadway, Suite 101A

Albany, New York 12207

Tel: 518.724.5159

Fax: 518.320.8633

MEP Engineer:

Architect:

	Engineered Solutions 646 Plank Road #104 Clifton Park, NY 12061 phone: (518) 280-2410 fax: (518) 280-2481 www.engineered-solutions.net Electrical
engineered solutions	

HAMLIN

DESIGN

GROUP



Peekskill, NY 10566 **Peekskill Reconstruction**

Peekskill City School District

SED Project: 66-15-00-01-0-005-020 HDG Project: 201


Oakside Elementary

1031 Elm St.

200 Decatur Ave., Peekskill, NY 10566 SED Project: 66-15-00-01-0-008-017 HDG Project: 203 **Woodside Elementary**

612 Depew St., Peekskill, NY 10566


DRAWN BY: MLB

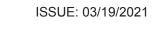





DESCRIPTION First Floor HVAC Plan - Area C



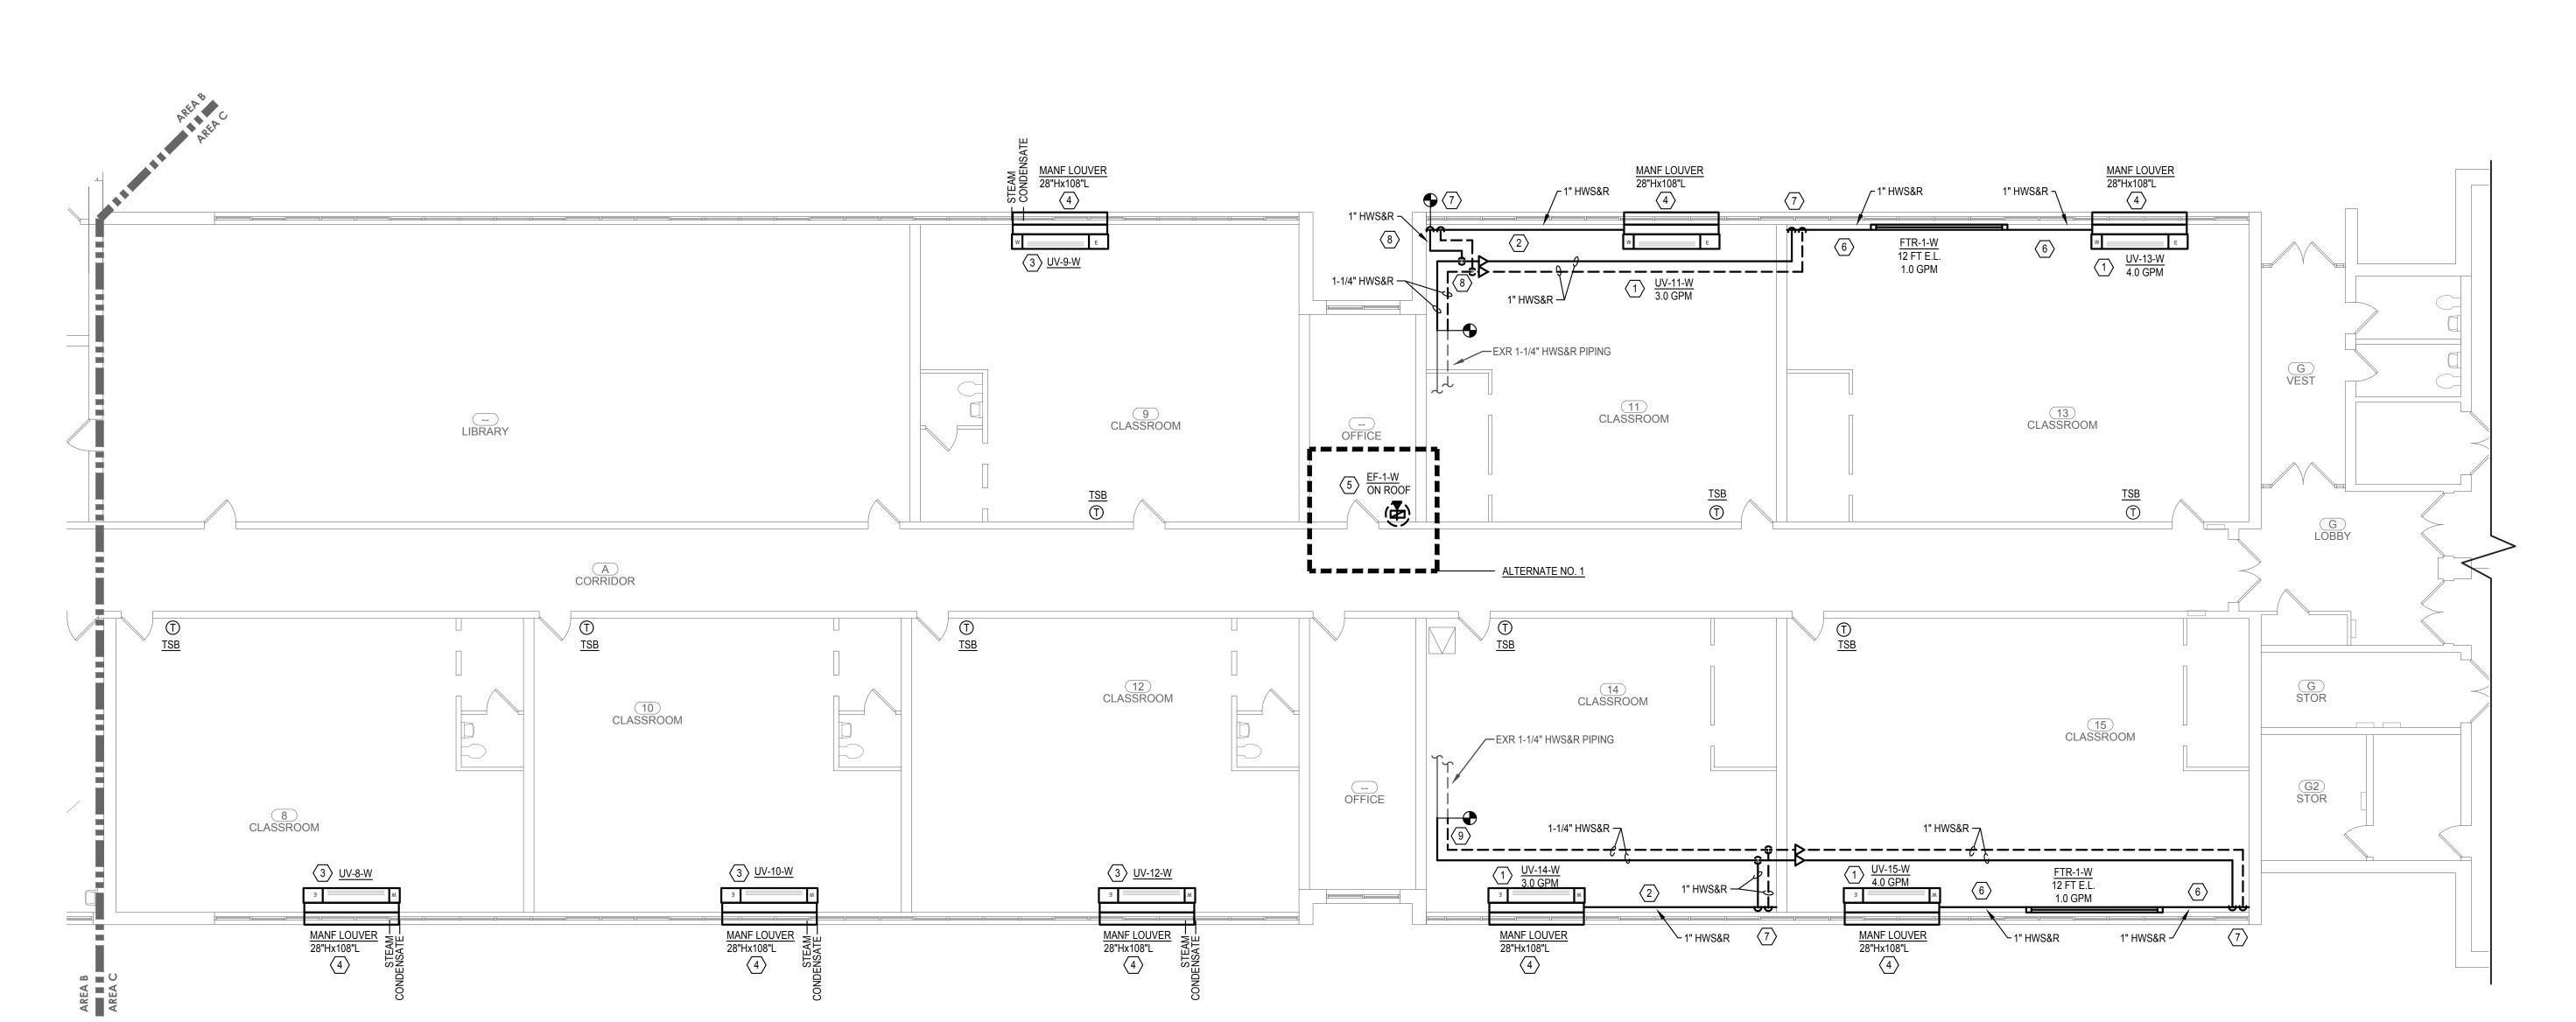




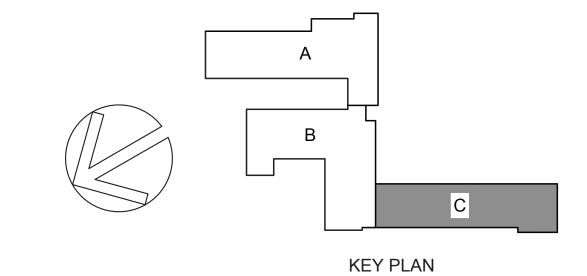

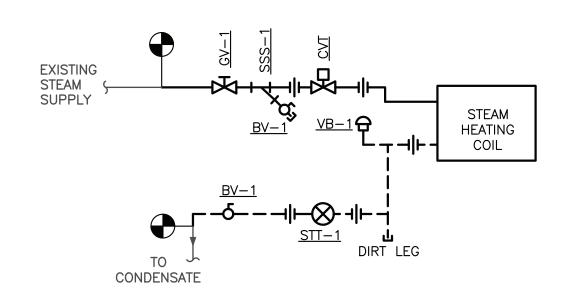


STEAM UV HEATING COIL DIAGRAM

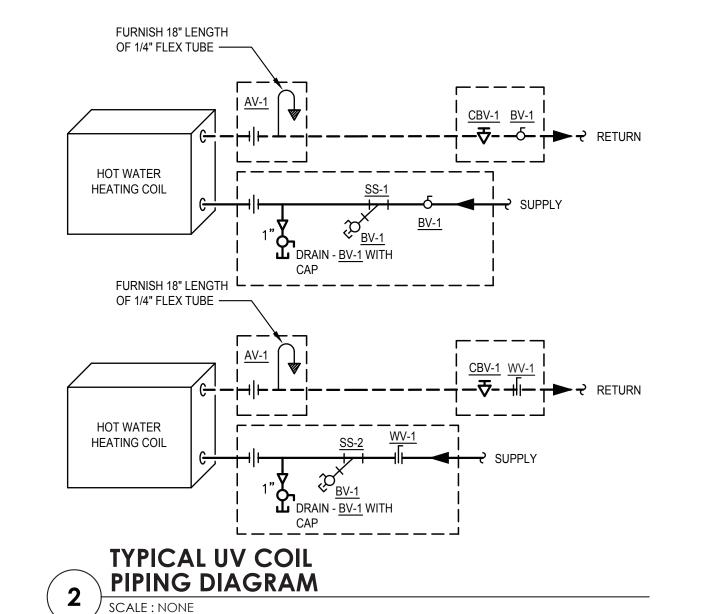

FCV SIZED TO MATCH FLOW.

2. PROVIDE UNIONS ON COIL AND CONTROL VALVE CONNECTIONS. 3. AREAS SHOWN IN DASHED BOXES WILL BE ALLOWED FOR COIL KITS.

4. COILS KITS THAT ARE SUPPLIED WITH FLEXIBLE HOSES WILL BE REJECTED WITHOUT REVIEW.

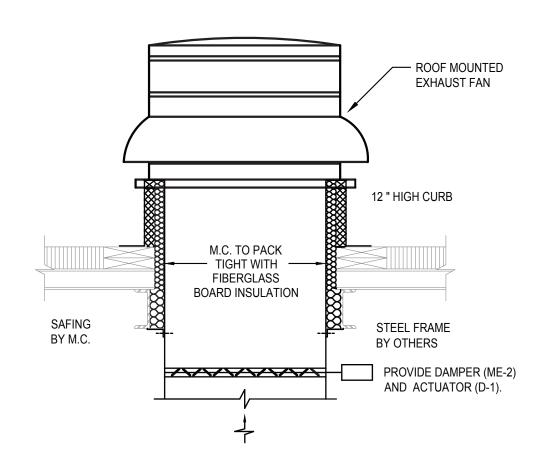

DOWNBLAST EXHAUST FAN DIAGRAM SCALE : NONE

DESIGN GROUP

Architect:

Hamlin Design Group 915 Broadway, Suite 101A

Albany, New York 12207 Tel: 518.724.5159 Fax: 518.320.8633

Hazardous Material Consultant:

Web: hamlindesigngroup.com



MEP Engineer:

Engineered Solutions
646 Plank Road #104
Clifton Park, NY 12061
phone: (518) 280-2410
fax: (518) 280-2481
www.engineered-solutions.net

00000

------ Electrical ------



1031 Elm St. Peekskill, NY 10566

Peekskill City School District

Peekskill Reconstruction


SED Project: 66-15-00-01-0-005-020 HDG Project: 201

Oakside Elementary

200 Decatur Ave., Peekskill, NY 10566 SED Project: 66-15-00-01-0-008-017

HDG Project: 203 **Woodside Elementary**

612 Depew St., Peekskill, NY 10566

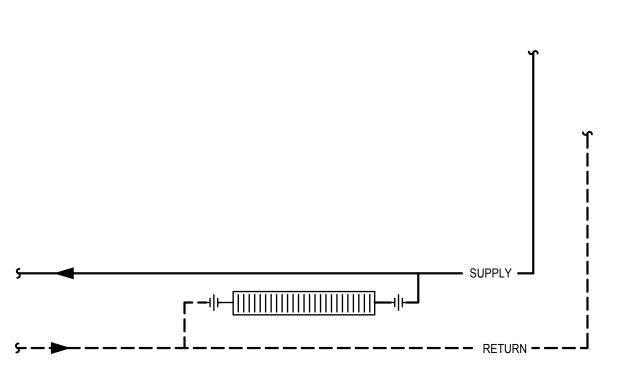


TYPICAL FIN TUBE PIPING DIAGRAM

NOTES:

1. REFER TO PIPING DETAIL FOR FIN SPECIALTIES.

2. RUN ALL PIPING AND FIN UNDER FIN COVER.

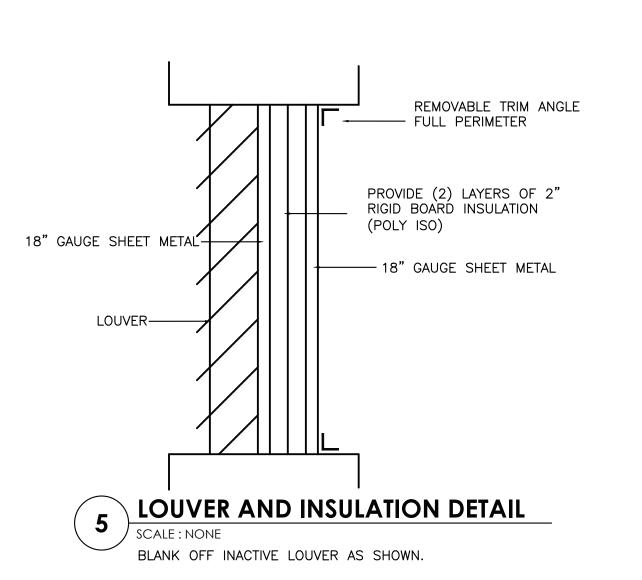

TYPICAL FIN TUBE PIPING DIAGRAM (HW)

SCALE : NONE

NOTES:

1. FIN TUBE MFR. TO FURNISH ACCESS DOORS AT ALL VALVE LOCATIONS.

2. COLOR AND OR TEMPERATURE CONTROL DIAGRAM, F' 2. WHERE INDICATED ON PLANS OR TEMPERATURE CONTROL DIAGRAM, FURNISH OTHER TYPE CONTROL VALVE BY TEMPERATURE CONTROL CONTRACTOR WHERE INDICATED ON PLANS OR

REMOTE SENSING

TEMPERATURE CONTROL DIAGRAM. 3. FCV SIZED TO MATCH FLOW.

FURNISH 18" LENGTF

OF 1/4" FLEX TUBE

DRAWN BY:


MLB

ISSUE: 03/19/2021



DESCRIPTION HVAC Details and Diagrams

W-M.601.00

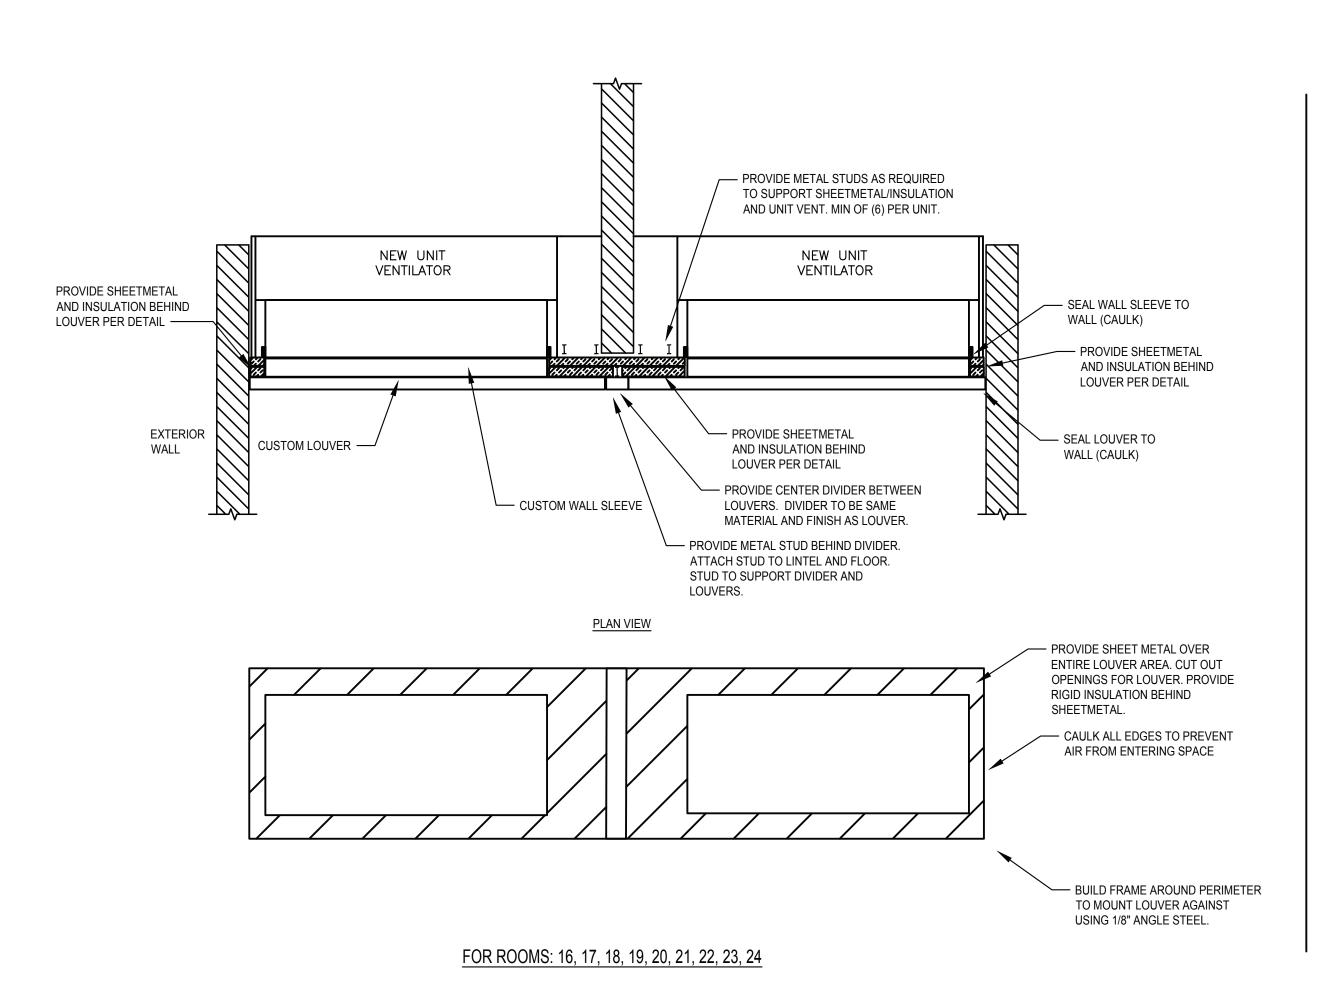


PROVIDE ALUMINUM ANGLE. TO COVER GAP BETWEEN WINDOW AND NEW UNIT / WALL SLEEVE FINISH TOP EXTERIOR ── WALL SLEEVE WALL PROVIDE LINTEL — LOUVER -PROVIDE CUSTOM WALL SLEEVE WITH DIVIDER TO PREVENT **\$** THE AIR STREAMS FROM CROSSING. -► ROOM AIR DAMPER — OA AIR DAMPER

ELEVATION VIEW

UNIT IS TO BE INSTALLED TIGHT AGAINST OUTSIDE WALL WITH MANUFACTURERS WALL SLEEVE FULLY INTO ROOM. PROVIDE CUSTOM WALL SLEEVE FROM UNIT VENT TO LOUVER. SLEEVE TO HAVE DIVIDER IN IT TO PREVENT THE AIR STREAMS FROM CROSSING. UNIT TO BE SEALED AGAINST OUTSIDE WALL SO NO OUTSIDE AIR ENTERS UNIT OR ROOM.

2. INSTALL PER MANUFACTURERS RECOMMENDATIONS.

FOR ALL UNITS FOR ALL UNITS

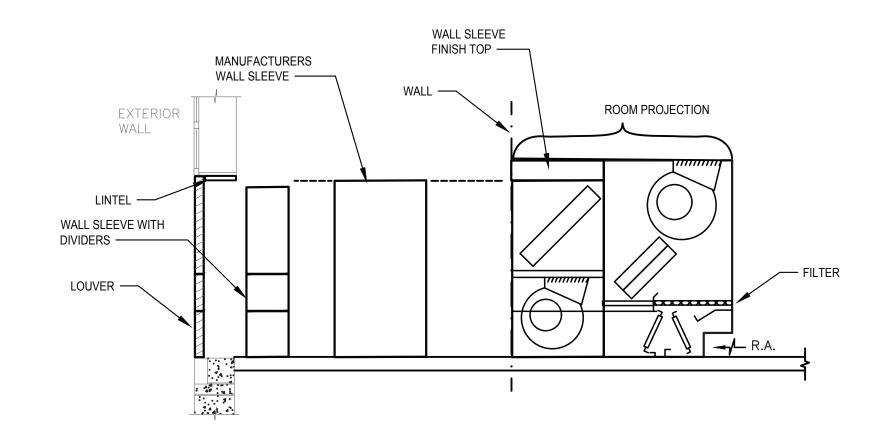

ELEVATION VIEW

Engineered Solutions
646 Plank Road #104
Clifton Park, NY 12061
phone: (518) 280-2410
fax: (518) 280-2481 www.engineered-solutions.net 00000

NYS/NJS Certified WBE & SBA EDWOSB & DBE

DESIGN

GROUP

Hamlin Design Group

Web: hamlindesigngroup.com

Hazardous Material Consultant:

915 Broadway, Suite 101A

Albany, New York 12207

Tel: 518.724.5159

Fax: 518.320.8633

MEP Engineer:

Architect:

engineered**solutions** ———— ES # 19071 ————

1031 Elm St. Peekskill, NY 10566

Peekskill City School District

Peekskill Reconstruction

SED Project: 66-15-00-01-0-005-020 HDG Project: 201

Oakside Elementary

200 Decatur Ave., Peekskill, NY 10566 SED Project: 66-15-00-01-0-008-017

HDG Project: 203 **Woodside Elementary** 612 Depew St.,

Peekskill, NY 10566

FINISH TOP / WALL SLEEVE EXTERIOR WALL LOUVER ---PIPE PENETRATION SHALL FALL WITHIN MASONRY JOINT. 3/4" CONDENSATE DRAIN UNIT SEAL TRAP THROUGH WALL (COPPER TUBING AND ELBOW) PROVIDE PIPING FROM SEAL TRAP TO OUTSIDE AS SHOWN

— WALL SLEEVE

6. THIS CONTRACTOR IS RESPONSIBLE TO ENSURE THAT NO WATER ENTERS BUILDING AROUND NEW LOUVER. CAULK AS REQUIRED. IF JOINT IS LARGER THAN 1/4" CONTRACTOR SHALL PROVIDE A METAL BACKING MATERIAL BETWEEN LOUVER AND WALL AND THEN CAULK

3. REFER TO PIPING DETAIL FOR WATER SPECIALTIES.

FIRMLY AGAINST THE WALL.

WEATHERTIGHT. 7. INSTALL PER MANUFACTURERS INSTRUCTIONS.

1. THE MC SHALL REMOVE AT LEAST (3) OF THE EXISTING LOUVERS, MEASURE THE WALL TO VERIFY THE WIDTH, HEIGHT AND DEPTH AND RE-INSTALL THE LOUVER AT THE START OF THE PROJECT BEFORE ANY SUBMITTALS HAVE BEEN SENT TO VERIFY WALL CONSTRUCTION AND WALL SLEEVE DEPTH. CONTRACTOR TO VERIFY ALL LOUVERS IN FIELD PRIOR TO SUBMITTALS.

UNIT VENTILATOR DETAIL

1. IT IS THE RESPONSIBILITY OF THIS CONTRACTOR TO INSURE THAT ALL AREAS OF THE UNIT

2. AS WALL CONDITIONS VARY AT EACH INDIVIDUAL UNIT THIS CONTRACTOR MUST PROVIDE

VENTILATOR ARE COMPLETELY SEALED AND INSULATED TO THE OUTSIDE AIR INTAKE.

SAFING, INSULATION, SHEET METAL, AND ACCESSORIES REQUIRED TO SEAT UNIT VENTILATOR

4. THE END COMPARTMENTS OF EACH UNIT VENTILATOR MUST BE COMPLETELY SEALED-OFF AND

RE-INSULATED TO PREVENT ANY OUTSIDE AIR FROM ENTERING THE UNIT OR THE ROOM.


THE CONTRACTOR IS RESPONSIBLE TO VERIFY AND ORDER THE CORRECT SIZE LOUVER

GENERAL UNIT VENTILATOR INSTALLATION NOTES

2. THE CONTRACTOR SHALL INSTALL ONE UNIT AND HAVE THE OWNER AND ENGINEER REVIEW THE INSTALLATION BEFORE THE OTHER UNITS ARE INSTALLED.

- 1. PROVIDE CONDENSATE DRAIN THROUGH EXTERIOR WALL, EXPOSED DRAIN PIPE SHALL BE COPPER.
- 2. PENETRATIONS THROUGH WALL SHALL BE CORE DRILLED AND SEALED WATER & AIR TIGHT.
- 3. EXTREME CARE SHALL BE TAKEN WHILE LOCATING PENETRATION. COORDINATE WORK GENERAL CONTRACTOR FOR ALIGNMENT WITH MORTAR
- 4. REVIEW EXISTING WALL MORTAR CONDITIONS WITH GC PRIOR TO START OF WORK THROUGHOUT RENOVATED AREAS.



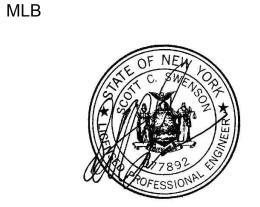

ISSUE: 03/19/2021

DESCRIPTION HVAC Details and Diagrams

DRAWN BY:

