Rye City School District

555 Theodore Fremd Ave, Rye, NY 10580

Midland Elementary School

312 Midland Avenue, Rye, New York 10580

SED #: 6618-0001-0003-026

Number Name

UNIFORM SAFETY STANDARDS COMMISIONER'S REGULATIONS 155.5

1. Statement:

"The occupied portion of any school building shall always comply with the minimum requirements necessary to maintain a certificate of occupancy.

2. Indication that all school areas to be disturbed during renovation or demolition have been or will be tested for lead and asbestos. Note, the project folder should contain a letter regarding the presence of asbestos. 3. Statement:

"General safety and security standards for construction projects.

1. All construction materials shall be stored in a safe and secure manner 2. Fences around construction supplies or debris shall be maintained. 3. Gates shall always be locked unless a worker is in attendance to prevent unauthorized

4. During exterior renovation work, overhead protection shall be provided for any sidewalks or areas immediately beneath the work site or such areas shall be fenced off and provided with warning signs to prevent entry.

5. Workers shall be required to wear photo-identification badges at all times for identification and security purposes while working at occupied sites." 4. Statement:

"Separation of construction areas from occupied spaces. Construction areas which are under the control of a contractor and therefore not occupied by district staff or students shall be separated from occupied areas. Provisions shall be made to prevent the passage of dust and contaminants into occupied parts of the building. Periodic inspection and repairs of the containment barriers must be made to prevent exposure to dust or contaminants. Gypsum board must be used in exit ways or other areas that require fire rated separation. Heavy duty plastic sheeting may be used only for a vapor, fine dust or air infiltration barrier, and shall not be used to separate occupied spaces from construction areas.

1. A specific stairwell and/or elevator should be assigned for construction worker use during work hours. In general, workers may not use corridors, stairs or elevators designated for students or school staff.

2. Large amounts of debris must be removed by using enclosed chutes or a similar sealed system. There shall be no movement of debris through halls of occupied spaces of the building. No material shall be dropped or thrown outside the walls of the building. 3. All occupied parts of the building affected by renovation activity shall be cleaned at the close of each workday. School buildings occupied during a construction project shall maintain required health, safety and educational capabilities at all times that classes 4. A plan detailing how exiting required by the applicable building code will be

5. A plan detailing how adequate ventilation will be maintained during construction.

5. Statement:

"Construction and maintenance operations shall not produce noise in excess of 60 dba in occupied spaces or shall be scheduled for times when the building or affected building spaces are not occupied or acoustical abatement measures shall be taken."

6. Statement:

contaminates produced by welding, gasoline or diesel engines, roofing, paving, painting, etc. to ensure they do not enter occupied portions of the building or air intakes."

"The contractor shall be responsible to ensure that activities and materials which result in

"The contractor shall be responsible for the control of chemical fumes, gases, and other

"off-gassing" of volatile organic compounds such as glues, paints, furniture, carpeting, wall covering, drapery, etc. are scheduled, cured or ventilated in accordance with manufacturers recommendations before a space can be occupied."

8. Statement: "Large and small asbestos abatement projects as defined by 12NYCRR56 shall not be performed while the building is occupied". Note, It is our interpretation that the term "building", as referenced in this section, means a wing or major section of a building that can be completely isolated from the rest of the building with sealed non combustible construction. The isolated portion of the building must contain exits that do not pass through the occupied portion and ventilation systems must be physically separated and sealed at the isolation

Exterior work such as roofing, flashing, siding, or soffit work may be performed on occupied buildings provided proper variances are in place as required, and complete isolation of ventilation systems and at windows is provided. Care must be taken to schedule work so that classes are not disrupted by noise or visual distraction.

9. Surfaces that will be disturbed by reconstruction must have a determination made as to the presence of lead. Projects which disturb surfaces that contain lead shall have in the specifications a plan prepared by a certified Lead Risk Assessor or Supervisor which details provisions for occupant protection, worksite preparation, work methods, cleaning and clearance testing which are in general accordance with the HUD Guidelines.

DRAWINGS INDEX


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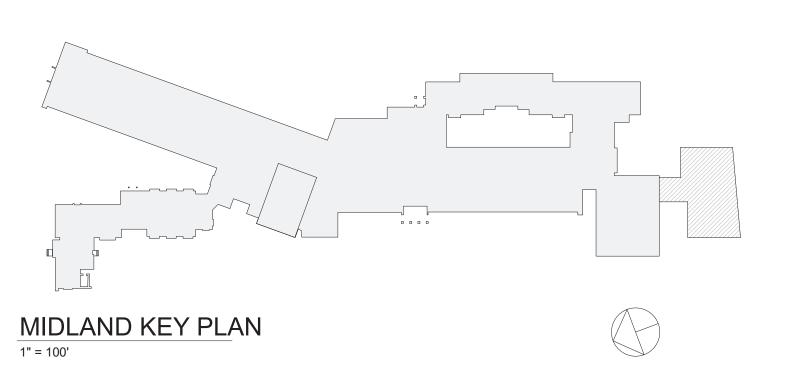
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Current Revision

Date

LOCATION MAP



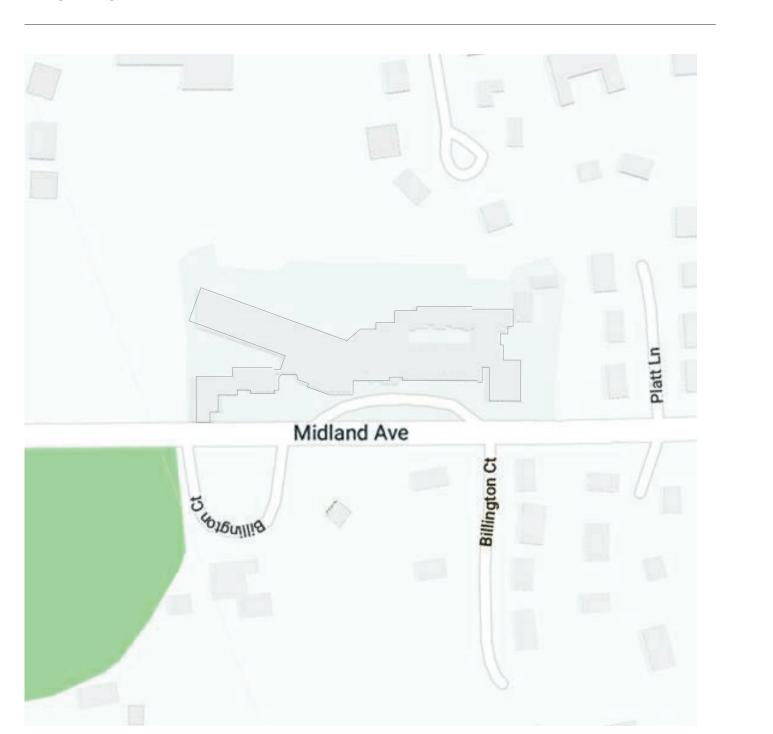

Geddis Architects

Revision Schedule

Description

10/23/2020

08/10/202

8/16/2021

8/23/2021

SED SUBMISSION

FOR BID Addendum 1

Addendum 2

ADDITIONS: ISSUED

Architecture. Planning. Interiors

71 Old Post Road P.O. Box 1020 Southport, CT 06890 (203) 256-8700



Transforming Education by Design

259 Water Street Suite 1L Warren, RI 02885 USA +1 401-289-2789



CONSULTING ENGINEERS 39 MARBLE AVE PLEASANTVILLE, NY 10570 914.328.6060 GENERAL@BGA-ENG.com www.BGA-ENG.com

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Structural Engineer **ODEH ENGINEERS** 1223 Mineral Spring Ave North Providence, RI 02904

401-724-1771 Civil Engineer **WESTON & SAMPSON** 1 Winners Circle, Suite 130 Albany, NY 12205 518-463-4400

Roof Consultant WATSKY ASSOCIATES INC. 20 Madison Ave

Valhalla, NY 10595 914-948-3450 **Acoustic Consultant** DP DESIGN 12 Cold Spring Street

Providence, RI 401-861-3218 CAVANAUGH TOCCI 327 F Boston Post Road Sudbury, MA 01776-3027 978-443-7871

SED#: 6618-0001-0003-026

PROJECT

Rye City Schools 555 Theodore Fremd Ave, Rye, NY 10580

Midland Elementary School

312 Midland Ave, Rye NY 10580

TITLE SHEET - PHASE 3

Approver

PROJECT No: 9200 DRAWING BY: Author CHK BY: Checker DWG No: T3-001

TYPICAL ARCHITECTURAL ABBREVIATIONS

METAL MINIMUM MOUNTED NOT APPLICABLE NUMBER NOMINAL NOT TO SCALE NOT IN CONTRACT ON CENTER OVERHEAD PLASTIC LAMINATE PLATE

PREFABRICATED PRESSURE TREATED PAINTED QUANTITY REINFORCED STAINLESS STEEL THICK THRESHOLD TOP AND BOTTOM TYPICAL

UNLESS NOTED OTHERWISE VINYL COMPOSITION TILE WATER CLOSET WOOD

WELDED WIRE FABRIC

ROOM NAME ROOM TAG SQ. FT 000X DOOR TAG WINDOW TYPE


 $\sqrt{1/8" = 1'}$ -0" SCALE OF DRAWING

LEGEND

CASEWORK - ADDITION LIBRARIES

WALL TYPE SPECIALITY EQUIPMENT DRAWING TITLE

DETAIL NUMBER

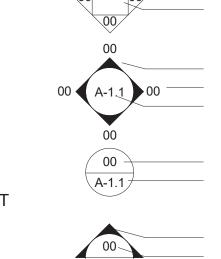


INTERIOR ELEVATION TAG CALL OUT SYMBOL SECTION SYMBOL

EXTERIOR ELEVATION TAG

ADDITIONS: ISSUED FOR BID


LEVEL TAG NAME ELEVATION

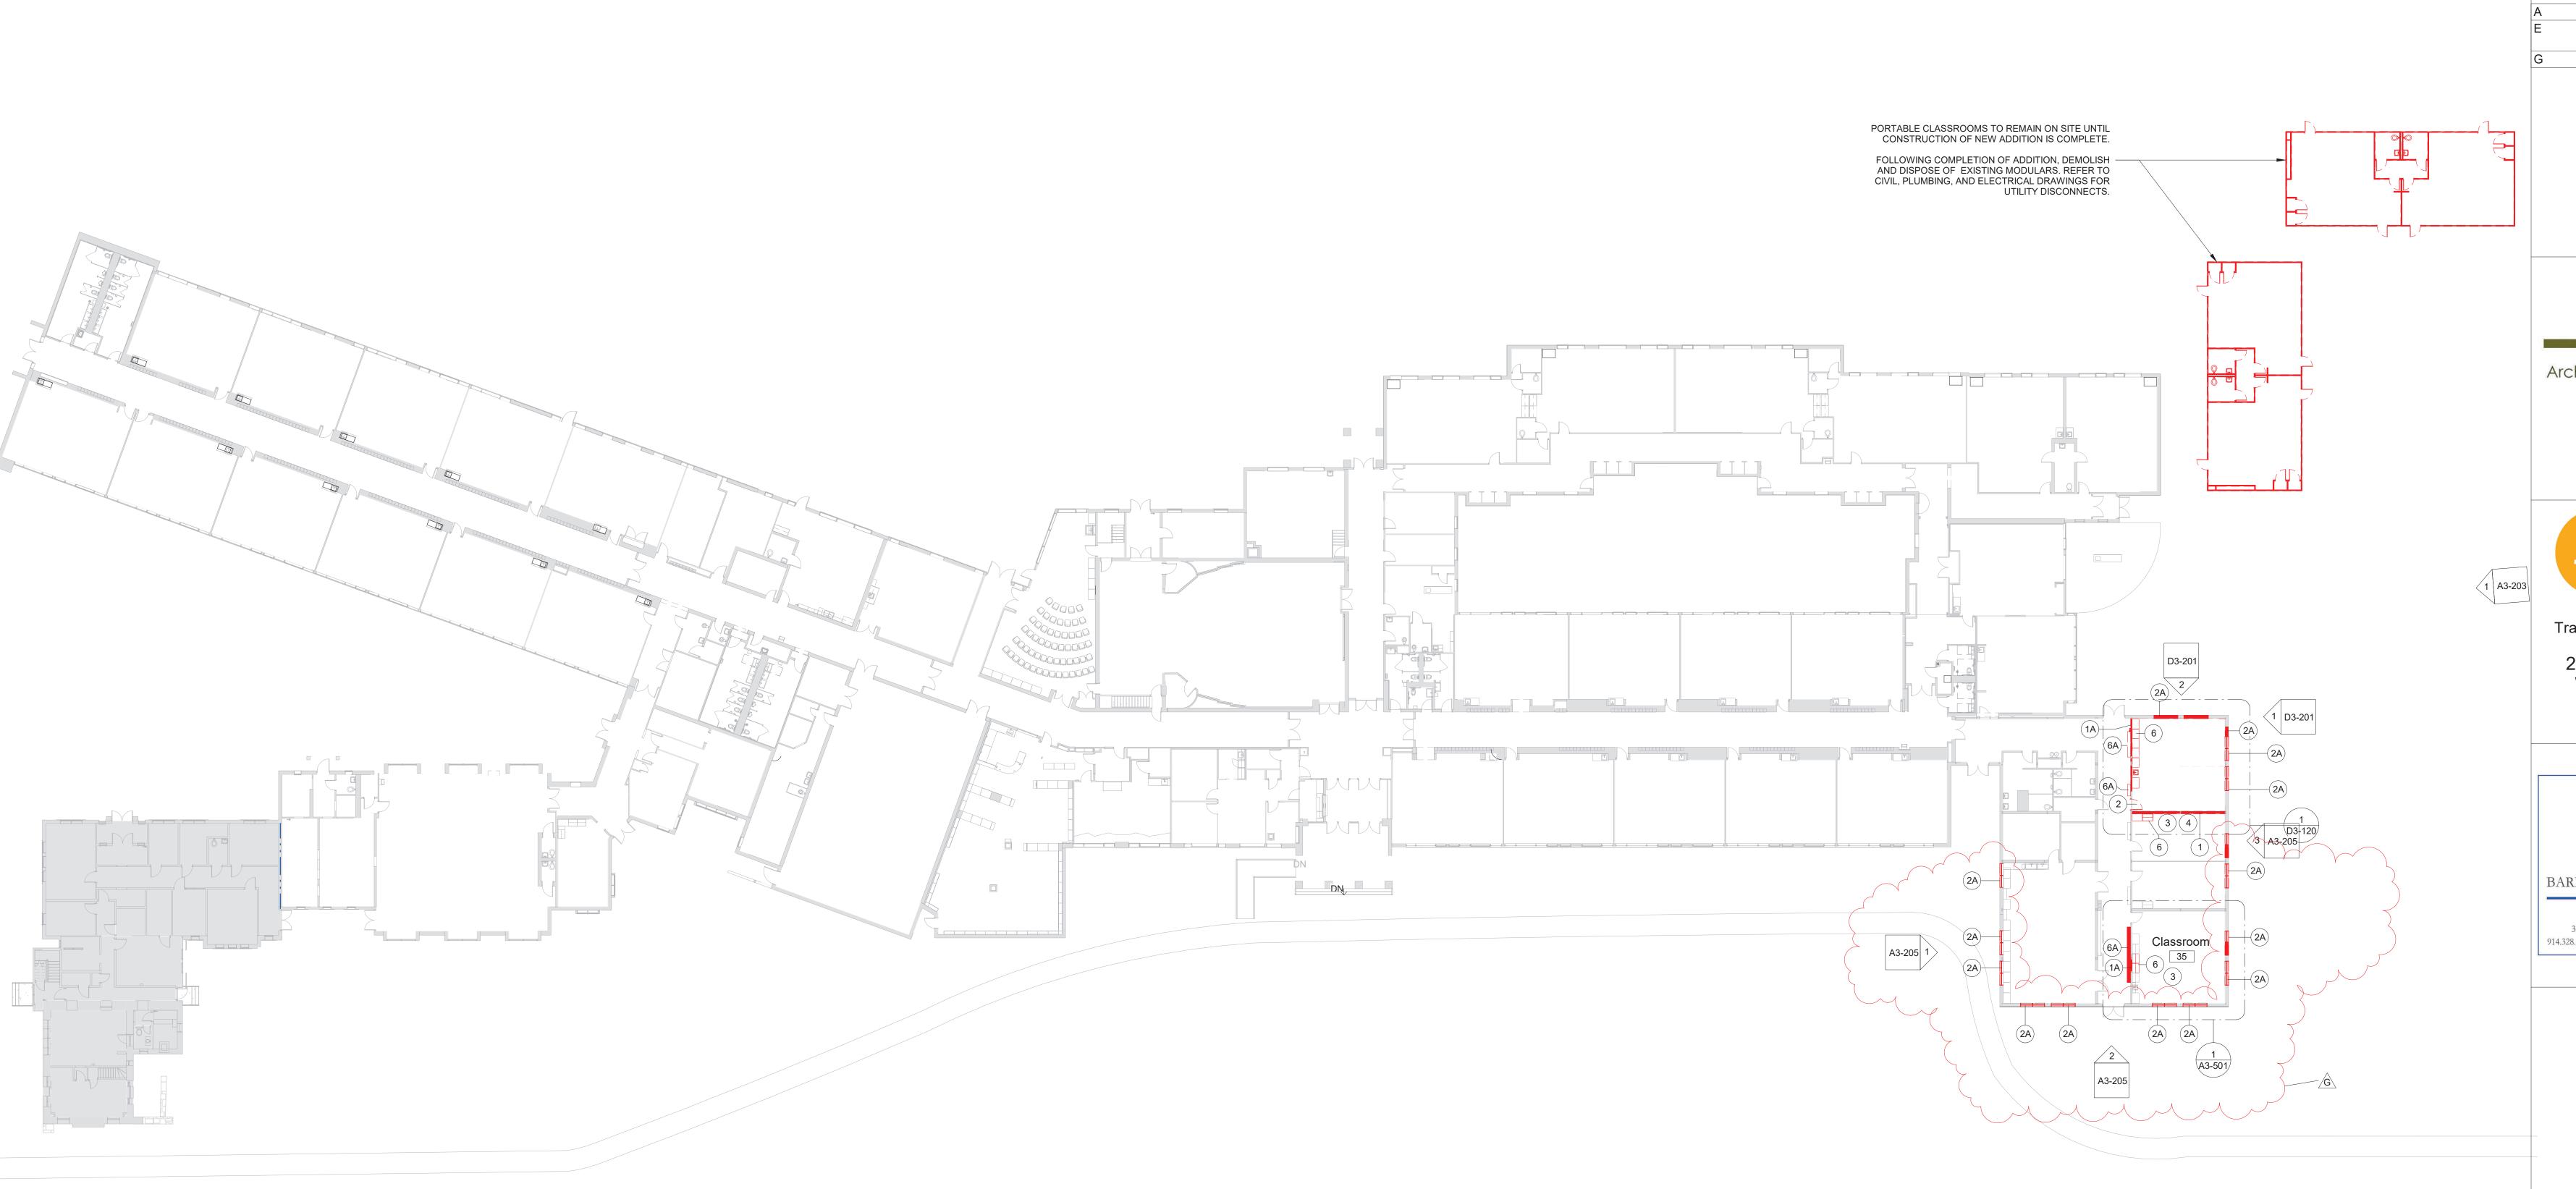

1 First Floor Plan - Demo
SCALE: 1" = 20'-0"

| DEM | O LEGEND | |
|-----|-----------------------------|--|
| | DEMO EXISTING WALLS & DOORS | |
| | DEMO EXISTING WALL FINISHES | |
| | AREA NOT IN SCOPE | |

| Key Value | Keynote Text | | | | | | | |
|-----------|---|--|--|--|--|--|--|--|
| 1 | REMOVE EXISTING MASONRY/GYP. BD/TILE WALL ASSEMBLY. | | | | | | | |
| 1A | REMOVE EXISTING MASONRY/GYP. BD/TILE WALL ASSEMBLY TO CREATE A DOOR OPENING. SEE DOOR SCHEDULE. | | | | | | | |
| 1B | REMOVE EXISTING GYP. BD./ TILE ON TAG SIDE OF THE WALL. EXISTING STUDS TO REMAIN. | | | | | | | |
| 1C | REMOVE EXISTING MASONRY/GYP. BD/TILE WALL ASSEMBLY TO CREATE A WINDOW OPENING. SEE WINDOW TYPES. | | | | | | | |
| 2 | REMOVE EXISTING DOOR, FRAME AND ASSOCIATED HARDWARE. | | | | | | | |
| 2A | REMOVE EXISTING EXTERIOR WINDOW, FRAME AND ASSOCIATED HARDWARE. | | | | | | | |
| 2B | REMOVE EXISTING INTERIOR WINDOW, FRAME AND ASSOCIATED HARDWARE. | | | | | | | |
| 3 | REMOVE EXISTING FLOORING, BASE, ADHESIVE AND ALL APPLIED ACCESSORIES. FLASH PATCH AS REQUIRED TO ACHIEVE SMOOTH AND LEVEL SUBSTRATE PER MANUF. SPEC. FOR NEW FLOORING. PITCH TO NEW FLOOR DRAINS. | | | | | | | |
| 4 | REMOVE EXISTING GYP. BD. CEILINGS, CEILING GRID, TILES & SOFFITS BELOW STRUCTURAL DECK. REMOVE EXISTING LIGHT FIXTURES AND DEVICES. | | | | | | | |
| 5 | REMOVE EXISTING PLUMBING FIXTURES, TOILET PARTITIONS & ASSOCIATED PLUMBING AND ACCESSORIES. | | | | | | | |
| 6 | REMOVE EXISTING MILLWORK COUNTER, CABINETS AND SHELVING. | | | | | | | |
| 6A | REMOVE EXISTING LOCKERS AND ASSOCIATED HARDWARE. | | | | | | | |
| 7 | REMOVE EXISTING MECHANICAL EQUIPMENT. | | | | | | | |

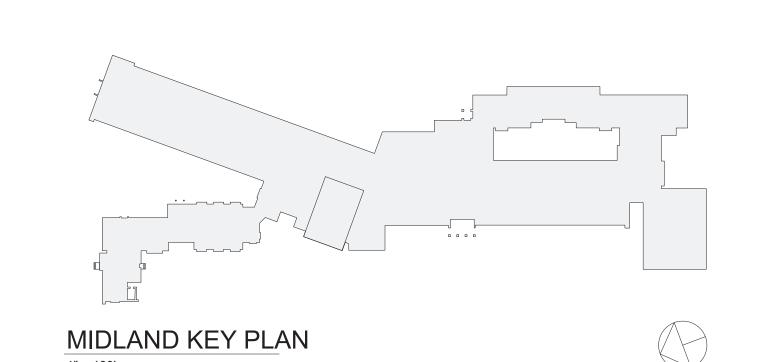

Geddis

Architects

Revision Schedule

Description

10/23/2020

08/10/2021

8/23/2021

SED SUBMISSION

Addendum 2

ADDITIONS: ISSUED FOR BID

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> 914-769-3200

Structural Engineer
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PROJECT


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Midland Elementary School

312 Midland Ave, Rye NY 10580

FIRST FLOOR DEMOLITION PLAN

SEAL & SIGNATURE | DATE:____ PROJECT No: 9200 DRAWING BY: Author CHK BY: Checker DWG No: D3-101

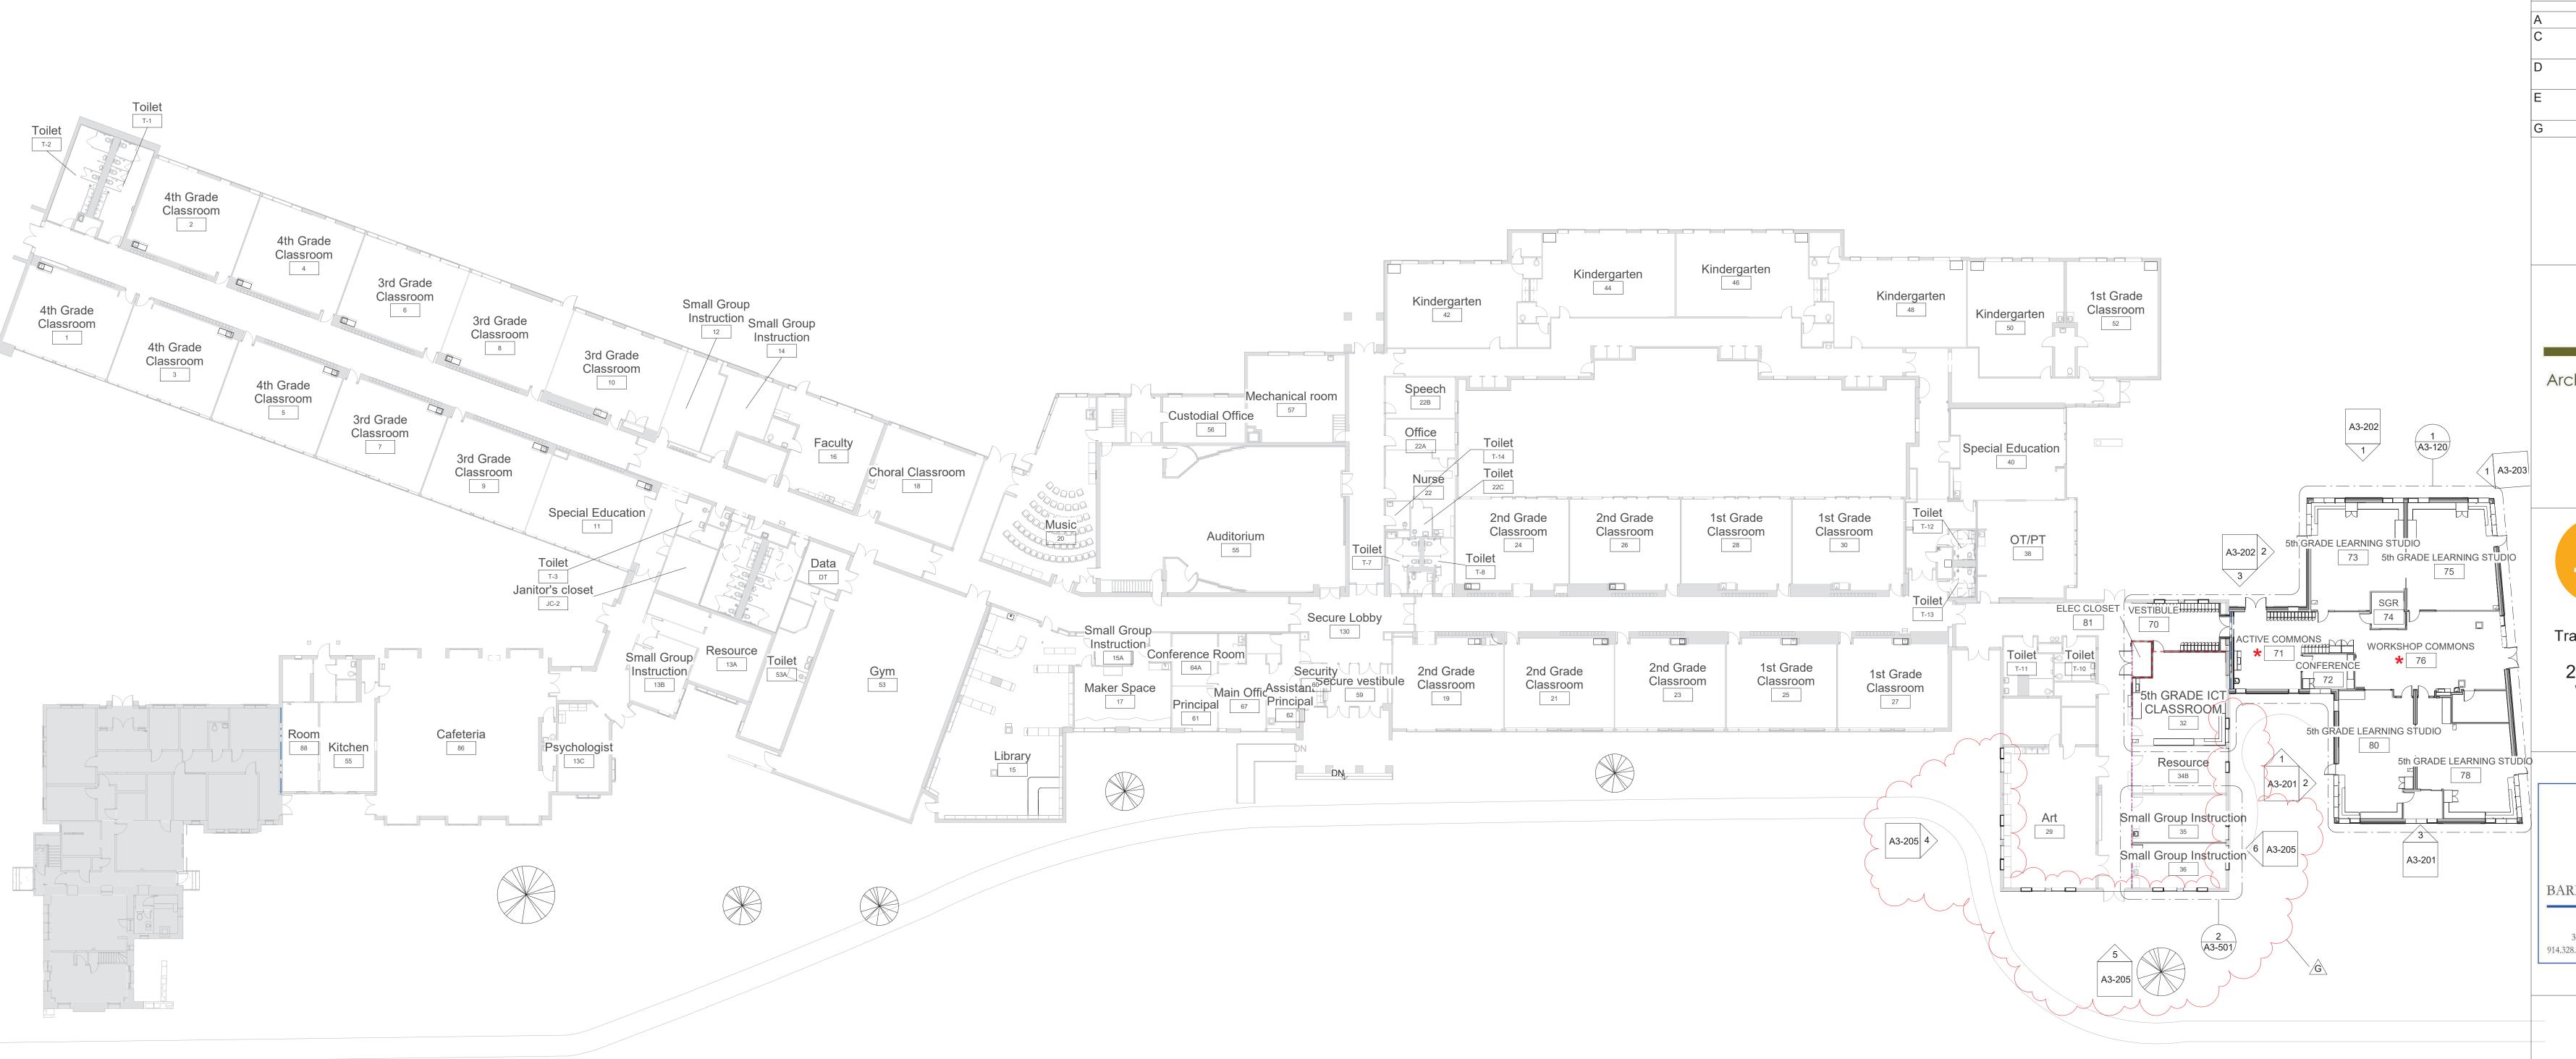

1 First Floor Plan

LEGEND

NEW 1-HR RATED FIRE PARTITION

EXISTING 1-HR RATED FIRE PARTITION

NEW 2-HR RATED FIRE BARRIER


---- EXISTING 2-HR RATED FIRE BARRIER

---- EXISTING 2-HR RATED FIRE WALL

--- NEW 2-HR RATED FIRE WALL

STEAM NOTE

THE ACTIVE COMMONS AND WORKSHOP COMMONS ARE INTENDED TO BE USED FOR STEAM RELATED ACTIVITIES. THE LAYOUT ALLOWS FOR DIRECT ACCESS FROM THE COMMONS SPACES FROM THE 4 ADJACENT NEW CLASSROOMS.

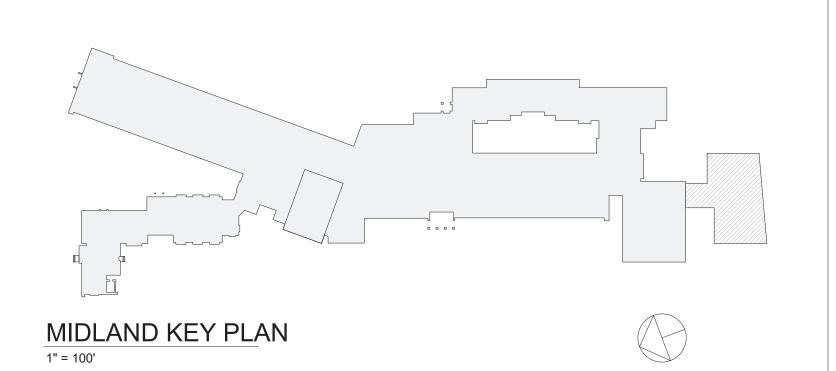

Revision Schedule No. Description Date SED SUBMISSION 10/23/2020 ADDITIONS: SED 5/28/21 ADDENDUM #2 ADDITIONS: SED 6/28/2021 ADDENDUM #4 ADDITIONS: ISSUED 08/10/2021 FOR BID Addendum 2 8/23/2021

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914-769-3200

<u>Structural Engineer</u>

ODEH ENGINEERS

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North Providence, RI 02904

401-724-1771

<u>Civil Engineer</u>
WESTON & SAMPSON
1 Winners Circle, Suite 130
Albany, NY 12205

518-463-4400 Roof Consultant

WATSKY ASSOCIATES INC. 20 Madison Ave Valhalla, NY 10595 914-948-3450

Acoustic Consultant
DP DESIGN
12 Cold Spring Street
Providence, RI

401-861-3218

978-443-7871

AV Consultant CAVANAUGH TOCCI 327 F Boston Post Road Sudbury, MA 01776-3027

SED#: 6618-0001-0003-026

PROJECT

Rye City Schools

555 Theodore Fremd Ave, Rye, NY 10580

Midland Elementary School

312 Midland Ave, Rye NY 10580

FIRST FLOOR PLAN

Approver

SEAL & SIGNATURE


PROJECT No: 9200


DRAWING BY: Author

CHK BY: Checker

DWG No:

A3-101

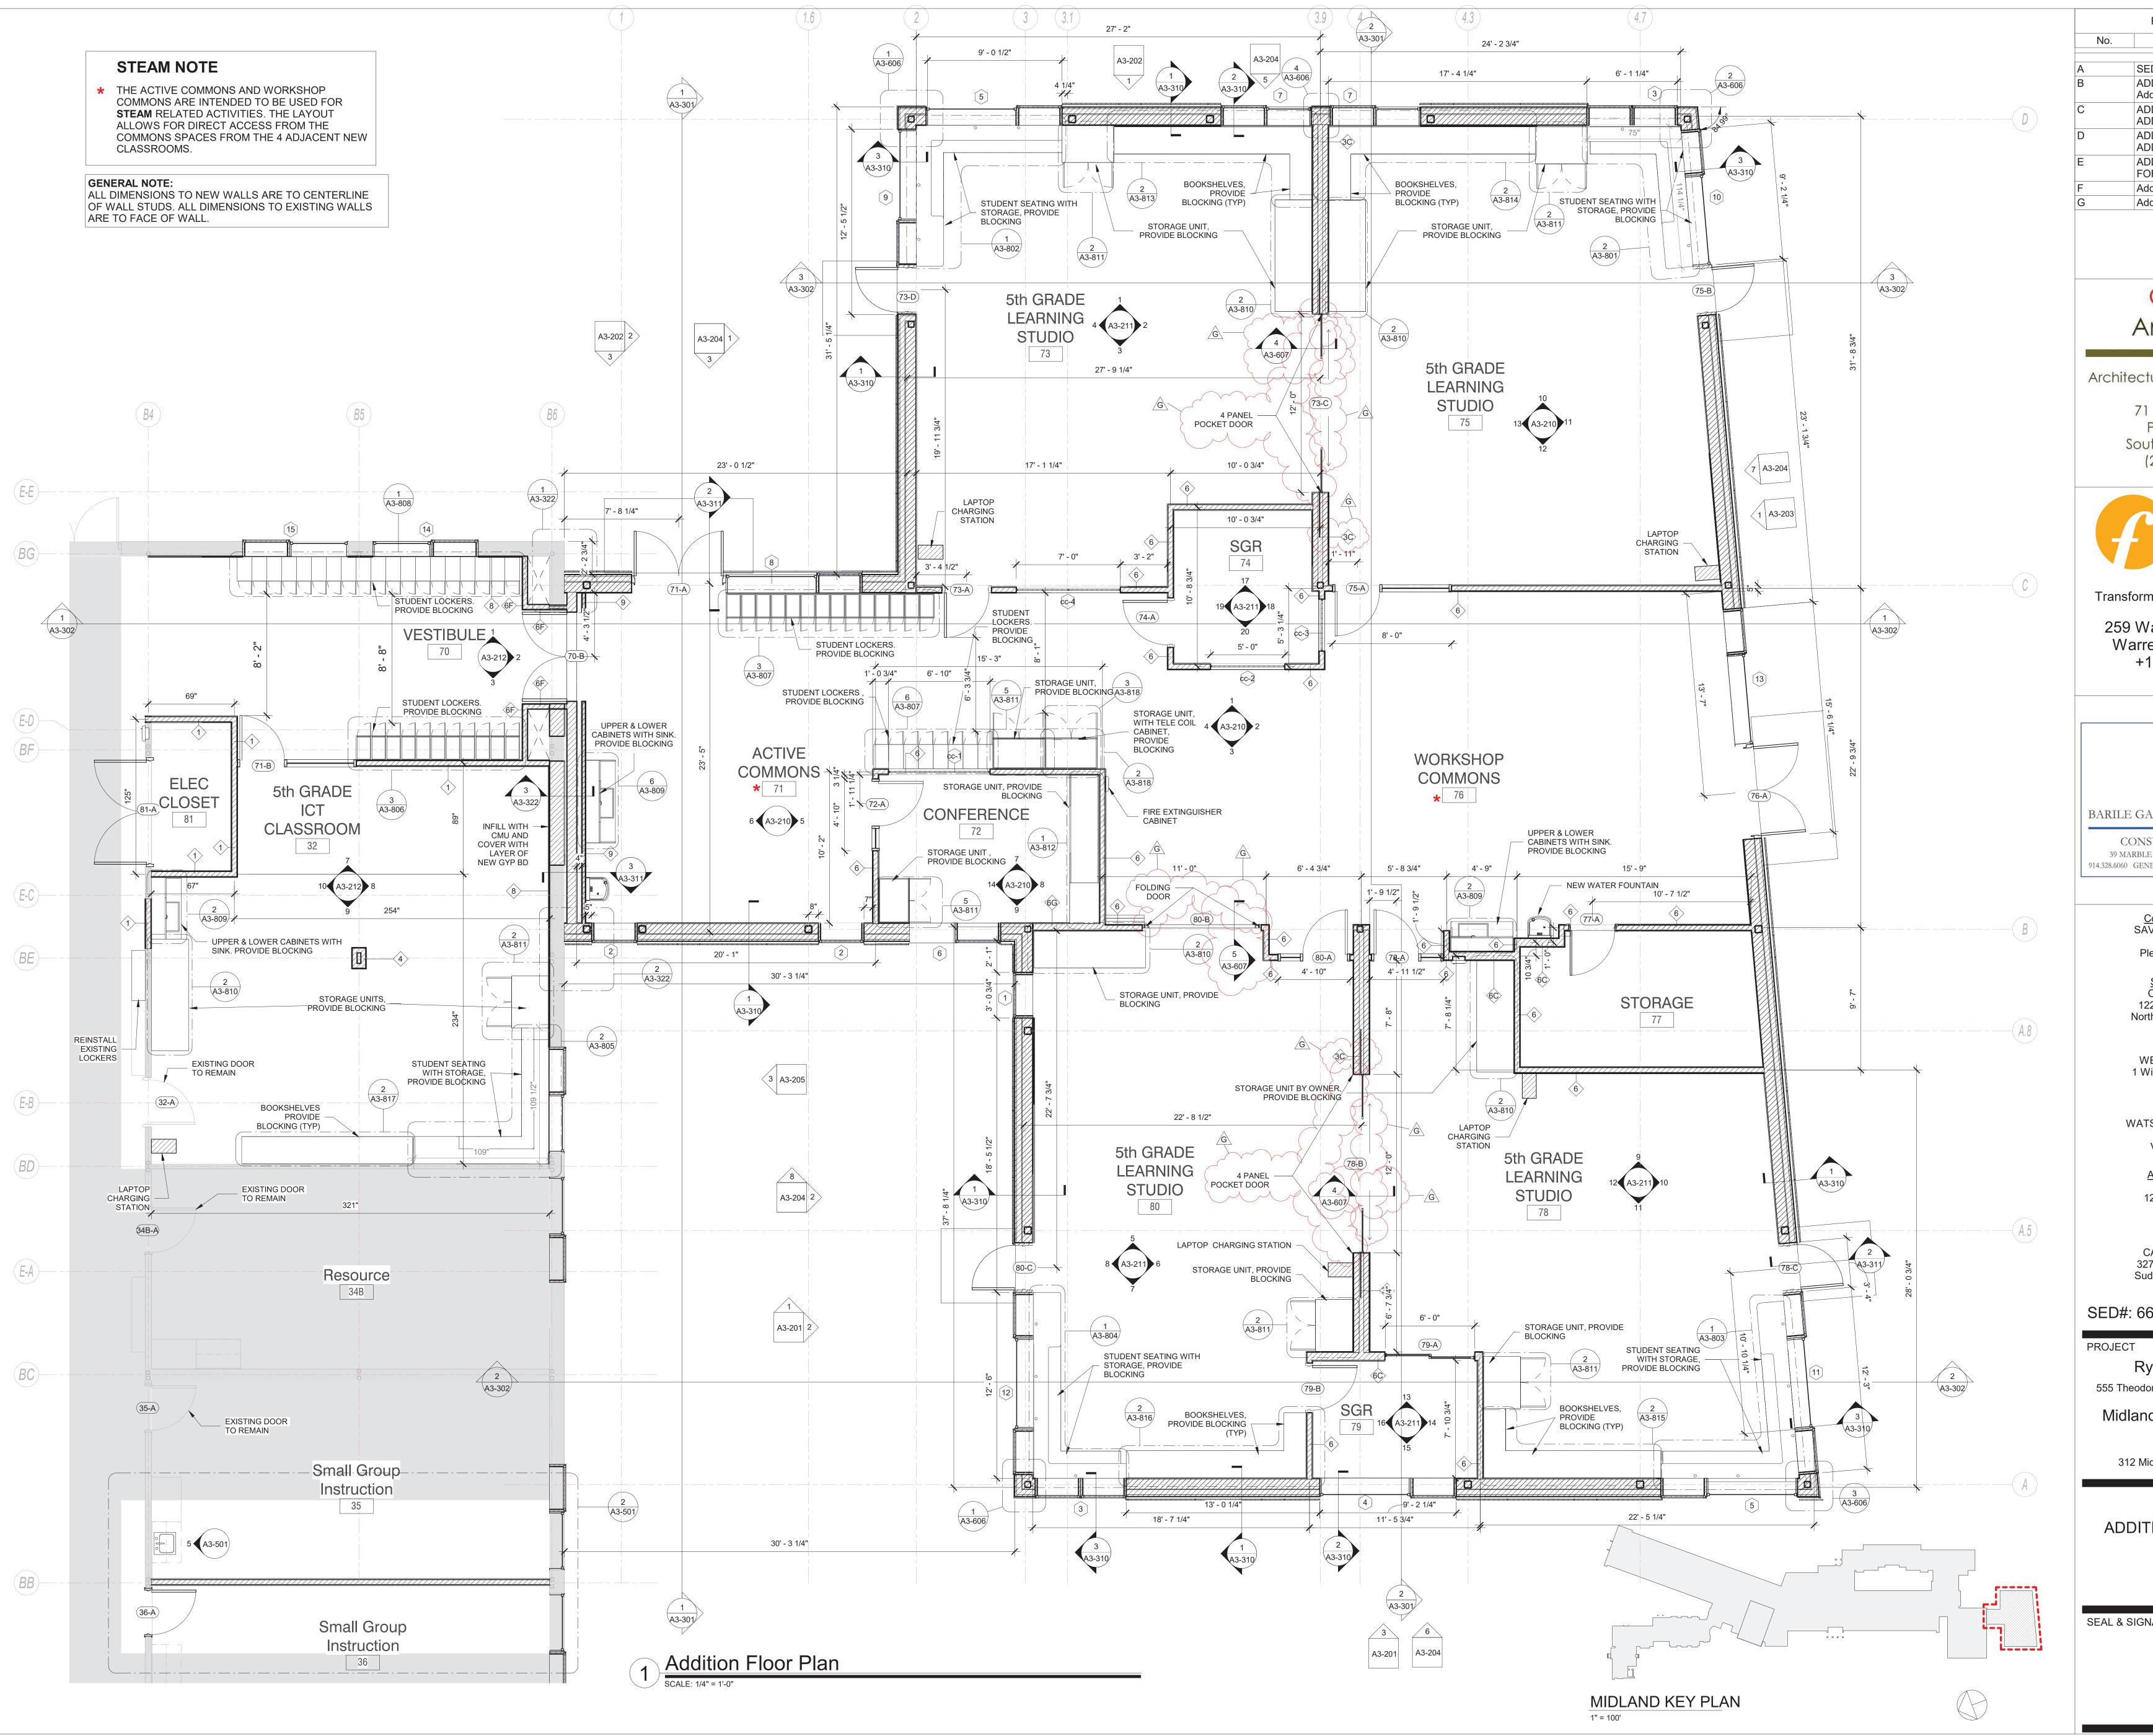

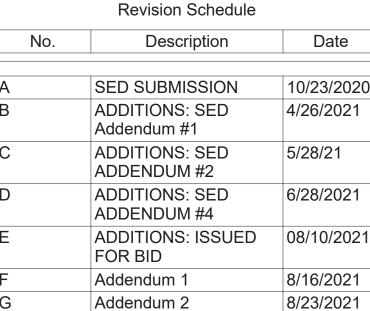

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ODEH ENGINEERS 1223 Mineral Spring Ave

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SED#: 6618-0001-0003-026

PROJECT

Rye City Schools

555 Theodore Fremd Ave, Rye, NY 10580

Midland Elementary School


312 Midland Ave, Rye NY 10580

ADDITION FLOOR PLAN

Approver

| NATURE | DATE: | 12/12/ |
|--------|------------|--------|
| | PROJECT No | 920 |
| | DRAWING BY | :_Auth |
| | CHK BY: | Check |
| | | |

DWG No: A3-120

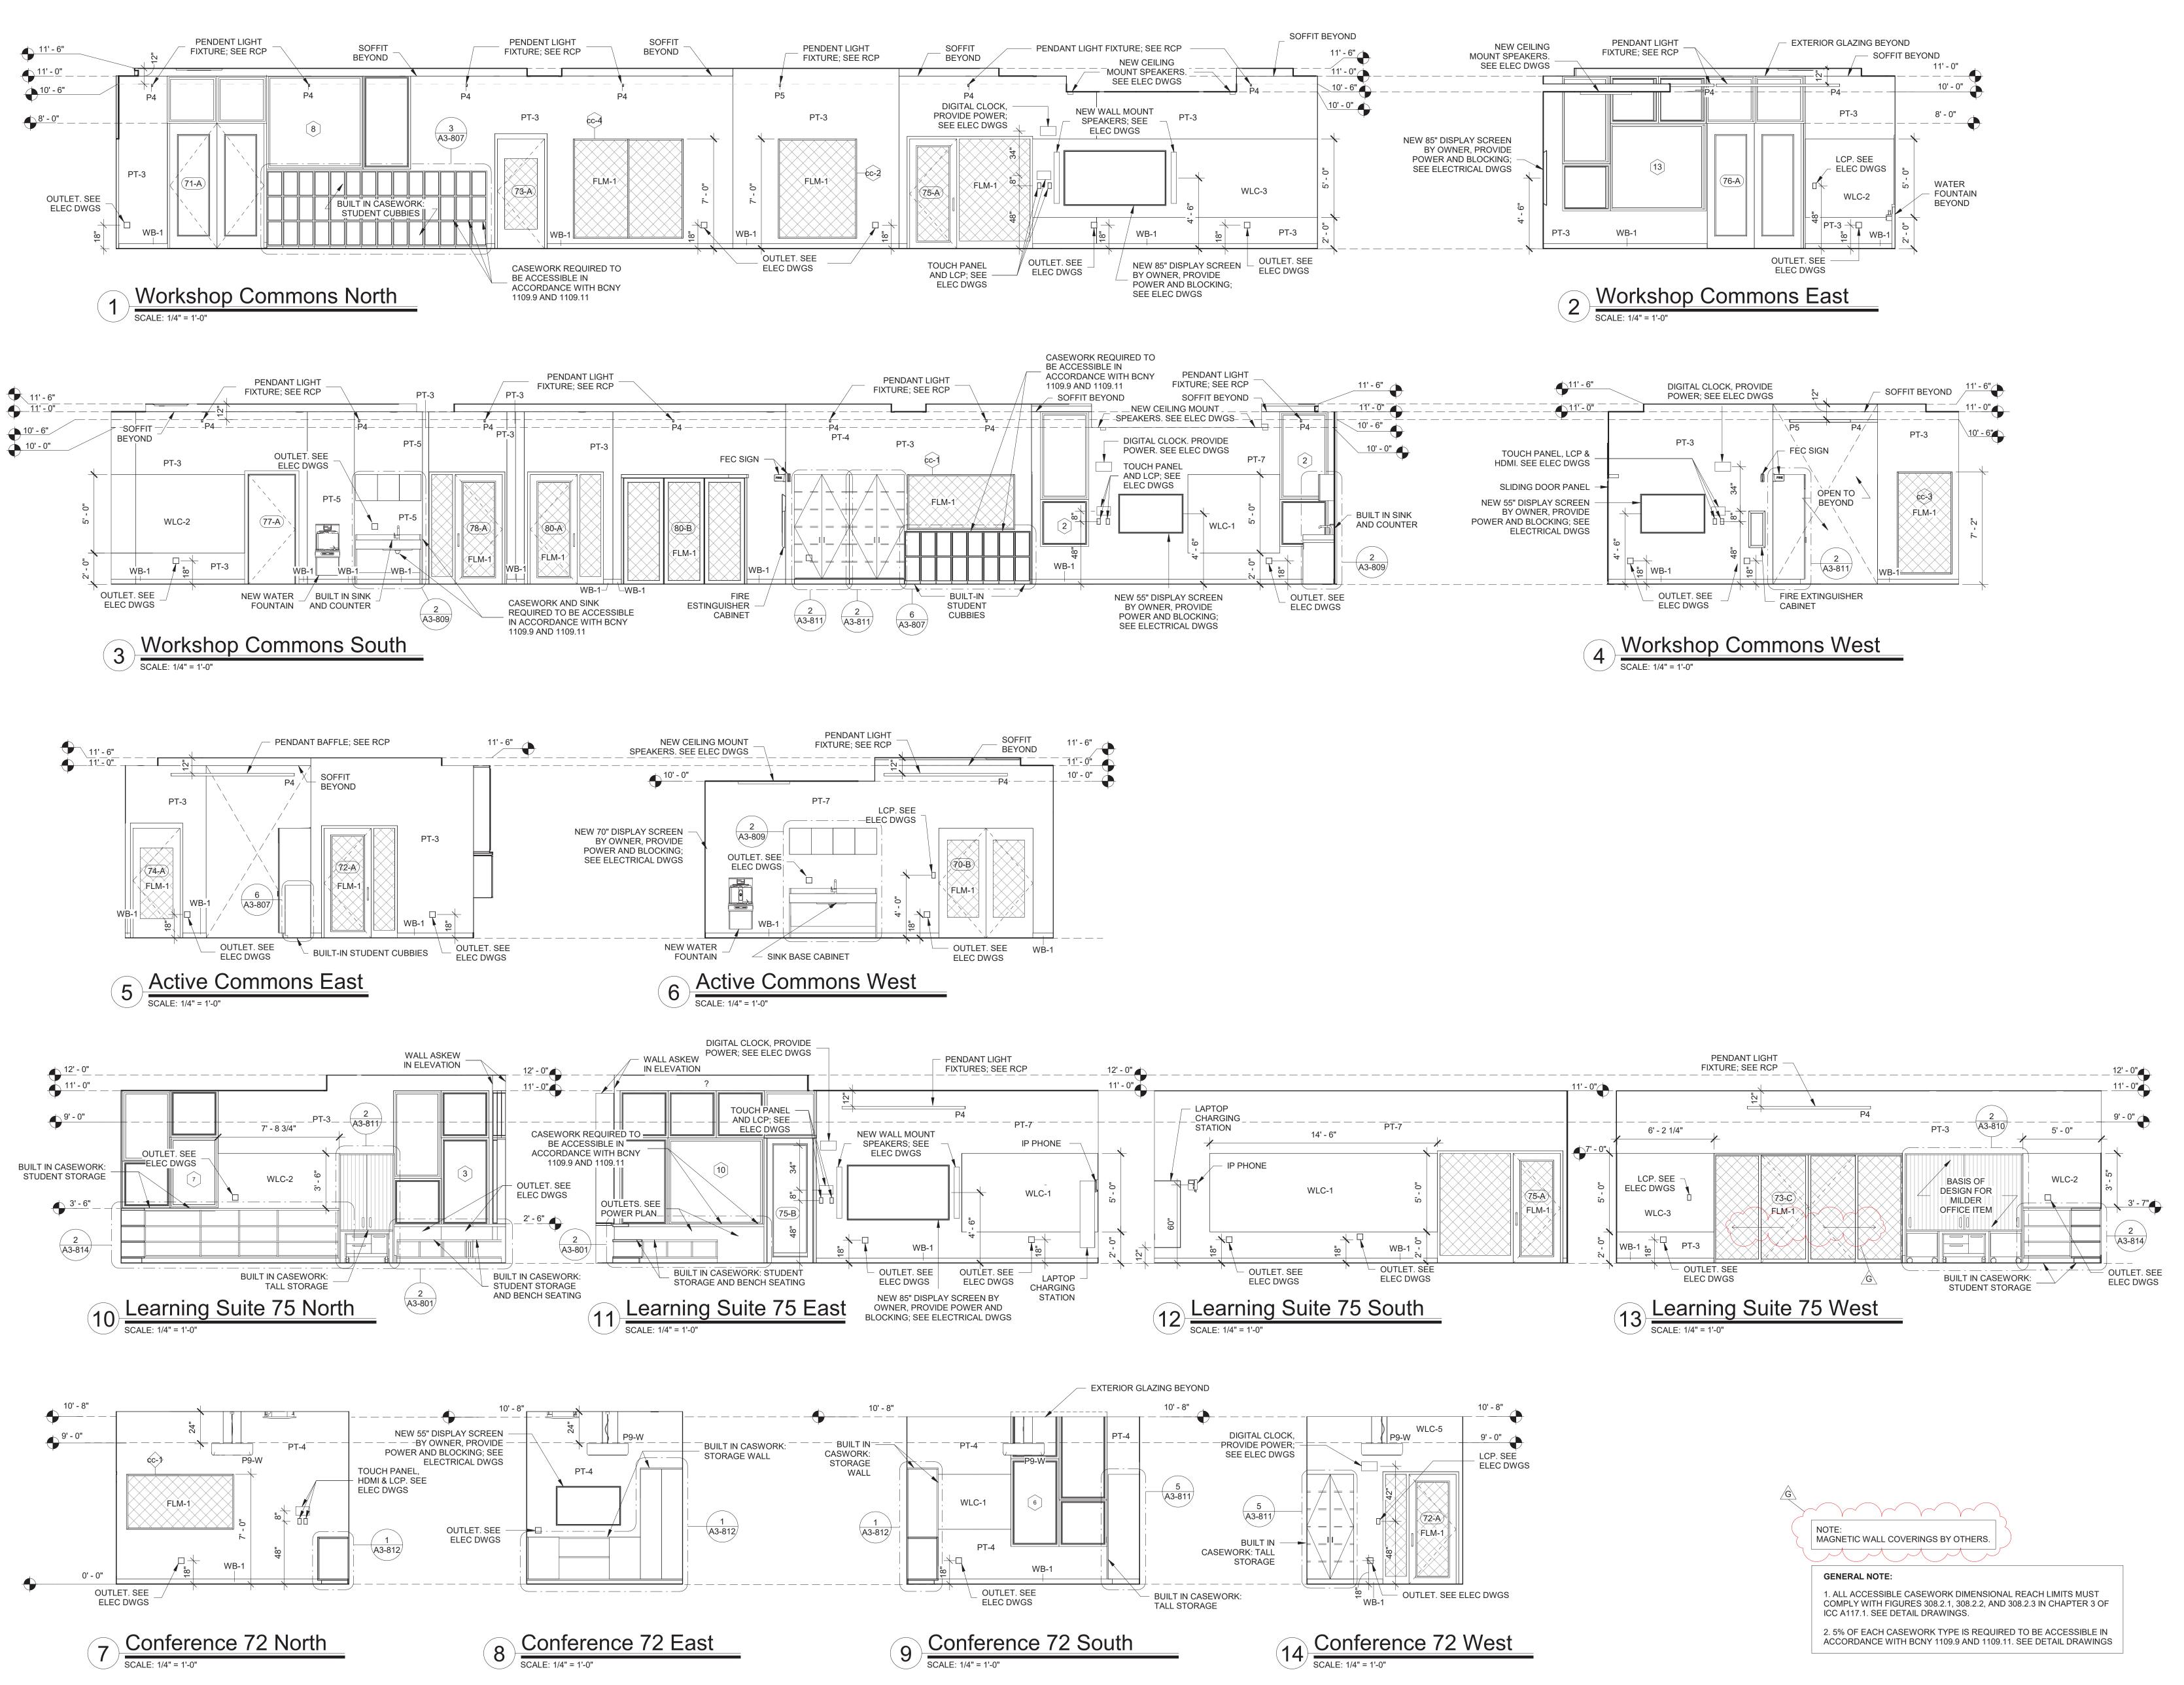

| Revision Schedule | | | | | | | | |
|-------------------|-------------------------------|------------|--|--|--|--|--|--|
| No. | Description | Date | | | | | | |
| | | | | | | | | |
| Α | SED SUBMISSION | 10/23/2020 | | | | | | |
| В | ADDITIONS: SED Addendum #1 | 4/26/2021 | | | | | | |
| E | ADDITIONS: ISSUED FOR BID | 08/10/2021 | | | | | | |
| G | Addendum 2 | 8/23/2021 | | | | | | |
| | | | | | | | | |

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PROJECT

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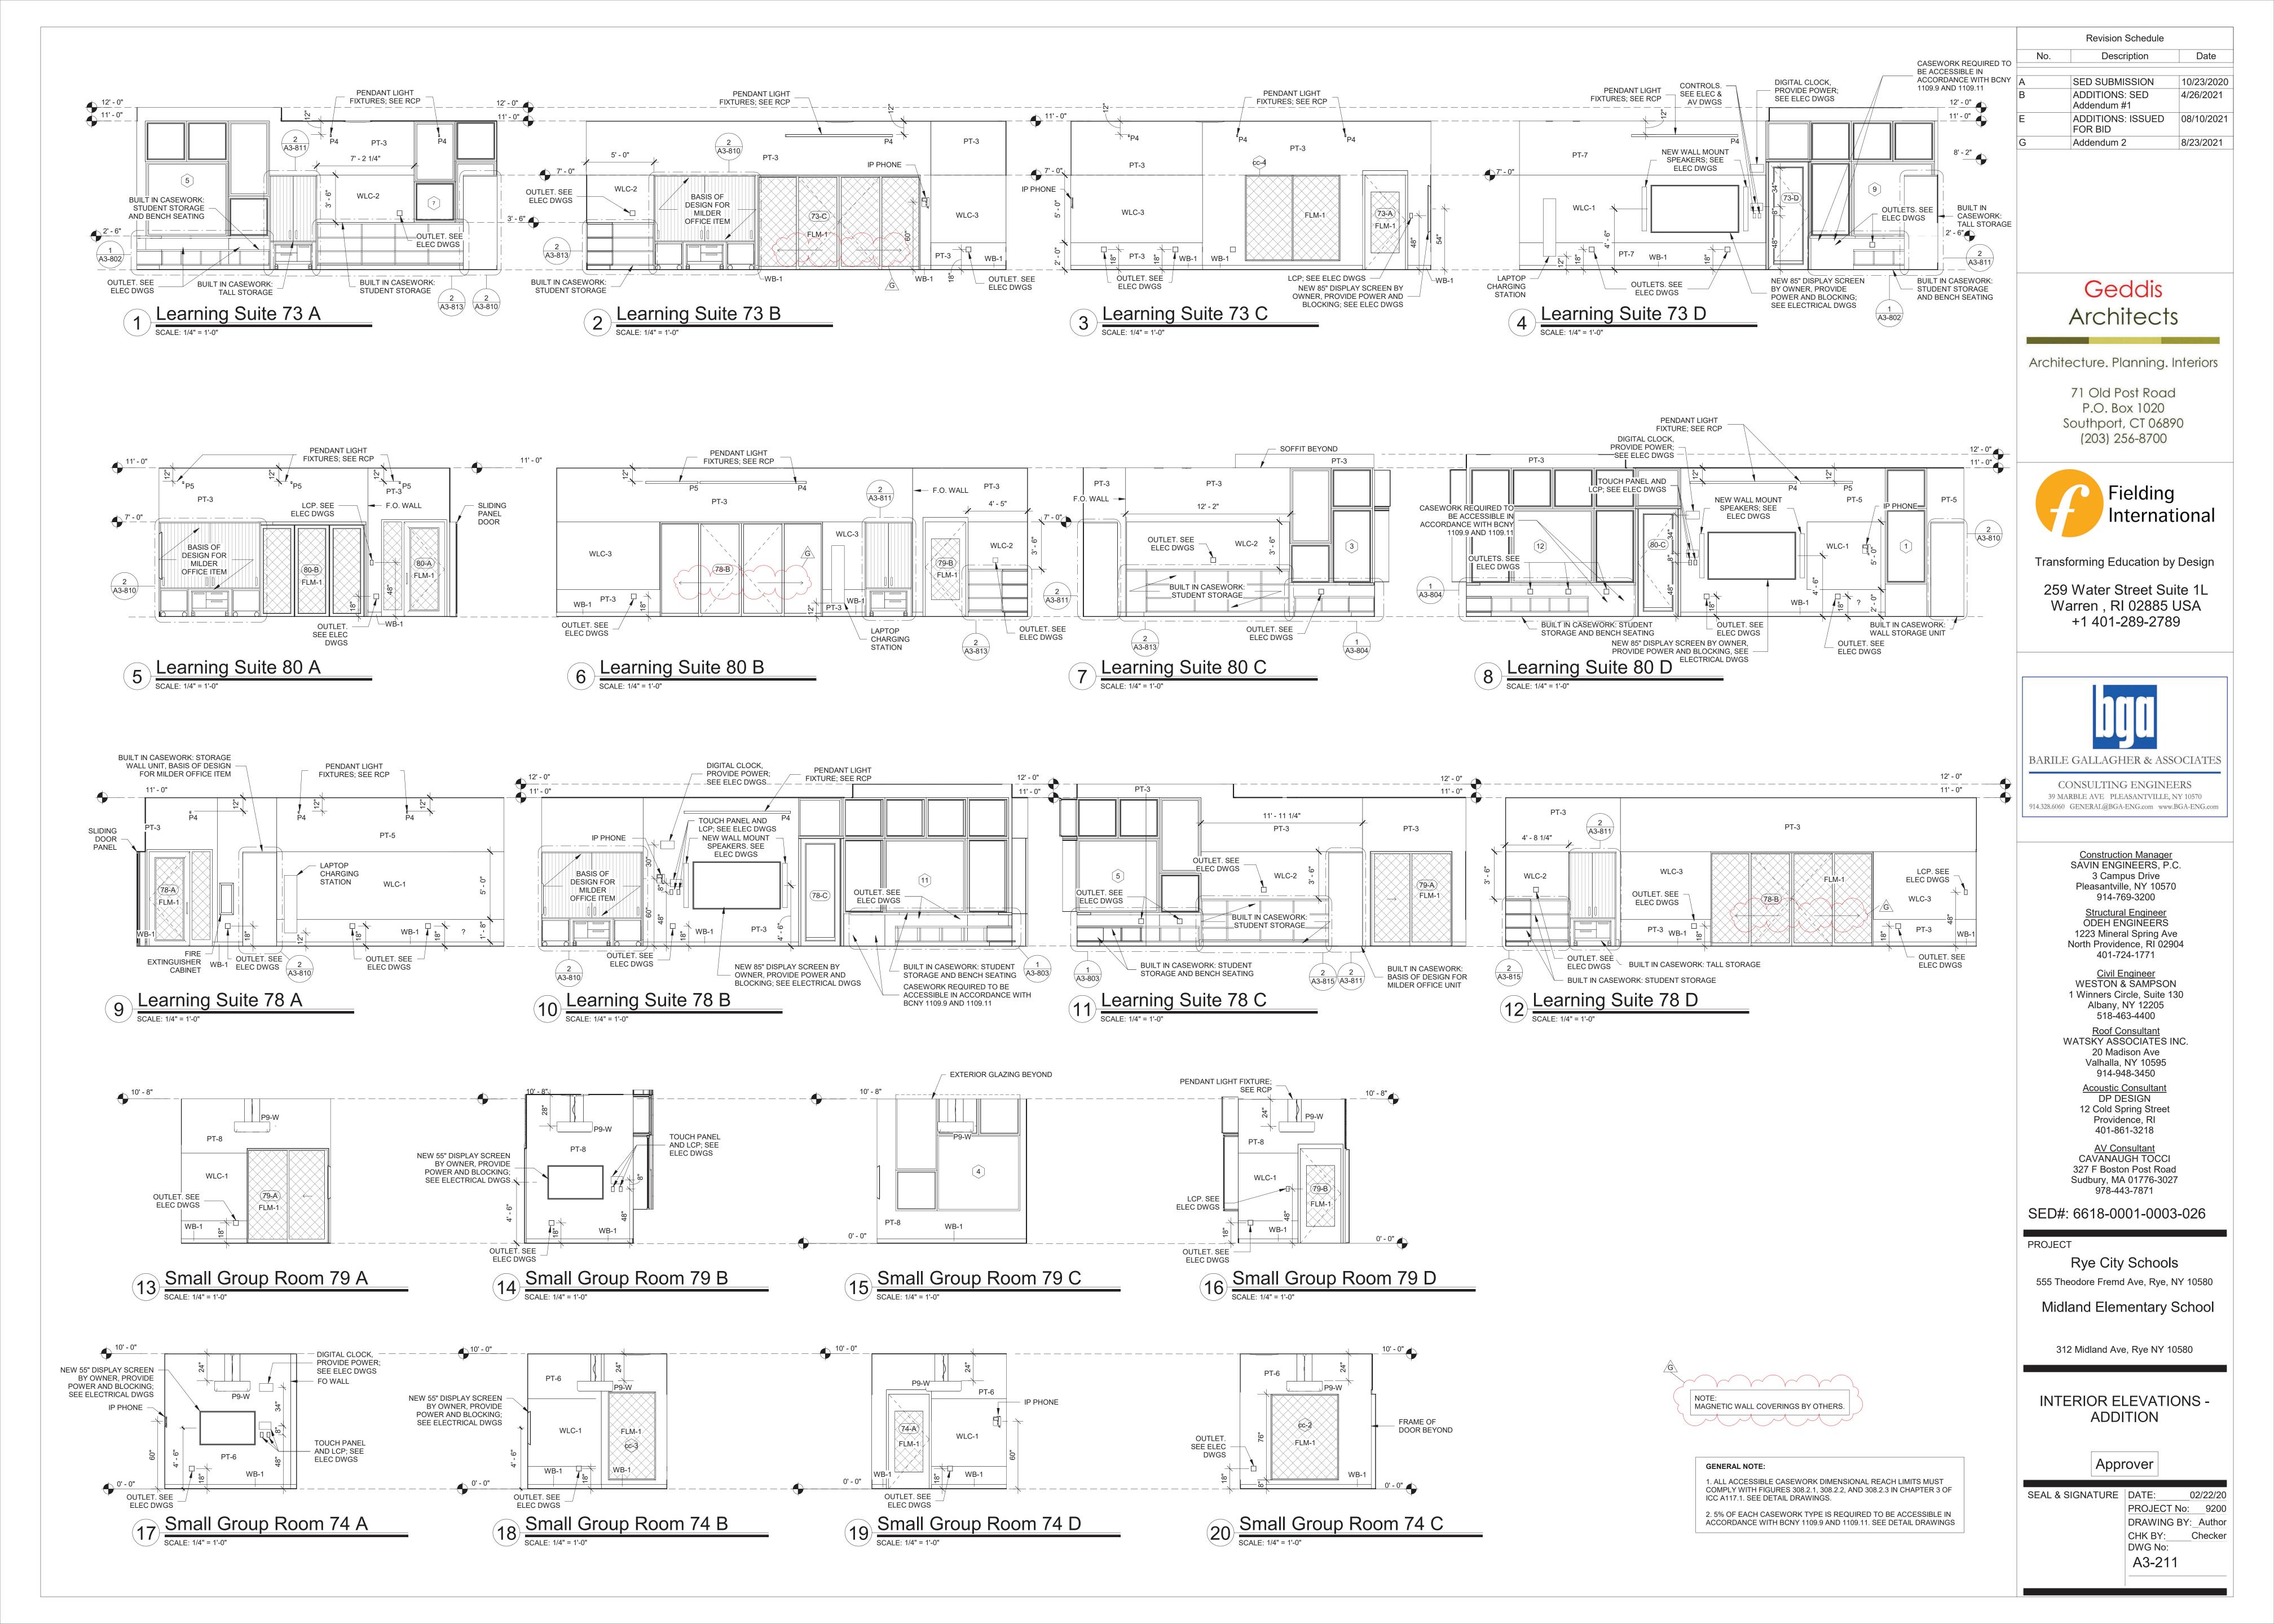
312 Midland Ave, Rye NY 10580


INTERIOR ELEVATIONS -ADDITION


Approver

SEAL & SIGNATURE DATE:

DATE: 02/17/20
PROJECT No: 9200
DRAWING BY: Author
CHK BY: Checker
DWG No:
A3-210



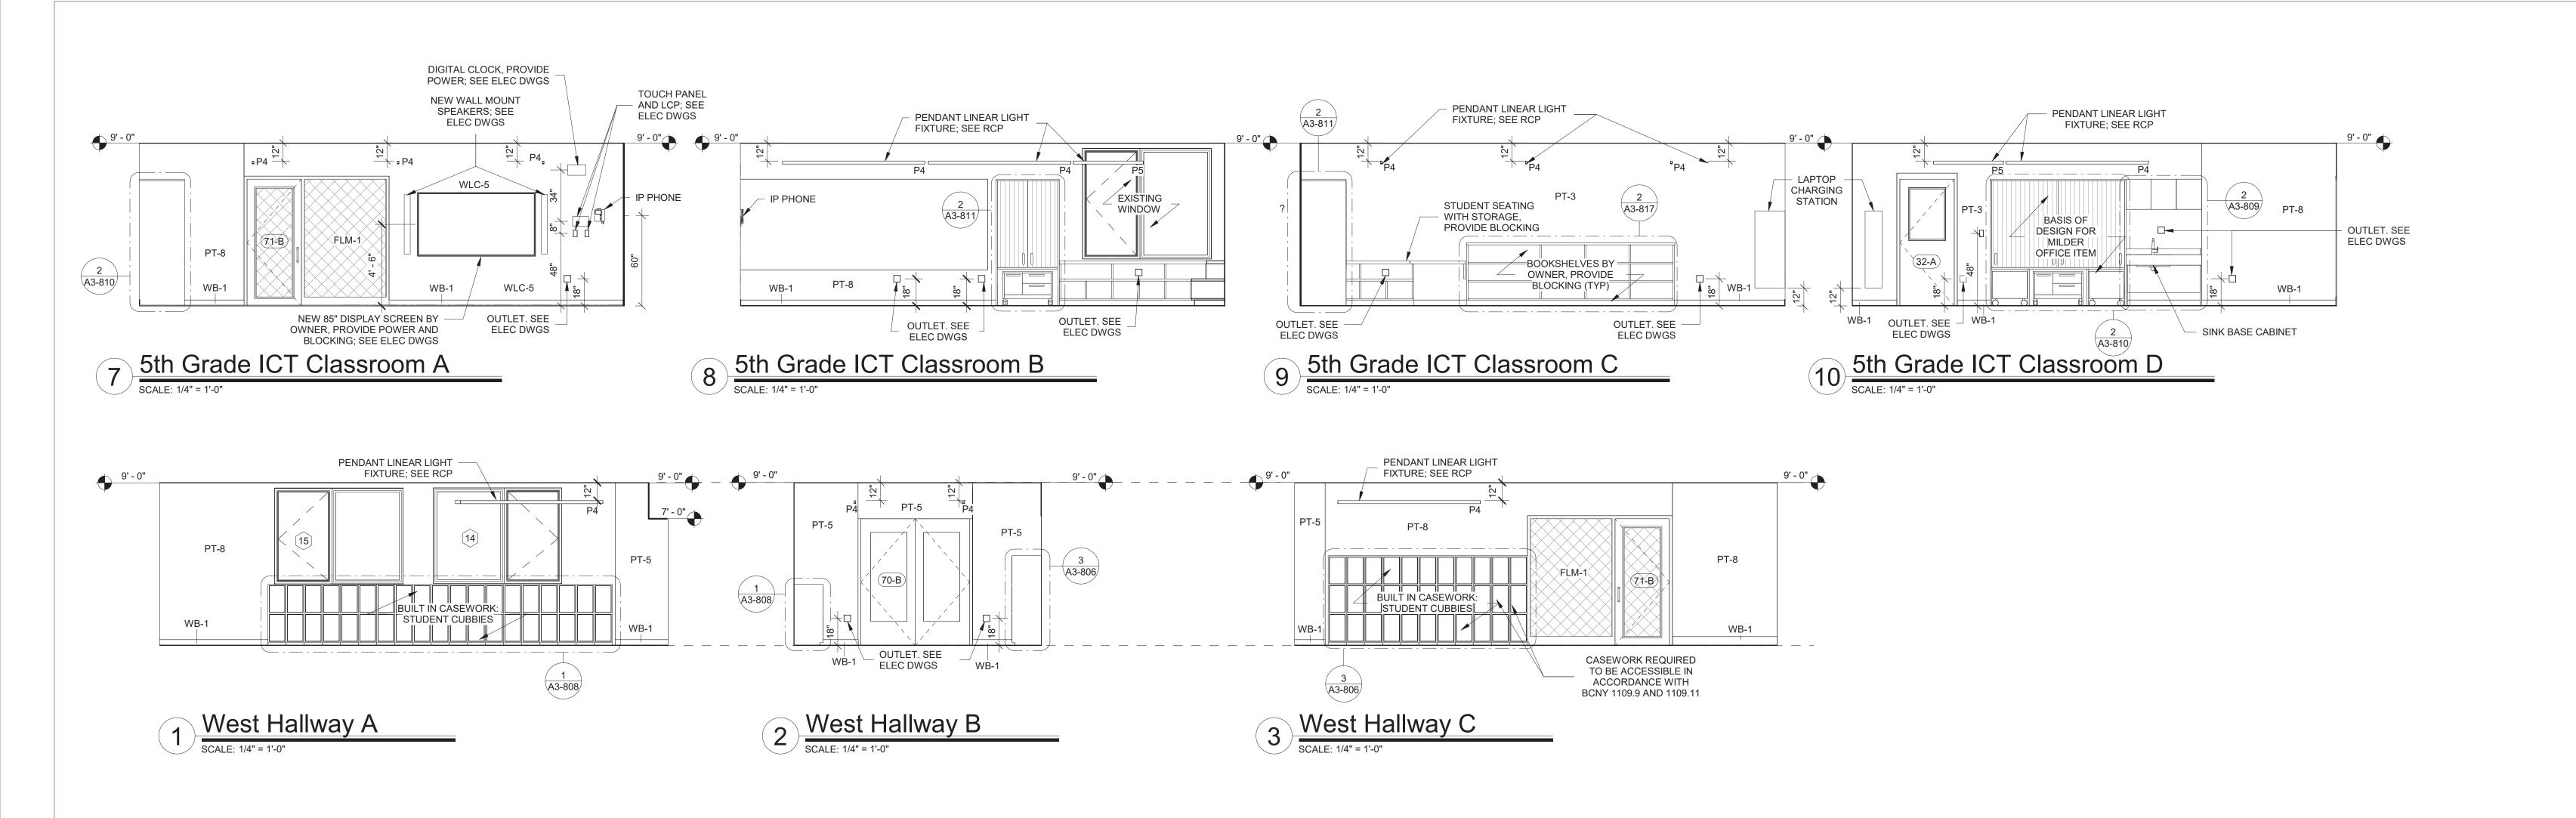

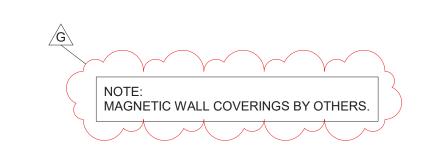

GENERAL NOTE:

1. ALL ACCESSIBLE CASEWORK DIMENSIONAL REACH LIMITS MUST COMPLY WITH FIGURES 308.2.1, 308.2.2, AND 308.2.3 IN CHAPTER 3 OF ICC A117.1. SEE DETAIL DRAWINGS.

2. 5% OF EACH CASEWORK TYPE IS REQUIRED TO BE ACCESSIBLE IN ACCORDANCE WITH BCNY 1109.9 AND 1109.11. SEE DETAIL DRAWINGS

| | Revision Schedule | |
|-----|-------------------------------|------------|
| No. | Date | |
| | | |
| Α | SED SUBMISSION | 10/23/2020 |
| В | ADDITIONS: SED Addendum #1 | 4/26/2021 |
| E | ADDITIONS: ISSUED FOR BID | 08/10/2021 |
| G | Addendum 2 | 8/23/2021 |

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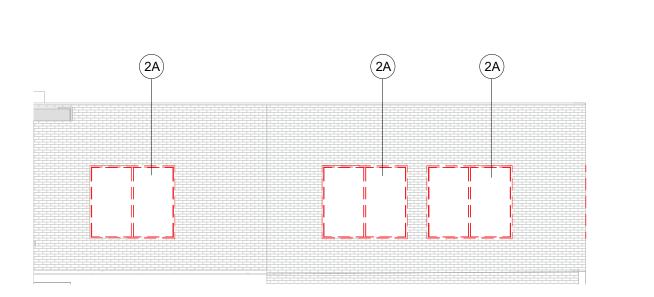
INTERIOR ELEVATIONS -

ADDITION


Approver

SEAL & SIGNATURE

DATE: 05/05/20
PROJECT No: 9200
DRAWING BY: Author
CHK BY: Checker
DWG No:
A3-212




DEMOLITION EXTERIOR ELEVATION B

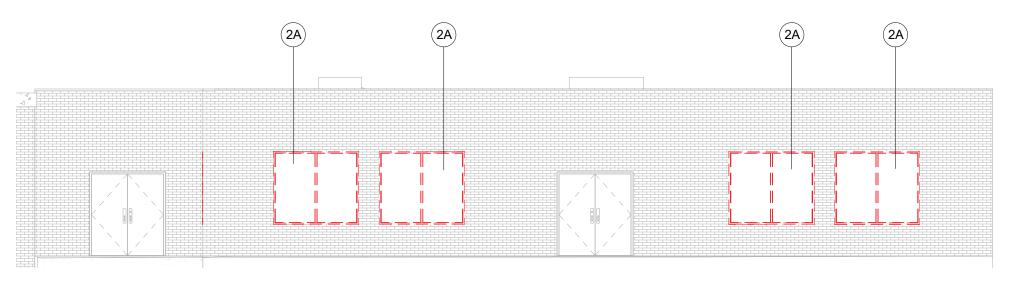


2 DEMOLITION EXTERIOR ELEVATION C

SCALE: 1/8" = 1'-0"

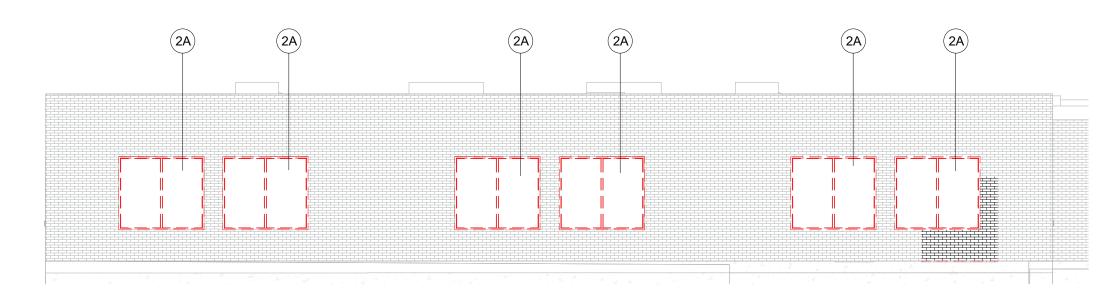


EXTERIOR ELEVATION D-1

SCALE: 1/8" = 1'-0"

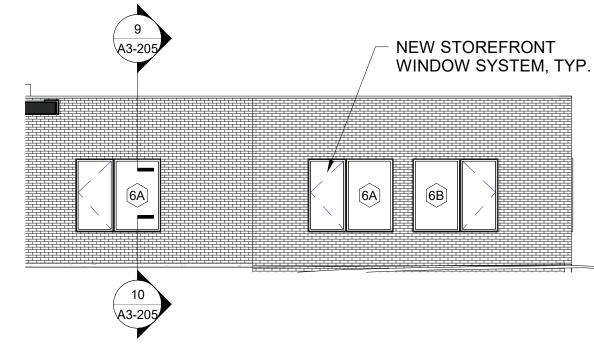


4 EXTERIOR ELEVATION B


SCALE: 1/8" = 1'-0"

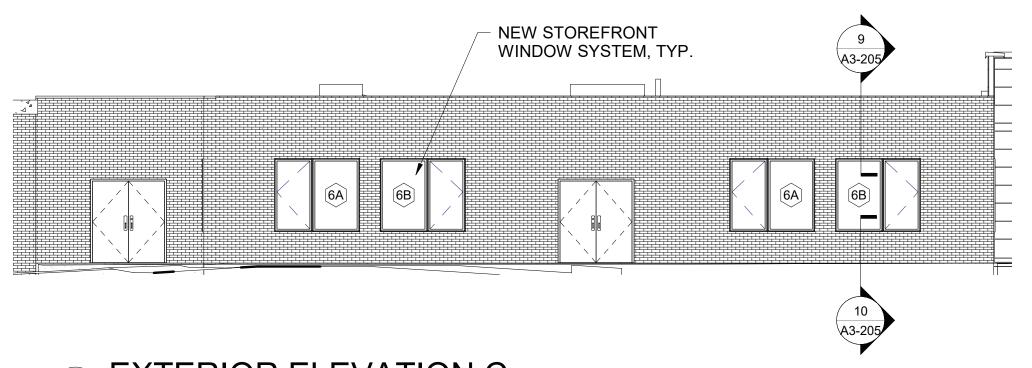


5 EXTERIOR ELEVATION C

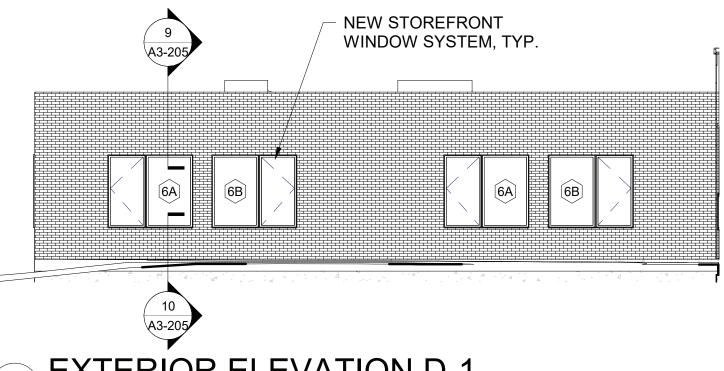


6 EXTERIOR ELEVATION D-1

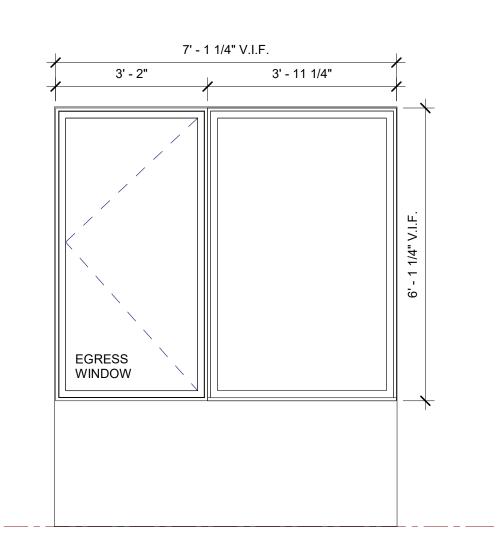

7 WINDOW TYPE 6A

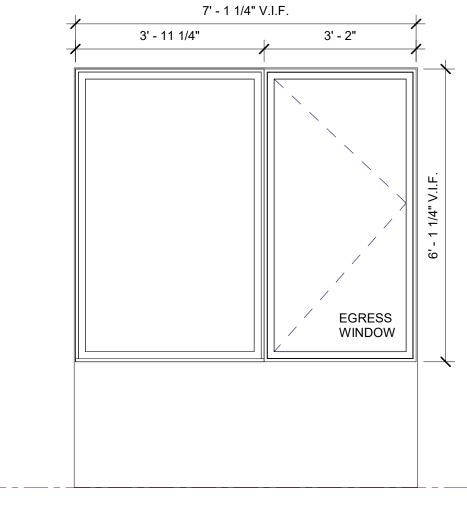


8 WINDOW TYPE 6B SCALE: 1/2" = 1'-0"

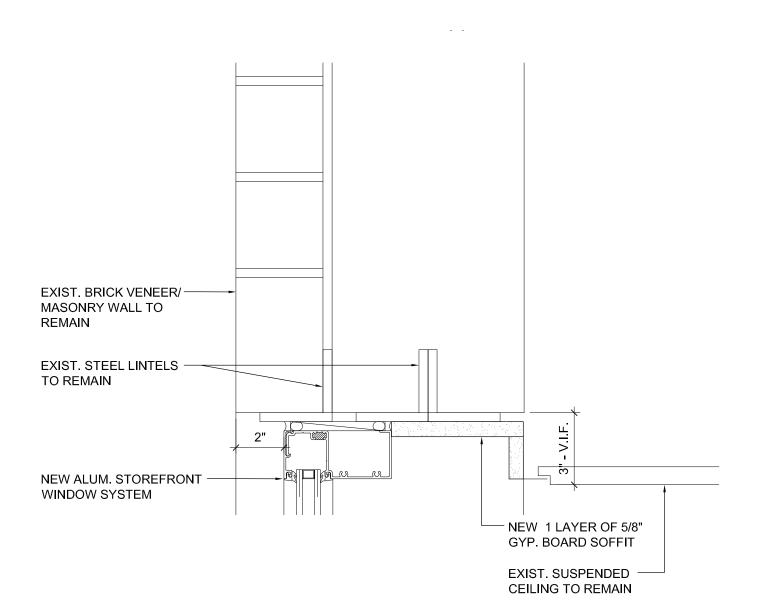


9 WINDOW DETAIL - HEAD

SCALE: 3" = 1'-0"

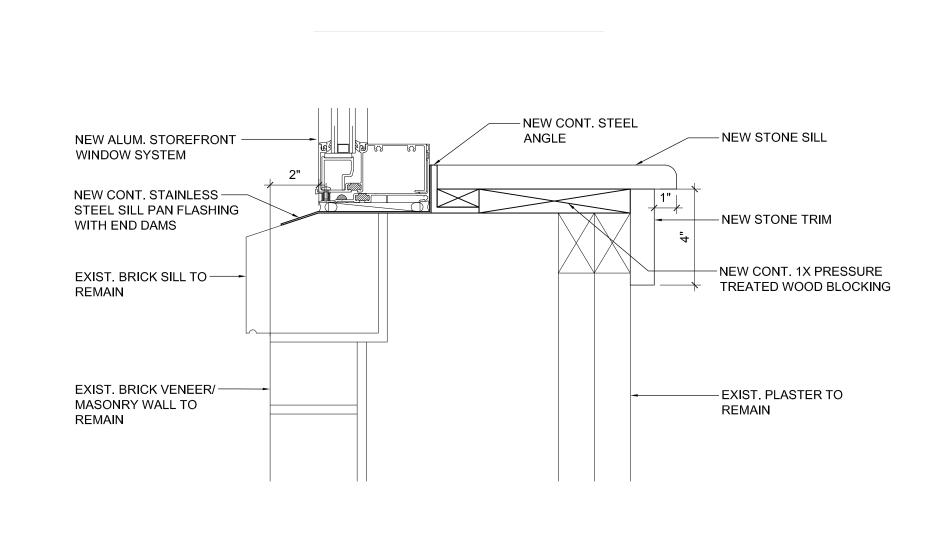

10 WINDOW DETAIL - SILL

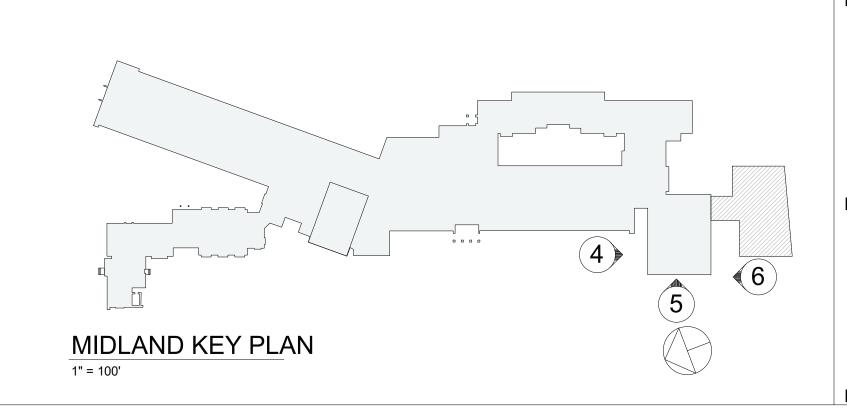

Geddis **Architects**

Revision Schedule

Description

Addendum 2

Date

8/23/2021

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CAVANAUGH TOCCI 327 F Boston Post Road Sudbury, MA 01776-3027 978-443-7871

SED#: 6618-0001-0003-026

PROJECT


Rye City Schools 555 Theodore Fremd Ave, Rye, NY 10580

Midland Elementary School

312 Midland Ave, Rye NY 10580


EXTERIOR ELEVATIONS, WINDOW TYPES & DETAILS


SEAL & SIGNATURE DATE: PROJECT No: 9200 DRAWING BY: Author CHK BY: Checker

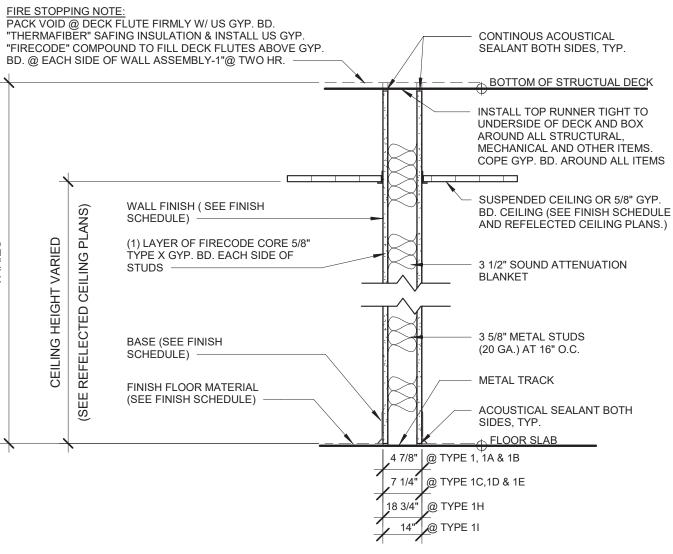

ONE HOUR RATED PARTITION

- 3 5/8" METAL STUDS AT 16" O.C. GYPSUM BOARD TYPE "X" EACH SIDE (1 HOUR RATED UL DESIGN # U419) WITH 49 STC RATING
- 1A SIMILAR TO 1 WITH 5/8" CEMENT BOARD IN LIEU OF GYP. BD. ON TOILET SIDE
- (1 HOUR RATED UL DESIGN # U433) 1B SIMILAR TO 1 WITH 5/8" CEMENT BOARD EACH SIDE
- (1 HOUR RATED UL DESIGN # U433)
- 1C 6" METAL STUDS AT 16" O.C. GYPSUM BOARD EACH SIDE (1 HOUR RATED - UL DESIGN # U419) WITH 56 STC RATING
- 1D SIMILAR TO 1C WITH 5/8" CEMENT BOARD IN LIEU OF GYP. BD. ON TOILET SIDE (1 HOUR RATED - UL DESIGN # U433)
- 1E SIMILAR TO 1C WITH 5/8" CEMENT BOARD IN LIEU OF GYP. BD. ON EACH SIDE (1 HOUR RATED UL DESIGN # U433)
- 1F SIMILAR TO 1 WITH 5/8" GYPSUM BOARD ON ONE SIDE
- (UL DESIGN # U419) WITH 52 STC RATING 1H 3 5/8" METAL STUDS AT 16" O.C. GYPSUM BOARD TYPE "X" EACH SIDE
- (UL DESIGN # U419) WITH 49 STC RATING 11 3 5/8" METAL STUDS AT 16" O.C. GYPSUM BOARD TYPE "X" EACH SIDE (UL DESIGN # U419) WITH 49 STC RATING

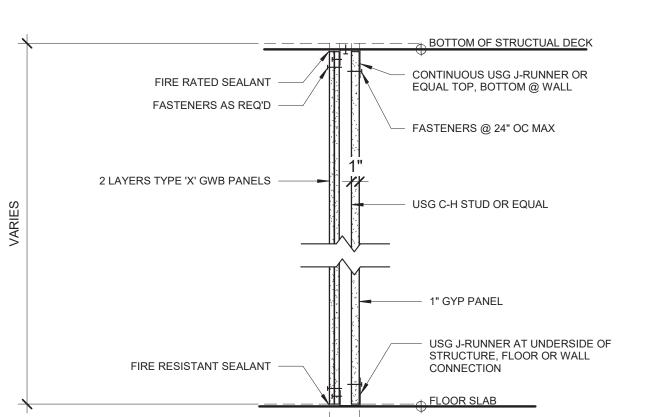

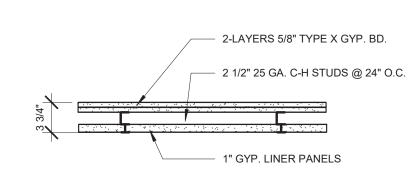


2 HOUR RATED SHAFT WALL PARTITION


5 2-HR. RATED SHAFT WALL (UL DESIGN # U438)

2 HR RATED SHAFTS REQUIRED

FOR BUILDINGS OVER 4 STORIES

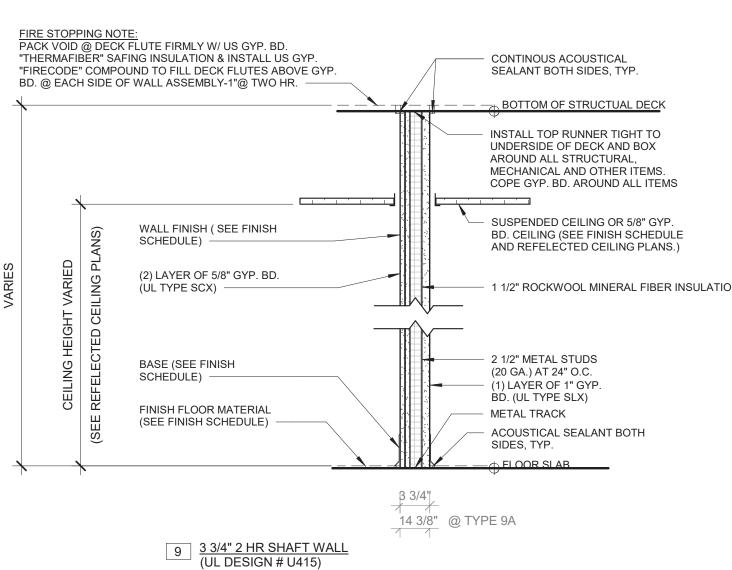


9A 14 3/8" 2 HR SHAFT WALL (UL DESIGN # U415)

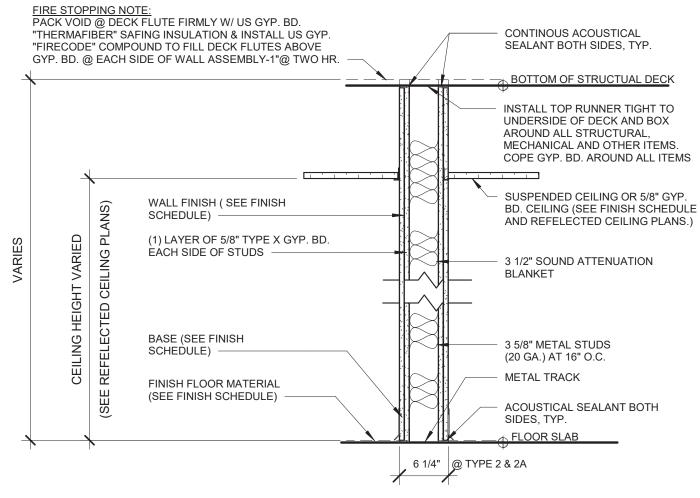

TWO HOUR RATED PARTITION

2 HR. RATED - 3 5/8" METAL STUDS AT 16" O.C 2 LAYERS TYPE "X" GYP. BD. EACH SIDE (UL DESIGN # U411)


2A SIMILAR TO 2A WITH 1 LAYER OF TYPE "X" GYP. BD. AND ONE LAYER OF 5/8" CEMENT BOARD IN LIEU OF 2 LAYERS OF GYP. BD. ON TOILET SIDE (UL DESIGN # U411)

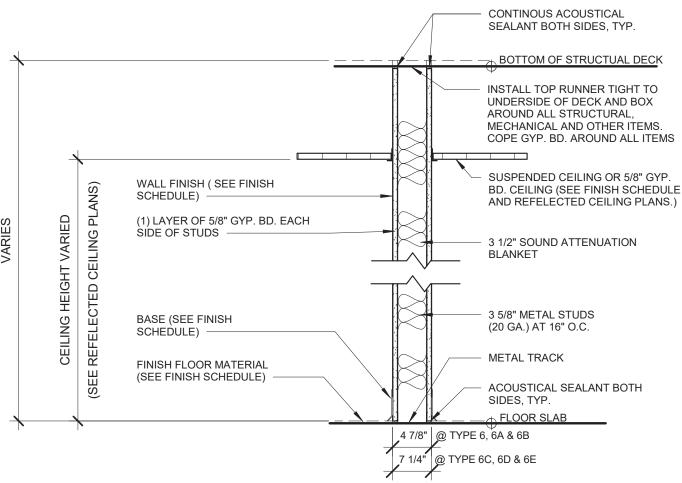



NON-RATED PARTITION

- 6 3 5/8" METAL STUDS AT 16" O.C. GYPSUM BOARD EACH SIDE 6A SIMILAR TO 1 WITH 5/8" CEMENT BOARD IN LIEU OF GYP. BD. ON TOILET SIDE
- 6B SIMILAR TO 1 WITH 5/8" CEMENT BOARD EACH SIDE
- 6C 6" METAL STUDS AT 16" O.C. GYPSUM BOARD EACH SIDE
- 6D SIMILAR TO 6C WITH 5/8" CEMENT BOARD IN LIEU OF GYP. BD. ON TOILET SIDE
- 6E SIMILAR TO 6C WITH 5/8" CEMENT BOARD IN LIEU OF GYP. BD. ON EACH SIDE
- 6F SIMILAR TO 6 WITH 5/8" GYPSUM BOARD ONLY ON EXTERIOR SIDE

6G SIMILAR TO 6 WITH 5" METAL STUDS AT 16" O.C.

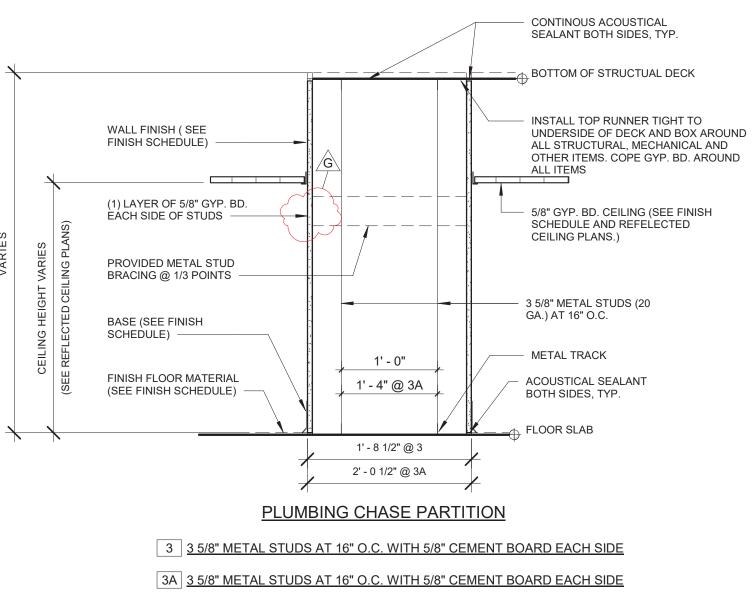

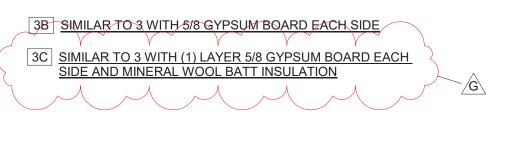

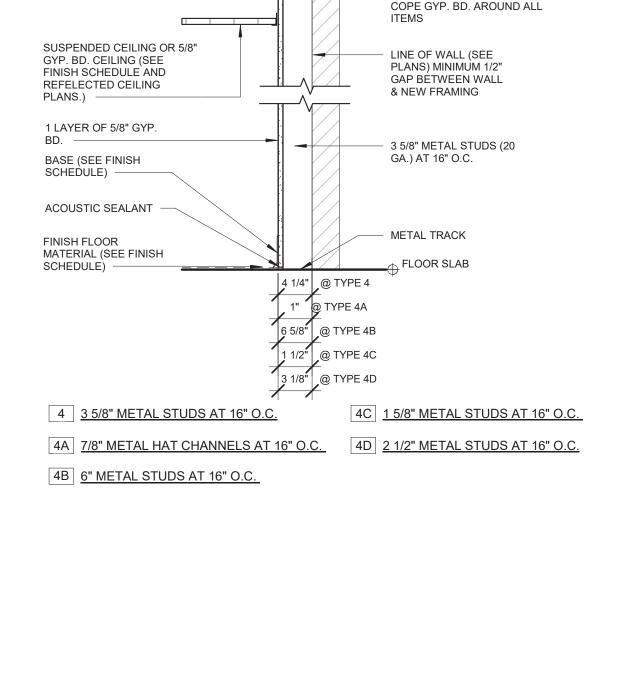

CONTINOUS ACOUSTICAL

WALL FINISH (SEE

FINISH SCHEDULE)

SEALANT BOTH SIDES, TYP.

BOTTOM OF


STRUCTUAL

INSTALL TOP RUNNER TIGHT TO


UNDERSIDE OF DECK AND BOX

MECHANICAL AND OTHER ITEMS.

AROUND ALL STRUCTURAL,

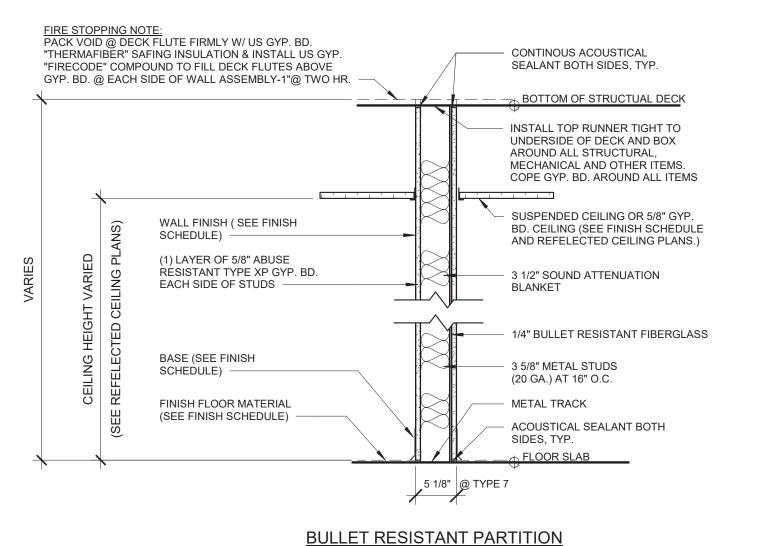

7 1 HR. RATED - 3 5/8" METAL STUDS AT 16" O.C 1 LAYERS TYPE "X" GYP. BD. EACH SIDE (UL DESIGN # 752)

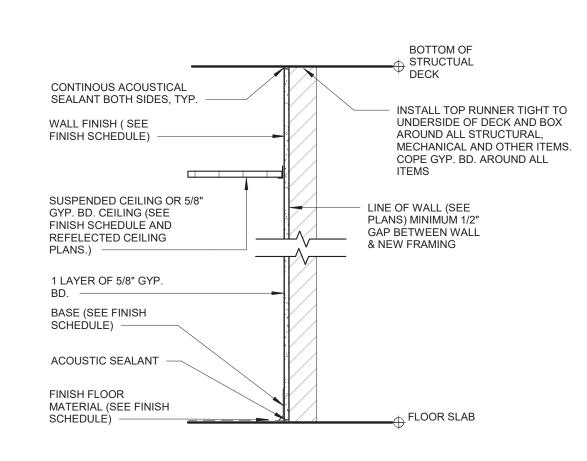

8 1 LAYER 5/8" GYP APPLIED DIRECTLY OVER EXISTING WALL FINISH ON TAG SIDE OF WALL

8A 1 LAYER 5/8" GYP ATTACHED TO EXISTING WALL FRAMING ON TAG SIDE OF WALL

8B 1 LAYER 5/8" GYP APPLIED DIRECTLY OVER EXISTING WALL FINSH EACH SIDE

8D 2 LAYERS 5/8" GYP ATTACHED TO EXISTING WALL FRAMING ON TAG SIDE OF WALL

8E 2 LAYERS 5/8" GYP ATTACHED TO EXISTING WALL FRAMING EACH SIDE

Architecture. Planning. Interiors 71 Old Post Road

Revision Schedule

Description

SED SUBMISSION

FOR BID

Addendum 2

ADDITIONS: ISSUED

Date

10/23/2020

08/10/2021

8/23/2021

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SED#: 6618-0001-0003-026

PROJECT

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312 Midland Ave, Rye NY 10580

WALL TYPE

Approver

SEAL & SIGNATURE | DATE: PROJECT No: 9200 DRAWING BY: Author CHK BY: Checker DWG No: A3-300



| | | | | Addition Door Schedule | | | | | | No. |
|------------------------|---|--|--|---|----------------------------------|-----------------------|----------------|---|---|--------|
| DOOR NUMBER 36-A | FROM ROOM CORRIDOR | TO ROOM CLASSROOM | DOOR DOOR MATERIAL TYPE D-6 WOOD, GLASS | DOOR PANEL HEIGHT WIDTH FRAME TYPE FINISH 7' - 0" 3' - 0" F-1 | FRAME FRAME MATERIAL FINISH H.M. | E HARDWARE I GROUP | DETAIL RATING | | GENERAL NOTES: | A |
| 70-B | 70 VESTIBULE | 71 ACTIVE COMMONS | | 7' - 0" 6' - 0" F-7 | H.M. | 02 | 90 min | CPSC 16 CFR 1201 TYPE 2 | 1. FIRE RATINGS OF OPENING PROTECTIVES THROUGH 1HR FIRE PARTITION CONSTRUCTION TO BE IN | В |
| 71-A 71-B | 71 ACTIVE COMMONS 70 VESTIBULE | EXTERIOR 32 LEARNING SUITE | D-9 ALUM., GLASS, INTRUDER RESISTANT D-6 WOOD, GLASS | 8' - 0" 6' - 0" INCLUDED IN EXTERIOR WINDOW FRAME 7' - 0" 3' - 0" F-5 | ALUM H.M. | 10 09 | 45 min | SAFETY GLASS IN ACCORDANCE WITH CPSC 16 CFR 1201 TYPE 2 SAFETY GLASS IN ACCORDANCE WITH CPSC 16 CFR 1201 TYPE 2 | 2. PROVIDE ALL DOORS AND DOOR SIDELIGHTS WITH | E |
| 72-A 73-A | 71 ACTIVE COMMONS 71 ACTIVE COMMONS | 72 CONFERENCE 73 LEARNING SUITE | D-6 WOOD, GLASS D-6 WOOD, GLASS | 7' - 0" 3' - 0" F-4 7' - 0" 3' - 0" F-1 | H.M. H.M. | 09 | | SAFETY GLASS IN ACCORDANCE WITH CPSC 16 CFR 1201 TYPE 2 SAFETY GLASS IN ACCORDANCE WITH CPSC 16 CFR 1201 TYPE 2 | SAFETY GLASS IN ACCORDANCE WITH CPSC 16 CFR 1201 TYPE 2. | 0 |
| 73-C | 73 LEARNING SUITE | 75 LEARNING SUITE | D-5 ALUM., GLASS | 7' - 0" 12' - 0" F-10 | ALUM | By MFG | 1/A3-607 | CRL SLIDING DOOR SERIES 2000, SAFETY GLASS IN ACCORDANCE WITH CPSC 16 CFR 1201 TYPE 2 | | |
| 73-D 74-A | 73 LEARNING SUITE 80 LEARNING SUITE | EXTERIOR 79 SGR | D-8 ALUM., GLASS, INTRUDER RESISTANT D-6 WOOD, GLASS | 8' - 0" 3' - 0" INCLUDED IN EXTERIOR WINDOW FRAME 7' - 0" 3' - 0" F-1 | ALUM H.M. | 11 09 | | SAFETY GLASS IN ACCORDANCE WITH CPSC 16 CFR 1201 TYPE 2 SAFETY GLASS IN ACCORDANCE WITH CPSC 16 CFR 1201 TYPE 2 | | |
| 75-A 75-B | 76 WORKSHOP COMMONS 75 LEARNING SUITE | 75 LEARNING SUITE EXTERIOR | D-6 WOOD, GLASS D-8 ALUM., GLASS, INTRUDER RESISTANT | 7' - 0" 3' - 0" F-5 8' - 0" 3' - 0" INCLUDED IN EXTERIOR WINDOW FRAME | H.M. ALUM | 08 | | SAFETY GLASS IN ACCORDANCE WITH CPSC 16 CFR 1201 TYPE 2 SAFETY GLASS IN ACCORDANCE WITH CPSC 16 CFR 1201 TYPE 2 | | |
| 76-A 77-A | 71 ACTIVE COMMONS 76 WORKSHOP COMMONS | EXTERIOR 77 STORAGE | D-9 ALUM., GLASS, INTRUDER RESISTANT D-1 WOOD | 8' - 0" 6' - 0" INCLUDED IN EXTERIOR WINDOW FRAME 7' - 0" 3' - 0" F-1 | ALUM H.M. | 10 09 | | SAFETY GLASS IN ACCORDANCE WITH CPSC 16 CFR 1201 TYPE 2 | | |
| 78-A 78-B | 76 WORKSHOP COMMONS 78 LEARNING SUITE | 78 LEARNING SUITE 80 LEARNING SUITE | D-6 WOOD, GLASS D-5 ALUM., GLASS | 7' - 0" 3' - 0" F-4 7' - 0" 12' - 0" F-10 | H.M. ALUM | 08 By MFG | 1/A3-607 | SAFETY GLASS IN ACCORDANCE WITH CPSC 16 CFR 1201 TYPE 2 CRL SLIDING DOOR SERIES 2000, SAFETY GLASS IN ACCORDANCE WITH CPSC 16 | | |
| 78-C | 78 LEARNING SUITE | EXTERIOR | D-8 ALUM., GLASS, INTRUDER RESISTANT | 8' - 0" 3' - 0" INCLUDED IN EXTERIOR WINDOW FRAME | ALUM | 11 | | CFR 1201 TYPE 2 SAFETY GLASS IN ACCORDANCE WITH CPSC 16 CFR 1201 TYPE 2 | | |
| 79-A 79-B | 78 LEARNING SUITE 80 LEARNING SUITE | 79 SGR 79 SGR | D-4 ALUM., GLASS D-6 WOOD, GLASS | 7' - 0" 6' - 0" F-8 7' - 0" 3' - 0" F-1 | ALUM H.M. | By MFG 09 | | CRL SLIDING DOOR SERIES 2000 SAFETY GLASS IN ACCORDANCE WITH CPSC 16 CFR 1201 TYPE 2 | | |
| 80-A 80-B | 76 WORKSHOP COMMONS 76 WORKSHOP COMMONS | 80 LEARNING SUITE 80 LEARNING SUITE | D-6 WOOD, GLASS D-3 ALUM., GLASS | 7' - 0" 3' - 0" F-4 7' - 0" 8' - 0" F-6 | H.M. ALUM | 08 By MFG | | SAFETY GLASS IN ACCORDANCE WITH CPSC 16 CFR 1201 TYPE 2 CRL MONTEREY S55 SERIES, SAFETY GLASS IN ACCORDANCE WITH CPSC 16 CFR | | Arc |
| 80-C | 80 LEARNING SUITE | EXTERIOR | D-8 ALUM., GLASS, INTRUDER RESISTANT | 8' - 0" 3' - 0" INCLUDED IN EXTERIOR WINDOW FRAME | | 11 | | 1201 TYPE 2 SAFETY GLASS IN ACCORDANCE WITH CPSC 16 CFR 1201 TYPE 2 | | |
| 81-A | CORRIDOR | 81 ELEC CLOSET | D-2 WOOD | 7' - 0" | H.M. | 04A | 45 min | | | |
| DOOR | | | Addition Door Roller Shade Schedule | | | <u>/</u> 0 | G | DAMINO TYPES | | |
| NUMBER 36-A | Count Opening 1 4' - 6" X 2' - 1" | g size H x W | Manufacturer Fabric 1 Hunter Douglas Sheer Weave 7000 Canyon | Model Comments RB 500 HEAVY DUTY 4" BRACKET SET L WITH FRONT FASCIA COVER | | | Г | RAMING TYPES | | |
| 70-B | 2 4' - 6" X 2' - 1" | | Hunter Douglas Sheer Weave 7000 Canyon | DOOR WITH HOLD DOWN PROFILE AND HEM BAR RB 500 HEAVY DUTY 4" BRACKET SET L WITH FRONT FASCIA COVER | _ | | + | 3' - 4" 2" 6' - 0" 2" 2" | 6' - 0" 3' - 0" 2" 2' - 6" 2" 4' - 10" 2" 1' - 4" 2" 3' - 0" 2" | |
| 71-A | INCLUDED IN EXTERIOR | R WINDOW SCHEDULE | | DOOR WITH HOLD DOWN PROFILE AND HEM BAR | _ | | / / | | | |
| 71-B | 1 4' - 6" X 2' - 1", 7' - 2" X 4 | | Hunter Douglas Sheer Weave 7000 Canyon | DOOR WITH HOLD DOWN PROFILE AND HEM BAR | | | | | | |
| 72-A | 1 4' - 6" X 2' - 1", 7' - 2" X 1 | ' - 4" | Hunter Douglas Sheer Weave 7000 Canyon | DOOR WITH HOLD DOWN PROFILE AND HEM BAR | | | | | | Tra |
| 73-A 73-C | 1 4' - 6" X 2' - 1" 1 7' - 0" X 12' - 0" | | Hunter Douglas Sheer Weave 7000 Canyon Hunter Douglas Sheer Weave 7000 Canyon | DOOR WITH HOLD DOWN PROFILE AND HEM BAR | - | | | | | 4 |
| 73-C | INCLUDED IN EXTERIOR | R WINDOW SCHEDI II E | | DOOR WITH HOLD DOWN PROFILE AND HEM BAR | | | | 7 - 2 | 7 - 2" | |
| 74-A | 1 4' - 6" X 2' - 1" | N WINDOW GOLIEDOLE | Hunter Douglas Sheer Weave 7000 Canyon | RB 500 HEAVY DUTY 4" BRACKET SET L WITH FRONT FASCIA COVER DOOR WITH HOLD DOWN PROFILE AND HEM BAR | | | | | | |
| 75-A | 1 4' - 6" X 2' - 1", 7' - 2" X 4 | ' - 6" | Hunter Douglas Sheer Weave 7000 Canyon | | | | | | | |
| 75-B 76-A | INCLUDED IN EXTERIOR | | | | | | | | | |
| 77-A 78-A | 1 4' - 6" X 2' - 1", 7' - 2" X 1 | ' - 4" | Hunter Douglas Sheer Weave 7000 Canyon | RB 500 HEAVY DUTY 4" BRACKET SET L WITH FRONT FASCIA COVER | | | | F-1 F-2 | F-3 | |
| 78-B | 1 7' - 0" X 12' - 0" | | Hunter Douglas Sheer Weave 7000 Canyon | | | | | 2' - 4" | 8' - 4" | BAR |
| 78-C | INCLUDED IN EXTERIOR | R WINDOW SCHEDULE | | DOOR WITH HOLD DOWN PROFILE AND HEM BAR | | | | 2" 2" 3'-0" 2" 4'-6" 2" | 2" 2" | |
| 79-A | 1 7' - 0" x 6' - 0" | | Hunter Douglas Sheer Weave 7000 Canyon | DOOR WITH HOLD DOWN PROFILE AND HEM BAR | | | | | | 914.32 |
| 79-B 80-A | 1 4' - 6" X 2' - 1" 1 4' - 6" X 2' - 1", 7' - 2" X 1 | · "/" | Hunter Douglas Sheer Weave 7000 Canyon Hunter Douglas Sheer Weave 7000 Canyon | DOOR WITH HOLD DOWN PROFILE AND HEM BAR | | | | | | |
| 80-A | 1 7' - 0" x 8' - 0" | - 4 | Hunter Douglas Sheer Weave 7000 Canyon | DOOR WITH HOLD DOWN PROFILE AND HEM BAR | | | | | | |
| 80-C | INCLUDED IN EXTERIOR | R WINDOW SCHEDULE | | DOOR WITH HOLD DOWN PROFILE AND HEM BAR | | | | 7 - 2" | 7' - 3 1/2' | |
| 81-A | | | | | | | | | | |
| | | | | | | | G | | | |
| | DOOR PANE | L TYPES | 71. 01 | 8' - 0" | 6' - 0" | | | | | _ |
| | 3' - 0" | 2' - 0" | 7' - 0" | 2'-0" 2'-0" 2'-0" | EQ EQ | | | F-9 F-5 | F-6 4 Panel Folding Door Frame | |
| <u>.</u> | | | | | | | | 6' - 4" | 6' - 4" | |
| | | | | | | | | 2" 2" 2" 2" 2" 2" 2" 2" 2" 2" 2" 2" 2" 2 | 2" 2" 2" | |
| | | | | | | | | | | |
| .0 | 09 | .0 .9 | 5 | | | | | | | |
| 7 | | - i- / | | | | \Rightarrow | | | | |
| | META KICKE | AL / | | | | | | 7 - 2 | 7 - 2" | |
| | | | | | | | | | | |
| | = | 1-1- | | | | | | | | SE. |
| | D-1 | D-10 | D-2 | 4 Panel Folding Door | D-4 2 Panel Sliding Door | | | | | SE |
| | | 12' - 0" | Y Y Y G | | | | | F-7 2 Panel Swing Door Frame F-8 2 Panel Slidi | ng Door Frame F-8 2 Panel Sliding Door Frame | PRC |
| | 6' - 0" | 6' - | - 0" | 6' - 0" | 3' - 0" | + | 6' - 0" | | 2 Tanoi Siang Bool Hamo | 55 |
| | 3' - 0" | 3' - 0" | 3' - 0" | 3' - 0" 3' - 0" | | + | 3' - 0" 3' | -0" 12' - 4" | 7'-4" | N |
| + | | | | | | | | | | |
| | | | 5 1/2" 2' - 1" 5 1/2" | 5 1/2" 5 1/2" 2' - 1" | | | | | | |
| | | | | | | | | | | |
| | | | | | | .0- | | | | DC |
| - i- 0 = - | | | 6, 6 | 2 - 7 - 0 | | · | | | 7 - 2 | |
| | | | | | | | | | | |
| | | | | METAL KICKPLATE METAL KICKPLATE | | | | | | SEA |
| | | | | TORPLATE NIORPLATE | | | | | | |
| | и Ра | D-5 anel Pocket Door | D-6 | D-7 | D-8 | | D-9 | 4 Panel Pocket Door Frame F-10 | F-11 | |
| | | | | | | | | 1 - 10 | 1 - 1 1 | |
| | | | | | | | | | | |

 No.
 Description
 Date

 A
 SED SUBMISSION
 10/23/2020

 B
 ADDITIONS: SED 4/26/2021

 Addendum #1
 4/26/2021

 E
 ADDITIONS: ISSUED FOR BID
 08/10/2021

 G
 Addendum 2
 8/23/2021

Revision Schedule

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12 Cold Spring Street
Providence, RI
401-861-3218

AV Consultant CAVANAUGH TOCCI 327 F Boston Post Road Sudbury, MA 01776-3027 978-443-7871

SED#: 6618-0001-0003-026

PROJECT

Rye City Schools
555 Theodore Fremd Ave, Rye, NY 10580


Midland Elementary School


312 Midland Ave, Rye NY 10580

DOOR & FRAMING TYPES & SCHEDULES

Approver


EAL & SIGNATURE DATE: 07/27/20
PROJECT No: 9200
DRAWING BY: Author
CHK BY: Checker
DWG No:
A3-601

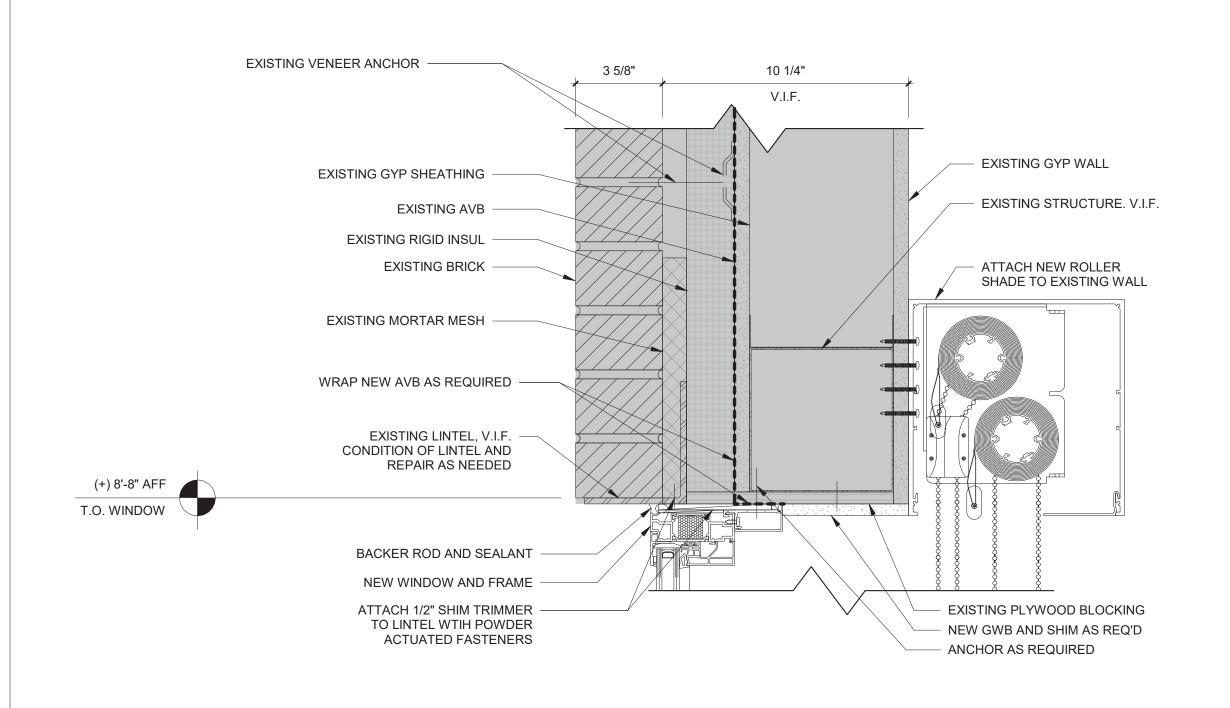

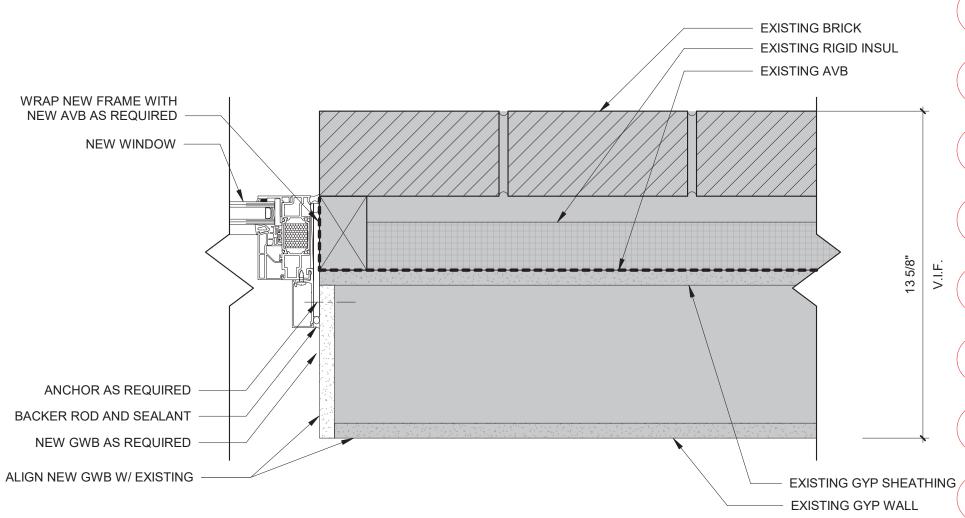


3 DETAIL - JAMB AT EXISTING WALL INFILL

SCALE: 3" = 1'-0"

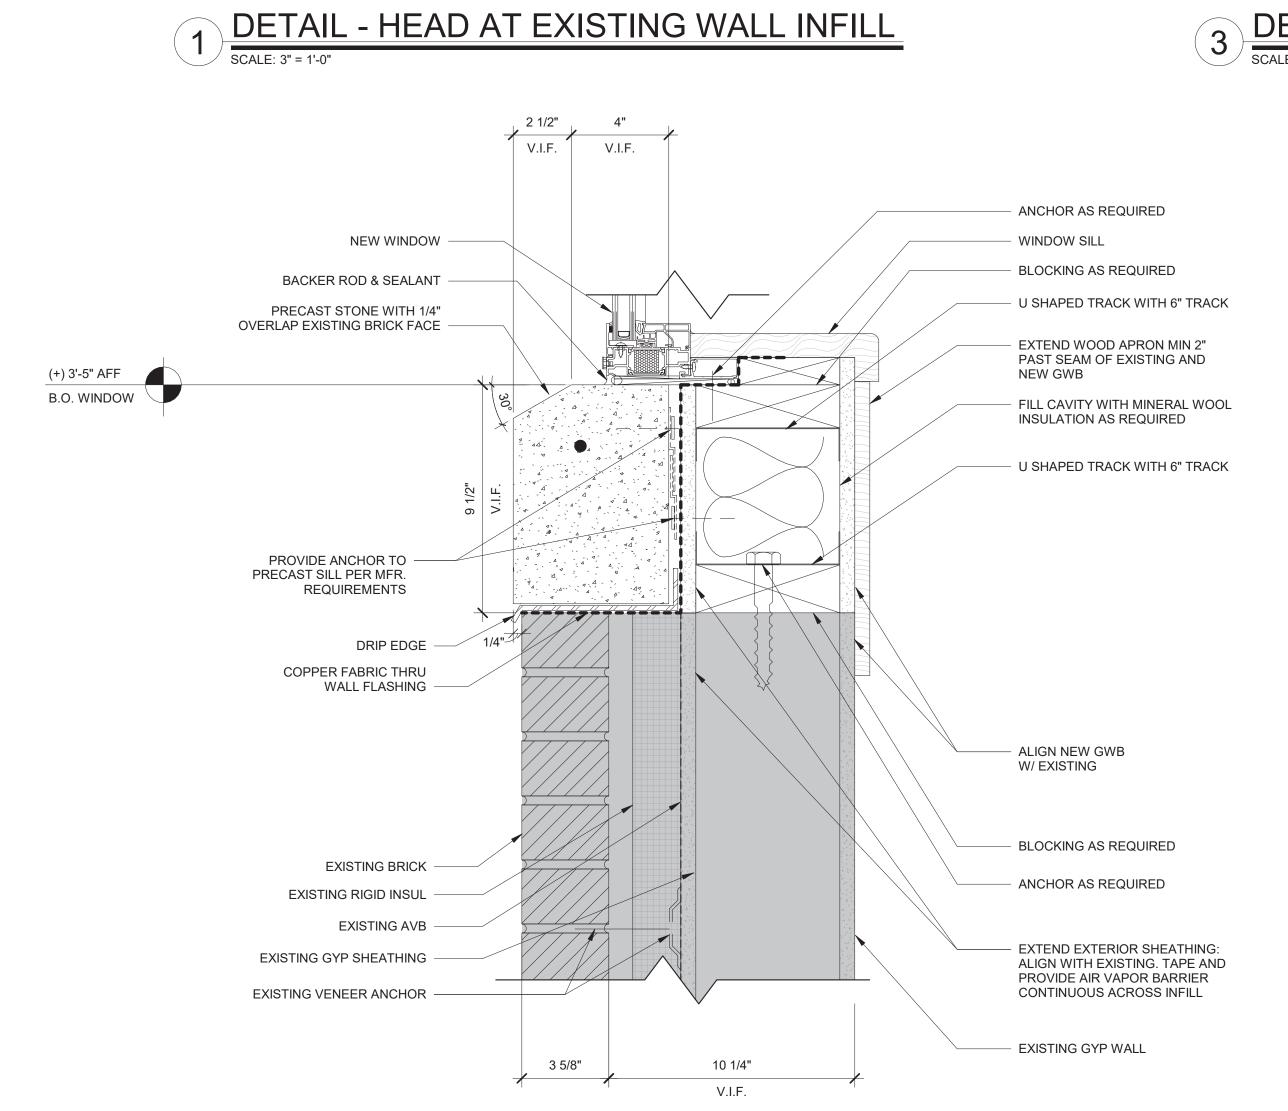


2 DETAIL - SILL AT EXISTING WALL INFILL

SCALE: 3" = 1'-0"

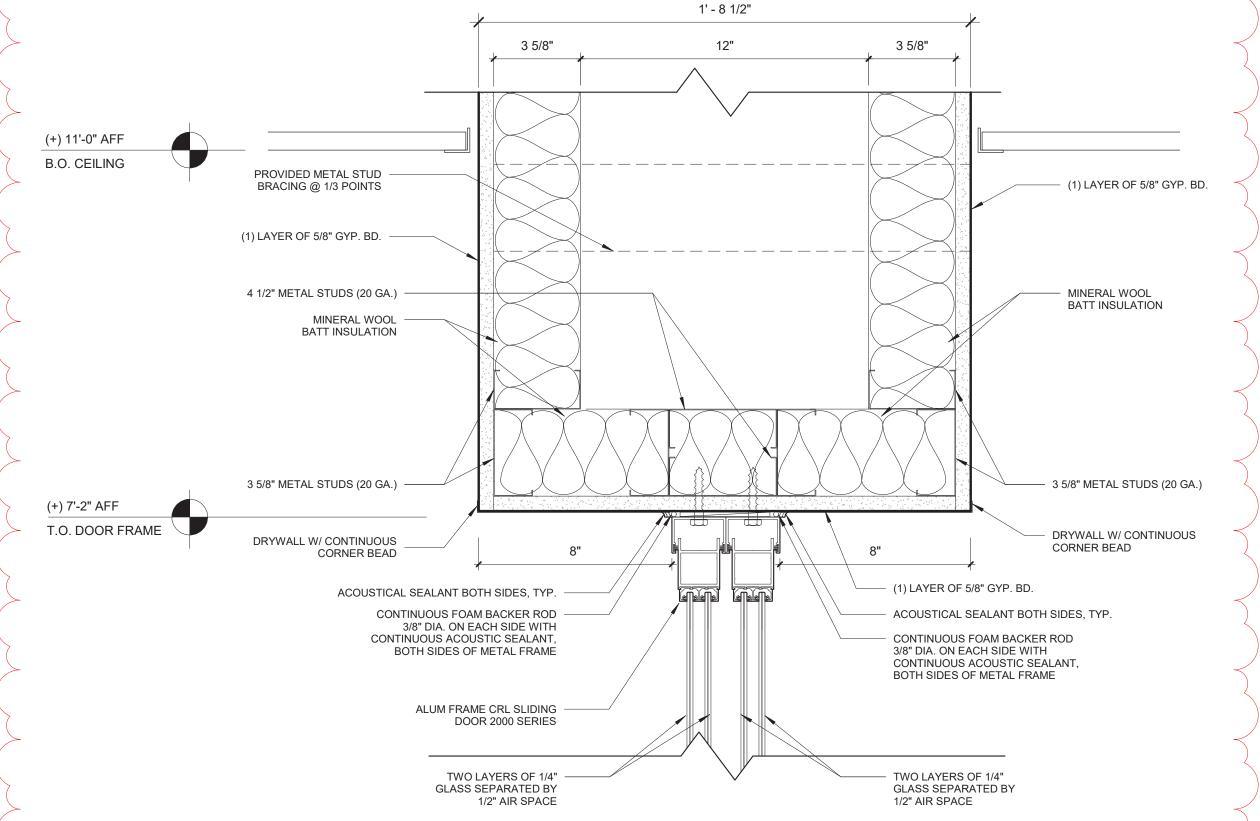

DETAIL - SLIDING DOOR HEAD SCALE: 3" = 1'-0"

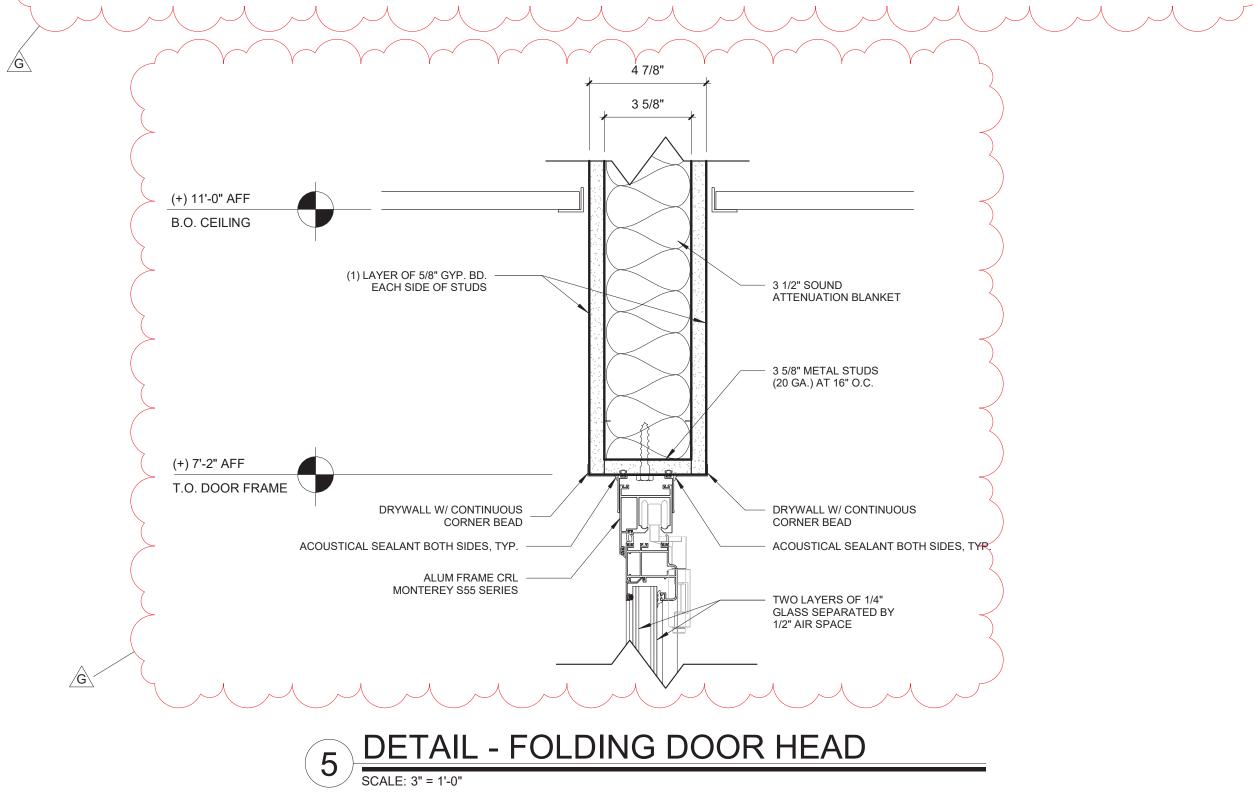

Geddis

Revision Schedule

Description

Addendum 1

Addendum 2

Date

8/16/2021

8/23/2021

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> Construction Manager SAVIN ENGINEERS, P.C 3 Campus Drive Pleasantville, NY 10570 914-769-3200

Structural Engineer
ODEH ENGINEERS 1223 Mineral Spring Ave North Providence, RI 02904

401-724-1771 <u>Civil Engineer</u> WESTON & SAMPSON 1 Winners Circle, Suite 130 Albany, NY 12205 518-463-4400

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401-861-3218 AV Consultant CAVANAUGH TOCCI 327 F Boston Post Road Sudbury, MA 01776-3027

978-443-7871

Providence, RI

SED#: 6618-0001-0003-026

PROJECT

Rye City Schools

555 Theodore Fremd Ave, Rye, NY 10580

Midland Elementary School

312 Midland Ave, Rye NY 10580

EXTERIOR WINDOW AND DOOR SECTION DETAILS

Approver

SEAL & SIGNATURE DATE: 07/29/21 PROJECT No: 9200 DRAWING BY: Author CHK BY: Checker DWG No: A3-607

| | | FINISH | LEGEND | | | |
|----------|--|--|-----------------|----------|--|--|
| | FLC | ORS . | | | WALLS | |
| FLOOR T | <u> </u> | | PAINT | | | |
| FT - 1 | DIME | OUCT: FLORIM BASALTINE PORCELAIN TILE NSIONS: 12" X 12" TILE BY FLORIM R: LIGHT GREY 1096207 WITH GRIP FINISH | PT - 1 | | PRODUCT: BENJAMIN MOORE SPEC 50 COLOR: BEACON GRAY – 2128-60 | 00 |
| | | | PT - 2 | NOT USED | | |
| LUXURY | VINYL TILE - PLANK FLOORING | | PT - 3 | | PRODUCT: BENJAMIN MOORE SPEC 50 COLOR: WHITE HERON OC-57 | 00 |
| LVT - 4 | | PRODUCT: SHAW CONTRACT SOLITUDE LVT DIMENSIONS: 6" x 48" COLOR: COTTONWOOD | PT - 4 | | PRODUCT: BENJAMIN MOORE SPEC 50 COLOR: BLUE HYDRANGEA 2062-60 | 00 |
| LVT - 5 | | PRODUCT: SHAW CONTRACT SOLITUDE LVT DIMENSIONS: 6" x 48" COLOR: FRENCH GREY | PT - 5 | | PRODUCT: BENJAMIN MOORE SPEC 50 COLOR: BLUE DAISY 2062-40 | 00 |
| LVT - 6 | | PRODUCT: SHAW CONTRACT COVE LVT 0927V DIMENSIONS: 9" x 48" | PT - 6 | | PRODUCT: BENJAMIN MOORE SPEC 50 COLOR: POTPOURRI GREEN 2029-50 | 00 |
| | | COLOR: WASH PRODUCT: SHAW CONTRACTCOVE LVT 0927V | PT - 7 | | PRODUCT: BENJAMIN MOORE SPEC 50 COLOR: STEM GREEN 2029-40 | 00 |
| LVT - 7 | P\$-50505050 | DIMENSIONS: 9" x 48" COLOR: GRAZE | PT - 8 | | PRODUCT: BENJAMIN MOORE SPEC 50 COLOR: TURQUOISE POWDER 2057-50 | |
| LVT - 8 | 68 68 68 68 68 68 68 68 68 68 68 68 68 6 | PRODUCT: SHAW CONTRACT COVE LVT 0927V DIMENSIONS: 9" x 48" COLOR: JADE | | | | |
| LVT - 9 | | PRODUCT: SHAW CONTRACT COVE LVT 0927V DIMENSIONS: 9" x 48" COLOR: SAPPHIRE | WALL TILE WT -1 | | PRODUCT: FLORIM BASALTINE PORCE DIMENSIONS: 12" X 24" TILE BY FLORIM COLOR: LIGHT GREY 1096219 | |
| | | | GROUT | | | |
| WALL BAS | PRODUCT: ROPPE PINI DIMESIONS: 6" HIGH S' COLOR: DOLPHIN 129 | | GT -1 | | PRODUCT: SPECTRALOCK PRO COLOR: RAVEN 45 | G |
| WALL TIL | LE BASE | | | | | NOTE: PREPARE WALLS FOR MAGNETIC |
| WTB -1 | PRODUCT: FLORIM BAS DIMESIONS: 6" X 12" COLOR: NUT 1096227 | SALTINE COVE BASE TILE | WALL COV | ERINGS | | WALL COVERINGS. MAGNETIC WAI COVERINGS BY OWNER. |
| | SUF | RFACES | WLC-1 | | PRODUCT: VISUAL MAGNETICS ASTROCOLOR: WHITE | D DRY ERASE WALLCOVERING |
| SOLID SU | URFACE COUNTERTOP | | WLC-2 | | PRODUCT: VISUAL MAGNETICS ASTRO | |
| SS - 1 | NOT USED | | WLO-2 | | | |
| SS - 2 | PRODUCT: CORIA COLOR: SILVER E | IN SOLID SURFACE IRCH | WLC-3 | | PRODUCT: VISUAL MAGNETICS ASTRO COLOR: MATCH BEN MOORE 2029-50 F | |
| CASEW | ORK FINISHES | | GLASS FILM | <u>s</u> | | |
| PLYFF-1 | PLYWOOD WITH EXPOSED EDGES FINISHED. PROVI APPROVAL. FINIS | PRE-FINISHED BALTIC BIRCH CLEAR, NON-YELLOWING UV FINISH; I, SANDED SMOOTH AND CLEAR DE SAMPLE TO ARCHITECT FOR H FOR CUSTOM FURNITURE BY FOR REFERENCE ONLY. | FLM-1 | | PRODUCT: DECORATIVE FILMS SOLYX | (SX-5037 SAMBE |
| PLYFF-2 | WILSONART 1573 LAMINATE on TAC OPPOSITE SIDE; FINISHED. PROVI | PRE-FINISHED BALTIC BIRCH PLYWOOD with MARKERBOARD FROSTY WHITE PLASTIC SIDE; CLEAR, NON-YELLOWING UV FINISH on EXPOSED EDGES, SANDED SMOOTH AND CLEAR DE SAMPLE TO ARCHITECT FOR APPROVAL. TOM FURNITURE BY OWNER. LISTED FOR | | | | |

| | | | | | FINISH SCHEE | DULE - ADDITION | | | | |
|--------|------------------------------|----------------------------|---------------------|--------|----------------------|-----------------------|----------------------|-----------------------|---------------------------------------|--|
| ROOM | | | FLOOR | BASE | | WA | LL FINISH | | | |
| NUMBER | ROOM NAME | FLOOR FINISH | UNDERLAYMENT | FINISH | А | В | С | D | CEILING FINISH | NOTES |
| 32 | 5th GRADE ICT CLASSROOM< | LVT-4 | SHAW GROUNDWORKS | WB-1 | PT-8 | PT-8, WLC-1 | PT-3 | PT-3, PT-8 | CLG-1 | |
| 35 | Classroom | LVT-1 | SHAW GROUNDWORKS | WB-1 | PT-3 | PT-3 | PT-3 | PT-3 | CLG-1 | COUNTERTOP, BACKSPLASH & SIDESPLASH: SS- |
| 36 | Small Group Instruction | LVT-1 | SHAW GROUNDWORKS | WB-1 | PT-3 | PT-3 | PT-3 | PT-3 | CLG-1 | MATCH EXISTING DOOR TRIM COLOR ON CORRIDOR SIDE COUNTERTOP, BACKSPLASH & SIDESPLASH: SS- |
| 70 | VESTIBULE | LVT-5 | SHAW GROUNDWORKS | WB-1 | PT-8 | PT-5 | PT-8 | | CLG-1 | |
| 71 | ACTIVE COMMONS | LVT-5, LVT-8, LVT-9 | SHAW GROUNDWORKS | WB-1 | PT-3 | PT-3 | PT-3, PT-7, WLC-1 | PT-7 | CLG-1, CLG-5A, CLG-6A, CLG-6C | |
| 72 | CONFERENCE | LVT-4 | SHAW GROUNDWORKS | WB-1 | PT-4 | PT-4 | PT-4, WLC-1 | PT-4 | CLG-1 | |
| 73 | 5th GRADE LEARNING STUDIO | LVT-5, LVT-7, LVT-8 | SHAW GROUNDWORKS | WB-1 | PT-3, WLC-2 | PT-3, WLC-2 | PT-3, WLC-3 | PT-7, WLC-1 | CLG-1, CLG-5A, CLG-5C, CLG-6A, CLG-6C | |
| 74 | SGR | LVT-6 | SHAW GROUNDWORKS | WB-1 | PT-6 | PT-6, WLC-1 | PT-6 | PT-6, WLC-1 | CLG-1 | |
| 75 | 5th GRADE LEARNING STUDIO | LVT-5, LVT-7, LVT-8 | SHAW GROUNDWORKS | WB-1 | PT-3, WLC-2 | PT-3, PT-7, WLC-1 | PT-7, WLC-1 | PT-3, WLC-2, WLC-3 | CLG-1, CLG-5A, CLG-5C, CLG-6A, CLG-6C | |
| 76 | WORKSHOP COMMONS | LVT-9, LVT-5, LVT-7, LVT-8 | SHAW GROUNDWORKS | WB-1 | PT-3, WLC-3 | PT-3, WLC-2 | PT-3, WLC-2, PT-5 | PT-3 | CLG-1, CLG-5A, CLG-6 | |
| 77 | STORAGE | LVT-5 | N/A | WB-1 | PT-3 | PT-3 | PT-3 | PT-3 | CLG-1 | |
| '8 | 5th GRADE LEARNING STUDIO | LVT-5, LVT-6,LVT-9 | SHAW GROUNDWORKS | WB-1 | PT-3, PT-5, WLC-1 | PT-3 | PT-3, WLC-2 | PT-3, WLC-2, WLC-3 | CLG-1, CLG-5A, CLG-5C, CLG-6A, CLG-6C | |
| 79 | SGR | LVT-6 | SHAW GROUNDWORKS | WB-1 | PT-8, WLC-1 | PT-8 | PT-8 | PT-8, WLC-1 | CLG-1 | |
| 30 | 5th GRADE LEARNING STUDIO | LVT-5, LVT-6, LVT-9 | SHAW GROUNDWORKS | WB-1 | PT-3 | PT-3, WLC-3, WLC-2 | PT-3, WLC-2 | PT-3, PT-5, WLC-1 | CLG-1, CLG-5A, CLG-5C, CLG-6A, CLG-6C | |
| 31 | ELEC. CLOSET | LVT-4 | N/A | WB-1 | PT-3 | PT-3 | PT-3 | PT-3 | CLG-1 | |

NOTES: 1. NEW DOOR TRIM TO BE PT-1, UNLESS OTHERWISE NOTED.

GENERAL NOTE:

SEE INTERIOR ELEVATIONS AND FINISH PLANS FOR FLOORING PATTERN AND CUT LINES OF WALL FINISHES

Revision Schedule

No. Description Date

A SED SUBMISSION 10/23/2020

E ADDITIONS: ISSUED 08/10/2021 FOR BID

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SED#: 6618-0001-0003-026

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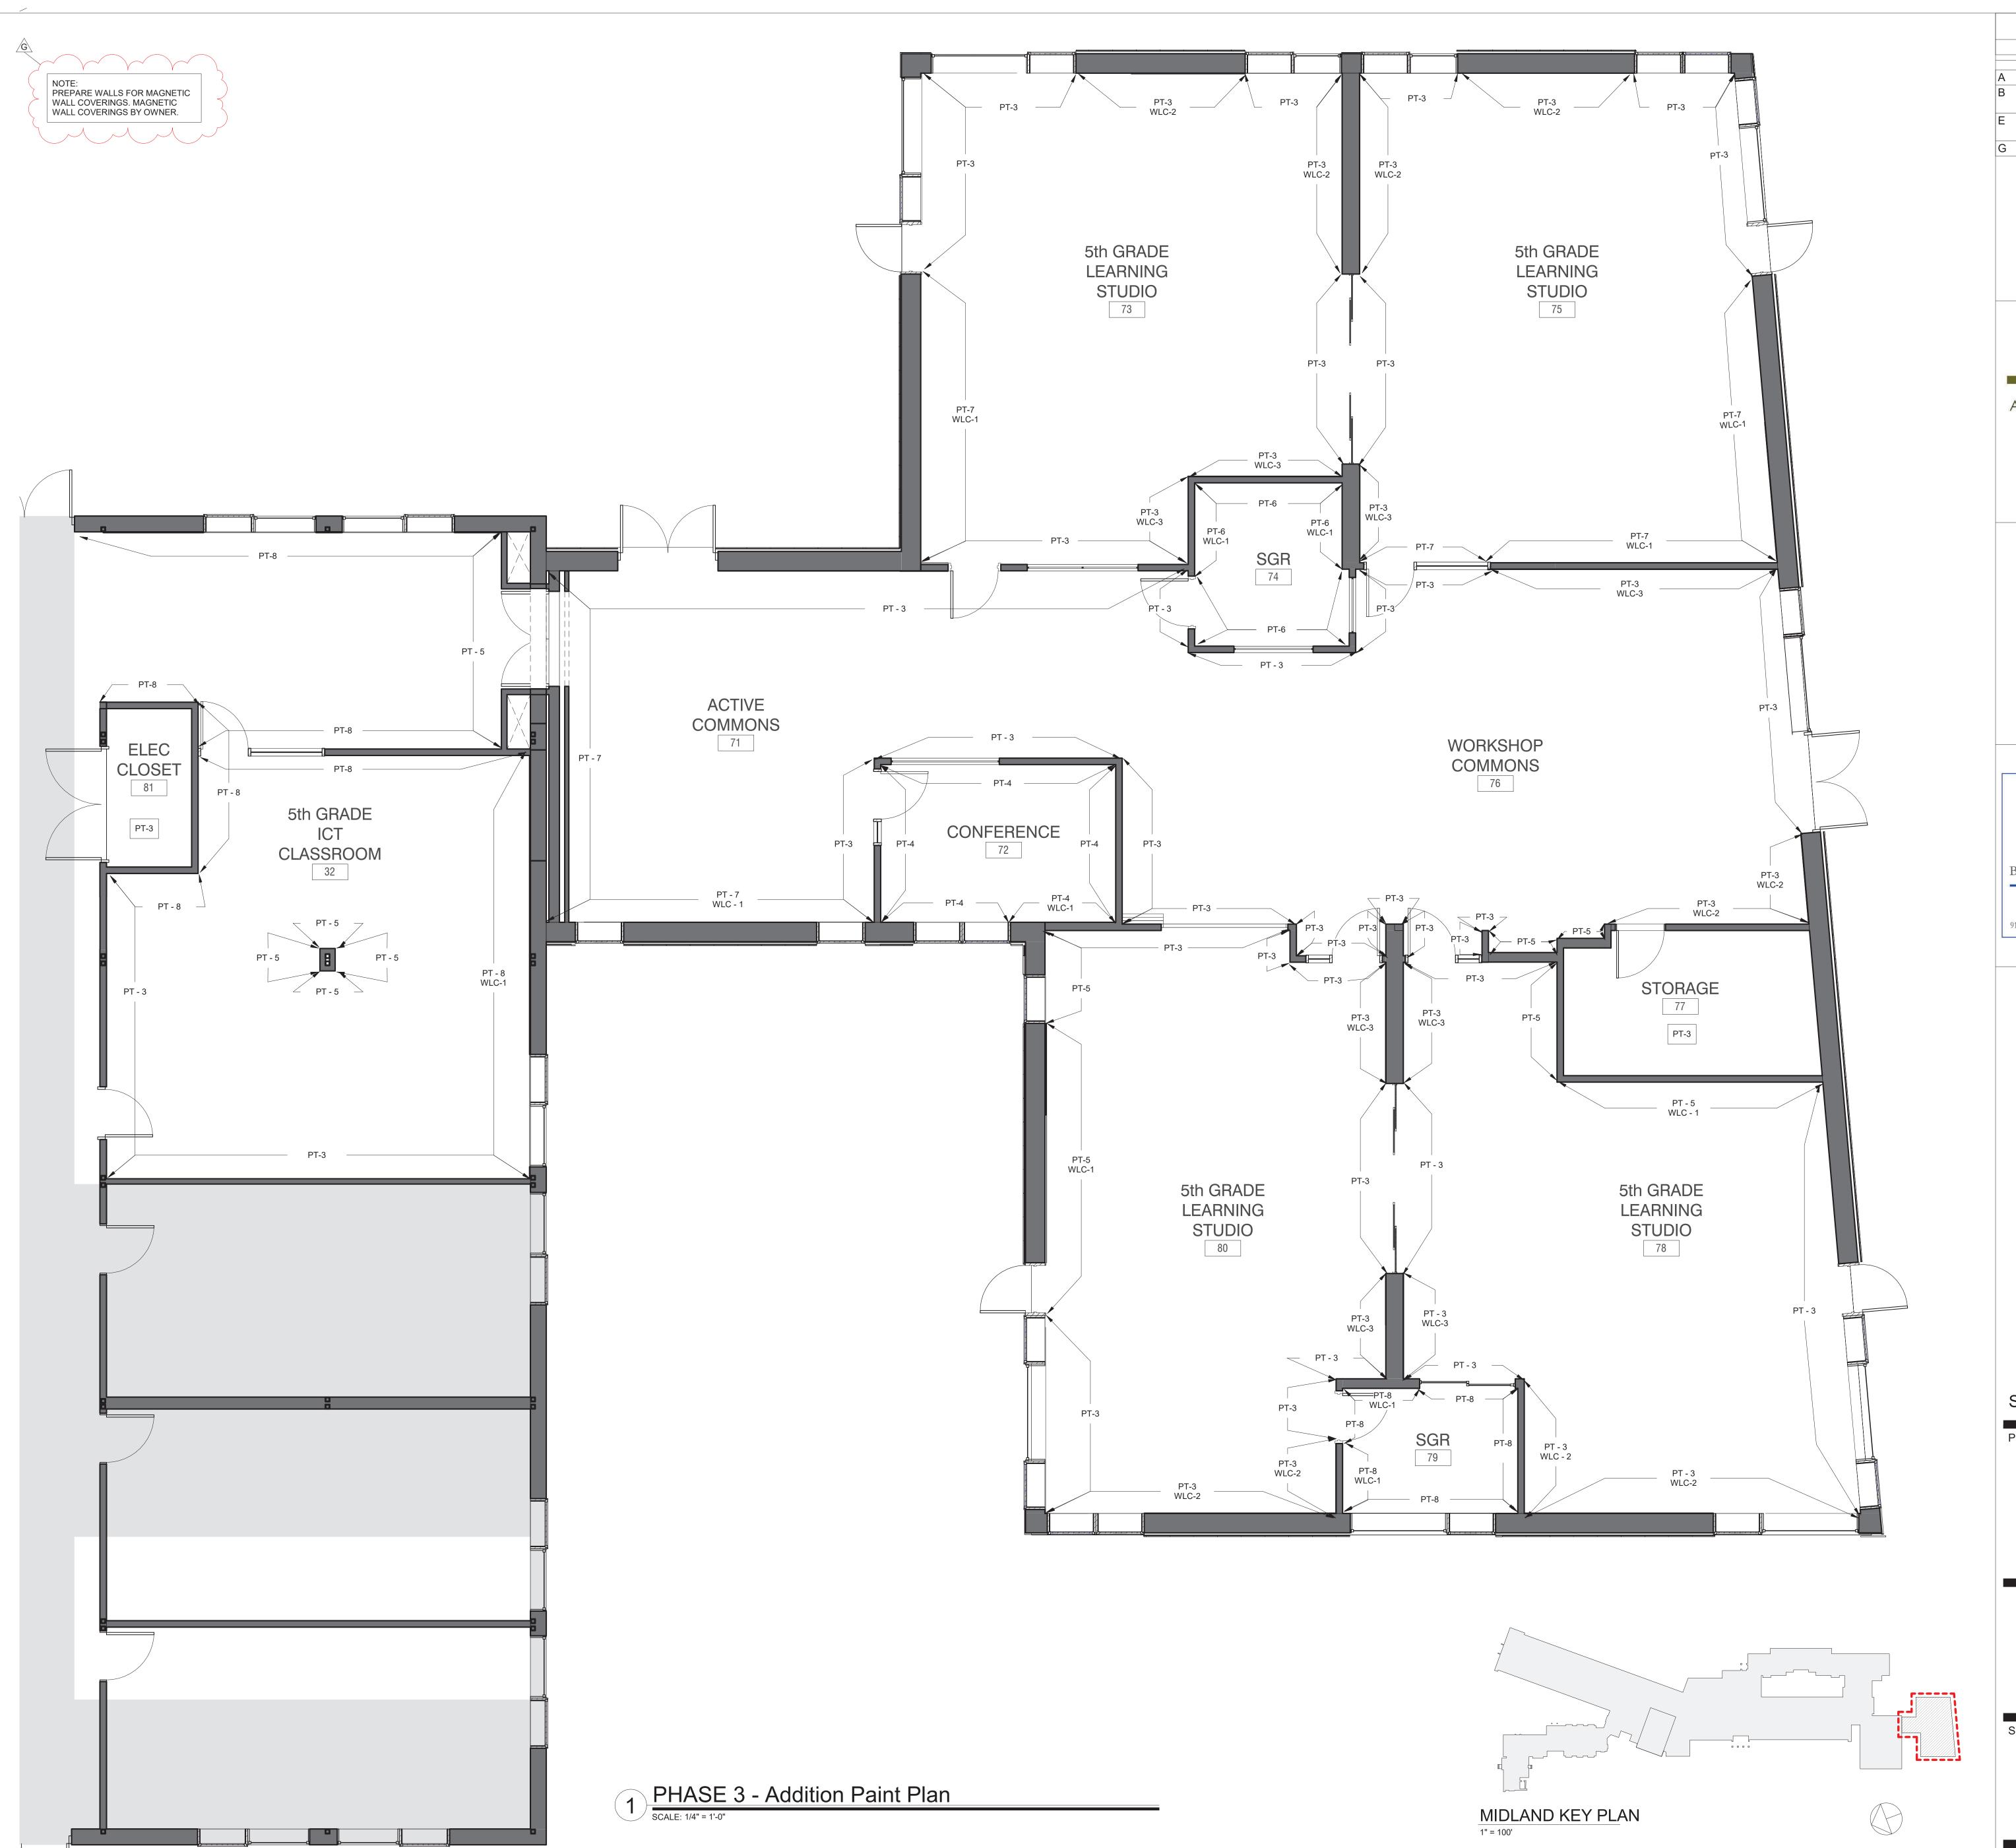
Midland Elementary School

312 Midland Ave, Rye NY 10580

FINISH SCHEDULES & LEGENDS

Approver

SEAL & SIGNATURE DATE: 07/27/20
PROJECT No: 9200
DRAWING BY: Author
CHK BY: Checker
DWG No:
A3-700



| | Revision Schedule | | | | | | | | | |
|-----|-------------------------------|------------|--|--|--|--|--|--|--|--|
| No. | Description | Date | | | | | | | | |
| | | | | | | | | | | |
| Α | SED SUBMISSION | 10/23/2020 | | | | | | | | |
| В | ADDITIONS: SED Addendum #1 | 4/26/2021 | | | | | | | | |
| E | ADDITIONS: ISSUED FOR BID | 08/10/2021 | | | | | | | | |
| G | Addendum 2 | 8/23/2021 | | | | | | | | |

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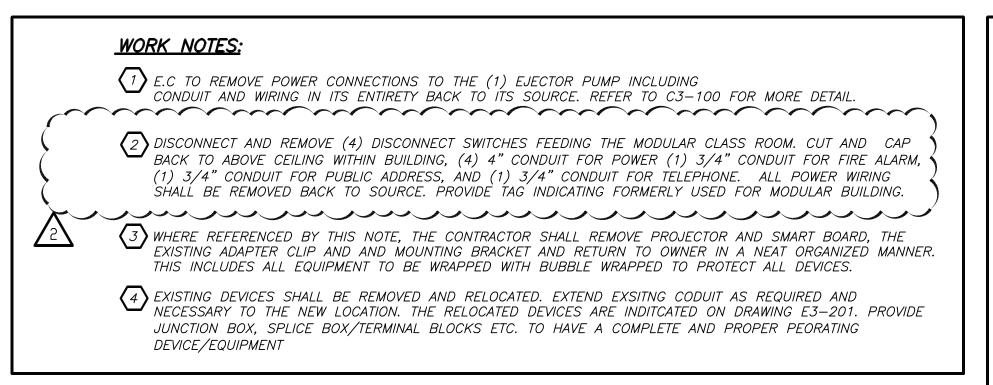
312 Midland Ave, Rye NY 10580


ADDITION - WALL FINISH PLAN

Approver

SEAL & SIGNATURE DATE: 04/29/20
PROJECT No: 9200
DRAWING BY: Author

PROJECT No: 9200
DRAWING BY: Author
CHK BY: Checker
DWG No:
A3-721



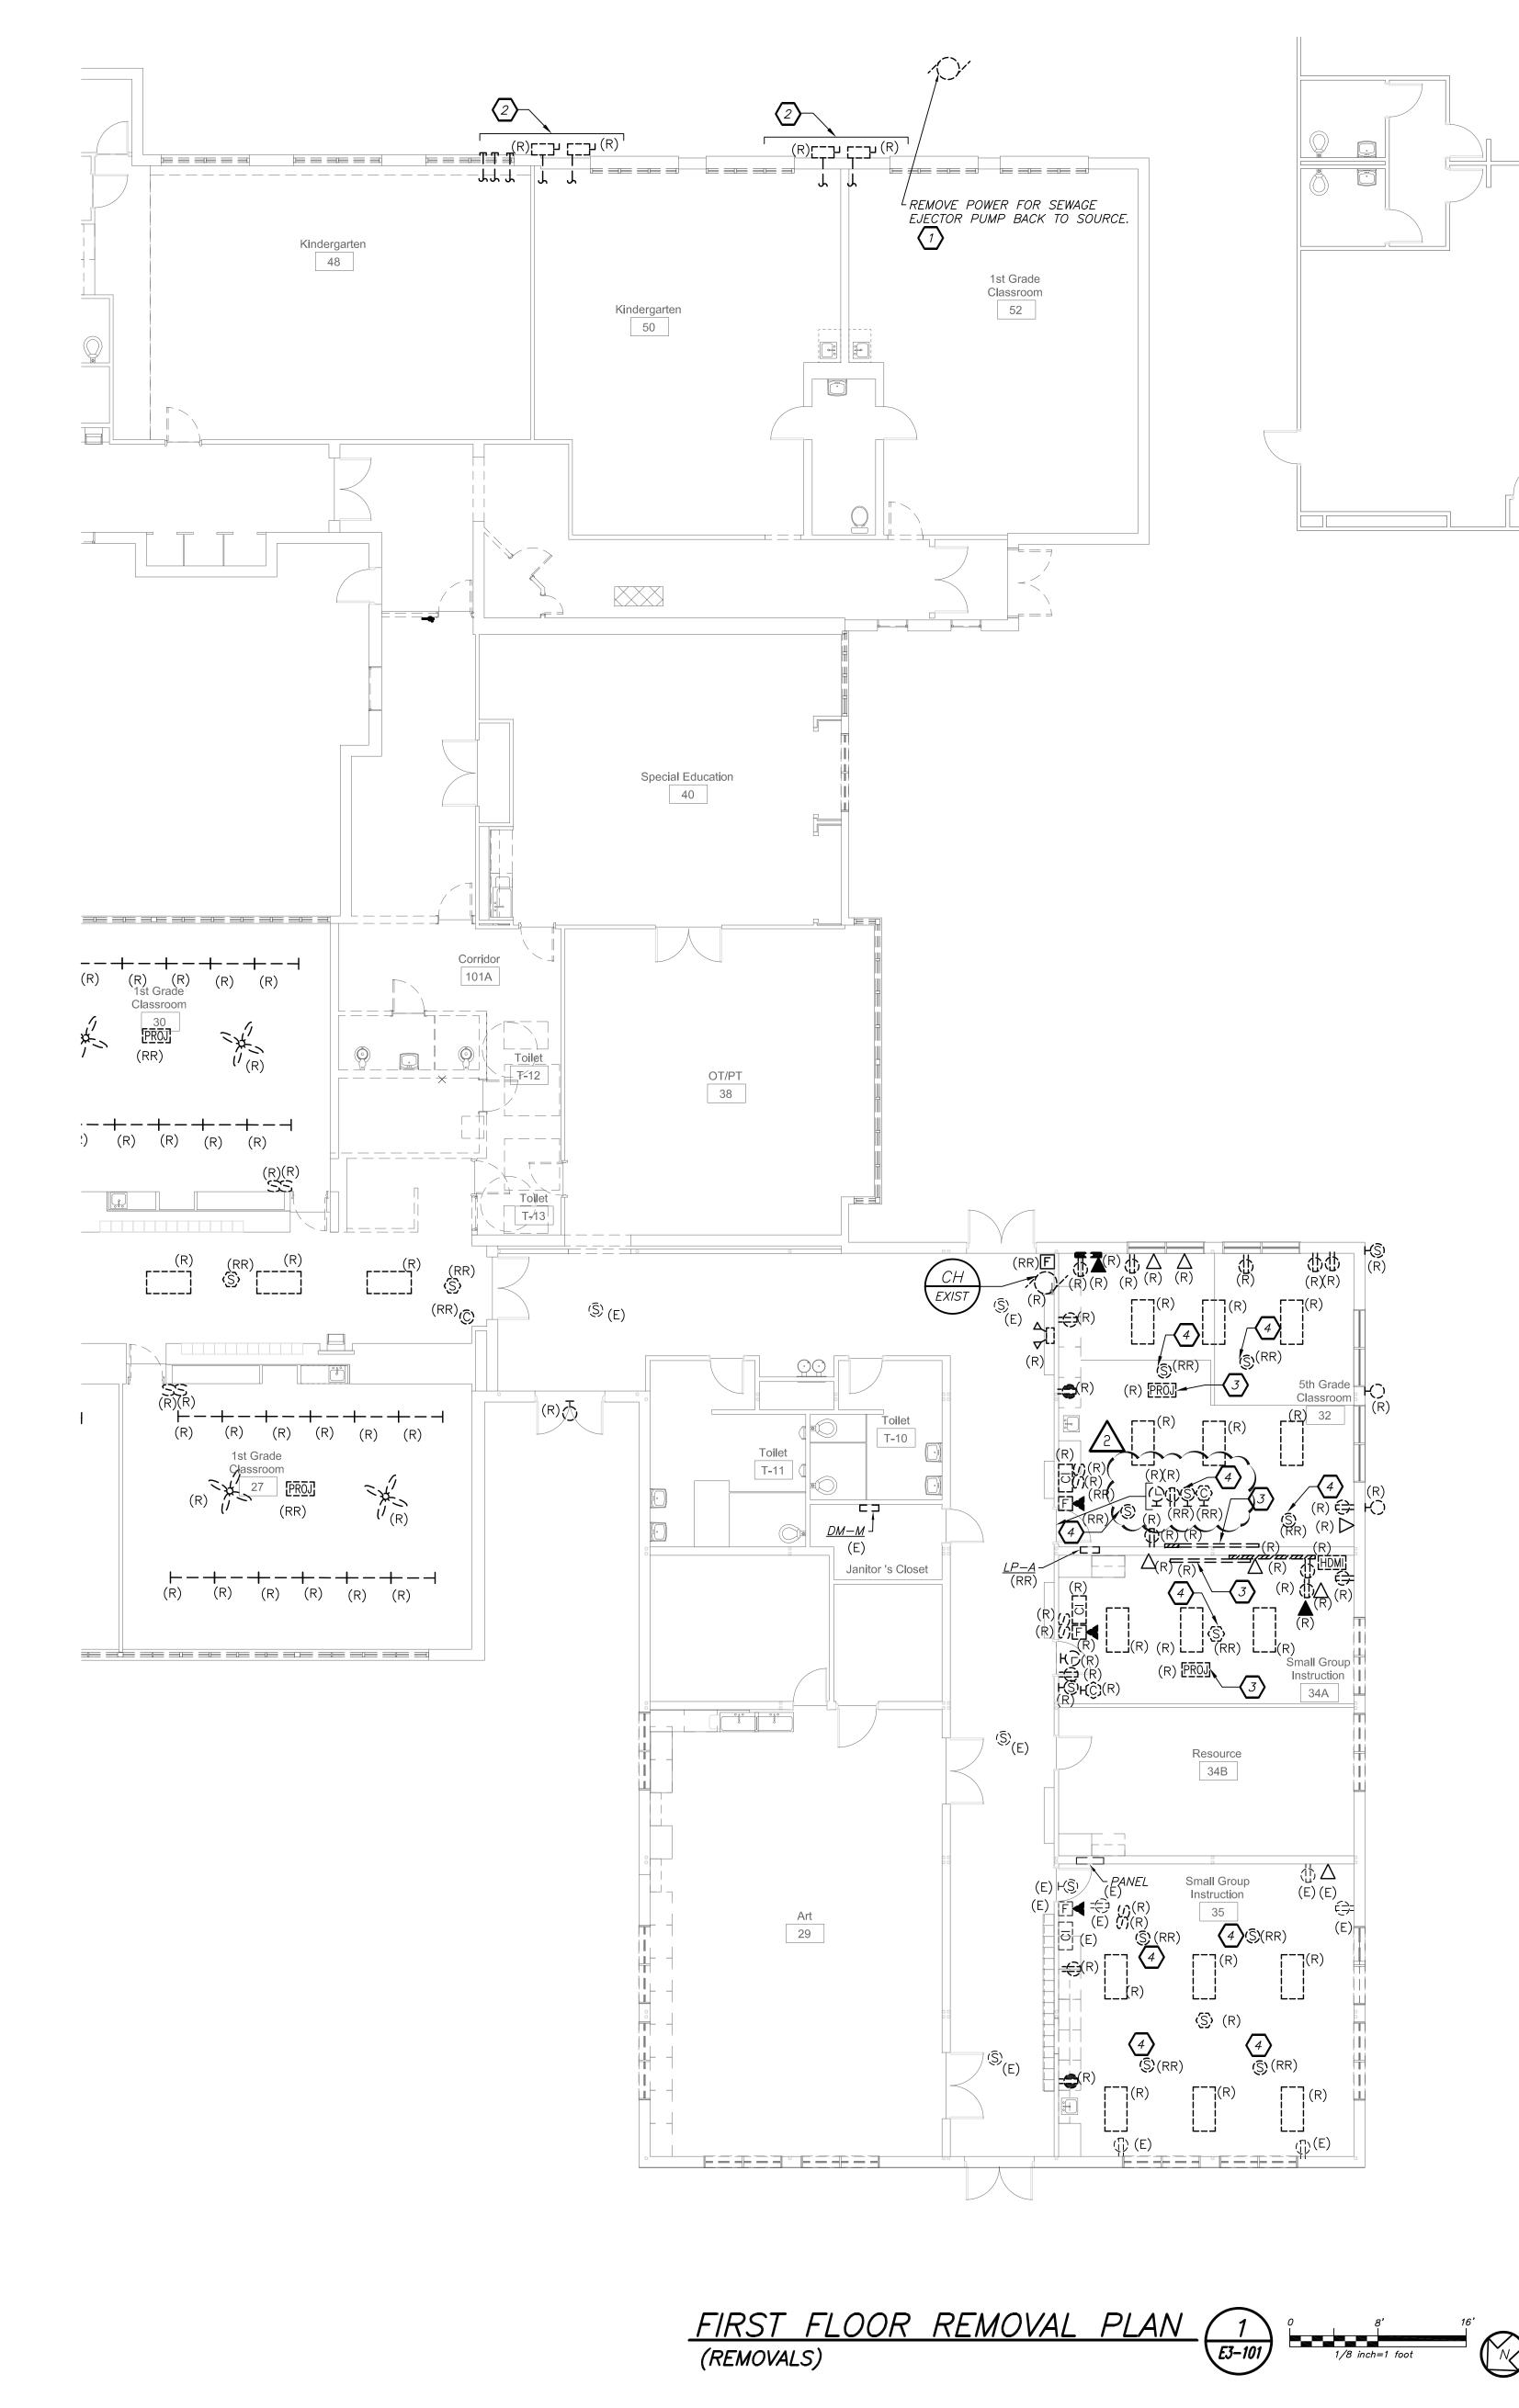

Revision Schedule

Description Date


 Description
 Date

 A
 SED Submission
 10/23/2020

 B
 ISSUED FOR BID
 08/10/2021

 C
 ADDENDUM #1
 08/16/2021

 D
 ADDENDUM #2
 2
 08/20/2021

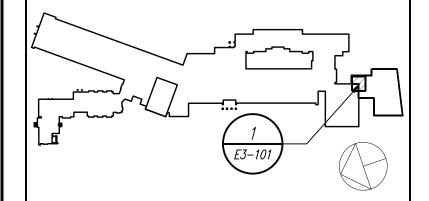

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DP DESIGN

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AV Consultant
CAVANAUGH TOCCI

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Sudbury, MA 01776-3027 978-443-7871

SED#: 6618-0001-0003-025

PROJECT

Rye City Schools
555 Theodore Fremd Ave, Rye, NY 10580

Midland Elementary School

312 Midland Ave, Rye NY 10580


ADDITION ELECTRICAL REMOVALS PLAN


SEAL & SIGNATURE DATE: 12/12/19


PROJECT No: 9200
DRAWING BY: Author
CHK BY: BGA/BGA
DWG No:
E3-101


BEFORE FABRICATION THIS CONTRACTOR SHALL VERIFY ALL MEASUREMENTS AND CONDITIONS ON JOB AND COORDINATE HIS WORK WITH THE WORK

DBE: TAB: 202900E2A-101 - Y:\RYE CITY SD\Rye CSD - 2019 Bond - Phase 2A MDES Addition (2029.00)\Drawings\Electrical\202900E2A-101-MDES.dwg - DATE: Aug 19, 2021 - 5:47pm

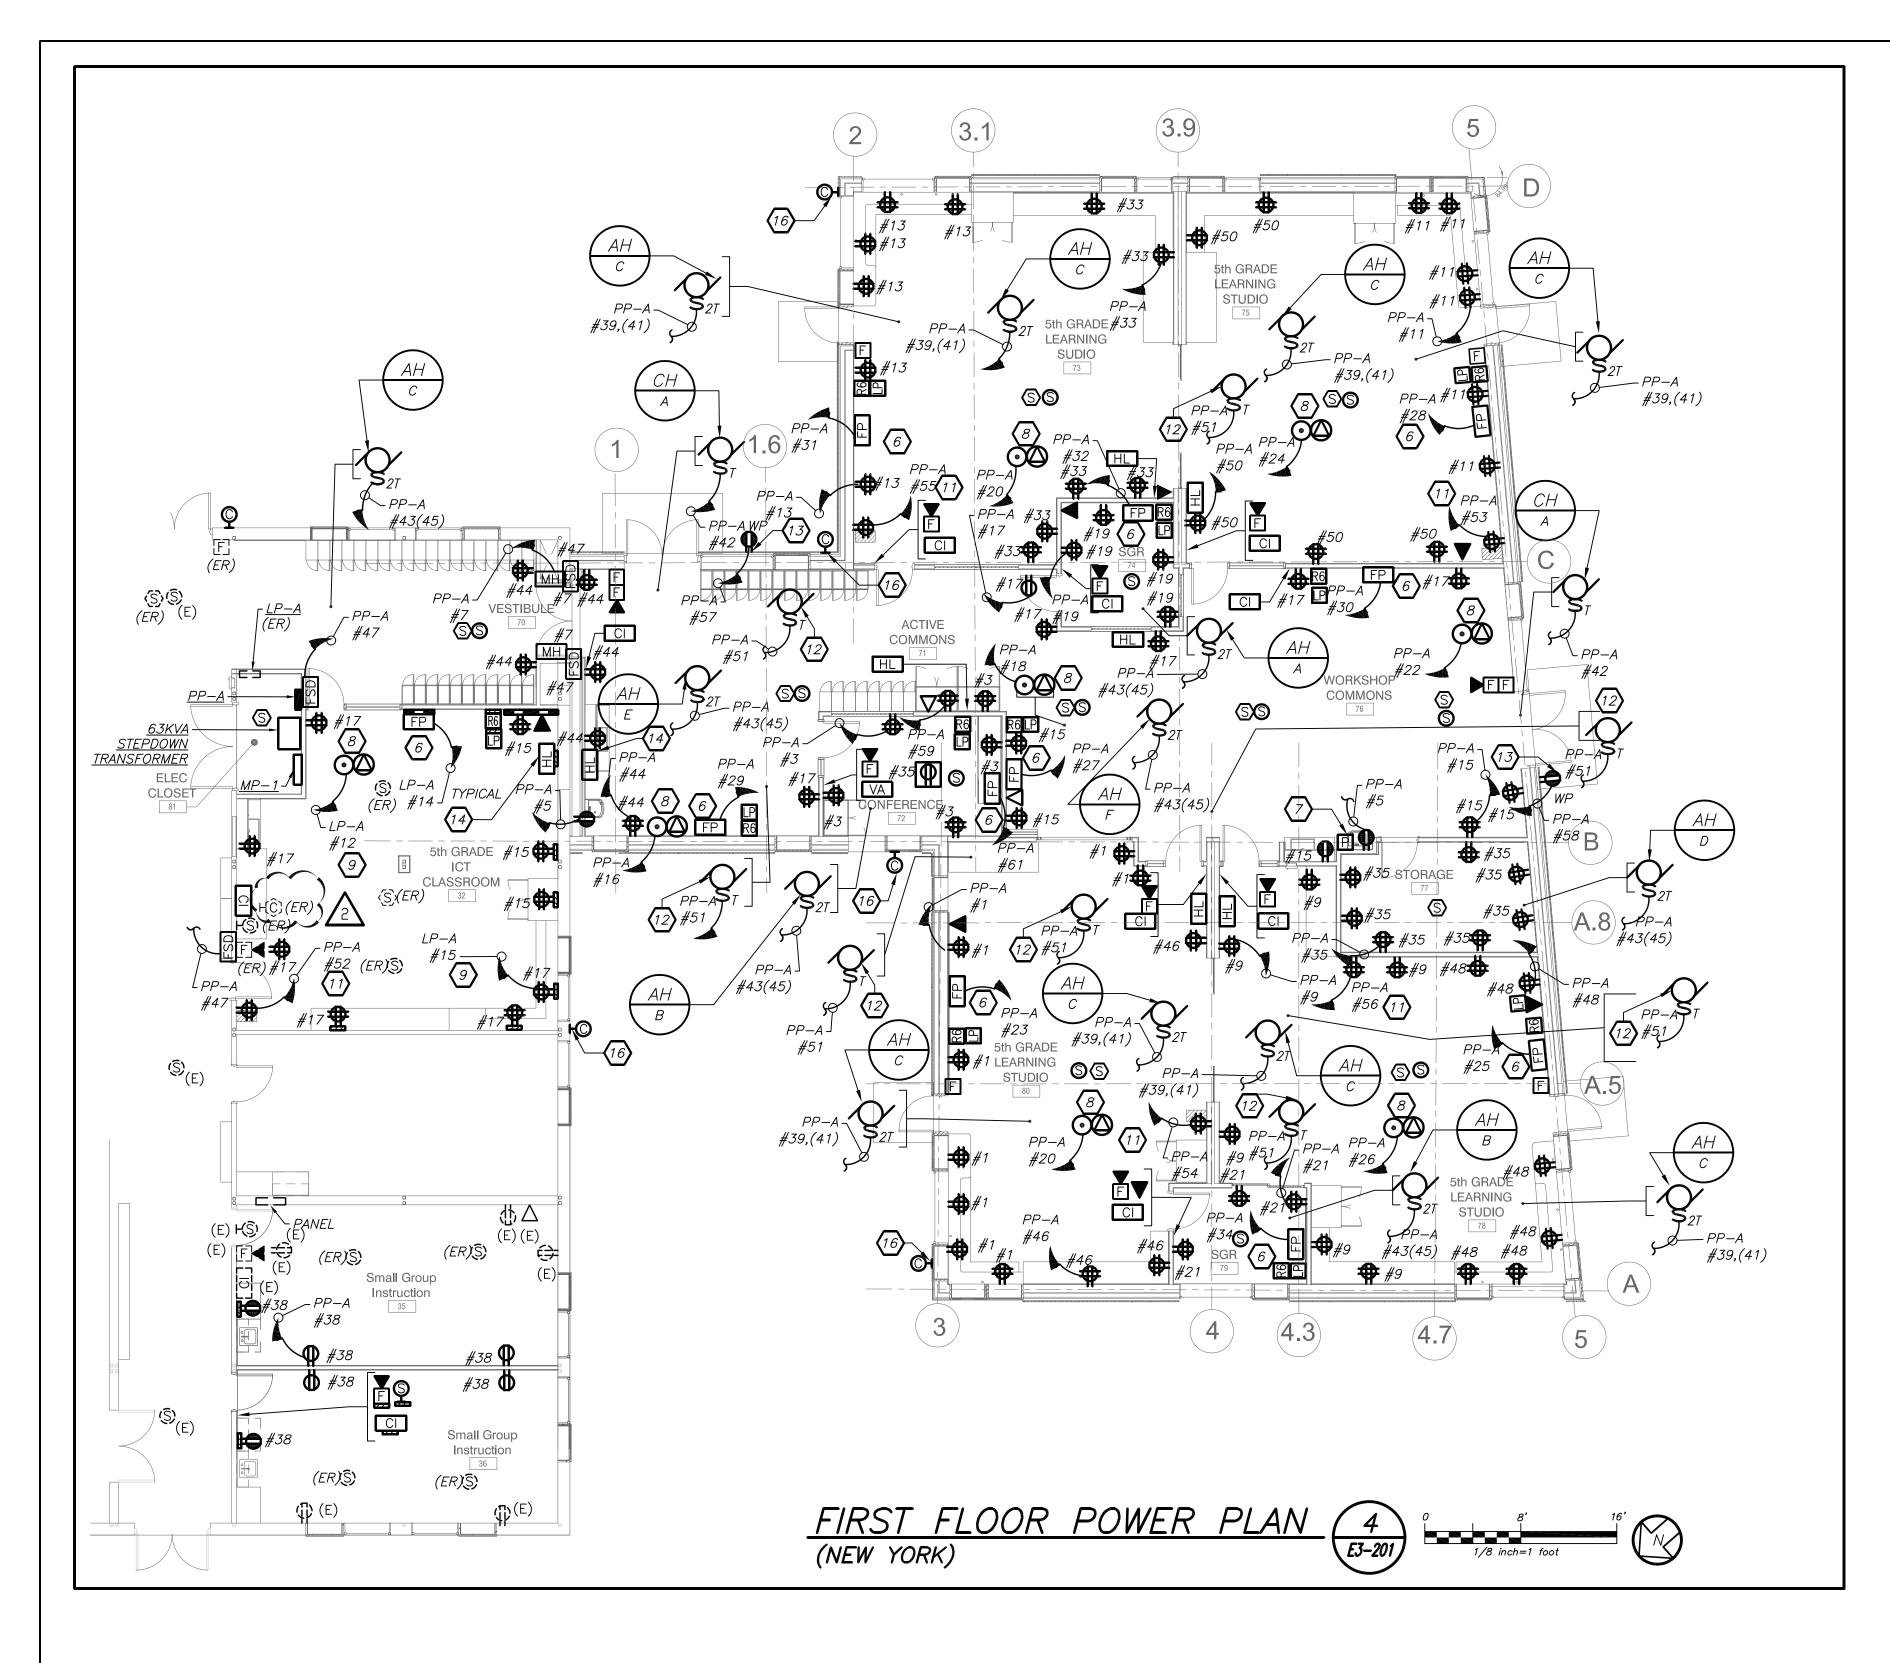

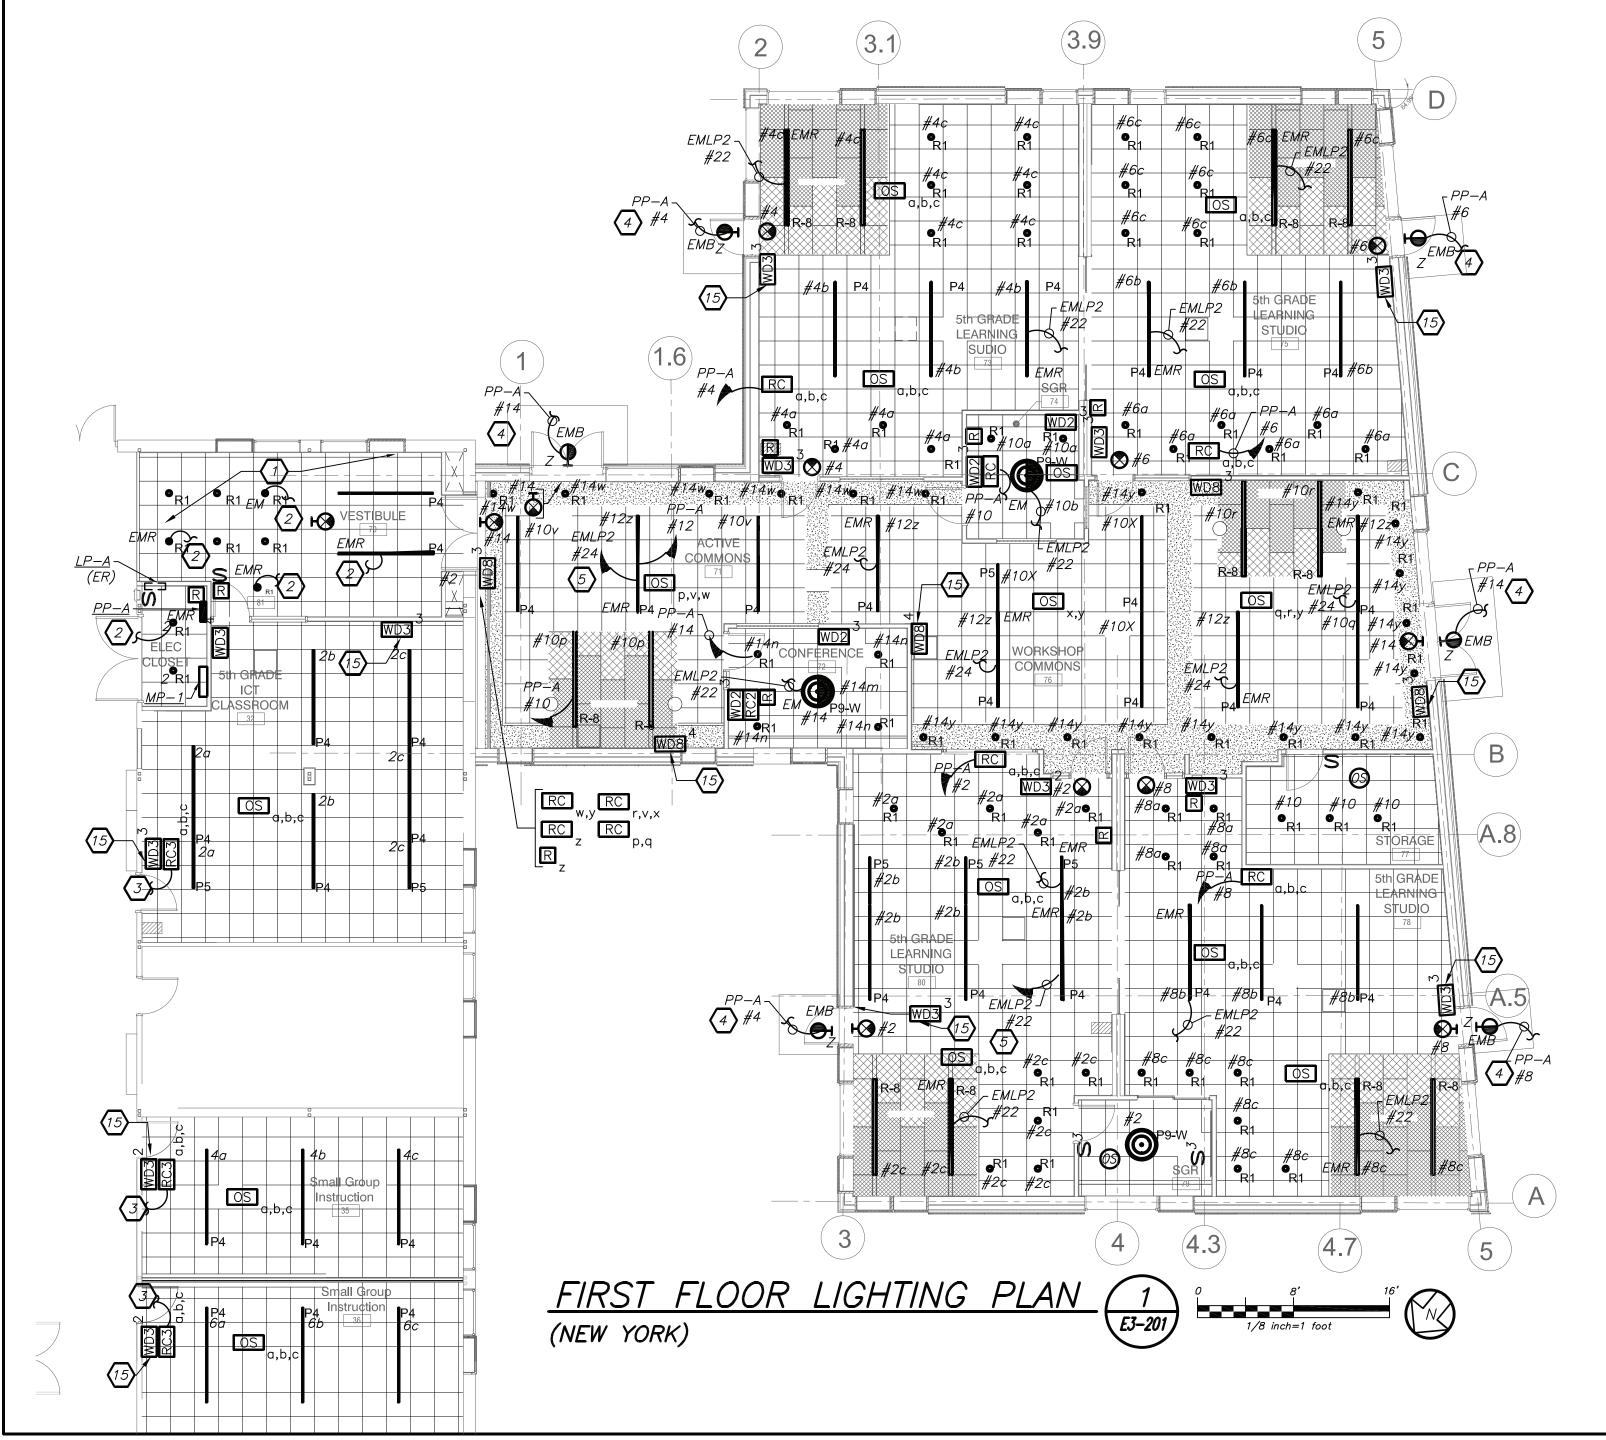

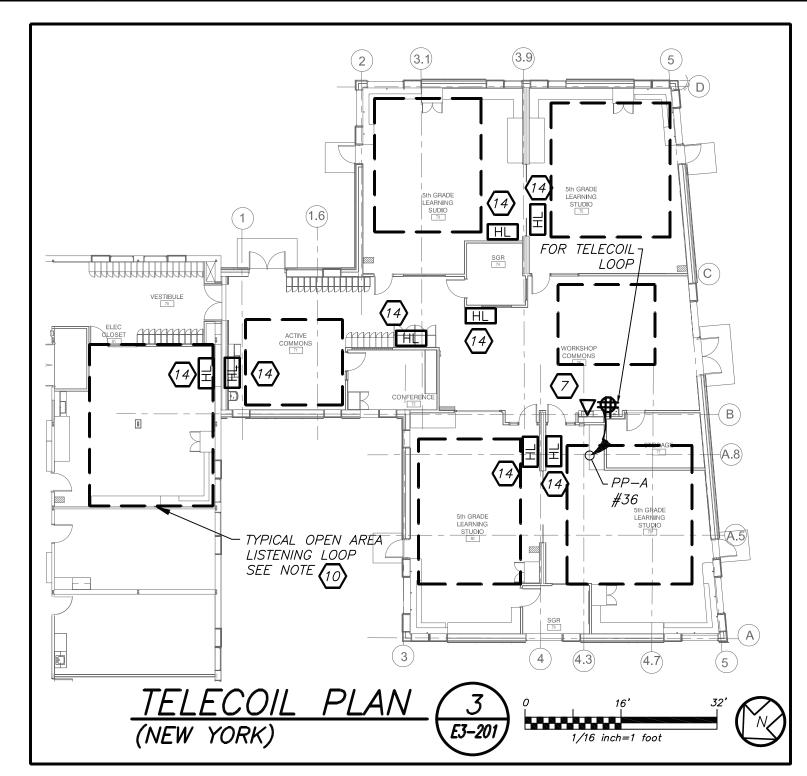

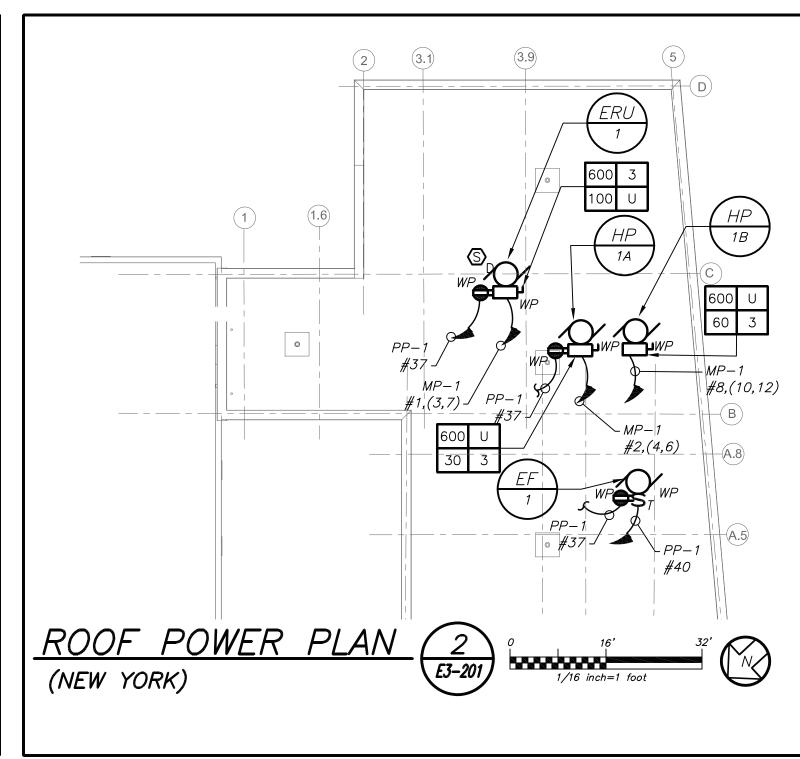

WORK NOTES:

MORE DETAILS.

BEFORE FABRICATION THIS CONTRACTOR SHALL VERIFY ALL MEASUREMENTS AND CONDITIONS ON

JOB AND COORDINATE HIS WORK WITH THE WORK

- (10) ELECTRICAL CONTRACTOR SHALL SCORE THE FLOOR AND FURNISH AND INSTALL TELECOIL LOOP. REFER TO AVE2 DRAWINGS FOR MORE DETAILS ON THE TOTAL SCOPE OF WORK INCLUDING 27000 SECTION OF SPECIFICATION.
- PROVIDE DEDICATED CIRCUIT FOR CHROME CARTS. COORDINATE EXACT LOCATION WITH OWNER AND ARCHITECT BEFORE THE START OF ANY WORK.
- PROVIDE POWER FOR MECHANICAL EQUIPMENT FS-A. REFER TO MECHANICAL DRAWINGS FOR
- PROVIDE WATERPROOF RECEPTACLE WITH LOCKABLE COVER. RECEPTACLE SHALL BE MOUNTED AT 18" AFF. IT SHALL BE SWITCHED FROM INSIDE THE BUILDING.
- FOR HEARING LOOP TERMINATION JUNCTION BOX. REFER TO LEGEND AND AV DRAWING FOR ADDITIONAL INFORMATION.
- (15) REFER TO ARCHITECTURAL DRAWINGS FOR EXACT LOCATION OF LIGHTING CONTROLS.
- EC TO PROVIDE RECESSED MOUNTED EXTERIOR WALL JUNCTION BOX WITH SLEEVE INTO BUILDING ABOVE HUNG CEILING. COORDINATE HEIGHT WITH OWNER/ARCHITECT BEFORE START OF ANY WORK

DATA. PROVIDE DRAG LINE.

- $ig(\, 1 \, ig)$ wire new lighting to existing corridor lighting and controls.
- (2) WIRE NEW EMERGENCY LIGHTING TO EXISTING CORRIDOR EMERGENCY LIGHTING CIRCUIT AND CONTROLS.
- (3) CIRCUIT NUMBER IS SHOWN FOR CONTRACTOR GUIDANCE ONLY. PROVIDE 2#12+1#12G IN 3/4" TO CIRCUIT AND BREAKER MADE SPARE BY LIGHTING DEMOLITION WORK.

 $\langle 4 \rangle$ CIRCUIT EXTERIOR LIGHTING FIXTURE TYPE "Z" TO INTERIOR NORMAL LIGHTING CIRCUIT AS

INCLUDE SELF CONTAINED BATTERY PACKS TO OVERRIDE ALL CONTROLS IN EVENT OF

SHOWN. FIXTURE SHALL BE CONTROLLED VIA INTEGRAL PHOTOCELL AND OCCUPANCY SENSOR.

- (5) WIRE EMERGENCY LIGHTING TO EMERGENCY LIGHTING CIRCUIT AS SHOWN. PROVIDE 2#12+1#12G IN 3/4" CONDUIT TO PANEL. PROVIDE 1P-20 AMP CIRCUIT BREAKER AT PANEL. PANEL EMPL2 IS LOCATED IN STORAGE ROOM 37.
- 6 FLAT PANEL "FP" BACK BOX AND TWO QUAD RECEPTACLES INSTALLED IN "FP" BOX SHALL BE MOUNTED AT HEIGHT SPECIFIED BY ARCHITECT. REFER TO AV DRAWINGS FOR EXACT LOCATION. $\langle 7 \rangle$ for telecoil loop amplifier coordinate exact location with architect and av DRAWINGS BEFORE THE START OF ANY WORK. PROVIDE 1-/12" EMPTY CONDUIT TO STUB UP
- 8 AV RACK SHALL BE MOUNTED ABOVE DROPPED CEILING. REFER TO AV DRAWINGS FOR EXACT LOCATION. PROVIDE CEILING MOUNTED QUAD RECEPTACLE AND DATA PORT ON CEILING TILE.

IN CEILING FOR HEARING LOOP AND 1-1/2" EMPTY CONDUIT TO ABOVE HUNG CEILING FOR

(9) PROVIDE 2#12+1#12G IN 3/4" TO CIRCUIT AS SHOWN. PROVIDE 1P-20 BREAKER AT THE


LIGHTING CONTROL AND SEQUENCE OF OPERATION:

- LEARNING STUDIOS. CONFERENCE ROOM ARE CONTROLLED VIA MANUAL ON DIMMABLE WALL SWITCH AND OCCUPANCY SENSORS. EACH STUDIO CONSISTS OF FULL DIMMING CAPABILITY OF THREE ZONES. WALL SWITCHES CONSISTS OF 'A', 'B', 'C' 'OFF', 'RAISE', AND 'LOWER' BUTTONS. THE OCCUPANCY SENSORS SHALL HAVE THE AUTO OFF FEATURE WHICH SHALL TURN ALL LIGHTS OFF AFTER 20 MINUTES WHEN THE ROOM IS VACANT. UL 924 EMERGENCY LIGHTING RELAY ARE INCLUDED TO OVERRIDE SWITCH AND FORCE EMERGENCY LIGHTS ON 100% IN THE EVENT OF EMERGENCY.
- 2. ALL COMMON AREAS SHALL BE CONTROLLED VIA LOCAL WALL SWITCHES AND OCCUPANCY SENSORS. EMERGENCY LIGHTING SHALL BE ACHIEVED VIA UL 924 EMERGENCY LIGHTING RELAY. IN THE EVENT OF AN EMERGENCY, LIGHTS ON THE EMERGENCY ZONE AND CIRCUIT WILL BE 100% ON.
- ^{3.} EXTERIOR BUILDING MOUNTED LIGHTS (TYPE Z) ARE CONTROLLED VIA BUILT—IN PHOTOCELL AND STEP-DIM MOTION SENSORS. PROVIDE ALL REQUIRED IN BUILT BATTERY BACKUP SHALL OVERRIDE ALL SENSORS (PHOTOCELL AND OCCUPANCY SENSOR) IN THE EVENT OF EMERGENCY AT EGRESS DOORS AS SHOWN.

GENERAL NOTES:

- 1. REFER TO DRAWING E3-001 FOR LEGEND AND LIGHTING CONTROL AND E3-601 FOR LIGHTING FIXTURE
- 2. REFER TO DRAWING E3-601 SERIES FOR PANELBOARD AND LIGHTING SCHEDULES.
- 3. REFER TO DRAWING E3-701 FOR LIGHTING CONTROL WIRING DIAGRAMS AND DETAILS.
- 4. NORMAL SIDE SENSING LINE ON ALL EMERGENCY LIGHTING RELAY SHALL BE CIRCUITED TO THE NORMAL LIGHTING CIRCUIT IN THE ROOM/AREA IT SERVES.
- 5. FOR ALL AREAS CONTROLLED BY ROOM CONTROLLER "RC", ELECTRICAL CONTRACTOR IS TO CIRCUIT ROOM CONTROLLER, THEN EXTEND LINE VOLTAGE CIRCUITRY TO EACH OF THE LIGHT FIXTURES DEPENDING ON
- CONTROL ZONES. REFER TO ROOM CONTROLLER WIRING DIAGRAM DETAILS ON DRAWING E3-701. 6. ALL EXIT LIGHTS SHALL BE CIRCUITED TO NORMAL LIGHTING CIRCUIT IN THE AREA, AHEAD OF ANY SWITCHING.
- 7. SET LIGHTING CONTROL SENSORS TO HIGHEST SENSITIVITY AVAILABLE PRIOR TO INSTALLATION.
- 8. COORDINATE EXACT FINAL LOCATION OF ALL AV RELATED BOXES AND EQUIPMENT WITH AV2 DRAWING AND VENDOR BEFORE THE START OF ANYWORK. ELECTRICAL CONTRACTOR SHALL NOT START INSTALLATION UNTIL YOU THEY HAVE A SIGN OF FROM SCHOOL DISTRICT AND CONSTRUCTION MANAGER.

SED Submission SSUED FOR BID ADDENDUM #1 ADDENDUM #2 2 08/20/2021

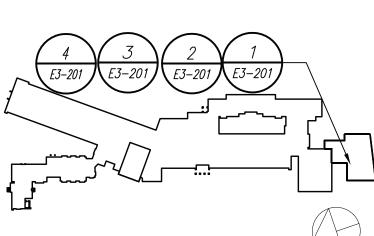

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ADDITION ELECTRICAL LIGHTING AND POWER PLAN

SEAL & SIGNATURE DATE: 12/12/19 PROJECT No: 9200 DRAWING BY: Author CHK BY: BGA/BGA DWG No:

E3-201

"OF /BLL/OTHAK/ODATRAGTORS," DBE: TAB: 202900E2A-101 - Y:\RYE CITY SD\Rye CSD - 2019 Bond - Phase 2A MDES Addition (2029.00)\Drawings\Electrical\202900E2A-201-MDES.dwg - DATE: Aug 18, 2021 - 10:26am