1. THIS DRAWING IS PROVIDED TO DEPICT THE IMPLEMENTATION SCHEDULE OF WORK IN ORDER TO MINIMIZE THE EFFECT OF CONSTRUCTION ON THE EDUCATIONAL

2. THIS DRAWING IS GENERAL IN NATURE AND DO NOT REFLECT THE ACTUAL EXISTING CONDITIONS. LATEST PROPOSED FLOOR PLAN, PROPOSED WORK AND WORK

SECTION 01 11 00

MILESTONE SCHEDULE

The following milestone schedule serves as a basis for bidding. A Master Schedule will be

ADDITION-Commence Construction October 18, 2021

Osborn ES Sitework and Modular Bldg's Commence Sitework

Asbestos Abatement at all schools and building is critical to the construction schedule

and shall be scheduled so that the abatement is complete within the first two weeks of

renovation construction. The Rye City School District will make arrangements to have

the building available for second shift and 24 hour work if necessary to complete the

LEGEND OF SYMBOLS

NSTALL PLYWOOD BARRIER ON EXTERIOR WALL WITH 3/4" CDX PLYWOOD ON 3 5/8" METAL STUDS @ 16" O.C. WITH

TWO LAYERS OF 5/8" TYPE 'X' GYPSUM BOARD, TAPE & COMPOUND WITH CAULKING AT THE PERIMETER, GYP. BOARD

EMPORARY DUST PROTECTION, PLASTIC CORRIDOR BARRIER WITH ZIPPER OPENING. GC WILL ALSO INSTALL PLASTIC BARRIERS AT

TEMPORARY SIGNAGE NOTES

December 2, 2022

June 26, 2023

June 26, 2023

August 18, 2023

August 18, 2023

September 22, 2023

This Master Schedule will incorporate the milestones listed below.

Award Contracts within 30 days of Contract Opening

Start Construction – Date of Award of Contracts

1.02 SUBSTANTIAL COMPLETION & MILESTONE DATES

Osborn Elementary School

Substantial Completion

Substantial Completion

Completion of Punchlist

& Project Closeout

Modular Relocation

asbestos abatement work in the first two weeks.

DESCRIPTION

8' HIGH TEMPORARY FENCE W/BOTTOM & TOP RAILS W/30" SILT FENCE & 8' HIGH SCREEN

DOORWAYS TO OFFICES AND CLASSROOMS WHERE NO WORK IS TAKING PLACE, AS DIRECTED BY CM.

PROVIDE TRAFFIC SIGNAGE DURING CONSTRUCTION WHERE REQUIRED TO IDENTIFY TRAFFIC FLOW AND PEDESTRIAN SAFETY. SIGNAGE TO INCLUDE BUT IS NOT LIMITED

Completion

Final Close-out of all Contract

a. Final Close-out of Contract

TEMPORARY STONE TRACKING PAD

PROPOSED STAGING AREAS AS INDICATED ON PLANS.

PHASE 1 - PROPOSED AREAS OF WORK

PHASE 2 - PROPOSED AREAS OF WORK

CONSTRUCTION ENTRANCE GATE

O BE PAINTED.

"ALL CONSTRUCTION VEHICLES MUST STOP AT THE GC TRAILER"

PROVIDE PAVEMENT MARKINGS AS REQUIRED FOR TRAFFIC FLOW. AFTER AND/OR REPLACE WHEN NECESSARY

SYMBOL

- x ---- x ---- x ---

TEMPORARY TRAFFIC SIGNAGE:

"DO NOT ENTER"

"TRUCKS ENTERING AND EXITING"

TEMPORARY PAVEMENT MARKINGS:

"NO ENTRY BETWEEN _____ AND _____"

RENOVATION-Commence

Milestone Dates

developed at a general meeting of the awarded contractor within 10 days of Award the Contracts.

3. THIS DRAWING IS FOR REFERENCE ONLY AND SHALL NOT TO BE USED FOR CONSTRUCTION.


PART 1 – GENERAL

1.01 MASTER SCHEDULE

AREAS. REFER TO ARCHITECTURAL, MECHANICAL, ELECTRICAL, PLUMBING, STRUCTURAL AND CIVIL DRAWINGS FOR SPECIFIC SCOPED WORK AND WORK AREAS.

4. ALL REGULATORY AGENCY REQUIREMENTS INCLUDING STATE AND LOCAL CODES AND PROPER SAFETY PRECAUTIONS SHALL APPLY AND TAKE PRECEDENCE OVER THE

KEY PLAN

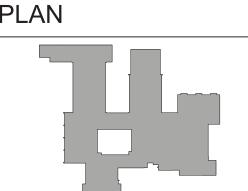



Geddis

Architecture. Planning. Interiors

71 Old Post Road P.O. Box 1020 Southport, CT 06890 (203) 256-8700



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259 Water Street Suite 1L Warren, RI 02885 USA +1 401-289-2789

BARILE GALLAGHER & ASSOCIATE

CONSULTING ENGINEERS 39 MARBLE AVE PLEASANTVILLE, NY 10570 914.328.6060 GENERAL@BGA-ENG.com www.BGA-ENG.com

Construction Manager SAVIN ENGINEERS, P.C. 3 Campus Drive

> 914-769-3200 Structural Engineer **ODEH ENGINEERS** 1223 Mineral Spring Ave

Pleasantville, NY 10570

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Acoustic Consultant DP DESIGN 12 Cold Spring Street Providence, RI 401-861-3218

AV Consultant CAVANAUGH TOCCI 327 F Boston Post Road Sudbury, MA 01776-3027

978-443-7871

SED#: 6618-0001-0001-024

PROJECT

Rye City Schools 555 Theodore Fremd Ave, Rye, NY 10580

Osborn Elementary School

10 Osborn Road, Rye NY 10580

CONSTRUCTION IMPLEMENTATION PLAN - GENERAL NOTES & MILESTONE SCHEDULES


SEAL & SIGNATURE DATE: 08/10/2021 PROJECT No:

DRAWING BY: CHK BY: DWG No: CIP-01

OSBORN CIP-1.dwg

STABILIZE ENTIRE PILE WITH -VEGETATION OR COVER SLOPE OR LESS


2. MAXIMUM SLOPE OF STOCKPILE SHALL BE 1:2. 3. UPON COMPLETION OF SOIL STOCKPILING, EACH PILE SHALL BE SURROUNDED WITH

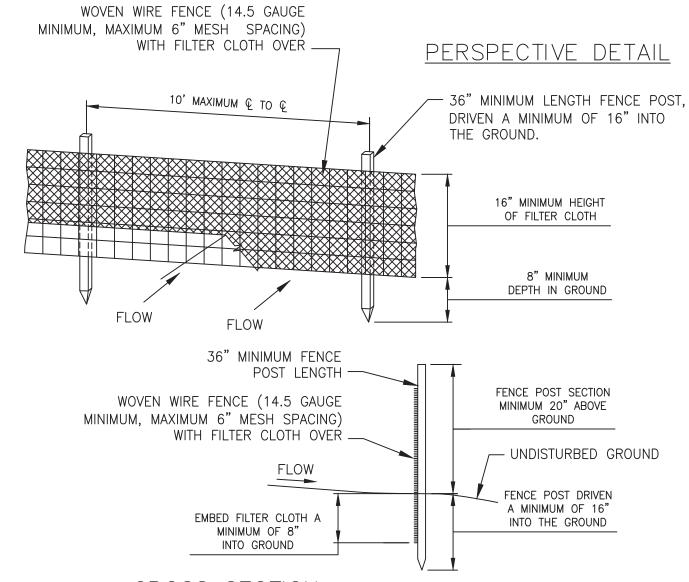

1. WOVEN WIRE FENCE TO BE FASTENED SECURELY TO FENCE POSTS WITH WIRE TIES OR STAPLES. 2. FILTER CLOTH TO BE FASTENED SECURELY TO WOVEN WIRE FENCE WITH TIES SPACED EVERY 24" AT TOP AND MID SECTION. 3. WHEN TWO SECTIONS OF FILTER CLOTH ADJOIN EACH OTHER THEY SHALL BE OVERLAPED BY SIX INCHES AND FOLDED. 4. MAINTENANCE SHALL BE PERFORMED AS NEEDED AND MATERIAL REMOVED WHEN "BULGES" DEVELOP IN THE SILT FENCE. 5. POST: STEEL EITHER "T" OR "U" TYPE OR 2" HARDWOOD

6. FENCE: WOVEN WIRE, 14.5 GAUGE 6" MAXIMUM MESH OPENING FILTER 7. CLOTH: FILTER X, MIRAFI 100X, STABILINKA T140N OR APPROVED EQUAL

> REPRODUCED FROM NEW YORK STANDARDS AND SPECIFICATIONS FOR EROSION AND SEDIMENT CONTROL

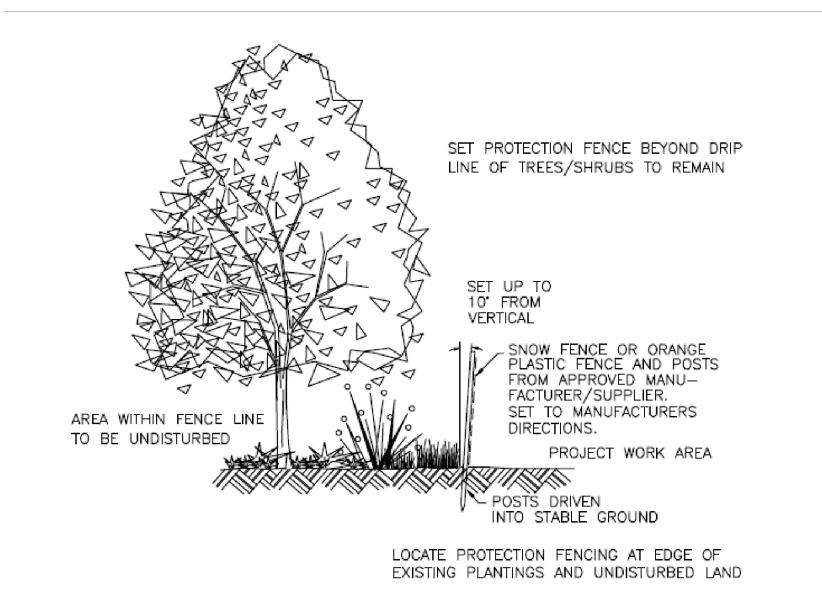

REFER TO CIVIL DRAWINGS FOR TREE PROTECTION

BE PROVIDED BY CONTRACTOR FOR THEIR RESPECTIVE PERSONNEL, INCLUDING ALL SUBCONTRACTORS.

NON-DISRUPTIVE WORK, THE CONTRACTOR SHALL BE ESCORTED BY THE CONSTRUCTION MANAGER.

1. ALL WORK SHALL COMPLY WITH THE STATE EDUCATION DEPARTMENT UNIFORM SAFETY STANDARDS.

3. SHIRTS ARE TO BE WORN AT ALL TIMES AND NO SHORT PANTS ARE PERMITTED.

\$1,000 PER OCCURRENCE.

BANNED FROM THE SITE.

12. NO ASBESTOS CONTAINING PRODUCTS TO BE USED ANYWHERE ON THIS PROJECT. 13. NO LEAD CONTAINING PRODUCTS TO BE USED ANYWHERE ON THIS PROJECT.

FOUNTAINS AND CLASSROOMS BY ANY CONTRACTOR'S PERSONNEL.

NON-DESIGNATED AREAS MAY BE TOWED AT CONTRACTOR'S EXPENSE.

14. PRIOR TO COMMENCEMENT OF WORK THE CONTRACTOR MUST SUBMIT CONSTRUCTION PLANS FOR REVIEW AND APPROVAL. WHICH SHOW THE LOCATION OF EXHAUST, FRESH AIR FANS, HVAC EQUIPMENT, LOUVERS, WINDOWS, DOORS, AND DUST CONTROL THAT WILL BE PROVIDED FOR EACH CONDITION. NOTING THAT WINDOWS AND DOORS ARE TO BE CLEANED ON A DAILY BASIS. 15. DUST CONTROL:

2.PER NYS LAW, SMOKING IS PROHIBITED ANYWHERE ON SCHOOL PROPERTY. VIOLATORS WILL BE SUBJECT TO ARREST AND/OR FINE OF

4. ANY CONTRACTOR'S PERSONNEL USING INAPPROPRIATE LANGUAGE OR WHO IS DISRUPTIVE TO THE SCHOOL ENVIRONMENT WILL BE

6. ANY CONTRACTOR'S PERSONNEL FOUND TO BE UNDER THE INFLUENCE OF ANY CONTROLLED SUBSTANCE OR ALCOHOL WILL BE

7. DURING SCHOOL OCCUPANCY NO DELIVERIES FROM THE CONTRACTOR WILL BE ALLOWED DURING BUS DROP OFF OR PICK UP HOURS

8.USE OF THE EXISTING BUILDING FACILITIES DURING CONSTRUCTION IS PROHIBITED INCLUDING TOILET ROOMS, TELEPHONE AND WATER

9. PARKING IS RESTRICTED TO AREAS DESIGNATED BY THE OWNER AND CONSTRUCTION MANAGER. ANY VEHICLES OR TRUCKS IN

10. SHOULD IT BECOME NECESSARY TO ACCESS THE EXISTING BUILDING DURING CONSTRUCTION HOURS FOR MEASUREMENTS OR OTHER

11. ALL WORKERS MUST WEAR PHOTO IDENTIFICATION BADGES AT ALL TIMES WHILE WORKING AT THE SITE. IDENTIFICATION BADGES MUST

AS DETERMINED BY THE OWNER, RYE CITY SCHOOL DISTRICT BETWEEN THE HOURS OF 7:30 AM TO 8:30 AM AM AND 2:30 PM TO

5. CONTRACTOR'S PERSONNEL SHALL NOT CONVERSE WITH SCHOOL EMPLOYEES, STUDENTS AND OR THE LOCAL RESIDENTS.

- 15.A. THE CONTRACTOR SHALL INSTALL DUST PROTECTION BARRIERS & POLY SHEETING WITH MINIMUM DAMAGE TO ADJACENT SURFACES. THE GENERAL CONTRACTOR IS RESPONSIBLE TO REPAIR ANY DAMAGE TO EXISTING SURFACES CAUSED BY CONSTRUCTION ACTIVITY. 15.A.1. DURING SUMMER MONTHS WHEN BUILDING/SPACES ARE UNOCCUPIED: CONTRACTOR SHALL PROVIDE AND INSTALL. ALL PENETRATIONS INTO THE BUILDING SHALL BE SEALED WITH A MINIMUM OF 6 MIL. POLYETHYLENE SHEETING TO PREVENT DUST CREATED BY DEMOLITION AND CONSTRUCTION ACTIVITY FROM ENTERING THE BUILDINGS. 15.A.2. DURING MONTHS WHEN SCHOOL IS OCCUPIED: ALL PENETRATIONS INTO THE BUILDING SHALL BE SEALED WITH TEMPORARY
- FIRE RATED PARTITIONS AND ACCESS DOORS TO PREVENT THE TRAVEL OF DUST BETWEEN WORK AREAS AND ADJACENT 15.A.3. THE CONTRACTOR IS ADDITIONALLY RESPONSIBLE FOR ALL DEBRIS AND DUST INFILTRATING ADJACENT AND UNDISTURBED AREAS OF AND OR PREVIOUSLY FINISHED AREAS OF THE BUILDING CONTRACTOR WILL PROVIDE FINAL CLEANING OF ALL SURFACES AS REQUIRED AND TO THE SATISFACTION OF THE OWNER AND CM ON A DAILY BASIS, FOR ALL AREAS IMPACTED BY CONSTRUCTION ACTIVITY.
- 15.B. CONTRACTOR SHALL BE RESPONSIBLE FOR MANAGING DUST AND DIRT ON THE EXTERIOR, SITE SHALL BE WATERED DOWN FREQUENTLY TO PREVENT DUST CLOUDS FROM RISING. ALL PAVED AREAS SHALL BE MAINTAINED CLEAN AT THE CONSTRUCTION
- 15.C. CONTRACTOR IS TO USE ONLY GRINDERS WITH VACUUM ATTACHMENTS AT THE WORK SITE AND IS TO CHANGE FILTERS REGULARLY. ALL HVAC EQUIPMENT, LOUVERS, FRESH AIR FANS ETC., ADJACENT TO THE WORK SITE ARE TO BE TURNED OFF AND THEN PROTECTED AND TURNED ON AFTER WORK HAS BEEN COMPLETED. AIR INTAKES ARE TO BE PROTECTED WITH REGULARLY MAINTAINED 3M HEPA FILTERS. WINDOWS, DOORS, AND DOORWAYS ADJACENT TO THE WORK SITE MUST HAVE PLASTIC PROTECTION INSTALLED AND REMOVED AND THE WINDOWS AND DOORS AND ADJACENT AREAS ARE TO BE CLEANED ON A DAILY BASIS. 15.D. ALL SMOKE HEADS AND ANY OTHER PIECES OF EQUIPMENT AND APPARATUS' THAT ARE TO REMAIN ARE TO BE COVERED &
- PROTECTED. IF THEY ARE ACTIVE PIECES OF EQUIPMENT THEN THEY NEED TO BE UNCOVERED AT THE CONCLUSION OF THE DAY'S WORK, RE-COVER THEM AT THE START OF THE WORK DAY. 16. THE CONTRACTOR SHALL BE RESPONSIBLE FOR PROTECTING OWNERS PROPERTY. ALL EXISTING SHRUBS, TREES, LAWN FIXTURES, SCULPTURES AND MISCELLANEOUS EQUIPMENT SHALL BE PROTECTED AT ALL TIMES. ANY REMOVALS OR RELOCATION OF SAID OBJECTS, IF ALLOWED SHALL BE AS DIRECTED BY OWNER AND CONSTRUCTION MANAGER. CONTRACTOR WILL ALSO REPAIR TO SATISFACTION OF

OWNER ALL DISTURBED EXTERIOR SITE AREAS DISTURBED BY CONSTRUCTION, INCLUDING BUT NOT LIMITED TO: LAWNS, PLANTINGS,

TREES, DRAINAGE PIPING, BASINS, MANHOLES, CURBS, SIDEWALKS, PAVEMENTS, ETC.. CONTRACTOR WILL ALSO REPAIR TO THE SATISFACTION OF OWNER ALL BUILDING EXTERIORS AND ROOF AREAS DISTURBED BY CONSTRUCTION ACTIVITIES, PRIOR TO SUBSTANTIAL 17. PAINTING OR OTHER CHEMICAL APPLICATIONS SHALL BE DONE IN THE EXISTING BUILDING ONLY WHEN UNOCCUPIED. STORAGE OF CHEMICALS AND PAINTING SHALL BE OUTSIDE THE EXISTING OR NEW STRUCTURES AND SHALL FOLLOW MANUFACTURER'S STORAGE

18. OXYGEN OR OTHER GAS CONTAINERS SHALL BE PROPERLY STORED AND SECURED PER OSHA REGULATIONS, TO THE SATISFACTION OF THE CONSTRUCTION MANAGER, AND OWNER. FAILURE TO DO SO WILL RESULT IN A \$250 BACK CHARGE, PER OCCURRENCE. THE CONTRACTOR AND TRADE CONTRACTOR IS RESPONSIBLE TO COMPLY WITH ALL OSHA REGULATIONS. GENERAL CONSTRUCTION CONTRACT SHALL SCHEDULE REGULARLY, PROJECT SITES WITH OSHA.

19. THE CONTRACTOR WILL PROVIDE AND MAINTAIN DUMPSTERS AS REQUIRED FOR THE DURATION OF THE PROJECT. THE CONTRACTOR WILL PROVIDE DUMPSTERS FOR ALL OTHER PRIMES AND TRADES TO USE AND PLACE CONSTRUCTION DEBRIS AND RUBBISH WITHIN, FOR DISPOSAL FROM THE SITE FOR THE DURATION OF THE PROJECT.

20. THE CONTRACTOR WILL REPLACE AND MAINTAIN ALL DUMPSTERS AS REQUIRED FOR THE DURATION OF THE PROJECT. THE CONTRACTOR SHALL BE RESPONSIBLE FOR PLACING THEIR OWN MATERIALS, DEBRIS AND RUBBISH IN DUMPSTERS PROVIDED BY THE CONTRACTOR ON A DAILY BASIS. FAILURE TO MAINTAIN A CLEAN WORK AREA AND SITE DAILY, WILL RESULT IN OTHERS PERFORMING THE WORK AND THE CONTRACTOR(S) RESPONSIBLE WILL BE BACK CHARGED FOR ALL ASSOCIATED COSTS INCURRED TO RESTORE A CLEAN WORK AREA AND SITE. THIS MAY BE DONE WITHOUT THE TYPICAL 3-DAY NOTICE TO CONTRACTOR(S). 21. THE CONTRACTOR MUST SEND A QUALIFIED REPRESENTATIVE, KNOWLEDGEABLE IN THE PROJECT AND AUTHORIZED TO MAKE DECISIONS

22. THE CONTRACTOR SHALL COOPERATE WITH THE SCHOOL PRINCIPAL AND CUSTODIAL STAFF IN COORDINATING WORK ACTIVITIES WITHIN THE SCHOOL. HOWEVER, IF ANY ADDITIONAL WORK IS REQUESTED THE CONTRACTOR SHALL NOT PROCEED UNLESS APPROVAL IS RECEIVED FROM THE CONSTRUCTION MANAGER. THE CONTRACTOR WILL NOT BE COMPENSATED FOR ANY ADDITIONAL WORK THAT IS PERFORMED WITHOUT THE CONSTRUCTION MANAGERS APPROVAL. 23. ANY DELIVERIES SENT TO THE SCHOOL WILL NOT BE SIGNED FOR OR UNLOADED BY THE OWNER OR CONSTRUCTION MANAGER. THEY

WILL BE DIRECTED TO THE CONSTRUCTION SITE AND IF NO EMPLOYEE IS ON SITE, THE DELIVERY WILL BE REJECTED, AT THE 24. ALL HOT TAR ROOFING SHALL BE INSTALLED AFTER SCHOOL HOURS OR ON WEEKENDS/HOLIDAYS ONLY. KETTLES SHALL NOT BE LIT UNTIL ALL STUDENTS HAVE LEFT THE BUILDING.

25. THE CONTRACTOR SHALL SUBMIT A TWO WEEK LOOK AHEAD WORK SCHEDULE AT ALL PROJECT MEETINGS, INDICATING WORK DAYS,

WORK HOURS AND MANPOWER ALLOCATION FOR ALL AREAS OF THE CONTRACT WORK. THE CONTRACTOR WILL COORDINATE WITH ALL

OTHER TRADES TO PERFORM THE WORK. CONSTRUCTION MANAGER AND OWNER TO APPROVE ACCESS TO THOSE AREAS SCHEDULED

26. THE CONTRACTOR SHALL PROVIDE, INSTALL AND MAINTAIN THE 8'-0" HIGH TEMP. CONSTRUCTION CHAIN LINK FENCE WITH TOP & BOTTOM RAILS, IN GOOD CONDITION AT ALL TIMES, FOR THE DURATION OF PROJECT. THIS INCLUDES ALL GATES AND LOCKS/CHAINS FOR SECURING SITE AFTER WORK HOURS. THE CONTRACTOR SHALL PROVIDE CONSTRUCTION MANAGER 3 COPIES OF ALL KEYS. THE CONTRACTOR WILL MAINTAIN THE CONSTRUCTION PERIMETER FENCE FOR THE DURATION OF THE PROJECT. AT THE COMPLETION OF

PROJECT OR AT THE DIRECTION OF THE OWNER, THE CONTRACTOR WILL REMOVE THE FENCE FROM THE SITE.

CONTRACTOR ON A REGULAR BASIS TO MAINTAIN SANITARY CONDITIONS.

27. NO STORAGE OF MATERIALS WILL BE PERMITTED WITHIN THE BUILDINGS AT ANY TIME DURING CONSTRUCTION. THE CONTRACTOR MUST PROVIDE EXTERIOR STORAGE CONTAINERS AS REQUIRED FOR MATERIAL & EQUIPMENT STORAGE. IF REQUIRED CONTRACTOR TO HEAT CONTAINERS AS REQUIRED DURING WINTER MONTHS TO MAKE SURE MATERIAL TEMPERATURES ARE PROPERLY MAINTAINED. FINAL LOCATION OF STORAGE CONTAINER SHALL BE BY OWNER AND CONSTRUCTION MANAGER. 28. THE CONTRACTOR SHALL PROVIDE, INSTALL AND MAINTAIN ALL REQUIRED SITE SAFETY SIGNAGE, IN ADDITION TO THOSE SHOWN ON

CIP DWGS FOR DURATION OF PROJECT. 29. THE CONTRACTOR SHALL PROVIDE, INSTALL & MAINTAIN ALL "BLACK" GEOTEXTILE FABRIC, 8'-0" HEIGHT (SILT FENCE) TO EXISTING & TEMPORARY CHAIN LINK FENCE. FABRIC TO BE TIE-WRAPPED TO FENCE SUFFICIENT TO SUPPORT FABRIC THROUGHOUT PROJECT. T CONTRACTOR WILL SUPPLY, INSTALL, AND MAINTAIN ALL ADDITIONAL SILT FENCING, GEOGRID AND TEMP. CONSTRUCTION FENCE AS REQUIRED BY THE OWNER FOR THE DURATION OF THE PROJECT. THE CONTRACTOR WILL REMOVE ALL TEMP. FENCING AT THE PROJECT

31. CONTRACTOR SHALL PROTECT ALL EXISTING ROOFS DURING CONSTRUCTION AND SHALL BE RESPONSIBLE FOR ANY DAMAGE TO ROOFS DURING CONSTRUCTION. THE CONTRACTOR SHALL MAKE ALL REPAIRS TO ANY DAMAGED AREAS, AS REQUIRED BY THE MANUFACTURER

30. CONTRACTOR TO PROVIDE AND SERVICE PORTABLE TOILETS FOR THE DURATION OF CONSTRUCTION. TOILETS TO BE SERVICED BY

32. CONTRACTOR SHALL BE RESPONSIBLE FOR PROVIDING WEATHER TIGHT SEAL PROTECTION OVER ALL ROUGH OPENINGS, INCLUDING WINDOWS AND ROOF OPENINGS. CONTRACTOR TO PROVIDE FOR DURATION OF PROJECT. 33. THE CONTRACTOR SHALL BE RESPONSIBLE FOR CONDUCTING PRE-CONSTRUCTION WALK-THRU'S AND VIDEO TAPING EXISTING

CONDITIONS. MANDATORY WALK-THRU SHALL BE PRE-SCHEDULED THROUGH THE CONSTRUCTION MANAGER AND SHALL HAVE OWNER, CONSTRUCTION MANAGER, CONTRACTOR PRESENT. FAILURE TO DO SO WILL RESULT IN OWNER ARRANGING FOR THESE SERVICES AND BACKCHARGING CONTRACTOR FOR ALL RELATED COSTS. 34. MANUFACTURERS MATERIAL SAFETY DATA SHEETS (MSDS) SHALL BE AVAILABLE AT THE SITE FOR ALL PRODUCTS USED IN THE PROJECT TO BE PROVIDED BY THE CONTRACTOR.

35. EGRESS TO BE MAINTAINED AT ALL TIMES DURING CONSTRUCTION. 36. CONTRACTOR SHALL PREPARE CIP DRAWINGS WHICH WILL INDICATE ALL 1-HOUR FIRE RATED TEMPORARY WALLS INCLUDING DUST PARTITIONS AND TEMPORARY CONSTRUCTION FENCES THAT SEPARATE OCCUPIED AREAS FROM AREAS WHERE WORK IS TO BE PERFORMED. THE CIP DRAWINGS SHALL ALSO INDICATE ALL STAGING AREAS INCLUDING LOCATION OF TRAILERS, STORAGE CONTAINERS AND SERVICEABLE TOILETS. FINAL LOCATIONS OF TEMPORARY WALLS, DUST PARTITIONS, TEMPORARY FENCES, STORAGE CONTAINERS AND SERVICEABLE TOILETS SHALL BE REVIEWED WITH THE OWNER AND CONSTRUCTION MANAGER PRIOR TO INSTALLATION.

PROVIDED BY ELECTRICAL CONTRACTOR. 38. BECAUSE OF THE CLOSE PROXIMITY OF THE CONSTRUCTION AREA TO THE EXISTING SCHOOL, ALL EQUIPMENT THAT PRODUCE ENGINE EXHAUST (I.E. VIA COMBUSTION ENGINES, ETC.) SHALL BE PERMANENTLY OUTFITTED WITH GAS OR DIESEL EXHAUST SCRUBBERS FOR THE DURATION OF THE WORK. IF AT ANY TIME THERE IS EQUIPMENT OPERATING WITHOUT THESE DEVICES IN PROPER FUNCTIONAL ORDER THE CONTRACTOR WILL BE FINED \$500 PER INSTANCE. FOR DELIVERIES, ENGINES CAN RUN/OPERATE FOR 5 MINUTES (SAME GUIDELINES AS BUSES) THAN NEED TO BE TURNED OFF. FOR EQUIPMENT SUCH AS CONCRETE PUMPERS THAT COME TO THE SITE INTERMITTENTLY. THEY SHALL BE REQUIRED TO OPERATE AS FAR AWAY FROM THE BUILDING AS POSSIBLE, IF THIS EFFORT IS NOT UNDERTAKEN EACH AND EVERY TIME UNDER ANY CIRCUMSTANCE, THEY SHALL BE DIRECTED TO LEAVE THE SITE IMMEDIATELY.

37. TEMPORARY OWNER'S TRAILER TO BE PROVIDED UNDER THE CONTRACT FOR GENERAL CONSTRUCTION. POWER FOR TRAILER TO BE

39. BECAUSE OF THE CLOSE PROXIMITY OF THE CONSTRUCTION AREA TO THE EXISTING SCHOOL, ALL EQUIPMENT SHALL HAVE MUFFLERS AND/OR NOISE INHIBITING PARAPHERNALIA EMPLOYED SO AS TO MINIMIZE OR CANCEL OUT NOISE. NOTE THAT THE MAXIMUM ALLOWABLE NOISE LEVEL ALLOWED BY THE SED IS 60DB.

WINTER CONDITION NOTES

1. ALL CONTRACTORS ARE TO TAKE NECESSARY MEASURES FOR SAFETY PRECAUTIONS.

2. GENERAL CONTRACTOR SHALL BE RESPONSIBLE FOR SNOW REMOVAL AND APPLICATION OF ROAD SALT AS REQUIRED.

5. WRAPPING OF BUILDING FOR PROTECTION FROM AND HEATING AGAINST COLD WEATHER, SEE TEMPORARY FACILITIES SPECS.

3. GENERAL CONTRACTOR TO PROVIDE WEEKLY WEATHER FORECASTS WITH THEIR TWO WEEK LOOK-AHEADS DURING COLD WEATHER MONTHS. 4. PROTECTION AND HEATING OF CONCRETE WORK, SEE TEMPORARY FACILITIES SPECS.

MIN. SLOPE _STRAWBALES OR SILTFENCE __/

INSTALLATION NOTES:


1. AREA CHOSEN FOR STOCKPILING OPERATIONS SHALL BE DRY AND STABLE. EITHER SILT FENCING OR STRAWBALES, THEN STABILIZED WITH VEGETATION OR COVERED.

NOT TO SCALE

CROSS SECTION

CONSTRUCTION NOTES FOR FABRICATED SILT FENCE

8. PREFABRICATED UNIT: GEOFAB. ENVIROFENCE, OR APPROVED EQUAL.

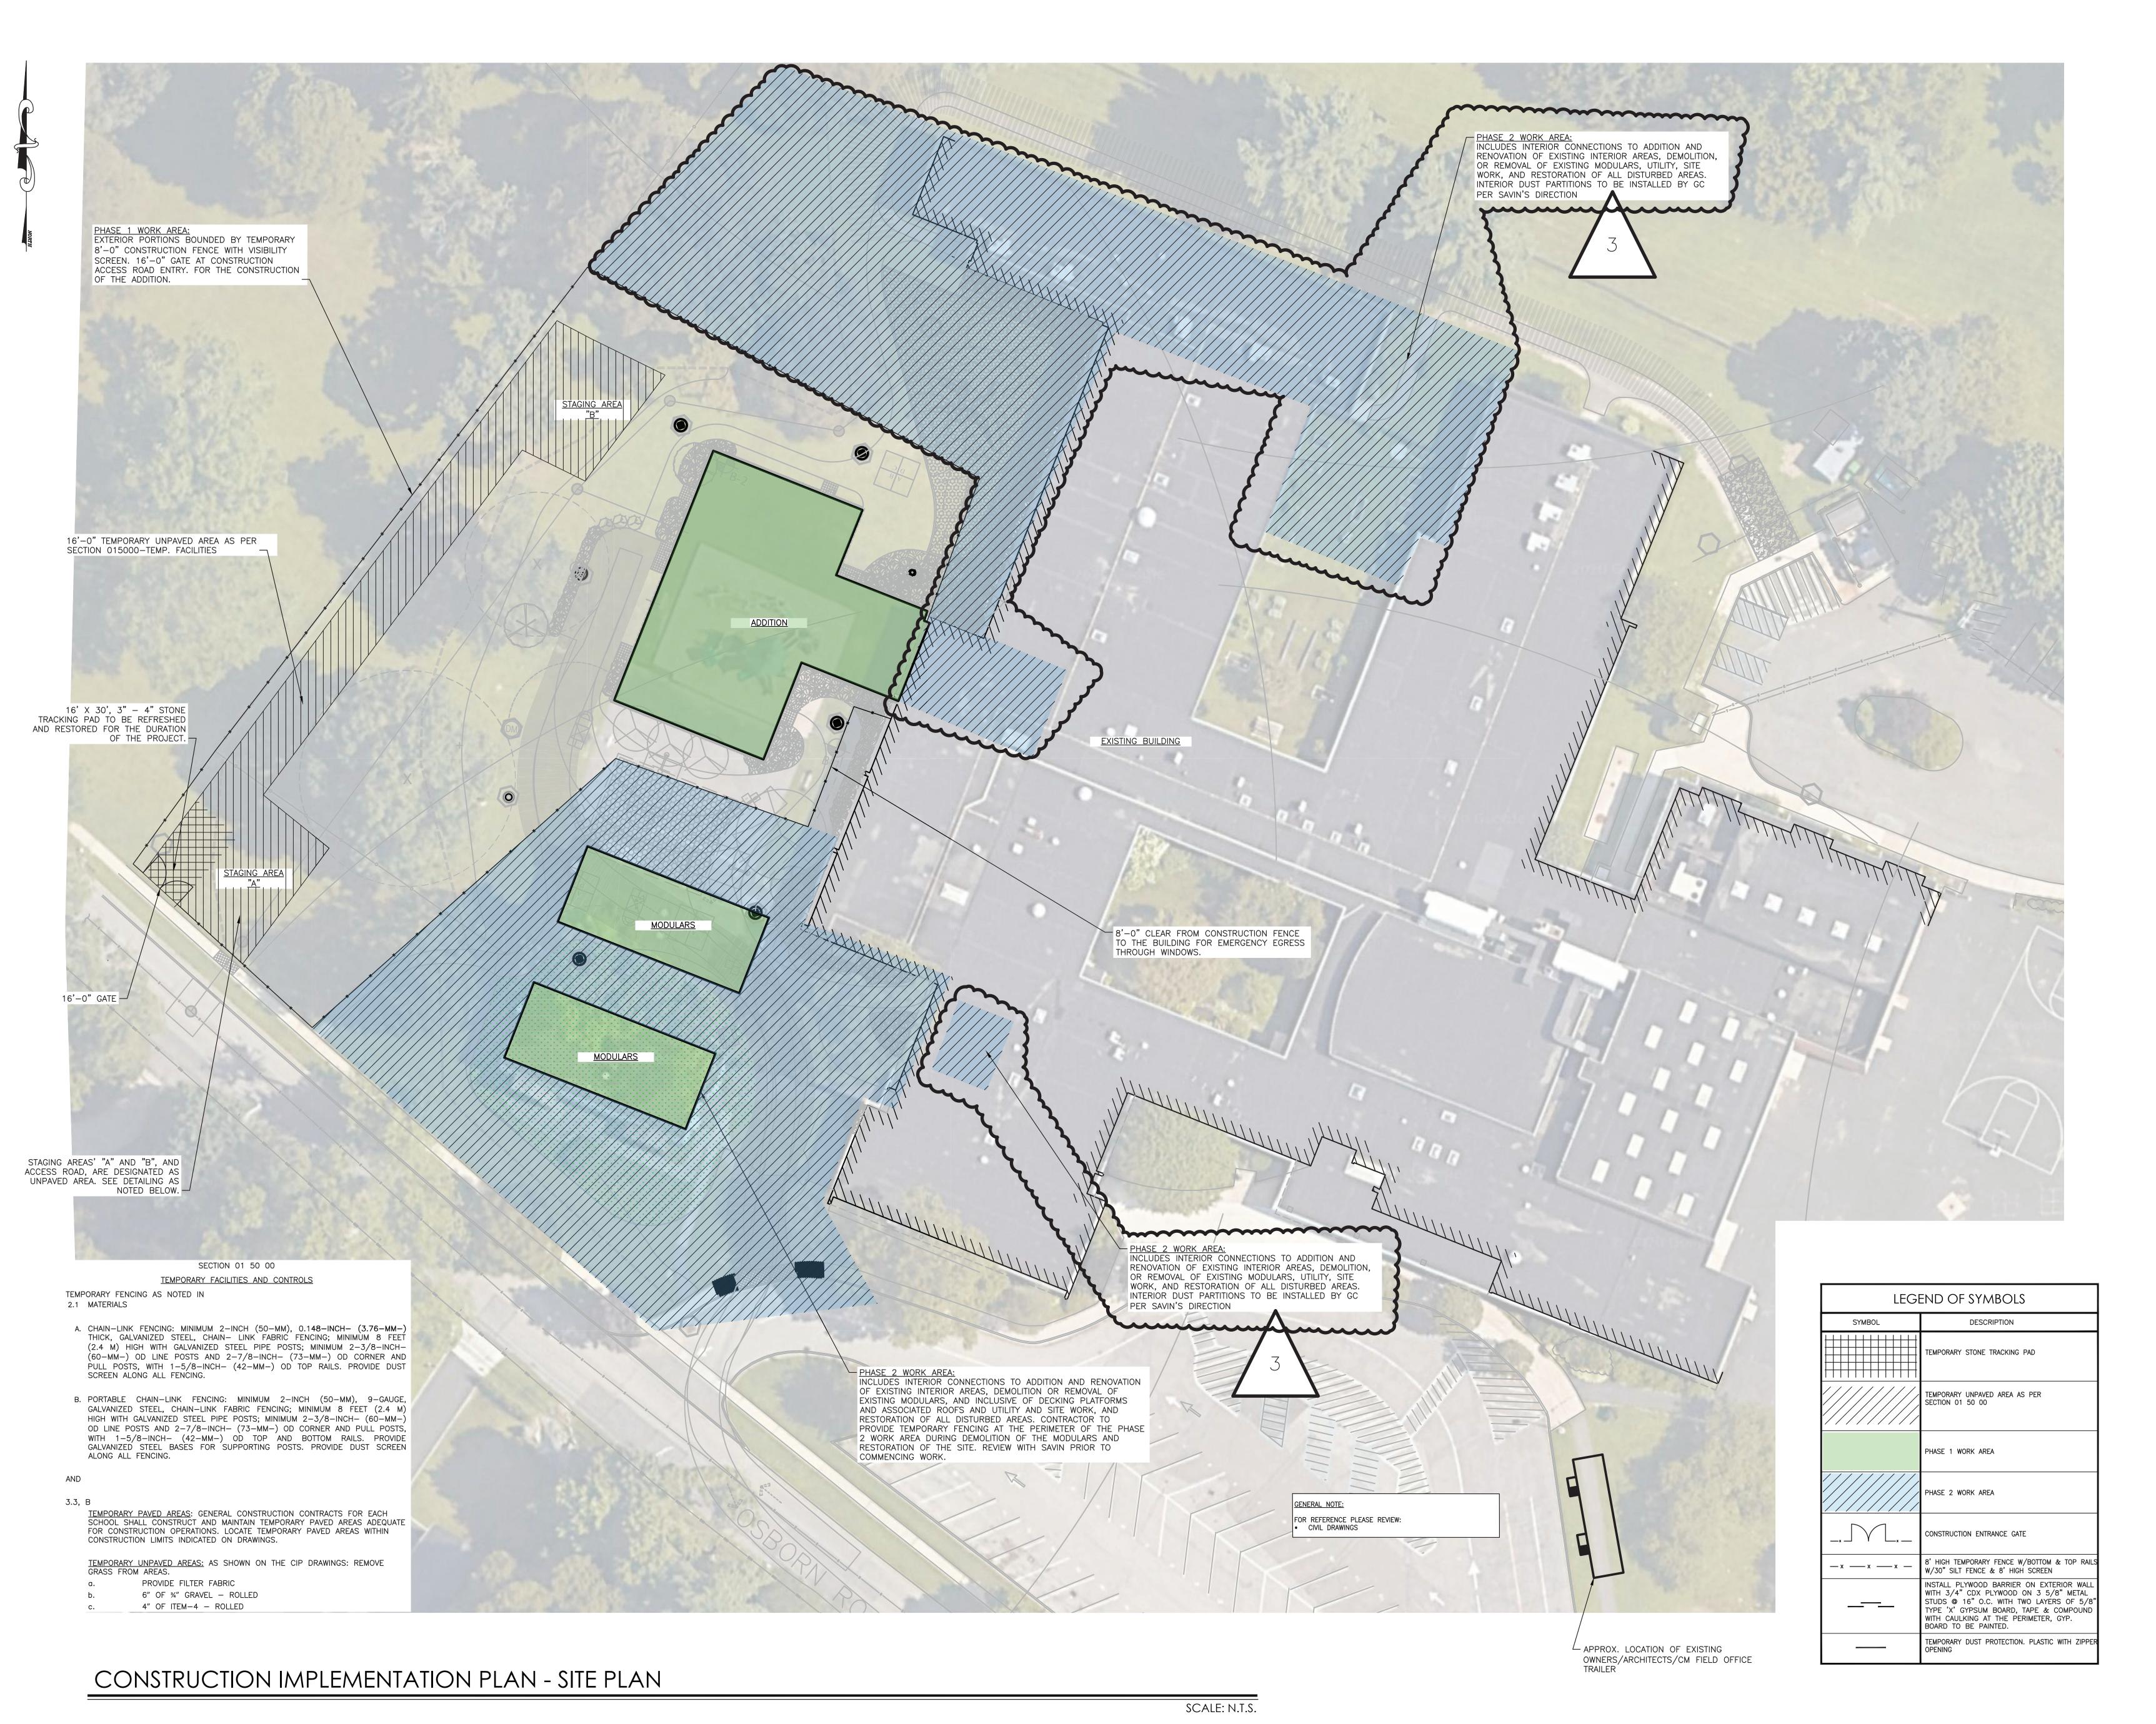

 Revision Schedule


 No.
 Description
 Date

 1
 SED SUBMISSION
 9/15/2020

 2
 ISSUED FOR BID
 8/10/2021

 ADDENDUM No. 2
 8/18/2021

KEY PLAN

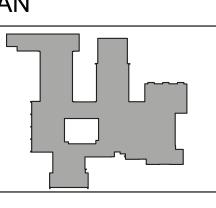



Geddis Architects

Architecture. Planning. Interiors

71 Old Post Road P.O. Box 1020 Southport, CT 06890 (203) 256-8700



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259 Water Street Suite 1L Warren , RI 02885 USA +1 401-289-2789



CONSULTING ENGINEERS
39 MARBLE AVE PLEASANTVILLE, NY 10570
914.328.6060 GENERAL@BGA-ENG.com www.BGA-ENG.com

Construction Manager SAVIN ENGINEERS, P.C. 3 Campus Drive

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1223 Mineral Spring Ave
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SED#: 6618-0001-0001-024

PROJECT

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Osborn Elementary School

10 Osborn Road, Rye NY 10580


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Scale:		Date:	
l			##########

CONSTRUCTION IMPLEMENTATION PLAN - EXISTING CONDITIONS & DEMOLITION PLAN

SEAL & SIGNATURE DATE: 08/10/202

PROJECT No:
DRAWING BY:
CHK BY:
DWG No:
CIP-02

OSBORN_CIP-2.dwg

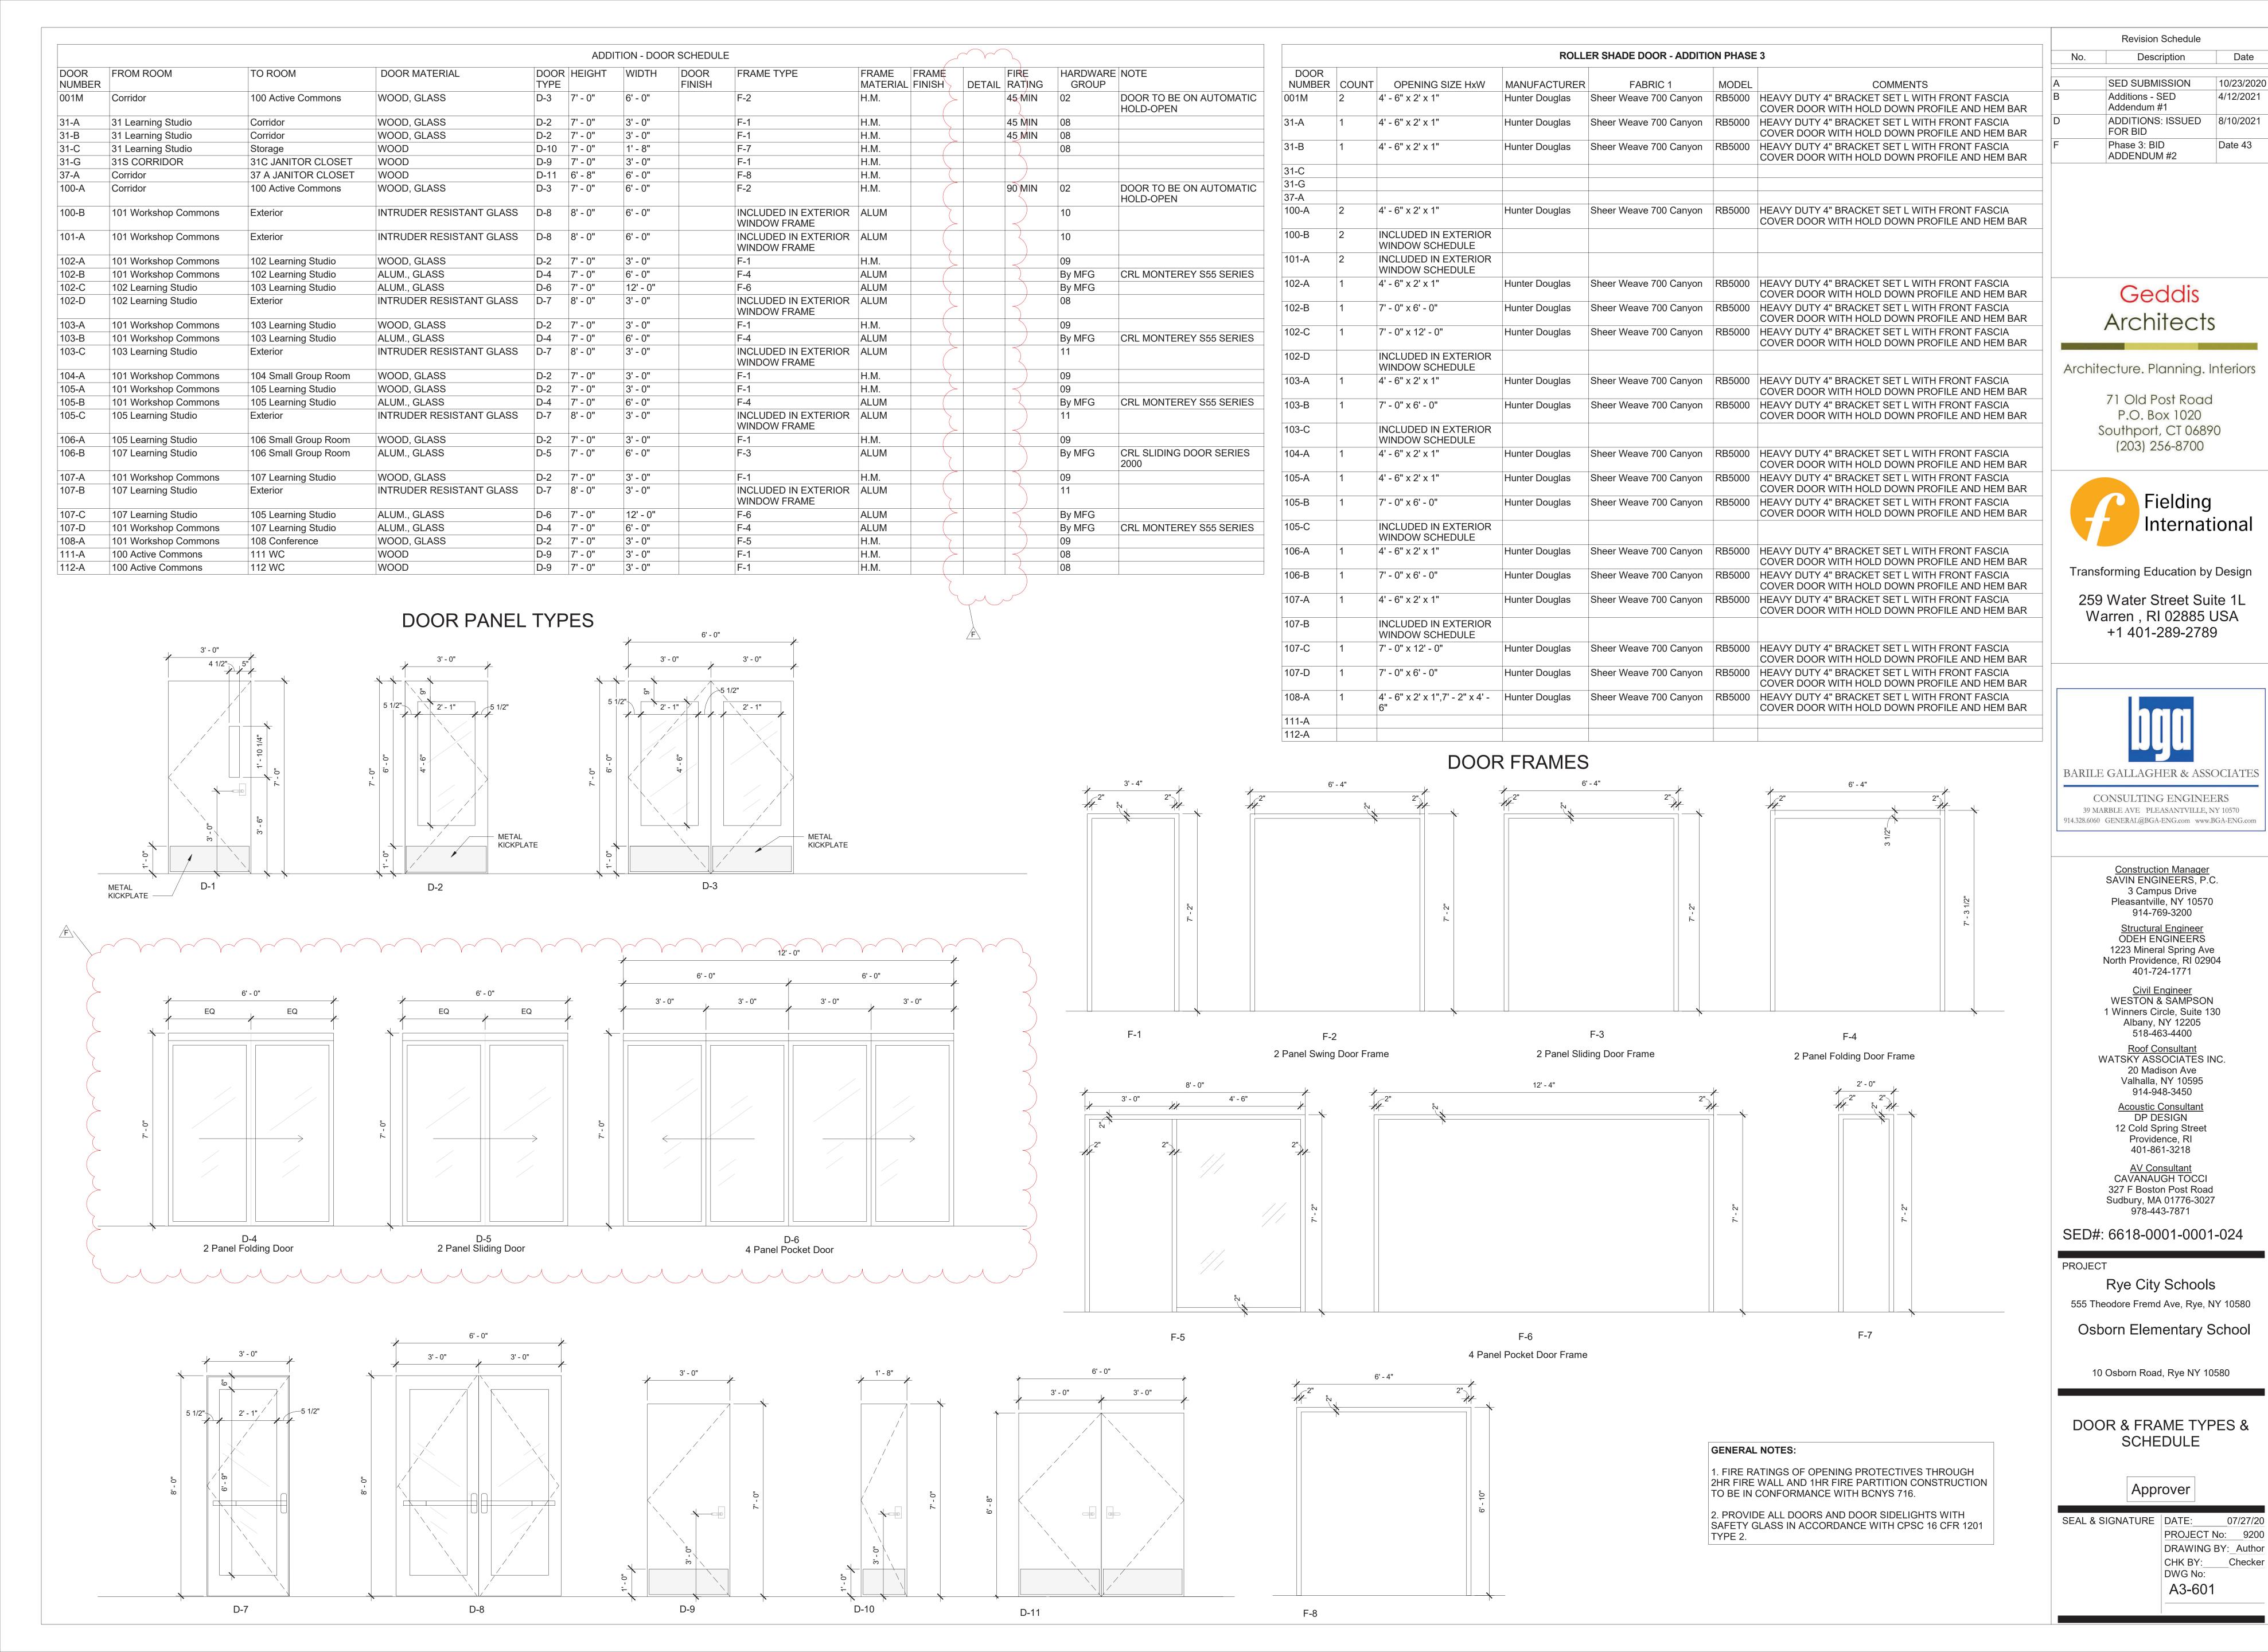


Date

10/23/2020

4/12/2021

8/10/2021

Date 43

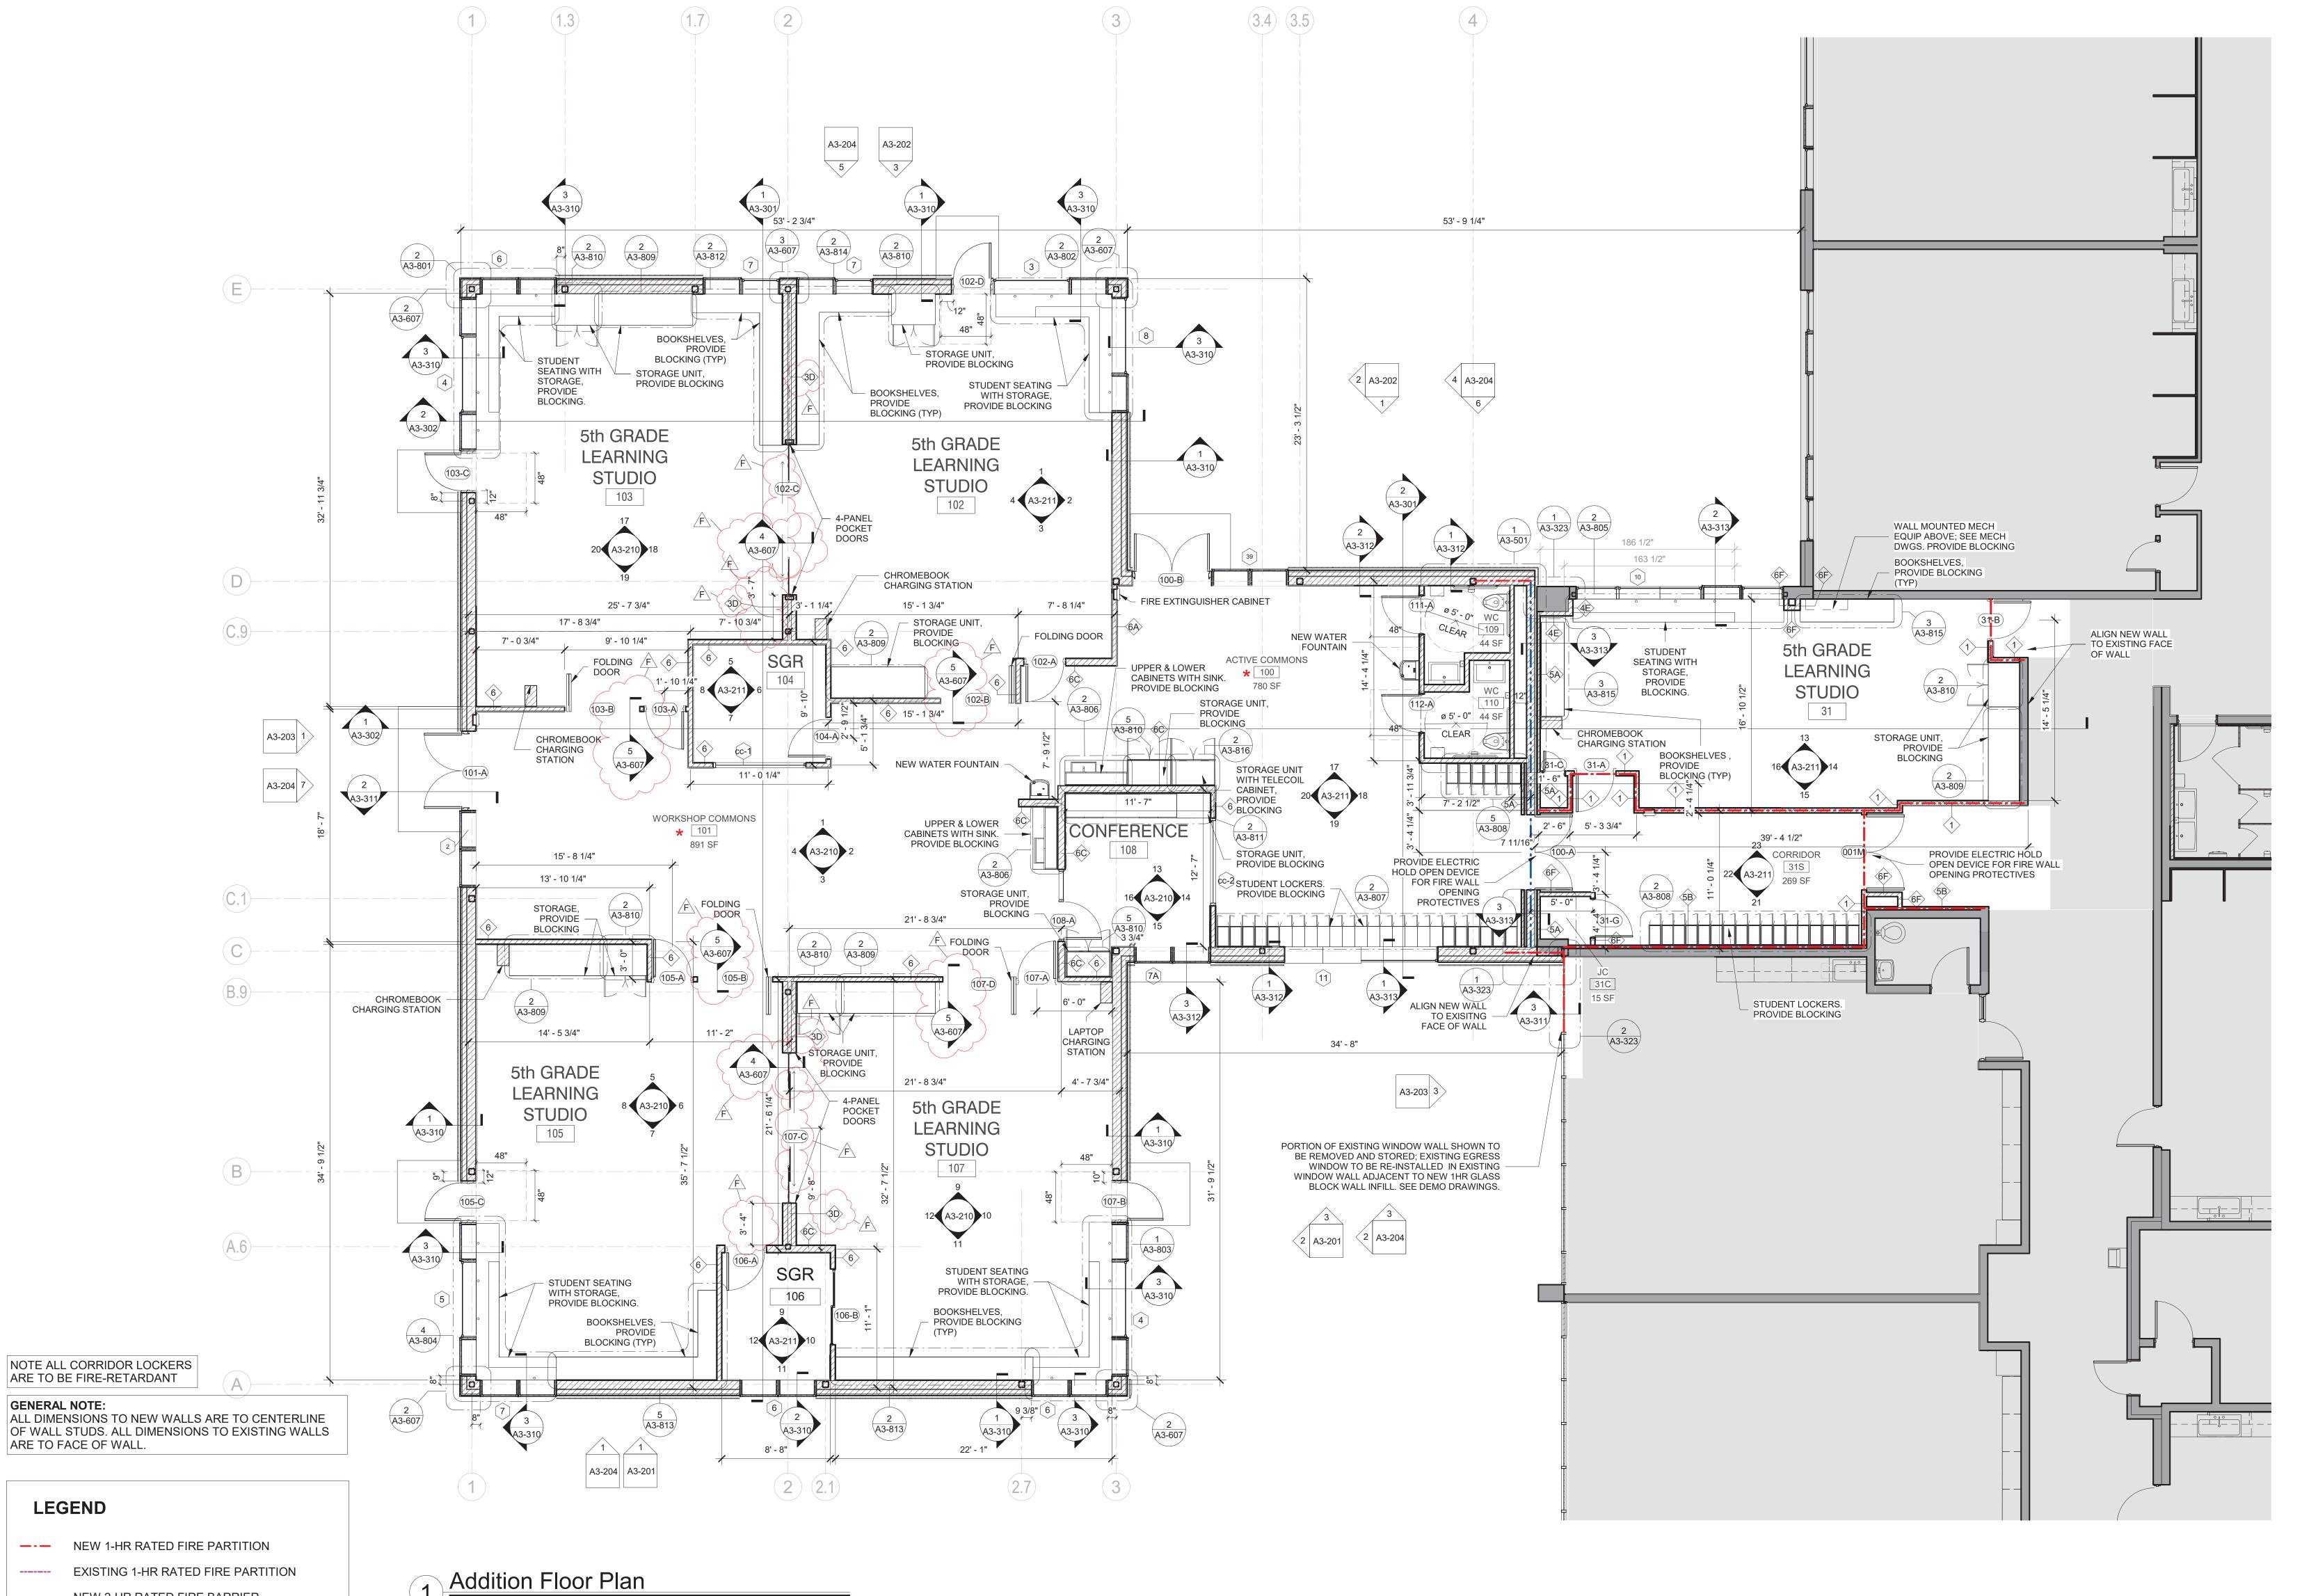

LEGEND

ARE TO FACE OF WALL.

NOTE ALL CORRIDOR LOCKERS

ARE TO BE FIRE-RETARDANT

GENERAL NOTE:

NEW 1-HR RATED FIRE PARTITION

EXISTING 1-HR RATED FIRE PARTITION NEW 2-HR RATED FIRE BARRIER

—— EXISTING 2-HR RATED FIRE BARRIER

NEW 2-HR RATED FIRE WALL


____ EXISTING 2-HR RATED FIRE WALL

NOTE: SEE DRAWING A3-300 FOR WALL TYPES

STEAM NOTE

★ THE ACTIVE COMMONS AND WORKSHOP COMMONS ARE INTENDED TO BE USED FOR **STEAM** RELATED ACTIVITIES. THE LAYOUT ALLOWS FOR DIRECT ACCESS FROM THE COMMONS SPACES FROM THE 4 ADJACENT NEW CLASSROOMS.

Addition Floor Plan

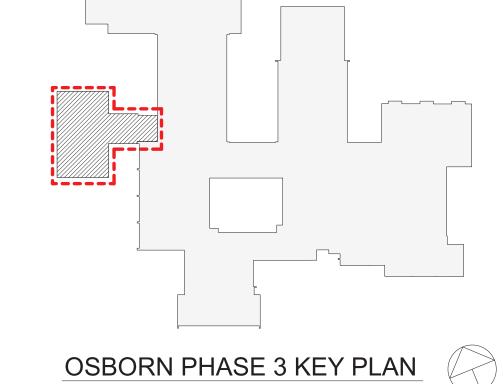

Geddis **Architects** Architecture. Planning. Interiors 71 Old Post Road P.O. Box 1020

Revision Schedule

Description

10/23/2020 4/12/2021

Date 30

6/28/2021

8/10/2021

8/16/2021

Date 43

SED SUBMISSION

Addition Pre-Bidding -

ADDITIONS: ISSUED

Additions - SED Addendum #1

Additions - SED

Addendum #3

Rev C

FOR BID

Phase 3: BID

Phase 3: BID

ADDENDUM #1

ADDENDUM #2



Southport, CT 06890

Transforming Education by Design

259 Water Street Suite 1L Warren, RI 02885 USA +1 401-289-2789



CONSULTING ENGINEERS 39 MARBLE AVE PLEASANTVILLE, NY 10570 914.328.6060 GENERAL@BGA-ENG.com www.BGA-ENG.com

> Construction Manager SAVIN ENGINEERS, P.C. 3 Campus Drive Pleasantville, NY 10570 914-769-3200

Structural Engineer
ODEH ENGINEERS 1223 Mineral Spring Ave North Providence, RI 02904

<u>Civil Engineer</u> WESTON & SAMPSON 1 Winners Circle, Suite 130 Albany, NY 12205 518-463-4400

401-724-1771

Roof Consultant WATSKY ASSOCIATES INC. 20 Madison Ave Valhalla, NY 10595

914-948-3450 Acoustic Consultant DP DESIGN 12 Cold Spring Street Providence, RI 401-861-3218

AV Consultant CAVANAUGH TOCCI 327 F Boston Post Road Sudbury, MA 01776-3027 978-443-7871

SED#: 6618-0001-0001-024

PROJECT

Rye City Schools

555 Theodore Fremd Ave, Rye, NY 10580 Osborn Elementary School


10 Osborn Road, Rye NY 10580


ADDITION FLOOR PLAN

Approver

SEAL & SIGNATURE | DATE: PROJECT No: 9200 DRAWING BY: Author CHK BY: Checker

DWG No: A3-120

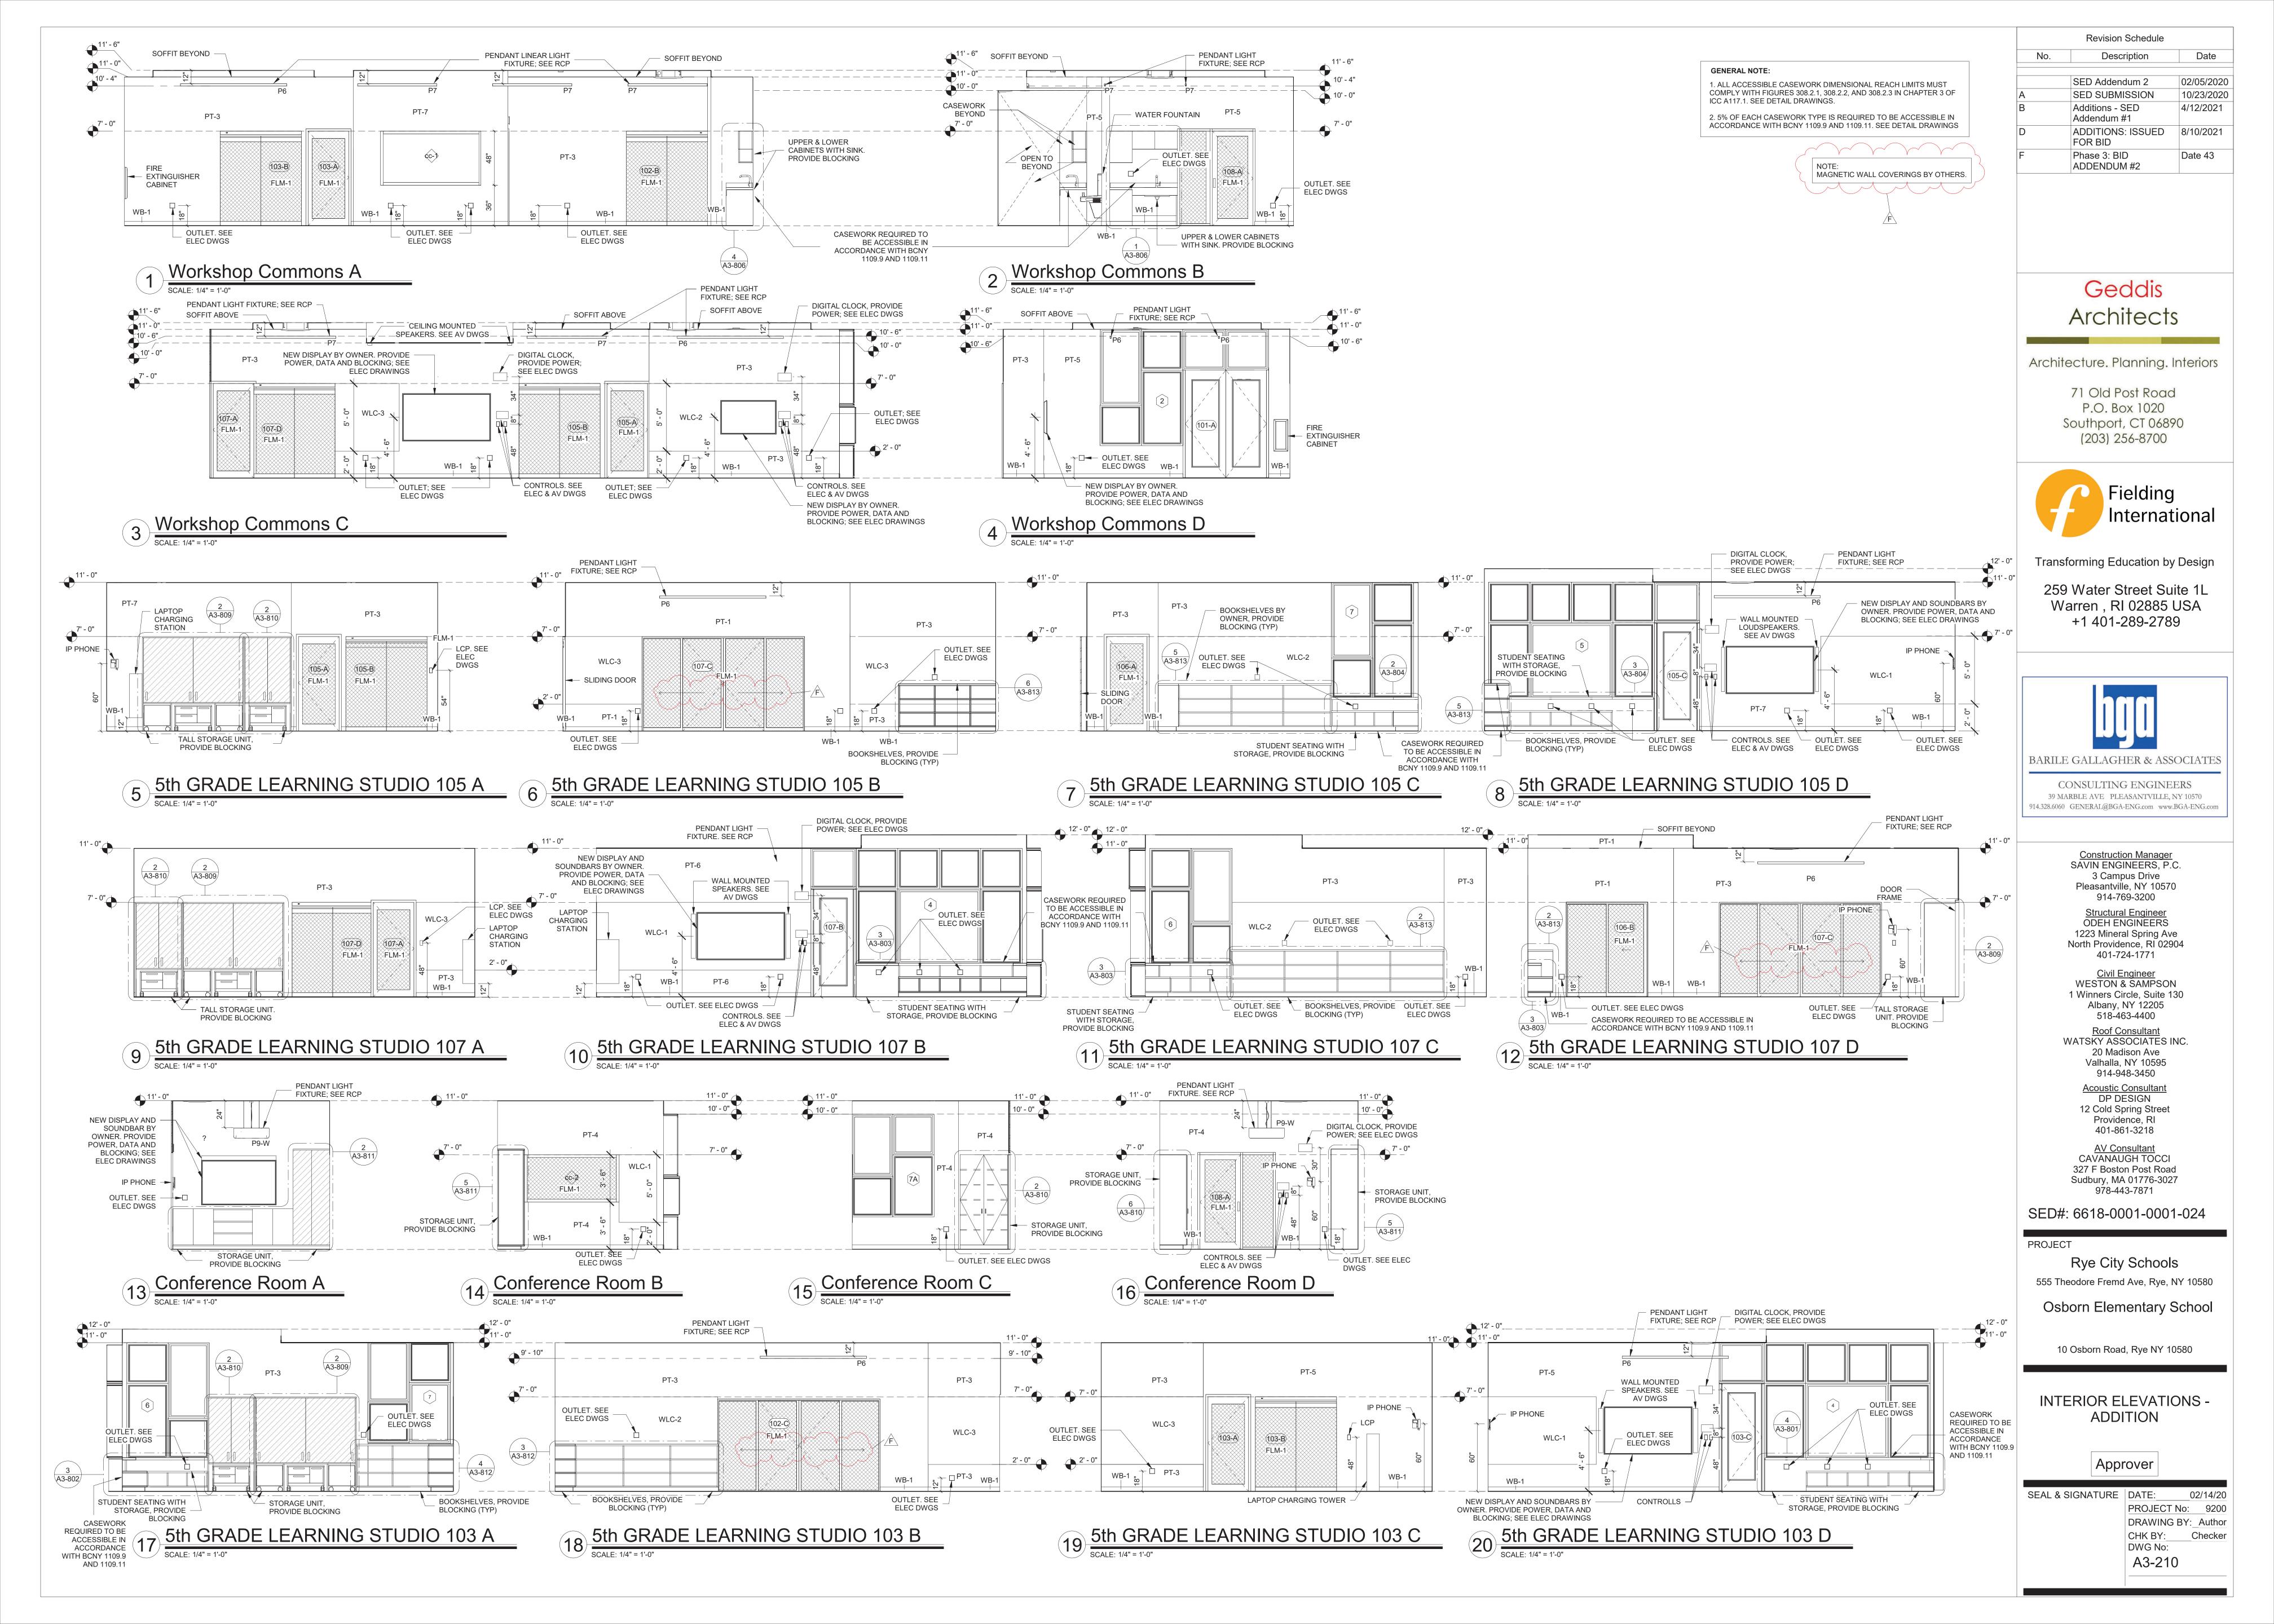

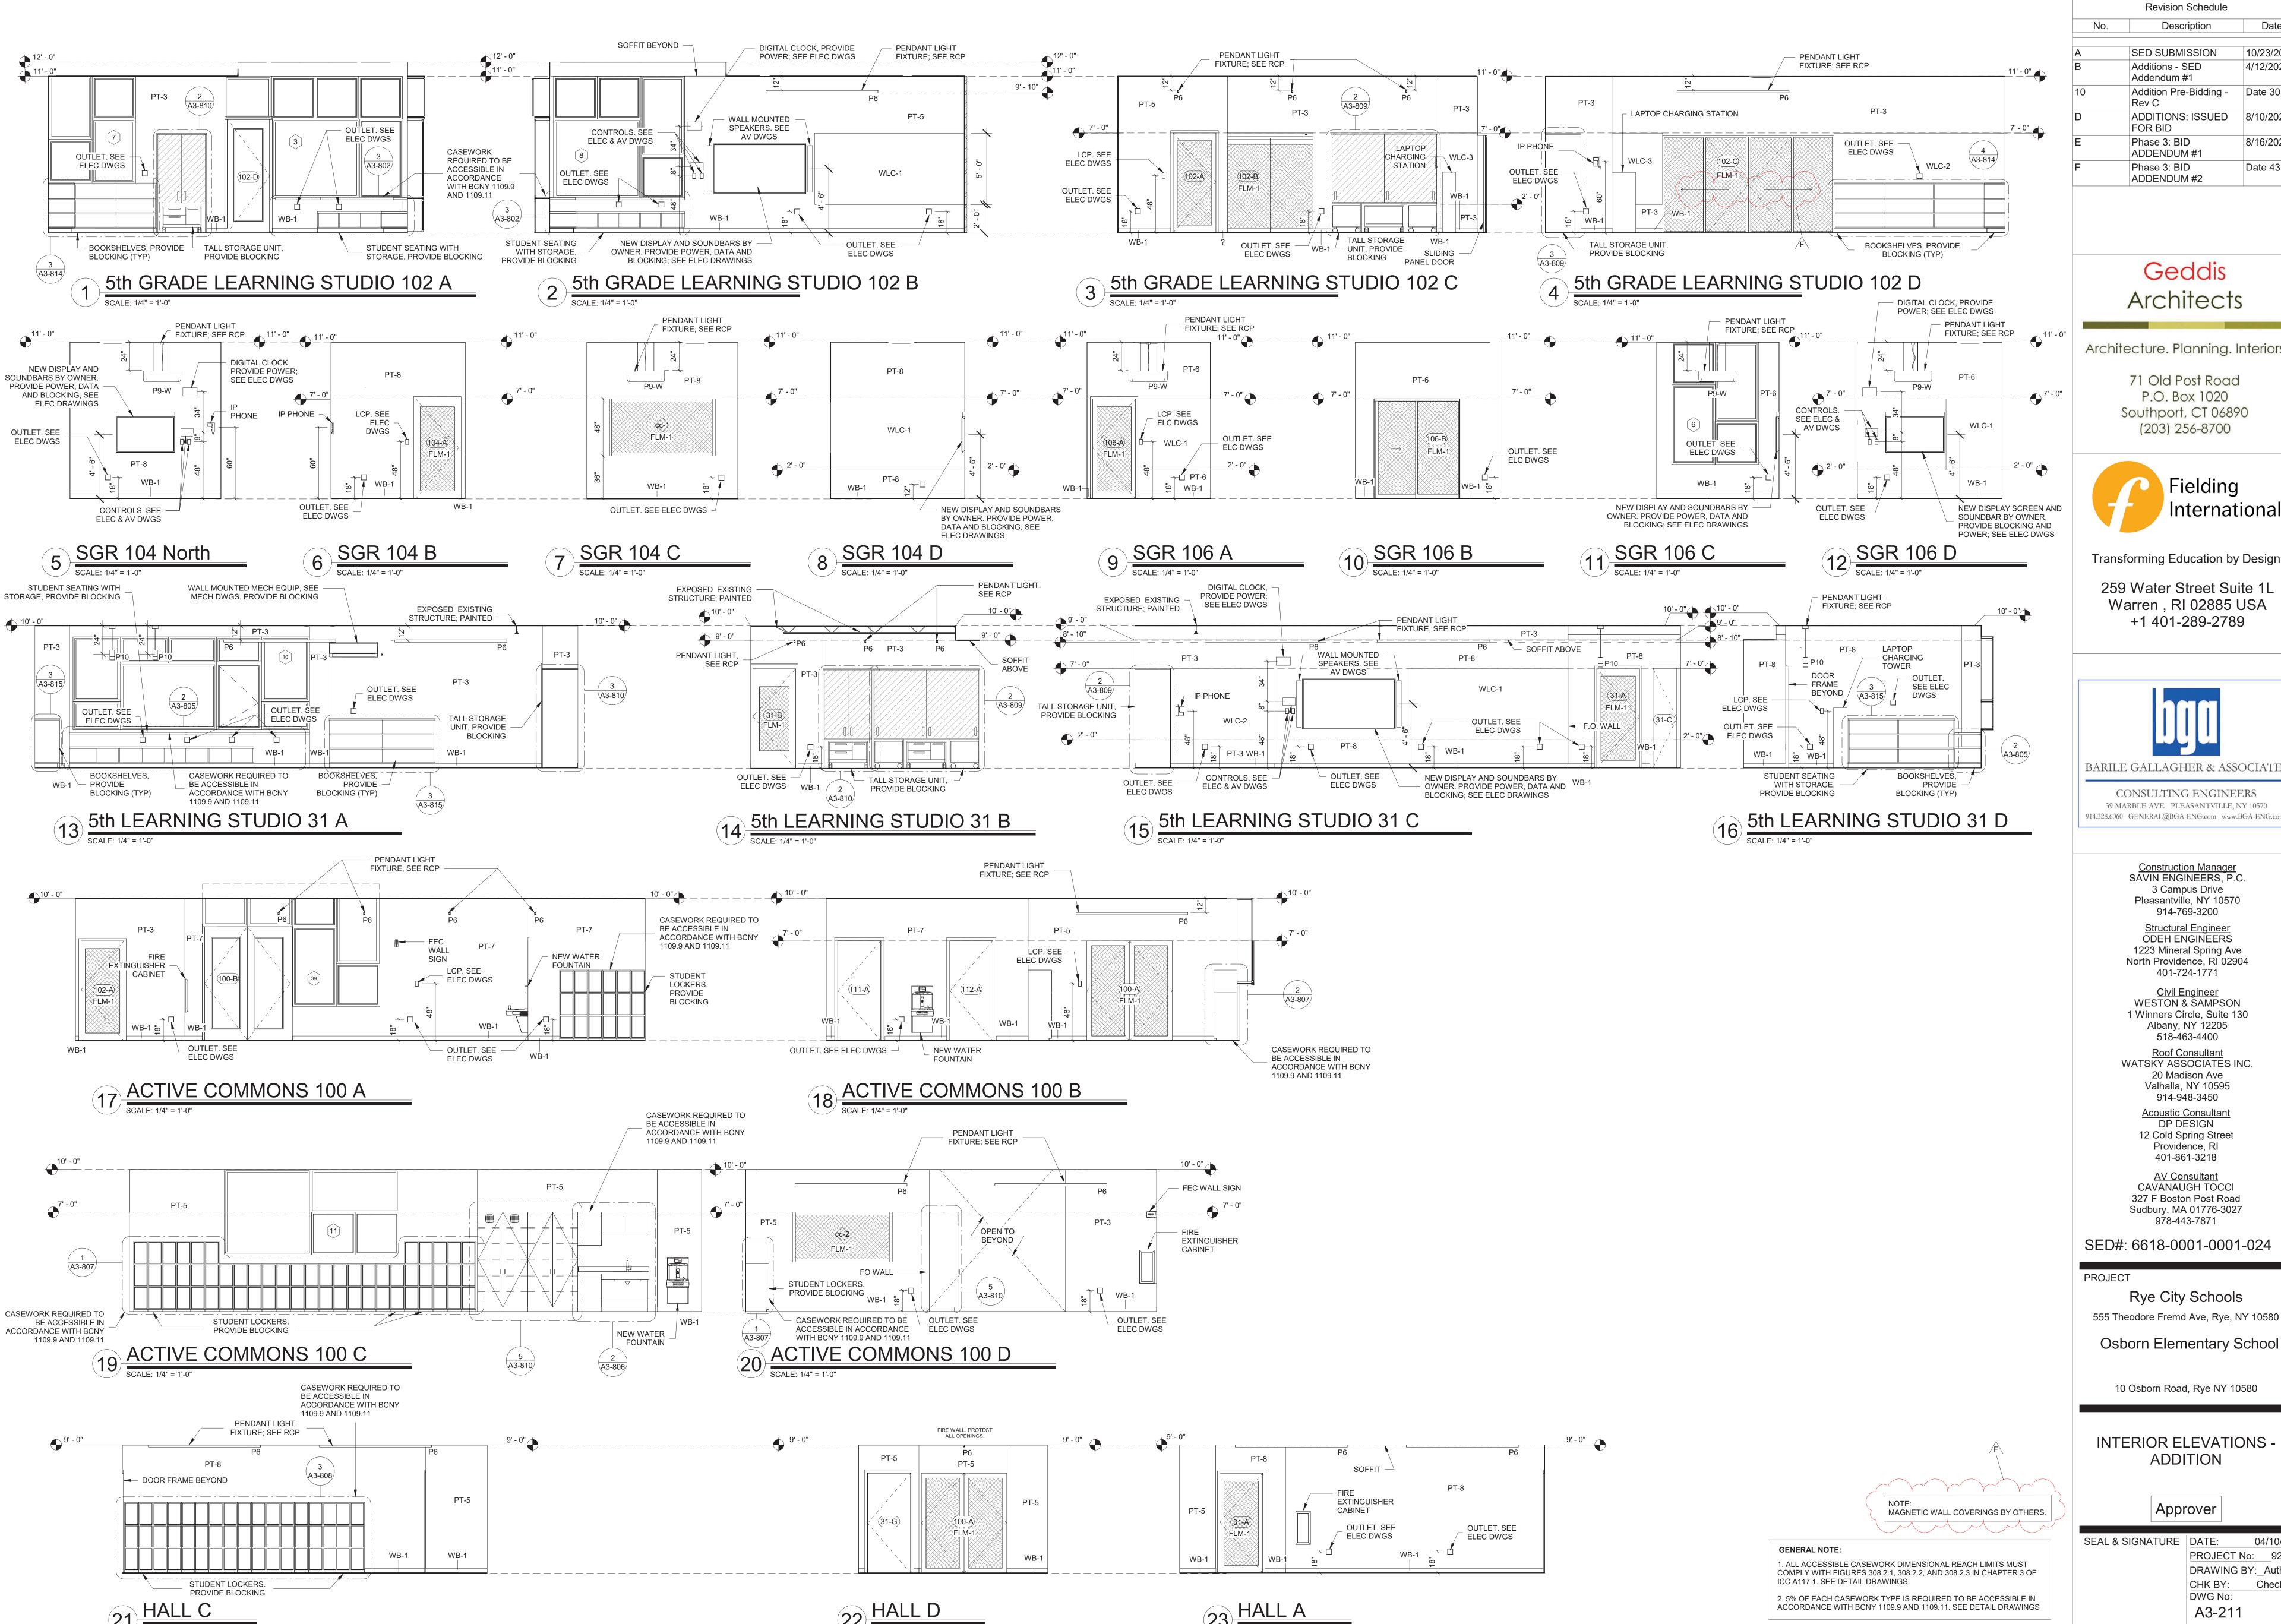

Revision Schedule Date Description 10/23/2020 SED SUBMISSION 4/12/2021 Additions - SED Addendum #1 Addition Pre-Bidding -Date 30 Rev C ADDITIONS: ISSUED 8/10/2021 FOR BID 8/16/2021 Phase 3: BID **ADDENDUM #1** Phase 3: BID Date 43

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BARILE GALLAGHER & ASSOCIATES

CONSULTING ENGINEERS 39 MARBLE AVE PLEASANTVILLE, NY 10570 014.328.6060 GENERAL@BGA-ENG.com www.BGA-ENG.com

> Construction Manager SAVIN ENGINEERS, P.C. 3 Campus Drive Pleasantville, NY 10570 914-769-3200

Structural Engineer
ODEH ENGINEERS

1223 Mineral Spring Ave North Providence, RI 02904 401-724-1771

<u>Civil Engineer</u> WESTON & SAMPSON 1 Winners Circle, Suite 130 Albany, NY 12205 518-463-4400

Roof Consultant WATSKY ASSOCIATES INC 20 Madison Ave

Valhalla, NY 10595 914-948-3450 Acoustic Consultant DP DESIGN 12 Cold Spring Street

Providence, RI 401-861-3218 AV Consultant **CAVANAUGH TOCCI**

Sudbury, MA 01776-3027 978-443-7871

SED#: 6618-0001-0001-024

Rye City Schools

555 Theodore Fremd Ave, Rye, NY 10580

10 Osborn Road, Rye NY 10580


INTERIOR ELEVATIONS -

ADDITION

Approver

SEAL & SIGNATURE | DATE: PROJECT No: 9200 DRAWING BY: Author CHK BY: Checker DWG No:

A3-211

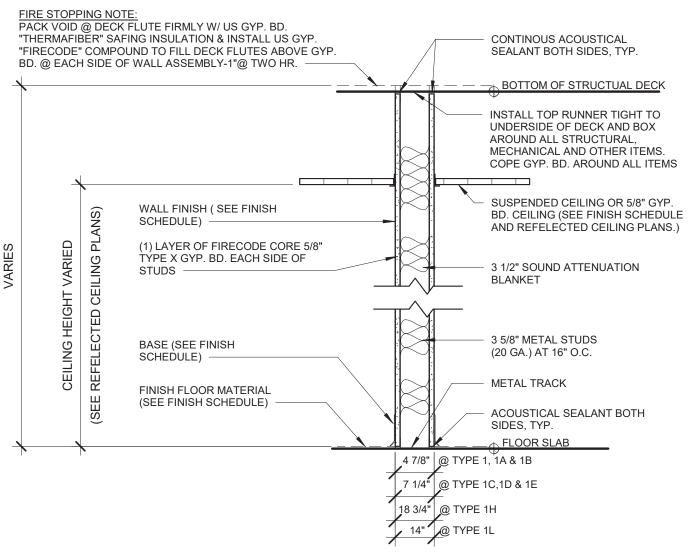

ONE HOUR RATED PARTITION

- 1 3 5/8" METAL STUDS AT 16" O.C. GYPSUM BOARD TYPE "X" EACH SIDE (1 HOUR RATED UL DESIGN # U419) WITH 49 STC RATING
- SIMILAR TO 1 WITH 5/8" CEMENT BOARD IN LIEU OF GYP. BD. ON TOILET SIDE (1 HOUR RATED UL DESIGN # U433)
- 1B SIMILAR TO 1 WITH 5/8" CEMENT BOARD EACH SIDE
- 6" METAL STUDS AT 16" O.C. GYPSUM BOARD EACH SIDE (1 HOUR RATED UL DESIGN # U419) WITH 56 STC RATING
- SIMILAR TO 1C WITH 5/8" CEMENT BOARD IN LIEU OF GYP. BD. ON TOILET SIDE (1 HOUR RATED UL DESIGN # U433)

BOTTOM OF STRUCTUAL DECK

CONTINUOUS USG J-RUNNER OR

EQUAL TOP, BOTTOM @ WALL

- FASTENERS @ 24" OC MAX

USG C-H STUD OR EQUAL

— 1" GYP LINER PANEL

FLOOR SLAB

2-LAYERS 5/8" TYPE X GYP. BD.

— 1" GYP. LINER PANELS

SHAFT WALL PARTITION

GYPSUM BOARD AND 1" GYP LINER PANELS

(UL DESIGN # U438)

2 HR RATED SHAFTS REQUIRED FOR BUILDINGS OVER 4 STORIES

5 2-HR. RATED SHAFT WALL: 2 1/2" CH STUDS AT 16" O.C. 2 LAYERS TYPE X

5A NON-RATED SHAFT WALL: SIMILAR TO 5 WITH 1 LAYER 5/8" GYPSUM BOARD

5B 1HR SHAFT WALL: SIMILAR TO 5 WITH 1 LAYER 5/8" GYPSUM BOARD

____ 2 1/2" 25 GA. C-H STUDS @ 24" O.C.

MINERAL WOOL INSULATION

USG J-RUNNER AT UNDERSIDE OF

STRUCTURE, FLOOR OR WALL

- SIMILAR TO 1C WITH 5/8" CEMENT BOARD IN LIEU OF GYP. BD. ON EACH SIDE (1 HOUR RATED UL DESIGN # U433)
- 1F SIMILAR TO 1 WITH 5/8" GYPSUM BOARD ON ONE SIDE
- SIMILAR TO 1 WITH 2 LAYERS TYPE "X" GYP. BD. EACH SIDE (UL DESIGN # U419) WITH 52 STC RATING
- 1H 3 5/8" METAL STUDS AT 16" O.C. GYPSUM BOARD TYPE "X" EACH SIDE (UL DESIGN # U419) WITH 49 STC RATING
- 3 5/8" METAL STUDS AT 16" O.C. GYPSUM BOARD TYPE "X" EACH SIDE (UL DESIGN # U419) WITH 49 STC RATING

FIRE RATED SEALANT

2 LAYERS TYPE 'X' GWB PANELS ----

FIRE RESISTANT SEALANT


FASTENERS AS REQ'D —


FIRE STOPPING NOTE:
PACK VOID @ DECK FLUTE FIRMLY W/ US GYP. BD.

"THERMAFIBER" SAFING INSULATION & INSTALL US GYP.

BD. @ EACH SIDE OF WALL ASSEMBLY-1"@ TWO HR. —

"FIRECODE" COMPOUND TO FILL DECK FLUTES ABOVE GYP.

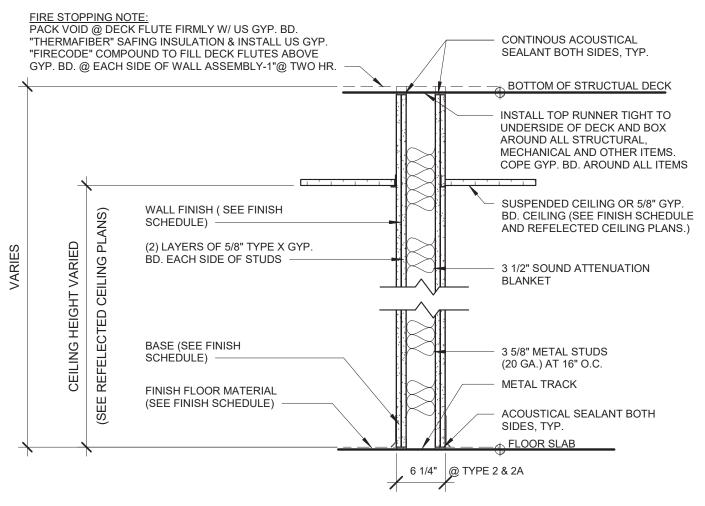

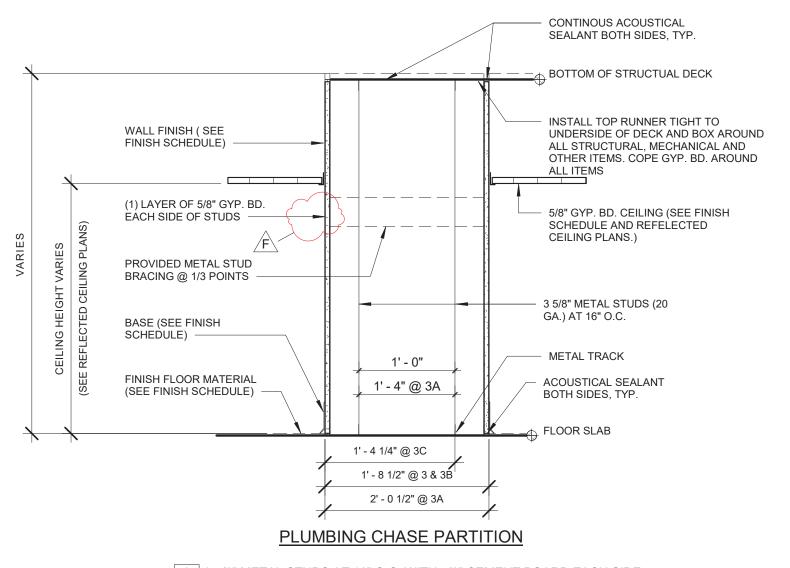

- 3 3 5/8" METAL STUDS AT 16" O.C. WITH 5/8" CEMENT BOARD EACH SIDE
- 3A 3 5/8" METAL STUDS AT 16" O.C. WITH 5/8" CEMENT BOARD EACH SIDE
- 3B SIMILAR TO 3 WITH 5/8 GYPSUM BOARD EACH SIDE

FIRE STOPPING NOTE:

PACK VOID @ DECK FLUTE FIRMLY W/ US GYP. BD.

"THERMAFIBER" SAFING INSULATION & INSTALL US GYP.

GYP. BD. @ EACH SIDE OF WALL ASSEMBLY-1"@ TWO HR.

SCHEDULE) -

WALL FINISH (SEE FINISH

(1) LAYER OF 5/8" ABUSE

EACH SIDE OF STUDS -

BASE (SEE FINISH

FINISH FLOOR MATERIAL

(SEE FINISH SCHEDULE)

SCHEDULE) -

RESISTANT TYPE XP GYP. BD.

"FIRECODE" COMPOUND TO FILL DECK FLUTES ABOVE

- SIMILAR TO 3 WITH 5/8 CEMENT BOARD ON TOILET SIDE, CHASE AGAINST EXISTING WALL
- 3D SIMILAR TO 3 WITH (1) LAYER 5/8 GYPSUM BOARD EACH SIDE AND MINERAL WOOL BATT INSULATION

- CONTINOUS ACOUSTICAL

SEALANT BOTH SIDES, TYP.

★ BOTTOM OF STRUCTUAL DECK

INSTALL TOP RUNNER TIGHT TO

UNDERSIDE OF DECK AND BOX

MECHANICAL AND OTHER ITEMS.

COPE GYP. BD. AROUND ALL ITEMS

SUSPENDED CEILING OR 5/8" GYP.

3 1/2" SOUND ATTENUATION

ACOUSTICAL SEALANT BOTH

3 5/8" METAL STUDS

(20 GA.) AT 16" O.C.

FLOOR SLAB

- METAL TRACK

SIDES, TYP.

5 1/8" @ TYPE 7

BULLET RESISTANT PARTITION


7 1 HR. RATED - 3 5/8" METAL STUDS AT 16" O.C 1 LAYERS TYPE "X" GYP. BD. EACH SIDE (UL DESIGN # 752)

BD. CEILING (SEE FINISH SCHEDULE

AND REFELECTED CEILING PLANS.)

1/4" BULLET RESISTANT FIBERGLASS

AROUND ALL STRUCTURAL,

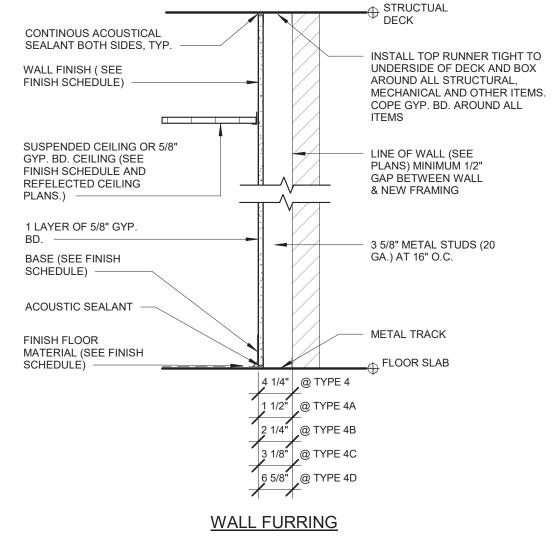

4 <u>3 5/8" METAL STUDS AT 16" O.C.</u>

4C 2 1/2" METAL STUDS AT 16" O.C.

BOTTOM OF

4A 7/8" METAL HAT CHANNELS AT 16" O.C 4B <u>1 5/8" METAL STUDS AT 16" O.C.</u>

CONTINOUS ACOUSTICAL

WALL FINISH (SEE

FINISH SCHEDULE)

SEALANT BOTH SIDES, TYP.

SUSPENDED CEILING OR 5/8"

GYP. BD. CEILING (SEE

FINISH SCHEDULE AND

REFELECTED CEILING

1 LAYER OF 5/8" GYP.

BASE (SEE FINISH

ACOUSTIC SEALANT

MATERIAL (SEE FINISH

SCHEDULE) —

FINISH FLOOR

SCHEDULE) -

4D 6" METAL STUDS AT 16" O.C.

BOTTOM OF

LINE OF WALL (SEE

PLANS) MINIMUM 1/2"

GAP BÉTWEEN WALL

8 1 LAYER 5/8" GYP APPLIED
DIRECTLY OVER EXISTING WALL

& NEW FRAMING

STRUCTUAL

INSTALL TOP RUNNER TIGHT TO

UNDERSIDE OF DECK AND BOX

MECHANICAL AND OTHER ITEMS. COPE GYP. BD. AROUND ALL

AROUND ALL STRUCTURAL,

4E SIMILAR TO TYPE 4 WITH MINERAL WOOL BATT INSUL IN WALL CAVITY

Fielding

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CONSULTING ENGINEERS 39 MARBLE AVE PLEASANTVILLE, NY 10570 914.328.6060 GENERAL@BGA-ENG.com www.BGA-ENG.com

> Construction Manager SAVIN ENGINEERS, P.C 3 Campus Drive Pleasantville, NY 10570

Structural Engineer **ODEH ENGINEERS**

401-724-1771 Civil Engineer **WESTON & SAMPSON** 1 Winners Circle, Suite 130

Roof Consultant

Acoustic Consultant DP DESIGN

401-861-3218 AV Consultant

PROJECT

Rye City Schools

WALL TYPES

Approver

ADDENDUM #2

Revision Schedule

Description

SED SUBMISSION

ADDITIONS: ISSUED

Additions - SED

Addendum #1

Phase 3: BID

FOR BID

Date

10/23/2020

4/12/2021

8/10/2021

Date 43



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CAVANAUGH TOCCI 327 F Boston Post Road Sudbury, MA 01776-3027 978-443-7871

SED#: 6618-0001-0001-024


555 Theodore Fremd Ave, Rye, NY 10580


Osborn Elementary School

10 Osborn Road, Rye NY 10580

SEAL & SIGNATURE DATE:

PROJECT No: 9200 DRAWING BY: Author CHK BY: Checker DWG No: A3-300

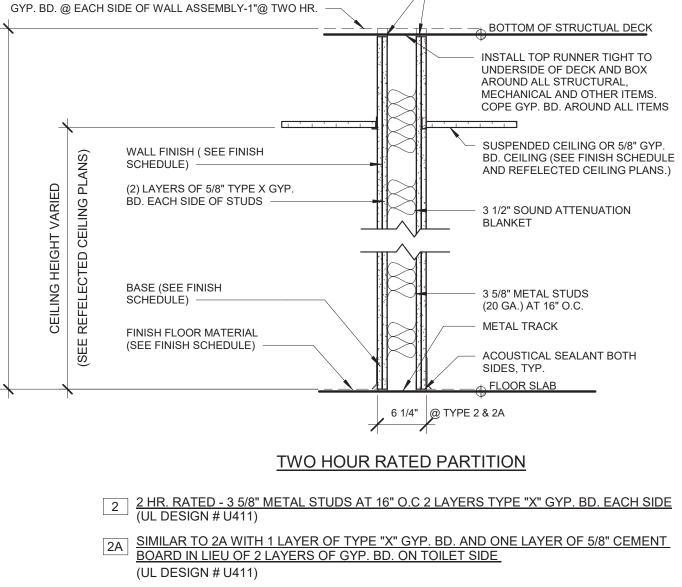


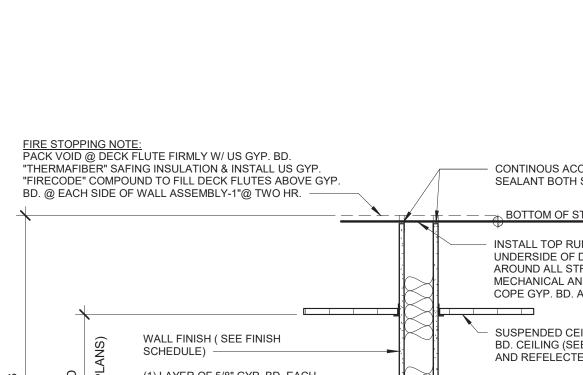

- 6A SIMILAR TO 6 WITH 5/8" CEMENT BOARD IN LIEU OF GYP. BD. ON TOILET SIDE
- 6B SIMILAR TO 6 WITH 5/8" CEMENT BOARD EACH SIDE
- 6D SIMILAR TO 6C WITH 5/8" CEMENT BOARD IN LIEU OF GYP. BD. ON TOILET SIDE

6F SIMILAR TO 6C WITH 5/8" CEMENT BOARD IN LIEU OF GYP. BD. ON EACH SIDE


- 6G SIMILAR TO 6C WITH 5/8" CEMENT ON EITHER SIDE

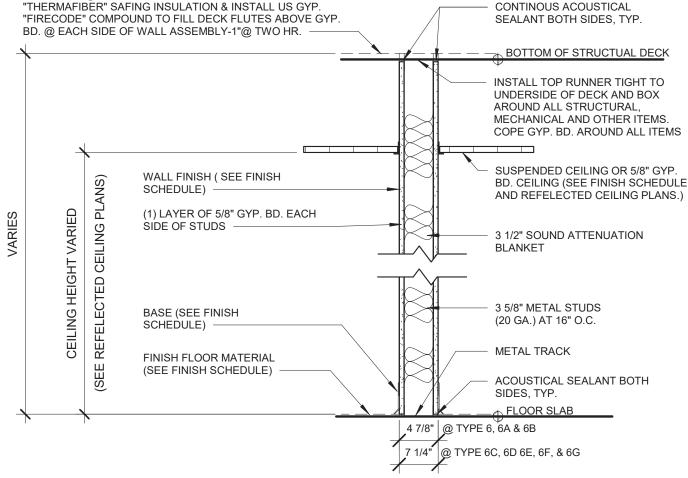

NON-RATED PARTITION

- 6 3 5/8" METAL STUDS AT 16" O.C. GYPSUM BOARD EACH SIDE

- 6C 6" METAL STUDS AT 16" O.C. GYPSUM BOARD EACH SIDE
- 6F SIMILAR TO 6 WITH 5/8" GYPSUM BOARD ONLY ON EXTERIOR SIDE
- 6H SIMILAR TO 6F WITH 5/8" CEMENT BOARD IN LIEU OF GYP. BD.

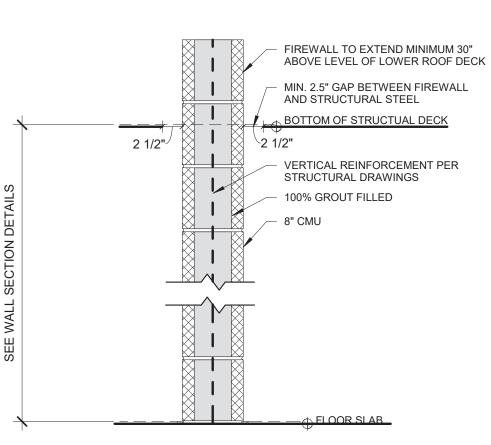


9 NON-LOADBEARING 2HR CMU FIREWALL

FIRE WALL NOTES:

1. 2HR FIRE WALL TO BE COMPLIANT WITH BCNYS 706. 2. PER BCNYS 703.7, PRIOR TO INSTALLATION OF CEILINGS AND ADDITIONAL NON-RATED PARTITIONS, MARK ALL AREAS OF FIRE WALL THAT WILL BE CONCEALED IN MIN. 3" LETTERING: "FIREWALL. PROTECT

ALL OPENINGS." 3. SEE WALL SECTION DETAIL 3/A3-313

4. REFER TO STRUCTURAL DRAWINGS FOR REINFORCING DETAILS.

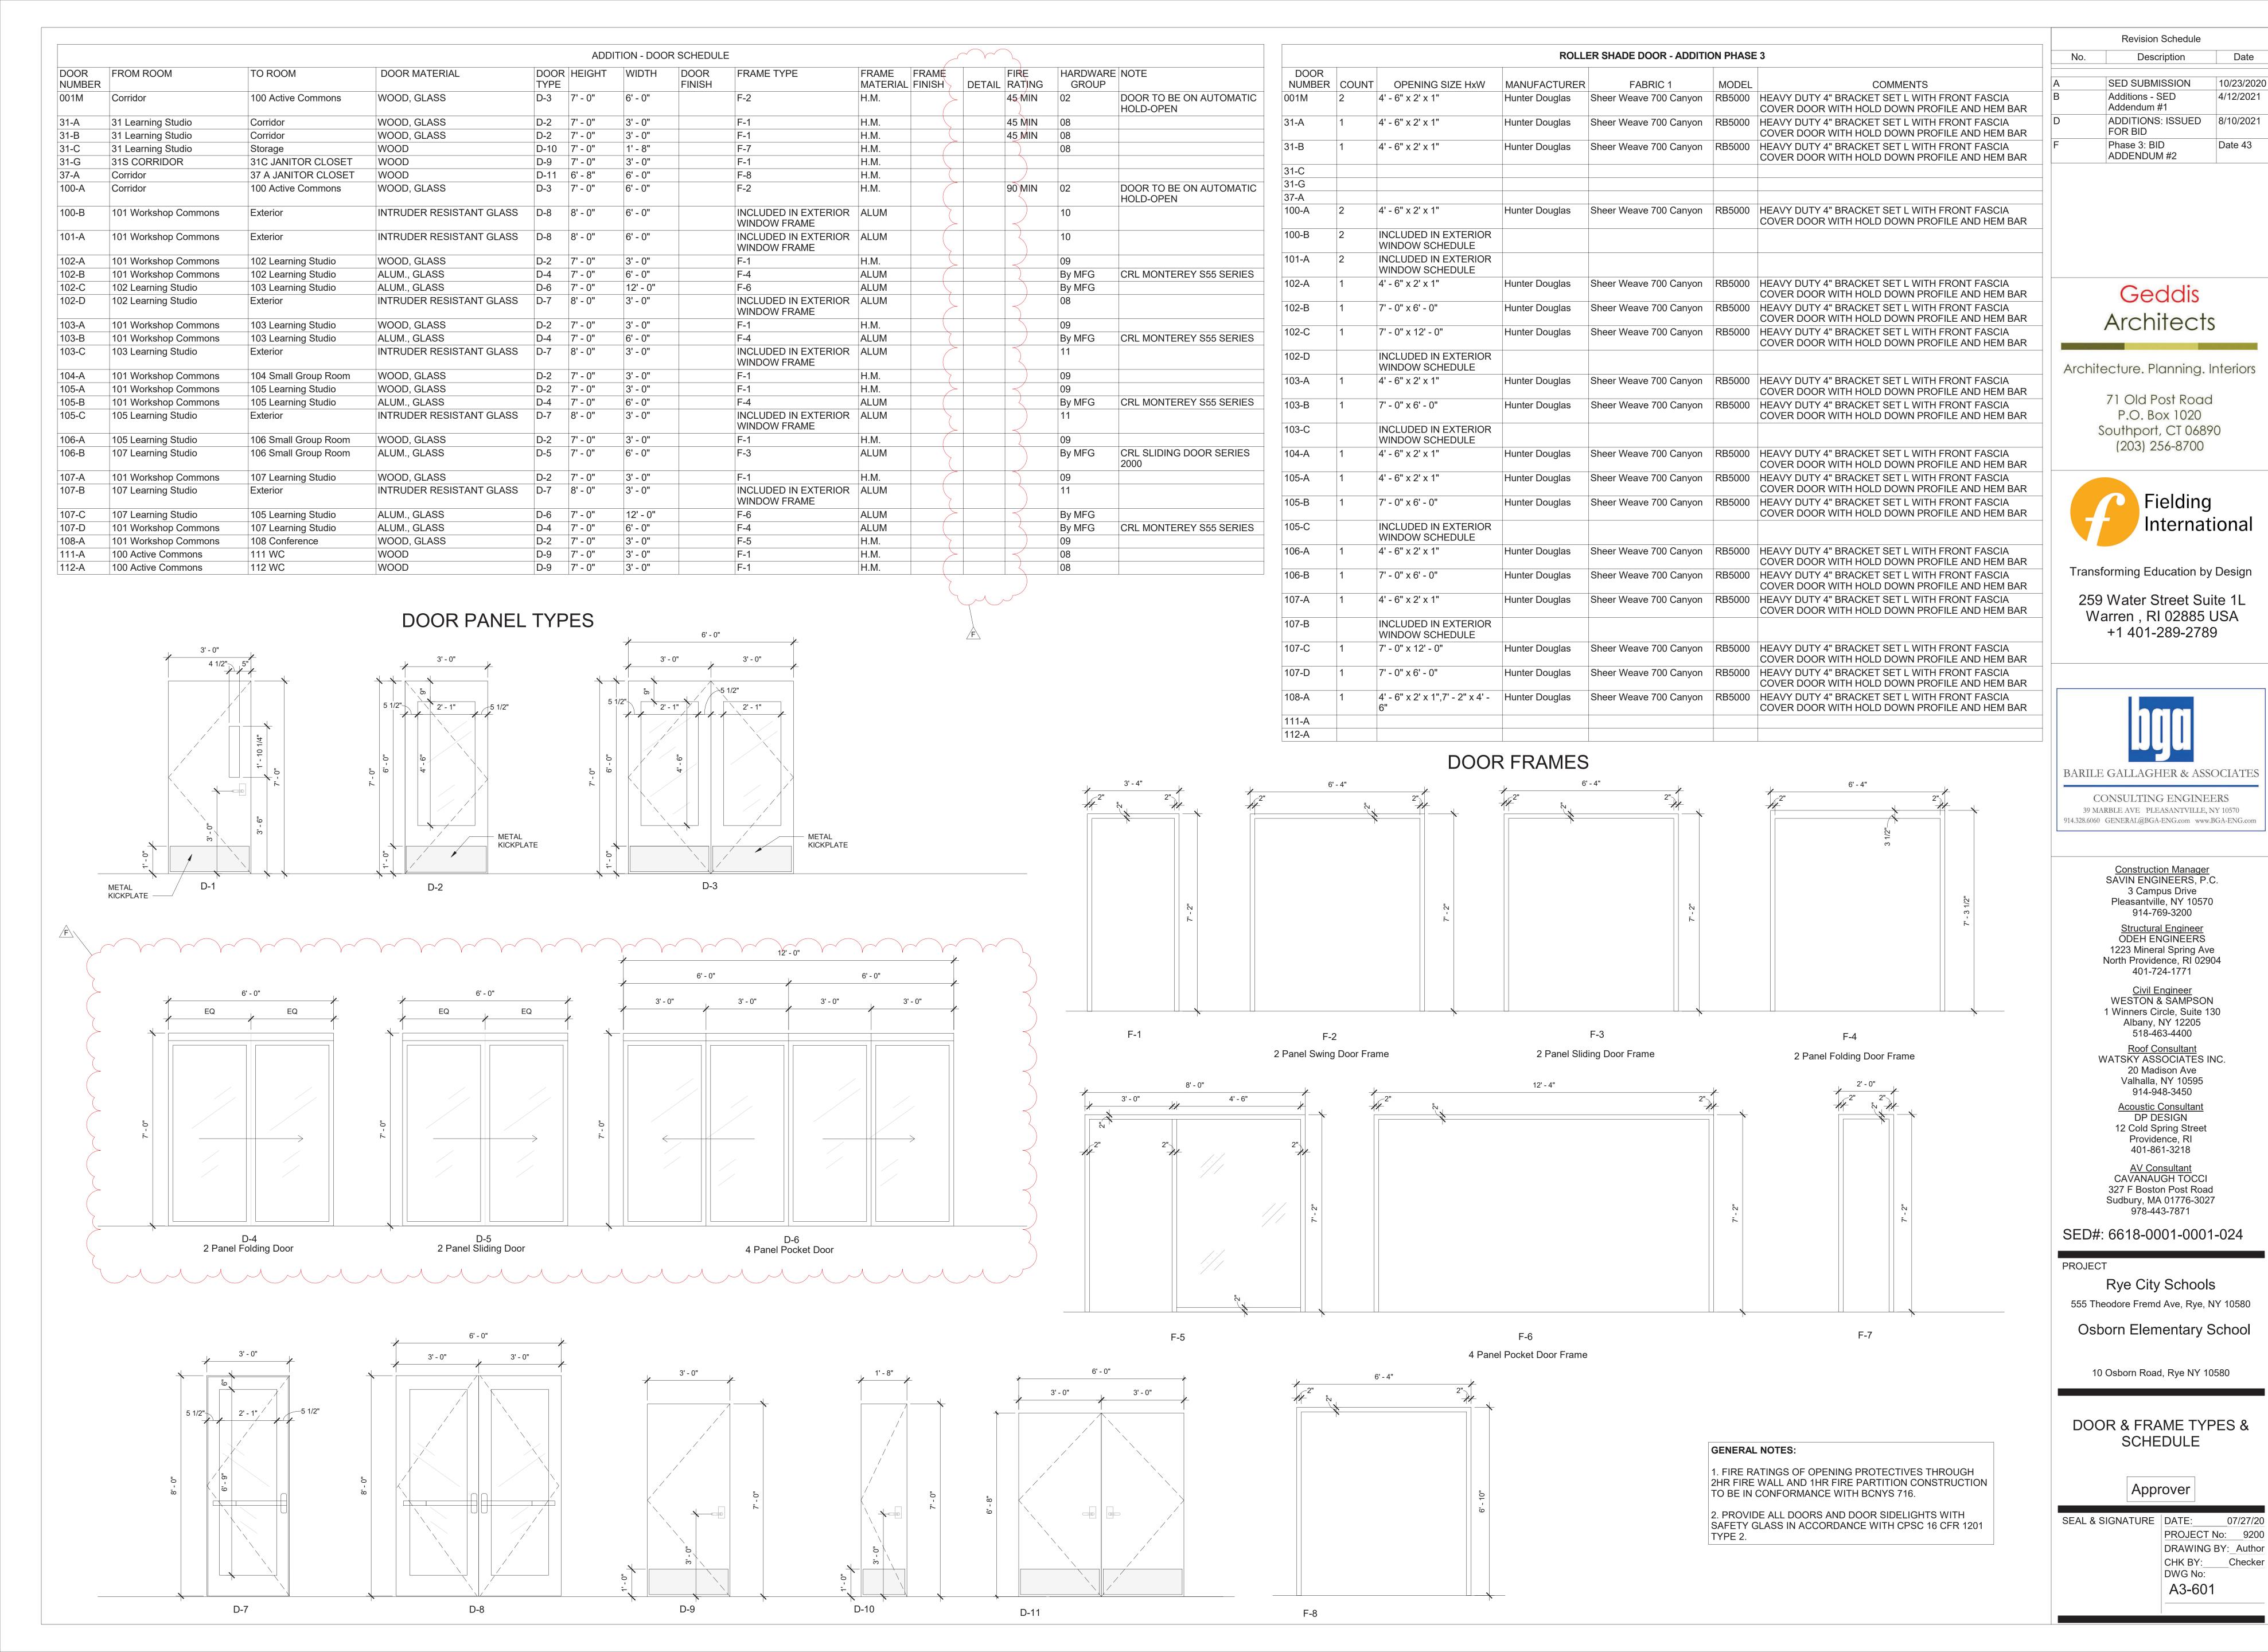


Date

10/23/2020


4/12/2021

8/10/2021

Date 43

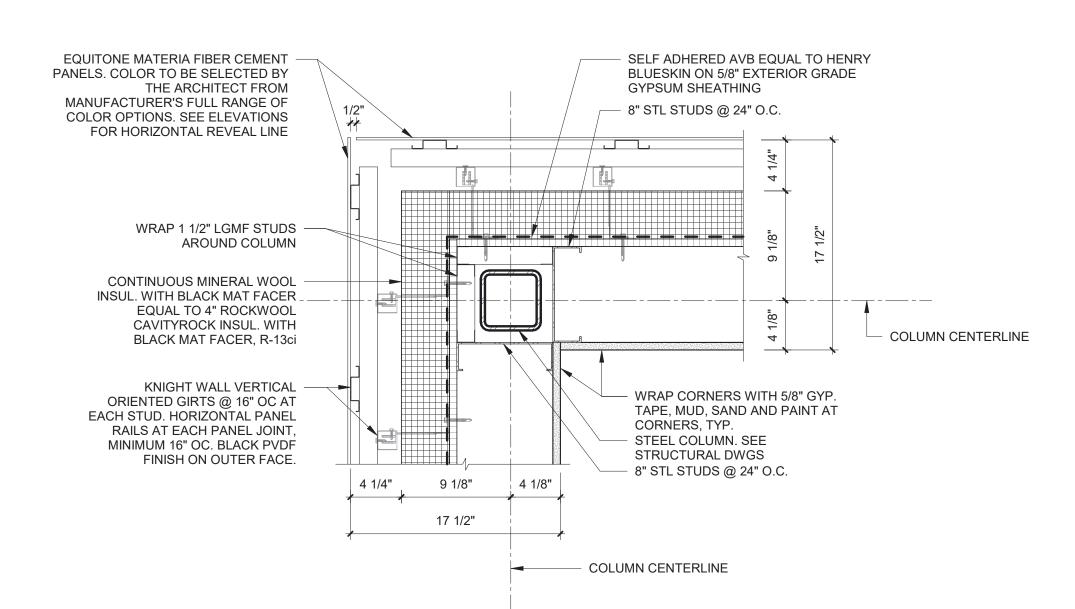


Corner Detail A

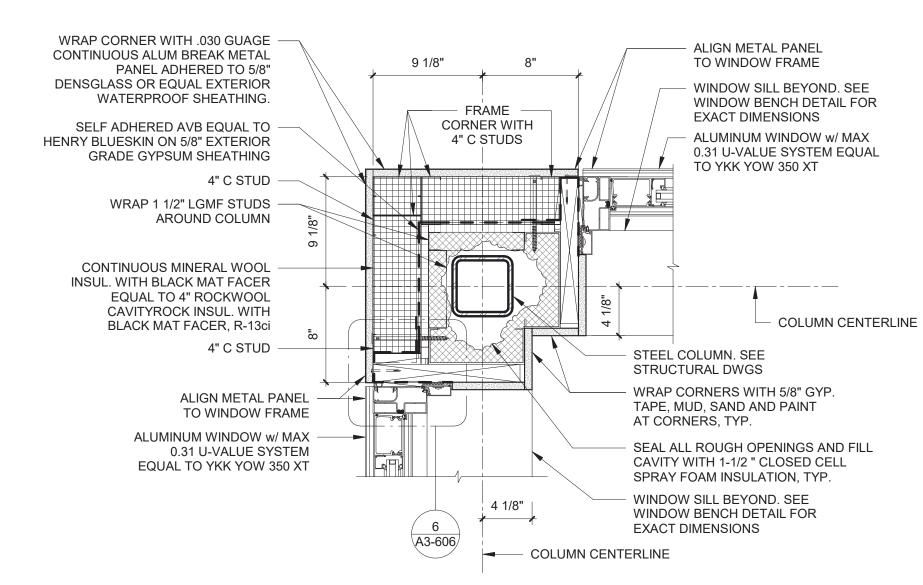

2 Corner Detail B

030 GUAGE CONTINUOUS ALUM BREAK METAL PANEL ADHERED TO 5/8" DENSGLASS OR STEEL COLUMN. SEE EQUAL EXTERIOR WATERPROOF SHEATHING. STRUCTURAL DWGS SELF ADHERED AVB EQUAL TO CONTINUOUS MINERAL WOOL INSUL HENRY BLUESKIN ON 5/8" EXTERIOR WITH BLACK MAT FACER EQUAL TO GRADE GYPSUM SHEATHING 4" ROCKWOOL CAVITYROCK INSUL. ALIGN METAL PANEL WITH BLACK MAT FACER, R-13ci TO WINDOW FRAME - ALIGN METAL PANEL TO WINDOW FRAME ALUMINUM WINDOW w/ MAX - COLUMN CENTERLINE 0.31 U-VALUE SYSTEM EQUAL TO YKK YOW 350 XT ALUMINUM WINDOW w/ MAX 0.31 U-VALUE SYSTEM 4" C STUD EQUAL TO YKK YOW 350 XT WINDOW SILL BEYOND. SEE WINDOW SILL BEYOND. SEE WINDOW -WINDOW BENCH DETAIL FOR BENCH DETAIL FOR EXACT DIMENSIONS **EXACT DIMENSIONS** SEAL ALL ROUGH OPENINGS AND FILL CAVITY WITH 1-1/2 " CLOSED CELL SPRAY FOAM INSULATION, TYP. 3 5/8" 3 5/8" METAL STUDS AT 16" O.C. - 3 5/8" METAL STUDS AT 16" O.C. 20 1/2" 5/8" INTERIOR GYP BD. SEE WALL 5/8" INTERIOR GYP BD. SEE WALL TYPES AND FINISH SCHEDULE TYPES AND FINISH SCHEDULE COLUMN CENTERLINE

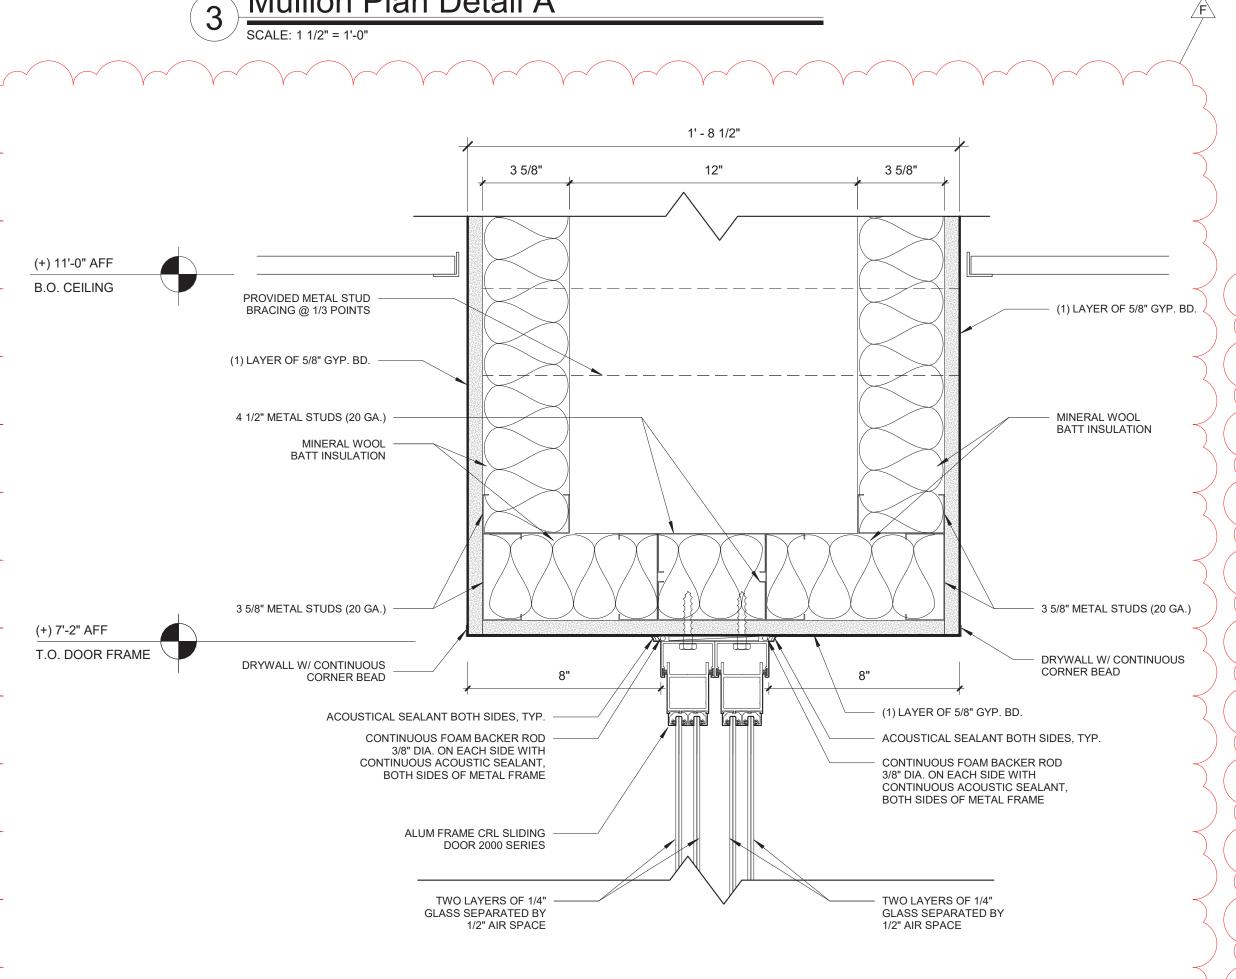

B.O. CEILING

(+) 7'-2" AFF

T.O. DOOR FRAME

(1) LAYER OF 5/8" GYP. BD. EACH SIDE OF STUDS

DRYWALL W/ CONTINUOUS

ACOUSTICAL SEALANT BOTH SIDES, TYP.


CORNER BEAD

DETAIL - FOLDING DOOR HEAD

ALUM FRAME CRL MONTEREY S55 SERIES

DETAIL - SLIDING DOOR HEAD

SCALE: 3" = 1'-0"

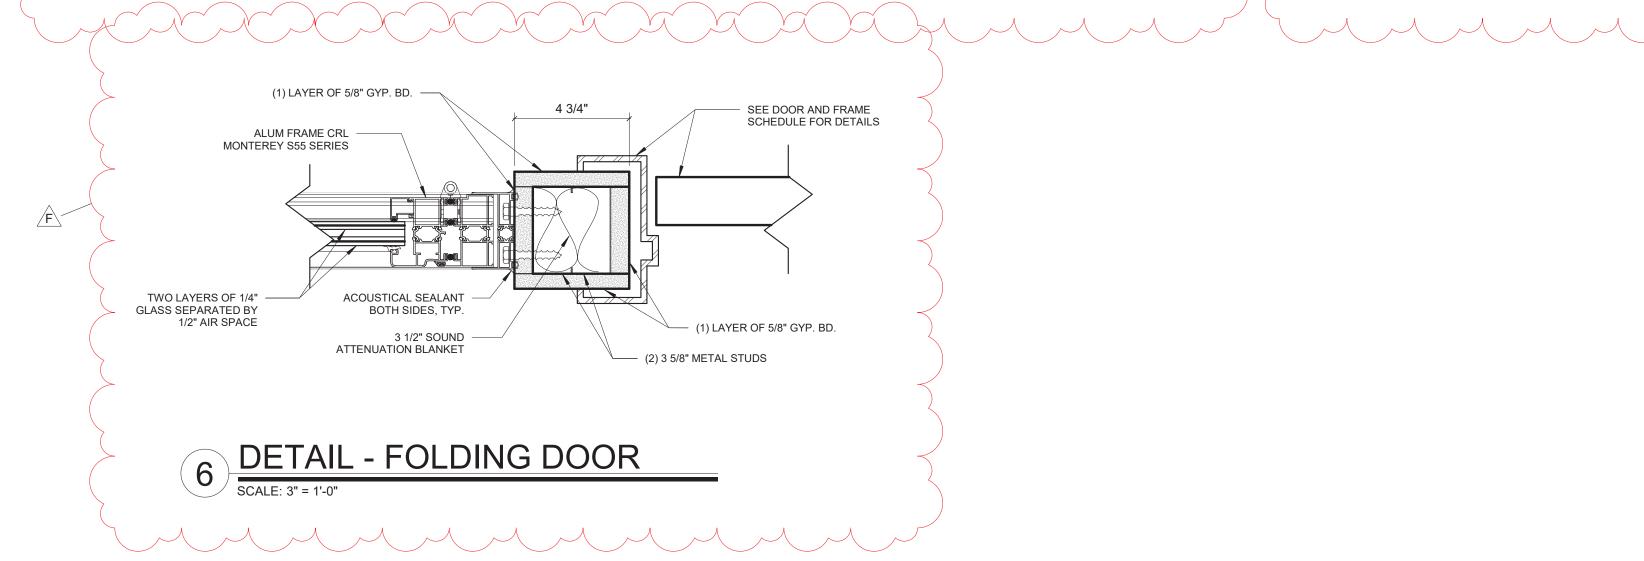

Revision Schedule

No. Description Date

D ADDITIONS: ISSUED 8/10/2021 FOR BID

F Phase 3: BID Date 43

ADDENDUM #2

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BARILE GALLAGHER & ASSOCIATES

CONSULTING ENGINEERS

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Providence, RI
401-861-3218

AV Consultant CAVANAUGH TOCCI 327 F Boston Post Road Sudbury, MA 01776-3027 978-443-7871

SED#: 6618-0001-0001-024

PROJECT _

ATTENUATION BLANKET

- 3 5/8" METAL STUDS

DRYWALL W/ CONTINUOUS

- ACOUSTICAL SEALANT BOTH SIDES, TYP.

(20 GA.) AT 16" O.C.

CORNER BEAD

TWO LAYERS OF 1/4"

GLASS SEPARATED BY

Rye City Schools

555 Theodore Fremd Ave, Rye, NY 10580

Osborn Elementary School

10 Osborn Road, Rye NY 10580

EXTERIOR DOOR & WINDOW DETAILS

Approver

SEAL & SIGNATURE DATE: 07/13/21
PROJECT No: 9200
DRAWING BY: Author
CHK BY: Checker
DWG No:

A3-607

			ISH LEGEND					
		<u>FLOORS</u>			WALLS			
FLOOR TI FT - 1	ILE	PRODUCT: FLORIM BASALTINE PORCELAIN TILE	PAINT PT - 1		PRODUCT: BENJAMIN MOORE SPEC 500			
		DIMENSIONS: 12" X 12" TILE BY FLORIM COLOR: LIGHT GREY 1096207 WITH GRIP FINISH		NOT USED	COLOR: BEACON GRAY – 2128-60			
					DDODUOT DENIAMBLAQODE ODEO 500			
<u>LUXURY \</u>	VINYL TILE - PLANK F	LOORING	PT - 3		PRODUCT: BENJAMIN MOORE SPEC 500 COLOR: WHITE HERON OC-57			
LVT - 4		PRODUCT: SHAW CONTRACT SOLITUDE LVT DIMENSIONS: 6" x 48" COLOR: COTTONWOOD	PT - 4		PRODUCT: BENJAMIN MOORE SPEC 500 COLOR: BLUE HYDRANGEA 2062-60			
LVT - 5		PRODUCT: SHAW CONTRACT SOLITUDE LVT DIMENSIONS: 6" x 48" COLOR: FRENCH GREY			PRODUCT: BENJAMIN MOORE SPEC 500 COLOR: BLUE DAISY 2062-40			
LVT - 6		PRODUCT: SHAW CONTRACT COVE LVT 092 DIMENSIONS: 9" x 48"	PT - 6		PRODUCT: BENJAMIN MOORE SPEC 500 COLOR: POTPOURRI GREEN 2029-50			
		COLOR: WASH PRODUCT: SHAW CONTRACTCOVE LVT 092	PT - 7		PRODUCT: BENJAMIN MOORE SPEC 500 COLOR: STEM GREEN 2029-40			
LVT - 7	P.0.2020.203	DIMENSIONS: 9" x 48" COLOR: GRAZE	PT - 8		PRODUCT: BENJAMIN MOORE SPEC 500 COLOR: TURQUOISE POWDER 2057-50			
LVT - 8	00000000000000000000000000000000000000	PRODUCT: SHAW CONTRACT COVE LVT 092 DIMENSIONS: 9" x 48" COLOR: JADE	7V					
LVT - 9		PRODUCT: SHAW CONTRACT COVE LVT 092 DIMENSIONS: 9" x 48" COLOR: SAPPHIRE	7V WALL TILE WT -1		PRODUCT: FLORIM BASALTINE PORCELAIN TO DIMENSIONS: 12" X 24" TILE BY FLORIM COLOR: LIGHT GREY 1096219	TILE		
VALL BAS	 <u>E</u>		GROUT					
WB-1 PRODUCT: ROPPE PINNACLE RUBBER BASE DIMESIONS: 6" HIGH STANDARD NOSE COLOR: DOLPHIN 129			GT -1		PRODUCT: SPECTRALOCK PRO COLOR: RAVEN 45			
WALL TIL	PRODUCT: I	FLORIM BASALTINE COVE BASE TILE		/ERINGS				
WTB -1 DIMESIONS: 6" X 12" COLOR: NUT 1096227					PRODUCT: VISUAL MAGNETICS ASTRO DRY ERASE WALLCOVERING COLOR: WHITE			
		<u>SURFACES</u>						
SOLID SURFACE COUNTERTOP			WLC-2		PRODUCT: VISUAL MAGNETICS ASTRO HUE COLOR: MATCH BEN MOORE 2062-60 BLUE H			
SS - 1 NOT USED PRODUCT: CORIAN SOLID SURFACE COLOR: SILVER BIRCH		WLC-3		PRODUCT: VISUAL MAGNETICS ASTRO HUE COLOR: MATCH BEN MOORE 2029-50 POTPO				
					F P	IOTE: PREPARE WALLS FOR MAGNETIC WALL COVERINGS. MAGNETIC WALL COVERINGS.		
CASEWO	ORK FINISHES		CLASS FILA					
PRODUCT: 18mm PRE-FINISHED BALTIC BIRCH PLYWOOD WITH CLEAR, NON-YELLOWING UV FINISH; EXPOSED EDGES, SANDED SMOOTH AND CLEAR FINISHED. PROVIDE SAMPLE TO ARCHITECT FOR APPROVAL. FINISH FOR CUSTOM FURNITURE BY OWNER. LISTED FOR REFERENCE ONLY.			GLASS FILM FLM-1		PRODUCT: DECORATIVE FILMS SOLYX SX-5	037 SAMBE		
PLYFF-2	WILSO LAMIN OPPO	PUCT: 18mm PRE-FINISHED BALTIC BIRCH PLYWOOD with DNART 1573 MARKERBOARD FROSTY WHITE PLASTIC NATE on TAG SIDE; CLEAR, NON-YELLOWING UV FINISH on PSITE SIDE; EXPOSED EDGES, SANDED SMOOTH AND CLEAR HED. PROVIDE SAMPLE TO ARCHITECT FOR APPROVAL.						

					ADDITION F	NISH SCHEDULE				
ROOM					WALL FINISH					
NUMBER	ROOM NAME	FLOOR FINISH	UNDERLAYMENT	BASE FINISH	А	В	С	D	CEILING FINISH	NOTES
31	5th Grade Classroom	LVT-4	SHAW GROUNDWORKS	WB-1	PT-3	PT-3	PT-3, PT-8, WLC-1, WLC-2	PT-8	CLG-1	
100	ACTIVE COMMONS	LVT-5, LVT-6	SHAW GROUNDWORKS	WB-1	PT-7	PT-8, PT-5	PT-5	PT-5, PT-3	CLG-1, CLG-2	
101	WORKSHOP COMMONS	S LVT-5, LVT-7, LVT-8. LVT-9	SHAW GROUNDWORKS	WB-1	PT-3, PT-7	PT-5	PT-3, WLC-2, WLC-3	PT-5	CLG-1, CLG-2	
102	5th GRADE LEARNING STUDIO	LVT-5, LVT-6, LVT-9	SHAW GROUNDWORKS	WB-1	PT-3	PT-3, PT-4, WLC-1	PT-3, PT-4, WLC-3	PT-3,WLC-2	CLG-1	
103	5th GRADE LEARNING STUDIO	LVT-5, LVT-6, LVT-9	SHAW GROUNDWORKS	WB-1	PT-3	PT-3, WLC-2	PT-3, PT-4, WLC-3	PT-3, PT-4, WLC-1	CLG-1	
104	SGR	LVT-6	SHAW GROUNDWORKS	WB-1	PT-8, WLC-1	PT-8	PT-8	PT-8, WLC-1	CLG-1	
105	5th GRADE LEARNING STUDIO	LVT-5, LVT-7, LVT-8	SHAW GROUNDWORKS	WB-1	PT-7, PT-3	PT-3, WLC-3, WLC-2	PT-3, WLC-2	PT-3, PT-7, WLC-1	CLG-1	
106	SGR	LVT-7	SHAW GROUNDWORKS	WB-1	PT-6	PT-6	PT-6	PT-6, WLC-1	CLG-1	
107	5th GRADE LEARNING STUDIO	LVT-5, LVT-7, LVT-8	SHAW GROUNDWORKS	WB-1	PT-3, WLC-3	PT-7, PT-3, WLC-1	PT-3, WLC-2	PT-3, WLC-3	CLG-1	
108	CONFERENCE	LVT-4	SHAW GROUNDWORKS	WB-1	PT-4	PT-4, WLC-1	PT-4	PT-4	CLG-1	
109	WC	FT-1	SHAW GROUNDWORKS	WTB-1	WT-1, PT-3	WT-1, PT-3	WT-1, PT-3	WT-1, PT-3	CLG-1	
110	WC	FT-1	SHAW GROUNDWORKS	WTB-1	WT-1, PT-3	WT-1, PT-3	WT-1, PT-3	WT-1, PT-3	CLG-1	
3-4	HALL	LVT-5	SHAW GROUNDWORKS	WB-1	PT-8	PT-8	PT-8	PT-5	CLG-1	
37 A	JC	FT-1	SHAW GROUNDWORKS	WTB-1	PT-3, WT-1	PT-3, WT-1	PT-3, WT-1	PT-3, WT-1	CLG-2	

NOTES: 1. NEW DOOR TRIM TO BE PT-1, UNLESS OTHERWISE NOTED.

GENERAL NOTE:

SEE INTERIOR ELEVATIONS AND FINISH PLANS FOR FLOORING PATTERN AND CUT LINES OF WALL FINISHES

Revision Schedule

No. Description Date

A SED SUBMISSION 10/23/2020
D ADDITIONS: ISSUED 8/10/2021
FOR BID

Geddis Architects

Architecture. Planning. Interiors

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259 Water Street Suite 1L Warren , RI 02885 USA +1 401-289-2789



BARILE GALLAGHER & ASSOCIATES

CONSULTING ENGINEERS
39 MARBLE AVE PLEASANTVILLE, NY 10570
914.328.6060 GENERAL@BGA-ENG.com www.BGA-ENG.com

Construction Manager
SAVIN ENGINEERS, P.C.
3 Campus Drive
Pleasantville, NY 10570
914-769-3200

Structural Engineer
ODEH ENGINEERS
1223 Mineral Spring Ave
North Providence, RI 02904
401-724-1771

Civil Engineer WESTON & SAMPSON 1 Winners Circle, Suite 130 Albany, NY 12205 518-463-4400

Roof Consultant
WATSKY ASSOCIATES INC.
20 Madison Ave
Valhalla, NY 10595

914-948-3450

Acoustic Consultant
DP DESIGN
12 Cold Spring Street
Providence, RI
401-861-3218

AV Consultant
CAVANAUGH TOCCI
327 F Boston Post Road
Sudbury, MA 01776-3027
978-443-7871

SED#: 6618-0001-0001-024

PROJECT

Rye City Schools
555 Theodore Fremd Ave, Rye, NY 10580

Osborn Elementary School

10 Osborn Road, Rye NY 10580

FINISH SCHEDULES

Approver

SEAL & SIGNATURE DATE: 06/03/20
PROJECT No: 9200
DRAWING BY: Author
CHK BY: Checker
DWG No:
A3-700



Geddis Architects

Revision Schedule

Description

SED SUBMISSION

Phase 3: BID ADDENDUM #2

ADDITIONS: ISSUED FOR BID

10/23/2020

8/10/2021

Date 43

Architecture. Planning. Interiors

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> 3 Campus Drive
> Pleasantville, NY 10570 914-769-3200

Structural Engineer
ODEH ENGINEERS
1223 Mineral Spring Ave
North Providence, RI 02904

401-724-1771

<u>Civil Engineer</u> WESTON & SAMPSON 1 Winners Circle, Suite 130 Albany, NY 12205 518-463-4400

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327 F Boston Post Road

Sudbury, MA 01776-3027 978-443-7871 SED#: 6618-0001-0001-024

PROJECT

Rye City Schools 555 Theodore Fremd Ave, Rye, NY 10580

Osborn Elementary School

10 Osborn Road, Rye NY 10580

ADDITION - WALL FINISH PLAN

Approver

SEAL & SIGNATURE DATE: 04/29/20 PROJECT No: 9200
DRAWING BY: Author
CHK BY: Checker
DWG No:

A3-721


OSBORN PHASE 3 KEY PLAN

1" = 80'




Phase 3 - Addition Wall Finish Plan

SCALE: 3/16" = 1'-0"

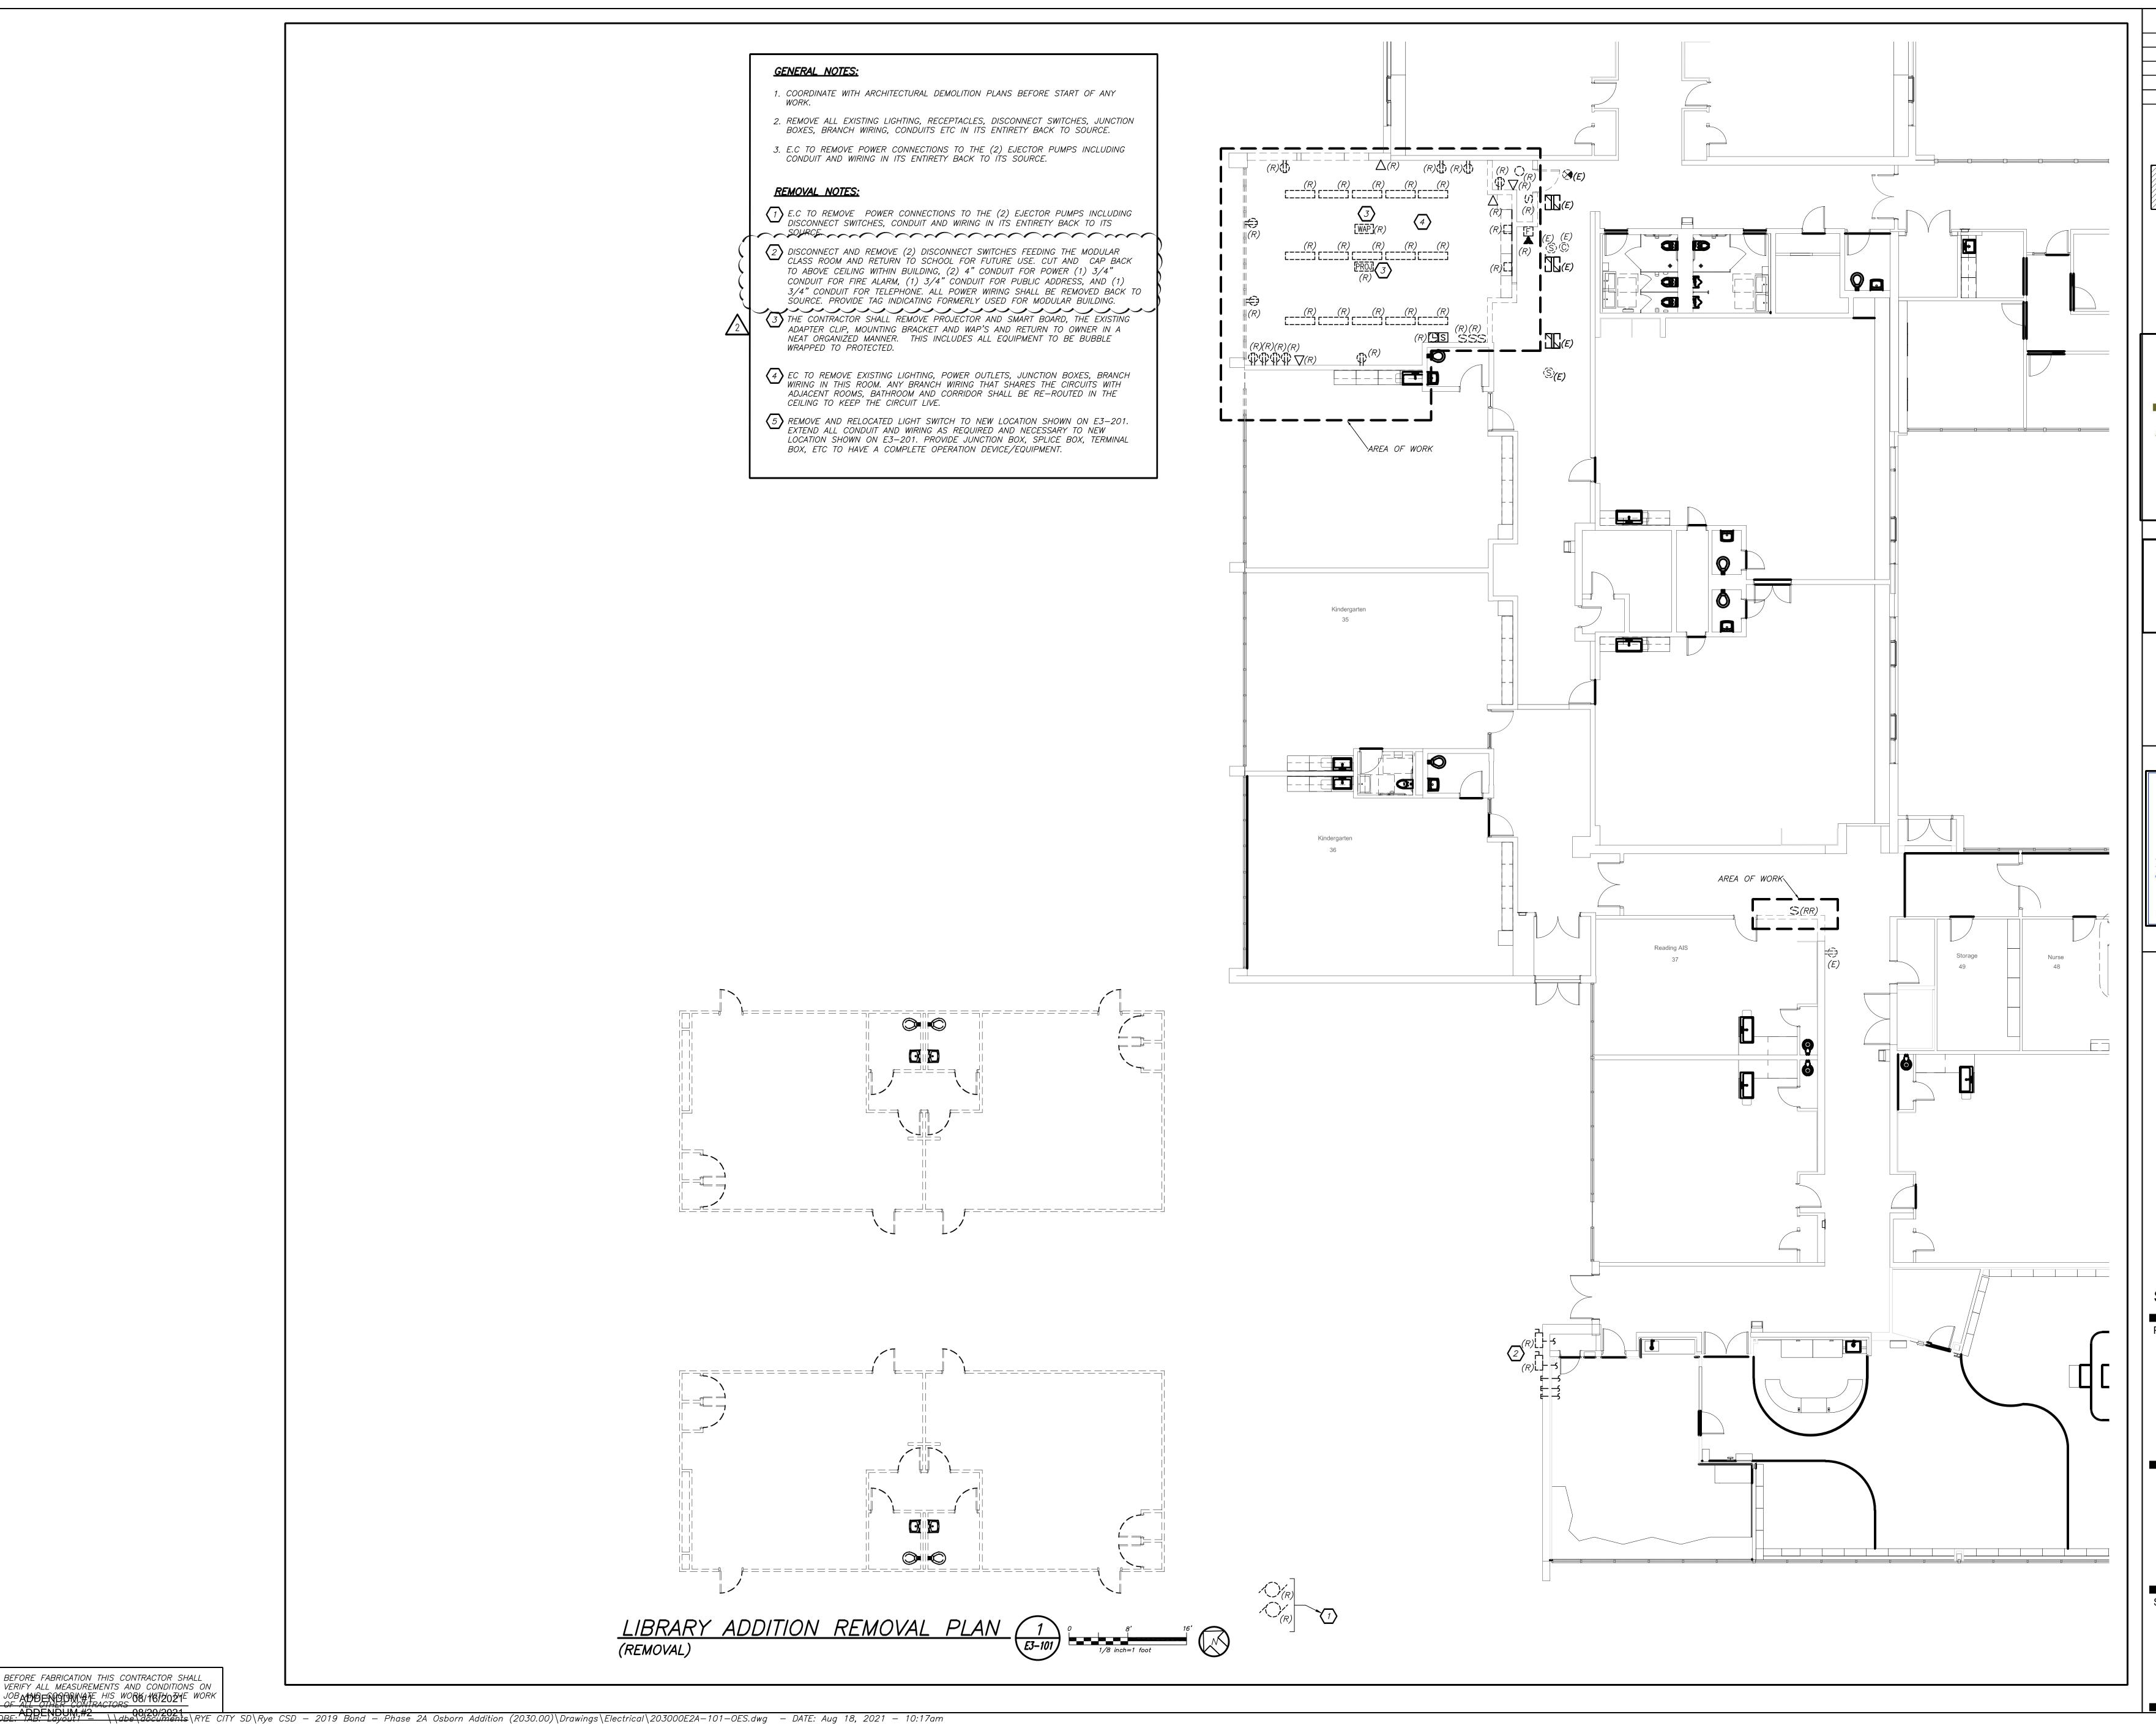

BEFORE FABRICATION THIS CONTRACTOR SHALL VERIFY ALL MEASUREMENTS AND CONDITIONS ON

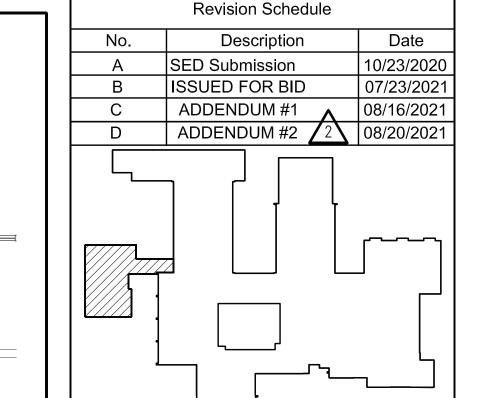

Geddis Architects

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ODEH ENGINEERS 1223 Mineral Spring Ave North Providence, RI 02904 401-724-1771

<u>Civil Engineer</u> WESTON & SAMPSON 1 Winners Circle, Suite 130 Albany, NY 12205 518-463-4400

> Acoustic Consultant
> DP DESIGN 12 Cold Spring Street Providence, RI 401-861-3218

AV Consultant
CAVANAUGH TOCCI 327 F Boston Post Road Sudbury, MA 01776-3027 978-443-7871

SED#: 6618-0001-0001-023

Rye City Schools 555 Theodore Fremd Ave, Suite B-101

Osborn Elementary School

10 Osborn Road, Rye NY 10580

ELECTRICAL REMOVAL PLAN

SEAL & SIGNATURE DATE:

DRAWING BY: BGA E3-101