



## TABLE OF LAND USE


BLOCK 601, LOT 4 ZONE "R-1" - "ONE-FAMILY RESIDENCE" PROPOSED USE: SCHOOL FIRE DISTRICT: PURCHASE FIRE DEPARTMENT WATER DISTRICT: WESTCHESTER JOINT WATER WORKS SCHOOL DISTRICT: HARRISON SCHOOL DISTRICT SEWER DISTRICT: BLIND BROOK SEWER DISTRICT


DECODIDATION					
DESCRIPTION		REQUIRED	EXISTING	PROPOSED	
PERMITTED USES		SCHOOL <sup>(1)</sup>	SCHOOL <sup>(1)</sup>	NO CHANGE	
MINIMUM LOT AREA	(ACRES)	13 (2)	±22.8	NO CHANGE	
MINIMUM LOT FRONTAGE	(FEET)	200 <sup>(3)</sup>	1,627	NO CHANGE	
MINIMUM LOT WIDTH	(FEET)	200 <sup>(3)</sup>	1,627	NO CHANGE	
MAXIMUM LOT COVERAGE	(PERCENTAGE)	15	7.44	7.33 <sup>(5)</sup>	
MAXIMUM BUILDING HEIGHT	(STORIES/FEET)	2.5/30	2.5/23.5	2.5/29	
MINIMUM BUILDING SETBACKS					
FRONT BUILDING SETBACK	(FEET)	50 <sup>(3)</sup>	53.5	NO CHANGE	
SIDE BUILDING SETBACK	(FEET)	50 <sup>(3)</sup>	125.6	NO CHANGE	
REAR BUILDING SETBACK	(FEET)	50	N/A	N/A	
PARKING SUMMARY					
PARKING RATIO	1 SP	ACE/3 PERMANENT	SEATS OF AUDITOR	RIUM SEATING AREA (4)	
STANDARD STALLS (9'X18')	(SPACES)	131 <sup>(4)</sup>	138	144	
HANDICAPPED	(SPACES)	3 <sup>(4)</sup>	4	6	
TOTAL SPACES	(SPACES)	134 <sup>(4)</sup>	142	150	

LAND USE NOTES:

- (1) SCHOOL IS PERMITTED AS A SPECIAL. EXEMPTION USE IN THE R-1 DISTRICT, IN ACCORDANCE WITH THE RESIDENCE DISTRICTS TABLE OF USE
- (2) MINIMUM LOT AREA WAS CALCULATED BASED ON THE TOWN OF HARRISON ZONING ORDINANCE, SECTION 235- 17, SPECIAL CONDITIONS AND SAFEGUARDS FOR SPECIFIC USES, SUB SECTION N, NON-PROFIT PUBLIC AND PRIVATE SCHOOL, CONDITION #3, WHEREAS SITE AREA SHALL BE FIVE (5) ACRES, PLUS TWO (2) ACRES FOR EACH ONE HUNDRED (100) PUPILS, WITH A MINIMUM OF 10 ACRES. THE SCHOOL PRESENTLY HAS THREE HUNDRED FIFTY SEVEN (357) PUPILS, WHICH WAS ROUNDED UP TO FOUR HUNDRED (400) FOR THE CALCULATION. (5 ACRES + (2 ACRES/ 100 PUPILS X 400))=5+8=13 ACRES REQUIRED.
- (3) THE PROPOSED ACTION IS ON A LOT WITHIN TAX BLOCK 601 AND WITHIN THE R-1 RESIDENCE DISTRICT. THEREFORE, THE MINIMUM LOT WIDTH AND FRONTAGE REQUIREMENTS WERE INCREASED TO TWO HUNDRED (200) FEET AND THE MINIMUM FRONT AND SIDE YARD REQUIREMENTS WERE INCREASED TO FIFTY (50) FEET.
- (4) REQUIRED PARKING FOR A SCHOOL IS 1 SPACE PER EMPLOYEE + 1 SPACE PER 8 SENIORS (91 EMPLOYEES+(55 SENIORS X 1 SPACE/8 SENIORS)=91+7=98 PARKING SPACES REQUIRED). REQUIRED PARKING FOR AN AUDITORIUM IS 1 SPACE PER 3 PERMANENT SEATS (400 SEATS X 1 SPACE/3 PERMANENT SEATS=134 PARKING SPACES REQUIRED).
- (5) PROPOSED LOT COVERAGE CALCULATION INCLUDES ALL PROPOSED SECOND FLOOR OVERHANGS.

REGULATIONS, WITHIN THE TOWN OF HARRISON ZONING ORDINANCE.

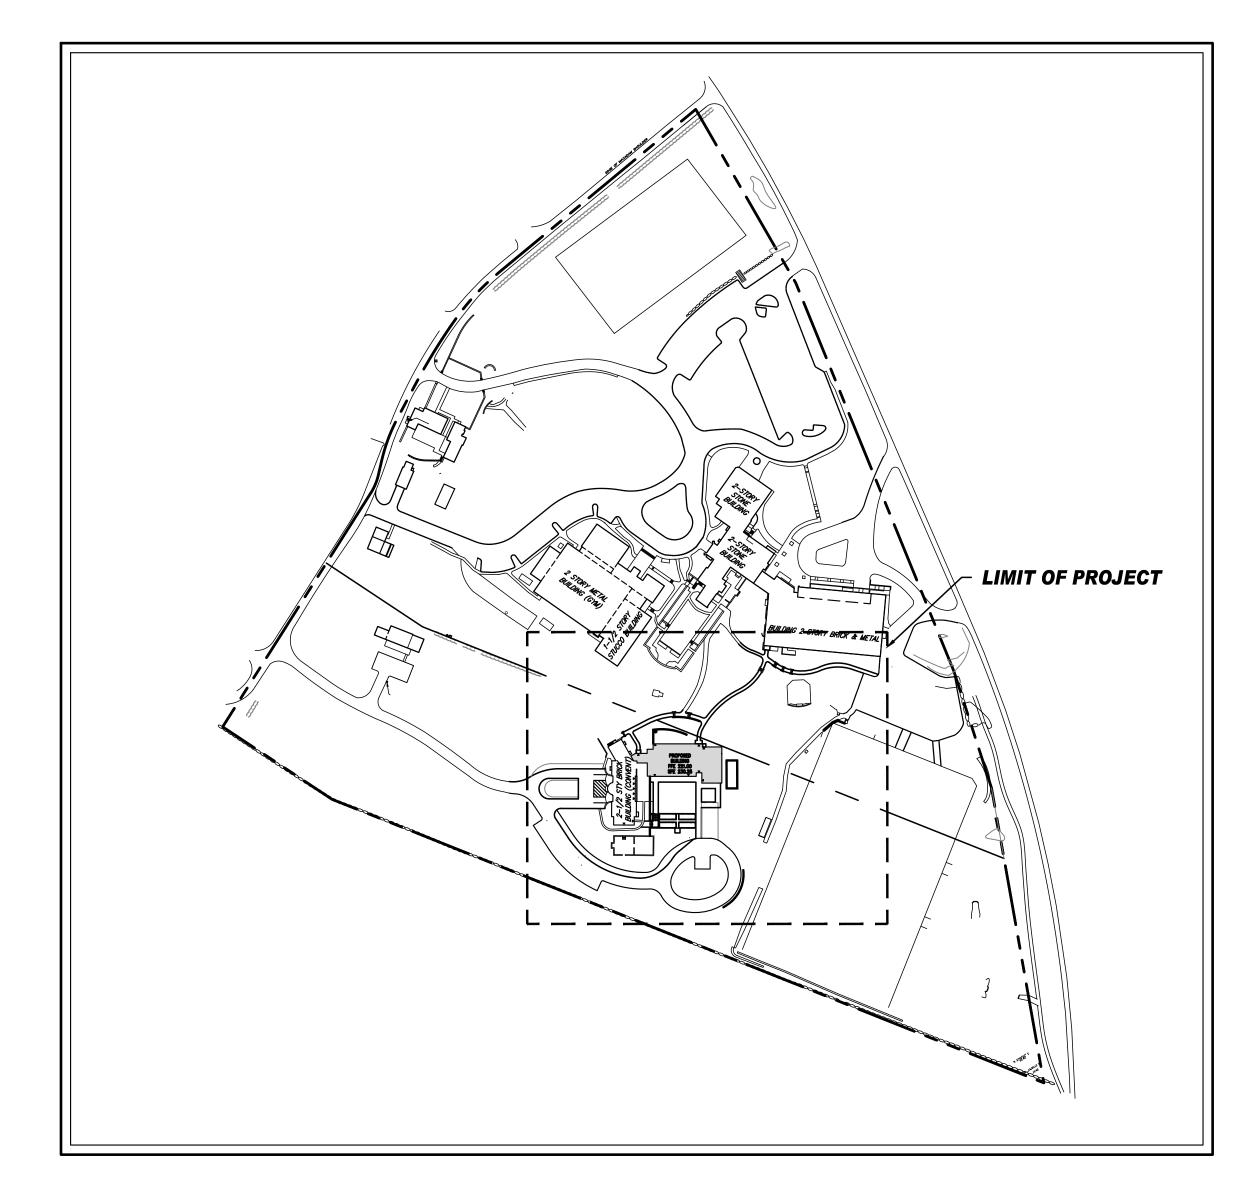

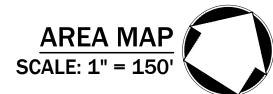

## GENERAL CONSTRUCTION NOTES APPLY TO ALL WORK HEREIN:

- 1. PRIOR TO CONSTRUCTION, THE CONTRACTOR SHALL CALL 811 "DIG SAFELY" (1-800-962-7962) TO HAVE UNDERGROUND UTILITIES LOCATED INCLUDING ARRANGING FOR A PRIVATE MARKOUT ON-SITE WHERE APPLICABLE. EXPLORATORY EXCAVATIONS SHALL COMPLY WITH CODE 753 REQUIREMENTS. NO WORK SHALL COMMENCE UNTIL ALL THE OPERATORS HAVE NOTIFIED THE CONTRACTOR THAT THEIR UTILITIES HAVE BEEN LOCATED. THE CONTRACTOR SHALL BE RESPONSIBLE FOR THE PRESERVATION OF ALL PUBLIC AND PRIVATE UNDERGROUND AND SURFACE UTILITIES AND STRUCTURES AT OR ADJACENT TO THE SITE OF CONSTRUCTION, INSOFAR AS THEY MAY BE ENDANGERED BY THE CONTRACTOR'S OPERATIONS. THIS SHALL HOLD TRUE WHETHER OR NOT THEY ARE SHOWN ON THE CONTRACT DRAWINGS. IF THEY ARE SHOWN ON THE DRAWINGS, THEIR LOCATIONS ARE NOT GUARANTEED EVEN THOUGH THE INFORMATION WAS OBTAINED FROM THE BEST AVAILABLE SOURCES, AND IN ANY EVENT, OTHER UTILITIES ON THESE PLANS MAY BE ENCOUNTERED IN THE FIELD. THE CONTRACTOR SHALL, AT HIS OWN EXPENSE, IMMEDIATELY REPAIR OR REPLACE ANY STRUCTURES OR UTILITIES THAT HE DAMAGES, AND SHALL CONSTANTLY PROCEED WITH CAUTION TO PREVENT UNDUE INTERRUPTION OF UTILITY SERVICE.
- 2. CONTRACTOR SHALL HAND DIG TEST PITS TO VERIFY THE LOCATION OF ALL EXISTING UNDERGROUND UTILITIES PRIOR TO THE START OF CONSTRUCTION. CONTRACTOR SHALL VERIFY EXISTING UTILITIES DEPTHS AND ADVISE OF ANY CONFLICTS WITH PROPOSED UTILITIES. IF CONFLICTS ARE PRESENT. THE OWNER'S FIELD REPRESENTATIVE, JMC, PLLC AND THE APPLICABLE MUNICIPALITY OR AGENCY SHALL BE NOTIFIED IN WRITING. THE EXISTING/PROPOSED UTILITIES RELOCATION SHALL BE DESIGNED BY JMC, PLLC.
- 3. CONTRACTOR IS RESPONSIBLE FOR OBTAINING ANY AND ALL LOCAL PERMITS REQUIRED.
- 4. ALL WORK SHALL BE DONE IN STRICT COMPLIANCE WITH ALL APPLICABLE NATIONAL, STATE, AND LOCAL CODES, STANDARDS, ORDINANCES, RULES, AND REGULATIONS. ALL CONSTRUCTION WORK SHALL BE PERFORMED IN ACCORDANCE WITH ALL SAFETY CODES. APPLICABLE SAFETY CODES MEAN THE LATEST EDITION INCLUDING ANY AND ALL AMENDMENTS, REVISIONS, AND ADDITIONS THERETO, TO THE FEDERAL DEPARTMENT OF LABOR, OCCUPATIONAL SAFETY AND HEALTH ADMINISTRATION'S OCCUPATIONAL SAFETY AND HEALTH STANDARDS (OSHA); AND APPLICABLE SAFETY, HEALTH REGULATIONS AND BUILDING CODES FOR CONSTRUCTION IN THE STATE OF NEW YORK. THE CONTRACTOR SHALL BE RESPONSIBLE FOR GUARDING AND PROTECTING ALL OPEN EXCAVATIONS IN ACCORDANCE WITH THE PROVISION OF SECTION 107-05 (SAFETY AND HEALTH REQUIREMENTS) OF THE NYSDOT STANDARD SPECIFICATIONS. IF THE CONTRACTOR PERFORMS ANY HAZARDOUS CONSTRUCTION PRACTICES, ALL OPERATIONS IN THE AFFECTED AREA SHALL BE DISCONTINUED AND IMMEDIATE ACTION SHALL BE TAKEN TO CORRECT THE SITUATION TO THE SATISFACTION OF THE APPROVAL AUTHORITY HAVING JURISDICTION.
- 5. CONTRACTOR SHALL MAINTAIN ACCESS TO ALL PROPERTIES AFFECTED BY THE SCOPE OF WORK SHOWN HEREON AT ALL TIMES TO THE SATISFACTION OF THE OWNERS REPRESENTATIVE. RAMPING CONSTRUCTION TO PROVIDE ACCESS MAY BE CONSTRUCTED WITH SUBBASE MATERIAL EXCEPT THAT TEMPORARY ASPHALT CONCRETE SHALL BE PLACED AS DIRECTED BY THE ENGINEER. THE CONTRACTOR SHALL BE RESPONSIBLE FOR PROVIDING SAFE PEDESTRIAN ACCESS AT ALL TIMES.
- 6. CONTRACTOR SHALL MAINTAIN THE INTEGRITY OF EXISTING PAVEMENT TO REMAIN.
- 7. CONTRACTOR SHALL REFER TO DRAWINGS BY OTHERS FOR DESIGN OF SITE IMPROVEMENTS SHOWN HEREON FOR INFORMATION AND SPECIFIED AS "DESIGNED BY LANDSCAPE ARCHITECT" OR "DESIGNED BY OTHERS". ANY DISCREPANCIES SHALL BE BE BROUGHT TO THE ATTENTION OF THE PROJECT DESIGN TEAM PRIOR TO THE START OF CONSTRUCTION.

SUBSURFACE UTILITY LOCATIONS ARE BASED ON A COMPILATION OF FIELD EVIDENCE, AVAILABLE RECORD PLANS AND/OR UTILITY MARK-OUTS. THE LOCATION OR COMPLETENESS OF UNDERGROUND INFORMATION CANNOT BE GUARANTEED. VERIFY THE ACTUAL LOCATION OF ALL UTILITIES PRIOR TO EXCAVATION OR CONSTRUCTION.



# STREAM

CENTER FOR EXPERIMENTAL LEARNING

SCHOOL OF THE HOLY CHILD 2225 WESTCHESTER AVE, RYE, NY



CONSTRUCTION **DOCUMENTS** 



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5 09/18/2020 REVISED FOR LDA 4 05/08/2020 90% CONSTRUCTION DOCUMENTS


2 02/21/2020 DESIGN DEVELOPMENT 1 11/26/2019 SITE PLAN SUBMISSION

3 | 02/25/2020 | REVISED FOR TB/PB APPROVAL

No. Date Sheet Title

Zoning Compliance

JMC-19067 11/26/2019 Drawn / Checked Scale 1"=60' DC/JAR Sheet Number

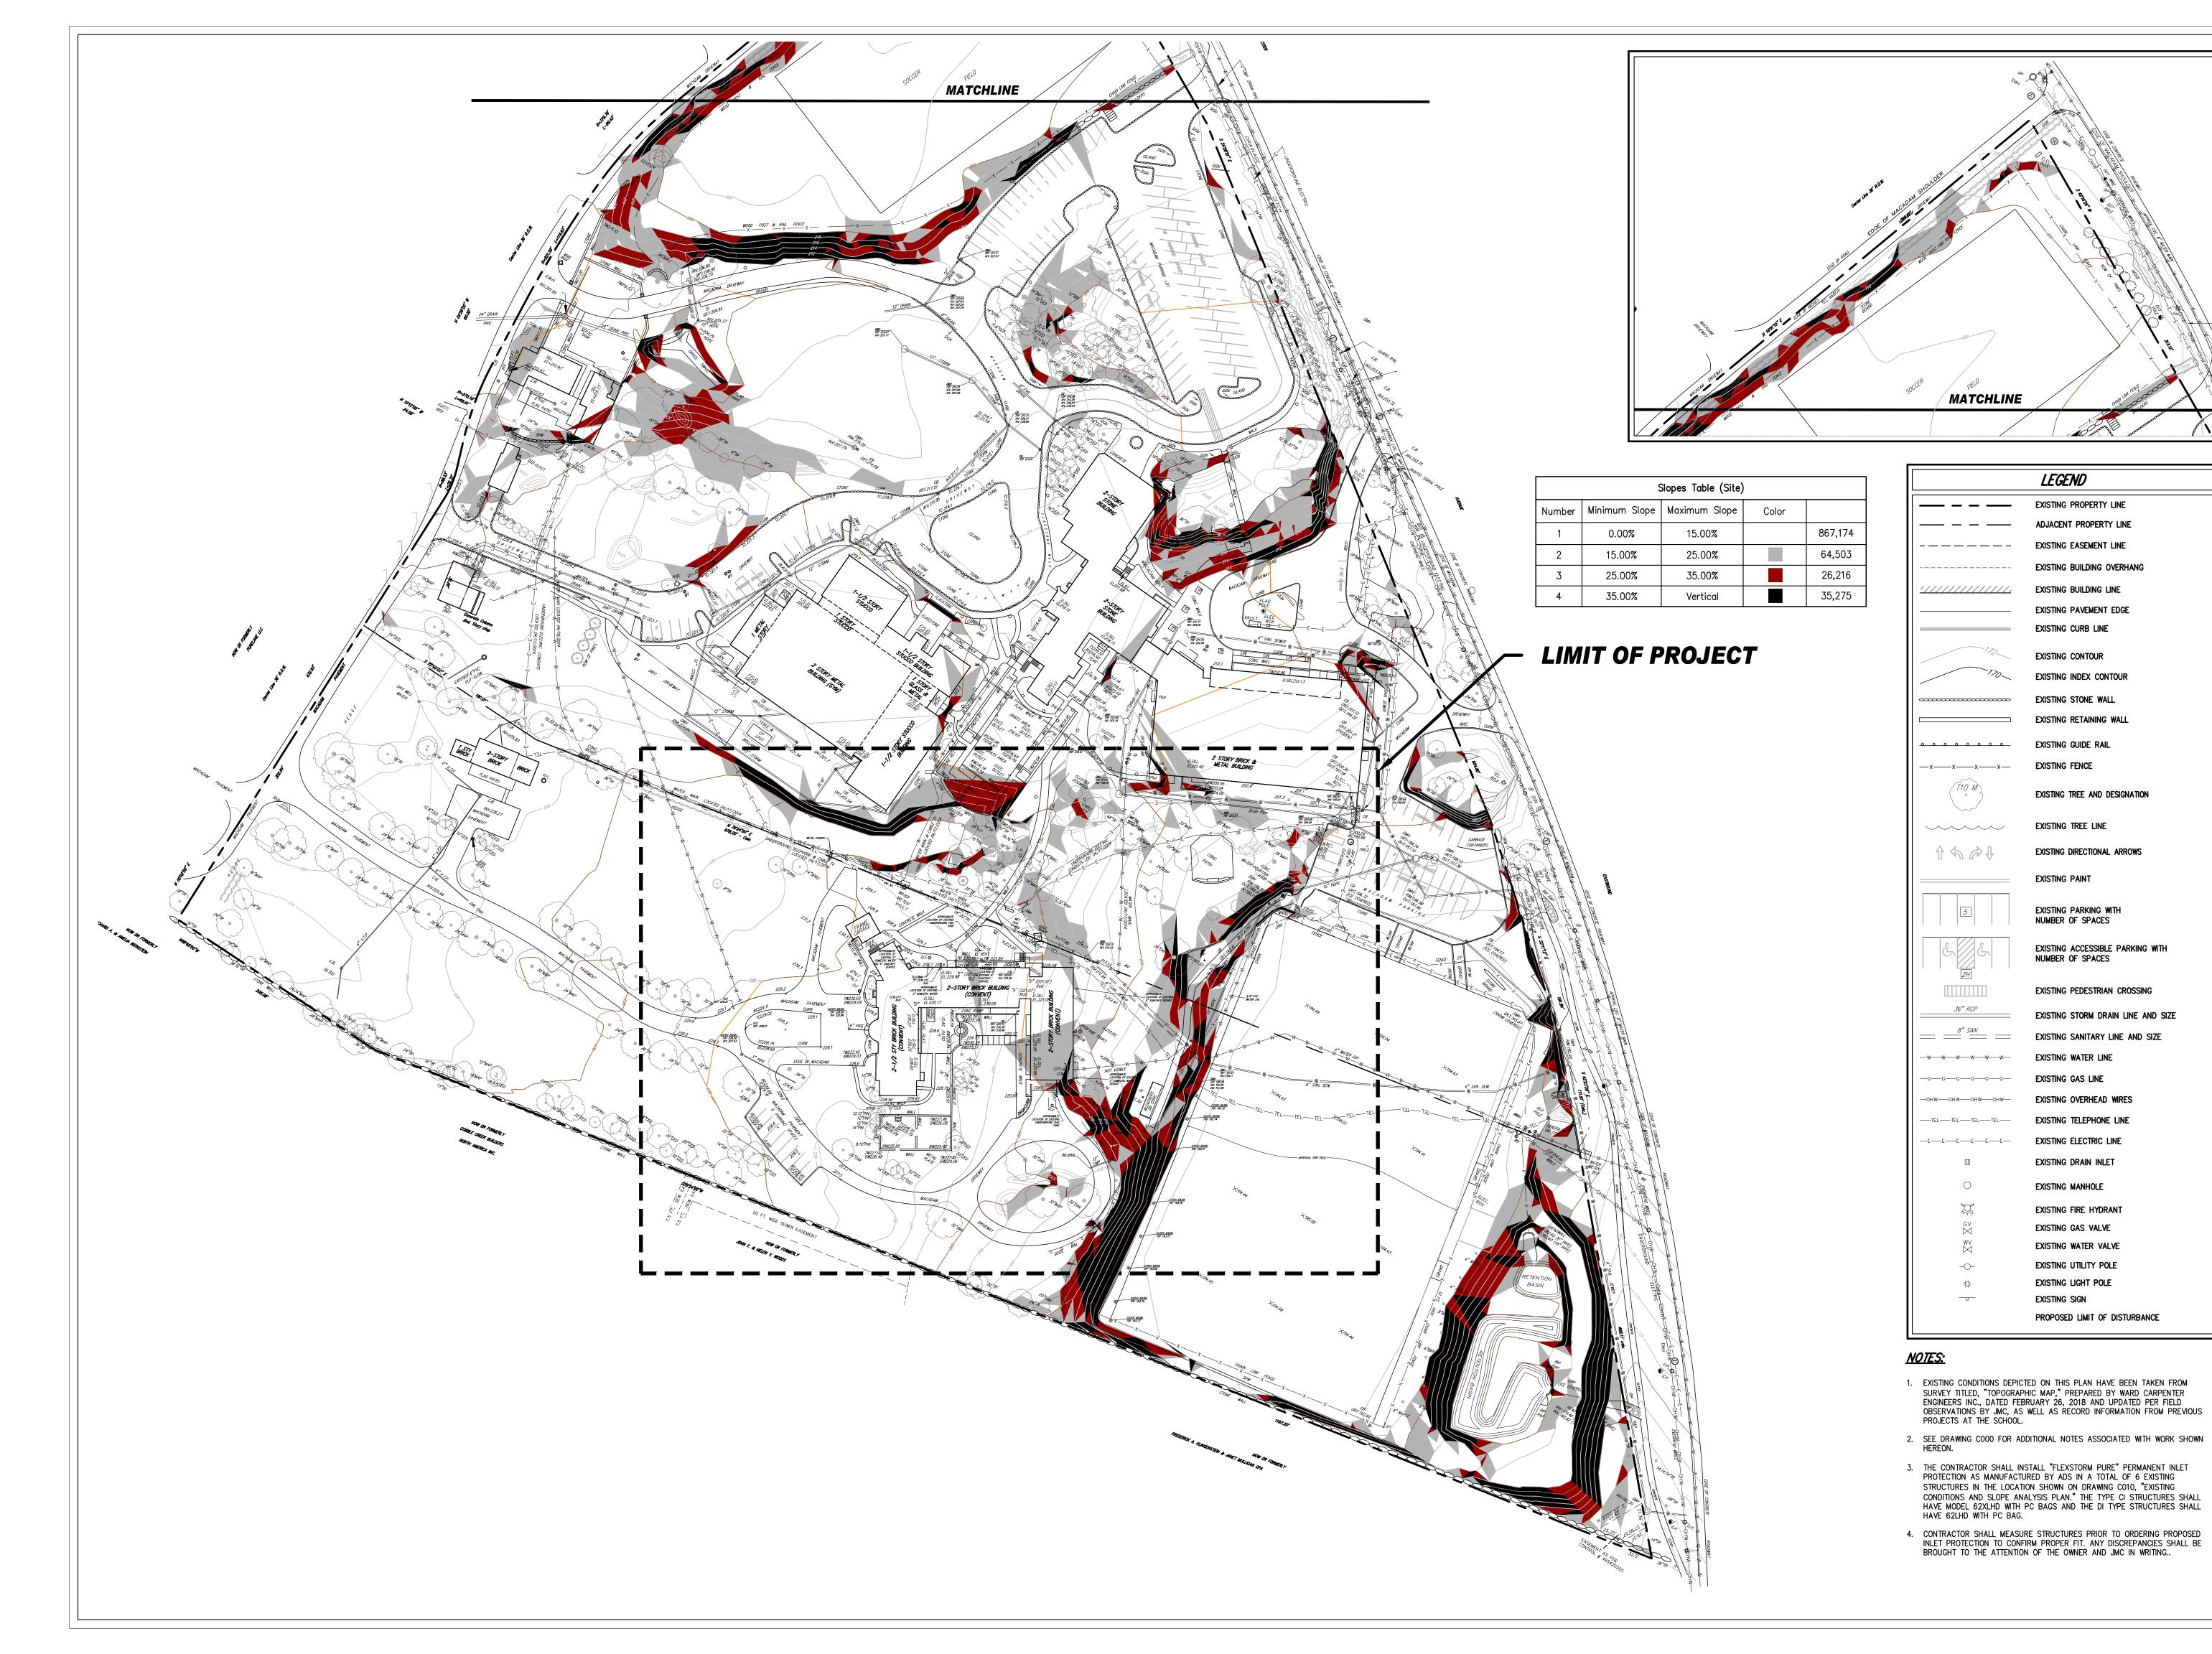

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CHILD 2225 WESTCHESTER AVE, RYE, NY



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CONSTRUCTION DOCUMENTS

MATCHLINE

LEGEND

EXISTING PROPERTY LINE

EXISTING EASEMENT LINE

EXISTING BUILDING LINE

EXISTING CURB LINE

EXISTING CONTOUR

EXISTING PAVEMENT EDGE

EXISTING INDEX CONTOUR

EXISTING STONE WALL

EXISTING GUIDE RAIL

EXISTING TREE LINE

EXISTING PAINT

EXISTING PARKING WITH NUMBER OF SPACES

NUMBER OF SPACES

EXISTING WATER LINE

EXISTING OVERHEAD WIRES

EXISTING TELEPHONE LINE

EXISTING ELECTRIC LINE

EXISTING DRAIN INLET

EXISTING FIRE HYDRANT EXISTING GAS VALVE EXISTING WATER VALVE

EXISTING UTILITY POLE EXISTING LIGHT POLE

PROPOSED LIMIT OF DISTURBANCE

EXISTING SIGN

STRUCTURES IN THE LOCATION SHOWN ON DRAWING CO10, "EXISTING

HAVE 62LHD WITH PC BAG.

EXISTING MANHOLE

EXISTING GAS LINE

----w-----w-----w-----w-----

—G—G—G—G—G—

—OHW——OHW——OHW—

EXISTING ACCESSIBLE PARKING WITH

EXISTING PEDESTRIAN CROSSING

EXISTING SANITARY LINE AND SIZE

EXISTING STORM DRAIN LINE AND SIZE

EXISTING TREE AND DESIGNATION


EXISTING FENCE

ADJACENT PROPERTY LINE

EXISTING BUILDING OVERHANG



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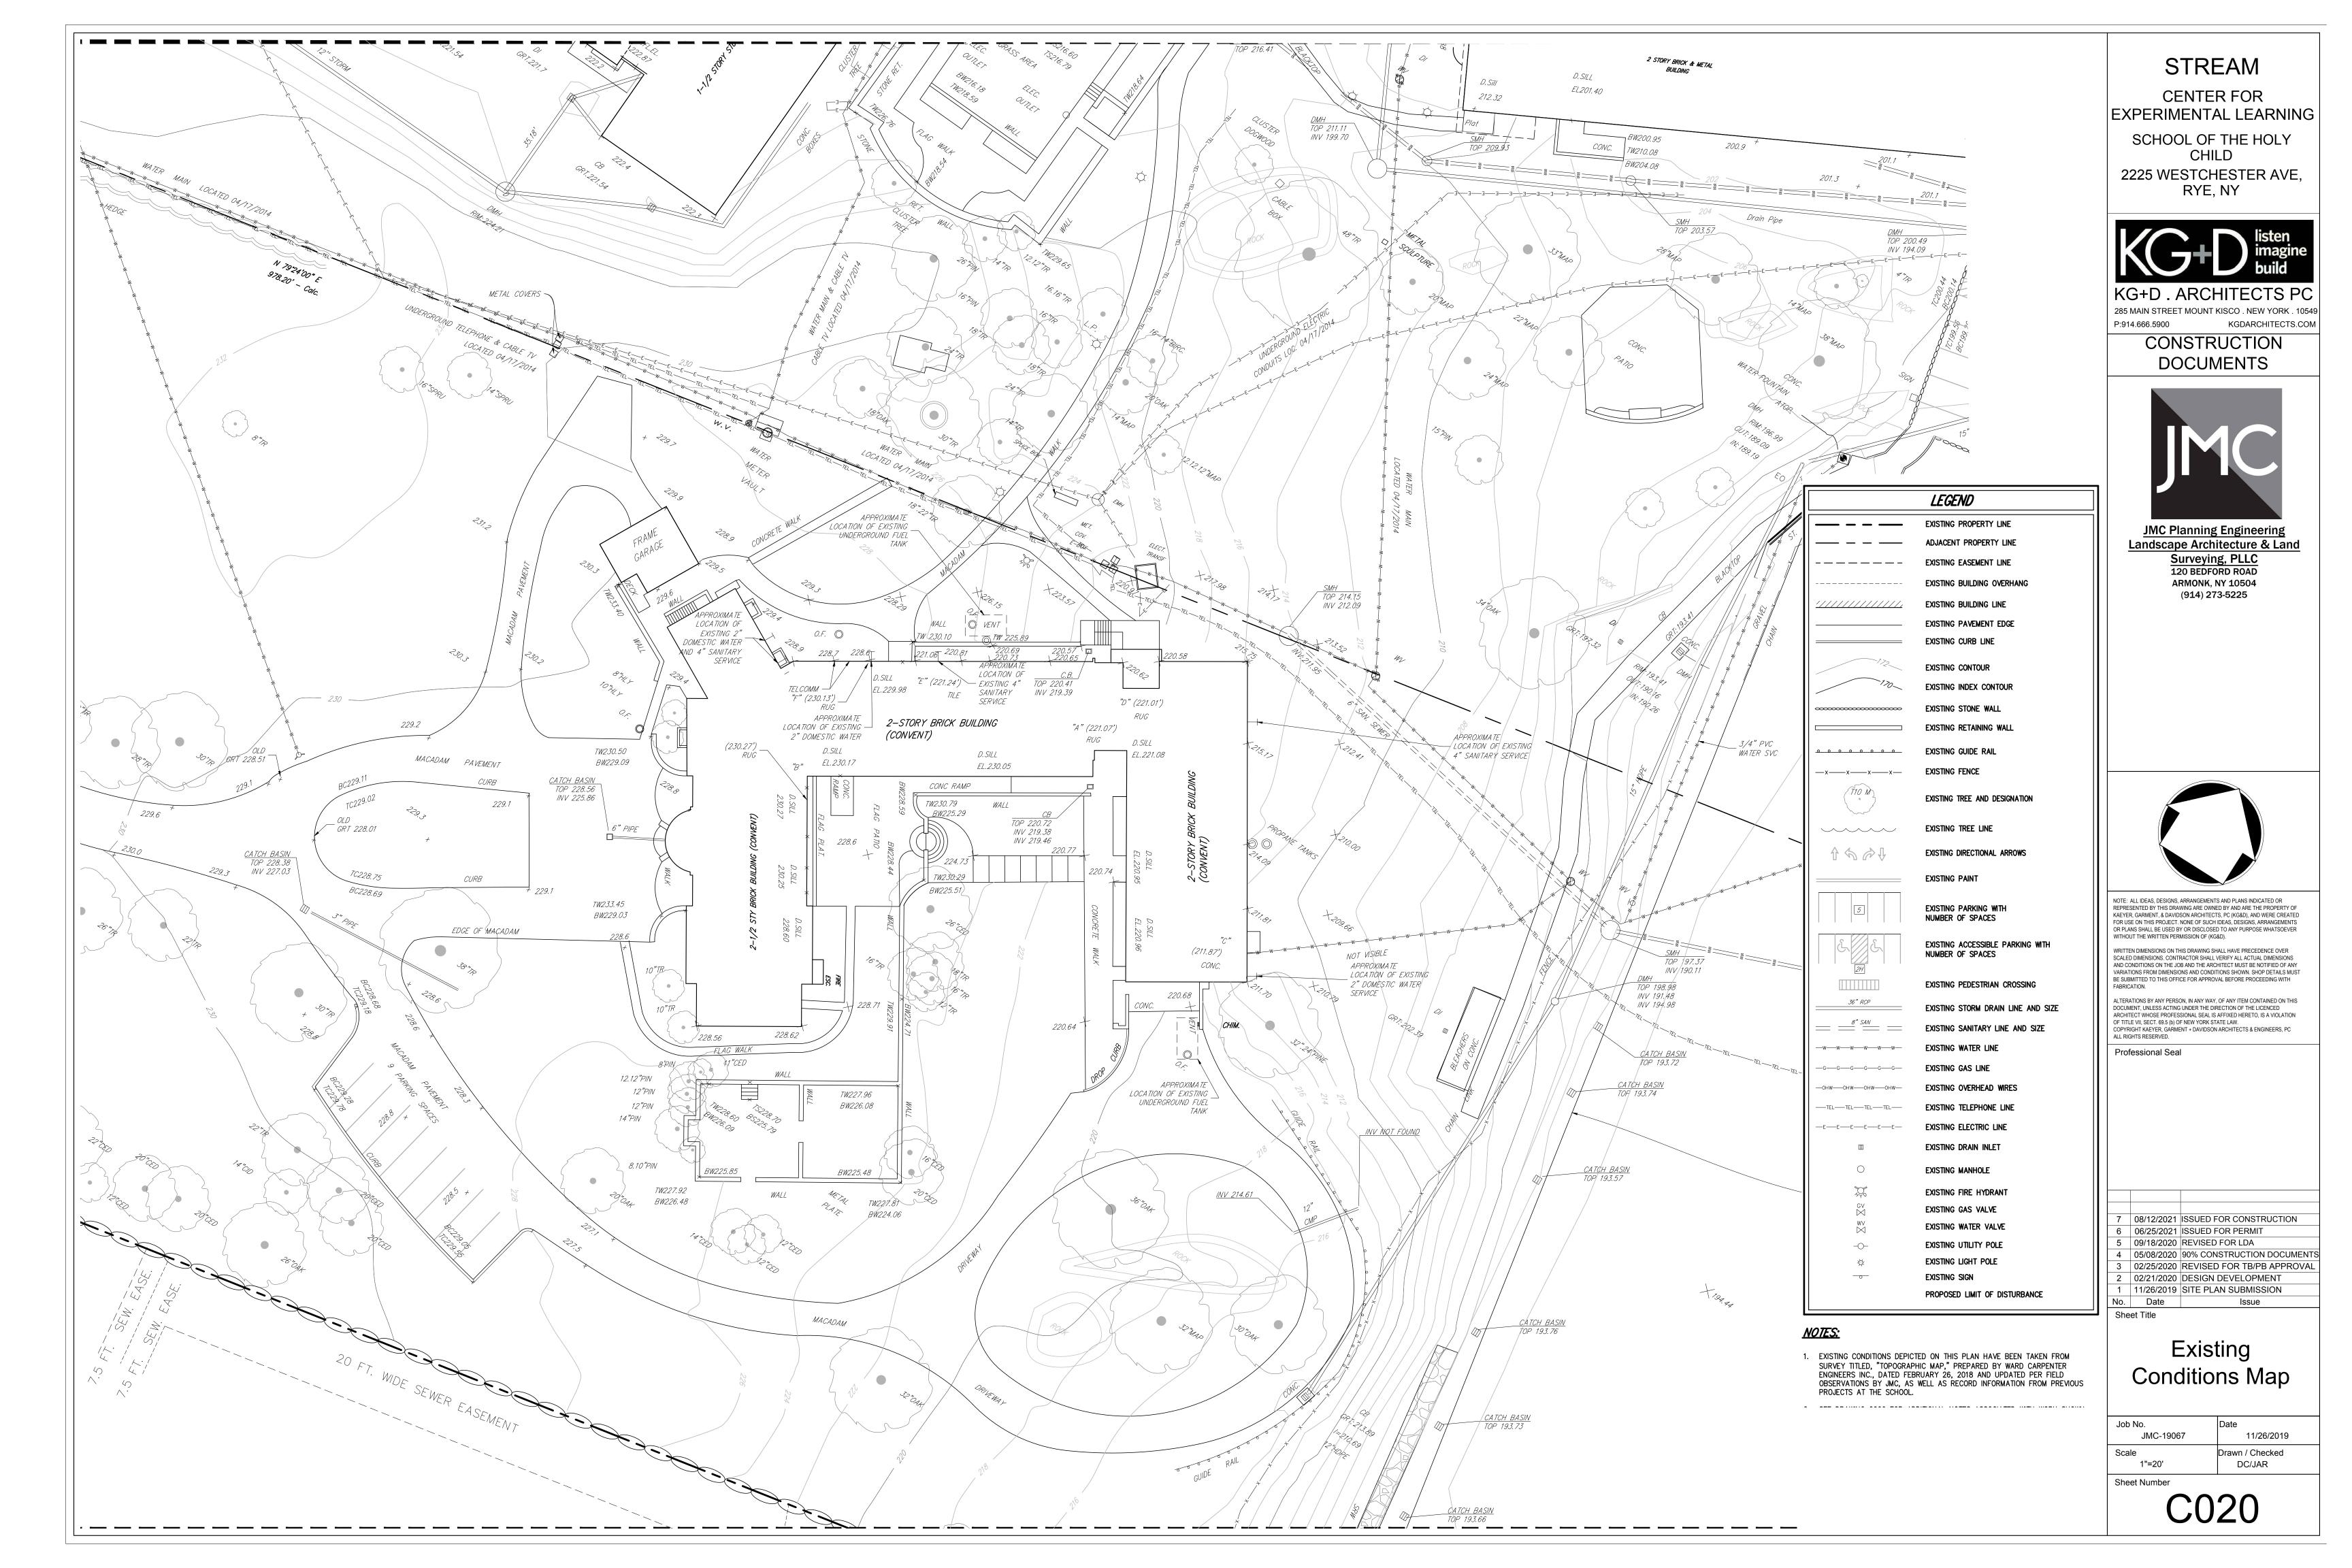
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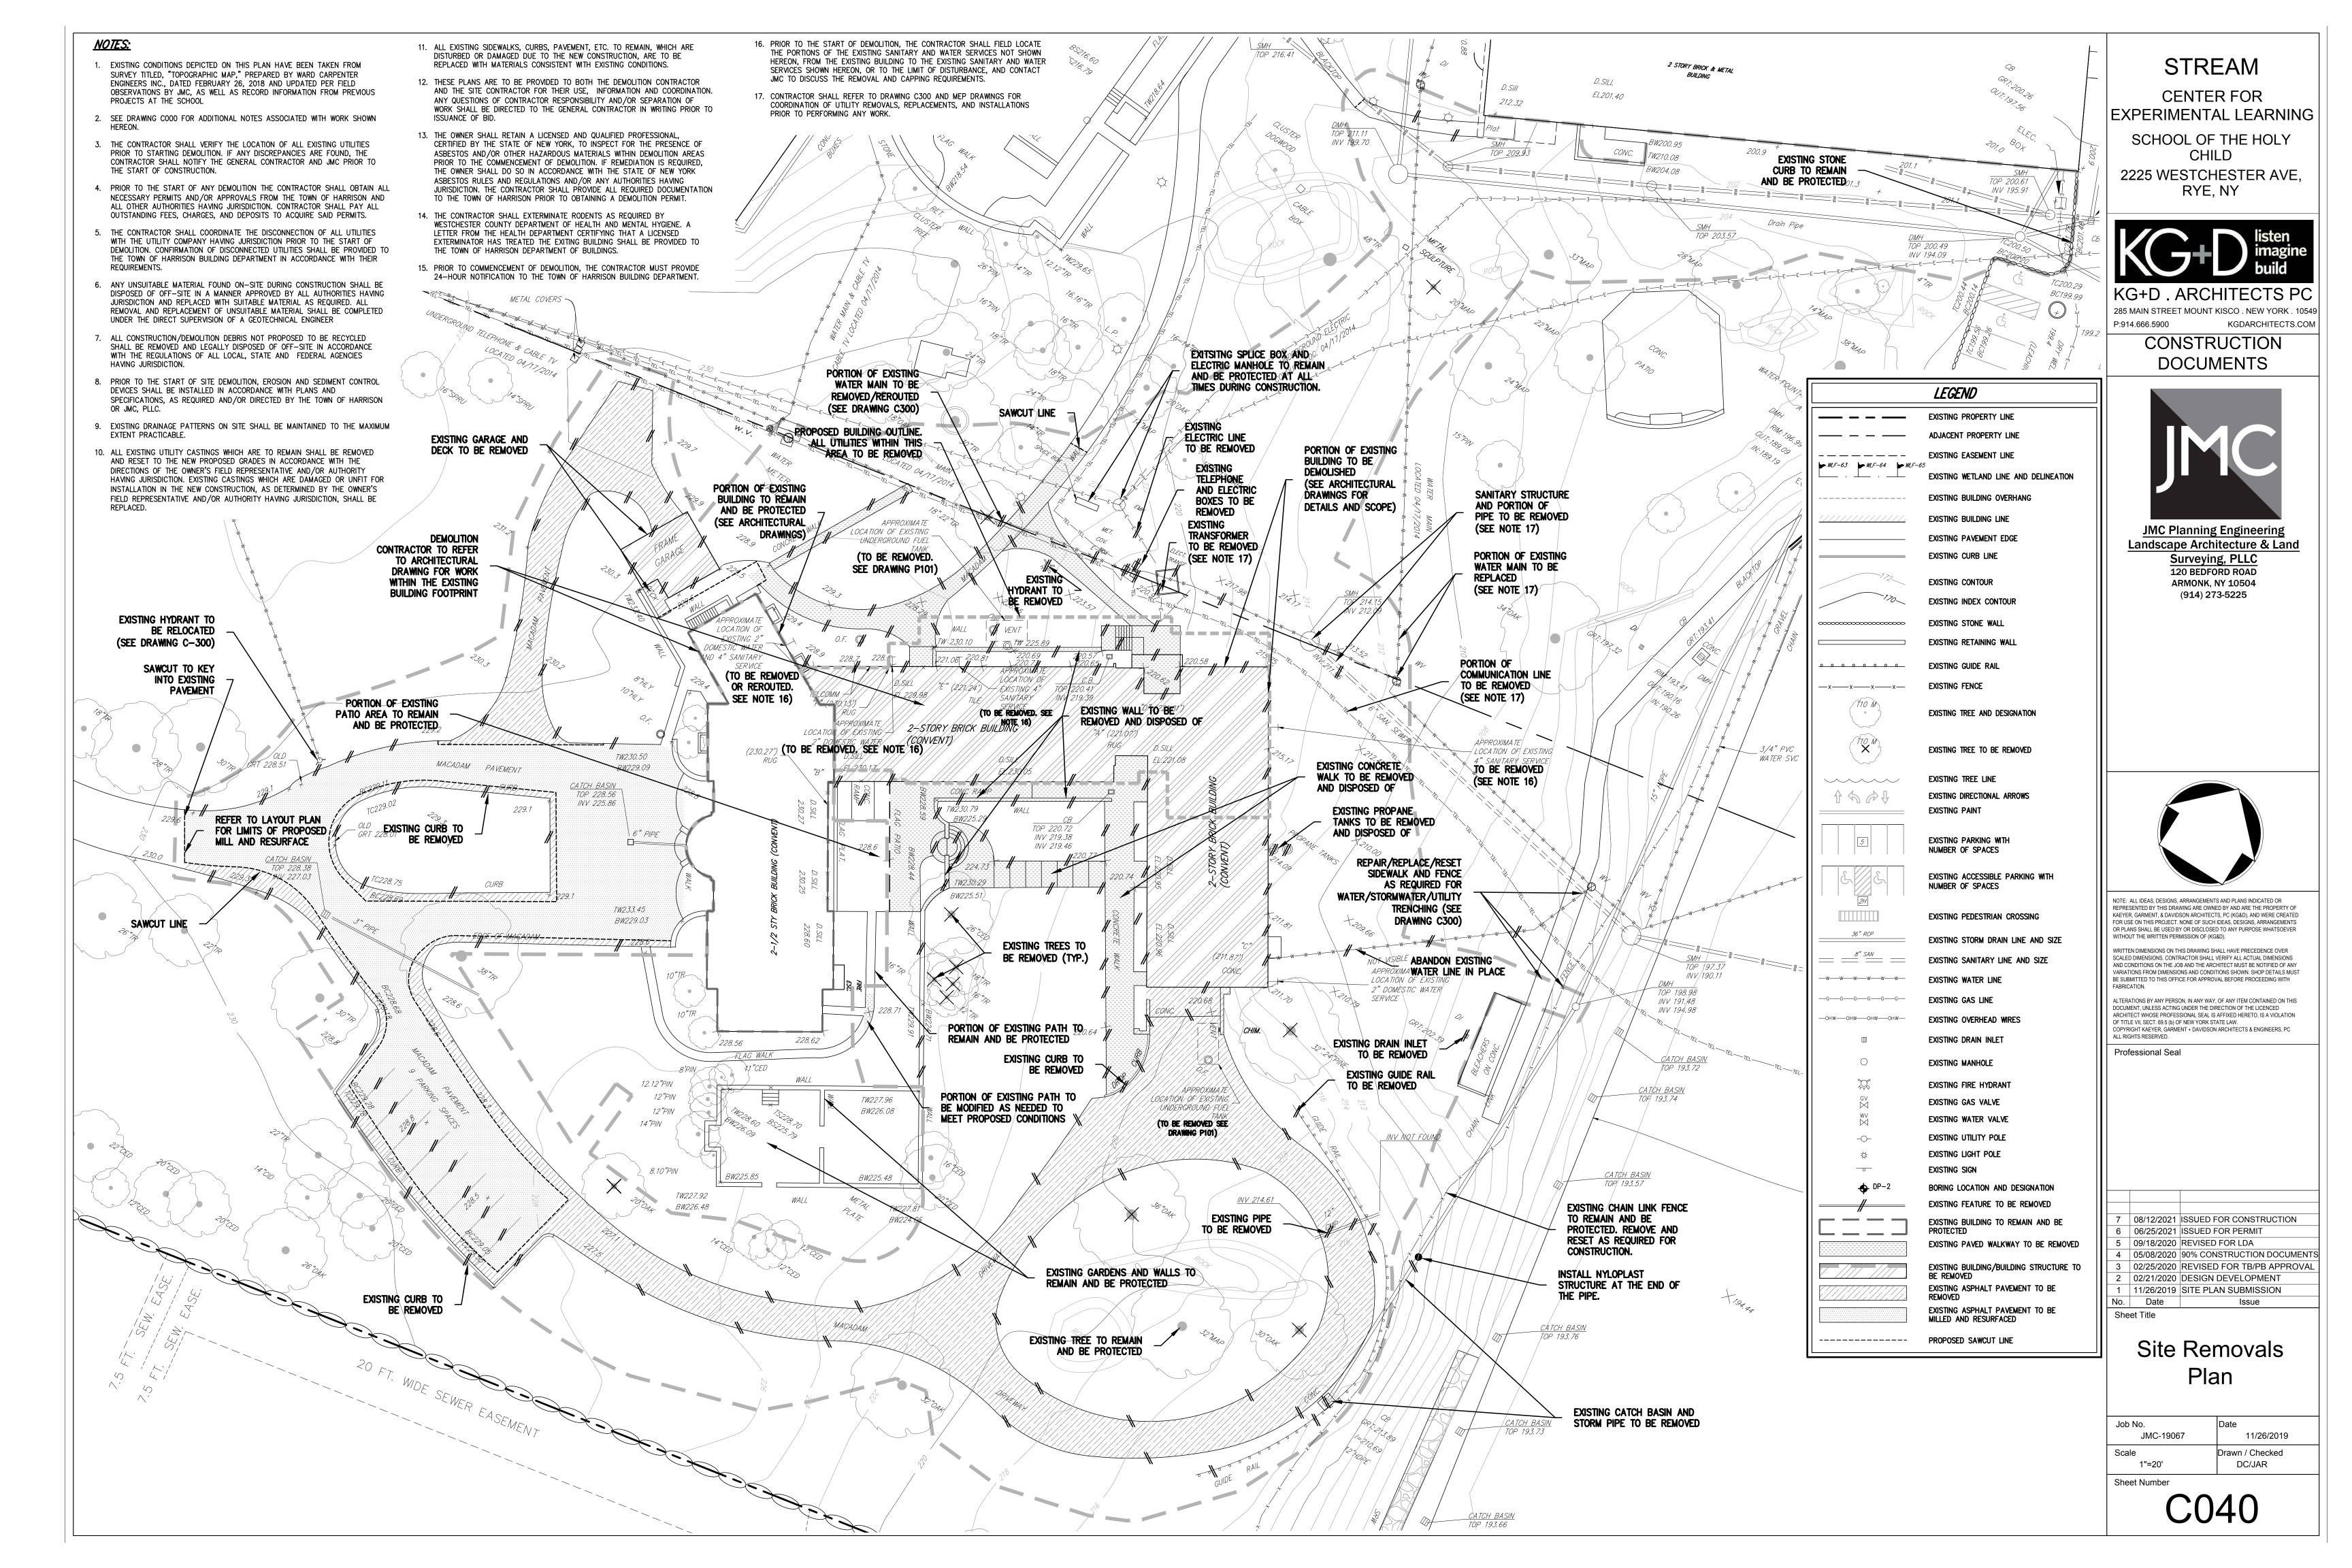
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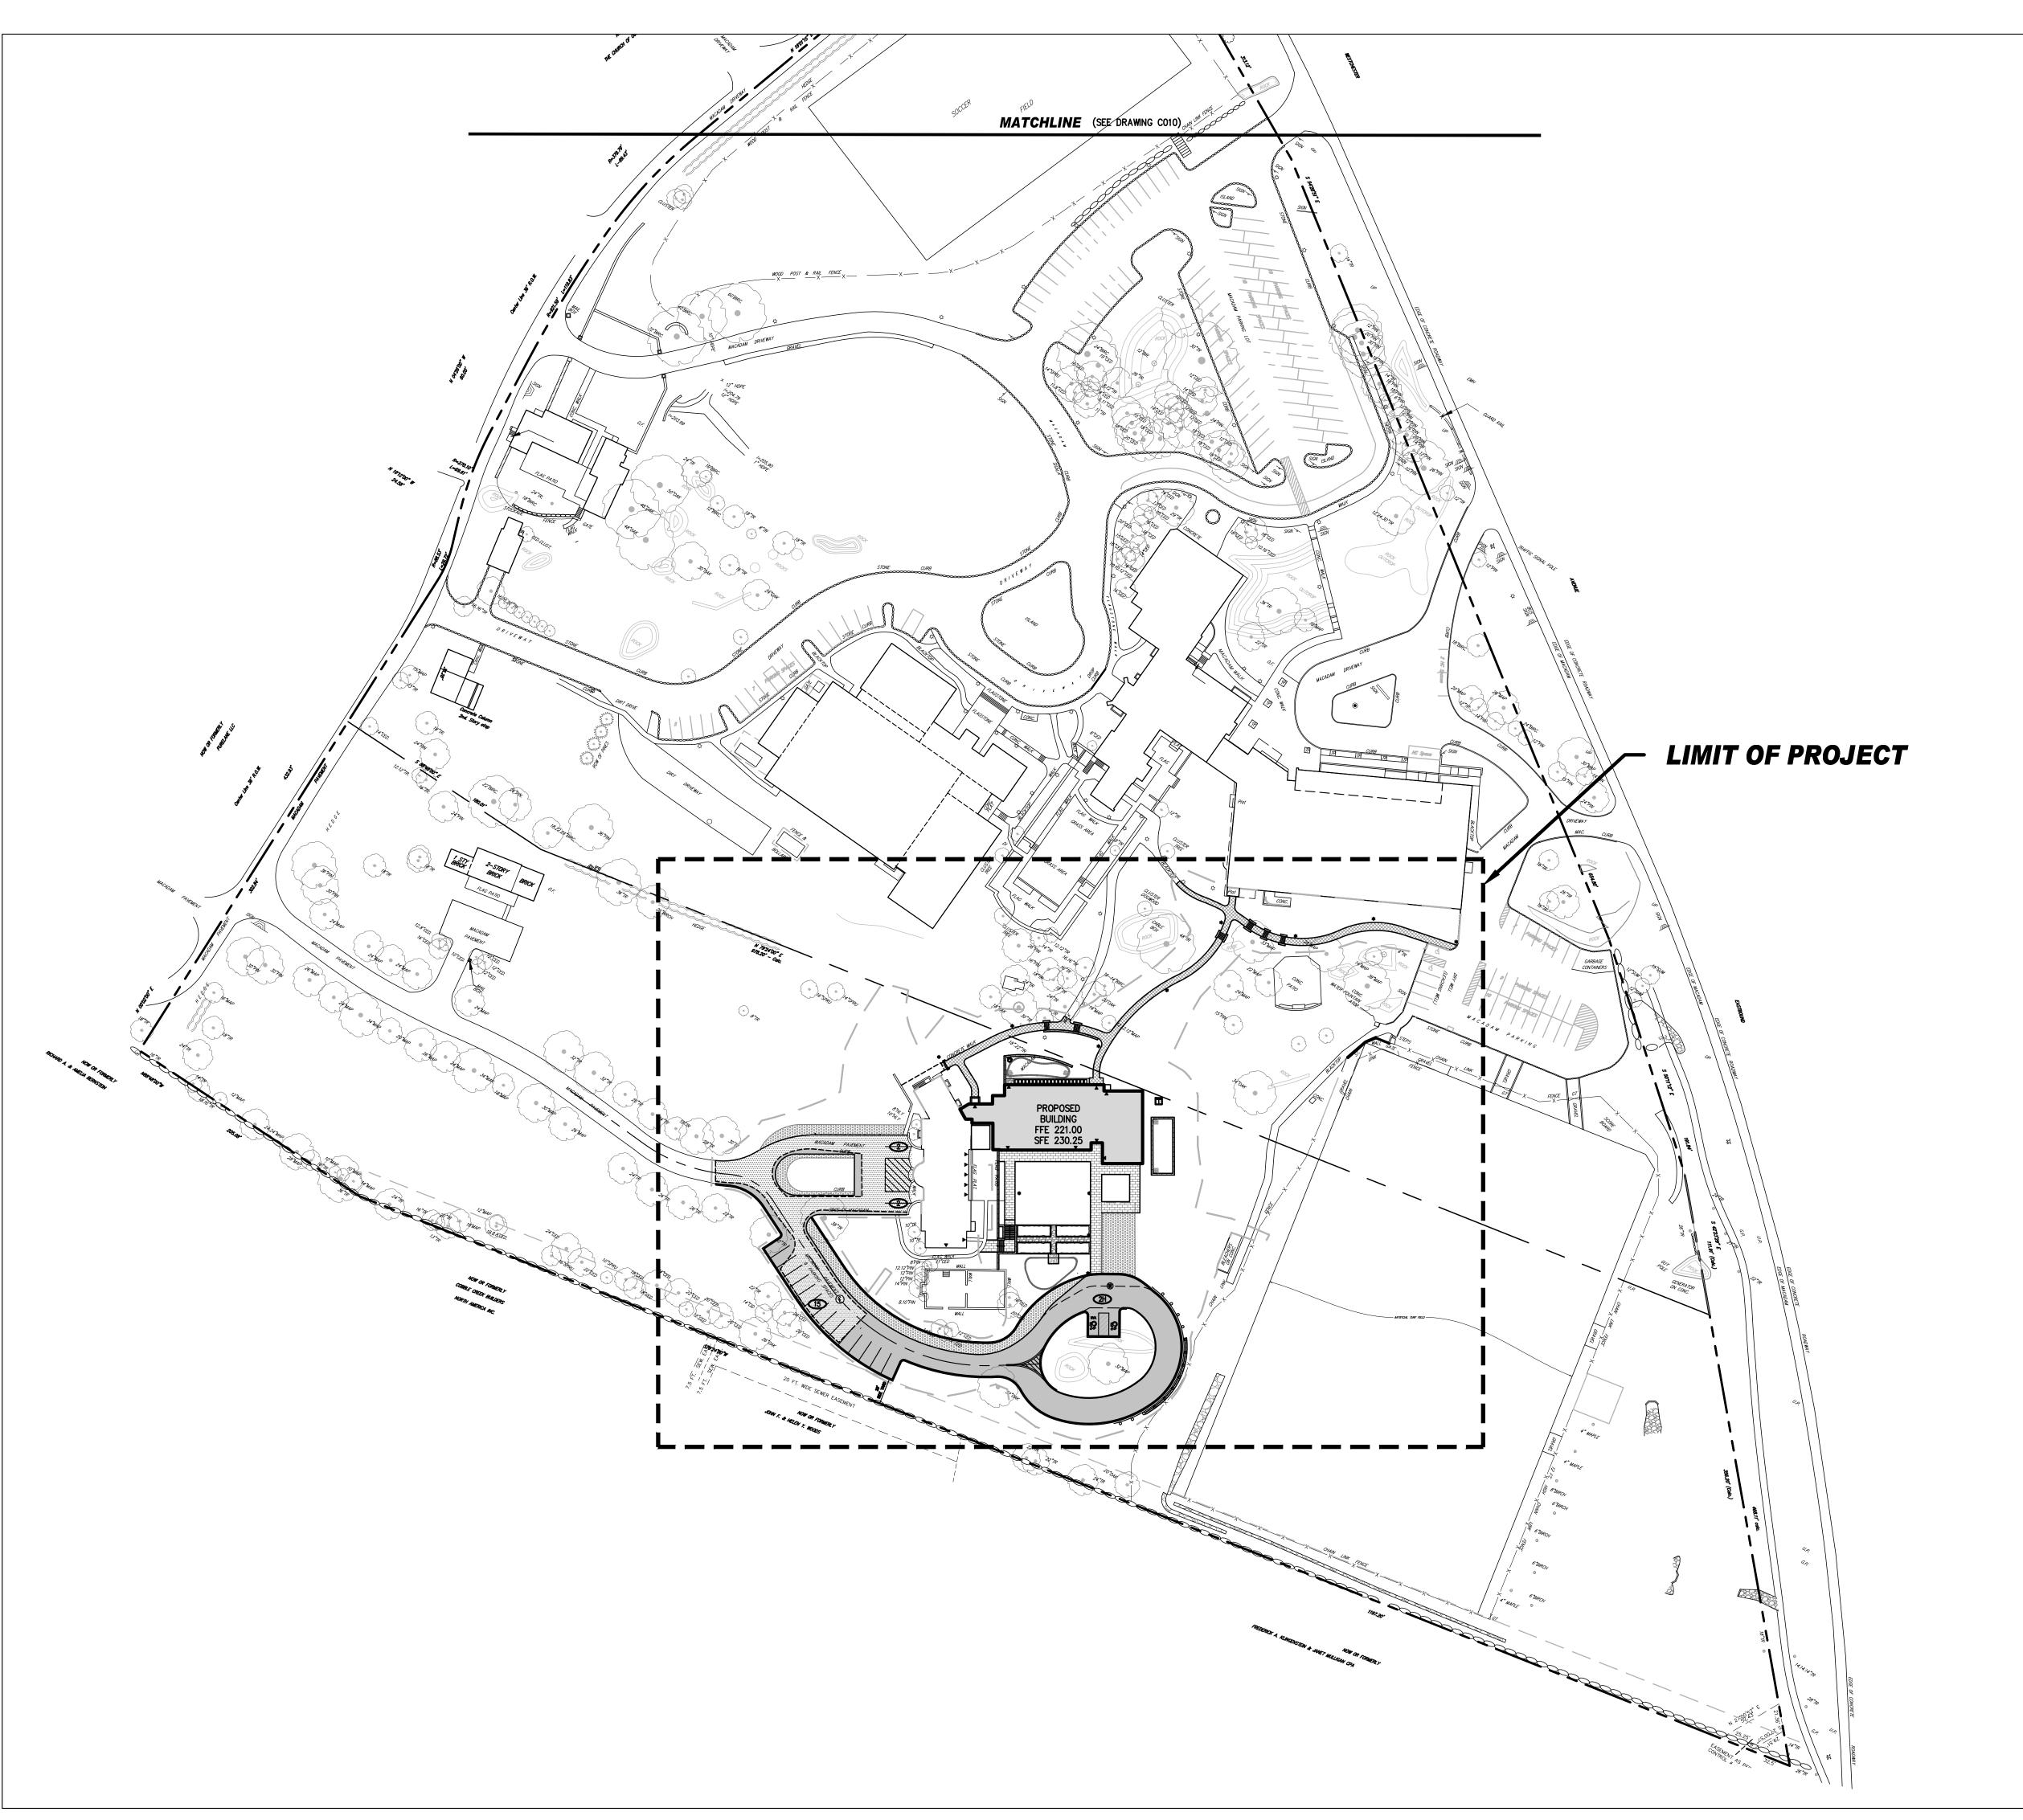
- 4 05/08/2020 90% CONSTRUCTION DOCUMENTS 02/25/2020 REVISED FOR TB/PB APPROVAL 02/21/2020 DESIGN DEVELOPMENT
- 1 11/26/2019 SITE PLAN SUBMISSION No. Date Issue

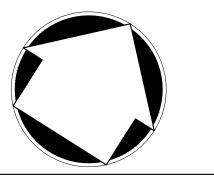Overall Existing Conditions and Slope Analysis Map

Job No.	Date
JMC-19067	11/26/2019
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## LEGEND EXISTING PROPERTY LINE ADJACENT PROPERTY LINE EXISTING EASEMENT LINE EXISTING BUILDING LINE EXISTING PAVEMENT EDGE EXISTING CURB LINE EXISTING STONE WALL EXISTING RETAINING WALL EXISTING GUIDE RAIL EXISTING FENCE \_x---x--x---x--EXISTING TREE AND DESIGNATION EXISTING TREE LINE EXISTING DIRECTIONAL ARROWS EXISTING PAINT EXISTING PARKING WITH NUMBER OF SPACES EXISTING ACCESSIBLE PARKING WITH NUMBER OF SPACES EXISTING PEDESTRIAN CROSSING EXISTING UTILITY POLE EXISTING LIGHT POLE EXISTING SIGN PROPOSED BUILDING LINE PROPOSED CONCRETE CURB PROPOSED RETAINING WALL (DESIGNED BY OTHERS) PROPOSED SIDEWALK/PATH (SEE NOTE 2) PROPOSED GUIDERAIL PROPOSED MILL AND RESURFACE PAVEMENT

## NOTE

1. EXISTING CONDITIONS DEPICTED ON THIS PLAN HAVE BEEN TAKEN FROM SURVEY TITLED, "TOPOGRAPHIC MAP," PREPARED BY WARD CARPENTER ENGINEERS INC., DATED FEBRUARY 26, 2018 AND UPDATED PER FIELD OBSERVATIONS BY JMC, AS WELL AS RECORD INFORMATION FROM PREVIOUS PROJECTS AT THE SCHOOL.

PROPOSED EXTENDED CURB

PROPOSED HEAVY DUTY PAVEMENT

PROPOSED GRASS PAVER SURFACE

- 2. SEE LANDSCAPE (L SERIES) DRAWINGS FOR SURFACE TREATMENT AND DETAILS.
- 3. SEE DRAWING COOO FOR ADDITIONAL NOTES ASSOCIATED WITH WORK SHOWN HEREON.

# STREAM

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SCHOOL OF THE HOLY




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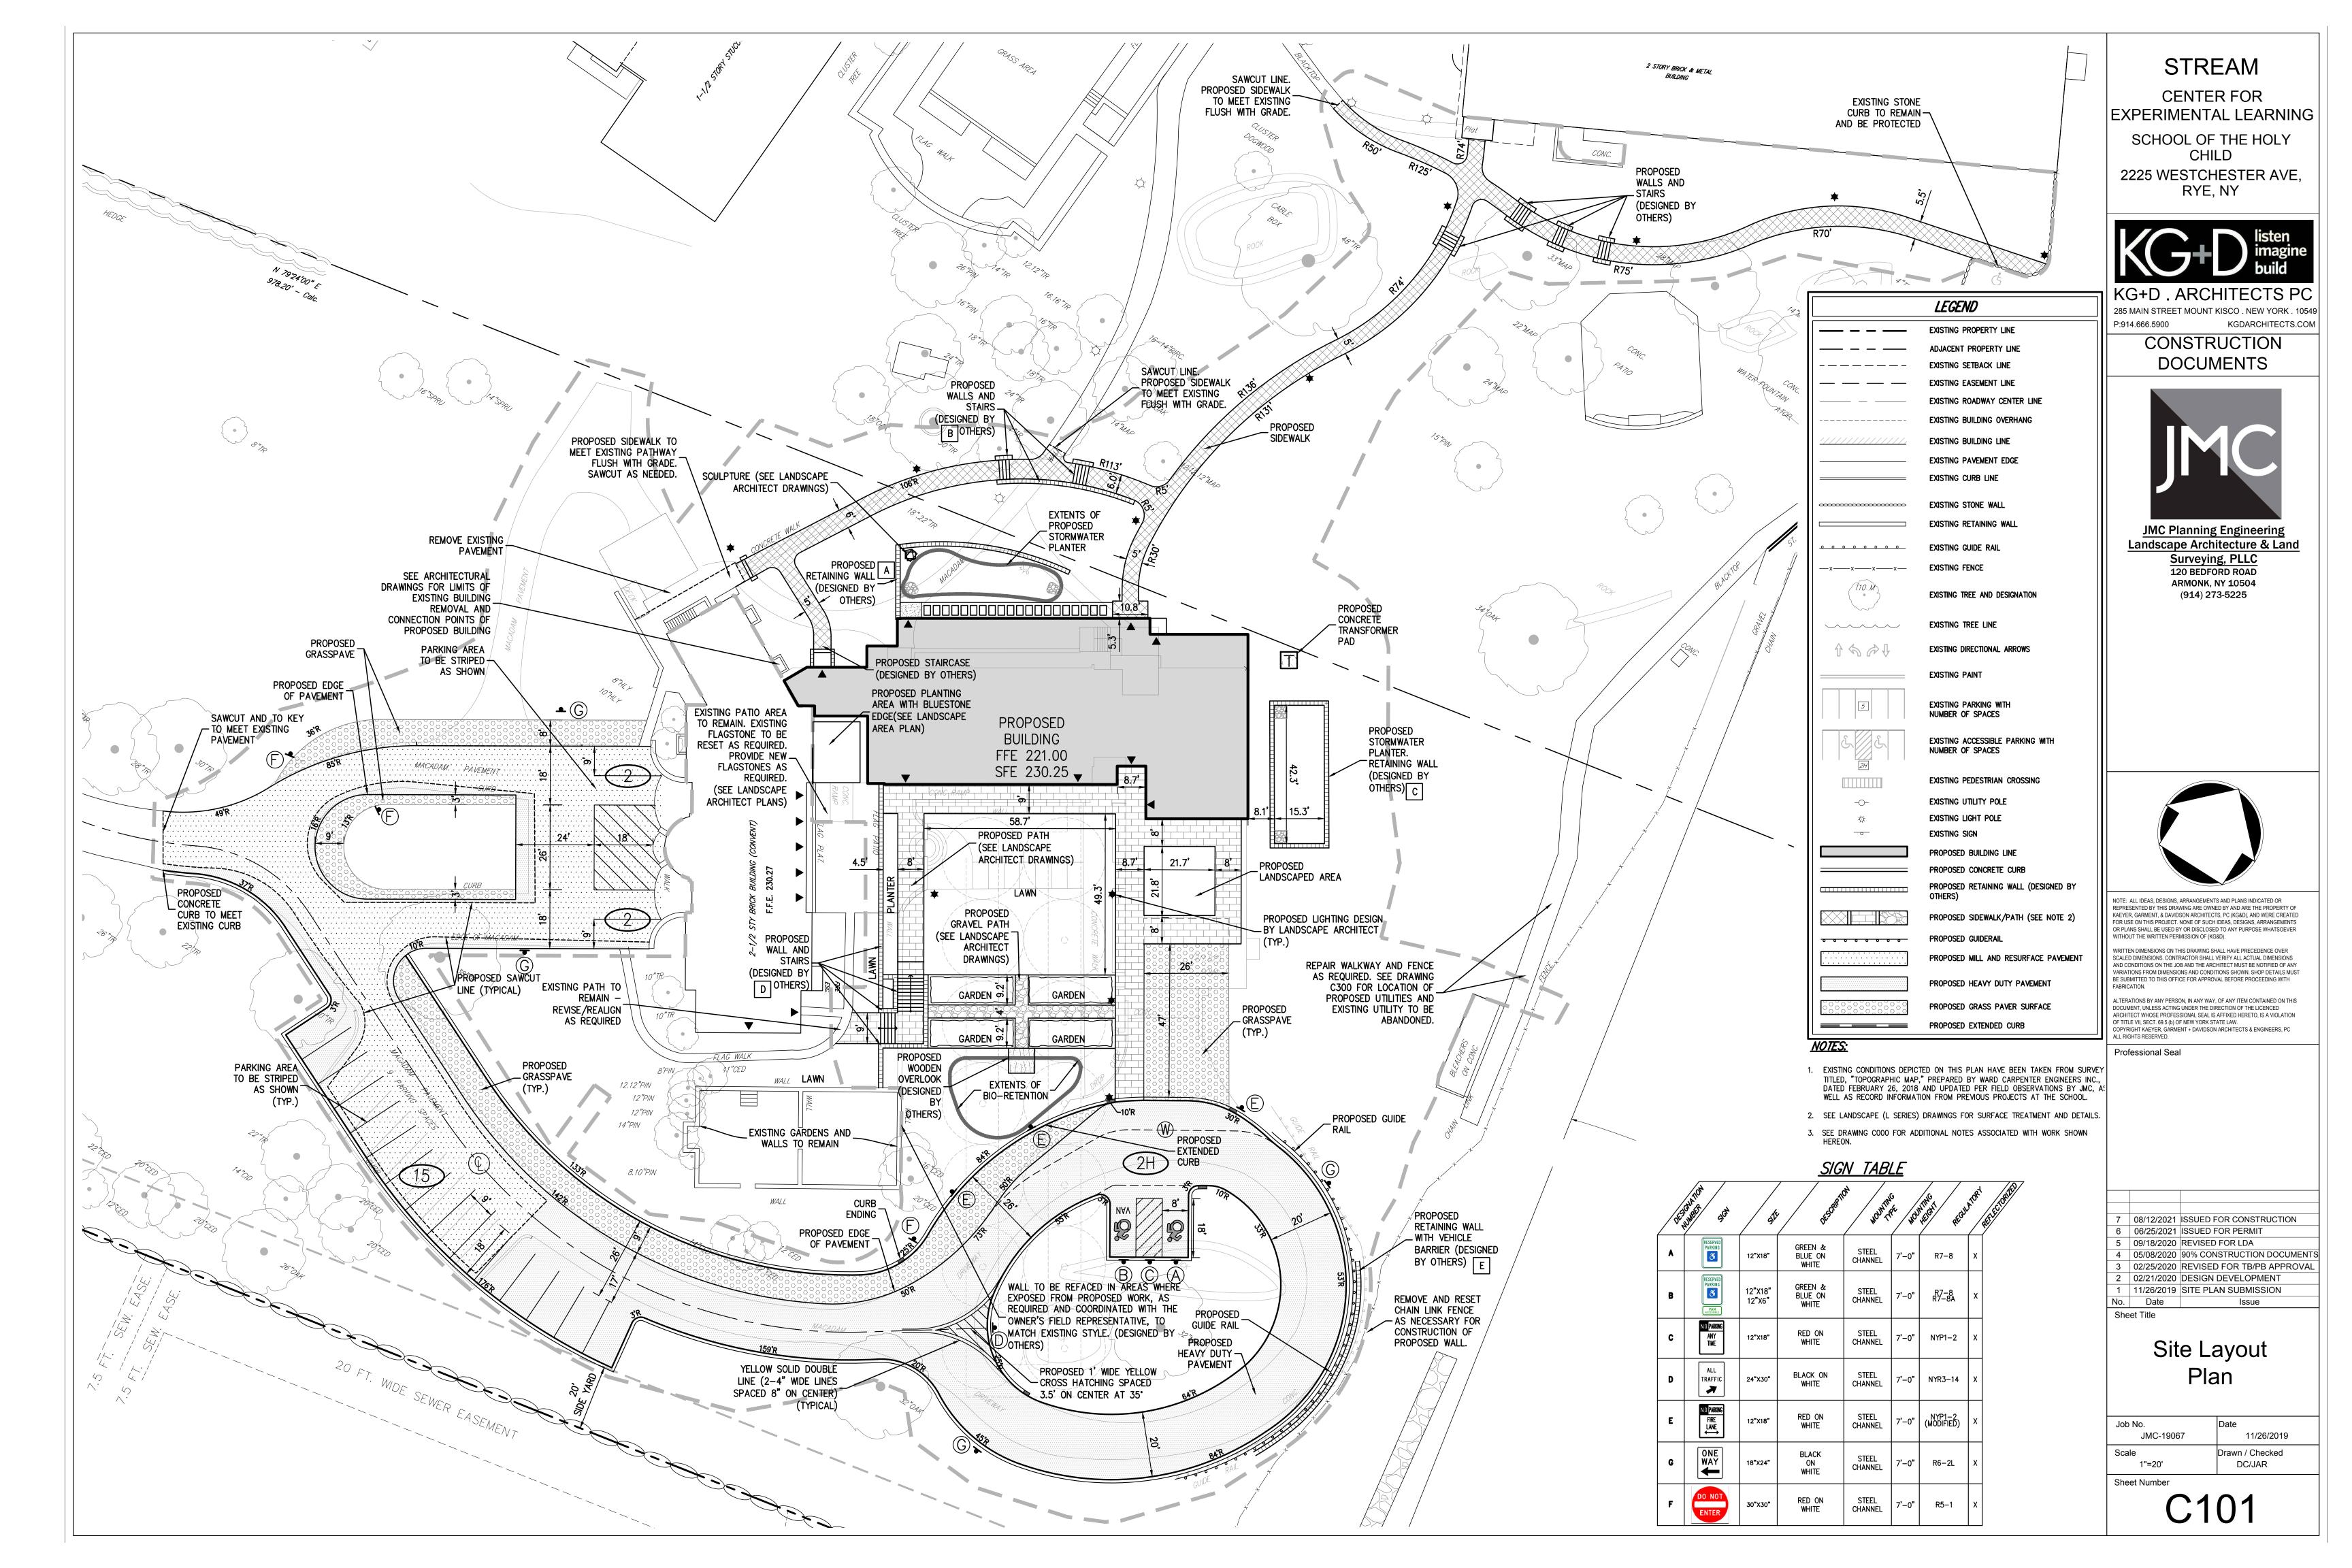
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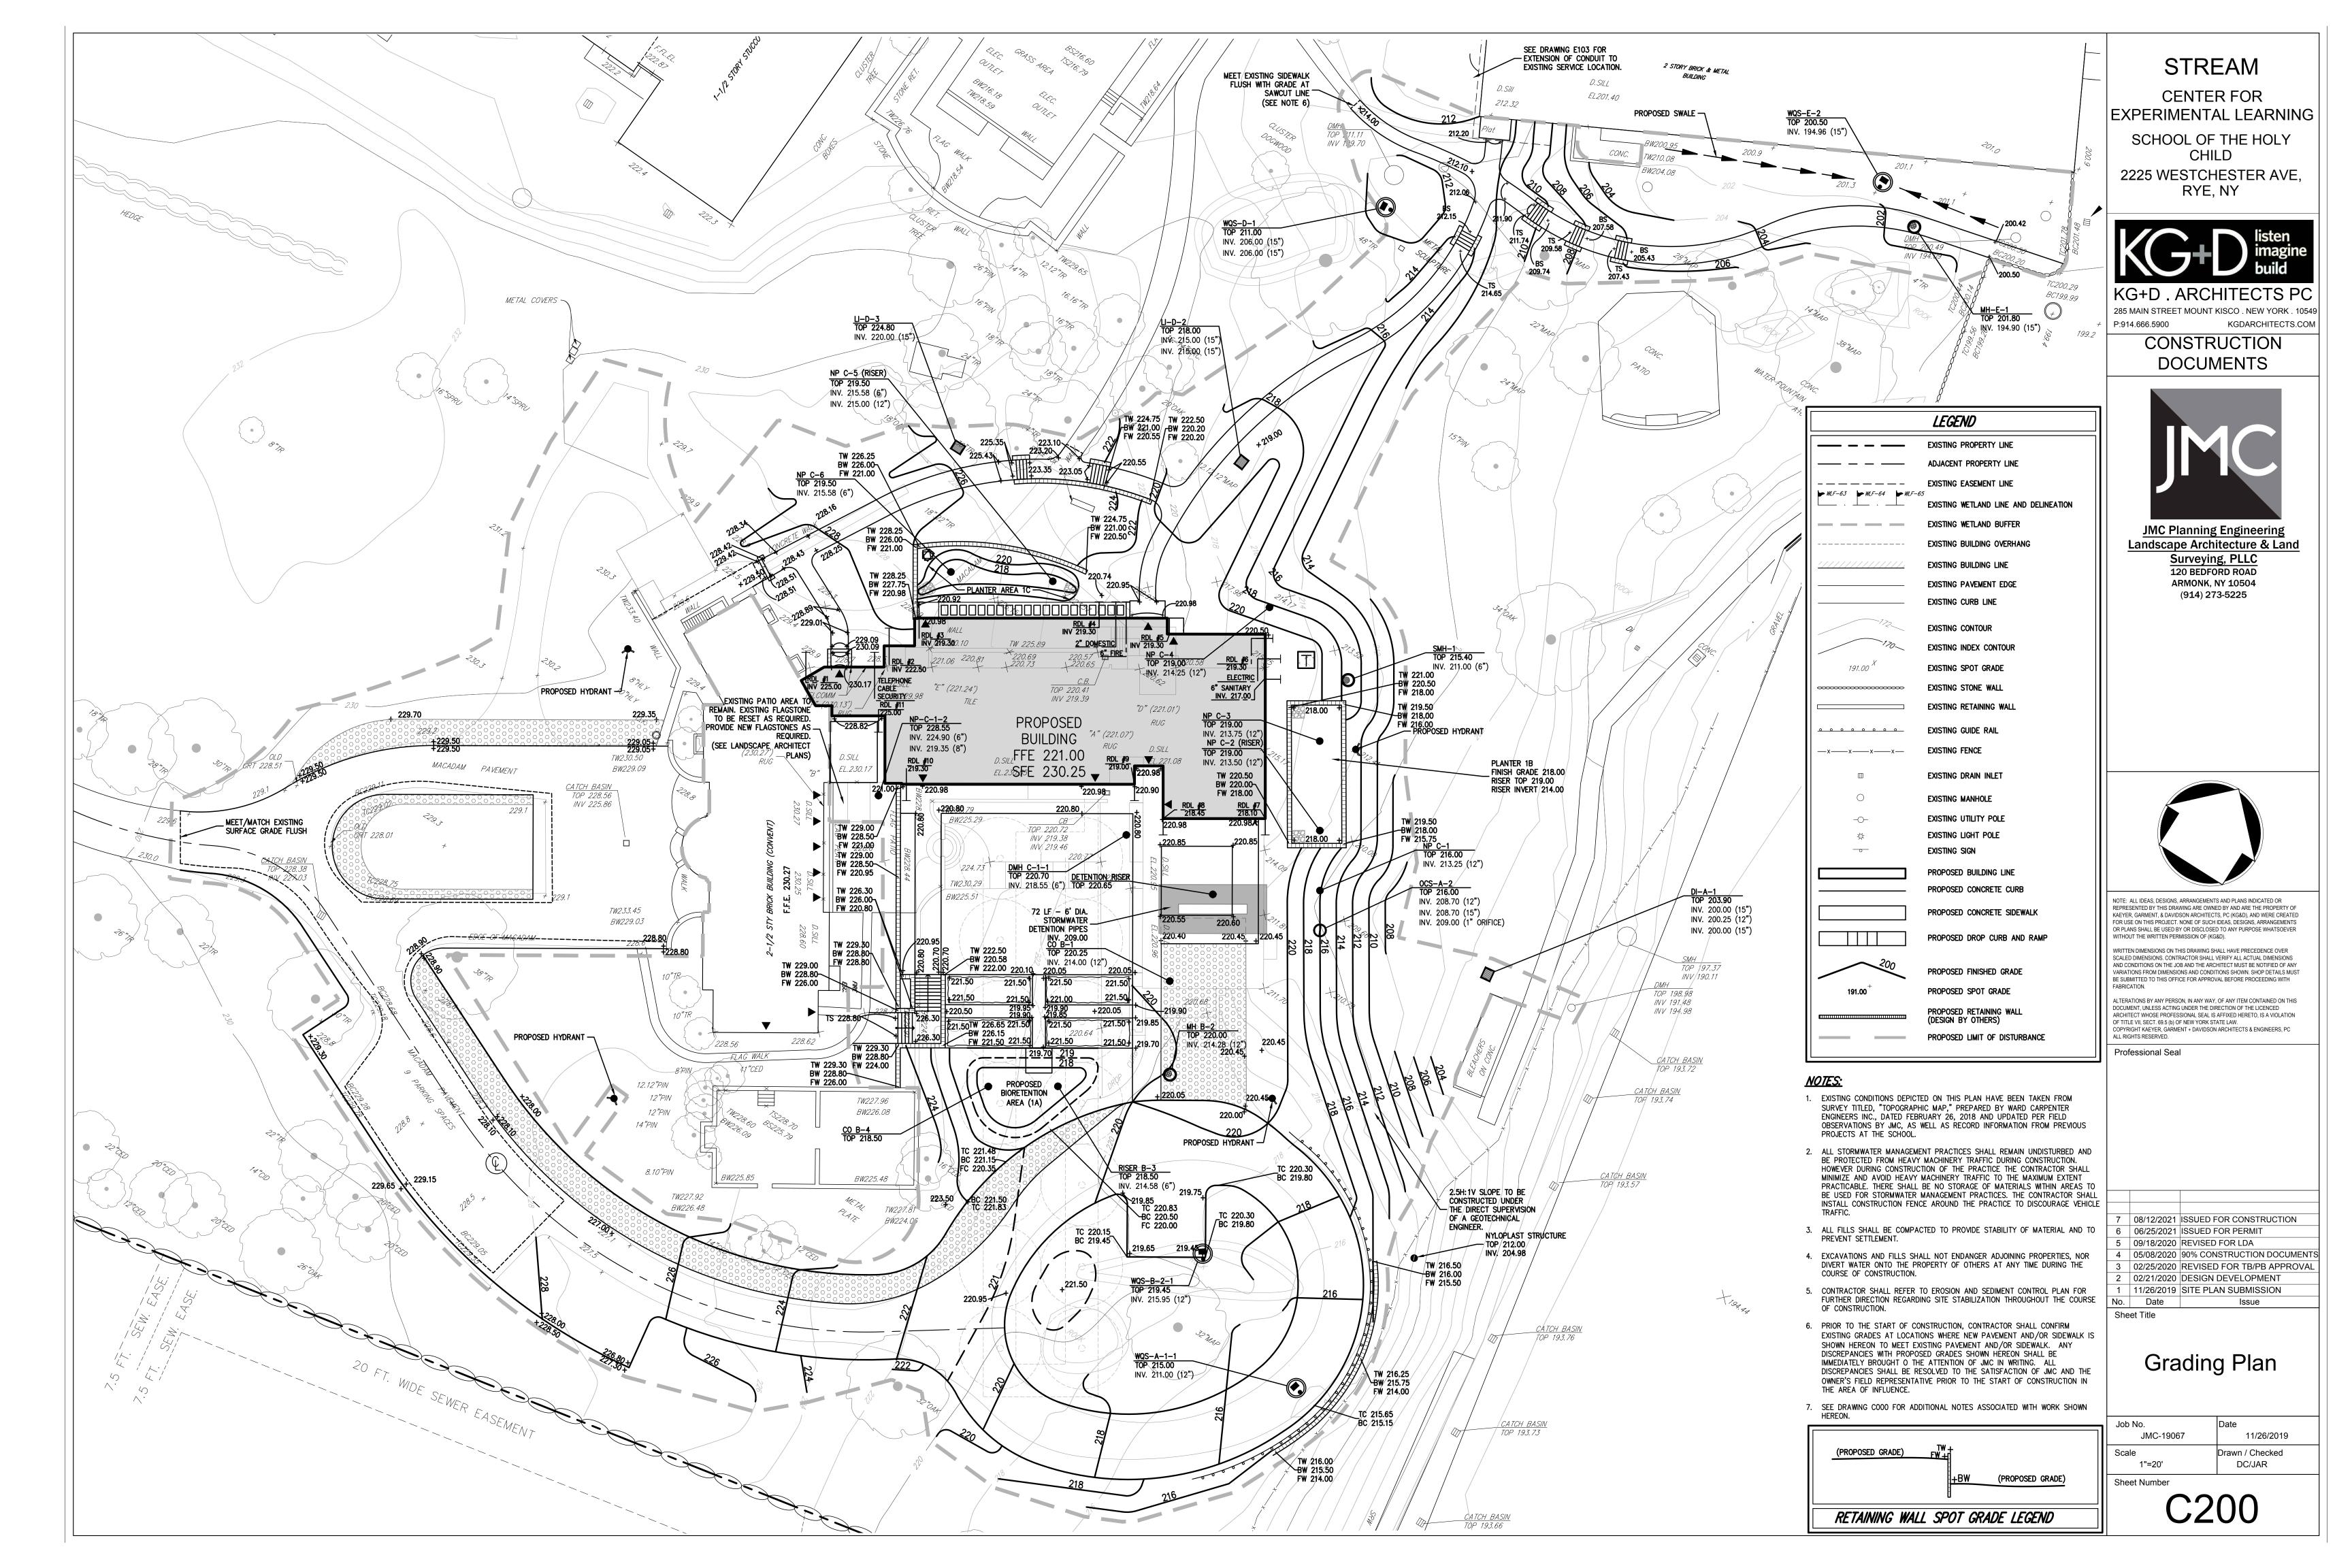
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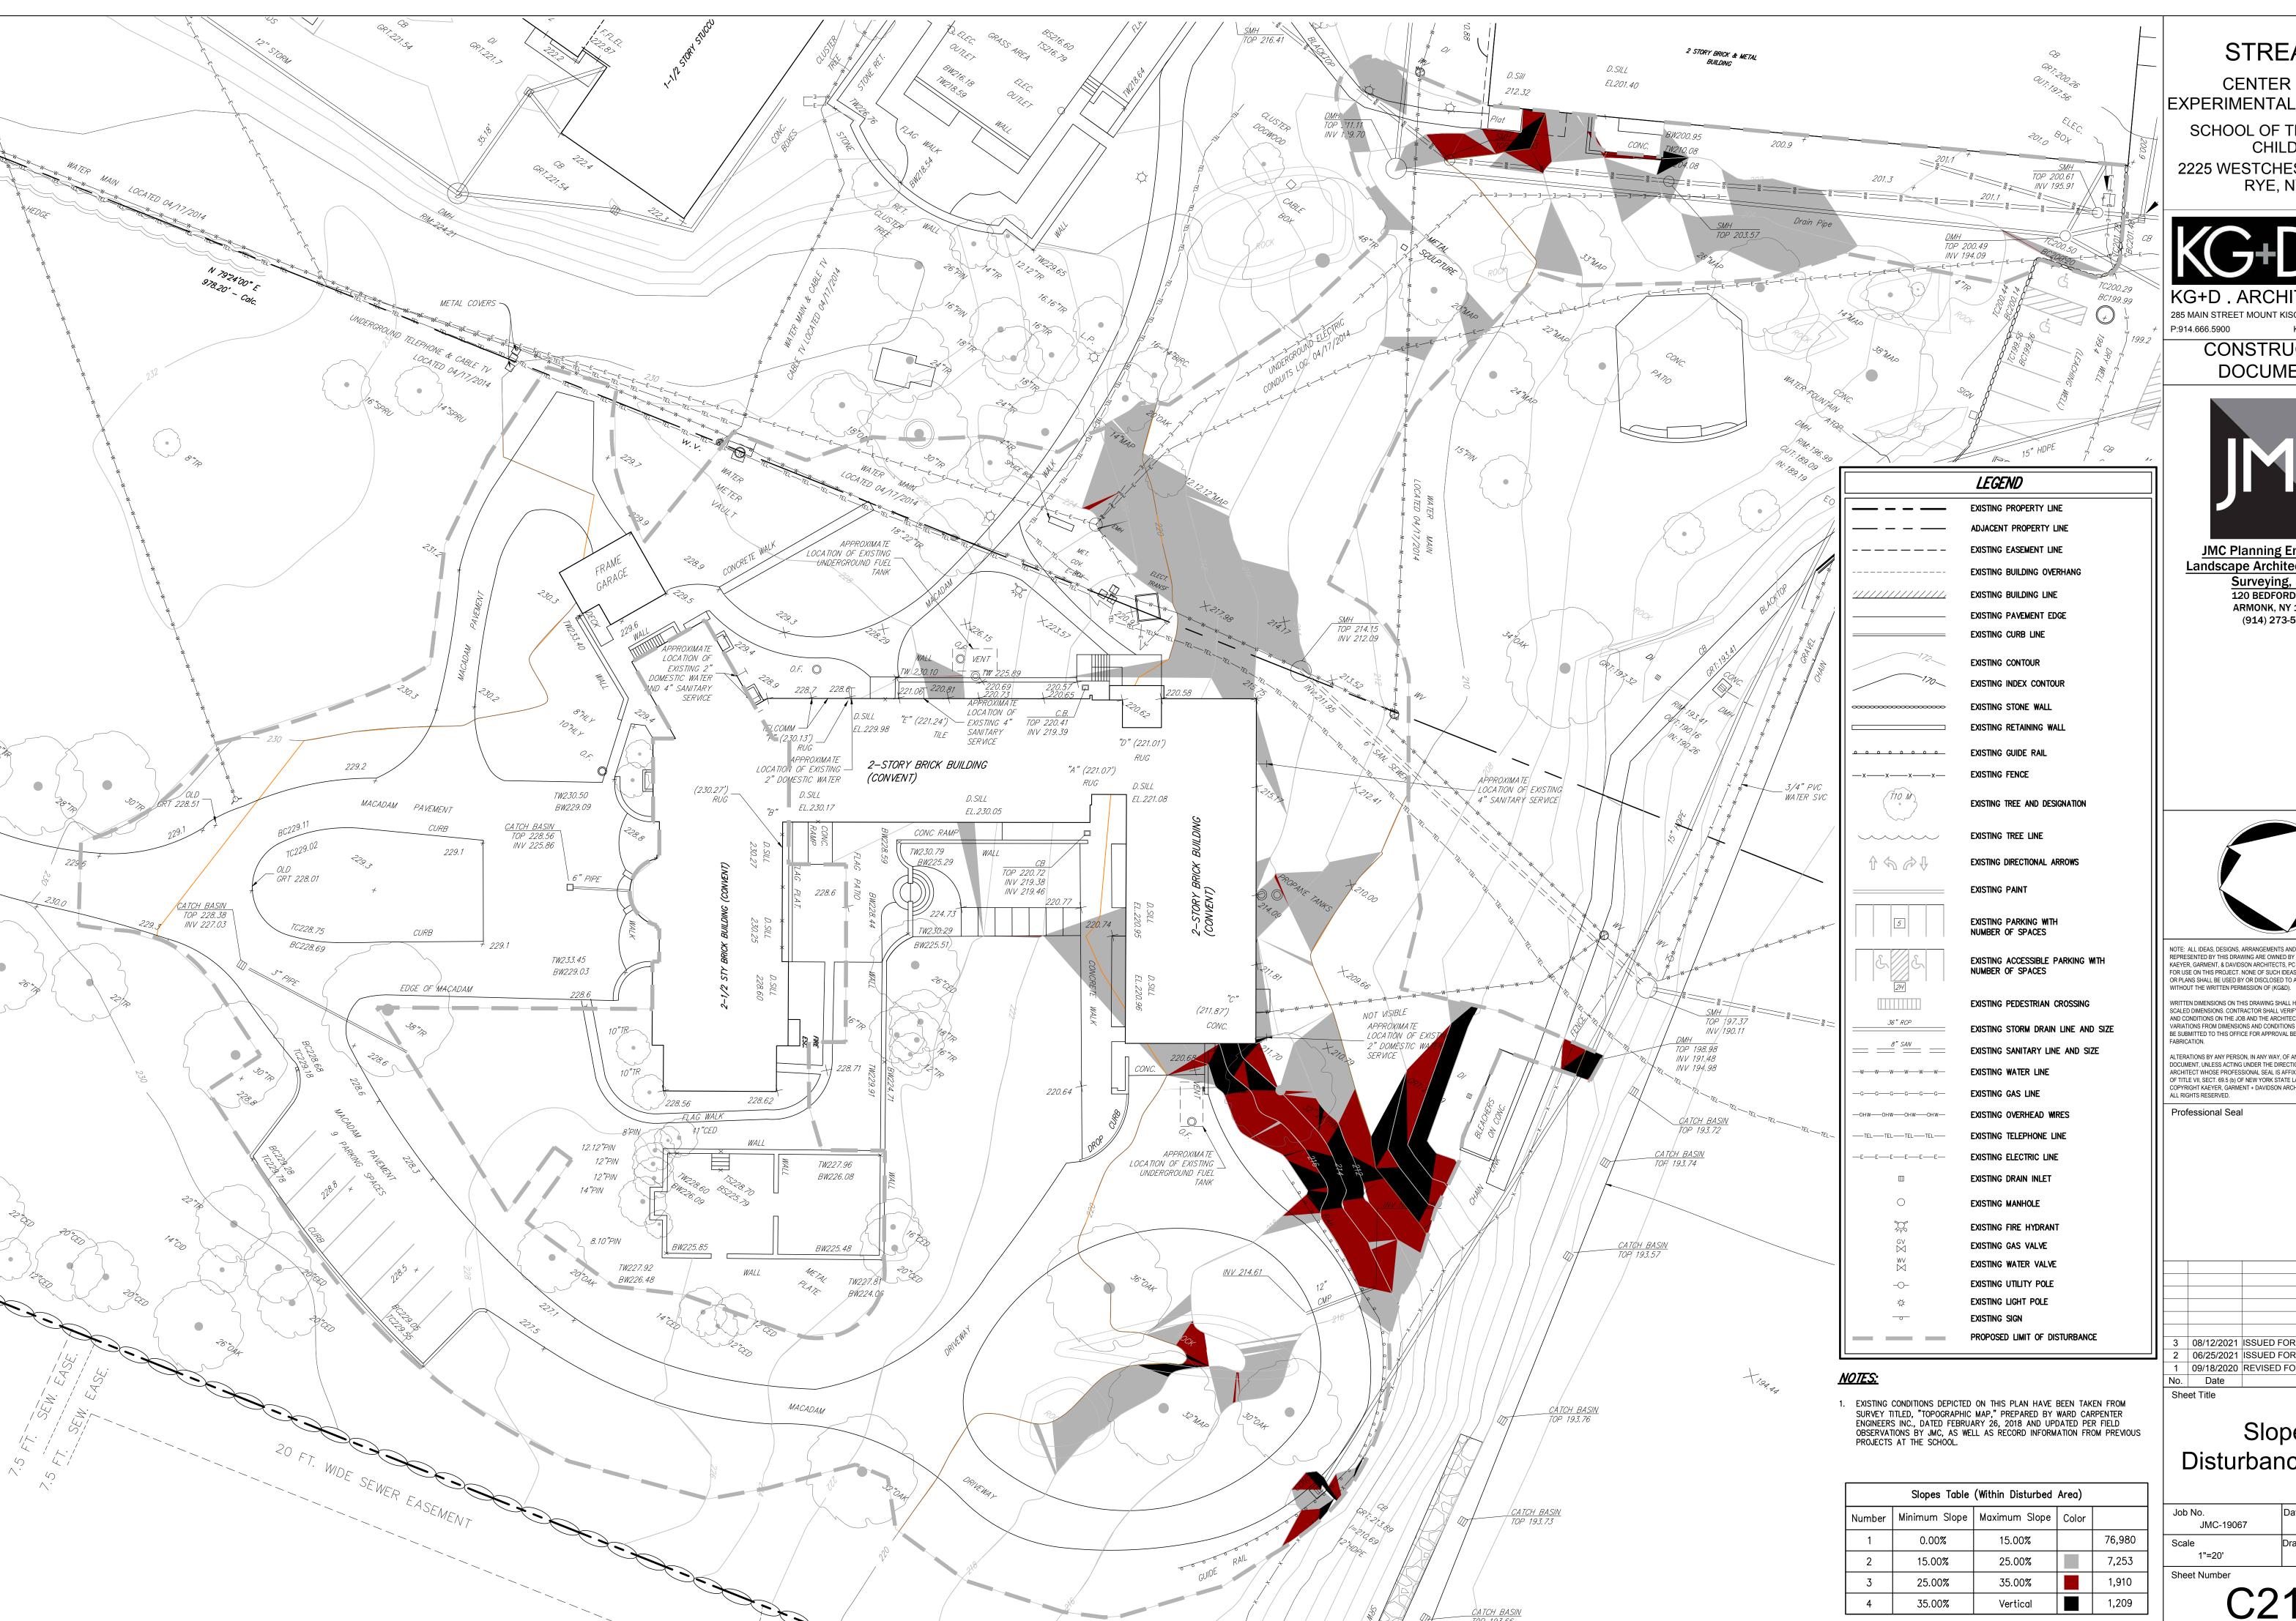
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## Overall Site Plan

J	Job No. JMC-19067	Date 11/26/2019
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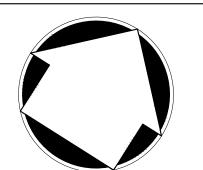


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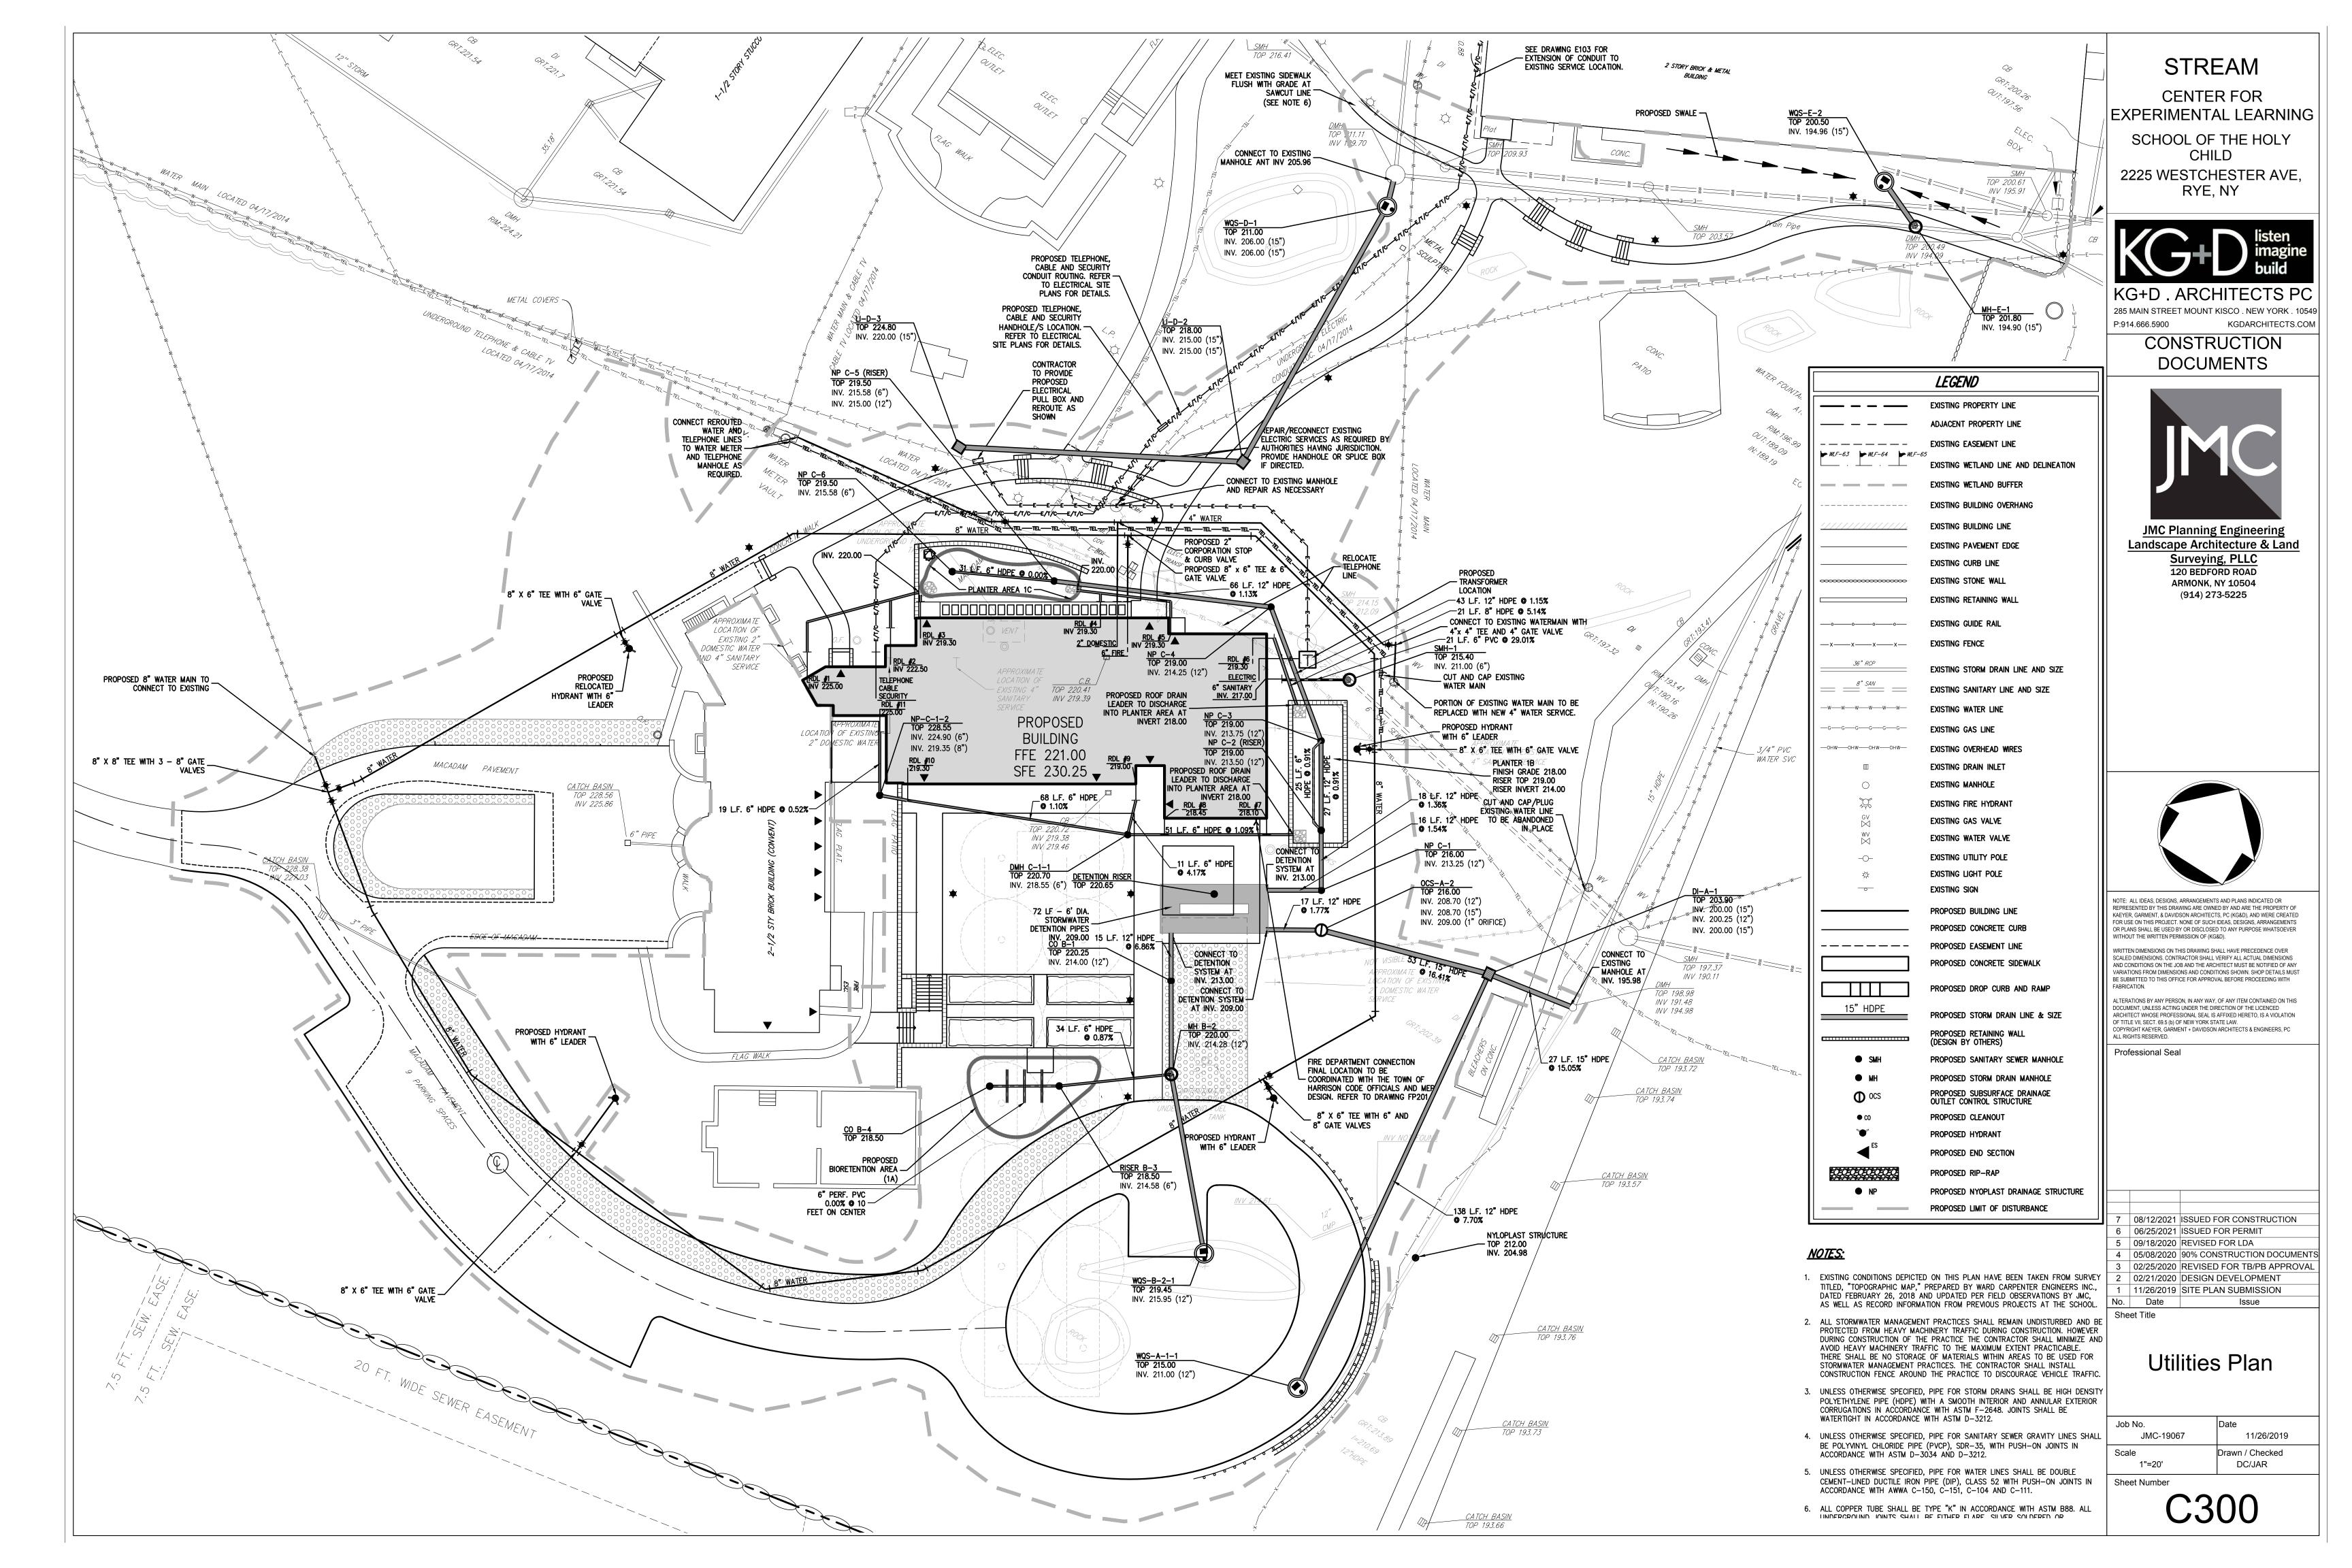
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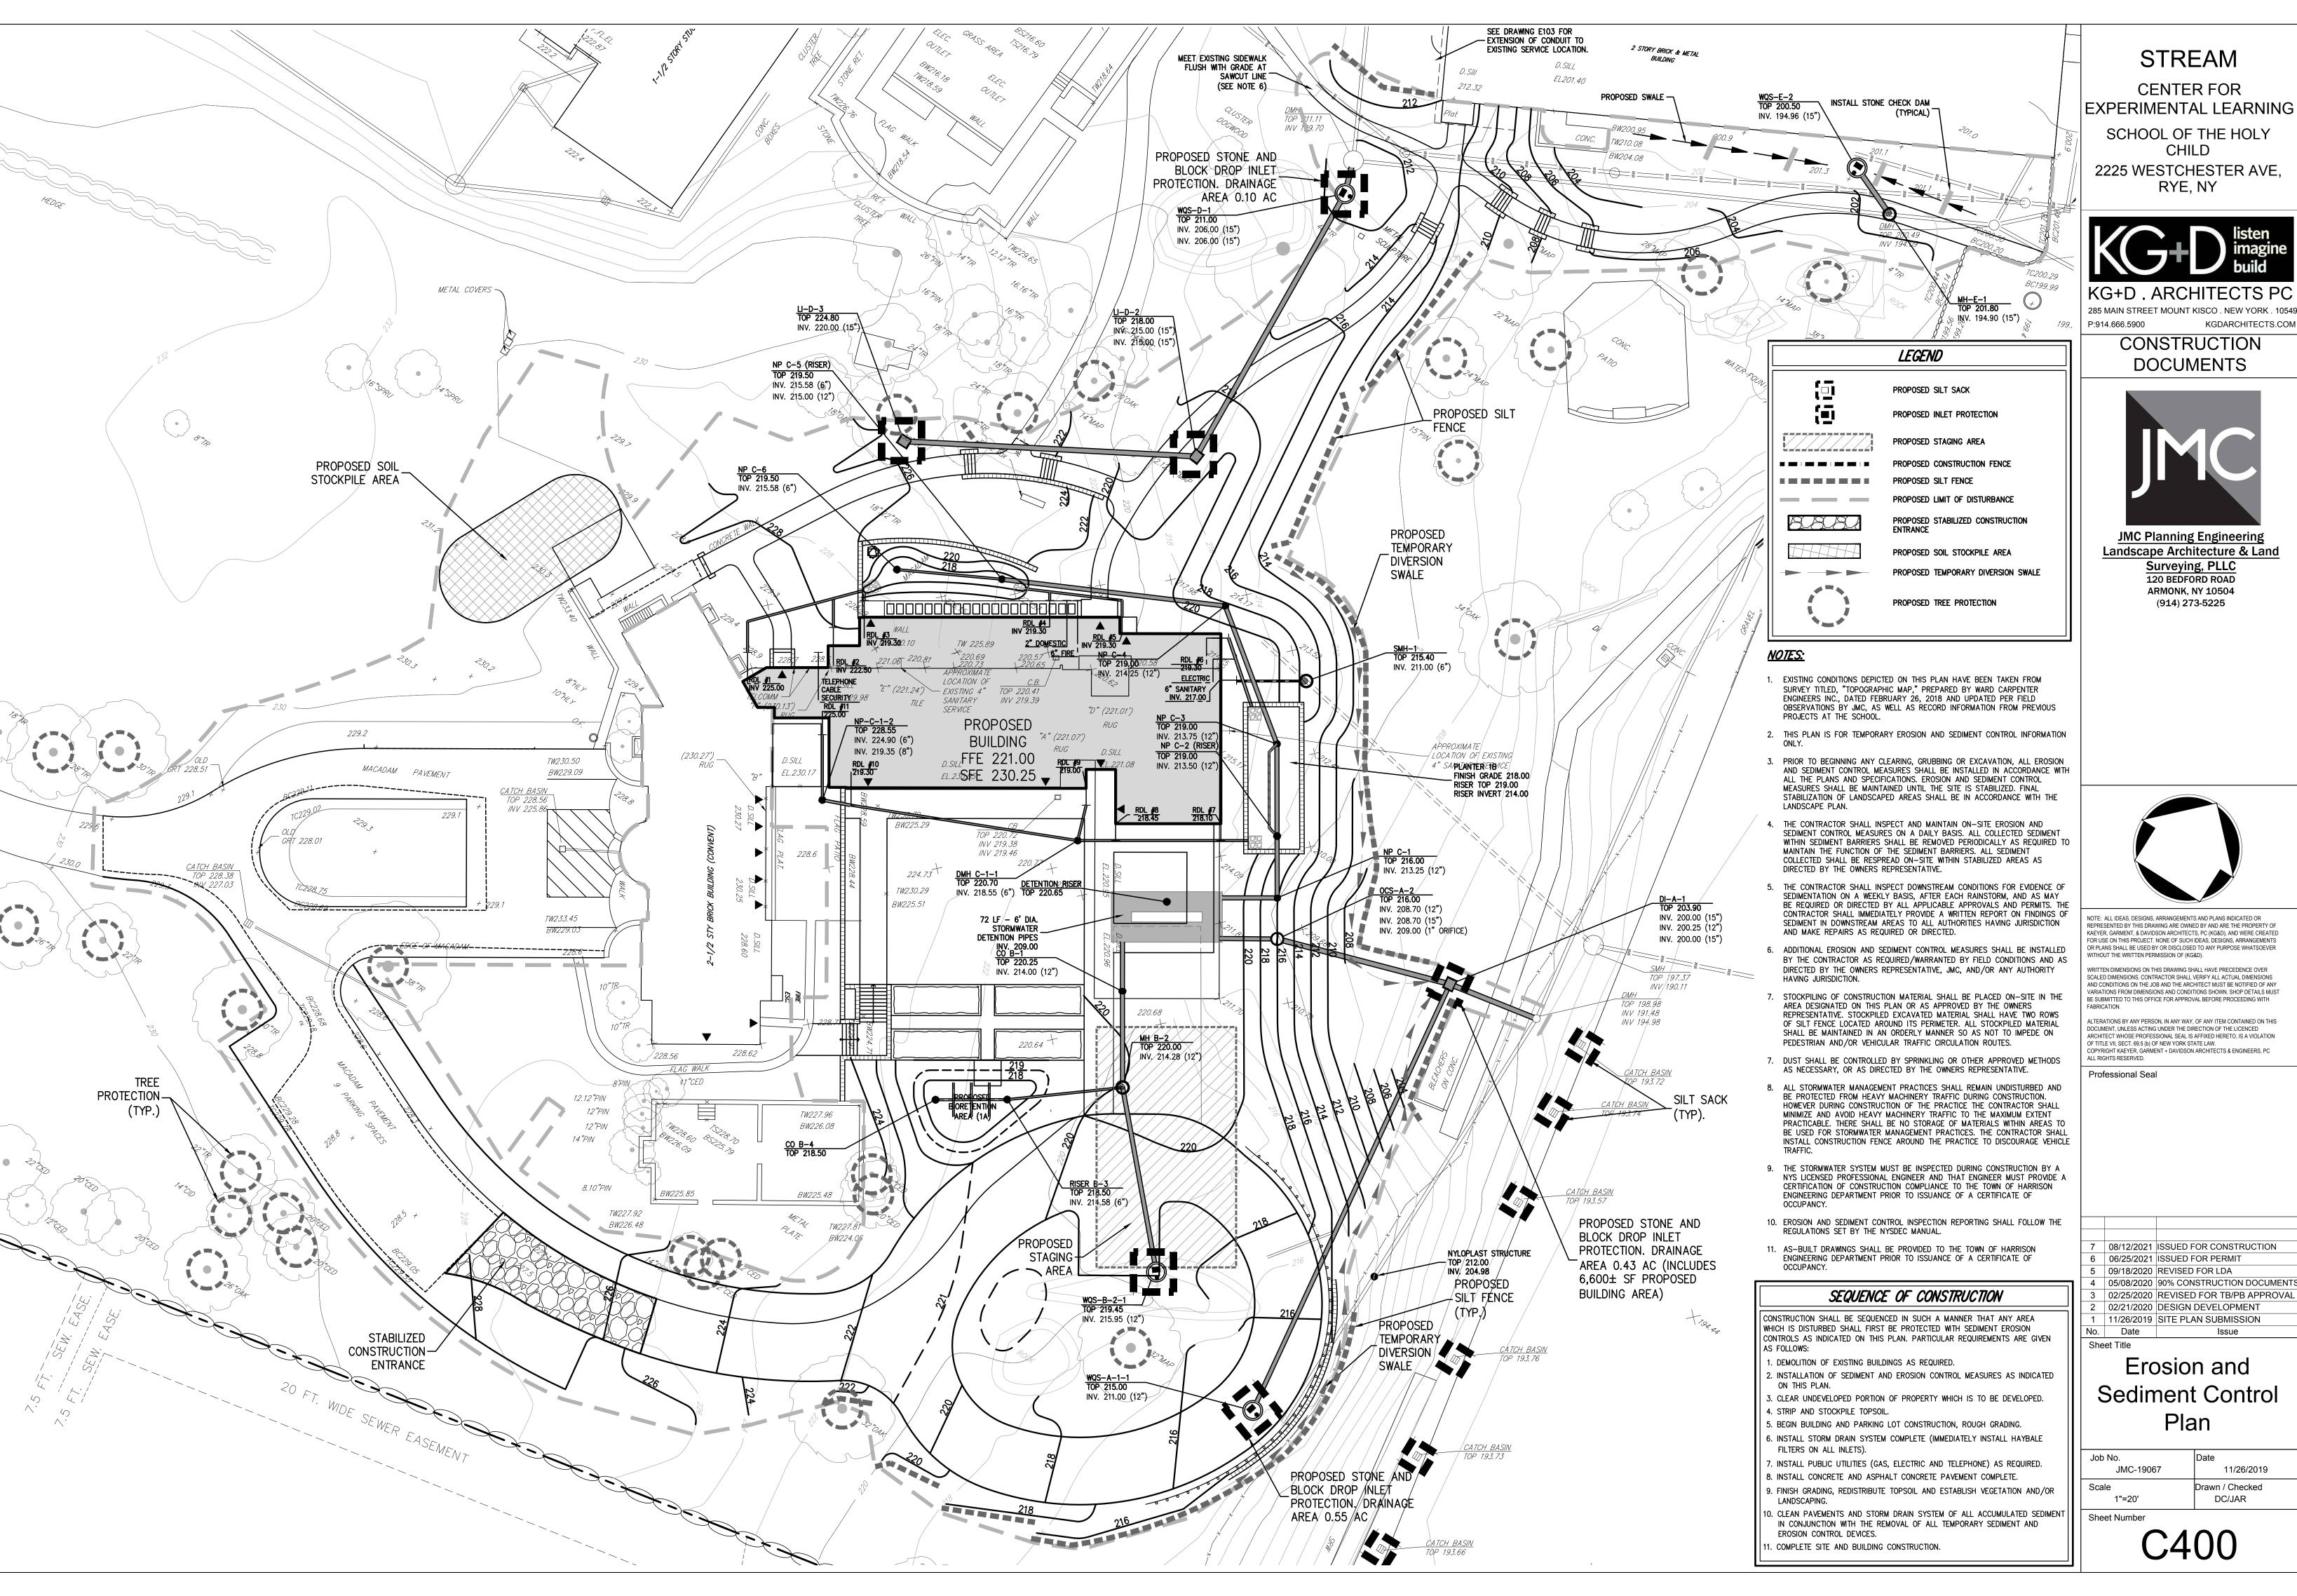
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Slope Disturbance Plan

Job No.	Date
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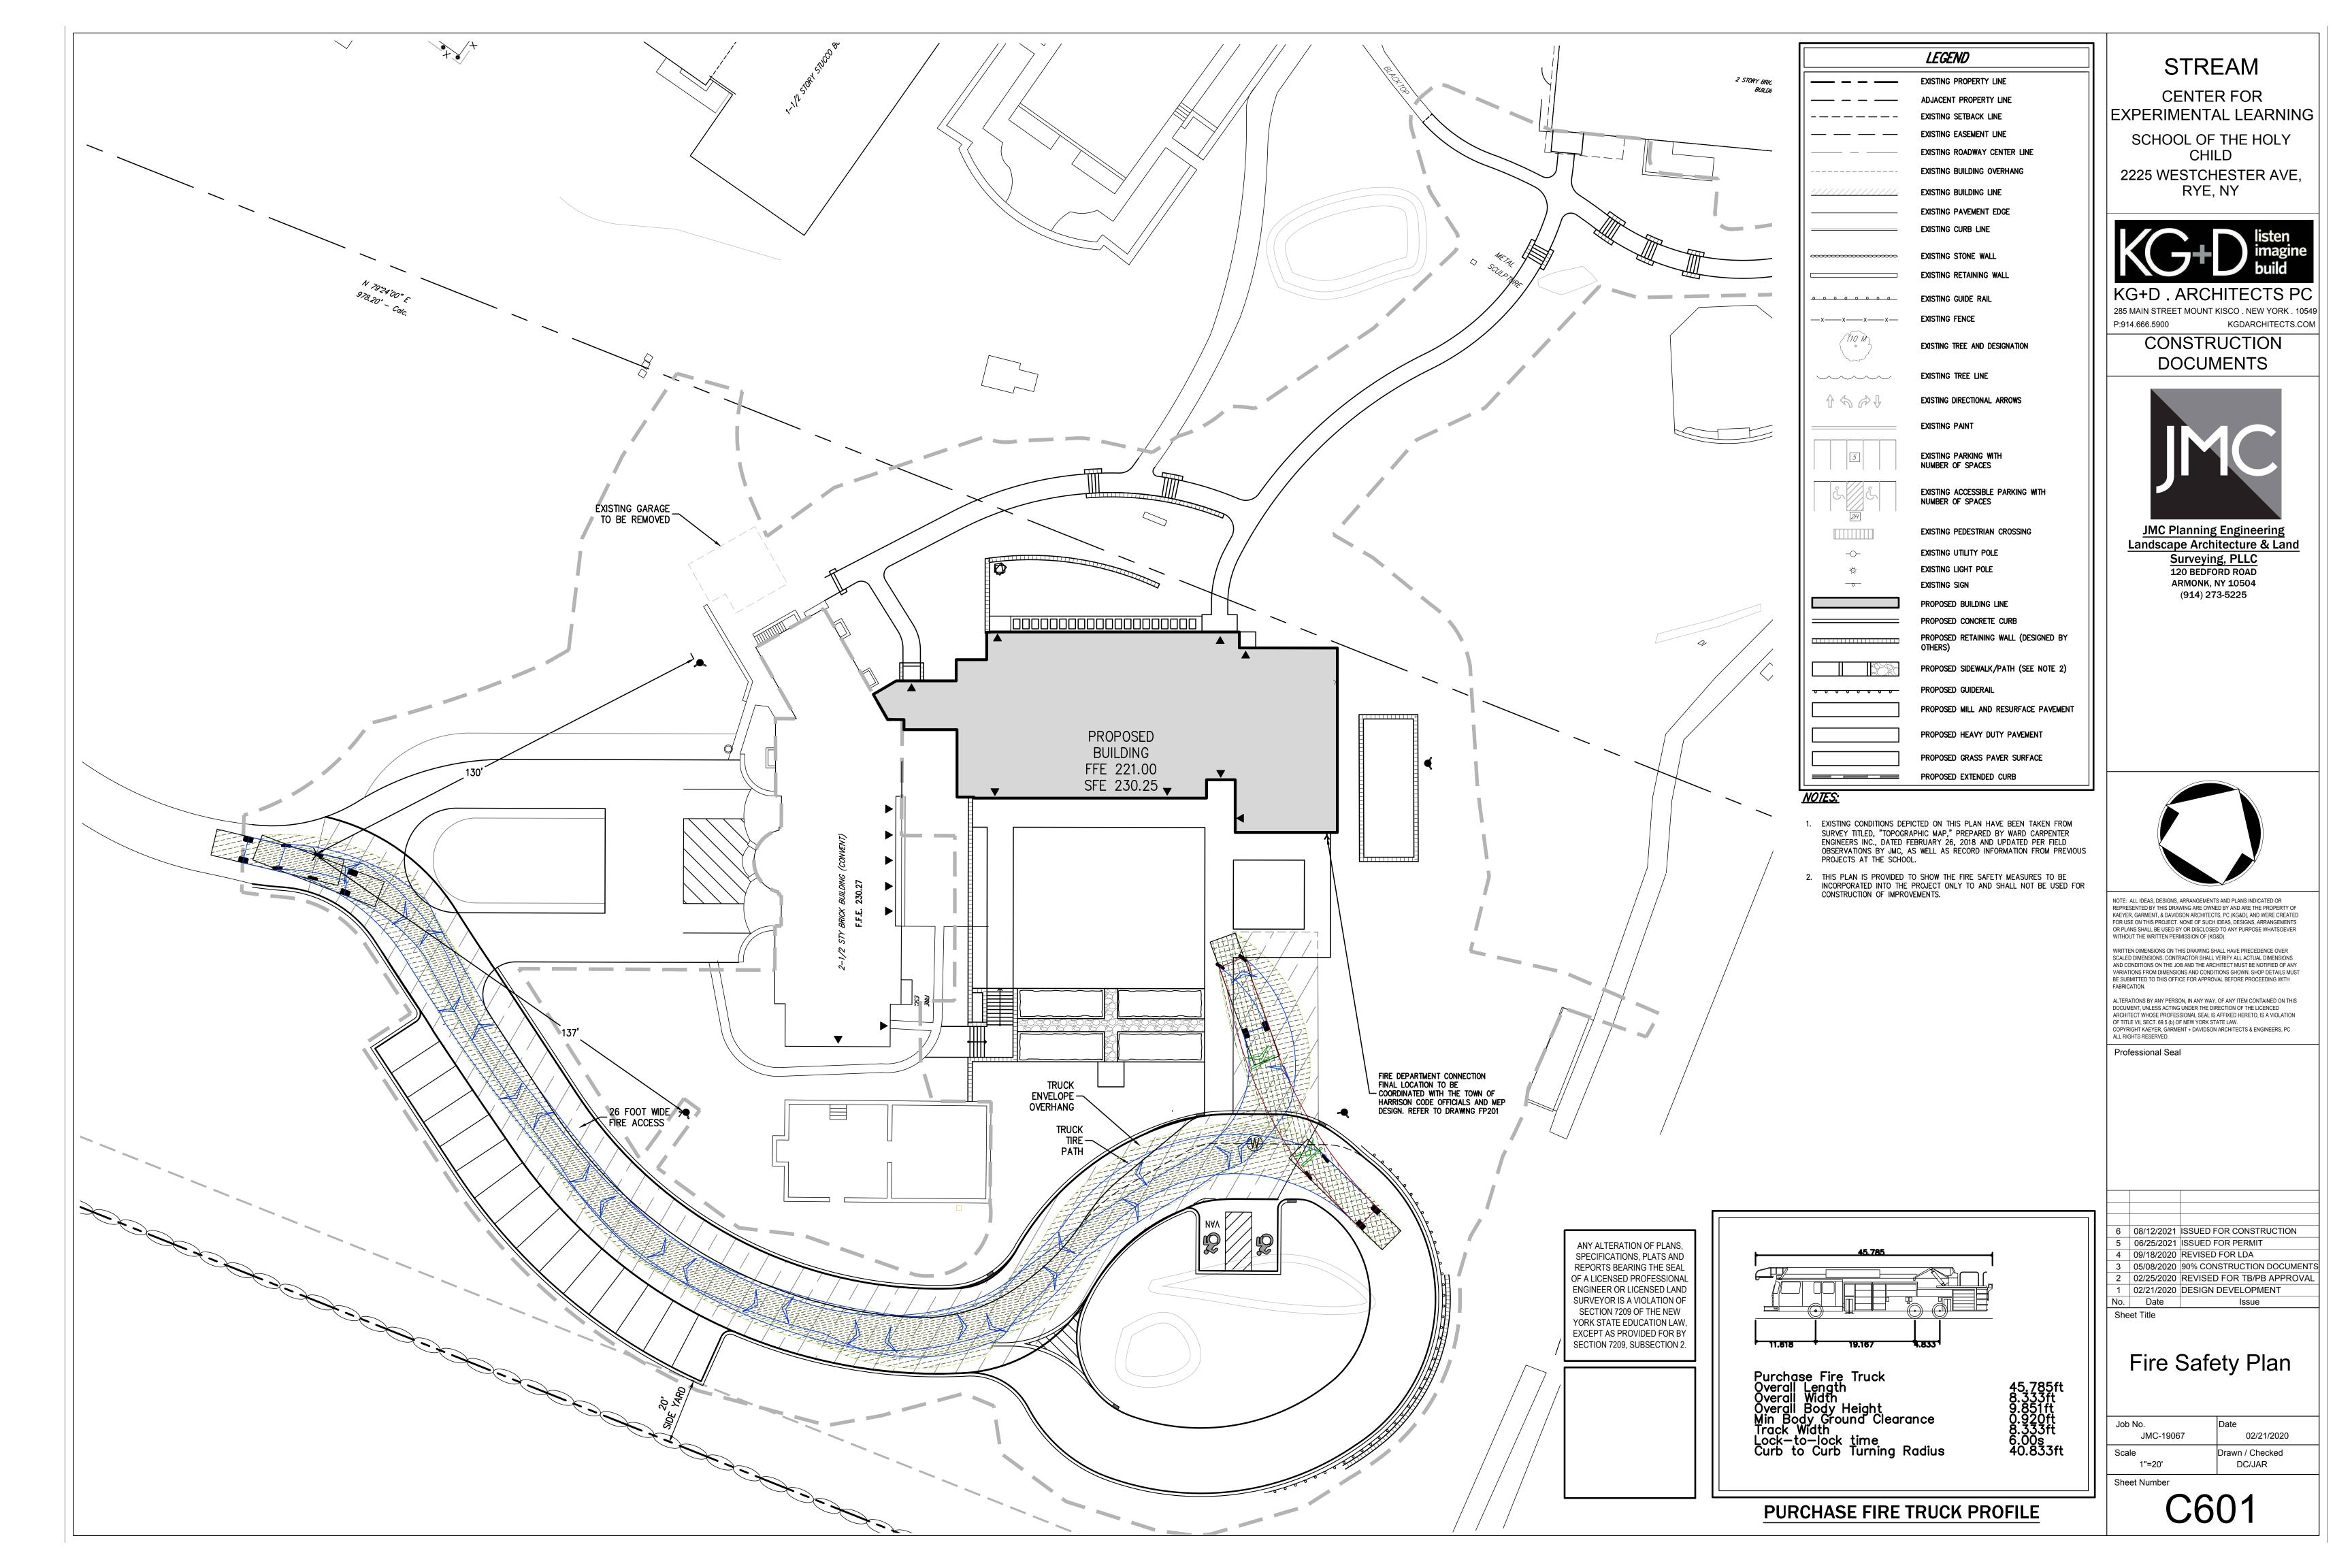
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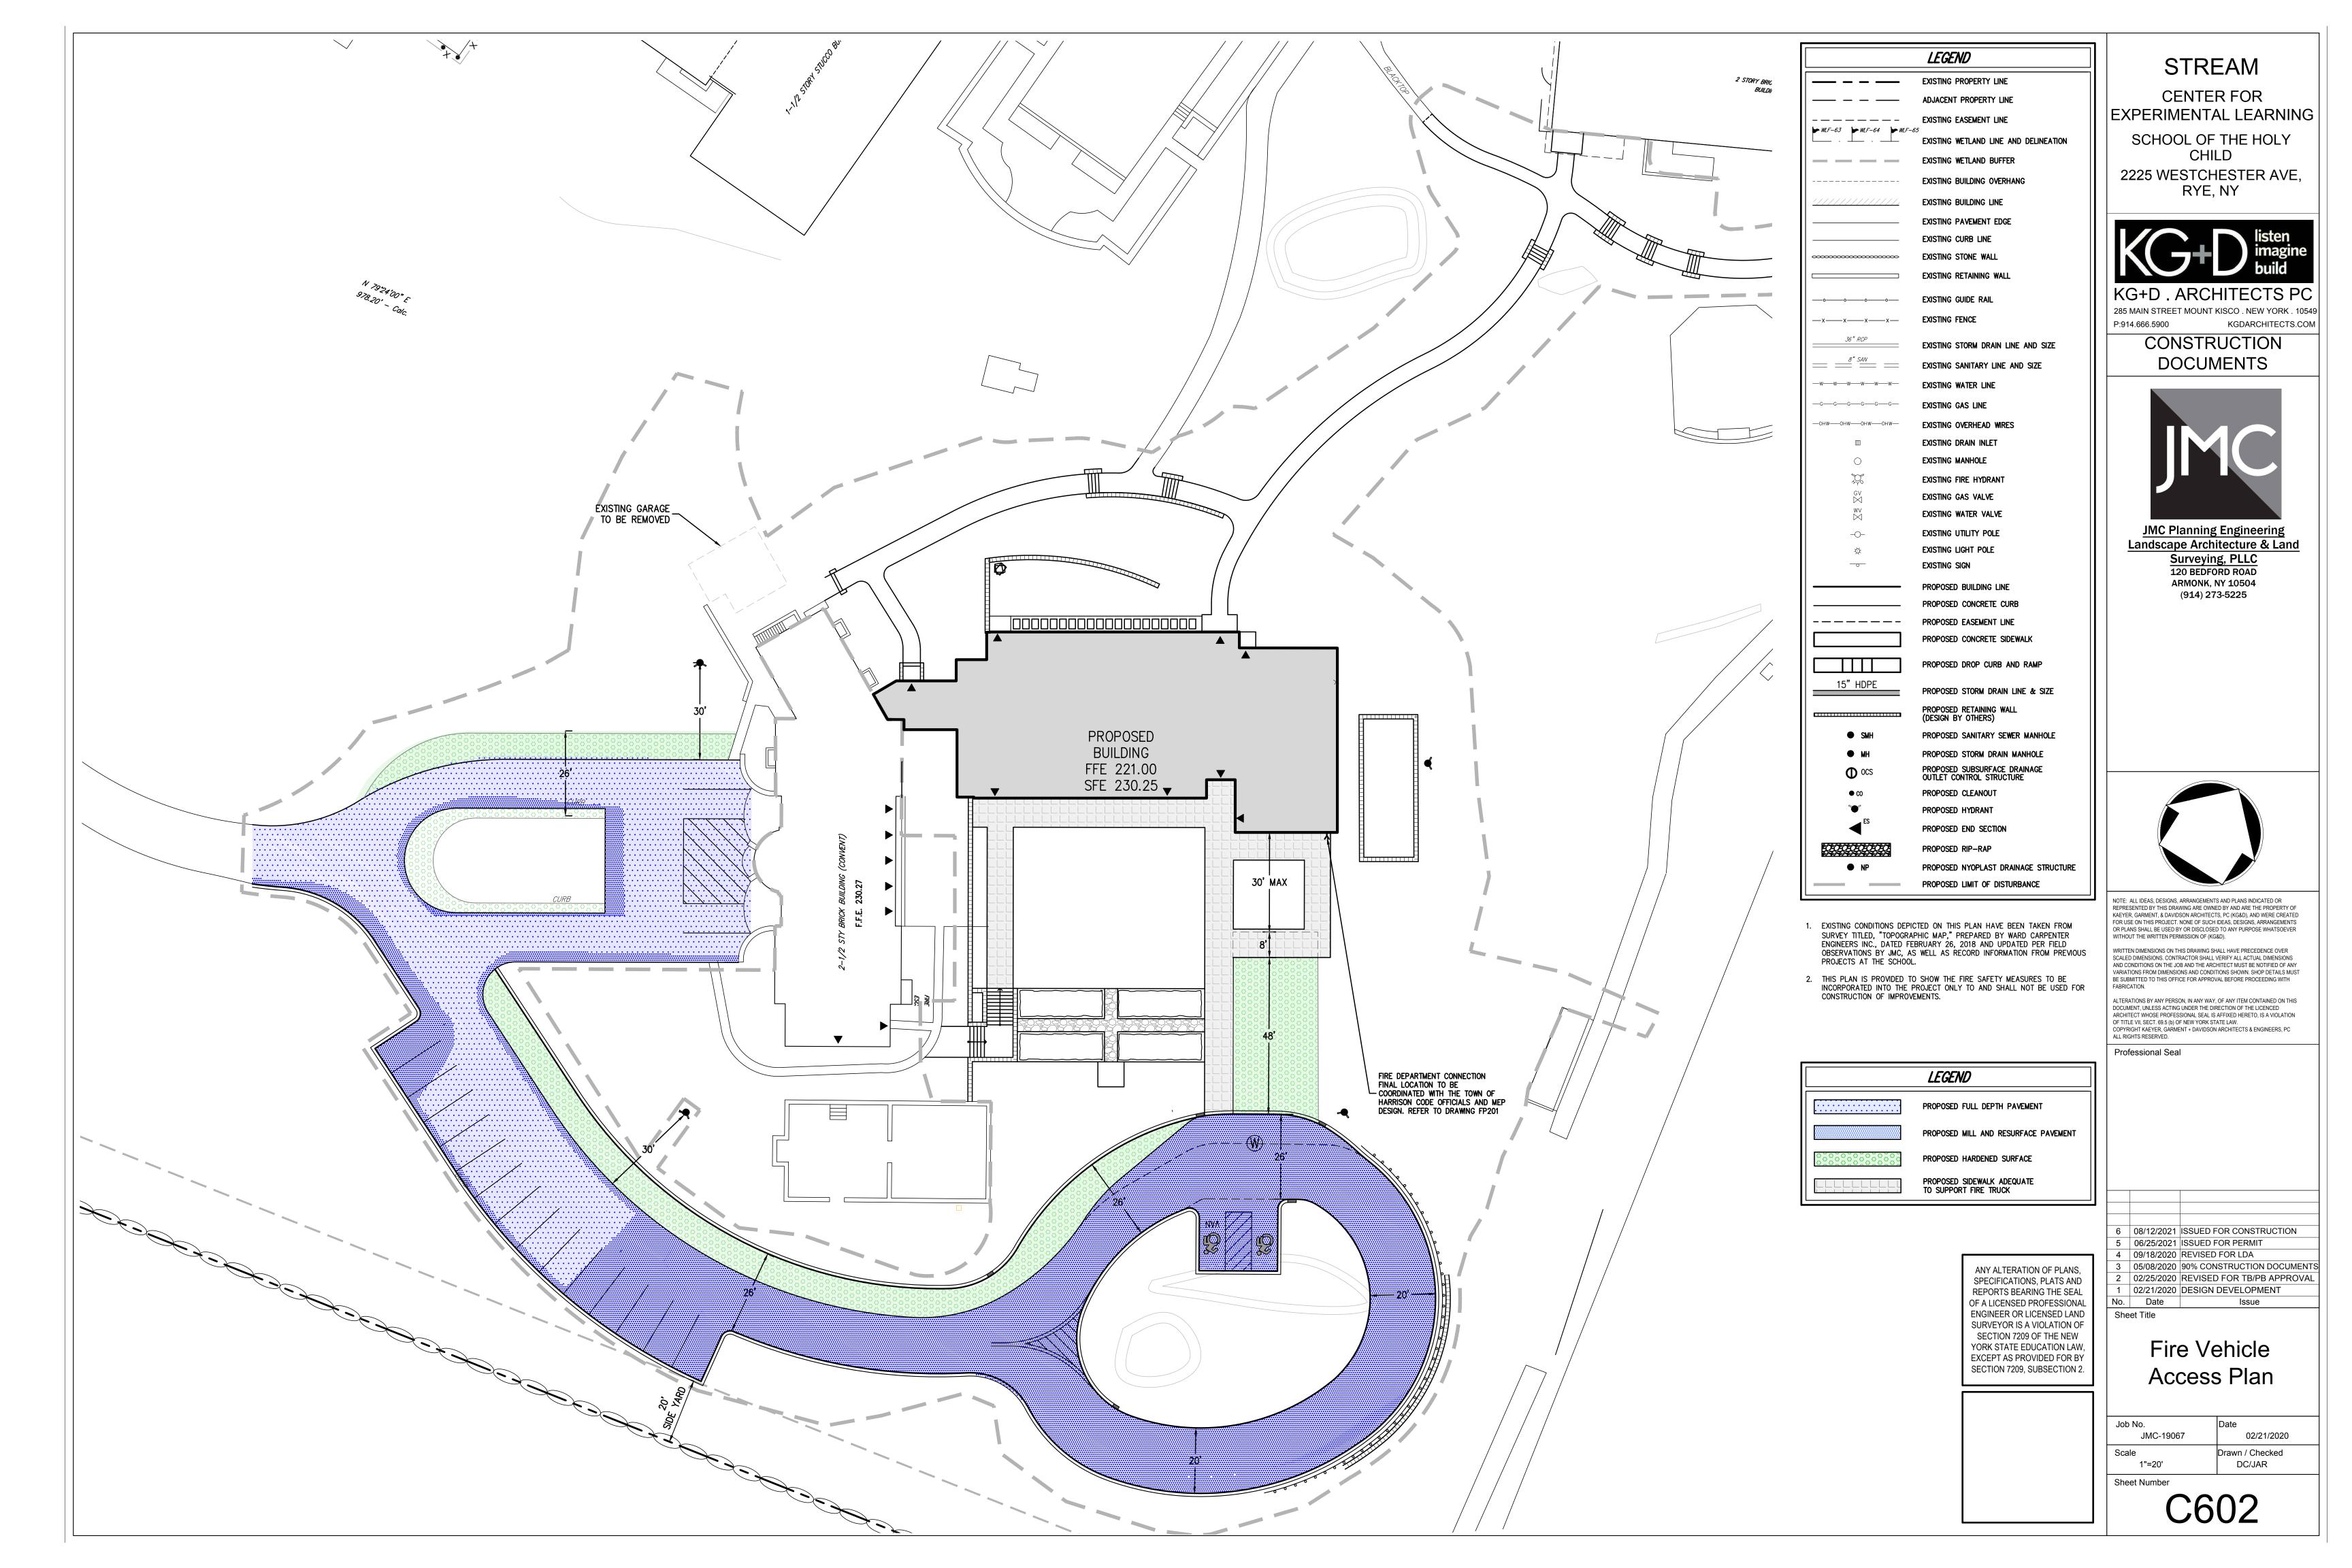
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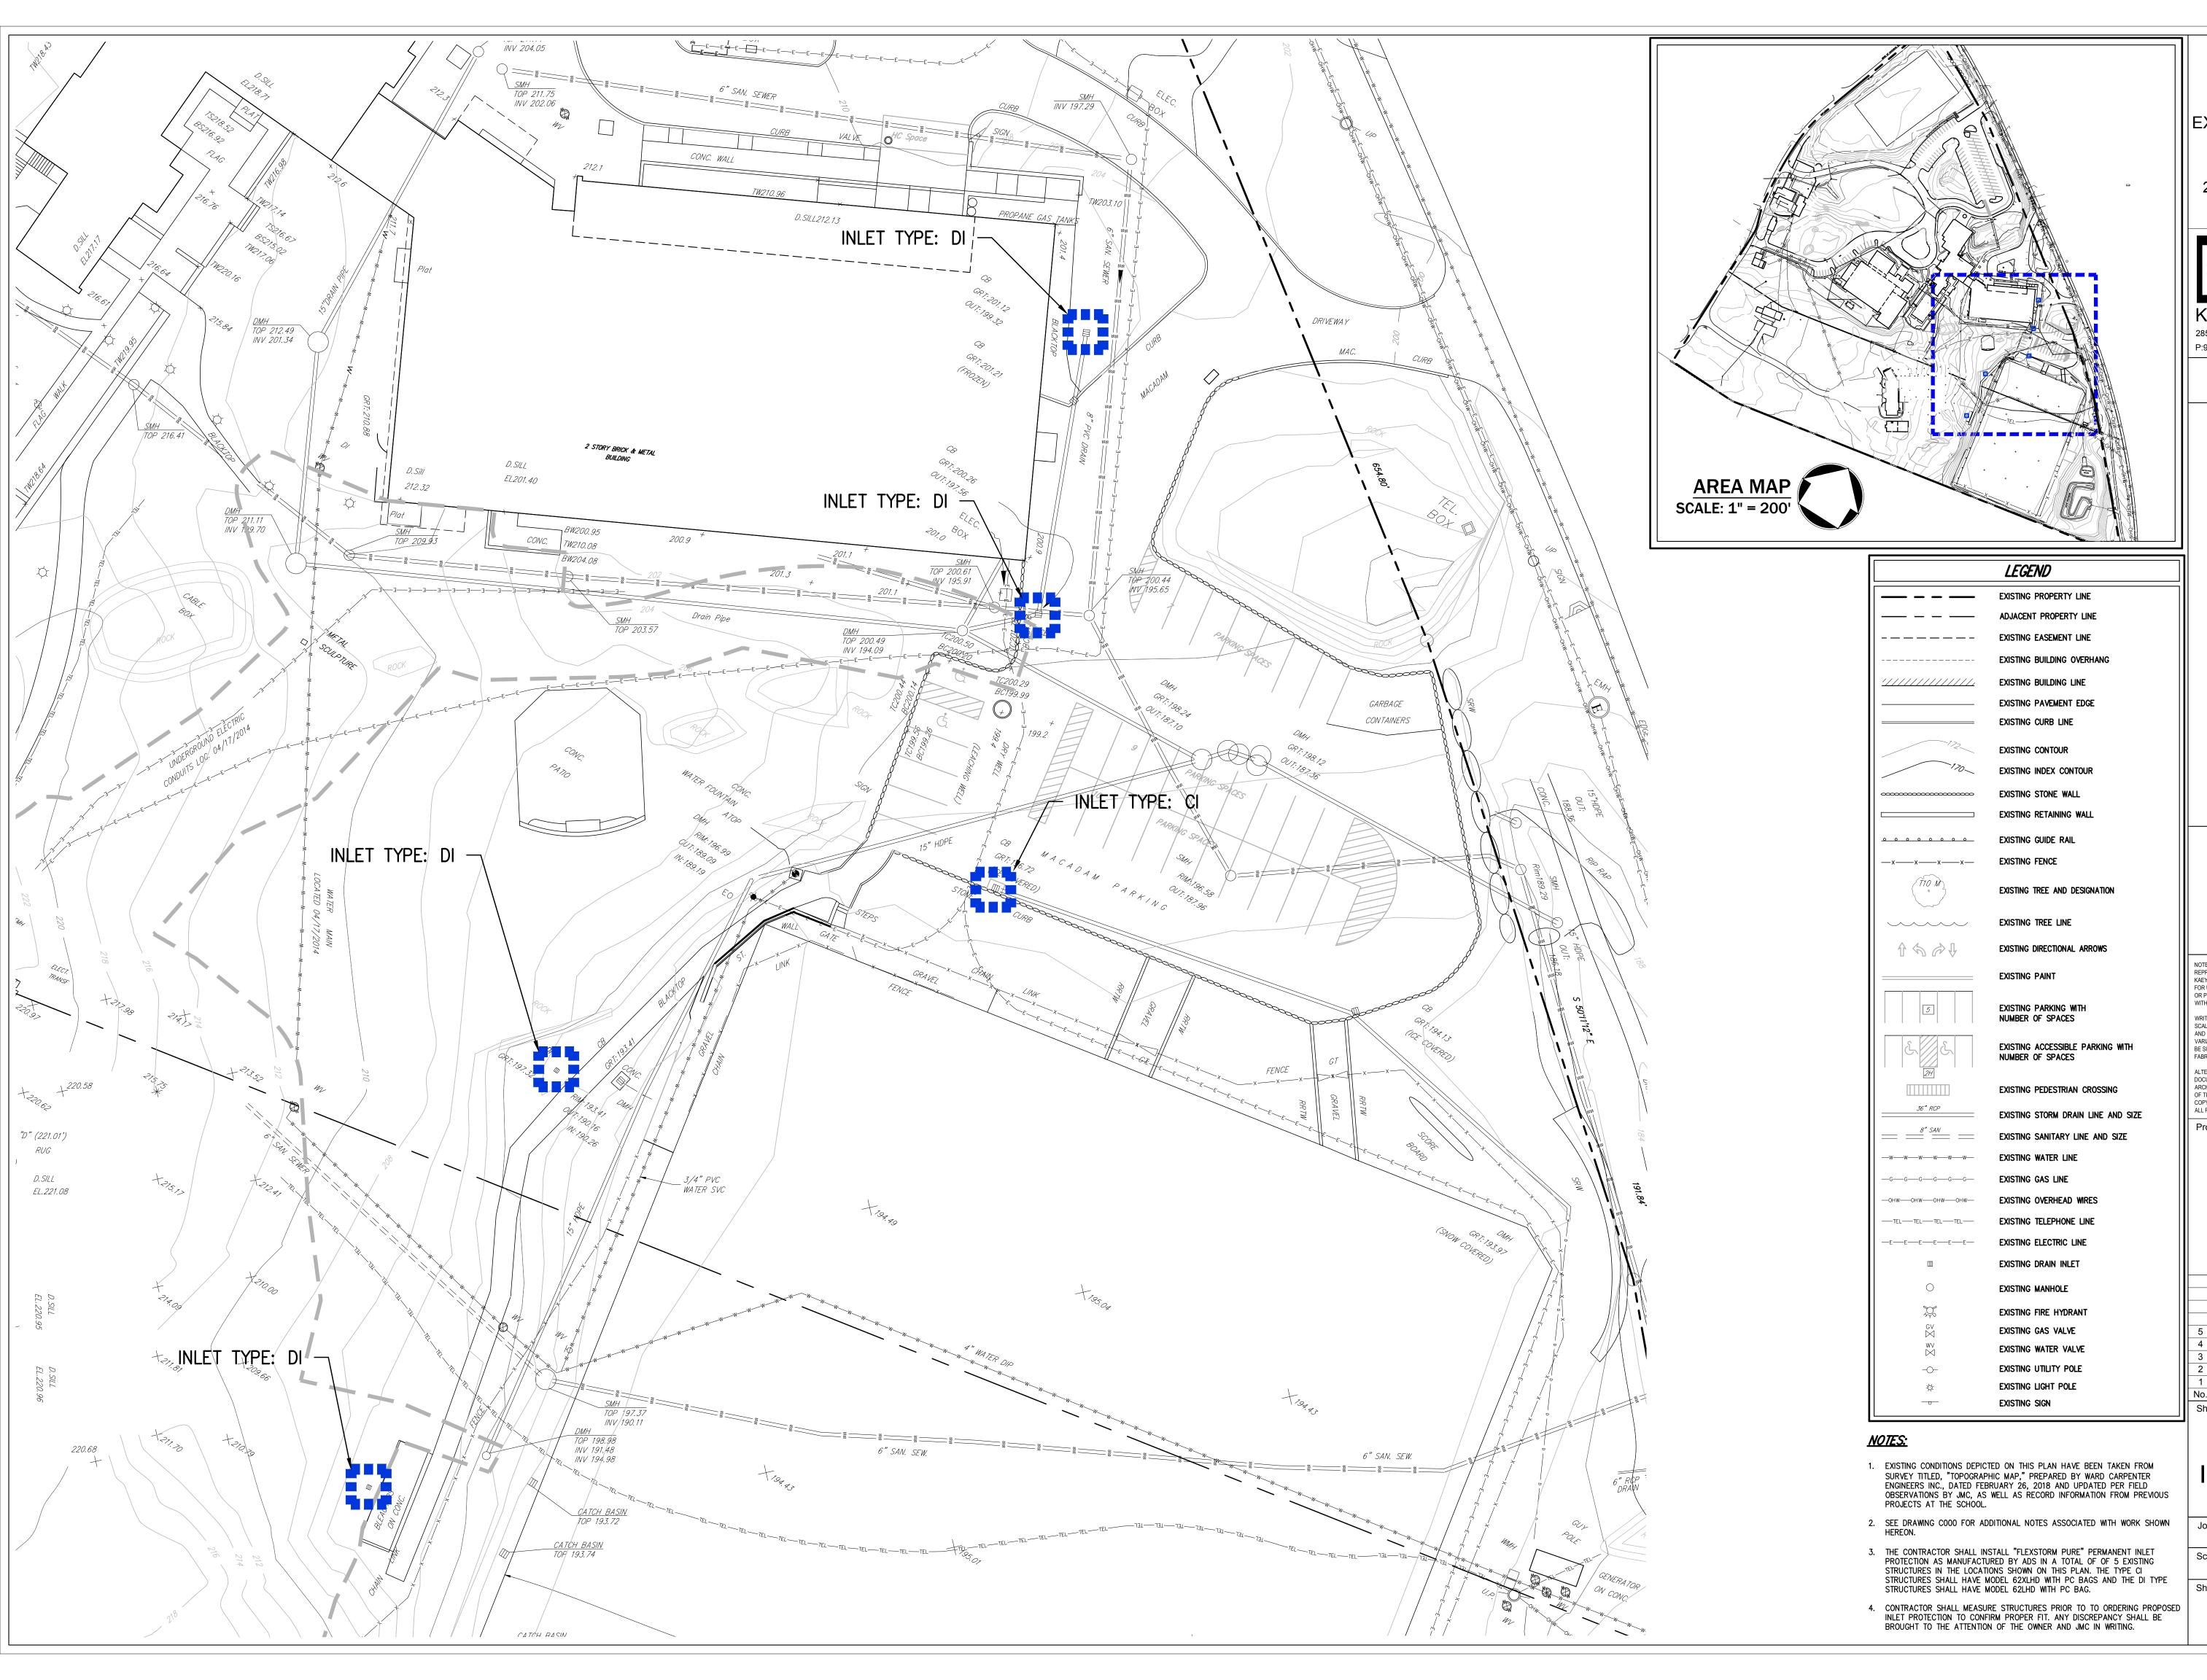
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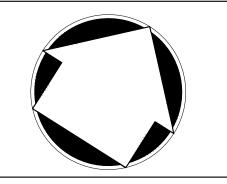
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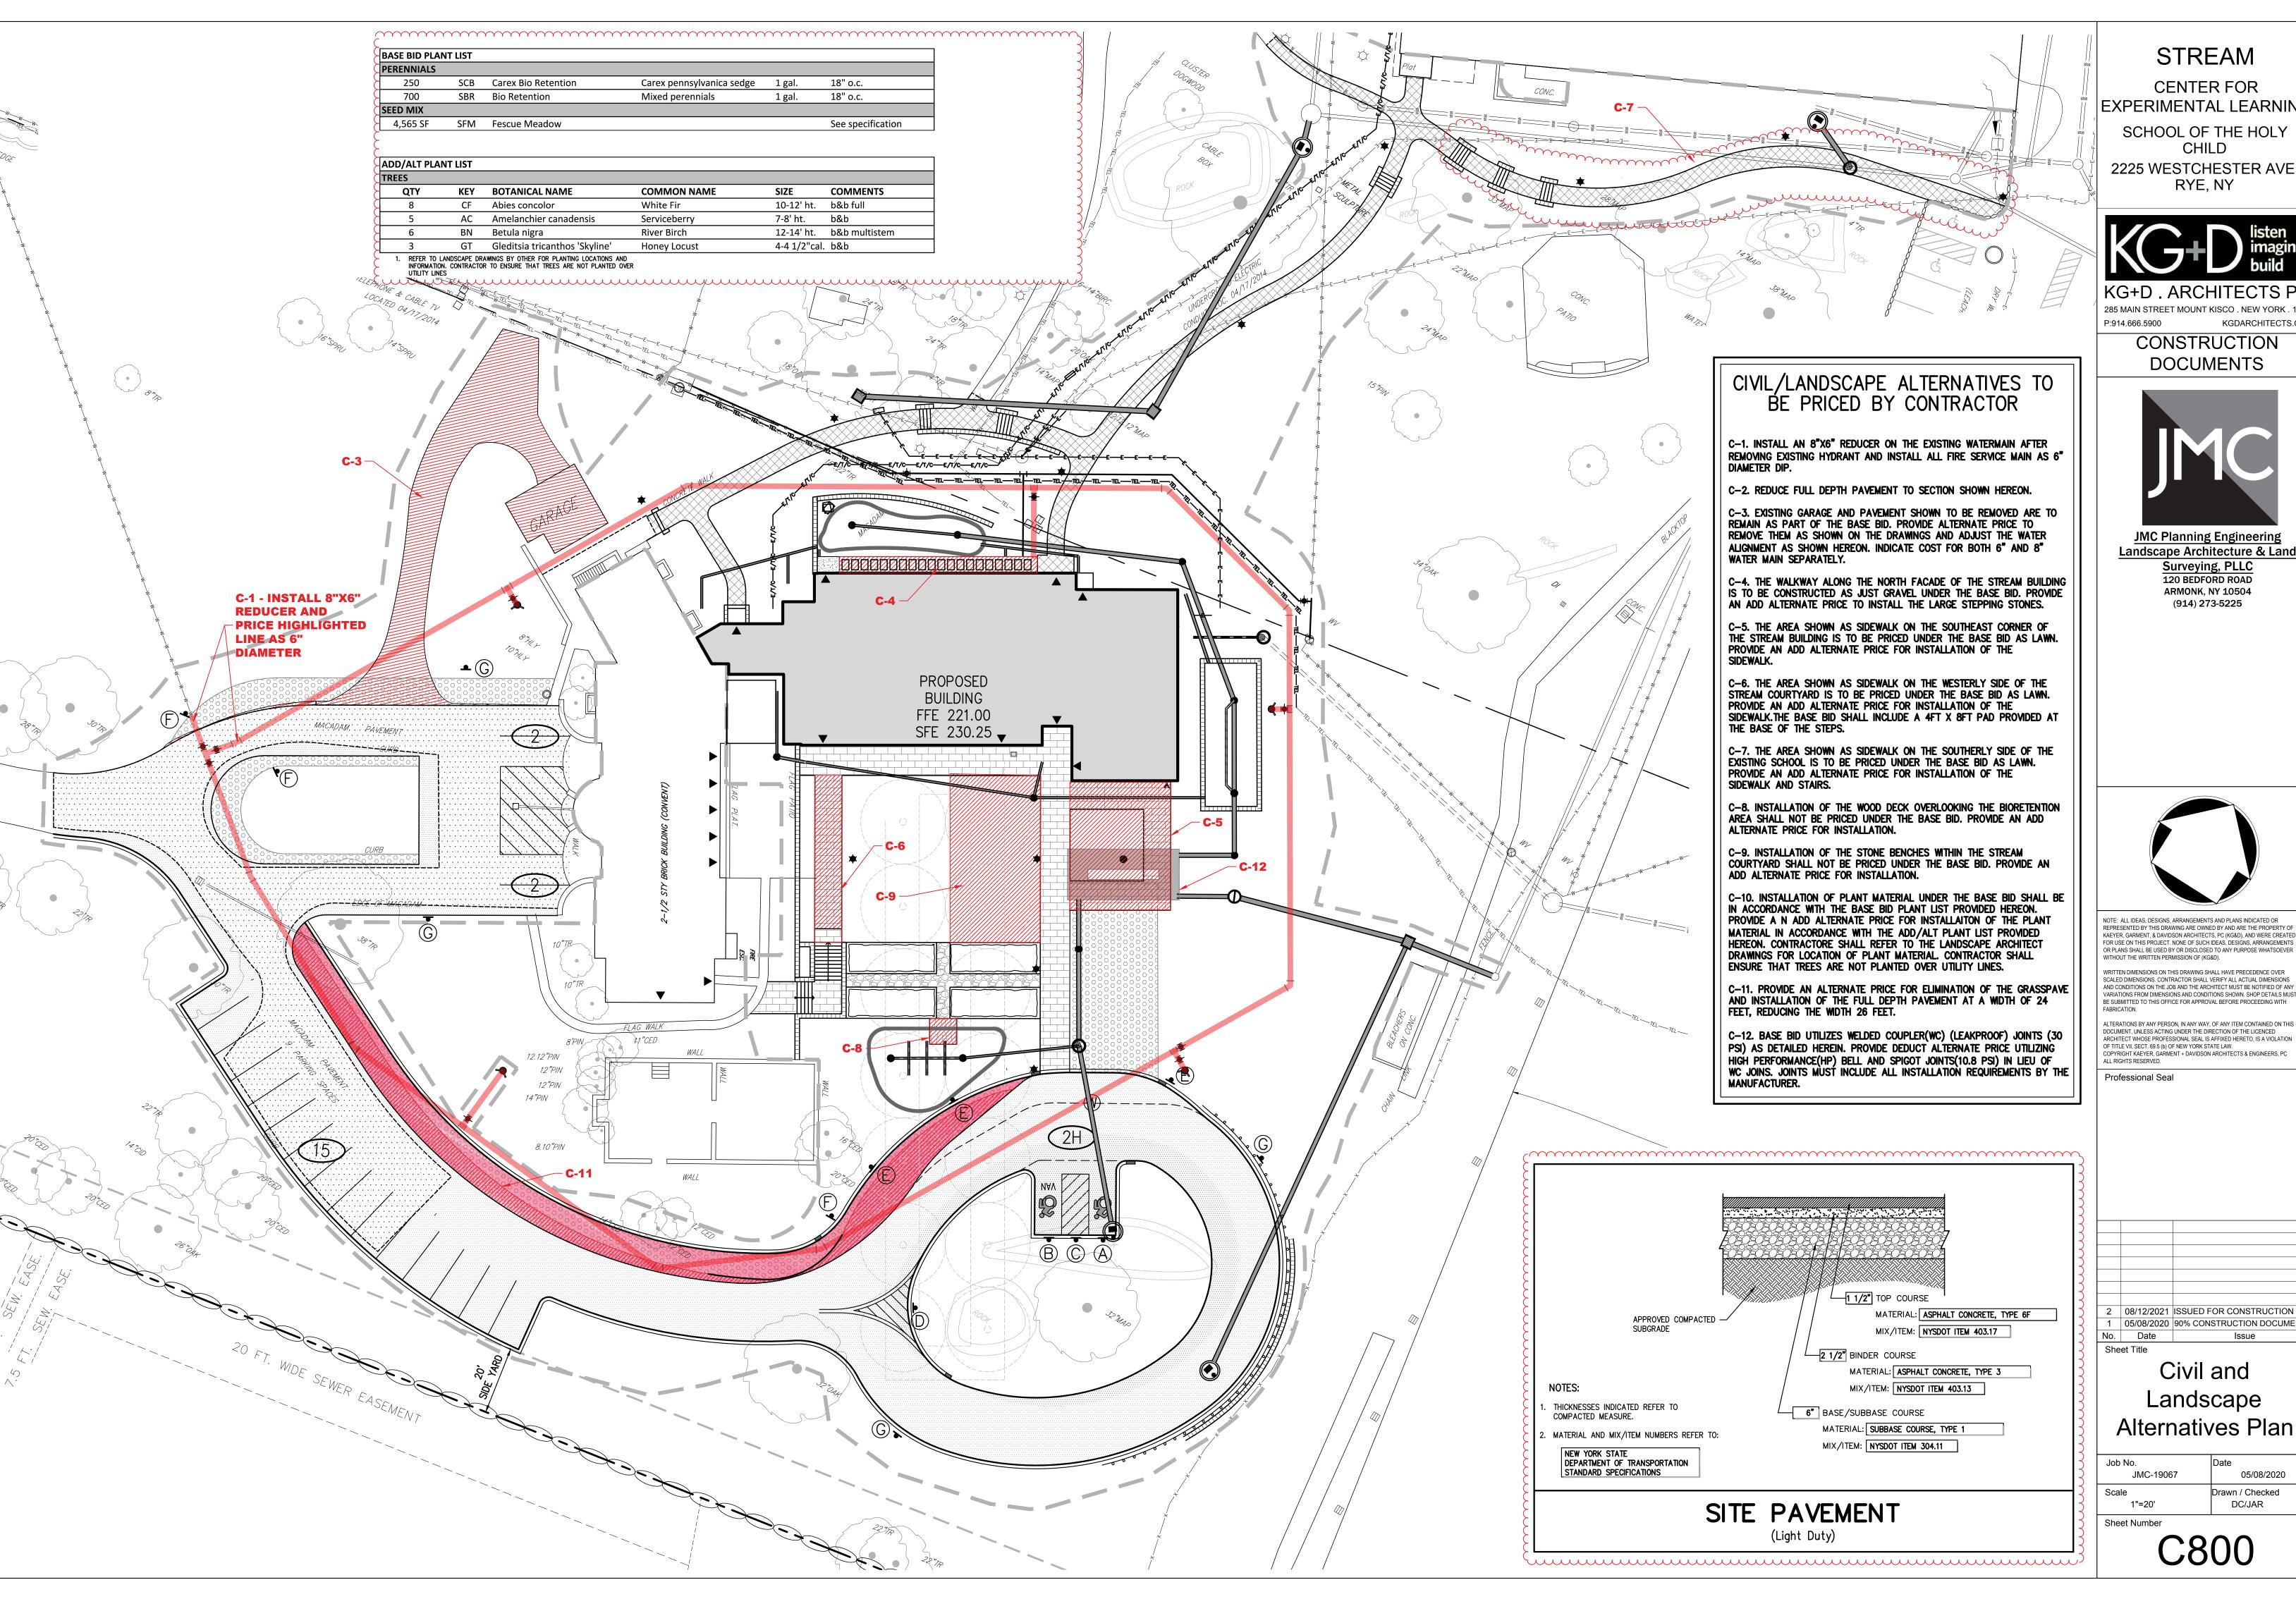
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# Water Quality

1 02/25/2020 REVISED FOR TB/PB APPROVAL

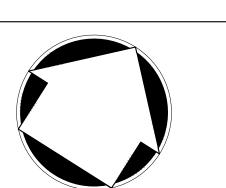Improvement Plan		
Job No.	Date	
JMC-19067	02/25/2020	

JOD INO.	Date
JMC-19067	02/25/2020
Scale	Drawn / Checked
1"=20'	DC/JAR
Sheet Number	



EXPERIMENTAL LEARNING


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**JMC Planning Engineering** Landscape Architecture & Land Surveying, PLLC 120 BEDFORD ROAD



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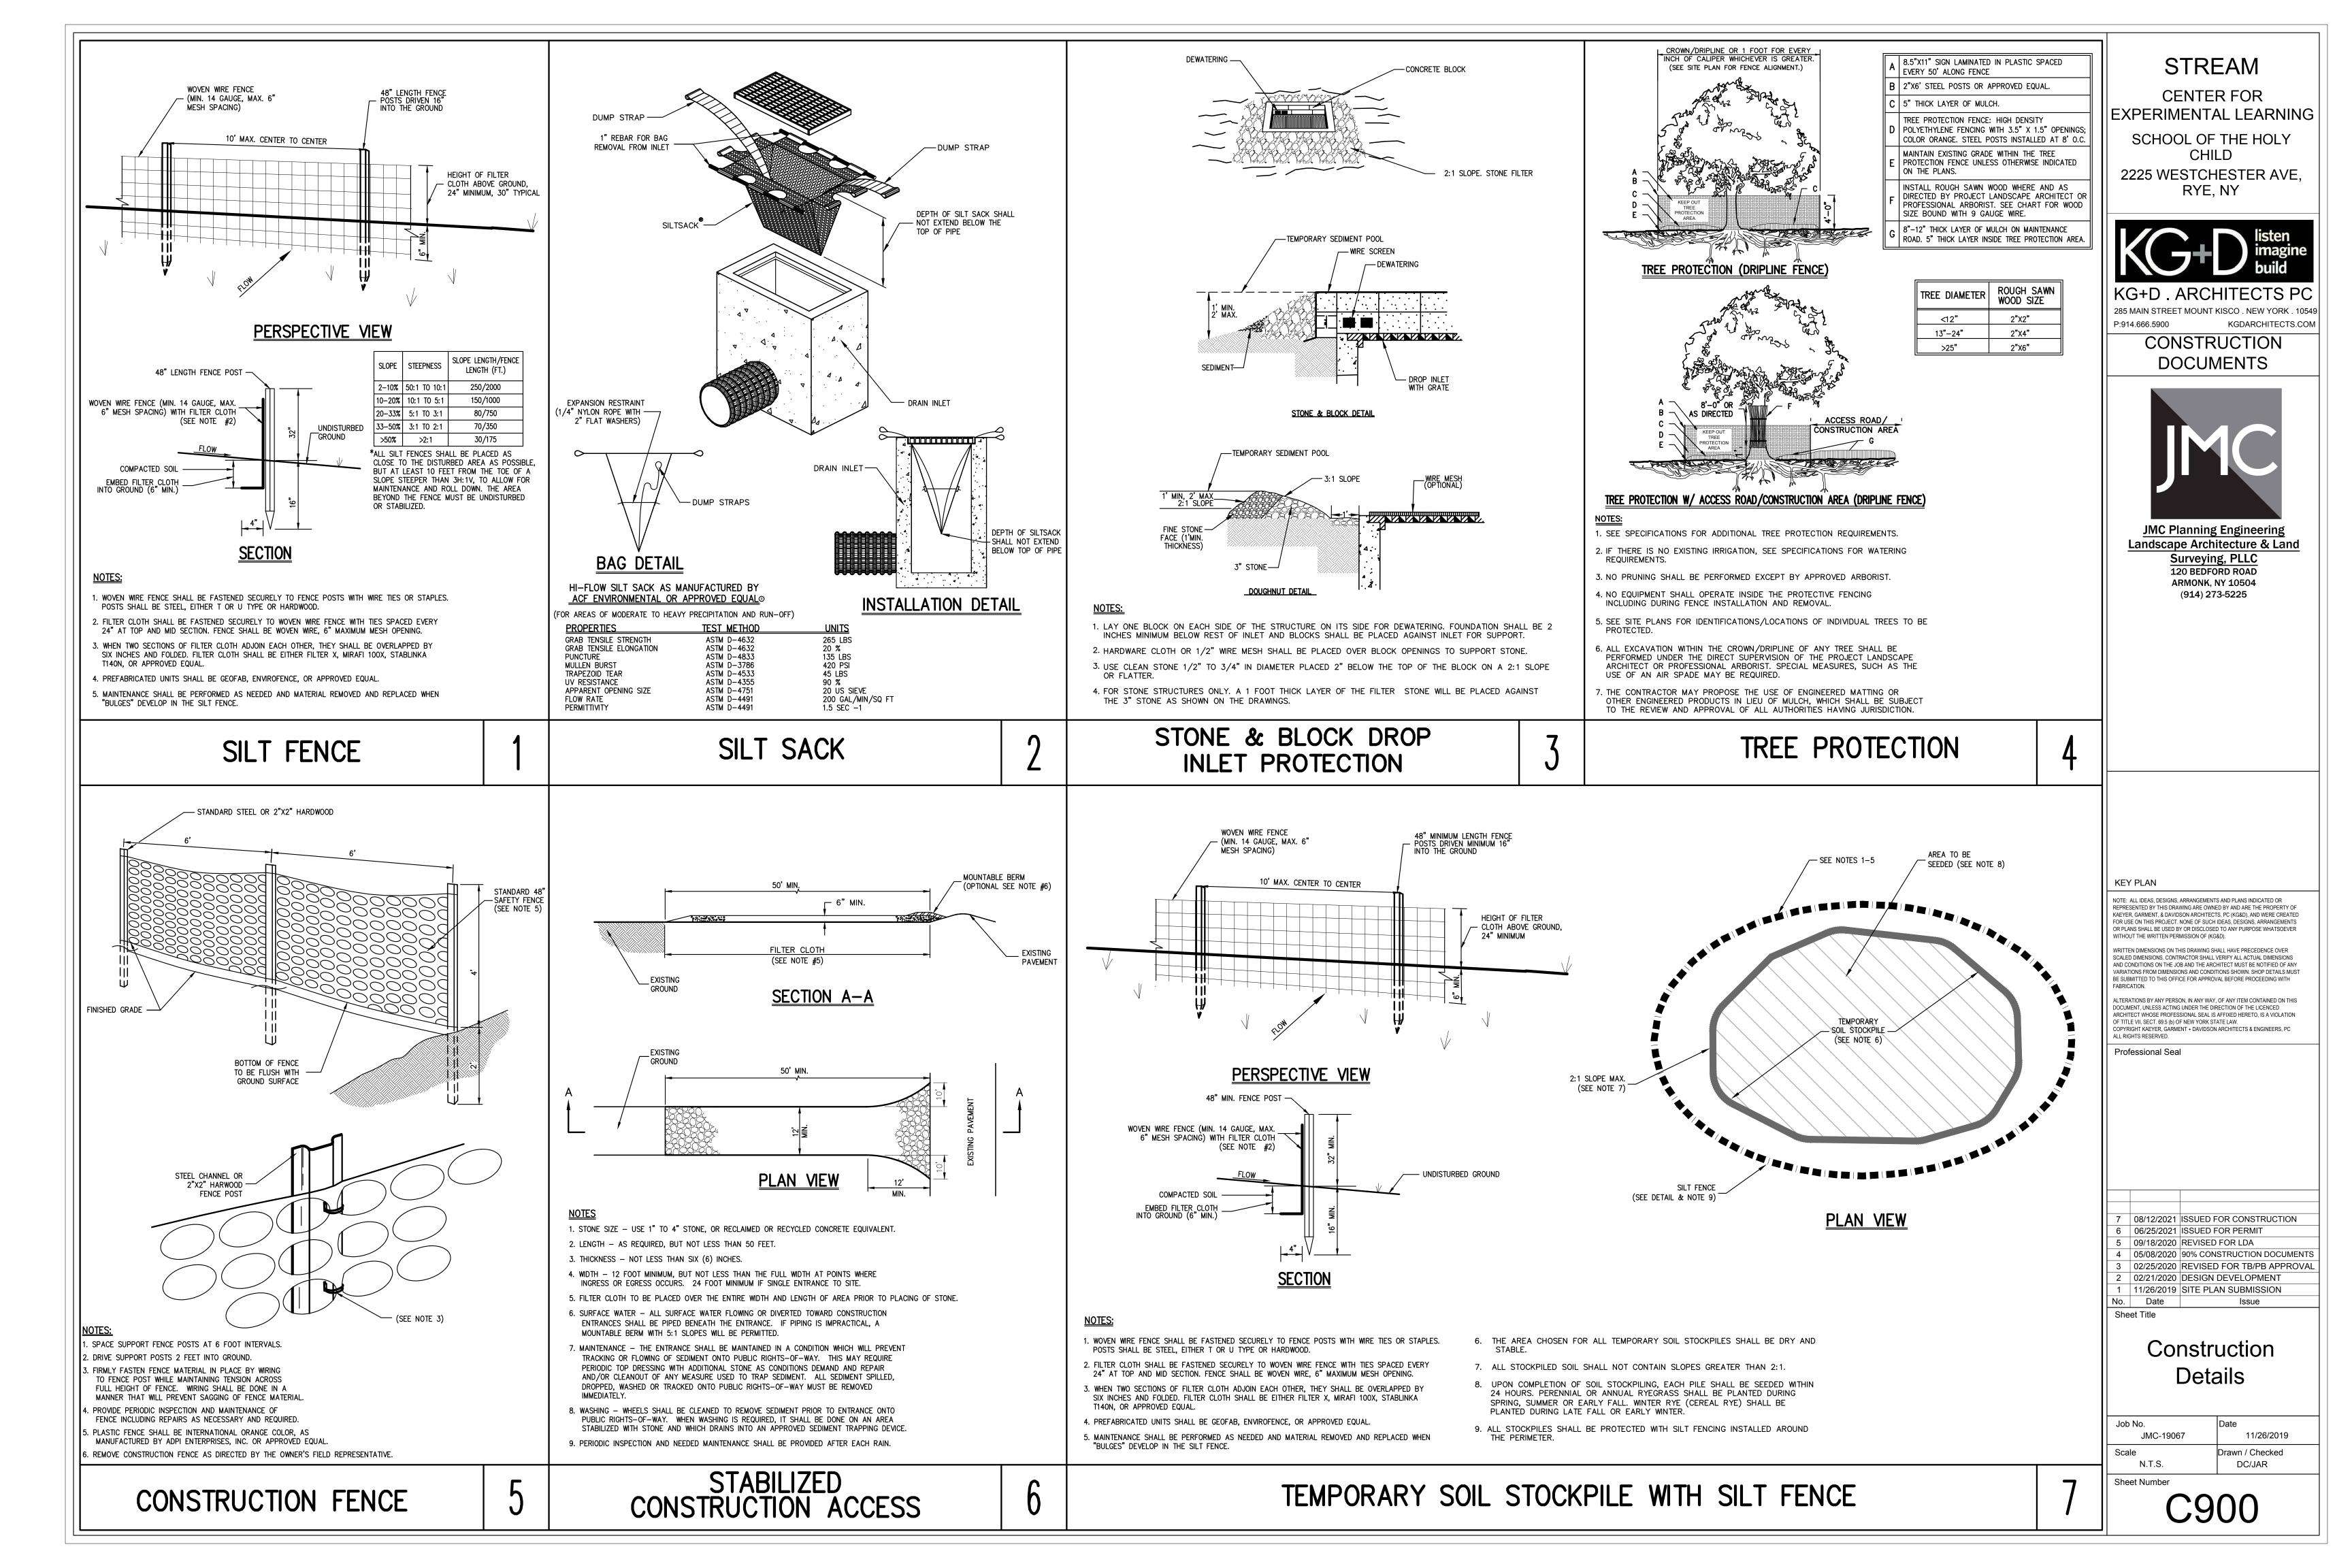
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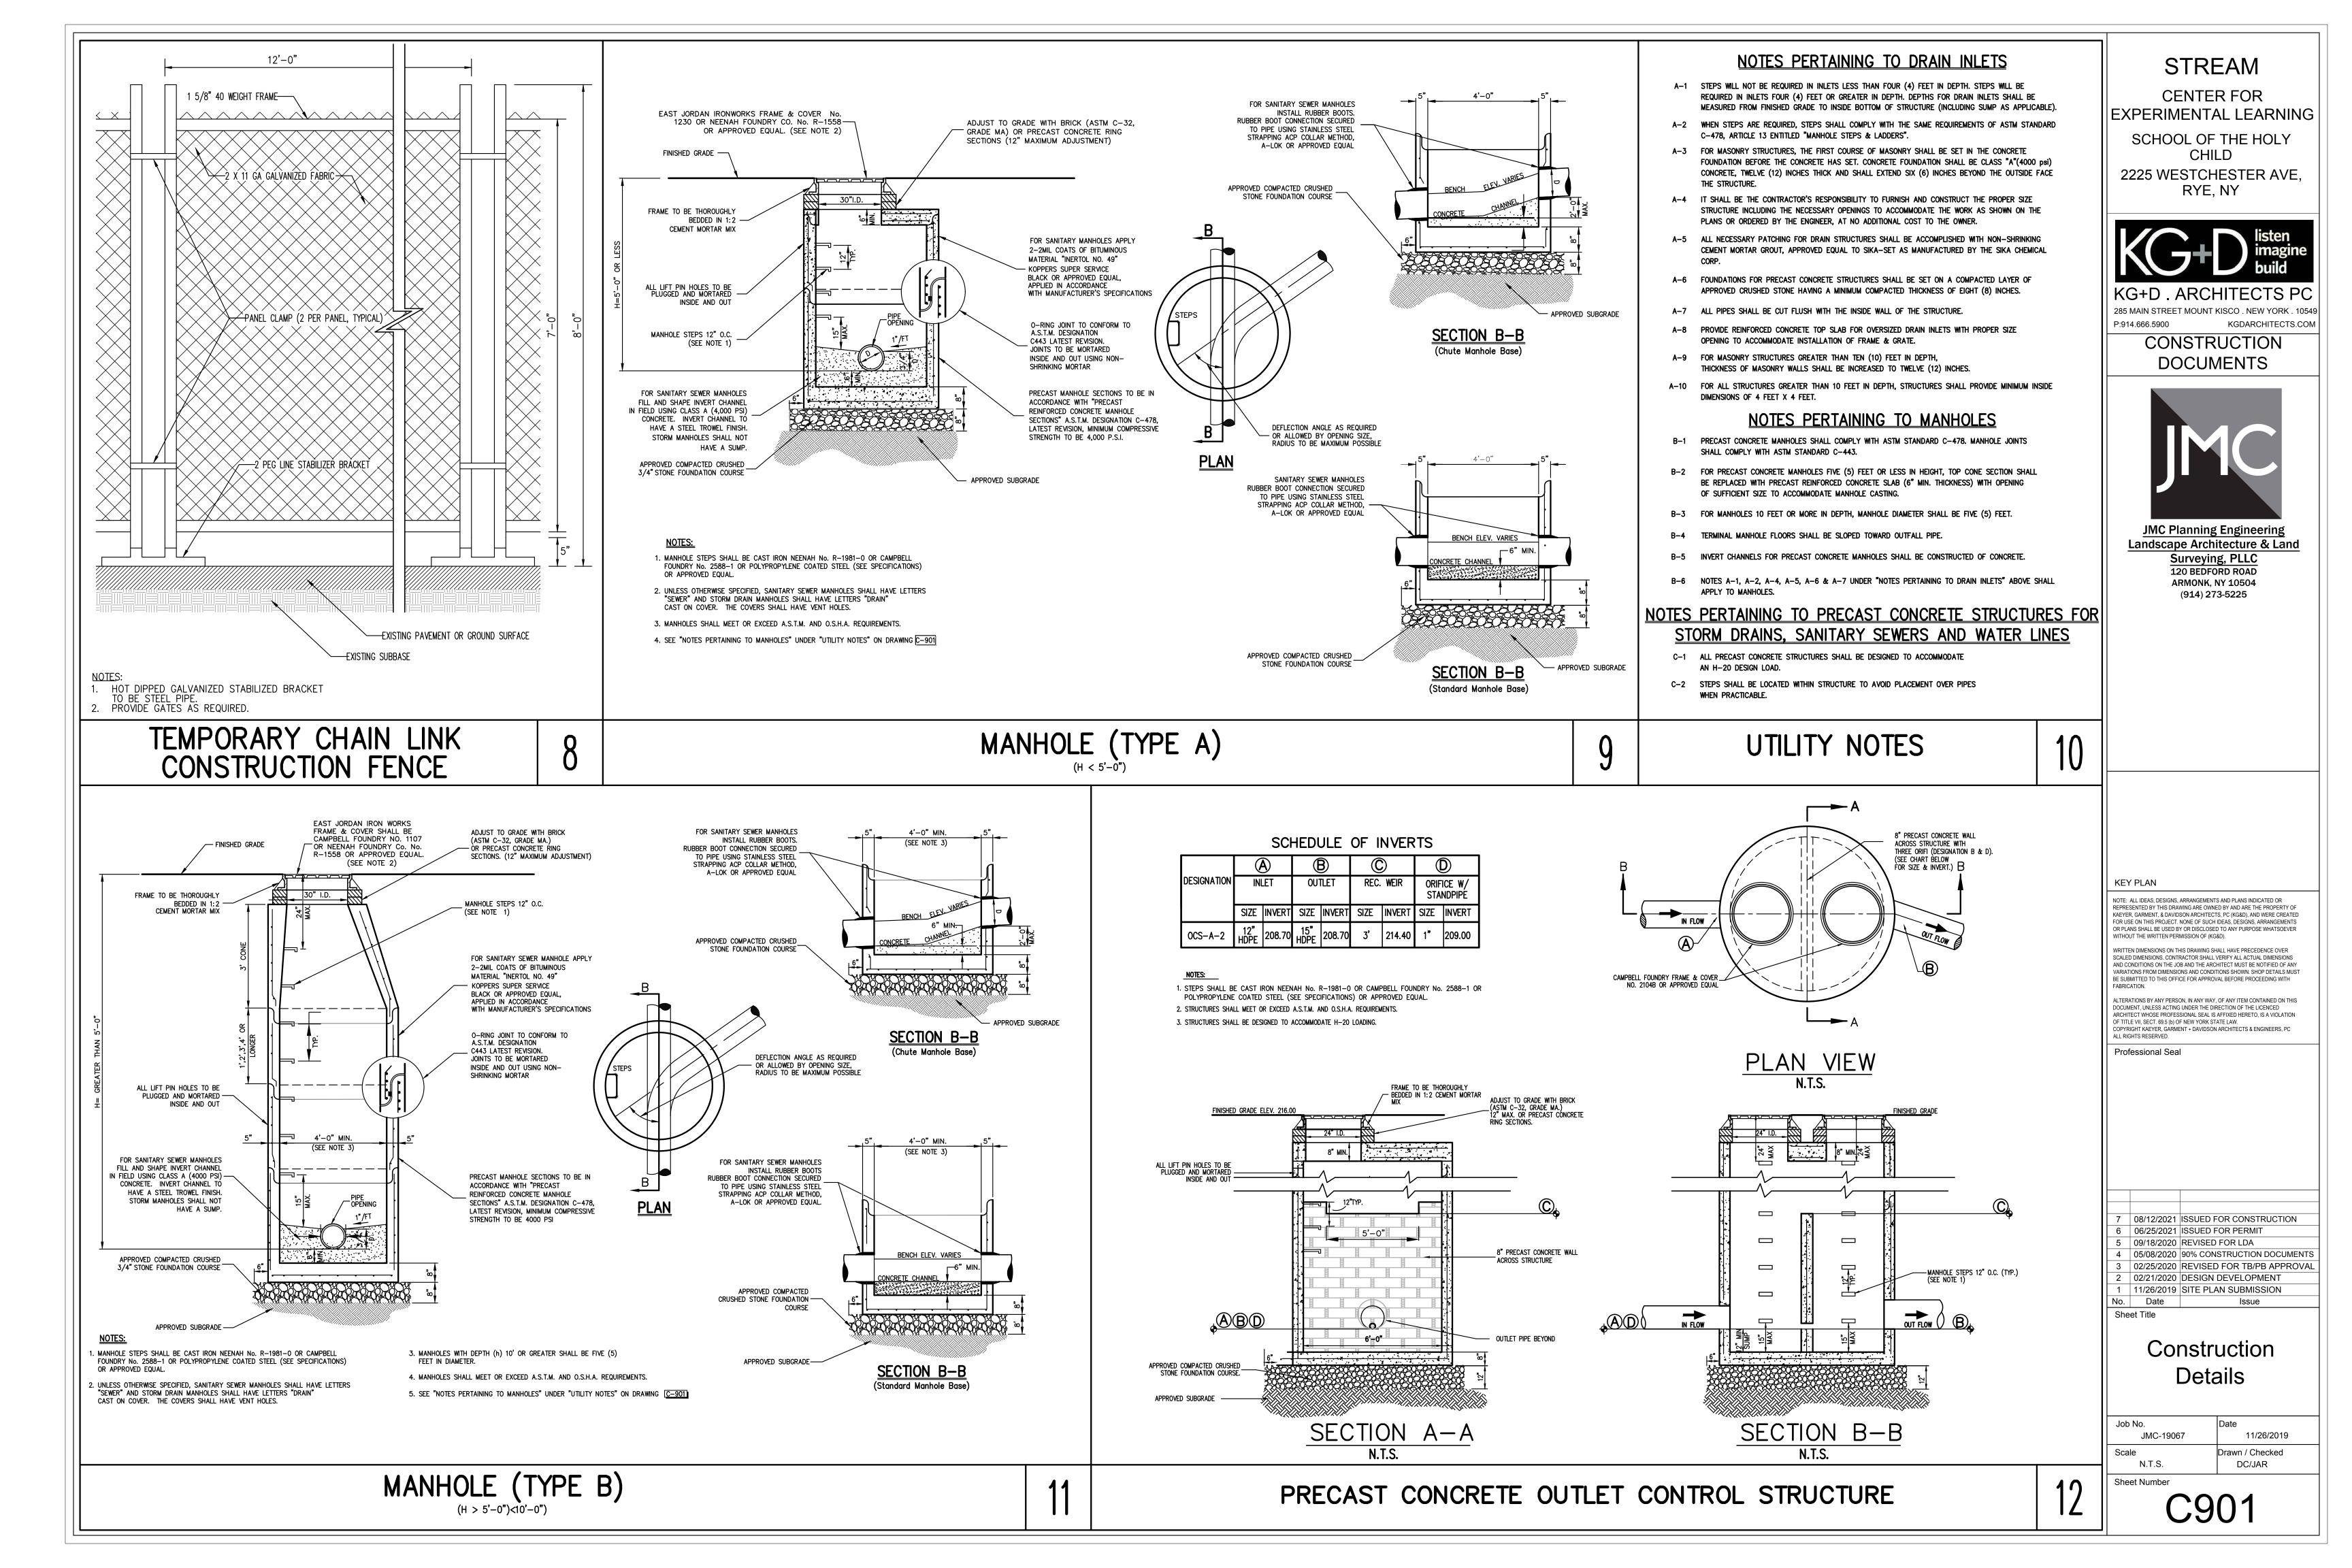
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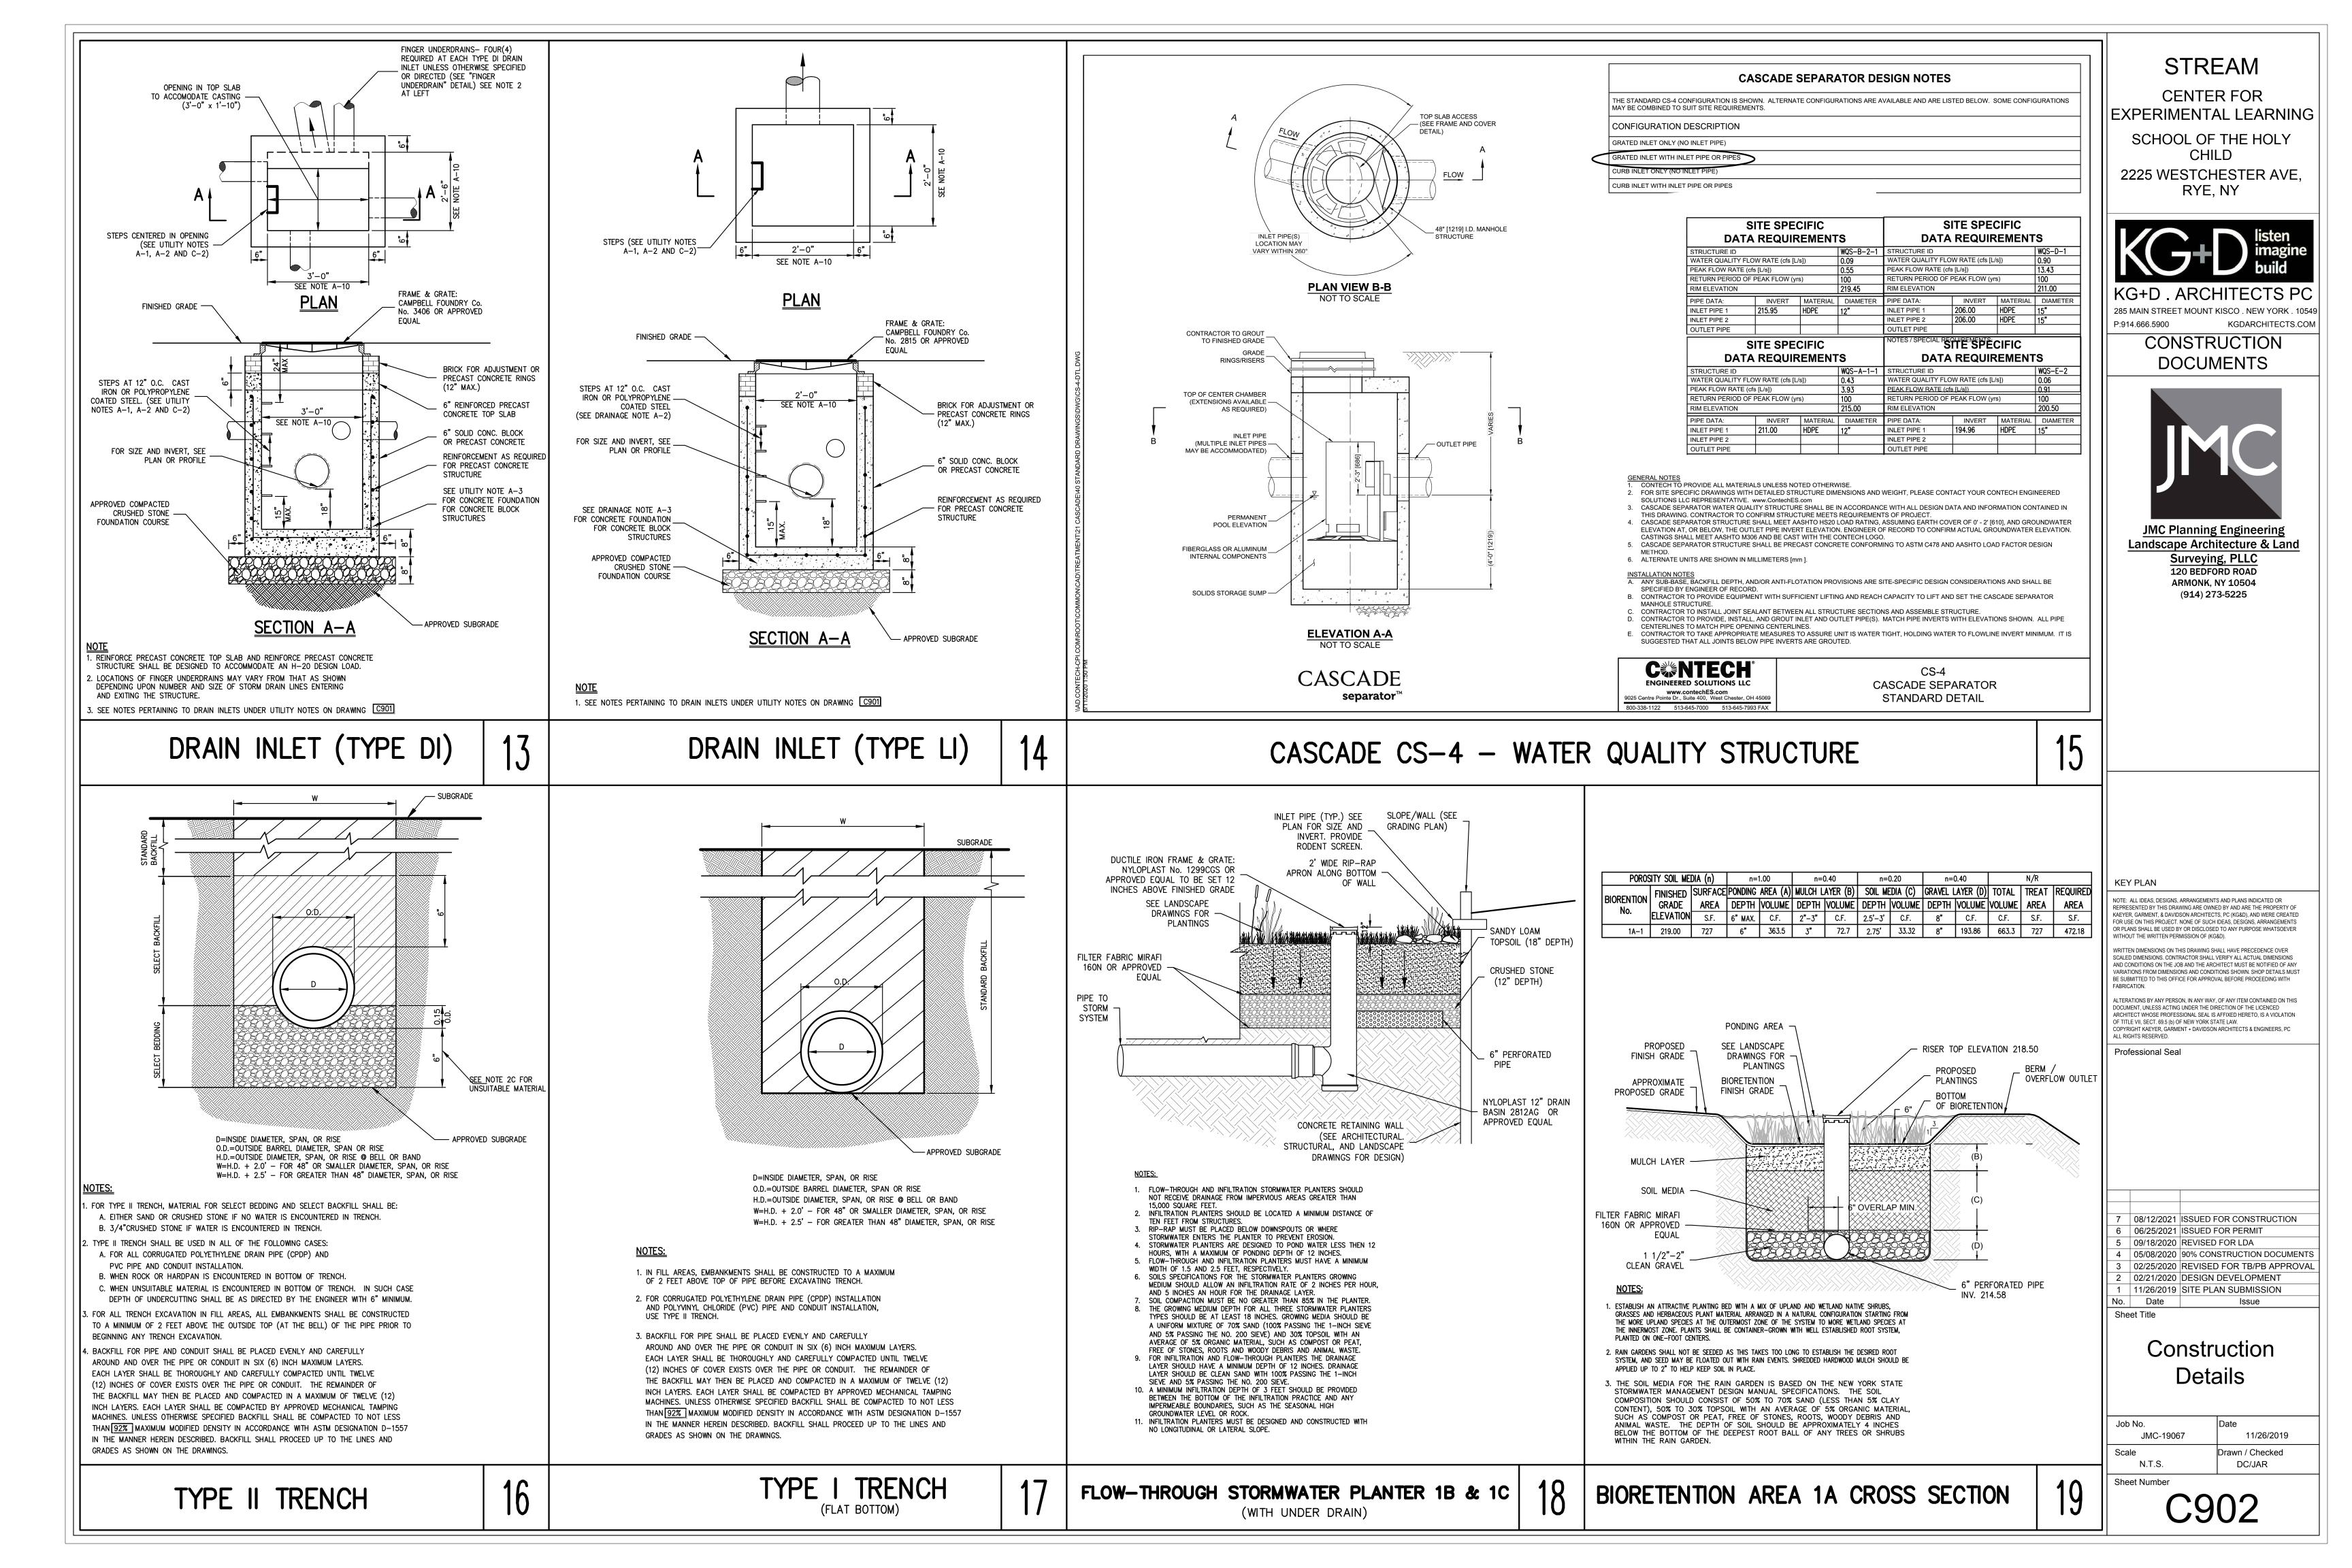
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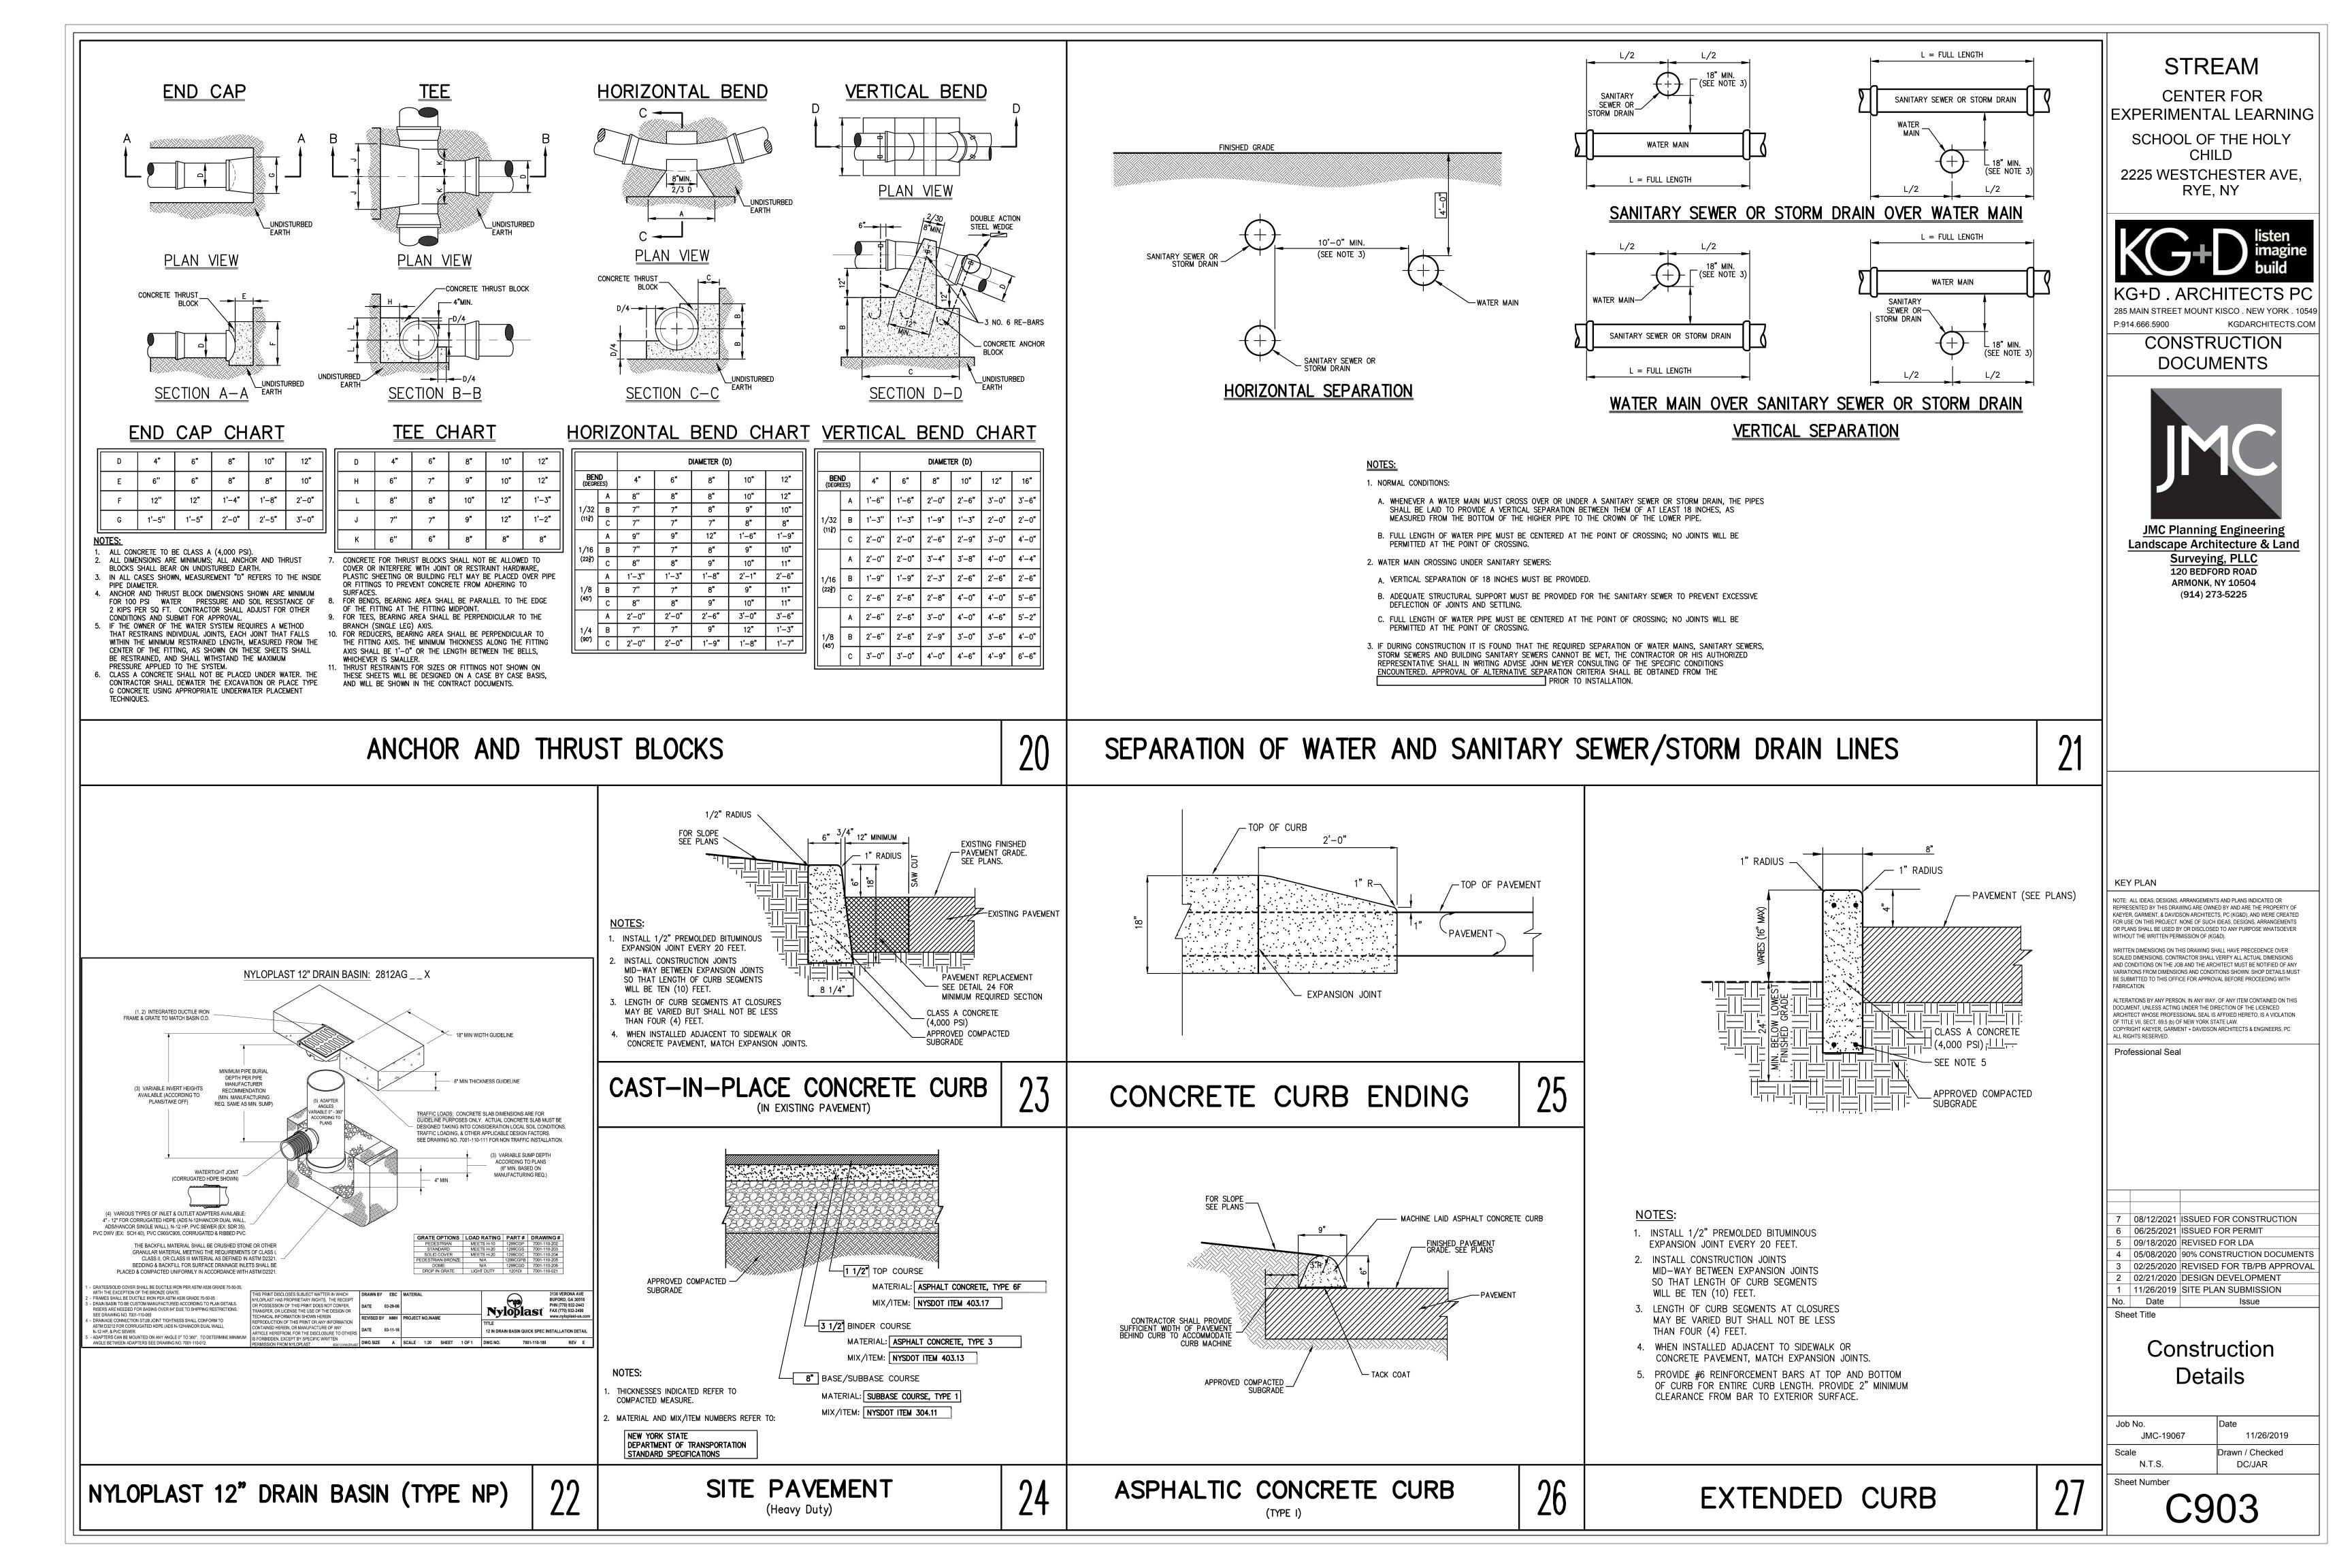
Civil and Landscape Alternatives Plan


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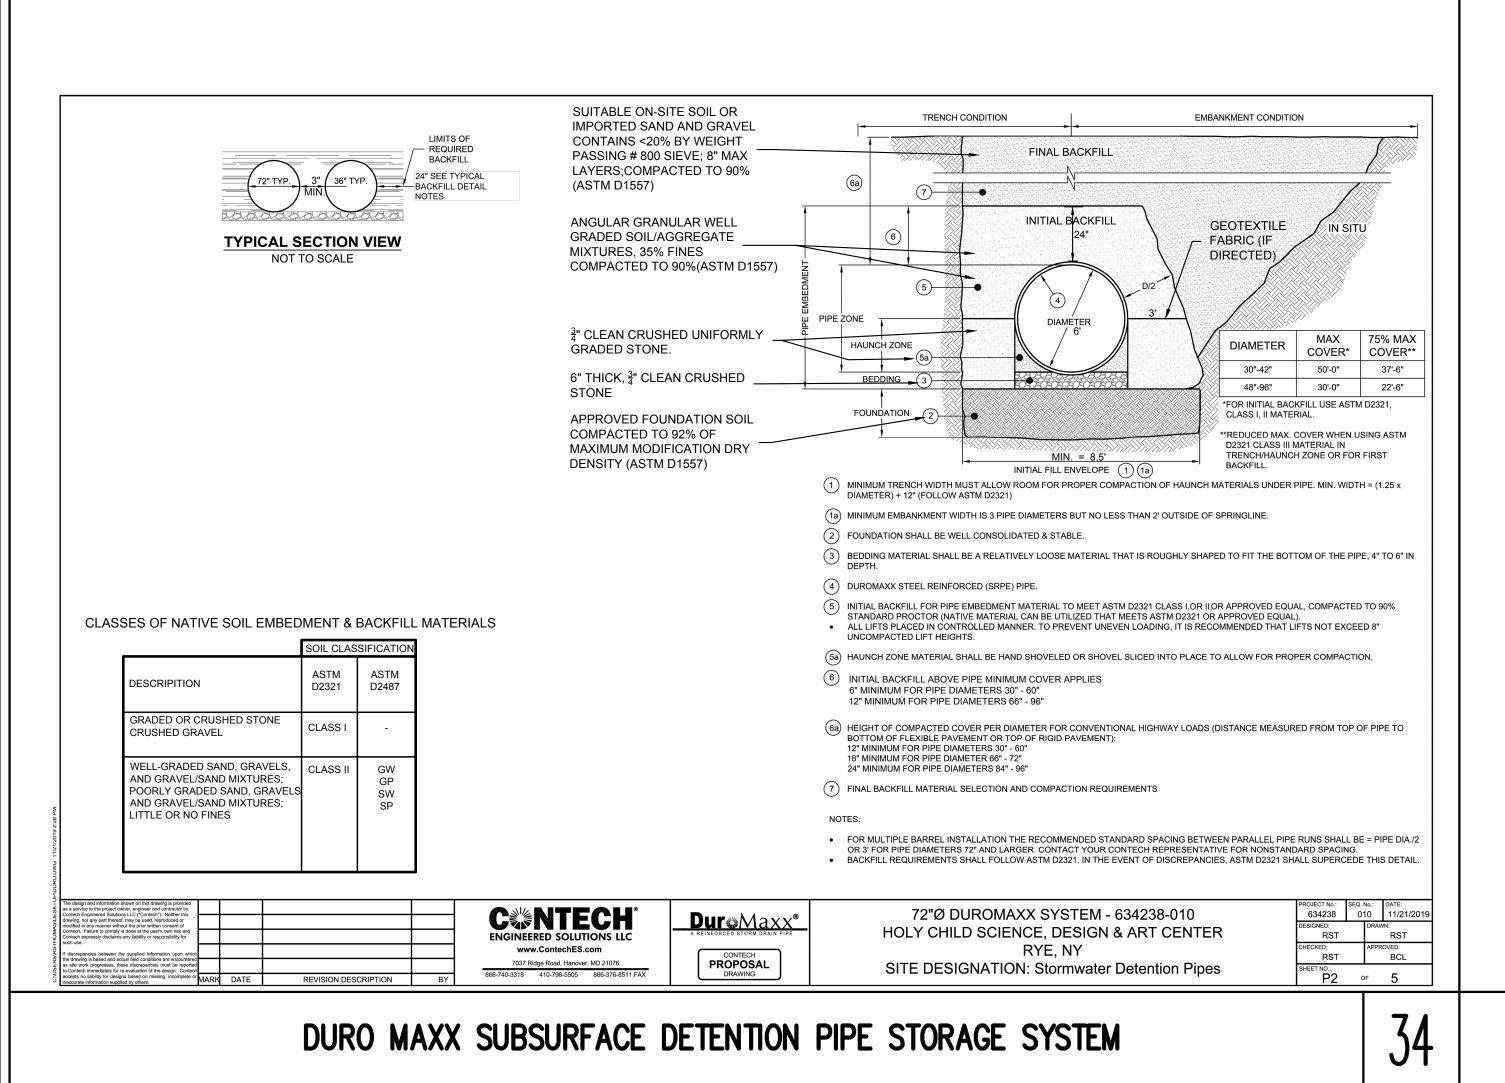





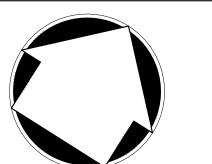







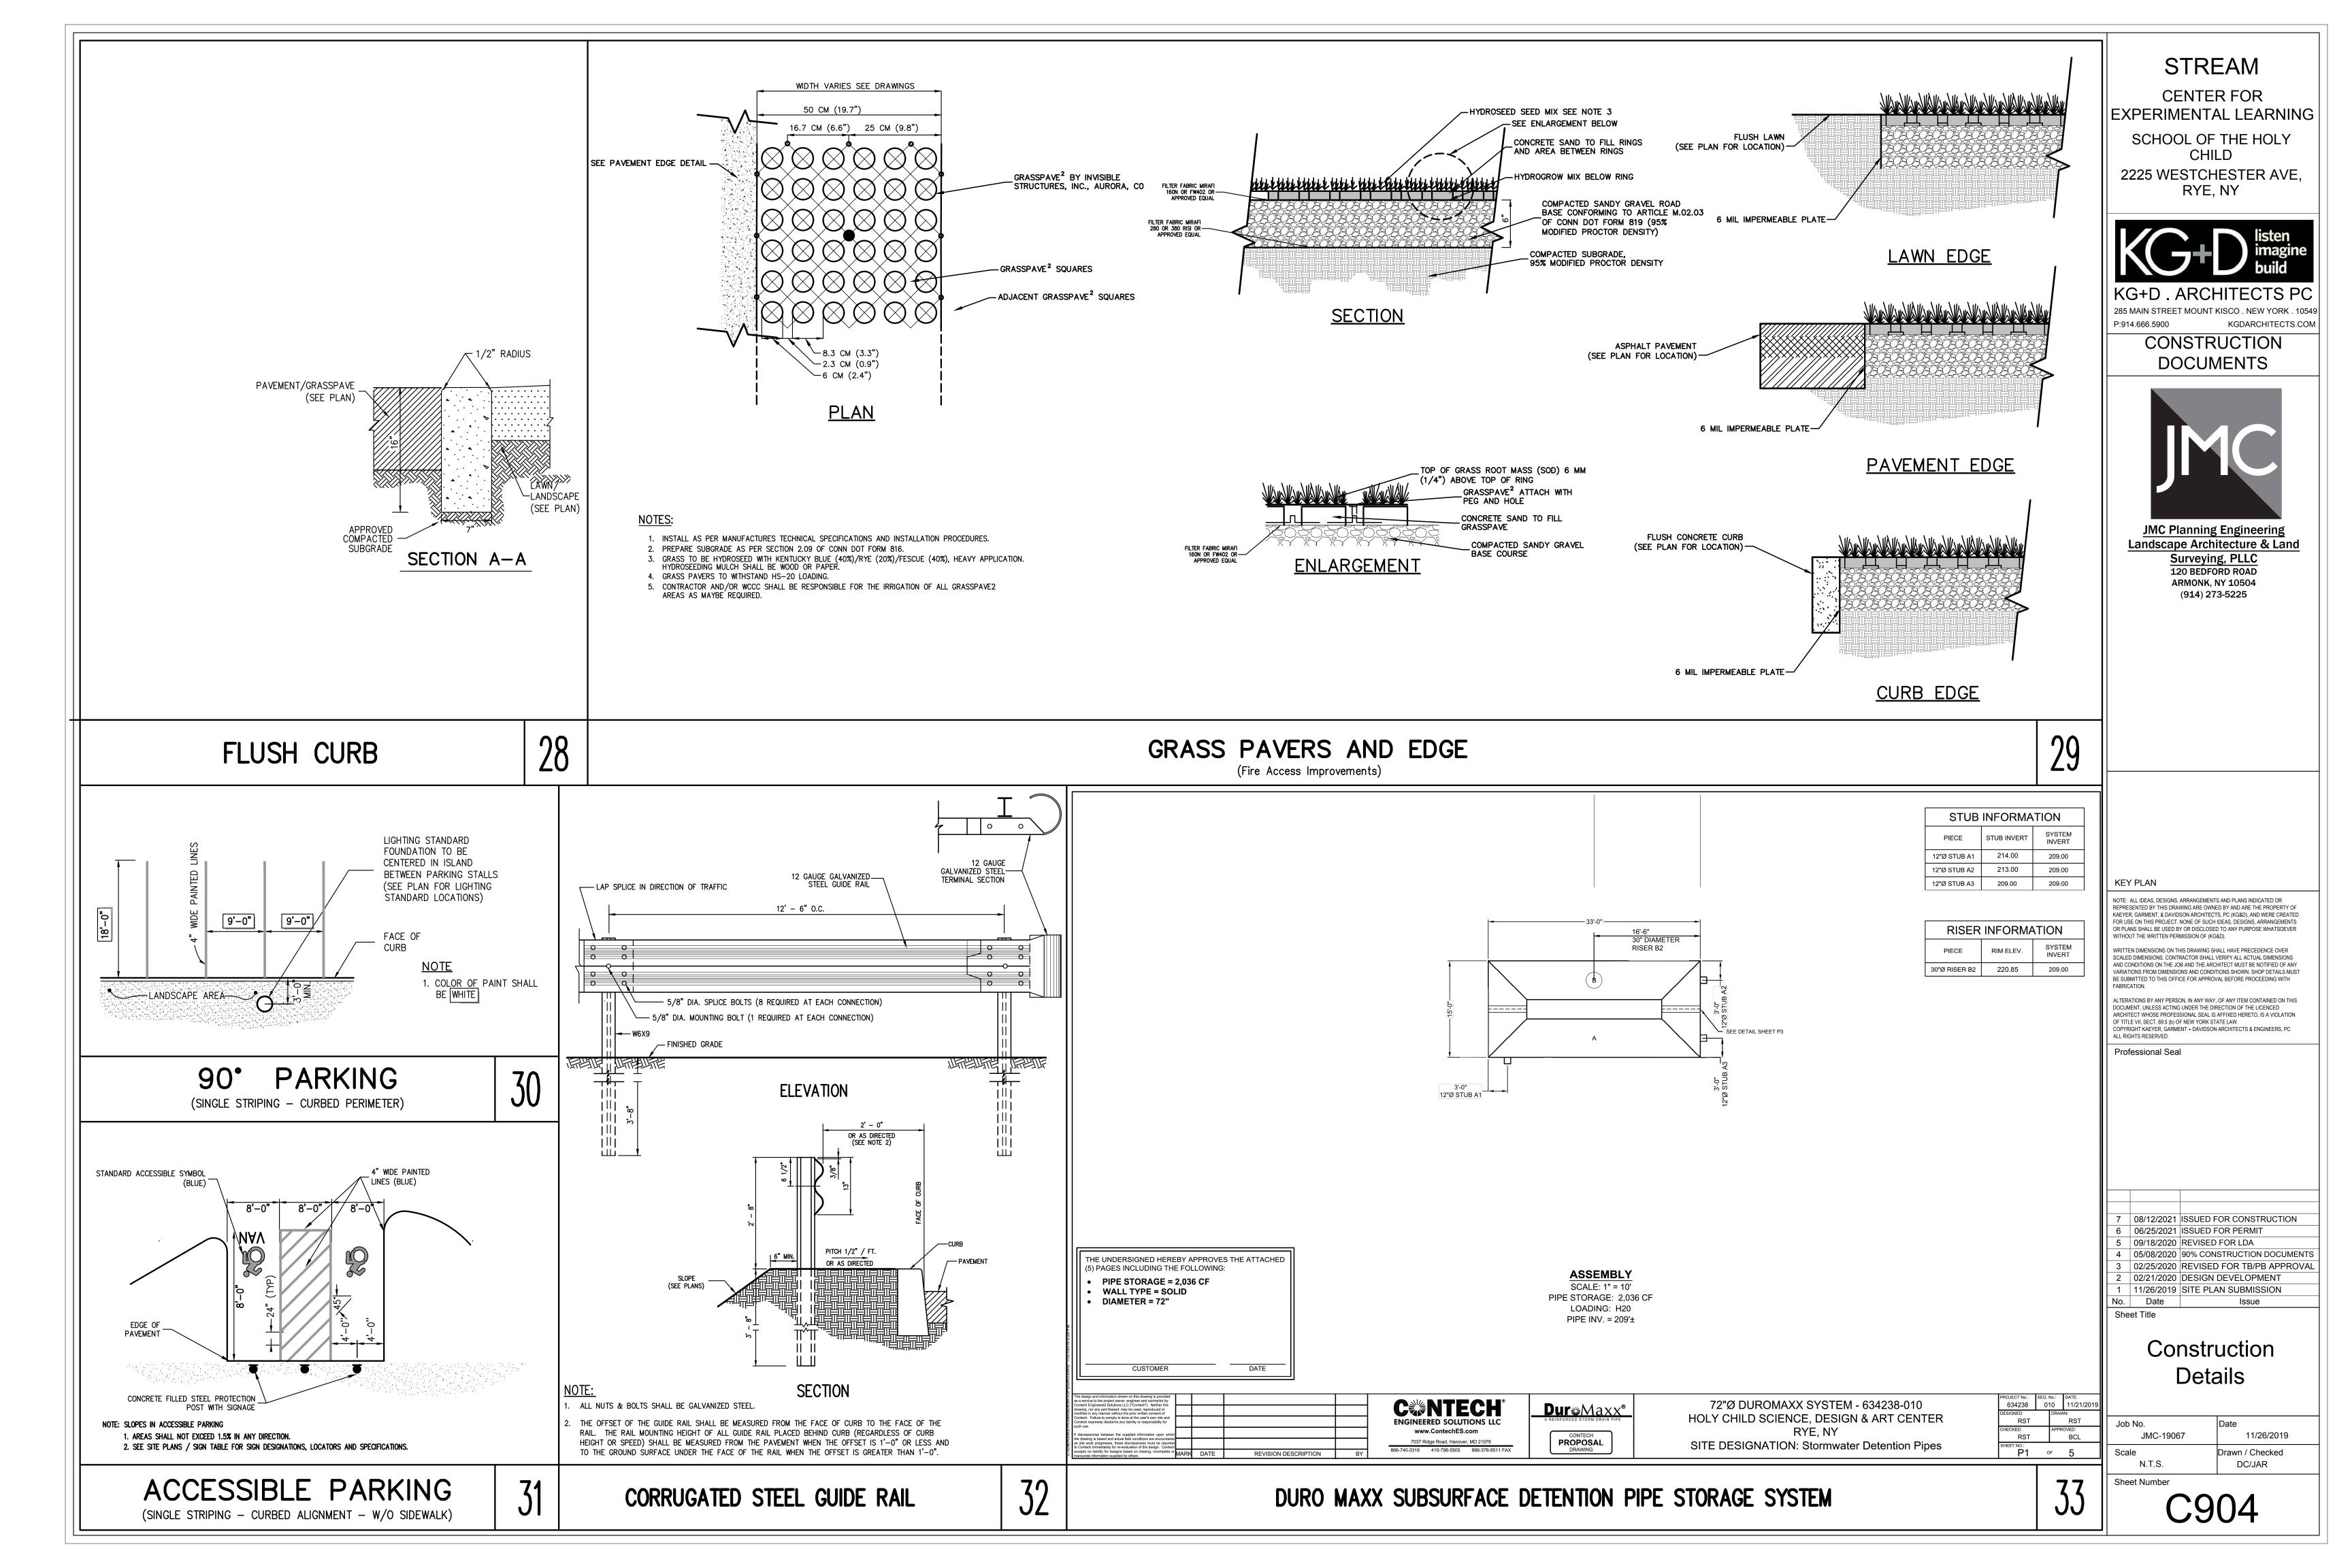

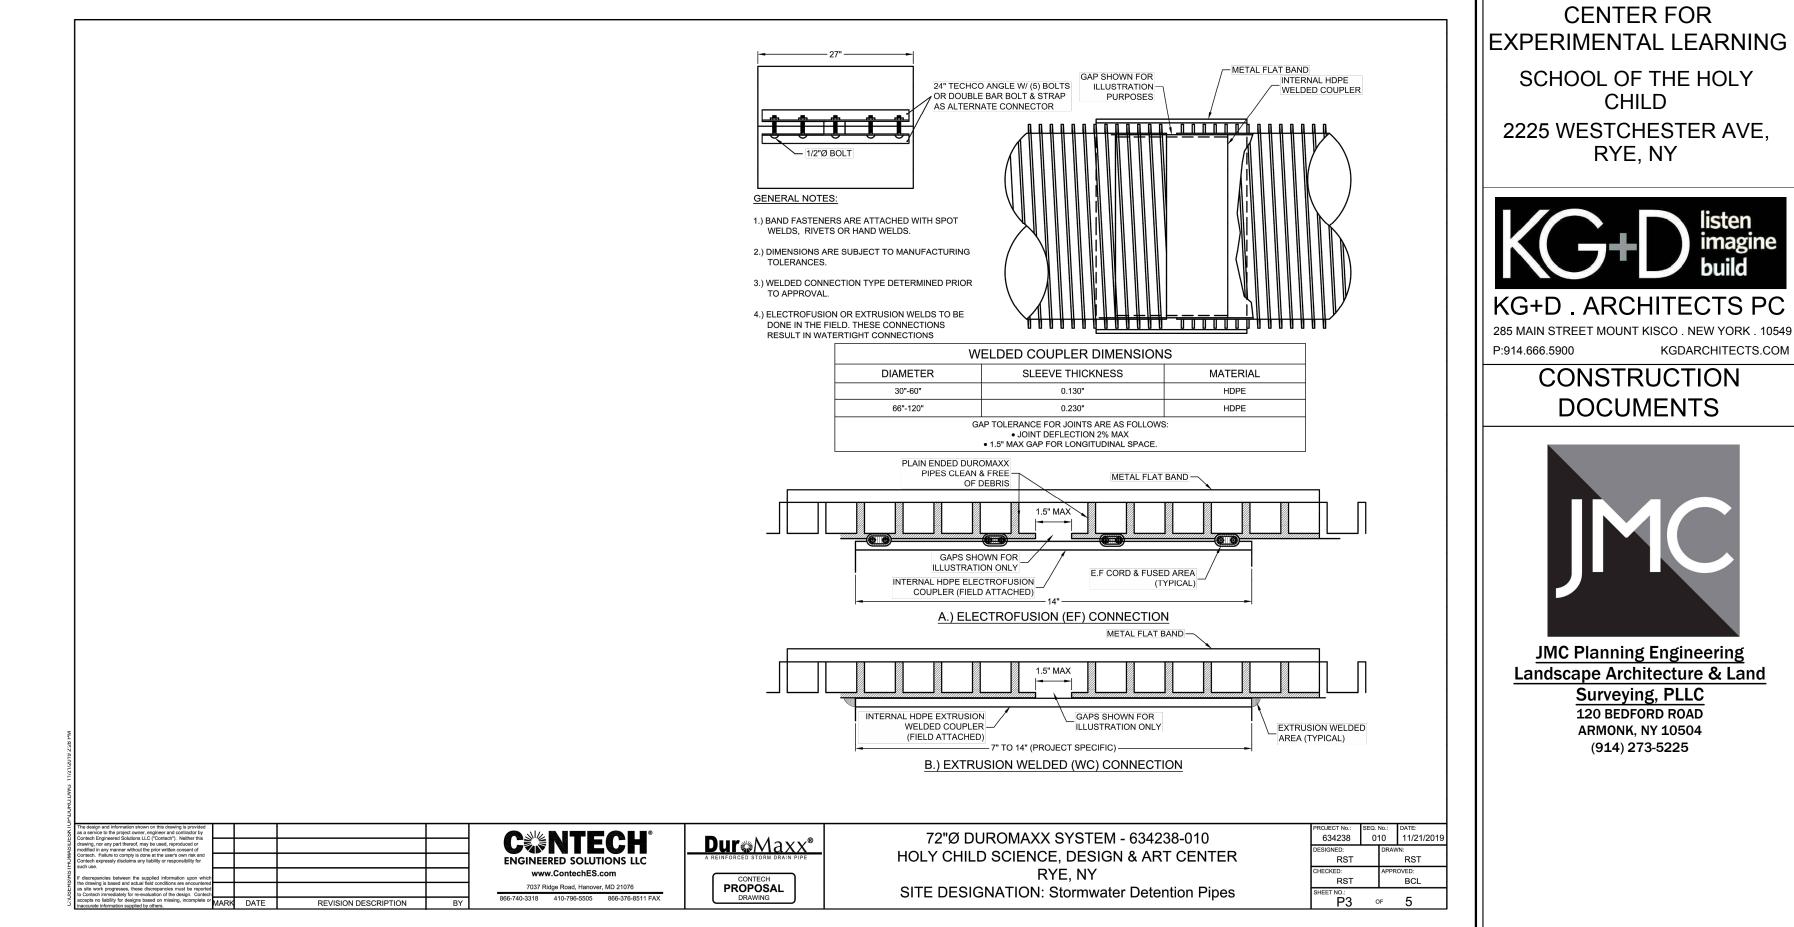

DURO MAXX SUBSURFACE DETENTION PIPE STORAGE SYSTEM

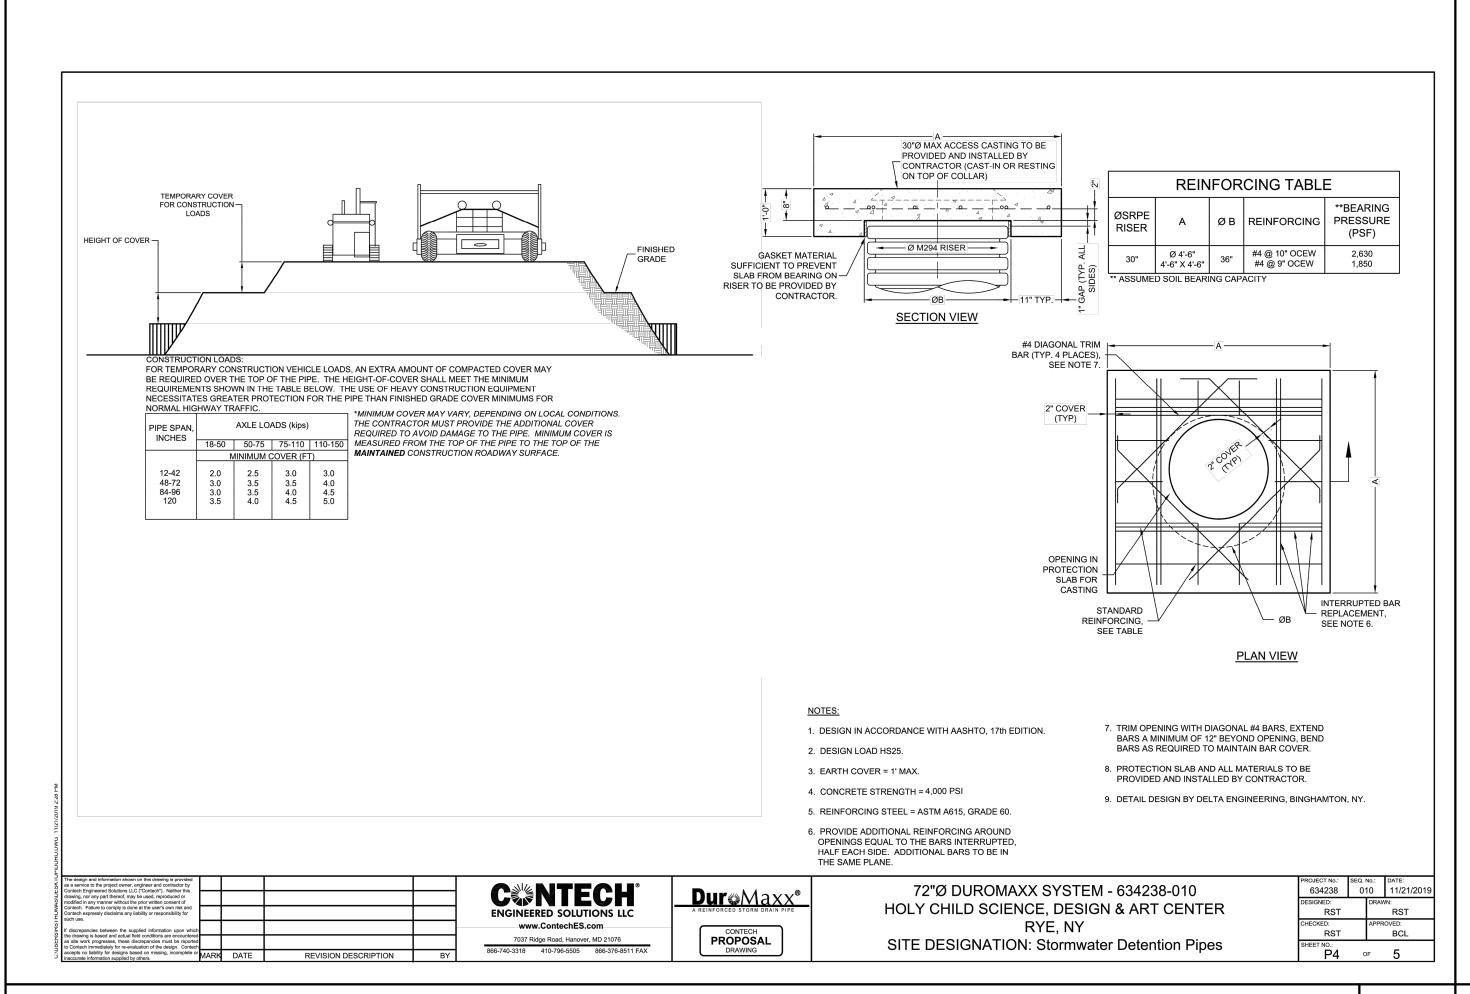

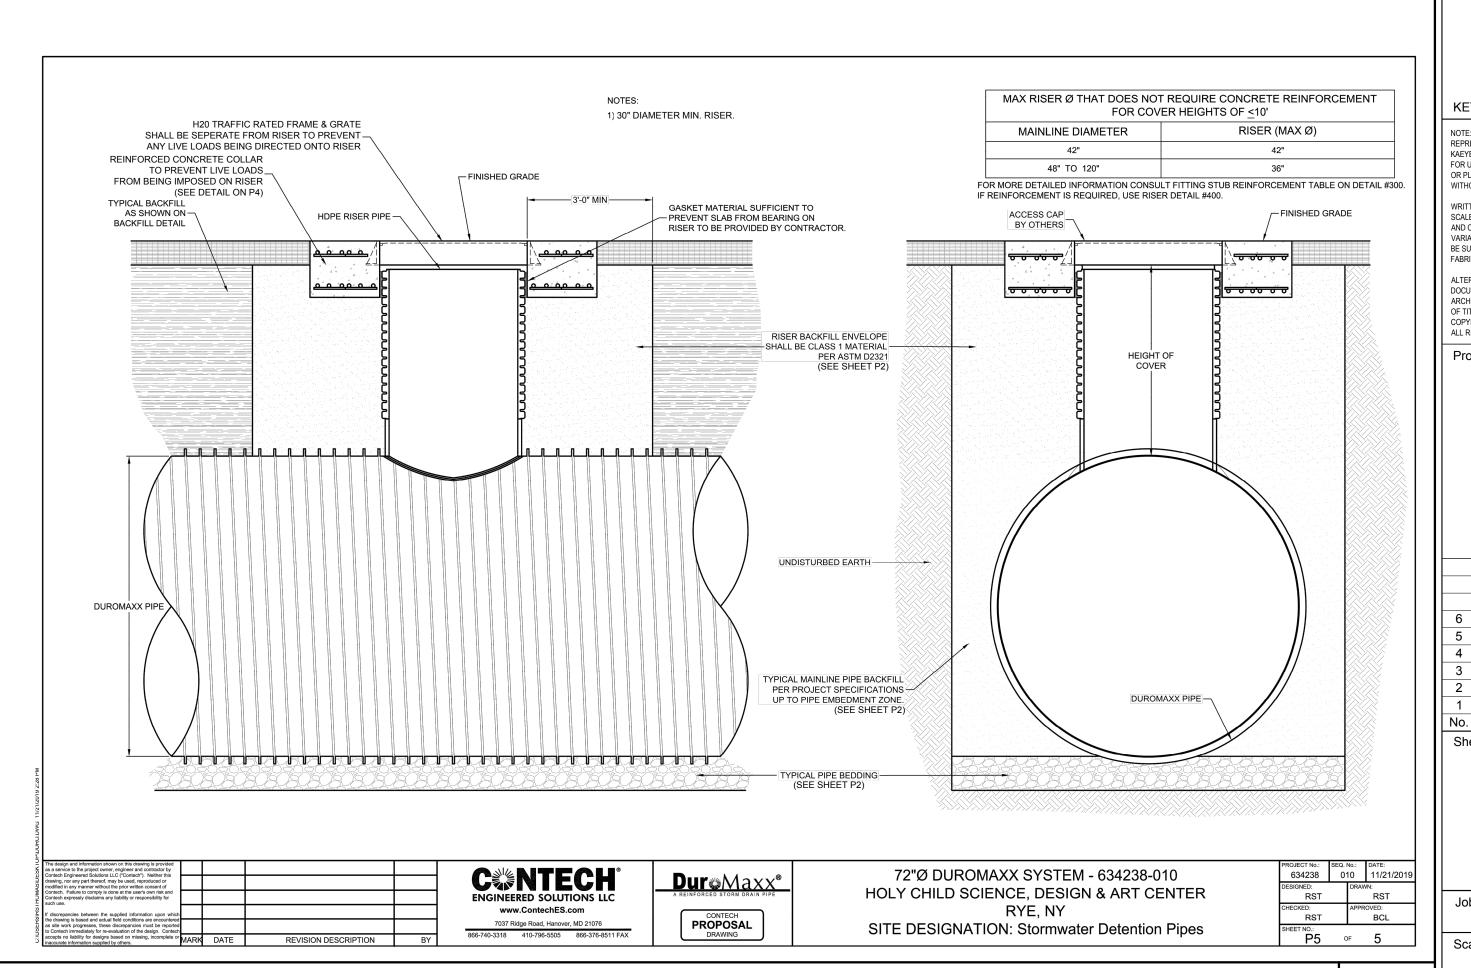

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STREAM

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DURO MAXX SUBSURFACE DETENTION PIPE STORAGE SYSTEM

N.T.S.

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FLEXSTORM™ Inlet Filter Specifications and Work Instructions

roduct: FLEXSTORM Inlet Filters


Manufacturer: Inlet & Pipe Protection, Inc <u>www.inletfilters.com</u>

A subsidiary of Advanced Drainage Systems (ADS) www.ads-pipe.com

#### 1.0 Description of Work:


1.1 The work covered shall consist of supplying, installing, and maintaining/cleaning of the FLEXSTORM Inlet Filter assembly. The purpose of the FLEXSTORM Inlet Filter system is to collect silt and sediment from surface storm water runoff at drainage locations shown on the plans or as directed by the Engineer. FLEXSTORM PURE, permanent filters, are capable of removing small particles, hydrocarbons, and other contaminants from drainage "hot spots".

#### 2.0 Material:

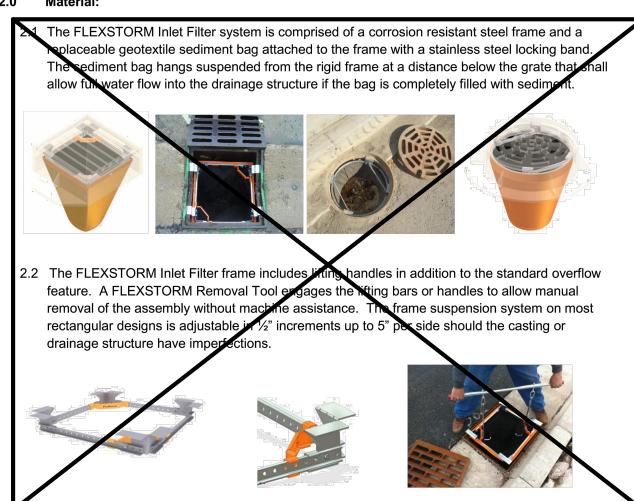






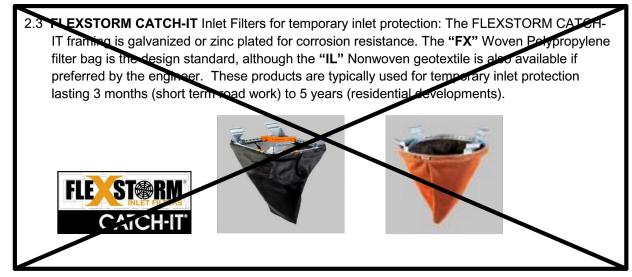

2.4 **FLEXSTORM PURE** Inlet Filters for permanent inlet protection: The FLEXSTORM PURE framing is comprised of 304 stainless steel with a 25 year life rating. Multiple filter bags are available: **FX, FX+, PC, PC+, LL** and others. The Post Construction "**PC+**" is the design standard consisting of the "**FX**" Woven Polypropylene sediment bag lined with Adsorb-it filter fabric, which is made from recycled polyester fibers. The "**PC+**" includes a replaceable hydrocarbon skimmer pouch strapped to the bottom of the bag for advanced TPH removal.



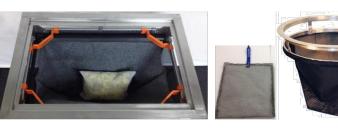

#### 3.0 Filter Bag Specifications and Capabilities:

3.1 Material Properties (taken from manufacturers average roll value):

	(22" depth)	(12" depth)	Clean Water	Min A.O.S. (US
FLEXSTORM FILTER BAGS	STD Bag P/N	Short Bag P/N	Flow Rate (GPM/SqFt)	Sieve)
FX. Standard Woven Dag	FX	FX S	200	10
FX1. Woven w/ Sil Skimmer	ГЖР	FXP S	200	40
FXO. Woven w/ Oil Doom	ГЖО	FXO-S	200	40
PC: Post Construction Bag	PC	<del></del>	137	140
PC:.PC w/ Oil Skimmer	rer	PEP 9	137	140
LL. Litter and Leaf Bas	<u>LL</u>	LL S	High	3.5
IL: IDOT Non-Weven Bag		IL S	145	70



3.2 Standard Bag Sizes and Capabilities: Bag Sizes are determined by clear opening dimensions of the drainage structure. Once frame design size is confirmed, Small - XL bag ratings can be confirmed to meet design criteria. Ratings below are for standard 22" deep bags.

Standard Bag Size <sup>§</sup>	Solids Storage Capacity	Filtered Flow Rate at 50% Max (CFS)			Oil Retention (Oz)	
	(CuFt)	FX	PC	IL	PC*	PCP*
Omall	1.0	1.2	0.0	0.0	- 00	155
n n Li	2.1	1.0	1,2	1.0	- 00	105
Large	3.8	2.2	1.5	1.0	120	200
XL	4.2	0.0	2.4	2.0	192	970

**4.0 Tested Filtration Efficiency and Removal Rates**: Filtration Efficiency, TSS, and TPH testing performed under large scale, real world conditions at accredited third party erosion and sediment control testing laboratory. (See Full Test Reports at <a href="www.inletfilters.com">www.inletfilters.com</a>)



Inside View of Hopper With Outlet Pipe Hopper Agitator Leading To Area Inlet

Area Inlet Simulated Showing Influent Discharge From Pipe

4.1 **FLEXSTORM** "FX" Filtration Efficiency Test Results: All testing performed in general accordance with the ASTM D 7351, Standard Test Method For Determination of Sediment Retention Device Effectiveness in Sheet Flow Application, with flow diverted into an area inlet. Test Soil used as sediment had the following characteristics with a nominal 7% sediment to water concentration mix. This is representative of a heavy sediment load running off of a construction

Soil Characteristics	Test Method	Value	Filtration Efficiency of "FX" FLEXSTORM Bag
% Gravel	ASTM D 422	2	
% Sand		60	
% Silt		24	
% Clay		14	82%
Liquid Limit, %		34	02 /0
Plasticity Index, %	A31WD 4310	9	
Soil Classification	USDA	Sandy Loam	
Soil Classification	USCS	Silty Sand (SM)	

FLE STORM

4.2 **FLEXSTORM "PC" and "PC+" Test Results:** TSS measured on effluent samples in accordance with SM 2540D and TPH in accordance with EPA 1664A.

Product Tested	110 micron Sediment Load	Ave Flow Rate GPM	% TSS Removal	Soil Retention Efficiency
FLEXSTORM PC	1750 mg/L using	23	99.28%	98.96%
Sediment Bag	OK-110 Silica Sand and Clean Water	48	99.32%	99.25%
		70	98.89%	98.80%


Product Tested	Street Sweep	Particle Size of	% TSS	Soil Retention
	Sediment Load	Sediment Load	Removal	Efficiency
FLEXSTORM PC Sediment Bag	2.5% = 100 lbs Sed / 4000 lbs water	.001 mm - 10.0 mm (median 200 micron)	99.68%	95.61%

Product Tested	Hydrocarbon Load	Ave Flow Rate GPM	% TPH Removal	Oil Retention Efficiency
EL EVOTORIA DO		40	00.040/	07.000/
I LEXOTORWI O	243 mg/L using 750		0010170	01.2270
FLEXSTORM PC	mL (1.45 lb) used motor oil + lube oil	20	97.67%	91.61%
EL EVOTORM BO.	and clean water     and clean water	22	00.000/	00.440/
I LEAGIGIMII O	7	JZ	<del>30.00</del> /0	55.1170

#### 5.0 Identification of Drainage Structures to Determine FLEXSTORM Item Codes:

5.1 The Installer (Contactor) shall inspect the plans and/or worksite to determine the quantity of each drainage structure casting type. The foundry casting number or the exact grate size and clear opening size will provide the information necessary to identify the required FLEXSTORM Inlet Filter part number. Inlet Filters are supplied to the field pre-configured to fit the specified drainage structure. Item Codes can be built using the FLEXSTORM Product Configurator at <a href="https://www.inletfilters.com">www.inletfilters.com</a>. Detailed Submittal / Specification drawings are linked to each Item Code and available for download by engineers and contractors to include on plans and/or verify field inlet requirements. An example of a typical drawing is shown below.



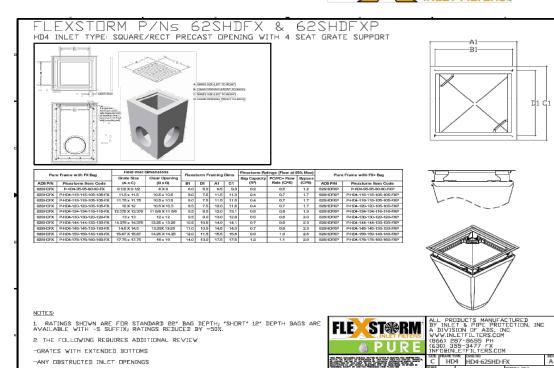

## 6.0 Installation Into Standard Grated Drainage Structures:

6.1 Remove the grate from the casting or concrete drainage structure. Clean the ledge (lip) of the casting frame or drainage structure to ensure it is free of stone and dirt. Drop in the FLEXSTORM Inlet Filter through the clear opening and be sure the suspension hangers rest firmly on the inside ledge (lip) of the casting. Replace the grate and confirm it is elevated no more than 1/8", which is the thickness of the steel hangers. For Curb Box Inlet Filters: Insert FLEXSTORM CATCH IT Inlet Filter as described above, pull the rear curb guard flap up and over the open curb box until tight, align magnets to ensure firm attachment to the top portion of the curb box casting. If the curb back opening is not magnetic, slide a typical rock sack or 2 x 4 through the 2-ply rear curb box flap to create a dam which will direct runoff into the sediment bag.





- 7.0 Maintenance Guidelines: The frequency of maintenance will vary depending on the application (during construction, post construction, or industrial use), the area of installation (relative to grade and runoff exposure), and the time of year relative to the geographic location (infrequent rain, year round rain, rain and snow conditions). The FLEXSTORM Operation & Maintenance Plan (as shown in 7.5) or other maintenance log should be kept on file.
- 7.1 Frequency of Inspections: Construction site inspection should occur following each ½" or more rain event. Post Construction inspections should occur three times per year (every four months) in areas with year round rainfall and three times per year (every three months) in areas with rainy seasons before and after snowfall season. Industrial application site inspections (loading ramps, wash racks, maintenance facilities) should occur on a regularly scheduled basis no less than three times per year.
- 7.2 General Maintenance for standard sediment bags: Upon inspection, the FLEXSTORM Inlet Filter should be emptied if the sediment bag is more than half filled with sediment and debris, or as directed by the Engineer. Remove the grate, engage the lifting bars or handles with the FLEXSTORM Removal Tool, and lift the FLEXSTORM Inlet Filter from the drainage structure. Machine assistance is not required. Dispose of the sediment or debris as directed by the Engineer. As an alternative, an industrial vacuum may be used to collect the accumulated sediment if available. Remove any caked on silt from the sediment bag and reverse flush the bag for optimal filtration. Replace the bag if the geotextile is torn or punctured to ½" diameter or greater on the lower half of the bag. If properly maintained, the Woven sediment bag will last a minimum of 4 years in the field.
- 7.3 Inspection and Handling of the FLEXSTORM PC / PC+ post construction sediment bag: The PC+ sediment bags will collect oil until saturated. Both the Adsorb-it filter liner and the skimmer pouch will retain oil. The volume of oils retained will depend on sediment bag size. Unlike other passive oil sorbent products, Adsorb-it filter fabric has the ability to remove hydrocarbons at high flow rates while retaining 10- 20 times its weight in oil (weight of fabric is 12.8 oz / sq yd). The average 2' x 2' PC Bag contains approx .8 sq yds, or 10 oz of fabric. At 50% saturation, the average Adsorb-it lined PC filter will retain approximately 75 oz (4.2 lbs) of oil. Once the bag has become saturated with oils, it can be centrifuged or passed through a wringer to recover the oils, and the fabric reused with 85% to 90% efficacy. If it is determined, per Maintenance Contracts or Engineering Instructions, that the saturated PC sediment bags will be completely replaced, it is the responsibility of the service technician to place the filter medium and associated debris in an approved container and dispose of in accordance with EPA regulations. Spent Adsorb-it can be recycled for its fuel value through waste to energy incineration with a higher BTU per pound value than coal. The oil skimmers start white in color and will gradually turn brown/black as they become saturated, indicating time for replacement. The average skimmer pouch will absorb approximately 62 oz (4 lbs) of oil before requiring replacement. To remove the pouch simply unclip it from the swivel strap sewn to the bottom of the bag. Dispose of all oil contaminated products in accordance to EPA guidelines. The ClearTec Rubberizer media used in the pouch, since a solidifier, will not leach under pressure and can be disposed of in most landfills, recycled for industrial applications, or burned as fuel.




7.4 Sediment Bag Replacement: When replacing a Sediment Bag, remove the bag by loosening or cutting off the clamping band. Take the new sediment bag, which is equipped with a stainless steel worm drive clamping band, and use a drill or screw driver to tighten the bag around the frame channel. Ensure the bag is secure and that there is no slack around the perimeter of the band. For Oil absorbent boom bags, simply replace the oil boom or pouch when saturated by sliding it through the mesh support sleeve.







7.5 Operation & Maintenance Plan. (Download at <a href="www.inletfilters.com">www.ads-pipe.com</a>)

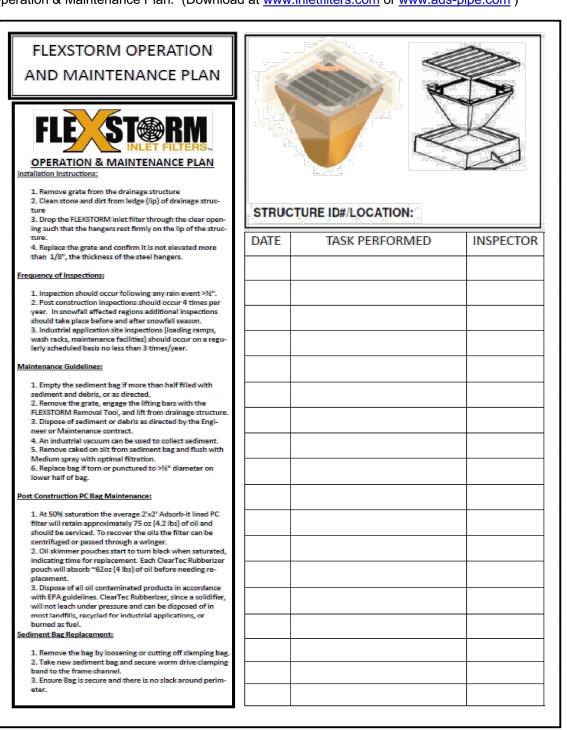

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KG+D . ARCHITECTS PC
285 MAIN STREET MOUNT KISCO . NEW YORK . 10549
P:914.666.5900 KGDARCHITECTS.COM

SITE PLAN SUBMISSION



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Landscape Architecture & Land
Surveying, PLLC
120 BEDFORD ROAD
ARMONK, NY 10504
(914) 273-5225

KEY PLAN

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