SYMBOLS A		EVIATIONS			
SYMBOL	ABBREVIATION	DESCRIPTION	SYMBOL	ABBREVIATION	DESCRIPTION
	-	CONDUIT AND WIRING	FACP	FACP	FIRE ALARM CONTROL PANEL
	-	CONDUIT & WIRING TO BE REMOVED UON	BPS	BPS	BOOSTER POWER SUPPLY
— — UG— —	-	BURIED CONDUIT	R	-	FIRE ALARM RELAY
				EOL	END OF LINE RESISTOR
	_	HOMERUN TO PANEL, ARROWS INDICATE # 1P	CFA	-	CALL FOR AID PULL STATION
	_	MULTI-POLE HOMERUN		_	CALL FOR AID A/V DEVICE
	_	ELECTRICAL EQUIPMENT AS INDICATED		_	
	_	ELECTRICAL EQUIPMENT AS INDICATED	EPO	EPO	ELECTRIC HAND DRYER EMERGENCY POWER OFF SWITC
	_				
			RASP	RASP -	RESCUE ASSIST. SYSTEM MASTE
	_		<u>ل</u> ج		REMOTE RESCUE STATION
		FUSED DISCONNECT SWITCH		СВ	
	-	UNFUSED DISCONNECT SWITCH	200AS	-	ENCLOSED CIRCUIT BREAKER
	-	COMBINATION MOTOR STARTER/FUSED DISC.	150AF	-	FUSED SWITCH
	-	MOTOR STARTER		GND	GROUND AS PER LOCAL CODE
	-	MOTOR	<b>TT</b>	-	GROUND BAR
	-	EXIT LIGHT, FACES-SHADED, CHEVRON-ARROW		-	GROUND ROD
S <sub>x</sub>	-	SINGLE POLE SWITCH (x - INDICATES FIXTURE BEING CONTROLLED)	T OR T	XFMR	TRANSFORMER
-			5	СТ	CURRENT TRANSFORMER
S <sub>x</sub> <sup>3</sup>	-	THREE WAY SWITCH (x - INDICATES FIXTURE BEING CONTROLLED)	<u>ک</u>	-	UTILITY POLE
				WM	WATER MAIN
$S_x^4$	-	FOUR WAY SWITCH (x - INDICATES FIXTURE BEING CONTROLLED)	В	-	BOILER BREAK GLASS STATION
			/ł	NC	NORMALLY CLOSED CONTACTS
<b>S</b> <sup>DIM</sup>	-	DIMMER SWITCH (x - INDICATES FIXTURE BEING CONTROLLED)		NO	NORMALLY OPEN CONTACTS
			M	MD	MOTORIZED DAMPER
S <sub>M</sub>	-	MOTOR RATED TOGGLE SWITCH		SD OR CFSD	SMOKE DAMPER
Sĸ	-	KEY OPERATED SINGLE POLE SWITCH		А	AMPERE(S)
∨	-	WALL MOUNTED OCCUPANCY SENSOR		AFF	ABOVE FINISHED FLOOR
		(V - INDICATES VACANCY SENSOR)		AF	AMPERAGE OF FUSE
(OC)V	-	CEILING MOUNTED OCCUPANCY SENSOR		AGL	ABOVE GRADE LEVEL
		(V - INDICATES VACANCY SENSOR)		AHU	AIR HANDLING UNIT
ŧ	-	DUPLEX RECEPTACLE		AL	ALUMINIUM
<b></b>	-	DOUBLE DUPLEX RECEPTACLE		ARC	ARC FAULT INTERRUPTER
$\ominus$	-	SPECIAL RECEPTACLE		AS	AMPERAGE OF SWITCH
$\bigtriangledown$	-	TELEPHONE OUTLET		ATS	AUTOMATIC TRANSFER SWITCH
▼ ×	-	DATA OUTLET (x - INDICATES # OF JACKS, 1 JACK		AWG	AMERICAN WIRE GAUGE
		UON)		С	CONDUIT
$\nabla$	-	COMBINATION TELEPHONE/DATA OUTLET		CD	CANDELA
WAP	-	WIRELESS ACCESS POINT		СКТ	CIRCUIT
↓ C	-	CAMERA		CLG	CEILING
CR	_	CARD READER		СТ	COUNTER-TOP
	_	FLOOR MOUNTED DOUBLE DUPLEX RECEPTACLE		CU	COPPER
	-	FLOOR MOUNTED DATA OUTLET (x - INDICATES #		DEM.	DEMOLISH AND REMOVE
		OF JACKS, 1 JACK UON)		DISC	DISCONNECT
Ē¢	-	FIRE ALARM COMBINATION AUDIO/VISUAL DEVICE		EMT	ELECTRICAL METALLIC TUBING
$\square \land \checkmark_{V}$		(15/75 CD - STROBE) V - DENOTES VOICE COMMUNICATION DEVICE		EMI	EMERGENCY
	_				
		FIRE ALARM COMBINATION AUDIO/VISUAL DEVICE (110 CD - STROBE) V - DENOTES VOICE		EX.	
<u> </u>				F	
) (110)		FIRE ALARM STROBE 15/75 CD		GFI	GROUND FAULT INTERRUPTER
) () () () () () () () () () () () () ()	-	FIRE ALARM STROBE 110 CD		HP	HORSEPOWER
$\langle S \rangle_{EL; SH; SC}$	-	SMOKE DETECTOR. EL - ELEVATOR LOBBY; SH - SMOKE HATCH; SC - PLENUM RATED ABOVE		KVA	KILO-VOLT-AMPERE
<u> </u>		CEILING		KW	KILO-WATT
S AC	-	DUCT MOUNTED SMOKE DETECTOR		MAX	MAXIMUM
H	-	HEAT DETECTOR		MCB	MAIN CIRCUIT BREAKER
TS	-	FIRE ALARM TAMPER SWITCH		MIN	MINIMUM
WF	-	FIRE ALARM WATER FLOW SWITCH		MLO	MAIN LUG ONLY
ANN	-	FIRE ALARM ANNUNCIATOR PANEL		NIC	NOT IN CONTRACT
СМ	СМ	FIRE ALARM CONTROL MODULE		NTS	NOT TO SCALE
MM	MM	FIRE ALARM MONITORING MODULE		Р	POLE
				РВО	PROVIDED BY OTHERS

**GENERAL NOTES** STREAM Center for 11.) WHERE GFI RECEPTACLES ARE CIRCUITED WITH GENERAL CONVENIENCE RECEPTACLES, THE GFI SYMBOL ABBREVIATION DESCRIPTION RECEPTACLE SHALL BE THE LAST DEVICE ON THE CIRCUIT ALARM CONTROL PANEL PNL PANEL 12.) INSTALL CONDUIT EXPANSION FITTINGS AT ALL LOCATIONS WHERE CONDUITS CROSS BUILDING OR STRUCTURE EXPANSION JOINTS. STER POWER SUPPLY SCH SCHEDULE 13.) CEILING MOUNTED RECEPTACLES SHALL BE MOUNTED FLUSH TO CEILING. ALARM RELAY SPD SURGE PROTECTION DEVICE 14.) UNLESS OTHERWISE NOTED, DISCONNECT SWITCHES, STARTERS, HOAS AND MOTOR RATED TOGGLE OF LINE RESISTOR SW SWITCH(ES) SWITCHES FOR MECHANICAL PUMPS, CABINET AND UNIT HEATERS, RETURN FANS, ROOF FANS, VAV BOXES, COMPRESSORS, FAN COIL UNITS, AIR HANDLERS AND CONDENSERS SHALL BE FURNISHED BY THE FOR AID PULL STATION TELCO **TELEPHONE COMPANY** MECHANICAL CONTRACTOR AND INSTALLED BY THE ELECTRICAL CONTRACTOR. COORDINATE ALL WORK WITH THE MECHANICAL CONTRACTOR. FOR AID A/V DEVICE TYP TYPICAL 15.) DISCONNECT SWITCHES FOR MOTORIZED DAMPERS, CFSD/SD AND VAV BOXES SUPPLIED BY UNDERGROUND UG TRIC HAND DRYER MECHANICAL CONTRACTOR AND INSTALLED AND WIRED BY ELECTRICAL CONTRACTOR. SWITCHES NOT SHOWN ON PLANS. UON UNLESS OTHERWISE NOTED RGENCY POWER OFF SWITCH 16.) INCLUDE IN BASE BID (4) 1P-20A CIRCUITS ON EACH LEVEL (150' LENGTH EACH) FOR HVAC SYSTEM CONTROL PANELS. EXACT LOCATION OF CONTROL PANELS SHALL BE COORDINATED WITH DIVISION 23 IN THE CUE ASSIST. SYSTEM MASTER STATION VOLT(S) V FIELD. CIRCUITS SHALL ORIGINATE FROM THE FOLLOWING PANELBOARDS: WP WEATHERPROOF MOTE RESCUE STATION FIRST FLOOR - PP11-29, 31,33 AND 35 UIT BREAKER SECOND FLOOR - PP21-23, 25, 27 AND 29 1.) ALL SYMBOLS AND ABBREVIATIONS MAY NOT BE APPLICABLE FOR THIS PROJECT. 2.) SEE LIGHTING FIXTURE SCHEDULE FOR LIGHT FIXTURE SYMBOLS. 17.) THE ELECTRICAL CONTRACTOR SHALL PROVIDE ALL CUTTING, PATCHING, PAINTING, AND FINAL OSED CIRCUIT BREAKER RESTORATION REQUIRED TO FACILITATE THE DEMOLITION AND INSTALLATION OF ALL ELECTRICAL EQUIPMENT, INCLUDING BUT NOT LIMITED TO PANELBOARDS, CONDUITS, WIRING, DEVICES, FIXTURES, ETC. ED SWITCH TYPICAL BRANCH CIRCUIT WIRING LEGEND INCLUDING ABOVE CEILINGS, CONTRACTOR TO REMOVE AND REPLACE CEILINGS, AND OPEN AND PATCH WALLS, AS REQUIRED TO EXECUTE THE ELECTRICAL WORK. OUND AS PER LOCAL CODE \_\_\_\_\_ 2-#12 & 1-#12 GND (1-1P-20A OR 1-1P-15A CB) 18.) ELECTRICAL CONTRACTOR SHALL COORDINATE WITH ARCHITECTURAL POWER AND DATA DRAWINGS \_\_\_\_\_ 3-#12 & 1-#12 GND (3P-20A OR 3P-15A CB) A211, A401, A402, A403, A404 FOR LOCATIONS, MOUNTING HEIGHTS AND WIRELESS ACCESS POINTS LOCATIONS. \_\_\_\_\_ 2-#12 & 1-#12 GND (2P-20A OR 2P-15A CB) 18.) ELECTRICAL CONTRACTOR SHALL COORDINATE WITH ARCHITECTURAL CEILING DRAWINGS A601, FOR **NSFORMER** -LIGHT FIXTURE TYPE LIGHTING FIXTURE LOCATIONS AND TYPES . -CIRCUIT # -SWITCH CONTROL RENT TRANSFORMER -RECEPTACLE -LIGHT FIXTURE 19.) ELECTRICAL CONTRACTOR SHALL PROVIDE BACK-BOXES AND BLANK COVERS FOR ALL WIRING DEVICES. CIRCUIT # **PV SYSTEM** NOTES: 1.) EACH 120V AND 277V CIRCUIT SHALL HAVE A DEDICATED NEUTRAL CONDUCTOR. SHARED 1.) ELECTRICAL CONTRACTOR SHALL PROVIDE (1) 2" EMPTY CONDUIT WITH DRAGLINES BETWEEN NEUTRAL HOMERUNS ARE NOT PERMITTED. THE ROOF AND THE MAIN ELECTRICAL ROOM FOR THE PV SYSTEM. COORDINATE FINAL 2.) CONDUCTORS SHALL BE INCREASED FOR VOLTAGE DROP AND DERATING AS PER ER BREAK GLASS STATION LOCATION WITH PV INSTALLER. APPLICABLE ELECTRICAL CODE. FOR CIRCUITS THAT ARE BETWEEN 100' AND 150' IN LENGTH, PHASE AND NEUTRAL CONDUCTORS SHALL BE #10 AWG. FOR CIRCUITS THAT ARE MALLY CLOSED CONTACTS BETWEEN 150' AND 225' IN LENGTH, PHASE AND NEUTRAL CONDUCTORS SHALL BE #8 AWG. DEMOLITION NOTES FOR LENGTHS GREATER THAN 225' IN LENGTH, VERIFY CONDUCTOR SIZES WITH ENGINEER MALLY OPEN CONTACTS 1.) ALL EQUIPMENT SHALL BE DISCONNECTED AND REMOVED BACK TO POWER SOURCE ORIGINATION UNLESS ORIZED DAMPER TRENCHING NOTES OTHERWISE NOTED (UON) EXISTING TO REMAIN (EX.). KE DAMPER 2.) CONTRACTOR SHALL VERIFY EXTENT OF DEMOLITION WORK IN THE FIELD PRIOR TO BID AND SHALL 1.) CONTRACTOR SHALL LOCATE ALL EXISTING UNDERGROUND UTILITIES THAT ARE NOT INCLUDE ALL LABOR AND MATERIALS IN BASE BID INCLUDING ALL TEMPORARY CONNECTIONS, CONDUIT AND PART OF N.Y. STATE "CODE 753" PRIOR TO DIGGING. WIRE IN ORDER TO ACCOMMODATE CONSTRUCTION AND PROVIDE CONTINUOUS SERVICE TO DEVICES AND SYSTEMS TO REMAIN. TEMPORARY AND PERMANENTLY. WORK REQUIRING THE SHUT-DOWN OF THE 2.) ALL EXCAVATING IN THE AREA OF THE EXISTING UNDERGROUND EQUIPMENT, PIPES AND VE FINISHED FLOOR BUILDING POWER SHALL BE PERFORMED DURING OVERTIME AND SHALL BE INCLUDED IN BASE BID. CONDUITS SHALL BE PERFORMED BY HAND. 3.) CIRCUIT BREAKER, CONDUIT AND CONDUCTOR SIZES INDICATED SHALL BE FIELD VERIFIED PRIOR TO BID. ERAGE OF FUSE 3.) ANY AREA/PLANTS OR LANDSCAPING OR PAVEMENTS DISTURBED DURING THE EXCAVATION SHALL BE RESTORED OR REPLACED TO MATCH EXISTING CONDITIONS BY THE 4.) ALL EXISTING ELECTRICAL EQUIPMENT NO LONGER IN USE, SUCH AS DISCONNECT SWITCHES, MOTOR VE GRADE LEVEL CONTRACTOR AT NO COST TO THE OWNER. CONTROLLERS, MOTOR STARTER PANELS, ETC. SHALL BE REMOVED UON. HANDLING UNIT 4.) ANY EXISTING BURIED CONDUITS, DRAINAGE, SPRINKLER PIPING, ETC. THAT IS DISTURBED 5.) ALL DISCONNECTED & REMOVED EXISTING ELECTRICAL ITEMS THAT ARE NOT BEING REUSED SHALL BE AND/OR DAMAGED DURING CONSTRUCTION SHALL BE REPAIRED BY THE CONTRACTOR AT NO RETURNED TO THE OWNER OR DISPOSED OF AS DIRECTED. COST TO THE OWNER. 6.) THE CONTRACTOR SHALL INCLUDE IN THE BASE BID FOR ALL MATERIAL & LABOR REQUIRED FOR THE FAULT INTERRUPTER 5.) THE PLANS SHOW SOME KNOWN SUBSURFACE STRUCTURES, ABOVE GROUND EXTENSIONS, REROUTING & RELOCATION OF EXISTING SYSTEM COMPONENTS, EQUIPMENT, WIRING, STRUCTURES AND/OR UTILITIES BELIEVED TO EXIST IN THE WORKING AREA. EXACT CONDUITS & CABLING SO AS TO MAINTAIN OPERATION OF ALL SYSTEMS THROUGHOUT THE BUILDING DURING | KEY PLAN ERAGE OF SWITCH LOCATION OF WHICH MAY VARY FROM THE LOCATIONS INDICATED. IN PARTICULAR, THE **DEMOLITION & CONSTRUCTION PHASES.** CONTRACTOR IS WARNED THAT THE EXACT OR EVEN APPROXIMATE LOCATION OF SUCH OMATIC TRANSFER SWITCH PIPELINES, SUBSURFACE STRUCTURES AND/OR UTILITIES IN THE AREA MAY OR MAY NOT BE **DEFINITION OF TERMS** SHOWN; AND IT SHALL BE HIS RESPONSIBILITY TO PROCEED WITH GREAT CARE IN RICAN WIRE GAUGE EXECUTING ANY WORK. 48 HOURS BEFORE YOU DIG. DRILL OR BLAST. CALL 1-800-962-7962 1.) WHEREVER IN THE CONTRACT DOCUMENTS THE WORD "CLIENT" IS USED, IT MUST BE UNDERSTOOD THAT (NY STATE). "SCHOOL OF THE HOLY CHILD" IS INTENDED. FIRE RADIO DRAWINGS 2.) WHEREVER IN THE CONTRACT DOCUMENTS THE WORD "ARCHITECT" IS USED. IT MUST BE UNDERSTOOD THAT "KAEYER, GARMENT, & DAVIDSON ARCHITECTS, P.C." IS INTENDED.

1.) FIRE RADIO DRAWINGS SHALL BE PRICED AS AN ADD/ALTERNATE.

## GENERAL NOTES

1.) ALL WORK SHOWN IS NEW UNLESS OTHERWISE NOTED (UON) EXISTING TO REMAIN (EX.).

2.) THE DRAWINGS ARE TO BE CONSIDERED SCHEMATIC ONLY AND DO NOT NECESSARILY SHOW THE EXACT LOCATIONS AND DETAILS OF THE WORK TO BE INSTALLED.

3.) THE ELECTRICAL CONTRACTOR SHALL BE RESPONSIBLE FOR OBTAINING ALL NECESSARY PERMITS AND PAYING ALL FEES ASSOCIATED WITH THIS WORK INCLUDING FILING WITH THE UTILITY COMPANY (AS REQUIRED), AND WITH LOCAL AUTHORITY HAVING JURISDICTION.

4.) ALL WORK INVOLVING THE ELECTRIC SERVICE SHALL BE COORDINATED AND APPROVED BY THE UTILITY COMPANY.

5.) ALL CONDUCTORS SHALL BE COPPER UON "ON DRAWINGS".

6.) ELECTRONIC FILES OF THE MECHANICAL, ELECTRICAL, PLUMBING AND FIRE PROTECTION DRAWINGS ARE AVAILABLE TO THE CONTRACTOR. THE ENGINEER MAY GRANT THE CONTRACTOR A LIMITED LICENSE TO MAKE A DERIVATIVE WORK OF THE DATABASE FOR THE PURPOSE OF SHOP DRAWINGS, SUBMITTALS AND AS-BUILT DRAWINGS. UPON REQUEST, THE ENGINEER SHALL PROVIDE A RELEASE FORM THAT MUST BE SIGNED AND RETURNED BY THE CONTRACTOR PRIOR TO RELEASE OF THE ELECTRONIC FILES.

7.) CIRCUIT NUMBERS ARE FOR INFORMATION PURPOSES ONLY. ACTUAL CIRCUIT NUMBERS SHALL BE DETERMINED IN THE FIELD.

8.) CORE DRILLING OR TRENCHING THROUGH AN EXISTING FLOOR SLAB, WHEN REQUIRED SHALL BE COORDINATED WITH THE OWNER. FLOOR SLABS SHALL BE RADAR SCANNED PRIOR TO CORE DRILLING OR TRENCHING. ALL WORK, INCLUDING CORE DRILLING, RADAR SCAN, INSTALLATION OF FIRE STOPPING, & CONDUIT/CABLE INSTALLATION SHALL BE PERFORMED DURING NON-BUSINESS HOURS AND INCLUDED IN BASE BID. USE EXTREME CAUTION DURING ANY CUTTING OPERATION TO AVOID DAMAGE TO EXISTING EQUIPMENT/SYSTEMS. ANY ITEMS DAMAGED AS A RESULT OF CORE DRILLING SHALL BE REPAIRED AT NO COST TO THE CLIENT. ALL CORES SHALL BE FIRE SEALED.

9.) FOR EACH WALL MOUNTED COMMUNICATIONS OUTLET, PROVIDE A 1900 JUNCTION BOX WITH AN EXTENDER COLLAR AND 1 INCH CONDUIT WITH DRAGLINE FROM THE OUTLET TO THE DATA ROOM FOR INSTALLATION OF CABLE BY ELECTRICAL CONTRACTOR.

10.) COMMUNICATION WIRING BY ELECTRICAL CONTRACTOR. COORDINATE COMMUNICATION JACKS WITH REPRESENTATIVE. TYPICAL

C.) "AMEND AND RESUBMIT" MEANS THAT THE COMMENTS AND/OR CORRECTION ARE SO EXTENSIVE AND IMPORTANT THAT THE REVIEWER WANTS TO SEE HOW THE COMMENTS AND/OR CORRECTIONS ARE RESOLVED PRIOR TO RELEASE FOR FABRICATION AND/OR PURCHASE. FABRICATIONS AND/OR PURCHASE MAY NOT

COMMENCE. D.) "REJECTED" MEANS THAT THE SHOP DRAWING DOES NOT COMPLY OR CONFORM TO THE CONTRACT DRAWINGS AND/OR SPECIFICATIONS. FABRICATION AND/OR PURCHASE MAY NOT COMMENCE.

DOCUMENTS.

RESPECTS.

3.) WHEREVER IN THE CONTRACT DOCUMENTS THE WORD "ENGINEER" IS USED, IT MUST BE UNDERSTOOD THAT "OLA CONSULTING ENGINEERS" IS INTENDED.

4.) WHEREVER IN THE CONTRACT DOCUMENTS THE WORDS "ELECTRICAL UTILITY" OR "POWER COMPANY" ARE USED, IT MUST BE UNDERSTOOD THAT "CON EDISON" IS INTENDED.

5.) WHEREVER IN THE CONTRACT DOCUMENTS THE WORDS "TELEPHONE UTILITY" OR "TELCO" ARE USED, IT MUST BE UNDERSTOOD THAT "VERIZON" IS INTENDED.

6.) WHEREVER IN THE CONTRACT DOCUMENTS THE WORDS "FIRE ALARM SYSTEM" OR "FIRE ALARM VENDOR" ARE USED, IT MUST BE UNDERSTOOD THAT "MARSCHALL ALARM SYSTEMS, INC." IS INTENDED. 7.) "WORK" MUST BE DEEMED TO CONSIST OF ALL LABOR AND OPERATIONS, TRANSPORTATION, HOISTING, MATERIALS, TOOLS, EQUIPMENT, SERVICES, INSPECTIONS, INVESTIGATIONS, COORDINATION AND SUPERVISION REQUIRED AND / OR REASONABLY NECESSARY TO PRODUCE THE CONSTRUCTION REQUIRED BY THE CONTRACT

8.) "FURNISH" MEANS THE DESIGN, FABRICATION, PURCHASE AND DELIVERY TO THE JOB SITE.


11.) THE FOLLOWING ARE DEFINITIONS OF SHOP DRAWING STAMP ACTIONS:

9.) "INSTALL OR INSTALLATION" MEANS THE ACT OF PHYSICALLY PLACING, APPLYING, SETTING, ERECTING, ANCHORING, SECURING, ETC., CONSTRUCTION MATERIALS, EQUIPMENT, FURNISHINGS, APPLIANCES, AND SIMILAR ITEMS SPECIFIED AND FURNISHED AT THE JOB SITE. INSTALLATION OF SPECIFIED ITEMS MUST BE COMPLETE IN ALL

10.) "PROVIDE" MEANS TO FURNISH AND INSTALL CONSTRUCTION MATERIAL, EQUIPMENT, ETC. AS DEFINED ABOVE.

A.) "NO EXCEPTIONS TAKEN" MEANS THAT THE SHOP DRAWING IS CORRECT AS TO PERFORMANCE, CAPACITY, ETC AND SUBSTANTIAL CONFORMANCE TO THE CONTRACT DRAWINGS AND SPECIFICATIONS. FABRICATION AND/OR PURCHASE MAY COMMENCE.

B.) "MAKE CORRECTIONS NOTED" MEANS THAT THE SHOP DRAWING IS CORRECT AS TO PERFORMANCE, CAPACITY ETC. AND SUBSTANTIAL CONFORMANCE TO THE CONTRACT DRAWINGS AND/OR SPECIFICATIONS, SUBJECT TO AND IN COMPLIANCE WITH THE ANNOTATIONS AND/OR CORRECTIONS INDICATED ON THE SHOP DRAWING. FABRICATION AND/OR PURCHASE MAY COMMENCE.

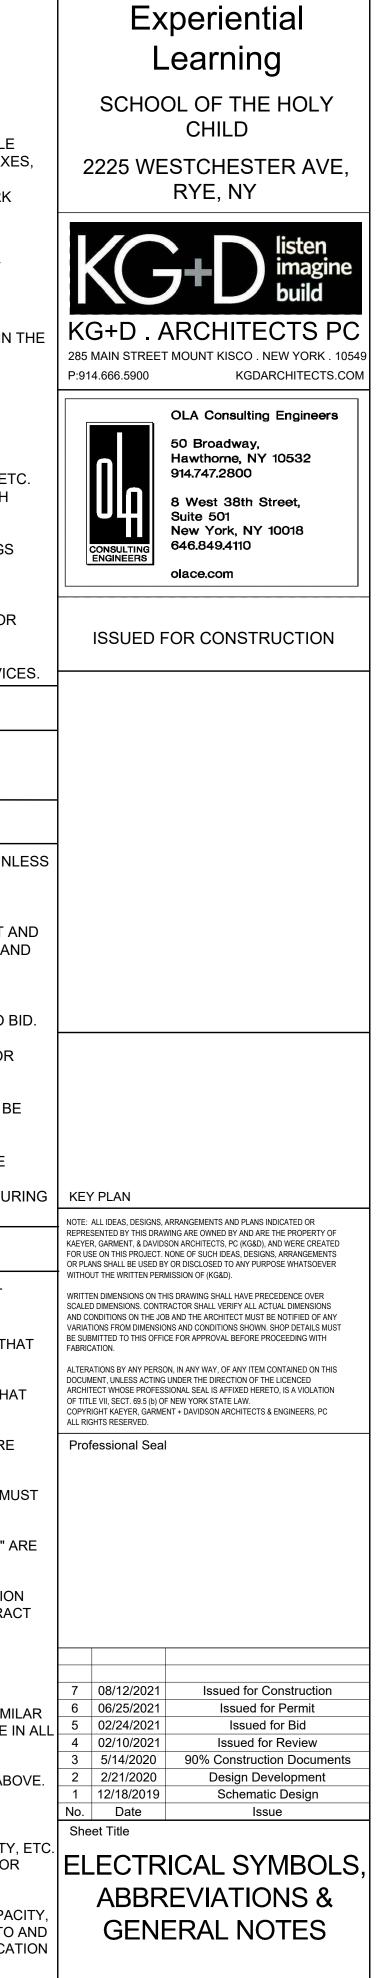

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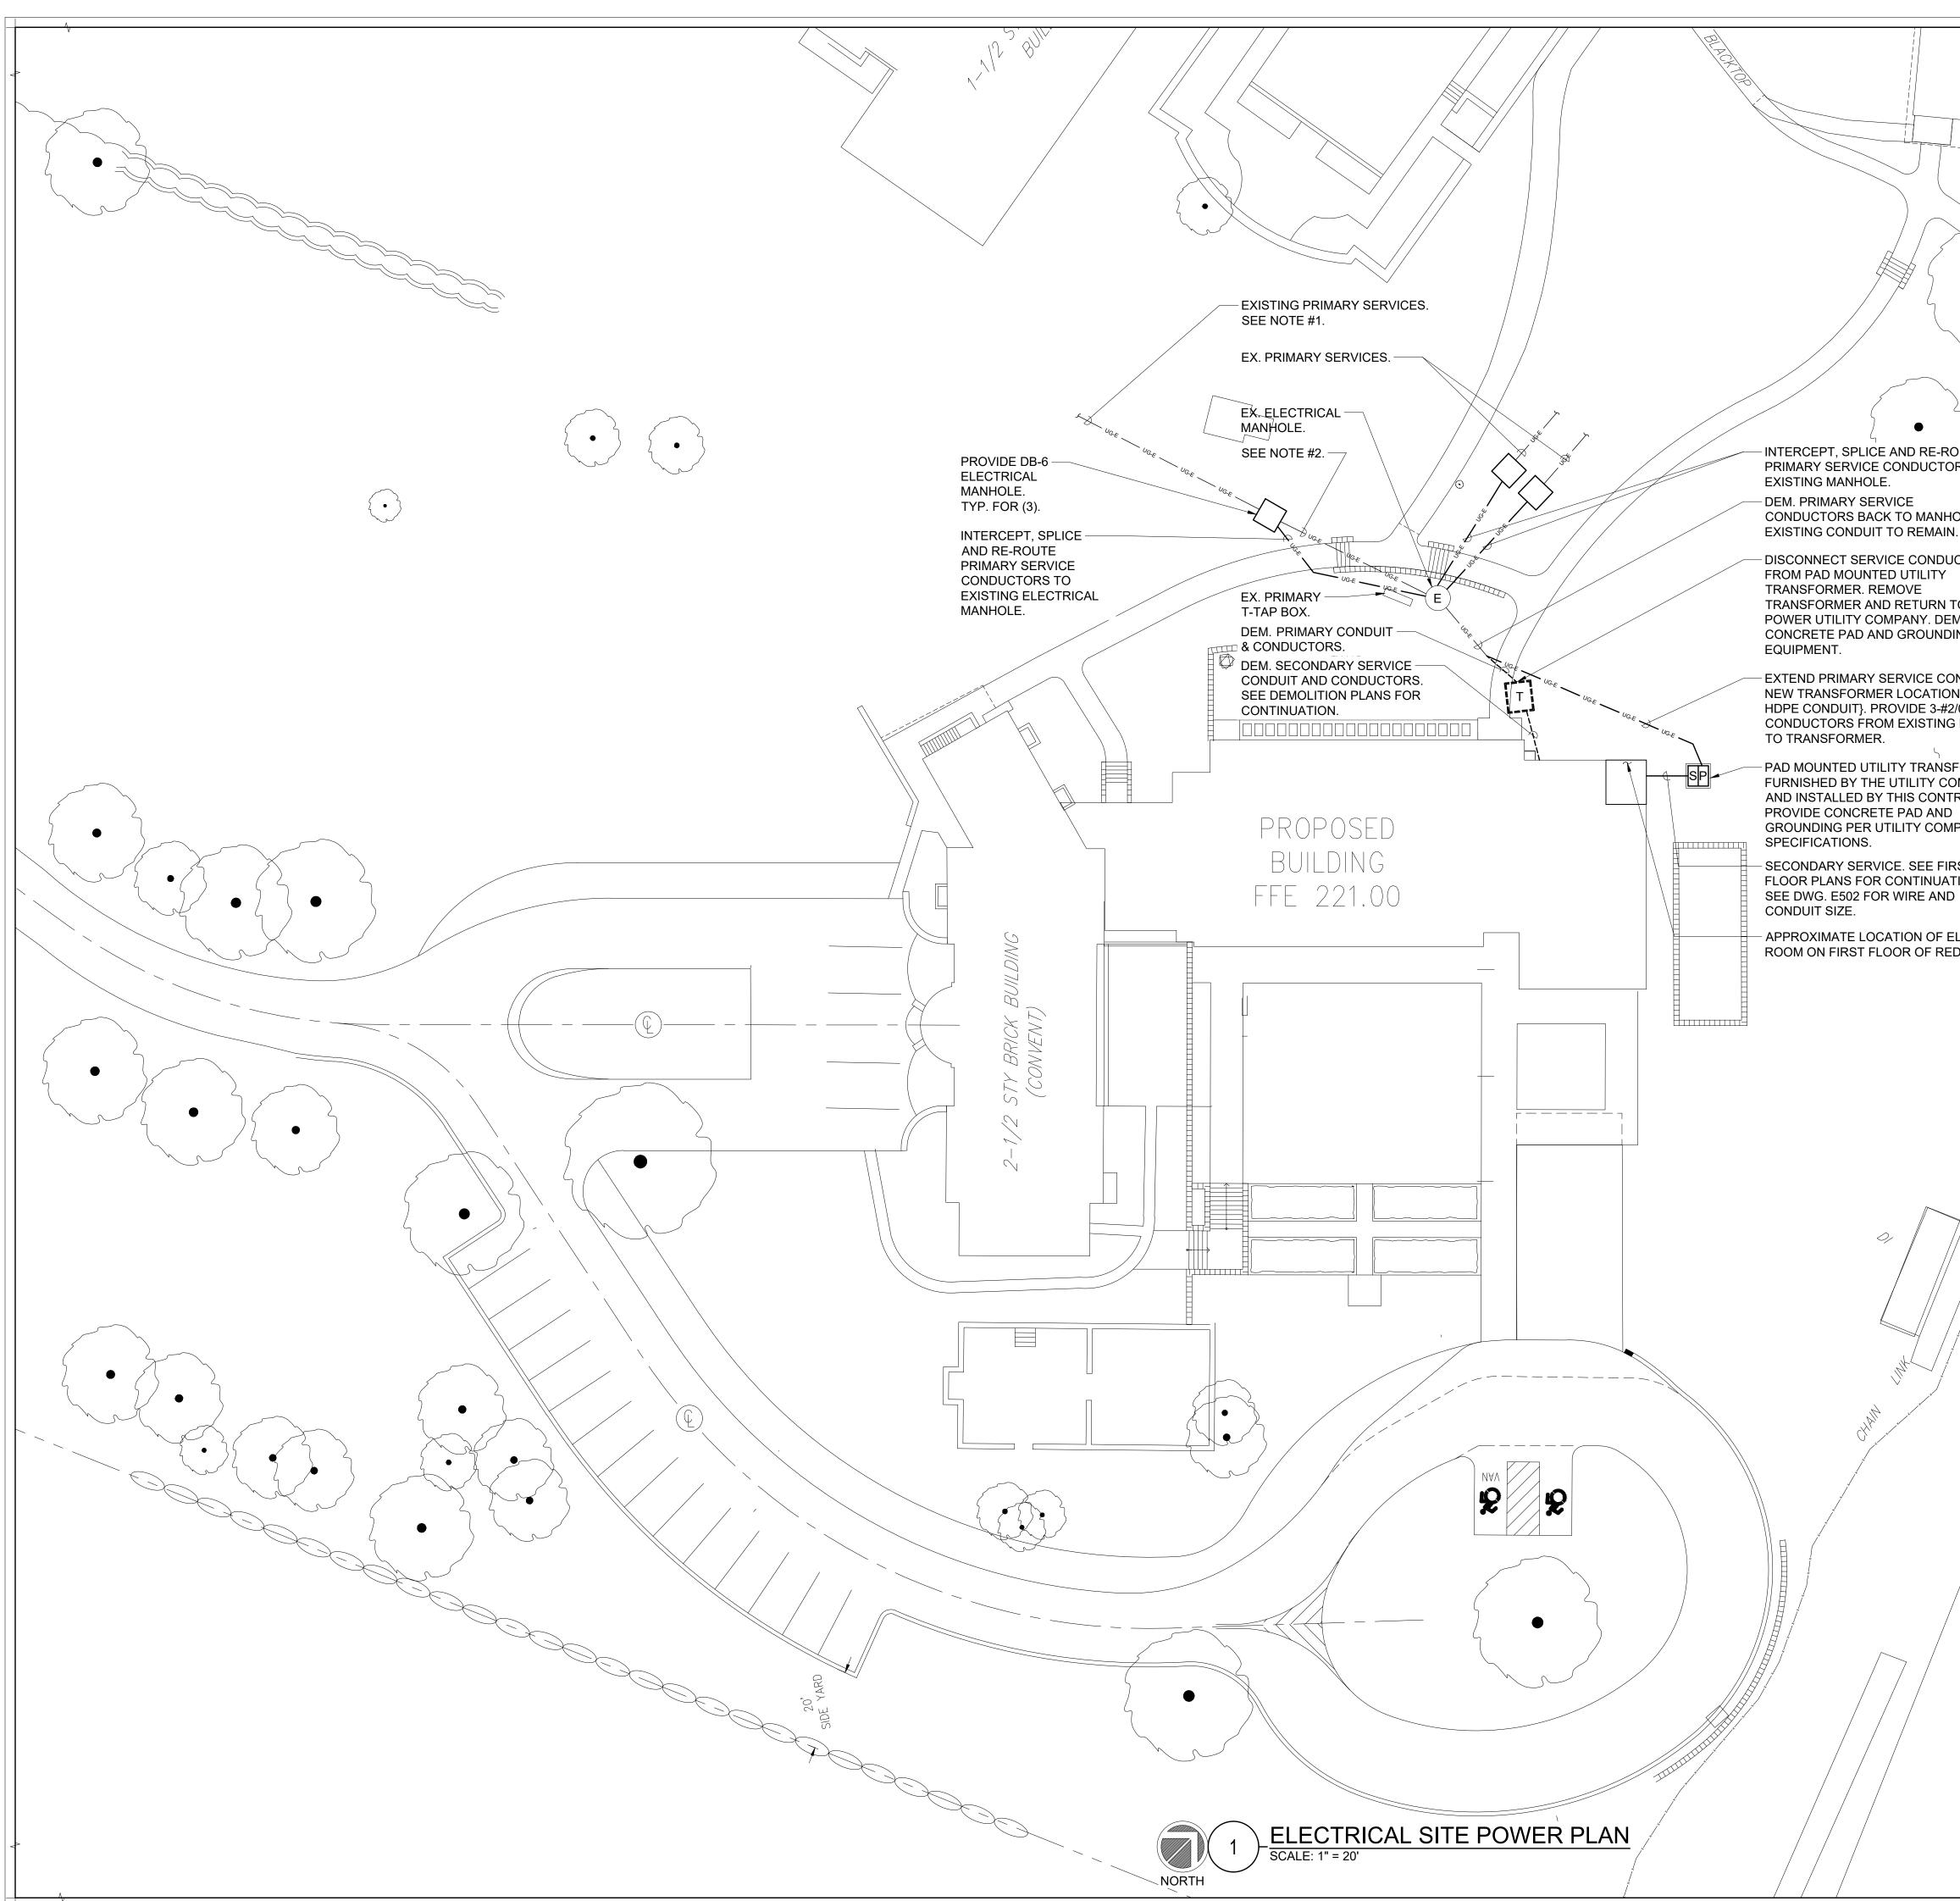
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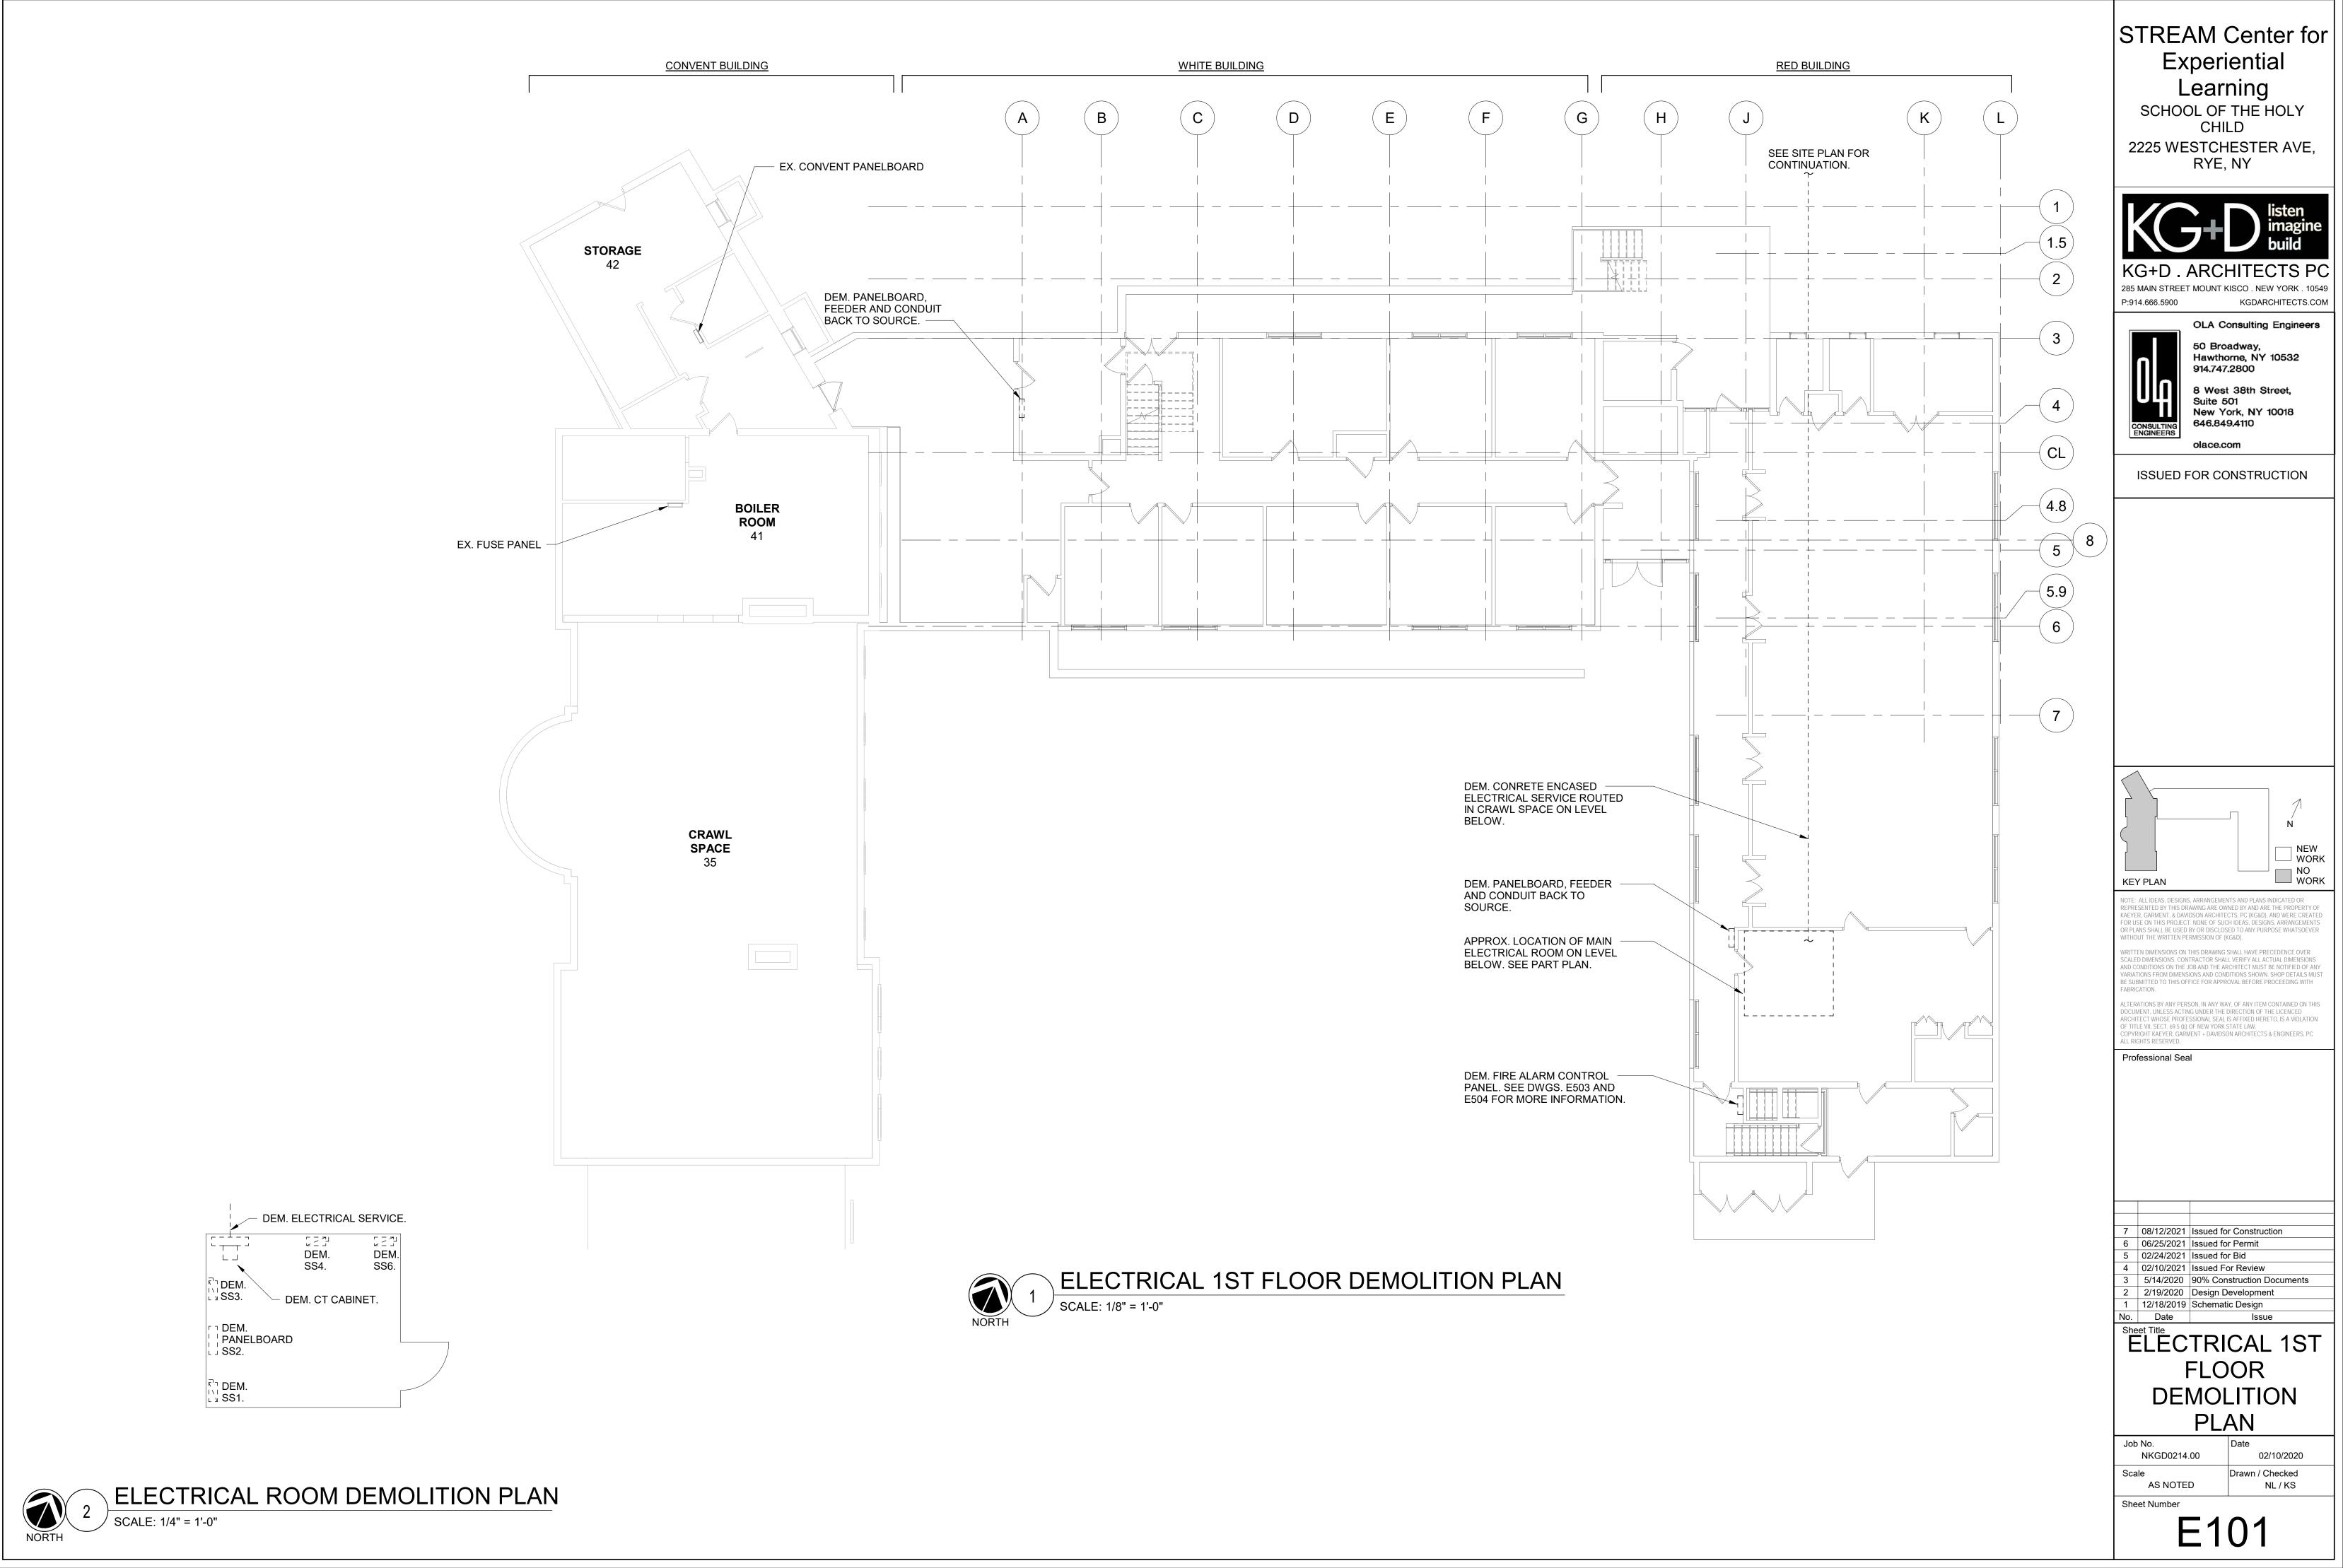
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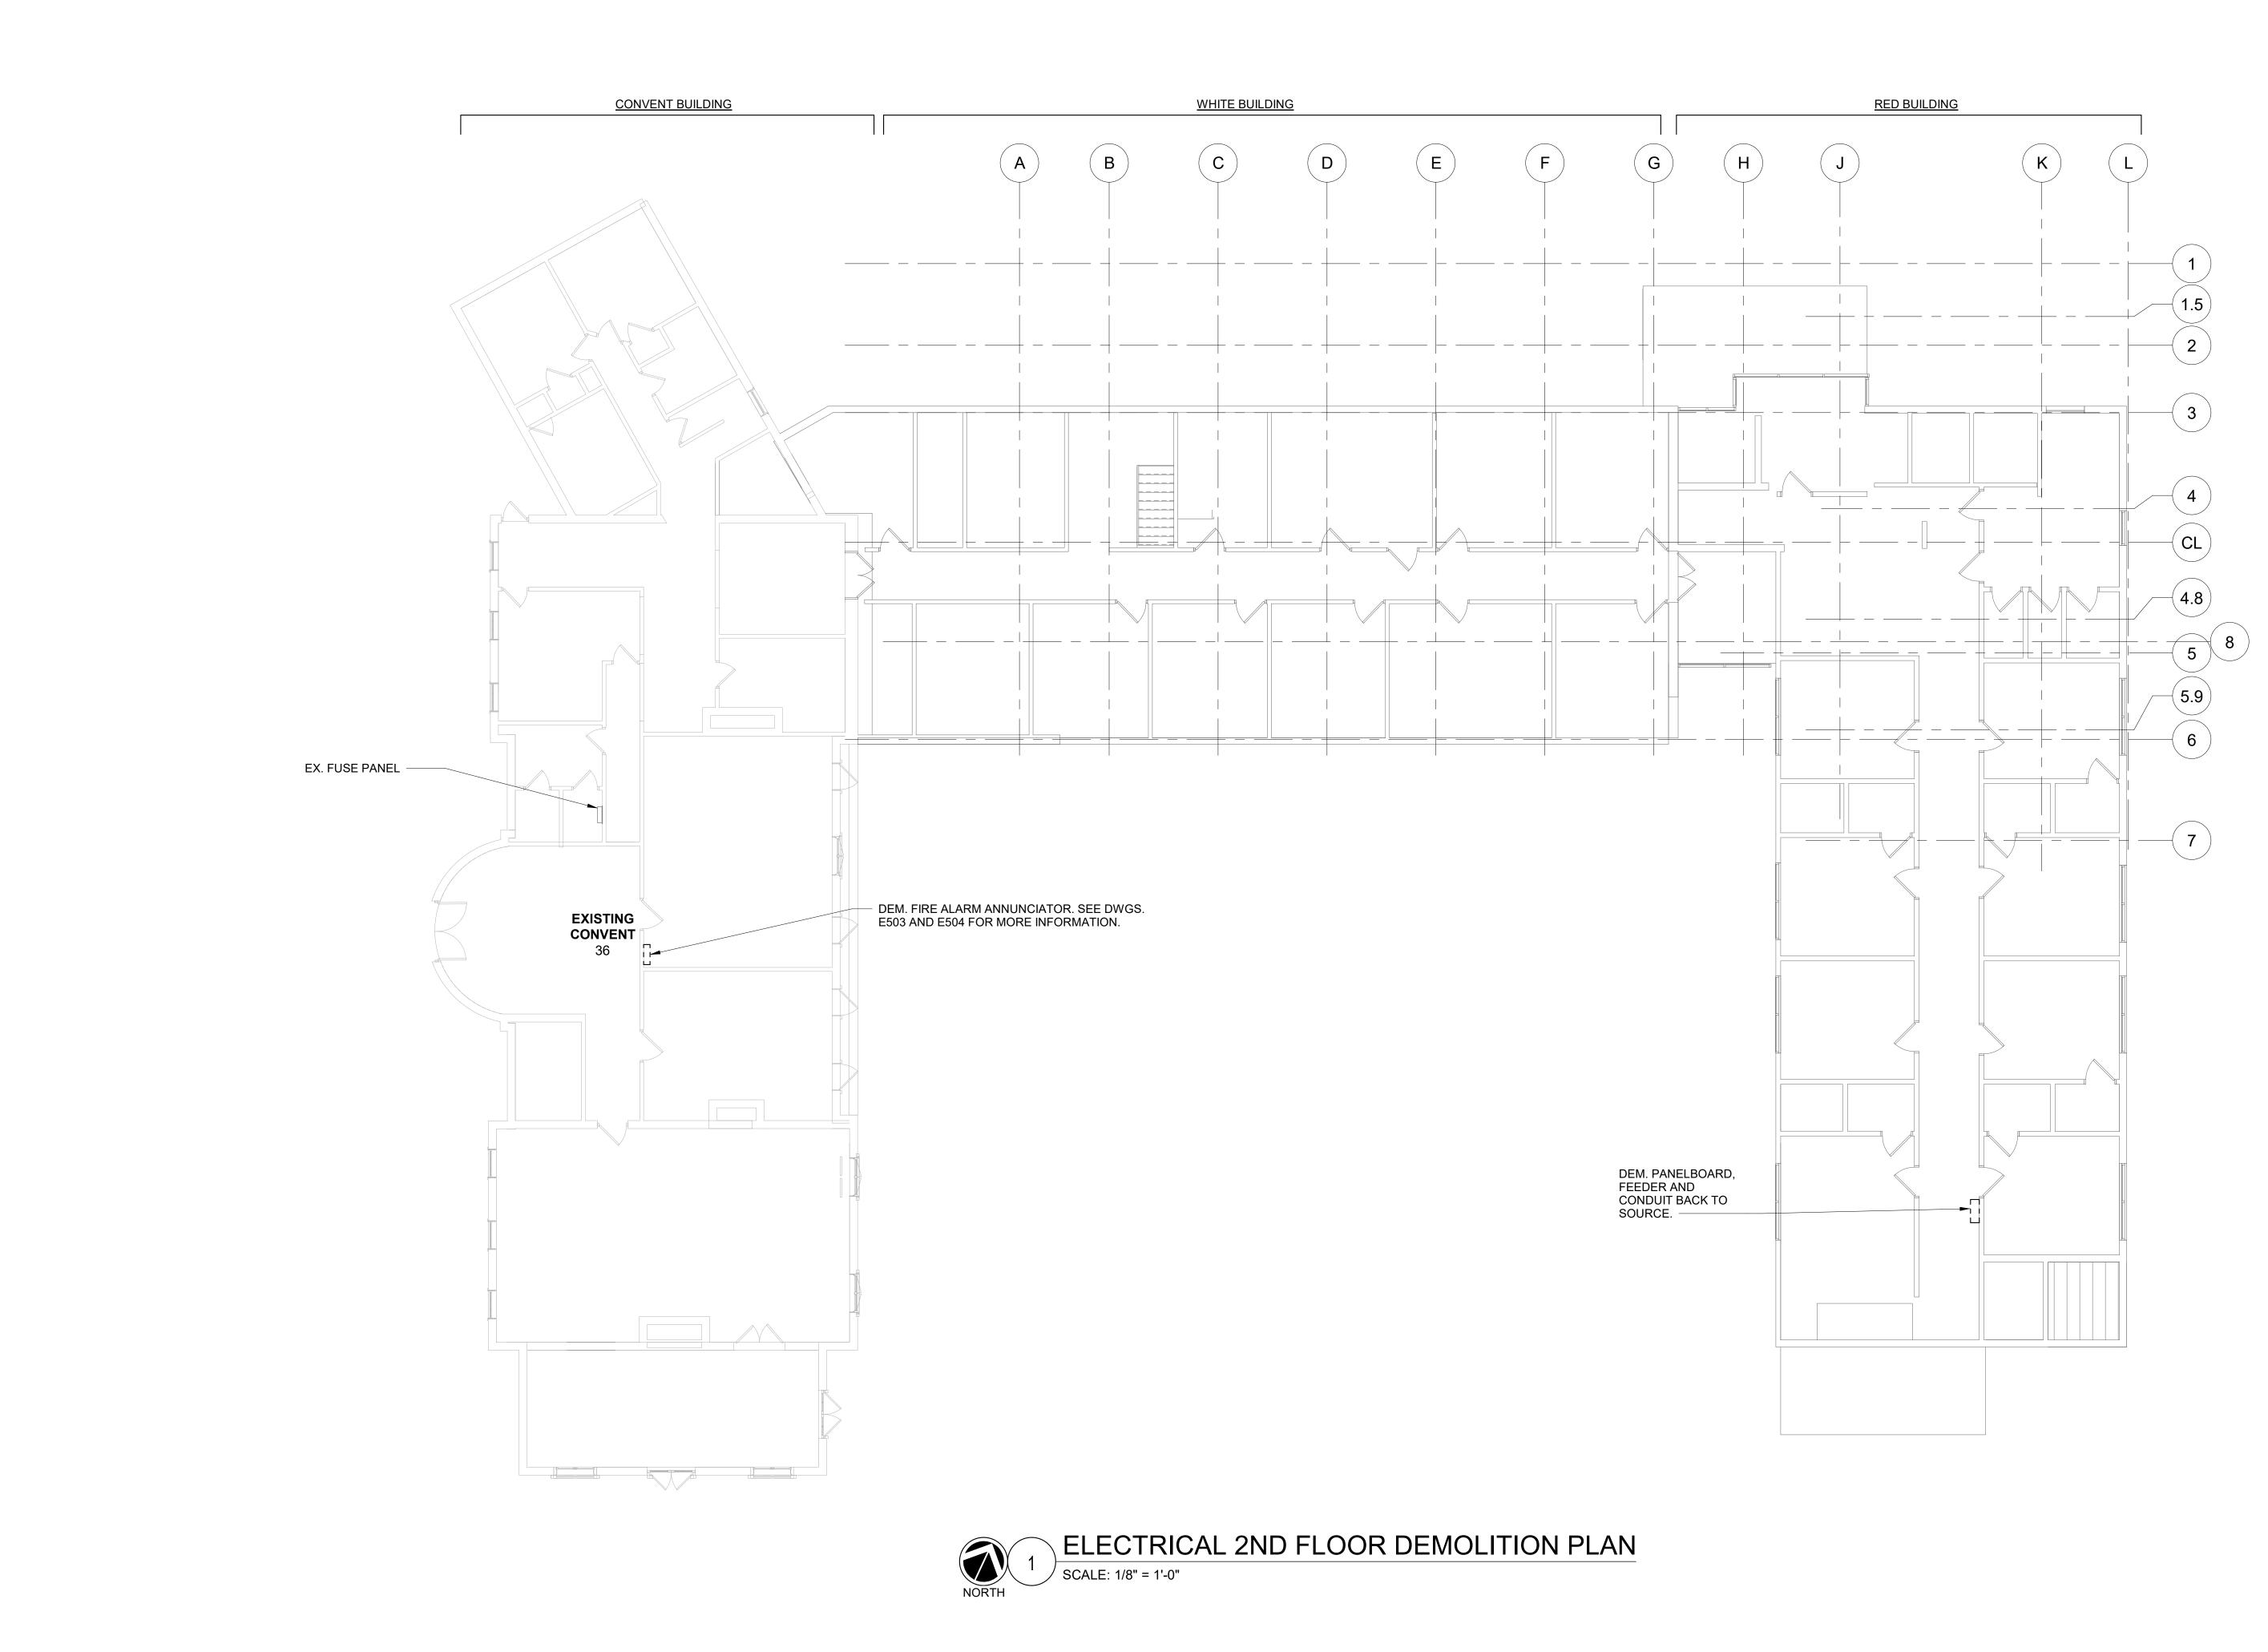
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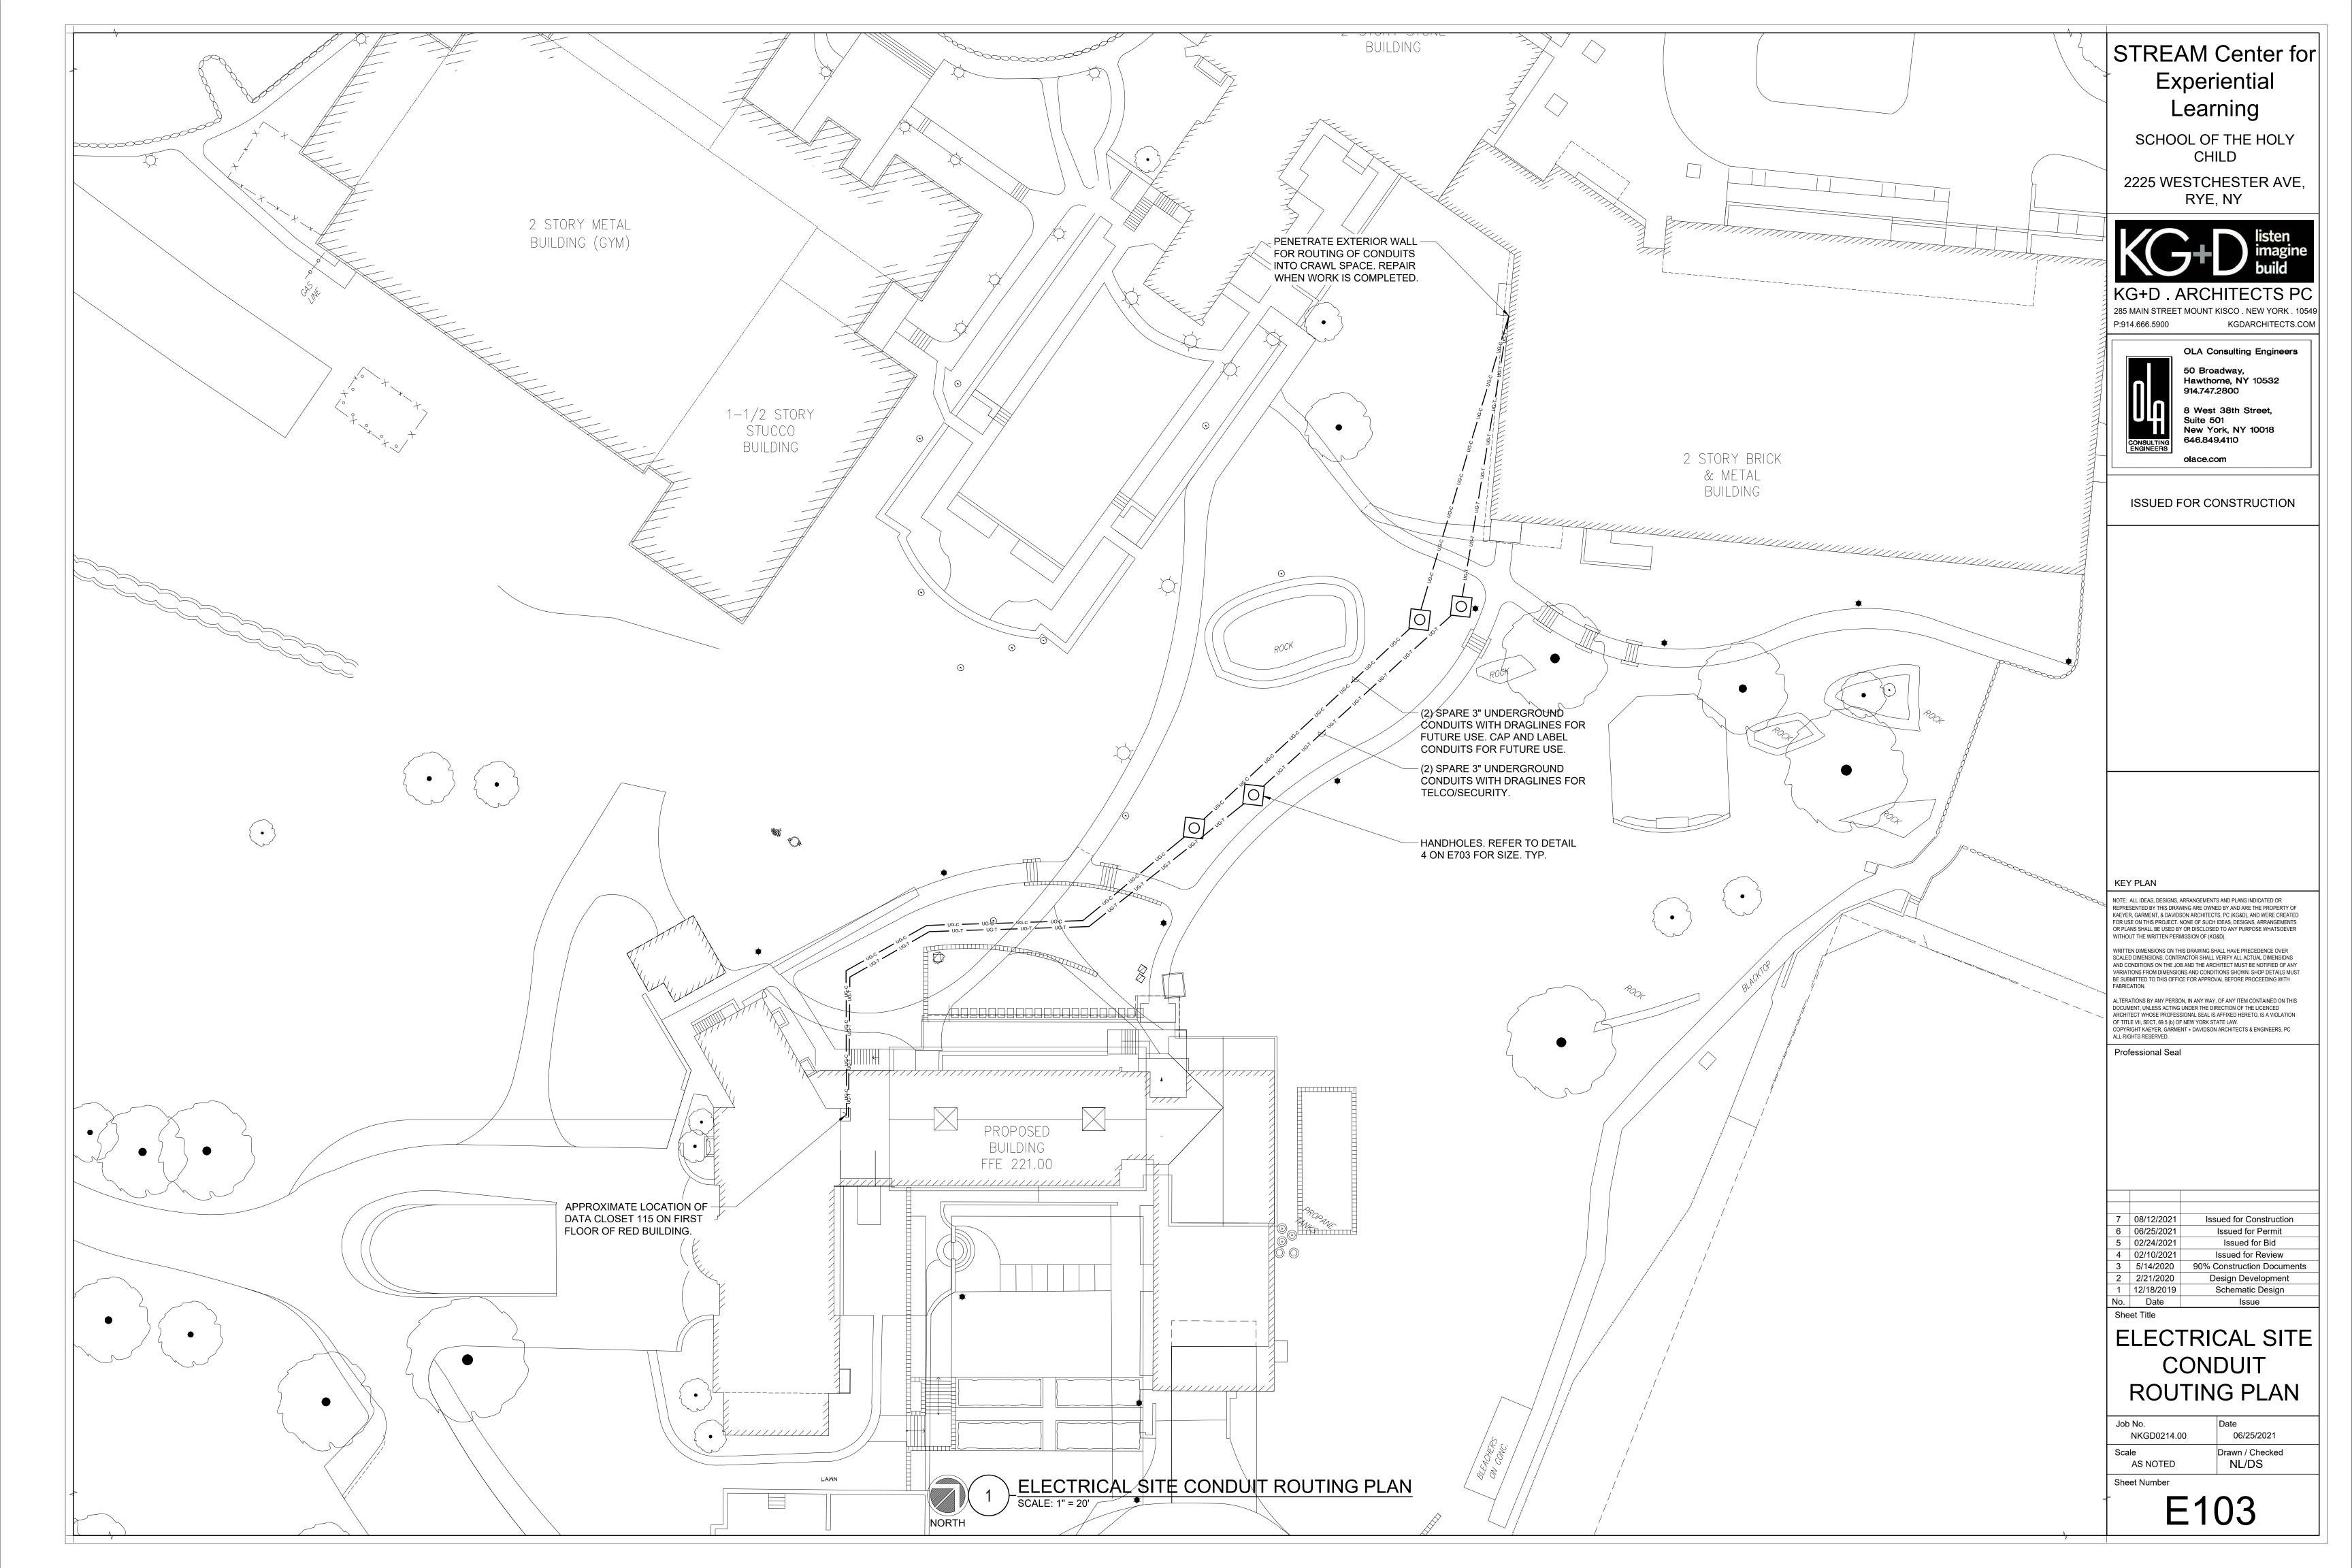
2 STORY BRICK & METAL BUILDING	STREAM Center for Experiential Learning
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	KG+D       listen         KG+D.       ARCHITECTS PC         285 MAIN STREET MOUNT KISCO.       NEW YORK.         P:914.666.5900       KGDARCHITECTS.COM
DUTE NEW DRS BACK TO	OLA Consulting Engineers 50 Broadway, Hawthorne, NY 10532 914.747.2800
OLE. J. DCTORS	8 West 38th Street, Suite 501 New York, NY 10018 646.849.4110 olace.com
TO M. ING	ISSUED FOR CONSTRUCTION
DNDUIT TO N {(1) 4" 2/0 AL 15KV S MANHOLE	
FORMER DMPANY RACTOR.	
RST TION.	
ELECTRICAL D BUILDING.	KEY PLAN
	NOTE: ALL IDEAS, DESIGNS, ARRANGEMENTS AND PLANS INDICATED OR REPRESENTED BY THIS DRAWING ARE OWNED BY AND ARE THE PROPERTY OF KAEYER, GARMENT, & DAVIDSON ARCHITECTS, PC (KG&D), AND WERE CREATED FOR USE ON THIS PROJECT. NONE OF SUCH IDEAS, DESIGNS, ARRANGEMENTS OR PLANS SHALL BE USED BY OR DISCLOSED TO ANY PURPOSE WHATSOEVER WITHOUT THE WRITTEN PERMISSION OF (KG&D). WRITTEN DIMENSIONS ON THIS DRAWING SHALL HAVE PRECEDENCE OVER SCALED DIMENSIONS. CONTRACTOR SHALL VERIFY ALL ACTUAL DIMENSIONS AND CONDITIONS ON THE JOB AND THE ARCHITECT MUST BE NOTIFIED OF ANY VARIATIONS FROM DIMENSIONS AND CONDITIONS SHOWN. SHOP DETAILS MUST BE SUBMITTED TO THIS OFFICE FOR APPROVAL BEFORE PROCEEDING WITH FABRICATION. ALTERATIONS BY ANY PERSON, IN ANY WAY, OF ANY ITEM CONTAINED ON THIS DOCUMENT, UNLESS ACTING UNDER THE DIRECTION OF THE LICENCED ARCHITECT WHOSE PROFESSIONAL SEAL IS AFFIXED HERETO, IS A VIOLATION OF TITLE VII, SECT. 69.5 (b) OF NEW YORK STATE LAW. COPYRIGHT KAEYER, GARMENT + DAVIDSON ARCHITECTS & ENGINEERS, PC ALL RIGHTS RESERVED. PROFESSIONAL SEAL
ARTIFICIAL TO	
NOTES: 1.) INTERCEPT, SPLICE AND RE-DIRECT EXISTING PRIMARY FEEDERS AS NECESSARY TO ACCOMMODATE NEW SITE WORK . PROVIDE DB-6 MANHOLES AS REQUIRED.	708/12/2021Issued for Construction606/25/2021Issued for Permit502/24/2021Issued for Bid402/10/2021Issued for Review35/14/202090% Construction Documents22/21/2020Design Development112/18/2019Schematic DesignNo.DateIssueSheet Title
2.) DISCONNECT AND REMOVE SERVICE CONDUCTORS. EXISTING CONDUIT SHALL REMAIN.	ELECTRICAL SITE POWER PLAN
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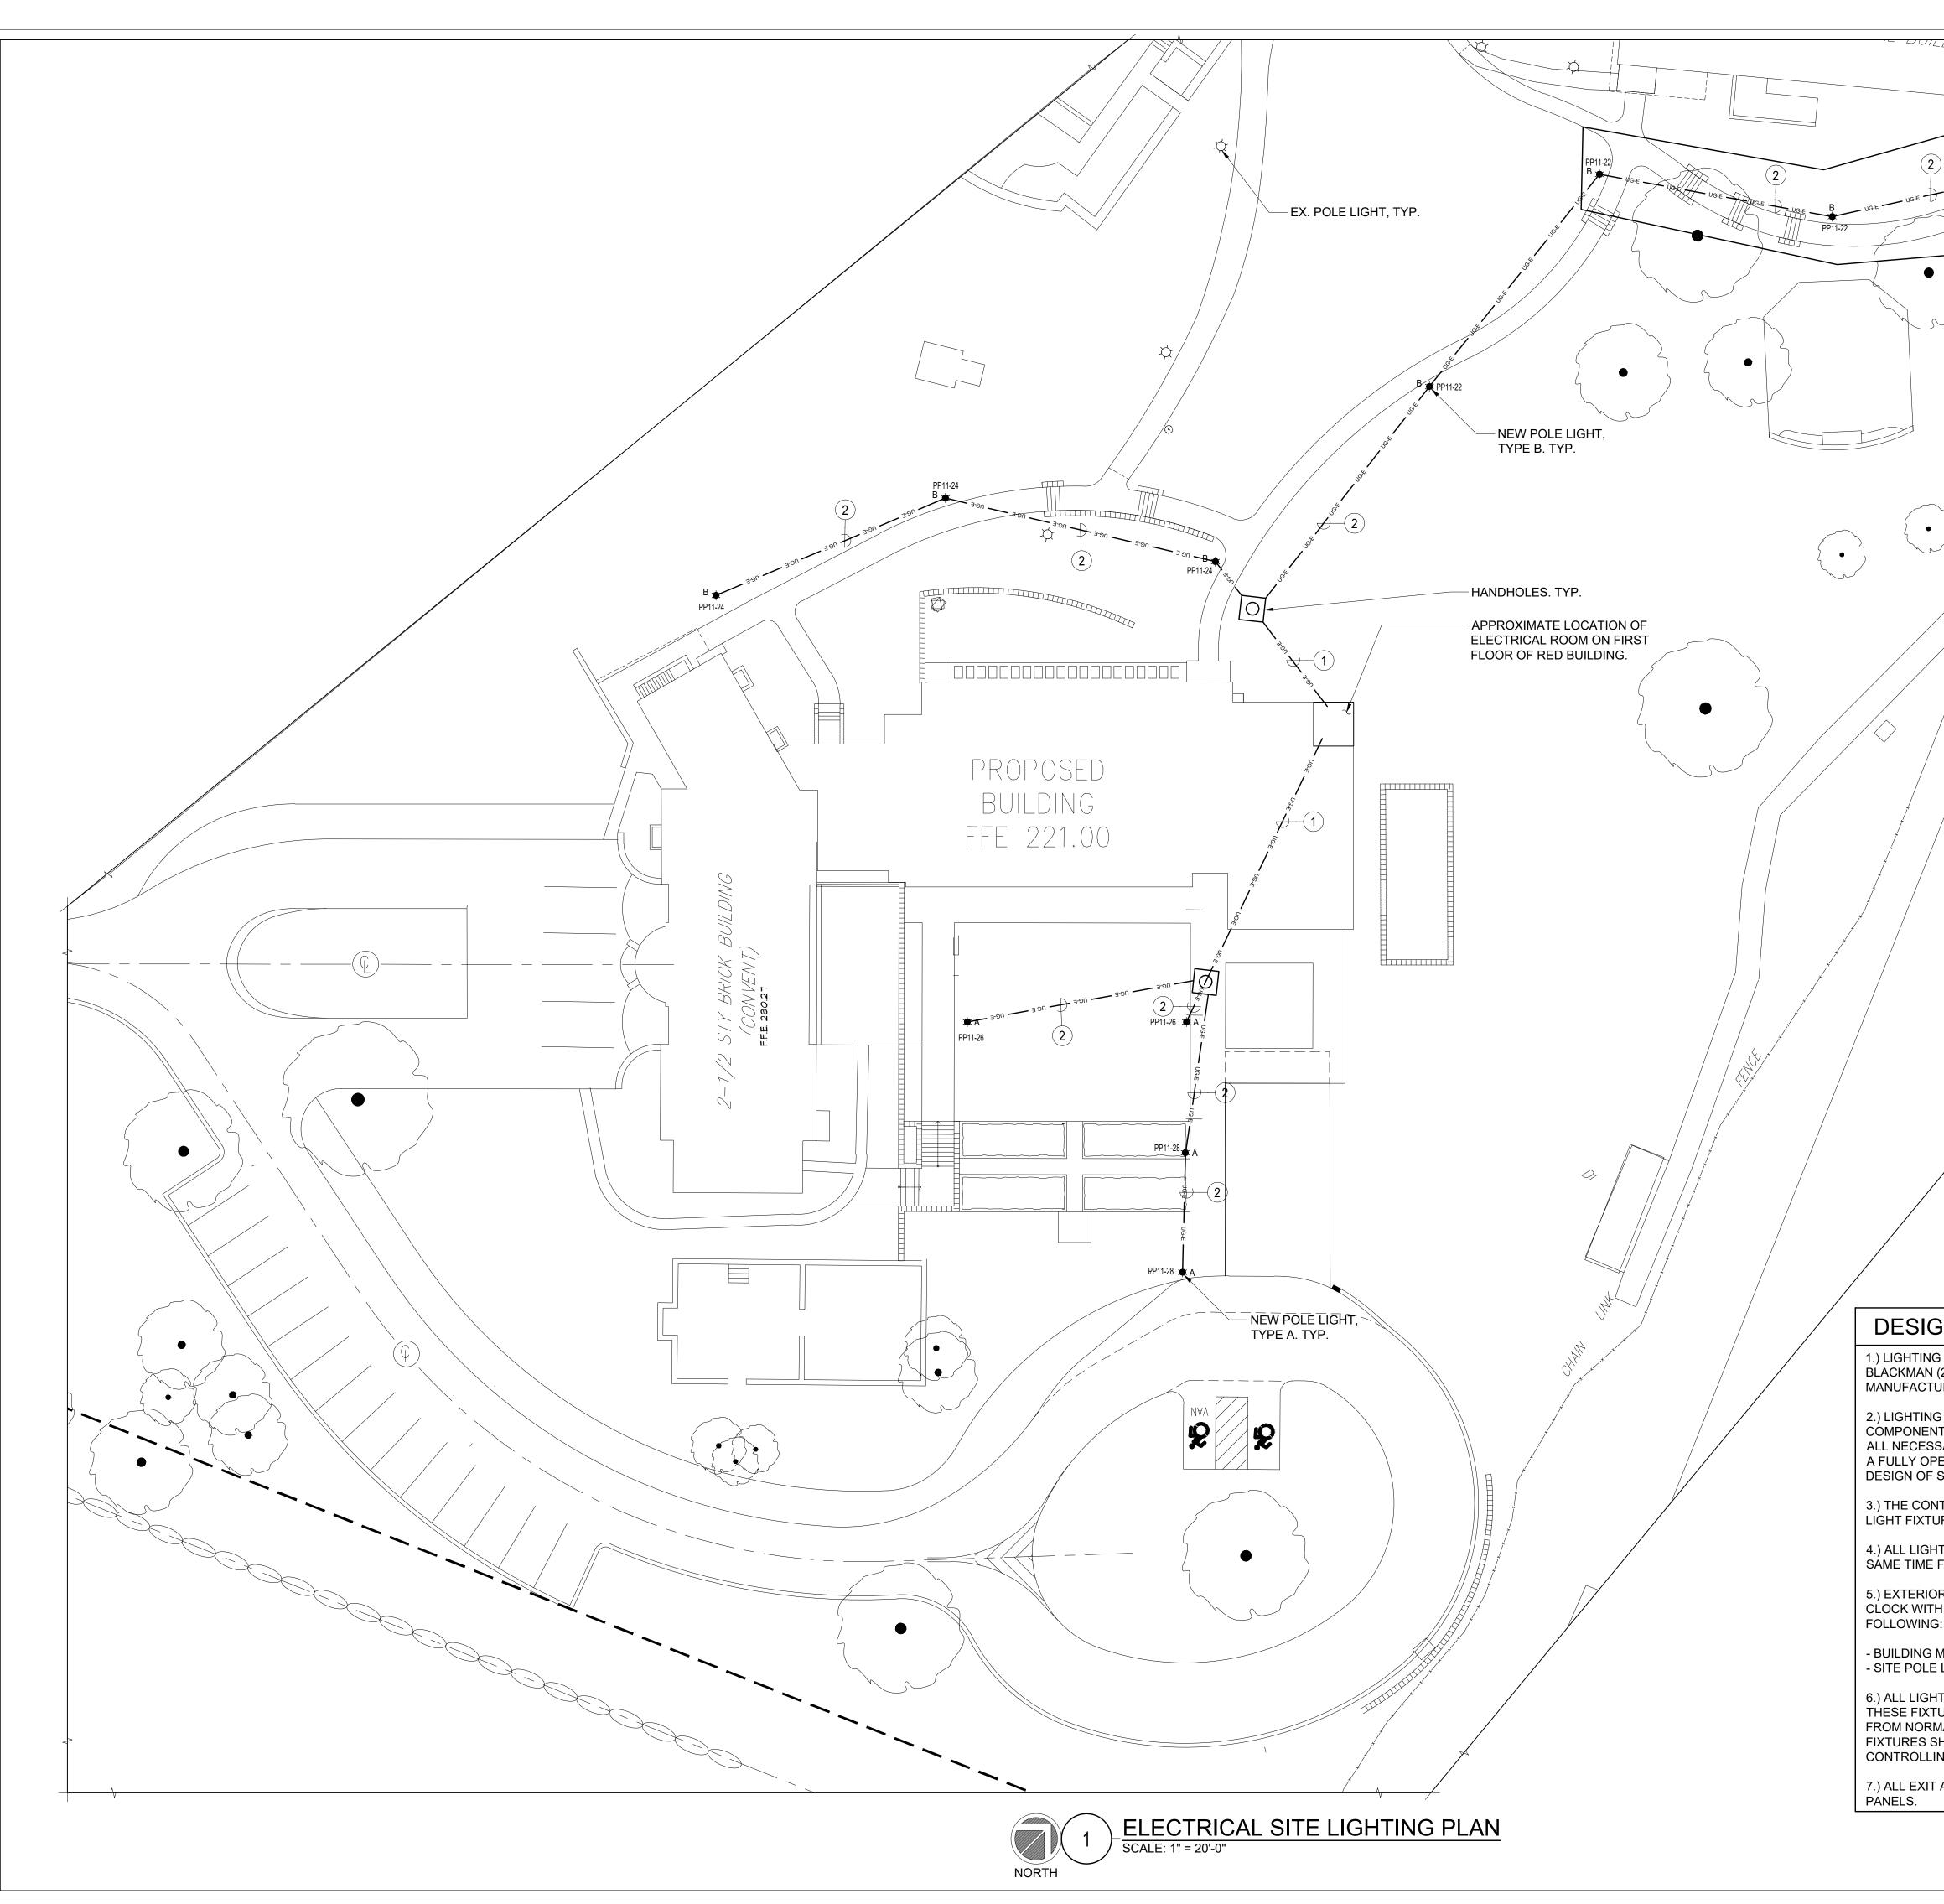






STREAM Center for Experiential Learning SCHOOL OF THE HOLY CHILD 2225 WESTCHESTER AVE, RYE, NY			
Isten imagine build         KG+D listen imagine build         KG+D ARCHITECTS PC         285 MAIN STREET MOUNT KISCO . NEW YORK . 10549         P:914.666.5900       KGDARCHITECTS.COM         OLA Consulting Engineers         50 Broadway, Hawthorne, NY 10532         914.747.2800         8 West 38th Street, Suite 501         New York, NY 10018			
CONSULTING ENGINEERS       646.849.4110         olace.com         ISSUED FOR CONSTRUCTION			
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Professional Seal          Professional Seal         7         08/12/2021         Issued for Construction         6       06/25/2021         Issued for Permit         5       02/24/2021			
4       02/10/2021       Issued For Review         3       5/14/2020       90% Construction Documents         2       2/19/2020       Design Development         1       12/18/2019       Schematic Design         No.       Date       Issue         Sheet Title         FLOOR         DEMOLITION         DEMOLITION         DEMOLITION         Job No.         Date         NUCCD0214 00			
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ENTITE PERIAD	STREAM Center for Experiential Learning SCHOOL OF THE HOLY CHILD 2225 WESTCHESTER AVE, RYE, NY
ADD/ALTERNATE 1.) SCOPE OF WORK IN THIS AREA SHALL BE PRICED AS AN ADD/ALTERNATE.	KEY PLAN NOTE: ALL IDEAS, DESIGNS, ARRANGEMENTS AND PLANS INDICATED OR REPRESENTED BY THIS DRAWING ARE OWNED BY AND ARE THE PROPERTY OF KAEYER, GARMENT, & DAVIDSON ARCHITECTS, PC (KG&D), AND WERE CREATED FOR USE ON THIS PROJECT. NONE OF SUCH IDEAS, DESIGNS, ARRANGEMENTS OR DIVING CHILL DE LIGED BY DO DIVISIONED TO ANY UNDODOS
FIELD WIRING/CONDUIT LEGEND         1       4-#8 & 1-#8 GND IN 1-1/2"C.         2       2-#8 & 1-#8 GND IN 1"C.	OR PLANS SHALL BE USED BY OR DISCLOSED TO ANY PURPOSE WHATSOEVER WITHOUT THE WRITTEN PERMISSION OF (KG&D). WRITTEN DIMENSIONS ON THIS DRAWING SHALL HAVE PRECEDENCE OVER SCALED DIMENSIONS. CONTRACTOR SHALL VERIFY ALL ACTUAL DIMENSIONS AND CONDITIONS ON THE JOB AND THE ARCHITECT MUST BE NOTIFIED OF ANY VARIATIONS FROM DIMENSIONS AND CONDITIONS SHOWN. SHOP DETAILS MUST BE SUBMITTED TO THIS OFFICE FOR APPROVAL BEFORE PROCEEDING WITH FABRICATION. ALTERATIONS BY ANY PERSON, IN ANY WAY, OF ANY ITEM CONTAINED ON THIS DOCUMENT, UNLESS ACTING UNDER THE DIRECTION OF THE LICENCED ARCHITECT WHOSE PROFESSIONAL SEAL IS AFFIXED HERETO, IS A VIOLATION OF TITLE VII, SECT. 69.5 (b) OF NEW YORK STATE LAW. COPYRIGHT KAEYER, GARMENT + DAVIDSON ARCHITECTS & ENGINEERS, PC ALL RIGHTS RESERVED.
<b>EXAMPLE 1</b> STORE	Professional Seal
SYSTEM BASED ON THE DESIGN INTENT INCLUDED ON THESE DRAWINGS. ITRACTOR SHALL BE RESPONSIBLE TO COORDINATE LIGHTING CONTROLS WITH JRES. IT FIXTURE AND LIGHTING CONTROL SUBMITTALS SHALL BE SUBMITTED AT THE	7         08/12/2021         Issued for Construction           6         06/25/2021         Issued for Permit           5         02/24/2021         Issued for Bid           4         02/10/2021         Issued for Review
FOR APPROVAL. OR MOUNTED LIGHT FIXTURES ARE TO BE CONTROLLED VIA PHOTOCELL AND TIME H MANUAL OVERRIDE SWITCH. PROVIDE SEPARATE CONTROL CIRCUITS FOR THE	35/14/202090% Construction Documents22/21/2020Design Development112/18/2019Schematic DesignNo.DateIssue
G: MOUNTED LIGHTS (UON). E LIGHTS (UON). IT FIXTURES TAGGED AS "EM" SHALL BE FED FROM EMERGENCY POWER PANELS. FURES SHALL BE SWITCHED AS INDICATED ALONG WITH LIGHTING FIXTURES FED	Sheet Title ELECTRICAL SITE LIGHTING PLAN
MAL POWER SOURCES. UPON LOSS OF NORMAL POWER, EMERGENCY LIGHT SHALL BE AUTOMATICALLY SHUNTED FULL BRIGHT REGARDLESS OF STATE OF NG SWITCH. SEE DETAIL FOR ADDITIONAL INFORMATION.	Job No. NKGD0214.00 Scale AS NOTED Sheet Number

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# DESIGN INTENT - LIGHTING CONTROL SYSTEM

1. LIGHTING CONTROL SYSTEM IS BASED ON N-LIGHT BY SENSOR SWITCH (KAREN BLACKMAN (212) 462-0088 x5237) OR APPROVED EQUAL. (OTHER ACCEPTABLE MANUFACTURERS ARE LUTRON & COOPER LIGHTING).

2. LIGHTING CONTROL COMPONENTS SHOWN ARE FOR GENERAL DESIGN INTENT. ALL COMPONENTS AND WIRING ARE NOT SHOWN. CONTRACTOR SHALL BE RESPONSIBLE FOR ALL NECESSARY COMPONENTS, WIRING (LINE AND LOW VOLTAGE) AND PROGRAMMING FOR A FULLY OPERATIONAL SYSTEM. CONTRACTOR IS RESPONSIBLE FOR FULL DESIGN OF SYSTEM BASED ON THE DESIGN INTENT INCLUDED ON THESE DRAWINGS.

THE CONTRACTOR SHALL BE RESPONSIBLE TO COORDINATE LIGHTING CONTROLS WITH LIGHT FIXTURES.
 ALL LIGHT FIXTURE AND LIGHTING CONTROL SUBMITTALS SHALL BE SUBMITTED AT THE SAME TIME FOR

5. EXTERIOR MOUNTED LIGHT FIXTURES ARE TO BE CONTROLLED VIA PHOTOCELL AND TIME CLOCK WITH MANUAL OVERRIDE SWITCH. - BUILDING MOUNTED LIGHTS (UON)

6. LIGHT FIXTURES INDICATED AS EMERGENCY (EM) ON DRAWINGS SHALL CONTAIN EMERGENCY BATTERY BACKUP BALLASTS. WHERE POSSIBLE, THE BALLAST SHALL BE INTEGRAL TO FIXTURE WITH A VISUAL INDICATING CHARGE LAMP AND TEST SWITCH. IF IT IS NOT POSSIBLE TO INSTALL THE EMERGENCY BATTERY BALLAST IN THE FIXTURE, THE CONTRACTOR SHALL FURNISH & INSTALL A REMOTE EMERGENCY BALLAST. EACH BATTERY PACK SHALL BE CONNECTED SO THAT THE FIXTURE CAN BE SWITCHED UNDER NORMAL CONDITIONS AND IN THE EVENT OF A POWER OUTAGE, THE BATTERY PACK AND FLOURESCENT LAMPS SHALL AUTOMATICALLY ILLUMINATE FOR 90 MINUTES WITH A 12000 LUMEN OUTPUT (TOTAL FROM FIXTURE), MINIMUM.

## 7. ALL EXIT AND EMERGENCY FIXTURES SHALL BE FED FROM UNSWITCHED LEG OF ASSOCIATED LOCAL LIGHTING CIRCUITS.

- SITE POLE LIGHTS

APPROVAL.

## LIGHTING CONTROLS LEGEND

## 1 DAYLIGHT HARVESTING ZONE WITH PHOTOCELL SENSOR


 $\fbox{(2)}$  LINE VOLTAGE WALL SWITCH WITH DUAL TECHNOLOGY OCCUPANCY SENSOR

- 3 LOW VOLTAGE MANUAL ON WALL SWITCH/DIMMER WITH CEILING MOUNTED DUAL TECHNOLOGY VACANCY SENSOR. ONE SWITCH CONTROLLING ALL THE LIGHTS IN ROW NEAREST TO TEACHING WALL AND THE OTHER SWITCH CONTROLLING ALL REMAINING LIGHTS IN THE SPACE.
- TIME CLOCK WITH OCCUPANCY SENSOR OVERRIDE AFTER HOURS.
- 5 LOW VOLTAGE WALL MOUNTED SWITCH WITH CEILING MOUNTED DUAL TECHNOLOGY
- OCCUPANCY SENSOR.
- (6) LOW VOLTAGE MANUAL DIMMER SWITCH WITH CEILING MOUNTED DUAL TECHNOLOGY
- OCCUPANCY SENSOR.
- 7 EXTERIOR LIGHTING CONTROLS. SEE DESIGN INTENT, NOTE #5.
- 8 LOW VOLTAGE MANUAL ON WALL SWITCH WITH CEILING MOUNTED DUAL TECHNOLOGY VACANCY SENSOR.
- (9) LINE VOLTAGE WALL SWITCH DUAL TECHNOLOGY VACANCY SENSOR.

(10) TIME CLOCK WITH OCCUPANCY SENSOR OVERRIDE AFTER HOURS WITH 50% DIMMING. DURING NORMAL BUSINESS HOURS, LIGHT FIXTURES SHALL BE ON FULL BRIGHT. DURING NON-BUSINESS HOURS, LIGHT FIXTURES SHALL BE CONTROLLED BY OCCUPANCY SENSORS AND SHALL DIM TO 50% WHEN IN OCCUPANCY SENSOR MODE.


(11) LOW VOLTAGE MANUAL ON WALL SWITCH/DIMMER WITH CEILING MOUNTED DUAL TECHNOLOGY VACANCY SENSOR.


12 LINE VOLTAGE WALL SWITCH.

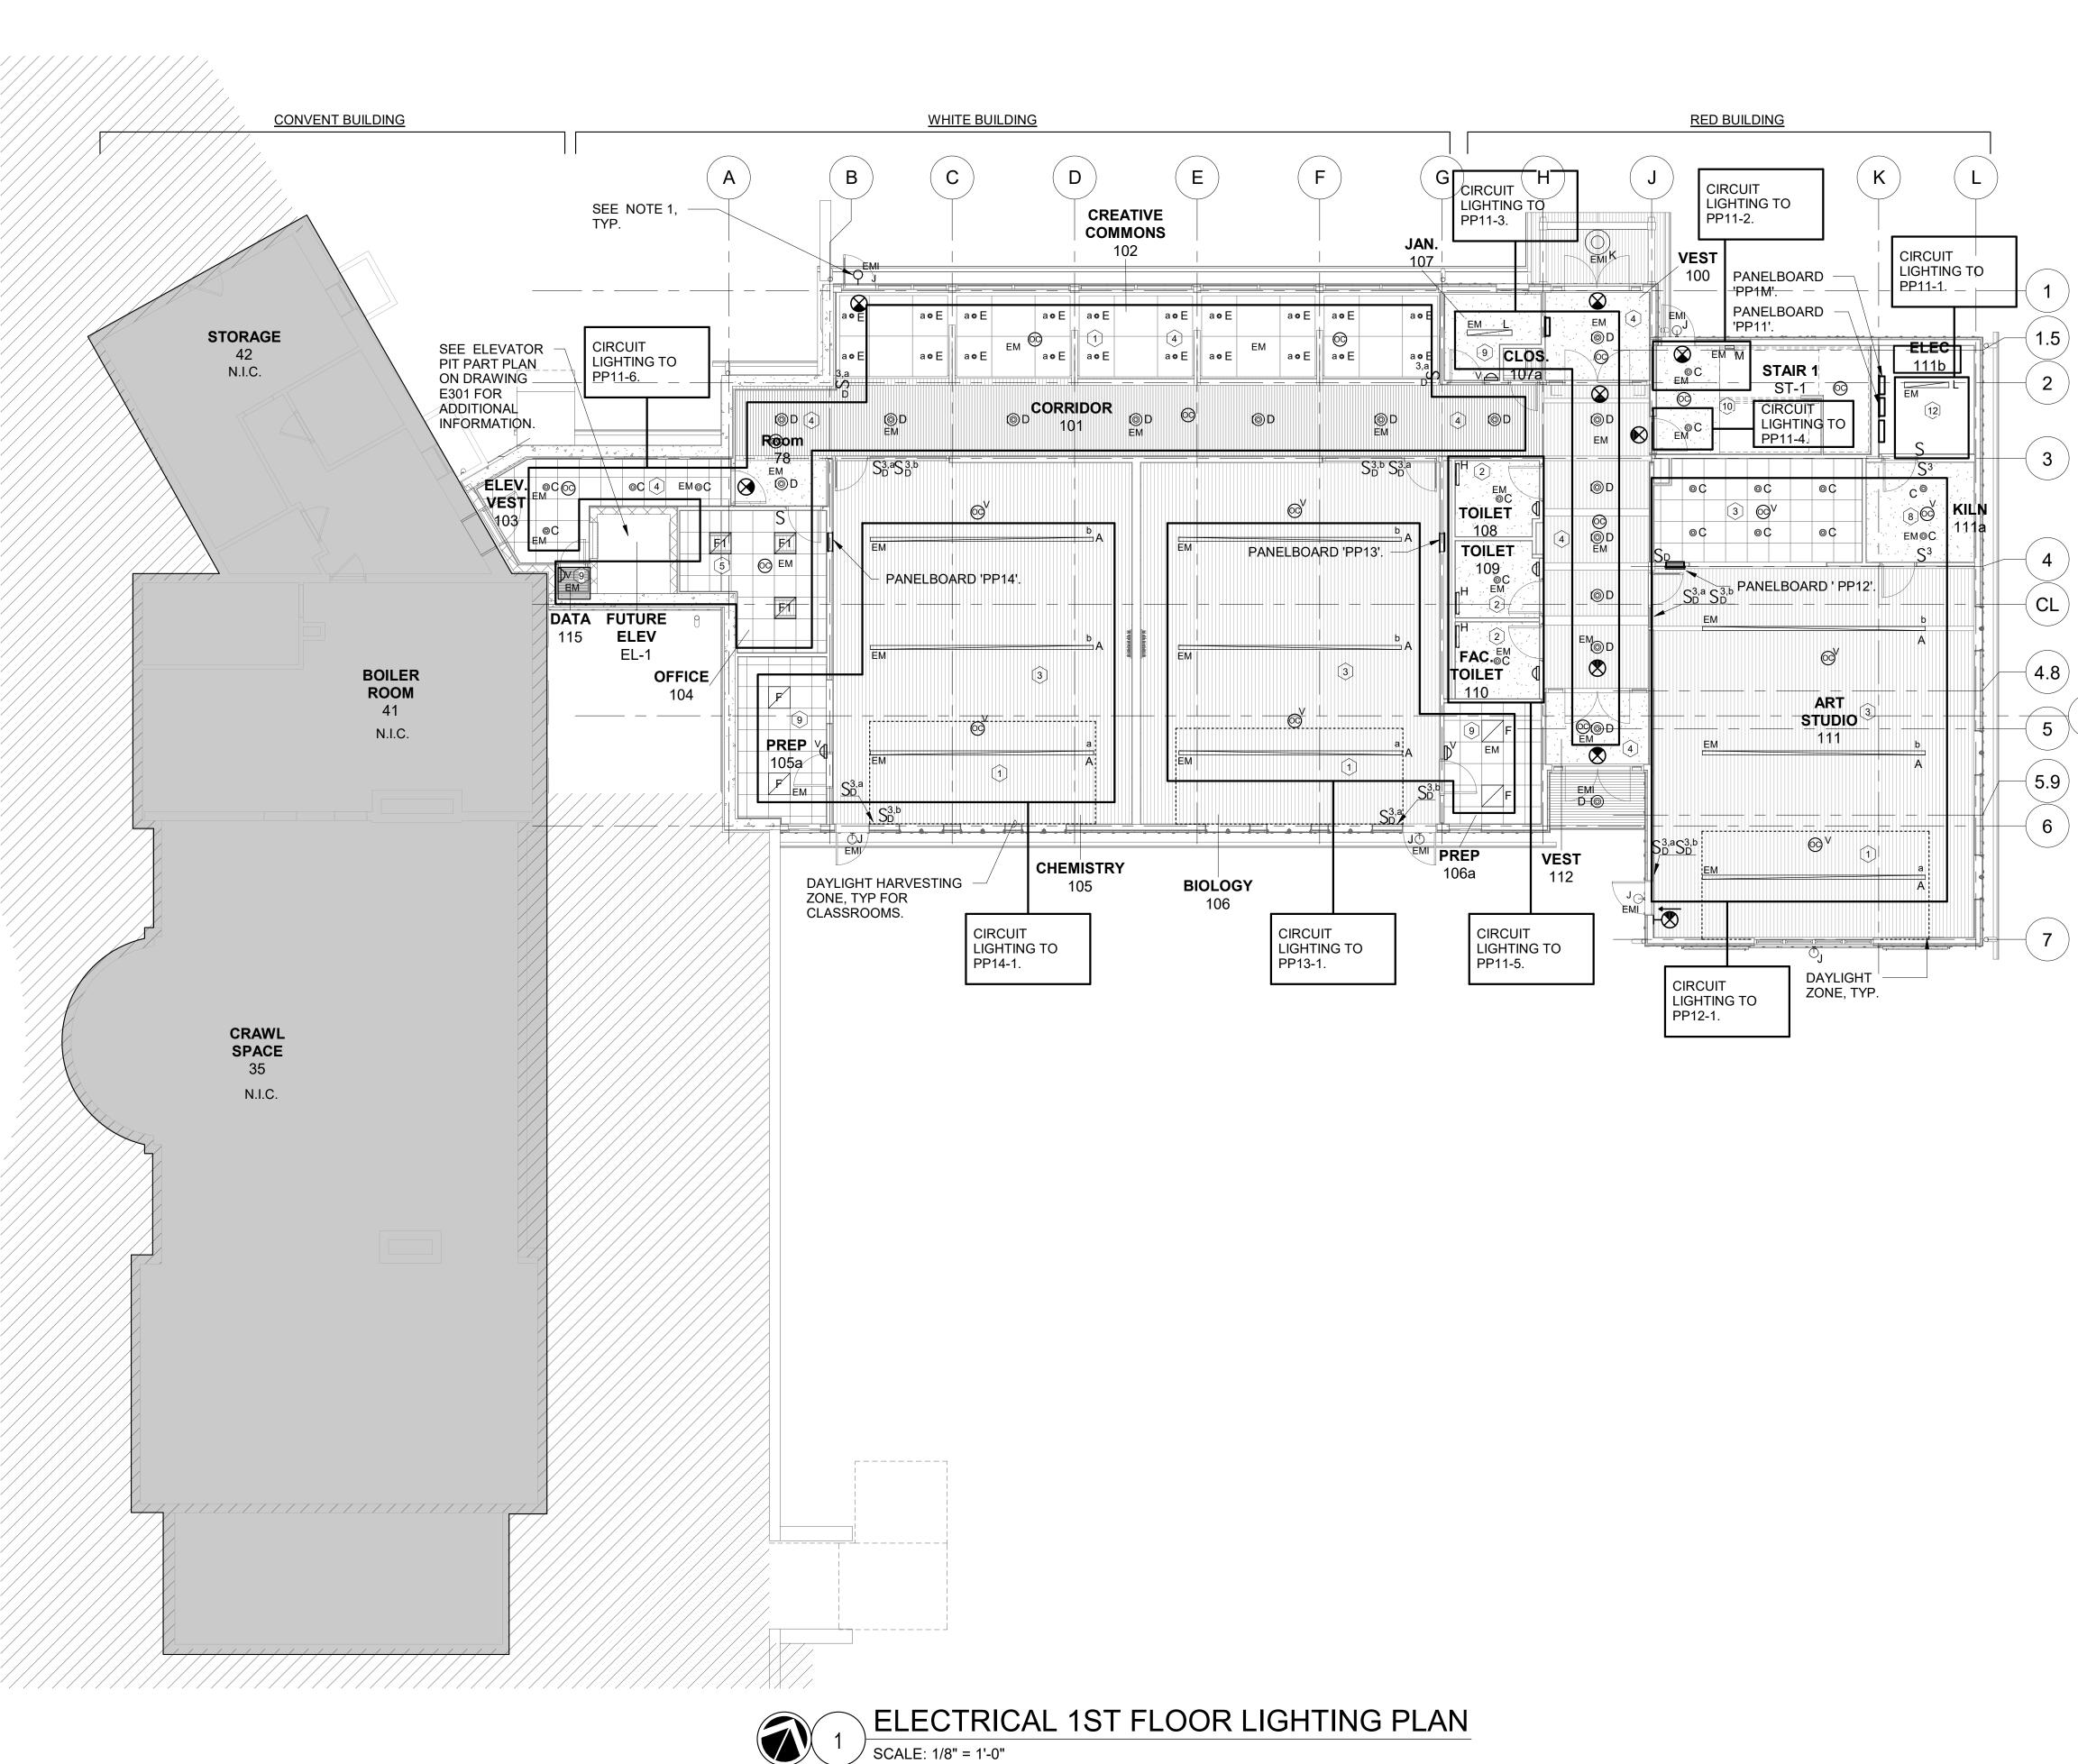


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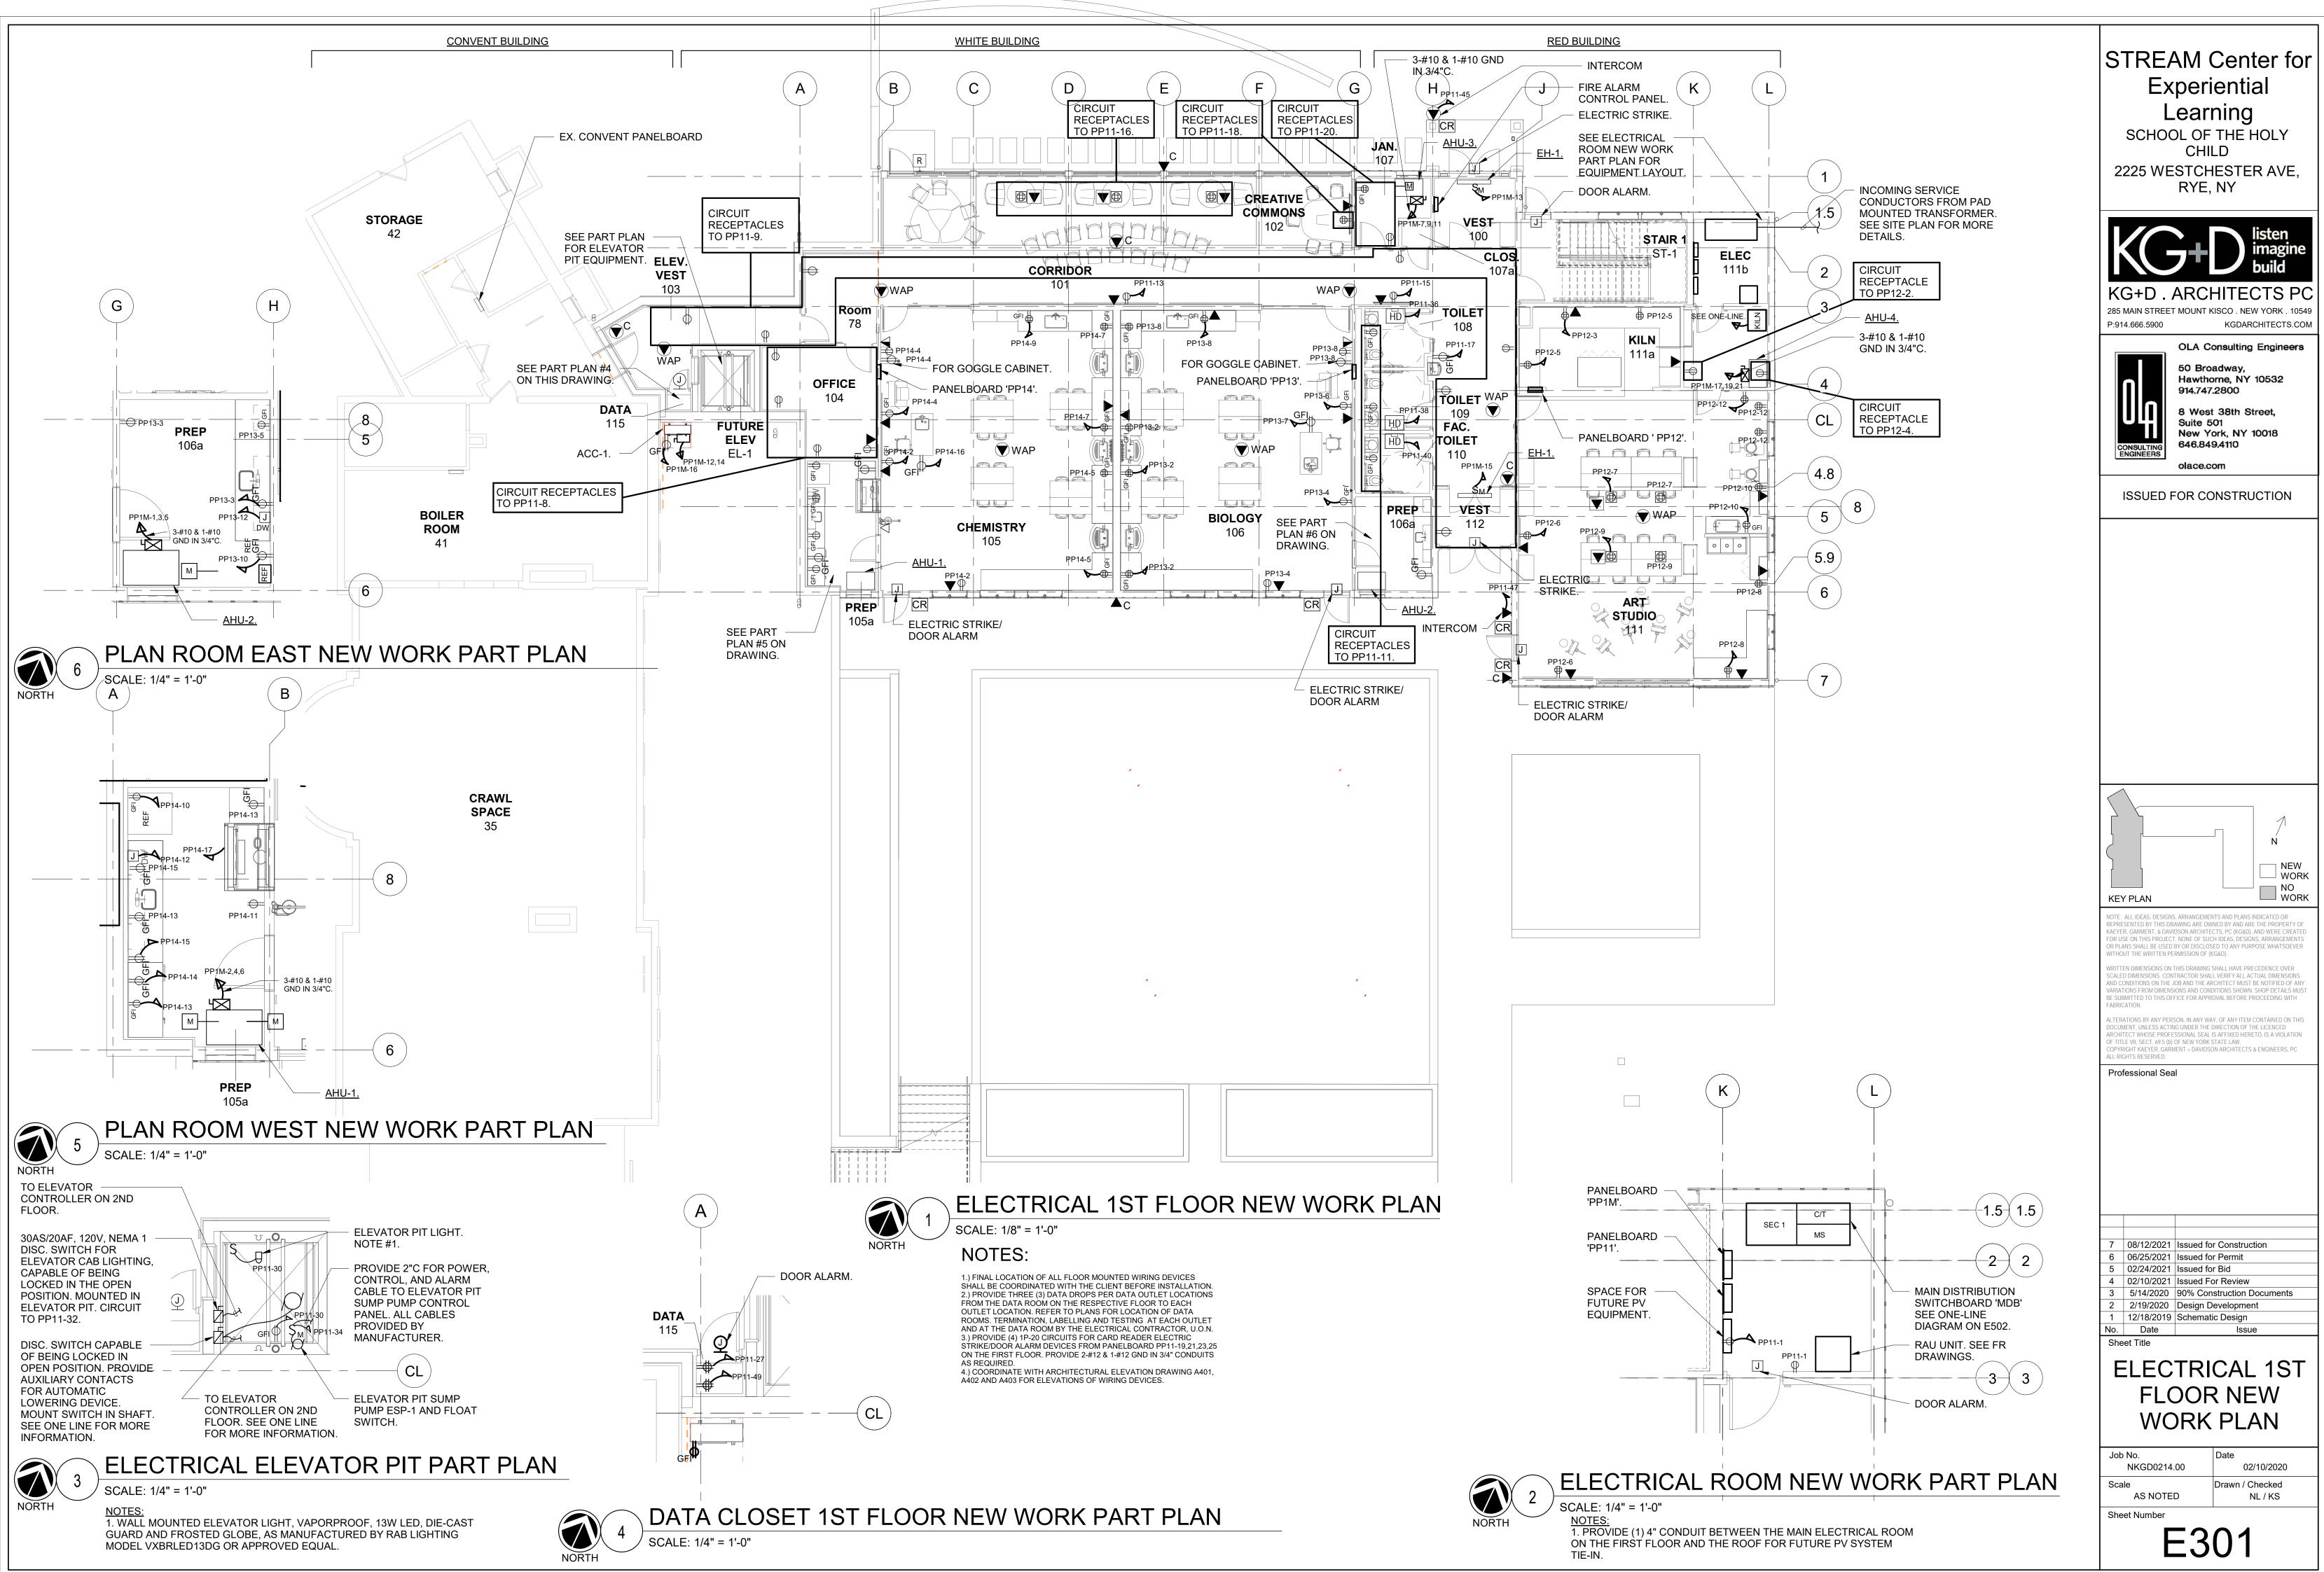
 CIRCUIT EXTERIOR LIGHTING TO PP11-7 AND PP11-43.
 ALL TIMECLOCKS CONTROLLING LIGHT FIXTURES IN CORRIDORS AND STAIRS SHALL BE LOCATED IN THE MAIN ELECTRICAL ROOM ON THE FIRST FLOOR.
 PROVIDE FIVE (5) MINI-INVERTERS SIMILAR TO IOTA IIS-125-I FOR LIGHT FIXTURES D, J AND K BY EXTERIOR DOORS ON THE FIRST FLOOR. LOCATE MINI-INVETERS ABOVE DROP CEILINGS.




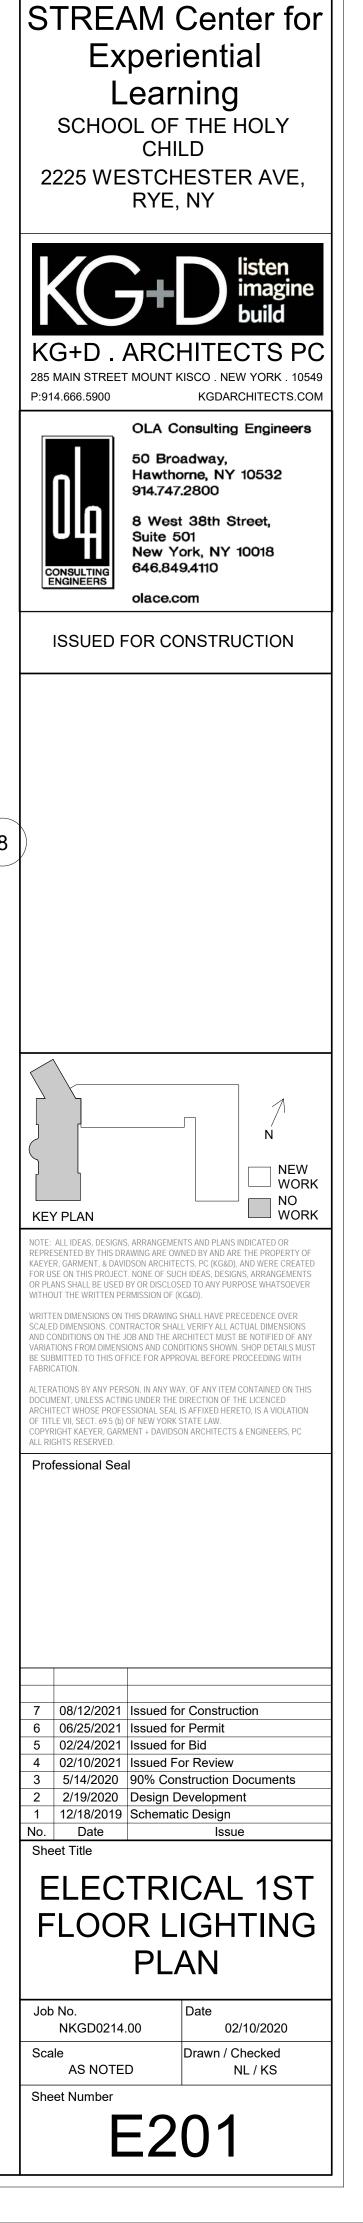


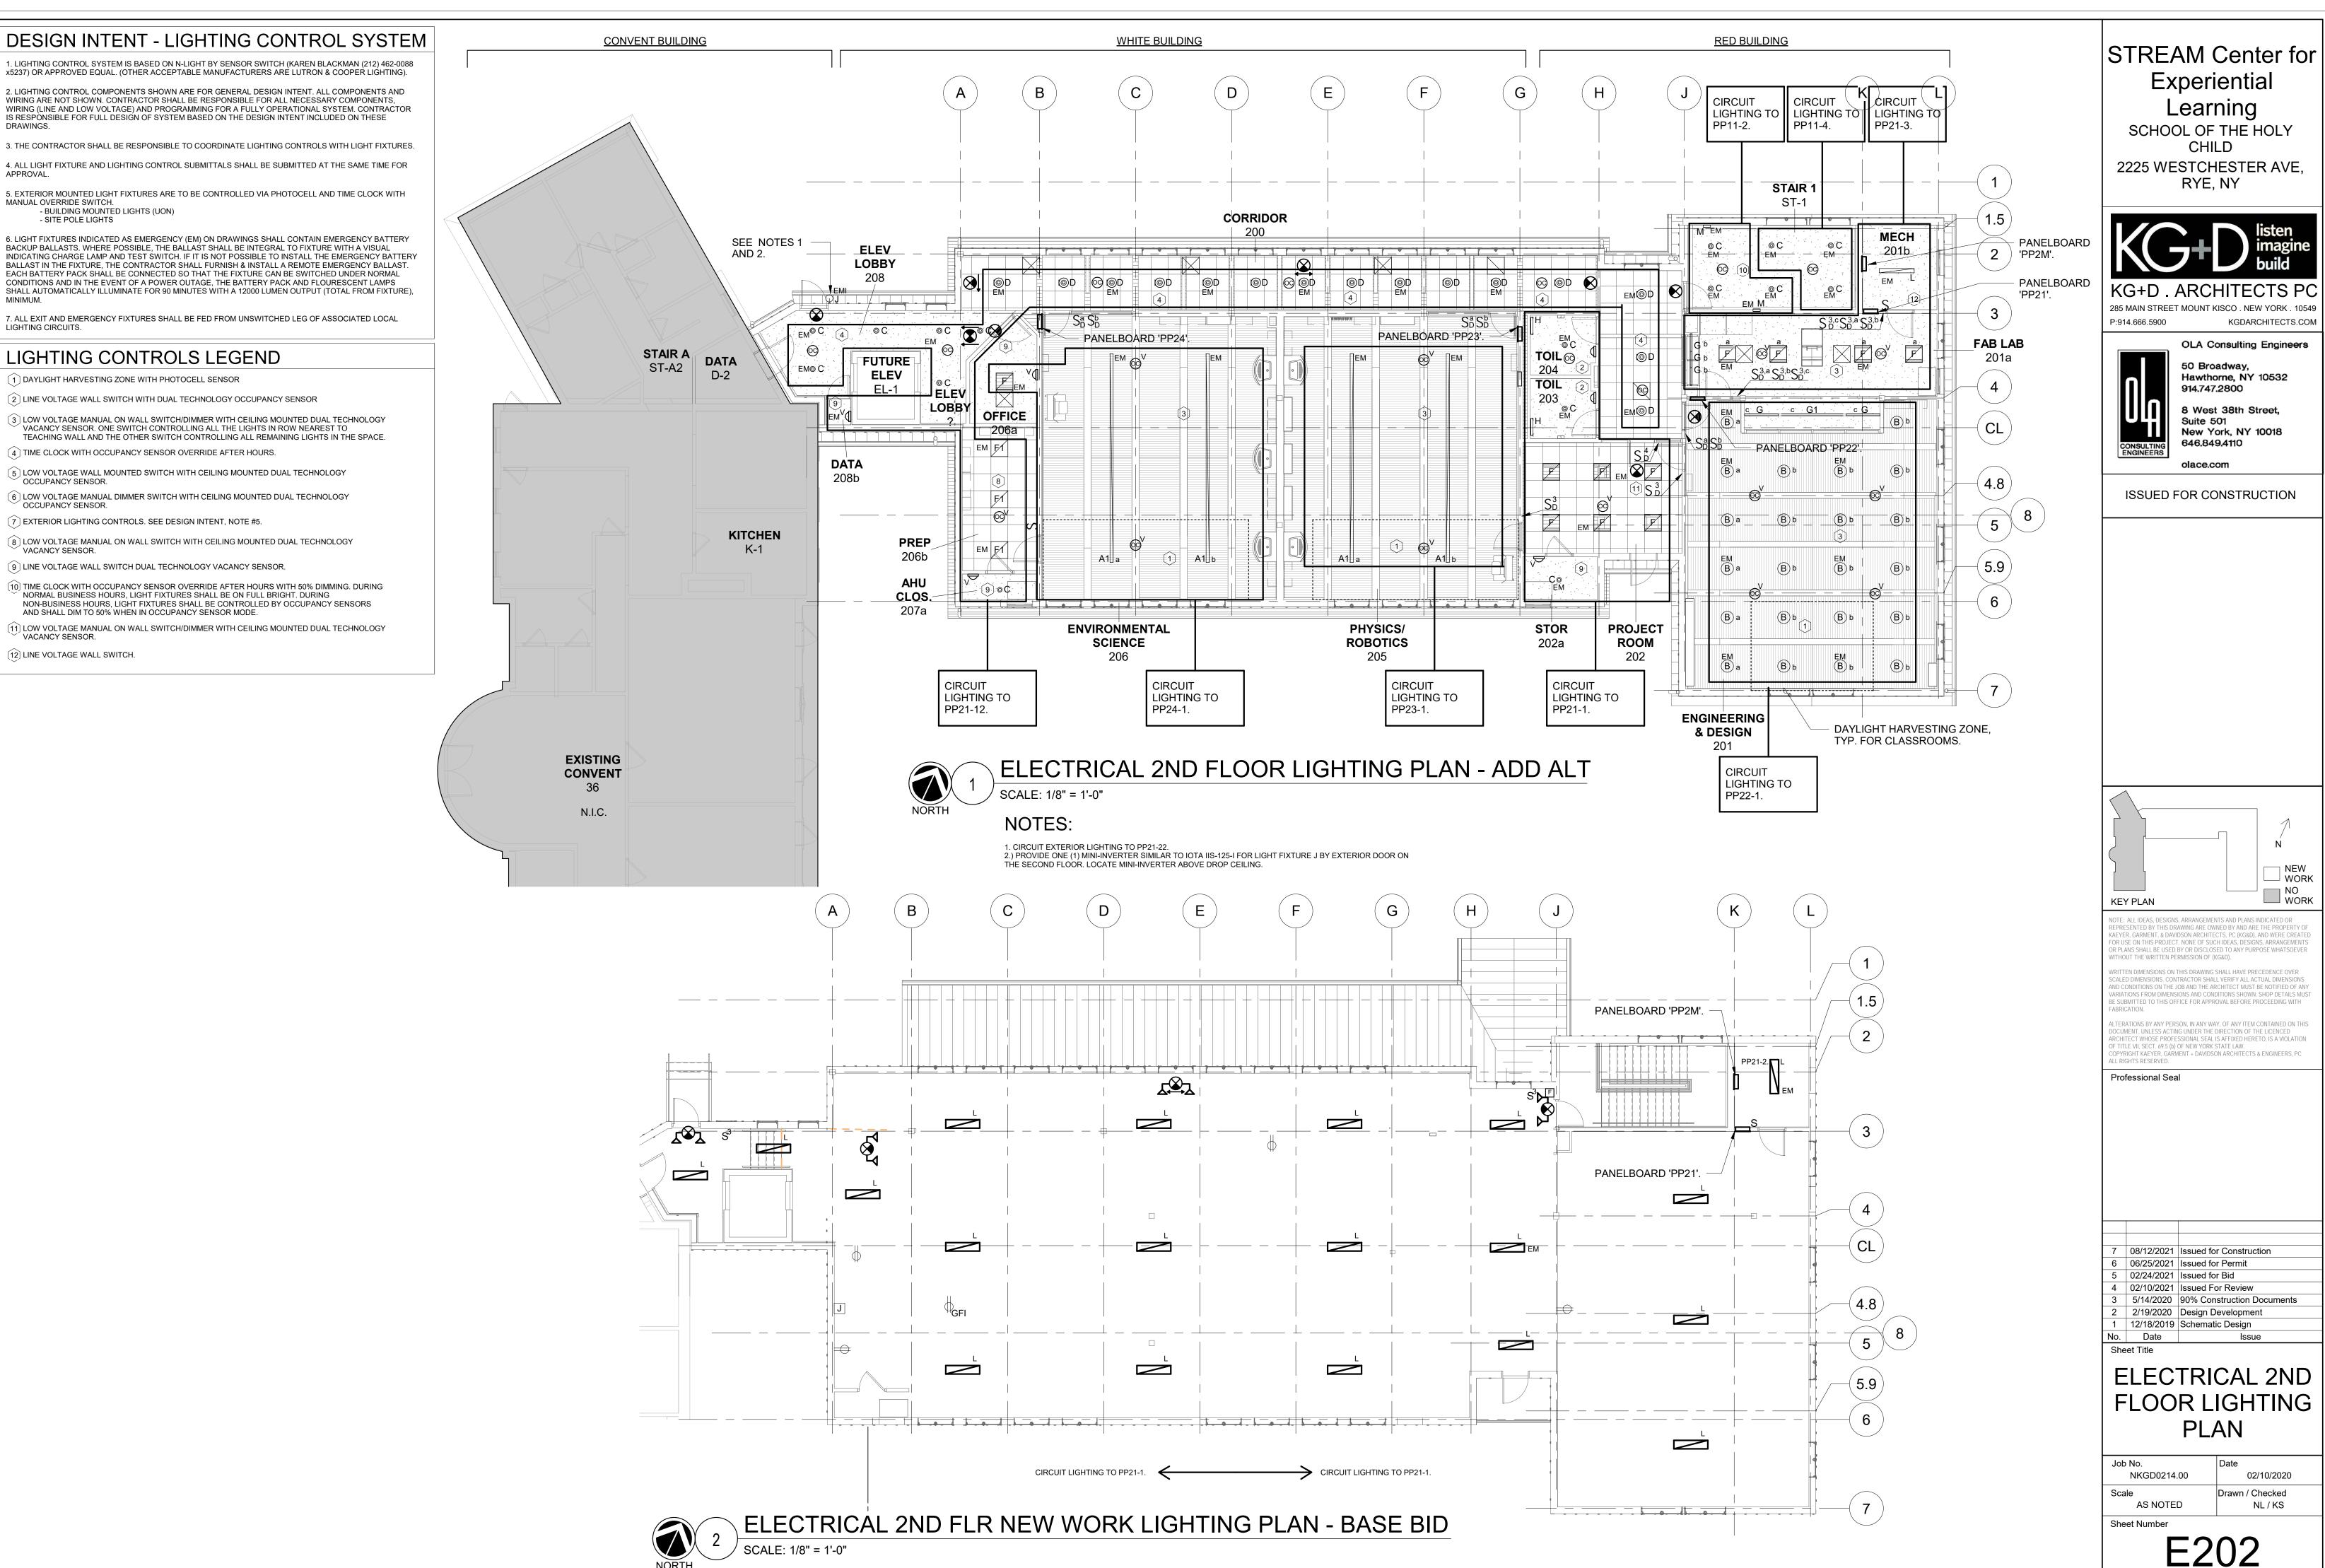

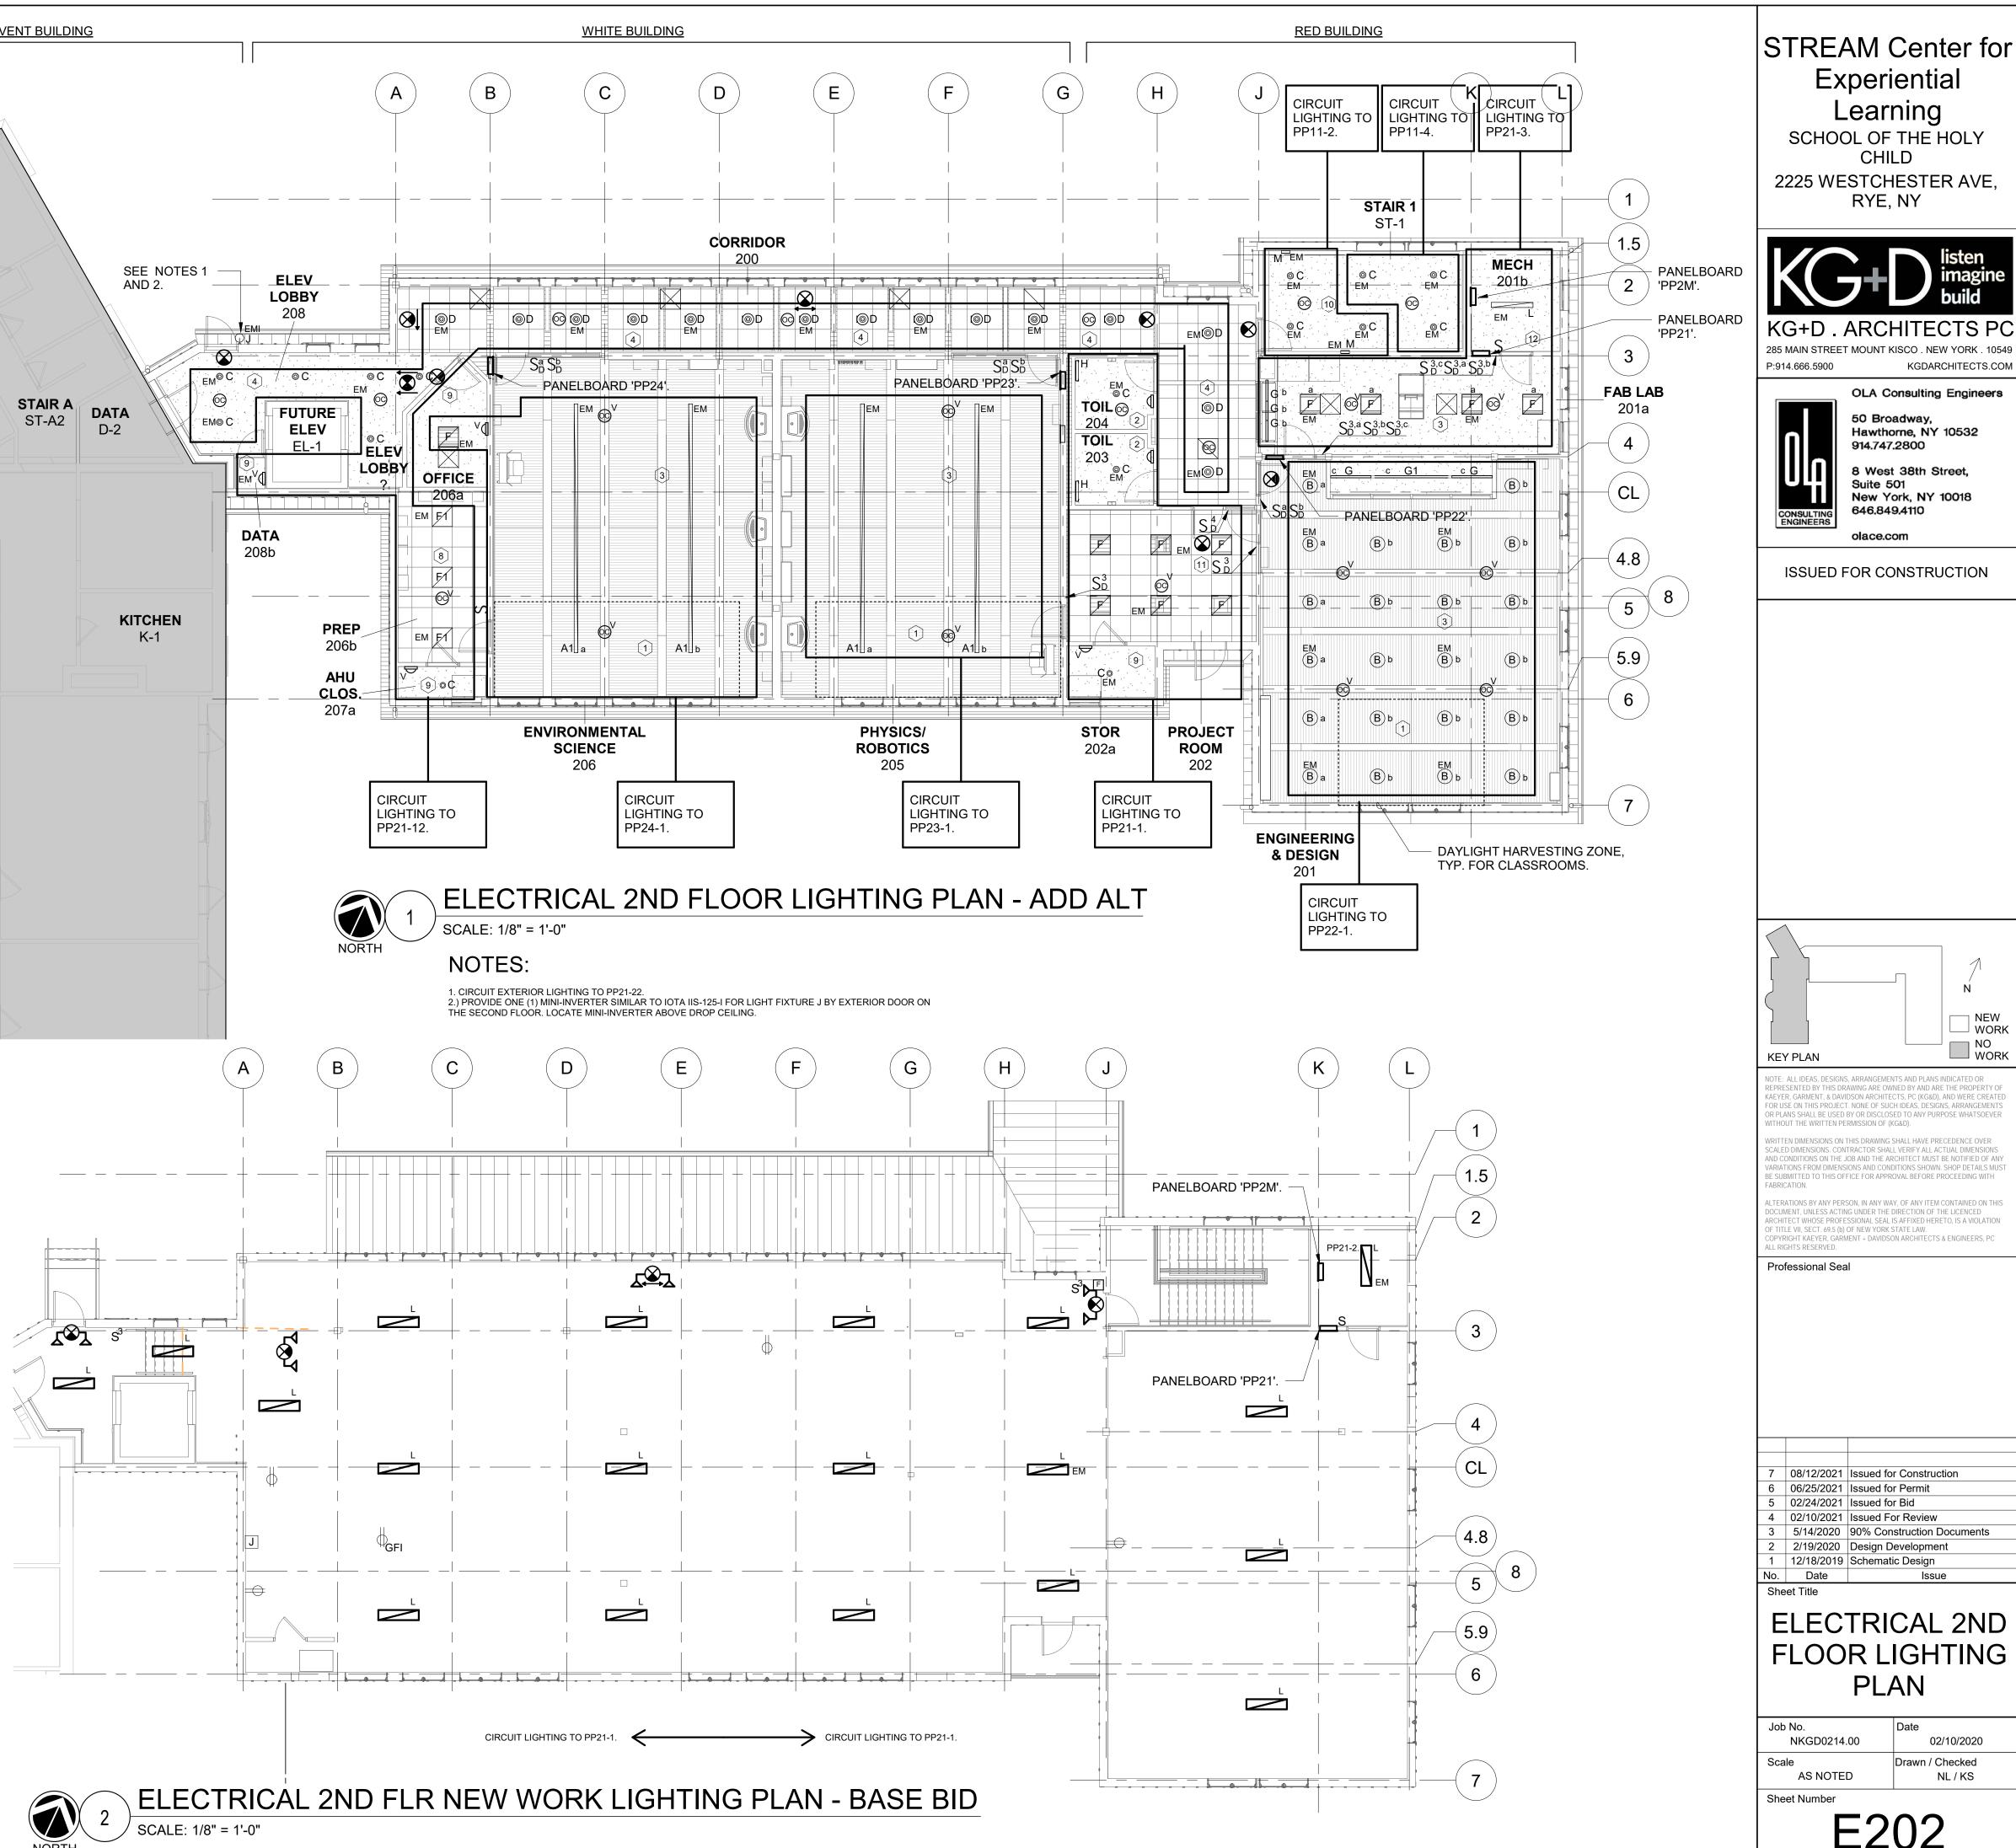



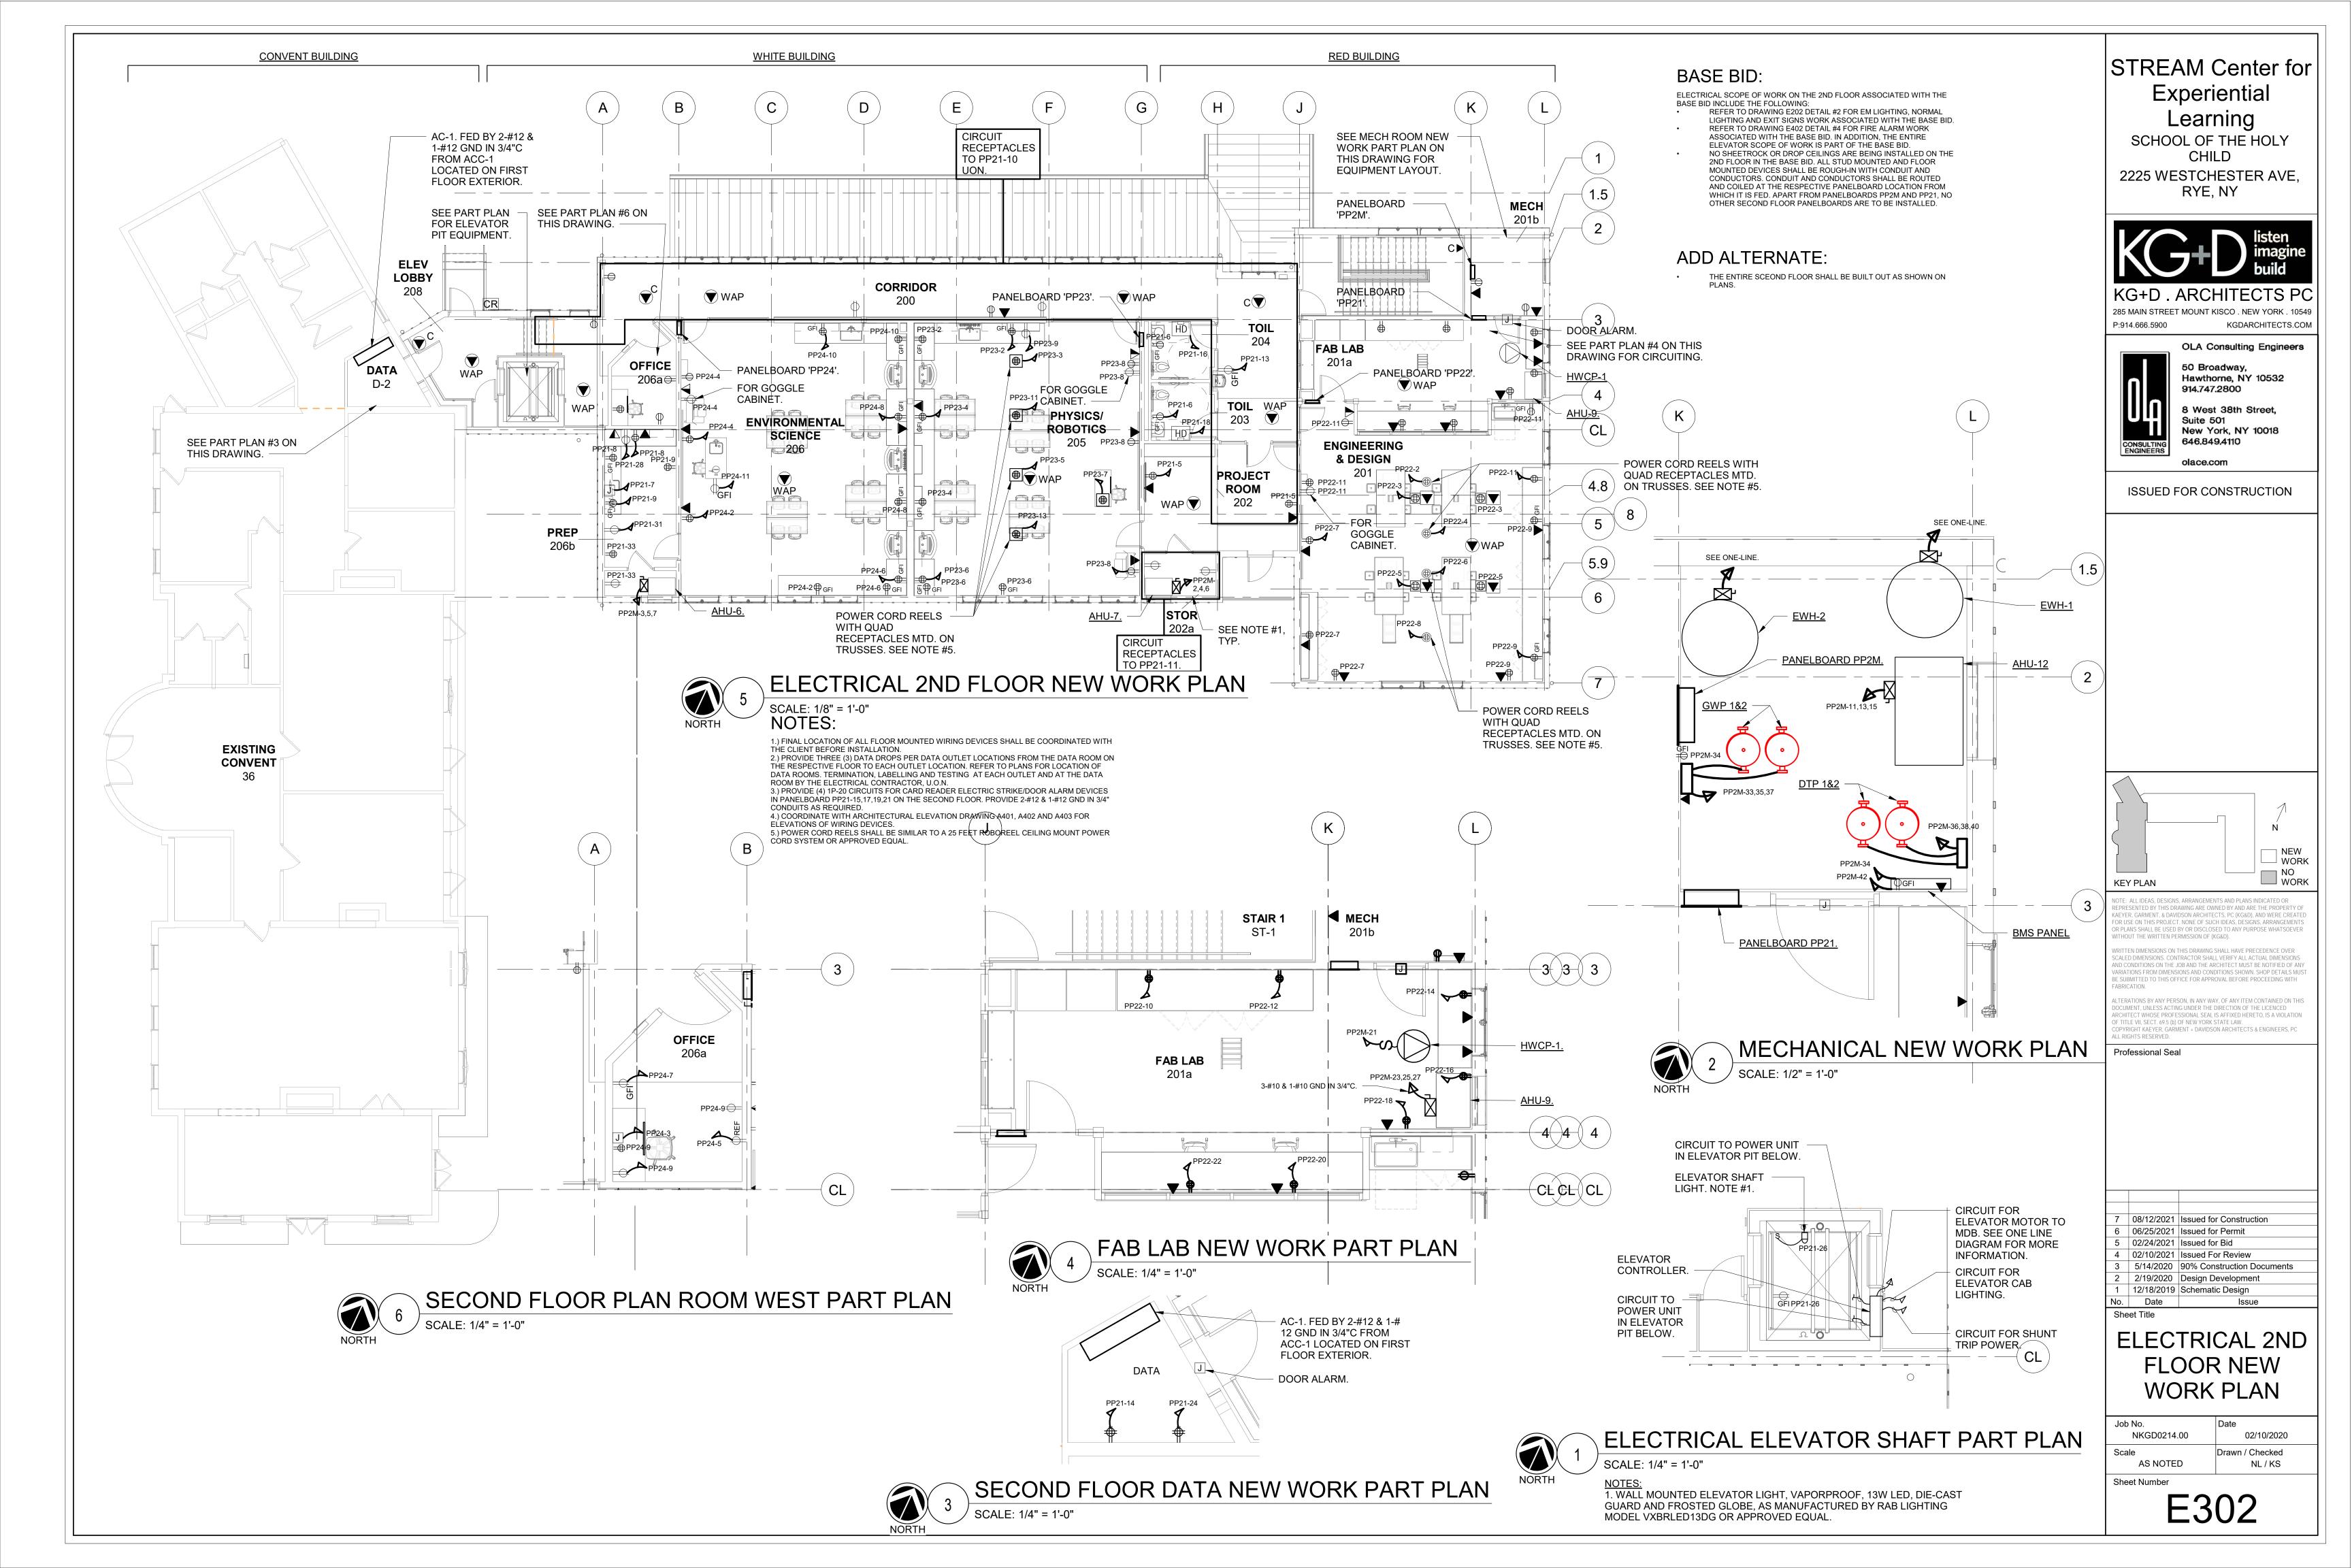

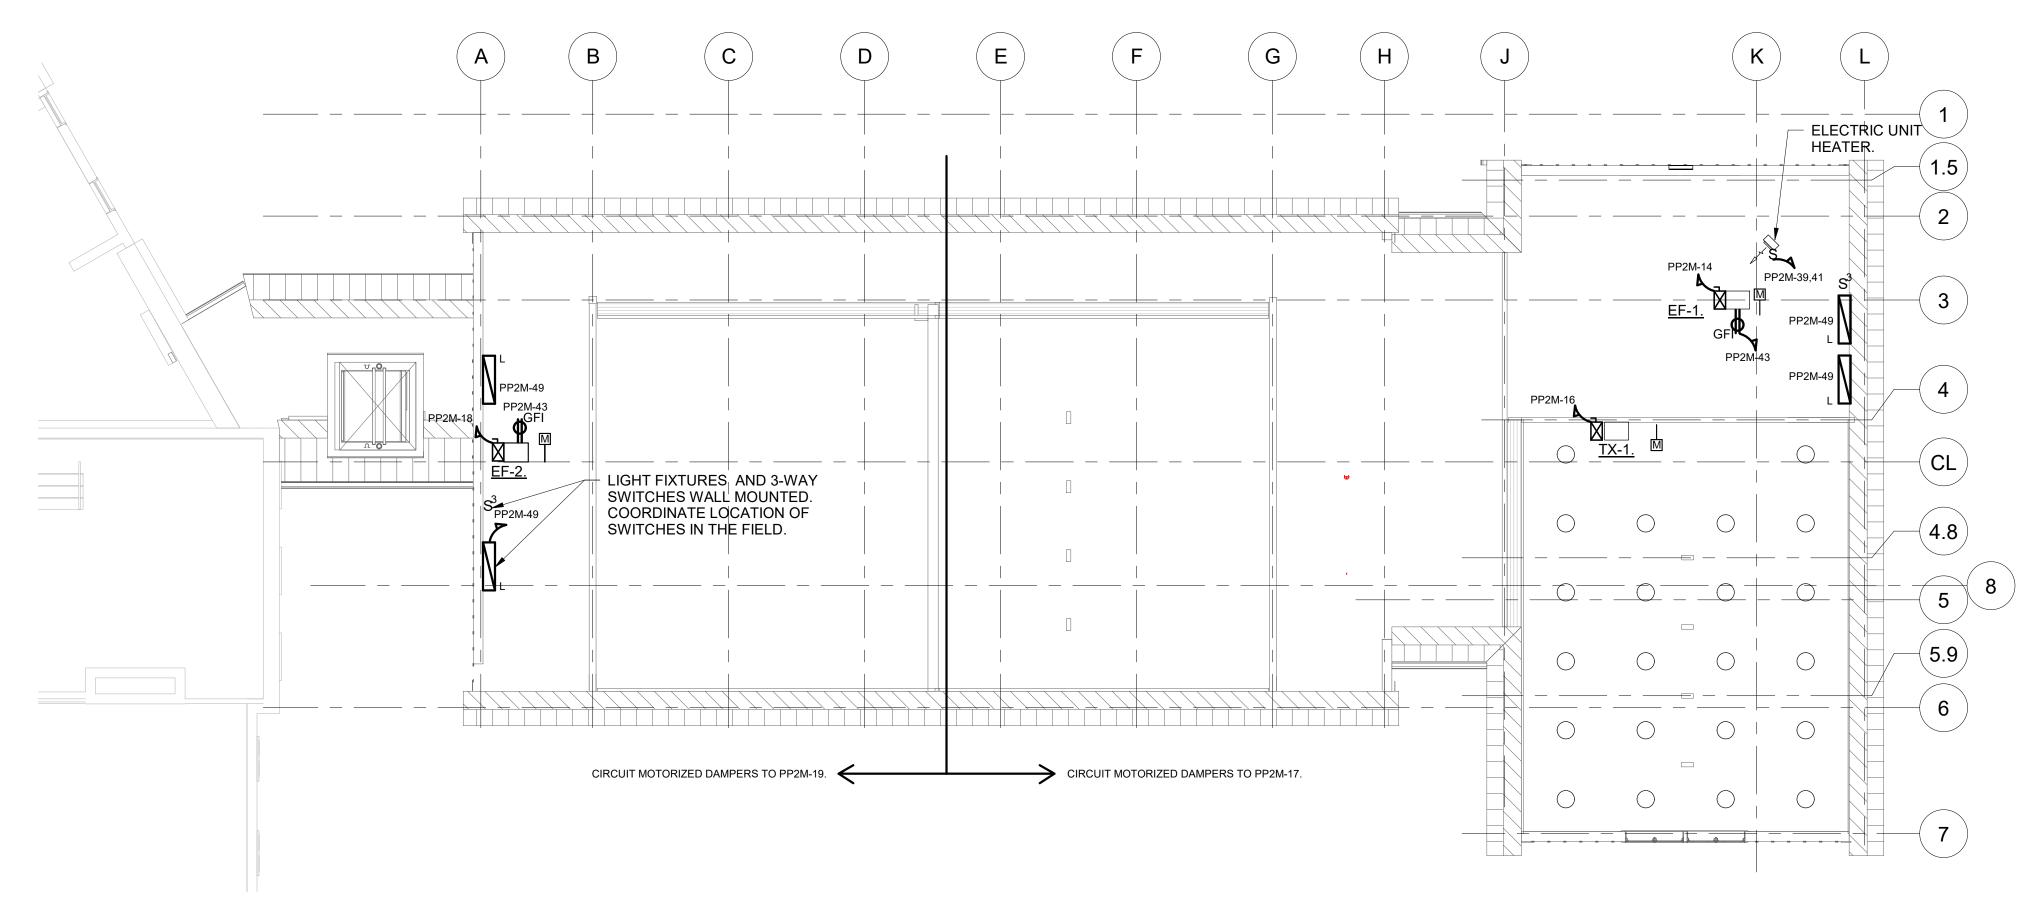


ELECTRICAL ATTIC NEW WORK PLAN NORTH


SCALE: 1/8" = 1'-0" NOTES:

1. CIRCUIT ALL MOTORIZED DAMPERS TO PP2M-48 AND PP2M-50.


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Isten imagine build         Consulting Engineers         OLA Consulting Engineers         So Broadway, Hawthorne, NY 10532         A West 38th Street, Suite 501         New York, NY 10018         A West 38th Street, Suite 501         New York, NY 10018         A West 38th Street, Suite 501         New York, NY 10018
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Job No. NKGD0214.00 Scale AS NOTED Sheet Number E303

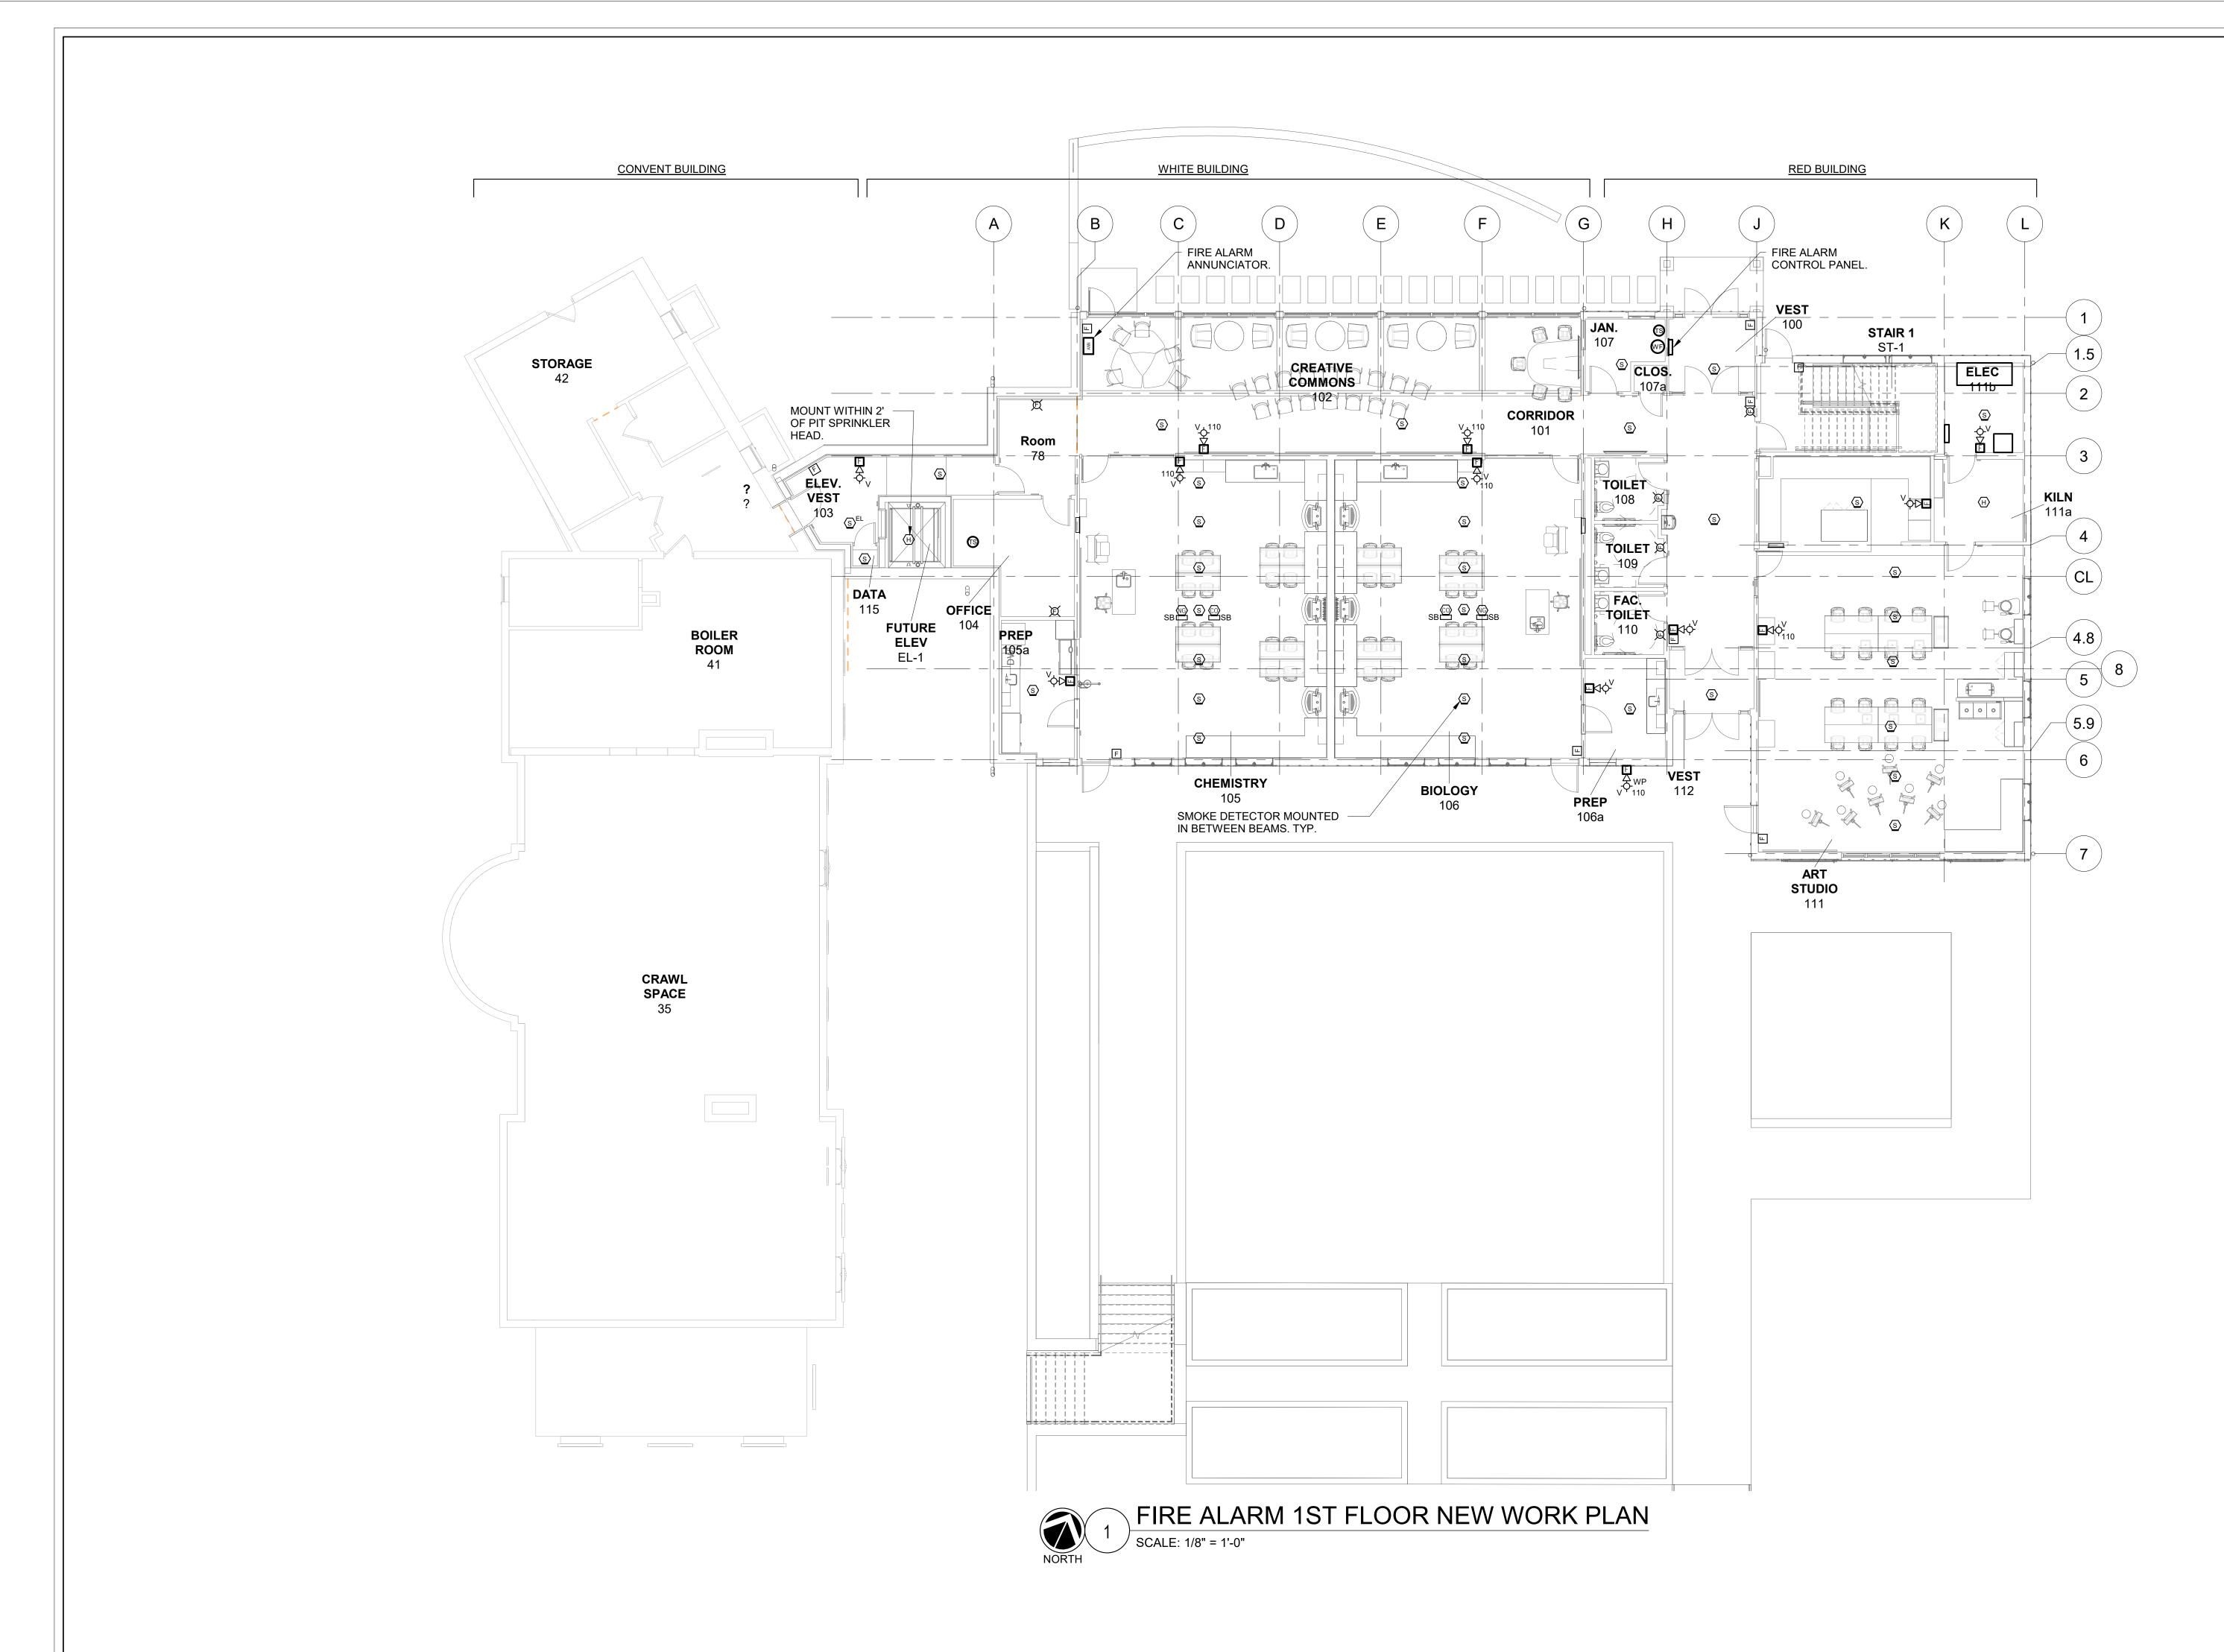


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Job No.       Date         NKGD0214.00       Date         Scale       Drawn / Checked         AS NOTED       Drawn / Checked         Sheet Number       E401		

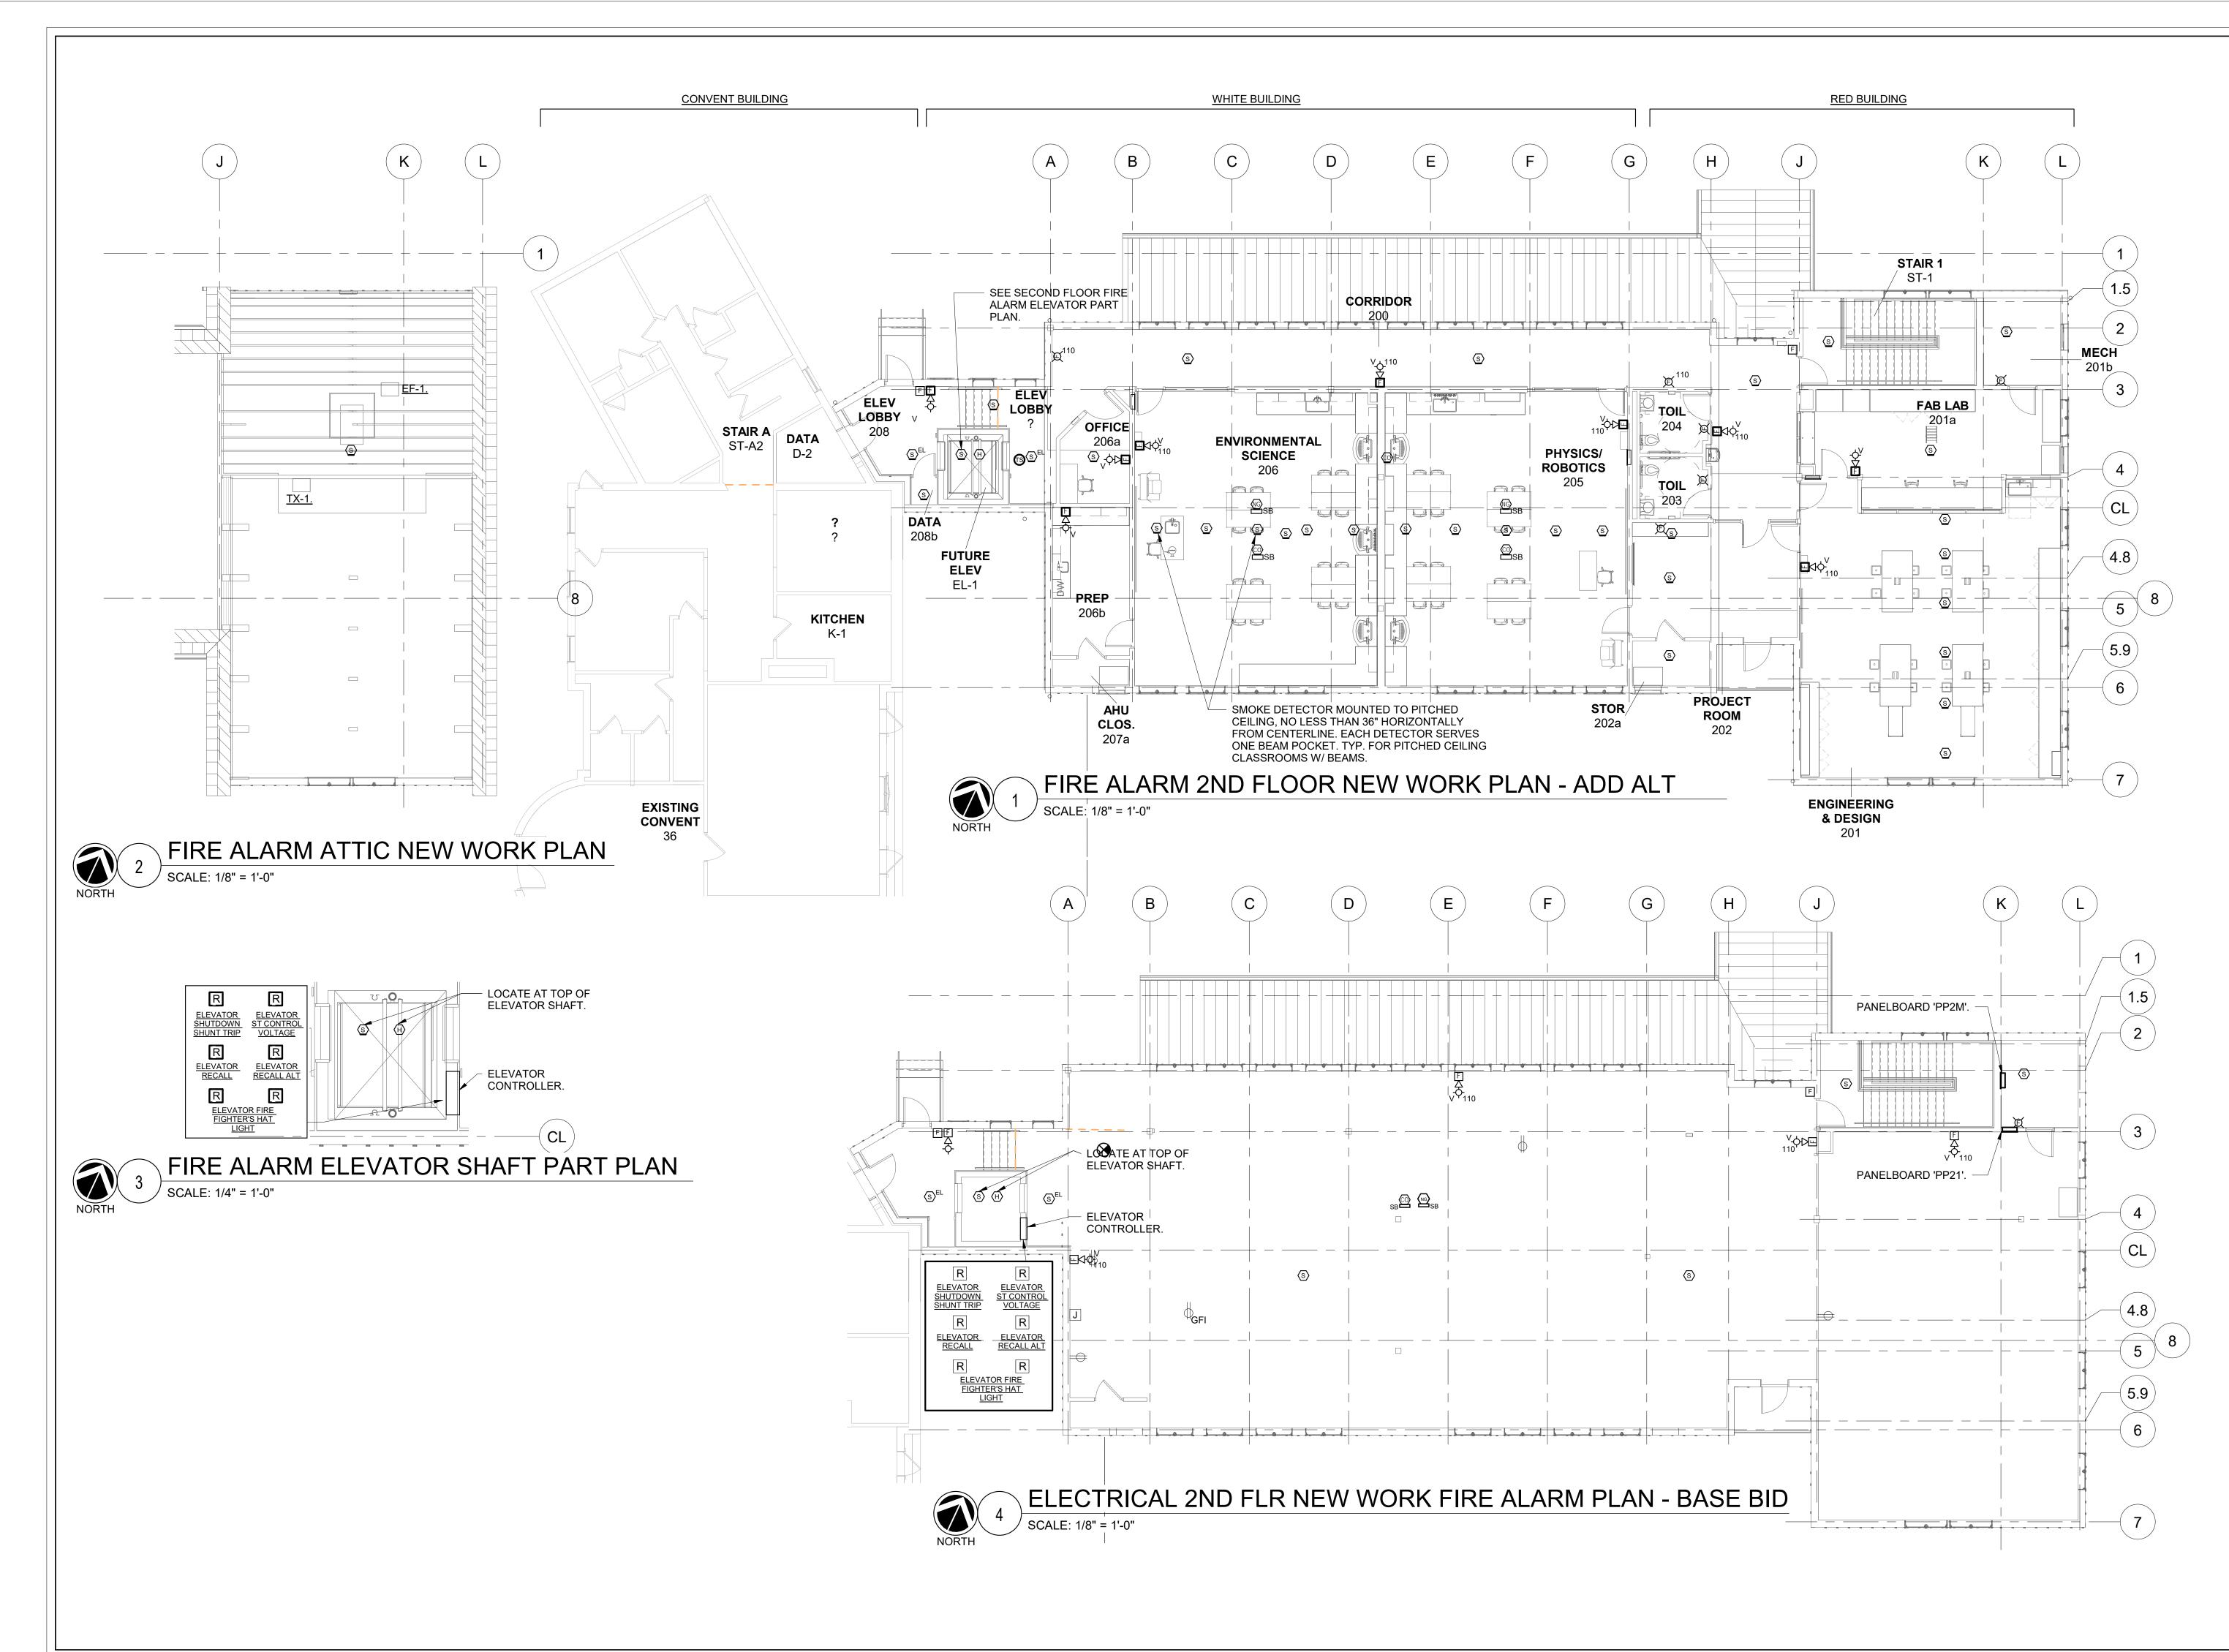

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FIRE ALARM 2ND		
WORK PLAN		
Job No. Date NKGD0214.00 02/10/2020		
NKGD0214.00     02/10/2020       Scale     Drawn / Checked       AS NOTED     NL / KS		
Sheet Number		
E402		

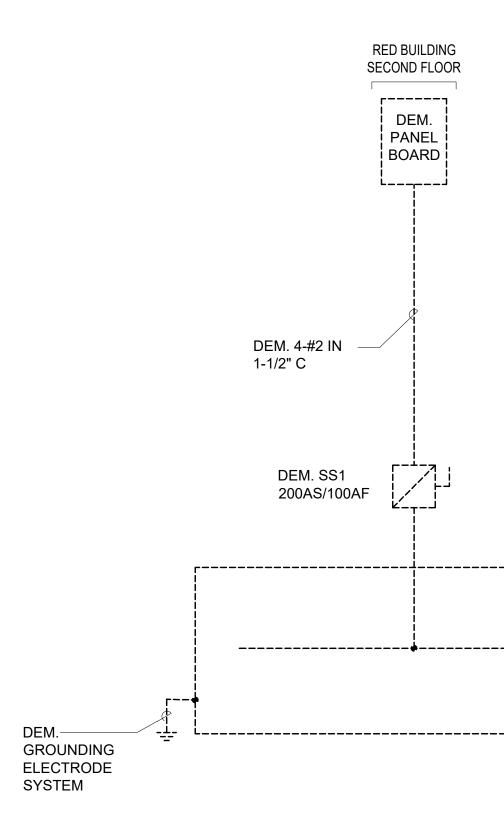

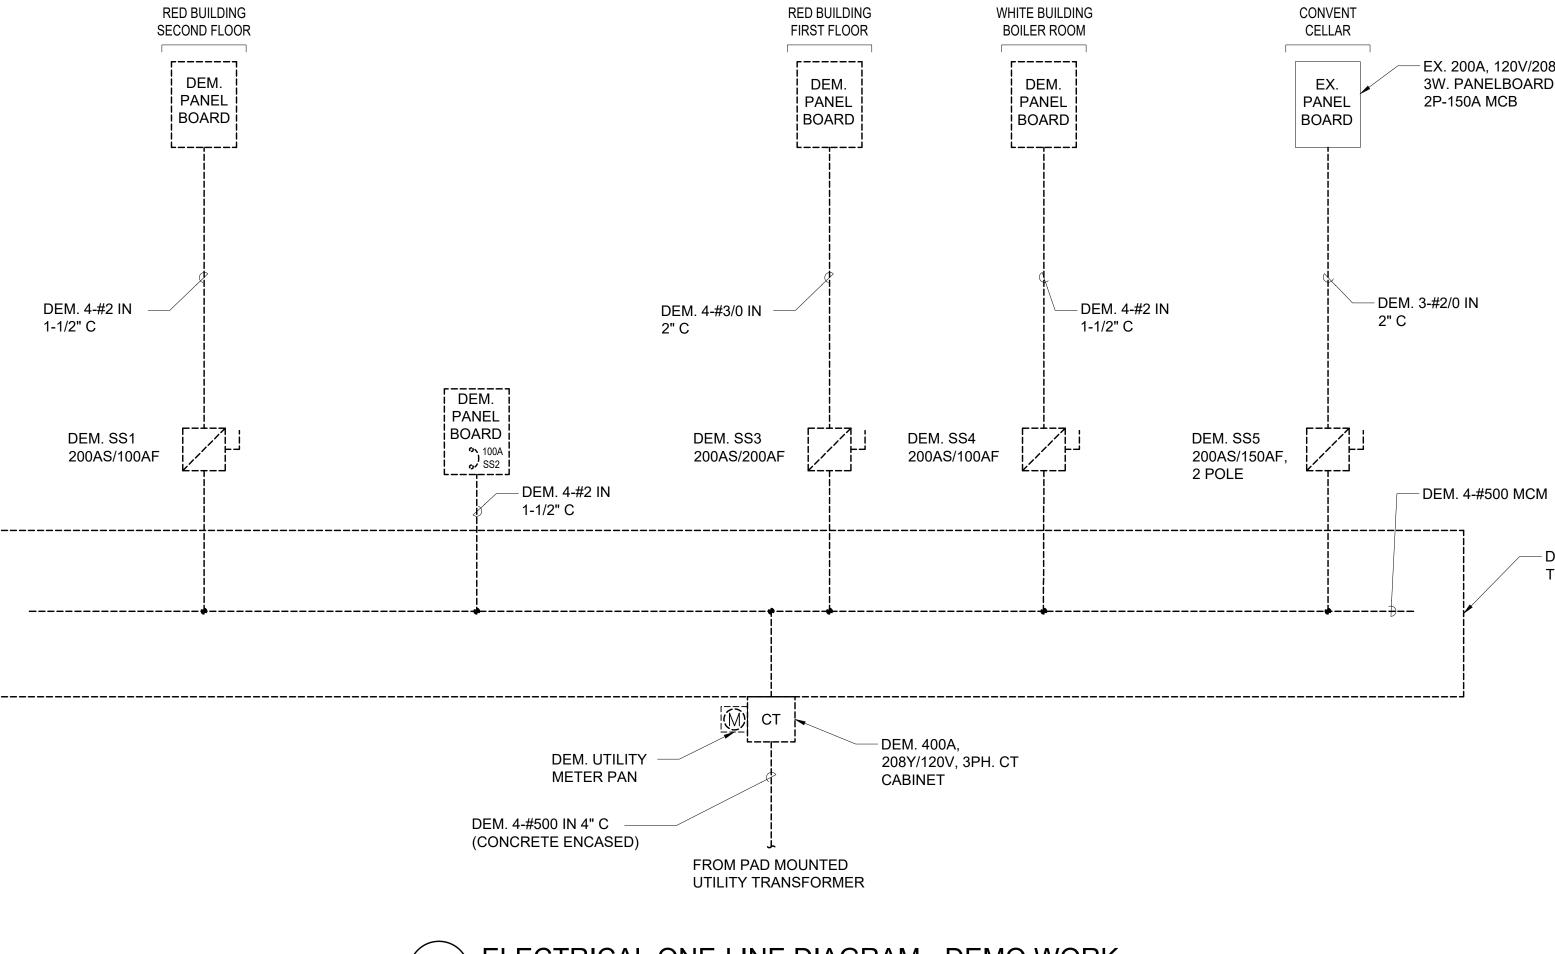

# ELECTRICAL ONE-LINE DIAGRAM - DEMO WORK

# NOTE:


1.) ALL SWITCHES AND CIRCUIT BREAKERS ARE 3 POLE, U.O.N. 2.) ALL EQUIPMENT IS LOCATED IN EXISTING BASEMENT ELECTRICAL ROOM U.O.N.

— EX. 200A, 120V/208Y. 1PH. 3W. PANELBOARD WITH

- DEM. TROUGH

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ONE-LINE DIAGRAM
DEMO WORK
Job No. Date
Job No.     Date       NKGD0214.00     06/25/2021       Scale     Drawn / Checked
AS NOTED NL/DS
E501

## ROOF

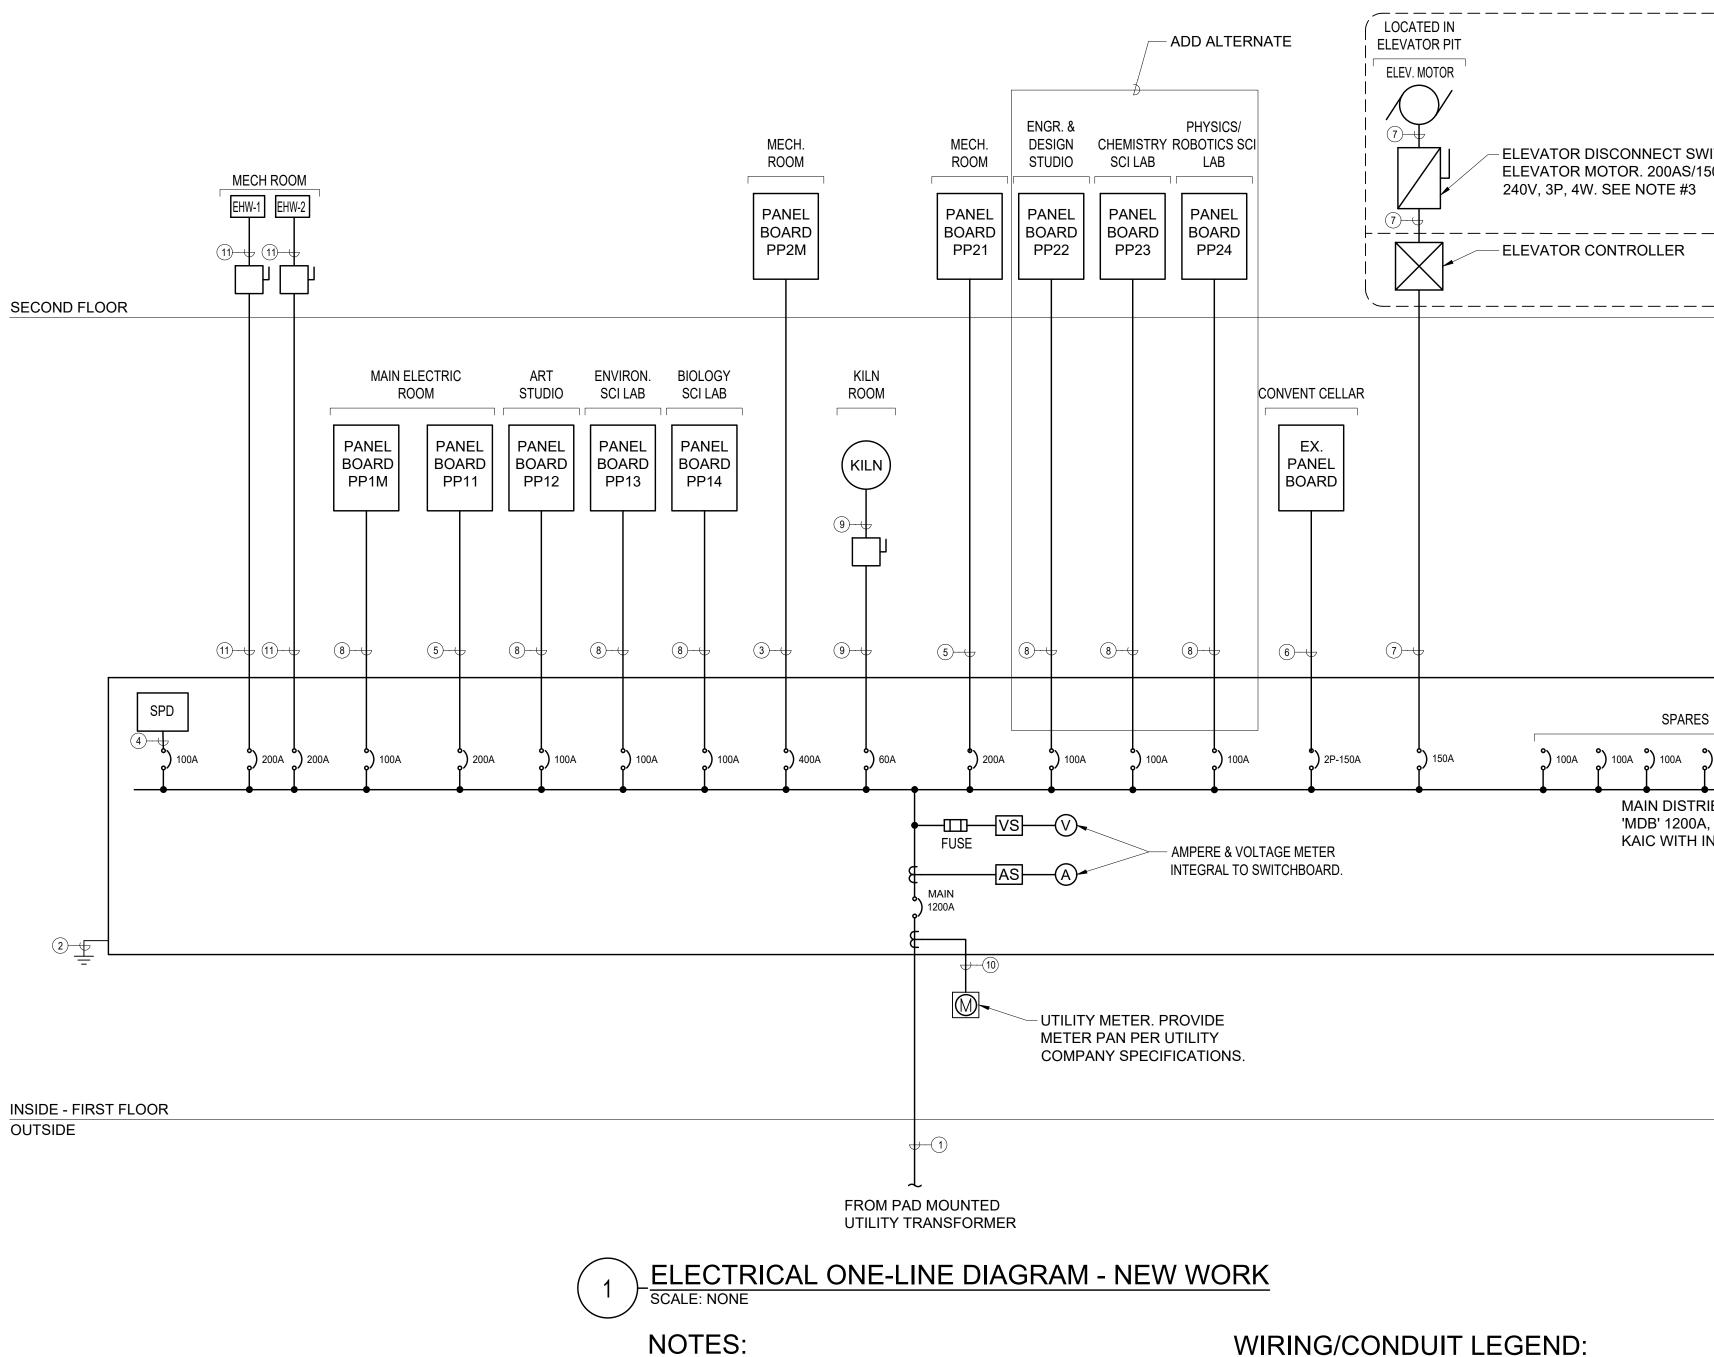

INSIDE - FIRST FLOOR OUTSIDE

1.) ALL SWITCHES AND CIRCUIT BREAKERS ARE 3 POLE, U.O.N.

2.) ALL EQUIPMENT TO BE INSTALLED IN THE MAIN ELECTRICAL ROOM U.O.N.

3.) ELEVATOR DISCONNECT SWITCH TO HAVE THE CAPABILITY TO BE LOCKED IN THE OPEN POSITION. PROVIDE WITH AUXILIARY CONTACT FOR AUTOMATIC LOWERING DEVICE. MOUNT SWITCH ON STRIKE SIDE OF EMR DOOR, ADJACENT TO LIGHT SWITCH. PROVIDE WITH SHUNT TRIP CAPABILITY AND 2-NO & 2-NC AUXILIARY CONTACTS IN NEMA 1 ENCLOSURE FOR ELEVATOR MOTOR.

4.) PANELBOARDS FED WITH 100A FEEDERS SHALL BE RATED 125A, 208Y/120V, 3Ø, 4W PANELBOARD.

5.) PANELBOARDS FED WITH 200A FEEDERS SHALL BE RATED 225A, 208Y/120V, 3Ø, 4W PANELBOARD.

# WIRING/CONDUIT LEGEND:

- (1) (4) SETS OF 4-#500 MCM IN (4) 4"C
- (2) #3/0 SERVICE GROUND. REFER TO DETAIL
- #12 ON DWG. E701. 3 4-#500 MCM & 1-1/0 GND IN 3"C
- 4 5-#2 IN 1-1/2"C
- (5) 4-#3/0 & 1-#6 GND IN 2"C
- (6) 3-#1/0 & 1-#6 GND IN 1-1/2"C
- (7) 3-#1 & 1-#1 GND IN 1-1/2"C
- (8) 4-#2 & 1-#8 GND IN 1-1/4"C
- (9) 3-#4 & 1-#10 GND IN 1-1/4"C
- (10) WIRE AND CONDUIT AS REQUIRED.
- (11) 3-#3/0 & 1-#6 GND IN 2"C

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/ITCH AT 50AF,	P:914.666.5900 KGDARCHITECTS.COM
LOCATED IN ELEVATOR SHAFT 	ISSUED FOR CONSTRUCTION
S 200A 2 200A 2 200A	
IBUTION SWITCH BOARD , 208Y/120V, 3PH. 4W, 65 NTEGRAL SPD.	KEY PLAN NOTE: ALL IDEAS, DESIGNS, ARRANGEMENTS AND PLANS INDICATED OR REPRESENTED BY THIS DRAWING ARE OWNED BY AND ARE THE PROPERTY OF
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	Job No.DateNKGD0214.0006/25/2021ScaleDrawn / CheckedAS NOTEDNL/DSSheet Number
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г----r----г----i \_-----DEM. MAIN FIRE ALARM ZONED CONTROL PANEL ┛┛┛┛╾╾┷┺┹╾╾╾╴ ⊢−−−-\_\_\_\_ -----DEM. ----RADIONICS D8024 FACP -----·----۶ ----DEM. TWO DEDICATED ------PHONE LINES FOR -----CENTRAL STATION \_\_\_\_ COMMUNICATIONS. -----DEM. BATTERY BACKUP. \_\_\_\_\_ ------------DEM. GROUND MAIN —— BUILDING GROUNDING SYSTEM. └└────── L\_\_\_\_\_ L\_\_\_\_\_ L\_\_\_\_\_ L\_\_\_\_\_

BASEMENT


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2ND FLOOR

RED/WHITE BUILDING	CONVENT
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(1) - FIRE ALARM RISER DIAGRAM - DEMO WORK	$- \underbrace{S \rightarrow H \rightarrow S }$ $- \underbrace{F \rightarrow F}$

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	Job No. Date NKGD0214.00 06/25/2021 Scale Drawn / Checked AS NOTED NL/DS
	Sheet Number E503

\_**F**→

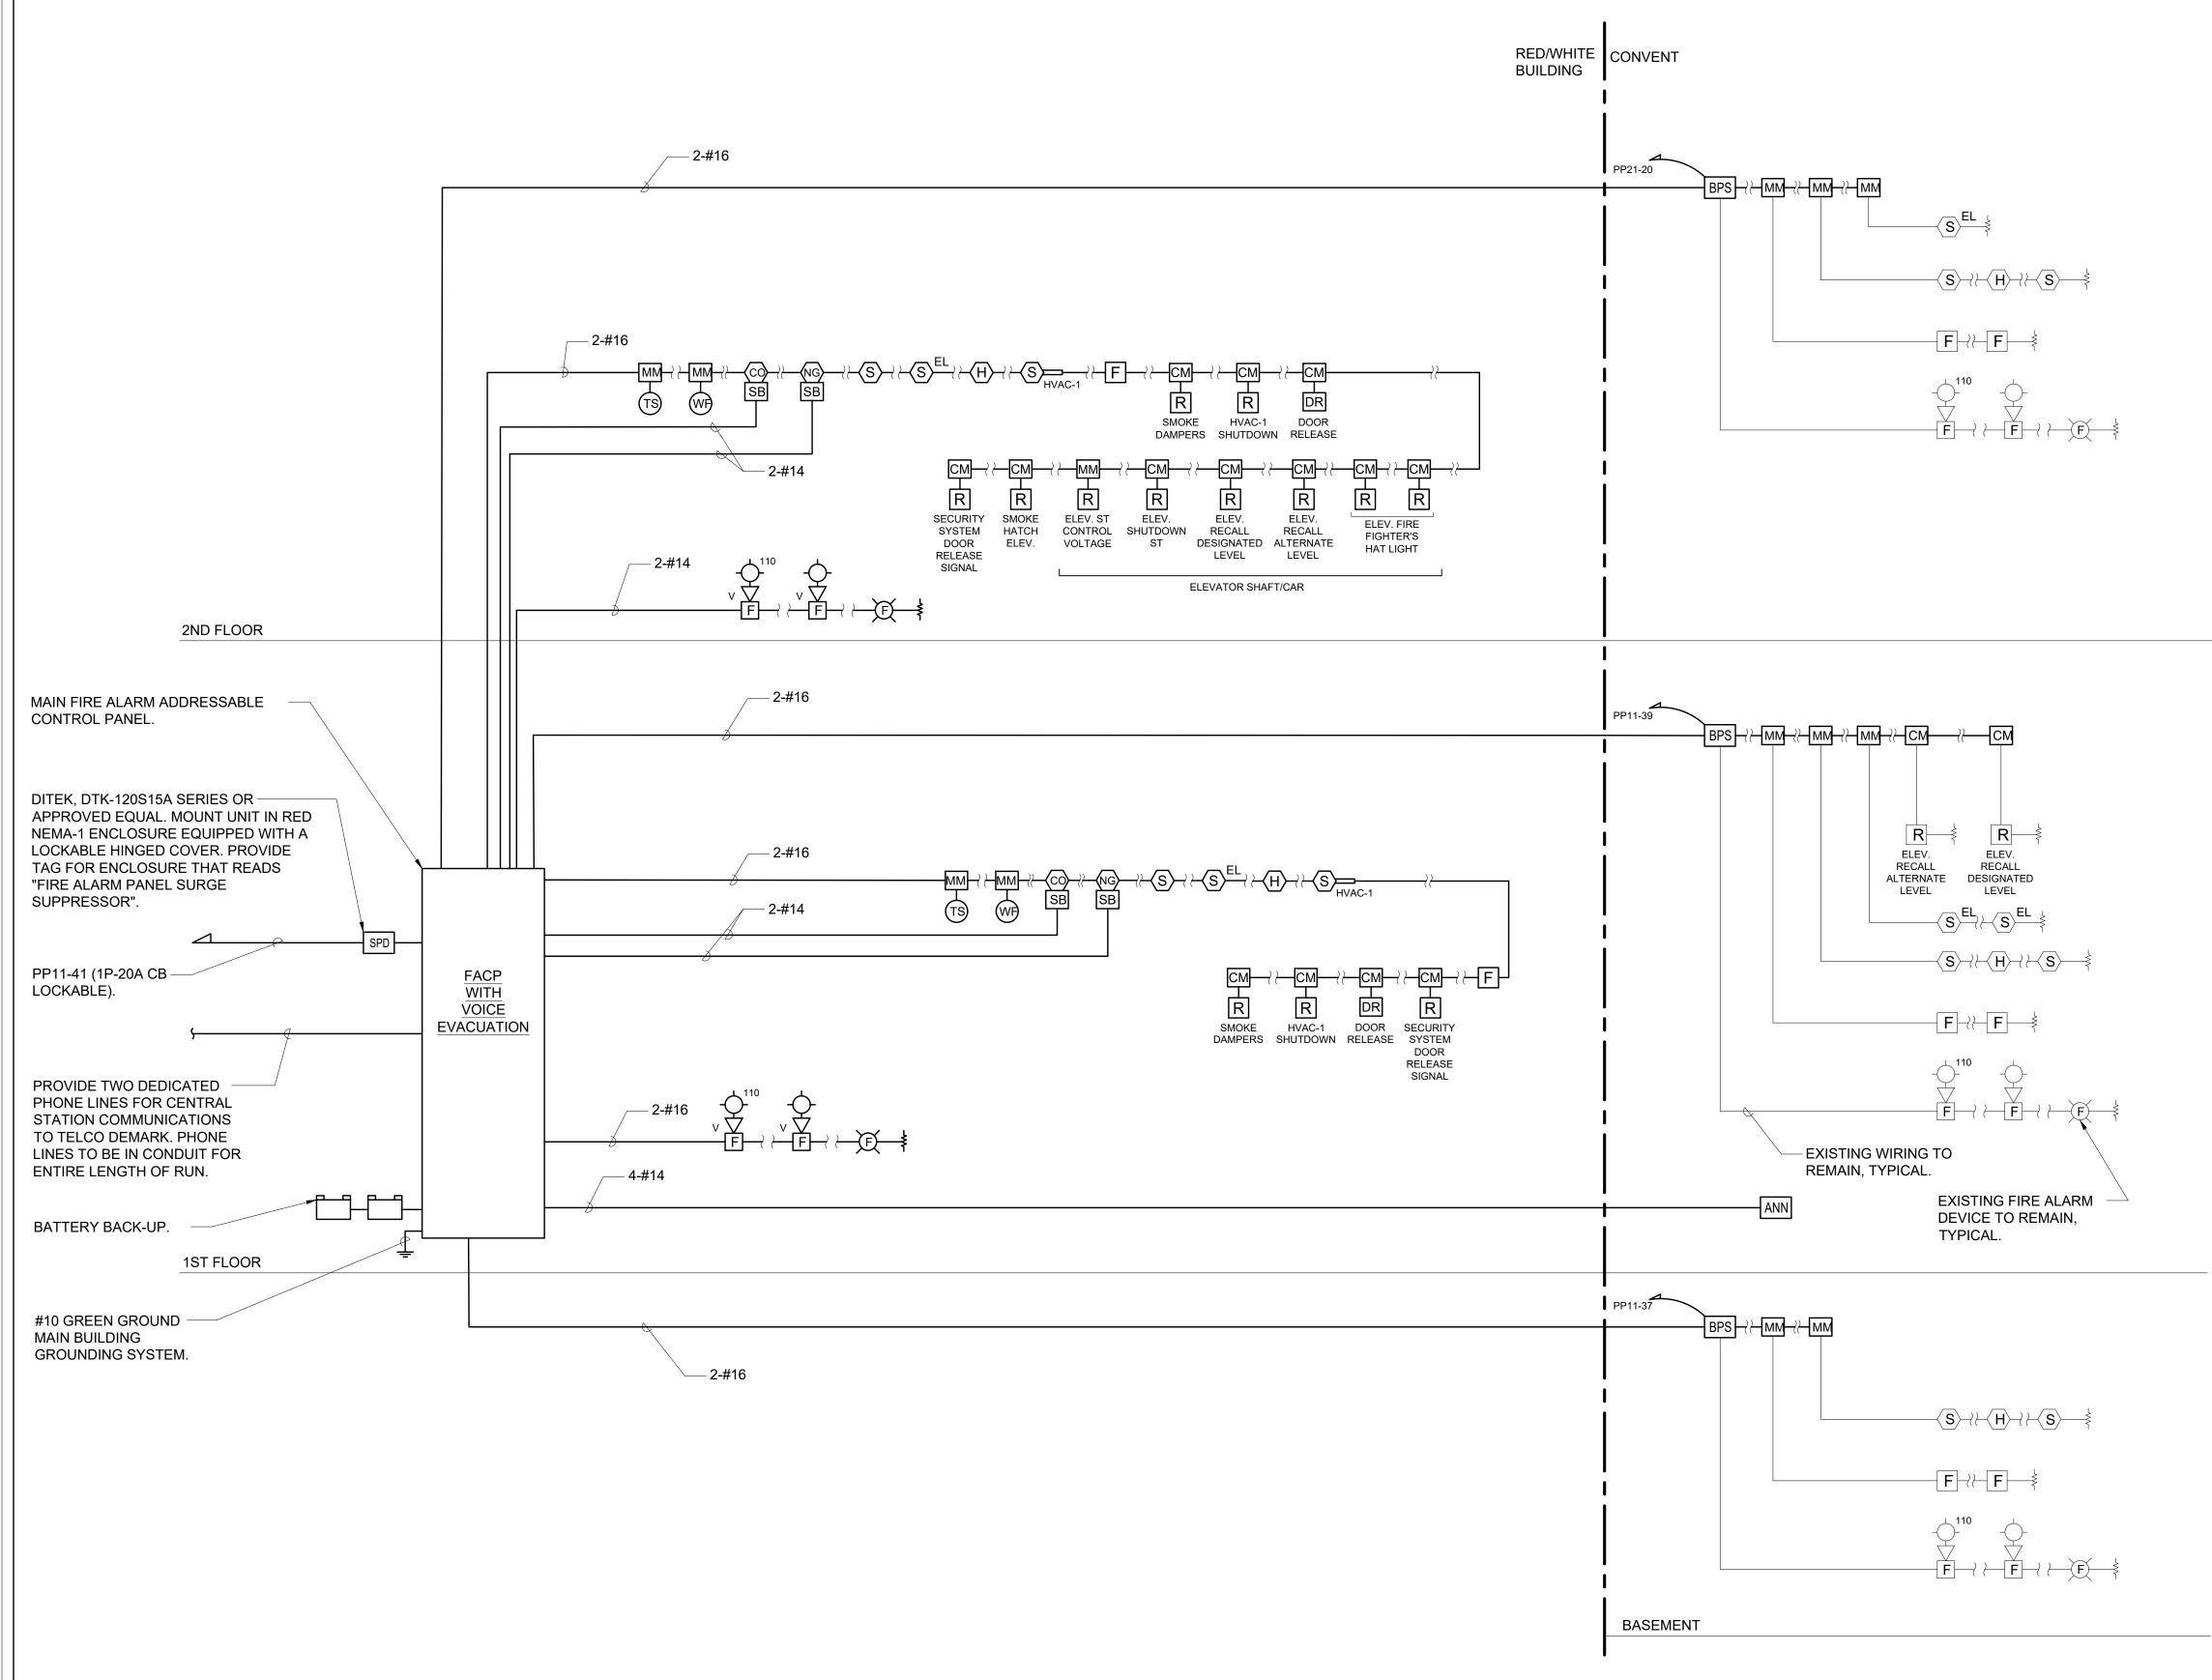

1 - FIRE ALARM RISER DIAGRAM - NEW WORK SCALE: NONE

# **RISER NOTES**:

1.) THIS IS NOT A POINT-TO-POINT WIRING DIAGRAM. PRIOR TO STARTING ANY WORK, A WORKING POINT-TO-POINT WIRING DIAGRAM SHALL BE OBTAINED FROM FIRE ALARM SYSTEM VENDOR AND PERFORM ALL WORK IN ACCORDANCE WITH THAT DIAGRAM.

2.) ELECTRICAL CONTRACTOR SHALL INCLUDE IN THE BASE BID ALL 120V CIRCUITS THAT ARE REQUIRED TO SUPPORT THE OPERATION OF THE FIRE ALARM SYSTEM. COORDINATE REQUIREMENTS WITH THE FIRE ALARM VENDOR.

3.) QUANTITY OF STROBE BOOSTER POWER SUPPLY PANELS AND ASSOCIATED 120V CIRCUITS SHALL BE COORDINATED WITH SELECTED FIRE ALARM SYSTEM MANUFACTURER AND/OR FIRE ALARM VENDOR.

4.) PROVIDE ALL NECESSARY WIRING, MODULES, COMPONENTS, EXTENDER CABINET, AND PROGRAMMING REQUIRED TO CONNECT EXISTING DEVICES TO NEW SYSTEM.

5.) PROVIDE ALL NECESSARY HARDWARE AND PROGRAMMING TO PROVIDE THE CLIENT WITH 20% SPARE CAPACITY ON ALL INITIATING AND INDICATING CIRCUITS.

6.) PROVIDE AS PART OF THE BASE CONTRACT ALL LABOR AND MATERIALS TO INSTALL FIFTEEN (15) ADDITIONAL FIRE ALARM DEVICES DURING CONSTRUCTION. THE FIFTEEN (15) FIRE ALARM DEVICES CAN BE BUT NOT LIMITED TO SMOKE DETECTOR, HEAT DETECTOR, DOOR HOLDER, DUCT DETECTOR, FAN SHUTDOWN, TAMPER SWITCHES, FLOW SWITCHES, ETC. INCLUDE ALL LABOR AND MATERIALS INCLUDING WIRE, BOXES, CONDUIT, TERMINATIONS, HARDWARE, SOFTWARE, PROGRAMMING AND TESTING.

7.) HEAT DETECTORS IN ELEVATOR MACHINE ROOM AND/OR SHAFT SHALL HAVE A LOWER TEMPERATURE RATING THAN THE NEARBY SPRINKLER HEAD(S). HEAT DETECTORS SHALL BE INSTALLED 2'-0" MAXIMUM AWAY FROM EACH SPRINKLER HEAD IN THE ELEVATOR MACHINE ROOM AND EACH HEAD LOCATED GREATER THAN 2'-0" ABOVE THE FLOOR OF THE ELEVATOR SHAFT. UPON ACTIVATION OF A HEAT DETECTOR USED FOR ELEVATOR POWER SHUTDOWN, THERE SHALL BE A DELAY IN THE ACTIVATION OF THE POWER SHUNT TRIP. THIS DELAY SHALL BE THE TIME THAT IT TAKES THE ELEVATOR CAB TO TRAVEL FROM THE TOP OF THE HOISTWAY TO THE LOWEST RECALL LEVEL. COORDINATE WITH ELEVATOR CONTRACTOR.

8.) DUCT SMOKE DETECTORS SHALL BE FURNISHED AND WIRED BY ELECTRICAL CONTRACTOR AND INSTALLED IN DUCT WORK BY MECHANICAL CONTRACTOR.

9.) CARBON MONOXIDE DETECTORS SHALL BE SUPERVISED BY FIRE ALARM SYSTEM AND SHALL NOT SEND AN ALARM SIGNAL TO THE SYSTEM. THESE DETECTORS SHALL BE MOUNTED ON SOUNDER BASES WHICH PROVIDE LOCAL ALARM ONLY IN A TEMPORAL 4 PATTERN OR CONSTANT TONE.

10.) NATURAL GAS DETECTORS SHALL BE SUPERVISED BY FIRE ALARM SYSTEM BUT SHALL NOT SEND AN ALARM SIGNAL TO THE SYSTEM. THESE DETECTORS SHALL CONTAIN INTERNAL HORNS TO PROVIDE LOCAL ALARM ONLY.

11.) ALL VISUAL ALARM DEVICES SHALL BE ADA COMPLIANT.

12.) ELECTRICAL CONTRACTOR TO PROVIDE A RELAY FOR EACH SMOKE DAMPER/COMBINATION FIRE SMOKE DAMPER. RELAYS ARE NOT SHOWN ON PLANS FOR CLARITY.

13.) PROVIDE REMOTE LED INDICATORS FOR ALL CONCEALED FIRE ALARM DEVICES SUCH AS DUCT SMOKE DETECTORS, ABOVE CEILING SMOKE DETECTORS, ELEVATOR SHAFT DETECTORS, MONITORING AND CONTROL MODULES, ETC. LED INDICATORS FOR DEVICES MOUNTED ABOVE DROP CEILINGS SHALL BE MOUNTED BELOW ASSOCIATED DEVICES. LABEL INDICATORS TO INDICATE DEVICE SERVED.

14.) CONTRACTOR TO PROVIDE SMOKE DETECTOR(S) IN ALL LOCATIONS CONTAINING FIRE ALARM CONTROL PANELS, DATA GATHERING PANELS, BOOSTER POWER SUPPLIES, OR ANY OTHER FIRE ALARM SYSTEM PANEL, WHETHER SHOWN ON PLANS OR NOT.

15.) CONTROL MODULES USED TO INITIATE EMERGENCY CONTROL FUNCTIONS THAT DO NOT FAIL IN A SAFE POSITION SHALL BE LOCATED WITHIN 3 FEET OF THE COMPONENT CONTROLLING THE EMERGENCY CONTROL FUNCTION PER NFPA 72. THIS INCLUDES, BUT IS NOT LIMITED TO, CONTROL MODULES CONNECTED TO FAN MOTOR CONTROLLERS, ELEVATOR CONTROLLERS, ETC.

16.) BATTERY BACKUP FOR FACP SHALL PROVIDE A MINIMUM OF 24 HOURS OF STAND BY POWER FOLLOWED BY 45 MINUTES OF ALARM.

17.) ALL FIRE ALARM PANELS, JUNCTION BOX COVERS, ETC SHALL BE PAINTED "FIRE DEPARTMENT RED".


# STREAM Center for Experiential Learning

SCHOOL OF THE HOLY CHILD

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ISSUED FOR CONSTRUCTION

KEY PLAN

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Professional Seal

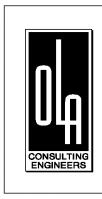7	08/12/2021	Issued for Construction
6	06/25/2021	Issued for Permit
5	02/24/2021	Issued for Bid
4	02/10/2021	Issued for Review
3	5/14/2020	90% Construction Documents
2	2/21/2020	Design Development
1	12/18/2019	Schematic Design
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FIXTURE	MANUFACTURER	CATALOG NUMBER	LAMPS	VOLTS	MOUNTING	REMARKS
		CATALOG NUMDER	LAIVIFO	VULIS		ΠΕΙΝΙΑΓΙΟ
INTERIOR		12-0-1-L-C-C-Q-E				'JUMP'. LINEAR LED. TO BE SUSPENDED ALONG BOTTOM CHORI
A	LEDALITE	-16-N-D-E 12-0-1-L-C-C-Q-E	45.6W/4FT LED 80 CRI/3000K	UNV	SUSPENDED	OF TRUSSES WITH AIRCRAFT CABLE. PROVIDE WITH INTEGRAL BATTERY WHERE DESIGNATED BY "EM". COORDINATE FINISH,
A1		-20-N-D-E	4900 LM/4FT 13W/56W LED			MOUNT TYPE AND SUSPENSION HEIGHT WITH ARCHITECT.
В	DELRAY	IL7801-1050-W30-1 -D-W11-EM	UP/DOWN 3000K 2275/5400 LM	120	SUSPENDED	'INDUSTRIAL'. LOW BAY LED WITH UP AND DOWN LIGHTING, HOUSED IN DIE-CAST ALUMINUM. STANDARD 6FT POWER CORE OR SPECIFY FOR ADDITIONAL LENGTH. PROVIDE WITH INTEGRAL BATTERY WHERE DESIGNATED BY "EM".
С	PHILIPS	C6-R-EM/C6-L-25-8-30-M- Z10/C6-R-DL-CC	21.3W LED 3500K 2454 LM	UNV	RECESSED	'LIGHTOILER'. 2'X2' RECESSED PLENUM LUMINAIRE. FRAME: 6R-N-EM; TRIM: C6-R-DL-CC. PROVIDE WITH INTEGRAL BATTERY WHERE DESIGNATED BY "EM".
D	DELRAY	KLS33-3-W30-D- EM-120	33W LED 92 CRI 3000 LM	120	SURFACE	'KONE3 KLS33'. SEMI-RECESSED DOWNLIGHT. PROVIDE WITH INTEGRAL BATTERY WHERE DESIGNATED BY "EM".
E	3G LIGHTING	3G-DL33RF70-15-S80- 30K-60D-UNV- DIM-WT-NCF-SF70	14W LED 80 CRI 1484LM	120	RECESSED	PROVIDE WITH INTEGRAL BATTERY WHERE DESIGNATED BY "EM".
F/F1	PHILIPS	2-ST-G-30L-830- 2-DS-UNV-DIM-EMLED	26.3W LED 80 CRI/3000K 3000 LM	UNV	RECESSED	'DAY-BRITE CFI'. 2'X2' RECESSED PLENUM LUMINAIRE. PROVIDE WITH INTEGRAL BATTERY WHERE DESIGNATED BY "EM".
G	FOCAL POINT	FSM2L-FL-125LF- 30K-1C-UNV-LD1- CXF2-EM-WH	5W/4FT LED 80 CRI/3000K 125 LM/1FT	UNV	RECESSED	'SEEM 2'. RECESSED, WALL TO CEILING CORNER, LED LUMINAIRE. PROVIDE WITH INTEGRAL BATTERY WHERE DESIGNATED BY "EM".
Н	WAC	WS-77624-30-AL	20W LED 3000K 1440 LM	UNV	WALL	'BRINK'. BATHROOM SCONCE. HOUSED IN ALUMINUM WITH BRUSHED FINISH. PROVIDE WITH INTEGRAL BATTERY WHERE DESIGNATED BY "EM".
J	HUBBARDTON FORGE	302711-1000	50W INCANDESCANT PAR20 BULB	120	WALL	'HENRY DARK SKY FRIENDLY OUTDOOR SCONCE'. OUTDOOR GOOSENECK SCONCE. UL OUTDOOR RATED. INCANDESCENT LAMPING MAX 50W, BULB NOT INCLUDED. PROVIDE WITH REMOTE MINI-INVERTER BATTERY WHERE DESIGNATED BY "EM
К	HUBBARDTON FORGE	363010-1010	100W INCANDESCANT A19 BULB	120	PENDANT	'HENRY OUTDOOR PENDANT'. OUTDOOR PENDANT FIXTURE . U OUTDOOR RATED. INCANDESCENT LAMPING 100W MAX, BULB NOT INCLUDED. PROVIDE WITH REMOTE MINI-INVERTER BATTERY WHERE DESIGNATED BY "EMI".
L	PHILIPS	LBX-40L-835-UNV- FD-EMLED	31W LED 80 CRI/3000K 4000 LM/4FT	UNV	SURFACE	'LINEAR LBX'. LINEAR SURFACE MOUNT LED. PROVIDE WITH INTEGRAL BATTERY WHERE DESIGNATED BY "EM".
Μ	OXYGEN	32-601-24-EM	21.2W LED 90 CRI/3000K 1110 LM	UNV	SURFACE	'PEEPERS'. SCONCE LED MOUNTED WITHIN STAIRWELL. PROVIDE WITH INTEGRAL BATTERY WHERE DESIGNATED BY "EM".
$\mathbf{X}$	LITHONIA LIGHTING	EDGR-1-R-EL	3.8W LED	UNV	SURFACE	LED EXIT SIGN WITH 90 MINUTES OF BATTERY BACKUP TIME. 8" RED LETTERS ON CLEAR BACKGROUND.
EXTERIOR						
A	SPECTRUM LIGHTING INC.	WS1611GV -27L35K-EX	18W LED 3500K 2700 LM	UNV	SURFACE	'WAREHOUSE'. EXTERIOR RATED LED MOUNTED OUTSIDE BUILDING.
В	SPRING CITY	ALMYRK-M2-LE040/ EVX/X2-30-CR3 -YSDP-FBR-CU	40W LED 3000K	120-277	POLE	'YORKTOWN'. POLE MOUNTED LED LUMINAIRE ON SITE.

# NOTES:

1.) VERIFY ALL FIXTURE CATALOG NUMBERS FOR INTENDED APPLICATIONS WITH REQUIRED ACCESSORIES. 2.) ALL BALLASTS IN FIXTURES LOCATED OUTDOORS SHALL BE ZERO DEGREE RATED STARTING TEMPERATURE. REFER TO DRAWINGS FOR LOCATION OF FIXTURES. 3.) ALL EXIT AND EMERGENCY FIXTURES SHALL BE FED FROM UNSWITCHED LEG OF ASSOCIATED LOCAL LIGHTING CIRCUITS. 4.) LIGHT FIXTURES INDICATED AS EMERGENCY (EM) ON DRAWINGS SHALL CONTAIN AN EMERGENCY BATTERY BACKUP BALLAST. WHERE POSSIBLE THE BALLAST SHALL BE INTERNAL TO THE FIXTURE WITH A VISUAL INDICATING CHARGE LAMP AND TEST SWITCH. IF IT IS NOT POSSIBLE TO INSTALL THE EMERGENCY BATTERY BALLAST IN THE FIXTURE, THE CONTRACTOR SHALL FURNISH & INSTALL A REMOTE EMERGENCY BALLAST. EACH BATTERY PACK SHALL BE CONNECTED SO THAT THE FIXTURE CAN BE SWITCHED UNDER NORMAL CONDITIONS AND IN THE EVENT OF A POWER OUTAGE, THE BATTERY PACK SHALL BE CONNECTED SO THAT THE FIXTURE CAN BE SWITCHED UNDER NORMAL CONDITIONS AND IN THE EVENT OF A POWER OUTAGE, THE BATTERY PACK AND FLORESCENT LAMPS SHALL AUTOMATICALLY ILLUMINATE FOR 90 MINUTES WITH A 1200 LUMEN OUTPUT (TOTAL FROM FIXTURE), MINIMUM. 5.) IN THE EVENT THE CONTRACTOR CHOOSES TO SUBSTITUTE LIGHT FIXTURES FOR THOSE THAT ARE SPECIFIED ON THE LIGHT FIXTURE SCHEDULE, THE CONTRACTOR SHALL SUBMIT POINT-TO-POINT PHOTOMETRIC CALCULATIONS FOR ALL AREAS WHERE THE SUBSTITUTED FIXTURES ARE INDICATED TO BE INSTALLED ON THE DRAWINGS. THESE CALCULATIONS SHALL BE SUBMITTED ALONG WITH THE LIGHT FIXTURE SHOP DRAWINGS.

_[(	GHTING SYSTEM FUNCTIONAL TESTING/COMMISSION
I.	FUNCTIONAL TESTING
	OR TO PASSING FINAL INSPECTION, THE CONTRACTOR SHALL PROVIDE EVIDENCE TO TH /NER AND THE ENGINEER THAT THE LIGHTING CONTROL SYSTEMS HAVE BEEN TESTED TO EN NTROL HARDWARE AND SOFTWARE ARE CALIBRATED, ADJUSTED, PROGRAMMED AND ORKING CONDITION IN ACCORDANCE WITH THE CONSTRUCTION DOCUMENTS AND MANUF CUMENTS. FUNCTIONAL TESTING, FOR THE APPLICABLE CONTROL TYPE, SHALL BE IN ACCORD E FOLLOWING:
1.	OCCUPANT SENSOR CONTROLS
	IERE OCCUPANT SENSOR CONTROLS ARE PROVIDED, THE FOLLOWING PROCEDURES RFORMED:
	CERTIFY THAT THE OCCUPANT SENSOR HAS BEEN LOCATED AND AIMED IN ACCORD MANUFACTURER RECOMMENDATIONS. FOR PROJECTS WITH SEVEN OF FEWER OCCUPANT SENSORS, EACH SENSOR SHALL BE TEST FOR PROJECTS WITH MORE THAN SEVEN OCCUPANT SENSORS, TESTING SHALL BE DONE UNIQUE COMBINATION OF SENSOR TYPE AND SPACE GEOMETRY. WHERE MULTIPLES OF EA COMBINATION OF SENSOR TYPE AND SPACE GEOMETRY ARE PROVIDED, NOT LESS THAN 1 BUT IN NO CASE LESS THAN ONE, OF EACH COMBINATION SHALL BE TESTED UNLESS TH OFFICIAL OR DESIGN PROFESSIONAL REQUIRES A HIGHER PERCENTAGE TO BE TESTED. PERCENT OR MORE OF THE TESTED CONTROLS FAIL, ALL REMAINING IDENTICAL COMBINAT BE TESTED.
	R OCCUPANT SENSOR CONTROLS TO BE TESTED, VERIFY THE FOLLOWING: WHERE OCCUPANT SENSOR CONTROLS INCLUDE STATUS INDICATORS, VERIFY
	CORRECT OPERATION. ii. THE CONTROLLED LIGHTS TURN OFF OR DOWN TO THE PERMITTED LEVEL WITHIN THE REQU iii. FOR AUTO-ON OCCUPANT SENSOR CONTROLS, THE LIGHTS TURN ON TO THE PERMITTED L AN OCCUPANT ENTERS THE SPACE. iv. FOR MANUAL-ON OCCUPANT SENSOR CONTROLS, THE LIGHTS TURN ON ONLY WHEN
	ACTIVATED. v. THE LIGHTS ARE NOT INCORRECTLY TURNED ON BY MOVEMENT IN ADJACENT AREAS O OPERATION.
2.	
WF	IERE TIME-SWITCH CONTROLS ARE PROVIDED, THE FOLLOWING PROCEDURES SHALL BE PERF
	CONFIRM THAT THE TIME-SWITCH CONTROL IS PROGRAMMED WITH ACCURATE WEEKDAY, WE
C. D. E. F.	<ul> <li>HOLIDAY SCHEDULES.</li> <li>PROVIDE DOCUMENTATION TO THE OWNER OF TIME-SWITCH CONTROLS PROGRAMMING WEEKDAY, WEEKEND, HOLIDAY SCHEDULES, AND SET-UP AND PREFERENCE PROGRAM SETT VERIFY THE CORRECT TIME AND DATE IN THE TIME SWITCH.</li> <li>VERIFY THAT ANY BATTERY BACK-UP IS INSTALLED AND ENERGIZED.</li> <li>VERIFY THAT THE OVERRIDE TIME LIMIT IS SET TO NOT MORE THAN 2 HOURS.</li> <li>SIMULATE OCCUPIED CONDITION. VERIFY AND DOCUMENT THE FOLLOWING:</li> <li>i. ALL LIGHTS CAN BE TURNED ON AND OFF BY THEIR RESPECTIVE AREA CONTROL SWITCH.</li> <li>ii. THE SWITCH ONLY OPERATES LIGHTING IN THE ENCLOSED SPACE IN WHICH THE SWITCH IS SIMULATE UNOCCUPIED CONDITION. VERIFY AND DOCUMENT THE FOLLOWING:</li> <li>i. NONEXEMPT LIGHTING TURNS OFF.</li> <li>ii. MANUAL OVERRIDE SWITCH ALLOWS ONLY THE LIGHTS IN THE ENCLOSED SPACE V OVERRIDE SWITCH IS LOCATED TO TURN ON OR REMAIN ON UNTIL THE NEXT SCHEDULE</li> </ul>
<b>з</b> г	OCCURS.
	IERE DAYLIGHT RESPONSIVE CONTROLS ARE PROVIDED, THE FOLLOWING SHALL BE VERIFIED:
B.	CONTROL DEVICES HAVE BEEN PROPERLY LOCATED, FIELD CALIBRATED AND SET FOR ACC POINTS AND THRESHOLD LIGHT LEVELS. DAYLIGHT CONTROLLED LIGHTING LOADS ADJUST TO LIGHT LEVEL SET POINTS IN RE AVAILABLE DAYLIGHT.
C.	THE CALIBRATION ADJUSTMENT EQUIPMENT IS LOCATED FOR READILY ACCESS ONLY BY A PERSONNEL.
11.	DOCUMENTATION REQUIREMENTS
	E DOCUMENTS DESCRIBED IN THIS SECTION SHALL BE PROVIDED TO THE BUILDING OWNER ( THORIZED AGENT WITHIN 60 DAYS OF THE DATE OF RECEIPT OF THE CERTIFICATE OF OCCUPA
A.	DRAWINGS: i. AS-BUILT CONSTRUCTION DOCUMENTS, SHOWING THE LOCATION AND CATALOG NUMBER PIECE OF EQUIPMENT.
B.	
	<ul> <li>NAME AND ADDRESS OF NOT LESS THAN ONE SERVICE AGENCY FOR INSTALLED EQUIPME</li> <li>A NARRATIVE OF HOW EACH SYSTEM IS INTENDED TO OPERATE, INCLUDING RECOMMEND POINTS.</li> </ul>
	iii. SUBMITTAL DATA INDICATING ALL SELECTED OPTIONS FOR EACH PIECE OF LIGHTING EQU AND LIGHTING CONTROLS.
	<ul> <li>iv. OPERATION AND MAINTENANCE MANUALS FOR EACH PIECE OF LIGHTING EQUIPMENT. RE ROUTINE MAINTENANCE ACTIONS, CLEANING AND RECOMMENDED RELAMPING SHALL BE ( IDENTIFIED.</li> <li>v. A SCHEDULE FOR INSPECTING AND RECALIBRATING ALL LIGHTING CONTROLS.</li> </ul>
C.	REPORT: A REPORT OF TEST RESULTS SHALL BE PROVIDED AND INCLUDE THE FOLLOWING.

- i. RESULTS OF FUNCTIONAL PERFORMANCE TESTS.
- ii. DISPOSITION OF DEFICIENCIES FOUND DURING TESTING, INCLUDING DETAILS OF CORRECTIVE MEASURES USED OR PROPOSED.

ING/COMMISSION	ING

PROVIDE EVIDENCE TO THE BUILDING MS HAVE BEEN TESTED TO ENSURE THAT USTED, PROGRAMMED AND IN PROPER ON DOCUMENTS AND MANUFACTURER'S OL TYPE, SHALL BE IN ACCORDANCE WITH

FOLLOWING PROCEDURES SHALL BE

ED AND AIMED IN ACCORDANCE WITH

EACH SENSOR SHALL BE TESTED. DRS, TESTING SHALL BE DONE FOR EACH TRY. WHERE MULTIPLES OF EACH UNIQUE PROVIDED, NOT LESS THAN 10 PERCENT, SHALL BE TESTED UNLESS THE BUILDING PERCENTAGE TO BE TESTED. WHERE 30 MAINING IDENTICAL COMBINATIONS SHALL

ITTED LEVEL WITHIN THE REQUIRED TIME. URN ON TO THE PERMITTED LEVEL WHEN

GHTS TURN ON ONLY WHEN MANUALLY

EMENT IN ADJACENT AREAS OR BY HVAC

PROCEDURES SHALL BE PERFORMED:

/ITH ACCURATE WEEKDAY, WEEKEND AND

CONTROLS PROGRAMMING INCLUDING PREFERENCE PROGRAM SETTINGS.

PACE IN WHICH THE SWITCH IS LOCATED. HE FOLLOWING:

IN THE ENCLOSED SPACE WHERE THE N UNTIL THE NEXT SCHEDULED SHUTOFF

ALIBRATED AND SET FOR ACCURATE SET

LEVEL SET POINTS IN RESPONSE TO

R READILY ACCESS ONLY BY AUTHORIZED

ED TO THE BUILDING OWNER OR OWNER'S THE CERTIFICATE OF OCCUPANCY.

TION AND CATALOG NUMBER OF EACH

BE PROVIDED AND INCLUDE THE

NCY FOR INSTALLED EQUIPMENT. ATE, INCLUDING RECOMMENDED SET

EACH PIECE OF LIGHTING EQUIPMENT

OF LIGHTING EQUIPMENT. REQUIRED ENDED RELAMPING SHALL BE CLEARLY

HTING CONTROLS.

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_	ARCHITECTS PC MOUNT KISCO . NEW YORK . 10549 KGDARCHITECTS.COM
CONSULTING ENGINEERS	OLA Consulting Engineers 50 Broadway, Hawthorne, NY 10532 914.747.2800 8 West 38th Street, Suite 501 New York, NY 10018 646.849.4110 olace.com
ISSUED F	FOR CONSTRUCTION
REPRESENTED BY THIS DRAV KAEYER, GARMENT, & DAVIDS FOR USE ON THIS PROJECT.	ARRANGEMENTS AND PLANS INDICATED OR VING ARE OWNED BY AND ARE THE PROPERTY OF SON ARCHITECTS, PC (KG&D), AND WERE CREATED NONE OF SUCH IDEAS, DESIGNS, ARRANGEMENTS Y OR DISCLOSED TO ANY PURPOSE WHATSOEVER WISSION OF (KG&D).
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7         08/12/2021           6         06/25/2021           5         02/24/2021           4         02/10/2021           3         5/14/2020           2         2/21/2020           1         12/18/2019           No.         Date           Sheet Title	Issued for Construction Issued for Permit Issued for Bid Issued for Review 90% Construction Documents Design Development Schematic Design Issue
	ECTRICAL
Job No. NKGD0214.0 Scale AS NOTED Sheet Number	Date 06/25/2021 Drawn / Checked NL / KS <b>E601</b>

	MAIN RATING: 100A	MA	IN C.B.:	<u>100A</u>		KAIC RATING: <u>22KAIC</u>
	VOLTAGE: <u>208Y/120V</u>	PH	ASE: <u>3</u>	WI	RE: <u>4</u>	MOUNTING: <u>RECESSED</u>
CIRC. NO.	LOAD DESCRIPTION	BKR. AMPS	NO. OF POLES	NO. OF POLES	BKR. AMPS	LOAD DESCRIPTION
1	LTG - ART RM/KILN	20	1	1	20	REC - KILN
3	REC - ART STOR	20	1	1	20	REC - KILN
5	REC - ART STOR	20	1	1	20	REC - ART STUDIO
7	REC - FLOOR	20	1	1	20	REC - ART STUDIO
9	REC - FLOOR	20	1	1	20	REC - ART STUDIO
11	SPARE	20	1	1	20	REC - ART STUDIO
13	SPARE	20	1	1	20	SPARE
15	SPARE	20	1	1	20	SPARE
17	SPARE	20	1	1	20	SPARE
19	SPARE	20	1	1	20	SPARE
21	SPARE	20	1	1	20	SPARE
23	SPARE	20	1	1	20	SPARE
25	SPARE	20	1	1	20	SPARE
27	SPARE	20	1	1	20	SPARE
29	SPARE	20	1	1	20	SPARE
	ROVIDE LOCKING TABS ON C.B.; GF ARC FAULT TYPE C.B.; ST - SHUNT T		′PE C.B.;	GP - GF	P TYPE	Е С.В.;

CIRC	E: <u>208Y/120V</u>	PH.					
CIRC.		111/	ASE: <u>3</u>	WI	RE: <u>4</u>	MOUNTING: <u>RECESSED</u>	
NO.	SCRIPTION	BKR. AMPS	NO. OF POLES	NO. OF POLES	BKR. AMPS	LOAD DESCRIPTION	CIF
1 LTG - BIO ROOM	1	20	1	1	20	REC - BIOLOGY	2
3 REC - PREP		20	1	1	20	REC - BIOLOGY	4
5 REC - PREP		20	1	1	20	REC - BIOLOGY	6
7 REC - DEMONSTRA	FION TABLE - BIOLOGY	20	1	1	20	REC - BIOLOGY	8
9 SPARE		20	1	1	20	REC - PREP REF	1
11 SPARE		20	1	1	20GF	REC - PREP DISHWASHER	1
13 SPARE		20	1	1	20	SPARE	1
15 SPARE		20	1	1	20	SPARE	1
17 SPARE		20	1	1	20	SPARE	1
19 SPARE		20	1	1	20	SPARE	2
21 SPARE		20	1	1	20	SPARE	2
23 SPARE		20	1	1	20	SPARE	2
25 SPARE		20	1	1	20	SPARE	2
27 SPARE		20	1	1	20	SPARE	2
29 SPARE		20	1	1	20	SPARE	3

	MAIN RATING: 100A	MA	IN C.B.:	<u>100A</u>		KAIC RATING: <u>22KAIC</u>	
	VOLTAGE: <u>208Y/120V</u>	PH	ASE: <u>3</u>	WI	RE: <u>4</u>	MOUNTING: <u>RECESSED</u>	
CIRC. NO.	LOAD DESCRIPTION	BKR. AMPS	NO. OF POLES	NO. OF POLES	BKR. AMPS	LOAD DESCRIPTION	CIRC NO.
1	LTG - CHEM RM	20	1	1	20	REC - CHEM RM	2
3	REC - CHEM RM	20	1	1	20	REC - CHEM RM	4
5	REC - CHEM RM	20	1	1	20	REC - CHEM RM	6
7	REC - CHEM RM	20	1	1	20	REC - CHEM RM	8
9	REC - CHEM RM	20	1	1	20	REC - PREP REF	10
11	REC - PREP	20	1	1	20GF	PREP DISHWASHER	12
13	REC - PREP	20	1	1	20	REC - CHEM RM - ICEMAKER	14
15	REC - PREP ICE	20	1	1	20	REC - DEMONSTRATION TABLE - CHEM	16
17	CHEM RM - FUME HOOD	20	1	1	20	SPARE	18
19	SPARE	20	1	1	20	SPARE	20
21	SPARE	20	1	1	20	SPARE	22
23	SPARE	20	1	1	20	SPARE	24
25	SPARE	20	1	1	20	SPARE	26
27	SPARE	20	1	1	20	SPARE	28
29	SPARE	20	1	1	20	SPARE	30
	PROVIDE LOCKING TABS ON C.B.; GI ARC FAULT TYPE C.B.; ST - SHUNT T ES:		ΈΕ C.B.;	GP - GF	P TYPE	E C.B.;	

	MAIN RATING: 100A	MA	NN C.B.:	<u>100A</u>		KAIC RATING: <u>42KAIC</u>	
	VOLTAGE: <u>208Y/120V</u>	PH	ASE: <u>3</u>	WI	RE: <u>4</u>	MOUNTING: <u>SURFACE</u>	
CIRC. NO.	LOAD DESCRIPTION	BKR. AMPS	NO. OF POLES	NO. OF POLES	BKR. AMPS	LOAD DESCRIPTION	CIRC NO.
1	REC - ELEC RM	20	1	1	20	LTG - STAIR	2
3	LTG - CORR/VEST/JAN/ELEC	20	1	1	20	LTG - STAIR	4
5	LTG - TOILETS	20	1	1	20	LTG - CORR/FACULTY	6
7	LTG - EXTERIOR	20	1	1	20	SPARE	8
9	REC - CORR	20	1	1	20	SPARE	10
11	REC - TOILET	20	1	1	20	SPARE	12
13	REC - CORR	20	1	1	20	SPARE	14
15	REC - CORR TV	20	1	1	20	REC - CREATIVE COMMONS	16
17	WATER FOUNTAIN - CORR	20	1	1	20	REC - CREATIVE COMMONS	18
19	CARD READER/ELEC STRIKE	20	1	1	20	REC - JAN	20
21	CARD READER/ELEC STRIKE	20	1	1	20	SITE LIGHTING	22
23	CARD READER/ELEC STRIKE	20	1	1	20	SITE LIGHTING	24
25	CARD READER/ELEC STRIKE	20	1	1	20	SITE LIGHTING	26
27	REC - DATA RM	20	1	1	20	SITE LIGHTING	28
29	CONTROL PANEL	20	1	1	20	ELEV - LTG AND REC	30
31	CONTROL PANEL	20	1	1	20	ELEV - CAB LTG	32
33	CONTROL PANEL	20	1	1	20	ELEV - SUMP PUMP	34
35	CONTROL PANEL	20	1	1	20	HAND DRYER	36
37	BPS	20	1	1	20	HAND DRYER	38
39	BPS	20	1	1	20	HAND DRYER	40
41	SPD	20	1	1	20	SPARE	42
43	LTG - EXTERIOR			1	20	SPARE	44
45	INTERCOM	20	1	1	20	SPARE	46
47	INTERCOM	20	1	1	20	SPARE	48
49	REC - DATA RM	20	1	1	20	SPARE	50
51	SPARE	20	1	1	20	SPARE	52
53	SPARE	20	1	1	20	SPARE	54
LK - P	PROVIDE LOCKING TABS ON C.B.; GF ARC FAULT TYPE C.B.; ST - SHUNT TR	- GFI T					

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	MAIN RATING: 100A	MA	IN C.B.:	<u>100A</u>		KAIC RATING: <u>42KAIC</u>	
	VOLTAGE: <u>208Y/120V</u>	PH	ASE: <u>3</u>	WI	RE: <u>4</u>	MOUNTING: <u>SURFACE</u>	
CIRC. NO.	LOAD DESCRIPTION	BKR. AMPS	NO. OF POLES	NO. OF POLES	BKR. AMPS	LOAD DESCRIPTION	CIRC. NO.
1							2
3	AHU-2 - 1ST FLR PREP	30	3	3	30	AHU-1 - 1FT FLR PREP	4
5							6
7				1	20	OUTDOOR RECEPT.	8
9	AHU-3 - 1ST FLR JAN	30	3	1	20	SPARE	10
11				2	15	ACC-1/AC-1	12
13	EH-1	15	1	2	15	ACC-1/AC-1	14
15	EH-1	15	1	1	20	GFI/WP REC.	16
17				1	20	SPARE	18
19	AHU-4 - 1ST FLR KILN	40	3	1	20	SPARE	20
21				1	20	SPARE	22
23	SPARE	20	1	1	20	SPARE	24
25	SPARE	20	1	1	20	SPARE	26
27	SPARE	20	1	1	20	SPARE	28
29	SPARE	20	1	1	20	SPARE	30
AF - A	ROVIDE LOCKING TABS ON C.B.; GF - ARC FAULT TYPE C.B.; ST - SHUNT TR		PE C.B.	; GP - GF	P TYPE	E C.B.;	
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COPYRIGHT KAEVER, GAMMENT + DAVIDSON ARCHITECTS & ENGINEERS, PC         ALL RIGHTS RESERVED.         Professional Seal         7       08/12/2021         Issued for Construction         6       06/25/2021         Issued for Permit         5       02/24/2021         Issued for Review         3       5/14/2020         90% Construction Documents         2       2/21/2020         Design Development         1       12/18/2019         Scheet Title         ELECTRICAL SCHEDULESS         Job No.       Date         NKGD0214.00       Date         06/25/2021       Drawn / Checked NL / KS	DOCUMENT, UNLESS ACTING UNDER THE DIRECTION OF THE LICENCED ARCHITECT WHOSE PROFESSIONAL SEAL IS AFFIXED HERETO, IS A VIOLATION
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Sheet Number	Scale Drawn / Checked

,	VOLTAGE: <u>208Y/120V</u>	PHA	ASE: <u>3</u>	WI	RE: <u>4</u>	MOUNTING: <u>SURFACE</u>	
CIRC. NO.	LOAD DESCRIPTION	BKR. AMPS	NO. OF POLES	NO. OF POLES	BKR. AMPS	LOAD DESCRIPTION	CIRC NO.
1	SPARE	20	1				2
3				3	25	AHU-7 - 2ND FLR STOR	4
	AHU-6 - 2ND FLR STOR	25	3				6
7			-	1	20	SPARE	8
9	SPARE	20	1	1	20	SPARE	10
11				1	20	SPARE	12
13	AHU-12 - 2ND FLR MECH	25	3	1	15	EF-1 - ATTIC	14
15				1	15	TX-1 - ATTIC	16
17	MOTORIZED DAMPERS	20	1	1	15	EF-2 - ATTIC	18
19	MOTORIZED DAMPERS	20	1	1	20	SPARE	20
21	HWCP-1	25	1	1	20	SPARE	22
23	AHU-9 - 2ND FLR FAB LAB			1	20	SPARE	24
25		30	20     1       25     1       30     3       20     1	1	20	SPARE	26
27				1	20	SPARE	28
29	SPARE	20	1	1	20	SPARE	30
31	SPARE	20	1				32
33				1	20	REC - MECH RM	34
35	GWP-1&2	30	3				36
37				3	30	DPT-1 & 2	38
39			0				40
41	ELECTRIC HEATER - ATTIC	20	2	1	20	BMS	42
43	REC - ATTIC	20	1	1	20	SPARE	44
45	ACC 1/AC 1	45	2	1	20	SPARE	46
47	ACC-1/AC-1	15	2	1	20	SPARE	48
49	GFI/WP REC. ON ROOF.	20	1	1	20	SPARE	50
51	SPARE	20	1	1	20	SPARE	52
54	SPARE	20	1	1	20	SPARE	54

	PP24 PANEL SCHEDULE - ADD ALT												
	MAIN RATING: 100A	MAI	N C.B.:	<u>100A</u>		KAIC RATING: <u>22KAIC</u>							
	VOLTAGE: <u>208Y/120V</u>	PHA	ASE: <u>3</u>	WI	RE: <u>4</u>	MOUNTING: <u>RECESSED</u>							
CIRC. NO.	LOAD DESCRIPTION	BKR. AMPS	NO. OF POLES	NO. OF POLES	BKR. AMPS	LOAD DESCRIPTION	CIRC. NO.						
1	LTG - ENVI SCI	20	1	1	20	REC - ENVI SCIENCE	2						
3	REC - PREP DISHWASHER	20GF	1	1	20	REC - ENVI SCIENCE	4						
5	REC - PREP REF	20	1	1	20	REC - ENVI SCIENCE	6						
7	REC - PREP RM	20	1	1	20	REC - ENVI SCIENCE	8						
9	REC - PREP RM	20	1	1	20	REC - ENVI SCIENCE	10						
11	REC - DEMONSTRATION TABLE - ENV SC	20	1	1	20	SPARE	12						
13	SPARE	20	1	1	20	SPARE	14						
15	SPARE	20	1	1	20	SPARE	16						
17	SPARE	20	1	1	20	SPARE	18						
19	SPARE	20	1	1	20	SPARE	20						
21	SPARE	20	1	1	20	SPARE	22						
23	SPARE	20	1	1	20	SPARE	24						
25	SPARE	20	1	1	20	SPARE	26						
27	SPARE	20	1	1	20	SPARE	28						
29	SPARE	20	1	1	20	SPARE	30						
AF - A	LK - PROVIDE LOCKING TABS ON C.B.; GF - GFI TYPE C.B.; GP - GFP TYPE C.B.; AF - ARC FAULT TYPE C.B.; ST - SHUNT TRIP C.B. NOTES:												

# PP21 PANEL SCHEDULE - BASE BID

	MAIN RATING: 100A	MA	IN C.B.:	<u>100A</u>		KAIC RATING: <u>22KAIC</u>	
	VOLTAGE: <u>208Y/120V</u>	PH	ASE: <u>3</u>	WI	RE: <u>4</u>	MOUNTING: <u>RECESSED</u>	
CIRC. NO.	LOAD DESCRIPTION	BKR. AMPS	NO. OF POLES	NO. OF POLES	BKR. AMPS	LOAD DESCRIPTION	CIRC NO.
1	LIGHTING - OPEN SPACE	20	1	1	20	LIGHTING - MECH RM.	2
3	RECEPTACLES	20	1				4
5	SPARE	20	1	1	20	SPARE	6
7	SPARE	20	1	1	20	SPARE	8
9	SPARE	20	1	1	20	SPARE	10
11	SPARE	20	1	1	20	SPARE	12
13	SPARE	20	1	1	20	SPARE	14
15	SPARE	20	1	1	20	SPARE	16
17	SPARE	20	1	1	20	SPARE	18
19	SPARE	20	1	1	20	SPARE	20
21	SPARE	20	1	1	20	SPARE	22
23	SPARE	20	1	1	20	SPARE	24
25	SPARE	20	1	1	20	SPARE	26
27	SPARE	20	1	1	20	SPARE	28
29	SPARE	20	1	1	20	SPARE	30
	PROVIDE LOCKING TABS ON C.B.; GF - ARC FAULT TYPE C.B.; ST - SHUNT TR		′PE C.B.;	GP - GF	P TYPE	Е С.В.;	
NOTE	ES:						

	MAIN RATING: 100A	MA	IN C.B.:	<u>100A</u>		KAIC RATING: <u>22KAIC</u>	
	VOLTAGE: <u>208Y/120V</u>	PH	ASE: <u>3</u>	<u>w</u>	RE: <u>4</u>	MOUNTING: <u>RECESSED</u>	
CIRC. NO.	LOAD DESCRIPTION	BKR. AMPS	NO. OF POLES	NO. OF POLES	BKR. AMPS	LOAD DESCRIPTION	CIRC. NO.
1	LTG - PROJ RM/STOR/TOILET	20	1	1	20	REC - KILN	2
3	LTG - CORR/MECH	20	1	1	20	REC - KILN	4
5	REC - PROJECT ROOM	20	1	1	20	REC - TOILETS	6
7	PREP - DISHWASHER	20GF	1	1	20	REC - PHOTO/VIDEO	8
9	REC - PREP	20	1	1	20	REC - CORR	10
11	REC - STOR	20	1	1	20	LTG - CORR	12
13	WATER FOUNTAIN - CORR	20	1	1	20	REC - DATA RM	14
15	CARD READER/ELEC STRIKE	20	1	1	20	HAND DRYER	16
17	CARD READER/ELEC STRIKE	20	1	1	20	HAND DRYER	18
19	CARD READER/ELEC STRIKE	20	1	1	20	BPS	20
21	CARD READER/ELEC STRIKE	20	1	1	20	EXTERIOR LTG	22
23	CONTROL PANEL	20	1	1	20	REC - DATA RM	24
25	CONTROL PANEL	20	1	1	20	ELEV. SHAFT LIGHT/GFI REC.	26
27	CONTROL PANEL	20	1	1	20	REC - PREP -ICE MAKER	28
29	CONTROL PANEL	20	1	1	20	SPARE	30
31	REC - PREP - REF	20	1	1	20	SPARE	32
33	REC - PREP	20	1	1	20	SPARE	34
35	SPARE	20	1	1	20	SPARE	36
37	SPARE	20	1	1	20	SPARE	38
39	SPARE	20	1	1	20	SPARE	40
41	SPARE	20	1	1	20	SPARE	42
	ROVIDE LOCKING TABS ON C.B.; GF - ARC FAULT TYPE C.B.; ST - SHUNT TR		(PE C.B.;	GP - GF	P TYPE	E C.B.;	
	-0.						

MAIN RATING: 100A	MAIN C.B.: <u>100A</u>	KAIC RATING: <u>22KAIC</u>
VOLTAGE: <u>208Y/120V</u>	PHASE: <u>3</u> WIRE: <u>4</u>	MOUNTING: <u>RECESSED</u>
	NO. NO. DKD	

PP23 PANEL SCHEDULE - ADD ALT

CIRC. NO.	LOAD DESCRIPTION	BKR. AMPS	NO. OF POLES	NO. OF POLES	BKR. AMPS	LOAD DESCRIPTION	CIRC NO.
1	LTG - PHYSICS/ROBOTICS	20	1	1	20	REC - PHYSICS	2
3	REC - CLG REEL	20	1	1	20	REC - PHYSICS	4
5	REC - CLG REEL	20	1	1	20	REC - PHYSICS	6
7	REC - DEMONSTRATION TABLE - CHEM	20	1	1	20	REC - PHYSICS	8
9	REC - PHYSICS - UC FRIDGE	20	1	1	20	SPARE	10
11	REC - CLG REEL	20	1	1	20	SPARE	12
13	REC - CLG REEL	20	1	1	20	SPARE	14
15	SPARE	20	1	1	20	SPARE	16
17	SPARE	20	1	1	20	SPARE	18
19	SPARE	20	1	1	20	SPARE	20
21	SPARE	20	1	1	20	SPARE	22
23	SPARE	20	1	1	20	SPARE	24
25	SPARE	20	1	1	20	SPARE	26
27	SPARE	20	1	1	20	SPARE	28
29	SPARE	20	1	1	20	SPARE	30


	MAIN RATING: <u>100A</u> VOLTAGE: 208Y/120V		IN C.B.: ASE: 3	<u>100A</u>	RE: 4	KAIC RATING: <u>22KAIC</u> MOUNTING: RECESSED	
CIRC. NO.	LOAD DESCRIPTION	BKR. AMPS	NO. OF POLES	NO. OF POLES	BKR. AMPS	LOAD DESCRIPTION	CIRC. NO.
1	LTG - ENGR	20	1	1	20	REC - CLG REEL	2
3	REC - FLR QUAD	20	1	1	20	REC - CLG REEL	4
5	REC - FLR QUAD	20	1	1	20	REC - CLG REEL	6
7	REC - ENGR RM WALL	20	1	1	20	REC - CLG REEL	8
9	REC - ENGR RM WALL	20	1	1	20	REC - FAB LAB	10
11	REC - ENGR RM WALL	20	1	1	20	REC - FAB LAB	12
13	SPARE	20	1	1	20	REC - FAB LAB	14
15	SPARE	20	1	1	20	REC - FAB LAB	16
17	SPARE	20	1	1	20	REC - FAB LAB	18
19	SPARE	20	1	1	20	REC - FAB LAB	20
21	SPARE	20	1	1	20	REC - FAB LAB	22
23	SPARE	20	1	1	20	SPARE	24
25	SPARE	20	1	1	20	SPARE	26
27	SPARE	20	1	1	20	SPARE	28
29	SPARE	20	1	1	20	SPARE	30
LK - PROVIDE LOCKING TABS ON C.B.; GF - GFI TYPE C.B.; GP - GFP TYPE C.B.; AF - ARC FAULT TYPE C.B.; ST - SHUNT TRIP C.B.							
NOTE	ES:						

## NOTES:

PP21 PANEL SCHEDULE - ADD ALT

PP22 PANEL SCHEDULE - ADD ALT

STREAM Center for	or				
Experiential					
Learning					
SCHOOL OF THE HOLY					
CHILD					
2225 WESTCHESTER AVE	,				
RYE, NY					
listen					
imagine build	e				
KG+D . ARCHITECTS P	C				
285 MAIN STREET MOUNT KISCO . NEW YORK . 10 P:914.666.5900 KGDARCHITECTS.C					
OLA Consulting Engineers					
50 Broadway, Hawthorne, NY 10532					
914.747.2800					
8 West 38th Street, Suite 501 New York, NY 10018					
CONSULTING ENGINEERS 646.849.4110					
olace.com					
ISSUED FOR CONSTRUCTION					
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REPRESENTED BY THIS DRAWING ARE OWNED BY AND ARE THE PROPERTY OF KAEYER, GARMENT, & DAVIDSON ARCHITECTS, PC (KG&D), AND WERE CREATED FOR USE ON THIS PROJECT. NONE OF SUCH IDEAS, DESIGNS, ARRANGEMENTS					
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SCALED DIMENSIONS. CONTRACTOR SHALL VERIFY ALL ACTUAL DIMENSIONS AND CONDITIONS ON THE JOB AND THE ARCHITECT MUST BE NOTIFIED OF ANY VARIATIONS FROM DIMENSIONS AND CONDITIONS SHOWN. SHOP DETAILS MUST					
BE SUBMITTED TO THIS OFFICE FOR APPROVAL BEFORE PROCEEDING WITH FABRICATION. ALTERATIONS BY ANY PERSON, IN ANY WAY, OF ANY ITEM CONTAINED ON THIS					
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7         08/12/2021         Issued for Construction           6         06/25/2021         Issued for Permit					
5         02/24/2021         Issued for Bid           4         02/10/2021         Issued for Review					
3     5/14/2020     90% Construction Document       2     2/21/2020     Design Development       4     12/40/2010     Schemetic Design	S				
1     12/18/2019     Schematic Design       No.     Date     Issue					
ELECTRICAL					
SCHEDULES					
Job No. Date NKGD0214.00 06/25/2021					
Scale Drawn / Checked AS NOTED NL / KS					
Sheet Number					
E603					

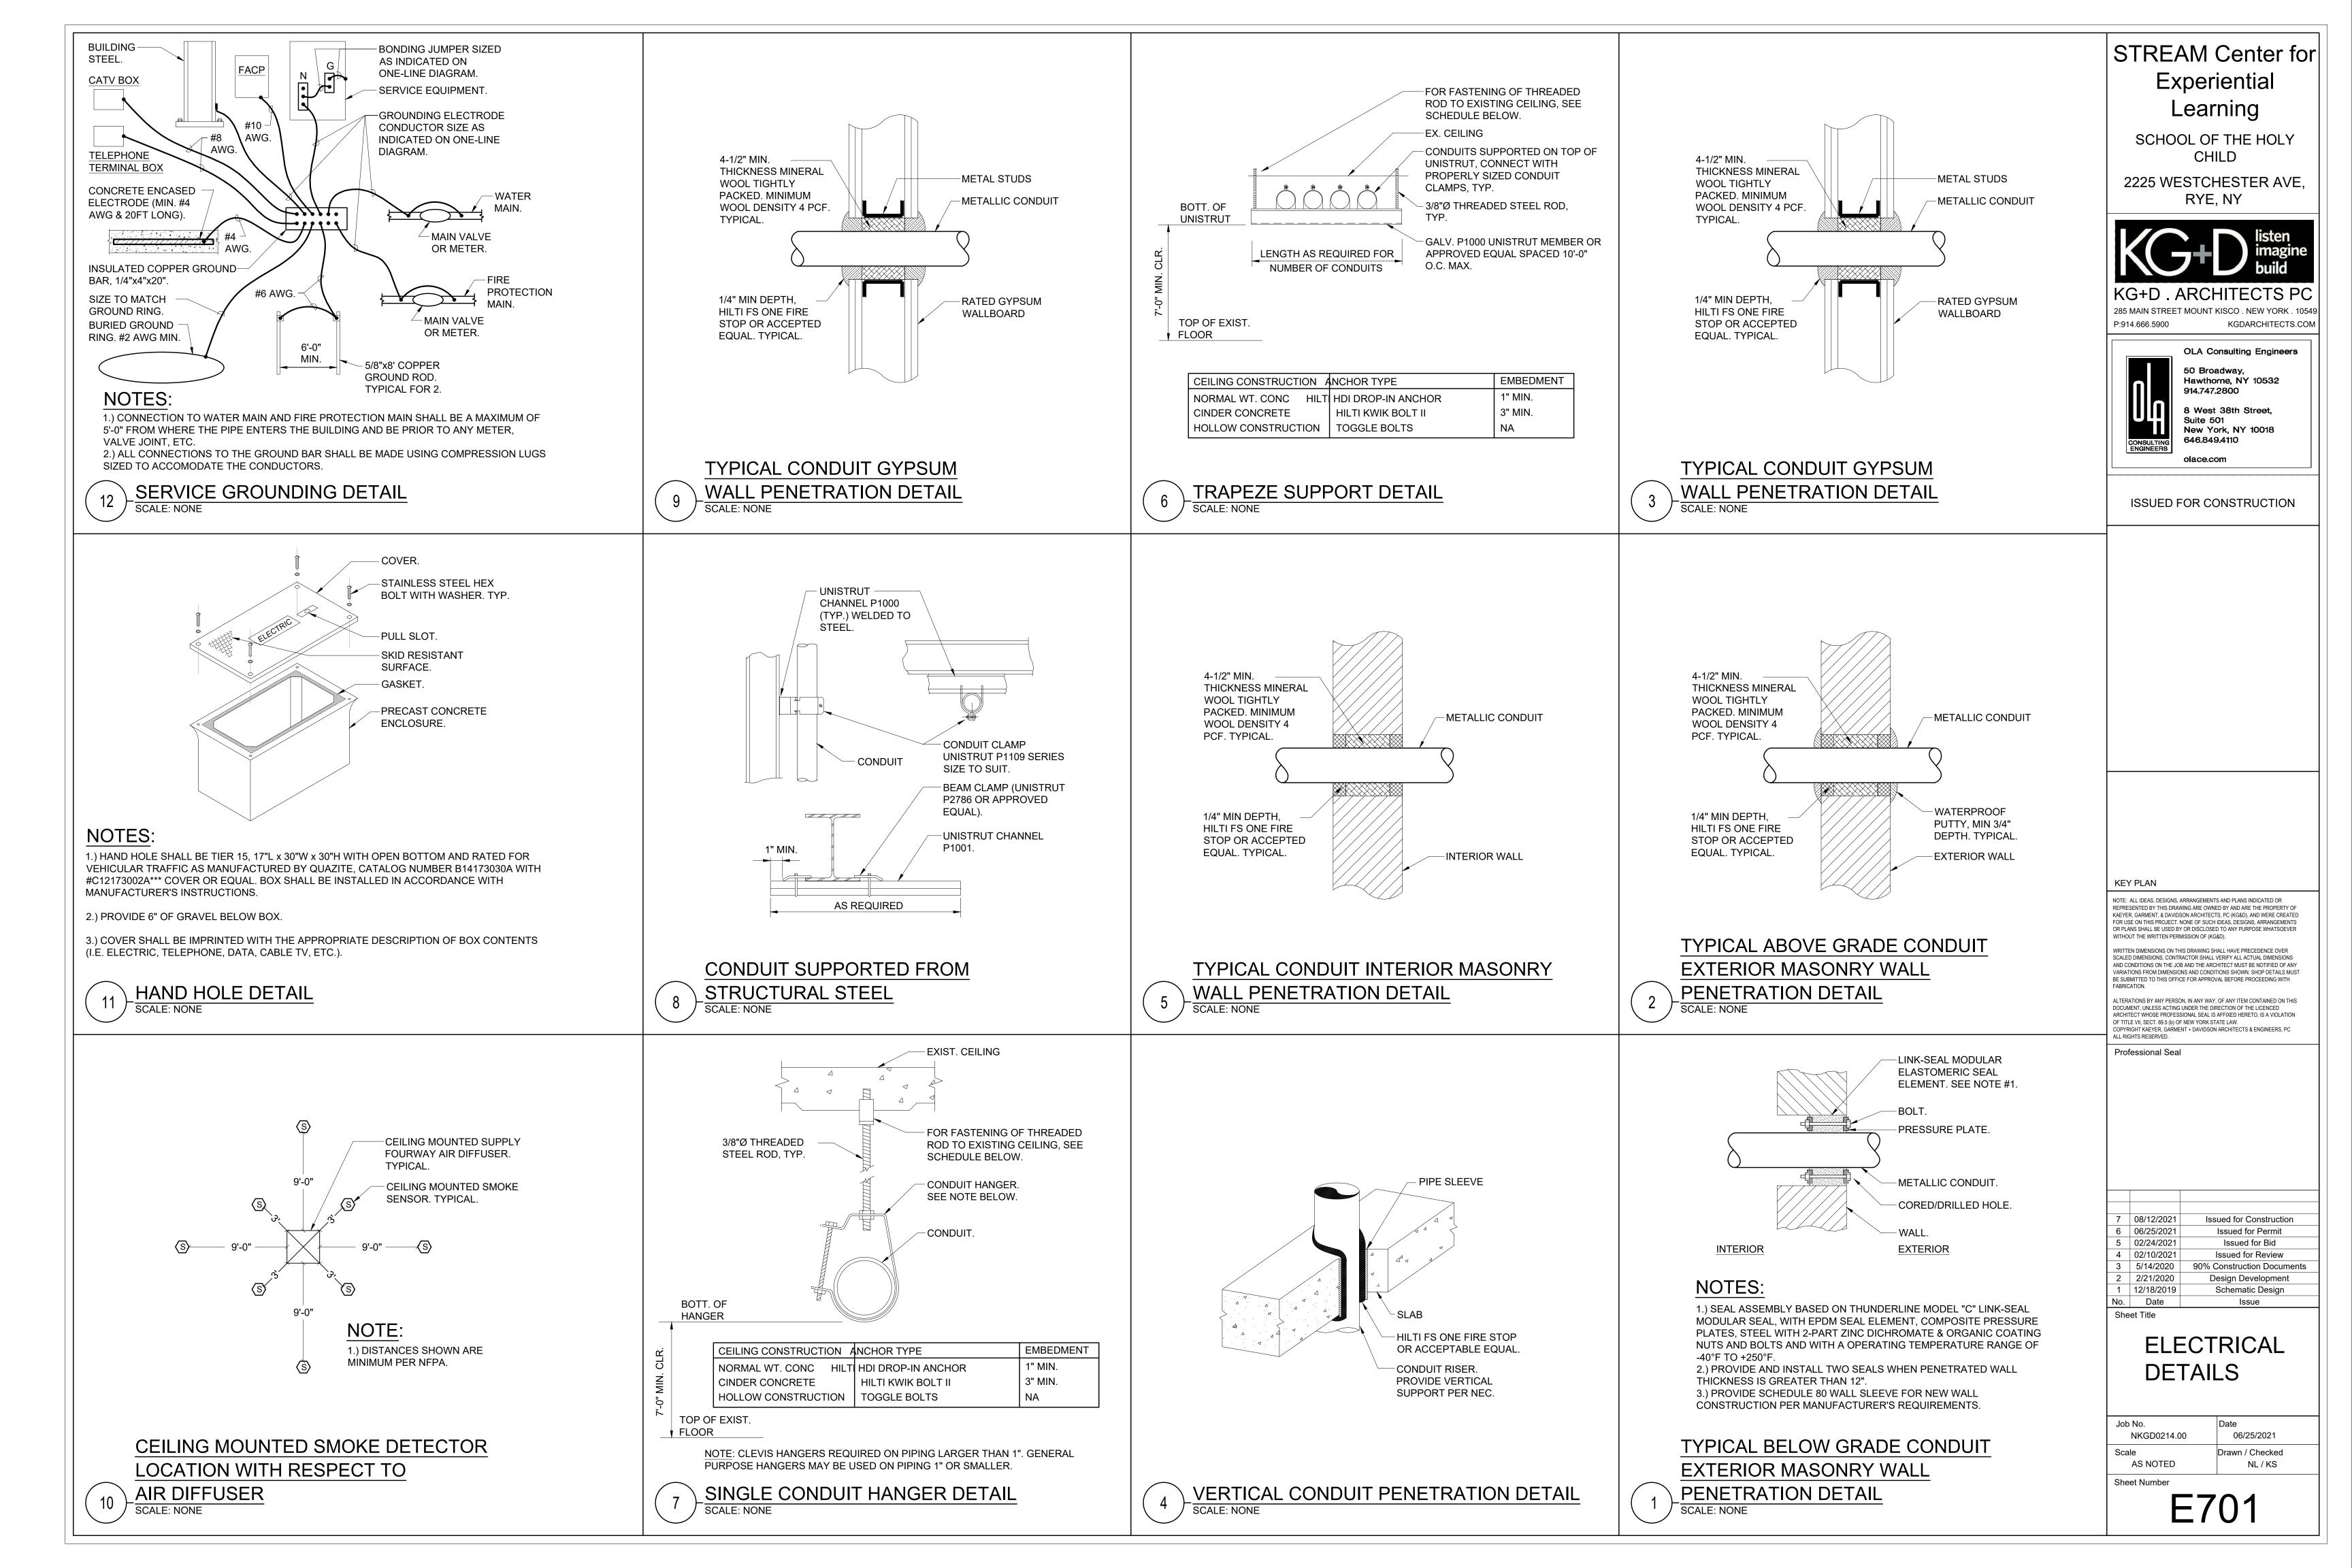


# 15 KV CABLE TESTING:

- REFERENCES: ANSI/IEEE C2 NATIONAL ELECTRICAL SAFETY CODE, ANSI/NFPA 70 NATIONAL ELECTRICAL CODE, IEEE 48 - TEST PROCEDURES AND REQUIREMENTS FOR HIGH-VOLTAGE ALTERNATING-CURRENT CABLE TERMINATIONS.
- 2. SUBMITTALS: PROVIDE FOR CABLE, TERMINATIONS, ACCESSORIES & TEST REPORTS. MANUFACTURER'S INSTRUCTIONS: INDICATE APPLICATION CONDITIONS AND LIMITATIONS OF USE STIPULATED BY PRODUCT TESTING AGENCY SPECIFIED UNDER REGULATORY REQUIREMENTS.
- 3. PROJECT RECORD DOCUMENTS: ACCURATELY RECORD ACTUAL SIZES AND LOCATIONS OF CABLES.
- 4. OPERATION AND MAINTENANCE DATA: INCLUDE INSTRUCTIONS FOR TESTING AND CLEANING CABLE AND ACCESSORIES.
- 5. QUALIFICATIONS: MANUFACTURER, COMPANY SPECIALIZING IN MANUFACTURING PRODUCTS SPECIFIED IN THIS SECTION WITH MINIMUM THREE YEARS DOCUMENTED EXPERIENCE. INSTALLER, COMPANY SPECIALIZING IN INSTALLING PRODUCTS SPECIFIED IN THIS SECTION WITH MINIMUM THREE YEARS DOCUMENTED EXPERIENCE.
- 6. MANUFACTURERS: 1) OKONITE COMPANY, 2) KING WIRE INC. 3) KERITE.
- 7. FIELD QUALITY CONTROL: INSPECT EXPOSED CABLE SECTIONS FOR PHYSICAL DAMAGE, PROPER CONNECTIONS AS SHOWN ON DRAWINGS AND AS REQUIRED, GROUNDING, CABLE SUPPORTS, AND TERMINATIONS FOR PROPER INSTALLATION. PERFORM DC HIGH POTENTIAL TEST OF EACH CONDUCTOR IN ACCORDANCE WITH NEMA WC 8 AND THE FOLLOWING REQUIRED TESTS.
- 8. THE 15KV CABLE SHALL BE DC PROOF TESTED BY AN INDEPENDENT TESTING FIRM. THE ATTACHED DC PROOF TESTING FORM SHALL BE COMPLETED BY THE TESTING FIRM AND SUBMITTED FOR REVIEW.
- 9. TEST LEVELS: A DIRECT-CURRENT VOLTAGE TEST SHALL BE MADE FOR SOLID DIELECTRIC CABLE IN ACCORDANCE WITH THE FOLLOWING TABLE:

RATED CIRCUIT V	DC TEST VOLTA	GΕ	
PHASE TO PHASE	<u>E KV</u>	KV	
15	40		

- A. THE VOLTAGE SHALL BE APPLIED BETWEEN THE CONDUCTOR AND THE METALLIC SHEATH, SHIELD OR CONCENTRIC NEUTRAL WIRES.
- B. THE MAXIMUM APPLIED DIRECT-CURRENT VOLTAGE SHALL NOT BE GREATER THAN THREE (3) TIMES THE ALTERNATING CURRENT VOLTAGE RATING OF THE CABLE OR CABLE ACCESSORY.
- C. THE RATE OF INCREASE FROM THE INITIALLY APPLIED VOLTAGE TO THE SPECIFIED TEST VOLTAGE SHALL BE APPROXIMATELY UNIFORM AND SHALL NOT BE OVER 100 PERCENT IN 10 SECONDS OR LESS THAN 100 PERCENT IN 60 SECONDS.
- D. THE DURATION OF THE TEST SHALL BE 15 MINUTES AT FULL VOLTAGE AND THE LEAKAGE CURRENT SHALL NOT BE RECORDED UNTIL AT FULL VOLTAGE. THE CABLE MUST MAINTAIN THE SPECIFIED TEST VOLTAGE FOR THE DURATION OF THE TEST TO BE CONSIDERED ACCEPTABLE.
- 10. PREPARATION FOR TESTING: THE INDEPENDENT TESTING COMPANY PERSONNEL SHALL COMPLY WITH THE FOLLOWING MINIMUM REQUIREMENTS:
- A. SAFETY (TO PRECLUDE ACCIDENTAL CONTACT WITH THE CABLE(S) BEING TESTED)
- 1. THE TEST AREA AND THE CABLE (S) UNDER TEST SHALL BE ROPED OFF.
- 2. "DANGER-HIGH VOLTAGE" SIGNS SHALL BE DISPLAYED AROUND ALL ROPED OFF AREAS.
- 3. TEST PERSONNEL SHALL BE STATIONED AT ALL EXPOSED CABLE TERMINATIONS.
- B. CLEARANCES THE CABLE UNDER TEST MUST BE COMPLETELY ISOLATED FROM ALL EQUIPMENT.
- 1. TO REDUCE LEAKAGE CURRENT DURING TESTING, CLEAN THE TERMINATIONS AND COVER ANY EXPOSED METALLIC SURFACES WITH PLASTIC WRAP OR DUCT SEAL TO REDUCE CORONA EFFECTS.
- 2. MAINTAIN A CLEARANCE OF AT LEAST TWO FEET BETWEEN TEST POINT OR EXPOSED CABLE ENDS UNDER TEST AND ANY UNENERGIZED SURFACE AND AT LEAST THREE FEET BETWEEN TEST POINT OR EXPOSED CABLE ENDS AND ANY ENERGIZED SURFACE (BUS IN SWITCHGEAR, OTHER CIRCUITS OR CABLES, ETC.)
- 11. GROUNDING:
  - A. THE METALLIC SHIELDS (CONCENTRIC NEUTRALS, COPPER OR ZINC TAPES, DRAIN WIRES) OR METALLIC SHEATHS OF SHIELDED CABLE MUST BE GROUNDED DURING THE TEST.
  - B. CABLES NOT UNDER TEST MUST BE GROUNDED ON BOTH CONDUCTORS AND METALLIC SHEATHS.
  - C. AFTER EACH CABLE TEST THE CABLE SHALL BE ALLOWED TO DISCHARGE TO 10KV OR BELOW BEFORE APPLYING A GROUND. AN APPROPRIATE GROUNDING STICK OR RUBBER GLOVE SHALL BE USED AND/OR WORN WHEN APPLYING THE GROUND. GROUND MUST REMAIN ON FOR AT LEAST 15 MINUTES TO DRAIN CHARGE FROM TESTING.
- 12. CONNECTIONS
- A. ALL BOLTED TERMINATIONS SWITCHES SHALL BE UNBOLTED AND PULLED INTO CLEARANCES AS NOTED ABOVE.
- B. ALL LEADS EXTENDING FROM THE TOP OF ANY TERMINATION TO OVERHEAD LINES MUST BE REMOVED AND THE TERMINATION LOWERED TO OBTAIN ADEQUATE CLEARANCE.

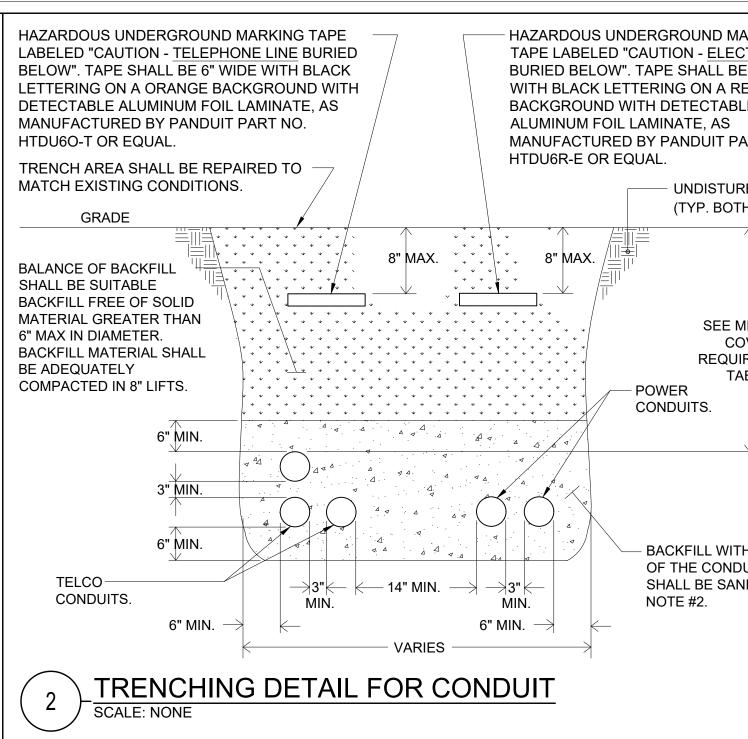

13. SAMPLE: REPORTING FORM - DC PROOF TESTING

REPORTING FORM - DC PROOF TESTING						
TESTING COMPANY NAM	E					
CUSTOMER						
DATE OF TESTTEST						
HUMIDITY % TEMPER	RATURE_					
WEATHER: CLOUDY_F	RAINS	NOW				
FOG SUNNY						
PHASE IDENTIFICATION				CABLE MANUFACTURER:		
KV TEST VOLTAGE				CABLE RELATED VOLTAGE:		
MICROAMPERES	,u	ju	,u	OPERATING VOLTAGE:		
TEST SET LEAKAGE	,u	,u	ju	CONDUCTOR SIZE:		
15 SECONDS				TYPE OF INSULATION:		
30 SECONDS				NUMBER OF CONDUCTORS:		
45 SECONDS				LENGTH:		
1 MINUTE				AGE:		
2 MINUTES				TYPE OF JACKET:		
3 MINUTES				SEPARATE NEUTRAL:		
4 MINUTES				OR		
5 MINUTES				CONCENTRIC NEUTRAL WIRES:		
6 MINUTES				TYPE OF TERMINATIONS AT TEST		
7 MINUTES				END:		
8 MINUTES						
9 MINUTES						
10 MINUTES				TYPE OF TERMINATIONS AT		
11 MINUTES				OPPOSITE END:		
12 MINUTES						
13 MINUTES				REMARKS:		
14 MINUTES						
15 MINUTES						

- 14. PROTECTION:
- A. PROTECT INSTALLED CABLES FROM ENTRANCE OF MOISTURE.

MARKING CTRIC LINE BE 6" WIDE		EQUIREMENT TABLE	STREAM Center for
RED BLE PART NO.		NONMETALLIC RACEWAYS LISTED FOR DIRECT BURIAL WITHOUT	Experiential Learning
JRBED SOIL		CONCRETE ENCASEMENT OR OTHER APPROVED RACEWAYS 18"	SCHOOL OF THE HOLY CHILD
	ALL LOCATION NOT SPECIFIED BELOW. IN TRENCH BELOW 2-IN. THICK	10	2225 WESTCHESTER AVE, RYE, NY
MINIMUM COVER JIREMENT FABLE.	CONCRETE OR EQUIVALENT. UNDER MINIMUM OF 4-IN. THICK CONCRETE EXTERIOR SLAB WITH NO VEHICULAR TRAFFIC AND THE SLAB EXTENDING NOT LESS THAN 6 IN. BEYOND THE UNDERGROUND	4" SEE NOTE #2.	KG+D listen imagine build
	UNDER STREETS, HIGHWAYS, ROADS, ALLEYS, DRIVEWAYS, AND PARKING LOTS.	24"	KG+D. ARCHITECTS PC 285 MAIN STREET MOUNT KISCO . NEW YORK . 10549 P:914.666.5900 KGDARCHITECTS.COM OLA Consulting Engineers
DUIT AND. SEE	NOTES: 1.) DETAIL SHOWN FOR INFORMATION P ALSO APPLY FOR SINGLE CONDUITS. 2.) SAND MAY BE OMITTED FOR INSTALL REQUIREMENTS ARE 6" OR LESS.		50 Broadway, Hawthorne, NY 10532 914.747.2800 8 West 38th Street, Suite 501 New York, NY 10018 646.849.4110 olace.com
	B	HO TREES, BUSHES OR BHRUBS INSIDE THIS BOUNDARY.	
1.) A AND WOF 2.) U BUS	REA IN FRONT OF DOOR TO BE CLEAR O OTHER OBSTRUCTIONS SO THAT THE O RKING AREA. JILLITY COMPANY SHALL HAVE THE RIGH HES TO WITHIN STATED CLEARANCES. ANSFORMER PAD LE: NONE	OF ALL ROCKS, STUMPS OPERATOR HAS A SAFE IT TO CUT BACK GROWING	KEY PLAN NOTE: ALL IDEAS, DESIGNS, ARRANGEMENTS AND PLANS INDICATED OR REPRESENTED BY THIS DRAWING ARE OWNED BY AND ARE THE PROPERTY OF KAEYER, GARMENT, & DAVIDSON ARCHITECTS, PC (KG&D), AND WERE CREATED FOR USE ON THIS PROJECT. NONE OF SUCH IDEAS, DESIGNS, ARRANGEMENTS OR PLANS SHALL BE USED BY OR DISCLOSED TO ANY PURPOSE WHATSOEVER WITHOUT THE WRITTEN PERMISSION OF (KG&D). WRITTEN DIMENSIONS ON THIS DRAWING SHALL HAVE PRECEDENCE OVER SCALED DIMENSIONS CONTRACTOR SHALL VERIFY ALL ACTUAL DIMENSIONS AND CONDITIONS ON THE JOB AND THE ARCHITECT MUST BE NOTIFIED OF ANY VARIATIONS FROM DIMENSIONS AND CONDITIONS SHOWN. SHOP DETAILS MUST BE SUBMITTED TO THIS OFFICE FOR APPROVAL BEFORE PROCEEDING WITH FABRICATION. ALTERATIONS BY ANY PERSON, IN ANY WAY, OF ANY ITEM CONTAINED ON THIS DOCUMENT, UNLESS ACTING UNDER THE DIRECTION OF THE LICENCED ARCHITECT WHOSE PROFESSIONAL SEAL IS AFFIXED HERETO, IS A VIOLATION OF TITLE VII, SECT. 69.5 (b) OF NEW YORK STATE LAW. COPYRIGHT KAEYER, GARMENT + DAVIDSON ARCHITECTS & ENGINEERS, PC ALL RIGHTS RESERVED. PROFESSIONAL SEAL
			7       08/12/2021       Issued for Construction         6       06/25/2021       Issued for Permit         5       02/24/2021       Issued for Review         3       5/14/2020       90% Construction Documents         2       2/21/2020       Design Development         1       12/18/2019       Schematic Design         No.       Date       Issue         Sheet Title       Issue       Issue         Job No.       Date       06/25/2021         Scale       Drawn / Checked       NL / KS         Sheet Number       ETTRE       ETTRE

