STREAM Center for Experiential Learning SCHOOL OF THE HOLY CHILD 2225 WESTCHESTER AVE, RYE, NY



00 GENERAL CC-1	CODE COMPLIANCE INFORMATION
CC-2	
G001	GENERAL INFORMATION
01 CIVIL	
C000	ZONING COMPLIANCE SHEET
C010	OVERALL EXISTING CONDITIONS MAP
C020	EXISTING CONDITIONS MAP
C040	SITE REMOVALS PLAN
C100	OVERALL SITE PLAN
C101	SITE LAYOUT PLAN
C200	GRADING PLAN
C210	SLOPE DISTRUBANCE PLAN
C300	UTILITIES PLAN
C400	EROSION AND SEDIMENT CONTROL PLAN
C601	FIRE SAFETY PLAN
C603	FIRE VEHICLE ACCESS PLAN
C700	WATER QUALITY IMPROVEMENT PLAN
C800	CIVIL AND LANDSCAPE ALTERNATIVES PLAN
C900	CONSTRUCTION DETAILS
C901	CONSTRUCTION DETAILS
C902	CONSTRUCTION DETAILS
C903	CONSTRUCTION DETAILS
C904	CONSTRUCTION DETAILS
C905	CONSTRUCTION DETAILS
C906	CONSTRUCTION DETAILS
C907	CONSTRUCTION DETAILS
02 LANDSCA	PE
L100	SITE GRADING & MATERIALS PLAN
L101	COURTYARD GRADING & MATERIALS PLAN
L200	PLANTING & TREE REMOVALS PLAN
L300	SITE DETAILS
L301	SITE DETAILS

L302	'E' WALL SITE DETAILS			
L400 PHOTOMETRIC STUDY				
3 STRUCTL	IRAL			
S001	GENERAL NOTES AND MATERIAL SPECIFICATIONS			
S002	GENERAL NOTES AND MATERIAL SPECIFICATIONS			
S101	FIRST FLOOR SLAB-ON-GRADE AND FDN PLAN			
S102	SECOND FLOOR FRAMING PLAN			
S103	ROOF FRAMING PLAN			
S201	FOUNDATION SCHEDULES AND TYPICAL DETAILS			
S202	FOUNDATION SCHEDULES AND TYPICAL DETAILS			
S210	FOUNDATION SECTIONS			
S211	FOUNDATION SECTIONS			
S301	FRAMING DETAILS & SECTIONS			
S310	TRUSS ELEVATIONS			
S401	MASONRY SCHEDULE AND TYPICAL DETAILS			
S402	TYPICAL MASONRY DETAILS			
S501	COLD FORMED FRAMING SCHEDULES AND TYPICAL DETAILS			
3.5 HAZARI	DOUS MATERIAL			
ASB-100	BASEMENT BUILDING 1930			
ASB-101	1ST FLOOR BUILDING 1930			
ASB-102	ATTIC BUILDING 1930			
ASB-103	CRAWL SPACE BUILDING 1930			
ASB-104	ROOF BUILDING 1930			
ASB-105	1ST FLOOR BUILDING 1950			
ASB-106	2ND FLOOR BUILDING 1950			
ASB-107	ROOF BUILDING 1950			
ASB-108	1ST FLOOR BUILDING 1970			
ASB-109	2ND FLOOR BUILDING 1970			
ASB-110	ROOF BUILDING 1970			
4 ARCHITE	CTURE			
A101	FIRST FLOOR DEMO PLAN			
A102	SECOND FLOOR DEMO PLAN			

ISSUED FOR BID 8/12/2021

CONSTRUCTION DOCUMENTS

LIST OF DRAWINGS

A201	FIRST FLOOR PLAN		A903	WINDOW TYPES	M703	MECHANICAL DETAILS
A202	SECOND FLOOR PLAN		05 FIRE PROTECTION		08 ELECTRIC	CÁL
A211	POWER & DATA PLANS		FP001	FIRE PROTECTION SYMBOLS, ABBREVIATIONS & NOTES	E001	ELECTRICAL SYMBOLS, ABBI
A250	ROOF PLAN		FP201	FIRE PROTECTION 1ST FLOOR PLAN	E100	ELECTRICAL SITE POWER PL
A301	EXTERIOR ELEVATIONS & SECTION		FP202A	FIRE PROTECTION 2ND FLOOR & ATTIC PLANS BASE BID	E101	ELECTRICAL FIRST FLOOR D
A302	EXTERIOR ELEVATION & SECTIONS		FP202B	FIRE PROTECTION 2ND FLOOR & ATTIC PLANS ADD/ALT	E102	ELECTRICAL SECOND FLOOF
A401	ENLARGED PLAN & INTERIOR ELEV - ART STUDIO		FP701	FIRE PROTECTION DETAILS 1 OF 2	E103	ELECTRICAL SITE CONDUIT
A402	ENLARGED PLAN & INTERIOR ELEV - SCIENCE LAB		FP702	FIRE PROTECTION DETAILS 2 OF 2	E200	ELECTRICAL SITE LIGHTING
A403	ENLARGED PLAN & INTERIOR ELEV - SCIENCE LAB		FR001	FIRE RADIO SYMBOLS, ABBREVIATIONS & GENERAL NOTES	E201	ELECTRICAL FIRST FLOOR L
A404	ENLARGED PLAN & INTERIOR ELEV - ENGINEERING LAB		FR301	FIRE RADIO FIRST FLOOR PLAN	E202	ELECTRICAL SECOND FLOOF
A430	TOILET ROOM PLANS & ELEVATIONS		FR302	FIRE RADIO SECOND FLOOR PLAN	E301	ELECTRICAL FIRST FLOOR N
4440	TYPICAL CASEWORK/ MILLWORK DETAILS		FR501	FIRE RADIO COMMUNICATIONS (ERRCS) ONE-LINE DIAGRAM	E302	ELECTRICAL SECOND FLOOP
A441	TYPICAL CASEWORK / MILLWORK DETAILS	- '	06 PLUMBIN	3	E303	ELECTRICAL ATTIC NEW WO
A501	CASEWORK, MILLWORK, & FINISH SCHEDULE		P001	PLUMBING SYMBOLS, ABBREVIATIONS & NOTES	E401	FIRE ALARM FIRST FLOOR N
A502	FINISH FLOOR PLANS		P101	PLUMBING DEMOLITION PLAN	E402	FIRE ALARM SECOND FLOOF
4530	SIGNAGE SCHEDULE		P201	PLUMBING 1ST FLOOR NEW WORK PLAN	E501	ELECTRICAL ONE-LINE DIAG
4601	REFLECTED CEILING PLANS		P202A	PLUMBING 2ND FLOOR NEW WORK PLAN BASE BID	E502	ELECTRICAL ONE-LINE DIAG
4602	CEILING DETAILS		P202B	PLUMBING 2ND FLOOR NEW WORK PLAN ADD/ALT	E503	FIRE ALARM RISER DIAGRAM
4701	ELEVATOR, STAIR PLANS & SECTIONS		P501	PLUMBING RISER DIAGRAM	E504	FIRE ALARM RISER DIAGRAM
A702	TYPICAL STAIR DETAILS		P701	PLUMBING DETAILS 1 OF 2	E601	ELECTRICAL SCHEDULES
A801	WALL SECTIONS		P702	PLUMBING DETAILS 2 OF 2	E602	ELECTRICAL SCHEDULES
A802	WALL SECTIONS		07 MECHANI	ĊAL	E603	ELECTRICAL SCHEDULES
A803	WALL SECTIONS		M001	MECHANICAL SYMBOLS, ABBREVIATIONS & NOTES	E701	ELECTRICAL DETAILS
A804	WALL SECTIONS		M201	MECHANICAL 1ST FLOOR NEW WORK PLAN	E702	ELECTRICAL DETAILS
A805	BUILDING DETAILS		M202A	MECHANICAL 2ND FLOOR NEW WORK PLAN BASE BID	E703	ELECTRICAL DETAILS
A806	BUILDING DETAILS		M202B	MECHANICAL 2ND FLOOR NEW WORK PLAN ADD/ALT		
A807	SITE WALL SECTIONS		M203	MECHANICAL ATTIC NEW WORK PLAN		
A811	EXTERIOR FINISH DETAILS		M401	MECHANICAL SITE PLAN		
A812	EXTERIOR FINISH DETAILS		M601	MECHANICAL EQUIPMENT NOTES & SCHEDULES		
A831	PLAN DETAILS		M602	MECHANICAL SCHEDULES		
A901	PARTITION TYPES	-	M701	MECHANICAL DETAILS		
A902	DOOR SCHEDULE AND TYPICAL DOOR DETAILS	-1	M702	MECHANICAL DETAILS		

STREAM Center for Experiential Learning

KG&D Project No. 2018-1078

DESIGN TEAM

ARCHITECT **KG&D ARCHITECTS**

285 Main Street Mt Kisco, NY 10549 phone: 914-666-5900

MECHANICAL ENGINEER OLA Consulting Engineers, PC

50 Broadway, Hawthorne, NY 10532 phone: (914) 747-0453

STRUCTURAL ENGINEER

The Di Salvo Engineering Group

83 Wooster Heights Road, Suite 200 Danbury, CT 06810 phone: 203-430-4140

CIVIL ENGINEER JMC PLANNING ENGINEERING LANDSCAPE ARCHITECTURE & LAND SURVEY, PLLC

120 Bedford Road Armonk, NY 10504 phone: 914 273-5225

LANDSCAPE CONSULTANT **IQ Landscape Architects**

31 Mamaroneck Ave. 7th Flr White Plains, NY 10601 phone: 914.232.0200

BOLS, ABBREVIATIONS & GENERAL NOTES POWER PLAN T FLOOR DEMOLITION PLAN OND FLOOR DEMOLITION PLAN CONDUIT ROUTING PLAN LIGHTING PLAN T FLOOR LIGHTING PLAN OND FLOOR LIGHTING PLAN T FLOOR NEW WORK PLAN OND FLOOR NEW WORK PLAN C NEW WORK PLAN T FLOOR NEW WORK PLAN OND FLOOR NEW WORK PLAN -LINE DIAGRAM - DEMO WORK -LINE DIAGRAM - NEW WORK R DIAGRAM - DEMO WORK R DIAGRAM - NEW WORK

ADD/ALTERNATE LIST:

ADD/ALT #1

SECOND FLOOR BUILD-OUT

- ALL CASEWORK, COUNTERTOPS
- APPLIANCES DOORS, JAMBS, INTERIOR OPENINGS •
- U.N.O.
- ALL FINISH WORK ON A403 & A404 •
- TOILET ROOMS 14/A430 & A15-22 A430 •
- FINISH SCHEDULE A501 SECOND
- FLOOR FINISH FLOOR PLANS - 3/A502 & 4/A502 •
- REFLECTED CEILING PLANS 2/A601
- DOOR SCHEDULE A902 SECOND FLOOR
- ADD/ALT #2

 ELEVATOR SYSTEM & EQUIPMENT SEE DETAILS 3/A701 & 4/A701

ADD/ALT #3

First Floor millwork and cabinetry scope to be clarified via Addendum

FURTHER ALTERNTES AS INDICATED IN RFP ATTACHMENT #3

1- BUILDING AREA CALCULATIONS

(As defined by IBC 2015 Does not include elevator shaft space, but includes canopies and includes overhangs if overhangs exceed 2 ft) BLDG CONST DEMO TOTAL STORIES EXISTING NEW TYPE 4,048 SF VB 4,048 SF 1920s 2+Basement BASEMENT Α Convent Building Wood framed, 4,464 SF 1st FLOOR 4,464 SF not sprinklered 4,464 SF 4,464 SF 2nd FLOOR 2,070 SF Attic 2,070 SF SUBTOTAL 15,046 SF 15,046 SF 1950s and 1970s BASEMENT 7,706 SF (-) 7,706 SF 0 SF VB 2+Basement В Existing: Wood framed Convent Additions 1st FLOOR 6,998 SF 0 SF (-) 6,998 SF 0 SF 2nd FLOOR 6,904 SF (-) 6,904 SF SUBTOTAL 21,608 SF (-) 21,608 SF 0 SF New STREAM VB 1st FLOOR 6,601 SF 6,601 SF С Wood and Steel frame, Center -2nd FLOOR 5,754 SF 5,754 SF sprinklered Classroom Building SUBTOTAL 12,355 SF 12,355 SF TOTAL 36,654 SF (-) 21,608 SF 12,355 SF 27,401 SF **2- FIRE AREA CALCULATIONS** CONST STORIES FIRE EXISTING CONSTRUCPROPOSED PROPOSED REMARKS AREA CONSTRUCTION FIRE AREA VB 3 15,046 SF 1920s Convent EXISTING NONCONFORMING, 15,046 SF NON SPRINKLERED NOT IN USE VB 2 2020 Classroom Buildling 12,550 SF 12,550 SF NEW FIRE AREA 2 CONFORMING SPRINKLERED 1HR FB) à (FIRST FLOOR AREA PLAN 1 1/32" = 1'-0" 1HR FB SECOND FLOOR AREA PLAN 2 1/32" = 1'-0"

3 - USE, CLASSIFICATION, & BUILDING HEIGHTS AND AREAS

EXISTING	BUILDING					
USE	& OCCUPANCY CLAS	SIFICATION:	R-2 (0	currently not in	use)	-
CON	ISTRUCTION TYPE:		5B, n	ot sprinklered		
BUIL	DING HEIGHT & AREA	:	PERM	IITTED	ACTUAL	-
	HEIGHT STORIES FLOOR A	; REA	60' 2 45 88	5 SF	30'+/- 3+basement* 15,046 SF	-
		REA,1ST			4,464 SF	
		ISTING NON		-		
	Aa= Aa=	=[At+(NSxIf)]) At=NS= 9 Ns= 9500 If= [F/P-0. Sa=3 stor W=30 =[9500+(9500	xŠa /500 .25]W/30 /ies Dx.61)]x3=		5]30/30=0.61	
		story shall e +(9500x.61)]		where value \$ 5	5a=1	
NEW ADD	ITION					
USE	& OCCUPANCY CLAS	SIFICATION:	Е			
CON	STRUCTION TYPE:		VB, s	prinklered		
BUIL	DING HEIGHT & AREA	:	PERM	/IITTED	ACTUAL	
	HEIGHT		60'		29' +/-	
	by IBC . The vertical dis of surface. Average of 36	+ 21/ 2= 28.5	5)	plane to the a		
	STORIES FLOOR A STORY A		2 69,35 34,67		2 12,550 SF 6,601 SF	
	Aa= Aa= No Single Aa=[2850	=[At+(NSxIf)]) At=Sm= 2 Ns= 9500 If= [F/P-0. Sa=2 stor W=30 =[28500+(950 story shall et 0+(9500x.65)	xŠa 28500 .25]W/30 ies 00x.65)]x2 xceed Aa)]x1= 34,6		5]30/30=0.65 Sa=1	
4 - FIRE-	-RESISTAN(CE-RA	TED	CONS	TRUCTION	8
SSEMBLY	FIRE-RESISTANCE RA		LOCA			
IRE WALL	2 HOURS	BET	IWEEN E	UILDING ARE	EAS	
IRE BARRIER	1 HOUR 1 HOUR 1 HOUR 1 HOUR 1 HOUR 1 HOUR 1 HOUR 1 HOUR	STA SHA ELE ME(KILI EXT	AIRS LES AFT WAL EVATOR S CHANICA N ROOM	S THAN 4 ST LS LESS THA SHAFT LESS L ROOM VALLS & ROO	S PREACTION SPRINKLER ORIES N 4 STORIES THAN 4 STORIES DF 10 FT FROM FIREWALL	
*** SEE DRAW	ING CC.2 FOR LOCATI	ON OF FIRE	-RESIST	ANCE-RATED	CONSTRUCTION ***	
5 - MEAN	NS OF EGRI	ESS				9
EGRESS INFOR	MATION:			DWG SHOW	N	
	ROOM USE DESIGNA	TIONS		CC-2		
	ROOM SQUARE FOO	TAGE		CC-2		
	ROOM OCCUPANCY			CC-2		
	EXIT TRAVEL DISTAN	NCES		CC-2		
	GROUND FL:			T MAX TO EX RINKLERED	TERIOR DOOR BUILDLING	
	AREA OF REFUGE		NOT BUILI		I SPRINKLERED	
MEANS OF EGI	RESS ARE PROVIDED			TH IBC 2018	CHAPTER 10	
		PROVIDED)			
EXIT SIGNS		YES				
MEANS OF EGI	RESS	YES				
ACCESSIBLE M OF EGRESS	IEANS	YES				

YES

PANIC HARDWARE

6 - ACCESSIBILITY

ACCESSIBILITY INFORMATION: ACCESSIBLE ROUTE ACCESSIBLE ENTRANCES PARKING FACILITIES TOILET FACILITIES SIGNAGE VERTICAL ACCESS/ ELEVATOR

7 - FIRE PROTECTI\

SEE MEP DRAWINGS FOR FIRE PROTI

AUTO SPRINKLER SYSTEM

STANDPIPE SYSTEMS

PORTABLE FIRE EXTINGUISHERS

FIRE ALARM & DETECTION SYSTEMS

EMERGENCY ALARM SYSTEMS

SMOKE CONTROL SYSTEMS

SMOKE AND HEAT VENTS

FIRE COMMAND CENTER

8 - PLUMBING FIXTU

2020 Plumbing Code of NYS For Educational facilites:

Water Closets: 1 per 50 occupants 189/50 = Bathtubs/ Showers: Not Applicable Water fountains: 1 per 100 = 189/100 = Others: 1 service sink

9 - ENERGY CODE RE

Energy Code Review 2018 IECC/ 2020 4A Climate Zone Using R value method

Roof Insulation entirely above roof deck R30 Attic and other: R-38

Walls above grade Metal Framed: R-13 + R-7.5 ci

Below grade wall R-7.5


Floors Joist Framing R-30

Slab on Grade Floors Unheated Slabs: R10 for 24" below

NY STATE ENERGY CODE WRITTEN

To the best of my knowledge, belief, and plans and specifications are in complian

Y	STREAM Center for Experiential
	Learning
DWG SHOWN	SCHOOL OF THE HOLY CHILD
CC.2	2225 WESTCHESTER AVE,
CC.2	RYE, NY
SITE PLAN	
CC.2	Iisten imagine build
A530	build
CC.2	KG+D . ARCHITECTS PC
	285 MAIN STREET MOUNT KISCO . NEW YORK . 10549P:914.666.5900KGDARCHITECTS.COM
	CONSTRUCTION
VE SYSTEMS	DOCUMENTS
FECTION DEVICES AND LOCATIONS	
PROVIDED	
YES FOR 1ST FLOOR	
NO	
YES	
YES	
YES	
NO	
NO	
YES	
IRE COUNT	KEY PLAN
	NOTE: ALL IDEAS, DESIGNS, ARRANGEMENTS AND PLANS INDICATED OR REPRESENTED BY THIS DRAWING ARE OWNED BY AND ARE THE PROPERTY OF
0/50 = 4	KAEYER, GARMENT, & DAVIDSON ARCHITECTS, PC (KG&D), AND WERE CREATED FOR USE ON THIS PROJECT. NONE OF SUCH IDEAS, DESIGNS, ARRANGEMENTS OR PLANS SHALL BE USED BY OR DISCLOSED TO ANY PURPOSE WHATSOEVER WITHOUT THE WRITTEN PERMISSION OF (KG&D).
= 4	WRITTEN DIMENSIONS ON THIS DRAWING SHALL HAVE PRECEDENCE OVER SCALED DIMENSIONS. CONTRACTOR SHALL VERIFY ALL ACTUAL DIMENSIONS
= 2	AND CONDITIONS ON THE JOB AND THE ARCHITECT MUST BE NOTIFIED OF ANY VARIATIONS FROM DIMENSIONS AND CONDITIONS SHOWN. SHOP DETAILS MUST BE SUBMITTED TO THIS OFFICE FOR APPROVAL BEFORE PROCEEDING WITH FABRICATION.
	ALTERATIONS BY ANY PERSON, IN ANY WAY, OF ANY ITEM CONTAINED ON THIS DOCUMENT, UNLESS ACTING UNDER THE DIRECTION OF THE LICENCED ARCHITECT WHOSE PROFESSIONAL SEAL IS AFFIXED HERETO, IS A VIOLATION
	OF TITLE VIII, SECT. 69.5 (b) OF NEW YORK STATE LAW. COPYRIGHT KAEYER, GARMENT + DAVIDSON ARCHITECTS & ENGINEERS, PC ALL RIGHTS RESERVED.
	Professional Seal
EQUIREMENTS	
<u>0 NYS</u> <u>Fenestration U factor</u>	
Prescriptive: Fixed Fenestration U= .38	
Operable Fenestration U=.45 0 ci Entrance Doors U=0.77	
	7 8/12/2021 ISSUED FOR BID
	7 8/12/2021 ISSUED FOR BID 6 6/25/2021 ISSUED FOR PERMIT 3 02/21/2020 DESIGN DEVELOPMENT
	No. Date Issue Sheet Title Issue
	CODE
	COMPLIANCE
	INFORMATION
STATEMENT OF COMPLIANCE	
nd professional judgement, the STREAM building's	Job No. Date 2018-1078 02/12/2020
nce with the Energy Code.	Scale Drawn / Checked AS NOTED KG+D / KG+D
	Sheet Number
	CC-1

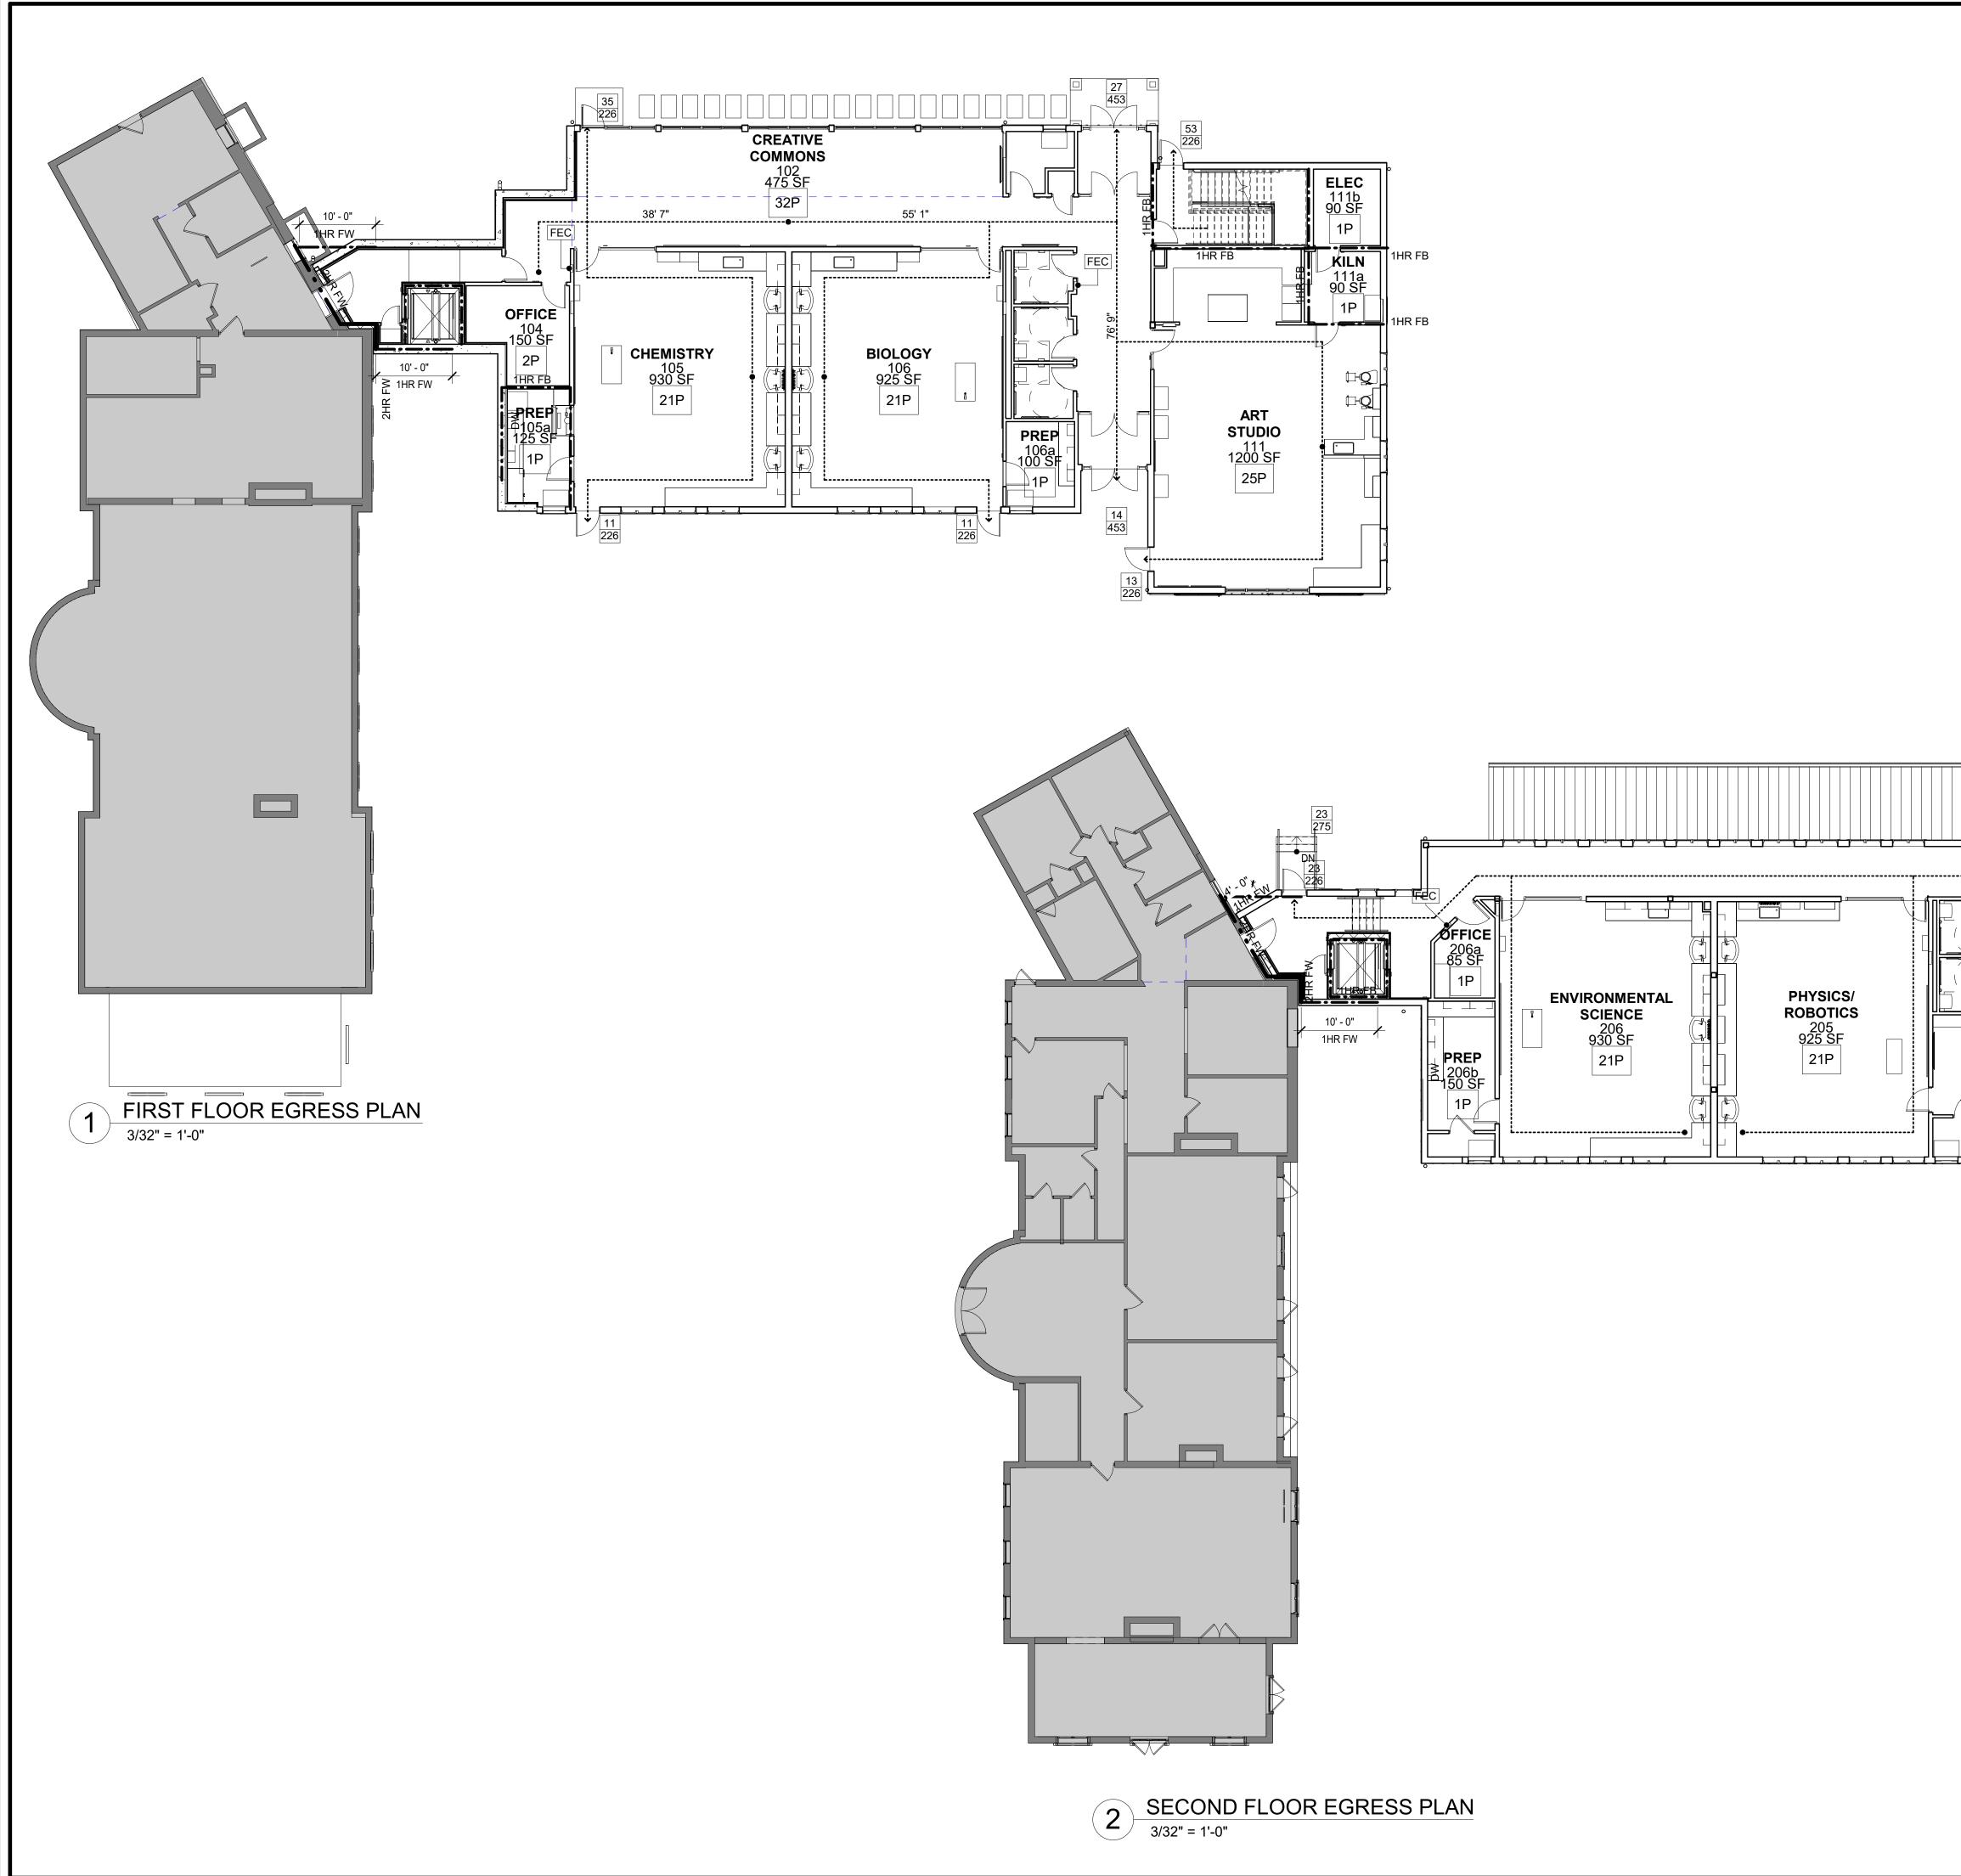

STREAM Center for
Experiential Learning
SCHOOL OF THE HOLY CHILD
2225 WESTCHESTER AVE, RYE, NY
KG+D listen imagine build
KG+D. ARCHITECTS PC 285 MAIN STREET MOUNT KISCO . NEW YORK . 10549 P:914.666.5900 KGDARCHITECTS.COM
CONSTRUCTION DOCUMENTS
DOCOMILINIS
KEY PLAN
NOTE: ALL IDEAS, DESIGNS, ARRANGEMENTS AND PLANS INDICATED OR REPRESENTED BY THIS DRAWING ARE OWNED BY AND ARE THE PROPERTY OF KAEYER, GARMENT, & DAVIDSON ARCHITECTS, PC (KG&D), AND WERE CREATED FOR USE ON THIS PROJECT. NONE OF SUCH IDEAS, DESIGNS, ARRANGEMENTS
OR PLANS SHALL BE USED BY OR DISCLOSED TO ANY PURPOSE WHATSOEVER WITHOUT THE WRITTEN PERMISSION OF (KG&D). WRITTEN DIMENSIONS ON THIS DRAWING SHALL HAVE PRECEDENCE OVER SCALED DIMENSIONS. CONTRACTOR SHALL VERIFY ALL ACTUAL DIMENSIONS AND CONDITIONS ON THE ADDITION AND THE ACTUAL DIMENSIONS
AND CONDITIONS ON THE JOB AND THE ARCHITECT MUST BE NOTIFIED OF ANY VARIATIONS FROM DIMENSIONS AND CONDITIONS SHOWN. SHOP DETAILS MUST BE SUBMITTED TO THIS OFFICE FOR APPROVAL BEFORE PROCEEDING WITH FABRICATION. ALTERATIONS BY ANY PERSON, IN ANY WAY, OF ANY ITEM CONTAINED ON THIS
DOCUMENT, UNLESS ACTIONG UNDER THE DIRECTION OF THE LICENCED ARCHITECT WHOSE PROFESSIONAL SEAL IS AFFIXED HERETO, IS A VIOLATION OF TITLE VII, SECT. 69.5 (b) OF NEW YORK STATE LAW. COPYRIGHT KAEYER, GARMENT + DAVIDSON ARCHITECTS & ENGINEERS, PC ALL RIGHTS RESERVED.
Professional Seal
7 8/12/2021 ISSUED FOR BID
6 6/25/2021 ISSUED FOR PERMIT 3 02/21/2020 DESIGN DEVELOPMENT No. Date Issue Sheet Title Issue
CODE
COMPLIANCE DRAWINGS
Job No. Date
2018-1078 02/12/2020 Scale Drawn / Checked AS NOTED KG+D / KG+D
Sheet Number

	53 226	MECH 201b 90 SF 1P
	THR FB FAB LAB 201 a 345 SF 7P	
PROJECT ROOM 202 245 SF 3P	ENGINEER & DESIG 201 945 SF 21P	
	182' to furth point c	hest

CODE COMPL	IANCE LEGEND
	1 HR FIRE BARRIER
— • • —	2 HR FIRE WALL
50'	EXIT DISTANCE
10P	ROOM OCCUPANCY
45 226	ACTUAL EGRESS OCCUPANCY MAX ALLOWABLE LOADING

ABBREVIATIONS

ahap Ahu Alum Amp	ABOVE FINISH FLOOR ASBESTOS CONTAINING MATERIAL ACOUSTIC PANEL ACOUSTIC CEILING TILE ADJUSTABLE AIR CONDITIONING AMERICAN WITH DISABILITIES ACT ARCHITECTURAL EXPOSED STRUCTURAL STEEL AS HIGH AS POSSIBLE AIR HANDLING UNIT ALUMINUM ACRYLIC MODIFIED POLYESTER APPROXIMATE	MAINT MAX MFG MSNRY MO MATL MECH MTL MCP MCB MS MLWK MIN
BEPO BTW BLKG BOT BLDG BL	BROADCAST EPOXY BETWEEN BLOCKING BOTTOM BUILDING BUILDING LINE	MISC MLDG MTD MTG NIC NTS
CAB CFS CI CLG CL CMU COL CONC CONF CONST CONTR CONT	CABINET CEMENT BOARD COLD FORMED STEEL CAST IRON CEILING CENTER LINE CONCRETE MASONRY UNIT COLUMN CONCRETE CONFERENCE CONFERENCE CONSTRUCTION CONTRACTOR CONTINUOUS	NO OC OPNG OPP OH OTS OUT OD OF P PT PTB
CPT CT CTB DA DET DF DIM DR DN	CARPET CERAMIC TILE CERAMIC TILE BASE DEVICE ARRANGEMENT DETAIL DRINKING FOUNTAIN DIMENSION DOOR DOWN	PTD PR PNL PTN PL PLAM PLMB PLYWD PTWD
EJ ELEC EL/ELEV ENCL EOD EOS EPO EPS EQ ES EXST ETR	DRAWING EACH EACH END EXTERIOR INSULATION FINISH SYSTEM EXPANSION JOINT ELECTRIC/ELECTRICAL ELEVATION ENCLOSURE EDGE OF DECK EDGE OF SLAB EPOXY EDGE OF POUR STOP EQUAL EACH SIDE EXISTING EXISTING TO REMAIN EXISTING TO BE RELOCATED	QT QTB QTY RCP REFL REQD RB RTN RA REV RFI RO RT RTB RTT RW
EXT EW FAB FTF FIN FA FD FDMPR FE FEC FF FHC FHVC FP	EXISTING TO BE RELOCATED EXPANSION JOINT EXTERIOR EACH WAY FABRIC FACE TO FACE FINISHED FIRE ALARM FLOOR DRAIN FIRE DAMPER FIRE EXTINGUISHER FIRE EXTINGUISHER FIRE EXTINGUISHER FIRE EXTINGUISHER FIRE HOSE CABINET FIRE HOSE CABINET FIRE HOSE VALVE CABINET FIRE PROTECTION	S SCHED SECT SF SFB SH SIM SL STC SPEC SQFT ST STSTL STSTL STR SUSP
FRTD FIX FL/FLR FLUOR FL MTD FT	FLUORESCENT FLUSH MOUNTED FOOT/FEET	T TB TBD TERR TFF THERM THK TMP GL T&B TO TOS TOSS TOSS TOES TRT
GL GOG GWB H	GLASS GOGGLE GYPSUM WALLBOARD HEIGHT AFF HARDWARE	TYP UNFIN UNO UR UTIL
HDWD HD HDR HVAC HR HT HM HMFR	HARDWOOD HEAD HEADER	VAT VCT VEN VERT VET VIF VRS VT VWC
IF IN INCL INFO INSUL INT JC JT	INSIDE FACE INCH/INCHES INCLUDE/INCLUSIVE INFORMATION INSULATION INTERIOR JANITOR'S CLOSET JOINT	WB WC WF WGL W/ W/C W/O WOM
JT KPL KD KO LAM	JOINT KICK PLATE KNOCKDOWN KNOCKOUT LAMINATED	WD WD BLF WD DR WP WR WR WW
LAM LAMGL LT LTG LWC LIN LVT	LAMINATED GLASS LIGHT LIGHTING LIGHT WEIGHT CONCRETE LINOLEUM LUXURY VINYL PLANK & TILE	YD _YCO ZCC

MAINT MAX MFG MSNRY MO MATL MECH MTL MCP MCB MS MLWK MIN MISC MLDG MTD MTD MTG NIC NTS NO	MAINTAIN/MAINTENANCE MAXIMUM MANUFACTURER MASONRY MASONRY OPENING MATERIAL MECHANICAL METAL METAL COMPOSITE PANEL METAL COMPOSITE PANEL METAL COMPOSITE PANEL METAL STUD MILL WORK MINIMUM MISCELLANEOUS MOLDING MOUNTED MOUNTING NOT IN CONTRACT NOT TO SCALE NUMBER	
OC OPNG OPP OH OTS OUT OD OF	ON CENTER OPENING OPPOSITE OPPOSITE HAND OPEN TO STRUCTURE OUTLET OUTSIDE DIAMETER OUTSIDE FACE	
P PT PTB PTD PR PNL PTN PL PLAM PLAM PLMB PLYWD PTWD	PAINTED PORCELAIN TILE PORCELAIN TILE BASE PAINTED PAIR PANEL PARTITION PROPERTY LINE PLASTIC LAMINATE PLUMBING PLYWOOD PRESERVATIVE TREATED WOOD	
QT QTB QTY	QUARRY TILE QUARRY TILE BASE QUANTITY	
	REFLECTED REQUIRED RUBBER BASE RETURN RETURN AIR REVISED/REVISION REQUEST FOR INFORMATION ROUGH OPENING RUBBER TREATD/TILE RUBBER TREAD BASE RESILIENT TERRAZZO TILE	
S SCHED SECT SF SFB SH SIM SL STC SPEC SQFT ST STSTL STSTL STL STR SUSP	SECTION SQUARE FEET SPLIT FACE BLOCK SHELVING/SHELF/SHELVES SIMILAR SLATE SOUND TRANSMISSION CLASS SPECIFICATION SQUARE FOOT SAND, STAIN & SEAL STAINLESS STEEL STEEL STEEL STRUCTURAL/STRUCTURE	1
T TB TBD TERR TFF THERMO THK TMP GL T&B TO TOS TOSS TOSS TOES TRT TYP	THICK	
UNFIN UNO UR UTIL	UNFINISHED UNLESS NOTED OTHERWISE URINAL UTILITY	
VAT VCT VEN VERT VET VIF VRS VT VWC	VINYL ASBESTOS TILE VINYL COMPOSITE TILE VENEER VERTICAL VINYL ENHANCED TILE VERIFY IN FIELD VINYL REDUCER STRIP VINYL TILE VINYL WALL COVERING	
WB WC WF W/C W/C W/O WOM WD WD BLKC	WHITEBOARD WATER CLOSET WATER FOUNTAIN WIRE GLASS WITH WHEEL CHAIR WITHOUT WALK OFF MAT WOOD G WOOD BLOCKING	
WD DR WP WR WW	WOOD DOOR WATERPROOFING WARDROBE WINDOW WALL	
YD _YCO ZCC	YARD —YARD CLEANOUT ZINC COATED COPPER	_

SHEET IDENTIFI

	SHEET	PLINE DESIGNAT T TYPE DESIGN/ ENCE NUMBER	
	DISCIF G CC PH HM C L S A F P M E	GENERAL CODE COMPL PHASING HAZARDOUS I ABATEMENT CIVIL LANDSCAPE STRUCTURAL ARCHITECTUF FIRE PROTEC PLUMBING MECHANICAL ELECTRICAL	IANCE MATERIAL RAL
SYI	MB	OLS L	EG
ROOM NAME 101 150 SF			ROOM TA((NAME, NU
(-)	_		WALL TYP RATING TA WINDOW
101			DOOR DES
СЈ			CONTROL
			COLUMN I
1 A101			EXTERIOF
1 (A101) 1	1		INTERIOR
1 A101	SIM	I	WALL OR

MATERIAL LEGE

	CMU WALL
	CMU WALL
n de la companya de l la companya de la comp la companya de la comp	GWB (SEE DRAWINGS
	MASONRY VENEER
	EXPOSED TO WEATHE
	WOOD BLOCKING (PR TREATED ALL AREAS WEATHER OR MOISTL

FICATION I	LEGEND				
A10	1	CONSTRUCTION AND MAINT			
		THE OCCUPIED PORTION OF THE EXISTING SCHOOL NECESSARY TO MAINTAIN A CERTIFICATE OF OCCU			
		ALL SCHOOL AREAS TO BE DISTURBED DURING REN ASBESTOS.			
SHEET TYPE DESIGNAT	<u>OR</u>	GENERAL SAFETY AND SECURITY STANDARDS FOR			
 4 ENLARGED PLAN 5 FINISHES 6 REFLECTED CEII 7 VERTICAL CIRCU 	JLATION S & ENLARGED DETAILS	 (A) ALL CONSTRUCTION MATERIALS SHALL (B) FENCES AROUND CONSTRUCTION SUPP (C) GATES SHALL ALWAYS BE LOCKED UNLE (D) DURING EXTERIOR RENOVATION WORK, AREAS IMMEDIATELY BENEATH THE WO WARNING SIGNS TO PREVENT ENTRY. (E) WORKERS SHALL BE REQUIRED TO WEA SECURITY PURPOSES WHILE WORKING 			
		SEPARATION OF CONSTRUCTION AREAS FROM OCC			
END		CONSTRUCTION AREAS WHICH ARE UNDER THE CO STAFF OR STUDENTS SHALL BE SEPARATED FROM OF DUST AND CONTAMINANTS INTO OCCUPIED PAR CONTAINMENT BARRIERS MUST BE MADE TO PREVE IN EXIT WAYS OR OTHER AREAS THAT REQUIRE FIR FOR A VAPOR, FINE DUST OR AIR INFILTRATION BAR CONSTRUCTION AREAS.			
		(A) A SPECIFIC STAIRWELL AND/OR ELEVAT HOURS. IN GENERAL, WORKERS MAY NO SCHOOL STAFF.			
NG UMBER, & AREA)	DENOTES EXISTING AREA OF THE BUILDING TO REMAIN (NO MAJOR GENERAL CONSTRUCTION). DENOTES EXISTING WALL TO REMAIN	(B) LARGE AMOUNTS OF DEBRIS MUST BE F THERE SHALL BE NO MOVEMENT OF DEB SHALL BE DROPPED OR THROWN OUTSI			
PE & FIRE AG		(C) ALL OCCUPIED PARTS OF THE BUILDING			
TYPE TAG	DENOTES EXISTING WALL TO BE DEMOLISHED	EACH WORKDAY. SCHOOL BUILDINGS O HEALTH, SAFETY AND EDUCATIONAL CA			
SIGNATION TAG	DENOTES 1hr OR NON-RATED WALL	A PLAN DETAILING HOW EXITING REQUIRED BY THE			
_ JOINT	DENOTES 2hr RATED WALL	A PLAN DETAILING HOW ADEQUATE VENTILATION W			
LINE	DENOTES WALL TYPE & FIRE RATING	CONSTRUCTION AND MAINTENANCE OPERATIONS S SHALL BE SCHEDULED FOR TIMES WHEN THE BUILD ABATEMENT MEASURES SHALL BE TAKEN.			
R ELEVATION	Image: Constraint of the second state of the seco	THE CONTRACTOR SHALL BE RESPONSIBLE FOR TH PRODUCED BY WELDING, GASOLINE OR DIESEL ENC OCCUPIED PORTIONS OF THE BUILDING OR AIR INT/			
RELEVATION	DENOTES EXISTING DOOR TO REMAIN (U.N.O)	THE CONTRACTOR SHALL BE RESPONSIBLE TO ENS VOLATILE ORGANIC COMPOUNDS SUCH AS GLUES, SCHEDULED, CURED OR VENTILATED IN ACCORDAN OCCUPIED.			
	DENOTES EXISTING DOOR AND OR FRAME TO BE DEMOLISHED. SEE DOOR SCHEDULE.	LARGE AND SMALL ASBESTOS ABATEMENT PROJECT BUILDING IS OCCUPIED". NOTE, IT IS OUR INTERPRE MEANS A WING OR MAJOR SECTION OF A BUILDING WITH SEALED NON COMBUSTIBLE CONSTRUCTION.			
BUILDING SECTION	DENOTES NEW DOOR AND OR FRAME. SEE DOOR SCHEDULE	NOT PASS THROUGH THE OCCUPIED PORTION AND THE ISOLATION BARRIER. EXTERIOR WORK SUCH AS ROOFING, FLASHING, SIL PROVIDED PROPER VARIANCES ARE IN PLACE AS R WINDOWS IS PROVIDED. CARE MUST BE TAKEN TO VISUAL DISTRACTION.			
END		SURFACES THAT WILL BE DISTURBED BY RECONST LEAD. PROJECTS WHICH DISTURB SURFACES THAT CERTIFIED LEAD RISK ASSESSOR OR SUPERVISOR PREPARATION, WORK METHODS, CLEANING AND CL			
	∅(((CAULK w/ BACKER ROD	GUIDELINES.			

IER OR MOISTURE)

RESSURE S EXPOSED TO URE)

///

WATERPROOFING MEMBRANE, OR ROOFING MEMBRANE OR FLASHING **RIGID INSULATION** BATT INSULATION

POROUS FILL

SUITABLE COMPACTED BACKFILL (SEE SPEC)

UNDISTURBED SOIL

CAST-IN-PLACE CONCRETE OR CAST STONE

GLASS SURFACE

PROJECT INFORMATION

OWNER SCHOOL OF THE HOLY 2225 WESTCHESTER AV RYE, NEW YORK 10580 TELEPHONE: 914.96 PROJECT SCHOOL OF THE HOLY LOCATION 2225 WESTCHESTER AV RYE, NEW YORK 10580 TYPE OF PROJECT NEW CONSTRUCTION PROJECT COMMENCEMENT TO BE DETERMINED PROJECT COMPLETION TO BE DETERMINED APPLICABLE CODES 2020 INTERNATIONAL B 2020 INTERNATIONAL E 2020 INTERNATIONAL F ADDITION

WORK AREAS

SEE DRAWING CC-2 FO

RDS FOR SCHOOL ITENANCE PROJECTS

OL BUILDING SHALL ALWAYS COMPLY WITH THE MINIMUM REQUIREMENTS CUPANCY.

ENOVATION OR DEMOLITION HAVE BEEN OR WILL BE TESTED FOR LEAD AND

OR CONSTRUCTION PROJECTS:

L BE STORED IN A SAFE AND SECURE MANNER.

PPLIES OR DEBRIS SHALL BE MAINTAINED. VLESS A WORKER IS IN ATTENDANCE TO PREVENT UNAUTHORIZED ENTRY RK, OVERHEAD PROTECTION SHALL BE PROVIDED FOR ANY SIDEWALKS OR ORK SITE OR SUCH AREAS SHALL BE FENCED OFF AND PROVIDED WITH

EAR PHOTO-IDENTIFICATION BADGES AT ALL TIMES FOR IDENTIFICATION AND IG AT OCCUPIED SITES.

CCUPIED SPACES:

CONTROL OF A CONTRACTOR AND THEREFORE NOT OCCUPIED BY DISTRICT M OCCUPIED AREAS. PROVISIONS SHALL BE MADE TO PREVENT THE PASSAGE ARTS OF THE BUILDING. PERIODIC INSPECTION AND REPAIRS OF THE EVENT EXPOSURE TO DUST OR CONTAMINANTS. GYPSUM BOARD MUST BE USED IRE RATED SEPARATION. HEAVY DUTY PLASTIC SHEETING MAY BE USED ONLY ARRIER, AND SHALL NOT BE USED TO SEPARATE OCCUPIED SPACES FROM

ATOR SHOULD BE ASSIGNED FOR CONSTRUCTION WORKER USE DURING WORK NOT USE CORRIDORS, STAIRS OR ELEVATORS DESIGNATED FOR STUDENTS OR

REMOVED BY USING ENCLOSED CHUTES OR A SIMILAR SEALED SYSTEM. EBRIS THROUGH HALLS OF OCCUPIED SPACES OF THE BUILDING. NO MATERIAL TSIDE THE WALLS OF THE BUILDING.

NG AFFECTED BY RENOVATION ACTIVITY SHALL BE CLEANED AT THE CLOSE OF OCCUPIED DURING A CONSTRUCTION PROJECT SHALL MAINTAIN REQUIRED CAPABILITIES AT ALL TIMES THAT CLASSES ARE IN SESSION.

HE APPLICABLE BUILDING CODE WILL BE MAINTAINED.

WILL BE MAINTAINED DURING CONSTRUCTION.

S SHALL NOT PRODUCE NOISE IN EXCESS OF 60 DBA IN OCCUPIED SPACES OR ILDING OR AFFECTED BUILDING SPACES ARE NOT OCCUPIED OR ACOUSTICAL

THE CONTROL OF CHEMICAL FUMES, GASES, AND OTHER CONTAMINATES NGINES, ROOFING, PAVING, PAINTING, ETC. TO ENSURE THEY DO NOT ENTER TAKES.

NSURE THAT ACTIVITIES AND MATERIALS WHICH RESULT IN "OFF-GASSING" OF , PAINTS, FURNITURE, CARPETING, WALL COVERING, DRAPERY, ETC. ARE ANCE WITH MANUFACTURERS RECOMMENDATIONS BEFORE A SPACE CAN BE

ECTS AS DEFINED BY 12NYCRR56 SHALL NOT BE PERFORMED WHILE THE RETATION THAT THE TERM "BUILDING", AS REFERENCED IN THIS SECTION, IG THAT CAN BE COMPLETELY ISOLATED FROM THE REST OF THE BUILDING N. THE ISOLATED PORTION OF THE BUILDING MUST CONTAIN EXITS THAT DO ID VENTILATION SYSTEMS MUST BE PHYSICALLY SEPARATED AND SEALED AT

SIDING, OR SOFFIT WORK MAY BE PERFORMED ON OCCUPIED BUILDINGS REQUIRED, AND COMPLETE ISOLATION OF VENTILATION SYSTEMS AND AT O SCHEDULE WORK SO THAT CLASSES ARE NOT DISRUPTED BY NOISE OR

STRUCTION MUST HAVE A DETERMINATION MADE AS TO THE PRESENCE OF AT CONTAIN LEAD SHALL HAVE IN THE SPECIFICATIONS A PLAN PREPARED BY A R WHICH DETAILS PROVISIONS FOR OCCUPANT PROTECTION, WORKSITE CLEARANCE TESTING WHICH ARE IN GENERAL ACCORDANCE WITH THE HUD

CHILD VE				
67.5622				
CHILD VE				
				FOR BID
				FOR PERMIT DEVELOPMENT
	No.	Date		lssue
	Shee	et Title		
		GENERAL		
EXISTING BUILDLING CODE FIRE CODE	INFORMATION			
DR WORK AREA PLANS	Job I	No. 2018-1078	3	Date 02/12/2020
	Scale	e AS NOTEI	D	Drawn / Checked KG+D / KG+D
	Sheet Number G001			

