# WEBUTUCK CENTRAL SCHOOL DISTRICT

# OPEN DOOR SBHC/ SCHOOL HEALTH OFFICE WEBUTUCK MIDDLE/HIGH SCHOOL

194 HAIGHT ROAD, AMENIA, NY 12501 SED # 13-11-01-04-0-002-020

#### OWNER:

### WEBUTUCK CENTRAL SCHOOL DISTRICT

194 HAIGHT ROAD, AMENIA, NY 12501 PHONE: (845) 373-4100

#### ARCHITECT / ENGINEER:

#### CPL

50 FRONT STREET, SUITE 202, NEWBURGH, NY 12550 PHONE: (800) 274-9000

THE DESIGN OF THIS PROJECT CONFORMS TO ALL APPLICABLE PROVISIONS OF NEW YORK STATE UNIFORM FIRE

PREVENTION AND BUILDING CODE, THE NEW YORK STATE ENERGY CONSERVATION CODE, AND THE BUILDING

STANDARDS OF THE NEW YORK STATE EDUCATION DEPARTMENT.

#### LIST OF DRAWINGS LOCATION MAP **GENERAL:** WEBUTUCK HIGH SCHOOL T000 TITLE SHEET 194 HAIGHT RD, AMENIA, NY 12501 ARCHITECTURAL: CODE COMPLIANCE PLAN DEMOLITION FLOOR PLAN & REFLECTED CEILING PLAN NEW WORK FLOOR PLAN, WALL TYPES, & FINISH SCHEDULE CASEWORK ELEVATIONS Kildonan School NEW WORK REFLECTED CEILING PLAN **SCHEDULES & DETAILS** A901 MECHANICAL: MECHANICAL SYMBOLS LIST Strauss J M DVM MECHANICAL DEMOLITION & NEW WORK PLANS **ELECTRICAL: ELECTRICAL SYMBOLS LIST** ELECTRICAL DEMOLITION PLAN ELECTRICAL NEW WORK PLAN ELECTRICAL LIGHTING PLAN PLUMBING: P000 PLUMBING LEGEND PLUMBING DEMOLITION & NEW WORK PLANS NORTH GENERAL NOTES

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ARCHITECTURE FINGINEERING PLANNING

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NO. DATE BY DESCRIPTION

SENTRAL SCHOOL DISTRICT
OPEN DOOR SBHC /
SCHOOL HEALTH OFFICE
WEBUTUCK MIDDLE/HIGH SCHOOL
SED # 13-11-01-04-0-002-020

DATE DRAWN CHECK
09/18/2020 NWH M.

SCALE AS NOTED


SHEET TITLE

TITLE SHEET

15650.00

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DRAWING NUMBER



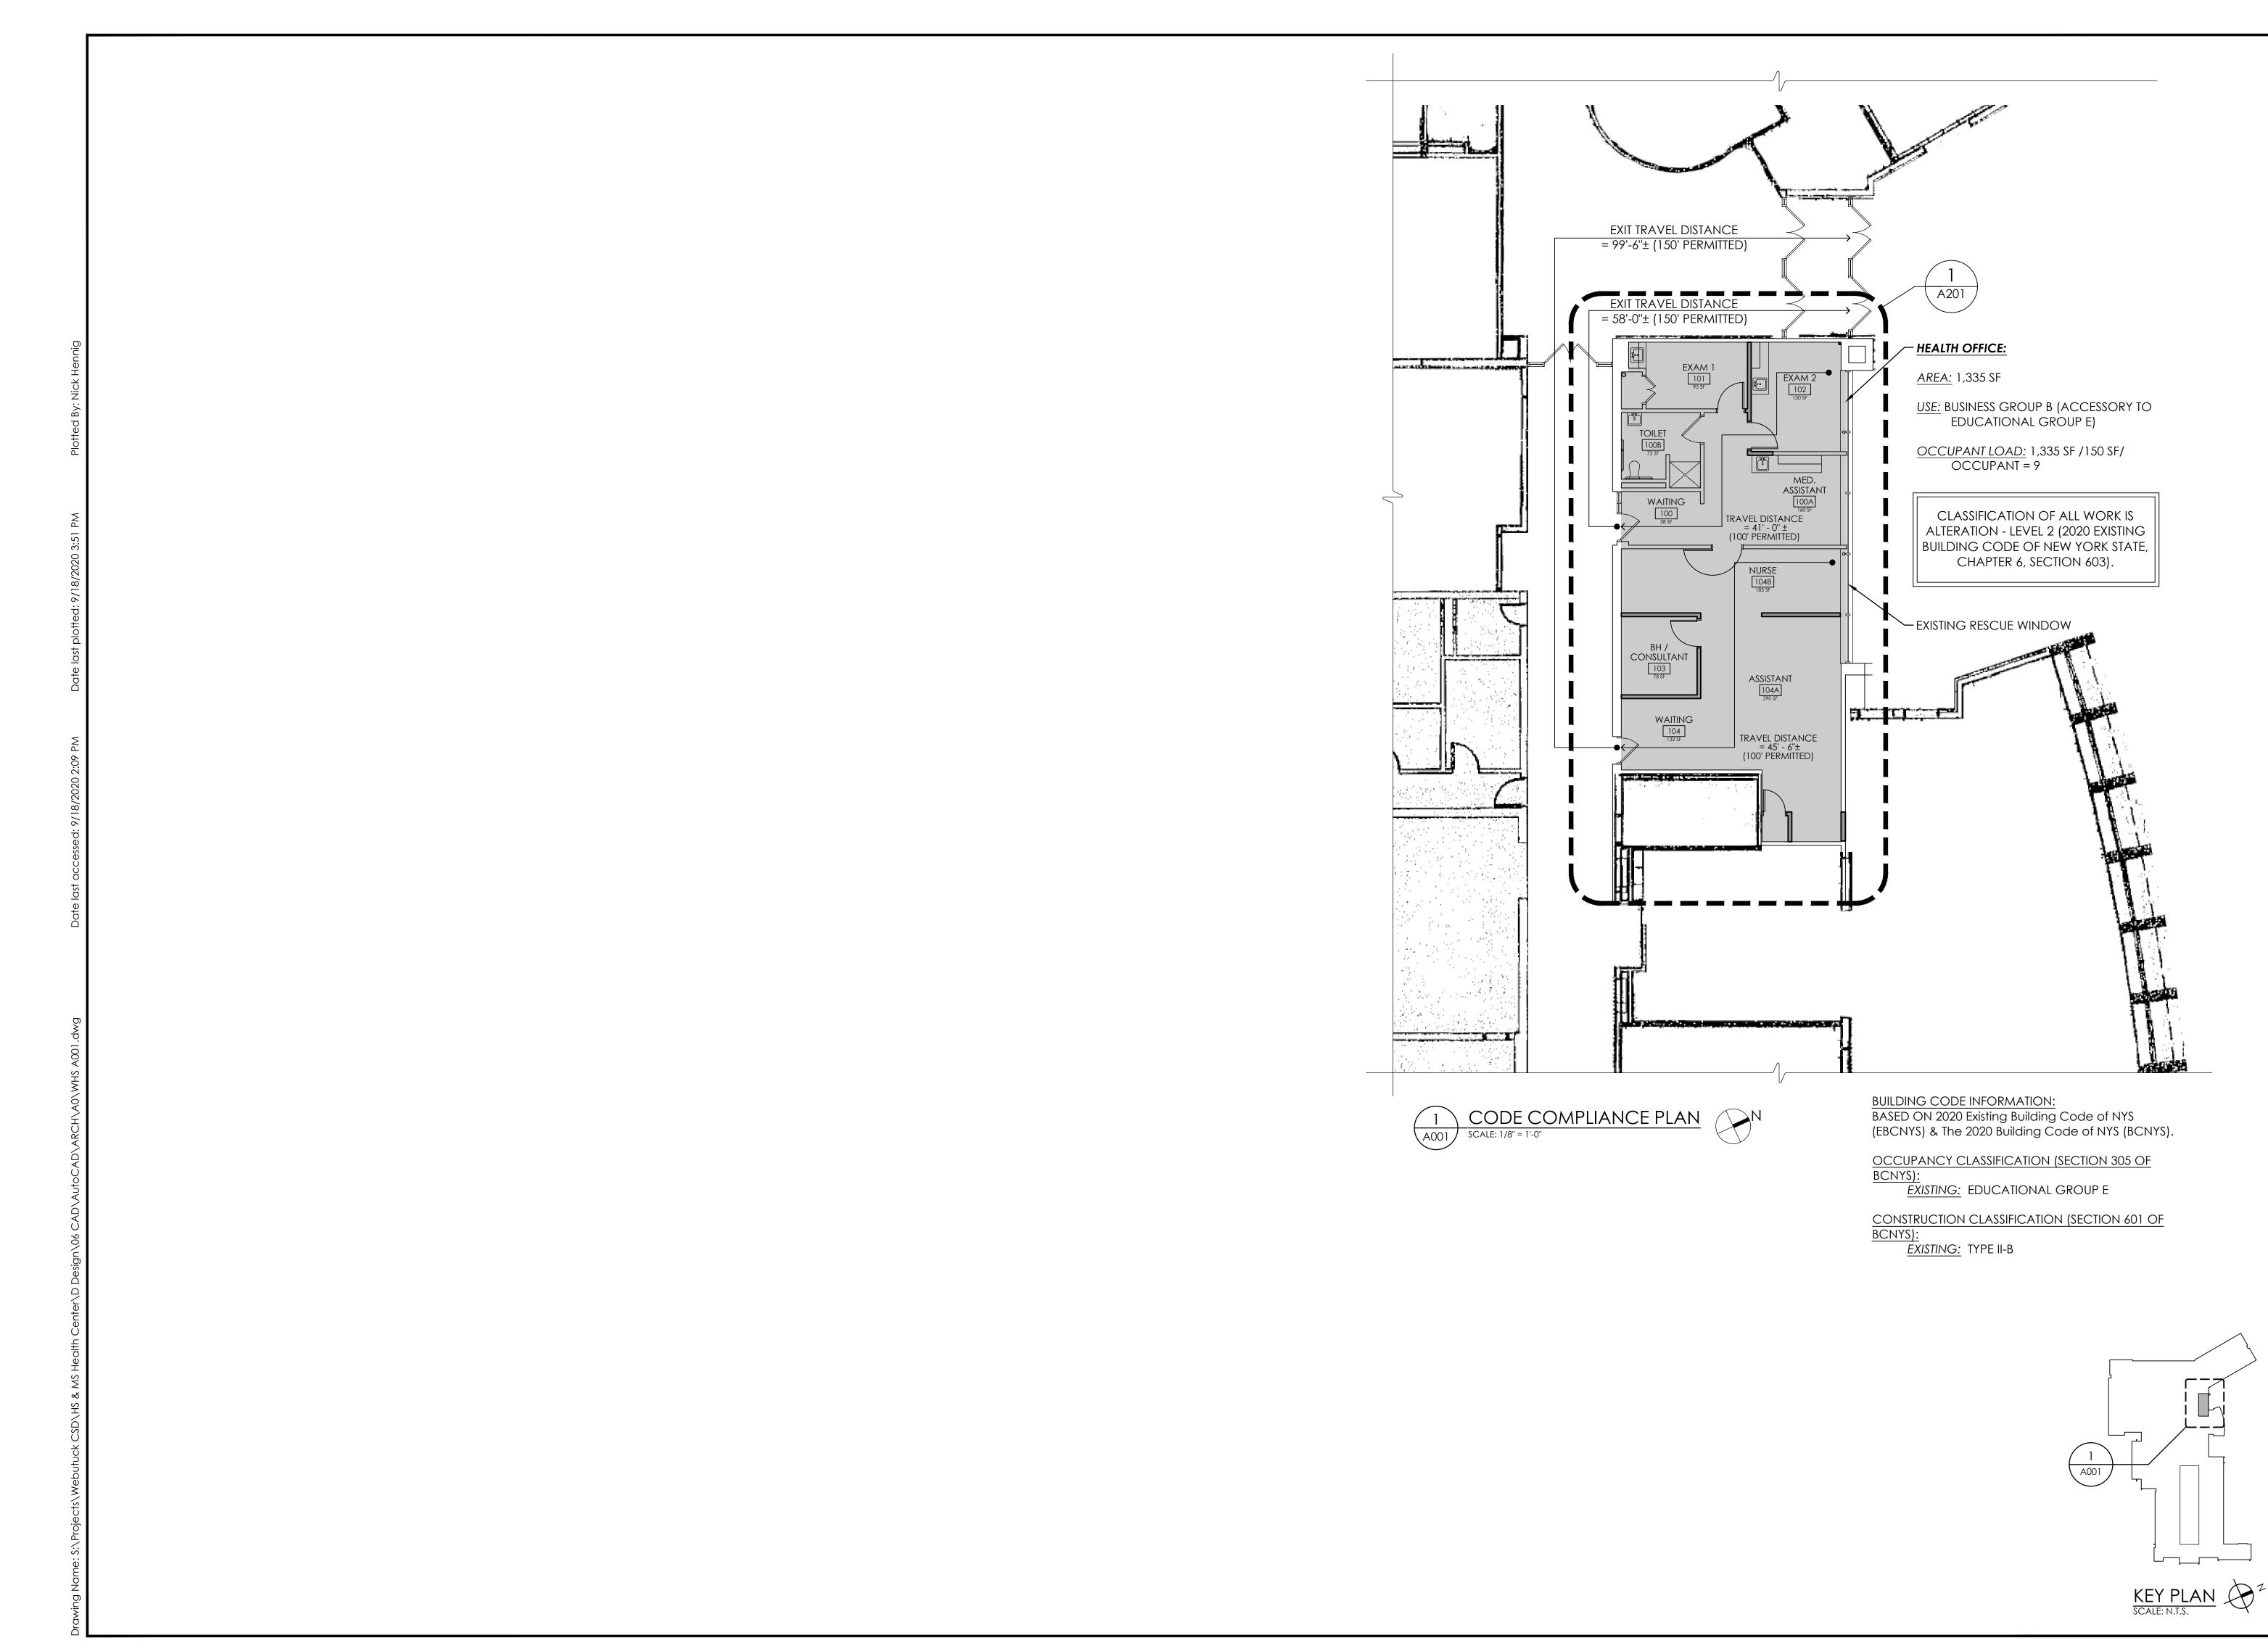

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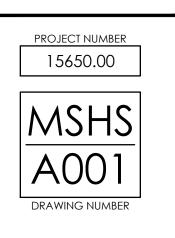
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SHEET TITLE

CODE COMPLIANCE
PLAN




#### GENERAL DEMOLITION NOTES:

- A. IT IS THE CONTRACTOR'S RESPONSIBILITY TO FAMILIARIZE THEMSELVES WITH ALL EXISTING CONDITIONS AND DETAILS INVOLVED IN THE DEMOLITION WORK.
- B. THE OWNER SHALL PROVIDE THE CONTRACTOR WITH A LIST OF ALL ITEMS TO BE SALVAGED PRIOR TO CONSTRUCTION.
- C. THE CONTRACTOR SHALL PROTECT ADJACENT SURFACES AND FINISHES NOT SCHEDULED FOR DEMOLITION WORK AND SHALL REPAIR ANY DAMAGED AREAS AS A RESULT OF CONTRACTED WORK AT NO ADDITIONAL COST TO THE OWNER.
- D. THE CONTRACTOR SHALL COORDINATE THE DEMOLITION WORK WITH THE OVERALL PROJECT PHASING.
- E. THE CONTRACTOR SHALL MAINTAIN AND CONTINUE SAFE ACCESS TO ALL EXITS FOR THE BUILDING OCCUPANTS DURING CONSTRUCTION.

#### DEMOLITION NOTES:

- REMOVE EXISTING WALL AS INDICATED. PATCH ADJACENT  $\langle \ | \ \rangle$  areas with like construction as necessary. Prepare AREA TO ACCOMMODATE NEW WORK.
- REMOVE EXISTING DOOR AND FRAME. PATCH ADJACENT AREAS WITH LIKE CONSTRUCTION AS NECESSARY. PREPARE AREA TO ACCOMMODATE NEW WORK.
- REMOVE EXISTING BUILT-IN CASEWORK IN ITS ENTIRETY. PATCH ADJACENT AREAS WITH LIKE CONSTRUCTION AS NECESSARY. PREPARE AREA TO ACCOMMODATE NEW WORK.
- REMOVE EXISTING PLUMBING FIXTURES IN ITS ENTIRETY. PREPARE AREA TO ACCOMMODATE NEW WORK.
- FEMOVE & RELOCATE EXISTING TACKBOARD. PREPARE AREA TO ACCOMMODATE NEW WORK. COORDINATE NEW LOCATION WITH OWNER.
- 6 CUT OPENING IN EXISTING PARTITION TO ACCOMMODATE NEW DOOR.
- 7 REMOVE EXISTING FLOORING AS NEEDED TO ACCOMMODATE NEW WORK. PATCH TO MATCH EXISTING.
- 8 REMOVE EXISTING CUBICLE CURTAINS AND TRACKS IN THEIR ENTIRETY.
- 9 MODIFY/REMOVE/REINSTALL/REPLACE EXISTING 2' x 2' SUSPENDED CEILING TILE & GRID AS REQUIRED TO ACCOMMODATE FOR NEW WORK. NEW MATERIALS SHALL MATCH EXISTING.
- REMOVE EXISTING DRY ERASE BOARD. TURN OVER TO OWNER. PREPARE AREA TO ACCOMMODATE NEW WORK.
- REMOVE/DISCONNECT EXISTING SMART BOARD. TURN OVER TO OWNER.

x'-x"± APPROXIMATE CEILING HEIGHT

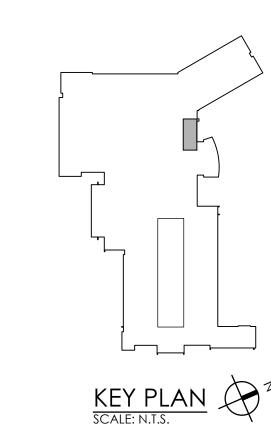



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09/18/2020 NWH SCALE AS NOTED

DEMOLITION FLOOR PLAN & REFLECTED CEILING PLAN

> 15650.00 MSHS A101

1. PAINT ALL NEW AND EXISTING GYP BOARD/CMU WALLS.

ROOM

NAME

WAITING

M.A. ASSIST.

TOILET

EXAM RM. 1

EXAM RM. 2

BH/CONSULT.

WAITING

NURSE ASSIST.

NURSE

STORAGE

CLOSET

SERVER

CLOSET

ROOM

NO.

100

100A

100B

101

102

103

104

104A

104B

101A

104C

2. NEW CWT WAINSCOT TO MATCH EXISTING (HEIGHT COLOR, PATTERN, ETC)

**FLOOR** 

VCT/ETR

3. PAINT COLORS TO BE SELECTED BY ARCHITECT. MULTIPLE COLORS MAY BE SELECTED

NORTH

VCT/ETR ETR CMU, PTD WITH ETR CMU,

ETR CMU, PTD WITH CWT

ETR GYP BD, WITH

CWT

NEW GYP BD, PTD

WITH CWT

NEW GYP.

BD, PTD

ETR CMU,

ETR CMU,

ETR GYP

BD, PTD

NEW GYP

BD, PTD

PTD

ETR CMU, PTD WITH NEW GYP BD, PTD

WALLS

ETR CMU, & ETR GYP BD,
GYP BD, PTD WITH PTD W/ CWT + NEW

SOUTH

PTD WITH CWT

ETR CMU WITH CWT

WITH CWT

ETR CMU,

ETR CMU, & GYP BD, PTD

NEW GYP BD, PTD

ETR CMU,

PTD

ETR CMU, PTD

ETR GYP

BD, PTD

EAST

ETR GYP BD,

PTD WITH CWT

ETR GYP BD,

PTD WITH CWT

ETR GYP BD, WITH

CWT

ETR GYP BD,

GYP BD, PTD W/ CWT

ETR GYP BD,

PTD WITH CWT

NEW GYP.

BD, PTD

ETR GYP BD, PTD

BD, PTD

NEW GYP BD, PTD

BD, PTD

ETR GYP

BD, PTD

ETR GYP BD, PTD

NEW GYP

BD, PTD


ETR GYP

BD, PTD

NEW GYP

BD, PTD



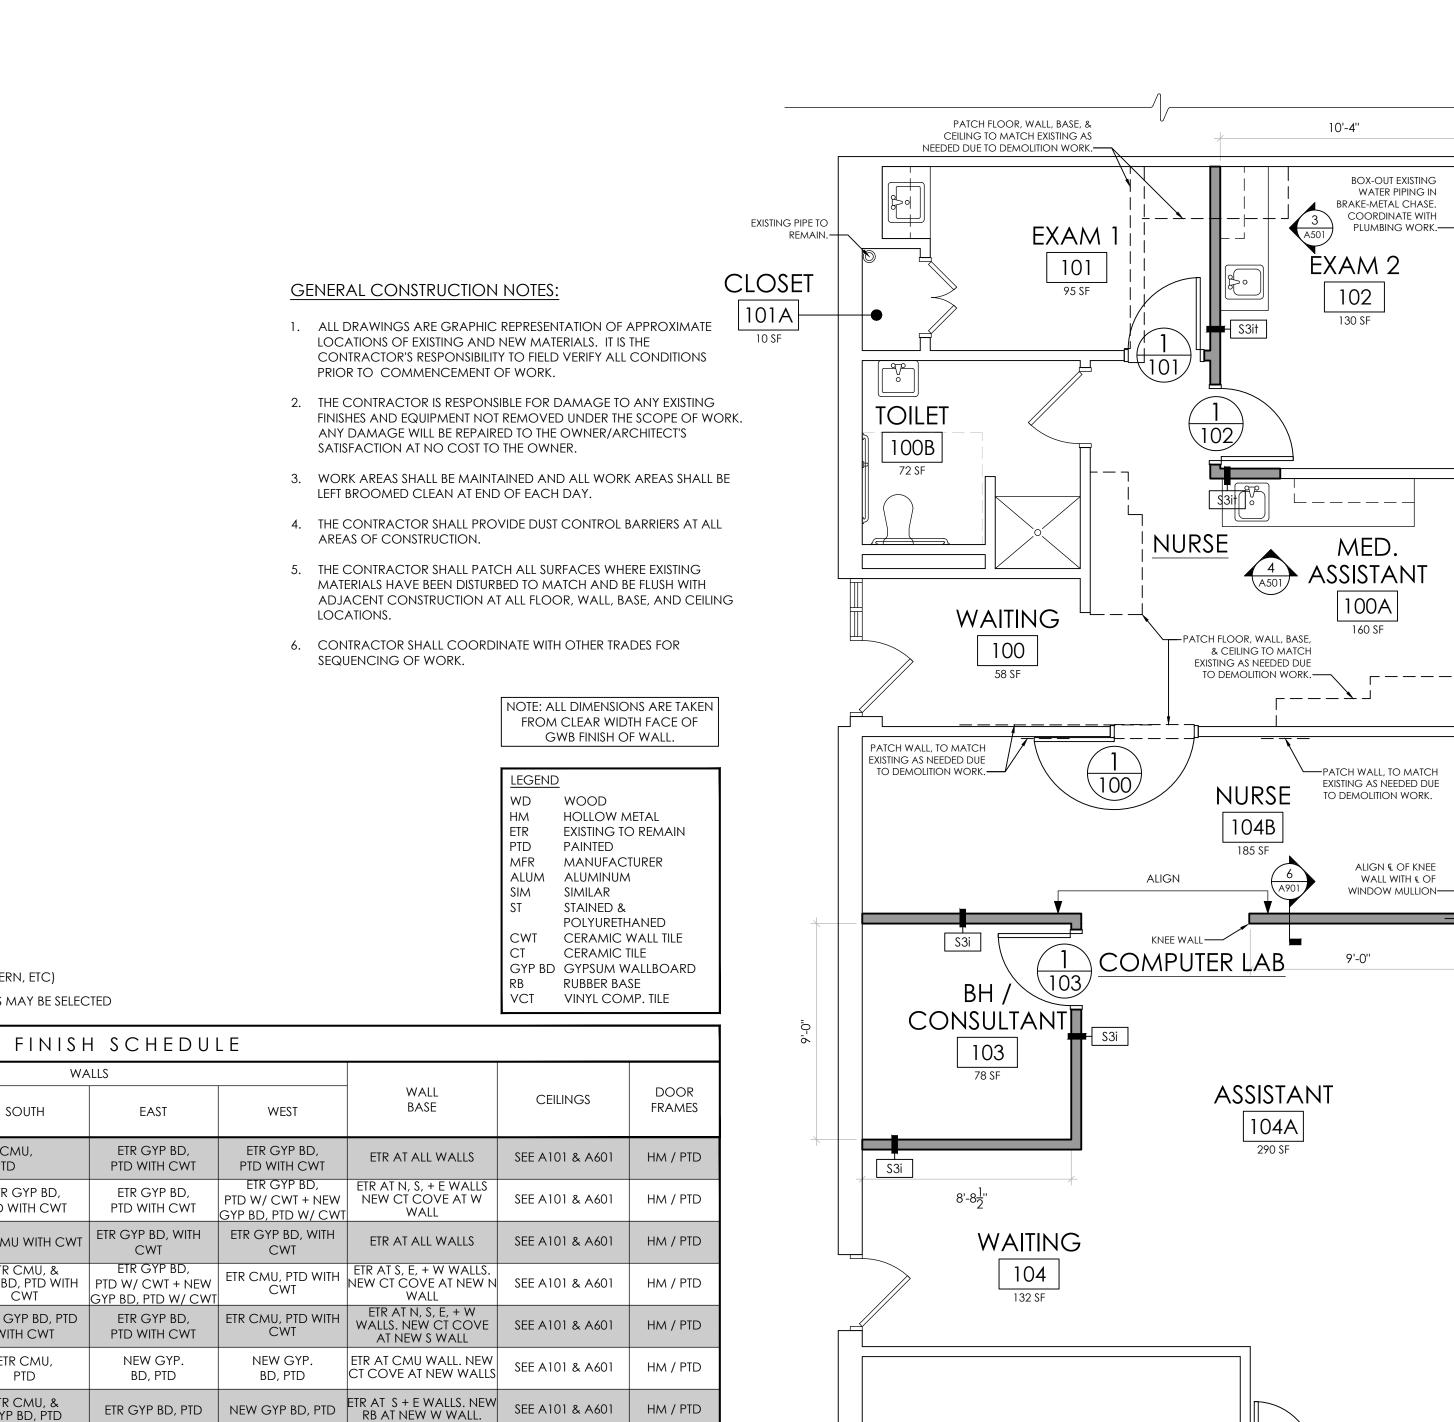

SEE A101 & A601

SEE A101 & A601

SEE A101 & A601

SEE A101 & A601

ETR AT N, E, + W WALLS. NEW RB AT NEW S WALL.

WALLS.

ETR AT ALL WALLS.

ETR AT S + E WALLS. NEW

RB AT NEW N + W WALLS

ETR AT N, + S WALLS.
NEW RB AT NEW E + W SEE A101 & A601

HM / PTD




SERVER


CLOSET

104C

3'-0''

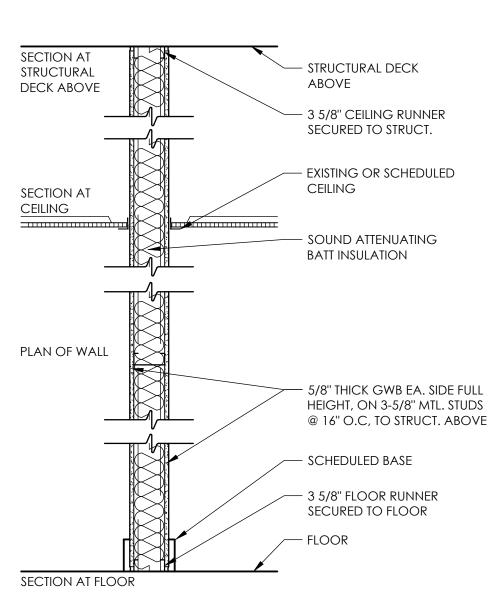


TYPE	FIRE TEST LAB & DESIGN	FIRE RATING	STC
S3i	NA	NR	47

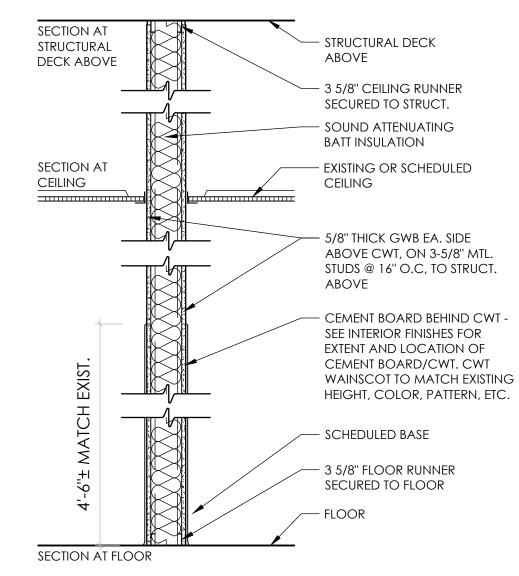

TYPE	FIRE TEST LAB & DESIGN	FIRE RATING	STC
S3it	NA	NR	47



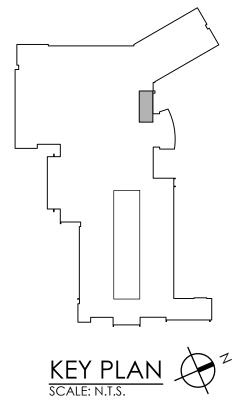

DRAWN CHECKE 09/18/2020 | NWH | SCALE AS NOTED SHEET TITLE NEW WORK FLOOR PLAN WALL TYPES & FINISH


SCHEDULE


FICE SCHOOL

DISTRIC

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SCALE AS NOTED


SHEET TITLE

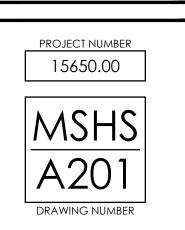CASEWORK ELEVATIONS

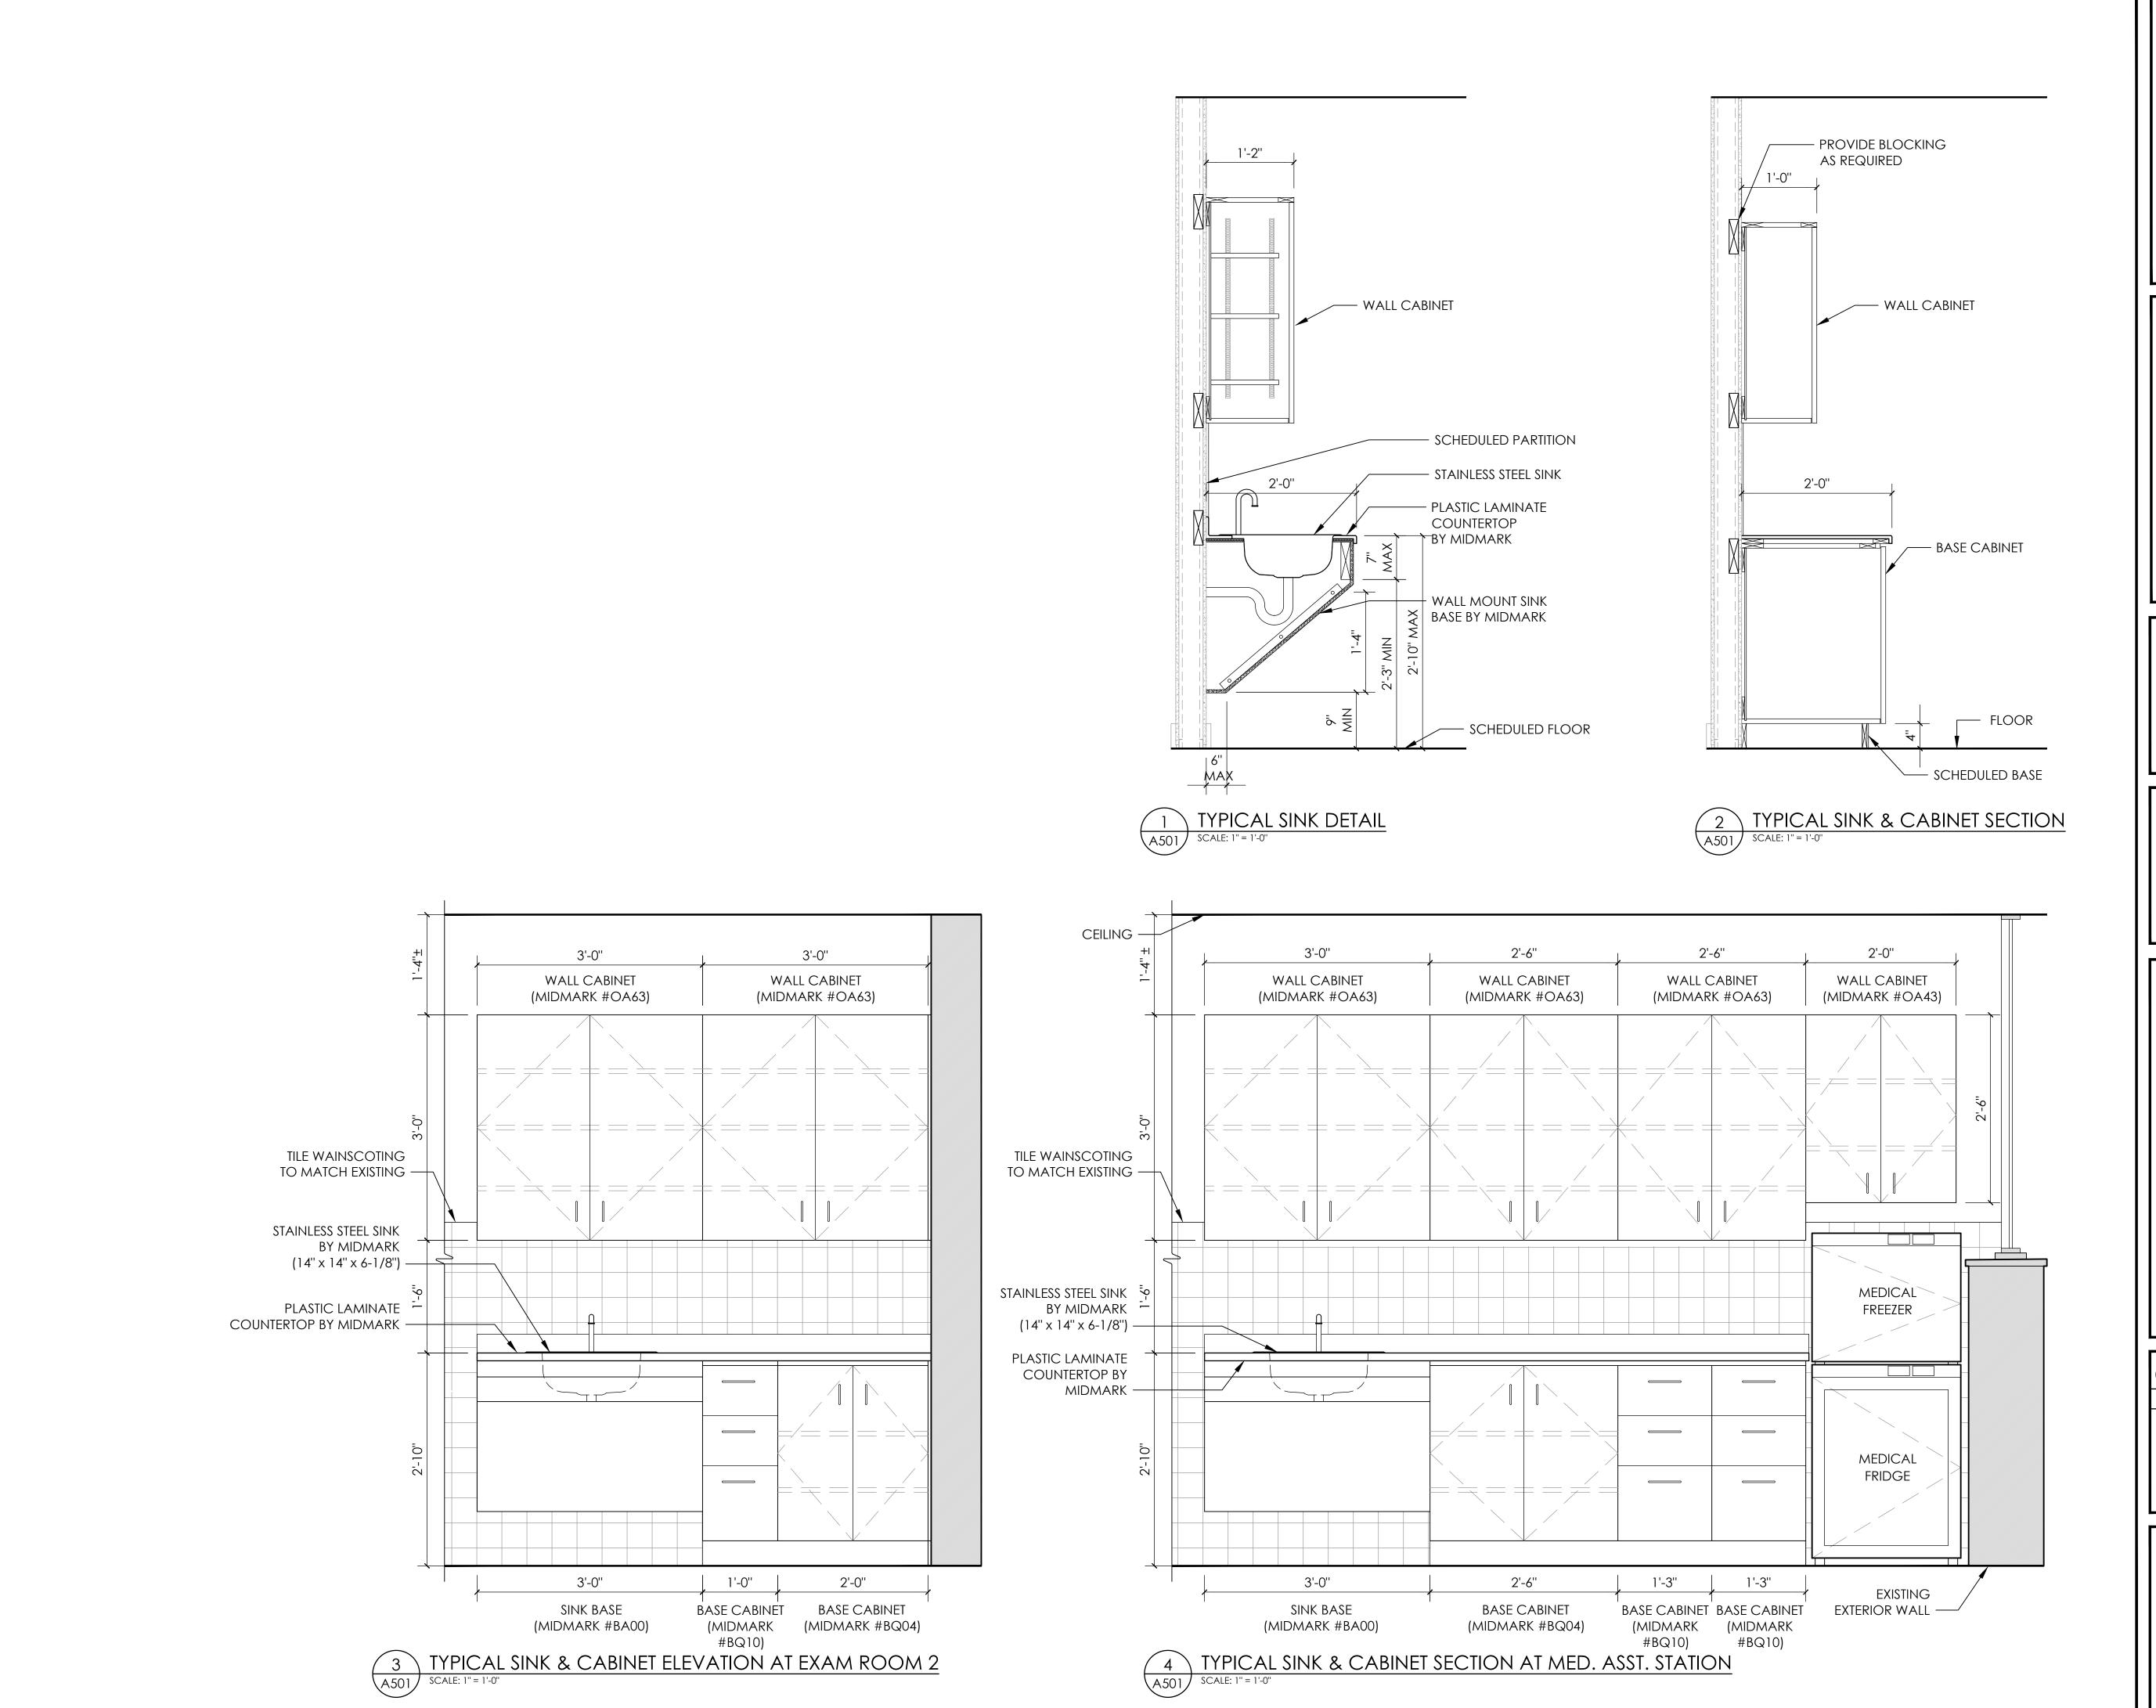15650.00

MSHS
A501

DRAWING NUMBER

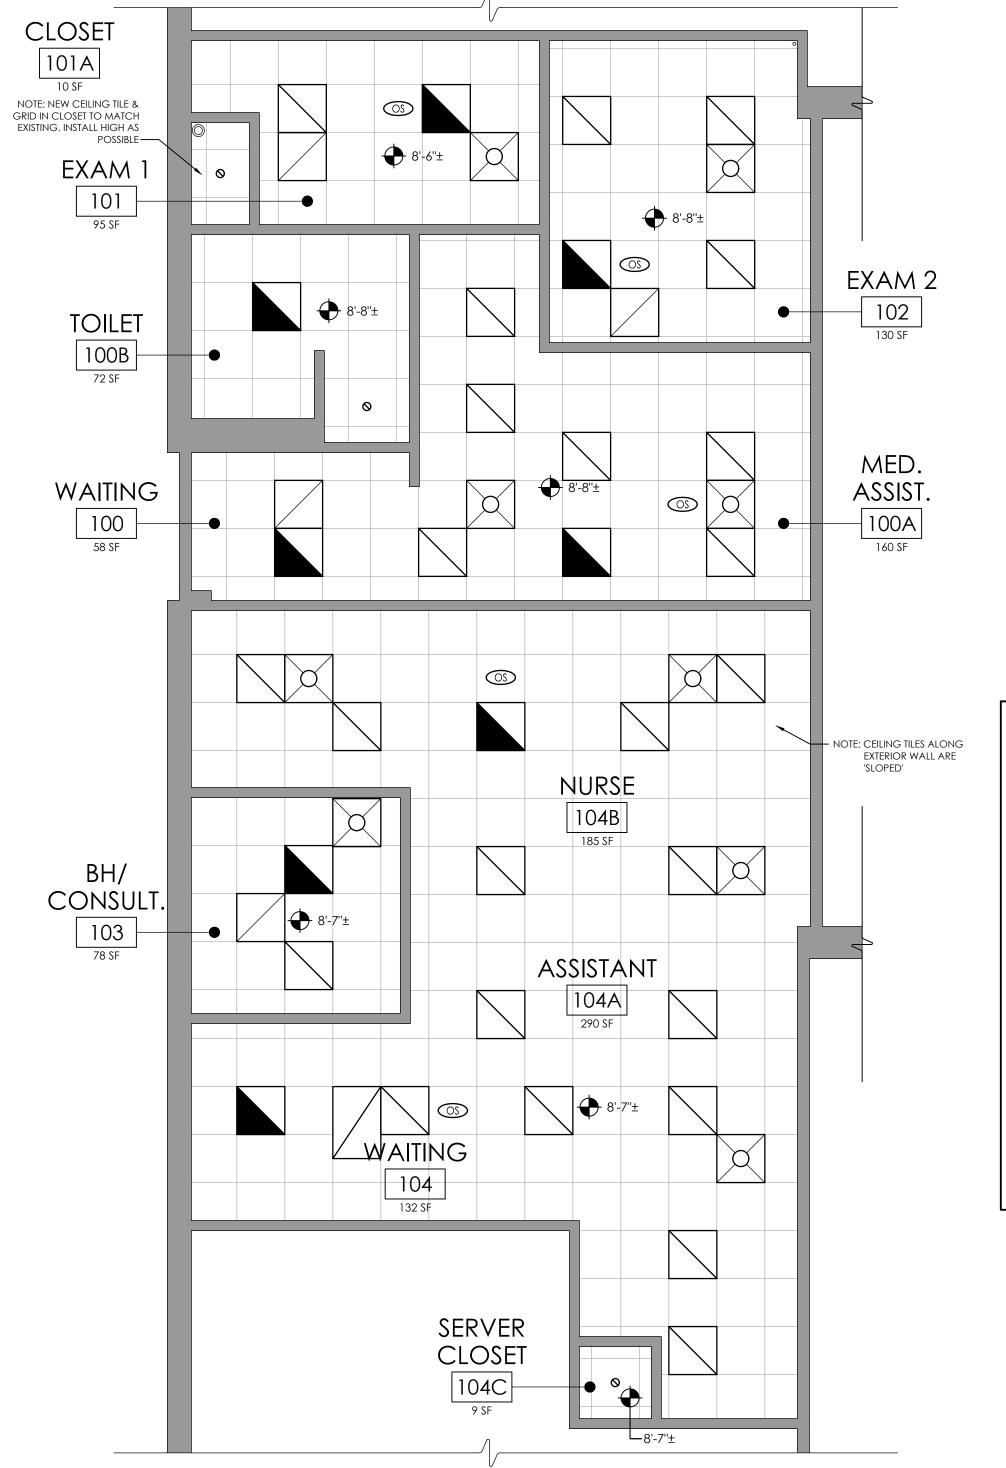


NEW WORK REFLECTED CEILING PLAN
SCALE: 1/4" = 1'-0"


#### GENERAL DEMOLITION NOTES:

- A. IT IS THE CONTRACTOR'S RESPONSIBILITY TO FAMILIARIZE THEMSELVES WITH ALL EXISTING CONDITIONS AND DETAILS INVOLVED IN THE DEMOLITION WORK.
- B. THE OWNER SHALL PROVIDE THE CONTRACTOR WITH A LIST OF ALL ITEMS TO BE SALVAGED PRIOR TO CONSTRUCTION.
- C. THE CONTRACTOR SHALL PROTECT ADJACENT SURFACES AND FINISHES NOT SCHEDULED FOR DEMOLITION WORK AND SHALL REPAIR ANY DAMAGED AREAS AS A RESULT OF CONTRACTED WORK AT NO ADDITIONAL COST TO THE OWNER.
- D. THE CONTRACTOR SHALL COORDINATE THE DEMOLITION WORK WITH THE OVERALL PROJECT PHASING.
- E. THE CONTRACTOR SHALL MAINTAIN AND CONTINUE SAFE ACCESS TO ALL EXITS FOR THE BUILDING OCCUPANTS DURING CONSTRUCTION.
- F. PROVIDE NEW CEILING TILES TO MATCH EXISTING WHERE MISSING (FOR BID PROPOSALS PROVIDE 96 SF OF NEW TILES).

#### GENERAL CONSTRUCTION NOTES:

- 1. ALL DRAWINGS ARE GRAPHIC REPRESENTATION OF APPROXIMATE LOCATIONS OF EXISTING AND NEW MATERIALS. IT IS THE CONTRACTOR'S RESPONSIBILITY TO FIELD VERIFY ALL CONDITIONS PRIOR TO COMMENCEMENT OF WORK.
- 2. THE CONTRACTOR IS RESPONSIBLE FOR DAMAGE TO ANY EXISTING FINISHES AND EQUIPMENT NOT REMOVED UNDER THE SCOPE OF WORK. ANY DAMAGE WILL BE REPAIRED TO THE OWNER/ARCHITECT'S SATISFACTION AT NO COST TO THE OWNER.
- 3. WORK AREAS SHALL BE MAINTAINED AND ALL WORK AREAS SHALL BE LEFT BROOMED CLEAN AT END OF EACH DAY.
- 4. THE CONTRACTOR SHALL PROVIDE DUST CONTROL BARRIERS AT ALL AREAS OF CONSTRUCTION.
- 5. THE CONTRACTOR SHALL PATCH ALL SURFACES WHERE EXISTING MATERIALS HAVE BEEN DISTURBED TO MATCH AND BE FLUSH WITH ADJACENT CONSTRUCTION AT ALL FLOOR, WALL, AND CEILING LOCATIONS.
- 6. CONTRACTOR SHALL COORDINATE WITH OTHER TRADES FOR SEQUENCING OF WORK.

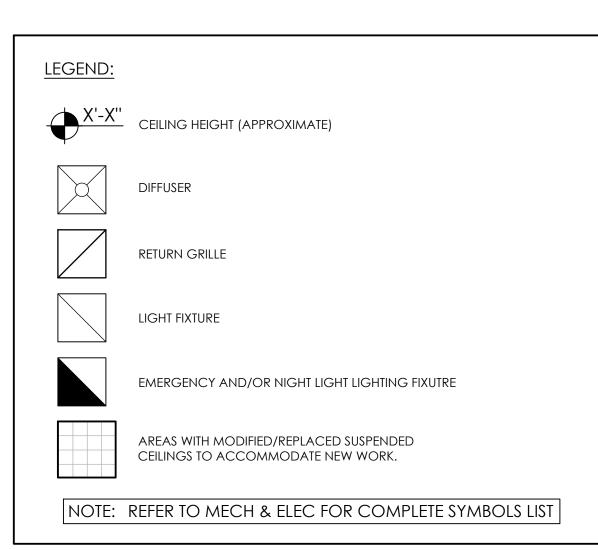

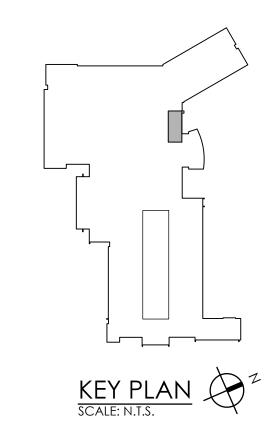



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DATE DRAWN CHECK 09/18/2020 NWH MJ SCALE AS NOTED

SCALE AS NOTED


SHEET TITLE

NEW WORK REFLECTED
CEILING PLAN

15650.00


MSHS
A601

DRAWING NUMBER

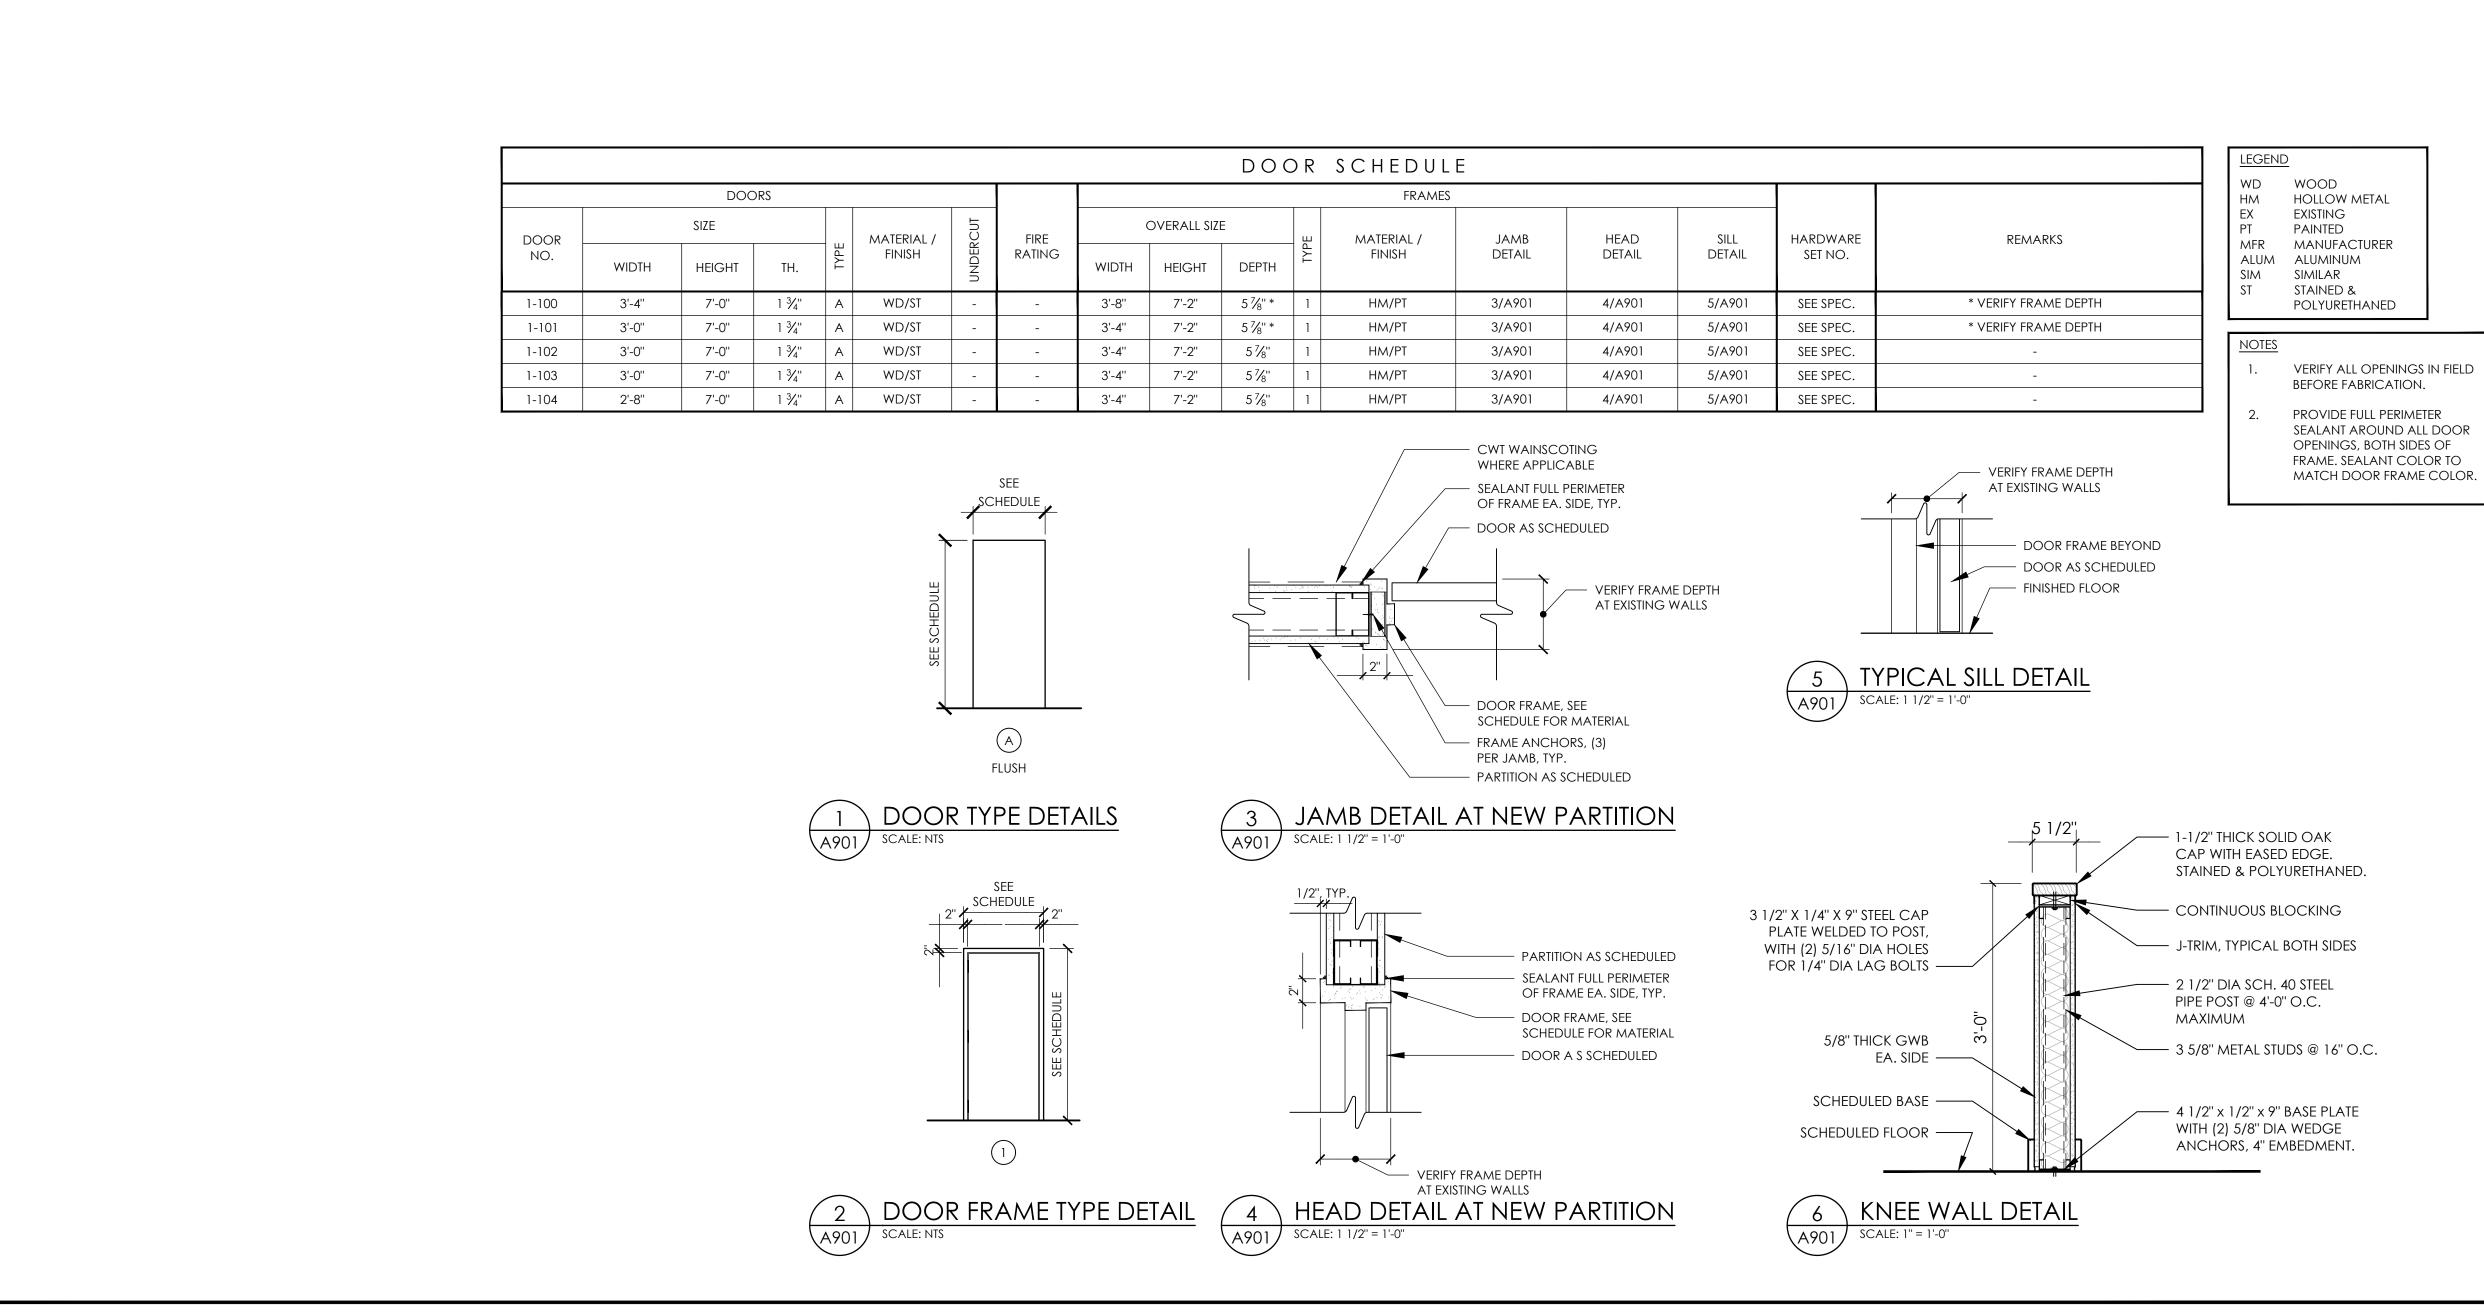

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SED # 13-11-01-04-0-002-020

DRAWN CHECKED 09/18/2020 NWH SCALE AS NOTED SHEET TITLE SCHEDULES & DETAILS

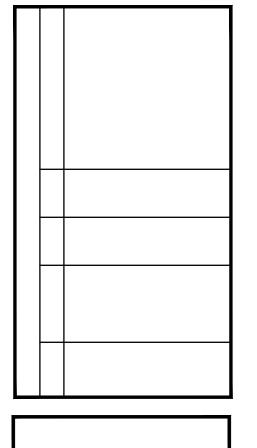PROJECT NUMBER 15650.00 MSHS A901 DRAWING NUMBER

LINING - 2 INCH THICK

HVAC SYMBOLS LIST

#### **SYMBOLS GENERAL NOTES:**

SYMBOL

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(H)

DESCRIPTION

**CURRENT TRANSDUCER** 

OPEN/CLOSED

**ENABLE/DISABLE** 

FLOW TRANSMITTER

PRESSURE TRANSMITTER

**DUCT SMOKE DETECTOR** 

SPACE TEMPERATURE SENSOR

SPACE CARBON DIOXIDE SENSOR

SPACE CARBON MONOXIDE SENSOR

VARIABLE SPEED / FREQUENCY DRIVE

DIFFERENTIAL STATIC PRESSURE SWITCH

DIGITAL INPUT (TO BUILDING MANAGEMENT SYSTEM)

ANALOG INPUT (TO BUILDING MANAGEMENT SYSTEM)

DIGITAL OUTPUT (FROM BUILDING MANAGEMENT SYSTEM)

ANALOG OUTPUT (FROM BUILDING MANAGEMENT SYSTEM)

SPACE NATURAL GAS SENSOR

SPACE SENSOR WITH GUARD

SPACE HUMIDISTAT

WATER FLOW SENSOR

PNEUMATIC ACTUATOR

**ELECTRIC ACTUATOR** 

**COOLING COIL** 

**HEATING COIL** 

GAS FURNACE

HUMIDIFIER

ALARM

STATUS

RELAY

FLOW SWITCH

PRESSURE GAUGE

**ELECTRICAL INTERFACE** 

POSITION FEEDBACK

FREEZE STAT SENSOR

TRAVERSE AVERAGING SENSOR

SPEED FEED BACK

**END SWITCH** 

PROBE SENSOR

 $\sim$ 

-11

•—

SPACE THERMOSTAT

START/STOP

**ELECTRIC/PNEUMATIC SWITCH OR RELAY** 

PNEUMATIC/ELECTRIC SWITCH OR RELAY

TEMPERATURE SENSOR (DUCT OR PIPE MOUNTED)

**HUMIDITY SENSOR (DUCT MOUNTED)** 

DIFFERENTIAL PRESSURE TRANSMITTER

**ELECTRIC/PNEUMATIC TRANSDUCER** 

ELECTRIC/ELECTRONIC TRANSDUCER

1) VALVE AND DAMPER ACTUATOR TYPES (ELECTRIC OR PNEUMATIC) WHICH ARE INDICATED IN HVAC TEMPERATURE CONTROL DRAWINGS SHALL SUPERSEDE TYPE INDICATED ON ALL OTHER HVAC DRAWINGS.

#### **HVAC CONTRACTOR GENERAL NOTES:**


- A. IT IS THE RESPONSIBILITY OF THE CONTRACTOR TO FIELD VERIFY EXISTING CONDITIONS WITHIN THE BUILDING PRIOR TO COMMENCEMENT OF ALL DEMOLITION AND NEW WORK.
- IT IS THE RESPONSIBILITY OF THE CONTRACTOR TO REMOVE AND REPLACE EXISTING CEILINGS, UNLESS OTHERWISE NOTED ON THE ARCHITECTURAL DRAWINGS, FOR PERFORMING DEMOLITION OR NEW WORK WITHIN THE BUILDING. THE EXISTING CEILINGS SHALL BE REMOVED IN A MANNER TO AVOID DAMAGE TO THE CEILING SYSTEMS. STORAGE OF CEILING SYSTEM COMPONENTS FOR REINSTALLATION IS THE RESPONSIBILITY OF THE CONTRACTOR. THE STORAGE OF ALL MATERIAL SHALL BE IN AREAS OR LOCATIONS APPROVED BY THE OWNER. THE OWNER WILL NOT COMPENSATE FOR ANY DAMAGED OR LOST MATERIAL WHILE IN STORAGE. AFTER COMPLETION OF ALL DEMOLITION OR NEW WORK, THE CONTRACTOR SHALL REINSTALL THE CEILING SYSTEMS TO MATCH THE ORIGINAL INSTALLATION.
- DEMOLITION DRAWINGS SHOW MAJOR EQUIPMENT, PIPING, AND DUCTWORK REMOVALS. THE INTENT IS NOT TO IDENTIFY ALL MISCELLANEOUS PIPING, PIPING ACCESSORIES, DUCTWORK, DUCTWORK ACCESSORIES, SUPPORTS, CONTROLS, CONTROL ACCESSORIES, CONTROL WIRING, CONDUIT, AND PNEUMATIC CONTROL TUBING TO BE DISCONNECTED AND REMOVED, BUT IS THE REQUIREMENT UNDER THIS CONTRACT. NO EQUIPMENT, PIPING, OR DUCTWORK SHALL BE ABANDONED IN PLACE, UNLESS OTHERWISE NOTED ON THE DRAWINGS.
- ALL EQUIPMENT INDICATED TO BE TURNED OVER TO THE OWNER SHALL BE DISCONNECTED AND REMOVED FROM THE EXISTING SYSTEMS AND DELIVERED (INCLUDING LOADING AND UNLOADING) TO A STORAGE AREA WITHIN THE BUILDING AS SELECTED BY THE OWNER. IT WILL BE THE RESPONSIBILITY OF THE CONTRACTOR TO REPAIR ANY EQUIPMENT DAMAGED DURING REMOVAL AND DELIVERY. ANY DAMAGE TO EQUIPMENT PRIOR TO DISCONNECTING SHOULD BE REPORTED TO THE OWNER'S REPRESENTATIVE. IF NOT REPORTED, THE CONTRACTOR TAKES FULL RESPONSIBILITY FOR REPAIRS TO THE EQUIPMENT.
- BEFORE DISCONNECTING, REMOVING, OR SERVICING ANY AIR CONDITIONING EQUIPMENT OR SYSTEMS CONTAINING REFRIGERANTS, THE **EQUIPMENT OR SYSTEMS SHALL BE EVACUATED OF ALL REFRIGERANT PER THE** LATEST ADOPTED RULES AND REGULATIONS BY THE UNITED STATES **ENVIRONMENTAL PROTECTION AGENCY (EPA). THE CONTRACTOR OR** TECHNICIAN PERFORMING THE WORK SHALL BE CERTIFIED BY AN EPA APPROVED CERTIFYING AGENCY OR ORGANIZATION.
- ALL DUCTWORK, PIPING, AND CONDUIT PENETRATIONS THROUGH RATED WALLS OR FLOORS SHALL BE PROVIDED WITH FIRE/SMOKE STOPPINGS PER SPECIFICATION. REFER TO CODE ANALYSIS DRAWING FOR ALL RATED WALL LOCATIONS. ALL FLOORS SHALL BE CONSIDERED RATED.
- UNLESS SHOWN ON THE ARCHITECTURAL DRAWINGS, IT IS THE RESPONSIBILITY OF THIS CONTRACT TO PATCH AND FINISH ALL EXISTING DUCTWORK OR PIPE PENETRATIONS THROUGH FLOORS, ROOFS, INTERIOR WALLS, AND EXTERIOR WALLS AFTER DEMOLITION WORK. IN ADDITION, ALL NEW PENETRATIONS SHALL BE PROVIDED FOR INSTALLATION OF MECHANICAL SYSTEMS INCLUDING, BUT NOT LIMITED TO, EQUIPMENT, CURBING, DUCTWORK, PIPING, CONTROLS, ETC. PATCHING AND FINISHING SHALL MATCH EXISTING CONSTRUCTION INCLUDING FIRE RATINGS. PROVIDE LINTELS PER LINTEL SCHEDULE.
- H. IT IS NOT THE INTENT OF THE DRAWINGS TO SHOW ALL AIR VENTS AND DRAINS IN THE PIPING SYSTEMS. IT IS THE RESPONSIBILITY OF THE CONTRACTOR TO PROVIDE AIR VENTS AT ALL SYSTEM HIGH POINTS AND AT AREAS WITHIN THE PIPING SYSTEMS THAT COULD ACCUMULATE OR TRAP AIR WHICH WOULD PREVENT PROPER VENTING OR OPERATION OF THE SYSTEMS. DRAINS SHALL BE PROVIDED AT ALL LOW POINTS WITHIN THE PIPING SYSTEM TO FACILITATE COMPLETE DRAINING OF THE SYSTEM.
- PROVIDE THERMAL EXPANSION COMPENSATORS AND THERMAL EXPANSION LOOPS IN PIPING SYSTEM PER INDUSTRY STANDARDS.



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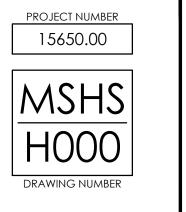
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REVISIONS	ON	



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WEBUTUCK MIDDLE/HIGH SCHOOL FICE SCHOOL

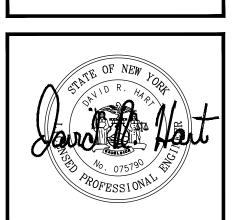DATE	DRAWN	CHECK			
09/18/2020	BKM	JJV			
scale NT	S				
SHEET TITLE					
MECHANICAL					
SYMBOLS	SLIST				



	WEBUTUCK HEALTH SUITE OUTSIDE AIR CALCULATIONS										
					TOTAL						
				Occupant	OCCUPANCY	O.A. PER	O.A. PER				
Equipment			TOTAL	Density	FOR	PERSON	SQ. FT.	Vbz		Voz=Vot	
Tag	Space	Occupancy Classification	SQ. FT.	#/1000sq.ft.	VENTILATION	(CFM)	(CFM)	(CFM)	Ez	(CFM)	Provided OA
RTU-7	Exam 1	Office Space	98	5	2	5	0.06	16	0.8	20	75
RTU-7	Exam 2	Office Space	129	5	2	5	0.06	18	0.8	22	75
RTU-7	M.A.	Reception Area	193	30	6	5	0.06	42	0.8	52	75
RTU-7	Wating 100	Main Entry Lobby	56	10	3	5	0.06	18	0.8	23	75
RTU-8	Nurse	Office Space	186	5	3	5	0.06	26	0.8	33	150
RTU-8	BH/Consultant	Office Space	75	5	3	5	0.06	20	0.8	24	50
RTU-8	Assistant	Reception Area	150	30	5	5	0.06	34	0.8	43	100
RTU-8	Waiting	Main Entry Lobby	270	10	4	5	0.06	36	0.8	45	100

#### **GENERAL NOTES:**

1. VERIFY ALL DUCT AND PIPE SIZES AND LOCATIONS PRIOR TO DEMOLITION.


#### **DEMOLITION NOTES:**

- REMOVE EXISTING SUPPLY DIFFUSERS AND ALL ASSOCIATED DUCTWORK TO POINT INDICATED BEFORE HEATING COIL. PREPARE FOR NEW WORK.
- REMOVE EXISTING RETURN GRILLE AND ALL ASSOCIATED DUCTWORK BACK TO DROP FROM ROOFTOP UNIT. PREPARE FOR NEW WORK.


#### **KEY NOTES:**

- (1) RUN DUCTWORK THROUGH JOISTS.


REGISTERS, GRILLES, AND DIFFUSERS							
MARK	APPLICATION	MATERIAL	TYPE	FINISH	FACE SIZE	DESIGN EQUIP.	REMARKS
D1	SUPPLY	STEEL	LAY IN	WHITE	24X24	PRICE SCD	
G1	RETURN/EA	STEEL	LAY IN	WHITE	24X24	PRICE PDDR	
G2	RETURN/EA	STEEL	LAY IN	WHITE	-	PRICE 530	
REMARKS:							

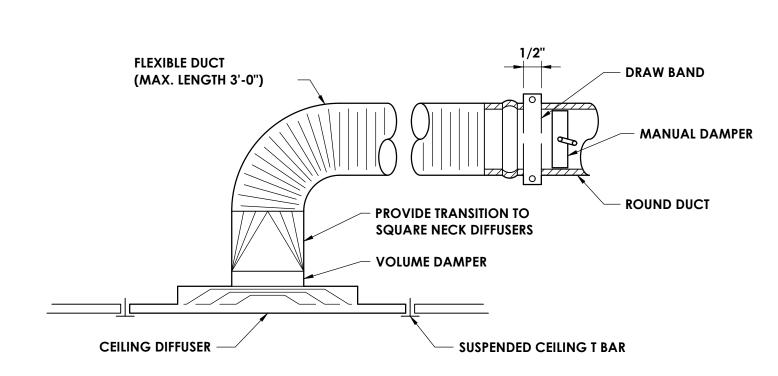



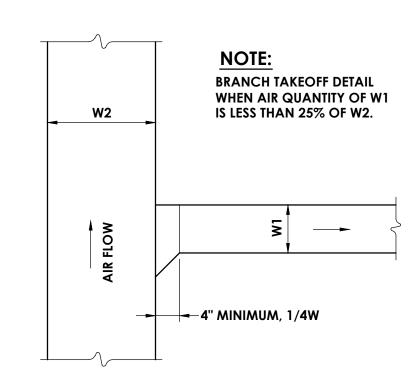



**BRANCH TAKE-OFF DETAIL** H201

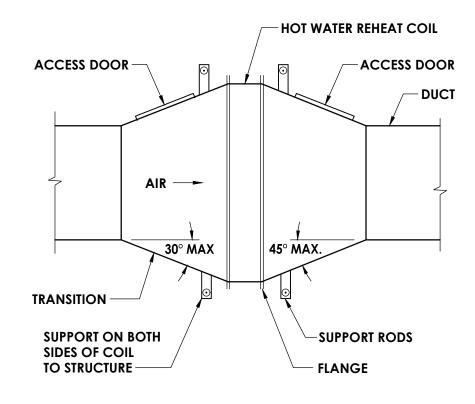


SUPPORT DUCTWORK INDEPENDENTLY OF THE COIL.




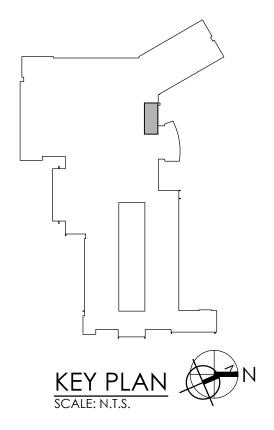


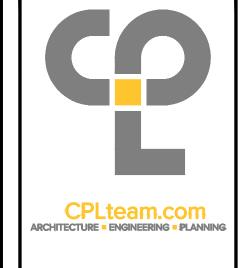


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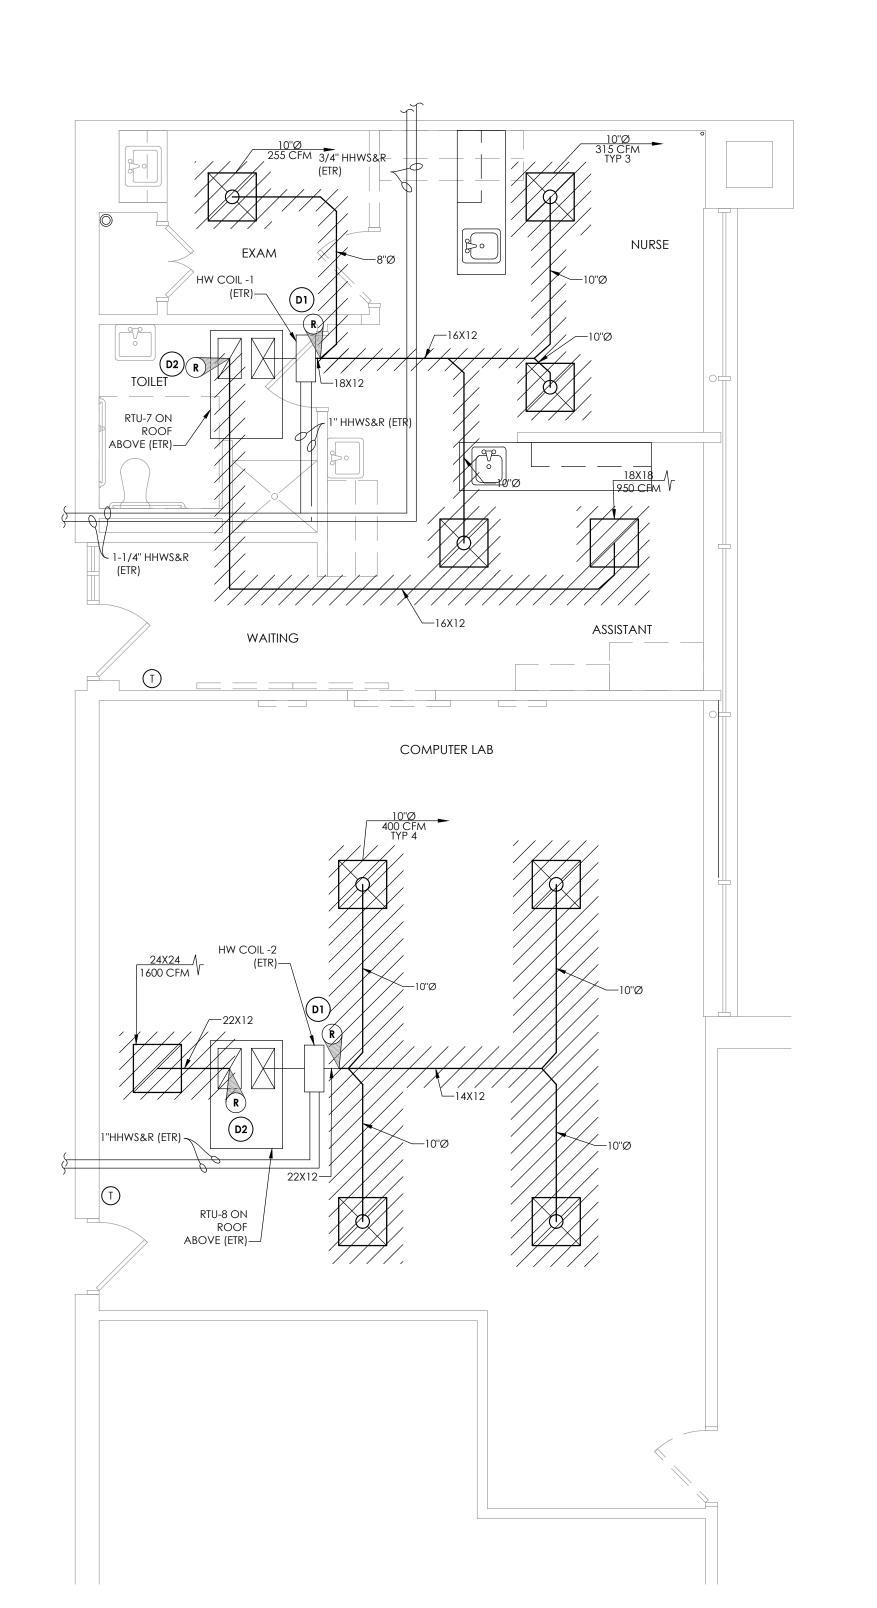


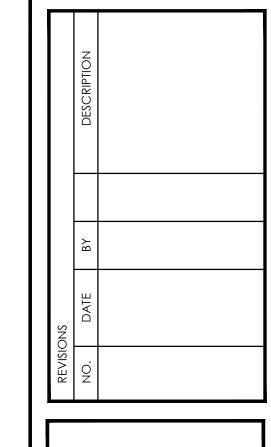

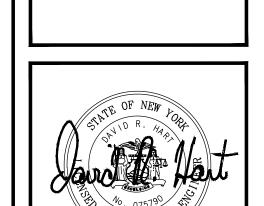

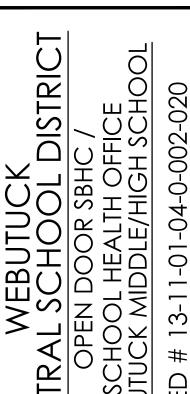
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	MECHAN	ICAL	
	DEMOLIT	ION AND	)
	NEW WO	RK PLAN	1S



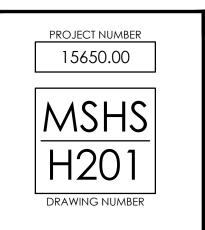



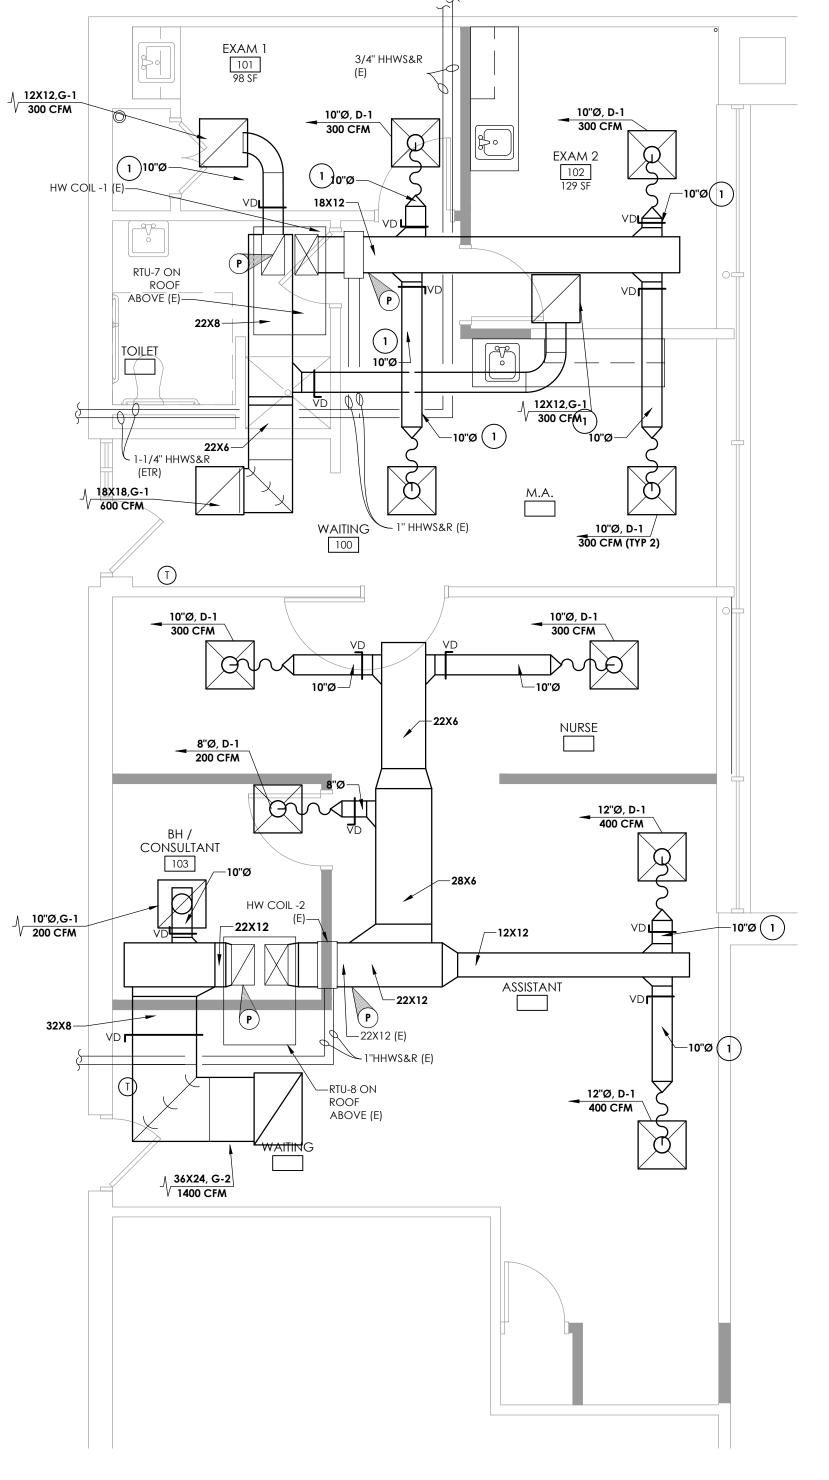

HVAC NEW WORK PLAN
SCALE: 1/4" = 1'-0"

#### SINGLE LINE DIAGRAM LEGEND: EARTH GROUND

CHASSIS GROUND TRANSFORMER - KVA, PRIMARY AND SECONDARY 45 KVA 480-VOLTAGE INDICATED. CONNECTIONS, K-RATING, AND SHIELD SPECIFIED 208/120V CURRENT TRANSFORMER POTENTIAL TRANSFORMER DISCONNECT/LOADBREAK SWITCH CIRCUIT BREAKER CIRCUIT BREAKER DRAWOUT MOUNTED (LOW VOLTAGE) **AUTOMATIC TRANSFER SWITCH** (NORMAL POSITION SHOWN) \_\_\_\_M\_\_\_ ENCLOSED CIRCUIT BREAKER LIGHTNING ARRESTER <del>-----</del> FUSED DISCONNECT SWITCH PANEL PANELBOARD-RATINGS AS SPECIFIED IN SINGLE LINE

#### **COMMUNICATIONS LEGEND:**

DIAGRAM AND ON PANELBOARD SCHEDULE

**TELEPHONE** (1) CAT3 - TELEPHONE JACK & CABLE

208-120V

(NONE) STANDARD MODULAR JACK FOR TELEPHONE W WALL MOUNTED TELEPHONE MODULAR JACK P PUBLIC TELEPHONE MODULAR JACK

C COUNTER HEIGHT MODULAR JACK

TELEPHONE FLOOR OUTLET (1) CAT3 - TELEPHONE JACK & CABLE

DATA OUTLET WITH FLUSH BOX AND FACEPLATE (1) CAT5e - DATA JACK & CABLE

COMPUTER FLOOR OUTLET

(1) CAT5e - DATA JACK & CABLE

COMBINATION TELEPHONE CABLE AND DATA OUTLETS IN DOUBLE GANG FLUSH MOUNTED BOX WITH FACEPLATE

WIRELESS TRANSMITTER (PROVIDED BY OWNER) CONTRACTOR TO PROVIDE (2) CAT5e DATA JACKS & CABLING

T/D J BACK BOX FOR OWNER PROVIDED TEL/COM WIRING & DEVICES

DATA RACK

COAX CABLE (TYPE F CONNECTOR)

CEILING MOUNT LCD PROJECTOR

SPEAKER (PUBLIC ADDRESS)

(NONE) CEILING MOUNTED W WALL MOUNTED

SPEAKER (LOCAL SOUND SYSTEM)

SPEAKER HORN

MICROPHONE JACK

SPEAKER JACK

**VOLUME CONTROL** 

CLOCK DOUBLE FACE CLOCK

COMBINATION CLOCK AND SPEAKER

INTERCOM STATION

REMOTE PRE-AMPLIFIER AND PAGING MICROPHONE

CONSOLE JACK

HOUSE LIGHT CONTROL STATION

WALL BOX AS SPECIFIED

FB FLOOR BOX

#### NOTE:

SYMBOLS SHOWN ON THIS ELECTRICAL SYMBOLS LIST ARE FOR REFERENCE PURPOSES ONLY. ALL OF THESE SYMBOLS MAY NOT BE USED FOR THIS PROJECT.

#### FIRE/LIFE SAFETY LEGEND:

FIRE ALARM PULL STATION

FIRE ALARM BELL

FIRE ALARM HORN

FIRE ALARM HORN AND STROBE COMBINATION

FIRE ALARM HORN AND STROBE COMBINATION, WEATHER PROOF

FIRE ALARM SPEAKER

FIRE ALARM SPEAKER - CEILING MOUNTED

FIRE ALARM SPEAKER AND STROBE COMBINATION

FIRE ALARM STROBE

FIRE ALARM STROBE - CEILING MOUNTED

SMOKE DETECTOR

SMOKE DETECTOR WITH GUARD

CARBON MONOXIDE DETECTOR

NATURAL GAS SENSOR

HEAT DETECTOR COMBINATION SMOKE/HEAT DETECTOR

HEAT DETECTOR - 190° FIXED TEMPERATURE

HEAT DETECTOR - EXPLOSION PROOF

BEAM SMOKE DETECTOR TRANSMITTER

BEAM SMOKE DETECTOR RECEIVER

**DUCT DETECTOR** 

SA INDICATES INSTALLATION IN SUPPLY AIR RA INDICATES INSTALLATION IN RETURN AIR

REMOTE TEST STATION FOR DUCT DETECTOR

FIRE ALARM SHUT DOWN RELAY

FIRE DOOR HOLD OPEN

TAMPER SWITCH

FLOW SWITCH

FIRE SUPRESSION ANSUL SYSTEM CONNECTION

SMOKE DAMPER RELAY CONNECTION SD/FD SMOKE DAMPER AND FIRE DAMPER

sd SMOKE DAMPER

CONTROL MODULE, ADDRESSABLE

AREA OF RESCUE CALL STATION

AREA OF RESCUE MASTER TELEPHONE STATION

#### **SECURITY LEGEND:**

SECURITY KEY PAD

VIDEO CAMERA

CCTV VIDEO MONITOR

PASSIVE INFRARED MOTION DETECTOR

PROXIMITY CARD READER

CALL SWITCH

DOOR CONTACT

WINDOW CONTACT

ELECTRIC STRIKE DOOR RELEASE

MAGNETIC DOOR RELEASE

#### **NURSE CALL LEGEND:**

NURSE CALL BUTTON

NURSE CALL PATIENT BED STATION

CODE CALL BUTTON

NURSE CALL STAFF ASSIST STATION

NURSE CALL STAFF STATION NURSE CALL DUTY/STAFF STATION

NURSE CALL DUTY STATION

NURSE CALL LIGHT

NURSE CALL CODE LIGHT

NURSE CALL ZONE LIGHT

NURSE CALL MASTER STATION NURSE CALL EMERGENCY PULL STATION

NURSE CALL INFRARED SENSOR

#### LIGHT FIXTURE LEGEND:

LIGHTING FIXTURE

(SEE LIGHTING FIXTURE SCHEDULE FOR LETTER DESIGNATION AND DESCRIPTION OF FIXTURES)

EMERGENCY AND/OR NIGHT LIGHT LIGHTING FIXTURE

EXIT LIGHTING FIXTURE UNIVERSAL MOUNT, SINGLE/DOUBLE FACE (WHERE USED, ARROW INDICATES CHEVRON DIRECTION)

BATTERY POWERED EMERGENCY LIGHT

POLE MOUNTED LIGHTING (QUANTITY AND ORIENTATION OF HEADS AS SHOWN)

OCCUPANCY SENSOR - CEILING MOUNTED

EMERGENCY LIGHT REMOTE HEAD

VACANCY SENSOR - CEILING MOUNTED

OCCUPANCY SENSOR - WALL MOUNTED

TRACK LIGHTING

LIGHTING CONTACTOR

**SWITCH** 

PHOTOCELL

LV LOW VOLTAGE 1-4 BUTTON STATION

(CONNECT TO LIGHTING CONTROL STATION) OCCUPANCY SENSOR SWITCH

DIMMER (INCANDESCENT)

D3 THREE WAY DIMMER (INCANDESCENT) DF DIMMER (FLUORESCENT)

V VACANCY SENSOR SWITCH

#### **PANEL LEGEND:**

EXISTING ELECTRICAL PANEL

NEW ELECTRICAL PANEL

MDP MAIN DISTRIBUTION PANEL LVP LOW VOLTAGE PANEL HVP HIGH VOLTAGE PANEL

LP LIGHTING CONTROL PANEL IG ISOLATED GROUND PANEL

MSB MAIN SWITCH BOARD MCC MOTOR CONTROL CENTER

TVSS TRANSIENT VOLTAGE SURGE SUPPRESSION

AUTOMATIC TRANSFER SWITCH

ELECTRICAL SYSTEMS PANEL

SACP SECURITY ALARM CONTROL PANEL FACP FIRE ALARM CONTROL PANEL

PA PUBLIC ADDRESS CONTROL PANEL FAAP FIRE ALARM ANNUNCIATOR PANEL

#### ELECTRICAL PANELBOARD LABELING PLACARD

LINE 1 - PANELBOARD NAME: PP1 (EXAMPLE)

LINE 2 - VOLTAGE AND PHASE: 480/277V-3PH-4W (EXAMPLE) LINE 3 - WHERE PANELBOARD IS FED FROM: FF MSB BREAKER #14 (EXAMPLE)

#### **GENERAL ELECTRICAL NOTES:**

COMPUTER OUTLET = 18"

1) HATCHED AREAS ///// DESIGNATE EXISTING EQUIPMENT TO BE REMOVED, UNLESS OTHERWISE NOTED.

2) ALL WORK TO BE DONE IN ACCORDANCE WITH THE 2014 EDITION OF THE NATIONAL ELECTRIC CODE (NFPA 70).

3) CONTRACTOR SHALL FIELD VERIFY ALL CONDITIONS AND COORDINATE WITH EXISTING EQUIPMENT PRIOR TO BIDDING. BUILDING:

4) INSTALLATION HEIGHT TO CENTER OF EQUIPMENT ABOVE FINISHED FLOOR UNLESS OTHERWISE NOTED TO BE: RECEPTACLE = 18" SWITCH = 44"MODULAR JACK FOR WALL MOUNTED TELEPHONE = 52" MODULAR TELEPHONE JACK = 18" AUDIO/VISUAL FIRE ALARM INDICATORS = 88" FIRE ALARM PULL STATIONS = 48" TELEVISION OUTLET = 7'-0"

CALL SWITCH = 44" REMOTE TEST STATION FOR DUCT DETECTOR = 52" C = ABOVE COUNTER BACKSPLASH, COORDINATE WITH ARCHITECTURAL ELEVATIONS AND MILLWORK.

5) INSTALL DATA JACKS FOR CEILING MOUNTED WIRELESS TRANSMITTERS ABOVE CEILING IN ALL AREAS WHERE THERE IS AN ACCESSIBLE CEILING. PROVIDE FLUSH MOUNTED JACKS IN ALL HARD CEILINGS.

6) ALL CONDUIT AND WIRING TO BE CONCEALED IN WALLS, FLOOR, OR ABOVE CEILINGS UNLESS OTHERWISE NOTED OR APPROVED BY THE ARCHITECT/ENGINEER. ALL DEVICE OUTLET BOXES SHALL BE RECESSED UNLESS OTHERWISE NOTED OR APPROVED BY THE ARCHITECT/ENGINEER. WHERE APPROVED OR NOTED, SURFACE METAL RACEWAY AND DEVICE BOXES SHALL BE USED IN-LIEU OF CONDUIT AND CONCEALED BOXES AT NO EXTRA COST TO THE OWNER.

7) ALL CONDUIT ROUTES SHOWN ARE APPROXIMATE ONLY. CONTRACTOR SHALL FIELD VERIFY FINAL ROUTE.

8) CONDUIT RUNS SHOWN ARE SCHEMATICAL AND DO NOT INDICATE THE NECESSARY FITTINGS AND JUNCTION BOXES THAT ARE INCLUDED IN THE SCOPE OF THE WORK.

#### GROUNDING:


9) ALL METAL RACEWAYS, INCLUDING CONDUIT, WIRE TROUGHS, WIREMOLD, ETC., SHALL BE GROUNDED. ALL CONNECTIONS IN METAL RACEWAYS SHALL BE COMPLETED IN SUCH A MANNER AS TO MAINTAIN A CONTINUOUS PATH TO GROUND THROUGHOUT THE ENTIRE LENGTH OF THE RACEWAY.


#### WIRING:

10) UNLESS NOTED OTHERWISE ON THE DRAWINGS OR ON THE EQUIPMENT WIRING SCHEDULE, EACH BRANCH CIRCUIT SHALL BE THREE (3) #12 AWG THHN/THWN (1 HOT, 1 NEUTRAL & 1 EQUIPMENT GROUND) IN 3/4" EMT CONDUIT. PROTECT EACH CIRCUIT WITH A 20 AMPERE, 1-POLE OVERCURRENT DEVICE UNLESS OTHERWISE NOTED. PROVIDE #10 AWG FOR 120V BRANCH CIRCUITS LONGER THAN 100 FEET. COMBINED NEUTRALS ARE NOT PERMITTED.



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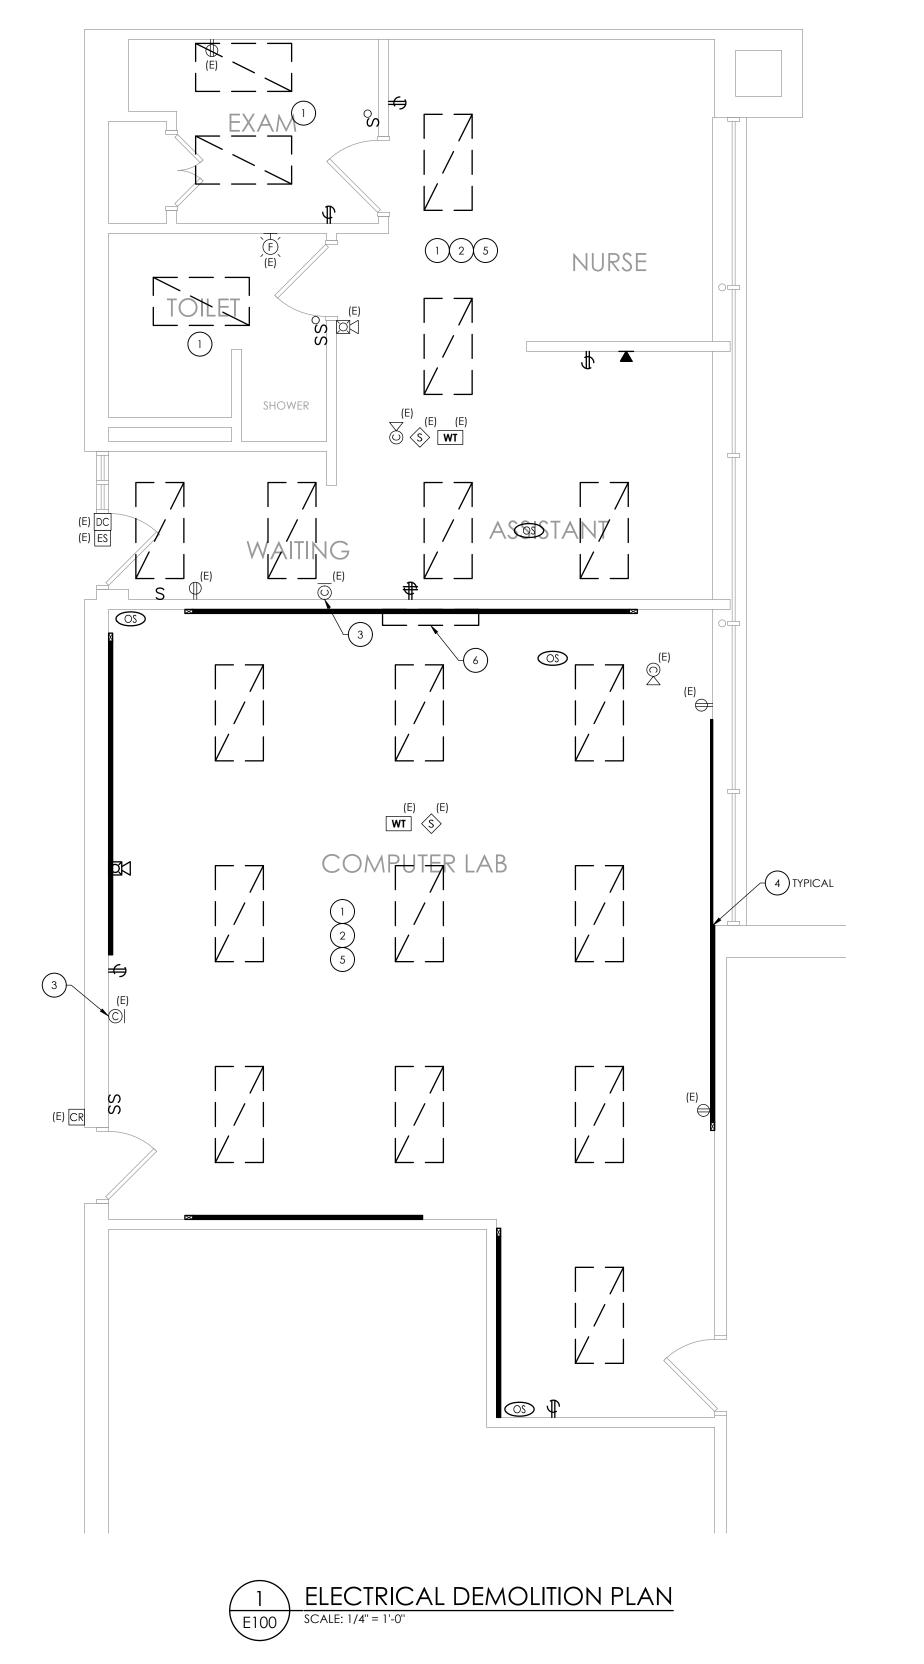
SHEET TITLE ELECTRICAL LEGEND & ABBREVIATIONS

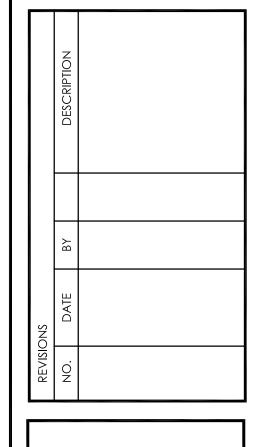SCALE AS NOTED

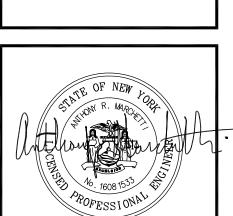PROJECT NUMBER 15650.00

DRAWING NUMBER

**MSHS** 





- A. ALL ITEMS SHOWN ARE TO BE REMOVED UNLESS LABELED AS (E) EXISTING TO REMAIN. ANY DEVICE, AS WELL AS ITS ASSOCIATED CIRCUITING, AND CONDUIT, LABELED "(E)" SHALL REMAIN, UNLESS OTHERWISE NOTED.
- B. INFORMATION ON DRAWINGS WAS OBTAINED THROUGH FIELD OBSERVATION AND AS-BUILT DOCUMENTATION. THE CONTRACTOR IS RESPONSIBLE FOR THE REMOVAL AND REPLACEMENT OF ANY DEVICES AND CABLING THAT MAY NOT BE SHOWN ON DRAWING AT NO ADDITIONAL COST TO OWNER.
- C. DRAWINGS ARE GRAPHICAL REPRESENTATIONS OF APPROXIMATE EQUIPMENT AND DEVICE LOCATIONS. CONTRACTOR SHALL VISIT THE SITE TO DETERMINE THE EXACT EXTENT OF ELECTRICAL WORK REQUIRED TO COMPLETE THE PROJECT. EXISTING CONDITIONS ARE TAKEN FROM FIELD OBSERVATION AND EXISTING BUILDING DOCUMENTS. OTHER ELECTRICAL ITEMS MAY EXIST FOR WHICH THE CONTRACTOR IS RESPONSIBLE AT NO ADDITIONAL COST.
- D. THE CONTRACTOR SHALL REMOVE THE EXISTING ELECTRIC IN AREAS OF NEW RENOVATIONS TO ACCOMMODATE NEW CONSTRUCTION. REROUTING OF EXISTING MAY BE REQUIRED AT NEW OPENINGS IN EXISTING CONSTRUCTION OR INTERFERENCE WITH OTHER NEW WORK AS NOTED IN THE FOLLOWING NOTES.
- E. DRAWINGS INDICATE SPECIFIC ITEMS TO BE REMOVED AND/OR RELOCATED IN ORDER TO INDICATE GENERAL SCOPE. ADDITIONAL ITEMS NOT INDICATED, BUT NECESSARY FOR PROJECT RENOVATIONS, SHALL BE REMOVED, RELOCATED AND/OR REROUTED AS REQUIRED TO ACCOMMODATE THE NEW CONSTRUCTION.
- F. COORDINATE DEMOLITION OF EQUIPMENT, DEVICES, ETC. WITH OTHER DISCIPLINES AS APPLICABLE.
- G. ALL ITEMS (DEVICES, FIXTURES, ETC.) SHOWN ARE TO BE REMOVED UNLESS LABELED AS EXISTING TO REMAIN - (E). THESE ITEMS AND THEIR RELATED WIRING/CONDUIT SHALL BE REMOVED BACK TO THE SOURCE CONTROL PANEL/PANELBOARD UNLESS OTHERWISE NOTED. ON CIRCUITS WHERE OTHER DEVICES, FIXTURES, ETC. ARE FOUND THAT MUST REMAIN, MAINTAIN CIRCUIT CONTINUITY BY PROVIDING ADDITIONAL WIRING, TO FEED THROUGH TO THESE REMAINING ITEMS. RELOCATE ANY CIRCUITS THAT REMAIN, TO AVOID CONFLICT WITH NEW CONSTRUCTION AS REQUIRED. PROPERLY TERMINATE ALL
- H. CONTRACTOR SHALL PROPERLY DISPOSE OF ALL ITEMS AND/OR EQUIPMENT BEING REMOVED AS PART OF THE PROJECT. THE OWNER SHALL HAVE THE RIGHT OF RETAINING ANY ITEMS BEING REMOVED.
- I. CONTRACTOR SHALL PROVIDE NEW COVERPLATES ON ALL UNUSED FLUSH MOUNT DEVICE BOXES UPON COMPLETION OF PROJECT.
- J. FIREPROOFING AND/OR FIRE STOP MATERIALS REMOVED FROM FIRE RATED WALLS AND CEILINGS AS A RESULT OF DEMOLITION SHALL BE RE-INSTALLED USING AN APPROVED METHOD AS DESCRIBED IN ASSOCIATED PROJECT SPECIFICATIONS.

#### KEY NOTES:


- (1) DISCONNECT AND REMOVE LIGHT FIXTURES. EXISTING CONDUIT AND WIRING TO REMAIN FOR RE-USE.
- (2) CEILING DEVICES TAGGED AS (E) ARE TO BE REMOVED AND STORED FOR RELOCATION. TAG WIRING FOR RE-USE. REFER TO DRAWING E-200 FOR NEW LOCATIONS.
- (3) EXISTING CLOCKS TO BE REMOVED AND STORED FOR RELOCATION. TAG WIRING FOR RE-USE. REFER TO DRAWING E-200 FOR NEW LOCATIONS.
- 4) DISCONNECT AND REMOVE ALL SURFACE RACEWAY INDICATED. TAG ALL DATA CABLING WIRING FOR RE-USE AT NEW LOCATIONS. REMOVE ALL OTHER WIRING BACK TO SOURCE.
- (5) DISCONNECT AND REMOVE ALL RECEPTACLES AS SHOWN. PULL BACK CIRCUITRY AND TAG FOR RE-USE. REFER TO DRAWING E-200 FOR NEW
- 6 DISCONNECT AND REMOVE EXISTING SMARTBOARD. TURN OVER TO OWNER. REMOVE ALL ASSOCIATED CABLING AND TURN OVER TO



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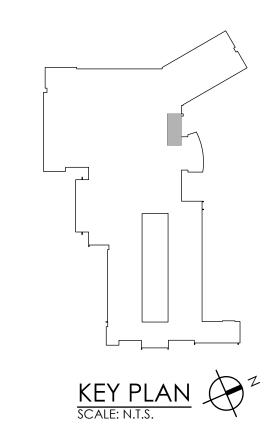
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WEBUTUCK
OPEN DOOR SBHC /
SCHOOL HEALTH OFFICE
WEBUTUCK MIDDLE/HIGH SCHOOL
SED # 13-11-01-04-0 mm 2000

09/18/2020 MAY SCALE AS NOTED ELECTRICAL DEMOLITION

> PROJECT NUMBER 15650.00 **MSHS** DRAWING NUMBER

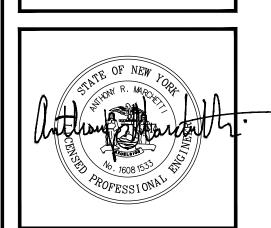

## GENERAL NOTES:

- A. FOR ALL 120V DEVICES SHOWN, WIRE WITH (2)#12, #12G IN 3/4"C AND CONNECT TO 20A/1P CIRCUIT BREAKER IN PANEL OF CIRCUIT INDICATED ADJACENT TO DEVICE.
- B. FOR ALL WALL MOUNT VOICE/DATA DROPS SHOWN, PROVIDE FLUSH MOUNT 2-GANG BOX WITH SINGLE GANG DEVICE RING. PROVIDE (2) CATEGORY 6 UTP CABLES IN 1-1/4" CONDUIT ABOVE FINISHED CEILING SPACE TO ASSOCIATED FLOOR DATA RACK. PROVIDE ASSOCIATED 2-PORT FACEPLATE, (2) RJ45 JACKS, ETC. AT DROP LOCATION.


#### KEY NOTES:


- (1) CEILING DEVICES TAGGED AS (E) ARE RELOCATED TO LOCATION INDICATED. CONNECT TO EXISTING TAGGED WIRING. REWORK/EXTEND EXISTING WIRING AS NECESSARY TO ACCOMMODATE NEW DEVICE LOCATIONS.
- (2) RELOCATED CLOCK LOCATIONS. CONNECT TO EXISTING WIRING. REWORK/EXTEND EXISTING WIRING AS NECESSARY TO ACCOMMODATE NEW DEVICE LOCATIONS.
- (3) UTILIZE EXISTING TAGGED DATA WIRING FOR NEW DEVICES. REWORK/EXTEND EXISTING WIRING AS NECESSARY TO ACCOMMODATE NEW DEVICE LOCATIONS.
- 4 CONNECT NEW RECEPTACLES TO EXISTING CIRCUITRY TAGGED FOR RE-USE. NUMBERS ADJACENT TO RECEPTACLES ARE EXISTING CIRCUITS USED IN THESE SPACES.




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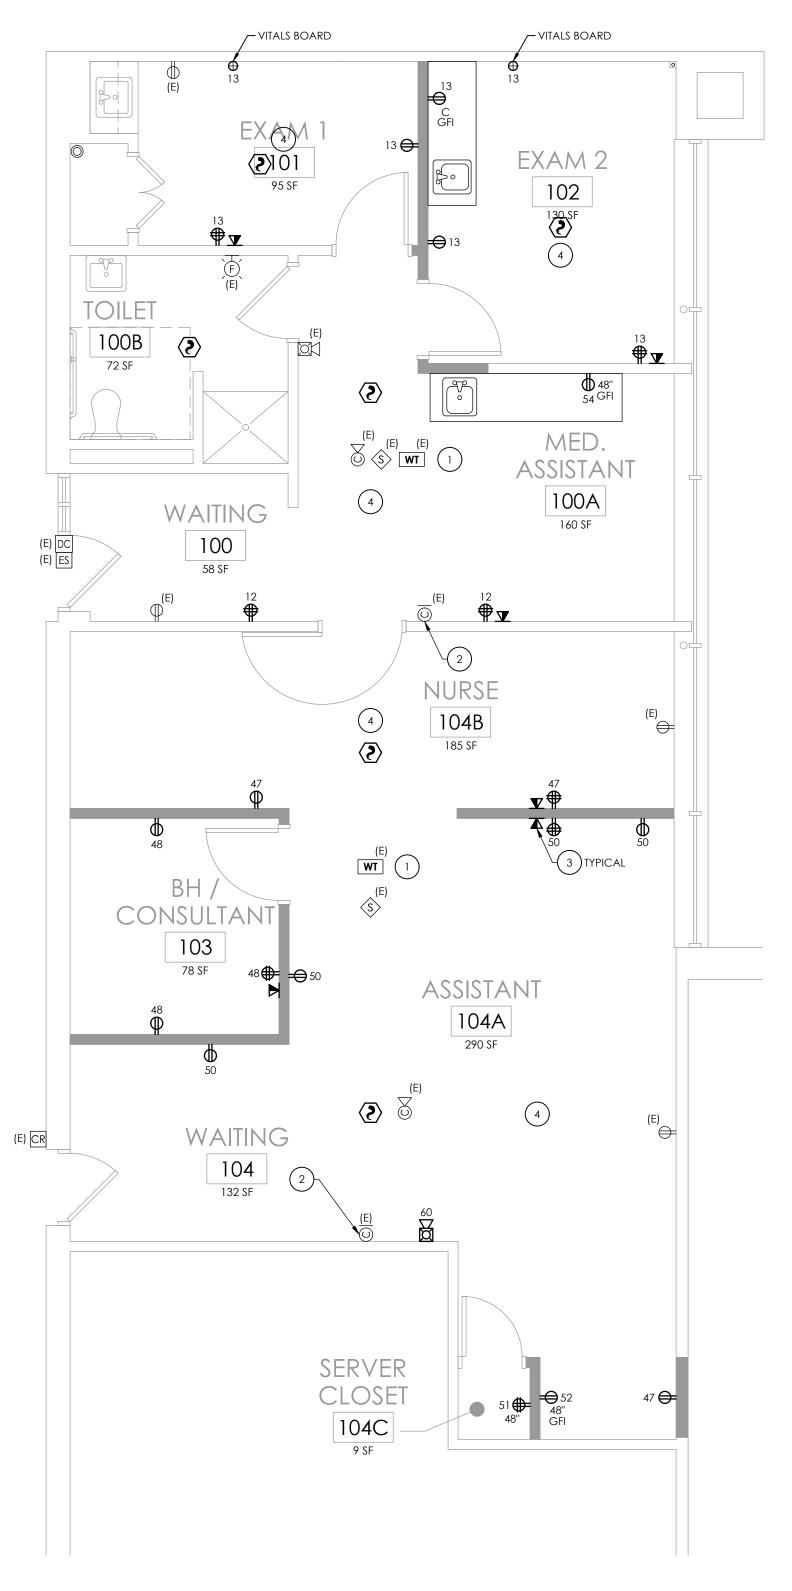


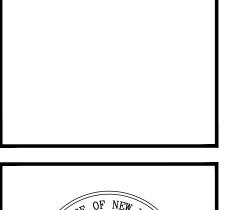

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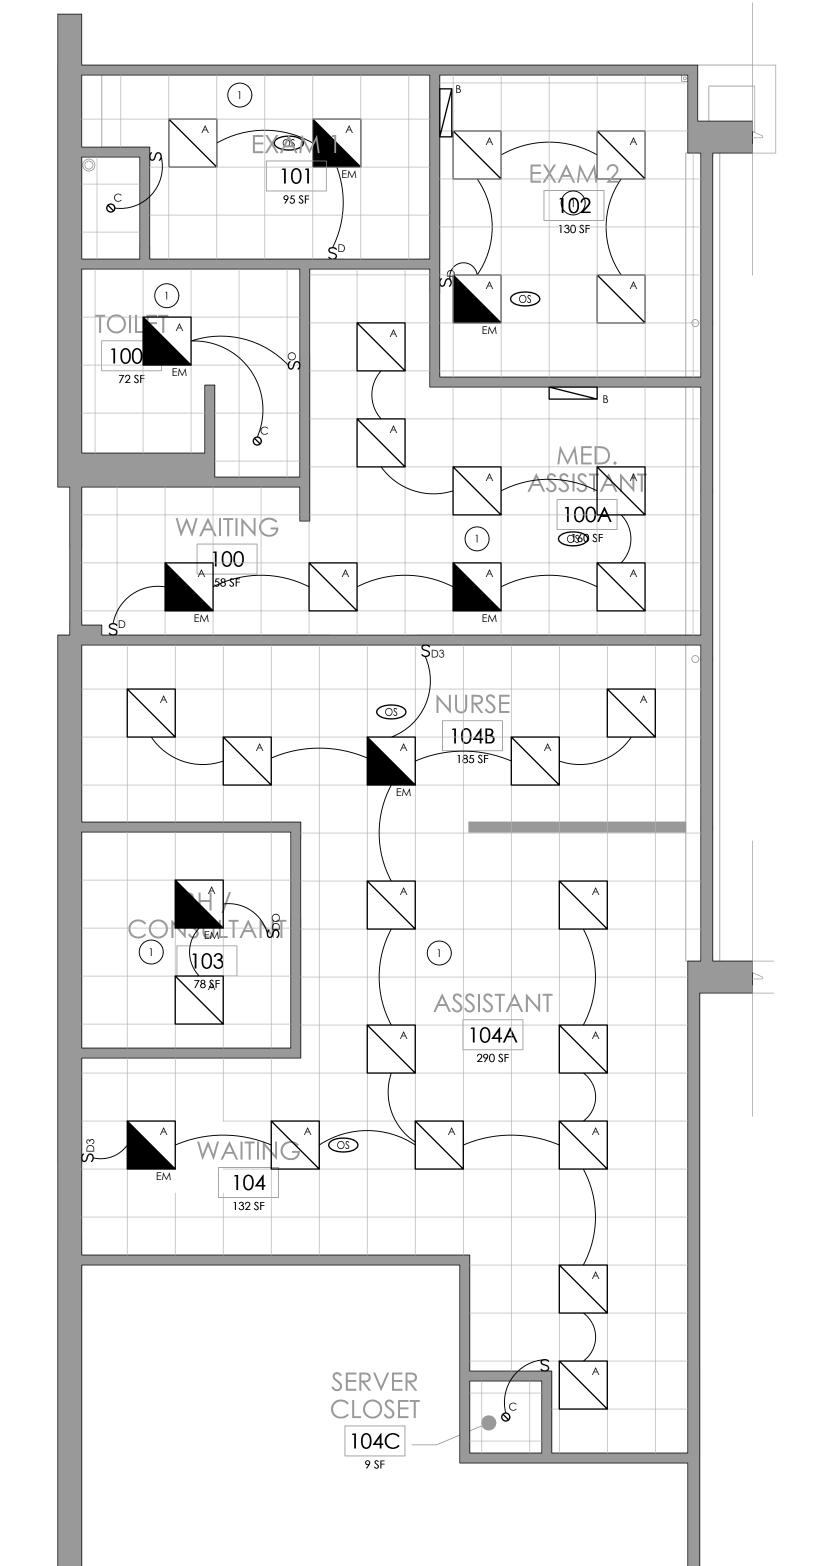


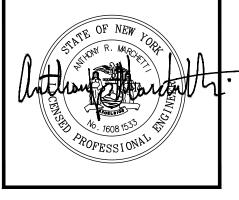KEY PLAN SCALE: N.T.S.

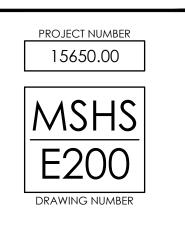

1 ELECTRICAL NEW WORK PLAN
SCALE: 1/4" = 1'-0"





## ELECTRICAL LIGHTING PLAN SCALE: 1/4" = 1'-0"

LUMIN	LUMINAIRE SCHEDULE							
MARK	DESCRIPTION	DESIGN MAKE	MODEL #	VOLTS	QTY	L WATTS	AMP MODEL#	REMARKS
А	2X2 RECESSED LED TROFFER	HUBBELL LIGHTING	50L-G-D-22-SOF-C1-35K9-D400-D01-UNV	UNV	-	34	3500K	-
A/EM	2X2 RECESSED LED TROFFER WITH EMERGENCY BATTERY BALLAST	HUBBELL LIGHTING	50L-G-D-22-\$OF-C1-35K9-D400-D01-UNV-EF	UNV	-	34	3500K	2,3
В	UNDERCABINET LED LIGHT WITH INTERNAL ROCKER SWITCH	HUBBELL LIGHTING	CUC2-ED120	UNV	-	14	3000K	-
С	4" RECESSED LED DOWNLIGHT	HUBBELL LIGHTING	CTR-4RD-H-ML-30L-DM1-LTR-4RD-T-ML-35K-9-MD-SS-WC-FM	UNV	-	35	3500K	1

#### **REMARKS**:

- PROVIDE FIXTURE WITH DRYWALL FLANGE KIT.
   ALL FIXTURES SHOWN WITH AN "EM" DESIGNATION INDICATES EMERGENCY LIGHTING FIXTURE. PROVIDE EMERGENCY BATTERY BACKUP FOR EACH FIXTURE INDICATED.
- 3. ALL EMERGENCY FIXTURES "EM" SHALL HAVE 90-MINUTE BATTERY CAPACITY AND HAVE INTEGRAL TEST SWITCH.

#### GENERAL NOTES:

- A. FIXTURE TYPE MARK IS INDICATED ADJACENT TO NEW LIGHT FIXTURES. REFER TO LUMINAIRE SCHEDULE ON SHEET MSHS-E300 FOR FIXTURE DESCRIPTIONS, NOTES, AND SPECIFICATIONS.
- B. LIGHT FIXTURES SHOWN SHALL BE WIRED WITH (2) #12, (1) #12 GND IN 3/4" CONDUIT, WIRED TO PANEL AND CIRCUIT INDICATED. CIRCUITS EXCEEDING 100' SHALL BE WIRED WITH #10 CONDUCTORS.
- C. INSTALL SWITCHING AND LOW-VOLTAGE SENSORS AS SHOWN.
   PROVIDE ALL LOW-VOLTAGE WIRING BETWEEN SENSORS, SWITCHES, CONTROLLERS, AND LUMINAIRES.
- D. PROVIDE ANY ADDITIONAL POWER SUPPLIES OR OTHER MISCELLANEOUS COMPONENTS REQUIRED FOR A COMPLETE OPERATIONAL LIGHTING SYSTEM TO MEET INTENT OF LIGHTING SEQUENCE OF OPERATION AS SHOWN.
- E. ALL FIXTURES INDICATED WITH "EM" DESIGNATION SHALL HAVE EMERGENCY BATTERY BACKUP, WIRED TO UNSWITCHED HOT LEG OF CIRCUITRY FEEDING THIS SPACE.


#### KEY NOTES:


1) NEW LIGHTING TO BE TIED INTO EXISTING CIRCUITRY TAGGED FOR RE-USE. REWORK/EXTEND EXISTING WIRING AS NECESSARY TO ACCOMMODATE NEW LIGHTING LAYOUT.




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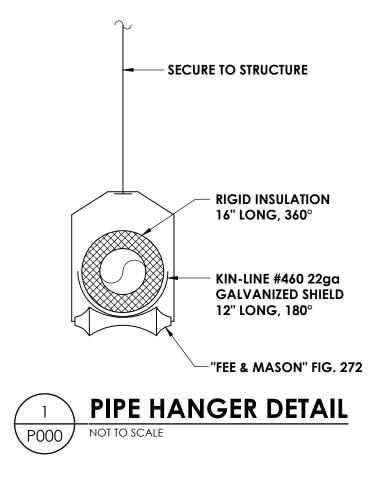


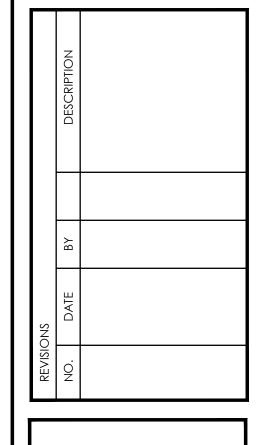

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	PLUMBING EQUIPMENT & FIXTURE SCHEDULE								
MARK	FIXTURE	CW	HW	SAN	V	GAS	DESCRIPTION	MANUFACTURER & MODEL NUMBER	REMARKS
SK-1	SINK, ACCESSIBLE	1/2"	1/2"	1-1/2"	1-1/2"	-	COUNTER MOUNT, SINGLE BOWL, STAINLESS STEEL SINK, OD 17x19", ID 14x14", 6-3/16" DEEP, GOOSENECK FAUCET WITH WRISTBLADES. 1.5 GPM	ELKAY D11719	1
REMARKS:	REMARKS: 1. ALL ACCESSIBLE EQUIPMENT/FIXTURES TO BE INSTALLED PER ADA REQUIREMENTS.								

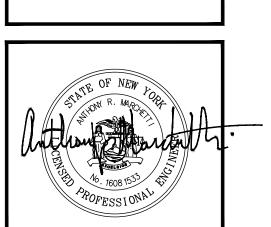

#### PIPING LEGEND

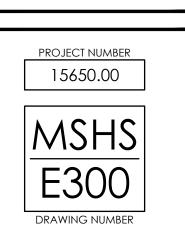
<u>PIPING</u>	<u>LEGEND</u>	FIXTURES & F	ITTINGS LEGEND
xx	PIPING	<del></del>	TEE OUTLET - UP
XX	PIPING BELOW GRADE	<del></del>	TEE OUTLET - DOWN
XX	EXISTING PIPING	<del></del>	CONNECTION - BOTTOM
CW	COLD WATER	<del></del>	CONNECTION - TOP
HW	HOT WATER	Ol	ELBOW - TURNED UP
HWR	HOT WATER RECIRCULATING	C+	ELBOW - TURNED DOWN
SAN	SANITARY SEWER	E	PIPE CAP
AW	ACID WASTE		UNION
IW	INDIRECT WASTE	——————————————————————————————————————	FLANGE
ST	STORM SEWER	——δ	BALL VALVE
RL	RAIN LEADER	$$ $\delta_{M}$	BALL VALVE WITH MEMORY STOP
CA	COMPRESSED AIR		BALANCING VALVE
LA	LABORATORY COMPRESSED AIR		CHECK VALVE
MA	MEDICAL COMPRESSED AIR	——————————————————————————————————————	BUTTERFLY VALVE
CL	CHLORINATED WATER	—— <del>\$</del> ——	CONTROL VALVE, PNEUMATIC 2
DE	DEIONIZED WATER		GATE VALVE
DI	DISTILLED WATER		GLOBE VALVE
SW	SOFT WATER	<del></del>	PLUG VALVE
DWS	CHILLED DRINKING WATER SUPPLY	₿ P	PRESSURE RELIEF VALVE
DWR	CHILLED DRINKING WATER RECIRCULATING	TP	TEMPERATURE-PRESSURE RELIEF V
LS	LAWN SPRINKLER SUPPLY		PRESSURE REDUCING VALVE
DF	DIESEL FUEL	—— <del>•</del>	COMBINATION VALVE (ISOLATIO
FILL	FILL LINE		MOTOR OPERATED VALVE
FOF	FUEL OIL FILL	<u> </u>	SOLENOID OPERATED VALVE
FOG	FUEL OIL GAUGE	——————————————————————————————————————	GAS PRESSURE REGULATOR
FOS	FUEL OIL SUPPLY	D	REDUCER, CONCENTRIC
FOR	FUEL OIL RETURN		REDUCER, ECCENTRIC
LO	LUBRICATING OIL	co ⊩	CLEAN OUT
WO	WASTE OIL	FCO	FLOOR CLEAN OUT
G	GAS - LOW PRESSURE	wco ⊩	WALL CLEAN OUT
MG	GAS - MEDIUM PRESSURE	НВ ∕ ₩	HOSE BIBB
HG	GAS - HIGH PRESSURE	NFHB #	NON FREEZE HOSE BIBB
LPG	LIQUEFIED PROPANE GAS	NFWH #	NON FREEZE WALL HYDRANT
NLG	NON-LEADED GASOLINE	YH	YARD HYDRANT
PG	PREMIUM GASOLINE	FD O	FLOOR DRAIN
RG	REGULAR GASOLINE	FFD O	FUNNEL FLOOR DRAIN
Н	HUMIDIFICATION LINE	FS O	FLOOR SINK
O2	OXYGEN	RD O	ROOF DRAIN
L02	LIQUID OXYGEN		PIPE GUIDE
N2	NITROGEN	<del></del>	PIPE ANCHOR
N2O	NITROUS OXIDE		FLEXIBLE PIPE CONNECTOR
CO2	CARBON DIOXIDE		EXPANSION JOINT
VA	VACUUM	FS	FLOW SWITCH
VPD	VACUUM PUMP DISCHARGE	PS	PRESSURE SWITCH
MV	MEDICAL VACUUM	AQ	AQUASTAT
LV	LABORATORY VACUUM		
WVC	WET VACUUM CLEANING		PRESSURE GAUGE
DVC	DRY VACUUM CLEANING	<u> </u>	PRESSURE GAUGE WITH SYPHON
SP	FIRE PROTECTION/SPRINKLER	Ψ	THERMOMETER
v	VENT		STRAINER
AV	ACID WASTE VENT		STRAINER WITH BLOWOFF
GV	GAS VENT	<b>≯</b> □ <b>v</b>	
FOV	FUEL OIL VENT		VACUUM BREAKER
WOV	WASTE OIL VENT		INLINE PUMP
<del>/////////////////////////////////////</del>	PLUMBING TO BE REMOVED	<b>—A</b>	WATER HAMMER ARRESTER
(ETR)	EXISTING TO REMAIN	RPZ	REDUCED PRESSURE ZONE BACK FLOW PREVENTER
(E)	EXISTING	DC	DOUBLE CHECK VALVE ASSEMBL
			STEAM TRAP
		_ <b>▼</b>	SHOWER HEAD
		— <b>○</b> - <b>▽</b> - <b>M</b> -	

FIXTURES & FIT	TINGS LEGEND
	TEE OUTLET - UP
	TEE OUTLET - DOWN
_	CONNECTION - BOTTOM
ı	
I	CONNECTION - TOP
	ELBOW - TURNED UP
	ELBOW - TURNED DOWN
E	
	UNION
——————————————————————————————————————	
	BALL VALVE
——	BALL VALVE WITH MEMORY STOP
————	BALANCING VALVE
	CHECK VALVE
——————————————————————————————————————	BUTTERFLY VALVE
——————————————————————————————————————	CONTROL VALVE, PNEUMATIC 2-WAY
$-\!$	GATE VALVE
<b>_</b>	GLOBE VALVE
<del></del>	PLUG VALVE
<u></u> ₽	PRESSURE RELIEF VALVE
TP TP	TEMPERATURE-PRESSURE RELIEF VALVE
	PRESSURE REDUCING VALVE
	COMBINATION VALVE (ISOLATION, CHECK, BALANCING)
[A]	MOTOR OPERATED VALVE
, ,	SOLENOID OPERATED VALVE
	GAS PRESSURE REGULATOR
	REDUCER, CONCENTRIC
	REDUCER, ECCENTRIC
co ⊩——	
	FLOOR CLEAN OUT
	WALL CLEAN OUT
HB / #	
	NON FREEZE HOSE BIBB
NFWH #	NON FREEZE WALL HYDRANT
YH / #	YARD HYDRANT
FD O	FLOOR DRAIN
FFD O	FUNNEL FLOOR DRAIN
FS O	FLOOR SINK
RD O	ROOF DRAIN
	PIPE GUIDE
——×	PIPE ANCHOR
	FLEXIBLE PIPE CONNECTOR
	EXPANSION JOINT
FS	FLOW SWITCH
PS PS	PRESSURE SWITCH
AQ	AQUASTAT
<b>\rightarrow</b>	
	PRESSURE GAUGE
	PRESSURE GAUGE WITH SYPHON (STEAM)
	THERMOMETER
	STRAINER
	STRAINER WITH BLOWOFF
<i>₹</i> ₽ <b>v</b>	
	VACUUM BREAKER
—— ( <del>)</del> ——	INLINE PUMP
— <b>A</b>	WATER HAMMER ARRESTER
RPZ RPZ	REDUCED PRESSURE ZONE BACK FLOW PREVENTER
DC	DOUBLE CHECK VALVE ASSEMBLY
T	STEAM TRAP
<b>▼</b>	SHOWER HEAD
O_V_M_	GAS OUTLET (O2, VACUUM, MEDICAL AIR)
——————————————————————————————————————	SPRINKLER HEAD
P	POINT OF CONNECTION
R	POINT OF REMOVAL

POINT OF REMOVAL



50 FRONT STREET, SUITE 202 NEWBURGH, NEW YORK 12550 TEL (800) 274-9000 FAX (845) 567-9614

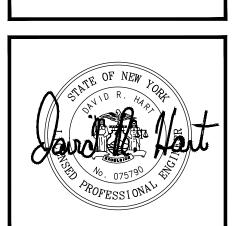

WEBUTUCK
CENTRAL SCHOOL DISTRICT
OPEN DOOR SBHC /
SCHOOL HEALTH OFFICE
WEBUTUCK MIDDLE/HIGH SCHOOL
SED # 13-11-01-04-0-002-020

DATE DRAWN CHECKED 09/18/2020 BKM JJM PLUMBING LEGEND

> 15650.00 DRAWING NUMBER

 VERIFY ALL PIPES SIZES AND LOCATIONS PRIOR TO DEMOLITION. **DEMOLITION NOTES:** 

REMOVE EXISTING SINK IN ITS ENTIRETY AND ALL ASSOCIATED SANITARY, VENT AND DOMESTIC PIPING BACK TO POINTS INDICATED. PREPARE FOR NEW WORK.


**KEY NOTES:** 


- INSTALL NEW SINK AND PROVIDE NEW DOMESTIC, SANITARY AND VENT PIPING. CONNECT TO EXISTING MAINS AS SHOWN. PROVIDE ALL SLAB CUTTING, REMOVAL, TRENCHING, BACKFILLING, NEW CONCRETE SLAB, AND FINISHES AS REQUIRED TO ACCOMMODATE NEW YORK.
- RELOCATE EXISTING ISOLATION VALVE PIPE DROP TO ABOVE CEILING TO PROVIDE ACCESS TO VALVE FOR NEW PIPE CHASE. MODIFY PIPING AS NECESSARY. COORDINATE SHUTTING OFF WATER WITH DISTRICT.

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ARCHITECTURE - ENGINEERING - PLANNING





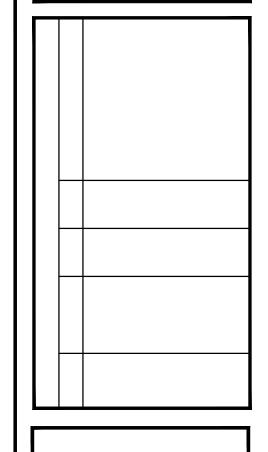
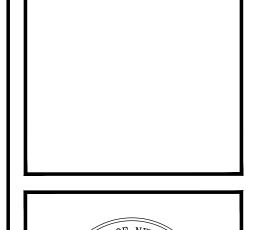
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DATE DRAWN CHECK
09/18/2020 BKM JJN

SCALE NTS


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SHEET TITLE
PLUMBING DEMOLITION
AND NEW WORK
PLAN


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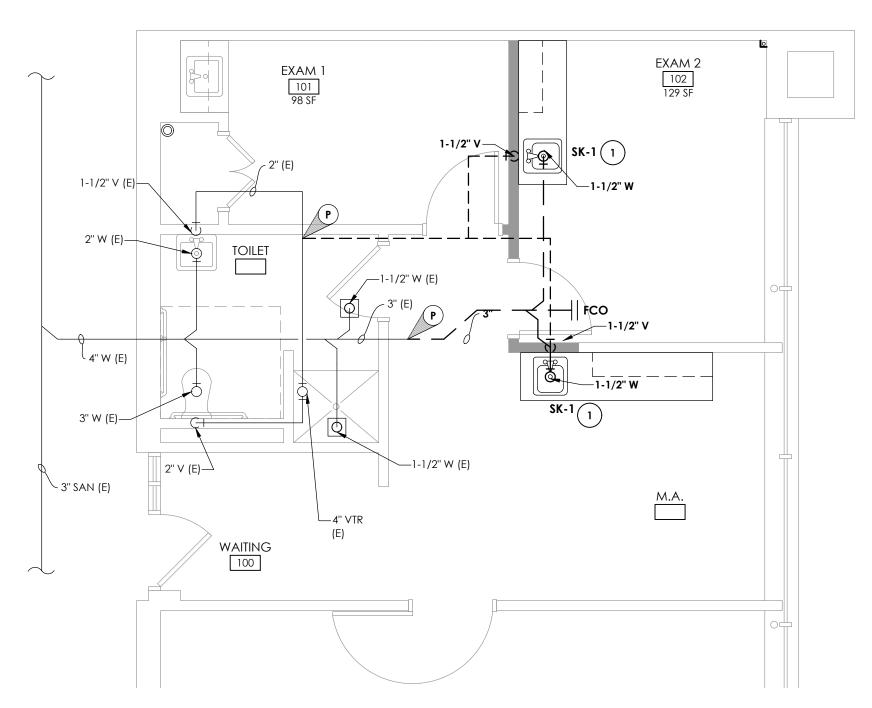
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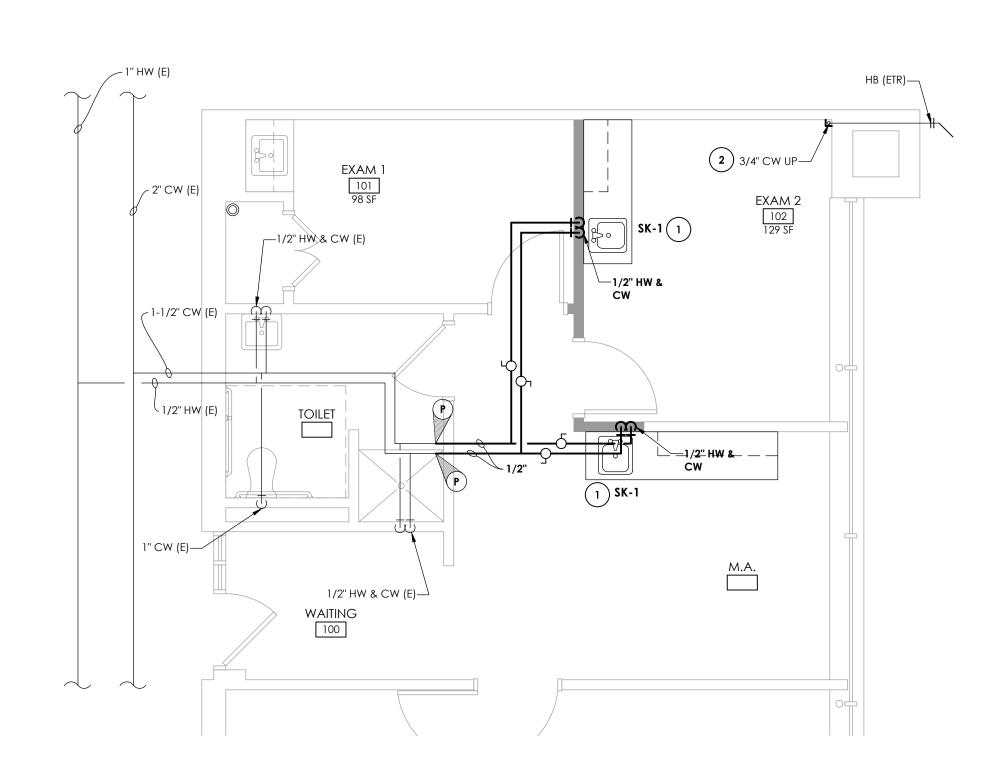




3 DOMESTIC PIPING DEMOLITION PLAN
SCALE: 1/4" = 1'-0"

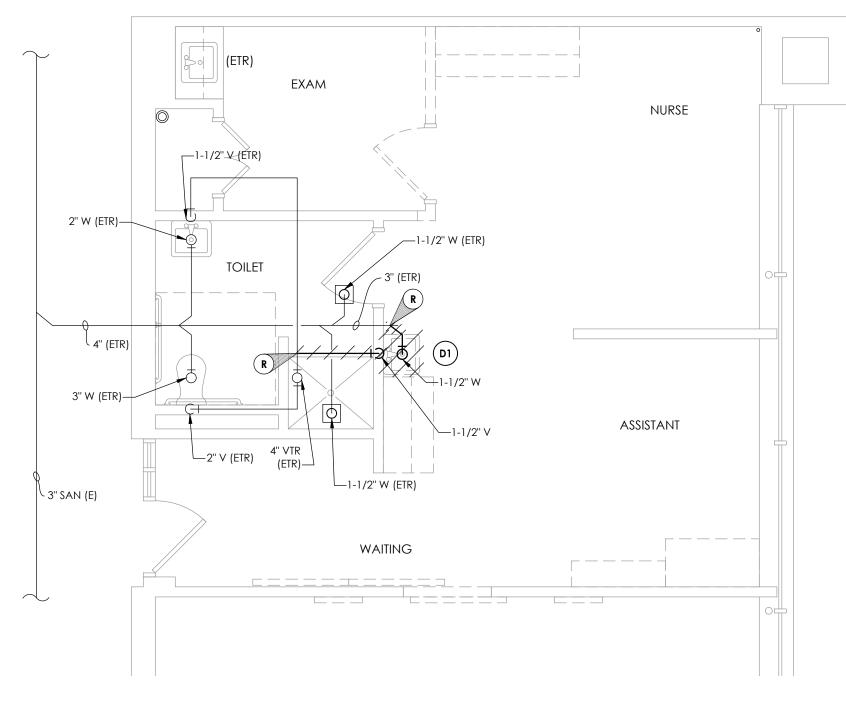

2 SANITARY AND VENT NEW WORK PLAN
SCALE: 1/4" = 1'-0"

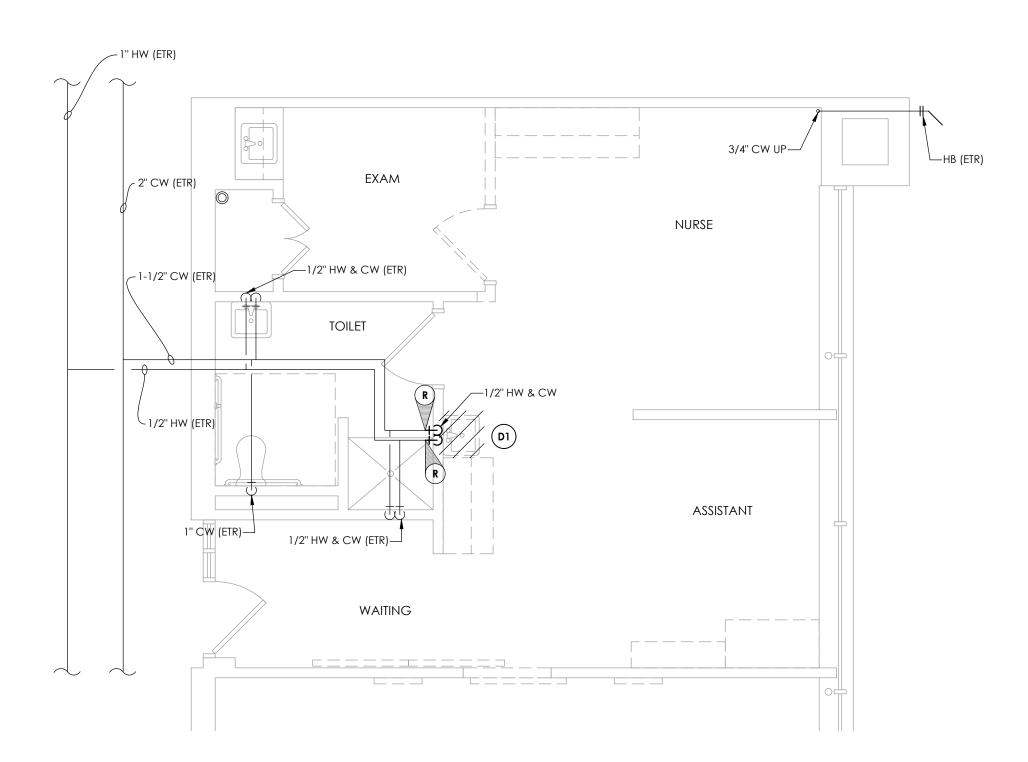

4 DOMESTIC PIPING NEW WORK PLAN
P201 SCALE: 1/4" = 1'-0"