

LEGAL NOTICE:

Tel 845-353-1300


ALTERATIONS BY ANY PERSON, IN ANY WAY, OF ANY ITEM CONTAINED ON THIS DOCUMENT, UNLESS ACTING UNDER DIRECTION OF THE LICENSED ARCHITECT WHOSE PROFESSIONAL SEAL IS AFFIXED HERETO, IS A


WRITTEN DIMENSIONS ON THIS DRAWING SHALL HAVE PRECEDENCE OVER SCALED DIMENSIONS AND CONDITIONS ON THE JOB. THIS OFFICE MUST BE NOTIFIED OF ANY VARIATIONS FROM DIMENSIONS AND CONDITIONS SHOWN BY THESE DRAWINGS. SHOP DETAILS MUST BE SUBMITTED TO THIS OFFICE FOR APPROVAL BEFORE PROCEEDING WITH FABRICATION.

GAS CONNECTION NOTES

- 1. PRIOR TO ANY GAS WORK COMMENCING, FINAL APPROVAL MUST BE OBTAINED FROM WESTCHESTER COUNTY AND CON EDISON TO ALLOW POTENTIAL USE OF THE EXISTING 4" ABANDONED GAS MAIN AS SHOWN ON THE PLANS.
- ONCE APPROVALS ARE OBTAINED FOR THE ABANDONED MAIN, IT SHALL BE THE CONTRACTOR'S RESPONSIBILITY TO PERFORM ANY AND ALL TESTING NECESSARY TO ENSURE THAT THE ABANDONED MAIN COULD BE PUT BACK INTO SERVICE AND HOLD THE NECESSARY PRESSURES TO SERVE THE BUILDING. COSTS ASSOCIATED TO THIS WORK SHALL BE INCLUDED UNDER THE BASE BID.

- PENDING RESULTS OF TESTING, THE CONTRACTOR SHALL THEN PERFORM THE NECESSARY MEASURES TO RECONNECT THE LINE AND MAKE IT OPERATIONAL.
- 4. THE WORK OUTLINED IN THESE NOTES SHALL BE IN LIEU OF THE 4" GAS LINE CONNECTION AT DANA ROAD. THIS WORK IS NOT TO REPLACE ALTERNATE NO. 2. ALTERNATE NO. 2 SHALL BE USED IN THE EVENT THAT THE ABANDONED MAIN CAN NOT BE PLACED BACK INTO SERVICE.

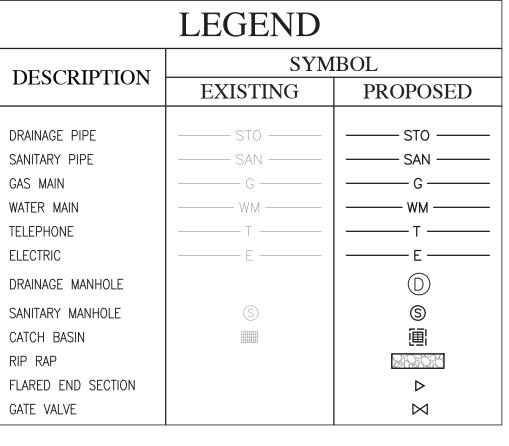

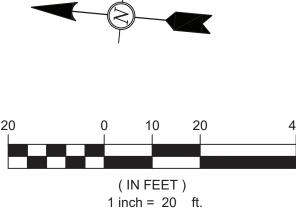



www.DCAK-MSA.com

Fax 845-353-1614

Email: info@DCAK-MSA.com


VIOLATION OF TITLE VII, SEC. 69.5 (B) OF NEW YORK STATE LAW.



OAKLAND, NJ 07436

Tel: 201-416-4012

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914.747.2800 12 East 49th Street, 11th Flr. New York, NY 10017 646.849.4110 olace.com

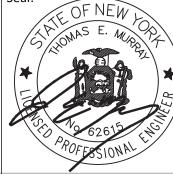
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rs ,						AS BUILT — CHANGES AS NOTED AS BUILT — NO CHANGES	
Flr.						CONTRACTOR PROJECT COORDINATOR NAME NAME	
	1	12/20/21	JS	DC	ADDENDUM #3	SIGNATURE SIGNATURE	
	REVISION NUMBER	DATE	MADE BY	APP'D BY	REVISION	TITLE DATE TITLE DATE	L


WESTCHESTER COUNTY, NEW YORK DEPARTMENT OF PUBLIC WORKS AND TRANSPORTATION DIVISION OF ENGINEERING

NEW EQUIPMENT STORAGE BUILDING
RICHARD A. FLYNN, SR. FIRE TRAINING CENTER
VALHALLA CAMPUS, VALHALLA, NEW YORK
GAS AND TELEPHONE LINE PLAN

•	CONTRACT NUMBER	SHEET NUMBER		
)N	17-521	C-102.1		
	SHEET NO. 6	of 53		
	SCALE: AS S DATE: 11/			
•	DPW FILE NO.	RE\ NO		

38-47-G-688-0

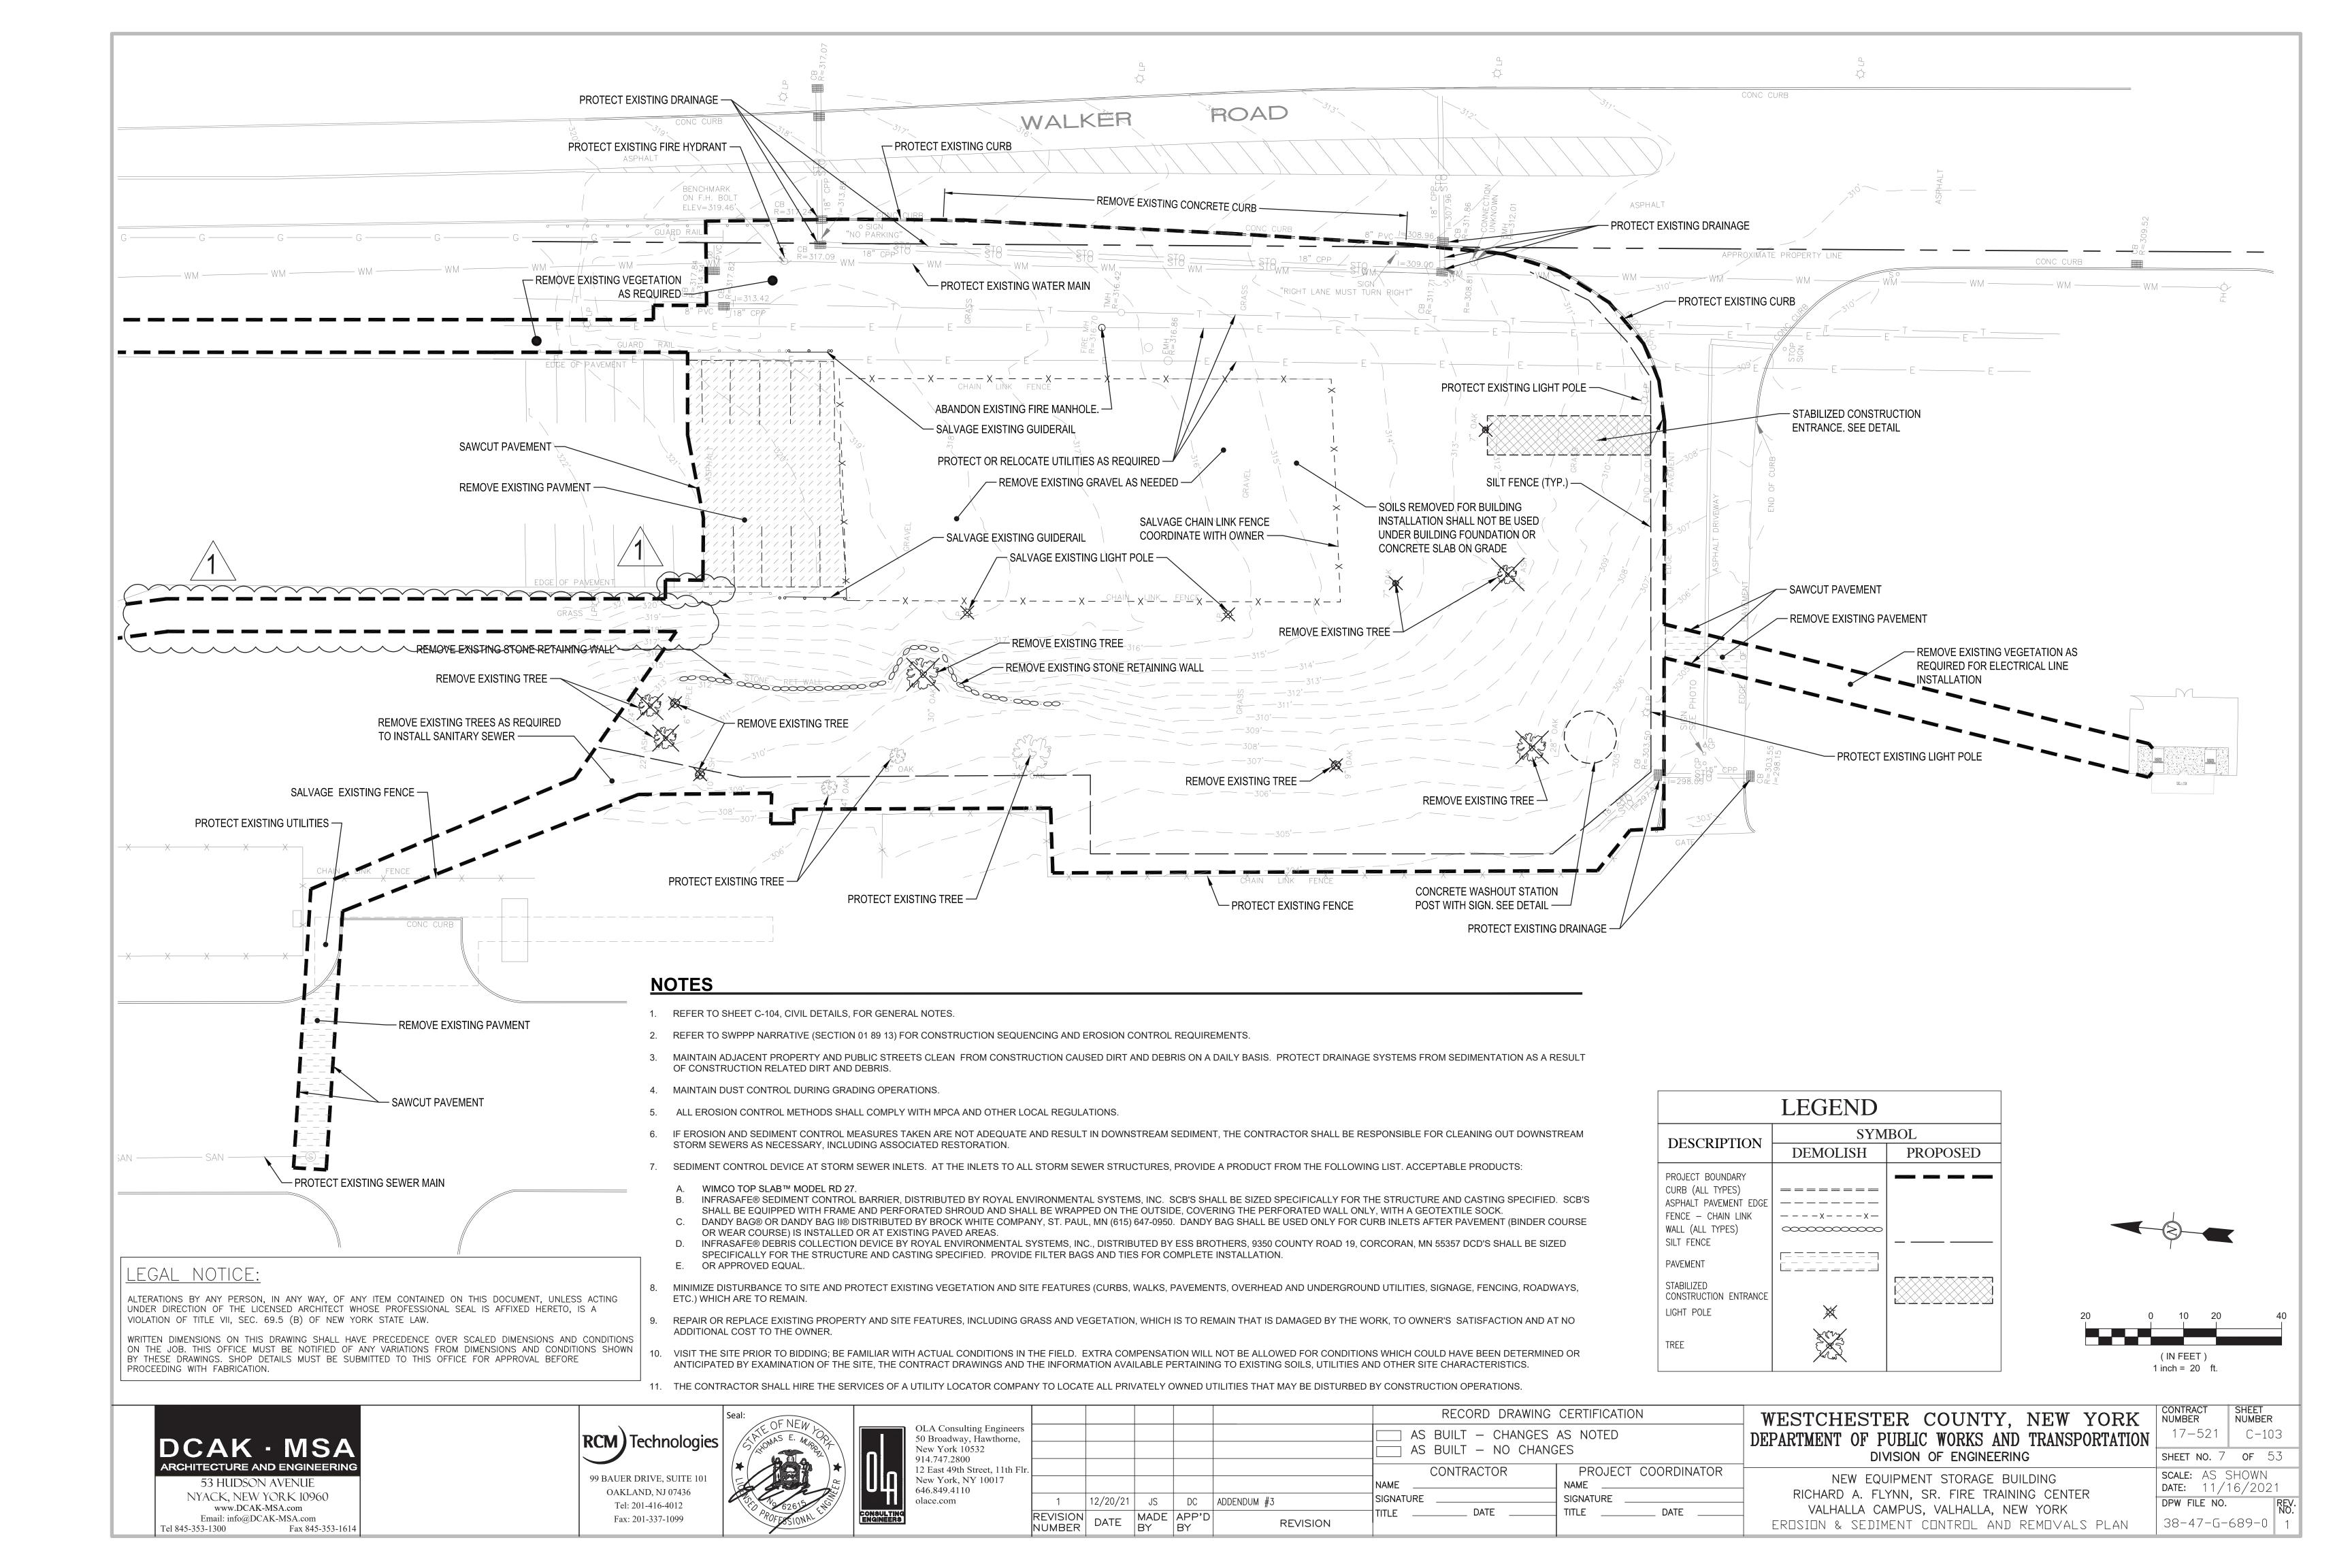


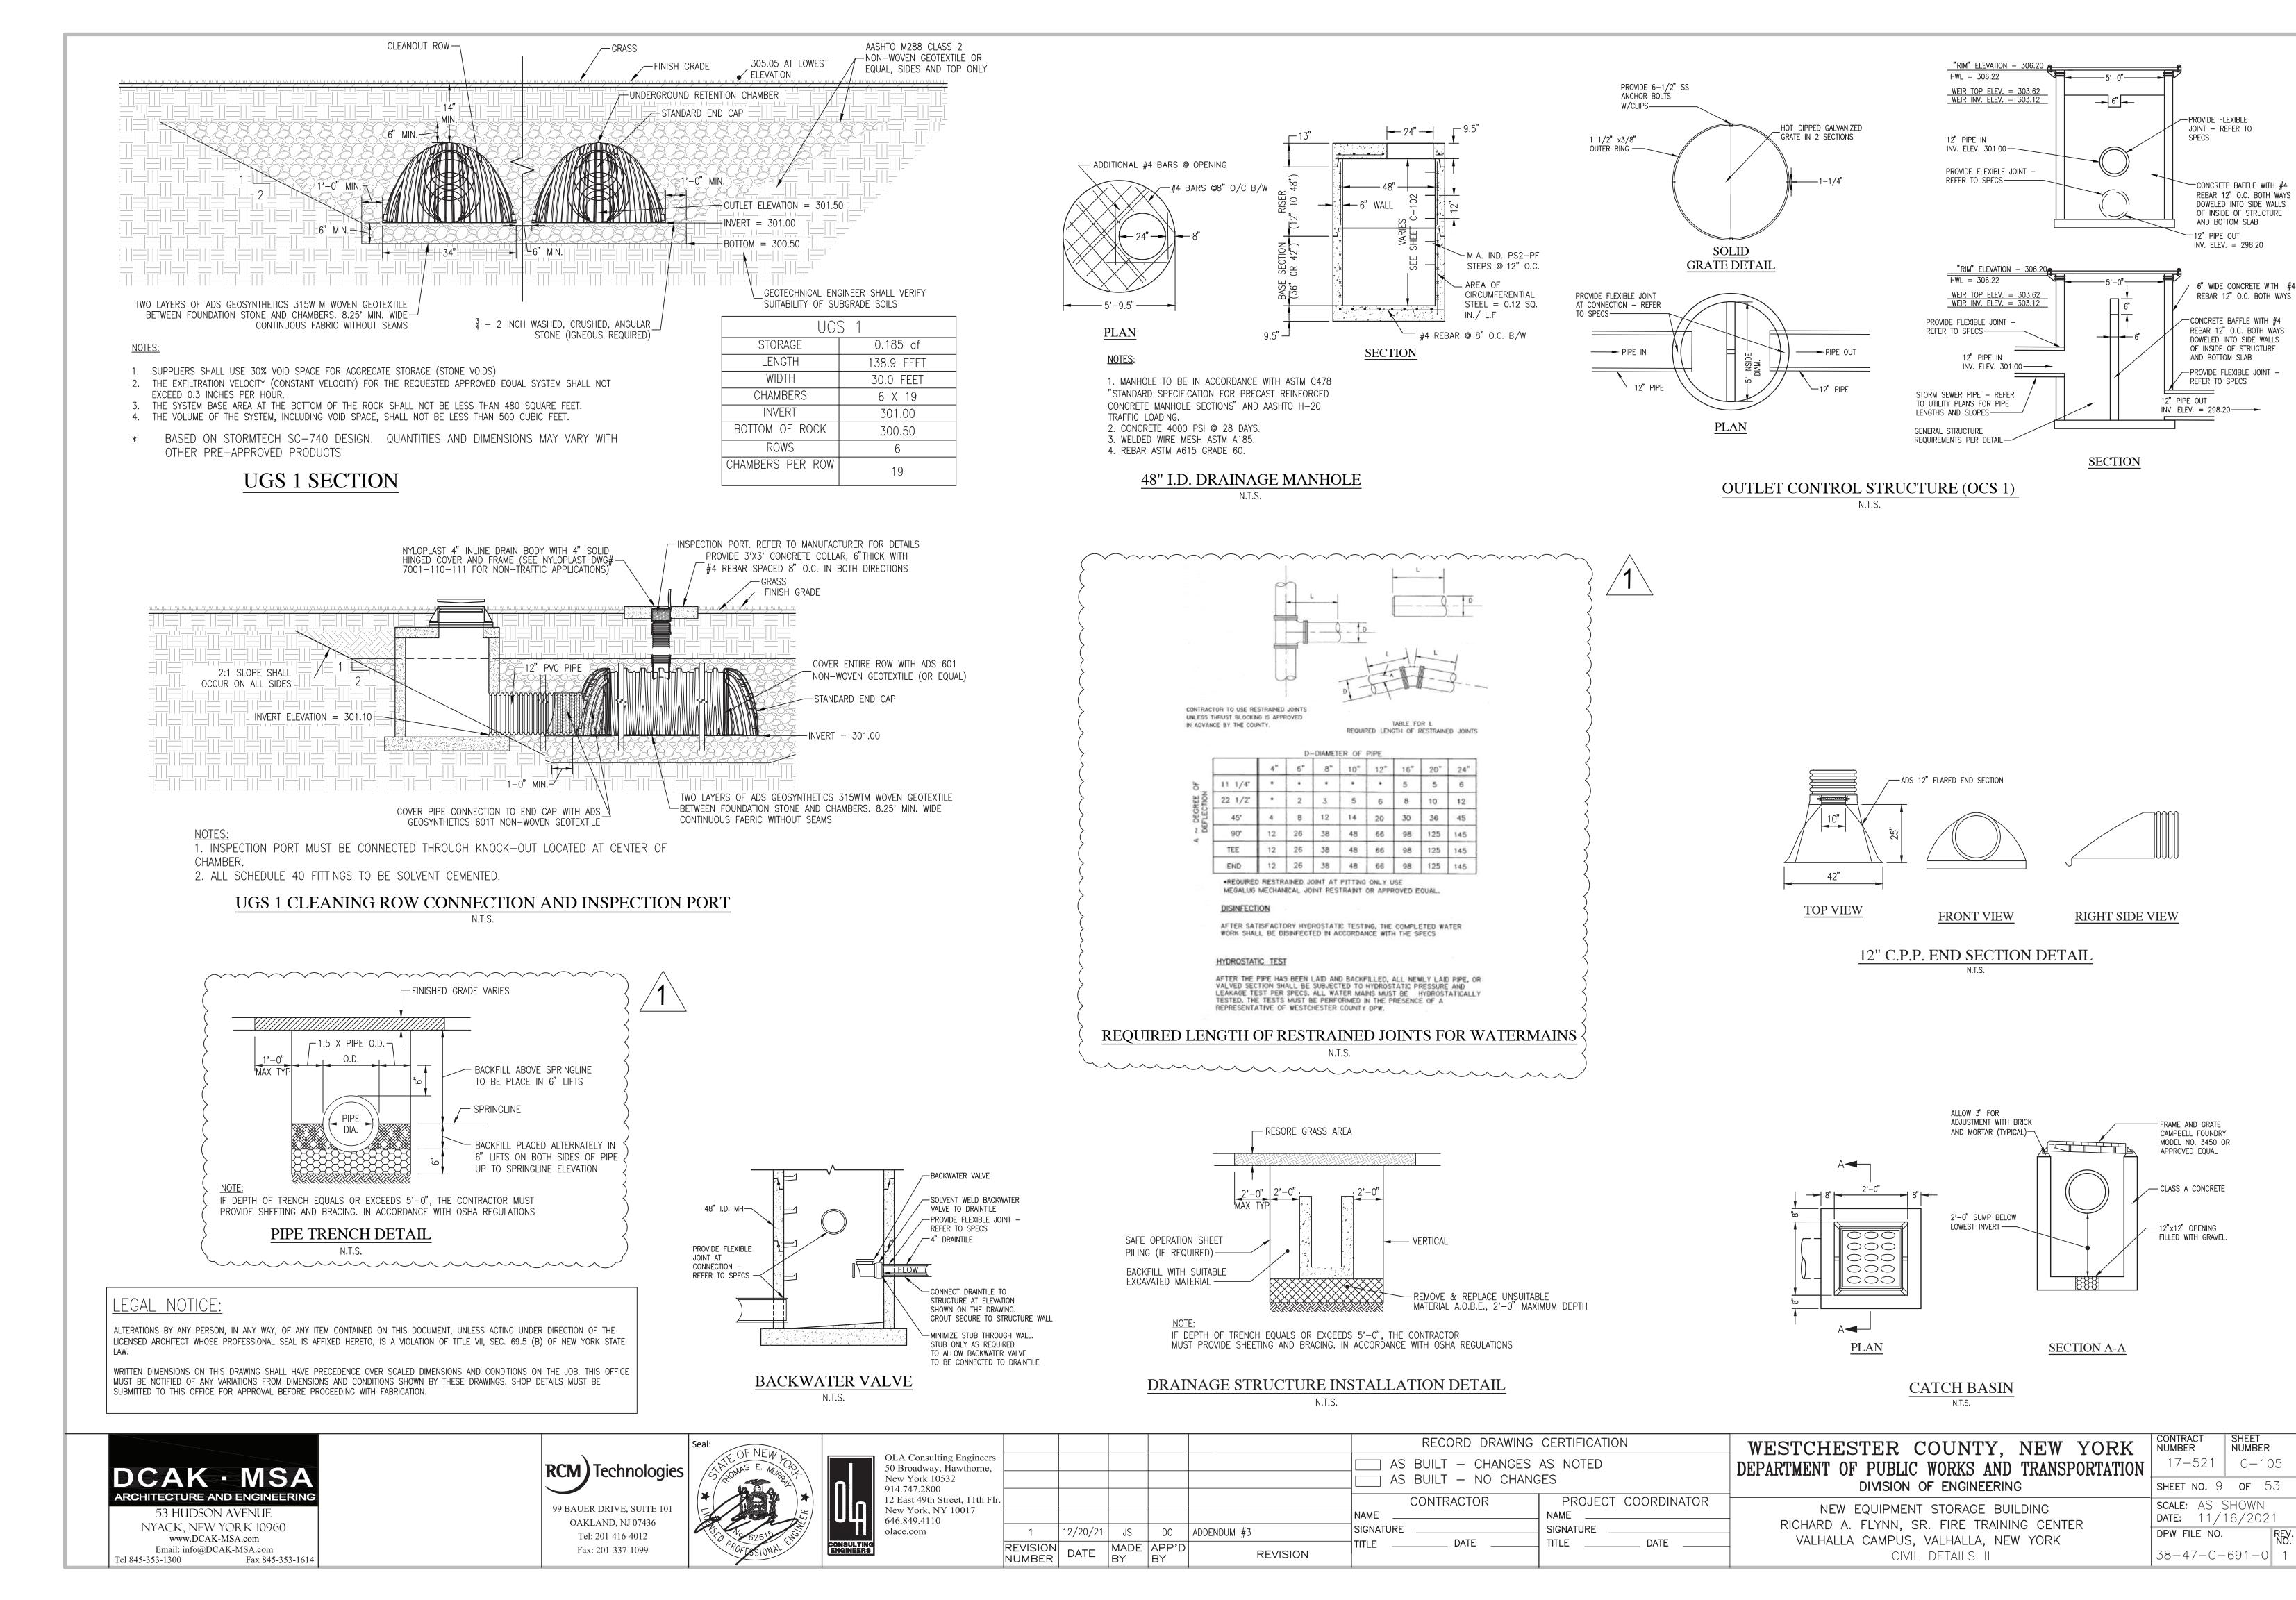



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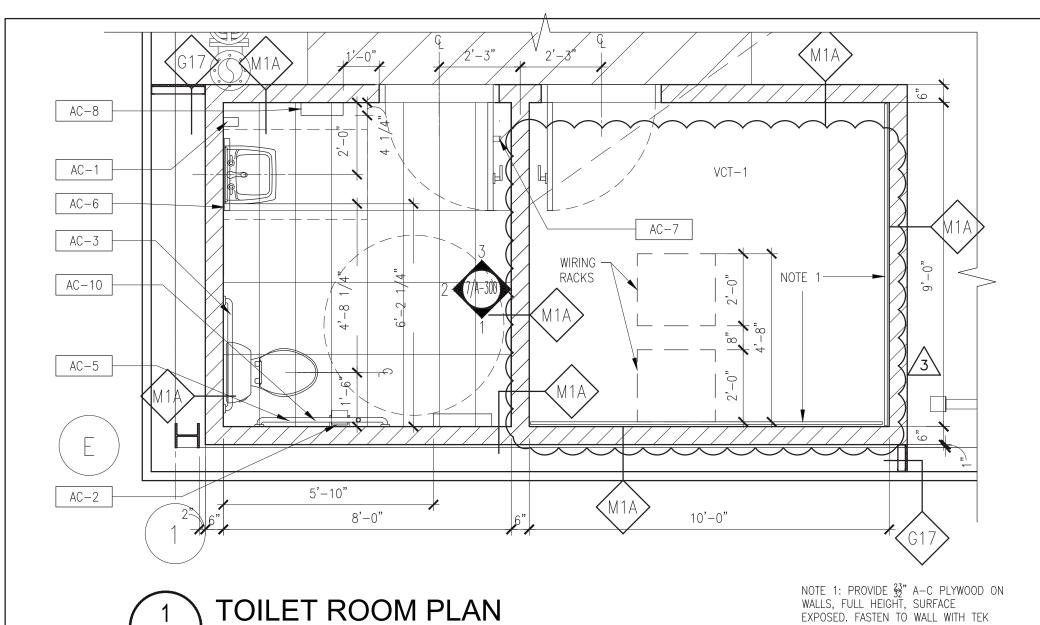
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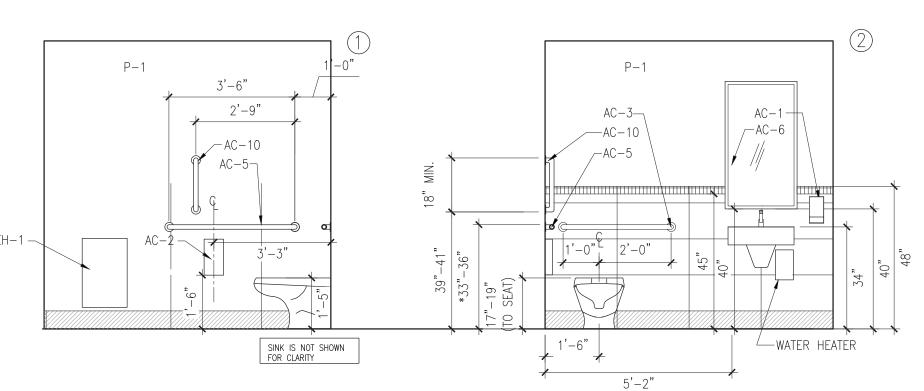






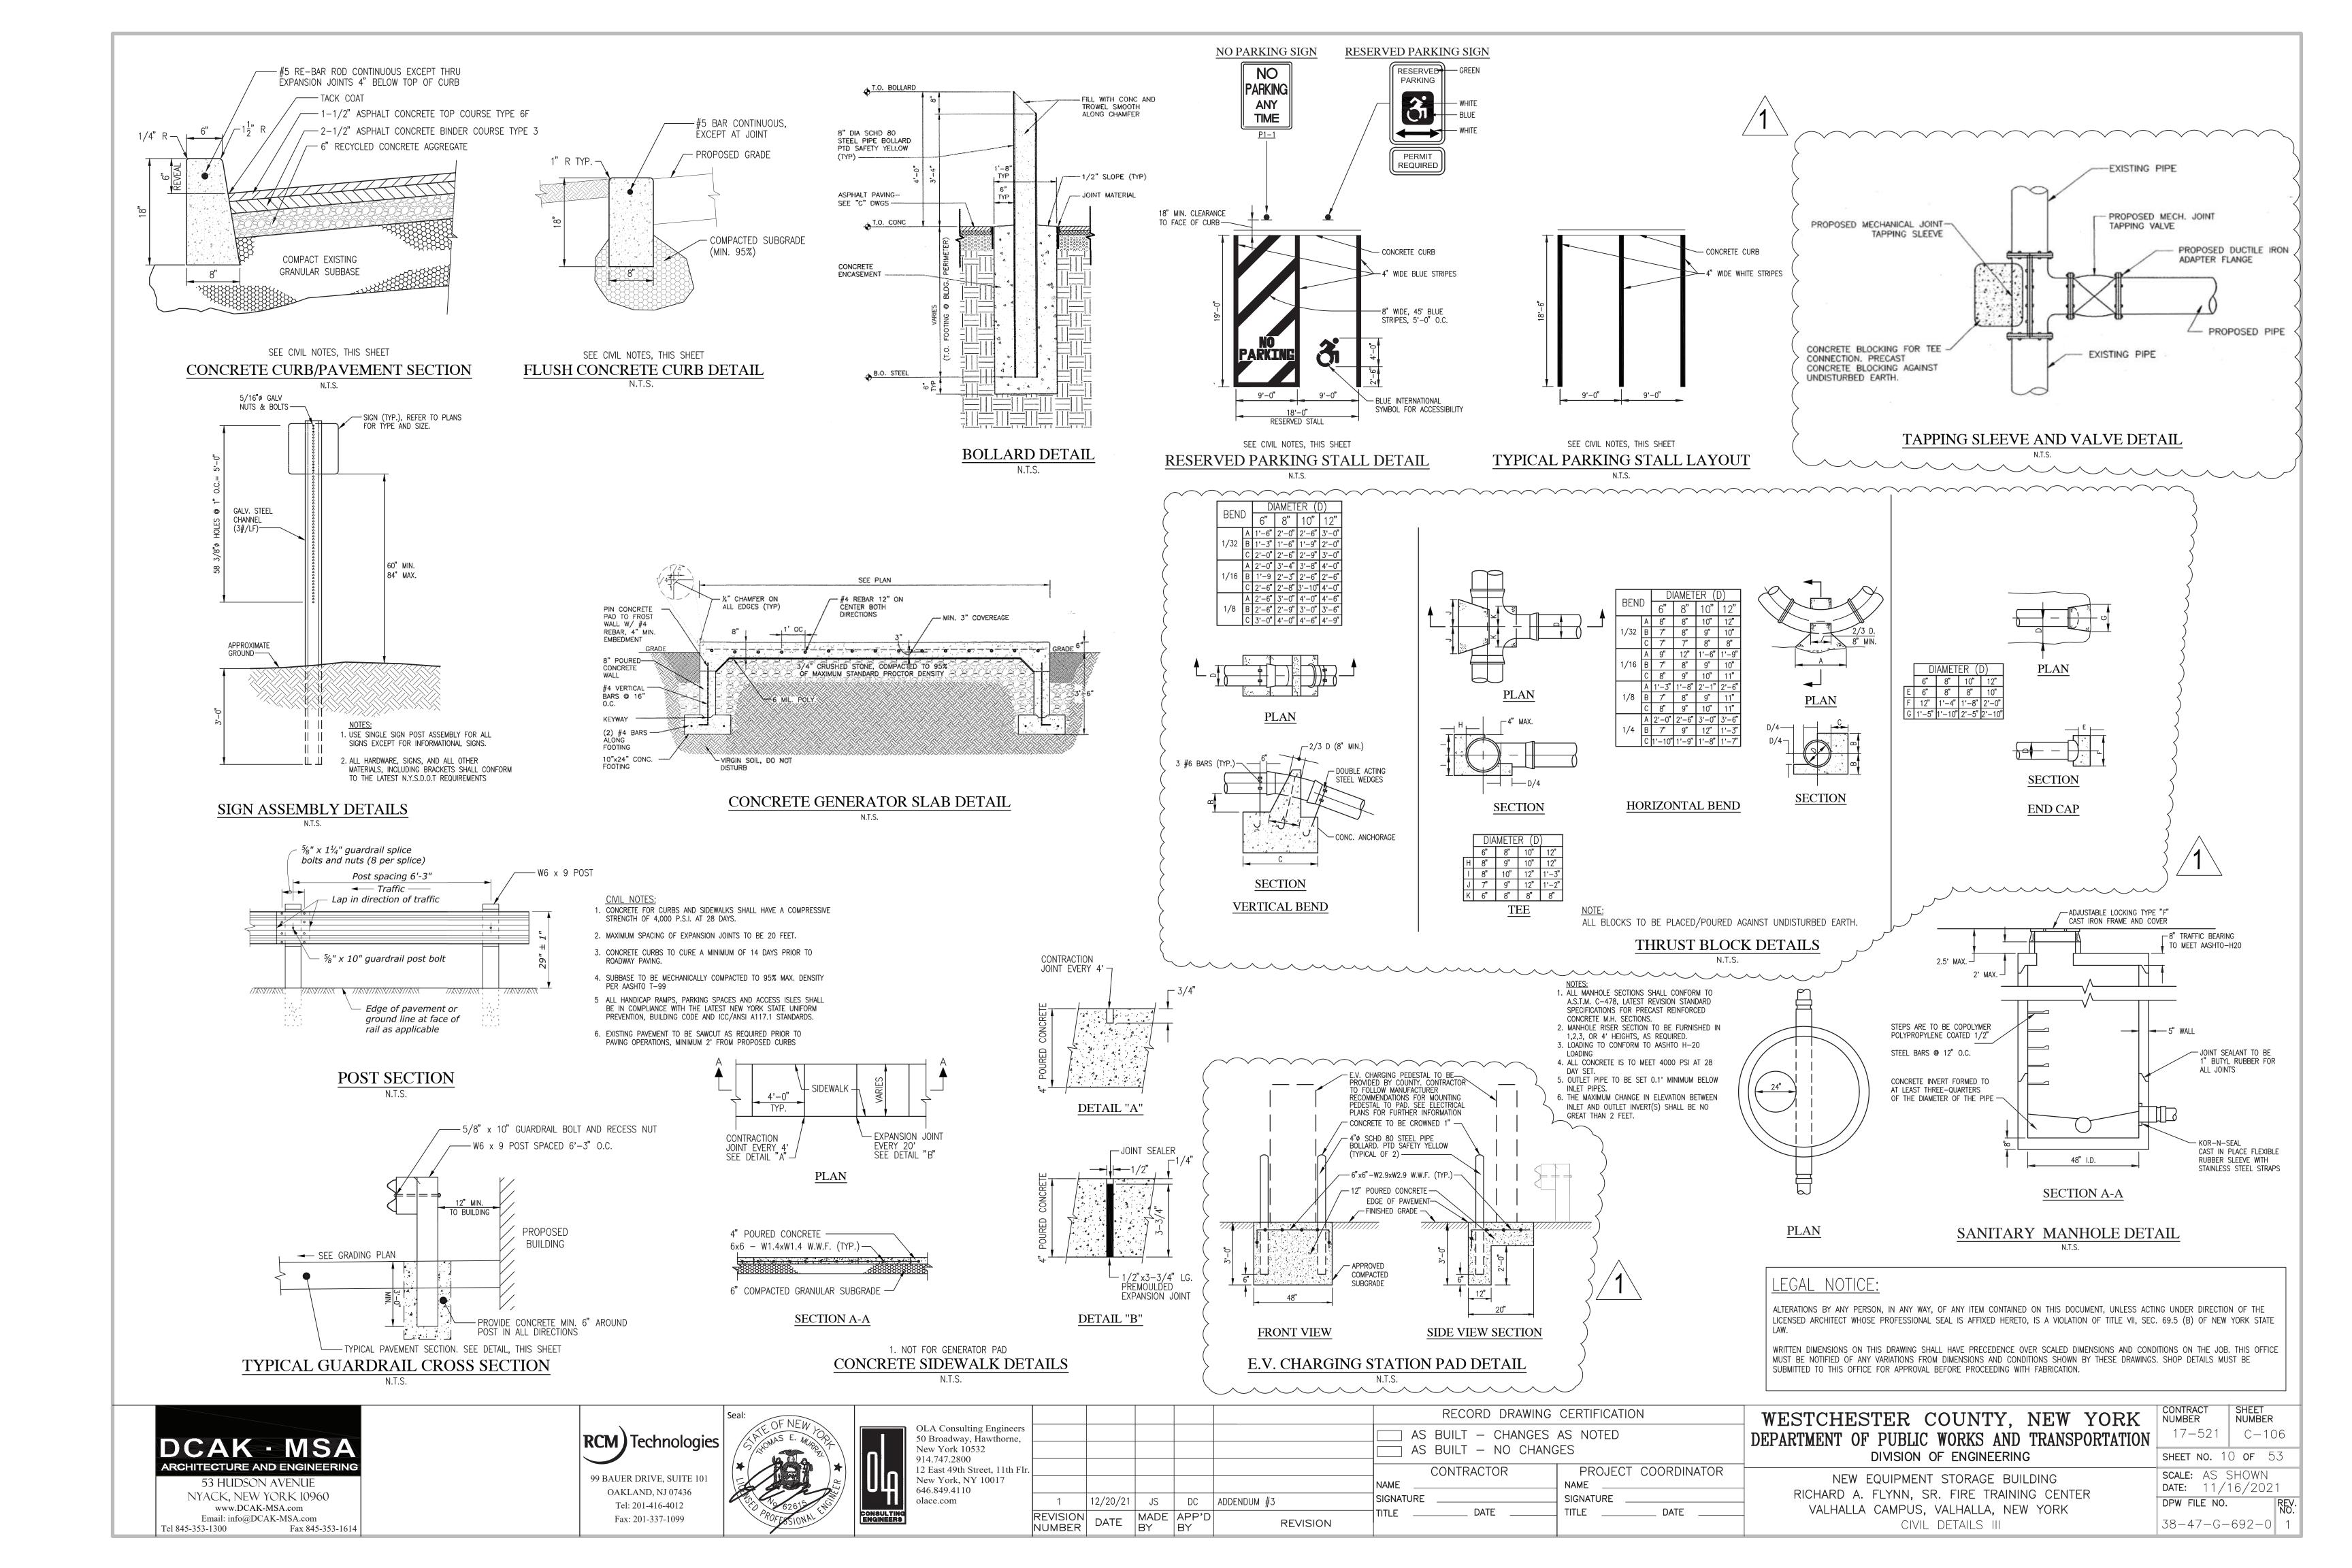


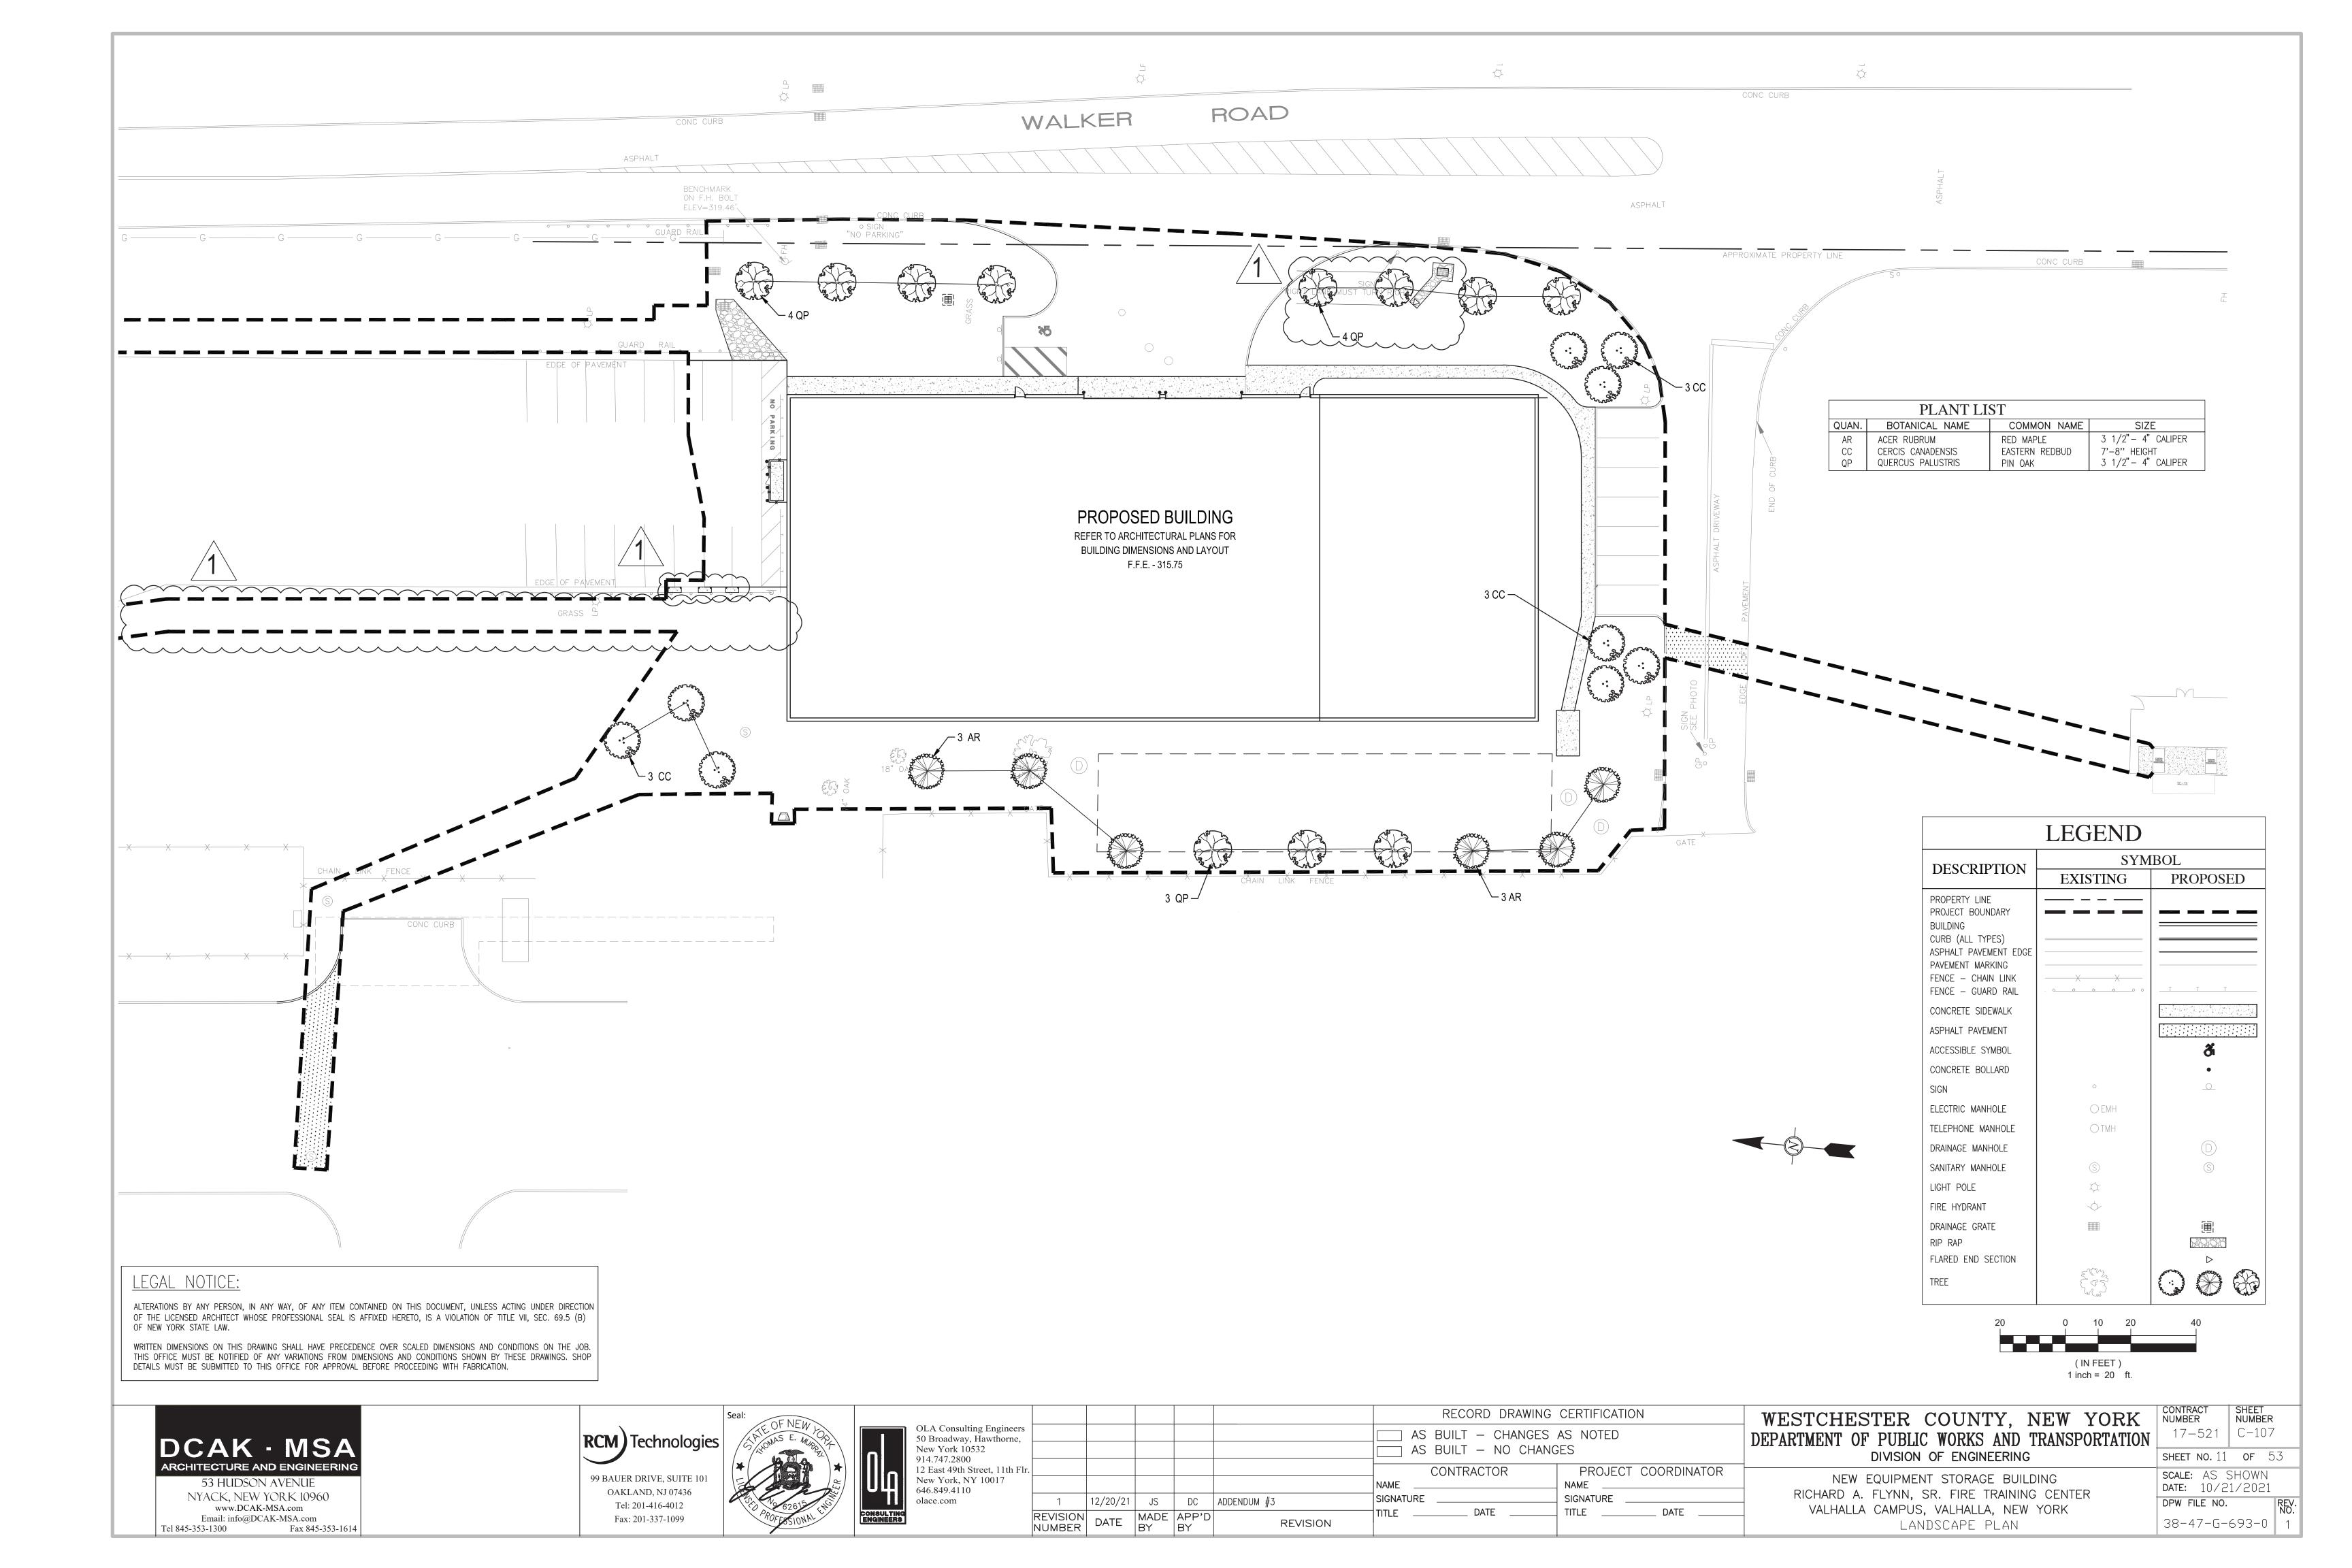


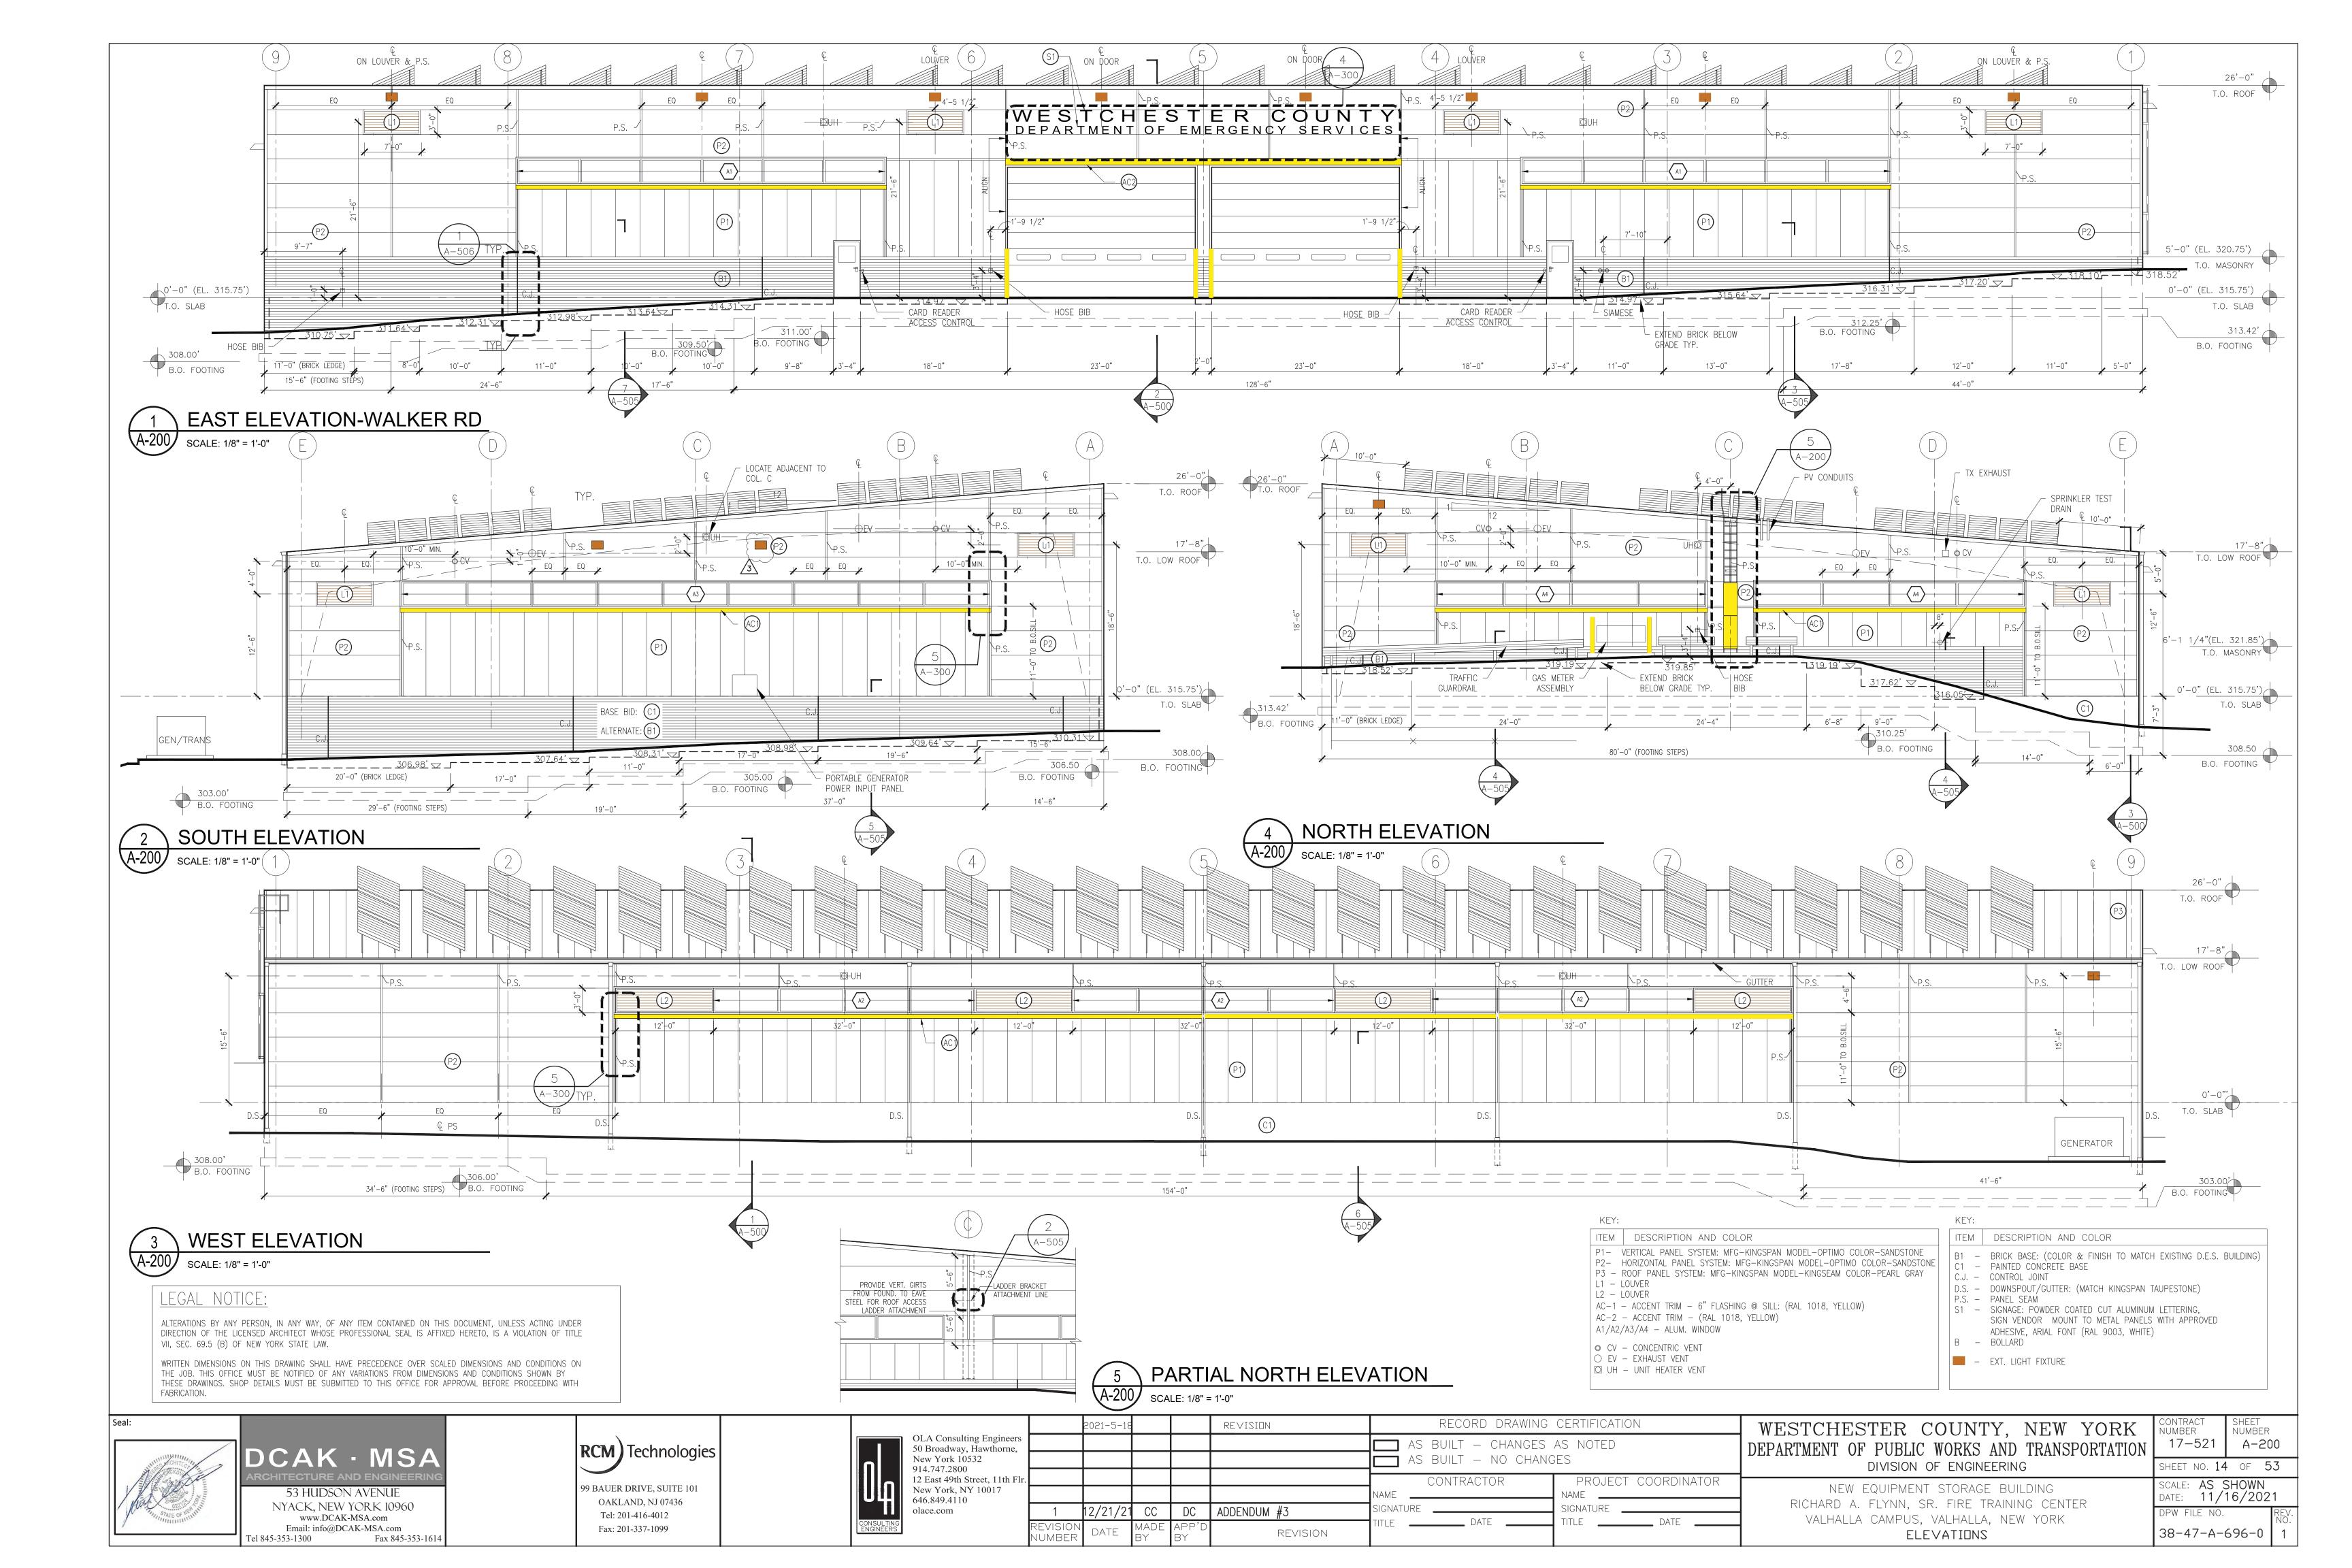

EXPOSED. FASTEN TO WALL WITH TEK

SCREWS @ 24" O.C.

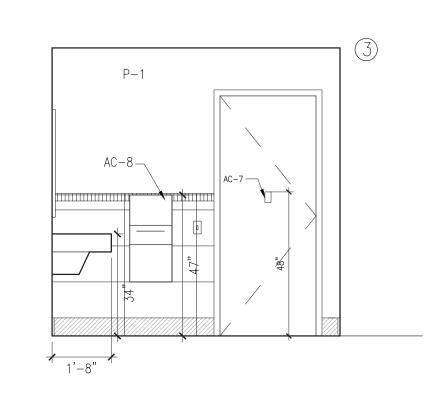

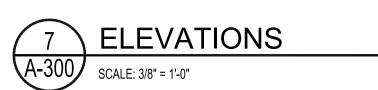

SCALE: 3/8" = 1'-0"

GENERAL NOTES:

- A. NOT USED
- B. NOT USED
- C. ALL BATHROOM ACCESSORIES TO BE STAINLESS STEEL WITH SATIN FINISH.
- D. PROVIDE PAINTED WOOD SPACER BEHIND MIRRORS AND OTHER ACCESSORIES ABOVE CERAMIC TILE TO FILL GAP BETWEEN MIRROR FRAME AND GWB. COLOR TO MATCH WALL.
- E. PROVIDE LAVATORY PIPE/VALVE AND TRAP INSULATION PER ADA CODE.
- F. PROVIDE ADA COMPLIANT DOOR AND HARDWARE
- G. PROVIDE ADA COMPLIANT TACTILE SIGN CONSISTING OF PICTOGRAM, ROOM NAME AND BRAILLE MOUNTED BETWEEN 48"& 60" HIGH.
- H. TILE PATTERN SHALL BE CENTERED IN THE SPACE U.O.N.


CERAMIC TILE LEGEND							
	FLOOR TILE	WALL TILE					
	CT-I	СТ-3					
	-	CT-4 BULL NOSE					
	-	CT-2 BASE					


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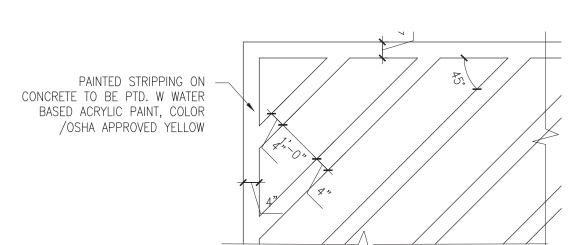
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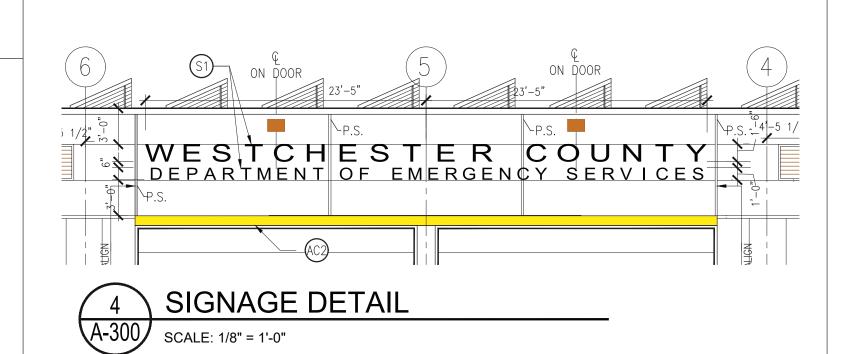
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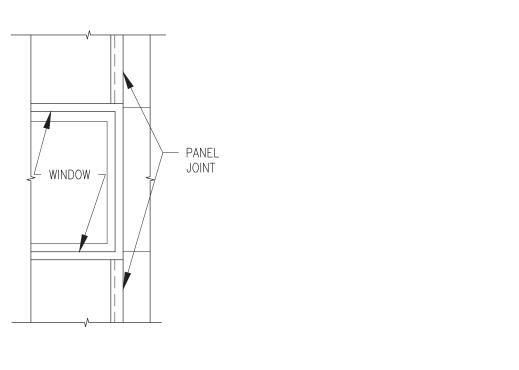









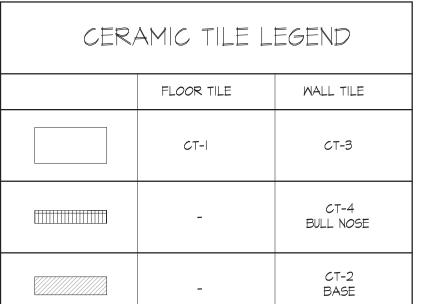


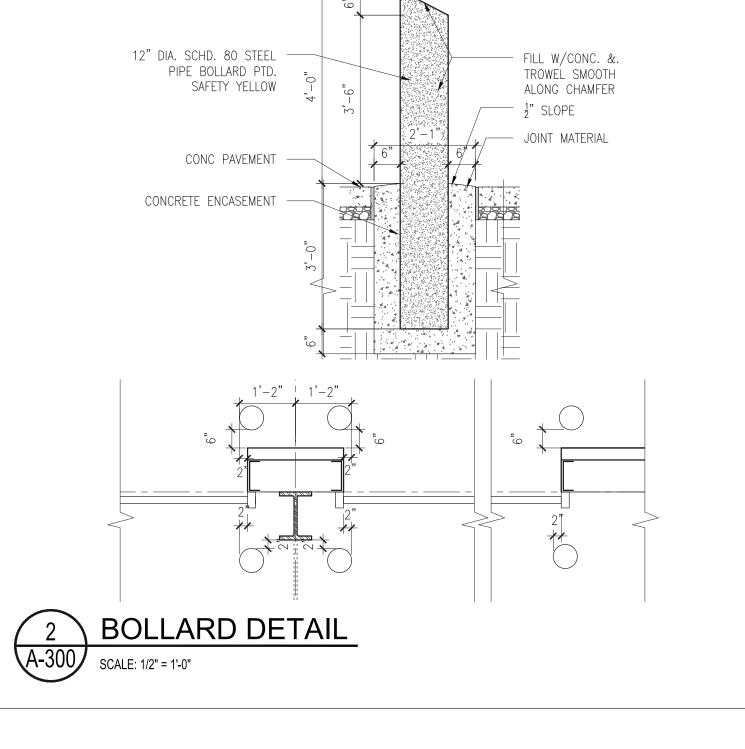



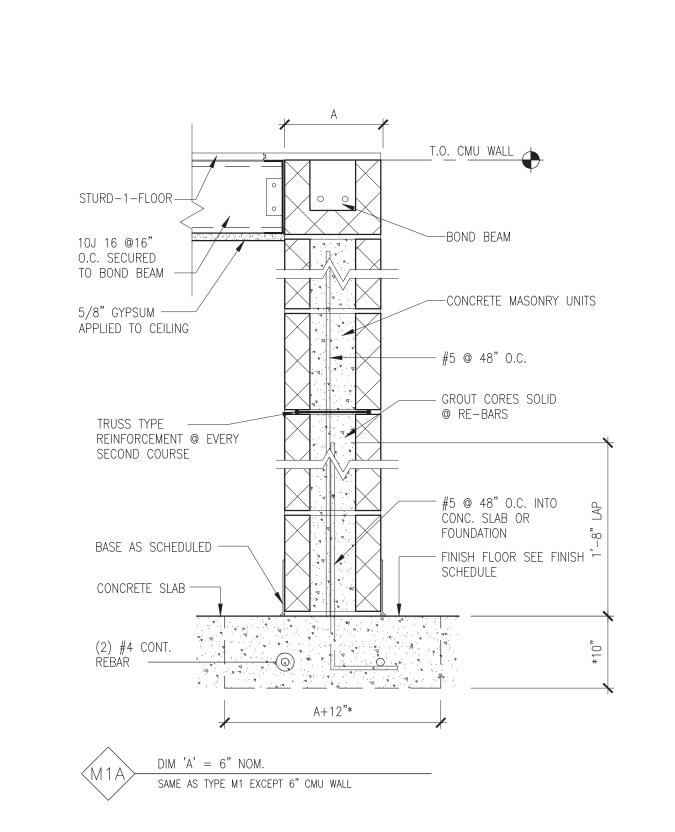



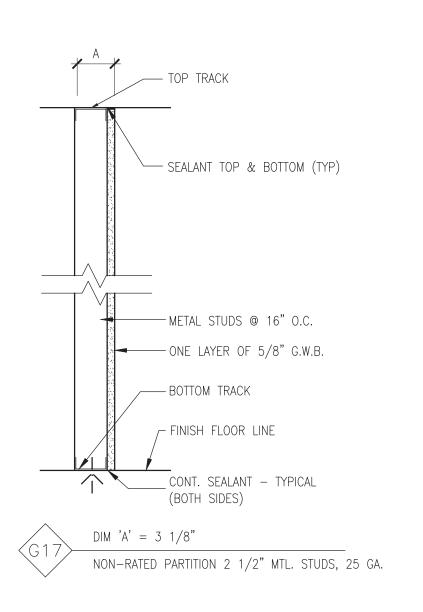





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11th Flr.						Г
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	1	12/7/21	CC	DC	ADDENDUM #3	S
	REVISION NUMBER	DATE	MADE BY	APP'D BY	REVISION	TI

RECORD DRAWING CERTIFICATION AS BUILT — CHANGES AS NOTED AS BUILT - NO CHANGES CONTRACTOR PROJECT COORDINATOR NAME __ SIGNATURE ____

WESTCHESTER COUNTY, NEW YORK DEPARTMENT OF PUBLIC WORKS AND TRANSPORTATION


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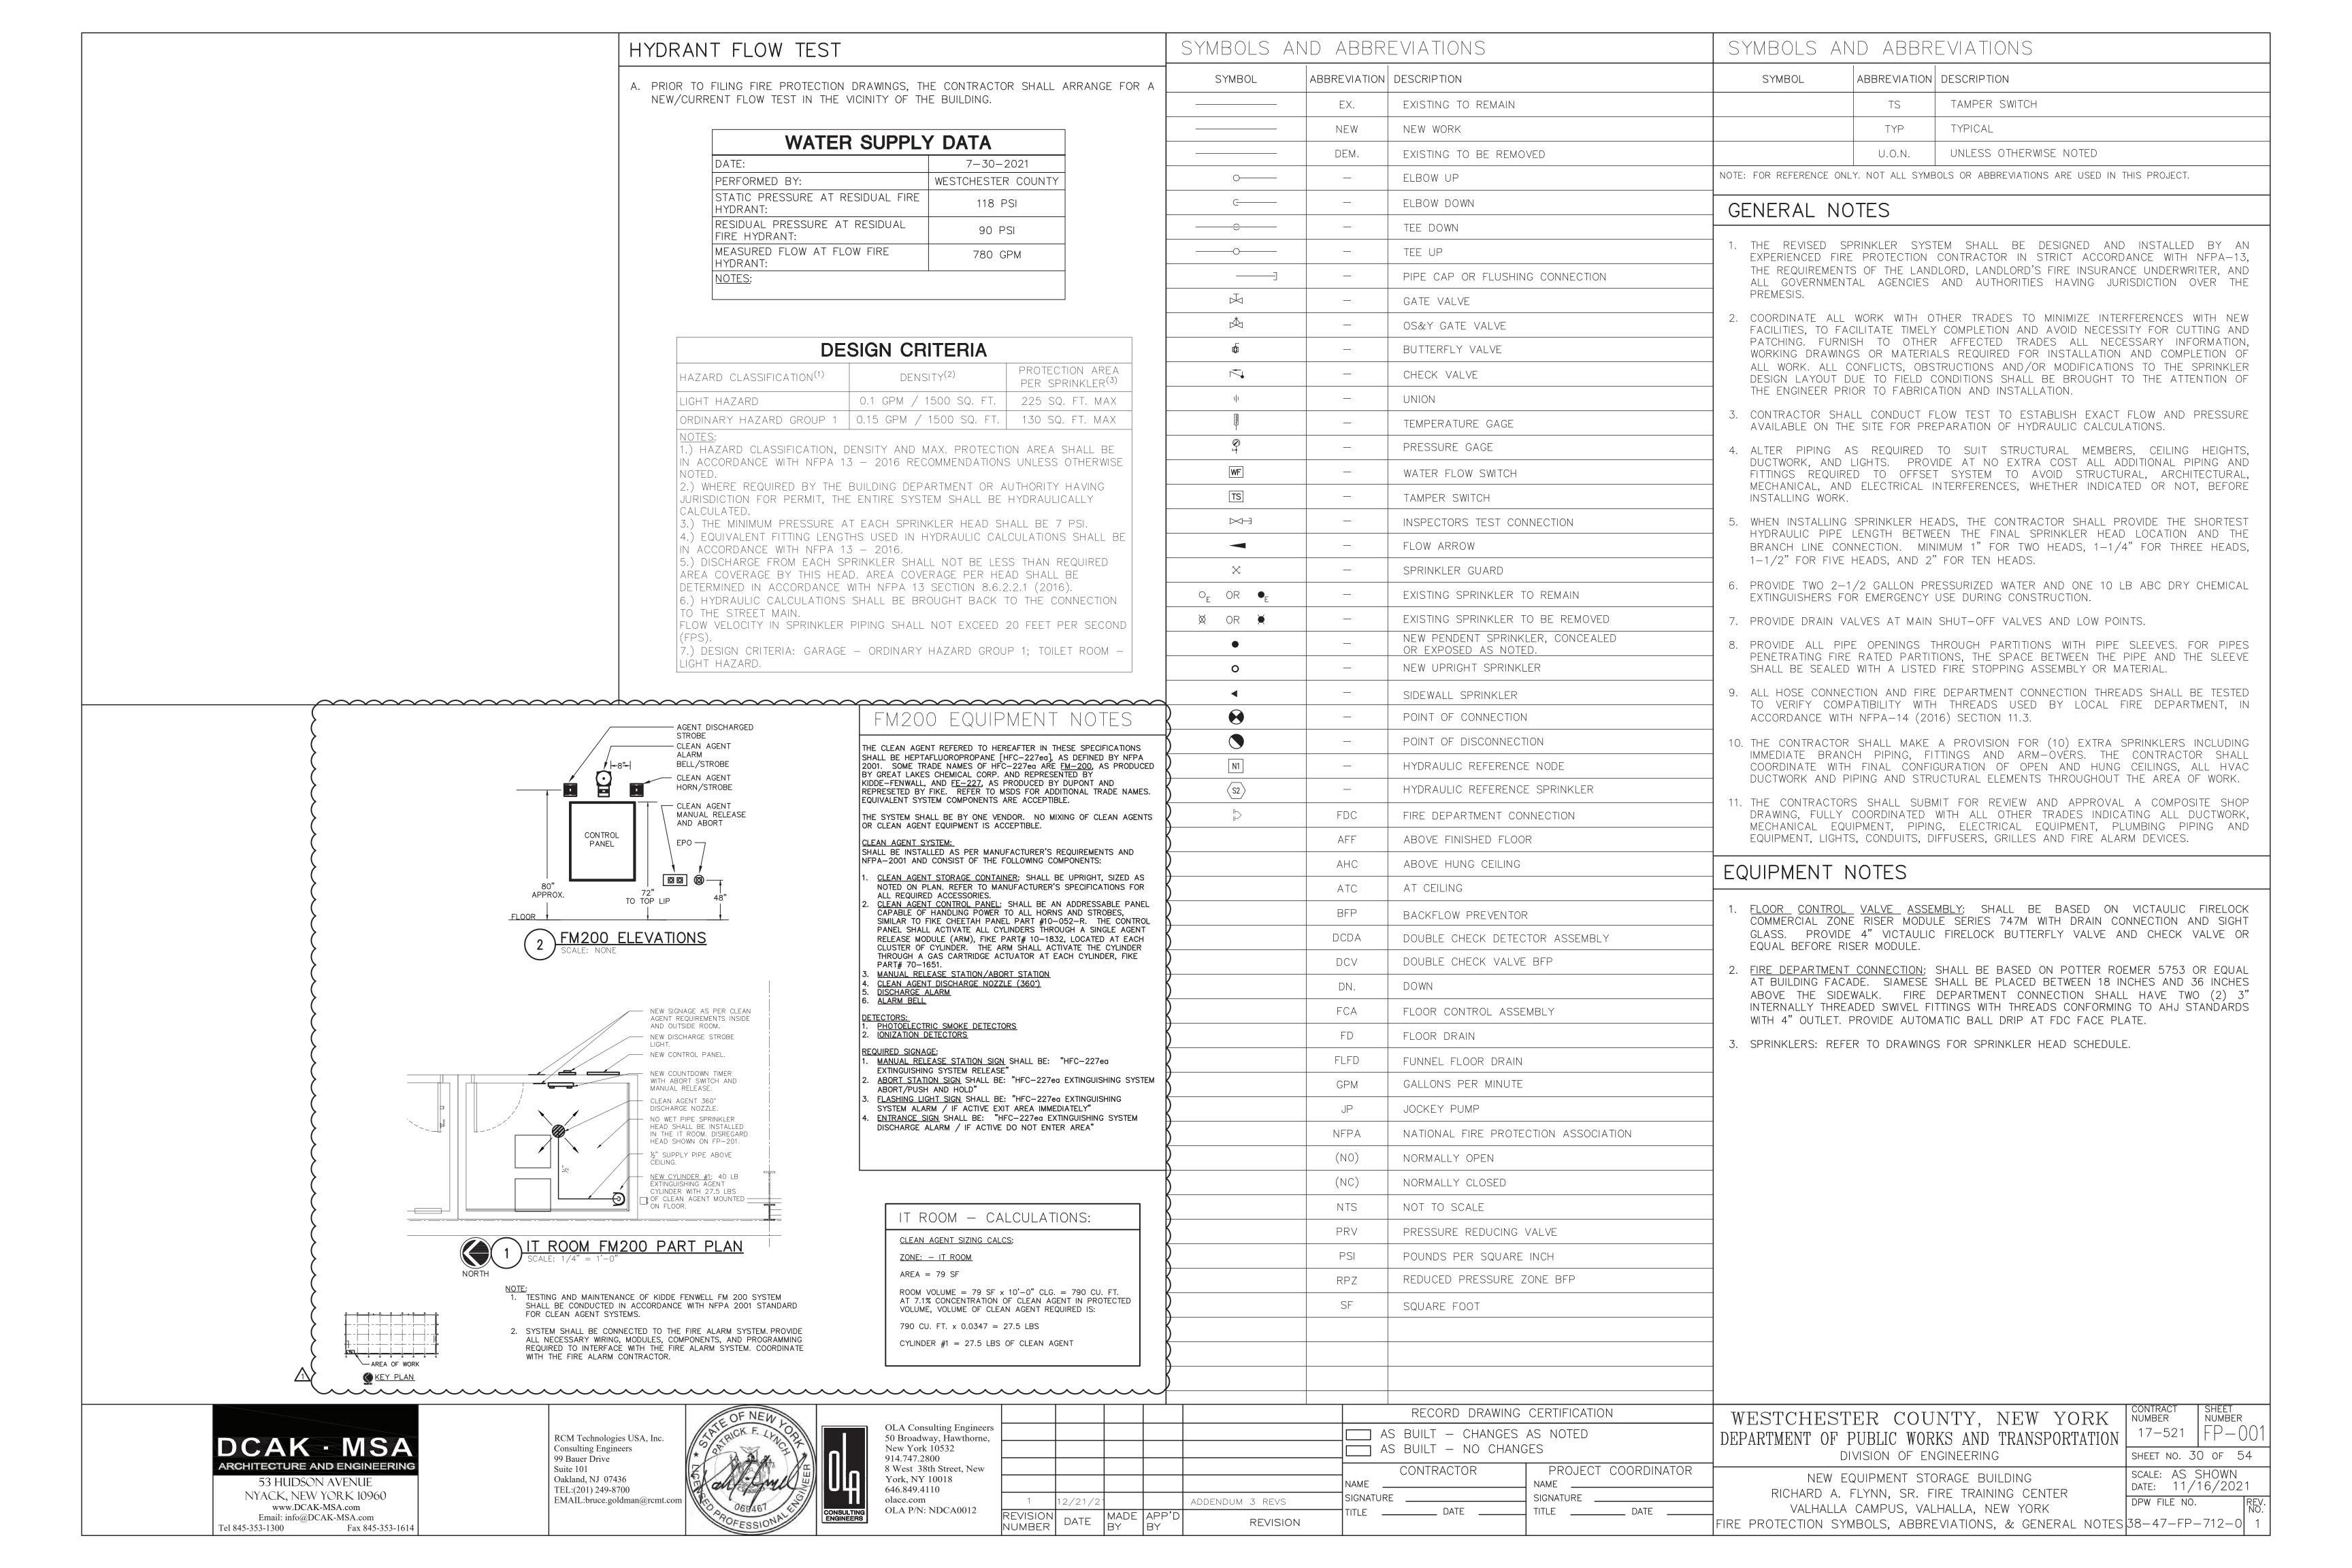
DIVISION OF ENGINEERING NEW EQUIPMENT STORAGE BUILDING RICHARD A. FLYNN, SR. FIRE TRAINING CENTER VALHALLA CAMPUS, VALHALLA, NEW YORK


17-521 A-300 SHEET NO. 16 OF 53 SCALE: AS SHOWN DATE: 11/16/2021 DPW FILE NO. 38-47-A-698-0


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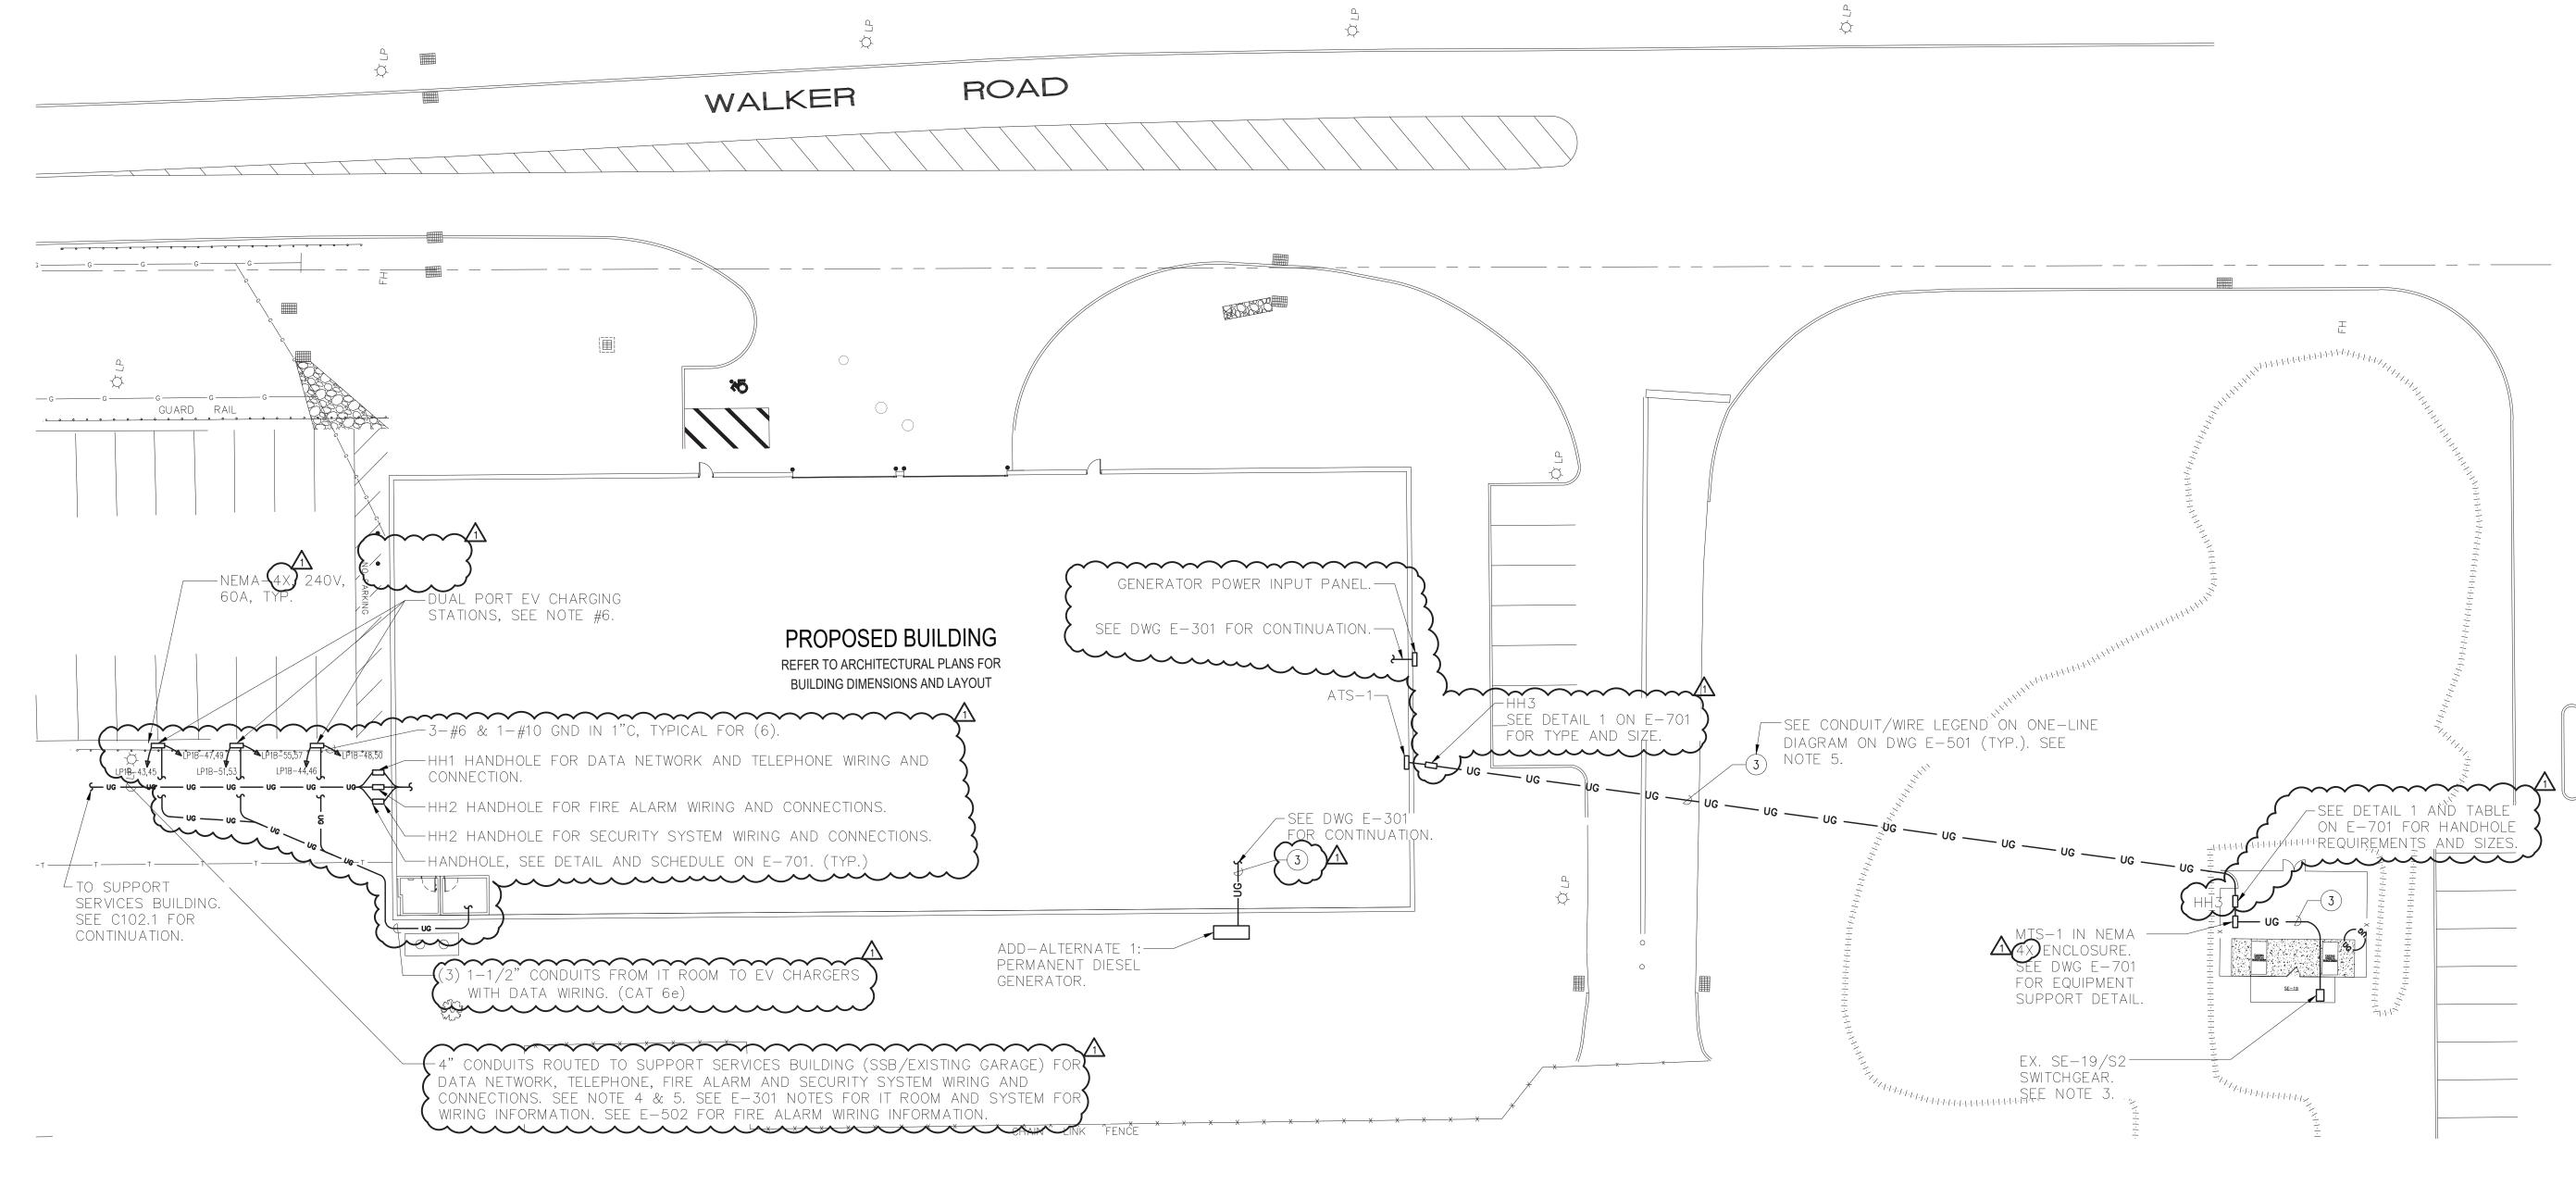






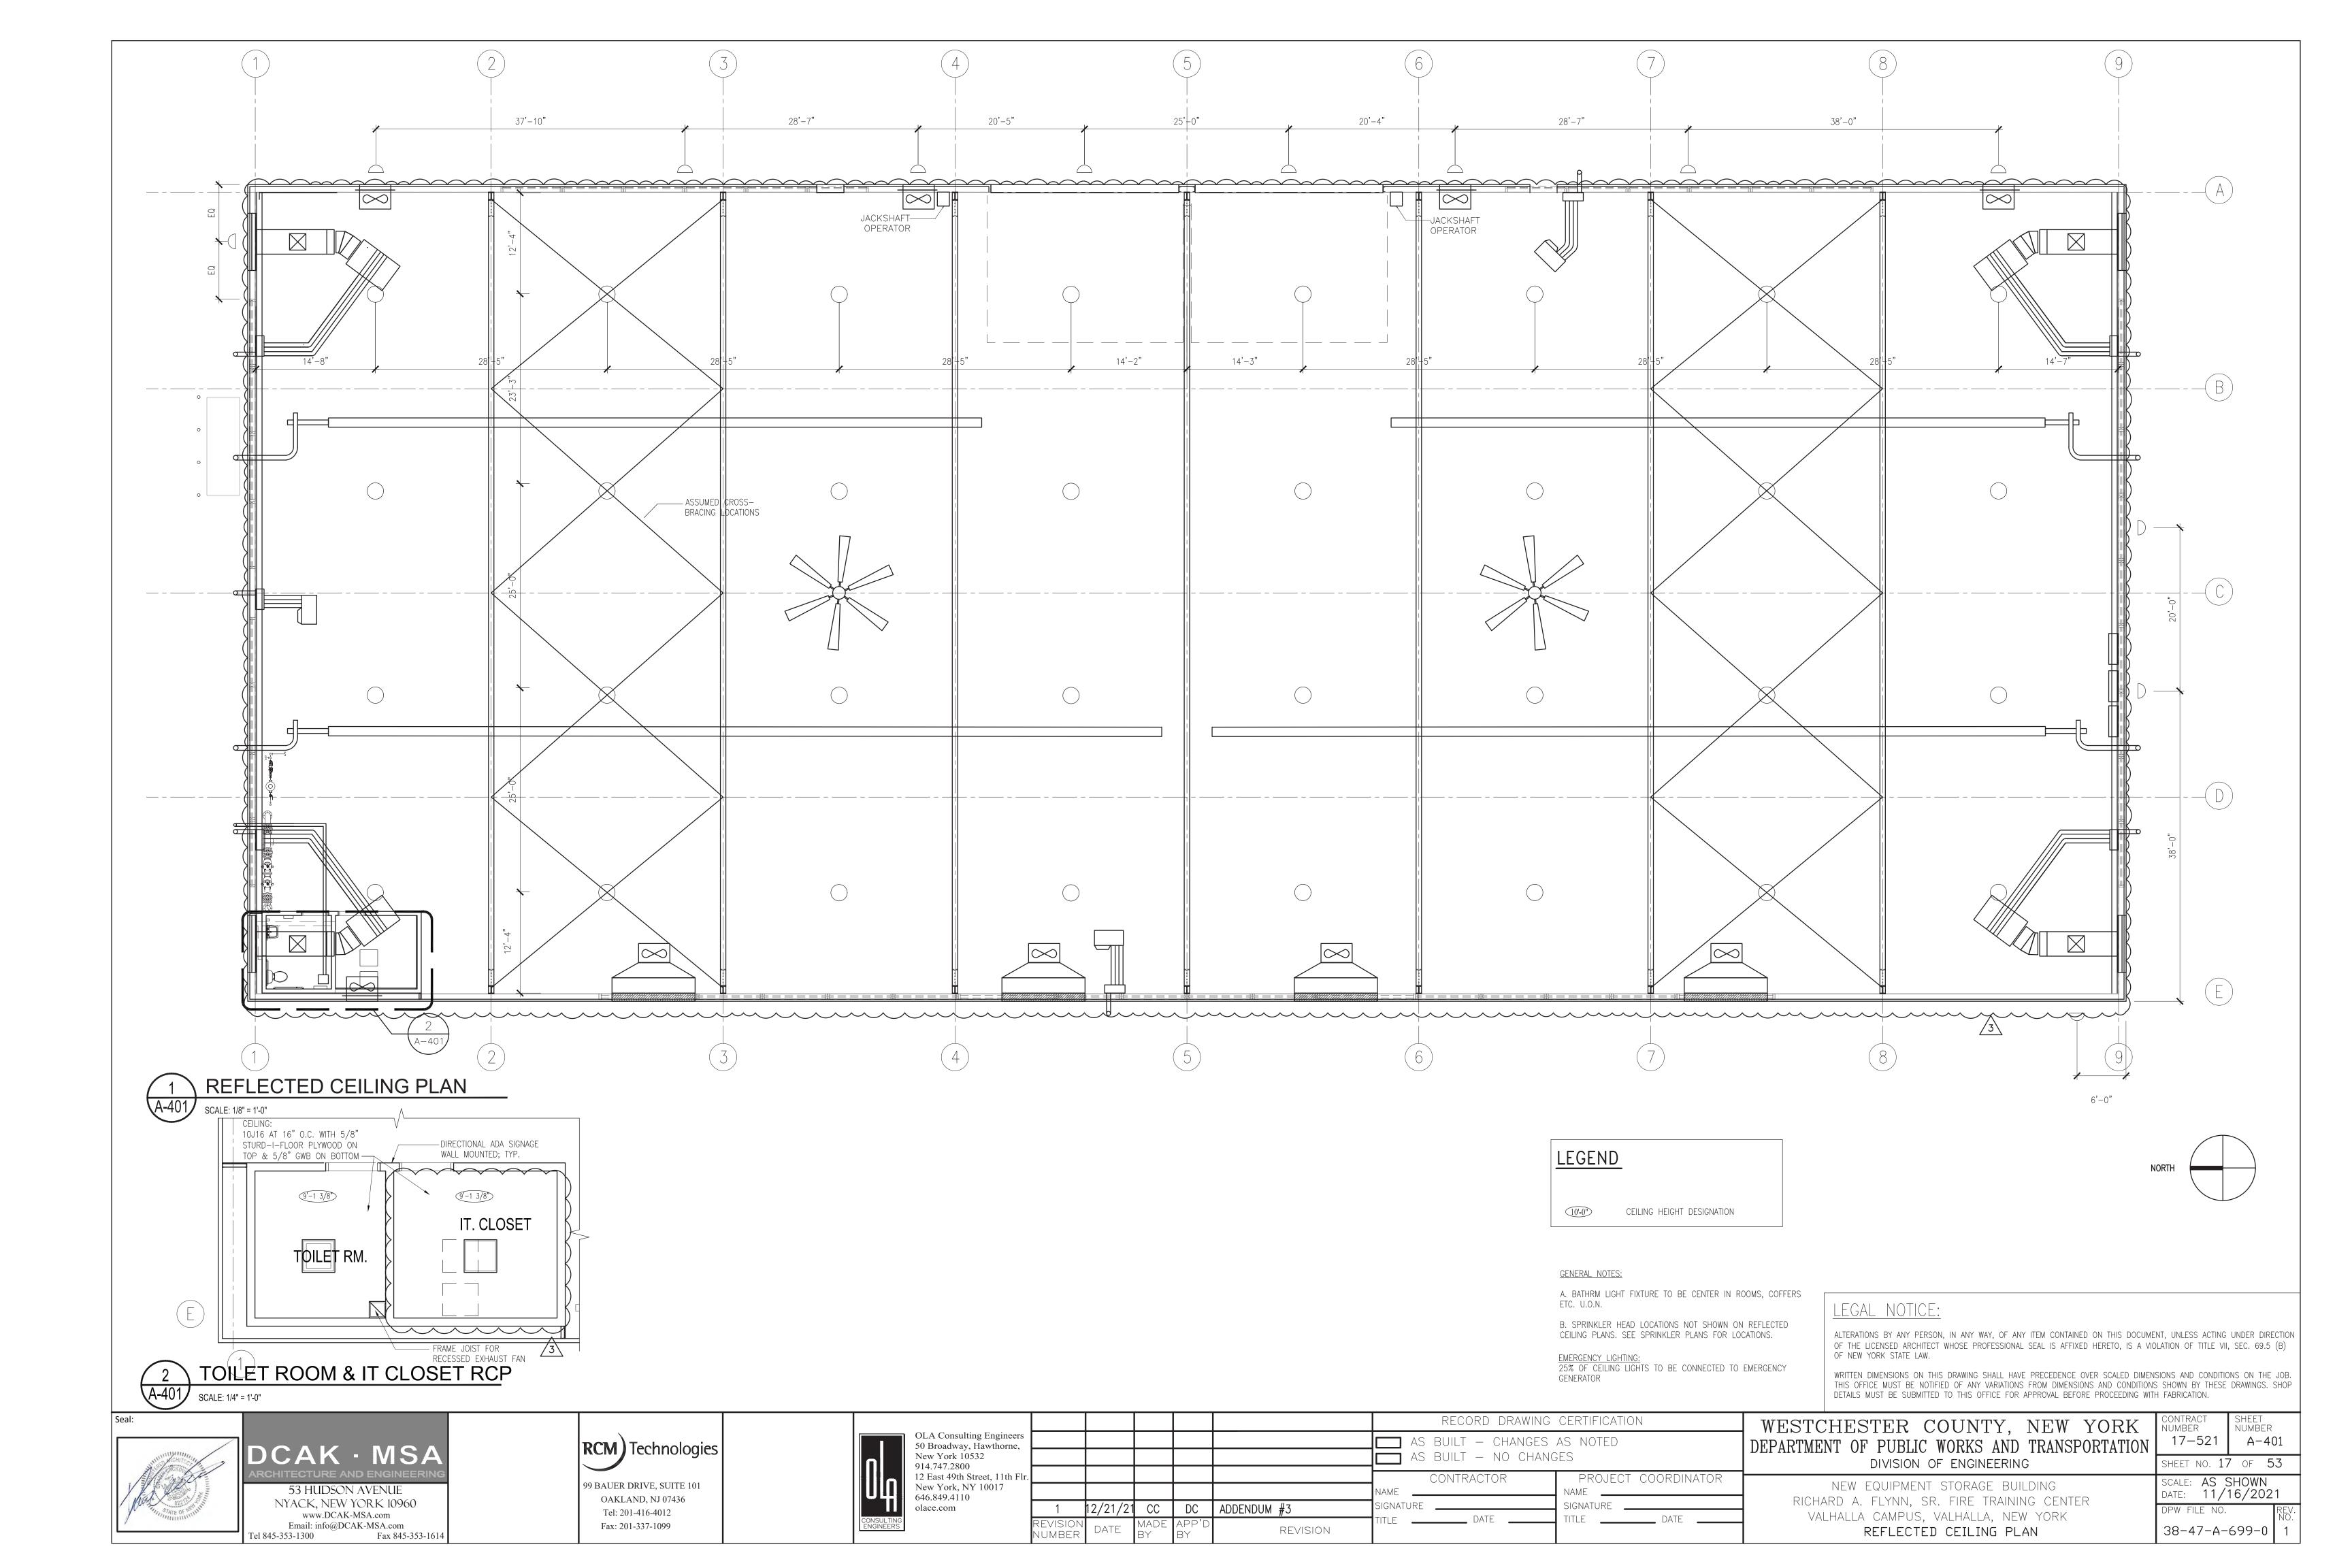

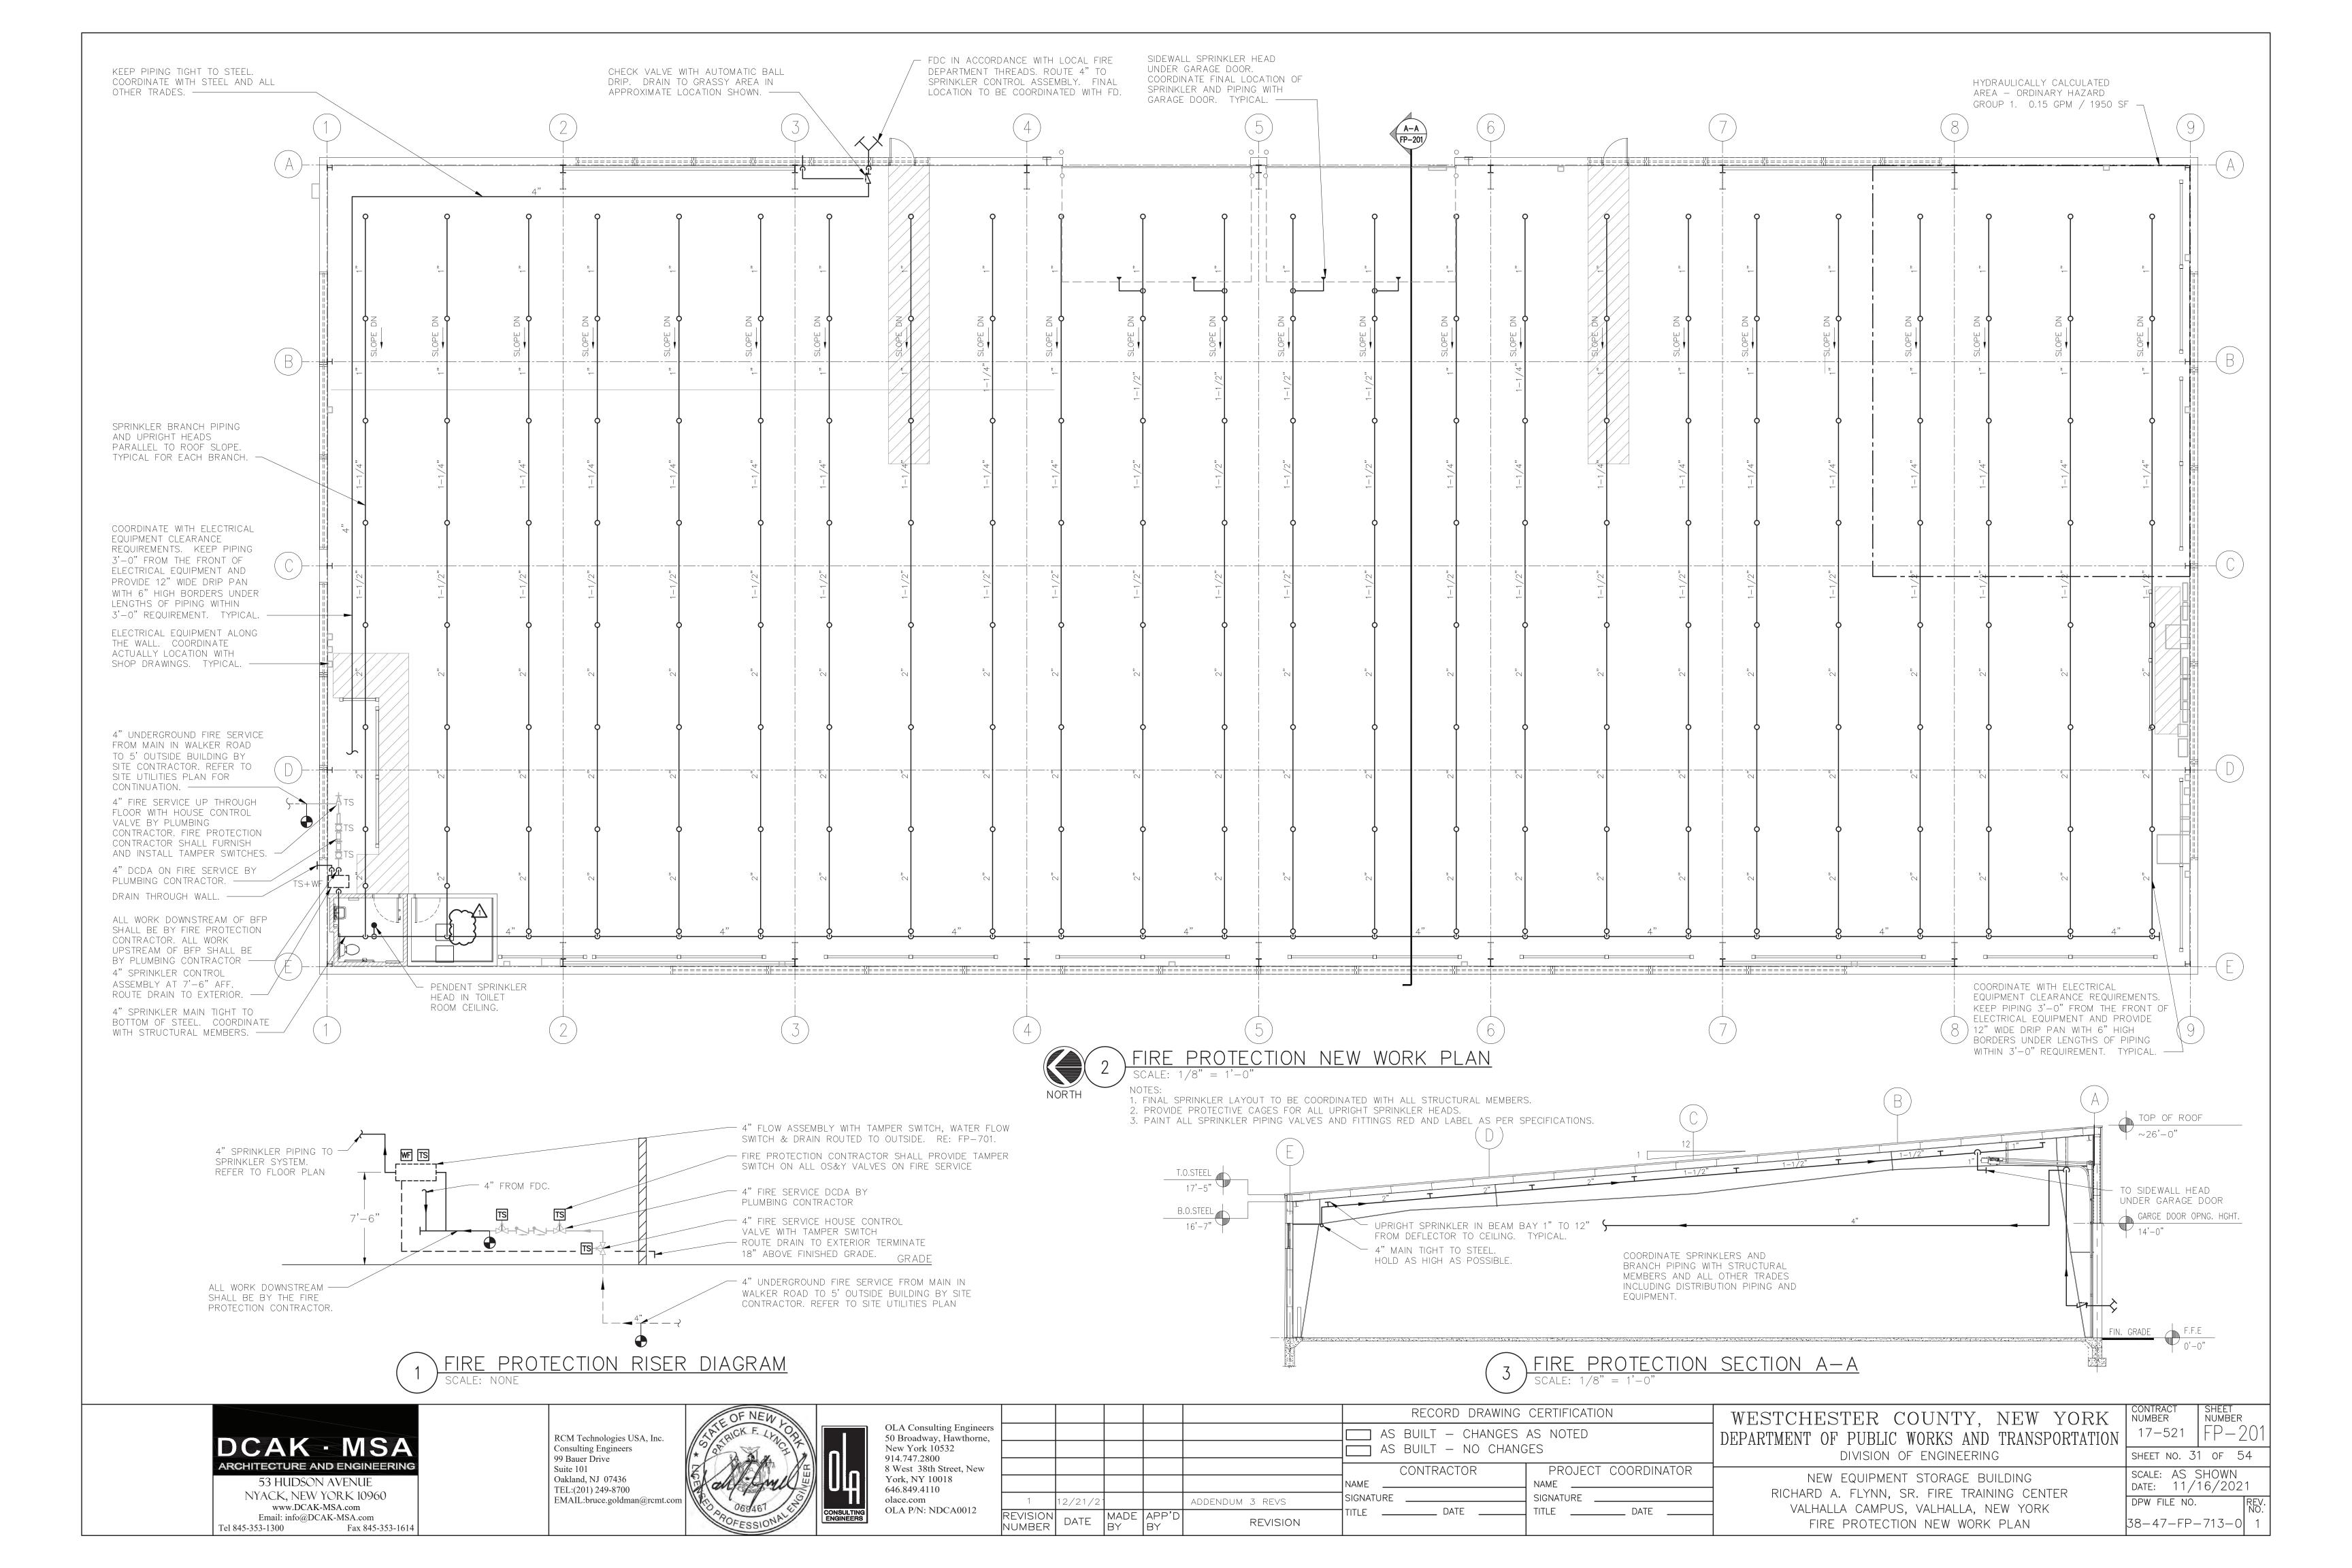	AND ABBREVIATIONS		<u> </u>			DEFINITION OF TERMS
30L	ABBREVIATION DESCRIPTION	SYMBOL	ABBREVIATION	DESCRIPTION	SYMBOL ABBREVIATION DESCRIPTION	7. "INSTALL OR INSTALLATION" MEANS THE ACT OF PHYSICALLY PLACING, APPLYING, SE ERECTING, ANCHORING, SECURING, ETC., CONSTRUCTION MATERIALS, EQUIPMENT, FURN APPLIANCES, AND SIMILAR ITEMS SPECIFIED AND FURNISHED AT THE JOB SITE. INST
	- CONDUIT AND WIRING	E 110	_	FIRE ALARM STROBE 15/75 CD	KW KILO-WATT	OF SPECIFIED HEMS MUST BE COMPLETE IN ALL RESPECTS.
	- CONDUIT & WIRING TO BE REMOVED UON	E 110	_	FIRE ALARM STROBE 110 CD	MAX MAXIMUM	8. "PROVIDE" MEANS TO FURNISH AND INSTALL CONSTRUCTION MATERIAL, EQUIPMENT, EDEFINED ABOVE.
; 	- BURIED CONDUIT	SSH; SC	_	SMOKE DETECTOR. SH — SMOKE HATCH; SC — PLENUM RATED ABOVE CEILING	MCB MAIN CIRCUIT BREAKER	9. THE FOLLOWING ARE DEFINITIONS OF SHOP DRAWING STAMP ACTIONS:
	- OVERHEAD CONDUCTORS	⟨H⟩		LIEAT DETECTOR	MIN MINIMUM	A. "NO EXCEPTIONS TAKEN" MEANS THAT THE SHOP DRAWING IS CORRECT AS TO PERFORMANCE, CAPACITY, ETC. AND SUBSTANTIAL CONFORMANCE TO THE CONT
1	- HOMERUN TO PANEL, ARROWS INDICATE # 1P	<u> </u>	_	HEAT DETECTOR	MLO MAIN LUG ONLY MTS MANUAL TRANSFER SWITCH	DRAWINGS AND SPECIFICATIONS. FABRICATION AND/OR PURCHASE MAY COMMENCE. B. "MAKE CORRECTIONS NOTED" MEANS THAT THE SHOP DRAWING IS CORRECT AS
	- MULTI-POLE HOMERUN - ELECTRICAL EQUIPMENT AS INDICATED		_	CARBON MONOXIDE DETECTOR FIRE ALARM TAMPER SWITCH	MTS MANUAL TRANSFER SWITCH NIC NOT IN CONTRACT	PERFORMANCE, CAPACITY, ETC. AND SUBSTANTIAL CONFORMANCE TO THE CONTED DRAWINGS AND/OR SPECIFICATIONS, SUBJECT TO AND IN COMPLIANCE WITH THE
	- ELECTRICAL EQUIPMENT AS INDICATED - ELECTRICAL EQUIPMENT TO BE REMOVED UON		_	FIRE ALARM WATER FLOW SWITCH	NTS NOT TO SCALE	ANNOTATIONS AND/OR CORRECTIONS INDICATED ON THE SHOP DRAWING. FABRIC, AND/OR PURCHASE MAY COMMENCE.
<u>_ '</u>]	- ELECTRICAL EQUIPMENT TO BE REMOVED OUN - ELECTRIC METER	WS WS	_	FIRE ALARM WATER FLOW SWITCH FIRE ALARM WARDEN STATION	P POLE	C. "AMEND AND RESUBMIT" MEANS THAT THE COMMENTS AND/OR CORRECTION ARE
<u>''</u>]	- JUNCTION BOX	ANN	_	FIRE ALARM ANNUNCIATOR PANEL	PV PHOTOVOLTAIC	EXTENSIVE AND IMPORTANT THAT THE REVIEWER WANTS TO SEE HOW THE COMM AND/OR CORRECTIONS ARE RESOLVED PRIOR TO RELEASE FOR FABRICATION AND PURCHASE. FABRICATIONS AND/OR PURCHASE MAY NOT COMMENCE.
ነ ጕ	- FUSED DISCONNECT SWITCH	CM	CM	FIRE ALARM CONTROL MODULE	PNL PANEL	D. "REJECTED" MEANS THAT THE SHOP DRAWING DOES NOT COMPLY OR CONFORM
<u>ነ</u>	- UNFUSED DISCONNECT SWITCH	MM	MM	FIRE ALARM MONITORING MODULE	PVC POLY VINYL CHLORIDE	CONTRACT DRAWINGS AND/OR SPECIFICATIONS. FABRICATION AND/OR PURCHASE COMMENCE.
]	- COMBINATION MOTOR STARTER/FUSED DISC.	FACP		FIRE ALARM CONTROL PANEL	REL. REMOVE AND RELOCATE	
	- MOTOR STARTER	BPS	BPS	BOOSTER POWER SUPPLY	RGS RIGID GALVANIZED STEEL	GENERAL NOTES
), ₇	- MOTOR, NUMBER INDICATES HORSE POWER		_	FIRE ALARM RELAY	SCH SCHEDULE	
<u>/</u> }	- BATTERY PACK EMERGENCY LIGHT FIXTURE		EOL	END OF LINE RESISTOR	SPD SURGE PROTECTION DEVICE	1. ALL WORK SHOWN IS NEW UNLESS OTHERWISE NOTED (UON) EXISTING TO REMAIL
N.4.	- MOTOR RATED TOGGLE SWITCH	CR	_	CARD READER	SW SWITCH(ES)	2. THE DRAWINGS ARE TO BE CONSIDERED SCHEMATIC ONLY AND DO NOT NECESSARIUS SHOW THE EXACT LOCATIONS AND DETAILS OF THE WORK TO BE INSTALLED.
M ⊏	- DUPLEX RECEPTACLE		A	AMPERE(S)	TELCO TELEPHONE COMPANY	3. THE ELECTRICAL CONTRACTOR SHALL BE RESPONSIBLE FOR OBTAINING ALL NECLOSED PERMITS AND PAYING ALL FEES ASSOCIATED WITH THIS WORK INCLUDING FILING
	- DOUBLE DUPLEX RECEPTACLE		AC	AIR CONDITIONER	TYP TYPICAL	UTILITY COMPANY (AS REQUIRED), AND WITH LOCAL AUTHORITY HAVING JURISDIC
<u> </u>	- SPECIAL RECEPTACLE		ACC	AIR CONDITIONER CONDENSER	UG UNDERGROUND	4. ELECTRICAL CONTRACTOR (LÍCÉNSED WITH WESTCHESTER COUNTY) SHALL BE RES TO HIRE A THIRD PARTY ELECTRICAL HISPECTION AGENCY TO PROVIDE UL INSPE AND SUBMIT A CERTIFICATE OF INSPECTION PRIOR TO FINAL REQUEST FOR PAYN
7	- TELEPHONE OUTLET		AFF	ABOVE FINISHED FLOOR	UON UNLESS OTHERWISE NOTED	5. ALL WORK INVOLVING THE ELECTRIC SERVICE SHALL BE COORDINATED AND APPR
7 ×	– DATA OUTLET (x — INDICATES # OF JACKS, 2 JACKS		AF	AMPERAGE OF FUSE	UV UNIT VENTILATOR	THE UTILITY COMPANY.
	PER LOCATION, UON)		AGL	ABOVE GRADE LEVEL	WP WEATHERPROOF	6. ALL CONDUCTORS SHALL BE COPPER UON "ON DRAWINGS".
7	- COMBINATION TELEPHONE/DATA OUTLET		AHU	AIR HANDLING UNIT	VIF VERIFY IN FIELD	7. ELECTRONIC FILES OF THE MECHANICAL, ELECTRICAL, PLUMBING AND FIRE PROTE DRAWINGS ARE AVAILABLE TO THE CONTRACTOR. THE ENGINEER MAY GRANT T CONTRACTOR A LIMITED LICENSE TO MAKE A DERIVATIVE WORK OF THE DATABA
	EOL END OF LINE RESISTOR		AL	ALUMINIUM	V VOLT(S)	THE PURPOSE OF SHOP DRAWINGS, SUBMITTALS AND AS—BUILT DRAWINGS. UP- REQUEST, THE ENGINEER SHALL PROVIDE A RELEASE FORM THAT MUST BE SIGN
)	- CLOCK		ARC	ARC FAULT INTERRUPTER	WG WIRE GUARD	RETURNED BY THE CONTRACTOR PRIOR TO RELEASE OF THE ELECTRONIC FILES.
]	- PUSHBUTTON		AS	AMPERAGE OF SWITCH	WH WATER HEATER	8. CIRCUIT NUMBERS ARE FOR INFORMATION PURPOSES ONLY. ACTUAL CIRCUIT NUI SHALL BE DETERMINED IN THE FIELD.
<u>-</u> D	EPO EMERGENCY POWER OFF SWITCH		ATS	AUTOMATIC TRANSFER SWITCH	NOTES:	9. CORE DRILLING OR TRENCHING THROUGH AN EXISTING FLOOR SLAB, WHEN REQU SHALL BE COORDINATED WITH THE OWNER. FLOOR SLABS SHALL BE RADAR SC
ò	CB CIRCUIT BREAKER		AWG	AMERICAN WIRE GAUGE	1. ALL SYMBOLS AND ABBREVIATIONS MAY NOT BE APPLICABLE FOR THIS PROJECT.	PRIOR TO CORE DRILLING OR TRENCHING. ALL WORK, INCLUDING CORE DRILLING, SCAN, INSTALLATION OF FIRE STOPPING, & CONDUIT/CABLE INSTALLATION SHALL
ò	- ENCLOSED CIRCUIT BREAKER		BCW	BARE COPPER WIRE	2. SEE LIGHTING FIXTURE SCHEDULE FOR LIGHT FIXTURE SYMBOLS.	PERFORMED DURING NON-BUSINESS HOURS AND INCLUDED IN BASE BID. USE E CAUTION DURING ANY CUTTING OPERATION TO AVOID DAMAGE TO EXISTING
00AS 50AF	- FUSED SWITCH		BLDG	BUILDING	TYPICAL BRANCH CIRCUIT WIRING LEGEND	CAUTION DURING ANY CUTTING OPERATION TO AVOID DAMAGE TO EXISTING EQUIPMENT/SYSTEMS. ANY ITEMS DAMAGED AS A RESULT OF CORE DRILLING S REPAIRED AT NO COST TO THE CLIENT. ALL CORES SHALL BE FIRE SEALED.
)	GEN GENERATOR		BMS	BUILDING MANAGEMENT SYSTEM		10. FOR EACH WALL MOUNTED COMMUNICATIONS OUTLET, PROVIDE A 1900 JUNCTION WITH AN EXTENDER COLLAR AND 1 INCH CONDUIT WITH DRAGLINE FROM OUTLET
	- GENERATOR RECEPTACLE		С	CONDUIT	2-#12 & 1-#12 GND IN 3/4"C (1-1P-20A OR 1-1P-15A CB) 	INCHES BELOW CEILING.
\overline{A}	GND GROUND AS PER LOCAL CODE		CD	CANDELA	——→ 2-#12 & 1-#12 GND IN 3/4"C (2P-20A OR 2P-15A CB)	12. WHERE GFI RECEPTACLES ARE CIRCUITED WITH GENERAL CONVENIENCE RECEPTAGE
•	- GROUND BAR		CKT	CIRCUIT	LIGHT FIXTURE TYPE	GFI RECEPTACLE SHALL BE THE LAST DEVICE ON THE CIRCUIT.
•	- GROUND ROD		CLG	CEILING	CIRCUIT # SWITCH CONTROL -RECEPTACLE LIGHT FIXTURE	13. INSTALL CONDUIT EXPANSION FITTINGS AT ALL LOCATIONS WHERE CONDUITS CROBUILDING OR STRUCTURE EXPANSION JOINTS.
F	- TRANSFER SWITCH		COL	COLUMN	CIRCUIT #	14. UNLESS OTHERWISE NOTED, DISCONNECT SWITCHES, STARTERS, HOAS AND MOTO TOGGLE SWITCHES FOR MECHANICAL PUMPS, CABINET AND UNIT HEATERS, RETU
RT	XFMR TRANSFORMER		CU	COPPER	NOTES: 1. EACH 120V AND 277V CIRCUIT SHALL HAVE A DEDICATED NEUTRAL CONDUCTOR. SHARED	ROOF FANS, VAV BOXES, COMPRESSORS, FAN COIL UNITS, AIR HANDLERS AND CONDENSERS SHALL BE FURNISHED BY THE MECHANICAL CONTRACTOR AND INST
	CT CURRENT TRANSFORMER		DEM.	DEMOLISH AND REMOVE	NEUTRAL HOMERUNS ARE NOT PERMITTED.	BY THE ELECTRICAL CONTRACTOR. COORDINATE ALL WORK WITH THE MECHANICA CONTRACTOR.
)	- UTILITY POLE		DISC	DISCONNECT	2. CONDUCTORS SHALL BE INCREASED FOR VOLTAGE DROP AND DERATING AS PER APPLICABLE ELECTRICAL CODE. FOR CIRCUITS THAT ARE BETWEEN 100' AND 150' IN LENGTH, PHASE AND NEUTRAL CONDUCTORS SHALL BE #10 AWG. FOR CIRCUITS THAT	15. DISCONNECT SWITCHES FOR MOTORIZED DAMPERS, CFSD/SD AND VAV BOXES SU BY MECHANICAL CONTRACTOR AND INSTALLED AND WIRED BY ELECTRICAL CONTI
M	WM WATER MAIN		DWG	DRAWING	LENGTH, PHASE AND NEUTRAL CONDUCTORS SHALL BE #10 AWG. FOR CIRCUITS THAT ARE BETWEEN 150' AND 225' IN LENGTH, PHASE AND NEUTRAL CONDUCTORS SHALL BE #8 AWG. FOR LENGTHS GREATER THAN 225' IN LENGTH, VERIFY CONDUCTOR SIZES WITH	SWITCHES NOT SHOWN ON PLANS.
)	- CEILING MOUNTED OCCUPANCY SENSOR		EF	EXHAUST FAN	#8 AWG. FOR LENGTHS GREATER THAN 225 IN LENGTH, VERIFY CONDUCTOR SIZES WITH ENGINEER.	16. EACH DUPLEX AND QUAD RECEPTACLE SHALL BE LABELED WITH THE CIRCUIT NU WHICH IT SERVES. ALPHANUMERICS TO BE 1/8" HIGH AND BLACK ON CLEAR
	- BOILER BREAK GLASS STATION		EM	EMERGENCY	3. MC CABLE MY BE USED IF CONCEALED IN WALL OR CEILING.	BACKGROUND. LABELS SHALL BE SELF ADHESIVE. IDENTIFY ASSOCIATED PANE CIRCUIT NUMBER.
, <u> </u>	NC NORMALLY CLOSED CONTACTS		ЕМТ	ELECTRICAL METALLIC TUBING	DEFINITION OF TERMS	17. THE ELECTRICAL CONTRACTOR SHALL PROVIDE ALL CUTTING, PATCHING, PAINTIN FINAL RESTORATION REQUIRED TO FACILITATE THE DEMOLITION AND INSTALLATIO
	NO NORMALLY OPEN CONTACTS		EXIST	EXISTING	1. WHEREVER IN THE CONTRACT DOCUMENTS THE WORD "CLIENT" IS USED, IT MUST BE UNDERSTOOD THAT "WESTCHESTER COUNTY FIRE TRAINING CENTER" IS INTENDED.	ELECTRICAL EQUIPMENT, INCLUDING BUT NOT LIMITED TO PANELBOARDS, CONDUI WIRING, DEVICES, FIXTURES, ETC. INCLUDING ABOVE CEILINGS. CONTRACTOR TO F
	MD MOTORIZED DAMPER		EX.	EXISTING TO REMAIN	2. WHEREVER IN THE CONTRACT DOCUMENTS THE WORD "ARCHITECT" IS USED, IT MUST BE	AND RÉPLACE CÉILINGS, AND OPEN AND PATCH WALLS, AS REQUIRED TO EXECU ELECTRICAL WORK.
_	SD OR CFSD SMOKE DAMPER		F	FLOOR	UNDERSTOOD THAT "DCAK MSA" IS INTENDED.	18. ALL ELECTRICAL RACEWAYS SHALL BE SURFACE MOUNTED, UON. ROOM #002 AN BATHROOM #001 SHALL HAVE RECESSED CONDUITS, SWITCHES, AND OUTLET BOX
UH	UH UNIT HEATER		GEN	GENERATOR	3. WHEREVER IN THE CONTRACT DOCUMENTS THE WORD "ENGINEER" IS USED, IT MUST BE UNDERSTOOD THAT "OLA CONSULTING ENGINEERS" IS INTENDED.	J WITCHES, AND COTELL BOX
	- FIRE ALARM MANUAL PULL STATION		GFI	GROUND FAULT INTERRUPTER	4. WHEREVER IN THE CONTRACT DOCUMENTS THE WORDS "ELECTRICAL UTILITY" OR "POWER COMPANY" ARE USED IT MUST BE UNDERSTOOD THAT "CONTEDISON" IS INTENDED	
	- FIRE ALARM COMBINATION AUDIO/VISUAL DEVICE (15/75 CD - STROBE)		HP	HORSEPOWER	COMPANY" ARE USED, IT MUST BE UNDERSTOOD THAT "CON EDISON" IS INTENDED. 5. "WORK" MUST BE DEEMED TO CONSIST OF ALL LABOR AND OPERATIONS. TRANSPORTATION.	
			HVAC	HEATING VENTILATION AIR CONDITIONING	5. "WORK" MUST BE DEEMED TO CONSIST OF ALL LABOR AND OPERATIONS, TRANSPORTATION, HOISTING, MATERIALS, TOOLS, EQUIPMENT, SERVICES, INSPECTIONS, INVESTIGATIONS, COORDINATION AND SUPERVISION REQUIRED AND / OR REASONABLY NECESSARY TO PRODUCE	
<u> </u>	- FIRE ALARM COMBINATION AUDIO/VISUAL DEVICE (110 CD - STROBE)		IG	ISOLATED GROUND	THE CONSTRUCTION REQUIRED BY THE CONTRACT DOCUMENTS.	
			KVA	KILO-VOLT-AMPERE	6. "FURNISH" MEANS THE DESIGN, FABRICATION, PURCHASE AND DELIVERY TO THE JOB SITE.	I CONITRACT C
		ANTE OF NE	WIO	OLA Consulting Engineers	RECORD DRAWING CERTIFICATION AS BUILT — CHANGES AS NOTED	WESTCHESTER COUNTY, NEW YORK CONTRACT NUMBER 17-521
	PCAK - NSA RCM Technologies I Consulting Engineers 99 Bauer Drive	USA, Inc.	12 F	50 Broadway, Hawthorne, New York 10532 914.747.2800	AS BUILT — CHANGES AS NOTED AS BUILT — NO CHANGES	DEPARTMENT OF PUBLIC WORKS AND TRANSPORTATION 17-521 SHEET NO. 43
	ARCHITECTURE AND ENGINEERING 53 HUDSON AVENUE Suite 101 Oakland, NJ 07436		HE WELL	914.747.2800 8 West 38th Street, New York, NY 10018 646.849.4110	CONTRACTOR PROJECT COORDINATOR	NEW EQUIPMENT STORAGE BUILDING PICHARD A FLYNN SR FIRE TRAINING CENTER STEEL NO. 10 SCALE: AS SH DATE: 11/16
	TEL:(201) 249-8700		and the second of the second o		LINAME LINAME	Ι ΓΛΤΓ. 11/1Γ

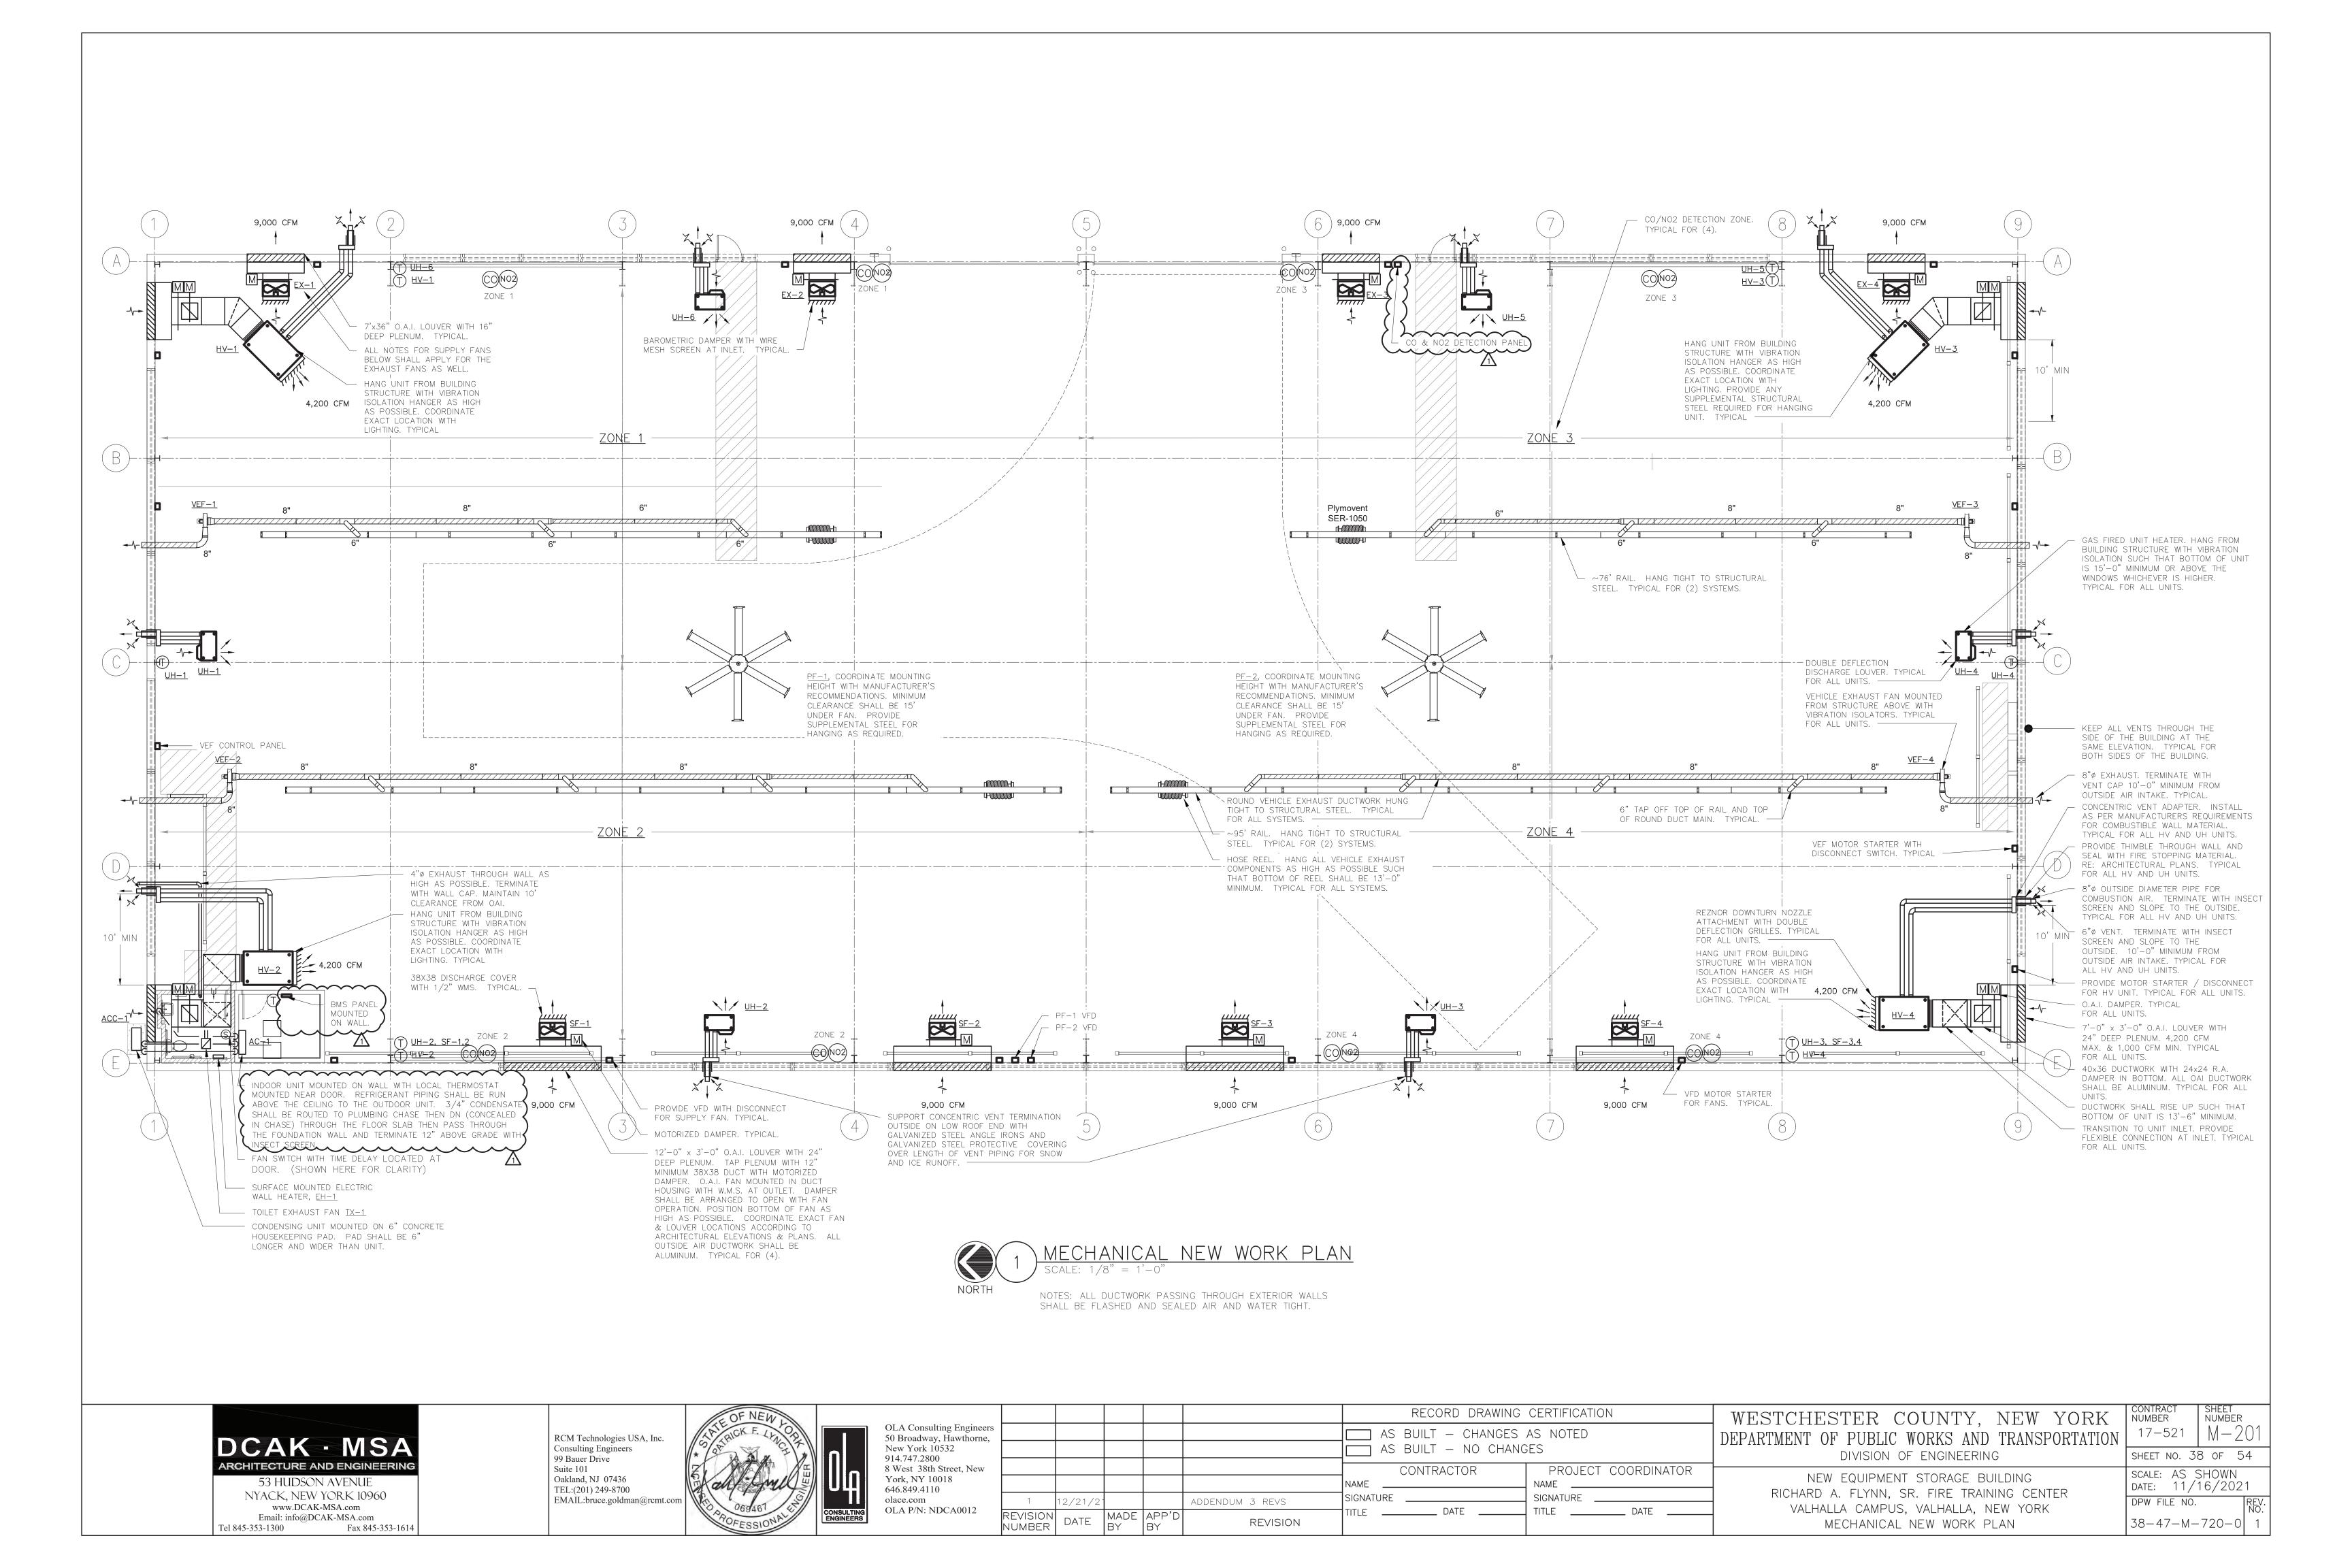

NOTES:

- 1. SEE ONE-LINE DIAGRAM ON DWG E-501.
- 2. FOR ADDITIONAL GENERATOR DETAILS, SEE DWG E-701.
- 3. INTERRUPTION OF EXISTING ELECTRIC SERVICE: DO NOT INTERRUPT ELECTRIC SERVICE TO FACILITIES OCCUPIED BY OWNER OR OTHERS UNLESS PERMITTED UNDER THE FOLLOWING CONDITIONS AND THEN ONLY AFTER ARRANGING TO PROVIDE TEMPORARY ELECTRIC SERVICE. NOTIFY ARCHITECT, ENGINEER, AND OWNER NO FEWER THAN 20 DAYS IN ADVANCE OF PROPOSED INTERRUPTION OF ELECTRIC SERVICE. INDICATE METHOD OF PROVIDING TEMPORARY ELECTRIC SERVICE. DO NOT PROCEED WITH INTERRUPTION OF ELECTRIC SERVICE WITHOUT OWNER'S WRITTEN PERMISSION. COMPLY WITH NFPA 70E.
- 4. PROVIDE AND INSTALL ALL DATA AND COMMUNICATION WIRES.
 - 5. INSTALL ALL UNDERGROUND CONDUITS IN CONCRETE ENCASED DUCT BANK WHERE CROSSING ROADWAY OR SUBJECT TO VEHICULAR TRAFFIC.
- 6. VEHICLE CHARGING STATIONS BASED ON BTCPOWER DUAL PORT CHARGING STATION MODEL L2P-30-240-D OR APPROVED EQUAL. VEHICLE CHARGING STATIONS SHALL BE PROVIDED BY THE COUNTY. THE CONTRACTOR SHALL BE RESPONSIBLE TO PICK UP THE CHARGERS FROM THE COUNTY AND BRING THEM TO THE SITE. THE CONTRACTOR SHALL BE RESPONSIBLE FOR THE INSTALLATION OF THE CHARGERS AND MAKE OPERATIONAL PER MANUFACTURES REQUIREMENTS.

Fax 845-353-1614



TRENCHING NOTES:

- A. CONTRACTOR SHALL LOCATE ALL EXISTING UNDERGROUND UTILITIES THAT ARE NOT PART OF N.Y. STATE "CODE 753" PRIOR TO DIGGING.
- B. ALL EXCAVATION IN THE AREA OF THE EXISTING UNDERGROUND EQUIPMENT, PIPES AND CONDUITS SHALL BE PERFORMED BY HAND.
- C. ANY AREA/PLANTS OR LANDSCAPING OR PAVEMENTS DISTURBED DURING THE EXCAVATION SHALL BE RESTORED OR REPLACED TO MATCH EXISTING CONDITIONS BY THE CONTRACTOR AT NO COST TO THE OWNER.
- D. ANY EXISTING BURIED CONDUITS, DRAINAGE, SPRINKLER PIPING, ETC. THAT IS DISTURBED AND/OR DAMAGED DURING CONSTRUCTION SHALL BE REPAIRED BY THE CONTRACTOR AT NO COST TO THE OWNER.
- E. THE PLANS SHOW SOME KNOWN SUBSURFACE STRUCTURES, ABOVE GROUND STRUCTURES AND/OR UTILITIES BELIEVED TO EXIST IN THE WORKING AREA, EXACT LOCATION OF WHICH MAY VARY FROM THE LOCATIONS INDICATED. IN PARTICULAR, THE CONTRACTOR IS WARNED THAT THE EXACT OR EVEN APPROXIMATE LOCATION OF SUCH PIPELINES, SUBSURFACE STRUCTURES AND/OR UTILITIES IN THE AREA MAY OR MAY NOT BE SHOWN; AND IT SHALL BE HIS RESPONSIBILITY TO PROCEED WITH GREAT CARE IN EXECUTING ANY WORK. 48 HOURS BEFORE YOU DIG, DRILL OR BLAST, CALL 1-800-962-7962 (NY STATE).



Tel 845-353-1300

RCM Technologies USA, Inc.
Consulting Engineers
99 Bauer Drive
Suite 101
Oakland, NJ 07436
TEL:(201) 249-8700
EMAIL:bruce.goldman@remt.com




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New York 10532
914.747.2800
8 West 38th Street, New
York, NY 10018
646.849.4110
olace.com
OLA P/N: NDCA0012


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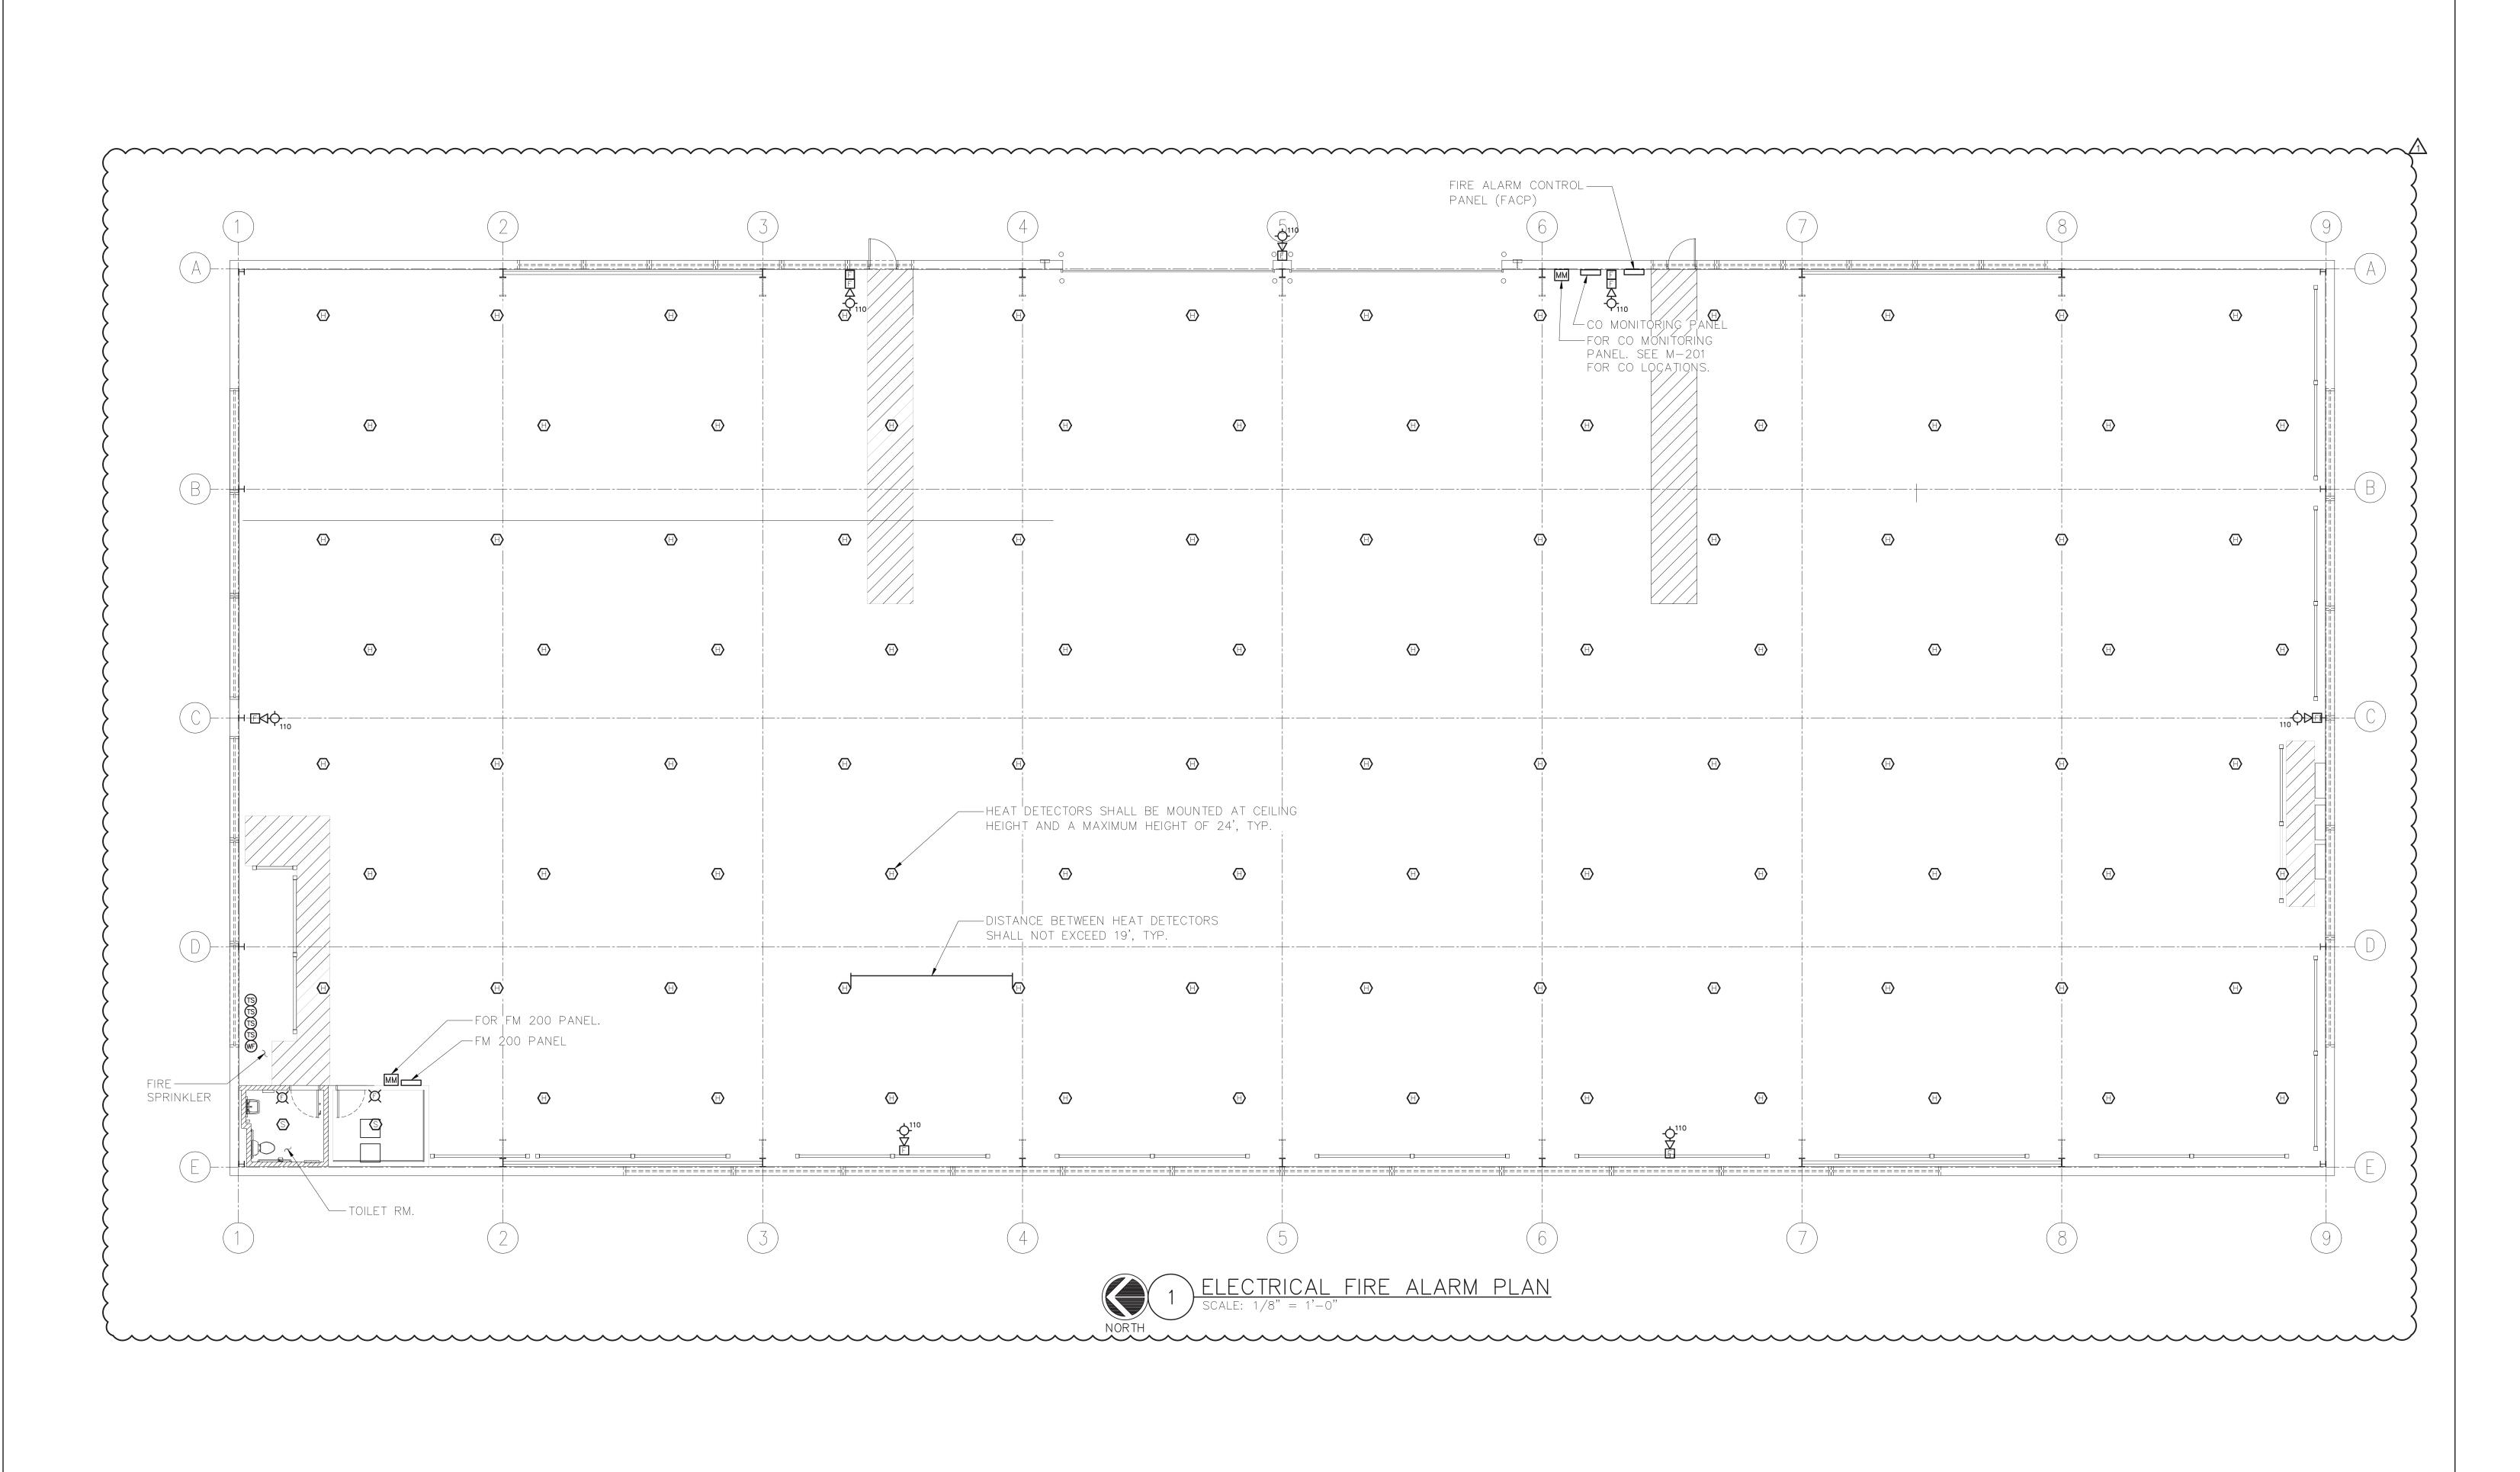
WESTCHESTER COUNTY, NEW YORK EPARTMENT OF PUBLIC WORKS AND TRANSPORTATION DIVISION OF ENGINEERING

NEW EQUIPMENT STORAGE BUILDING RICHARD A. FLYNN, SR. FIRE TRAINING CENTER VALHALLA CAMPUS, VALHALLA, NEW YORK ELECTRICAL SITE PLAN

CONTRACT NUMBER 17-521	SHEET NUMBER	01
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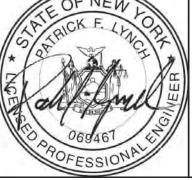




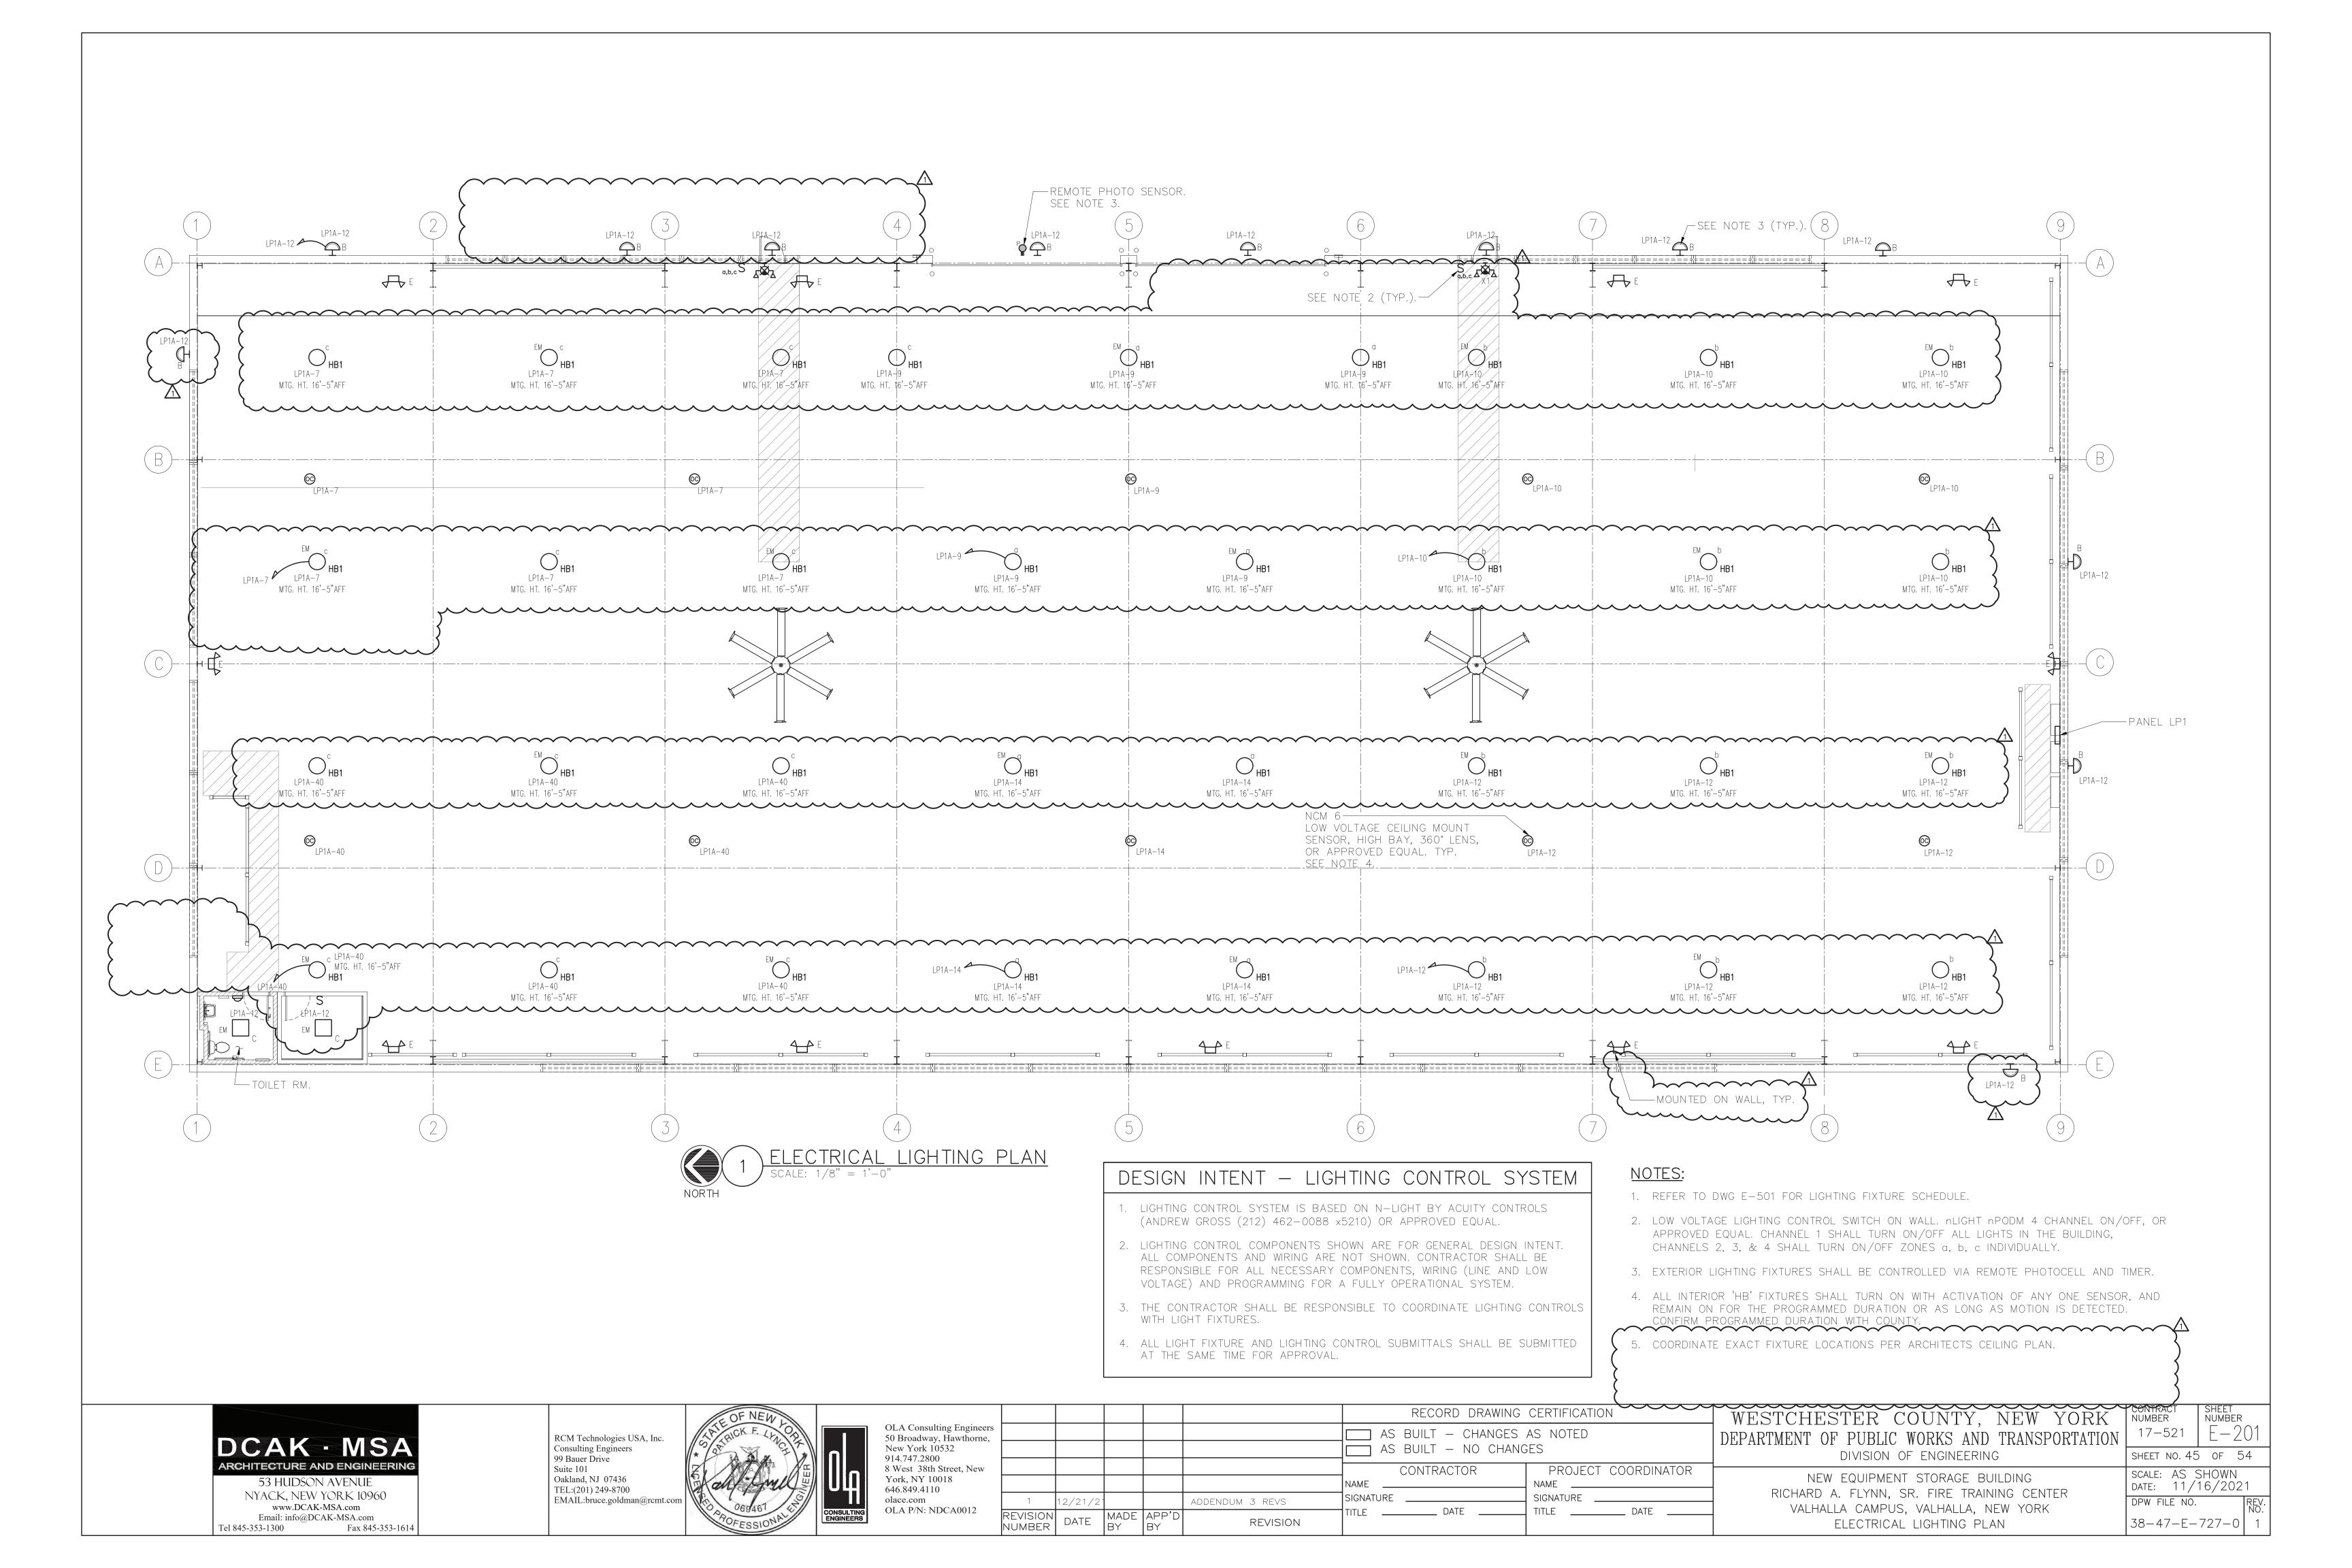

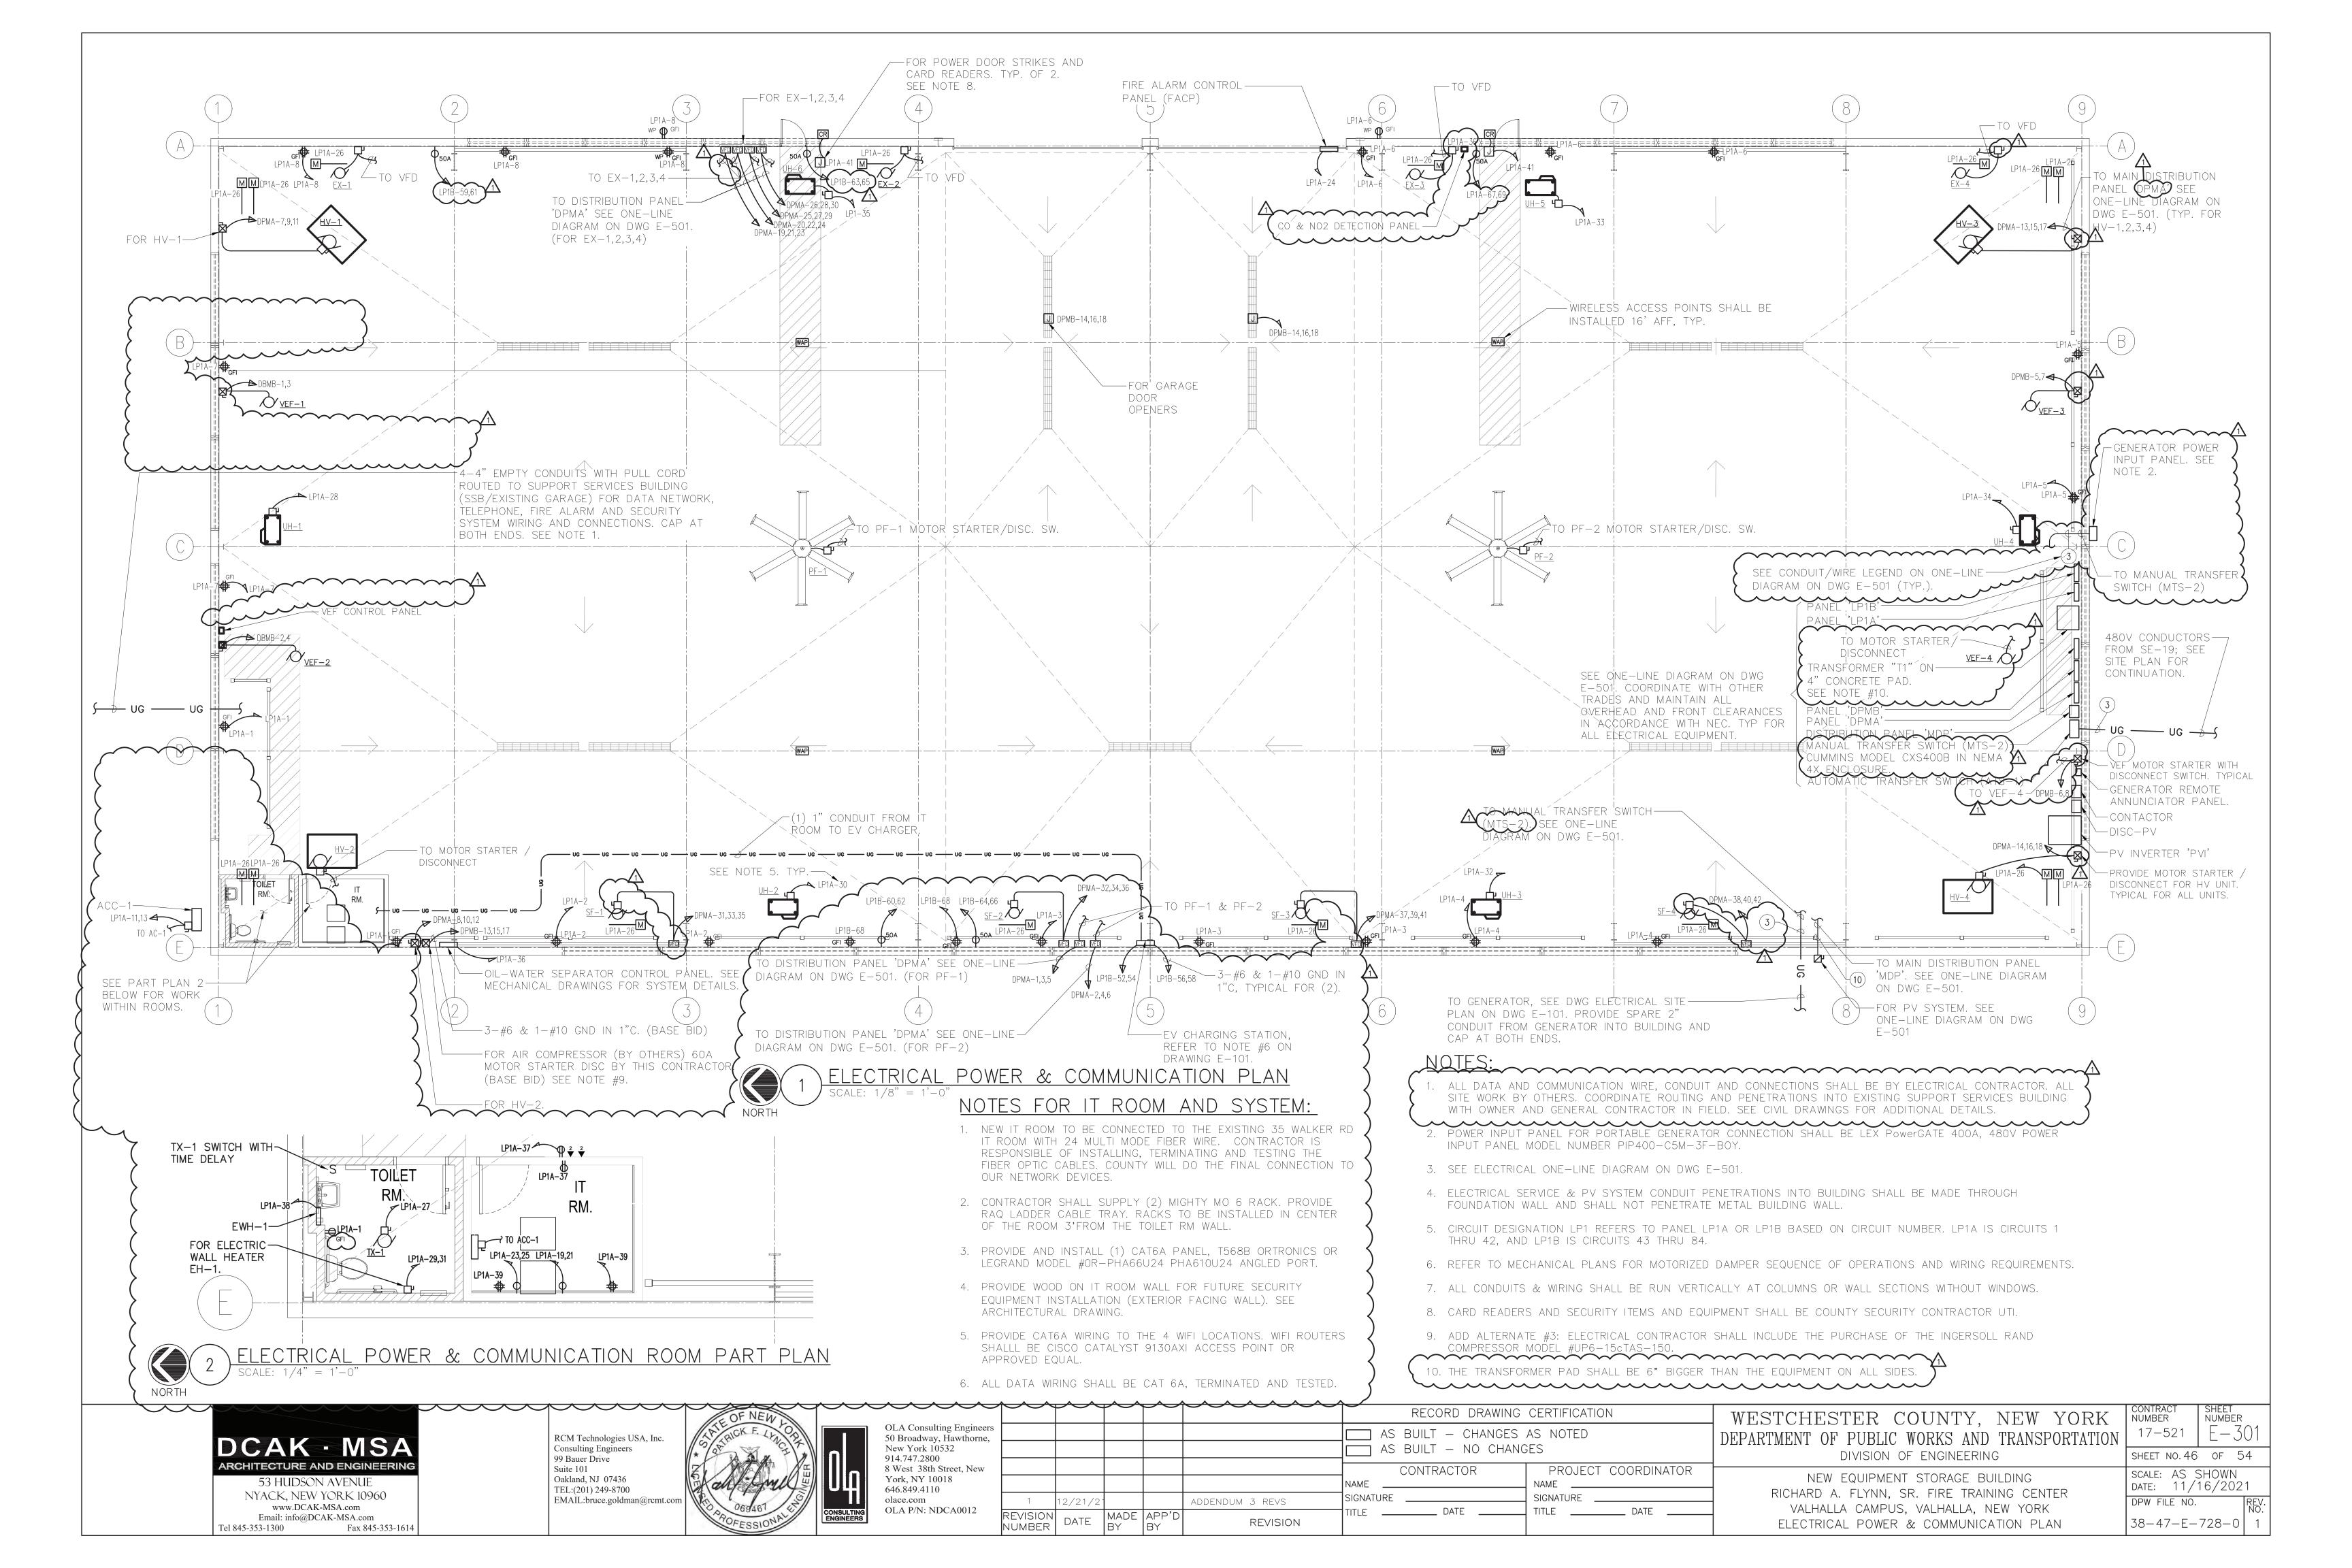ARCHITECTURE AND ENGINEERING 53 HUDSON AVENUE NYACK, NEW YORK 10960 www.DCAK-MSA.com Email: info@DCAK-MSA.com Tel 845-353-1300 Fax 845-353-1614

RCM Technologies USA, Inc. Consulting Engineers 99 Bauer Drive Suite 101 Oakland, NJ 07436 TEL:(201) 249-8700 EMAIL:bruce.goldman@rcmt.com



OLA Consulting Enginee 50 Broadway, Hawthorne, New York 10532 914.747.2800 8 West 38th Street, New York, NY 10018 646.849.4110 olace.com OLA P/N: NDCA0012

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WESTCHESTER COUNTY, NEW YORK DEPARTMENT OF PUBLIC WORKS AND TRANSPORTATION DIVISION OF ENGINEERING


NEW EQUIPMENT STORAGE BUILDING RICHARD A. FLYNN, SR. FIRE TRAINING CENTER VALHALLA CAMPUS, VALHALLA, NEW YORK FIRE ALARM PLAN

PROJECT COORDINATOR

TITLE _____ DATE .


CONTRACT NUMBER SHEET NUMBER 17-521 SHEET NO.48 OF 54 SCALE: AS SHOWN

DATE: 11/16/2021 DPW FILE NO. 38-47-E-730-0

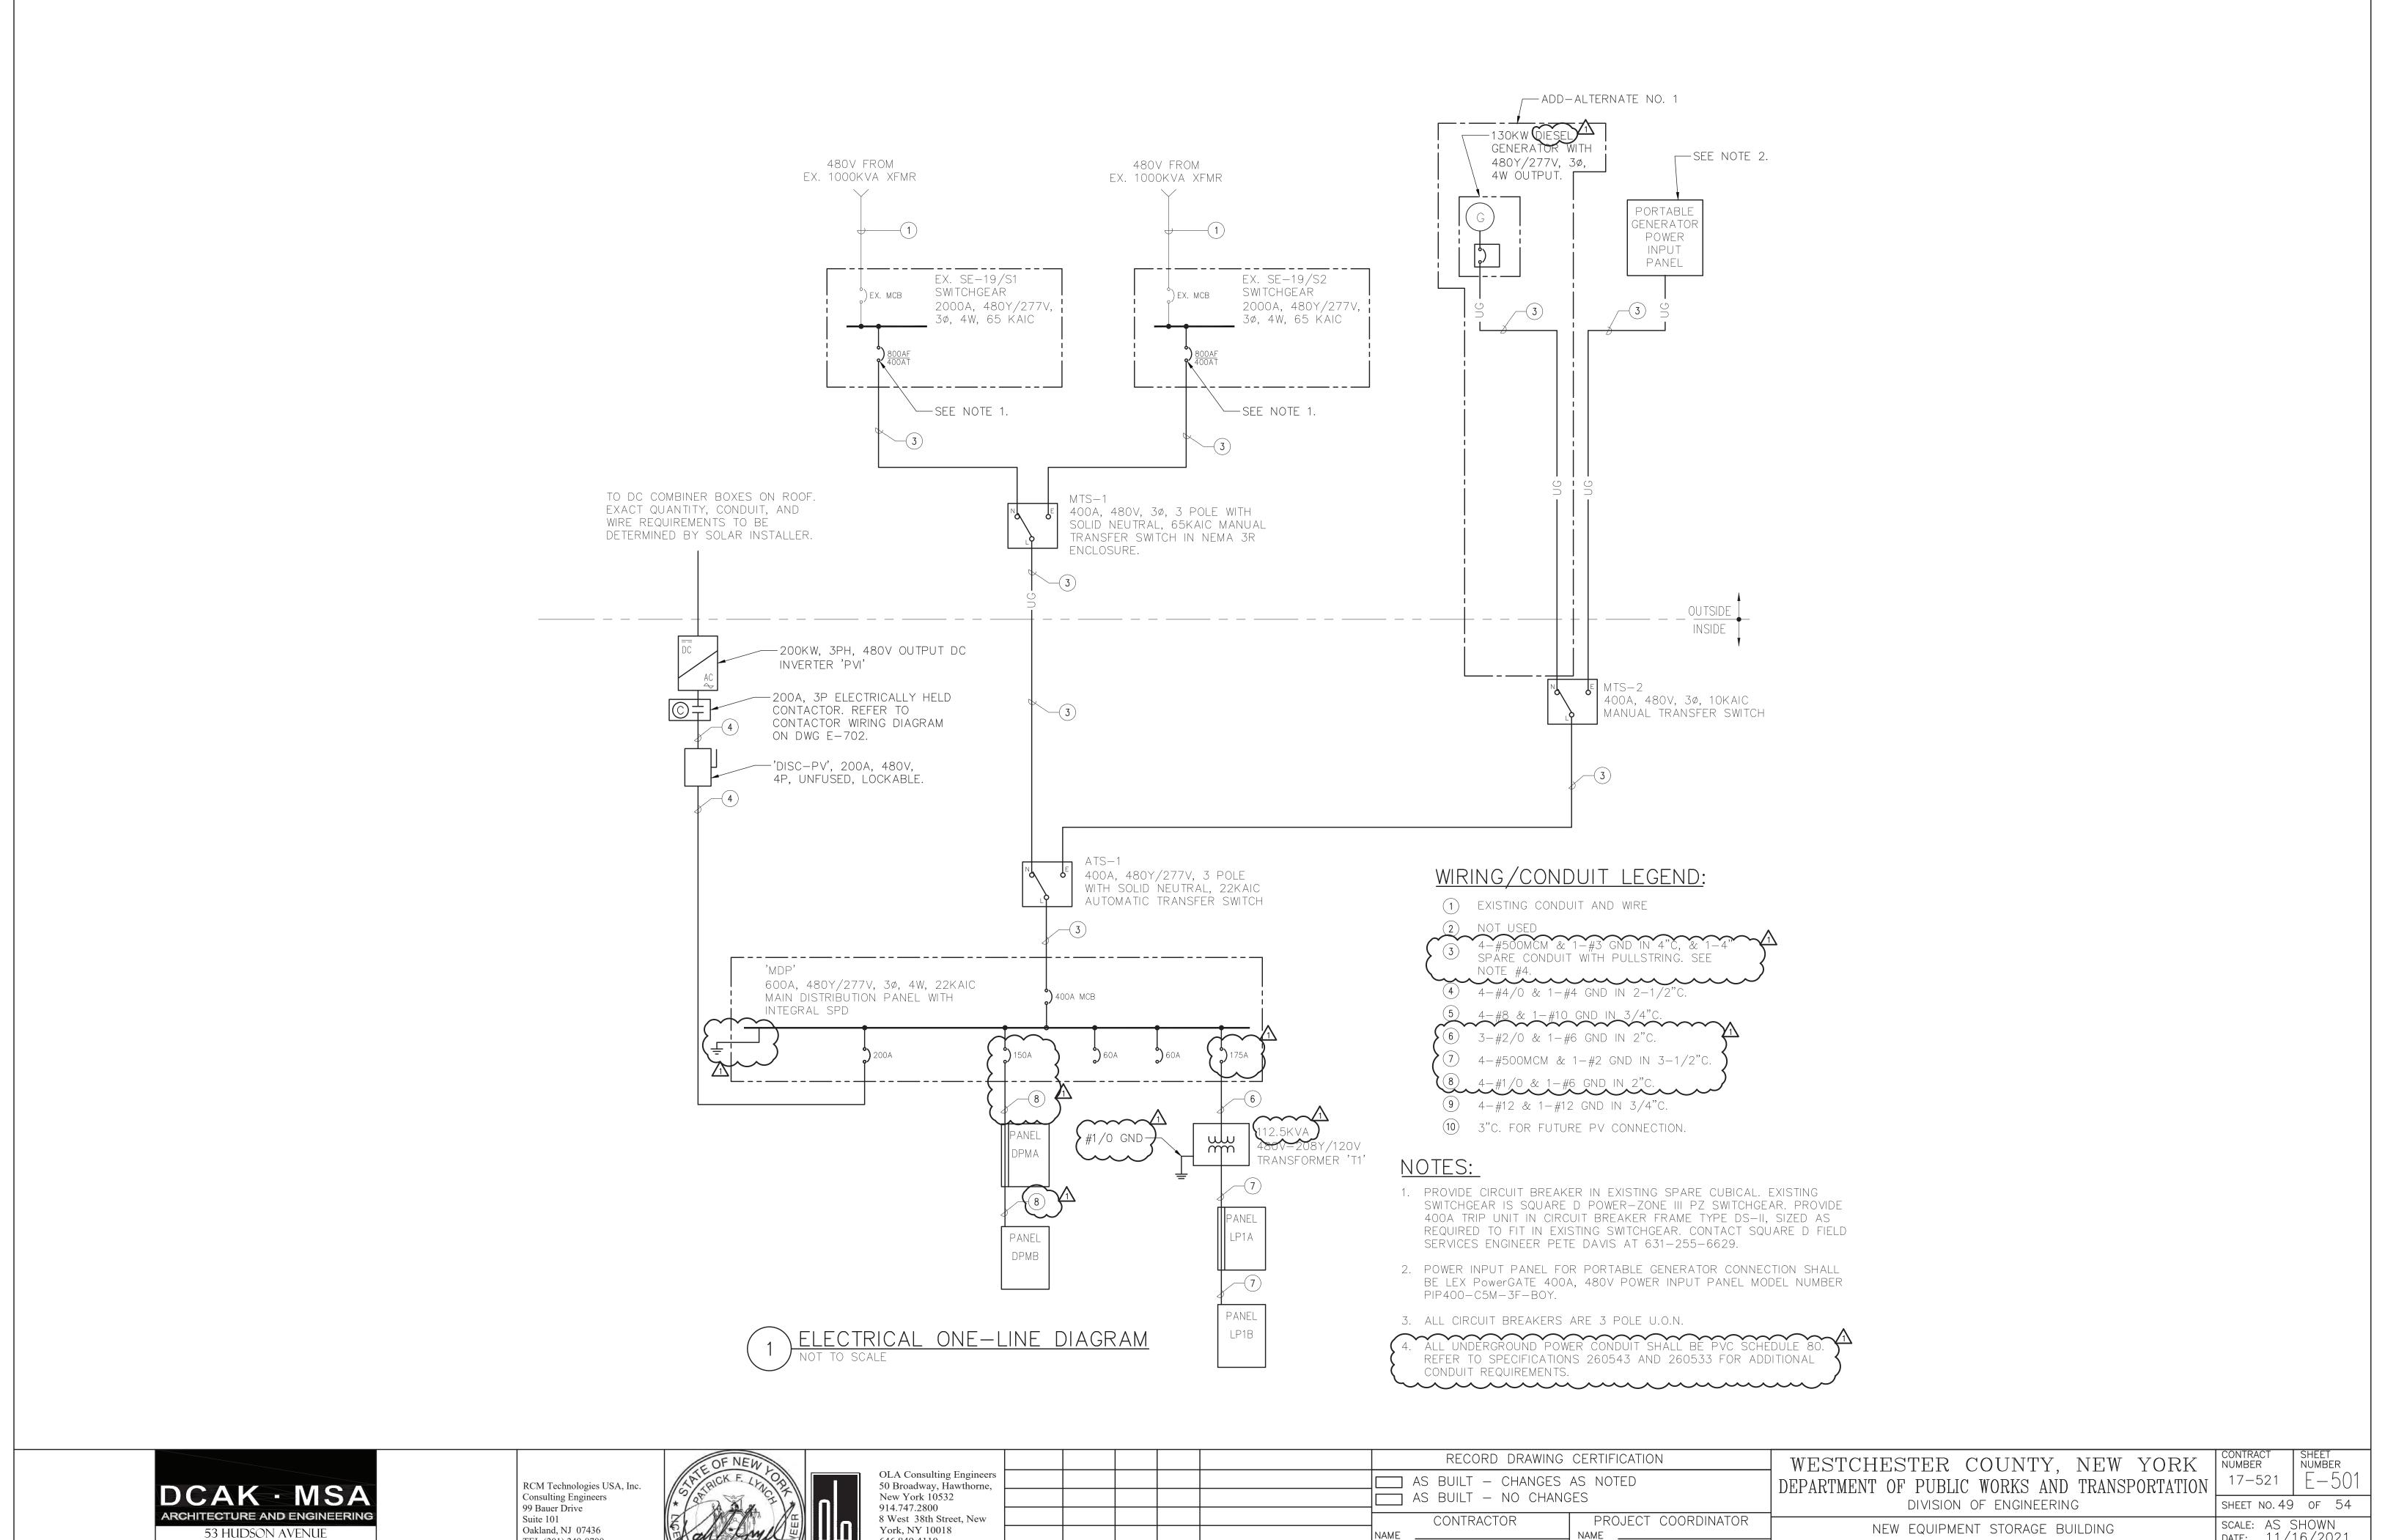

53 HUDSON AVENUE NYACK, NEW YORK 10960 www.DCAK-MSA.com Email: info@DCAK-MSA.com Tel 845-353-1300 Fax 845-353-1614

Oakland, NJ 07436 TEL:(201) 249-8700 EMAIL:bruce.goldman@rcmt.com

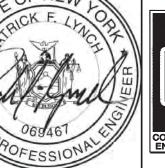

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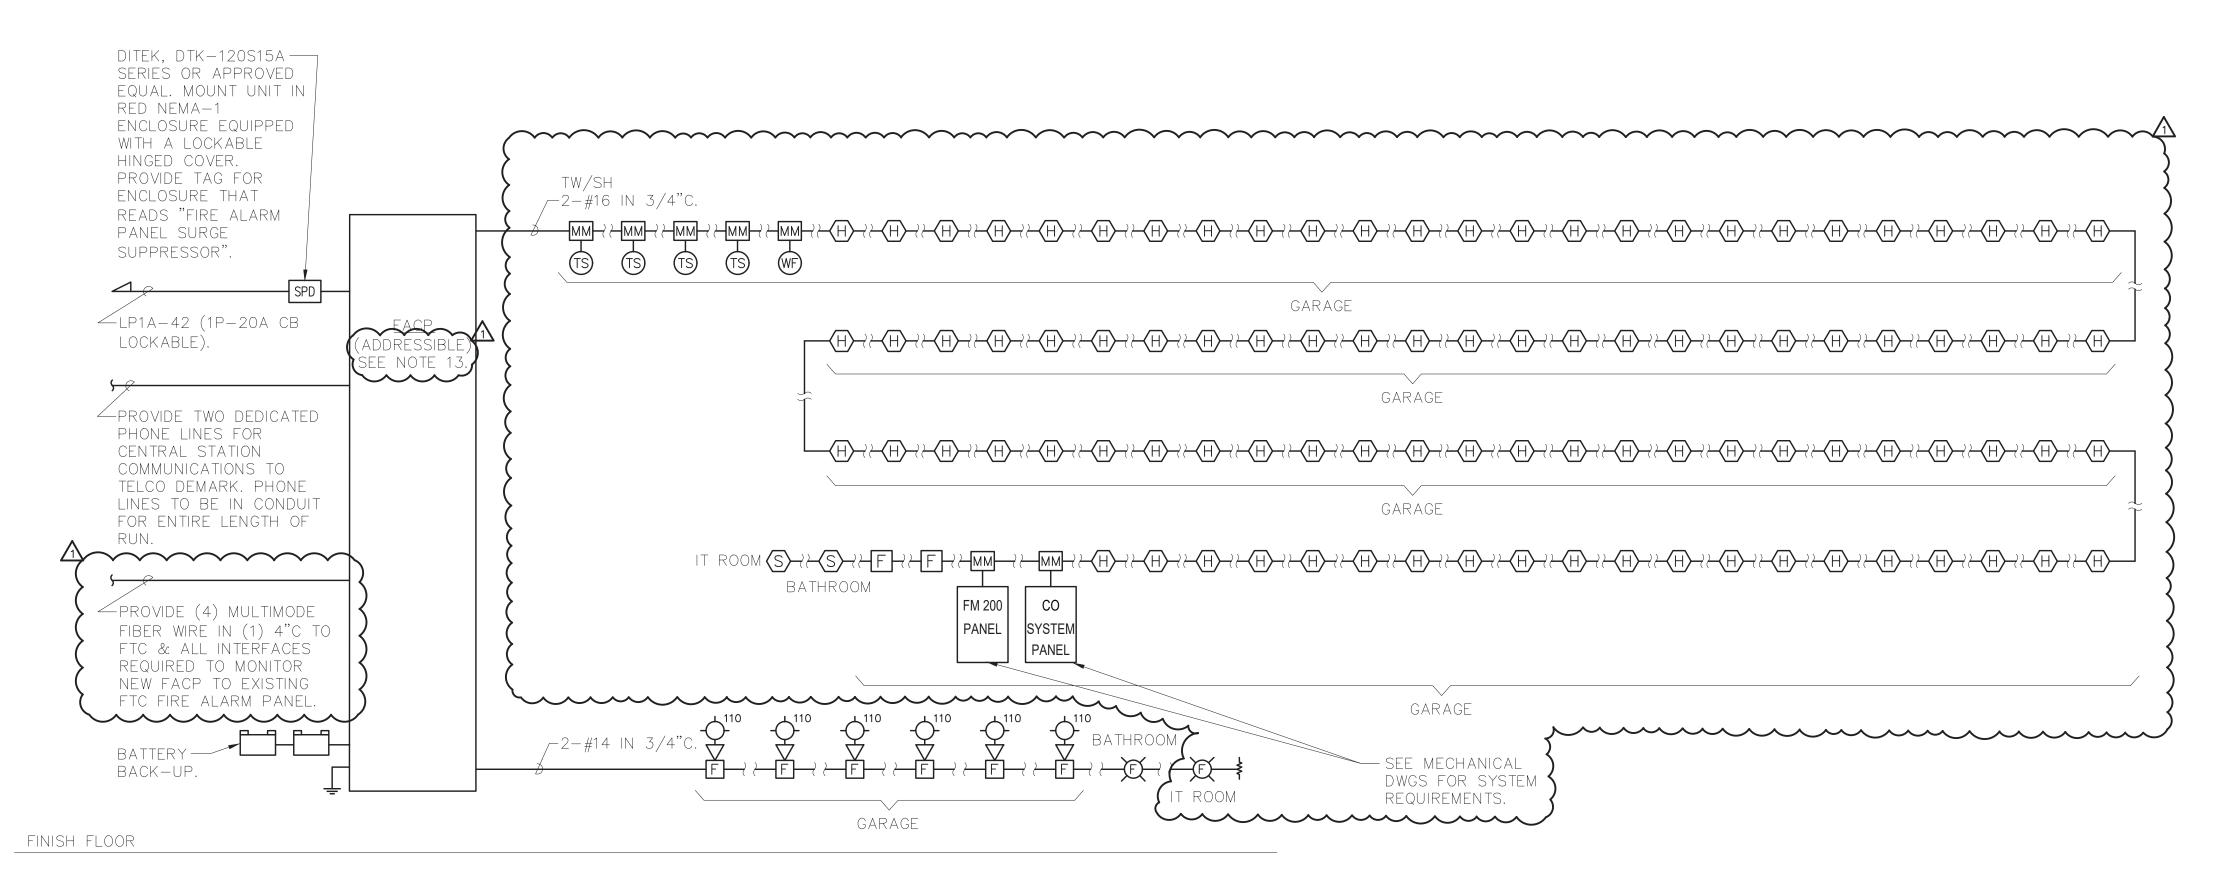
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NEW EQUIPMENT STORAGE BUILDING RICHARD A. FLYNN, SR. FIRE TRAINING CENTER VALHALLA CAMPUS, VALHALLA, NEW YORK ELECTRICAL ONE-LINE DIAGRAM

SIGNATURE ____

TITLE _____ DATE

DATE: 11/16/2021 DPW FILE NO. 38-47-E-731-0



1 FIRE ALARM RISER DIAGRAM NOT TO SCALE

RISER NOTES:

- 1. THIS IS NOT A POINT—TO—POINT WIRING DIAGRAM. PRIOR TO STARTING ANY WORK, A WORKING POINT—TO—POINT WIRING DIAGRAM SHALL BE OBTAINED FROM FIRE ALARM SYSTEM VENDOR AND PERFORM ALL WORK IN ACCORDANCE WITH THAT DIAGRAM.
- 2. ELECTRICAL CONTRACTOR SHALL INCLUDE IN THE BASE BID ALL 120V CIRCUITS THAT ARE REQUIRED TO SUPPORT THE OPERATION OF THE FIRE ALARM SYSTEM. COORDINATE REQUIREMENTS WITH THE FIRE ALARM VENDOR.
- 3. QUANTITY OF STROBE BOOSTER POWER SUPPLY PANELS AND ASSOCIATED 120V CIRCUITS SHALL BE COORDINATED WITH SELECTED FIRE ALARM SYSTEM MANUFACTURER AND/OR FIRE ALARM VENDOR.
- 4. PROVIDE ALL NECESSARY WIRING, MODULES, COMPONENTS, ENTENDER CABINET, AND PROGRAMMING REQUIRED TO CONNECT NEW DEVICES TO EXISTING SYSTEM.
- 5. PROVIDE ALL NECESSARY HARDWARE AND PROGRAMMING TO PROVIDE THE CLIENT WITH 20% SPARE CAPACITY ON ALL INITIATING AND INDICATING CIRCUITS.
- 6. PROVIDE AS PART OF THE BASE CONTRACT ALL LABOR AND MATERIALS TO INSTALL FIFTEEN (15) ADDITIONAL FIRE ALARM DEVICES DURING CONSTRUCTION. THE FIFTEEN (15) FIRE ALARM DEVICES CAN BE BUT NOT LIMITED TO SMOKE DETECTOR, HEAT DETECTOR, DOOR HOLDER, DUCT DETECTOR, FAN SHUTDOWN, TAMPER SWITCHES, FLOW SWITCHES, ETC. INCLUDE ALL LABOR AND MATERIALS INCLUDING WIRE, BOXES, CONDUIT, TERMINATIONS, HARDWARE, SOFTWARE, PROGRAMMING AND TESTING.
- 7. ALL VISUAL ALARM DEVICES SHALL BE ADA COMPLIANT.

- 8. MAKE CONNECTIONS TO SIDES OR BOTTOM OF FACP ONLY.
- 9. ELECTRICAL CONTRACTOR TO PROVIDE A RELAY FOR EACH SMOKE DAMPER/COMBINATION FIRE SMOKE DAMPER. RELAYS ARE NOT SHOWN ON PLANS FOR CLARITY.
- 10. PROVIDE REMOTE LED INDICATORS FOR ALL CONCEALED FIRE ALARM DEVICES SUCH AS DUCT SMOKE DETECTORS, ABOVE CEILING SMOKE DETECTORS, ELEVATOR SHAFT DETECTORS, MONITORING AND CONTROL MODULES, ETC. LED INDICATORS FOR DEVICES MOUNTED ABOVE DROP CEILINGS SHALL BE MOUNTED BELOW ASSOCIATED DEVICES. LABEL INDICATORS TO INDICATE DEVICE SERVED.
- 11. THE CONTRACTOR SHALL BE RESPONSIBLE TO PROVIDE THE ENGINEER WITH AN ACCURATE AS—BUILT FIRE ALARM DRAWING, SHOWING INSTALLED DEVICE LOCATIONS AND A COMPLETE INTERCONNECTION WIRING DIAGRAM OF THE SYSTEM. THE DRAWINGS SHALL BE PROVIDED IN AUTOCAD FORMAT AND HARD COPIES. AS—BUILT DRAWINGS MUST BE PROVIDED TO THE ENGINEER BEFORE PROJECT CAN BE CLOSEOUT.
- 12. CONTRACTOR TO PROVIDE SMOKE DETECTOR(S) IN ALL LOCATIONS CONTAINING FIRE ALARM CONTROL PANELS, DATA GATHERING PANELS, BOOSTER POWER SUPPLIES, OR ANY OTHER FIRE ALARM SYSTEM PANEL, WHETHER SHOWN ON PLANS OR NOT.
- 13. FIRE ALARM PANEL & SYSTEM BASED ON EDWARDS EST 101000 OR APPROVED EQUAL. CONTACT NICK DELFICO AT REDHAWK/ADT AT 914-418-9445.

DCAK - MSA

ARCHITECTURE AND ENGINEERING

53 HUDSON AVENUE

NYACK, NEW YORK 10960


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WESTCHESTER COUNTY, NEW YORK DEPARTMENT OF PUBLIC WORKS AND TRANSPORTATION DIVISION OF ENGINEERING

NEW EQUIPMENT STORAGE BUILDING RICHARD A. FLYNN, SR. FIRE TRAINING CENTER VALHALLA CAMPUS, VALHALLA, NEW YORK FIRE ALARM RISER DIAGRAM CONTRACT NUMBER 17-521 E-502SHEET NO.50 OF 54

SCALE: AS SHOWN DATE: 11/16/2021

DPW FILE NO. REV NO. 38-47-E-732-0 1

FIXTURE DESIGNATION	MANUFACTURER	CATALOG NUMBER	LAMPS	VOLTS	INPUT WATTS	MOUNTING	REMARKS
В	RAB LIGHTING	SLIM37N/BL	LED	120	37	SURFACE	LED WALLPACKS OUTDOOR LIGHTING FIXTURE.
С	RAB LIGHTING	EZPANHE2'X2'23W/E2	LED	120	24.2	RECESSED	2'X2' RECESSED FIXTURE WITH INTEGRAL BATTERY BALLAST. FIXTURE TYPE BY ARCHITECT.
E	EATON SURE-LITES	SELD-D-W 60-SD-HAZ	LED (300 LUMEN)	120	5	SURFACE	TWO HEADS EMERGENCY LIGHTING
HB1	HOLOPHANE	PHZ-18000LM-MD -XXX-50K-70CR I-XX-XX	LED 18000LM 5000K	120	130	PENDANT	ROUND LED LIGHTING FIXTURE. PROVIDE INTEGRAL BATTERY BALLAST WHERE DENOTED 'EM'
X1	EATON SURE-LITES	APC7RSQ	LED	120	3.7	SURFACE	EXIT LIGHTING WITH TWO HEADS EMERGENCY LIGHTING

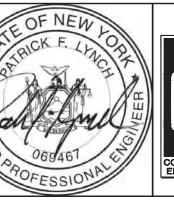NOTES:

- 1. VERIFY ALL FIXTURE CATALOG NUMBERS FOR INTENDED APPLICATIONS WITH REQUIRED ACCESSORIES.
- 2. ALL BALLASTS IN FIXTURES LOCATED OUTDOORS SHALL BE ZERO DEGREE RATED STARTING TEMPERATURE. REFER TO DRAWINGS FOR LOCATION OF FIXTURES.
- 3. LIGHT FIXTURES INDICATED AS EMERGENCY (EM) ON DRAWINGS SHALL CONTAIN AN EMERGENCY BATTERY BACK-UP BALLAST INTERNAL TO FIXTURE WITH A VISUAL INDICATING CHARGE LAMP AND TEST SWITCH. EACH BATTERY PACK SHALL BE CONNECTED SO THAT THE FIXTURE CAN BE SWITCHED UNDER NORMAL CONDITIONS AND IN THE EVENT OF A POWER OUTAGE, THE BATTERY PACK AND LAMPS SHALL AUTOMATICALLY ILLUMINATE FOR 90 MINUTES WITH A 1200 LUMEN OUTPUT (TOTAL FROM FIXTURE), MINIMUM.
- 4. ALL EXIT AND EMERGENCY FIXTURES SHALL BE FED FROM UNSWITCHED LEG OF ASSOCIATED LOCAL LIGHTING CIRCUITS.
- 5. IN THE EVENT THE CONTRACTOR CHOOSES TO SUBSTITUTE LIGHT FIXTURES FOR THOSE THAT ARE SPECIFIED ON THE LIGHT FIXTURE SCHEDULE, THE CONTRACTOR SHALL SUBMIT POINT—TO—POINT PHOTOMETRIC CALCULATIONS FOR ALL AREAS WHERE THE SUBSTITUTED FIXTURES ARE INDICATED TO BE INSTALLED ON THE DRAWINGS. THESE CALCULATIONS SHALL BE SUBMITTED ALONG WITH THE LIGHT FIXTURE SHOP DRAWINGS.

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		LP1A SEC	10IT	1 1	PAN	EL	SCHEDULE }	
	(	MAIN RATING: 400A	MA	IN CB:	<u>350A</u>	7	KAIC RATING: 44KAIC	
		VOLTAGE: <u>208Y/120V</u>	PH	ASE: <u>3</u>		RE: <u>4</u>	MOUNTING: <u>SURFACE</u>	
CIRC. NO.	LOAD	DESCRIPTION	BKR. AMPS	NO. OF POLES	NO. OF POLES	BKR. AMPS	LOAD DESCRIPTION	CIRC NO.
1	RECEPTACLE		20	1	1	20	RECEPTACLE	2
3	RECEPTACLE		20	1	1	20	RECEPTACLE	4
5	RECEPTACLE		20	1	1	20	RECEPTACLE	6
7	LIGHTING		20	1	1	20	LIGHTING	8
9	LIGHTING		20	1	1	20	LIGHTING	10
11 <b>(</b>	ACC-1 & AC-1		20LK	$\frac{\sqrt{1}}{2}$	1	20	LIGHTING	12
13	ACC-1 & AC-1		ZULK	<b>\</b> _	1	20 (	LIGHTING	14
15	SPARE		15	$\begin{pmatrix} 2 \end{pmatrix}$	1	20	LIGHTING	16
17					1	20	GENERATOR	18
19	DATA RACK		30	2	1	20	GENERATOR	20
21 >				_	1	20	GENERATOR	22
23	DATA RACK		30	2	11	20	FIRE ALARM CONTROL PANEL (FACP)	24
25		· ······			11	20	MOTORIZED DAMPERS	26
27	TX-1		20	1	1	20	UH-1	28
29	EH-1		20	2	1		UH-2	30
31				4			UH-3	32
33	UH-5	Λ	20			20	UH-4	34
35	UH-6		$\sim$ 20	1	1	20	OWS CONTROL PANEL & CO DETECTION PANEL	. 36
37	IT ROOM RECEPTAGE		20	1	1	40	EWH-1	38
39 <b>(</b> 41	IT ROOM RECEPTA	KES & CARD READERS	20 20	1	1	20 <b>(</b>	LIGHTING FACP	40 42

# FEED THROUGH LUGS TO LP1B

LK - PROVIDE LOCKING TABS ON C.B.; GF - GFI TYPE C.B.; AF - ARC FAULT TYPE C.B.; ST - SHUNT TRIP C.B.

NOTES:

		DDMA SE		1 1		IEI	SCHEDULE	
		DEMA SL		<u> </u>	T AI		30HLDULL	
		MAIN RATING: 225A	T MA	IN CB:	<u>150A</u>		KAIC RATING: 22KAIC	<b>Y</b> 1
		VOLTAGE: <u>480Y/277V</u>	PH	ASE: 3	S WIF	RE: <u>4</u>	MOUNTING: <u>SURFACE</u>	
CIRC. NO.		LOAD DESCRIPTION	BKR. AMPS	NO. OF POLES	NO. OF POLES	BKR. AMPS	LOAD DESCRIPTION	CIRC. NO.
1 3	PF-1		15	3	3	15	PF-2	2 4
5								6
7	_							8
9	HV-1		20	3	3	20	HV-2	10
11								12
15	HV-3		20	3	3	20	HV-4	14
17			20			20		18
19								20
21	EX-1		20	3	3	20	EX-2	22
23								24
25								26
27	EX-3		20	3	3	20	EX-4	28
29								30
31				7	3			32
33 35	SF-1		20	3	)	20	SF-2	34
37								38
39	SF-3		20	3	3	20	SF-4	40
41						_ ~		42
							1.1.0.0	1

## FEED THROUGH LUGS TO DPMB

LK — PROVIDE LOCKING TABS ON C.B.; GF — GFI TYPE C.B.; AF — ARC FAULT TYPE C.B.; ST - SHUNT TRIP C.B.

NOTES:

						SCHEDULE }			
	MAIN RATING: 400A	) MA	IN CB:	350A ·	<del></del>	KAIC RATING: 44KAIC			
	VOLTAGE: <u>208Y/120V</u>		ASE: 3		, re: <u>4</u>	MOUNTING: <u>SURFACE</u>			
CIRC. NO.	LOAD DESCRIPTION	BKR. AMPS	NO. OF POLES	NO. OF POLES	BKR. AMPS	LOAD DESCRIPTION	CIRC. NO.	CIRC. NO.	LOAD
43 45	208V VEHICLE CHARGING RECEPTACLE	40LK	2	2	40LK	208V VEHICLE CHARGING RECEPTACLE	44 1	3	VEHICLE EXHAUST
47 49	208V VEHICLE CHARGING RECEPTACLE	40LK	2	2	40LK	208V VEHICLE CHARGING RECEPTACLE	48	5 7	- VEHICLE EXHAUST
51	208V VEHICLE CHARGING RECEPTACLE	40LK	2	2	40LK	208V VEHICLE CHARGING RECEPTACLE	52	9	- SPARE
55 57	208V VEHICLE CHARGING RECEPTACLE	40LK	2	2	40LK	208V VEHICLE CHARGING RECEPTACLE	56	13	AIR COMPRESSOR
59 61	RECEPTACLE	50LK	2	2	50LK	RECEPTACLE	60	17	
63 65	RECEPTACLE	50LK	2	2	50LK	RECEPTACLE	64	21	SPARE
67 69	RECEPTACLE	50LK	2		20	RECEPTACLE SPACE	68	25 27	SPARE
71	SPARE SPARE	20		1			72	29	
	<b>S</b> PARE	20	1	1	20	SPACE	74	31	_   spare
	SPARE	20	1	1	20	SPACE	76	35	
	SPARE	20	1		20	SPACE (	78	37	
	SPARE	20	1	1	20	SPACE	( 80 )	39	-   SPARE
	SPARE SDARE	20	1		20	SPACE SPACE	82	41	
_K _	PROVIDE LOCKING TABS ON C.B.; GF — GFI SHUNT TRIP C.B.		 C.B.; Af	<u>                                     </u>					- PROVIDE LOCKING - SHUNT TRIP C.B.
NOTE								NOT!	ES:

### MAIN CB: (150A) MAIN RATING: <u>225A</u> KAIC RATING: <u>22KAIC</u> VOLTAGE: <u>480Y/277V</u> PHASE: <u>3</u> WIRE: <u>4</u> MOUNTING: <u>SURFACE</u> NO. BKR. I BKR. OF OF AMPS AMPS LOAD DESCRIPTION LOAD DESCRIPTION 2 20 VEHICLE EXHAUST FAN 2 - VEHICLE EXHAUST FAN 1 2 | 20 | VEHICLE EXHAUST FAN 4 VEHICLE EXHAUST FAN 3 $\frac{1}{11}$ SPARE 20 2 2 20 SPARE 15 AIR COMPRESSOR (|50lk**k** 3 | 3 | 20 | GARAGE DOOR OPENERS 20 | 3 | 3 | 20 | SPARE 21 SPARE 20 | 3 | 3 | 20 | SPARE 27 | SPARE 20 3 3 20 SPARE 33 | SPARE 20 3 3 20 SPARE 39 | SPARE K - PROVIDE LOCKING TABS ON C.B.; GF - GFI TYPE C.B.; AF - ARC FAULT TYPE C.B.;

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WESTCHESTER COUNTY, NEW YORK DEPARTMENT OF PUBLIC WORKS AND TRANSPORTATION DIVISION OF ENGINEERING

NEW EQUIPMENT STORAGE BUILDING RICHARD A. FLYNN, SR. FIRE TRAINING CENTER VALHALLA CAMPUS, VALHALLA, NEW YORK ELECTRICAL SCHEDULES

CONTRACT NUMBER SHEET NUMBER E-60117-521 SHEET NO.51 OF 54 SCALE: AS SHOWN DATE: 11/16/2021 DPW FILE NO.

38-47-E-733-0

