



	SYMBOL & ABBREVIATIONS			GENERAL NOTES	EQUIPMENT NOTES CONTINUED
	SYMBOL	ABBREVIATION	DESCRIPTION	<div><div>1. THE CONTRACT DRAWINGS INDICATE THE EXTENT AND GENERAL ARRANGEMENTS OF THE PLUMBING SYSTEMS. IF ANY DEPARTURES FROM THE DRAWINGS ARE DEEMED NECESSARY BY THE PLUMBING CONTRACTOR, DETAILS OF SUCH DEPARTURES AND THE REASONS THEREFORE SHALL BE SUBMITTED TO THE OWNER AND ENGINEER FOR APPROVAL. NO SUCH DEPARTURES SHALL BE MADE WITHOUT PRIOR WRITTEN APPROVAL OF THE OWNER AND ENGINEER. EQUIPMENT AND PIPING ARRANGEMENTS SHALL PROVIDE ADEQUATE AND ACCEPTABLE CLEARANCES FOR ENTRY, SERVICING, AND MAINTENANCE. ANY CHANGES TO PIPING AND EQUIPMENT LOCATIONS NECESSARY TO AVOID INTERFERENCE WITH OTHER TRADES SHALL BE MADE AT NO EXTRA COST.</div><div>2. THE PLUMBING WORK SHALL BE PERFORMED IN STRICT ACCORDANCE WITH THE LATEST EDITION OF THE PREVAILING NEW YORK STATE PLUMBING AND BUILDING CODES. IN CASE OF CONFLICT BETWEEN THE CONTRACT DOCUMENTS AND A GOVERNING CODE OR ORDINANCE, THE MORE STRINGENT STANDARD SHALL APPLY.</div><div>3. THE PLUMBING CONTRACTOR SHALL BE RESPONSIBLE FOR OBTAINING ALL NECESSARY PERMITS AND FOR PAYING RELATED FEES.</div><div>4. CONNECTIONS TO EXISTING UTILITIES AND SERVICES ARE SHOWN ACCORDING TO THE BEST INFORMATION AVAILABLE. THE CONTRACTOR SHALL VERIFY THE EXACT LOCATIONS, INVERT ELEVATIONS, AND SIZES OF EXISTING PLUMBING SERVICES IN FIELD, AND SHALL CONNECT NEW PLUMBING SERVICES AS INDICATED ON DRAWINGS.</div><div>5. PRIOR TO FABRICATION, THIS CONTRACTOR SHALL VERIFY ALL MEASUREMENTS AND CONDITIONS ON JOB SITE, AND COORDINATE THIS WORK WITH THE WORK OF ALL OTHER TRADES.</div><div>6. ALL ACCESS PANELS SHALL BE BY GENERAL CONTRACTOR. THE PLUMBING CONTRACTOR SHALL BE RESPONSIBLE FOR THEIR LOCATION.</div><div>7. PROVIDE ALL PLUMBING FIXTURES, PIPING, VALVES AND ACCESSORY ITEMS AS SPECIFIED AND AS REQUIRED FOR A COMPLETE INSTALLATION. ROUGHING DIMENSIONS OF FIXTURES MUST BE COORDINATED WITH THE GENERAL CONTRACTOR.</div><div>8. PITCH ALL WASTE, SANITARY, AND STORM DRAIN PIPING AT MAXIMUM SLOPE POSSIBLE, BUT NOT LESS THAN 1/8" PER FOOT FOR PIPING ≥3" AND 1/4" PER FOOT FOR PIPING ≤ 2½".</div><div>9. NO PIPING SHALL RUN EXPOSED IN FINISHED AREAS.</div><div>10. PROVIDE DIELECTRIC FITTINGS OR COUPLINGS WHEREVER DISSIMILAR METALS ARE JOINED.</div><div>11. PROVIDE SHUTOFF VALVES AT ALL FIXTURES AND EQUIPMENT ON COLD WATER, AND HOT WATER PIPES.</div><div>12. ALL WORK SHALL BE PROPERLY TESTED, BALANCED, AND CLEANED AND DISINFECTED. PROVIDE A ONE YEAR WARRANTY FROM DATE OF FINAL INSPECTION ON ALL PARTS AND LABOR.</div><div>13. PROVIDE ALL PIPE OPENINGS THROUGH PARTITIONS WITH PIPE SLEEVES. FOR PIPES PENETRATING FIRE RATED PARTITIONS, THE SPACE BETWEEN THE PIPE AND THE SLEEVE SHALL BE SEALED WITH FIRE STOPPING MATERIAL. PENETRATIONS FOR PIPING SHALL BE MADE BY CORE DRILLING WHENEVER POSSIBLE.</div><div>14. PROVIDE TRAP SEAL PRIMERS FOR FLOOR DRAINS WHERE INDICATED ON PLAN. INSTALL THE PRIMER VALVE IN THE COLD WATER SERVICE, WITH THE TRAP CONNECTION PIPED TO THE FLOOR DRAIN TRAP. LOCATE THE VALVE IN AN ACCESSIBLE LOCATION.</div><div>15. NEW PIPING LAYOUT IS PREDICATED ON RECORD DRAWING DATA OF EXISTING RISERS AND DRAWINGS. MODIFICATIONS TO THE LAYOUT MAY BE REQUIRED DUE TO DIFFERENT ACTUAL CONDITIONS, OBSTRUCTIONS, INTERFERENCES, ETC.</div><div>16. SEE THE ARCHITECTURAL DRAWINGS FOR EXACT PHASING AND TIME SCHEDULE FOR CONSTRUCTION.</div><div>17. ALL MOTOR STARTERS AND DISCONNECT SWITCHES FOR PLUMBING EQUIPMENT SHALL BE FURNISHED BY THE PLUMBING CONTRACTOR AND INSTALLED BY THE ELECTRICAL CONTRACTOR, UNLESS OTHERWISE NOTED. DISCONNECT SWITCHES FURNISHED BY THE PLUMBING CONTRACTOR FOR PLUMBING EQUIPMENT SHALL BE HEAVY DUTY TYPE.</div><div>18. THE CONTRACTOR SHALL BE RESPONSIBLE FOR PROVIDING TEMPORARY VENTILATION AND EXHAUST AIR WHEN WELDING OR SOLDERING OPERATIONS ARE PERFORMED, AS REQUIRED BY OSHA.</div></div> <div><div>1.) <u>DOMESTIC HOT WATER HEATER</u>, HWH-1 SHALL BE ELECTRIC AO-SMITH XI - MODEL DRE-52-6; PROVIDING 25 GPH RECOVERY AT 40°-140°, 6kW INPUT, 50 GALLONS NOMINAL STORAGE CAPACITY, 55" HIGH, 27" DIAMETER, 260 POUNDS SHIPPING WEIGHT. PROVIDE CONDENSATE NEUTRALIZATION SYSTEM &amp; P-TRAP. FURNISH DISCONNECT SWITCH FOR EACH HOT WATER HEATER TO BE INSTALLED BY THE ELECTRICAL CONTRACTOR.</div><div>2.) DOMESTIC HOT WATER RE-CIRCULATION PUMP, HWC-1, TO BE BASED ON BELL &amp; GOSSETT MODEL NBF-18S, 100% LEAD FREE, 90 WATTS, 115V-1 PHASE-60 HERTZ, 0.74 FULL LOAD AMPS, 3000 RPM AND 5 GPM @ 10 FEET HEAD. FURNISH DISCONNECT SWITCH TO BE INSTALLED BY THE ELECTRICAL CONTRACTOR.</div></div>	<div>5.) <u>GASOLINE TANK – MAINTENANCE BUILDING</u>: SHALL BE ENVIRO-SAFE FIREGUARD 500 GALLON DOUBLE-WALL ABOVEGROUND FUEL TANK WITH INTEGRAL FUEL DISPENSING SYSTEM. PROVIDE STEEL SUPPORT SADDLES, LIFTING LUGS, 6" EMERGENCY VENT, 2" STACK VENT, 818 CLOCK GAUGE WITH FLOAT, 7.5 GALLON OVERSPILL WITH LOCKABLE CAP, SPIN ON FILTER AND HOUSING ASSEMBLY, INTERSTITIAL LEAK GAUGE, STEP LADDER AND PLATFORM, 16" MAN-WAY, BRACKET, PIPING BALL VALVE AND ANTI-SIPHON VALVE, SUCTION LINE FOOT-VALVE 6" FROM BOTTOM TANK, FILL-RITE 711VA PUMP 1" ASSEMBLY METER AND FILTER, 1" AUTOMATIC SHUT-OFF NOZZLE, SWIVEL, &amp; BREAKAWAY 18' X 1" HOSE. TANK SHALL BE PROVIDED WITH EPOXY PRIMER &amp; ACRYLIC POLYURETHANE COATING, UL2085 LABELED AND LISTED, NFPA-30-30A TESTED, 2-HOUR FIRE TESTED, IMPACT AND BALLISTIC TESTED. 60" DIAMETER X 100" LONG; DRY WEIGHT: 3,100 LBS. PROVIDE PNEUMERCATOR LS-600 LEVEL SWITCHES &amp; MP 450S LEVEL GAUGE PROBES. PROVIDE COMPLETE FIRE SUPPRESSION SYSTEM FOR COVERAGE OF THE TANK AND DISPENSING SYSTEM. COORDINATE WITH ARCHITECTURAL STRUCTURE ABOVE TANK.</div> <div>6.) <u>GASOLINE TANK – CART STORAGE</u>: SHALL BE ENVIRO-SAFE FIREGUARD 500 GALLON DOUBLE-WALL ABOVEGROUND FUEL TANK WITH INTEGRAL FUEL DISPENSING SYSTEM. PROVIDE STEEL SUPPORT SADDLES, LIFTING LUGS, 6" EMERGENCY VENT, 2" STACK VENT, 818 CLOCK GAUGE WITH FLOAT, 7.5 GALLON OVERSPILL WITH LOCKABLE CAP, SPIN ON FILTER AND HOUSING ASSEMBLY, INTERSTITIAL LEAK GAUGE, STEP LADDER AND PLATFORM, 16" MAN-WAY, BRACKET, PIPING BALL VALVE AND ANTI-SIPHON VALVE, SUCTION LINE FOOT-VALVE 6" FROM BOTTOM TANK, FILL-RITE 711VA PUMP 1" ASSEMBLY METER AND FILTER, 1" AUTOMATIC SHUT-OFF NOZZLE, SWIVEL, &amp; BREAKAWAY 18' X 1" HOSE. TANK SHALL BE PROVIDED WITH EPOXY PRIMER &amp; ACRYLIC POLYURETHANE COATING, UL2085 LABELED AND LISTED, NFPA-30-30A TESTED, 2-HOUR FIRE TESTED, IMPACT AND BALLISTIC TESTED. 60" DIAMETER X 100" LONG; DRY WEIGHT: 3,100 LBS. PROVIDE PNEUMERCATOR LS-600 LEVEL SWITCHES &amp; MP 450S LEVEL GAUGE PROBES. PROVIDE COMPLETE FIRE SUPPRESSION SYSTEM FOR COVERAGE OF THE TANK AND DISPENSING SYSTEM. COORDINATE WITH ARCHITECTURAL STRUCTURE ABOVE TANK.</div> <div>7.) <u>DIESEL TANK</u>: SHALL BE ENVIRO-SAFE FIREGUARD 500 GALLON DOUBLE-WALL ABOVEGROUND FUEL TANK WITH INTEGRAL FUEL DISPENSING SYSTEM. PROVIDE STEEL SUPPORT SADDLES, LIFTING LUGS, 6" EMERGENCY VENT, 2" STACK VENT, 818 CLOCK GAUGE WITH FLOAT, 7.5 GALLON OVERSPILL WITH LOCKABLE CAP, SPIN ON FILTER AND HOUSING ASSEMBLY, INTERSTITIAL LEAK GAUGE, STEP LADDER AND PLATFORM, 16" MAN-WAY, BRACKET, PIPING BALL VALVE AND ANTI-SIPHON VALVE, SUCTION LINE FOOT-VALVE 6" FROM BOTTOM TANK, FILL-RITE 711VA PUMP 1" ASSEMBLY METER AND FILTER, 1" AUTOMATIC SHUT-OFF NOZZLE, SWIVEL, &amp; BREAKAWAY 18' X 1" HOSE. TANK SHALL BE PROVIDED WITH EPOXY PRIMER &amp; ACRYLIC POLYURETHANE COATING, UL2085 LABELED AND LISTED, NFPA-30-30A TESTED, 2-HOUR FIRE TESTED, IMPACT AND BALLISTIC TESTED. 60" DIAMETER X 100" LONG; DRY WEIGHT: 3,100 LBS. PROVIDE PNEUMERCATOR LS-600 LEVEL SWITCHES &amp; MP 450S LEVEL GAUGE PROBES. PROVIDE COMPLETE FIRE SUPPRESSION SYSTEM FOR COVERAGE OF THE TANK AND DISPENSING SYSTEM. COORDINATE WITH ARCHITECTURAL STRUCTURE ABOVE TANK.</div> <div>8.) <u>FUEL OIL STORAGE TANK</u>: SHALL BE ENVIRO-SAFE FIREGUARD 1,000 GALLON DOUBLE-WALL ABOVEGROUND FUEL OIL STORAGE TANK. PROVIDE STEEL SUPPORT SADDLES, LIFTING LUGS, 6" EMERGENCY VENT, 2" STACK VENT, 818 CLOCK GAUGE WITH FLOAT, 7.5 GALLON 4" ALUMINUM OVERSPILL CONTAINER 179 SERIES WITH HINGED STYLE FILL CAP, MEMCO 1" RETURN LINE, 1.5" PICKUP WITH DROP TUBE AND FOOT VALVE 6" FROM BOTTOM TANK, INTERSTITIAL LEAK GAUGE, STEP LADDER WITH PLATFORM, &amp; 16" MAN-WAY. TANK SHALL BE PROVIDED WITH EPOXY PRIMER &amp; ACRYLIC POLYURETHANE COATING, UL2085 LABELED AND LISTED, NFPA-30-30A TESTED, 2-HOUR FIRE TESTED, IMPACT AND BALLISTIC TESTED. 56" DIAMETER X 150" LONG; DRY WEIGHT: 5,800 LBS. PROVIDE PNEUMERCATOR LS-600 LEVEL SWITCHES &amp; MP 450S LEVEL GAUGE PROBES. PROVIDE COMPLETE FIRE SUPPRESSION SYSTEM FOR COVERAGE OF THE TANK. COORDINATE WITH ARCHITECTURAL STRUCTURE ABOVE TANK.</div> <div>9.) <u>TANK LEVEL MONITORING SYSTEM</u>: SHALL BE BASED ON PNEUMERCATOR TMS3000 SERIES MODULAR MULTI-TANK GAUGING SYSTEM WITH EPA COMPLIANT IN TANK AND SECONDARY CONTAINMENT LEAK DETECTION; ELECTRICAL: 115/230V/1/60. PROVIDE (1) MONITORING SYSTEM AT THE MAINTENANCE BUILDING FOR MONITORING OF THE GASOLINE, DIESEL, AND FUEL OIL TANKS. PROVIDE (1) MONITORING SYSTEM AT THE CART STORAGE BUILDING FOR MONITORING OF THE GASOLINE TANK.</div>
<div><div><div><div><div></div><div>OLA Consulting Engineers</div><div>50 Broadway, Hawthorne, New York 10632 914.747.2800</div><div>8 West 38th Street, Suite 501 New York, NY 10018 646.849.4110</div><div>olaee.com</div></div><div>DBA0006.00</div></div><div><div>STATE OF NEW YORK</div><div>STEVEN ABBATISTO</div><div>077237</div><div>REGISTERED PROFESSIONAL ENGINEER</div></div></div></div>					
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SIGNATURE		SIGNATURE			
TITLE	DATE	TITLE	DATE		
WESTCHESTER COUNTY, NEW YORK DEPARTMENT OF PUBLIC WORKS			CONTRACT NUMBER 17 - 539	SHEET NUMBER P-001	
DIVISION OF ENGINEERING			SHEET NO. 29 OF 59		
NEW GOLF CART STORAGE FACILITY AND CLUBHOUSE UPGRADES MOHANSIC GOLF COURSE, YORKYOWN, NEW YORK			SCALE: NONE DATE: 6/4/21		
PLUMBING SYMBOLS, ABBREVIATIONS, & NOTES			DPW FILE NO. 10-02-P-62-0	REV. NO. 0	

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MADE BY <u>AMB</u>	





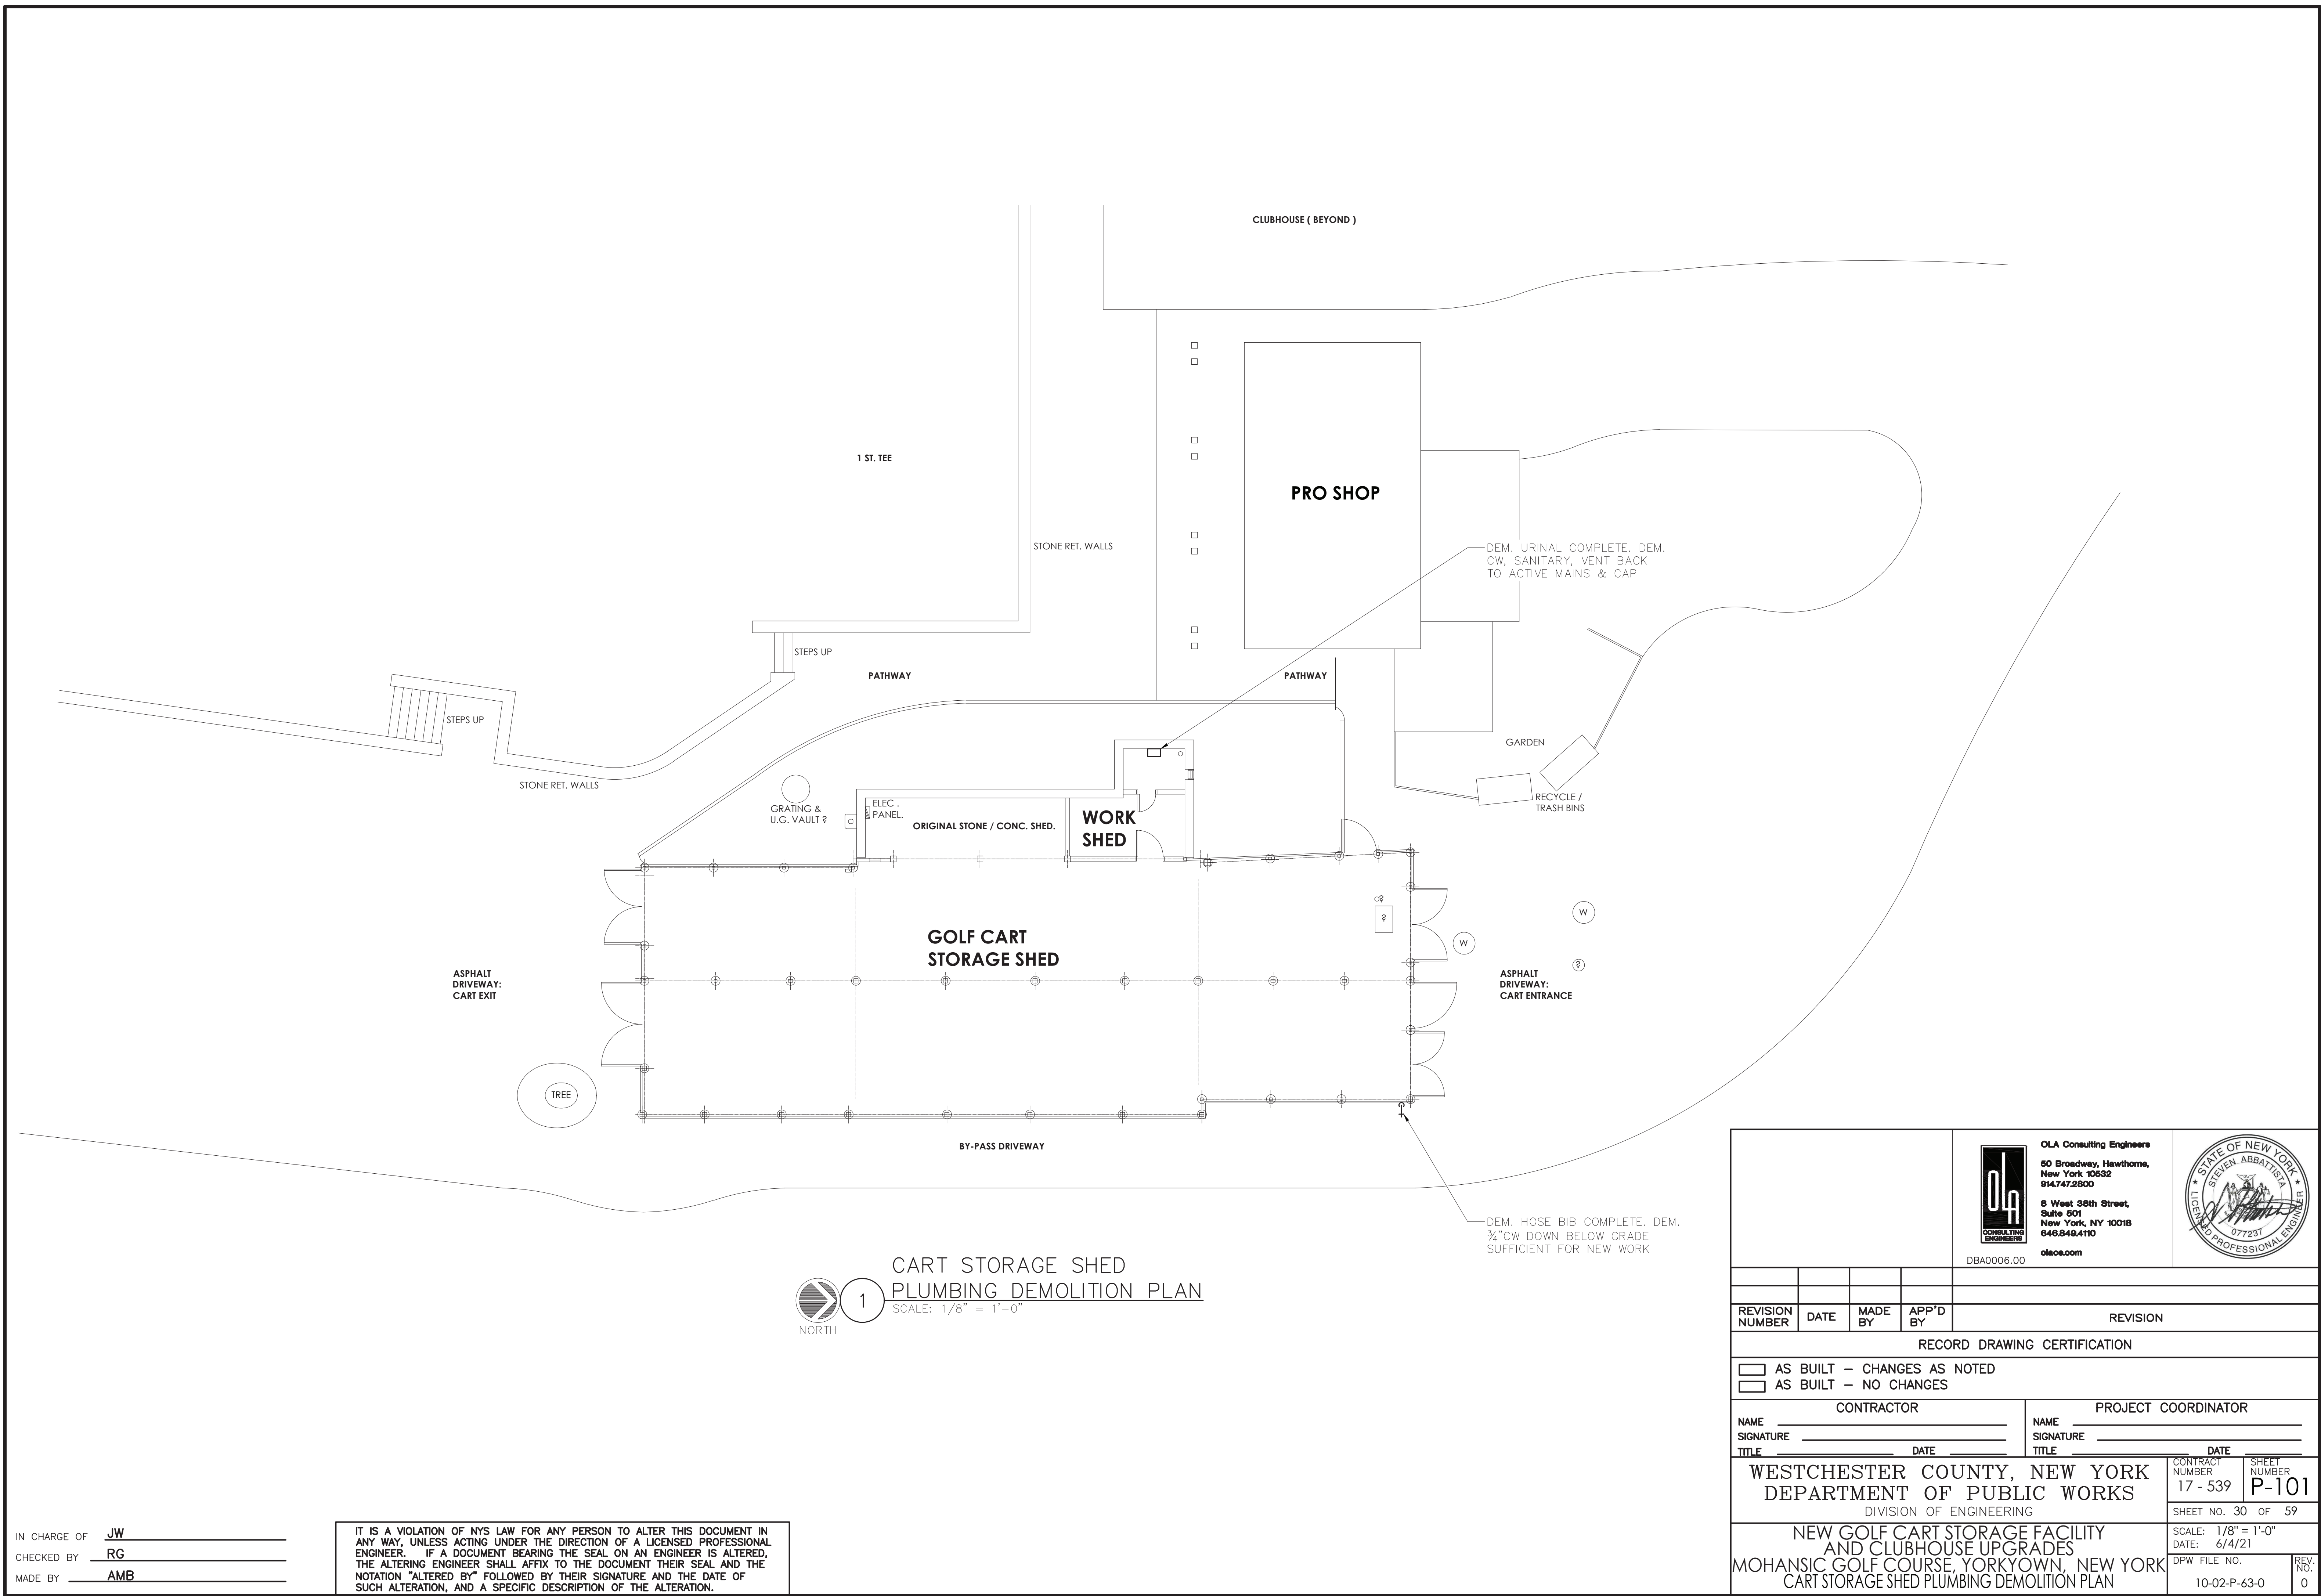



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CART STORAGE SHED  
PLUMBING DEMOLITION PLAN  
SCALE: 1/8" = 1'-0"

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WESTCHESTER COUNTY, NEW YORK DEPARTMENT OF PUBLIC WORKS DIVISION OF ENGINEERING		CONTRACT NUMBER 17 - 539	SHEET NUMBER P-101
NEW GOLF CART STORAGE FACILITY AND CLUBHOUSE UPGRADES MOHANSIC GOLF COURSE, YORKYOWN, NEW YORK CART STORAGE SHED PLUMBING DEMOLITION PLAN		SCALE: 1/8" = 1'-0" DATE: 6/4/21 DPW FILE NO. 10-02-P-63-0	
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




 **1** BATHROOMS & LOCKERS  
PLUMBING DEMOLITION PLAN  
SCALE: 1/4" = 1'-0"

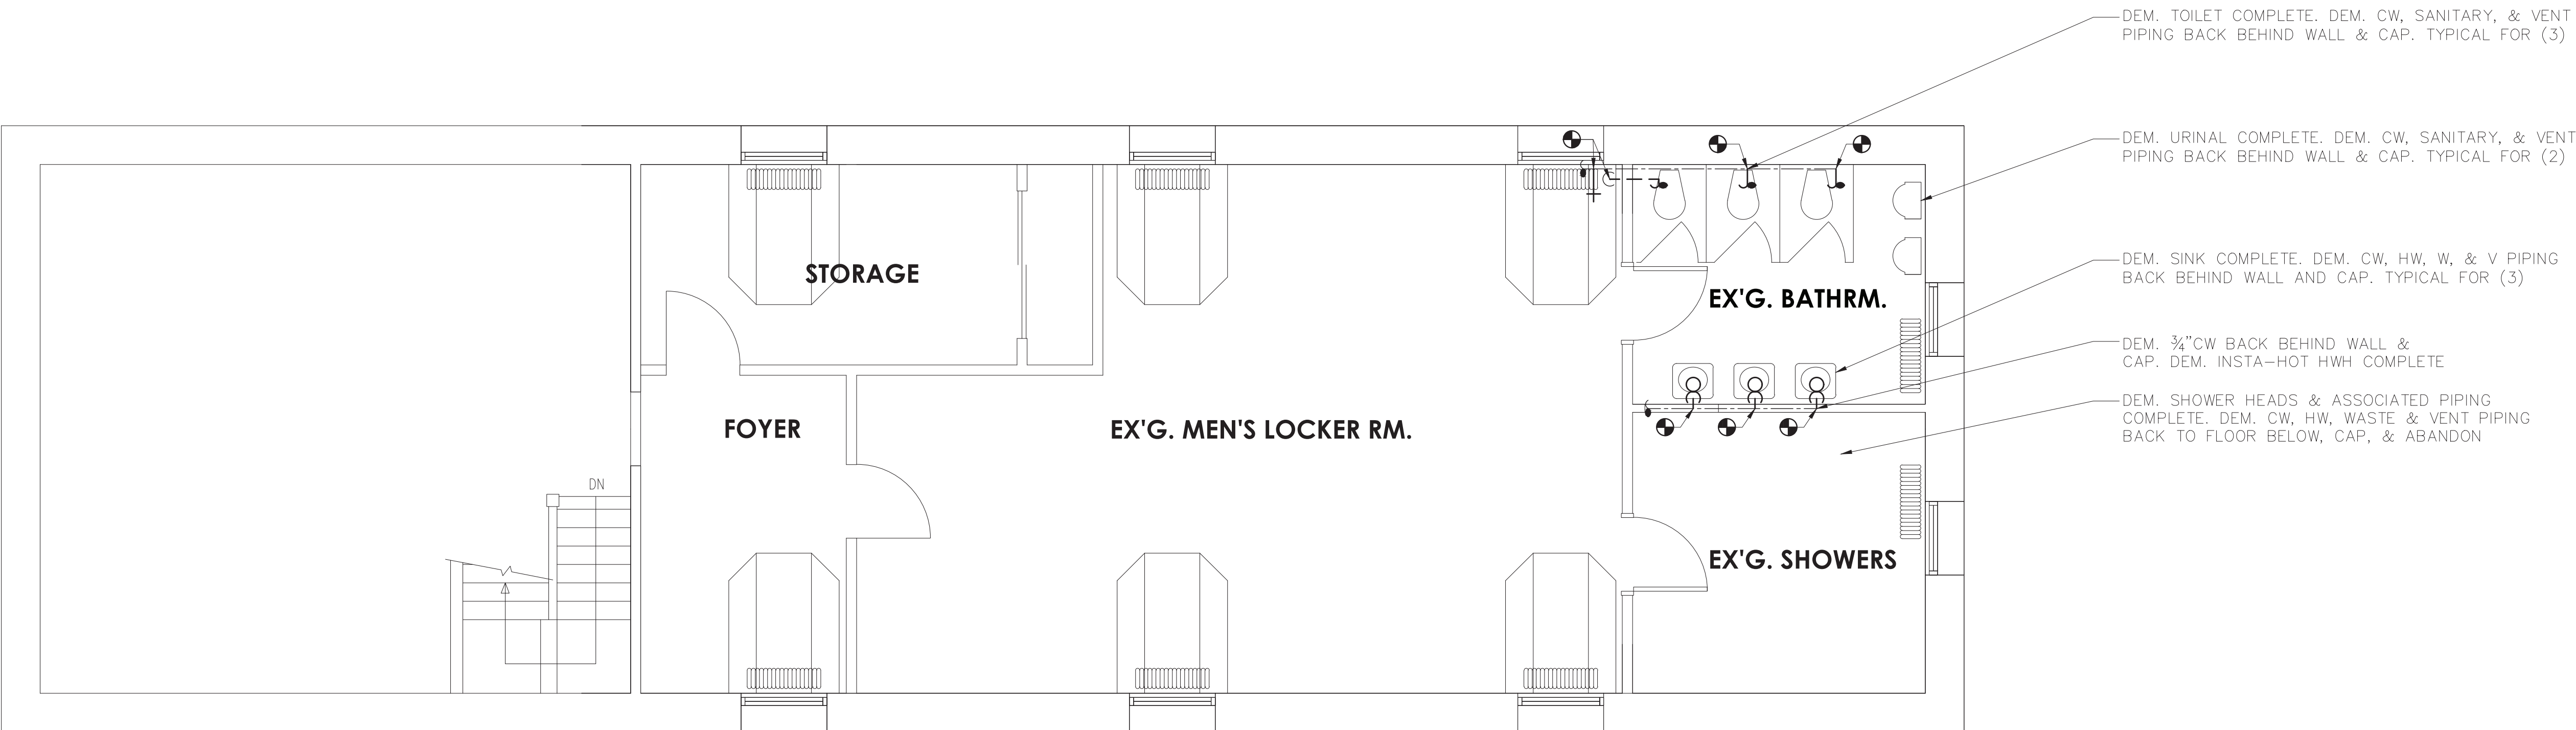
NOTES:  
1. COORDINATE CUTTING & PATCHING OF FIRST FLOOR PRO SHOP CEILING FOR WORK ASSOCIATED WITH BATHROOM RENOVATIONS.  
2. DEM. GREASE INTERCEPTOR (G.I.) COMPLETE AT KITCHEN. PROVIDE 3" WASTE SPOOL PIECE TO CONNECT INLET & OUTLET PIPING AT REMOVED G.I. INSPECT, SCOPE, CLEAN, JET-WASH, ETC. EX. 3"W LINE FROM KITCHEN. PROVIDE RESULTS TO OWNER/ENGINEER FOR REVIEW & RECORD.

IN CHARGE OF JW  
CHECKED BY RG  
MADE BY AMB

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TITLE	DATE	TITLE	DATE
WESTCHESTER COUNTY, NEW YORK DEPARTMENT OF PUBLIC WORKS DIVISION OF ENGINEERING		CONTRACT NUMBER 17 - 539	SHEET NUMBER P-102
NEW GOLF CART STORAGE FACILITY AND CLUBHOUSE UPGRADES MOHANSIC GOLF COURSE, YORKYOWN, NEW YORK BATHROOMS & LOCKERS PLUMBING DEMOLITION PLAN		SHEET NO. 31 OF 59	SCALE: 1/4" = 1'-0" DATE: 6/4/21 DPW FILE NO. 10-02-P-64-0
		REV. NO. 0	



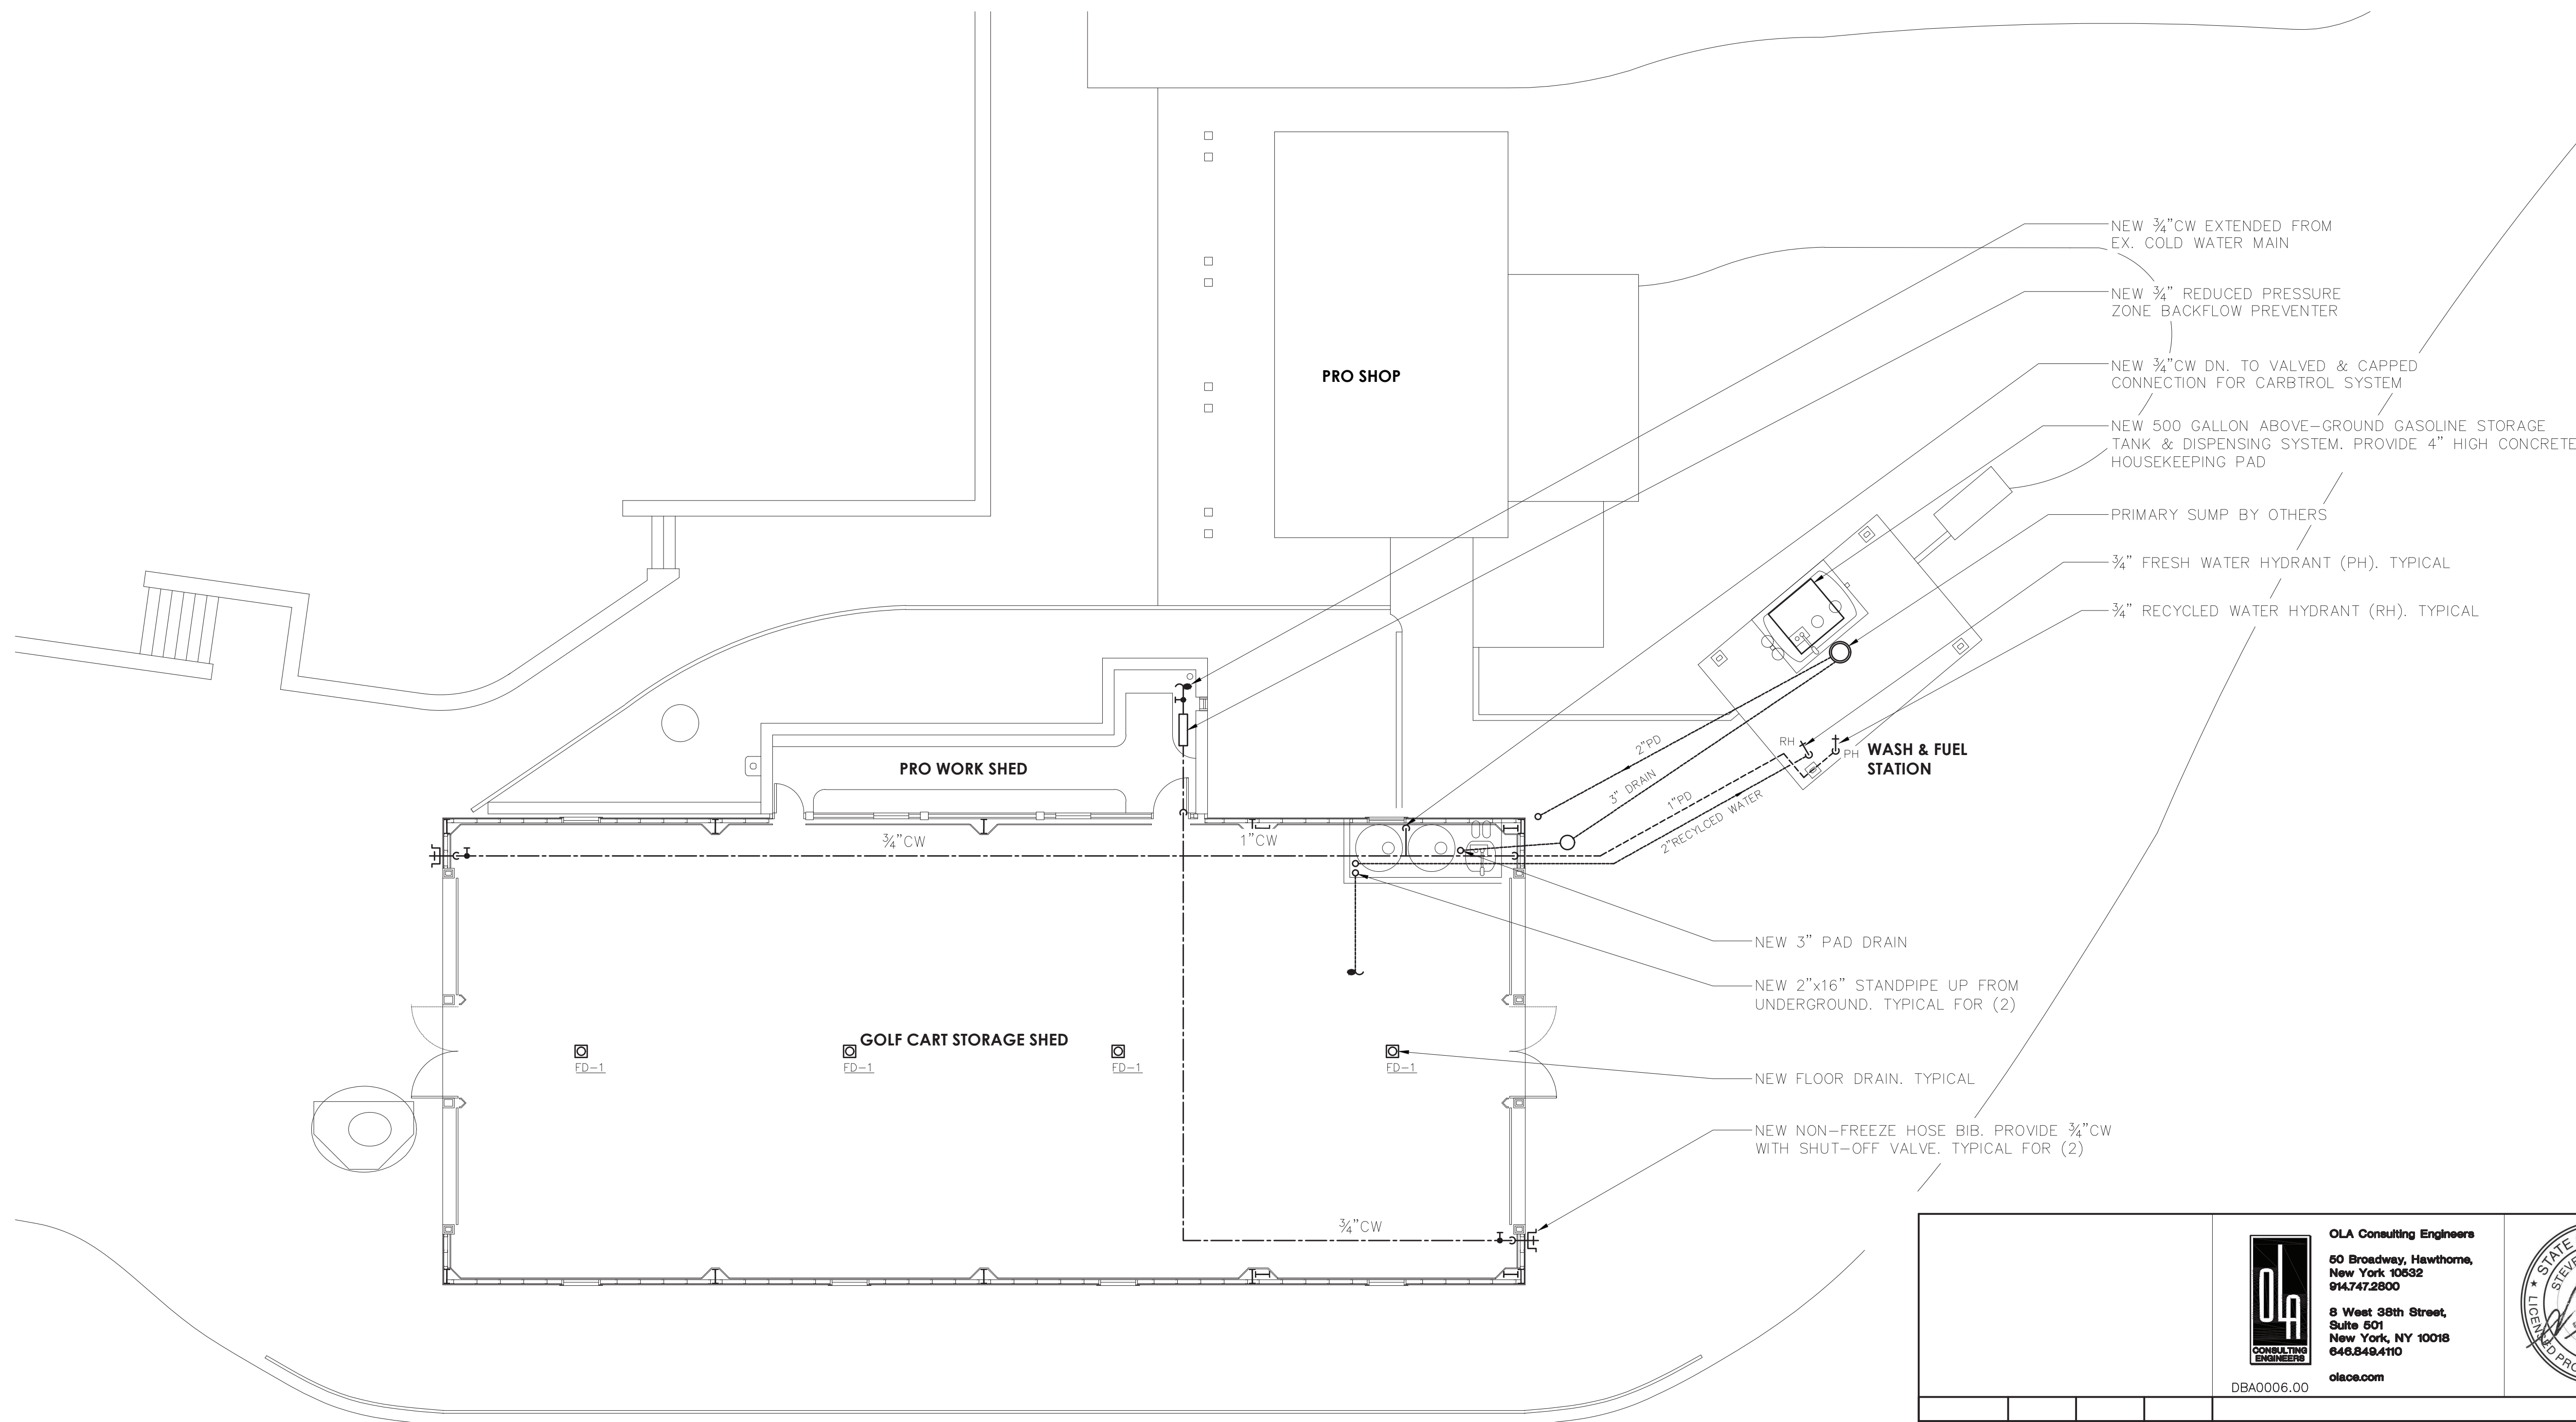

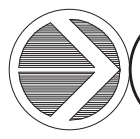 1  
CART STORAGE SHED  
PLUMBING NEW WORK PLAN  
SCALE: 1/8" = 1'-0"

NOTES:


1. ALL DOMESTIC WATER PIPING WITHIN CART STORAGE SHALL BE HEAT TRACED TO AVOID FREEZING DURING WINTER MONTHS.
2. PROVIDE VALVED & CAPPED CONNECTIONS AT LOW POINTS FOR WINTER DRAIN DOWN OF THE DOMESTIC WATER SYSTEM.
3. REFER TO CARBTROL WASH RECYCLE EQUIPMENT DRAWING EQ-101 FOR UNDERGROUND PIPING REQUIREMENTS RELATED TO WASH STATIONS. FINAL LAYOUT & POINTS OF CONNECTION, COORDINATE SIZE, LOCATION, & MATERIALS WITH CARBTROL.

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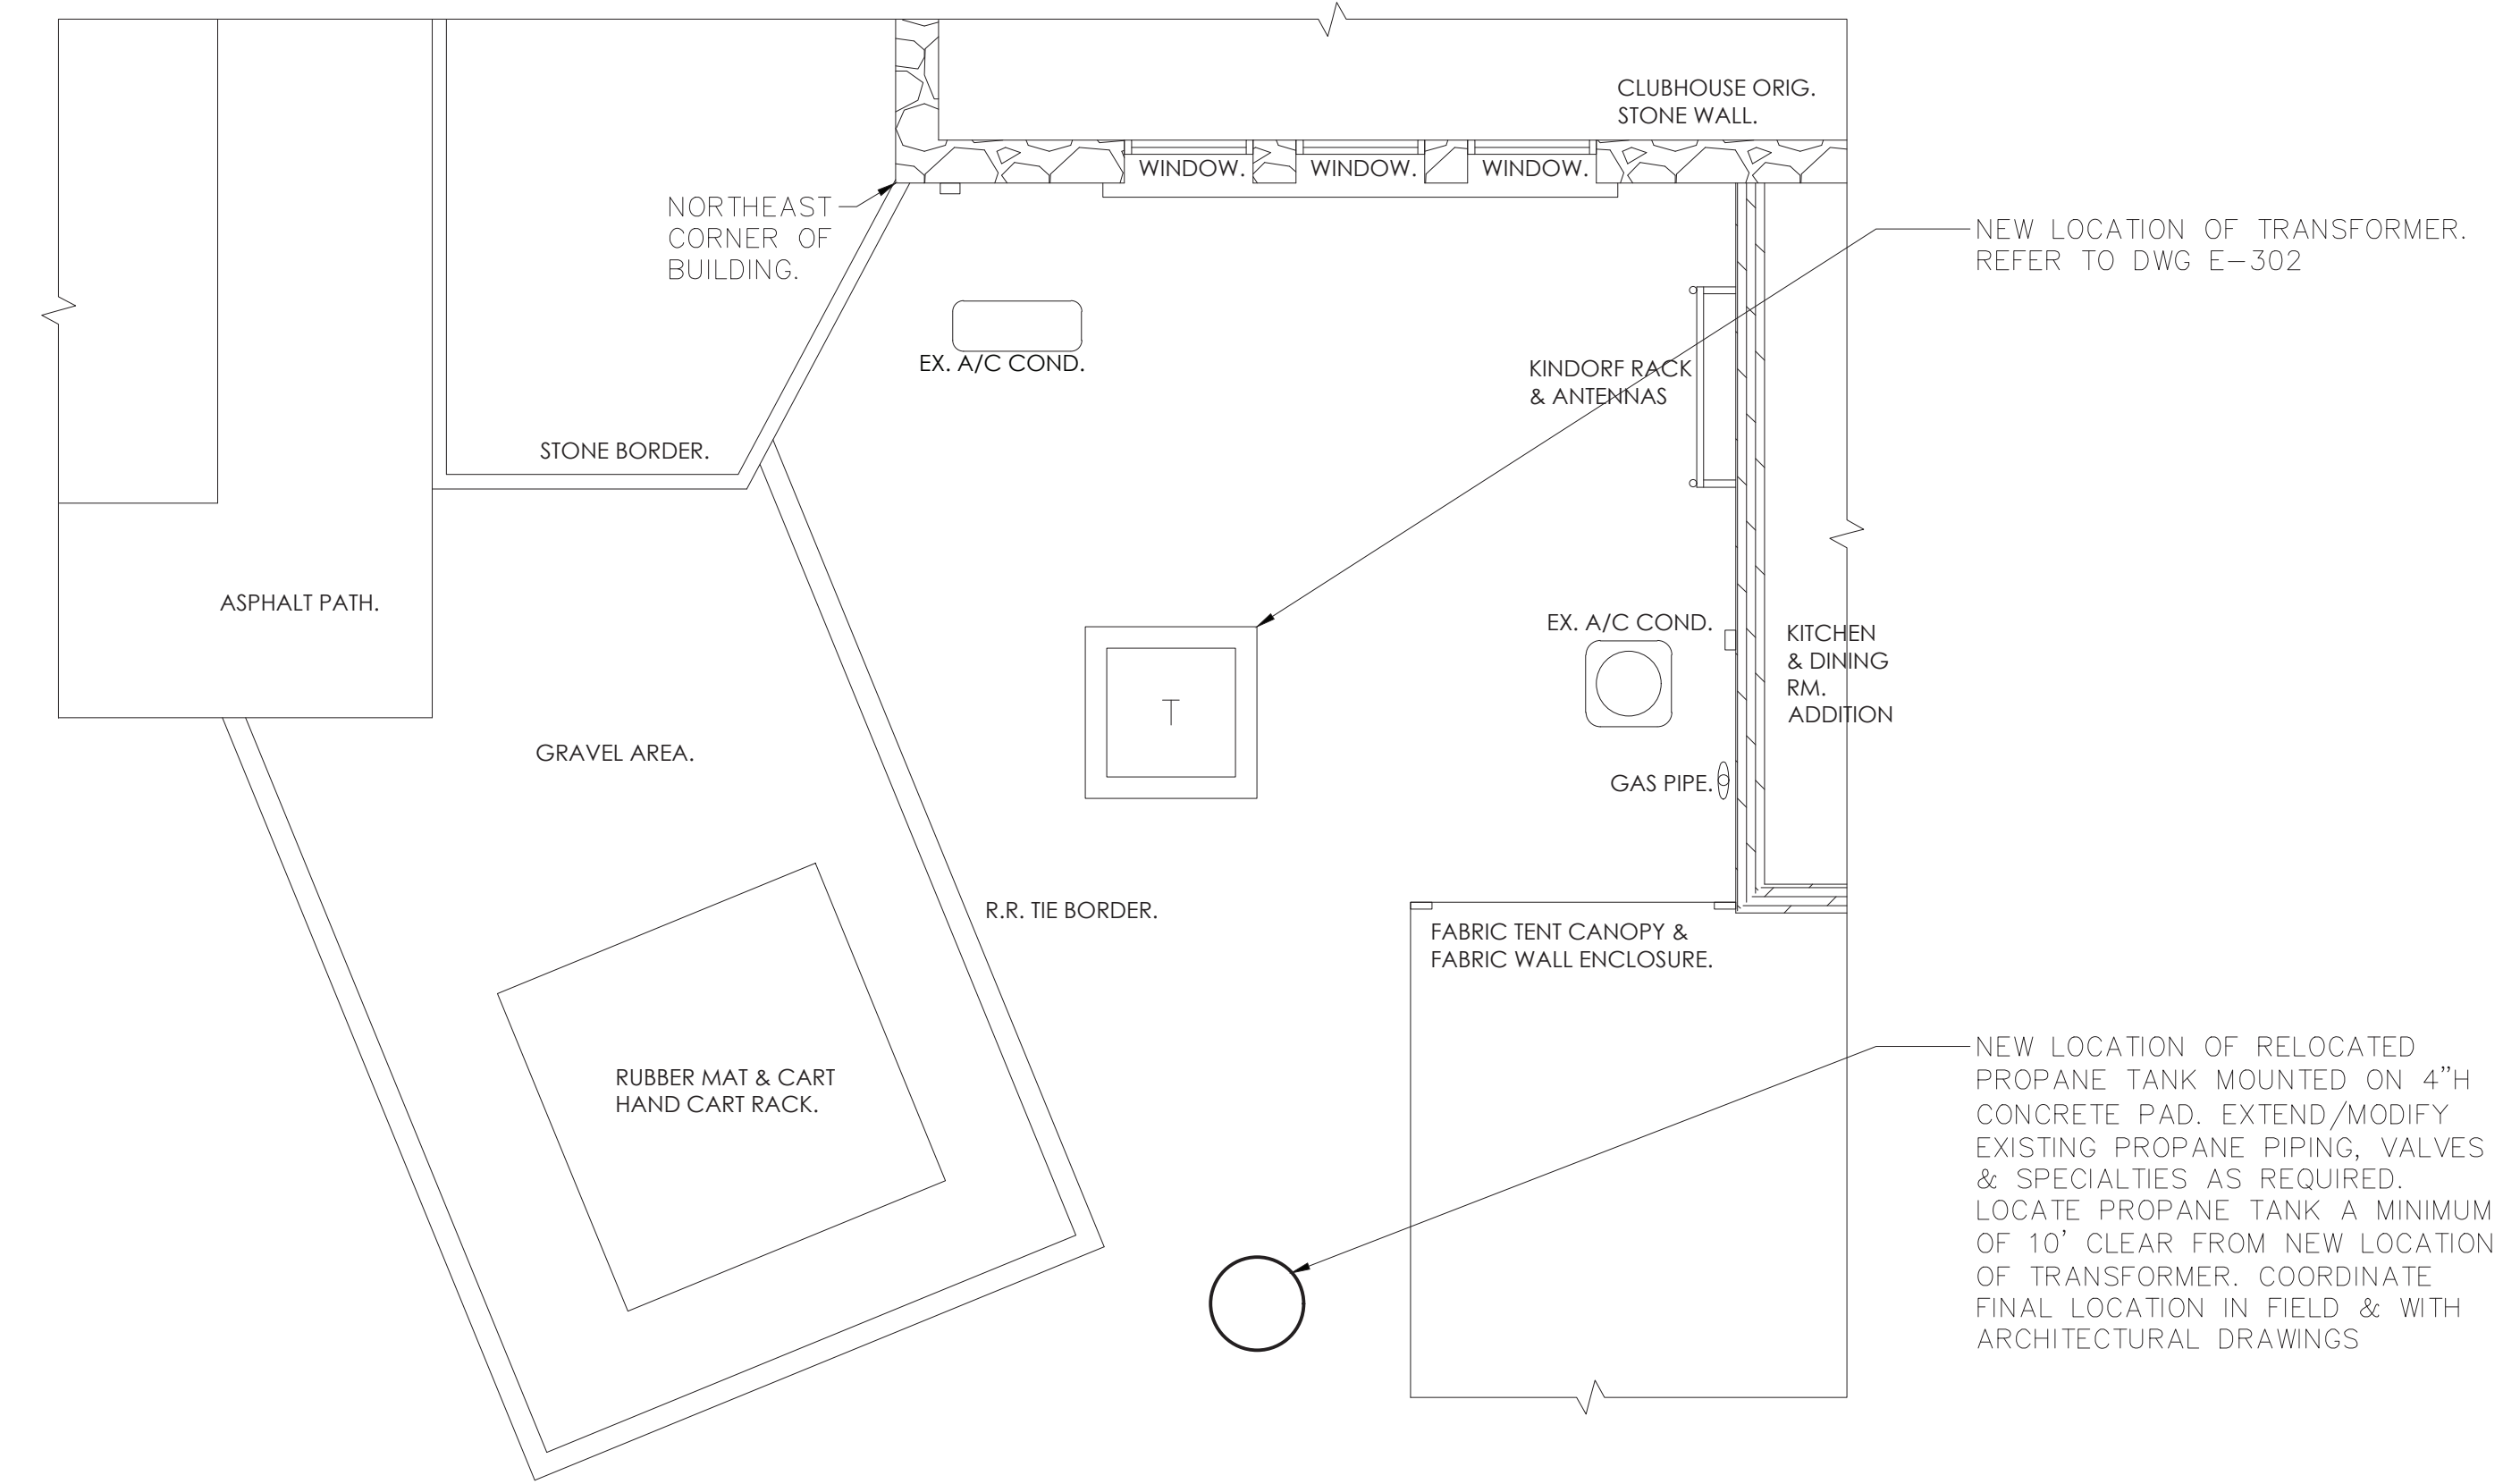
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WESTCHESTER COUNTY, NEW YORK DEPARTMENT OF PUBLIC WORKS DIVISION OF ENGINEERING		CONTRACT NUMBER 17 - 539 SHEET NUMBER P-201 SHEET NO. 32 OF 59		
NEW GOLF CART STORAGE FACILITY AND CLUBHOUSE UPGRADES MOHANSIC GOLF COURSE, YORKYOWN, NEW YORK CART STORAGE SHED PLUMBING NEW WORK PLAN		SCALE: 1/8" = 1'-0" DATE: 6/4/21 DPW FILE NO. 10-02-P-65-0 REV. NO. 0		





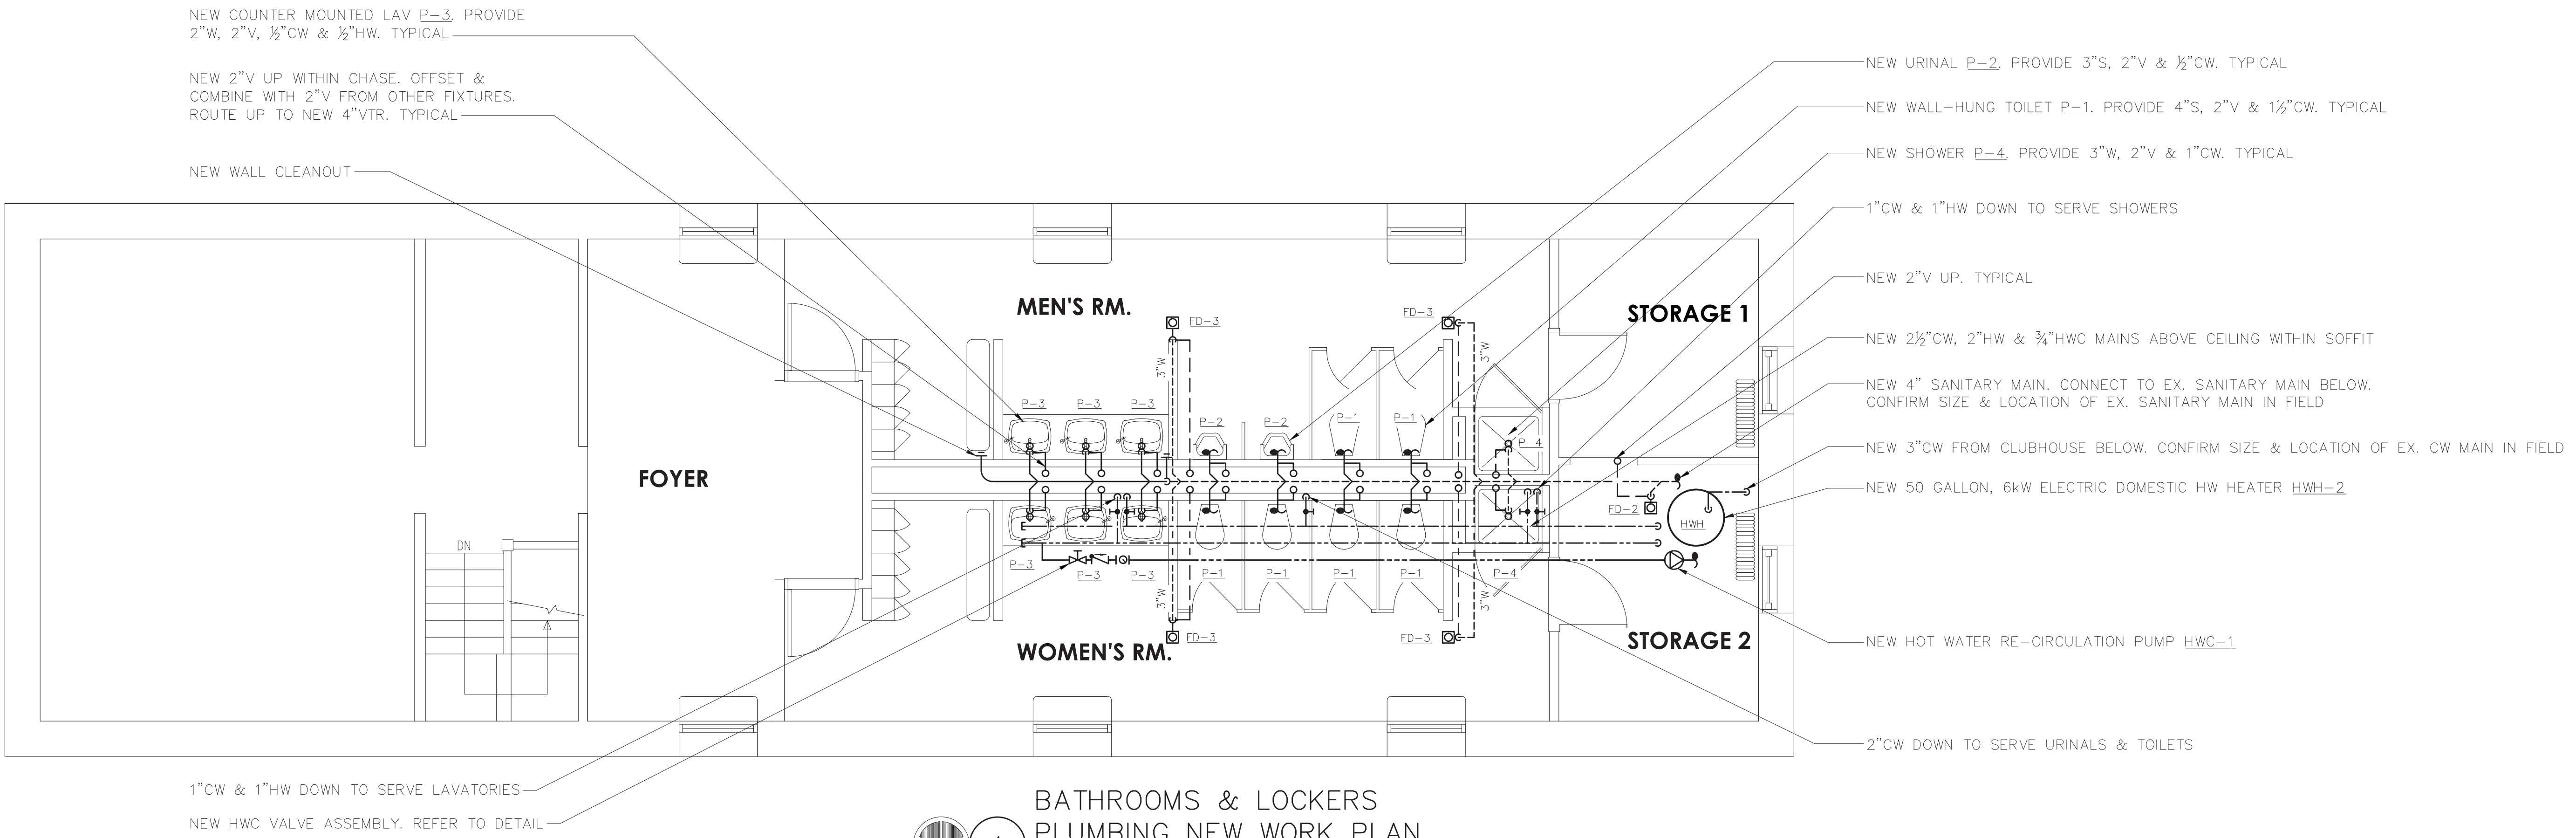

**BATHROOMS & LOCKERS**  
**PLUMBING NEW WORK PLAN**  
SCALE: 1/4" = 1'-0"  
NOTES:  
1. FLOOR DRAINS SHALL BE PROVIDED WITH A TRAP PRIMER.






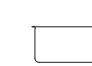
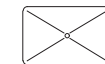











**PLUMBING SITE PROPANE TANK PART PLAN**  
SCALE: 1/4" = 1'-0"

IN CHARGE OF JW  
CHECKED BY RG  
MADE BY AMB

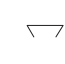

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REVISION			
RECORD DRAWING CERTIFICATION			
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CONTRACTOR		PROJECT COORDINATOR	
NAME	SIGNATURE	NAME	SIGNATURE
TITLE	DATE	TITLE	DATE
WESTCHESTER COUNTY, NEW YORK DEPARTMENT OF PUBLIC WORKS DIVISION OF ENGINEERING		CONTRACT NUMBER 17 - 539	SHEET NUMBER P-202
NEW GOLF CART STORAGE FACILITY AND CLUBHOUSE UPGRADES MOHANSIC GOLF COURSE, YORKYOWN, NEW YORK BATHROOMS & LOCKERS PLUMBING NEW WORK PLAN		SCALE: 1/4" = 1'-0" DATE: 6/4/21 DPW FILE NO. 10-02-P-66-0	REV. NO. 0


PLUMBING FIXTURE SCHEDULE								
TAG	SYMBOLS		FIXTURES	PLUMBING CONNECTIONS				DESCRIPTION
	PLAN	ELEVATION		WASTE	VENT	COLD WATER	HOT WATER	
P-1			WATER CLOSET WALL HUNG	4"	2"	1½"	–	TOILET; MAKE: AMERICAN STANDARD MODEL: 3351.101AF WALL MILLENIUM FLOWISE 1.28 GPF FLUSHOMETER TOILET SYSTEM 1.28 GPF WALL-MOUNT ELONGATED FLUSHOMETER VALVE TOILET, ADA COMPLIANT, 1½" INLET SPUD, FULLY GLAZED 2½" TRAPWAY.  AMERICAN STANDARD FLUSHOMETER SELECTRONIC FLOWISE MODEL 6065.122 1.28 GALLONS PER FLUSH, ELECTRONIC FLUSH VALVE, HARD-WIRED, FULLY MECHANICAL MANUAL OVERRIDE BUTTON, AUTOMATIC FLUSH AFTER 24 HOURS OF NON-USE, 3-SECOND FLUSH DELAY, 1" IPS SCREWDRIVER BAK-CHECK ANGLE STOP, VANDAL RESISTANT STOP CAP, ADJUSTABLE TAILPIECE, INTEGRAL VACUUM BREAKER AND 1½" SPUD COUPLING  PROVIDE WALL CARRIER SIMILAR TO WATTS ISCA-101-R & ISCA-131 FOR BACK TO BACK INSTALLATION & ROUTING OF WASTE HORIZONTAL WITHIN CHASE.
P-2			URINAL	2"	2"	1"	–	URINAL; MAKE: AMERICAN STANDARD MODEL: DECORUM FLOWISE 0.5 GPF HIGH EFFICIENCY URINAL 0.5 GPF VITREOUS CHINA URINAL, ADA COMPLIANT, ¾" INLET SPUD, OUTLET CONNECTION THREADED 2" INSIDE, PROVIDE WALL CARRIER.  AMERICAN STANDARD FLUSHOMETER SELECTRONIC FLOWISE MODEL 6062.002 0.125 GALLONS PER FLUSH, ELECTRONIC FLUSH VALVE, HARD-WIRED, FULLY MECHANICAL MANUAL OVERRIDE BUTTON, AUTOMATIC FLUSH AFTER 24 HOURS OF NON-USE, 3-SECOND FLUSH DELAY, 1" IPS SCREWDRIVER BAK-CHECK ANGLE STOP, VANDAL RESISTANT STOP CAP, ADJUSTABLE TAILPIECE, INTEGRAL VACUUM BREAKER AND 1½" SPUD COUPLING. SEE ARCHITECTS DRAWINGS FOR MOUNTING HEIGHTS.
P-3			COUNTERTOP LAVATORY	2"	2"	½"	½"	LAVATORY; MAKE: KOHLER MODEL: K-2189-1 LADENA 20⅞"x14⅞"x8⅞" DROP-IN MOUNT BATHROOM SINK, RECTANGULAR BASIN WITH CURVED BOTTOM, NO FAUCET HOLES; REQUIRES WALL OR COUNTER MOUNT FAUCET.  FAUCET; MAKE: AMERICAN STANDARD MODEL: 2064.195 SENSOR OPERATED PROXIMITY LAVATORY FAUCET, HARD-WIRED AC, 0.5 GPM PCA, VR MULTI-LAMINAR SPRAY. PROVIDE THERMOSTATIC MIXING VALVE 605XTMV10701.
P-4			SHOWER	2"	1-1/2"	1/2"	1/2"	SHOWER; MAKE: AMERICAN STANDARD MODEL: T675.507.002 COLONY SOFT COLLECTION COLONY SOFT FLOWISE SHOWER TRIM KIT. POLISHED CHROME FINISH, METAL LEVER HANDLES, 1.5 GPM MAX FLOW. SHOWER PAN; MAKE: ZORO MODEL: G 2245680, 36"x36" TERRAZZO SHOWER PAN FOR TILED WALL APPLICATION.
NFHB			HOSE BIB	–	–	–	–	IN UNFINISHED SPACES, WASHDOWN FAUCET SHALL BE POLISHED CHROME-PLATED WALL FAUCET WITH ½" MALE INLET AND ¾" HOSE THREAD OUTLET: CHICAGO #5 WITH #E27 VACUUM BREAKER OR ACCEPTABLE EQUIVALENT.
FD-1			FLOOR DRAIN	3"	2"	–	–	FOR TRAFFIC AREA OF GOLF CART STORAGE & MAINT. GARAGE: WADE #W-1210-27 WITH CAST IRON BODY, CAST IRON DRAINAGE FLANGE, SEDIMENT BUCKET, FLASHING COLLAR, 12" ROUND HEAVY DUTY CAST IRON GRATE. PROVIDE PROSET TRAP GUARD.
FD-2			FLOOR DRAIN	3"	2"	–	–	FOR MECHANICAL AREA: WADE #W-1100-STD5-1-27 WITH 5" ROUND ADJUSTABLE NICKEL-BRASS STRAINER, CAST IRON BODY, CAST IRON DRAINAGE FLANGE, FLASHING CLAMP, AND SEDIMENT BUCKET. PROVIDE PROSET TRAP GUARD.
FD-3			FLOOR DRAIN	3"	2"	–	–	FOR BATHROOMS: WADE #W-1100-STD5-1-27 WITH 5" ROUND ADJUSTABLE NICKEL-BRASS STAINER, CAST IRON BODY, CAST IRON DRAINAGE FLANGE, FLASHING CLAMP, AND SEDIMENT BUCKET.
NOTES: 1.) REFER TO ARCHITECTURAL DRAWINGS FOR FIXTURE, QUANTITY, LOCATIONS, & MOUNTING HEIGHTS.								

IN CHARGE OF JW  
CHECKED BY RG  
MADE BY AMB


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SIGNATURE		SIGNATURE		
TITLE	DATE	TITLE	DATE	
WESTCHESTER COUNTY, NEW YORK		CONTRACT NUMBER	17 - 539	SHEET NUMBER
DEPARTMENT OF PUBLIC WORKS		P-601		
DIVISION OF ENGINEERING		SHEET NO. 34 OF 59		
NEW GOLF CART STORAGE FACILITY AND CLUBHOUSE UPGRADES		SCALE: NONE		
MOHANSIC GOLF COURSE, YORKYOWN, NEW YORK		DATE: 6/4/21		
PLUMBING SCHEDULES		DPW FILE NO.	10-02-P-67-0	REV. NO. 0




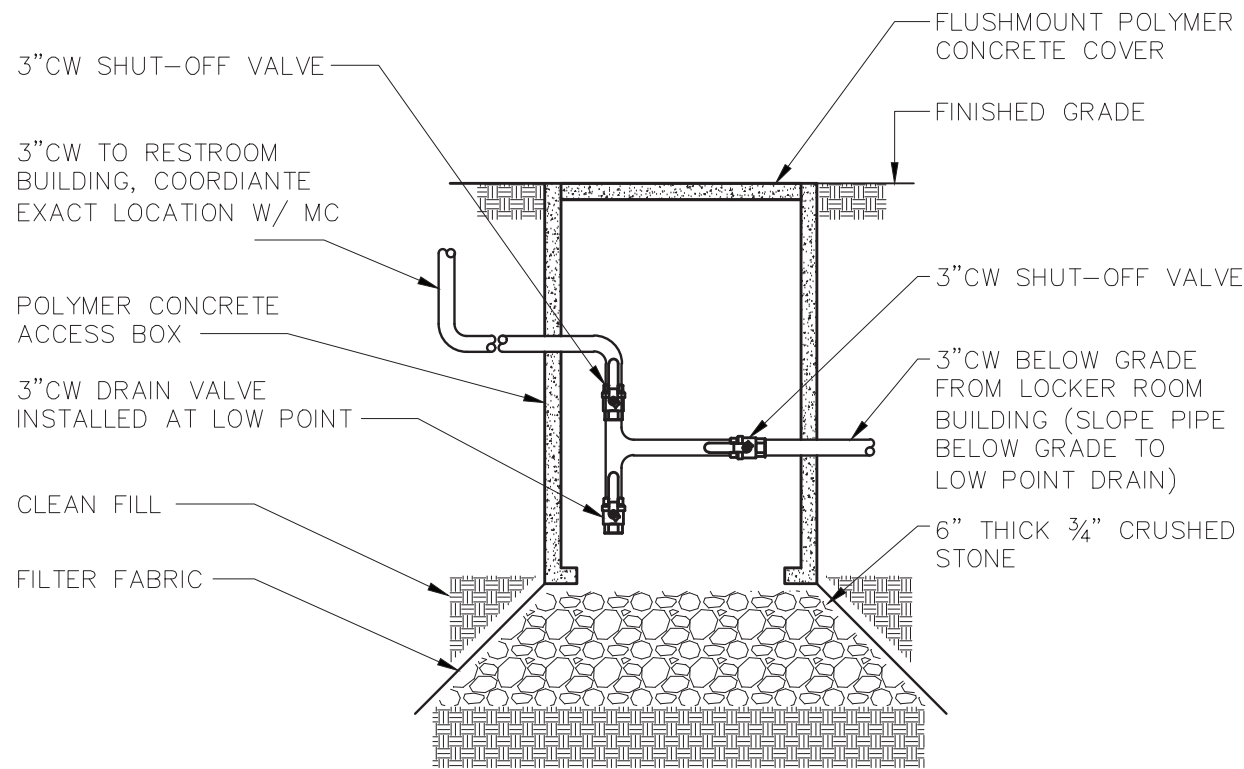


8 DOMESTIC WATER SYSTEM DRAIN PIT DETAIL  
SCALE: NONE

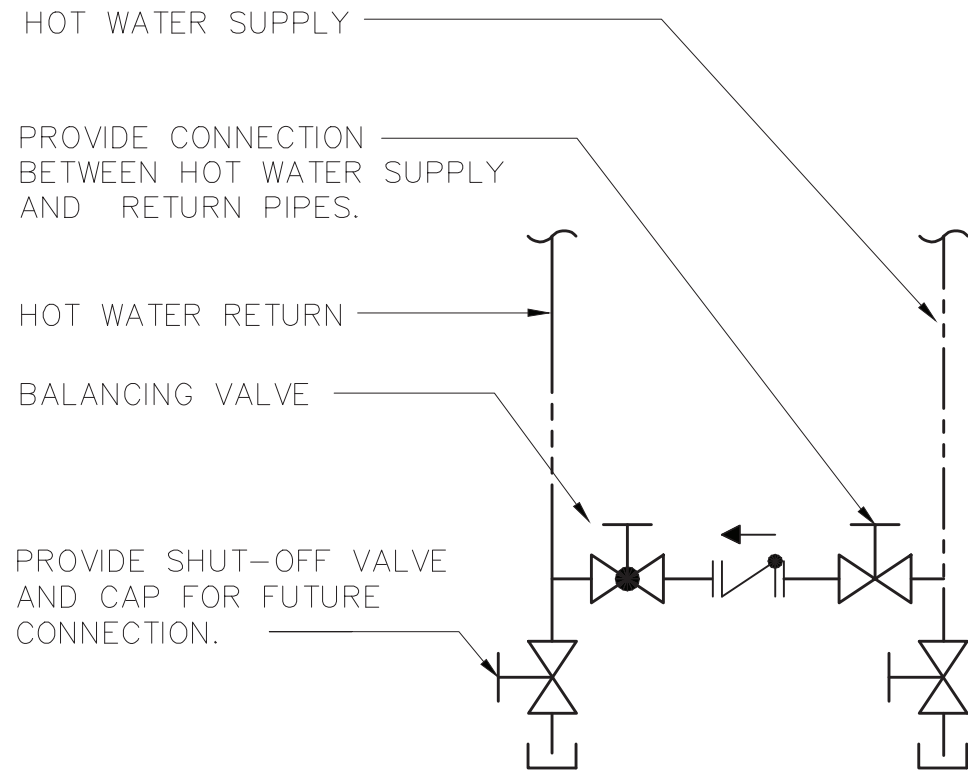

6 HOT WATER CONNECTION DETAIL  
SCALE: NONE

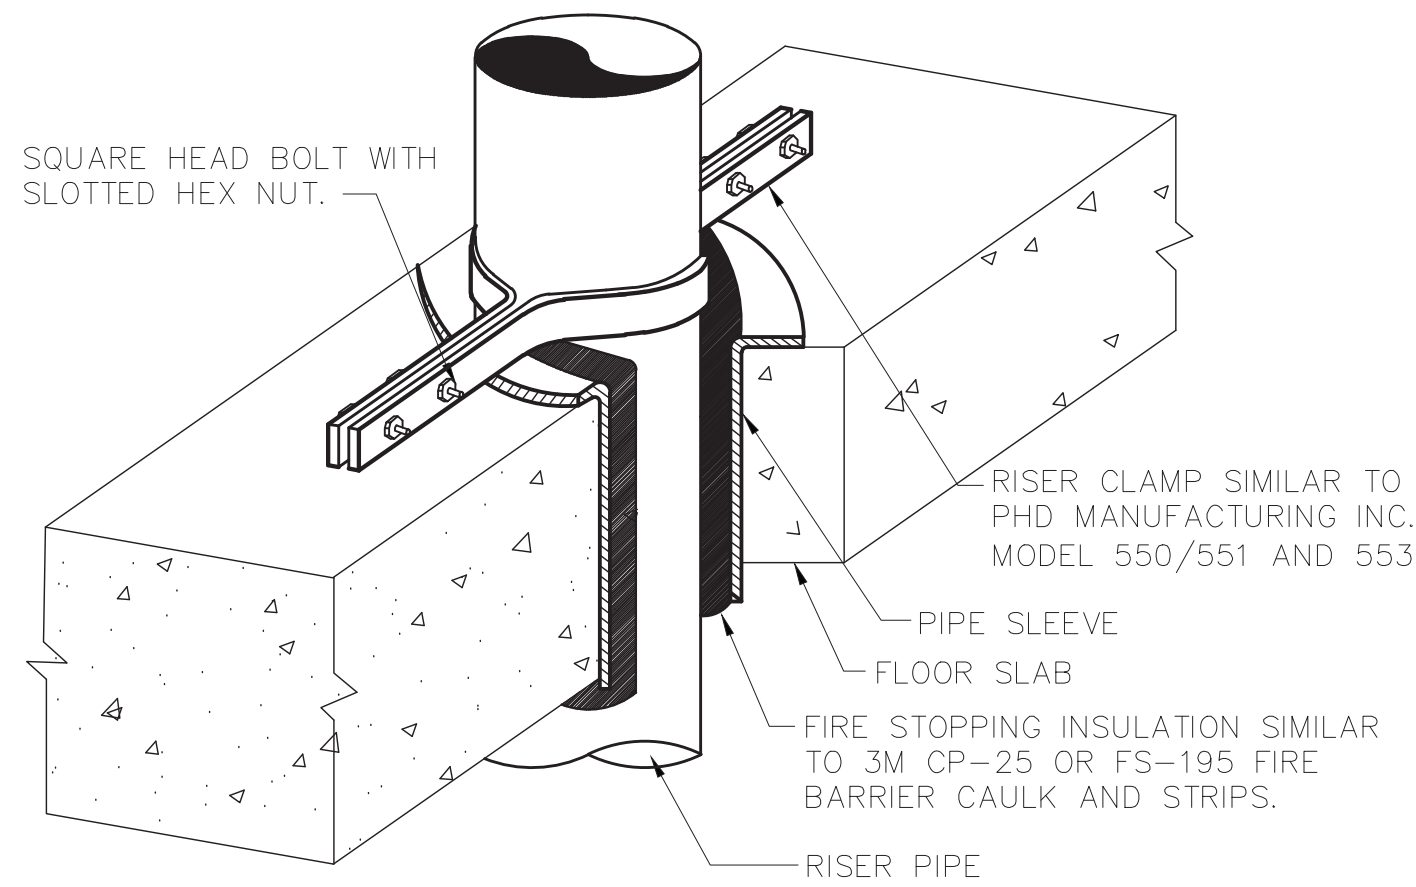


4 VERTICAL PIPE SUPPORT DETAIL  
SCALE: NONE

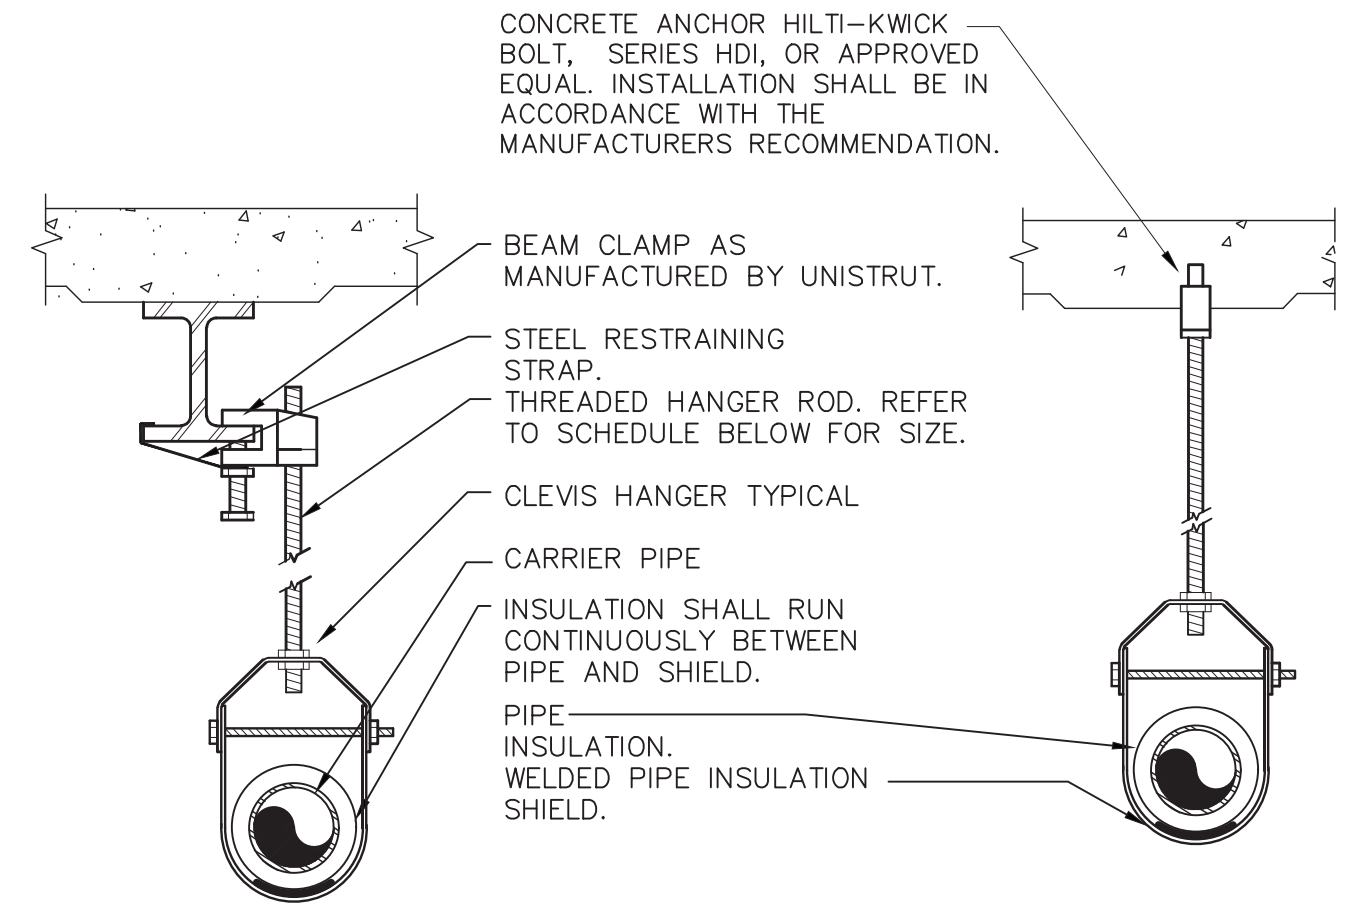


PIPE HANGER SCHEDULE					
PIPE DIA.	3/4"-2"	2 1/2"-3"	4"-5"	6"	8"-12"
HANGER DIA.	3/8"	1/2"	5/8"	3/4"	7/8"

- NOTES:
- CLEVIS HANGERS WITH WELDED INSULATION SHIELDS SIMILAR TO RAUCH FIG. 100SH ON ALL PIPES LARGER THAN 1".
  - FOR PIPES 1" OR SMALLER, A BAND HANGER WITH INSULATION SHIELD MAY BE USED SIMILAR TO RAUCH FIG. NO. 1ASH.
  - FOR NONINSULATED PIPE, INSULATION SHIELDS MAY BE OMITTED.
  - ALL PIPE HANGERS SHALL BE GALVANIZED STEEL OR FACTORY PAINTED BLACK WITH ENAMEL.
  - FOR NON FERROUS PIPING WITHOUT INSULATION, ALL HANGERS SHALL COPPER PLATED OR FURNISHED WITH A DI-ELECTRIC BETWEEN PIPE AND HANGERS.


2 ABOVEGROUND PIPE HANGER DETAIL  
SCALE: NONE

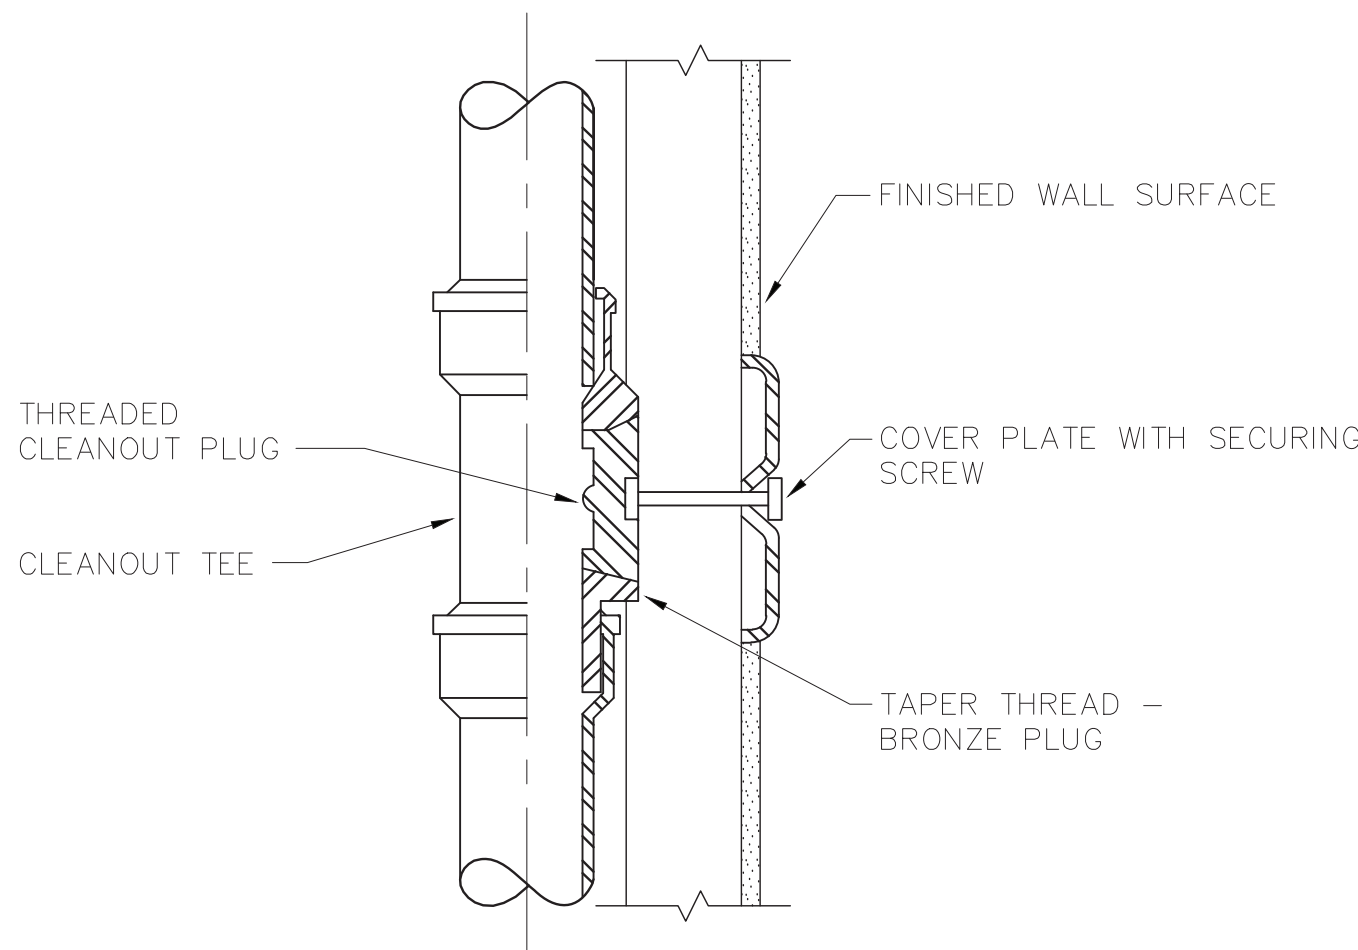

7 CLEANOUT FOR DRAINAGE PIPING  
CONCEALED BEHIND WALLS  
SCALE: NONE

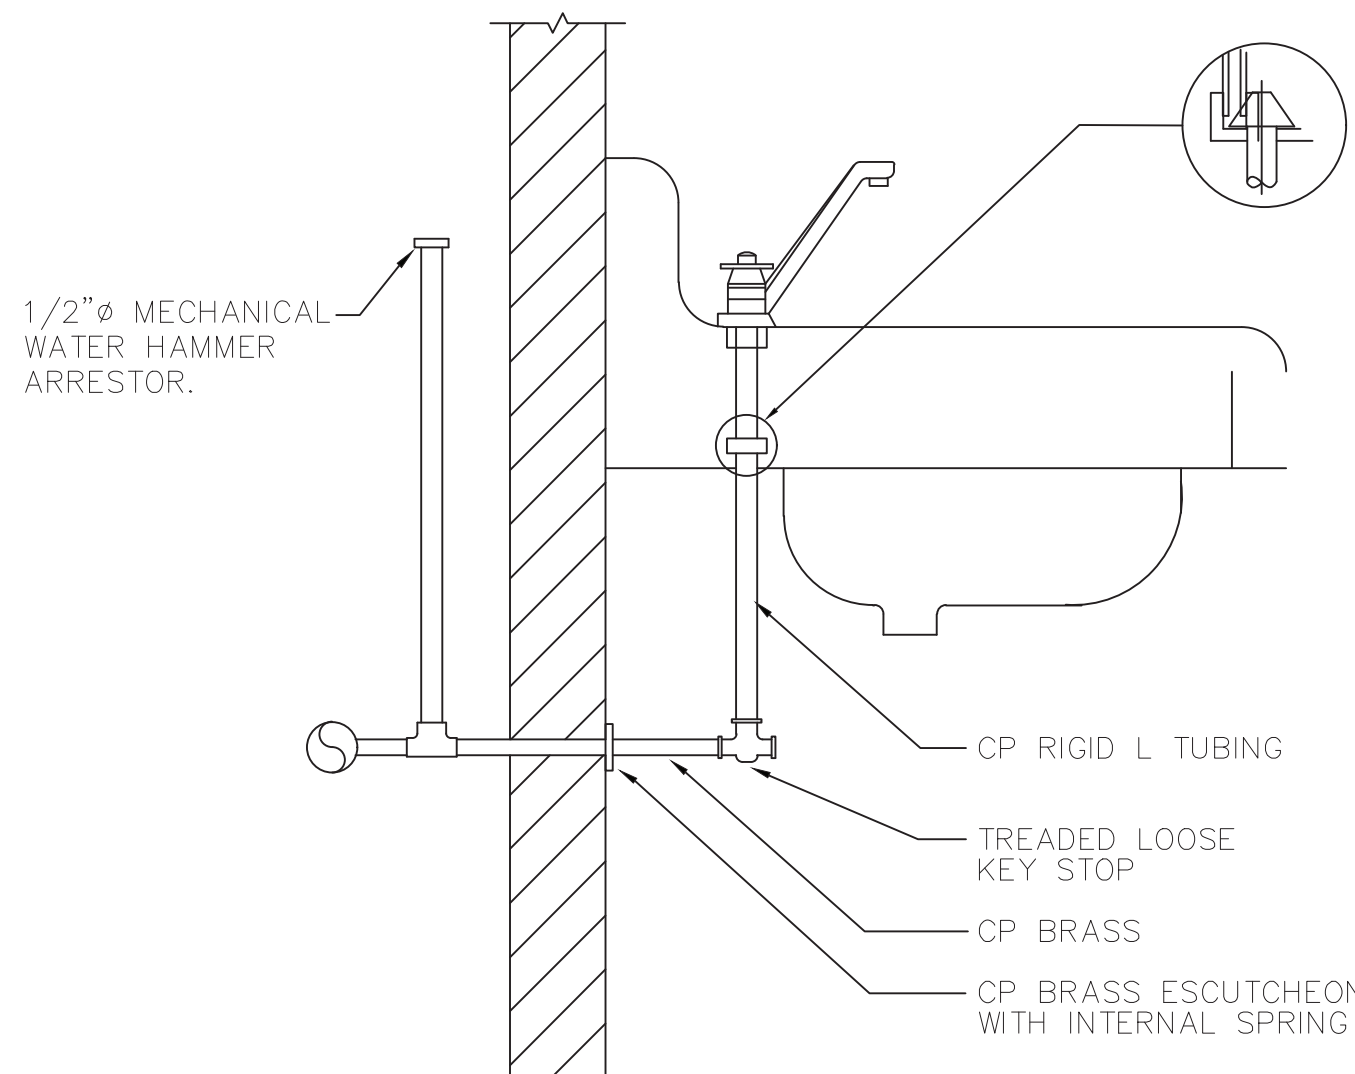

3 TYPICAL LAVATORY SUPPLY CONNECTION  
SCALE: NONE

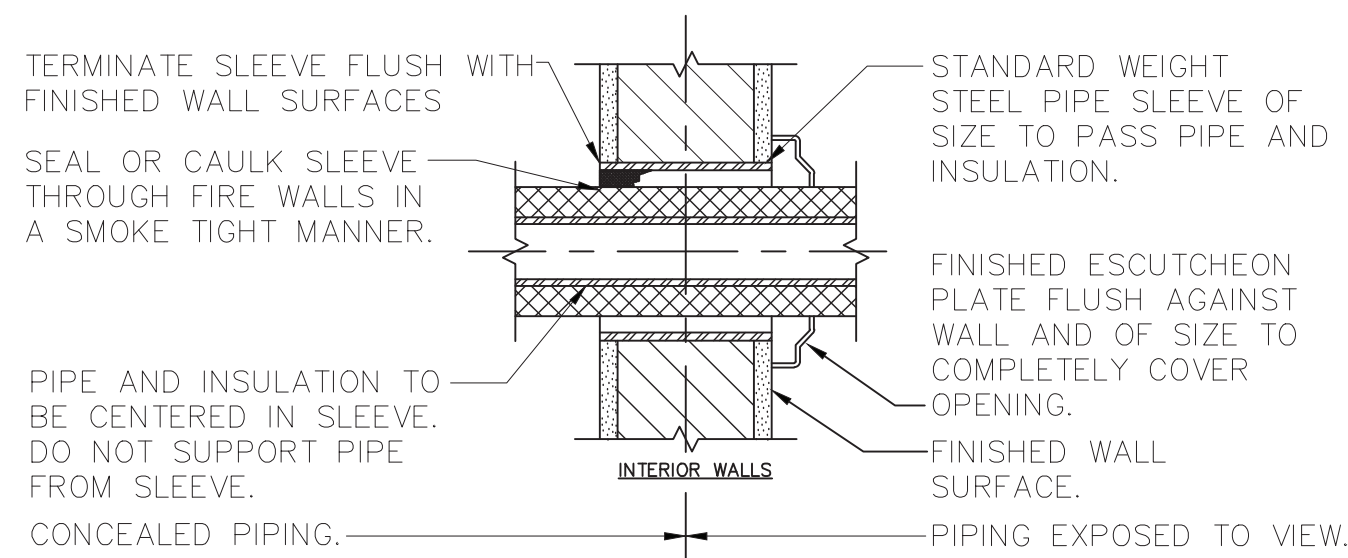


1 PIPE WALL SLEEVE DETAIL  
SCALE: NONE

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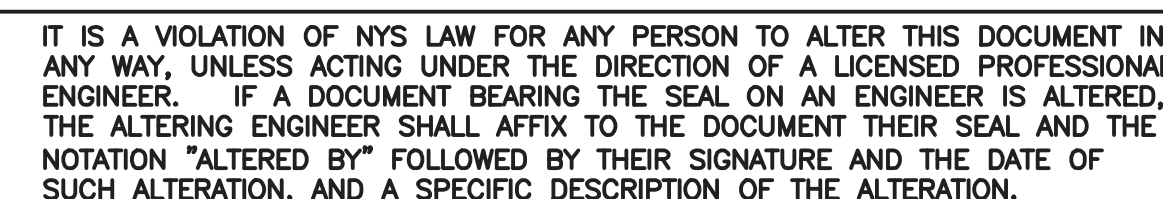
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
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TITLE	DATE	TITLE	DATE	DATE
WESTCHESTER COUNTY, NEW YORK DEPARTMENT OF PUBLIC WORKS DIVISION OF ENGINEERING				CONTRACT NUMBER 17-539 SHEET NUMBER P-701 SHEET NO. 35 OF 59
NEW GOLF CART STORAGE FACILITY AND CLUBHOUSE UPGRADES MOHANSIC GOLF COURSE, YORKTOWN, NEW YORK PLUMBING DETAILS 1 OF 2				SCALE: NONE DATE: 6/4/21 DPW FILE NO. 10-02-P-68-0 REV. NO. 0



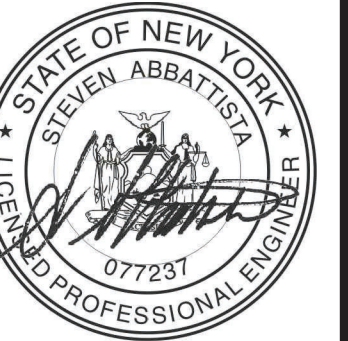

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WESTCHESTER COUNTY, NEW YORK DEPARTMENT OF PUBLIC WORKS DIVISION OF ENGINEERING		
CONTRACT NUMBER 17 - 539		SHEET NUMBER P-702
SHEET NO. 36 OF 59		SCALE: NONE DATE: 6/4/21
DPW FILE NO.		REV. NO.: 0
NEW GOLF CART STORAGE FACILITY AND CLUBHOUSE UPGRADES MOHANSIC GOLF COURSE, YORKYOWN, NEW YORK PLUMBING DETAILS 2 OF 2		
10-02-P-69-0		