Project:

CITY OF YONKERS POLICE 3RD PRECINCT LOBBY RENOVATION 435 RIVERDALE AVENUE YONKERS, NEW YORK 10705

OWNER:

CITY OF YONKERS POLICE DEPARTMENT 104 SOUTH BROADWAY YONKERS, NEW YORK 10701

Site Address 435 RIVERDALE AVENUE YONKERS, NEW YORK 10705

MAYOR: HONORABLE MIKE SPANO POLICE COMMISSIONER: JOHN MUELLER

SOME SYMBOLS SHOWN IN LEGEND MAY NOT BE

DETAIL MARKER

INTERIOR ELEVATION

CONCRETE

BLOCK - PLAN

BLOCK - SECTION

BATT INSULATION

RIGID INSULATION

METAL

EARTH

ROUGH WOOD

POROUS FILL

NEW CONSTRUCTION:

NEW CONSTRUCTION: REFER TO WALL TYPES

EXISTING TO REMAIN

ELEVATION MARKER

EXISTING TO BE DEMOLISHED

REFER TO WALL TYPES

BRICK PLAN / SECTION

- SECTION OR DETAIL NUMBER _

EXTERIOR ELEVATION MARKER

- DRAWING SHEET NUMBER

REPRESENTED ON PLANS



845.368.4050

GPINET.COM

Greenman-Pedersen, Inc. 400 Rella Boulevard, Suite 207 Montebello, NY 10901

GENERAL NOTES

1. THESE DRAWINGS ARE INTENDED TO BE USED ONLY BY A COMPETENT, EXPERIENCED CONTRACTOR WHO HAS THOROUGHLY REVIEWED THE CONTRACT AVAILABLE TO ANSWER QUESTIONS AND TO ASSIST THE CONTRACTOR BY EXPLAINING THE DESIGN INTENT. FAILURE BY THE CONTRACTOR WITHOUT A COMPLETE SET OF DESIGN DOCUMENTS WILL PUT BOTH THE PROJECT AND INDIVIDUALS AT RISK. THE CONTRACTOR ASSUMES TOTAL RESPONSIBILITY FOR ANY CONSEQUENCES OF THAT ACTION.

2. ALL CONTRACTORS AND SUBCONTRACTORS ARE RESPONSIBLE FOR ADHERING TO THE PROJECT REQUIREMENTS FOUND ON THE DRAWINGS, IN THE SPECIFICATIONS AND OTHER DOCUMENTS WHICH ARE PART OF THE CONTRACT. ALL PARTIES MUST CAREFULLY STUDY ALL NOTES FOR ITEMS WHICH MAY PERTAIN TO THEIR TRADES. FAILURE TO READ THESE NOTES DOES NOT PERMIT THE CONTRACTOR TO DEVIATE FROM THEIR REQUIREMENTS.

3. ALL CONTRACTORS AND SUBCONTRACTORS ON THIS PROJECT SHALL BE RESPONSIBLE FOR THE PROPER PERFORMANCE OF THEIR WORK, COORDINATION WITH OTHER TRADES, METHODS, SAFETY AND SECURITY ON THE JOB SITE. ELEMENT ARCHITECTURAL GROUP AND ITS AGENTS AND EMPLOYEES ARE NOT RESPONSIBLE OR LIABLE FOR THE ABOVE AND SHALL BE HELD HARMLESS AND INDEMNIFIED BY ALL CONTRACTORS AND SUBCONTRACTORS FROM ANY AND ALL CLAIMS, LOSSES, SUITS AND LEGAL ACTION WHATSOEVER ARISING FROM THE PERFORMANCE OF WORK ON THIS PROJECT.

4. HAZARDOUS MATERIALS MAY EXIST AT THIS SITE. CONTRACTOR SHALL CONSULT WITH OWNER'S AUTHORIZED REPRESENTATIVES REGARDING POSSIBLE LOCATIONS OF HAZARDOUS MATERIALS. IF CONTRACTOR ENCOUNTERS HAZARDOUS MATERIALS DURING CONSTRUCTION, HE SHALL STOP WORK IMMEDIATELY AND NOTIFY THE OWNER. THE OWNER SHALL BE RESPONSIBLE FOR MAKING ALL ARRANGEMENTS FOR THE SAFE REMOVAL OF ALL HAZARDOUS MATERIALS BEFORE THE CONTRACTOR CAN RESUME WORK.

5. ACCEPTANCE OF DEVIATIONS FROM ANY OF THE REQUIREMENTS OF THESE NOTES SHALL BE AT THE SOLE DISCRETION OF THE ARCHITECT. ACCEPTANCE OF A DEVIATION FROM ANY REQUIREMENT SHALL NOT BE CONSTRUED AS PERMITTING ANY OTHER DEVIATION.

6. CONTRACTOR SHALL FIELD VERIFY ALL DIMENSIONS AND CONDITIONS ON THE JOB AND BRING TO THE ATTENTION OF THE ARCHITECT ANY DISCREPANCIES BETWEEN THE EXISTING CONDITIONS AND THE INTENDED DESIGN. DO NOT SCALE THE DRAWINGS. WRITTEN DIMENSIONS TAKE PRECEDENCE OVER SCALED DIMENSIONS.

7. CONTRACTOR SHALL BE RESPONSIBLE FOR ALL ON-SITE SAFETY AND FOR ALL PROPERTY AND PERSONAL DAMAGE OR INJURY RESULTING FROM CONSTRUCTION OPERATIONS. CONTRACTOR SHALL PROVIDE AND MAINTAIN NECESSARY PRECAUTIONS IN PROTECTING HIS MATERIALS AND WORK AREA.

8. THE SCOPE OF WORK, AS DETAILED BY THESE DOCUMENTS, REQUIRES ONE OR MORE BUILDING PERMITS FROM THE LOCAL MUNICIPALITY. THE CONTRACTOR SHALL BE RESPONSIBLE FOR APPLYING FOR, AND OBTAINING ALL BUILDING PERMITS APPLICABLE, FROM THE LOCAL MUNICIPALITY HAVING JURISDICTION OVER THE PROJECT. NO CONSTRUCTION SHALL PROCEED PRIOR TO ISSUANCE OF THE NECESSARY PERMITS.

9. DUST AND NOISE CONTROL BARRIERS SHALL BE PROVIDED THROUGHOUT THE DURATION OF CONSTRUCTION WHERE DIRECTED BY THE OWNER TO PREVENT CONTAMINATION OF OCCUPIED AREAS.

10. ALLOWANCES: INCLUDE AN ALLOWANCE OF \$20,000 FOR MISCELLANEOUS ITEMS REQUIRED DURING CONSTRUCTION.

OF DRAWINGS

FIRST FLOOR DEMOLITION PLANS AND PHASING PLAN CONSTRUCTION PLAN, FLOOR PLATFORM PLAN. FIRST FLOOR REFLECTED CEILING PLAN AND CEILING DETAILS ELEVATIONS, DETAILS, AND NOTES.

EXTERIOR ELEVATION, SECTIONS, SCHEDULES, AND NOTES GENERAL NOTES, SYMBOLS, AND ABBREVIATIONS

LOBBY LEVEL MECHANICAL PLANS M - 501MECHANICAL DETAILS. REFERENCE DRAWING LOWER LEVEL PLAN PLUMBING & HVAC

REFERENCE DRAWING UPPER LEVEL PLAN PLUMBING & HVAC GENERAL NOTES, SYMBOLS, AND ABBREVIATIONS E-001 E-101 LOBBY LEVEL ELECTRICAL DEMOLITION PLANS

E-102 LOBBY LEVEL ELECTRICAL PLANS FIRE PROTECTION PLAN, NOTES, LEGEND AND DETAILS

ASB-200 ACM LOCATION PLAN

BUILDING DEPT. NOTES

B (BUSINESS) CONSTRUCTION TYPE OF BUILDING:

CONSTRUCTION SQUARE FOOTAGE: 1,029 S.F. (FOR LOBBY AND ANCILLARY AREAS)

THE SCOPE OF WORK FOR THIS PROJECT CONSISTS OF THE RENOVATION OF THE LOBBY, FRONT DESK, ROLL CALL LOCKER ROOM AND VARIOUS OFFICES, INCLUDING MILLWORK, PARTITIONS, ELEVATED FLOOR EXTENSION, BULLET PROOF GLAZING, FINISHES, AND MECHANICAL, ELECTRICAL AND PLUMBING UPGRADES

THE WORK SHALL COMPLY WITH THE REQUIREMENTS OF THE 2020 BUILDING CODE OF NEW YORK STATE, 2020 MECHANICAL CODE OF NEW YORK STATE, 2020 PLUMBING CODE OF NEW YORK STATE, AND 2020 FIRE CODE OF NEW YORK STATE. (ADOPTED ALL ICC 2018 CODS WITH AMENDMENTS)

ALL OF THE WORK SHALL COMPLY WITH THE BARRIER FREE REQUIREMENTS, AND ALL REFERENCES TO THE ICC/ANSI A117.1-2009 AS WELL AS ALL ADA STATE AND LOCAL REGULATIONS.

THE WORK MUST COMPLY WITH ALL OSHA RULES AND REGULATIONS.

NO CHANGE TO THE EXISTING BUILDING USE, OR OCCUPANCY, IS BEING PROPOSED UNDER THIS APPLICATION. NO ADDITIONAL AREA WILL BE ADDED. OCCUPANT LOAD AND EGRESS REQUIREMENTS REMAIN THE SAME. MEANS OF EGRESS CAPACITY IS EITHER MAINTAINED OR INCREASED. ALL WOOD BASED PRODUCTS USED FOR SHEATHING, BLOCKING, AND/OR FRAMING SHALL BE FIRE-RETARDANT.

ALL DRAWINGS AND WRITTEN MATERIAL APPEARING HEREIN CONSTITUTE ORIGINAL AND UNPUBLISHED WORK OF THE ARCHITECT AND THE ENGINEER AND MAY NOT BE DUPLICATED, USED OR DISCLOSED WITHOUT WRITTEN CONSENT OF THE ARCHITECT OR ENGINEER.

WARNING:

THE ALTERATION OF THIS MATERIAL IN ANY WAY, UNLESS DONE UNDER THE DIRECTION OF A COMPARABLE PROFESSIONAL, I.E. AN ARCHITECT FOR AN ARCHITECT, A LANDSCAPE ARCHITECT FOR A LANDSCAPE ARCHITECT, OR A PROFESSIONAL ENGINEER FOR A PROFESSIONAL ENGINEER. IS A VIOLATION OF NEW YORK STATE EDUCATION LAW AND REGULATIONS AND IS A CLASS "A" MISDEMEANOR.

SYMBOLS LEGEND REGULATED MATERIALS NOTE

A. ASBESTOS: THE CONTRACTOR SHALL NOTIFY THE OWNER'S FIELD REPRESENTATIVE IF THEY SUSPECT THAT ASBESTOS

1. THE CITY OF YONKERS ASBESTOS TESTING CONSULTANT, WARREN PANZER BUILDING. A REPORT, WITH RESULTS, HAS DETERMINED THAT THE MATERIAL REFER TO DRAWING ASB-200 "ASBESTOS CONTAINING MATERIAL

"ASBESTOS REMOVAL AND DISPOSAL" FOR ADDITIONAL INFORMATION ON

B. LEAD PAINT: THE PLANNED DEMOLITION IS NOT CONSIDERED A "LEAD ABATEMENT PROJECT" BY THE STATE OF NEW YORK. THE POSSIBILITY STILL EXISTS THAT LEAD MAY BE PRESENT IN SOME OF THE EXISTING MATERIALS SCHEDULED TO BE DEMOLISHED . FOR PURPOSES OF BIDDING, THE CONTRACTOR SHALL ASSUME THAT THEY WILL ENCOUNTER LEAD AND/OR LEAD-BASED MATERIALS ON THIS PROJECT. AS SUCH, THE CONTRACTOR SHALL BE PREPARED TO CONDUCT PAINT REMOVAL IN SUCH AREAS USING "LEAD-SAFE PRACTICES" AS NEEDED AND SUCH WORK SHALL BE INCLUDED IN THEIR BASE BID. THESE PRACTICES INCLUDE THE FOLLOWING:

* INSTALLATION OF PLASTIC DUST BARRIERS AND TARP GROUND

* USE OF HEPA VACUUM ATTACHMENTS ON ALL APPLICABLE TOOLS.

* REMOVAL OF LEAD-BASED MATERIALS IN AN INTACT STATE AS MUCH AS POSSIBLE.

* DEMOLITION WITHOUT GRINDING, SAWING AND DRILLING OF MATERIALS CONTAINING LEAD.

* WETTING DOWN OF MATERIALS DURING REMOVAL PROCESS. WIPING DOWN ALL SURFACES WITH A DAMP CLOTH AFTER REMOVAL.

* CLEANING ALL GROUND SURFACES DURING CLEAN UP.

ABBREVIATIONS

GYP.

H.M.

GYPSUM


HOLLOW METAL

LAMINATE AIR CONDITIONER м.О. ACCOUSTICAL TILE MASONRY OPENING MAX. A.F.F. ABOVE FINISHED FLOOR MAXIMUM **MECH** MECHANICA ALUMINUM MINIMUM NOT IN CONTRACT ARCH. ARCHITEC1 NOT TO SCALE BD. BOARD BLK. 0.C. BLOCK ON CENTER вм. BEAM OPPOSITE C.T. **OPNG** CERAMIC TILE OPENING CLG. CEILING PRESSURE TREATED CMU CONC. MASONRY UNIT PTN **PARTITION** CONC. CONCRETE RISER ROOF DRAIN CONTINUOUS COL. REINFORCING COLUMN DIA. DIAMETER REQUIRED DN DOWN ROOF HATCH DS ROUGH OPENING DOWNSPOU' DRAWING SIMILAR STD. STANDARD EACH ELEV. **ELEVATION** STL. STEEL EQUAL STRUCT. STRUCTURAL TONGUE AND GROOVE EXIST. **EXISTING** FLOOR DRAIN T.O. TOP OF FIN. TYP. TYPICAL FINISH GA. VENT GAUGE VINYL COMPOSITION TILE GALVANIZED GYPSUM WALL BOARD VIF VERIFY IN FIELD

W/

WOOD

DESIGN PROFESSIONAL: STAMP AND SIGNATURE

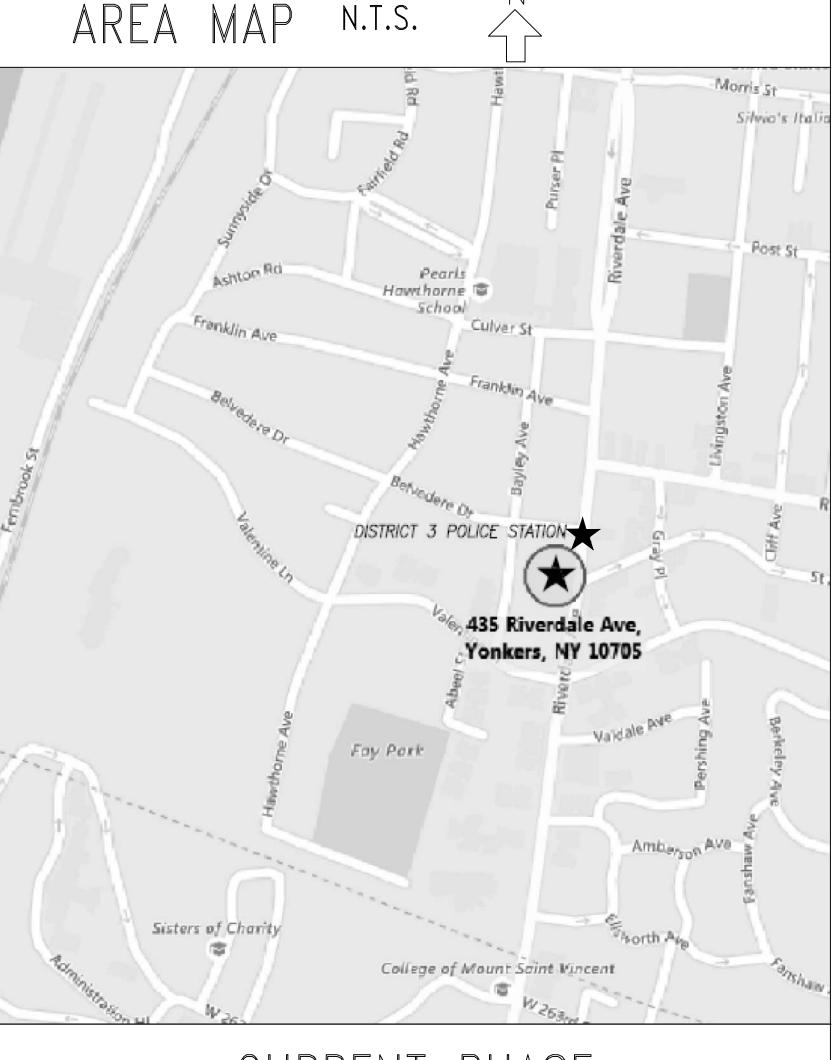


CURRENT PHASE


ISSUED FOR BID 02-11-2021


DWG. 1 OF 16


2016-34


CITY OF YONKERS POLICE 3RD PRECINCT LOBBY RENOVATION

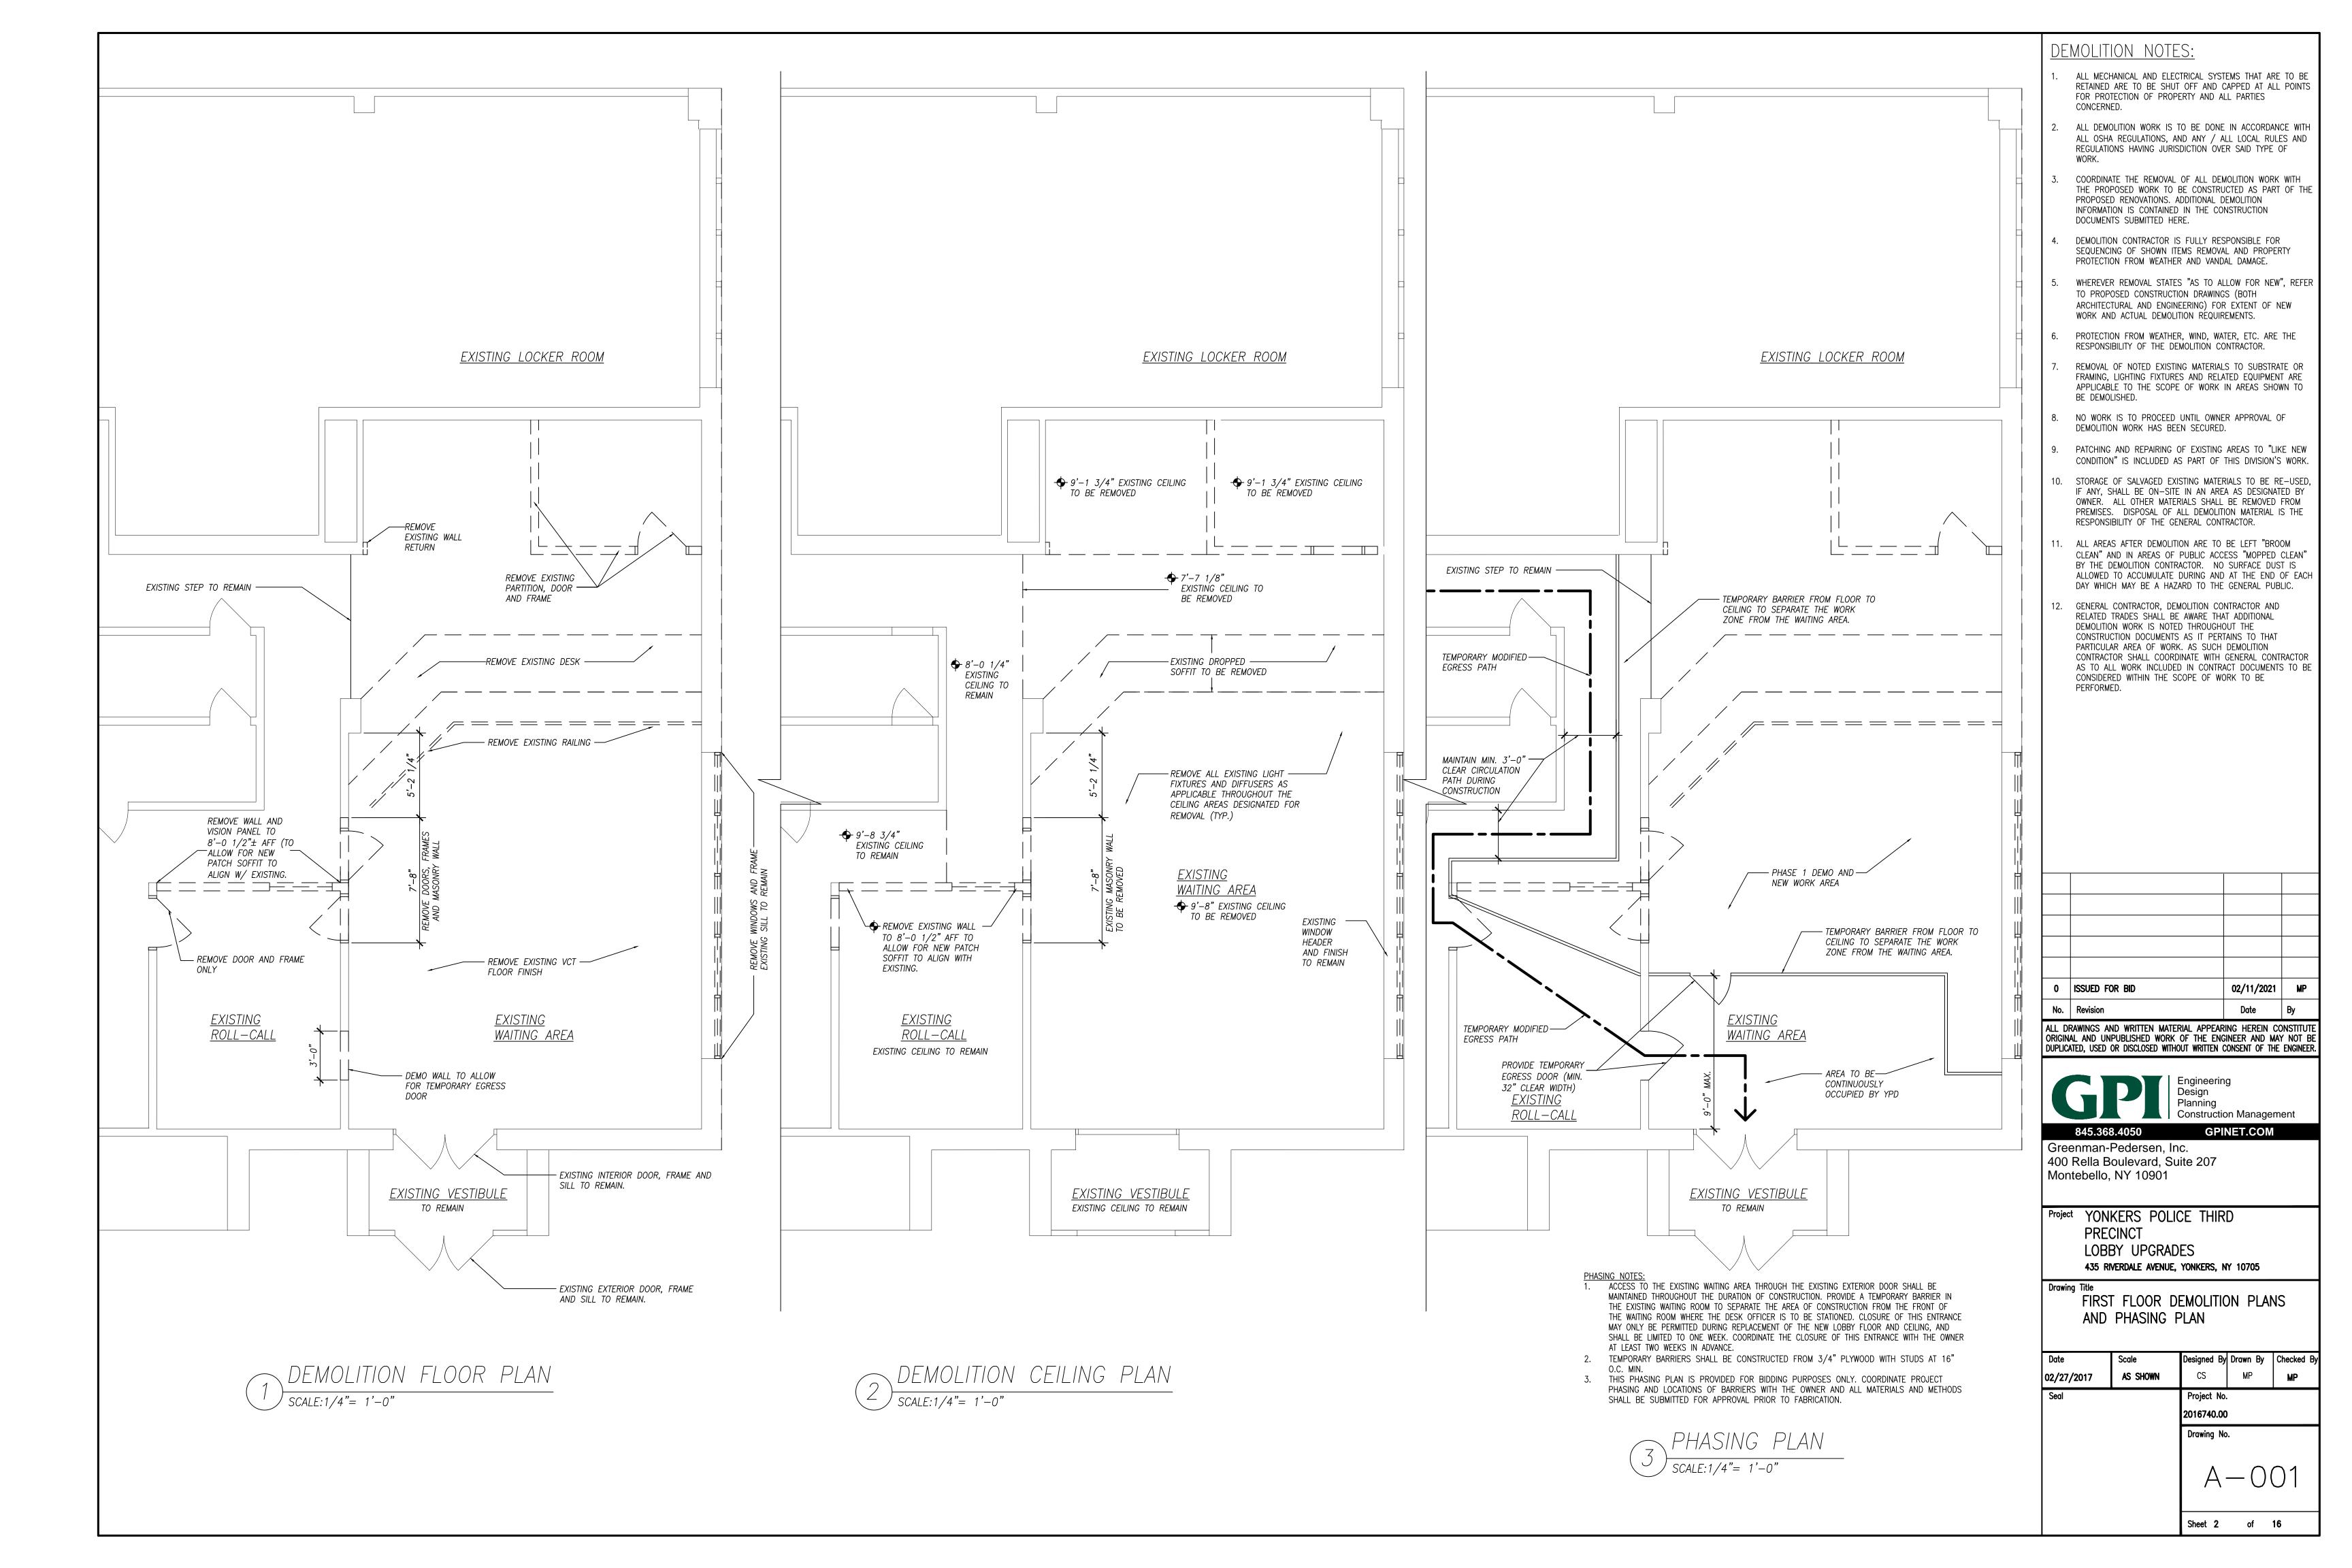


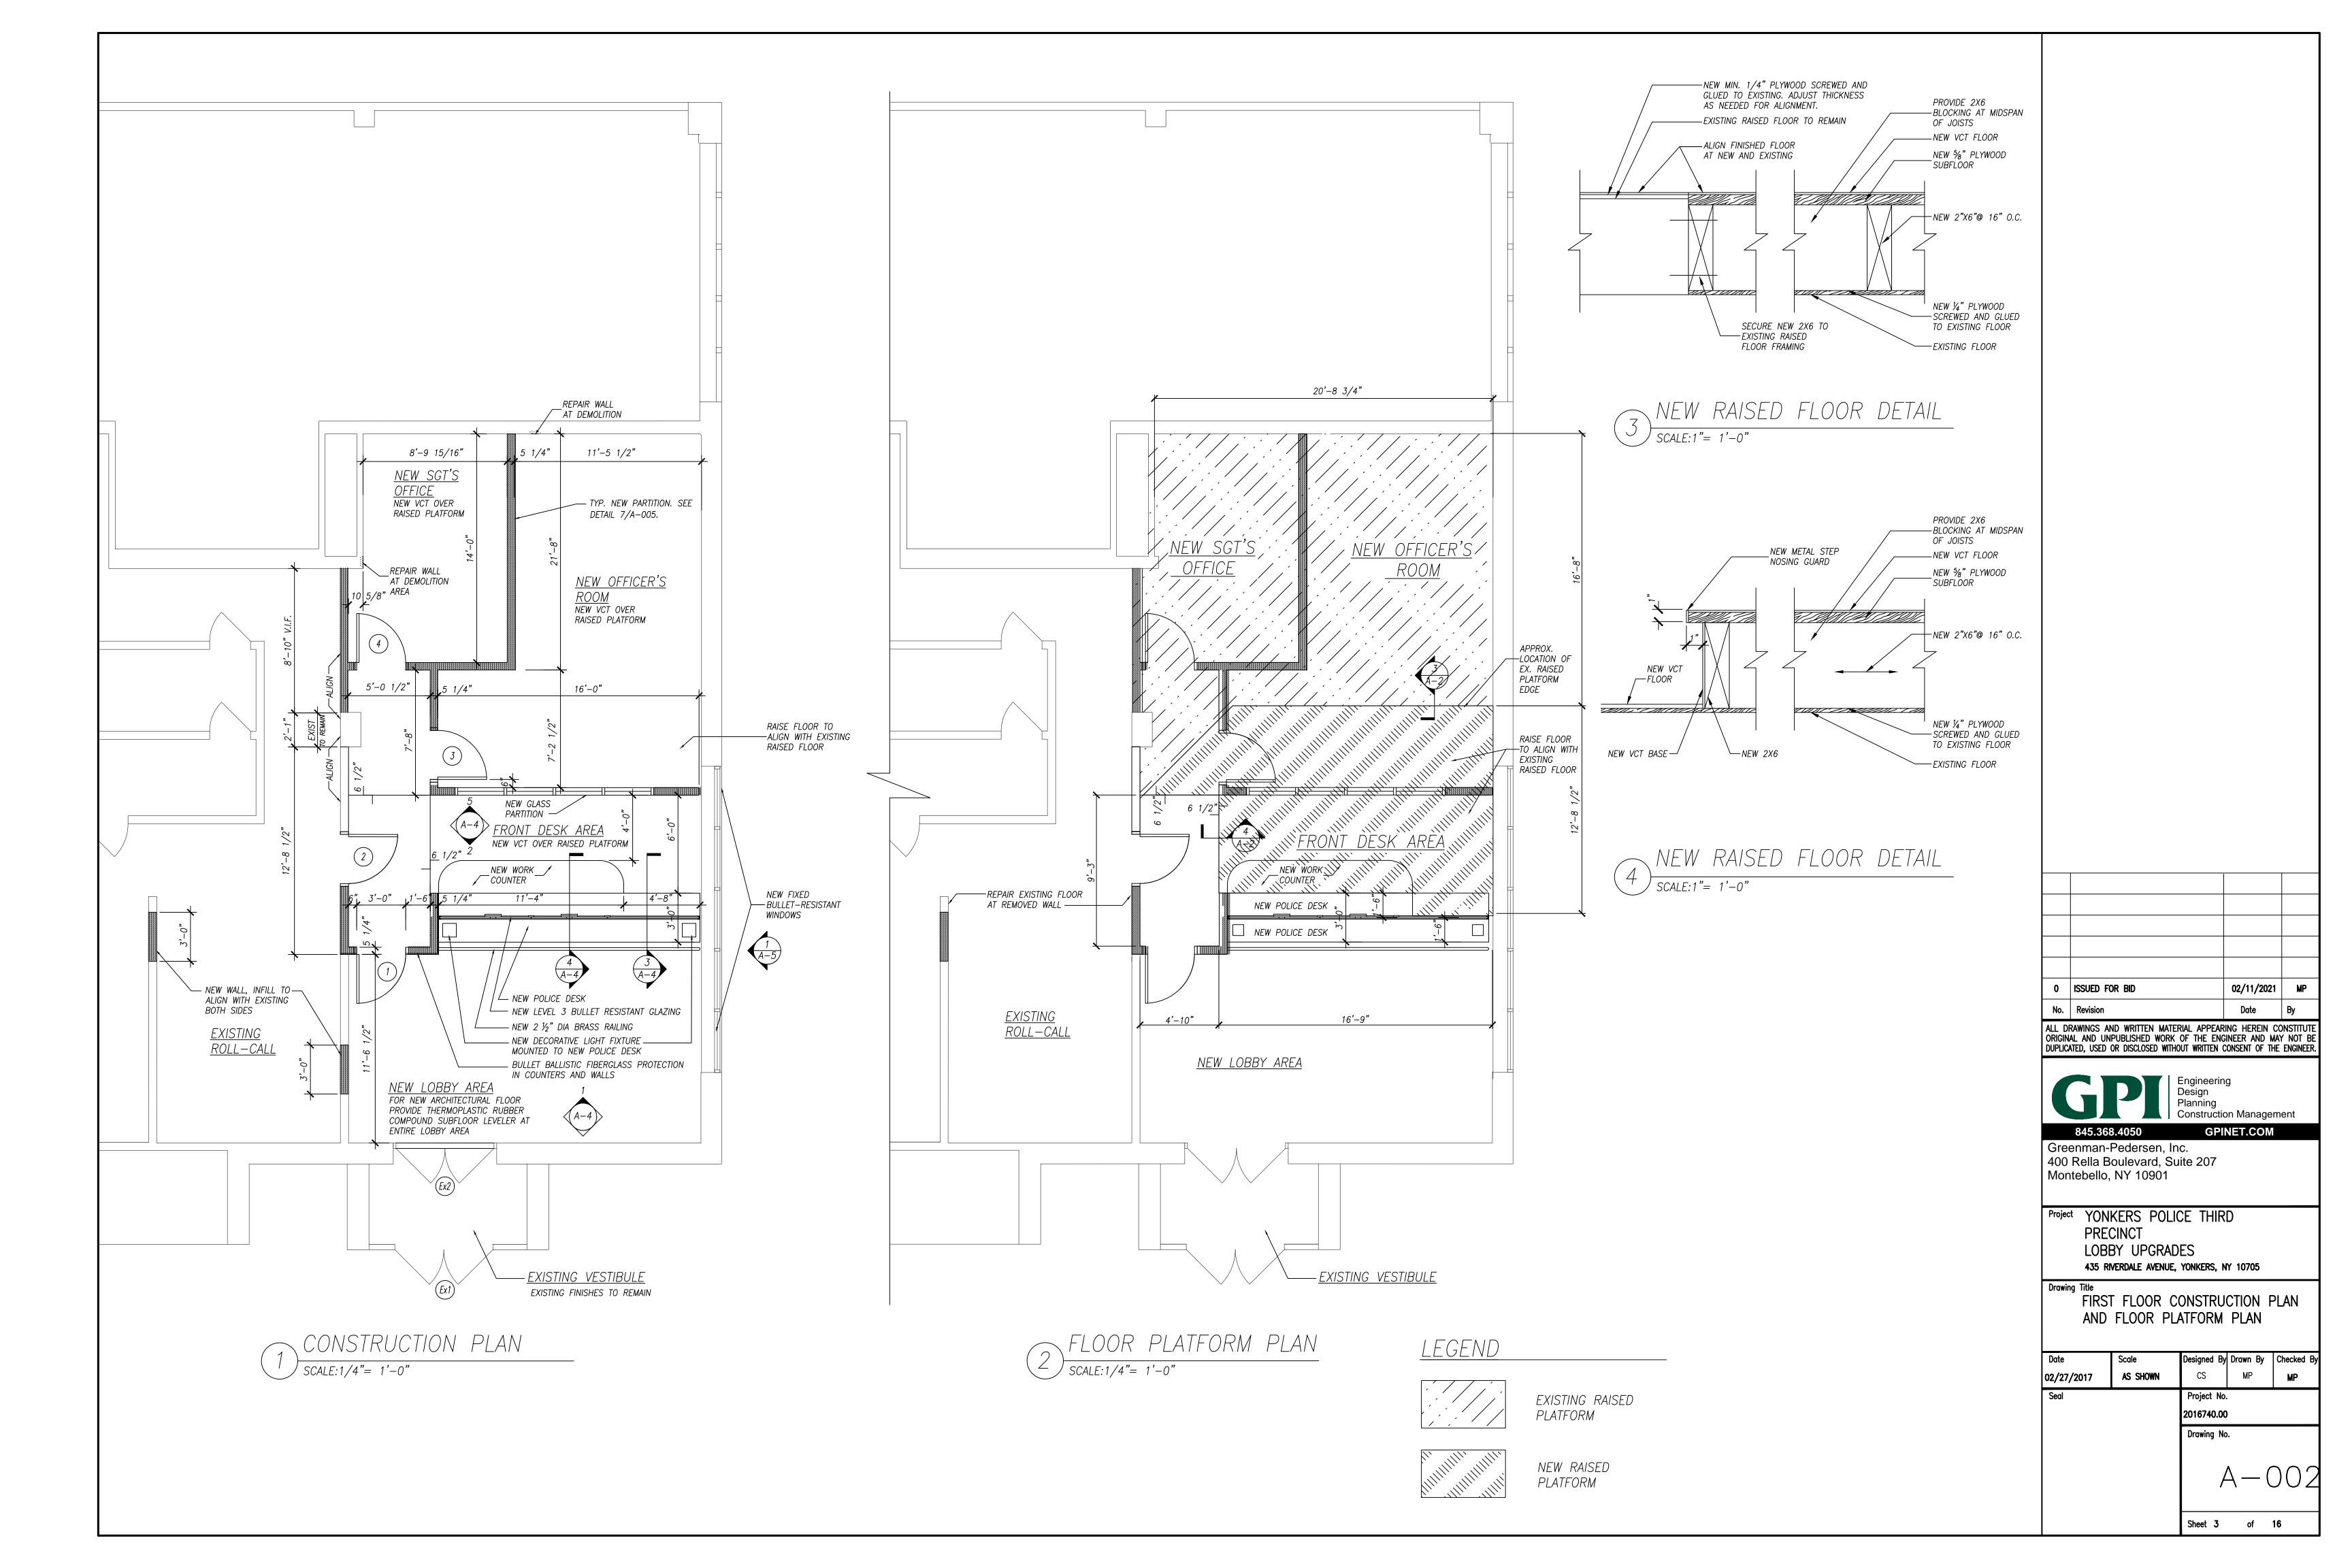

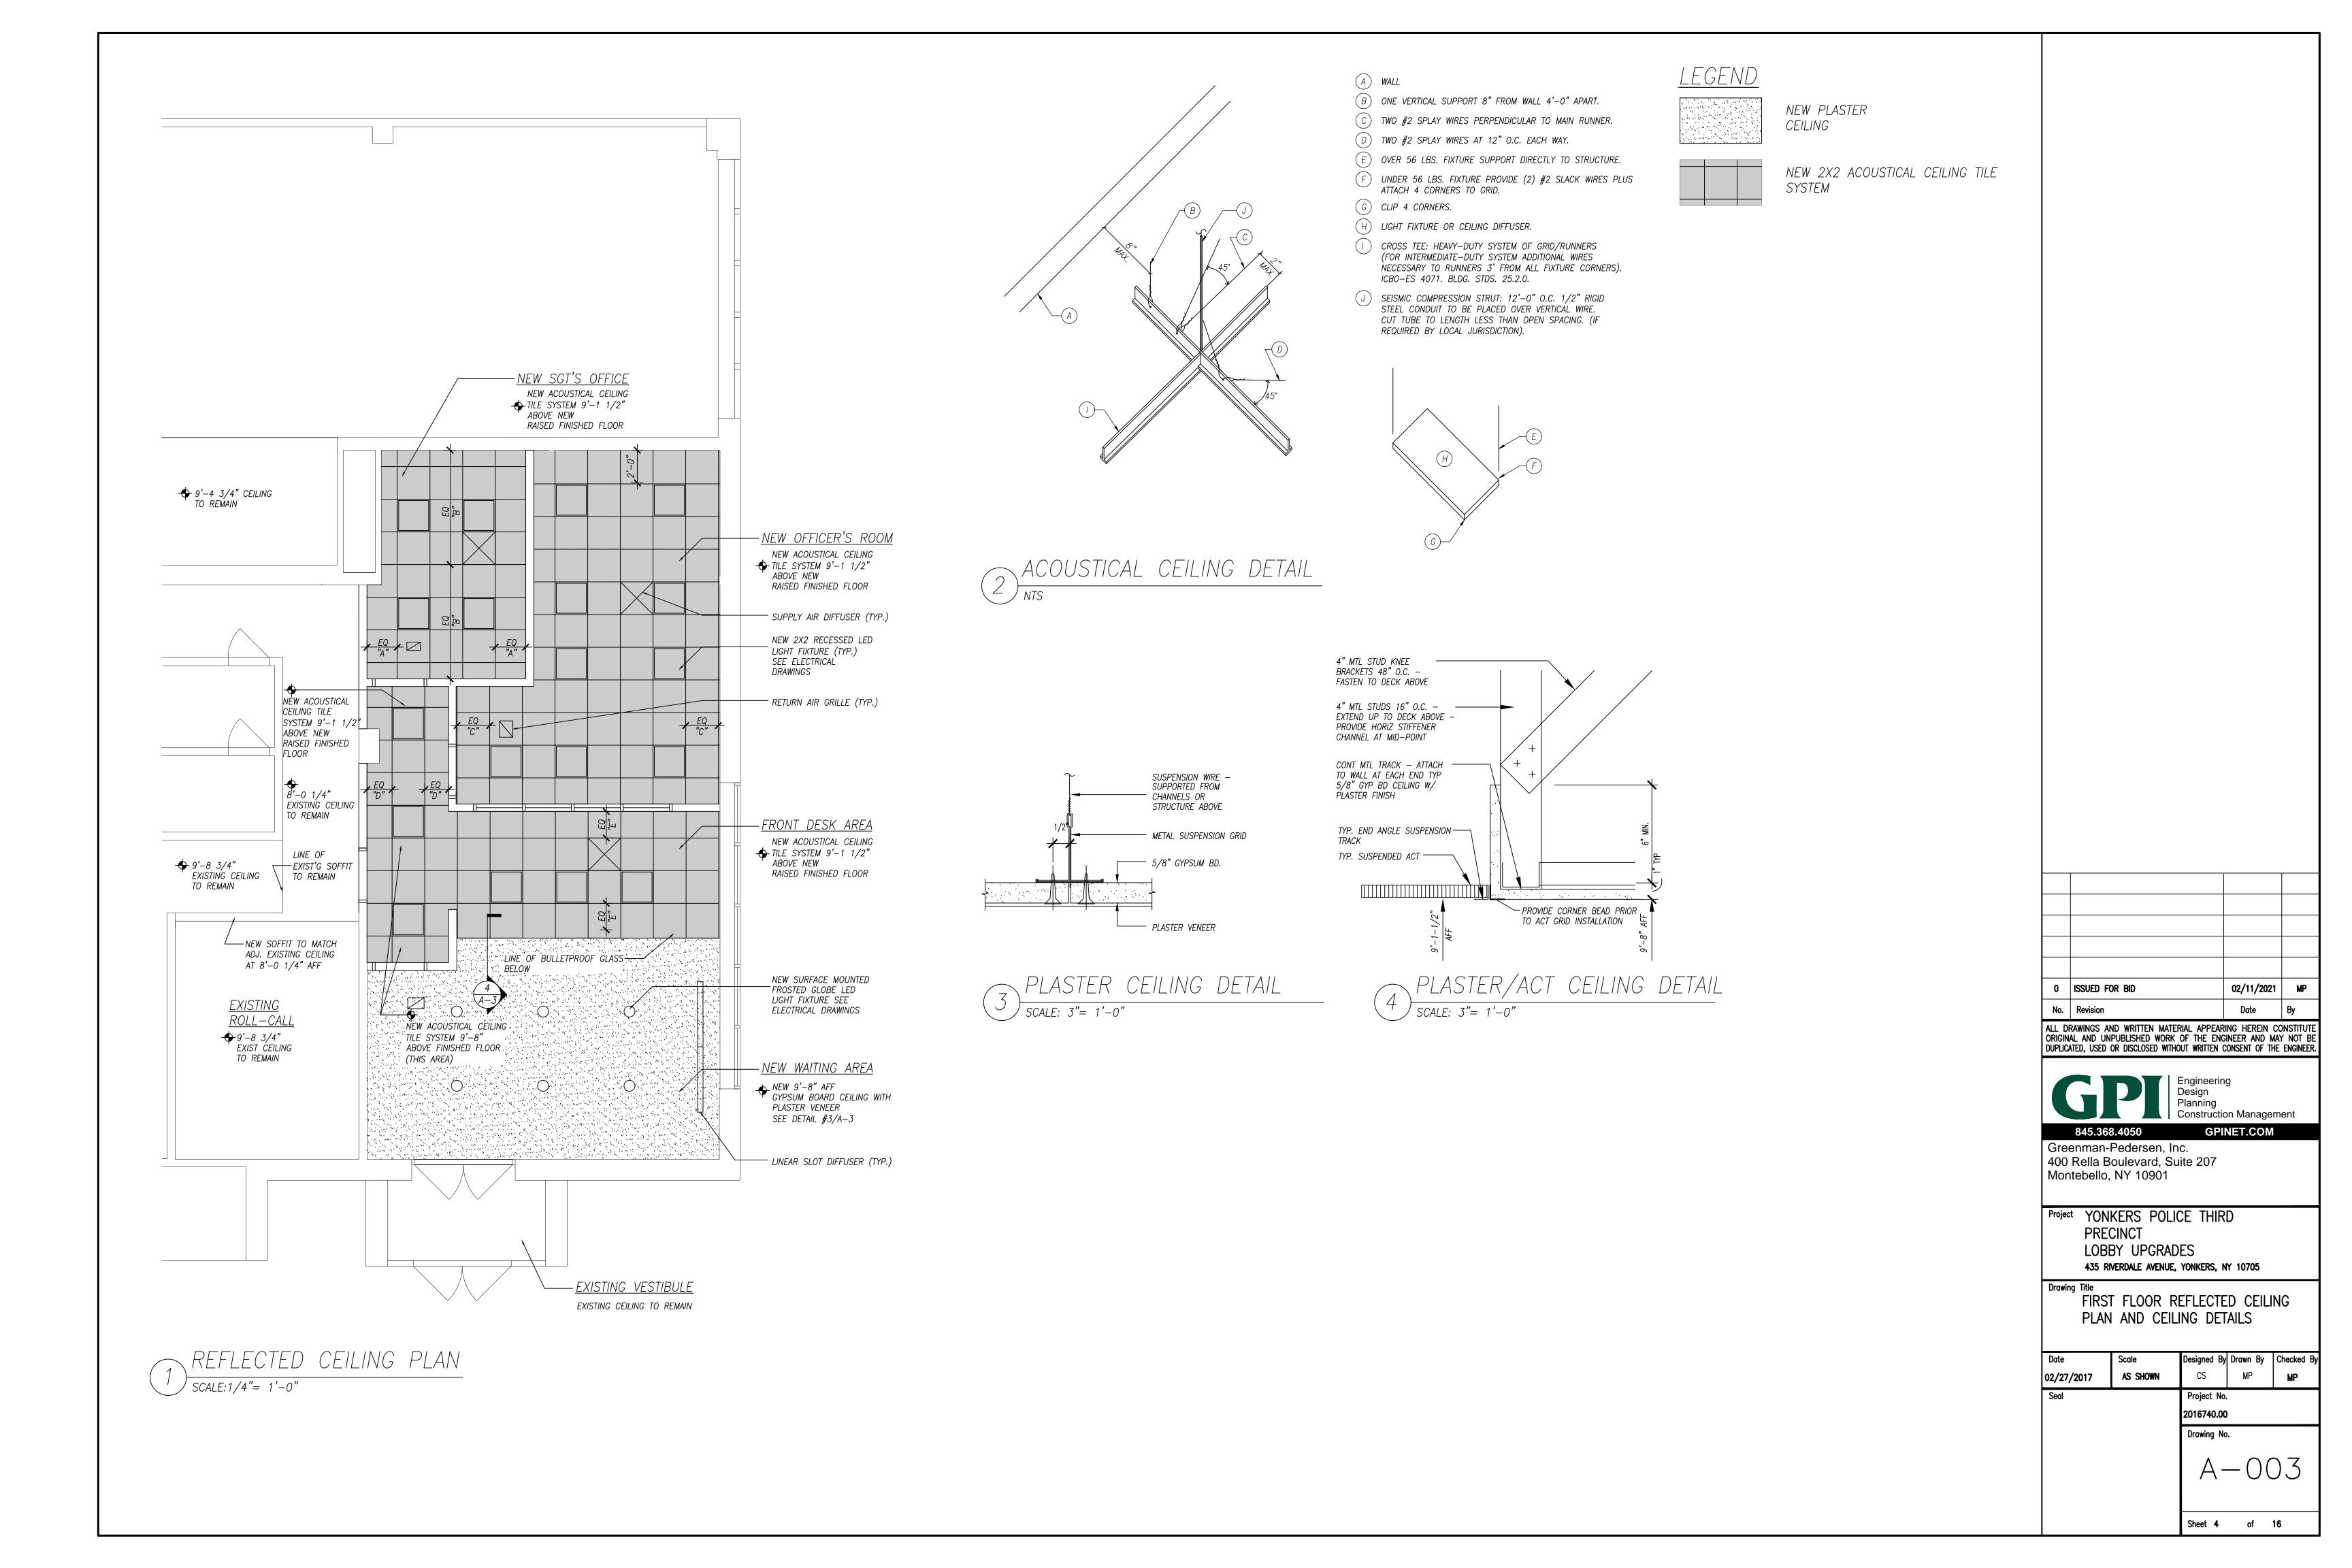

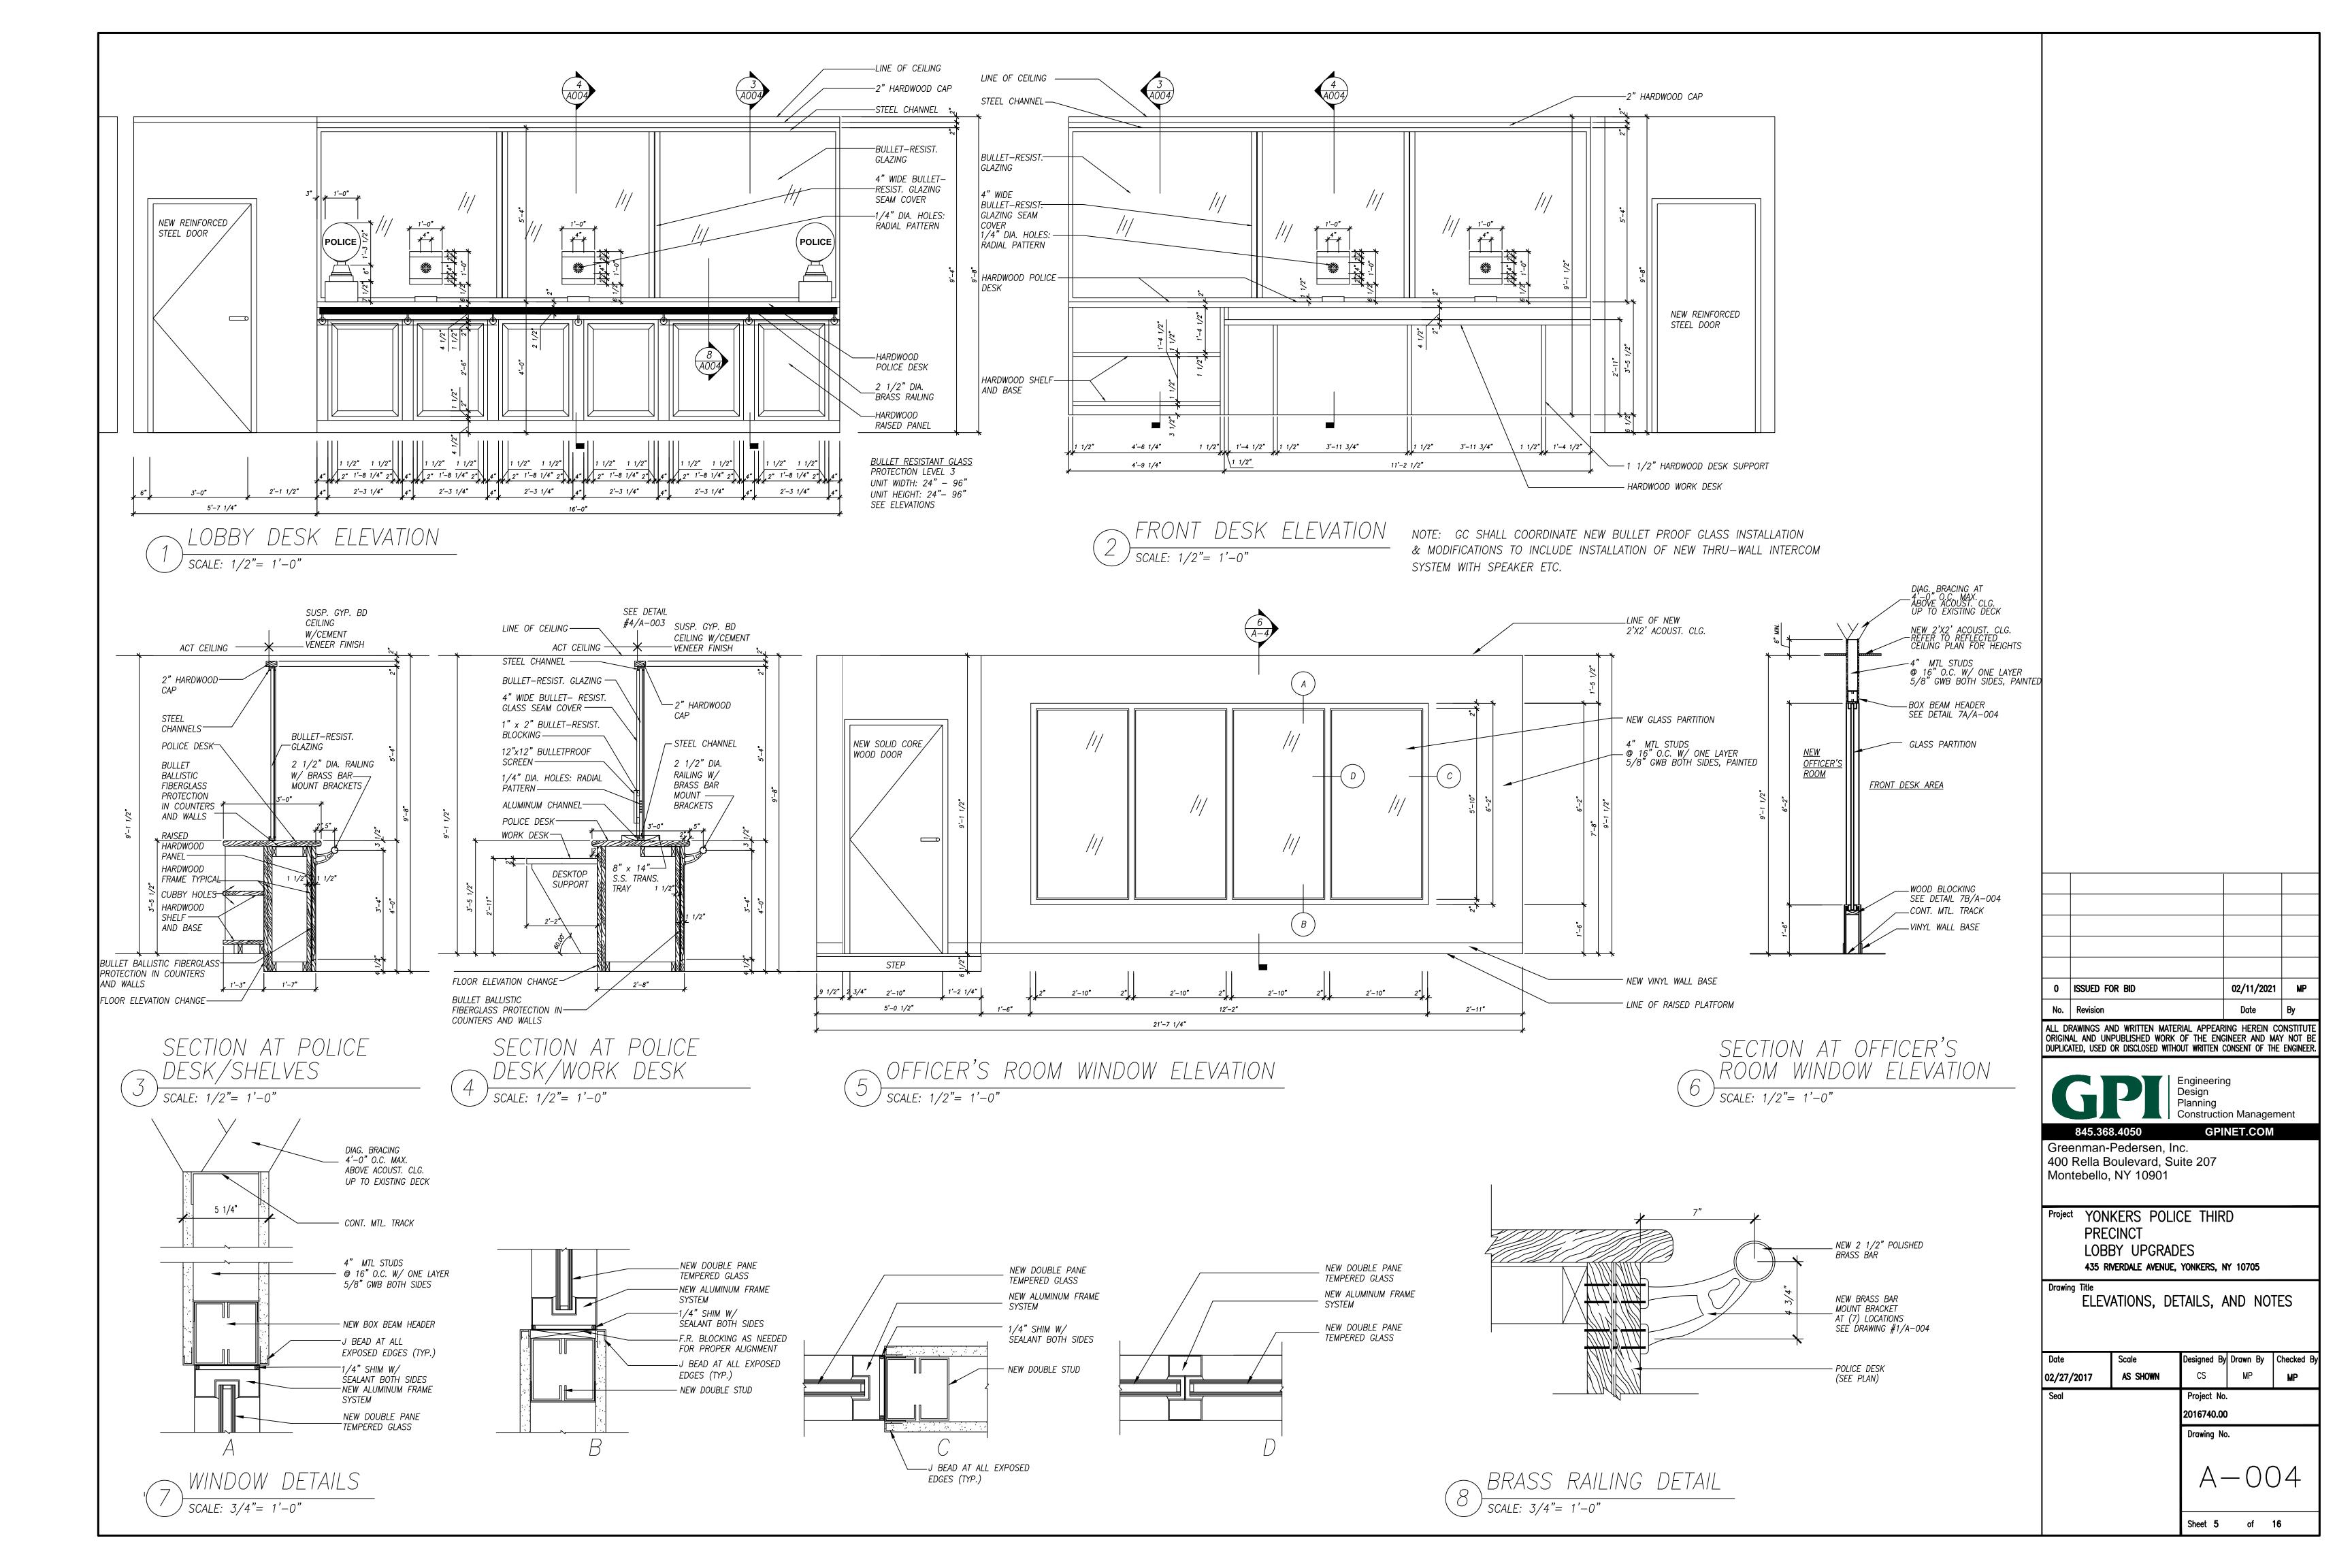

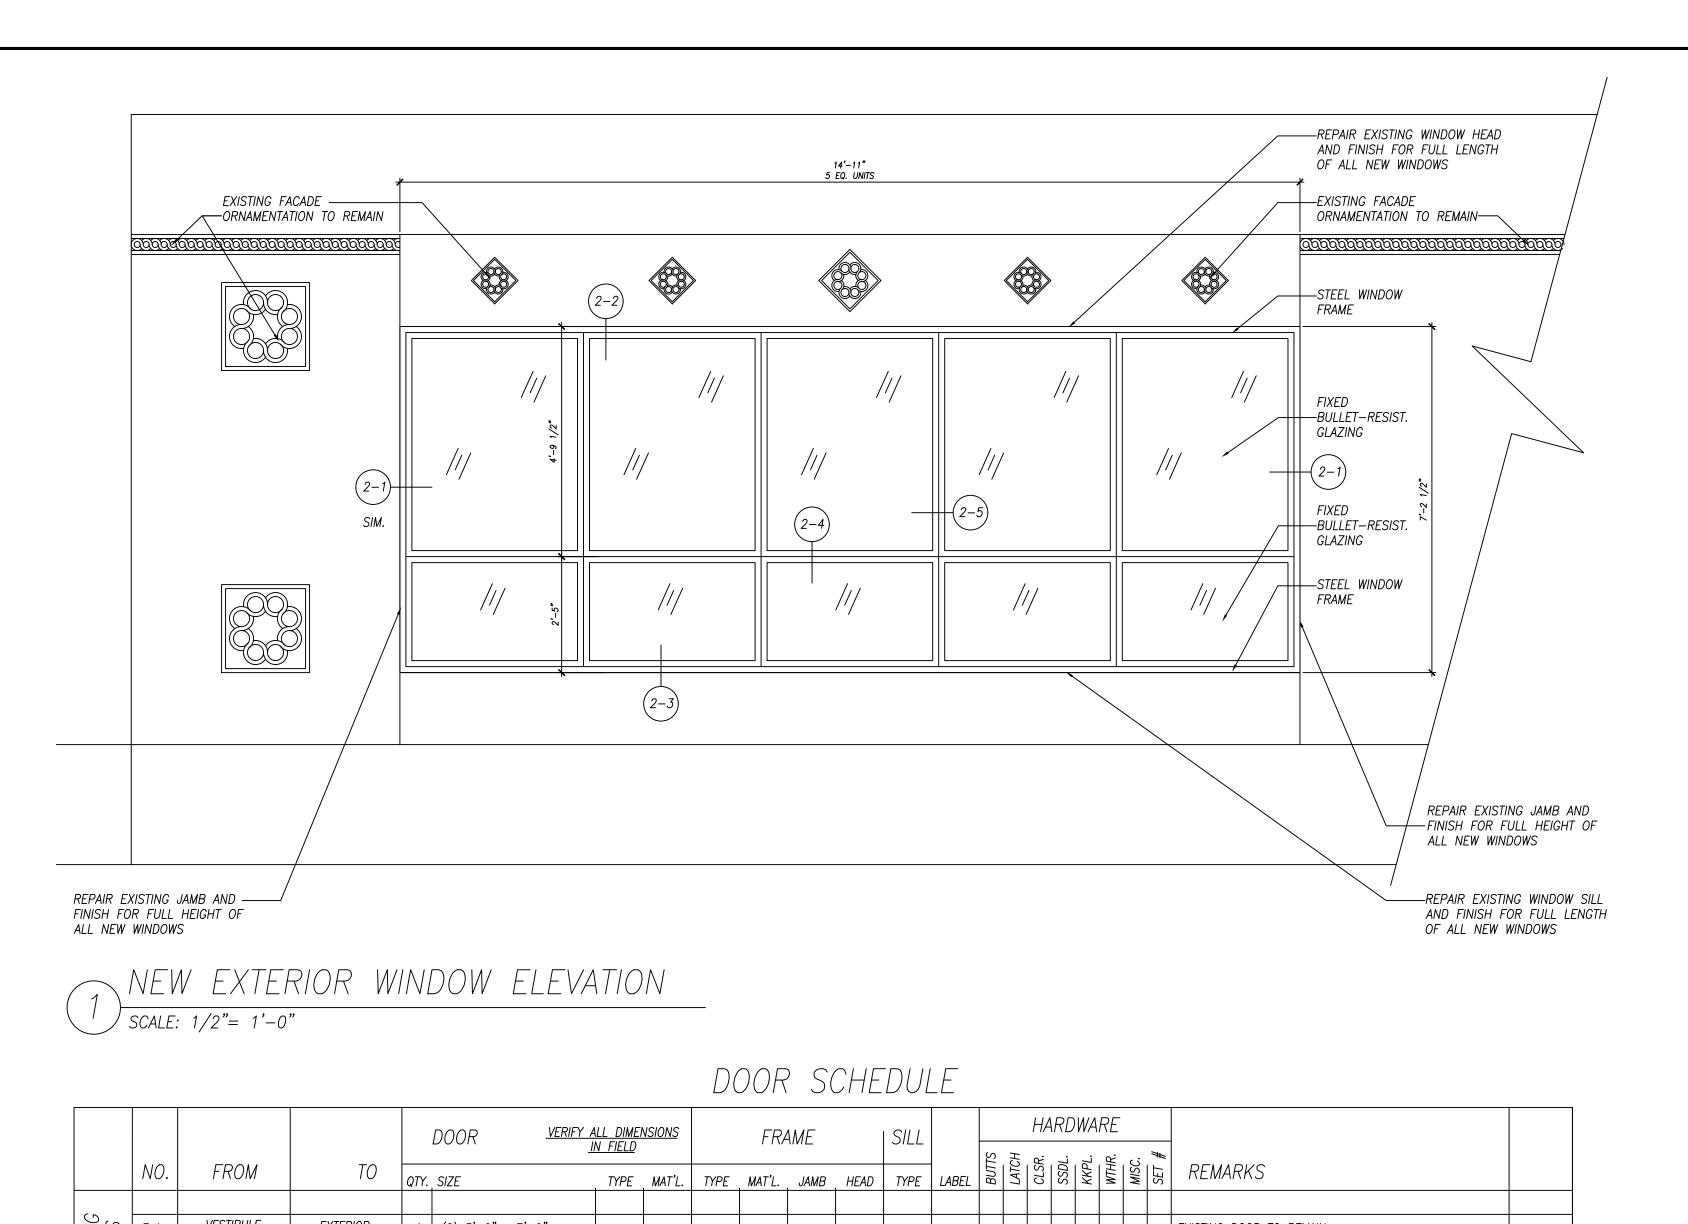

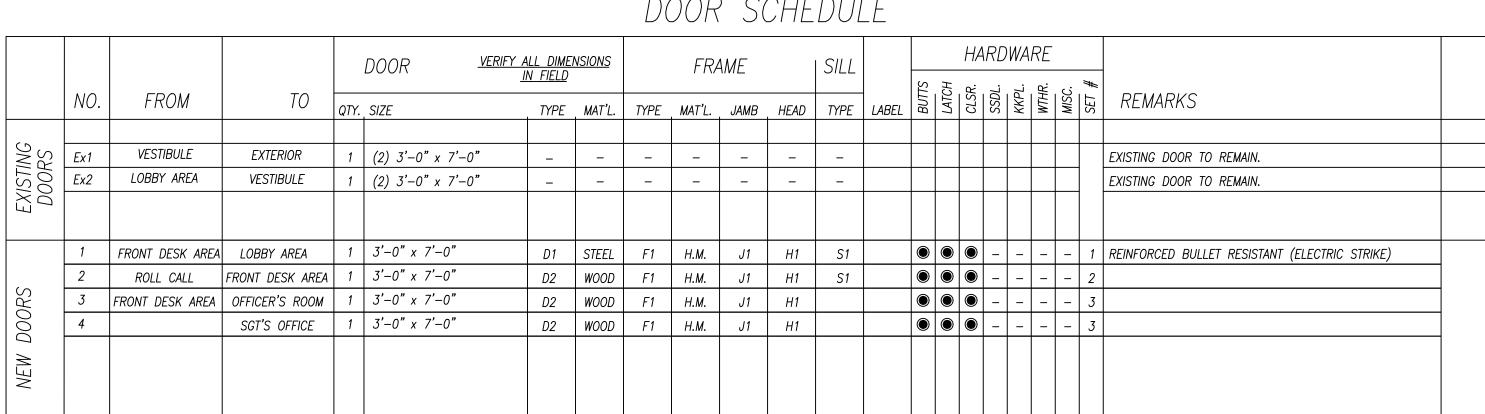

NEW 14 GAUGE ---

PER JAMB

NEW ----

PARTITION

(SEE PLAN)

H.M. FRAME W/ 3-ANCHORS

NEW DOUBLE STUD DOOR LINER —

NOTE: REFER TO SPECIFICATIONS FOR HARDWARE SETS AND FINISHES.

NEW PARTITION

(SEE PLAN)

- NEW BOX BEAM HEADER

FRAME (PAINTED TO MATCH

– NEW 14 GAUGE H.M.

ADJACENT WALL)


TYPICAL DOOR HEAD/JAMB


5 1/4"


FINISH SCHEDULE

FLC)OR		W/	ALL		CEILING	
MATL	BASE	NORTH	EAST	SOUTH	WEST	MATL	COMMENTS
-	_	_	_	_	_	_	EXISTING, NO CHANGES
VCT	VINYL	PAINT	PAINT	PAINT	PAINT	PAINT	_
VCT	VINYL	PAINT	PAINT	PAINT	PAINT	SUSP. ACT	_
VCT	VINYL	PAINT	PAINT	PAINT	PAINT	SUSP. ACT	_
VCT	VINYL	PAINT	PAINT	PAINT	PAINT	SUSP. ACT	-
	MATL - VCT VCT VCT	VCT VINYL VCT VINYL VCT VINYL	MATL BASE NORTH VCT VINYL PAINT VCT VINYL PAINT VCT VINYL PAINT	MATL BASE NORTH EAST VCT VINYL PAINT PAINT VCT VINYL PAINT PAINT VCT VINYL PAINT PAINT	MATLBASENORTHEASTSOUTHVCTVINYLPAINTPAINTPAINTVCTVINYLPAINTPAINTPAINTVCTVINYLPAINTPAINTPAINT	MATLBASENORTHEASTSOUTHWESTVCTVINYLPAINTPAINTPAINTPAINTVCTVINYLPAINTPAINTPAINTPAINTPAINTVCTVINYLPAINTPAINTPAINTPAINTPAINT	MATL BASE NORTH EAST SOUTH WEST MATL - - - - - - VCT VINYL PAINT PAINT PAINT PAINT PAINT PAINT VCT VINYL PAINT PAINT PAINT PAINT SUSP. ACT VCT VINYL PAINT PAINT PAINT PAINT SUSP. ACT


NOTE: REFER TO SPECIFICATIONS FOR FINISHES. SUBMIT COLOR AND TEXTURE INFORMATION FOR APPROVAL PRIOR TO FABRICATION.

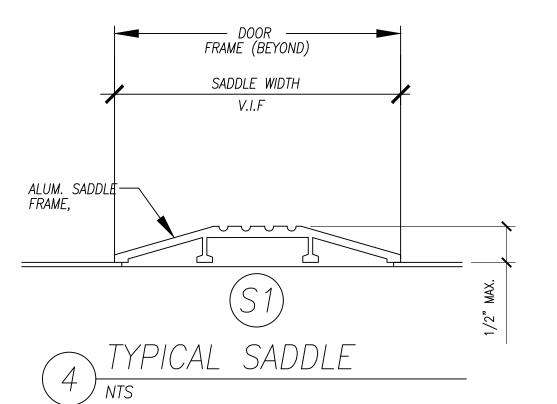


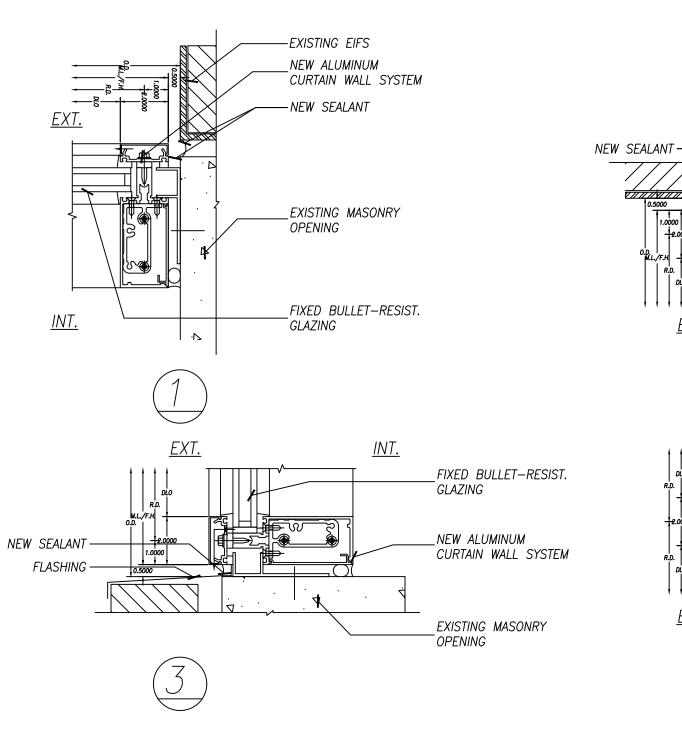

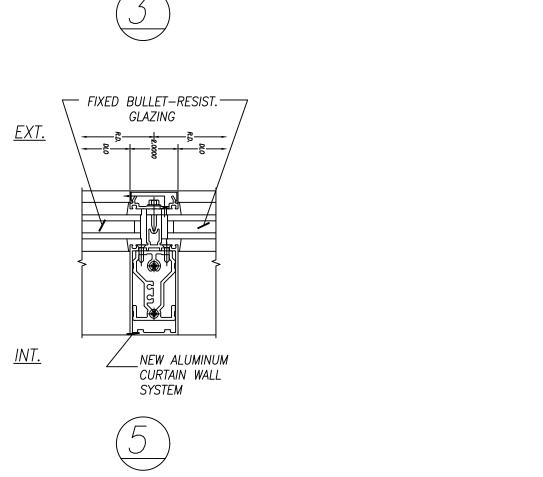



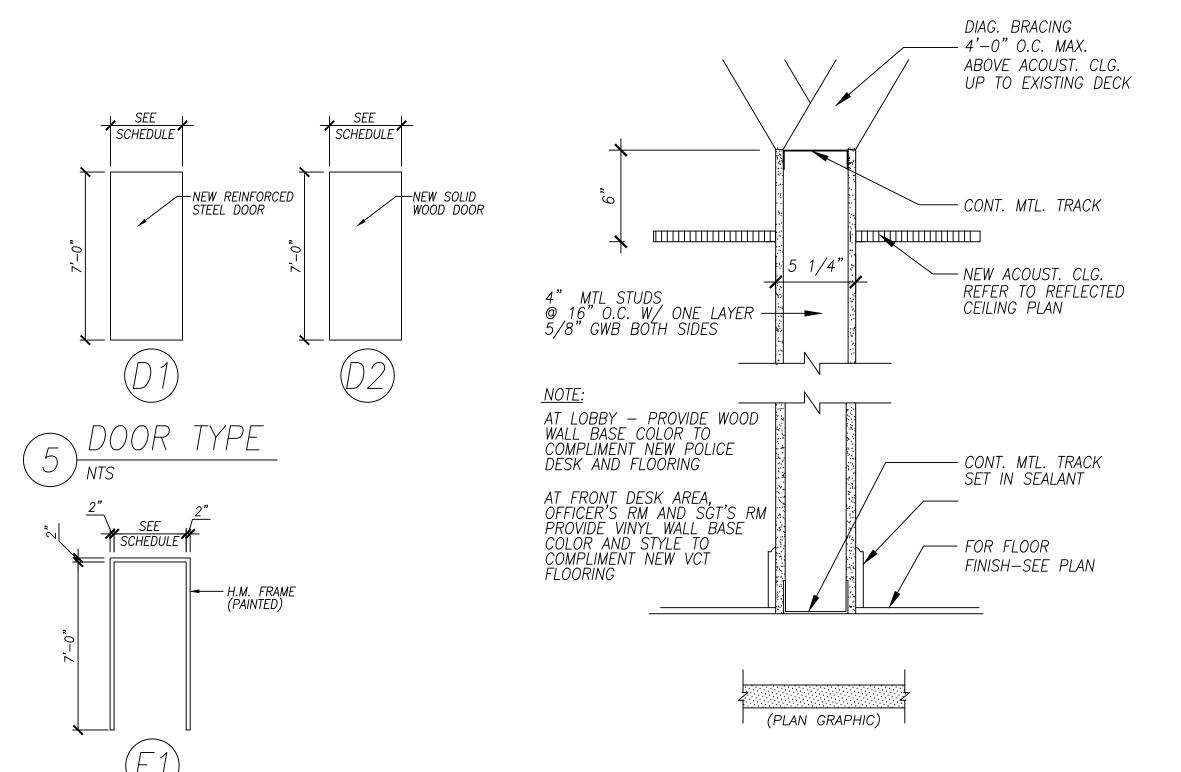

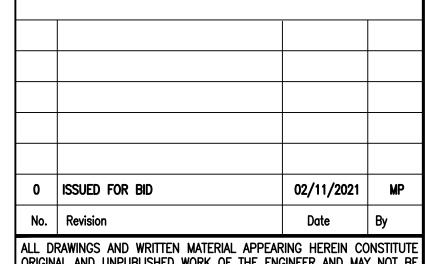

ORIGINAL AND UNPUBLISHED WORK OF THE ENGINEER AND MAY NOT I DUPLICATED, USED OR DISCLOSED WITHOUT WRITTEN CONSENT OF THE ENGINEER



_EXISTING MASONRY

OPENING

GLAZING

GLAZING

GLAZING

_NEW ALUMINUM

<u>EXT.</u>

EXT.

-NEW SEALANT

_NEW ALUMINUM

CURTAIN WALL SYSTEM FIXED BULLET-RESIST.

_FIXED_BULLET—RESIST.

CURTAIN WALL SYSTEM

_FIXED_BULLET—RESIST.

Greenman-Pedersen, Inc. 400 Rella Boulevard, Suite 207 Montebello, NY 10901

Project YONKERS POLICE THIRD **PRECINCT** LOBBY UPGRADES 435 RIVERDALE AVENUE, YONKERS, NY 10705

Drawing Title EXTERIOR ELEVATIONS, SECTIONS, SCHEDULES, AND NOTES

Date	Scale	Designed By	Drawn By	Checked By
02/27/2017	AS SHOWN	CS	MP	MP
Seal		Project No.	•	
		2016740.00)	
		Drawing No) .	
		Ι Δ -	- ()(75
		Sheet 6	of	16

GENERAL NOTES:

THE FOLLOWING NOTES SHALL APPLY THROUGHOUT. EXCEPTIONS ARE SPECIFICALLY NOTED ON EACH DRAWING.

- 1. THE CONTRACTOR SHALL FIELD VERIFY ALL DIMENSIONS AND CONDITIONS OF THE SITE AND/OR BUILDING. ALL DIMENSIONS AND EQUIPMENT IS SHOWN DIAGRAMMATICALLY. COORDINATE WITH ACTUAL FIELD CONDITION. PERFORM PRELIMINARY TESTING AND COMPARE WITH WATERFLOW REQUIREMENTS UNDER THIS PROJECT. IDENTIFY DEFICIENCIES PRIOR TO THE COMMENCEMENT OF NEW MECHANICAL CONTRACT WORK.
- 2. THE CONTRACTOR SHALL, UNLESS OTHERWISE PROVIDED IN THE CONTRACT DOCUMENTS, SECURE AND PAY FOR THE REQUIRED CONSTRUCTION PERMIT(S). FEES. LICENSES AND INSPECTIONS NECESSARY FOR THE PROPER EXECUTION OF THE WORK.
- 3. COORDINATION OF ALL WORK UNDER THIS CONTRACT SHALL BE MAINTAINED TO ENSURE THE QUALITY AND TIMELY COMPLETION OF THE WORK/PROJECT.
- 4. THE CONTRACTOR SHALL PERFORM ALL CUTTING AND PATCHING REQUIRED TO COMPLETE THE WORK OR TO MAKE ITS PARTS FIT TOGETHER PROPERLY WITHOUT COMPROMISING THE QUALITY OF THE WORK.
- 5. THE CONTRACTOR SHALL BE RESPONSIBLE FOR ADEQUATELY BRACING AND PROTECTING ALL WORK DURING CONSTRUCTION AGAINST DAMAGE, BREAKAGE, COLLAPSE, DISTORTIONS, AND OFF ALIGNMENTS ACCORDING TO CODES AND STANDARDS OF GOOD PRACTICE.
- 6. THE TERM "FINISH FLOOR" SHALL MEAN THE NORMAL FINISHED SURFACE OF THE FLOOR LEVEL. ALL ELEVATIONS GIVEN FOR EXISTING BUILDINGS ARE TO FINISHED FLOOR. THE CONTRACTOR SHALL FIELD VERIFY ALL ELEVATIONS FOR EXISTING STRUCTURES PRIOR TO THE COMMENCEMENT OF WORK.
- 7. THE CONTRACTOR SHALL PATCH AND REPAIR ALL FLOORS, WALLS, CEILINGS, ETC. DAMAGED OR EXPOSED DUE TO WORK OR REMOVALS AND FINISH TO MATCH ADJOINING SURFACES.
- 8. WHERE MANUFACTURERS NAMES AND PRODUCT NUMBERS ARE INDICATED ON THE DRAWINGS IT SHALL BE CONSTRUED TO MEAN THE ESTABLISHING OF QUALITY AND PERFORMANCE STANDARDS OF SUCH ITEMS. ALL OTHER PRODUCTS MUST BE SUBMITTED TO THE ENGINEER FOR APPROVAL BEFORE THEY SHALL BE DEEMED EQUAL.
- 9. ADDITIONAL NOTES WHICH ARE APPLICABLE TO THIS PROJECT MAY BE FOUND THROUGHOUT THE CONTRACT DRAWINGS.
- D. DRAWINGS ARE NOT TO BE SCALED. USE DIMENSIONS ONLY. ALL DIMENSIONS AND CONDITIONS SHOWN AND ASSUMED ON THE DRAWINGS MUST BE VERIFIED AT THE SITE BY THE CONTRACTOR BEFORE ORDERING ANY MATERIAL OR DOING ANY WORK. ANY DISCREPANCIES IN THE DRAWINGS AND SPECIFICATIONS SHALL BE REPORTED TO THE ENGINEER. NO CHANGE IN DRAWINGS OR SPECIFICATIONS IS PERMISSIBLE WITHOUT THE WRITTEN CONSENT OF THE ENGINEER.
- 1. ALL WORK ON THESE DRAWINGS SHALL BE CONSIDERED NEW WORK WHETHER STATED OR NOT EXCEPT WHERE SPECIFICALLY NOTED AS "EXISTING TO REMAIN".
- 2. DETAILS NOT SHOWN OR SPECIFIED, BUT NECESSARY FOR PROPER AND ACCEPTABLE CONSTRUCTION, INSTALLATION OR OPERATION OF ANY PART OF THE WORK AS DETERMINED BY THE ENGINEER, SHALL BE INCLUDED IN THE WORK THE SAME AS IF HEREIN SPECIFIED OR INDICATED.
- 13. ALL WORK SHALL BE INSTALLED SO THAT ALL PARTS REQUIRED ARE READILY ACCESSIBLE FOR INSPECTION, OPERATION, MAINTENANCE AND REPAIR.
- 14. ANY EXISTING WORK DAMAGED DUE TO THE MASONRY REPAIR AND OTHER RELATED WORK, SHALL BE PATCHED, REPAIRED, REFINISHED, ETC. BY THE CONTRACTOR TO MATCH EXISTING FINISHES TO THE CLOSEST EXISTING CORNER.
- 15. CONTRACTOR SHALL KEEP WORK SITE FREE FROM DEBRIS AND ACCUMULATED REFUSE, AND SHALL HAVE SOLE RESPONSIBILITY FOR PROTECTING ALL DANGEROUS AREAS FROM ENTRY BY UNAUTHORIZED PARTIES. WORK AREA WILL BE LEFT BROOM CLEAN AT THE END OF COMPLETION OF WORK AND UNTIL THE SPACE IS READY TO BE OCCUPIED.
- 6. PROVIDE BARRICADES AROUND WORK AREAS AS REQUIRED TO PREVENT UNAUTHORIZED PERSONS FROM ENTERING THEREIN.
- 17. THE WORD "PROVIDE" USED ON DRAWINGS AND SPECIFICATIONS ASSOCIATED WITH THIS PROJECT MEANS "FURNISH AND INSTALL". WHEN ONLY ONE PART OF ACTION IS REQUIRED. EITHER "FURNISH" OR "INSTALL" WILL BE USED ACCORDINGLY (TYP., U.O.N.).
- 18. DUST CONTROL: EXISTING CONSTRUCTION AND EQUIPMENT SHALL BE PROTECTED FROM DUST THROUGHOUT THE DURATION OF THE WORK AND TO THE SATISFACTION OF THE OWNER. PROVIDE DUST BARRIERS AND/OR COVER EXISTING WORKSTATIONS AND EQUIPMENT TO PREVENT CONTAMINATION. WHEN DRILLING OR CUTTING IN OCCUPIED AREAS OF THE BUILDING, ALL TOOLS USED SHALL BE EQUIPPED WITH DUST FILTERS.
- 9. THE SITE SHALL BE CLEANED AT THE END OF EVERY SHIFT AT A MINIMUM, AND SHALL BE MAINTAINED IN A CLEAN CONDITION AT ALL TIMES. NO DUST, DEBRIS, REFUSE OR ODORS SHALL BE PERMITTED TO ACCUMULATE AT ANY TIME.
- 20. NOISE GENERATED BY THE WORK SHALL BE KEPT TO A MINIMUM, AND SHALL BE KEPT TO A LEVEL ACCEPTABLE TO THE OWNER.

MECHANICAL NOTES:

- . PROVIDE LABOR, MATERIALS, TOOLS, MACHINERY, EQUIPMENT, AND SERVICES NECESSARY TO COMPLETE THE HVAC WORK UNDER THIS CONTRACT. ALL SYSTEMS AND EQUIPMENT SHALL BE COMPLETE IN EVERY ASPECT AND ALL ITEMS OF MATERIAL, EQUIPMENT AND LABOR SHALL BE PROVIDED FOR A FULLY OPERATIONAL SYSTEM AND READY FOR USE. COORDINATE THE WORK WITH THE WORK OF THE OTHER SUBCONTRACTORS IN ORDER TO RESOLVE ALL CONFLICTS WITHOUT IMPEDING THE JOB PROGRESS.
- . EXAMINE THE ARCHITECTURAL, DRAWINGS AND OTHER DIVISIONS, AND SECTIONS OF THE SPECIFICATIONS IN ORDER TO DETERMINE THE EXTENT OF THE WORK REQUIRED TO BE COMPLETED UNDER THIS DIVISION. FAILURE TO EXAMINE ALL THE CONTRACT DOCUMENTS FOR THIS PROJECT WILL NOT RELIEVE THIS CONTRACTOR OF HIS RESPONSIBILITIES TO PERFORM THE WORK REQUIRED FOR A COMPLETE FULLY OPERATIONAL AND SATISFACTORY
- 3. THE WORK INCLUDES BUT IS NOT LIMITED TO THE DEPICTED SYSTEMS, EQUIPMENT AND SERVICES, AS SPECIFIED HEREIN.
- 4. START-UP SERVICES SHALL BE INCLUDED.
- 5. ALL SYSTEMS, EQUIPMENT AND SERVICES SPECIFIED HEREIN SHALL BE PROVIDED COMPLETE AND READY FOR USE. ALL EQUIPMENT, DUCTWORK, PIPING, DAMPERS, OUTLETS ARE NEW, FURNISHED AND INSTALLED BY THIS CONTRACTOR, UNLESS OTHERWISE NOTED.
- 6. DUCTWORK AND PIPING ARE SHOWN DIAGRAMMATICALLY AND DO NOT SHOW ALL OFFSETS, DROPS AND RISES OF RUNS. THE CONTRACTOR SHALL ALLOW IN HIS PRICE FOR ROUTING OF PIPING TO AVOID OBSTRUCTIONS. EXACT LOCATIONS ARE SUBJECT TO APPROVAL OF ENGINEER. COORDINATION WITH THE EXISTING SERVICES, INCLUDING THOSE OF OTHER SUBCONTRACTORS IS REQUIRED. PROVIDE COORDINATION DRAWINGS SHOWING ALL TRADES WORK AND EXISTING CONDITION.
- INSTALL WORK SO AS TO BE READILY ACCESSIBLE FOR OPERATION, MAINTENANCE AND REPAIR. MINOR DEVIATIONS FROM DRAWINGS MAY BE MADE TO ACCOMPLISH THIS, BUT CHANGES INVOLVING EXTRA COST SHALL NOT BE MADE WITHOUT APPROVAL.
- 8. VERIFY FINAL LOCATIONS FOR ROUGH WORK WITH FIELD MEASUREMENTS AND WITH THE REQUIREMENTS OF THE ACTUAL EQUIPMENT BEING CONNECTED.
- 9. PROVIDE A COMPLETE SYSTEM OF VIBRATION ISOLATION FOR EACH ITEM OF HVAC EQUIPMENT AND APPARATUS AS SPECIFIED HEREIN, AS SHOWN ON THE DRAWINGS AND AS NEEDED FOR A COMPLETE AND PROPER INSTALLATION.
- 10. THE CONTRACTOR SHALL KEEP ALL EQUIPMENT AND MATERIALS, AND ALL PARTS OF THE BUILDING, EXTERIOR SPACE AND ADJACENT STREETS, SIDEWALKS AND PAVEMENTS, FREE FROM MATERIAL AND DEBRIS RESULTING FROM THE EXECUTION OF THIS WORK. EXCESS MATERIALS WILL NOT BE PERMITTED TO ACCUMULATE EITHER IN THE INTERIOR OR THE EXTERIOR.
- 1. ALL PRESENT MATERIAL, EQUIPMENT AND CONSTRUCTION DEBRIS TO BE REMOVED UNDER THIS CONTRACT SHALL BECOME THE PROPERTY OF THE CONTRACTOR WITH THE EXCEPTION OF SPECIFIC EQUIPMENT AND APPARATUS REQUESTED BY NYPL, OR AS NOTED TO BE RELOCATED ON THE DRAWINGS, AND SHALL BE PROPERLY DISPOSED OF BY THE CONTRACTOR.
- 12. THE FINAL ACCEPTANCE WILL BE MADE AFTER THE CONTRACTOR HAS ADJUSTED HIS EQUIPMENT, BALANCED THE VARIOUS SYSTEMS, DEMONSTRATED THAT IT FULFILLS THE REQUIREMENTS OF THE DRAWINGS AND SPECIFICATIONS AND HAS FURNISHED ALL THE REQUIRED CERTIFICATES OF INSPECTION AND APPROVAL.
- 13. PROVIDE DIELECTRIC UNIONS AT JOINTS BETWEEN DISSIMILAR PIPING.

SAFETY NOTES

- SPECIAL PRECAUTIONS SHALL BE TAKEN BY THE CONTRACTOR SO THAT EQUIPMENT ON THE APPLICATION AND ITS INSTALLATION WILL NOT AFFECT THE FOLLOWING: - EGRESS TO AND FROM THE BUILDING FIRE SAFETY OR CREATE A FIRE HAZARD
 - STRUCTURAL SAFETY OF THE BUILDING. CONFORM TO CHAPTER 33 OF THE 2020 NYSBC FOR SAFETY DURING CONSTRUCTION AND DEMOLITION. - ACCUMULATION OF DUST AND DEBRIS. THE CONTRACTOR SHALL LEAVE THE SITE BROOM CLEAN EACH DAY.
- 2. ASBESTOS MUST FIRST BE INVESTIGATED AND VERIFY IN FIELD BEFORE ANY DEMOLITION OR CONSTRUCTION WORK TO BE DONE UNDER THIS PROJECT. ASBESTOS FREE MUST BE CERTIFIED FOR ALL HVAC EQUIPMENT, DUCTWORK, AND ALL PIPING INSULATION.
- 3. CONSTRUCTION WORK SHALL BE CONFINED TO WORK AREAS NOTED ON THE DRAWINGS AND SHALL INVOLVE TEMPORARY INTERRUPTION OF HEATING, WATER AND ELECTRIC SERVICES TO THE BUILDING SYSTEMS ONLY AS SCHEDULED WITH THE
- 4. FIRE SAFETY: ALL BUILDING MATERIALS STORED IN CONSTRUCTION AREA, AND/OR IN ANY AREA OF THE BUILDING ARE TO BE SECURED IN A LOCKED AREA ONLY WHERE PERMITTED BY THE OWNER.
- 5. CONTRACTOR SHALL PROVIDE BARRICADES AROUND WORK AREAS AS REQUIRED TO
- 6. THE CONTRACTOR SHALL SUBMIT SAFETY PLAN FOR APPROVAL

PREVENT UNAUTHORIZED PERSONS FROM ENTERING THEREIN.

BUILDING DEPARTMENT NOTES:

THE FOLLOWING NOTES SHALL APPLY THROUGHOUT:

- 1. WORK SHALL BE EXECUTED IN FULL COMPLIANCE WITH THE APPLICABLE PROVISIONS OF ALL LAWS, BY-LAWS, STATUTES, ORDINANCES, CODES, RULES, REGULATIONS AND LAWFUL ORDERS OF PUBLIC AUTHORITIES BEARING ON THE PERFORMANCE AND EXECUTION OF THE WORK.
- 2. NO CHANGE IN USE EGRESS OR OCCUPANCY GROUP PROPOSED UNDER THIS APPLICATION.

AIR BALANCING:

1. RECORD AIRFLOWS OF EXISTING SUPPLIES, RETURNS, AND EXHAUSTS THORUGHOUT THE SYSTEM CONNECTED TO RT-2 AND WHEREVER ELSE AFFECTED BY THE WORK OF THIS CONTRACT PRIOR TO BEGINNING THE WORK. SUBMIT A REPORT OF THESE AIRFLOWS TO THE OWNER FOR RECORD.

- PERFORM A COMPLETE BALANCING OF THE SYSTEM CONNECTED TO RT-2, INCLUDING ALL SUPPLIES, RETURNS, AND EXHAUSTS, BOTH EXISTING AND NEW, THROUGHOUT THE AREA OF WORK AND ALL OTHER AREAS OF THE BUILDING SERVED BY RT-2. ALSO VERIFY OUTSIDE AIR FLOW AT THE RT-2 OA HOOD. BALANCING SHALL BE PERFORMED WITH THE UPGRADED FILTERS. SUBMIT A FINAL BALANCING REPORT FOR APPROVAL.
- 3. REFER TO THE PLANS AND SPECIFICATIONS FOR ADDITIONAL BALANCING REQUIREMENTS. SEE THE REFERENCE DRAWING M-503 FOR DETAILS OF THE EXISTING RT-2 SYSTEM WHICH SHALL BE BALANCED UNDER THIS CONTRACT.

LEGEND:		<u>SYMBOLS:</u>	
	EXISTING	—— S ——	HOT WATER SUPPLY
/////	TO BE REMOVED (ON DEMOLITION DRAWINGS)		HOT WATER RETURN
	WORK OF THIS CONTRACT		PIPE DROPPING DOWN
\bigcirc	THERMOSTAT		PIPE UP
•	DISCONNECT POINT		PIPE BOTTOM CONNECTION PIPE TOP CONNECTION
•	TIE-IN POINT	1	
\bigcirc	WALL MOUNTED JUNCTION BOX		BALL VALVE GATE/SHUTOFF VALVE
<u>ABBREVIATION</u>	<u> </u>		
BHP	BREAK HORSE POWER	— \\\\\\\\\\\\\\\\\\\\\\\\\\\\\\\\\\\\	BALANCING VALVE
D	DRAIN	— /9 —	CHECK VALVE
DN	DOWN	NT4	BALANCING COCK
DWG	DRAWING	—×—	DALANCING COCK
EX.	EXISTING	— \	BALANCING VALVE
FPI	FINS PER INCH		
FTR HP	FINNED TUBE RADIATION HORSE POWER	-X	PIPE ANCHOR
MAX	MAXIMUM		PIPE BREAK
MBH	1000 BTU/H		PRESSURE GAUGE
MHP	MOTOR HORSE POWER	Y	
MIN.	MINIMUM	- \\	STRAINER
N/A	NOT APPLICABLE	•	DELIEE VALVE
N.I.C.	NOT IN CONTRACT	— ₽ 	RELIEF VALVE
NTS	NOT TO SCALE	l	
P-#	PUMP TAG	A	AIR VENT
PH R	PHASE HOT WATER RETURN	1	DRAIN COCK W/ HOSE BIBB
R RPM	REVOLUTION PER MINUTE	£	DIVAIN COCK WY 1100E BIBB
S	HOT WATER SUPPLY	№ 1	OONOENTDIO DEDUCED
T	THERMOSTAT	─ ⋈	CONCENTRIC REDUCER
TYP.	TYPICAL		ECCENTRIC REDUCER
V	VOLT	Ma	
U.O.N.	UNLESS OTHERWISE NOTED	H	THERMOMETER

DIELECTRIC FLANGED CONNECTION

___\\\\\\\\\___

PEDESTAL CONVECTOR MOUNTING DETAIL

M001 NO SCALE

(1) PEDESTAL CONVECTOR. INSTALL

(3) FASTEN CONVECTOR TO FLOOR

PER MANUFACTURER'S

PER MANUFACTURER'S

RECOMMENDATIONS.

(2) ELEMENTS WITH FINS AS

SPECIFIED.

INSTRUCTIONS.

1"TUBE

FINISHED FLOOR

NO SCALE

M001

MOO1 / NO SCALE

AIR F	FILTER SCH	HEDULE				
TAG	SERVICE	TYPE	MODULE SIZE (IN)	QUANTITY	MERV	REMARKS
F-1	EX. RTU (RT-2)	PLEATED	16x25x2	4	13A	SEE NOTES

REPLACE FILTERS AT EXISTING RTU SERVING THE AREA OF WORK WITH MERV 13A AND REBALANCE THE RTU. CLEAN FILTERS SHALL BE INSTALLED AT PROJECT TURNOVER. VERIFY IN FIELD SIZE OF


TILILING.								
AIR (DUTLETS S	CHEDULE						
TAG	SERVICE	TYPE	MODULE SIZE	DIRECTION	NOISE CRITERIA		OF DESIGN	REMARKS
			(IN)		(NC)	MANUFACTURER	MODEL #	
SD	SUPPLY	DIFFUSER	AS NOTED	4-WAY	25	TITUS	TMS	SEE NOTES
LSD	SUPPLY	LINEAR SLOT	48", 3-SLOT	2-WAY	30	TITUS	ML-37	SEE NOTES
RG	EXHAUST	GRILLE	AS NOTED	-	25	TITUS	350RL	SEE NOTES


AIR OUTLET SCHEDULE NOTES:

- NECK SIZES ARE INDICATED ON THE PLANS. PROVIDE STANDARD BORDER FOR APPLICABLE CEILING TYPE.
- SLOT DIFFUSERS SHALL BE PROVIDED WITH INSULATED PLENUM.

	HOT WATER CONVECTOR SCHEDULE													
UNIT #	EWT °F	LWT °F	GPM	ACTIVE LENGTH (FT)	TUBE SIZE (IN)	ROWS OR TIERS	FINS/ FT	FIN THICK NESS (IN)	FIN SIZE (IN)	MINIMUM BTU/(H*LF)	ENCLOSURE TYPE	ELEMENT	BASIS OF DESIGN	REMARKS
C-1 THRU C-3	200	180	3.4	14	1	2	50	0.020	4.5x4.5	1200	PEDESTAL	COPPER/ALUM.	SLANT-FIN FS-7 C-440	NOTE 1,2

HOT WATER CONVECTOR SCHEDULE NOTES:

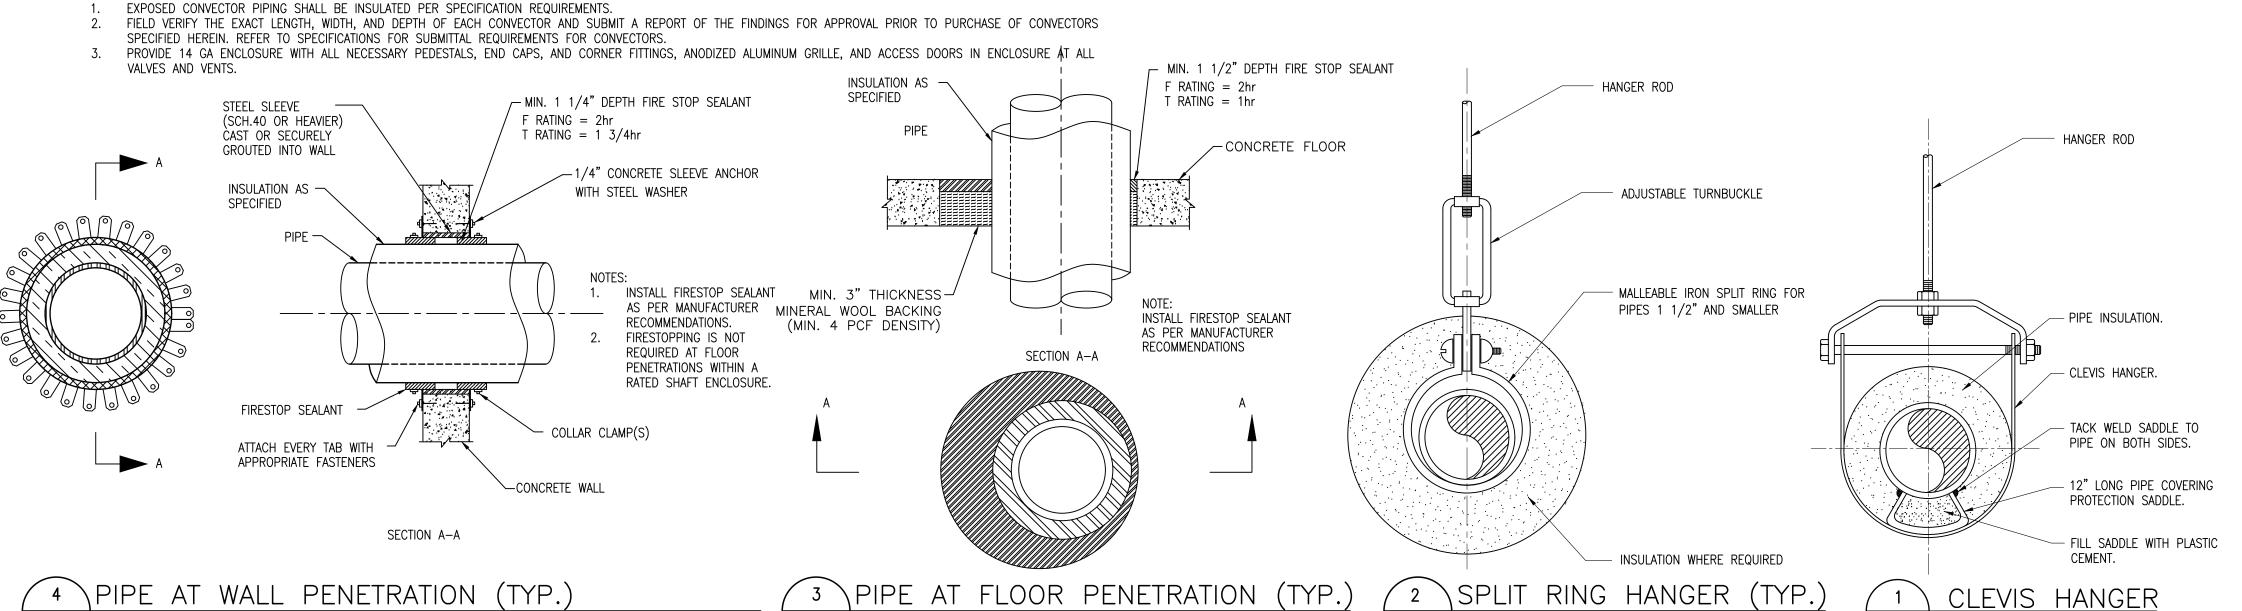

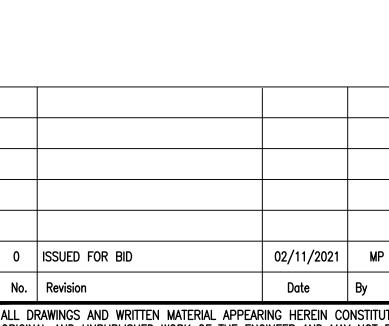

ALL DRAWINGS AND WRITTEN MATERIAL APPEARING HEREIN CONSTITU ORIGINAL AND UNPUBLISHED WORK OF THE ENGINEER AND MAY NOT F DUPLICATED, USED OR DISCLOSED WITHOUT WRITTEN CONSENT OF THE ENGINEER

Engineering





GPINET.COM Greenman-Pedersen, Inc. 400 Rella Boulevard, Suite 207 Montebello, NY 10901

Project YONKERS POLICE THIRD PRECINC₁ LOBBY UPGRADES 435 RIVERDALE AVENUE, YONKERS, NY 10705

GENERAL NOTES, SYMBOLS, AND ABBREVIATIONS

esigned By Drawn By Checked E 02/27/2017 AS SHOWN JM Project No. 2016740.00 Drawing No. Sheet **7** of 16

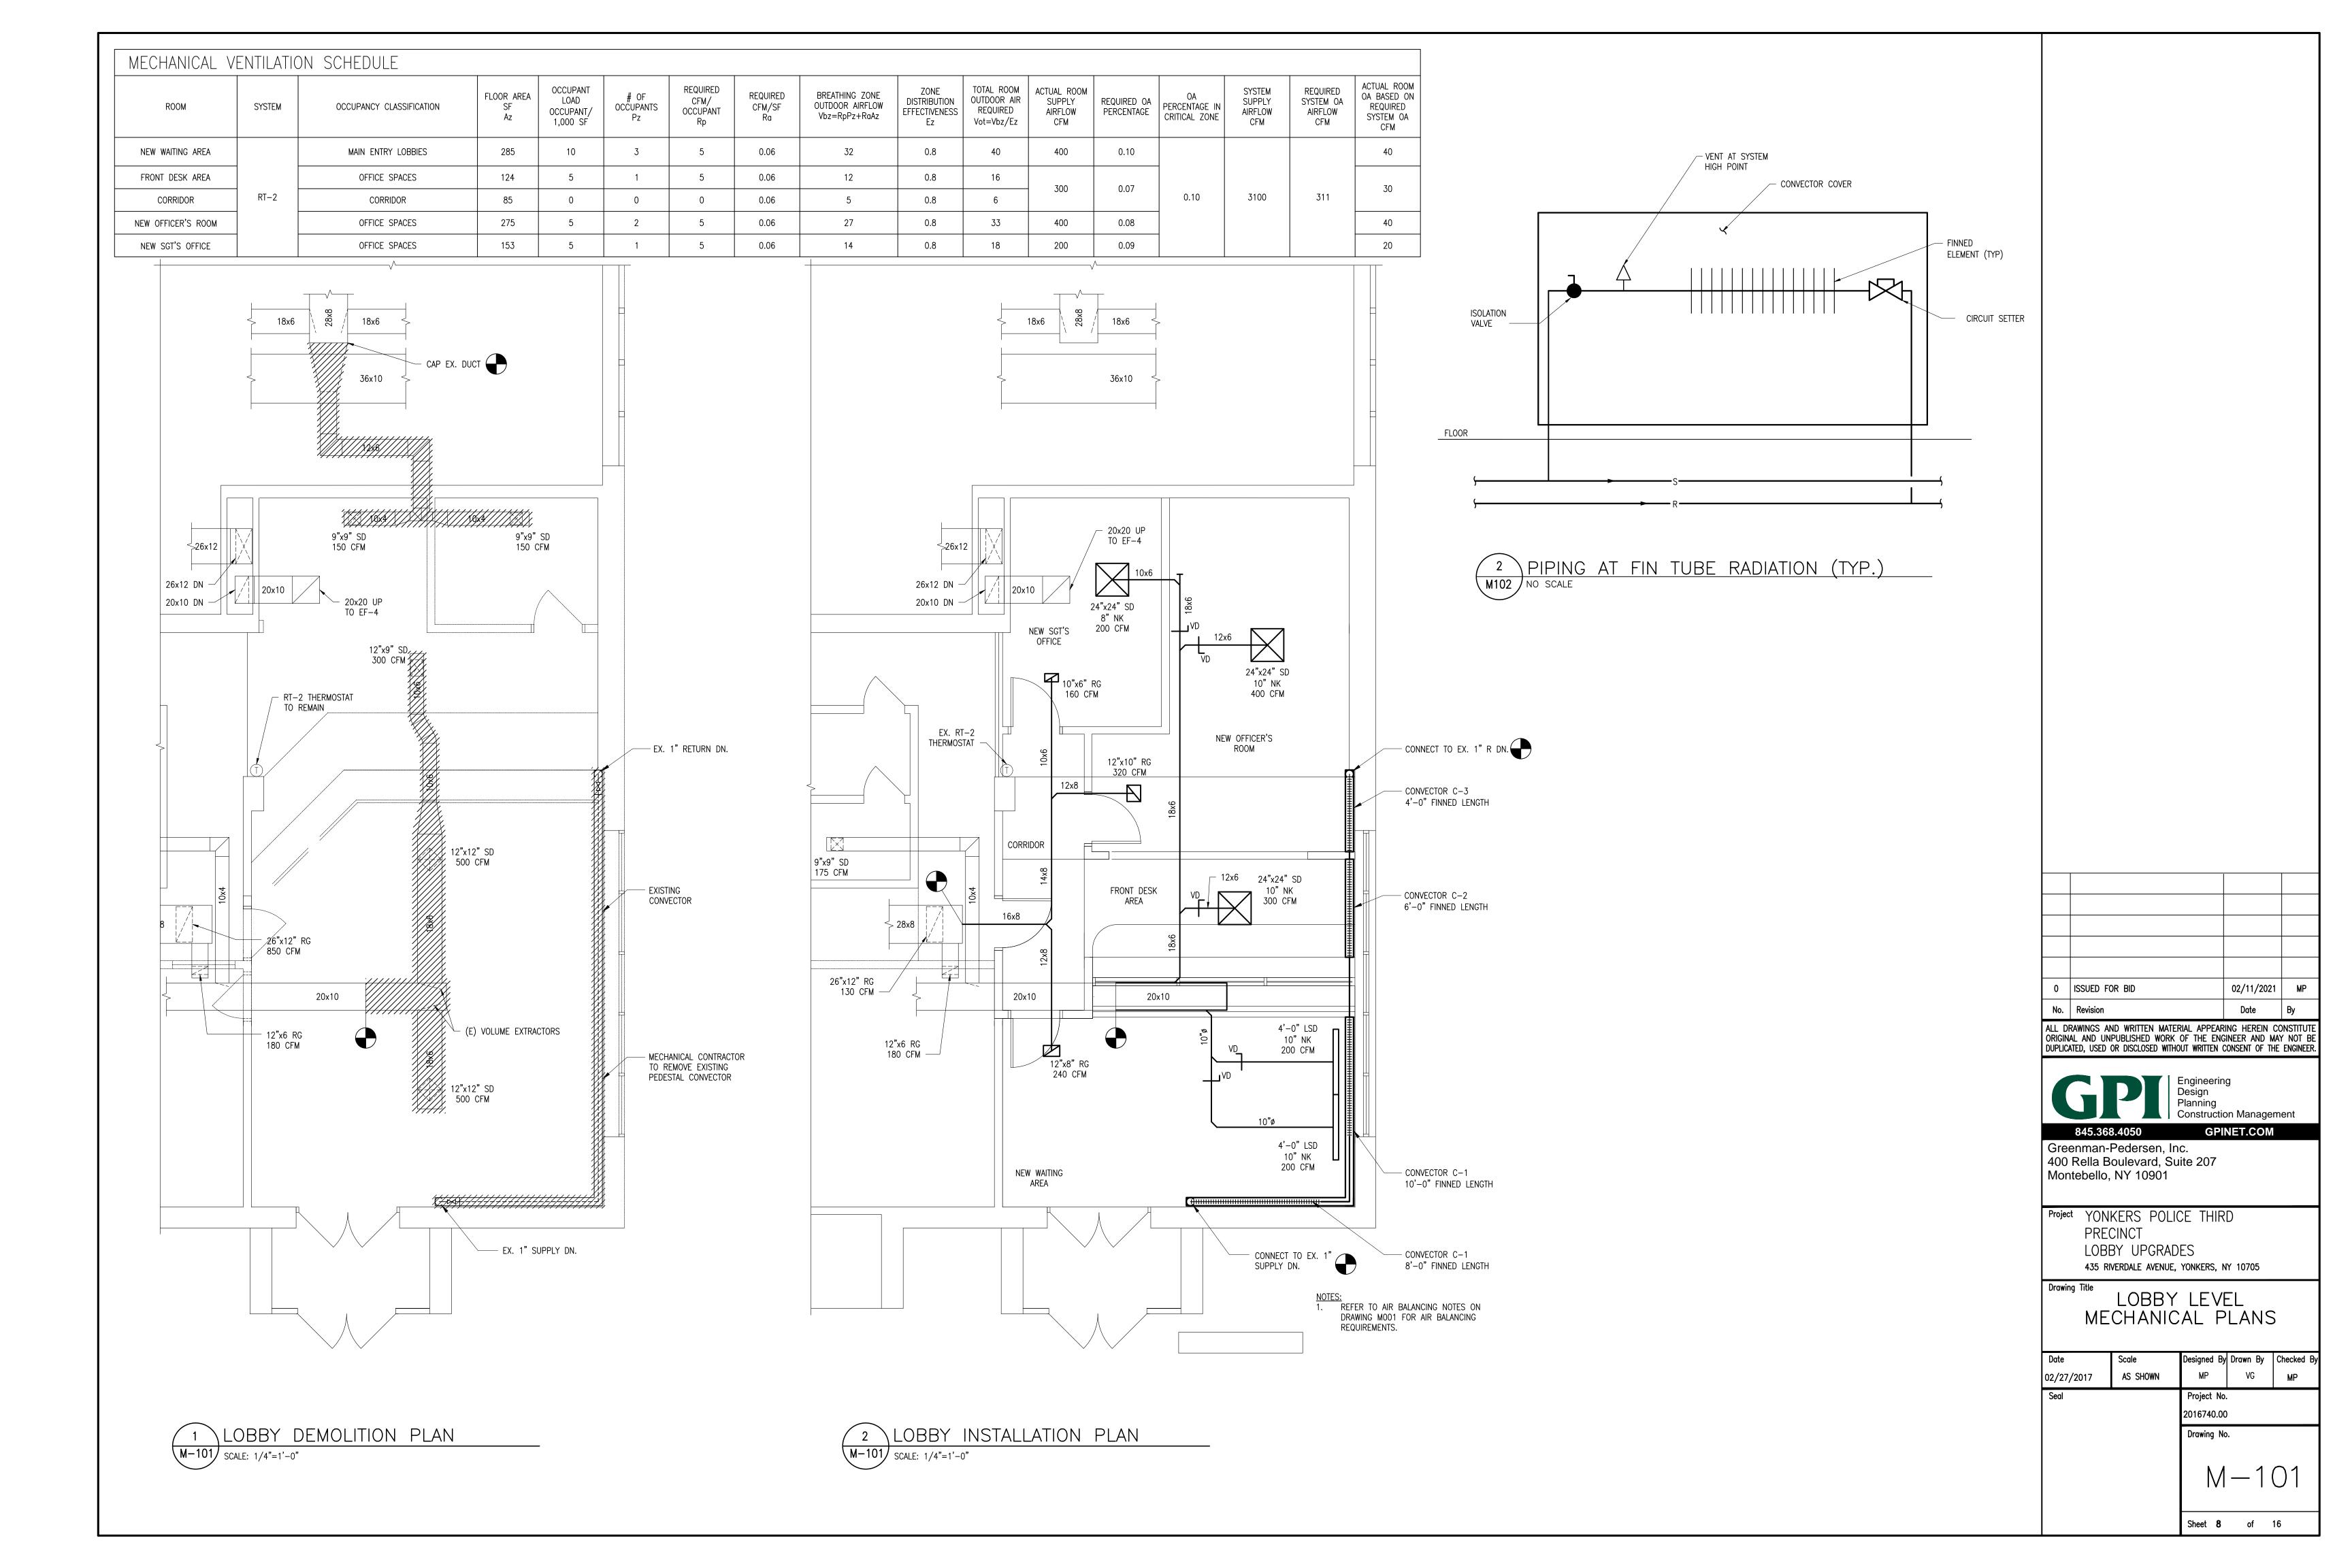

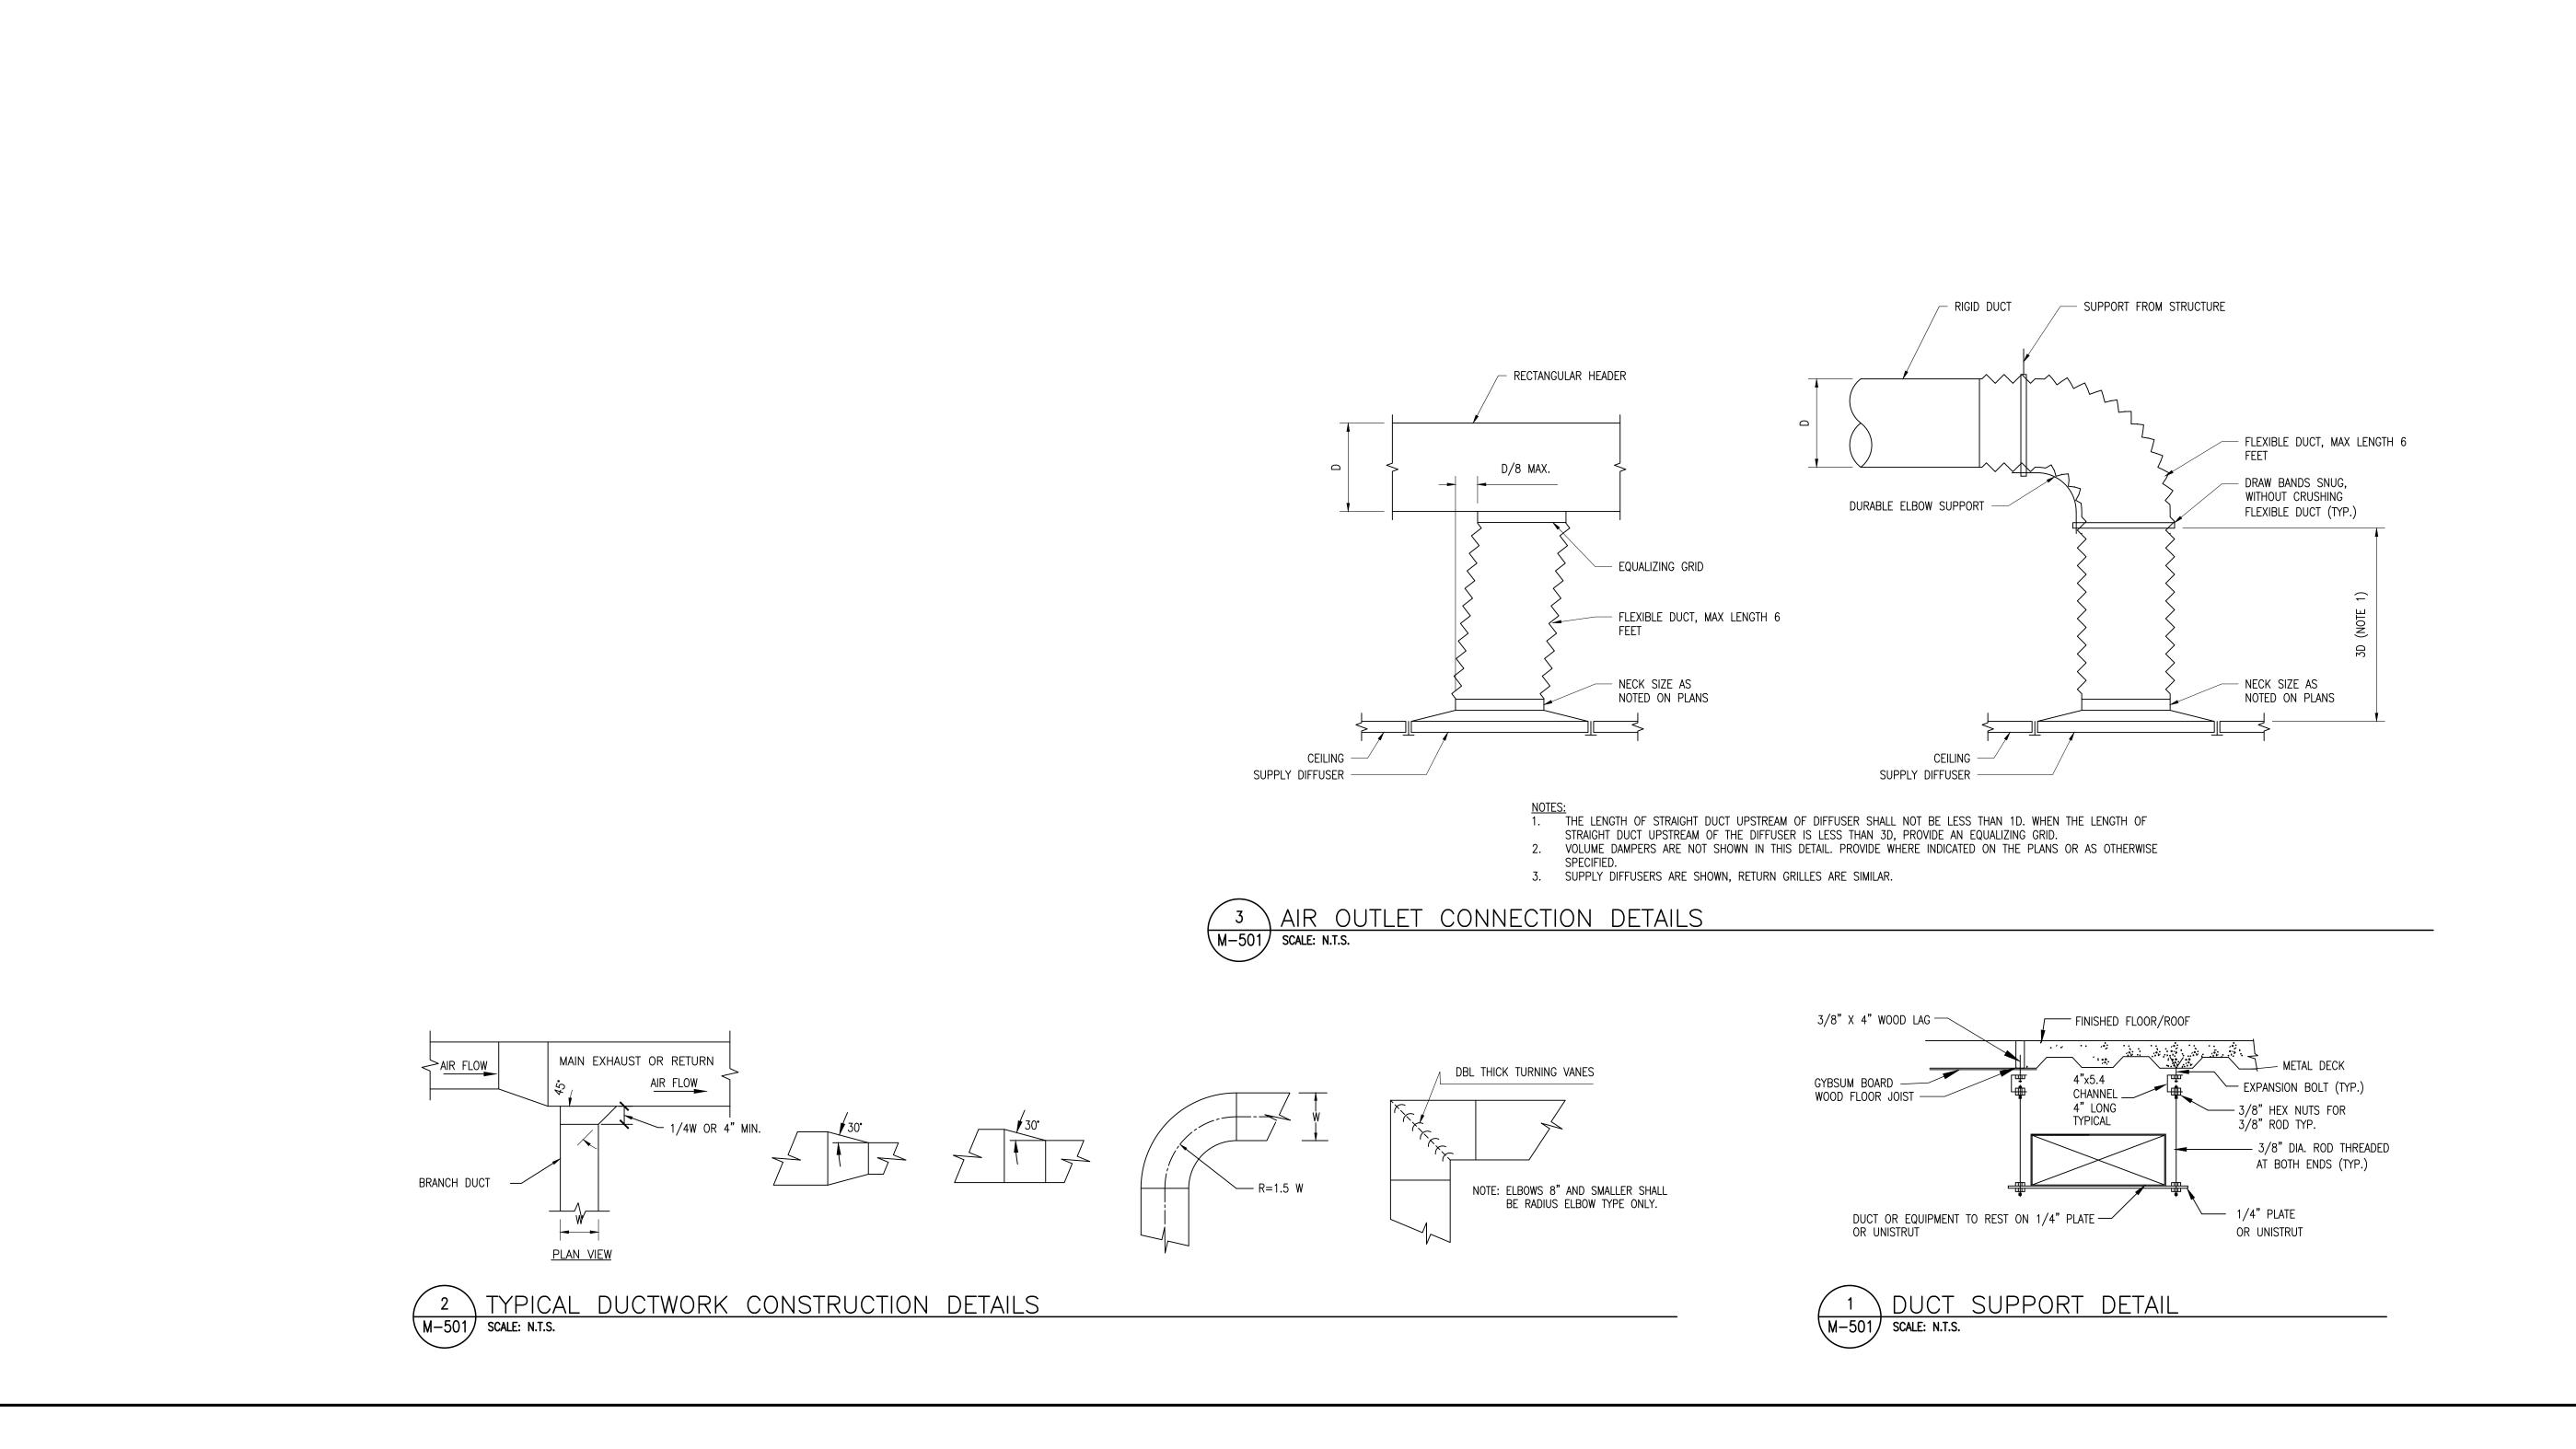



ALL DRAWINGS AND WRITTEN MATERIAL APPEARING HEREIN CONSTITUTE ORIGINAL AND UNPUBLISHED WORK OF THE ENGINEER AND MAY NOT BE DUPLICATED, USED OR DISCLOSED WITHOUT WRITTEN CONSENT OF THE ENGINEER.

845.368.4050


Greenman-Pedersen, Inc. 400 Rella Boulevard, Suite 207 Montebello, NY 10901


Project YONKERS POLICE THIRD PRECINCT LOBBY UPGRADES 435 RIVERDALE AVENUE, YONKERS, NY 10705

Drawing Title MECHANICAL DETAILS

Seal Project No. 2016740.00	Seal Project No.	Date	Scale	Designed By	Drawn By	Checked		
2016740.00	2016740.00	02/27/2017	AS SHOWN	MP	MP	MP		
		Seal		Project No.				
	Drawing No.			2016740.00)			
Drawing No.				Drawing No	Drawing No.			
				I 1\/1	— ·)			

Sheet **9** of 16

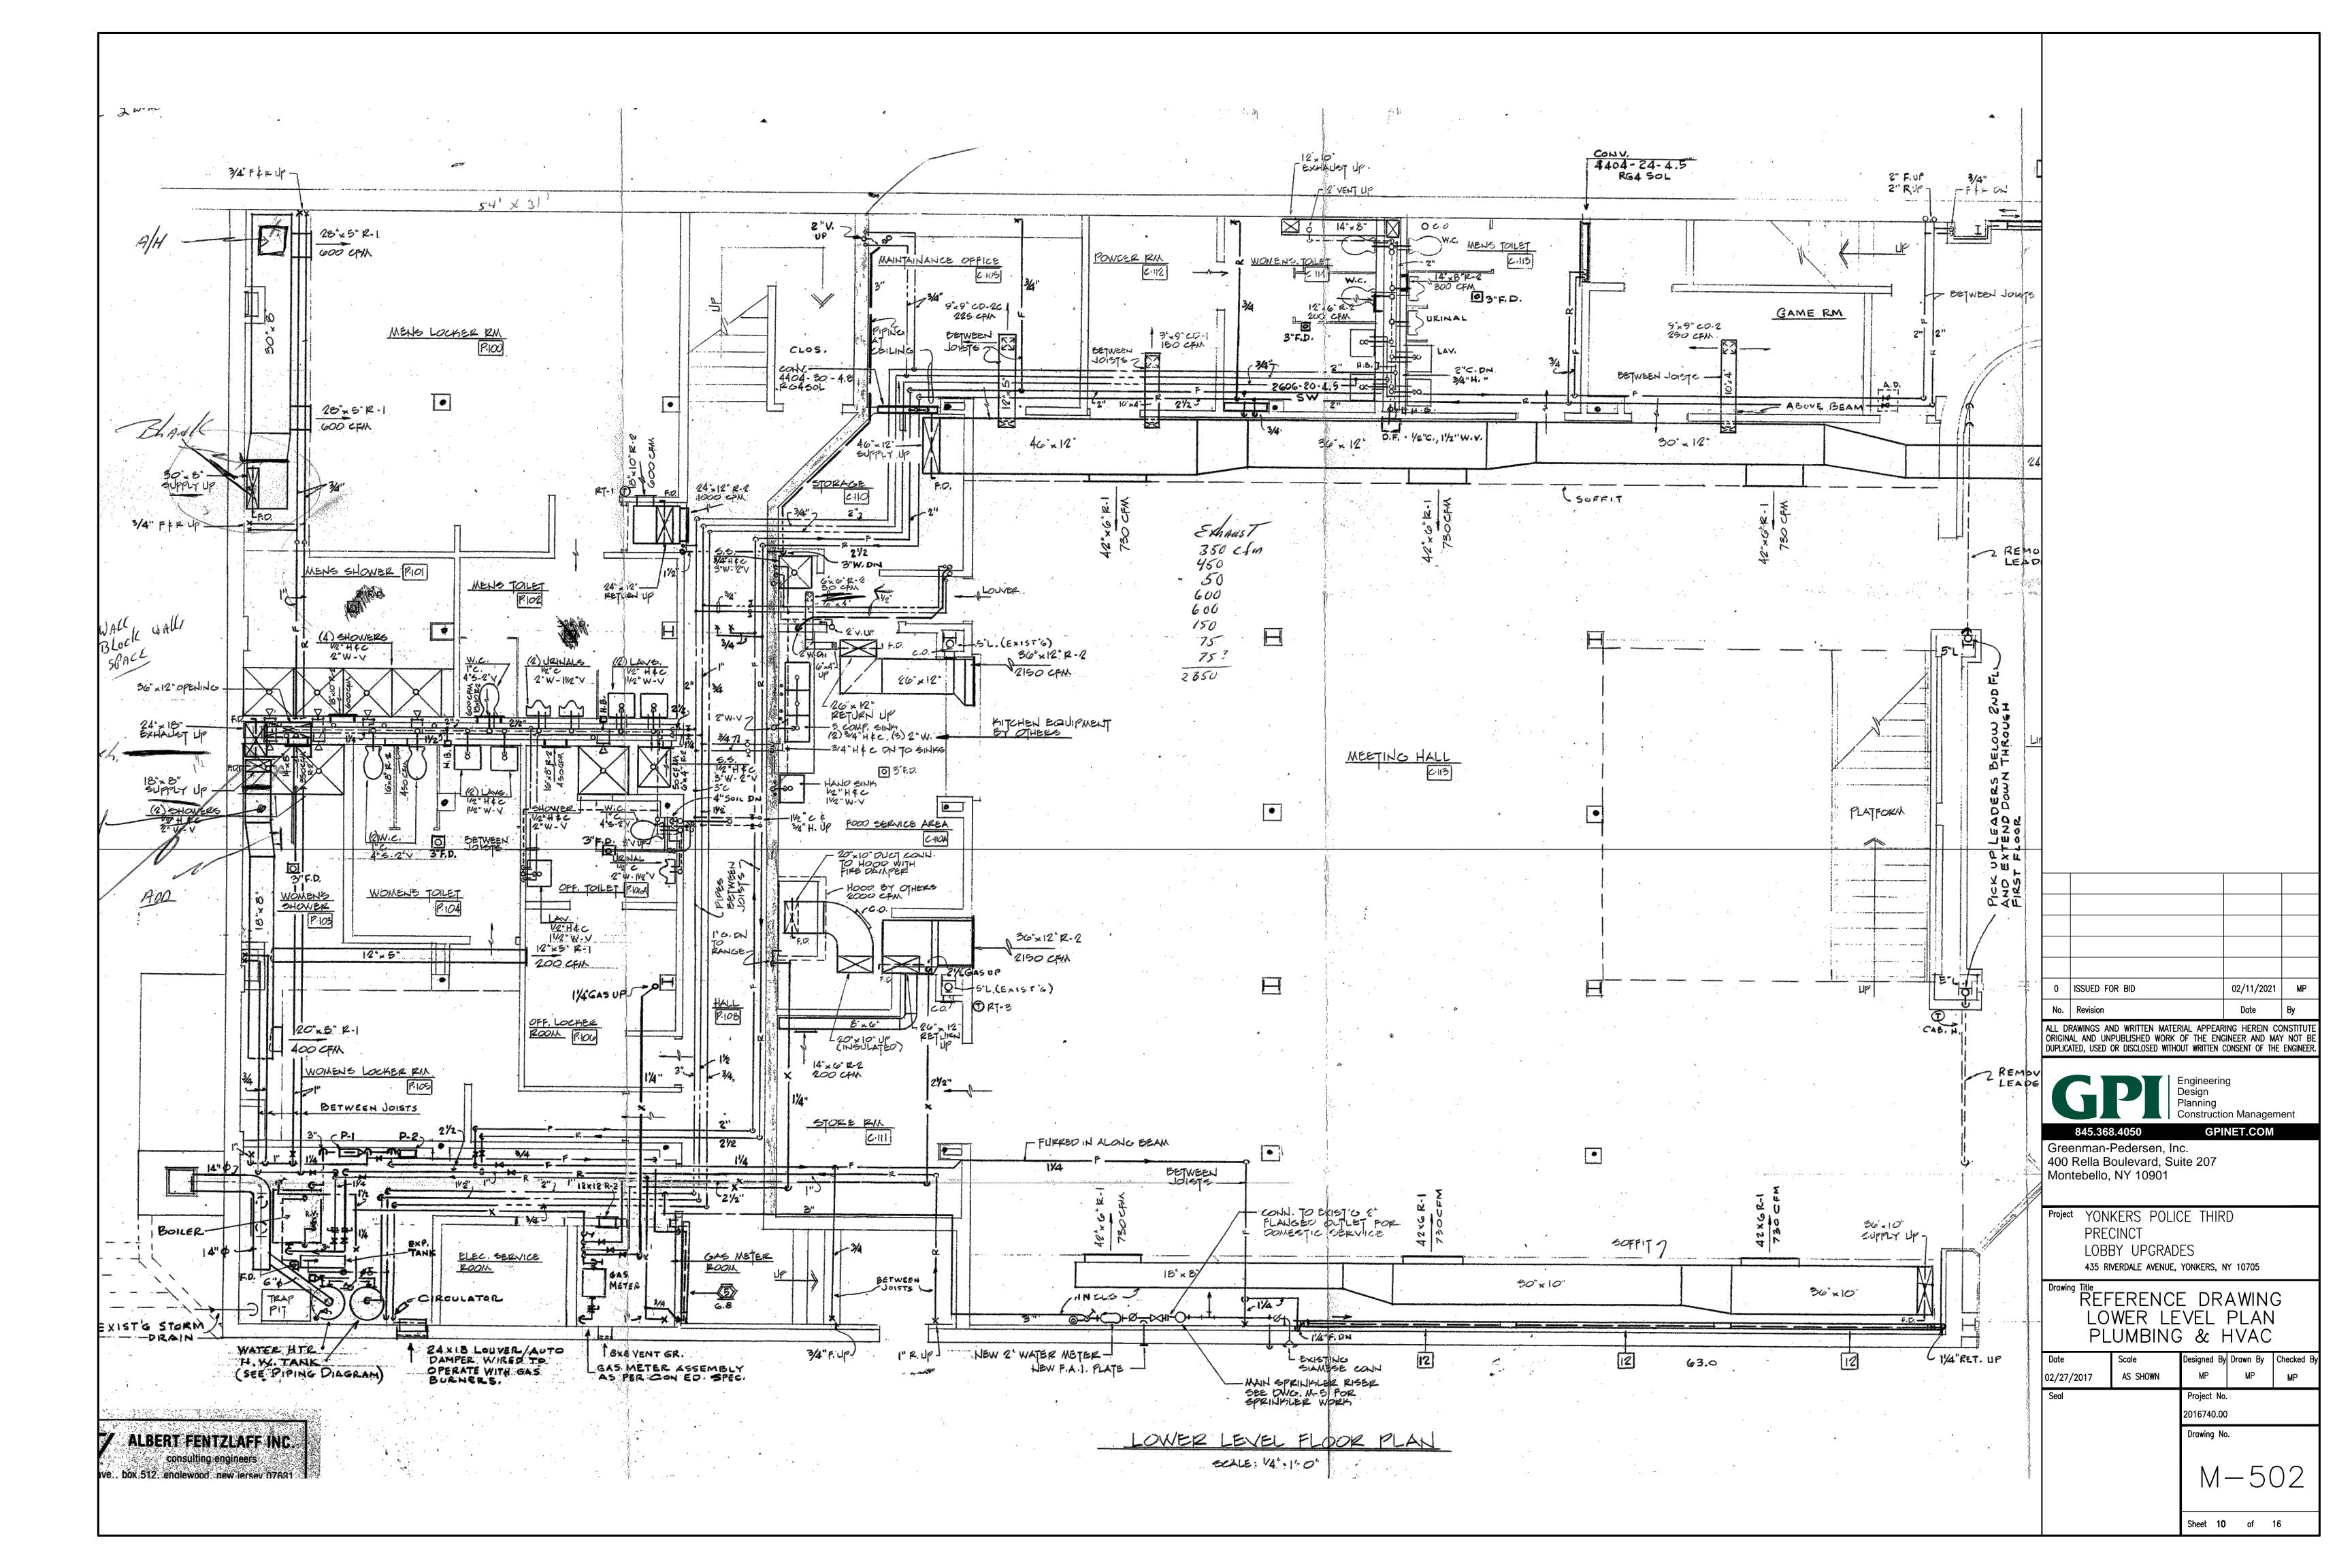

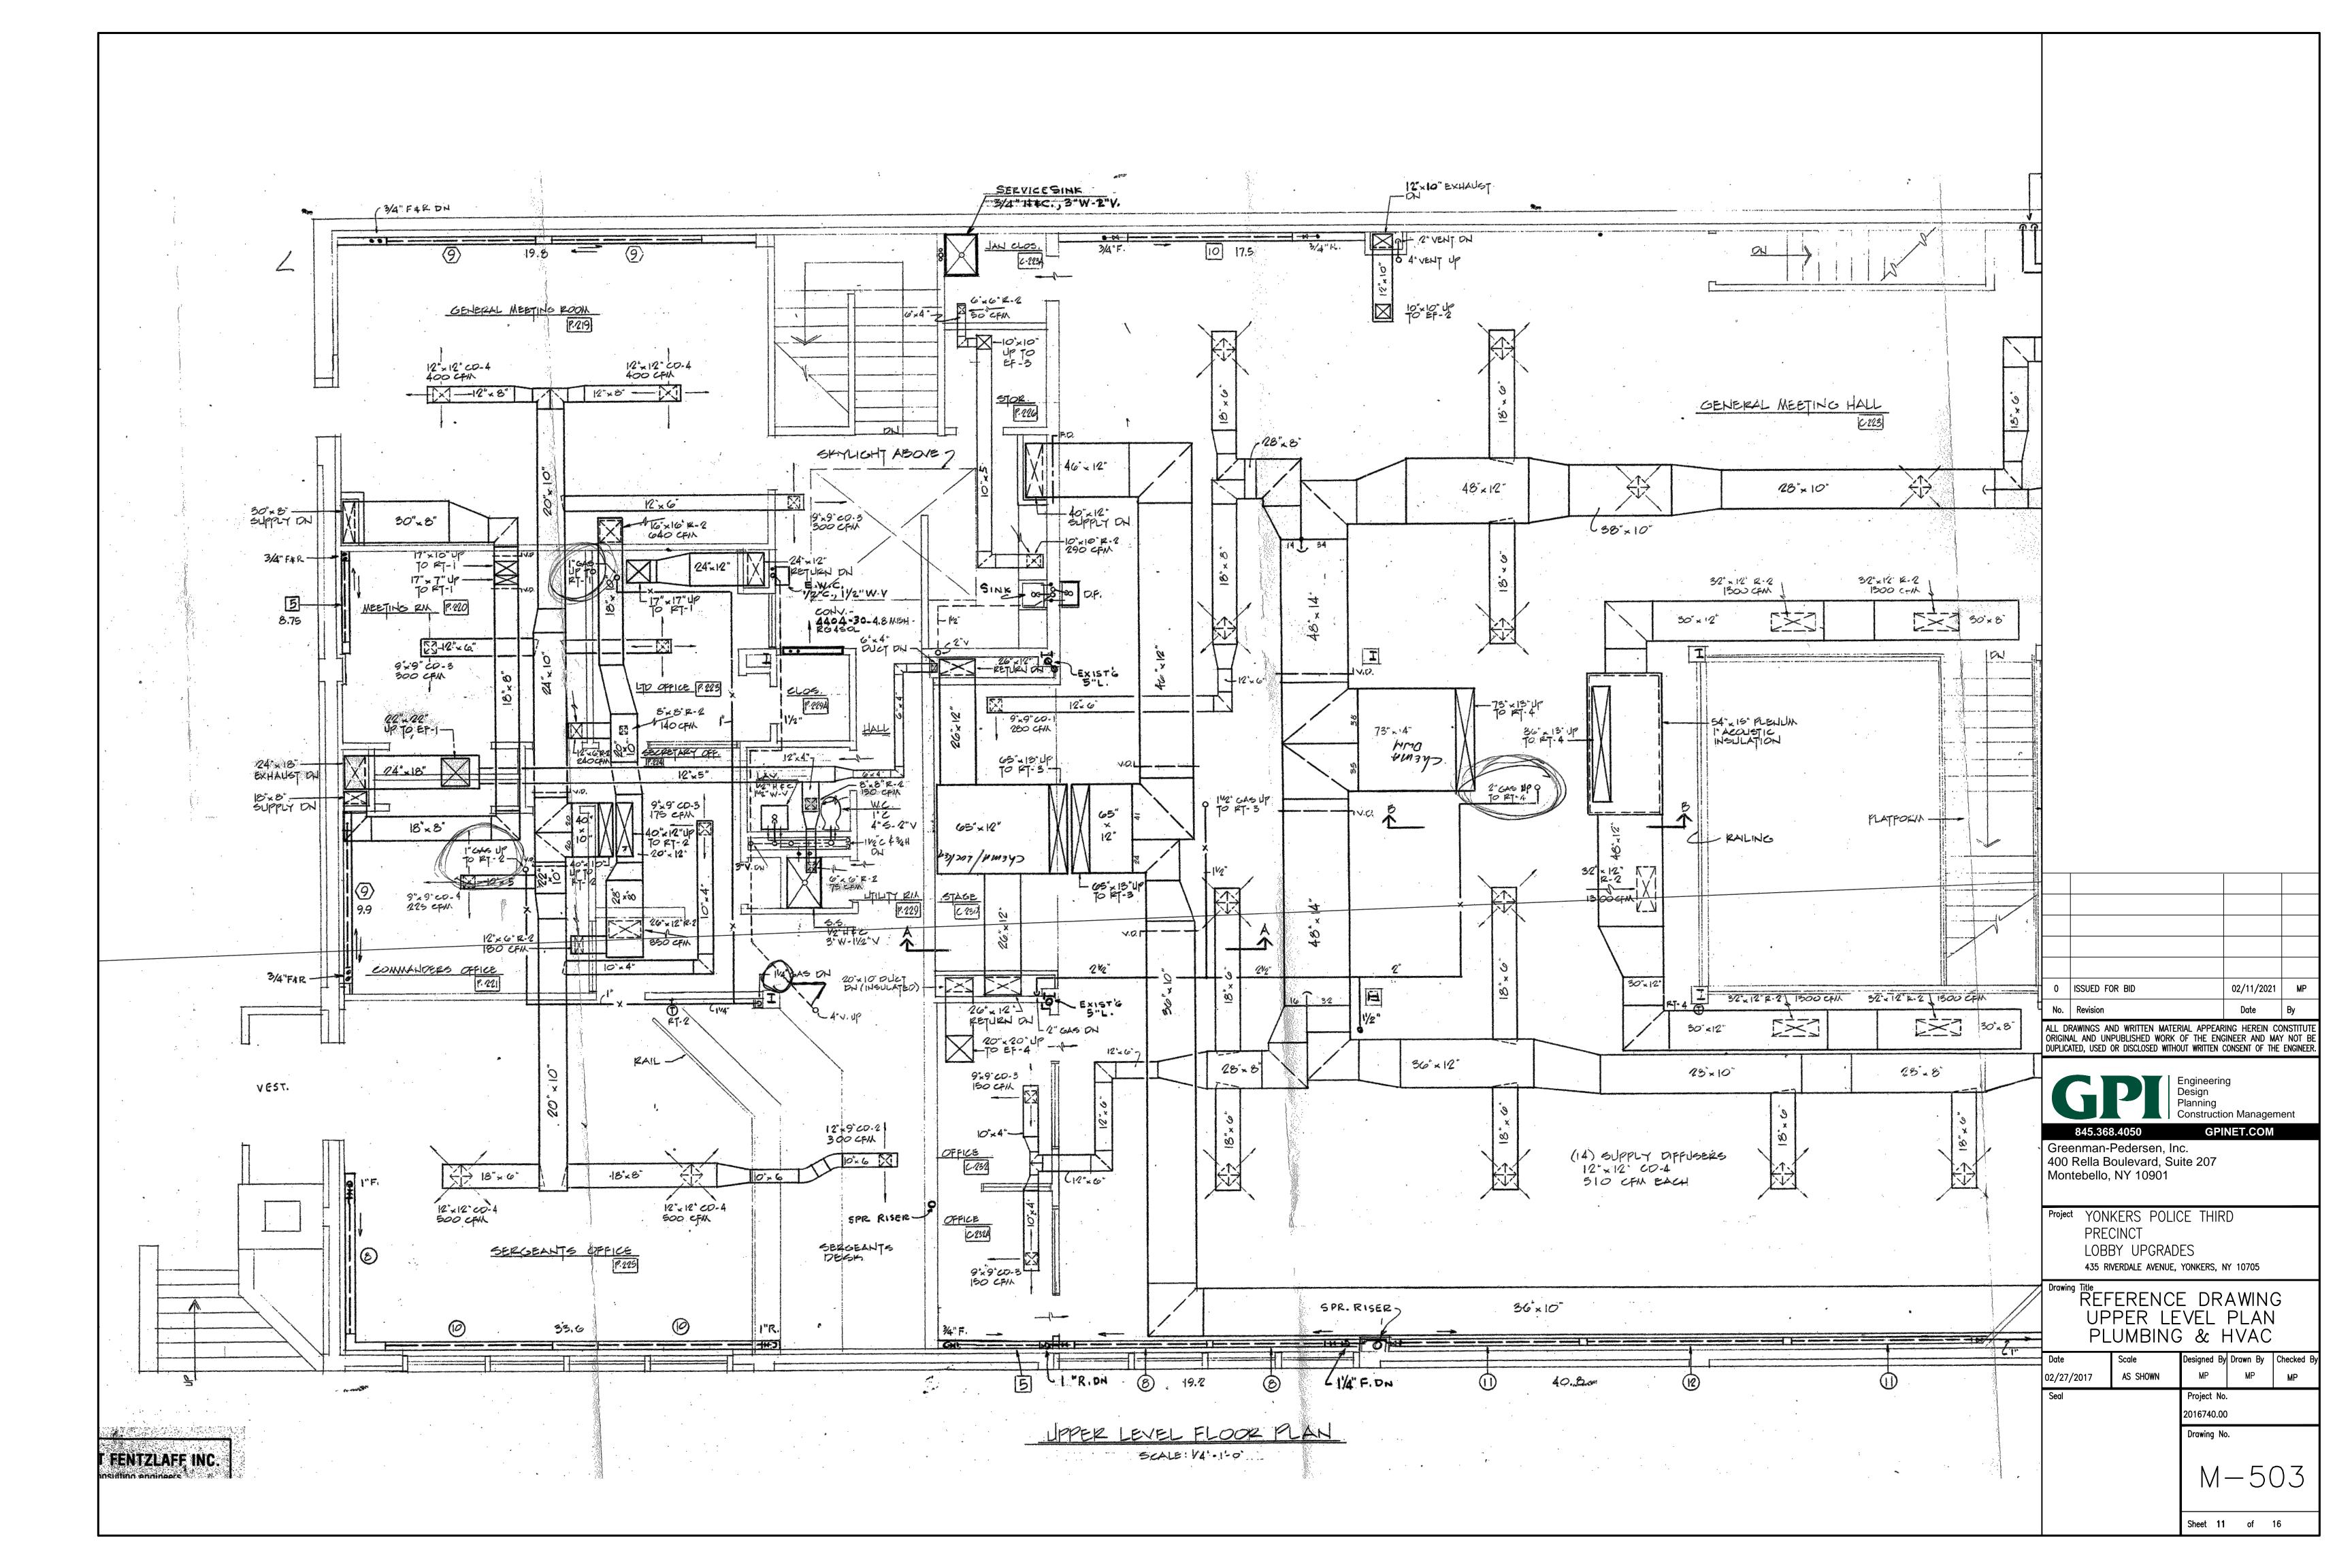

GENERAL NOTES


- 1. THE CONTRACTOR SHALL BE HELD TO HAVE VISITED THE PREMISES AND TO HAVE COMPARED THEIR OBSERVATIONS WITH THE DRAWINGS AND SPECIFICATIONS, AND TO HAVE VERIFIED THE EXISTING CONDITIONS THROUGHOUT THE BUILDING. LATER CLAIMS MADE BY THE CONTRACTOR FOR HAVING INCURRED EXTRA COSTS SHALL NOT BE CONSIDERED WITHOUT FIRST SECURING SUFFICIENT PROOF IN SUPPORT OF EVIDENCE OF SUCH EXTRA CLAIMS. IT IS THE CONTRACTORS RESPONSIBILITY TO IDENTIFY AREAS WHERE INSUFFICIENT INFORMATION IS AVAILABLE, OR WHERE IT CAN BE DOCUMENTED WITH PHOTOS, AND OTHER SUPPORTING INFORMATION THAT SUCH EVIDENCE WAS BEYOND THE MEANS OF THE CONTRACTOR AS JUDGED BY THE OWNER. FINAL JUDGMENT FOR SUCH CLAIMS SHALL BE BY THE OWNER.
- 2. VERIFY ALL EXISTING CONDITIONS AND DIMENSIONS IN THE FIELD, AND BE RESPONSIBLE FOR THE SAME PRIOR TO COMMENCING WORK. ANY DISCREPANCIES BETWEEN THE DRAWINGS AND FIELD CONDITIONS SHALL BE REPORTED TO THE OWNER, THE ARCHITECT AND THE ENGINEER ON RECORD.
- 3. ALL ELECTRICAL WIRING SHALL ADHERE TO THE LATEST REVISION OF BOTH NATIONAL ELECTRICAL CODE AND THE NEW YORK STATE BUILDING CODES.
- 4. ALL WORK SHALL BE IN ACCORDANCE WITH ALL APPLICABLE AND MOST RECENT EDITION OF THE STATE AND LOCAL CODES AND SHALL MEET THE REQUIREMENTS OF ALL OTHER AUTHORITIES, ORGANIZATIONS AND GOVERNMENT AGENCIES
- 5. THE WORK OF THIS CONTRACT IS TO BE PERFORMED WITH A HIGH LEVEL OF QUALITY. WORK WHICH IS, IN THE OPINION OF DESIGNATED REPRESENTATIVE NOT IN COMPLIANCE WITH THE HIGHEST RECOGNIZED INDUSTRY STANDARD FOR WORKMANSHIP OR WORK WHICH HAS BEEN DAMAGED BY FACILITY WORKMANSHIP, WILL BE REMOVED AND REPLACED, OR REPAIRED TO THE SATISFACTION OF THE OWNER.
- 6. PROVIDE ALL LABOR, MATERIALS, EQUIPMENT AND SERVICES NECESSARY TO COMPLETE THE WORK DESCRIBED HEREIN AND/OR AS INDICATED ON THE DRAWINGS AND SPECIFICATIONS. DETAILS NOT USUALLY SHOWN OR SPECIFIED, BUT NECESSARY FOR THE PROPER CONSTRUCTION SHALL BE INCLUDED AS IF THEY WERE ON THE DRAWINGS.
- 7. THE LOCATIONS SHOWN ON THE DRAWINGS INDICATE INTENT AND SHALL BE VERIFIED IN THE FIELD.
- 8. ALL HOLES MADE BY THE CONTRACTOR DURING CONSTRUCTION SHALL BE PROPERLY PATCHED AND REPAIRED. ALL CONDUIT PENETRATIONS THROUGH FLOORS AND WALLS SHALL BE SEALED.
- 9. THE CONTRACTOR SHALL DO ALL CUTTING, PATCHING AND REPAIRING AS REQUIRED TO PERFORM ALL WORK INDICATED ON THE DRAWINGS, AND ALL OTHER WORK THAT MAY BE REQUIRED TO COMPLETE THE JOB.
- 10. THE CONTRACTOR SHALL PROVIDE ALL PHYSICAL PROTECTION REQUIRED TO PROTECT ALL EQUIPMENT DURING CONSTRUCTION.
- 11. WHERE CONDUIT ROUTING HAS NOT BEEN SHOWN ON THE DRAWINGS, THE ROUTING OF POWER BRANCH CIRCUITS WILL BE AT THE CONTRACTOR'S DISCRETION AND THE OWNER APPROVAL IN ACCORDANCE WITH CODES AND SPECIFICATIONS.

	ABBREVIATIONS							
A	AMPERE	LP	120/208V PANEL					
AC	ALTERNATING CURRENT	LS	LOUDSPEAKER					
ACS	ADMINISTRATIVE CONTROL STATION	LTG	LIGHTING					
ADA	AMERICANS WITH DISABILITIES ACT	MATV	MASTER TELEVISION					
AFF	ABOVE FINISHED FLOOR	MCC	MOTOR CONTROL CENTER					
ARCH	ARCHITECTURAL	MECH	MECHANICAL					
ATS	AUTOMATIC TRANSFER SWITCH	MER	MECHANICAL EQUIPMENT ROOM					
A/C	AIR CONDITIONING	MIC	MICROPHONE					
C	CONDUIT	MTD	MOUNTED					
CAB	CABINET	N	NEUTRAL					
CLG	CEILING	N.C.	NORMALLY CLOSED					
CB	CIRCUIT BREAKER	N.O.	NORMALLY OPEN					
CKT(S)	CIRCUIT(S)	0 & R	ORANGE AND ROCKLAND					
COL	COLUMN	Р	POLE(S)					
DWG	DRAWING	PB	PULL BOX					
EC	EMPTY CONDUIT	PNL	PANEL					
ELEC	ELECTRIC	PP	277/480V PANEL					
EMR	ELEVATOR MECHANICAL ROOM	RC	REMOTE CONTROL					
EMT	ELECTRIC METALLIC TUBING	SP	SPARE					
EXH	EXHAUST	SSB	SOLID STATE BALLAST					
EXIST	EXISTING	STD	STANDARD					
FATB	FIRE ALARM TERMINAL BOX	SW	SWITCH					
FL	FLOOR	SWBD	SWITCHBOARD					
G	GUARD	TEL	TELEPHONE					
GND	GROUND	TV	TELEVISION					
GFI	GROUND FAULT INTERRUPTER	TYP	TYPICAL					
GRC	GALVANIZED RIGID CONDUIT	V	VOLT					
IG	ISOLATED GROUND	W	WATT					
JB	JUNCTION BOX	WP	WEATHERPROOF					
1.01.11								

INSTALLATION NOTES

- 1. CONTRACTOR SHALL PERMANENTLY FASTEN ALL THE EQUIPMENT AS INDICATED ON THE DRAWINGS IN AN APPROVED MANNER, WITH ALL NECESSARY HARDWARE.
- 2. CONTRACTOR SHALL PROVIDE ALL CONDUITS, WIRING, OUTLET BOXES AND ALL ACCESSORIES NECESSARY TO COMPLETE THE WIRING TO ALL COMPONENTS OF THE SYSTEM. ALL CONNECTIONS SHALL BE MADE COMPLETE AND TESTED.

	SYMBOL LIST
Φ_{GFI}	DUPLEX RECEPTACLE 125V, 20A (NEMA 5–20R) GFI=GROUND FAULT INTERRUPTOR A = PROVIDED WITH USB
⊕	QUADRUPLEX RECEPTACLE 125V, 20A (NEMA 5-20R) GFI=GROUND FAULT INTERRUPTOR A = PROVIDED WITH USB
J ▼	WALL MOUNTED JUNCTION BOX VOICE OUTLET LOCATION WITH 1" CONDUIT TERMINATED IN A 90 DEG. BEND 6" INTO NEAREST ACCESSIBLE CEILING
4	VOICE & DATA OUTLET LOCATION WITH 1" CONDUIT TERMINATED IN A 90 DEG. BEND 6" INTO NEAREST ACCESSIBLE CEILING
TV	TV COAXIAL OUTLET. PROVIDE BACKBOX WITH 1" EMT. ROUTE FROM CABLE BOX LOCATED AT FRONT DESK AREA.
Ø,	TO BE DEMOLISHED
\$	LIGHTING SWITCH
	PANELBOARD
S	CEILING MOUNTED OCCUPANCY SENSOR
OS	WALL MOUNTED OCCUPANCY SENSOR SWITCH
	HOMERUN
✓ 🌣	WALL MOUNTED EXIT SIGN LIGHT
F	FIRE ALARM PULL STATION
CR	CARD READER
REX	REQUEST TO EXIT DEVICE
	EMERGENCY BATTERY BACKUP UNIT
(E)	EXISTING TO REMAIN
IC I	INTERCOM DEVICE
CAM	WALL MOUNTED CAMERA

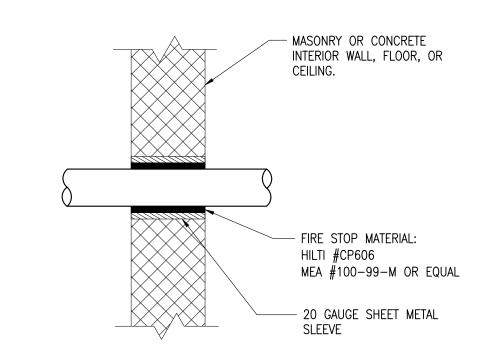



	LIGHT	ING F	'IXTURE	SCHE	EDULE	
TYPE	DESCRIPTION	MOUNTING	LAMPS	VOLTS.	MANUFACTURER/MODEL BASE BID	COMMENTS
OA	14" LED SURFACE MOUNTED FIXTURE	SURFACE	LED	MVOLT	WINONA WFP5520-14DIA-SCHOOL-120-OG-AB	PROVIDE LED CONVERSION KIT
В	2'X2' VT SERIES VOLUMETRIC LED TROFFER	RECESSED	LED	MVOLT	LITHONIA 2VTL-MVOLT OR APPROVED EQUAL	
С	12" DESK MOUNTED LED GLOBE LIGHT	SURFACE	LED	MVOLT	STERNBERGLIGHTING G12/G20 PF GLOBE SERIES G12WAPF/673PB/ABZT	PROVIDE LED CONVERSION KIT AND PIER BASE

KVA

KILOVOLT AMPERE

KILOWATT HOUR


KILOWATT

- 1. CONTRACTOR SHALL COORDINATE ALL THE MOUNTING REQUIREMENTS WITH THE ARCHITECT AND THE MANUFACTURERS
- CATALOG SHEET. PROVIDE AND INSTALL ALL BRACKETS AND MOUNTING HARDWARE FOR A COMPLETE INSTALLATION.
 2. COORDINATE ALL FINISHES WITH THE ARCHITECT.


			CONDUIT FILL FO	DR CAT. 6 CABLES			
CONDUIT SIZE TYPE	3/4"	1"	1 1/4"	1 1/2"	2"	2 1/2"	3"
NON-PLEN/PLENUM:	3	6	10	15	20	30	40

NOTE: BASED ON CABLE OUTSIDE DIAMETER OF 0.24".



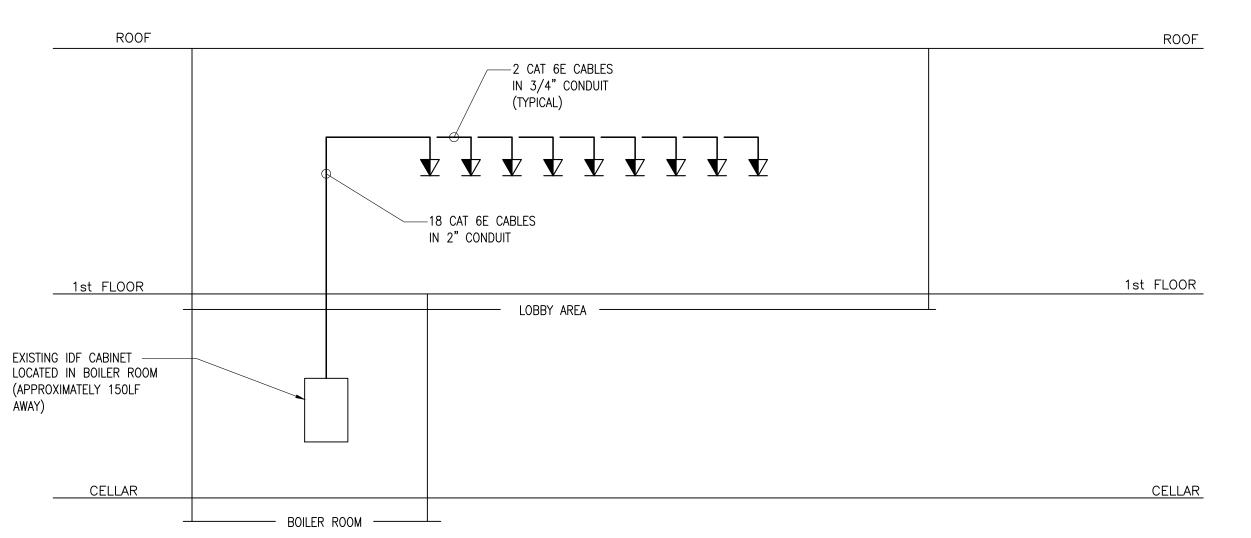



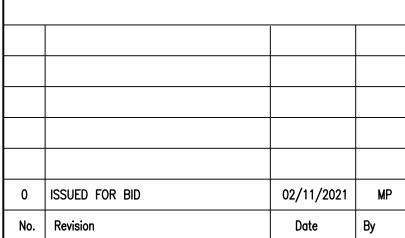

ALL DRAWINGS AND WRITTEN MATERIAL APPEARING HEREIN CONSTITUTE ORIGINAL AND UNPUBLISHED WORK OF THE ENGINEER AND MAY NOT BE DUPLICATED, USED OR DISCLOSED WITHOUT WRITTEN CONSENT OF THE ENGINEER.




Greenman-Pedersen, Inc. 400 Rella Boulevard, Suite 207 Montebello, NY 10901

Project YONKERS POLICE THIRD
PRECINCT
LOBBY UPGRADES
435 RIVERDALE AVENUE, YONKERS, NY 10705

GENERAL NOTES, SYMBOLS, AND ABBREVIATIONS

Data	I coale	Designed De	D D	I Ohaaliad Di			
Date	Scale	Designed By		Checked By			
02/27/2017	AS SHOWN	JM	JM	MP			
Seal		Project No.					
		2016740.00)				
		Drawing No	·				
			$ \cup$	\cup \square			

Sheet **12** of 16

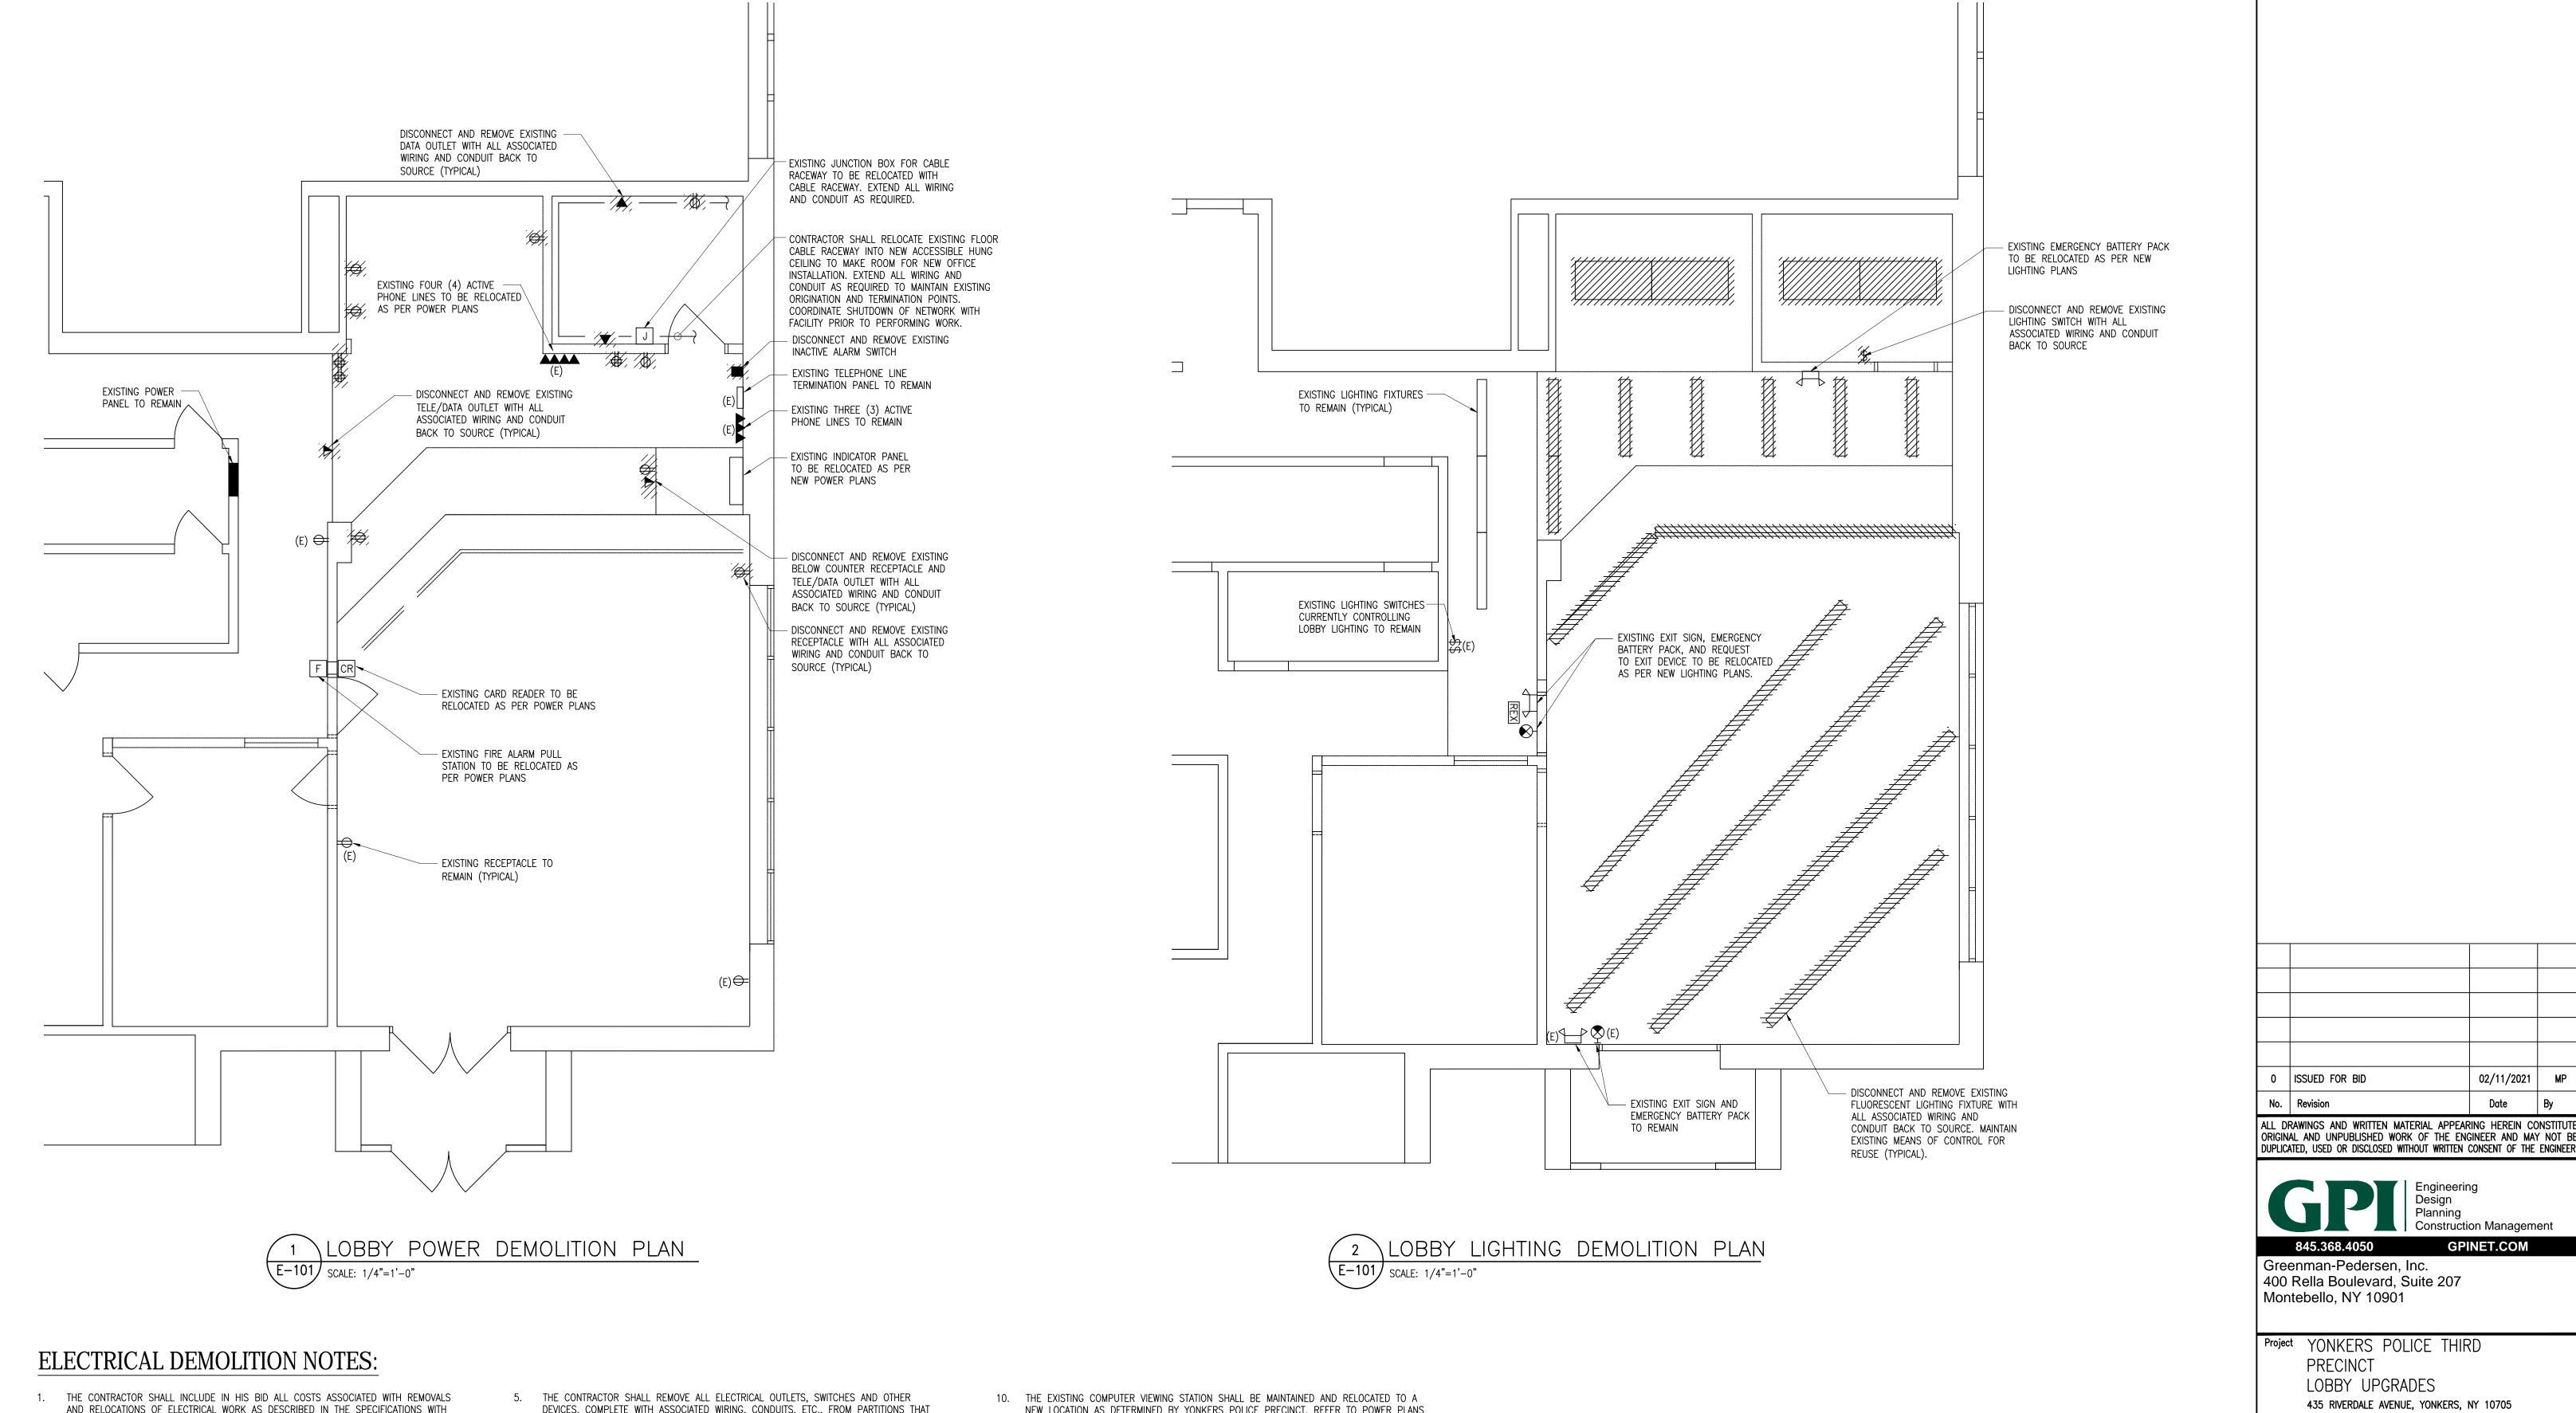

- AND RELOCATIONS OF ELECTRICAL WORK AS DESCRIBED IN THE SPECIFICATIONS WITH ALLOWANCES FOR EXPECTED OR UNFORESEEN DIFFICULTIES WHEN CONCEALED WORK HAS BEEN OPENED. NO CLAIMS FOR ADDITIONAL WORK ASSOCIATED WITH DEMOLITION WILL BE ACCEPTED, EXCEPT IN CERTAIN CASES CONSIDERED JUSTIFIABLE BY THE ARCHITECT.
- 2. THE CONTRACTOR SHALL REMOVE AND/OR RELOCATE ALL EXISTING ELECTRICAL WORK WHICH INTERFERES WITH THE NEW ARCHITECTURAL AND ELECTRICAL LAYOUTS IN FULL COORDINATION WITH THE ARCHITECT'S DEMOLITION PLANS. ALL SYSTEMS WHICH ARE NO LONGER REQUIRED TO FUNCTION SHALL BE DE-ENERGIZED AND DISCONNECTED AT THE SOURCE OF POWER SUPPLY.
- THE CONTRACTOR SHALL PERFORM DEMOLITION AND REMOVAL WORK WITH MINIMUM INTERFERENCE WITH FUNCTIONING ELECTRICAL SYSTEMS. ALL AFFECTED SYSTEMS SHALL BE RECONNECTED AND RESTORED.
- 4. DEMOLITION AND REMOVAL WORK SHALL BE PERFORMED IN A NEAT AND WORKMANLIKE MANNER. THE CONTRACTOR SHALL PATCH, REPAIR OR OTHERWISE RESTORE ANY DAMAGED INTERIOR OR EXTERIOR BUILDING SURFACE TO ITS ORIGINAL CONDITION.
- DEVICES, COMPLETE WITH ASSOCIATED WIRING, CONDUITS, ETC., FROM PARTITIONS THAT ARE TO BE REMOVED. WHERE THE REMOVAL OF THESE ITEMS DISRUPTS EXISTING WIRING THAT IS TO REMAIN, THE CONTRACTOR SHALL INSTALL JUNCTION BOXES AND OTHER DEVICES AND PROVIDE BYPASS CONNECTIONS NECESSARY TO MAKE CIRCUITS AFFECTED CONTINUOUS AND READY FOR OPERATION. OTHERWISE, WIRING SHALL BE REMOVED BACK TO THE NEAREST ELECTRICAL JUNCTION BOX THAT IS TO REMAIN OR TO PANELBOARD.
- 6. ALL RACEWAYS WHICH BECOME EXPOSED DURING THE ALTERATION WORK SHALL BE REMOVED AND REROUTED CONCEALED BEHIND FINISHED SURFACES.
- 7. ALL UNUSED OUTLET BOXES OR CAPPED FLOOR OUTLETS SHALL BE PROVIDED WITH MATCHING BLANK COVERS.
- PORTIONS OF FEEDER RUNS TO BE REMOVED OR ABANDONED AS A RESULT OF DEMOLITION WORK, BUT WHICH ARE REQUIRED TO REMAIN ENERGIZED, SHALL BE CUT AT CONVENIENT LOCATIONS, REROUTED AND RECONNECTED. NEW FEEDER EXTENSIONS SHALL MATCH EXISTING ONES IN ALL RESPECTS, CABLE TYPE, CONDUCTOR AMPACITY, CONDUIT SIZES, ETC.
- 9. ALL EXISTING MATERIAL AND EQUIPMENT IN USABLE CONDITION, WHICH IS TO BE REMOVED UNDER THIS CONTRACT, SHALL REMAIN THE PROPERTY OF THE OWNER OR SHALL BE DISPOSED OF BY THE ELECTRICAL CONTRACTOR, AS DIRECTED BY THE OWNER.

NEW LOCATION AS DETERMINED BY YONKERS POLICE PRECINCT. REFER TO POWER PLANS FOR ADDITIONAL SCOPE.


GPINET.COM 400 Rella Boulevard, Suite 207

435 RIVERDALE AVENUE, YONKERS, NY 10705

LOBBY LEVEL ELECTRICAL DEMOLITION PLANS

02/11/2021 MP

Date	Scale	Designed By	Drawn By	Checked By	
02/27/2017	AS SHOWN	MP	VG	MP	
Seal		Project No.			
		2016740.00)		
		Drawing No),		
		E	E-101		
		Sheet 13	of	16	

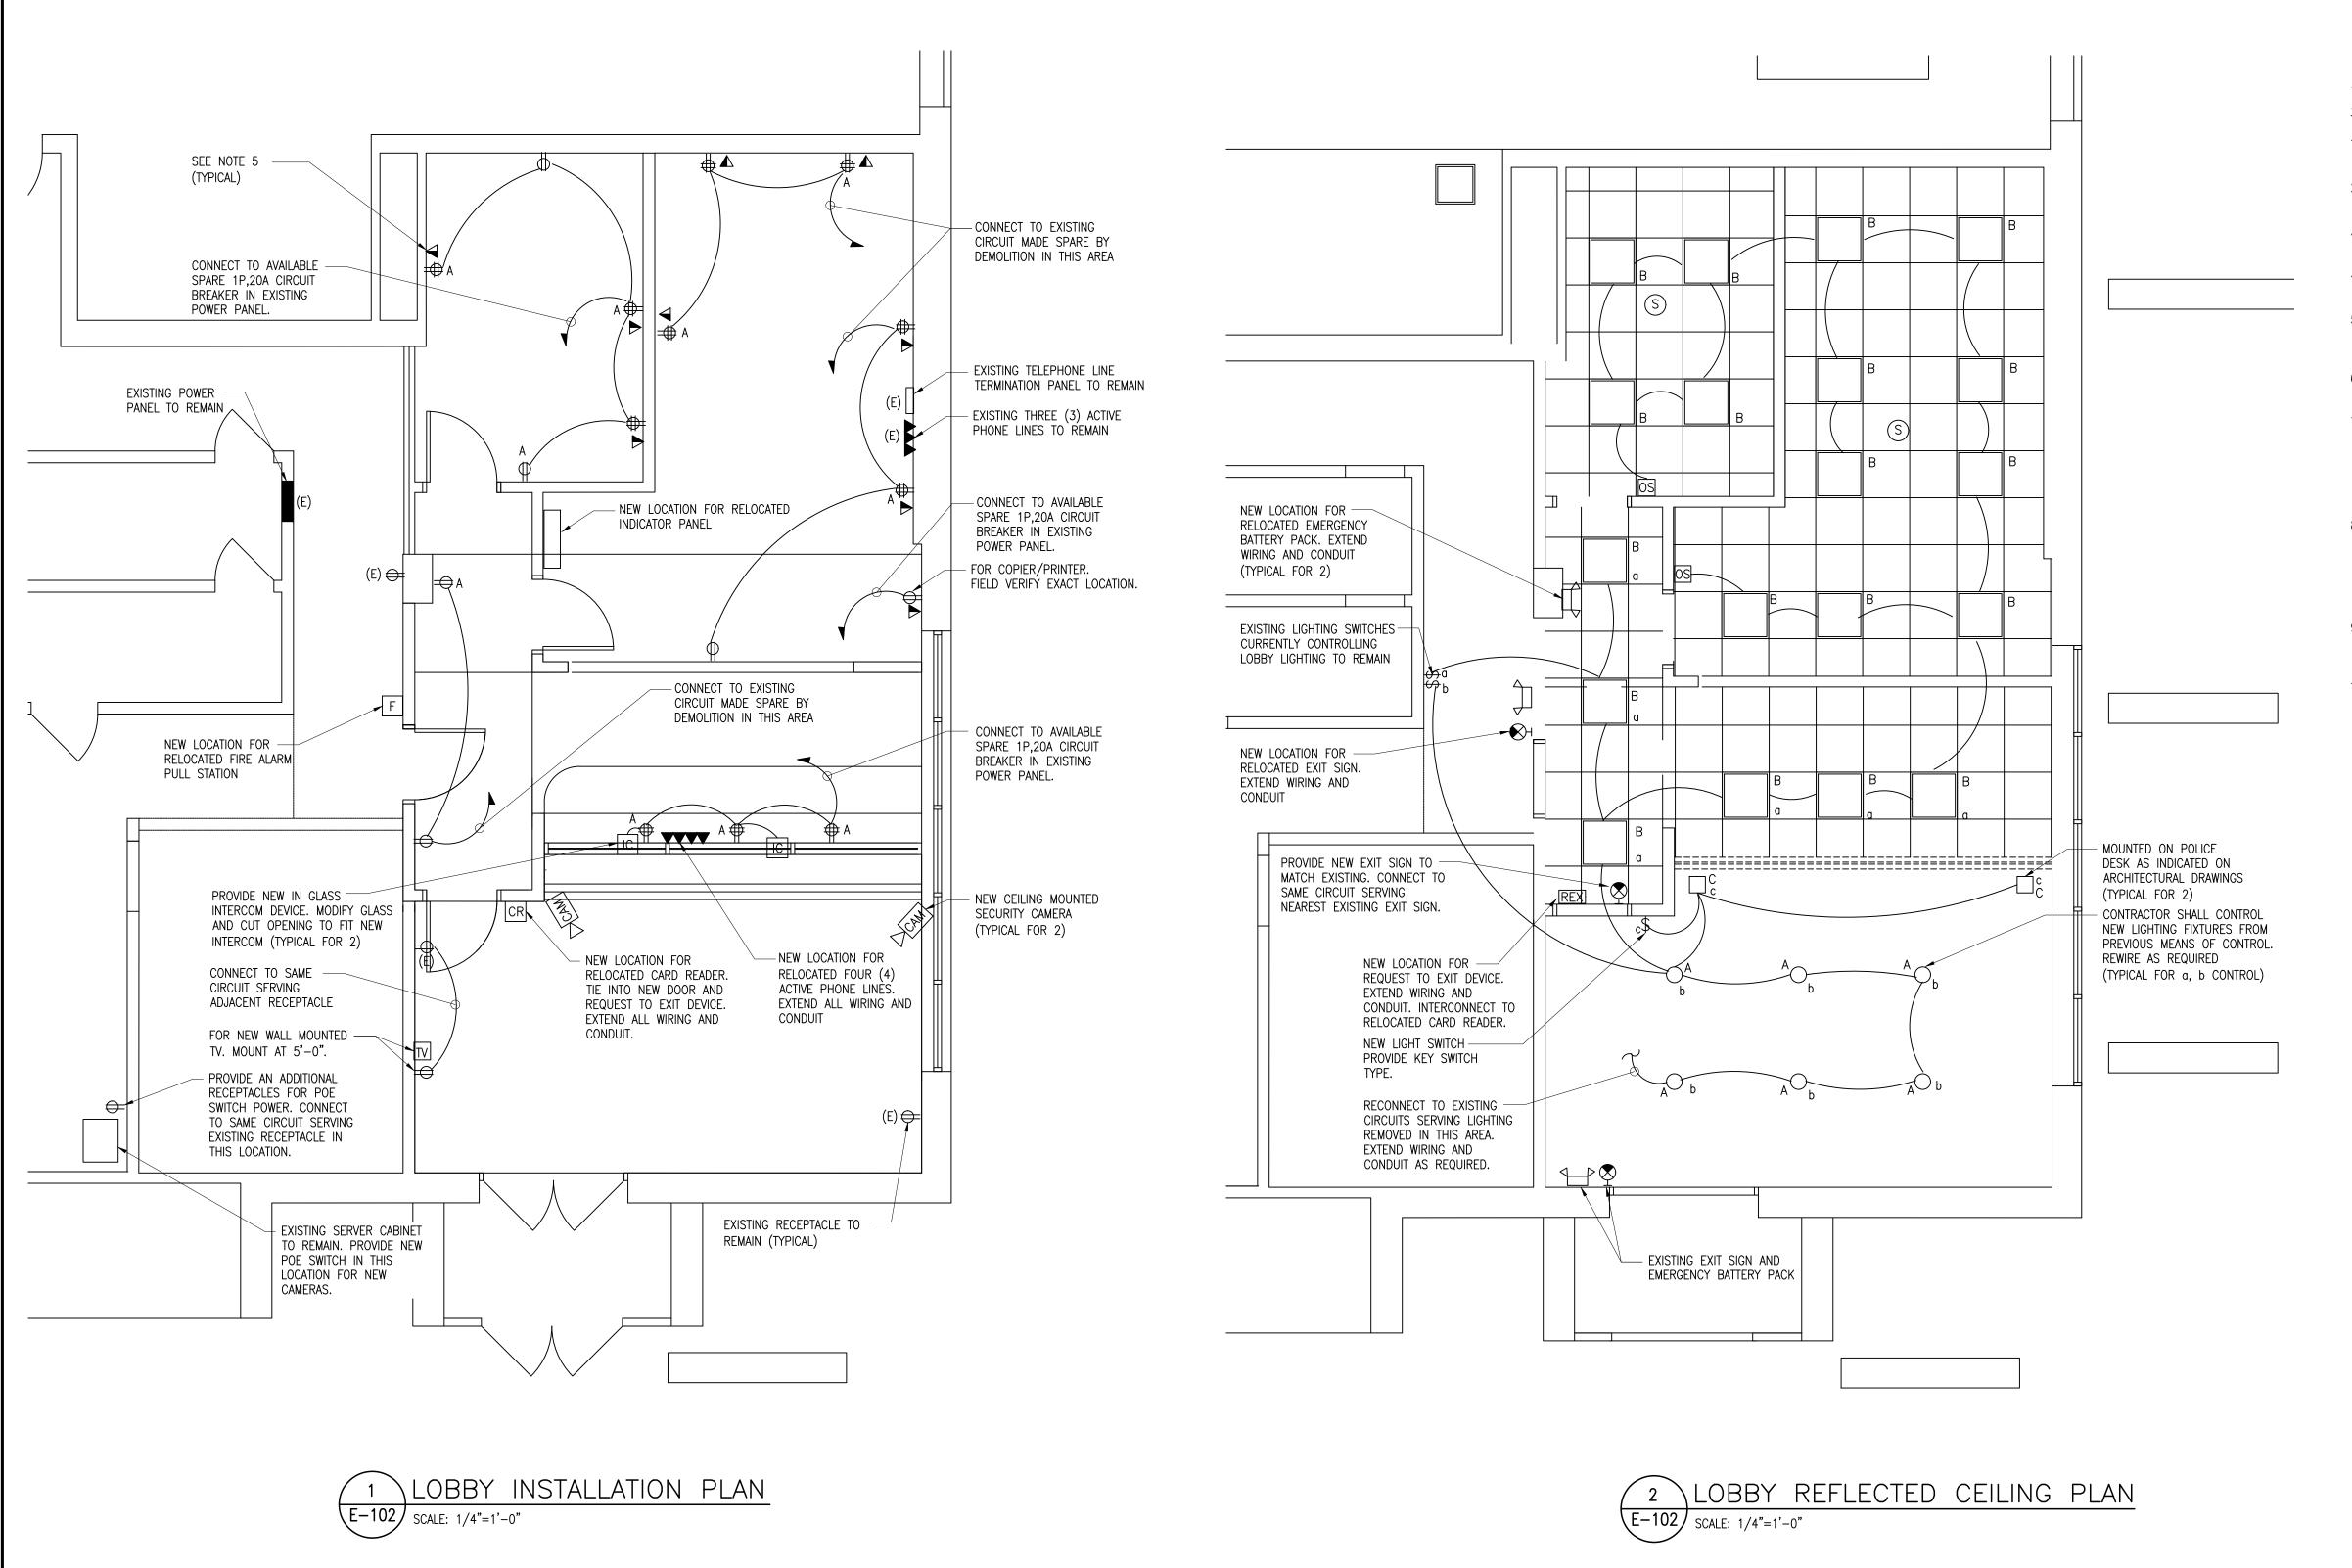

SPECIAL EQUIPMENT PART LIST				
QNTY.	PART NUMBER	DESCRIPTION	MANUFACTURER	REMARKS
2	IFS08D20CWIT	8MP MINI-DOME CEILING IR CAMERA	TYCO	VANDAL RESISTANT
1	EX17082	8 PORT POE ETHERNET SWITCH	ETHERWAN	_
1	LS32D85KTSR/ZA	32" LED MONITOR FOR VIEWING STATION	SAMSUNG	_
2	TTU-7X TALK-THRU	IN-GLASS INTERCOM DEVICE	NORCON	CONFIRM QTY


NOTES:


1. SECURE BISCUIT BOX TO BUILDING STRUCTURE

2. REFER TO DRAWINGS FOR QUANTITIES

3. CONTRACTOR MAY SUBMIT AS EQUAL FOR APPROVAL.

4. PROVIDE ALL ADDITIONAL CABLES, CONNECTORS AND HARDWARE.

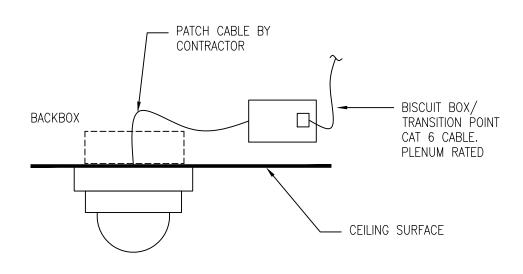

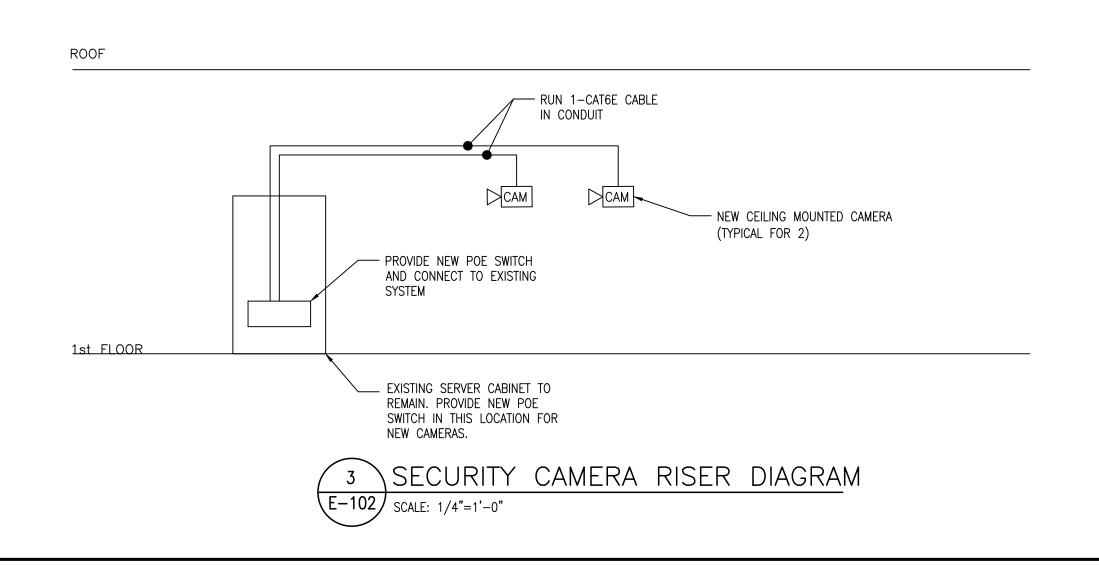

INSTALLATION NOTES:

- 1. UNLESS OTHERWISE NOTED, ALL NEW WIRING SHALL BE 2#12+1#12G IN 3/4" CONDUIT.
- 2. ALL LIGHTING FIXTURES IN OFFICES SHALL BE CONTROLLED VIA OCCUPANCY SENSOR.
- 3. NEW LOBBY LIGHTING TO BE CONTROLLED VIA EXISTING LIGHT SWITCHES.
- 4. FOR SYMBOLS, NOTES, ABBREVIATIONS, AND DETAILS SEE DRAWING
- 5. NEW TELE/DATA OUTLETS TO BE WIRED AND CONNECTED AS PER DETAIL 3 ON DRAWING E-001. IDF CABINET IS LOCATED IN BOILER ROOM AT CELLAR BELOW (APPROXIMATELY 150LF AWAY).
- 6. PROVIDE ALL ADDITIONAL WIRING AND CABLING TO MAINTAIN EXISTING MAIN ENTRANCE DOOR RELEASE SYSTEM.
- 7. THE CONTRACTOR SHALL INCLUDE IN THEIR BID ALL ADDITIONAL REQUIRED MAINTENANCE, CABLE CLEANUP, REROUTING, ADDITIONAL SECURING AND REPLACEMENT OF EXISTING CABLES WITH ANY WORK ASSOCIATED WITH THE EXISTING SERVER RACK. INSTALL AND SECURE A NEW POE SWITCH WITHIN THE SERVER RACK. PROVIDE ALL ADDITIONAL MOUNTING HARDWARE AND CABLES AS REQUIRED.
- 8. COORDINATE WITH YONKERS POLICE PRECINCT FOR NEW LOCATION FOR RELOCATED CAMERA STATION. PROVIDE AN ADDITIONAL DATA OUTLET AT THE FINAL DETERMINED LOCATION. PROVIDE ADDITIONAL LICENSING SOFTWARE AND LICENSES FOR INTEGRATION OF NEW CAMERAS INTO THE EXISTING SYSTEM. REPLACE EXISTING VIEWING STATION MONITOR WITH NEW MONITOR AS NOTED IN PARTS LIST.
- 9. WHERE TEL/DATA OUTLETS ARE NOTED TO BE RELOCATED. THE CONTRACTOR SHALL INCLUDE IN THEIR BID ALL REQUIRED TRACING AND REPLACEMENT OF EXISTING CABLE IF DEEMED NECESSARY.
- 10. COORDINATE ALL FINAL LOCATIONS AND VIEWING ANGLES OF CAMERAS WITH YONKERS POLICE PRECINCT. PROVIDE ALL REQUIRED PROGRAMMING, FOCUSING AND ALIGNMENT. INCLUDE ALL NECESSARY HARDWARE AND ACCESSORIES FOR A FULLY FUNCTIONING SYSTEM.

0	ISSUED FOR BID	02/11/2021	MP
No	Revision	Date	Bv

ALL DRAWINGS AND WRITTEN MATERIAL APPEARING HEREIN CONSTITUTE ORIGINAL AND UNPUBLISHED WORK OF THE ENGINEER AND MAY NOT BE DUPLICATED, USED OR DISCLOSED WITHOUT WRITTEN CONSENT OF THE ENGINEER



Engineering
Design
Planning
Construction Management


GPINET.COM


Greenman-Pedersen, Inc. 400 Rella Boulevard, Suite 207 Montebello, NY 10901

Project YONKERS POLICE THIRD
PRECINCT
LOBBY UPGRADES
435 RIVERDALE AVENUE, YONKERS, NY 10705

LOBBY LEVEL ELECTRICAL PLANS

Date	Scale	Designed By	Drawn By	Checked B
02/27/2017	AS SHOWN	MP	VG	MP
Seal		Project No		
		2016740.00)	
		Drawing No	ο.	
		E-102		
		Sheet 14	of	16

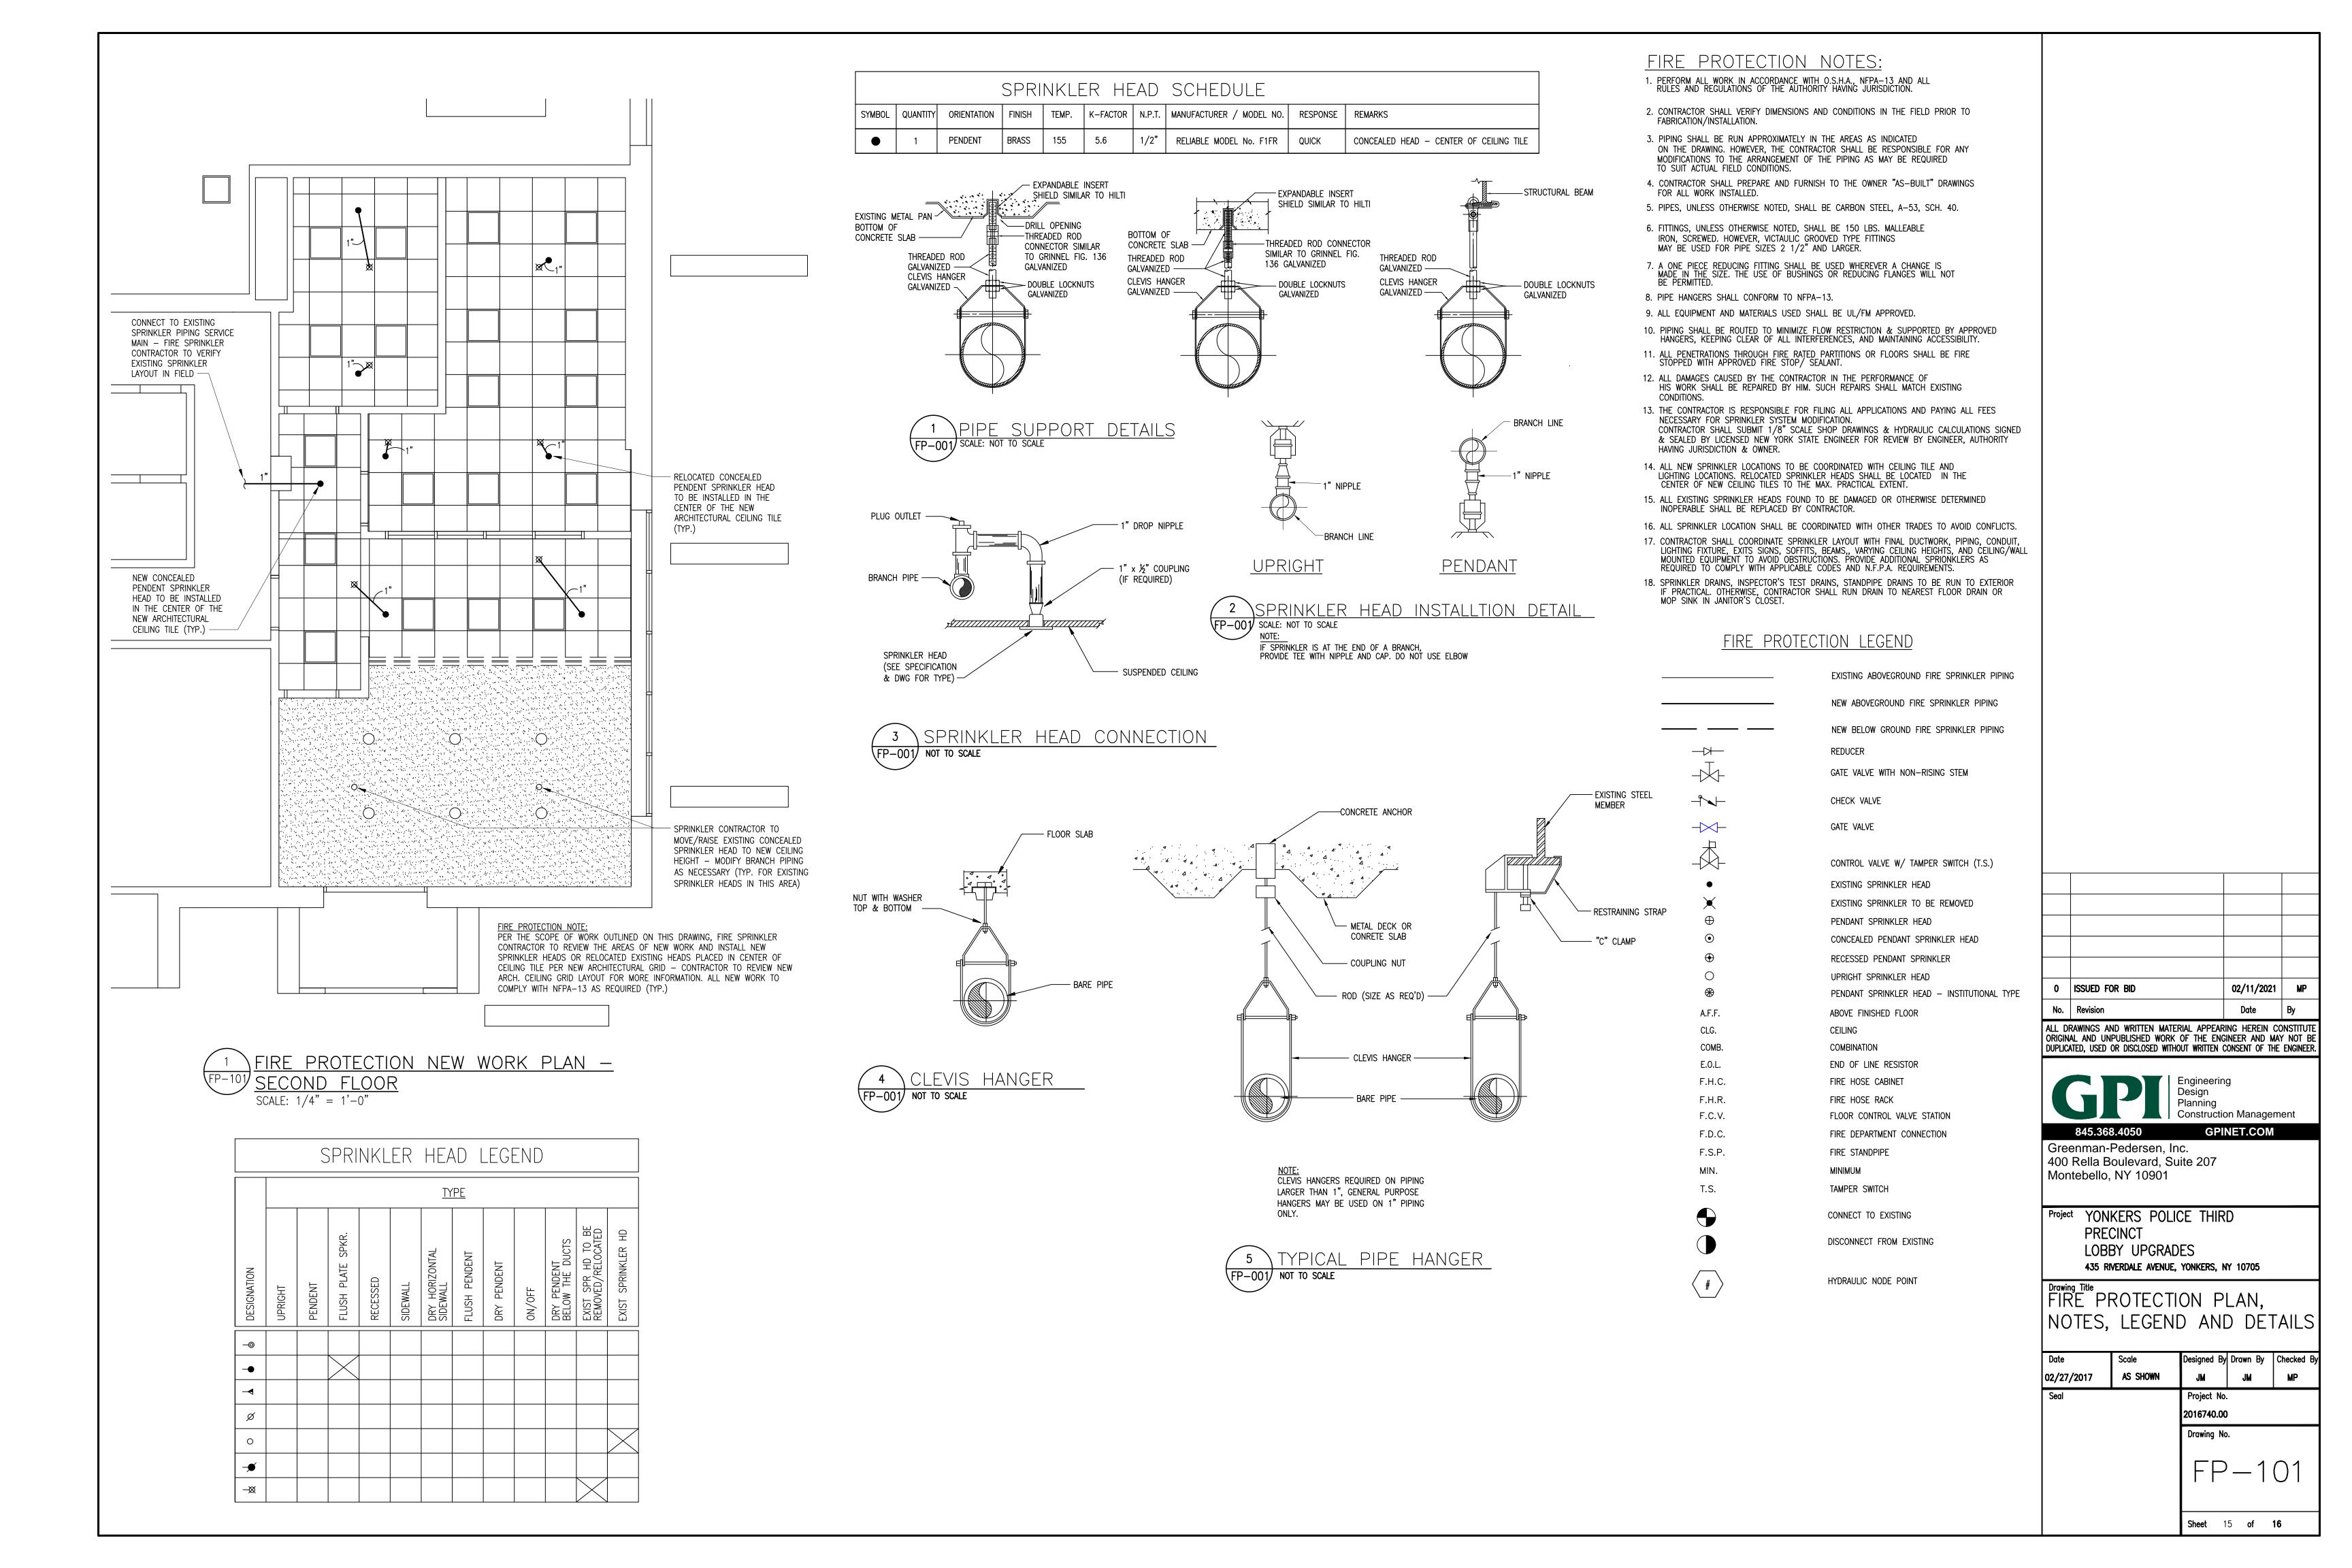

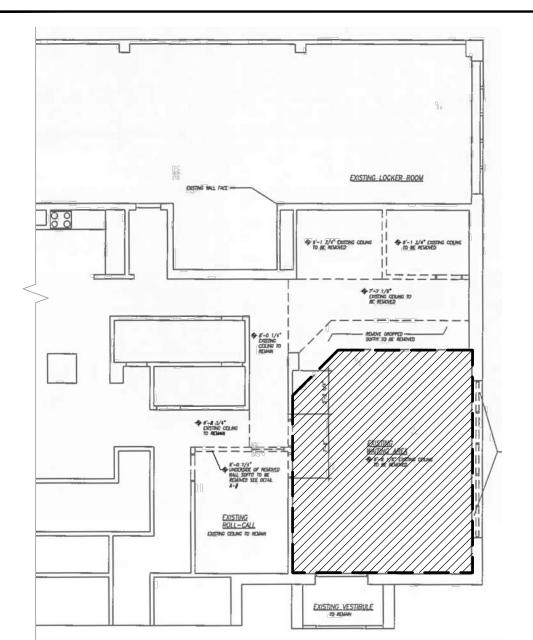

KEY		
ASBESTOS CONTAINING MATERIAL	APPROXIMATELY QUANTITY	LEGEND
FLOOR TILE AND ASSOCIATED MASTIC	600 SF	

PARTIAL FLOOR PLAN SCALE: N.T.S.

CONSULTANT:

WARREN PANZER
228 EAST 45TH STREET
NEW YORK, NY 10017
(212) 922-0077

Warren
panzer

CLIENT:

CITY OF YONKERS
ENGINEERING DEPARTMENT
40 SOUTH BROADWAY
YONKERS, NY 10701

PROJECT ADDRESS:

CITY OF YONKERS POLICE 3RD PRECINCT 435 RIVERDALE AVENUE YONKERS, NY 10705

ASBESTOS CONTAINING MATERIAL LOCATION PLAN

SCALE: AS SHOWN	DATE: 10/04/2017	
DRAWN BY: AV	CHCKD BY: PS	
PROJ NO: 2182.04.02	SHEET No: 1 OF 1	

ASB-200