ksqdesign

ADDENDUM 03

BID ADDENDUM NUMBER | 03

Date | 11/23/2021

PROJECT | Yorktown Central School District District Wide Improvements 2020 Phase II

PROJECT NUMBER | 1910404.00

OFFICE ADDRESS | KSQ DESIGN

215 W 40th Street, 15th Floor New York, NY 10018 914.682.3700

NOTICE TO CONTRACTORS

This Addendum issued prior to receipt of Bid shall and does hereby become a part of the Construction Documents for the above project.

All principal Contractors shall be responsible for seeing that their Subcontractors are properly apprised of the Contents of this Addendum.

All information contained in this Addendum shall supersede and shall take precedence over any conflicting information in the original Bidding Documents dated 10/25/2021 and all pervious addenda.

All Contractors shall acknowledge receipt of this Addendum in the space provided in the Proposal Form. Failure to do so may subject Bidder to disqualification.

A. CHANGES TO SPECIFICATIONS

NONE

B. CHANGES TO DRAWINGS

Drawing YHS-E100 – Replace entire sheet with attached.

Drawing YHS-E104 – Replace entire sheet with attached.

Drawing YHS-E500 – Replace entire sheet with attached.

C. CLARIFICATIONS:

- 1. RFI Question: Please confirm if new RTU units #1 and #2 are being installed as per PP-HSAC schedule on Drawing YHS-E-000. If they are being installed, please provide locations.
 - a. RTU-1 and RTU-2 are existing to remain. Panel PP-HSAC was installed in pervious project and is existing to remain. Panel PP-HSAC currently serves RTU-1 and RTU-2 and currently has a spare breaker that will serve RTU-3. Refer to updated sheet YHS-E000 and YHS-E104 for more information.
- 2. RFI Question: 1) Page MS-H101 shows 4 new windows labeled R4 what type of windows are these. Fixed? or awning to match what's existing. 2) Page MS-A111 shows 4 windows to be replaced. They want awning windows also. or fixed. (existing windows are awnings) but they show a fixed window.
 - a. New aluminum windows are Fixed Unit type as specified in section 08 51 13. The frame Profile and finish shall match existing as noted in Drawings MS-A111.
- 3. RFI Question: Location: Mildred E.S. Middle School; Upon review of spec section 23 31 15-1.1.C, Duct Sox color is to be a custom color matching school colors, with school logo, selection by Architect. During walkthrough it was mentioned that color would be selected from manufacturer's standard color selection. Please advise. In addition,

upon review with product vendor it was stated that Chem Sox spec fabric is typically reserved for installation in a caustic environment. Please advise if required.

- a. The Fabric Duct shall be a flame retardant polyester material with an antimicrobial treatment per basis of design, spec section 23 31 15.2.2. Chem Sock is not required.
- b. Color shall be picked by the Architect/Owner from the available standard color chart.
- 4. RFI Question: On Drawing No. YHS-E500 in the Light Fixture Schedule they indicate a Type L1 which is an LED high bay light fixture that is used in the Gym at the other schools. Please confirm if this light fixture type is used for Yorktown High School project, if so please forward a corresponding drawing for these light fixture quantities, or should this light fixture type be removed from the Light Fixture Schedule.
 - a. DELTA- Fixture type 'L1' was shown on sheet YHS-E500 in error and has now been removed. Each school drawing set has its own light fixture schedule. Light fixtures for a specific school are to be based on the individual school's light fixture schedule.
- 5. RFI Question: On Drawing No. YHS-E000 and YHS-E104 they indicate New Panel PP-HSAC. Please confirm this panel is new or existing (installed as part of another project). On Drawing No. YHS-E000 in the panel schedule they indicate RTU-1 and RTU-2 for the GYM North and South which I think was a project from last year? Please confirm exact scope of work and if it is new are RTU-1 and RTU-2 for future work as they are not shown on the electrical drawings?
 - a. Refer to RFI Question No. 1 above.

D. ENCLOSURES:

DRAWINGS:

GENERAL	CIVIL	STRUCT	ARCH	MECH	ELEC	PLUMB	FIRE PROT.
					YHS-E000		
					YHS-E104		
					YHS-E500		

END OF ADDENDA 03

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LIGHTING							
○ [⊥] *	CEILING MOUNTED 2Ft. × 4Ft. LED LIGHTING FIXTURE CAPITAL LETTER AND NUMERAL INDICATES FIXTURE TYPE (REFER TO LIGHTING FIXTURE SCHEDULE ON DRAWING YHS-E500)						
L*	CEILING RECESSED LED 4Ft. LINEAR LIGHTING FIXTURE -CAPITAL LETTER AND NUMERAL INDICATES FIXTURE TYPE -(REFER TO LIGHTING FIXTURE SCHEDULE ON DRAWING YHS-E500)						
ES S	CEILING OR WALL MOUNTED EXIT SIGNCAPITAL LETTERS AND NUMERAL INDICATES FIXTURE TYPE -ARROW INDICATES DIRECTION OR EXIT PATH -SHADING INDICATES ILLUMINATION -(REFER TO LIGHTING FIXTURE SCHEDULE ON DRAWING YHS-E500)						
\$ L3	LOW VOLTAGE WHITE BUTTON STATION WITH ON/OFF, RAISE AND LOWER BUTTONS ACUITY nPODM DX OR APPROVED EQUAL. $\langle 5 \rangle$						
\$ _{L6}	LOW VOLTAGE WHITE BUTTON STATION WITH (2) ON/OFF AND (2) RAISE LOWER BUTTONS ACUITY nPODM 2P DX OR APPROVED EQUAL. 5						
LC	ACUITY NLIGHTING NPP16D DIMMING RELAY POWER PACK CEILING. SEE DETAILS ON DRAWINGS YHS-E500 FOR WIRING REQUIREMENTS.						
	ACUITY nCM PDT9 OR 10 CEILING MOUNTED OCCUPANCY SENSOR - SEE DETAILS ON DRAWINGS YHS-E500 FOR WIRING REQUIREMENTS.						
← ^ ^{EM∗}	WALL MOUNTED EMERGENCY LIGHTING BATTERY UNIT. CAPITAL LETTERS AND NUMERAL INDICATES FIXTURE TYPE. (REFER TO LIGHTING FIXTURE SCHEDULE ON DRAWING YHS-E500). $\boxed{2}$						

	REMOVALS
\odot	JUNCTION BOX
	UNIT VENTILATOR
	ROOFTOP UNIT
· []]]	DISCONNECT ELECTRIC TO MOTOR AND REMOVE IN ITS ENTIRETY BACK TO
ۍ ۵	SOURCE FIRE ALARM DUCT SMOKE DETECTOR
S F	FIRE ALARM SMOKE DETECTOR
E XX	FIRE ALARM MANUAL PULL STATION
	FIRE ALARM COMBINATION AUDIO/VISUAL DEVICE
\bigcirc	PENDANT CEILING MOUNTED HID HIGHBAY LIGHTING FIXTURE
$\begin{bmatrix} \bullet \end{bmatrix}$	RECESSED CEILING MOUNTED 2Ft. x 4Ft. FLUORESCENT LIGHTING FIXTURE
<u>^</u>	WALL MOUNTED EMERGENCY LIGHTING BATTERY UNIT
\otimes	CEILING MOUNTED EXIT SIGN
⊗	WALL MOUNTED EXIT SIGN
\$	LIGHTING SWITCH
$(\overline{\mathbf{v}})^{W}$	CEILING MOUNTED WIRELESS DATA ACCESS POINT
(T)	SECURITY CAMERA
Ś	PUBLIC ADDRESS SYSTEM CEILING SPEAKER
M	OUNTING HEIGHTS
EQUIPME	OTHERWISE NOTED, MOUNT DEVICES AND NT AT HEIGHTS MEASURED FROM FINISHED D DEVICE/ EQUIPMENT CENTERLINE AS LISTED
COORDIN	ATE DEVICE LOCATIONS WITH ARCHITECTURAL NS PRIOR TO ROUGH-IN.
	TRUCTURAL OR OTHER INTERFERENCE'S
WHERE S	COMPLIANCE WITH MOUNTING HEIGHTC
WHERE S PREVENT LISTED B	COMPLIANCE WITH MOUNTING HEIGHTS ELOW, CONSULT OWNER'S REPRESENTATIVE
WHERE S PREVENT LISTED B	ELOW, CONSULT OWNER'S REPRESENTATIVE ROVAL TO CHANGE LOCATION BEFORE

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	10		9	8	7	6	5	4
_			POWER & SYS	STEMS			ABBREVIATI	ONS
-								
		DISCONNEC	T SWITCH, RATINGS AS INDICA	TED ON FLOOR PLANS		<u>ABBRE VIA TIO</u>	N DESCRIPTION	
		CONDUIT W	ITH CONDUCTORS			AFF	ABOVE FINISHED FLOO	
	D	MOTOR (FU	IRNISHED AND INSTALLED BY M	IC, LINE VOLTAGE WIRING BY EC	\$)	AFG AFR AWG	ABOVE FINISHED GRAI ABOVE FINISHED ROOI AMERICAN WIRE GUAG	F
	TLP- 1 RTU-*	CIRCUITS. (CAPITAL LETTER WITH NUMERAL PANEL CIRCUIT BREAKER NUME	NRD. NUMBER OF ARROWS INDICA LS INDICATE PANEL DESIGNATION BER. STANDALONE NUMBER INDIC	N AND NUMERAL	BFG C CB	BELOW FINISHED GRAD CONDUIT CIRCUIT BREAKER	DE
		HVAC ROOF HAS INTEG	FTOP UNIT, (PROVIDED UNDER RAL 120 VOLT GFCI RECEPTACI	MC CONTRACT, LINE VOLTAGE W LE.	VIRING BY EC) UNIT	EAHU EC	EXISTING AIR HANDLIN ELECTRICAL CONTRAC	TOR
		DISTRIBUTIO	ON POWER PANELBOARD			EGC EXR	EQUIPMENT GROUNDIN EXISTING TO REMAIN	G CONDUCTOR
	φ	DUPLEX RE	CEPTACLE			FBO	FURNISHED BY OWNER	R
		EXISTING S	URFACE MOUNTED PANELBOAR	D		FIBO	FURNISHED AND INSTA	ALLED BY OWNER
	-	EXISTING R	ECESS MOUNTED PANELBOARD			G	VANDAL GUARD $\overline{5}$	_
	FACP	EXISTING F	IRE ALARM SYSTEM CONTROL F	PANEL. $\langle 1 \rangle$		GC GFI	GENERAL CONTRACTOR GROUND FAULT INTER	
				1 120V ELECTRIC HEATER LOCAT		HID	HIGH INTENSITY DISCH	IARGE (METAL HALI
	⟨D ⟩ _{**}	HVAC DUCT ** = EQUIF	I WORK. FURNISH TO MC FOR PMENT DESIGNATION. SEE NOTE	INSTALLATION INTO DUCTWORK. $-\frac{1}{1}$		МС	MECHANICAL CONTRAC	CTOR
	\$ м	MANUAL DI	SCONNECT SNAP SWITCH			NIC	NOT IN CONTRACT	
	R	FIRE ALARM	M FAN SHUT-DOWN RELAY (1)	>		NTS	NOT TO SCALE	
	S	FIRE ALARM	M SMOKE DETECTOR (1)			RGS	RIGID GALVANIZED ST	EEL
	F	FIRE ALARM	M MANUAL PULL STATION $\langle 1 angle$			TYP		ATED
	XXcd n E		RM COMBINATION SPEAKER = STROBE CANDELA RAT	$2/STROBE DEVICE. SEE NOT NOT \left< 1 \right>$	Έ -	UON WP	UNLESS OTHERWISE N WEATHER PROOF WHIL	
	$\langle S \rangle$	REINSTALL	EXISTING PUBLIC ADDRESS SYS	STEM CEILING SPEAKER				
		REINSTALL	EXISTING SECURITY CAMERA					
	\bigcirc ^w	REINSTALL	EXISTING CEILING MOUNTED WI	RELESS DATA ACCESS POINT				
	Q	WALL MOUN	NTED 15" ROUND WIRELESS BRO	G MASTER CLOCK				
	V S	WALL MOUN	NTED PUBLIC ADDRESS SYSTEM	HORN SPEAKER 3				
	B	WALL MOUN	NTED BUILDING LOCK DOWN VIS	UAL INDICATOR DEVICE (AMBER	COLOR) 4			
	K∗ _b K∗		•	SHED BY GC, INSTALLED AND W NISHED BY GC, INSTALLED AND	,			

PRIMARY CODE-CONTROL STATION (FURNISHED BY GC, INSTALLED AND WIRED BY EC) SECONDARY KEY CONTROL STATION (FURNISHED BY GC, INSTALLED AND WIRED BY EC) SP-XFMR VOLTAGE TRANSFORMER (FURNISHED BY GC, INSTALLED AND WIRED BY EC) PIR SENSOR (FURNISHED BY GC, INSTALLED AND WIRED BY EC)

GENERAL NOTES - INSTALLATION

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V M

- 1. NEW BRANCH CIRCUITRY SHALL BE INSTALLED ABOVE CEILING WHERE POSSIBLE, AS HIGH AS POSSIBLE.
- 2. ALL EQUIPMENT SHOWN ON REMOVALS PLANS SHALL BE REMOVED, UNLESS OTHERWISE NOTED. REMOVE ONLY ASSOCIATED WIRING WITHIN ROOM. ASSOCIATED EXISTING BRANCH CIRCUIT WIRING HOMERUN BACK TO PANEL IN EACH ROOM SHALL REMAIN FOR CONNECTION TO NEW LIGHTING BRANCH CIRCUIT WIRING SHOWN, UNLESS OTHERWISE NOTED.
- COORDINATE ALL CONDUIT RUNS WITH OTHER TRADES PRIOR TO ROUGH-IN. RELOCATE ANY CONDUITS AS NECESSARY TO PERMIT INSTALLATION OF DUCTWORK OR PIPING.
- 4. INSTALL ALL CIRCUITING CONCEALED INSIDE WALL CAVITY WHERE EVER POSSIBLE. PROVIDE SURFACE MOUNTED BACKBOXES AND RACEWAY FOR WIRING DEVICES LOCATED ON EXISTING SOLID WALL CONSTRUCTION. PROVIDE SHALLOW TYPE BACKBOXES FOR SURFACE MOUNTED POWER AND SWITCHING APPLICATIONS. REFER TO ARCHITECTURAL PLANS FOR WALL TYPES.
- 5. FIRESTOP ALL LOW VOLTAGE SLEEVES AND PENETRATIONS AFTER INSTALLATION OF CABLE.

 PROVIDE OPEN TOP CABLE HANGERS 4' ON CENTER SUPPORTED TO SUPPORT ALL LOW VOLTAGE CABLING ABOVE ACCESSIBLE CEILINGS. PROVIDE SEPARATE CABLE
 HANGERS FOR FIRE ALARM CABLING. INSTALL ALL EXPOSED CABLES IN EMT CONDUIT OR SURFACE RACEWAY IN FINISHED AREAS.

- 7. ALL LOW VOLTAGE CABLING SHALL BE PLENUM RATED.
- 8. OBTAIN WIRING AND INSTALLATION DIAGRAMS FOR ALL ELECTRICAL CONNECTIONS TO EQUIPMENT PROVIDED BY MECHANICAL CONTRACTOR PRIOR TO ROUGHING. WORK THAT IS NOT PROPERLY COORDINATED WILL BE RELOCATED AT NO COST TO THE OWNER.

GENERAL NOTES FIRE ALARM

- 1. PROVIDE FAN SHUTDOWN RELAYS FOR ALL FANS OVER 1000 CFM. VERIFY CFM ON MECHANICAL SCHEDULE AND PROVIDE SHUTDOWNS AS REQUIRED.
- 2. PROVIDE MODIFICATIONS AND WIRING REQUIRED TO CONNECT TO EXISTING
- EDWARDS FIRE ALARM CONTROL PANEL. 3. PROVIDE REMOTE TEST SWITCH FOR ALL DUCT MOUNTED SMOKE DETECTORS.
- 4. PROVIDE INDEPENDENT CABLE SUPPORTS FOR FIRE ALARM CABLE.

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5. ALL EXPOSED FIRE ALARM CABLE SHALL BE RUN IN CONDUIT OR SURFACE METAL RACEWAY AND BE INDEPENDENT OF ALL OTHER CABLING. REFER TO FIRE ALARM RISER DIAGRAM YHS-E501.

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SYMBOL REPRESENTS KEYED NOTE THAT APPL DRAWING ONLY.


SYMBOL REPRESENTS REMOVAL KEYED NOTE TO THAT REMOVAL DRAWING ONLY.


						
(E E	XIST	ing e	DISTR	IBUTI	ON P.
\rangle	DESIGNATION PP-HSAC ENCLOSURE TYPE: NEMA 1		SWITCHBOARE <u>45,000</u> RMS UL LISTED I RT CIRCUIT F	SYMMETRIC. NTEGRATED	AL AMPERES	5. F
	MOUNTING: SURFACE					DIS
7	VOLTAGE: 208/120	NO.	FRAME	POLES	ATE	L
(PHASE: 3	1	250	3	250	RTU-1 (G
	NO. WIRES: 4	2	250	3	250	RTU-2 (G
7	DISTRIBUTION SECTION	3	250	3	250	RTU-3 (CA
	VERTICAL BUS	4	100	3	20	CAFETERI
	CURRENT RATING: 800A	5	100	3	100	SPARE
7	LOCATION: ELEC STORAGE	6	100	3	100	SPARE
,	OTHER REQ:	7	100	3		PREPAREI
		8	100	3		PREPAREI

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1		3		2		1		\square	ARCHITECT
									ksqdesign
				DIAGRAM, YHS-E5 PROVIDE UNSWITC	501. CHED POWER	EE FIRE ALARM ON TO EXIT SIGNS, F ND LED INDICATION	FOR	L	NEW YORK OKLAHOMA NORTH CAROLINA
				NORMAL POWER L OPERATION.	_OSS, SIGNA	SYSTEM RISER DIA	Υ		TEXAS COLORADO
			$\langle 4 \rangle$	DRAWING 2/YHS-	E501. NG LOCKDON	WN VISUAL RISER E			215 West 40th Street 15th Floor New York, NY 10018 914.682.3700 office www.ksq.design
		•	$\langle 5 \rangle$	PROVIDE PROTECT	E LIGHTING TIVE COVER NG THERMO	SWITCHES L3 AND EMERSON F29-019 STAT GUARD, CLEA	98	к	Owner Yorktown Central School District 2725 Crompond Road Yorktown Heights, NY 10598 914 243 8000 office
ALIDE)								J	Construction Manager Arris Contracting Co. 189 Smith Street Poughkeepsie, NY 12601 845 473 6300 office 845 473 1453 fax MEP Engineer DELTA Engineers, Architects, & Land
									Surveyors, DPC 220 Harborside Dr, Suite #202 Schenectady, NY 12305 518.690.0046 office Structural Engineer Clapper Structural Engineering, PLLC
2								H	160 Partition Street Saugetties, New York 12477 845.943.9601 office www.clapperstructural.com Civil Engineer The Chazen Companies 547 River Street
								G	Troy, New York 12180 518.266.7323 office www.chazencompanies.com
				GENERA	L NO'	TFS			SED CONTROL NUMBERS YHS - #66-24-02-06-0-005-028 MS - #66-24-02-06-0-007-027 CES - #66-24-02-06-0-003-022 MES - #66-24-02-06-0-004-025 BES - #66-24-02-06-0-002-020
LIES TO THAT		-	1.	PROVIDE 200 ACT 2'X4' TILES TO M/ COORDINATE WITH DAMAGED TILES F WORK. REUSE AN PREVIOUSLY HOUS INSTALL REPLACE	T CEILING TI ATCH EXISTI I OWNER FO FROM THE R D RELOCATE SING FIRE A MENT DEVIC MOUNTING,	ILES OF EACH SIZE NG WITHIN THE BU REXACT TYPE. RE RESULT OF FIRE AL E EXISTING GOOD T LARM CEILING DEV RES INTO. IF TILE IS PROVIDE REPLACE	JILDING. EPLACE .ARM CEILING TILES 1/CES TO S NOT	F	
THAT APPLIES	5			PLANS SHALL BE CONDUIT BACK TO EC IS RESPONSIBI TO MATCH FINISH AROUND ALL FIRE WHEN INSTALLED	REMOVED, O SOURCE, LE TO PATC ED SPACE I E ALARM WA WHERE EXIS	T SHOWN ON DEMO INCLUDING WIRING UNLESS OTHERWISE CH AND PAINT AS MATERIALS AND PA ALL MOUNTED DEVI STING WALL DEVICE OWNER FOR PAINT	AND E NOTED. NECESSARY AINT CE BOXES E WAS	E	Yorktown High School Yorktown CENTRAL SCHOOL DISTRICT
				AND CONDUIT LOO MATERIALS AND F PAINT TO MATCH INSTALLED IN CMU OWNER FOR PAIN REMOVE AND REIN SYSTEM TILES AS	CATIONS TO PAINT. PROV FINISHED S U BLOCK W. T TYPES. NSTALL EXIS REQUIRED	OVED WALL MOUNT MATCH FINISHED /IDE BLANK COVER PACE WHERE DEVIC ALLS. COORDINATE STING ACOUSTICAL TO INSTALL ELECT	SPACE PLATES AND CES WERE WITH CEILING RICAL WORK.	D	DISTRICT WIDE IMPROVEMENTS 2020 PHASE II YORKTOWN HIGH SCHOOL 2727 CROMPOND RD.
\checkmark	\frown	\frown	·	REPLACE ANY DA	MAGED TILE	S AS A RESULT O	FWOR	Н	YORKTOWN HEIGHTS, NY 108
PANEL S	МА	JLE in device						С	No. Description Date 1. ADDENDUM 3 11/22/2021
800A 3 ISTRIBUTION SEC					<)		Н	
LOAD DESCRIPTI GYM NORTH) EXI GYM SOUTH)EXIS	STING		EMARK		<	/			
AFETERIA) RIA LIGHTING		ALTERNATE EC	;-2		\langle)		в	ISSUED: BID ISSUE
ED SPACE								Щ	DATE: 10/25/2021 SCALE: AS NOTED
ED SPACE					Ĵ			А	SHEET NAME: ELECTRICAL LEGEND & ABBREVIATIONS
									SHEET NUMBER: YHS-E000



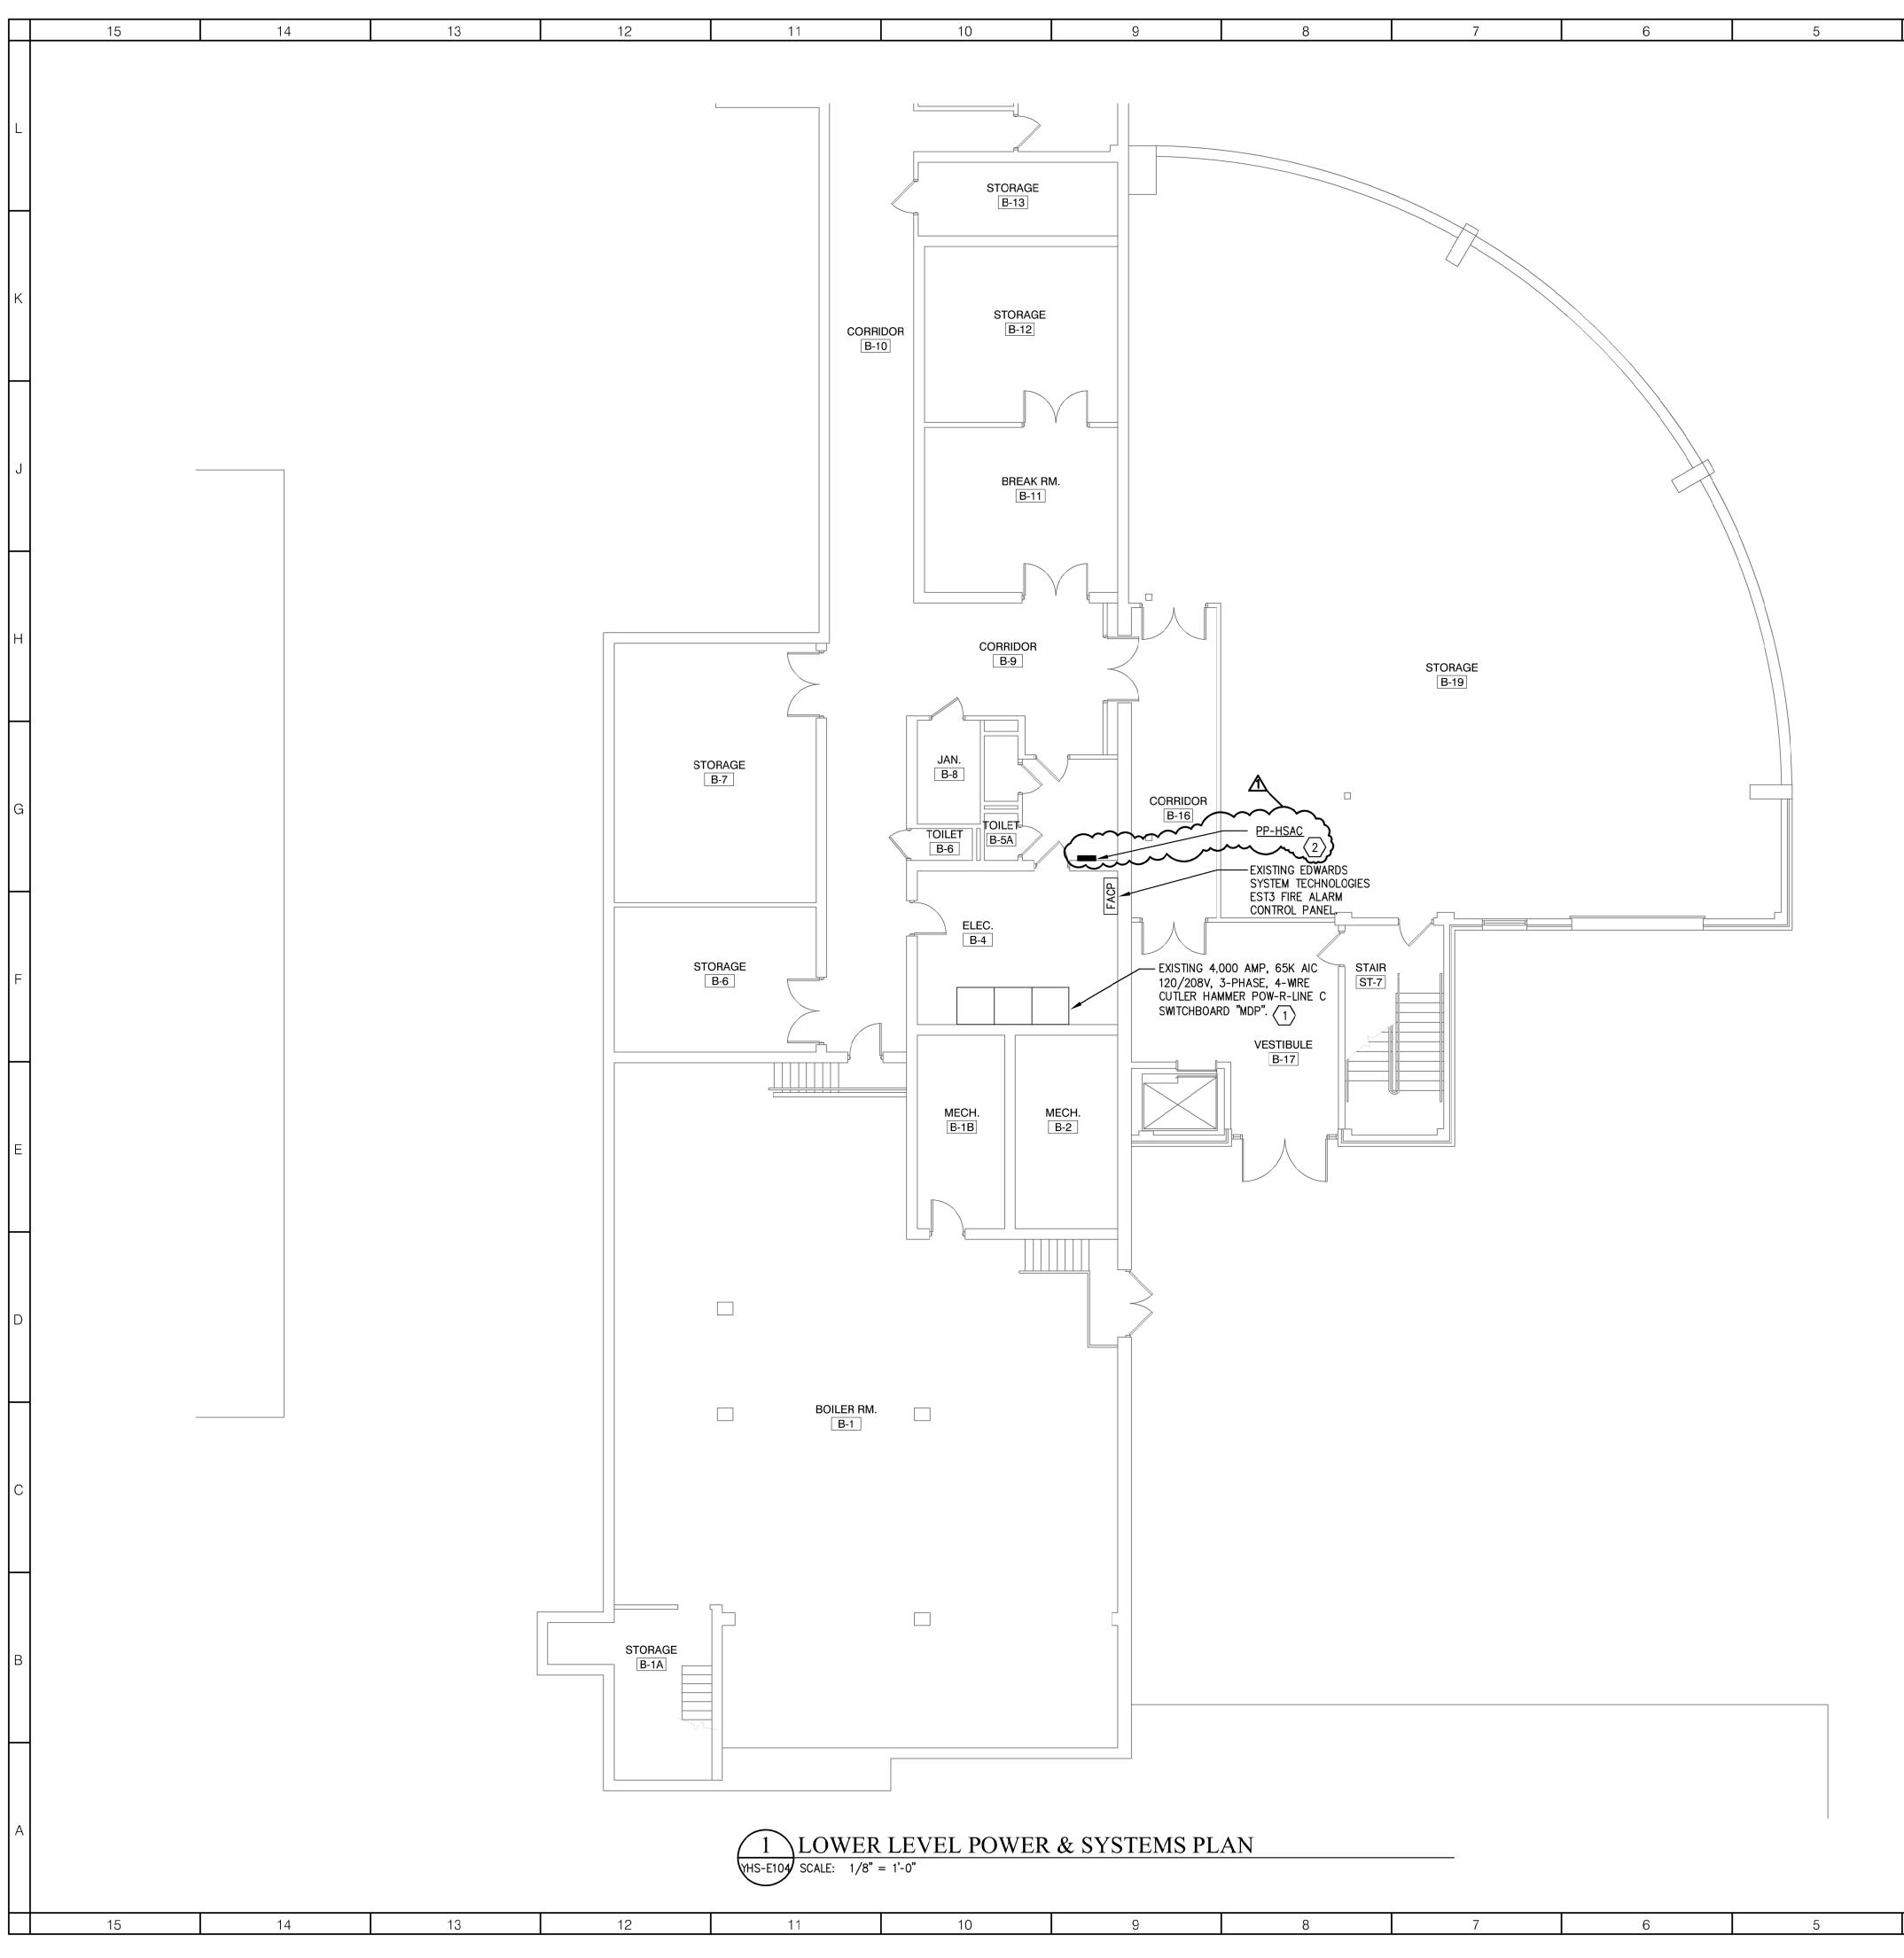


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PROJECT NUMBER: 1710402
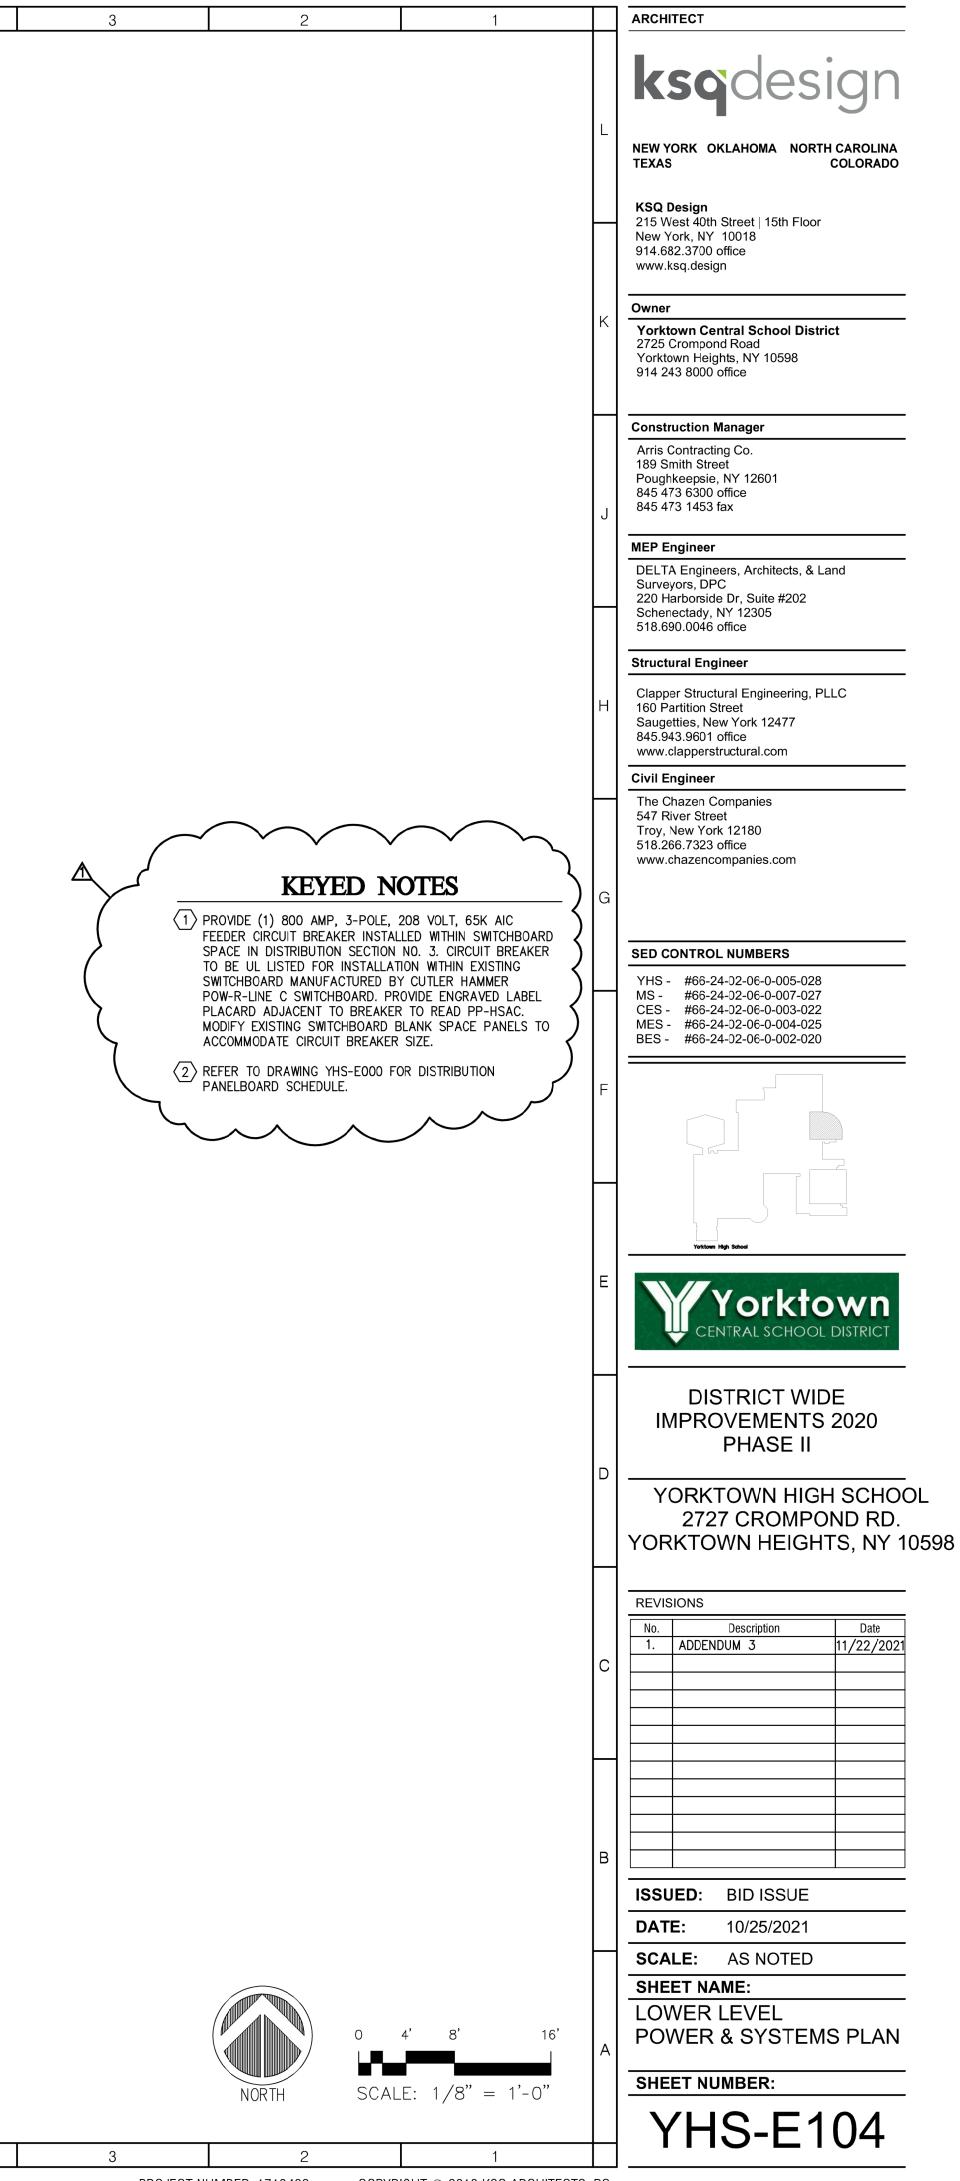
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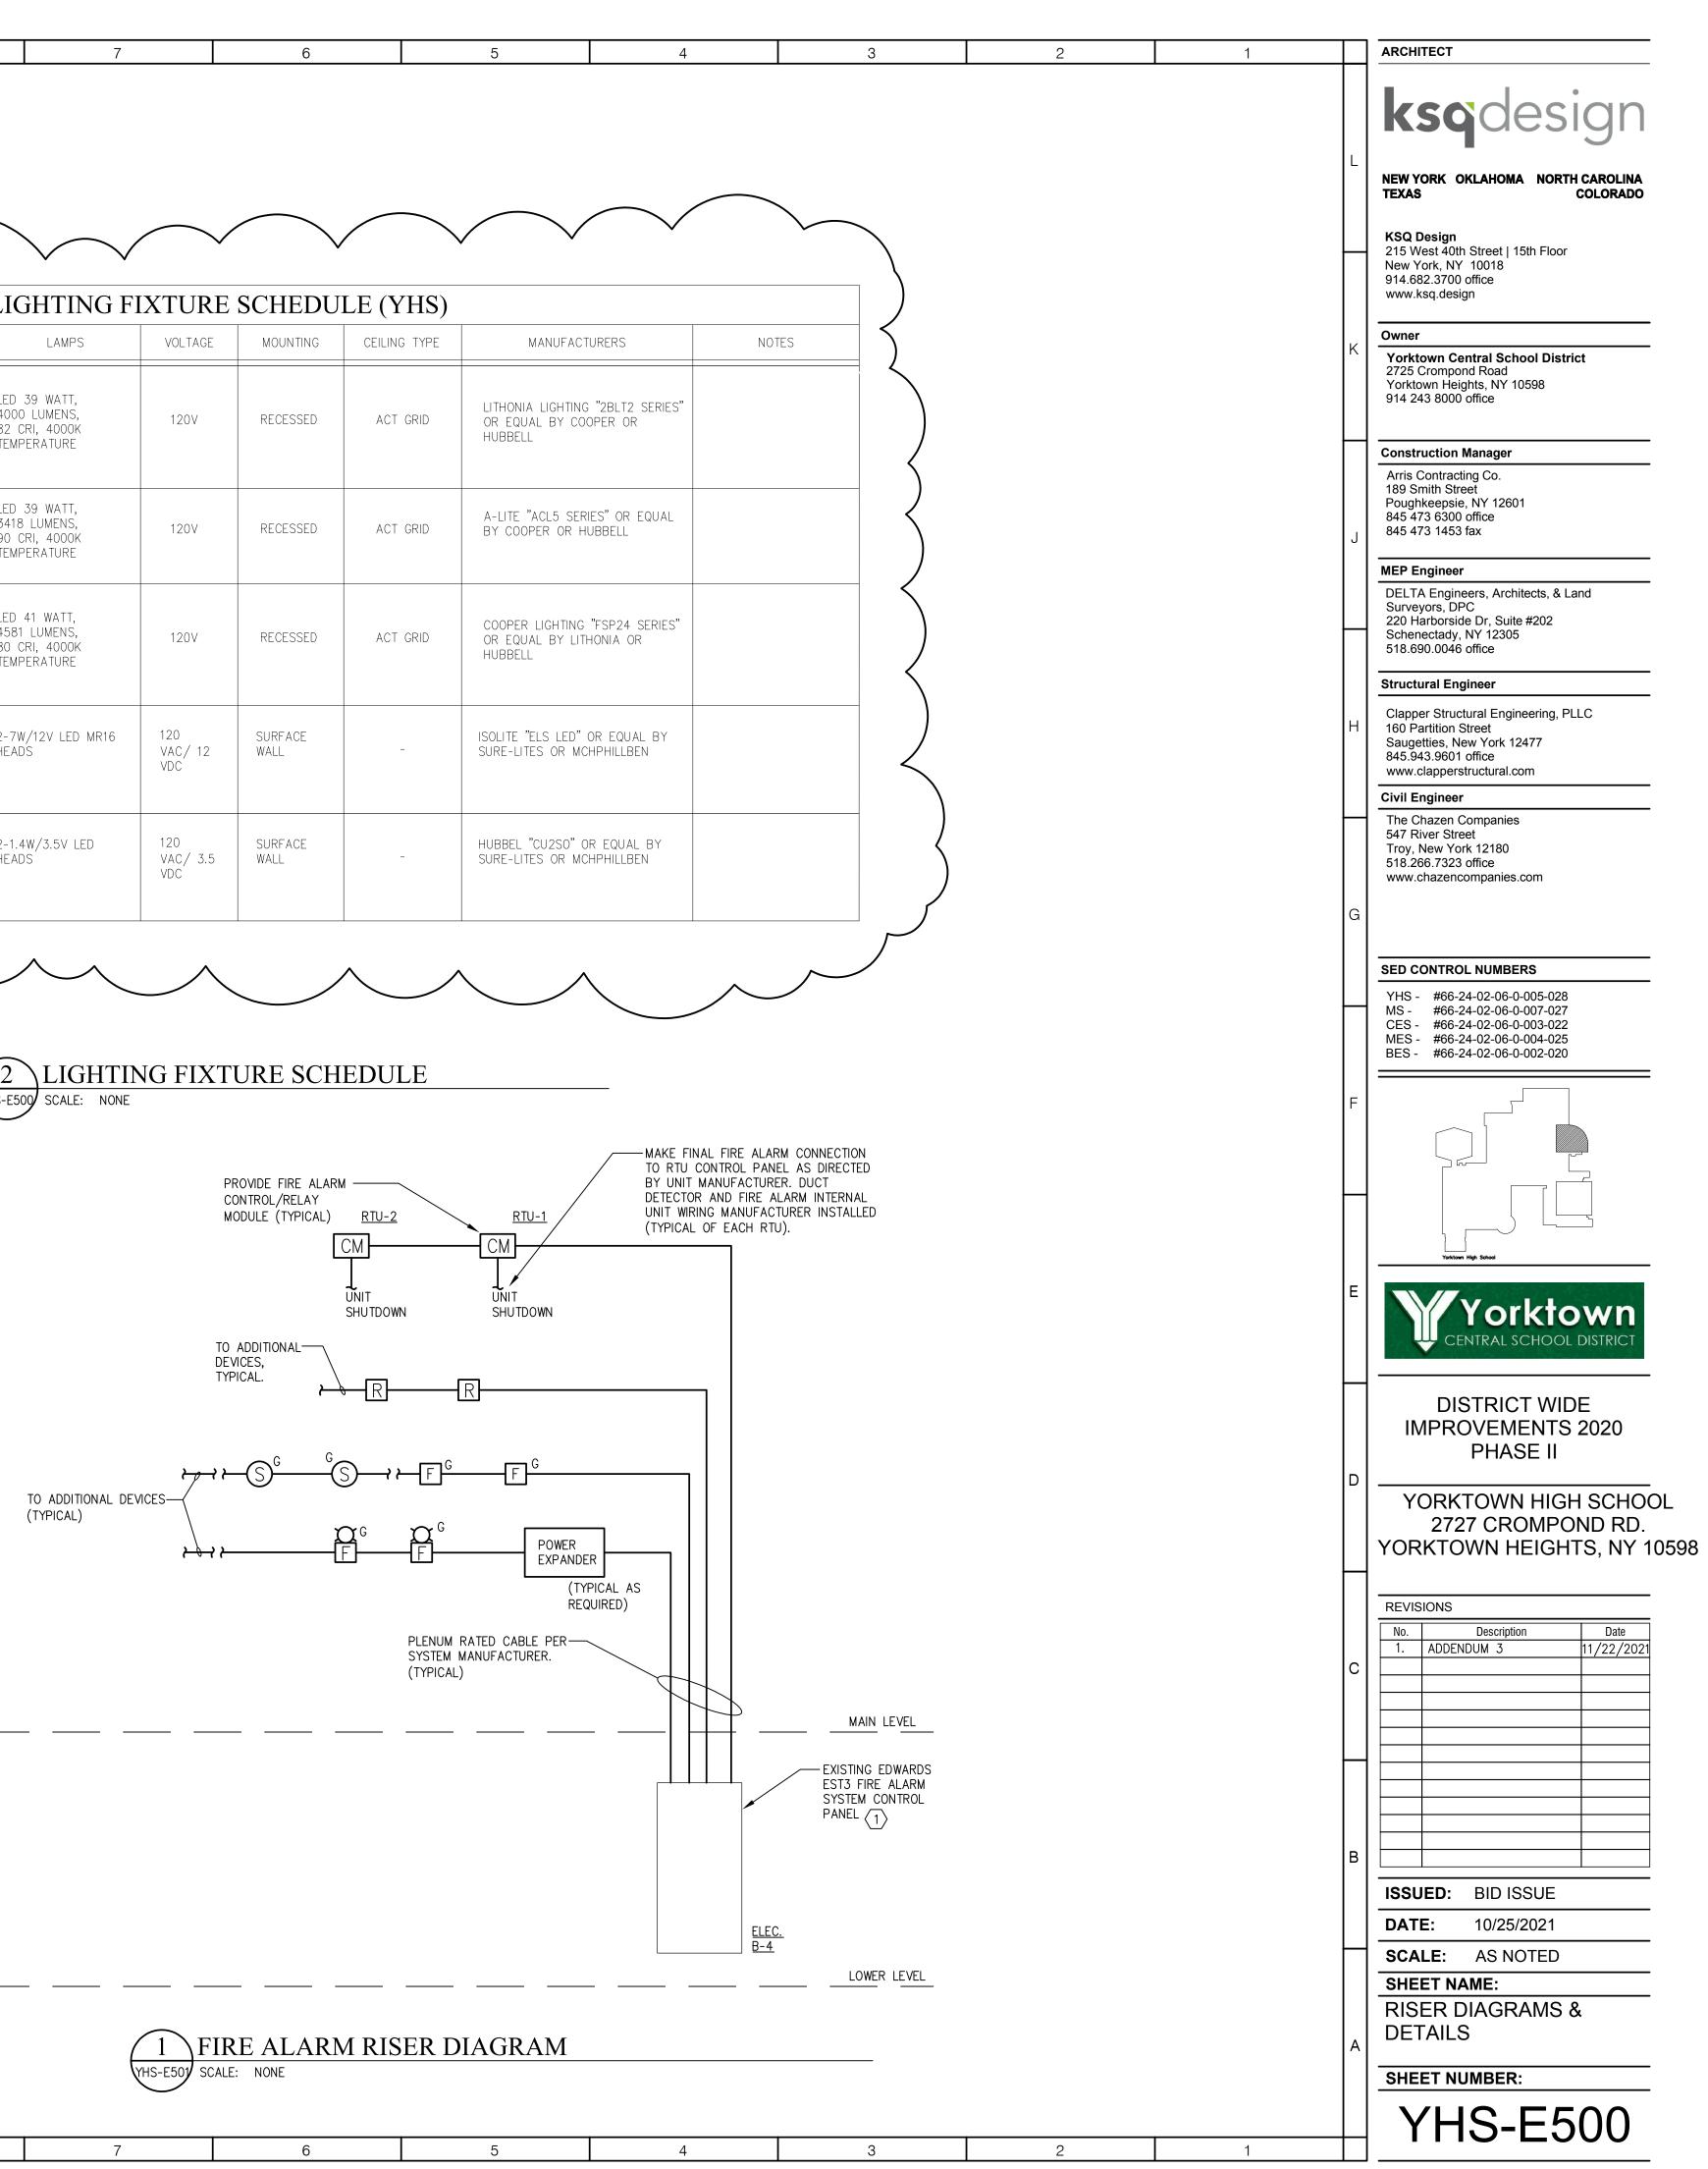


		LIGHTING FI	XTURE	SCHEDU	LIGHTING FIXTURE SCHEDULE (YHS)											
TYPE	DESCRIPTION	LAMPS	VOLTAGE	MOUNTING	CEILING TYPE	MANUFACTURERS	NC									
L2	NOMINAL 2' X 4' RECESS MOUNTED LED VOLUMETRIC TROFFER WITH CURVED SMOOTH CENTER ACRYLIC LENS, BAKED MATTE WHITE ENAMEL STEEL HOUSING AND ALUMINUM DOOR FRAME WITH MITERED CORNERS. nLIGHT INTEGRAL PIR OCCUPANCY SENSOR, NLIGHT N80 CONTROL, ELDOLED DIMMING DRIVER 0-10V CONTINUOUS DIMMING DRIVER DOWN TO 1% STANDARD EFFICIENCY.	LED 39 WATT, 4000 LUMENS, 82 CRI, 4000K TEMPERATURE	120V	RECESSED	ACT GRID	LITHONIA LIGHTING "2BLT2 SERIES" OR EQUAL BY COOPER OR HUBBELL										
2 (ALT C-1)	NOMINAL 2-1/4" WIDE X 46" LENGTH RECESS MOUNTED LED FIXTURE WITH FLAT FROSTED ACRYLIC LENS, STEEL HOUSING AND DIRECT DOWNLIGHT OPTICS. LED DIMMING DRIVER 0-10V CONTINUOUS DIMMING DRIVER DOWN TO 1% STANDARD EFFICIENCY.	LED 39 WATT, 3418 LUMENS, 90 CRI, 4000K TEMPERATURE	120V	RECESSED	ACT GRID	A-LITE "ACL5 SERIES" OR EQUAL BY COOPER OR HUBBELL										
L3	NOMINAL 2' X 4' RECESS MOUNTED LED CLEAN ROOM TROFFER WITH CLEAR ACRYLIC LENS, HIGH STRENGTH DOUBLE SIDED ADHESIVE LENS GASKET, AND CLOSED CELL GASKET SEALS BETWEEN FIXTURE AND T-GRID. FIXTURE FITTED WITH STANDARDUNVERSAL 120-277V DRIVER WITH 0-10V DIMMING TO 10% STANDARD. IP66 WASHDOWN PROOF RATED	LED 41 WATT, 4581 LUMENS, 80 CRI, 4000K TEMPERATURE	120V	RECESSED	ACT GRID	COOPER LIGHTING "FSP24 SERIES" OR EQUAL BY LITHONIA OR HUBBELL										
EM1	WHITE STEEL EMERGENCY LIGHTING UNIT WITH TOP MOUNTED ADJUSTABLE AIMABLE TWIN LED LAMP HEADS, SELF-DIAGNOSTICS, INTEGRAL NICKEL-CADMIUM BATTERY 90 MINUTE MINIMUM EMERGENCY OPERATION.	2-7W/12V LED MR16 HEADS	120 VAC/ 12 VDC	SURFACE WALL	_	ISOLITE "ELS LED" OR EQUAL BY SURE-LITES OR MCHPHILLBEN										
EM2	WHITE SEALED OPTIC LED EMERGENCY LIGHT, LISTED FOR WET LOCATIONS. FULLY AJUSTABLE LAMP-HEADS INSIDE FULLY GASKETED SHIELDED HOUSING.	2-1.4W/3.5V LED HEADS	120 VAC/ 3.5 VDC	SURFACE WALL	_	HUBBEL "CU2SO" OR EQUAL BY SURE-LITES OR MCHPHILLBEN										

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LIGHTING FIXTURE SCHEDULE 2YHS-E500 SCALE: NONE

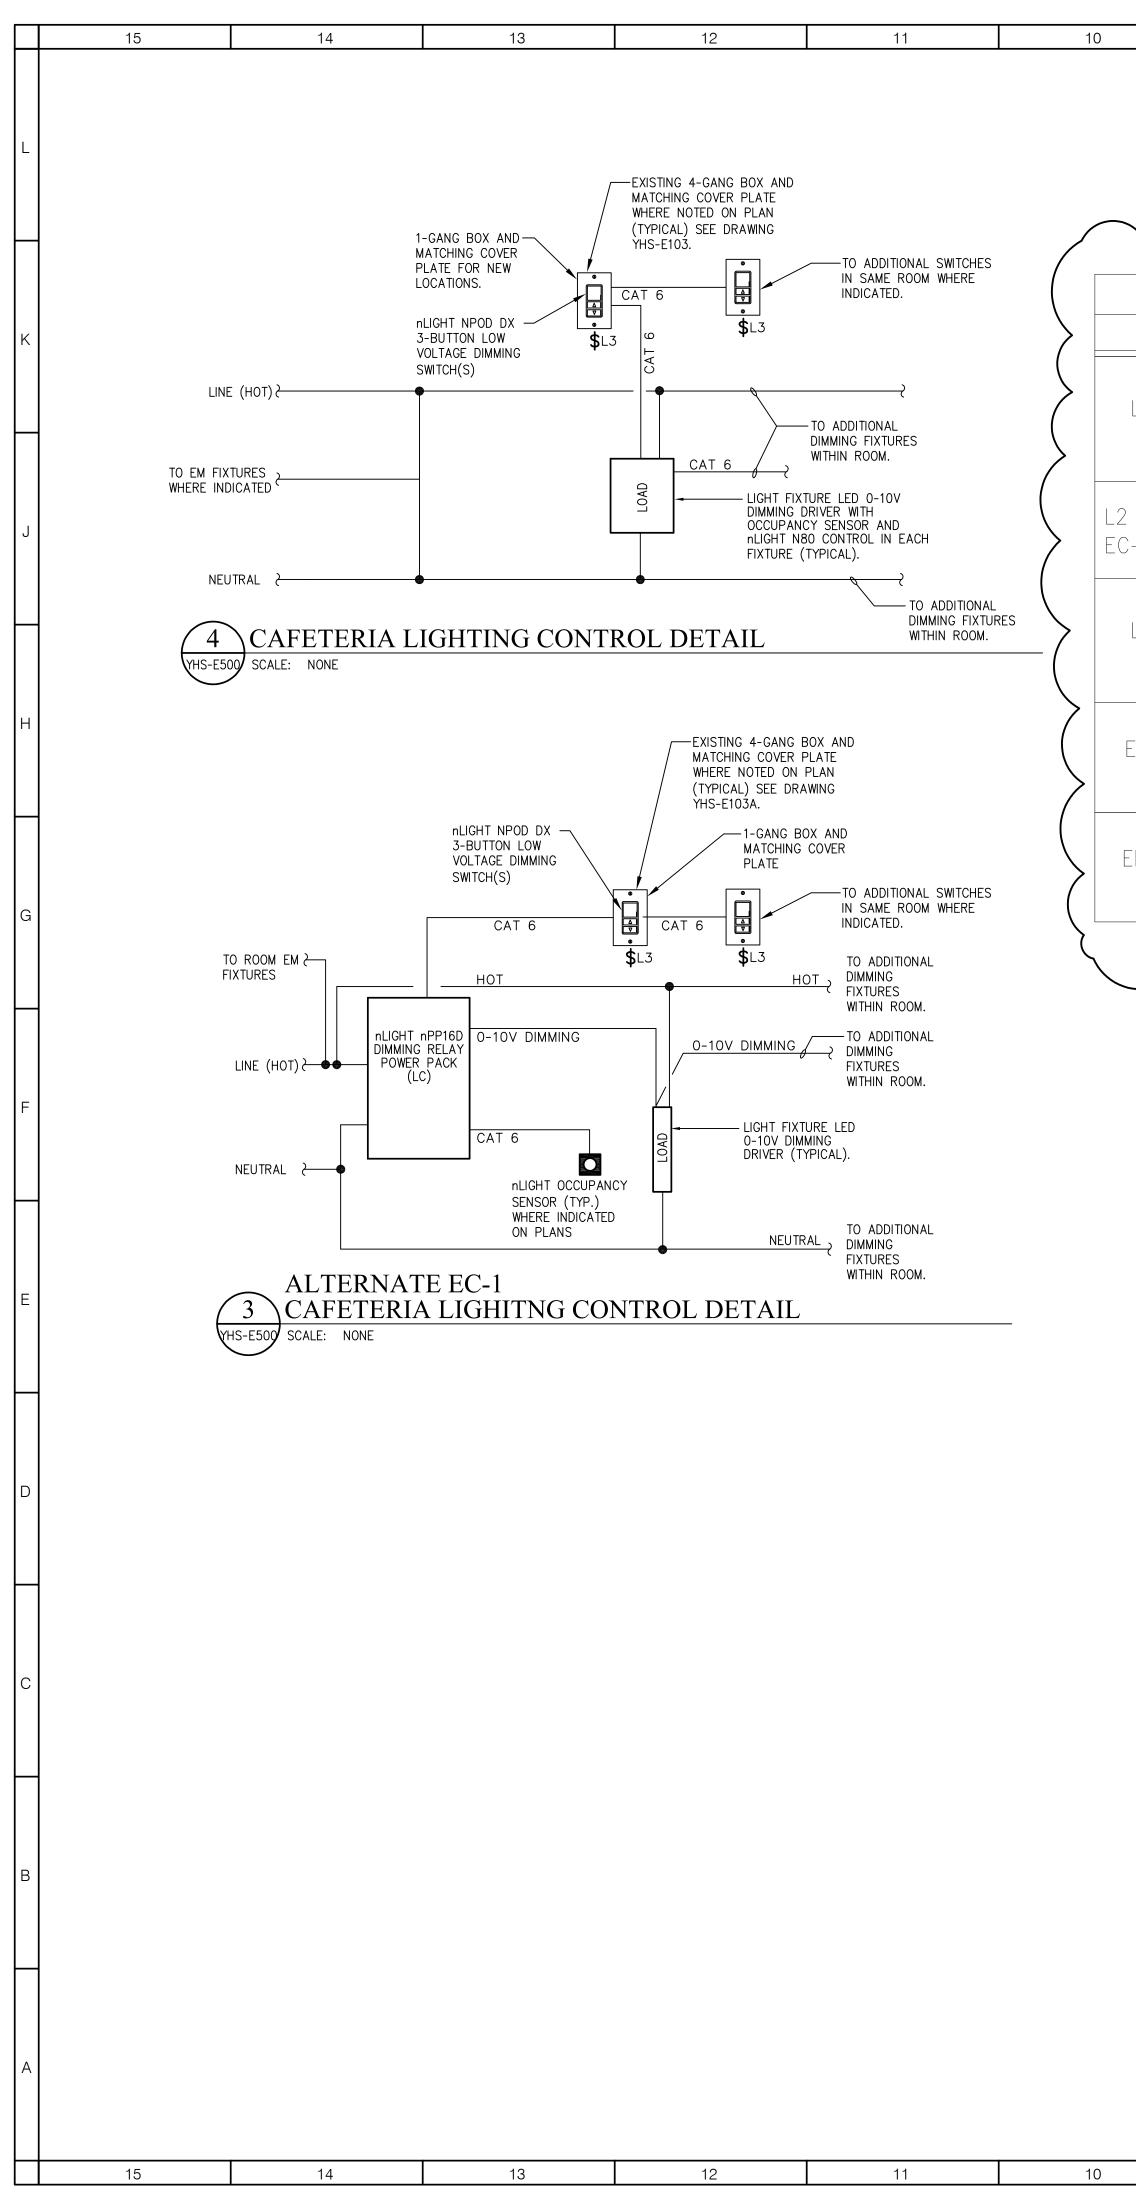

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