BRIARCLIFF MANOR U.F.S.D.

DISTRICT ADMINISTRATION OFFICES

444 PLEASANTVILLE RD, BRIARCLIFF MANOR, NY 10510

PHASE 1 BOND IMPROVEMENTS

AT

BRIARCLIFF MANOR MIDDLE/ HIGH SCHOOL

444 PLEASANTVILLE RD SED No.: 66-14-02-02-0-004-022 BBS No.: 21-274A

TODD ELEMENTARY SCHOOL

45 INGHAM RD SED No.: 66-14-02-02-0-002-020 BBS No.: 21-274B

TODD ELEMENTARY SCHOOL BRIARCLIFF MANOR MIDDLE/HIGH SCHOOL LOCATION MAP A3.01 ROOF DEMOLITION PLAN A3.02 ROOF PROPOSED PLAN A3.03 ROOF DETAILS A0.01 FIRST FLOOR KEY PLAN M1.01 ROOF DEMOLITION PART PLAN AREAS A, B & 0 TODD ELEMENTARY M1.03 FIRST FLOOR DEMOLITION AND NEW WORK PART PLANS AREAS E & F M2.01 ROOF NEW HVAC PART PLAN AREAS A, B & C M2.02 ROOF NEW HVAC PART PLAN AREAS D, E & F SCHOOL A2.04 SECOND FLOOR ENLARGED PLAN, ELEVATIONS & SECTIONS M6.01 SCHEDULES, EQUIPMENT NOTES AND DETAILS A2.05 SECOND FLOOR ENLARGED PLAN, ELEVATIONS & SECTIONS E1.01 FIRST FLOOR PROPOSED PLAN E1.02 GENERAL NOTES AND ROOF PLAN A3.03 ROOF PROPOSED PLAN A3.04 ROOF PROPOSED PLAN A3.05 ROOF DETAILS A8.01 DOOR SCHEDULE AND DETAILS M0.01 GENERAL NOTES, LEGENDS AND SYMBOLS M1.01 ROOF DEMOLITION PART PLAN AREA A M1.02 ROOF & FIRST FLOOR DEMOLITION PART PLANS AREA B M2.01 ROOF NEW HVAC PART PLAN AREA A M2.02 ROOF & FIRST FLOOR NEW HVAC PART PLANS AREA B M6.01 SCEDULES AND DETAILS P1.01 FIRST FLOOR DEMOLITION PART PLANS AREA A Saw Mill Capital P2.01 FIRST FLOOR NEW WORK PART PLANS AREA A P7.01 PLUMBING FLOR DIAGRAMS, EQUIPMENT NOTES, SCHEDULES AND DETAILS E1.01 FIRST AND SECOND FLOOR DEMOLITION AND PROPOSED PLANS E1.02 GENERAL NOTES AND ROOF PLANS BRIARCLIFF MANOR MIDDLE/ HIGH SCHOOL

B ARCHITECTS LANDSCAPE ARCHITECTS ENGINEERS

BRANCH PROJECT CONTACT: 187 WOLF ROAD, SUITE 205 | ALBANY | NEW YORK 12205 | T. 518.621.7650 244 EAST MAIN STREET | PATCHOGUE | NEW YORK 11772 | T. 631.475.0349 | F. 631.475.0361

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ARCHITECTS CERTIFICATION
THE UNDERSIGNED CERTIFIES THAT TO THE BEST OF HIS KNOWLEDGE, INFORMATION, AND BELIEF, THE PLANS AND SPECIFICATIONS ARE IN ACCORDANCE WITH APPLICABLE REQUIREMENTS OF THE NEW YORK STATE UNIFORM FIRE PREVENTION AND BUILDING CODE, THE NEW YORK STATE ENERGY CONSERVATION CONSTRUCTION CODE, AND THE CONSTRUCTION STANDARDS OF THE EDUCATION DEPARTMENT.

T0.00

BBS FILE No. 21-274A & B
ISSUE FOR BID: JANUARY 8, 2022

LAWRENCE SALVESEN, A.I.A.

LIC. No. 020623



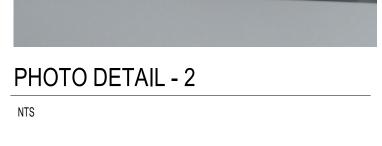



PHOTO DETAIL - 1

G.C. SHALL SCRAPE CLEAN 4' OF FIRE PROOFING FROM COLUMN AND BRACE ABOVE FLOOR. G.C. SHALL PROVIDE & INSTALL NEW **CEMENTITIOUS FIREPROOFING** 1 7/16" THICK MIN TO MEET 2-HR UL X854 RATING.







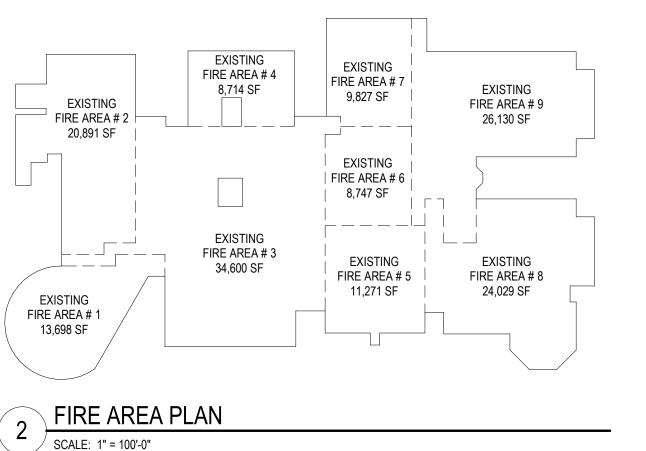

PROVIDED **TABLE 803.11** INTERIOR WALL AND CEILING FINISH REQUIREMENTS BY OCCUPANCY (A-3, SPRINKLERED) REQUIRED CLASS B CLASS A INTERIOR EXIT STAIRWAYS, INTERIOR EXIT RAMPS AND EXIT PASSAGEWAY. CORRIDORS AND ENCLOSURES FOR EXIT ACCESS STAIRWAYS AND EXIT RAMPS CLASS B CLASS A CLASS C CLASS A ROOMS AND ENCLOSED SPACES TABLE 1006.2.1 SPACES WITH ONE EXIT OR EXIT ACCESS DOORWAY ASSEMBLY OCCUPANCY (CHILDREN'S LIBRARY 121, NORTHWEST CORNER) PROPOSED MAXIMUM OCCUPANT LOAD OF SPACE EXIT ACCESS TRAVEL DISTANCE 150'-0" (1ST Fl.) 120'-0" (2ND FL.) GROUP E OCCUPANCY 1020.4 DEAD ENDS WHERE MORE THAN ONE EXIT OR EXIT ACCESS DOORWAY IS REQUIRED, THE EXIT ACCESS SHALL BE ARRANGED SUCH THAT THRE ARE NO DEAD ENDS IN CORRIDORS MORE THAN 1 1/2 X THE CORRIDOR 12-0" * ACCESSORY BUSINESS OCCUPANCY AREA, FULLY SPRINKLERED BC CHAPTER 11 - ACCESSIBILITY

SIGNAGE SHALL BE PROVIDED AT ALL LOCATIONS REQUIRED BY THE PROVISIONS OF THIS SECTION

FIRE RATING LEGEND 1 HR FIRE BARRIERS 2 HR FIRE BARRIERS ALL CONSTRUCTION SHALL BE DESIGNED AND CONSTRUCTED TO BE ACCESSIBLE IN ACCORDANCE WITH ALL PROVISIONS OF THIS BC CHAPTER AND ICC A117.1 2009.

THESE DRAWINGS ARE BA: DRAWINGS NOT PREPARED BY ARCHITECTS AND ENGINEERS NOT REPRESENT THE CONDITIO TIME. ALL EXISTING CONDITIO AS SUGGESTIVE INFORMATION BUILT AND DETAILED PER THE O THE OWNERS IT	BBS ARCHITECTS, LANDSCAPE , PC. AND, THEREFORE, MAY ONS AS CONSTRUCTED AT THE NS SHOWN ARE REPRESENTED AS THEY MAY NOT HAVE BEEN RIGINAL DOCUMENTS OR PER
AREA "C" AREA "A" AREA "D"	AREA "E" AREA "F" AREA "H"
KEY PLAN	NO SCALE
BRIARCLIFF MANOR U.F.S.D. PHASE 1 BOND IMPROVEMENTS BRIARCLIFF MANOR MIDDLE / HIGH SCHOOL 444 PLEASANTVILLE RD, BRIARCLIFF MANOR, NY 10510	FIRST FLOOR KEY PLAN
PROJECT	DWGTITLE
DRWG. BY: E.F CHK. BY: G.E	P.S. E.O.
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THESE DRAWINGS ARE BASED ON CONSTRUCTION

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67,886 SF

237,480 SF

7,138 SF

5,518 SF

REFER TO DOOR SCHEDULE FOR ADD'L INFORMATION

G.C. TO FIRESTOP/SEAL PENETRATIONS AND TOP OF WALL. SEE TYPICAL CONDITION AT PHOTO DETAIL 2

APPLY FIRE PROOFING OVER STEEL COLUMNS AND

G.C. TO REPAIR MISSING FIRE PROOFING SPRAY.


BRACES. SEE PHOTO DETAIL 1 @ A0.01

SED No. 66-14-02-02-0-004-022 **DISTRICT** BRIARCLIFF MANOR U.F.S.D. <u>PROJECT</u> PHASE 1 BOND IMPROVEMENTS <u>DWG TITLE</u> FIRST FLOOR KEY PLAN SCALE: AS NOTED DATE:

21-274A

BID P/U DATE:

FILE NO.

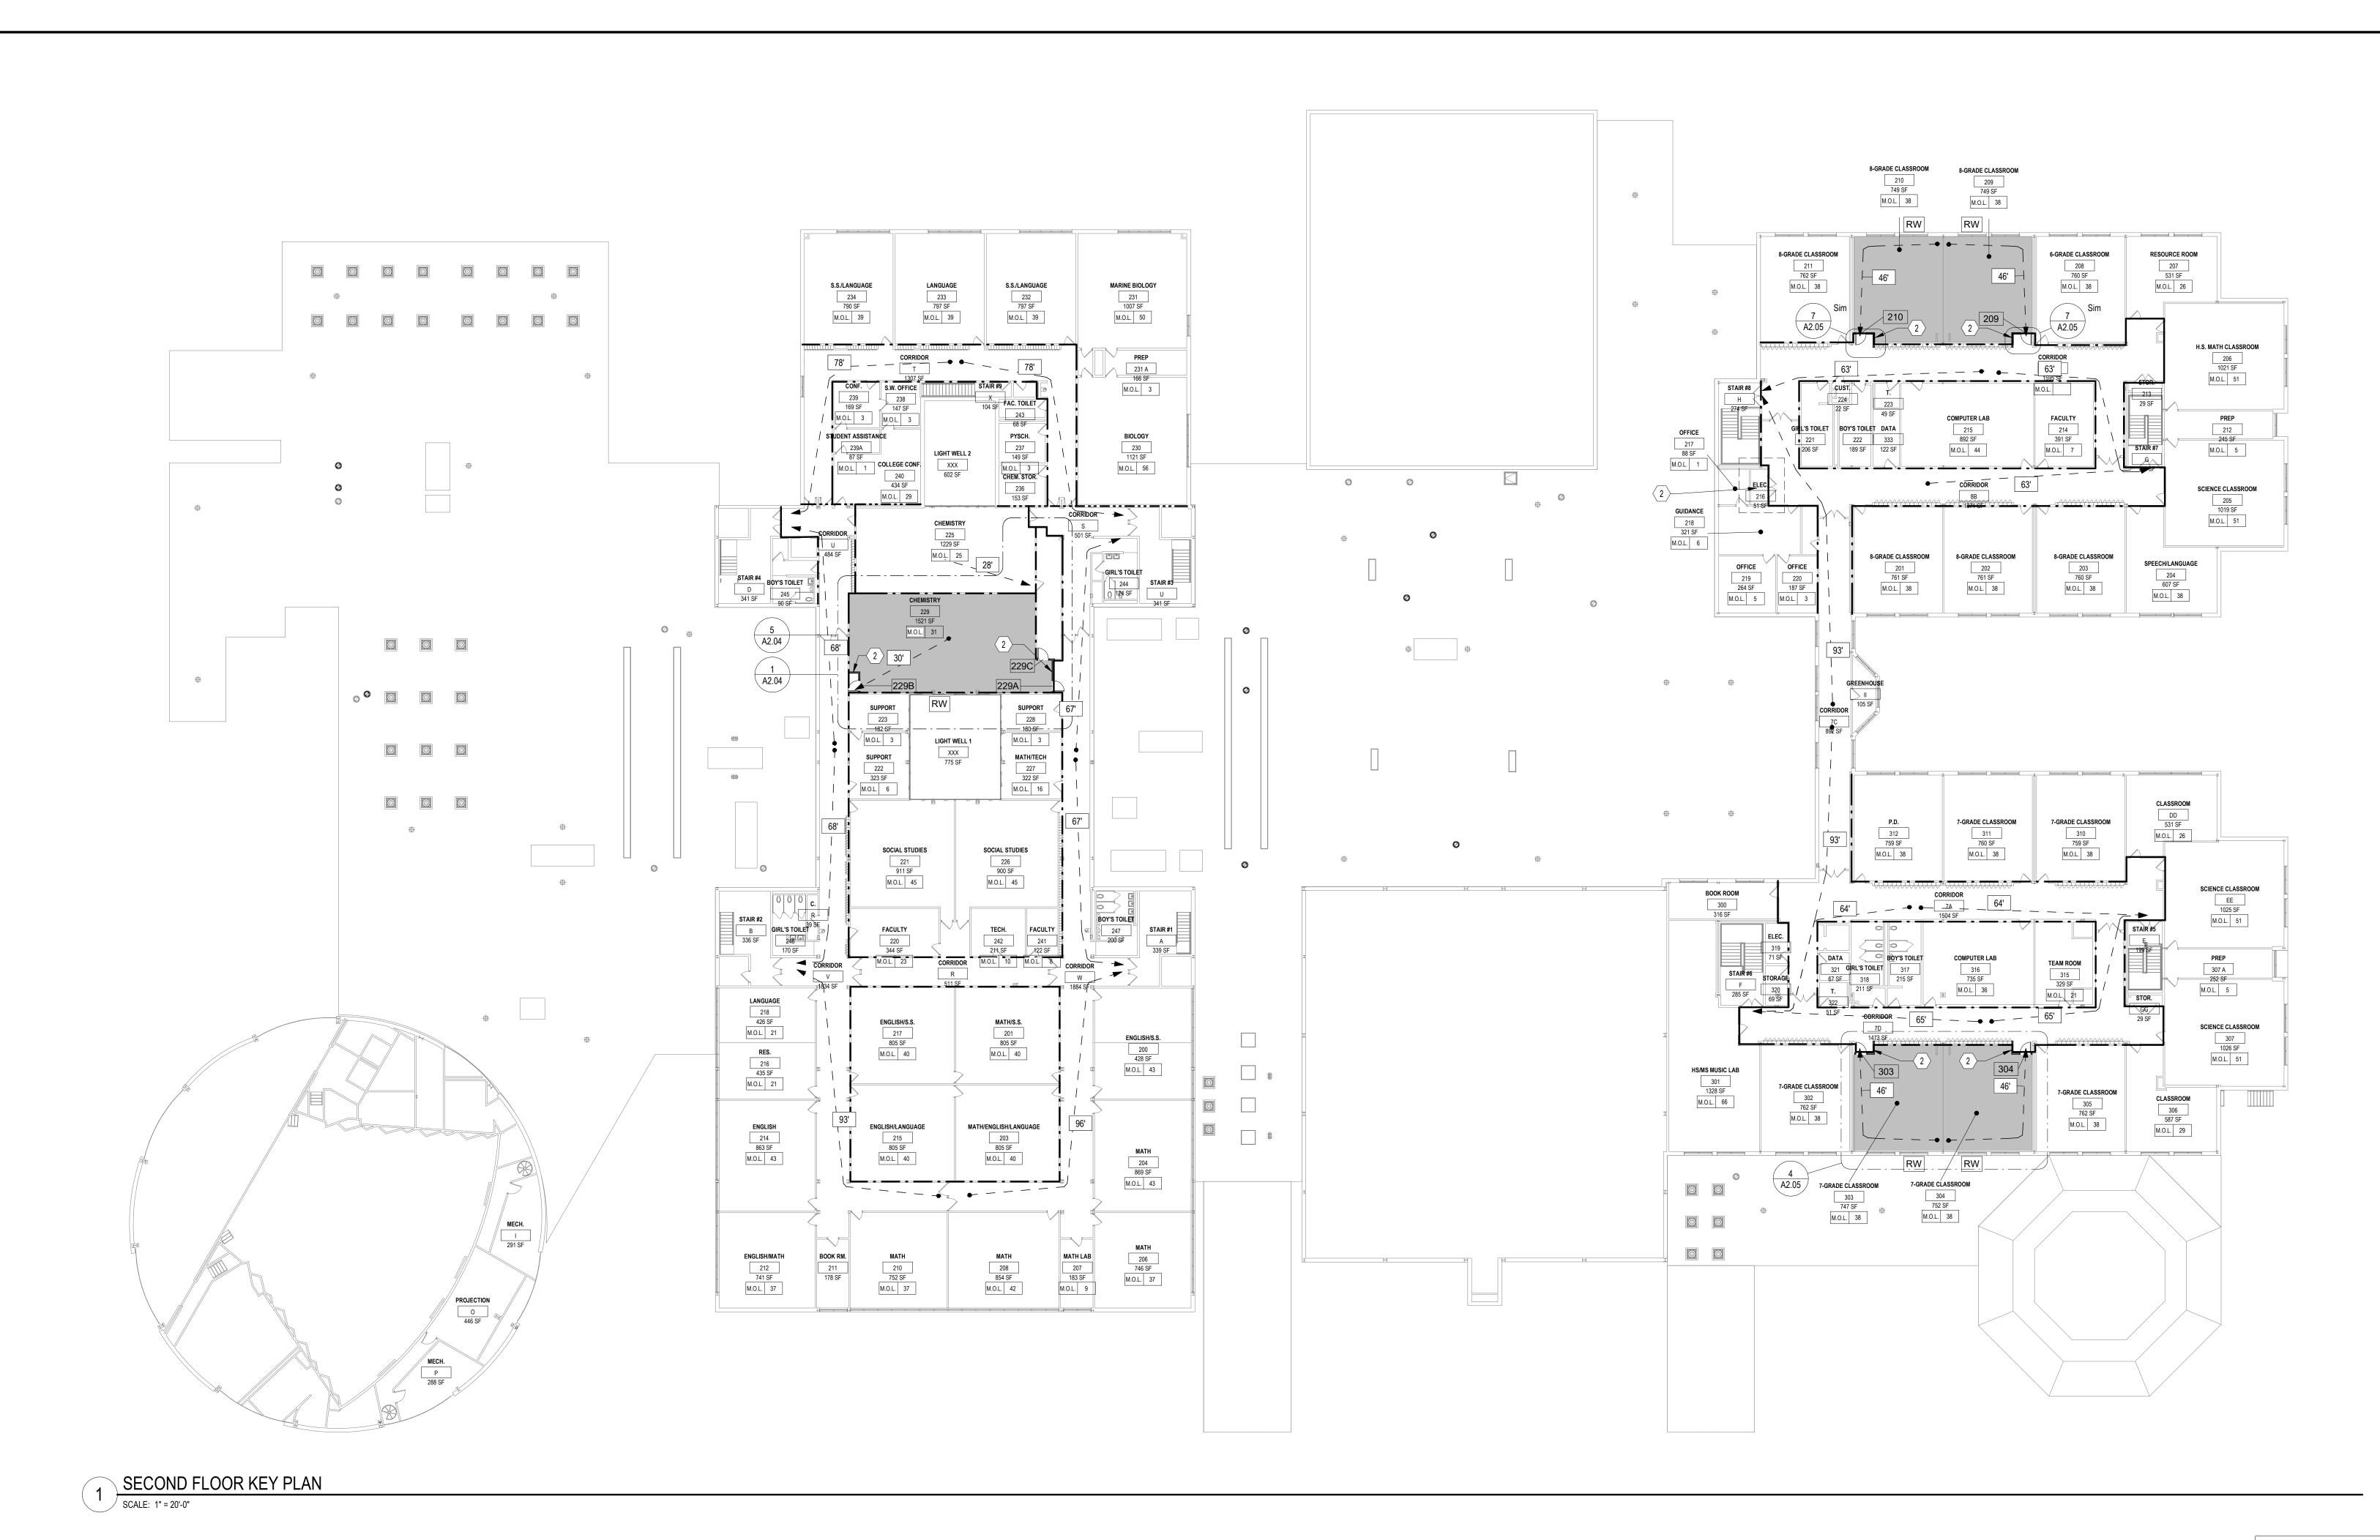

BUILDING AREAS

TOTAL OF PROPOSED RENOVATION	12,656 SF
PROPOSED 2ND FLOOR RENOVATION	5,518 SF
PROPOSED 1ST FLOOR RENOVATION	7,138 SF
BUILDING TOTAL AREA	237,480 SF
EXISTING 2ND FLOOR	67,886 SF
EXISTING 1ST FLOOR	169,594 SF

GENERAL KEY NOTES

- G.C. TO PROVIDE AUTOMATIC DOOR HOLD OPEN,
 DEVICES TO BE INSTALL BY E.C..
 G.C. TO REMOVE EXISTING MANUAL HOLD OPEN
 DEVICES.
 REFER TO DOOR SCHEDULE FOR ADD'L INFORMATION
- G.C. TO FIRESTOP/SEAL PENETRATIONS AND TOP OF WALL. SEE TYPICAL CONDITION AT PHOTO DETAIL 2 @ A0.01
- G.C. TO REPAIR MISSING FIRE PROOFING SPRAY.
 APPLY FIRE PROOFING OVER STEEL COLUMNS AND
 BRACES. SEE PHOTO DETAIL 1 @ A0.01

FIRE RATING LEGEND

1 HR FIRE BARRIERS
2 HR FIRE BARRIERS

AREA "B"	AREA "F"	AREA 'H'
KEY PLAN	NO SCAL	E
BRIARCLIFF MANOR U.F.S.D. PHASE 1 BOND IMPROVEMENTS BRIARCLIFF MANOR MIDDLE / HIGH SCHOOL 444 PLEASANTVILLE RD, BRIARCLIFF MANOR, NY 10510	SECOND FLOOR KEY PLAN	
PROJECT	DWGTITLE	
DRWG, BY; E.F	P.S. E.O.	
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DISTRICT BRIARCLIFF MANOR U.F.S.D.

PROJECT
PHASE 1 BOND IMPROVEMENTS

DWG TITLE
SECOND FLOOR KEY PLAN


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 AS NOTED


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 1/18/2022

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DRWG. BY: E.P.S.

CHK. BY: G.E.O.

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PLAN, ELEVATIONS &

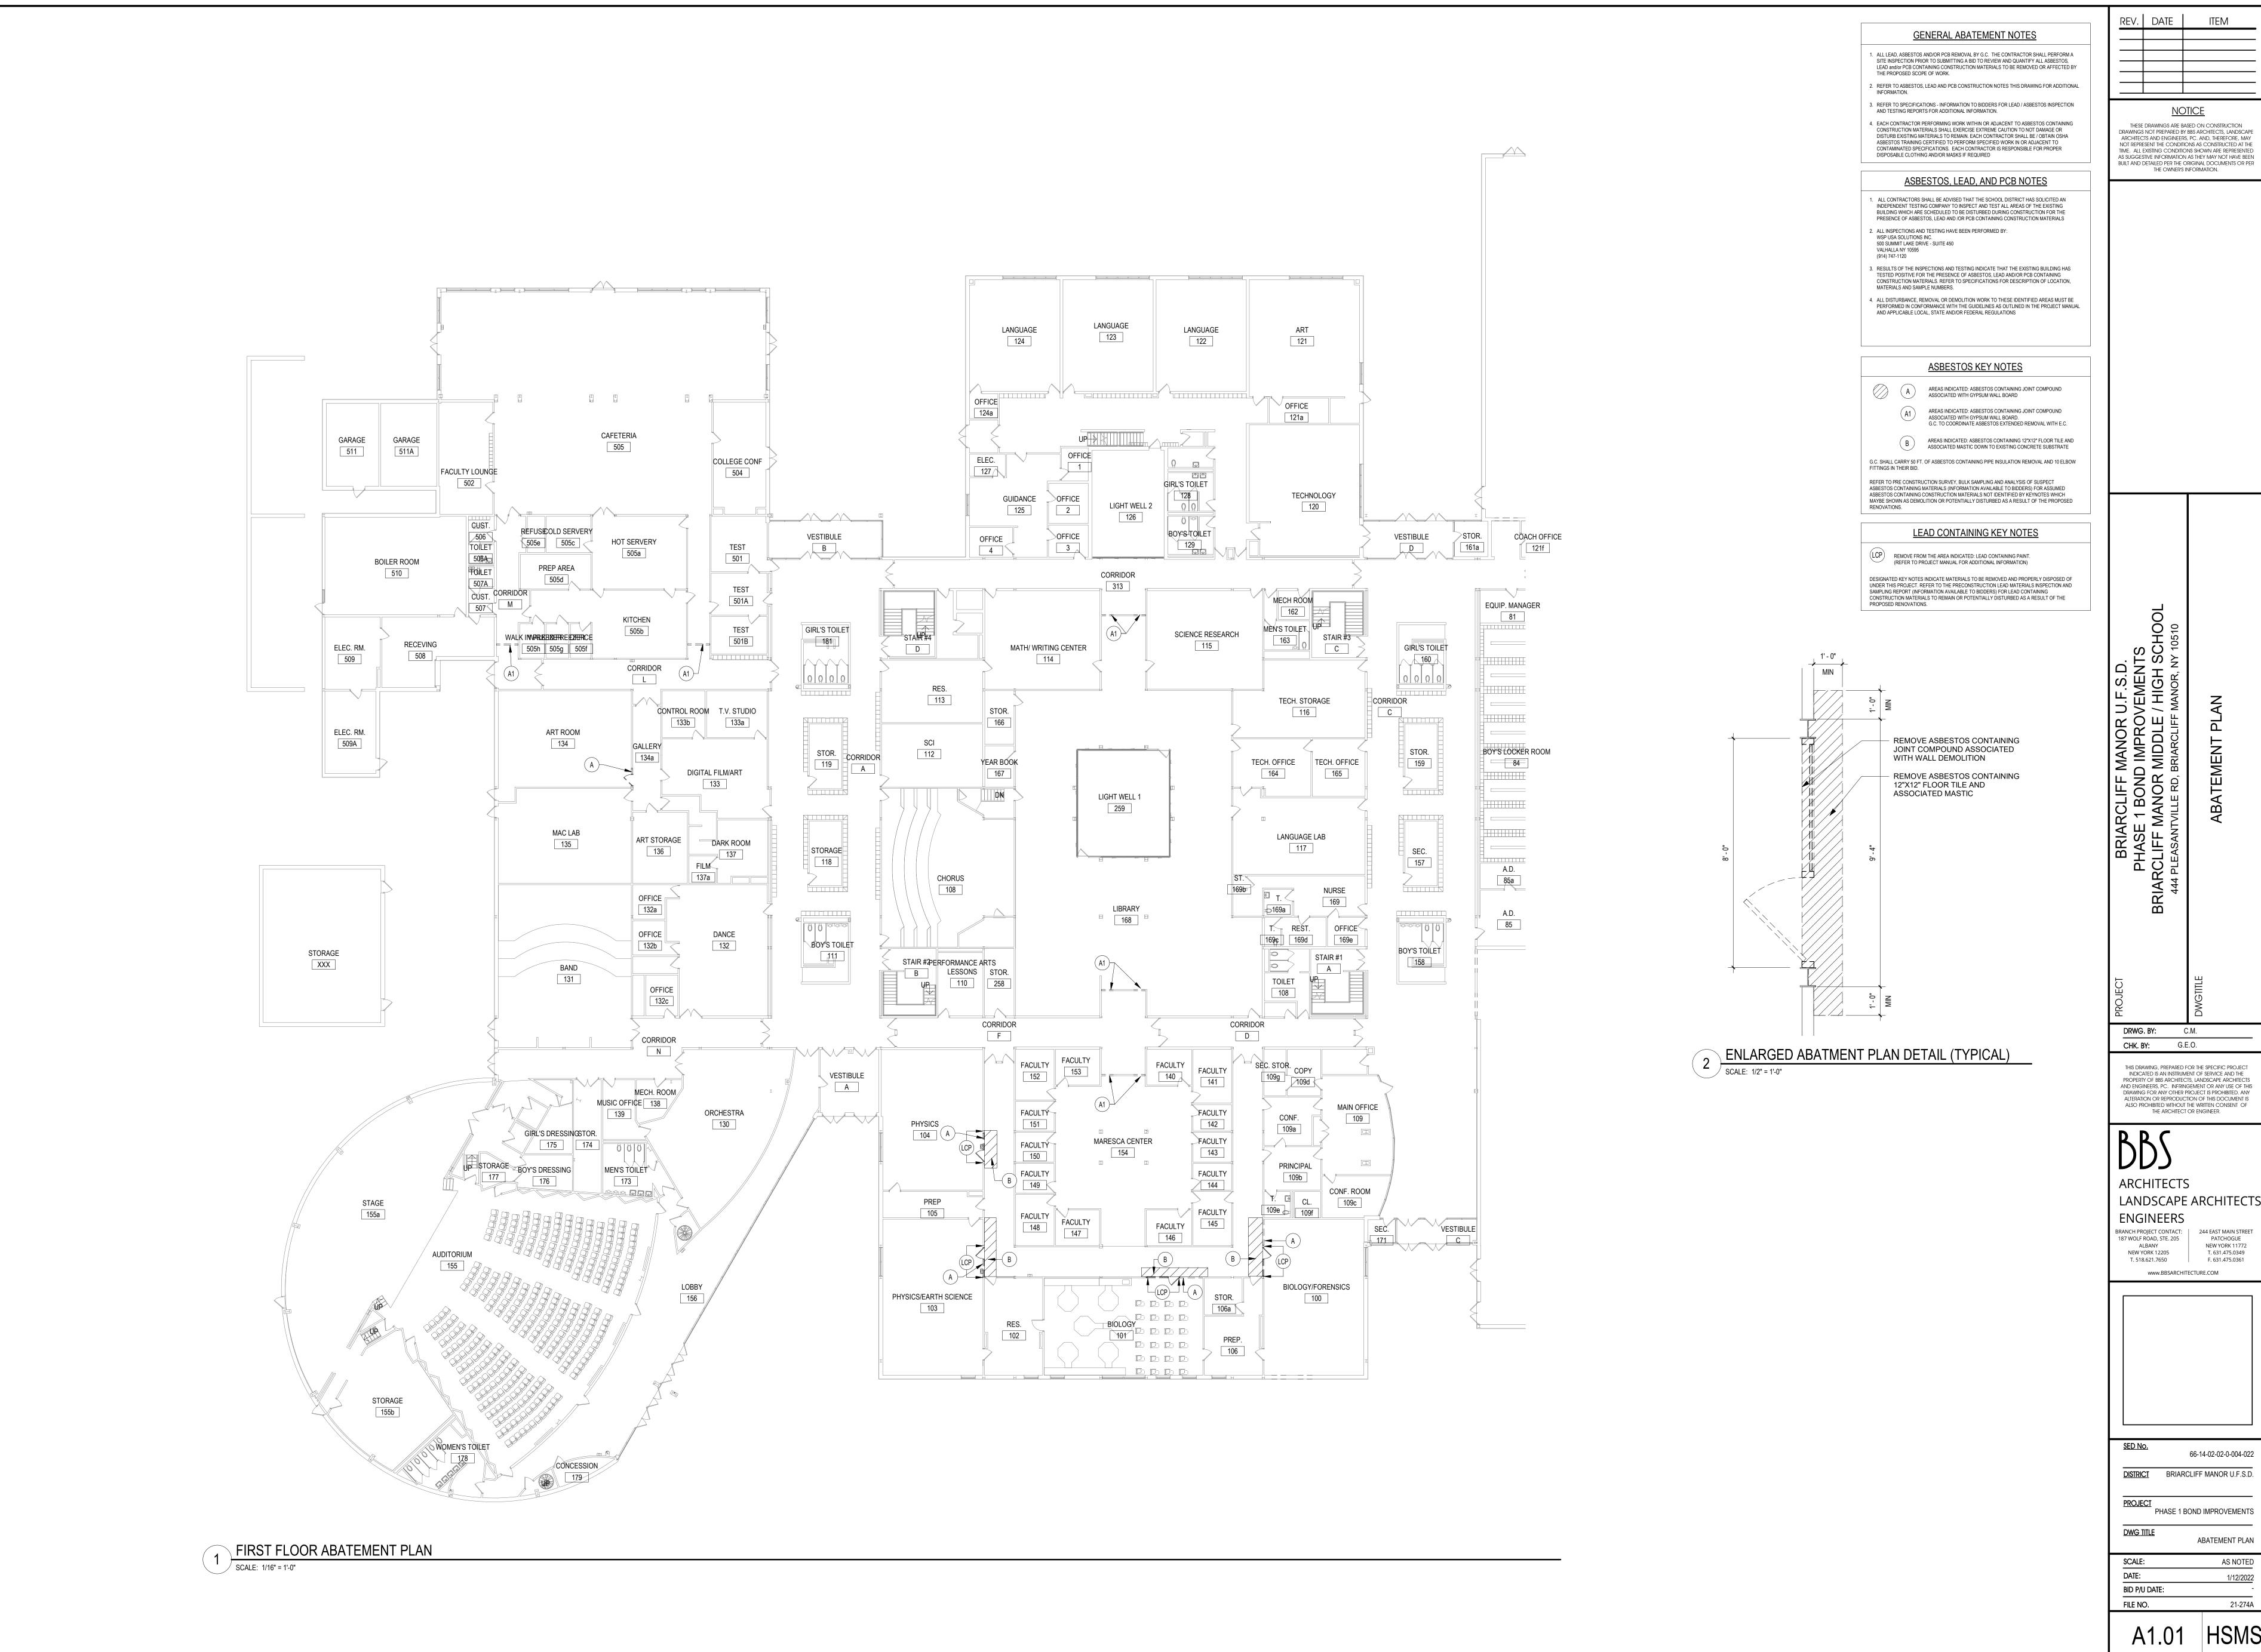SECTIONS

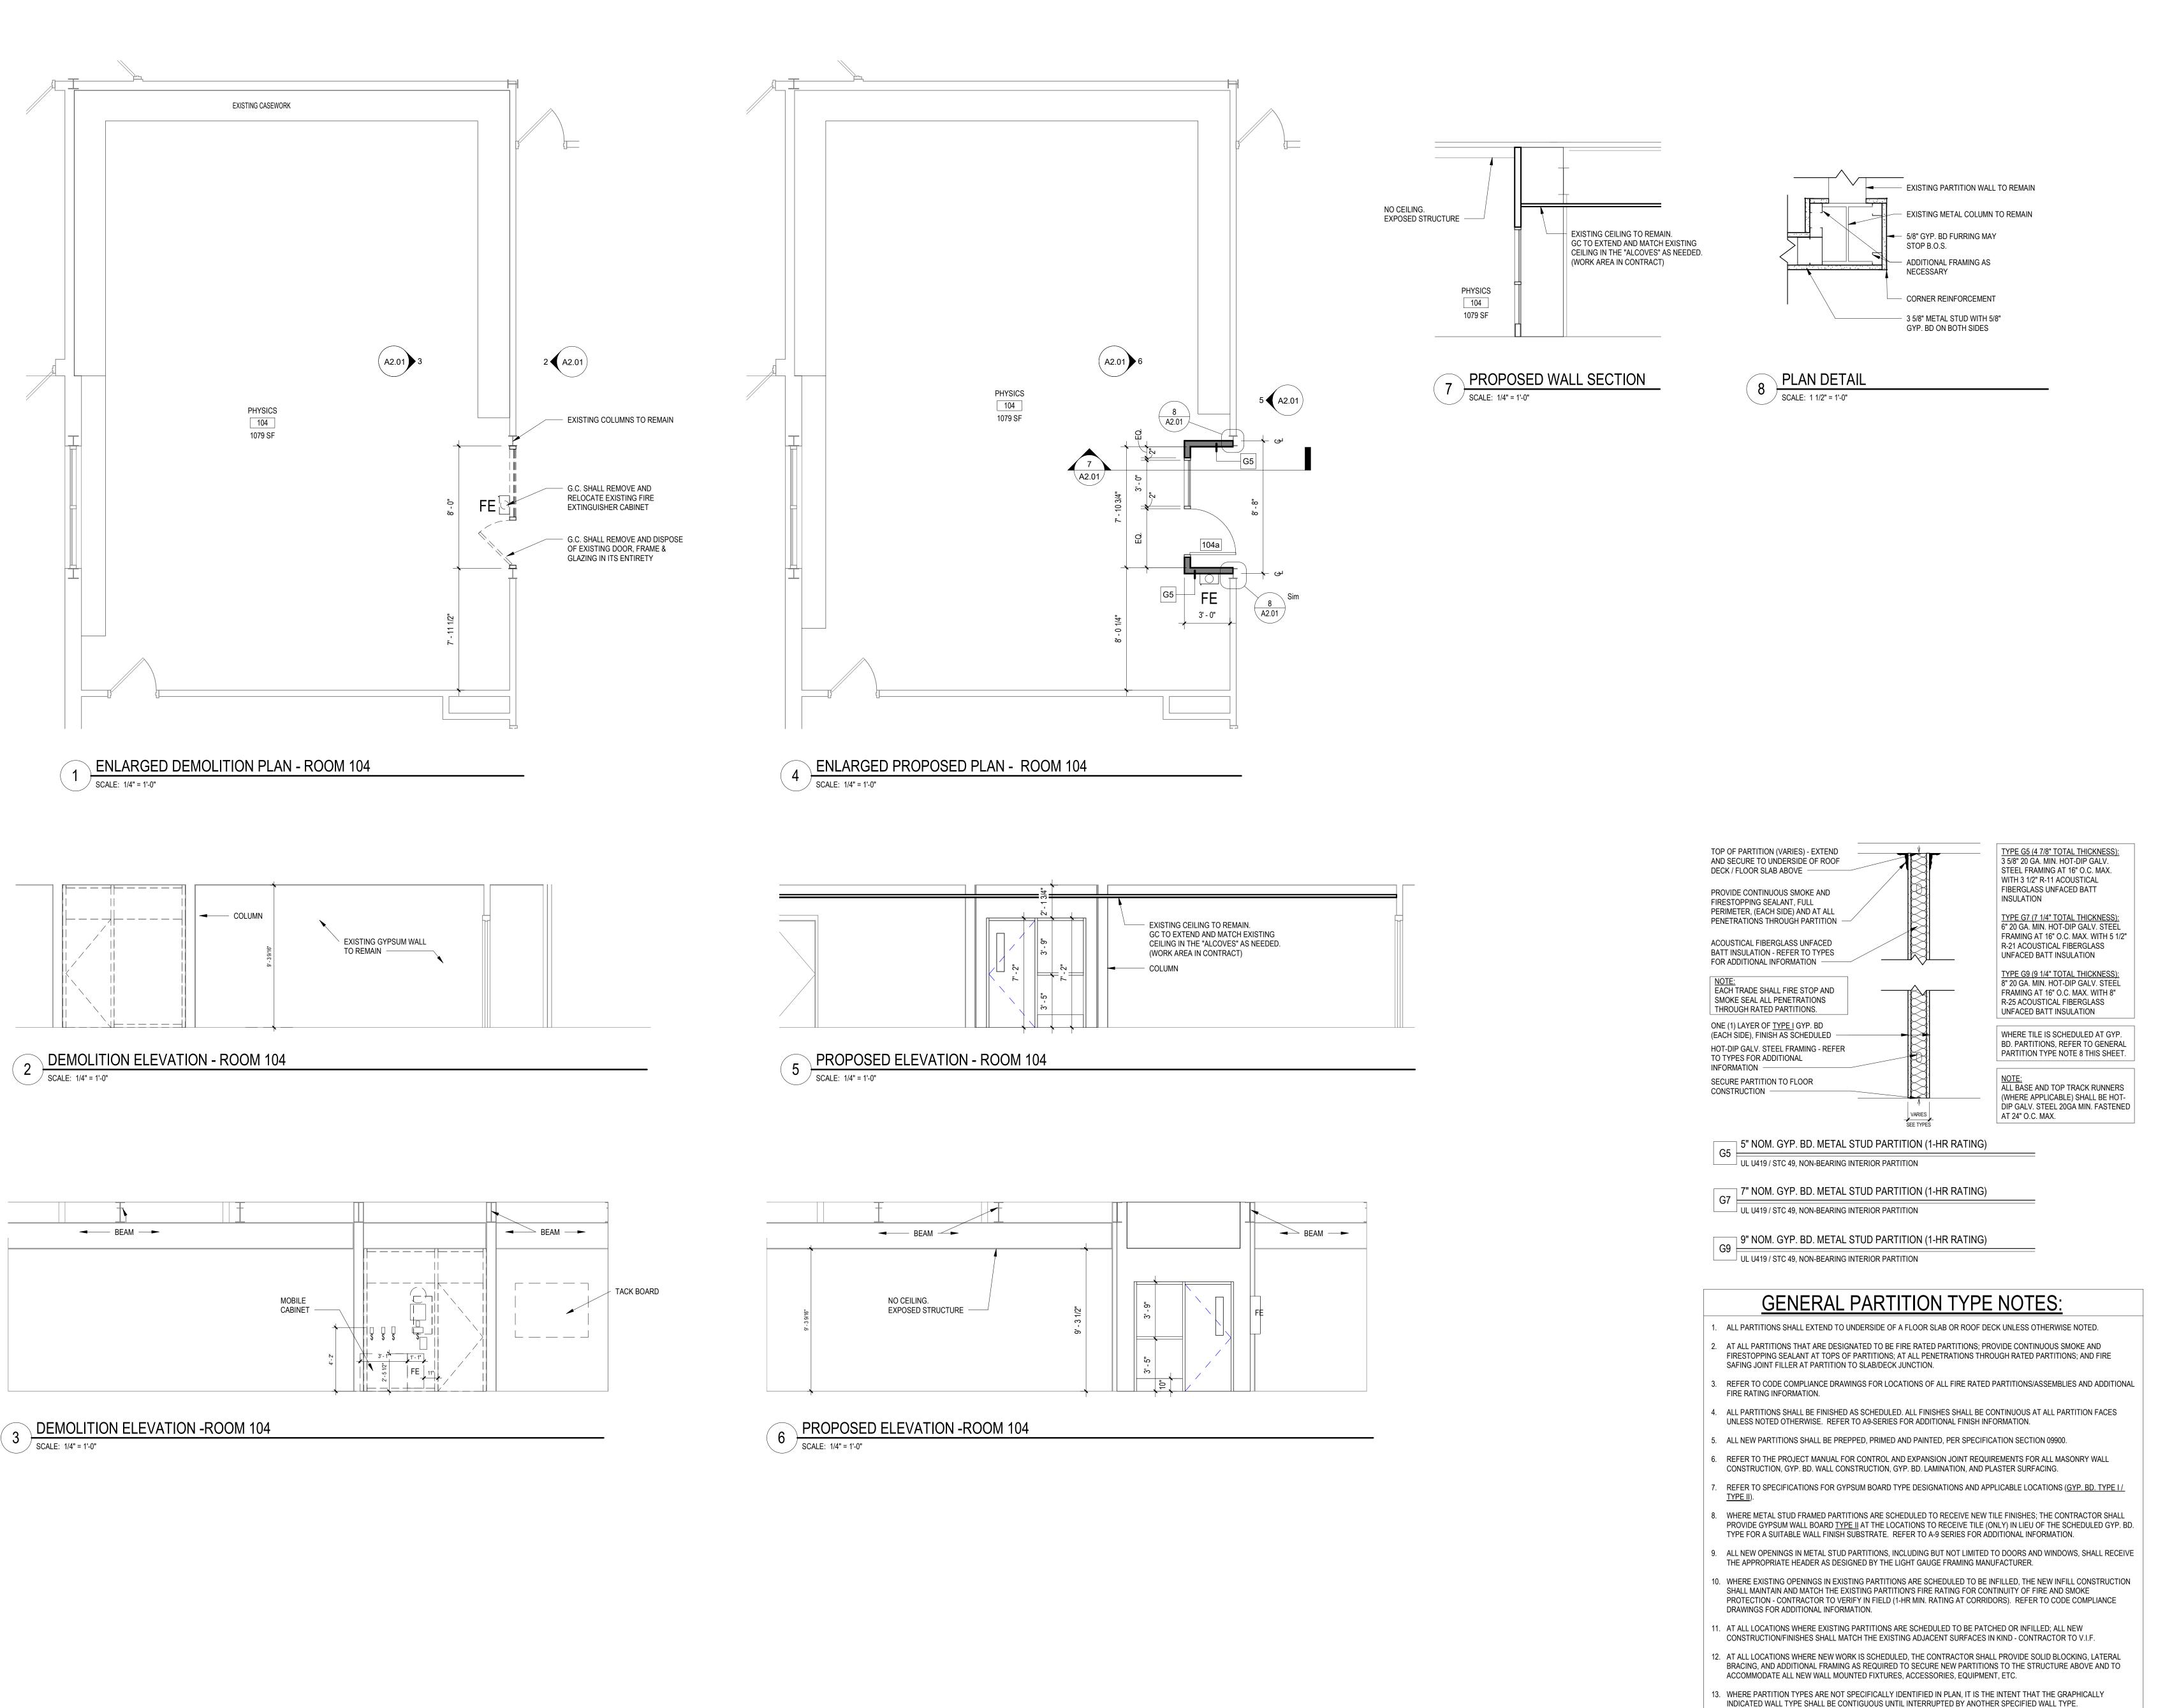AS NOTED


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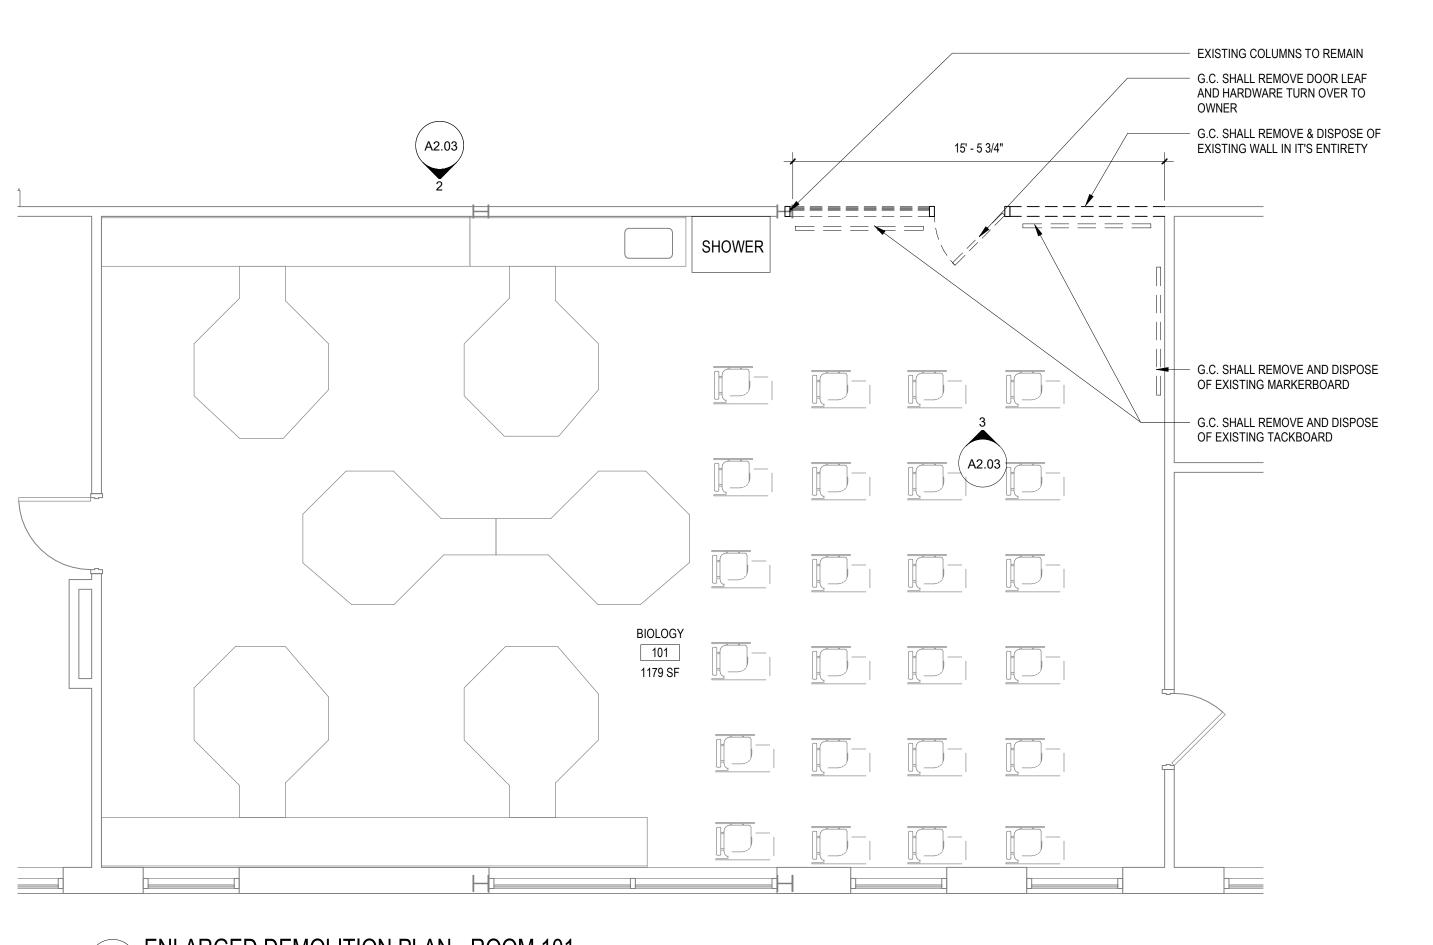
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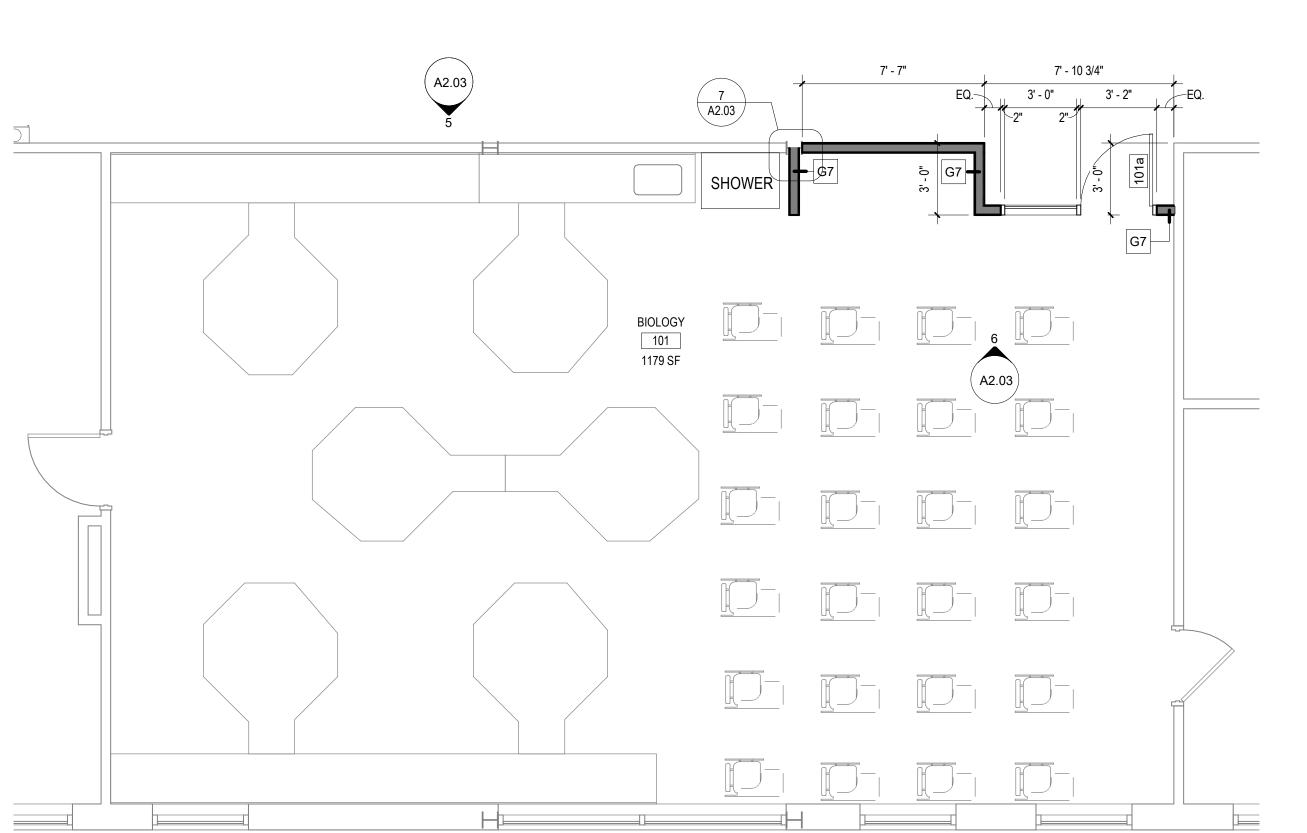
DISTRICT BRIARCLIFF MANOR U.F.S.D.


DWG TITLE FIRST FLOOR ENLARGED

PHASE 1 BOND IMPROVEMENTS





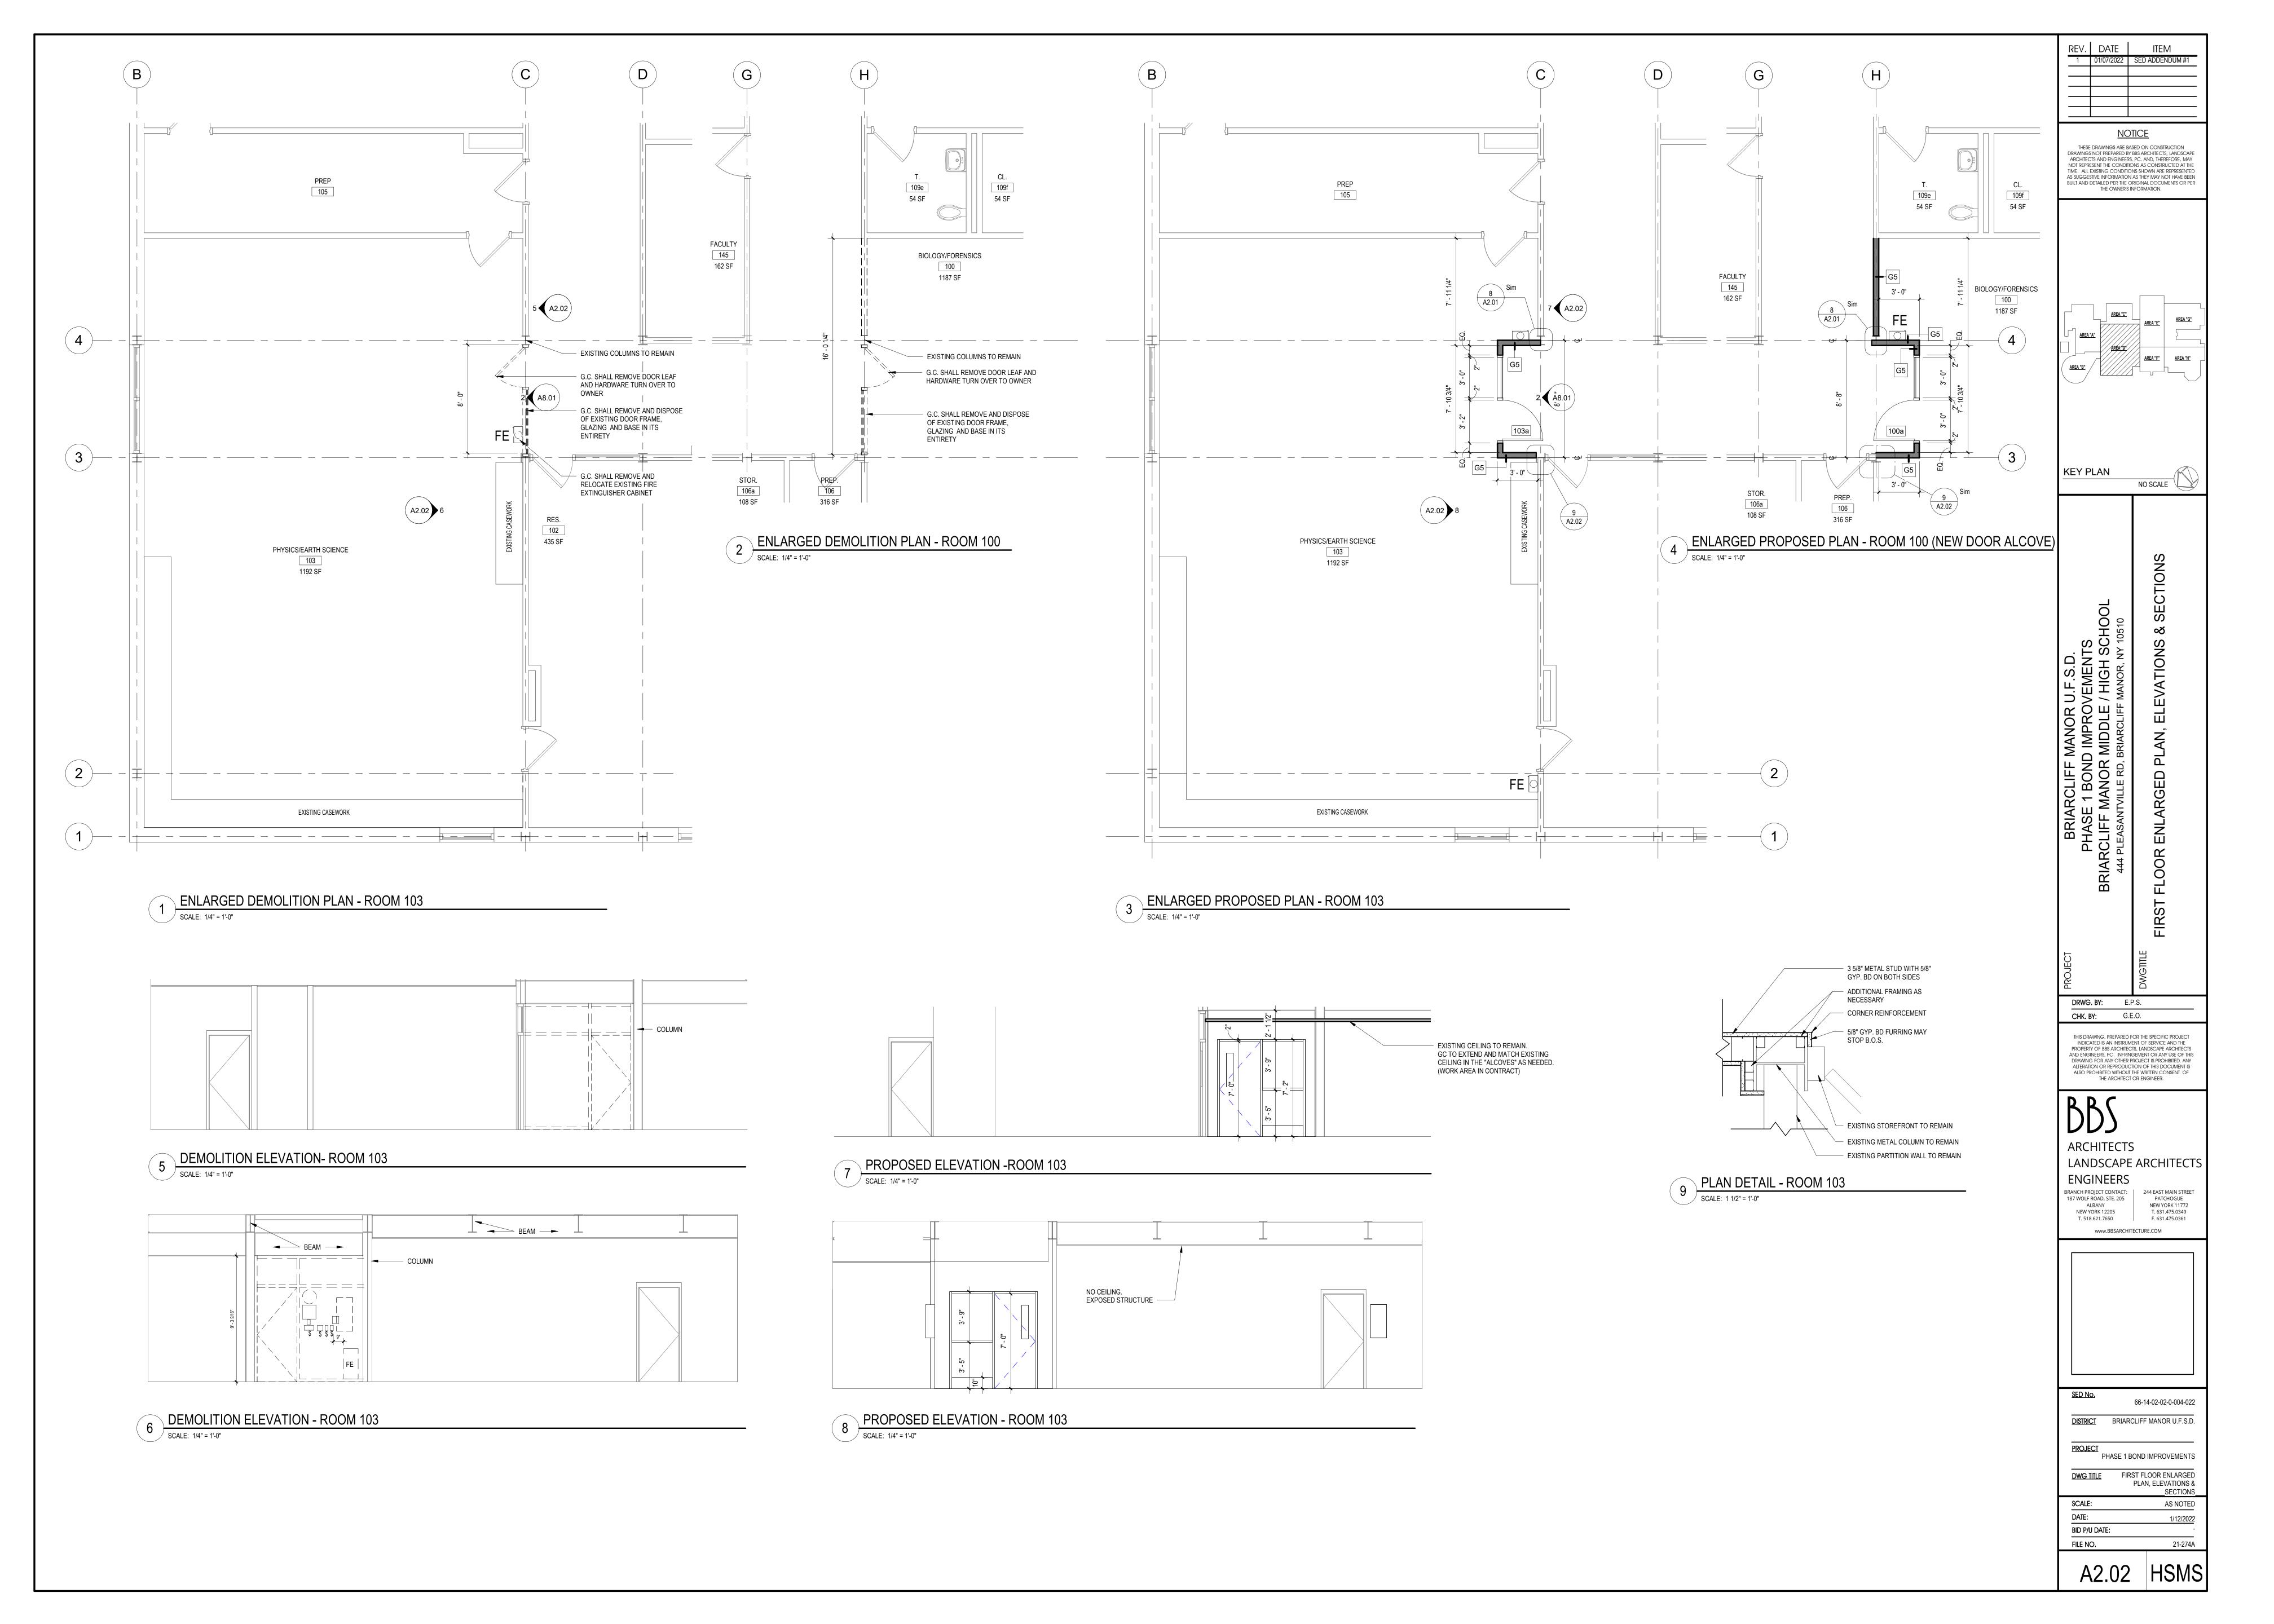

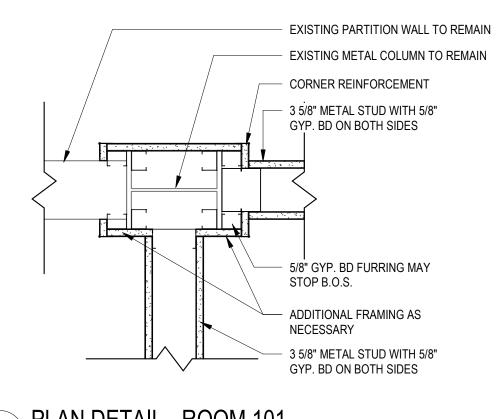



7 PLAN DETAIL - ROOM 101


SCALE: 1 1/2" = 1'-0"

1 ENLARGED DEMOLITION PLAN - ROOM 101


SCALE: 1/4" = 1'-0"

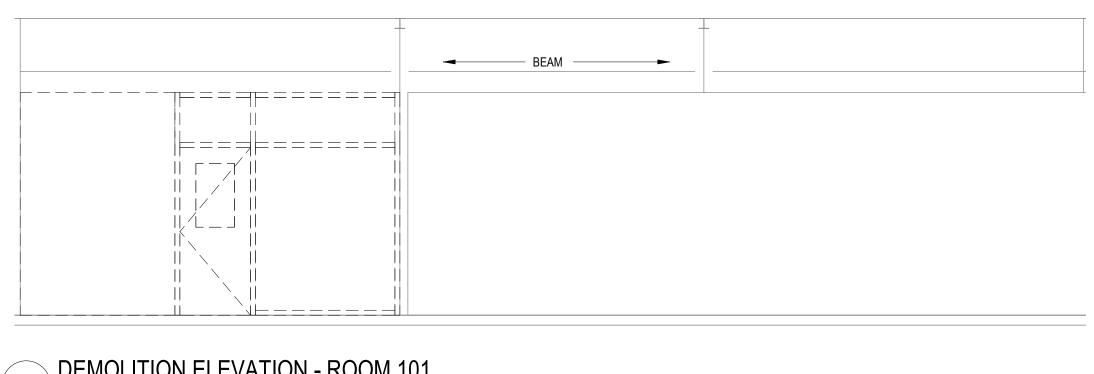

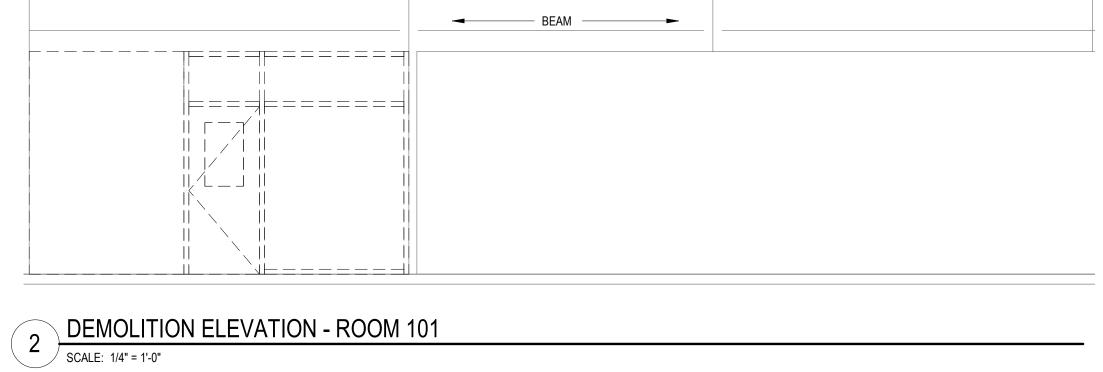

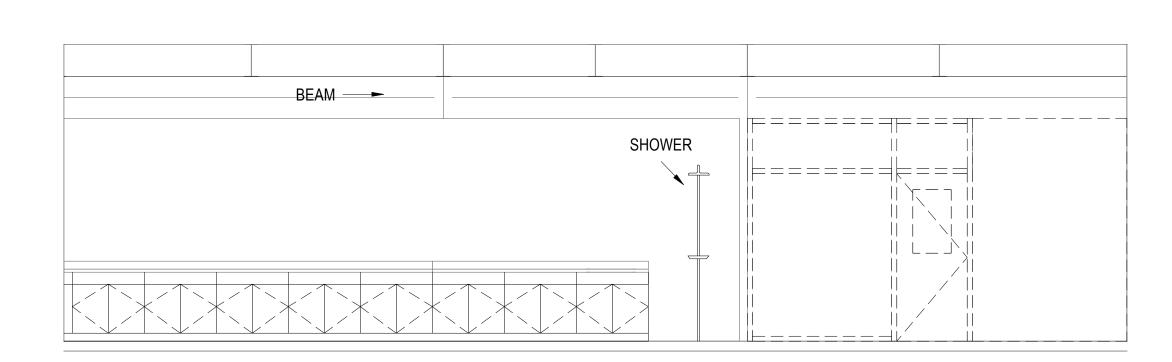


DEMOLITION ELEVATION- ROOM 101 SCALE: 1/4" = 1'-0"

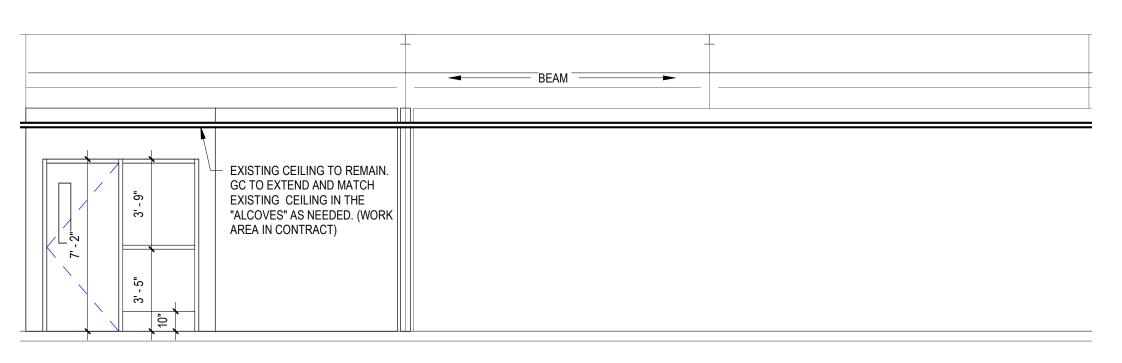

PROPOSED ELEVATION - ROOM 101 SCALE: 1/4" = 1'-0"

4 ENLARGED PROPOSED PLAN -ROOM 101

SCALE: 1/4" = 1'-0"

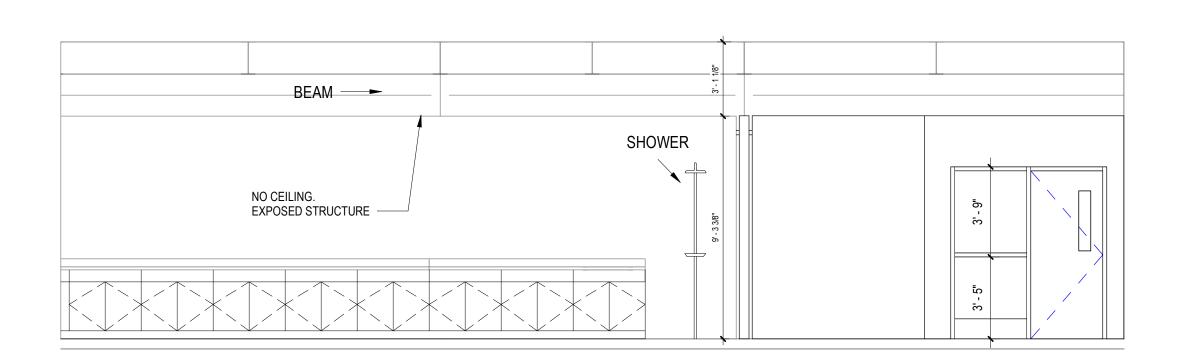

PROPOSED ELEVATION -ROOM 101 SCALE: 1/4" = 1'-0"

KEY PLAN	NO SCALE
BRIARCLIFF MANOR U.F.S.D. PHASE 1 BOND IMPROVEMENTS BRIARCLIFF MANOR MIDDLE / HIGH SCHOOL 444 PLEASANTVILLE RD, BRIARCLIFF MANOR, NY 10510	FIRST FLOOR ENLARGED PLAN, ELEVATIONS & SECTIONS
PROJECT	DWGTITLE
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 REV.
 DATE
 ITEM

 1
 01/07/2022
 SED ADDENDUM #1


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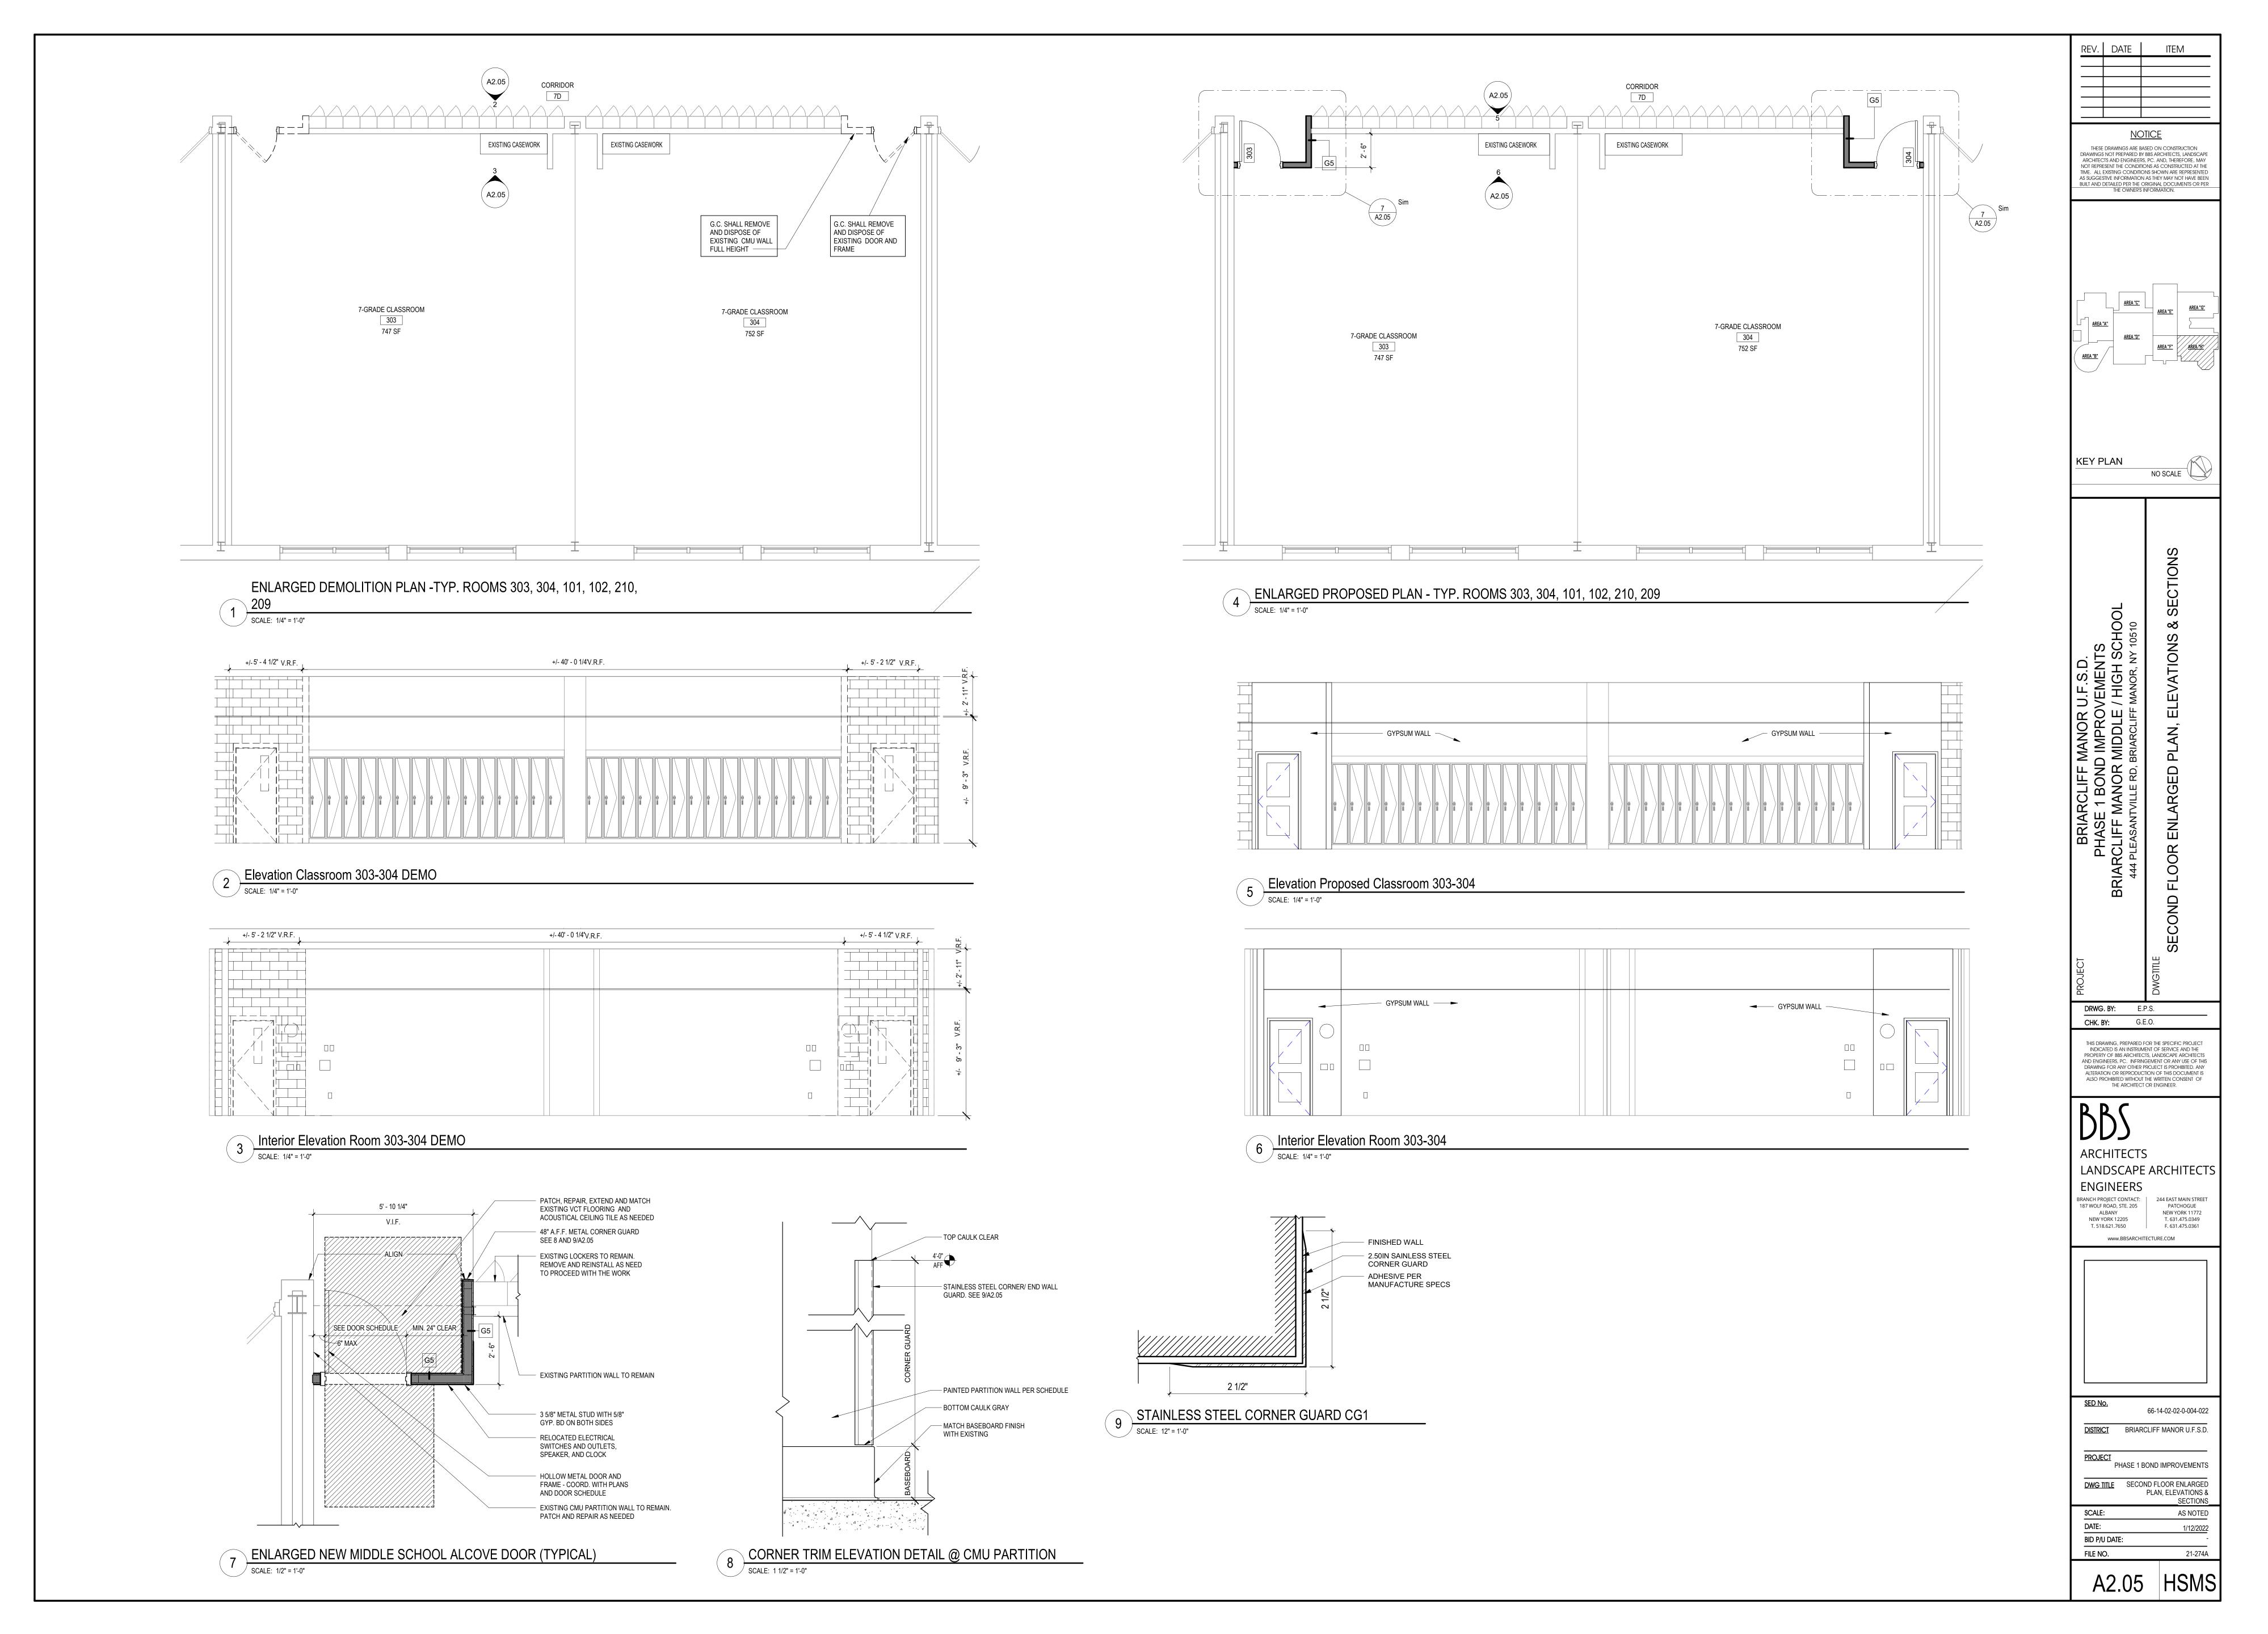
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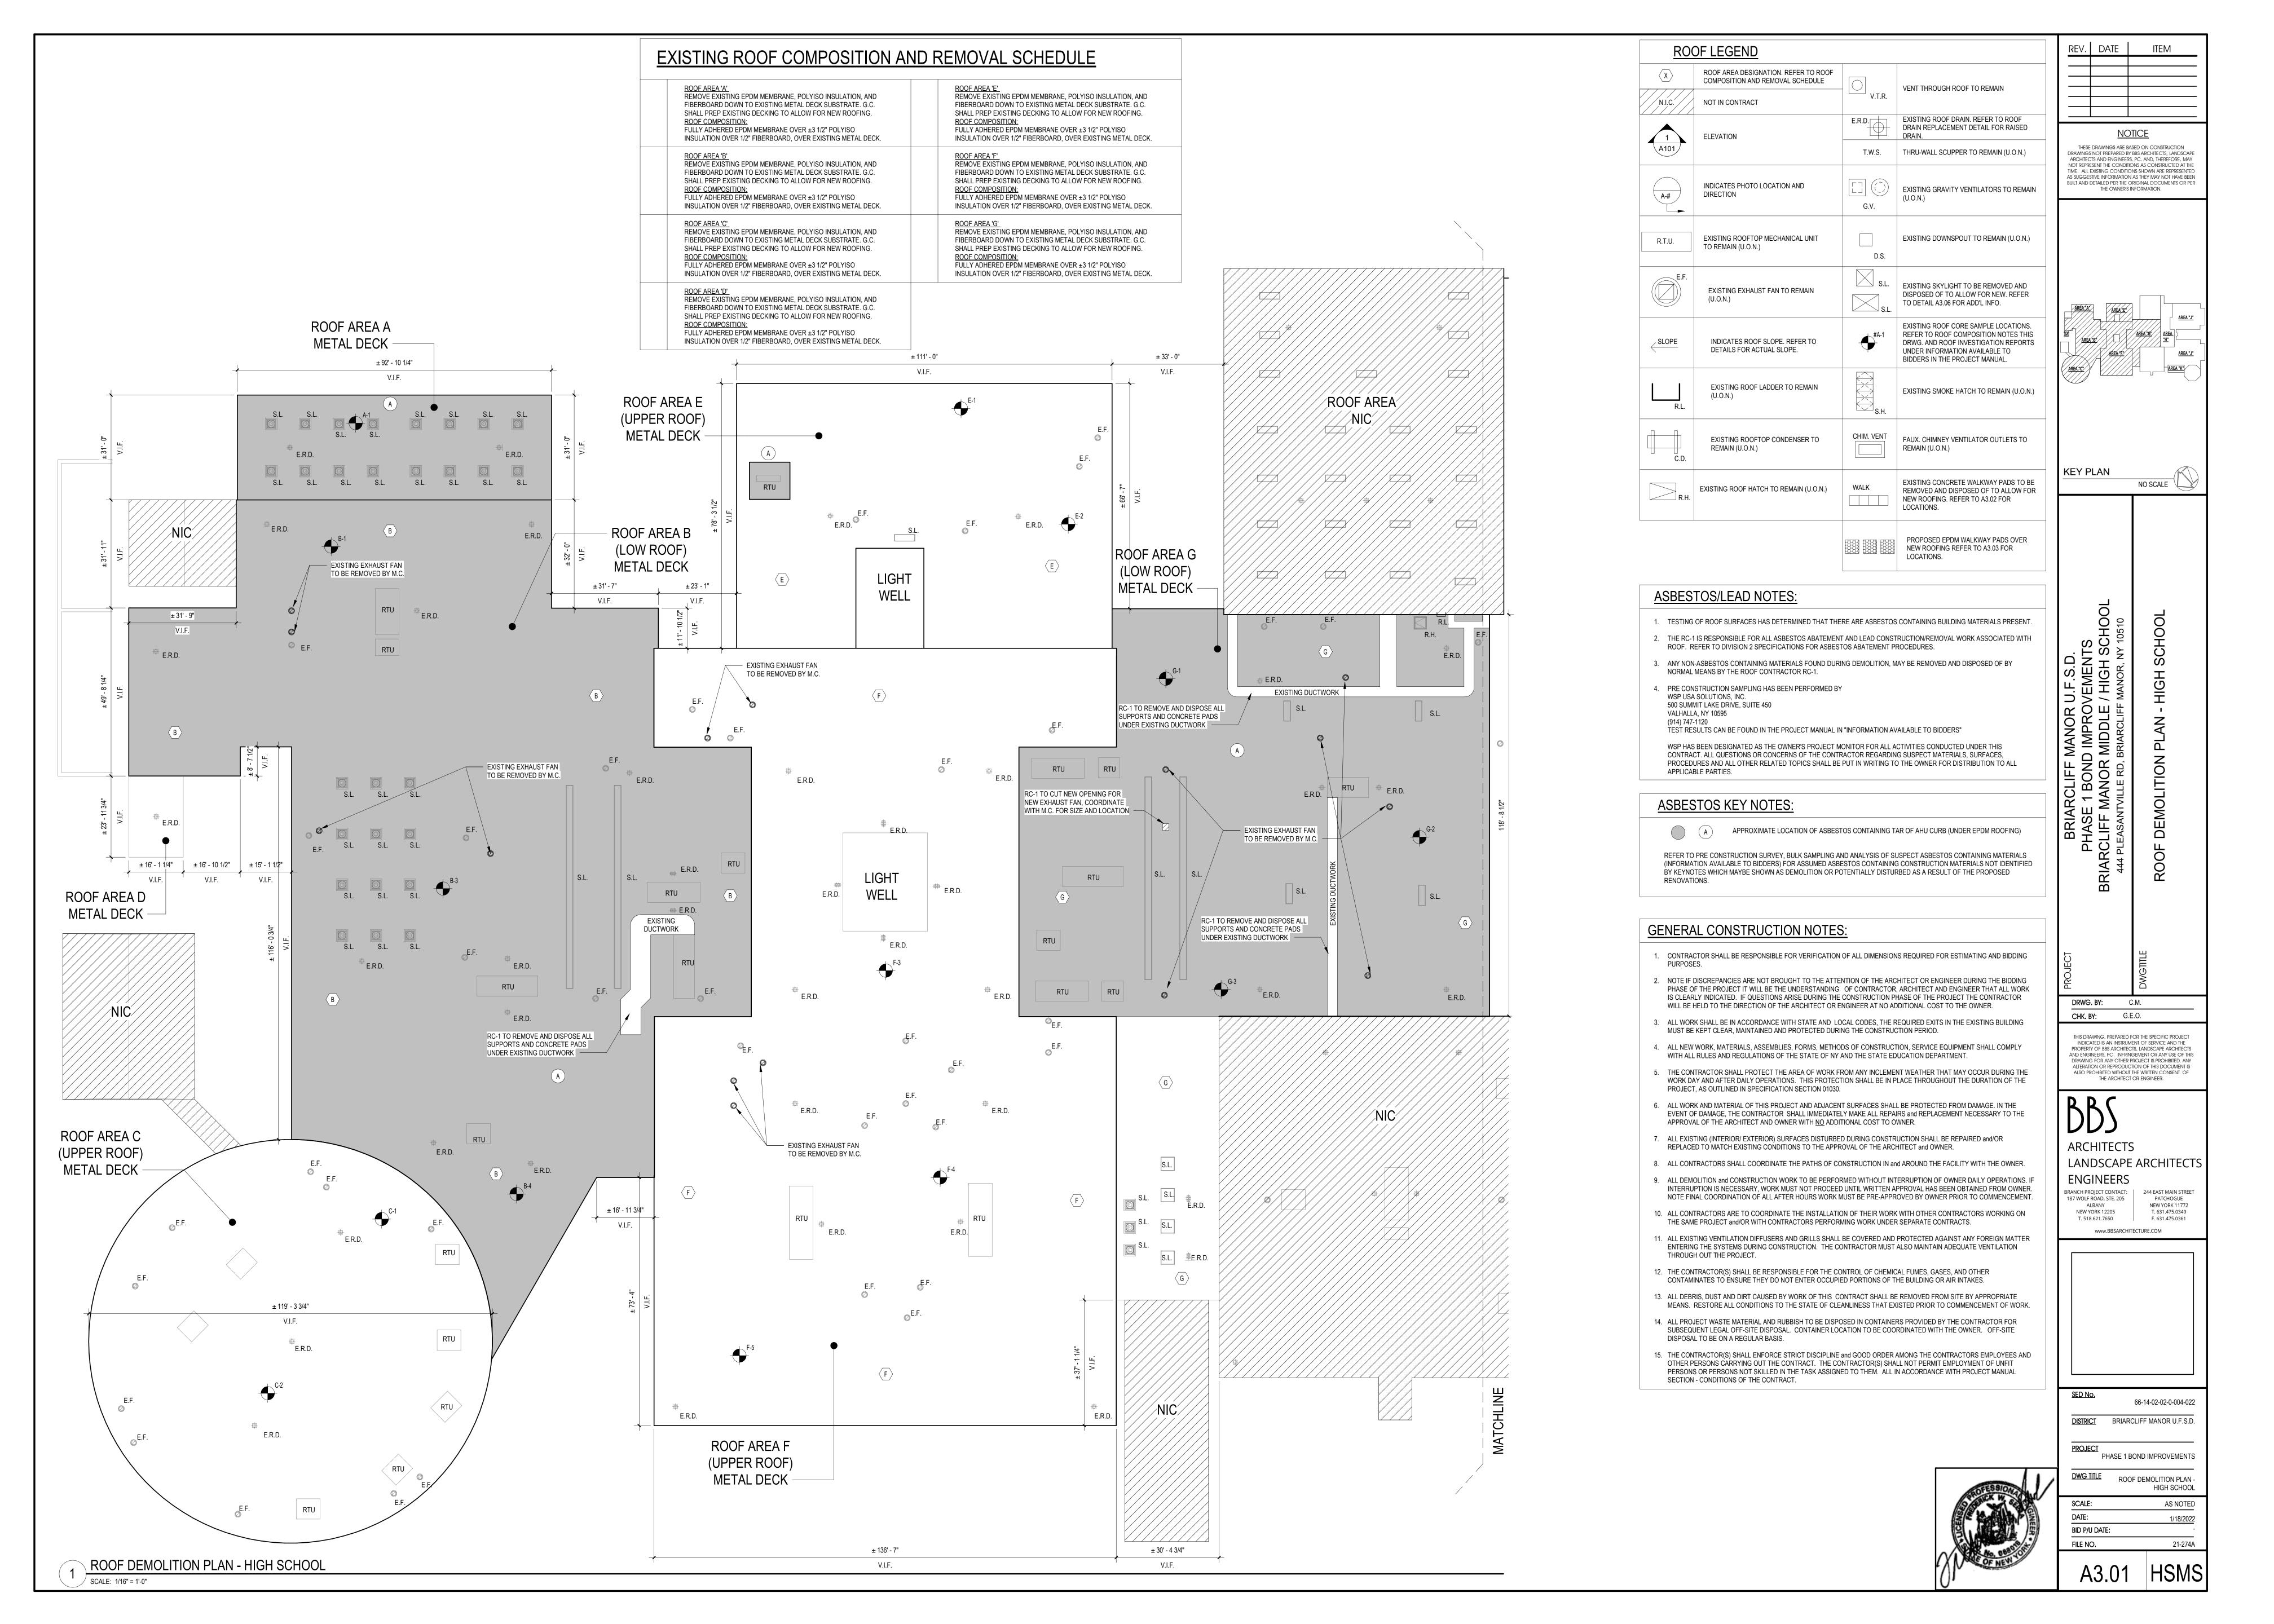
66-14-02-02-0-004-022 **DISTRICT** BRIARCLIFF MANOR U.F.S.D. PROJECT
PHASE 1 BOND IMPROVEMENTS DWG TITLE FIRST FLOOR ENLARGED PLAN, ELEVATIONS & SECTIONS SCALE:


DATE:

BID P/U DATE: FILE NO.





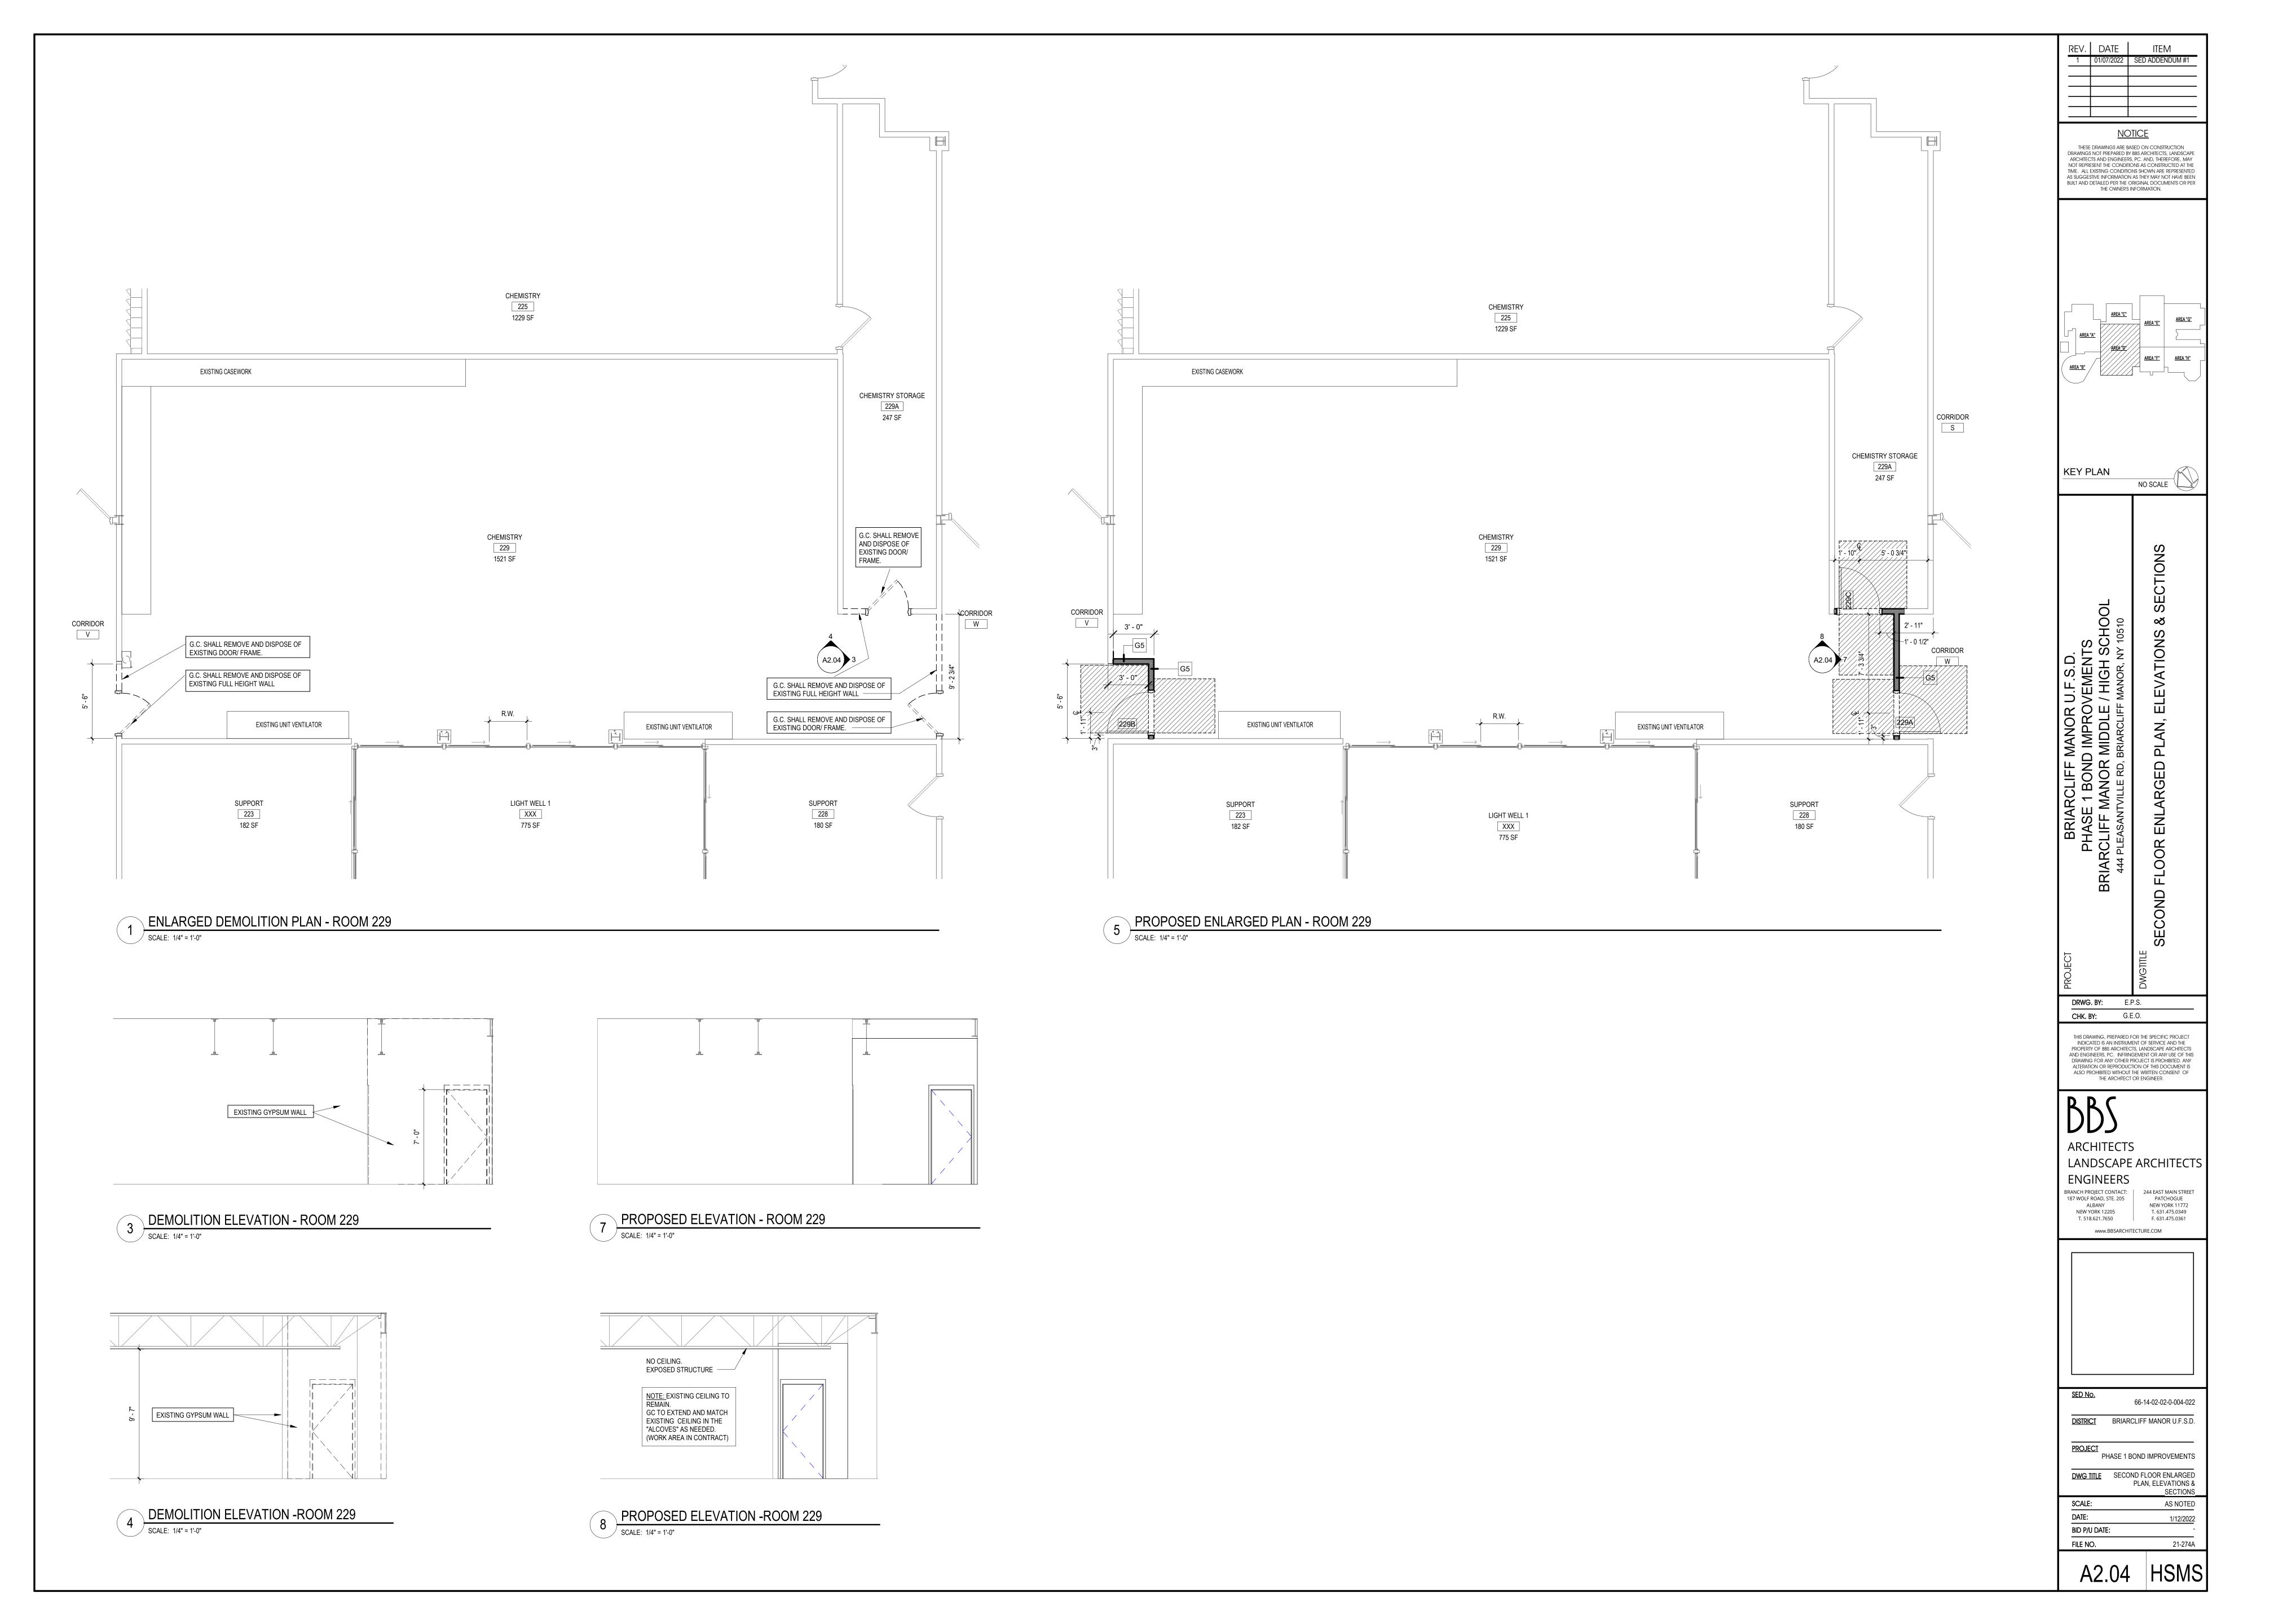

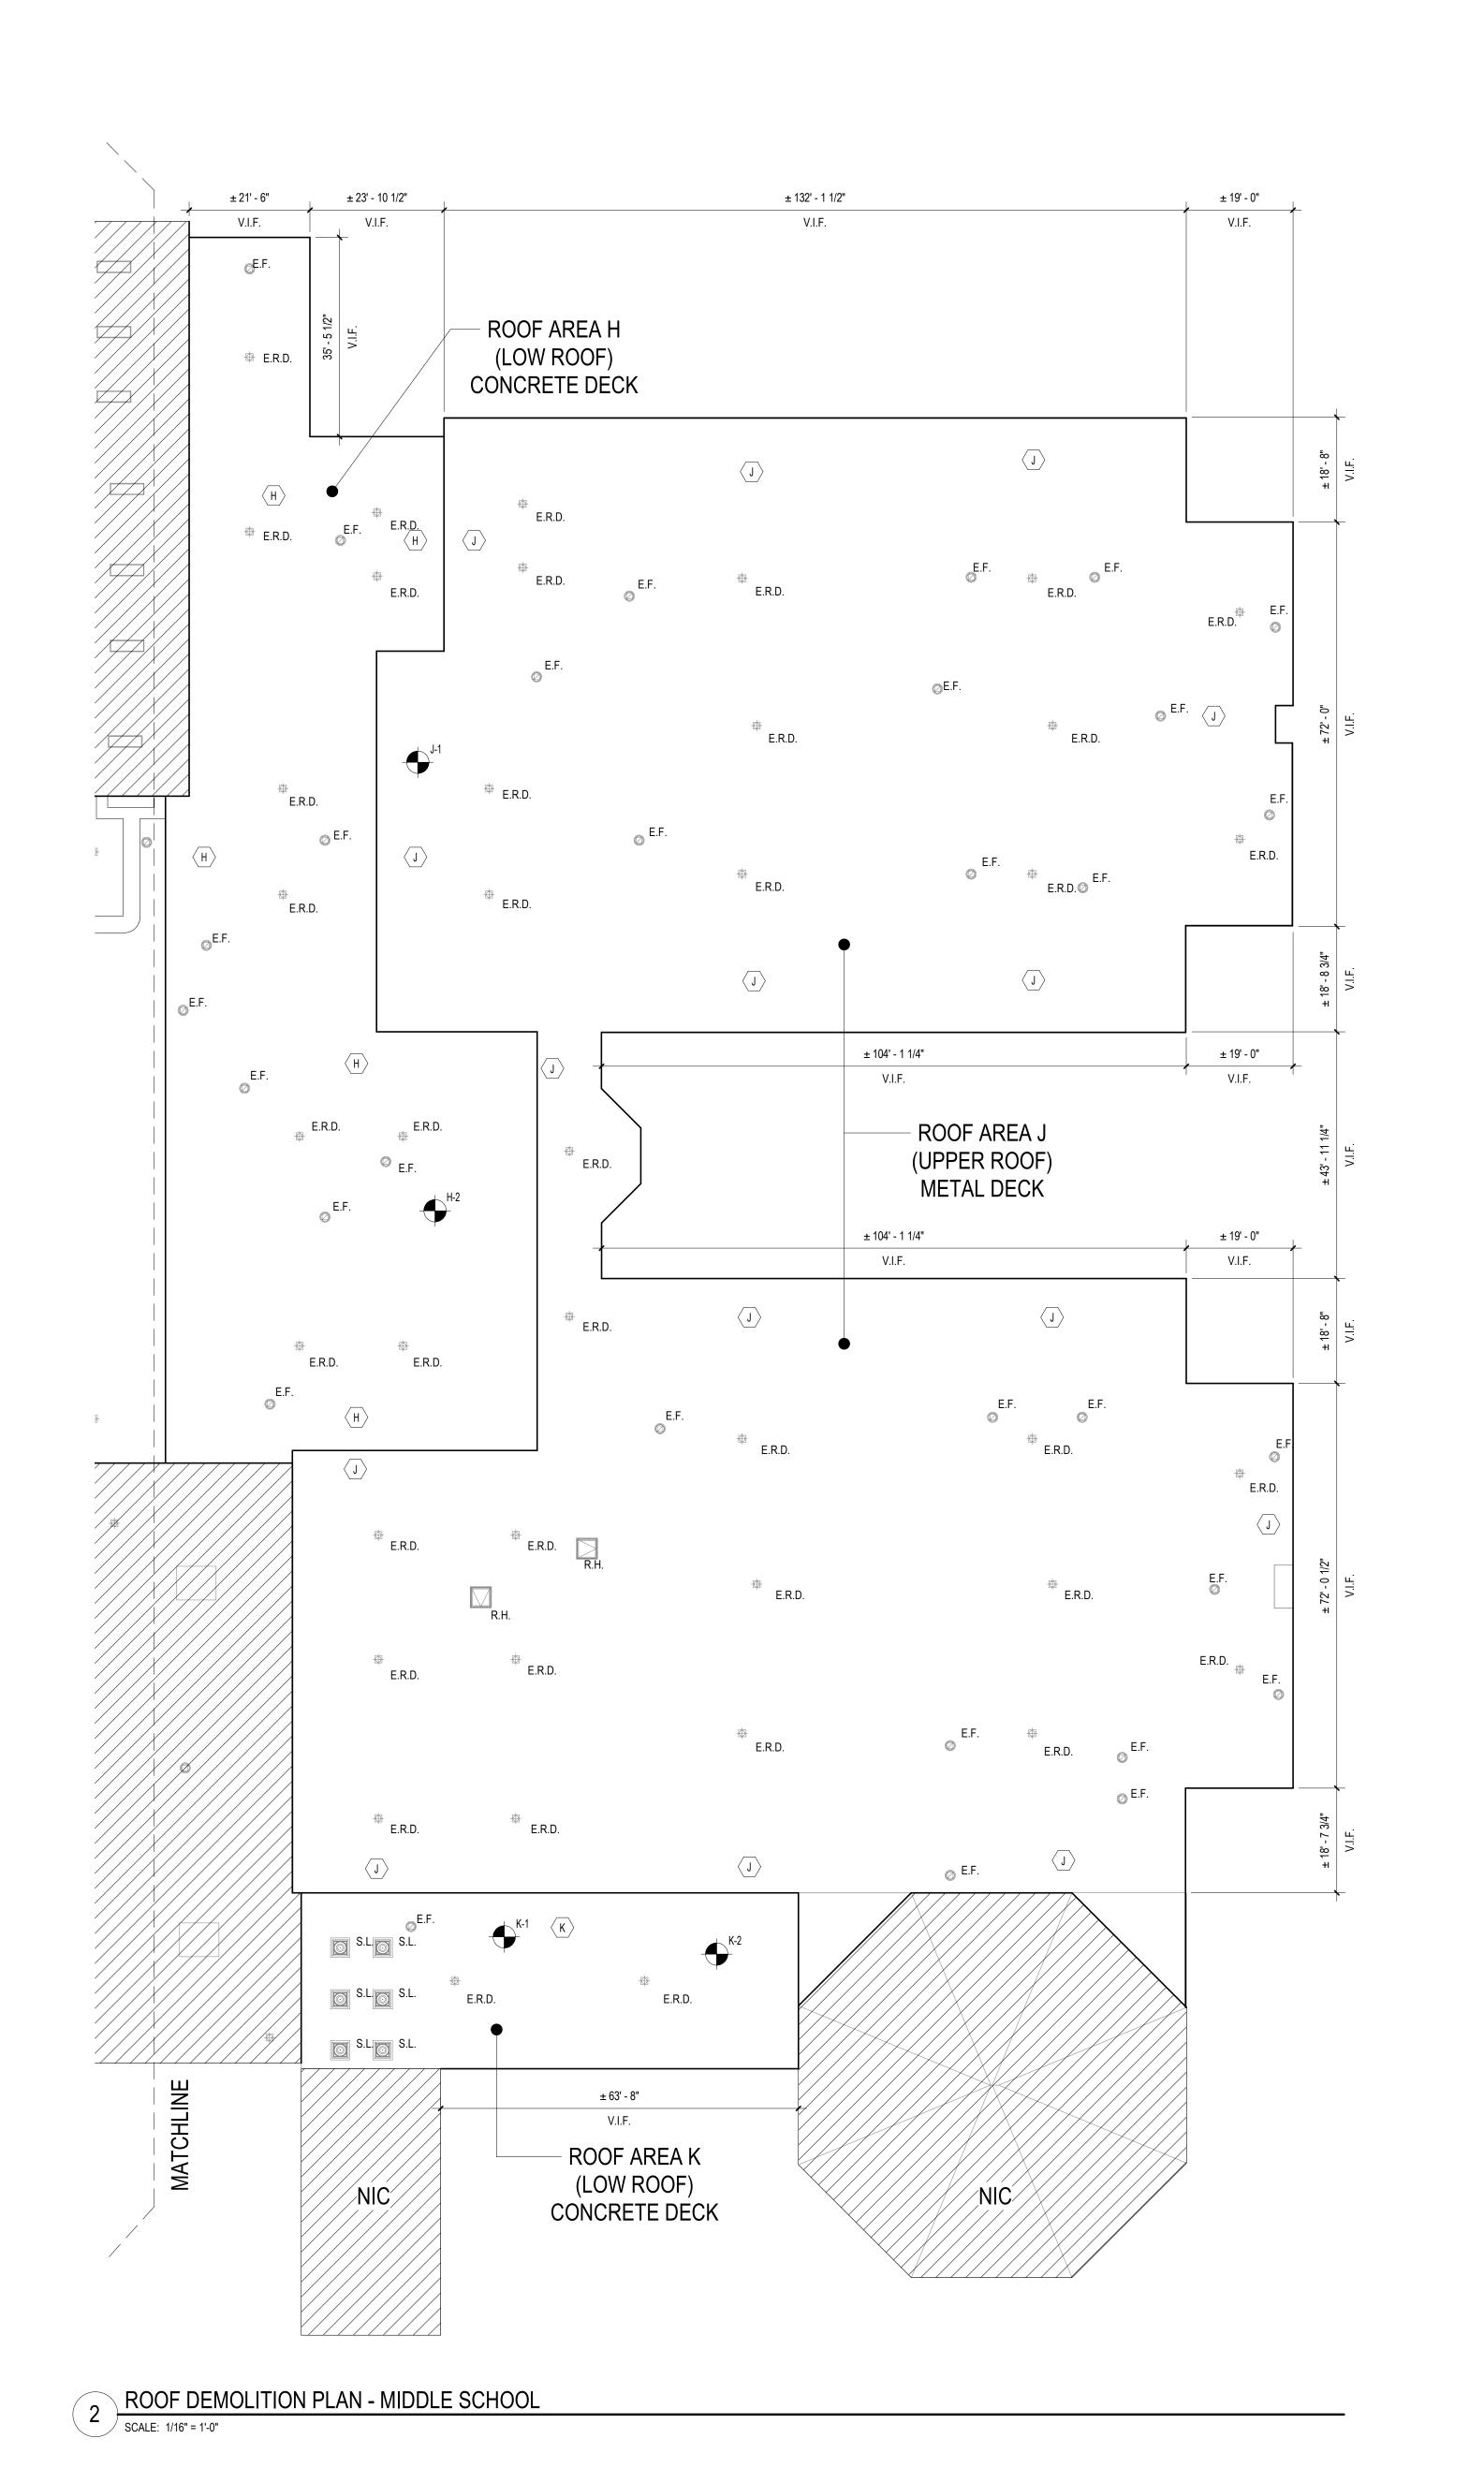

EXISTING ROOF COMPOSITION AND REMOVAL SCHEDULE


ROOF AREA 'H'
REMOVE EXISTING EPDM MEMBRANE, POLYISO INSULATION, AND
FIBERBOARD DOWN TO EXISTING CONCRETE DECK SUBSTRATE. G.C.
SHALL PREP EXISTING DECKING TO ALLOW FOR NEW ROOFING.
ROOF COMPOSITION:
FULLY ADHERED EPDM MEMBRANE OVER ±3 1/2" POLYISO INSULATION
OVER 1/2" FIBERBOARD, OVER EXISTING CONCRETE DECK.

ROOF AREA 'J'
REMOVE EXISTING EPDM MEMBRANE, POLYISO INSULATION, AND FIBERBOARD DOWN TO EXISTING METAL DECK SUBSTRATE. G.C. SHALL PREP EXISTING DECKING TO ALLOW FOR NEW ROOFING. ROOF COMPOSITION:
FULLY ADHERED EPDM MEMBRANE OVER ±3 1/2" POLYISO INSULATION OVER 1/2" FIBERBOARD, OVER EXISTING METAL DECK.

ROOF AREA 'K'
REMOVE EXISTING EPDM MEMBRANE, POLYISO INSULATION, AND
FIBERBOARD DOWN TO EXISTING CONCRETE DECK SUBSTRATE. G.C.
SHALL PREP EXISTING DECKING TO ALLOW FOR NEW ROOFING.
ROOF COMPOSITION:
FULLY ADHERED EPDM MEMBRANE OVER ±3 1/2" POLYISO INSULATION
OVER 1/2" FIBERBOARD, OVER EXISTING CONCRETE DECK.

REV.	DATE	ITEM

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KEY PLAN

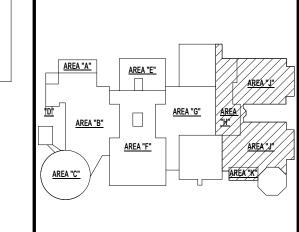NO SCALE

BRIARCLIFF MANOR U.F.S.D.
PHASE 1 BOND IMPROVEMENTS
BRIARCLIFF MANOR MIDDLE / HIGH SCHOOL
444 PLEASANTVILLE RD, BRIARCLIFF MANOR, NY 10510

ROOF DEMOLITION PLAN - MIDDLE SCHOOL

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CHK. BY: G.E.O.

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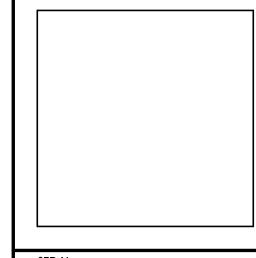
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PROJECT
PHASE 1 BOND IMPROVEMENTS

DWG TITLE

ROOF DEMOLITION PLAN - MIDDLE SCHOOL

SCALE:

AS NOTED


DATE: 1/18/2022

SCALE: AS NOTED

DATE: 1/18/2022

BID P/U DATE:
FILE NO. 21-274A

A3.02 HSMS

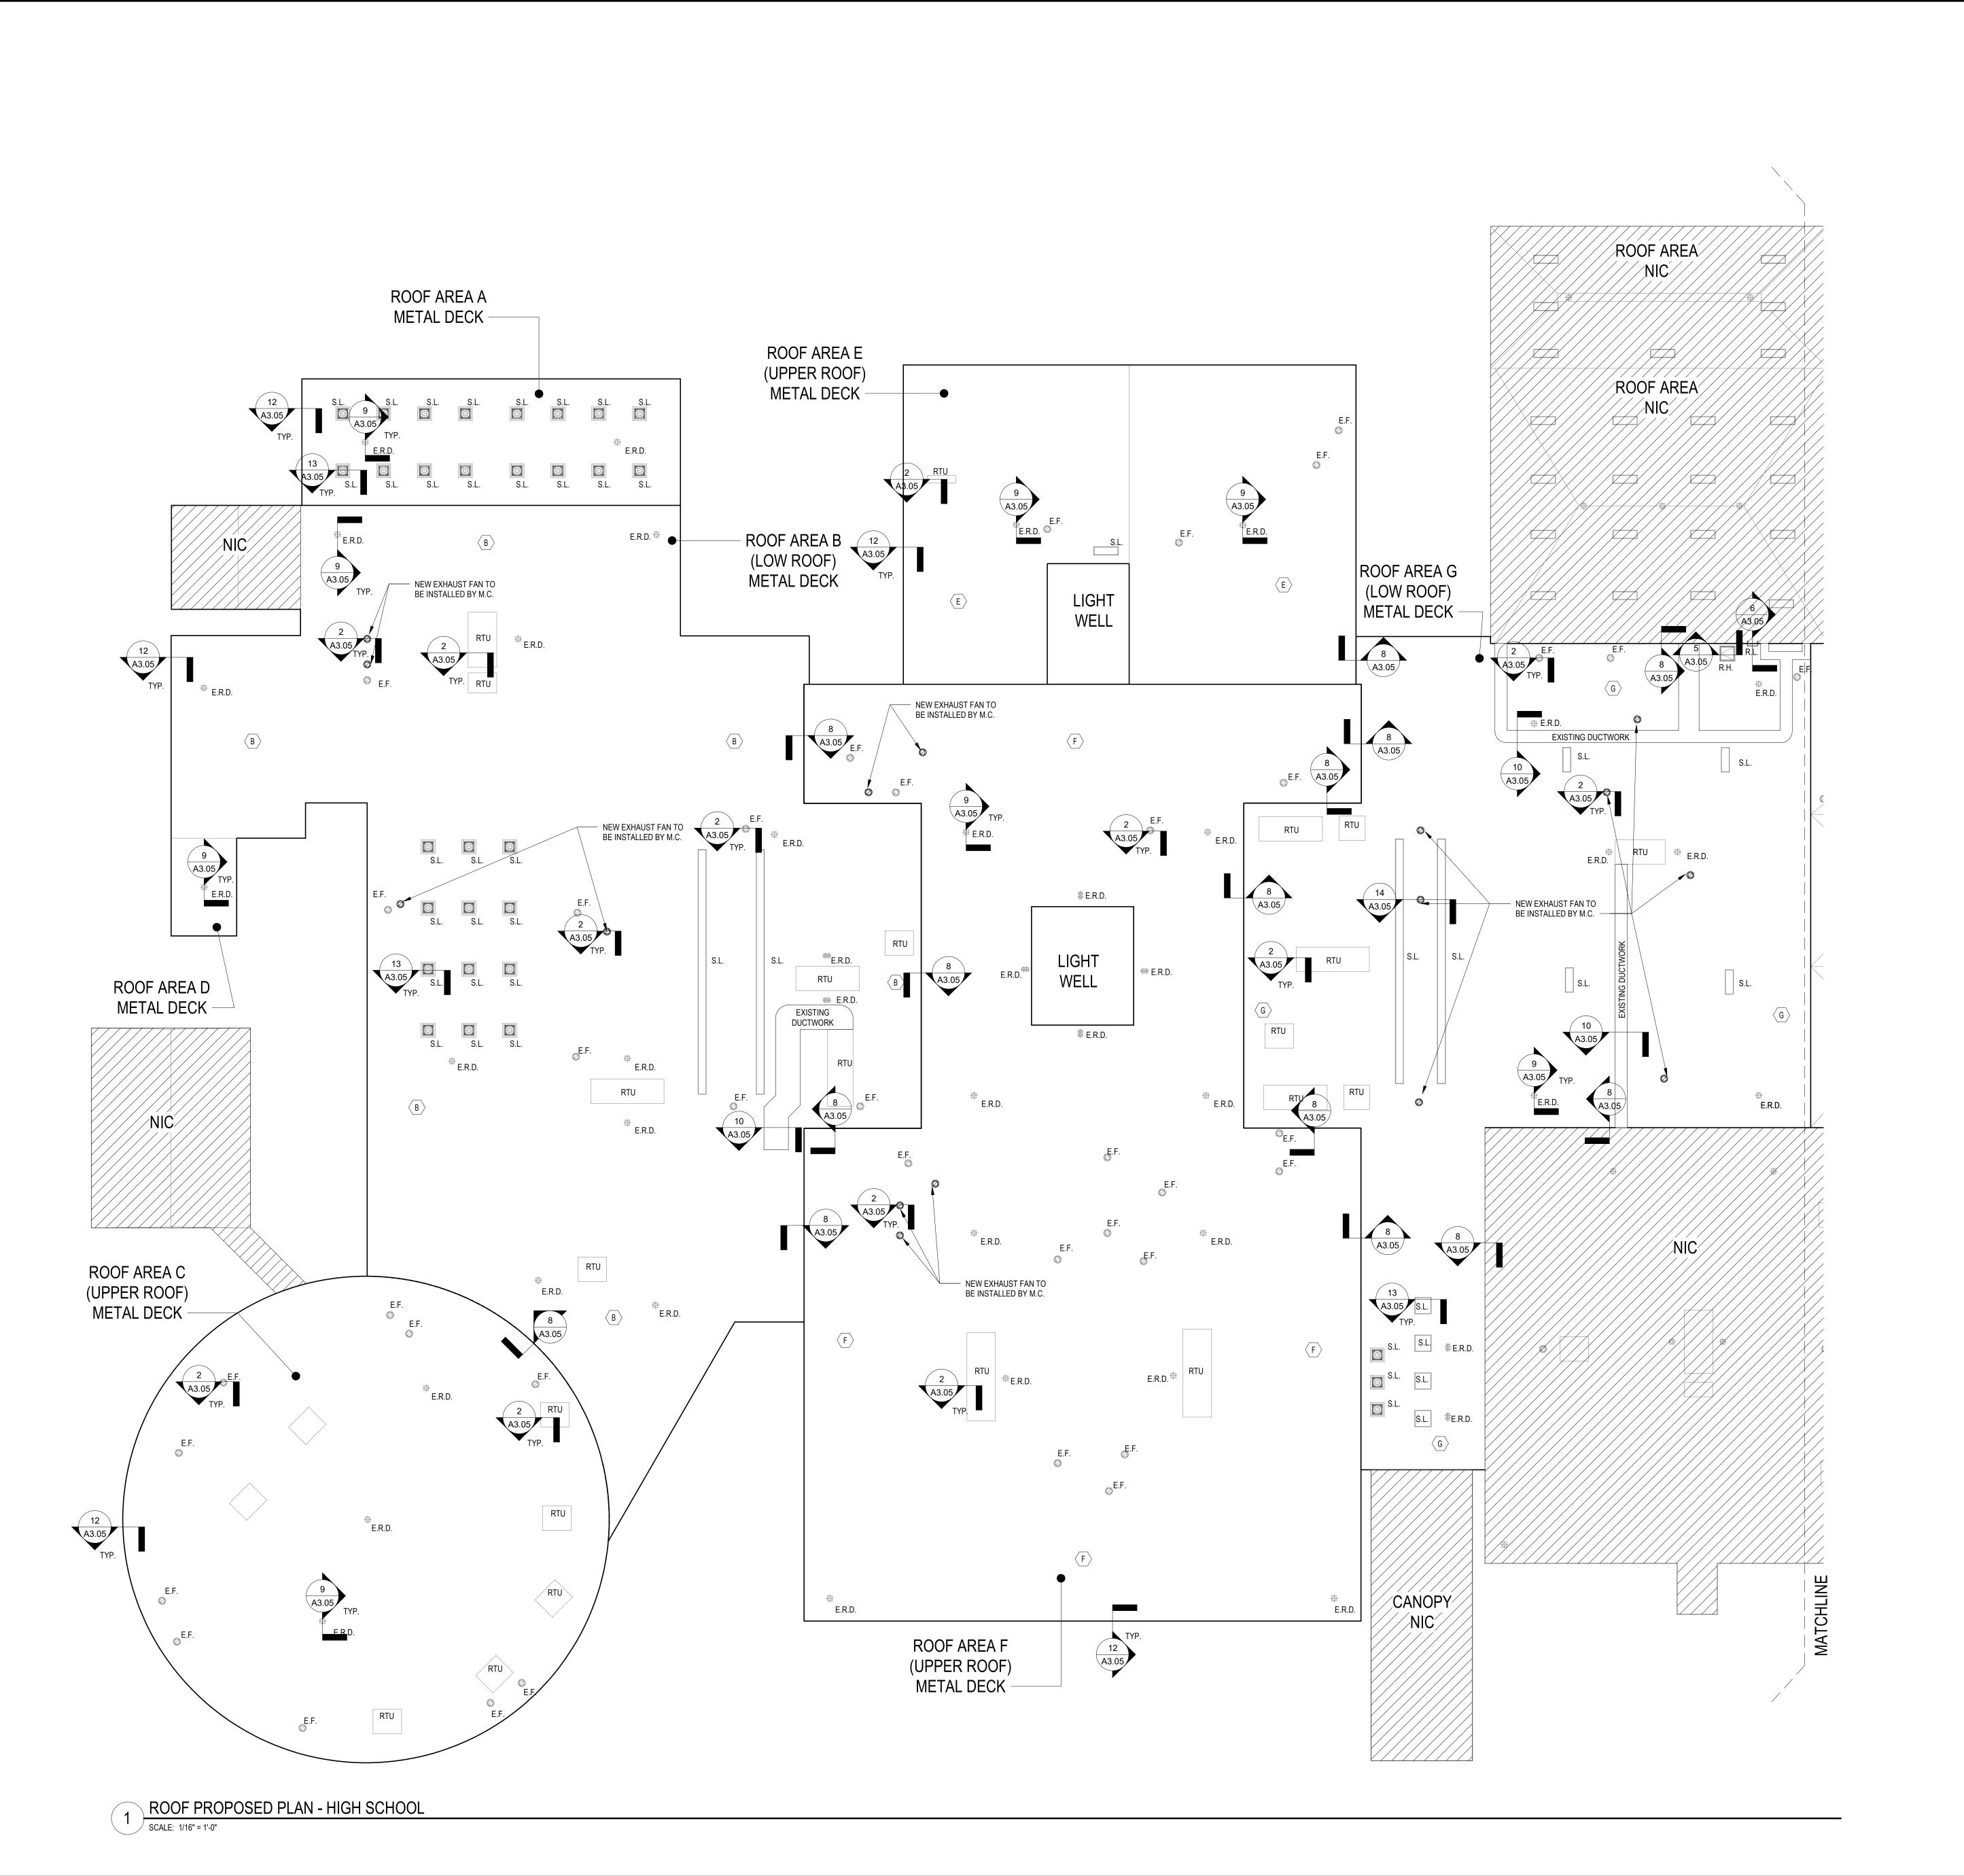

GENERAL NOTES:

- . ALL NEW FLAT ROOFING SHALL BE TPO ROOF SYSTEM. REFER TO SPEC. SECTION 07534 FOR ADDITIONAL INFORMATION. THE NEW ROOF SYSTEM TO BE PROVIDED AND INSTALLED IN ACCORDANCE WITH
- SPECIFICATION SECTION DIVISION 7. ALL WORK TO BE PERFORMED IN ACCORDANCE WITH THE GENERAL CONDITIONS OF THE SPECIFICATIONS & OTHER APPLICABLE SPECIFICATIONS. 3. ALL FLASHING ON WALLS, MECHANICAL UNITS, VENTS, AND SKYLIGHTS MUST BE

INSTALLED AT A DISTANCE ABOVE NEW FINISHED ROOF SURFACE TO INSURE

CONFORMANCE WITH ROOFING MANUFACTURERS WARRANTY REQUIREMENTS.

- CONTRACTOR SHALL BE RESPONSIBLE FOR INSTALLING ALL NEW PERIMETER WOOD BLOCKING TO HEIGHTS AS REQUIRED FOR NEW TAPERED INSULATION LAYOUT NECESSARY FOR NEW ALUM. GRAVEL STOPS AND EXPANSION JOINTS AS DETAILED. REFER TO TAPERED LAYOUT DRAWING FOR TAPERED HEIGHT REQUIREMENTS.
- THE CONTRACTOR SHALL VERIFY ALL EXISTING CONDITIONS PRIOR TO PROCEEDING WITH WORK. NOTIFY ARCHITECT OF ANY DISCREPANCIES IN WRITING PRIOR TO START OF
- 6. CONTRACTOR SHALL BE RESPONSIBLE FOR VERIFICATION OF ALL DIMENSIONS REQUIRED FOR ESTIMATING. CONTRACTOR TO PROTECT AND MAKE WATER TIGHT ALL AREAS OF WORK FROM
- INCLEMENT WEATHER DURING AND AT THE END OF DAILY WORK OPERATIONS. CONTRACTOR SHALL INSTALL EQUIPMENT RAILS, ROOF CURBS & PITCH POCKETS FOR ALL H.V.A.C. AND ELECTRICAL CONDUIT & PIPING AS NECESSARY (PROVIDED BY EACH RESPECTIVE CONTRACTOR). PROVIDE AND INSTALL TAPERED CRICKETS TO DIVERT WATER AWAY FROM CURBS TYPICAL FOR ALL CURBS ON ROOF. CONTRACTOR TO PROVIDE TAPERED ROOF INSULATION LAYOUT FOR APPROVAL. SHOW PITCH ON ROOF
- . CONTRACTOR TO VERIFY WITH STRUCTURAL DRAWINGS ON ALL ROOF PENETRATIONS, ROOF TOP EQUIPMENT SUPPORTS, AND ALL OTHER OBJECTIVES THAT ARE APPLICABLE

ROOF SYSTEM NOTES:

CONFORM TO APPLICABLE CODES FOR ROOF ASSEMBLY FIRE HAZARD REQUIREMENTS. FACTORY MUTUAL ENGINEERING AND RESEARCH CORP. (FM): A. ROOF ASSEMBLY CLASSIFICATION OF CLASS 1 CONSTRÚCTION, WIND UPLIFT REQUIREMENTS OF 1-135 IN ACCORDANCE WITH FM CONSTRUCTION BULLETIN 1-28. B. CONTACT ROOFING MANUFACTURER'S TECHNICAL REPRESENTATIVE FOR ADD. INFO. UNDERWRITERS LABORATORIES, INC. (UL)- CLASS 'A' FIRE HAZARD CLASSIFICATION.

WOOD BLOCKING & PERIMETER EDGE NOTES:

- CONTRACTOR IS TO BE ADVISED THAT IT IS THE SOLE RESPONSIBILITY OF THE CONTRACTOR TO DETERMINE THE EXTENT OF WOOD BLOCKING REQUIRED FOR ALL PERIMETER GRAVEL STOPS, MECHANICAL CURBS, EXPANSION JOINTS, ETC. IN ACCORDANCE WITH THE TAPERED INSULATION LAYOUTS INCLUDED IN THESE
- CONSTRUCTION DOCUMENTS AND EXISTING CONDITIONS. THE DETAILS SHOWN MAY NOT DEPICT THE REQUIRED HEIGHT OF BLOCKING REQUIRED AND REPRESENT THE INTENT OF THE DETAIL AT THIS CONDITION.
- THE CONTRACTOR IS RESPONSIBLE TO MAINTAIN THE HEIGHT OF THE TOP OF GRAVEL STOP AT EACH ROOF ELEVATION AND MAKE THE NECESSARY MODIFICATIONS AT THE EDGE CONDITIONS TO MEET THE TAPERED ELEVATION HEIGHTS IN ACCORDANCE WITH THE ROOF MANUFACTURERS REQUIREMENTS. THE CONTRACTOR IS RESPONSIBLE TO MODIFY THE HEIGHTS OF ALL BREAK METAL

DETAILS SHOWN AND THE CONDITIONS AS THEY CURRENTLY EXIST.

FASCIAS & FASCIA EXTENDERS AS REQUIRED TO CONFORM TO THE INTENT OF THE

NOTE TO CONTRACTOR:


- ALL FOLIPMENT SHOWN ON ROOF PLANS ARE FOR DIAGRAMMATIC REFERENCE ONLY MORE SPECIFIC DETAILS ARE INDICATED ON THE 'M' SERIES DRAWINGS AND MAY REQUIRE ADDITIONAL MODIFICATION. G.C. TO COORDINATE WITH M.C. FOR ALL NEW ROOFTOP EQUIPMENT AND PENETRATIONS.
- ANY SQUARE FOOTAGES AND/OR DIMENSIONS SHOWN SHALL BE CONSIDERED APPROXIMATE. THE CONTRACTOR IS FULLY RESPONSIBLE TO FIELD-VERIFY ALL ROOF AREA DIMENSIONS AND INCLUDE ALL CONDITIONS AS A PART OF ANY BID COST.

ROOF CONSTRUCTION NOTES:

DRAWINGS FOR ADDITIONAL INFORMATION.

- . REFER TO SPECIFICATIONS FOR COMPLETE DESCRIPTION OF ROOF ASSEMBLY AND
- 2. COLOR AND FINISH OF ALL ALUMINUM COPINGS, FASCIAS AND "J" COVERS TO BE SELECTED BY ARCHITECT
- G.C. SHALL PROVIDE ADDITIONAL CRICKETS / SLOPE AS REQUIRED TO ENSURE PROPER DRAINAGE SLOPE. G.C. SHALL BE RESPONSIBLE TO PROVIDE AND INSTALL ALL MATERIALS REQUIRED FOR A FULL AND COMPLETE ROOFING SYSTEM INSTALLATION AS INDICATED ON THE DRAWINGS. MATERIALS SHALL INCLUDE, BUT NOT BE LIMITED TO: ALL TREATED WOOD BLOCKING AT ALL NEW ROOF TERMINATIONS AND EXPANSION JOINTS, ROOF FASTENERS, ROOFING BOARDS, ROOF EXPANSION JOINTS, COVERS AND ROOF FLASHING, ROOFING SHEETS,
- ANCHOR BOLTS, FLASHING REGLETS, COPING AND "J" COVERS. ALL NEW ROOFTOP H.V.A.C. EQUIPMENT CURBS SHALL BE SUPPLIED BY THE M.C. AND INSTALLED BY THE G.C. G.C. SHALL PROVIDE ALL PENETRATIONS, STEEL SUPPORT FRAMING, WOOD BLOCKING AND FLASHING FOR ALL SAID CURBS. SEE TYPICAL WELDED ANGLE FRAMING DETAIL ON SHEET S5.02, REFER TO MECHANICAL DRAWINGS FOR
- QUANTITY AND LOCATIONS 6. G.C. SHALL ALSO PROVIDE ALL PENETRATIONS AND FLASHING REQUIRED FOR ALL PLUMBING VENTS AND DRAINS. SEE PLUMBING DRAWINGS FOR COORDINATION. REFER TO ROOF DETAILS AND WALL SECTIONS FOR OTHER DETAILS NOT SHOWN. COORDINATE ALL MECHANICAL, ELECTRICAL, AND PLUMBING ITEMS AND WORK AS PART OF THIS CONTRACT EVEN IF NOT SHOWN ON THIS DRAWING. ROOF RELATED WORK IS


SHOWN FOR REFERENCE ONLY. REFER TO MECHANICAL, ELECTRICAL, AND PLUMBING

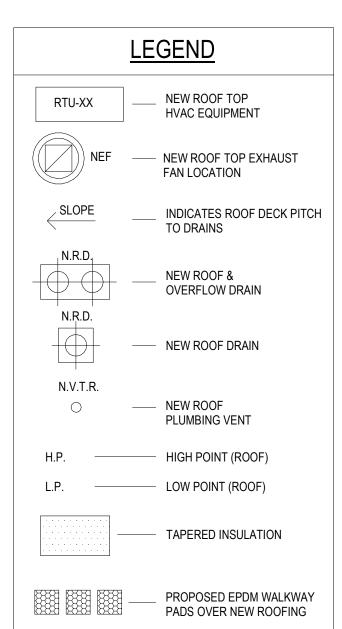

REV. DATE

NOTICE

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KEY PLAN

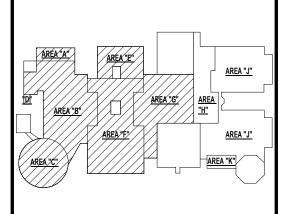NO SCALE

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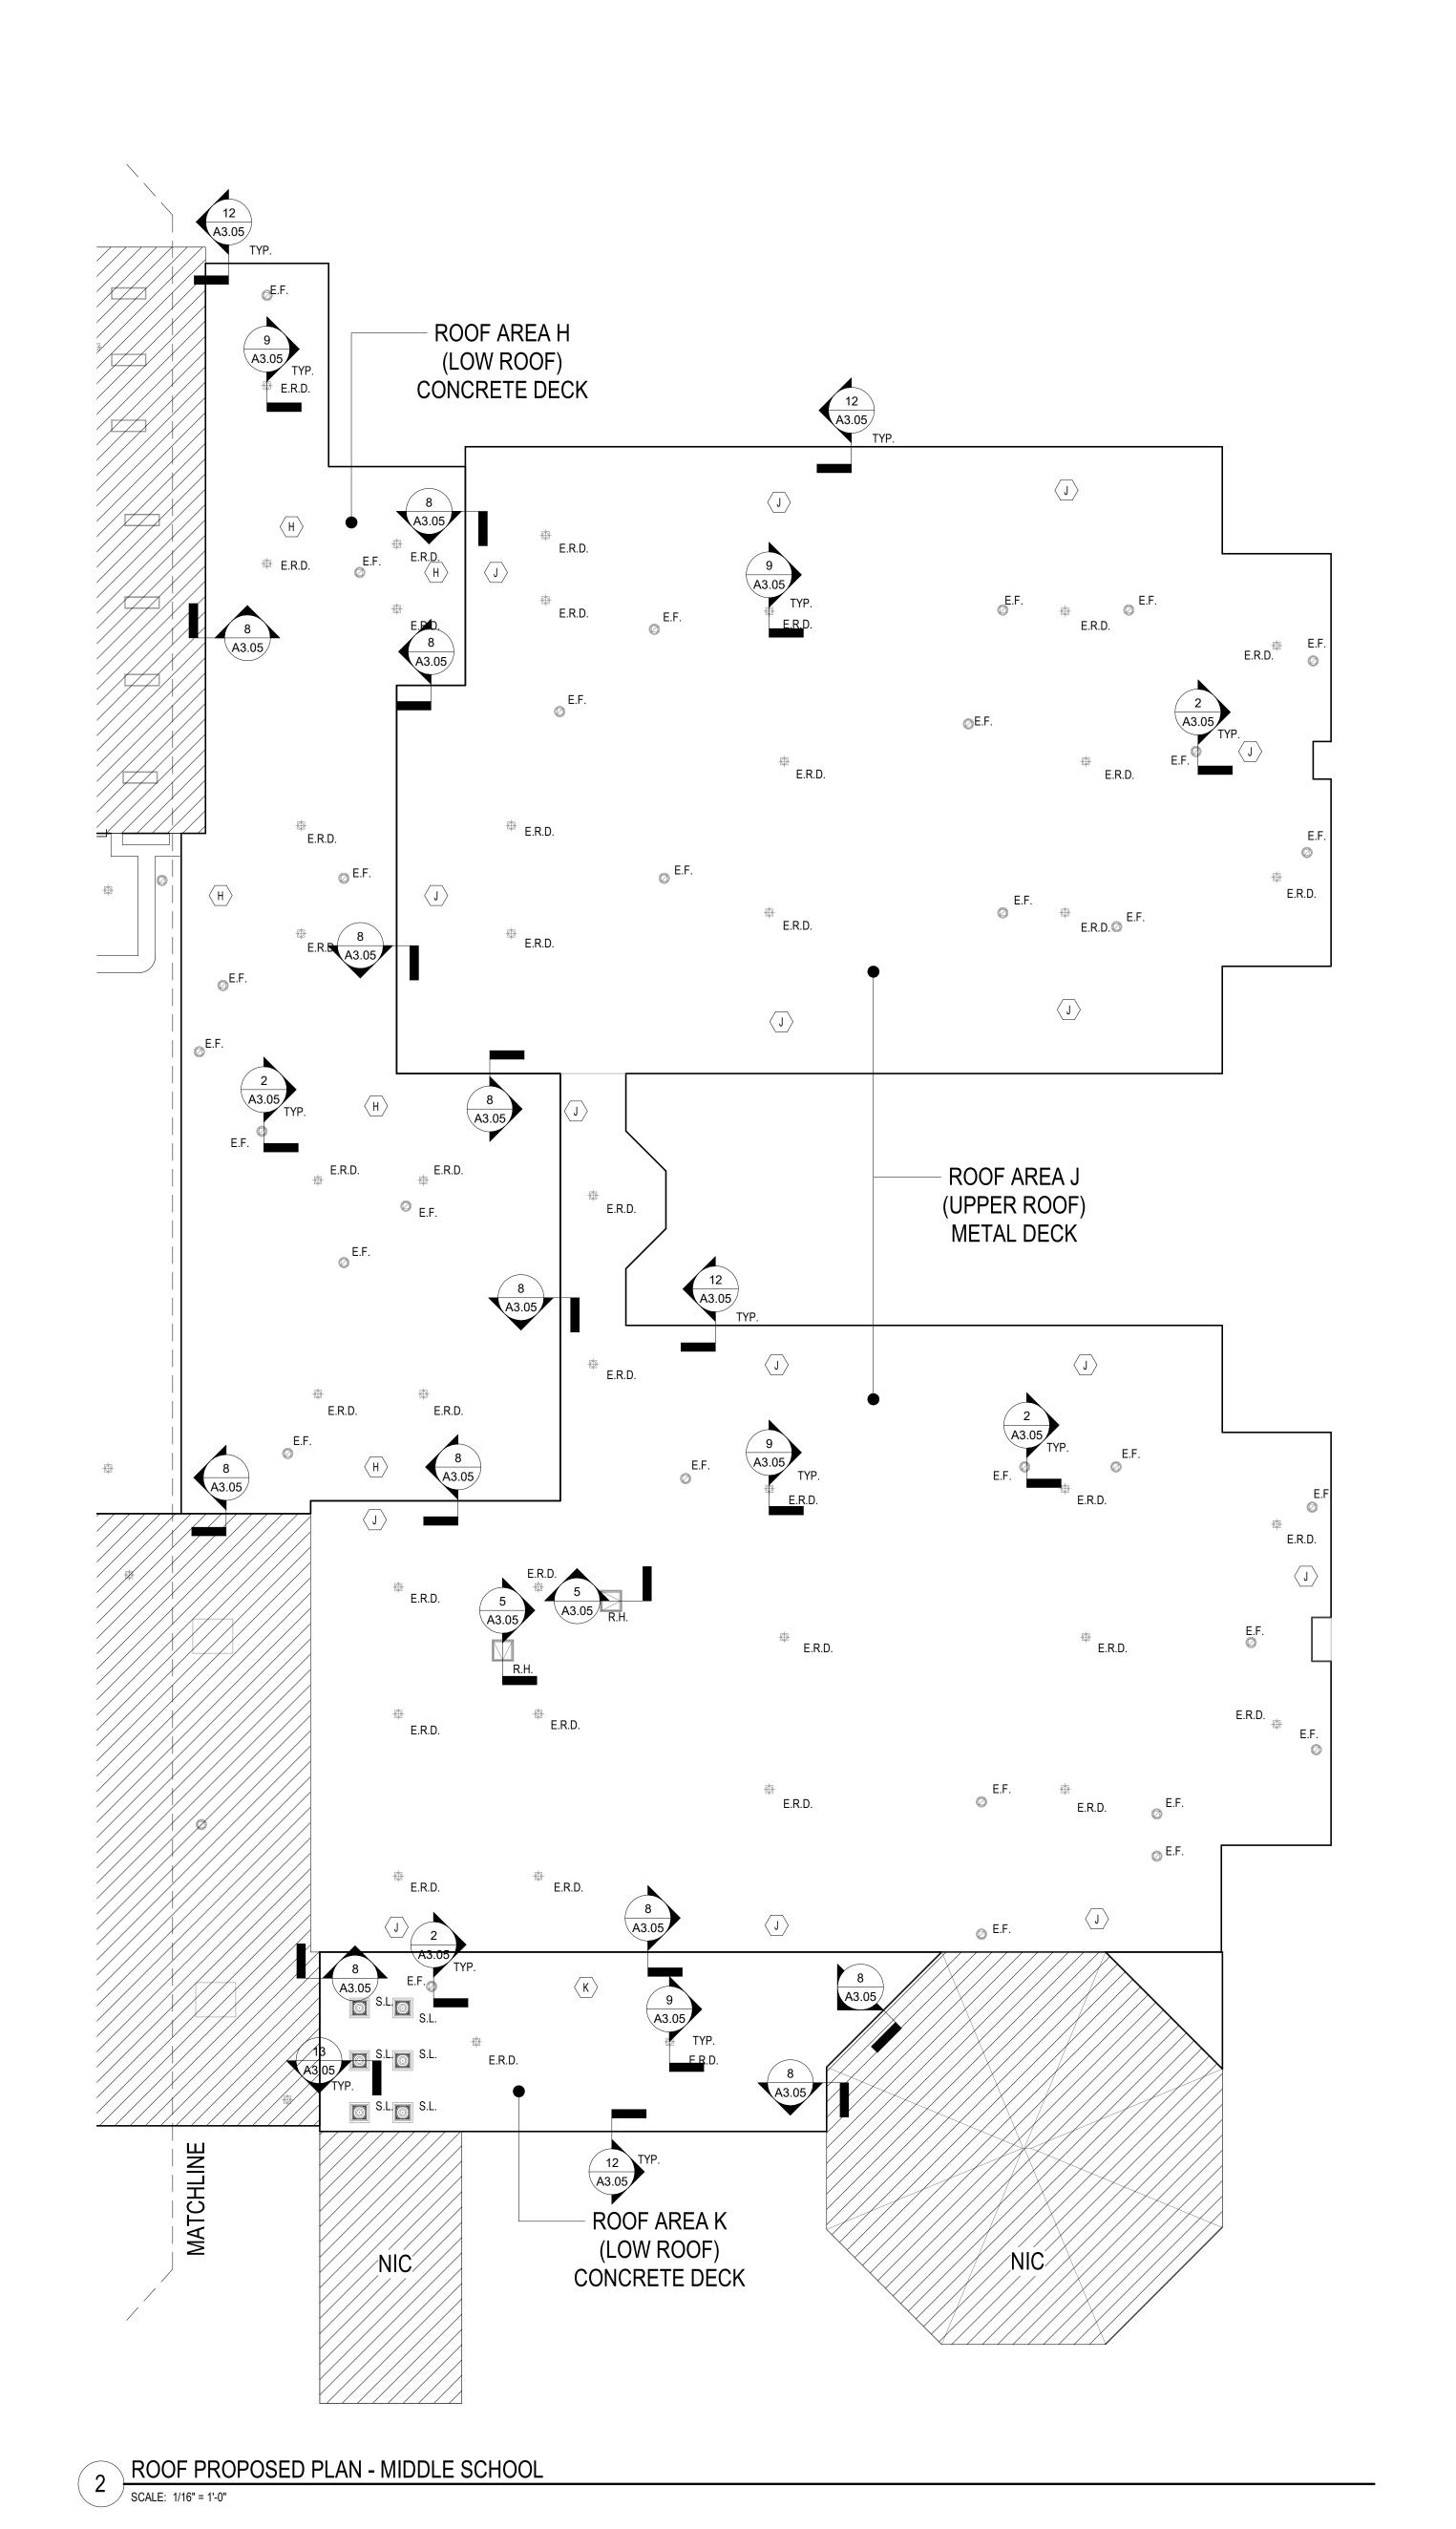
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66-14-02-02-0-004-022 **DISTRICT** BRIARCLIFF MANOR U.F.S.D PROJECT PHASE 1 BOND IMPROVEMENTS

DWG IIILE ROOF PROPOSED PLAN - HIGH SCHOOL SCALE: AS NOTED DATE: BID P/U DATE:

FILE NO.

A3.03 HSMS



GENERAL NOTES:

- 1. ALL NEW FLAT ROOFING SHALL BE TPO ROOF SYSTEM. REFER TO SPEC. SECTION 07534 FOR ADDITIONAL INFORMATION.
- 2. THE NEW ROOF SYSTEM TO BE PROVIDED AND INSTALLED IN ACCORDANCE WITH SPECIFICATION SECTION DIVISION 7. ALL WORK TO BE PERFORMED IN ACCORDANCE WITH THE GENERAL CONDITIONS OF THE SPECIFICATIONS & OTHER APPLICABLE SPECIFICATIONS.
- 3. ALL FLASHING ON WALLS, MECHANICAL UNITS, VENTS, AND SKYLIGHTS MUST BE INSTALLED AT A DISTANCE ABOVE NEW FINISHED ROOF SURFACE TO INSURE CONFORMANCE WITH ROOFING MANUFACTURERS WARRANTY REQUIREMENTS.
- 4. CONTRACTOR SHALL BE RESPONSIBLE FOR INSTALLING ALL NEW PERIMETER WOOD BLOCKING TO HEIGHTS AS REQUIRED FOR NEW TAPERED INSULATION LAYOUT NECESSARY FOR NEW ALUM. GRAVEL STOPS AND EXPANSION JOINTS AS DETAILED. REFER TO TAPERED LAYOUT DRAWING FOR TAPERED HEIGHT REQUIREMENTS.
- THE CONTRACTOR SHALL VERIFY ALL EXISTING CONDITIONS PRIOR TO PROCEEDING WITH WORK. NOTIFY ARCHITECT OF ANY DISCREPANCIES IN WRITING PRIOR TO START OF
- 6. CONTRACTOR SHALL BE RESPONSIBLE FOR VERIFICATION OF ALL DIMENSIONS REQUIRED FOR ESTIMATING.

PROVIDE TAPERED ROOF INSULATION LAYOUT FOR APPROVAL. SHOW PITCH ON ROOF

- CONTRACTOR TO PROTECT AND MAKE WATER TIGHT ALL AREAS OF WORK FROM INCLEMENT WEATHER DURING AND AT THE END OF DAILY WORK OPERATIONS.
 CONTRACTOR SHALL INSTALL EQUIPMENT RAILS, ROOF CURBS & PITCH POCKETS FOR ALL H.V.A.C. AND ELECTRICAL CONDUIT & PIPING AS NECESSARY (PROVIDED BY EACH RESPECTIVE CONTRACTOR). PROVIDE AND INSTALL TAPERED CRICKETS TO DIVERT WATER AWAY FROM CURBS TYPICAL FOR ALL CURBS ON ROOF. CONTRACTOR TO
- 9. CONTRACTOR TO VERIFY WITH STRUCTURAL DRAWINGS ON ALL ROOF PENETRATIONS, ROOF TOP EQUIPMENT SUPPORTS, AND ALL OTHER OBJECTIVES THAT ARE APPLICABLE TO THE ROOF PLAN.

ROOF SYSTEM NOTES:

FLAT ROOF:

CONFORM TO APPLICABLE CODES FOR ROOF ASSEMBLY FIRE HAZARD REQUIREMENTS.
 FACTORY MUTUAL ENGINEERING AND RESEARCH CORP. (FM):
 A. ROOF ASSEMBLY CLASSIFICATION OF CLASS 1 CONSTRUCTION, WIND UPLIFT REQUIREMENTS OF 1-135 IN ACCORDANCE WITH FM CONSTRUCTION BULLETIN 1-28.
 B. CONTACT ROOFING MANUFACTURER'S TECHNICAL REPRESENTATIVE FOR ADD. INFO.

UNDERWRITERS LABORATORIES, INC. (UL)- CLASS 'A' FIRE HAZARD CLASSIFICATION.

WOOD BLOCKING & PERIMETER EDGE NOTES:

- 1. CONTRACTOR IS TO BE ADVISED THAT IT IS THE SOLE RESPONSIBILITY OF THE CONTRACTOR TO DETERMINE THE EXTENT OF WOOD BLOCKING REQUIRED FOR ALL PERIMETER GRAVEL STOPS, MECHANICAL CURBS, EXPANSION JOINTS, ETC. IN ACCORDANCE WITH THE TAPERED INSULATION LAYOUTS INCLUDED IN THESE
- CONSTRUCTION DOCUMENTS AND EXISTING CONDITIONS.

 2. THE DETAILS SHOWN MAY NOT DEPICT THE REQUIRED HEIGHT OF BLOCKING REQUIRED AND REPRESENT THE INTENT OF THE DETAIL AT THIS CONDITION.
- AND REPRESENT THE INTENT OF THE DETAIL AT THIS CONDITION.

 3. THE CONTRACTOR IS RESPONSIBLE TO MAINTAIN THE HEIGHT OF THE TOP OF GRAVEL STOP AT EACH ROOF ELEVATION AND MAKE THE NECESSARY MODIFICATIONS AT THE EDGE CONDITIONS TO MEET THE TAPERED ELEVATION HEIGHTS IN ACCORDANCE WITH THE ROOF MANUFACTURERS REQUIREMENTS.
- THE CONTRACTOR IS RESPONSIBLE TO MODIFY THE HEIGHTS OF ALL BREAK METAL FASCIAS & FASCIA EXTENDERS AS REQUIRED TO CONFORM TO THE INTENT OF THE DETAILS SHOWN AND THE CONDITIONS AS THEY CURRENTLY EXIST.

NOTE TO CONTRACTOR:

- ALL EQUIPMENT SHOWN ON ROOF PLANS ARE FOR DIAGRAMMATIC REFERENCE ONLY.
 MORE SPECIFIC DETAILS ARE INDICATED ON THE 'M' SERIES DRAWINGS AND MAY
 REQUIRE ADDITIONAL MODIFICATION. G.C. TO COORDINATE WITH M.C. FOR ALL NEW
 ROOFTOP EQUIPMENT AND PENETRATIONS.
- ANY SQUARE FOOTAGES AND/OR DIMENSIONS SHOWN SHALL BE CONSIDERED APPROXIMATE. THE CONTRACTOR IS FULLY RESPONSIBLE TO FIELD-VERIFY ALL ROOF AREA DIMENSIONS AND INCLUDE ALL CONDITIONS AS A PART OF ANY BID COST.

ROOF CONSTRUCTION NOTES:


- REFER TO SPECIFICATIONS FOR COMPLETE DESCRIPTION OF ROOF ASSEMBLY AND
- 2. COLOR AND FINISH OF ALL ALUMINUM COPINGS, FASCIAS AND "J" COVERS TO BE SELECTED BY ARCHITECT
- G.C. SHALL PROVIDE ADDITIONAL CRICKETS / SLOPE AS REQUIRED TO ENSURE PROPER DRAINAGE SLOPE.
 G.C. SHALL BE RESPONSIBLE TO PROVIDE AND INSTALL ALL MATERIALS REQUIRED FOR A FULL AND COMPLETE ROOFING SYSTEM INSTALLATION AS INDICATED ON THE DRAWINGS. MATERIALS SHALL INCLUDE, BUT NOT BE LIMITED TO: ALL TREATED WOOD BLOCKING AT ALL NEW ROOF TERMINATIONS AND EXPANSION JOINTS, ROOF FASTENERS, ROOFING


BOARDS, ROOF EXPANSION JOINTS, COVERS AND ROOF FLASHING, ROOFING SHEETS,

- ANCHOR BOLTS, FLASHING REGLETS, COPING AND "J" COVERS.

 5. ALL NEW ROOFTOP H.V.A.C. EQUIPMENT CURBS SHALL BE SUPPLIED BY THE M.C. AND INSTALLED BY THE G.C. G.C. SHALL PROVIDE ALL PENETRATIONS, STEEL SUPPORT FRAMING, WOOD BLOCKING AND FLASHING FOR ALL SAID CURBS. SEE TYPICAL WELDED ANGLE FRAMING DETAIL ON SHEET S5.02, REFER TO MECHANICAL DRAWINGS FOR
- ANGLE FRAMING DETAIL ON SHEET S5.02, REFER TO MECHANICAL DRAWINGS FOR QUANTITY AND LOCATIONS

 6. G.C. SHALL ALSO PROVIDE ALL PENETRATIONS AND FLASHING REQUIRED FOR ALL PLUMBING VENTS AND DRAINS. SEE PLUMBING DRAWINGS FOR COORDINATION.
- REFER TO ROOF DETAILS AND WALL SECTIONS FOR OTHER DETAILS NOT SHOWN.
 COORDINATE ALL MECHANICAL, ELECTRICAL, AND PLUMBING ITEMS AND WORK AS PART OF THIS CONTRACT EVEN IF NOT SHOWN ON THIS DRAWING. ROOF RELATED WORK IS SHOWN FOR REFERENCE ONLY. REFER TO MECHANICAL, ELECTRICAL, AND PLUMBING DRAWINGS FOR ADDITIONAL INFORMATION.

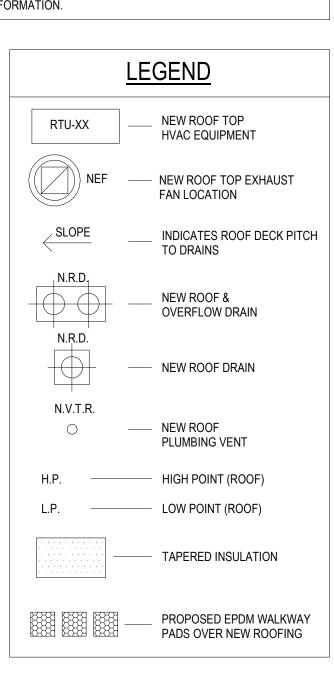


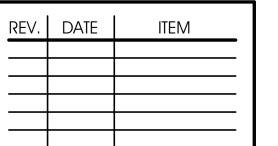

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KEY PLAN

NO SCALE

PROJECT
BRIARCLIFF MANOR U.F.S.D.
PHASE 1 BOND IMPROVEMENTS
BRIARCLIFF MANOR MIDDLE / HIGH SCHOOL
444 PLEASANTVILLE RD, BRIARCLIFF MANOR, NY 10510

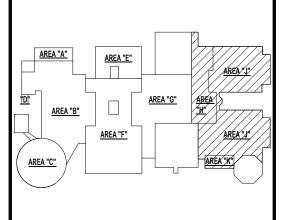ROOF PROPOSED PLAN - MIDDLE SCHOOL

CHK. BY: G.E.O.

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DRWG, BY: C.M.

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SED No.

66-14-02-02-0-004-022

DISTRICT BRIARCLIFF MANOR U.F.S.D.

PROJECT
PHASE 1 BOND IMPROVEMENTS

DWG TITLE ROOF PROPOSED PLAN - MIDDLE SCHOOL


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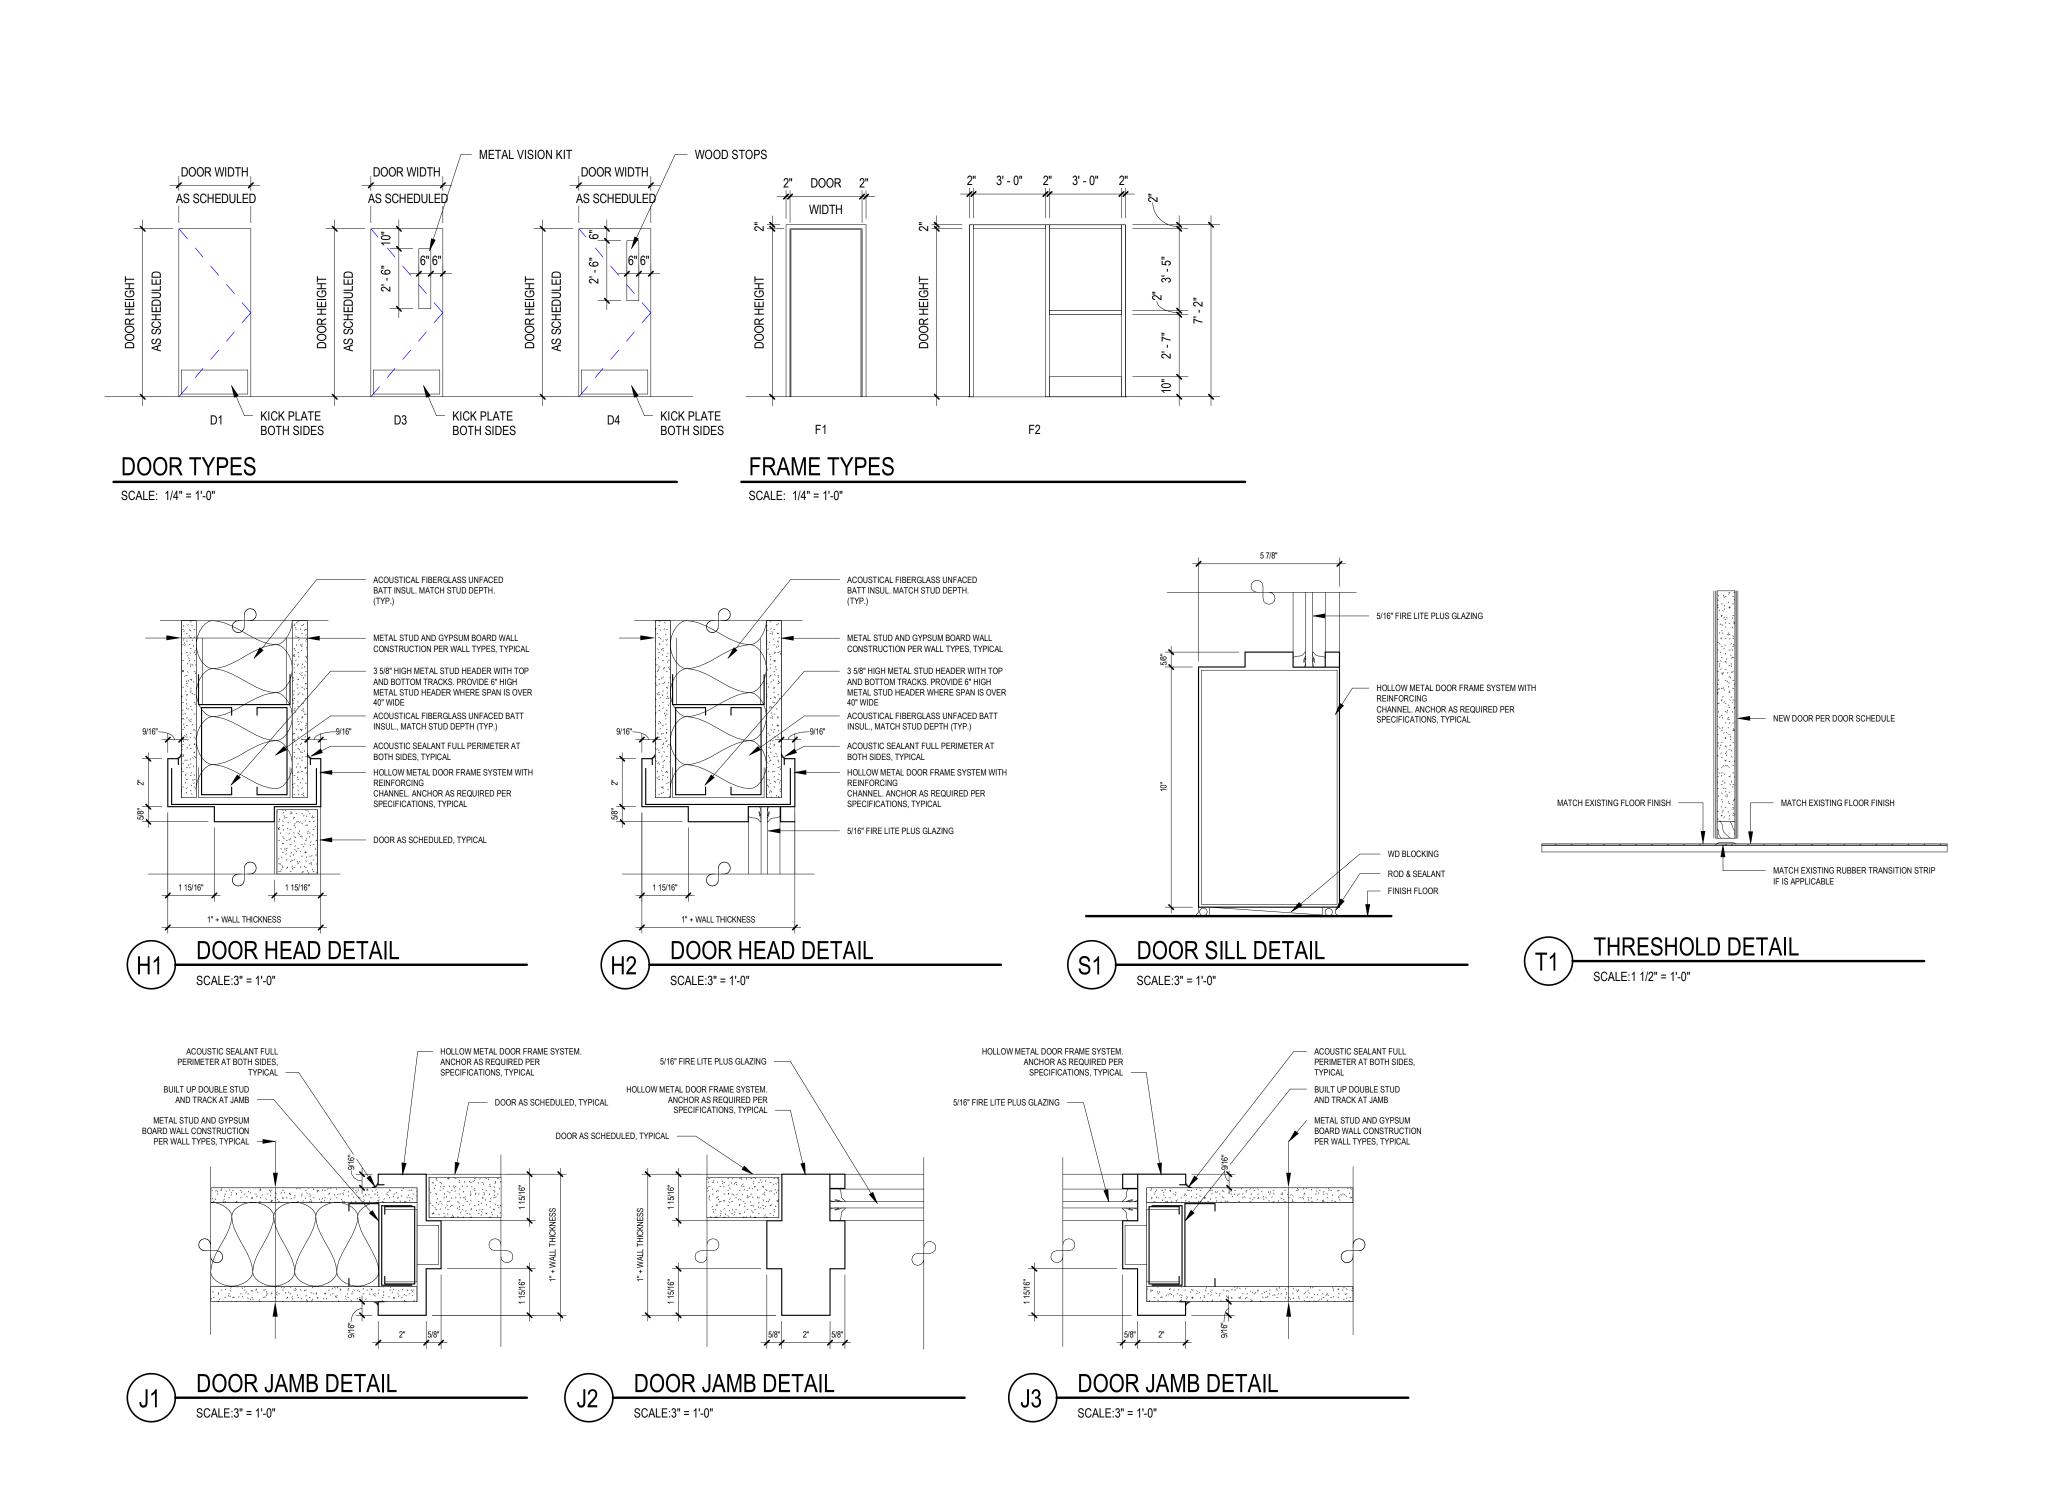
BID P/U DATE:

FILE NO.

A3.04 HSMS



ı	LOCATI	LOCATION									FRAME				DETAI	DETAILS			
000R#	FROM ROOM	TO ROOM	LEAF	WIDTH	HEIGHT	DOOR THICKNESS	TYPE	MATERIAL	GLAZING	TYPE	MATERIAL	GLAZING	HARDWARE	HEAD	JAMB	SILL	T'HOLD	FIRE RATING	REMARKS
IGH SCHOO		TO ROOM	LEAF	חוטוויי	HEIGHT	THICKNESS	IIFE	IVIATERIAL	GLAZING	ITFE	IVIATERIAL	GLAZING		ПЕАО	JAIVID	SILL	THOLD		
100a	BIOLOGY/FORENSICS (100)	CORRIDOR (D1)	1	3' - 0"	7' - 0"	1 3/4"	D4		F.L.P.	F2	HM	F.L.P.	01	H1/H2	J1/J2/J3	S1	T1	45 MIN.	M.C.M.V. DOOR WITH KICK PLATE AND CLOSER
101a	CORRIDOR (D1)	BIOLOGY (101)	1	3' - 0"	7' - 0"	1 3/4"	D4		F.L.P.	F2	HM	F.L.P.	01	H1/H2	J1/J2/J3	S1	T1	45 MIN.	M.C.M.V. DOOR WITH KICK PLATE AND CLOSER
103a	CORRIDOR (D1)	PHYSICS/EARTH SCIENCE (103)	1	3' - 0"	7' - 0"	1 3/4"	D4		F.L.P.	F2	HM	F.L.P.	01	H1/H2	J1/J2/J3	S1	T1	45 MIN.	M.C.M.V. DOOR WITH KICK PLATE AND CLOSER
104a	CORRIDOR (D1)	PHYSICS (104)	1	3' - 0"	7' - 0"	1 3/4"	D4		F.L.P.	F2	HM	F.L.P.	01	H1/H2	J1/J2/J3	S1	T1	45 MIN.	M.C.M.V. DOOR WITH KICK PLATE AND CLOSER
134a	ART ROOM (134)	GALLERY (134a)	1	3' - 0"	7' - 0"	1 3/4"	D3	M.C.M.V.	F.L.P.	F1	НМ	-	01	H1	J1	-	T1	45 MIN.	
229A	CHEMISTRY (229)	CORRIDOR (W)	1	3' - 0"	7' - 0"	1 3/4"	D1	M.C.M.V.	F.L.P.	F1	НМ	-	01	H1	J1		T1	45 MIN.	
229B	CHEMISTRY (229)	CORRIDOR (V)	1	3' - 0"	7' - 0"	1 3/4"	D1	M.C.M.V.	F.L.P.	F1	НМ	-	01	H1	J1		T1	45 MIN.	
29C	CHEMISTRY (229)	CHEMISTRY STORAGE (229A)	1	3' - 0"	7' - 0"	1 3/4"	D1	M.C.M.V.	F.L.P.	F1	НМ	-	02	H1	J1		T1	45 MIN.	
DDLE SCHO	OOL				1					1	-	-	1						
101	(6-8) HEALTH (101)	CORRIDOR (7B)	1	3' - 0"	7' - 0"	1 3/4"	D4	S.C.L.C.O.V	F.L.P.	F1	HM	-	01	H1	J1		T1	20 MIN.	
102	6-GRADE CLASSROOM (102)	CORRIDOR (7B)	1	3' - 0"	7' - 0"	1 3/4"	D4	S.C.L.C.O.V	F.L.P.	F1	HM	-	01	H1	J1	-	T1	20 MIN.	
209	8-GRADE CLASSROOM (209)	CORRIDOR (8A)	1	3' - 0"	7' - 0"	1 3/4"	D4	S.C.L.C.O.V	F.L.P.	F1	HM	-	01	H1	J1	-	T1	20 MIN.	
210	8-GRADE CLASSROOM (210)	CORRIDOR (8A)	1	3' - 0"	7' - 0"	1 3/4"	D4	S.C.L.C.O.V	F.L.P.	F1	HM	-	01	H1	J1	-	T1	20 MIN.	
303	7-GRADE CLASSROOM (303)	CORRIDOR (7D)	1	3' - 0"	7' - 0"	1 3/4"	D4	S.C.L.C.O.V	F.L.P.	F1	HM	-	01	H1	J1	-	T1	20 MIN.	
304	7-GRADE CLASSROOM (304)	CORRIDOR (7D)	1	3' - 0"	7' - 0"	1 3/4"	D4	S.C.L.C.O.V	F.L.P.	F1	HM	-	01	H1	J1	-	T1	20 MIN.	
W MAGNET	TIC DOOR HOLDER OPEN - HIGH S	CHOOL EXISTING DOOR TO REMAIN																	
31b	BAND (131)	CORRIDOR (N)	PR	3' - 0"	7' - 0"	1 3/4"	D1	S.C.L.C.O.V		EXIST. FRAME			06						G.C TO PROVIDE NEW MAGNETIC DOOR HOLDER OPEN FOR EXISTING DOO
54A	MARESCA CENTER (154)	CORRIDOR (F)	1	3' - 0"	7' - 0"	1 3/4"		EXIST. DOOR		EXIST. FRAME			03						G.C TO PROVIDE NEW MAGNETIC DOOR HOLDER OPEN FOR EXISTING DOO
54B	CORRIDOR (F)	MARESCA CENTER (154)	1	3' - 0"	7' - 0"	1 3/4"		EXIST. DOOR		EXIST. FRAME			03						G.C TO PROVIDE NEW MAGNETIC DOOR HOLDER OPEN FOR EXISTING DOOR
68A	LIBRARY (168)	CORRIDOR (313)	1	3' - 0"	7' - 0"	1 3/4"	D1	EXIST. DOOR		EXIST. FRAME			03						G.C TO PROVIDE NEW MAGNETIC DOOR HOLDER OPEN FOR EXISTING DOO
168B	CORRIDOR (313)	LIBRARY (168)	1	3' - 0"	7' - 0"	1 3/4"	D1	EXIST. DOOR		EXIST. FRAME			03						G.C TO PROVIDE NEW MAGNETIC DOOR HOLDER OPEN FOR EXISTING DOO
68C	CORRIDOR (F)	LIBRARY (168)	1	3' - 0"	7' - 0"	1 3/4"		EXIST. DOOR		EXIST. FRAME			03						G.C TO PROVIDE NEW MAGNETIC DOOR HOLDER OPEN FOR EXISTING DOO
168D	LIBRARY (168)	CORRIDOR (F)	1	3' - 0"	7' - 0"	1 3/4"		EXIST. DOOR		EXIST. FRAME			03						G.C TO PROVIDE NEW MAGNETIC DOOR HOLDER OPEN FOR EXISTING DOO
C3	H.S. GYM (89)	CORRIDOR (C)	PR	3' - 0"	7' - 0"	1 3/4"		EXIST. DOOR		EXIST. FRAME			04						G.C TO PROVIDE NEW MAGNETIC DOOR HOLDER OPEN FOR EXISTING DOO
C4	H.S. GYM (89)	CORRIDOR (C)	PR	3' - 0"	7' - 0"	1 3/4"	D1	EXIST. DOOR		EXIST. FRAME			05						G.C TO PROVIDE NEW MAGNETIC DOOR HOLDER OPEN FOR EXISTING DOO
L1	CAFETERIA (505)	CORRIDOR (L)	PR	3' - 0"	7' - 0"	1 3/4"	D1	EXIST. DOOR		EXIST. FRAME			04						G.C TO PROVIDE NEW MAGNETIC DOOR HOLDER OPEN FOR EXISTING DOO
M1	CORRIDOR (M)		PR	3' - 0"	7' - 0"	1 3/4"	D1	EXIST. DOOR		EXIST. FRAME			04						G.C TO PROVIDE NEW MAGNETIC DOOR HOLDER OPEN FOR EXISTING DOO
		SCHOOL EXISTING DOOR TO REMA	IN .					1		T									
	ARGE GROUP INSTRUCTION (85)	CORRIDOR (K)	1	3' - 0"	7' - 0"	1 3/4"		EXIST. DOOR		EXIST. FRAME			03						G.C TO PROVIDE NEW MAGNETIC DOOR HOLDER OPEN FOR EXISTING DOOR
	ARGE GROUP INSTRUCTION (85)	CORRIDOR (K)	1	3' - 0"	7' - 0"	1 3/4"		EXIST. DOOR		EXIST. FRAME			03						G.C TO PROVIDE NEW MAGNETIC DOOR HOLDER OPEN FOR EXISTING DOO
	ARGE GROUP INSTRUCTION (85)	000000000000000000000000000000000000000	PR	3' - 0"	7' - 0"	1 3/4"		EXIST. DOOR		EXIST. FRAME			04						G.C TO PROVIDE NEW MAGNETIC DOOR HOLDER OPEN FOR EXISTING DOO
120A	LIBRARY (120)	CORRIDOR (H)	PR	3' - 0"	7' - 0"	1 3/4"		EXIST. DOOR		EXIST. FRAME			04						G.C TO PROVIDE NEW MAGNETIC DOOR HOLDER OPEN FOR EXISTING DOO
121A	M.S. GYM (121)	CORRIDOR (C)	PR	3' - 0"	7' - 0"	1 3/4"		EXIST. DOOR		EXIST. FRAME			04						G.C TO PROVIDE NEW MAGNETIC DOOR HOLDER OPEN FOR EXISTING DOC
21B	M.S. GYM (121)	CORRIDOR (G)	PR	3' - 0"	7' - 0"	1 3/4"		EXIST. DOOR		EXIST. FRAME			04						G.C TO PROVIDE NEW MAGNETIC DOOR HOLDER OPEN FOR EXISTING DOC
1100	CORRIDOR (H)	CORRIDOR (J)	PR	3' - 0"	7' - 0"	1 3/4"		EXIST. DOOR		EXIST. FRAME			06						G.C TO PROVIDE NEW MAGNETIC DOOR HOLDER OPEN FOR EXISTING DOO
101	CORRIDOR (J)	CORRIDOR (H)	PR	3' - 0"	7' - 0"	1 3/4"	D1	EXIST. DOOR		EXIST. FRAME			06						G.C TO PROVIDE NEW MAGNETIC DOOR HOLDER OPEN FOR EXISTING DOO
J102	H.S. GYM (89)	CORRIDOR (J)	PR	3' - 0"	7' - 0"	1 3/4"	D1	EXIST. DOOR		EXIST. FRAME			05						G.C TO PROVIDE NEW MAGNETIC DOOR HOLDER OPEN FOR EXISTING DOOR
1103	H.S. GYM (89)	CORRIDOR (J)	PR	3' - 0"	7' - 0"	1 3/4"		EXIST. DOOR		EXIST. FRAME			04						G.C TO PROVIDE NEW MAGNETIC DOOR HOLDER OPEN FOR EXISTING DOO
(100	CORRIDOR (K)	CORRIDOR (J)	PR	3' - 0"	7' - 0"	1 3/4"		EXIST. DOOR		EXIST. FRAME			06						G.C TO PROVIDE NEW MAGNETIC DOOR HOLDER OPEN FOR EXISTING DOOR
K101 K104	CORRIDOR (K)	CORRIDOR (J)	PR	3' - 0"	7' - 0"	1 3/4"		EXIST. DOOR		EXIST. FRAME			06						G.C TO PROVIDE NEW MAGNETIC DOOR HOLDER OPEN FOR EXISTING DOO
		CORRIDOR (K)	PR	3' - 0"	7' - 0"	1 3/4"	D1	EXIST. DOOR	1	EXIST. FRAME	1		06		1				G.C TO PROVIDE NEW MAGNETIC DOOR HOLDER OPEN FOR EXISTING DOO

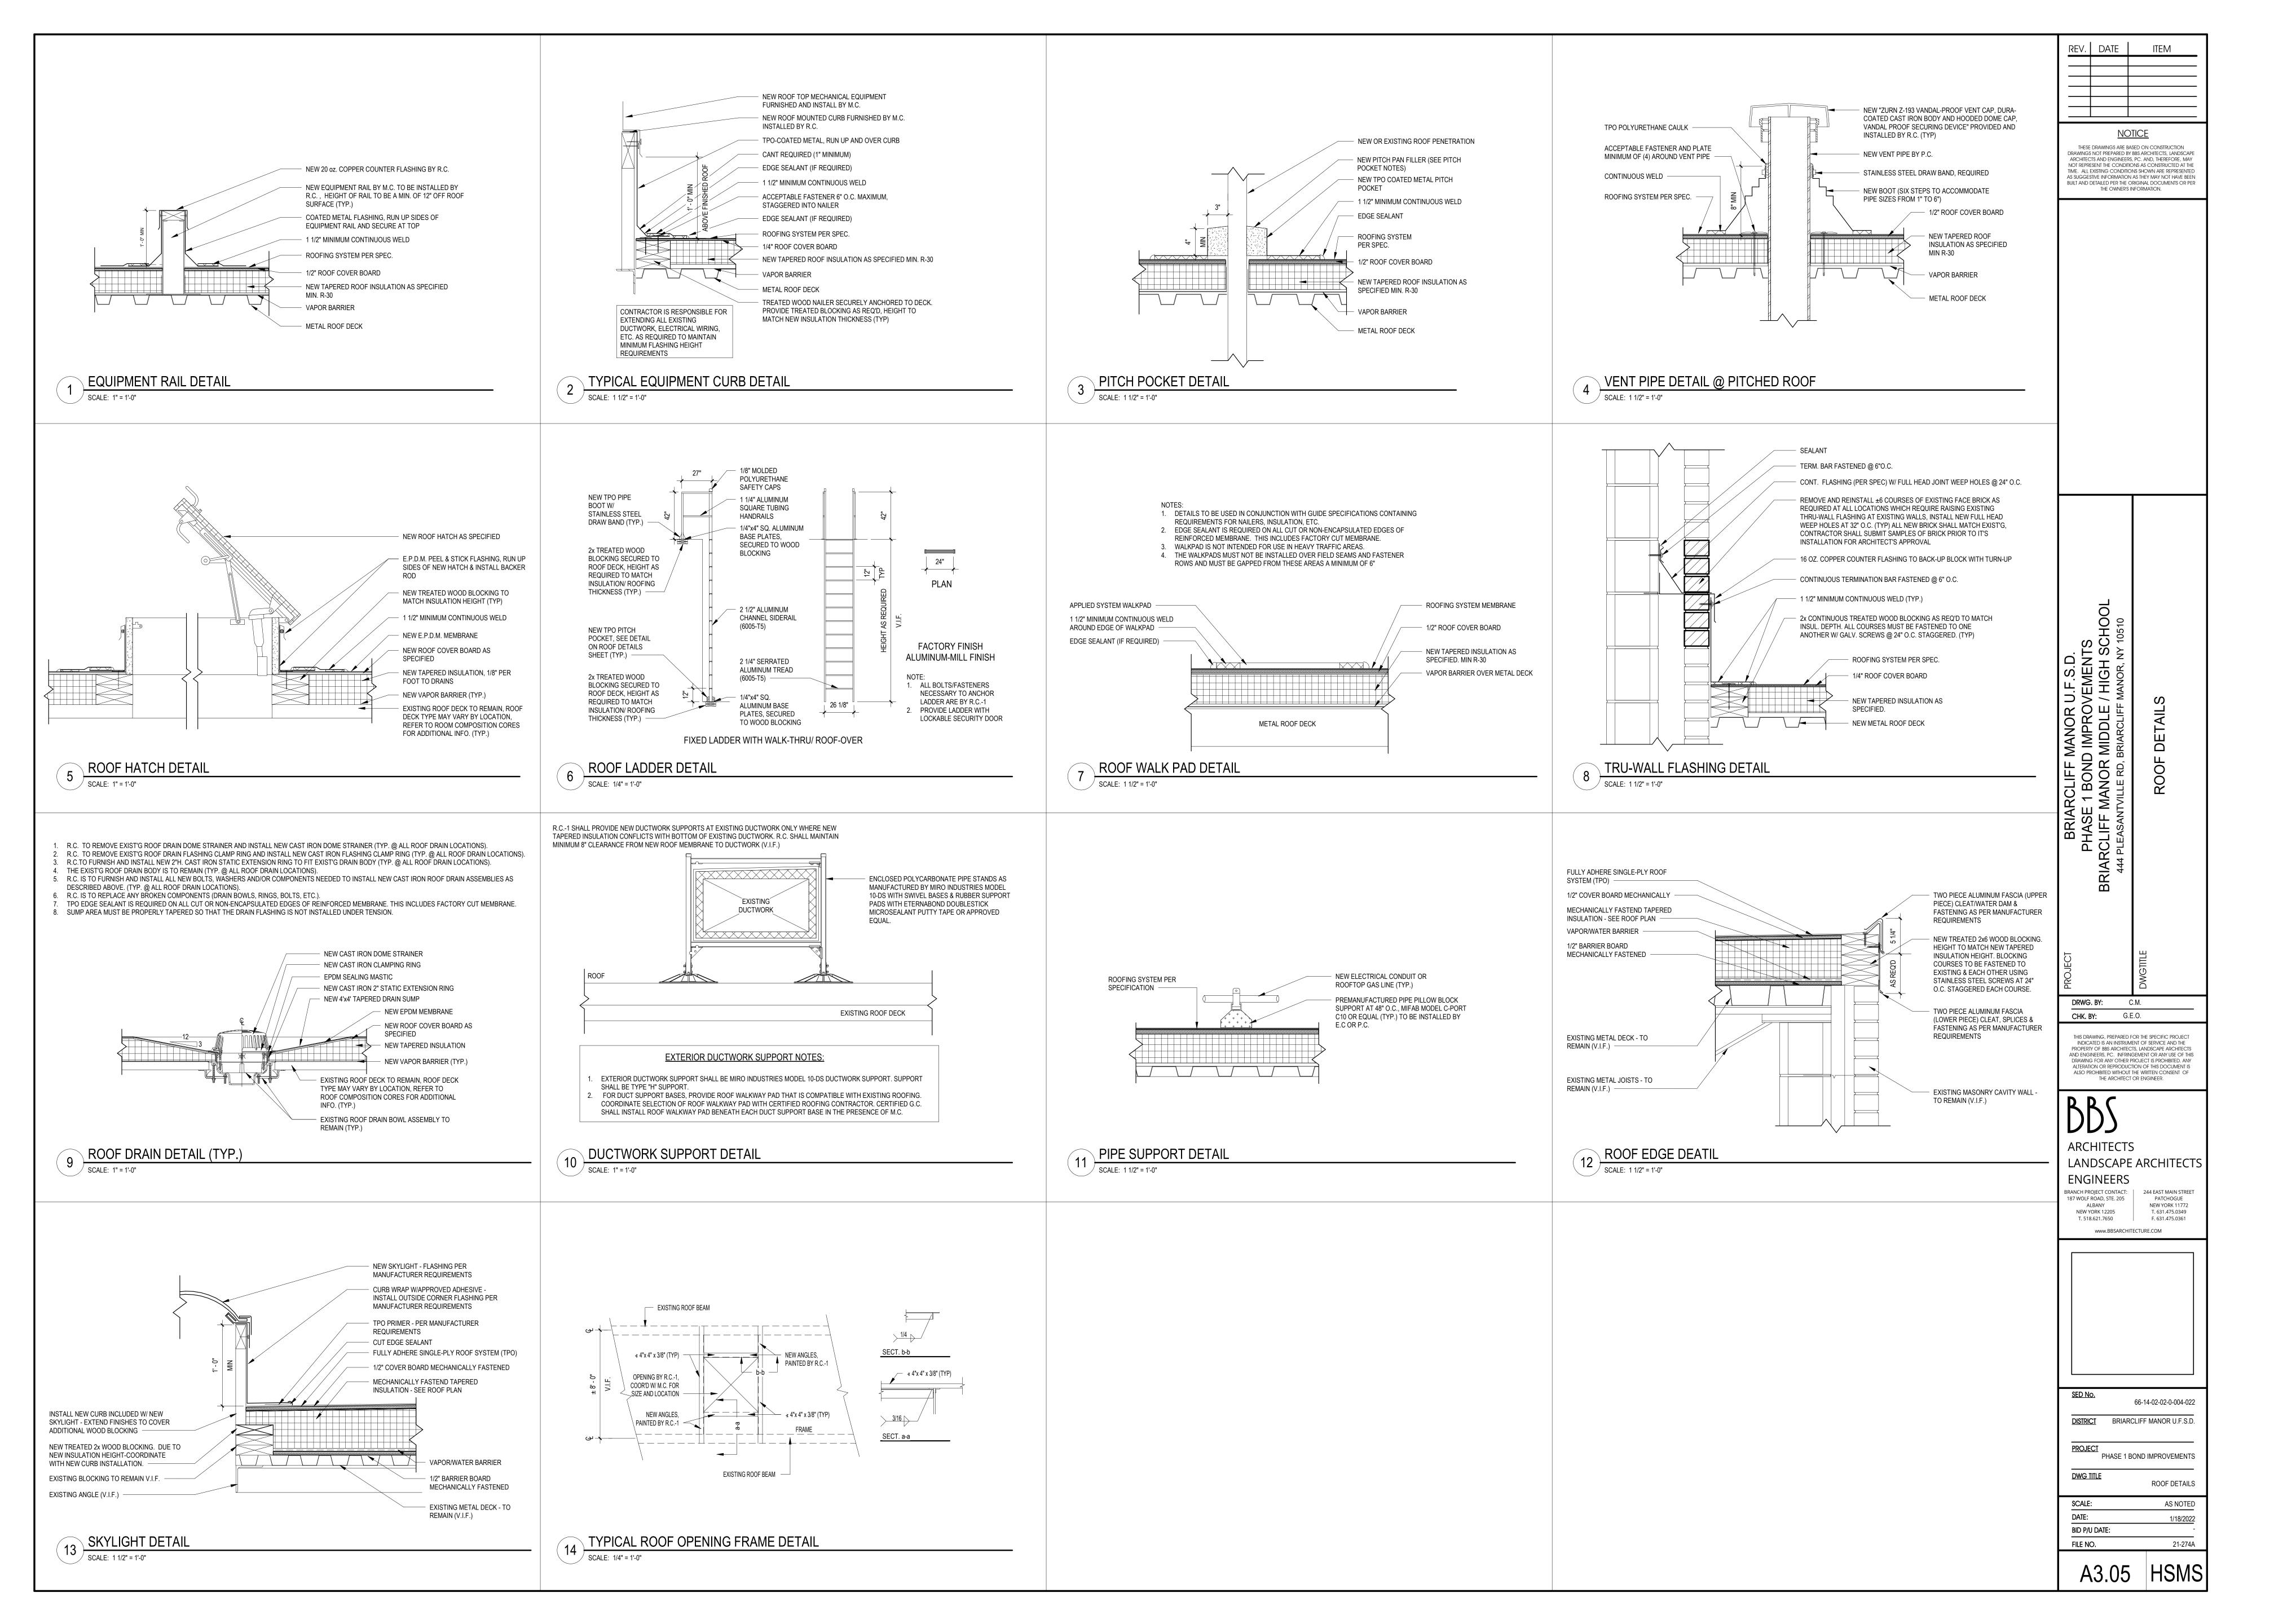

<u>ABBREV</u>	<u>IATIONS</u>
ALUM	M.C.O.V
F.G	S.C.L.C.M.V SOLID COMPOSITE LUMBER CORE MAPLE VENEER
F.L.P 5/16" FIRE-LITE PLUS	S.C.L.C.O.V SOLID COMPOSITE LUMBER CORE OAK VENEER
F.R.P	S.L
H.M	TEMP
INSUL	OBSC OBSCURE GLASS
M.C.M.V MINERAL CORE MAPLE VENEER	

REV.	DATE	ITEM	
		_	

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THE OWNER'S INFORMATION.

NOTES

- 1. ALL DOORS, FRAMES AND HARDWARE SHALL BE PROVIDED AND INSTALLED BY GENERAL CONTRACTOR UNLESS OTHERWISE NOTED.
- GENERAL CONTRACTOR SHALL COORDINATE ALL KEYING WITH OWNER.
- 3. ALL FIRE RATED WOOD DOORS SHALL HAVE SOLID MINERAL CORE, ALL OTHER WOOD DOORS SHALL HAVE SOLID COMPOSITE LUMBER CORE
- 4. FLUSH WOOD DOORS SHALL BE 5 PLY LAMINATED FACE SHEETS WITH 2 PLY FINISH VENEER OVER SPECIFIED CORE. AT FIRE RATED DOORS, TOP AND BOTTOM RAILS AND STILES SHALL BE FIRE RESISTANT COMPOSITION MATERIAL BONDED TO CORE. REFER TO SPECIFICATION SECTION 08211 FOR ADDITIONAL INFORMATION.
- ALL GLAZING IN DOORS SHALL BE INSTALLED IN METAL VISION KIT TO MATCH FIRE LABEL. VISION KIT COLOR SHALL BE AS SELECTED BY
- ALL NEW H.M. FRAMES SHALL BE WRAP AROUND TYPE (UNLESS OTHERWISE NOTED OR DETAILED). THROATS SHALL BE SIZED ACCORDING TO WALL THICKNESS AND FINISH, REFER TO FLOOR PLAN AND ENLARGED DETAILS FOR ADDITIONAL INFORMATION.
- 7. GENERAL CONTRACTOR SHALL MODIFY AND PATCH EXISTING WOOD OR H.M. DOOR FRAMES (DESIGNATED TO REMAIN) TO ACCOMMODATE NEW DOOR OPERATOR, LOCKSET LATCH, HINGES, DOOR SWING AND/OR CLOSER, ETC. AS REQUIRED FOR COMPLETE AND FUNCTIONAL
- 8. GENERAL CONTRACTOR IS RESPONSIBLE FOR VERIFYING HEIGHT AND WIDTH OF PROPOSED DOORS TO BE INSTALLED IN EXISTING FRAMES (PRIOR TO SHOP DRAWING SUBMITTAL) TO ENSURE PROPER FIT AND DOOR FUNCTION.
- 9. ALL NEW HOLLOW METAL FRAMES AND HOLLOW METAL DOORS SHALL BE FINISH PAINTED. COLOR TO MATCH EXISTING.
- 10. GENERAL CONTRACTOR SHALL PROVIDE AND INSTALL A.D.A. ACCESSIBLE SIGNAGE AT ALL DOORS (WHERE SPECIFIED IN DOOR SCHEDULE AND/OR SHOWN ON FLOOR PLANS) AND INSTALLED IN CONFORMANCE WITH ALL A.D.A. REQUIREMENTS.
- ▼ A. WHERE DENOTED IN SCHEDULE, PROVIDE 4"x4" SIGNAGE WITH BRAILLE INDICATING ROOM NUMBER (COORD. WITH OWNER),
- MODEL E-BTCUST.

 ▼ B. WHERE DENOTED IN SCHEDULE, PROVIDE 4"x12" SIGNAGE WITH BRAILLE INDICATING ROOM NAME AND NUMBER (COORD.

- AT MULTI-USE TOILET ROOMS, PROVIDE AND INSTALL MODEL No. X-5687 (WOMEN), X-5672 (MEN), X-7095 (BOYS), X-7096

- WITH OWNER), MODEL E-BTCUST.


 ▼ C. WHERE DENOTED IN SCHEDULE, PROVIDE 8"x8" SIGNAGE WITH BRAILLE INDICATING GENDER AND WHEELCHAIR PICTOGRAMS AND ROOM NAME AT MULTI-USE TOILET ROOMS.
- (GIRLS)
 AT MULTI-USE ACCESSIBLE TOILET ROOMS, PROVIDE AND INSTALL MODEL No. X-5688 (WOMEN), X-5671 (MEN), X-7108 (BOYS), X-7107 (GIRLS)

 ▼ D. WHERE DENOTED IN SCHEDULE, PROVIDE 6"x9" SIGNAGE WITH BRAILLE INDICATING GENDER AND WHEELCHAIR PICTOGRAMS
- AND ROOM NAME AT SINGLE-USE TOILET ROOMS.


 AT SINGLE-USE TOILET ROOMS, PROVIDE AND INSTALL MODEL No. E-BTCUST. SIGN SHALL SPECIFY STAFF OR STUDENT USE, IF REQUIRED.

 AT SINGLE-USE ACCESSIBLE TOILET ROOMS, PROVIDE AND INSTALL MODEL No. E-BTCUST. SIGN SHALL SPECIFY STAFF
- OR STUDENT USE, IF REQUIRED

 MANUFACTURER: "ALLSTATE SIGN AND PLAQUE" (REFER TO DOOR SCHEDULE AND FLOOR PLANS FOR SIGN TYPE AND LOCATION). ALL
 SIGNAGE SHALL BE SUBMITTED TO ARCHITECT FOR REVIEW AND APPROVAL.
- 11. ALL REMOVABLE MULLIONS ARE TO BE KEYED ALIKE AND TO MATCH EXISTING BUILDING SYSTEM.
- 12. GLAZING WITH SURFACE APPLIED FILMS WILL NOT BE CONSIDERED EQUIVALENT WHERE LAMINATED FILM IS SPECIFIED.

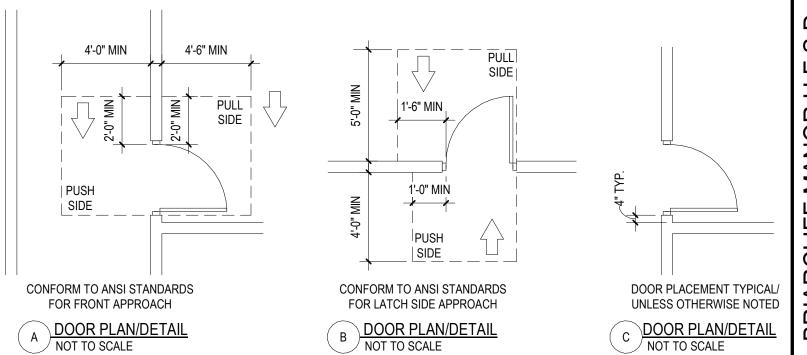

DOOR PLACEMENT DETAILS

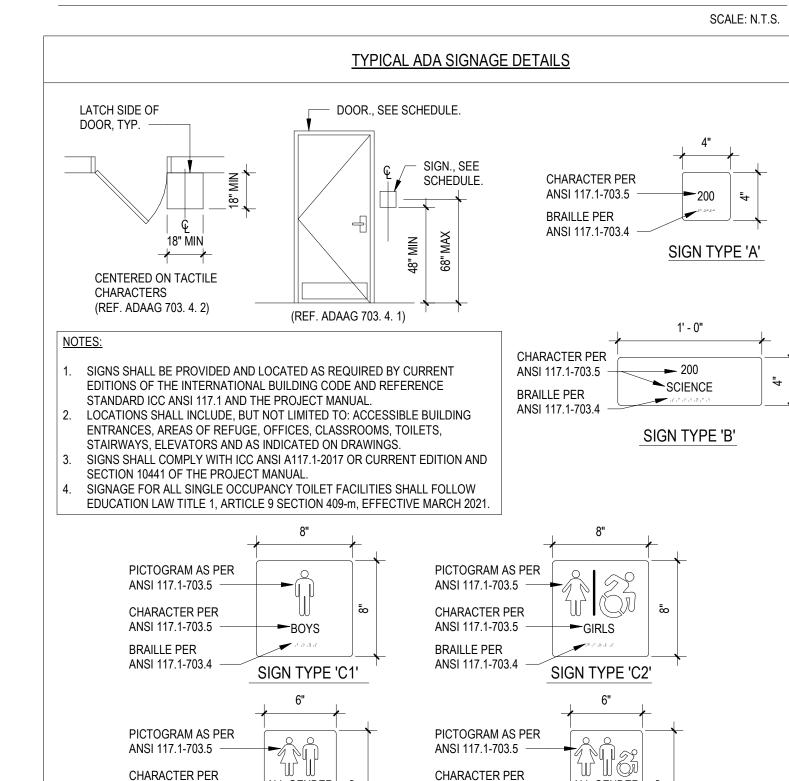

ALL GENDER

RESTROOM

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ANSI 117.1-703.4

BRAILLE PER


_ALL GENDER ಕ

RESTROOM

STUDENTS

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PROJECT
PHASE 1 BOND IMPROVEMENTS

DWG TITLE
DOOR SCHEDULE AND DETAILS

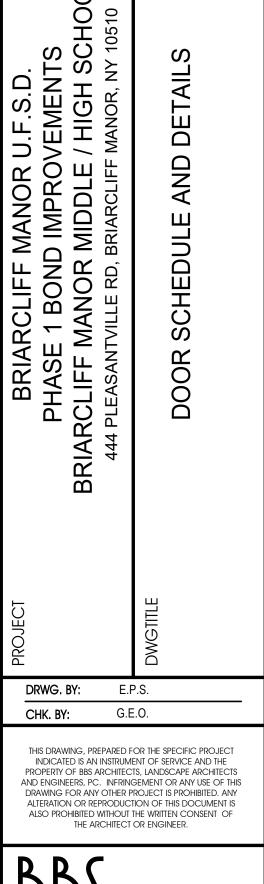SCALE: AS NOTED
DATE: 1/18/2022
BID P/U DATE: FILE NO. 21-274A

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A.F.F																ABOVE FINISHED FLOOR
B.D																BACKDRAFT.DAMPER
CFM .																CUBIC FEET OF AIR PER MINUTE
D																DEEP / DEPTH
DIA./~ .																DIAMETER
FPM .																FEET PER MINUTE
FLEX .																FLEXIBLE
Н																HJGH
H.C																HANDICAPPED
HP											٠			٠		HORSEPOWER
I.D																INSIDE DIAMETER
KW																KILOWATT.
L																LQNG
LAT		•														LEAVING AIR TEMPERATURE
LWT .																LEAVING WATER TEMPERATURE
MAX	٠	٠									٠	٠		٠		MAXIMUM
MIN																MINIMUM
MFŖ																MANUFACTURER
MIS.C																MISCELLANEOUS
MTD																MOUNTED
N.I.C																NOT IN CONTRACT.
No/#.																NUMBER
NOM		٠										•				NOMINAL
N.T.S		٠										•				NOT TO SCALE
O.A																OUTSIDE AIR
O.C																ON CENTER
O.D		٠										•				OUTSIDE DIAMETER
O.C																ON CENTER
PE																PNEUMATIC / ELECTRIC
PREFAB	3.															PREFABRICATED
PSI																POUNDS PER SQUARE INCH
REQ'D.																REQUIRED
RPM .																REVOLUTIONS PER MINUTE
SCH																SCHEDULE
S.P.																STATIC PRESSURE
STD																STANDARD.
т	٠															TEMPERATURE
TYP																
VOL																
V.D																VOLUME DAMPER
VEL																VELOCITY.
VFD .																VARIABLE FREQUENCY DRIVE
W																
W/																
W/O .																WITHOUT.
WB																WET BULB TEMPERATURE
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MECHANICAL SYMBOL LEGEND												
SYMBOL	DESCRIPTION											
24x12 / 20"~	RECTANGULAR GALVANIZED DUCTWORK - DIMENSIONS 'W' x 'H'											
	NEW EXHAUST DUCTWORK TO RISE UP											
	NEW EXHAUST DUCTWORK TO DROP DOWN											
	TRANSITION IN DUCTWORK											
	ELBOW IN DUCTWORK w/ TURNING VANES											
	ELBOW IN DUCTWORK (RADIUS + 1.5 x D)											
	45 DEG. TAKEOFF FITTING											
	90 DEG. TAKEOFF w/ BELLMOUTH FITTING											
	CEILING RETURN AIR REGISTER											
	ROOF MOUNTED EXHAUST FAN											

DUCTWORK NOTES:

- PROVIDE ALL NEW DUCTWORK AS SHOWN AND SPECIFIED UNDER SPECIFICATION SECTION 015891, AND II CONFORMANCE WITH 'SMACNA' SPECIFICATIONS.
- IF A DUCT ELBOW IS SHOWN TO BE RADIUSED, THEN RADIUSED ELBOWS SHALL BE INSTALLED. SQUARE ELBOWS MAY NOT BE SUBSTITUTED WHERE RADIUSED ELBOWS ARE SHOWN. WHERE SQUARE ELBOWS ARE SHOWN, TURNING VANES SHALL BE INSTALLED UPON APPROVAL BY THE ENGINEER.
- WHERE FLEXIBLE DUCTWORK IS USED, LENGTHS MAY NOT EXCEED 4 FEET TOTAL IN ANY ONE RUN OF FLEXIBLE DUCTWORK. FLEXIBLE DUCTWORK SHALL BE RATED IN ACCORDANCE WITH UL 181, CLASS 1 REFER TO SPECIFICATION SECTION 15891 FOR FURTHER INFORMATION.
- MECHANICAL CONTRACTOR SHALL PROVIDE A BUTTERFLY TYPE VOLUME DAMPER WITH LOCKING QUADRANT HANDLE PRIOR TO EACH AIR OUTLET SHOWN. INSTALL DAMPER AT LEAST 5 FEET AWAY FROM AIR OUTLET WHEREVER POSSIBLE.
- MECHANICAL CONTRACTOR SHALL PROVIDE FLEXIBLE DUCT CONNECTIONS WHERE DUCT SYSTEMS CONNECT TO EQUIPMENT. REFER TO SPECIFICATION SECTION 15891 FOR FURTHER INFORMATION.

LOCK OUT-TAG OUT NOTIFICATION:

WORKING ON, PRIOR TO DISMANTLING FOR SERVICE OR CLEANING.

CONTRACTOR ABBREVIATIONS:

M.C. = MECHANICAL CONTRACTOR

C.C. = CONTROLS CONTRACTOR

G.C. = GENERAL CONTRACTOR

R.C. = ROOFING CONTRACTOR

1. IN ACCORDANCE WITH OSHA REGULATIONS - ALL CONTRACTORS MUST

PROPERLY LOCK-OUT & TAG OUT ALL ELECTRICAL EQUIPMENT THEY ARE

P.C. = PLUMBING CONTRACTOR

E.C. = ELECTRICAL CONTRACTOR

C.W.C. = CASEWORK CONTRACTOR

GENERAL NOTES:

- REMOVAL & RELOCATION OF CERTAIN EXISTING WORK SHALL BE NECESSARY FOR THE PERFORMANCE OF THE NEW WORK SHOWN HEREIN. ALL EXISTING CONDITIONS ARE NOT COMPLETELY DETAILED ON THE DRAWINGS. THE CONTRACTOR SHALL SURVEY THE SITE & MAKE ALL NECESSARY CHANGES BASED ON EXISTING CONDITIONS AS REQUIRED FOR PROPER DEMOLITION OF EXISTING WORK & SHALL INCLUDE ALL MATERIALS & LABOR FOR SAME IN HIS BID PRICE. NO ALLOWANCE WILL BE MADE FOR FAILURE TO DO SO.
- PRIOR TO SUBMITTING A BID, THE CONTRACTOR SHALL VISIT THE PREMISES OF THE PROPOSED WORK & SHALL CAREFULLY EXAMINE THE ENGINEERING DRAWINGS, EXISTING CONDITIONS & LIMITATIONS THEREOF. VERIFY ACTUAL LOCATIONS WHERE THE NEW PIPING WILL BE ROUTED, COORDINATE WITH NEW & EXISTING WORK & PROVIDE CLEARANCE W/ BUILDING STRUCTURE, OTHER SERVICES, ETC.. THE CONTRACTOR SHALL INCLUDE ALL COSTS WHATSOEVER WHICH ARE INCURRED AS A RESULT OF LIMITATIONS OF THE EXISTING & NEW CONDITIONS. LATER CLAIMS FOR EXTRA LABOR, EQUIPMENT, MATERIALS, ETC. REQUIRED DUE TO DIFFICULTIES WHICH COULD HAVE BEEN FORESEEN WILL NOT BE CONSIDERED AS EXTRA WORK.
- INSTALL WORK SO AS TO BE READILY ACCESSIBLE FOR OPERATING, MAINTENANCE & REPAIR. MINOR DEVIATIONS FROM DRAWINGS MAY BE MADE TO ACCOMPLISH THIS, BUT CHANGES OF MAGNITUDE WHICH INVOLVE EXTRA COST SHALL NOT BE MADE WITHOUT APPROVAL.
- INVESTIGATE EACH SPACE THROUGH WHICH EQUIPMENT MUST BE MOVED. WHEN NECESSARY, EQUIPMENT SHALL BE SHIPPED FROM MANUFACTURER IN CRATED SECTIONS OF SIZE SUITABLE FOR MOVING THROUGH AREAS AVAILABLE. ASCERTAIN FROM BUILDING OWNER AT WHAT TIMES OF DAY EQUIPMENT MAY BE MOVED THROUGH THE BUILDING.
- COORDINATE THE EXACT SIZE & LOCATION OF NEW OPENINGS WITH EXISTING STRUCTURE. PATCH / INSULATE AS REQUIRED. CONTRACTOR SHALL FIRESTOP ALL PENETRATIONS FROM NEW PIPING, CONDUIT, DUCTWORK, ETC. THROUGH EXISTING OR NEW FIRE/ SMOKE BARRIERS. REFER TO SPECIFICATION SECTION 15511 FOR FURTHER DETAILS.
- IT IS THE INTENT OF THIS CONTRACT FOR REMAINING SYSTEMS TO BE LEFT IN GOOD WORKING ORDER, READY FOR OPERATION. COORDINATE ANY REQUIRED SYSTEM SHUTDOWNS WITH OWNER 48 HOURS IN ADVANCE. EXISTING SYSTEM SHUTDOWNS WILL NOT BE PERMITTED IF THEY INTERFERE WITH THE DAILY OPERATIONS OF THE BUILDING. CONTRACTOR WILL BE REQUIRED TO TAKE PROPER PRECAUTIONS AGAINST DAMAGING OR DISRUPTING BUILDING SYSTEMS, WIRING, PIPING OR CONTROL TUBING. ANY DAMAGE TO THESE ITEMS SHALL BE REPAIRED AT THE CONTRACTOR'S COST AS A PART OF THIS CONTRACT.
- THE CONTRACTOR SHALL REPAIR / RESTORE TO ORIGINAL CONDITION ANY EXISTING EQUIPMENT OR MATERIALS DAMAGED IN THE PROCESS OF INSTALLATION, OR DEMOLITION TO THE SATISFACTION OF THE OWNER'S REPRESENTATIVE. CONTRACTOR SHALL MAKE REPAIRS USING THE SAME OR EQUIVALENT MATERIALS. WORK WILL BE PERFORMED AT THE CONTRACTOR'S COST.
- CONTRACTOR SHALL INCUR ANY COSTS OR BURDENS ASSOCIATED WITH LOST OR STOLEN EQUIPMENT / MATERIALS.
- DURING THE LIFE OF THE CONTRACT PERIOD, CONTRACTOR SHALL REMOVE ALL RUBBISH / EXCESS MATERIAL ACCUMULATED AS A RESULT OF HIS OPERATIONS ON A DAILY BASIS. ALL AREAS / EQUIPMENT AFFECTED UNDER THIS CONTRACT SHALL BE KEPT CLEAN OF DUST / DEBRIS. ALL AREAS SHALL RECEIVE A FINAL CLEANING PRIOR TO FINAL ACCEPTANCE BY THE OWNER.
- PROVIDE FOR LEGAL REMOVAL / DISPOSAL OF ALL RUBBISH / DEBRIS FROM THE BUILDING & SITE. PROTECT ALL WORK NOT SLATED FOR DEMOLITION.
- THIS CONTRACTOR SHALL COORDINATE HIS WORK WITH ALL OTHER TRADES PRIOR TO SCHEDULING THE WORK. WORK SHALL BE PERFORMED IN PROPER SEQUENCE, AS AGREED TO BY ALL TRADES. ANY COSTS INCURRED BY THE OWNER DUE TO IMPROPER SEQUENCING OF WORK WILL BE PAID FOR BY THIS
- CONTRACTOR SHALL OBTAIN ALL PERMITS, PAY ALL FEES, CONNECTION CHARGES, ETC. ASSOCIATED WITH THE WORK UNDER THEIR CONTRACT.
- PAINT / TOUCH UP ALL SURFACES MARRED AS A RESULT OF THE PERFORMANCE OF THE CONTRACT
- THE MECHANICAL CONTRACTOR SHALL REFER TO / REVIEW ALL OTHER TRADE DRAWINGS IN THE BID PACKAGE & SHALL BE RESPONSIBLE FOR / PERFORM ALL WORK INDICATED AS (M.C.) MECHANICAL WORK AS A PART OF THE BASE BID UNLESS SPECIFICALLY NOTED OTHERWISE.
- SUBSTITUTED EQUIPMENT OF GREATER OR LARGER POWER, DIMENSIONS, CAPACITIES & RATINGS MAY BE ·URNISHED PROVIDED THAT SAID EQUIPMENT IS APPROVED IN WRITING PRIOR TO ORDER. . . CONNECTING MECHANICAL SERVICES, ELECTRICAL SERVICES, BASES, STRUCTURAL APPURTENANCES, ETC. REQUIRED TO BE INCREASED DUE TO THE USE OF SAID EQUIPMENT WILL BE PAID FOR IN FULL BY THE MECHANICAL CONTRACTOR, INCLUDING ANY ADDITIONAL REQUIRED ENGINEERING FEES.
- EACH PIECE OF EQUIPMENT SHALL BE PROVIDED WITH A PERMANENT TYPE LAMINATED. BLACK FINISH. WHITE CORE, PHENOLIC NAMEPLATE. NAMEPLATES SHOULD INDICATE THE NAME & NUMBER OF THE UNIT, UNIT VOLTAGE, & ANY INTERLOCK REFERENCE. STARTERS / DISCONNECT SWITCHES SHOULD ALSO BE EQUIPPED WITH AN IDENTICAL NAMEPLATE WITH THE SAME INFORMATION.
- MECHANICAL CONTRACTOR SHALL PROVIDE (1) SPARE MOTOR FOR EACH SIZE MOTOR USED ON THE PROJECT. IN INSTANCES WHERE MORE THAN TEN OF THE SAME MOTOR ARE USED, MECHANICAL CONTRACTOR SHALL PROVIDE (1) SPARE MOTOR FOR EVERY TEN MOTORS OF A GIVEN SIZE USED ON THE
- MAINTENANCE MANUAL: UPON COMPLETION OF THE PROJECT, THE MECHANICAL CONTRACTOR SHALL PROVIDE A BINDER CONTAINING THE OPERATIONS & MAINTENANCE MANUALS FOR EACH NEW PEICE OF EQUIPMENT INSTALLED UNDER THIS PROJECT. THE FIRST SECTION OF THE MAINTENANCE MANUAL SHALL CONTAIN A LIST OF EACH PEICE OF EQUIPMENT, COMPLETE WITH INFORMATION SHOWING APPROPRIATE REPLACEMENT FILTER SIZES / TYPES, APPROPRIATE REPLACEMENT BELT SPECIFICATIONS, REPLACEMENT MOTOR SPECIFICATIONS, REPLACEMENT BEARING SPECIFICATIONS, VOLTAGES OF UNIT, ETC. THIS SHALL SERVE AS A WRITTEN DATABASE DESCRIBING ALL MAINTENANCE INFORMATION FOR EACH NEW PEICE OF EQUIPMENT USED.

ROOFING CONSTRUCTION NOTES:

1. ALL EXISTING DIMENSIONS AND CONDITIONS ARE APPROXIMATE. MECHANICAL CONTRACTORS MUST FIELD VERIFY ALL CONDITIONS AND NOTIFY THE ENGINEER OF ANY DISCREPANCIES PRIOR TO BIDDING. THE MECHANICAL CONTRACTOR SHALL BE RESPONSIBLE FOR VERIFICATION OF ALL DIMENSIONS REQUIRED FOR BIDDING AND ESTIMATING. PRE-BID SITE INSPECTION IS STRONGLY RECOMMENDED. ALL CONTRACTORS SHALL CONTACT THE SCHOOL TO MAKE AN APPOINTMENT FOR SITE VISIT. UNDER NO CIRCUMSTANCES WILL ANY CONTRACTOR BE ALLOWED TO SHOW UP WITHOUT AN APPOINTMENT.

2. IN ACCORDANCE WITH STATE AND LOCAL CODES, THE REQUIRED EXITS IN THE EXISTING BUILDING MUST BE MAINTAINED AS CLEAR, AND PROTECTED DURING THE ENTIRE CONSTRUCTION PERIOD.

3. ALL WORK AND MATERIAL OF THIS PROJECT AND ADJACENT SURFACES SHALL BE PROTECTED FROM DAMAGE. IN THE EVENT OF DAMAGE. THE MECHANICAL CONTRACTOR SHALL IMMEDIATELY NOTIFY THE ARCHITECT AND THE OWNER, AND MAKE ALL REPAIRS AND REPLACEMENTS NECESSARY TO THE APPROVAL OF THE ARCHITECT AND OWNER AND AT NO ADDITIONAL COST TO THE OWNER.

4. THE MECHANICAL CONTRACTOR IS TO PROTECT AND MAKE WATER TIGHT ALL AREAS OF HIS WORK FROM INCLEMENT WEATHER DURING AND AT THE END OF EVERY DAY OF WORK OPERATIONS.

5. ALL PROJECT WASTE MATERIAL AND RUBBISH GENERATED BY THE MECHANICAL CONTRACTOR AND / OR HIS SUB-CONTRACTORS SHALL BE DISPOSED IN CONTAINERS FOR SUBSEQUENT LEGAL OFF-SITE DISPOSAL. CONTAINER LOCATION TO BE COORDINATED WITH BUILDINGS AND GROUNDS. OFF-SITE DISPOSAL TO BE ON A REGULAR BASIS.

6. ALL FLASHING ON MECHANICALS MUST BE INSTALLED AT A DISTANCE ABOVE THE FINISHED ROOF SURFACE TO INSURE CONFORMANCE WITH ROOFING MANUFACTURER'S WARRANTY REQUIREMENTS. INCLUSIVE OF ALL CONDITIONS, NO EXCEPTIONS 7. THE ROOFING CONTRACTOR SHALL BE SURE TO MAINTAIN ANY/ALL EXISTING ROOFING WARRANTEE IN PLACE AT THOSE ROOFS WHICH

CUTTING, PATCHING AND RE-FLASHING IS REQUIRED. THE ROOFING CONTRACTOR SHALL BE RESPONSIBLE TO MAKE ANY & ALL REPAIRS TO

EXISTING ROOFING SYSTEM AS REQUIRED TO CONSTRUCTION ACTIVITIES AT NO ADDITIONAL COST TO THE OWNER. ALL WORK SHALL BE DONE IN ACCORDANCE WITH THE MANUFACTURER'S SPECIFICATIONS AND SHALL MAINTAIN ALL EXISTING WARRANTIES. 8. THE ROOFING CONTRACTOR (R.C.) SHALL BE RESPONSIBLE FOR ALL NEW ROOF PENETRATIONS FOR NEW MECHANICAL UNITS ON EXISTING ROOF. R.C. SHALL COORDINATE SETTING OF CURBS WITH THE MECHANICAL CONTRACTOR (M.C.) AND R.C. SHALL BE RESPONSIBLE FOR ALL

PATCHING/FLASHING OF EXISTING ROOF. THE MECHANICAL CONTRACTOR SHALL USE CERTIFIED ROOF INSTALLER AS APPROVED BY MANUFACTURER OF EXISTING ROOF AS TO NOT VOID EXISTING ROOF WARRANTY. COORDINATE WITH OWNER.

9. THE MECHANICAL CONTRACTOR SHALL BE RESPONSIBLE TO COORDINATE INSTALLATION OF ALL MECHANICAL UNITS/ EQUIPMENT WITH ALL

10. ALL WALL & FLOOR PENETRATIONS SHALL BE DONE BY GENERAL CONTRACTOR WITH MECHANICAL CONTRACTOR PRESENT.

GENERAL NOTES FOR ALL ROOFTOP EQUIPMENT:

- 1. PROVIDE DISCONNECT SWITCH FOR EACH NEW EQUIPMENT.
- 2. R.C. SHALL MAKE ALL ROOF PENETRATIONS IN THE PRESENCE OF THE MECHANICAL CONTRACTOR.

3. MECHANICAL CONTRACTOR SHALL FURNISH NEW ROOF CURBS TO R.C. R.C. SHALL CUT HOLES IN ROOF IN PRESENCE OF M.C. AND R.C. SHALL INSTALL NEW ROOF CURBS IN THE PRESENCE OF THE CERTIFIED M.C. R.C. SHALL BE RESPONSIBLE FOR FLASHING ALL NEW ROOF CURBS. REFER TO ARCHITECTURAL DRAWINGS FOR FURTHER DETAILS OF FLASHING ROOF CURBS.

GENERAL MECHANICAL NOTES:

- PROVIDE AND INSTALL 2" ACOUSTIC FIBERGLASS 3-LBS. DENSITY WITHIN ROOF CURBS AND ADAPTER ROOF CURBS.
- ALL DISCONNECT SWITCHES AND STARTERS TO BE FURNISHED BY MECHANICAL CONTRACTOR AND INSTALLED AND WIRED BY THE
- DUCT SIZE DIMENSIONS SHOWN ARE 'CLEAR' INSIDE DIMENSIONS
- CONTROLS CONTRACTOR SHALL FURNISH ALL CONTROLS EQUIPMENT AND PROVIDE TO MECHANICAL CONTRACTOR TO INSTALL. CONTROLS CONTRACTOR SHALL WIRE ALL CONTROLS EQUIPMENT.
- UNLESS OTHERWISE NOTED. THE GENERAL CONTRACTOR (G.C.) SHALL MAKE ALL INTERIOR WALL, CEILING, & FLOOR PENETRATIONS FOR PIPING & DUCTWORK. M.C. SHALL BE RESPONSIBLE TO COORDINATE WITH ALL TRADES. M.C. SHALL BE PRESENT WHEN G.C. MAKES PENETRATIONS FOR ALL MECHANICAL PIPING & DUCTWORK.

GENERAL EXHAUST FAN NOTES:

- E.C. SHALL DISCONNECT & REMOVE EXISTING STARTERS FOR ALL EXHAUST FANS SHOWN TO BE REPLACED. THEN M.C. SHALL PROVIDE NEW STARTERS & DISCONNECTS FOR THOSE EXHAUST FANS BEING REPLACED. E.C. SHALL INSTALL NEW STARTERS / DISCONNECTS. VERIFY EXISTING LOCATIONS OF ALL EXISTING EXHAUST FAN STARTERS.
- M.C. SHALL PROVIDE AND INSTALL NEW ADAPTER CURB ASSEMBLIES AS REQ'D. TO MOUNT NEW EXHAUST FANS IN EXIST. EXHAUST FAN
- M.C. SHALL MODIFY AS NECESSARY ALL EXIST. EXHAUST FAN EQUIPMENT TO COMPLETELY INSTALL THE NEW REPLACEMENT EXHAUST FAN
- D. FOR FURTHER DETAILS ON ALL MECHANICAL EXHAUST FAN EQUIPMENT REFER TO MECHANICAL DRAWINGS.

FIRESTOPPING NOTES:

- 1. ALL PENETRATIONS THROUGH FIRE RATED WALLS, FLOORS OR OTHER STRUCTURES SHALL BE FIRE STOPPED BY MECHANICAL CONTRACTOR.
- 2. THE FIRE STOP MATERIALS SHALL BE HILTI TYPE FS-657 FIRE BLOCK, FS-ONE SEALANT, CP-672 JOINT SPRAY, CP-601S ELASTOMERIC SEALANT, 6P-606 FLEXIBLE SEALANT, CP-643 OR CP-642 COLLAR, CP-618 PUTTY STICK, OR FS-635 TROWEL ABLE COMPOUND, AS SUITABLE.
- 3. CONTRACTOR SHALL SUBMIT SHOP DRAWINGS OF PRODUCTS TO BE USED.

DRAWINGS FOR FURTHER DETAILS ON ROOF PATCHING.

4. FIRESTOP MATERIALS OTHER THAN HILTI SHALL INCLUDE FULL TECHNICAL DATA WITH SHOP DRAWINGS TO DEMONSTRATE EQUALITY WITH THE SPECIFIED FIRE STOPS.

ROOFTOP MECHANICAL EQUIPMENT DEMOLITION PLAN GENERAL NOTES:

- MECHANICAL CONTRACTOR SHALL VERIFY IN THE FIELD THE EXACT LOCATION OF ALL EXISTING MECHANICAL RELATED EQUIPMENT, DUCTWORK, PIPING, LOUVERS, AND ROOFTOP EQUIPMENT PRIOR TO START OF ANY WORK.
- MECHANICAL CONTRACTOR SHALL COORDINATE ALL ROOF DEMOLITION PLAN WORK AND WALL DEMOLITION PLAN WORK WITH ROOFING
- AND ASSOCIATED DUCTWORK AND ASSOCIATED ROOF CURBS, ASSOCIATED DUCTWORK, WALL LOUVERS, WHERE CALLED OUT IN KEY PLAN NOTES. MECHANICAL CONTRACTOR SHALL COORDINATE REMOVAL OF ALL ROOF MECHANICAL EQUIPMENT WITH ROOFING CONTRACTOR. ROOFING CONTRACTOR SHALL BE RESPONSIBLE FOR PATCHING ANY ROOF PENETRATION THAT SHALL NOT BE RE-USED. REFER TO ARCHITECTURAL

REMOVE EXISTING EQUIPMENT AS SHOWN ON PLANS. MECHANICAL CONTRACTOR IS RESPONSIBLE FOR REMOVAL OF ALL MECHANICAL EQUIPMENT


GENERAL CONTRACTOR (G.C) SHALL BE RESPONSIBLE FOR PATCHING ALL WALL PENETRATIONS. ROOFING CONTRACTOR (R.C.) SHALL BE RESPONSIBLE FOR PATCHING ALL ROOF PENETRATIONS AND FLASHING ALL NEW ROOF CURBS. MECHANICAL CONTRACTOR (M.C.) SHALL BE RESPONSIBLE FOR MAKING ALL WALL PENETRATIONS IN THE PRESENCE OF THE GENERAL CONTRACTOR. ROOFING CONTRACTOR (R.C.) SHALL BE RESPONSIBLE FOR MAKING ALL ROOF PENETRATIONS AND INSTALLING ROOF CURBS.

TESTING and BALANCING NOTES

- MECHANICAL CONTRACTOR WILL BE REQUIRED TO PERFORM ALL EQUIPMENT & SYSTEM TESTING BALANCING REQUIRED UNDER THIS CONTRACT. PROVIDE A FULL REPORT DETAILING ALL DESIGN 8 ACTUAL CONDITIONS FOR ALL AIR SYSTEMS SHOWN ON THE DRAWINGS. REFER TO SPECIFICATION SECTIONS 15990 & 15997 FOR FURTHER DETAILS.
- UPON NOTICE OF COMPLETION OF WORK BY THE CONTRACTOR, OWNER WILL OBTAIN THE SERVICES OF AN INDEPENDENT TESTING & BALANCING CONTRACTOR TO VERIFY THE RESULTS OF THE TESTING & BALANCING REPORT SUBMISSION. INDEPENDENT TESTING AGENCY SHALL SELECT A RANDOM NUMBER OF MEASUREMENTS TO BE CHECKED. MEASUREMENTS WILL BE CHECKED IN THE SAME MANNER AS ORIGINALLY MEASURED. NUMBER OF VERIFICATION MEASUREMENTS SHALL BE APPROXIMATELY 25% OF THE TOTAL MEASUREMENTS FOR THE PROJECT.
- IF MORE THAN 10% OF THE VERIFICATION TESTING SHOWS DEVIATIONS OF 10% OR MORE / SOUND LEVEL OF 2dB DIFFERENT THAN THAT ORIGINALLY MEASURED, THE ORIGINAL REPORT WILL BE REJECTED. ALI SYSTEMS WILL THEN BE REQUIRED TO BE COMPLETELY RE-TESTED. WITH A SECOND REPORT SUBMITTED. IN THE EVENT THAT THE ORIGINAL REPORT IS REJECTED, ALL SYSTEMS SHALL BE READJUSTED & TESTED, NEW CERTIFIED REPORTS SUBMITTED, AND NEW VERIFICATION TESTS MADE, AT NO ADDITIONAL COST TO THE OWNER. THE CONTRACTOR WILL BE RESPONSIBLE FOR ALL COSTS INVOLVED WITH THE VERIFICATION TESTS.

ELECTRICAL WORK UNDER MECHANICAL CONTRACT

- MECHANICAL CONTRACTOR SHALL PROVIDE ALL STARTERS & DISCONNECT SWITCHES REQUIRED FOR ALI NEW MECHANICAL EQUIPMENT. STARTER / DISCONNECT SWITCH INSTALLATION TO BE PERFORMED UNDER THE ELECTRICAL CONTRACT. COORDINATE WORK W/ ELECTRICAL CONTRACTOR PRIOR TO START
- POWER WIRING REQUIRED FOR CONTROLS SHALL BE PERFORMED UNDER THE MECHANICAL CONTRACT UNLESS SPECIFICALLY NOTED OTHERWISE ON THE ELECTRICAL DRAWINGS. MECHANICAL CONTRACTOR SHALL OBTAIN THE SERVICES OF A LICENSED ELECTRICIAN (PER NEC REQUIREMENTS) TO PERFORM ALL ELECTRICAL WORK.

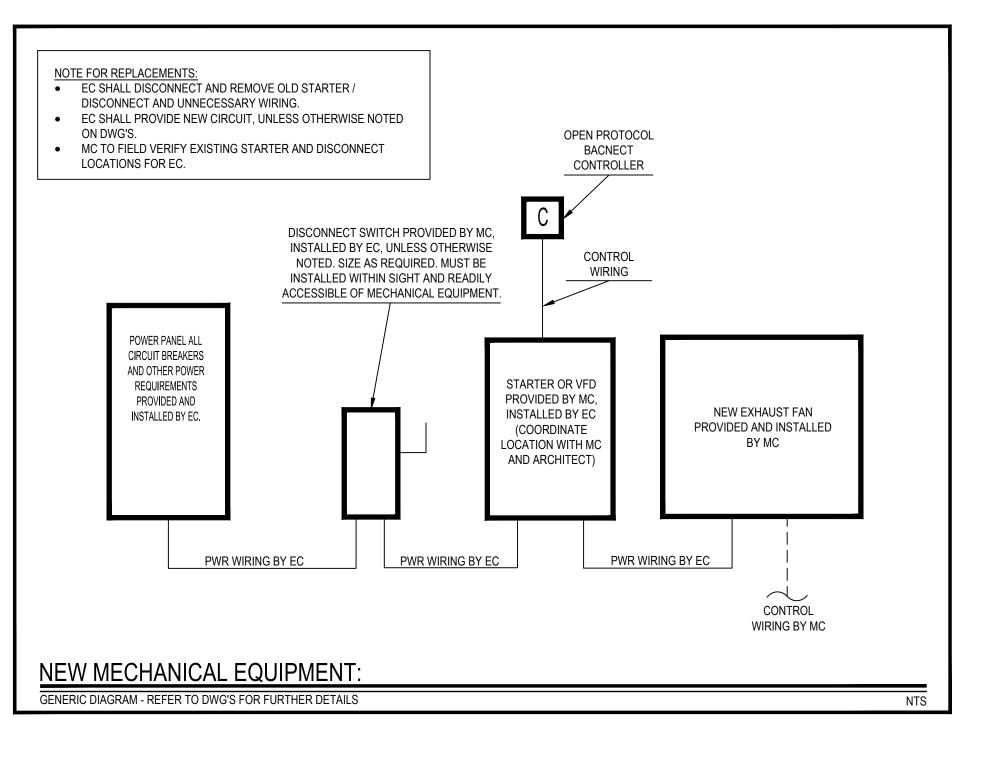


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NFORMATION AS THEY MAY NOT HAVE BEEN BUILT AND DETAILE

1 1/14/2022 ISSUED FOR BID

REV. DATE

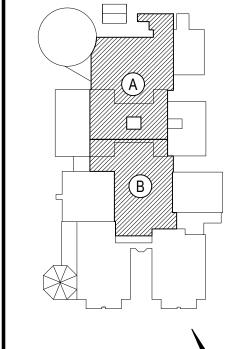

KEY PLAN NOT TO SCALE

DRAWING BY: RDP CHECK BY:


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LANDSCAPE ARCHITECTS ENGINEERS

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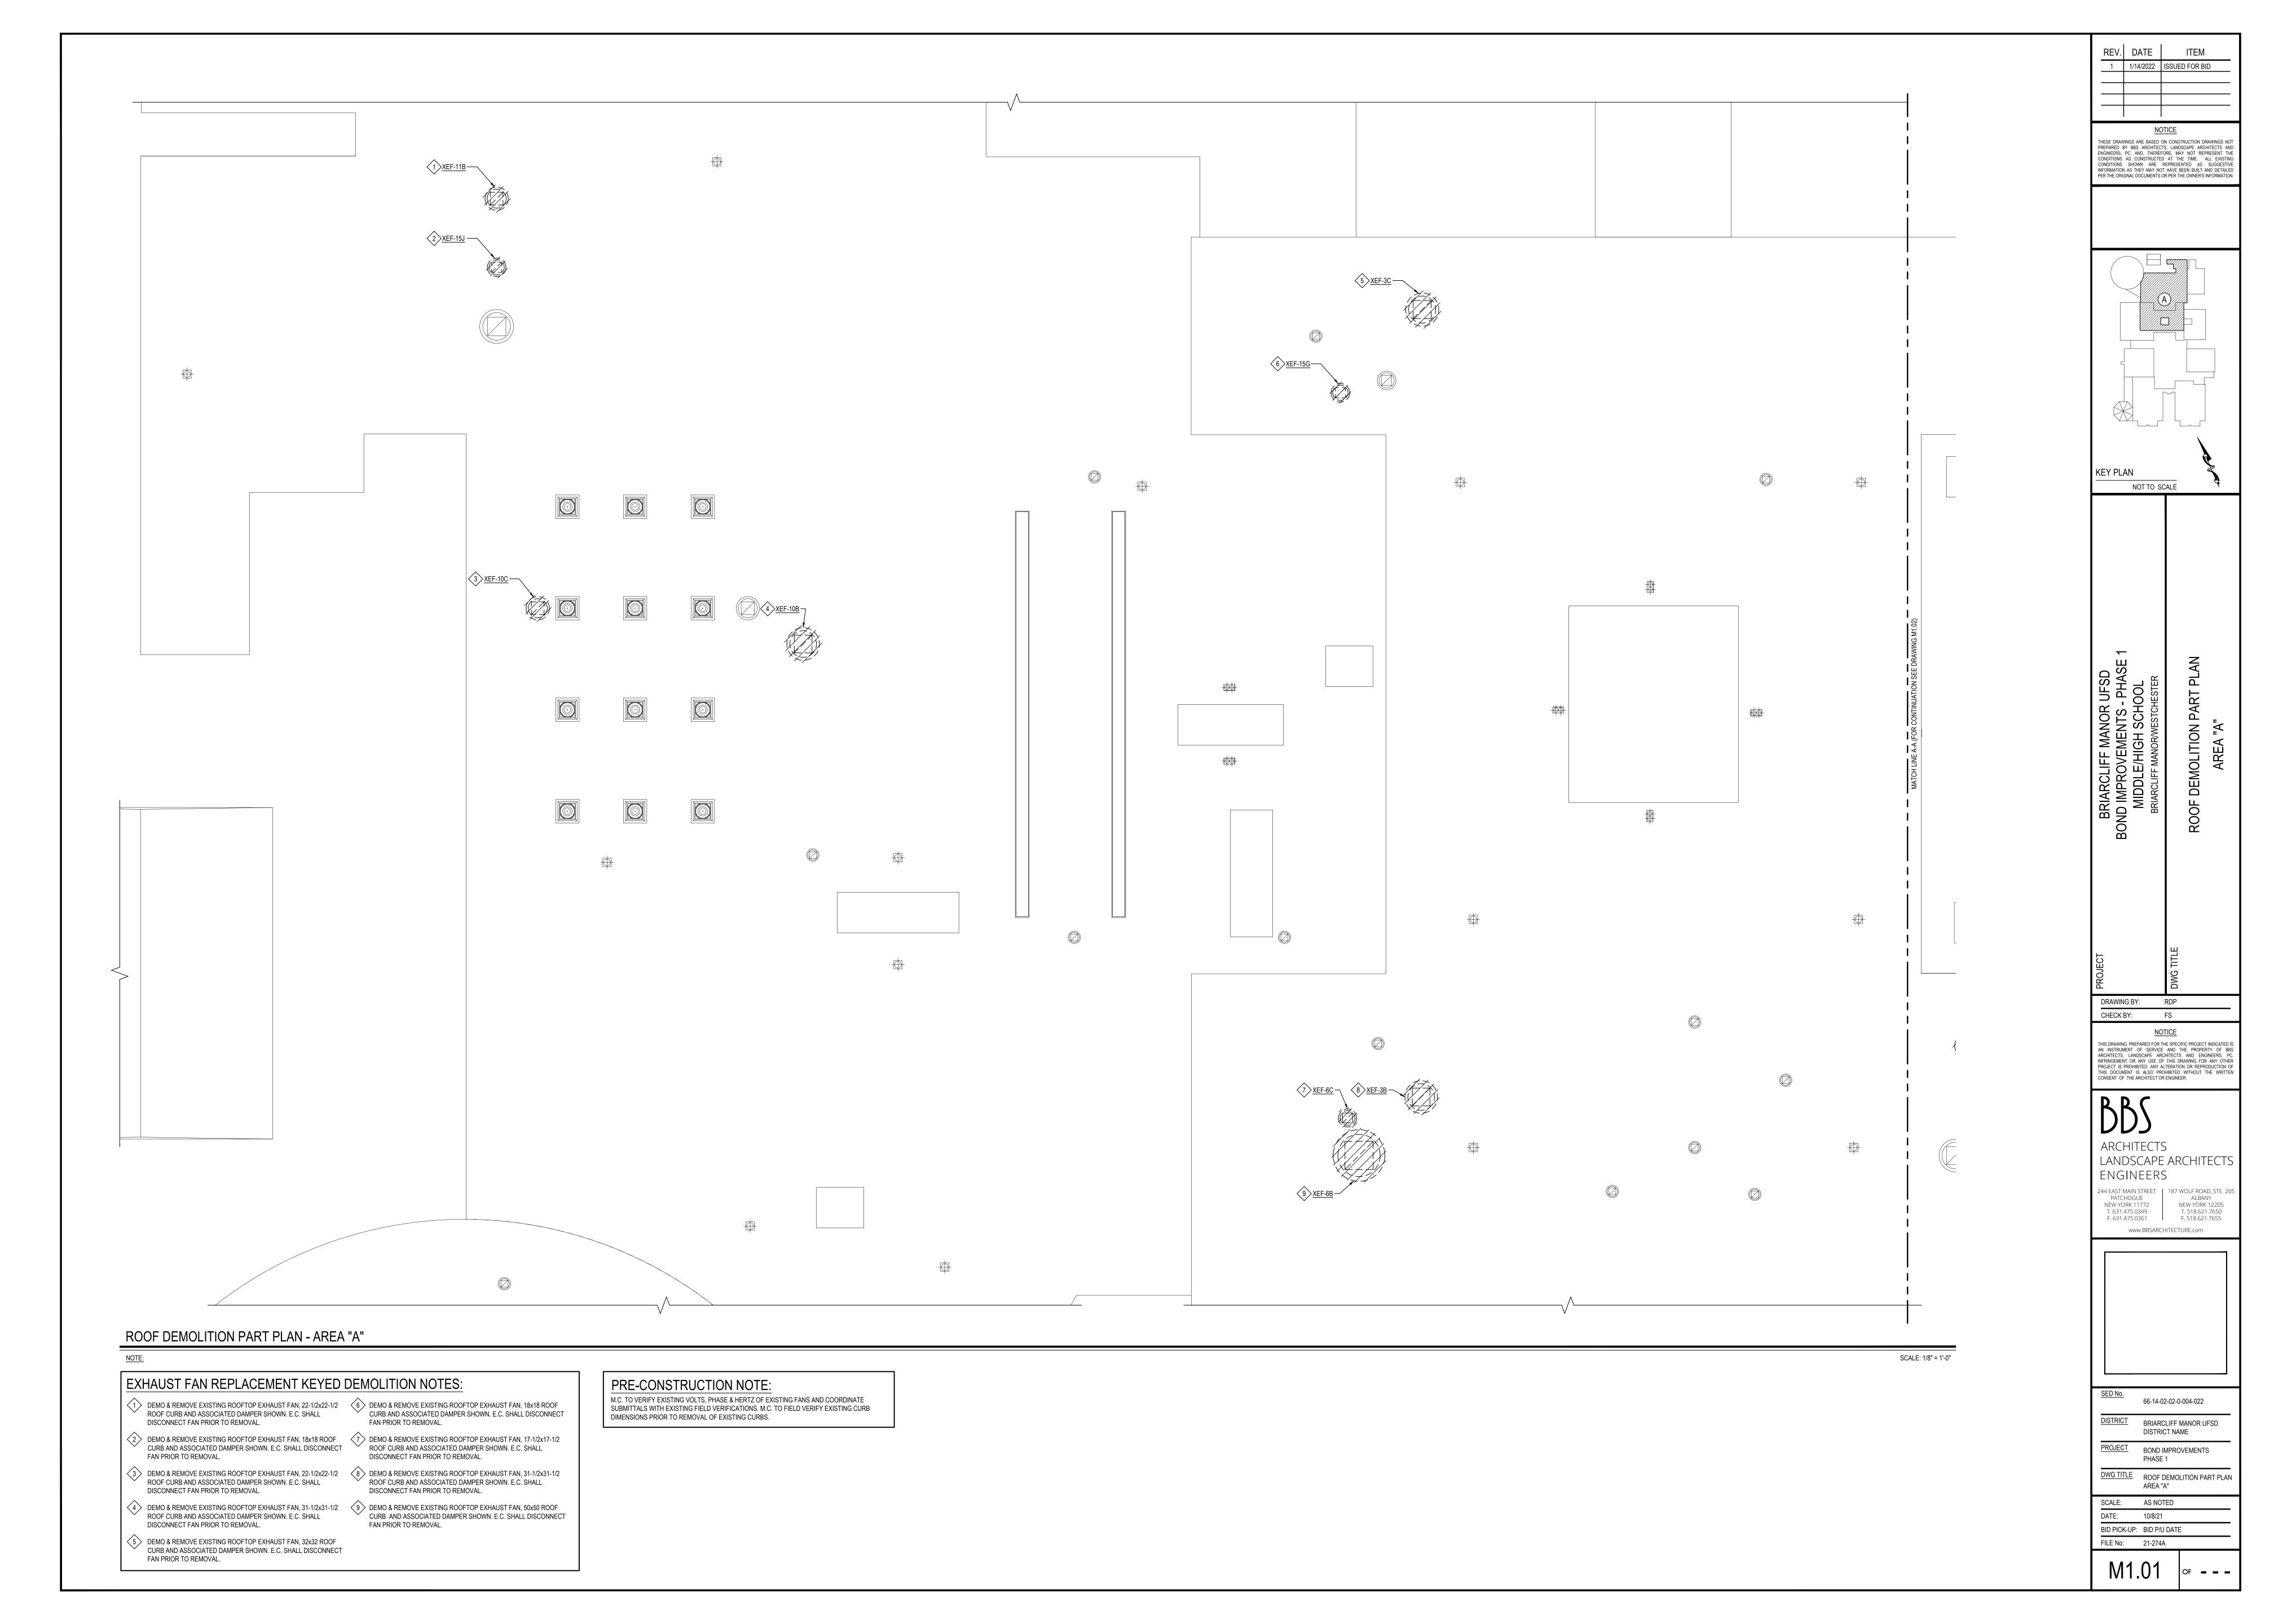



66-14-02-02-0-004-022 DISTRICT BRIARCLIFF MANOR UFSD DISTRICT NAME <u>PROJECT</u> BOND IMPROVEMENTS PHASE 1

<u>DWG TITLE</u> GENERAL NOTES, LEGENDS AND SYMBOLS SCALE: AS NOTED DATE: 10/8/21

BID PICK-UP: 1/17/2022

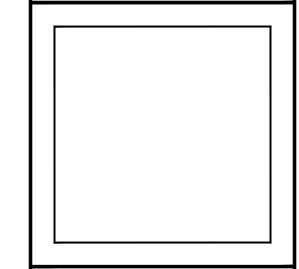FILE No: 21-274A M0.01



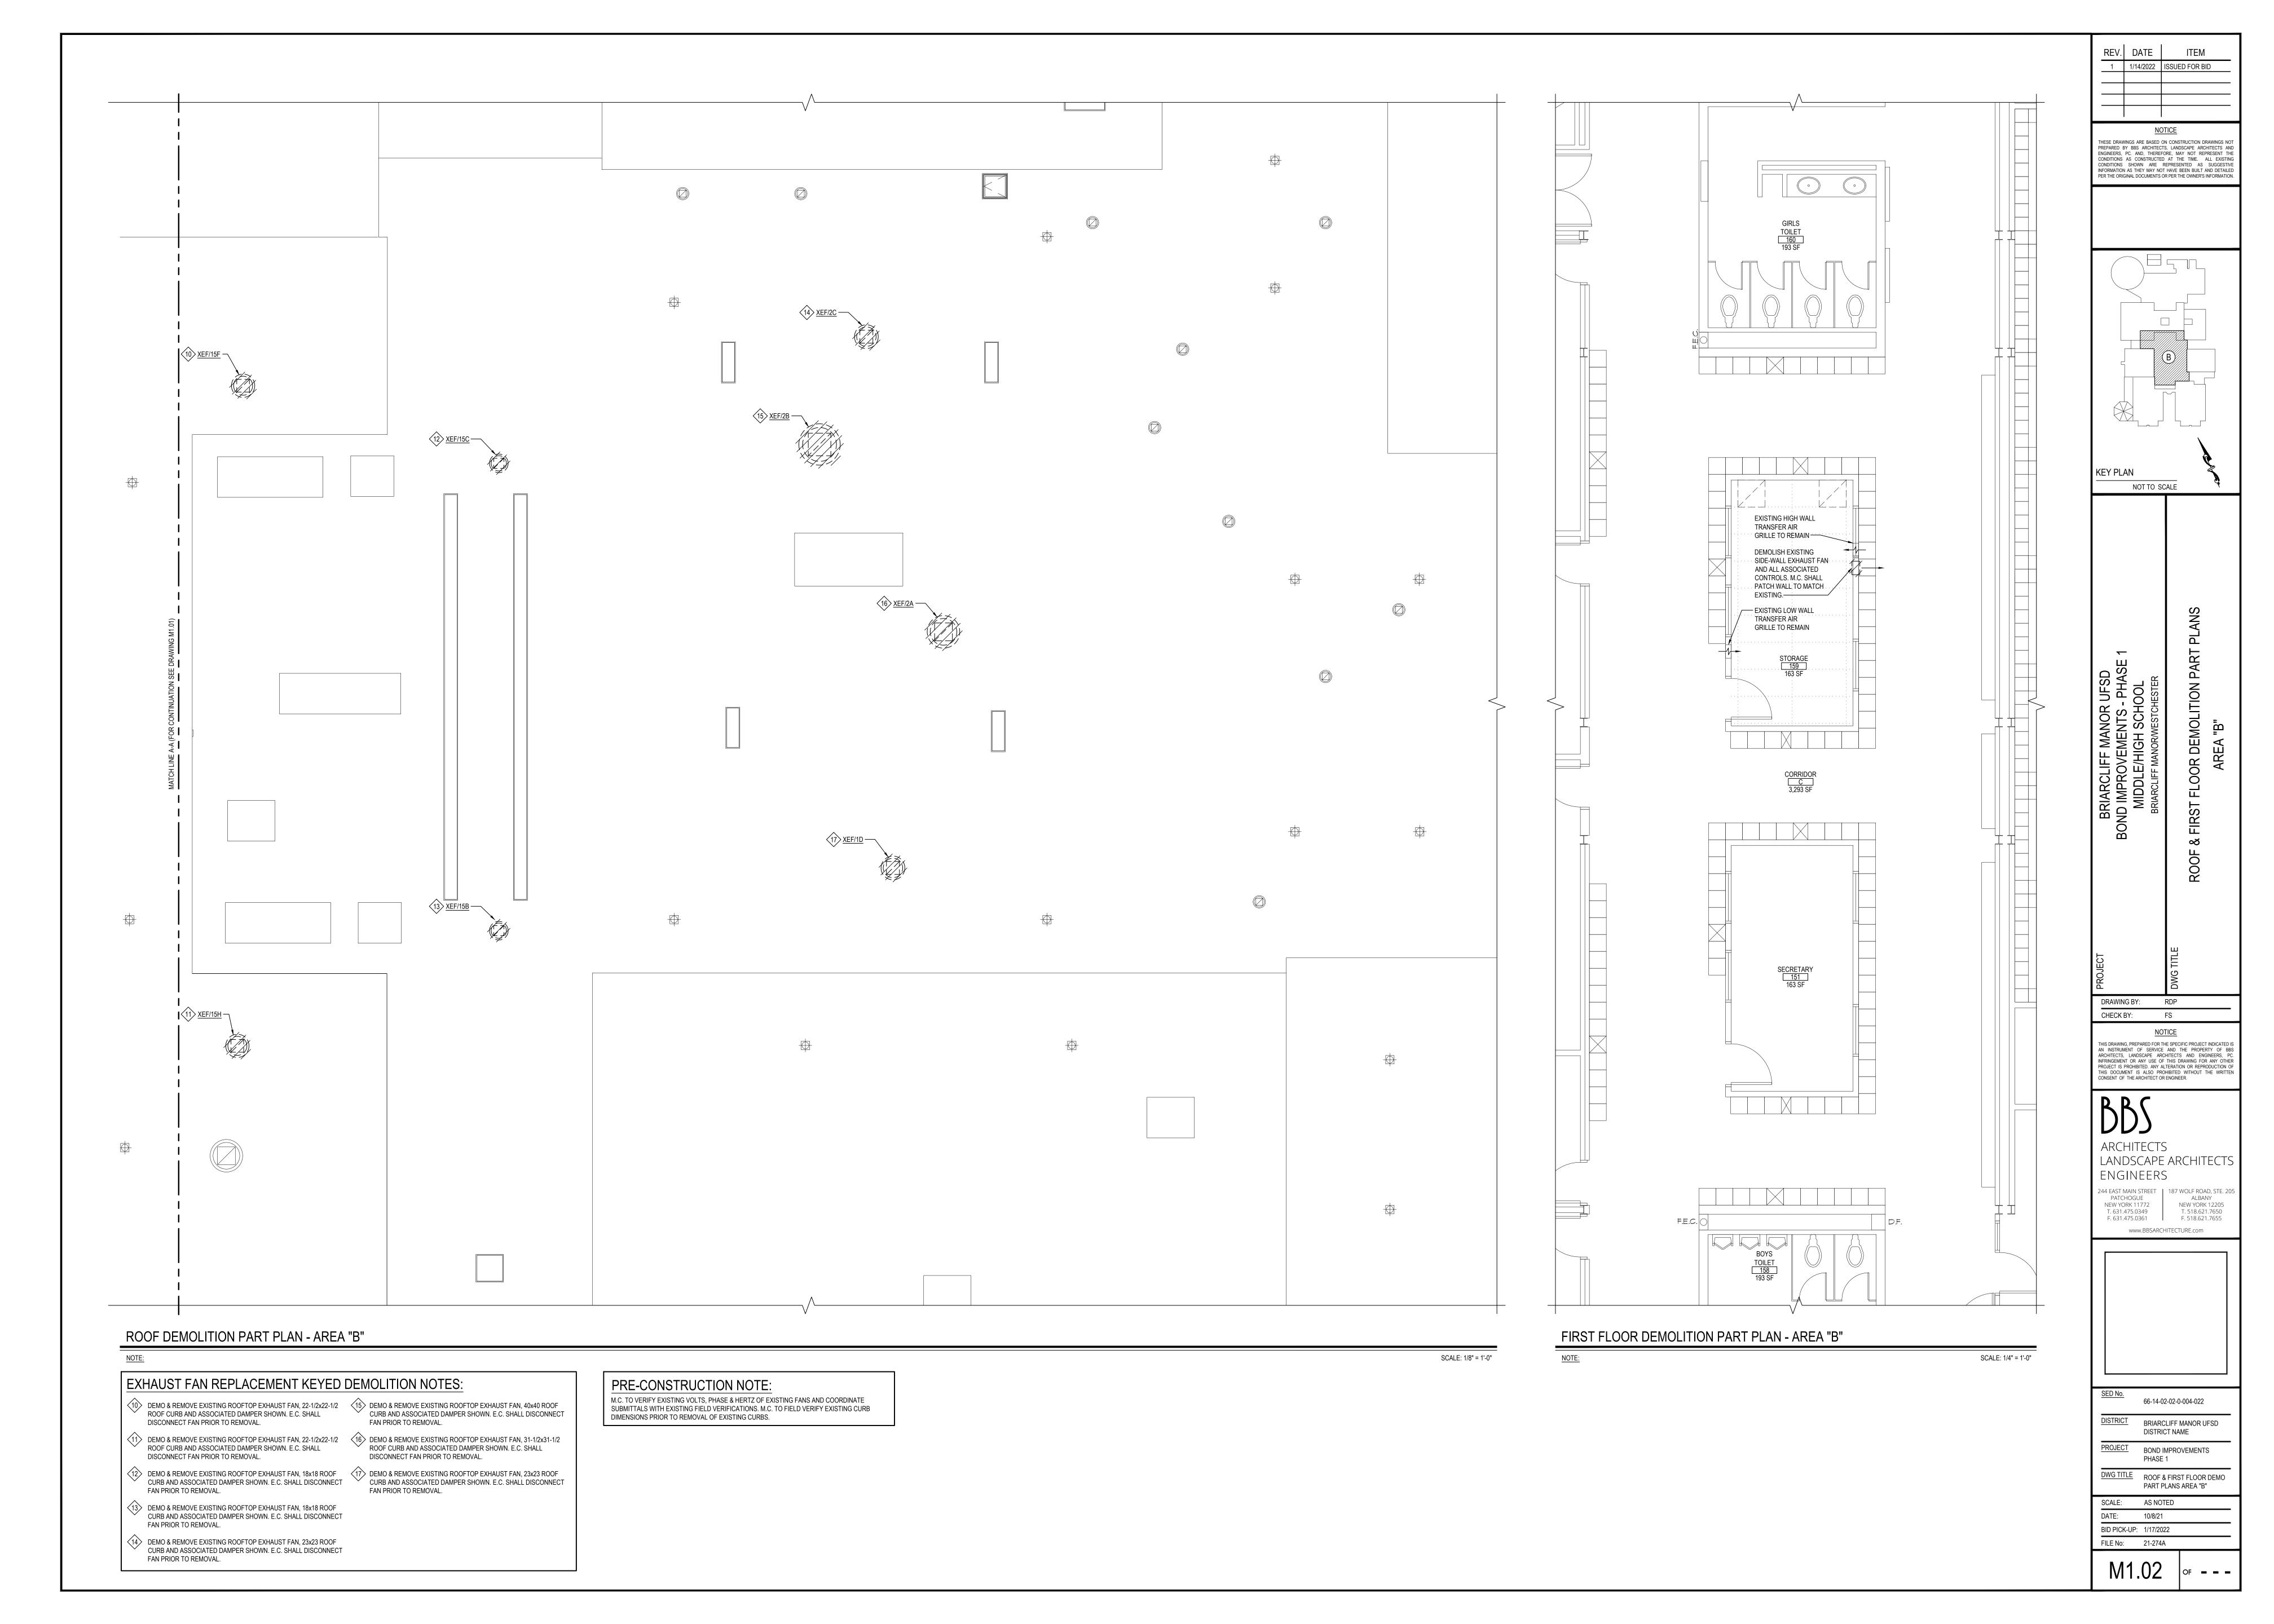



PROVIDE & MOUNT NEW FAN STARTERS & DISCONNECT SWITCHES FOR EACH FAN BEING REPLACED. COORDINATE LOCATIONS WITH THE ELECTRICAL CONTRACTOR. NEW STARTERS TO BE CAPABLE OF INTERFACE WITH THE BMS. ALL DISCONNECT SWITCHES MAY BE UNFUSED TYPE. ALL ELECTRICAL HARDWARE TO BE NEMA-1 (INDOOR) OR NEMA-3R (IF USED OUTDOORS). STARTERS, DISCONNECT SWITCH & FAN POWER WIRING SHALL BE PERFORMED BY THE ELECTRICAL CONTRACTOR. ALL CONTROL WIRING, WHETHER LOW OR LINE

VOLTAGE, SHALL BE PERFORMED BY THE MECHANICAL CONTRACTOR.

REV. DATE 1 1/14/2022 ISSUED FOR BID

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ROOF NEW HVAC PART P AREA "A"

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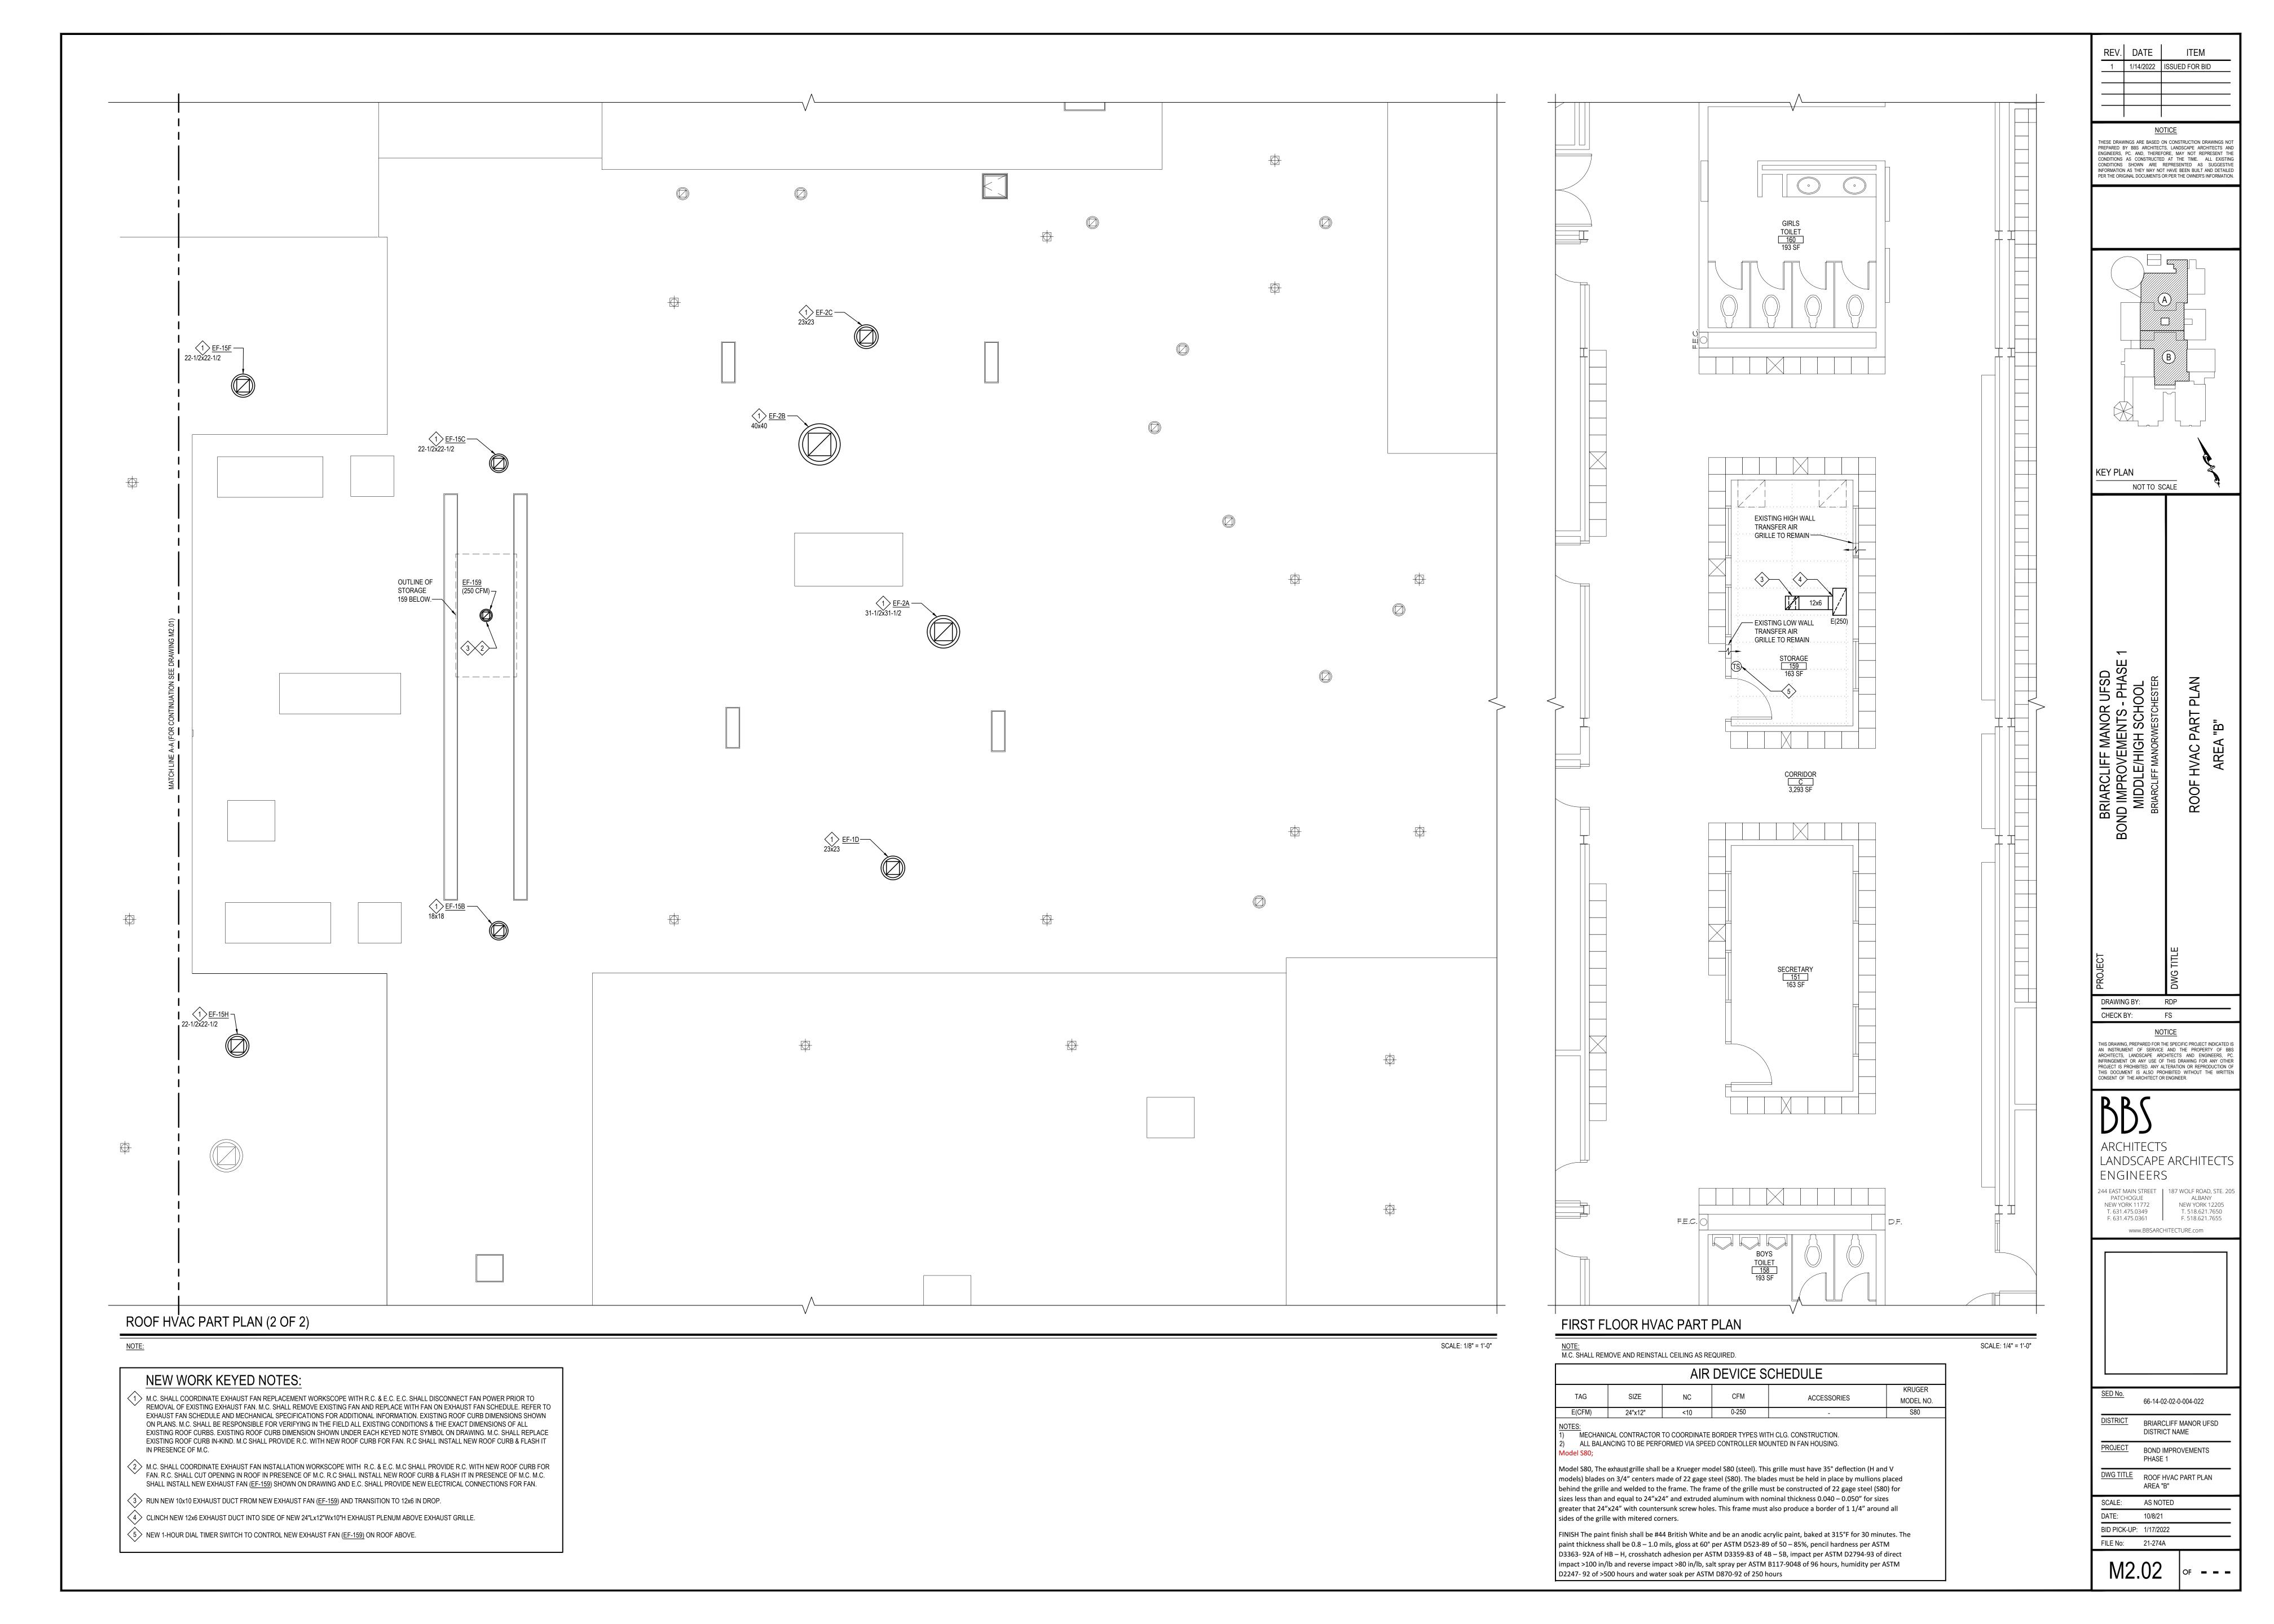
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66-14-02-02-0-004-022

DISTRICT BRIARCLIFF MANOR UFSD

DWG TITLE ROOF NEW HVAC PART PLAN

BID PICK-UP: BID P/U DATE FILE No: 21-274A



					EXHAUS	T FAN S	SCHEDULE				GREENHECK AS STD.
			4			MOTOR			WEIGHT	OPTIONS AND	
TAG	SERVICE	MODEL	CFM	ESP	FAN RPM	(HP)	INLET SONES	VOLT/PH	(LBS)	ACCESSORIES	NOTES
EF-1D	STORAGE ROOMS A102 & A103	G-100-VG	1000	0.75	1619	1/4	8.9	115/1	75.0	1,2,3,4,6,7,13	PROVIDE W/VCD-43 MOTORIZED DAMPER
EF-2A	OFFICE A111, TOILET A114, SHOWER RMS. A118, A119 & A120 & TOILET A115	GB-180-VGD-15	3790	0.75	1162	1 1/2	16.0	230/3	167.0	1,2,3,5,6,7	PROVIDE W/VCD-43 MOTORIZED DAMPER
EF-2B	DRYING ROOM A121, SHOWER RM. A117, FOOTBALL LOCKERS & TOILETS	GB-220-VGD-10	4000	0.75	738	1.0	12.9	208/3	197.0	1,2,3,5,6,7	PROVIDE W/VCD-43 MOTORIZED DAMPER
EF-2C	STOR. A105, CLEAT RM. A106, LAUNDRY A126 & STOR. A125	G-100-VG	1000	0.75	1619	1/4	8.9	115/1	75.0	1,2,3,4,6,7,13	PROVIDE W/VCD-43 MOTORIZED DAMPER
EF-3B	LIB. OFFICE B154, OFFICE B234, SEC'Y B233, CLASSROOM B213 & AV STOR. B235	GB-180-VGD-7	2500	0.75	924	3/4	10.7	208/3	169.0	1,2,3,5,6,7	PROVIDE W/VCD-43 MOTORIZED DAMPER
EF-3C	CONF., FACULTY, PROF. LIB., SEMINAR & CLASSROOM B166	G-140-VG	2510	0.75	1601	1.0	16.0	115/1	97.0	1,2,3,4,6,7,13	PROVIDE W/VCD-43 MOTORIZED DAMPER
EF-6B	SCIENCE STUDY AREA B121 & CHEM. STOR. B135	GB-330-VGD-15	7150	0.5	418	1 1/2	10.3	208/3	261.0	1,2,3,5,6,7	PROVIDE W/VCD-43 MOTORIZED DAMPER
EF-6C	FUME HOODS	CUE-099-VG	700	0.75	1529	1/4	8.8	115/1	51.0	1,2,3,4,6,7,13	PROVIDE W/VCD-43 MOTORIZED DAMPER
EF-10B	HOME ARTS C117/GRAPHICS C121	GB-220HP-VGD-10	3400	0.75	773	1.0	10.9	208/3	169.0	1,2,3,5,6,7	PROVIDE W/VCD-43 MOTORIZED DAMPER
EF-10C	FINE ARTS C138	G-100-VG	900	0.75	1543	1/4	8.1	115/1	75.0	1,2,3,4,6,7,13	PROVIDE W/VCD-43 MOTORIZED DAMPER
EF-11B	DISHWASHER C131	CUE-120-VG	1000	0.75	1292	1/4	10.5	115/1	85.0	1,2,3,4,6,7,13,14	PROVIDE W/VCD-43 MOTORIZED DAMPER
EF-15B	BOYS TOILET B169	G-098-VG	450	0.75	1488	1/4	8.4	115/1	40.0	1,2,3,4,6,7,13	PROVIDE W/VCD-43 MOTORIZED DAMPER
EF-15C	GIRLS TOILET B170	G-098-VG	450	0.75	1488	1/4	8.4	115/1	40.0	1,2,3,4,6,7,13	PROVIDE W/VCD-43 MOTORIZED DAMPER
EF-15F	GIRLS TOILET B275, MENS TOILET B176 & CUST. B188	G-099-VG	600	0.75	1425	1/4	8.9	115/1	75.0	1,2,3,4,6,7,13	PROVIDE W/VCD-43 MOTORIZED DAMPER
EF-15G	CUST. B189 & BOYS TOILET B220	G-099-VG	600	0.75	1425	1/4	8.9	115/1	75.0	1,2,3,4,6,7,13	PROVIDE W/VCD-43 MOTORIZED DAMPER
EF-15H	CUST. B137, TOILET B173 & BOOYS TOILET B221	G-099-VG	700	0.75	1496	1/4	9.7	115/1	75.0	1,2,3,4,6,7,13	PROVIDE W/VCD-43 MOTORIZED DAMPER
EF-15J	LOCKER/TOILET	G-099-VG	600	0.75	1425	1/4	8.9	115/1	75.0	1,2,3,4,6,7,13	PROVIDE W/VCD-43 MOTORIZED DAMPER
EF-159	COPY ROOM	G-099-VG	300	0.375	1520	1/10	7.1	115/1	48.0	2,3,4,6,13	PROVIDE W/VCD-43 MOTORIZED DAMPER

1. Aluminum roof curb adapter (factory mounted), contractor to field verify existing curb dimensions prior to fabrication

- 2. UL-705 Listing
- 3. Disconnect Switch 4. Varigreen motor w/balancing dial, soft start and thermal overload protection
- 5. Varigreen drive (factory mounted, wired and programmed) w/fan mounted speed adjustment dial. Field mounted VFDs will not be accepted
- 6. Roof Curb w/damper tray 7. Roof curb extension (aluminum construction) w/damper tray and access panel

- ADDITIONAL SCHEDULE NOTES:

 8. REFER TO SPECIFICATIONS FOR SEQUENCE OF OPERATIONS FOR NEW UNIT. PROVIDE FACTORY-AUTHORIZED REPRESENTATIVE TO BE PRESENT FOR START-UP, COMMISSIONING, AND
- TRAINING OF EQUIPMENT TO OWNER'S PERSONNEL.

 10. FACTORY-AUTHORIZED MANUFACTURER'S REPRESENTATIVE SHALL BE PRESENT FOR RIGGING OF EQUIPMENT.
- PROVIDE A 24" HEIGHT ROOF CURB.
- 12. PROVIDE BIRDSCREEN WITH FAN. 13. PROVIDE ALL SINGLE PHASE FANS WITH A GREENHECK VARIGREEN H.O.A. CONTROLLER.
- 14. NEW DISHWASHER FAN SHALL HAVE THE EXISTING ON/OFF SWITCH AND EXISTING INTERLOCKS TIED INTO NEW FAN.


		DA	MPER SCI	HEDULE	GREENHECK AS STD
				ACTUATOR	
TAG	SERVICE	MODEL	DUCT SIZE	VOLTAGE	NOTES
EF-1D	STORAGE ROOMS A102 & A103	VCD-43	16x16	120 VAC	ALUMINUM CONSTRUCTIUON w/AUX SWITCHES
EF-2A	OFFICE A111, TOILET A114, SHOWER RMS. A118, A119 & A120 & TOILET A115	VCD-43	21x21	24 VDC	ALUMINUM CONSTRUCTIUON w/AUX SWITCHES
EF-2B	DRYING ROOM A121, SHOWER RM. A117, FOOTBALL LOCKERS & TOILETS	VCD-43	28x28	24 VDC	ALUMINUM CONSTRUCTIUON w/AUX SWITCHES
EF-2C	STOR. A105, CLEAT RM. A106, LAUNDRY A126 & STOR. A125	VCD-43	16x16	120 VAC	ALUMINUM CONSTRUCTIUON w/AUX SWITCHES
EF-3B	LIB. OFFICE B154, OFFICE B234, SEC'Y B233, CLASSROOM B213 & AV STOR. B235	VCD-43	21x21	24 VDC	ALUMINUM CONSTRUCTIUON w/AUX SWITCHES
EF-3C	CONF., FACULTY, PROF. LIB., SEMINAR & CLASSROOM B166	VCD-43	21x21	120 VAC	ALUMINUM CONSTRUCTIUON w/AUX SWITCHES
EF-6B	SCIENCE STUDY AREA B121 & CHEM. STOR. B135	VCD-43	39x39	24 VDC	ALUMINUM CONSTRUCTIUON w/AUX SWITCHES
EF-6C	FUME HOODS	VCD-43	11x11	120 VAC	ALUMINUM CONSTRUCTIUON w/AUX SWITCHES
EF-10B	HOME ARTS C117/GRAPHICS C121	VCD-43	21x21	24 VDC	ALUMINUM CONSTRUCTIUON w/AUX SWITCHES
EF-10C	FINE ARTS C138	VCD-43	11x11	120 VAC	ALUMINUM CONSTRUCTIUON w/AUX SWITCHES
EF-11B	DISHWASHER C131	VCD-43	16x16	120 VAC	ALUMINUM CONSTRUCTIUON w/AUX SWITCHES
EF-15B	BOYS TOILET B169	VCD-43	16x16	120 VAC	ALUMINUM CONSTRUCTIUON w/AUX SWITCHES
EF-15C	GIRLS TOILET B170	VCD-43	16x16	120 VAC	ALUMINUM CONSTRUCTIUON w/AUX SWITCHES
EF-15F	GIRLS TOILET B275, MENS TOILET B176 & CUST. B188	VCD-43	16x16	120 VAC	ALUMINUM CONSTRUCTIUON w/AUX SWITCHES
EF-15G	CUST. B189 & BOYS TOILET B220	VCD-43	16x16	120 VAC	ALUMINUM CONSTRUCTIUON w/AUX SWITCHES
EF-15H	CUST. B137, TOILET B173 & BOOYS TOILET B221	VCD-43	16x16	120 VAC	ALUMINUM CONSTRUCTIUON w/AUX SWITCHES
EF-15J	LOCKER/TOILET	VCD-43	11x11	120 VAC	ALUMINUM CONSTRUCTIUON w/AUX SWITCHES
EF-159	COPY ROOM	VCD-43	10x10	120 VAC	ALUMINUM CONSTRUCTIUON w/AUX SWITCHES

1. Aluminum roof curb adapter (factory mounted), contractor to field verify existing curb dimensions prior to fabrication

2. UL-705 Listing 3. Disconnect Switch

4. Varigreen motor w/balancing dial, soft start and thermal overload protection

5. Varigreen drive (factory mounted, wired and programmed) w/fan mounted speed adjustment dial. Field mounted VFDs will not be accepted

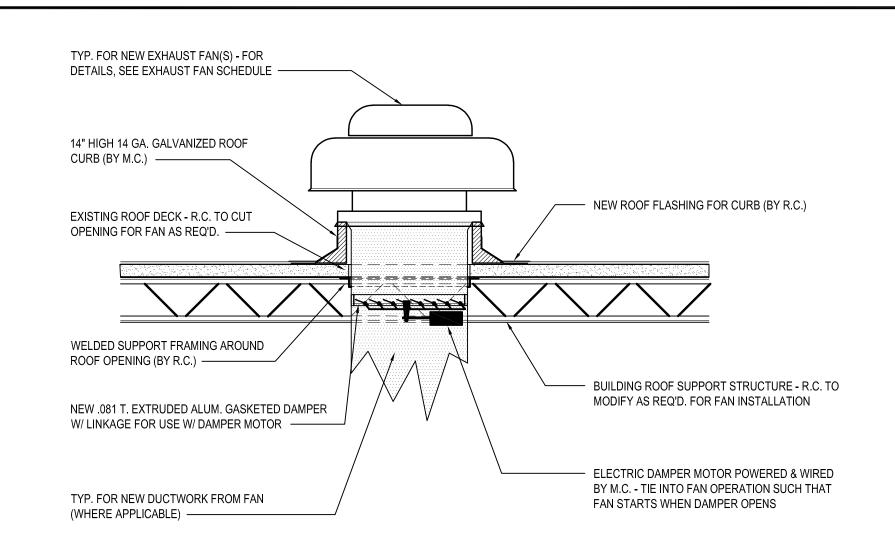

NEW ROOF MOUNTED EXHAUST FAN INSTALLATION

SCALE: N.T.S.

ROOF CURB - (BASIS: GREENHECK)

Roof Curb **Model: GPI**

Standard Construction Features:

- Roof Curb fits between the building roof and the fan mounted directly to the roof support structure - Constructed of either 18 ga galvanized steel or 0.064 in. aluminum - Straight Sided without a cant - 2 in. mounting flange - 3 lb density insulation -Height - Available from 12 in. to 42 in. as specified in 0.5 in. increments.


- The maximum roof opening dimension should not be greater than the "Actual" top outside dimension minus 2 in.. - The minimum roof opening dimension should be at least 2.5 in. more than the damper dimension or recommended duct - The Roof Opening Dimension may or may not be the same as the Structural Opening Dimension. - Damper Tray is optional and must be specified. Tray size is same as damper size.

- Security bars are optional and must be specified. Frames and gridwork are all 12 ga steel. Gridwork is welded to the frame and the frame is welded to the curb.

CONTROL DAMPER - (BASIS: GREENHECK)

Control Damper Model: VCD-43

Standard Construction Features:

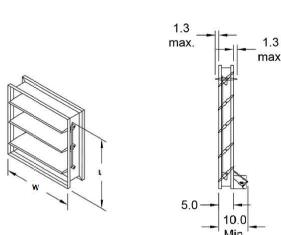

- Model VCD-43 is an extremely low leakage control damper for commercial control dampers - Aluminum channel frame - Heavy gauge extruded aluminum blades, airfoil shape - Side mounted steel linkage is out of airstream, concealed in frame - Extruded silicone rubber blade seals - Axles are steel and 0.5 in. dia. -Synthetic axle bearings - Width and height furnished approximately 0.25 in. undersized - Field wiring is required to individual components


ID #:	Tag:	Quantity:	W (in.):	H (in.):	Act Qty:	Actuator Model
2	EF-1D	1	12	12	1	MS4104F1210
3	EF-2A	1	18	18	1	TFB24-S
4	EF-2B	1	24	24	1	TFB24-S
5	EF-2C	1	12	12	1	MS4104F1210
6	EF-3B	1	18	18	1	TFB24-S
7	EF-3C	1	16	16	1	MS4104F1210
8	EF-6B	1	36	36	1	MS8105A1130
9	EF-6C	1	12	12	1	MS4104F1210
10	EF-10B	1	24	24	1	TFB24-S
11	EF-10C	1	12	12	1	MS4104F1210
12	EF-11B	1	12	12	1	MS4104F1210
13	EF-15B	1	12	12	1	MS4104F1210
14	EF-15C	1	12	12	1	MS4104F1210
15	EF-15F	1	12	12	1	MS4104F1210
16	EF-15G	1	12	12	1	MS4104F1210
17	EF-15H	1	12	12	1	MS4104F1210
18	EF-15J	1	12	12	1	MS4104F1210
21	EF-NEW	1	10	10	1	MS4104F1210

Notes: All dimensions shown are in units of in. Width And height furnished approximately 0.25 in. undersize

REV.	DATE	ITEM
1	1/14/2022	ISSUED FOR BID

<u>NOTICE</u>

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RDP

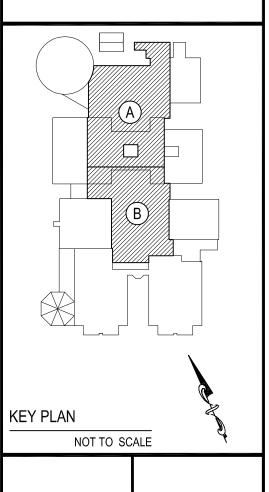DRAWING BY:

CHECK BY:

ARCHITECTS LANDSCAPE ARCHITECTS ENGINEERS

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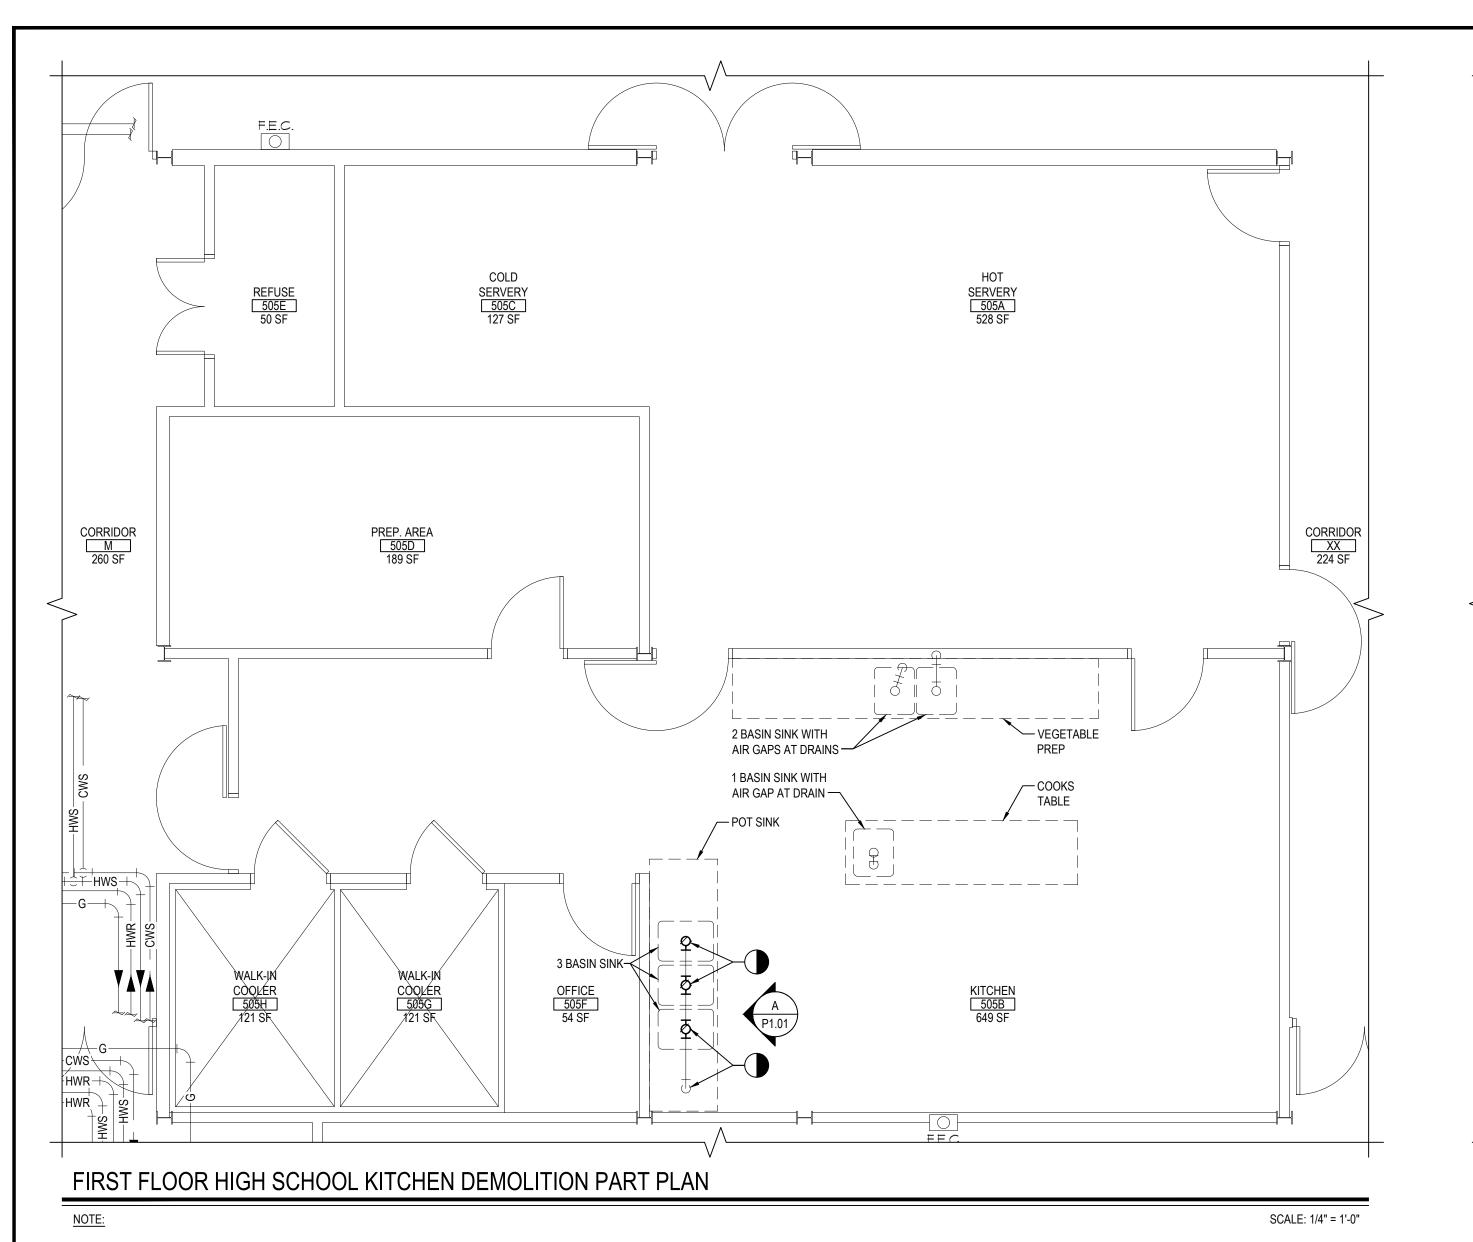
66-14-02-02-0-004-022

DISTRICT BRIARCLIFF MANOR UFSD PROJECT BOND IMPROVEMENTS

DWG TITLE SCHEDULES AND DETAILS

SCALE: AS NOTED

BID PICK-UP: 1/17/2022 FILE No: 21-274A



-1-1/4" BOILER/CHILLED WATER MAKE-UP BACKFLOW PREVENTER (2) EXISTING RAYPAK HIGH DELTA DOMESTIC HOT WATER HEATERS (STACKED) -(2) EXISTING STORAGE TANK CIRCULATOR PUMPS √
□EXISTING DOMESTIC HQ7 |||WATER STORAGE TANK -XCP/1 (DISCONNECTED) **EXISTING BOILER #3 EXISTING BOILER #1** EXISTING BOILER #2 -MIXING VALVE STATION ELECTRICAL BOILER ROOM DEMOLITION PART PLAN

KITCHEN KEYED DEMOLITION NOTES: 1 P.C. TO REMOVE SECTION OF 2"Ø COPPER DRAIN PIPE AS INDICATED

ELEVATION - A

EXISTING 3 BASIN SINK ¬

GENERAL NOTES

- REMOVAL & RELOCATION OF CERTAIN EXISTING WORK SHALL BE NECESSARY FOR THE PERFORMANCE OF THE NEW WORK SHOWN HEREIN. ALL EXISTING CONDITIONS ARE NOT COMPLETELY DETAILED ON THE DRAWINGS. THE CONTRACTOR SHALL SURVEY THE SITE & MAKE ALL NECESSARY CHANGES BASED ON EXISTING CONDITIONS AS REQUIRED FOR PROPER DEMOLITION OF EXISTING WORK & SHALL INCLUDE ALL MATERIALS & LABOR FOR SAME IN HIS BID PRICE. NO ALLOWANCE WILL BE MADE FOR FAILURE TO DO SO.
- PRIOR TO SUBMITTING A BID, THE CONTRACTOR SHALL VISIT THE PREMISES OF THE PROPOSED WORK & SHALL CAREFULLY EXAMINE THE ENGINEERING DRAWINGS, EXISTING CONDITIONS & LIMITATIONS THEREOF. VERIFY ACTUAL LOCATIONS WHERE THE NEW PIPING WILL BE ROUTED, COORDINATE WITH NEW & EXISTING WORK & PROVIDE CLEARANCE W/ BUILDING STRUCTURE, OTHER SERVICES, ETC.. THE CONTRACTOR SHALL INCLUDE ALL COSTS WHATSOEVER WHICH ARE INCURRED AS A RESULT OF LIMITATIONS OF THE EXISTING & NEW CONDITIONS. LATER CLAIMS FOR EXTRA LABOR, EQUIPMENT, MATERIALS, ETC. REQUIRED DUE TO DIFFICULTIES WHICH COULD HAVE BEEN FORESEEN WILL NOT BE CONSIDERED AS EXTRA WORK.
- INSTALL WORK SO AS TO BE READILY ACCESSIBLE FOR OPERATING, MAINTENANCE & REPAIR. MINOR DEVIATIONS FROM DRAWINGS MAY BE MADE TO ACCOMPLISH THIS, BUT CHANGES OF MAGNITUDE WHICH INVOLVE EXTRA COST SHALL NOT BE MADE WITHOUT APPROVAL.
- INVESTIGATE EACH SPACE THROUGH WHICH EQUIPMENT MUST BE MOVED. WHEN NECESSARY. EQUIPMENT SHALL BE SHIPPED FROM MANUFACTURER IN CRATED SECTIONS OF SIZE SUITABLE FOR MOVING THROUGH AREAS AVAILABLE. ASCERTAIN FROM BUILDING OWNER AT WHAT TIMES OF DAY EQUIPMENT MAY BE MOVED THROUGH THE BUILDING.
- COORDINATE THE EXACT SIZE & LOCATION OF NEW OPENINGS WITH EXISTING STRUCTURE. PATCH / INSULATE AS REQUIRED. CONTRACTOR SHALL FIRESTOP ALL PENETRATIONS FROM NEW PIPING, CONDUIT, DUCTWORK, ETC. THROUGH EXISTING OR NEW FIRE/ SMOKE BARRIERS. REFER TO SPECIFICATION SECTION 15511 FOR FURTHER DETAILS.
- IT IS THE INTENT OF THIS CONTRACT FOR REMAINING SYSTEMS TO BE LEFT IN GOOD WORKING ORDER, READY FOR OPERATION. COORDINATE ANY REQUIRED SYSTEM SHUTDOWNS WITH OWNER 48 HOURS IN ADVANCE. EXISTING SYSTEM SHUTDOWNS WILL NOT BE PERMITTED IF THEY INTERFERE WITH THE DAILY OPERATIONS OF THE BUILDING. CONTRACTOR WILL BE REQUIRED TO TAKE PROPER PRECAUTIONS AGAINST DAMAGING OR DISRUPTING BUILDING SYSTEMS, WIRING, PIPING OR CONTROL TUBING. ANY DAMAGE TO THESE ITEMS SHALL BE REPAIRED AT THE CONTRACTOR'S COST AS A PART OF THIS
- THE CONTRACTOR SHALL REPAIR / RESTORE TO ORIGINAL CONDITION ANY EXISTING EQUIPMENT OR MATERIALS DAMAGED IN THE PROCESS OF INSTALLATION, OR DEMOLITION TO THE SATISFACTION OF THE OWNER'S REPRESENTATIVE. CONTRACTOR SHALL MAKE REPAIRS USING THE SAME OR EQUIVALENT MATERIALS. WORK WILL BE PERFORMED AT THE CONTRACTOR'S COST.
- CONTRACTOR SHALL INCUR ANY COSTS OR BURDENS ASSOCIATED WITH LOST OR STOLEN EQUIPMENT / MATERIALS.
- DURING THE LIFE OF THE CONTRACT PERIOD. CONTRACTOR SHALL REMOVE ALL RUBBISH / EXCESS MATERIAL ACCUMULATED AS A RESULT OF HIS OPERATIONS ON A DAILY BASIS. ALL AREAS / EQUIPMENT AFFECTED UNDER THIS CONTRACT SHALL BE KEPT CLEAN OF DUST / DEBRIS. ALL AREAS SHALL RECEIVE A FINAL CLEANING PRIOR TO FINAL ACCEPTANCE BY THE OWNER.

- 10. PROVIDE FOR LEGAL REMOVAL / DISPOSAL OF ALL RUBBISH / DEBRIS FROM THE BUILDING & SITE. PROTECT ALL WORK NOT SLATED FOR DEMOLITION.
- 1. THIS CONTRACTOR SHALL COORDINATE HIS WORK WITH ALL OTHER TRADES PRIOR TO SCHEDULING THE WORK. WORK SHALL BE PERFORMED IN PROPER SEQUENCE, AS AGREED TO BY ALL TRADES. ANY COSTS INCURRED BY THE OWNER DUE TO IMPROPER SEQUENCING OF WORK WILL BE PAID FOR BY THIS CONTRACTOR.

12. CONTRACTOR SHALL OBTAIN ALL PERMITS, PAY ALL FEES, CONNECTION CHARGES, ETC. ASSOCIATED

5. SUBSTITUTED EQUIPMENT OF GREATER OR LARGER POWER, DIMENSIONS, CAPACITIES & RATINGS MAY BE

FURNISHED PROVIDED THAT SAID EQUIPMENT IS APPROVED IN WRITING PRIOR TO ORDER. ANY

CONNECTING MECHANICAL SERVICES, ELECTRICAL SERVICES, BASES, STRUCTURAL APPURTENANCES,


- WITH THE WORK UNDER THEIR CONTRACT. 13. PAINT / TOUCH UP ALL SURFACES MARRED AS A RESULT OF THE PERFORMANCE OF THE CONTRACT
- 4. THE MECHANICAL CONTRACTOR SHALL REFER TO / REVIEW ALL OTHER TRADE DRAWINGS IN THE BID PACKAGE & SHALL BE RESPONSIBLE FOR / PERFORM ALL WORK INDICATED AS (M.C.) MECHANICAL WORK AS A PART OF THE BASE BID UNLESS SPECIFICALLY NOTED OTHERWISE.
- ETC. REQUIRED TO BE INCREASED DUE TO THE USE OF SAID EQUIPMENT WILL BE PAID FOR IN FULL BY THE MECHANICAL CONTRACTOR, INCLUDING ANY ADDITIONAL REQUIRED ENGINEERING FEES. 6. EACH PIECE OF EQUIPMENT SHALL BE PROVIDED WITH A PERMANENT TYPE LAMINATED, BLACK FINISH, WHITE CORE, PHENOLIC NAMEPLATE, NAMEPLATES SHOULD INDICATE THE NAME & NUMBER OF THE UNIT.
- UNIT VOLTAGE, & ANY INTERLOCK REFERENCE. STARTERS / DISCONNECT SWITCHES SHOULD ALSO BE EQUIPPED WITH AN IDENTICAL NAMEPLATE WITH THE SAME INFORMATION. 17. "ATTIC STOCK" - UPON COMPLETION OF THE PROJECT, MECHANICAL CONTRACTOR SHALL COMPLETELY
- REMOVE / DISPOSE OF FILTERS USED DURING CONSTRUCTION & START-UP PROCEDURES. INSTALL NEW FILTERS IN ALL EQUIPMENT, MERV-8 OR BETTER UPON TURN OVER OF THE PROJECT TO THE OWNER. IN ADDITION, PROVIDE (2) COMPLETE SETS OF FILTERS FOR EACH PEICE OF EQUIPMENT & TURN OVER TO
- 18. MECHANICAL CONTRACTOR SHALL PROVIDE (1) SPARE MOTOR FOR EACH SIZE MOTOR USED ON THE PROJECT. IN INSTANCES WHERE MORE THAN TEN OF THE SAME MOTOR ARE USED, MECHANICAL CONTRACTOR SHALL PROVIDE (1) SPARE MOTOR FOR EVERY TEN MOTORS OF A GIVEN SIZE USED ON THE PROJECT.
- 19. MAINTENANCE MANUAL: UPON COMPLETION OF THE PROJECT, THE MECHANICAL CONTRACTOR SHALL PROVIDE A BINDER CONTAINING THE OPERATIONS & MAINTENANCE MANUALS FOR EACH NEW PEICE OF EQUIPMENT INSTALLED UNDER THIS PROJECT. THE FIRST SECTION OF THE MAINTENANCE MANUAL SHALL CONTAIN A LIST OF EACH PEICE OF EQUIPMENT, COMPLETE WITH INFORMATION SHOWING APPROPRIATE REPLACEMENT FILTER SIZES / TYPES, APPROPRIATE REPLACEMENT BELT SPECIFICATIONS, REPLACEMENT MOTOR SPECIFICATIONS. REPLACEMENT BEARING SPECIFICATIONS. VOLTAGES OF UNIT, ETC. THIS SHALL SERVE AS A WRITTEN DATABASE DESCRIBING ALL MAINTENANCE INFORMATION FOR EACH NEW PEICE OF EQUIPMENT USED.

ABBREVIATIONS . ABOVE FINISHED FLOOR NOM. . BACKDRAFT DAMPER . COLD WATER SUPPLY. CUBIC FEET OF AIR PER MINUTE . DIAMETER FLOAT & THERMOSTATIC FEET PER MINUTE FLAT OVAL DUCTWORK GALLONS PER.HOUR GALLONS PER MINUTE HANDICAPPED HEATING SYSTEM HOT WATER SUPPLY. HORSEPOWER INSIDE DIAMETER WATER TEMPERATURE DROP. WATER TEMPERATURE RISE

BOILER ROOM KEYED DEMOLITION NOTES:

 $\langle 1 \rangle$ P.C. TO REMOVE EXISTING HOT WATER MIXING VALVE AND REPLACE WITH NEW. REFER TO SCHEDULES AND SPECIFICATIONS FOR ADDITIONAL INFORMATION.

(2) P.C. TO REPLACE EXISTING HOT WATER AQUASTAT, LIKE-IN-KIND.

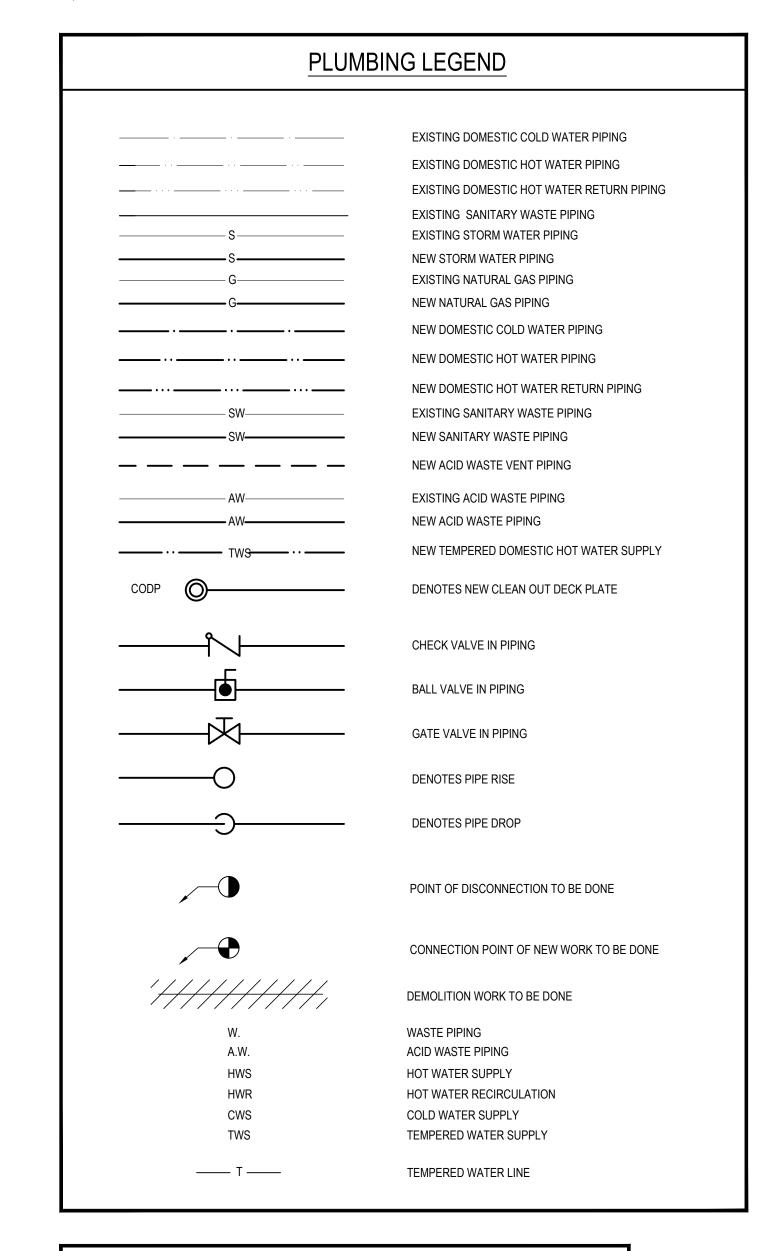

GENERAL UTILITY NOTES

SCALE: 1/4" = 1'-0"

PIPING LOCATIONS ARE SCHEMATIC AND EACH TRADE SHALL RUN PIPING IN ORDER TO USE THE LEAST AMOUNT OF MATERIAL. PLUMBING CONTRACTOR SHALL PROVIDE VENT PIPING FOR ALL PLUMBING FIXTURES AS

PLUMBING NOTE: PIPING SIZES SEE SCHEDULE THIS SHEET.


EACH TRADE CONTRACTOR TO VERIFY SIZE OF SERVICE REQUIRED, SIZE AND EXACT LOCATION OF CONNECTIONS TO EACH PIECE OF EQUIPMENT.

FLOOR & WALL PENETRATION NOTES FOR PLUMBING CONTRACTOR

PLUMBING CONTRACTOR SHALL BE RESPONSIBLE FOR ALL PIPING WALL, FLOOR, & CEILING PENETRATIONS& PATCHING. IF TEST RESULTS INDICATE POSSIBILITY OF LEAD-CONTAINING AND/OR ASBESTOS-CONTAINING MATERIALS AT THE PENETRATION LOCATIONS, THE P.C. SHALL CARRY THE ASSOCIATED ABATEMENT COSTS WITHIN HIS/HER BASE BID SUBMITTED.

REV. DATE 1 1/14/2022 ISSUED FOR BID

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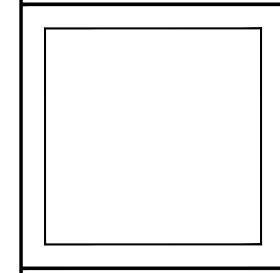
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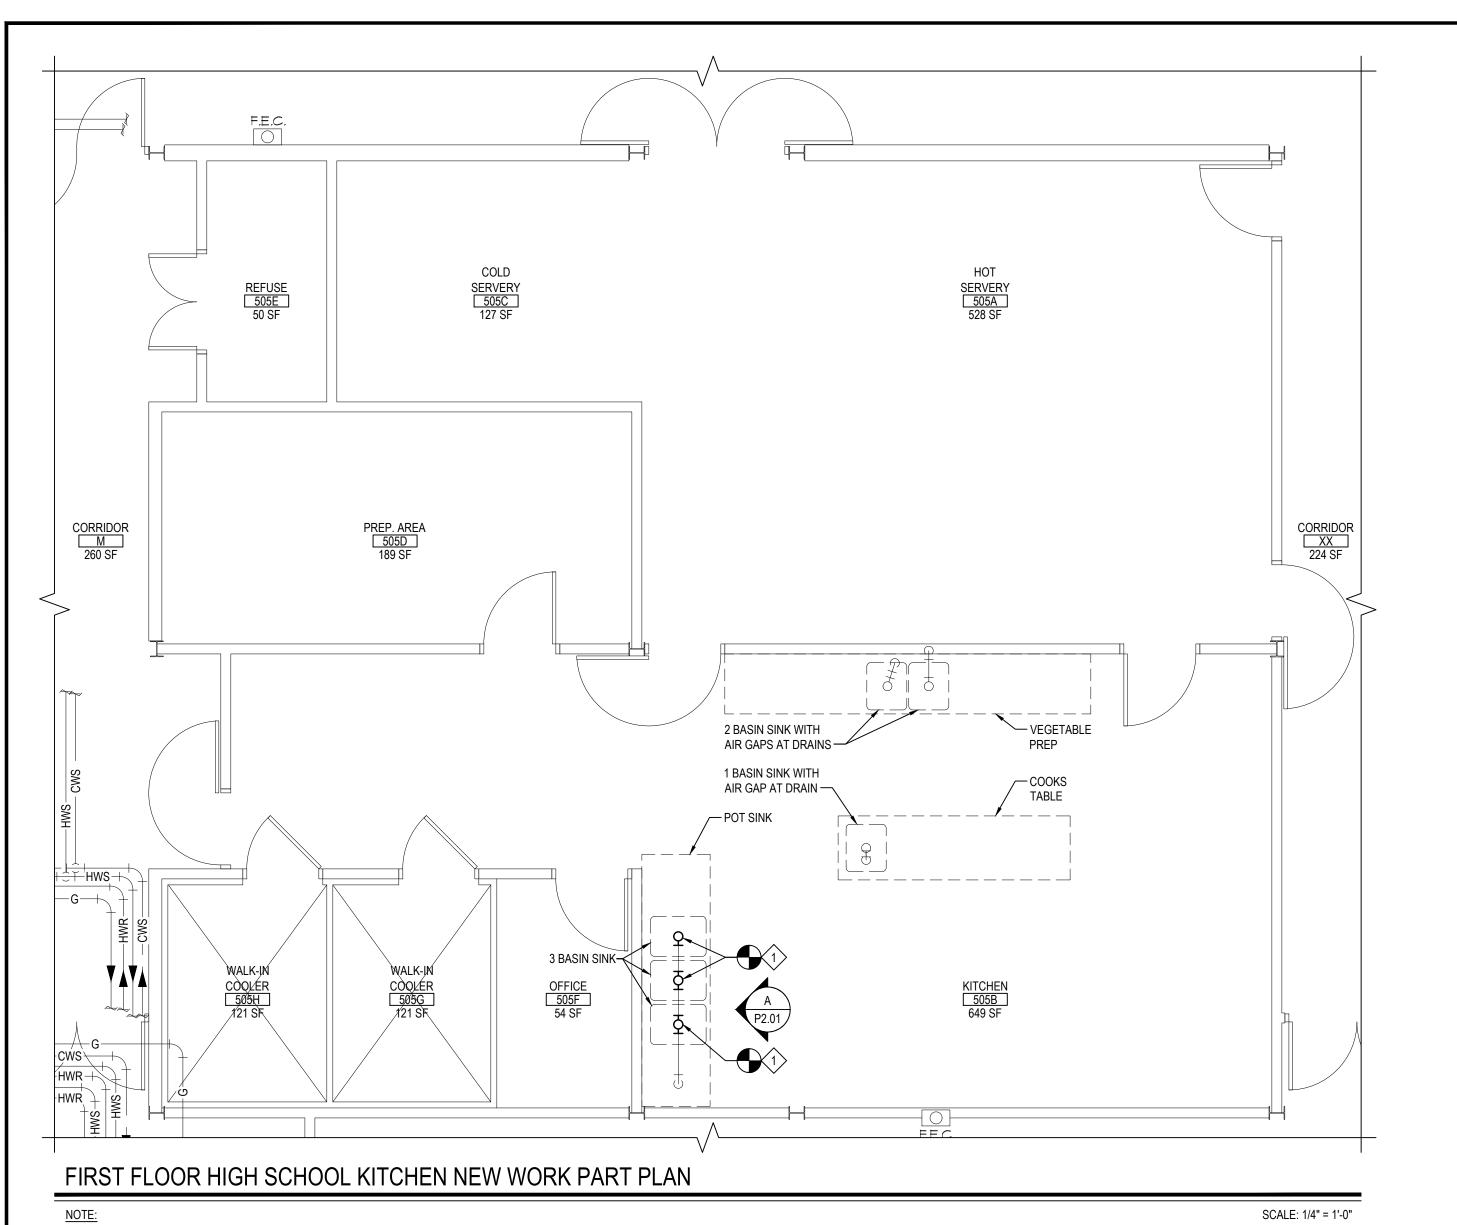
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<u>SED NO.</u>	66-14-02-02-0-004-022
DISTRICT	BRIARCLIFF MANOR UFSD DISTRICT NAME
PROJECT	BOND IMPROVEMENTS PHASE 1
DWG TITLE	FIRST FLOOR DEMOLITION PART PLANS AREA "A"

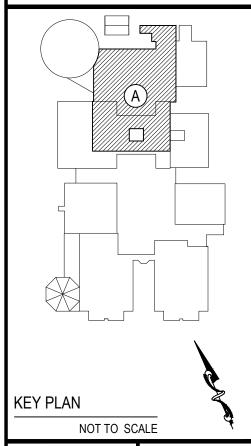SCALE: AS NOTED DATE: 10/8/21 BID PICK-UP: BID P/U DATE FILE No: 21-274A




SCALE: 1/2" = 1'-0"

ELEVATION - A

KITCHEN KEYED NEW WORK NOTES:

- P.C. TO PROVIDE & INSTALL 2" x 4" COPPER REDUCER. P.C. TO PROVIDE A MINIMUM OF 1" AIR-GAP BETWEEN TOP OF REDUCER AND BOTTOM OF SINK DRAIN PIPE (TYPICAL FOR 3).
- P.C. TO PROVIDE & INSTALL STAINLESS STEEL FLOOR MOUNTED CLAMP-STYLE PIPE SUPPORTS. ANCHOR TO FLOOR TO ENSURE THAT DRAIN PIPE IS IMMOBILIZED IN ALL DIRECTIONS (TYPICAL FOR 2).

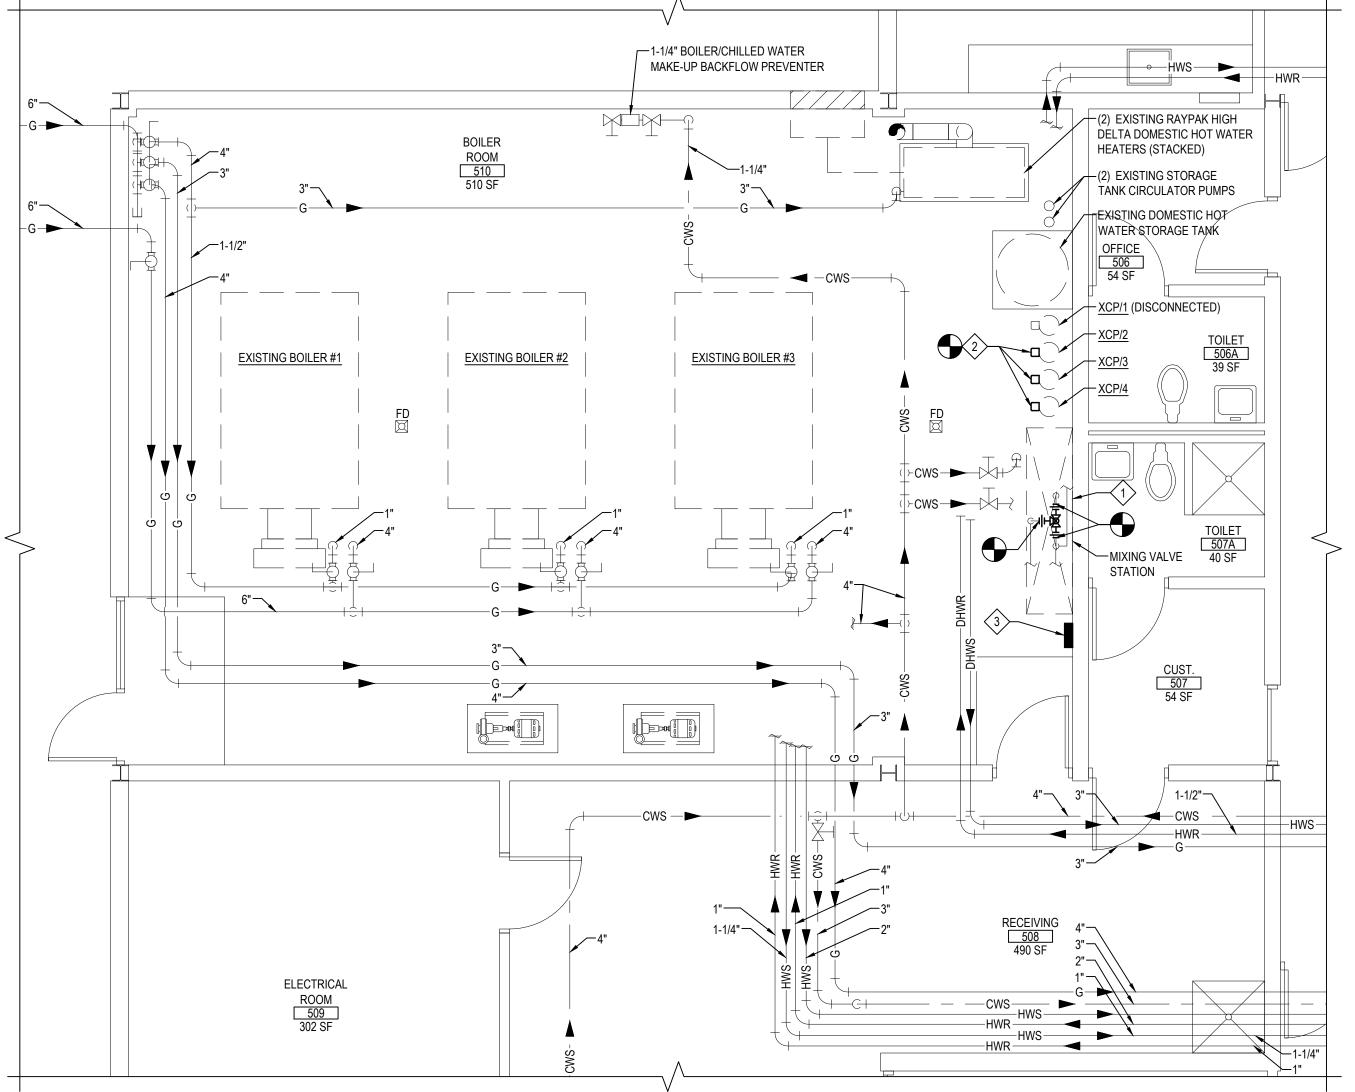


BOILER ROOM NEW WORK PART PLAN

NOTE:

BOILER ROOM KEYED NEW WORK NOTES:


- P.C. TO REMOVE EXISTING HOT WATER MIXING VALVE AND REPLACE WITH NEW. REFER TO SCHEDULES AND SPECIFICATIONS FOR ADDITIONAL INFORMATION. SEE DETAILS, DRAWING NO. P7.01.
- P.C. TO REPLACE EXISTING HOT WATER AQUASTAT, LIKE-IN-KIND. REFER TO SCHEDULES AND SPECIFICATIONS FOR ADDITIONAL INFORMATION. SEE DETAILS, DRAWING NO. P7.01.
- 3 PROVIDE NEW 4-CHANNEL TIME-CLOCK.

SCALE: 1/4" = 1'-0"

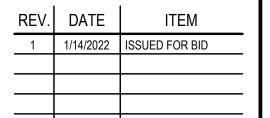

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<u>NOTICE</u>

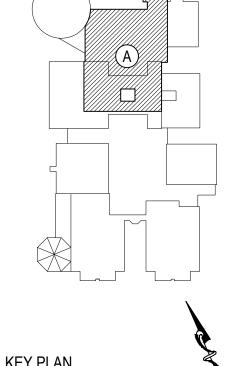

NOT TO SCALE


FIRST FLOOR NEW WORK PART AREA "A"

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66-14-02-02-0-004-022 DISTRICT BRIARCLIFF MANOR UFSD DISTRICT NAME PROJECT BOND IMPROVEMENTS PHASE 1 DWG TITLE FIRST FLOOR NEW WORK PART PLANS AREA "A"

SCALE: AS NOTED

DATE: 10/8/21 BID PICK-UP: BID P/U DATE

P2.01

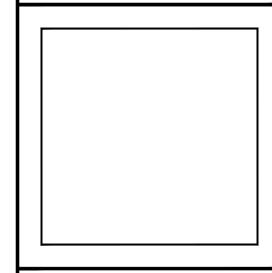—TO H.S. KITCHEN TO M.S. KITCHEN BUILDING BUILDING — BUILDING — BUILDING KITCHEN (120°F) (120°F) (140°F) TWO STAGE GAS (TYPICAL) ---(TYPICAL) FIRED DOMESTIC WATER HEATER — TANK STAT. AQUASTAT (TYPICAL)— DRAIN VALVE -GAS BURNER (TYPICAL)— (TYPICAL) CIRCULATOR **EXPANSION** PUMP — STORAGE TANK FINISHED FLOOR-DRAIN VALVE WITH THREADED HOSE END (TYPICAL) ————

DOMESTIC HOT WATER SCHEMATIC PIPING DIAGRAM - DEMOLITION

NOT TO SCALE NOTE: 1. XCP/1 HAS BEEN PARTIALLY REMOVED FROM SYSTEM AND VALVED OFF. ←TO H.S. KITCHEN TO M.S. KITCHEN BUILDING — BUILDING — BUILDING BUILDING KITCHEN FROM?-(110°F) (110°F) (140°F) TWO STAGE GAS (TYPICAL) — (TYPICAL) — WATER HEATER — TANK STAT. XCP/3— AQUASTAT (TYPICAL)— DRAIN VALVE -GAS BURNER (TYPICAL)— (TYPICAL) CIRCULATOR PUMP —— STORAGE TANK FINISHED FLOOR—

DOMESTIC HOT WATER SCHEMATIC PIPING DIAGRAM - NEW WORK

NOT TO SCALE NOTE:

DRAIN VALVE WITH THREADED

HOSE END (TYPICAL)

KEYED DEMOLITION NOTES:

1 P.C. TO REMOVE EXISTING HOT WATER THERMOSTATIC MIXING VALVE. 2 P.C. TO REPLACE EXISTING HOT WATER AQUASTAT, LIKE-IN-KIND. (TYPICAL FOR 3)

KEYED NEW WORK NOTES:

P.C. TO REPLACE WITH NEW HOT WATER THERMOSTATIC MIXING VALVE.
REFER TO SCHEDULES AND SPECIFICATIONS FOR ADDITIONAL INFORMATION. 2 P.C. TO REPLACE EXISTING HOT WATER AQUASTAT, LIKE-IN-KIND. P.C. TO SET AQUASTAT TO 110°F

P.C. TO REPLACE EXISTING HOT WATER AQUASTAT, LIKE-IN-KIND. P.C. TO SET AQUASTAT TO 140°F

NEW THERMOSTATIC MIXING VALVE SCHEDULE (BASIS OF DESIGN: LAWLER)

DATA SHEET

temperedwater.com 5330 East 25th St. Indianapolis, IN 46218 Phone (317) 261-1212 Fax (317) 261-1208

CAPACITIES - MODEL 803

Pressure Drop PSI 5 10 20 30 45 60 80


FLOW (GPM)




Master water mixing valve shall be of the thermostatic type with liquid-filled thermal motor. It shall have lead free brass body construction with replaceable corrosion-resistant components. Valve construction shall employ a sliding piston control mechanism. Sliding piston and liner shall be of stainless steel material. Valve shall come equipped with union end stop and check inlets with removable stainless steel strainers. Valve shall control temperature from a low flow of 3 GPM* up to a maximum flow rate for a given pressure differential. Valve shall provide protection against




803-GPM

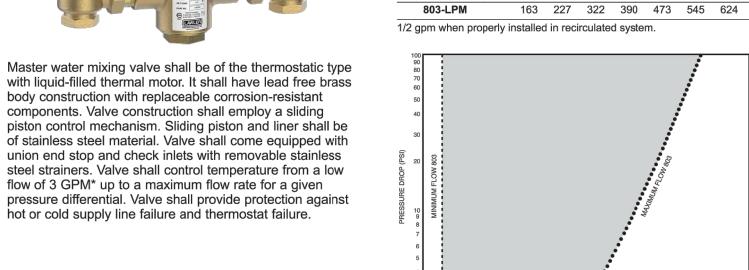

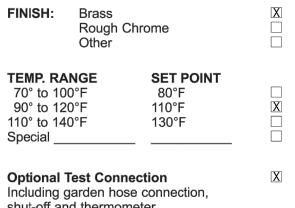

Optional Test Connection Including garden hose connection, shut-off and thermometer. Rough Chrome

ASSE 1017 Approved
ASSE Lead Free Certified Design and specifications subject to change without notice. temperedwater.com/patents Please refer to **temperedwater.com** to ensure most current data sheet and other design solutions. Certified to CSA B125.3

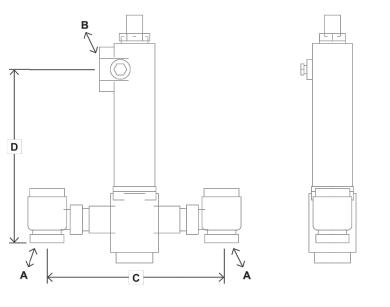

DIMENSIONS Valve Number A N.P.T. B N.P.T. C **803** 1-1/4" 1-1/2" 12-3/4" Dimensions are for reference purposes only. For rough-in dimensions

please refer to Lawler's Revit/BIM models found at temperedwater.com.

Model 803 Unit No. 73004

Typical Installation

Install the mixing valve below the hot water tank or heater. If this is not possible, pipe in a heat trap as shown in Figure 1 with an approximate 2' drop.

Connect a tempered water return line as shown in Figure 1. This allows flow through both ports of the mixing valve during periods of no draw.

ENG. NO. 73004-A

If a dual temperature system is used, a separate recirculating loop and pump are required to return high temperature hot water to the water heater. See Figure 2.

Install an aquastat at the tempered water return pump. Install the water heater per manufacturer's instructions.

Figure 1 When used in a single temperature recirculating system


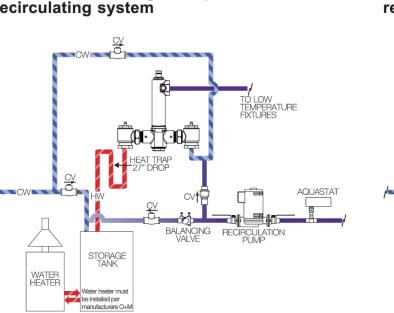



Figure 2 When used in a dual temperature recirculating system

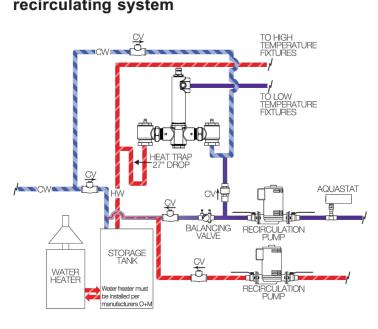

Design and specifications subject to change without notice. Please refer to **temperedwater.com** to ensure most current data sheet and other design solutions.

REV. DATE 1 1/14/2022 ISSUED FOR BID

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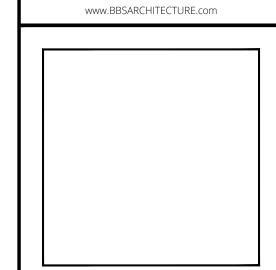
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NOTICE

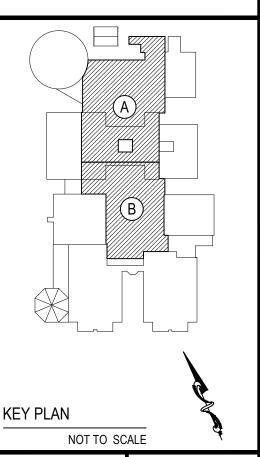
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SED No.	66-14-02-02-0-004-022
DISTRICT	BRIARCLIFF MANOR UFSD DISTRICT NAME
PROJECT	BOND IMPROVEMENTS PHASE 1
DWG TITLE	SCHEM. DIAGRAMS, EQUIPMEN' NOTES, SCHEDULES & DETAILS
SCALE:	AS NOTED
DATE:	10/8/21
BID PICK-UP:	BID P/U DATE

P7.01



GENERAL ELECTRICAL CONSTRUCTION NOTES:

- . ALL WORK SHALL BE DONE IN ACCORDANCE WITH THE LATEST EDITIONS OF THE NEC, APPLICABLE LOCAL CODES, STATE CODES, SCHOOL WORKING RULES AND SCHEDULE DIRECTIVES, AND THE ENGINEER'S SPECIFICATIONS.
- 2. THE VOLTAGE CHARACTERISTIC OF THIS SCHOOL IS 480/277VAC, 4 WIRE, 3PH, GROUNDED NEUTRAL, WYE. ALL EQUIPMENT SHALL BE COMPATIBLE WITH THESE CHARACTERISTICS.
- 3. THE DRAWINGS SHOW SCHEMATICALLY, THE APPROXIMATE LOCATION OF ALL EQUIPMENT, CONDUITS, DEVICES, ETC. THE EXACT OCATION OF WHICH SHALL BE SUBJECT TO APPROVAL BY THE ARCHITECT/OWNER WHO RESERVES THE RIGHT TO MAKE PRIOR TO INSTALLATION, ANY REASONABLE CHANGES IN LOCATION INDICATED WITHOUT EXTRA COST TO THE OWNER. CONTRACTOR SHALL VERIFY ALL INDICATED OR APPROXIMATED DIMENSIONS DRAWN OR DENOTED.
- 4. DIVISION 16 CONTRACTOR SHALL EXAMINE THE SITE TO VERIFY WORK TO BE PERFORMED AS SHOWN ON DRAWINGS AND SPECIFICATIONS BEFORE SUBMITTING HIS BID. ANY DISCREPANCY BETWEEN DRAWINGS/SPECIFICATIONS AND ACTUAL FIELD CONDITIONS SHALL BE BROUGHT TO ARCHITECT/ENGINEERS ATTENTION BEFORE BID SUBMITTAL. ANY FIELD CONDITION FOUND AFTER BID APPROVAL WHICH HAMPERS AND/OR PREVENTS ANY WORK TO BE PERFORMED AS SHOWN ON DRAWINGS AND SPECIFICATIONS SHALL BE THE RESPONSIBILITY OF THE DIVISION 16 CONTRACTOR. THE DIVISION 16 CONTRACTOR SHALL BID THE HIGHER SPECIFICATION FOR ANY DISCREPANCY BETWEEN DRAWINGS AND SPECIFICATIONS.
- 5. DIVISION 16 CONTRACTOR SHALL PROVIDE ALL LABOR SERVICE MATERIALS, EQUIPMENT, AND RELATED ITEMS TO COMPLETE THE WORK OF THIS DIVISION, AS REQUIRED BY THE NATIONAL ELECTRIC CODE, AND ALL STATE AND LOCAL AUTHORITIES HAVING
- 6. DIVISION 16 CONTRACTOR SHALL PROVIDE ALL ELECTRICAL HARDWARE SHOWN ON THESE DRAWINGS AND RELATED DETAIL MATERIALS NOT SPECIFICALLY SHOWN OR SPECIFIED. ALL NEW ELECTRICAL MATERIAL AND EQUIPMENT SHALL CONFORM TO THE STANDARDS AND BEAR THE INSPECTION LABEL OF THE UNDERWRITERS LABORATORIES AND SHALL BE APPROVED FOR USE BY ALL OCAL AUTHORITIES HAVING JURISDICTION.
- 7. THE DIVISION 16 CONTRACTOR SHALL REFER TO ALL OTHER DRAWINGS IN BID PACKAGE AND PERFORM THE WORK (INCLUDE IN HIS BID) INDICATED AS ELECTRICAL CONTRACTOR (E.C.) WORK. CONTRACTOR TO COORDINATE ALL LOCATIONS WITH GENERAL
- 8. ELECTRICAL CONTRACTOR SHALL COORDINATE WITH THE MECHANICAL CONTRACTOR FOR ALL MECHANICAL EQUIPMENT REQUIRING ELECTRICAL POWER. THE EC IS RESPONSIBLE TO INSTALL ALL MOTOR STARTERS AND ASSOCIATED POWER WIRING. THE LOCATIONS OF MOTOR STARTERS SHALL BE DETERMINED BY THE CONTRACTOR IN THE FIELD AND SUBMITTED TO THE ENGINEER FOR APPROVAL UNLESS IT IS SPECIFIED ON THE DRAWINGS. THE EC SHALL REFER TO THE MECHANICAL EQUIPMENT SCHEDULES & NOTES AND INCLUDE IN HIS BID PRICE ALL ELECTRICAL WORK ASSOCIATED WITH THEIR INSTALLATION, AND THE REMOVAL OF ANY STARTERS/DISCONNECTS NO LONGER REQUIRED.
- 9. ALL WORK SHALL BE IN ACCORDANCE WITH MANUFACTURER'S RECOMMENDATIONS AND DIRECTIVES OF THE OWNER.
- 10. ALL ELECTRICAL WORK SHALL BE PERFORMED BY A LICENSED ELECTRICAL CONTRACTOR WHO SHALL OBTAIN AN APPROVED ELECTRICAL INSPECTION CERTIFICATE FROM THE LOCAL AHJ AND PAY ASSOCIATED FEE. SUBMIT A PHOTOCOPY OF THIS CERTIFICATE O THE ENGINEER WITH FINAL PAYMENT APPLICATION. SUBMIT A COPY OF THIS CERTIFICATE TO THE OWNER.
- 1. DIVISION 16 CONTRACTOR SHALL GUARANTEE ALL MATERIALS AND THEIR INSTALLATION TO BE FREE OF DEFECTS FOR A PERIOD AS DEFINED IN THE PROJECT MANUAL.
- 12. IF ADDITIONAL POLE POSITIONS ARE REQUIRED FOR NEW CIRCUITS IN EXISTING PANELS SERVICING RENOVATED AREAS, REMOVE (3). ADJACENT 1 POLE BREAKERS PROVIDE AND INSTALL 3P, 60A BREAKER FOR SUB FEED TO A SURFACE MOUNTED 100A, 3PH, 18 POLE SUB PANEL AND ESTABLISH OVERFLOW CIRCUITS IN NEW SUB PANEL, EACH WITH A 1P, 20A BREAKER. PROVIDE (3) 1P, 20A BREAKERS FOR DISCONNECTED CIRCUITS IN MAIN PANEL AND RECONNECT THEM IN SUB PANEL. SUB PANEL FEED TO BE 3#6 + 1#6(N) + 1#10(G) IN 1"C.
- 13. IT IS EXPECTED THAT STRUCTURAL DEMOLITION BY THE GENERAL CONTRACTOR WILL CAUSE VARIOUS ELECTRIC SUPPLIES, OF /ARIOUS VOLTAGES AND PURPOSES, TO BE CUT AND RENDER SOME DEVICES TEMPORARILY INACTIVE. IT IS THE ELECTRICAL CONTRACTOR'S RESPONSIBILITY TO RECONSTRUCT AND RECONNECT SUCH ELECTRIC SOURCES UPON COMPLETION. NOTE THAT MOST REINSTALLED ITEMS WILL BE IN DIFFERENT LOCATIONS FROM THE REMOVAL LOCATION. THE ELECTRICAL CONTRACTOR SHALL MAKE ALL REQUIRED CIRCUIT EXTENSIONS OR MODIFICATIONS TO PROVIDE SERVICE TO A REINSTALLED ITEM AS RELOCATED. NOTE THAT THIS REQUIREMENT ALSO APPLIES TO THE ROOMS AND ELECTRICAL ITEMS WITHIN THAT ARE NOMINALLY NOT IN CONTRACT. SUCH RESTORATION OF SERVICE, IF NEEDED, IS SPECIFICALLY IN THE ELECTRICAL CONTRACTOR'S CONTRACT.
- 14. THE ELECTRICAL CONTRACTOR SHALL PROVIDE TEMPORARY LIGHTING AND POWER TO ALL TRADES FOR THE DURATION OF THE PROJECT. SERVICE SHALL BE SUPPLIED TO CONTRACTOR'S CONSTRUCTION TRAILERS WHERE SUCH IS REQUESTED. USE THE EXISTING POWER PANELS FOR SUCH SUPPLY. POWER COSTS WILL BE PAID BY THE OWNER. ALL CONSTRUCTION POWER RECEPTACLES SHALL BE GFI PROTECTED.
- 15. IT SHALL BE THE ELECTRICAL CONTRACTOR'S RESPONSIBILITY TO PROTECT ALL ELECTRICAL DEVICES FROM DAMAGES DURING CONSTRUCTION. THIS INCLUDES DEVICES WHICH ARE EITHER INDICATED TO REMAIN, AND/OR TO BE REMOVED AND REINSTALLED THROUGHOUT ALL CONSTRUCTION AREAS. DEVICES SHALL INCLUDE BUT WILL NOT BE LIMITED TO: SMOKE DETECTORS, EMERGENCY LIGHTS, EXIT SIGNS, OCCUPANCY SENSORS, SPEAKERS, LIGHT FIXTURES, SWITCHES, RECEPTACLES, ETC. IN THE EVENT OF DAMAGES NCURRED DUE TO CONSTRUCTION ACTIVITIES, THE ELECTRICAL CONTRACTOR SHALL BE RESPONSIBLE TO REPLACE ANY DAMAGED DEVICES AT NO ADDITIONAL COST TO OWNER.
- 16. THE INDICATED SOURCE OF EXISTING CIRCUITS MAY NOT BE KNOWN OR HAS NOT BEEN VERIFIED. IT IS THE DIVISION 16 CONTRACTOR'S RESPONSIBILITY TO TRACE OUT, LOCATE AND VERIFY THE DISCONNECTING MEANS OF EXISTING CIRCUIT(S) TO BE IMPACTED BY THE WORK. SAFE OFF THE CIRCUIT(S) AS REQUIRED TO SAFELY PERFORM THE WORK, AND RE-ENERGIZE UPON COMPLETION. UPDATE PANEL DIRECTORIES UPON COMPLETION.
- 17. ALL WIRING TO BE 1#12+1#12(N)+1#12(G)-3/4" EMT, OR STEEL JACKETED MC CABLE (WHERE CODE PERMITTED), UNLESS OTHERWISE SPECIFIED ON DRAWINGS. ALUMINUM JACKETED MC CABLE IS NOT ACCEPTABLE. ALL DEVICES LOCATED OUTSIDE THE BUILDING SHALL
- 18. RUN WIRING & CONDUITS IN DROPPED CEILINGS, VOIDS, & CHASES. ALL DEVICES, WIRING & CONDUITS ON NEW CONSTRUCTION MUST BE RECESSED. FOR EXISTING SURFACES: MECHANICAL/WORK SPACES- DEVICES, WIRING & CONDUITS MAY BE SURFACE MOUNTED. EXISTING PUBLIC/FINISHED AREAS- CONDUITS SHALL BE CONCEALED WHEREVER POSSIBLE (IN HUNG CEILINGS, VOIDS/CHASES, FLOOR BELOW OR BEHIND WALLS) ALL WIRING THAT CANNOT BE CONCEALED IN MUST BE RUN IN FINISHED SURFACE RACEWAY SUCH AS WIREMOLD (V-500/700), COLOR PER ARCHITECT. USE OF ADHESIVE IS PROHIBITED, SURFACE RACEWAY MUST BE SECURED USING MECHANICALLY FASTENED CLIPS. WIRING IN DROPPED CEILINGS SHALL BE SUSPENDED FROM BUILDING STEEL EVERY 5 FT. USE EMT IN AREAS WHERE CONDUIT WOULD BE SUBJECT TO POTENTIAL PHYSICAL DAMAGE SUCH AS GYMNASIUMS, WORK/ CUSTODIAL AREAS, BOILER ROOMS, ETC.

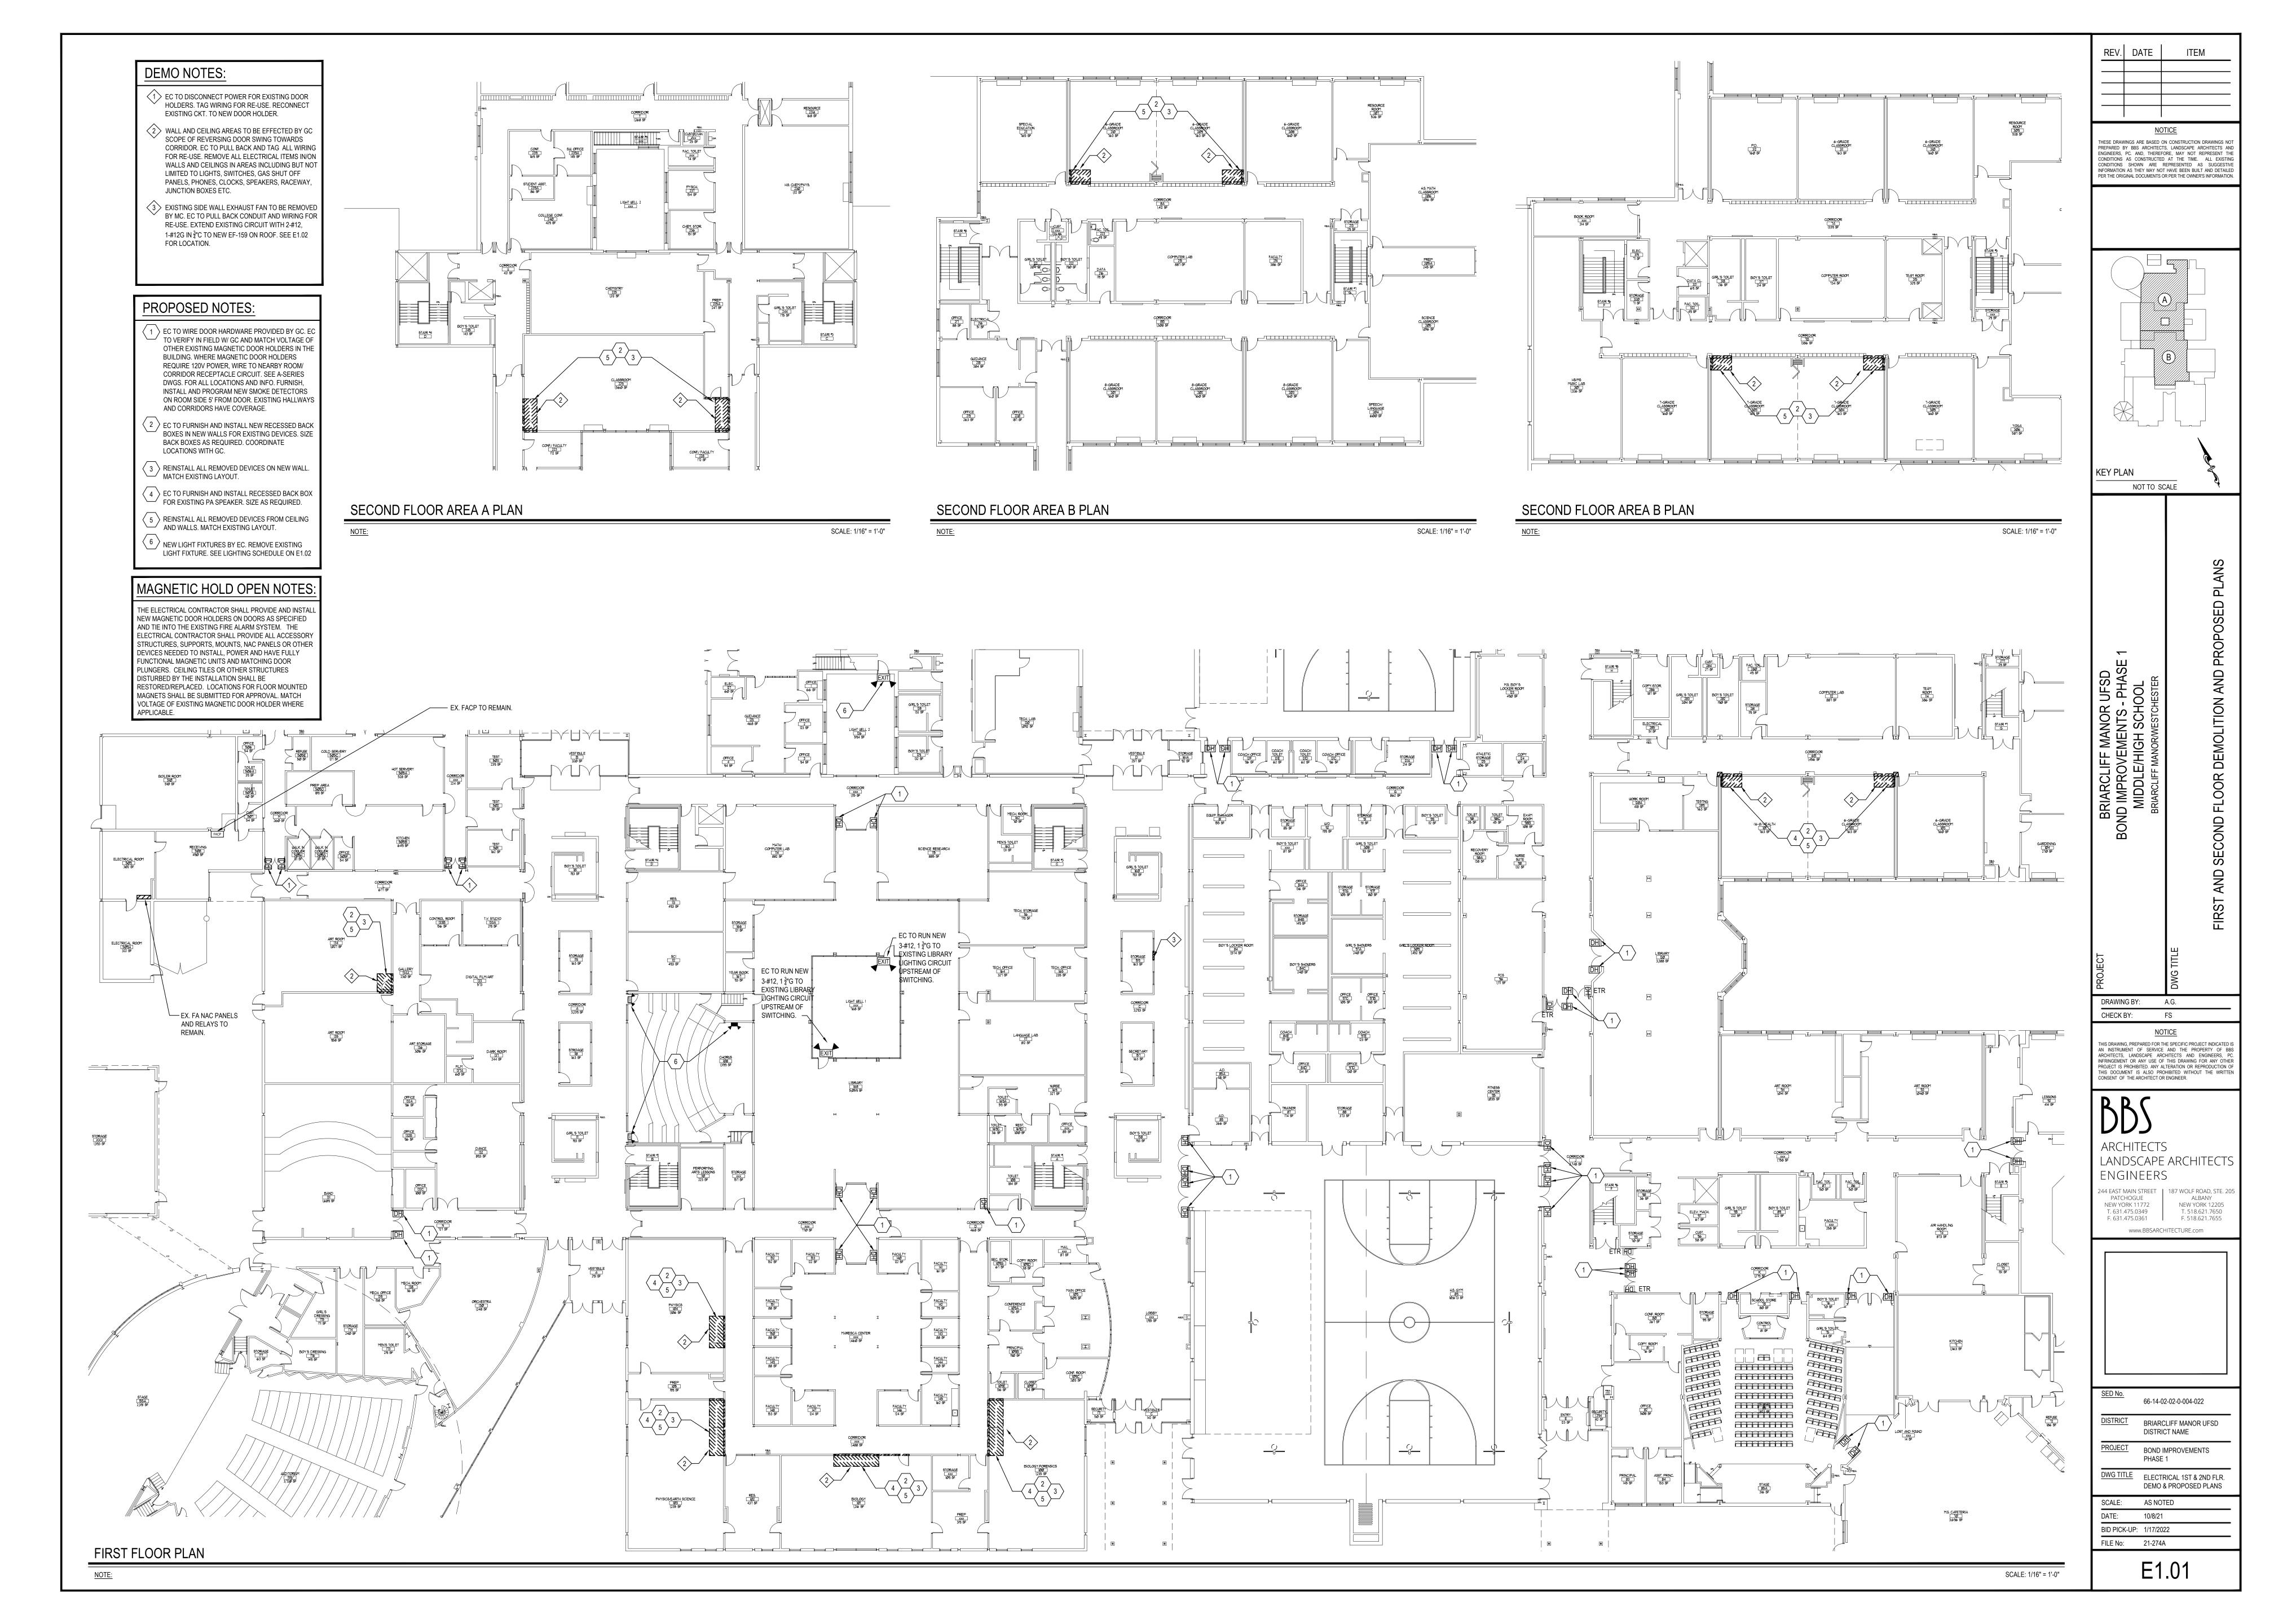ABBREVIATIONS

- SP = SPARE EX = EXISTING N.I.C. = NOT IN CONTRACT A = AMPS EC = ELECTRICAL CONTRACTO
- C/B = CIRCUIT BREAKER V.I.F. = VERIFY IN FIELD ETR = EXISTING TO REMAIN (E) = EXISTING WP = WEATHER PROOF

EF = EXHAUST FAN

FA = FIRE ALARM

FIRE STOP NOTES:

- 1. ALL CONDUIT AND CABLE PENETRATIONS THROUGH FIRE RATED WALLS, FLOORS OR OTHER STRUCTURES SHALL BE FIRE STOPPED.
- 2. THE FIRE STOP MATERIALS SHALL BE HILTI TYPE FS-657 FIRE BLOCK, FS-ONE SEALANT, CP-672 JOINT SPRAY, CP-601S ELASTOMERIC SEALANT, 6P-606 FLEXIBLE SEALANT, CP-643 OR CP-642 COLLAR, CP-618 PUTTY STICK, OR FS-635 TROWEL ABLE COMPOUND, AS SUITABLE.
- 3. CONTRACTOR SHALL SUBMIT SHOP DRAWINGS OF PRODUCTS SPECIFIED OR EQUAL. 4. FIRE STOP MATERIALS OTHER THAN HILTI SHALL INCLUDE FULL TECHNICAL DATA WITH SHOP DRAWINGS TO DEMONSTRATE EQUALITY WITH THE SPECIFIED FIRE STOPS AND STATEMENT FROM MANUFACTURER THAT THEY MEET OR EXCEED THE PRODUCTS SPECIFIED HERE.
- 5. ALL SYSTEMS SHALL HAVE THEIR OWN SLEEVE THROUGH FIRE RATED WALLS. IE FIRE ALARM, PUBLIC ADDRESS, TELEPHONE, DATA, POWER AND LIGHTING.

NEW WORK NOTES

- . ALL CONTRACTORS ON THE WORK SITE SHALL COORDINATE THEIR RESPECTIVE WORK SHOWN IN THE DRAWING SET. THE MC HAS PRIORITY OVER WORK CONDUCT ISSUES AS LOCATIONS, SCHEDULES, AND OTHER MATTERS THAT MAY INTERACT WITH THE EC.
- LEC SHALL WIRE EXHAUST FANS VIA VFD'S/MOTOR STARTERS FURNISHED BY MC. EC TO MOUNT AND WIRE POWER FOR VFD'S/MOTOR STARTERS. COORDINATE LOCATION WITH MC. ALL CONTROL WIRING BY MC.
- 3. EC TO REMOVE AND REINSTALL EXISTING FA MOTOR SHUTDOWN RELAYS.
- 4. COORDINATE W/ MC FOR ALL ROOF PENETRATIONS. SINGLE PENETRATIONS FOR ELECTRICAL AND REFRIGERANT PIPE BY MC.
- 5. EC TO WIRE ALL LINE VOLTAGE. COORDINATE W/ MC.

	ELECTRICAL SYMBOL LEGEND						
Ì	SYMBOL						
	\$,	MOTOR DISCONNECT FURNISHED BY MC. WIRED AND INSTALLED BY EC					
	~	EXISTING CIRCUIT					
		ONE POLE CIRCUIT 2-#12, 1-#12G, 3/4"C UNLESS OTHERWISE NOTE.					
	DH	DOOR HOLDER					

<u>LIGHTING SCHEDULE</u>							
CODE	SYMBOL	DESCRIPTION					
	1	NEW EMERGENCY LED LIGHT FIXTURE W/ 90-MINUTE NICAD BATTERY EXITRONIX #LED-90-G2 OR EQUAL.					
		SUBSCRIPT 'VG' - PROVIDE W/ POLYCARBONATE VANDAL GUARD					
	EXIT	NEW EMERGENCY LED LIGHT FIXTURE W/ 90-MINUTE NICAD BATTERY EXITRONIX #LED-90-G2 OR EQUAL					
		SUBSCRIPT 'VG' - PROVIDE W/ POLYCARBONATE VANDAL GUARD					

1. EC SHALL CONNECT EMERGENCY INVERTER/ EMERGENCY LIGHT BATTERY/ EXIT SIGN LEADS DIRECTLY TO THE EXISTING AREA LIGHTING CIRCUIT UPSTREAM OF SWITCHES, CONTACTORS, CONTROLS ETC.

ROOF PLAN

NOTE:

GENERAL FA NOTES:

1. ALL NEW FIRE ALARM DEVICES TO BE COMPATIBLE WITH THE EXISTING FACP.


2. CONTRACTOR MAY UTILIZE EXISTING BACKBOXES WHEN CODE AND ADA REQUIREMENTS ARE MET AND COMPATIBLE WITH NEW FIRE ALARM DEVICES. COVER ALL UNUSED REMAINING BACKBOXES WITH STAINLESS STEEL 302 BLANK FACE PLATES. IF BOXES ARE RE-USED DEVICES SHALL BE SWAPPED AT THE TIME OF LOOP SWITCH-OVERS TO ENSURE SYSTEM IS OPERATIONAL FOR THE DURATION OF THE PROJECT.

3. ALL BACK BOXES SHALL BE SIZED TO COMPLETELY FIT THE RESPECTIVE DEVICE AND WIRING WITH NO GAPS, SPACES, OR EXTRA UNNECESSARY ROOM. WIREMOLD BOXES IN FINISHED AREAS ARE REQUIRED, AND SHALL BE RECESSED WHERE POSSIBLE. CONTRACTOR IS RESPONSIBLE TO VERIFY ALL DEVICES ARE COMPATIBLE WITH THE APPROPRIATE BACKBOXES.

4. ANY OPENINGS LEFT WHEN DEVICES/CABINETS/PANELS ARE REMOVED SHALL BE COMPLETELY COVERED WITH BLANK METAL PLATES, COLOR TO MATCH ADJACENT. EC IS RESPONSIBLE TO PATCH/PAINT ALL AREAS DISTURBED BY DEMO & INSTALLATION WORK TO MATCH ADJACENT. ALL FINISH WORK IS THE RESPONSIBILITY OF THE EC UNLESS OTHERWISE NOTED.

5. DIVISION 16 CONTRACTOR SHALL PROVIDE AND INSTALL ALL POWER SUPPLIES, AUXILIARY CABINETS/BOXES, NAC PANELS, EXPANSION MODULES, BRANCH CIRCUITS ETC. AS REQUIRED BY THE FIRE ALARM MANUFACTURER TO MAINTAIN A FULLY OPERATIONAL SYSTEM. THESE ITEMS ARE NOT SHOWN ON THE PLANS AND ARE THE RESPONSIBILITY OF THE FIRE ALARM VENDOR TO LOCATE AND THE EC TO POWER. LOCATIONS OF ANY TERMINAL CABINETS, BOOSTER POWER SUPPLIES, OR SIMILAR COMPONENTS MUST BE SUBMITTED TO THE ARCHITECT/ENGINEER FOR APPROVAL DURING THE SHOP DRAWINGS PHASE. ANY SMOKE HEADS OR INCIDENTAL DEVICES REQUIRED TO PROTECT SAID CABINETS SHALL BE INCLUDED IN THE CONTRACTOR'S BID PRICE. EC TO INCLUDE IN BID NAC PANEL(S), POWER SUPPLIES, EXPANSION MODULES, ETC. AS REQUIRED TO EXPAND THE EXISTING FACP SYSTEMS PER PLANS.

- 6. AFTER THE SYSTEM IS COMPLETE, TEST ALL COMPONENTS IN ACCORDANCE WITH SEQUENCE OF OPERATION PRIOR TO FIRE DEPARTMENT INSPECTION.
- 7. WHERE EXISTING FIRE ALARM SYSTEMS ARE MODIFIED DURING THE COURSE OF THE PROJECT, CONTRACTOR SHALL PROVIDE OWNER WITH UPDATED COMPLETION RECORD DOCUMENTATION PER NFPA 72, ARTICLE 10.18. INCLUDE COPY OF UPDATED SITE SPECIFIC SOFTWARE. ANY ADDITIONAL DEVICES SHALL BE MAPPED INTO THE SYSTEM WITH THE APPROPRIATE ADDRESSES/LABELS.
- 8. FIRE ALARM WIRING FOR NEW DEVICES SHALL BE NEW, PLENUM RATED, AND PER MFG INSTRUCTIONS.

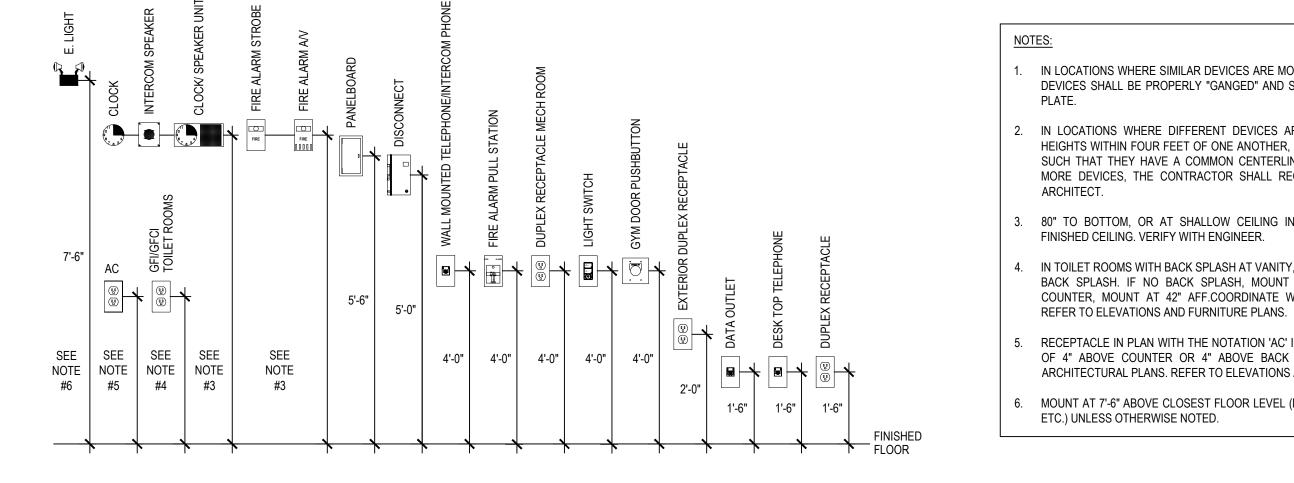

IN LOCATIONS WHERE SIMILAR DEVICES ARE MOUNTED AT THE SAME HEIGHT, DEVICES SHALL BE PROPERLY "GANGED" AND SHALL HAVE A SINGLE COVER

> IN LOCATIONS WHERE DIFFERENT DEVICES ARE MOUNTED AT DIFFERENT HEIGHTS WITHIN FOUR FEET OF ONE ANOTHER, DEVICES SHALL BE MOUNTED SUCH THAT THEY HAVE A COMMON CENTERLINE. IF THERE ARE THREE OR MORE DEVICES, THE CONTRACTOR SHALL REQUEST A DETAIL FROM THE

- 80" TO BOTTOM, OR AT SHALLOW CEILING INSTALLATIONS, WITHIN 6" OF FINISHED CEILING. VERIFY WITH ENGINEER. IN TOILET ROOMS WITH BACK SPLASH AT VANITY, MOUNT CENTER AT 4" ABOVE BACK SPLASH. IF NO BACK SPLASH, MOUNT 4" ABOVE COUNTER. IF NO COUNTER, MOUNT AT 42" AFF.COORDINATE WITH ARCHITECTURAL PLANS.
- RECEPTACLE IN PLAN WITH THE NOTATION 'AC' INDICATES MOUNTING HEIGHT OF 4" ABOVE COUNTER OR 4" ABOVE BACK SPLASH. COORDINATE WITH ARCHITECTURAL PLANS. REFER TO ELEVATIONS AND FURNITURE PLANS.
- MOUNT AT 7'-6" ABOVE CLOSEST FLOOR LEVEL (LANDINGS, STEPPED FLOORS, ETC.) UNLESS OTHERWISE NOTED.

SCALE: N.T.S. KEY PLAN Let EXISTING UNIT TO BE REMOVED BY MC. EC TO DISCONNECT AND TAG WIRING FOR RE-USE, PULL BACK/ RE-ROUTE/ EXTEND WIRING AS REQUIRED. RECONNECT TO NEW UNIT. (TYP. 17) SEE M6.01 FOR MORE DETAILS. NEW SERVICE RECEPTACLE IN WEATHERPROOF ENCLOSURE. MOUNT AS REQUIRED. —— NEW EXHAUST FAN BY MC. EC TO WIRE. USE EXISTING CIRCUIT FROM PREVIOUS FAN. SEE E1.01 FOR LOCATION. CHECK BY: PROJECT IS PROHIBITED. ANY ALTERATION OR REPRODUCTION OF THIS DOCUMENT IS ALSO PROHIBITED WITHOUT THE WRITTEN ONSENT OF THE ARCHITECT OR ENGINEER. ENGINEERS PATCHOGUE NEW YORK 11772 F. 631.475.0361

NOTICE HESE DRAWINGS ARE BASED ON CONSTRUCTION DRAWINGS NO PREPARED BY BBS ARCHITECTS, LANDSCAPE ARCHITECTS AN CONDITIONS AS CONSTRUCTED AT THE TIME. ALL EXISTI INFORMATION AS THEY MAY NOT HAVE BEEN BUILT AND DETAILE

REV. DATE

NOT TO SCALE

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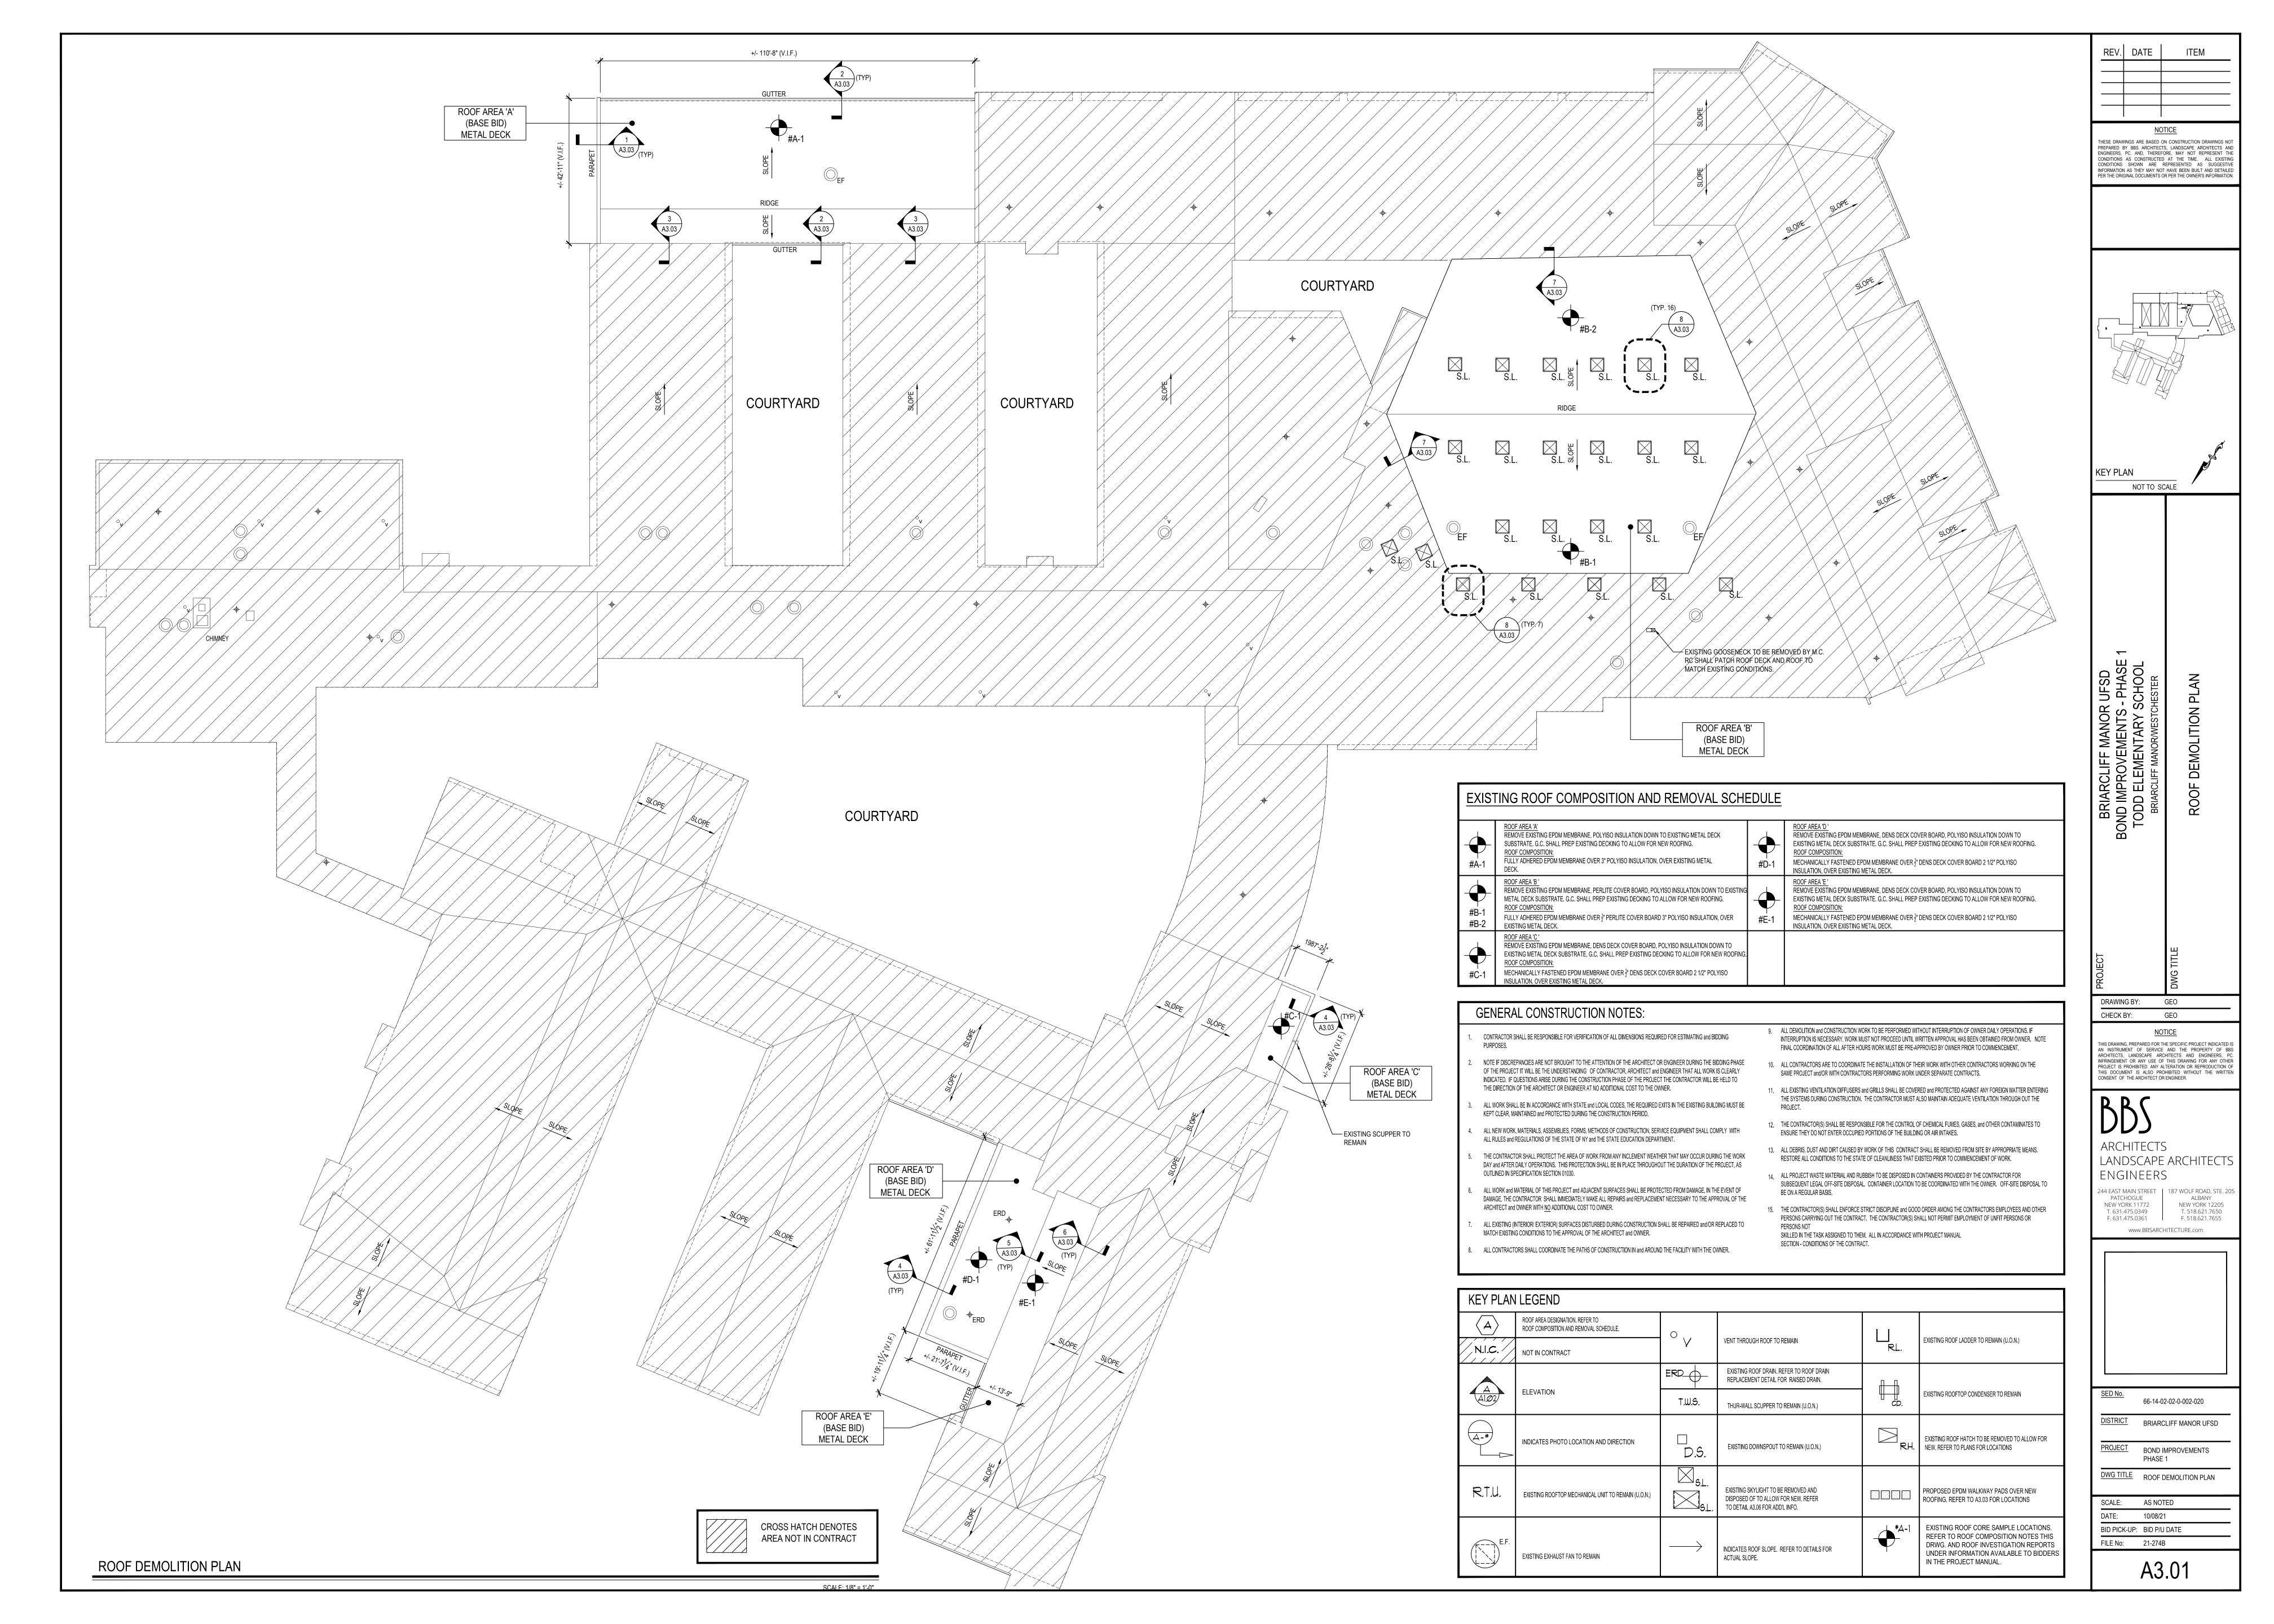
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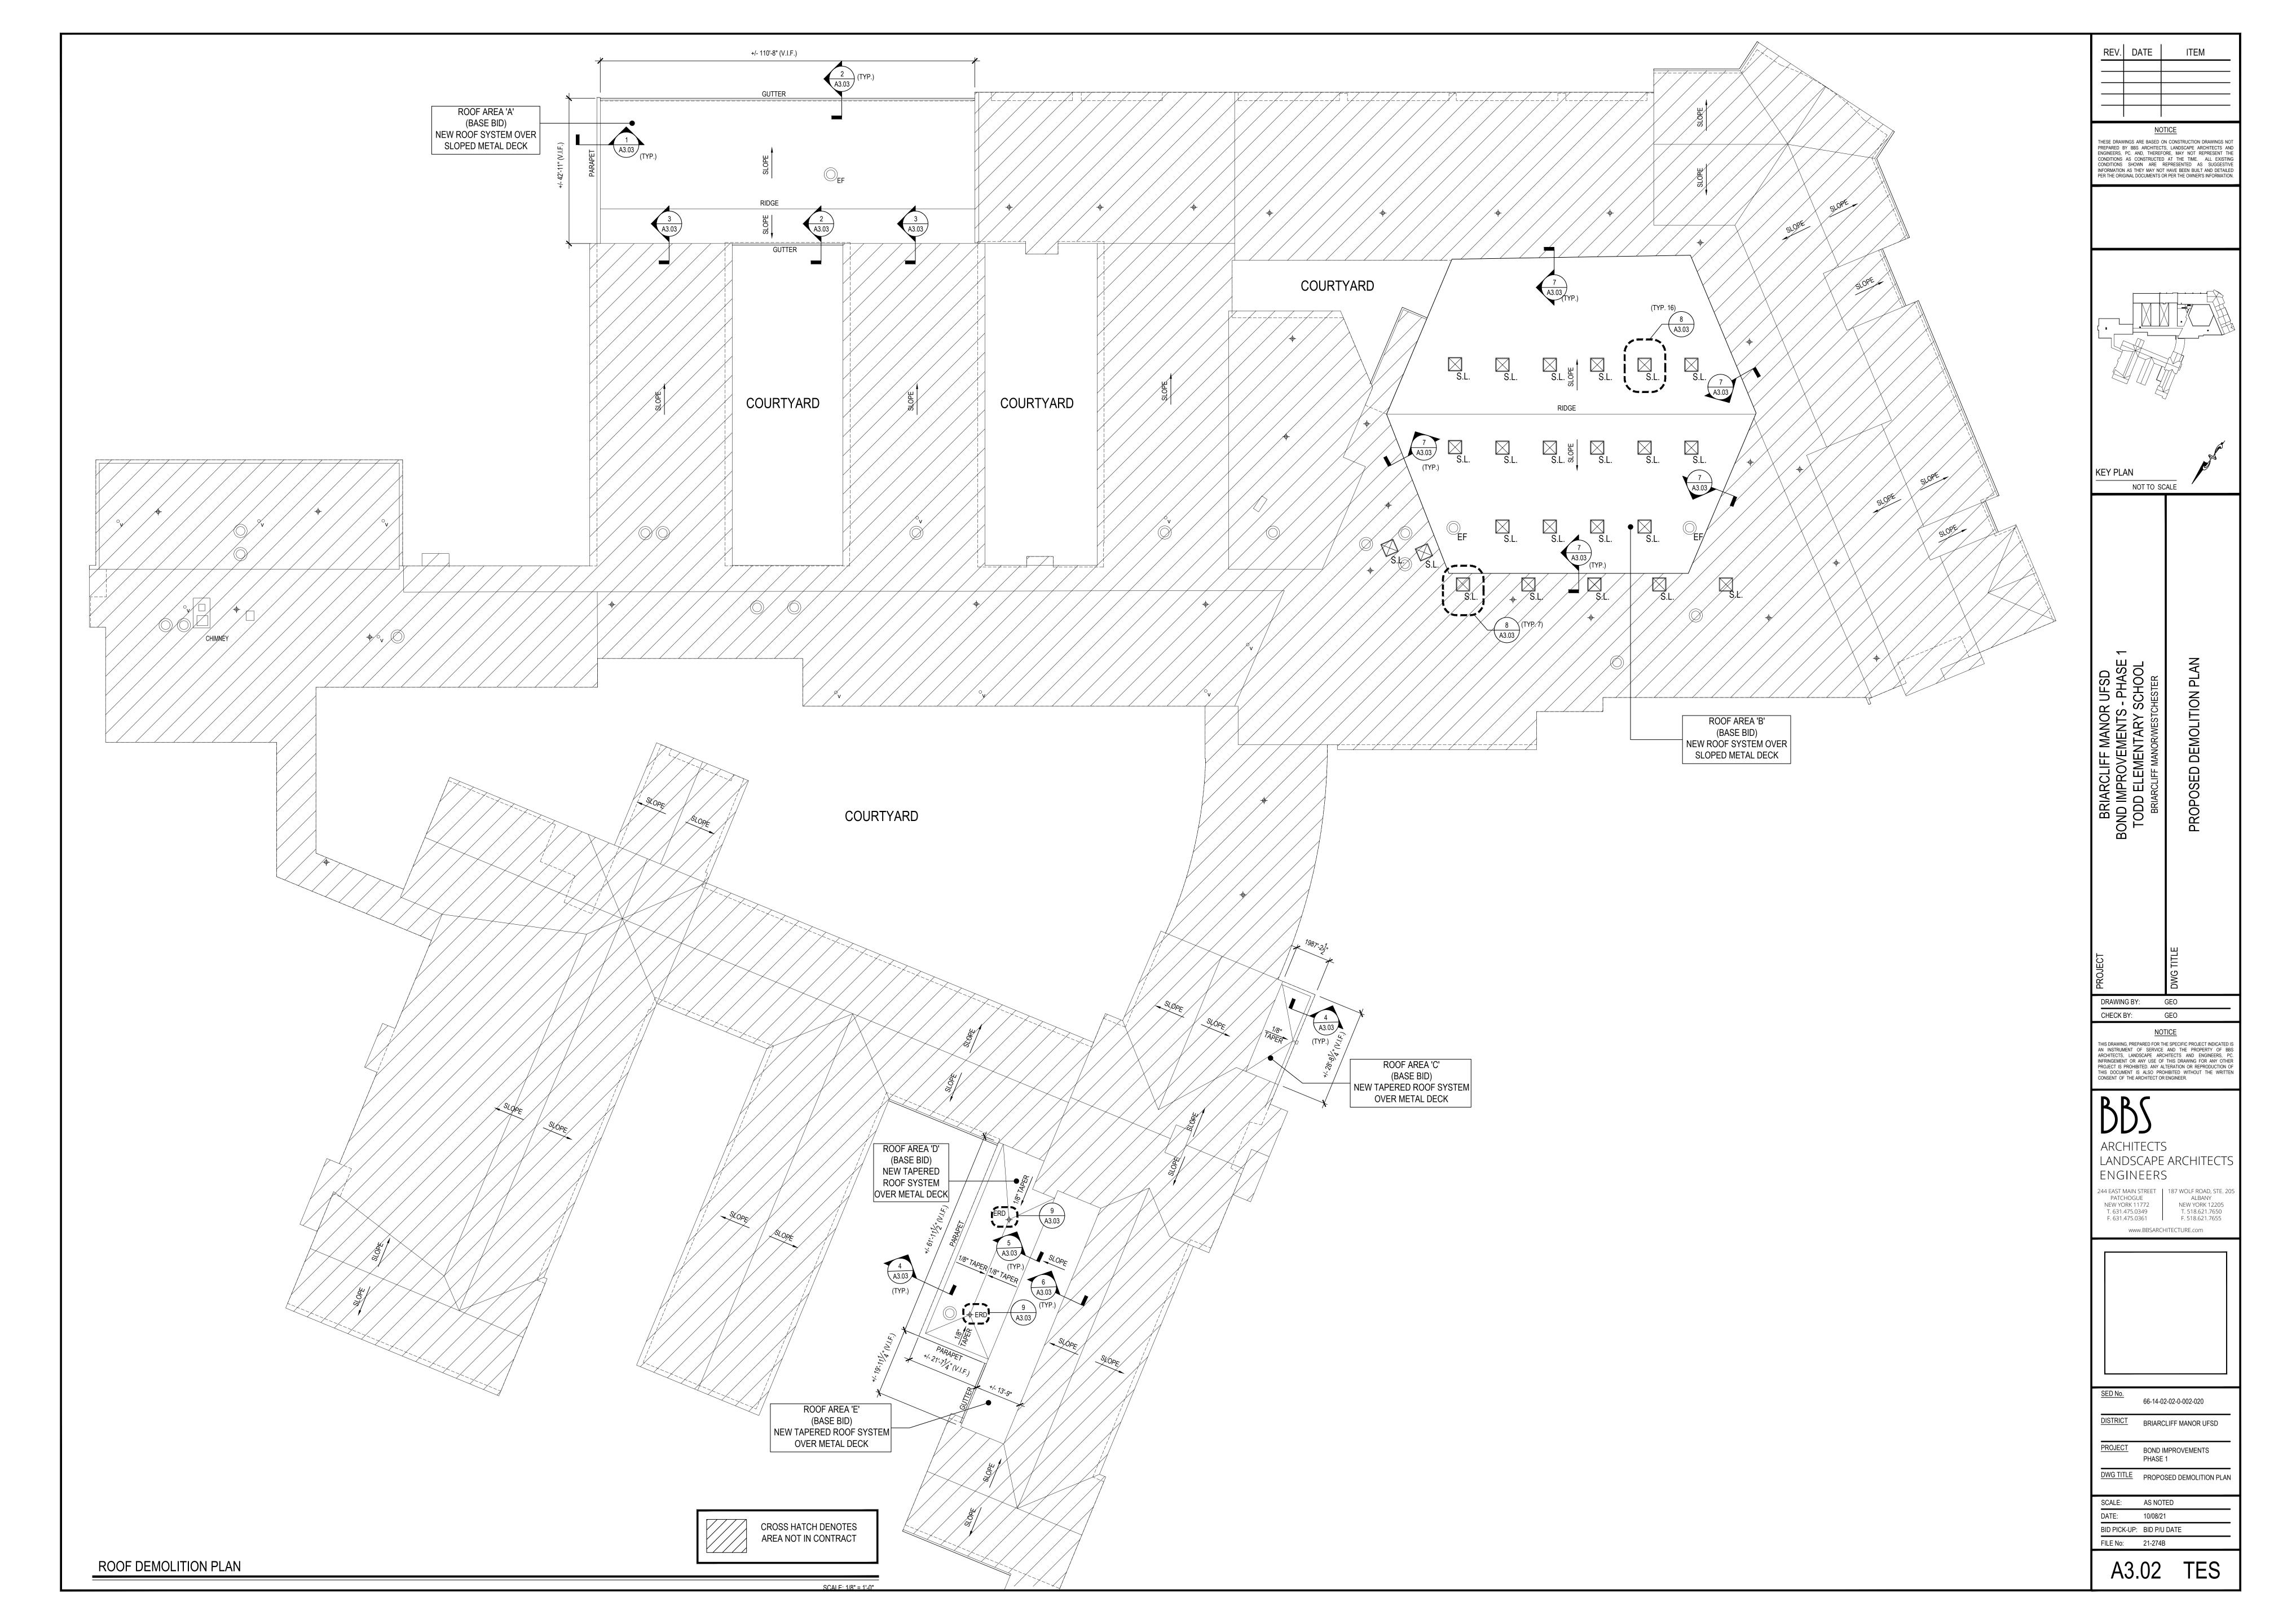
66-14-02-02-0-004-022 DISTRICT BRIARCLIFF MANOR UFSD DISTRICT NAME PROJECT BOND IMPROVEMENTS DWG TITLE ELECTRICAL


GEN. NOTES AND ROOF PLAN SCALE: AS NOTED BID PICK-UP: 1/17/2022

FILE No: 21-274A E1.02

SCALE: 1/16" = 1'-0"





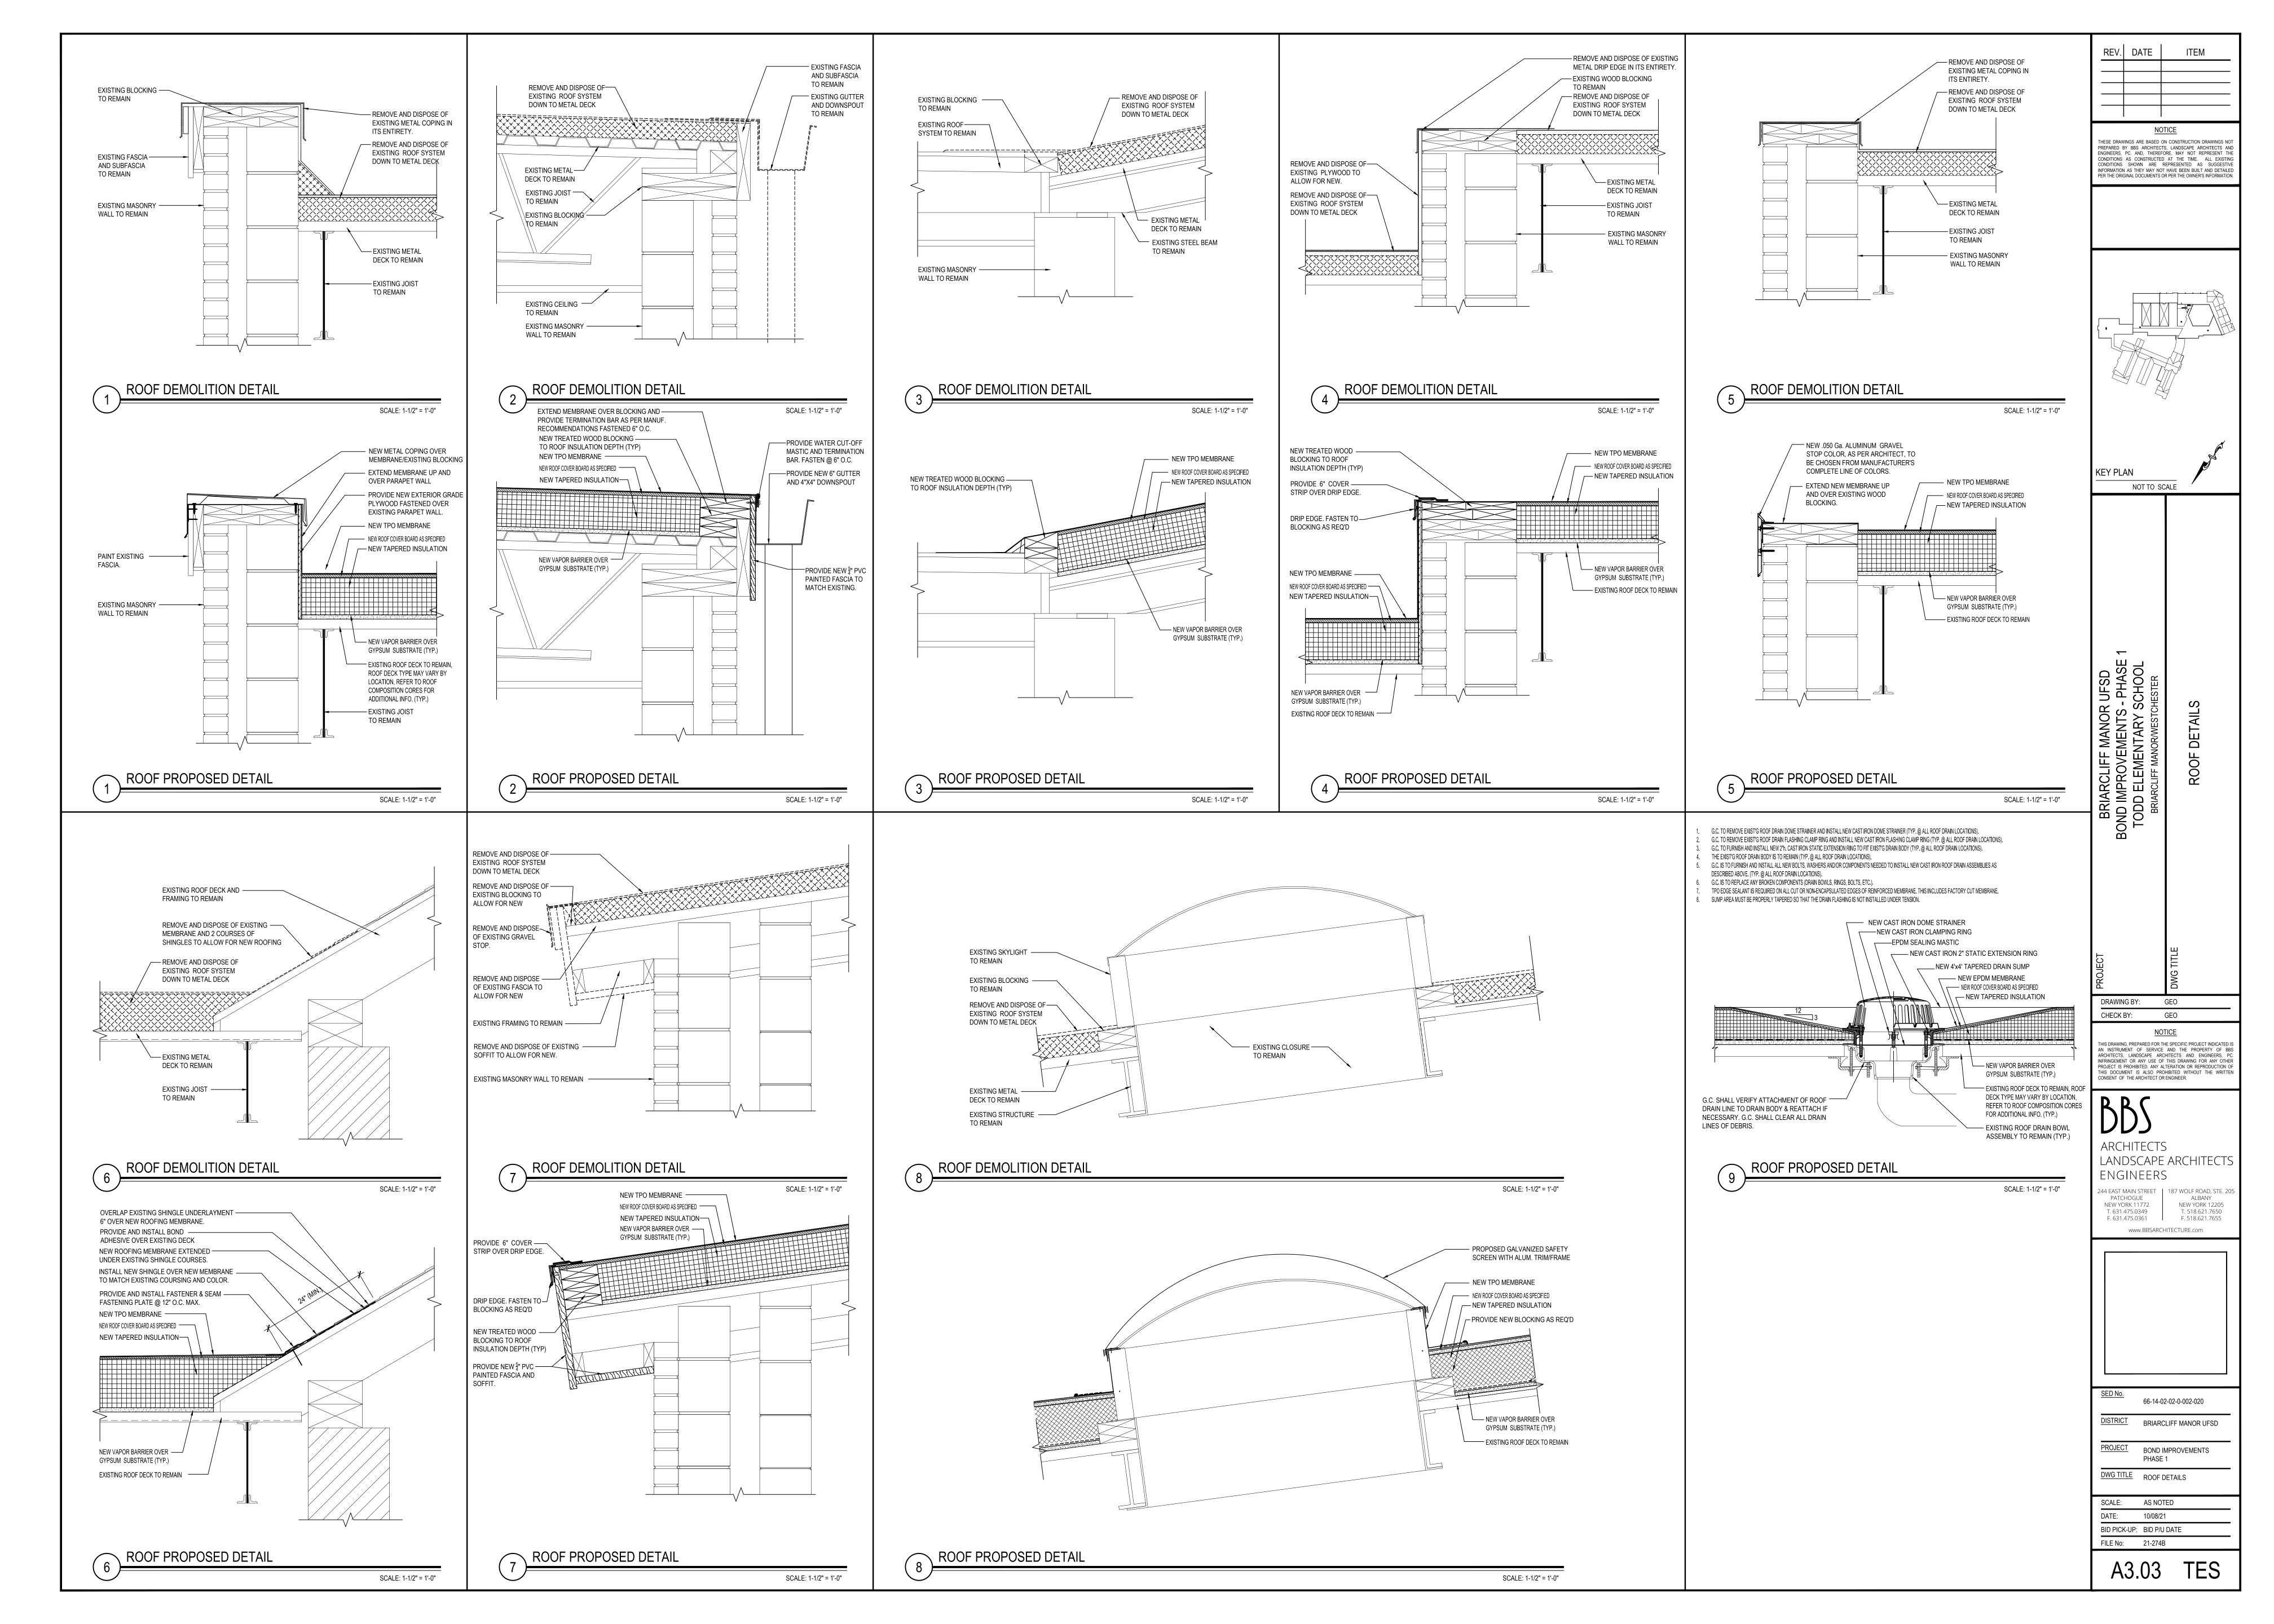

SYMBOL	DESCRIPTION
191	— PIPING TO RISE UP
•	— PIPING TO DROP DOWN
P.A.	— PIPING ANCHOR
	— PIPING GUIDE
	— COLD WATER SUPPLY PIPING
HWS —	HEATING SYSTEM SUPPLY PIPING
HWR —	HEATING SYSTEM RETURN PIPING
	CHILLED WATER SUPPLY PIPING
	CHILLED WATER RETURN PIPING
	CONDENSER WATER SUPPLY PIPING
—	CONDENSER WATER RETURN PIPING
CD	CONDENSATE DRAINAGE PIPING
F.O.S. —	— FUEL OIL SUPPLY PIPING
F.O.R. —	
G	LOW PRESSURE NATURAL GAS PIPING
EG	ELEVATED PRESSURE NATURAL GAS PIPING
₩	GAS COCK
	DIRT LEG IN PIPING
	LIQUEFIED PETROLEUM GAS PIPING
V	- VENT PIPING
	LINEAR EXPANSION COMPENSATOR
	EXPANSION LOOP IN PIPING
	— UNION IN PIPING
'l' 	PIPING STRAINER (w/ BLOWDOWN VALVE)
	REDUCER / INCREASER FITTINGS IN PIPING
	ECCENTRIC REDUCER IN PIPING
	THERMOMETER
<u> </u>	PRESSURE GAUGE
	— FULL PORT BALL VALVE
	— GATE VALVE
	— SWING CHECK VALVE
	BALANCING VALVE
	3-WAY VALVE (w/ OPERATOR)
子 - 子	CIRCUIT CETTER
3	TRIPLE DUTY VALVE
	— WAFER VALVE
1 1	PLUG / CAP IN PIPING
<u> </u>	PNEUMATIC CONTROL VALVE OPERATOR
	ELECTRIC CONTROL VALVE OPERATOR

SYMBOL	DESCRIPTION
24x12 / 20"~	RECTANGULAR GALVANIZED DUCTWORK - DIMENSIONS 'W' x 'H'
£ \	NEW EXHAUST DUCTWORK TO RISE UP
\$	NEW EXHAUST DUCTWORK TO DROP DOWN
E 3	TRANSITION IN DUCTWORK
74 Jan 1	ELBOW IN DUCTWORK w/ TURNING VANES
	ELBOW IN DUCTWORK (RADIUS + 1.5 x D)
	45 DEG. TAKEOFF FITTING
	90 DEG. TAKEOFF w/ BELLMOUTH FITTING
	CEILING RETURN AIR REGISTER
	ROOF MOUNTED EXHAUST FAN

DUCTWORK NOTES:

- PROVIDE ALL NEW DUCTWORK AS SHOWN AND SPECIFIED UNDER SPECIFICATION SECTION 015891, AND IN CONFORMANCE WITH 'SMACNA' SPECIFICATIONS.
- IF A DUCT ELBOW IS SHOWN TO BE RADIUSED, THEN RADIUSED ELBOWS SHALL BE INSTALLED. SQUARE ELBOWS MAY NOT BE SUBSTITUTED WHERE RADIUSED ELBOWS ARE SHOWN. WHERE SQUARE ELBOWS ARE SHOWN, TURNING VANES SHALL BE INSTALLED UPON APPROVAL BY THE ENGINEER.
- WHERE FLEXIBLE DUCTWORK IS USED, LENGTHS MAY NOT EXCEED 4 FEET TOTAL IN ANY ONE RUN OF FLEXIBLE DUCTWORK. FLEXIBLE DUCTWORK SHALL BE RATED IN ACCORDANCE WITH UL 181. CLASS 1. REFER TO SPECIFICATION SECTION 15891 FOR FURTHER INFORMATION.
- MECHANICAL CONTRACTOR SHALL PROVIDE A BUTTERFLY TYPE VOLUME DAMPER WITH LOCKING QUADRANT HANDLE PRIOR TO EACH AIR OUTLET SHOWN. INSTALL DAMPER AT LEAST 5 FEET AWAY FROM AIR OUTLET WHEREVER POSSIBLE.
- MECHANICAL CONTRACTOR SHALL PROVIDE FLEXIBLE DUCT CONNECTIONS WHERE DUCT SYSTEMS CONNECT TO EQUIPMENT. REFER TO SPECIFICATION SECTION 15891 FOR FURTHER INFORMATION.

GENERAL NOTES

- REMOVAL & RELOCATION OF CERTAIN EXISTING WORK SHALL BE NECESSARY FOR THE PERFORMANCE OF THE NEW WORK SHOWN HEREIN. ALL EXISTING CONDITIONS ARE NOT COMPLETELY DETAILED ON THE DRAWINGS. THE CONTRACTOR SHALL SURVEY THE SITE & MAKE ALL NECESSARY CHANGES BASED ON EXISTING CONDITIONS AS REQUIRED FOR PROPER DEMOLITION OF EXISTING WORK & SHALL INCLUDE ALL MATERIALS & LABOR FOR SAME IN HIS BID PRICE. NO ALLOWANCE WILL BE MADE FOR FAILURE TO DO SO.
- PRIOR TO SUBMITTING A BID, THE CONTRACTOR SHALL VISIT THE PREMISES OF THE PROPOSED WORK & SHALL CAREFULLY EXAMINE THE ENGINEERING DRAWINGS, EXISTING CONDITIONS & LIMITATIONS THEREOF. VERIFY ACTUAL LOCATIONS WHERE THE NEW PIPING WILL BE ROUTED, COORDINATE WITH NEW & EXISTING WORK & PROVIDE CLEARANCE W/ BUILDING STRUCTURE, OTHER SERVICES, ETC.. THE CONTRACTOR SHALL INCLUDE ALL COSTS WHATSOEVER WHICH ARE INCURRED AS A RESULT OF LIMITATIONS OF THE EXISTING & NEW CONDITIONS. LATER CLAIMS FOR EXTRA LABOR. EQUIPMENT MATERIALS, ETC. REQUIRED DUE TO DIFFICULTIES WHICH COULD HAVE BEEN FORESEEN WILL NOT BE CONSIDERED AS EXTRA WORK.
- INSTALL WORK SO AS TO BE READILY ACCESSIBLE FOR OPERATING, MAINTENANCE & REPAIR. MINOR DEVIATIONS FROM DRAWINGS MAY BE MADE TO ACCOMPLISH THIS, BUT CHANGES OF MAGNITUDE WHICH INVOLVE EXTRA COST SHALL NOT BE MADE WITHOUT APPROVAL.
- INVESTIGATE EACH SPACE THROUGH WHICH EQUIPMENT MUST BE MOVED. WHEN NECESSARY EQUIPMENT SHALL BE SHIPPED FROM MANUFACTURER IN CRATED SECTIONS OF SIZE SUITABLE FOR MOVING THROUGH AREAS AVAILABLE. ASCERTAIN FROM BUILDING OWNER AT WHAT TIMES OF DAY EQUIPMENT MAY BE MOVED THROUGH THE BUILDING.
- COORDINATE THE EXACT SIZE & LOCATION OF NEW OPENINGS WITH EXISTING STRUCTURE. PATCH / INSULATE AS REQUIRED. CONTRACTOR SHALL FIRESTOP ALL PENETRATIONS FROM NEW PIPING, CONDUIT, DUCTWORK, ETC. THROUGH EXISTING OR NEW FIRE/ SMOKE BARRIERS. REFER TO SPECIFICATION SECTION 15511 FOR FURTHER DETAILS.
- IT IS THE INTENT OF THIS CONTRACT FOR REMAINING SYSTEMS TO BE LEFT IN GOOD WORKING ORDER, READY FOR OPERATION. COORDINATE ANY REQUIRED SYSTEM SHUTDOWNS WITH OWNER 48 HOURS IN ADVANCE. EXISTING SYSTEM SHUTDOWNS WILL NOT BE PERMITTED IF THEY INTERFERE WITH THE DAILY OPERATIONS OF THE BUILDING. CONTRACTOR WILL BE REQUIRED TO TAKE PROPER PRECAUTIONS AGAINST DAMAGING OR DISRUPTING BUILDING SYSTEMS, WIRING, PIPING OR CONTROL TUBING. ANY DAMAGE TO THESE ITEMS SHALL BE REPAIRED AT THE CONTRACTOR'S COST AS A PART OF THIS
- MATERIALS DAMAGED IN THE PROCESS OF INSTALLATION, OR DEMOLITION TO THE SATISFACTION OF THE OWNER'S REPRESENTATIVE. CONTRACTOR SHALL MAKE REPAIRS USING THE SAME OR EQUIVALENT MATERIALS. WORK WILL BE PERFORMED AT THE CONTRACTOR'S COST.
- CONTRACTOR SHALL INCUR ANY COSTS OR BURDENS ASSOCIATED WITH LOST OR STOLEN EQUIPMENT

THE CONTRACTOR SHALL REPAIR / RESTORE TO ORIGINAL CONDITION ANY EXISTING EQUIPMENT OR

- DURING THE LIFE OF THE CONTRACT PERIOD, CONTRACTOR SHALL REMOVE ALL RUBBISH / EXCESS MATERIAL ACCUMULATED AS A RESULT OF HIS OPERATIONS ON A DAILY BASIS. ALL AREAS / EQUIPMENT AFFECTED UNDER THIS CONTRACT SHALL BE KEPT CLEAN OF DUST / DEBRIS. ALL AREAS SHALL RECEIVE A FINAL CLEANING PRIOR TO FINAL ACCEPTANCE BY THE OWNER.
- PROVIDE FOR LEGAL REMOVAL / DISPOSAL OF ALL RUBBISH / DEBRIS FROM THE BUILDING & SITE PROTECT ALL WORK NOT SLATED FOR DEMOLITION.
- THIS CONTRACTOR SHALL COORDINATE HIS WORK WITH ALL OTHER TRADES PRIOR TO SCHEDULING THE WORK. WORK SHALL BE PERFORMED IN PROPER SEQUENCE, AS AGREED TO BY ALL TRADES. ANY COSTS INCURRED BY THE OWNER DUE TO IMPROPER SEQUENCING OF WORK WILL BE PAID FOR BY THIS
- CONTRACTOR SHALL OBTAIN ALL PERMITS, PAY ALL FEES, CONNECTION CHARGES, ETC. ASSOCIATED WITH THE WORK UNDER THEIR CONTRACT.
- PAINT / TOUCH UP ALL SURFACES MARRED AS A RESULT OF THE PERFORMANCE OF THE CONTRACT
- THE MECHANICAL CONTRACTOR SHALL REFER TO / REVIEW ALL OTHER TRADE DRAWINGS IN THE BID PACKAGE & SHALL BE RESPONSIBLE FOR / PERFORM ALL WORK INDICATED AS (M.C.) MECHANICAL WORK AS A PART OF THE BASE BID UNLESS SPECIFICALLY NOTED OTHERWISE.
- SUBSTITUTED EQUIPMENT OF GREATER OR LARGER POWER, DIMENSIONS, CAPACITIES & RATINGS MAY BE FURNISHED PROVIDED THAT SAID EQUIPMENT IS APPROVED IN WRITING PRIOR TO ORDER. ANY CONNECTING MECHANICAL SERVICES, ELECTRICAL SERVICES, BASES, STRUCTURAL APPURTENANCES, ETC. REQUIRED TO BE INCREASED DUE TO THE USE OF SAID EQUIPMENT WILL BE PAID FOR IN FULL BY THE MECHANICAL CONTRACTOR, INCLUDING ANY ADDITIONAL REQUIRED ENGINEERING FEES.
- . EACH PIECE OF EQUIPMENT SHALL BE PROVIDED WITH A PERMANENT TYPE LAMINATED, BLACK FINISH. WHITE CORE, PHENOLIC NAMEPLATE. NAMEPLATES SHOULD INDICATE THE NAME & NUMBER OF THE UNIT UNIT VOLTAGE, & ANY INTERLOCK REFERENCE. STARTERS / DISCONNECT SWITCHES SHOULD ALSO BE EQUIPPED WITH AN IDENTICAL NAMEPLATE WITH THE SAME INFORMATION.
- "ATTIC STOCK" UPON COMPLETION OF THE PROJECT, MECHANICAL CONTRACTOR SHALL COMPLETELY REMOVE / DISPOSE OF FILTERS USED DURING CONSTRUCTION & START-UP PROCEDURES. INSTALL NEW FILTERS IN ALL EQUIPMENT, MERV-8 OR BETTER UPON TURN OVER OF THE PROJECT TO THE OWNER. IN ADDITION, PROVIDE (2) COMPLETE SETS OF FILTERS FOR EACH PEICE OF EQUIPMENT & TURN OVER TO
- MECHANICAL CONTRACTOR SHALL PROVIDE (1) SPARE MOTOR FOR EACH SIZE MOTOR USED ON THE PROJECT. IN INSTANCES WHERE MORE THAN TEN OF THE SAME MOTOR ARE USED, MECHANICAL CONTRACTOR SHALL PROVIDE (1) SPARE MOTOR FOR EVERY TEN MOTORS OF A GIVEN SIZE USED ON THE
- MAINTENANCE MANUAL: UPON COMPLETION OF THE PROJECT, THE MECHANICAL CONTRACTOR SHALL PROVIDE A BINDER CONTAINING THE OPERATIONS & MAINTENANCE MANUALS FOR EACH NEW PEICE OF EQUIPMENT INSTALLED UNDER THIS PROJECT. THE FIRST SECTION OF THE MAINTENANCE MANUAL SHALL CONTAIN A LIST OF EACH PEICE OF EQUIPMENT, COMPLETE WITH INFORMATION SHOWING APPROPRIATE REPLACEMENT FILTER SIZES / TYPES. APPROPRIATE REPLACEMENT BELT SPECIFICATIONS. REPLACEMENT MOTOR SPECIFICATIONS. REPLACEMENT BEARING SPECIFICATIONS. VOLTAGES OF UNIT, ETC. THIS SHALL SERVE AS A WRITTEN DATABASE DESCRIBING ALL MAINTENANCE INFORMATION FOR EACH NEW PEICE OF EQUIPMENT USED.

ROOFING CONSTRUCTION NOTES

. ALL EXISTING DIMENSIONS AND CONDITIONS ARE APPROXIMATE. MECHANICAL CONTRACTORS MUST FIELD VERIFY ALL CONDITIONS AND NOTIFY THE ENGINEER OF ANY DISCREPANCIES PRIOR TO BIDDING. THE MECHANICAL CONTRACTOR SHALL BE RESPONSIBLE FOR VERIFICATION OF ALL DIMENSIONS REQUIRED FOR BIDDING AND ESTIMATING. PRE-BID SITE INSPECTION IS STRONGLY RECOMMENDED. ALL CONTRACTORS SHALL CONTACT THE SCHOOL TO MAKE AN APPOINTMENT FOR SITE VISIT. UNDER NO CIRCUMSTANCES WILL ANY CONTRACTOR BE ALLOWED TO SHOW UP WITHOUT AN APPOINTMENT.

2. IN ACCORDANCE WITH STATE AND LOCAL CODES, THE REQUIRED EXITS IN THE EXISTING BUILDING MUST BE MAINTAINED AS CLEAR, AND PROTECTED DURING THE ENTIRE CONSTRUCTION PERIOD.

3. ALL WORK AND MATERIAL OF THIS PROJECT AND ADJACENT SURFACES SHALL BE PROTECTED FROM DAMAGE. IN THE EVENT OF DAMAGE, THE MECHANICAL CONTRACTOR SHALL IMMEDIATELY NOTIFY THE ARCHITECT AND THE OWNER, AND MAKE ALL REPAIRS AND REPLACEMENTS NECESSARY TO THE APPROVAL OF THE ARCHITECT AND OWNER AND AT NO ADDITIONAL COST TO THE OWNER.

I. THE MECHANICAL CONTRACTOR IS TO PROTECT AND MAKE WATER TIGHT ALL AREAS OF HIS WORK FROM INCLEMENT WEATHER DURING AND AT THE END OF EVERY DAY OF WORK OPERATIONS.

5. ALL PROJECT WASTE MATERIAL AND RUBBISH GENERATED BY THE MECHANICAL CONTRACTOR AND / OR HIS SUB-CONTRACTORS SHALL BE DISPOSED IN CONTAINERS FOR SUBSEQUENT LEGAL OFF-SITE DISPOSAL. CONTAINER LOCATION TO BE COORDINATED WITH BUILDINGS AND GROUNDS. OFF-SITE DISPOSAL TO BE ON A REGULAR BASIS.

6. ALL FLASHING ON MECHANICALS MUST BE INSTALLED AT A DISTANCE ABOVE THE FINISHED ROOF SURFACE TO INSURE CONFORMANCE WITH ROOFING MANUFACTURER'S WARRANTY REQUIREMENTS. INCLUSIVE OF ALL CONDITIONS, NO EXCEPTIONS

7. THE ROOFING CONTRACTOR SHALL BE SURE TO MAINTAIN ANY/ALL EXISTING ROOFING WARRANTEE IN PLACE AT THOSE ROOFS WHICH CUTTING, PATCHING AND RE-FLASHING IS REQUIRED. THE ROOFING CONTRACTOR SHALL BE RESPONSIBLE TO MAKE ANY & ALL REPAIRS TO EXISTING ROOFING SYSTEM AS REQUIRED TO CONSTRUCTION ACTIVITIES AT NO ADDITIONAL COST TO THE OWNER. ALL WORK SHALL BE DONE IN ACCORDANCE WITH THE MANUFACTURER'S SPECIFICATIONS AND SHALL MAINTAIN ALL EXISTING WARRANTIES

8. THE ROOFING CONTRACTOR (R.C.) SHALL BE RESPONSIBLE FOR ALL NEW ROOF PENETRATIONS FOR NEW MECHANICAL UNITS ON EXISTING ROOF. R.C. SHALL COORDINATE SETTING OF CURBS WITH THE MECHANICAL CONTRACTOR (M.C.) AND R.C. SHALL BE RESPONSIBLE FOR ALL PATCHING/FLASHING OF EXISTING ROOF. THE MECHANICAL CONTRACTOR SHALL USE CERTIFIED ROOF INSTALLER AS APPROVED BY MANUFACTURER OF EXISTING ROOF AS TO NOT VOID EXISTING ROOF WARRANTY. COORDINATE WITH OWNER.

9. THE MECHANICAL CONTRACTOR SHALL BE RESPONSIBLE TO COORDINATE INSTALLATION OF ALL MECHANICAL UNITS/ EQUIPMENT WITH ALL

ALL WALL & FLOOR PENETRATIONS SHALL BE DONE BY ROOFING CONTRACTOR WITH MECHANICAL CONTRACTOR PRESENT.

GENERAL NOTES FOR ALL ROOFTOP EQUIPMENT:

- 1. PROVIDE DISCONNECT SWITCH FOR EACH NEW EQUIPMENT.
- 2. R.C. SHALL MAKE ALL ROOF PENETRATIONS IN THE PRESENCE OF THE MECHANICAL CONTRACTOR.
- 3. MECHANICAL CONTRACTOR SHALL FURNISH NEW ROOF CURBS TO R.C. R.C. SHALL CUT HOLES IN ROOF IN PRESENCE OF M.C. AND R.C. SHALL INSTALL NEW ROOF CURBS IN THE PRESENCE OF THE CERTIFIED M.C. R.C. SHALL BE RESPONSIBLE FOR FLASHING ALL NEW ROOF CURBS. REFER TO ARCHITECTURAL DRAWINGS FOR FURTHER DETAILS OF FLASHING ROOF CURBS.

GENERAL MECHANICAL NOTES:

- PROVIDE AND INSTALL 2" ACOUSTIC FIBERGLASS 3-LBS. DENSITY WITHIN ROOF CURBS AND ADAPTER ROOF CURBS.
- ALL DISCONNECT SWITCHES AND STARTERS TO BE FURNISHED BY MECHANICAL CONTRACTOR AND INSTALLED AND WIRED BY THE ELECTRICIAN.
- DUCT SIZE DIMENSIONS SHOWN ARE 'CLEAR' INSIDE DIMENSIONS.
- CONTROLS CONTRACTOR SHALL FURNISH ALL CONTROLS EQUIPMENT AND PROVIDE TO MECHANICAL CONTRACTOR TO INSTALL. CONTROLS CONTRACTOR SHALL WIRE ALL CONTROLS EQUIPMENT.
- UNLESS OTHERWISE NOTED, THE GENERAL CONTRACTOR (G.C.) SHALL MAKE ALL INTERIOR WALL, CEILING, & FLOOR PENETRATIONS OR PIPING & DUCTWORK. M.C. SHALL BE RESPONSIBLE TO COORDINATE WITH ALL TRADES. M.C. SHALL BE PRESENT WHEN G.C.

GENERAL EXHAUST FAN NOTES:

ABBREVIATIONS

MAKES PENETRATIONS FOR ALL MECHANICAL PIPING & DUCTWORK.

- E.C. SHALL DISCONNECT & REMOVE EXISTING STARTERS FOR ALL EXHAUST FANS SHOWN TO BE REPLACED. THEN M.C. SHALL PROVIDE NEW STARTERS & DISCONNECTS FOR THOSE EXHAUST FANS BEING REPLACED. E.C. SHALL INSTALL NEW STARTERS / DISCONNECTS. VERIFY EXISTING LOCATIONS OF ALL EXISTING EXHAUST FAN STARTERS.
- M.C. SHALL PROVIDE AND INSTALL NEW ADAPTER CURB ASSEMBLIES AS REQ'D. TO MOUNT NEW EXHAUST FANS IN EXIST. EXHAUST FAN
- M.C. SHALL MODIFY AS NECESSARY ALL EXIST. EXHAUST FAN EQUIPMENT TO COMPLETELY INSTALL THE NEW REPLACEMENT EXHAUST FAN

ABOVE FINISHED FLOOR

BACKDRAFT DAMPER

COLD WATER SUPPLY

FLOAT & THERMOSTATION

FLAT OVAL DUCTWORK

GALLONS PER HOUF

GALLONS PER MINUT

HEATING SYSTEM HOT WATER SUPPLY

HEATING SYSTEM HOT WATER RETURN

_HANDICAPPED

INSIDE DIAMETER

MANUFACTURE

MISCELLANEOUS

NATURAL GAS

NOT IN CONTRACT

LEAVING AIR TEMPERATURE

EAVING WATER TEMPERATURE

FEET PER MINUTE

<u>CUBIC FEET OF AIR PER MINUTE</u>

FIRE DAMPER - DUCT MOUNTE

FOR FURTHER DETAILS ON ALL MECHANICAL EXHAUST FAN EQUIPMENT REFER TO MECHANICAL DRAWINGS.

FIRESTOPPING NOTES

CONTRACTOR.

- ALL PENETRATIONS THROUGH FIRE RATED WALLS, FLOORS OR OTHER STRUCTURES SHALL BE FIRE STOPPED BY MECHANICAL CONTRACTOR.
- THE FIRE STOP MATERIALS SHALL BE HILTI TYPE FS-657 FIRE BLOCK, FS-ONE SEALANT, CP-672 JOINT SPRAY, CP-601S ELASTOMERIC SEALANT, 6P-606 FLEXIBLE SEALANT, CP-643 OR CP-642 COLLAR, CP-618 PUTTY STICK, OR FS-635 TROWEL ABLE COMPOUND, AS SUITABLE.
- . CONTRACTOR SHALL SUBMIT SHOP DRAWINGS OF PRODUCTS TO BE USED.

EC SHALL DISCONNECT AND REMOVE OLD STARTER /

EC SHALL PROVIDE NEW CIRCUIT, UNLESS OTHERWISE

DISCONNECT SWITCH PROVIDED BY MC,

INSTALLED BY EC, UNLESS OTHERWISE

NOTED. SIZE AS REQUIRED. MUST BE

INSTALLED WITHIN SIGHT AND READILY

ACCESSIBLE OF MECHANICAL EQUIPMENT.

DISCONNECT AND UNNECESSARY WIRING.

MC TO FIELD VERIFY EXISTING STARTER AND

NEW MECHANICAL EQUIPMENT

GENERIC DIAGRAM - REFER TO DWG'S FOR FURTHER DETAILS

NUMBER

NOMINAL

NOT TO SCALE

OUTSIDE AIR

ON CENTER

ON CENTER

RETURN AIF

REQUIRE

SUPPLY AIR

SCHEDULE

STANDARI

TYPICAL

WITHOU

TEMPERATURE

/OLUME DAMPER

STATIC PRESSURE

PREFABRICATE

OUTSIDE DIAMETER

OUTSIDE SCREW & YOK!

PNEUMATIC / ELECTRI

POUNDS PER SQUARE INCH

REVOLUTIONS PER MINUTE

THERMAL EXPANSION VALVE

ARIABI F FREQUENCY DRIVE

WET BULB TEMPERATURE

WATER TEMPERATURE DROP

WATER TEMPERATURE RISE

WATER PRESSURE DROP

DISCONNECT LOCATIONS FOR EC.

NOTED ON DWG'S.

POWER PANEL

ALL CIRCUIT

BREAKERS AND

OTHER POWER

REQUIREMENTS

PROVIDED AND

INSTALLED BY EC

FIRESTOP MATERIALS OTHER THAN HILTI SHALL INCLUDE FULL TECHNICAL DATA WITH SHOP DRAWINGS TO DEMONSTRATE EQUALITY WITH

ROOFTOP MECHANICAL EQUIPMENT DEMOLITION PLAN GENERAL NOTES:

- MECHANICAL CONTRACTOR SHALL VERIFY IN THE FIELD THE EXACT LOCATION OF ALL EXISTING MECHANICAL RELATED EQUIPMENT, DUCTWORK, PIPING, LOUVERS, AND ROOFTOP EQUIPMENT PRIOR TO START OF ANY WORK.
- MECHANICAL CONTRACTOR SHALL COORDINATE ALL ROOF DEMOLITION PLAN WORK AND WALL DEMOLITION PLAN WORK WITH GENERAL
- REMOVE EXISTING EQUIPMENT AS SHOWN ON PLANS. MECHANICAL CONTRACTOR IS RESPONSIBLE FOR REMOVAL OF ALL MECHANICAL EQUIPMENT AND ASSOCIATED DUCTWORK AND ASSOCIATED ROOF CURBS, ASSOCIATED DUCTWORK, WALL LOUVERS, WHERE CALLED OUT

IN KEY PLAN NOTES. MECHANICAL CONTRACTOR SHALL COORDINATE REMOVAL OF ALL ROOF MECHANICAL EQUIPMENT WITH ROOFING

- ROOFING CONTRACTOR SHALL BE RESPONSIBLE FOR PATCHING ANY ROOF PENETRATION THAT SHALL NOT BE RE-USED. REFER TO ARCHITECTURAL DRAWINGS FOR FURTHER DETAILS ON ROOF PATCHING.
- GENERAL CONTRACTOR (G.C) SHALL BE RESPONSIBLE FOR PATCHING ALL WALL PENETRATIONS. ROOFING CONTRACTOR SHALL BE RESPONSIBLE FOR PATCHING ALL ROOF PENETRATIONS AND FLASHING ALL NEW ROOF CURBS. MECHANICAL CONTRACTOR (M.C.) SHALL BE RESPONSIBLE FOR MAKING ALL WALL PENETRATIONS IN THE PRESENCE OF THE GENERAL CONTRACTOR. ROOFING CONTRACTOR SHALL BE RESPONSIBLE FOR MAKING ALL ROOF PENETRATIONS AND INSTALLING ROOF CURBS.

OPEN PROTOCOL

BACNECT

CONTROLLER

NEW EXHAUST FAN

PROVIDED AND INSTALLED

CONTROL

WIRING BY MC

BY MC

PWR WIRING BY EC

STARTER OR VFD

PROVIDED BY MC

INSTALLED BY EC

(COORDINATE

LOCATION WITH MC

TESTING and BALANCING NOTES

- MECHANICAL CONTRACTOR WILL BE REQUIRED TO PERFORM ALL EQUIPMENT & SYSTEM TESTING BALANCING REQUIRED UNDER THIS CONTRACT. PROVIDE A FULL REPORT DETAILING ALL DESIGN & ACTUAL CONDITIONS FOR ALL AIR & HYDRONIC SYSTEMS SHOWN ON THE DRAWINGS. REFER TO SPECIFICATION SECTIONS 15990 & 15997 FOR FURTHER DETAILS.
- UPON NOTICE OF COMPLETION OF WORK BY THE CONTRACTOR, OWNER WILL OBTAIN THE SERVICES OF AN INDEPENDENT TESTING & BALANCING CONTRACTOR TO VERIFY THE RESULTS OF THE TESTING & BALANCING REPORT SUBMISSION. INDEPENDENT TESTING AGENCY SHALL SELECT A RANDOM NUMBER OF MEASUREMENTS TO BE CHECKED. MEASUREMENTS WILL BE CHECKED IN THE SAME MANNER AS ORIGINALLY MEASURED. NUMBER OF VERIFICATION MEASUREMENTS SHALL BE APPROXIMATELY 25% OF THE TOTAL MEASUREMENTS FOR THE PROJECT.
- IF MORE THAN 10% OF THE VERIFICATION TESTING SHOWS DEVIATIONS OF 10% OR MORE / SOUND LEVEL OF 2dB DIFFERENT THAN THAT ORIGINALLY MEASURED, THE ORIGINAL REPORT WILL BE REJECTED. ALL SYSTEMS WILL THEN BE REQUIRED TO BE COMPLETELY RE-TESTED, WITH A SECOND REPORT SUBMITTED IN THE EVENT THAT THE ORIGINAL REPORT IS REJECTED, ALL SYSTEMS SHALL BE READJUSTED & TESTED, NEW CERTIFIED REPORTS SUBMITTED, AND NEW VERIFICATION TESTS MADE, AT NO ADDITIONAL COST TO THE OWNER. THE CONTRACTOR WILL BE RESPONSIBLE FOR ALL COSTS INVOLVED WITH THE VERIFICATION TESTS.

ELECTRICAL WORK UNDER MECHANICAL CONTRACT


- MECHANICAL CONTRACTOR SHALL PROVIDE ALL STARTERS & DISCONNECT SWITCHES REQUIRED FOR ALL NEW MECHANICAL EQUIPMENT. STARTER / DISCONNECT SWITCH INSTALLATION TO BE PERFORMED UNDER THE ELECTRICAL CONTRACT. COORDINATE WORK W/ ELECTRICAL CONTRACTOR PRIOR TO START
- POWER WIRING REQUIRED FOR CONTROLS SHALL BE PERFORMED UNDER THE MECHANICAL CONTRACT UNLESS SPECIFICALLY NOTED OTHERWISE ON THE ELECTRICAL DRAWINGS. MECHANICAL CONTRACTOR SHALL OBTAIN THE SERVICES OF A LICENSED ELECTRICIAN (PER NEC REQUIREMENTS) TO PERFORM ALL ELECTRICAL WORK.


LOCK OUT-TAG OUT NOTIFICATION

IN ACCORDANCE WITH OSHA REGULATIONS - ALL CONTRACTORS MUST PROPERLY LOCK-OUT & TAG OUT ALL ELECTRICAL EQUIPMENT THEY ARE WORKING ON, PRIOR TO DISMANTLING FOR SERVICE OR CLEANING.

CONTRACTOR ABBREVIATIONS

M.C. = MECHANICAL CONTRACTOR P.C. = PLUMBING CONTRACTOR C.C. = CONTROLS CONTRACTOR E.C. = ELECTRICAL CONTRACTOR G.C. = GENERAL CONTRACTOR C.W.C. = CASEWORK CONTRACTOR R.C. = ROOFING CONTRACTOR

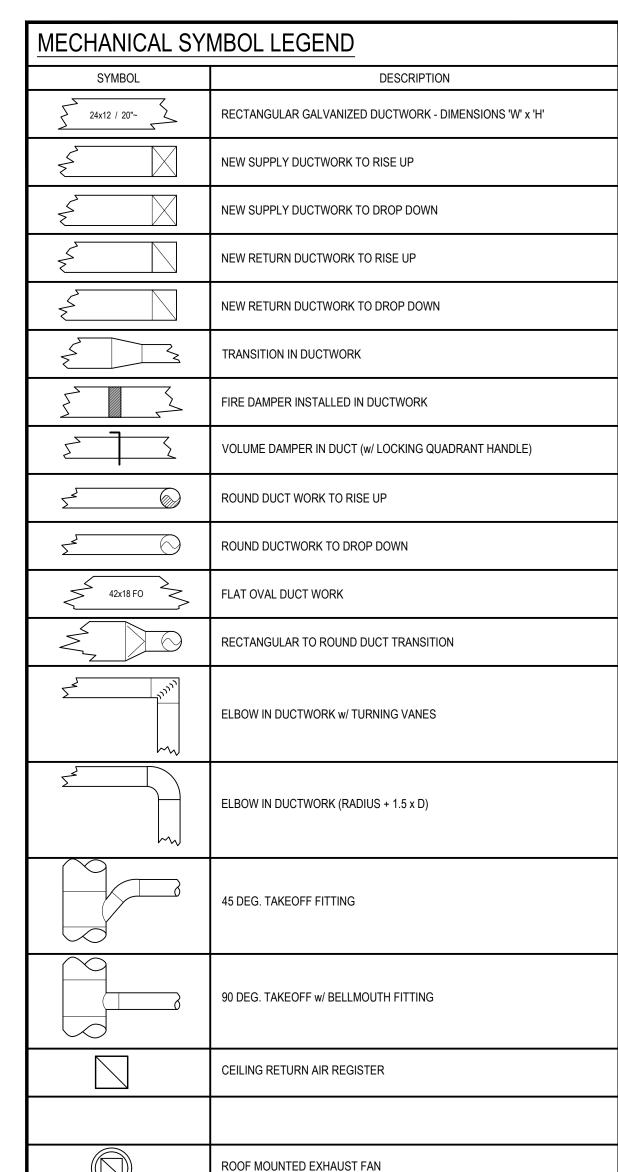

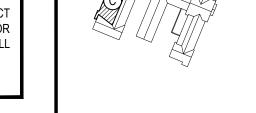

KEY PLAN

REV. DATE

1 | 1/14/2022 | ISSUED FOR BID

NOTICE

ESE DRAWINGS ARE BASED ON CONSTRUCTION DRAWINGS NOT


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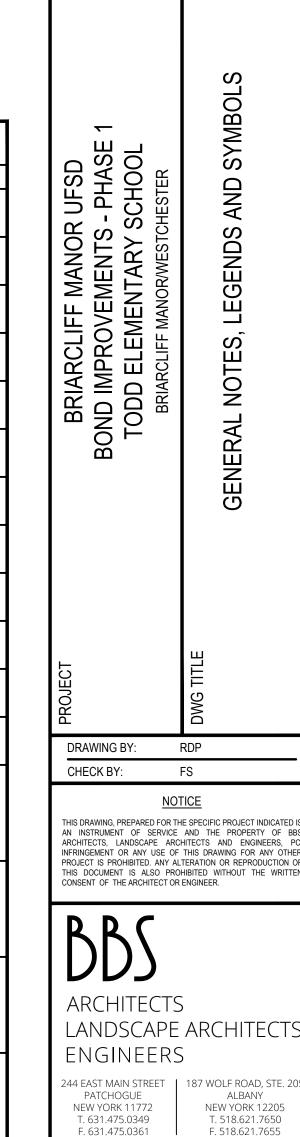
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R THE ORIGINAL DOCUMENTS OR PER THE OWNER'S INFORMATION



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66-14-02-02-0-002-020

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DISTRICT BRIARCLIFF MANOR UFSD PROJECT BOND IMPROVEMENTS PHASE 1


AND SYMBOLS SCALE: AS NOTED DATE: 10/08/21

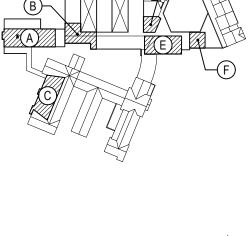BID PICK-UP: 1/17/2022


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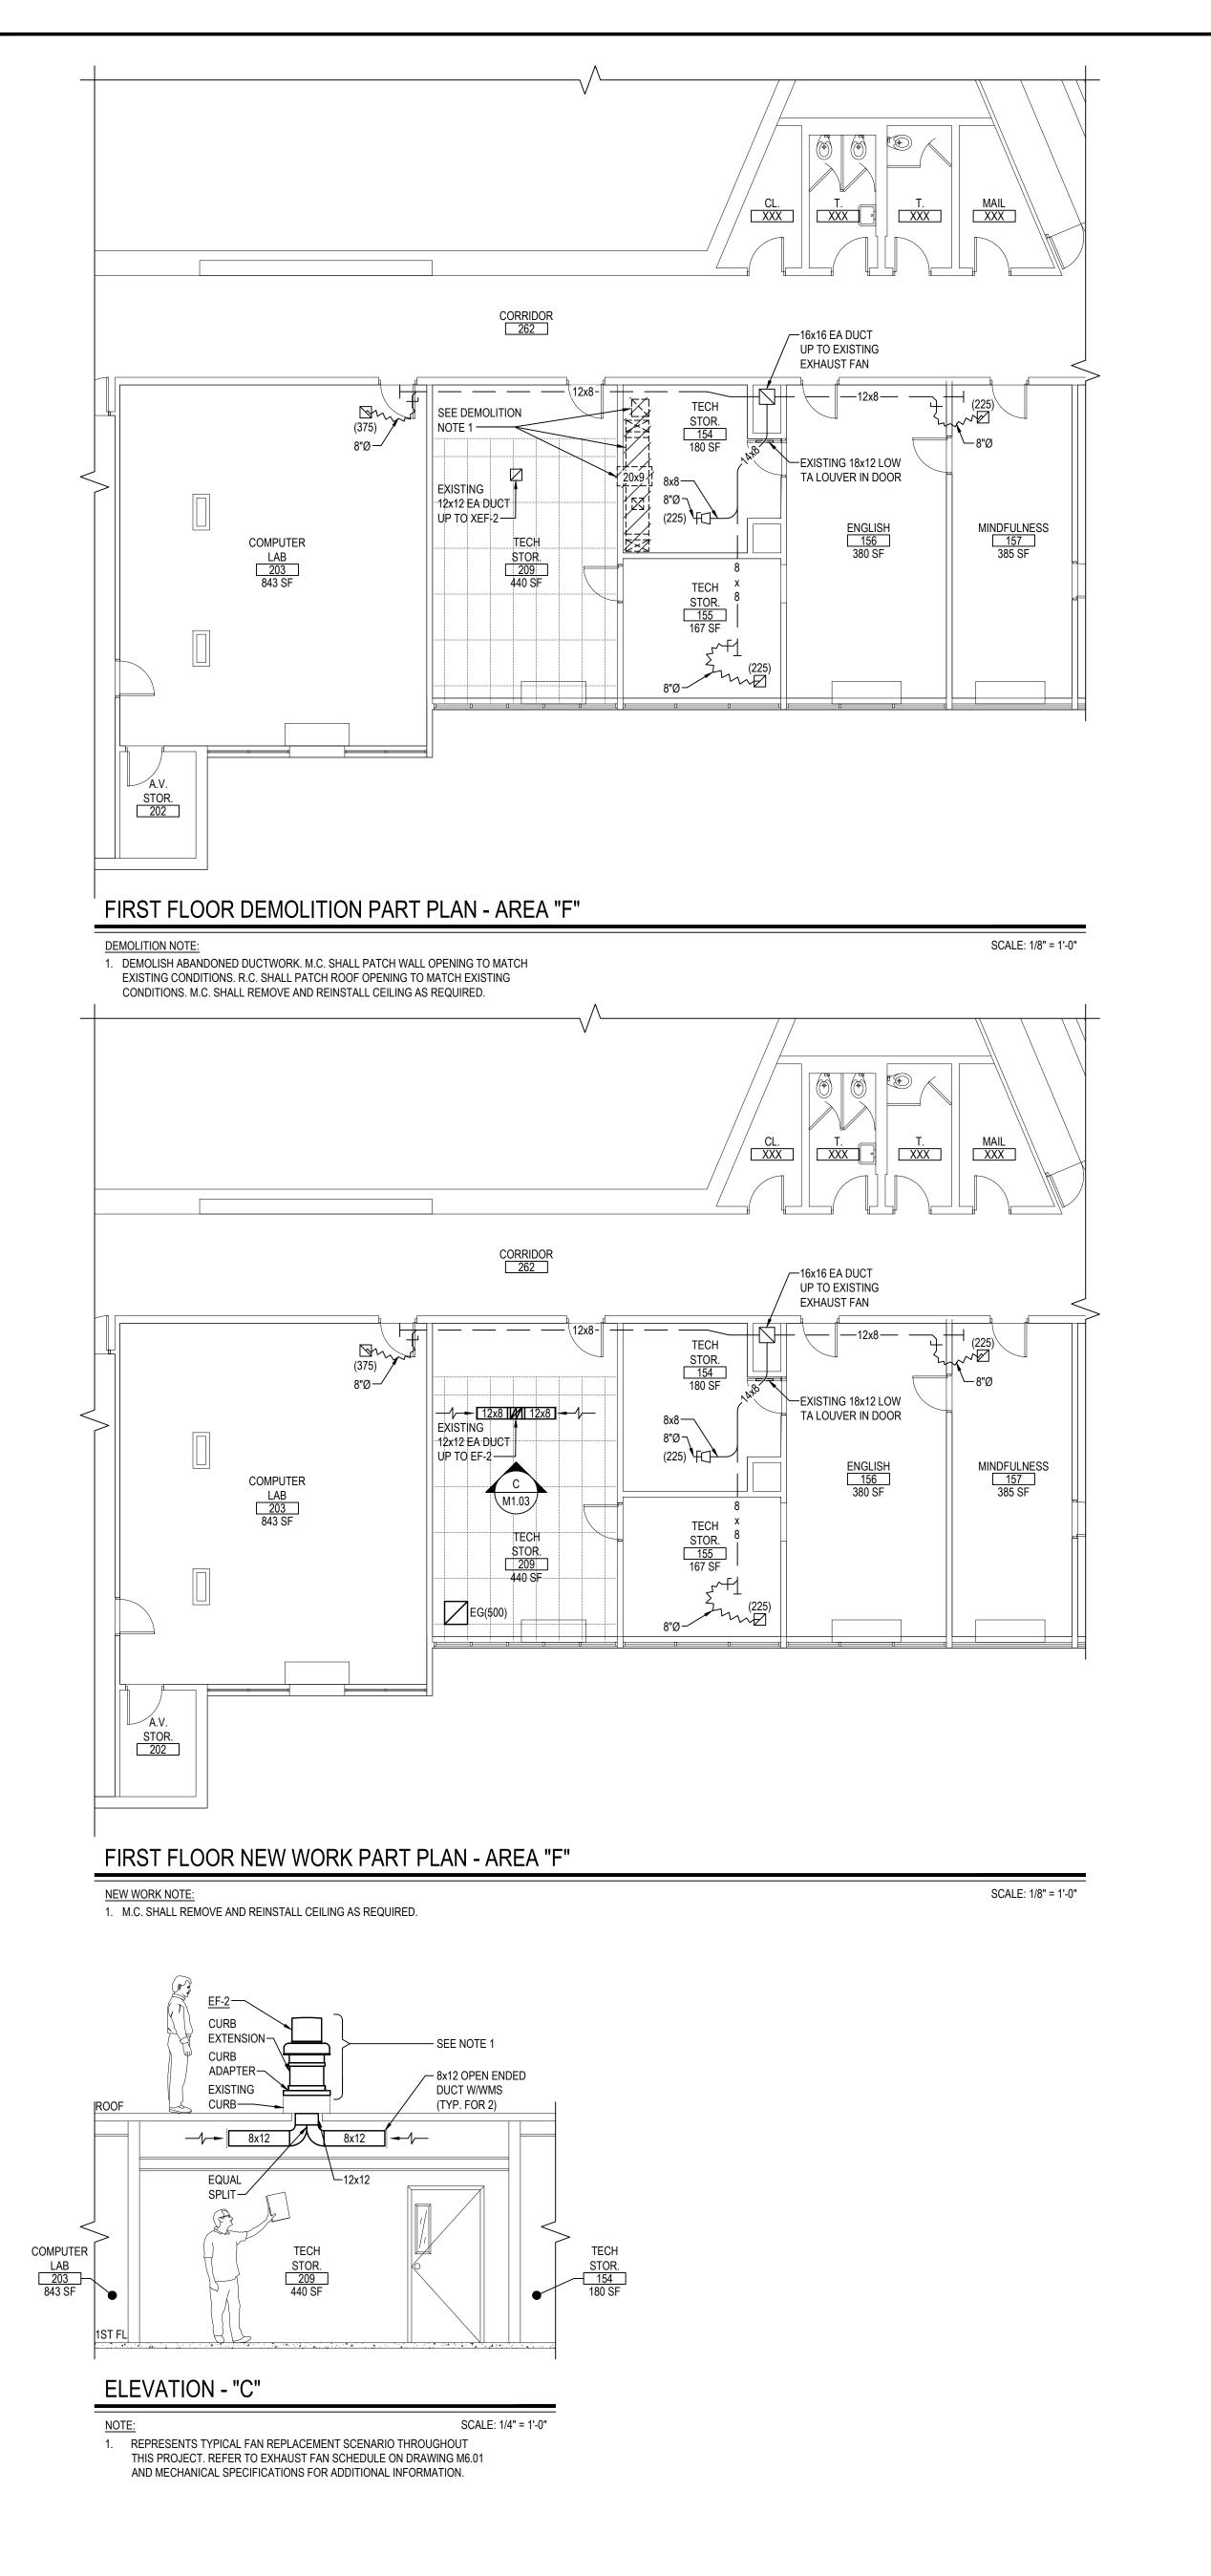
<u>DWG TITLE</u> GENERAL NOTES, LEGENDS


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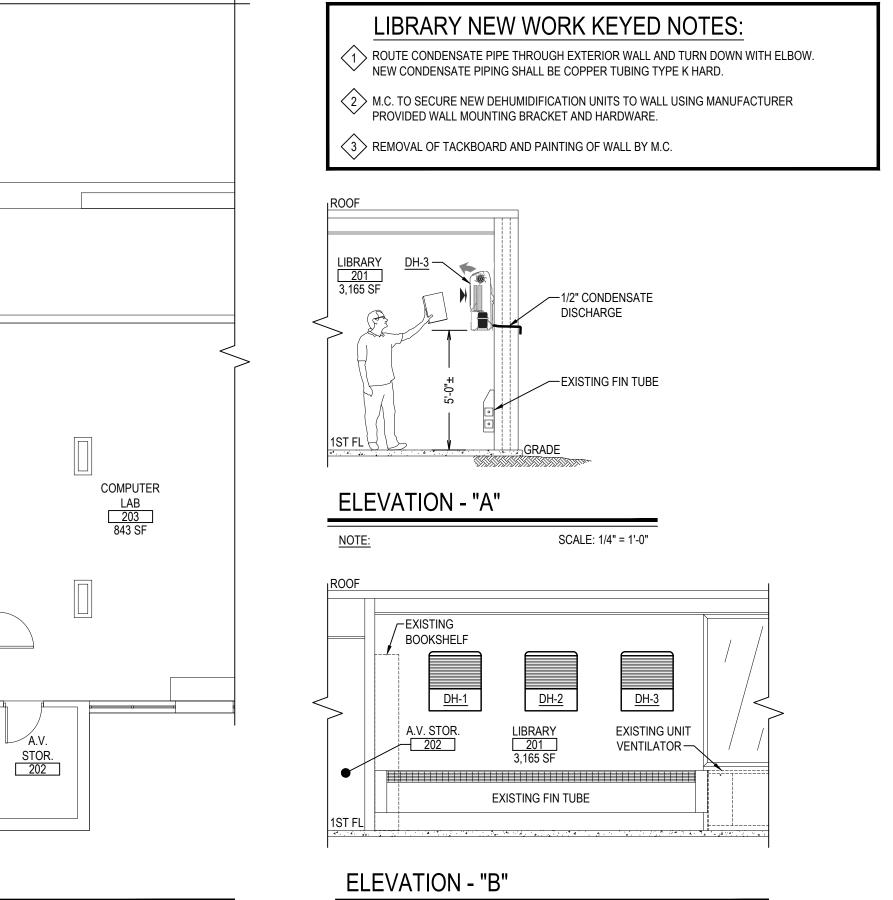


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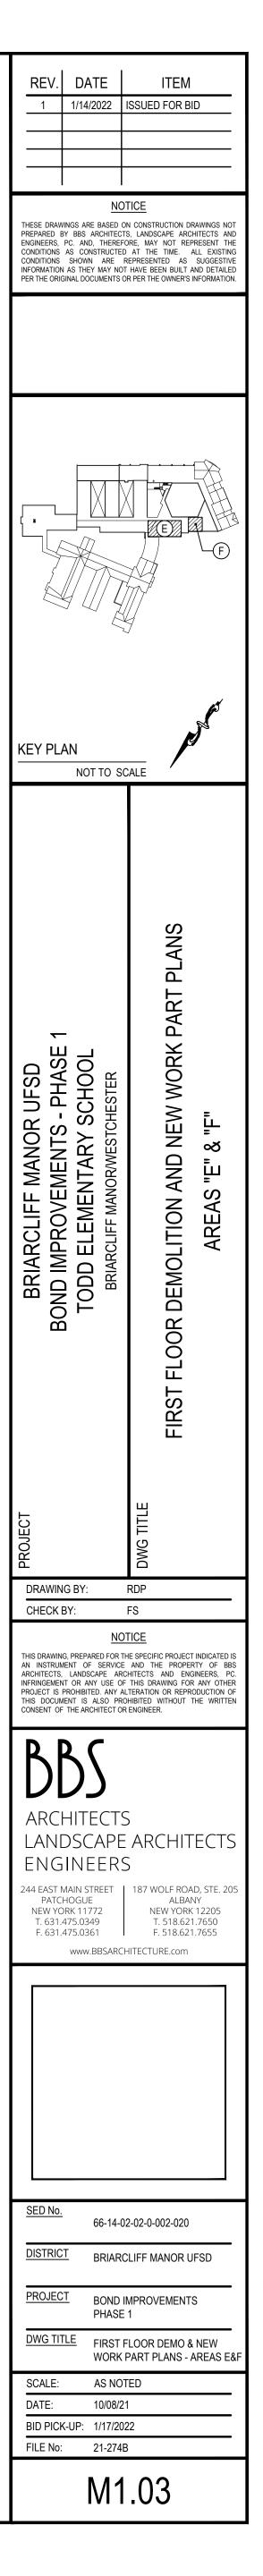


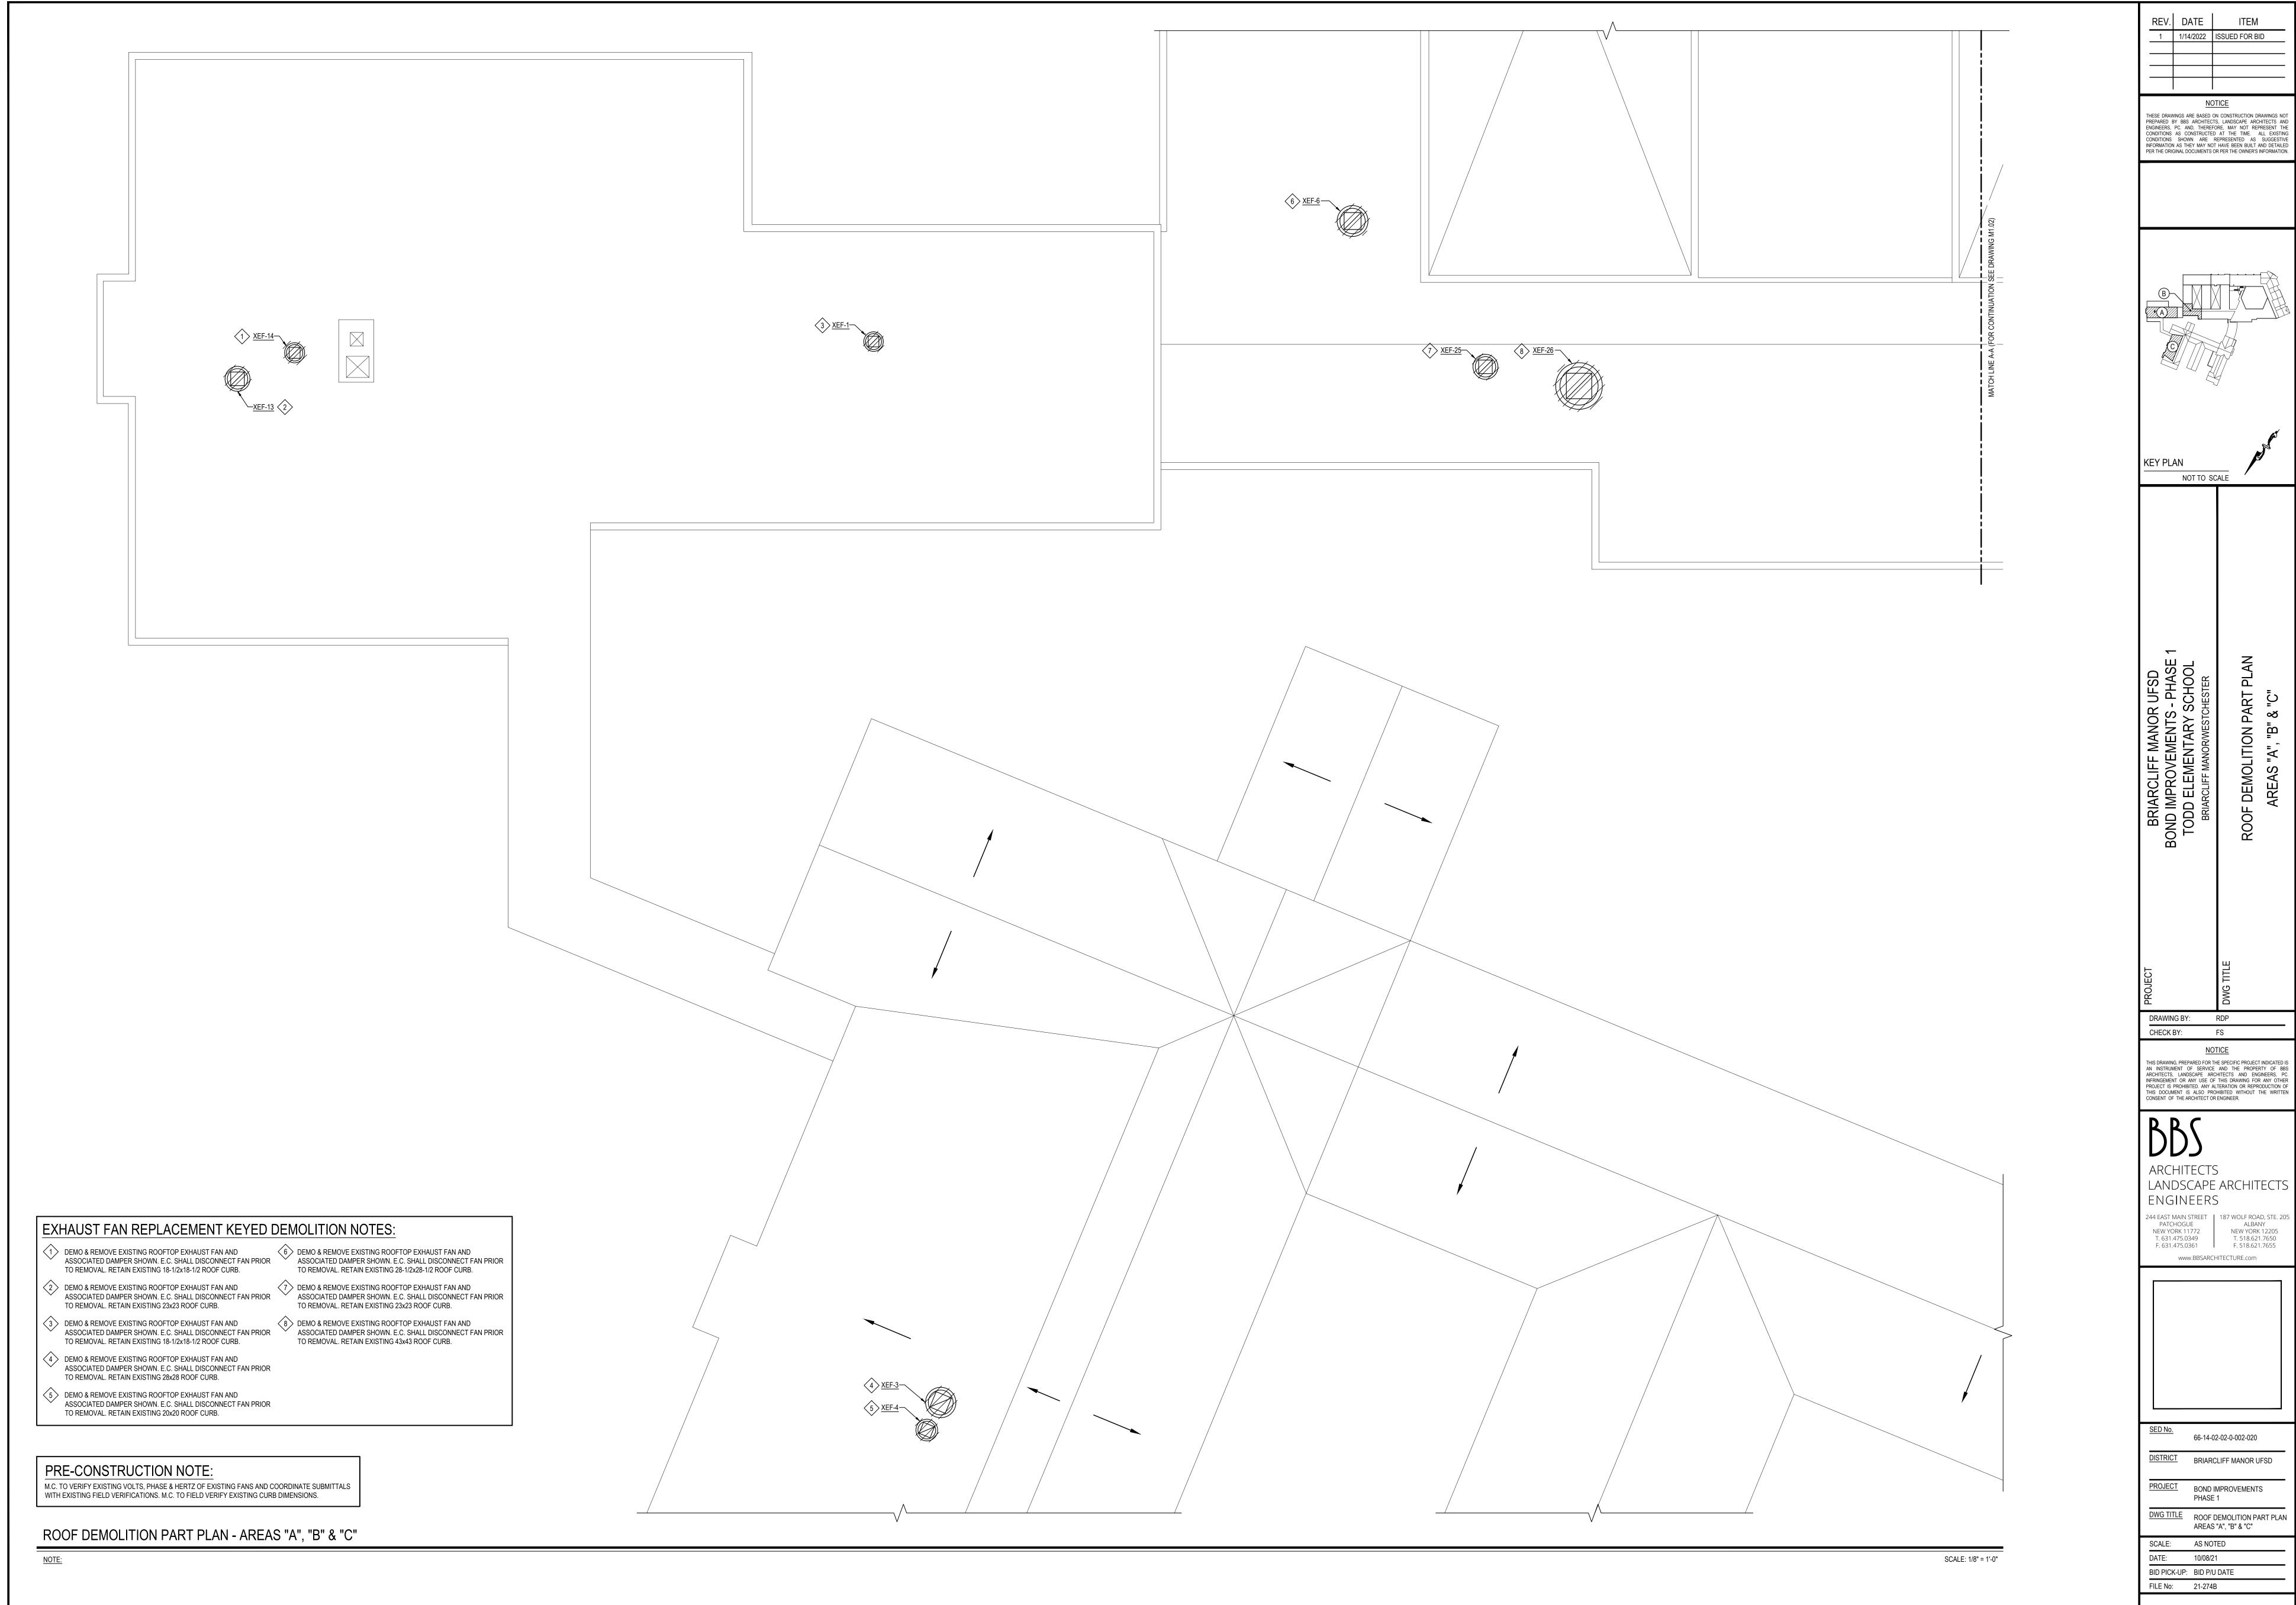


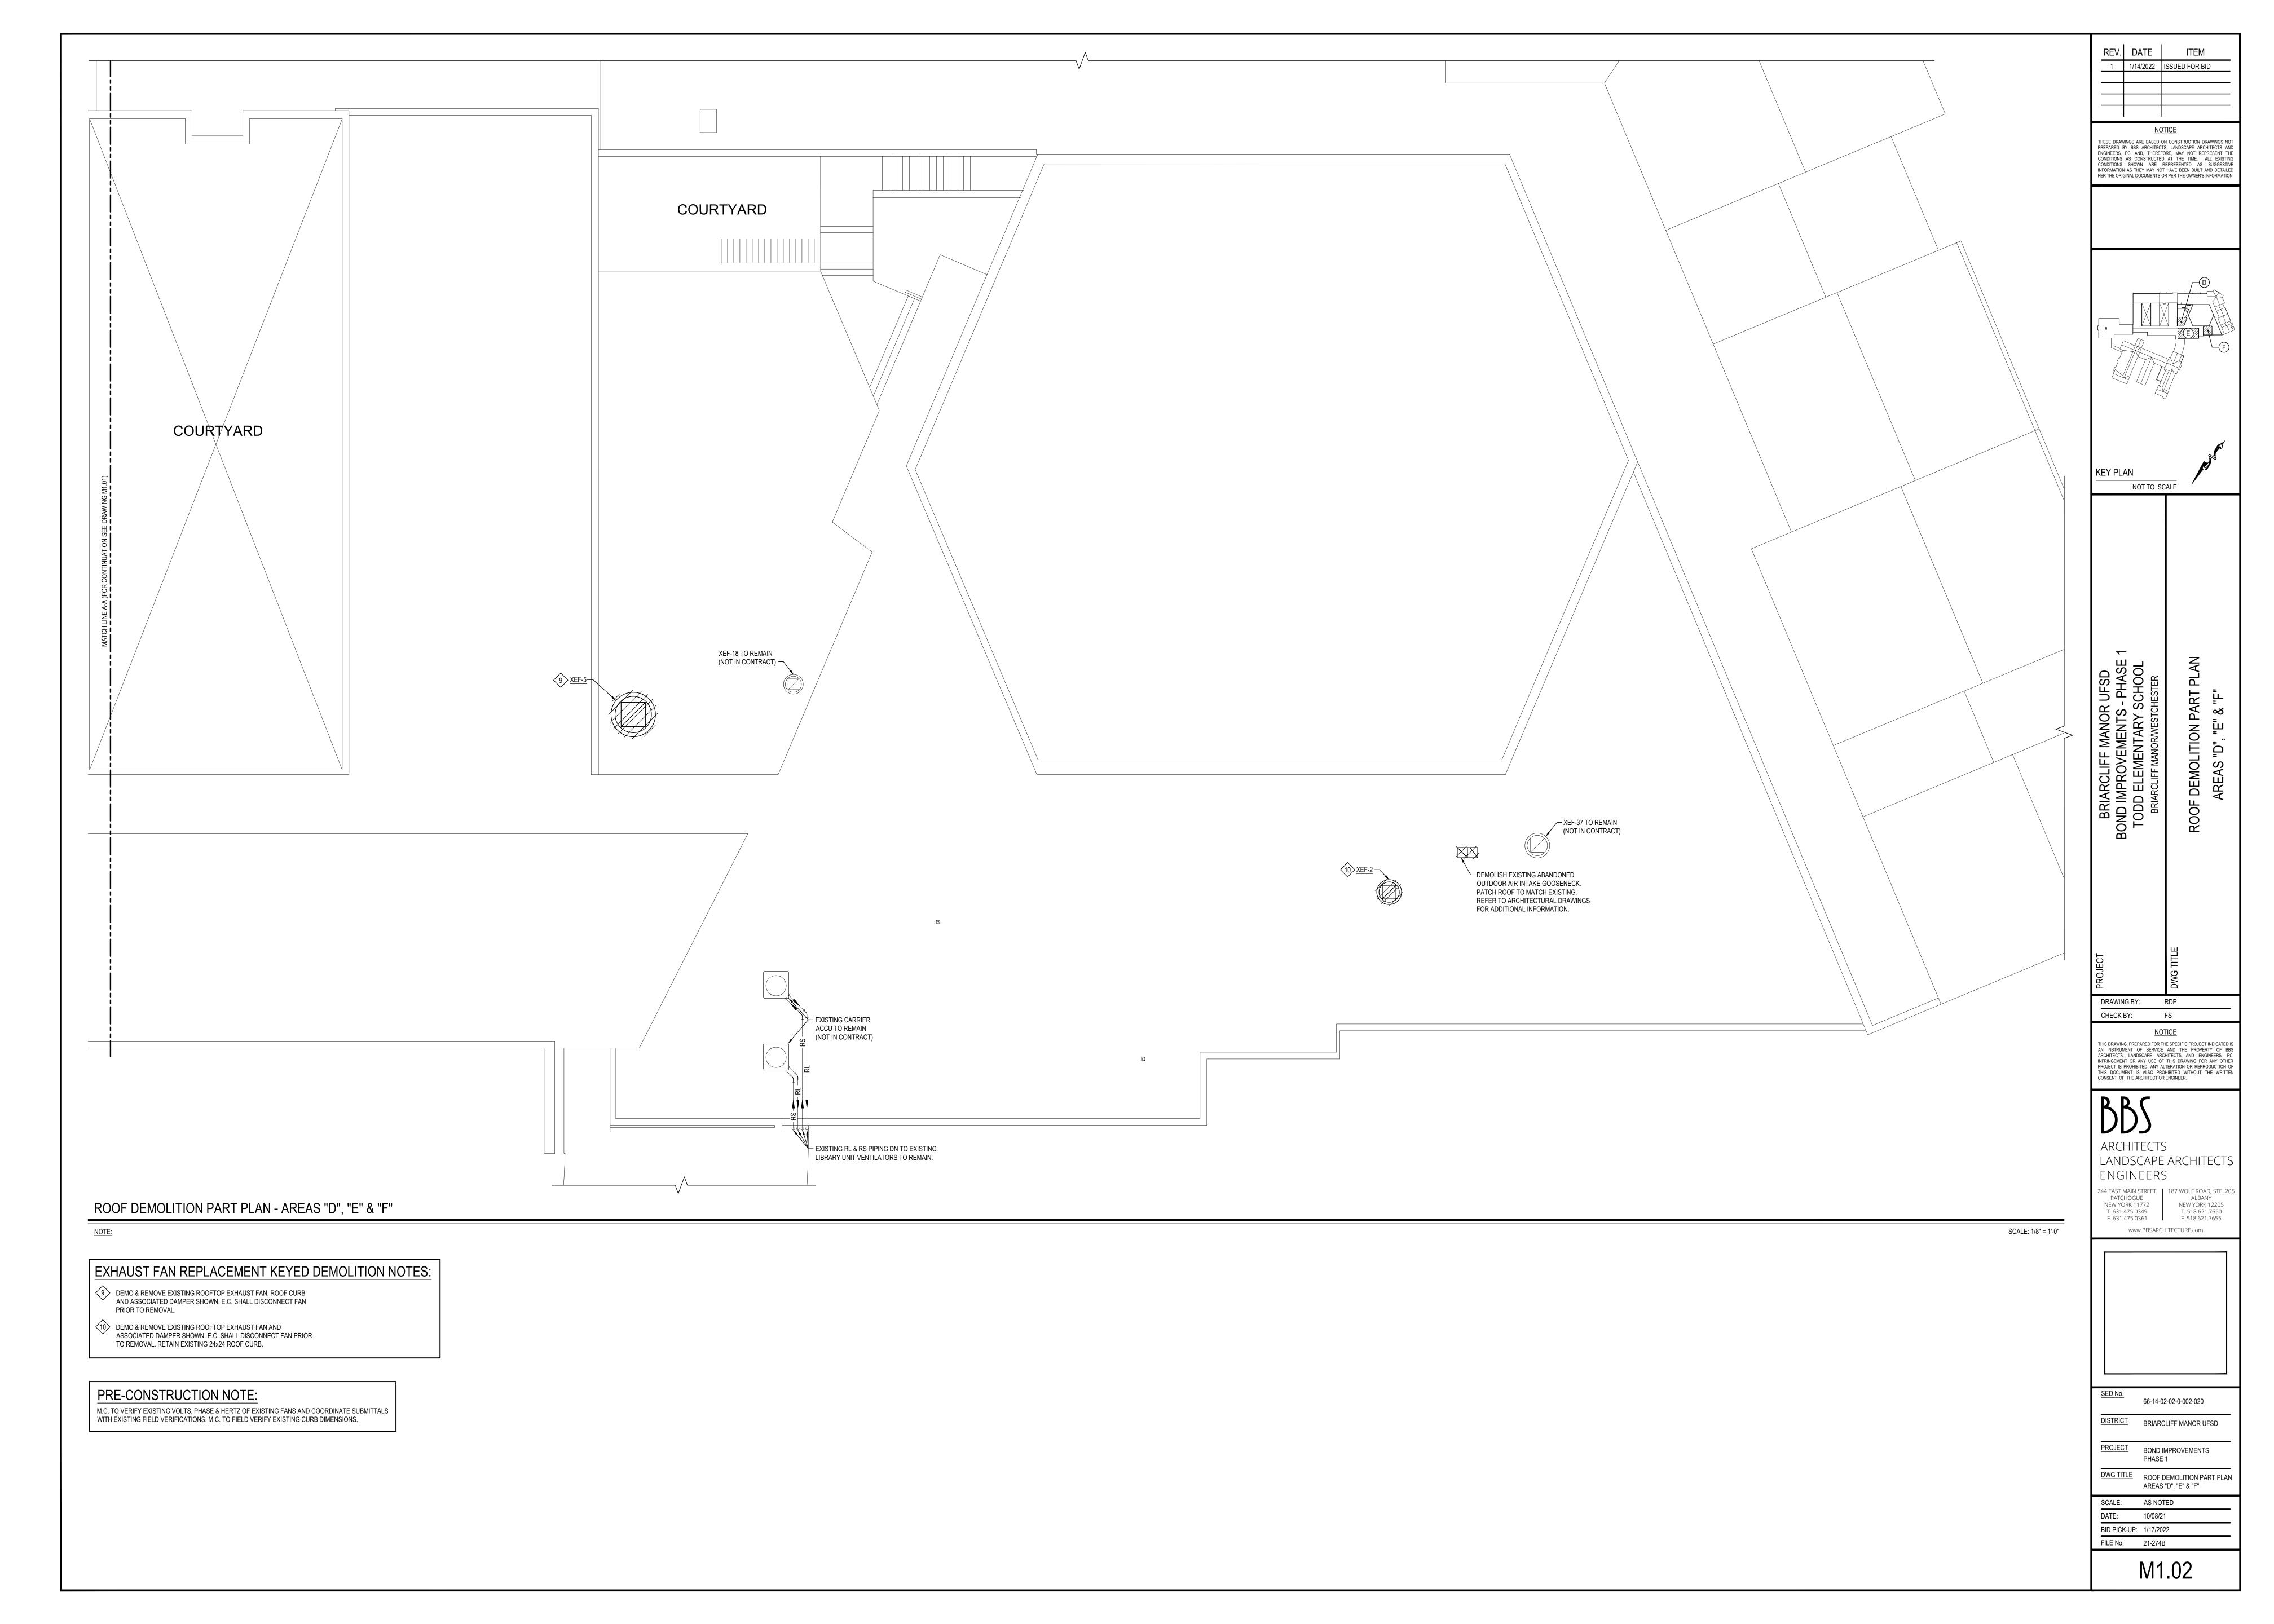

NOTE:

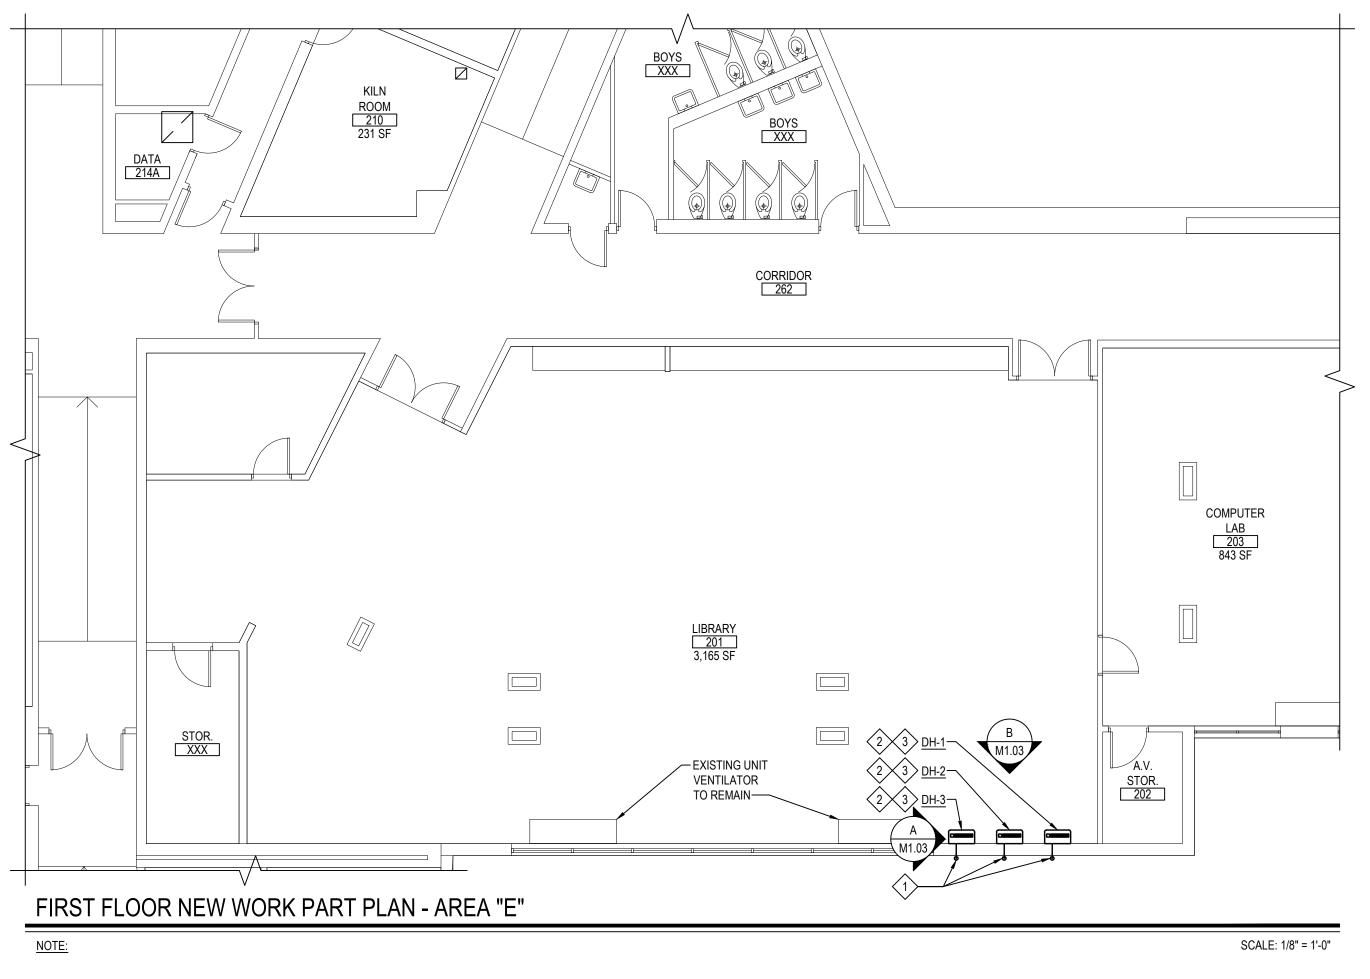SCALE: 1/4" = 1'-0"



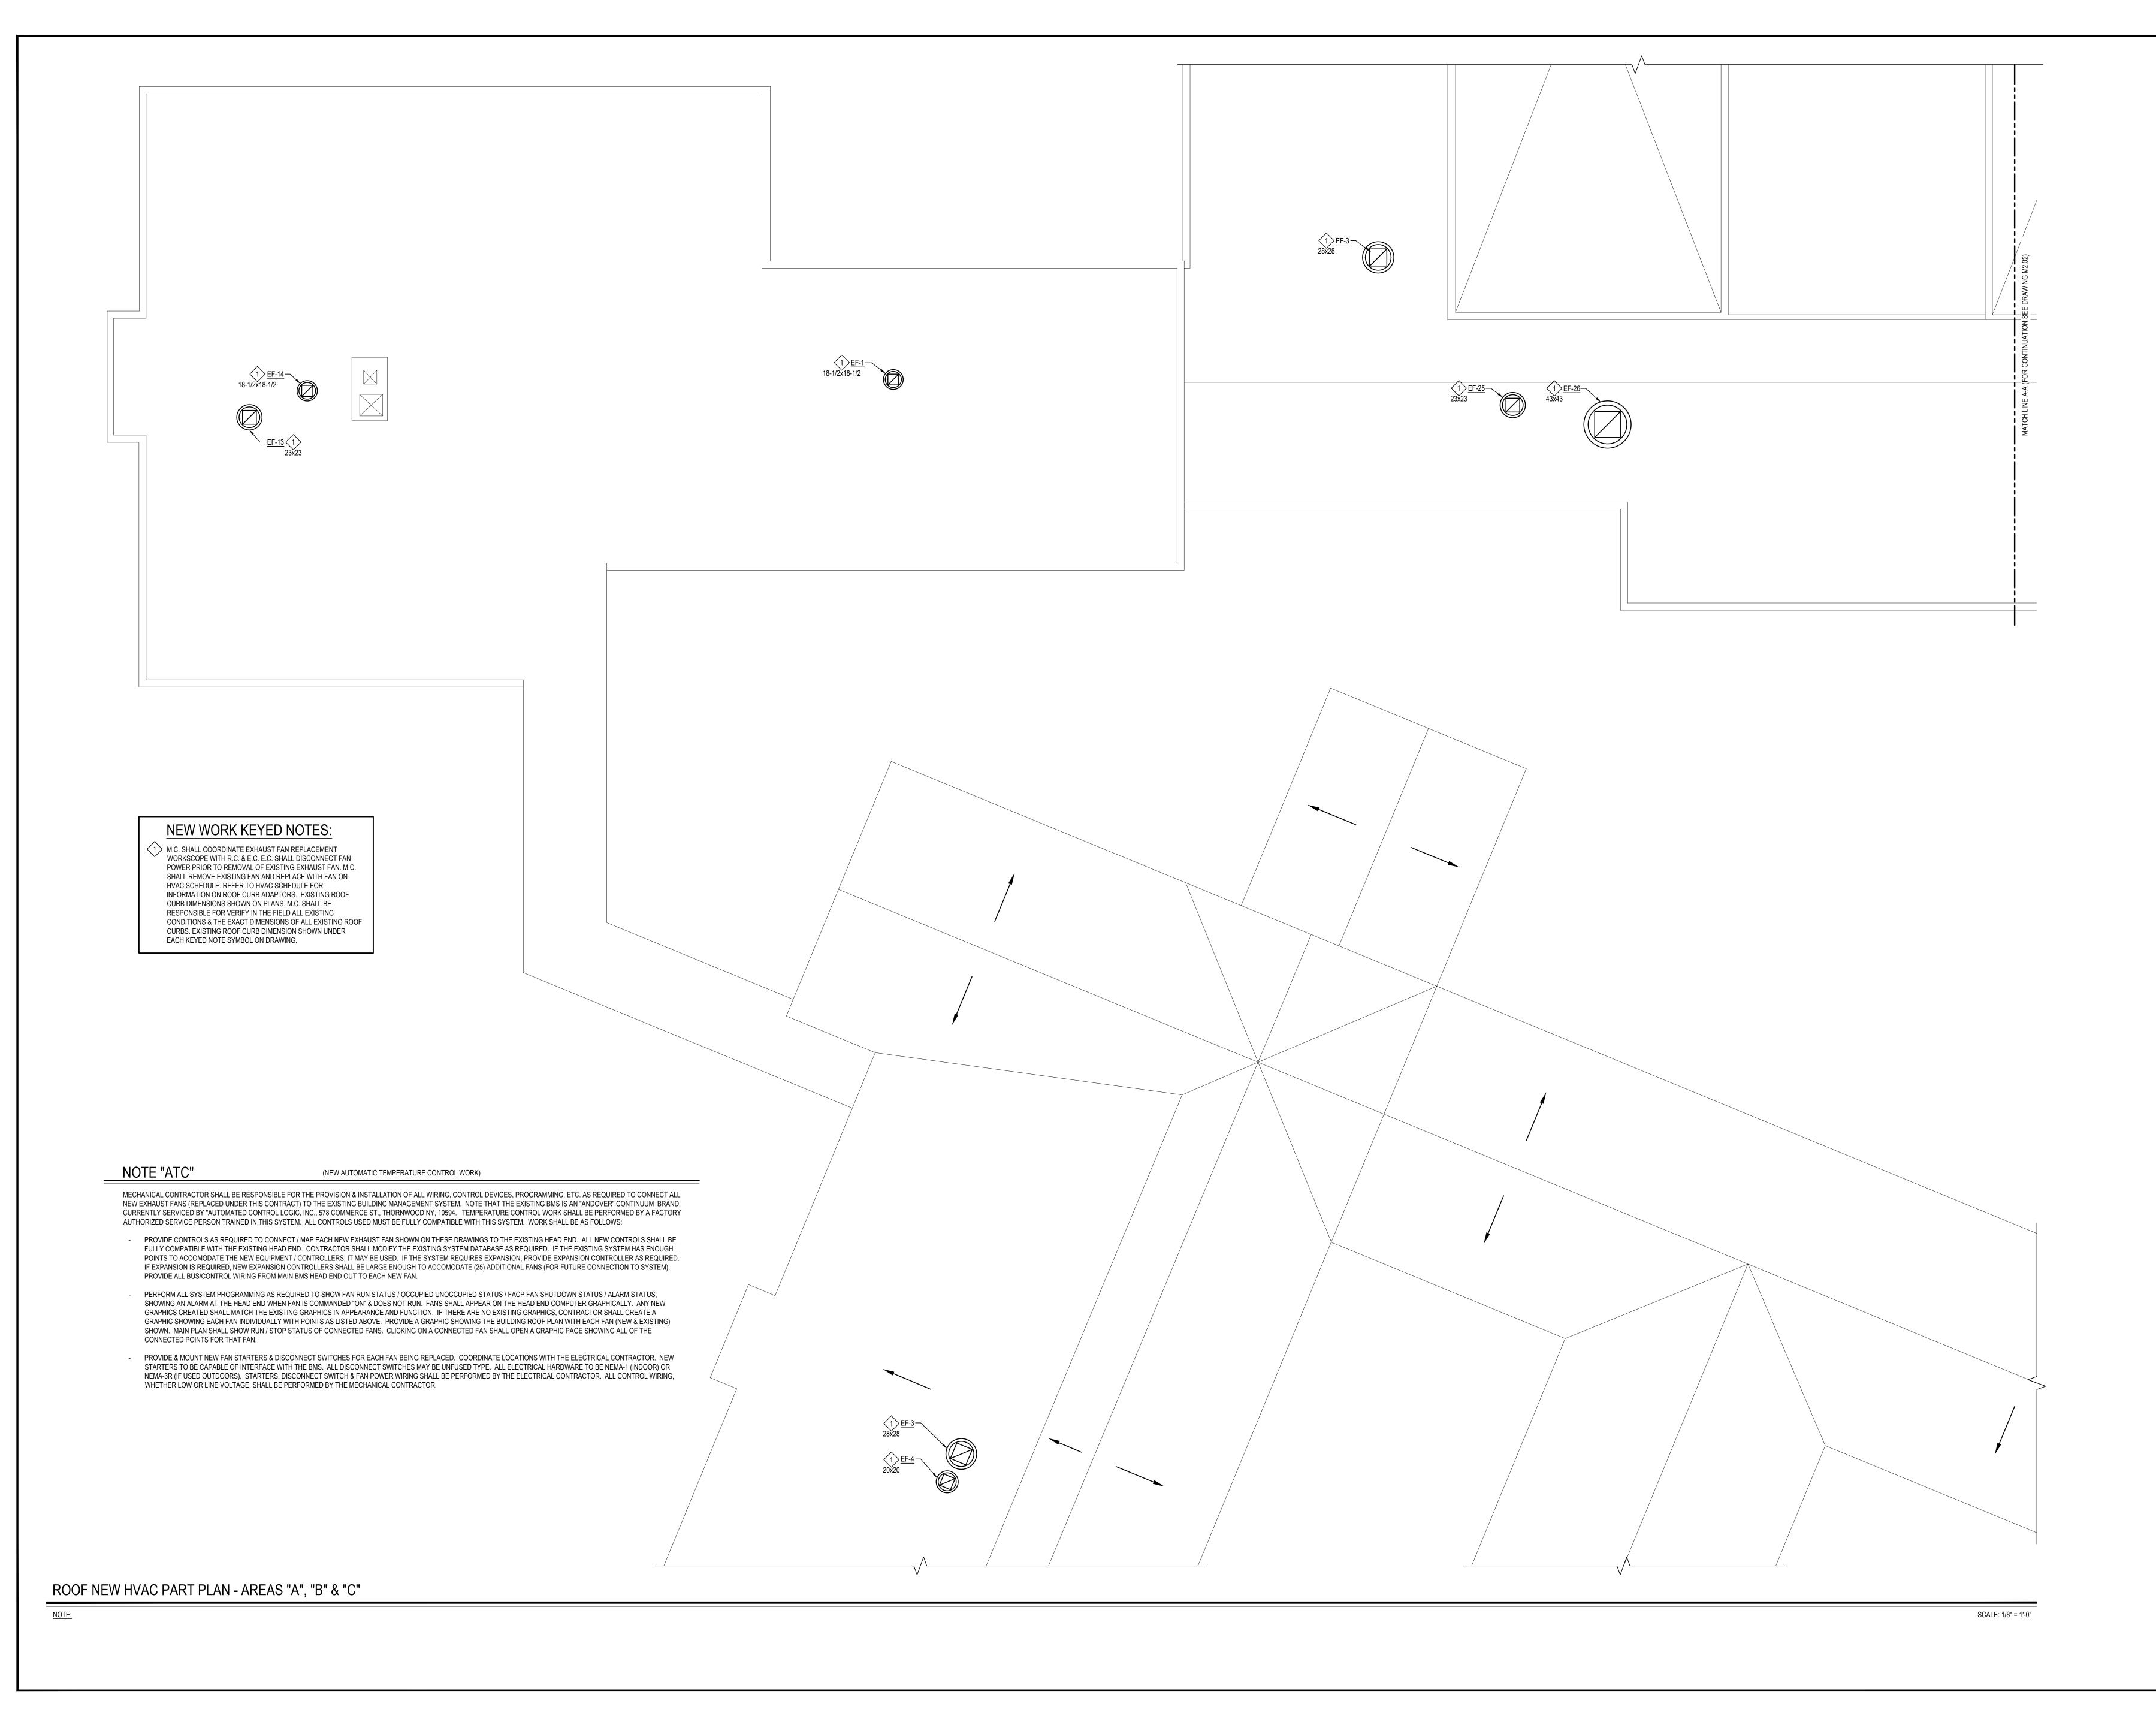

NOTICE

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BOND IMPROVEMENTS - PI
TODD ELEMENTARY SCH
BRIARCLIFF MANORWESTCHES

ROOF NEW HVAC PART I

DRAWING BY: RDP

CHECK BY: FS

NOTICE

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DISTRICT BRIARCLIFF MANOR UFSD

PROJECT
BOND IMPROVEMENTS
PHASE 1


DWG TITLE
ROOF NEW HVAC PART PLAN
AREAS "A", "B" & "C"

SCALE: AS NOTED

DATE: 10/08/21

BID PICK-UP: 1/17/2022

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				EXHAU	ST FAN	SCHEDU	JLE				GREENHECK AS STD.
						MOTOR		_	WEIGHT	OPTIONS AND	
TAG	SERVICE	MODEL	CFM	ESP	FAN RPM	(HP)	INLET SONES	VOLT/PH	(LBS)	ACCESSORIES	NOTES
EF-1	2 CLASSROOM 231, 232 & ASSOC. TOILETS (BG)	G-097-VG	100	0.375	1000	1/4	3.6	115/1	61.0	1,2,3,4,6	PROVIDE W/VCD-43 MOTORIZED DAMPER
EF-2	TECH. STOR. 209	G-098-VG	500	0.75	1535	1/4	8.9	115/1	96.0	1,2,3,4,6	PROVIDE W/VCD-43 MOTORIZED DAMPER
EF-3	CLASSROOM 118 & 119	G-095-VG	600	0.375	1400	1/6	7.2	115/1	84.0	1,2,3,4,6	PROVIDE W/VCD-43 MOTORIZED DAMPER
EF-4	CLASSROOM 118 & 119 TOILETS	G-097-VG	150	0.5	1236	1/4	5.7	115/1	96.0	1,2,3,4,6	PROVIDE W/VCD-43 MOTORIZED DAMPER
EF-5	ART CLASSROOM 212, OFFICE 213, ART STOR. 211 & 214	GB-180-VGD-7	2500	0.75	924	3/4	10.1	208/3	138.0	1,2,3,5,6,7	PROVIDE W/VCD-43 MOTORIZED DAMPER
EF-6	READING 225, MATH/YMCA 226 & YMCA 227 (BG)	G-100-VG	800	0.5	1308	1/4	6.7	115/1	96.0	1,2,3,4,6	PROVIDE W/VCD-43 MOTORIZED DAMPER
EF-13	INNOVATION CLASSROOM 230	G-080-VG	225	0.5	1534	1/10	7.5	115/1	80.0	1,2,3,4,6	PROVIDE W/VCD-43 MOTORIZED DAMPER
EF-14	INNOVATION CLASSROOM TOILET	G-097-VG	75	0.375	954	1/4	3.2	115/1	61.0	1,2,3,4,6	PROVIDE W/VCD-43 MOTORIZED DAMPER
EF-25	TOILETS BETWEEN READING CLASSROOM 232A & 3 CLASSROOM 233 (BG)	G-095-VG	300	0.5	1333	1/6	7.0	115/1	84.0	1,2,3,4,6	PROVIDE W/VCD-43 MOTORIZED DAMPER
EF-26	3 CLASSROOMS 233, 234, 235(CT) & FACULTY 236 (BG)	GB-180-VGD-5	1500	0.75	904	1/2	9.4	208/3	183.0	1,2,3,5,6	PROVIDE W/VCD-43 MOTORIZED DAMPER

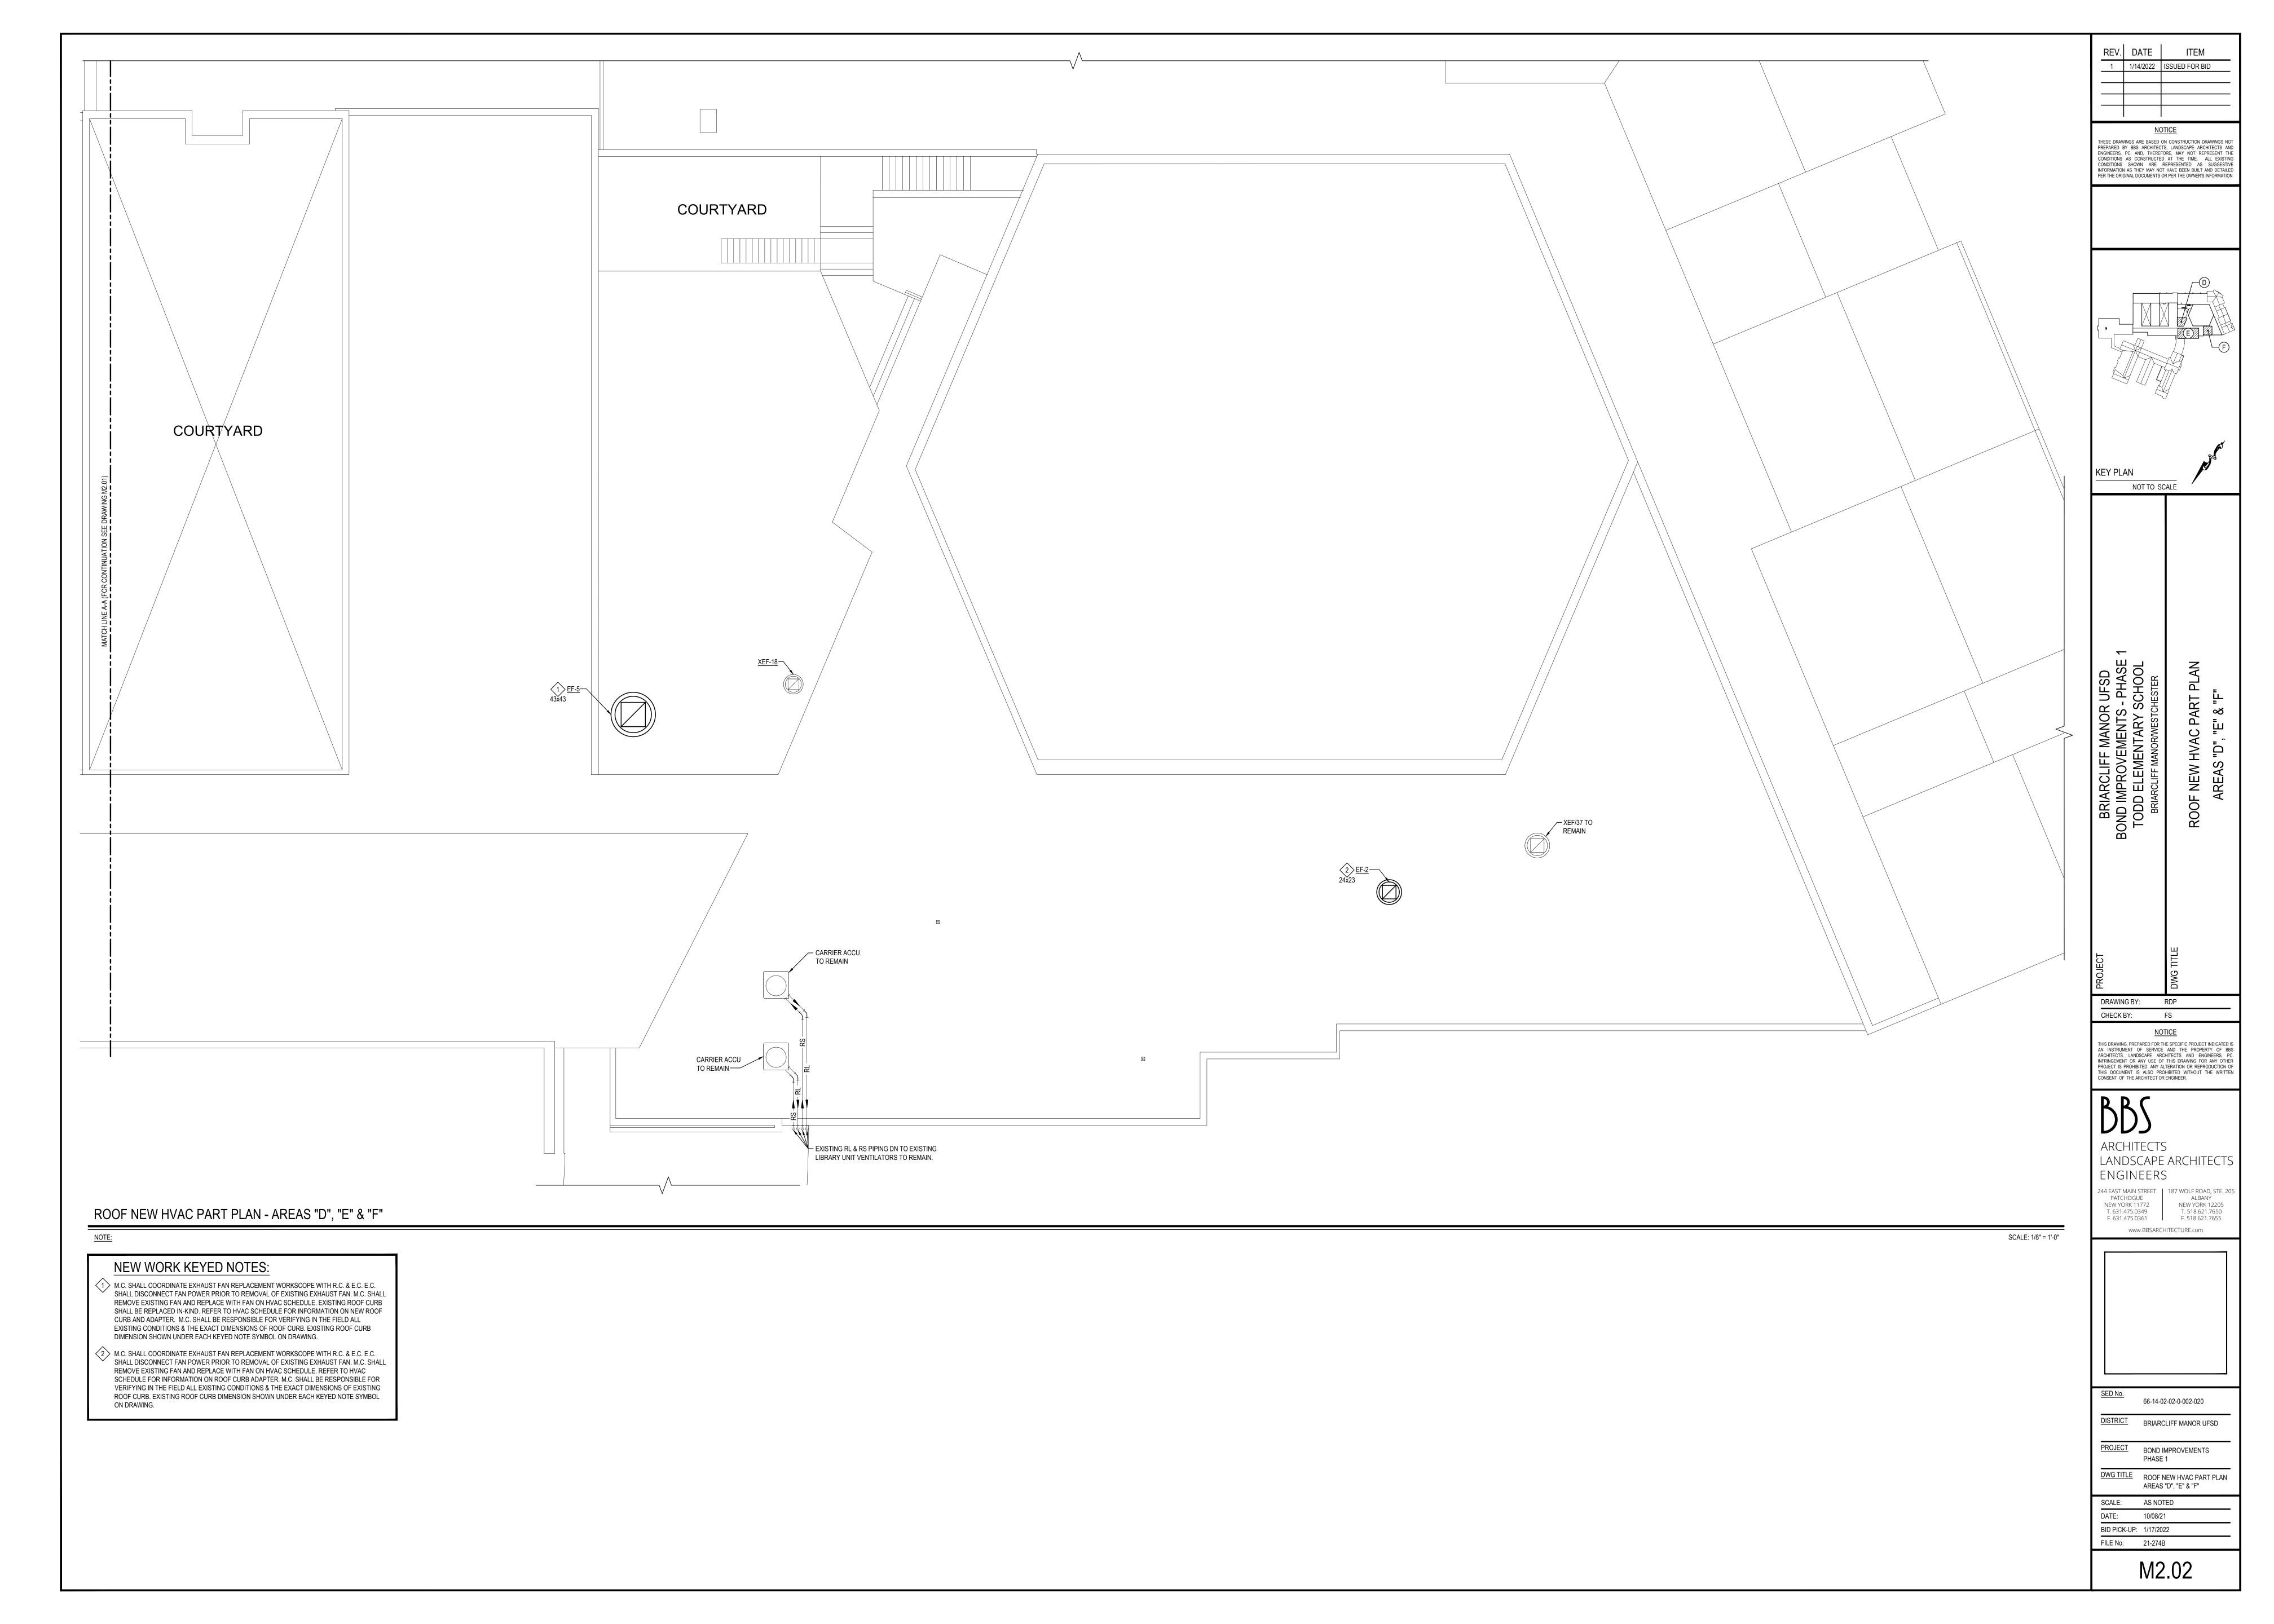Options / Accessories:

1. Aluminum roof curb adapter (factory mounted), contractor to field verify existing curb dimensions prior to fabrication

2. UL-705 Listing

3. Disconnect Switch 4. Varigreen motor w/balancing dial, soft start and thermal overload protection

5. Varigreen drive (factory mounted, wired and programmed) w/fan mounted speed adjustment dial. Field mounted VFDs will not be accepted

6. Roof curb extension (aluminum construction) w/damper tray and access panel 7. 24" High Roof Curb w/damper tray

ADDITIONAL SCHEDULE NOTES:

7. REFER TO SPECIFICATIONS FOR SEQUENCE OF OPERATIONS FOR NEW UNIT. 8. PROVIDE FACTORY-AUTHORIZED REPRESENTATIVE TO BE PRESENT FOR START-UP, COMMISSIONING, AND TRAINING OF


EQUIPMENT TO OWNER'S PERSONNEL. 9. FACTORY-AUTHORIZED MANUFACTURER'S REPRESENTATIVE SHALL BE PRESENT FOR RIGGING OF EQUIPMENT.

PROVIDE BIRDSCREEN WITH FAN 11. PROVIDE ALL SINGLE PHASE FANS WITH A GREENHECK VARIGREEN H.O.A. CONTROLLER.

	DEHUMIDIFIER SCHEDULE											
					WATER EXTRACTION				WEIGHT	DIMS. W x H x D		
TAG	SERVICE	MANUFACTURER	MODEL	CFM	(GPH)	MCA	MOCP	VOLT/PH	(LBS)	(IN.)	DBA	OPTIONS/ACCESSORIES
DH-1	LIBRARY	EIPL	AD850E	294	0.5	10	20	115/1	86.0	26x29.5x13.6	50.0	1, 2, 3
DH-2	LIBRARY	EIPL	AD850E	294	0.5	10	20	115/1	86.0	26x29.5x13.6	50.0	1, 2, 3
DH-3	LIBRARY	EIPL	AD850E	294	0.5	10	20	115/1	86.0	26x29.5x13.6	50.0	1, 2, 3
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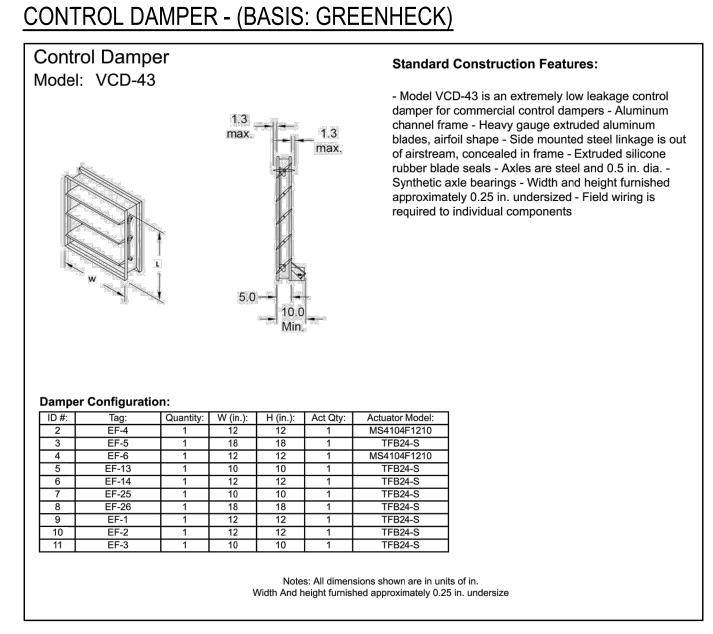
OPTIONS/ACCESSORIES: 1. Wall mount kit

2. UL-474 Listing 3. Disconnect Switch

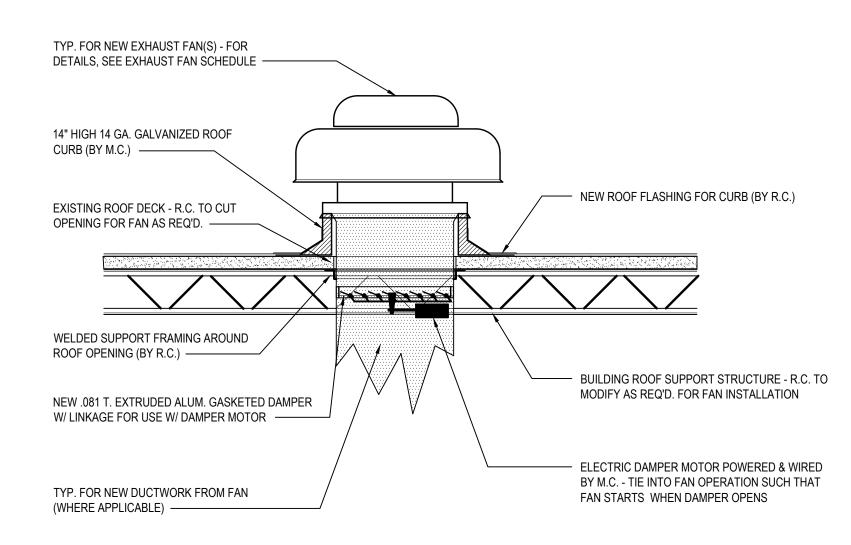


NEW ROOF MOUNTED EXHAUST FAN INSTALLATION

SCALE: N.T.S.



ROOF CURB - (BASIS: GREENHECK)

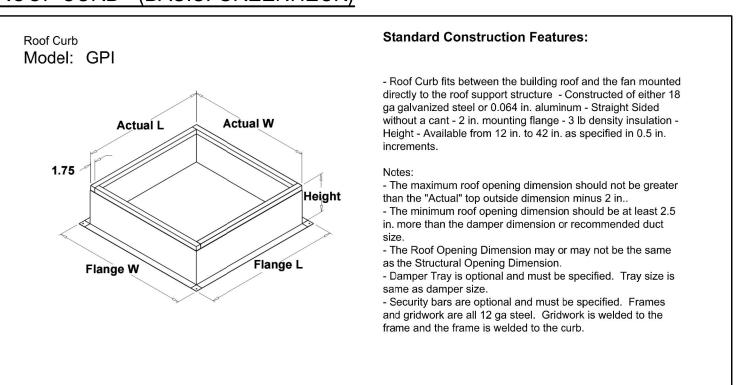


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SCHEDULES, EQUIPMENT NOTES

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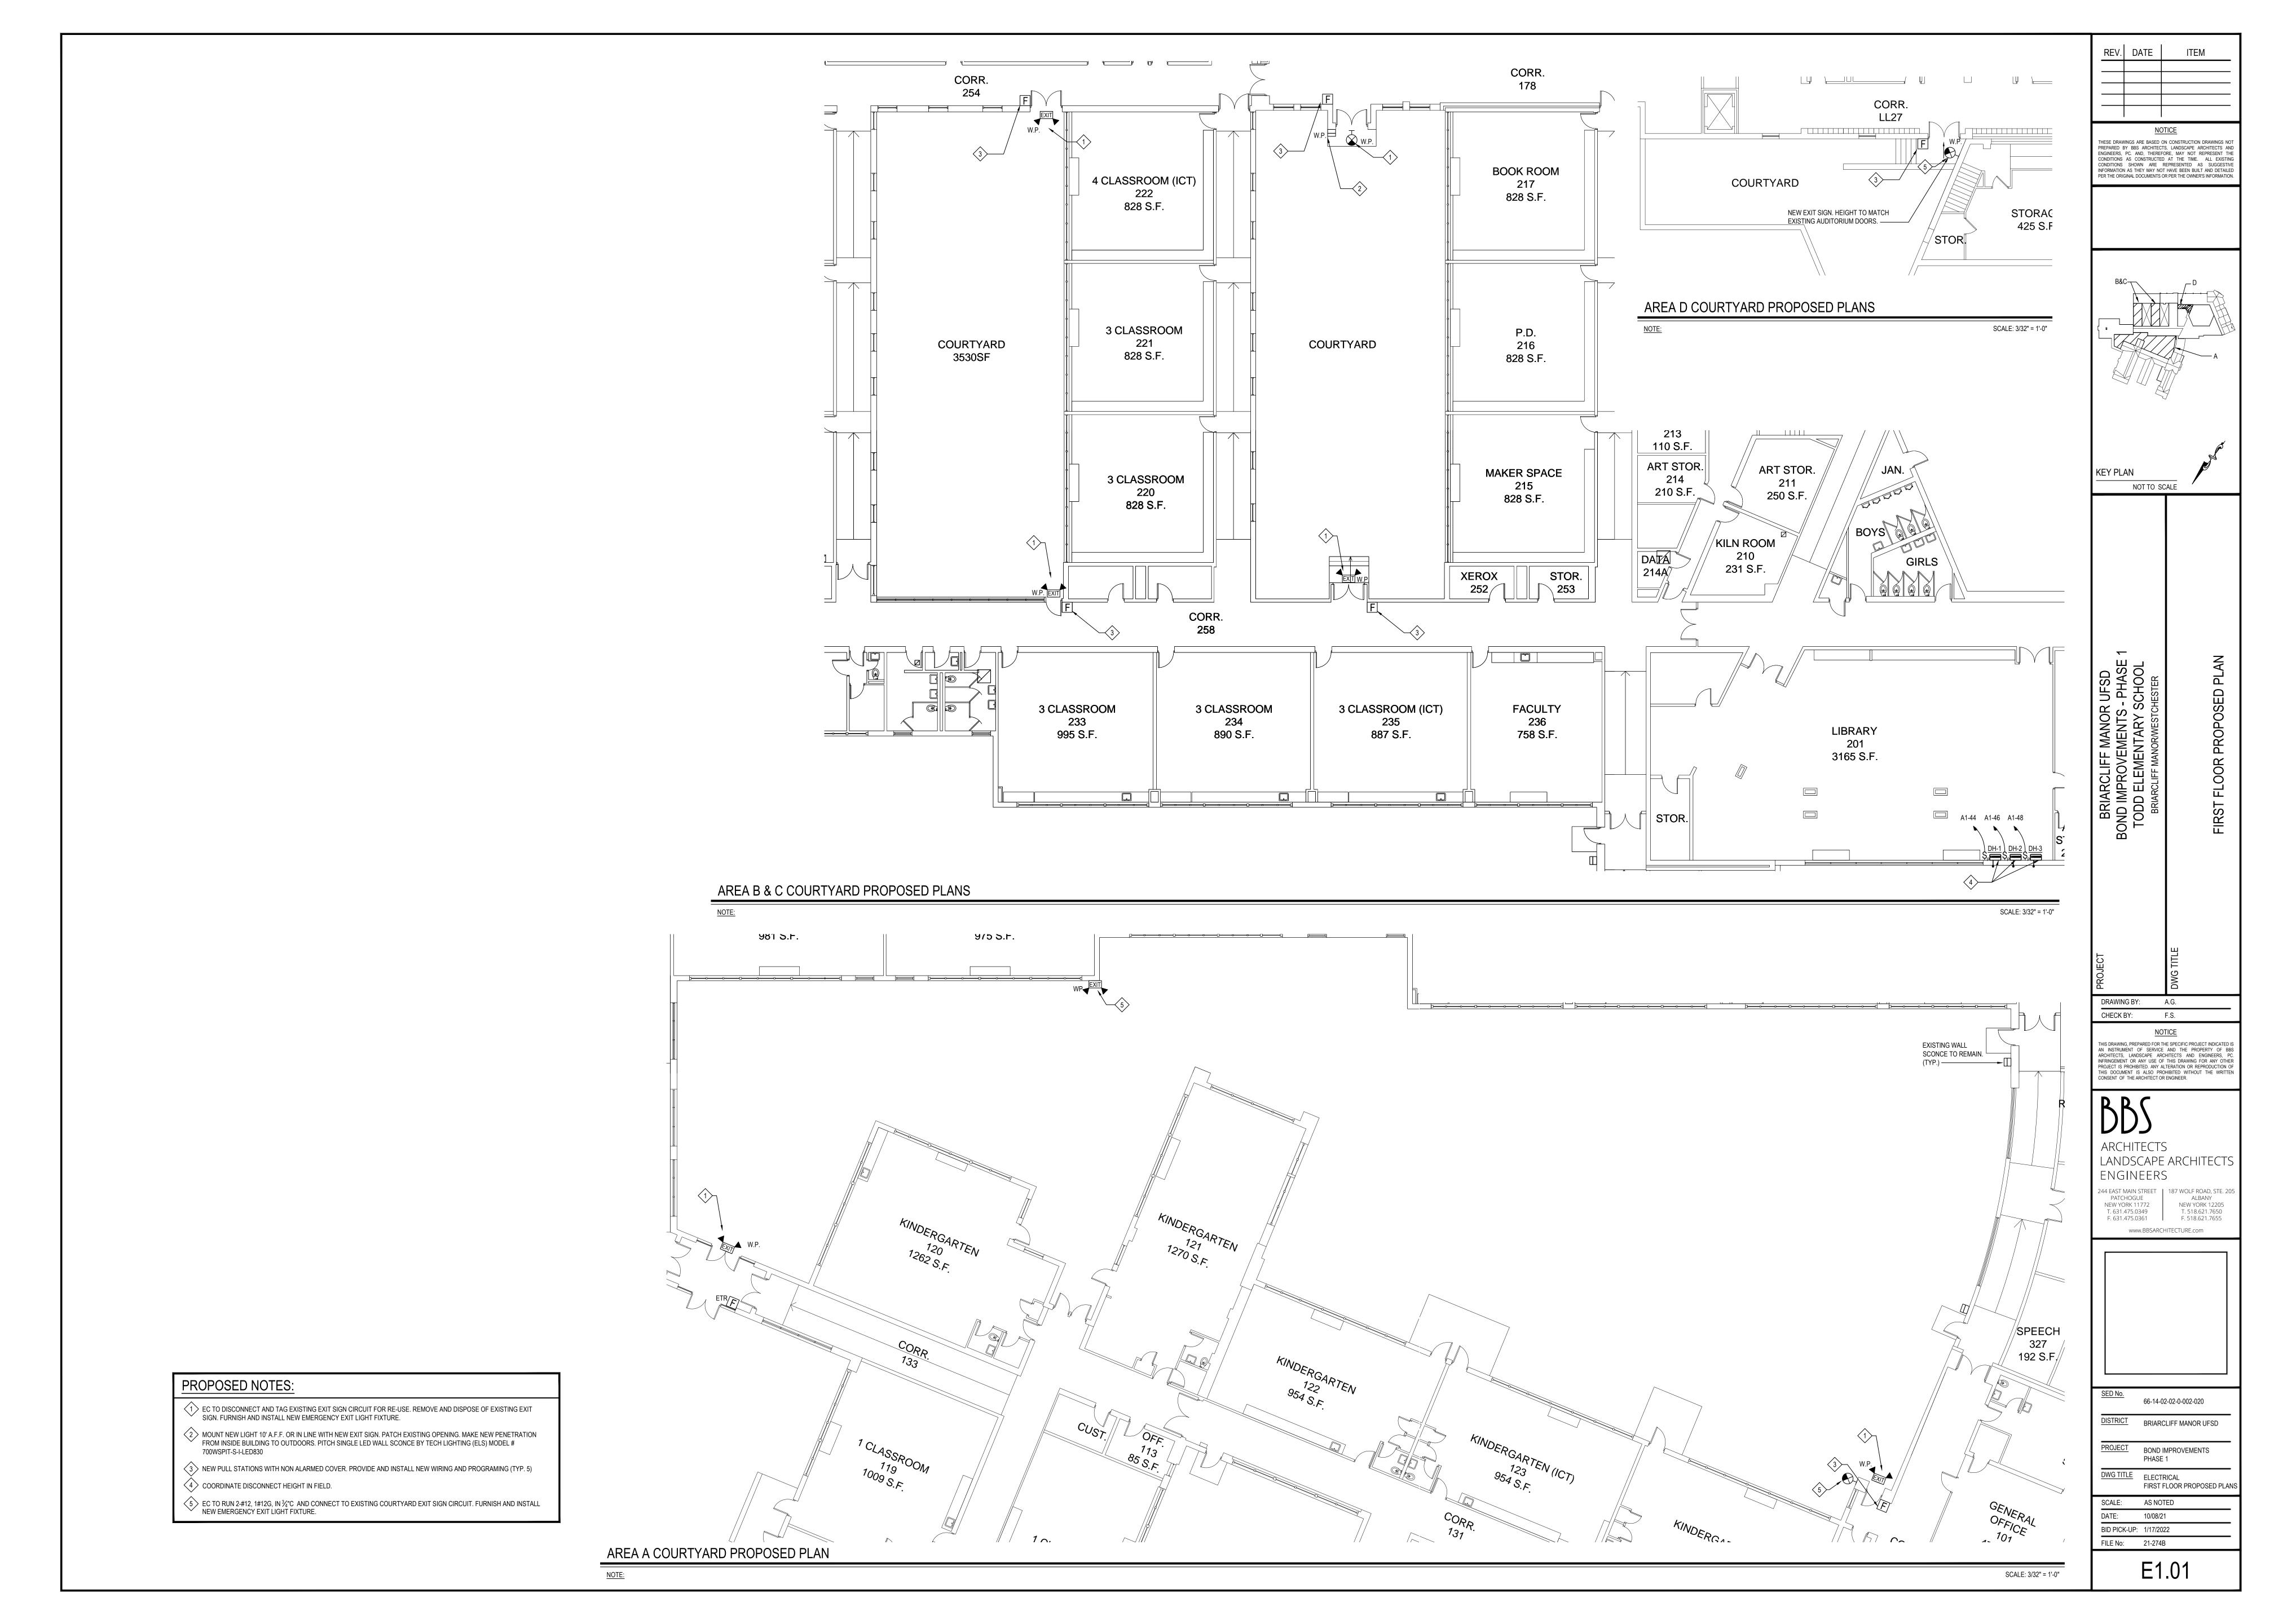


	66-14-02-02-0-002-020
DISTRICT	BRIARCLIFF MANOR UFSD
PROJECT	BOND IMPROVEMENTS PHASE 1
DWG TITLE	SCHEDULES, EQUIPMENT AND DETAILS

SCALE: AS NOTED

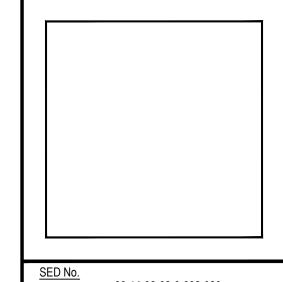DATE: 10/08/21

M6.01



GENERAL ELECTRICAL CONSTRUCTION NOTES:

1. ALL WORK SHALL BE DONE IN ACCORDANCE WITH THE LATEST EDITIONS OF THE NEC, APPLICABLE LOCAL CODES, STATE CODES, SCHOOL WORKING RULES AND SCHEDULE DIRECTIVES, AND THE ENGINEER'S SPECIFICATIONS.

2. THE VOLTAGE CHARACTERISTIC OF THIS SCHOOL IS 120/208VAC, 4 WIRE, 3PH, GROUNDED NEUTRAL, WYE. ALL EQUIPMENT SHALL BE COMPATIBLE WITH THESE CHARACTERISTICS.

3. THE DRAWINGS SHOW SCHEMATICALLY, THE APPROXIMATE LOCATION OF ALL EQUIPMENT, CONDUITS, DEVICES, ETC. THE EXACT LOCATION OF WHICH SHALL BE SUBJECT TO APPROVAL BY THE ARCHITECT/OWNER WHO RESERVES THE RIGHT TO MAKE PRIOR TO INSTALLATION, ANY REASONABLE CHANGES IN LOCATION INDICATED WITHOUT EXTRA COST TO THE OWNER. CONTRACTOR SHALL VERIFY ALL INDICATED OR APPROXIMATED DIMENSIONS DRAWN OR DENOTED.

4. DIVISION 16 CONTRACTOR SHALL EXAMINE THE SITE TO VERIFY WORK TO BE PERFORMED AS SHOWN ON DRAWINGS AND SPECIFICATIONS BEFORE SUBMITTING HIS BID. ANY DISCREPANCY BETWEEN DRAWINGS/SPECIFICATIONS AND ACTUAL FIELD CONDITIONS SHALL BE BROUGHT TO ARCHITECT/ENGINEERS ATTENTION BEFORE BID SUBMITTAL. ANY FIELD CONDITION FOUND AFTER BID APPROVAL WHICH HAMPERS AND/OR PREVENTS ANY WORK TO BE PERFORMED AS SHOWN ON DRAWINGS AND SPECIFICATIONS SHALL BE THE RESPONSIBILITY OF THE DIVISION 16 CONTRACTOR. THE DIVISION 16 CONTRACTOR SHALL BID THE HIGHER SPECIFICATION FOR ANY DISCREPANCY BETWEEN DRAWINGS AND SPECIFICATIONS.

5. DIVISION 16 CONTRACTOR SHALL PROVIDE ALL LABOR SERVICE MATERIALS, EQUIPMENT, AND RELATED ITEMS TO COMPLETE THE WORK OF THIS DIVISION, AS REQUIRED BY THE NATIONAL ELECTRIC CODE, AND ALL STATE AND LOCAL AUTHORITIES HAVING JURISDICTION.

6. DIVISION 16 CONTRACTOR SHALL PROVIDE ALL ELECTRICAL HARDWARE SHOWN ON THESE DRAWINGS AND RELATED DETAIL MATERIALS NOT SPECIFICALLY SHOWN OR SPECIFIED. ALL NEW ELECTRICAL MATERIAL AND EQUIPMENT SHALL CONFORM TO THE STANDARDS AND BEAR THE INSPECTION LABEL OF THE UNDERWRITERS LABORATORIES AND SHALL BE APPROVED FOR USE BY ALL LOCAL AUTHORITIES HAVING JURISDICTION.

7. THE DIVISION 16 CONTRACTOR SHALL REFER TO ALL OTHER DRAWINGS IN BID PACKAGE AND PERFORM THE WORK (INCLUDE IN HIS BID) INDICATED AS ELECTRICAL CONTRACTOR (E.C.) WORK. CONTRACTOR TO COORDINATE ALL LOCATIONS WITH GENERAL CONTRACTOR AND OTHER TRADES.

8. ELECTRICAL CONTRACTOR SHALL COORDINATE WITH THE MECHANICAL CONTRACTOR FOR ALL MECHANICAL EQUIPMENT REQUIRING ELECTRICAL POWER. THE EC IS RESPONSIBLE TO INSTALL ALL MOTOR STARTERS AND ASSOCIATED POWER WIRING. THE LOCATIONS OF MOTOR STARTERS SHALL BE DETERMINED BY THE CONTRACTOR IN THE FIELD AND SUBMITTED TO THE ENGINEER FOR APPROVAL UNLESS IT IS SPECIFIED ON THE DRAWINGS. THE EC SHALL REFER TO THE MECHANICAL EQUIPMENT SCHEDULES & NOTES AND INCLUDE IN HIS BID PRICE ALL ELECTRICAL WORK ASSOCIATED WITH THEIR INSTALLATION, AND THE REMOVAL OF ANY STARTERS/DISCONNECTS NO LONGER REQUIRED.

9. ALL WORK SHALL BE IN ACCORDANCE WITH MANUFACTURER'S RECOMMENDATIONS AND DIRECTIVES OF THE OWNER.

10. ALL ELECTRICAL WORK SHALL BE PERFORMED BY A LICENSED ELECTRICAL CONTRACTOR WHO SHALL OBTAIN AN APPROVED ELECTRICAL INSPECTION CERTIFICATE FROM THE LOCAL AHJ AND PAY ASSOCIATED FEE. SUBMIT A PHOTOCOPY OF THIS CERTIFICATE TO THE ENGINEER WITH FINAL PAYMENT APPLICATION. SUBMIT A COPY OF THIS CERTIFICATE TO THE OWNER.

11. DIVISION 16 CONTRACTOR SHALL GUARANTEE ALL MATERIALS AND THEIR INSTALLATION TO BE FREE OF DEFECTS FOR A PERIOD AS DEFINED IN THE PROJECT MANUAL.

12. IF ADDITIONAL POLE POSITIONS ARE REQUIRED FOR NEW CIRCUITS IN EXISTING PANELS SERVICING RENOVATED AREAS, REMOVE (3) ADJACENT 1 POLE BREAKERS PROVIDE AND INSTALL 3P, 60A BREAKER FOR SUB FEED TO A SURFACE MOUNTED 100A, 3PH, 18 POLE SUB PANEL AND ESTABLISH OVERFLOW CIRCUITS IN NEW SUB PANEL, EACH WITH A 1P, 20A BREAKER. PROVIDE (3) 1P, 20A BREAKERS FOR DISCONNECTED CIRCUITS IN MAIN PANEL AND RECONNECT THEM IN SUB PANEL. SUB PANEL FEED TO BE 3#6 + 1#6(N) + 1#10(G) IN 1"C.

13. IT IS EXPECTED THAT STRUCTURAL DEMOLITION BY THE GENERAL CONTRACTOR WILL CAUSE VARIOUS ELECTRIC SUPPLIES, OF VARIOUS VOLTAGES AND PURPOSES, TO BE CUT AND RENDER SOME DEVICES TEMPORARILY INACTIVE. IT IS THE ELECTRICAL CONTRACTOR'S RESPONSIBILITY TO RECONSTRUCT AND RECONNECT SUCH ELECTRIC SOURCES UPON COMPLETION. NOTE THAT MOST REINSTALLED ITEMS WILL BE IN DIFFERENT LOCATIONS FROM THE REMOVAL LOCATION. THE ELECTRICAL CONTRACTOR SHALL MAKE ALL REQUIRED CIRCUIT EXTENSIONS OR MODIFICATIONS TO PROVIDE SERVICE TO A REINSTALLED ITEM AS RELOCATED. NOTE THAT THIS REQUIREMENT ALSO APPLIES TO THE ROOMS AND ELECTRICAL ITEMS WITHIN THAT ARE NOMINALLY NOT IN CONTRACT. SUCH RESTORATION OF SERVICE, IF NEEDED, IS SPECIFICALLY IN THE ELECTRICAL CONTRACTOR'S CONTRACT.

14. THE ELECTRICAL CONTRACTOR SHALL PROVIDE TEMPORARY LIGHTING AND POWER TO ALL TRADES FOR THE DURATION OF THE PROJECT. SERVICE SHALL BE SUPPLIED TO CONTRACTOR'S CONSTRUCTION TRAILERS WHERE SUCH IS REQUESTED. USE THE EXISTING POWER PANELS FOR SUCH SUPPLY. POWER COSTS WILL BE PAID BY THE OWNER. ALL CONSTRUCTION POWER RECEPTACLES SHALL BE GFI PROTECTED.

15. IT SHALL BE THE ELECTRICAL CONTRACTOR'S RESPONSIBILITY TO PROTECT ALL ELECTRICAL DEVICES FROM DAMAGES DURING CONSTRUCTION. THIS INCLUDES DEVICES WHICH ARE EITHER INDICATED TO REMAIN. AND/OR TO BE REMOVED AND REINSTALLED THROUGHOUT ALL CONSTRUCTION AREAS. DEVICES SHALL INCLUDE BUT WILL NOT BE LIMITED TO: SMOKE DETECTORS, EMERGENCY LIGHTS, EXIT SIGNS, OCCUPANCY SENSORS, SPEAKERS, LIGHT FIXTURES, SWITCHES, RECEPTACLES, ETC. IN THE EVENT OF DAMAGES INCURRED DUE TO CONSTRUCTION ACTIVITIES, THE ELECTRICAL CONTRACTOR SHALL BE RESPONSIBLE TO REPLACE ANY DAMAGED DEVICES AT NO ADDITIONAL COST TO OWNER.

16. THE INDICATED SOURCE OF EXISTING CIRCUITS MAY NOT BE KNOWN OR HAS NOT BEEN VERIFIED. IT IS THE DIVISION 16 CONTRACTOR'S RESPONSIBILITY TO TRACE OUT, LOCATE AND VERIFY THE DISCONNECTING MEANS OF EXISTING CIRCUIT(S) TO BE IMPACTED BY THE WORK. SAFE OFF THE CIRCUIT(S) AS REQUIRED TO SAFELY PERFORM THE WORK, AND RE-ENERGIZE UPON COMPLETION. UPDATE PANEL DIRECTORIES UPON COMPLETION.

17. ALL WIRING TO BE 1#12+1#12(N)+1#12(G)-3/4" EMT, OR STEEL JACKETED MC CABLE (WHERE CODE PERMITTED), UNLESS OTHERWISE SPECIFIED ON DRAWINGS. ALUMINUM JACKETED MC CABLE IS NOT ACCEPTABLE. ALL DEVICES LOCATED OUTSIDE THE BUILDING SHALL

18. RUN WIRING & CONDUITS IN DROPPED CEILINGS, VOIDS, & CHASES. ALL DEVICES, WIRING & CONDUITS ON NEW CONSTRUCTION MUST BE RECESSED. FOR EXISTING SURFACES: MECHANICAL/WORK SPACES- DEVICES, WIRING & CONDUITS MAY BE SURFACE MOUNTED. EXISTING PUBLIC/FINISHED AREAS- CONDUITS SHALL BE CONCEALED WHEREVER POSSIBLE (IN HUNG CEILINGS, VOIDS/CHASES, FLOOR BELOW OR BEHIND WALLS) ALL WIRING THAT CANNOT BE CONCEALED IN MUST BE RUN IN FINISHED SURFACE RACEWAY SUCH AS WIREMOLD (V-500/700), COLOR PER ARCHITECT. USE OF ADHESIVE IS PROHIBITED, SURFACE RACEWAY MUST BE SECURED USING MECHANICALLY FASTENED CLIPS. WIRING IN DROPPED CEILINGS SHALL BE SUSPENDED FROM BUILDING STEEL EVERY 5 FT. USE EMT IN AREAS WHERE CONDUIT WOULD BE SUBJECT TO POTENTIAL PHYSICAL DAMAGE SUCH AS GYMNASIUMS, WORK/ CUSTODIAL AREAS, BOILER ROOMS, ETC.

ABBREVIATIONS

SP = SPARE EX = EXISTING N.I.C. = NOT IN CONTRACT A = AMPS

EC = ELECTRICAL CONTRACTOR C/B = CIRCUIT BREAKER V.I.F. = VERIFY IN FIELD ETR = EXISTING TO REMAIN (E) = EXISTING WP = WEATHER PROOF EF = EXHAUST FAN FA = FIRE ALARM

NEW WORK NOTES

1. ALL CONTRACTORS ON THE WORK SITE SHALL COORDINATE THEIR RESPECTIVE WORK SHOWN IN THE DRAWING SET. THE MC HAS PRIORITY OVER WORK CONDUCT ISSUES AS LOCATIONS, SCHEDULES, AND OTHER MATTERS THAT MAY INTERACT WITH THE EC.

2. EC SHALL WIRE EXHAUST FANS VIA VFD'S/MOTOR STARTERS FURNISHED BY MC. EC TO MOUNT AND WIRE POWER FOR VFD'S/MOTOR STARTERS. COORDINATE LOCATION WITH MC. ALL CONTROL WIRING BY MC.

3. EC TO REMOVE AND REINSTALL EXISTING FA MOTOR SHUTDOWN RELAYS.

4. COORDINATE W/ MC FOR ALL ROOF PENETRATIONS. SINGLE PENETRATIONS FOR ELECTRICAL AND REFRIGERANT PIPE BY MC.

5. EC TO WIRE ALL LINE VOLTAGE. COORDINATE W/ MC.

	ELECTRICAL SYMBOL LEGEND
SYMBOL	
\$ _P	MOTOR DISCONNECT FURNISHED BY MC. WIRED AND INSTALLED BY EC
~	EXISTING CIRCUIT
•	ONE POLE CIRCUIT 2-#12, 1-#12G, 3/4"C UNLESS OTHERWISE NOTE.
DH	DOOR HOLDER

LIGHTING SCHEDULE		
CODE	SYMBOL	DESCRIPTION
	EXIT —	NEW EMERGENCY LED LIGHT FIXTURE, WET LOCATION, INTERNAL BATTERY HEATER W/ 90-MINUTE NICAD BATTERY EXITRONIX #VEX-WPC-1-R-B-IH SUBSCRIPT 'VG' - PROVIDE W/ POLYCARBONATE VANDAL GUARD

1. EC SHALL CONNECT EMERGENCY INVERTER/ EMERGENCY LIGHT BATTERY/ EXIT SIGN LEADS DIRECTLY TO THE EXISTING AREA LIGHTING CIRCUIT UPSTREAM OF SWITCHES, CONTACTORS, CONTROLS ETC.

GENERAL FA NOTES:

1. ALL NEW FIRE ALARM DEVICES TO BE COMPATIBLE WITH THE EXISTING FACP.

2. CONTRACTOR MAY UTILIZE EXISTING BACKBOXES WHEN CODE AND ADA REQUIREMENTS ARE MET AND COMPATIBLE WITH NEW FIRE ALARM DEVICES. COVER ALL UNUSED REMAINING BACKBOXES WITH STAINLESS STEEL 302 BLANK FACE PLATES. IF BOXES ARE RE-USED DEVICES SHALL BE SWAPPED AT THE TIME OF LOOP SWITCH-OVERS TO ENSURE SYSTEM IS OPERATIONAL FOR THE DURATION OF THE PROJECT.

3. ALL BACK BOXES SHALL BE SIZED TO COMPLETELY FIT THE RESPECTIVE DEVICE AND WIRING WITH NO GAPS, SPACES, OR EXTRA UNNECESSARY ROOM. WIREMOLD BOXES IN FINISHED AREAS ARE REQUIRED, AND SHALL BE RECESSED WHERE POSSIBLE. CONTRACTOR IS RESPONSIBLE TO VERIFY ALL DEVICES ARE COMPATIBLE WITH THE APPROPRIATE BACKBOXES.

4. ANY OPENINGS LEFT WHEN DEVICES/CABINETS/PANELS ARE REMOVED SHALL BE COMPLETELY COVERED WITH BLANK METAL PLATES, COLOR TO MATCH ADJACENT. EC IS RESPONSIBLE TO PATCH/PAINT ALL AREAS DISTURBED BY DEMO & INSTALLATION WORK TO MATCH ADJACENT. ALL FINISH WORK IS THE RESPONSIBILITY OF THE EC UNLESS OTHERWISE NOTED.

5. DIVISION 16 CONTRACTOR SHALL PROVIDE AND INSTALL ALL POWER SUPPLIES, AUXILIARY CABINETS/BOXES, NAC PANELS, EXPANSION MODULES, BRANCH CIRCUITS ETC. AS REQUIRED BY THE FIRE ALARM MANUFACTURER TO MAINTAIN A FULLY OPERATIONAL SYSTEM. THESE ITEMS ARE NOT SHOWN ON THE PLANS AND ARE THE RESPONSIBILITY OF THE FIRE ALARM VENDOR TO LOCATE AND THE EC TO POWER. LOCATIONS OF ANY TERMINAL CABINETS, BOOSTER POWER SUPPLIES, OR SIMILAR COMPONENTS MUST BE SUBMITTED TO THE ARCHITECT/ENGINEER FOR APPROVAL DURING THE SHOP DRAWINGS PHASE. ANY SMOKE HEADS OR INCIDENTAL DEVICES REQUIRED TO PROTECT SAID CABINETS SHALL BE INCLUDED IN THE CONTRACTOR'S BID PRICE. EC TO INCLUDE IN BID NAC PANEL(S), POWER SUPPLIES, EXPANSION MODULES, ETC. AS REQUIRED TO EXPAND THE EXISTING FACP SYSTEMS PER PLANS.

6. AFTER THE SYSTEM IS COMPLETE, TEST ALL COMPONENTS IN ACCORDANCE WITH SEQUENCE OF OPERATION PRIOR TO FIRE DEPARTMENT INSPECTION.


WHERE EXISTING FIRE ALARM SYSTEMS ARE MODIFIED DURING THE COURSE OF THE PROJECT, CONTRACTOR SHALL PROVIDE OWNER WITH UPDATED COMPLETION RECORD DOCUMENTATION PER NFPA 72, ARTICLE 10.18. INCLUDE COPY OF UPDATED SITE SPECIFIC SOFTWARE. ANY ADDITIONAL DEVICES SHALL BE MAPPED INTO THE SYSTEM WITH THE APPROPRIATE ADDRESSES/LABELS.

8. FIRE ALARM WIRING FOR NEW DEVICES SHALL BE NEW, PLENUM RATED, AND PER MFG INSTRUCTIONS.

- EXISTING UNIT TO BE REMOVED BY MC. EC TO DISCONNECT AND TAG WIRING FOR RE-USE. PULL BACK/ RE-ROUTE/ EXTEND WIRING AS REQUIRED.

RECONNECT TO NEW UNIT. (TYP. 10) SEE M6.01 FOR MORE DETAILS.

PROPOSED ROOF PLAN

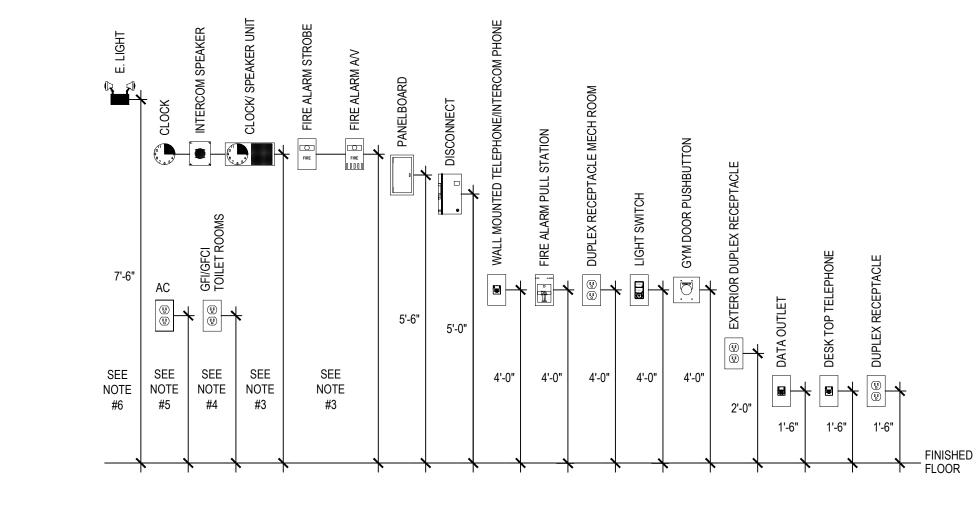

COURTYARD

NOTES:

COURTYARD

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IN LOCATIONS WHERE SIMILAR DEVICES ARE MOUNTED AT THE SAME HEIGHT, DEVICES SHALL BE PROPERLY "GANGED" AND SHALL HAVE A SINGLE COVER

IN LOCATIONS WHERE DIFFERENT DEVICES ARE MOUNTED AT DIFFERENT HEIGHTS WITHIN FOUR FEET OF ONE ANOTHER, DEVICES SHALL BE MOUNTED SUCH THAT THEY HAVE A COMMON CENTERLINE. IF THERE ARE THREE OR MORE DEVICES, THE CONTRACTOR SHALL REQUEST A DETAIL FROM THE

80" TO BOTTOM, OR AT SHALLOW CEILING INSTALLATIONS, WITHIN 6" OF FINISHED CEILING. VERIFY WITH ENGINEER.

IN TOILET ROOMS WITH BACK SPLASH AT VANITY, MOUNT CENTER AT 4" ABOVE BACK SPLASH. IF NO BACK SPLASH, MOUNT 4" ABOVE COUNTER. IF NO COUNTER, MOUNT AT 42" AFF.COORDINATE WITH ARCHITECTURAL PLANS. REFER TO ELEVATIONS AND FURNITURE PLANS.

RECEPTACLE IN PLAN WITH THE NOTATION 'AC' INDICATES MOUNTING HEIGHT OF 4" ABOVE COUNTER OR 4" ABOVE BACK SPLASH. COORDINATE WITH ARCHITECTURAL PLANS. REFER TO ELEVATIONS AND FURNITURE PLANS.

MOUNT AT 7'-6" ABOVE CLOSEST FLOOR LEVEL (LANDINGS, STEPPED FLOORS, ETC.) UNLESS OTHERWISE NOTED.

DEVICE MOUNTING HEIGHT DETAIL

COURTYARD

SCALE: N.T.S.

REV. DATE

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CONDITIONS SHOWN ARE REPRESENTED AS SUGGESTIVE INFORMATION AS THEY MAY NOT HAVE BEEN BUILT AND DETAILED

GINEERS, PC. AND, THEREFORE, MAY NOT REPRESENT TH CONDITIONS AS CONSTRUCTED AT THE TIME. ALL EXISTI

NOT TO SCALE

A.G. CHECK BY: F.S.

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66-14-02-02-0-002-020 DISTRICT BRIARCLIFF MANOR UFSD PROJECT BOND IMPROVEMENTS

DWG TITLE ELECTRICAL **GENERAL NOTES & ROOF PLA** SCALE: AS NOTED

DATE: 10/08/21 BID PICK-UP: 1/17/2022 FILE No: 21-274B

SCALE: 1/16" = 1'-0"

E1.02