| 0) 4 (5 0) | | | | | | | |
|------------|--|--|--|--|--|--|--|
| SYMBOL | DESCRIPTION - PIPING TO RISE UP | | | | | | |
| 191 | | | | | | | |
| ● | - PIPING TO DROP DOWN | | | | | | |
| X131. | PIPING ANCHOR | | | | | | |
| <u> </u> | - PIPING GUIDE | | | | | | |
| | COLD WATER SUPPLY PIPING | | | | | | |
| HWS — | HEATING SYSTEM SUPPLY PIPING | | | | | | |
| HWR — | HEATING SYSTEM RETURN PIPING | | | | | | |
| - | - CHILLED WATER SUPPLY PIPING | | | | | | |
| - | - CHILLED WATER RETURN PIPING | | | | | | |
| | - CONDENSER WATER SUPPLY PIPING | | | | | | |
| — | - CONDENSER WATER RETURN PIPING | | | | | | |
| CD | - CONDENSATE DRAINAGE PIPING | | | | | | |
| F.O.S. — | - FUEL OIL SUPPLY PIPING | | | | | | |
| F.O.R. — | - FUEL OIL RETURN PIPING | | | | | | |
| G | - LOW PRESSURE NATURAL GAS PIPING | | | | | | |
| EG | - ELEVATED PRESSURE NATURAL GAS PIPING | | | | | | |
| ₩ | GAS COCK | | | | | | |
| | DIRT LEG IN PIPING | | | | | | |
| <u>'</u> ± | - LIQUEFIED PETROLEUM GAS PIPING | | | | | | |
| LP | | | | | | | |
| V | - VENT PIPING | | | | | | |
| | - LINEAR EXPANSION COMPENSATOR | | | | | | |
| | EXPANSION LOOP IN PIPING | | | | | | |
| ——- | - UNION IN PIPING | | | | | | |
| ** | PIPING STRAINER (w/ BLOWDOWN VALVE) | | | | | | |
| | REDUCER / INCREASER FITTINGS IN PIPING | | | | | | |
| | ECCENTRIC REDUCER IN PIPING | | | | | | |
| <u> </u> | THERMOMETER | | | | | | |
| © | PRESSURE GAUGE | | | | | | |
| | - FULL PORT BALL VALVE | | | | | | |
| | - GATE VALVE | | | | | | |
| <u> </u> | SWING CHECK VALVE | | | | | | |
| - | BALANCING VALVE | | | | | | |
| | 3-WAY VALVE (w/ OPERATOR) | | | | | | |
| | CIRCUIT CETTER | | | | | | |
| 3 | - TRIPLE DUTY VALVE | | | | | | |
| | - WAFER VALVE | | | | | | |
| <u>'l'</u> | PLUG / CAP IN PIPING | | | | | | |
| | PNEUMATIC CONTROL VALVE OPERATOR | | | | | | |
| | ELECTRIC CONTROL VALVE OPERATOR | | | | | | |
| <u>- '</u> | AUTOMATIC AIR VENT | | | | | | |
| | - AUTOWATIO AIIX VEINT | | | | | | |

| SYMBOL | DESCRIPTION | | | | | | | |
|--------------|--|--|--|--|--|--|--|--|
| 24x12 / 20"~ | RECTANGULAR GALVANIZED DUCTWORK - DIMENSIONS 'W' x 'H' | | | | | | | |
| £ \ | NEW EXHAUST DUCTWORK TO RISE UP | | | | | | | |
| £ \ | NEW EXHAUST DUCTWORK TO DROP DOWN | | | | | | | |
| E | TRANSITION IN DUCTWORK | | | | | | | |
| 24 120 | ELBOW IN DUCTWORK w/ TURNING VANES | | | | | | | |
| | ELBOW IN DUCTWORK (RADIUS + 1.5 x D) | | | | | | | |
| | 45 DEG. TAKEOFF FITTING | | | | | | | |
| | 90 DEG. TAKEOFF w/ BELLMOUTH FITTING | | | | | | | |
| | CEILING RETURN AIR REGISTER | | | | | | | |
| | ROOF MOUNTED EXHAUST FAN | | | | | | | |

DUCTWORK NOTES:

PROVIDE ALL NEW DUCTWORK AS SHOWN AND SPECIFIED UNDER SPECIFICATION SECTION 015891, AND IN CONFORMANCE WITH 'SMACNA' SPECIFICATIONS.

ARE SHOWN, TURNING VANES SHALL BE INSTALLED UPON APPROVAL BY THE ENGINEER.

- IF A DUCT ELBOW IS SHOWN TO BE RADIUSED, THEN RADIUSED ELBOWS SHALL BE INSTALLED. SQUARE ELBOWS MAY NOT BE SUBSTITUTED WHERE RADIUSED ELBOWS ARE SHOWN. WHERE SQUARE ELBOWS
- WHERE FLEXIBLE DUCTWORK IS USED, LENGTHS MAY NOT EXCEED 4 FEET TOTAL IN ANY ONE RUN OF FLEXIBLE DUCTWORK. FLEXIBLE DUCTWORK SHALL BE RATED IN ACCORDANCE WITH UL 181, CLASS 1. REFER TO SPECIFICATION SECTION 15891 FOR FURTHER INFORMATION.
- MECHANICAL CONTRACTOR SHALL PROVIDE A BUTTERFLY TYPE VOLUME DAMPER WITH LOCKING QUADRANT HANDLE PRIOR TO EACH AIR OUTLET SHOWN. INSTALL DAMPER AT LEAST 5 FEET AWAY FROM AIR OUTLET WHEREVER POSSIBLE.
- MECHANICAL CONTRACTOR SHALL PROVIDE FLEXIBLE DUCT CONNECTIONS WHERE DUCT SYSTEMS CONNECT TO EQUIPMENT. REFER TO SPECIFICATION SECTION 15891 FOR FURTHER INFORMATION.

GENERAL NOTES

- REMOVAL & RELOCATION OF CERTAIN EXISTING WORK SHALL BE NECESSARY FOR THE PERFORMANCE OF THE NEW WORK SHOWN HEREIN. ALL EXISTING CONDITIONS ARE NOT COMPLETELY DETAILED ON THE DRAWINGS. THE CONTRACTOR SHALL SURVEY THE SITE & MAKE ALL NECESSARY CHANGES BASED ON EXISTING CONDITIONS AS REQUIRED FOR PROPER DEMOLITION OF EXISTING WORK & SHALL INCLUDE ALL MATERIALS & LABOR FOR SAME IN HIS BID PRICE. NO ALLOWANCE WILL BE MADE FOR FAILURE TO DO SO.
- PRIOR TO SUBMITTING A BID, THE CONTRACTOR SHALL VISIT THE PREMISES OF THE PROPOSED WORK & SHALL CAREFULLY EXAMINE THE ENGINEERING DRAWINGS, EXISTING CONDITIONS & LIMITATIONS THEREOF. VERIFY ACTUAL LOCATIONS WHERE THE NEW PIPING WILL BE ROUTED, COORDINATE WITH NEW & EXISTING WORK & PROVIDE CLEARANCE W/ BUILDING STRUCTURE, OTHER SERVICES, ETC.. THE CONTRACTOR SHALL INCLUDE ALL COSTS WHATSOEVER WHICH ARE INCURRED AS A RESULT OF LIMITATIONS OF THE EXISTING & NEW CONDITIONS. LATER CLAIMS FOR EXTRA LABOR. EQUIPMENT MATERIALS, ETC. REQUIRED DUE TO DIFFICULTIES WHICH COULD HAVE BEEN FORESEEN WILL NOT BE CONSIDERED AS EXTRA WORK.
- INSTALL WORK SO AS TO BE READILY ACCESSIBLE FOR OPERATING, MAINTENANCE & REPAIR. MINOR DEVIATIONS FROM DRAWINGS MAY BE MADE TO ACCOMPLISH THIS, BUT CHANGES OF MAGNITUDE WHICH INVOLVE EXTRA COST SHALL NOT BE MADE WITHOUT APPROVAL.
- INVESTIGATE EACH SPACE THROUGH WHICH EQUIPMENT MUST BE MOVED. WHEN NECESSARY, EQUIPMENT SHALL BE SHIPPED FROM MANUFACTURER IN CRATED SECTIONS OF SIZE SUITABLE FOR MOVING THROUGH AREAS AVAILABLE. ASCERTAIN FROM BUILDING OWNER AT WHAT TIMES OF DAY EQUIPMENT MAY BE MOVED THROUGH THE BUILDING.
- COORDINATE THE EXACT SIZE & LOCATION OF NEW OPENINGS WITH EXISTING STRUCTURE. PATCH / INSULATE AS REQUIRED. CONTRACTOR SHALL FIRESTOP ALL PENETRATIONS FROM NEW PIPING, CONDUIT, DUCTWORK, ETC. THROUGH EXISTING OR NEW FIRE/ SMOKE BARRIERS. REFER TO SPECIFICATION SECTION 15511 FOR FURTHER DETAILS.
- IT IS THE INTENT OF THIS CONTRACT FOR REMAINING SYSTEMS TO BE LEFT IN GOOD WORKING ORDER, READY FOR OPERATION. COORDINATE ANY REQUIRED SYSTEM SHUTDOWNS WITH OWNER 48 HOURS IN ADVANCE. EXISTING SYSTEM SHUTDOWNS WILL NOT BE PERMITTED IF THEY INTERFERE WITH THE DAILY OPERATIONS OF THE BUILDING. CONTRACTOR WILL BE REQUIRED TO TAKE PROPER PRECAUTIONS AGAINST DAMAGING OR DISRUPTING BUILDING SYSTEMS, WIRING, PIPING OR CONTROL TUBING. ANY DAMAGE TO THESE ITEMS SHALL BE REPAIRED AT THE CONTRACTOR'S COST AS A PART OF THIS
- MATERIALS DAMAGED IN THE PROCESS OF INSTALLATION, OR DEMOLITION TO THE SATISFACTION OF THE OWNER'S REPRESENTATIVE. CONTRACTOR SHALL MAKE REPAIRS USING THE SAME OR EQUIVALENT MATERIALS. WORK WILL BE PERFORMED AT THE CONTRACTOR'S COST.

THE CONTRACTOR SHALL REPAIR / RESTORE TO ORIGINAL CONDITION ANY EXISTING EQUIPMENT OR

- CONTRACTOR SHALL INCUR ANY COSTS OR BURDENS ASSOCIATED WITH LOST OR STOLEN EQUIPMENT
- DURING THE LIFE OF THE CONTRACT PERIOD, CONTRACTOR SHALL REMOVE ALL RUBBISH / EXCESS MATERIAL ACCUMULATED AS A RESULT OF HIS OPERATIONS ON A DAILY BASIS. ALL AREAS / EQUIPMENT AFFECTED UNDER THIS CONTRACT SHALL BE KEPT CLEAN OF DUST / DEBRIS. ALL AREAS SHALL RECEIVE A FINAL CLEANING PRIOR TO FINAL ACCEPTANCE BY THE OWNER.
- PROVIDE FOR LEGAL REMOVAL / DISPOSAL OF ALL RUBBISH / DEBRIS FROM THE BUILDING & SITE. PROTECT ALL WORK NOT SLATED FOR DEMOLITION.
- THIS CONTRACTOR SHALL COORDINATE HIS WORK WITH ALL OTHER TRADES PRIOR TO SCHEDULING THE WORK. WORK SHALL BE PERFORMED IN PROPER SEQUENCE, AS AGREED TO BY ALL TRADES. ANY COSTS INCURRED BY THE OWNER DUE TO IMPROPER SEQUENCING OF WORK WILL BE PAID FOR BY THIS
- CONTRACTOR SHALL OBTAIN ALL PERMITS, PAY ALL FEES, CONNECTION CHARGES, ETC. ASSOCIATED WITH THE WORK UNDER THEIR CONTRACT.
- PAINT / TOUCH UP ALL SURFACES MARRED AS A RESULT OF THE PERFORMANCE OF THE CONTRACT
- THE MECHANICAL CONTRACTOR SHALL REFER TO / REVIEW ALL OTHER TRADE DRAWINGS IN THE BID PACKAGE & SHALL BE RESPONSIBLE FOR / PERFORM ALL WORK INDICATED AS (M.C.) MECHANICAL WORK AS A PART OF THE BASE BID UNLESS SPECIFICALLY NOTED OTHERWISE.
- SUBSTITUTED EQUIPMENT OF GREATER OR LARGER POWER, DIMENSIONS, CAPACITIES & RATINGS MAY BE FURNISHED PROVIDED THAT SAID EQUIPMENT IS APPROVED IN WRITING PRIOR TO ORDER. ANY CONNECTING MECHANICAL SERVICES, ELECTRICAL SERVICES, BASES, STRUCTURAL APPURTENANCES. ETC. REQUIRED TO BE INCREASED DUE TO THE USE OF SAID EQUIPMENT WILL BE PAID FOR IN FULL BY THE MECHANICAL CONTRACTOR, INCLUDING ANY ADDITIONAL REQUIRED ENGINEERING FEES.
- . EACH PIECE OF EQUIPMENT SHALL BE PROVIDED WITH A PERMANENT TYPE LAMINATED, BLACK FINISH, WHITE CORE, PHENOLIC NAMEPLATE. NAMEPLATES SHOULD INDICATE THE NAME & NUMBER OF THE UNIT UNIT VOLTAGE, & ANY INTERLOCK REFERENCE. STARTERS / DISCONNECT SWITCHES SHOULD ALSO BE EQUIPPED WITH AN IDENTICAL NAMEPLATE WITH THE SAME INFORMATION.
- "ATTIC STOCK" UPON COMPLETION OF THE PROJECT, MECHANICAL CONTRACTOR SHALL COMPLETELY REMOVE / DISPOSE OF FILTERS USED DURING CONSTRUCTION & START-UP PROCEDURES. INSTALL NEW FILTERS IN ALL EQUIPMENT, MERV-8 OR BETTER UPON TURN OVER OF THE PROJECT TO THE OWNER. IN ADDITION, PROVIDE (2) COMPLETE SETS OF FILTERS FOR EACH PEICE OF EQUIPMENT & TURN OVER TO
- MECHANICAL CONTRACTOR SHALL PROVIDE (1) SPARE MOTOR FOR EACH SIZE MOTOR USED ON THE PROJECT. IN INSTANCES WHERE MORE THAN TEN OF THE SAME MOTOR ARE USED, MECHANICAL CONTRACTOR SHALL PROVIDE (1) SPARE MOTOR FOR EVERY TEN MOTORS OF A GIVEN SIZE USED ON THE
- MAINTENANCE MANUAL: UPON COMPLETION OF THE PROJECT, THE MECHANICAL CONTRACTOR SHALL PROVIDE A BINDER CONTAINING THE OPERATIONS & MAINTENANCE MANUALS FOR EACH NEW PEICE OF EQUIPMENT INSTALLED UNDER THIS PROJECT. THE FIRST SECTION OF THE MAINTENANCE MANUAL SHALL CONTAIN A LIST OF EACH PEICE OF EQUIPMENT, COMPLETE WITH INFORMATION SHOWING APPROPRIATE REPLACEMENT FILTER SIZES / TYPES. APPROPRIATE REPLACEMENT BELT SPECIFICATIONS. REPLACEMENT MOTOR SPECIFICATIONS, REPLACEMENT BEARING SPECIFICATIONS, VOLTAGES OF UNIT, ETC. THIS SHALL SERVE AS A WRITTEN DATABASE DESCRIBING ALL MAINTENANCE INFORMATION FOR EACH NEW PEICE OF EQUIPMENT USED.

ROOFING CONSTRUCTION NOTES:

. ALL EXISTING DIMENSIONS AND CONDITIONS ARE APPROXIMATE. MECHANICAL CONTRACTORS MUST FIELD VERIFY ALL CONDITIONS AND NOTIFY THE ENGINEER OF ANY DISCREPANCIES PRIOR TO BIDDING. THE MECHANICAL CONTRACTOR SHALL BE RESPONSIBLE FOR VERIFICATION OF ALL DIMENSIONS REQUIRED FOR BIDDING AND ESTIMATING. PRE-BID SITE INSPECTION IS STRONGLY RECOMMENDED. ALL CONTRACTORS SHALL CONTACT THE SCHOOL TO MAKE AN APPOINTMENT FOR SITE VISIT. UNDER NO CIRCUMSTANCES WILL ANY CONTRACTOR BE ALLOWED TO SHOW UP WITHOUT AN APPOINTMENT.

2. IN ACCORDANCE WITH STATE AND LOCAL CODES, THE REQUIRED EXITS IN THE EXISTING BUILDING MUST BE MAINTAINED AS CLEAR, AND PROTECTED DURING THE ENTIRE CONSTRUCTION PERIOD.

3. ALL WORK AND MATERIAL OF THIS PROJECT AND ADJACENT SURFACES SHALL BE PROTECTED FROM DAMAGE. IN THE EVENT OF DAMAGE, THE MECHANICAL CONTRACTOR SHALL IMMEDIATELY NOTIFY THE ARCHITECT AND THE OWNER, AND MAKE ALL REPAIRS AND REPLACEMENTS NECESSARY TO THE APPROVAL OF THE ARCHITECT AND OWNER AND AT NO ADDITIONAL COST TO THE OWNER.

I. THE MECHANICAL CONTRACTOR IS TO PROTECT AND MAKE WATER TIGHT ALL AREAS OF HIS WORK FROM INCLEMENT WEATHER DURING AND AT THE END OF EVERY DAY OF WORK OPERATIONS.

5. ALL PROJECT WASTE MATERIAL AND RUBBISH GENERATED BY THE MECHANICAL CONTRACTOR AND / OR HIS SUB-CONTRACTORS SHALL BE DISPOSED IN CONTAINERS FOR SUBSEQUENT LEGAL OFF-SITE DISPOSAL. CONTAINER LOCATION TO BE COORDINATED WITH BUILDINGS AND GROUNDS. OFF-SITE DISPOSAL TO BE ON A REGULAR BASIS.

6. ALL FLASHING ON MECHANICALS MUST BE INSTALLED AT A DISTANCE ABOVE THE FINISHED ROOF SURFACE TO INSURE CONFORMANCE WITH ROOFING MANUFACTURER'S WARRANTY REQUIREMENTS. INCLUSIVE OF ALL CONDITIONS, NO EXCEPTIONS

7. THE ROOFING CONTRACTOR SHALL BE SURE TO MAINTAIN ANY/ALL EXISTING ROOFING WARRANTEE IN PLACE AT THOSE ROOFS WHICH CUTTING, PATCHING AND RE-FLASHING IS REQUIRED. THE ROOFING CONTRACTOR SHALL BE RESPONSIBLE TO MAKE ANY & ALL REPAIRS TO EXISTING ROOFING SYSTEM AS REQUIRED TO CONSTRUCTION ACTIVITIES AT NO ADDITIONAL COST TO THE OWNER. ALL WORK SHALL BE DONE IN ACCORDANCE WITH THE MANUFACTURER'S SPECIFICATIONS AND SHALL MAINTAIN ALL EXISTING WARRANTIES.

8. THE ROOFING CONTRACTOR (R.C.) SHALL BE RESPONSIBLE FOR ALL NEW ROOF PENETRATIONS FOR NEW MECHANICAL UNITS ON EXISTING ROOF. R.C. SHALL COORDINATE SETTING OF CURBS WITH THE MECHANICAL CONTRACTOR (M.C.) AND R.C. SHALL BE RESPONSIBLE FOR ALL PATCHING/FLASHING OF EXISTING ROOF. THE MECHANICAL CONTRACTOR SHALL USE CERTIFIED ROOF INSTALLER AS APPROVED BY MANUFACTURER OF EXISTING ROOF AS TO NOT VOID EXISTING ROOF WARRANTY. COORDINATE WITH OWNER.

9. THE MECHANICAL CONTRACTOR SHALL BE RESPONSIBLE TO COORDINATE INSTALLATION OF ALL MECHANICAL UNITS/ EQUIPMENT WITH ALL

ALL WALL & FLOOR PENETRATIONS SHALL BE DONE BY ROOFING CONTRACTOR WITH MECHANICAL CONTRACTOR PRESENT.

GENERAL NOTES FOR ALL ROOFTOP EQUIPMENT:

- 1. PROVIDE DISCONNECT SWITCH FOR EACH NEW EQUIPMENT.
- 2. R.C. SHALL MAKE ALL ROOF PENETRATIONS IN THE PRESENCE OF THE MECHANICAL CONTRACTOR.
- 3. MECHANICAL CONTRACTOR SHALL FURNISH NEW ROOF CURBS TO R.C. R.C. SHALL CUT HOLES IN ROOF IN PRESENCE OF M.C. AND R.C. SHALL INSTALL NEW ROOF CURBS IN THE PRESENCE OF THE CERTIFIED M.C. R.C. SHALL BE RESPONSIBLE FOR FLASHING ALL NEW ROOF CURBS. REFER TO ARCHITECTURAL DRAWINGS FOR FURTHER DETAILS OF FLASHING ROOF CURBS.

GENERAL MECHANICAL NOTES:

- PROVIDE AND INSTALL 2" ACOUSTIC FIBERGLASS 3-LBS. DENSITY WITHIN ROOF CURBS AND ADAPTER ROOF CURBS.
- ALL DISCONNECT SWITCHES AND STARTERS TO BE FURNISHED BY MECHANICAL CONTRACTOR AND INSTALLED AND WIRED BY THE ELECTRICIAN.
- DUCT SIZE DIMENSIONS SHOWN ARE 'CLEAR' INSIDE DIMENSIONS.
- CONTROLS CONTRACTOR SHALL FURNISH ALL CONTROLS EQUIPMENT AND PROVIDE TO MECHANICAL CONTRACTOR TO INSTALL. CONTROLS CONTRACTOR SHALL WIRE ALL CONTROLS EQUIPMENT.
- UNLESS OTHERWISE NOTED, THE GENERAL CONTRACTOR (G.C.) SHALL MAKE ALL INTERIOR WALL, CEILING, & FLOOR PENETRATIONS OR PIPING & DUCTWORK. M.C. SHALL BE RESPONSIBLE TO COORDINATE WITH ALL TRADES. M.C. SHALL BE PRESENT WHEN G.C. MAKES PENETRATIONS FOR ALL MECHANICAL PIPING & DUCTWORK.

GENERAL EXHAUST FAN NOTES:

ABBREVIATIONS

- E.C. SHALL DISCONNECT & REMOVE EXISTING STARTERS FOR ALL EXHAUST FANS SHOWN TO BE REPLACED. THEN M.C. SHALL PROVIDE NEW STARTERS & DISCONNECTS FOR THOSE EXHAUST FANS BEING REPLACED. E.C. SHALL INSTALL NEW STARTERS / DISCONNECTS. VERIFY EXISTING LOCATIONS OF ALL EXISTING EXHAUST FAN STARTERS.
- M.C. SHALL PROVIDE AND INSTALL NEW ADAPTER CURB ASSEMBLIES AS REQ'D. TO MOUNT NEW EXHAUST FANS IN EXIST. EXHAUST FAN
- M.C. SHALL MODIFY AS NECESSARY ALL EXIST. EXHAUST FAN EQUIPMENT TO COMPLETELY INSTALL THE NEW REPLACEMENT EXHAUST FAN

ABOVE FINISHED FLOOR

BACKDRAFT DAMPER

COLD WATER SUPPL

FLOAT & THERMOSTATION

FEET PER MINUT

FLAT OVAL DUCTWORK

GALLONS PER HOUF

SALLONS PER MINUTE

<u>H</u>ANDICAPPED

INSIDE DIAMETER

MANUFACTURE

MISCELLANEOUS

MOUNTED

NATURAL GAS

NOT IN CONTRACT

LEAVING AIR TEMPERATURE

EAVING WATER TEMPERATURE

CUBIC FEET OF AIR PER MINUTE

FIRE DAMPER - DUCT MOUNTE

HEATING SYSTEM HOT WATER SUPPLY

<u>HEATING SYSTEM HOT WATER RETURN</u>

FOR FURTHER DETAILS ON ALL MECHANICAL EXHAUST FAN EQUIPMENT REFER TO MECHANICAL DRAWINGS.

FIRESTOPPING NOTES

CONTRACTOR.

NOTE FOR REPLACEMENTS

NOTED ON DWG'S.

POWER PANEL

ALL CIRCUIT

BREAKERS AND

OTHER POWER

REQUIREMENTS

PROVIDED AND

INSTALLED BY EC

EC SHALL DISCONNECT AND REMOVE OLD STARTER /

EC SHALL PROVIDE NEW CIRCUIT, UNLESS OTHERWISE

DISCONNECT SWITCH PROVIDED BY MC,

INSTALLED BY EC, UNLESS OTHERWISE

NOTED. SIZE AS REQUIRED. MUST BE

INSTALLED WITHIN SIGHT AND READILY

ACCESSIBLE OF MECHANICAL EQUIPMENT.

DISCONNECT AND UNNECESSARY WIRING.

MC TO FIELD VERIFY EXISTING STARTER AND

NEW MECHANICAL EQUIPMENT

NUMBER

NOMINAL

NOT TO SCALE

OUTSIDE AIR

ON CENTER

SUPPLY AIR

STANDARI

TEMPERATURE

OLUME DAMPER

WITHOU

STATIC PRESSURE

PREFABRICATED

OUTSIDE DIAMETER

OUTSIDE SCREW & YOKE

REVOLUTIONS PER MINUTE

THERMAL EXPANSION VALVE

ARIABLE FREQUENCY DRIVE

WET BULB TEMPERATURE

WATER TEMPERATURE DROP

WATER TEMPERATURE RISE

WATER PRESSURE DROP

GENERIC DIAGRAM - REFER TO DWG'S FOR FURTHER DETAILS

DISCONNECT LOCATIONS FOR EC.

- ALL PENETRATIONS THROUGH FIRE RATED WALLS, FLOORS OR OTHER STRUCTURES SHALL BE FIRE STOPPED BY MECHANICAL CONTRACTOR.
- THE FIRE STOP MATERIALS SHALL BE HILTI TYPE FS-657 FIRE BLOCK, FS-ONE SEALANT, CP-672 JOINT SPRAY, CP-601S ELASTOMERIC SEALANT, 6P-606 FLEXIBLE SEALANT, CP-643 OR CP-642 COLLAR, CP-618 PUTTY STICK, OR FS-635 TROWEL ABLE COMPOUND, AS SUITABLE.
- . CONTRACTOR SHALL SUBMIT SHOP DRAWINGS OF PRODUCTS TO BE USED.
- FIRESTOP MATERIALS OTHER THAN HILTI SHALL INCLUDE FULL TECHNICAL DATA WITH SHOP DRAWINGS TO DEMONSTRATE EQUALITY WITH

ROOFTOP MECHANICAL EQUIPMENT DEMOLITION PLAN GENERAL NOTES:

- MECHANICAL CONTRACTOR SHALL VERIFY IN THE FIELD THE EXACT LOCATION OF ALL EXISTING MECHANICAL RELATED EQUIPMENT, DUCTWORK, PIPING, LOUVERS, AND ROOFTOP EQUIPMENT PRIOR TO START OF ANY WORK.
- MECHANICAL CONTRACTOR SHALL COORDINATE ALL ROOF DEMOLITION PLAN WORK AND WALL DEMOLITION PLAN WORK WITH GENERAL
- REMOVE EXISTING EQUIPMENT AS SHOWN ON PLANS. MECHANICAL CONTRACTOR IS RESPONSIBLE FOR REMOVAL OF ALL MECHANICAL EQUIPMENT AND ASSOCIATED DUCTWORK AND ASSOCIATED ROOF CURBS, ASSOCIATED DUCTWORK, WALL LOUVERS, WHERE CALLED OUT IN KEY PLAN NOTES. MECHANICAL CONTRACTOR SHALL COORDINATE REMOVAL OF ALL ROOF MECHANICAL EQUIPMENT WITH ROOFING
- ROOFING CONTRACTOR SHALL BE RESPONSIBLE FOR PATCHING ANY ROOF PENETRATION THAT SHALL NOT BE RE-USED. REFER TO ARCHITECTURAL DRAWINGS FOR FURTHER DETAILS ON ROOF PATCHING.
- GENERAL CONTRACTOR (G.C) SHALL BE RESPONSIBLE FOR PATCHING ALL WALL PENETRATIONS. ROOFING CONTRACTOR SHALL BE RESPONSIBLE FOR PATCHING ALL ROOF PENETRATIONS AND FLASHING ALL NEW ROOF CURBS. MECHANICAL CONTRACTOR (M.C.) SHALL BE RESPONSIBLE FOR MAKING ALL WALL PENETRATIONS IN THE PRESENCE OF THE GENERAL CONTRACTOR. ROOFING CONTRACTOR SHALL BE RESPONSIBLE FOR MAKING ALL ROOF PENETRATIONS AND INSTALLING ROOF CURBS.

OPEN PROTOCOL

BACNECT

CONTROLLER

NEW EXHAUST FAN

PROVIDED AND INSTALLED

CONTROL

WIRING BY MC

BY MC

PWR WIRING BY EC

STARTER OR VFD

PROVIDED BY MC

INSTALLED BY EC

(COORDINATE

LOCATION WITH MC

TESTING and BALANCING NOTES

- MECHANICAL CONTRACTOR WILL BE REQUIRED TO PERFORM ALL EQUIPMENT & SYSTEM TESTING BALANCING REQUIRED UNDER THIS CONTRACT. PROVIDE A FULL REPORT DETAILING ALL DESIGN & ACTUAL CONDITIONS FOR ALL AIR & HYDRONIC SYSTEMS SHOWN ON THE DRAWINGS. REFER TO SPECIFICATION SECTIONS 15990 & 15997 FOR FURTHER DETAILS.
- UPON NOTICE OF COMPLETION OF WORK BY THE CONTRACTOR, OWNER WILL OBTAIN THE SERVICES OF AN INDEPENDENT TESTING & BALANCING CONTRACTOR TO VERIFY THE RESULTS OF THE TESTING & BALANCING REPORT SUBMISSION. INDEPENDENT TESTING AGENCY SHALL SELECT A RANDOM NUMBER OF MEASUREMENTS TO BE CHECKED. MEASUREMENTS WILL BE CHECKED IN THE SAME MANNER AS ORIGINALLY MEASURED. NUMBER OF VERIFICATION MEASUREMENTS SHALL BE APPROXIMATELY 25% OF THE TOTAL MEASUREMENTS FOR THE PROJECT.
- IF MORE THAN 10% OF THE VERIFICATION TESTING SHOWS DEVIATIONS OF 10% OR MORE / SOUND LEVEL OF 2dB DIFFERENT THAN THAT ORIGINALLY MEASURED, THE ORIGINAL REPORT WILL BE REJECTED. ALL SYSTEMS WILL THEN BE REQUIRED TO BE COMPLETELY RE-TESTED, WITH A SECOND REPORT SUBMITTED IN THE EVENT THAT THE ORIGINAL REPORT IS REJECTED, ALL SYSTEMS SHALL BE READJUSTED & TESTED, NEW CERTIFIED REPORTS SUBMITTED, AND NEW VERIFICATION TESTS MADE, AT NO ADDITIONAL COST TO THE OWNER. THE CONTRACTOR WILL BE RESPONSIBLE FOR ALL COSTS INVOLVED WITH THE VERIFICATION TESTS.

ELECTRICAL WORK UNDER MECHANICAL CONTRACT

- MECHANICAL CONTRACTOR SHALL PROVIDE ALL STARTERS & DISCONNECT SWITCHES REQUIRED FOR ALL NEW MECHANICAL EQUIPMENT. STARTER / DISCONNECT SWITCH INSTALLATION TO BE PERFORMED UNDER THE ELECTRICAL CONTRACT. COORDINATE WORK W/ ELECTRICAL CONTRACTOR PRIOR TO START
- POWER WIRING REQUIRED FOR CONTROLS SHALL BE PERFORMED UNDER THE MECHANICAL CONTRACT UNLESS SPECIFICALLY NOTED OTHERWISE ON THE ELECTRICAL DRAWINGS. MECHANICAL CONTRACTOR SHALL OBTAIN THE SERVICES OF A LICENSED ELECTRICIAN (PER NEC REQUIREMENTS) TO PERFORM ALL ELECTRICAL WORK.


IN ACCORDANCE WITH OSHA REGULATIONS - ALL CONTRACTORS MUST WORKING ON, PRIOR TO DISMANTLING FOR SERVICE OR CLEANING.

CONTRACTOR ABBREVIATIONS:


| SYMBOL | DESCRIPTION |
|--------------|--|
| 24x12 / 20"~ | RECTANGULAR GALVANIZED DUCTWORK - DIMENSIONS 'W' x 'H' |
| 5 | NEW SUPPLY DUCTWORK TO RISE UP |
| 5 | NEW SUPPLY DUCTWORK TO DROP DOWN |
| | NEW RETURN DUCTWORK TO RISE UP |
| | NEW RETURN DUCTWORK TO DROP DOWN |
| | TRANSITION IN DUCTWORK |
| | FIRE DAMPER INSTALLED IN DUCTWORK |
| | VOLUME DAMPER IN DUCT (w/ LOCKING QUADRANT HANDLE) |
| 5 | ROUND DUCT WORK TO RISE UP |
| | ROUND DUCTWORK TO DROP DOWN |
| 42x18 FO | FLAT OVAL DUCT WORK |
| | RECTANGULAR TO ROUND DUCT TRANSITION |
| Z-4 1200 | ELBOW IN DUCTWORK w/ TURNING VANES |
| 54 | ELBOW IN DUCTWORK (RADIUS + 1.5 x D) |
| | 45 DEG. TAKEOFF FITTING |
| | 90 DEG. TAKEOFF w/ BELLMOUTH FITTING |
| | CEILING RETURN AIR REGISTER |


LOCK OUT-TAG OUT NOTIFICATION

PROPERLY LOCK-OUT & TAG OUT ALL ELECTRICAL EQUIPMENT THEY ARE

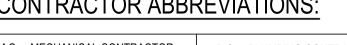

M.C. = MECHANICAL CONTRACTOR P.C. = PLUMBING CONTRACTOR C.C. = CONTROLS CONTRACTOR E.C. = ELECTRICAL CONTRACTOR G.C. = GENERAL CONTRACTOR C.W.C. = CASEWORK CONTRACTOR R.C. = ROOFING CONTRACTOR

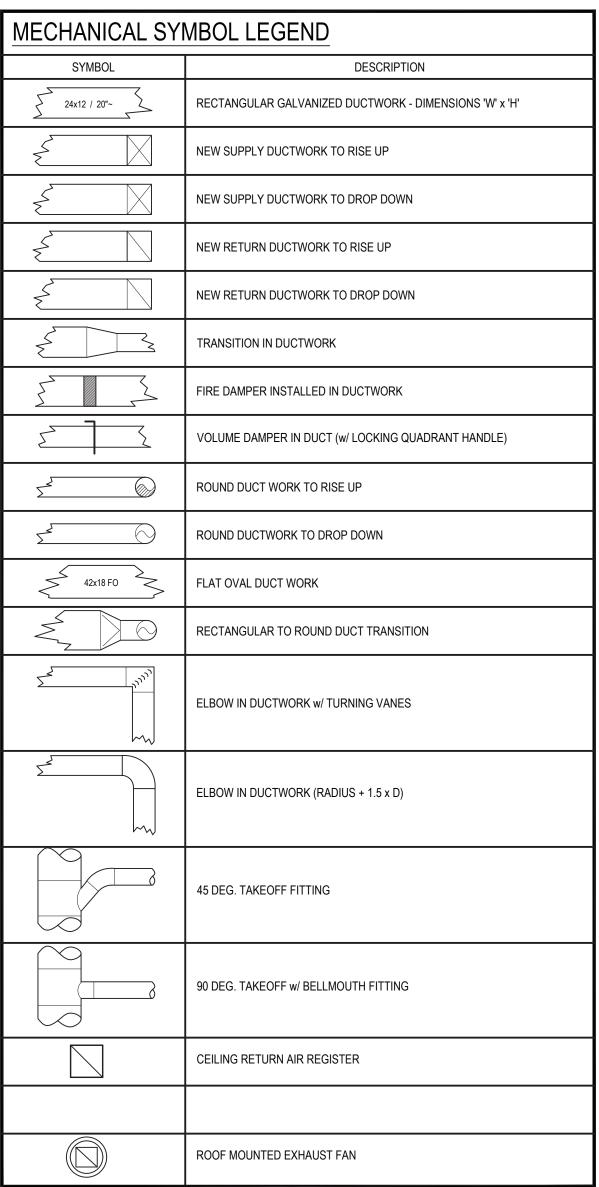

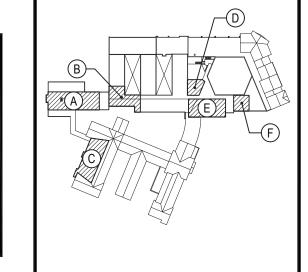

NOT TO SCALE

KEY PLAN

REV. DATE

1 1/14/2022 ISSUED FOR BID

NOTICE


SE DRAWINGS ARE BASED ON CONSTRUCTION DRAWINGS NOT

EPARED BY BBS ARCHITECTS, LANDSCAPE ARCHITECTS AN

SINEERS, PC. AND, THEREFORE, MAY NOT REPRESENT TH

CONDITIONS SHOWN ARE REPRESENTED AS SUGGESTIV NFORMATION AS THEY MAY NOT HAVE BEEN BUILT AND DETAILE

R THE ORIGINAL DOCUMENTS OR PER THE OWNER'S INFORMATIO

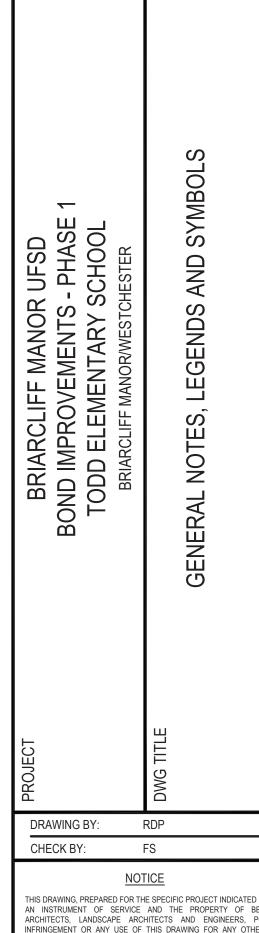


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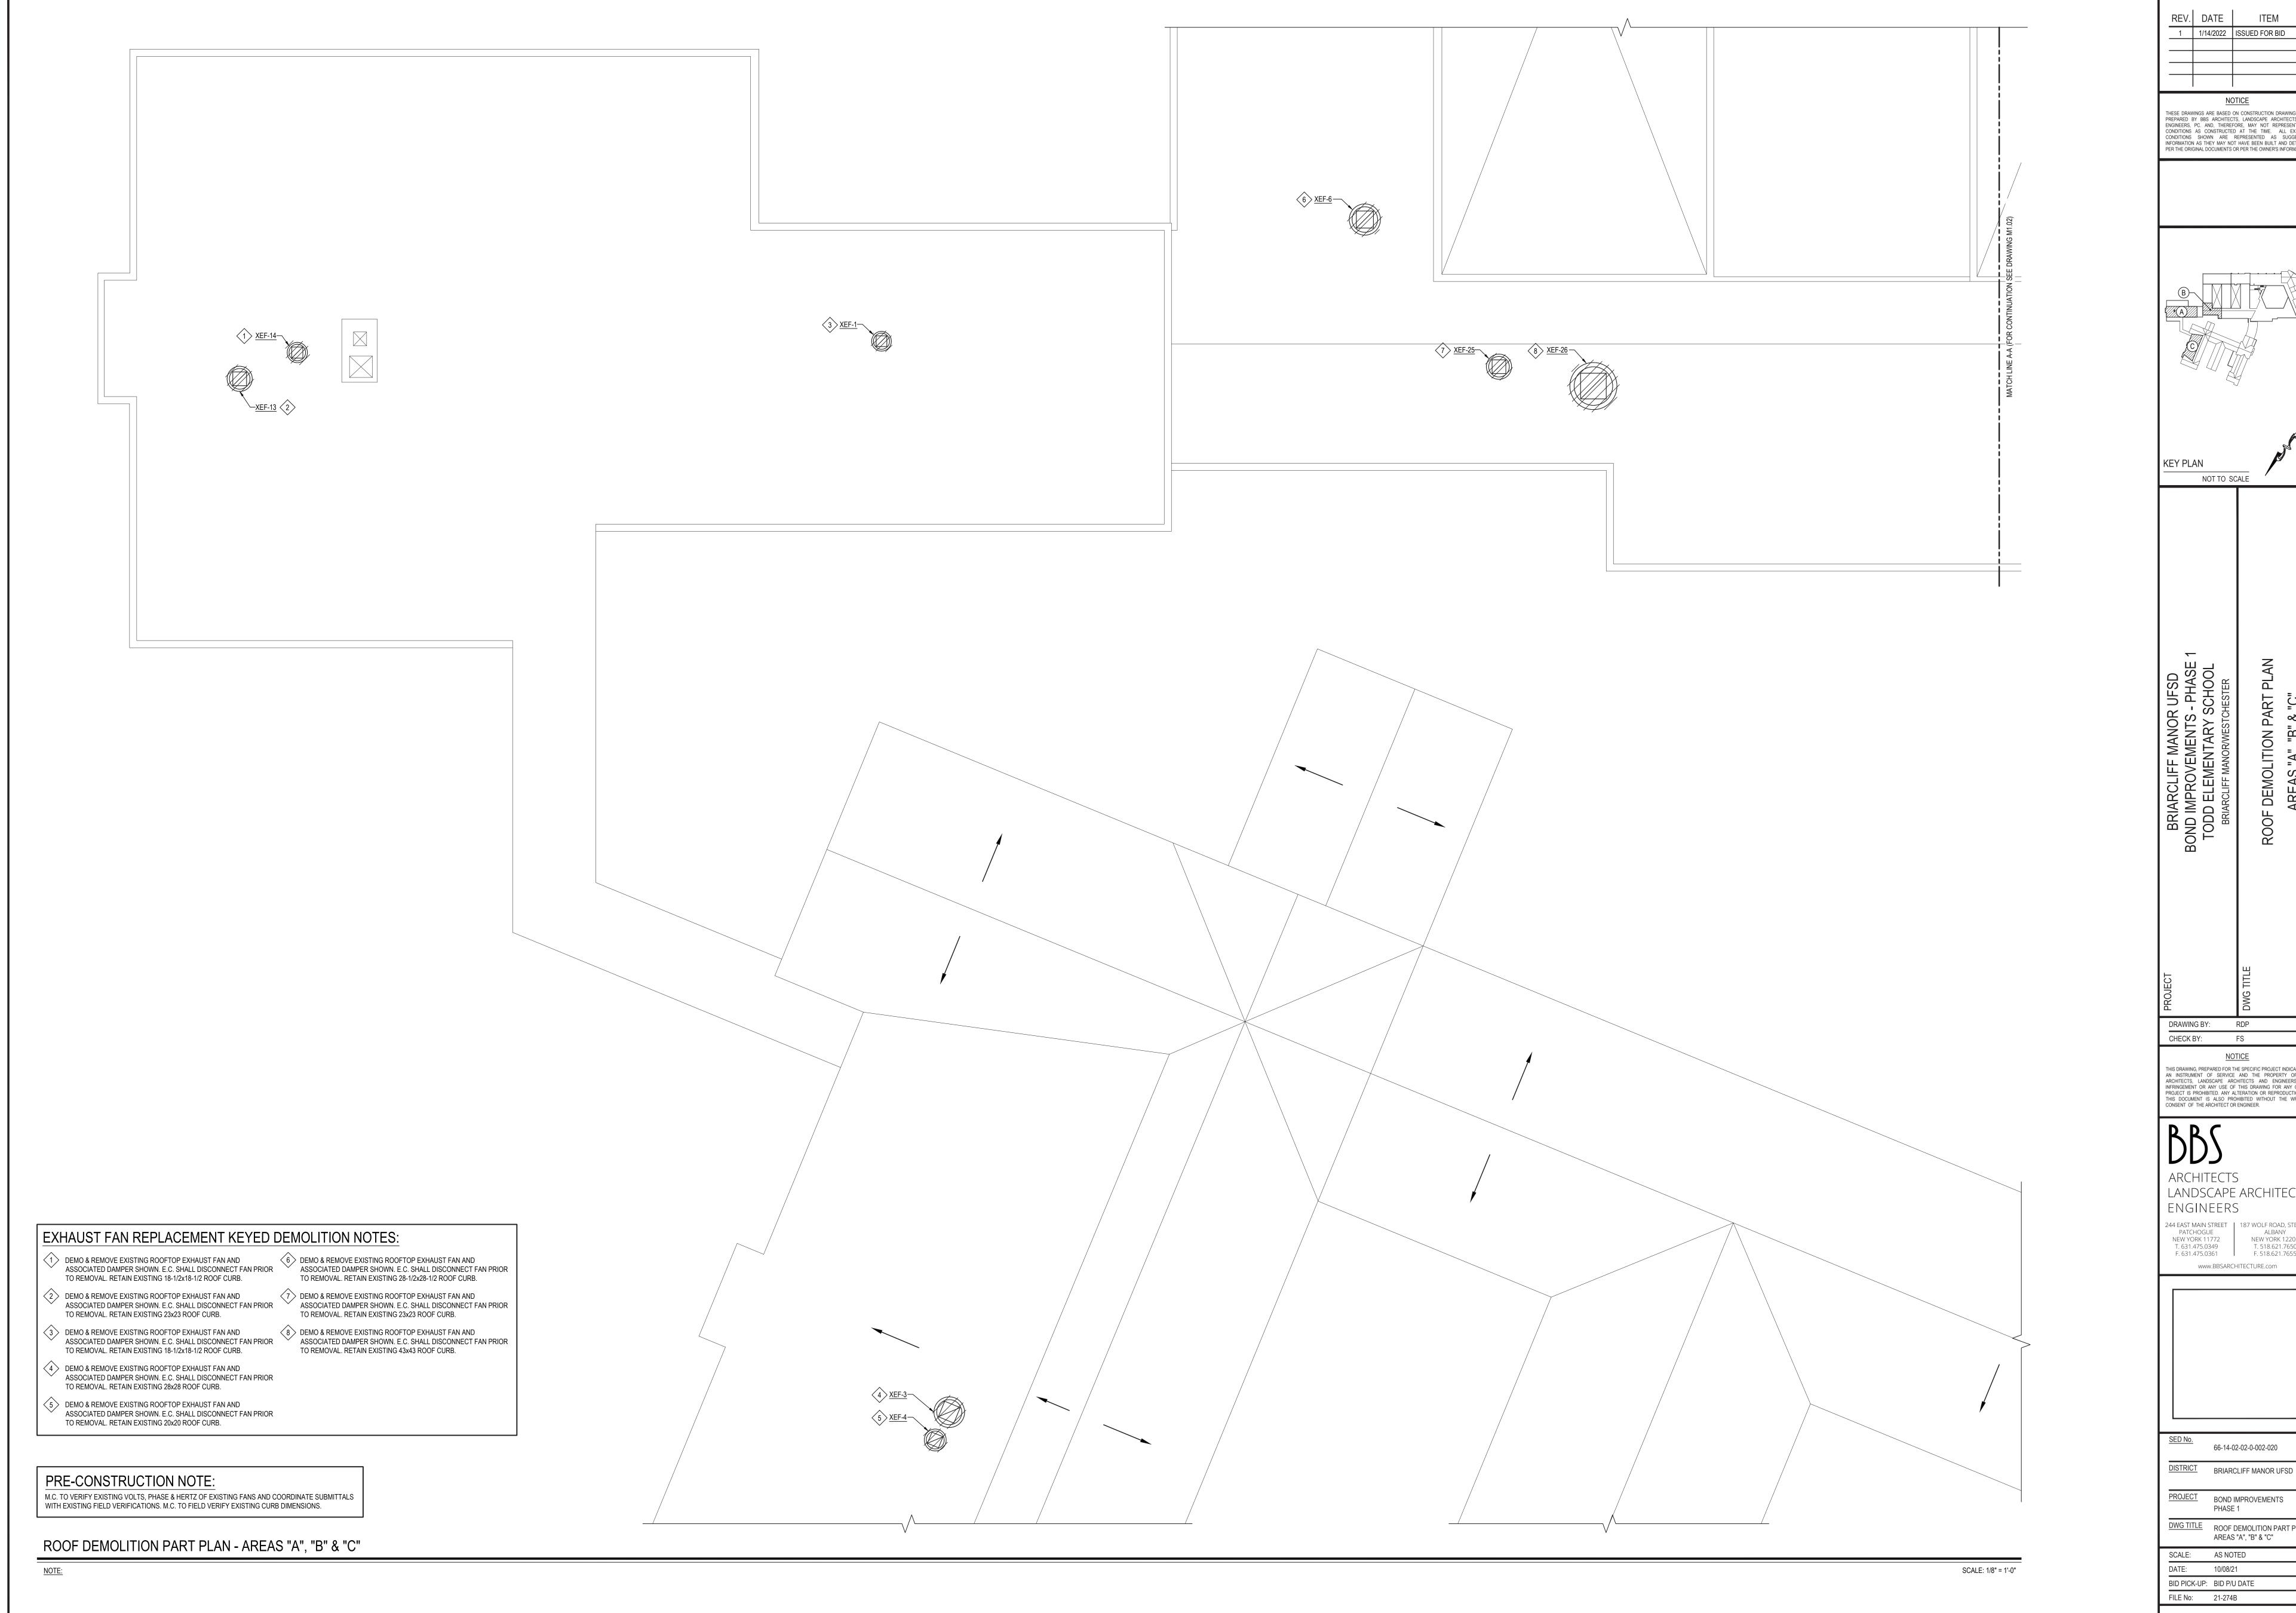


66-14-02-02-0-002-020 DISTRICT BRIARCLIFF MANOR UFSD PROJECT BOND IMPROVEMENTS

PHASE 1 <u>DWG TITLE</u> GENERAL NOTES, LEGENDS AND SYMBOLS SCALE: AS NOTED


BID PICK-UP: 1/17/2022 FILE No: 21-274B

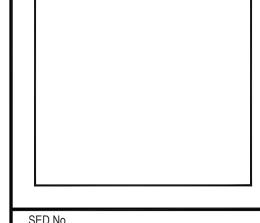
DATE: 10/08/21





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T. 631.475.0349 T. 518.621.7650
F. 631.475.0361 F. 518.621.7655 DISTRICT BRIARCLIFF MANOR UFSD DWG TITLE ROOF DEMOLITION PART PLAN


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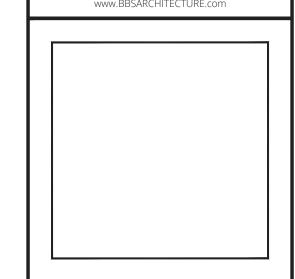


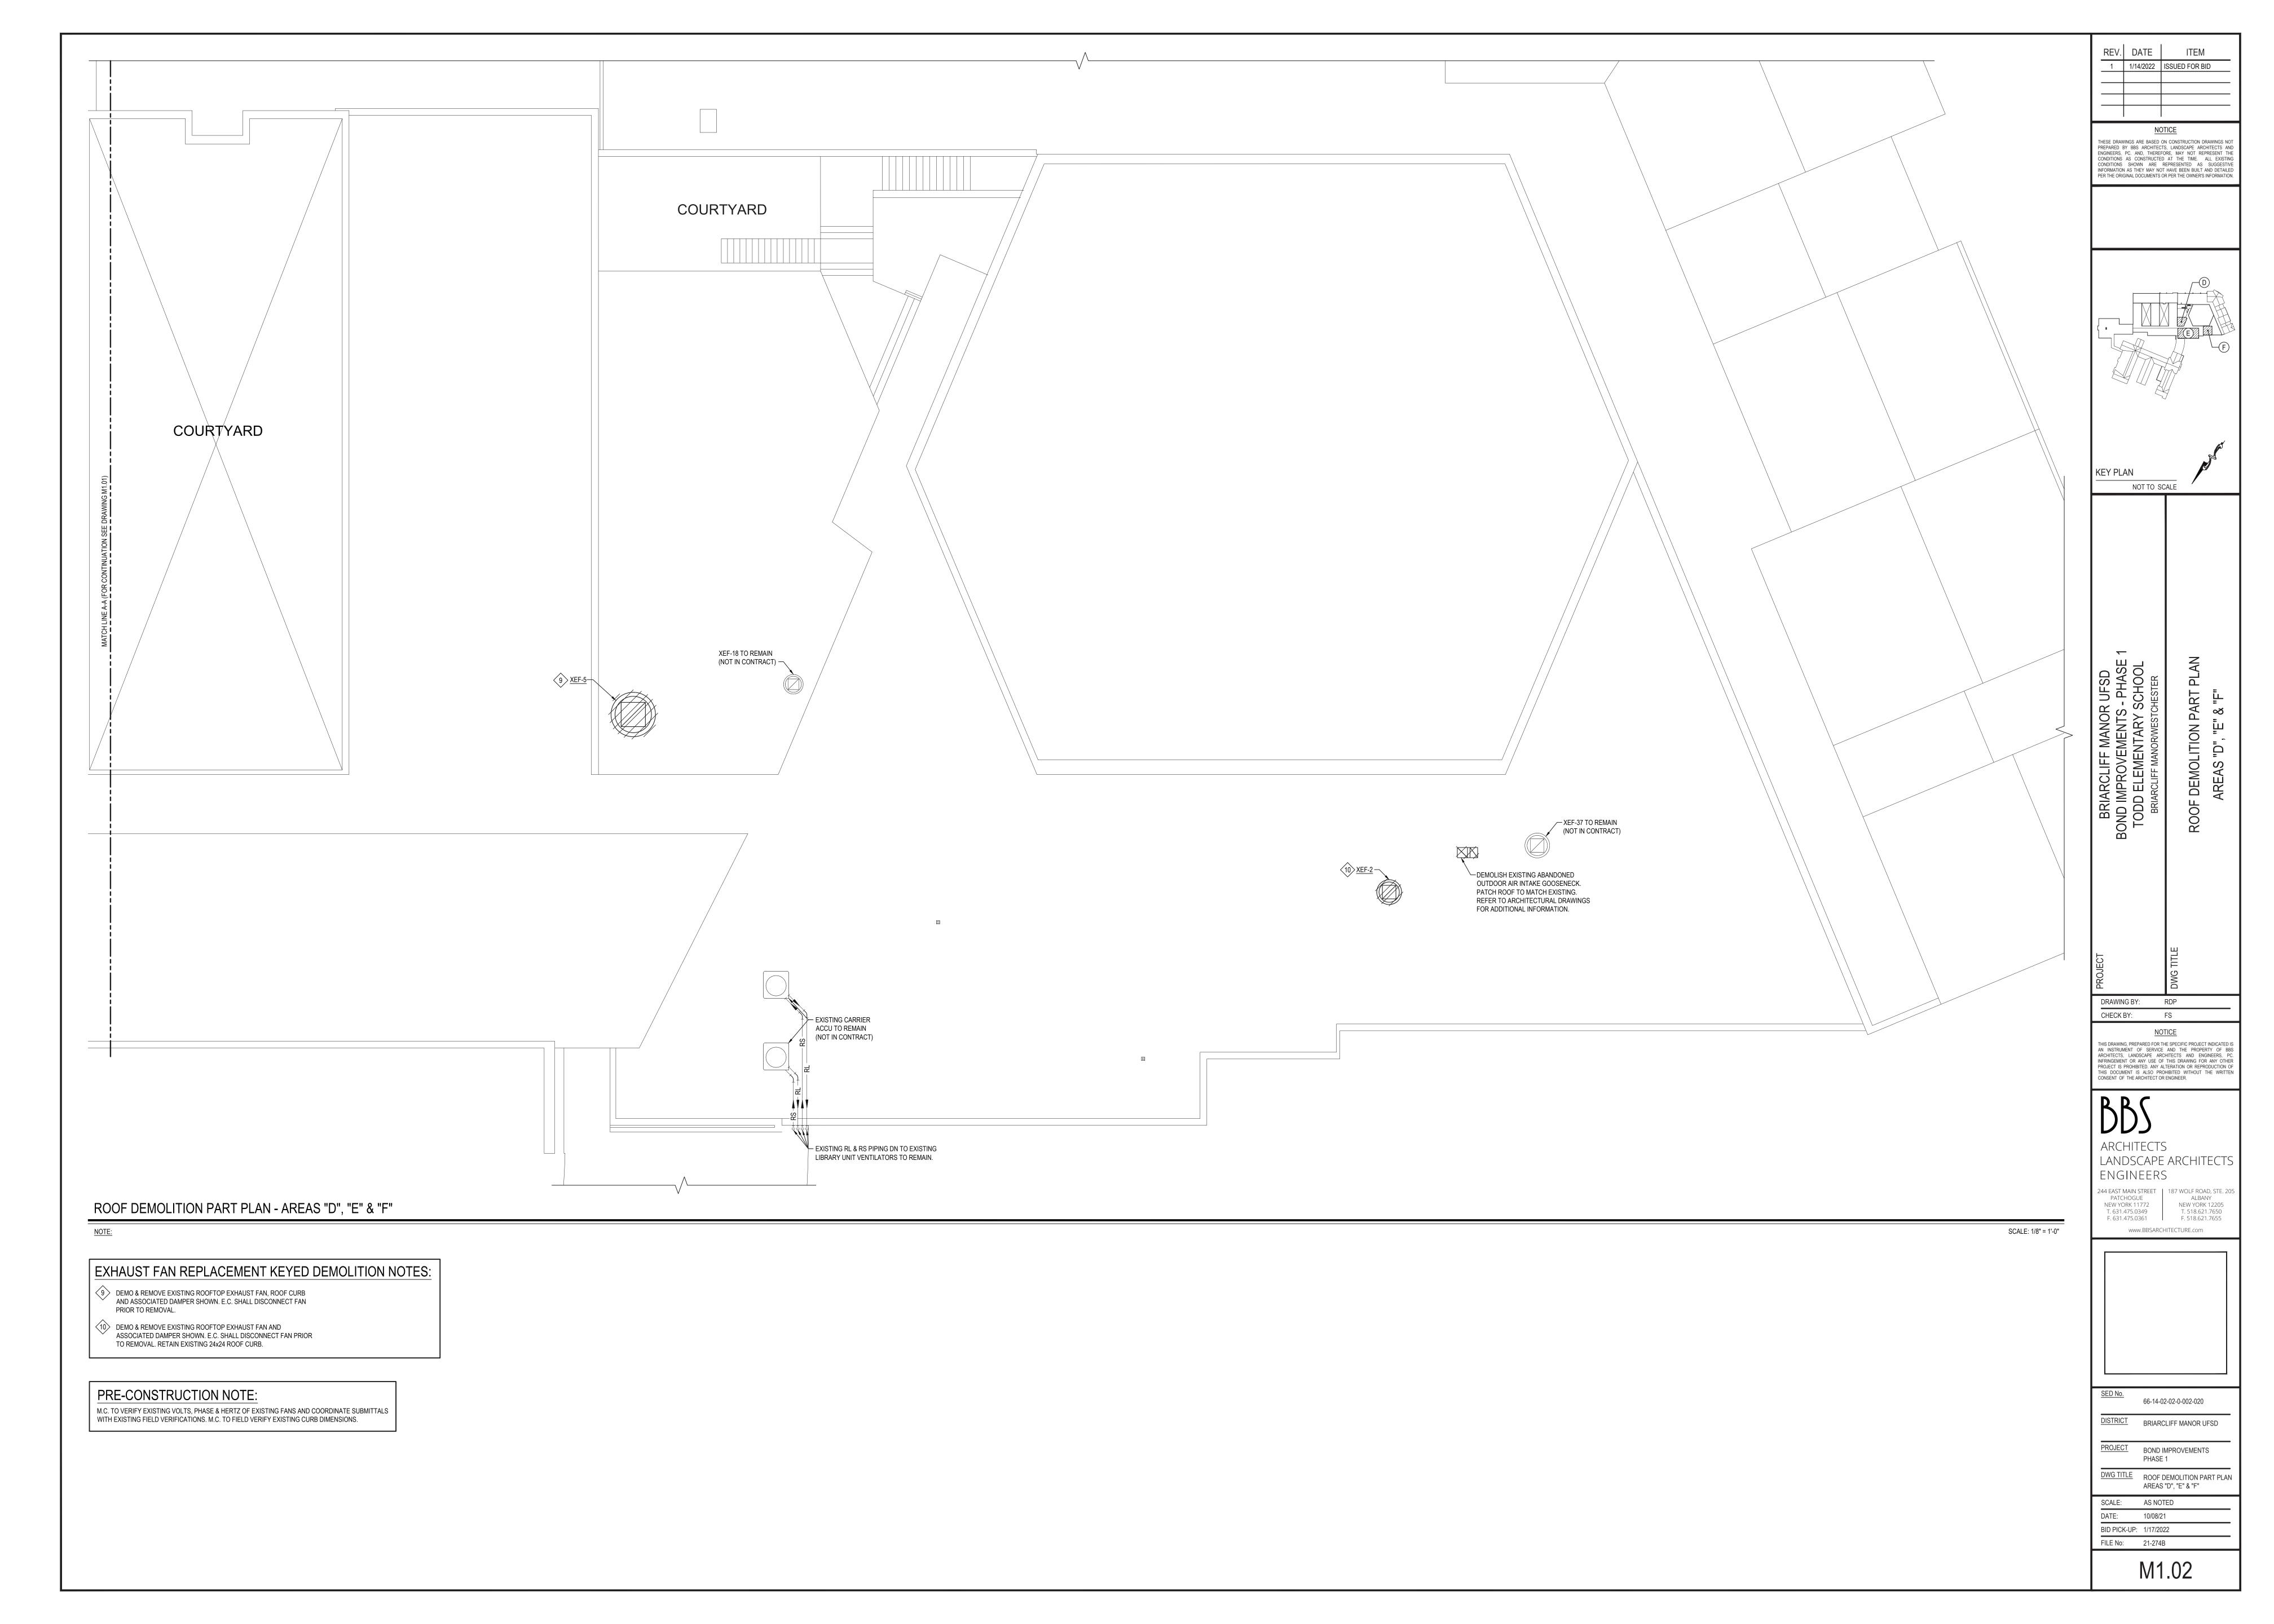
SCALE: 1/4" = 1'-0"

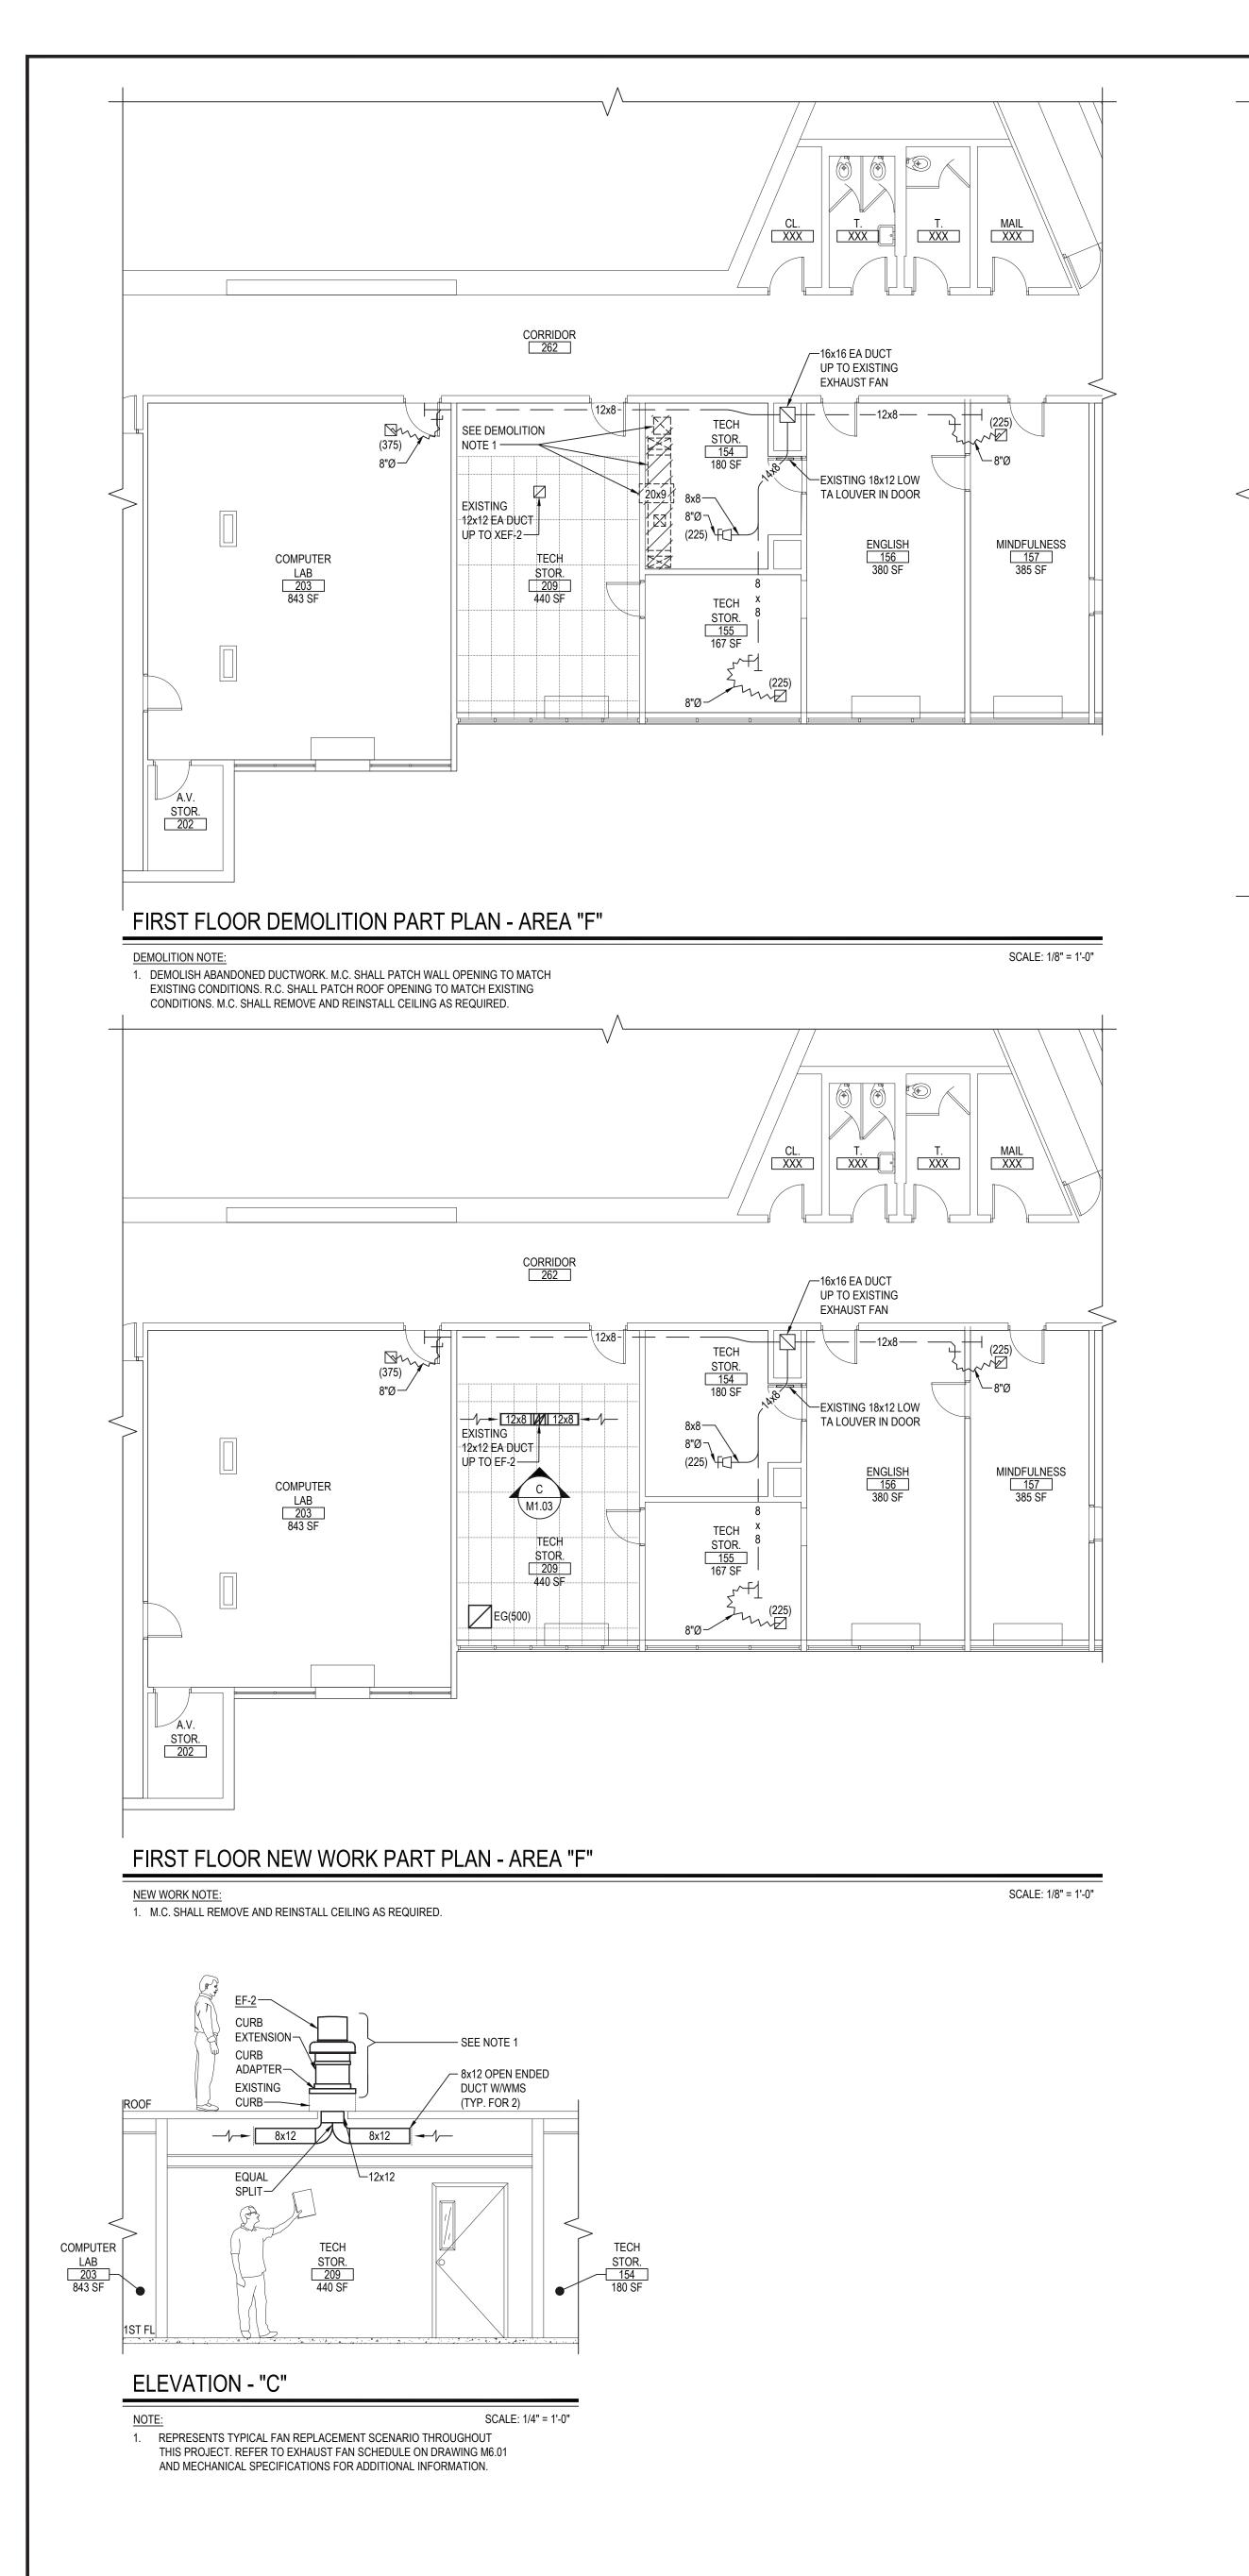NOTE:

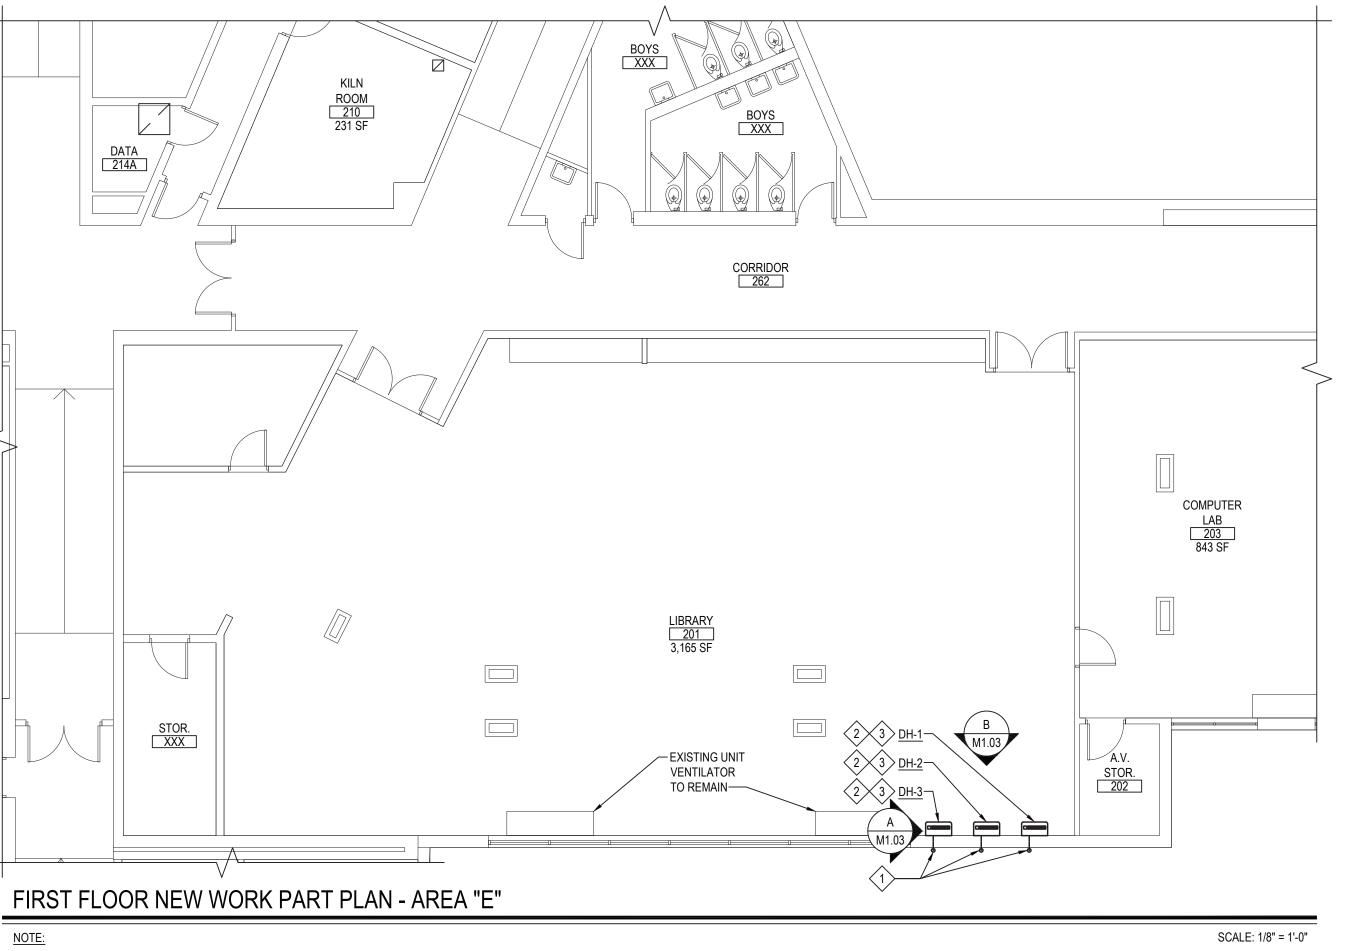REV. DATE

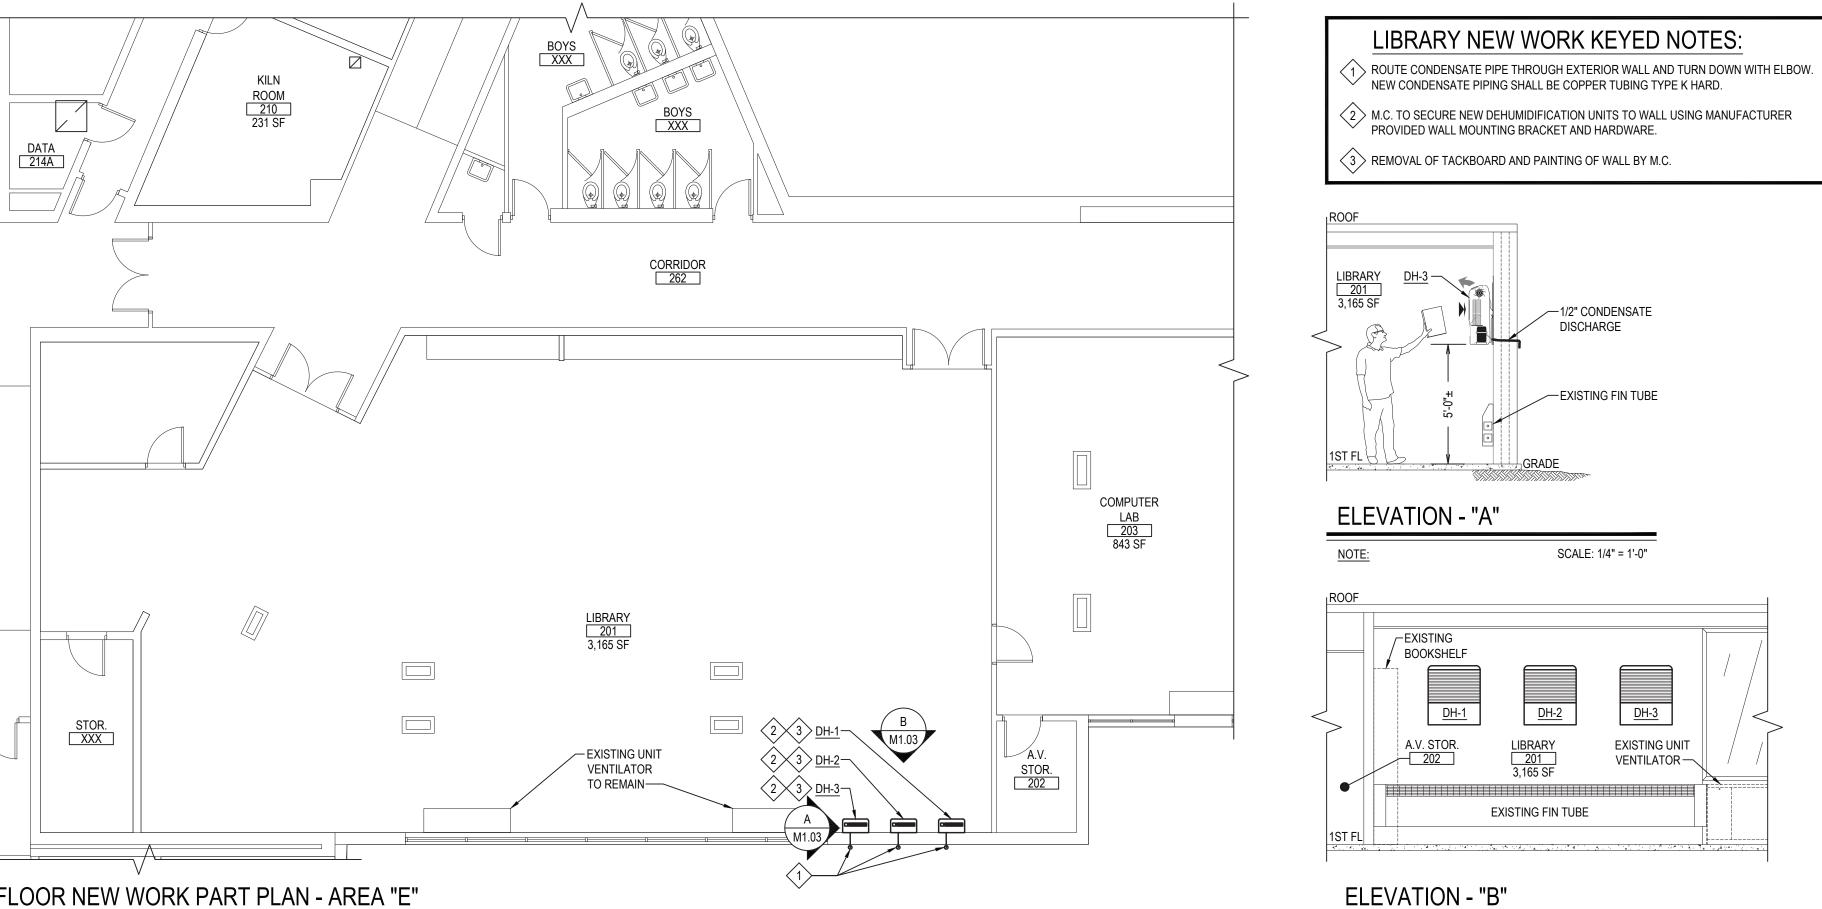

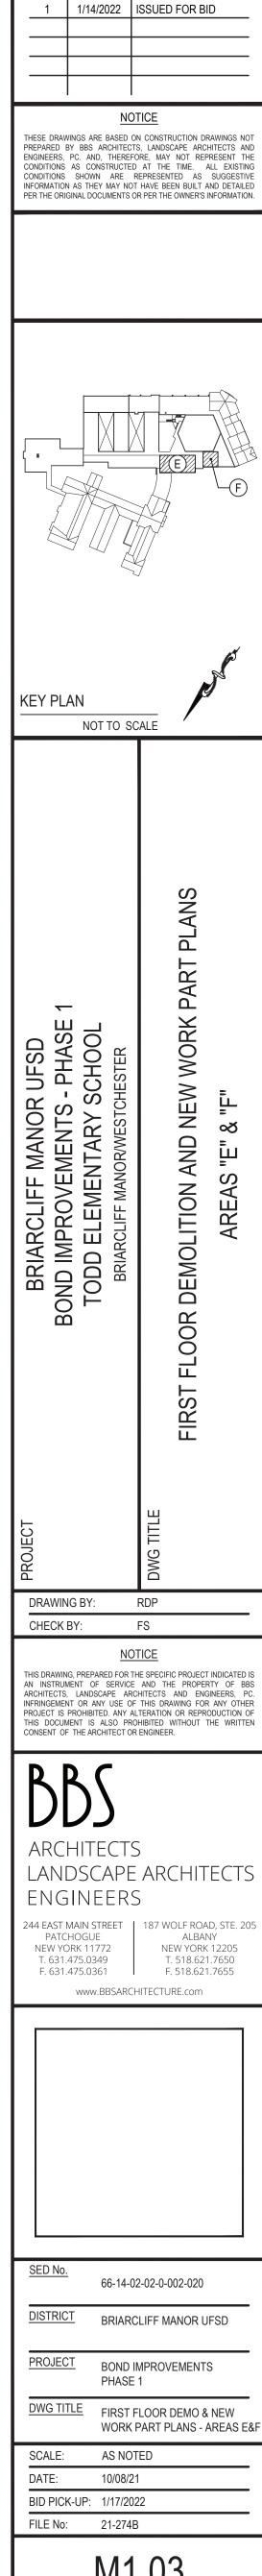

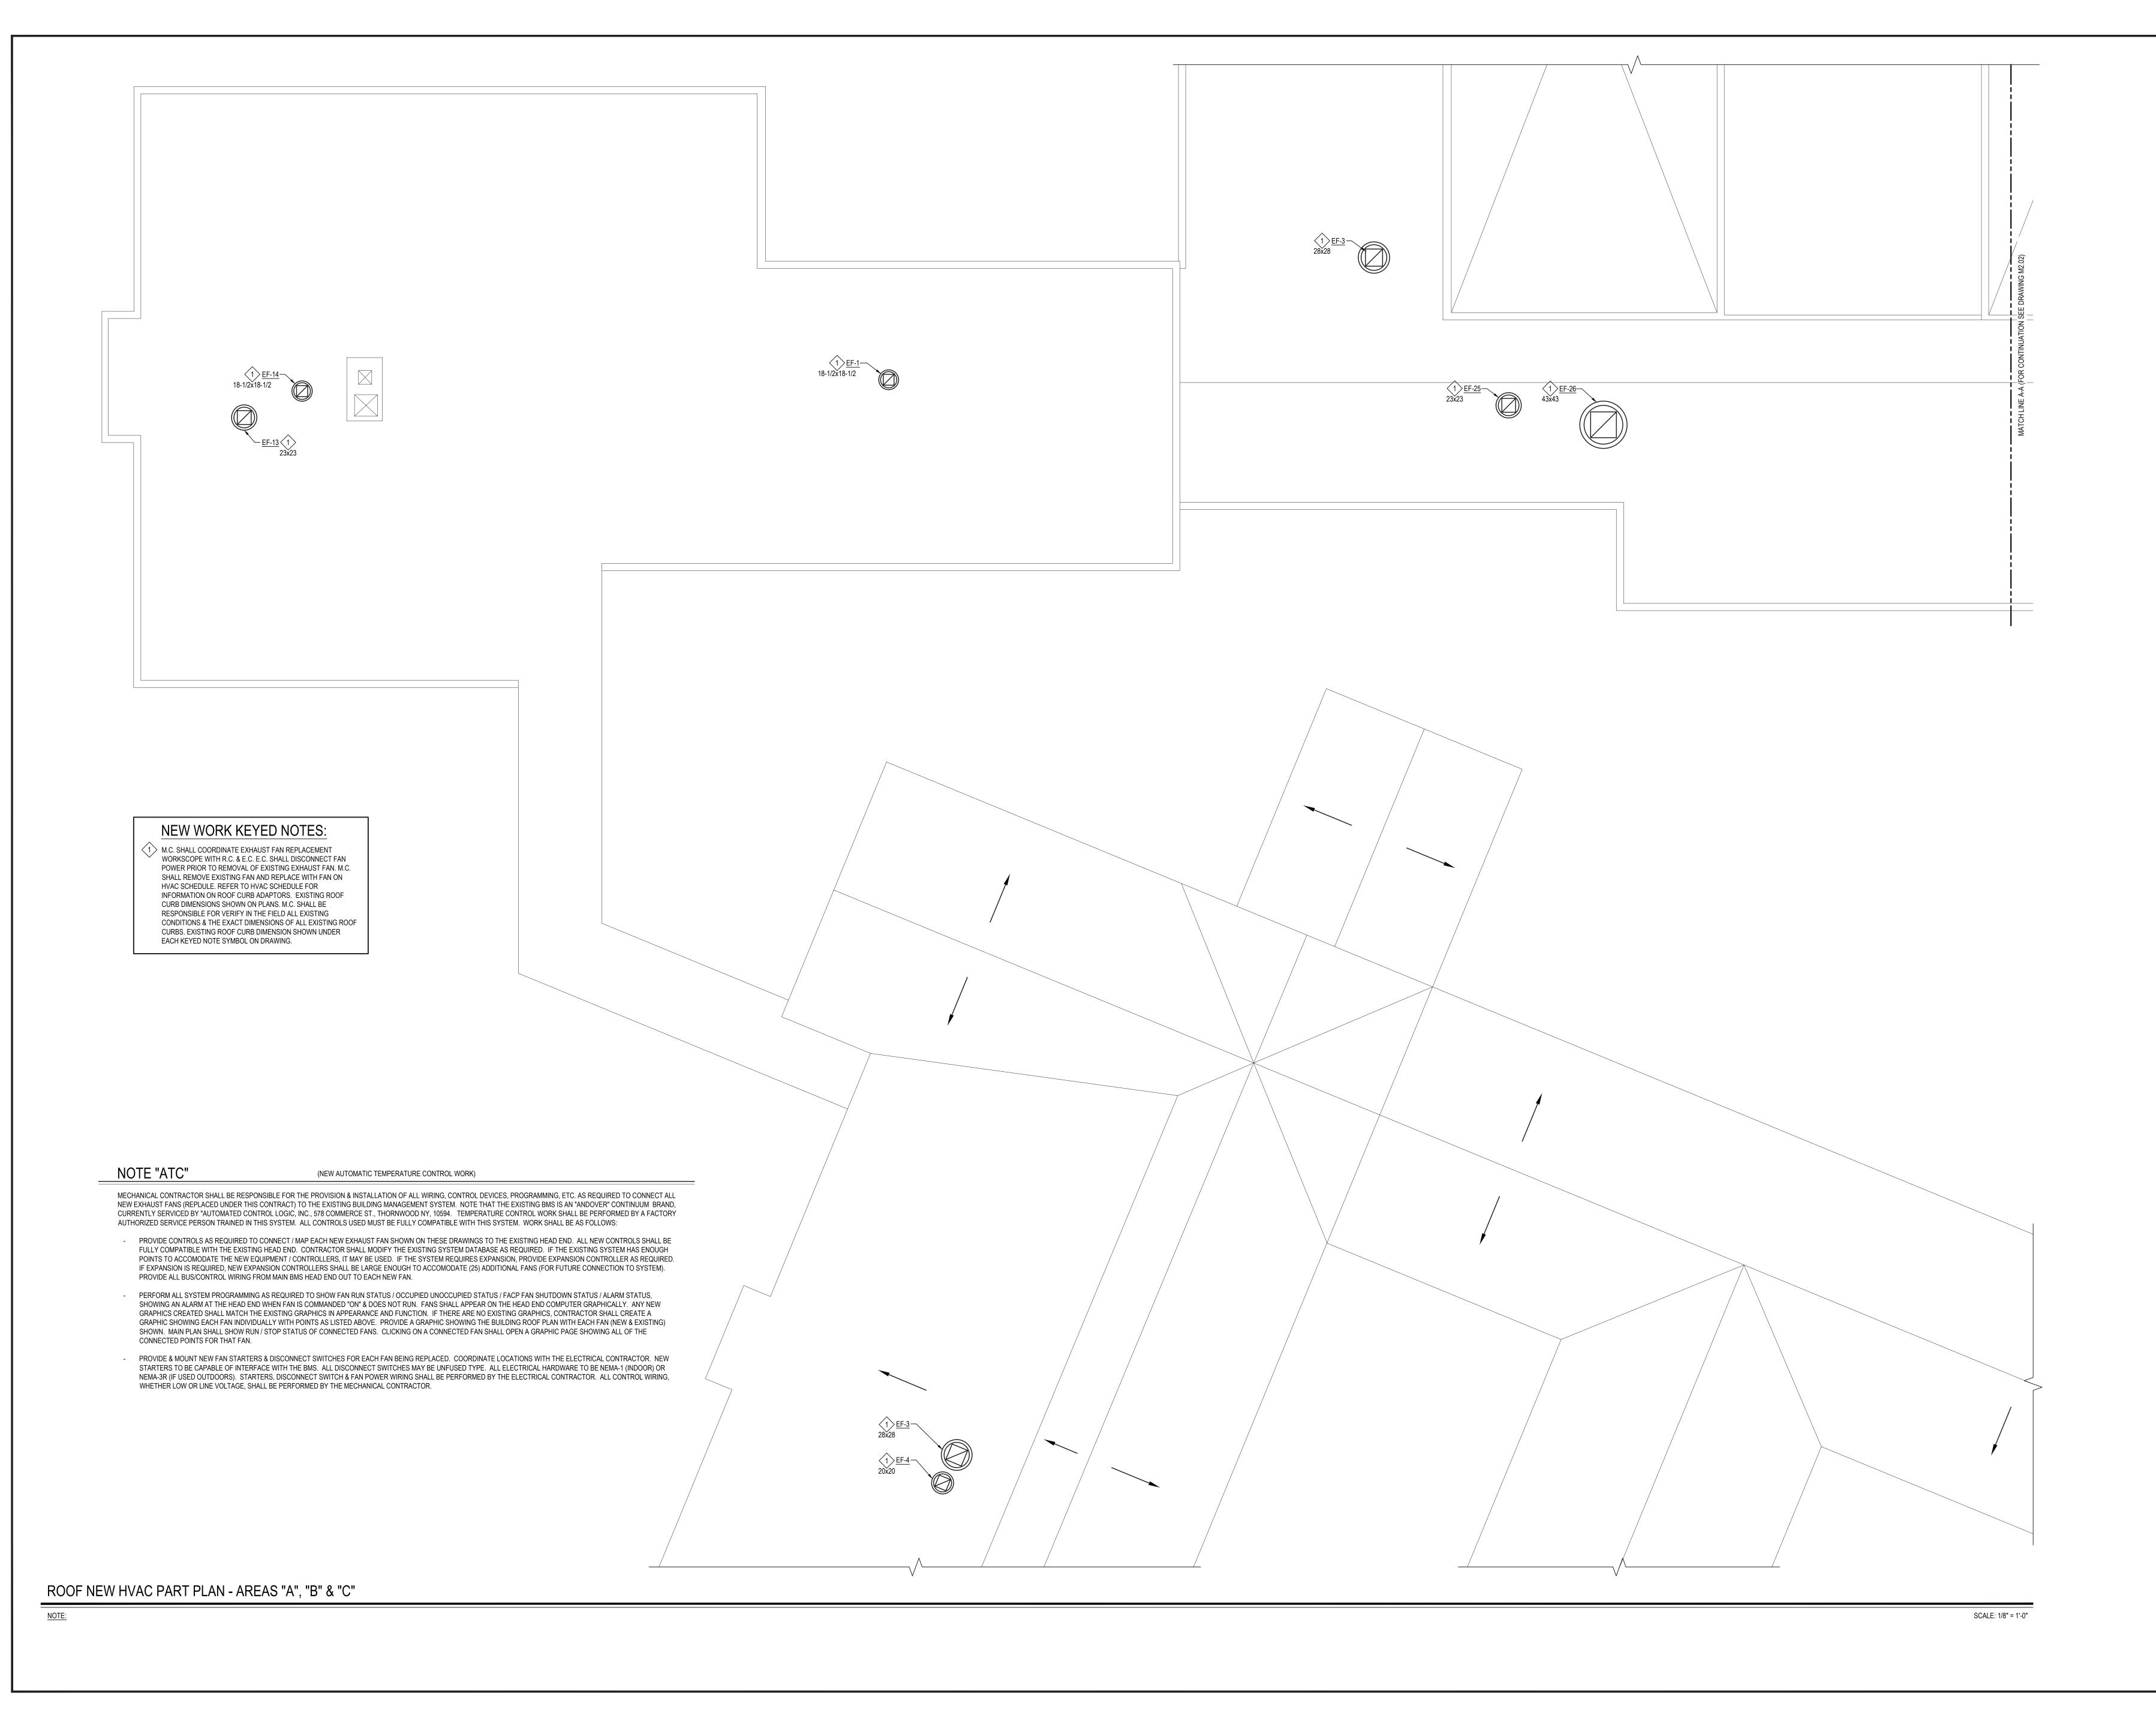

NOTICE

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KEY PLAN

NOT TO SCALE

KEY PLAN

NOT TO SCALE

DRAWING BY: RDP

CHECK BY: FS

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DISTRICT BRIARCLIFF MANOR UFSD

PROJECT BOND IMPROVEMENTS PHASE 1

DWG TITLE


ROOF NEW HVAC PART PLAN
AREAS "A", "B" & "C"

SCALE:

AS NOTED

BID PICK-UP: 1/17/2022 FILE No: 21-274B

M2.01

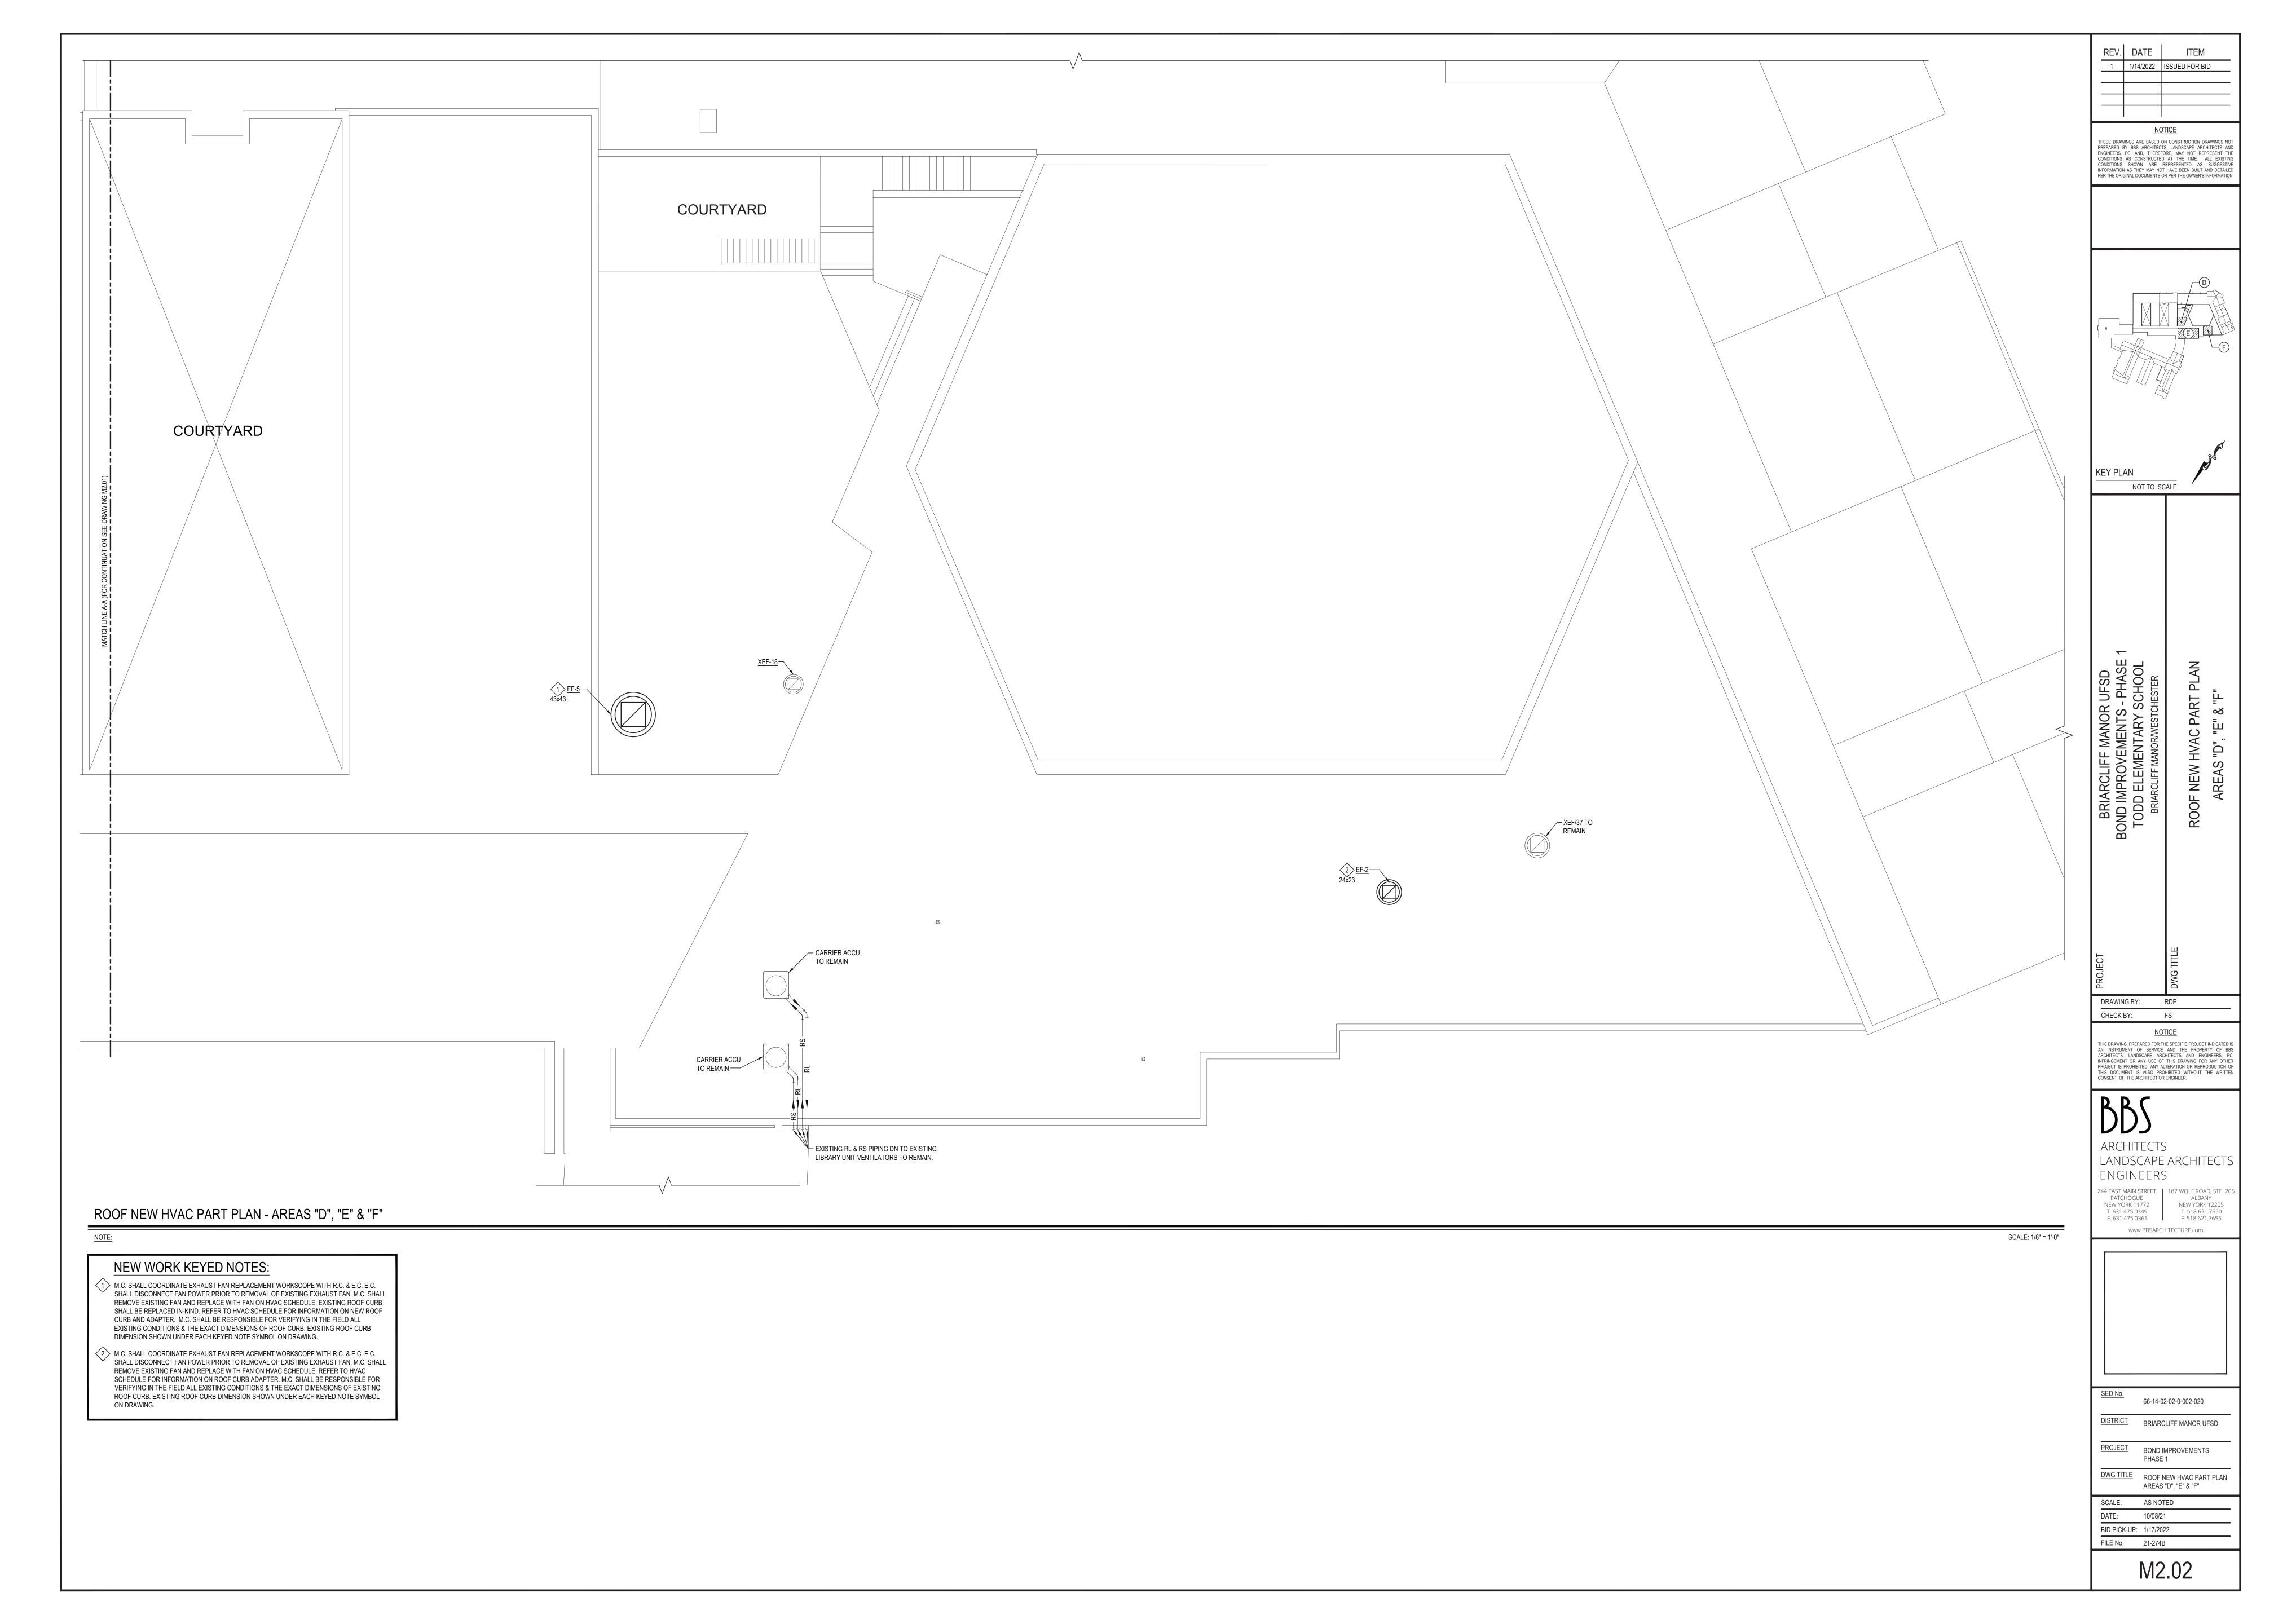

| | GREENHECK AS STD | | | | | | | | | | |
|-------|---|------------------------------|------|-------|---------|------|-------------|---------|-------|-------------|--------------------------------------|
| | | MOTOR WEIGHT OPTIONS AND | | | | | | | | | |
| TAG | SERVICE | MODEL | CFM | ESP | FAN RPM | (HP) | INLET SONES | VOLT/PH | (LBS) | ACCESSORIES | NOTES |
| EF-1 | 2 CLASSROOM 231, 232 & ASSOC. TOILETS (BG) | G-097-VG | 100 | 0.375 | 1000 | 1/4 | 3.6 | 115/1 | 61.0 | 1,2,3,4,6 | PROVIDE W/VCD-43 MOTORIZED DAMPER |
| EF-2 | TECH. STOR. 209 | G-098-VG | 500 | 0.75 | 1535 | 1/4 | 8.9 | 115/1 | 96.0 | 1,2,3,4,6 | PROVIDE W/VCD-43 MOTORIZED DAMPER |
| EF-3 | CLASSROOM 118 & 119 | G-095-VG | 600 | 0.375 | 1400 | 1/6 | 7.2 | 115/1 | 84.0 | 1,2,3,4,6 | PROVIDE W/VCD-43 MOTORIZED DAMPER |
| EF-4 | CLASSROOM 118 & 119 TOILETS | G-097-VG | 150 | 0.5 | 1236 | 1/4 | 5.7 | 115/1 | 96.0 | 1,2,3,4,6 | PROVIDE W/VCD-43 MOTORIZED DAMPER |
| EF-5 | ART CLASSROOM 212, OFFICE 213, ART STOR. 211 & 214 | GB-180-VGD-7 | 2500 | 0.75 | 924 | 3/4 | 10.1 | 208/3 | 138.0 | 1,2,3,5,6,7 | PROVIDE W/VCD-43 MOTORIZED DAMPER |
| EF-6 | READING 225, MATH/YMCA 226 & YMCA 227 (BG) | G-100-VG | 800 | 0.5 | 1308 | 1/4 | 6.7 | 115/1 | 96.0 | 1,2,3,4,6 | PROVIDE W/VCD-43 MOTORIZED DAMPER |
| EF-13 | INNOVATION CLASSROOM 230 | G-080-VG | 225 | 0.5 | 1534 | 1/10 | 7.5 | 115/1 | 80.0 | 1,2,3,4,6 | PROVIDE W/VCD-43 MOTORIZED DAMPER |
| EF-14 | INNOVATION CLASSROOM TOILET | G-097-VG | 75 | 0.375 | 954 | 1/4 | 3.2 | 115/1 | 61.0 | 1,2,3,4,6 | PROVIDE W/VCD-43 MOTORIZED DAMPER |
| EF-25 | TOILETS BETWEEN READING CLASSROOM 232A & 3 CLASSROOM 233 (BG) | G-095-VG | 300 | 0.5 | 1333 | 1/6 | 7.0 | 115/1 | 84.0 | 1,2,3,4,6 | PROVIDE W/VCD-43 MOTORIZED DAMPER |
| EF-26 | 3 CLASSROOMS 233, 234, 235(CT) & FACULTY 236 (BG) | GB-180-VGD-5 | 1500 | 0.75 | 904 | 1/2 | 9.4 | 208/3 | 183.0 | 1,2,3,5,6 | PROVIDE W/VCD-43 MOTORIZED DAMPER |
| | | | | | | | | | | | |

Options / Accessories:

1. Aluminum roof curb adapter (factory mounted), contractor to field verify existing curb dimensions prior to fabrication

2. UL-705 Listing

3. Disconnect Switch 4. Varigreen motor w/balancing dial, soft start and thermal overload protection

5. Varigreen drive (factory mounted, wired and programmed) w/fan mounted speed adjustment dial. Field mounted VFDs will not be accepted

6. Roof curb extension (aluminum construction) w/damper tray and access panel 7. 24" High Roof Curb w/damper tray

REFER TO SPECIFICATIONS FOR SEQUENCE OF OPERATIONS FOR NEW UNIT. 8. PROVIDE FACTORY-AUTHORIZED REPRESENTATIVE TO BE PRESENT FOR START-UP, COMMISSIONING, AND TRAINING OF

EQUIPMENT TO OWNER'S PERSONNEL. 9. FACTORY-AUTHORIZED MANUFACTURER'S REPRESENTATIVE SHALL BE PRESENT FOR RIGGING OF EQUIPMENT.


PROVIDE BIRDSCREEN WITH FAN

11. PROVIDE ALL SINGLE PHASE FANS WITH A GREENHECK VARIGREEN H.O.A. CONTROLLER.

| DEHUMIDIFIER SCHEDULE | | | | | | | | | | | | |
|-----------------------|-------------|--------------|--------|-----|------------------|-----|------|---------|--------|-----------------|------|---------------------|
| | | | | | WATER EXTRACTION | | | | WEIGHT | DIMS. W x H x D | | |
| TAG | SERVICE | MANUFACTURER | MODEL | CFM | (GPH) | MCA | MOCP | VOLT/PH | (LBS) | (IN.) | DBA | OPTIONS/ACCESSORIES |
| DH-1 | LIBRARY | EIPL | AD850E | 294 | 0.5 | 10 | 20 | 115/1 | 86.0 | 26x29.5x13.6 | 50.0 | 1, 2, 3 |
| DH-2 | LIBRARY | EIPL | AD850E | 294 | 0.5 | 10 | 20 | 115/1 | 86.0 | 26x29.5x13.6 | 50.0 | 1, 2, 3 |
| DH-3 | LIBRARY | EIPL | AD850E | 294 | 0.5 | 10 | 20 | 115/1 | 86.0 | 26x29.5x13.6 | 50.0 | 1, 2, 3 |
| PTIONS/ | ACCESSORIES | : | | | | | _ | • | | - | _ | |


1. Wall mount kit

2. UL-474 Listing 3. Disconnect Switch

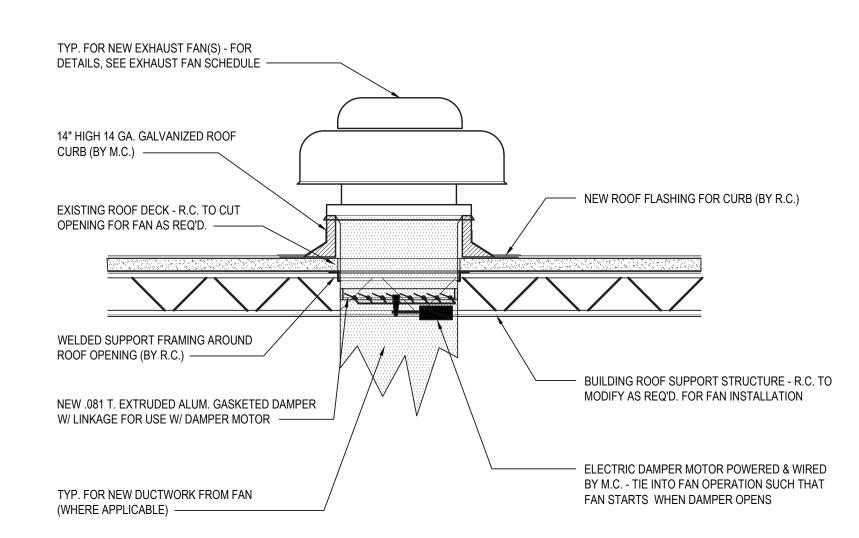


NEW ROOF MOUNTED EXHAUST FAN INSTALLATION

SCALE: N.T.S.

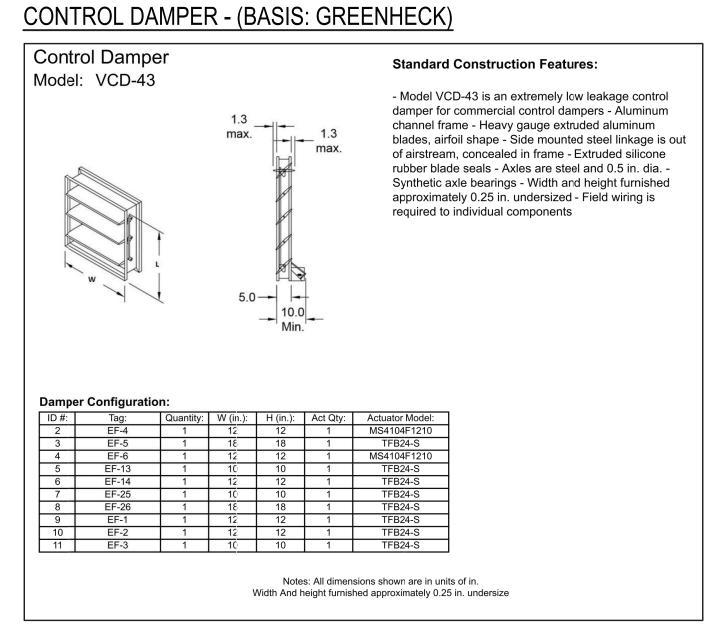

ROOF CURB - (BASIS: GREENHECK)

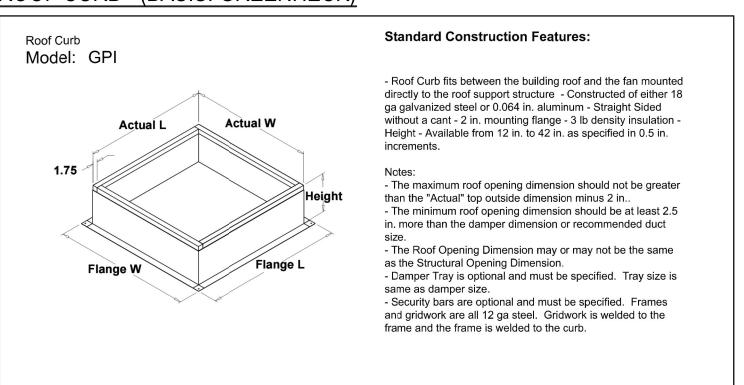

REV. DATE 1 1/14/2022 ISSUED FOR BID

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KEY PLAN NOT TO SCALE

SCHEDULES, EQUIPMENT NOTES

DRAWING BY: RDP CHECK BY: FS

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66-14-02-02-0-002-020 DISTRICT BRIARCLIFF MANOR UFSD

PROJECT BOND IMPROVEMENTS PHASE 1 DWG TITLE SCHEDULES, EQUIPMENT NOTES

SCALE: AS NOTED DATE: 10/08/21

BID PICK-UP: 1/17/2022

FILE No: 21-274B M6.01