

-1-1/4" BOILER/CHILLED WATER MAKE-UP BACKFLOW PREVENTER -(2) EXISTING RAYPAK HIGH DELTA DOMESTIC HOT WATER HEATERS (STACKED) -(2) EXISTING STORAGE TANK CIRCULATOR PUMPS TEXISTING DOMESTIC HOT || WATER STORAGE TANK -XCP/1 (DISCONNECTED) **EXISTING BOILER #3** EXISTING BOILER #1 EXISTING BOILER #2 -MIXING VALVE STATION ELECTRICAL BOILER ROOM DEMOLITION PART PLAN

EXISTING 3 BASIN SINK ¬

KITCHEN KEYED DEMOLITION NOTES: (1) P.C. TO REMOVE SECTION OF 2"Ø COPPER DRAIN PIPE AS INDICATED

(TYPICAL FOR 3).

GENERAL NOTES

**ELEVATION - A** 

REMOVAL & RELOCATION OF CERTAIN EXISTING WORK SHALL BE NECESSARY FOR THE PERFORMANCE OF THE NEW WORK SHOWN HEREIN. ALL EXISTING CONDITIONS ARE NOT COMPLETELY DETAILED ON THE DRAWINGS. THE CONTRACTOR SHALL SURVEY THE SITE & MAKE ALL NECESSARY CHANGES BASED ON

EXISTING CONDITIONS AS REQUIRED FOR PROPER DEMOLITION OF EXISTING WORK & SHALL INCLUDE ALL

- MATERIALS & LABOR FOR SAME IN HIS BID PRICE. NO ALLOWANCE WILL BE MADE FOR FAILURE TO DO SO. PRIOR TO SUBMITTING A BID, THE CONTRACTOR SHALL VISIT THE PREMISES OF THE PROPOSED WORK & SHALL CAREFULLY EXAMINE THE ENGINEERING DRAWINGS, EXISTING CONDITIONS & LIMITATIONS THEREOF. VERIFY ACTUAL LOCATIONS WHERE THE NEW PIPING WILL BE ROUTED, COORDINATE WITH NEW & EXISTING WORK & PROVIDE CLEARANCE W/ BUILDING STRUCTURE, OTHER SERVICES, ETC.. THE CONTRACTOR SHALL INCLUDE ALL COSTS WHATSOEVER WHICH ARE INCURRED AS A RESULT OF LIMITATIONS OF THE EXISTING & NEW CONDITIONS. LATER CLAIMS FOR EXTRA LABOR, EQUIPMENT, MATERIALS, ETC. REQUIRED DUE TO DIFFICULTIES WHICH COULD HAVE BEEN FORESEEN WILL NOT BE CONSIDERED AS EXTRA WORK.
- INSTALL WORK SO AS TO BE READILY ACCESSIBLE FOR OPERATING, MAINTENANCE & REPAIR. MINOR DEVIATIONS FROM DRAWINGS MAY BE MADE TO ACCOMPLISH THIS, BUT CHANGES OF MAGNITUDE WHICH INVOLVE EXTRA COST SHALL NOT BE MADE WITHOUT APPROVAL.
- INVESTIGATE EACH SPACE THROUGH WHICH EQUIPMENT MUST BE MOVED. WHEN NECESSARY, EQUIPMENT SHALL BE SHIPPED FROM MANUFACTURER IN CRATED SECTIONS OF SIZE SUITABLE FOR MOVING THROUGH AREAS AVAILABLE. ASCERTAIN FROM BUILDING OWNER AT WHAT TIMES OF DAY EQUIPMENT MAY BE MOVED THROUGH THE BUILDING.
- COORDINATE THE EXACT SIZE & LOCATION OF NEW OPENINGS WITH EXISTING STRUCTURE. PATCH / INSULATE AS REQUIRED. CONTRACTOR SHALL FIRESTOP ALL PENETRATIONS FROM NEW PIPING, CONDUIT, DUCTWORK, ETC. THROUGH EXISTING OR NEW FIRE/ SMOKE BARRIERS. REFER TO SPECIFICATION SECTION 15511 FOR FURTHER DETAILS.
- IT IS THE INTENT OF THIS CONTRACT FOR REMAINING SYSTEMS TO BE LEFT IN GOOD WORKING ORDER, READY FOR OPERATION. COORDINATE ANY REQUIRED SYSTEM SHUTDOWNS WITH OWNER 48 HOURS IN ADVANCE. EXISTING SYSTEM SHUTDOWNS WILL NOT BE PERMITTED IF THEY INTERFERE WITH THE DAILY OPERATIONS OF THE BUILDING. CONTRACTOR WILL BE REQUIRED TO TAKE PROPER PRECAUTIONS AGAINST DAMAGING OR DISRUPTING BUILDING SYSTEMS, WIRING, PIPING OR CONTROL TUBING. ANY DAMAGE TO THESE ITEMS SHALL BE REPAIRED AT THE CONTRACTOR'S COST AS A PART OF THIS
- THE CONTRACTOR SHALL REPAIR / RESTORE TO ORIGINAL CONDITION ANY EXISTING EQUIPMENT OR MATERIALS DAMAGED IN THE PROCESS OF INSTALLATION, OR DEMOLITION TO THE SATISFACTION OF THE OWNER'S REPRESENTATIVE. CONTRACTOR SHALL MAKE REPAIRS USING THE SAME OR EQUIVALENT MATERIALS. WORK WILL BE PERFORMED AT THE CONTRACTOR'S COST.
- CONTRACTOR SHALL INCUR ANY COSTS OR BURDENS ASSOCIATED WITH LOST OR STOLEN EQUIPMENT / MATERIALS.
- DURING THE LIFE OF THE CONTRACT PERIOD, CONTRACTOR SHALL REMOVE ALL RUBBISH / EXCESS MATERIAL ACCUMULATED AS A RESULT OF HIS OPERATIONS ON A DAILY BASIS. ALL AREAS / EQUIPMENT AFFECTED UNDER THIS CONTRACT SHALL BE KEPT CLEAN OF DUST / DEBRIS. ALL AREAS SHALL RECEIVE A FINAL CLEANING PRIOR TO FINAL ACCEPTANCE BY THE OWNER.


- 10. PROVIDE FOR LEGAL REMOVAL / DISPOSAL OF ALL RUBBISH / DEBRIS FROM THE BUILDING & SITE. PROTECT ALL WORK NOT SLATED FOR DEMOLITION.
- 11. THIS CONTRACTOR SHALL COORDINATE HIS WORK WITH ALL OTHER TRADES PRIOR TO SCHEDULING THE WORK. WORK SHALL BE PERFORMED IN PROPER SEQUENCE, AS AGREED TO BY ALL TRADES. ANY COSTS INCURRED BY THE OWNER DUE TO IMPROPER SEQUENCING OF WORK WILL BE PAID FOR BY THIS CONTRACTOR.
- 2. CONTRACTOR SHALL OBTAIN ALL PERMITS, PAY ALL FEES, CONNECTION CHARGES, ETC. ASSOCIATED WITH THE WORK UNDER THEIR CONTRACT.
- 13. PAINT / TOUCH UP ALL SURFACES MARRED AS A RESULT OF THE PERFORMANCE OF THE CONTRACT
- 14. THE MECHANICAL CONTRACTOR SHALL REFER TO / REVIEW ALL OTHER TRADE DRAWINGS IN THE BID PACKAGE & SHALL BE RESPONSIBLE FOR / PERFORM ALL WORK INDICATED AS (M.C.) MECHANICAL WORK AS A PART OF THE BASE BID UNLESS SPECIFICALLY NOTED OTHERWISE.
- 15. SUBSTITUTED EQUIPMENT OF GREATER OR LARGER POWER, DIMENSIONS, CAPACITIES & RATINGS MAY BE FURNISHED PROVIDED THAT SAID EQUIPMENT IS APPROVED IN WRITING PRIOR TO ORDER. ANY CONNECTING MECHANICAL SERVICES, ELECTRICAL SERVICES, BASES, STRUCTURAL APPURTENANCES, ETC. REQUIRED TO BE INCREASED DUE TO THE USE OF SAID EQUIPMENT WILL BE PAID FOR IN FULL BY THE MECHANICAL CONTRACTOR, INCLUDING ANY ADDITIONAL REQUIRED ENGINEERING FEES.
- 6. EACH PIECE OF EQUIPMENT SHALL BE PROVIDED WITH A PERMANENT TYPE LAMINATED, BLACK FINISH, WHITE CORE, PHENOLIC NAMEPLATE. NAMEPLATES SHOULD INDICATE THE NAME & NUMBER OF THE UNIT, UNIT VOLTAGE, & ANY INTERLOCK REFERENCE. STARTERS / DISCONNECT SWITCHES SHOULD ALSO BE EQUIPPED WITH AN IDENTICAL NAMEPLATE WITH THE SAME INFORMATION.
- 17. "ATTIC STOCK" UPON COMPLETION OF THE PROJECT, MECHANICAL CONTRACTOR SHALL COMPLETELY REMOVE / DISPOSE OF FILTERS USED DURING CONSTRUCTION & START-UP PROCEDURES. INSTALL NEW FILTERS IN ALL EQUIPMENT, MERV-8 OR BETTER UPON TURN OVER OF THE PROJECT TO THE OWNER. IN ADDITION, PROVIDE (2) COMPLETE SETS OF FILTERS FOR EACH PEICE OF EQUIPMENT & TURN OVER TO
- 18. MECHANICAL CONTRACTOR SHALL PROVIDE (1) SPARE MOTOR FOR EACH SIZE MOTOR USED ON THE PROJECT. IN INSTANCES WHERE MORE THAN TEN OF THE SAME MOTOR ARE USED, MECHANICAL CONTRACTOR SHALL PROVIDE (1) SPARE MOTOR FOR EVERY TEN MOTORS OF A GIVEN SIZE USED ON THE
- 9. MAINTENANCE MANUAL: UPON COMPLETION OF THE PROJECT, THE MECHANICAL CONTRACTOR SHALL PROVIDE A BINDER CONTAINING THE OPERATIONS & MAINTENANCE MANUALS FOR EACH NEW PEICE OF EQUIPMENT INSTALLED UNDER THIS PROJECT. THE FIRST SECTION OF THE MAINTENANCE MANUAL SHALL CONTAIN A LIST OF EACH PEICE OF EQUIPMENT, COMPLETE WITH INFORMATION SHOWING APPROPRIATE REPLACEMENT FILTER SIZES / TYPES, APPROPRIATE REPLACEMENT BELT SPECIFICATIONS, REPLACEMENT MOTOR SPECIFICATIONS, REPLACEMENT BEARING SPECIFICATIONS, VOLTAGES OF UNIT, ETC. THIS SHALL SERVE AS A WRITTEN DATABASE DESCRIBING ALL MAINTENANCE INFORMATION FOR EACH NEW PEICE OF EQUIPMENT USED.

ABBREVIATIONS	
A.F,F	No./#
B.D,	NOM
CWS	N.T.S
CFM	O.A
D	O.C
DIA,/~DIAMETER	O.D
F&TFLOAT & THERMOSTATIC	O.S. &.Y
FPM	O.C
FSD	PE
FLEX	PREFAB
FO	PRV
GAL GALLONS	PSI
GPH	R.A,
GPM	REQ'D
н	RPM
H.C	S.A
HWS	SCHSCHEDULE
HWR	S.P,
HP	STD
I.D	T
KW KILQWATT.	TXV
L	TYP
LAT	VOL
LWT LEAVING WATER TEMPERATURE	V.D
MAX	VEL
MIN	VFD
MBH	W
MFR	W/
M.H	W/O
MISC	WB
MTD	WTD
G	WTR
N.I.C	WPD

#### **BOILER ROOM KEYED DEMOLITION NOTES:**

 $\langle 1 \rangle$  P.C. TO REMOVE EXISTING HOT WATER MIXING VALVE AND REPLACE WITH NEW. REFER TO SCHEDULES AND SPECIFICATIONS FOR ADDITIONAL INFORMATION.

2 P.C. TO REPLACE EXISTING HOT WATER AQUASTAT, LIKE-IN-KIND.

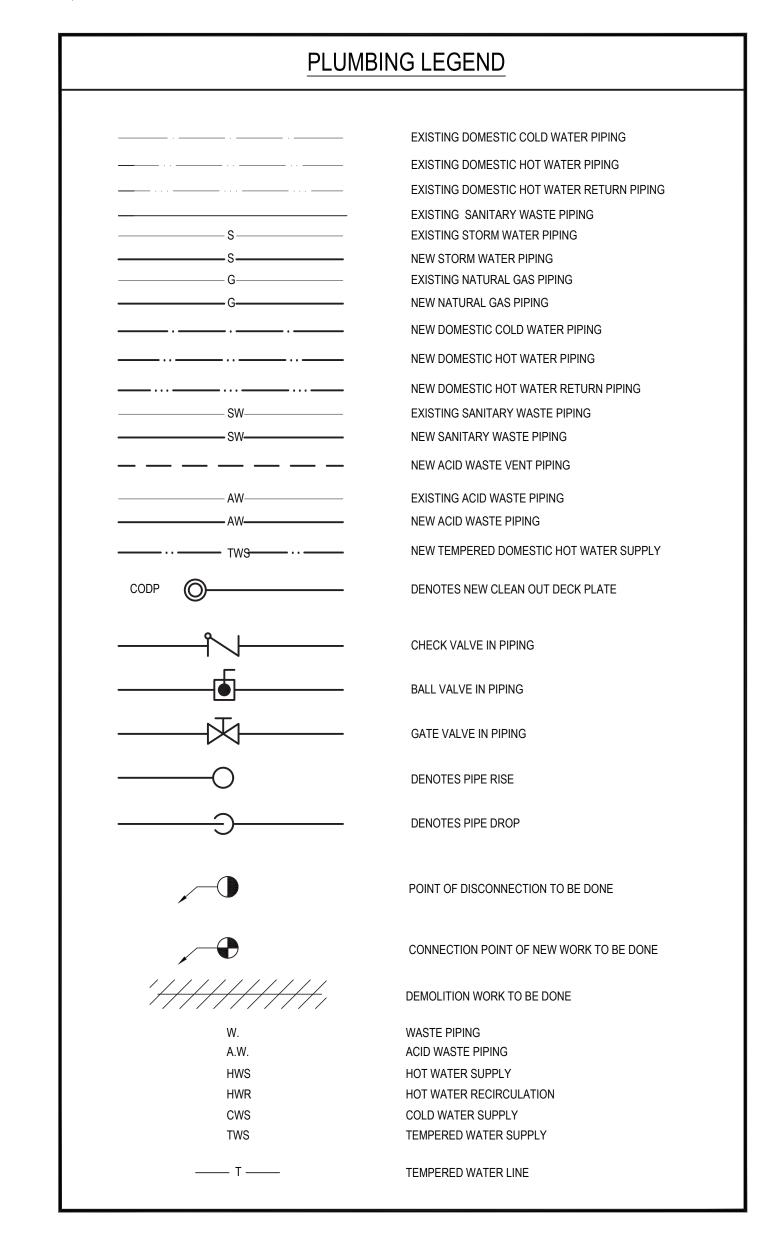

## GENERAL UTILITY NOTES

SCALE: 1/4" = 1'-0"

PIPING LOCATIONS ARE SCHEMATIC AND EACH TRADE SHALL RUN PIPING IN ORDER TO USE THE LEAST AMOUNT OF MATERIAL.

PLUMBING CONTRACTOR SHALL PROVIDE VENT PIPING FOR ALL PLUMBING FIXTURES AS

PLUMBING NOTE: PIPING SIZES SEE SCHEDULE THIS SHEET.


EACH TRADE CONTRACTOR TO VERIFY SIZE OF SERVICE REQUIRED, SIZE AND EXACT LOCATION OF CONNECTIONS TO EACH PIECE OF EQUIPMENT.

## FLOOR & WALL PENETRATION NOTES FOR PLUMBING CONTRACTOR

PLUMBING CONTRACTOR SHALL BE RESPONSIBLE FOR ALL PIPING WALL, FLOOR, & CEILING PENETRATIONS& PATCHING. IF TEST RESULTS INDICATE POSSIBILITY OF LEAD-CONTAINING AND/OR ASBESTOS-CONTAINING MATERIALS AT THE PENETRATION LOCATIONS, THE P.C. SHALL CARRY THE ASSOCIATED ABATEMENT COSTS WITHIN HIS/HER BASE BID SUBMITTED.

REV. DATE 1 | 1/14/2022 | ISSUED FOR BID

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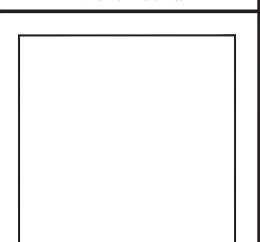
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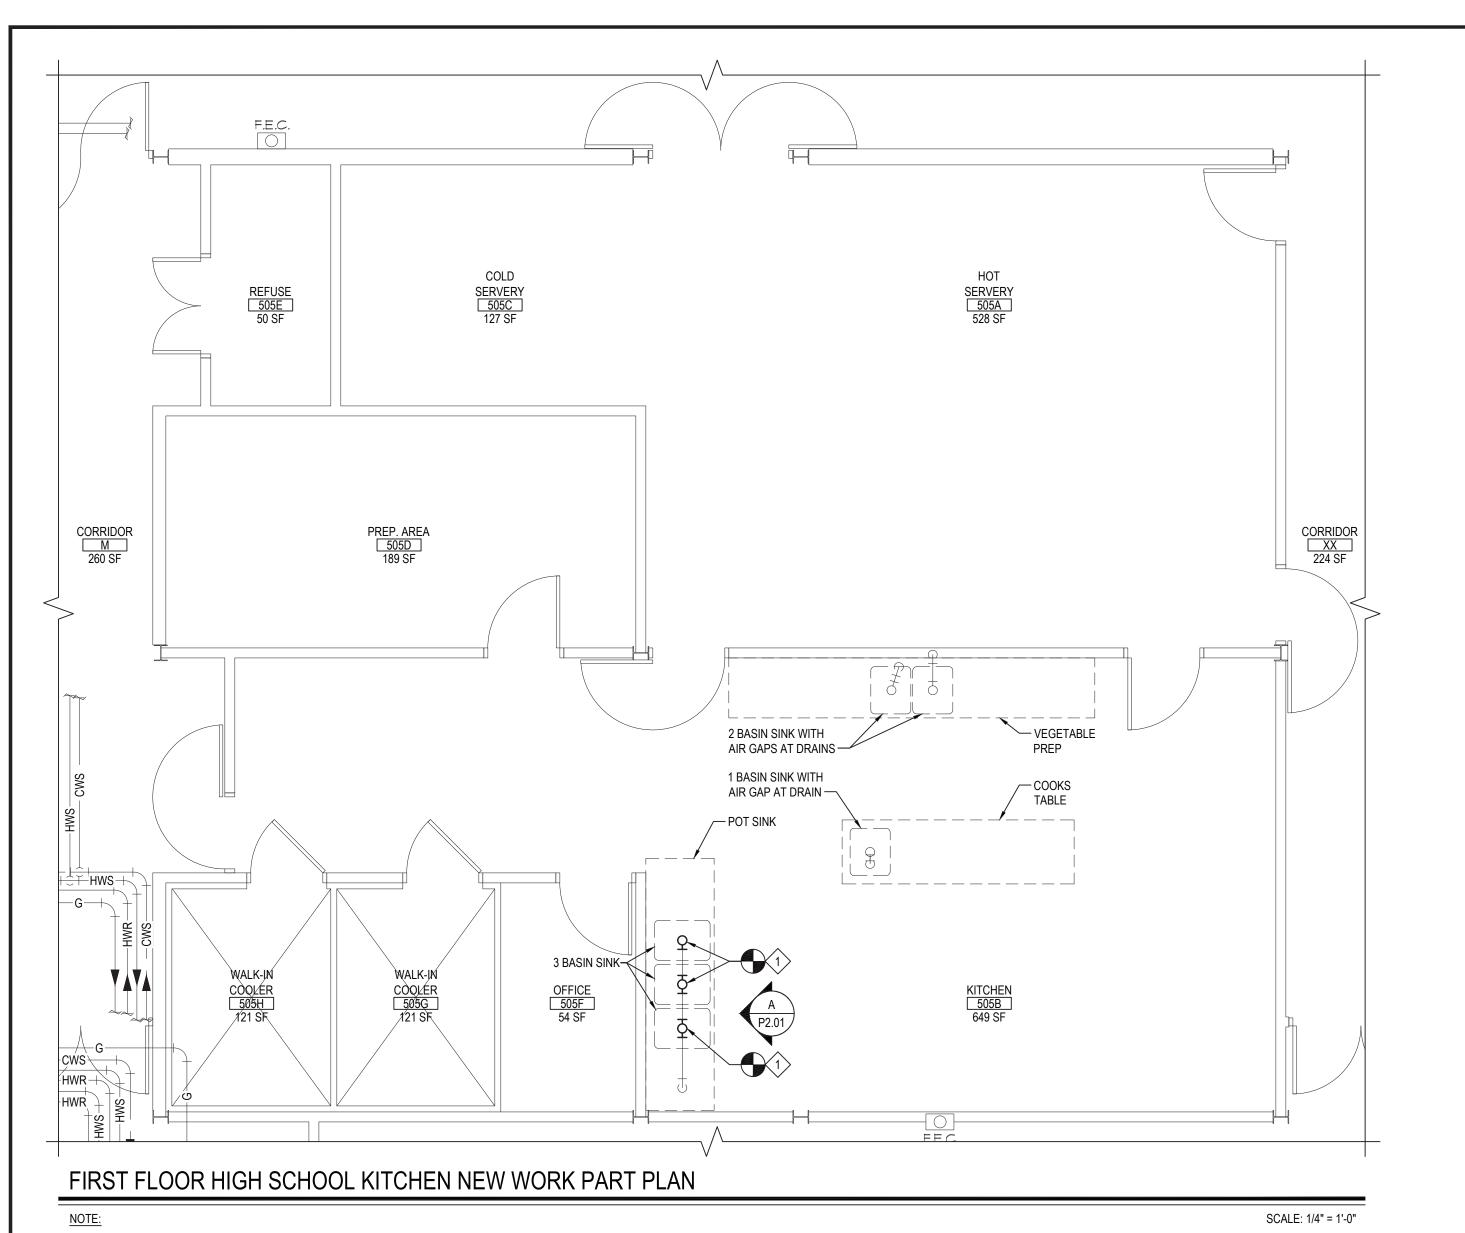
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66-14-02-02-0-004-022 DISTRICT BRIARCLIFF MANOR UFSD DISTRICT NAME PROJECT BOND IMPROVEMENTS PHASE 1 <u>DWG TITLE</u> FIRST FLOOR DEMOLITION PART PLANS AREA "A"

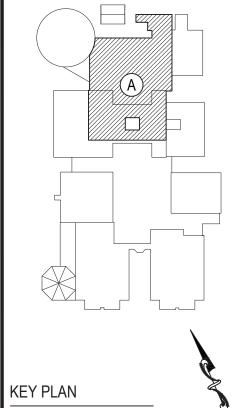SCALE: AS NOTED DATE: 10/8/21 BID PICK-UP: BID P/U DATE FILE No: 21-274A




SCALE: 1/2" = 1'-0"

**ELEVATION - A** 

## KITCHEN KEYED NEW WORK NOTES:

- P.C. TO PROVIDE & INSTALL 2" x 4" COPPER REDUCER. P.C. TO PROVIDE A MINIMUM OF 1" AIR-GAP BETWEEN TOP OF REDUCER AND BOTTOM OF SINK DRAIN PIPE (TYPICAL FOR 3).
- P.C. TO PROVIDE & INSTALL STAINLESS STEEL FLOOR MOUNTED CLAMP-STYLE PIPE SUPPORTS. ANCHOR TO FLOOR TO ENSURE THAT DRAIN PIPE IS IMMOBILIZED IN ALL DIRECTIONS (TYPICAL FOR 2).

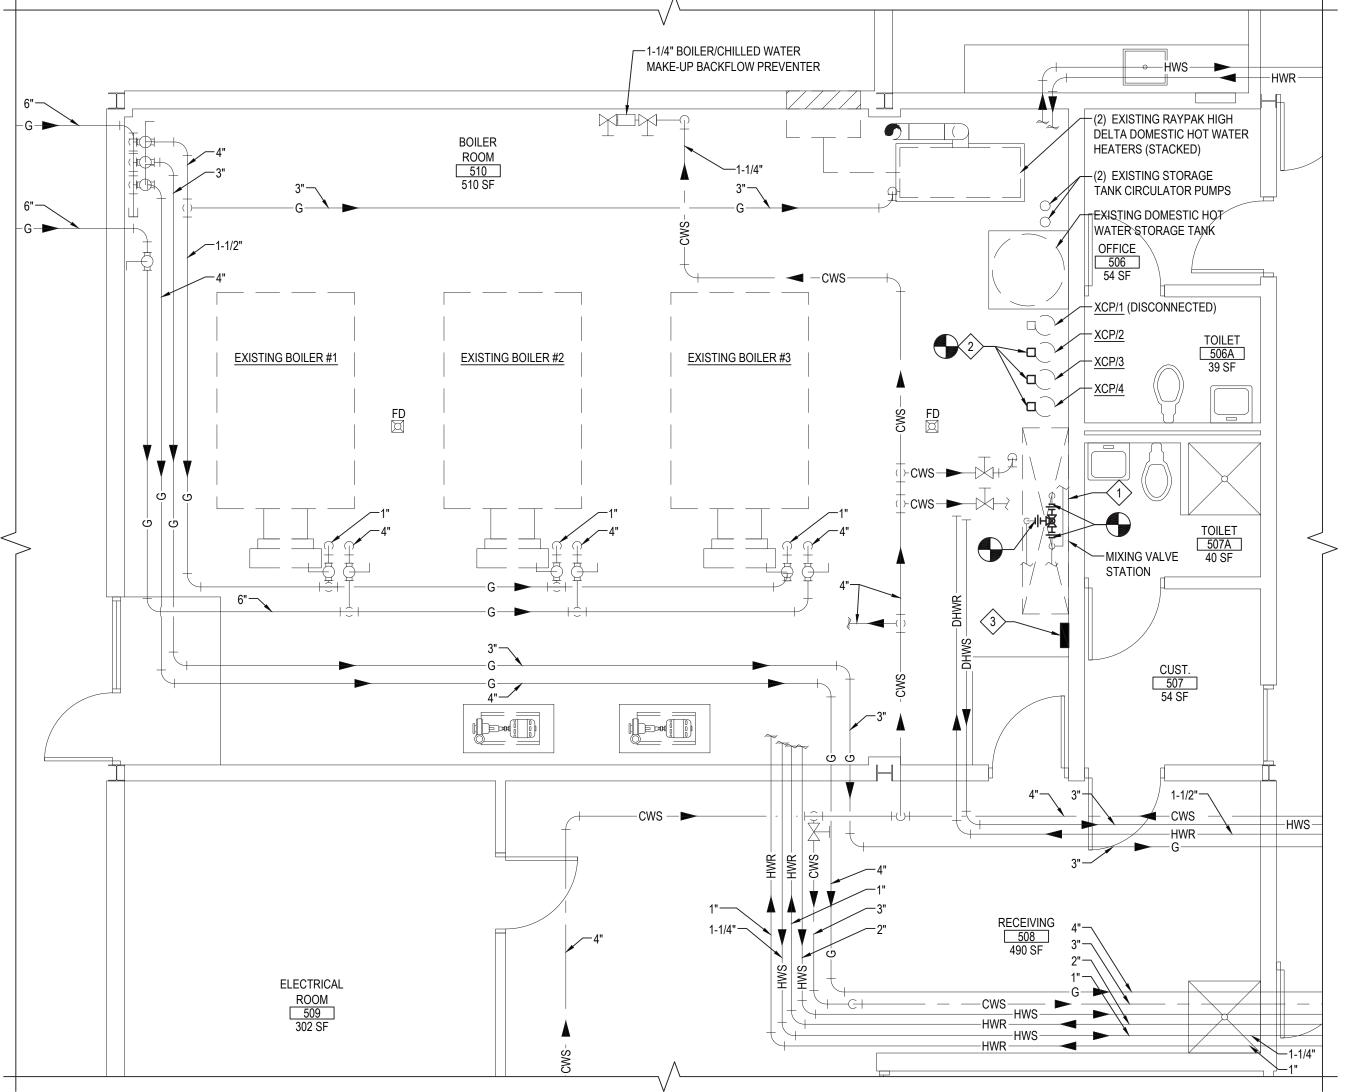


BOILER ROOM NEW WORK PART PLAN

NOTE:

## BOILER ROOM KEYED NEW WORK NOTES:


- P.C. TO REMOVE EXISTING HOT WATER MIXING VALVE AND REPLACE WITH NEW. REFER TO SCHEDULES AND SPECIFICATIONS FOR ADDITIONAL INFORMATION. SEE DETAILS, DRAWING NO. P7.01.
- P.C. TO REPLACE EXISTING HOT WATER AQUASTAT, LIKE-IN-KIND. REFER TO SCHEDULES AND SPECIFICATIONS FOR ADDITIONAL INFORMATION. SEE DETAILS, DRAWING NO. P7.01.
- 3 PROVIDE NEW 4-CHANNEL TIME-CLOCK.

SCALE: 1/4" = 1'-0"

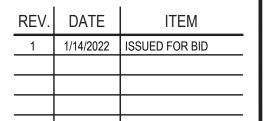

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<u>NOTICE</u>

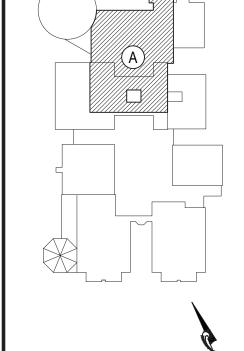

NOT TO SCALE

FIRST FLOOR NEW WORK PART AREA "A"


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SCALE: AS NOTED

DATE: 10/8/21 BID PICK-UP: BID P/U DATE FILE No: 21-274A


P2.01

#### —TO H.S. KITCHEN TO M.S. KITCHEN BUILDING BUILDING — BUILDING — BUILDING KITCHEN FROM?-(120°F) (120°F) (140°F) TWO STAGE GAS (TYPICAL) -(TYPICAL) -FIRED DOMESTIC WATER HEATER — TANK STAT. AQUASTAT (TYPICAL)— DRAIN VALVE —GAS BURNER (TYPICAL)— (TYPICAL) CIRCULATOR **EXPANSION** PUMP ----STORAGE TANK FINISHED FLOOR-DRAIN VALVE WITH THREADED HOSE END (TYPICAL) ————

## DOMESTIC HOT WATER SCHEMATIC PIPING DIAGRAM - DEMOLITION

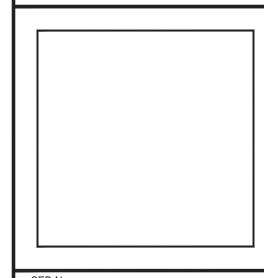DOMESTIC HOT WATER SCHEMATIC PIPING DIAGRAM - NEW WORK

NOTE:

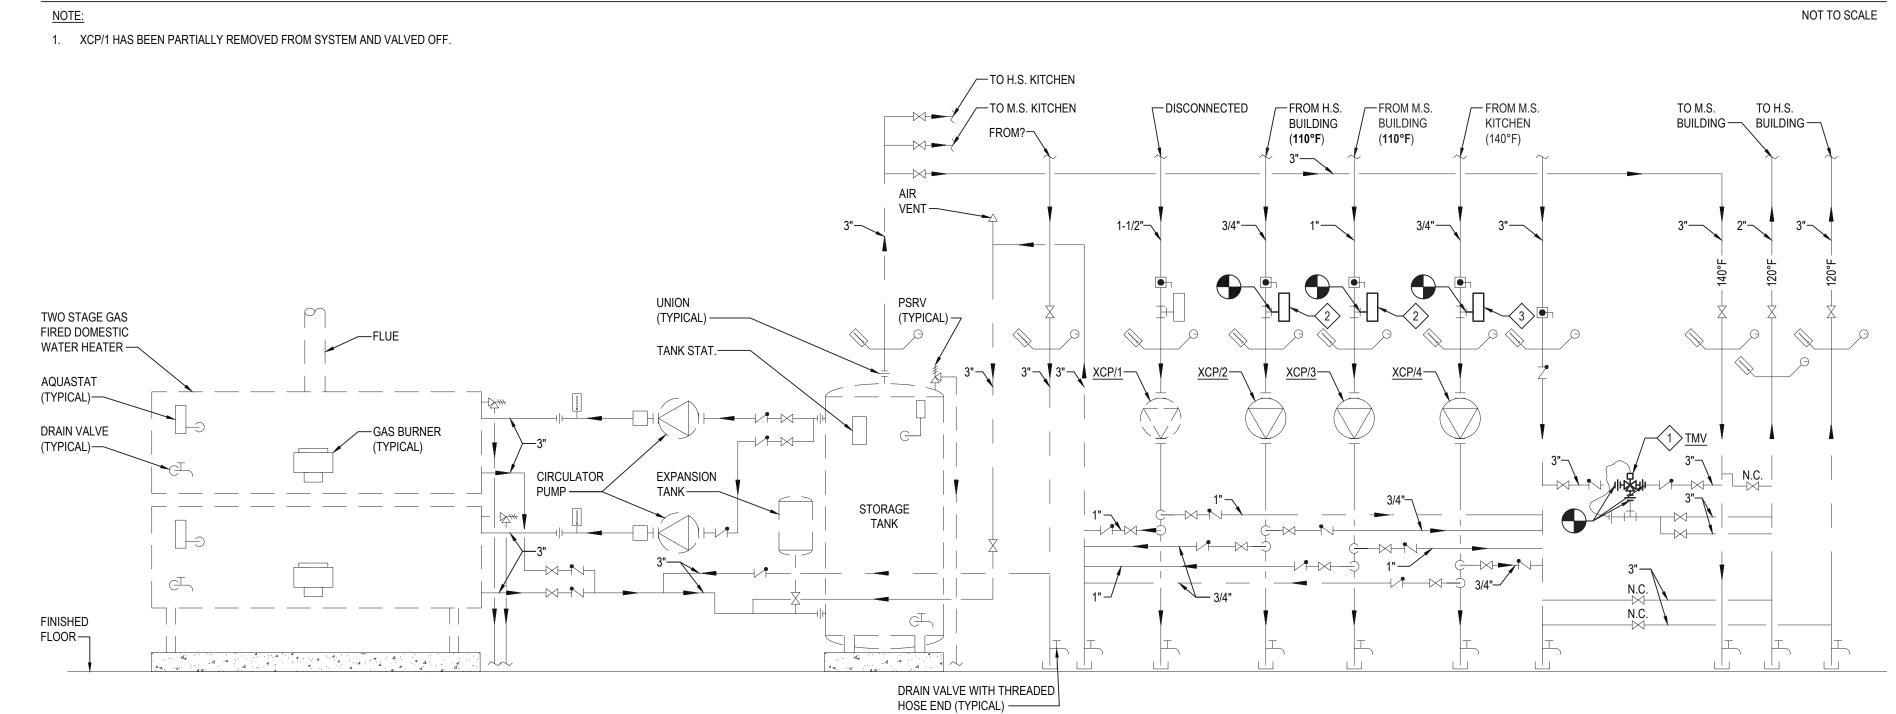

### **KEYED DEMOLITION NOTES:**

1) P.C. TO REMOVE EXISTING HOT WATER THERMOSTATIC MIXING VALVE. (2) P.C. TO REPLACE EXISTING HOT WATER AQUASTAT, LIKE-IN-KIND. (TYPICAL FOR 3)

## KEYED NEW WORK NOTES:

NOT TO SCALE

P.C. TO REPLACE WITH NEW HOT WATER THERMOSTATIC MIXING VALVE.
REFER TO SCHEDULES AND SPECIFICATIONS FOR ADDITIONAL INFORMATION. 2 P.C. TO REPLACE EXISTING HOT WATER AQUASTAT, LIKE-IN-KIND. P.C. TO SET AQUASTAT TO 110°F

3 P.C. TO REPLACE EXISTING HOT WATER AQUASTAT, LIKE-IN-KIND. P.C. TO SET AQUASTAT TO 140°F

## NEW THERMOSTATIC MIXING VALVE SCHEDULE (BASIS OF DESIGN: LAWLER)





temperedwater.com 5330 East 25th St. Indianapolis, IN 46218 Phone (317) 261-1212 Fax (317) 261-1208

REV. DATE

KEY PLAN

NOT TO SCALE

RAMS,

1 | 1/14/2022 | ISSUED FOR BID

NOTICE


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Model 803 **Thermostatic Water** Controller High-Low Water Mixer Unit No. 73004

CAPACITIES - MODEL 803 Pressure Drop PSI 5 10 20 30 45 60 80 803-GPM 803-LPM 163 227 322 390 473 545 624

Master water mixing valve shall be of the thermostatic type with liquid-filled thermal motor. It shall have lead free brass body construction with replaceable corrosion-resistant components. Valve construction shall employ a sliding piston control mechanism. Sliding piston and liner shall be of stainless steel material. Valve shall come equipped with union end stop and check inlets with removable stainless steel strainers. Valve shall control temperature from a low flow of 3 GPM\* up to a maximum flow rate for a given pressure differential. Valve shall provide protection against hot or cold supply line failure and thermostat failure.



Rough Chrome TEMP. RANGE **SET POINT** 70° to 100°F 80°F 110°F 90° to 120°F 110° to 140°F 130°F Special \_\_ **Optional Test Connection** Including garden hose connection, shut-off and thermometer.

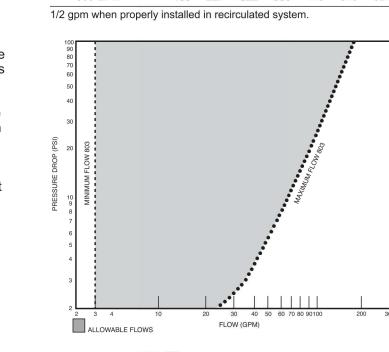Certified to CSA B125.3

Rough Chrome ASSE 1017 Approved
ASSE Lead Free Certified Design and specifications subject to change without notice. Please refer to temperedwater.com to ensure most

> Model 803 Unit No. 73004 Typical Installation

> > Connect a tempered water return line as shown in Figure 1. This allows flow through both ports of the mixing valve during periods of no draw. If a dual temperature system is used, a separate recirculating loop and pump are required to return high temperature hot water to the water heater. See Figure 2. Install an aquastat at the tempered water return pump.

Figure 1 When used in a single temperature recirculating system


**DIMENSIONS** 

Dimensions are for reference purposes only. For rough-in dimensions

please refer to Lawler's Revit/BIM models found at temperedwater.com.

Valve Number A N.P.T. B N.P.T. C

803 1-1/4" 1-1/2"

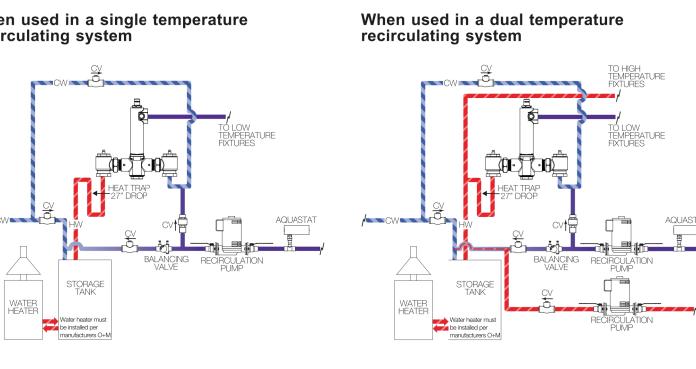

Design and specifications subject to change without notice.

Please refer to **temperedwater.com** to ensure most current data sheet and other design solutions.


# current data sheet and other design solutions.

Install the mixing valve below the hot water tank or heater. If this is not possible, pipe in a heat trap as shown in Figure 1 with an approximate 2' drop.

temperedwater.com/patents

ENG. NO. 73004-A

Install the water heater per manufacturer's instructions.

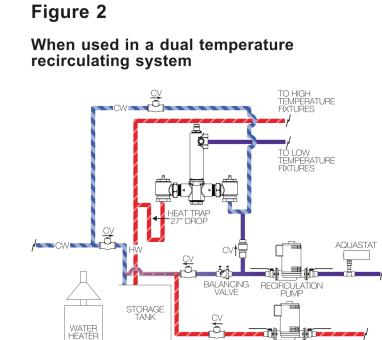

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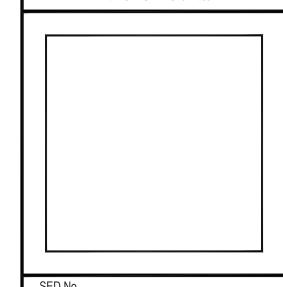
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SED No.	66-14-02-02-0-004-022
DISTRICT	BRIARCLIFF MANOR UFSD DISTRICT NAME
PROJECT	BOND IMPROVEMENTS PHASE 1
DWG TITLE	SCHEM. DIAGRAMS, EQUIPMEI NOTES, SCHEDULES & DETAIL
SCALE:	AS NOTED
DATE:	10/8/21
BID PICK-UP:	BID P/U DATE

P7.01

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