

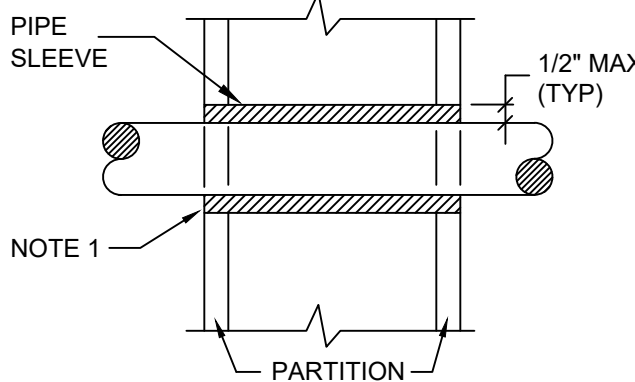
- NOTES:
- PIPE 8" AND LARGER SHALL HAVE ROLLER SUPPORTED WITH DUAL RODS.
  - FOR CHW SERVICE OVER 3" REPLACE SADDLE WITH 12" LONG 14 GA SHIELD WITH RIGID INSULATION BETWEEN PIPE AND SHIELD.

PIPE Ø (IN.)	MAX. SPACING BETWEEN HANGERS (FT.)			MIN. ROD SIZE (IN.)
	STEEL PIPE	COPPER PIPE	CPVC	
1/2 THRU 1	7	5	5	3/8
1-1/2 THRU 2	9	8	6	3/8
2-1/2	11	9	7.5	1/2
3	12	10	7.5	1/2
4	14	12	8.5	5/8
6	17	14	9	3/4
8	19	16	10	7/8
10	22	18	10.5	7/8

1  
M.101

### Pipe Hanger Support

N.T.S.

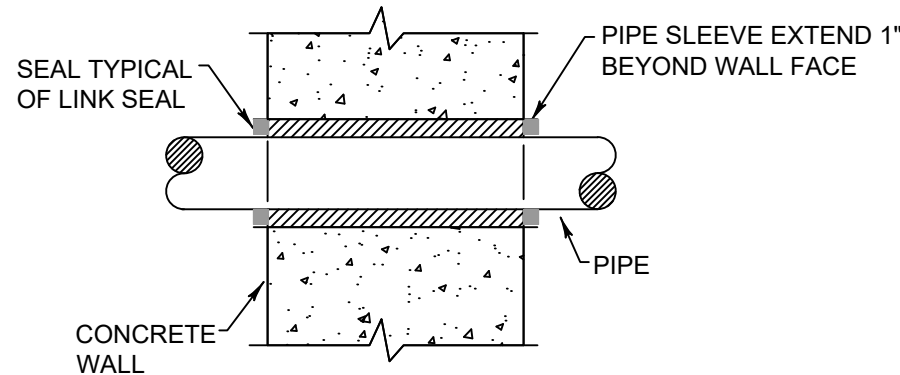


- NOTES:
- AT FIRE RATED PARTITIONS, ADD ADDITIONAL LAYER OF FIRE SAFING INSULATION AROUND PENETRATION SO AS TO FILL CAVITY.
  - DUCT AND PIPE PENETRATIONS THRU CORRIDOR WALLS ABOVE THE CEILING ARE TO BE FIRE STOPPED AROUND THE PENETRATION.

2  
M.101

### Partition Wall Pipe Penetration Detail

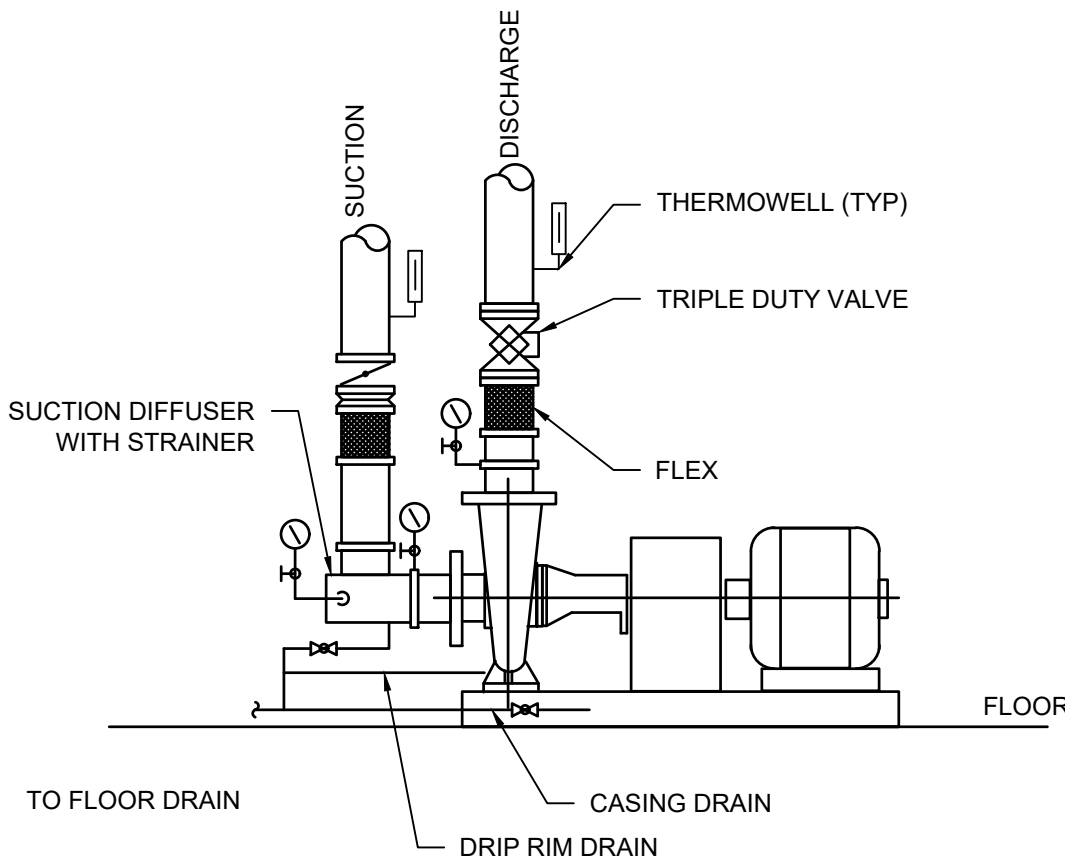
N.T.S.



3  
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### Exterior / Concrete Wall Pipe Penetration Detail

N.T.S.

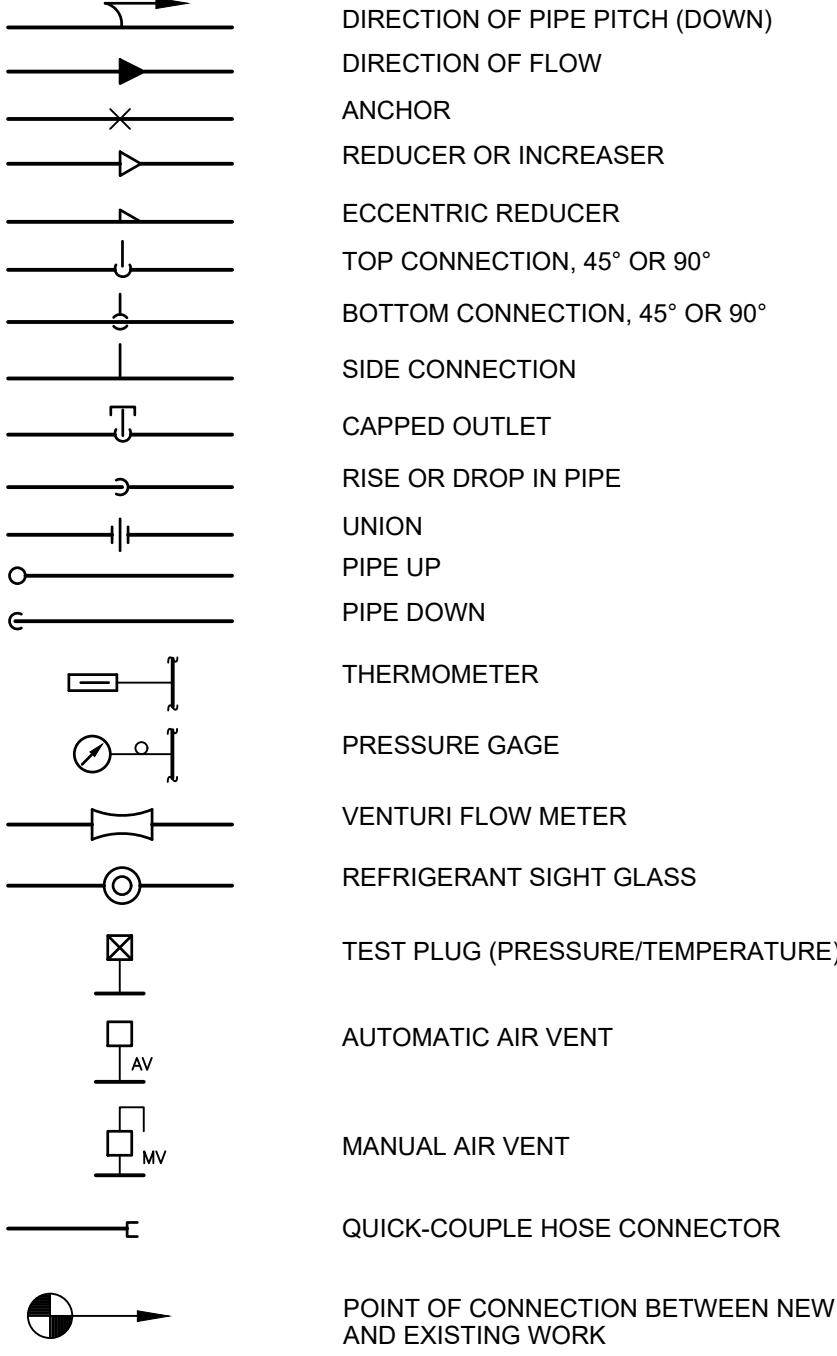


4  
M.101

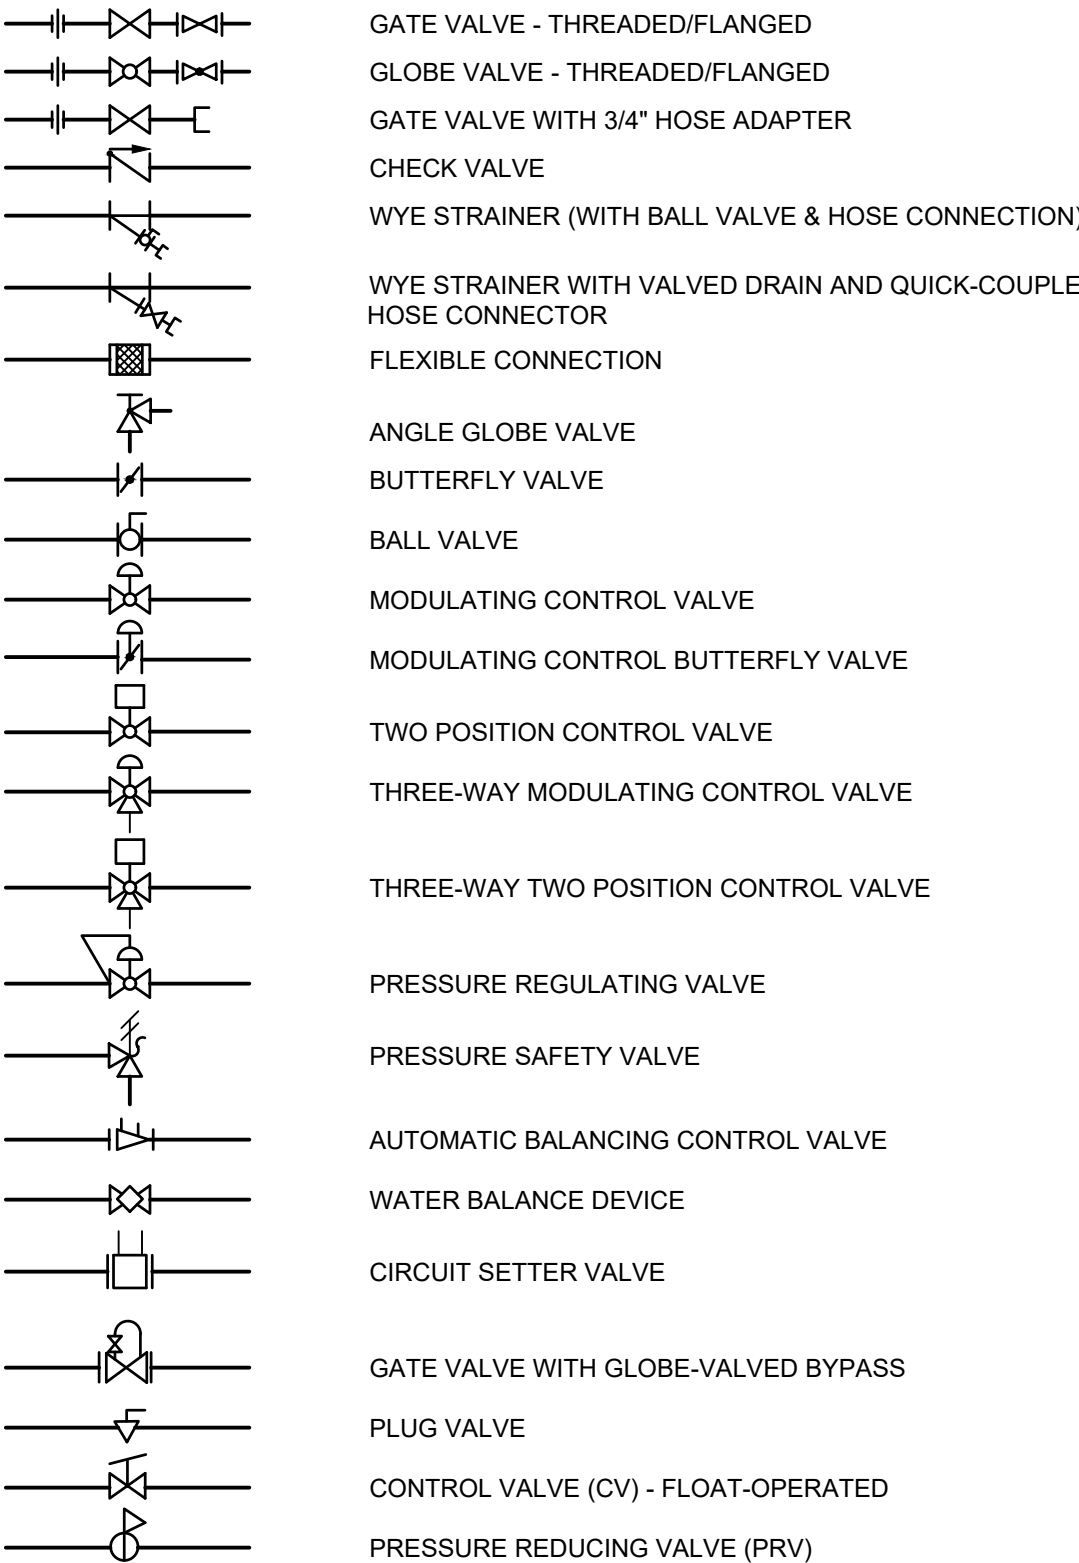
### Base Mounted Pump Detail

N.T.S.

#### General Symbols:



#### Valve Symbols:



#### Mechanical Notes:

- ALL MATERIALS AND EQUIPMENT ARE TO BE NEW, UNUSED, AND FREE FROM DEFECTS OF ANY KIND. THE BASIS OF QUALITY SHALL BE THE LATEST REVISION OF ASTM, ANSI, OR OTHER ACCEPTABLE STANDARDS.
- THESE DRAWINGS ARE DIAGRAMMATIC, AND INDICATE GENERAL ARRANGEMENT OF WORK. THE CONTRACTOR SHALL BE RESPONSIBLE TO HAVE REVIEWED THE SITE FOR HIS WORK PRIOR TO HAVING SUBMITTED HIS PROPOSAL. NO ADDITIONAL COMPENSATION WILL BE ALLOWED FOR CONDITIONS FOUND DURING THE COURSE OF THE CONTRACT.
- THE CONTRACTOR SHALL COORDINATE HIS WORK WITH THAT OF ALL OTHER TRADES.
- ALL WORK INCLUDING LABOR AND MATERIALS SHALL BE FULLY GUARANTEED FOR ONE (1) YEAR FROM THE DATE OF PAYMENT AND FINAL ACCEPTANCE BY THE OWNER AND ENGINEER.
- ALL CUTTING, PATCHING, FIRE-STOPPING, AND SURFACE RESTORATION IN CONNECTION WITH THIS TRADE SHALL BE COMPLETED BY THIS CONTRACTOR.
- A MINIMUM OF FOUR (4) COPIES OF SHOP DRAWINGS SHALL BE SUBMITTED TO THE ENGINEER FOR APPROVAL PRIOR TO ORDERING AND INSTALLATION OF THE EQUIPMENT AND/OR MATERIALS. BY SUBMITTING SHOP DRAWINGS, THE CONTRACTOR REPRESENTS THAT ACTUAL FIELD CONDITIONS ARE VERIFIED BY HIM AND ARE REFLECTED ON HIS SUBMITTALS.
- THIS CONTRACTOR SHALL PAY ALL FEES, GIVE ALL NOTICES, FILE ALL NECESSARY DRAWINGS, AND OBTAIN ALL PERMITS, INSPECTIONS AND CERTIFICATES OF APPROVAL REQUIRED IN CONNECTION WITH WORK UNDER THIS CONTRACT.
- ALL WORK IN ASSOCIATION WITH THIS CONTRACT SHALL BE COMPLETED IN STRICT COMPLIANCE WITH THE 2020 BUILDING CODE OF NEW YORK STATE, 2020 MECHANICAL CODE OF NEW YORK STATE & 2020 ENERGY CONSERVATION CONSTRUCTION CODE OF NEW YORK STATE.
- ALL DUCTWORK IS TO BE CONSTRUCTED OF GALVANIZED SHEET STEEL (EXCEPT WHERE OTHERWISE SPECIFIED) WITH GAUGES, BRACING AND CONSTRUCTION IN ACCORDANCE WITH THE LATEST SMACNA DUCT MANUAL STANDARDS AND ALL OTHER AUTHORITIES HAVING JURISDICTION.
- PROVIDE MANUAL DAMPERS AT EACH SPLIT OR TAP CONNECTION TO TRUNK DUCTS FOR BALANCING PURPOSES WHETHER OR NOT SPECIFICALLY SHOWN ON DRAWINGS. EACH DAMPER SHALL BE OF THE OPPOSED BLADE DAMPER TYPE INSTALLED WITH AN OPERATOR AND LOCKING DEVICE. ALL DAMPERS LOCATED ABOVE HARD OR INACCESSIBLE CEILINGS SHALL BE INSTALLED WITH REMOTE GEAR OPERATORS.
- FURNISH & INSTALL FUSIBLE LINK FIRE DAMPERS AT ALL LOCATIONS WHERE DUCT PENETRATES FIRE-RATED FLOOR OR CEILING ASSEMBLY WHETHER OR NOT SPECIFICALLY SHOWN. INSTALL DUCTWORK CASING ACCESS DOORS AND FRAMES AHEAD OF EACH FIRE DAMPER FOR INSPECTION AND MAINTENANCE. DOORS SHALL BE A MINIMUM OF 20 GA. DOUBLE PANEL INSULATED TYPE.
- INSTALL TURNING VANES ON ALL RECTANGULAR TURNS. TURNING VANES SHALL BE DOUBLE THICKNESS TYPE CONSTRUCTED IN ACCORDANCE WITH SMACNA MANUAL.
- ROUND SHEET STEEL ELBOWS ARE TO BE INSTALLED AT THE DUCT CONNECTION TO ALL SUPPLY AIR DIFFUSERS. SHEET STEEL PLENUM BOXES ARE TO BE INSTALLED AT THE DUCT CONNECTION TO ALL RETURN AND EXHAUST AIR GRILLES. THE CONTRACTOR IS TO PAINT THE INSIDE OF THE SHEET STEEL PLENUM BOXES FLAT BLACK.
- ALL SUPPLY AND RETURN DUCTWORK LOCATED IN UNCONDITIONED SPACES OR ABOVE CEILINGS SHALL BE INSULATED WITH A MINIMUM OF R-8 INSULATION. ALL DUCTWORK LOCATED OUTSIDE THE BUILDING ENVELOPE SHALL BE INSULATED WITH A MINIMUM OF R-12 INSULATION. INSULATION SHALL BE FIBERGLASS DUCT WRAP WITH VAPOR SEAL SECURELY TAPED AROUND DUCT. IF DUCT LINING IS TO BE USED, ALL DUCT SIZES SHOWN SHALL BE CONSIDERED TO BE INSIDE CLEAR DIMENSIONS.
- INSTALL ALL DUCTWORK AS HIGH AS POSSIBLE PROVIDING RISERS, DROPS AND OFFSETS TO CLEAR STRUCTURAL MEMBERS, LIGHT FIXTURES, OTHER PIPING, AND OTHER OBSTRUCTIONS. WHERE CONFLICTS ARISE, IT SHALL BE BROUGHT TO THE ENGINEER'S ATTENTION PRIOR TO PROCEEDING.
- THE CONTRACTOR IS RESPONSIBLE TO TEST ALL EQUIPMENT, PIPING, FIXTURES, AND SYSTEMS INSTALLED UNDER THIS CONTRACT TO ENSURE PROPER OPERATION PRIOR TO FINAL ACCEPTANCE BY THE OWNER AND ENGINEER.
- THE CONTRACTOR IS RESPONSIBLE TO DETERMINE WHETHER SPECIAL LICENSING IS REQUIRED IN ORDER TO PERFORM THE REQUIRED WORK IN THE MUNICIPALITY WHERE THE PROJECT IS LOCATED. IF THE CONTRACTOR CANNOT OBTAIN THE REQUIRED LICENSING TO COMPLETE THE WORK WITHIN THE PROJECT SCHEDULE, THEN THE CONTRACTOR SHALL NOT BE PERMITTED TO BID ON THIS PROJECT.
- CONTRACTOR IS RESPONSIBLE TO CREATE AND SUBMIT RED-LINE "AS-BUILT" PLANS TO THE ENGINEER AT THE END OF THE PROJECT. AS-BUILT PLANS SHALL ACCURATELY REPRESENT THE SYSTEMS AS THEY WERE INSTALLED.

#### Hydronic Piping Notes:

- ALL HYDRONIC HOT WATER PIPING AND FITTINGS ARE TO BE INSULATED WITH RIGID ONE-PIECE MOLDED SECTIONAL FIBERGLASS PIPE COVERING WITH UNIVERSAL JACKET. INSULATION SHALL BE 1-1/2" THICK FOR PIPING UP THRU 1-1/2" DIAMETER, AND 2" THICK FOR PIPING GREATER THAN 1-1/2" DIAMETER. ALL JOINTS ARE TO BE COMPLETELY SEALED A MINIMUM OF 6" BEYOND JOINT ENDS.
- ALL PIPING SHALL BE PROPERLY SUPPORTED AND ROUTED PARALLEL OR PERPENDICULAR TO BUILDING WALLS. THE CONTRACTOR SHALL FURNISH AND INSTALL ALL SUPPORT HANGERS AND MISCELLANEOUS METALS REQUIRED FOR PROPER INSTALLATION OF WORK.
- HYDRONIC PIPING SYSTEM MATERIALS ARE TO BE AS FOLLOWS:
  - PIPING UP THRU 3" DIAMETER IS TO BE TYPE L HARD DRAWN SEAMLESS COPPER TUBING MADE IN ACCORDANCE WITH ASTM B 88 WITH WROUGHT COPPER FITTINGS MADE IN ACCORDANCE WITH ASME B 16.22. JOINTS SHALL BE MADE BY APPLYING A FLUX CONFORMING WITH ASTM B 813, AND SOLDERED WITH A 95-5 LEAD-FREE SOLDER CONFORMING TO ASTM B 32.
  - PIPING GREATER THAN 3" DIAMETER IS TO BE SCHEDULE 40 GRADE B SEAMLESS CARBON STEEL MADE IN ACCORDANCE WITH ASTM A 53 WITH FITTINGS MADE IN ACCORDANCE WITH ASTM B 16.9. JOINTS SHALL BE WELDED, OR MAY BE MADE USING GROOVED AND SHOULDERED MECHANICAL JOINTS CONFORMING TO THE REQUIREMENTS OF ASTM F 1476.
- FURNISH & INSTALL DIELECTRIC UNIONS WHERE JOINING STEEL TO COPPER PIPING.
- ALL PIPING SHALL BE PITCHED SUCH THAT AIR IN THE SYSTEM CAN BE VENTED THROUGH MANUAL AIR VENTS.
- TEST PIPING AND PROVE TIGHT FOR AT LEAST TWO HOURS TO TWICE THE SYSTEM WORKING PRESSURE. TEST SHALL BE PERFORMED IN THE PRESENCE OF THE ENGINEER AND LOCAL INSPECTOR. TEST SHALL BE REPEATED IF NECESSARY UNTIL FINAL APPROVAL OF SYSTEM IS OBTAINED.
- SUPPORT HORIZONTAL PIPING UTILIZING A SPACING PER PIPING MANUFACTURER'S REQUIREMENTS.
- INSTALL VALVES ON THE ENTIRE DISTRIBUTION SYSTEM, SO LOCATED AS TO GIVE COMPLETE CONTROL TO ALL FIXTURES AND EQUIPMENT.
- INSTALL DRAIN VALVES AT BASE OF ALL RISERS AND AT LOW POINTS OF PIPING SYSTEM. INSTALL MANUAL AIR VENT VALVE FACILITIES AT THE TOP OF ALL RISERS AND AT HIGH POINTS OF THE PIPING SYSTEM.
- PROVIDE PROPER PROVISION FOR EXPANSION/CONTRACTION OF PIPING TO PREVENT STRAIN ON THE SYSTEM AND/OR THE BUILDING STRUCTURE.
- INSTALL ALL HYDRONIC PIPING AS HIGH AS POSSIBLE PROVIDING RISERS, DROPS AND OFFSETS TO CLEAR STRUCTURAL MEMBERS, LIGHT FIXTURES, OTHER PIPING, AND OTHER OBSTRUCTIONS. WHERE CONFLICTS ARISE, IT SHALL BE BROUGHT TO THE ENGINEER'S ATTENTION PRIOR TO PROCEEDING.
- THE ENTIRE HYDRONIC SYSTEM IS TO BE BALANCED TO WITHIN 10% OF THE SPECIFIED WATER FLOWRATE REQUIREMENTS. A CERTIFIED BALANCING REPORT AND VERIFICATION IS TO BE SUBMITTED TO THE ENGINEER PRIOR TO FINAL ACCEPTANCE.

#### PUMP SCHEDULE

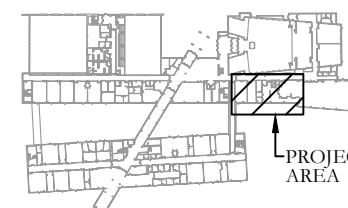
EQUIPMENT TAG	MANUFACTURER (OR ACCEPT. EQUAL)	MODEL	LOCATION	AREA SERVED	PUMP TYPE	CIRCULATING FLUID				MOTOR						NOTES
						FLUID	G.P.M.	HEAD (FT.)	TEMP. (°F)	NOM. H.P.	VOLT.	PHASE	HZ.	RPM	FLA	
P-6A	TACO	FI6011D	CHILLER ROOM	COOLING TOWER	BASE MOUNTED	CONDENSER WATER	1650	75	95	40	480	3	60	1760	52	-
P-6B	TACO	FI6011D	CHILLER ROOM	COOLING TOWER	BASE MOUNTED	CONDENSER WATER	1650	75	95	40	480	3	60	1760	52	-
P-7A	TACO	FI6011D	CHILLER ROOM	CHILLER	BASE MOUNTED	CHILLED WATER	1285	75	44	40	480	3	60	1760	52	-
P-7B	TACO	FI6011D	CHILLER ROOM	CHILLER	BASE MOUNTED	CHILLED WATER	1285	75	44	40	480	3	60	1760	52	-

#### COOLING TOWER SCHEDULE

COOLING TOWER SCHEDULE																				
EQUIPMENT TAG	MANUFACTURER (OR ACCEPT. EQUAL)	MODEL	LOCATION	SERVES	EWT (°F)	LWT (°F)	AMBIENT WB (°F)	FLOW RATE (GPM)	SUMP CAPACITY (GAL)	DRY WEIGHT (LBS)	OPERATING WEIGHT (LBS)	SHELL MATERIAL	FAN MOTORS							NOTES
													QTY.	NOM. H.P.	VOLT.	PHASE	HZ.	RPM	FLA	
CT-1	DELTA	TM-203312	ROOF	EXISTING CHILLER	95	85	75	1,650	960	13,000	24,400	POLYETHYLENE (HDPE)	4	3.0	480	3	60	900	4.8	1-7
1. PROVIDE W/ PREMIUM EFFICIENT VFD RATED MOTORS								5. PROVIDE W/ NEMA 4X VIBRATION CUT OFF SWITCH W/ MANUAL RESET												
2. PROVIDE W/ ALUMINUM LADDER AND OSHA SAFETY CAGE								6. PROVIDE W/ ANTI-MICROBIAL HDPE BLUE RESIN												
3. PROVIDE W/ UPPER SAFETY HANDRAIL SYSTEM & SAFETY GATE								7. PROVIDE W/ NEMA 3R VFD W/ MANUAL BYPASS PACKAGE												
4. PROVIDE W/ PVC MESH SCREEN OUTLET STRAINER																				

#### KEY PLAN:

### 'CORNWALL CENTRAL HIGH SCHOOL'



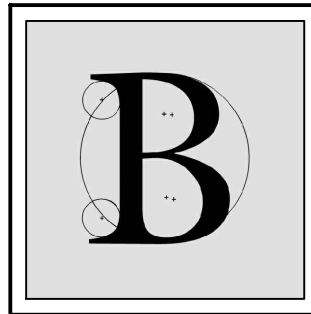
#### PROJECT:

### CORNWALL CENTRAL HIGH SCHOOL COOLING TOWER REPLACEMENT PROJECT

10 DRAGON DRIVE  
NEW WINDSOR, NEW YORK 12553  
SED #:44-03-01-06-0-012-008

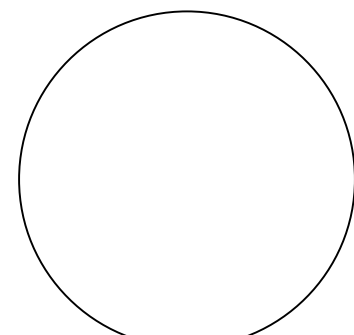
#### SUB-CONSULTANT:

#### ENGINEER:



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MA - 53197 CT - 32283 FL - 85928

### MECHANICAL NOTES, SYMBOLS, DETAILS & SCHEDULES

DATE:		DRN	CHK	DESCRIPTION
05.27.2022		BJK	MGB	CONSTRUCTION SET
REV.	DATE:	DRN	CHK	DESCRIPTION

PROJECT NO.

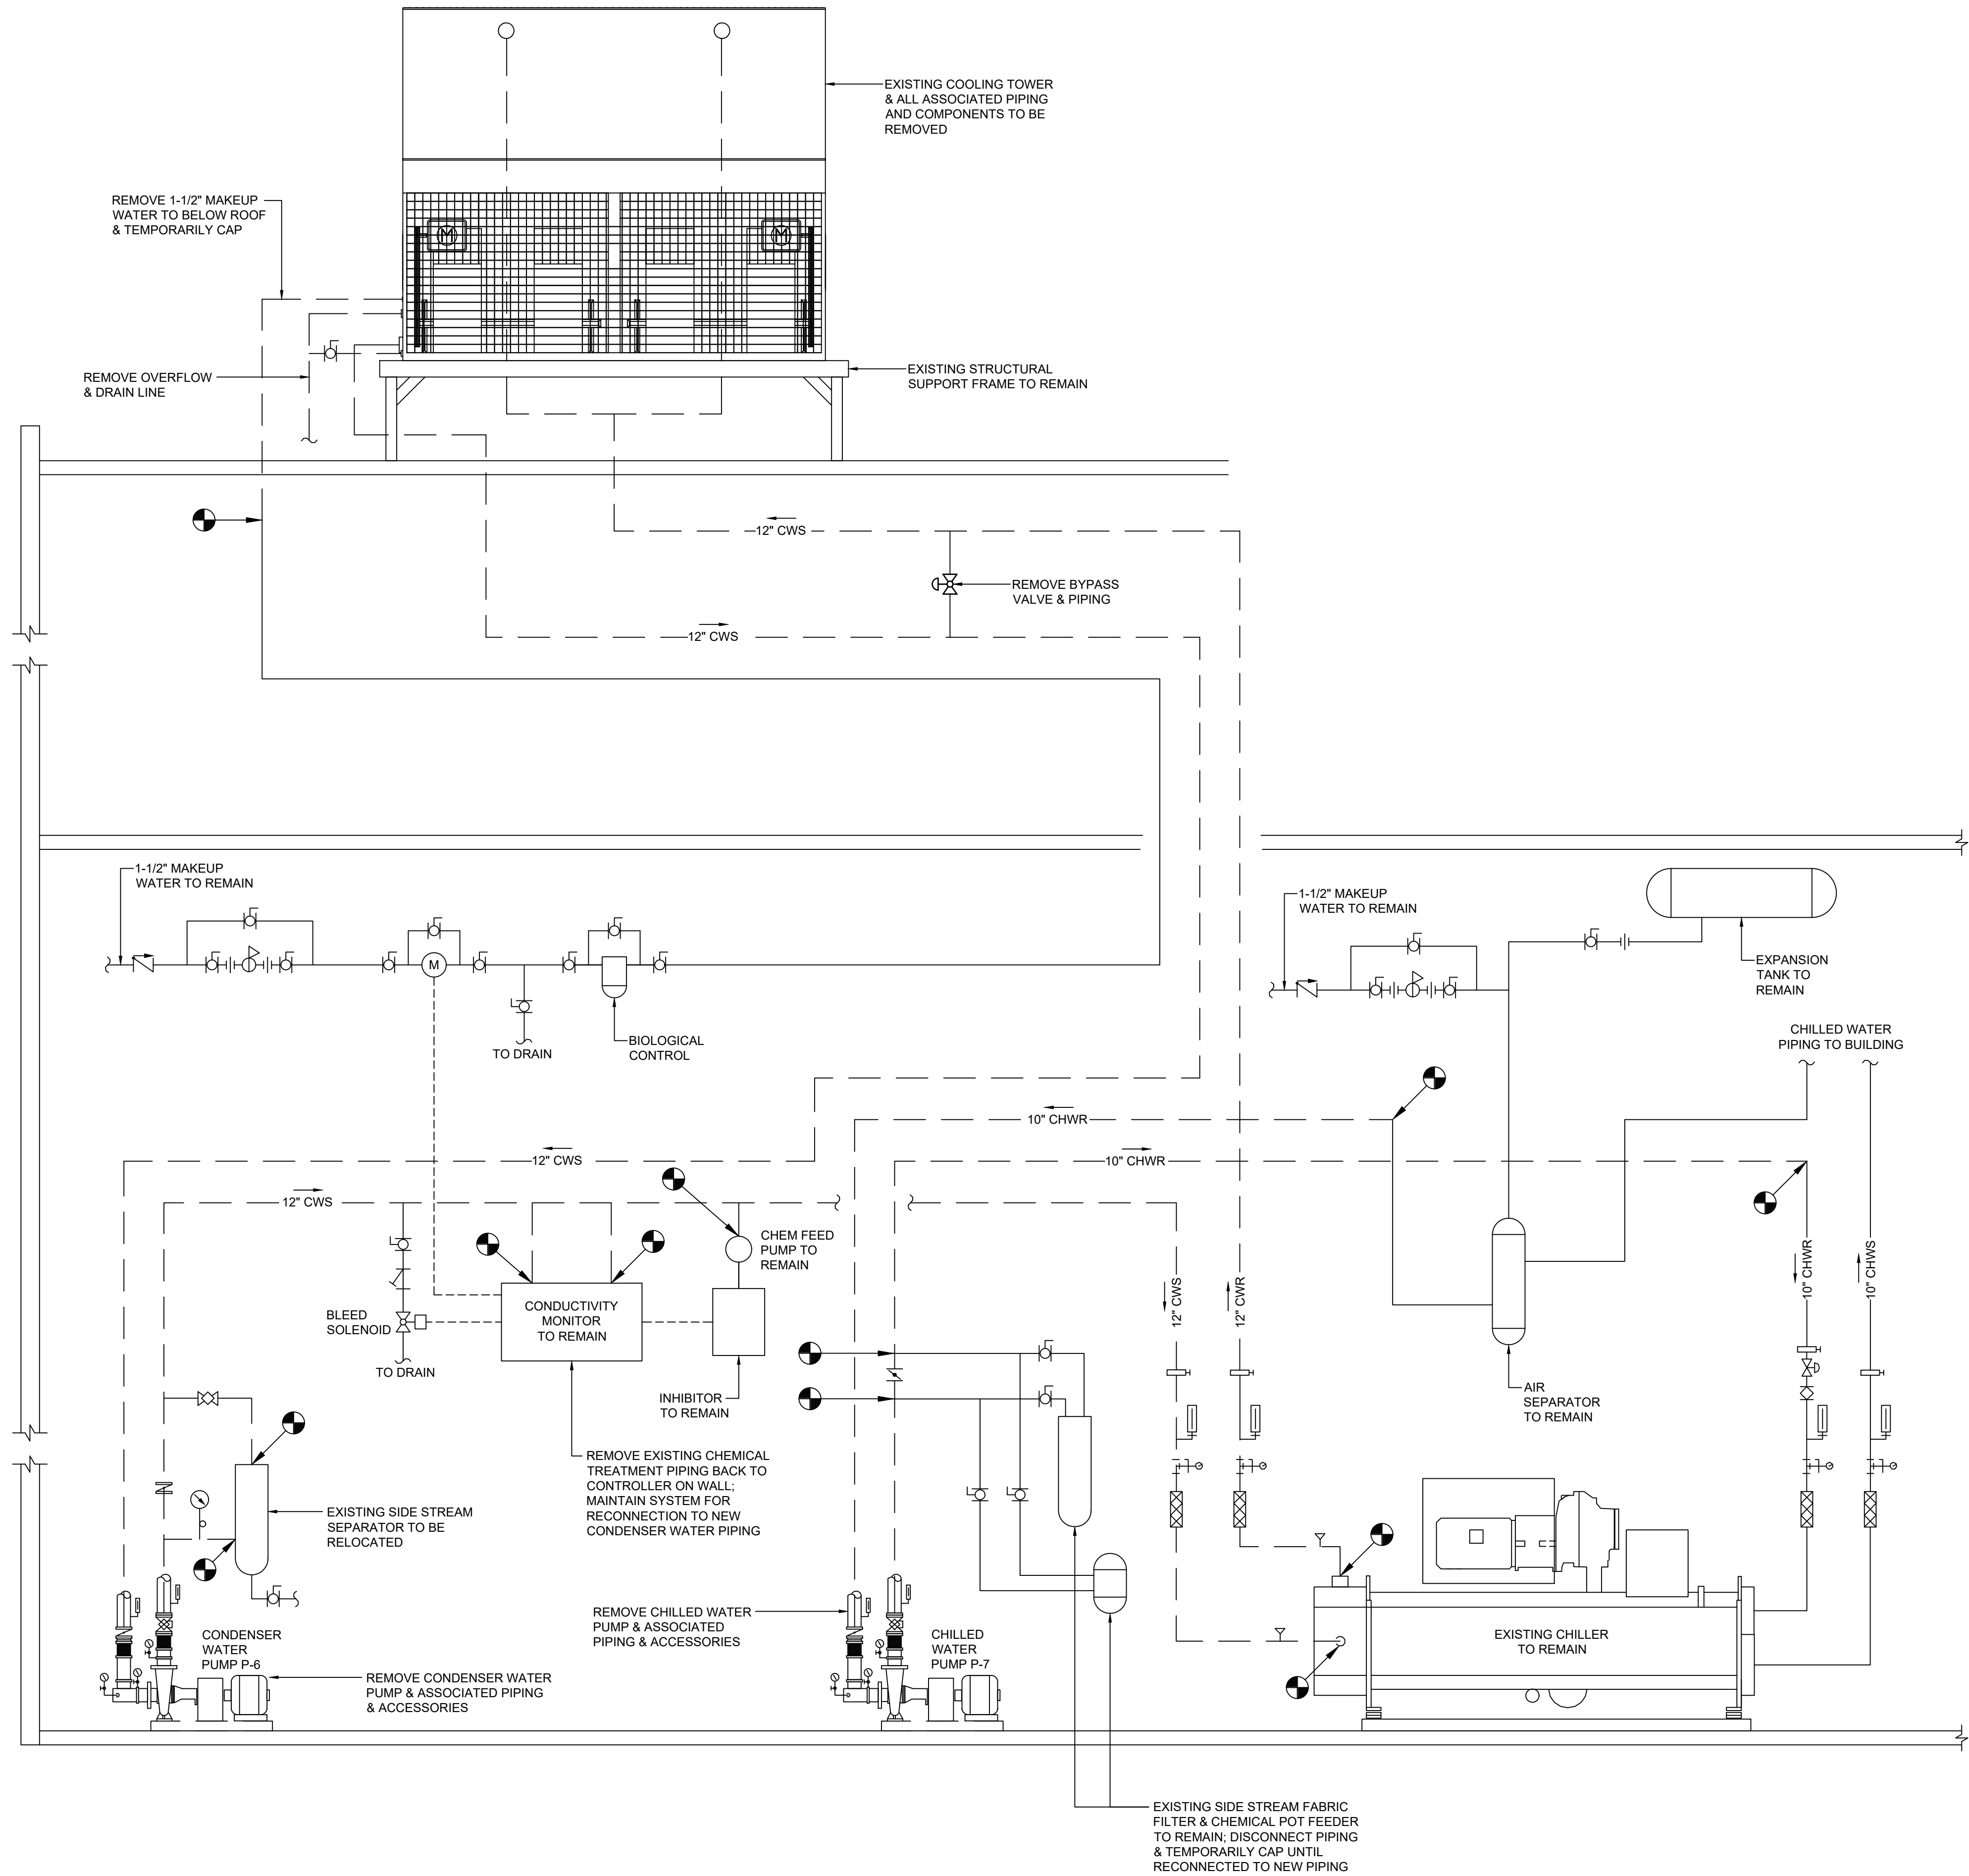
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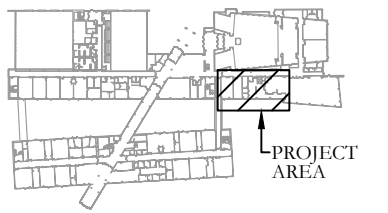


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M.102

Cooling Tower Demolition Piping Diagram  
N.T.S.

KEY PLAN:

'CORNWALL CENTRAL  
HIGH SCHOOL'

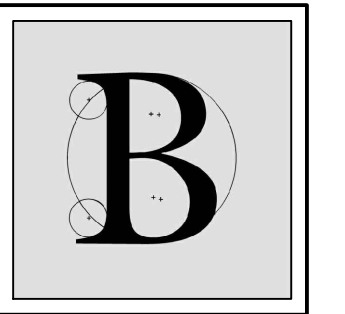


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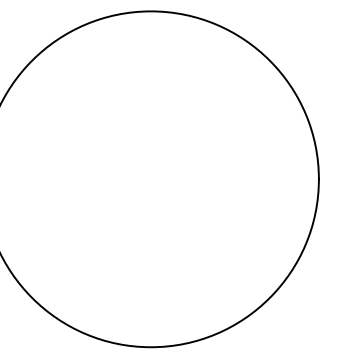
CORNWALL CENTRAL  
HIGH SCHOOL  
COOLING TOWER  
REPLACEMENT PROJECT  
10 DRAGON DRIVE  
NEW WINDSOR, NEW YORK 12553  
SED #44-03-01-06-0-012-008

SUB-CONSULTANT:

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COOLING TOWER  
DEMOLITION PIPING  
DIAGRAM

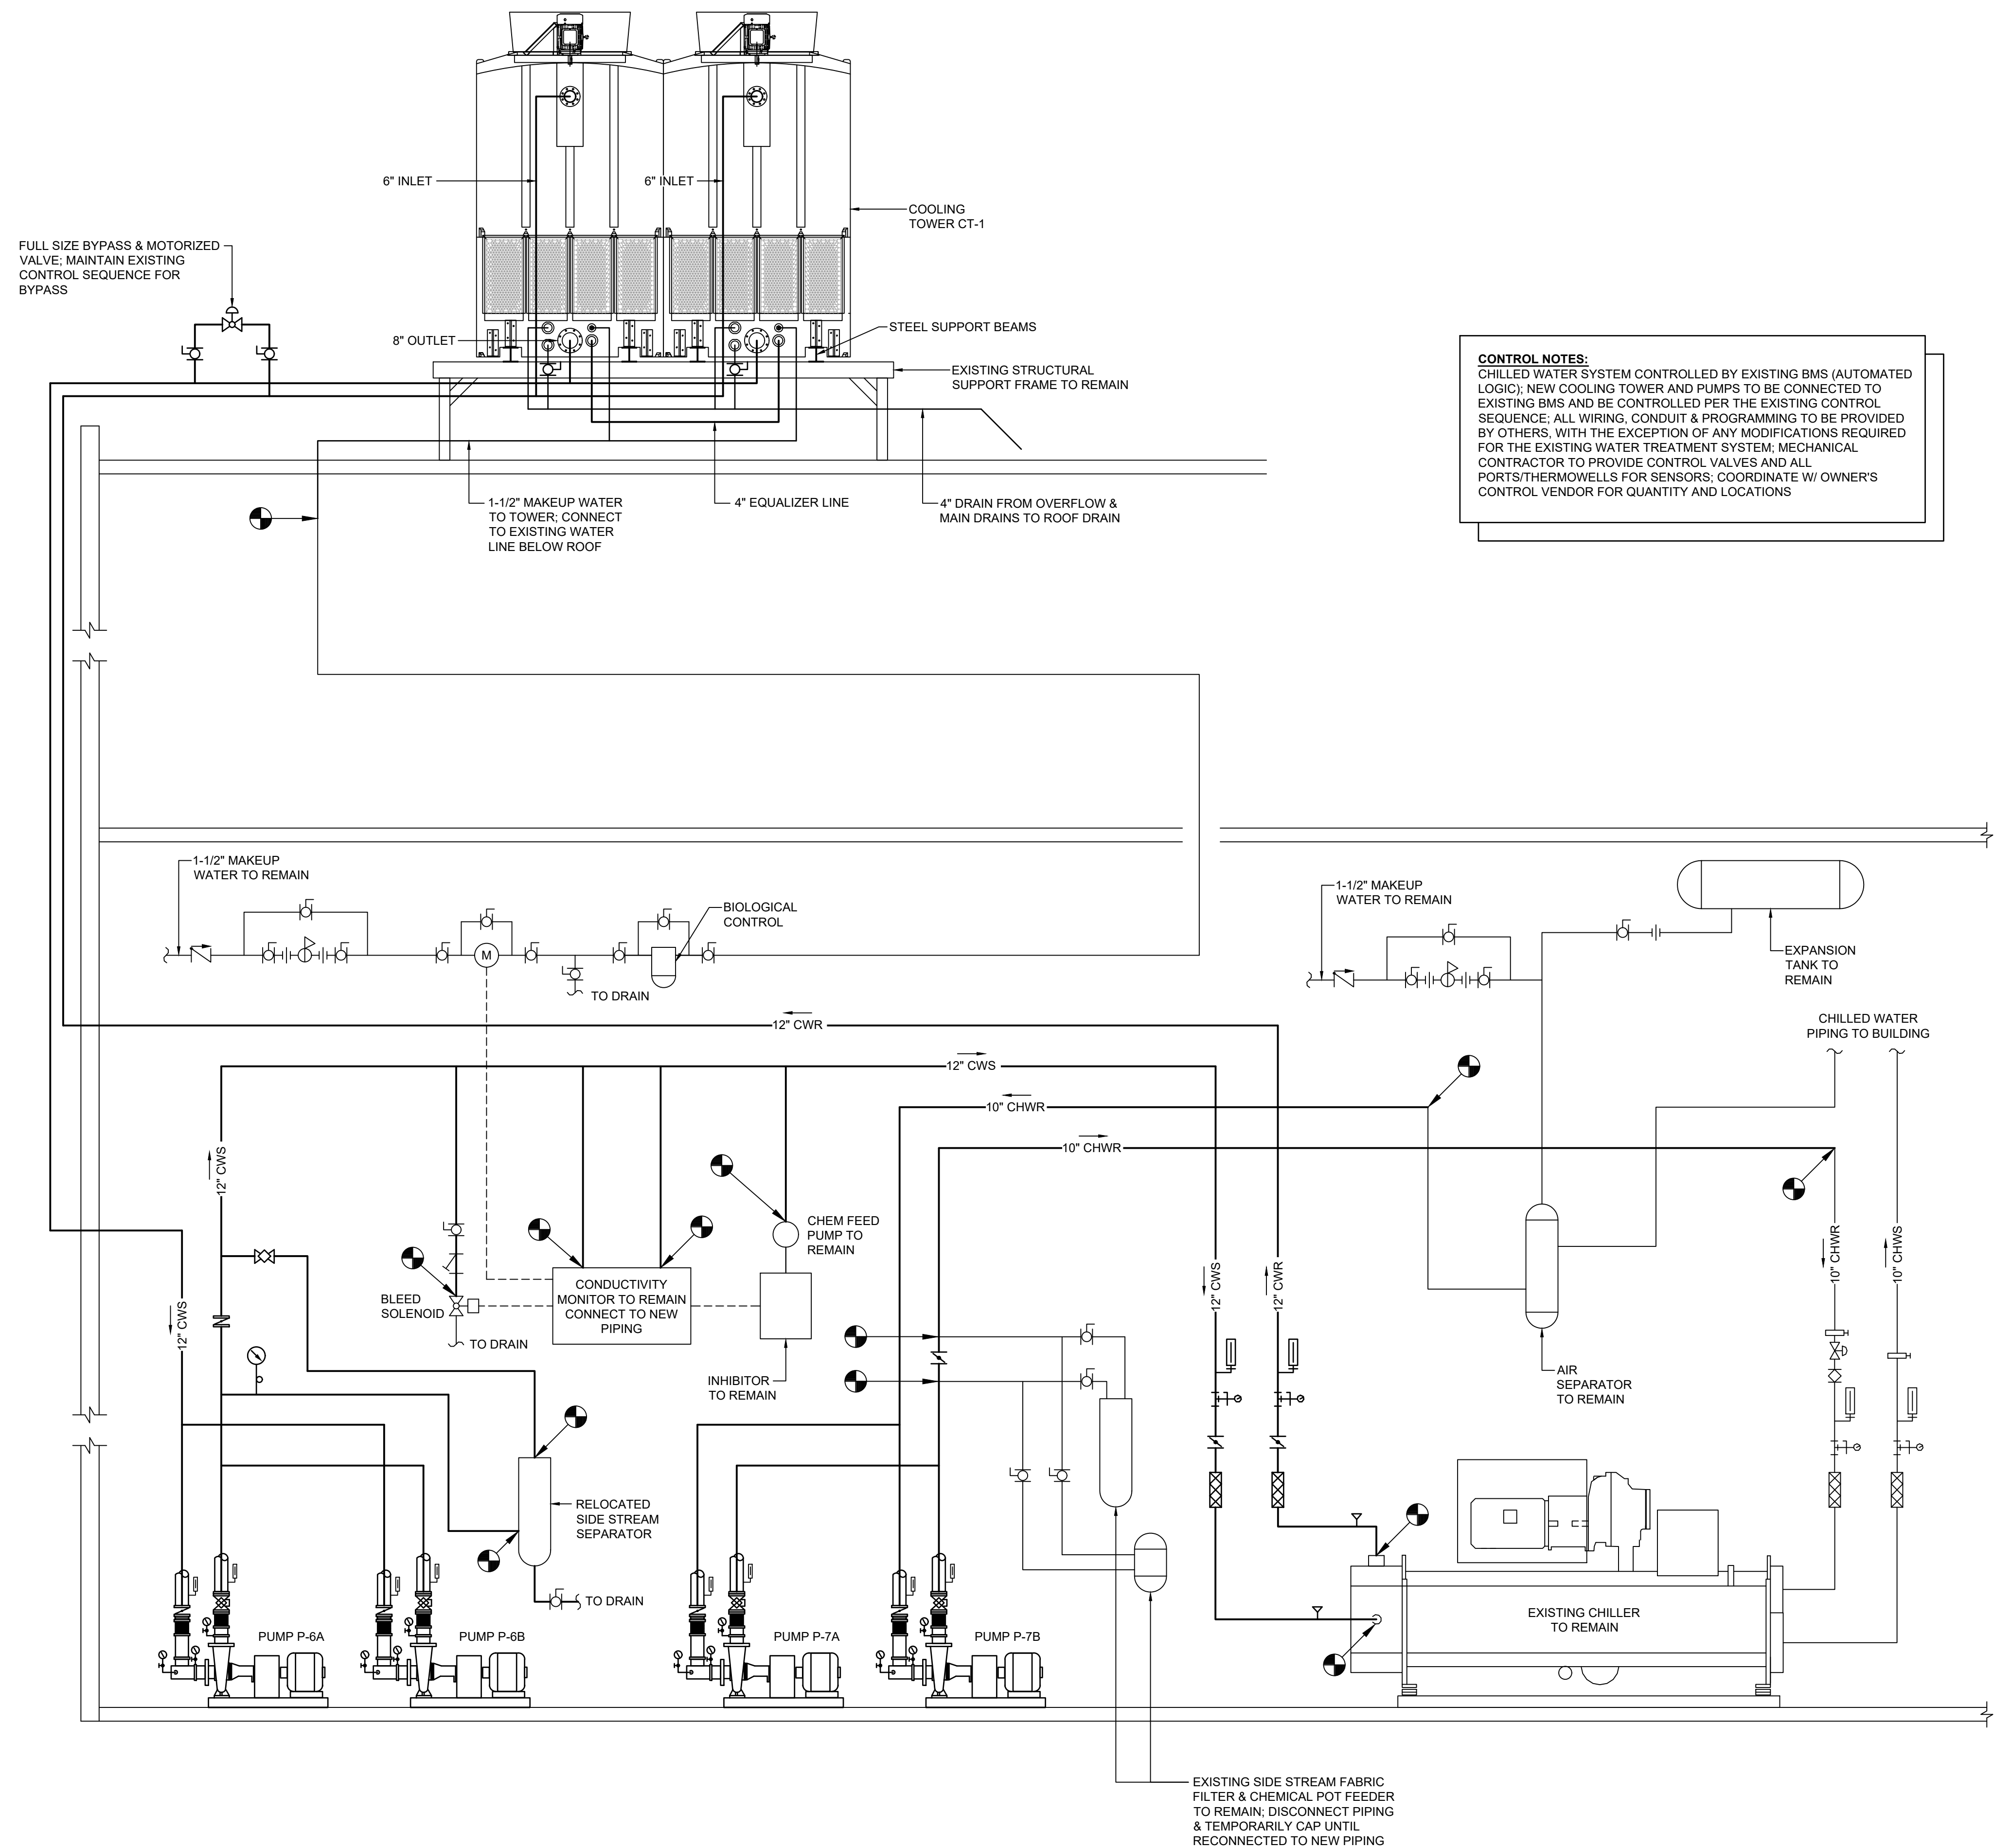
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05.27.2022	BJK	MGB	CONSTRUCTION SET

REV.	DATE	DRN	CHK	DESCRIPTION

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2149	M.102

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**CONTROL NOTES:**  
CHILLED WATER SYSTEM CONTROLLED BY EXISTING BMS (AUTOMATED LOGIC); NEW COOLING TOWER AND PUMPS TO BE CONNECTED TO EXISTING BMS AND BE CONTROLLED PER THE EXISTING CONTROL SEQUENCE; ALL WIRING, CONDUIT & PROGRAMMING TO BE PROVIDED BY OTHERS, WITH THE EXCEPTION OF ANY MODIFICATIONS REQUIRED FOR THE EXISTING WATER TREATMENT SYSTEM; MECHANICAL CONTRACTOR TO PROVIDE CONTROL VALVES AND ALL PORTS/THERMOWELLS FOR SENSORS; COORDINATE W/ OWNER'S CONTROL VENDOR FOR QUANTITY AND LOCATIONS

1 Cooling Tower Piping Diagram  
M.103 N.T.S.

KEY PLAN:

'CORNWALL CENTRAL HIGH SCHOOL'

PROJECT AREA

TRUE NORTH

PROJECT NORTH

ROUTE 94

PROJECT:

CORNWALL CENTRAL HIGH SCHOOL COOLING TOWER REPLACEMENT PROJECT

10 DRAGON DRIVE  
NEW WINDSOR, NEW YORK 12553  
SED #:44-03-01-06-0-012-008

SUB-CONSULTANT:

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COOLING TOWER PIPING DIAGRAM

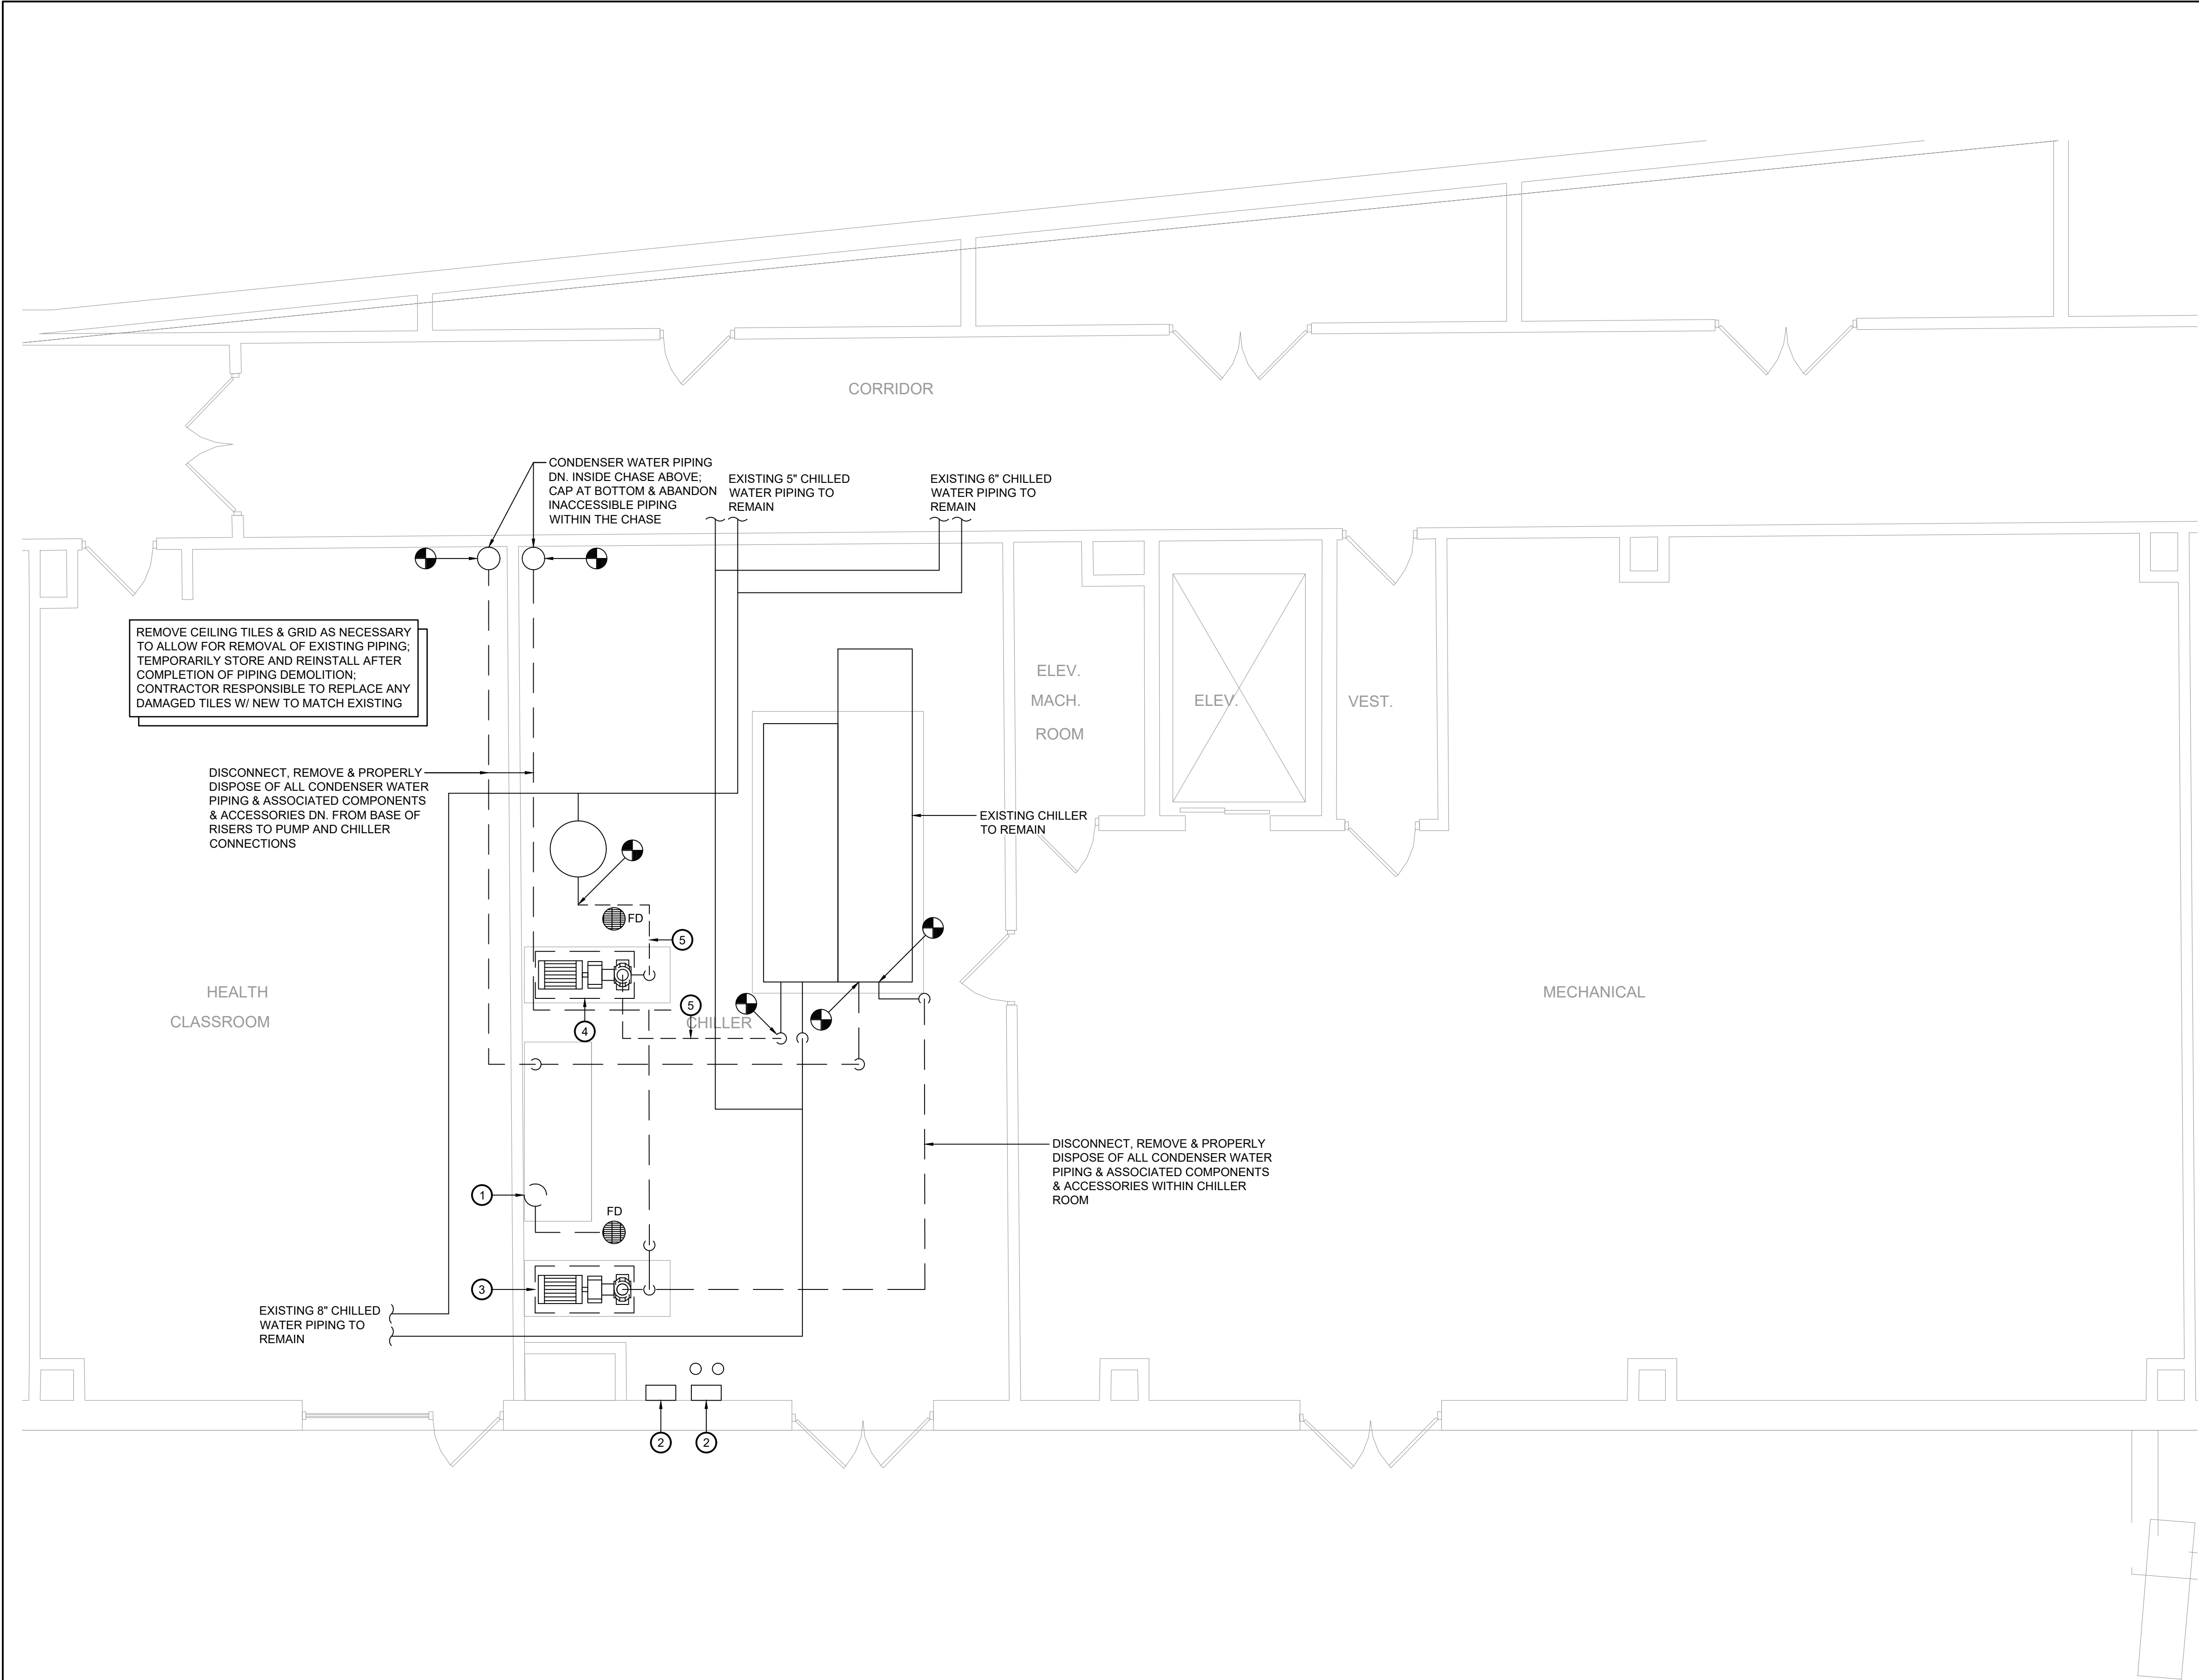
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REV.	DATE	DRN	CHK	DESCRIPTION

PROJECT NO.  
**2149**

SHEET NO.  
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- Key Notes:
- 1 DISCONNECT, REMOVE & PROPERLY DISPOSE OF EXISTING SEPARATOR FILTRATION SYSTEM AND ALL ASSOCIATED PIPING, VALVES AND CONTROLS
  - 2 EXISTING WATER TREATMENT SYSTEM TO REMAIN; REMOVE ALL PIPING (SAMPLING, CHEMICAL INJECTION, ETC.) FROM CONNECTIONS AT CONDENSER WATER PIPING BACK TO THE CONTROLLERS AT THE WALL
  - 3 DISCONNECT, REMOVE & PROPERLY DISPOSE OF EXISTING CONDENSER WATER PUMP AND ALL ASSOCIATED ACCESSORIES, VALVES, ETC.
  - 4 DISCONNECT, REMOVE & PROPERLY DISPOSE OF EXISTING CHILLED WATER PUMP AND ALL ASSOCIATED ACCESSORIES, VALVES, ETC.
  - 5 DISCONNECT, REMOVE & PROPERLY DISPOSE OF EXISTING CHILLED WATER PIPING AND ALL ASSOCIATED ACCESSORIES, VALVES, ETC. FROM THE PUMP TO THE LOCATIONS SHOWN

KEY PLAN:

'CORNWALL CENTRAL HIGH SCHOOL'

ROUTE 94

TRUE NORTH

PROJECT NORTH

PROJECT AREA

PROJECT:

CORNWALL CENTRAL HIGH SCHOOL COOLING TOWER REPLACEMENT PROJECT

10 DRAGON DRIVE  
NEW WINDSOR, NEW YORK 12553  
SED #:44-03-01-06-0-012-008

SUB-CONSULTANT:

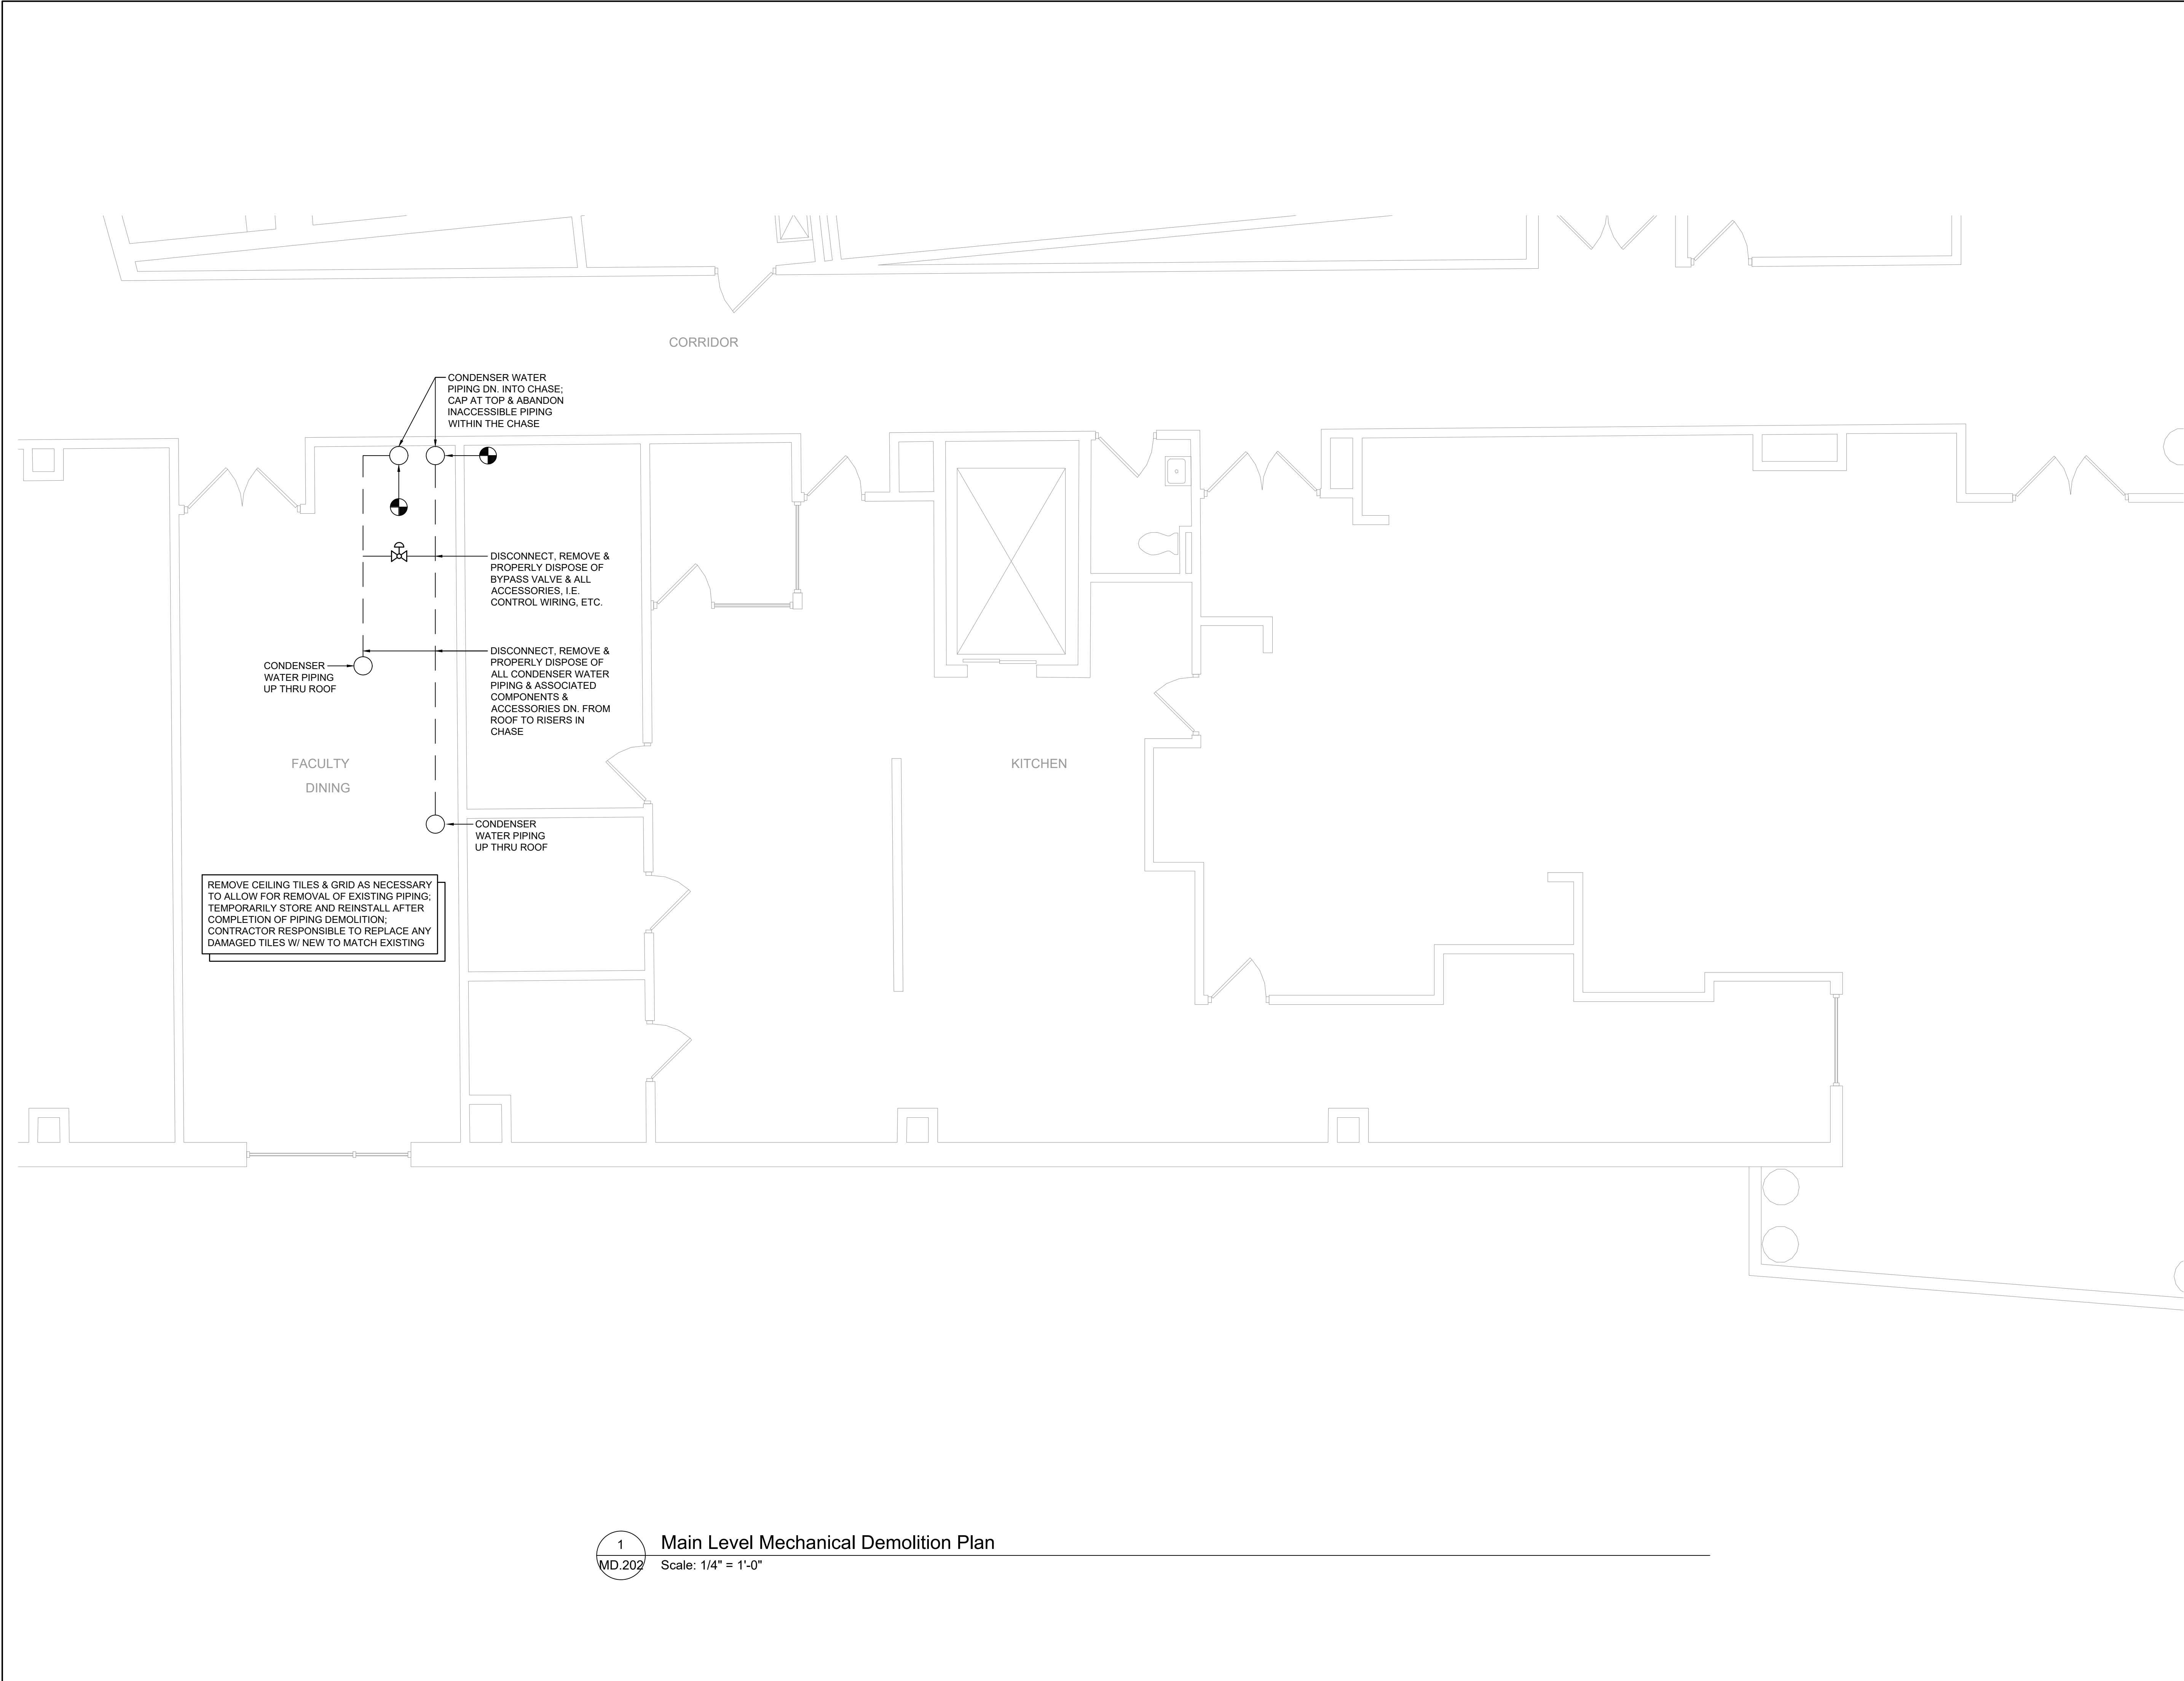
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LOWER LEVEL MECHANICAL DEMOLITION PLAN				
DATE:		DRN	CHK	DESCRIPTION
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REV.	DATE:	DRN	CHK	DESCRIPTION
PROJECT NO.		SHEET NO.		
2149		MD.201		
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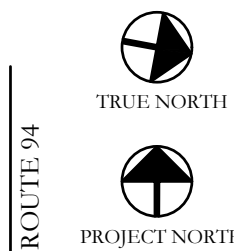
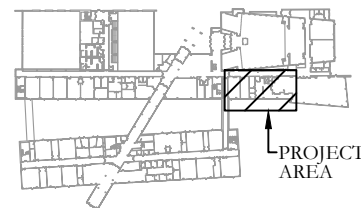
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MD.202

Main Level Mechanical Demolition Plan

Scale: 1/4" = 1'-0"

KEY PLAN:

'CORNWALL CENTRAL  
HIGH SCHOOL'

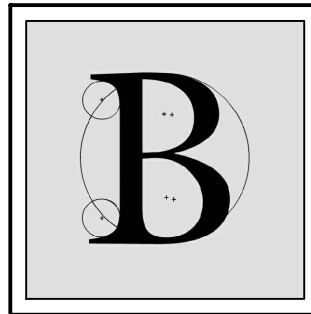


PROJECT:

CORNWALL CENTRAL  
HIGH SCHOOL  
COOLING TOWER  
REPLACEMENT PROJECT  
10 DRAGON DRIVE  
NEW WINDSOR, NEW YORK 12553  
SED #:44-03-01-06-0-012-008

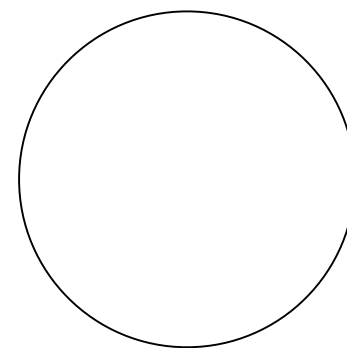
SUB-CONSULTANT:

ENGINEER:



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MAIN LEVEL MECHANICAL  
DEMOLITION PLAN

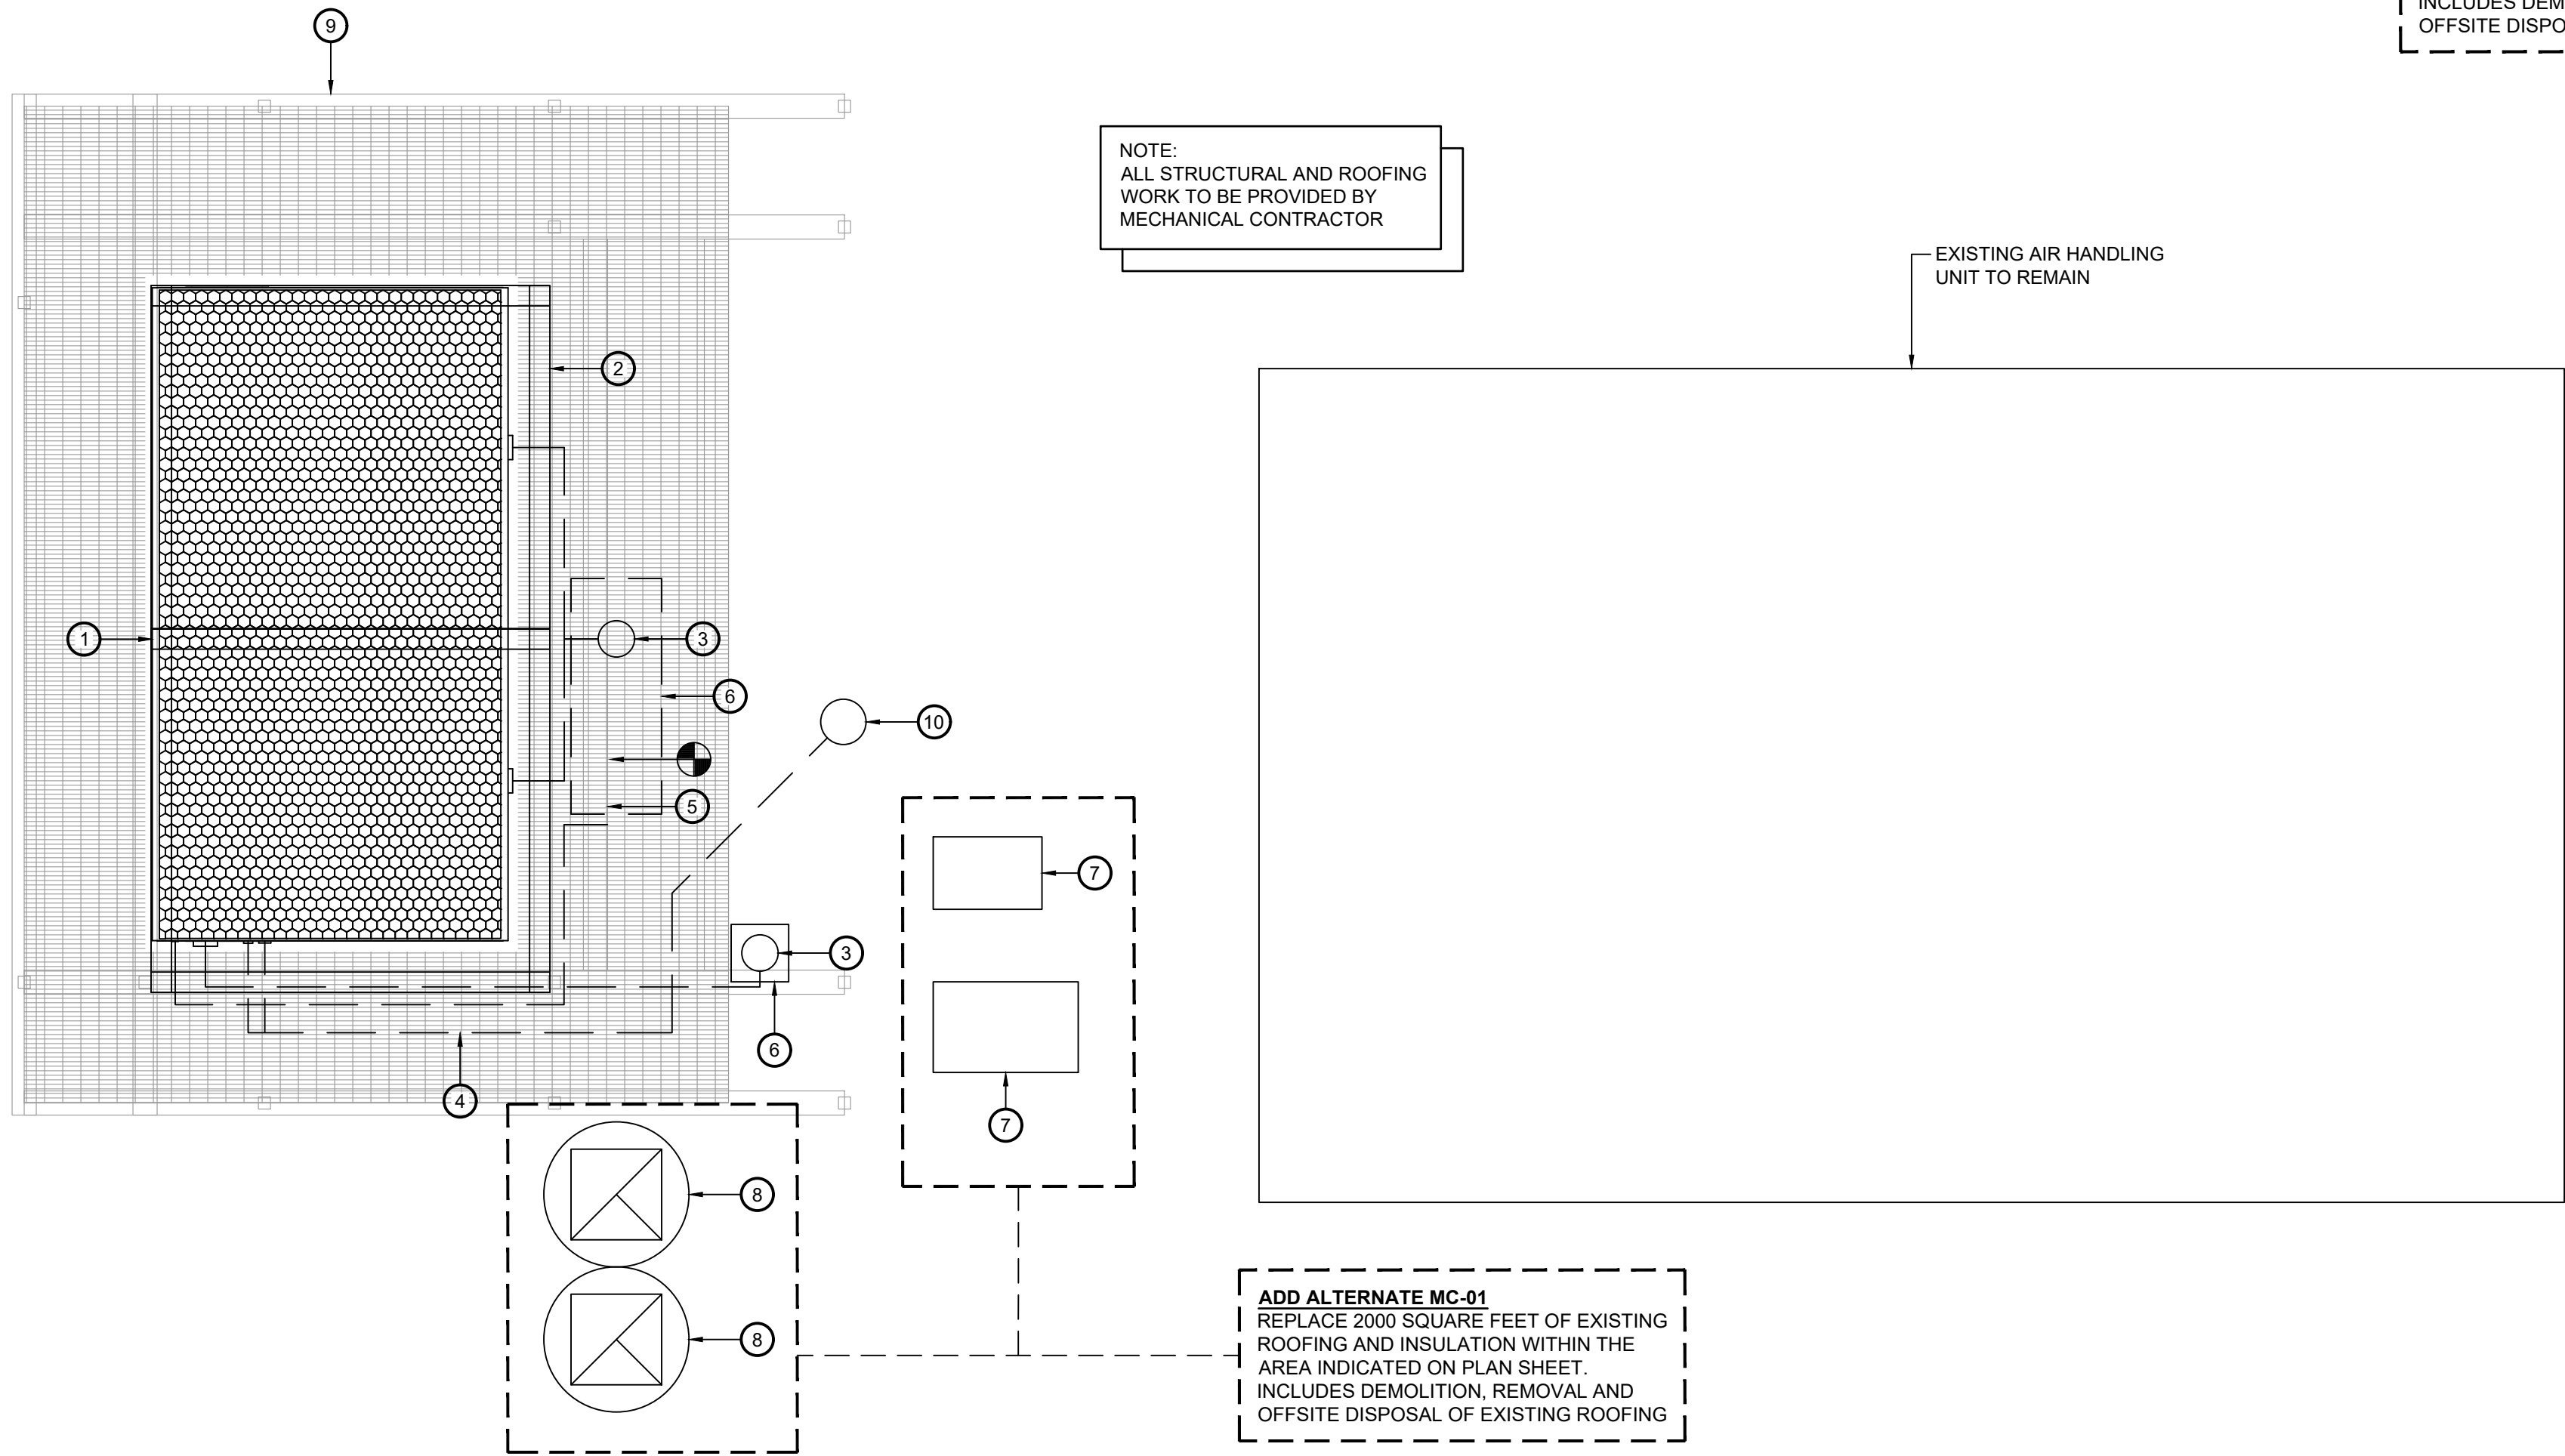
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REV.	DATE:	DRN	CHK	DESCRIPTION

PROJECT NO.	SHEET NO.
2149	MD.202

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Key Notes:

- 1 DISCONNECT, REMOVE & PROPERLY DISPOSE OF EXISTING EVAPORATIVE COOLING TOWER AND ALL ASSOCIATED COMPONENTS AND ACCESSORIES
- 2 EXISTING COOLING TOWER SUPPORT STRUCTURE TO REMAIN
- 3 DISCONNECT, REMOVE & PROPERLY DISPOSE OF ALL EXISTING CONDENSER WATER PIPING & ALL ASSOCIATED COMPONENTS & ACCESSORIES
- 4 DISCONNECT, REMOVE & PROPERLY DISPOSE OF ALL EXISTING DRAIN PIPING & ALL ASSOCIATED COMPONENTS & ACCESSORIES
- 5 DISCONNECT, REMOVE & PROPERLY DISPOSE OF EXISTING 1-1/2" COPPER MAKEUP WATER PIPING & ALL ASSOCIATED COMPONENTS & ACCESSORIES FROM COOLING TOWER TO BELOW ROOF; MAINTAIN WATER LINE BELOW ROOF FOR RECONNECTION TO NEW COOLING TOWER
- 6 DISCONNECT, REMOVE & PROPERLY DISPOSE OF EXISTING ROOF CURB; INFILL ROOF DECK W/ MATERIAL TO MATCH EXISTING DECK
- 7 EXISTING FREEZER/COOLER CONDENSING UNIT TO BE DISCONNECTED, REMOVED & STORED FOR REINSTALLATION; RECOVER REFRIGERANT & STORE UNTIL SYSTEM IS REINSTALLED; TEMPORARILY CAP PIPING; DISPOSE OF EXISTING WOOD BLOCKING; DEMOLISH EXISTING PITCH POCKETS; REFRIGERANT PIPING AND WIRING TO BE ROUTED THROUGH NEW PIPE PORTAL/ ROOF CURB
- 8 EXISTING EXHAUST FAN TO BE DISCONNECTED, REMOVED & STORED FOR REINSTALLATION; TEMPORARILY CAP DUCTWORK TO KEEP SYSTEM CLEAN UNTIL FAN IS REINSTALLED
- 9 EXISTING COOLING TOWER PLATFORM TO BE DISCONNECTED, REMOVED & PROPERLY DISPOSED OF; REMOVE ALL ASSOCIATED COMPONENTS INCLUDING BUT NOT LIMITED TO LADDER, GRATING, GUARDRAILS, & STRUCTURAL SUPPORTS (BEAMS, COLUMNS, CROSS BRACING, ETC.); REMOVE COLUMNS DOWN TO ROOF STRUCTURE
- 10 EXISTING ROOF DRAIN TO REMAIN; REPLACE DRAIN TOP GRATE W/ NEW

ADD ALTERNATE MC-01  
REPLACE 2000 SQUARE FEET OF EXISTING ROOFING AND INSULATION WITHIN THE AREA INDICATED ON PLAN SHEET.  
INCLUDES DEMOLITION, REMOVAL AND OFFSITE DISPOSAL OF EXISTING ROOFING

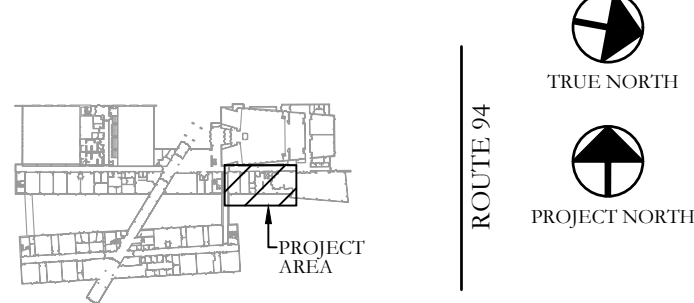
NOTE:  
ALL STRUCTURAL AND ROOFING WORK TO BE PROVIDED BY MECHANICAL CONTRACTOR

EXISTING AIR HANDLING UNIT TO REMAIN

ADD ALTERNATE MC-01  
REPLACE 2000 SQUARE FEET OF EXISTING ROOFING AND INSULATION WITHIN THE AREA INDICATED ON PLAN SHEET.  
INCLUDES DEMOLITION, REMOVAL AND OFFSITE DISPOSAL OF EXISTING ROOFING

KEY PLAN:

'CORNWALL CENTRAL HIGH SCHOOL'

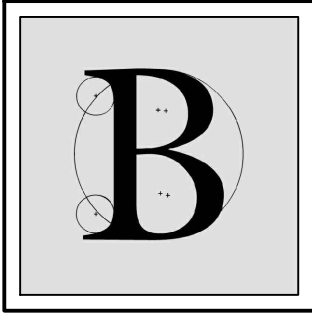


PROJECT:

CORNWALL CENTRAL HIGH SCHOOL  
COOLING TOWER REPLACEMENT PROJECT  
10 DRAGON DRIVE  
NEW WINDSOR, NEW YORK 12553  
SED #:44-03-01-06-0-012-008

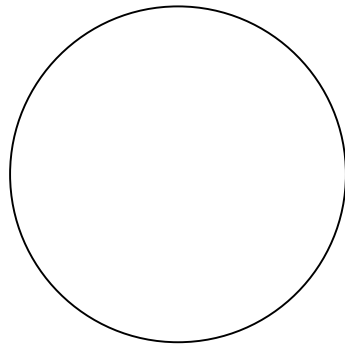
SUB-CONSULTANT:

ENGINEER:



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WESTTOWN, NEW YORK 10998  
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MATTHEW G. BLAKE, P.E., LEED AP  
NY - 89039 NJ - GE050037 PA - PE079303  
MA - 53197 CT - 32283 FL - 85928

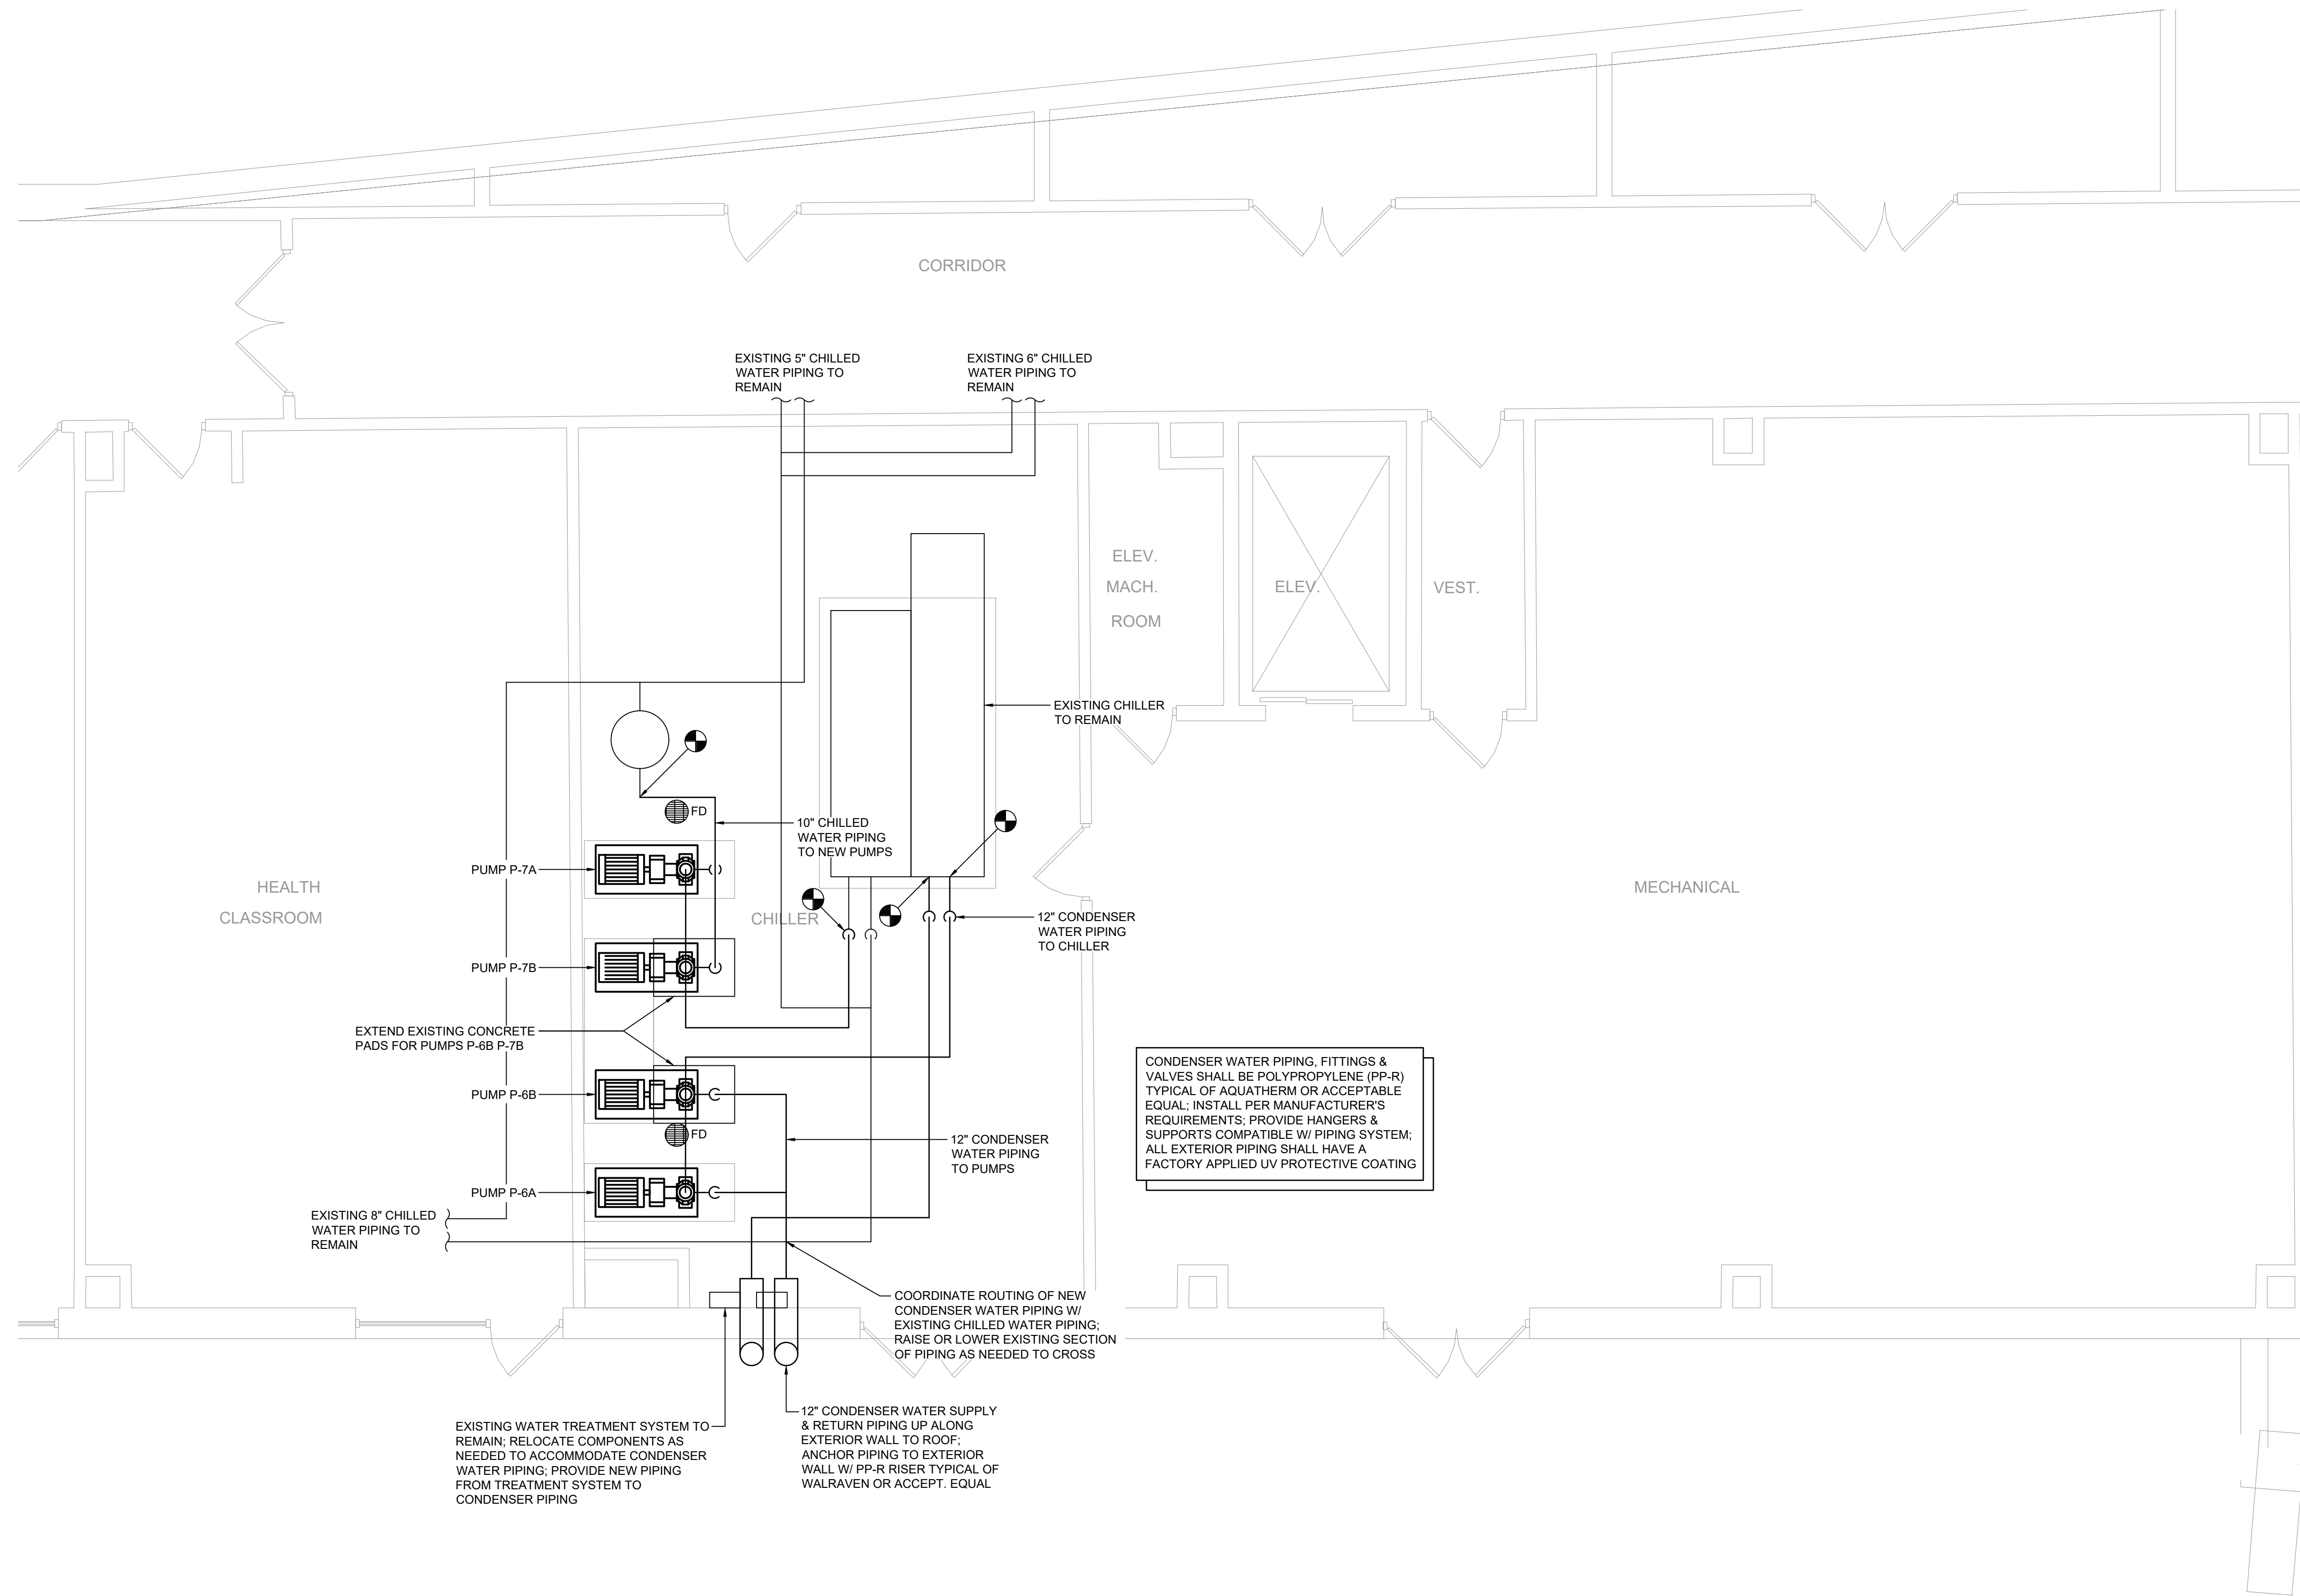
ROOF MECHANICAL DEMOLITION PLAN

DATE:		DRN	CHK	DESCRIPTION
05.27.2022		BJK	MGB	CONSTRUCTION SET
REV.	DATE:	DRN	CHK	DESCRIPTION

PROJECT NO.	SHEET NO.
2149	MD.203

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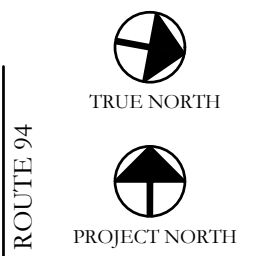
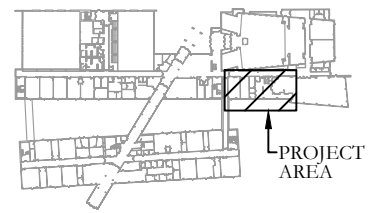
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1 Lower Level Mechanical Plan  
M.201 Scale: 1/4" = 1'-0"

KEY PLAN:

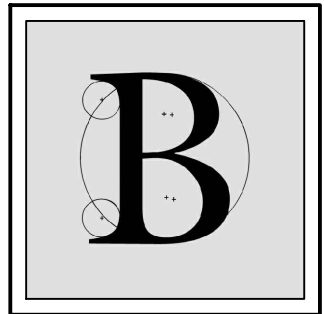
'CORNWALL CENTRAL  
HIGH SCHOOL'



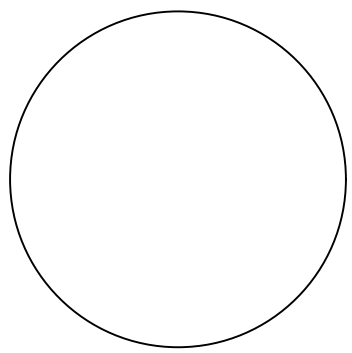
PROJECT:  
CORNWALL CENTRAL  
HIGH SCHOOL  
COOLING TOWER  
REPLACEMENT PROJECT  
10 DRAGON DRIVE  
NEW WINDSOR, NEW YORK 12553  
SED #:44-03-01-06-0-012-008

SUB-CONSULTANT:

ENGINEER:



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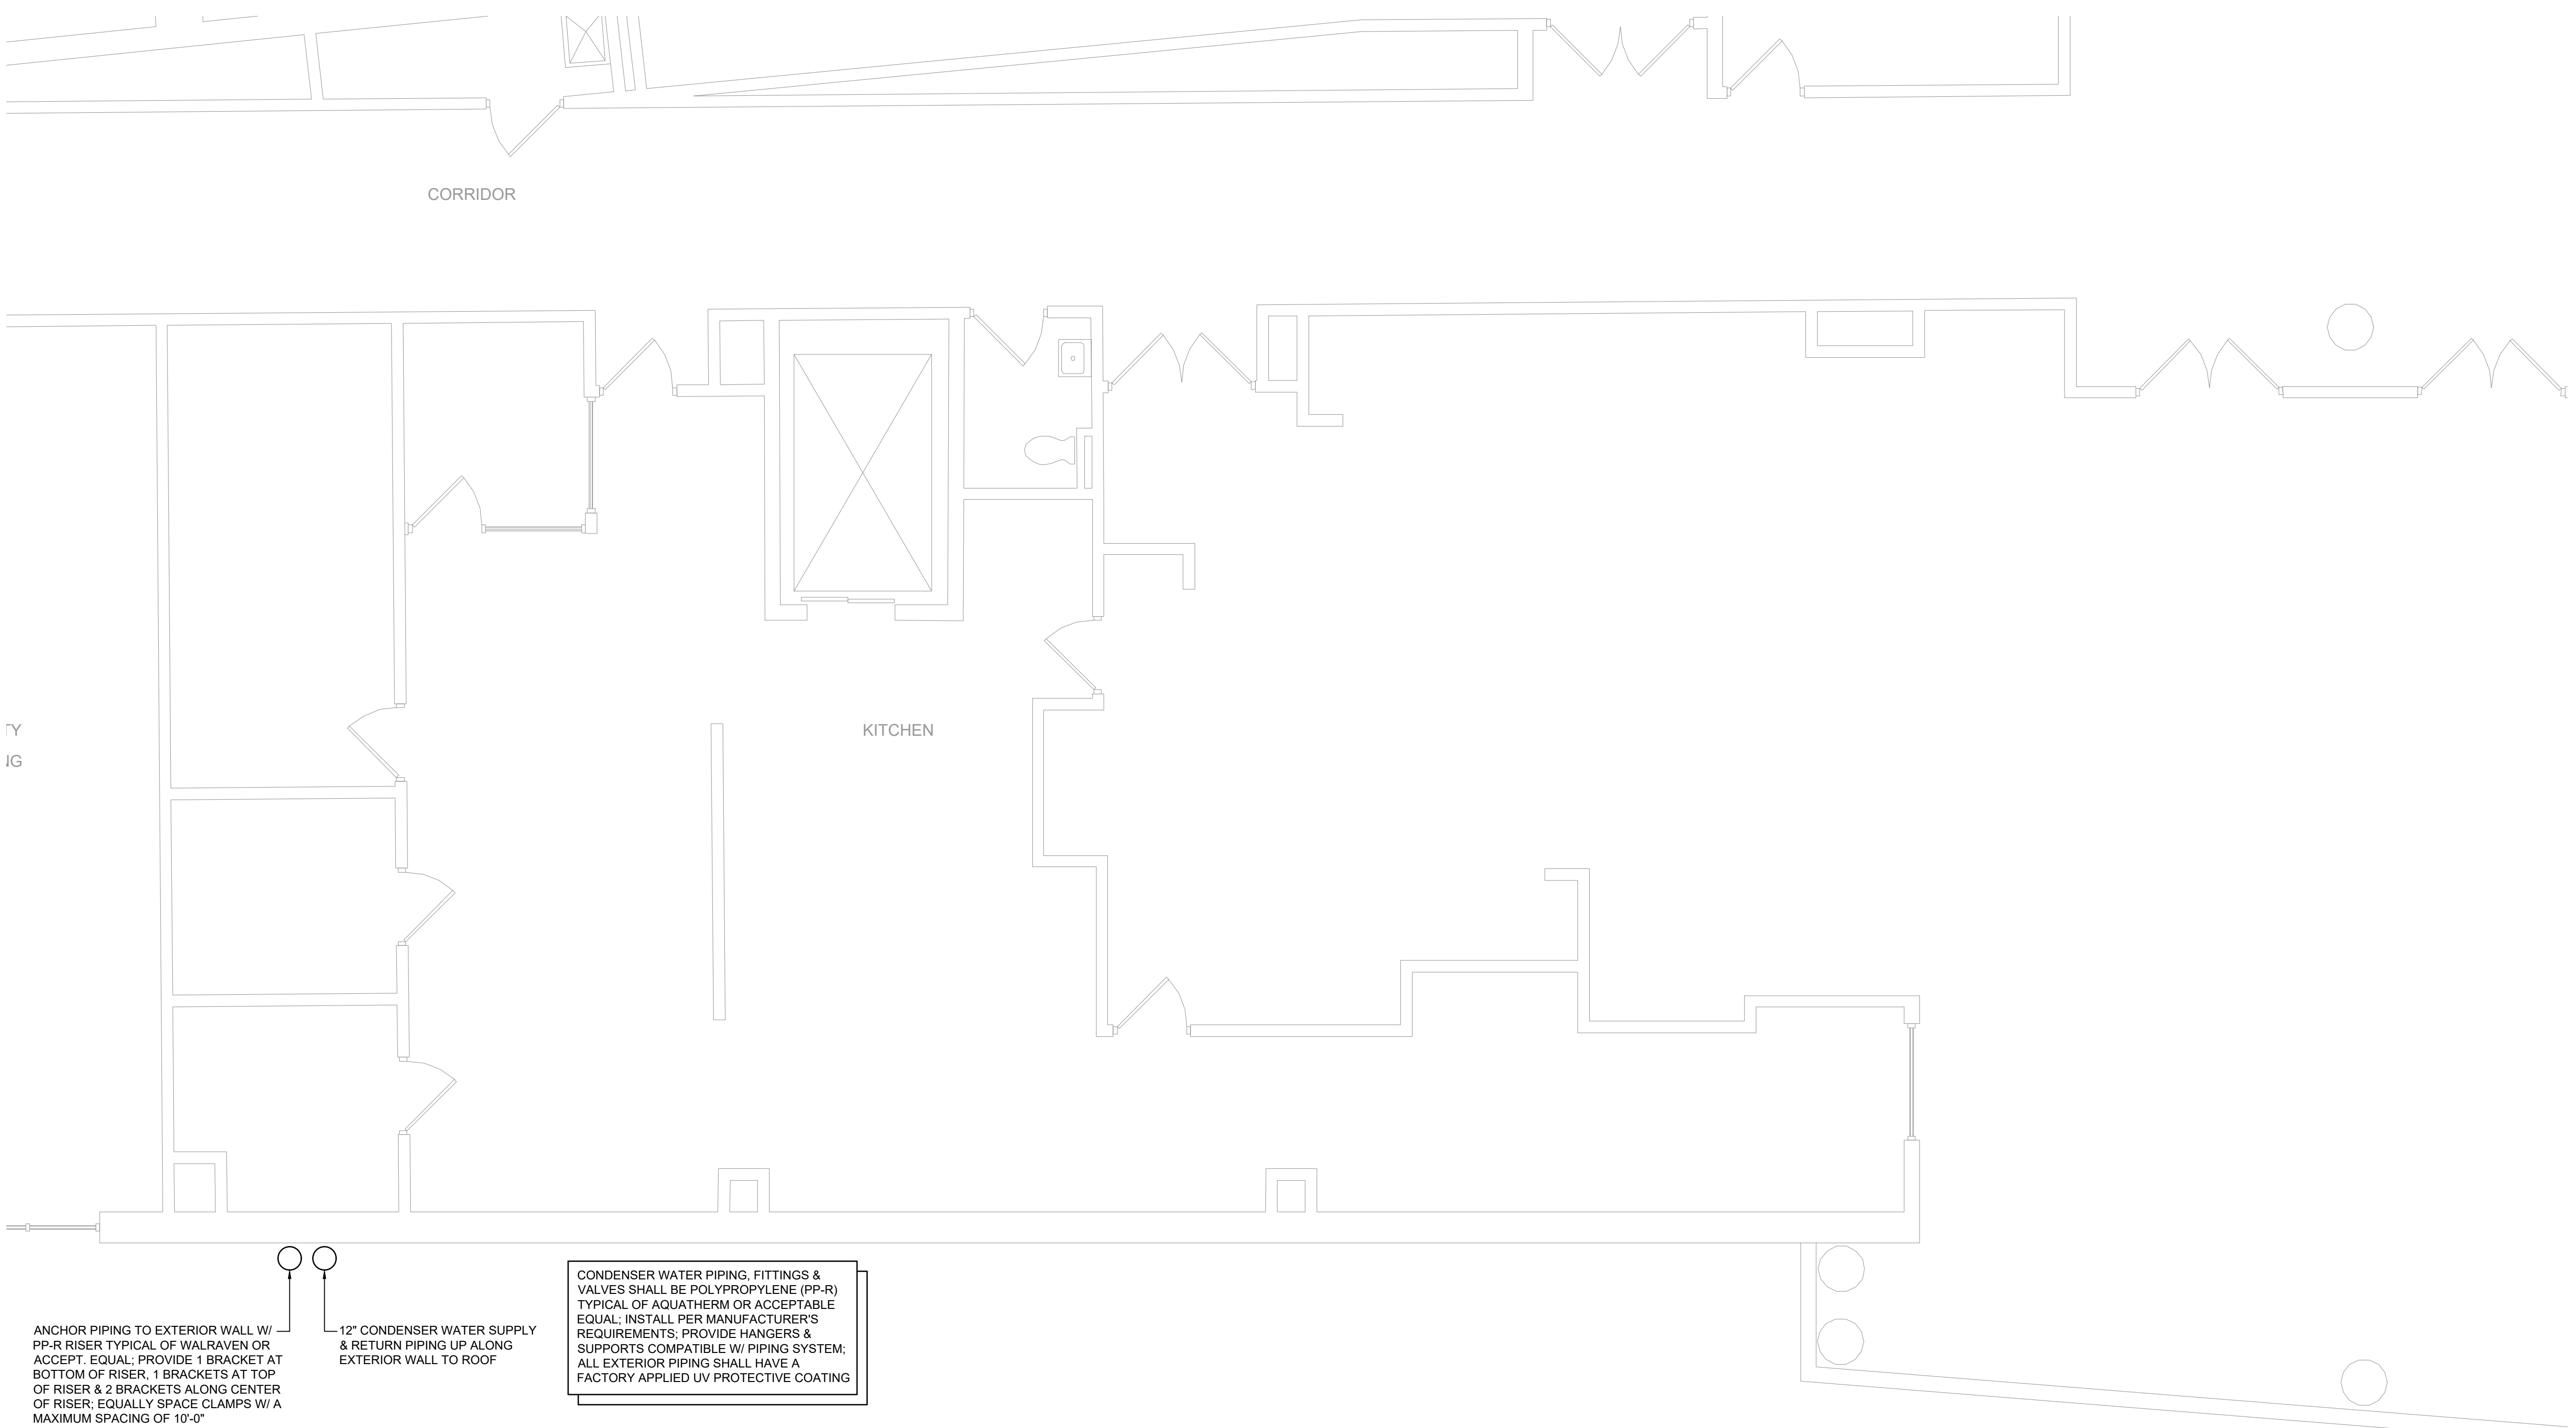
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MA - 53197 CT - 32283 FL - 85928

LOWER LEVEL  
MECHANICAL PLAN

DATE:		DRN	CHK	DESCRIPTION
05.27.2022		BJK	MGB	CONSTRUCTION SET
REV.	DATE:	DRN	CHK	DESCRIPTION

PROJECT NO.	SHEET NO.
2149	M.201

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ANCHOR PIPING TO EXTERIOR WALL W/ PP-R RISER TYPICAL OF WALRAVEN OR ACCEPT. EQUAL; PROVIDE 1 BRACKET AT BOTTOM OF RISER, 1 BRACKETS AT TOP OF RISER & 2 BRACKETS ALONG CENTER OF RISER; EQUALLY SPACE CLAMPS W/ A MAXIMUM SPACING OF 10'-0"

12" CONDENSER WATER SUPPLY & RETURN PIPING UP ALONG EXTERIOR WALL TO ROOF

CONDENSER WATER PIPING, FITTINGS & VALVES SHALL BE POLYPROPYLENE (PP-R) TYPICAL OF AQUATHERM OR ACCEPTABLE EQUAL; INSTALL PER MANUFACTURER'S REQUIREMENTS; PROVIDE HANGERS & SUPPORTS COMPATIBLE W/ PIPING SYSTEM; ALL EXTERIOR PIPING SHALL HAVE A FACTORY APPLIED UV PROTECTIVE COATING

1 Main Level Mechanical Plan  
M.202 Scale: 1/4" = 1'-0"

KEY PLAN:  
'CORNWALL CENTRAL HIGH SCHOOL'

ROUTE 94  
TRUE NORTH  
PROJECT NORTH

PROJECT:  
CORNWALL CENTRAL HIGH SCHOOL  
COOLING TOWER REPLACEMENT PROJECT  
10 DRAGON DRIVE  
NEW WINDSOR, NEW YORK 12553  
SED #:44-03-01-06-0-012-008

SUB-CONSULTANT:

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MAIN LEVEL MECHANICAL PLAN

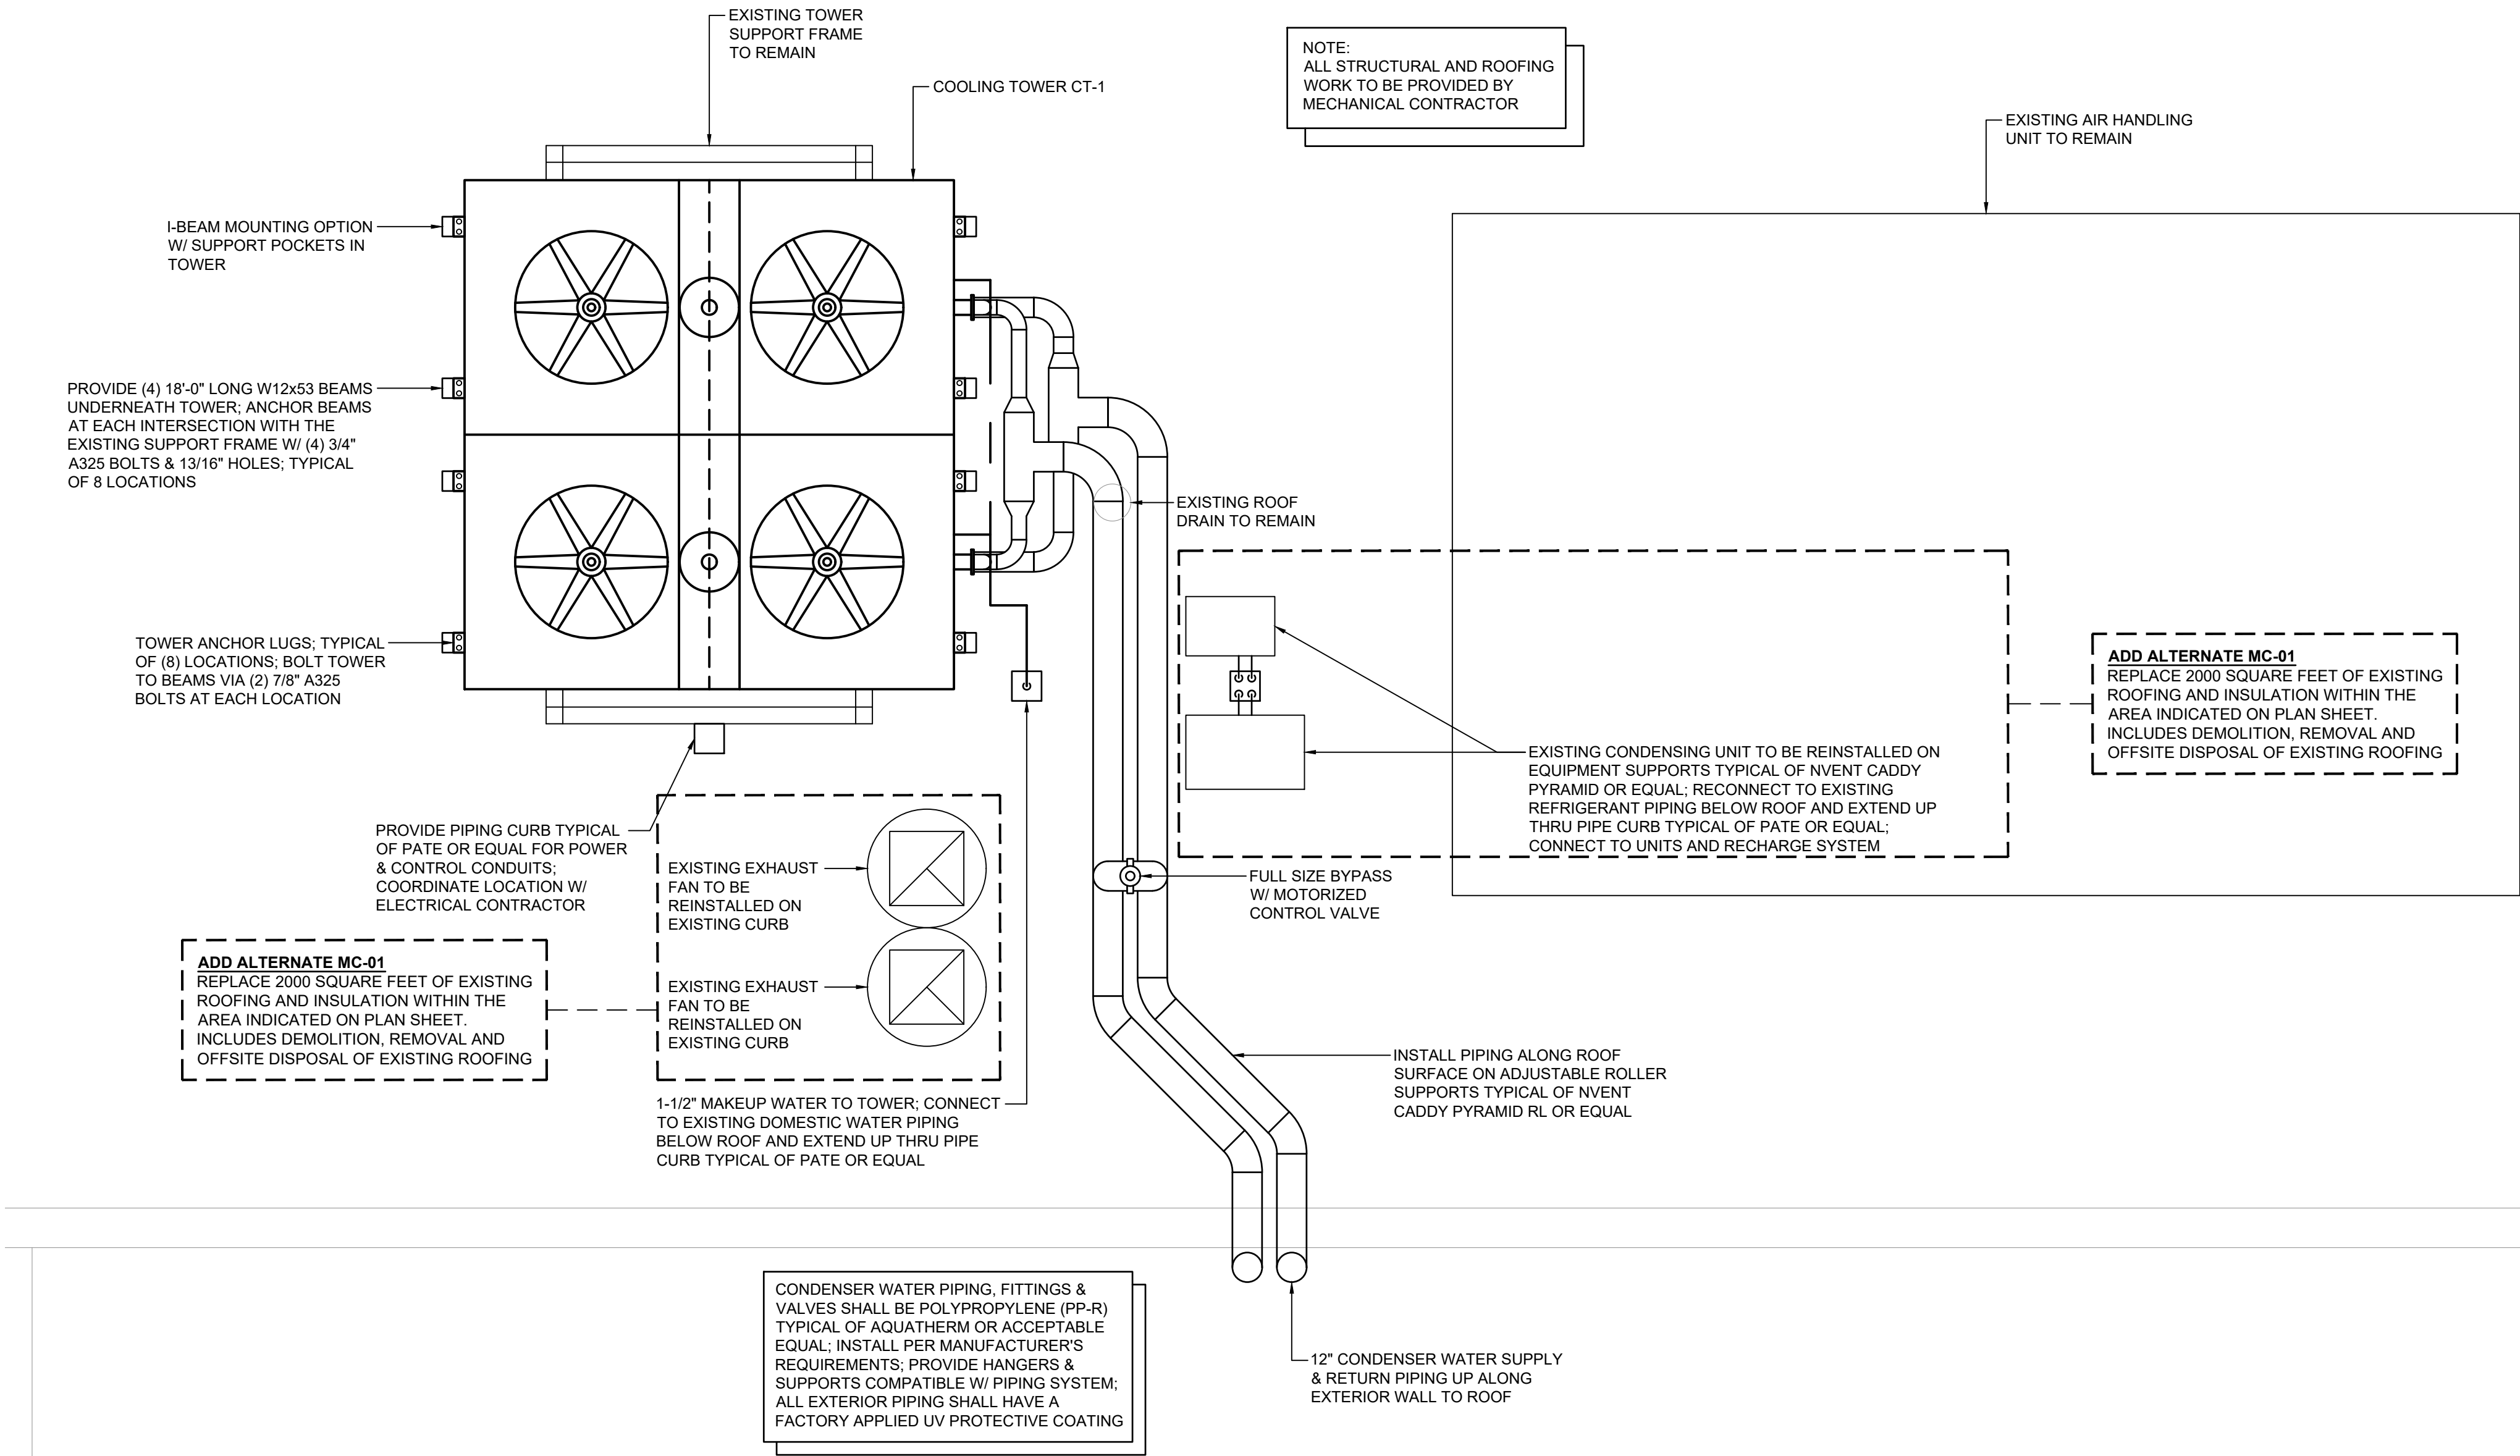
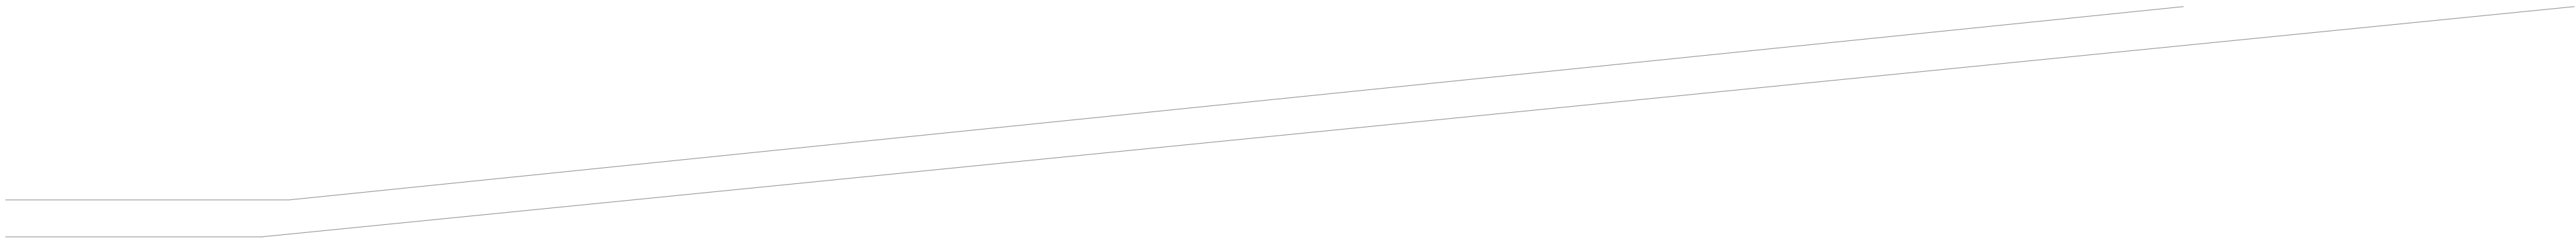
DATE:	DRN	CHK	DESCRIPTION	
05.27.2022	BJK	MGB	CONSTRUCTION SET	
REV.	DATE	DRN	CHK	DESCRIPTION

PROJECT NO.  
2149

SHEET NO.  
M.202

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1  
M.203

Roof Mechanical Plan

Scale: 1/4" = 1'-0"

- Drawing Notes:
- THE EXISTING COOLING TOWER SUPPORT FRAME HAS BEEN ANALYZED AND IT IS STRUCTURALLY ADEQUATE TO SUPPORT THE PROPOSED COOLING TOWER.
  - THE EXISTING ROOF STRUCTURE AND SUPPORTING FRAME DOWN TO THE FOUNDATION HAS BEEN ANALYZED AND IT IS STRUCTURALLY ADEQUATE TO SUPPORT THE PROPOSED COOLING TOWER.
  - THE PROPOSED COOLING TOWER MEETS THE REQUIREMENTS OF THE 2020 ECCCNYS SECTION C403.9.

KEY PLAN:

'CORNWALL CENTRAL HIGH SCHOOL'

ROUTE 94

TRUE NORTH

PROJECT NORTH

PROJECT:

CORNWALL CENTRAL HIGH SCHOOL COOLING TOWER REPLACEMENT PROJECT

10 DRAGON DRIVE  
NEW WINDSOR, NEW YORK 12553  
SED #:44-03-01-06-0-012-008

SUB-CONSULTANT:

ENGINEER:

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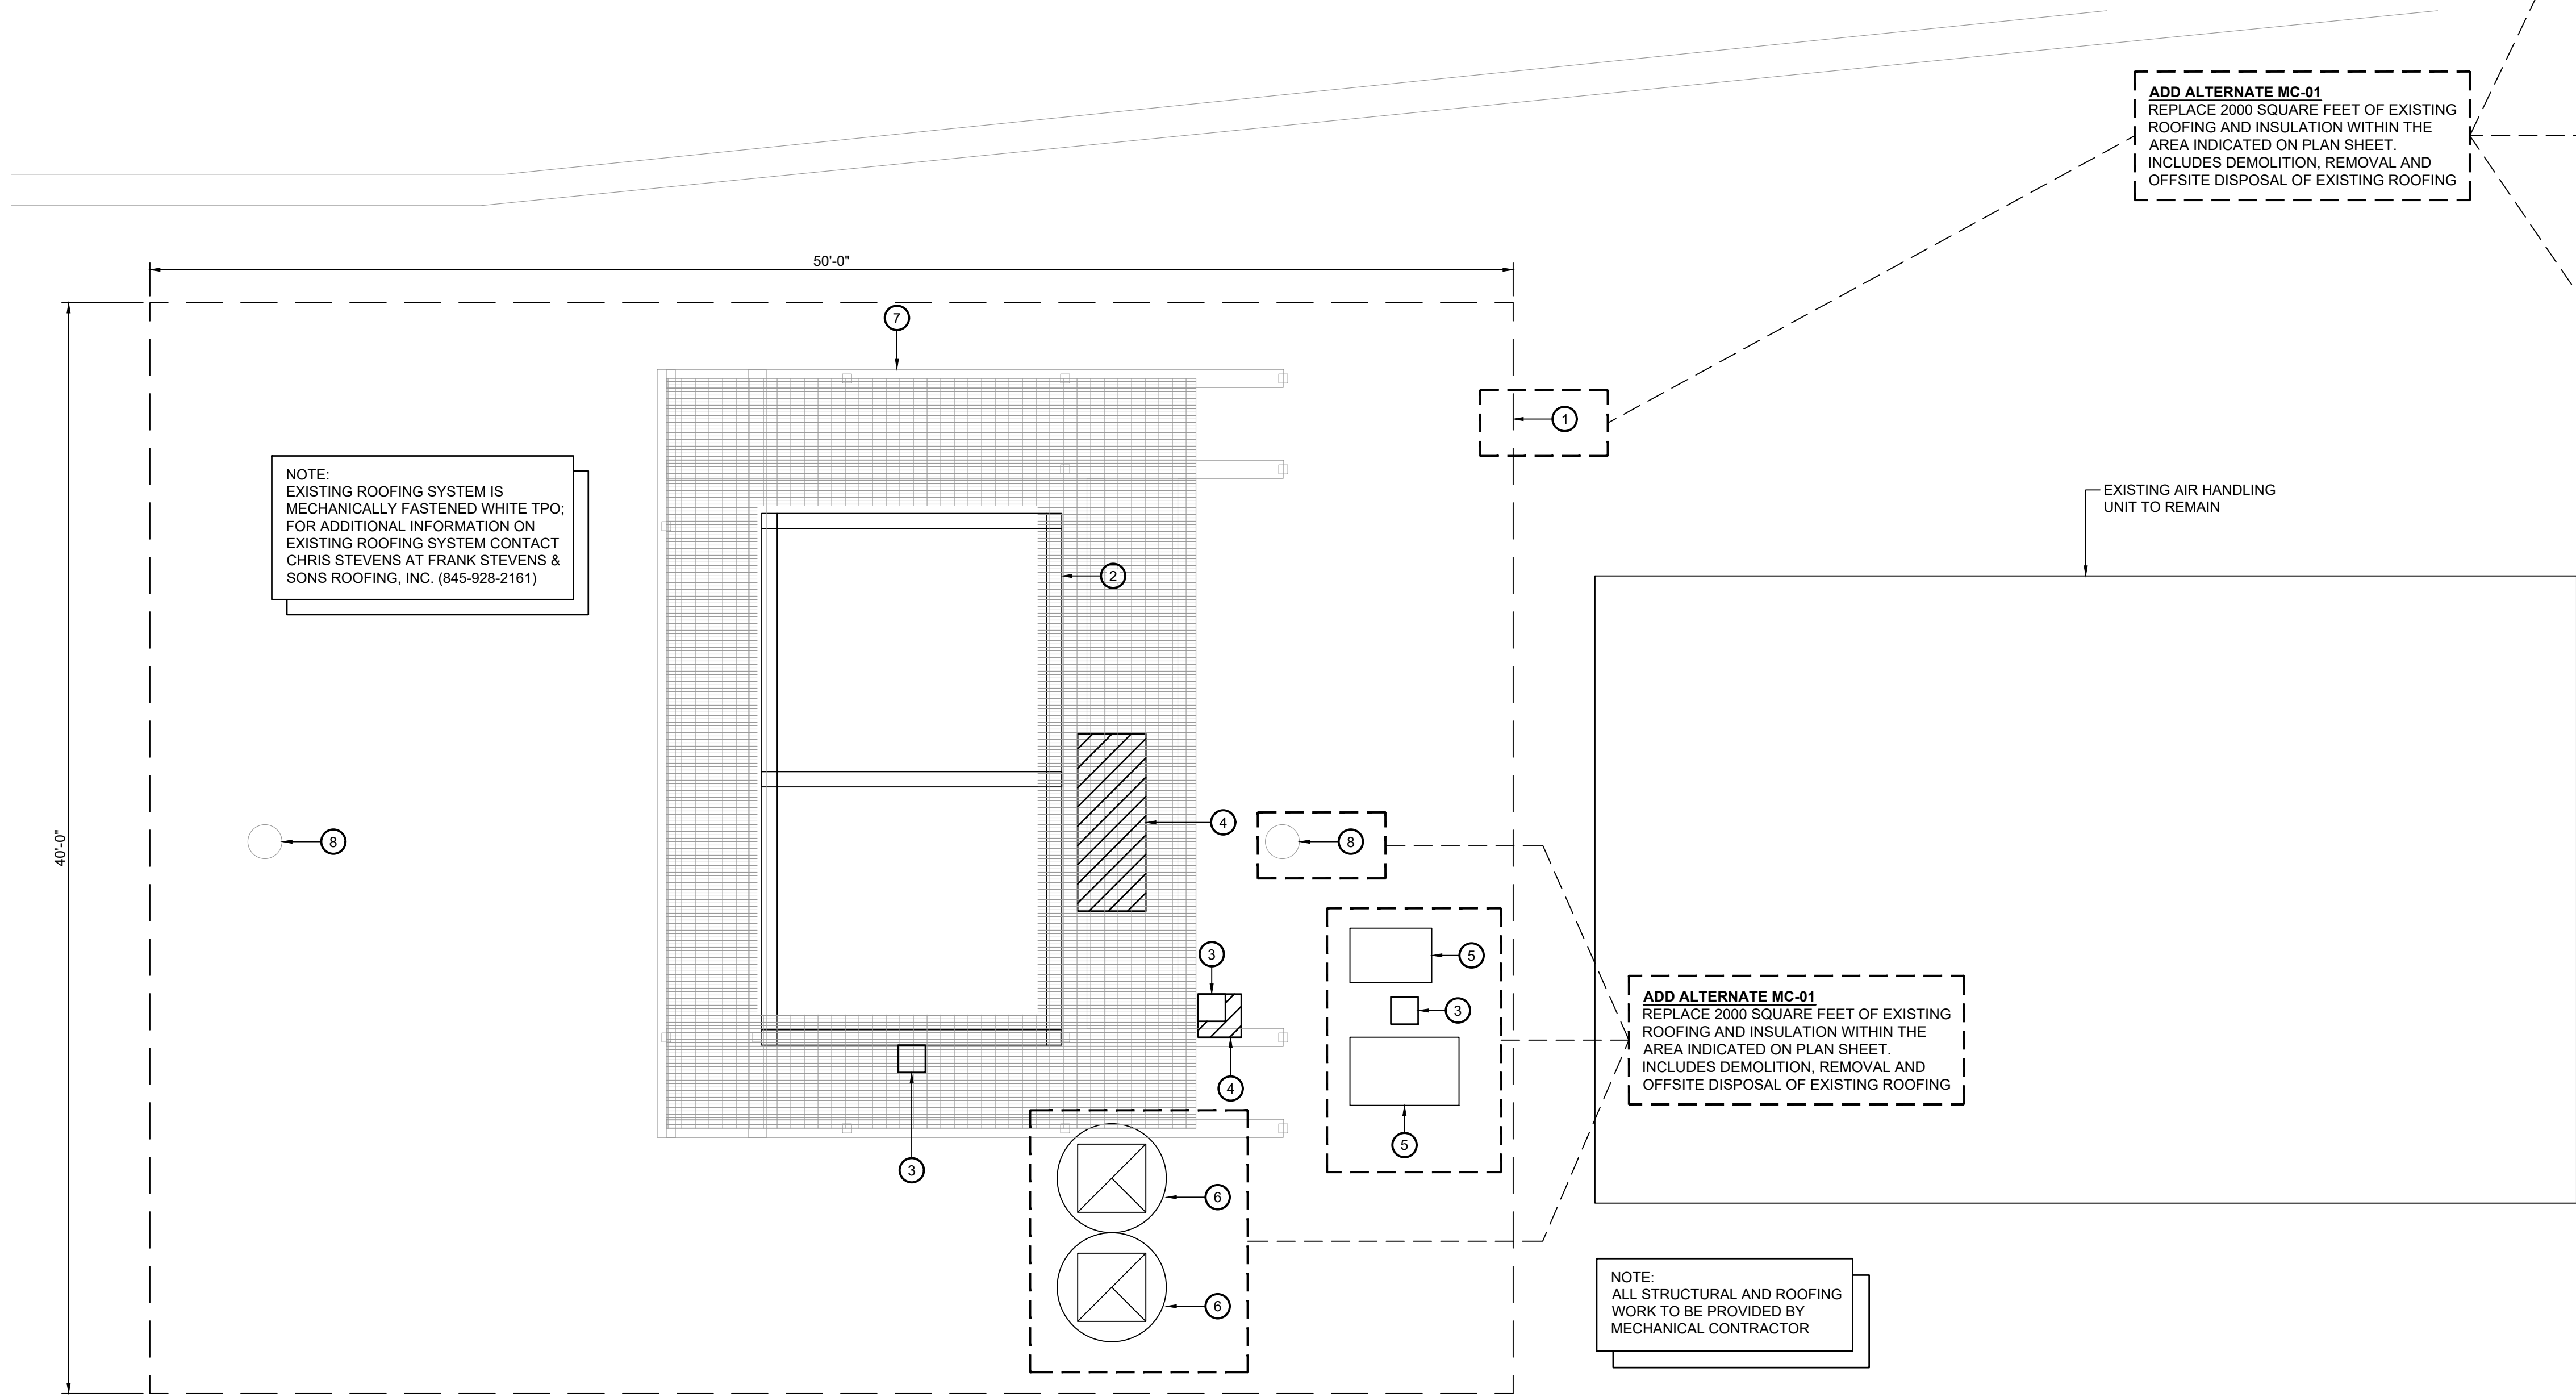
ROOF MECHANICAL PLAN

DATE:		DRN	CHK	DESCRIPTION
05.27.2022		BJK	MGB	CONSTRUCTION SET
REV.	DATE:	DRN	CHK	DESCRIPTION

PROJECT NO.	SHEET NO.
2149	M.203

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Key Notes:

- 1 REPLACE EXISTING ROOF AND ALL INSULATION WITHIN AREA INDICATED; MATCH EXISTING ROOFING SYSTEM AND INSULATION TYPE AND THICKNESS; MATCH EXISTING INSULATION TAPER TO MAINTAIN EXISTING DRAINAGE PATTERN
- 2 EXISTING COOLING TOWER SUPPORT STRUCTURE TO REMAIN, PROVIDE FLASHING AT STRUCTURAL SUPPORTS THRU ROOF
- 3 PIPING/CONDUIT CURB; FLASH INTO ROOF SYSTEM
- 4 DISCONNECT, REMOVE & PROPERLY DISPOSE OF EXISTING ROOF CURB; INFILL ROOF DECK W/ MATERIAL TO MATCH EXISTING DECK
- 5 EXISTING CONDENSING UNIT TO BE TEMPORARILY REMOVED AND REINSTALLED ON ROOF SUPPORT MTD. ON TOP OF ROOF SURFACE
- 6 EXISTING EXHAUST FAN TO BE TEMPORARILY REMOVED AND REINSTALLED; FLASH NEW ROOFING SYSTEM INTO EXISTING CURB
- 7 EXISTING COOLING TOWER MAINTENANCE PLATFORM TO BE DISCONNECTED, REMOVED; PATCH OVER WHERE STRUCTURAL SUPPORTS WERE REMOVED FROM ROOF
- 8 EXISTING ROOF DRAIN TO REMAIN; CONNECT NEW ROOFING SYSTEM INTO EXISTING DRAIN AND REPLACE DRAIN TOP GRATE W/ NEW

ADD ALTERNATE MC-01  
REPLACE 2000 SQUARE FEET OF EXISTING ROOFING AND INSULATION WITHIN THE AREA INDICATED ON PLAN SHEET. INCLUDES DEMOLITION, REMOVAL AND OFFSITE DISPOSAL OF EXISTING ROOFING

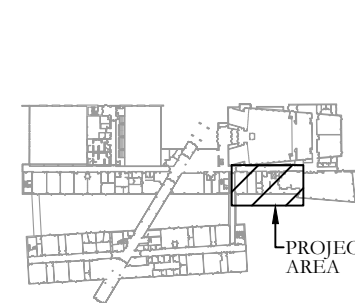
ADD ALTERNATE MC-01  
REPLACE 2000 SQUARE FEET OF EXISTING ROOFING AND INSULATION WITHIN THE AREA INDICATED ON PLAN SHEET. INCLUDES DEMOLITION, REMOVAL AND OFFSITE DISPOSAL OF EXISTING ROOFING

NOTE:  
ALL STRUCTURAL AND ROOFING WORK TO BE PROVIDED BY MECHANICAL CONTRACTOR

NOTE:  
EXISTING ROOFING SYSTEM IS MECHANICALLY FASTENED WHITE TPO; FOR ADDITIONAL INFORMATION ON EXISTING ROOFING SYSTEM CONTACT CHRIS STEVENS AT FRANK STEVENS & SONS ROOFING, INC. (845-928-2161)

KEY PLAN:

'CORNWALL CENTRAL  
HIGH SCHOOL'

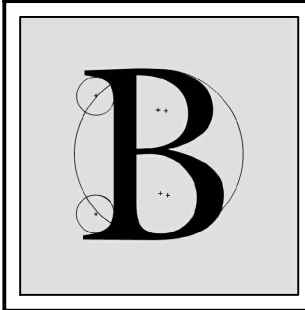


PROJECT:

CORNWALL CENTRAL  
HIGH SCHOOL  
COOLING TOWER  
REPLACEMENT PROJECT  
10 DRAGON DRIVE  
NEW WINDSOR, NEW YORK 12553  
SED #:44-03-01-06-0-012-008

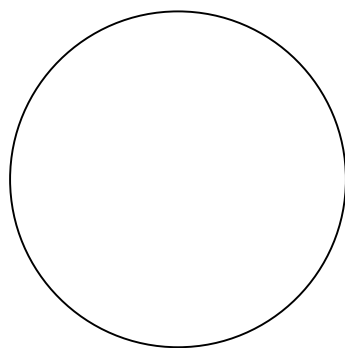
SUB-CONSULTANT:

ENGINEER:



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MA - 53197 CT - 32283 FL - 85928

ROOF REPLACEMENT PLAN

DATE:		DRN	CHK	DESCRIPTION
05.27.2022		BJK	MGB	CONSTRUCTION SET
REV.	DATE:	DRN	CHK	DESCRIPTION

PROJECT NO.

2149

SHEET NO.

M.204

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1  
M.204

Roof Replacement Plan

Scale: 1/4" = 1'-0"

120/208V 3Ø 4W+G; 65KAIC RATING				BUS RATING: 250A				MLO			
CONNECTED LOAD	CONDUCTORS	CKT. BREAKER AMPACITY	POSITION	L1 KVA	L2 KVA	L3 KVA	POSITION	CKT. BREAKER AMPACITY	CONDUCTORS	CONNECTED LOAD	
PUMP P-6A	(3) #4 CU & (1) #8 GND.	70	1 3 5 7	- - - -	- - - -	- - - -	2 4 6 8	70	(3) #4 CU & (1) #8 GND.	PUMP P-6B	
PUMP P-7A	(3) #4 CU & (1) #8 GND.	70	9 11	- -	- -	- -	10 12	70	(3) #4 CU & (1) #8 GND.	PUMP P-7B	
SPACE	-	-	13	-	-	-	14	-	-	SPACE	
SPACE	-	-	15	-	-	-	16	-	-	SPACE	
SPACE	-	-	17	-	-	-	18	-	-	SPACE	
SPACE	-	-	19	-	-	-	20	-	-	SPACE	
SPACE	-	-	21	-	-	-	22	-	-	SPACE	
SPACE	-	-	23	-	-	-	24	-	-	SPACE	
SPACE	-	-	19	-	-	-	20	-	-	SPACE	
SPACE	-	-	21	-	-	-	22	-	-	SPACE	
SPACE	-	-	23	-	-	-	24	-	-	SPACE	
SQUARE 'D' NF PANELBOARD W/ BOLT ON BREAKERS				-	-	-	- KVA TOTAL				

1  
E.101

New Panelboard BMLNH-3

Scale: None

277/480V 3Ø 4W+G				BUS RATING: 400A				MLO			
CONNECTED LOAD	CONDUCTORS	CKT. BREAKER AMPACITY	POSITION	L1 KVA	L2 KVA	L3 KVA	POSITION	CKT. BREAKER AMPACITY	CONDUCTORS	CONNECTED LOAD	
SPARE	-	125	1 3 5	- - -	- - -	- - -	2 4 6	125	EXISTING	EXISTING AHU 1A & 1B	
SPARE	-	100	7 9 11	- - -	- - -	- - -	8 10 12	20	EXISTING	EXISTING EF-28	
EXISTING AHU-5	EXISTING	40	13 15 17	- - -	- - -	- - -	14 16 18	20	EXISTING	EXISTING EF-27	
COOLING TOWER	(3) #10 CU & (1) #10 GND.	30	19 21 23	- - -	- - -	- - -	20 22 24	-	-	BLANK	
BLANK	-	-	25	-	-	-	26	-	-	BLANK	
BLANK	-	-	27	-	-	-	28	-	-	BLANK	
BLANK	-	-	29	-	-	-	30	-	-	BLANK	
BLANK	-	-	31	-	-	-	32	-	-	BLANK	
BLANK	-	-	33	-	-	-	34	-	-	BLANK	
BLANK	-	-	35	-	-	-	36	-	-	BLANK	
BLANK	-	-	37	-	-	-	38	-	-	BLANK	
BLANK	-	-	39	-	-	-	40	-	-	BLANK	
BLANK	-	-	41	-	-	-	42	-	-	BLANK	
SQUARE D NF PANEL				-	-	-	- KVA TOTAL				

- PROVIDE NEW CIRCUIT BREAKERS FOR ALL NEW OR MODIFIED CIRCUITS; BREAKERS SHALL MATCH EXISTING TYPE AND RATING
- PANEL SCHEDULE SHOWN BASED ON EXISTING DIRECTORY; CONTRACTOR SHALL VERIFY IN FIELD & ADJUST CIRCUIT LAYOUT AS NEEDED BASED ON AVAILABLE POSITIONS

2  
E.101

Existing Panelboard BFLNH2

Scale: None

DISCONNECT, REMOVE & DISPOSE  
OF EXISTING CIRCUITS TO EXISTING  
COOLING TOWER; MAINTAIN  
EXISTING BREAKERS AS SPARES

ELECTRICAL LEGEND:

	MOTOR
	EARTH GROUND
	JUNCTION BOX
	PULL BOX
	FUSE WITH RATING
	MOLDED CASE CIRCUIT BREAKER
	DISCONNECT SWITCH, FUSED
	DISCONNECT SWITCH, UNFUSED
	STARTER, COMBINATION WITH DISCONNECT SWITCH
	STARTER OR MOTOR CONTROLLER
	METER
	20A 120V DUPLEX CEILING MOUNTED RECEPTACLE
	20A 120V DUPLEX WALL MOUNTED RECEPTACLE; 18" A.F.F. UNLESS OTHERWISE NOTED
	20A 120V DUPLEX WALL MOUNTED RECEPTACLE WITH GROUND FAULT CIRCUIT INTERRUPTER
	20A 120V QUADRAPLEX RECEPTACLE
	WALL MOUNTED SPECIAL PURPOSE RECEPTACLE
	20A 120V WALL MOUNTED USB CHARGER RECEPTACLE TYPICAL OF HUBBELL USB20X OR ACCEPTABLE EQUAL
	FLOOR BOX WITH STAINLESS COVER TYPICAL OF LEW EECTRIC #OB-1-SP OR ACCEPTABLE EQUAL; PUSH BUTTON OPEN; FULLY IP66 RATED WATER PROOF (WHEN IN CLOSED POSITION); W/ 20A 125V E60120 GFCI RECEPTACLE (UNLESS OTHERWISE NOTED)
	WALL PHONE OUTLET MTD. 48" A.F.F.; 3/4" EMT CDT. IN WALL TO ABOVE CEILING W/ PULL CORD
	WALL BOX FOR TELEVISION CONNECTION; 1-1/4" EMT CDT. IN WALL TO ABOVE CEILING W/ PULL CORD
	TELEPHONE/DATA COMMUNICATION BOX W/ (2) 3/4" EMT CDT. IN WALL TO ABOVE CEILING W/ PULL CORD; NO FACE PLATE
	BRANCH CIRCUIT HOMERUN; LINES INDICATE NUMBER OF CIRCUITS, NEUTRAL, AND SWITCH LEG CONDUCTORS; ONE SEPARATE GROUNDING CONDUCTOR SHALL BE PROVIDED FOR EACH HOMERUN; NOT SHOWN
	SWITCH BLANK = SINGLE POLE 3 = THREE-WAY D = DIMMER P = WITH PILOT LIGHT T = TIMER OPERATED X = EXPLOSION PROOF
	DUAL TECHNOLOGY OCCUPANCY SENSOR
	DAYLIGHT SENSOR
	HORN/STROBE DEVICE, ONE ASSEMBLY; MTD. 80" A.F.F. UNLESS OTHERWISE NOTED; 15 CANDELA UNLESS OTHERWISE NOTED
	STROBE DEVICE; MTD. 80" A.F.F. UNLESS OTHERWISE NOTED; 15 CANDELA UNLESS OTHERWISE NOTED
	MANUAL PULL STATION; MTD. 48" A.F.F.
	WATER FLOW SWITCH
	VALVE TAMPER SWITCH
	DETECTOR; LETTER INDICATES AS FOLLOWS: BLANK = SMOKE DETECTOR P = PHOTOELECTRIC SMOKE M = MULTIPLE STATION SMOKE ALARM D = PHOTOELECTRIC DUCT SMOKE DETECTOR FSD = DUCT SMOKE DETECTOR FOR FIRE SMOKE DAMPER
	RATE OF RISE HEAT DETECTOR, 135°F
	CARBON MONOXIDE DETECTOR; MTD. 60" A.F.F.
	ADDRESSABLE FIRE ALARM CONTROL PANEL
	FIRE ALARM ANNUNCIATOR PANEL
	REMOTE TEST SWITCH & LED FOR DUCT SMOKE DETECTORS
	FIRE ALARM RELAY

ELECTRICAL NOTES:

- ALL MATERIALS AND EQUIPMENT ARE TO BE NEW, UNUSED, AND FREE FROM DEFECTS OF ANY KIND. THE BASIS OF QUALITY SHALL BE THE LATEST REVISION OF ASTM, ANSI, OR OTHER ACCEPTABLE STANDARDS.
- THESE DRAWINGS ARE DIAGRAMMATIC, AND INDICATE GENERAL ARRANGEMENT OF WORK. THE CONTRACTOR SHALL BE RESPONSIBLE TO HAVE REVIEWED THE SITE FOR HIS WORK PRIOR TO HAVING SUBMITTED HIS PROPOSAL. NO ADDITIONAL COMPENSATION WILL BE ALLOWED FOR CONDITIONS FOUND DURING THE COURSE OF THE CONTRACT.
- THE CONTRACTOR SHALL COORDINATE HIS WORK WITH THAT OF ALL OTHER TRADES.
- ALL WORK INCLUDING LABOR AND MATERIALS SHALL BE FULLY GUARANTEED FOR ONE (1) YEAR FROM THE DATE OF PAYMENT AND FINAL ACCEPTANCE BY THE OWNER AND ENGINEER.
- ALL CUTTING, PATCHING, FIRE-STOPPING, AND SURFACE RESTORATION IN CONNECTION WITH THIS TRADE SHALL BE COMPLETED BY THIS CONTRACTOR.
- A MINIMUM OF FOUR (4) COPIES OF SHOP DRAWINGS SHALL BE SUBMITTED TO THE ARCHITECT PRIOR TO ORDERING AND INSTALLATION OF THE EQUIPMENT AND/OR MATERIALS. BY SUBMITTING SHOP DRAWINGS, THE CONTRACTOR REPRESENTS THAT ACTUAL FIELD CONDITIONS ARE VERIFIED BY HIM AND ARE REFLECTED ON HIS SUBMITTALS.
- THIS CONTRACTOR SHALL PAY ALL FEES, GIVE ALL NOTICES, FILE ALL NECESSARY DRAWINGS, OBTAIN ALL PERMITS, INSPECTIONS, AND CERTIFICATES OF APPROVAL REQUIRED IN CONNECTION WITH WORK UNDER THIS CONTRACT.
- EQUIPMENT AND MATERIALS FOR WHICH UNDERWRITERS LABORATORIES INC. (UL) PROVIDES PRODUCT LISTING SERVICE SHALL BE LISTED AND BEAR THE LISTING MARK.
- ALL WORK IN ASSOCIATION WITH THIS CONTRACT SHALL BE COMPLETED IN STRICT COMPLIANCE WITH THE 2015 NATIONAL ELECTRIC CODE, 2020 BUILDING CODE OF NEW YORK STATE, 2020 FIRE CODE OF NEW YORK STATE & 2020 ENERGY CONSERVATION CONSTRUCTION CODE OF NEW YORK STATE.
- ALL NEW LIGHTING FIXTURES SHALL BE INSTALLED FULLY LAMPED AND OPERABLE. THE CONTRACTOR SHALL TURN OVER TO THE OWNER SPARE LAMPS OF EVERY TYPE ON THE PROJECT IN AN AMOUNT NOT LESS THAN 20% OF THE TOTAL NUMBER OF EACH TYPE (MINIMUM 1 PER TYPE).
- THIS CONTRACTOR SHALL BE RESPONSIBLE FOR ALL COORDINATION, APPLICATIONS AND FEES OF ALL WORK ASSOCIATED WITH THE LOCAL UTILITY COMPANY AND/OR THE TELEPHONE COMPANY. ALL WORK INVOLVING THE UTILITY COMPANY SHALL BE COMPLETED IN ACCORDANCE WITH THEIR REGULATIONS AND GUIDELINES.
- ALL CONDUCTORS SHALL BE COPPER, SHALL NOT BE LESS THAN #12 AWG, AND SHALL NOT EXCEED 70 FEET FROM PANEL BOARD TO FURTHEST CONNECTION UNLESS OTHERWISE NOTED ON PLANS.
- WIRING SHALL CONSIST OF METALLIC ARMORED CABLES (TYPE AC) INSTALLED WHERE CONCEALED IN FRAMED WALLS, CEILINGS, OR PERMITTED BY THE NEC. OTHER AREAS SHALL CONSIST OF INSULATED CONDUCTORS INSTALLED IN RIGID STEEL CONDUIT (RGS), ELECTRICAL METALLIC TUBING (EMT), INTERMEDIATE METAL CONDUIT (IMC), OR FLEXIBLE METALLIC ARMORED CABLE (GREENFIELD).
- LIGHTING LOADS SHALL NOT BE COMBINED ON THE SAME CIRCUIT AS ANY OTHER ELECTRICAL LOADS.
- CONTRACTOR SHALL BE RESPONSIBLE TO FURNISH & INSTALL ALL SMALL DETAILS AND INCIDENTAL WORK NOT SHOWN, BUT WHICH CAN BE REASONABLY INFERRED AS REQUIRED FOR A COMPLETE AND OPERATING SYSTEM OF HIGH QUALITY MEETING ALL APPLICABLE CODES AND REGULATIONS.
- FOR EACH NEW OR MODIFIED ELECTRICAL PANEL, THE CONTRACTOR SHALL PROVIDE A TYPE WRITTEN DIRECTORY CARD TO REFLECT ALL CIRCUITING. ADDITIONALLY, THE CONTRACTOR SHALL LABEL (WITH A PERMANENT MARKER OR LABEL) EACH RECEPTACLE ON THE INSIDE OF EACH FACE PLATE WITH PANEL AND CIRCUIT NUMBER DESIGNATION.
- MINIMUM REQUIREMENT FOR EQUIPMENT GROUNDING SHALL BE GOVERNED BY THE NEC. ALL GROUNDS, BONDING, ETC. SHALL MEET THESE REQUIREMENTS. THE CONTRACTOR SHALL FURNISH AND INSTALL ANY AND ALL ITEMS NECESSARY TO MEET THESE REQUIREMENTS AT NO EXTRA COST, EVEN IF SUCH ITEMS ARE NOT DETAILED ON THE DRAWINGS.
- ALL CONDUIT AND CABLE SHALL BE PROPERLY SUPPORTED AND ROUTED PARALLEL OR PERPENDICULAR TO BUILDING WALLS. THE CONTRACTOR SHALL FURNISH AND INSTALL ALL SUPPORT HANGERS AND MISCELLANEOUS METALS REQUIRED FOR PROPER INSTALLATION OF WORK.
- THE CONTRACTOR IS RESPONSIBLE TO TEST ALL EQUIPMENT, WIRING, DEVICES, AND SYSTEMS INSTALLED UNDER THIS CONTRACT TO ENSURE PROPER OPERATION PRIOR TO FINAL ACCEPTANCE BY THE OWNER AND ENGINEER.
- THE CONTRACTOR IS RESPONSIBLE TO DETERMINE WHETHER SPECIAL LICENSING IS REQUIRED IN ORDER TO PERFORM THE REQUIRED WORK IN THE MUNICIPALITY WHERE THE PROJECT IS LOCATED. IF THE CONTRACTOR CANNOT OBTAIN THE REQUIRED LICENSING TO COMPLETE THE WORK WITHIN THE PROJECT SCHEDULE, THEN THE CONTRACTOR SHALL NOT BE PERMITTED TO BID ON THIS PROJECT.

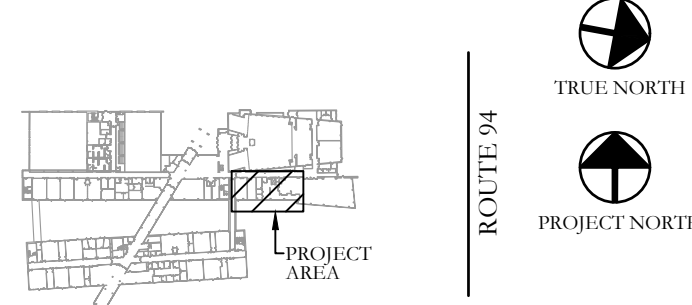
WIRE COLOR CODING TABLE

PHASE	WIRES	VOLTAGE	L1	L2	L3	NEUTRAL	GROUND
1	2 (1)	120	BLACK	-	-	WHITE	-
1	2 (1)	208	BLACK	RED	-	-	-
1	3	120	BLACK	-	-	WHITE	GREEN (2)
1	3	208	BLACK	RED	-	-	GREEN (2)
3	4	208	BLACK	RED	BLUE	-	GREEN (2)
3	5	208	BLACK	RED	BLUE	WHITE	GREEN (2)
1	3	277	BROWN	-	-	GRAY	GREEN (2)
1	3	277	BROWN	ORANGE	-	-	GREEN (2)
3	4	480	BROWN	ORANGE	YELLOW	-	GREEN (2)
3	5	480	BROWN	ORANGE	YELLOW	GRAY	GREEN (2)

- NOTES:
- FOR DOUBLE INSULATED EQUIPMENT ONLY.
  - GREEN/YELLOW MAY BE USED:
    - GREEN/YELLOW SHALL BE GREEN WITH ONE OR MORE YELLOW STRIPES.
    - GREEN = 50 TO 70%, YELLOW = 50 TO 30%.
    - GREEN/YELLOW IS THE ONLY COLOR INTERNATIONALLY ACCEPTED FOR USE AS AN EQUIPMENT GROUNDING CONDUCTOR.
    - GREEN OR GREEN/YELLOW MUST ONLY BE USED FOR GROUNDING CONDUCTORS.

KEY PLAN:

'CORNWALL CENTRAL  
HIGH SCHOOL'

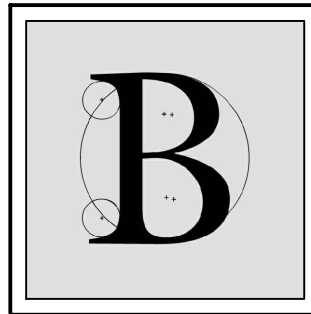


PROJECT:

CORNWALL CENTRAL  
HIGH SCHOOL  
COOLING TOWER  
REPLACEMENT PROJECT  
10 DRAGON DRIVE  
NEW WINDSOR, NEW YORK 12553  
SED #:44-03-01-06-0-012-008

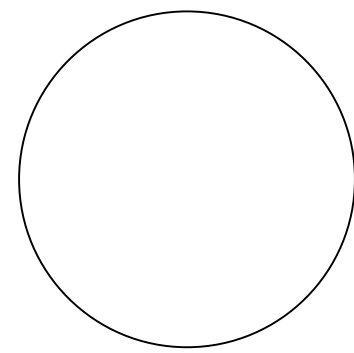
SUB-CONSULTANT:

ENGINEER:



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ELECTRICAL LEGEND,  
NOTES & PANEL SCHEDULE

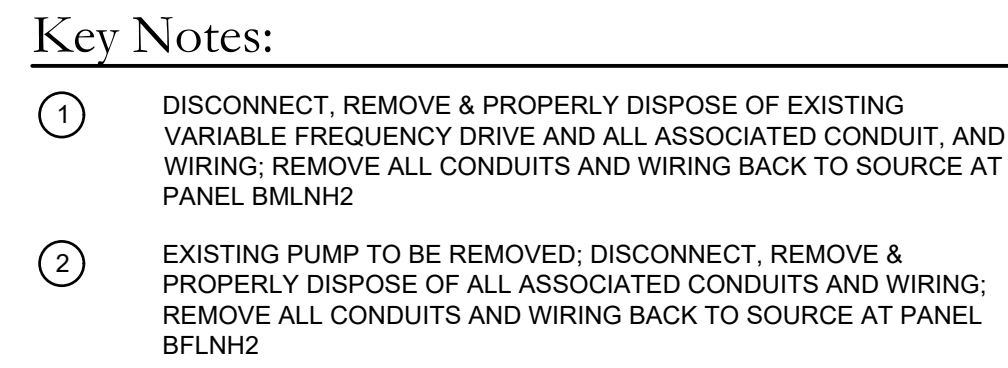
DATE:	DRN	CHK	DESCRIPTION
05.27.2022	BJK	MGB	CONSTRUCTION SET

REV.	DATE	DRN	CHK	DESCRIPTION

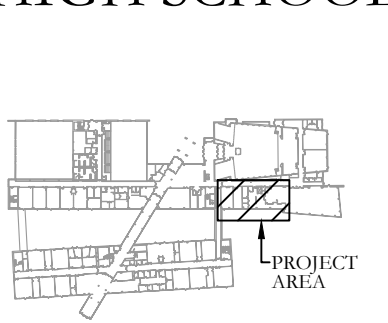
PROJECT NO.	SHEET NO.
2149	E.101

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'CORNWALL CENTRAL  
HIGH SCHOOL'



CORNWALL CENTRAL  
HIGH SCHOOL  
COOLING TOWER  
REPLACEMENT PROJECT  
10 DRAGON DRIVE  
NEW WINDSOR, NEW YORK 12553  
SED #:44-03-01-06-0-012-008

ENGINEER:

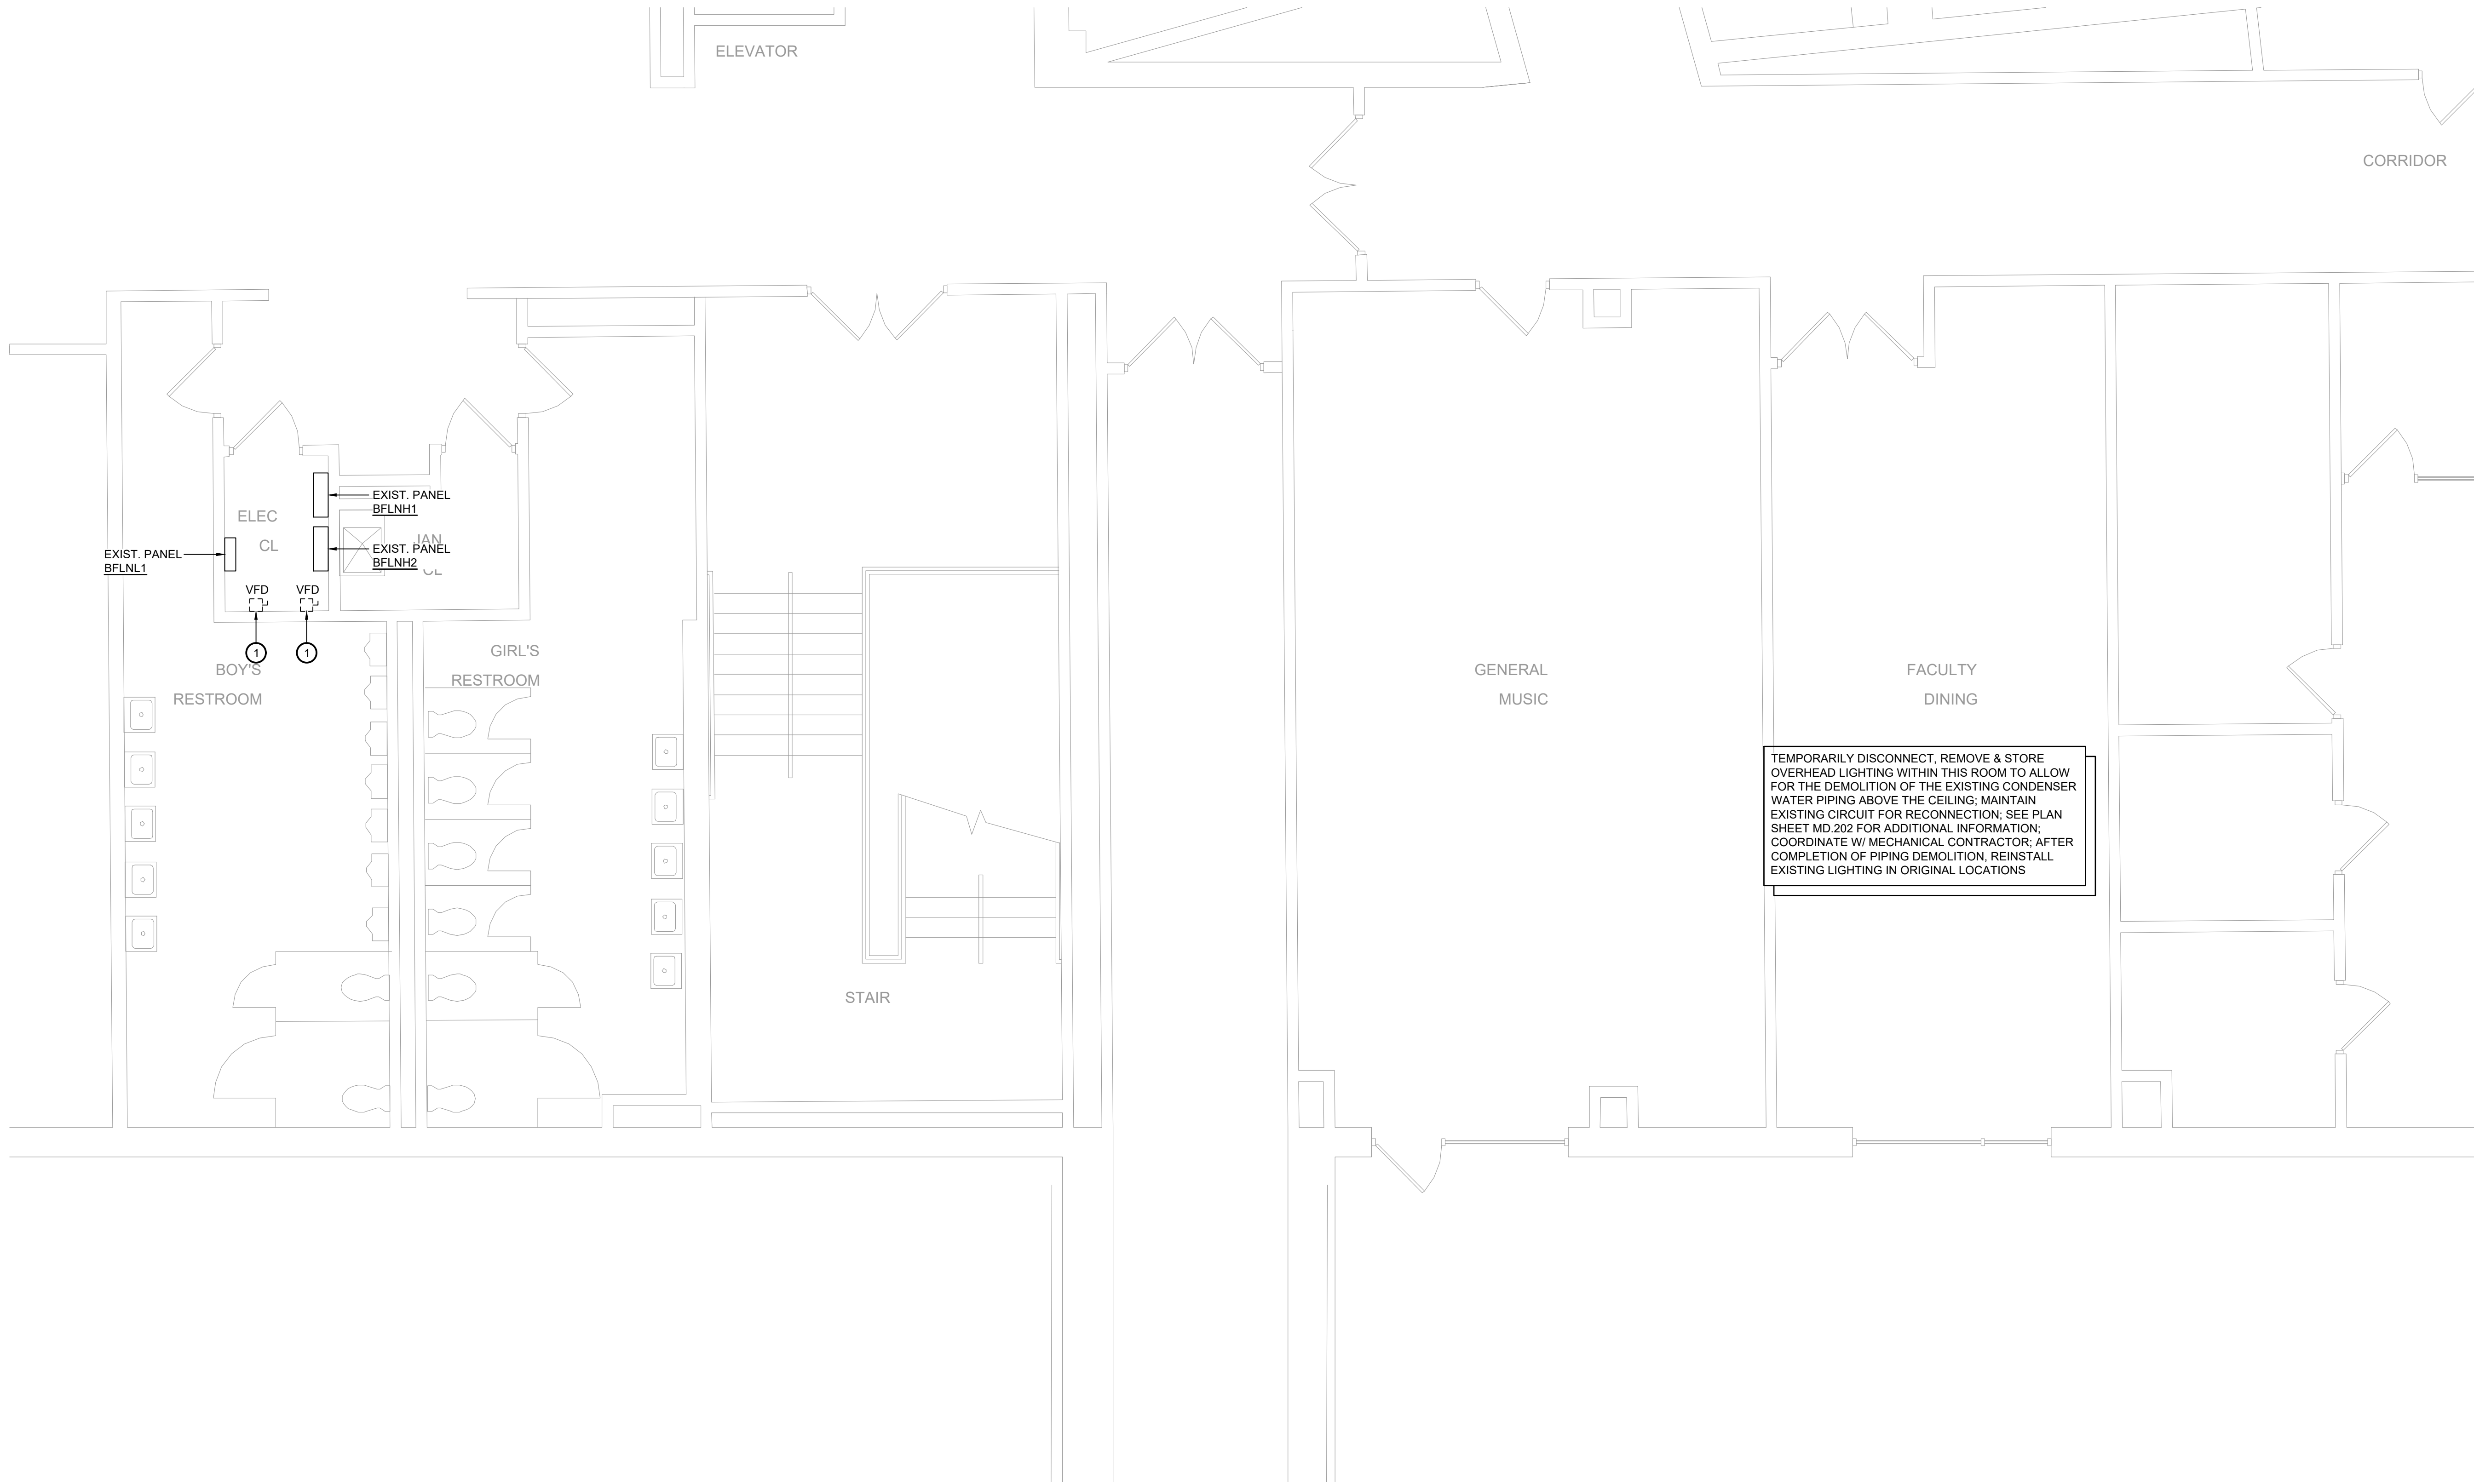


## LOWER LEVEL ELECTRICAL DEMOLITION PLAN

PROJECT NO.	SHEET NO.
2149	ED.201

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1 Lower Level Electrical Demolition Plan  
ED.201 Scale: 1/4" = 1'-0"



Key Notes:

① DISCONNECT, REMOVE & PROPERLY DISPOSE OF EXISTING VARIABLE FREQUENCY DRIVE AND ALL ASSOCIATED CONDUIT, AND WIRING; REMOVE ALL CONDUITS AND WIRING BACK TO SOURCE AT PANEL BFLNH2

KEY PLAN:

'CORNWALL CENTRAL HIGH SCHOOL'

ROUTE 94

TRUE NORTH

PROJECT NORTH

PROJECT AREA

PROJECT:

CORNWALL CENTRAL HIGH SCHOOL COOLING TOWER REPLACEMENT PROJECT

10 DRAGON DRIVE  
NEW WINDSOR, NEW YORK 12553  
SED #:44-03-01-06-0-012-008

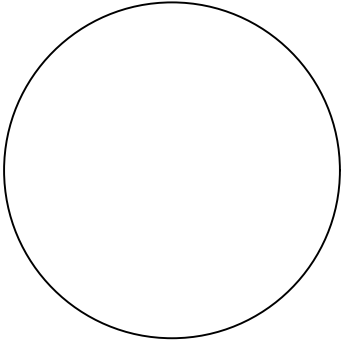
SUB-CONSULTANT:

ENGINEER:



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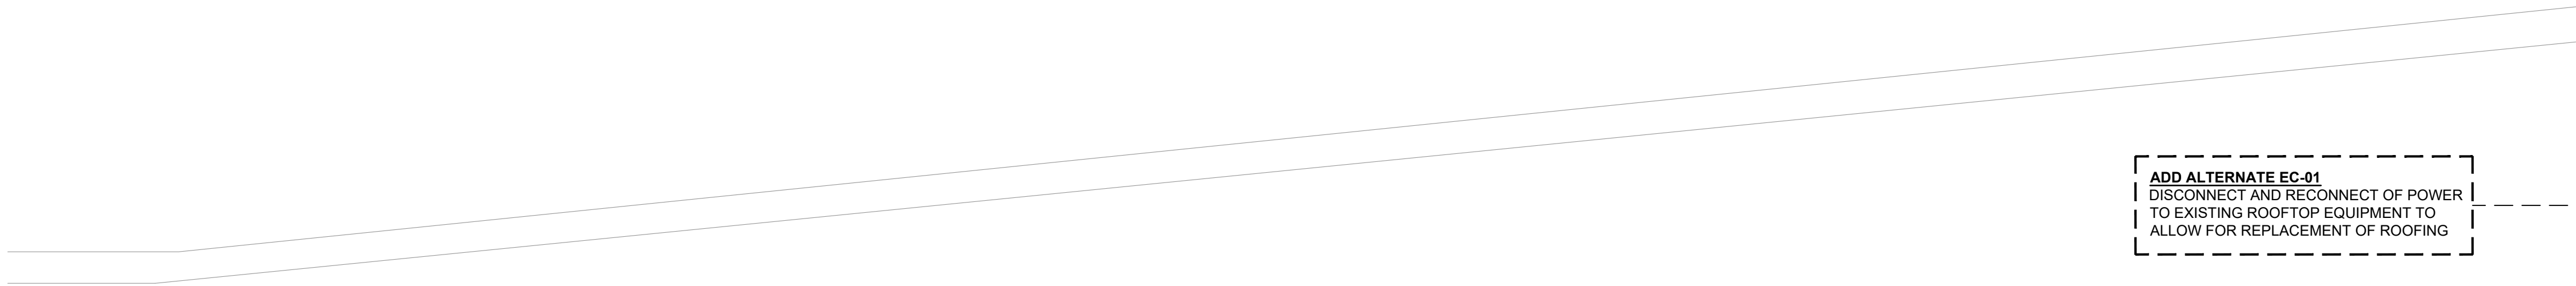
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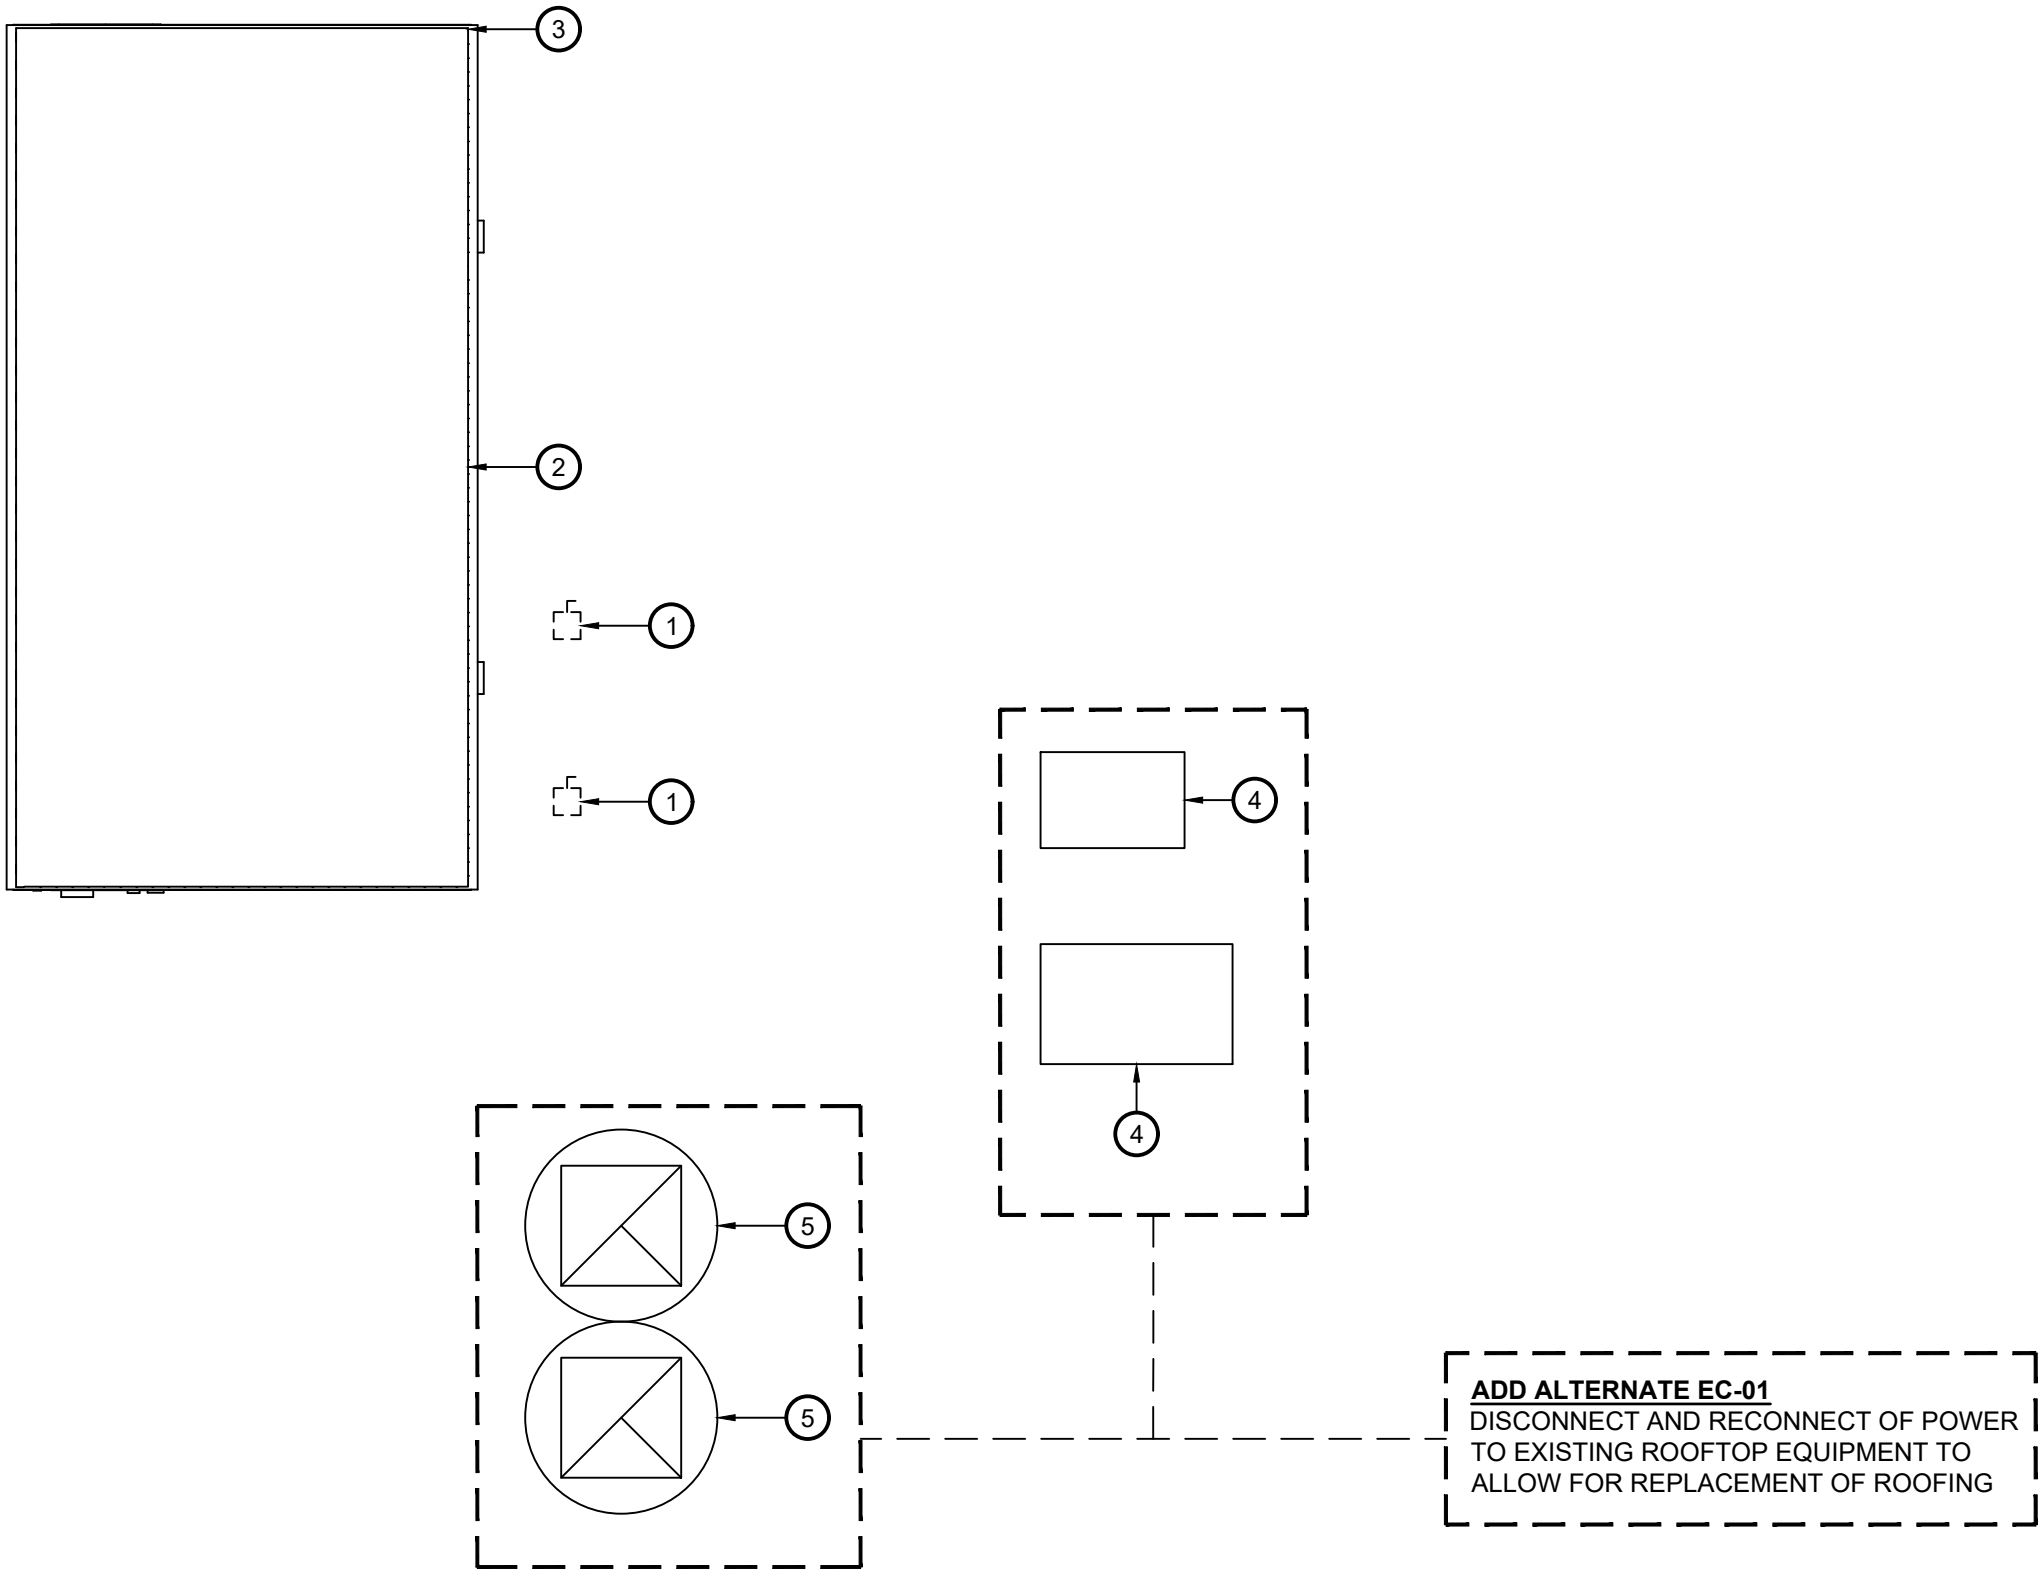
MAIN LEVEL ELECTRICAL DEMOLITION PLAN				
DATE:		DRN	CHK	DESCRIPTION
05.27.2022		BJK	MGB	CONSTRUCTION SET
REV.	DATE:	DRN	CHK	DESCRIPTION
PROJECT NO.		SHEET NO.		
2149		ED.202		
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1 Main Level Electrical Demolition Plan  
ED.202 Scale: 1/4" = 1'-0"





- Key Notes:**
- ① DISCONNECT, REMOVE & PROPERLY DISPOSE OF EXISTING DISCONNECT SWITCHES AND ALL ASSOCIATED CONDUIT, WIRING, COMPONENTS AND ACCESSORIES
  - ② DISCONNECT, REMOVE & PROPERLY DISPOSE OF EXISTING EVAPORATIVE COOLING TOWER AND ALL ASSOCIATED COMPONENTS AND ACCESSORIES; REMOVE ALL CONDUITS AND WIRING BACK TO SOURCE AT PANEL BFLNH2
  - ③ DISCONNECT, REMOVE & STORE LIGHTNING PROTECTION SYSTEM CONNECTED TO COOLING TOWER AND SUPPORT FRAME; STORE AIR TERMINALS, GROUNDING WIRE AND CONNECTIONS FOR RE-INSTALLATION ON REPLACEMENT TOWER
  - ④ EXISTING FREEZER/COOLER CONDENSING UNIT TO BE DISCONNECTED, REMOVED & STORED FOR REINSTALLATION BY MC; ELECTRICAL CONTRACTOR TO DISCONNECT POWER, TEMPORARILY SECURE EXISTING CIRCUIT DURING ROOF REPLACEMENT AND RECONNECT TO EXISTING EQUIPMENT; WIRING TO BE ROUTED THROUGH NEW PIPE PORTAL/ ROOF CURB
  - ⑤ EXISTING EXHAUST FAN TO BE DISCONNECTED, REMOVED & STORED FOR REINSTALLATION BY MC; ELECTRICAL CONTRACTOR TO DISCONNECT POWER, TEMPORARILY SECURE EXISTING CIRCUIT DURING ROOF REPLACEMENT AND RECONNECT TO EXISTING EQUIPMENT



1 Roof Electrical Demolition Plan  
ED.203 Scale: 1/4" = 1'-0"

**KEY PLAN:**

'CORNWALL CENTRAL HIGH SCHOOL'

ROUTE 94

TRUE NORTH

PROJECT NORTH

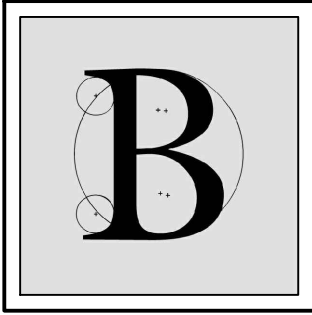
**PROJECT:**

CORNWALL CENTRAL HIGH SCHOOL COOLING TOWER REPLACEMENT PROJECT

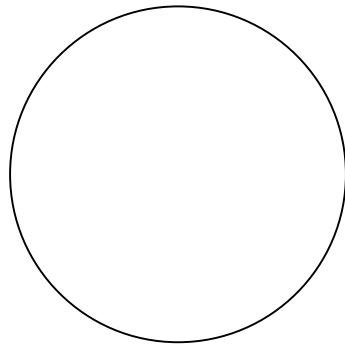
10 DRAGON DRIVE  
NEW WINDSOR, NEW YORK 12553  
SED #:44-03-01-06-0-012-008

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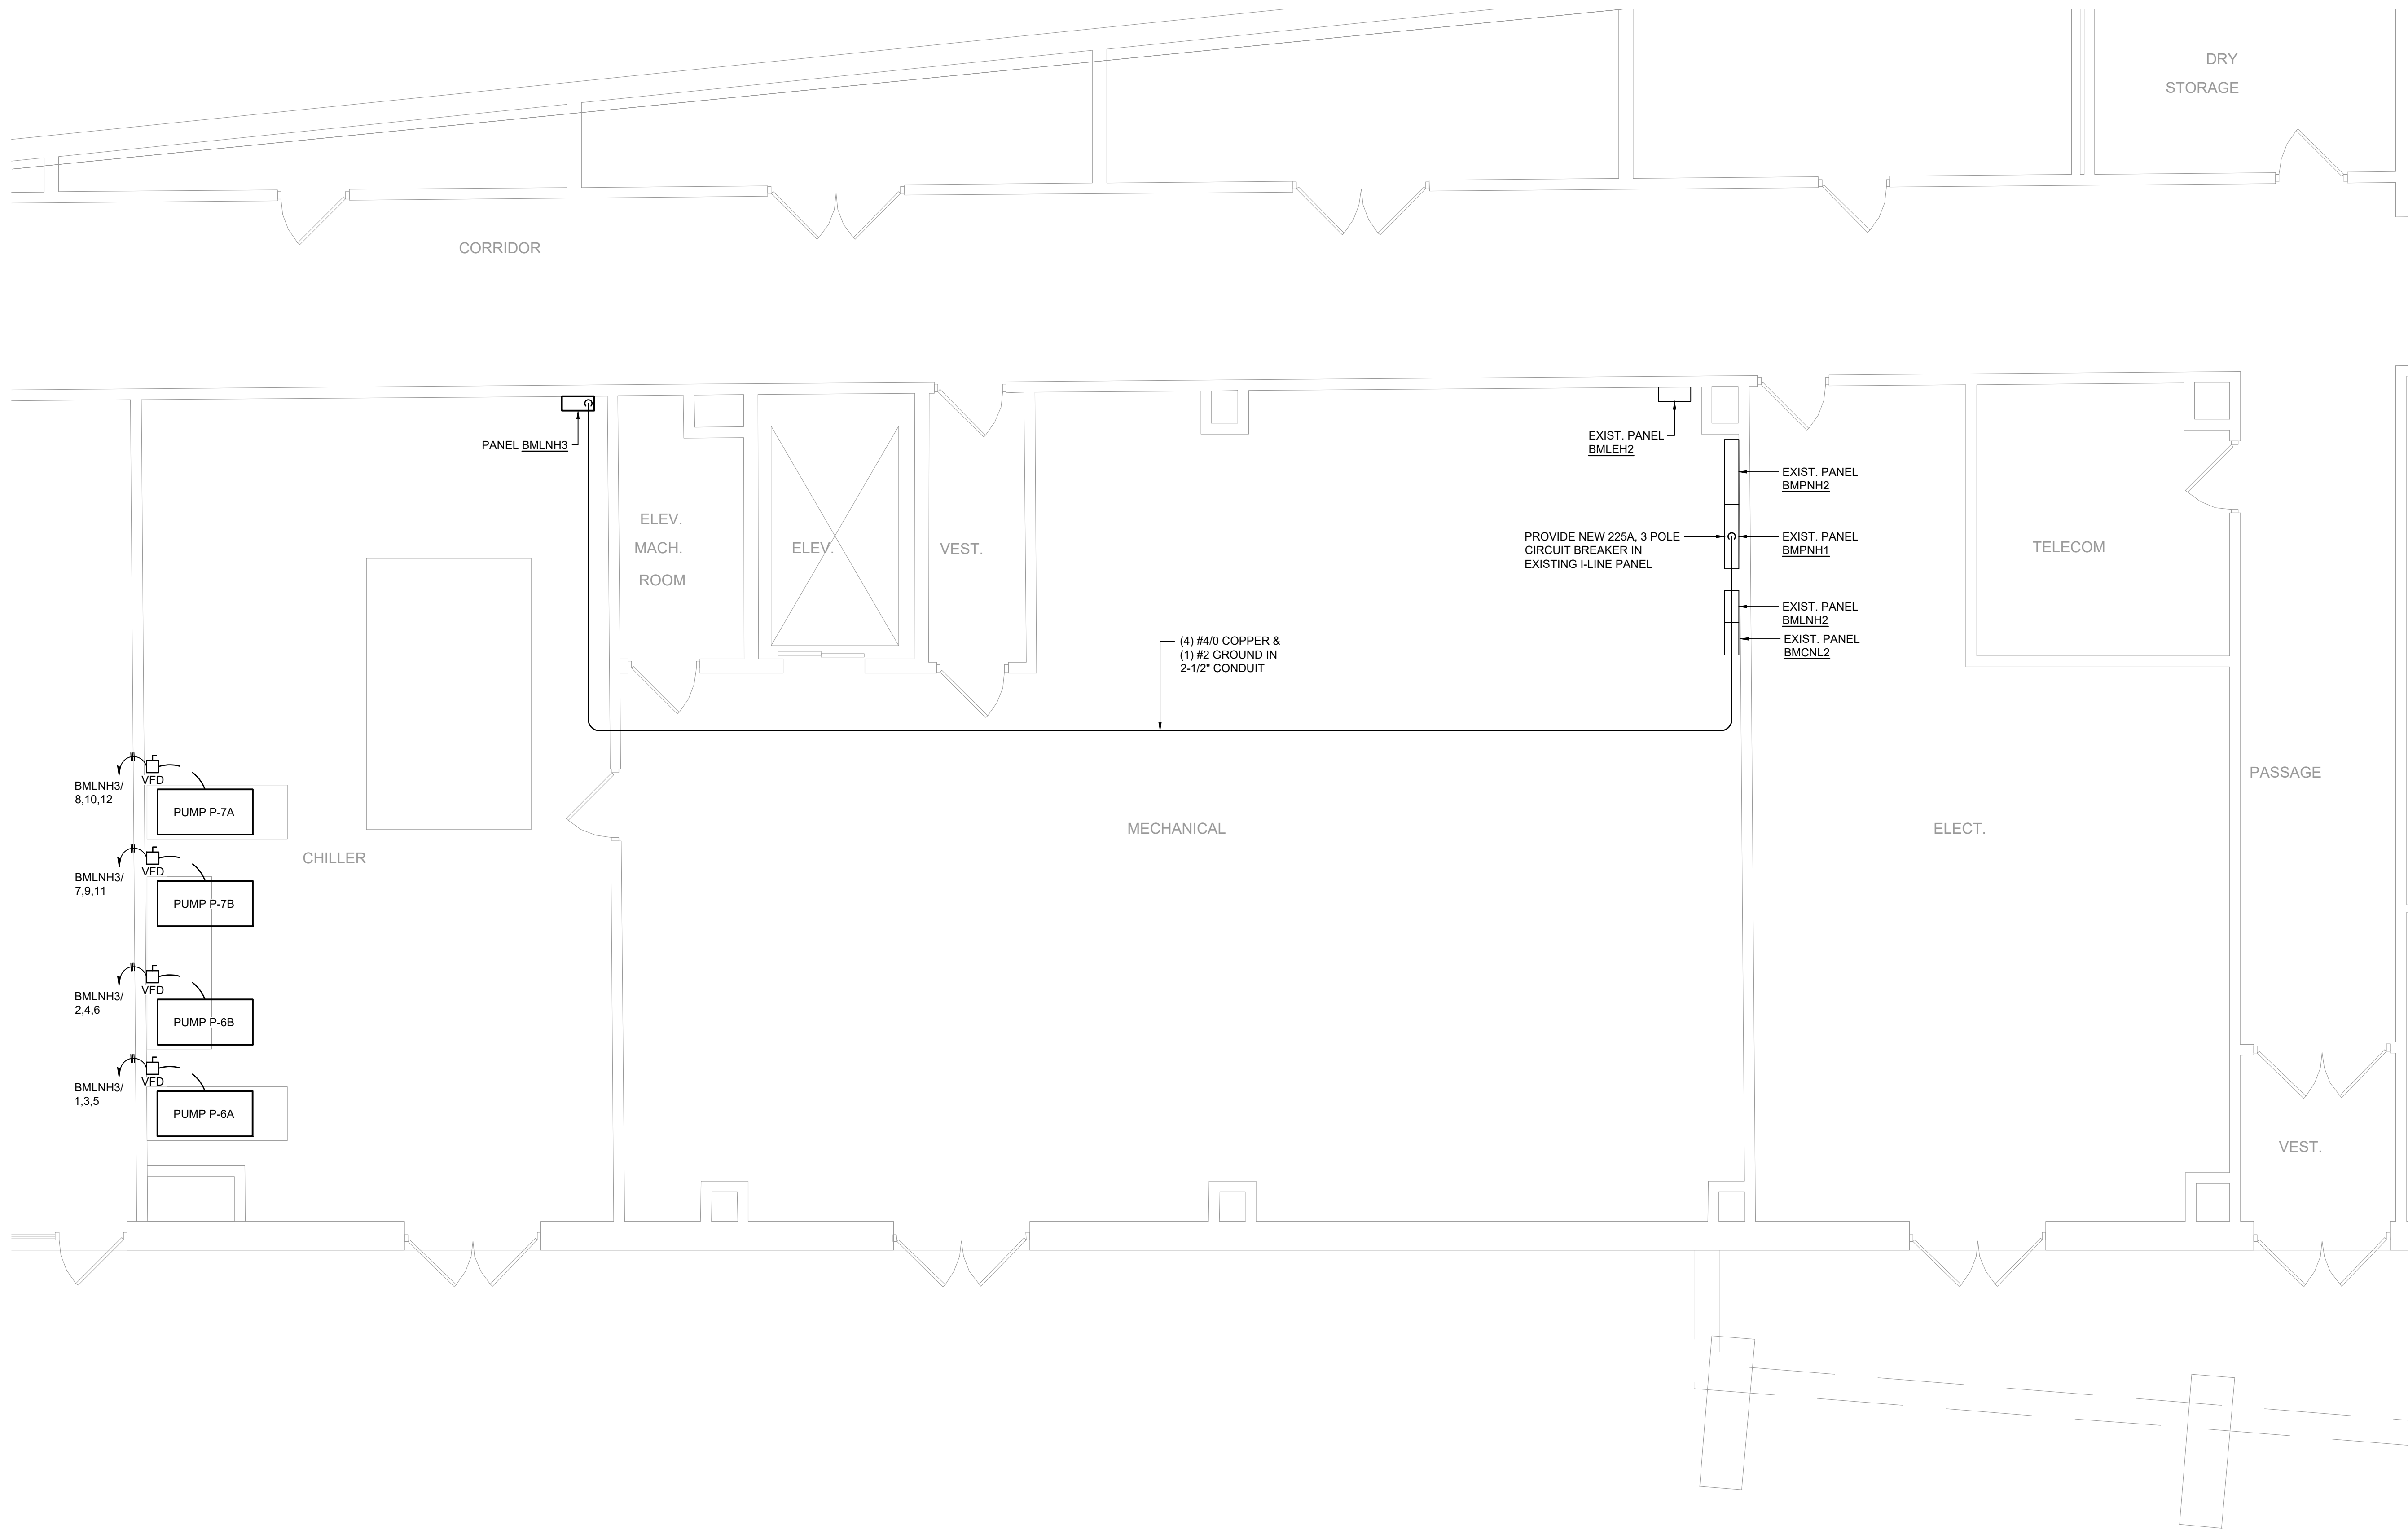
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**ROOF ELECTRICAL DEMOLITION PLAN**

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05.27.2022		BJK	MGB	CONSTRUCTION SET
REV.	DATE:	DRN	CHK	DESCRIPTION

PROJECT NO.	SHEET NO.
2149	ED.203

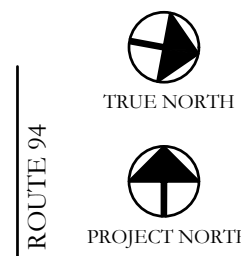
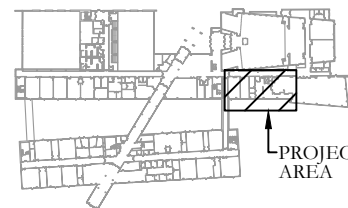
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1 Lower Level Electrical Plan  
E.201 Scale: 1/4" = 1'-0"

KEY PLAN:

'CORNWALL CENTRAL  
HIGH SCHOOL'

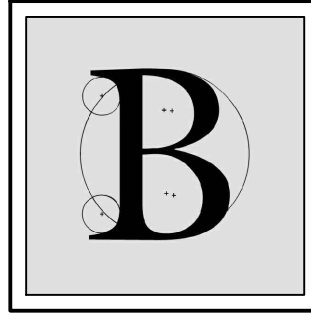


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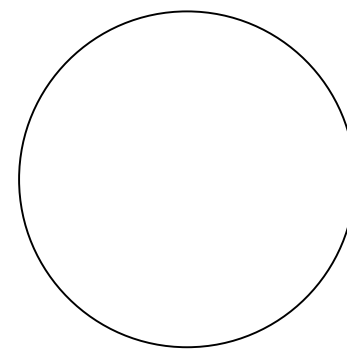
CORNWALL CENTRAL  
HIGH SCHOOL  
COOLING TOWER  
REPLACEMENT PROJECT  
10 DRAGON DRIVE  
NEW WINDSOR, NEW YORK 12553  
SED #:44-03-01-06-0-012-008

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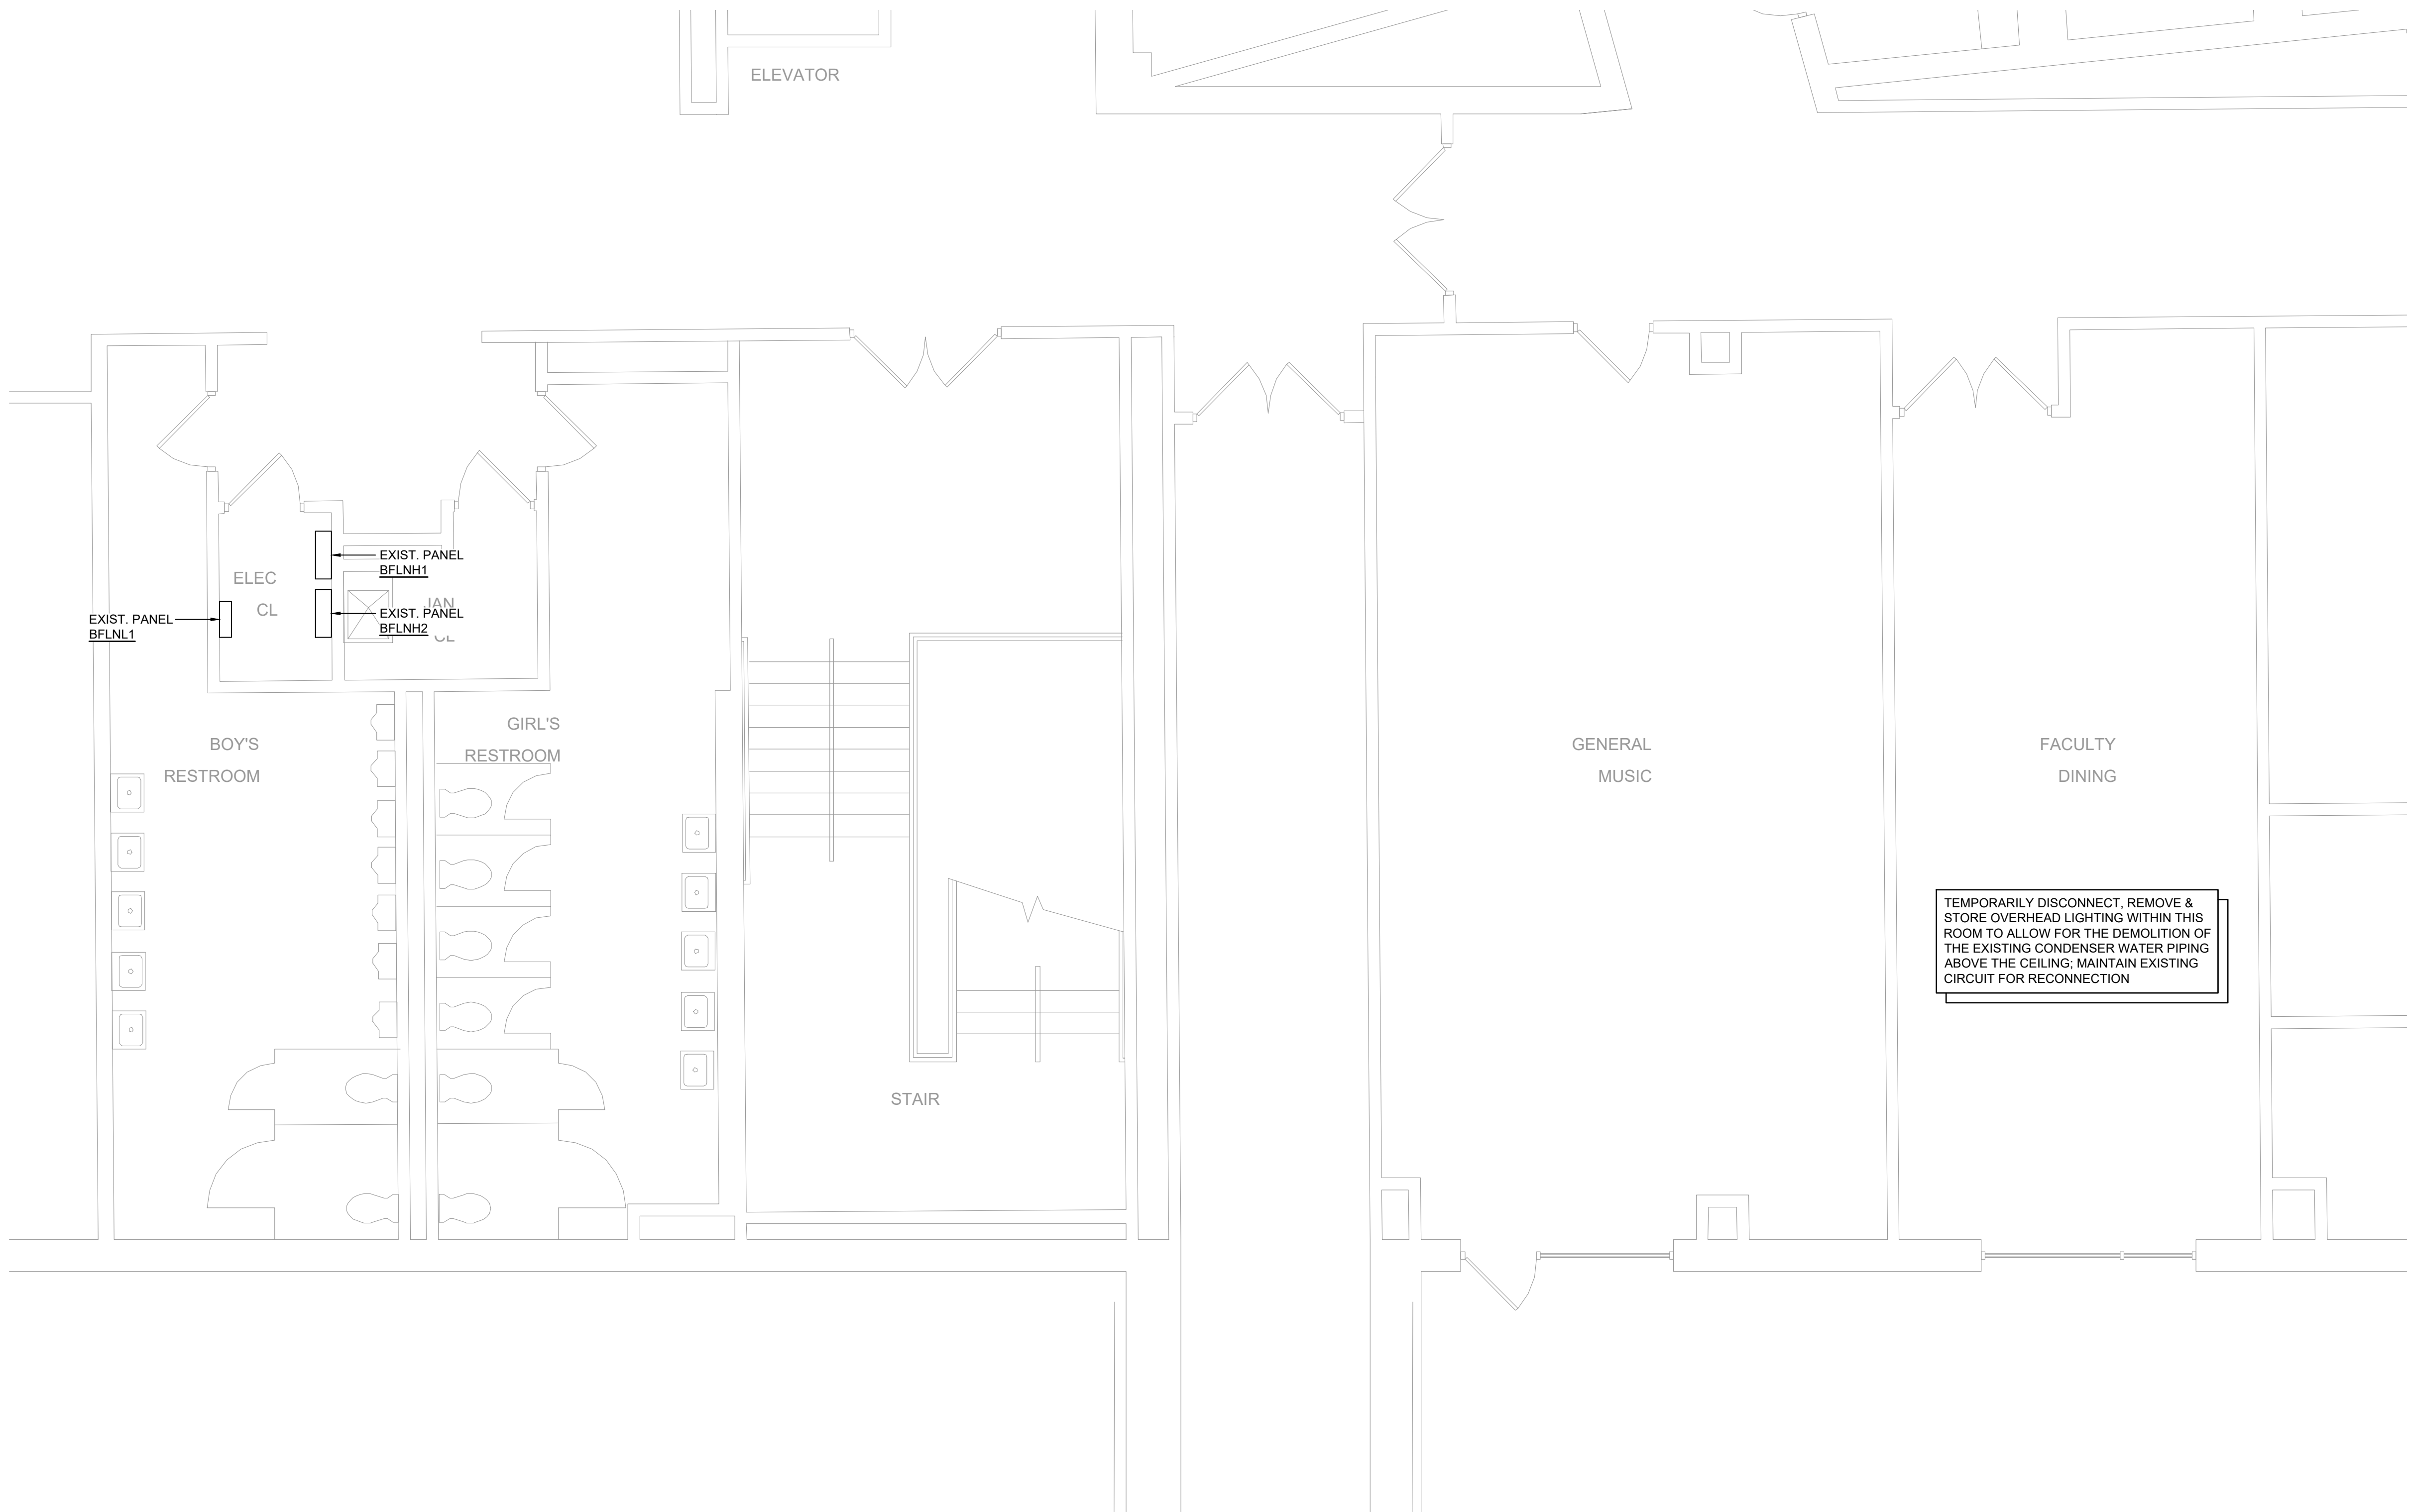
LOWER LEVEL ELECTRICAL  
PLAN

DATE:		DRN	CHK	DESCRIPTION
05.27.2022		BJK	MGB	CONSTRUCTION SET
REV.	DATE:	DRN	CHK	DESCRIPTION

PROJECT NO.	SHEET NO.
2149	E.201

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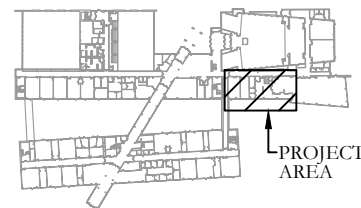
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1 Main Level Electrical Plan  
E.202 Scale: 1/4" = 1'-0"

KEY PLAN:

'CORNWALL CENTRAL  
HIGH SCHOOL'

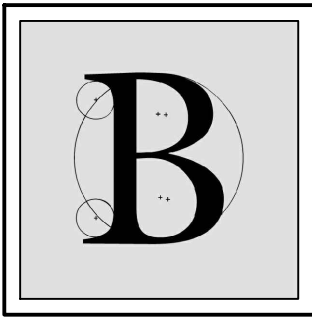


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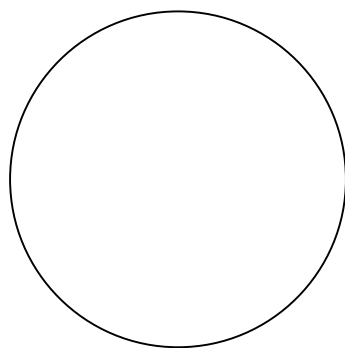
CORNWALL CENTRAL  
HIGH SCHOOL  
COOLING TOWER  
REPLACEMENT PROJECT  
10 DRAGON DRIVE  
NEW WINDSOR, NEW YORK 12553  
SED #:44-03-01-06-0-012-008

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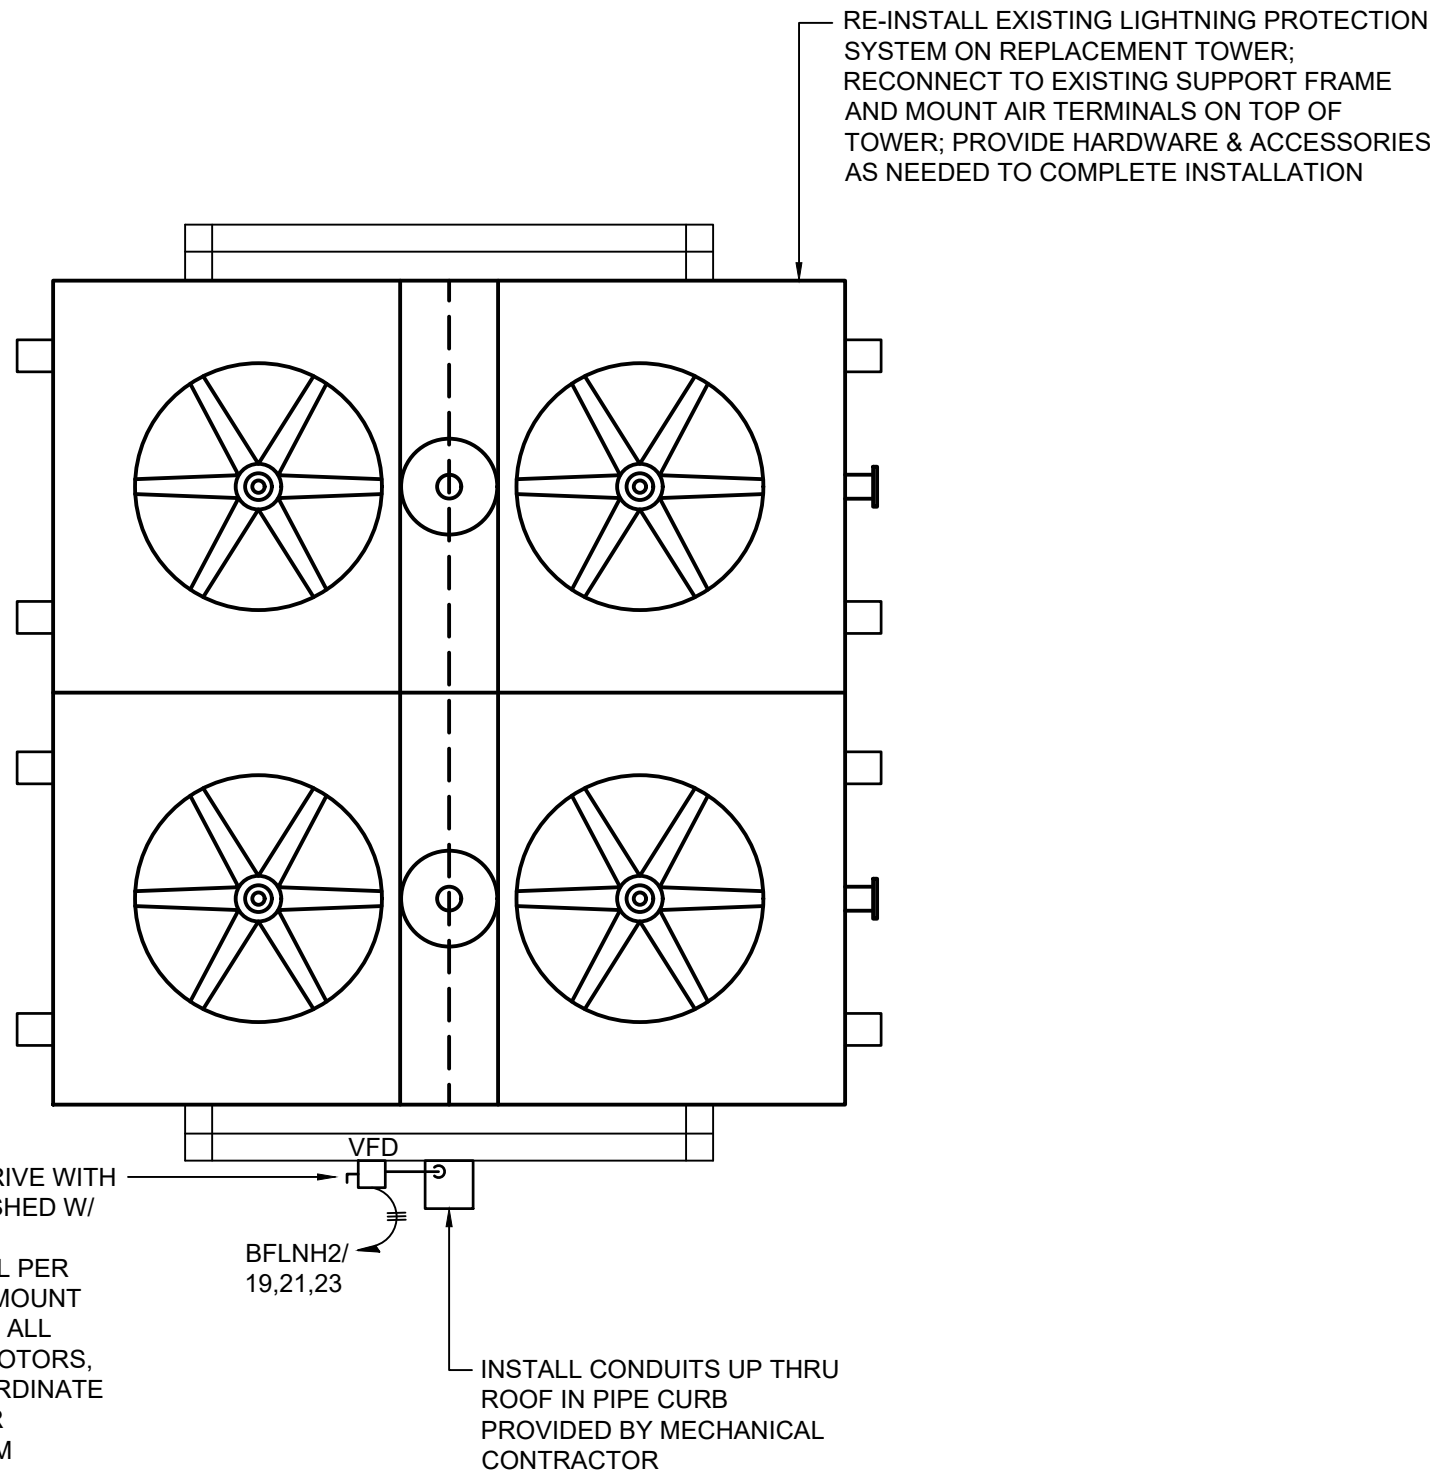
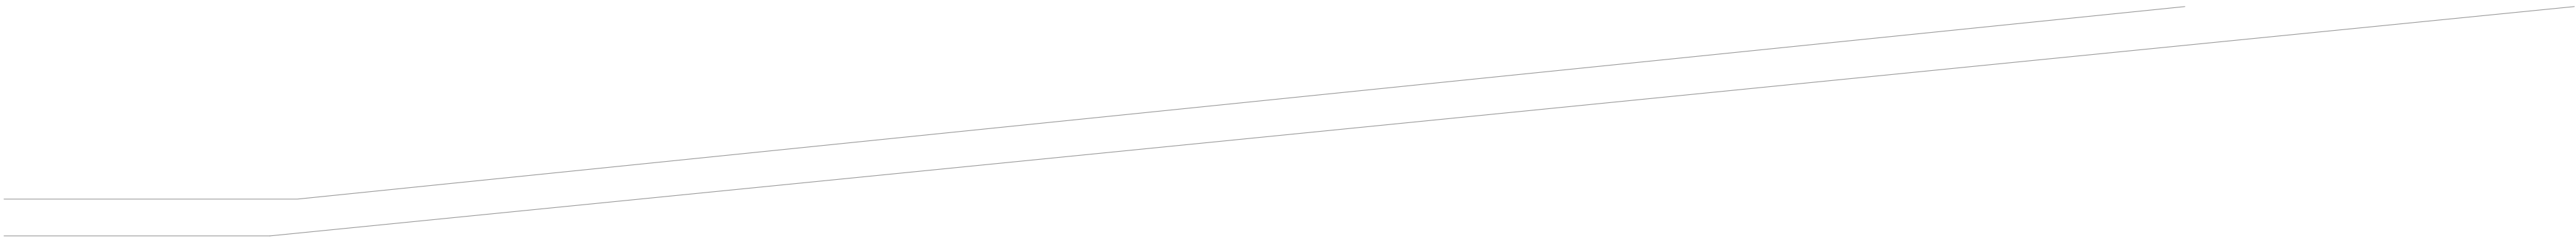
MAIN LEVEL ELECTRICAL  
PLAN

DATE:		DRN	CHK	DESCRIPTION
05.27.2022		BJK	MGB	CONSTRUCTION SET
REV.	DATE:	DRN	CHK	DESCRIPTION

PROJECT NO.	SHEET NO.
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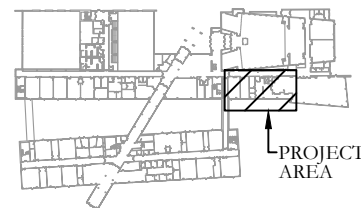


1  
E.203

Roof Electrical Plan  
Scale: 1/4" = 1'-0"

KEY PLAN:

'CORNWALL CENTRAL  
HIGH SCHOOL'

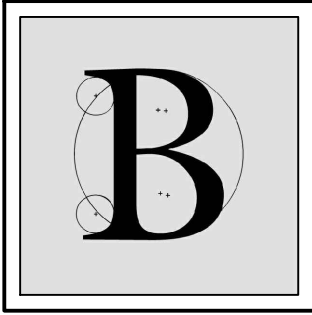


PROJECT:

CORNWALL CENTRAL  
HIGH SCHOOL  
COOLING TOWER  
REPLACEMENT PROJECT  
10 DRAGON DRIVE  
NEW WINDSOR, NEW YORK 12553  
SED #:44-03-01-06-0-012-008

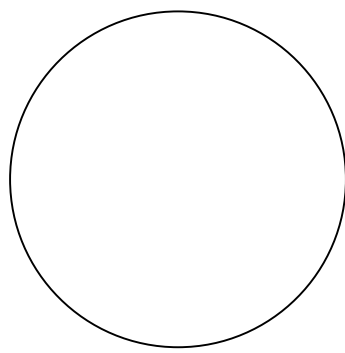
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ROOF ELECTRICAL PLAN

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