(NOTE 4):	HVAC LEGEND	
(NOTE: ALL 	SYMBOLS MAY NOT APPEAR ON DRAWINGS) LINED DUCTWORK	
<u>}</u>	SUPPLY DUCT	
	RETURN DUCT	
	EXHAUST DUCT	
	SUPPLY DUCT THROUGH ROOF	
	RETURN DUCT THROUGH ROOF	
	EXHAUST DUCT THROUGH ROOF	
	DIRECTION OF EXHAUST RELIEF	
	SUPPLY DIRECTION	
SP SP	STATIC PRESSURE SENSOR	
M	MOTORIZED VOLUME DAMPER	
/// BD	BACKDRAFT DAMPER	
<u> </u>	CONICAL TAP W/DAMPER	
φ	ROUND DUCT SIZE	
-	OVAL DUCT SIZE	
	FLEXIBLE DUCT RUNOUT	
	FLEXIBLE DUCT CONNECTION	
	MANUAL VOLUME DAMPER	
FD	FIRE DAMPER IN DUCT	
FSD	FIRE SMOKE DAMPER IN DUCT	
	DUCTWORK (SHEETMETAL) (WITH/DEPTH IN VIEW OF PLAN)	
	DUCTWORK, DIRECTION OF SLOPE	
\boxtimes	EXISTING SUPPLY AIR GRILLE	
(R)	EXISTING AIR DEVICE TO BE RELOCATED	
\boxtimes	NEW SUPPLY AIR DIFFUSER	
Ŧ	EXISTING SLOT DIFFUSER TO REMAIN	
(ER)	EXISTING SLOT DIFFUSER TO BE RELOCATED	
	NEW SLOT DIFFUSER	
S	DUCT MOUNTED SMOKE DETECTOR	

GENERAL NOTES FOR ALL MECHANICAL WORK

GENERAL ITEMS

- GENERAL NOTES ON THIS DRAWING ARE APPLICABLE TO EACH MECHANICAL DRAWING OF THIS SET. SEE EACH DRAWING FOR SPECIFIC NOTES APPLICABLE TO SPECIFIC SCOPE AREAS. VERIFY ALL MEASUREMENTS. NO EXTRA COMPENSATION WILL BE ALLOWED BECAUSE OF DIFFERENCES BETWEEN WORK SHOWN ON THE DRAWINGS AND ACTUAL MEASUREMENTS AT THE SITE OF CONSTRUCTION. DO NOT SCALE THE DRAWINGS. DRAWINGS ARE A DIAGRAMMATIC REPRESENTATION AND INTENDED
- TO CONVEY INTENT. UPON COMPLETION OF THE WORK, THOROUGHLY CLEAN ALL EXPOSED PORTIONS OF THE MECHANICAL AND ELECTRICAL EQUIPMENT PROVIDED AS WELL AS THE GENERAL SCOPE AREA. REMOVE ALL TRACES OF SOIL/DUST LABELS. GRADE. OIL. AND OTHER FOREIGN MATERIAL USING ONLY THE TYPE CLEANER RECOMMENDED BY THE MANUFACTURER OF ANY ITEM BEING CLEANED AND APPROVED BY OWNER FOR USE IN THE SCOPE AREA. CONTRACTOR SHALL DESIGNATE ONE PERSON TO SERVE AS PRIMARY POINT
- OF COMMUNICATION WITH PROJECT TEAM. WORK AMONG ALL TRADES SHALL BE FULLY COORDINATED AS REQUIRED IN THE FIELD TO AVOID SPACE CONFLICTS AND INTERRUPTION OF THE FLOW OF WORK. CONFLICTS SHALL BE IMMEDIATELY REPORTED IN WRITING TO ENGINEER AND OWNER'S REPRESENTATIVE. THE CONTRACTOR SHALL TAKE PROPER PRECAUTIONS TO PROTECT ANY EXISTING CONSTRUCTION AND ADJACENT PROPERTY, WITH WHICH WORK
- COMES IN CONTACT, AND OVER WHICH HE MAY TRANSPORT, HOIST OR MOVE MATERIALS, EQUIPMENT, DEBRIS, ETC., AND SHALL REPAIR SATISFACTORILY ALL DAMAGES CAUSED BY HIM DURING CONSTRUCTION. ALL EQUIPMENT SHALL BE NEW, UNLESS NOTED OTHERWISE, AND INSTALLED IN ACCORDANCE WITH MANUFACTURER'S PUBLISHED RECOMMENDATIONS FOR THE SERVICE INTENDED. PROVIDE ONLY PRODUCTS BEARING UNDERWRITERS LABORATORIES (UL) LABEL AS APPLICABLE.
- CONFIRM OUTSIDE AIR INTAKE OPENINGS FOR VENTILATION AIR ARE LOCATED AT LEAST 10 FEET MEASURED IN ANY DIRECTION FROM ANY FLUES, VENTS, CHIMNEYS, GAS METERS, GAS REGULATORS, PLUMBING VENTS UNLESS TOP OF SUCH INTAKE OPENING IS 2 FEET BELOW ANY OF THE LISTED ITEMS. OVERHEAD PIPING IN SPACES WITHOUT HUNG CEILINGS SHALL BE RUN AS CLOSE TO ROOF DECK AS PRACTICAL, AS CLOSE TO PARALLEL JOISTS AS POSSIBLE, AND ABOVE LIGHTING FIXTURES TO CONCEAL PIPING.
- CONCEALED UNLESS OTHERWISE NOTED. PROVIDE PIPE SLEEVES LARGE ENOUGH TO ALLOW FOR REQUIRED LATERAL MOVEMENT OF PIPING. MAINTAIN A MINIMUM CLEARANCE FOR LIGHTS OF 7" ABOVE FINISHED CEILING AND 1" MINIMUM BELOW ALL DUCTS, PIPES, CONDUIT OR ANY OTHER

OVERHEAD DUCTWORK AND PIPING IN SPACES WITH CEILINGS SHALL BE

- EQUIPMENT IN THE CEILING SPACE. MAINTAIN MANUFACTURER'S RECOMMENDED SERVICE ACCESS CLEARANCE AT ALL EQUIPMENT. COORDINATE LOCATION OF GRILLES, REGISTERS, DIFFUSERS, THERMOSTATS AND OTHER WALL OR CEILING MOUNTED HVAC ACCESSORIES WITH REFLECTED CEILING PLAN, LIGHTING FIXTURE LAYOUT AND ACCESSORIES INSTALLED BY OTHER TRADES SO AS TO PRESENT A NEAT AND ATTRACTIVE INSTALLATION THROUGHOUT THE ENTIRE BUILDING. IT IS THE INTENT FOR GRILLES, REGISTERS AND DIFFUSERS TO BE INSTALLED IN THE CENTER OF CEILING
- THE DIAMETER OF THE SUPPLY PIPE AT ANY GAS FIRED EQUIPMENT SHALL NOT BE OF A SMALLER SIZE THAN THE INLET CONNECTION TO THE EQUIPMENT.
- ARRANGE PIPING AND DUCTWORK, PARTICULARLY ABOVE CEILING, AS REQUIRED TO CLEAR STRUCTURE, DUCTS, CONDUITS, ETC. ALLOWING SPACE FOR PIPE HANGERS, EXPANSION LOOPS AND ACCESS TO VALVES, FILTERS, AND MAINTENANCE OF EQUIPMENT. CONTRACTOR SHALL VERIFY REFRIGERANT PIPE SIZES WITH EQUIPMENT
- MANUFACTURER FOR THE INDICATED INSTALLATION. COORDINATE LOCATION AND INSTALLATION OF EQUIPMENT WITH OTHER TRADES. DO NOT SCALE DRAWINGS. SEE ARCHITECTURAL DRAWINGS FOR EXACT LOCATION OF DOORS, WINDOWS, ETC. THERMOSTATS AND/OR TEMPERATURE SENSORS SHALL BE LOCATED IN THE ROOMS INDICATED. INSTALL TOP OF DEVICE NO MORE THAN 48" ABOVE FINISHED FLOOR TO MATCH THE HEIGHT OF WALL SWITCHES OR OTHER WALL
- PIPING, DUCTWORK, VENTS, ETC., EXTENDING THROUGH EXTERIOR WALLS AND ROOF SHALL BE FLASHED AND COUNTER FLASHED IN A WEATHERPROOF

MOUNTED DEVICES.

- VALVES AND SPECIALTIES SHALL BE LINE SIZE EXCEPT FOR CONTROL VALVES OR UNLESS NOTED OTHERWISE. EXTEND DRAIN LINES TO NEAREST FLOOR DRAIN OR AS INDICATED. ROUTING SHALL NOT INTERFERE WITH PASSAGEWAYS AND MAINTENANCE. DRAINS FROM
- AIR CONDITIONING CONDENSATE DRAIN PANS SHALL BE TRAPPED. SLOPE CONDENSATE DRAIN PIPING AT 1/8" PER FOOT. VERIFY INVERT IS ESTABLISHED AFTER AIR HANDLING UNIT IS INSTALLED BUT PRIOR TO DUCTWORK INSTALLATION. EQUIPMENT CONTAINING AIR CONDITIONING COILS WHICH DO NOT HAVE A SECONDARY DRAIN OR AUXILIARY DRAIN PAN SHALL BE FITTED WITH A WATER
- LEVEL SENSOR IN THE PRIMARY DRAIN PAN. THE SENSOR SHALL BE WIRED TO DE-ENERGIZE THE EQUIPMENT IF WATER RISES ABOVE THE DRAIN OUTLET. PIPING AND DUCTWORK INSULATION SHALL BE RUN CONTINUOUSLY THROUGH NON-RATED FLOORS, WALLS, ROOF AND PARTITIONS, UNLESS OTHERWISE
- NO PIPING SHALL BE SMALLER THAN 1/2" UNLESS OTHERWISE NOTED. FOR PIPE SIZES NOT INDICATED ON PLANS, SEE EQUIPMENT CONNECTION DETAILS, FLOW DIAGRAMS, RISER DIAGRAMS AND PIPE SIZING SCHEDULE. PROVIDE UNION OR FLANGED CONNECTIONS AT EACH PIECE OF EQUIPMENT

AND ON BOTH SIDES OF CONTROL VALVES AND PRESSURE REGULATING

- PROPERLY SUPPORT ALL EQUIPMENT, DUCTWORK, AND PIPING WITHIN THE BUILDING AND PROVIDE ADEQUATE PROVISIONS FOR SLOPE AND ANCHORAGE. PROVIDE ALL MATERIALS REQUIRED FOR THE SUPPORT OF SUCH ITEMS INCLUDING RODS, ANGLES, ETC., TO PROPERLY SUPPORT ALL ITEMS IN A PROPER AND SAFE MANNER. CONTRACTOR SHALL USE HANGER'S RODS. INSERTS ETC. LISTED BY UNDERWRITERS' LABORATORIES FOR THE SERVICE INTENDED. HANGERS FOR COPPER PIPING SHALL BE COPPER PLATED. SECURELY SUPPORT ALL EQUIPMENT FROM STRUCTURAL MEMBERS PROVIDED AS NEEDED, WHICH IN TURN ARE TO BE SUPPORTED DIRECTLY FROM THE BUILDING STRUCTURE. ALL HANGERS SHALL HAVE A MINIMUM FACTOR OF SAFETY OF 5. PIPING SHALL BE SUPPORTED IN ACCORDANCE WITH THE SPECIFICATIONS. ADDITIONAL SUPPORTS OR HANGERS SHALL BE ADJACENT TO ELBOWS, TO PREVENT WEIGHT OF PIPING BEING PLACED ON THE EQUIPMENT. CORRECT SETTING ON BALANCING FITTINGS SHALL BE PERMANENTLY MARKED.
- INSTALL ANCHORS AND EXPANSION LOOPS WHERE INDICATED AND WHERE REQUIRED TO ALLOW FOR EXPANSION. SUITABLE FLASHINGS FOR OPENINGS IN THE BUILDING WALLS, FLOOR OR ROOF SHALL BE FURNISHED BY THE CONTRACTOR PROVIDING THE PENETRATING ITEM. THE INSTALLATION OF THE FLASHING AND ITS WATERTIGHT INTEGRITY SHALL BE THE RESPONSIBILITY OF THE CONTRACTOR THAT PROVIDES THE SEALING AND FINISHING OF THE FLASHING, IN ALL CASES, THE FLASHING MATERIAL AND ITS INSTALLATION SHALL BE COORDINATED WITH THE GENERAL CONTRACTOR FLASHINGS FOR PENETRATIONS MAY ALSO BE PROVIDED ENTIRELY BY THE GENERAL CONTRACTOR. ALSO, REFER TO THE ARCHITECT'S SPECIFICATIONS TO COORDINATE THE COMPLETENESS OF THIS ITEM. ACCESSIBILITY REQUIREMENTS. (REFER TO ARCHITECTURAL PLANS FOR
 - ADDITIONAL INFORMATION/REQUIREMENTS). THE PLANS AND SPECIFICATIONS HAVE BEEN PREPARED IN ACCORDANCE WITH THE APPLICABLE PROVISIONS OF REGULATIONS, CODES AND ORDINANCES REGARDING HANDICAPPED PERSONS. IT IS ASSUMED THAT THE CONTRACTOR IS ALSO KNOWLEDGEABLE OF SAME AND THEIR APPLICATION WITH REGARD TO HIS WORK. THE CONTRACTOR SHALL VERIFY AND COORDINATE THE TYPE OF EQUIPMENT BEING INSTALLED AND ITS LOCATION, MOUNTING HEIGHT AND CLEARANCES AS PRESCRIBED BY ALL APPLICABLE HANDICAP
 - REGULATIONS, CODES AND ORDINANCES PRIOR TO PLACING EQUIPMENT ORDERS AND PRIOR TO INSTALLATION OF ALL WORK. GENERAL LISTING OF MOUNTING HEIGHTS: HEIGHT TO CENTER LINE ABOVE FINISHED FLOOR WATER COOLER

TOILETS 17"-19" TO RIM URINALS 17" TO RIM FLUSH VALVES THERMOSTATS, SWITCHES, ETC. 48" MAXIMUM RECEPTACLES

CONTRACTOR SHALL PROVIDE ALL DIMENSIONS FOR BLOCK OUTS, SLEEVES, ETC., AND THE DIMENSIONED LOCATIONS OF SAME. 33. SEE ELECTRICAL DRAWINGS FOR LOCATION OF MOTOR STARTERS.

THROUGH-PENETRATION FIRESTOP ASSEMBLIES

PROVIDE UL LISTED THROUGH-PENETRATION ASSEMBLIES FOR FIRE WALLS AND FLOORS. REVIEW ARCHITECTURAL DRAWINGS FOR FIRE PARTITION LOCATIONS AND UL LISTINGS.

- PROVIDE INTERNAL SOUND ABSORPTIVE DUCT LINING WHERE NOTED. DUCT DIMENSIONS ARE CLEAR INSIDE DUCT LINING DIMENSIONS. PROVIDE ACCESS DOORS IN DUCTWORK WHERE INDICATED OR REQUIRED FOR
- ACCESS TO SYSTEM COMPONENTS INCLUDING THE FOLLOWING: DAMPER MOTORS AND/OR MOTOR OPERATED DAMPERS HUMIDIFIERS
- FILTERS BOTH SIDES OF HEATING AND COOLING COILS FAN BEARINGS ENCLOSED IN DUCTS OR PLENUMS
- FIRE DAMPERS AND SMOKE DAMPERS CONTROL DAMPERS

REQUIREMENTS WITH ALL OTHER TRADES.

- SMOKE DETECTORS HIGH SIDEWALL REGISTERS OR GRILLES SHALL BE LOCATED 6" FROM CEILING
- TO TOP OF REGISTER OR GRILLE. SPACE ABOVE CEILING IS NOT TO BE USED AS A RETURN AIR PLENUM. PROVIDE A MINIMUM OF THREE TIMES THE FAN DIAMETER OF STRAIGHT
- DUCTWORK OFF THE SUPPLY AIR FAN DISCHARGE BEFORE ANY TAKEOFFS OR DUCTWORK SHALL BE CONSTRUCTED TO THE SMACNA STATIC PRESSURE
- CLASSIFICATION OF 2" WG AND SEAL CLASS "B". PROVIDE EXTENDED VOLUME DAMPER CONTROL RODS SO THAT HANDLES ARE CLEAR OF DUCT INSULATION.

MAINTENANCE

- 1. EQUIPMENT WITH FILTERS SHALL BE INSTALLED SO THAT FILTERS CAN BE EASILY REMOVED AND REPLACED. EQUIPMENT INSTALLED ABOVE CEILINGS SHALL BE MOUNTED APPROX. 12" ABOVE CEILING (UON) FOR MAINTENANCE ACCESS. INSTALL PIPE RUNS AT LEAST 6" ABOVE CEILING TILES. WHERE PRACTICAL INSTALL VALVES, AND OTHER MAINTAINABLE DEVICES LOW ENOUGH TO REACH WITH AN 8'-0" LADDER.
- PROVIDE ACCESS TO ANY INSPECTION OR MAINTAINABLE DEVICE, EQUIPMENT, ETC. - ACCESS OR ACCESS DOOR SHALL BE OF ADEQUATE SIZE TO WORK ON EXAMINE MANUFACTURER'S LITERATURE TO DETERMINE RECOMMENDED CLEARANCES, THESE CLEARANCES SHALL BE ESTABLISHED AND MAINTAINED. THE CONTRACTOR SHALL BE RESPONSIBLE FOR COORDINATING THESE



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FRITO-LAY

LIBERTY **PLANT**

PLANT ADDITION 89 MILL ST LIBERTY, NY 12754

Project Number: 2021-213 Drawing Date: 17 AUG 2022 Drawn: CBC Checked: MTS

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Sheet Title:

GENERAL NOTES AND LEGENDS

C1S ERTY

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AMPS. AMPERE ABC ABOVE COUNTER A/C AIR CONDITIONER ALTERNATING CURRENT ADJ ADJACENT AFF ABOVE FINISH FLOOR AFG ABOVE FINISH GRADE AH AIR HANDLER AHU AIR HANDLING UNIT AMB AMBIENT AUX AUXILIARY, AUXILIARIES BLDG BUILDING BOP BO BTU BRITISH THERMAL UNIT BTUH BRITISH THERMAL UNIT PER HOUR DFU DRAINAGE FIXTURE UNITS CAT CATALOGUE CD CONDENSATE DRAIN

CDA CLEAN DRY AIR

CI CAST IRON

CFH CUBIC FEET PER HOUR

CFM CUBIC FEET PER MINUTE

CHWR CHILLED WATER RETURN

CHWS CHILLED WATER SUPPLY

ABBREVIATIONS (NOTE: ALL ABBREVIATIONS MAY NOT APPEAR ON DRAWINGS) CLG CEILING CO CLEAN OUT COL COLUMN CONC CONCRETE CONST CONSTRUCTION CONT CONTINUOUS CONTR CONTRACTOR COP COEFFICIENT OF PERFORMANCE COOLING TOWER CVO COLD WATER VALVED OPENING CW DOMESTIC COLD WATER CWR CONDENSER WATER RETURN CWS CONDENSER WATER SUPPLY DFPTH DRY BULB EXIST EXISTING DEIONIZED (WATER) EXP EXPANSION DIAMETER DEGREES FAHRENHEIT DIWR DEIONIZED WATER RETURN FIRE ALARM DIWS DEIONIZED WATER SUPPLY FREE AREA FA DIFF DIFFUSER FAN COIL UNIT

FD

FIRE DAMPER

FLOOR DRAIN

FINISH FLOOR

DN DOWN

DTL DETAIL

DS DOWNSPOUT

DWG DRAWING EAT ENTERING AIR TEMPERATURE EDH ELECTRIC DUCT HEATER EER ENERGY EFFICIENCY RATIO ELEVATION ELEC ELECTRICAL ELEV ELEVATOR EMER EMERGENCY EQ EQUAL EQUIP EQUIPMENT ESP EXTERNAL STATIC PRESSURE ETR EXISTING TO REMAIN EWT ENTERING WATER TEMPERATURE EXH EXHAUST

FIXT FIXTURE FL FLOW LINE FPM FEET PER MINUTE TERMINAL UNIT FT FEET F/A FROM ABOVE F/B FROM BELOW GROUND GAUGE GAL GALLONS GALVANIZED GC GENERAL CONTRACTOR GPH GALLONS PER HOUR GPM GALLONS PER MINUTE HD HEAD HORIZ HORIZONTAL HP HORSEPOWER HTG HEATING

HWR DOMESTIC HOT WATER RETURN

HWS DOMESTIC HOT WATER SUPPLY

HHWR HEATING HOT WATER RETURN

HHWS HEATINGHOT WATER SUPPLY

IFGC INTERNATIONAL FUEL GAS CODE IMC INTERNATIONAL MECHANICAL FPW FAN POWERED VARIABLE VOLUME IPC INTERNATIONAL PLUMBING CODE INCHES IN WC INCHES WATER COLUMN IWW INDUSTRIAL WASTE WATER KW KILOWATT KWH KILOWATT - HOUR LENGTH LAT LEAVING AIR TEMPERATURE LAT LATENT (BTU)

POUNDS (WEIGHT)

MCF THOUSAND CUBIC FEET

LIN FT LINEAR FOOT

MAX MAXIMUM

MECH MECHANICAL

MISC MISCELLANEOUS

MIN MINIMUM

NORMALLY CLOSED NEMA NATIONAL ELECTRICAL ASSOCIATION NOT IN CONTRACT NORMALLY OPEN NUMBER LN2 LIQUID NITROGEN GAS NTS NOT TO SCALE LWT LEAVING WATER TEMPERATURE OUTSIDE AIR MBH THOUSAND BTU PER HOUR OC ON CENTER MCB MAIN CIRCUIT BREAKER OUTSIDE DIAMETER MCC MOTOR CONTROL CENTER

N2

MTRZD MOTORIZED MVD MANUAL VOLUME DAMPER NITROGEN GAS NOT APPLICABLE NEC NATIONAL ELECTRICAL CODE MANUFACTURERS ASSOCIATION

NFPA NATIONAL FIRE PROTECTION OBD OPPOSED BLADE DAMPER ODS OVERFLOW DOWNSPOUT OUNCE PRESSURE DROP

PCWR PROCESS CHILLED WATER

RETURN

PCWS PROCESS CHILLED WATER SUPPLY SEER SEASONAL ENERGY EFFICIENCY PERF PERFORATED SENS SENSIBLE (BTU) PLBG PLUMBING PSI POUNDS PER SQUARE INCH SFU SUPPLY FIXTURE UNITS PSIA POUNDS PER SQUARE INCH-ABSOLUTE SHTMTL SHEET METAL PSIG POUNDS PER SQUARE INCH-PVC POLYVINYL CHLORIDE PWR POWER QTY QUANTITY

RQMT REQUIREMENT

RTU ROOF TOP UNIT

SA SUPPLY AIR

SD STORM DRAIN

SiH4 SILANE SMACNA SHEET METAL & AIR CONDITIONING CONTRACTORS' NATIONAL ASSOCIATION RA RETURN AIR SP STATIC PRESSURE RCP REFLECTED CEILING PLAN SPECS SPECIFICATIONS RCP REFORCED CONCRETE PIPE SQ SQUARE REF REFERENCE SQFT SQUARE FEET REFR REFRIGERATOR SS. SAN SANITARY SEWER REQ'D REQUIRED STD STANDARD RLA RUNNING LOAD AMPS SURF SURFACE RM ROOM RPM REVOLUTIONS PER MINUTE

SYM SYMMETRICAL T-STAT THERMOSTAT TC TIMECLOCK TOT TOTAL (BTU) TYP TYPICAL UF UNDERFLOOR

WATER HEATER WP WEATHERPROOF WPO WASTE PLUGGED OPENING WT WEIGHT

UNO UNLESS NOTED OTHERWISE

VAV VARIABLE AIR VOLUME

VERIFY IN FIELD

VTR VENT THRU THE ROOF

VENT PLUGGED OPENING

VARIABLE VOLUME TERMINAL UNIT

VOLT

VALVE

VENTIL VENTILATION

VENT

WIDTH

WET BULB

VAC VACUUM

VERT VERTICAL

VPO

KEYED NOTES

- MARK COMMENT


 1 PROVIDE AND INSTALL AIR-COOLED CONDENSING UNIT WITH R-410A REFRIGERANT, CONDENSER GUARDS, LOW AMBIENT CONTROL AND ALL ASSOCIATED APPURTENANCES COMPLETE. MOUNT ON 4" CONCRETE HOUSEKEEPING PAD AND MAINTAIN MANUFACTURER'S RECOMMENDED CLEARANCES. SEE MECHANICAL SCHEDULE/DETAIL SHEETS.
- 2 PROVIDE AND INSTALL LP GAS FURNACE WITH DIRECT EXPANSION (DX) COOLING COIL ASSEMBLY COMPLETE WITH ALL HANGERS AND SUPPORTS. PROVIDE EMERGENCY DRAIN PAN WITH MOISTURE SENSOR BELOW COOLING COIL. SEE MECHANICAL SCHEDULE/DETAIL SHEETS.
- PROVIDE AND INSTALL IN-LINE EXHAUST FAN COMPLETE WITH HANGERS, SUPPORTS AND ALL ASSOCIATED APPURTENANCES. SUSPEND WITH 4-POINT VIBRATION ISOLATION SPRINGS. TERMINATE AS INDICATE ON PLAN.
 PROVIDE AND INSTALL ELECTRIC UNIT HEATER WITH UNIT-MOUNTED OR WALL-MOUNTED THERMOSTAT AS INDICATED. MOUNT APPROX. 9'- 0" FROM BOTTOM OF ELECTRIC HEATER TO FINISHED FLOOR. SUSPEND FROM WALL. SEE MECHANICAL SHEDULES/DETAIL SHEETS.
- PROVIDE AND INSTALL WALL-MOUNTED THERMOSTAT, CONDUIT AND CONTROL WIRING COMPLETE. MOUNT 48" AFF.
- PROVIDE AND INSTALL GALVANIZED EXTERNALLY INSULATED, LOW PRESSURE, SUPPLY/RETURN DUCTWORK COMPLETE WITH SUPPORTS, HANGERS AND ALL ASSOCIATED APPURTENANCES.
 PROVIDE AND INSTALL GALVANIZED EXTERNALLY INSULATED, LOW PRESSURE,

OUTSIDE AIR DUCTWORK COMPLETE WITH SUPPORTS, HANGERS AND ALL

ASSOCIATED APPURTENANCES.

8 PROVIDE AND INSTALL UN-INSULATED GENERAL EXHAUST DUCTWORK COMPLETE WITH HANGERS, SUPPORTS AND ALL ASSOCIATED APPURTENANCES. RUN CONCEALED IN PLENUM. GENERAL EXHAUST DUCTWORK TO BE OF

NON-COMBUSTIBLE GALVANIZED STEEL SHEET METAL CONSTRUCTION.

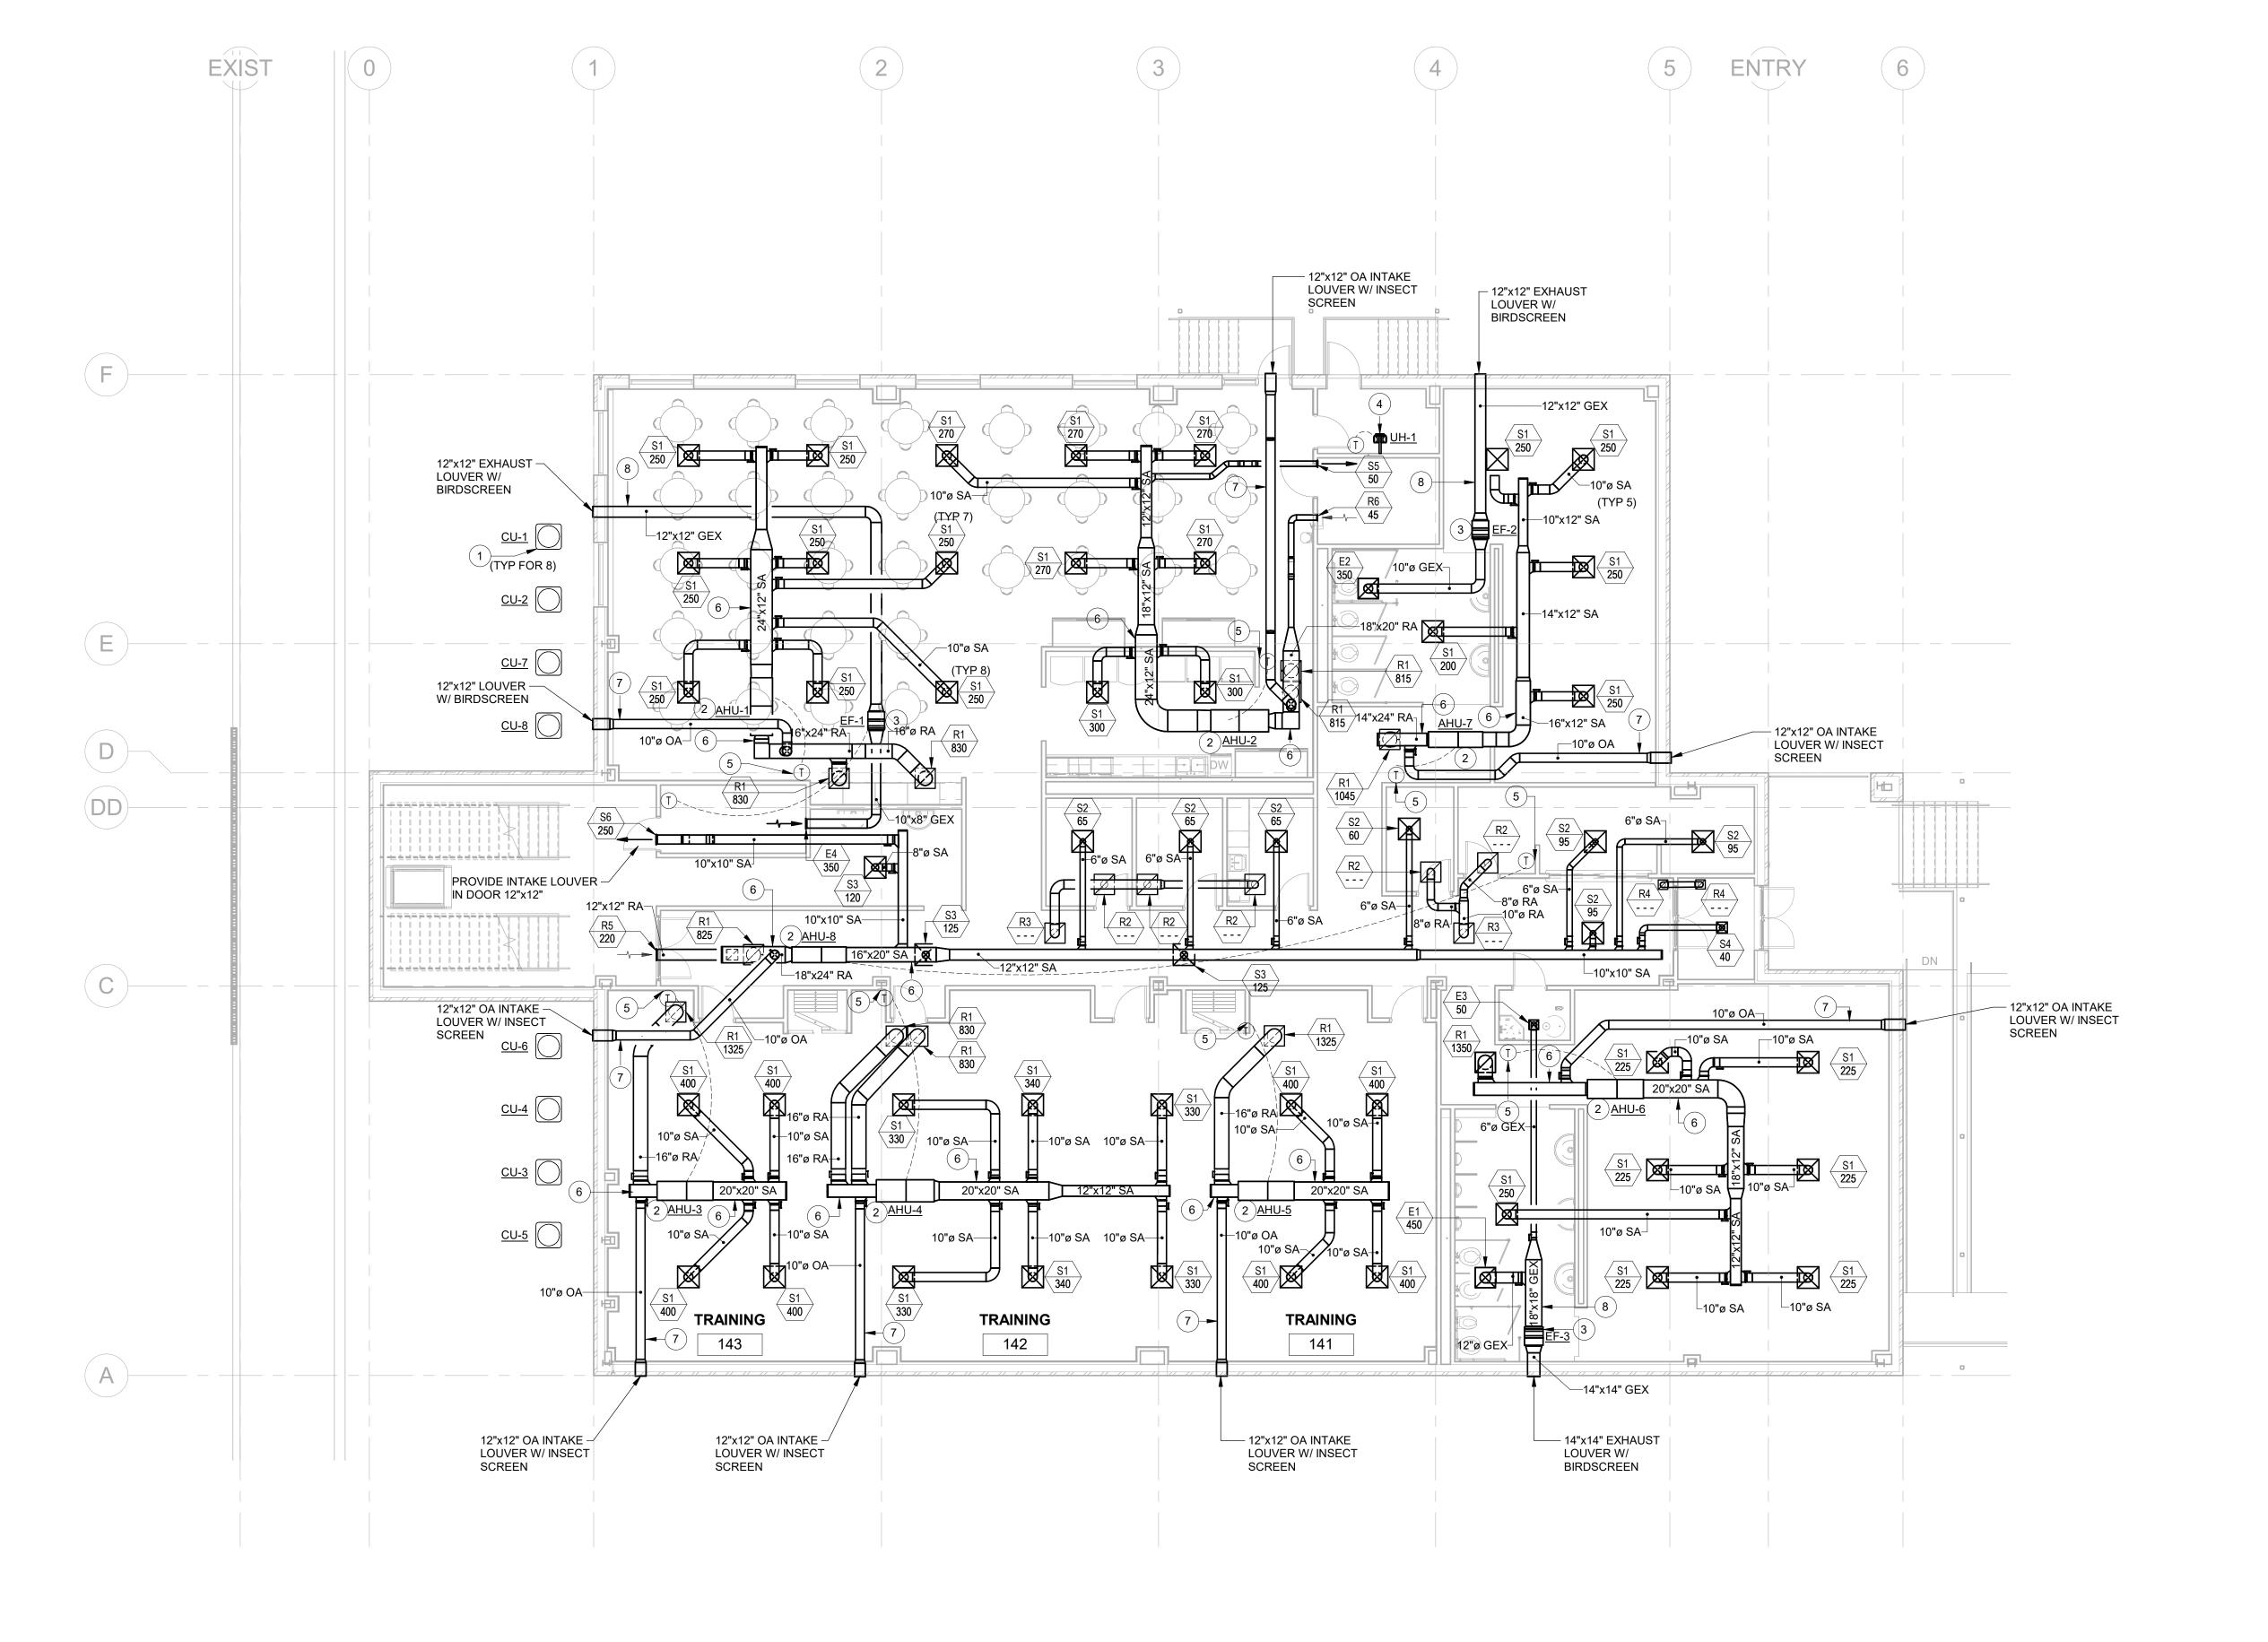



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LIBERTY PLANT

PLANT ADDITION 89 MILL ST LIBERTY, NY 12754

Project Number: 2021-213

Drawing Date: 17 AUG 2022

Drawn: CBC

Checked: MTS

Scale: 1/8" = 1'-0"

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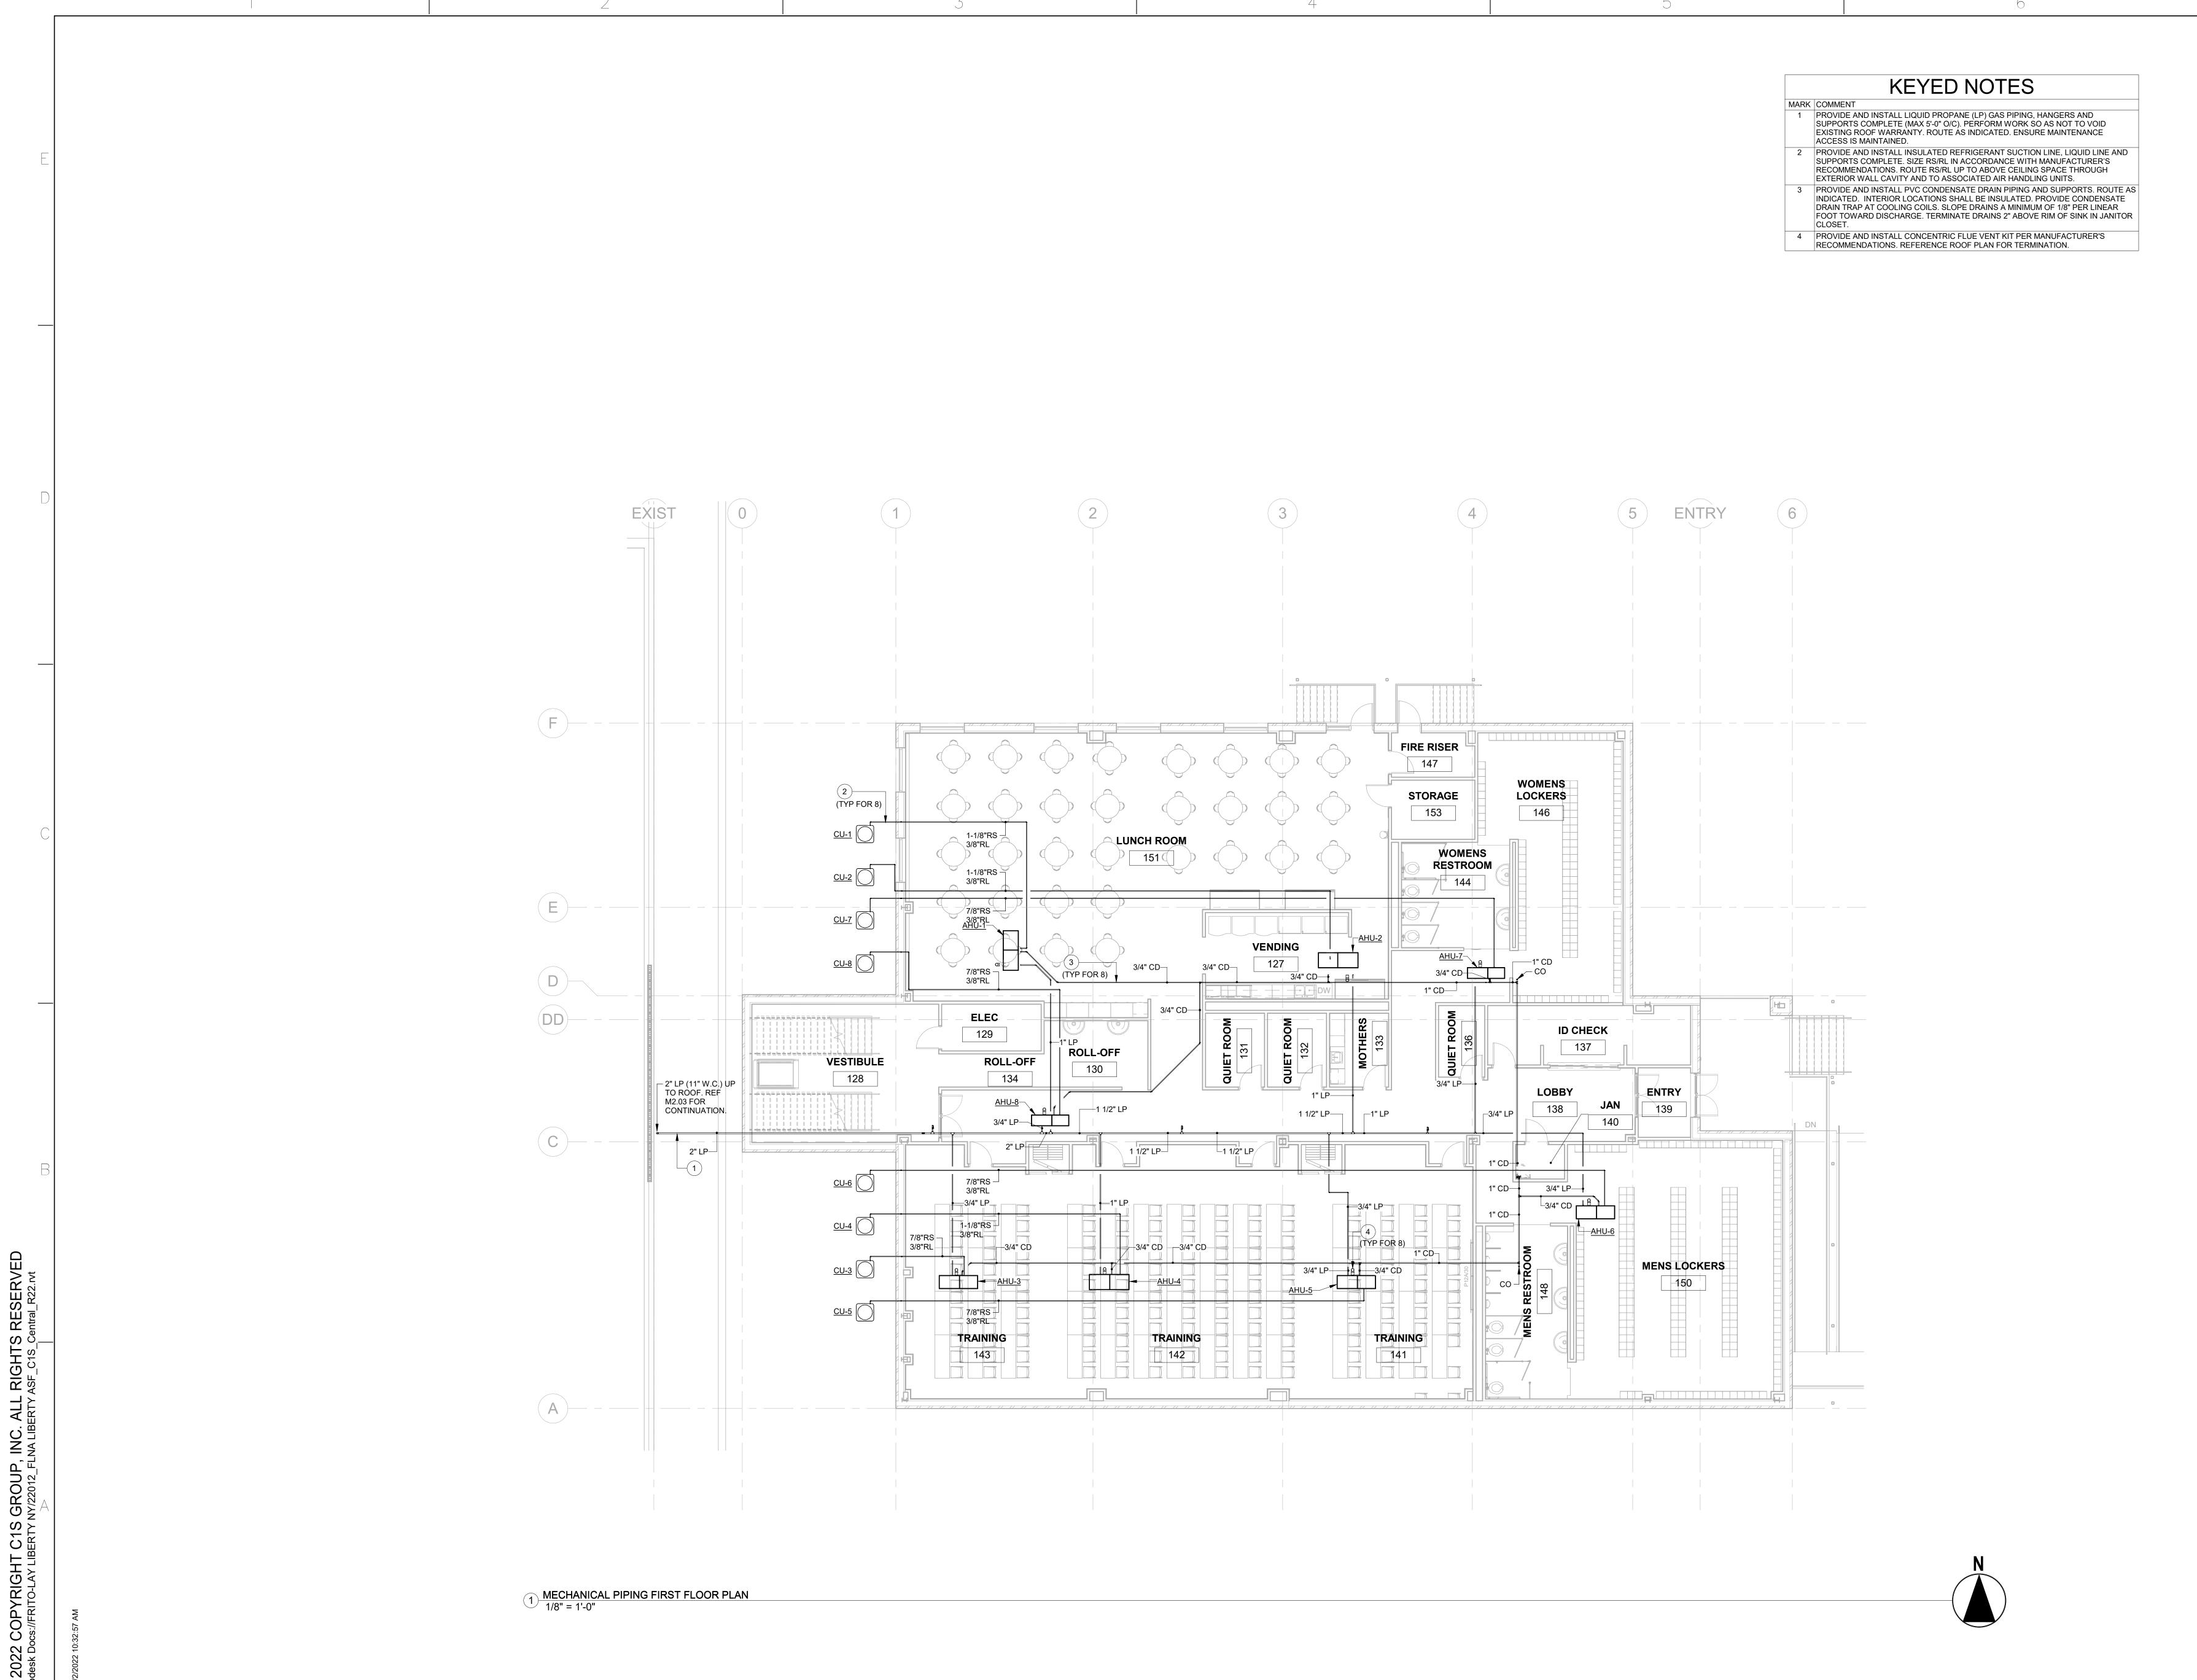
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MECHANICAL FIRST FLOOR PLAN

M2.01

1 MECHANICAL FIRST FLOOR PLAN 1/8" = 1'-0"





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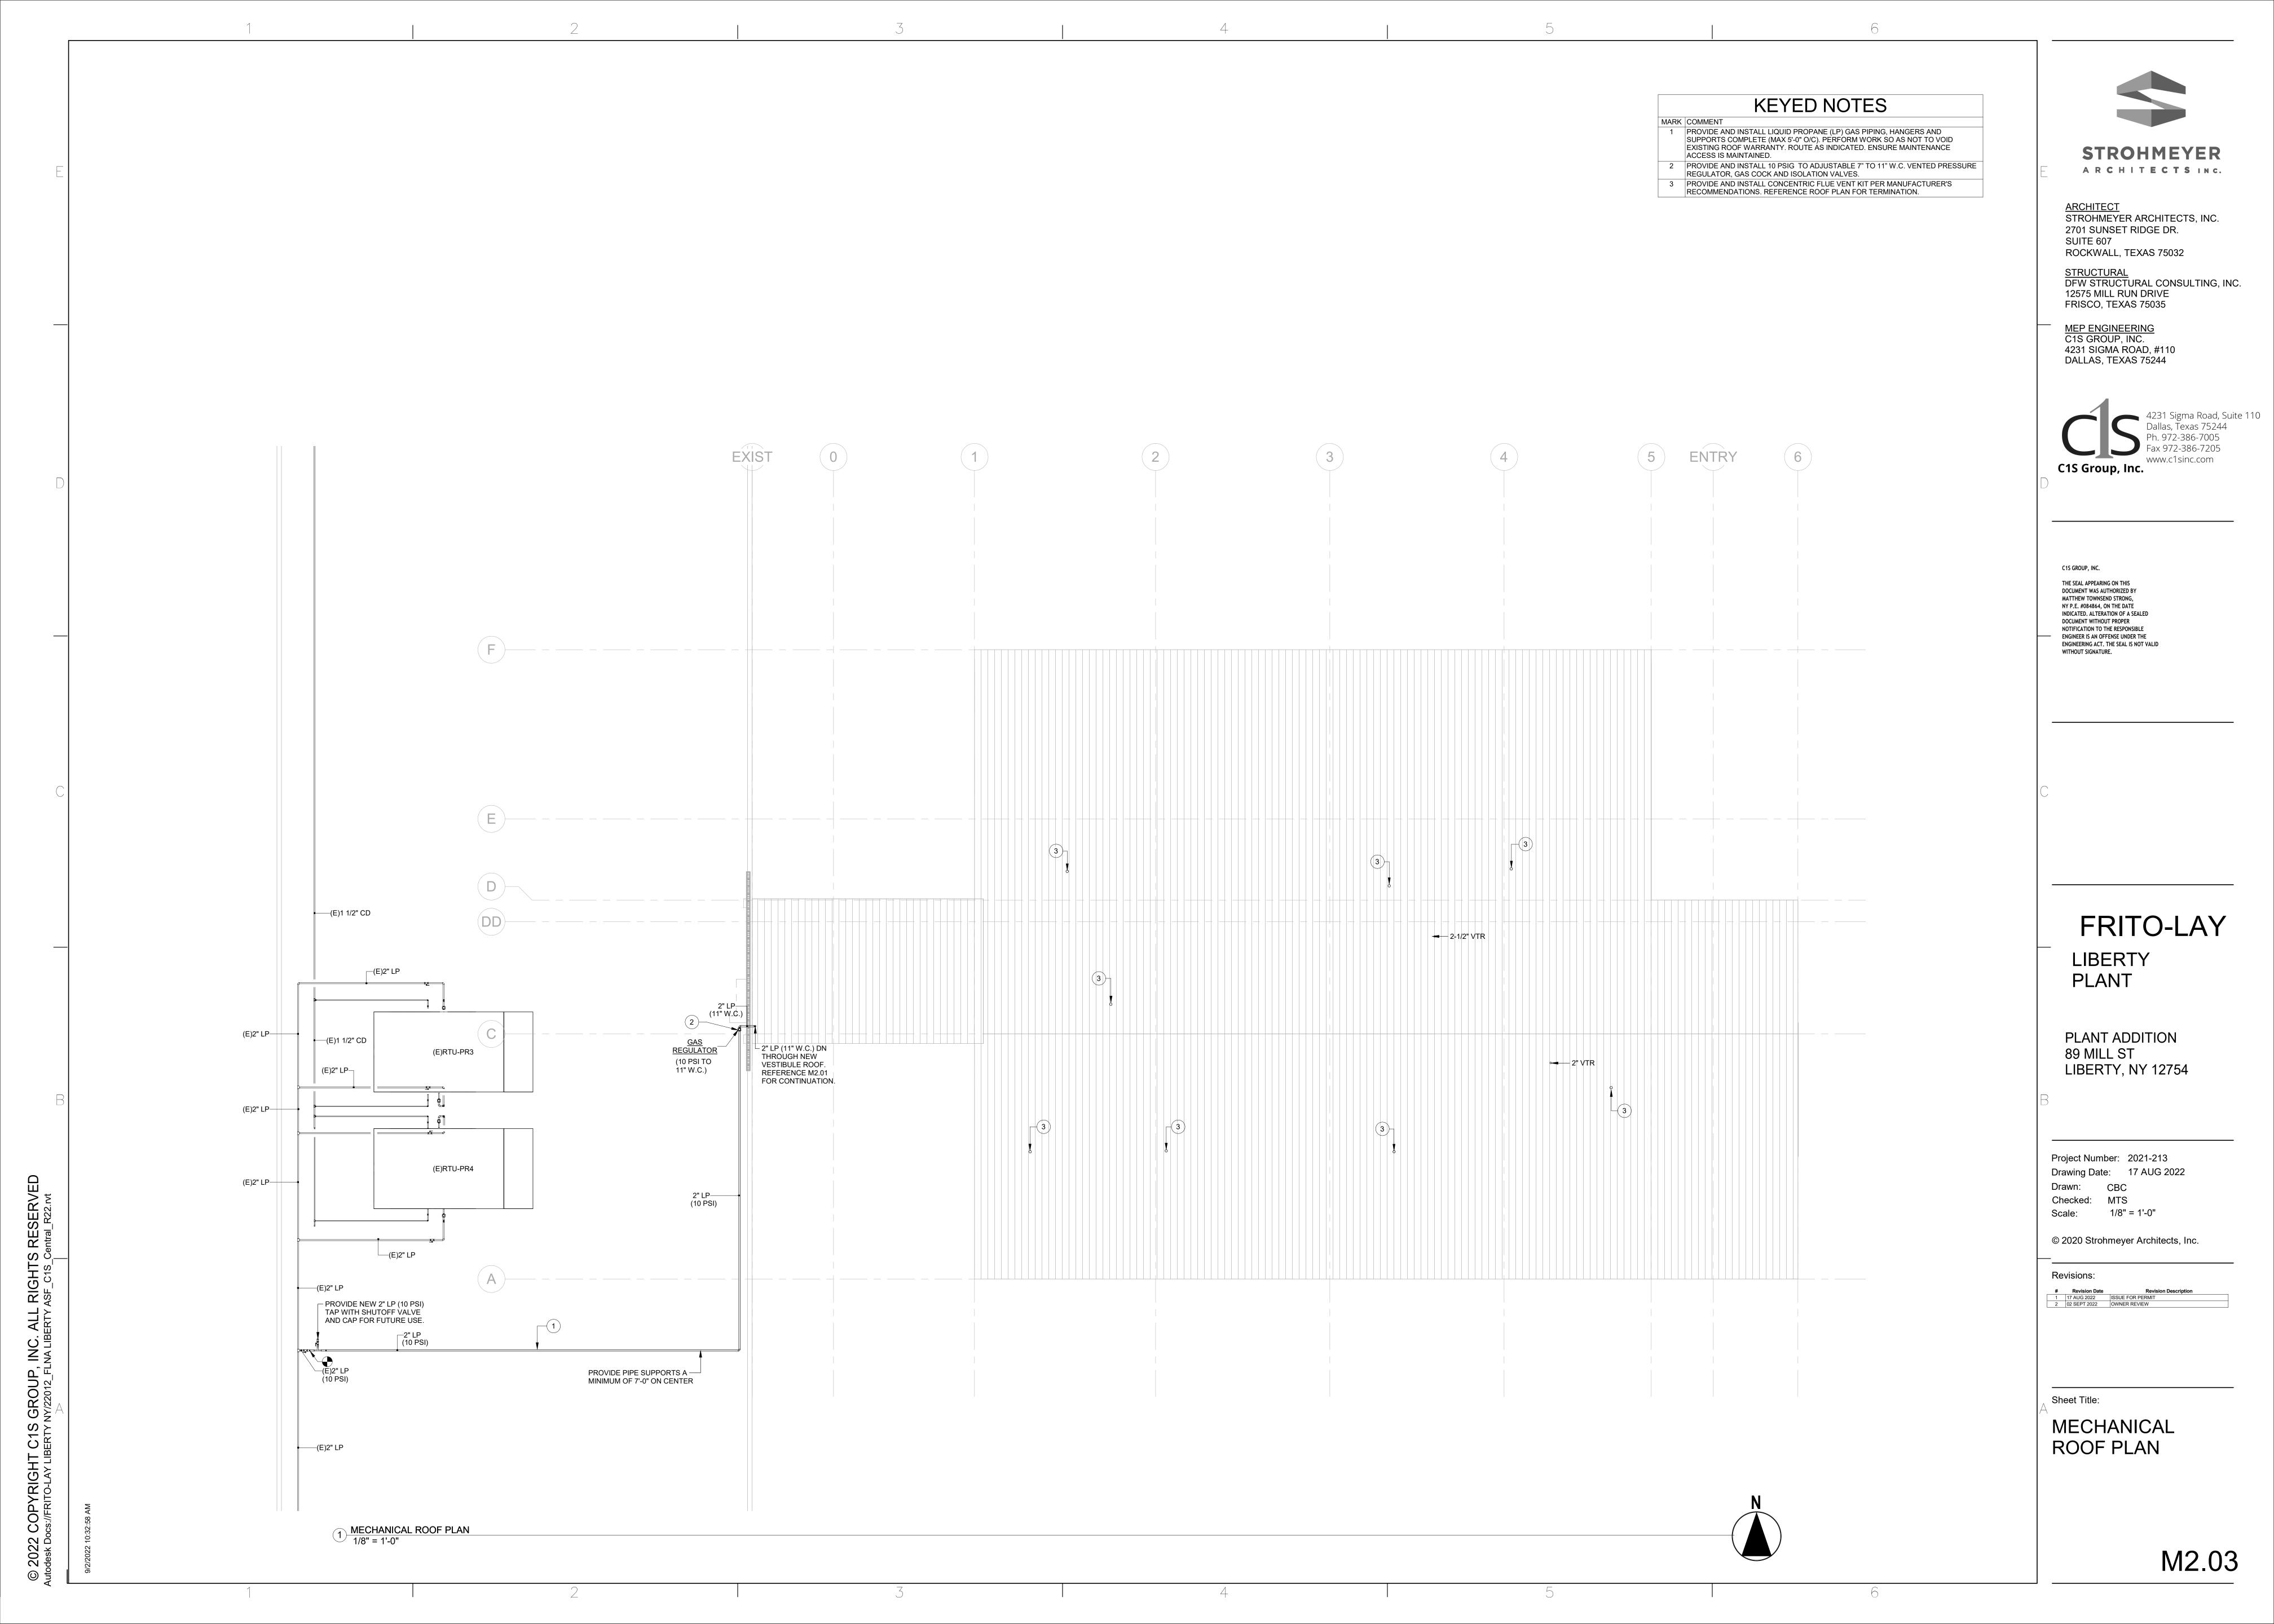
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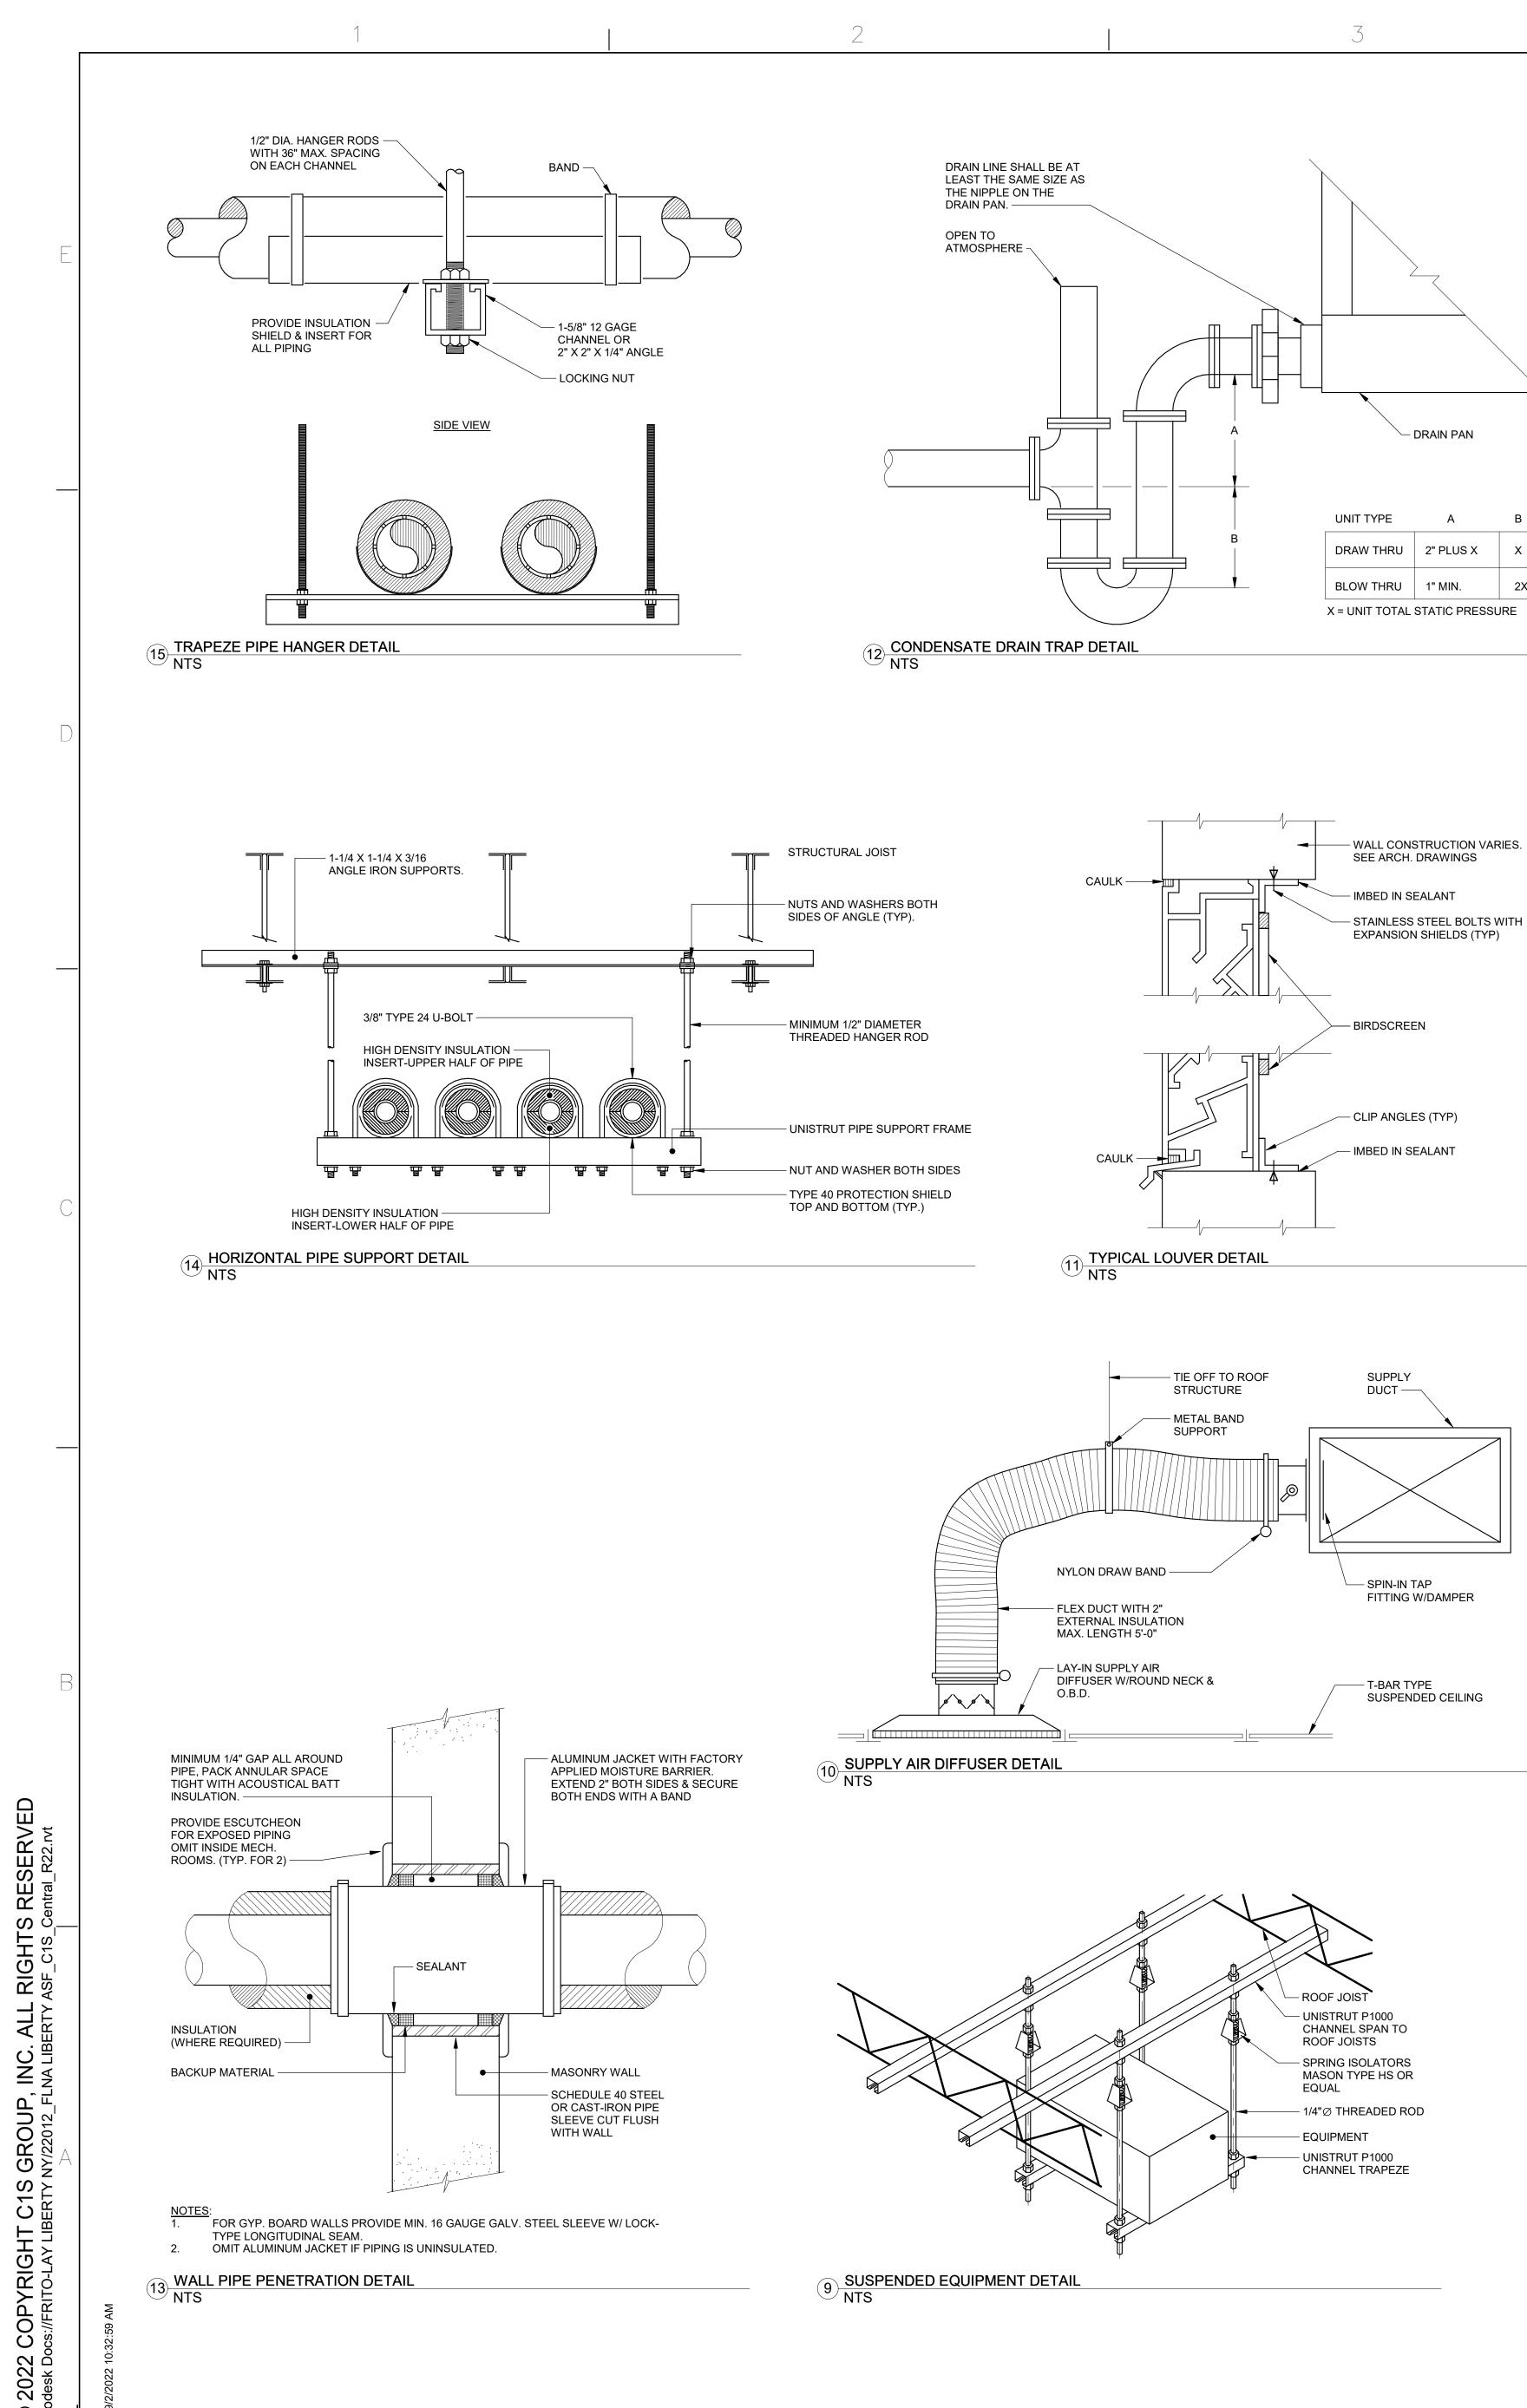
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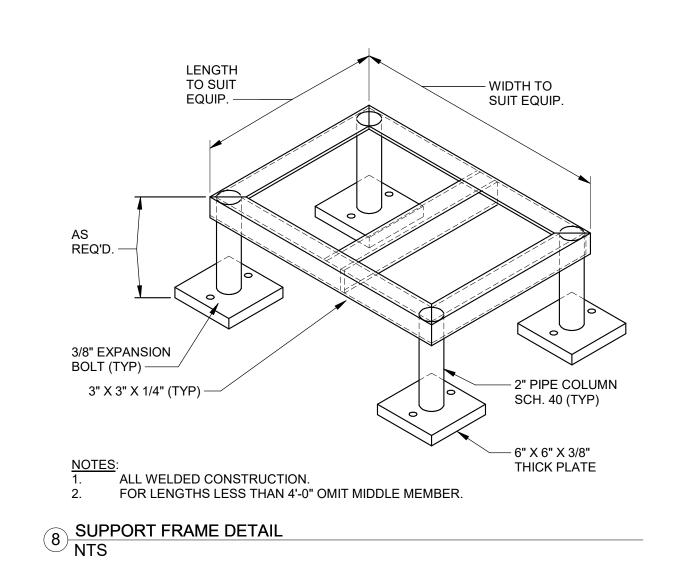
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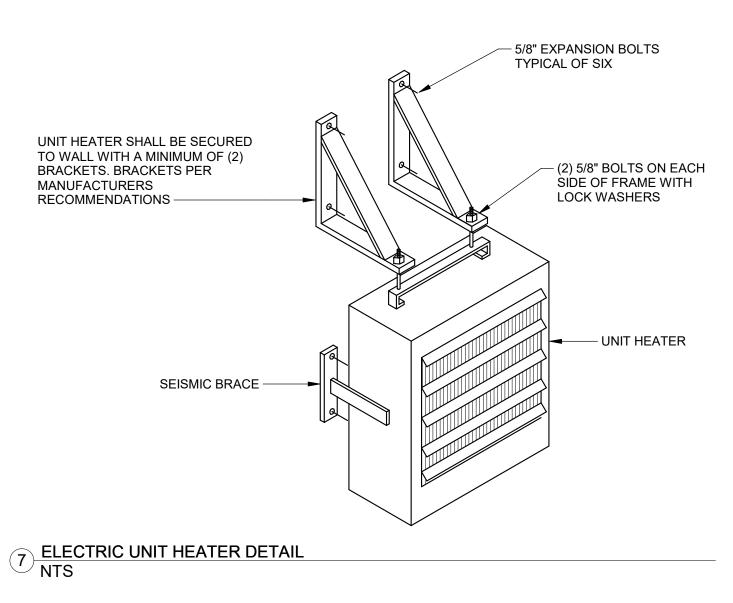
MECHANICAL PIPING FIRST FLOOR PLAN


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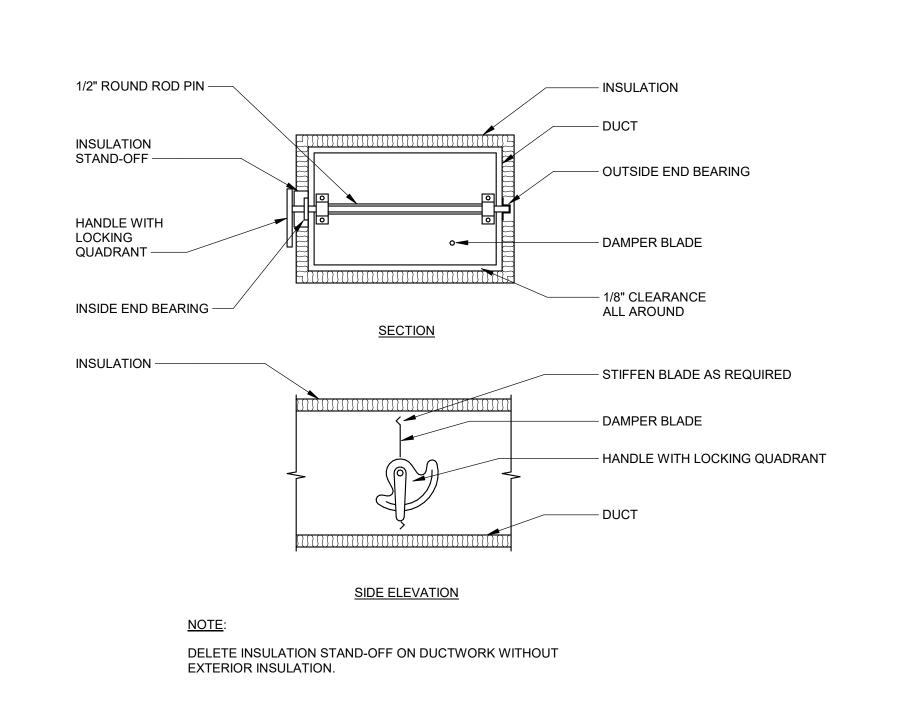












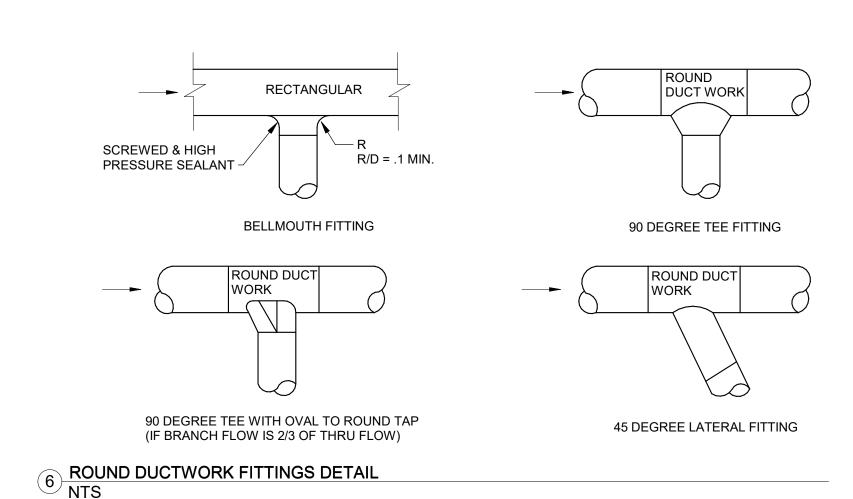

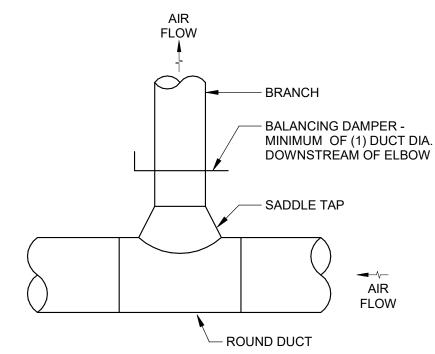


3 ROUND DUCT CONNECTION DETAIL NTS

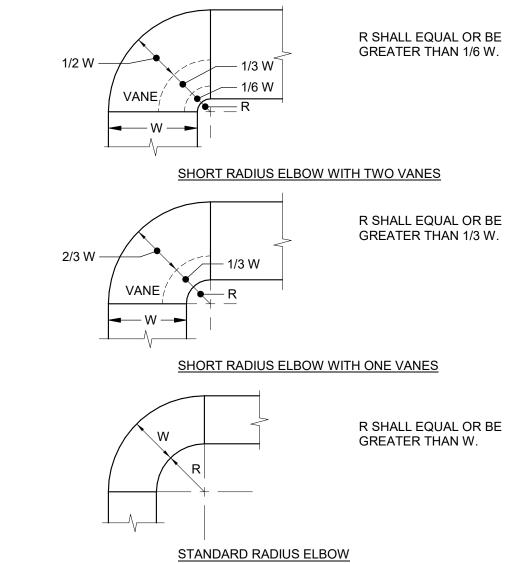


THE INTERIOR SURFACE OF ALL RADIUS ELBOWS SHALL BE MADE ROUND. ALL STANDARD RADIUS ELBOWS SHOWN ON PLANS MAY BE MADE SHORT RADIUS ELBOWS. ALL SHORT RADIUS ELBOWS SHALL HAVE VANES. VANES SHALL BE CONSTRUCTED, SUPPORTED AND FASTENED AS RECOMMENDED BY SMACNA.

4 RADIUS ELBOWS DETAIL NTS

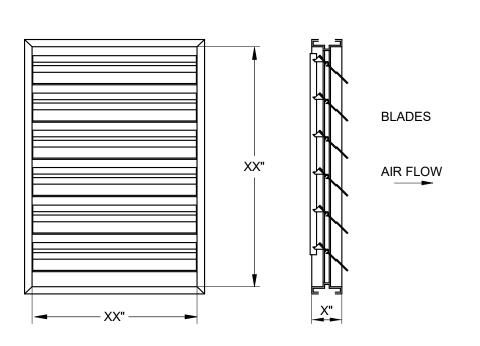

HOLD FOR VENDOR INFORMATION. TOTAL QTY - X (XXXXX) PER FAN TOWER. STAINLESS STEEL BLADE AXLES AND SINTERED PHOSPHOR BRONZE BEARINGS. BLADES AND FRAME TO BE EXTRUDED ALUMINUM CONSTRUCTION, NATURAL ANODIZED AFTER FABRICATION, WIPED AND CLEANED WITH IPA, VACUUMED, PLASTIC WRAPPED, AND DELIVERED TO SITE.

2 BACKDRAFT DAMPER DETAIL NTS

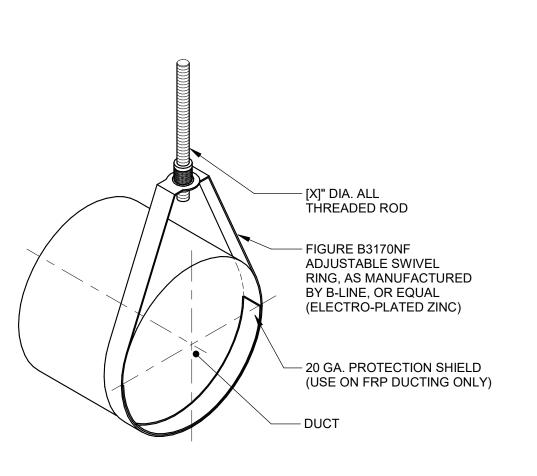

NOTE: FOR DUCT SIZES 8" AND SMALLER

1 ADJUSTABLE SWIVEL RING DUCT SUPPORT DETAIL NTS

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LIBERTY **PLANT**

PLANT ADDITION 89 MILL ST LIBERTY, NY 12754

Project Number: 2021-213 Drawing Date: 17 AUG 2022 CBC Drawn: Checked: MTS

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NTS

Revisions: Revision Date

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DETAILS

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| 1 | 17 AUG 2022 | ISSUE FOR PERMIT | 2 | 02 SEPT 2022 | OWNER REVIEW |

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					CC	ONDENSING	UNIT											FURNACE							DX	COIL		
TAG	SERVES	TOTAL CAI (MBH)	SENSIBLE CAP (MBH)	COOLING STAGES	REFRIGERANT SIZES (RS / RL)	WEIGHT	VOLTS	PHASE	MCA	МОСР	MODEL	SUPPLY AIR (CFM)	OUTSIDE AIR (CFM)	ESP (IN WG)	INPUT MBH	OUTPUT MBH	TEMP RISE RANGE	AFUE	HEATING STAGES	FURNACE WEIGHT	VOLTS PHAS	E MCA	MOCP	MODEL	WEIGHT	MODEL	MANUFACTURER	REMARKS
CU-1	LUNCH ROOM	63.0	48.5	1	1-1/8" / 3/8"	218	460	3	10.7	15	TSA060S4	2,000	340	0.5	132	106	35-65F	80%	2	188	120 1	<12	15	EL280UH-135P60D	76	CX34-62D-6F	LENNOX	SEE NOTES
CU-2	LUNCH ROOM/VENDING	63.0	48.5	1	1-1/8" / 3/8"	218	460	3	10.7	15	TSA060S4	2,000	325	0.5	132	106	35-65F	80%	2	188	120 1	<12	15	EL280UH-135P60D	76	CX34-62D-6F	LENNOX	SEE NOTES
CU-3	TRAINING WEST	50.0	40.0	1	7/8" / 3/8"	194	460	3	8.8	15	TSA048S4	1,600	275	0.5	110	86	35-65F	80%	2	161	120 1	<12	15	EL280UH-110P48C	72	CX34-49C-6F	LENNOX	SEE NOTES
CU-4	TRAINING MID	63.0	48.5	1	1-1/8" / 3/8"	218	460	3	10.7	15	TSA060S4	2,000	335	0.5	132	106	35-65F	80%	2	188	120 1	<12	15	EL280UH-135P60D	76	CX34-62D-6F	LENNOX	SEE NOTES
CU-5	TRAINING EAST	50.0	40.0	1	7/8" / 3/8"	194	460	3	8.8	15	TSA048S4	1,600	280	0.5	110	86	35-65F	80%	2	161	120 1	<12	15	EL280UH-110P48C	72	CX34-49C-6F	LENNOX	SEE NOTES
CU-6	MEN'S LOCKER/RR	50.0	40.0	1	7/8" / 3/8"	194	460	3	8.8	15	TSA048S4	1,600	250	0.5	110	86	35-65F	80%	2	161	120 1	<12	15	EL280UH-110P48C	72	CX34-49C-6F	LENNOX	SEE NOTES
CU-7	WOMEN'S LOCKER/RR	36.8	29.1	1	7/8" / 3/8"	135	460	3	7.8	15	TSA036S4	1,200	155	0.5	88	70	35-65F	80%	2	141	120 1	<12	15	EL280UH-090P36BE	51	CX34-38B-6F	LENNOX	SEE NOTES
CU-8	CENTRAL CORRIDOR	36.8	29.1	1	7/8" / 3/8"	135	460	3	7.8	15	TSA036S4	1,200	155	0.5	88	70	35-65F	80%	2	141	120 1	<12	15	EL280UH-090P36BE	51	CX34-38B-6F	LENNOX	SEE NOTES
4	MOUNT CONDENCING UNIT	2 0 11 4 11 10 11	FLUOIZ OONOF	DETE HOUSE	EKEEDING DADO	MACHINIT INI		IANDI INO	LINUTO E	OM OTOL	IOTUDE ABOVE	WITH ODDING	IOOL ATOD LIANG	2500	-	-					-			-	-	-		

MOUNT CONDENSING UNITS ON 4-INCH THICK CONCRETE HOUSEKEEPING PADS. MOUNT INDOOR AIR HANDLING UNITS FROM STRUCTURE ABOVE WITH SPRING ISOLATOR HANGERS.
PROVIDE DUCT SMOKE DETECTORS IN RETURN AIR SECTION ON ALL AIR HANDLING UNITS AND TIE INTO BUILDING FIRE ALARM SYSTEM. UPON DETECTION OF SMOKE IN THE RETURN AIR, THE UNIT SHALL SHUT DOWN.

PROVIDE MANUFACTURER'S SMART THERMOSTAT WITH AUTO-CHANGEOVER. UNIT FANS SHALL RUN CONTINUOUSLY TO PROVIDE APPROPRIATE OUTSIDE AIR TO THE SPACE AND COMPRESSORS SHALL CYCLE TO MAINTAIN SPACE TEMPERATURE SETPOINTS OF 75F COOLING AND 70F HEATING.

MAINTAIN MANUFACTURER'S SERVICE CLEARANCES FOR CONDENSING UNITS, FURNACES AND COOLING COILS.

PROVIDE CONCENTRIC VENT KIT FLUE DUCT FOR EACH FURNACE AND ROUTE UP THROUGH ROOF. FLASH ROOF WATER-TIGHT AT EACH ROOF PENETRATION.

PROVIDE 2" DEEP EMERGENCY DRAIN PAN BELOW COOLING COIL. EXTEND PAN 2" ON ALL DIMENSIONS OF COOLING COIL AND PROVIDE WITH MOISTURE SENSOR TO SHUTOFF UNIT ON DETECTION OF OVERFLOW CONDENSATE.

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TAG	LOCATION	FAN TYPE	CFM	ESP	DRIVE	HP	VOLTS	PHASE	BASIS O	REMARKS	
IAG		PANTIPE	CFIVI	(IN WG)	DRIVE				MANUFACTURER	MODEL NO	INLIMANNO
EF-1	ELECTRICAL ROOM	CENTRIFUGAL SQUARE INLINE	350	0.5	DIRECT	1/6	120	1	LOREN COOK	120SQN11D OR91	SEE NOTES
EF-2	WOMEN'S LOCKER/RR	CENTRIFUGAL SQUARE INLINE	350	0.5	DIRECT	1/6	120	1	LOREN COOK	120SQN11D OR91	SEE NOTES
EF-3	MEN'S LOCKER/RR	CENTRIFUGAL SQUARE INLINE	475	0.5	DIRECT	1/6	120	1	LOREN COOK	135SQN11D OR91	SEE NOTES

MOUNT EXHAUST FANS FROM STRUCTURE ABOVE AND PROVIDE WITH SPRING ISOLATOR SUPPORTS.
EF-1 SHALL BE PROVIDED WITH A ROOM THERMOSTAT TO ENERGIZE FAN ONCE SPACE TEMPERATURE REACHES 80F AND SHALL DE-ENERGIZE UPON A SPACE TEMPERATURE OF 78F
EF-2 AND EF-3 SHALL RUN CONTINUOUSLY.

U	NIT	HEA	TE	RS	CHEDU	JLE - E	LECTRIC		
TAG	KW	CFM	ELECT DA		BASIS OF D	DESIGN	REMARKS		
			VOLTS	PHASE	MANUFACTURER	MODEL NO			
UH-1	3.0	350	480	3	QMARK	MUH0341-PRO			
1.					WITH MANUFACTU				
2.	UNIT H	EATER SHA	LL BE P	ROVIDE	D WITH SPACE THE	RMOSTAT TO M	IAINTAIN AT LEAST 45F.		

		CDI	– –		СТГ	D O DIEELIO							
GRILLE, REGISTER & DIFFUSER SCHEDULE													
TAG	TYPE	SERVICE	CFM RANGE	NECK SIZE	MAX PD	MANUFACTURER/ MODEL NO	DESCRIPTION	REMARKS					
S1	CEILING DUCTED	SUPPLY	AS NOTED	10"ø	0.1	PRICE / ASCD	24"x24" SQUARE CONE DIFFUSER	SEE NOTES					
S2	CEILING DUCTED	SUPPLY	AS NOTED	6"ø	0.1	PRICE / ASCD	24"x24" SQUARE CONE DIFFUSER	SEE NOTES					
S3	CEILING DUCTED	SUPPLY	AS NOTED	8"ø	0.1	PRICE / ASCD	24"x24" SQUARE CONE DIFFUSER	SEE NOTES					
S4	CEILING DUCTED	SUPPLY	40	6"ø	0.1	PRICE / ASCD	12"x12" SQUARE CONE DIFFUSER	SEE NOTES					
S5	SIDEWALL	SUPPLY	50	6"x6"	0.1	PRICE / 610	SIDEWALL LOUVERED GRILLE	SEE NOTES					
S6	SIDEWALL	SUPPLY	250	10"x10"	0.1	PRICE / 610	SIDEWALL LOUVERED GRILLE	SEE NOTES					
R1	CEILING DUCTED	RETURN	AS NOTED	16"ø	0.1	PRICE / 630	24"x24" RETURN/EXHAUST LOUVERED GRILLE	SEE NOTES					
R2	CEILING DUCTED	RETURN	AS NOTED	8"ø	0.1	PRICE / 630	24"x24" RETURN/EXHAUST LOUVERED GRILLE	SEE NOTES					
R3	CEILING DUCTED	RETURN	AS NOTED	10"ø	0.1	PRICE / 630	24"x24" RETURN/EXHAUST LOUVERED GRILLE	SEE NOTES					
R4	CEILING DUCTED	RETURN	AS NOTED	6"ø	0.1	PRICE / 630	12"x12" RETURN/EXHAUST LOUVERED GRILLE	SEE NOTES					
R5	SIDEWALL	RETURN	220	12"x12"	0.1	PRICE / 630	SIDEWALL RETURN/EXHAUST LOUVERED GRILLE	SEE NOTES					
R6	SIDEWALL	RETURN	45	6"x6"	0.1	PRICE / 630	SIDEWALL RETURN/EXHAUST LOUVERED GRILLE	SEE NOTES					
E1	CEILING DUCTED	EXHAUST	450	12"ø	0.1	PRICE / 630	24"x24" RETURN/EXHAUST LOUVERED GRILLE	SEE NOTES					
E2	CEILING DUCTED	EXHAUST	350	10"ø	0.1	PRICE / 630	24"x24" RETURN/EXHAUST LOUVERED GRILLE	SEE NOTES					
E3	CEILING DUCTED	EXHAUST	50	6"ø	0.1	PRICE / 630	12"x12" RETURN/EXHAUST LOUVERED GRILLE	SEE NOTES					
E4	SIDEWALL	EXHAUST	350	10"x8"	0.1	PRICE / 630	SIDEWALL RETURN/EXHAUST LOUVERED GRILLE	SEE NOTES					

PROVIDE ALUMINUM CONSTRUCTION ON ALL GRD.
PROVIDE OPPOSED BLADE DAMPERS ON ALL SIDEWALL GRILLES AND REGISTERS.



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PLANT ADDITION 89 MILL ST LIBERTY, NY 12754

Project Number: 2021-213 Drawing Date: 17 AUG 2022 Drawn: CBC Checked: MTS

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MECHANICAL SCHEDULES

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