# GREENBURGH CENTRAL SCHOOL DISTRICT

# CENTRAL OFFICE ADMINISTRATION

475 WEST HARTSDALE AVENUE, HARTSDALE, NY 10530

# PHASE I - DISTRICT WIDE CAPITAL IMPROVEMENTS

# HIGHVIEW ELEMENTARY SCHOOL

LEE F. JACKSON ELEMENTARY SCHOOL

RICHARD J. BAILEY ELEMENTARY SCHOOL

WOODLANDS MIDDLE/ HIGH SCHOOL

PROGRAM 475 WEST HARTSDALE AVENUE

EARLY CHILDHOOD

200 NORTH CENTRAL AVENUE HARTSDALE, NY 10530 SED No.: 66-04-07-06-0-002-013

2 SARATOGA ROAD WHITE PLAINS, NY 10607 SED No.: 66-04-07-06-0-006-011

33 WEST HILLSIDE AVENUE, WHITE PLAINS, NY 10607 SED No.: 66-04-07-06-0-005-012 475 WEST HARTSDALE AVENUE HARTSDALE, NY 10530 SED No.: 66-04-07-06-0-007-022

HARTSDALE, NY 10530 SED No.: 66-04-07-06-0-011-008

# LIST of DRAWINGS

ROOF DEMOLITION AND PROPOSED PLANS ROOF DETAILS

A3.03 ROOF DETAILS DEMOLITION AND PROPOSED WINDOW AND INFILL PANEL REPLACEMENTS

#### MECHANICAL

MECHANICAL GENERAL NOTES AND SYMBOLS MECHANICAL LOWER FLOOR PLAN

### WOODLANDS MIDDLE/ HIGH SCHOOL - 'E

DEMOLITION AND PROPOSED WINDOW REPLACEMENTS

# MECHANICAL

MECHANICAL GENERAL NOTES AND SYMBOLS MECHANICAL SECOND AND THIRD FLOOR PLAN - AREA 'A' MECHANICAL FIRST FLOOR PLAN - AREA 'B' MECHANICAL GROUND AND SECOND FLOOR PLAN - AREA'C M1.04 MECHANICAL FIRST FLOOR PLAN - AREA 'D' MECHANICAL FIRST FLOOR PLAN - AREA 'E'

# ELECTRICA

ELECTRICAL NOTES AND PLANS ELECTRICAL FIRST FLOOR PLAN

MECHANICAL GENERAL NOTES AND SYMBOLS

#### ELECTRICAL

ELECTRICAL NOTES AND PLANS

EARLY CHILDHOOD PROGRAM - '

# ARCHITECTURAL

OVERALL FIRST FLOOR DEMOLITION AND PROPOSED PLANS DEMOLITION AND PROPOSED TOILET ROOM PLANS

MECHANICAL GENERAL NOTES AND SYMBOLS MECHANICAL DEMOLITION FIRST FLOOR PLAN MECHANICAL FIRST FLOOR AND BOILER ROOM NEW PLAN

PLUMBING GENERAL NOTES AND KEY PLAN PLUMBING DEMOLITION AND NEW PART PLANS AND DETAILS

MECHANICAL SCHEDULES

MECHANICAL DETAILS

# ELECTRICAL

ELECTRICAL NOTES AND LEGENDS ELECTRICAL PLANS

PROPOSED MASONRY RECONSTRUCTION PROPOSED ROOF PLAN DOOR SCHEDULE DOOR DETAILS

MECHANICAL GENERAL NOTES AND SYMBOLS MECHANICAL BASEMENT DEMOLITION PLAN MECHANICAL BASEMENT NEW PLAN MECHANICAL FIRST FLOOR DEMOLITION PLAN MECHANICAL FIRST FLOOR NEW PLAN MECHANICAL SECOND FLOOR DEMOLITION PLAN MECHANICAL SECOND FLOOR NEW PLAN MECHANICAL DEMOLITION AND NEW ATTIC AND ROOF PLAN MECHANICAL SCHEDULE


### ELECTRICAL

ELECTRICAL NOTES AND LEGENDS BASEMENT AND FIRST FLOOR DEMOLITION PLANS SECOND FLOOR DEMOLITION PLAN

MECHANICAL DETAILS

BASEMENT AND FIRST FLOOR POWER PLANS SECOND FLOOR AND ROOF POWER PLANS, RISER AND PANEL SCHEDULE

# LOCATION MAP

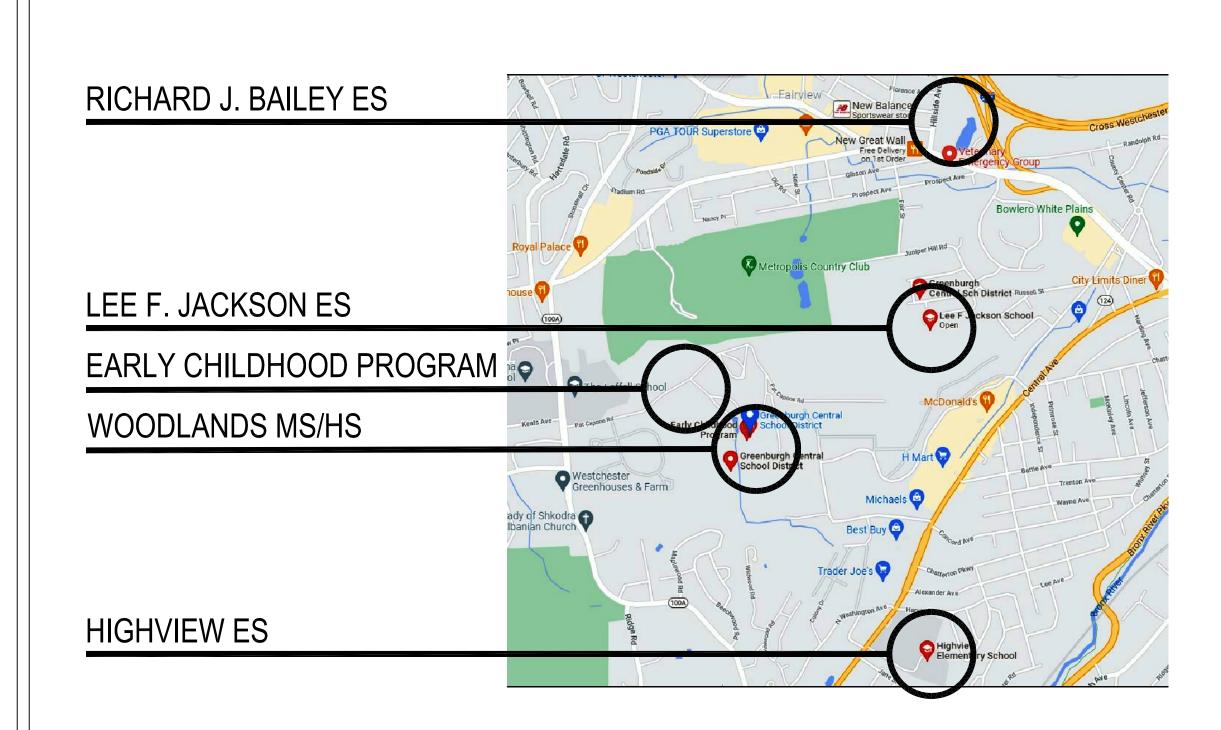

MAP DATA © GOOGL

# ARCHITECTS LANDSCAPE ARCHITECTS ENGINEERS

244 EAST MAIN STREET | PATCHOGUE | NEW YORK 11772 | T. 631.475.0349 | F. 631.475.0361 187 WOLF ROAD, SUITE 205 | ALBANY | NEW YORK 12205 | T. 518.621.7650 | F. 518.621.7655

www.BBSARCHITECTURE.COM

THE UNDERSIGNED CERTIFIES THAT TO THE BEST OF HIS KNOWLEDGE, INFORMATION. AND BELIEF, THE PLANS AND SPECIFICATIONS ARE IN ACCORDANCE WITH APPLICABLE REQUIREMENTS OF THE NEW YORK STATE UNIFORM FIRE PREVENTION AND BUILDING CODE, THE NEW YORK STATE ENERGY CONSERVATION CONSTRUCTION CODE, AND THE CONSTRUCTION STANDARDS OF THE EDUCATION DEPARTMENT.

LAWRENCE SALVESEN, A.I.A. LIC. No. 020623

BBS FILE No. 21-288 - 21-292 ISSUED FOR BID: MAY 27, 2022

#### 2020 ENERGY CONSERVATION CONSTRUCTION CODE of NEW YORK STATE DESIGN CRITERIA

OFTNEV	V TOIN ST	AIL DESIG		
2020 E.C.C.C. of N.Y. STATE	CLIMATE ZONE	INSULATION COMPONENT	R-VALUE	REFERENCE
SECTION C301 CLIMATE ZONES	ZONE 4A (WESTCHESTER COUNTY)			TABLE C301.1 NEW YORK STATE CLIMATE ZONES BY COUNTY
SECTION C402 BUILDING ENVELOPE REQUIREMENTS	ZONE 4	ROOFS - INSULATION ENTIRELY ABOVE ROOF DECK	R-30ci	TABLE C402.1.3  OPAQUE THERMAL ENVELOPE INSULATION COMPONENT MINIMUM REQUIREMENTS, R-VALUE METHOD

#### HAZARDOUS MATERIALS NOTES

- ALL CONTRACTORS SHALL BE ADVISED THAT THE SCHOOL DISTRICT HAS SOLICITED AN INDEPENDENT TESTING COMPANY TO INSPECT AND TEST ALL AREAS OF THE EXISTING BUILDING WHICH ARE SCHEDULED TO BE DISTURBED DURING CONSTRUCTION FOR THE PRESENCE OF ASBESTOS, LEAD AND /OR PCB CONTAINING CONSTRUCTION MATERIALS.
- ALL INSPECTIONS AND TESTING HAVE BEEN PERFORMED BY: ENVIROSCIENCE CONSULTANTS 37 MOORE AVENUE FIRST FLOOR MT. KISCO, NY 10549
- BUILDING HAS TESTED NEGATIVE FOR THE PRESENCE OF ASBESTOS, LEAD AND / OR PCB CONTAINING CONSTRUCTION MATERIALS. REFER TO PRE CONSTRUCTION SURVEY, BULK SAMPLING AND ANALYSIS OF SUSPECT ASBESTOS, LEAD OR PCB CONTAINING MATERIALS (PROJECT MANUAL - INFORMATION AVAILABLE TO BIDDERS) FOR ADDITIONAL INFORMATION.

RESULTS OF THE INSPECTIONS AND TESTING INDICATE THAT THE EXISTING

- ALL DISTURBANCES, REMOVAL OR DEMOLITION WORK TO THESE IDENTIFIED AREAS MUST BE PERFORMED IN CONFORMANCE WITH THE GUIDELINES AS OUTLINED IN THE PROJECT MANUAL AND APPLICABLE LOCAL, STATE AND/OR FEDERAL REGULATIONS.
- ALL LEAD, ASBESTOS AND PCB REMOVAL IS BY THE G.C. THE CONTRACTOR SHALL PERFORM A SITE INSPECTION PRIOR TO SUBMITTING A BID TO REVIEW AND QUANTIFY ALL ASBESTOS, LEAD and/or PCB CONTAINING CONSTRUCTION MATERIALS TO BE REMOVED OR AFFECTED BY THE PROPOSED SCOPE OF WORK.

WINI	D DESIGN DA	ΤΑ
DESIGN CRITERIA		REFERENCE
LTIMATE WIND SPEED	130 MPH	ASCE 7-16 FIG. 26.5-1B
ISK FACTOR	<b>II</b>	ASCE 7-16 TABLE 1.5-1
/IND EXPOSURE	CATEGORY B	ASCE 7-16 SECTION 26.7.3
ITERNAL PRESSURE COEFFICIENT	GCpi= +/- 0.18 ENCLOSED	ASCE 7-16 TABLE 26.11-1
OMPONENTS AND CLADDING	ZONE 1 = +20/ -31 PSF 2 = +20/ -51 PSF 3 = +20/ -77 PSF	ASCE 7-16 FIGURE 30.5-1 EQUATION 30.5-1

#### WOOD BLOCKING & PERIMETER EDGE NOTES

- CONTRACTOR IS TO BE ADVISED THAT IT IS THE SOLE RESPONSIBILITY OF THE CONTRACTOR TO DETERMINE THE EXTENT OF WOOD BLOCKING REQUIRED FOR ALL PERIMETER GRAVEL STOPS,. MECHANICAL CURBS, EXPANSION JOINTS, ETC. IN ACCORDNACE WITH THE TAPERED INSULATION LAYOUTS INCLUDED IN THESE CONSTRUCTION DOCUMENTS AND EXISTING CONDITIONS.
- THE DETAILS SHOWN MAY NOT DEPICT THE REQUIRED HEIGHT OF BLOCKING REQUIRED AND REPRESENT THE INTENT OF THE DETAIL AT THIS CONDITION.
- THE CONTRACTOR IS REPONSIBLE TO MAINTAIN THE HEIGHT OF THE TOP OF GRAVEL STOP AT EACH ROOF ELEVATION AND MAKE THE NECESSARY MODIFICATIONS AT THE EDGE CONDITIONS TO MEET THE TAPERED ELEVATION HEIGHTS IN ACCORDNACE WITH THE ROOF MANUFACTURERS
- THE CONTRACTOR IS RESPONSIBLE TO MODIFY THE HEIGHTS OF ALL BREAK METAL FASCIAS & FASCIA EXTENEDERS AS REQUIRED TO CONFORM TO THE INTENT OF THE DETAILS SHOWN AND THE CONDITIONS AS THEY CURRENTLY EXIST.
- PROVIDE APPROPRIATE BLOCKING FASTENERS AS REQ'D. TO SECURE BLOCKING TO EXIST. ROOF DECK IN ACCORDANCE W/ MANUF. ROOF SYSTEM REQUIREMENTS FOR COMPLIANCE W/ ASCE 7-10. CONTRACTOR SHALL PROVIDE N.Y.S. STRUCTURAL ENGINEERS CERTIFICATION FOR ANCHORING METHOD IN ACCORDANCE WITH ROOFING SPECIFICATIONS.

TAPERED INSULATION NOTES

ROOF AREAS IN CONTRACT.

MINIMUM PITCH OF 1/8" PER FOOT.

G.C. SHALL PROVIDE A TAPERED INSULATION PLAN FOR ALL

. G.C. SHALL FIELD VERIFY ROOF DIMENSIONS & ROOF DRAIN

TAPERED INSULATION LAYOUT SHALL CONFORM TO LATEST

TAPERED INSULATION PLAN SHALL SHOW ALL ROOF PITCHES

REQUIREMENTS OF THE N.Y. STATE ENERGY CODE.

& CRICKETS AS REQUIRED TO FACILITATE POSITIVE

#### ROOF DEMOLITION NOTES

- EXISTING MECHANICAL EQUIPMENT FANS SHALL BE REMOVED AND REINSTALLED AS REQUIRED TO FACILITATE REMOVAL AND INSTALLATION OF EXISTING OR NEW ROOFING. THE CONTRACTOR SHALL HIRE A LICENSED ELECTRICIAN TO DISCONNECT AND RECONNECT POWER TO FANS.
- EXISTING HVAC ROOF TOP EQUIPMENT SHALL BE REMOVED AND REINSTALLED AS REQUIRED TO FACILITATE REMOVAL AND INSTALLATION OF NEW OR EXISTING ROOFING. THE CONTRACTOR SHALL HIRE A LICENSED ELECTRICIAN TO DISCONNECT AND RECONNECT POWER TO RTU'S. THE CONTRACTOR SHALL HIRE A LICENSED PLUMBER TO DISCONNECT AND RECONNECT GAS SERVICE TO RTU'S WHERE APPLICABLE.
- CONTRACTOR SHALL REMOVE AND REPLACE EXISTING ROOF HATCHES WITH NEW AS SPECIFIED, SIZE TO MATCH EXISTING
- CONTRACTOR SHALL REMOVE EXISTING ROOFING SYSTEMS AS INDICATED FULL DEPTH AND PREPARE DECK TO RECEIVE NEW ROOFING SYSTEM.
- CONTRACTOR SHALL REMOVE EXISTING ROOF DRAIN DOME STRAINERS, FLASHING CLAMP RINGS AND INSTALL NEW C.I. OF THE SAME. CONTRACTOR TO FURNISH & INSTALL NEW 3" CAST IRON STATIC EXTENSION RINGS. THE CONTRACTOR SHALL SNAKE OUT EXISTING DRAIN LINES TO ENSURE PROPER FUNCTION OF DRAINAGE. TYPICAL AT ALL ROOF DRAIN LOCATIONS.
- ALL ROOF AREAS MARKED "NOT IN CONTRACT" SHALL BE PROTECTED DURING ROOF REPLACEMENT SCOPE OF WORK. THE CONTRACTOR. SHALL BE HELD RESPONSIBLE TO REPAIR AND RESTORE THESE AREAS IF ANY DAMAGE HAS BEEN CAUSED AT NO ADDITIONAL COST TO THE OWNER.

#### **EXISTING ROOF COMPOSITION CORES**

- \*\* ALL CORES ARE FROM THE TOP DOWN \*\*
- ROOF CORE SAMPLE #1, ROOF B AT FLASHING
- TOTAL THICKNESS ABOVE DECK: 4 INCHES GRAVEL BALLAST SURFACE
- CAP SHEET ASPHALT 1/2" PERLITE BOARD RIGID INSULATION BOARD, APPRX. 3-1/2" TOTAL
- METAL DECK STRUCTURE

#### ROOF CORE SAMPLE #2, ROOF B AT FIELD TOTAL THICKNESS ABOVE DECK: 3-1/2 INCHES GRAVEL BALLAST SURFACE

- CAP SHEET ASPHALT 1/2" PERLITE BOARD
- RIGID INSULATION BOARD, APPRX. 3" TOTAL METAL DECK STRUCTURE
- ROOF CORE SAMPLE #3, ROOF A AT FIELD TOTAL THICKNESS ABOVE DECK: 3-1/2 INCHES
- GRAVEL BALLAST SURFACE CAP SHEET - ASPHALT
- 1/2" PERLITE BOARD RIGID INSULATION BOARD, APPRX. 3" TOTAL
- VAPOR BARRIER METAL DECK STRUCTURE
- ROOF CORE SAMPLE #4, ROOF A AT FLASHING TOTAL THICKNESS ABOVE DECK: 3-1/2 INCHES
- GRAVEL BALLAST SURFACE CAP SHEET - ASPHALT
- 1/2" PERLITE BOARD • RIGID INSULATION BOARD, APPRX. 3" TOTAL
- VAPOR BARRIER METAL DECK STRUCTURE

#### ROOF CORE SAMPLE #5, ROOF OVER SMALL CANOPY TOTAL THICKNESS ABOVE DECK: 1/2 INCH

- GRAVEL BALLAST SURFACE CAP SHEET - ASPHALT
- 1/2" PERLITE BOARD CONCRETE DECK STRUCTURE
- ROOF CORE SAMPLE #6, ROOF A AT ROOF DRAIN TOTAL THICKNESS ABOVE DECK: 2-1/2 INCHES GRAVEL BALLAST SURFACE
- CAP SHEET ASPHALT 1/2" PERLITE BOARD
- RIGID INSULATION BOARD, APPRX. 2" TOTAL VAPOR BARRIER
- ROOF INSULATION TO BE A MIN. THICKNESS OF 5.2" AND R-30 ( CONTINUOUS INSULATION ) AS PER THE 2020 ENERGY METAL DECK STRUCTURE CONSERVATION CONSTRUCTION CODE

### PRE-ABATEMENT WORK NOTES:

I. THE CONTRACTOR SHALL DETERMINE EXACT FINAL LOCATIONS OF PERSONAL AND WASTE DECONTAMINATION ENCLOSURES, PICK UP AREA FOR REFUSE AND ASBESTOS DEBRIS. THESE LOCATIONS SHALL BE REVIEWED AND PROPERLY APPROVED BY THE DISTRICT PRIOR TO COMMENCEMENT OF WORK. THIS CONTRACTOR SHALL ESTABLISH, LABEL AND MAINTAIN PROPER EXITS AND WAYS OF DEPARTURE WITHIN EACH WORK AREA FOR NORMAL AND EMERGENCY USE BY WORKERS DURING ALL ABATEMENT.

POST-ABATEMENT WORK NOTES:

1. THE CONTRACTOR SHALL, UPON COMPLETION OF REMOVALS, PROVIDE WRITTEN DOCUMENTATION THAT THE PROJECT WORK AREAS ARE COMPLETELY FREE OF ALL HAZARDOUS

2. THE CONTRACTOR SHALL PROVIDE RECORDS OF ALL HAZARDOUS MATERIALS REMOVED FROM THE SITE.

# ABATEMENT NOTES

REMOVE FROM THE AREAS INDICATED; ALL ASSUMED ASBESTOS CONTAINING ELECTRICAL WIRE

INSULATION, AT ALL LOCATIONS BASED ON THIS PROJECT. LOCATED IN FAN ROOM AND INTERIOR OF AIR HANDLERS/ DUCT WORK SYSTEMS. REMOVAL SHALL BE IN COMPLIANCE WITH CODE RULE 56 AND SPECIFICATIONS.

REFER TO ENVIROSCIENCE CONSULTANTS, REPORT FOR PROJECT # 21819, CONTAINED WITHIN

THE PROJECT MANUAL, FOR ALL PRECONSTRUCTION SURVEY, BULK SAMPLING AND ANALYSIS

OF SUSPECT/ASSUMED ASBESTOS CONSTRUCTION MATERIALS. G.C. TO COORDINATE WITH ENVIROSCIENCE FOR PROJECT-SPECIFIC ABATEMENT & DISPOSAL PROTOCOL REQUIRED.

# LEAD CONTAINING NOTES



CONTRACTOR SHALL NOTE THAT LEAD PAINT EXISTS ON THE EXISTING LOWER LEVEL - LOBBY/ GYMNASIUM METAL DOOR FRAMES, METAL GLASS PARTITIONS, AND METAL I-BEAMS (GREEN/ WHITE). REFER TO SPECIFICATIONS FOR PROTOCOL ON REMOVALS AND IMPACT ON NEW WORK SCOPE.

MATERIALS IDENTIFIED ABOVE SHOULD BE CONSIDERED LEAD CONTAINING IN THE AREAS INDICATED AS WELL AS WHERE EVER THEY EXIST THROUGHOUT THE STRUCTURE.

DESIGNATED KEYNOTES INDICATE MATERIALS TO BE REMOVED AND PROPERLY DISPOSED OF UNDER THIS PROJECT. REFER TO PRE CONSTRUCTION LEAD MATERIALS INSPECTION, SAMPLING REPORT, AND LEAD WORK SAFE PLAN SPECIFICATION 02090 FOR ABATEMENT PROCEDURES AND LEGAL REMOVAL AND DISPOSAL REQUIREMENTS. REFER TO ENVIROSCIENCE CONSULTANTS, REPORT FOR PROJECT # 21819, CONTAINED WITHIN THE PROJECT MANUAL FOR LEAD-BASED PAINT INSPECTION DATA & APPENDIX C FOR LEAD XRF TEST RESULTS FOR PROJECT-SPECIFIC

#### ROOF SYMBOL LEGEND

REV. DATE

KEY PLAN

NOT TO SCALE

<u>NOTICE</u>

THESE DRAWINGS ARE BASED ON CONSTRUCTION DRAWINGS NOT

EPARED BY BBS ARCHITECTS, LANDSCAPE ARCHITECTS AN

GINEERS, PC. AND, THEREFORE, MAY NOT REPRESENT TH ONDITIONS AS CONSTRUCTED AT THE TIME. ALL EXISTING

CONDITIONS SHOWN ARE REPRESENTED AS SUGGESTIVE INFORMATION AS THEY MAY NOT HAVE BEEN BUILT AND DETAILED

PER THE ORIGINAL DOCUMENTS OR PER THE OWNER'S INFORMATION

\_\_\_\_\_

∥ RTU ∰ EXISTING ROOFTOP AIR HANDLER LOCATIONS ON EQUIPMENT RAILS

EXISTING A/C CONDENSER LOCATION ON EQUIPMENT RAILS

EXISTING ROOF TOP EXHAUST FAN LOCATION EXISTING ROOF DRAIN LOCATIONS

EXISTING PENETRATION POCKET THRU ROOF LOCATIONS TO REMAIN

 EXISTING PLUMBING VENT THRU ROOF LOCATIONS TO REMAIN

AREAS WHERE EXISTING THRU WALL FLASHING IS TO BE REMOVED AND RAISED, SEE DETAILS

ROOF CORE LOCATIONS, REFER TO EXISTING ROOF COMPOSITION NOTES FOR ADDITIONAL INFO.

 LOW POINT OF TAPERED INSULATION HIGH POINT OF TAPERED INSULATION

@ 1/8" PER FOOT - U.O.N.

INDICATES EXIST'G ROOF EXPANSION JOINT LOCATION. G.C. TO REMOVE & INSTALL NEW

AS DETAILED

SHEET METAL GOOSE NECK VENT STACK

INDICATES NEW ROOF WALKWAY PADS

INDICATES ROOF AREA NOT IN CONTRACT

MECHANICAL GRAVITY VENTS

EXISTING COPING MOUNTED SECURITY LIGHT, REMOVE AND REINSTALL

EXISTING SKYLIGHTS TO BE REMOVED AND REPLACED WITH NEW, SEE DETAILS

#### **GENERAL NOTES**

- IN ACCORDANCE WITH STATE AND LOCAL CODES, THE REQUIRED EXITS IN THE EXISTING BUILDING MUST BE KEPT CLEAR, MAINTAINED, AND PROTECTED.
- ALL WORK AND MATERIAL OF THIS PROJECT AND ADJACENT SURFACES AND THE INTERIOR OF THE BUILDING SHALL BE PROTECTED FROM DAMAGE. IN THE EVENT OF DAMAGE, THE RESPONSIBLE CONTRACTOR (I.E. GENERAL CONTRACTOR OR ASBESTOS CONTRACTOR) SHALL IMMEDIATELY MAKE ALL REPAIRS AND REPLACEMENTS NECESSARY TO THE APPROVAL OF THE ARCHITECT AND AT NO ADDITIONAL COST TO THE
- ALL DEMOLITION AND CONSTRUCTION WORK TO BE PERFORMED WITHOUT INTERRUPTION TO SCHOOL OPERATIONS AND SHALL COMPLY WITH PROCEDURES OUTLINED IN SPECIFICATION SECTION 01030 OF THE PROJECT
- EACH CONTRACTOR SHALL ENFORCE STRICT DISCIPLINE AND GOOD ORDER AMONG THE CONTRACTOR'S EMPLOYEES AND OTHER PERSONS CARRYING OUT THE CONTRACT. THE CONTRACTOR SHALL NOT PERMIT EMPLOYMENT OF UNFIT PERSONS OR PERSONS NOT SKILLED IN THE TASKS ASSIGNED
- EACH CONTRACTOR IS RESPONSIBLE FOR DISPOSAL OF ALL OF HIS OWN PROJECT WASTE MATERIAL AND RUBBISH FOR SUBSEQUENT LEGAL OFF-SITE DISPOSAL. CONTAINER LOCATION TO BE COORDINATED WITH THE OWNER. OFF-SITE DISPOSAL TO BE ON A REGULAR BASIS.
- 6. CONTRACTOR SHALL VERIFY ALL EXISTING CONDITIONS PRIOR TO BIDDING AND PRIOR TO PROCEEDING WITH WORK. NOTIFY ARCHITECT OF ANY DISCREPANCIES IN WRITING.
- CONTRACTOR SHALL BE RESPONSIBLE FOR VERIFICATION OF ALL DIMENSIONS REQUIRED FOR BIDDING AND ESTIMATING.
- . CONTRACTOR TO PROTECT ALL AREAS OF WORK FROM INCLEMENT WEATHER DURING AND AT THE END OF DAILY WORK OPERATIONS.
- 9. ALL PROJECT WASTE MATERIAL AND RUBBISH TO BE DISPOSED IN CONTAINERS PROVIDED BY EACH CONTRACTOR FOR SUBSEQUENT LEGAL OFF-SITE DISPOSAL. CONTAINER LOCATION TO BE COORDINATED WITH THE CONSTRUCTION MANAGER AND OWNER. OFF-SITE DISPOSAL TO BE ON A REGULAR BASIS.
- 10. ALL INTERIOR SURFACES DISTURBED DURING CONSTRUCTION SHOULD BE REPAIRED AND/OR REPLACED TO MATCH EXISTING CONDITIONS TO THE APPROVAL OF THE ARCHITECT AND
- 11. ALL DEBRIS, DUST, AND DIRT CAUSED BY WORK OF THIS CONTRACT SHALL BE REMOVED FROM SITE BY APPROPRIATE MEANS. RESTORE ALL CONDITIONS TO THE STATE OF CLEANLINESS THAT EXISTED PRIOR TO COMMENCEMENT OF

# WIRE AND CONDUIT NOTE

THE ROOF CONTRACTOR SHALL HAVE ALL ELECTRICAL CONDUIT IN THE VICINITY OF THE ROOF RECONSTRUCTION DISCONNECTED BY A LICENSED ELECTRICIAN AS NEEDED. CONDUIT SHOULD BE DISCONNECTED AS REQUIRED AS THE AREA THAT CONTAINS THE ELECTRICAL CONDUIT BECOMES IMPACTED BY ROOF RECONSTRUCTION WORK. THE CONTRACTOR MUST REVIEW & COORDINATE ALL ELECTRICAL CONDUIT DISCONNECTS WITH THE SCHOOL DISTRICT, SO AS NOT TO DISRUPT OR INTERFERE WITH SCHOOL OPERATIONS. WHEN ROOF RECONSTRUCTION WORK HAS BEEN COMPLETED IN A PARTICULAR AREA, ANY ELECTRICAL CONDUIT THAT CAN REASONABLY BE REINSTALLED WITHOUT EFFECTING ONGOING AREAS OF ROOF RECONSTRUCTION, SHALL BE SO REINSTALLED BY A LICENSED ELECTRICIAN. THE ROOF CONTRACTOR WILL PROVIDE PRE-MANUFACTURED PIPE SUPPORT PEDESTAL ASSEMBLIES FOR ALL CONDUIT. PIPE PEDESTAL SUPPORT DESIGN & SPACING SHALL BE SPECIFIED BY ROOF SURFACING MANUFACTURER & REVIEWED BY ARCHITECT PRIOR TO CONSTRUCTION OR PURCHASE BY THE THE CONTRACTOR. ALL ELECTRICAL CONNECTIONS SHALL BE RESTORED UPON COMPLETION OF THE WORK. ALL ELECTRICAL WORK TO EXISTING ROOF TOP EQUIPMENT WHICH MUST BE EXTENDED DUE TO NEW ELEVATION OF ROOF CURBS IS ALSO THE FULL RESPONSIBILITY OF THE ROOF CONTRACTOR.

NOTE TO CONTRACTOR:

ANY SQUARE FOOTAGES AND/OR DIMENSIONS SHOWN SHALL BE CONSIDERED APPROXIMATE. THE CONTRACTOR IS FULLY RESPONSIBLE TO FIELD-VERIFY ALL ROOF AREA DIMENSIONS AND INCLUDE ALL CONDITIONS AS A PART OF THE BASE BID COST.

F. 518.621.7655 F. 631.475.0361 www.BBSARCHITECTURE.com

DRAWING BY: SES

ONSENT OF THE ARCHITECT OR ENGINEER.

**ARCHITECTS** 

ENGINEERS

NEW YORK 11772

JWW

THIS DRAWING, PREPARED FOR THE SPECIFIC PROJECT INDICATED IS AN INSTRUMENT OF SERVICE AND THE PROPERTY OF BBS

ARCHITECTS, LANDSCAPE ARCHITECTS AND ENGINEERS, P INFRINGEMENT OR ANY USE OF THIS DRAWING FOR ANY OTHE

PROJECT IS PROHIBITED. ANY ALTERATION OR REPRODUCTION OF THIS DOCUMENT IS ALSO PROHIBITED WITHOUT THE WRITTEN

LANDSCAPE ARCHITECTS

87 WOLF ROAD, STE. 205

NEW YORK 12205

CHECK BY:


66-04-07-06-0-002-013 DISTRICT GREENBURGH CSD PROJECT PH. I - DW CAP. IMPROVEMENTS HIGHVIEW E.S.

PROPOSED PLANS SCALE: AS NOTED MAY 2022 BID PICK-UP: MAY 27, 2022

DWG TITLE ROOF DEMOLITION &


A3.01A


FILE No: 21-288

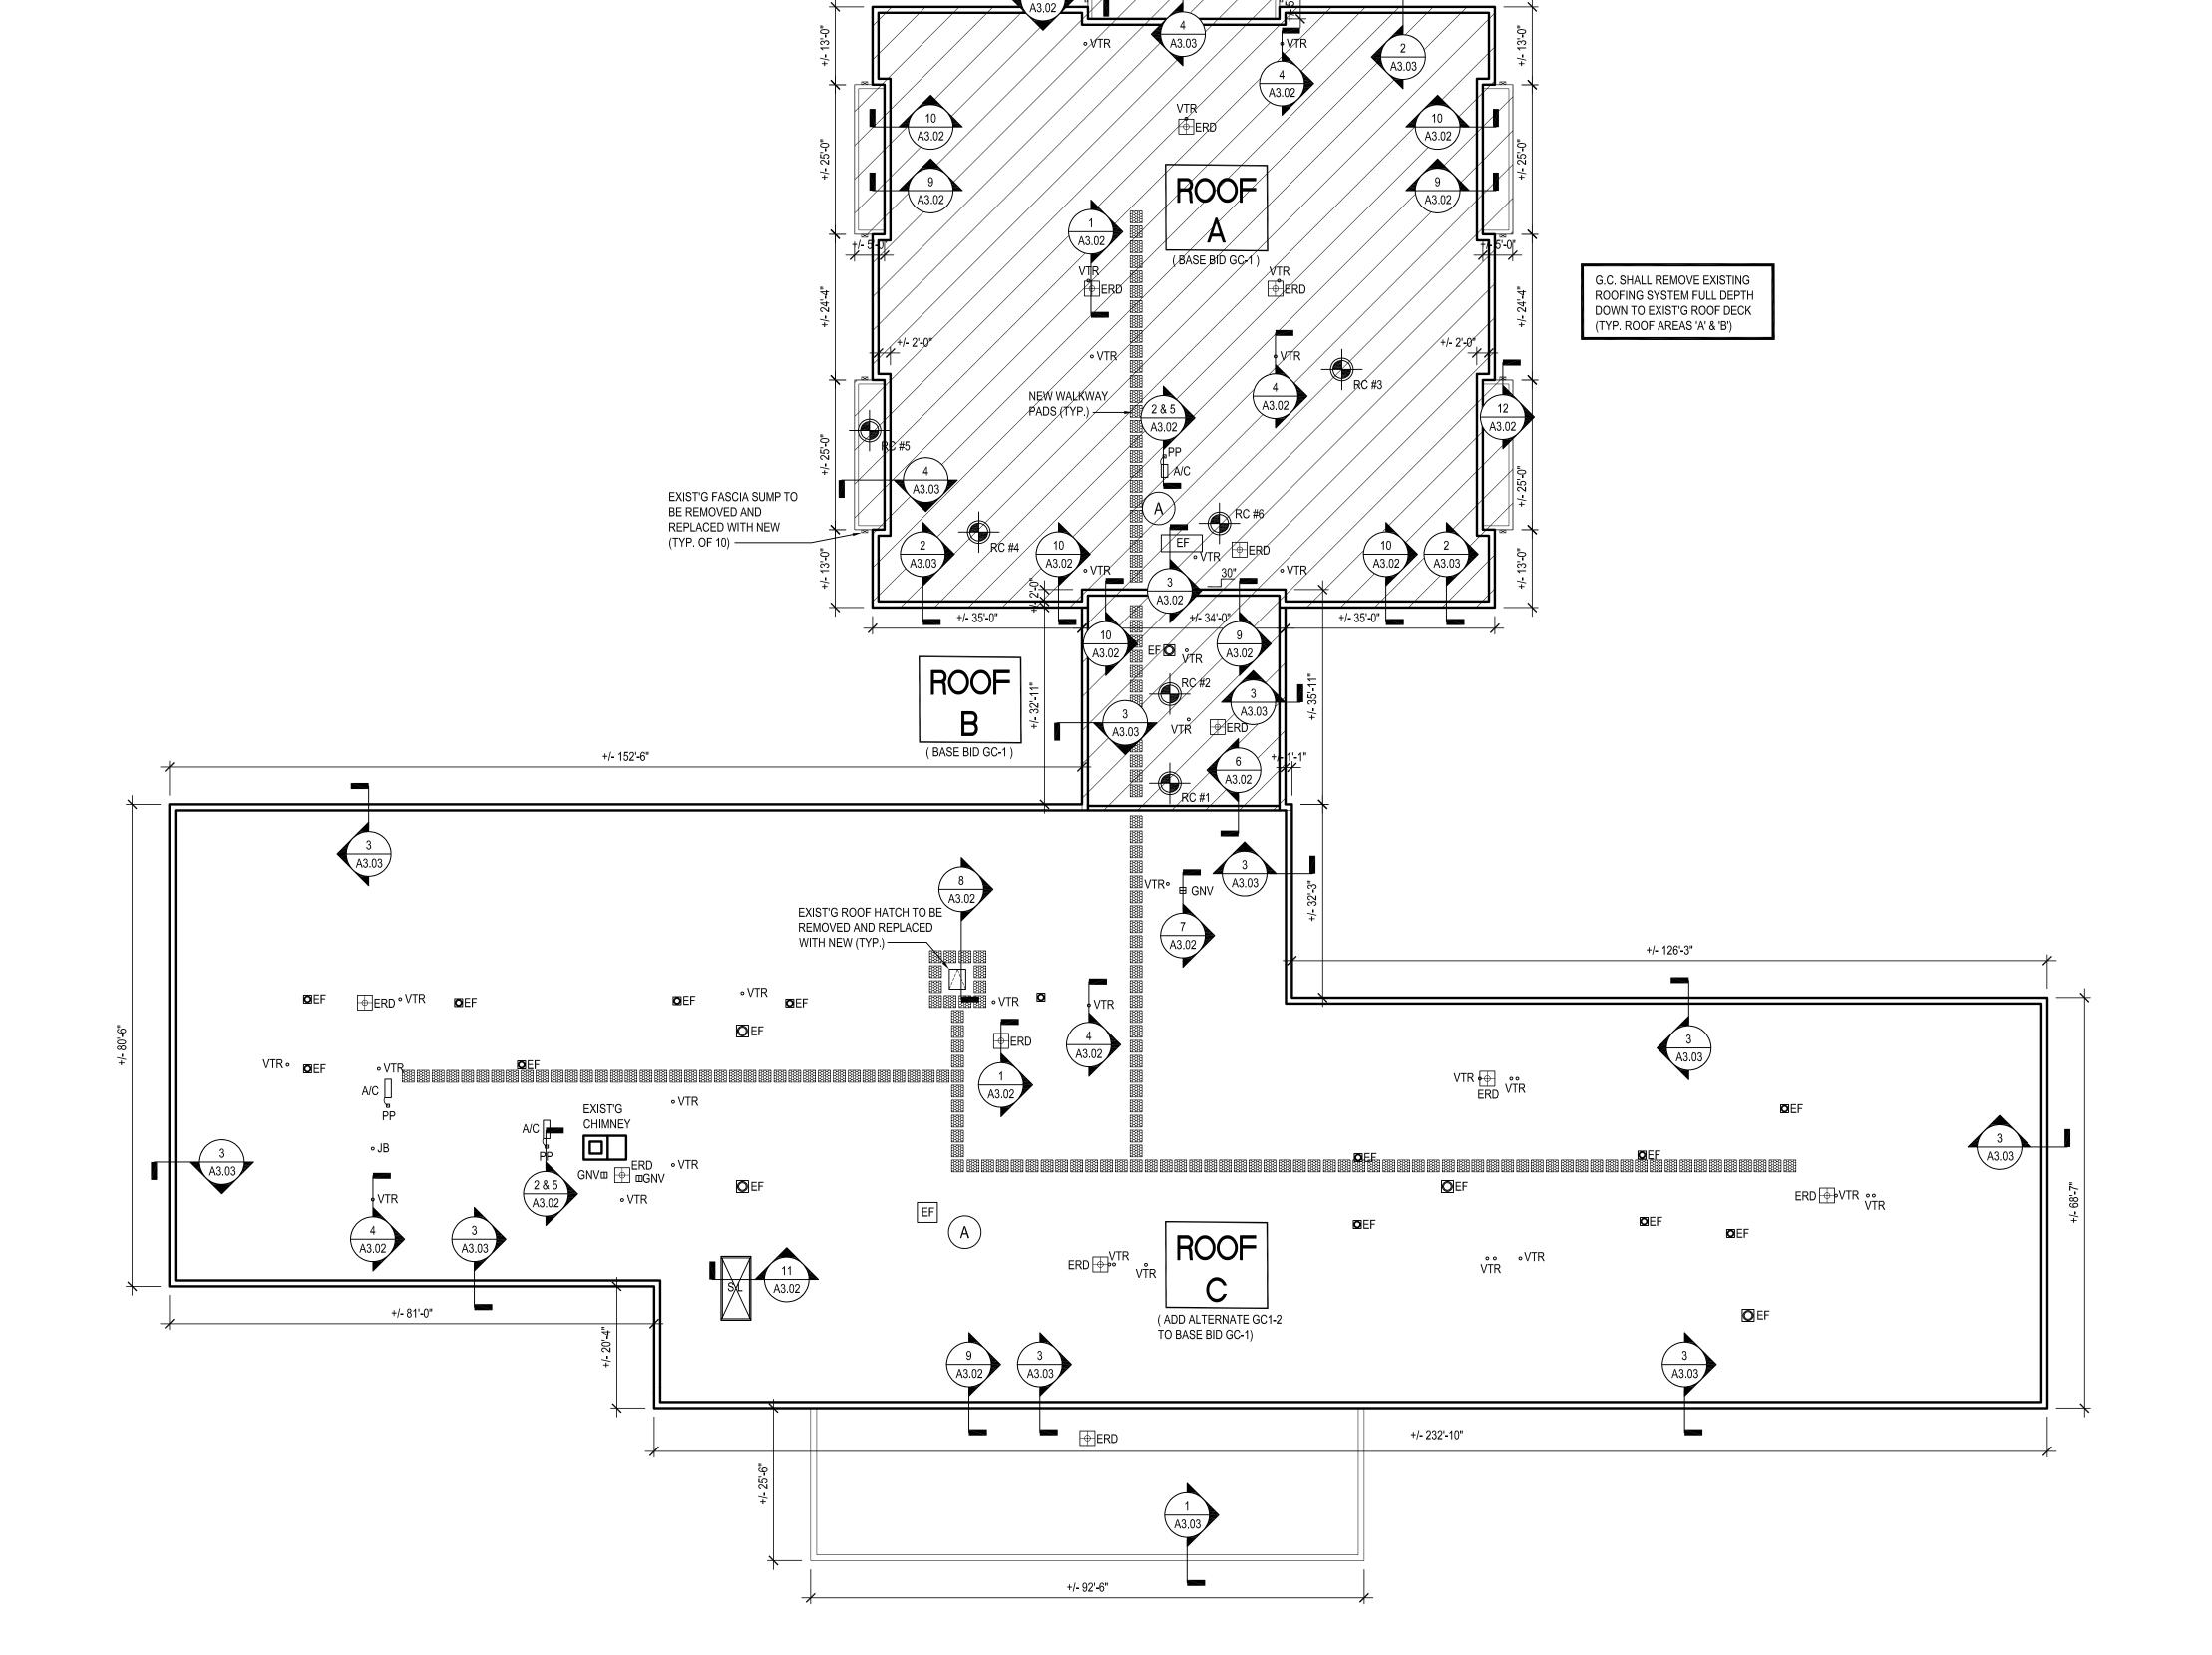


ROOF DEMOLITION AND PROPOSED PLAN

HIGHVIEW ELEMENTARY SCHOOL

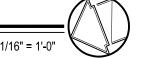

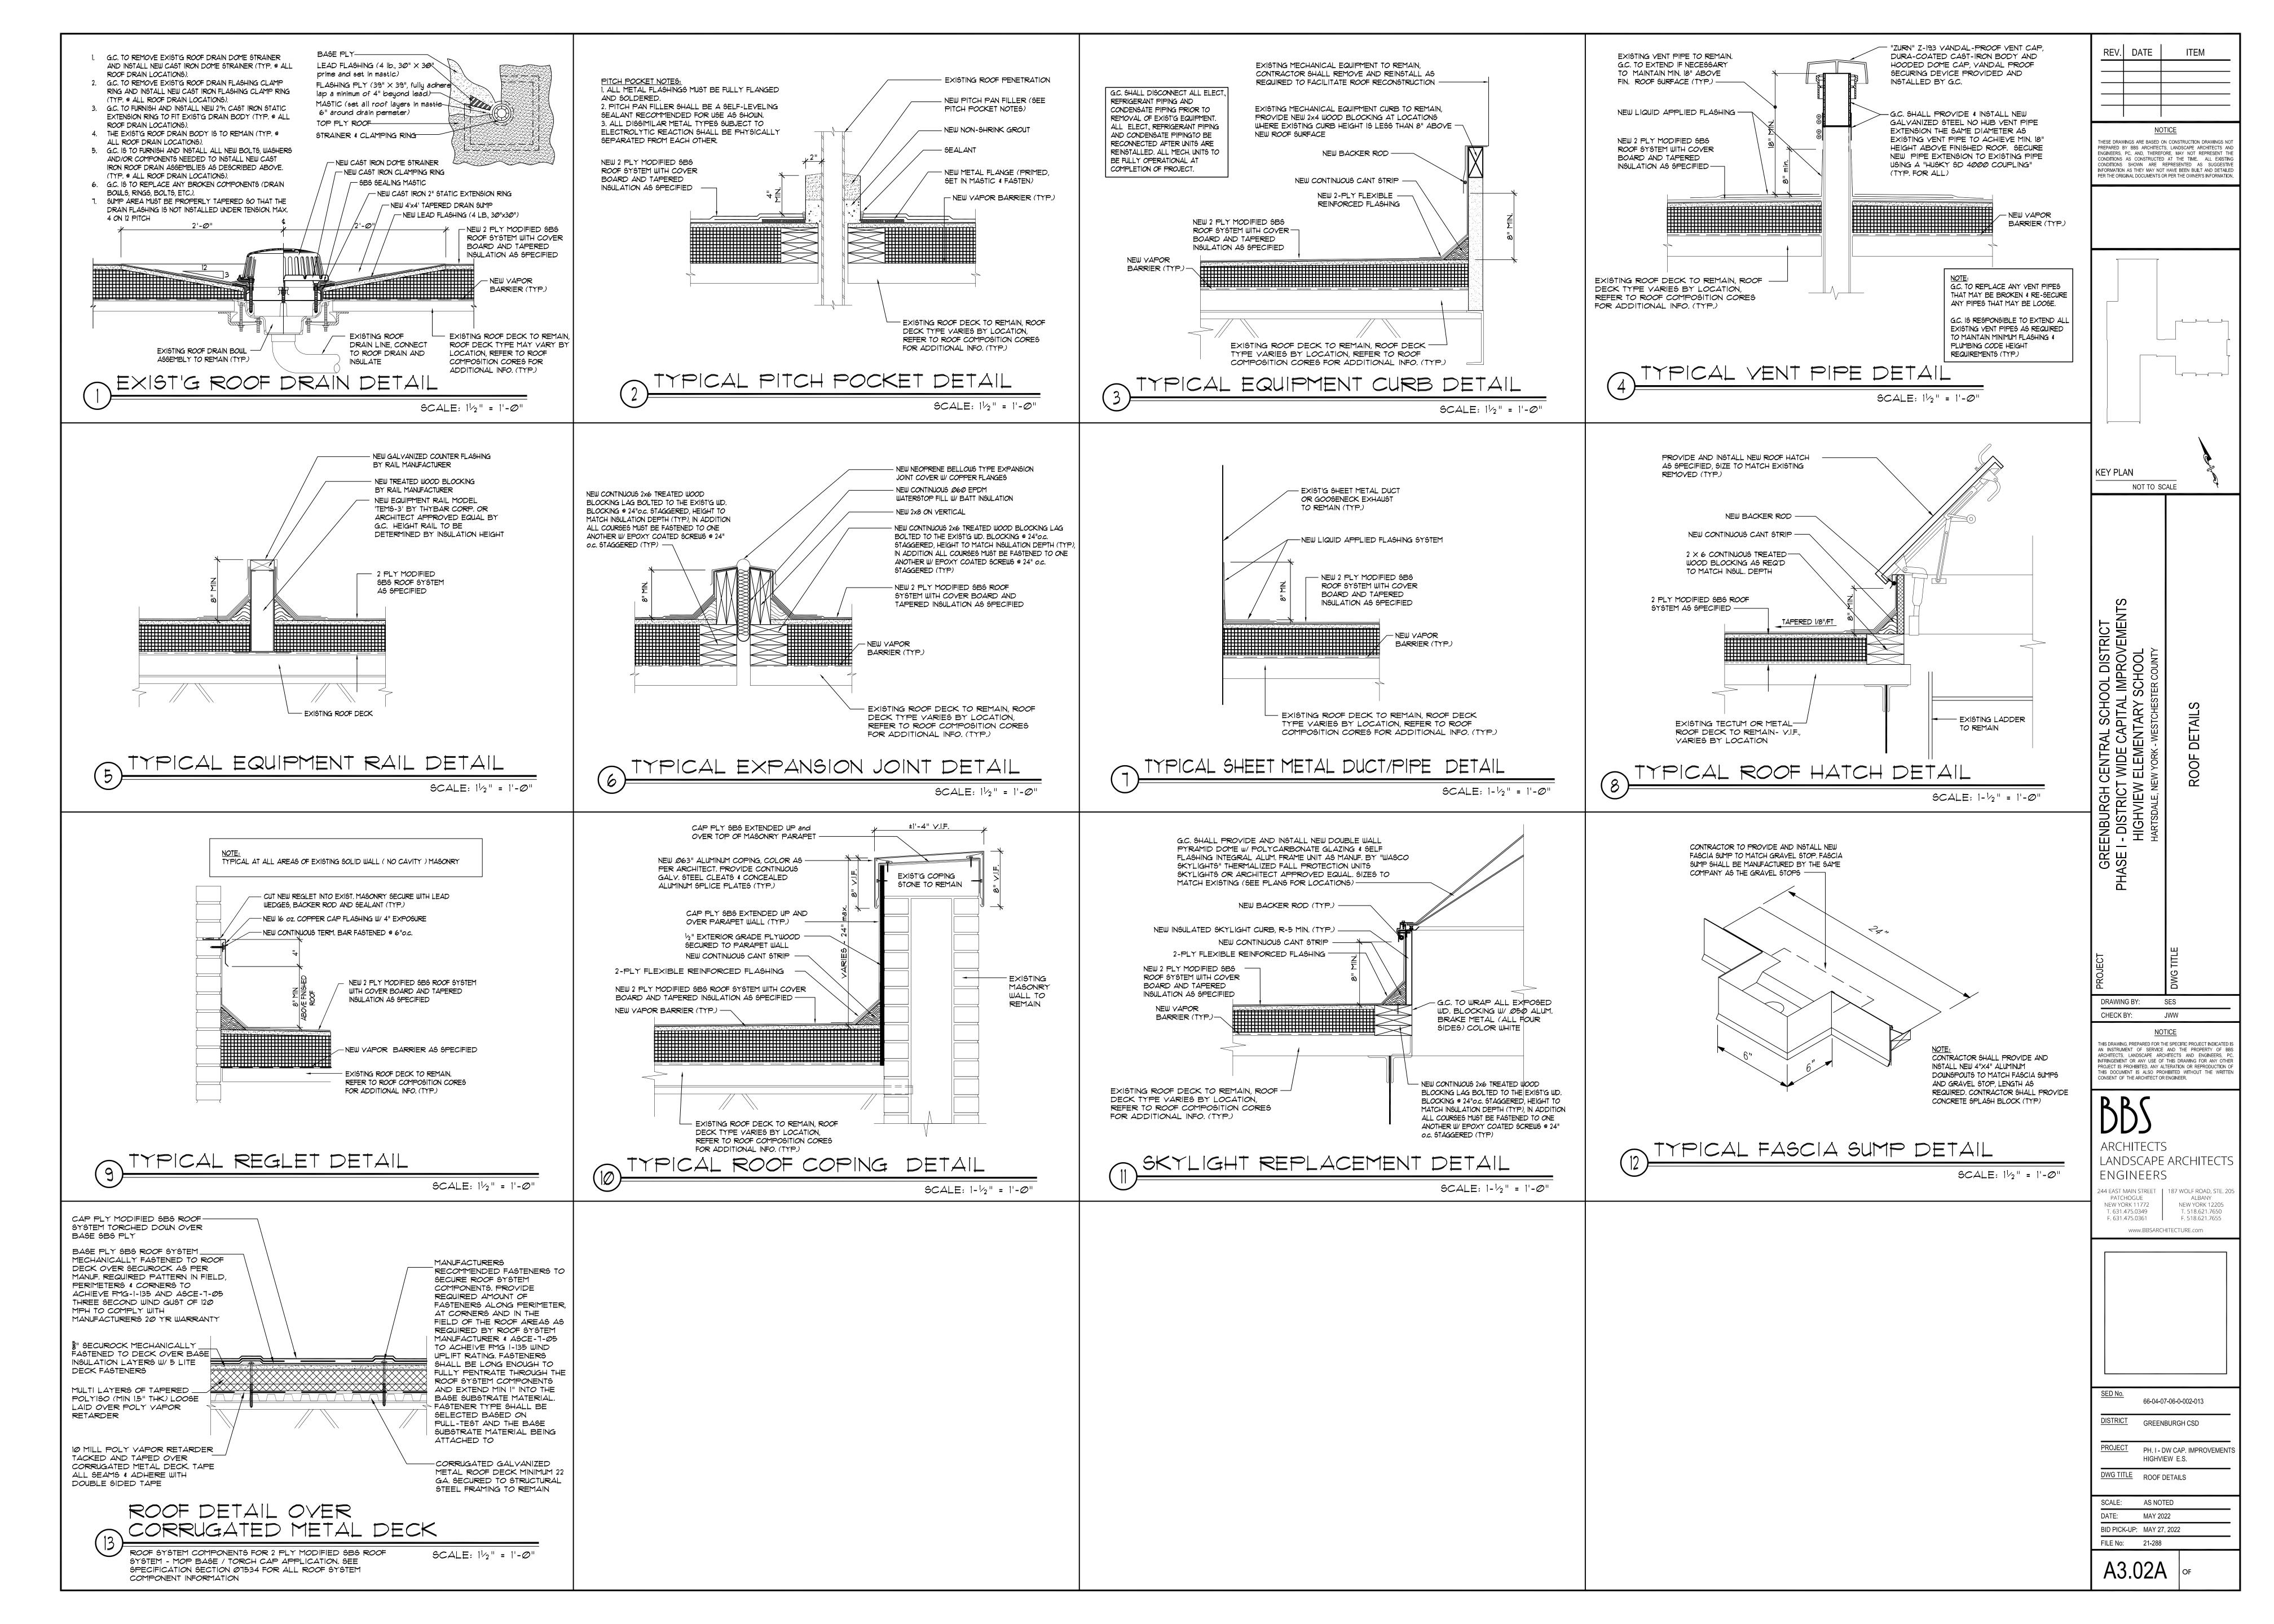


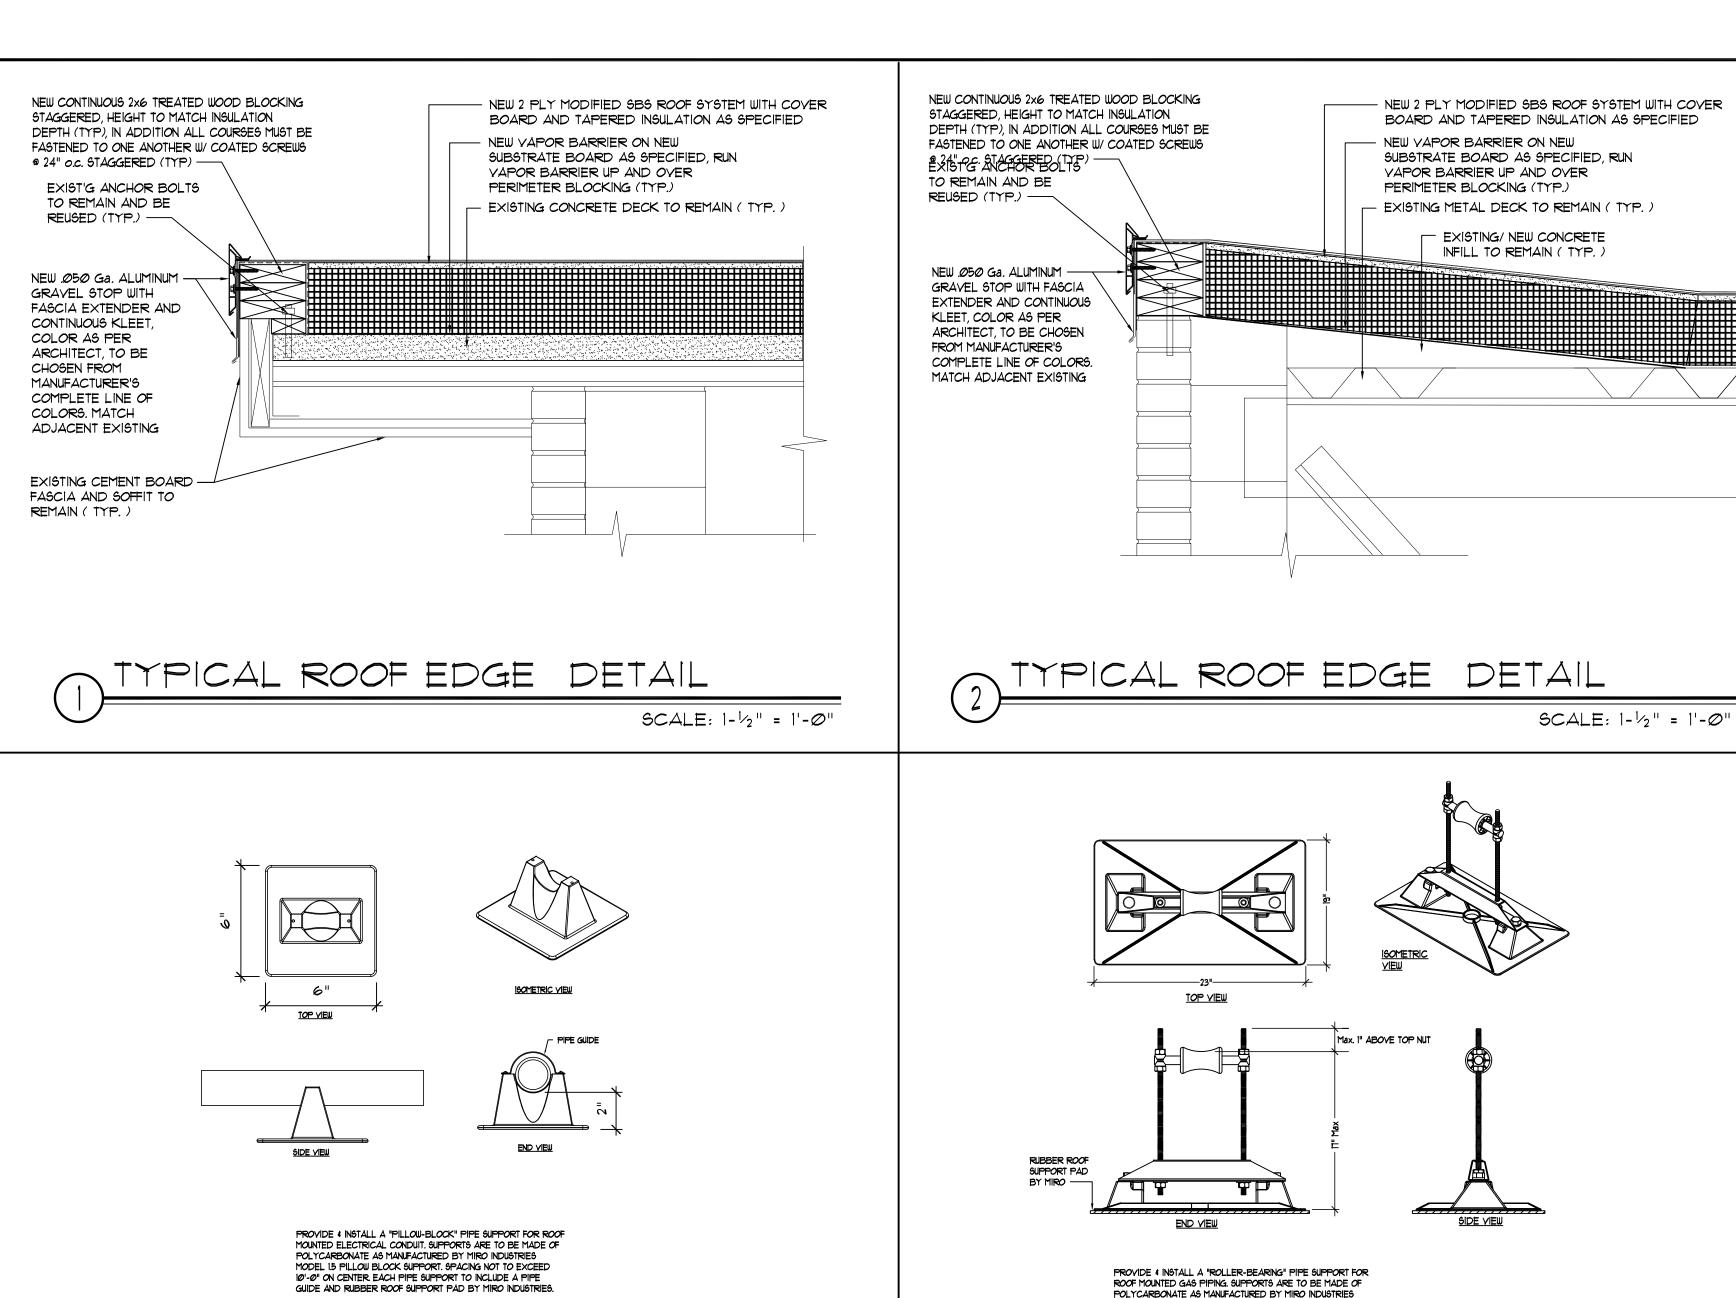

SCALE: NONE

ELECTRICAL CONDUIT SUPPORT DETAIL

AS REQUIRED

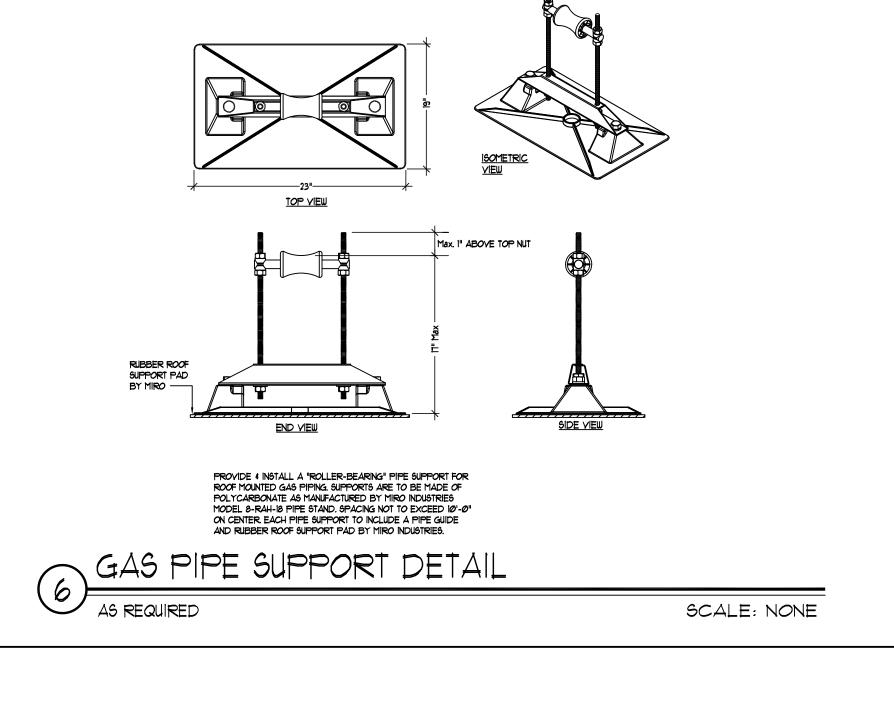

NEW CONTINUOUS 2x6 TREATED WOOD BLOCKING

DEPTH (TYP), IN ADDITION ALL COURSES MUST BE

FASTENED TO ONE ANOTHER W/ COATED SCREWS

SOME MODIFICATION OF THE SPACING SHOWN.

STANDARD SCREW SPACING FOR TECTUM PLANK SYSTEMS
NOT TO SCALE

TECTUM DECK REFASTENING DETAILS

STAGGERED, HEIGHT TO MATCH INSULATION

a 24" o.c. STAGGERED (TYP) ---

EXIST'G ANCHOR BOLTS

TO REMAIN AND BE

REUSED (TYP.)

NEW .050 Ga. ALUMINUM -

KLEET, COLOR AS PER

FROM MANUFACTURER'S

GRAVEL STOP WITH FASCIA\_\_\_

EXTENDER AND CONTINUOUS

ARCHITECT, TO BE CHOSEN

COMPLETE LINE OF COLORS.

MATCH ADJACENT EXISTING

- NEW 2 PLY MODIFIED 5B5 ROOF SYSTEM WITH COVER


BOARD AND TAPERED INSULATION AS SPECIFIED


AS SPECIFIED, RUN VAPOR BARRIER UP AND OVER

NEW YAPOR BARRIER ON NEW SUBSTRATE BOARD

- EXISTING METAL DECK TO REMAIN ( TYP. )

PERIMETER BLOCKING (TYP.)

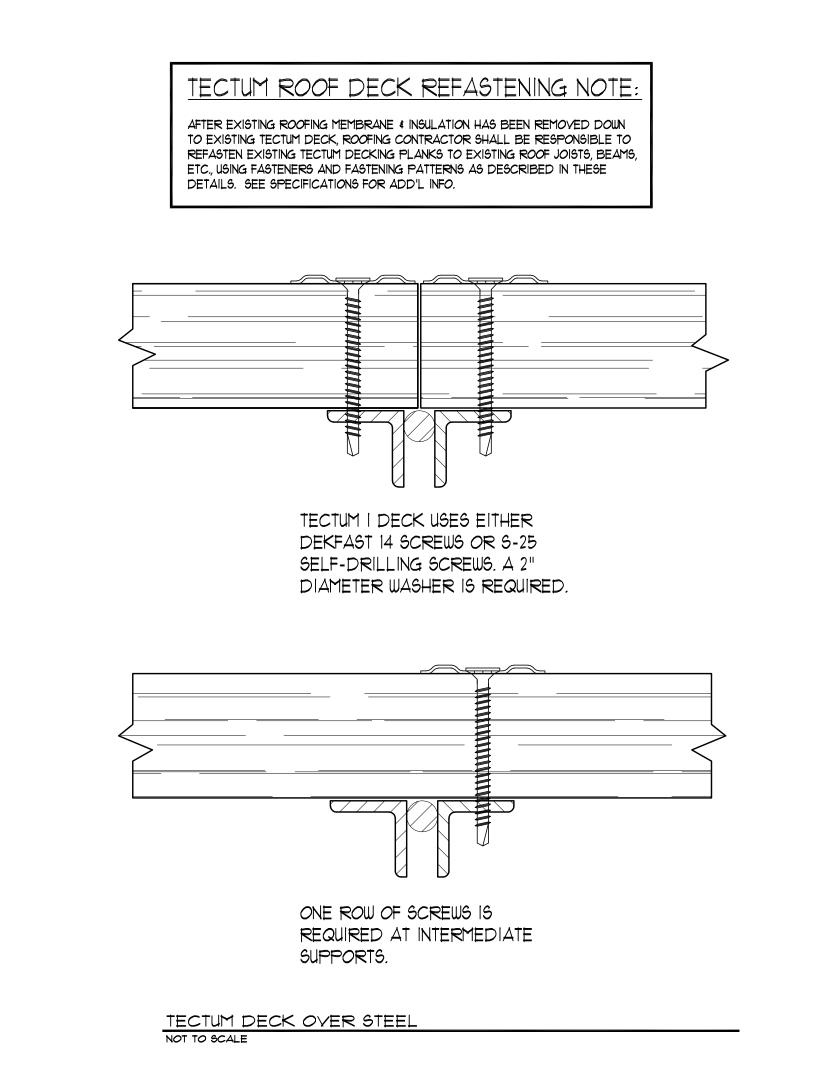

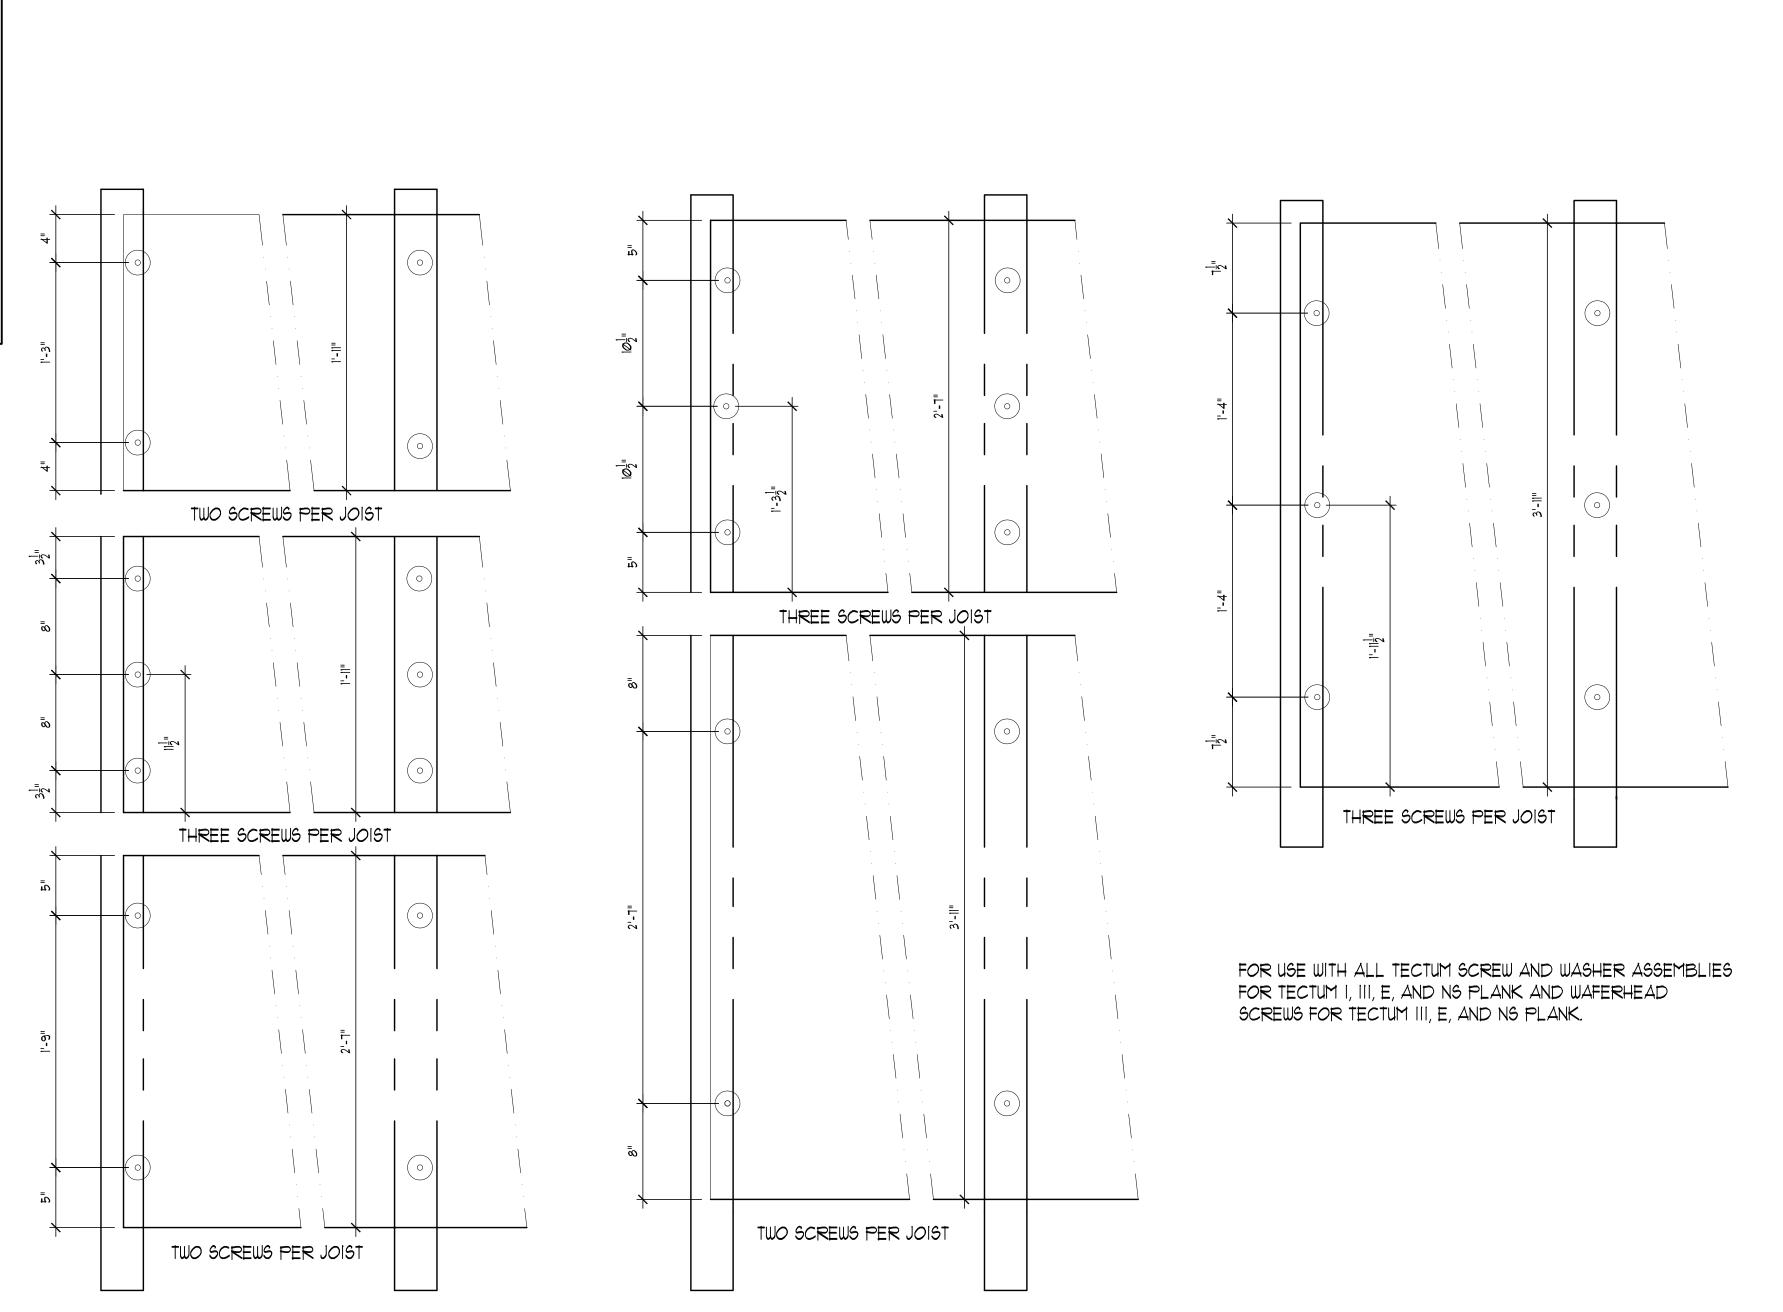

THE LOCATION OF ATTACHMENT SCREWS FOR TECTUM ROOF DECK PRODUCTS IS OFTEN VARIED. THIS DRAWING GIVES TECTUM INC. RECOMMENDED LOCATIONS. IT SHOULD BE NOTED THAT THE SCREWS ARE NOT PLACED AT THE EDGE OF THE PANELS BUT ARE SPACED IN FROM THE EDGE DEPENDING ON THE WIDTH OF THE PANELS AND THE NUMBER OF SCREWS PER JOIST. SPECIAL APPLICATIONS MAY REQUIRE 66-04-07-06-0-002-013 DISTRICT GREENBURGH CSD PH. I - DW CAP. IMPROVEMENTS HIGHVIEW E.S. DWG TITLE ROOF DETAILS SCALE: AS NOTED SCALE: N.T.S. BID PICK-UP: MAY 27, 2022 A3.03A

REV. DATE

KEY PLAN

NOT TO SCALE

DRAWING BY: SES

CONSENT OF THE ARCHITECT OR ENGINEER.

ARCHITECTS

ENGINEERS

NEW YORK 11772

F. 631.475.0361

JWW

THIS DRAWING, PREPARED FOR THE SPECIFIC PROJECT INDICATED IS AN INSTRUMENT OF SERVICE AND THE PROPERTY OF BBS ARCHITECTS, LANDSCAPE ARCHITECTS AND ENGINEERS, P. INFRINGEMENT OR ANY USE OF THIS DRAWING FOR ANY OTHE PROJECT IS PROHIBITED. ANY ALTERATION OR REPRODUCTION OF THIS DOCUMENT IS ALSO PROHIBITED WITHOUT THE WRITTEN

LANDSCAPE ARCHITECTS

www.BBSARCHITECTURE.com

187 WOLF ROAD, STE. 205

NEW YORK 12205

F. 518.621.7655

CHECK BY:

THESE DRAWINGS ARE BASED ON CONSTRUCTION DRAWINGS NOT PREPARED BY BBS ARCHITECTS, LANDSCAPE ARCHITECTS AND

CONDITIONS AS CONSTRUCTED AT THE TIME. ALL EXISTING

CONDITIONS SHOWN ARE REPRESENTED AS SUGGESTIVE INFORMATION AS THEY MAY NOT HAVE BEEN BUILT AND DETAILED

PER THE ORIGINAL DOCUMENTS OR PER THE OWNER'S INFORMATIO

\_\_\_\_\_

- NEW 2 PLY MODIFIED SBS ROOF SYSTEM

SUBSTRATE BOARD AS SPECIFIED, RUN

SCALE:  $1 - \frac{1}{2}$ " =  $1' - \emptyset$ "

WITH COVER BOARD AND TAPERED

INSULATION AS SPECIFIED

--- NEW YAPOR BARRIER ON NEW

YAPOR BARRIER UP AND OVER

- EXISTING DECK TO REMAIN ( TYP. )

PERIMETER BLOCKING (TYP.)

NEW CONTINUOUS 2×6 TREATED WOOD BLOCKING

DEPTH (TYP), IN ADDITION ALL COURSES MUST BE

FASTENED TO ONE ANOTHER W/ COATED SCREWS

STAGGERED, HEIGHT TO MATCH INSULATION

a 24" o.c. STAGGERED (TYP) ——

EXIST'G ANCHOR BOLTS

TO REMAIN AND BE

REUSED (TYP.)

NEW .050 Ga. ALUMINUM -

FROM MANUFACTURER'S

NEW .050 BRAKE METAL -

EXISTING METALS (TYP.)

WRAPPED WOOD BLOCKING

FASTENED TO EXISTING WOOD BLOCKING WITH COATED SCREWS,

COLOR AS PER ARCHITECT, TO

MATCH NEW GRAVEL STOP AND


EXISTING SOFFIT TO REMAIN ( TYP. ) -


GRAVEL STOP, COLOR AS PER

ARCHITECT, TO BE CHOSEN

COMPLETE LINE OF COLORS.

MATCH ADJACENT EXISTING

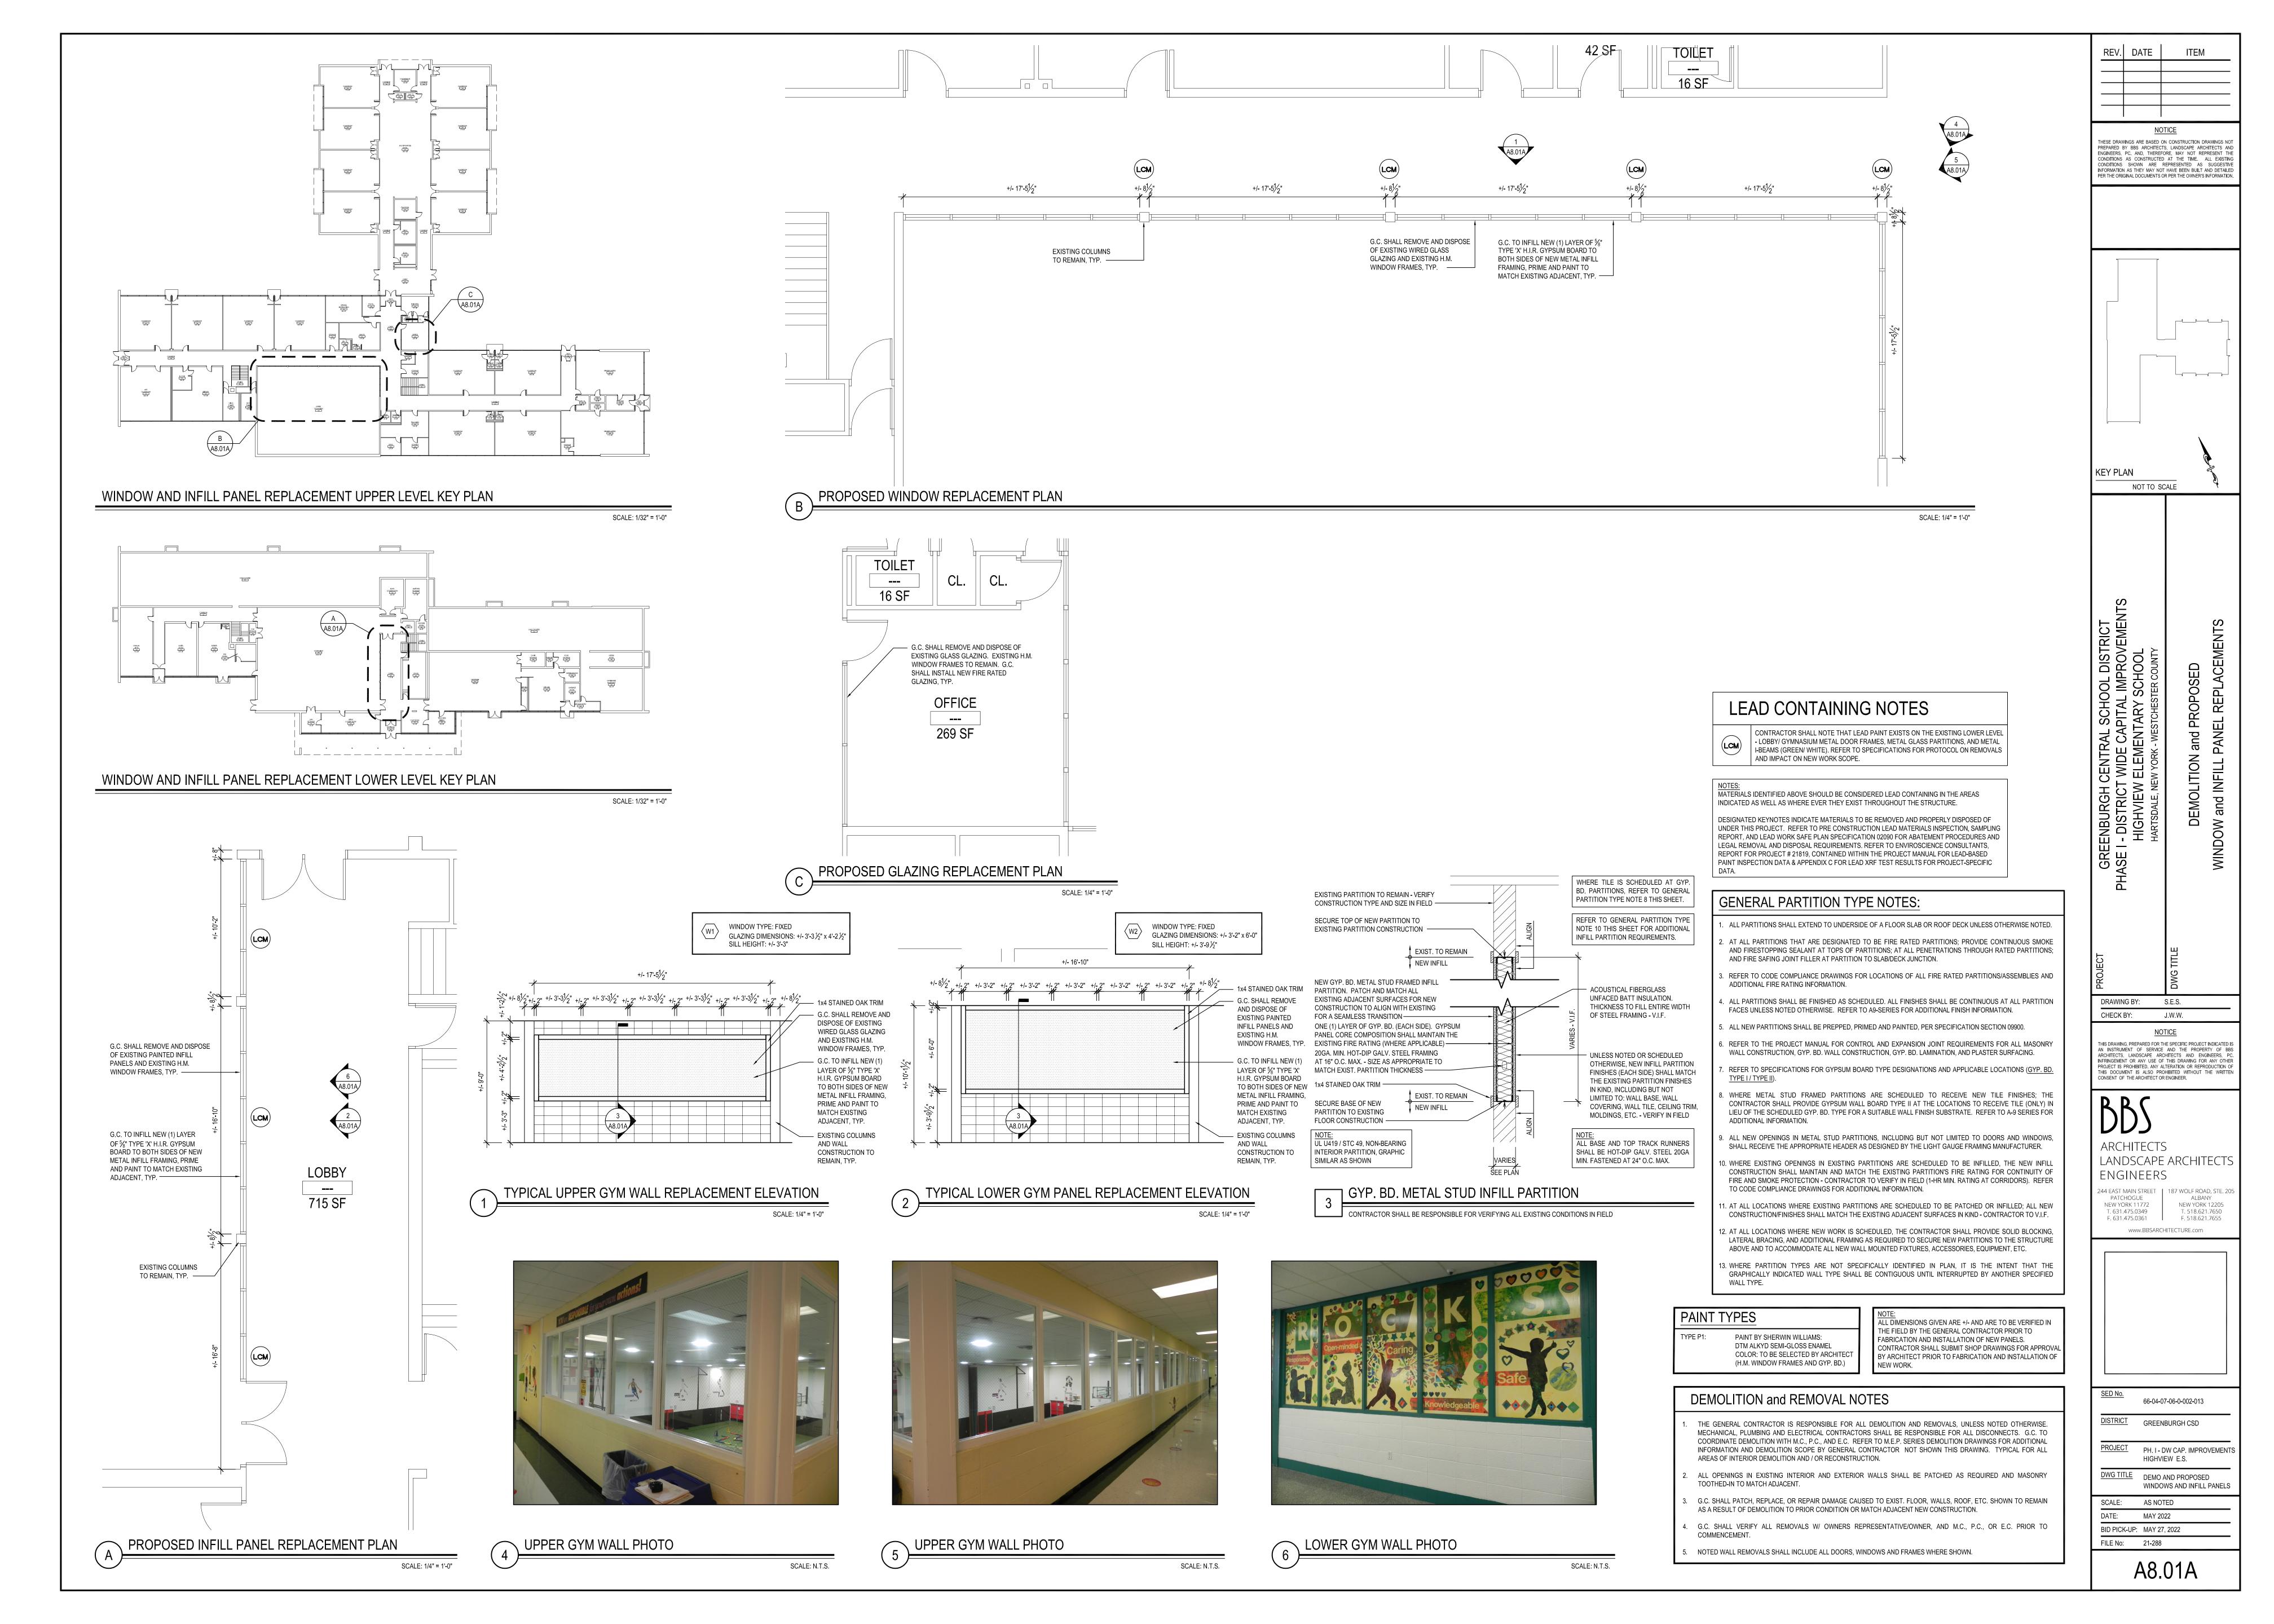


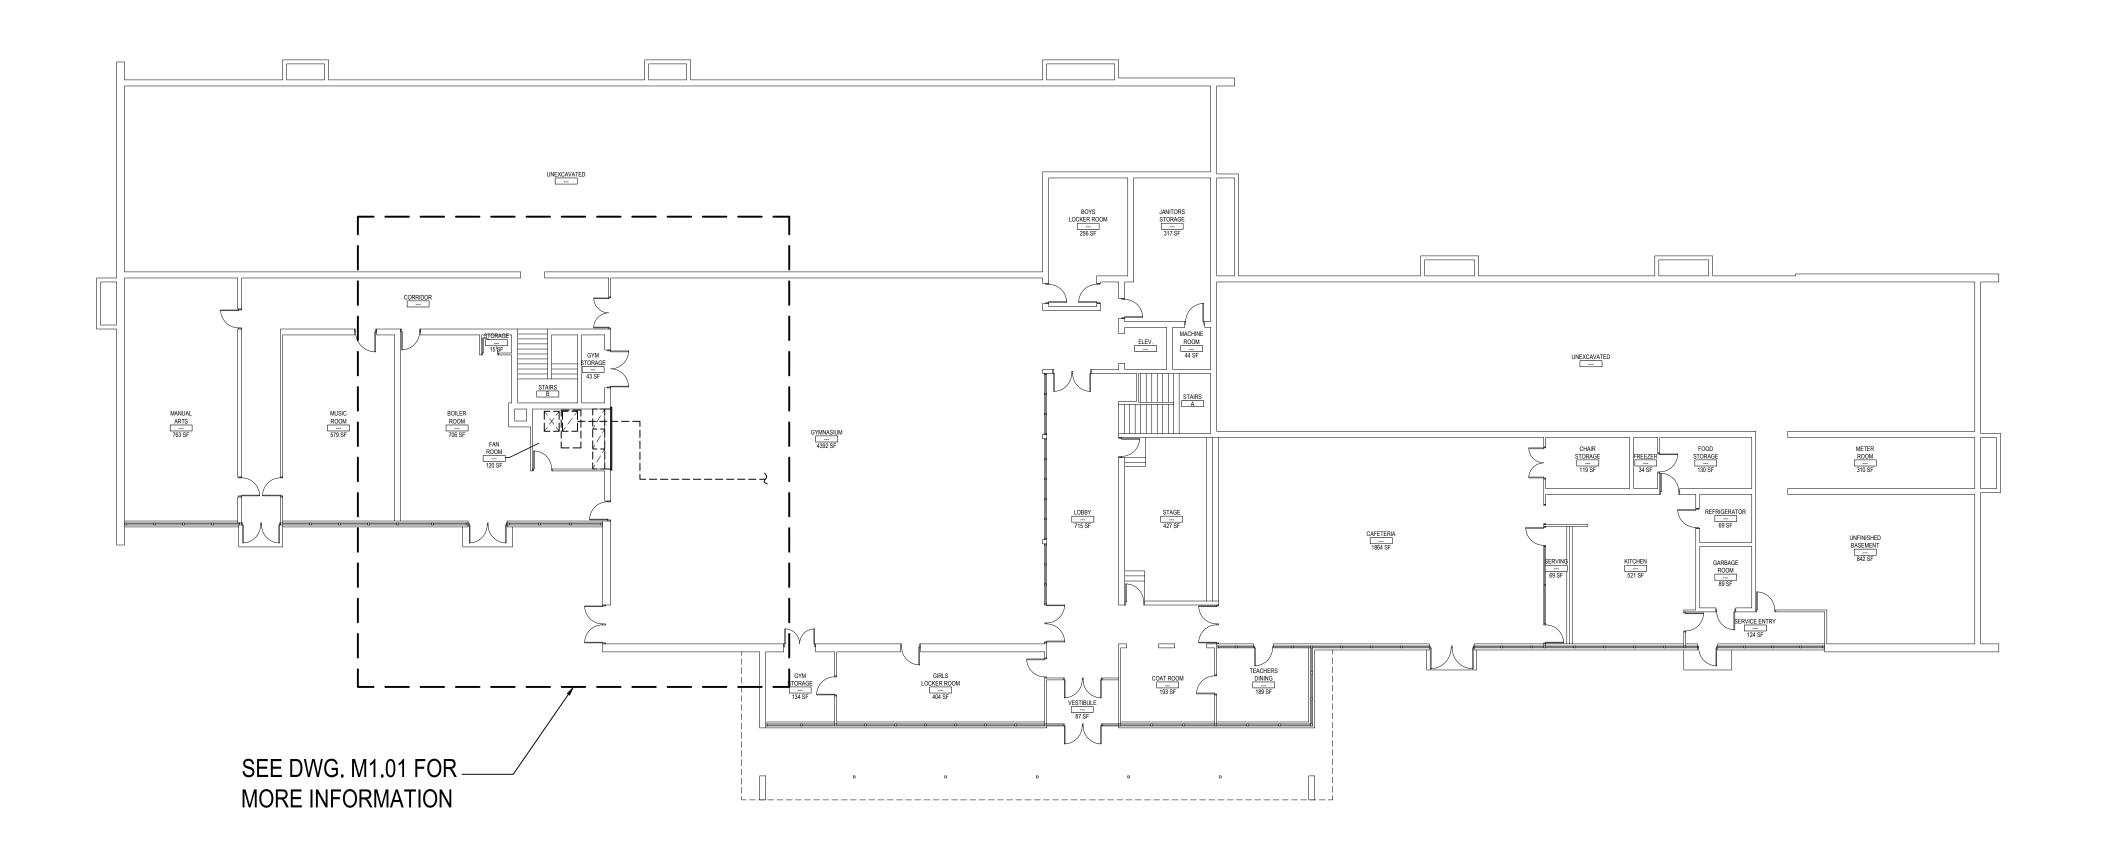

#### MECHANICAL LOWER FLOOR KEY PLAN

SCALE: 1/32" = 1'-0"

# MECHANICAL LEGEND, SYMBOLS, AND ABBREVIATIONS

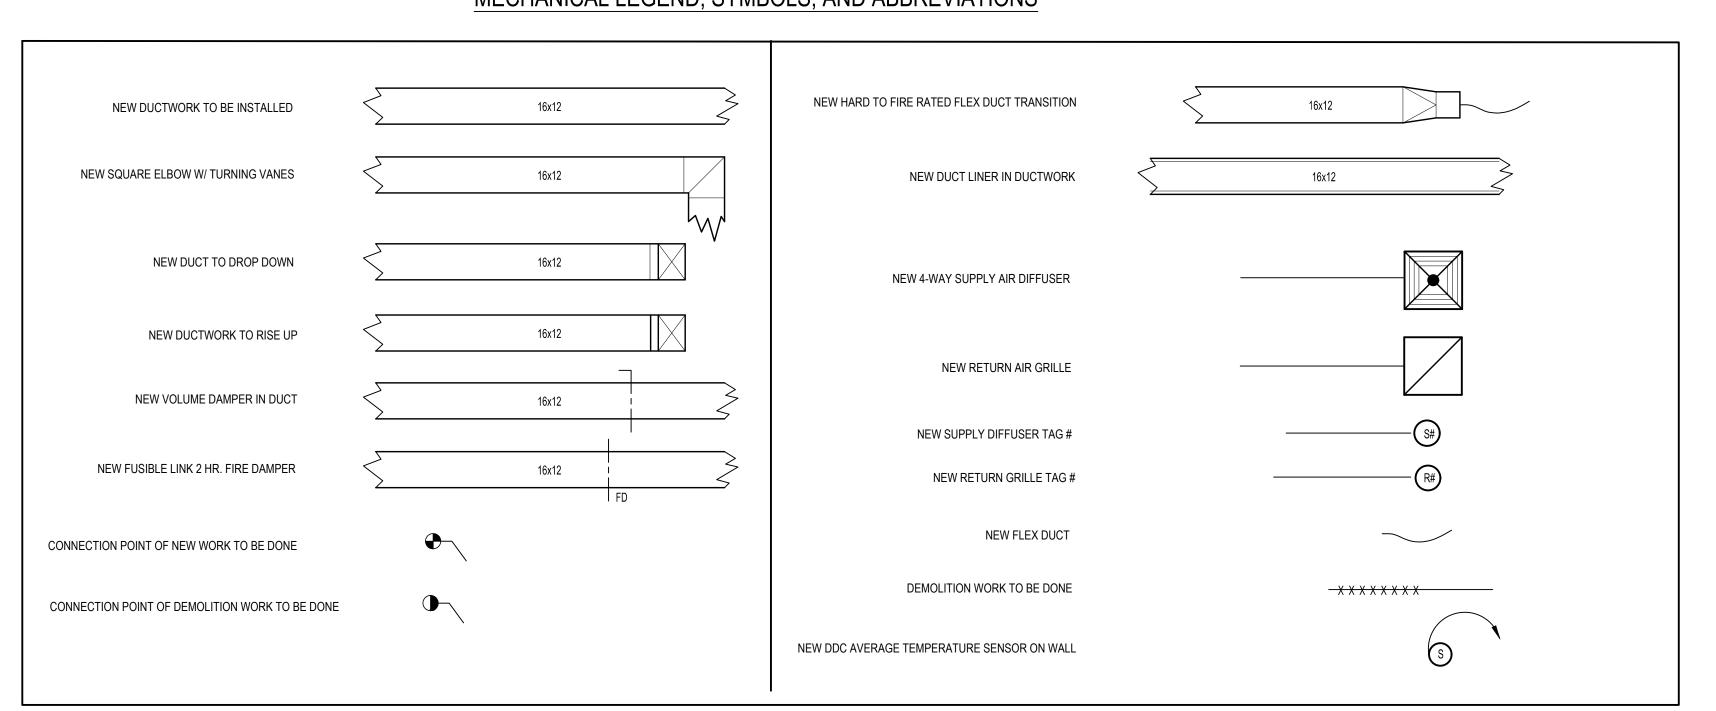

#### **GENERAL NOTES**

- 1. REMOVAL & RELOCATION OF CERTAIN EXISTING WORK SHALL BE NECESSARY FOR THE PERFORMANCE OF THE NEW WORK SHOWN HEREIN. ALL EXISTING CONDITIONS ARE NOT COMPLETELY DETAILED ON THE DRAWINGS. THE CONTRACTOR SHALL SURVEY THE SITE & MAKE ALL NECESSARY CHANGES BASED ON EXISTING CONDITIONS AS REQUIRED FOR PROPER DEMOLITION OF EXISTING WORK & SHALL INCLUDE ALL MATERIALS & LABOR FOR SAME IN HIS BID PRICE. NO ALLOWANCE WILL BE MADE FOR FAILURE TO DO SO.
- PRIOR TO SUBMITTING A BID, THE CONTRACTOR SHALL VISIT THE PREMISES OF THE PROPOSED WORK & SHALL CAREFULLY EXAMINE THE ENGINEERING DRAWINGS, EXISTING CONDITIONS & LIMITATIONS THEREOF. VERIFY ACTUAL LOCATIONS WHERE THE NEW PIPING WILL BE ROUTED, COORDINATE WITH NEW & EXISTING WORK & PROVIDE CLEARANCE W/ BUILDING STRUCTURE, OTHER SERVICES, ETC.. THE CONTRACTOR SHALL INCLUDE ALL COSTS WHATSOEVER WHICH ARE INCURRED AS A RESULT OF LIMITATIONS OF THE EXISTING & NEW CONDITIONS. LATER CLAIMS FOR EXTRA LABOR, EQUIPMENT, MATERIALS, ETC. REQUIRED DUE TO DIFFICULTIES WHICH COULD HAVE BEEN FORESEEN WILL NOT BE CONSIDERED AS EXTRA WORK.
- INSTALL WORK SO AS TO BE READILY ACCESSIBLE FOR OPERATING, MAINTENANCE & REPAIR. MINOR DEVIATIONS FROM DRAWINGS MAY BE MADE TO ACCOMPLISH THIS, BUT CHANGES OF MAGNITUDE WHICH INVOLVE EXTRA COST SHALL NOT BE MADE WITHOUT APPROVAL.
- INVESTIGATE EACH SPACE THROUGH WHICH EQUIPMENT MUST BE MOVED. WHEN NECESSARY, EQUIPMENT SHALL BE SHIPPED FROM MANUFACTURER IN CRATED SECTIONS OF SIZE SUITABLE FOR MOVING THROUGH AREAS AVAILABLE. ASCERTAIN FROM BUILDING OWNER AT WHAT TIMES OF DAY EQUIPMENT MAY BE MOVED THROUGH THE BUILDING.
- 5. COORDINATE THE EXACT SIZE & LOCATION OF NEW OPENINGS WITH EXISTING STRUCTURE. PATCH / INSULATE AS REQUIRED. CONTRACTOR SHALL FIRESTOP ALL PENETRATIONS FROM NEW PIPING, CONDUIT, DUCTWORK, ETC. THROUGH EXISTING OR NEW FIRE/ SMOKE BARRIERS. REFER TO SPECIFICATION SECTION 15511 FOR FURTHER DETAILS.
- 6. IT IS THE INTENT OF THIS CONTRACT FOR REMAINING SYSTEMS TO BE LEFT IN GOOD WORKING ORDER, READY FOR OPERATION. COORDINATE ANY REQUIRED SYSTEM SHUTDOWNS WITH OWNER 48 HOURS IN ADVANCE. EXISTING SYSTEM SHUTDOWNS WILL NOT BE PERMITTED IF THEY INTERFERE WITH THE DAILY OPERATIONS OF THE BUILDING. CONTRACTOR WILL BE REQUIRED TO TAKE PROPER PRECAUTIONS AGAINST DAMAGING OR DISRUPTING BUILDING SYSTEMS, WIRING, PIPING OR CONTROL TUBING. ANY DAMAGE TO THESE ITEMS SHALL BE REPAIRED AT THE CONTRACTOR'S COST AS A PART OF THIS CONTRACT.
- THE CONTRACTOR SHALL REPAIR / RESTORE TO ORIGINAL CONDITION ANY EXISTING EQUIPMENT OR MATERIALS DAMAGED IN THE PROCESS OF INSTALLATION, OR DEMOLITION TO THE SATISFACTION OF THE OWNER'S REPRESENTATIVE. CONTRACTOR SHALL MAKE REPAIRS USING THE SAME OR EQUIVALENT MATERIALS. WORK WILL BE PERFORMED AT THE CONTRACTOR'S COST.
- 8. CONTRACTOR SHALL INCUR ANY COSTS OR BURDENS ASSOCIATED WITH LOST OR STOLEN EQUIPMENT / MATERIALS.
- 9. DURING THE LIFE OF THE CONTRACT PERIOD, CONTRACTOR SHALL REMOVE ALL RUBBISH / EXCESS MATERIAL ACCUMULATED AS A RESULT OF HIS OPERATIONS ON A DAILY BASIS. ALL AREAS / EQUIPMENT AFFECTED UNDER THIS CONTRACT SHALL BE KEPT CLEAN OF DUST / DEBRIS. ALL AREAS SHALL RECEIVE A FINAL CLEANING PRIOR TO FINAL ACCEPTANCE BY THE OWNER.
- 10. PROVIDE FOR LEGAL REMOVAL / DISPOSAL OF ALL RUBBISH / DEBRIS FROM THE BUILDING & SITE. PROTECT ALL WORK NOT SLATED FOR DEMOLITION.
- 11. THIS CONTRACTOR SHALL COORDINATE HIS WORK WITH ALL OTHER TRADES PRIOR TO SCHEDULING THE WORK. WORK SHALL BE PERFORMED IN PROPER SEQUENCE, AS AGREED TO BY ALL TRADES. ANY COSTS INCURRED BY THE OWNER DUE TO IMPROPER SEQUENCING OF WORK WILL BE PAID FOR BY THIS CONTRACTOR.
- 12. CONTRACTOR SHALL OBTAIN ALL PERMITS, PAY ALL FEES, CONNECTION CHARGES, ETC. ASSOCIATED WITH THE WORK UNDER THEIR CONTRACT.
- 3. PAINT / TOUCH UP ALL SURFACES MARRED AS A RESULT OF THE PERFORMANCE OF THE CONTRACT WORK.
- 14. THE MECHANICAL CONTRACTOR SHALL REFER TO / REVIEW ALL OTHER TRADE DRAWINGS IN THE BID PACKAGE & SHALL BE RESPONSIBLE FOR / PERFORM ALL WORK INDICATED AS (M.C.) MECHANICAL WORK AS A PART OF THE BASE BID UNLESS SPECIFICALLY NOTED OTHERWISE.
- 5. SUBSTITUTED EQUIPMENT OF GREATER OR LARGER POWER, DIMENSIONS, CAPACITIES & RATINGS MAY BE FURNISHED PROVIDED THAT SAID EQUIPMENT IS APPROVED IN WRITING PRIOR TO ORDER. ANY CONNECTING MECHANICAL SERVICES, ELECTRICAL SERVICES, BASES, STRUCTURAL APPURTENANCES, ETC. REQUIRED TO BE INCREASED DUE TO THE USE OF SAID EQUIPMENT WILL BE PAID FOR IN FULL BY THE MECHANICAL CONTRACTOR, INCLUDING ANY ADDITIONAL REQUIRED ENGINEERING FEES.
- 6. EACH PIECE OF EQUIPMENT SHALL BE PROVIDED WITH A PERMANENT TYPE LAMINATED, BLACK FINISH, WHITE CORE, PHENOLIC NAMEPLATE. NAMEPLATES SHOULD INDICATE THE NAME & NUMBER OF THE UNIT, UNIT VOLTAGE, & ANY INTERLOCK REFERENCE. STARTERS / DISCONNECT SWITCHES SHOULD ALSO BE EQUIPPED WITH AN IDENTICAL NAMEPLATE WITH THE SAME INFORMATION.
- 17. "ATTIC STOCK" UPON COMPLETION OF THE PROJECT, MECHANICAL CONTRACTOR SHALL COMPLETELY REMOVE / DISPOSE OF FILTERS USED DURING CONSTRUCTION & START-UP PROCEDURES. INSTALL NEW FILTERS IN ALL EQUIPMENT, MERV-8 OR BETTER UPON TURN OVER OF THE PROJECT TO THE OWNER. IN ADDITION, PROVIDE (2) COMPLETE SETS OF FILTERS FOR EACH PEICE OF EQUIPMENT & TURN OVER TO
- MECHANICAL CONTRACTOR SHALL PROVIDE (1) SPARE MOTOR FOR EACH SIZE MOTOR USED ON THE PROJECT. IN INSTANCES WHERE MORE THAN TEN OF THE SAME MOTOR ARE USED, MECHANICAL CONTRACTOR SHALL PROVIDE (1) SPARE MOTOR FOR EVERY TEN MOTORS OF A GIVEN SIZE USED ON THE PROJECT.
- 19. MAINTENANCE MANUAL: UPON COMPLETION OF THE PROJECT, THE MECHANICAL CONTRACTOR SHALL PROVIDE A BINDER CONTAINING THE OPERATIONS & MAINTENANCE MANUALS FOR EACH NEW PEICE OF EQUIPMENT INSTALLED UNDER THIS PROJECT. THE FIRST SECTION OF THE MAINTENANCE MANUAL SHALL CONTAIN A LIST OF EACH PEICE OF EQUIPMENT, COMPLETE WITH INFORMATION SHOWING APPROPRIATE REPLACEMENT FILTER SIZES / TYPES, APPROPRIATE REPLACEMENT BELT SPECIFICATIONS, REPLACEMENT MOTOR SPECIFICATIONS, REPLACEMENT BEARING SPECIFICATIONS, VOLTAGES OF UNIT, ETC. THIS SHALL SERVE AS A WRITTEN DATABASE DESCRIBING ALL MAINTENANCE INFORMATION FOR EACH NEW PEICE OF EQUIPMENT USED.

CONTROLS SUBCONTRACTOR , UNDER CONTRACT TO MECHANICAL CONTRACTOR

#### FIRE STOPPING NOTES

- 1. ALL PENETRATIONS RELATED TO MECHANICAL WORK THROUGH FIRE RATED WALLS, FLOORS OR OTHER STRUCTURES SHALL BE FIRE STOPPED AS REQUIRED TO MAINTAIN THE RATING OF THE WALL BY MECHANICAL CONTRACTOR. IT IS ASSUMED THAT ALL WALLS IN THE CONSTRUCTION CARRY A MINIMUM FIRE RATING OF 1 HR. IT SHOULD BE ASSUMED THAT ALL MACHINE ROOM WALLS / BOILER ROOM WALLS / ELECTRIC ROOM WALLS CARRY A RATING OF 2 HR. MECHANICAL CONTRACTOR SHALL BE RESPONSIBLE FOR A COMPLETE REVIEW OF THE ARCHITECTURAL DRAWINGS IN ORDER TO DETERMINE FIRE RATINGS OF ALL WALLS / PARTITIONS RELATED TO WORK UNDER THIS CONTRACT.
- 2. MECHANICAL CONTRACTOR SHALL REVIEW THE COMPLETE ARCHITECTURAL SET OF DRAWINGS IN ORDER TO DETERMINE WHERE DUCT PENETRATIONS THROUGH RATED BARRIERS. DUCTS PENETRATING SAID RATED BARRIERS SHALL BE EQUIPPED WITH A UL LISTED FUSIBLE LINK TYPE FIRE DAMPER, RATED FOR SERVICE FOR WHICH IT IS BEING USED. FIRE DAMPERS SHALL BE PROVIDED & INSTALLED BY THE MECHANICAL CONTRACTOR, COMPLETE W/ DUCT ACCESS DOORS DIRECTLY ADJACENT TO THE DAMPER, POSITIONED FOR EASY REPLACEMENT OF THE LINK.
- 3. MECHANICAL CONTRACTOR SHALL REVIEW THE COMPLETE ARCHITECTURAL SET OF DRAWINGS IN ORDER TO DETERMINE WHERE DUCT PENETRATIONS THROUGH RATED BARRIERS OCCUR BETWEEN SEPARATE SMOKE ZONES. DUCTS PENETRATING SAID FIRE / SMOKE BARRIERS SHALL BE EQUIPPED WITH A ULLISTED COMBINATION FIRE / SMOKE DAMPER, RATED FOR SERVICE FOR WHICH IT IS BEING USED. FIRE / SMOKE DAMPERS SHALL BE PROVIDED & INSTALLED BY THE MECHANICAL CONTRACTOR, COMPLETE W/DUCT ACCESS DOORS DIRECTLY ADJACENT TO THE DAMPER. DAMPER ACTUATOR & RELATED WIRING SHALL BE PROVIDED & INSTALLED BY THE ELECTRICAL CONTRACTOR. COORDINATE DAMPER INSTALLATIONS W/ E.C. TO VERIFY PROPER CLEARANCES TO ASSURE PROPER DAMPER OPERATION.
- MECHANICAL CONTRACTOR SHALL PROVIDE A FULL SET OF AS-BUILT DRAWINGS, SHOWING EACH DAMPER LOCATION, TYPE OF DAMPER, ACCESS DOOR LOCATIONS, ETC.
   CONTRACTOR SHALL REFER TO SPECIFICATION SECTION 15511 FOR FURTHER DETAILS REGARDING FIRESTOPPING MATERIALS & METHODS.
- 6. CONTRACTOR SHALL SUBMIT SHOP DRAWINGS OF PRODUCTS TO BE USED. FIRESTOP MATERIALS OTHER THAN THE PRODUCTS SPECIFIED SHALL INCLUDE FULL TECHNICAL DATA WITH SHOP DRAWINGS TO DEMONSTRATE EQUALITY WITH THE SPECIFIED FIRESTOPPING MATERIALS.

#### GENERAL INSTRUMENTATION NOTES

- AT A MINIMUM, PROVIDE THERMOMETERS / WELLS AT THE FOLLOWING LOCATIONS:
- AT INLETS & OUTLET OF EACH THREE WAY VALVE (UNIT VENTILATORS / CABINET UNIT HEATER INSTALLATIONS EXCEPTED).
- AT INLET & OUTLET OF EACH HYDRONIC BOILER, CHILLER OR COOLING TOWER.
  AT INLET & OUTLET OF EACH HYDRONIC COIL IN AIR HANDLING UNITS & BUILT-UP CENTRAL SYSTEMS.
- AT A MINIMUM, PROVIDE LIQUID FILLED PRESSURE GAUGES / WELLS AT THE FOLLOWING LOCATIONS:
- AT SUCTION & DISCHARGE OF EACH PUMP. FOR EACH MAKEUP WATER LINE.
- BEFORE & AFTER ALL PRESSURE REDUCING VALVES.
   AT ACCESSIBLE HIGH POINT OF ALL HYDRONIC PIPING SYSTEMS.
   AT ALL EXPANSION / COMPRESSION TANKS.

#### PIPING SYSTEMS AND EQUIPMENT VENTING NOTES

- MECHANICAL CONTRACTOR WILL BE RESPONSIBLE FOR THE PROPER VENTING OF ALL NEWLY INSTALLED HYDRONIC PIPING SYSTEMS. AUTOMATIC AIR VENTS SHALL BE INSTALLED AT EVERY HIGH POINT IN THE PIPING SYSTEM WHERE AIR CAN COLLECT. PROVIDE COCK IN RISER PRIOR TO AUTOMATIC AIR VENT. NEW AIR VENTS SHALL BE "TACO" #HY-VENT OR EQUIVALENT.
- 2. MECHANICAL CONTRACTOR SHALL PROVIDE & INSTALL NEW AUTOMATIC AIR VENT FOR EACH AIR HANDLING UNIT COIL OR DUCT MOUNTED COIL. INSTALL SHUT-OFF COCK PRIOR TO VENT TIE-IN.
- 3. MECHANICAL CONTRACTOR SHALL PROVIDE NEW MANUAL AIR VENTS FOR ALL UNIT VENTILATOR COILS, CONVECTORS, FAN COIL UNITS, FIN TUBE RADIATORS, ETC. MANUAL VENTS SHALL BE "TACO" #417 COIN VENT OR EQUIVALENT. PROVIDE SHUT-OFF COCK PRIOR TO VENT. AIM COIN VENT DISCHARGE IN AN APPROPRIATE MANNER AS TO FACILITATE THE CAPTURE OF BLEED WATER WHILE PERFORMING SYSTEM BLEEDING OPERATIONS.

### ELECTRICAL WORK UNDER MECHANICAL CONTRACT

- 1. MECHANICAL CONTRACTOR SHALL PROVIDE ALL STARTERS & DISCONNECT SWITCHES REQUIRED FOR ALL NEW MECHANICAL EQUIPMENT. STARTER / DISCONNECT SWITCH INSTALLATION TO BE PERFORMED UNDER THE ELECTRICAL CONTRACT. COORDINATE WORK W/ ELECTRICAL CONTRACTOR PRIOR TO START
- POWER WIRING REQUIRED FOR CONTROLS SHALL BE PERFORMED UNDER THE MECHANICAL CONTRACT UNLESS SPECIFICALLY NOTED OTHERWISE ON THE ELECTRICAL DRAWINGS. MECHANICAL CONTRACTOR SHALL OBTAIN THE SERVICES OF A LICENSED ELECTRICIAN (PER NEC REQUIREMENTS) TO PERFORM ALL

### **DUCTWORK NOTES**

- PROVIDE ALL NEW DUCTWORK AS SHOWN AND SPECIFIED UNDER SPECIFICATION SECTION 015891, AND IN CONFORMANCE WITH 'SMACNA' SPECIFICATIONS.
- 2. IF A DUCT ELBOW IS SHOWN TO BE RADIUSED, THEN RADIUSED ELBOWS SHALL BE INSTALLED. SQUARE ELBOWS MAY NOT BE SUBSTITUTED WHERE RADIUSED ELBOWS ARE SHOWN. WHERE SQUARE ELBOWS ARE SHOWN, TURNING VANES SHALL BE INSTALLED UPON APPROVAL BY THE ENGINEER.
- PROVIDE DUCT LINING IN ALL DUCTWORK THAT IS CONVEYING BELOW AMBIENT TEMPERATURE AIR & IS NOT INSULATED. PROVIDE LINING IN SUPPLY & RETURN AIR DUCTWORK FROM AIR HANDLING EQUIPMENT TO 20 FEET AWAY FROM THE UNIT(S). IN ADDITION, INCLUDE LINING IN ANY OTHER DUCT SPECIFICALLY SHOWN OR SPECIFIED TO BE EQUIPPED WITH LINING. REFER TO SPECIFICATION SECTION 15891 & 15290 FOR FURTHER INFORMATION.
- 4. WHERE FLEXIBLE DUCTWORK IS USED, LENGTHS MAY NOT EXCEED 4 FEET TOTAL IN ANY ONE RUN OF FLEXIBLE DUCTWORK. FLEXIBLE DUCTWORK SHALL BE RATED IN ACCORDANCE WITH UL 181, CLASS 1. REFER TO SPECIFICATION SECTION 15891 FOR FURTHER INFORMATION.
- MECHANICAL CONTRACTOR SHALL PROVIDE A BUTTERFLY TYPE VOLUME DAMPER WITH LOCKING QUADRANT HANDLE PRIOR TO EACH AIR OUTLET SHOWN. INSTALL DAMPER AT LEAST 5 FEET AWAY FROM AIR OUTLET WHEREVER POSSIBLE.
- MECHANICAL CONTRACTOR SHALL PROVIDE FLEXIBLE DUCT CONNECTIONS WHERE DUCT SYSTEMS CONNECT TO EQUIPMENT. REFER TO SPECIFICATION SECTION 15891 FOR FURTHER INFORMATION.

# TESTING and BALANCING NOTES

- MECHANICAL CONTRACTOR WILL BE REQUIRED TO PERFORM ALL EQUIPMENT & SYSTEM TESTING / BALANCING REQUIRED UNDER THIS CONTRACT. PROVIDE A FULL REPORT DETAILING ALL DESIGN & ACTUAL CONDITIONS FOR ALL AIR & HYDRONIC SYSTEMS SHOWN ON THE DRAWINGS. REFER TO SPECIFICATION SECTIONS 15990 & 15997 FOR FURTHER DETAILS.
- 2. UPON NOTICE OF COMPLETION OF WORK BY THE CONTRACTOR, OWNER WILL OBTAIN THE SERVICES OF AN INDEPENDENT TESTING & BALANCING CONTRACTOR TO VERIFY THE RESULTS OF THE TESTING & BALANCING REPORT SUBMISSION. INDEPENDENT TESTING AGENCY SHALL SELECT A RANDOM NUMBER OF MEASUREMENTS TO BE CHECKED. MEASUREMENTS WILL BE CHECKED IN THE SAME MANNER AS ORIGINALLY MEASURED. NUMBER OF VERIFICATION MEASUREMENTS SHALL BE APPROXIMATELY 25% OF THE TOTAL MEASUREMENTS FOR THE PROJECT.
- 3. IF MORE THAN 10% OF THE VERIFICATION TESTING SHOWS DEVIATIONS OF 10% OR MORE / SOUND LEVEL OF 2dB DIFFERENT THAN THAT ORIGINALLY MEASURED, THE ORIGINAL REPORT WILL BE REJECTED. ALL SYSTEMS WILL THEN BE REQUIRED TO BE COMPLETELY RE-TESTED, WITH A SECOND REPORT SUBMITTED. IN THE EVENT THAT THE ORIGINAL REPORT IS REJECTED, ALL SYSTEMS SHALL BE READJUSTED & TESTED, NEW CERTIFIED REPORTS SUBMITTED, AND NEW VERIFICATION TESTS MADE, AT NO ADDITIONAL COST TO THE OWNER. THE CONTRACTOR WILL BE RESPONSIBLE FOR ALL COSTS INVOLVED WITH THE VERIFICATION TESTS.

### CONTRACTOR ABBREVIATIONS:

### M.C. = MECHANICAL CONTRACTOR

C.C. = CONTROLS CONTRACTOR


R.C. = CERTIFIED ROOFING CONTRACTOR


P.C. = PLUMBING CONTRACTOR E.C. = ELECTRICAL CONTRACTOR

REV. DATE


NOTICE

THESE DRAWINGS ARE BASED ON CONSTRUCTION DRAWINGS NO PREPARED BY BBS ARCHITECTS, LANDSCAPE ARCHITECTS AN ENGINEERS, PC. AND, THEREFORE, MAY NOT REPRESENT THE CONDITIONS AS CONSTRUCTED AT THE TIME. ALL EXISTIN CONDITIONS SHOWN ARE REPRESENTED AS SUGGESTIVE INFORMATION AS THEY MAY NOT HAVE BEEN BUILT AND DETAILE PER THE ORIGINAL DOCUMENTS OR PER THE OWNER'S INFORMATION.

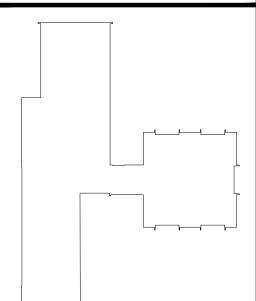

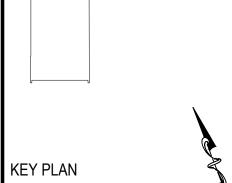

NOT TO SCALE

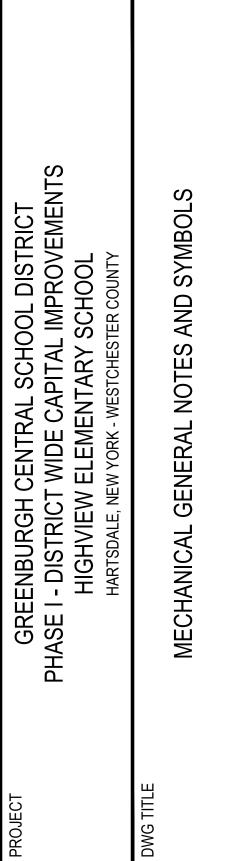

DRAWING BY: DS

CHECK BY: DS

NOTICE

THIS DRAWING, PREPARED FOR THE SPECIFIC PROJECT IN


THIS DRAWING, PREPARED FOR THE SPECIFIC PROJECT INDICATED IS AN INSTRUMENT OF SERVICE AND THE PROPERTY OF BIS ARCHITECTS, LANDSCAPE ARCHITECTS AND ENGINEERS, POINFRINGEMENT OR ANY USE OF THIS DRAWING FOR ANY OTHER PROJECT IS PROHIBITED. ANY ALTERATION OR REPRODUCTION OF THIS DOCUMENT IS ALSO PROHIBITED WITHOUT THE WRITTEN CONSENT OF THE ARCHITECT OR ENGINEER.

BBS

ARCHITECTS
LANDSCAPE ARCHITECTS
ENGINEERS

244 EAST MAIN STREET PATCHOGUE ALBANY NEW YORK 11772 NEW YORK 12205 T. 631.475.0349 F. 631.475.0361 F. 518.621.7655

www.BBSARCHITECTURE.com

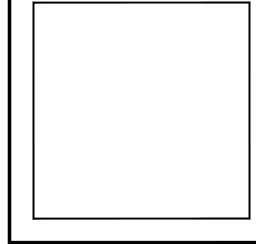

66-04-07-06-0-002-013

DISTRICT GREENBURGH CSD

PROJECT
PH. I - DW CAP. IMPROVEMENT HIGHVIEW E.S.

DWG TITLE MECHANICAL GENERAL

NOTES AND SYMBOLS


SCALE: AS NOTED

DATE: MAY 2022

BID PICK-UP: MAY 27, 2022

FILE No: 21-288

M0.01A

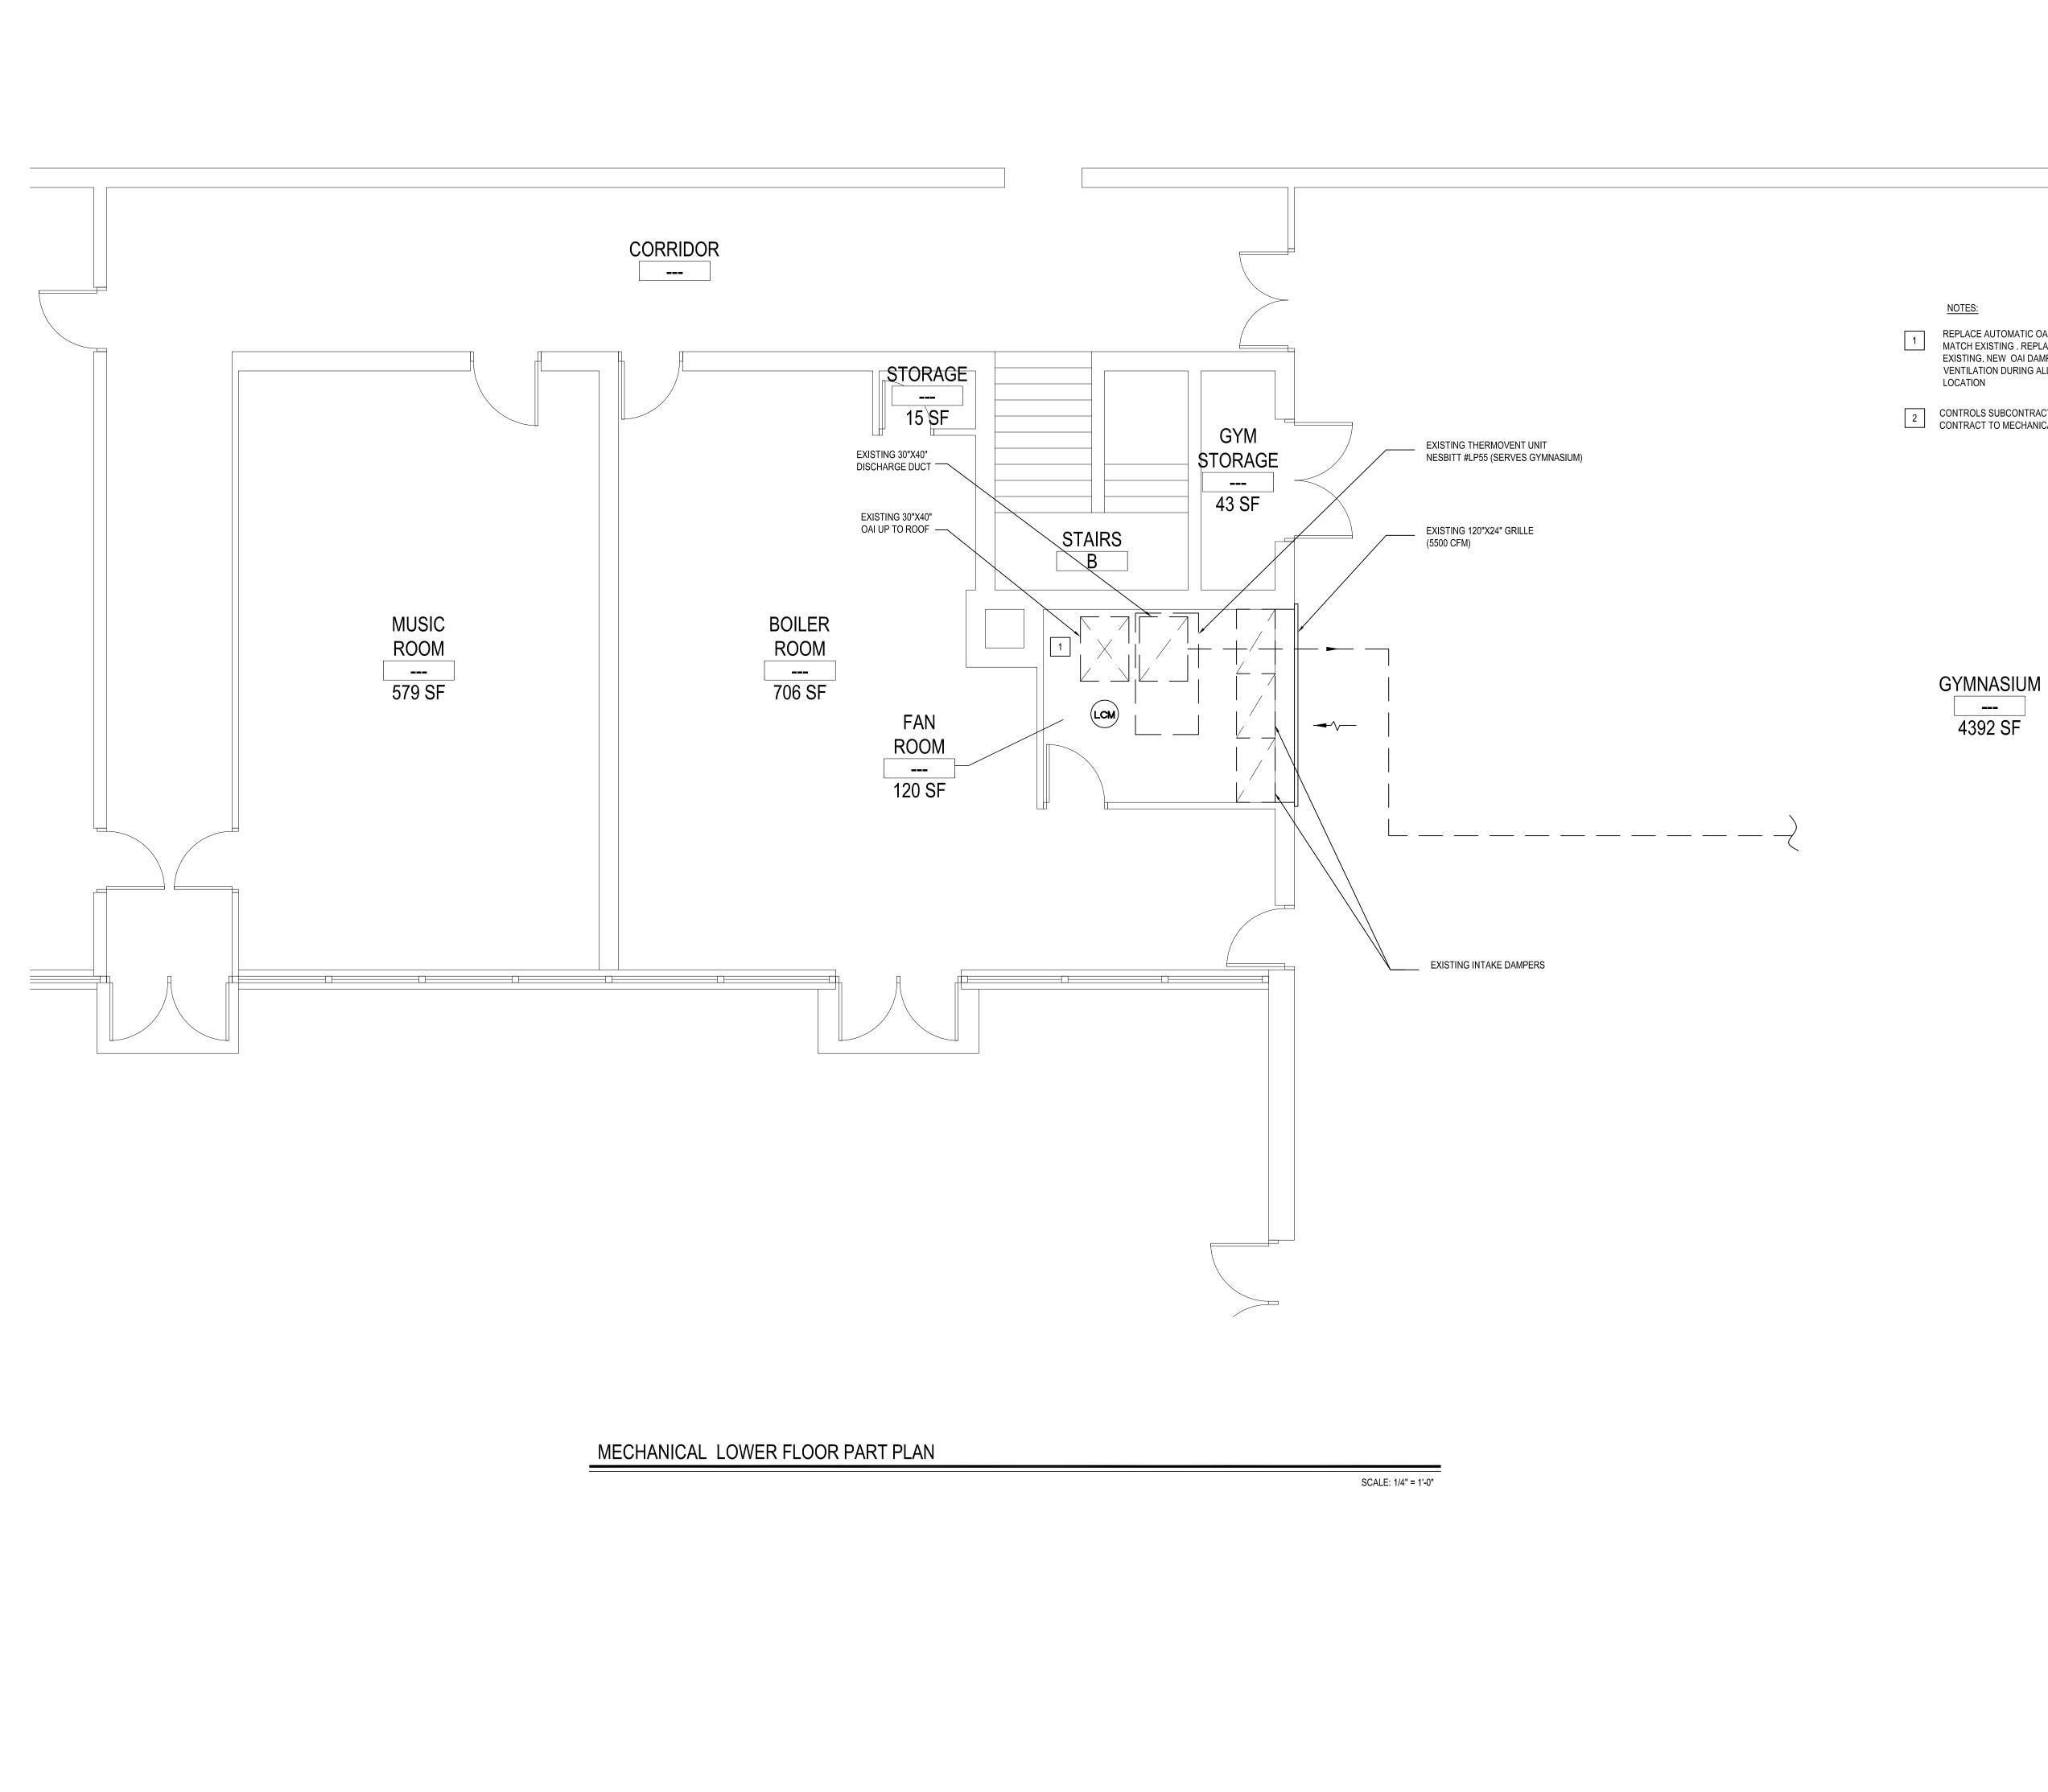

REPLACE AUTOMATIC OAI DAMPER AND RETURN PLENUM DAMPER WITH NEW TO MATCH EXISTING . REPLACE PNEUMATIC CONTROLS WITH NEW TO MATCH EXISTING. NEW OAI DAMPER TO BE OPENED TO BRING IN MIN. REQUIRED VENTILATION DURING ALL SEASONS. V.I.F EXISTING DAMPERS SIZES AND EXACT

2 CONTROLS SUBCONTRACTOR, UNDER CONTRACT TO MECHANICAL CONTRACTOR

LEAD CONTAINING NOTES

CONTRACTOR SHALL NOTE THAT LEAD PAINT EXISTS ON THE EXISTING LOWER LEVEL - LOBBY/ GYMNASIUM METAL DOOR FRAMES, METAL GLASS PARTITIONS, AND METAL I-BEAMS (GREEN/ WHITE). REFER TO SPECIFICATIONS FOR PROTOCOL ON REMOVALS AND IMPACT ON NEW WORK SCOPE.

NOTES:

MATERIALS IDENTIFIED ABOVE SHOULD BE CONSIDERED LEAD CONTAINING IN THE AREAS INDICATED AS WELL AS WHERE EVER THEY EXIST THROUGHOUT THE STRUCTURE.

DESIGNATED KEYNOTES INDICATE MATERIALS TO BE REMOVED AND PROPERLY DISPOSED OF UNDER THIS PROJECT. REFER TO PRE CONSTRUCTION LEAD MATERIALS INSPECTION, SAMPLING REPORT, AND LEAD WORK SAFE PLAN SPECIFICATION 02090 FOR ABATEMENT PROCEDURES AND LEGAL REMOVAL AND DISPOSAL REQUIREMENTS. REFER TO ENVIROSCIENCE CONSULTANTS, REPORT FOR PROJECT #21819, CONTAINED WITHIN THE PROJECT MANUAL FOR LEAD-BASED PAINT INSPECTION DATA & APPENDIX C FOR LEAD XRF TEST RESULTS FOR PROJECT-SPECIFIC DATA.

DRAWING BY: DS CHECK BY: DS <u>NOTICE</u>

REV. DATE

KEY PLAN

NOT TO SCALE

<u>NOTICE</u>

THESE DRAWINGS ARE BASED ON CONSTRUCTION DRAWINGS NOT PREPARED BY BBS ARCHITECTS, LANDSCAPE ARCHITECTS AND ENGINEERS, PC. AND, THEREFORE, MAY NOT REPRESENT THE CONDITIONS AS CONSTRUCTED AT THE TIME. ALL EXISTING CONDITIONS SHOWN ARE REPRESENTED AS SUGGESTIVE INFORMATION AS THEY MAY NOT HAVE BEEN BUILT AND DETAILED PER THE ORIGINAL DOCUMENTS OR PER THE OWNER'S INFORMATION.

THIS DRAWING, PREPARED FOR THE SPECIFIC PROJECT INDICATED IS AN INSTRUMENT OF SERVICE AND THE PROPERTY OF BBS ARCHITECTS, LANDSCAPE ARCHITECTS AND ENGINEERS, PC. INFRINGEMENT OR ANY USE OF THIS DRAWING FOR ANY OTHER PROJECT IS PROHIBITED. ANY ALTERATION OR REPRODUCTION OF THIS DOCUMENT IS ALSO PROHIBITED WITHOUT THE WRITTEN CONSENT OF THE ARCHITECT OR ENGINEER.

LANDSCAPE ARCHITECTS ENGINEERS 244 EAST MAIN STREET | 187 WOLF ROAD, STE. 205 PATCHOGUE | ALBANY

NEW YORK 12205 T. 518.621.7650 NEW YORK 11772 F. 631.475.0361 F. 518.621.7655 www.BBSARCHITECTURE.com


66-04-07-06-0-002-013

DISTRICT GREENBURGH CSD

PROJECT PH. I - DW CAP. IMPROVEMENTS HIGHVIEW E.S. DWG TITLE MECHANICAL LOWER FLOOR PART PLAN

SCALE: AS NOTED DATE: MAY 2022 BID PICK-UP: MAY 27, 2022 FILE No: 21-288

M1.01A

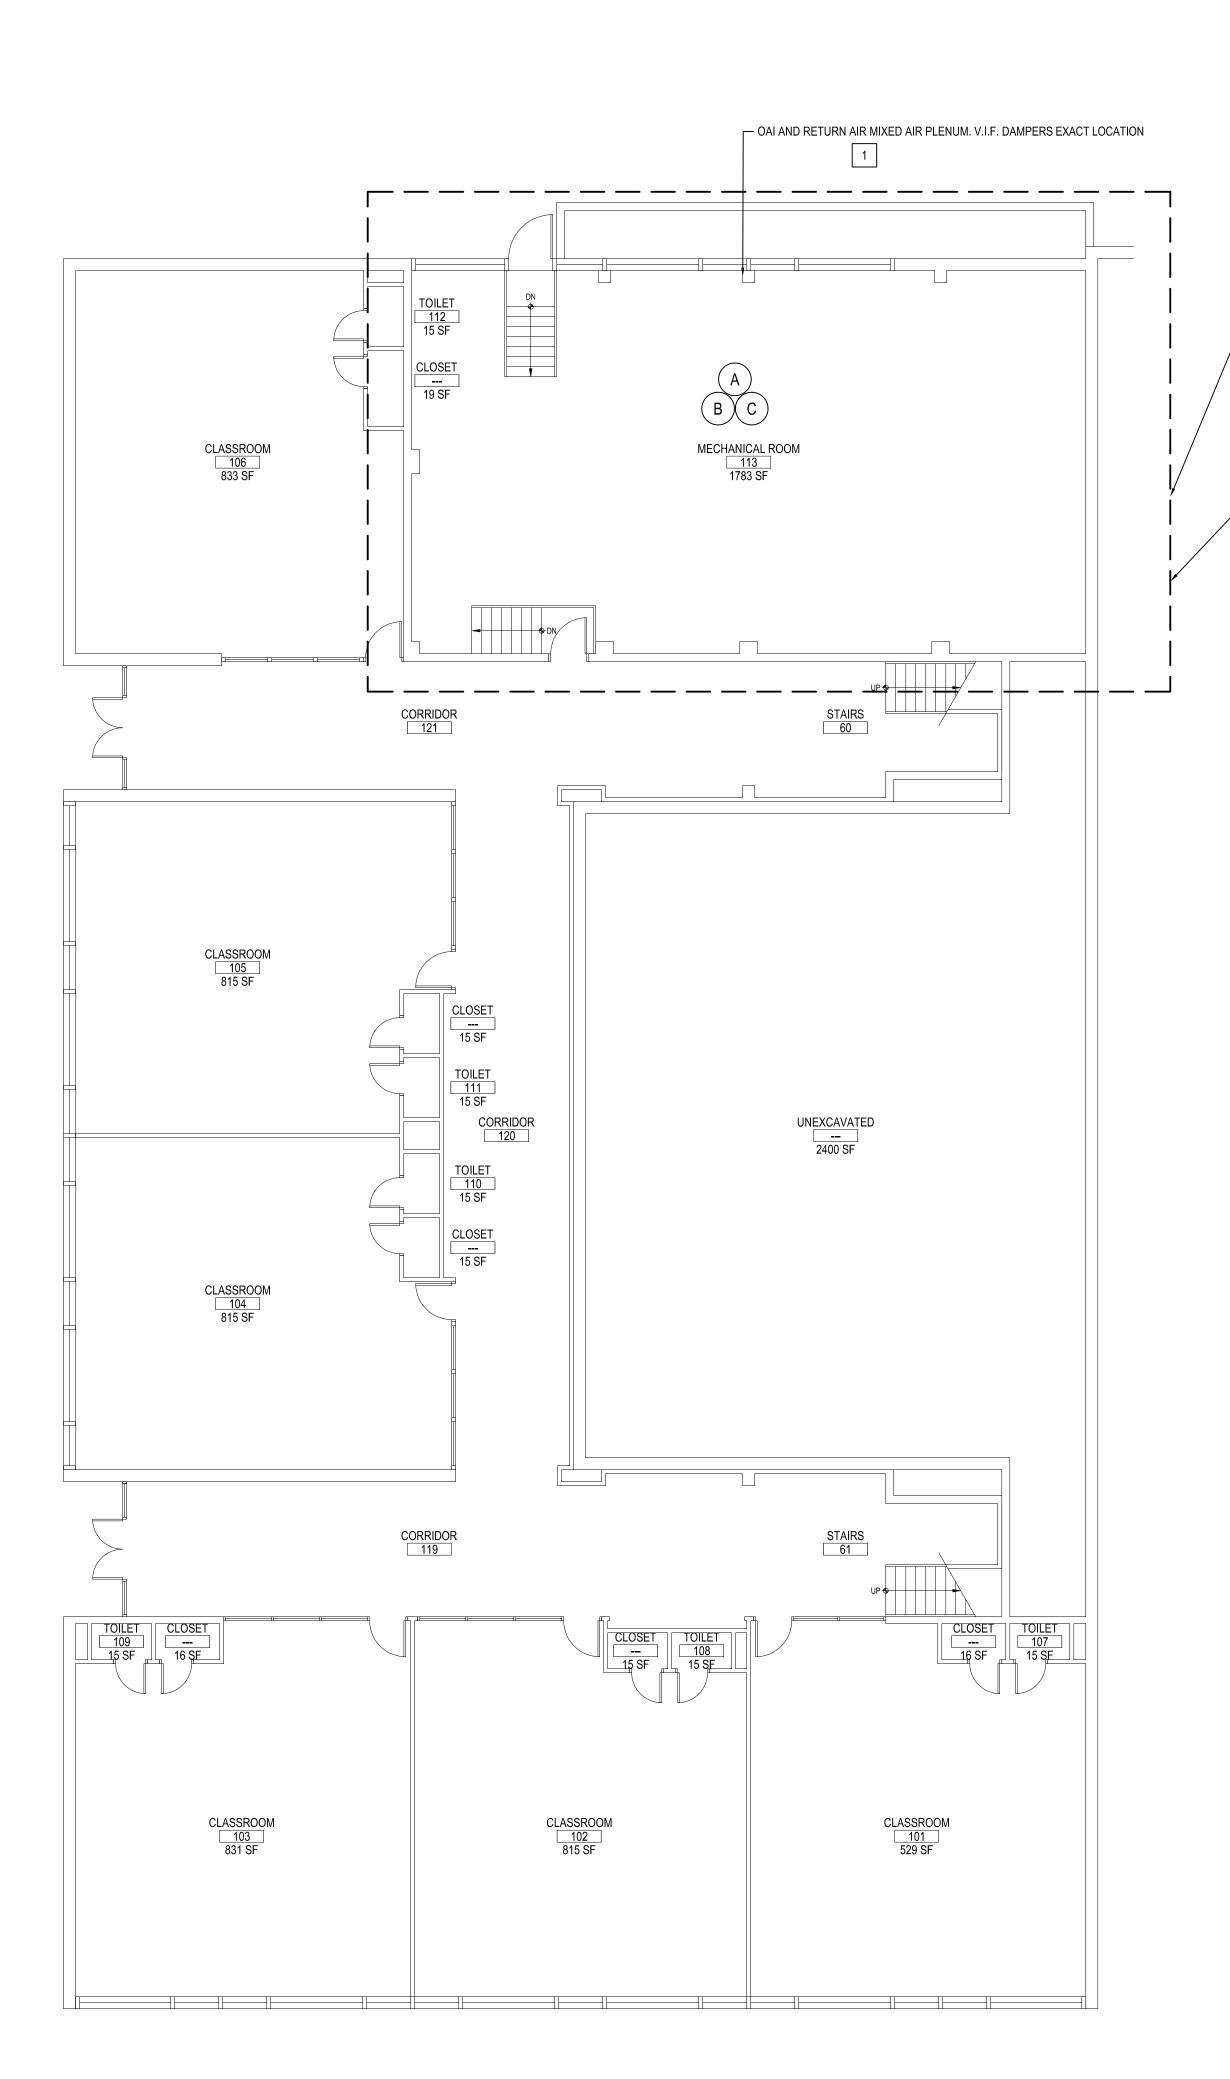

MECHANICAL GROUND FLOOR PLAN

SCALE: 1/32" = 1'-0"

#### GENERAL NOTES

EXISTING H&V UNIT LOCATED IN MECH. ROOM 113, SERVES GROUND AND 1ST

EXISTING CONTROL PANEL FOR H&V UNIT (DAMPERS), EXHAUST AND SUPPLY

PROVIDE A NEW STAND ALONE DDC CONTROL SYSTEM. REOPEN ALL FRESH AIR

EVEN IF AC IS ON. CONTROL EXHAUST FANS FOR DAY/NIGHT CONTROL & NIGHT

SETBACK. RECONNECT ALL LINKAGES AND ACTUATORS.

CONTROLS SUBCONTRACTOR, UNDER

CONTRACT TO MECHANICAL CONTRACTOR

INTAKE DAMPERS AND ENSURE SYSTEM RUNS DURING THE DAY/OCCUPIED MODE

FANS, BURNER IS LOCATED IN MECHANICAL ROOM 113

- REMOVAL & RELOCATION OF CERTAIN EXISTING WORK SHALL BE NECESSARY FOR THE PERFORMANCE OF THE NEW WORK SHOWN HEREIN. ALL EXISTING CONDITIONS ARE NOT COMPLETELY DETAILED ON THE DRAWINGS. THE CONTRACTOR SHALL SURVEY THE SITE & MAKE ALL NECESSARY CHANGES BASED ON EXISTING CONDITIONS AS REQUIRED FOR PROPER DEMOLITION OF EXISTING WORK & SHALL INCLUDE ALL MATERIALS & LABOR FOR SAME IN HIS BID PRICE. NO ALLOWANCE WILL BE MADE FOR FAILURE TO DO SO.
- PRIOR TO SUBMITTING A BID, THE CONTRACTOR SHALL VISIT THE PREMISES OF THE PROPOSED WORK & SHALL CAREFULLY EXAMINE THE ENGINEERING DRAWINGS, EXISTING CONDITIONS & LIMITATIONS THEREOF. VERIFY ACTUAL LOCATIONS WHERE THE NEW PIPING WILL BE ROUTED, COORDINATE WITH NEW & EXISTING WORK & PROVIDE CLEARANCE W/ BUILDING STRUCTURE, OTHER SERVICES, ETC.. THE CONTRACTOR SHALL INCLUDE ALL COSTS WHATSOEVER WHICH ARE INCURRED AS A RESULT OF LIMITATIONS OF THE EXISTING & NEW CONDITIONS. LATER CLAIMS FOR EXTRA LABOR, EQUIPMENT, MATERIALS, ETC. REQUIRED DUE TO DIFFICULTIES WHICH COULD HAVE BEEN FORESEEN WILL NOT BE CONSIDERED AS EXTRA WORK.
- INSTALL WORK SO AS TO BE READILY ACCESSIBLE FOR OPERATING, MAINTENANCE & REPAIR. MINOR DEVIATIONS FROM DRAWINGS MAY BE MADE TO ACCOMPLISH THIS, BUT CHANGES OF MAGNITUDE WHICH INVOLVE EXTRA COST SHALL NOT BE MADE WITHOUT APPROVAL.
- INVESTIGATE EACH SPACE THROUGH WHICH EQUIPMENT MUST BE MOVED. WHEN NECESSARY, EQUIPMENT SHALL BE SHIPPED FROM MANUFACTURER IN CRATED SECTIONS OF SIZE SUITABLE FOR MOVING THROUGH AREAS AVAILABLE. ASCERTAIN FROM BUILDING OWNER AT WHAT TIMES OF DAY EQUIPMENT MAY BE MOVED THROUGH THE BUILDING.
- COORDINATE THE EXACT SIZE & LOCATION OF NEW OPENINGS WITH EXISTING STRUCTURE. PATCH / INSULATE AS REQUIRED. CONTRACTOR SHALL FIRESTOP ALL PENETRATIONS FROM NEW PIPING, CONDUIT, DUCTWORK, ETC. THROUGH EXISTING OR NEW FIRE/ SMOKE BARRIERS. REFER TO SPECIFICATION SECTION 15511 FOR FURTHER DETAILS.
- IT IS THE INTENT OF THIS CONTRACT FOR REMAINING SYSTEMS TO BE LEFT IN GOOD WORKING ORDER, READY FOR OPERATION. COORDINATE ANY REQUIRED SYSTEM SHUTDOWNS WITH OWNER 48 HOURS IN ADVANCE. EXISTING SYSTEM SHUTDOWNS WILL NOT BE PERMITTED IF THEY INTERFERE WITH THE DAILY OPERATIONS OF THE BUILDING. CONTRACTOR WILL BE REQUIRED TO TAKE PROPER PRECAUTIONS AGAINST DAMAGING OR DISRUPTING BUILDING SYSTEMS, WIRING, PIPING OR CONTROL TUBING. ANY DAMAGE TO THESE ITEMS SHALL BE REPAIRED AT THE CONTRACTOR'S COST AS A PART OF THIS CONTRACT.
- THE CONTRACTOR SHALL REPAIR / RESTORE TO ORIGINAL CONDITION ANY EXISTING EQUIPMENT OR MATERIALS DAMAGED IN THE PROCESS OF INSTALLATION, OR DEMOLITION TO THE SATISFACTION OF THE OWNER'S REPRESENTATIVE. CONTRACTOR SHALL MAKE REPAIRS USING THE SAME OR EQUIVALENT MATERIALS. WORK WILL BE PERFORMED AT THE CONTRACTOR'S COST.
- CONTRACTOR SHALL INCUR ANY COSTS OR BURDENS ASSOCIATED WITH LOST OR STOLEN EQUIPMENT / MATERIALS.

DURING THE LIFE OF THE CONTRACT PERIOD, CONTRACTOR SHALL REMOVE ALL RUBBISH / EXCESS MATERIAL ACCUMULATED AS A RESULT OF HIS OPERATIONS ON A DAILY BASIS. ALL AREAS / EQUIPMENT AFFECTED UNDER THIS CONTRACT SHALL BE KEPT CLEAN OF DUST / DEBRIS. ALL AREAS SHALL RECEIVE A FINAL CLEANING PRIOR TO FINAL ACCEPTANCE BY THE OWNER.

- PROVIDE FOR LEGAL REMOVAL / DISPOSAL OF ALL RUBBISH / DEBRIS FROM THE BUILDING & SITE. PROTECT ALL WORK NOT SLATED FOR DEMOLITION.
- THIS CONTRACTOR SHALL COORDINATE HIS WORK WITH ALL OTHER TRADES PRIOR TO SCHEDULING THE WORK. WORK SHALL BE PERFORMED IN PROPER SEQUENCE, AS AGREED TO BY ALL TRADES. ANY COSTS INCURRED BY THE OWNER DUE TO IMPROPER SEQUENCING OF WORK WILL BE PAID FOR BY THIS CONTRACTOR.
- CONTRACTOR SHALL OBTAIN ALL PERMITS, PAY ALL FEES, CONNECTION CHARGES, ETC. ASSOCIATED WITH THE WORK UNDER THEIR CONTRACT.
- PAINT / TOUCH UP ALL SURFACES MARRED AS A RESULT OF THE PERFORMANCE OF THE CONTRACT
- 14. THE MECHANICAL CONTRACTOR SHALL REFER TO / REVIEW ALL OTHER TRADE DRAWINGS IN THE BID PACKAGE & SHALL BE RESPONSIBLE FOR / PERFORM ALL WORK INDICATED AS (M.C.) MECHANICAL WORK AS A PART OF THE BASE BID UNLESS SPECIFICALLY NOTED OTHERWISE.
- SUBSTITUTED EQUIPMENT OF GREATER OR LARGER POWER, DIMENSIONS, CAPACITIES & RATINGS MAY BE FURNISHED PROVIDED THAT SAID EQUIPMENT IS APPROVED IN WRITING PRIOR TO ORDER. ANY CONNECTING MECHANICAL SERVICES, ELECTRICAL SERVICES, BASES, STRUCTURAL APPURTENANCES, ETC. REQUIRED TO BE INCREASED DUE TO THE USE OF SAID EQUIPMENT WILL BE PAID FOR IN FULL BY THE MECHANICAL CONTRACTOR, INCLUDING ANY ADDITIONAL REQUIRED ENGINEERING FEES.
- EACH PIECE OF EQUIPMENT SHALL BE PROVIDED WITH A PERMANENT TYPE LAMINATED, BLACK FINISH WHITE CORE, PHENOLIC NAMEPLATE. NAMEPLATES SHOULD INDICATE THE NAME & NUMBER OF THE UNIT UNIT VOLTAGE, & ANY INTERLOCK REFERENCE. STARTERS / DISCONNECT SWITCHES SHOULD ALSO BE EQUIPPED WITH AN IDENTICAL NAMEPLATE WITH THE SAME INFORMATION.
- "ATTIC STOCK" UPON COMPLETION OF THE PROJECT, MECHANICAL CONTRACTOR SHALL COMPLETELY REMOVE / DISPOSE OF FILTERS USED DURING CONSTRUCTION & START-UP PROCEDURES. INSTALL NEW FILTERS IN ALL EQUIPMENT, MERV-8 OR BETTER UPON TURN OVER OF THE PROJECT TO THE OWNER. IN ADDITION, PROVIDE (2) COMPLETE SETS OF FILTERS FOR EACH PEICE OF EQUIPMENT & TURN OVER TO
- MECHANICAL CONTRACTOR SHALL PROVIDE (1) SPARE MOTOR FOR EACH SIZE MOTOR USED ON THE PROJECT. IN INSTANCES WHERE MORE THAN TEN OF THE SAME MOTOR ARE USED, MECHANICAL CONTRACTOR SHALL PROVIDE (1) SPARE MOTOR FOR EVERY TEN MOTORS OF A GIVEN SIZE USED ON THE
- MAINTENANCE MANUAL: UPON COMPLETION OF THE PROJECT, THE MECHANICAL CONTRACTOR SHAL PROVIDE A BINDER CONTAINING THE OPERATIONS & MAINTENANCE MANUALS FOR EACH NEW PEICE OF EQUIPMENT INSTALLED UNDER THIS PROJECT. THE FIRST SECTION OF THE MAINTENANCE MANUAL SHALL CONTAIN A LIST OF EACH PEICE OF EQUIPMENT, COMPLETE WITH INFORMATION SHOWING APPROPRIATE REPLACEMENT FILTER SIZES / TYPES, APPROPRIATE REPLACEMENT BELT SPECIFICATIONS, REPLACEMENT MOTOR SPECIFICATIONS, REPLACEMENT BEARING SPECIFICATIONS, VOLTAGES OF UNIT, ETC. THIS SHALL SERVE AS A WRITTEN DATABASE DESCRIBING ALL MAINTENANCE INFORMATION FOR EACH NEW PEICE OF EQUIPMENT USED.

### PRE-ABATEMENT WORK NOTES:

1. THE CONTRACTOR SHALL DETERMINE EXACT FINAL LOCATIONS OF PERSONAL AND WASTE DECONTAMINATION ENCLOSURES, PICK UP AREA FOR REFUSE AND ASBESTOS DEBRIS. THESE LOCATIONS SHALL BE REVIEWED AND PROPERLY APPROVED BY THE DISTRICT PRIOR TO COMMENCEMENT OF WORK. THIS CONTRACTOR SHALL ESTABLISH, LABEL AND MAINTAIN PROPER EXITS AND WAYS OF DEPARTURE WITHIN EACH WORK AREA FOR NORMAL AND EMERGENCY USE BY WORKERS DURING ALL ABATEMENT.

### POST-ABATEMENT WORK NOTES:

1. THE CONTRACTOR SHALL, UPON COMPLETION OF REMOVALS, PROVIDE WRITTEN DOCUMENTATION THAT THE PROJECT WORK AREAS ARE COMPLETELY FREE OF ALL HAZARDOUS

2. THE CONTRACTOR SHALL PROVIDE RECORDS OF ALL HAZARDOUS MATERIALS REMOVED FROM

### ABATEMENT NOTES

- REMOVE FROM THE AREAS INDICATED; ALL ASBESTOS CONTAINING ELBOWS TO ORIGINAL FIBERGLASS PIPE INSULATION, WHITE, AT ALL LOCATIONS BASED ON THIS PROJECT. LOCATED IN BOILER ROOM. REMOVAL SHALL BE IN COMPLIANCE WITH CODE RULE 56 AND SPECIFICATIONS.
- REMOVE FROM THE AREAS INDICATED: ALL ASBESTOS CONTAINING ROPE INSULATION TO DUC' HATCH, WHITE, AT ALL LOCATIONS BASED ON THIS PROJECT. LOCATED IN BOILER ROOM.
- REMOVE FROM THE AREAS INDICATED: ALL ASBESTOS CONTAINING MASTIC TO FIBERGLASS DUCT INSULATION CLAMPS, BROWN, AT ALL LOCATIONS BASED ON THIS PROJECT. LOCATED IN BOILER ROOM. REMOVAL SHALL BE IN COMPLIANCE WITH CODE RULE 56 AND SPECIFICATIONS.

ENVIROSCIENCE FOR PROJECT-SPECIFIC ABATEMENT & DISPOSAL PROTOCOL REQUIRED.

REMOVAL SHALL BE IN COMPLIANCE WITH CODE RULE 56 AND SPECIFICATIONS.

REFER TO ENVIROSCIENCE CONSULTANTS, REPORT FOR PROJECT # 21819, CONTAINED WITHIN THE PROJECT MANUAL, FOR ALL PRECONSTRUCTION SURVEY, BULK SAMPLING AND ANALYSIS OF SUSPECT/ASSUMED ASBESTOS CONSTRUCTION MATERIALS. G.C. TO COORDINATE WITH

#### FIRE STOPPING NOTES

- ALL PENETRATIONS RELATED TO MECHANICAL WORK THROUGH FIRE RATED WALLS, FLOORS OR OTHER STRUCTURES SHALL BE FIRE STOPPED AS REQUIRED TO MAINTAIN THE RATING OF THE WALL BY MECHANICAL CONTRACTOR. IT IS ASSUMED THAT ALL WALLS IN THE CONSTRUCTION CARRY A MINIMUM FIRE RATING OF 1 HR. IT SHOULD BE ASSUMED THAT ALL MACHINE ROOM WALLS / BOILER ROOM WALLS ELECTRIC ROOM WALLS CARRY A RATING OF 2 HR. MECHANICAL CONTRACTOR SHALL BE RESPONSIBLE FOR A COMPLETE REVIEW OF THE ARCHITECTURAL DRAWINGS IN ORDER TO DETERMINE FIRE RATINGS OF ALL WALLS / PARTITIONS RELATED TO WORK UNDER THIS CONTRACT.
- MECHANICAL CONTRACTOR SHALL REVIEW THE COMPLETE ARCHITECTURAL SET OF DRAWINGS IN ORDER TO DETERMINE WHERE DUCT PENETRATIONS THROUGH RATED BARRIERS. DUCTS PENETRATING SAID RATED BARRIERS SHALL BE EQUIPPED WITH A UL LISTED FUSIBLE LINK TYPE FIRE DAMPER, RATED FOR SERVICE FOR WHICH IT IS BEING USED. FIRE DAMPERS SHALL BE PROVIDED & INSTALLED BY THE MECHANICAL CONTRACTOR, COMPLETE W/ DUCT ACCESS DOORS DIRECTLY ADJACENT TO THE DAMPER POSITIONED FOR EASY REPLACEMENT OF THE LINK.
- MECHANICAL CONTRACTOR SHALL REVIEW THE COMPLETE ARCHITECTURAL SET OF DRAWINGS IN ORDER TO DETERMINE WHERE DUCT PENETRATIONS THROUGH RATED BARRIERS OCCUR BETWEEN SEPARATE SMOKE ZONES. DUCTS PENETRATING SAID FIRE / SMOKE BARRIERS SHALL BE EQUIPPED WITH A UL LISTED COMBINATION FIRE / SMOKE DAMPER, RATED FOR SERVICE FOR WHICH IT IS BEING USED. FIRE / SMOKE DAMPERS SHALL BE PROVIDED & INSTALLED BY THE MECHANICAL CONTRACTOR, COMPLETE W/ DUCT ACCESS DOORS DIRECTLY ADJACENT TO THE DAMPER. DAMPER ACTUATOR & RELATED WIRING SHALL BE PROVIDED & INSTALLED BY THE ELECTRICAL CONTRACTOR. COORDINATE DAMPER INSTALLATIONS W/ E.C. TO VERIFY PROPER CLEARANCES TO ASSURE PROPER DAMPER OPERATION.
- MECHANICAL CONTRACTOR SHALL PROVIDE A FULL SET OF AS-BUILT DRAWINGS, SHOWING EACH DAMPER LOCATION, TYPE OF DAMPER, ACCESS DOOR LOCATIONS, ETC. CONTRACTOR SHALL REFER TO SPECIFICATION SECTION 15511 FOR FURTHER DETAILS REGARDING FIRESTOPPING MATERIALS & METHODS.
- CONTRACTOR SHALL SUBMIT SHOP DRAWINGS OF PRODUCTS TO BE USED. FIRESTOP MATERIALS OTHER THAN THE PRODUCTS SPECIFIED SHALL INCLUDE FULL TECHNICAL DATA WITH SHOP DRAWINGS TO DEMONSTRATE EQUALITY WITH THE SPECIFIED FIRESTOPPING MATERIALS.

#### GENERAL INSTRUMENTATION NOTES

- AT A MINIMUM, PROVIDE THERMOMETERS / WELLS AT THE FOLLOWING LOCATIONS:
- AT INLETS & OUTLET OF EACH THREE WAY VALVE (UNIT VENTILATORS / CABINET UNIT HEATER INSTALLATIONS EXCEPTED).
- AT INLET & OUTLET OF EACH HYDRONIC BOILER, CHILLER OR COOLING TOWER. AT INLET & OUTLET OF EACH HYDRONIC COIL IN AIR HANDLING UNITS & BUILT-UP CENTRAL SYSTEMS.
- AT A MINIMUM, PROVIDE LIQUID FILLED PRESSURE GAUGES / WELLS AT THE FOLLOWING LOCATIONS:
- AT SUCTION & DISCHARGE OF EACH PUMP. FOR EACH MAKEUP WATER LINE.
- BEFORE & AFTER ALL PRESSURE REDUCING VALVES. AT ACCESSIBLE HIGH POINT OF ALL HYDRONIC PIPING SYSTEMS.
- AT ALL EXPANSION / COMPRESSION TANKS.

#### ELECTRICAL WORK UNDER MECHANICAL CONTRACT

- MECHANICAL CONTRACTOR SHALL PROVIDE ALL STARTERS & DISCONNECT SWITCHES REQUIRED FOR ALI NEW MECHANICAL EQUIPMENT. STARTER / DISCONNECT SWITCH INSTALLATION TO BE PERFORMED UNDER THE ELECTRICAL CONTRACT. COORDINATE WORK W/ ELECTRICAL CONTRACTOR PRIOR TO START
- POWER WIRING REQUIRED FOR CONTROLS SHALL BE PERFORMED UNDER THE MECHANICAL CONTRACT UNLESS SPECIFICALLY NOTED OTHERWISE ON THE ELECTRICAL DRAWINGS. MECHANICAL CONTRACTOR SHALL OBTAIN THE SERVICES OF A LICENSED ELECTRICIAN (PER NEC REQUIREMENTS) TO PERFORM ALL

#### TESTING and BALANCING NOTES

- MECHANICAL CONTRACTOR WILL BE REQUIRED TO PERFORM ALL EQUIPMENT & SYSTEM TESTING BALANCING REQUIRED UNDER THIS CONTRACT. PROVIDE A FULL REPORT DETAILING ALL DESIGN & ACTUAL CONDITIONS FOR ALL AIR & HYDRONIC SYSTEMS SHOWN ON THE DRAWINGS. REFER TO
- UPON NOTICE OF COMPLETION OF WORK BY THE CONTRACTOR, OWNER WILL OBTAIN THE SERVICES OF
- IF MORE THAN 10% OF THE VERIFICATION TESTING SHOWS DEVIATIONS OF 10% OR MORE / SOUND LEVEL OF 2dB DIFFERENT THAN THAT ORIGINALLY MEASURED, THE ORIGINAL REPORT WILL BE REJECTED. ALL SYSTEMS WILL THEN BE REQUIRED TO BE COMPLETELY RE-TESTED, WITH A SECOND REPORT SUBMITTED. IN THE EVENT THAT THE ORIGINAL REPORT IS REJECTED, ALL SYSTEMS SHALL BE READJUSTED & TESTED, NEW CERTIFIED REPORTS SUBMITTED, AND NEW VERIFICATION TESTS MADE, AT NO ADDITIONAL COST TO THE OWNER. THE CONTRACTOR WILL BE RESPONSIBLE FOR ALL COSTS INVOLVED WITH THE

### LEAD CONTAINING NOTES

NONE OF THE BUILDING MATERIALS AFFECTED BY THE SCOPE OF WORK WERE FOUND TO BE LEAD CONTAINING. PLEASE SEE TEST RESULTS AND REPORT BY ENVIROSCIENCE CONSULTANTS, REPORT FOR PROJECT # 21819, CONTAINED WITHIN THE PROJECT MANUAL, FOR ALL PRECONSTRUCTION SURVEY, BULK SAMPLING AND ANALYSIS OF SUSPECT/ASSUMED LEAD CONTAINING CONSTRUCTION MATERIALS.

ELECTRICAL WORK.

SPECIFICATION SECTIONS 15990 & 15997 FOR FURTHER DETAILS.

AN INDEPENDENT TESTING & BALANCING CONTRACTOR TO VERIFY THE RESULTS OF THE TESTING & BALANCING REPORT SUBMISSION. INDEPENDENT TESTING AGENCY SHALL SELECT A RANDOM NUMBER OF MEASUREMENTS TO BE CHECKED. MEASUREMENTS WILL BE CHECKED IN THE SAME MANNER AS ORIGINALLY MEASURED. NUMBER OF VERIFICATION MEASUREMENTS SHALL BE APPROXIMATELY 25% OF THE TOTAL MEASUREMENTS FOR THE PROJECT.

P.C. = PLUMBING CONTRACTOR

E.C. = ELECTRICAL CONTRACTOR

LANDSCAPE ARCHITECTS ENGINEERS 44 EAST MAIN STREET | 187 WOLF ROAD, STE. 209 PATCHOGUE NEW YORK 11772 NEW YORK 12205

T. 631.475.0349 F. 631.475.0361

DRAWING BY: DS

CONSENT OF THE ARCHITECT OR ENGINEER.

DS

THIS DRAWING, PREPARED FOR THE SPECIFIC PROJECT INDICATED IS AN INSTRUMENT OF SERVICE AND THE PROPERTY OF BBS

ARCHITECTS, LANDSCAPE ARCHITECTS AND ENGINEERS, FINFRINGEMENT OR ANY USE OF THIS DRAWING FOR ANY OTHER PROJECT IS PROHIBITED. ANY ALTERATION OR REPRODUCTION OF THIS DOCUMENT IS ALSO PROHIBITED WITHOUT THE WRITTEN

REV. DATE

KEY PLAN

NOT TO SCALE

HESE DRAWINGS ARE BASED ON CONSTRUCTION DRAWINGS NOT FPARED BY BBS ARCHITECTS LANDSCAPE ARCHITECTS AN

ONDITIONS AS CONSTRUCTED AT THE TIME. ALL EXISTIN

INFORMATION AS THEY MAY NOT HAVE BEEN BUILT AND DETAILED

PER THE ORIGINAL DOCUMENTS OR PER THE OWNER'S INFORMATION

www.BBSARCHITECTURE.com

F. 518.621.7655

66-04-07-06-0-006-011 DISTRICT GREENBURGH CSD

PROJECT PH. I - DW CAP. IMPROVEMENTS LEE F. JACKSON E.S. DWG TITLE MECHANICAL GENERAL

SCALE: AS NOTED MAY 2022 BID PICK-UP: MAY 27, 2022 FILE No: 21-289

M0.01B

NOTES AND SYMBOLS

**CONTRACTOR ABBREVIATIONS:** 

M.C. = MECHANICAL CONTRACTOR

C.C. = CONTROLS CONTRACTOR

R.C. = CERTIFIED ROOFING CONTRACTOR

#### **GENERAL CONSTRUCTION NOTES**

1. ALL WORK SHALL BE DONE IN ACCORDANCE WITH THE LATEST EDITIONS OF THE NEC, APPLICABLE LOCAL CODES, STATE CODES, SCHOOL WORKING RULES AND SCHEDULE DIRECTIVES, AND THE ENGINEER'S SPECIFICATIONS.

2. THE VOLTAGE CHARACTERISTIC OF THIS SCHOOL IS 120/208VAC, 4 WIRE, 3PH, GROUNDED NEUTRAL, WYE. ALL EQUIPMENT SHALL BE COMPATIBLE WITH THESE CHARACTERISTICS.

3. THE DRAWINGS SHOW SCHEMATICALLY. THE APPROXIMATE LOCATION OF ALL EQUIPMENT, CONDUITS. DEVICES, ETC. THE EXACT LOCATION OF WHICH SHALL BE SUBJECT TO APPROVAL BY THE ARCHITECT/OWNER WHO RESERVES THE RIGHT TO MAKE PRIOR TO INSTALLATION, ANY REASONABLE CHANGES IN LOCATION INDICATED WITHOUT EXTRA COST TO THE OWNER. CONTRACTOR SHALL VERIFY ALL INDICATED OR APPROXIMATED DIMENSIONS DRAWN OR DENOTED.

4. DIVISION 16 CONTRACTOR SHALL EXAMINE THE SITE TO VERIFY WORK TO BE PERFORMED AS SHOWN ON DRAWINGS AND SPECIFICATIONS BEFORE SUBMITTING HIS BID. ANY DISCREPANCY BETWEEN DRAWINGS/SPECIFICATIONS AND ACTUAL FIELD CONDITIONS SHALL BE BROUGHT TO ARCHITECT/ENGINEERS ATTENTION BEFORE BID SUBMITTAL. ANY FIELD CONDITION FOUND AFTER BID APPROVAL WHICH HAMPERS AND/OR PREVENTS ANY WORK TO BE PERFORMED AS SHOWN ON DRAWINGS AND SPECIFICATIONS SHALL BE THE RESPONSIBILITY OF THE DIVISION 16 CONTRACTOR. THE DIVISION 16 CONTRACTOR SHALL BID THE HIGHER SPECIFICATION FOR ANY DISCREPANCY BETWEEN DRAWINGS AND SPECIFICATIONS.

5. DIVISION 16 CONTRACTOR SHALL PROVIDE ALL LABOR SERVICE MATERIALS, EQUIPMENT, AND RELATED ITEMS TO COMPLETE THE WORK OF THIS DIVISION, AS REQUIRED BY THE NATIONAL ELECTRIC CODE, AND ALL STATE AND LOCAL AUTHORITIES HAVING JURISDICTION.

6. DIVISION 16 CONTRACTOR SHALL PROVIDE ALL ELECTRICAL HARDWARE SHOWN ON THESE DRAWINGS AND RELATED DETAIL MATERIALS NOT SPECIFICALLY SHOWN OR SPECIFIED. ALL NEW ELECTRICAL MATERIAL AND EQUIPMENT SHALL CONFORM TO THE STANDARDS AND BEAR THE INSPECTION LABEL OF THE UNDERWRITERS LABORATORIES AND SHALL BE APPROVED FOR USE BY ALL LOCAL AUTHORITIES HAVING JURISDICTION.

7. THE DIVISION 16 CONTRACTOR SHALL REFER TO ALL OTHER DRAWINGS IN BID PACKAGE AND PERFORM THE WORK (INCLUDE IN HIS BID) INDICATED AS ELECTRICAL CONTRACTOR (E.C.) WORK. CONTRACTOR TO COORDINATE ALL LOCATIONS WITH GENERAL CONTRACTOR AND OTHER TRADES.

8. ELECTRICAL CONTRACTOR SHALL COORDINATE WITH THE MECHANICAL CONTRACTOR FOR ALL MECHANICAL EQUIPMENT REQUIRING ELECTRICAL POWER. THE EC IS RESPONSIBLE TO INSTALL ALL MOTOR STARTERS AND ASSOCIATED POWER WIRING, THE LOCATIONS OF MOTOR STARTERS SHALL BE DETERMINED BY THE CONTRACTOR IN THE FIELD AND SUBMITTED TO THE ENGINEER FOR APPROVAL UNLESS IT IS SPECIFIED ON THE DRAWINGS. THE EC SHALL REFER TO THE MECHANICAL EQUIPMENT SCHEDULES & NOTES AND INCLUDE IN HIS BID PRICE ALL ELECTRICAL WORK ASSOCIATED WITH THEIR INSTALLATION, AND THE REMOVAL OF ANY STARTERS/DISCONNECTS NO LONGER REQUIRED.

9. ALL WORK SHALL BE IN ACCORDANCE WITH MANUFACTURER'S RECOMMENDATIONS AND DIRECTIVES OF THE

10. ALL ELECTRICAL WORK SHALL BE PERFORMED BY A LICENSED ELECTRICAL CONTRACTOR WHO SHALL OBTAIN AN APPROVED ELECTRICAL INSPECTION CERTIFICATE FROM THE LOCAL AHJ AND PAY ASSOCIATED FEE. SUBMIT A PHOTOCOPY OF THIS CERTIFICATE TO THE ENGINEER WITH FINAL PAYMENT APPLICATION. SUBMIT A COPY OF THIS CERTIFICATE TO THE OWNER.

11. DIVISION 16 CONTRACTOR SHALL GUARANTEE ALL MATERIALS AND THEIR INSTALLATION TO BE FREE OF DEFECTS FOR A PERIOD AS DEFINED IN THE PROJECT MANUAL.

12. IF ADDITIONAL POLE POSITIONS ARE REQUIRED FOR NEW CIRCUITS IN EXISTING PANELS SERVICING RENOVATED AREAS, REMOVE (3) ADJACENT 1 POLE BREAKERS PROVIDE AND INSTALL 3P, 60A BREAKER FOR SUB FEED TO A SURFACE MOUNTED 100A, 3PH, 18 POLE SUB PANEL AND ESTABLISH OVERFLOW CIRCUITS IN NEW SUB PANEL, EACH WITH A 1P, 20A BREAKER. PROVIDE (3) 1P, 20A BREAKERS FOR DISCONNECTED CIRCUITS IN MAIN PANEL AND RECONNECT THEM IN SUB PANEL. SUB PANEL FEED TO BE 3#6 + 1#6(N) + 1#10(G)

13. IT IS EXPECTED THAT STRUCTURAL DEMOLITION BY THE GENERAL CONTRACTOR WILL CAUSE VARIOUS ELECTRIC SUPPLIES, OF VARIOUS VOLTAGES AND PURPOSES, TO BE CUT AND RENDER SOME DEVICES TEMPORARILY INACTIVE. IT IS THE ELECTRICAL CONTRACTOR'S RESPONSIBILITY TO RECONSTRUCT AND RECONNECT SUCH ELECTRIC SOURCES UPON COMPLETION. NOTE THAT MOST REINSTALLED ITEMS WILL BE IN DIFFERENT LOCATIONS FROM THE REMOVAL LOCATION. THE ELECTRICAL CONTRACTOR SHALL MAKE ALL REQUIRED CIRCUIT EXTENSIONS OR MODIFICATIONS TO PROVIDE SERVICE TO A REINSTALLED ITEM AS RELOCATED. NOTE THAT THIS REQUIREMENT ALSO APPLIES TO THE ROOMS AND ELECTRICAL ITEMS WITHIN THAT ARE NOMINALLY NOT IN CONTRACT. SUCH RESTORATION OF SERVICE, IF NEEDED, IS SPECIFICALLY IN THE ELECTRICAL CONTRACTOR'S CONTRACT.

14. THE ELECTRICAL CONTRACTOR SHALL PROVIDE TEMPORARY LIGHTING AND POWER TO ALL TRADES FOR THE DURATION OF THE PROJECT. SERVICE SHALL BE SUPPLIED TO CONTRACTOR'S CONSTRUCTION TRAILERS WHERE SUCH IS REQUESTED. USE THE EXISTING POWER PANELS FOR SUCH SUPPLY. POWER COSTS WILL BE PAID BY THE OWNER. ALL CONSTRUCTION POWER RECEPTACLES SHALL BE GFI PROTECTED.

15. IT SHALL BE THE ELECTRICAL CONTRACTOR'S RESPONSIBILITY TO PROTECT ALL ELECTRICAL DEVICES FROM DAMAGES DURING CONSTRUCTION. THIS INCLUDES DEVICES WHICH ARE EITHER INDICATED TO REMAIN, AND/OR TO BE REMOVED AND REINSTALLED THROUGHOUT ALL CONSTRUCTION AREAS. DEVICES SHALL INCLUDE BUT WILL NOT BE LIMITED TO: SMOKE DETECTORS, EMERGENCY LIGHTS, EXIT SIGNS, OCCUPANCY SENSORS, SPEAKERS, LIGHT FIXTURES, SWITCHES, RECEPTACLES, ETC. IN THE EVENT OF DAMAGES INCURRED DUE TO CONSTRUCTION ACTIVITIES, THE ELECTRICAL CONTRACTOR SHALL BE RESPONSIBLE TO REPLACE ANY DAMAGED DEVICES AT NO ADDITIONAL COST TO OWNER.

16. THE INDICATED SOURCE OF EXISTING CIRCUITS MAY NOT BE KNOWN OR HAS NOT BEEN VERIFIED. IT IS THE DIVISION 16 CONTRACTOR'S RESPONSIBILITY TO TRACE OUT, LOCATE AND VERIFY THE DISCONNECTING MEANS OF EXISTING CIRCUIT(S) TO BE IMPACTED BY THE WORK. SAFE OFF THE CIRCUIT(S0 AS REQUIRED TO SAFELY PERFORM THE WORK, AND RE-ENERGIZE UPON COMPLETION. UPDATE PANEL DIRECTORIES UPON COMPLETION.

17. WHERE EXISTING FIRE ALARM SYSTEMS ARE MODIFIED DURING THE COURSE OF THE PROJECT, PROVIDE OWNER WITH UPDATED COMPLETION RECORD DOCUMENTATION PER NFPA 72, ARTICLE 10.18. INCLUDE COPY OF UPDATED SITE SPECIFIC SOFTWARE. ANY ADDITIONAL DEVICES SHALL BE MAPPED INTO THE SYSTEM WITH THE APPROPRIATE ADDRESSES/LABELS.

18. FURNISH AND INSTALL ALL INDICATED LIGHTING FIXTURES AND MOUNTING HARDWARE AS REQUIRED FOR A COMPLETE INSTALLATION. NOTE ALL LIGHT FIXTURES SHALL BE SUPPORTED FROM BUILDING STRUCTURE. UTILIZING CEILING FRAMING ALONE IS NOT ACCEPTABLE. NEW LIGHTING FIXTURES (OTHER THAN THEATRICAL EQUIPMENT) SHALL NOT BE DAISY CHAINED. RE-USE OF AN EXISTING LIGHTING CKT INCLUDES HOME RUN WIRING OR WIRING UP TO THE SWITCH. ANY WIRING DOWNSTREAM OF THE SWITCH IS SUBJECT TO REPLACEMENT/REARRANGEMENT. EC SHALL ALLOW FOR THIS IN THE BID PRICE.

19. ALL WIRING TO BE 1#12+1#12(N)+1#12(G)-3/4" EMT, OR STEEL JACKETED MC CABLE (WHERE CODE PERMITTED), UNLESS OTHERWISE SPECIFIED ON DRAWINGS. ALUMINUM JACKETED MC CABLE IS NOT ACCEPTABLE.


20. RUN BRANCH CIRCUITS IN DROPPED CEILINGS, VOIDS, & CHASES. ALL DEVICES & CONDUITS ON NEW CONSTRUCTION MUST BE RECESSED. FOR EXISTING SURFACES: MECHANICAL/WORK SPACES-CONDUITS MAY BE SURFACE MOUNTED . EXISTING PUBLIC/FINISHED AREAS- CONDUITS SHALL BE CONCEALED WHEREVER POSSIBLE (IN HUNG CEILINGS, VOIDS/CHASES, FLOOR BELOW OR BEHIND WALLS) ALL WIRING THAT CANNOT BE CONCEALED IN MUST BE RUN IN FINISHED SURFACE RACEWAY SUCH AS WIREMOLD, COLOR PER ARCHITECT. USE OF ADHESIVE IS PROHIBITED, SURFACE RACEWAY MUST BE SECURED USING MECHANICALLY FASTENED

21. ANY LIGHT FIXTURES INSTALLED IN GYMNASIUMS OR OTHER AREAS SUBJECT TO IMPACT OR PHYSICAL DAMAGE SHALL BE MOUNTED WITH SAFETY CHAINS AND SECURED TO STRUCTURE.

# |

DEVICE MOUNTING HEIGHT DETAIL

22. SEE SPEC. SECTION 16100 BASIC MATERIALS AND METHODS FOR COMPLETE NOTES ON INSTALLATION, MISCELLANEOUS MATERIALS AND ELECTRICAL DEVICES.

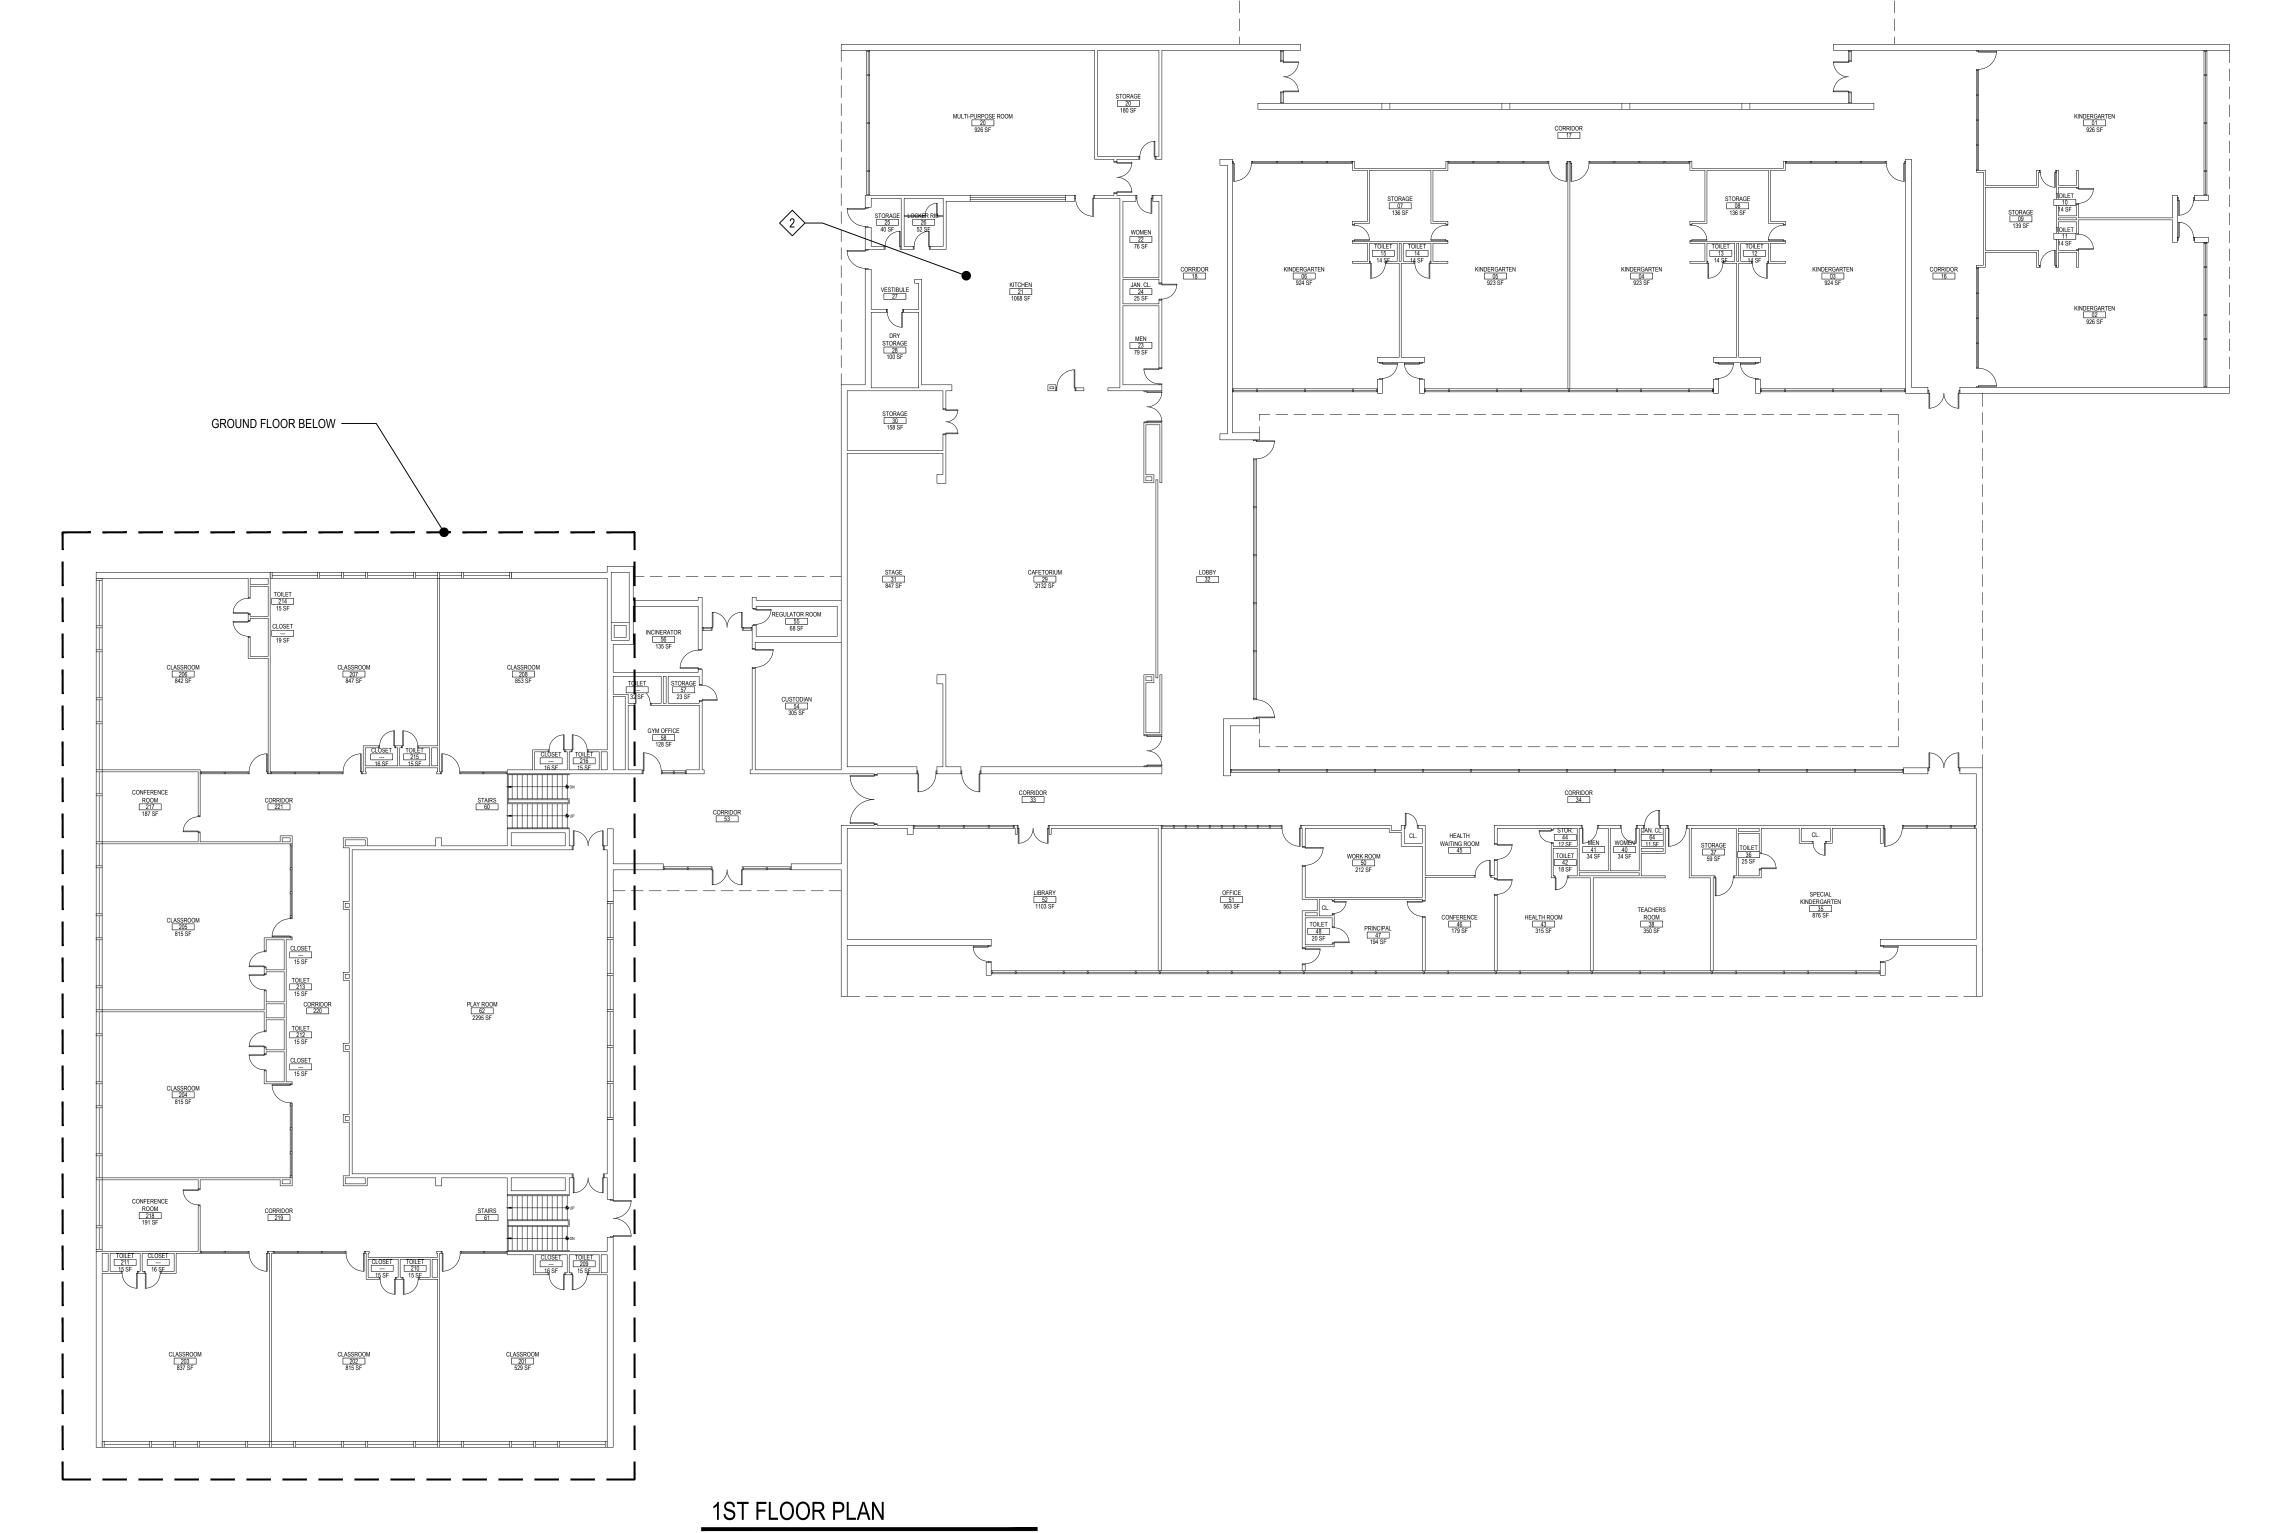

SCALE: 1/16" = 1'-0"

SCALE: N.T.S.

IN LOCATIONS WHERE SIMILAR DEVICES ARE MOUNTED AT THE SAME HEIGHT,

DEVICES SHALL BE PROPERLY "GANGED" AND SHALL HAVE A SINGLE COVER

IN LOCATIONS WHERE DIFFERENT DEVICES ARE MOUNTED AT DIFFERENT HEIGHTS WITHIN FOUR FEET OF ONE ANOTHER, DEVICES SHALL BE MOUNTED SUCH THAT THEY HAVE A COMMON CENTERLINE. IF THERE ARE THREE OR MORE DEVICES, THE CONTRACTOR SHALL REQUEST A DETAIL FROM THE

80" TO BOTTOM, OR AT SHALLOW CEILING INSTALLATIONS, WITHIN 6" OF

IN TOILET ROOMS WITH BACK SPLASH AT VANITY, MOUNT CENTER AT 4" ABOVE BACK SPLASH. IF NO BACK SPLASH, MOUNT 4" ABOVE COUNTER. IF NO COUNTER. MOUNT AT 42" AFF.COORDINATE WITH ARCHITECTURAL PLANS.

RECEPTACLE IN PLAN WITH THE NOTATION 'AC' INDICATES MOUNTING HEIGHT OF 4" ABOVE COUNTER OR 4" ABOVE BACK SPLASH. COORDINATE WITH ARCHITECTURAL PLANS. REFER TO ELEVATIONS AND FURNITURE PLANS.

MOUNT AT 7'-6" ABOVE CLOSEST FLOOR LEVEL (LANDINGS, STEPPED FLOORS

FINISHED CEILING. VERIFY WITH ENGINEER.

REFER TO ELEVATIONS AND FURNITURE PLANS.

ETC.) UNLESS OTHERWISE NOTED.

FIRE STOP NOTES

ALL CONDUIT AND CABLE PENETRATIONS THROUGH FIRE RATED WALLS, FLOORS OR OTHER STRUCTURES SHALL BE FIRE STOPPED.

THE FIRE STOP MATERIALS SHALL BE HILTI TYPE FS-657 FIRE BLOCK, FS-ONE SEALANT, CP-672 JOINT SPRAY, CP-601S ELASTOMERIC SEALANT, 6P-606 FLEXIBLE SEALANT, CP-643 OR CP-642 COLLAR, CP-618 PUTTY STICK, OR FS-635 TROWEL ABLE COMPOUND, AS SUITABLE.

CONTRACTOR SHALL SUBMIT SHOP DRAWINGS OF PRODUCTS SPECIFIED OR <u>EQUAL</u>.

FIRE STOP MATERIALS OTHER THAN HILTI SHALL INCLUDE FULL TECHNICAL DATA WITH SHOP DRAWINGS TO DEMONSTRATE EQUALITY WITH THE SPECIFIED FIRE STOPS AND STATEMENT FROM MANUFACTURER THAT THEY MEET OR EXCEED THE PRODUCTS SPECIFIED HERE.

ALL SYSTEMS SHALL HAVE THEIR OWN SLEEVE THROUGH FIRE RATED WALLS. IE FIRE ALARM, PUBLIC ADDRESS, TELEPHONE, DATA, POWER AND LIGHTING.

00

CLASSROOM 103 831 SE CLASSROOM 102 815 SF CLASSROOM 101 529 SF

SCALE: 1/16" = 1'-0"

GROUND FLOOR PLAN

NOTE: SYMBOLS AND ABBREVIATIONS ON HIS DRAWING ARE FOR REFERENCE ONLY, AND MAY NOT BE USED IN THE FOLLOWING DOCUMENTS.

REV. DATE <u>NOTICE</u> ESE DRAWINGS ARE BASED ON CONSTRUCTION DRAWINGS NOT

REPARED BY BBS ARCHITECTS, LANDSCAPE ARCHITECTS AND

ONDITIONS AS CONSTRUCTED AT THE TIME ALL EXISTIN

FORMATION AS THEY MAY NOT HAVE BEEN BUILT AND DETAILE

DRAWING NOTES:

WITH DISTRICT.

> ADD COMBO EXIT/EMERGENCY LIGHT TO MECHANICAL ROOM

SURE-LITE #APC7RSQ OR EQUAL. WIRE TO AREA LIGHTING CIRCUIT AHEAD OF ANY SWITCHING. COORDINATE LOCATION

ADD EMERGENCY LIGHT TO KITCHEN . SURE-LITE #MODEL

CU2-LED OR EQUAL. WIRE TO AREA LIGHTING CIRCUIT AHEAD

OF ANY SWITCHING. COORDINATE LOCATION WITH DISTRICT.

KEY PLAN NOT TO SCALE

DRAWING BY: DG CHECK BY:

THIS DRAWING, PREPARED FOR THE SPECIFIC PROJECT INDICATED IS AN INSTRUMENT OF SERVICE AND THE PROPERTY OF BBS ARCHITECTS, LANDSCAPE ARCHITECTS AND ENGINEERS, PC. INFRINGEMENT OR ANY USE OF THIS DRAWING FOR ANY OTHER PROJECT IS PROHIBITED. ANY ALTERATION OR REPRODUCTION OF THIS DOCUMENT IS ALSO PROHIBITED WITHOUT THE WRITTEN CONSENT OF THE ARCHITECT OR ENGINEER.

LANDSCAPE ARCHITECTS ENGINEERS

44 EAST MAIN STREET | 1 187 WOLF ROAD, STE. 20: PATCHOGUE NEW YORK 11772 NEW YORK 12205 T. 631.475.0349 F. 631.475.0361 F. 518.621.7655

www.BBSARCHITECTURE.com


66-04-07-06-0-006-011 DISTRICT GREENBURGH CSD


PROJECT PH. I - DW CAP. IMPROVEMENT LEE F. JACKSON E.S. <u>DWG TITLE</u> ELECTRICAL NOTES & PLANS


SCALE: AS NOTED DATE: MAY 2022 BID PICK-UP: MAY 27, 2022

FILE No: 21-289

E1.01B

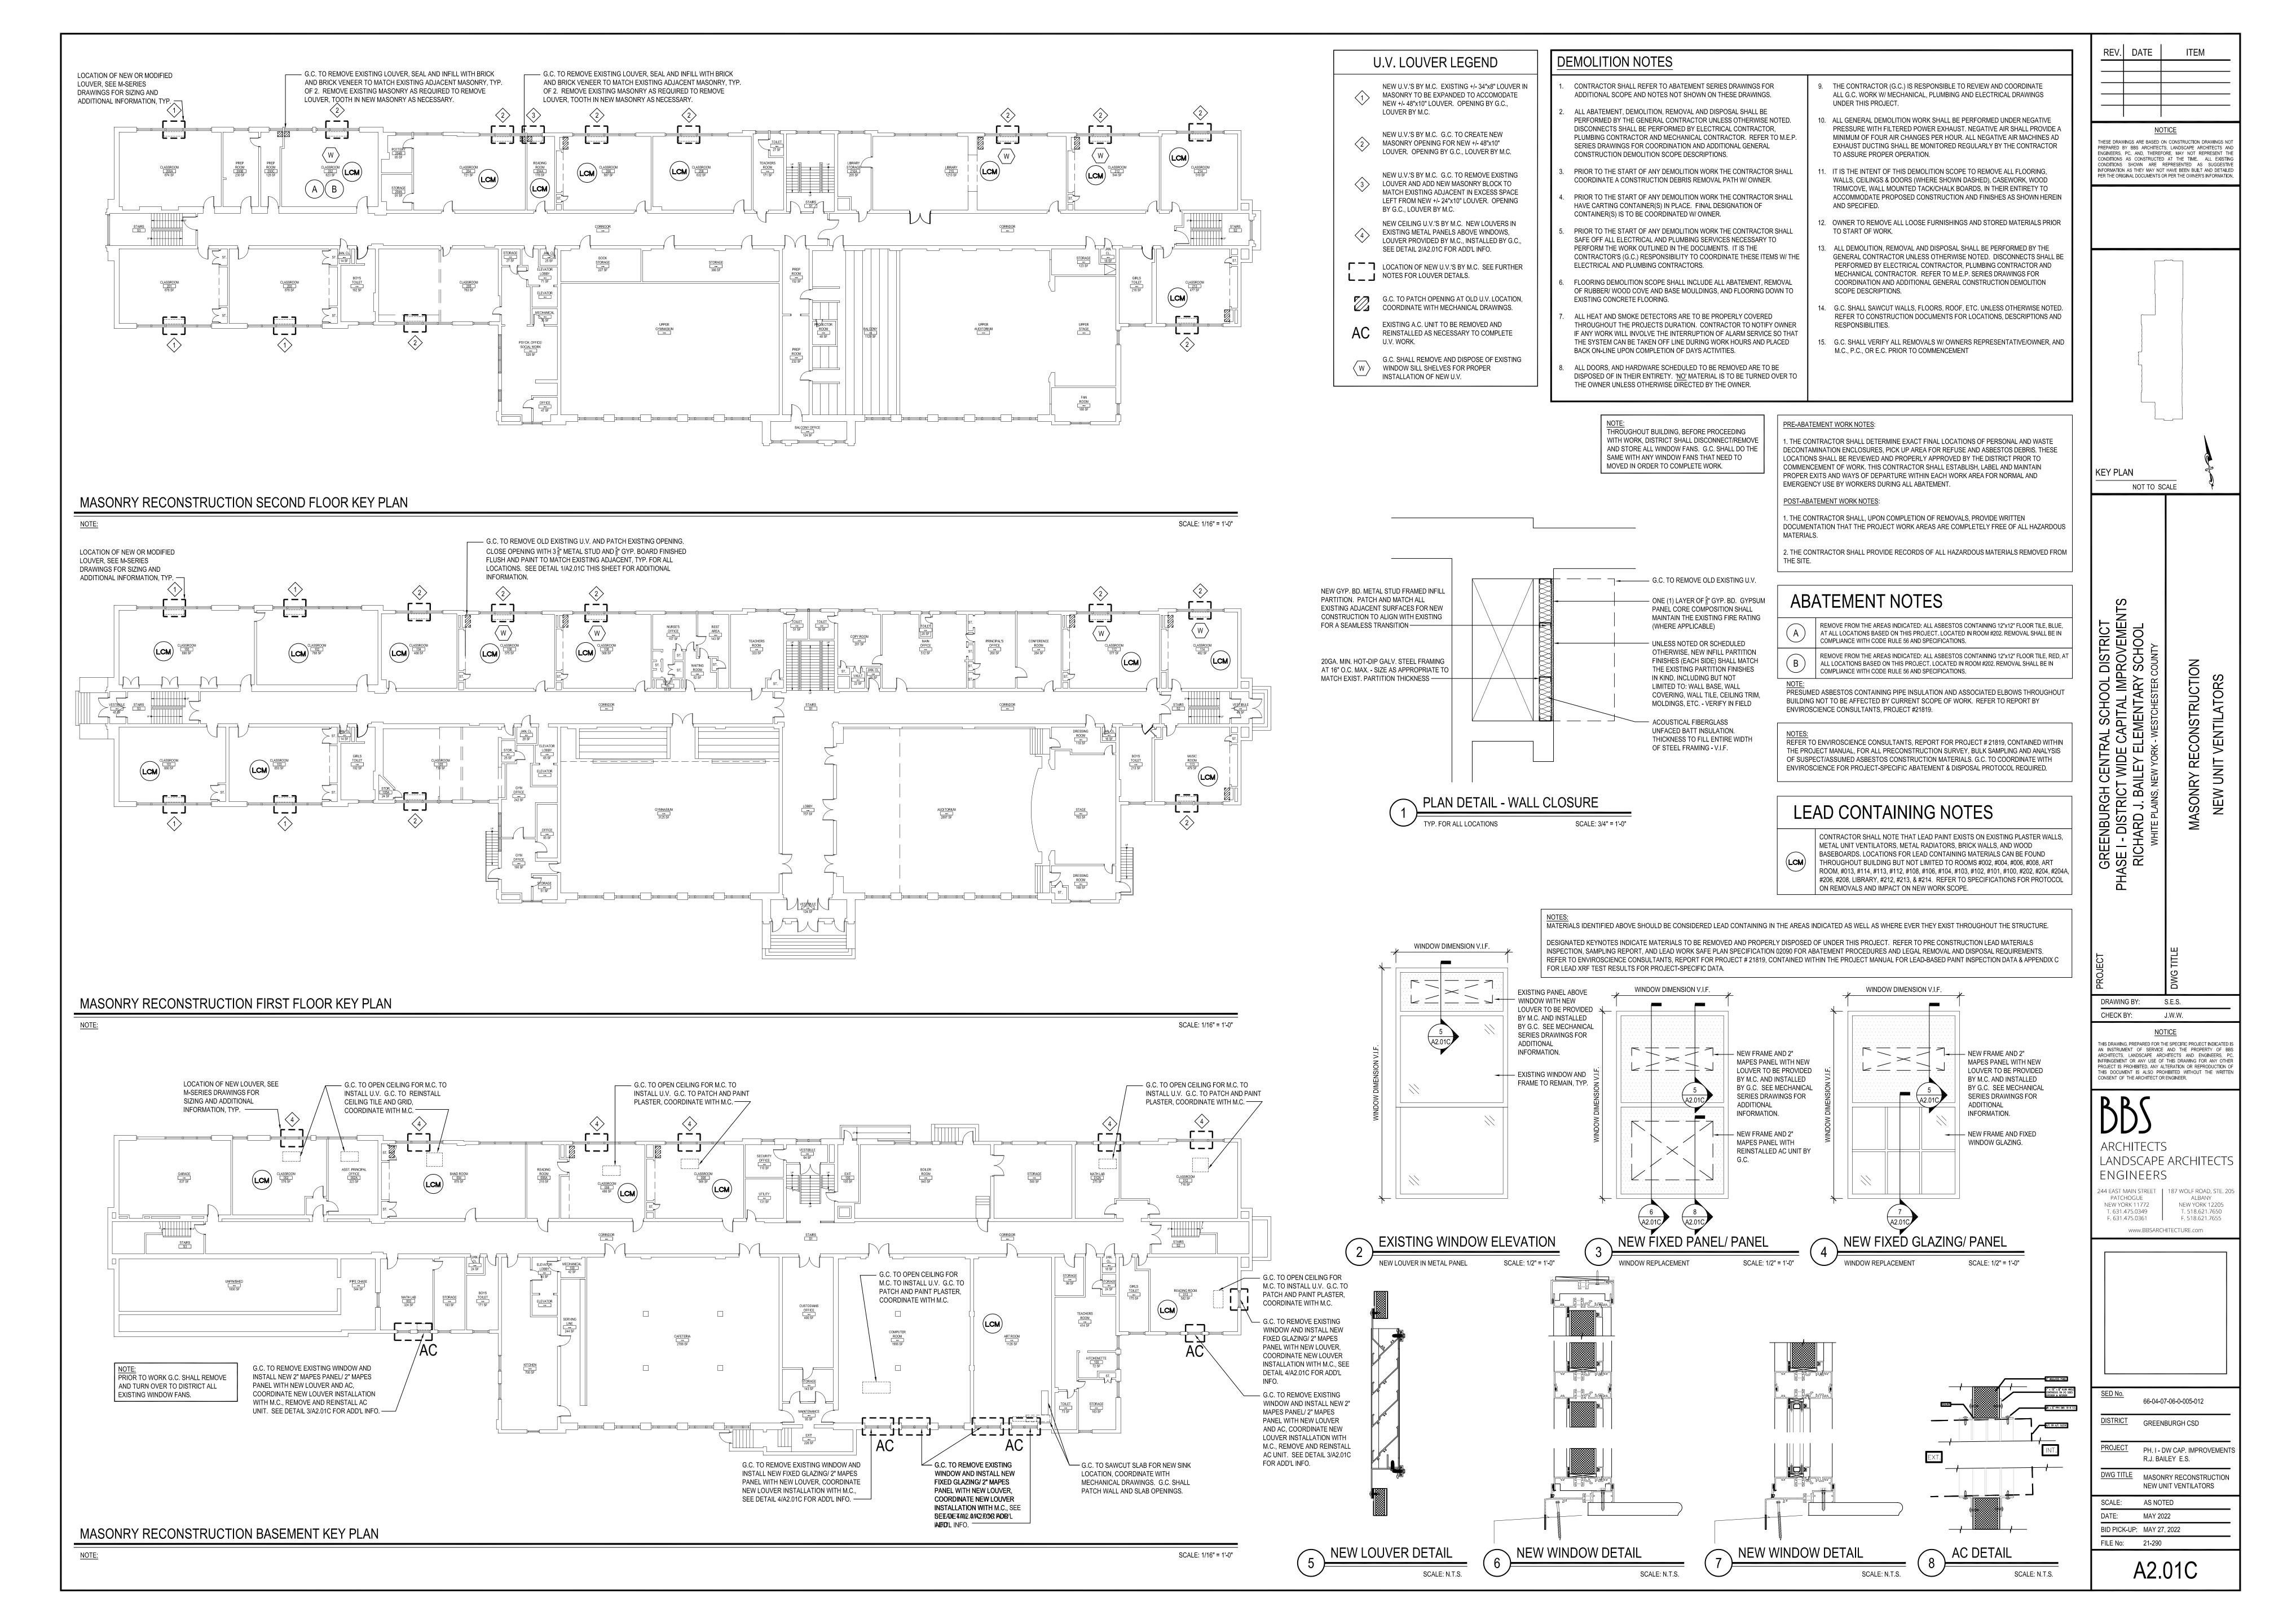

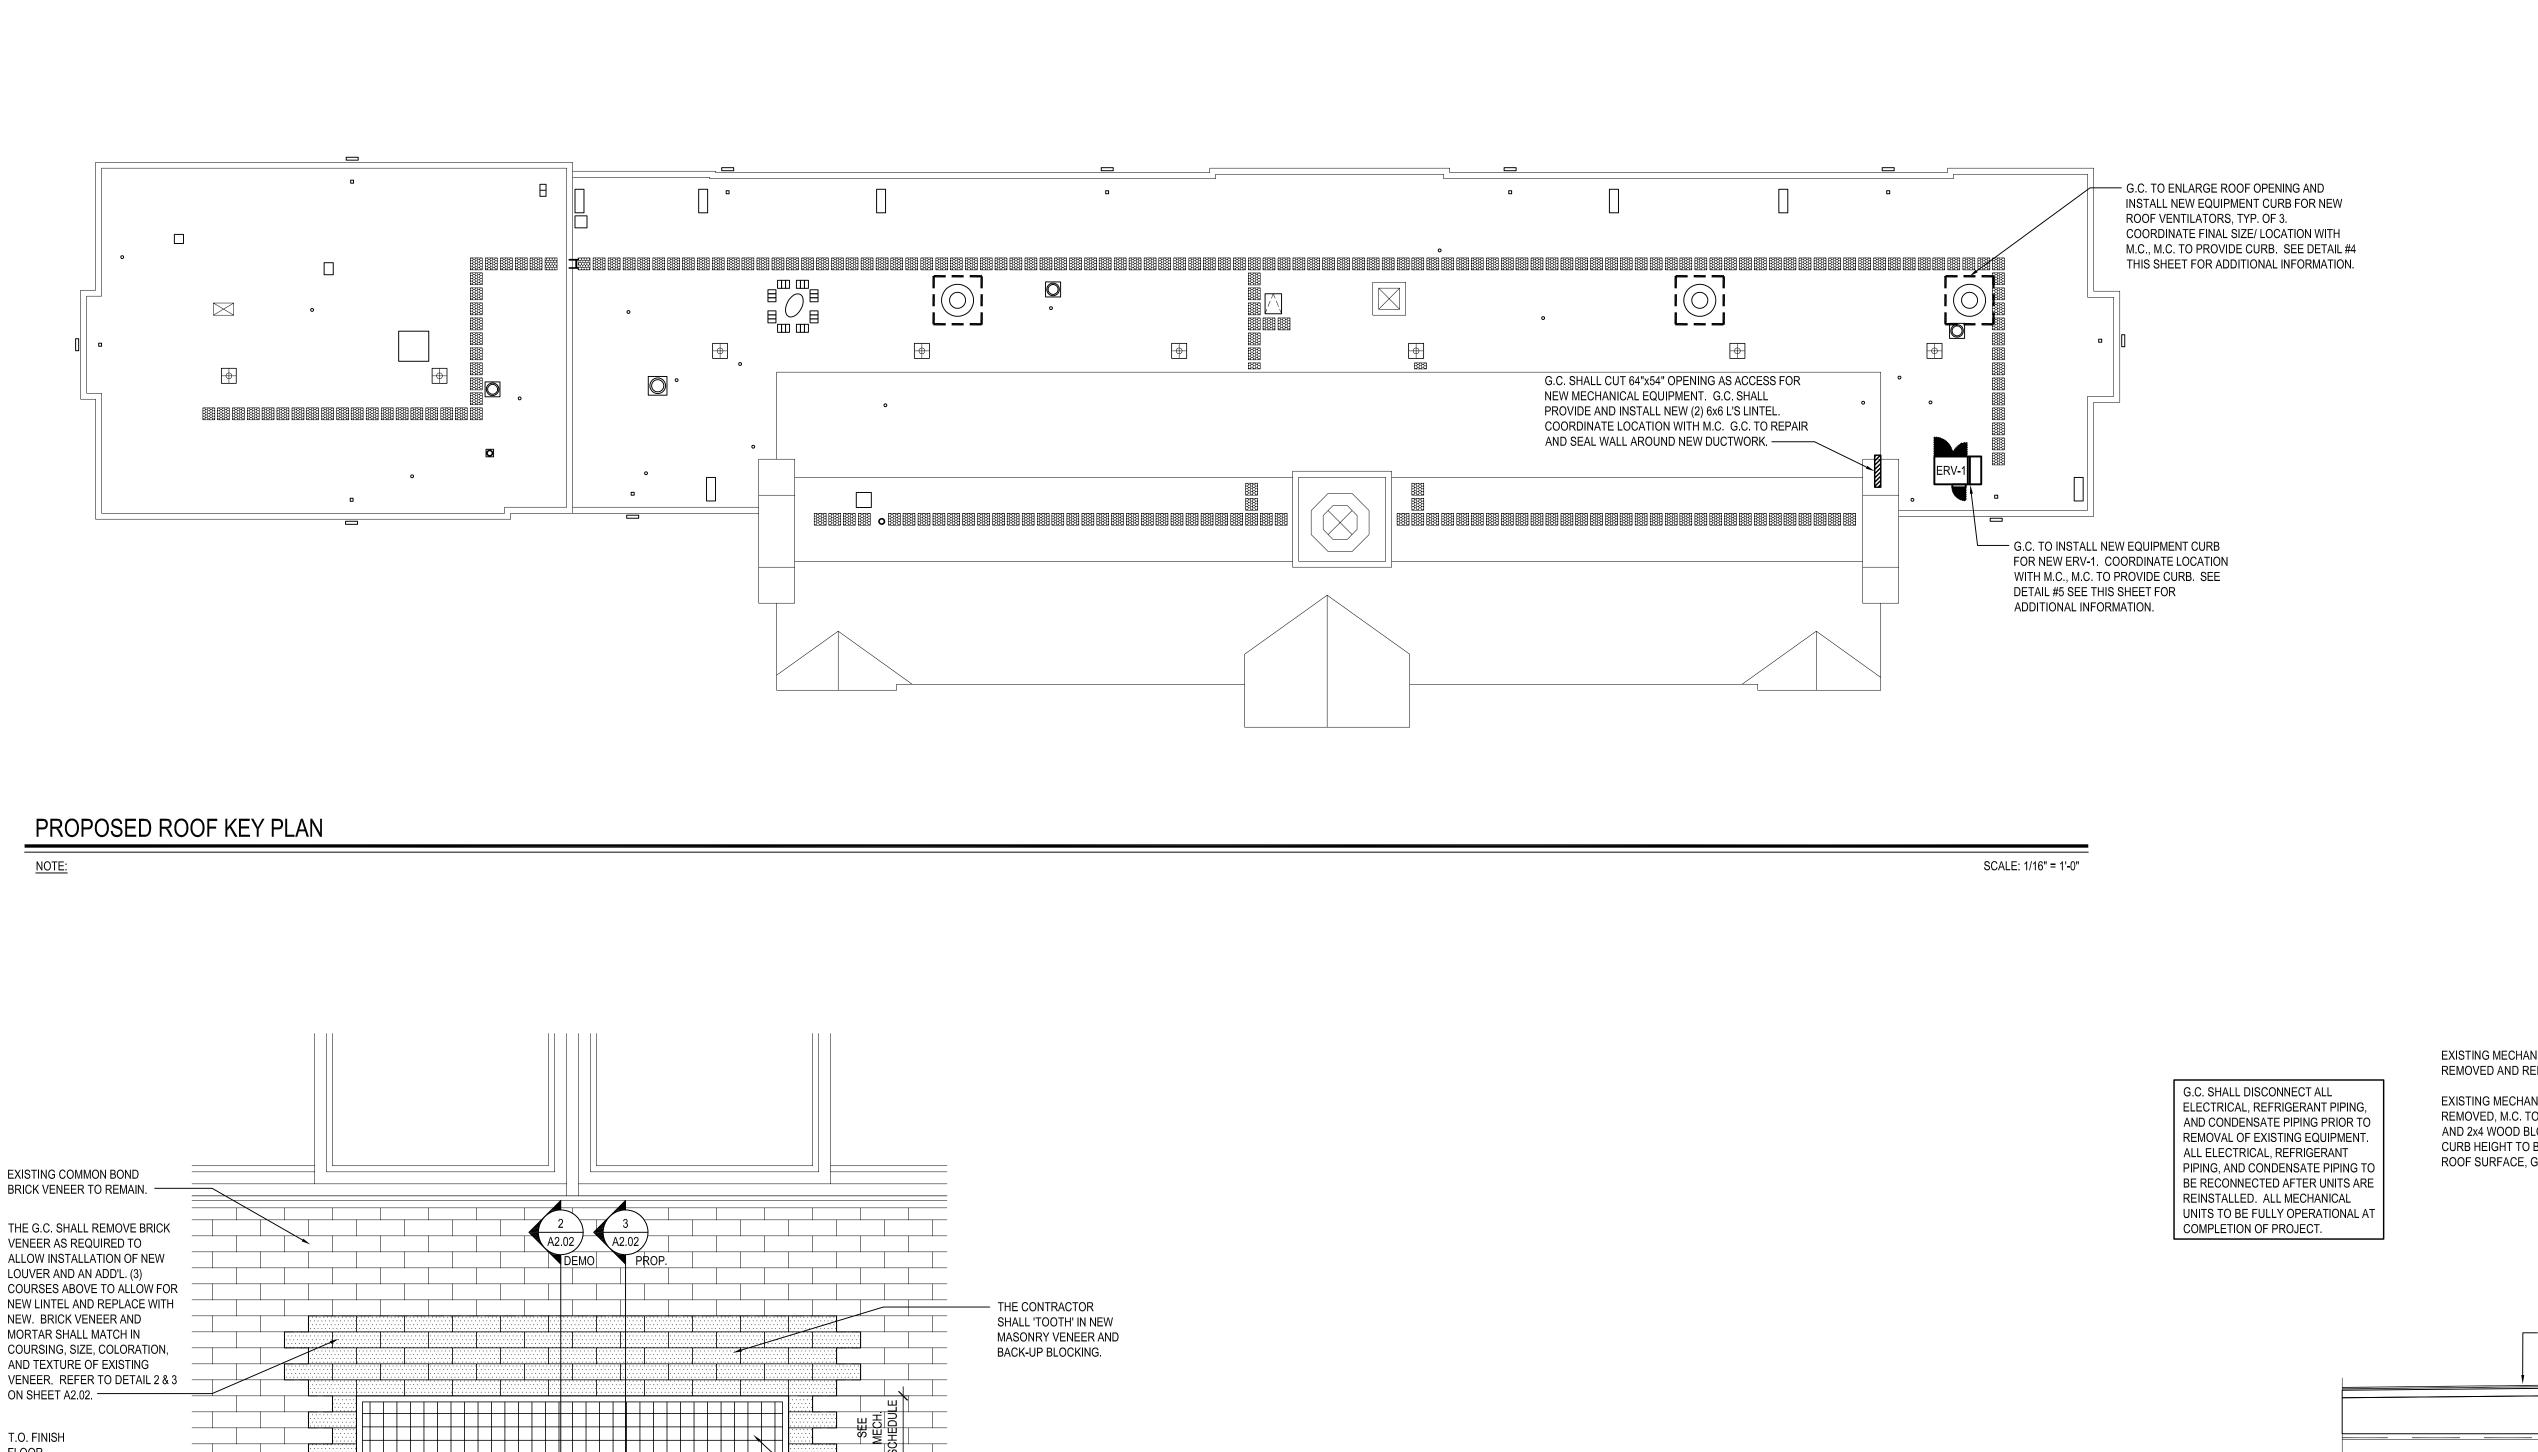

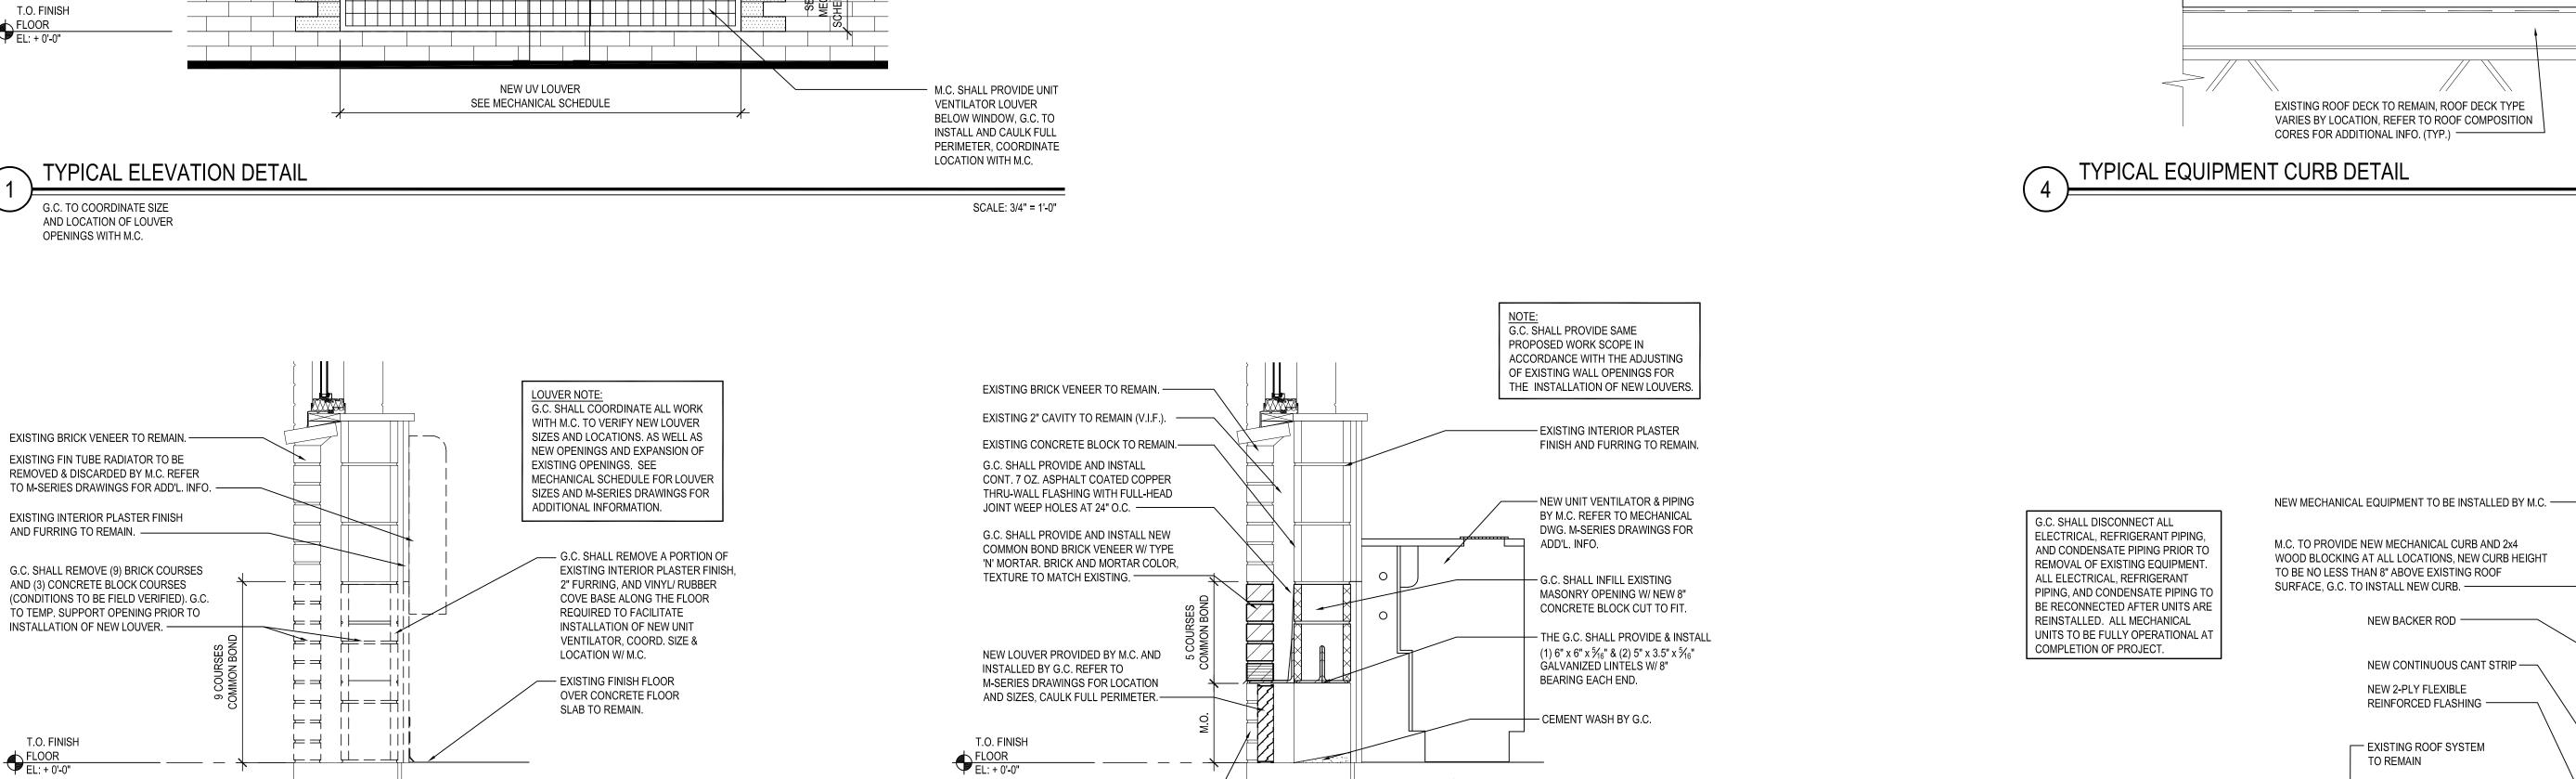

— EXISTING FINISH FLOOR

OVER CONCRETE FLOOR SLAB TO REMAIN.

- EXISTING FOUNDATION WALL

SCALE: 1" = 1'-0"

TO REMAIN.


EXISTING BRICK VENEER BEYOND TO REMAIN.

——X———X

 $\longrightarrow$ X

EXISTING FOUNDATION WALL TO REMAIN.

SECTION DETAIL

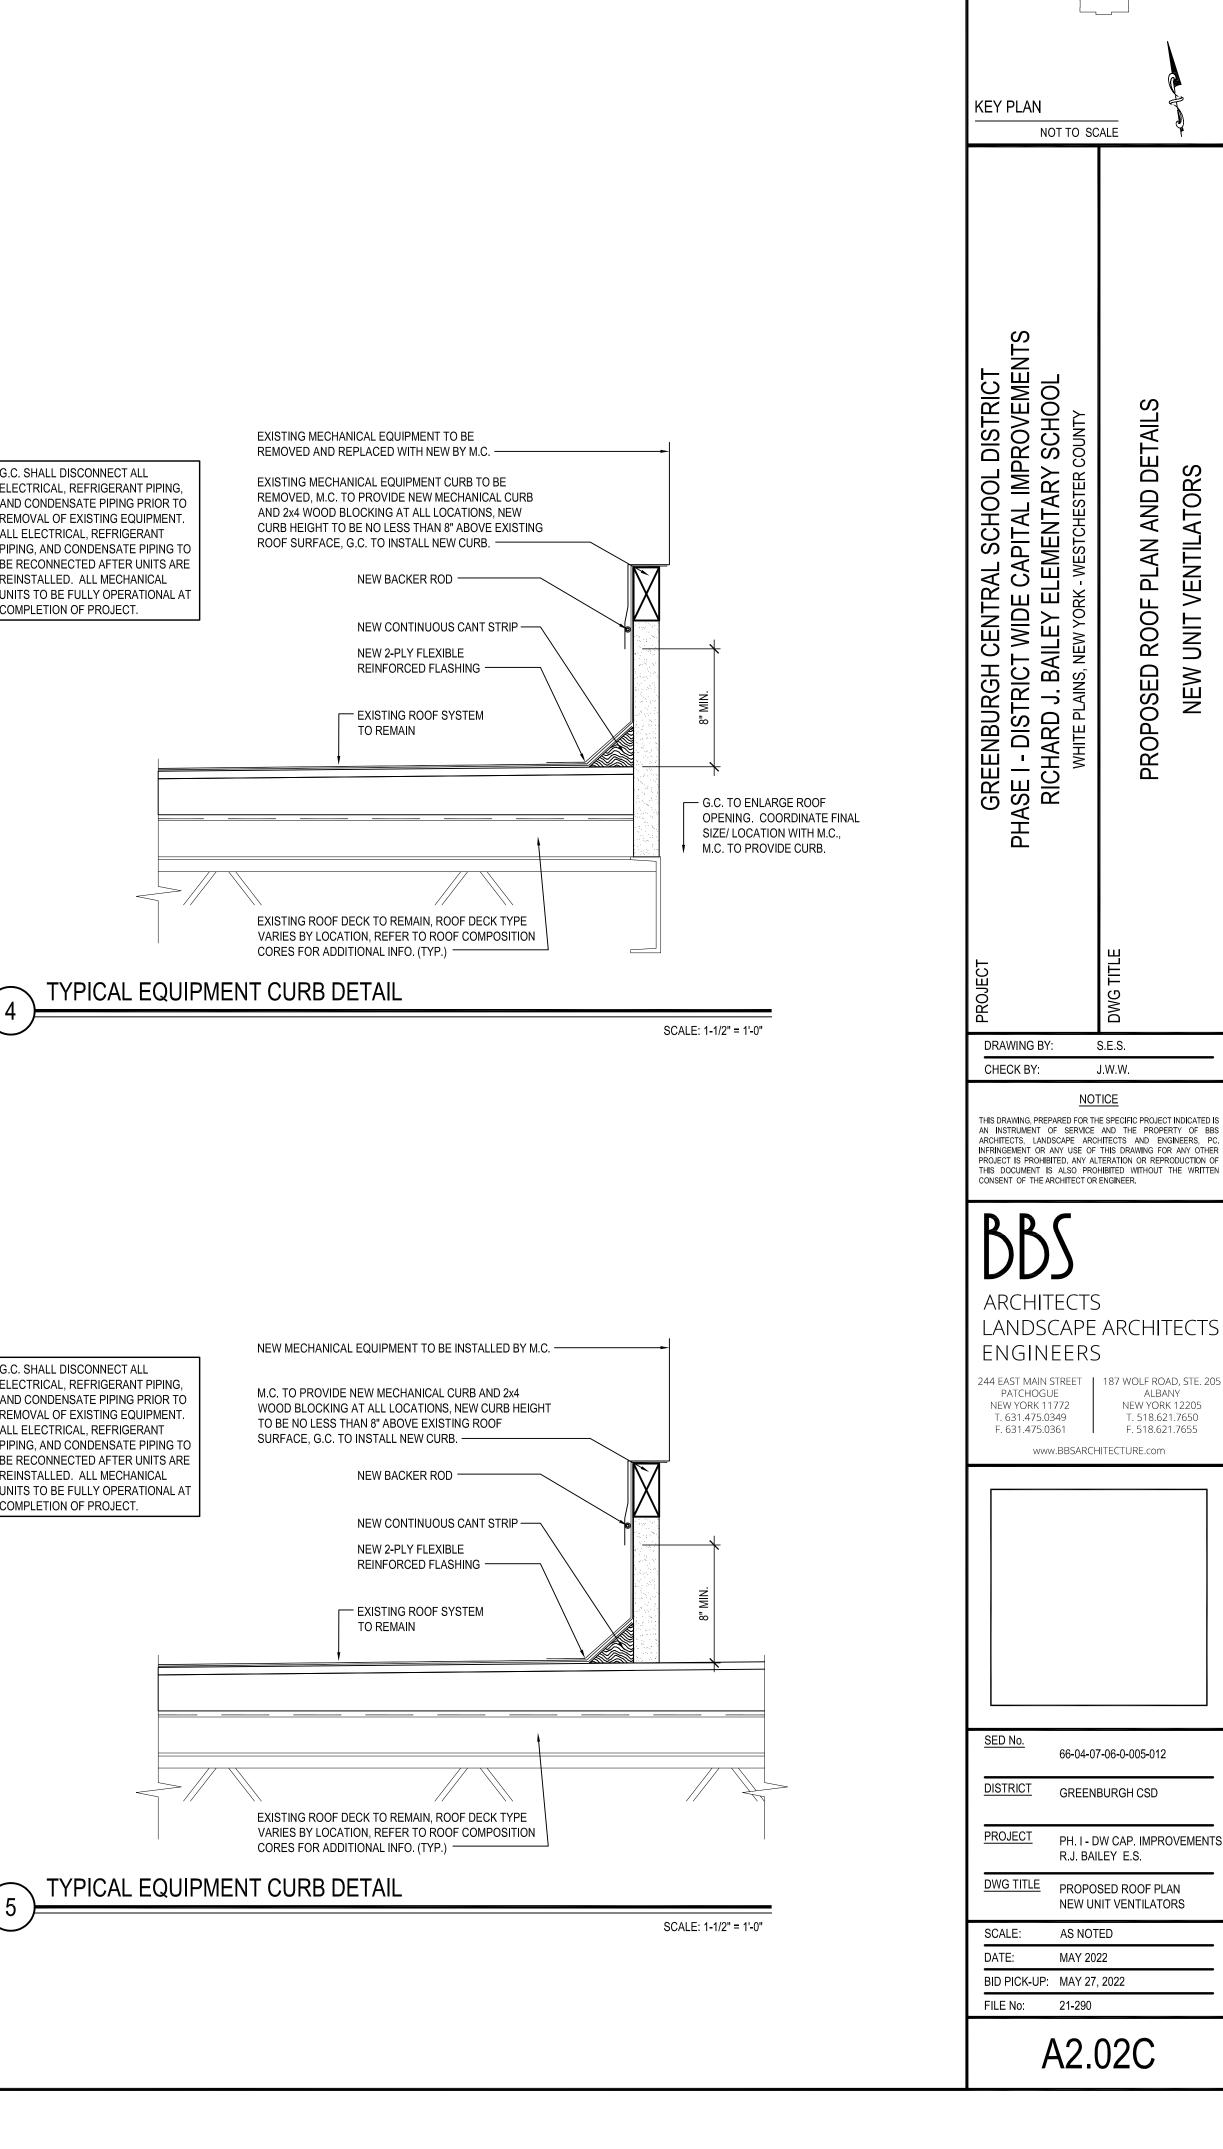


REV. DATE

THESE DRAWINGS ARE BASED ON CONSTRUCTION DRAWINGS NOT PREPARED BY BBS ARCHITECTS, LANDSCAPE ARCHITECTS AND ENGINEERS, PC. AND, THEREFORE, MAY NOT REPRESENT THE CONDITIONS AS CONSTRUCTED AT THE TIME. ALL EXISTING CONDITIONS SHOWN ARE REPRESENTED AS SUGGESTIVE INFORMATION AS THEY MAY NOT HAVE BEEN BUILT AND DETAILED


PER THE ORIGINAL DOCUMENTS OR PER THE OWNER'S INFORMATION

	DOOR SCHEDULE																				
AREA	DOOR	LOCATION	SIGNAGE	DOOR	IMADTU	LUCIOUT	TTUIOUNEOO	TELEV TYPE	Is 4 a T	TOL A 71N I O	FRAME	Inda T	01.471110	HARDWARE SET		LIANAD	Tour	TULOUD	FIRE	REMARKS	DOOR
	INO.	CODDIDOD & OIDLO TOILET		LEAVES	WDTH 21.0"	HEIGHT	THICKNESS	ELEV. TYPE		GLAZING	TYPE.	MAT.	GLAZING	01	_	JAMB	SILL	T'HOLD	RATING		NO.
<b>~</b>	001	CORRIDOR to GIRLS TOILET		1	3'-0"	7'-0"	1 3/4"	A	SCLCOV		F1	H.M.		01	H1	J1			60 M		001
OR	002	CORRIDOR to BOYS TOILET	C	1	3'-0"	7'-0"	1 3/4"	A	SCLCOV		F2	H.M.		01	H1	J1		11	60 M	IIIN.	002
Ŏ																					
<u> </u>																					
RS																					
□□□□□□□□□□□□□□□□□□□□□□□□□□□□□□□□□□□□□□																					
~	003	CORRIDOR to BOYS TOILET	С	1	3'-0"	7'-0"	1 3/4"	А	SCLCOV		F1	H.M.		01	H1	J1		T1	60 M	IIN.	003
S. S.	004	LIBRARY #210 to CORRIDOR	В	2	3'-0"	7'-0"	1 3/4"	В	SCLCOV	F.G.	F3	H.M.		02	H1	J1		T2	60 M	IIN. PROVIDE MAGNETIC HOLD OPENS	004
ŏ	005	CORRIDOR to GIRLS TOILET	С	1	3'-0"	7'-0"	1 3/4"	Α	SCLCOV		F2	H.M.		01	H1	J1		T1	60 M		005
										+											
										+			+								
SECOND										-		_									

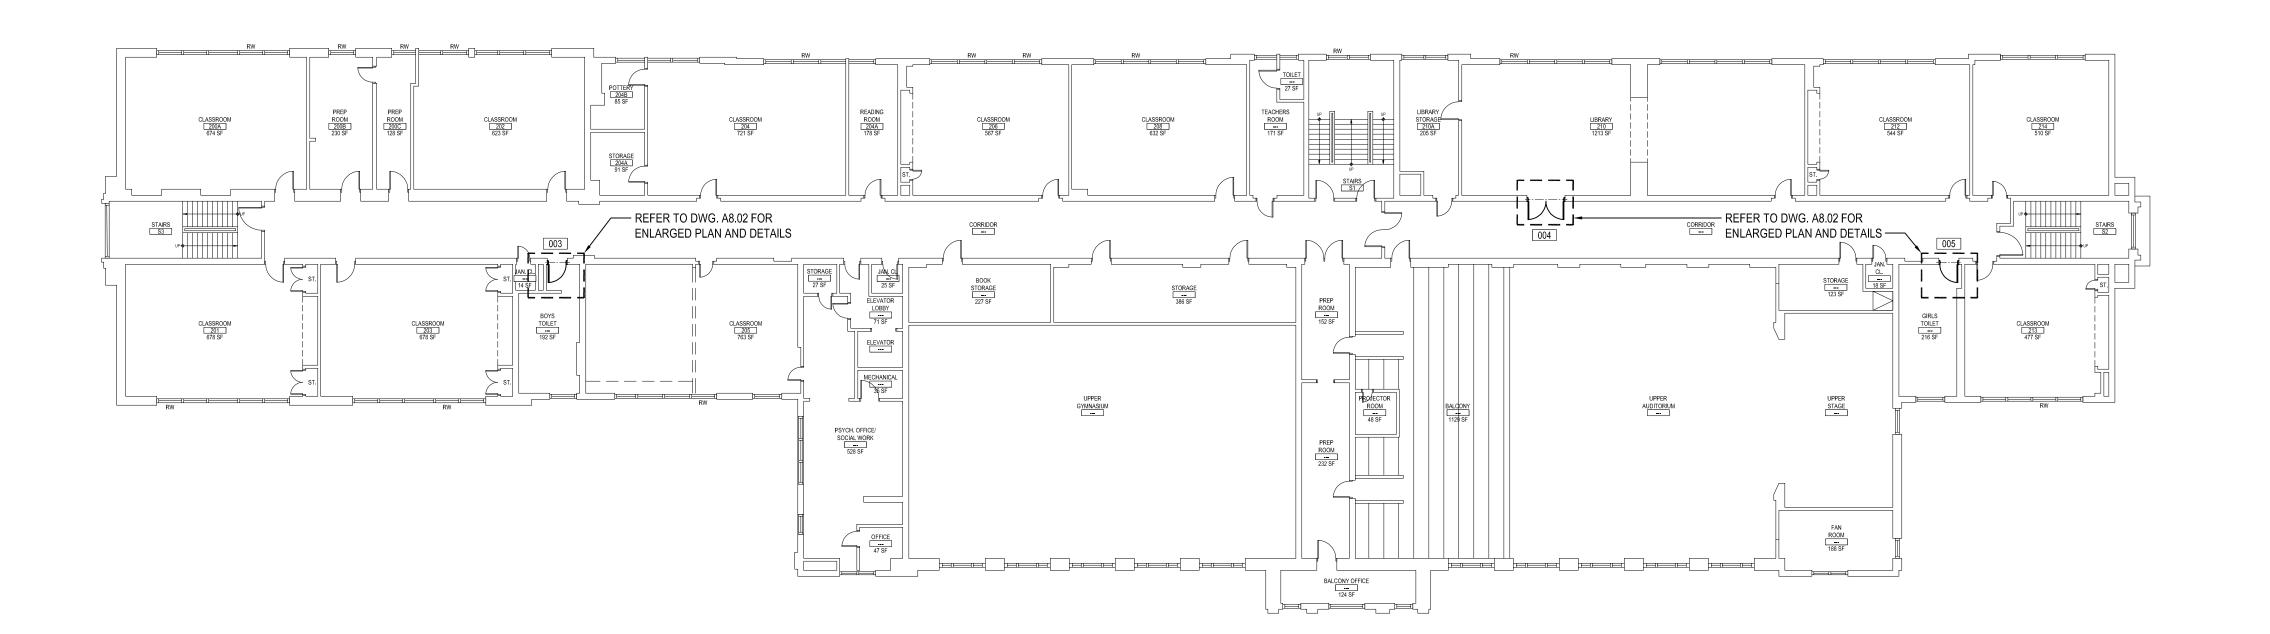

# DOOR REPLACEMENT SECOND FLOOR KEY PLAN

NOTE: SCALE: 1/16" = 1'-0"

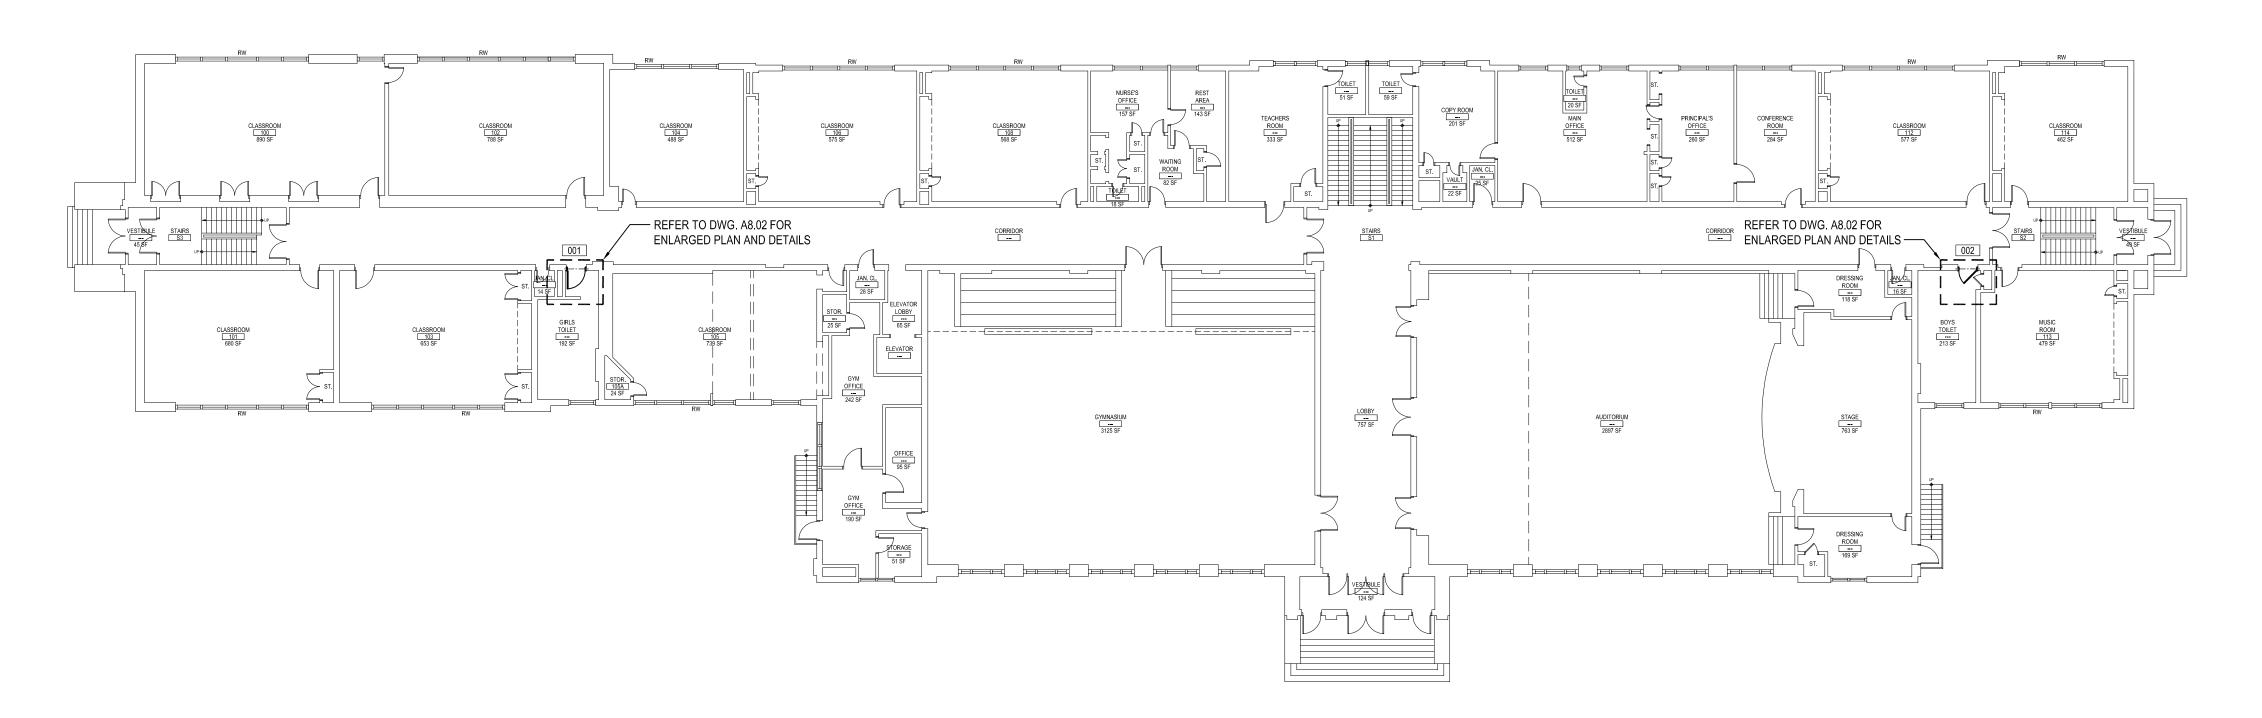

# DOOR REPLACEMENT FIRST FLOOR KEY PLAN

NOTE:

ALUM		S.F	SECURITY FIL
S.C.L.C.O.V.	SOLID COMPOSITE LUMBER CORE OAK VENEER	SG-1	5√16" SHOOTER ATTACK GLAZIN
M.C.O.V	MINERAL CORE.OAK VENEER	SG-2	1".INSULATED SHOOTER.ATTACK.GLAZIN
S.C.L.C.M.V.	SOLID COMPOSITE LUMBER CORE MAPLE VENEER	SG-3	
M.C.M.V	MINERAL CORE MAPLE VENEER	SG-4	
F.R.P.	FIBERGLASS REINFORCED POLYESTER		
H.M	HOLLOW METAL	.SG-6	90.MIN, SHOOTER ATTACK GLAZIN
F.G		BRG-L1	LEVEL 1 BULLET RESISTANT GLAZIN
F.L.P.		BRG-L2	LEVEL 2 BULLET RESISTANT GLAZIN
PYRO	PYROSTOP.GLAZING	BRG-L3.	LEVEL 3 BULLET RESISTANT GLAZIN
	1" INSULATED.GLAZING		LEVEL 1 BULLET RESISTANT SECURITY PANE
S.L		SGP-L2	LEVEL 2 BULLET RESISTANT SECURITY PANE
OBSC	OBSCURE GLAZING	SGP-L3	LEVEL 3 BULLET RESISTANT SECURITY PANE
U.O.N			

#### DOOR NOTES


- . ALL DOORS, FRAMES AND HARDWARE SHALL BE PROVIDED AND INSTALLED BY GENERAL CONTRACTOR UNLESS OTHERWISE NOTED.
- GENERAL CONTRACTOR SHALL COORDINATE ALL KEYING WITH OWNER.
- FIRE RATED WOOD DOORS (60 MIN. AND ABOVE ONLY) SHALL HAVE SOLID MINERAL CORE, ALL OTHER WOOD DOORS SHALL HAVE SOLID COMPOSITE LUMBER CORE.
- 4. FLUSH WOOD DOORS SHALL BE 5 PLY LAMINATED FACE SHEETS WITH 2 PLY FINISH VENEER OVER SPECIFIED CORE. AT FIRE RATED DOORS, TOP AND BOTTOM RAILS AND STILES SHALL BE FIRE RESISTANT COMPOSITION MATERIAL BONDED TO CORE. PROVIDE SOLID BLOCKING FOR CLOSER AND HARDWARE. REFER TO SPECIFICATION SECTION 08211 FOR ADDITIONAL INFORMATION.
- 5. ALL GLAZING IN DOORS SHALL BE INSTALLED IN METAL VISION KIT TO MATCH FIRE LABEL. VISION KIT COLOR SHALL BE AS SELECTED BY ARCHITECT. INTERIOR GLAZING TYPES AND SIZES SHALL CONFORM TO NFPA 80 AND/OR ASTM E119. WHERE SECURITY GLAZING IS INDICATED, VISION KIT SHALL BE THROUGH BOLT TYPE.
- 6. ALL NEW H.M. FRAMES SHALL BE FULLY WELDED WRAP AROUND TYPE (UNLESS OTHERWISE NOTED OR DETAILED). THROATS SHALL BE SIZED ACCORDING TO WALL THICKNESS AND FINISH, REFER TO FLOOR PLAN AND ENLARGED DETAILS FOR ADDITIONAL INFORMATION.
- 7. FOR DOOR REPLACEMENTS IN KIND, GENERAL CONTRACTOR SHALL MODIFY AND PATCH EXISTING WOOD OR H.M. DOOR FRAMES (DESIGNATED TO REMAIN) TO ACCOMMODATE NEW DOOR OPERATOR, LOCKSET, LATCH, HINGES, DOOR SWING AND/OR CLOSER, ETC. AS REQUIRED FOR COMPLETE AND FUNCTIONAL OPERATION.

  8. GENERAL CONTRACTOR IS DESPONSIBLE FOR MEDICAL AND WINTER OF PROPOSED DOORS TO BE INSTALLED IN EXISTING FRAMES (RPIOR TO SHOP DRAWING SURMITTAL) TO
- 8. GENERAL CONTRACTOR IS RESPONSIBLE FOR VERIFYING HEIGHT AND WIDTH OF PROPOSED DOORS TO BE INSTALLED IN EXISTING FRAMES (PRIOR TO SHOP DRAWING SUBMITTAL) TO ENSURE PROPER FIT AND DOOR FUNCTION.
- 9. ALL NEW HOLLOW METAL FRAMES AND HOLLOW METAL DOORS SHALL BE FINISH PAINTED. REFER TO SPECIFICATION SECTION 09900 FOR PAINT TYPE. COLOR AS SELECTED BY ARCHITECT.
- 10. GENERAL CONTRACTOR SHALL PROVIDE AND INSTALL A.D.A. COMPLIANT SIGNAGE AT ALL DOORS WHERE SPECIFIED IN DOOR SCHEDULE AND/OR SHOWN ON FLOOR PLANS. INSTALL IN CONFORMANCE WITH ALL ADA HEIGHT AND PLACEMENT REQUIREMENTS.
- ▲ A. WHERE DENOTED IN SCHEDULE, PROVIDE 4"x4" SIGNAGE WITH BRAILLE INDICATING ROOM NUMBER (COORD. WITH OWNER), MODEL No. E-BTCUST.
   ▲ B. WHERE DENOTED IN SCHEDULE, PROVIDE 4"x12" SIGNAGE WITH BRAILLE INDICATING ROOM NAME AND NUMBER (COORD. WITH OWNER), MODEL No. E-BTCUST.
   ▲ C. WHERE DENOTED IN SCHEDULE, PROVIDE 8"x8" SIGNAGE WITH BRAILLE INDICATING GENDER AND WHEELCHAIR PICTOGRAMS AND ROOM NAME AT MULTI-USE TOILET ROOMS.
- AT SINGLE-USE ACCESSIBLE TOILET ROOMS, PROVIDE AND INSTALL MODEL No. E-BTCUST. SIGN SHALL SPECIFY STAFF OR STUDENT USE AS REQUIRED.

  MANUFACTURER: "ALL STATE SIGN AND PLACUE", DEER PARK MY OR APPROVED FOLIAL, ALL SIGNAGE SHALL BE SUBMITTED TO ARCHITECT FOR REVIEW AND APPROVAL. CO

MANUFACTURER: "ALLSTATE SIGN AND PLAQUE", DEER PARK, NY OR APPROVED EQUAL. ALL SIGNAGE SHALL BE SUBMITTED TO ARCHITECT FOR REVIEW AND APPROVAL. COLOR AS SELECTED BY ARCHITECT

- 1. ALL REMOVABLE MULLIONS ARE TO BE KEYED ALIKE AND TO MATCH EXISTING BUILDING SYSTEM.
- 3. AUTOMATIC DOOR OPERATORS THE ELECTRICAL CONTRACTOR SHALL PROVIDE A LINE VOLTAGE CIRCUIT TO THE AUTO OPERATOR. LOCATION SHALL BE COORDINATED WITH THE GENERAL CONTRACTOR. THE GENERAL CONTRACTOR IS RESPONSIBLE FOR ALL WIRING ASSOCIATED WITH AUTOMATIC DOOR OPERATORS, INCLUDING ELECTRONIC STRIKE, PUSH BUTTONS, TRANSFORMERS AND ANY OTHER DEVICES REQUIRED FOR A FULLY OPERATIONAL SYSTEM.
- FIRE RATED GLAZING WITH SURFACE APPLIED FILMS WILL NOT BE CONSIDERED EQUIVALENT WHERE LAMINATED FILM IS SPECIFIED.

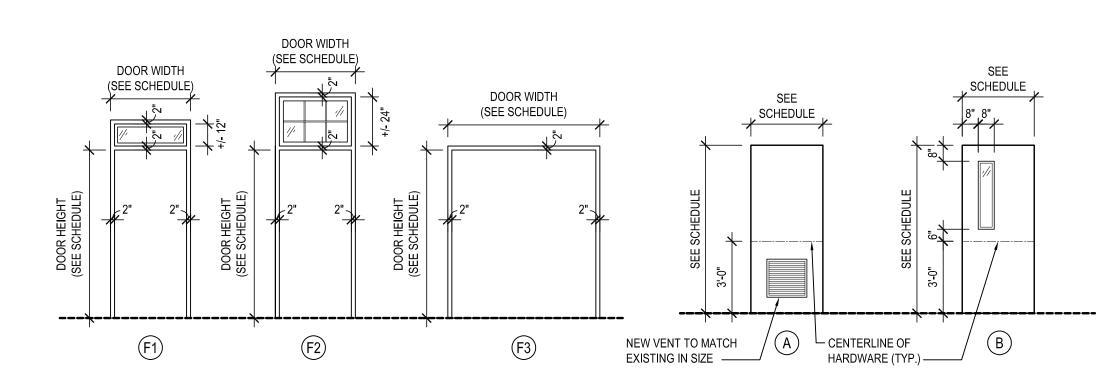

FRAME TYPE ELEVATIONS

SIGN TYPE 'C'

NOTE: REFER TO DOOR SCHEDULE SCALE: 1/4" = 1'-0" FOR DOOR FRAME MATERIAL.

DOOR TYPE ELEVATIONS

NOTE: REFER TO DOOR SCHEDULE FOR DOOR MATERIAL AND GLAZING TYPE (WHERE APPLICABLE).

SIGN TYPE 'D'

LE SCALE: 1/4" = 1'-0"

CHECK BY: J.W.W.

NOTICE

THIS DRAWING, PREPARED FOR THE SPECIFIC PROJECT INDICATED IS AN INSTRUMENT OF SERVICE AND THE PROPERTY OF BBS ARCHITECTS, LANDSCAPE ARCHITECTS AND ENGINEERS, PC. INFRINGEMENT OR ANY USE OF THIS DRAWING FOR ANY OTHER PROJECT IS PROHIBITED. ANY ALTERATION OR REPRODUCTION OF THIS DOCUMENT IS ALSO PROHIBITED WITHOUT THE WRITTEN

BBS ARCHITECTS

DRAWING BY:

S.E.S.

REV. DATE

KEY PLAN

NOT TO SCALE


THESE DRAWINGS ARE BASED ON CONSTRUCTION DRAWINGS NOT PREPARED BY BBS ARCHITECTS, LANDSCAPE ARCHITECTS AND ENGINEERS, PC. AND, THEREFORE, MAY NOT REPRESENT THE CONDITIONS AS CONSTRUCTED AT THE TIME. ALL EXISTING CONDITIONS SHOWN ARE REPRESENTED AS SUGGESTIVE INFORMATION AS THEY MAY NOT HAVE BEEN BUILT AND DETAILED PER THE ORIGINAL DOCUMENTS OR PER THE OWNER'S INFORMATION.

LANDSCAPE ARCHITECTS
ENGINEERS

ONSENT OF THE ARCHITECT OR ENGINEER.

244 EAST MAIN STREET PATCHOGUE ALBANY
NEW YORK 11772 NEW YORK 12205
T. 631.475.0349 T. 518.621.7650
F. 631.475.0361 F. 518.621.7655

www.BBSARCHITECTURE.com

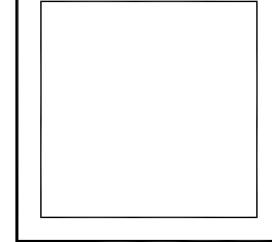

 SED No.
 66-04-07-06-0-005-012

 DISTRICT
 GREENBURGH CSD

PROJECT
PH. I - DW CAP. IMPROVEMENTS
R.J. BAILEY E.S.

DWG TITLE
DOOR SCHEDULE


SCALE: AS NOTED


DATE: MAY 2022

BID PICK-UP: MAY 27, 2022


FILE No: 21-290

A8.01C

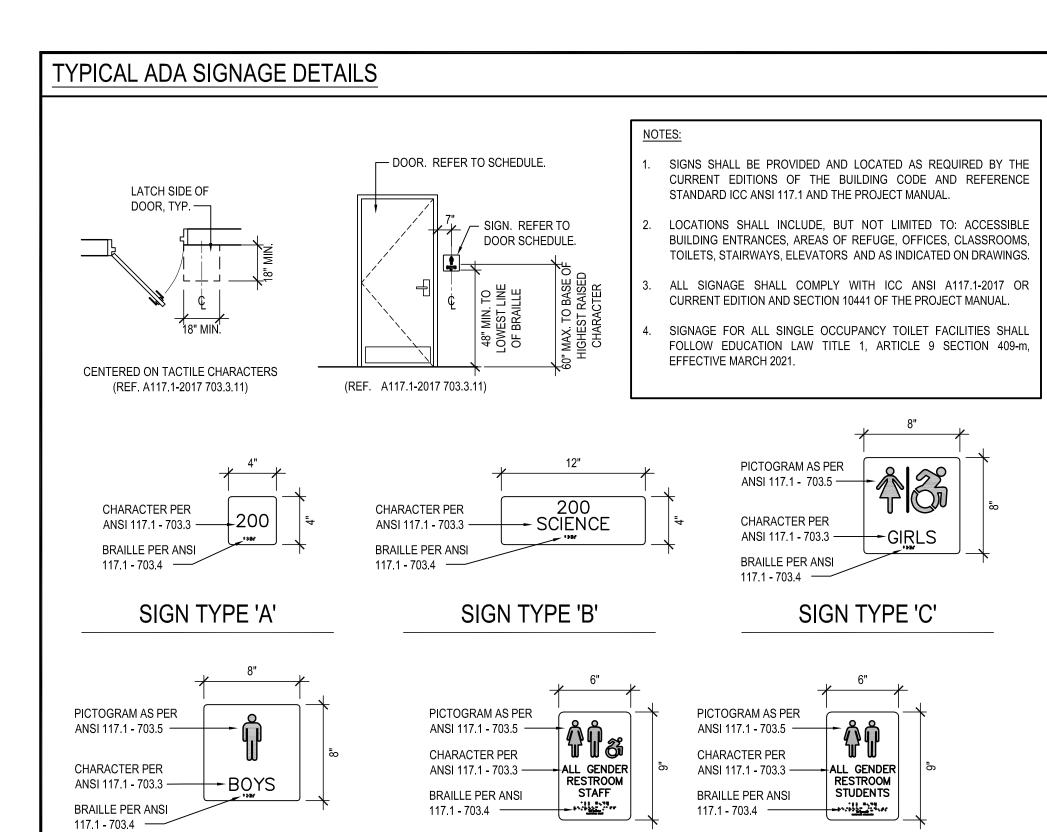

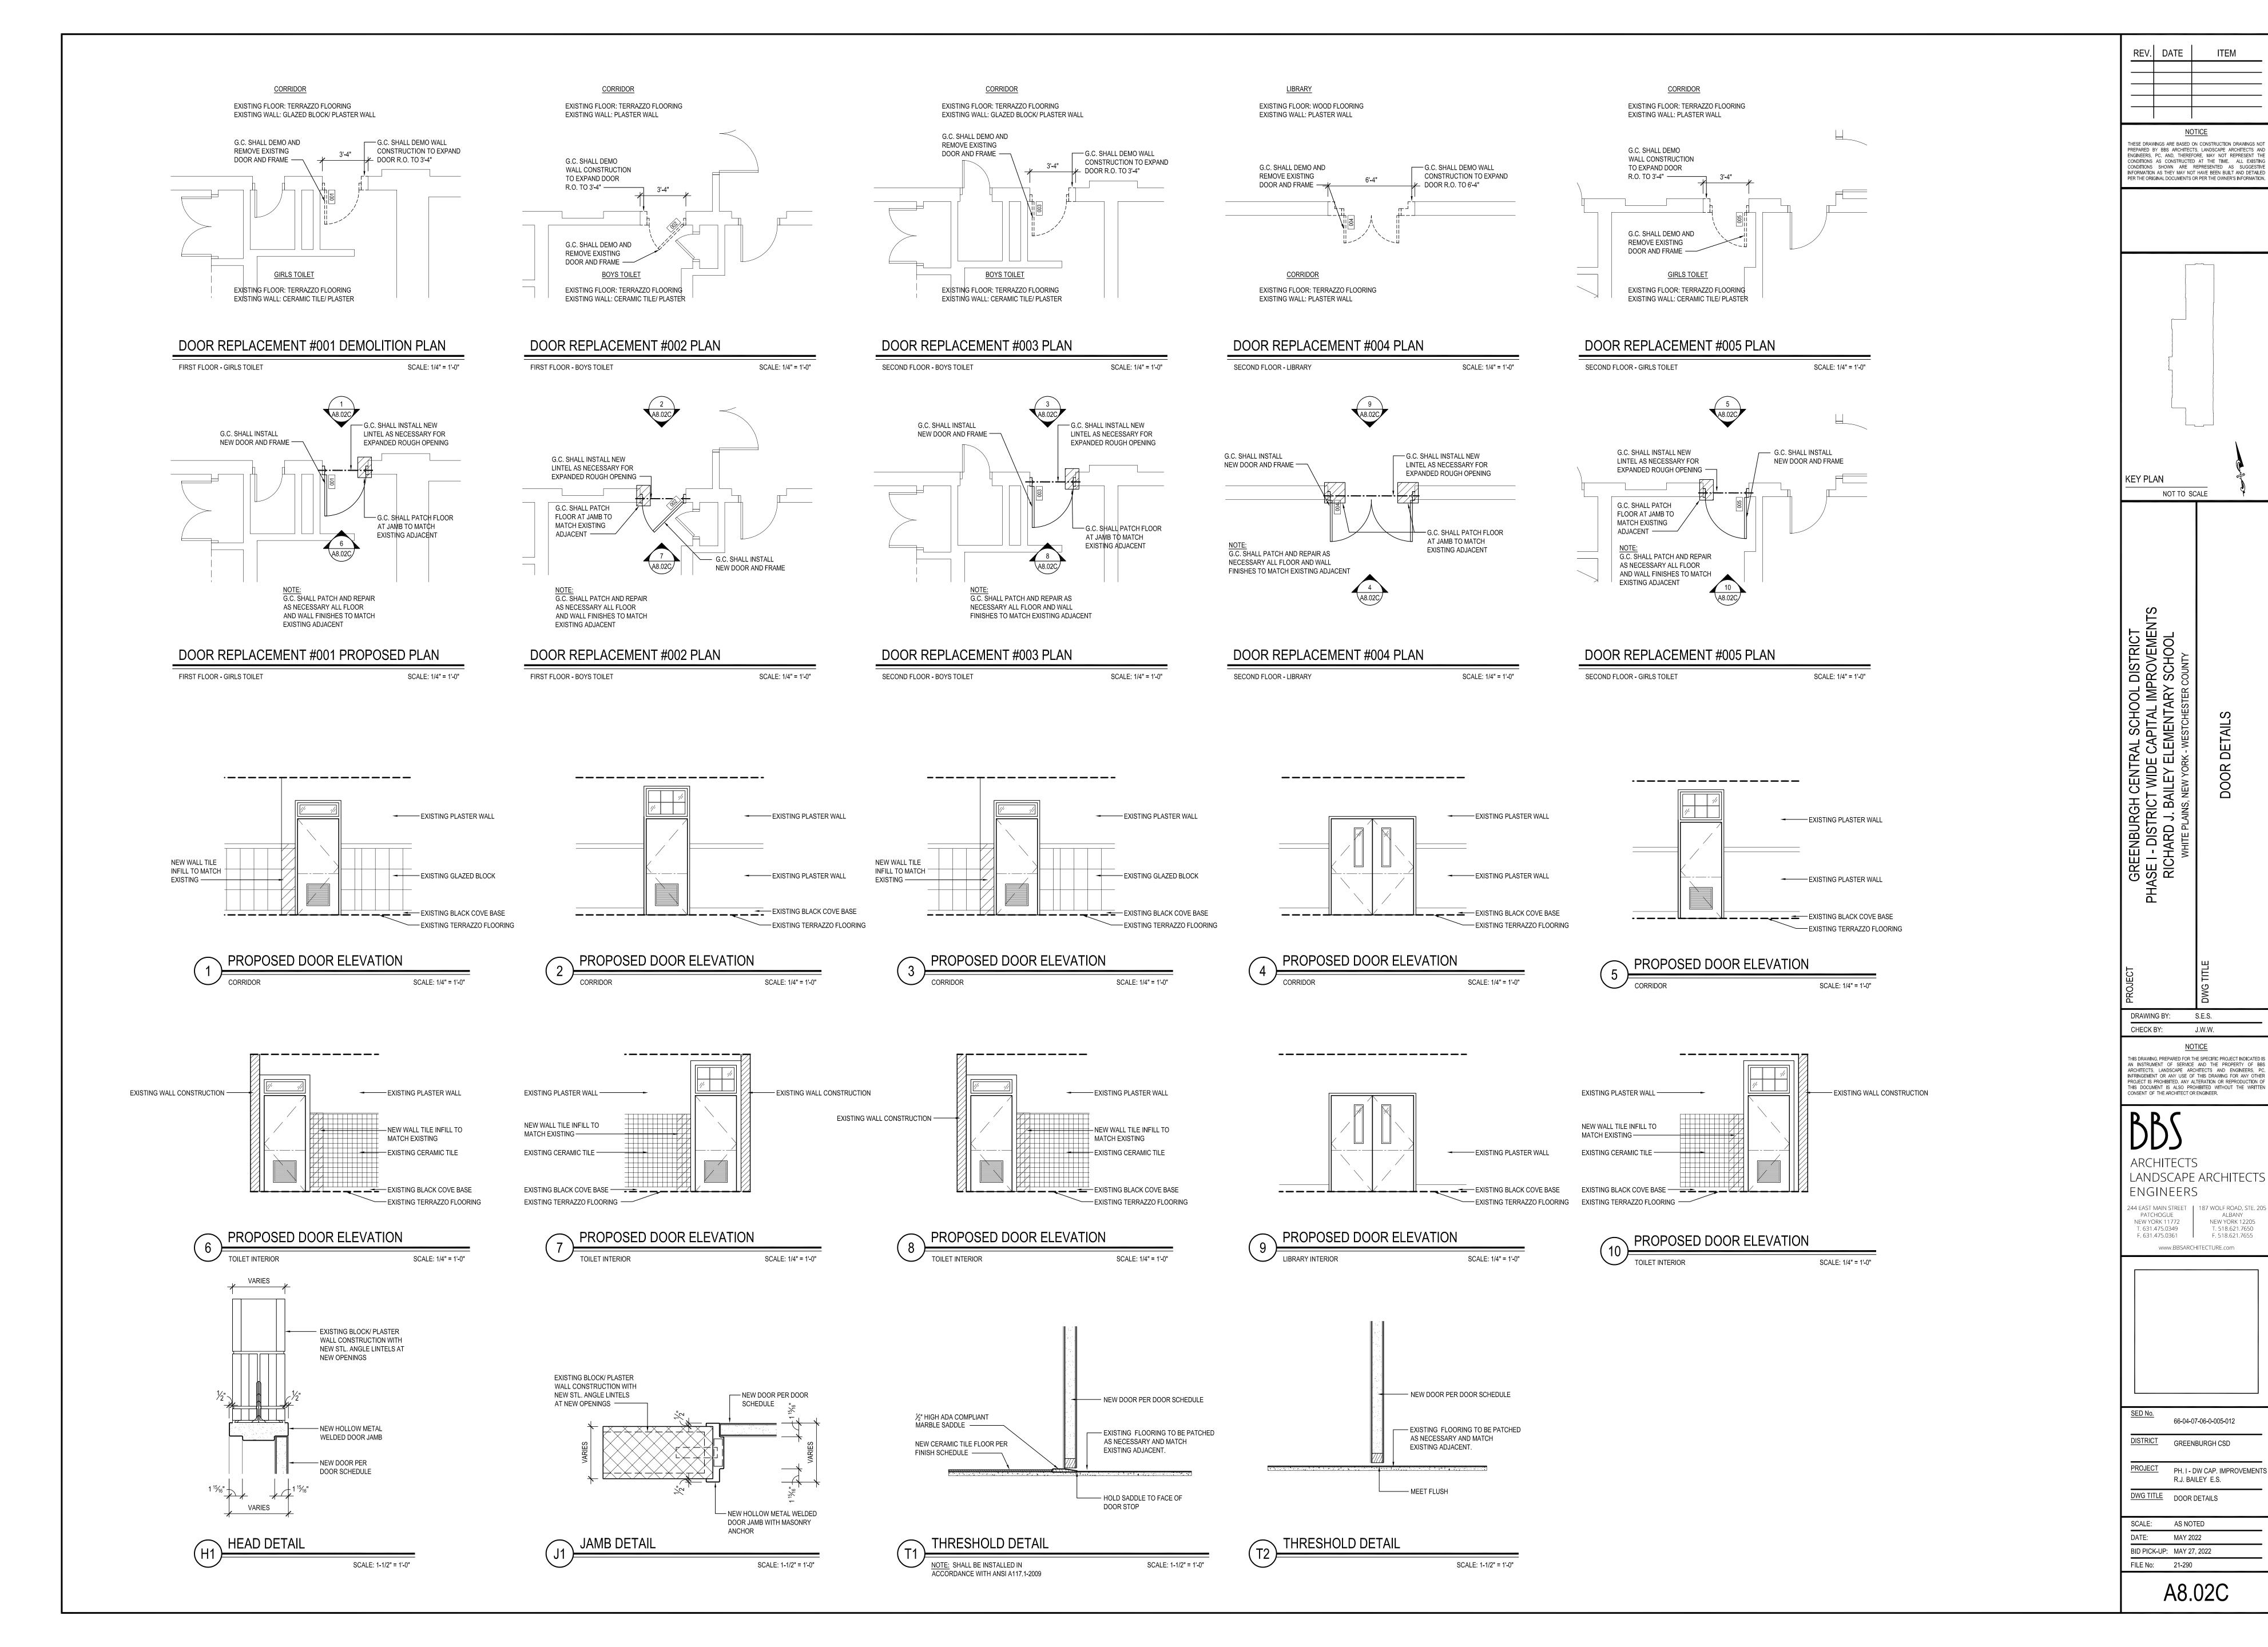

#### MECHANICAL LEGEND, SYMBOLS, AND ABBREVIATIONS

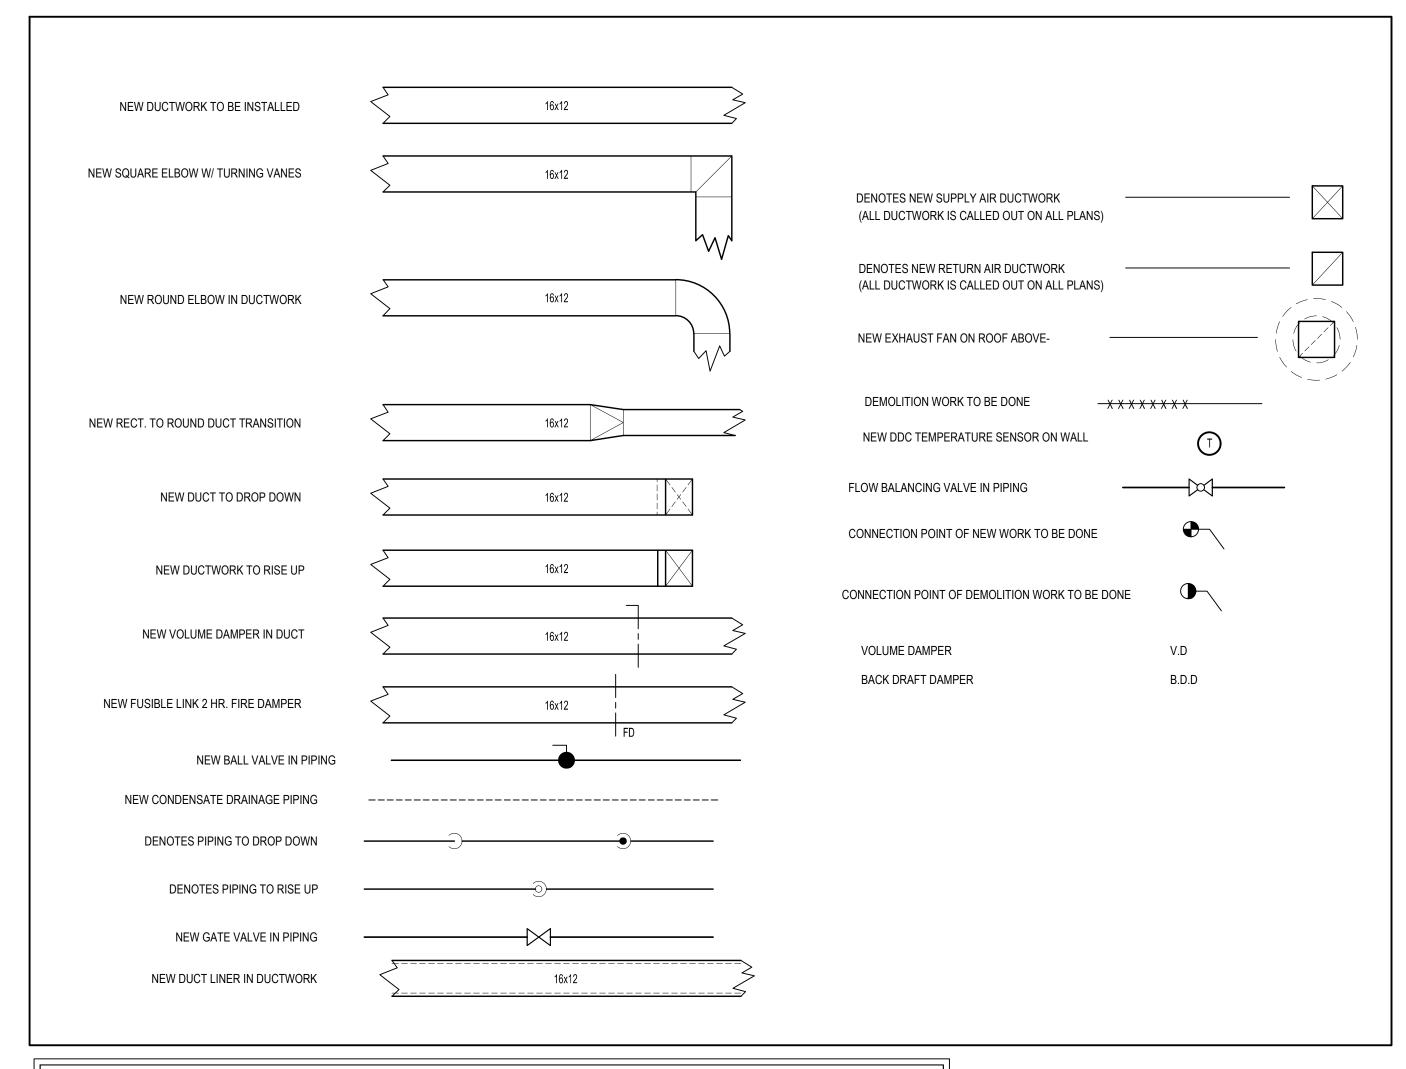

CONTRACTOR ABBREVIATIONS:

M.C. = MECHANICAL CONTRACTOR

C.C. = CONTROLS CONTRACTOR

P.C. = PLUMBING CONTRACTOR E.C. = ELECTRICAL CONTRACTOR

R.C. = CERTIFIED ROOFING CONTRACTOR

# VENTILATION SCHEDULE

Room Number	Occupancy Classification	Occupancy Density (People Per 1000SF)	People Outdoor Airflow Rate in Breathing Zone, Rp (CFM/Person)	Area Outdoor Airflow Rate in Breathing Zone, Ra (CFM/SF)		Area (SF)	Number of People (Pz)	Ventilation in Breathing Zone, Vbz (CFM)	Zone Air Distribution Effectiveness, Ez	Corrected Zone Outdoor Airflow CFM, Voz	OAI (CFM) Supplied
1	Auditorium	150	5	0.06	0	3784	568	3068	1	3068	4000
2	Stages OR Studio	70	10	0.06	0	763	54	586	1	586	600
_002	Classroom (age 9 plus)	35	10	0.12	0	576	21	280	0.8	350	350
_002A Comp Rm	Classroom (age 9 plus)	35	10	0.12	0	576	21	280	0.8	350	350
_004	Classroom (age 9 plus)	35	10	0.12	0	878	31	416	0.8	520	520
_006	Classroom (age 9 plus)	35	10	0.12	0	486	18	239	0.8	299	300
_008	Classroom (age 9 plus)	35	10	0.12	0	569	20	269	0.8	337	340
_003	Classroom (age 9 plus)	35	10	0.12	0	324	12	159	0.9	177	200
_012a	Classroom (age 9 plus)	35	10	0.12	0	275	10	133	0.8	167	180 L
_012	Classroom (age 9 plus)	35	10	0.12	0	716	26	346	0.8	433	450
_013	Classroom (age 9 plus)	35	10	0.12	0	582	21	280	0.8	350	360
_BSM Art Room	Classroom (age 9 plus)	35	10	0.12	0	1126	40	536	0.9	596	600
_Computer Room	Classroom (age 9 plus)	35	10	0.12	0	1400	49	658	0.9	732	730
100	Classroom (age 9 plus)	35	10		0	890	32		0.9		475
101	Classroom (age 9 plus)	35	10	0.12	0	680	24	322	0.9	358	360
102	Classroom (age 9 plus)	35	10	0.12	0	788	28				420
103	Classroom (age 9 plus)	35	10	0.12	0	653	23			344	350
104	Classroom (age 9 plus)	35	10	0.12	0	488	18				270
106	Classroom (age 9 plus)	35	10		0	575	21				350
108	Classroom (age 9 plus)	35	10	0.12	0	568	20				300
112	Classroom (age 9 plus)	35	10		0	577	21				320
114	Classroom (age 9 plus)	35	10	0.12	0	462	17			10.1	250
113	Classroom (age 9 plus)	35	10	0.12	0	479	17	1.0		254	250
200A	Classroom (age 9 plus)	35	10		0	674	24	3.20			260
	Classroom (age 9 plus)	35	10		0	678	24				360
202	Classroom (age 9 plus)	35	10	0.12	0	623	22	295			330
203	Classroom (age 9 plus)	35	10	0.12	0	678	24		3.11		360
204	Classroom (age 9 plus)	35	10	0.12	0	721	26	347	0.9	386	400
204A	Classroom (age 9 plus)	35	10	0.12	0	178	7	92	0.9	103	120
206	Classroom (age 9 plus)	35	10	0.12	0	609	22	294	0.9	327	330
200A	Classroom (age 9 plus)	35	10	0.12	L	674	24	321	0.9	357	260
208	Classroom (age 9 plus)	35	10	0.12	0	632	23	306	0.9	340	340
210	Libraries	10	5	0.12	0	1213	13	211	0.9	235	240
212	Classroom (age 9 plus)	35	10	0.12	0	544	20	266	0.9	296	300
214	Classroom (age 9 plus)	35	10	0.12	0	510	18	242	0.9	269	270
213	Classroom (age 9 plus)	35	10	0.12	0	632	23	306	0.9	340	340

#### **GENERAL NOTES**

- 1. REMOVAL & RELOCATION OF CERTAIN EXISTING WORK SHALL BE NECESSARY FOR THE PERFORMANCE OF THE NEW WORK SHOWN HEREIN. ALL EXISTING CONDITIONS ARE NOT COMPLETELY DETAILED ON THE DRAWINGS. THE CONTRACTOR SHALL SURVEY THE SITE & MAKE ALL NECESSARY CHANGES BASED ON EXISTING CONDITIONS AS REQUIRED FOR PROPER DEMOLITION OF EXISTING WORK & SHALL INCLUDE ALL MATERIALS & LABOR FOR SAME IN HIS BID PRICE. NO ALLOWANCE WILL BE MADE FOR FAILURE TO DO SO.
- 2. PRIOR TO SUBMITTING A BID, THE CONTRACTOR SHALL VISIT THE PREMISES OF THE PROPOSED WORK & SHALL CAREFULLY EXAMINE THE ENGINEERING DRAWINGS, EXISTING CONDITIONS & LIMITATIONS THEREOF. VERIFY ACTUAL LOCATIONS WHERE THE NEW PIPING WILL BE ROUTED, COORDINATE WITH NEW & EXISTING WORK & PROVIDE CLEARANCE W/ BUILDING STRUCTURE, OTHER SERVICES, ETC.. THE CONTRACTOR SHALL INCLUDE ALL COSTS WHATSOEVER WHICH ARE INCURRED AS A RESULT OF LIMITATIONS OF THE EXISTING & NEW CONDITIONS. LATER CLAIMS FOR EXTRA LABOR, EQUIPMENT, MATERIALS, ETC. REQUIRED DUE TO DIFFICULTIES WHICH COULD HAVE BEEN FORESEEN WILL NOT BE CONSIDERED AS EXTRA WORK.
- 3. INSTALL WORK SO AS TO BE READILY ACCESSIBLE FOR OPERATING, MAINTENANCE & REPAIR. MINOR DEVIATIONS FROM DRAWINGS MAY BE MADE TO ACCOMPLISH THIS, BUT CHANGES OF MAGNITUDE WHICH INVOLVE EXTRA COST SHALL NOT BE MADE WITHOUT APPROVAL.
- . INVESTIGATE EACH SPACE THROUGH WHICH EQUIPMENT MUST BE MOVED. WHEN NECESSARY, EQUIPMENT SHALL BE SHIPPED FROM MANUFACTURER IN CRATED SECTIONS OF SIZE SUITABLE FOR MOVING THROUGH AREAS AVAILABLE. ASCERTAIN FROM BUILDING OWNER AT WHAT TIMES OF DAY EQUIPMENT MAY BE MOVED THROUGH THE BUILDING.
- COORDINATE THE EXACT SIZE & LOCATION OF NEW OPENINGS WITH EXISTING STRUCTURE. PATCH / INSULATE AS REQUIRED. CONTRACTOR SHALL FIRESTOP ALL PENETRATIONS FROM NEW PIPING, CONDUIT, DUCTWORK, ETC. THROUGH EXISTING OR NEW FIRE/ SMOKE BARRIERS. REFER TO SPECIFICATION SECTION 15511 FOR FURTHER DETAILS.
- IT IS THE INTENT OF THIS CONTRACT FOR REMAINING SYSTEMS TO BE LEFT IN GOOD WORKING ORDER, READY FOR OPERATION. COORDINATE ANY REQUIRED SYSTEM SHUTDOWNS WITH OWNER 48 HOURS IN ADVANCE. EXISTING SYSTEM SHUTDOWNS WILL NOT BE PERMITTED IF THEY INTERFERE WITH THE DAILY OPERATIONS OF THE BUILDING. CONTRACTOR WILL BE REQUIRED TO TAKE PROPER PRECAUTIONS AGAINST DAMAGING OR DISRUPTING BUILDING SYSTEMS, WIRING, PIPING OR CONTROL TUBING. ANY DAMAGE TO THESE ITEMS SHALL BE REPAIRED AT THE CONTRACTOR'S COST AS A PART OF THIS CONTRACT.
- . THE CONTRACTOR SHALL REPAIR / RESTORE TO ORIGINAL CONDITION ANY EXISTING EQUIPMENT OR MATERIALS DAMAGED IN THE PROCESS OF INSTALLATION, OR DEMOLITION TO THE SATISFACTION OF THE OWNER'S REPRESENTATIVE. CONTRACTOR SHALL MAKE REPAIRS USING THE SAME OR EQUIVALENT MATERIALS. WORK WILL BE PERFORMED AT THE CONTRACTOR'S COST.
- . CONTRACTOR SHALL INCUR ANY COSTS OR BURDENS ASSOCIATED WITH LOST OR STOLEN EQUIPMENT /
- 9. DURING THE LIFE OF THE CONTRACT PERIOD, CONTRACTOR SHALL REMOVE ALL RUBBISH / EXCESS MATERIAL ACCUMULATED AS A RESULT OF HIS OPERATIONS ON A DAILY BASIS. ALL AREAS / EQUIPMENT AFFECTED UNDER THIS CONTRACT SHALL BE KEPT CLEAN OF DUST / DEBRIS. ALL AREAS SHALL RECEIVE A FINAL CLEANING PRIOR TO FINAL ACCEPTANCE BY THE OWNER.
- 0. PROVIDE FOR LEGAL REMOVAL / DISPOSAL OF ALL RUBBISH / DEBRIS FROM THE BUILDING & SITE. PROTECT ALL WORK NOT SLATED FOR DEMOLITION.
- THIS CONTRACTOR SHALL COORDINATE HIS WORK WITH ALL OTHER TRADES PRIOR TO SCHEDULING THE WORK. WORK SHALL BE PERFORMED IN PROPER SEQUENCE, AS AGREED TO BY ALL TRADES. ANY COSTS INCURRED BY THE OWNER DUE TO IMPROPER SEQUENCING OF WORK WILL BE PAID FOR BY THIS CONTRACTOR.
- CONTRACTOR SHALL OBTAIN ALL PERMITS, PAY ALL FEES, CONNECTION CHARGES, ETC. ASSOCIATED WITH THE WORK UNDER THEIR CONTRACT.
- 13. PAINT / TOUCH UP ALL SURFACES MARRED AS A RESULT OF THE PERFORMANCE OF THE CONTRACT WORK.
- I. THE MECHANICAL CONTRACTOR SHALL REFER TO / REVIEW ALL OTHER TRADE DRAWINGS IN THE BID PACKAGE & SHALL BE RESPONSIBLE FOR / PERFORM ALL WORK INDICATED AS (M.C.) MECHANICAL WORK AS A PART OF THE BASE BID UNLESS SPECIFICALLY NOTED OTHERWISE.
- 15. SUBSTITUTED EQUIPMENT OF GREATER OR LARGER POWER, DIMENSIONS, CAPACITIES & RATINGS MAY BE FURNISHED PROVIDED THAT SAID EQUIPMENT IS APPROVED IN WRITING PRIOR TO ORDER. ANY CONNECTING MECHANICAL SERVICES, ELECTRICAL SERVICES, BASES, STRUCTURAL APPURTENANCES, ETC. REQUIRED TO BE INCREASED DUE TO THE USE OF SAID EQUIPMENT WILL BE PAID FOR IN FULL BY THE MECHANICAL CONTRACTOR, INCLUDING ANY ADDITIONAL REQUIRED ENGINEERING FEES.
- 6. EACH PIECE OF EQUIPMENT SHALL BE PROVIDED WITH A PERMANENT TYPE LAMINATED, BLACK FINISH WHITE CORE, PHENOLIC NAMEPLATE. NAMEPLATES SHOULD INDICATE THE NAME & NUMBER OF THE UNIT UNIT VOLTAGE, & ANY INTERLOCK REFERENCE. STARTERS / DISCONNECT SWITCHES SHOULD ALSO BE EQUIPPED WITH AN IDENTICAL NAMEPLATE WITH THE SAME INFORMATION.
- . "ATTIC STOCK" UPON COMPLETION OF THE PROJECT, MECHANICAL CONTRACTOR SHALL COMPLETELY REMOVE / DISPOSE OF FILTERS USED DURING CONSTRUCTION & START-UP PROCEDURES. INSTALL NEW FILTERS IN ALL EQUIPMENT, MERV-8 OR BETTER UPON TURN OVER OF THE PROJECT TO THE OWNER. IN ADDITION, PROVIDE (2) COMPLETE SETS OF FILTERS FOR EACH PEICE OF EQUIPMENT & TURN OVER TO OWNER.
- . MECHANICAL CONTRACTOR SHALL PROVIDE (1) SPARE MOTOR FOR EACH SIZE MOTOR USED ON THE PROJECT. IN INSTANCES WHERE MORE THAN TEN OF THE SAME MOTOR ARE USED, MECHANICAL CONTRACTOR SHALL PROVIDE (1) SPARE MOTOR FOR EVERY TEN MOTORS OF A GIVEN SIZE USED ON THE
- 19. MAINTENANCE MANUAL: UPON COMPLETION OF THE PROJECT, THE MECHANICAL CONTRACTOR SHALL PROVIDE A BINDER CONTAINING THE OPERATIONS & MAINTENANCE MANUALS FOR EACH NEW PEICE OF EQUIPMENT INSTALLED UNDER THIS PROJECT. THE FIRST SECTION OF THE MAINTENANCE MANUAL SHALL CONTAIN A LIST OF EACH PEICE OF EQUIPMENT, COMPLETE WITH INFORMATION SHOWING APPROPRIATE REPLACEMENT FILTER SIZES / TYPES, APPROPRIATE REPLACEMENT BELT SPECIFICATIONS, REPLACEMENT MOTOR SPECIFICATIONS, REPLACEMENT BEARING SPECIFICATIONS, VOLTAGES OF UNIT, ETC. THIS SHALL SERVE AS A WRITTEN DATABASE DESCRIBING ALL MAINTENANCE INFORMATION FOR EACH NEW PEICE OF EQUIPMENT USED.

THE MECHANICAL CONTRACTOR (M.C.) SHALL BE ENTIRELY RESPONSIBLE FOR FIELD VERIFYING ALL EXISTING EQUIPMENT LAYOUT, DIMENSIONS, EXISTING PIPING & DUCTWORK SIZES IN THE FIELD PRIOR TO THE START OF ANY WORK. M.C. SHALL SUBMIT DETAILED SCALED SHOP DRAWINGS OF PROPOSED DUCTWORK, EQUIPMENT LAYOUT, PIPING, ETC FOR REVIEW AND APPROVAL PROCESS.

#### FIRE STOPPING NOTES

- 1. ALL PENETRATIONS RELATED TO MECHANICAL WORK THROUGH FIRE RATED WALLS, FLOORS OR OTHER STRUCTURES SHALL BE FIRE STOPPED AS REQUIRED TO MAINTAIN THE RATING OF THE WALL BY MECHANICAL CONTRACTOR. IT IS ASSUMED THAT ALL WALLS IN THE CONSTRUCTION CARRY A MINIMUM FIRE RATING OF 1 HR. IT SHOULD BE ASSUMED THAT ALL MACHINE ROOM WALLS / BOILER ROOM WALLS / ELECTRIC ROOM WALLS CARRY A RATING OF 2 HR. MECHANICAL CONTRACTOR SHALL BE RESPONSIBLE FOR A COMPLETE REVIEW OF THE ARCHITECTURAL DRAWINGS IN ORDER TO DETERMINE FIRE RATINGS OF ALL WALLS / PARTITIONS RELATED TO WORK UNDER THIS CONTRACT.
- MECHANICAL CONTRACTOR SHALL REVIEW THE COMPLETE ARCHITECTURAL SET OF DRAWINGS IN ORDER TO DETERMINE WHERE DUCT PENETRATIONS THROUGH RATED BARRIERS. DUCTS PENETRATING SAID RATED BARRIERS SHALL BE EQUIPPED WITH A UL LISTED FUSIBLE LINK TYPE FIRE DAMPER, RATED FOR SERVICE FOR WHICH IT IS BEING USED. FIRE DAMPERS SHALL BE PROVIDED & INSTALLED BY THE MECHANICAL CONTRACTOR, COMPLETE W/ DUCT ACCESS DOORS DIRECTLY ADJACENT TO THE DAMPER, POSITIONED FOR EASY REPLACEMENT OF THE LINK.
- 3. MECHANICAL CONTRACTOR SHALL REVIEW THE COMPLETE ARCHITECTURAL SET OF DRAWINGS IN ORDER TO DETERMINE WHERE DUCT PENETRATIONS THROUGH RATED BARRIERS OCCUR BETWEEN SEPARATE SMOKE ZONES. DUCTS PENETRATING SAID FIRE / SMOKE BARRIERS SHALL BE EQUIPPED WITH A UL LISTED COMBINATION FIRE / SMOKE DAMPER, RATED FOR SERVICE FOR WHICH IT IS BEING USED. FIRE / SMOKE DAMPERS SHALL BE PROVIDED & INSTALLED BY THE MECHANICAL CONTRACTOR, COMPLETE W/ DUCT ACCESS DOORS DIRECTLY ADJACENT TO THE DAMPER. DAMPER ACTUATOR & RELATED WIRING SHALL BE PROVIDED & INSTALLED BY THE ELECTRICAL CONTRACTOR. COORDINATE DAMPER INSTALLATIONS W/ E.C. TO VERIFY PROPER CLEARANCES TO ASSURE PROPER DAMPER OPERATION.
- MECHANICAL CONTRACTOR SHALL PROVIDE A FULL SET OF AS-BUILT DRAWINGS, SHOWING EACH DAMPER LOCATION, TYPE OF DAMPER, ACCESS DOOR LOCATIONS, ETC.
   CONTRACTOR SHALL REFER TO SPECIFICATION SECTION 15511 FOR FURTHER DETAILS REGARDING FIRESTOPPING MATERIALS & METHODS.
- 6. CONTRACTOR SHALL SUBMIT SHOP DRAWINGS OF PRODUCTS TO BE USED. FIRESTOP MATERIALS OTHER THAN THE PRODUCTS SPECIFIED SHALL INCLUDE FULL TECHNICAL DATA WITH SHOP DRAWINGS TO DEMONSTRATE EQUALITY WITH THE SPECIFIED FIRESTOPPING MATERIALS.

#### GENERAL INSTRUMENTATION NOTES

- 1. AT A MINIMUM, PROVIDE THERMOMETERS / WELLS AT THE FOLLOWING LOCATIONS:
- AT INLETS & OUTLET OF EACH THREE WAY VALVE (UNIT VENTILATORS / CABINET UNIT HEATER INSTALLATIONS EXCEPTED).
- AT INLET & OUTLET OF EACH HYDRONIC BOILER, CHILLER OR COOLING TOWER.
- AT INLET & OUTLET OF EACH HYDRONIC COIL IN AIR HANDLING UNITS & BUILT-UP CENTRAL SYSTEMS.
- 2. AT A MINIMUM, PROVIDE LIQUID FILLED PRESSURE GAUGES / WELLS AT THE FOLLOWING LOCATIONS:
- AT SUCTION & DISCHARGE OF EACH PUMP.
  FOR EACH MAKEUP WATER LINE.
- BEFORE & AFTER ALL PRESSURE REDUCING VALVES.
- AT ACCESSIBLE HIGH POINT OF ALL HYDRONIC PIPING SYSTEMS. AT ALL EXPANSION / COMPRESSION TANKS.

#### PIPING SYSTEMS AND EQUIPMENT VENTING NOTES

- 1. MECHANICAL CONTRACTOR WILL BE RESPONSIBLE FOR THE PROPER VENTING OF ALL NEWLY INSTALLED HYDRONIC PIPING SYSTEMS. AUTOMATIC AIR VENTS SHALL BE INSTALLED AT EVERY HIGH POINT IN THE PIPING SYSTEM WHERE AIR CAN COLLECT. PROVIDE COCK IN RISER PRIOR TO AUTOMATIC AIR VENT. NEW AIR VENTS SHALL BE "TACO" #HY-VENT OR EQUIVALENT.
- . MECHANICAL CONTRACTOR SHALL PROVIDE & INSTALL NEW AUTOMATIC AIR VENT FOR EACH AIR HANDLING UNIT COIL OR DUCT MOUNTED COIL. INSTALL SHUT-OFF COCK PRIOR TO VENT TIE-IN.
- 3. MECHANICAL CONTRACTOR SHALL PROVIDE NEW MANUAL AIR VENTS FOR ALL UNIT VENTILATOR COILS, CONVECTORS, FAN COIL UNITS, FIN TUBE RADIATORS, ETC. MANUAL VENTS SHALL BE "TACO" #417 COIN VENT OR EQUIVALENT. PROVIDE SHUT-OFF COCK PRIOR TO VENT. AIM COIN VENT DISCHARGE IN AN APPROPRIATE MANNER AS TO FACILITATE THE CAPTURE OF BLEED WATER WHILE PERFORMING SYSTEM BLEEDING OPERATIONS.

#### ELECTRICAL WORK UNDER MECHANICAL CONTRACT

- MECHANICAL CONTRACTOR SHALL PROVIDE ALL STARTERS & DISCONNECT SWITCHES REQUIRED FOR ALL NEW MECHANICAL EQUIPMENT. STARTER / DISCONNECT SWITCH INSTALLATION TO BE PERFORMED UNDER THE ELECTRICAL CONTRACT. COORDINATE WORK W/ ELECTRICAL CONTRACTOR PRIOR TO START
- 2. POWER WIRING REQUIRED FOR CONTROLS SHALL BE PERFORMED UNDER THE MECHANICAL CONTRACT UNLESS SPECIFICALLY NOTED OTHERWISE ON THE ELECTRICAL DRAWINGS. MECHANICAL CONTRACTOR SHALL OBTAIN THE SERVICES OF A LICENSED ELECTRICIAN (PER NEC REQUIREMENTS) TO PERFORM ALL ELECTRICAL WORK.

## **DUCTWORK NOTES**

- PROVIDE ALL NEW DUCTWORK AS SHOWN AND SPECIFIED UNDER SPECIFICATION SECTION 015891, AND IN CONFORMANCE WITH 'SMACNA' SPECIFICATIONS.
- 2. IF A DUCT ELBOW IS SHOWN TO BE RADIUSED, THEN RADIUSED ELBOWS SHALL BE INSTALLED. SQUARE ELBOWS MAY NOT BE SUBSTITUTED WHERE RADIUSED ELBOWS ARE SHOWN. WHERE SQUARE ELBOWS ARE SHOWN, TURNING VANES SHALL BE INSTALLED UPON APPROVAL BY THE ENGINEER.
- PROVIDE DUCT LINING IN ALL DUCTWORK THAT IS CONVEYING BELOW AMBIENT TEMPERATURE AIR & IS NOT INSULATED. PROVIDE LINING IN SUPPLY & RETURN AIR DUCTWORK FROM AIR HANDLING EQUIPMENT TO 20 FEET AWAY FROM THE UNIT(S). IN ADDITION, INCLUDE LINING IN ANY OTHER DUCT SPECIFICALLY SHOWN OR SPECIFIED TO BE EQUIPPED WITH LINING. REFER TO SPECIFICATION SECTION 15891 & 15290 FOR FURTHER INFORMATION.
- WHERE FLEXIBLE DUCTWORK IS USED, LENGTHS MAY NOT EXCEED 4 FEET TOTAL IN ANY ONE RUN OF FLEXIBLE DUCTWORK. FLEXIBLE DUCTWORK SHALL BE RATED IN ACCORDANCE WITH UL 181, CLASS 1. REFER TO SPECIFICATION SECTION 15891 FOR FURTHER INFORMATION.
- 5. MECHANICAL CONTRACTOR SHALL PROVIDE A BUTTERFLY TYPE VOLUME DAMPER WITH LOCKING QUADRANT HANDLE PRIOR TO EACH AIR OUTLET SHOWN. INSTALL DAMPER AT LEAST 5 FEET AWAY FROM AIR OUTLET WHEREVER POSSIBLE.
- MECHANICAL CONTRACTOR SHALL PROVIDE FLEXIBLE DUCT CONNECTIONS WHERE DUCT SYSTEMS CONNECT TO EQUIPMENT. REFER TO SPECIFICATION SECTION 15891 FOR FURTHER INFORMATION.

# TESTING and BALANCING NOTES


- MECHANICAL CONTRACTOR WILL BE REQUIRED TO PERFORM ALL EQUIPMENT & SYSTEM TESTING / BALANCING REQUIRED UNDER THIS CONTRACT. PROVIDE A FULL REPORT DETAILING ALL DESIGN & ACTUAL CONDITIONS FOR ALL AIR & HYDRONIC SYSTEMS SHOWN ON THE DRAWINGS. REFER TO SPECIFICATION SECTIONS 15990 & 15997 FOR FURTHER DETAILS.
- UPON NOTICE OF COMPLETION OF WORK BY THE CONTRACTOR, OWNER WILL OBTAIN THE SERVICES OF AN INDEPENDENT TESTING & BALANCING CONTRACTOR TO VERIFY THE RESULTS OF THE TESTING & BALANCING REPORT SUBMISSION. INDEPENDENT TESTING AGENCY SHALL SELECT A RANDOM NUMBER OF MEASUREMENTS TO BE CHECKED. MEASUREMENTS WILL BE CHECKED IN THE SAME MANNER AS ORIGINALLY MEASURED. NUMBER OF VERIFICATION MEASUREMENTS SHALL BE APPROXIMATELY 25% OF THE TOTAL MEASUREMENTS FOR THE PROJECT.
- IF MORE THAN 10% OF THE VERIFICATION TESTING SHOWS DEVIATIONS OF 10% OR MORE / SOUND LEVEL OF 2dB DIFFERENT THAN THAT ORIGINALLY MEASURED, THE ORIGINAL REPORT WILL BE REJECTED. ALL SYSTEMS WILL THEN BE REQUIRED TO BE COMPLETELY RE-TESTED, WITH A SECOND REPORT SUBMITTED. IN THE EVENT THAT THE ORIGINAL REPORT IS REJECTED, ALL SYSTEMS SHALL BE READJUSTED & TESTED, NEW CERTIFIED REPORTS SUBMITTED, AND NEW VERIFICATION TESTS MADE, AT NO ADDITIONAL COST TO THE OWNER. THE CONTRACTOR WILL BE RESPONSIBLE FOR ALL COSTS INVOLVED WITH THE VERIFICATION TESTS.

REV. DATE ITEM

NOTICE

THESE DRAWINGS ARE BASED ON CONSTRUCTION DRAWINGS NOT PREPARED BY BBS ARCHITECTS, LANDSCAPE ARCHITECTS AND ENGINEERS, PC. AND, THEREFORE, MAY NOT REPRESENT THE CONDITIONS AS CONSTRUCTED AT THE TIME. ALL EXISTING CONDITIONS SHOWN ARE REPRESENTED AS SUGGESTIVE INFORMATION AS THEY MAY NOT HAVE BEEN BUILT AND DETAILED

ER THE ORIGINAL DOCUMENTS OR PER THE OWNER'S INFORMATIC

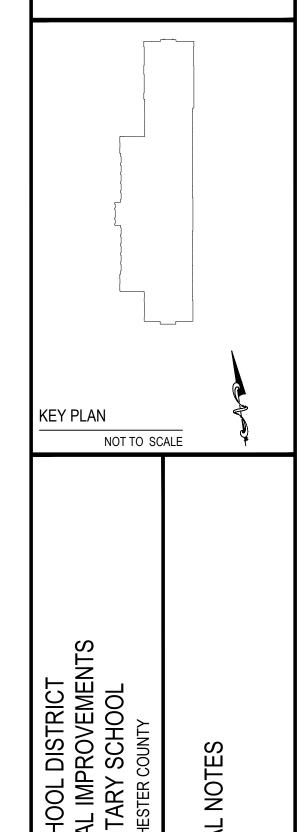

DRAWING BY: D.S.

CHECK BY: D.S.

GREENBURGH ( ASE I - DISTRICT RICHARD J. BAI

NOTICE


THIS DRAWING, PREPARED FOR THE SPECIFIC PROJECT INDICATED IS AN INSTRUMENT OF SERVICE AND THE PROPERTY OF BBS ARCHITECTS, LANDSCAPE ARCHITECTS AND ENGINEERS, PC INFRINGEMENT OR ANY USE OF THIS DRAWING FOR ANY OTHER PROJECT IS PROHIBITED. ANY ALTERATION OR REPRODUCTION OF THIS DOCUMENT IS ALSO PROHIBITED WITHOUT THE WRITTEN CONSENT OF THE ARCHITECT OR ENGINEER.

ARCHITECTS
LANDSCAPE ARCHITECTS

ENGINEERS

244 EAST MAIN STREET | 187 WOLF ROAD, STE. 20
PATCHOGUE | ALBANY | NEW YORK 11772 | NEW YORK 12205 | T. 518.621.7650 |
T. 631.475.0349 | T. 518.621.7650 | T. 518.6

475.0361 | F. 518.621.7 www.BBSARCHITECTURE.com

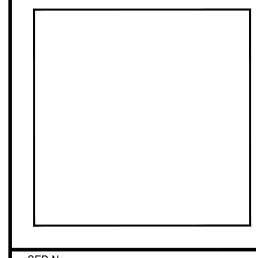

<u>SED No.</u> 66-04-07-06-0-005-012 <u>DISTRICT</u> GREENBURGH CSD

PROJECT PH. I - DW CAP. IMPROVEMENTS R.J. BAILEY E.S.

DWG TITLE MECHANICAL GENERAL

NOTES


SCALE: AS NOTED

DATE: MAY 2022

BID PICK-UP: MAY 27, 2022

| M0.01C | oF - - -

FILE No: 21-290

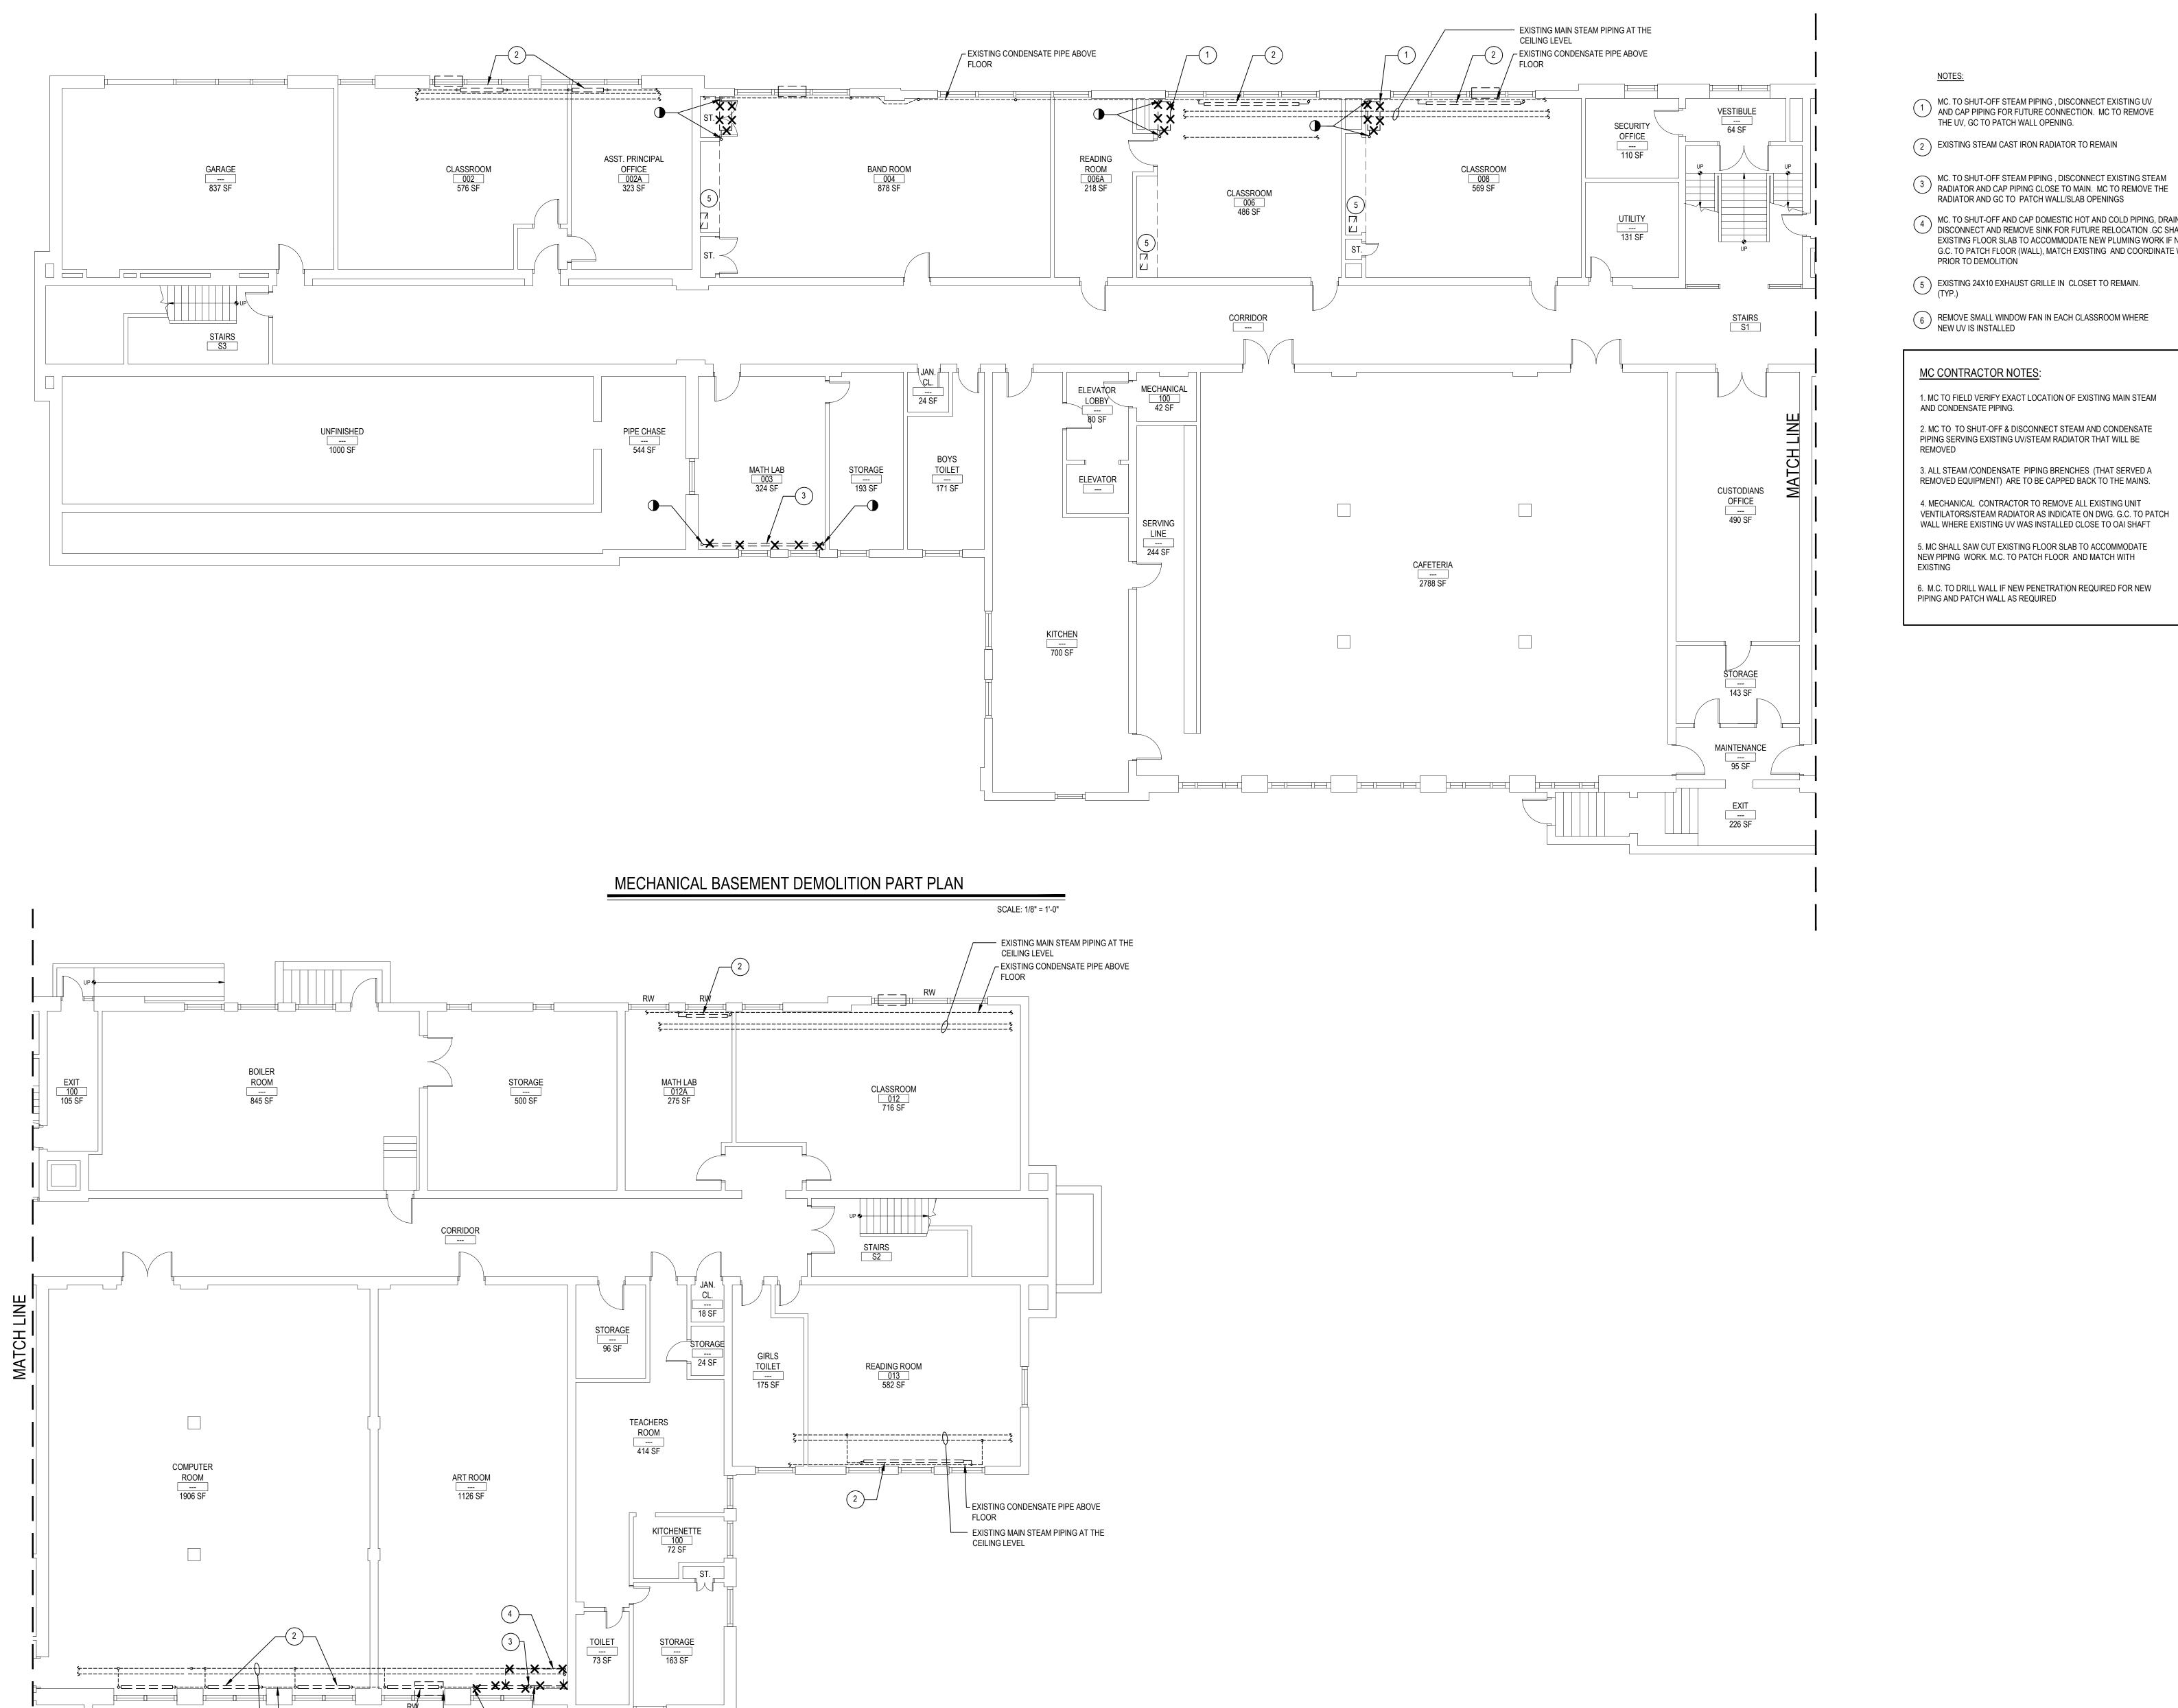

CONTINUATION MECHANICAL BASEMENT DEMOLITION PART PLAN

SCALE: 1/8" = 1'-0"

EXISTING CONDENSATE PIPE ABOVE

EXISTING MAIN STEAM PIPING AT THE

CEILING LEVEL

LEXISTING ESCAPE LADDER

NOTES:

- MC. TO SHUT-OFF STEAM PIPING , DISCONNECT EXISTING UV AND CAP PIPING FOR FUTURE CONNECTION. MC TO REMOVE THE UV, GC TO PATCH WALL OPENING.
- 2 EXISTING STEAM CAST IRON RADIATOR TO REMAIN
- MC. TO SHUT-OFF STEAM PIPING , DISCONNECT EXISTING STEAM RADIATOR AND CAP PIPING CLOSE TO MAIN. MC TO REMOVE THE RADIATOR AND GC TO PATCH WALL/SLAB OPENINGS
- MC. TO SHUT-OFF AND CAP DOMESTIC HOT AND COLD PIPING, DRAINAGE, DISCONNECT AND REMOVE SINK FOR FUTURE RELOCATION .GC SHALL SAW CUT EXISTING FLOOR SLAB TO ACCOMMODATE NEW PLUMING WORK IF NECESSARY. G.C. TO PATCH FLOOR (WALL), MATCH EXISTING AND COORDINATE WITH M.C. PRIOR TO DEMOLITION
- 5 EXISTING 24X10 EXHAUST GRILLE IN CLOSET TO REMAIN. (TYP.)
- 6 REMOVE SMALL WINDOW FAN IN EACH CLASSROOM WHERE NEW UV IS INSTALLED

MC CONTRACTOR NOTES:

1. MC TO FIELD VERIFY EXACT LOCATION OF EXISTING MAIN STEAM AND CONDENSATE PIPING.

2. MC TO TO SHUT-OFF & DISCONNECT STEAM AND CONDENSATE PIPING SERVING EXISTING UV/STEAM RADIATOR THAT WILL BE REMOVED

3. ALL STEAM /CONDENSATE PIPING BRENCHES (THAT SERVED A REMOVED EQUIPMENT) ARE TO BE CAPPED BACK TO THE MAINS.

5. MC SHALL SAW CUT EXISTING FLOOR SLAB TO ACCOMMODATE NEW PIPING WORK. M.C. TO PATCH FLOOR AND MATCH WITH

6. M.C. TO DRILL WALL IF NEW PENETRATION REQUIRED FOR NEW PIPING AND PATCH WALL AS REQUIRED

REV. DATE

<u>NOTICE</u> THESE DRAWINGS ARE BASED ON CONSTRUCTION DRAWINGS NOT PREPARED BY BBS ARCHITECTS, LANDSCAPE ARCHITECTS AND ENGINEERS, PC. AND, THEREFORE, MAY NOT REPRESENT THE CONDITIONS AS CONSTRUCTED AT THE TIME. ALL EXISTING CONDITIONS SHOWN ARE REPRESENTED AS SUGGESTIVE INFORMATION AS THEY MAY NOT HAVE BEEN BUILT AND DETAILED PER THE ORIGINAL DOCUMENTS OR PER THE OWNER'S INFORMATION.

KEY PLAN NOT TO SCALE


DRADMSING BY: CHECS.BY:

THIS DRAWING, PREPARED FOR THE SPECIFIC PROJECT INDICATED IS
AN INSTRUMENT OF SERVICE AND THE PROPERTY OF BBS
ARCHITECTS, LANDSCAPE ARCHITECTS AND ENGINEERS, PC.
INFRINGEMENT OR ANY USE OF THIS DRAWING FOR ANY OTHER PROJECT IS PROHIBITED. ANY ALTERATION OR REPRODUCTION OF THIS DOCUMENT IS ALSO PROHIBITED WITHOUT THE WRITTEN CONSENT OF THE ARCHITECT OR ENGINEER.

ARCHITECTS LANDSCAPE ARCHITECTS ENGINEERS

244 EAST MAIN STREET | 187 WOLF ROAD, STE. 20: PATCHOGUE | ALBANY NEW YORK 11772 NEW YORK 12205 F. 631.475.0361 F. 518.621.7655

www.BBSARCHITECTURE.com

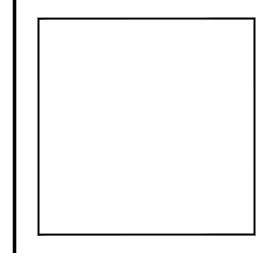


66-04-07-06-0-005-012


DISTRICT GREENBURGH CSD PROJECT PH. I - DW CAP. IMPROVEMENTS

DWG TITLE MECHANICAL BASEMENT DEMOLITION PLAN

R.J. BAILEY E.S.

SCALE: AS NOTED BID PICK-UP: MAY 27, 2022 FILE No: 21-290

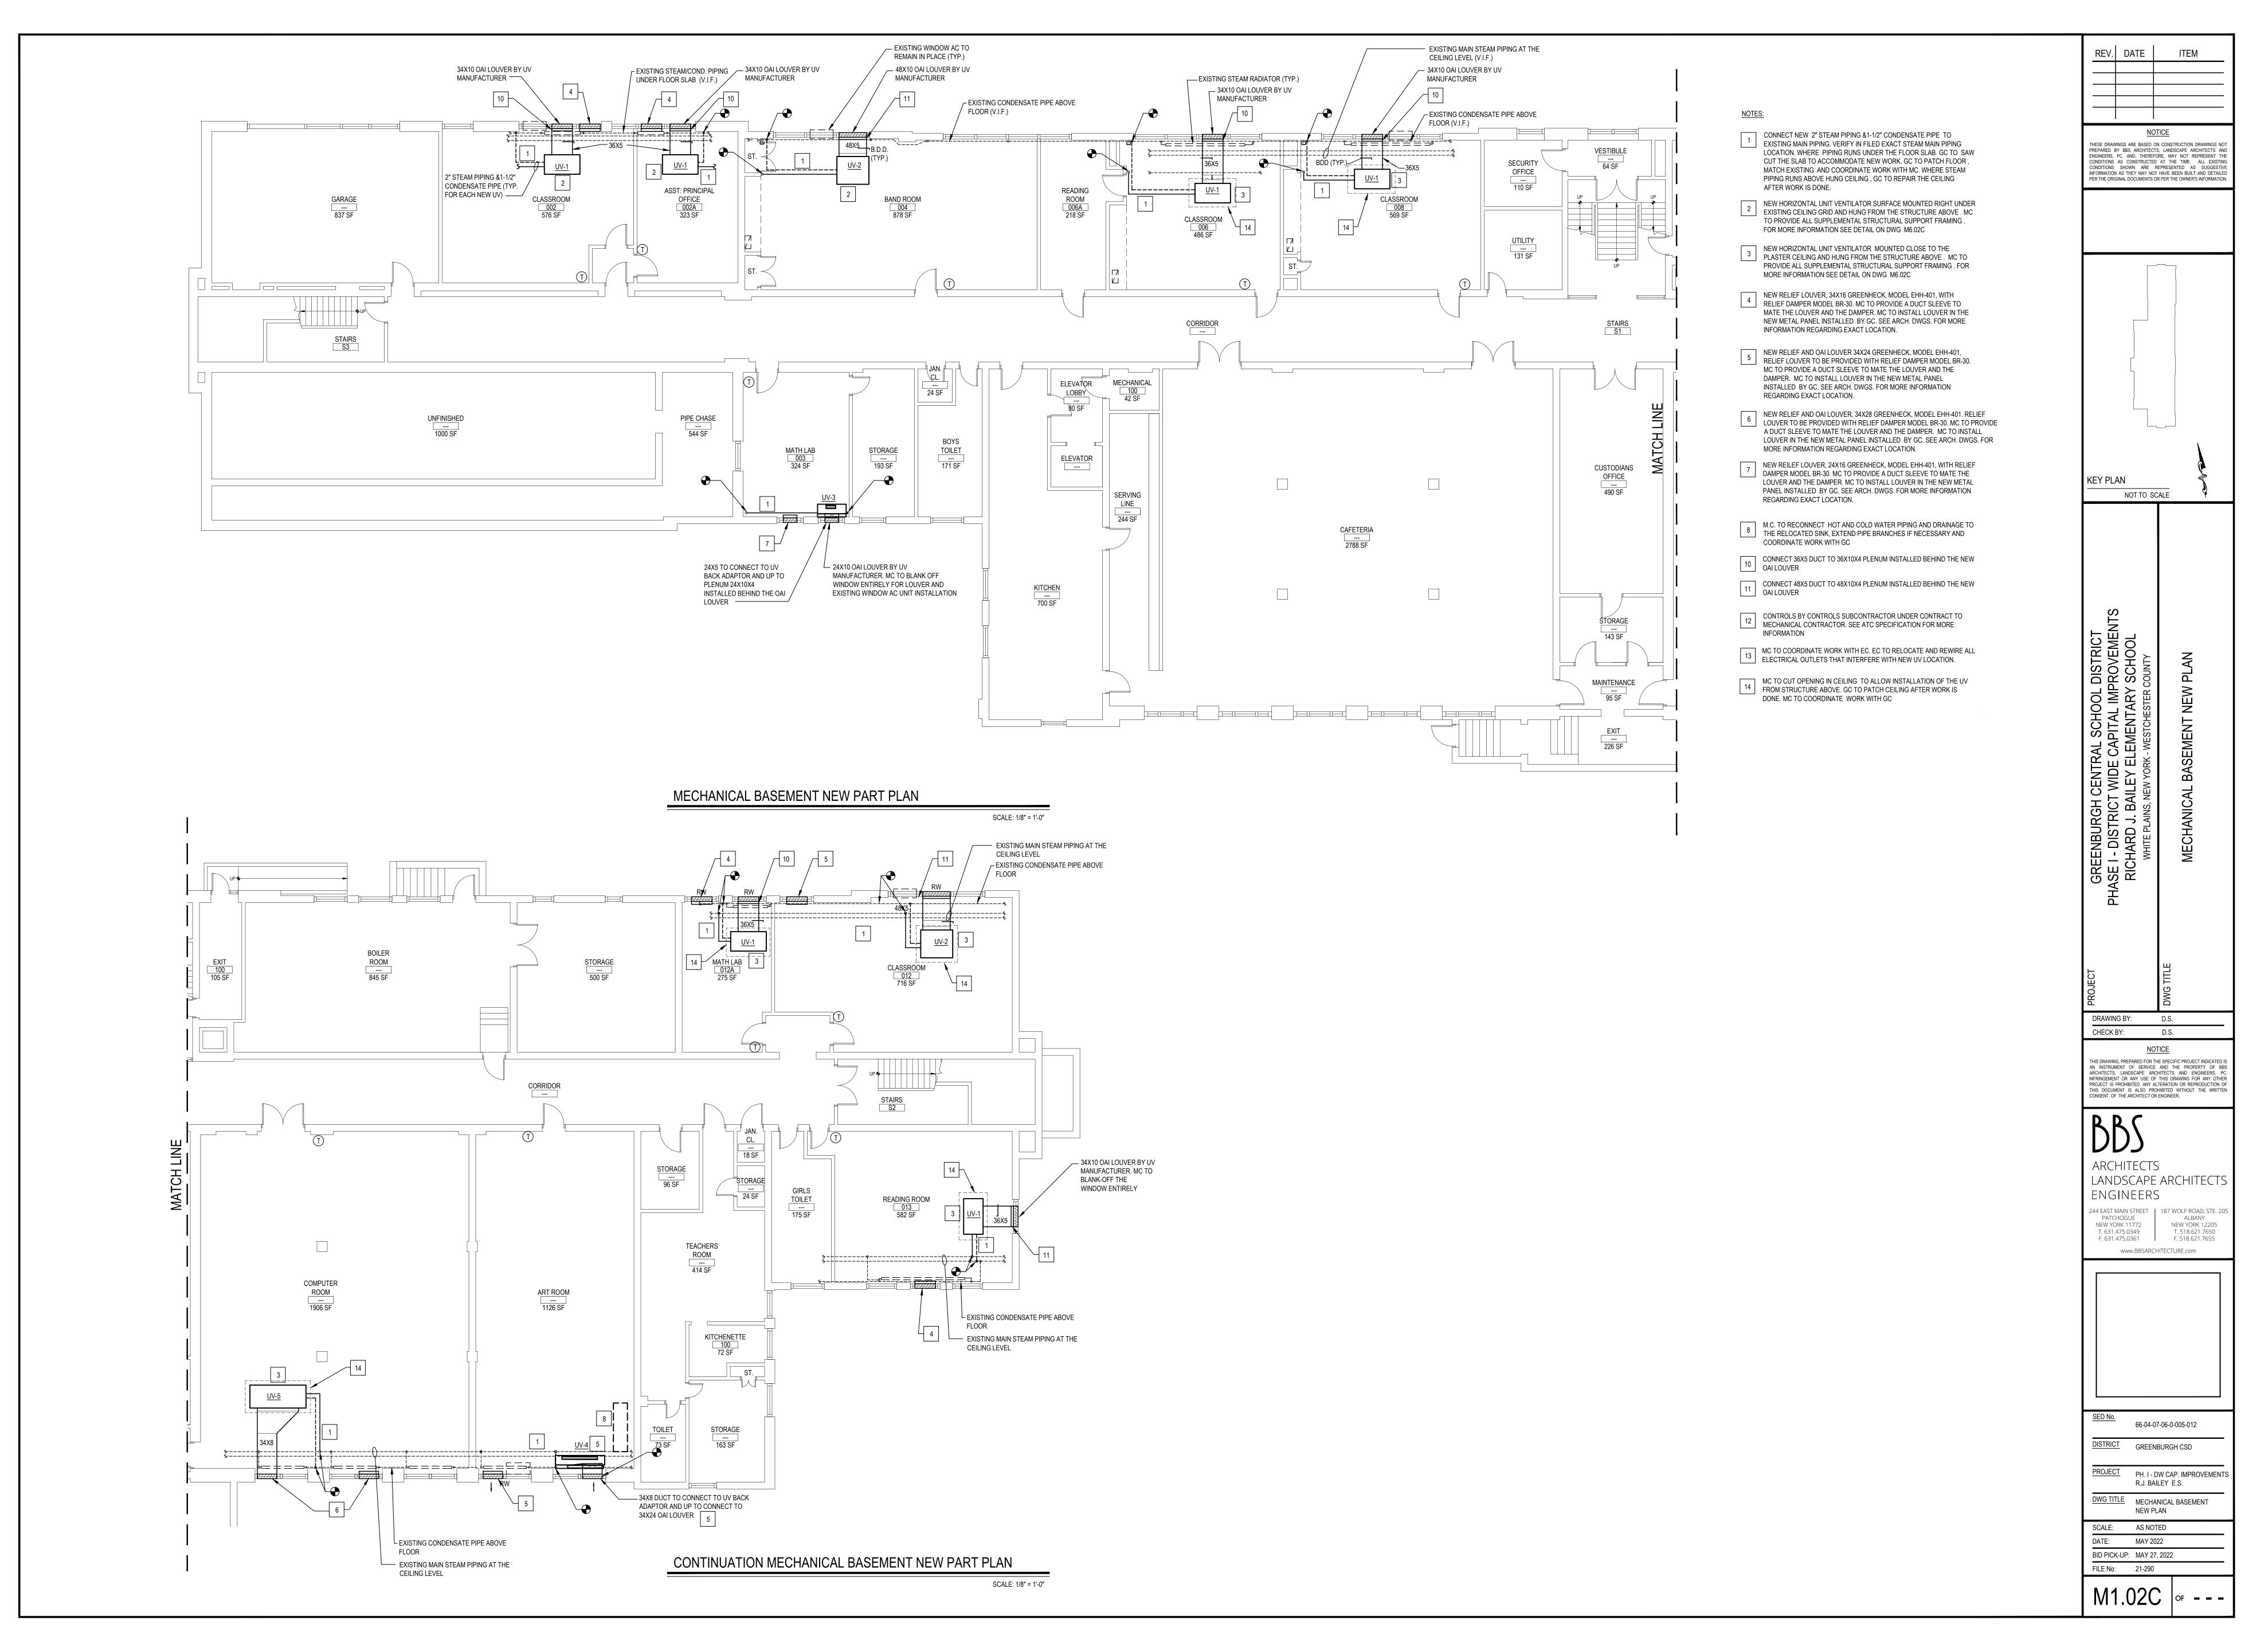

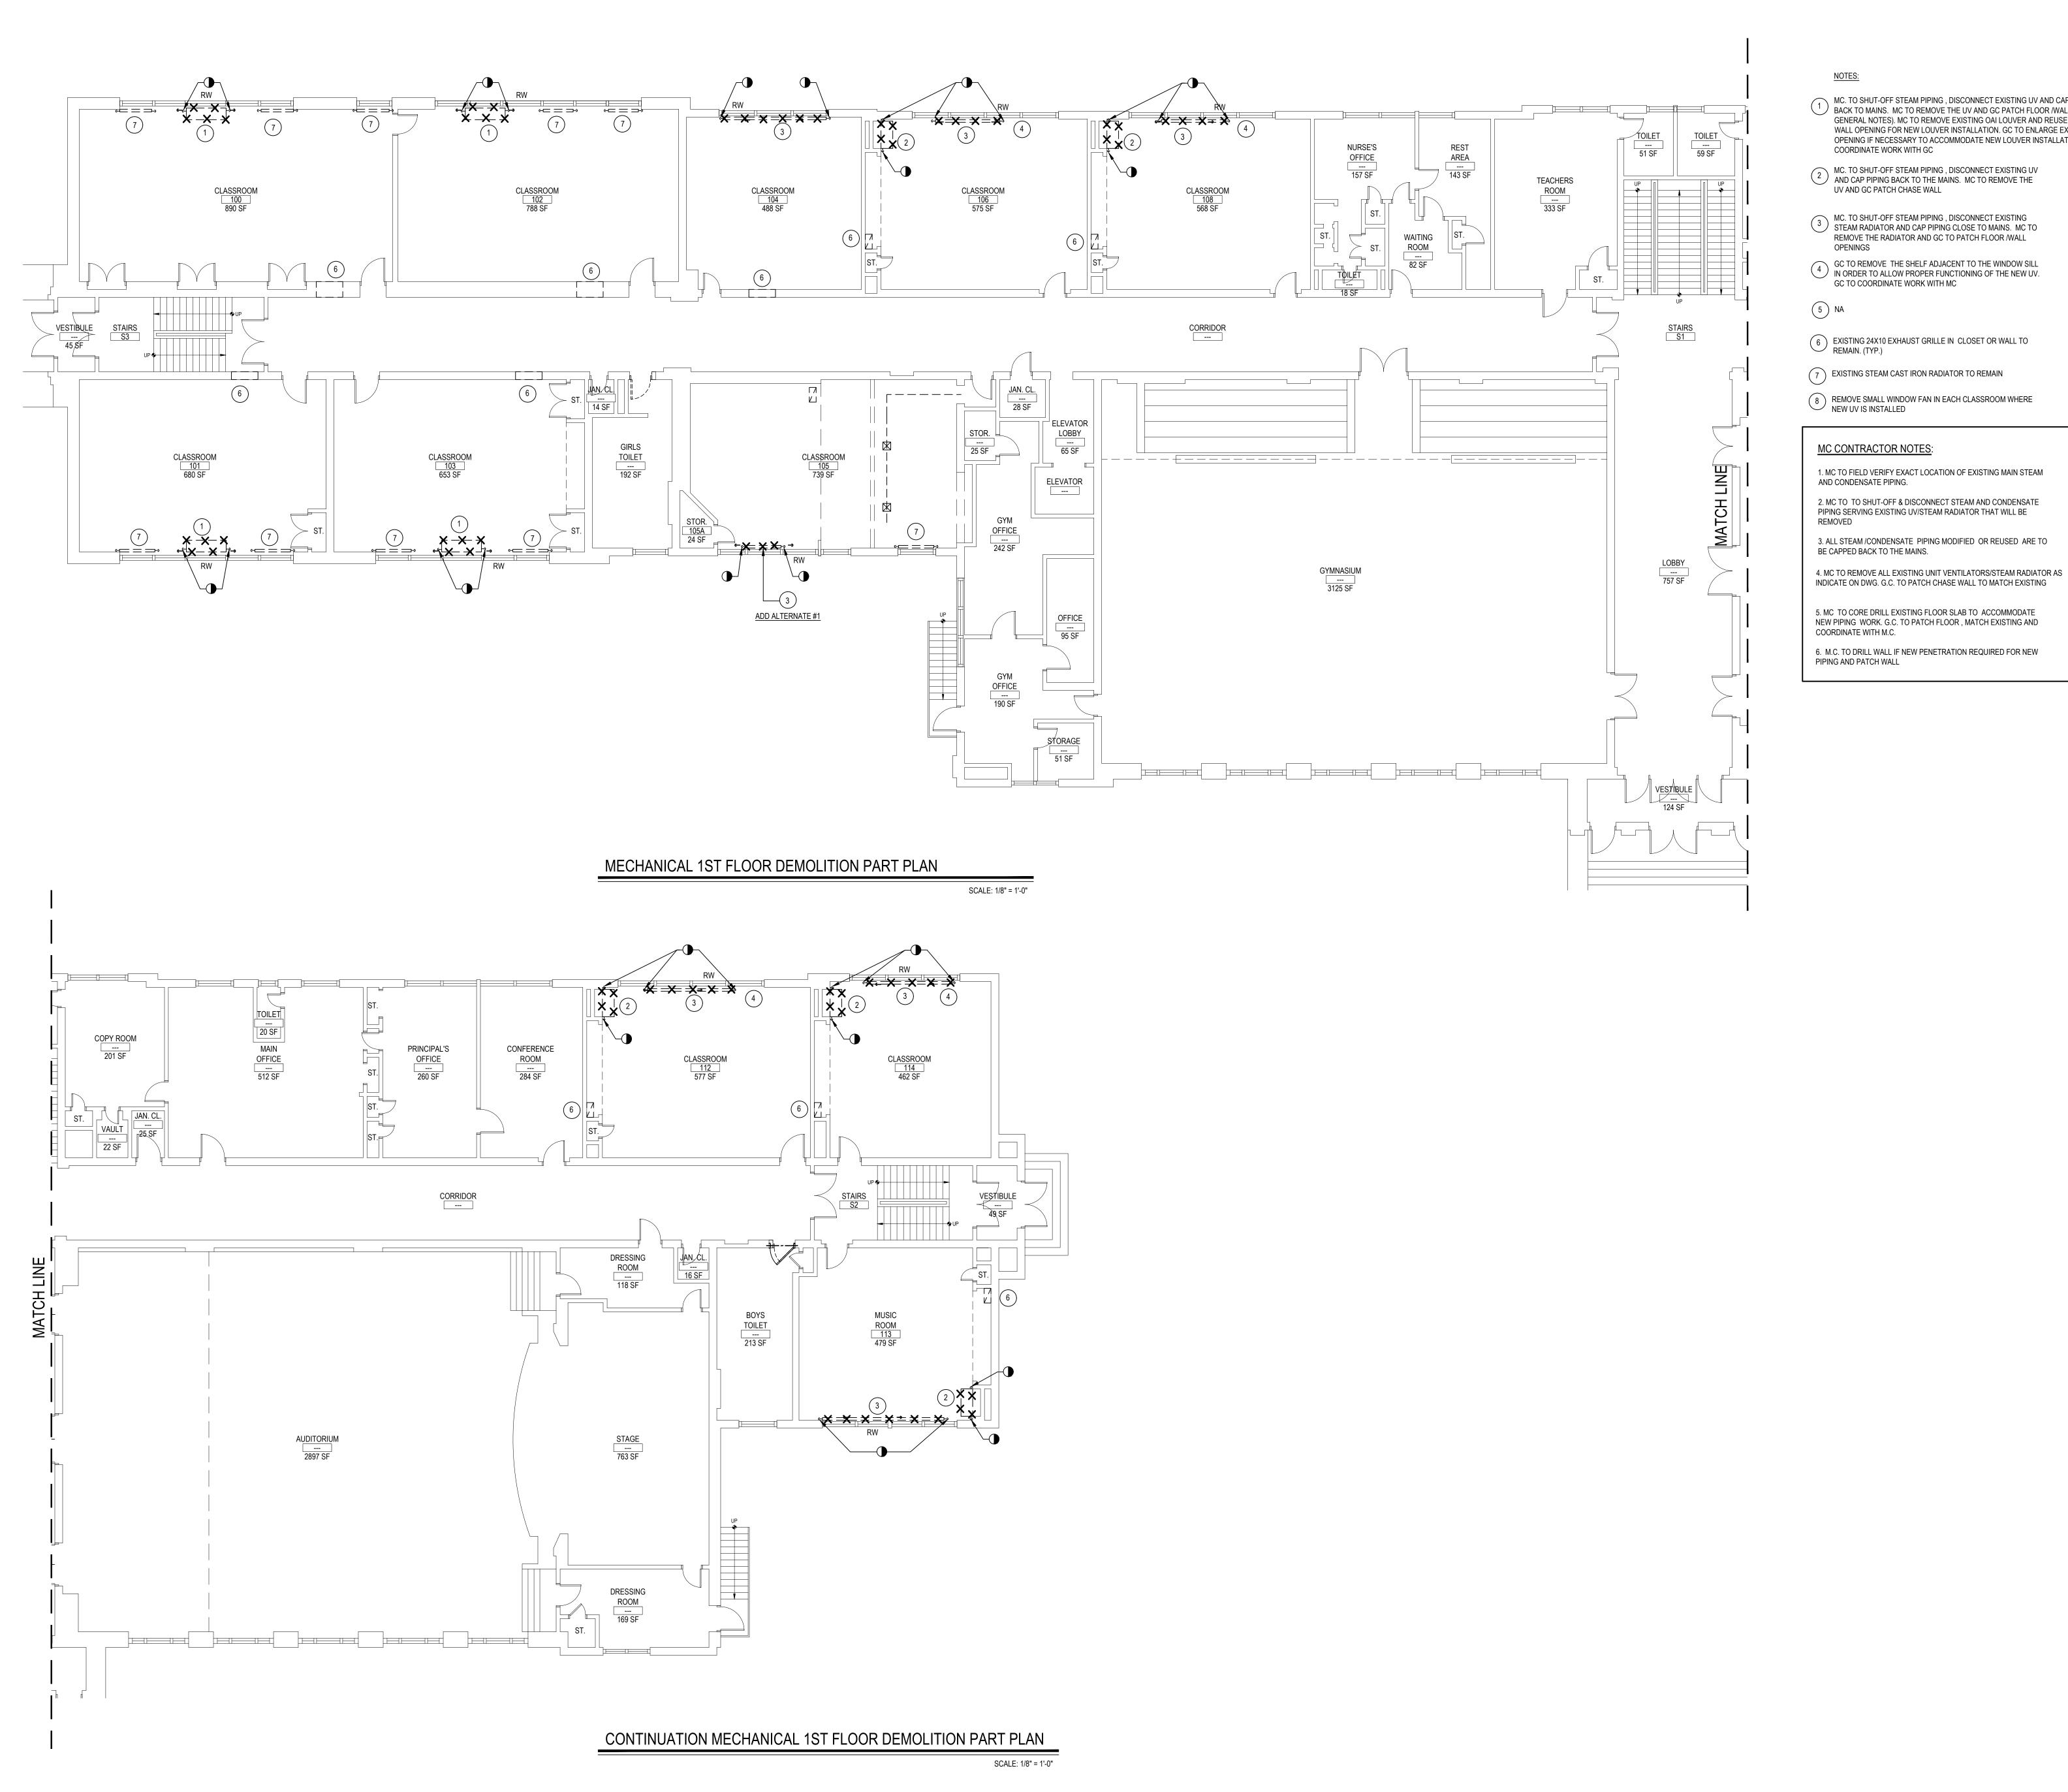

- MC. TO SHUT-OFF STEAM PIPING , DISCONNECT EXISTING UV AND CAP PIPING BACK TO MAINS. MC TO REMOVE THE UV AND GC PATCH FLOOR /WALL( SEE GENERAL NOTES). MC TO REMOVE EXISTING OAI LOUVER AND REUSE EXISTING WALL OPENING FOR NEW LOUVER INSTALLATION. GC TO ENLARGE EXISTING OPENING IF NECESSARY TO ACCOMMODATE NEW LOUVER INSTALLATION. MC TO COORDINATE WORK WITH GC
- MC. TO SHUT-OFF STEAM PIPING , DISCONNECT EXISTING UV AND CAP PIPING BACK TO THE MAINS. MC TO REMOVE THE
- MC. TO SHUT-OFF STEAM PIPING , DISCONNECT EXISTING STEAM RADIATOR AND CAP PIPING CLOSE TO MAINS. MC TO REMOVE THE RADIATOR AND GC TO PATCH FLOOR /WALL
- GC TO REMOVE THE SHELF ADJACENT TO THE WINDOW SILL IN ORDER TO ALLOW PROPER FUNCTIONING OF THE NEW UV. GC TO COORDINATE WORK WITH MC
- 6 EXISTING 24X10 EXHAUST GRILLE IN CLOSET OR WALL TO REMAIN. (TYP.)
- 7 EXISTING STEAM CAST IRON RADIATOR TO REMAIN
- 8 REMOVE SMALL WINDOW FAN IN EACH CLASSROOM WHERE NEW UV IS INSTALLED

1. MC TO FIELD VERIFY EXACT LOCATION OF EXISTING MAIN STEAM

2. MC TO TO SHUT-OFF & DISCONNECT STEAM AND CONDENSATE PIPING SERVING EXISTING UV/STEAM RADIATOR THAT WILL BE

3. ALL STEAM / CONDENSATE PIPING MODIFIED OR REUSED ARE TO

INDICATE ON DWG. G.C. TO PATCH CHASE WALL TO MATCH EXISTING

NEW PIPING WORK. G.C. TO PATCH FLOOR, MATCH EXISTING AND

6. M.C. TO DRILL WALL IF NEW PENETRATION REQUIRED FOR NEW

REV. DATE

<u>NOTICE</u> THESE DRAWINGS ARE BASED ON CONSTRUCTION DRAWINGS NOT PREPARED BY BBS ARCHITECTS, LANDSCAPE ARCHITECTS AND ENGINEERS, PC. AND, THEREFORE, MAY NOT REPRESENT THE CONDITIONS AS CONSTRUCTED AT THE TIME. ALL EXISTING CONDITIONS SHOWN ARE REPRESENTED AS SUGGESTIVE INFORMATION AS THEY MAY NOT HAVE BEEN BUILT AND DETAILED PER THE ORIGINAL DOCUMENTS OR PER THE OWNER'S INFORMATION.

KEY PLAN NOT TO SCALE


CHECK BY: D.S. <u>NOTICE</u>

THIS DRAWING, PREPARED FOR THE SPECIFIC PROJECT INDICATED IS AN INSTRUMENT OF SERVICE AND THE PROPERTY OF BBS ARCHITECTS, LANDSCAPE ARCHITECTS AND ENGINEERS, PC. INFRINGEMENT OR ANY USE OF THIS DRAWING FOR ANY OTHER PROJECT IS PROHIBITED. ANY ALTERATION OR REPRODUCTION OF THIS DOCUMENT IS ALSO PROHIBITED WITHOUT THE WRITTEN CONSENT OF THE ARCHITECT OR ENGINEER.

ARCHITECTS LANDSCAPE ARCHITECTS

ENGINEERS 244 EAST MAIN STREET | 187 WOLF ROAD, STE. 20 PATCHOGUE | ALBANY NEW YORK 11772 NEW YORK 12205 T. 631.475.0349 T. 518.621.7650 F. 518.621.7655

F. 631.475.0361 www.BBSARCHITECTURE.com

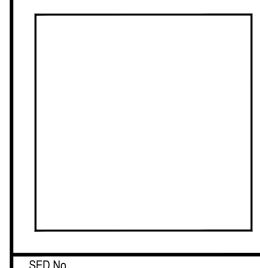


66-04-07-06-0-005-012 DISTRICT GREENBURGH CSD PROJECT PH. I - DW CAP. IMPROVEMENTS

DWG TITLE MECHANICAL 1ST FLOOR DEMOLITION PLAN

R.J. BAILEY E.S.


SCALE: AS NOTED BID PICK-UP: MAY 27, 2022 FILE No: 21-290

M2.01C | OF - - -

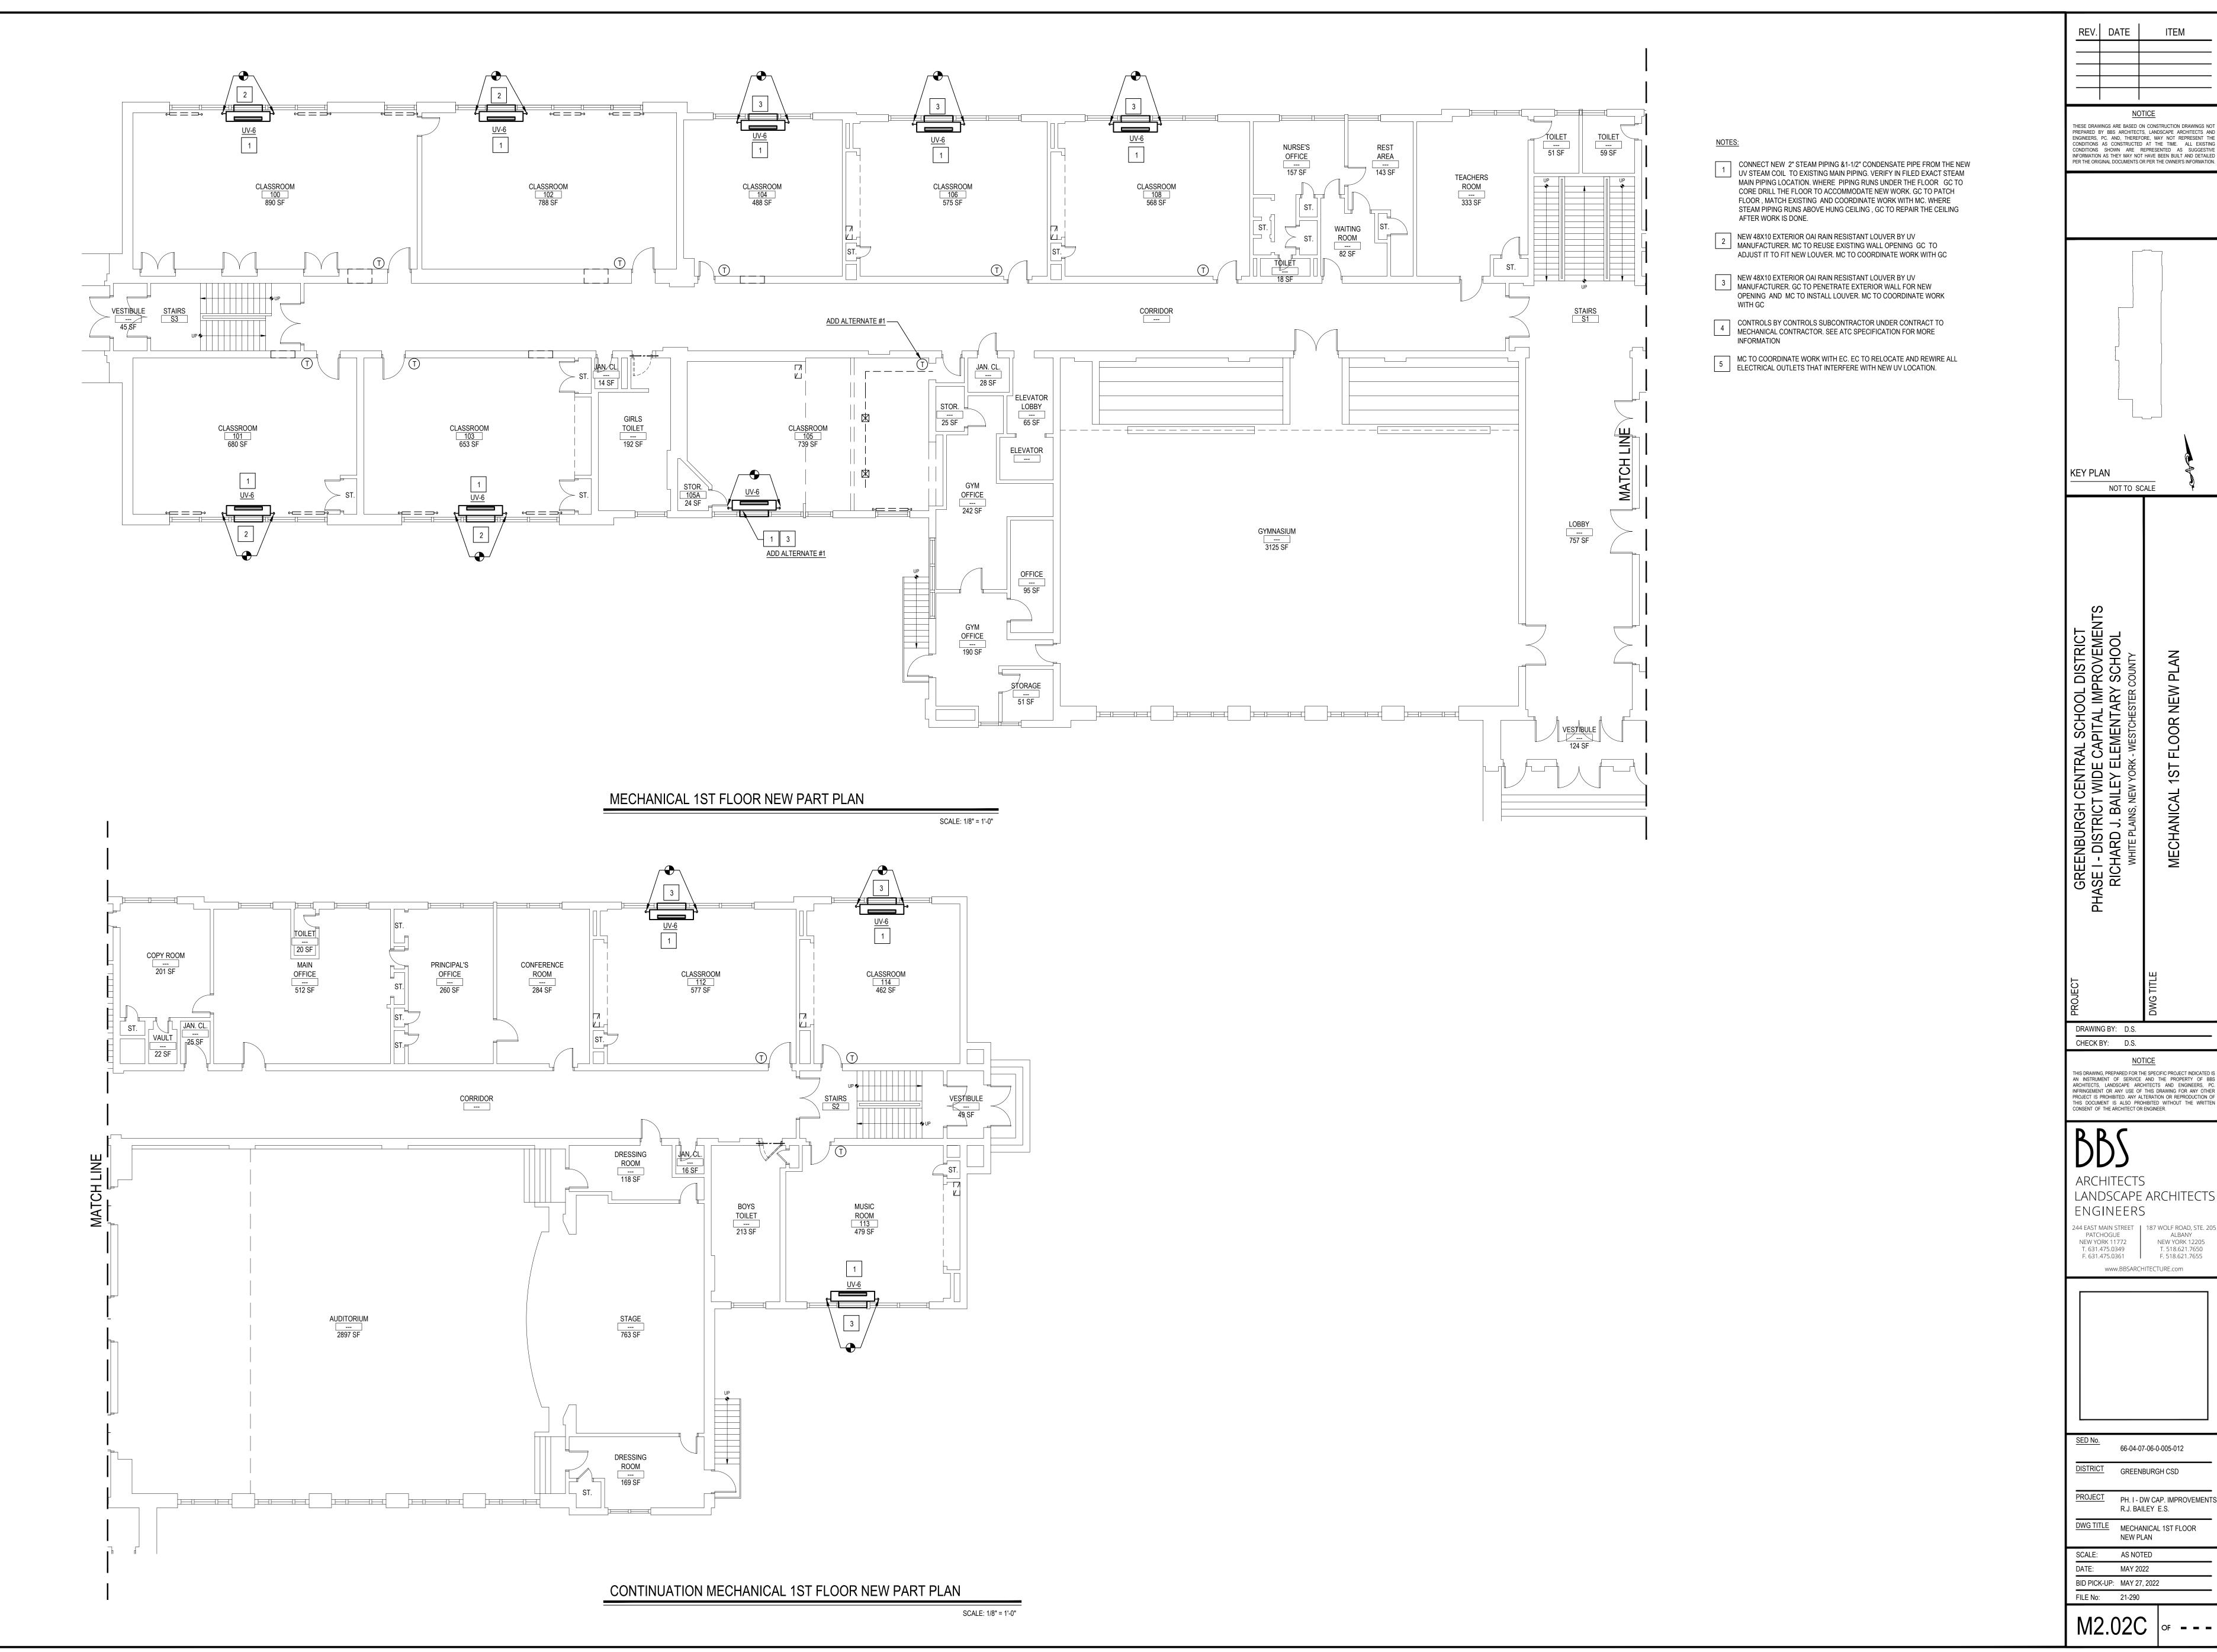

<u>NOTICE</u> THESE DRAWINGS ARE BASED ON CONSTRUCTION DRAWINGS NOT PREPARED BY BBS ARCHITECTS, LANDSCAPE ARCHITECTS AND ENGINEERS, PC. AND, THEREFORE, MAY NOT REPRESENT THE CONDITIONS AS CONSTRUCTED AT THE TIME. ALL EXISTING CONDITIONS SHOWN ARE REPRESENTED AS SUGGESTIVE INFORMATION AS THEY MAY NOT HAVE BEEN BUILT AND DETAILED PER THE ORIGINAL DOCUMENTS OR PER THE OWNER'S INFORMATION. KEY PLAN NOT TO SCALE CHECK BY: D.S. <u>NOTICE</u> THIS DRAWING, PREPARED FOR THE SPECIFIC PROJECT INDICATED IS AN INSTRUMENT OF SERVICE AND THE PROPERTY OF BBS ARCHITECTS, LANDSCAPE ARCHITECTS AND ENGINEERS, PC. INFRINGEMENT OR ANY USE OF THIS DRAWING FOR ANY OTHER PROJECT IS PROHIBITED. ANY ALTERATION OR REPRODUCTION OF THIS DOCUMENT IS ALSO PROHIBITED WITHOUT THE WRITTEN CONSENT OF THE ARCHITECT OR ENGINEER. ARCHITECTS LANDSCAPE ARCHITECTS ENGINEERS 244 EAST MAIN STREET | 187 WOLF ROAD, STE. 20: PATCHOGUE | ALBANY NEW YORK 12205 T. 518.621.7650 NEW YORK 11772 T. 631.475.0349 F. 631.475.0361 F. 518.621.7655 www.BBSARCHITECTURE.com

66-04-07-06-0-005-012

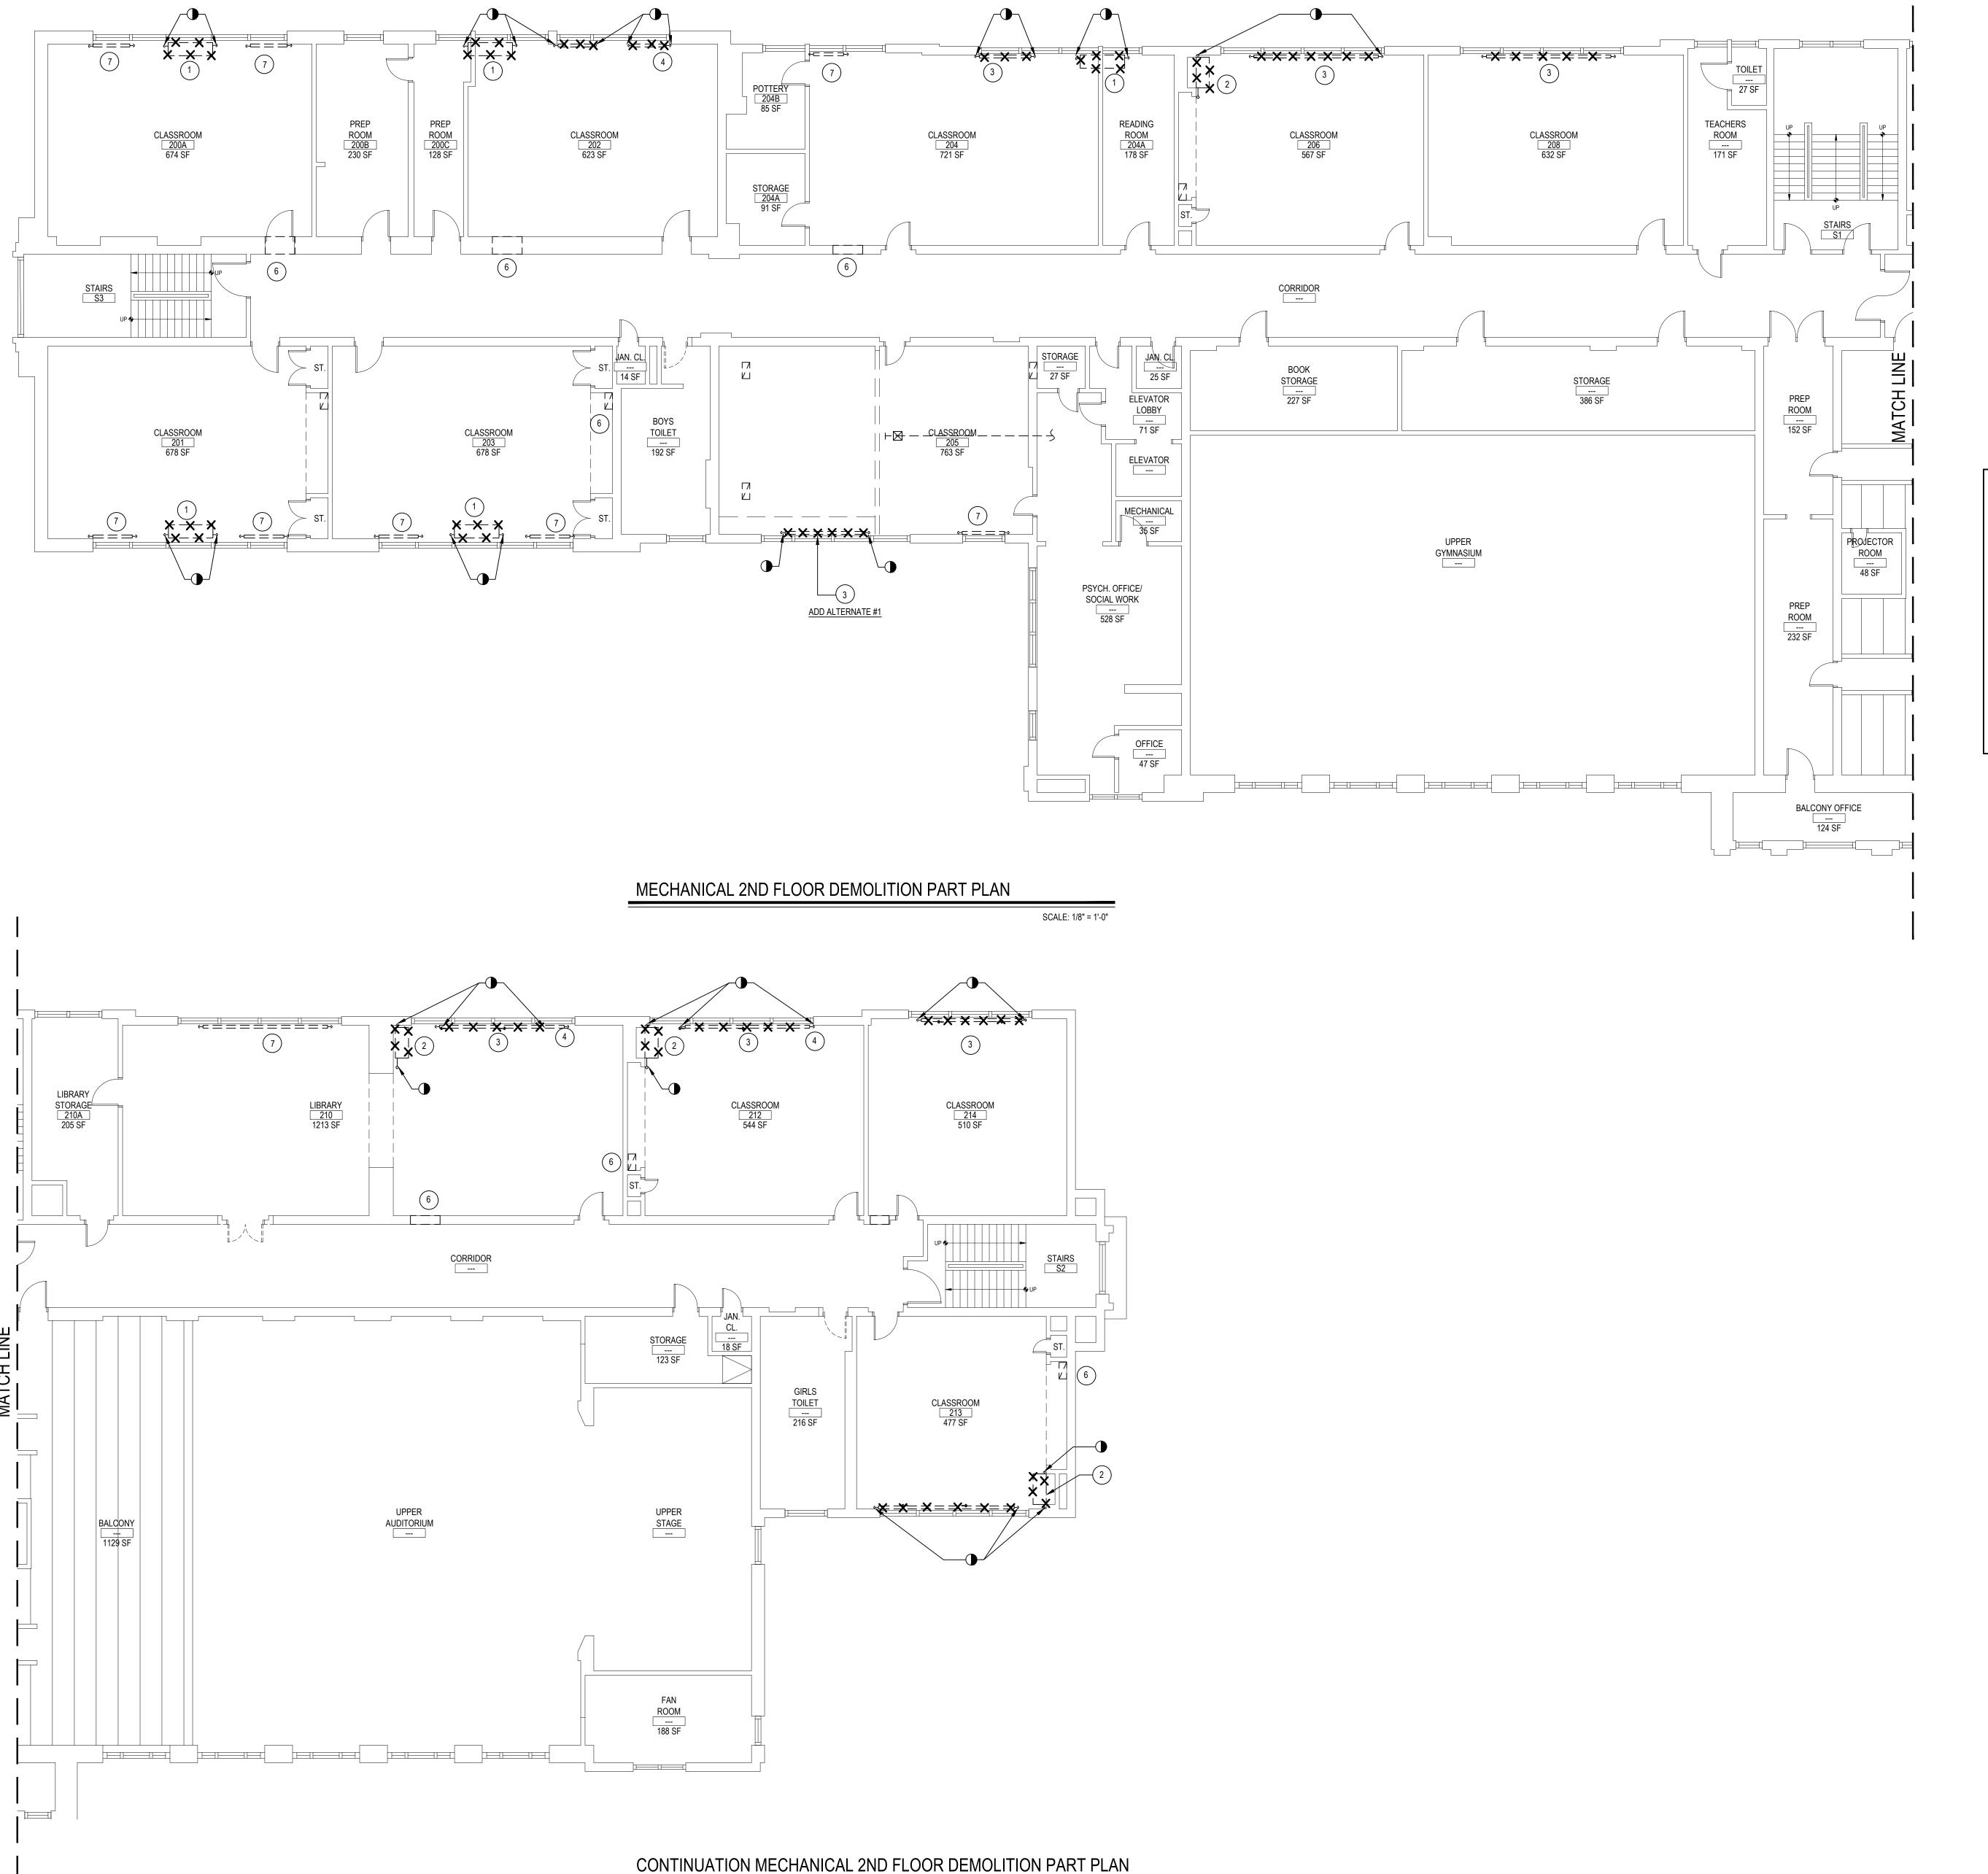

SCALE: 1/8" = 1'-0"

NOTES:

- MC. TO SHUT-OFF STEAM PIPING , DISCONNECT EXISTING UV AND CAP PIPING  $^{
  m \prime}$  BACK TO MAINS. MC TO REMOVE THE UV AND GC PATCH FLOOR /WALL( SEE GENERAL NOTES). MC TO REMOVE EXISTING OAI LOUVER AND REUSE EXISTING WALL OPENING FOR NEW LOUVER INSTALLATION. GC TO ENLARGE EXISTING OPENING IF NECESSARY TO ACCOMMODATE NEW LOUVER INSTALLATIO. MC TO COORDINATE WORK WITH GC
  - MC. TO SHUT-OFF STEAM PIPING , DISCONNECT EXISTING UV AND CAP PIPING BACK TO THE MAINS. MC TO REMOVE THE UV AND GC PATCH CHASE WALL
  - MC. TO SHUT-OFF STEAM PIPING, DISCONNECT EXISTING STEAM RADIATOR AND CAP PIPING CLOSE TO MAINS. MC TO REMOVE THE RADIATOR AND GC TO PATCH FLOOR /WALL
  - GC TO REMOVE THE SHELF ADJACENT TO THE WINDOW SILL IN ORDER TO ALLOW PROPER FUNCTIONING OF THE NEW UV. GC TO COORDINATE WORK WITH MC
  - 5 NA
  - 6 EXISTING 24X10 EXHAUST GRILLE IN CLOSET OR WALL TO REMAIN. (TYP.)
  - 7 EXISTING STEAM CAST IRON RADIATOR TO REMAIN
  - 8 REMOVE SMALL WINDOW FAN IN EACH CLASSROOM WHERE NEW UV IS INSTALLED

#### MC CONTRACTOR NOTES:

- 1. MC TO FIELD VERIFY EXACT LOCATION OF EXISTING MAIN STEAM AND CONDENSATE PIPING.
- 2. MC TO TO SHUT-OFF & DISCONNECT STEAM AND CONDENSATE
- PIPING SERVING EXISTING UV/STEAM RADIATOR THAT WILL BE 3. ALL STEAM /CONDENSATE PIPING MODIFIED OR REUSED ARE TO
- BE CAPPED BACK TO THE MAINS. 4. MC TO REMOVE ALL EXISTING UNIT VENTILATORS/STEAM RADIATOR AS
- INDICATE ON DWG. G.C. TO PATCH CHASE WALL TO MATCH EXISTING
- 5. MC TO CORE DRILL EXISTING FLOOR SLAB TO ACCOMMODATE NEW PIPING WORK. G.C. TO PATCH FLOOR, MATCH EXISTING AND COORDINATE WITH M.C.
- 6. M.C. TO DRILL WALL IF NEW PENETRATION REQUIRED FOR NEW PIPING AND PATCH WALL

<u>NOTICE</u> THESE DRAWINGS ARE BASED ON CONSTRUCTION DRAWINGS NOT PREPARED BY BBS ARCHITECTS, LANDSCAPE ARCHITECTS AND ENGINEERS, PC. AND, THEREFORE, MAY NOT REPRESENT THE CONDITIONS AS CONSTRUCTED AT THE TIME. ALL EXISTING CONDITIONS SHOWN ARE REPRESENTED AS SUGGESTIVE INFORMATION AS THEY MAY NOT HAVE BEEN BUILT AND DETAILED PER THE ORIGINAL DOCUMENTS OR PER THE OWNER'S INFORMATION.

REV. DATE

KEY PLAN NOT TO SCALE

DRAWING BY: D.S.

CHECK BY: D.S. NOTICE THIS DRAWING, PREPARED FOR THE SPECIFIC PROJECT INDICATED IS AN INSTRUMENT OF SERVICE AND THE PROPERTY OF BBS ARCHITECTS, LANDSCAPE ARCHITECTS AND ENGINEERS, PC. INFRINGEMENT OR ANY USE OF THIS DRAWING FOR ANY OTHER PROJECT IS PROHIBITED. ANY ALTERATION OR REPRODUCTION OF THIS DOCUMENT IS ALSO PROHIBITED WITHOUT THE WRITTEN CONSENT OF THE ARCHITECT OR ENGINEER.

ARCHITECTS LANDSCAPE ARCHITECTS

ENGINEERS 244 EAST MAIN STREET | 187 WOLF ROAD, STE. 20 PATCHOGUE | ALBANY NEW YORK 11772 NEW YORK 12205 T. 631.475.0349 T. 518.621.7650 F. 631.475.0361 F. 518.621.7655

www.BBSARCHITECTURE.com


66-04-07-06-0-005-012 DISTRICT GREENBURGH CSD PROJECT PH. I - DW CAP. IMPROVEMENTS

R.J. BAILEY E.S. DWG TITLE MECHANICAL 2ND FLOOR DEMOLITION PLAN

BID PICK-UP: MAY 27, 2022

SCALE: AS NOTED

FILE No: 21-290 M3.01C | OF - - -

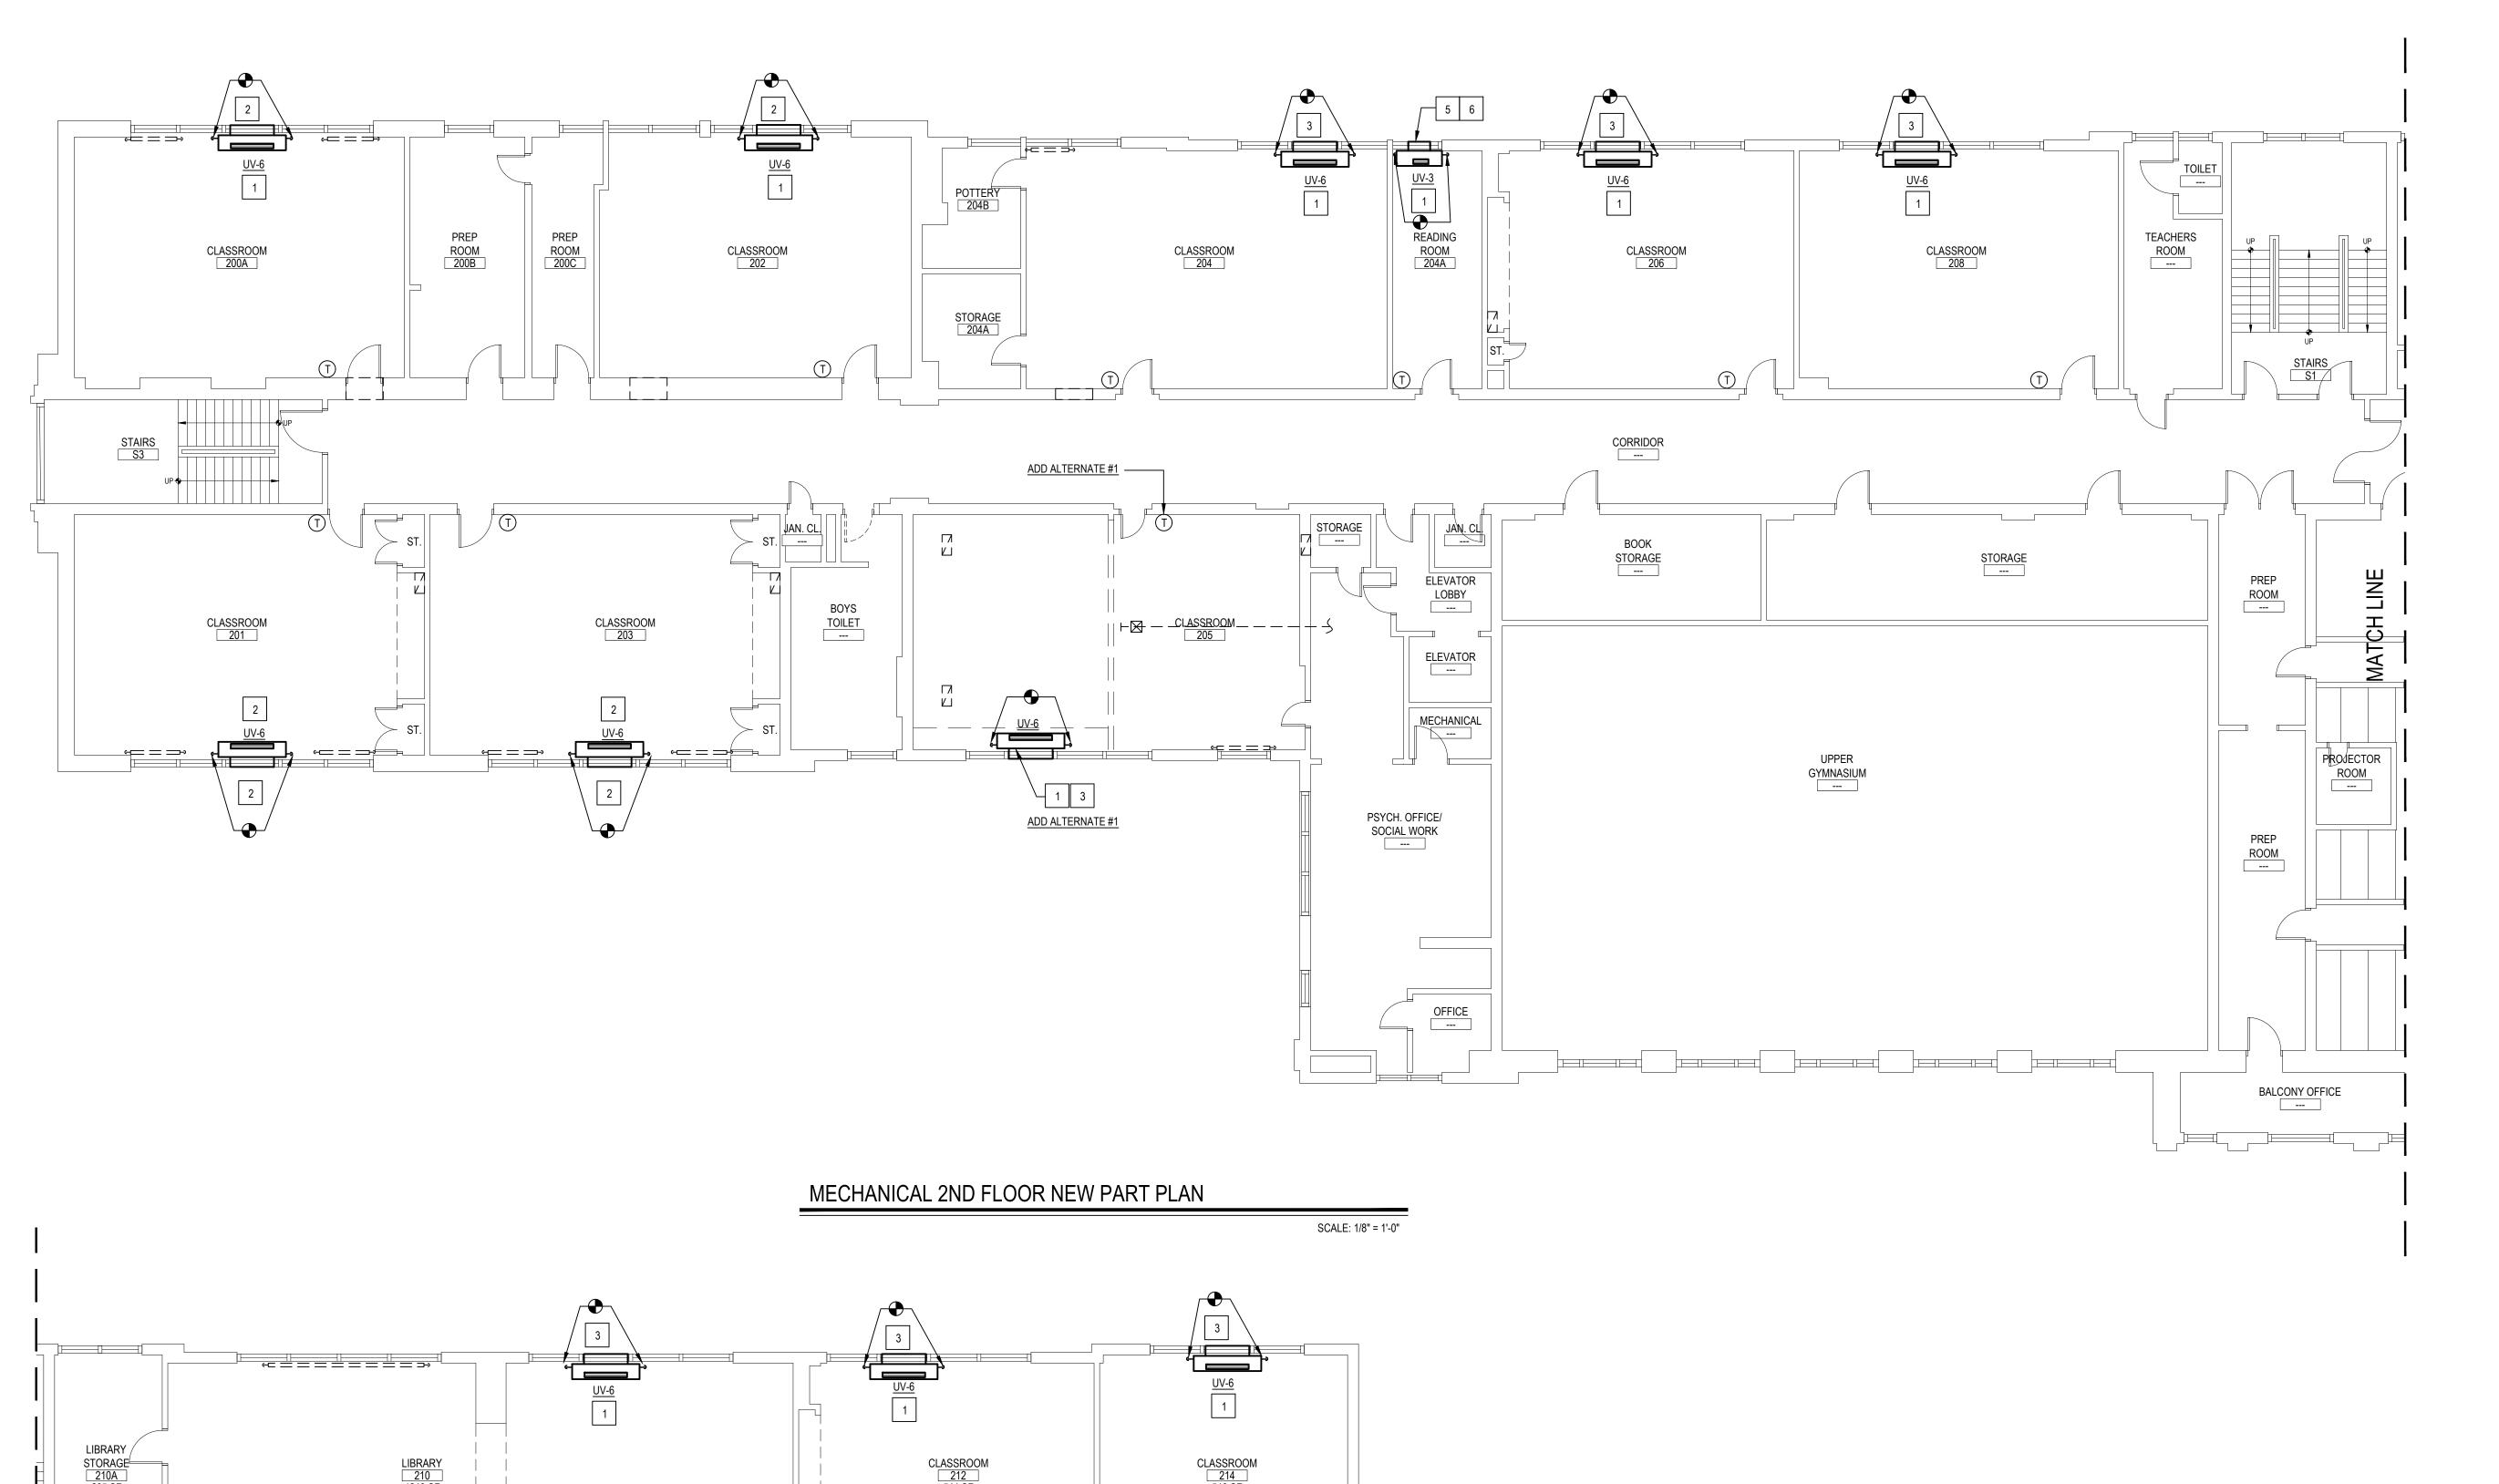

STORAGE ---123 SF

UPPER STAGE

UPPER AUDITORIUM

GIRLS TOILET ---216 SF

CONTINUATION MECHANICAL 2ND FLOOR NEW PART PLAN


- CONNECT NEW 2" STEAM PIPING &1-1/2" CONDENSATE PIPE FROM THE NEW UV STEAM COIL TO EXISTING MAIN PIPING. VERIFY IN FILED EXACT STEAM MAIN PIPING LOCATION. WHERE PIPING RUNS UNDER THE FLOOR GC TO CORE DRILL THE FLOOR TO ACCOMMODATE NEW WORK. GC TO PATCH FLOOR, MATCH EXISTING AND COORDINATE WORK WITH MC. WHERE STEAM PIPING RUNS ABOVE HUNG CEILING, GC TO REPAIR THE CEILING AFTER WORK IS DONE.
- NEW 48X10 EXTERIOR OAI RAIN RESISTANT LOUVER BY UV 2 MANUFACTURER. MC TO REUSE EXISTING WALL OPENING GC TO ADJUST IT TO FIT NEW LOUVER. MC TO COORDINATE WORK WITH GC
- NEW 48X10 EXTERIOR OAI RAIN RESISTANT LOUVER BY UV MANUFACTURER. GC TO PENETRATE EXTERIOR WALL FOR NEW OPENING AND MC TO INSTALL LOUVER. MC TO COORDINATE WORK WITH GC
- MC TO COORDINATE WORK WITH EC. EC TO RELOCATE AND REWIRE ALL ELECTRICAL OUTLETS THAT INTERFERE WITH NEW UV LOCATION.
- NEW 24X10 EXTERIOR OAI RAIN RESISTANT LOUVER BY UV MANUFACTURER. GC TO PENETRATE EXTERIOR WALL FOR NEW OPENING AND MC TO INSTALL LOUVER. MC TO COORDINATE WORK WITH GC
- 6 NEW REILEF LOUVER INSTALLED IN THE EXISTING METAL WINDOW PAN, 24X16 GREENHECK, MODEL EHH-401, WITH RELIEF DAMPER MODEL BR-30. MC TO PROVIDE A DUCT SLEEVE TO MATE THE LOUVER AND THE DAMPER.
- 7 CONTROLS BY CONTROLS SUBCONTRACTOR UNDER CONTRACT TO MECHANICAL CONTRACTOR. SEE ATC SPECIFICATION FOR MORE

REV. DATE <u>NOTICE</u> THESE DRAWINGS ARE BASED ON CONSTRUCTION DRAWINGS NOT PREPARED BY BBS ARCHITECTS, LANDSCAPE ARCHITECTS AND ENGINEERS, PC. AND, THEREFORE, MAY NOT REPRESENT THE CONDITIONS AS CONSTRUCTED AT THE TIME. ALL EXISTING CONDITIONS SHOWN ARE REPRESENTED AS SUGGESTIVE INFORMATION AS THEY MAY NOT HAVE BEEN BUILT AND DETAILED PER THE ORIGINAL DOCUMENTS OR PER THE OWNER'S INFORMATION. KEY PLAN NOT TO SCALE CHECK BY: D.S. <u>NOTICE</u> THIS DRAWING, PREPARED FOR THE SPECIFIC PROJECT INDICATED IS AN INSTRUMENT OF SERVICE AND THE PROPERTY OF BBS ARCHITECTS, LANDSCAPE ARCHITECTS AND ENGINEERS, PC. INFRINGEMENT OR ANY USE OF THIS DRAWING FOR ANY OTHER PROJECT IS PROHIBITED. ANY ALTERATION OR REPRODUCTION OF THIS DOCUMENT IS ALSO PROHIBITED WITHOUT THE WRITTEN CONSENT OF THE ARCHITECT OR ENGINEER. ARCHITECTS

LANDSCAPE ARCHITECTS ENGINEERS

244 EAST MAIN STREET | 187 WOLF ROAD, STE. 201 PATCHOGUE | ALBANY NEW YORK 11772 NEW YORK 12205 T. 631.475.0349 T. 518.621.7650 F. 631.475.0361 F. 518.621.7655

www.BBSARCHITECTURE.com

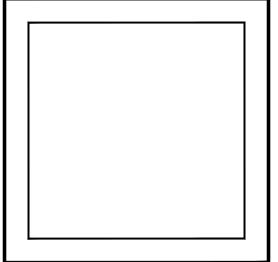

66-04-07-06-0-005-012


DISTRICT GREENBURGH CSD PROJECT PH. I - DW CAP. IMPROVEMENTS R.J. BAILEY E.S.


DWG TITLE MECHANICAL 2ND FLOOR **NEW PLAN** 

SCALE: AS NOTED BID PICK-UP: MAY 27, 2022 FILE No: 21-290

M3.02C | OF - - -

SCALE: 1/8" = 1'-0"

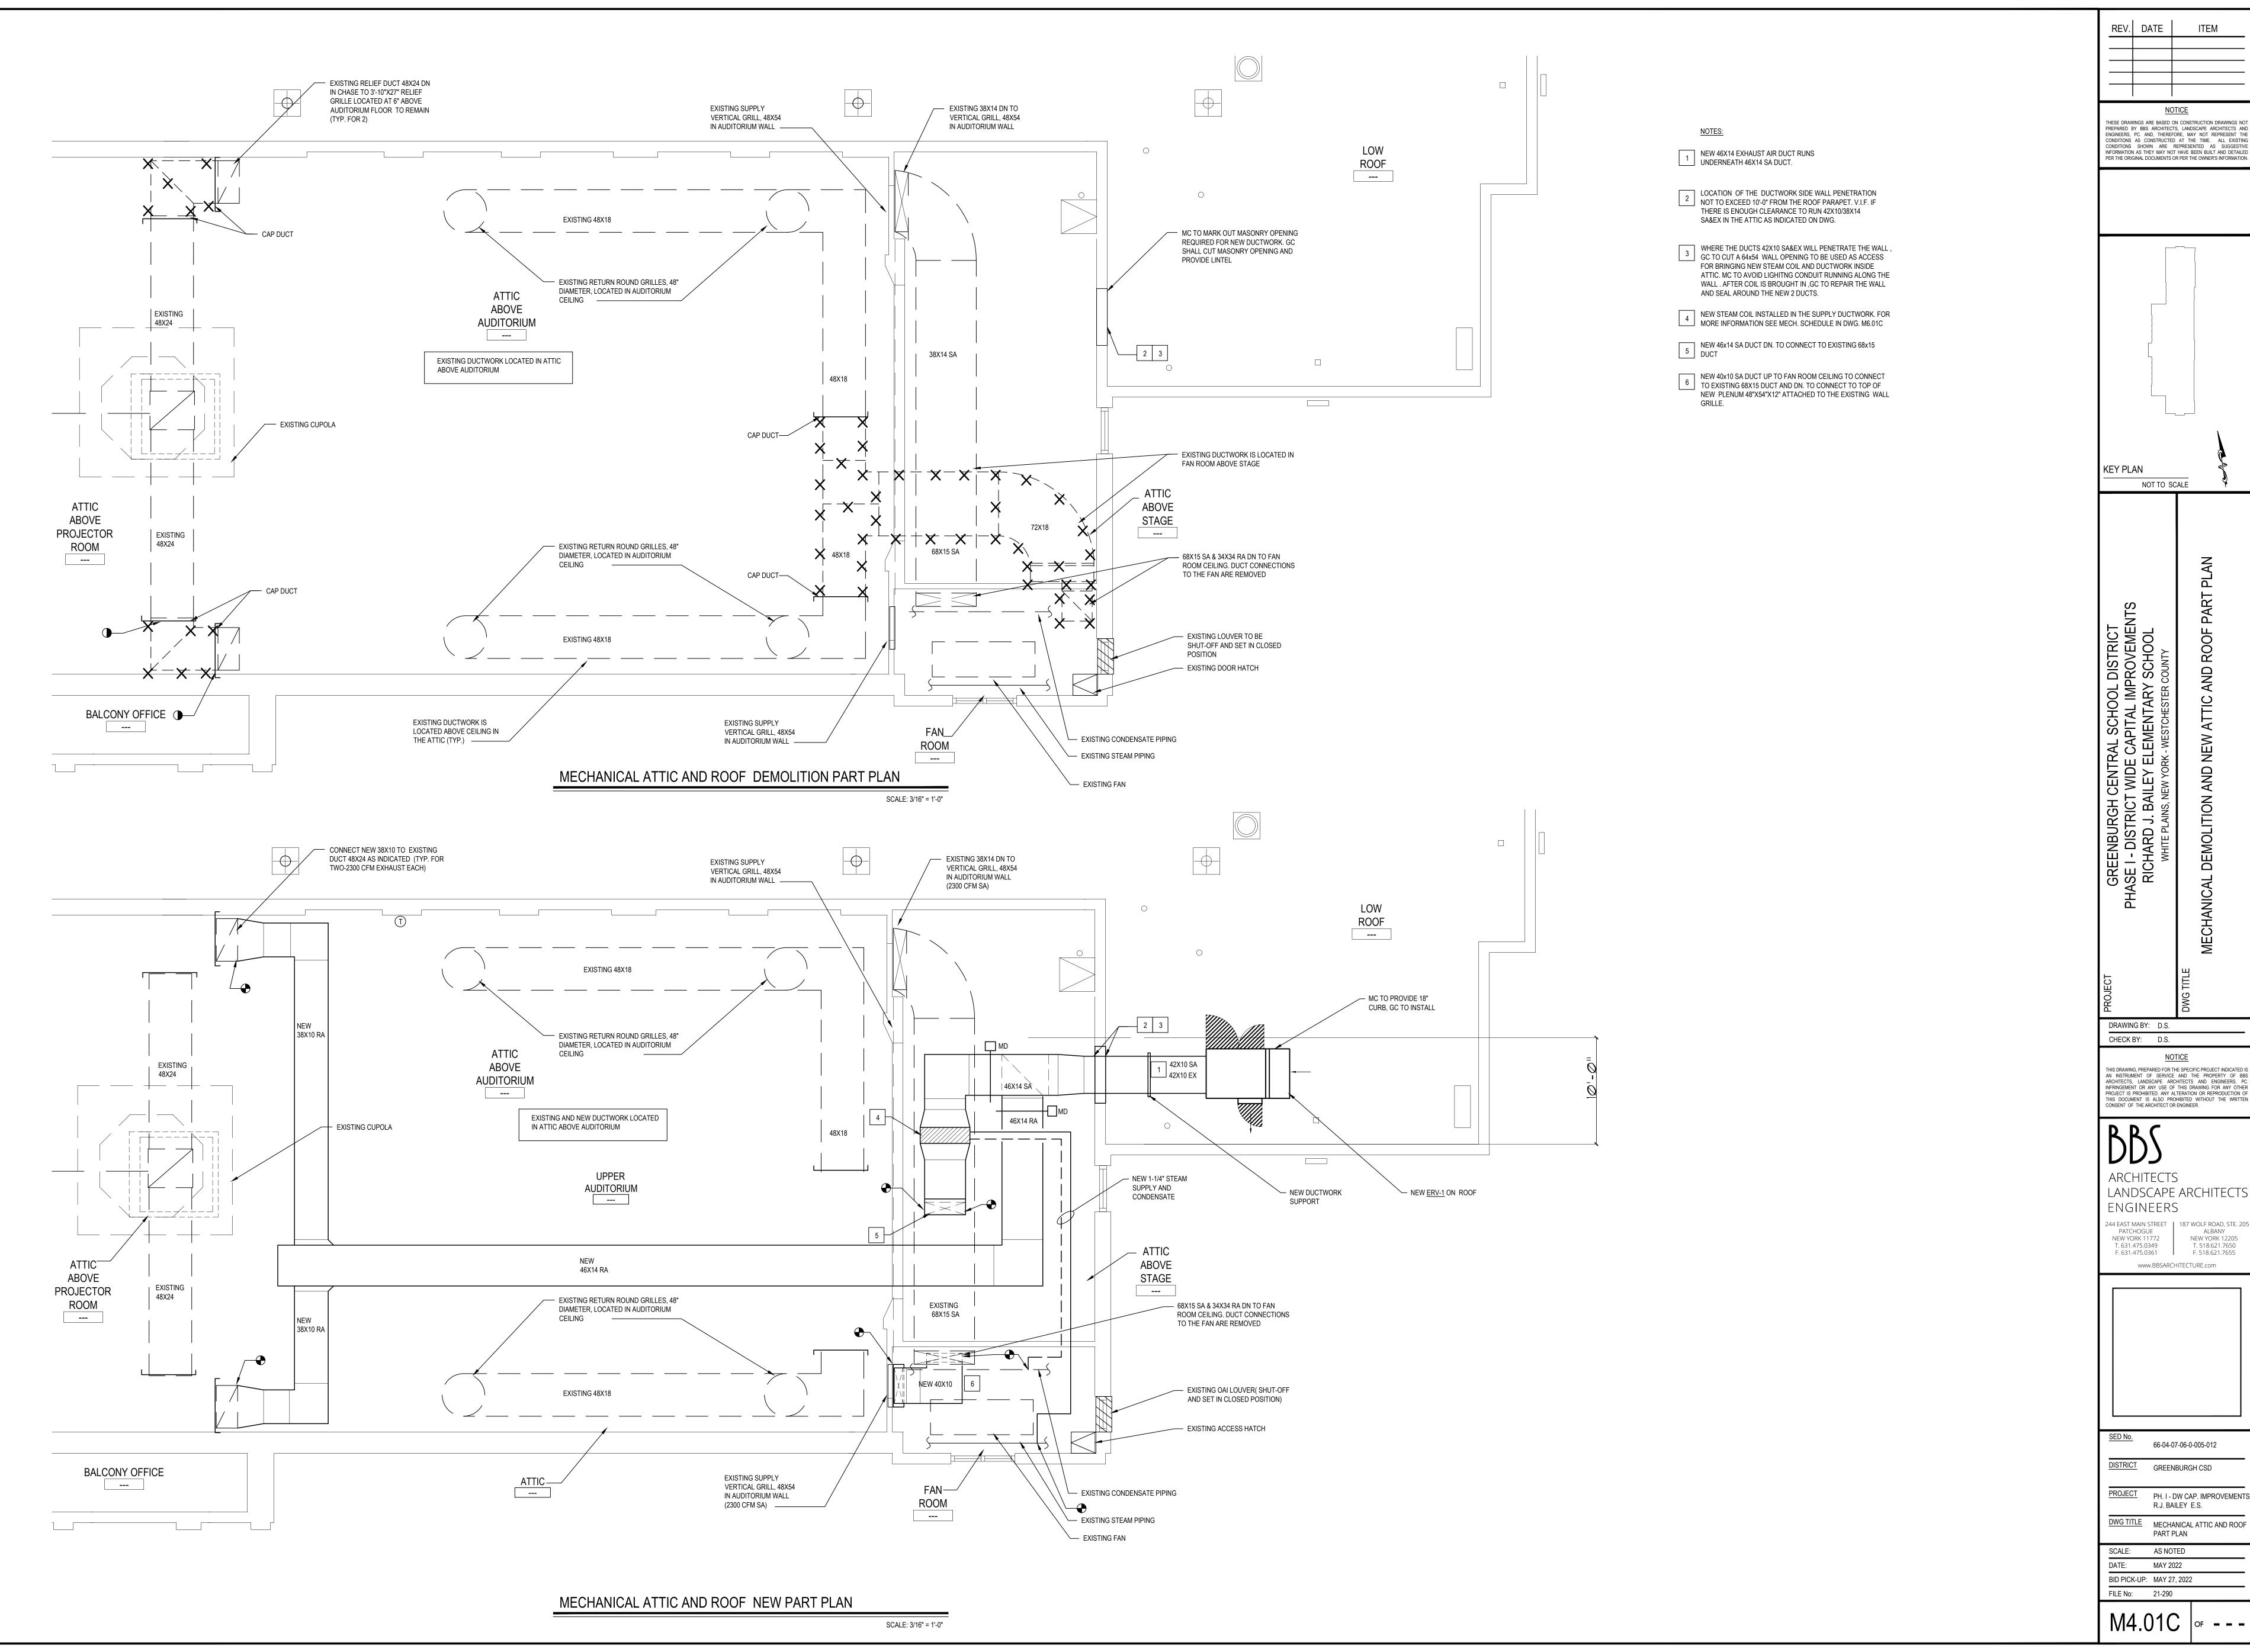


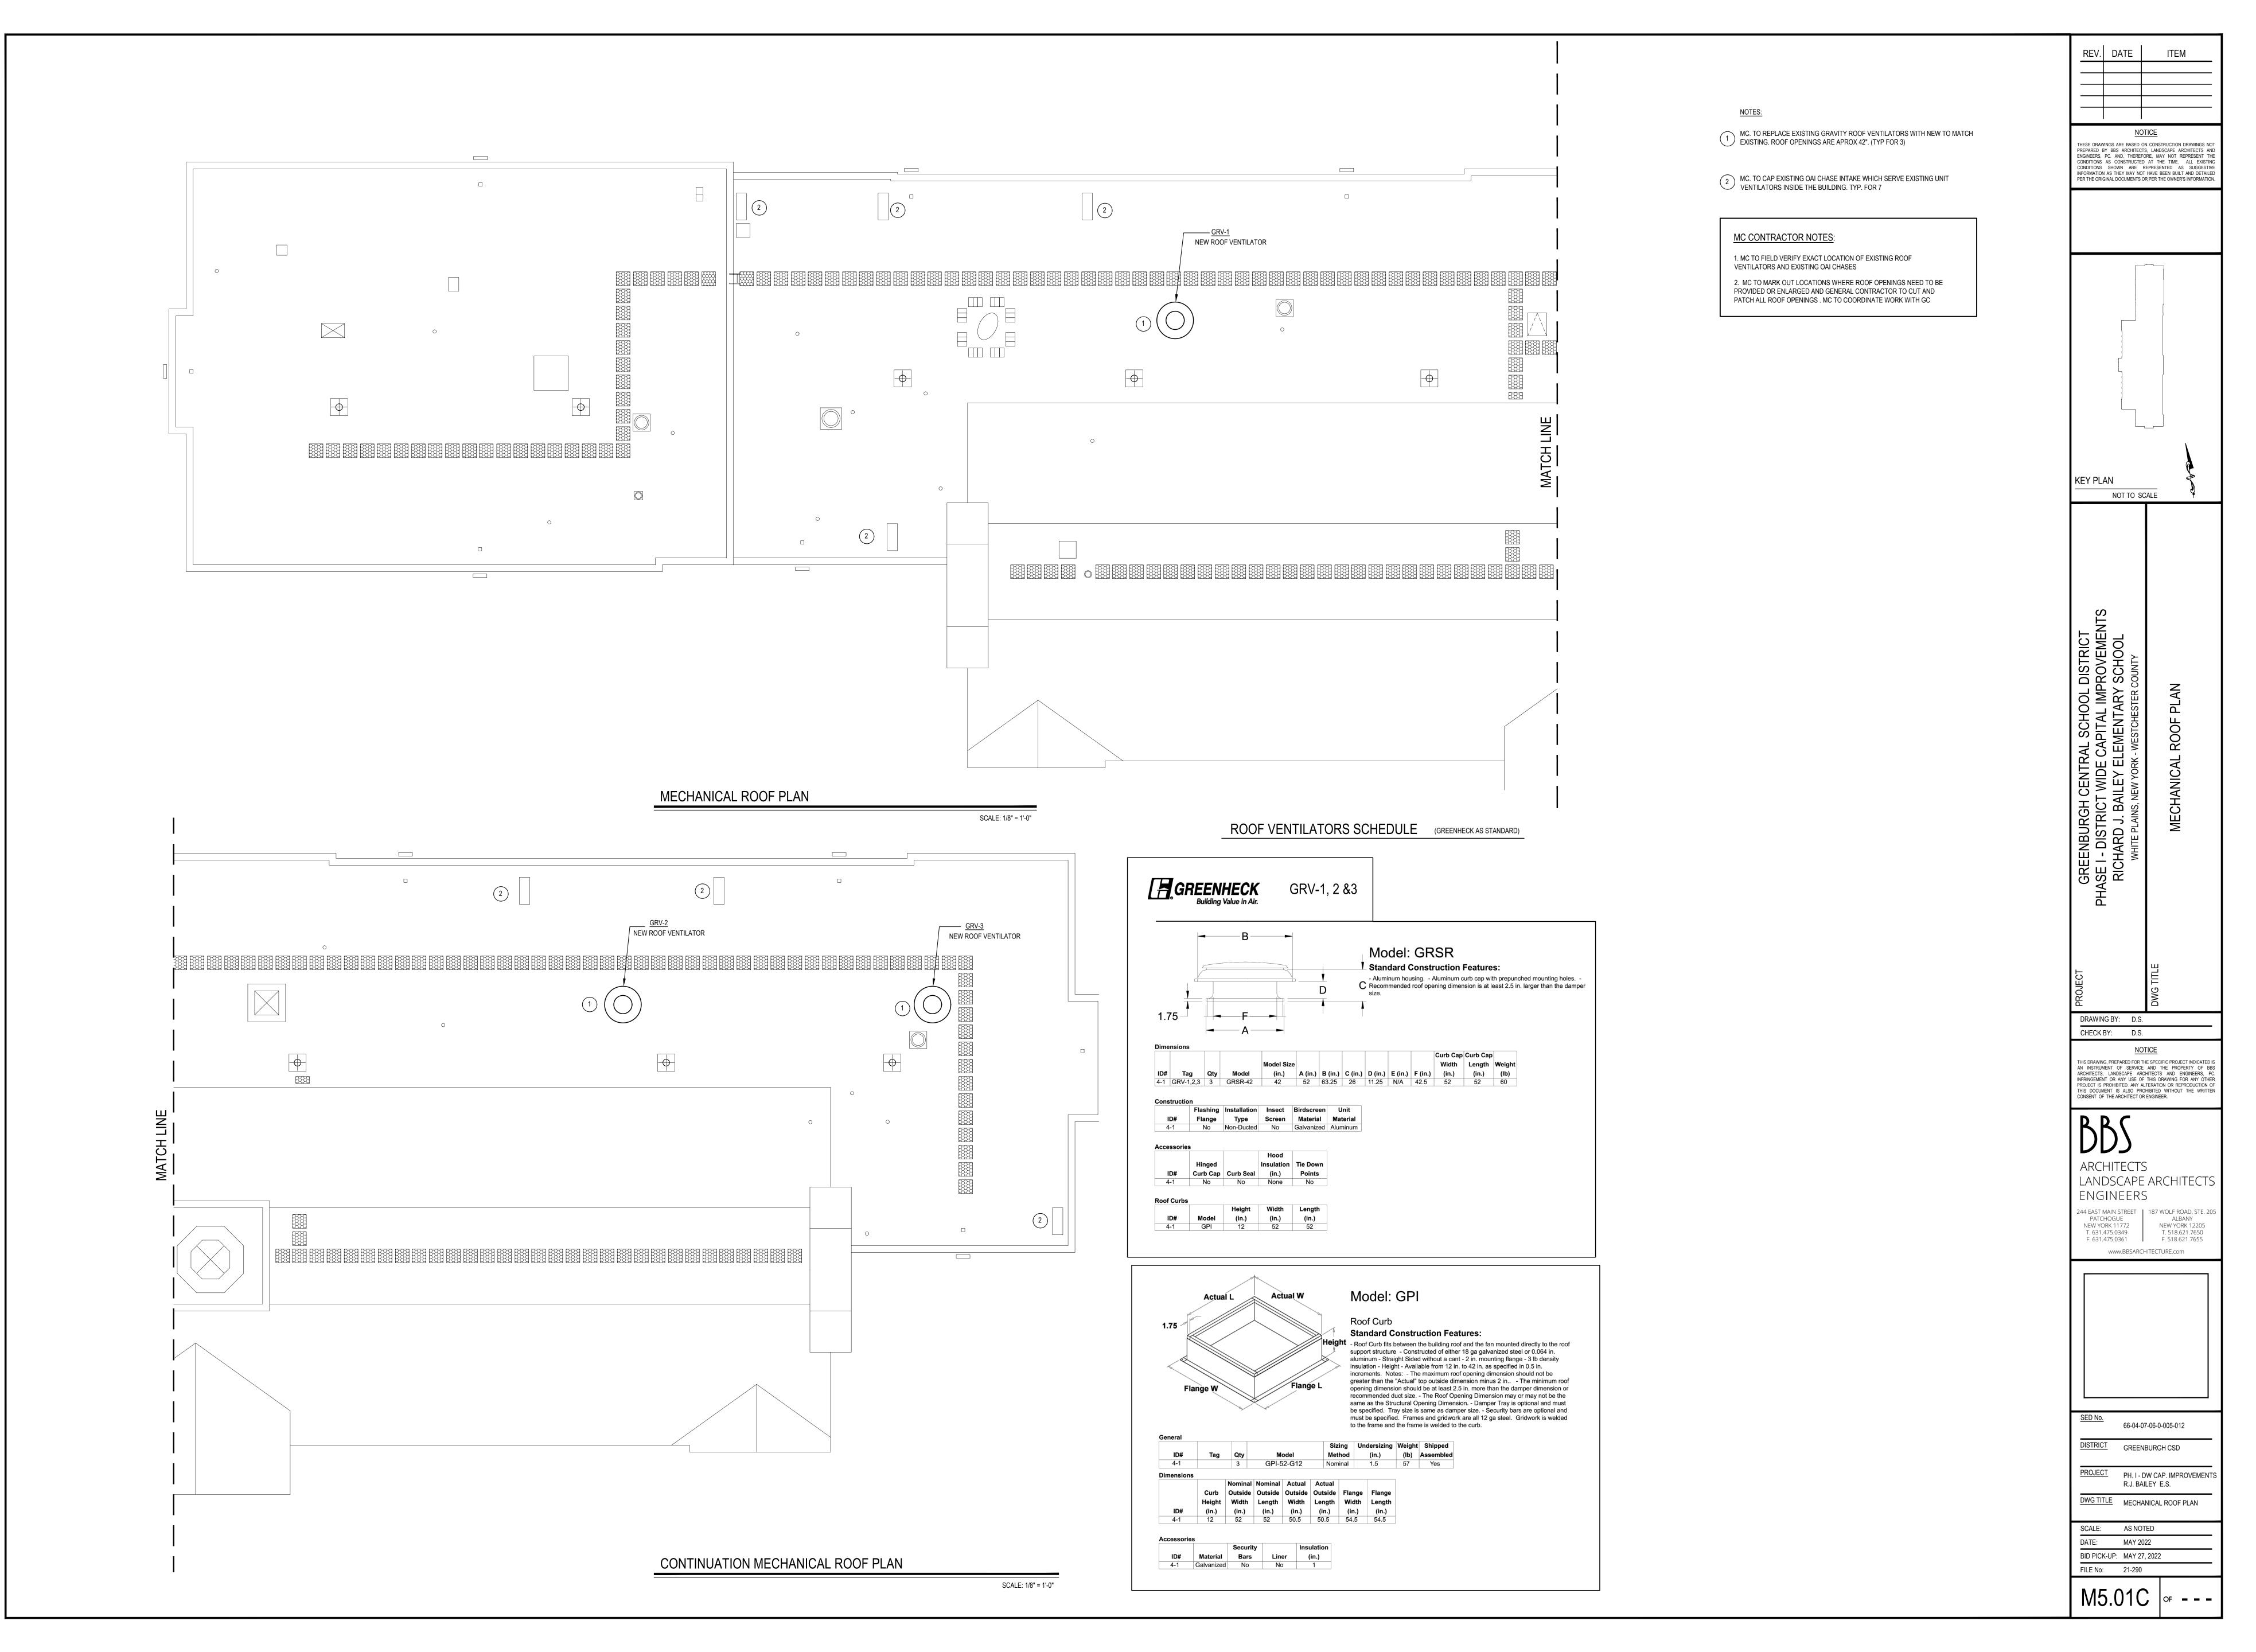


	TERMINAL UNIT SCHEDULE (MAGIC AIRE AS STANDARD)										
Tag No.	MFG. / MODEL #	CFM / E.S.P. OA DAMPER POS.	MO' HP	TOR (I FLA	ECM) MCA	ELECT. Req. VOLT / PHASE	HEATING COIL TYPE	HEAT OUTPUT / STEAM P.D.	CABINET TYPE	EXTERIOR LOUVER SIZE	COMMENTS/CONTROLS
<u>UV-1</u>	'MAGIC AIRE' UNIT VENTILATOR #MAUHF2	750 @ .01 45%	1/3	2.3	2.9			46.8 MBH @ 2PSIG	HORIZONTAL UH	34"x10"	
<u>UV-2</u>	'MAGIC AIRE' UNIT VENTILATOR #MAUHF3	1000 @ .01 45%	1/3	2.6	3.2			62 MBH @ 2PSIG	HORIZONTAL UH	48"x10"	REFER TO ATC SPECIFICATION SECTION 15903 FOR FURTHER DETAILS
<u>UV-3</u>	'MAGIC AIRE' UNIT VENTILATOR #MAUVF1	500 @ .01 45%	1/3	1.3	1.6	208V., 1 PH.	STEAM 1 COIL ROW	37 MBH @ 2PSIG	VERTICAL UV	24"x10"	REGARDING UNIT TEMPERATURE CONTROLS. REFER TO DWGS. #M6.03 FOR PIPING / INSTALLATION DETAILS. PROVIDE NEW CLEAR ANODIZED
<u>UV-4</u>	'MAGIC AIRE' UNIT VENTILATOR #MAUVF4	1250 @ .01 45%	1/2	3.3	4.1			78 MBH @ 2PSIG	VERTICAL UV	NA	LOUVER.
<u>UV-5</u>	'MAGIC AIRE' UNIT VENTILATOR #MAUHF5	1500 @ .01 45%	1/2	3.3	4.1			93.6 MBH @ 2PSIG	HORIZONTAL UH	NA	CONTROLS SUBCONTRACTOR , UNDER CONTRACT TO MECHANICAL CONTRACTOR
<u>UV-6</u>	'MAGIC AIRE' UNIT VENTILATOR #MAUVF3	1000 @ .01 45%	1/3	2.6	3.2		-	62 MBH @ 2PSIG	VERTICAL UV	48"x10"	

1. - UNITS SHALL BE 21-7/8" DEEP UNITS. - UNITS ARE TO BE EQUIPPED WITH VALVE CONTROL FOR STEAM


-PROVIDE MERV 13 FILTERS

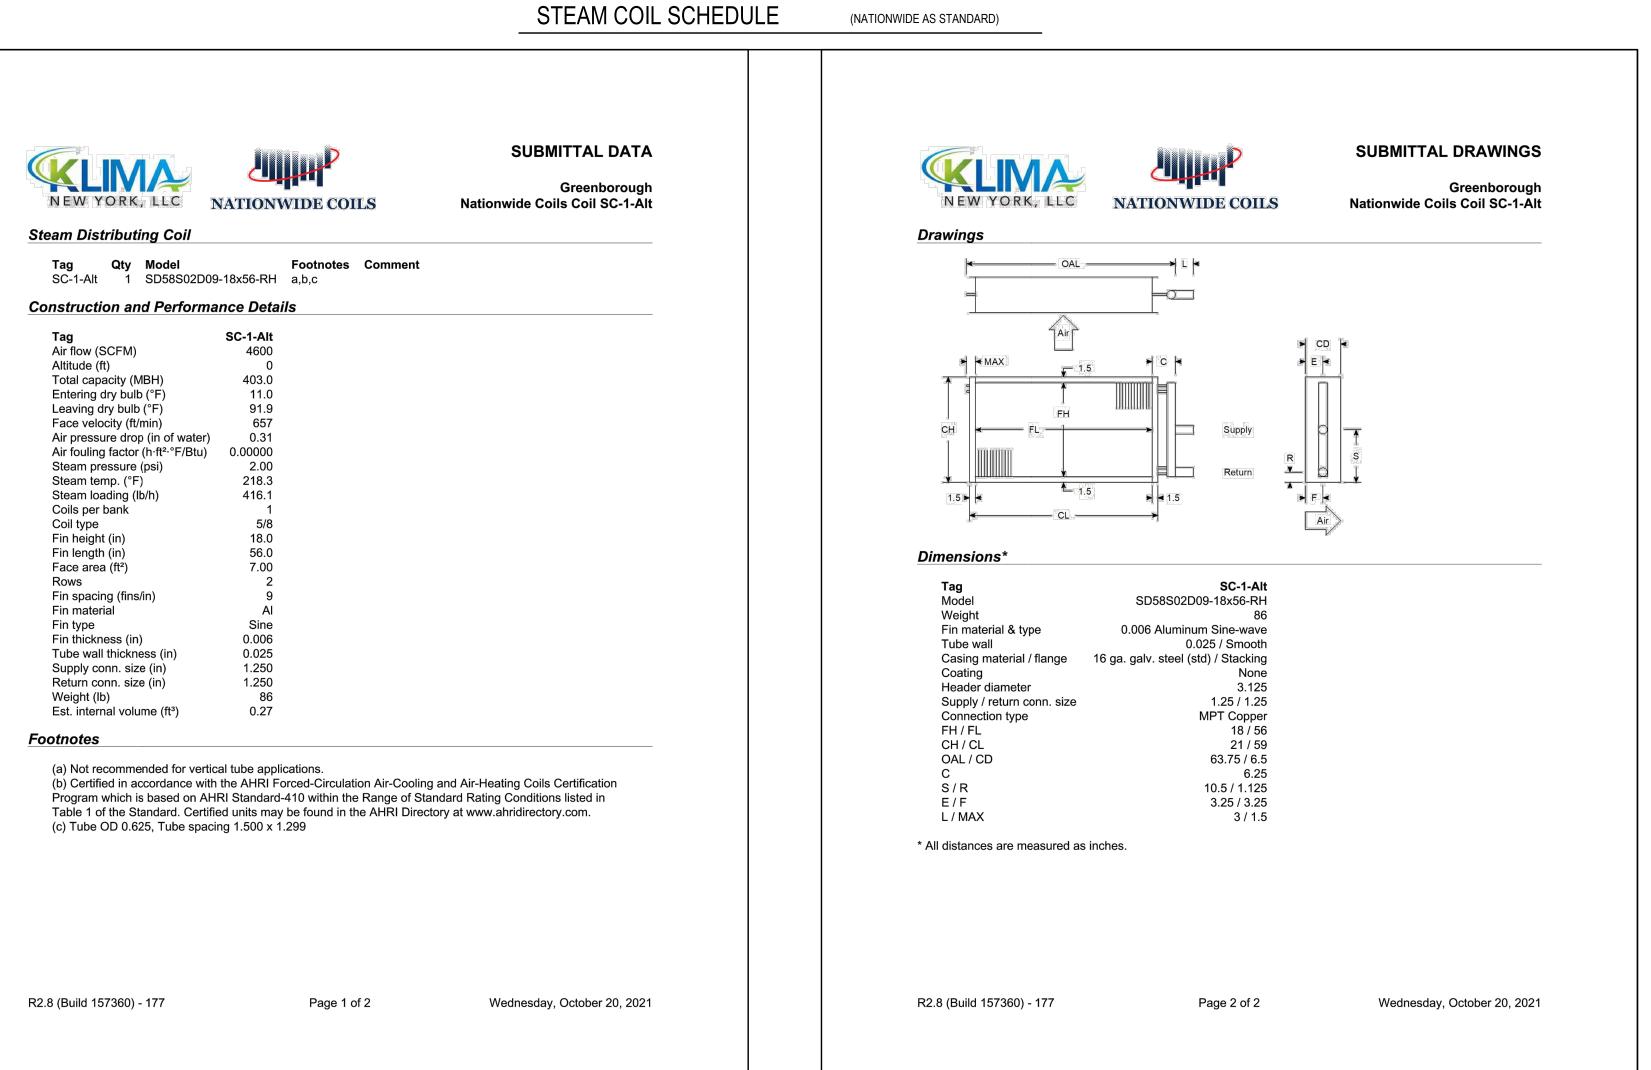

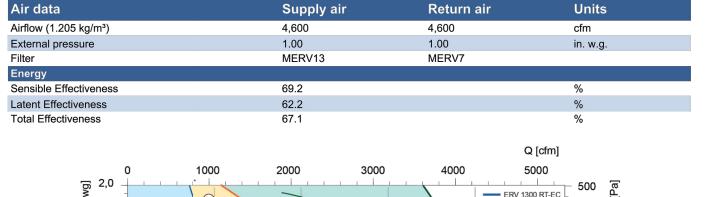


(SYSTEMAIR AS STANDARD)


**ERV SCHEDULE** 

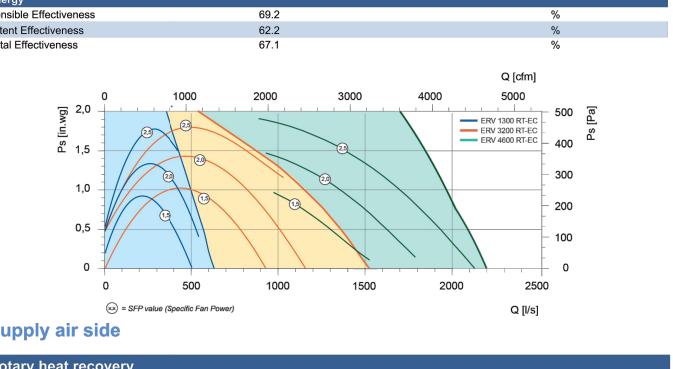


Supply air side				
Rotary heat recovery				
N	Model		N-E20-1197	
1	Note			
		Winter Conditions	Summer Conditions	
\ \	Supply airflow	4,462	4,717	cfm
E	Extract airflow	4,240	4,777	cfm
\ \ \ \ \ \ \ \ \ \ \ \ \ \ \ \ \ \ \	Transferred power	270.82	-98.12	MBtu
5	Supply temperature before/after	11.0 / 51.6	92.0 / 81.0	°F
S	Supply RH before/after	90 / 54	44 / 54	%
E	Extract temperature before/after	70.0 / 29.5	75.0 / 86.1	°F
E	Extract RH before/after	40 / 93	52 / 43	%
S	Sensible Effectiveness	69.2	64.9	%
L	atent Effectiveness	62.2	42.9	%
Т	Total Effectiveness	67.1	53.1	%
F	Rotor active	Yes	Yes	-


Total weight	1,400 lb
Ecodesign Heat recovery type	
Heat recovery type	Enthalpy
MCA	18.9
MOP	25

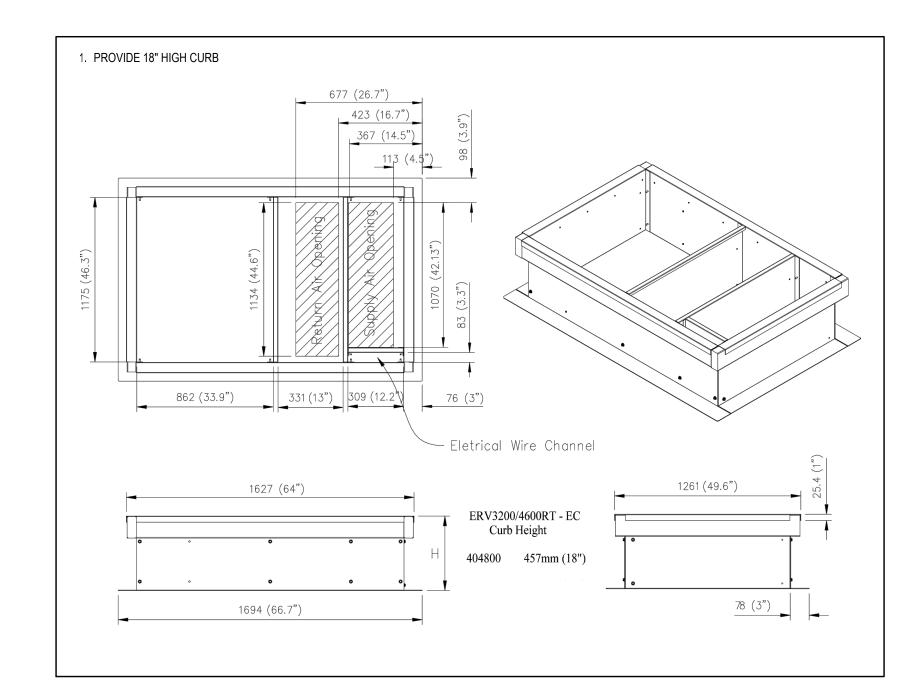

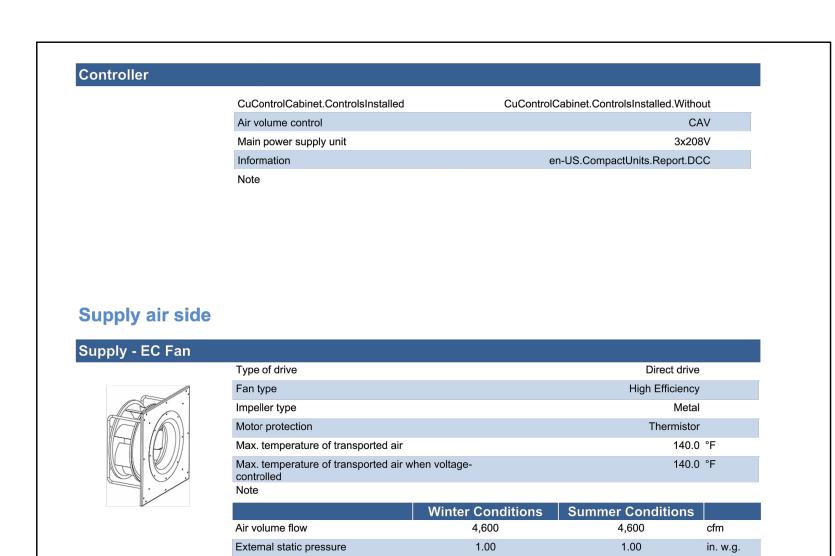


2.70

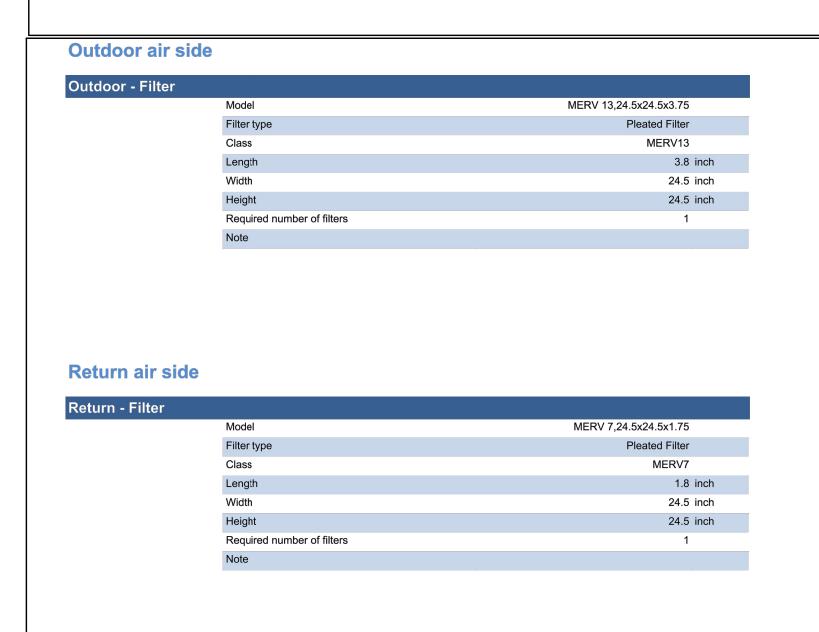

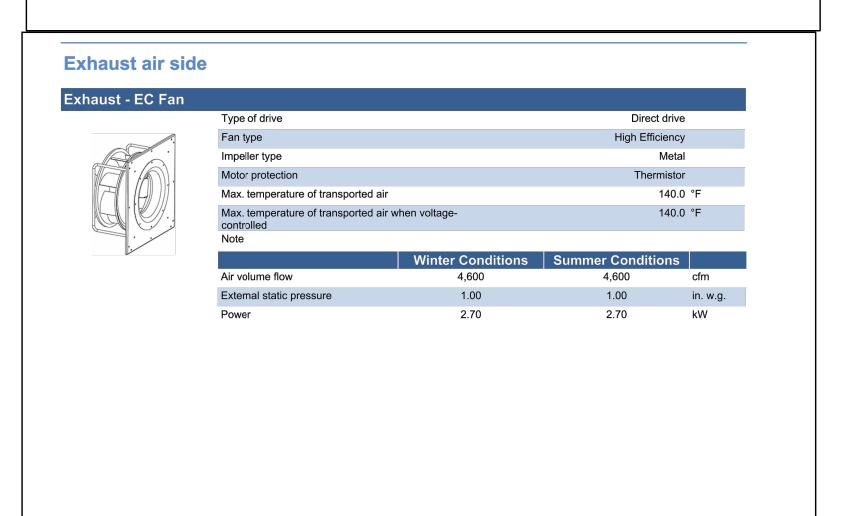

EV.	DATE	ITEM	

**NOTICE** THESE DRAWINGS ARE BASED ON CONSTRUCTION DRAWINGS NOT PREPARED BY BBS ARCHITECTS, LANDSCAPE ARCHITECTS AND ENGINEERS, PC. AND, THEREFORE, MAY NOT REPRESENT THE CONDITIONS AS CONSTRUCTED AT THE TIME. ALL EXISTIN CONDITIONS SHOWN ARE REPRESENTED AS SUGGESTIVE INFORMATION AS THEY MAY NOT HAVE BEEN BUILT AND DETAILED

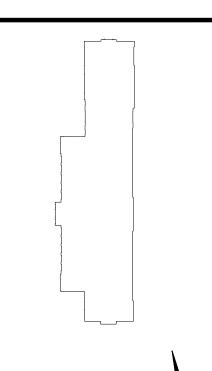

KEY PLAN NOT TO SCALE


DRAWING BY: D.S. CHECK BY: D.S.

THIS DRAWING, PREPARED FOR THE SPECIFIC PROJECT INDICATED IS AN INSTRUMENT OF SERVICE AND THE PROPERTY OF BBS ARCHITECTS, LANDSCAPE ARCHITECTS AND ENGINEERS, PC. INFRINGEMENT OR ANY USE OF THIS DRAWING FOR ANY OTHER PROJECT IS PROHIBITED. ANY ALTERATION OR REPRODUCTION OF THIS DOCUMENT IS ALSO PROHIBITED WITHOUT THE WRITTEN CONSENT OF THE ARCHITECT OR ENGINEER.

LANDSCAPE ARCHITECTS ENGINEERS 244 EAST MAIN STREET | 187 WOLF ROAD, STE. 201

NEW YORK 11772 NEW YORK 12205 F. 631.475.0361 F. 518.621.7655 www.BBSARCHITECTURE.com

PATCHOGUE

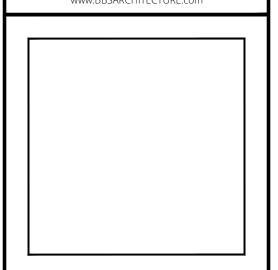

OLD NO.	66-04-07-06-0-005-012
DISTRICT	GREENBURGH CSD
PROJECT	PH. I - DW CAP. IMPROVEME


DWG TITLE MECHANICAL SCHEDULES SCALE: AS NOTED

DATE: MAY 2022

BID PICK-UP: MAY 27, 2022

FILE No: 21-290

M6.01C of

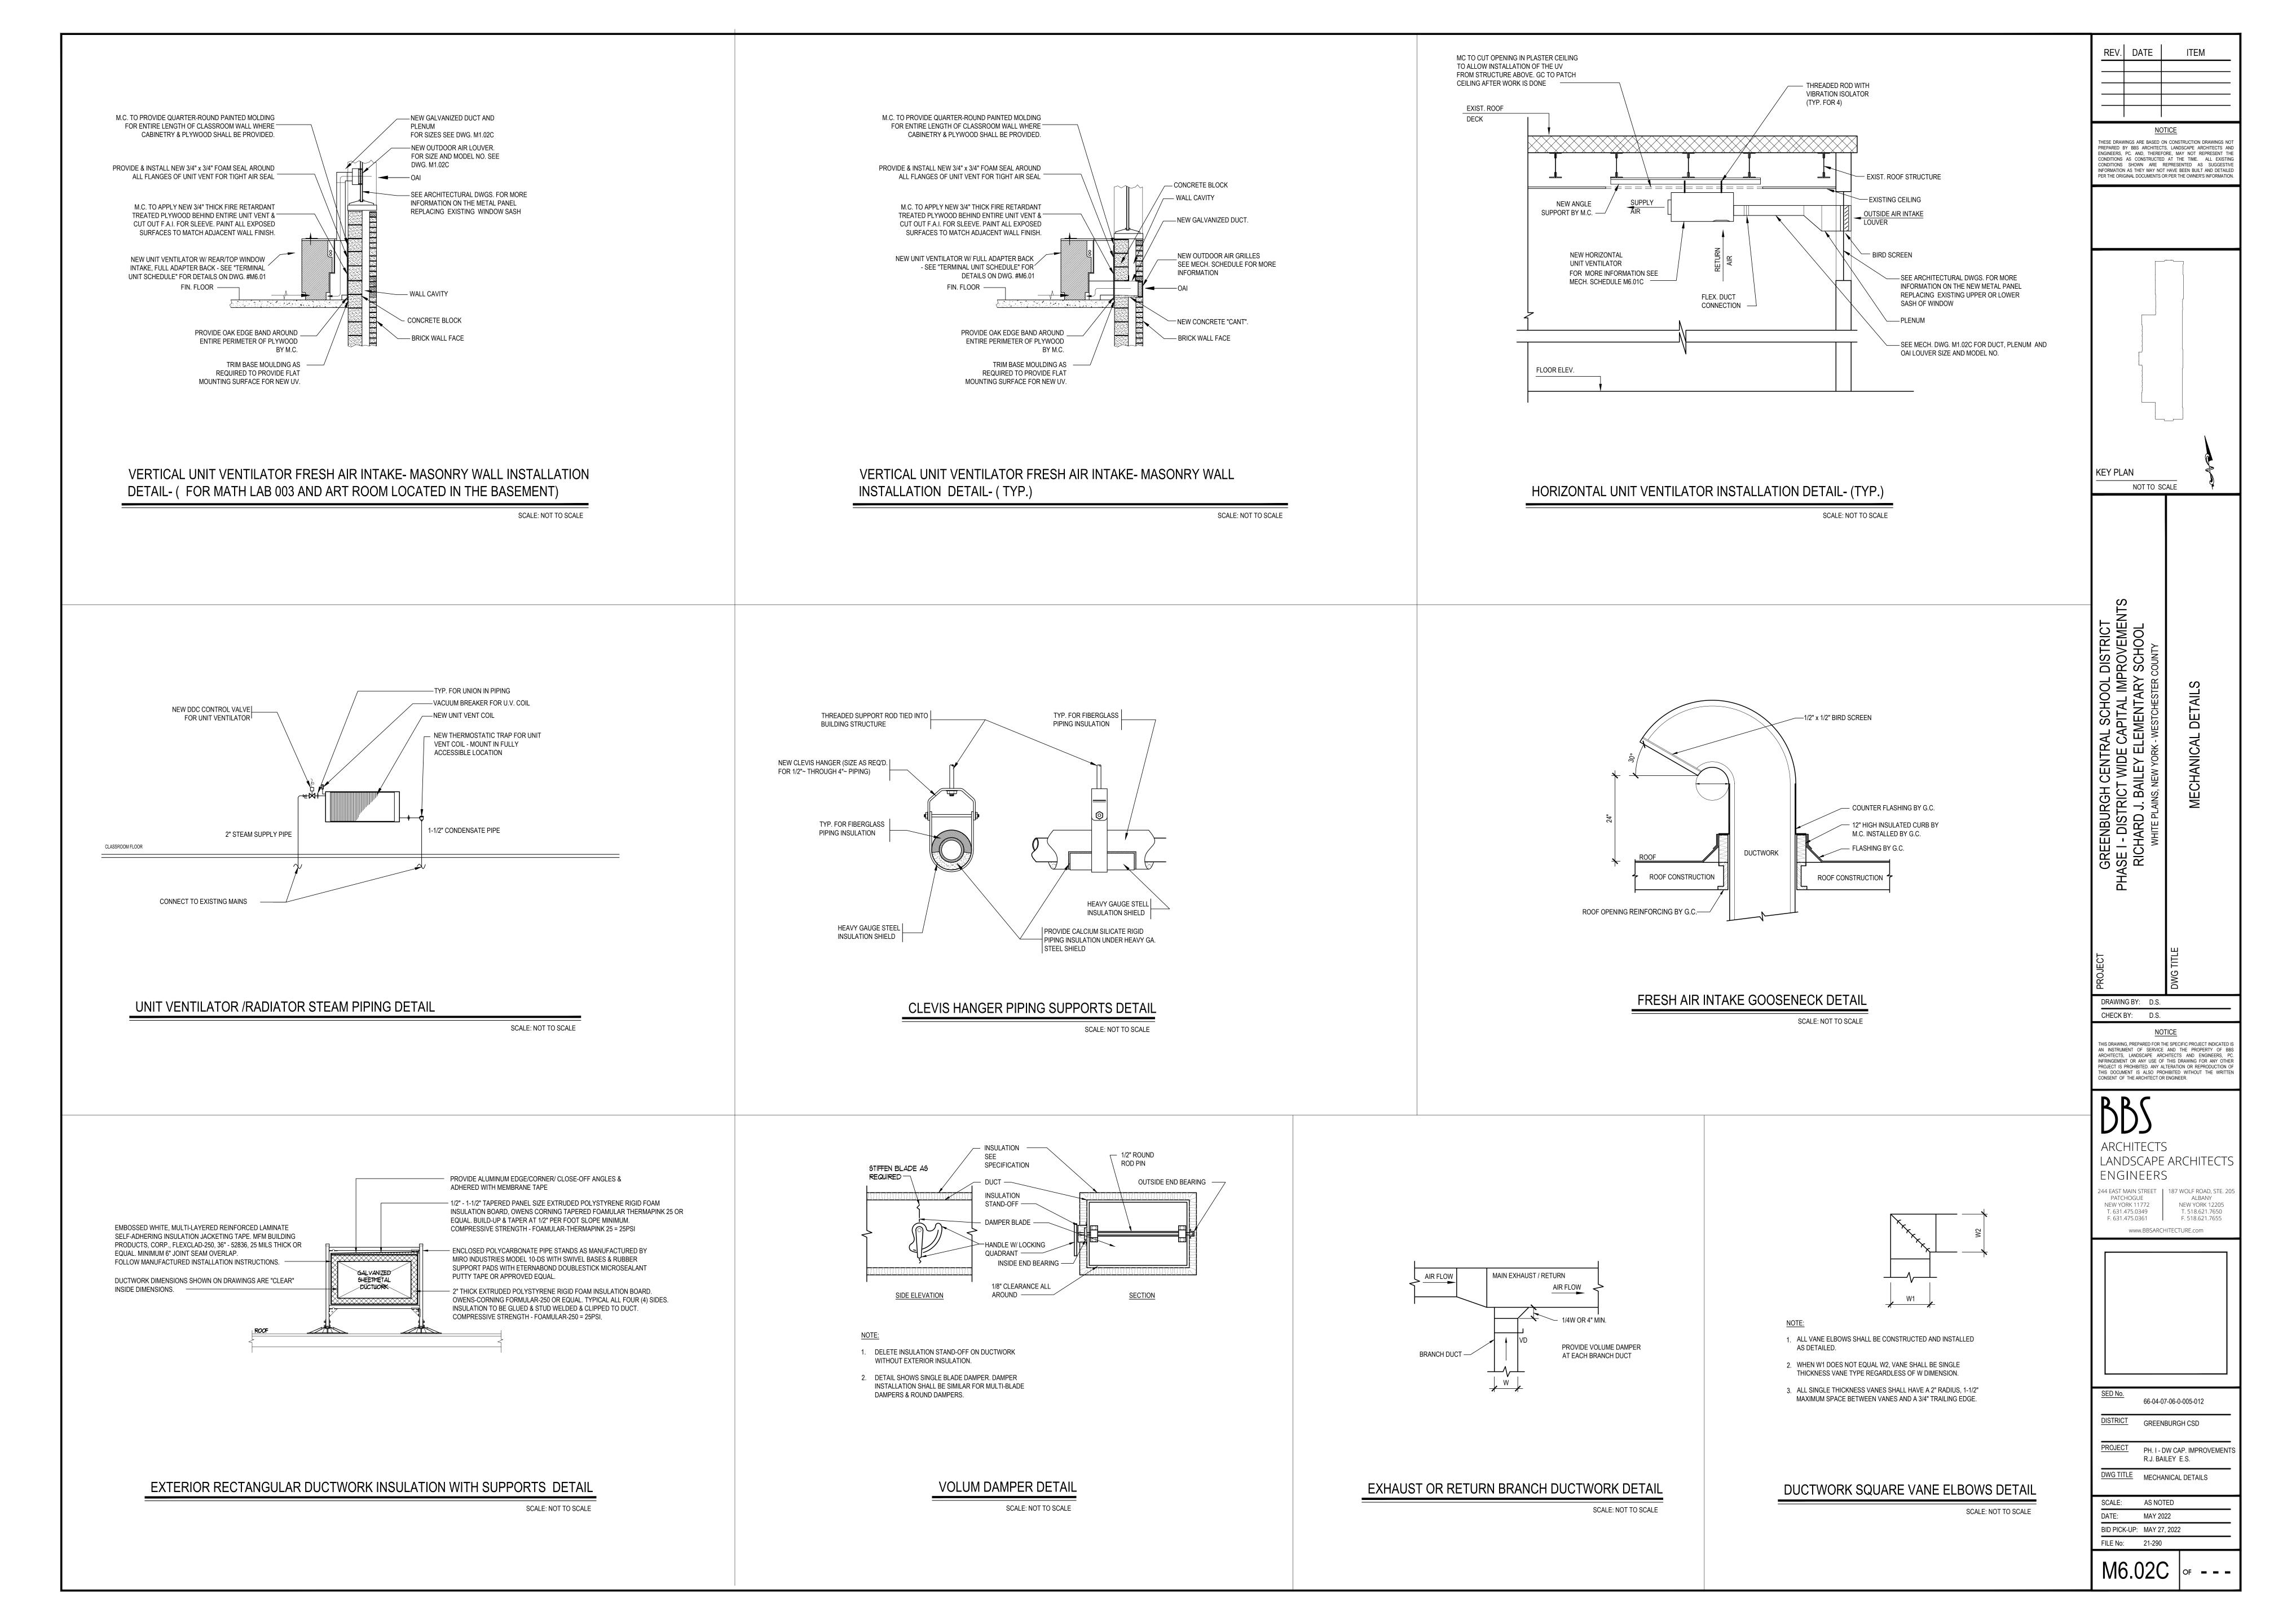

#### **GENERAL CONSTRUCTION NOTES**

1. ALL WORK SHALL BE DONE IN ACCORDANCE WITH THE 2017 EDITION OF THE NEC, APPLICABLE LOCAL CODES, STATE CODES, SCHOOL WORKING RULES AND SCHEDULE DIRECTIVES, AND THE ENGINEER'S SPECIFICATIONS.

2. THE VOLTAGE CHARACTERISTIC OF THIS SCHOOL IS 120/208VAC, 4 WIRE, 3PH, GROUNDED NEUTRAL, WYE. ALL EQUIPMENT SHALL BE COMPATIBLE WITH THESE CHARACTERISTICS.

3. THE DRAWINGS SHOW SCHEMATICALLY, THE APPROXIMATE LOCATION OF ALL EQUIPMENT, CONDUITS, DEVICES, ETC. THE EXACT LOCATION OF WHICH SHALL BE SUBJECT TO APPROVAL BY THE ARCHITECT/OWNER WHO RESERVES THE RIGHT TO MAKE PRIOR TO INSTALLATION, ANY REASONABLE CHANGES IN LOCATION INDICATED WITHOUT EXTRA COST TO THE OWNER. CONTRACTOR SHALL VERIFY ALL INDICATED OR APPROXIMATED DIMENSIONS DRAWN OR DENOTED.

4. DIVISION 16 CONTRACTOR SHALL EXAMINE THE SITE TO VERIFY WORK TO BE PERFORMED AS SHOWN ON DRAWINGS AND SPECIFICATIONS BEFORE SUBMITTING HIS BID. ANY DISCREPANCY BETWEEN DRAWINGS/SPECIFICATIONS AND ACTUAL FIELD CONDITIONS SHALL BE BROUGHT TO ARCHITECT/ENGINEERS ATTENTION BEFORE BID SUBMITTAL. ANY FIELD CONDITION FOUND AFTER BID APPROVAL WHICH HAMPERS AND/OR PREVENTS ANY WORK TO BE PERFORMED AS SHOWN ON DRAWINGS AND SPECIFICATIONS SHALL BE THE RESPONSIBILITY OF THE DIVISION 16 CONTRACTOR. THE DIVISION 16 CONTRACTOR SHALL BID THE HIGHER SPECIFICATION FOR ANY DISCREPANCY BETWEEN DRAWINGS AND SPECIFICATIONS.

5. DIVISION 16 CONTRACTOR SHALL PROVIDE ALL LABOR SERVICE MATERIALS, EQUIPMENT, AND RELATED ITEMS TO COMPLETE THE WORK OF THIS DIVISION, AS REQUIRED BY THE NATIONAL ELECTRIC CODE, AND ALL STATE AND LOCAL AUTHORITIES HAVING JURISDICTION.

6. DIVISION 16 CONTRACTOR SHALL PROVIDE ALL ELECTRICAL HARDWARE SHOWN ON THESE DRAWINGS AND RELATED DETAIL MATERIALS NOT SPECIFICALLY SHOWN OR SPECIFIED. ALL NEW ELECTRICAL MATERIAL AND EQUIPMENT SHALL CONFORM TO THE STANDARDS AND BEAR THE INSPECTION LABEL OF THE UNDERWRITERS LABORATORIES AND SHALL BE APPROVED FOR USE BY ALL LOCAL AUTHORITIES HAVING JURISDICTION.

7. THE DIVISION 16 CONTRACTOR SHALL REFER TO ALL OTHER DRAWINGS IN BID PACKAGE AND PERFORM THE WORK (INCLUDE IN HIS BID) INDICATED AS ELECTRICAL CONTRACTOR (E.C.) WORK. CONTRACTOR TO COORDINATE ALL LOCATIONS WITH GENERAL CONTRACTOR AND OTHER TRADES.

8. ELECTRICAL CONTRACTOR SHALL COORDINATE WITH THE MECHANICAL CONTRACTOR FOR ALL MECHANICAL EQUIPMENT REQUIRING ELECTRICAL POWER. THE EC IS RESPONSIBLE TO INSTALL ALL MOTOR STARTERS AND ASSOCIATED POWER WIRING. THE LOCATIONS OF MOTOR STARTERS SHALL BE DETERMINED BY THE CONTRACTOR IN THE FIELD AND SUBMITTED TO THE ENGINEER FOR APPROVAL UNLESS IT IS SPECIFIED ON THE DRAWINGS. THE EC SHALL REFER TO THE MECHANICAL EQUIPMENT SCHEDULES & NOTES AND INCLUDE IN HIS BID PRICE ALL ELECTRICAL WORK ASSOCIATED WITH THEIR INSTALLATION, AND THE REMOVAL OF ANY STARTERS/DISCONNECTS NO LONGER REQUIRED.

9. ALL WORK SHALL BE IN ACCORDANCE WITH MANUFACTURER'S RECOMMENDATIONS AND DIRECTIVES OF THE

10. ALL ELECTRICAL WORK SHALL BE PERFORMED BY A LICENSED ELECTRICAL CONTRACTOR WHO SHALL OBTAIN AN APPROVED ELECTRICAL INSPECTION CERTIFICATE FROM THE LOCAL AHJ AND PAY ASSOCIATED FEE. SUBMIT A PHOTOCOPY OF THIS CERTIFICATE TO THE ENGINEER WITH FINAL PAYMENT APPLICATION. SUBMIT A COPY OF THIS CERTIFICATE TO THE OWNER.

11. DIVISION 16 CONTRACTOR SHALL GUARANTEE ALL MATERIALS AND THEIR INSTALLATION TO BE FREE OF DEFECTS FOR A PERIOD AS DEFINED IN THE PROJECT MANUAL.

12. IF ADDITIONAL POLE POSITIONS ARE REQUIRED FOR NEW CIRCUITS IN EXISTING PANELS SERVICING RENOVATED AREAS, REMOVE (3) ADJACENT 1 POLE BREAKERS PROVIDE AND INSTALL 3P, 60A BREAKER FOR SUB FEED TO A SURFACE MOUNTED 100A, 3PH, 18 POLE SUB PANEL AND ESTABLISH OVERFLOW CIRCUITS IN NEW SUB PANEL, EACH WITH A 1P, 20A BREAKER. PROVIDE (3) 1P, 20A BREAKERS FOR DISCONNECTED CIRCUITS IN MAIN PANEL AND RECONNECT THEM IN SUB PANEL. SUB PANEL FEED TO BE 3#6 + 1#6(N) + 1#10(G) IN 1"C

13. IT IS EXPECTED THAT STRUCTURAL DEMOLITION BY THE GENERAL CONTRACTOR WILL CAUSE VARIOUS ELECTRIC SUPPLIES, OF VARIOUS VOLTAGES AND PURPOSES, TO BE CUT AND RENDER SOME DEVICES TEMPORARILY INACTIVE. IT IS THE ELECTRICAL CONTRACTOR'S RESPONSIBILITY TO RECONSTRUCT AND RECONNECT SUCH ELECTRIC SOURCES UPON COMPLETION. NOTE THAT MOST REINSTALLED ITEMS WILL BE IN DIFFERENT LOCATIONS FROM THE REMOVAL LOCATION. THE ELECTRICAL CONTRACTOR SHALL MAKE ALL REQUIRED CIRCUIT EXTENSIONS OR MODIFICATIONS TO PROVIDE SERVICE TO A REINSTALLED ITEM AS RELOCATED. NOTE THAT THIS REQUIREMENT ALSO APPLIES TO THE ROOMS AND ELECTRICAL ITEMS WITHIN THAT ARE NOMINALLY NOT IN CONTRACT. SUCH RESTORATION OF SERVICE, IF NEEDED, IS SPECIFICALLY IN THE ELECTRICAL CONTRACTOR'S CONTRACT.

14. THE ELECTRICAL CONTRACTOR SHALL PROVIDE TEMPORARY LIGHTING AND POWER TO ALL TRADES FOR THE DURATION OF THE PROJECT. SERVICE SHALL BE SUPPLIED TO CONTRACTOR'S CONSTRUCTION TRAILERS WHERE SUCH IS REQUESTED. USE THE EXISTING POWER PANELS FOR SUCH SUPPLY. POWER COSTS WILL BE PAID BY THE OWNER. ALL CONSTRUCTION POWER RECEPTACLES SHALL BE GFI PROTECTED.

15. IT SHALL BE THE ELECTRICAL CONTRACTOR'S RESPONSIBILITY TO PROTECT ALL ELECTRICAL DEVICES FROM DAMAGES DURING CONSTRUCTION. THIS INCLUDES DEVICES WHICH ARE EITHER INDICATED TO REMAIN, AND/OR TO BE REMOVED AND REINSTALLED THROUGHOUT ALL CONSTRUCTION AREAS. DEVICES SHALL INCLUDE BUT WILL NOT BE LIMITED TO: SMOKE DETECTORS, EMERGENCY LIGHTS, EXIT SIGNS, OCCUPANCY SENSORS, SPEAKERS, LIGHT FIXTURES, SWITCHES, RECEPTACLES, ETC. IN THE EVENT OF DAMAGES INCURRED DUE TO CONSTRUCTION ACTIVITIES, THE ELECTRICAL CONTRACTOR SHALL BE RESPONSIBLE TO REPLACE ANY DAMAGED DEVICES AT NO ADDITIONAL COST TO OWNER.

16. THE INDICATED SOURCE OF EXISTING CIRCUITS MAY NOT BE KNOWN OR HAS NOT BEEN VERIFIED. IT IS THE DIVISION 16 CONTRACTOR'S RESPONSIBILITY TO TRACE OUT, LOCATE AND VERIFY THE DISCONNECTING MEANS OF EXISTING CIRCUIT(S) TO BE IMPACTED BY THE WORK. SAFE OFF THE CIRCUIT(SO AS REQUIRED TO SAFELY PERFORM THE WORK, AND RE-ENERGIZE UPON COMPLETION. UPDATE PANEL DIRECTORIES UPON

17. WHERE EXISTING FIRE ALARM SYSTEMS ARE MODIFIED DURING THE COURSE OF THE PROJECT, PROVIDE OWNER WITH UPDATED COMPLETION RECORD DOCUMENTATION PER NFPA 72, ARTICLE 10.18. INCLUDE COPY OF UPDATED SITE SPECIFIC SOFTWARE. ANY ADDITIONAL DEVICES SHALL BE MAPPED INTO THE SYSTEM WITH THE APPROPRIATE ADDRESSES/LABELS.

18. FURNISH AND INSTALL ALL INDICATED LIGHTING FIXTURES AND MOUNTING HARDWARE AS REQUIRED FOR A COMPLETE INSTALLATION. NOTE ALL LIGHT FIXTURES SHALL BE SUPPORTED FROM BUILDING STRUCTURE. UTILIZING CEILING FRAMING ALONE IS NOT ACCEPTABLE. NEW LIGHTING FIXTURES (OTHER THAN THEATRICAL EQUIPMENT) SHALL NOT BE DAISY CHAINED. RE-USE OF AN EXISTING LIGHTING CKT INCLUDES HOME RUN WIRING OR WIRING UP TO THE SWITCH. ANY WIRING DOWNSTREAM OF THE SWITCH IS SUBJECT TO REPLACEMENT/REARRANGEMENT. EC SHALL ALLOW FOR THIS IN THE BID PRICE.

19. UNLESS OTHERWISE NOTED ON THE PLANS BRANCH CIRCUIT HOMERUNS OF 100 FT OR LESSSHALL BE 2#12, 1#12G, 3/4"C OR EQUIVALENT. HOMERUNS. HOMERUNS LONGR THAN 100 FT SHALL BE 2#10, 1#10G; 3/4" OR EQUIVALENT.

20. ALL BRANCH CIRCUIT WIRING TO BE 1#12+1#12(N)+1#12(G)-3/4" EMT, OR STEEL JACKETED MC CABLE (WHERE CODE PERMITTED), UNLESS OTHERWISE SPECIFIED ON DRAWINGS. ALUMINUM JACKETED MC CABLE IS NOT

ACCEPTABLE.

21. RUN BRANCH CIRCUITS IN DROPPED CEILINGS, VOIDS, & CHASES. ALL DEVICES & CONDUITS ON NEW CONSTRUCTION MUST BE RECESSED. FOR EXISTING SURFACES: MECHANICAL/WORK SPACES-CONDUITS MAY BE SURFACE MOUNTED. EXISTING PUBLIC/FINISHED AREAS- CONDUITS SHALL BE CONCEALED WHEREVER POSSIBLE (IN HUNG CEILINGS, VOIDS/CHASES, FLOOR BELOW OR BEHIND WALLS) ALL WIRING THAT CANNOT BE CONCEALED IN MUST BE RUN IN FINISHED SURFACE RACEWAY SUCH AS WIREMOLD, COLOR PER ARCHITECT. USE OF ADHESIVE IS PROHIBITED, SURFACE RACEWAY MUST BE SECURED USING MECHANICALLY FASTENED

22. ANY LIGHT FIXTURES INSTALLED IN GYMNASIUMS OR OTHER AREAS SUBJECT TO IMPACT OR PHYSICAL DAMAGE SHALL BE MOUNTED WITH SAFETY CHAINS AND SECURED TO STRUCTURE.

23. EMERGENCY AND EXIT LIGHTING FIXTURES SHALL BE WIRED TO THE LOCAL AREA WIRING CIRCUIT AHEAD OF ANY SWITCHING.

24. NEW CIRCUIT BREAKERS INSTALLED IN EXSITING PANELS SHALL BE LISTED FOR USE IN THE INTENDED PANEL AND SHALL MEET OR EXCEED THE AIC RATING OF THE PANEL.

MISCELLANEOUS MATERIALS AND ELECTRICAL DEVICES.

25. SEE SPEC. SECTION 16100 BASIC MATERIALS AND METHODS FOR COMPLETE NOTES ON INSTALLATION,

#### **DEMOLITION NOTES**

THE ITEMS SPECIFICALLY SHOWN ON THE DEMOLITION DRAWINGS ARE TO BE ADDRESSED BY THE ELECTRICAL CONTRACTOR. THE ITEMS ARE TO BE TREATED AS NOTED AND RANGE FROM DIRECT REMOVAL AND DISPOSAL TO REMOVAL, STORAGE AND REINSTALLATION

- 2. MANY OTHER ELECTRIC ITEMS EXIST THAT ARE NOT SHOWN INCLUDING, BUT ARE NOT LIMITED TO, SWITCHES, RECEPTACLES, FLOOR OUTLETS, LOW VOLTAGE JACKS, LOW VOLTAGE DEVICES AND WIRING, TELEPHONE PUNCH DOWN BLOCKS, AND OUT OF SERVICE ITEMS. ALL SUCH ITEMS SHALL BE PERMANENTLY DE-ENERGIZED, DISCONNECTED, AND OTHERWISE MADE SAFE FOR DEMOLITION BY NON-ELECTRICAL CONTRACTORS. THE ELECTRICAL CONTRACTOR IS RESPONSIBLE FOR ASSURING THAT ALL ELECTRIC DEVICES SCHEDULED FOR DEMOLITION, OF ANY VOLTAGE OR FUNCTION, ARE SAFE AND ADVISE THE OTHER CONTRACTORS.
- 3. AFTER THE ELECTRICAL CONTRACTOR HAS DISCONNECTED ELECTRIC SUPPLIES TO ITEMS TO BE DEMOLISHED, HE SHALL ADVISE THE GENERAL CONTRACTOR OF ANY ELECTRIC ITEMS TO BE RETAINED FOR FUTURE USE AND THEREFOR NOT TO BE DEMOLISHED. THE GENERAL CONTRACTOR SHALL THEN PERFORM ALL WORK ZONE DEMOLITION. THIS MATTER APPLIES TO ALL ELECTRIC ITEMS, OF ANY VOLTAGE OR PURPOSE.
- 4. THE SPECIAL/SPECIFIC ITEMS SHOWN ON THE DRAWING FOR ELECTRICAL CONTRACTOR TO ACT ON WERE FOUND BY SURVEY. NUMEROUS LOCATIONS WERE BLOCKED BY FURNITURE, ETC. AND ADDITIONAL EQUAL TYPE ITEMS MAY BE PRESENT. THE ELECTRICAL CONTRACTOR SHALL ALLOW FOR THIS IN HIS BID PRICE AND ATTEND TO THOSE EQUAL OR SIMILAR DEVICES AS MAY BE DISCOVERED.
- 5. REMOVAL ITEMS THAT ARE LISTED AS TO BE TURNED OVER TO OWNER'S INVENTORY SHALL BE DISCUSSED WITH THE DISTRICT BUILDINGS AND GROUNDS MANAGER. THOSE ITEMS THAT THE OWNER DECLINES SHALL THEN BE DISPOSED OF BY THE CONTRACTOR IN THE MANOR OF OTHER PERMANENT REMOVALS. ANY PCB BEARING FLUORESCENT FIXTURES SHALL BE DISPOSED OF PER REGULATIONS.
- 6. RETAIN EXISTING RECEPTACLES IN WALLS THAT WILL NOT BE IN CONFLICT WITH NEW CONSTRUCTION. RETAIN LIGHT SWITCH LOCATIONS THAT WILL NOT BE IN CONFLICT WITH NEW CONSTRUCTION. INSTALL BLANKING PLATE COVERS OVER THE UNUSED PORTION OF GANG BOXES HAVING MORE GANG POSITIONS THAN NEEDED FOR NEW SWITCHES.
- 7. LIGHT FIXTURES ARE TO BE REMOVED AS GENERAL, NON ELECTRIC, CONTRACTOR DEMOLITION. ELECTRICAL CONTRACTOR IS RESPONSIBLE TO SAFE OFF LIGHTING CIRCUITS FOR REMOVAL BY OTHERS. NO SPECIFIC QUANTITIES OR LOCATIONS ARE SHOWN. RETURN WHATEVER QUANTITY, IF ANY, OF THESE TO OWNER'S INVENTORY IF HE SO SPECIFIES OR THEY ARE OTHERWISE TO BE DISPOSED OF. ELECTRICAL CONTRACTOR SHALL EXAMINE FIXTURES FOR PRESENCE OF PCB'S AND SPECIAL DISPOSAL.
- 8. THE ELECTRICAL CONTRACTOR SHALL COVER ALL BACK BOXES IN THE WALL THAT BECOME EXPOSED DUE TO DEVICE REMOVALS. THIS INSTRUCTION ALSO APPLIES TO EXPOSED ELECTRICAL BACK BOXES AS MAY EXIST AT THE SITE PRIOR TO THIS PROJECT. THE COVER SHALL BE BRUSHED ALUMINUM WITH CHAMFERED EDGES AND COVER THE HOLE COMPLETELY WITH AT LEAST 3/4" EXTRA MARGIN ON ALL SIDES. MOUNT THE COVER WITH SCREWS TO MATCH THE ORIGINAL PATTERN.
- 9. IT IS EXPECTED THAT STRUCTURAL DEMOLITION BY THE GENERAL CONTRACTOR WILL CAUSE VARIOUS ELECTRIC SUPPLIES, OF VARIOUS VOLTAGES AND PURPOSES, TO BE CUT AND RENDER SOME DEVICES TEMPORARILY INACTIVE. IT IS THE ELECTRICAL CONTRACTOR'S RESPONSIBILITY TO RECONSTRUCT AND RECONNECT SUCH ELECTRIC SOURCES WHEN THE NEW STRUCTURE IS BUILT. NOTE THAT MOST REINSTALLED ITEMS WILL BE IN DIFFERENT LOCATIONS FROM THE REMOVAL LOCATION. THE ELECTRICAL CONTRACTOR SHALL MAKE ALL REQUIRED CIRCUIT EXTENSIONS OR MODIFICATIONS TO PROVIDE SERVICE TO A REINSTALLED ITEM AS RELOCATED. PROVIDE ALL REQUIRED CIRCUIT EXTENSIONS AS REQUIRED TO RESTORE SERVICE TO DEVICES. NOTE THAT THIS REQUIREMENT ALSO APPLIES TO THE ROOMS AND ELECTRICAL ITEMS WITHIN THAT ARE NOMINALLY NOT IN CONTRACT. SUCH RESTORATION OF SERVICE, IF NEEDED, IS SPECIFICALLY IN THE ELECTRICAL CONTRACTOR'S CONTRACT.
- 10. IT SHALL BE THE ELECTRICAL CONTRACTOR'S RESPONSIBILITY TO PROTECT ALL ELECTRICAL DEVICES, FROM DAMAGES DURING CONSTRUCTION, WHICH ARE EITHER INDICATED TO REMAIN, AND/OR TO BE REMOVED AND REINSTALLED THROUGHOUT ALL CONSTRUCTION AREAS. DEVICES SHALL INCLUDE BUT WILL NOT BE LIMITED TO: SMOKE DETECTORS, EMERGENCY LIGHTS, EXIT SIGNS, OCCUPANCY SENSORS, SPEAKERS, LIGHT FIXTURES, SWITCHES, RECEPTACLE, ETC. IN THE EVENT OF DAMAGES INCURRED DUE TO CONSTRUCTION ACTIVITIES, THE ELECTRICAL CONTRACTOR SHALL BE RESPONSIBLE TO REPLACE ANY DAMAGED DEVICES AT NO ADDITIONAL COST TO OWNER.
- ALL SYSTEM ASSOCIATED WITH THE DEVICES SCHEDULED TO BE REMOVED. STORED AND PROTECTED SHALL BE TESTED BY THE MANUFACTURER'S CERTIFIED TESTING VENDOR PRIOR TO ANY DEMOLITION ACTIVITY. ANY DEVICE WHICH FAILS THE TEST SHALL BE REPLACED WITH A FORM, FIT AND FUNCTION COMPONENT PER UNIT PRICES, AND SUCH DEVICES ARE NOT INCLUDED IN THIS RESPONSIBILITY STATEMENT, BUT ALSO SUCH INSTALLATION SHALL BE IN THE ELECTRICAL CONTRACTOR'S BASE BID. THE ELECTRICAL CONTRACTOR SHALL RE-TEST ALL SUCH SYSTEM COMPONENTS BY A MANUFACTURER CERTIFIED TESTING VENDOR OF SUCH SYSTEM OF ALL PREVIOUSLY TESTED SYSTEM COMPONENTS AFTER ALL WORK BY ALL TRADES HAS BEEN COMPLETED, AND ALL SYSTEM COMPONENTS HAVE BEEN INSTALLED. ANY COMPONENT WHICH FAILS SHALL BE REPLACED, AND PROGRAMMED IF NECESSARY BY THE ELECTRICAL CONTRACTOR. ALL SUCH REPLACEMENT AND PROGRAMMING COSTS SHALL BE ELECTRICAL CONTRACTOR'S RESPONSIBILITY. ALL COSTS ASSOCIATED WITH THE TESTING OF AFFECTED SYSTEM SUCH AS BUT NOT LIMITED TO FIRE ALARM, PUBLIC ADDRESS, INTERCOM, TELEPHONE, AND SECURITY SYSTEMS SHALL BE THE RESPONSIBILITY OF THE ELECTRICAL CONTRACTOR. ALL EQUIPMENT, DEVICES, WIRING AND THEIR ASSOCIATED MATERIAL SPECIFIED TO REMAIN, WHICH IS NOT STORED AND PROTECTED, SHALL BE PROTECTED DURING THE DEMOLITION ACTIVITIES, AND ALL TRADES SHALL BE INFORMED OF SUCH COMPONENTS. ANY OF SUCH COMPONENTS WHICH BECOME DAMAGED DURING DEMOLITION SHALL BE REPLACED FORM, FIT AND FUNCTION BY THE ELECTRICAL CONTRACTOR AT HIS
- 2. EC IS RESPONSIBLE TO RESTORE AND COMPLETE SURFACES CAUSED BY THE REMOVAL OF DEVICES, CONDUITS, ETC. ALL FINISHES TO MATCH ADJACENT AREAS.

# FIRE STOP NOTES

SHALL BE FIRE STOPPED.

- ALL CONDUIT AND CABLE PENETRATIONS THROUGH FIRE RATED WALLS, FLOORS OR OTHER STRUCTURES
- 2. THE FIRE STOP MATERIALS SHALL BE HILTI TYPE FS-657 FIRE BLOCK, FS-ONE SEALANT, CP-672 JOINT SPRAY, CP-601S ELASTOMERIC SEALANT, 6P-606 FLEXIBLE SEALANT, CP-643 OR CP-642 COLLAR, CP-618 PUTTY STICK, OR FS-635 TROWEL ABLE COMPOUND, AS SUITABLE.
- 3. CONTRACTOR SHALL SUBMIT SHOP DRAWINGS OF PRODUCTS SPECIFIED OR <u>EQUAL</u>.
- 4. FIRE STOP MATERIALS OTHER THAN HILTI SHALL INCLUDE FULL TECHNICAL DATA WITH SHOP DRAWINGS TO DEMONSTRATE EQUALITY WITH THE SPECIFIED FIRE STOPS AND STATEMENT FROM MANUFACTURER THAT THEY MEET OR EXCEED THE PRODUCTS SPECIFIED HERE.
- 5. ALL SYSTEMS SHALL HAVE THEIR OWN SLEEVE THROUGH FIRE RATED WALLS. IE FIRE ALARM, PUBLIC

## EXISTING FIRE ALARM SYSTEM NOTES

- 1. DIVISION 16 CONTRACTOR SHALL EXTEND THE EXISTING 'HONEYWELL S3' SYSTEM TO PROVIDE COVERAGE FOR THE NEW AREAS AND/OR DEVICES AND INTEGRATE THEM INTO THE SYSTEM. PROVIDE NEW UPATED GRAPHIC MAPS AT EACH LOCATION. NEW DEVICES SHALL BE COMPATIBLE WITH THE EXISTING FIRE ALARM PANEL WHICH IS TO REMAIN. ALL NEW DEVICES SHALL BE INSTALLED PER ADA REQUIREMENTS AND FULLY INTEGRATED INTO THE SYSTEM. THE CONTRACTOR SHALL PROVIDE THE ITEMS ON THE DRAWING AND ALL RELATED EXPANSION, ADAPTIVE, AND CONNECTING WIRING, REPROGRAMMING AND DEVICES FOR A FULLY FUNCTIONING SYSTEM.
- ALL FIRE ALARM WORK SHALL BE PERFORMED BY MANUFACTURER CERTIFIED TECHNICIANS.
- DIVISION 16 CONTRACTOR SHALL OBTAIN ALL REQUIRED PERMITS AND APPROVALS FOR THIS PROJECT AND PAY RELATED FEES. HE SHALL SUBMIT SHOP DRAWINGS ON ALL HARDWARE. THE SHOP DRAWINGS SHALL CONTAIN A SYSTEM RISER DIAGRAM.
- 4. DIVISION 16 CONTRACTOR TO PROTECT OR TEMPORARILY DISCONNECT / RECONNECT EXISTING FIRE ALARM DEVICES TO ACCOMMODATE NEW CONSTRUCTION AS REQUIRED. COORDINATE WITH GENERAL CONTRACTOR. WHERE PLANS CALL FOR EXISTING DEVICE TO BE RELOCATED, EXTEND WIRING AS REQUIRED.
- 5. ALL NEW FIRE ALARM DEVICES SHALL BE OF THE SAME MANUFACTURER AND COMPATIBLE WITH THE FIRE ALARM PANEL.
- 6. PROVIDE ADAPTIVE HARDWARE TO POWER THE HORN STROBES, STROBES AND MAGNETIC DOOR HOLDERS
- 7. ALL WORK SHALL BE IN ACCORDANCE WITH SYSTEM MANUFACTURER SPECIFICATIONS, LATEST EDITION OF NEC, ANY LOCAL, STATE CODES, AND ENGINEERING SPECIFICATIONS.
- 8. ALL WIRING SHALL BE AS SPECIFIED BY SYSTEM MANUFACTURER AND PLENUM RATED.
- 9. DIVISION 16 CONTRACTOR SHALL PROVIDE ANY ADDITIONAL EQUIPMENT, SYSTEM MODULES, POWER SUPPLIES ETC. NEEDED TO HAVE A COMPLETE AND OPERATIONAL SYSTEM. PROVIDE NEW REMOTE ANNUNCIATOR PANEL(S) WHERE INDICATED INCLUDING UPDATED GRAPHIC MAPS. UPDATED MAPS SHALL ALSO INDICATE THE LOCATIONS OF ALL AREA OF RESCUE ASSISTANCE (REFUGE) CALL STATIONS. SUBMIT PROPOSED MAPS FOR APPROVAL.
- D. THE DIVISION 16 CONTRACTOR SHALL FIELD SELECT THE PROPER OUTPUT SETTINGS OF FIRE ALARM HORNS AND STROBES TO MEET THE MINIMUM CODE PERFORMANCE REQUIREMENTS TO SUIT THE AREAS BEING SERVED.
- 11. PROVIDE AS-BUILT DRAWINGS <u>AND COPY OF UPDATED SITE SPECIFIC SYSTEM SOFTWARE INCLUDING PASSWORDS TO THE DISTRICT AT NO ADDITIONAL CHARGE.</u>
- 12. ALL NEW MAGNETIC DOOR HOLDERS ARE TO BE WIRED AT 24V. WHEN REPLACING AN EXISTING MAGNETIC DOOR HOLDER, THE CONTRACTOR SHALL MATCH EXISTING VOLTAGE.
- CONTRACTOR TO ENSURE ALL POINTS ARE PROPERLY ENROLLED IN THE SYSTEM AND OLD POINTS NOT LONGER IN USE ARE REMOVED.

Α			 AMPERAGE OR AMF
AC			ALTERNATING CURREN
ACT			ABOVE COUNTER TO
			ABOVE FINISHED FLOC
NFG			ABOVE, FINISHED GRAI
_			BELOW CEILIN
3			CONDL
CB			CIRCUIT BREAK
CKT			 
CM			 CEILING MOUNT
OC			 DIRECT CURRE
DH			 DOOR HOLD
DISC			DISCONNE
			ELECTRICAL CONTRACTO
ΞΜ			EMERGEN
			ELECTRICAL METALLIC TUBI
ETR			EXISTING TO REM
			EXISTJ
A			 FIRE ALA
MC			 FLEXIBLE METAL COND
₹T			 
GC			 GENERAL CONTRACTO
GFÇI, GFI			 
G			ISOLATED GROU
IN			 IŅCḤ
⟨W			 
LFMC			 . LIQUID TIGHT FLEXIBLE METAL CONDI
MAX			 MAXIM
MC			 MECHANICAL CONTRACT
			MAIN ÇIRCUIT BREAK
MDP			MAIN DISTRIBUTION PAN
MH			MANHÇ
MIN			 
MLQ			 MAIN LUG ON
MTD			 MOŲNŢ
MTḤ			 MOUNTING HEIG
Ν			 NEUTF
NEC			NATIONAL ELECTRICAL CO
			ELECTRICAL MANUFACTURES ASSOCIATI
			NOT IN CONTRA
			NIGHT,LIG
			NOT TO SCA
PA			 PUBLIC ADDRE
PC			 
PV			 P.HQTQVQLT/
PVÇ			POLYVINYL CHLORI
REQ'D			
חו			RELOCAT
SCH			
SCH			 SURFACE MOUNT
SCH SM SPD	<ul><li></li><li></li><li></li></ul>		 SURFACE MOUNT SURGE PROTECTIVE DEV
SCH SM SPD SQ	<ul><li></li><li></li><li></li></ul>		 SURFACE MOUNT SURGE PROTECTIVE DEV. SQUA
SCH SM	<ul><li></li><li></li><li></li><li></li><li></li></ul>		SURFACE MOUNT SURGE PROTECTIVE DEV. SQUA SWITCHBOA
SCH SM			SURFACE MOUNT SURGE PROTECTIVE DEV. SQUA SWITCHBOA STEEL WIRE GUA
SCH SM			SURFACE MOUNT SURGE PROTECTIVE DEV. SQUA SWITCHBOA STEEL WIRE GUA TWISTED SHIELDED P
SCH SM. SPD SQ. SWBD. SWG TSP			SURFACE MOUNT SURGE PROTECTIVE DEV SQUA SWITCHBOA STEEL WIRE GUA TWISTED SHIELDED PA
SCH SM SPD SQ SWBD SWB TSP TV\$S			SURFACE MOUNT SURGE PROTECTIVE DEV SQUA SWITCHBOA STEEL WIRE GUA TWISTED SHIELDED PA
SCH SM. SPD SQ. SWBD SWG TSP TV\$S			SURFACE MOUNT SURGE PROTECTIVE DEV. SQUA SWITCHBOA STEEL WIRE GUA TWISTED SHIELDED PA TRANSIENT VOLTAGE SURGE SUPPRESSA
SCH SM. SPD SQ. SWBD. SWG TSP TVSS TYP	<ul> <li></li> &lt;</ul>		SURFACE MOUNT SURGE PROTECTIVE DEV. SQUA SWITCHBOA STEEL WIRE GUA TWISTED SHIELDED P, TRANSIENT VOLTAGE SURGE SUPPRESS UNDER COUNT
SCH SM. SPD SQ. SWBD. SWG TSP TVSS TYP UC.	<ul> <li></li> &lt;</ul>		SURFACE MOUNT SURGE PROTECTIVE DEV SQUA SWITCHBOA STEEL WIRE GUA TWISTED SHIELDED P TRANSIENT VOLTAGE SURGE SUPPRESS TYPIC UNDER COUNT
SCH SM SPD SQ SWBD SWG TSP TVSS TYP UC UG			SURFACE MOUNT SURGE PROTECTIVE DEV. SQUA SWITCHBOA STEEL WIRE GUA TWISTED SHIELDED PA TRANSIENT VOLTAGE SURGE SUPPRESSI UNDER COUNT UNDER GROU
SCH SM. SPD SQ. SWBD. SWG TSP TV\$S TYP UC. UG. UTP	<ul> <li></li> <li></li></ul>	<ul> <li></li> <li></li></ul>	SURFACE MOUNT SURGE PROTECTIVE DEV. SQUA SWITCHBOA STEEL WIRE GUA TWISTED SHIELDED P, TRANSIENT VOLTAGE SURGE SUPPRESSI UNDER COUNT UNDER GROU UNSHIELDED TWISTED P,
SCH SM. SPD SQ. SWBD. SWG TSP TV\$S TYP UC UG UTP UWS V	<ul> <li></li> <li>&lt;</li></ul>	<ul> <li></li> <li></li></ul>	SURFACE MOUNT SURGE PROTECTIVE DEV. SQUA SWITCHBOA STEEL WIRE GUA TWISTED SHIELDED P, TRANSIENT VOLTAGE SURGE SUPPRESSI UNDER COUNT UNDER GROU UNSHIELDED TWISTED P, UNTWIST
SCH SM SPD SQ SWBD SWG TSP TV\$S TYP UC UG UTP UWS V VFD	<ul> <li></li> <li></li></ul>	<ul> <li></li></ul>	SURFACE MOUNT SURGE PROTECTIVE DEV. SQUA SWITCHBOA STEEL WIRE GUA TWISTED SHIELDED P, TRANSIENT VOLTAGE SURGE SUPPRESSI TYPIC UNDER GROU UNDER GROU UNSHIELDED TWISTED P, UNTWIST VOLTAGE OR VOL VARIABLE FREQUENCY DR
SCH SM SPD SQ SWBD SWG TSP TV\$S TYP UC UG UTP UWS V	<ul> <li></li> <li></li></ul>	<ul> <li></li></ul>	SURFACE MOUNT SURGE PROTECTIVE DEVI SQUA SWITCHBOA STEEL WIRE GUA TWISTED SHIELDED PA TRANSIENT VOLTAGE SURGE SUPPRESSI UNDER COUNT UNDER GROU UNSHIELDED TWISTED PA UNTWIST VOLTAGE OR VOL VARIABLE FREQUENCY DR
SCH SM	<ul> <li></li> <li></li></ul>		SURFACE MOUNT SURGE PROTECTIVE DEVI SQUA SWITCHBOA STEEL WIRE GUA TWISTED SHIELDED PA TRANSIENT VOLTAGE SURGE SUPPRESSI UNDER COUNT UNDER GROU UNSHIELDED TWISTED PA UNTWIST VOLTAGE OR VOL VARIABLE FREQUENCY DR
SCH SM	<ul> <li></li> <li></li></ul>	.	SURFACE MOUNT SURGE PROTECTIVE DEVI SQUA SWITCHBOA STEEL WIRE GUA TWISTED SHIELDED PA TRANSIENT VOLTAGE SURGE SUPPRESSI TYPIC UNDER COUNT UNDER GROU UNSHIELDED TWISTED PA UNTWIST VOLTAGE OR VOL VARIABLE FREQUENCY DRI WATTAGE OR WAT
SCH SM. SPD SQ. SWBD. SWG TSP TV\$S. TYP UC. UG. UTP UWS V VFD W WG	<ul> <li></li> <li></li></ul>	<td>SURFACE MOUNT SURGE PROTECTIVE DEVI SURGE PROTECTIVE DEVI SQUA SWITCHBOA STEEL WIRE GUA TWISTED SHIELDED PA TRANSIENT VOLTAGE SURGE SUPPRESSI TYPIC UNDER COUNT UNDER GROU UNSHIELDED TWISTED PA UNTWIST VOLTAGE OR VOL VARIABLE FREQUENCY DRI WATTAGE OR WAT WIRE GUA</td>	SURFACE MOUNT SURGE PROTECTIVE DEVI SURGE PROTECTIVE DEVI SQUA SWITCHBOA STEEL WIRE GUA TWISTED SHIELDED PA TRANSIENT VOLTAGE SURGE SUPPRESSI TYPIC UNDER COUNT UNDER GROU UNSHIELDED TWISTED PA UNTWIST VOLTAGE OR VOL VARIABLE FREQUENCY DRI WATTAGE OR WAT WIRE GUA
SCH SM. SPD SQ. SWBD. SWG TSP TVSS TYP UC. UG. UTP UWS V VFD W WG WM	<ul> <li></li> <li></li></ul>	.	SURFACE MOUNT SURGE PROTECTIVE DEVI SQUA SWITCHBOA STEEL WIRE GUA TWISTED SHIELDED PA TRANSIENT VOLTAGE SURGE SUPPRESSI TYPIC UNDER GOUNT UNDER GROU UNSHIELDED TWISTED PA UNTWIST VOLTAGE OR VOL VARIABLE FREQUENCY DRI WATTAGE OR WAT WIRE GUA WALL MOUNT WEATHER PRO TRANSFORM

**ABBREVIATIONS** 

SYMBOL	DESCRIPTION
φ	TAMPER-RESISTANT DUPLEX ELECTRICAL OUTLET FOR CONVENIENCE POWER WITH 302/304 STAINLESS STEEL FACEPLATE, NEMA 5-20R.
#	TAMPER-RESISTANT DOUBLE DUPLEX ELECTRICAL OUTLET FOR CONVENIENCE POWER WITH 302/304 STAINLESS STEEL FACEPLATE, NEMA 5-20R.
P	TAMPER-RESISTANT GROUND FAULT INTERRUPTED DUPLEX ELECTRICAL OUTLET FOR CONVENIENCE POWER WITH 302/304 STAINLESS STEEL FACEPLATE, NEMA 5-20R.
φ	TAMPER-RESISTANT SINGLE ELECTRICAL OUTLET FOR CONVENIENCE POWER WITH 302/304 STAINLESS STEEL FACEPLATE, NEMA 5-20R.
φ	TAMPER-RESISTANT SPECIAL PURPOSE SINGLE ELECTRICAL OUTLET FOR CONVENIENCE POWER WITH 302/304 STAINLESS STEEL FACEPLATE, 250V, NEMA 6-20R.
φ	TWIST-LOCK SINGLE ELECTRICAL OUTLET FOR CONVENIENCE POWER WIT 302/304 STAINLESS STEEL FACEPLATE, 125V, 30A, NEMA L5-30R.
Φ	TAMPER-RESISTANT USB CHARGER DUPLEX ELECTRICAL OUTLET FOR CONVENIENCE POWER WITH 302/304 STAINLESS STEEL FACEPLATE, NEMA 5-20R.
	DATA & POWER SURFACE RACEWAY - NUMBER OF TRIANGLES INDICATES NUMBER OF DATA DROPS - PROVIDE (2) DUPLEX RECEPTACLES PER DATA DROP.
<u> </u>	POWER CORD REEL, NEMA 5-20R.
M	FIRE RATED POWER FEED POKE-THROUGH.
FB	FLOOR BOX.
WB	MULTIPLE SERVICE WALL BOX.
J	JUNCTION BOX, SIZE AS REQUIRE.
(HP)	MOTOR, HORSEPOWER AS INDICATED.
	UN-FUSED DISCONNECT SWITCH.
F	FUSED DISCONNECT SWITCH.
HD	HAND DRYER.
	PANEL.
36	TRANSFORMER.
\$	SWITCH:  LOWER CASE LETTER INDICATES SWITCHING DESIGNATION  UPPER CASE LETTER(S) OR NUMBER SUBSCRIPTS:  (NONE) = SINGLE POLE, 20 A, HEAVY DUTY SPEC GRADE SWITCH  K = KEY SWITCH D = DIMMER SWITCH  3 = TREE WAY SWITCH 4 = FOUR WAY SWITCH  MC = MOMENTARY CONTACT SWITCH  LV = LOW VOLTAGE BUTTON SWITCH  EF = COMMERCIAL GRADE EXHAUST FAN SWITCH
(S) (S) (S)	CEILING MOUNTED OCCUPANCY/ VACANCY/ DAYLIGHT SENSOR, LOW VOLTAGE, DUAL TECHNOLOGY, COMPLETE W/ POWER PACK(S) AS REQUIR
(WOS) (WOS)	WALL MOUNTED OCCUPANCY/ VACANCY, LOW VOLTAGE, DUAL TECHNOLOGY, COMPLETE W/ POWER PACK(S) AS REQUIRED.
\$08	DUAL TECHNOLOGY SINGLE LEVEL OCCUPANCY SENSING WALL SWITCH.
PC	PHOTOCELL.
RC	ROOM CONTROLLER.

WIRING LEGEND				
SYMBOL	DESCRIPTION			
#	SINGLE POLE CIRCUIT 2-#12, #12G, ¾"C UNLESS OTHERWISE NOTED			
	TWO POLE CIRCUIT 3-#12, #12G, ¾"C UNLESS OTHERWISE NOTED			
	THREE POLE CIRCUIT 4-#12, #12G, 3/4"C UNLESS OTHERWISE NOTED			

SYMBOL	DESCRIPTION
FACP	FIRE ALARM CONTROL PANEL. PROVIDE BUILDING SHATTERPROOF FRAMED SCHOOL GRAPHIC PAPER MAP WITHIN SIGHT OF PANEL.
RAP	REMOTE ANNUNCIATOR PANEL. PROVIDE BUILDING SHATTERPROOF FRAMED SCHOOL GRAPHIC PAPER MAP WITHIN SIGHT OF PANEL.
RCC	REMOTE COMMAND CENTER.
F	MANUAL PULL STATION WITH STI STOPPER PROTECTIVE SHIELD WITHOUT ALARM (OR SIMILAR).
<b>⊘</b> xx	SMOKE DETECTOR WITH BASE.  CO = SMOKE AND CARBON MONOXIDE COMBINATION DETECTOR LED = REMOTE LED INDICATOR
<b>(\$</b> )	DUCT DETECTOR WITH HOUSING AND REMOTE LED INDICATOR.
٥	CARBON MONOXIDE DETECTOR WITH SOUNDER BASE.
<b> 1</b> xx	HEAT DETECTOR. FIXED TEMPERATE OF RISE UNLESS OTHERWISE NOTED. (NONE) = 135°F 195°F
Ť	WALL MOUNT SPEAKER / STROBE NOTIFICATION DEVICE. THE STROBE CANDELA IS 15 cd UNLESS OTHERWISE INDICATED ON DRAWING.
\rightarrow{\right	WALL MOUNT SPEAKER NOTIFICATION DEVICE.
) F	WALL MOUNT STROBE NOTIFICATION DEVICE. THE STROBE CANDELA IS 15 (UNLESS OTHERWISE INDICATED ON DRAWING.
Ø	CEILING MOUNT SPEAKER / STROBE NOTIFICATION DEVICE. THE STROBE CANDELA IS 15 cd UNLESS OTHERWISE INDICATED ON DRAWING.
<b>©</b>	CEILING MOUNT SPEAKER NOTIFICATION DEVICE.
Ē	CEILING MOUNT STROBE NOTIFICATION DEVICE. THE STROBE CANDELA IS 1 cd UNLESS OTHERWISE INDICATED ON DRAWING.
DH	ELECTROMAGNETIC HOLD OPEN DEVICE. VOLTAGE TO MATCH SYSTEM.
R	FIRE ALARM RELAY.
ANSUL	HOOD FIRE SUPPRESSION SYSTEM.

REV.	DATE	ITEM
PREPARED B ENGINEERS, CONDITIONS CONDITIONS INFORMATION	INGS ARE BASED BY BBS ARCHITEC PC. AND, THERE AS CONSTRUCTE SHOWN ARE I AS THEY MAY NO	OTICE ON CONSTRUCTION DRAWINGS NOT STS, LANDSCAPE ARCHITECTS AND FORE, MAY NOT REPRESENT THE SED AT THE TIME. ALL EXISTING REPRESENTED AS SUGGESTIVE DT HAVE BEEN BUILT AND DETAILED
PER THE ORIG	BINAL DOCUMENTS	OR PER THE OWNER'S INFORMATION.
VEV DI	ANI	
KEY PL/	NOT TO S	CALE
σ.	)	
STRICT	RICHARD J. BAILEY ELEMENTARY SCHOOL WHITE PLAINS, NEW YORK - WESTCHESTER COUNTY	S
GREENBURGH CENTRAL SCHOOL DISTRICT	ITARY SC HESTER COU	LEGENDS
TRAL SC	ELEMEN	ELECTRICAL NOTES &
GH CEN	BAILEY INS, NEW YO	TRICAL
EENBUR I - DISTE	CHARD J	ELEC
GR		
		ш
PROJECT PROJECT	G RY:	DWG TITLE
CHECK	3Y:	DTICE
AN INSTRUM ARCHITECTS, INFRINGEMEN PROJECT IS I THIS DOCUM	IENT OF SERVIC LANDSCAPE AF IT OR ANY USE C PROHIBITED. ANY .	THE SPECIFIC PROJECT INDICATED IS E AND THE PROPERTY OF BBS RCHITECTS AND ENGINEERS, PC. FT HIS DRAWING FOR ANY OTHER ALTERATION OR REPRODUCTION OF ROHIBITED WITHOUT THE WRITTEN IR ENGINEER.
B	35	
LAN[	HITECT DSCAPE INEER	E ARCHITECTS
PATCI NEW YC T. 631.4	MAIN STREET HOGUE PKK 11772 475.0349 475.0361 www.BBSARG	187 WOLF ROAD, STE. 205 ALBANY NEW YORK 12205 T. 518.621.7650 F. 518.621.7655
SED No.		07-06-0-005-012
DISTRIC PROJEC	_	NBURGH CSD  DW CAP, IMPROVEMENTS
DWG TIT	R.J. B/	AILEY E.S.

E0.01C


DWG TITLE ELECTRICAL NOTES & LEGEND

SCALE: AS NOTED

DATE: MAY 2022

FILE No: 21-290


BID PICK-UP: MAY 27, 2022

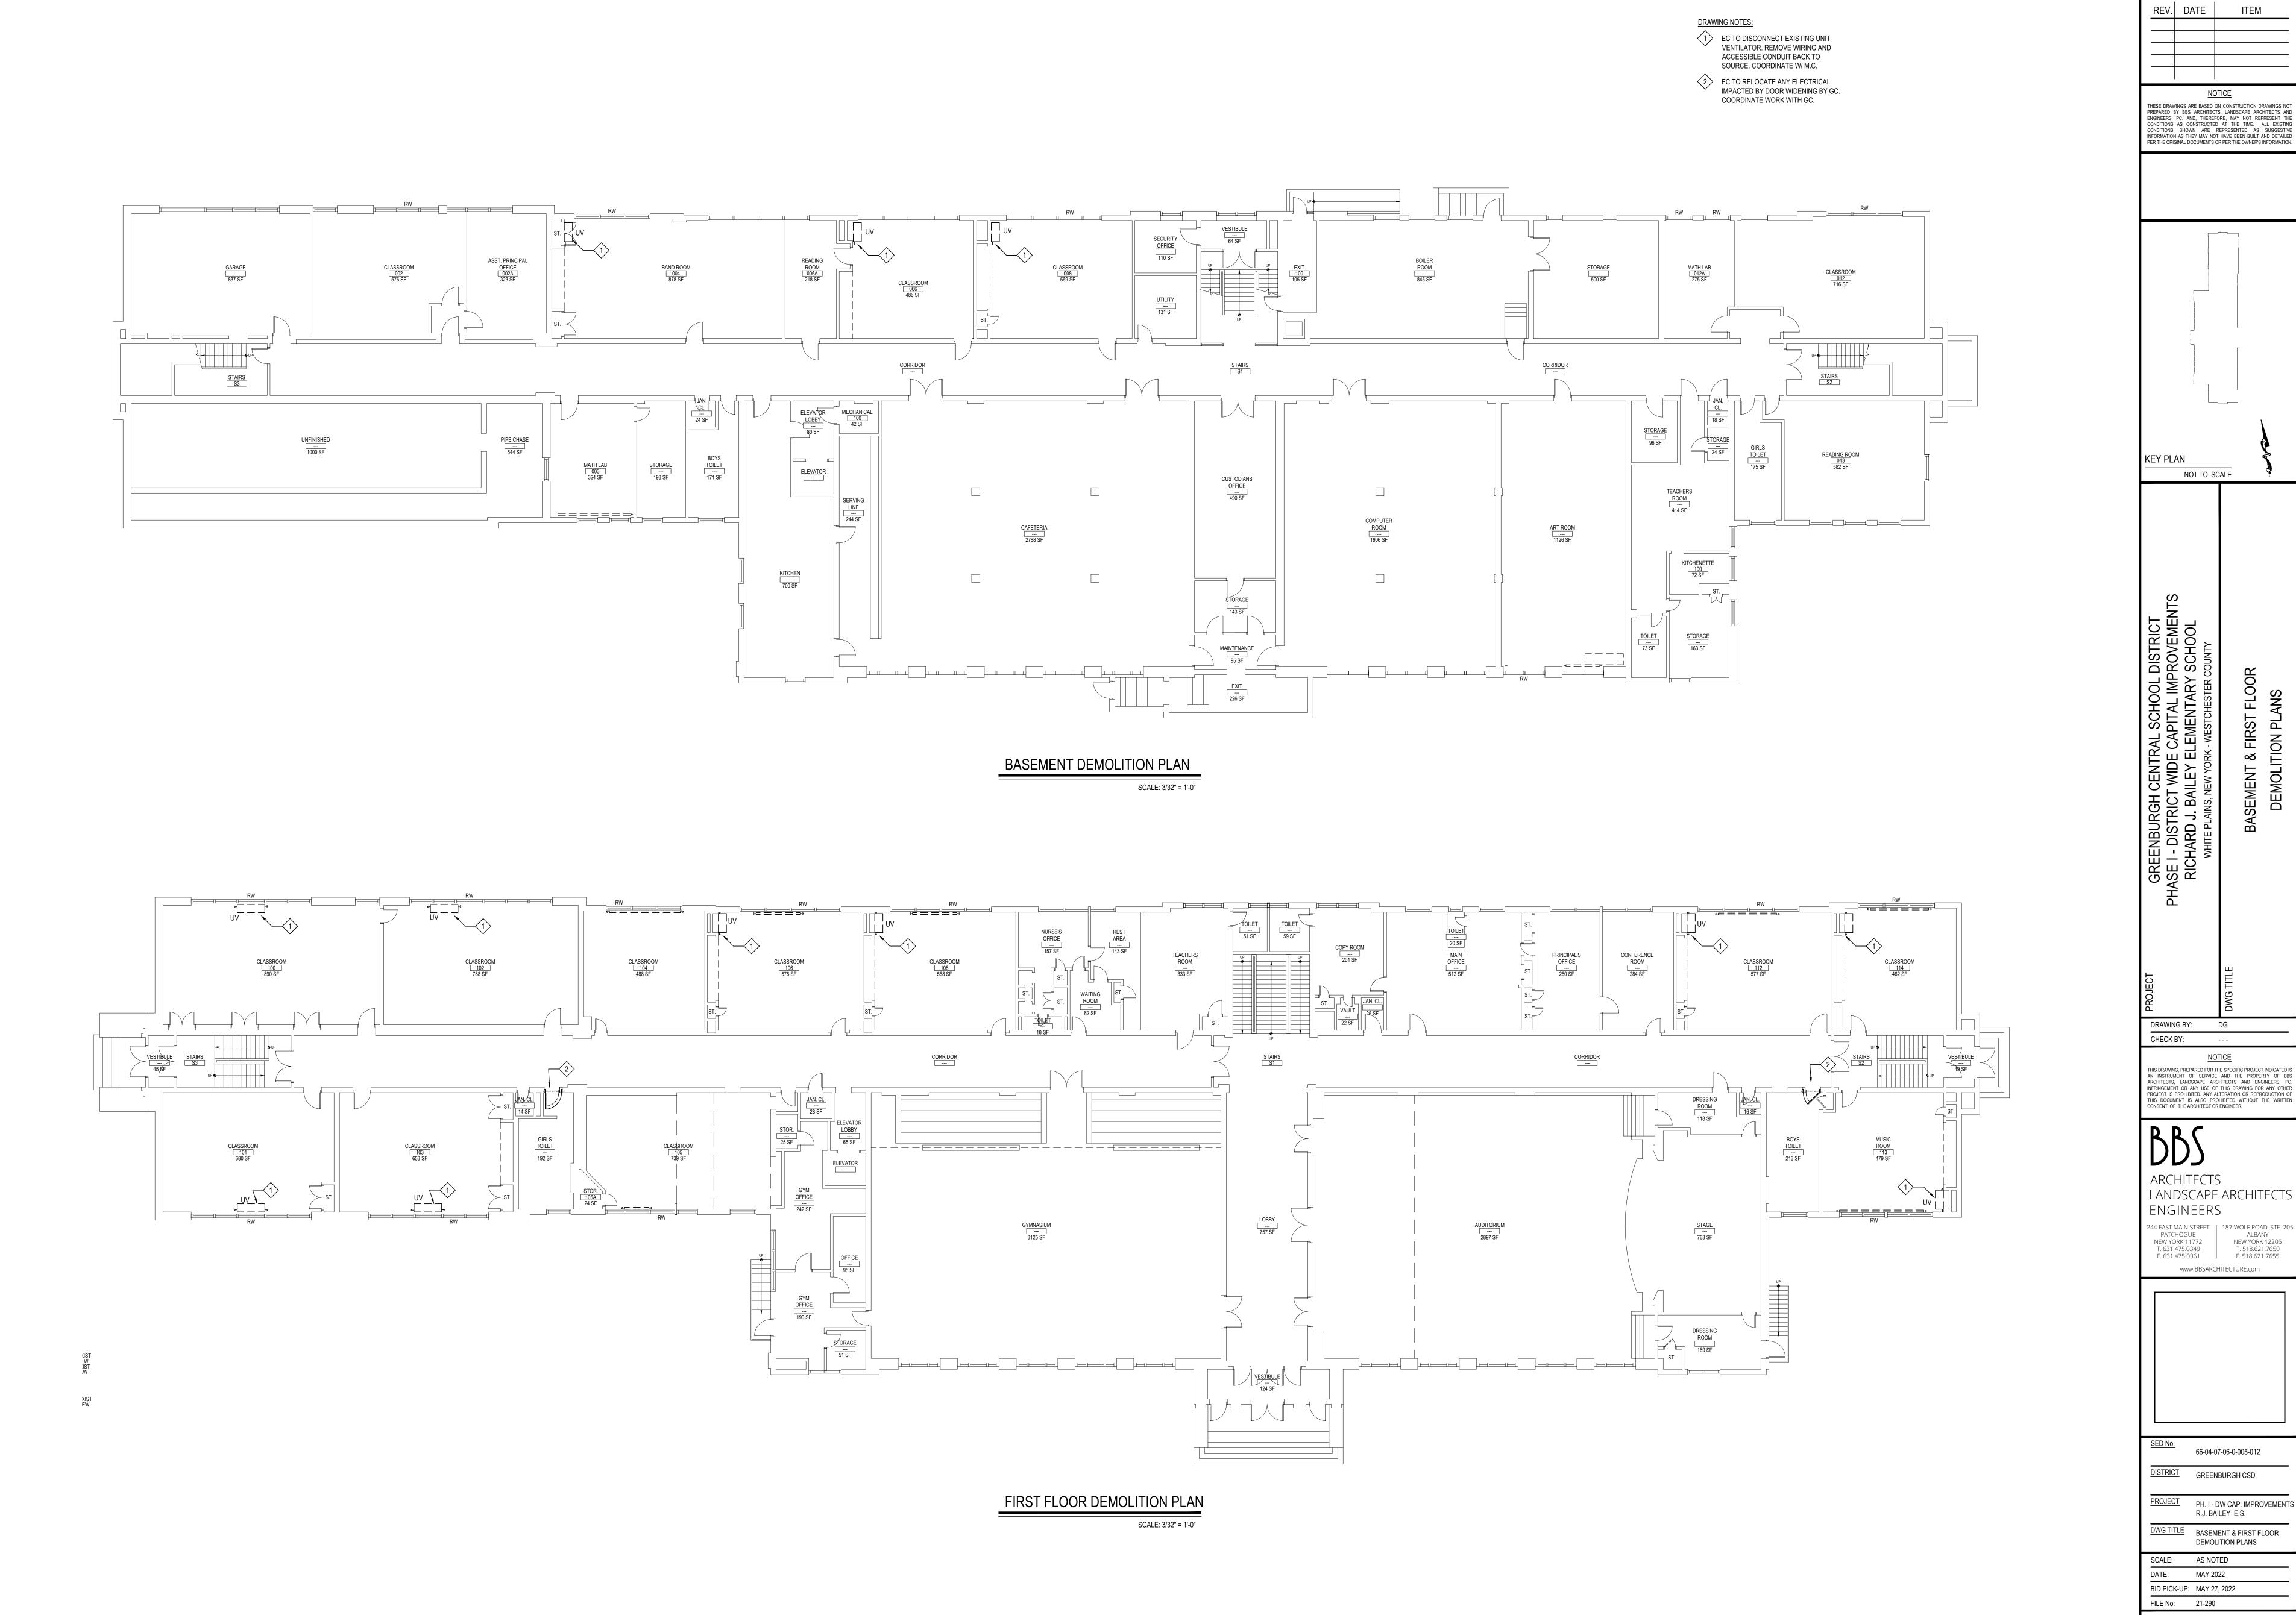

<u>NOTICE</u> THESE DRAWINGS ARE BASED ON CONSTRUCTION DRAWINGS NOT PREPARED BY BBS ARCHITECTS, LANDSCAPE ARCHITECTS AND ENGINEERS, PC. AND, THEREFORE, MAY NOT REPRESENT THE CONDITIONS AS CONSTRUCTED AT THE TIME. ALL EXISTING CONDITIONS SHOWN ARE REPRESENTED AS SUGGESTIVE INFORMATION AS THEY MAY NOT HAVE BEEN BUILT AND DETAILED PER THE ORIGINAL DOCUMENTS OR PER THE OWNER'S INFORMATION. KEY PLAN NOT TO SCALE CHECK BY: <u>NOTICE</u> THIS DRAWING, PREPARED FOR THE SPECIFIC PROJECT INDICATED IS AN INSTRUMENT OF SERVICE AND THE PROPERTY OF BBS ARCHITECTS, LANDSCAPE ARCHITECTS AND ENGINEERS, PC. INFRINGEMENT OR ANY USE OF THIS DRAWING FOR ANY OTHER PROJECT IS PROHIBITED. ANY ALTERATION OR REPRODUCTION OF THIS DOCUMENT IS ALSO PROHIBITED WITHOUT THE WRITTEN CONSENT OF THE ARCHITECT OR ENGINEER. ARCHITECTS LANDSCAPE ARCHITECTS ENGINEERS 244 EAST MAIN STREET PATCHOGUE ALBANY
NEW YORK 11772 NEW YORK 12205
T. 631.475.0349 T. 518.621.7650
F. 631.475.0361 F. 518.621.7655 www.BBSARCHITECTURE.com

> DWG TITLE
>
> BASEMENT & FIRST FLOOR
>
> DEMOLITION PLANS SCALE: AS NOTED
>
> DATE: MAY 2022

> > E1.01C

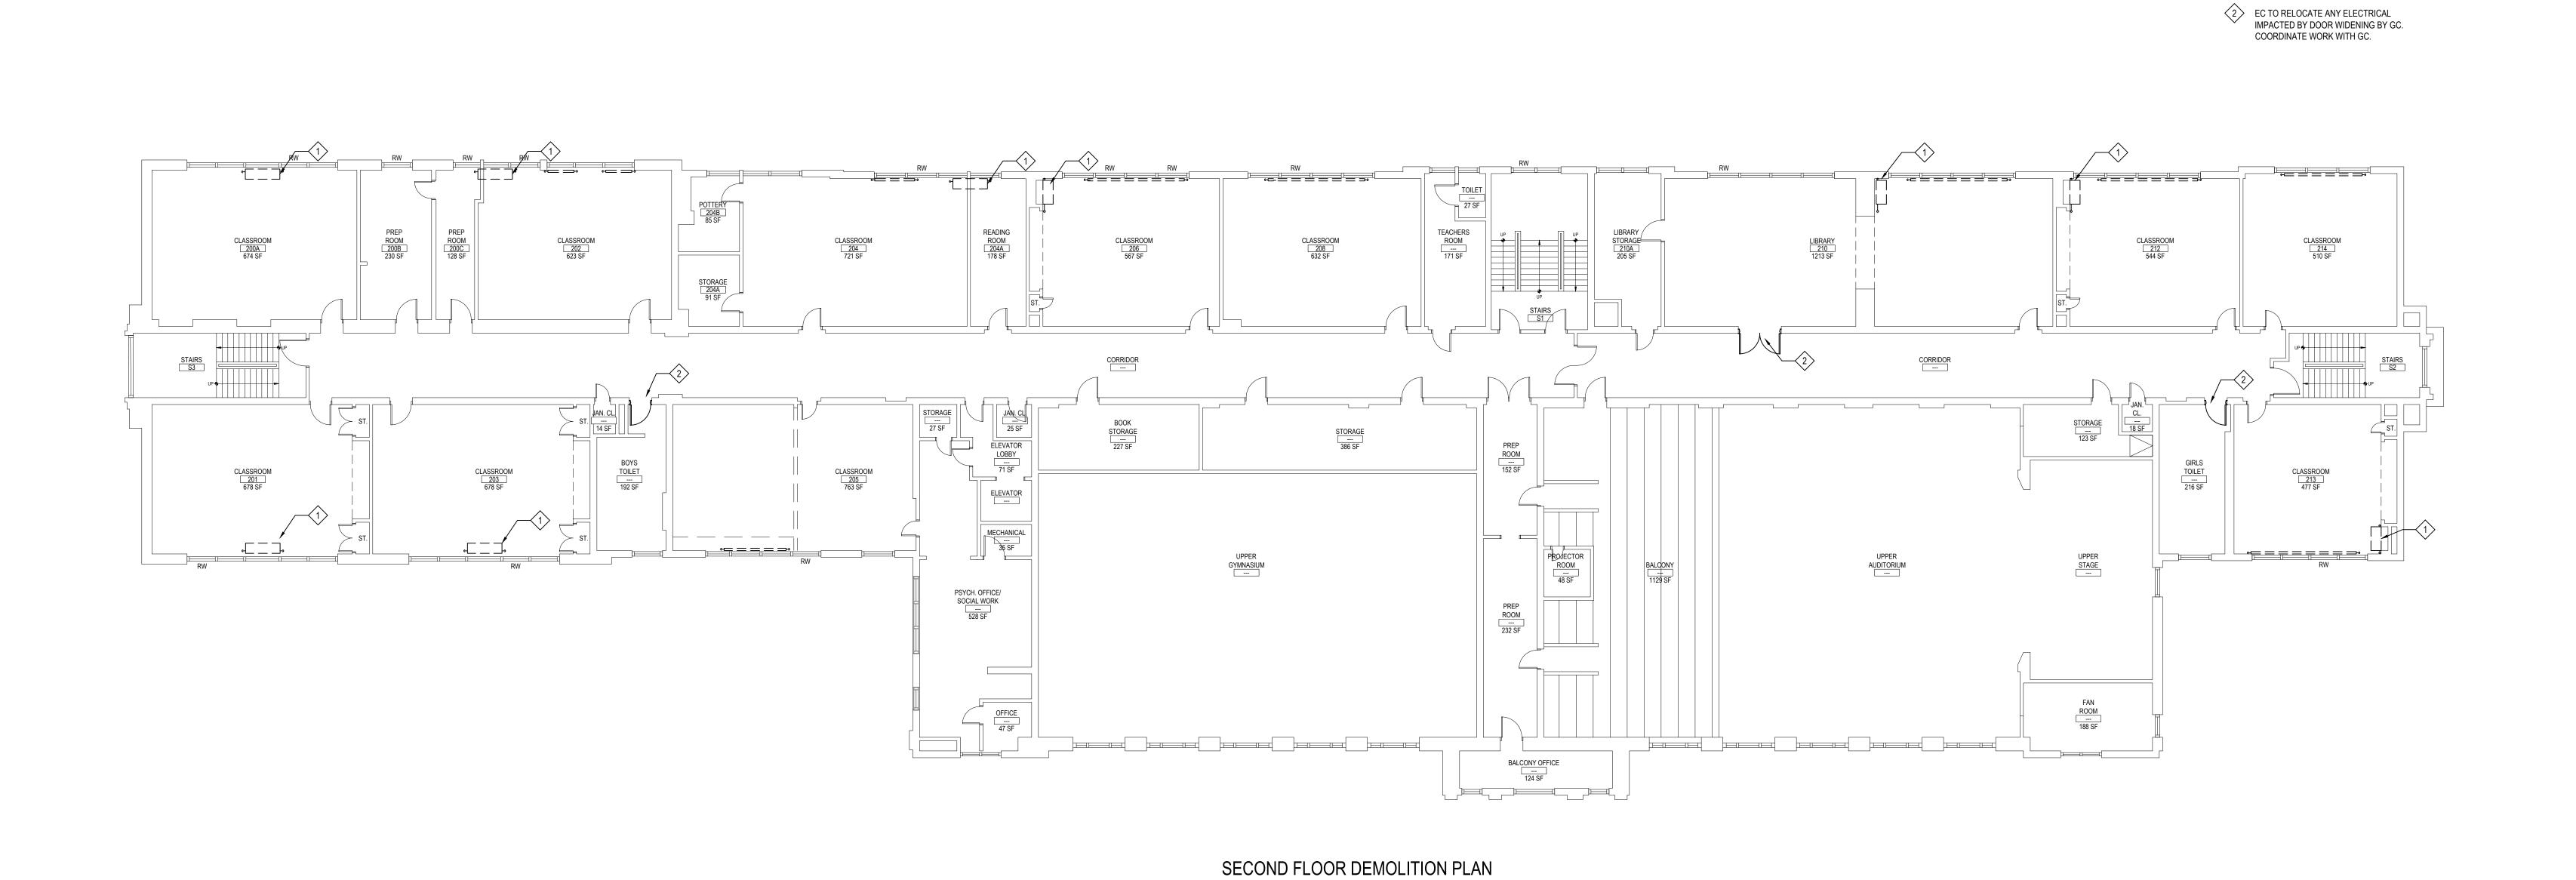

SCALE: 3/32" = 1'-0"

REV. DATE <u>NOTICE</u> THESE DRAWINGS ARE BASED ON CONSTRUCTION DRAWINGS NOT PREPARED BY BBS ARCHITECTS, LANDSCAPE ARCHITECTS AND ENGINEERS, PC. AND, THEREFORE, MAY NOT REPRESENT THE CONDITIONS AS CONSTRUCTED AT THE TIME. ALL EXISTING CONDITIONS SHOWN ARE REPRESENTED AS SUGGESTIVE INFORMATION AS THEY MAY NOT HAVE BEEN BUILT AND DETAILED PER THE ORIGINAL DOCUMENTS OR PER THE OWNER'S INFORMATION. KEY PLAN NOT TO SCALE

DRAWING NOTES:

EC TO DISCONNECT EXISTING UNIT VENTILATOR. REMOVE WIRING AND ACCESSIBLE CONDUIT BACK TO SOURCE. COORDINATE W/ M.C.

DRAWING BY: DG CHECK BY: <u>NOTICE</u> THIS DRAWING, PREPARED FOR THE SPECIFIC PROJECT INDICATED IS AN INSTRUMENT OF SERVICE AND THE PROPERTY OF BBS ARCHITECTS, LANDSCAPE ARCHITECTS AND ENGINEERS, PC. INFRINGEMENT OR ANY USE OF THIS DRAWING FOR ANY OTHER PROJECT IS PROHIBITED. ANY ALTERATION OR REPRODUCTION OF THIS DOCUMENT IS ALSO PROHIBITED WITHOUT THE WRITTEN CONSENT OF THE ARCHITECT OR ENGINEER.

SECOND FLOOR DEMOLITION

ARCHITECTS LANDSCAPE ARCHITECTS ENGINEERS 244 EAST MAIN STREET PATCHOGUE ALBANY
NEW YORK 11772 NEW YORK 12205
T. 631.475.0349 T. 518.621.7650
F. 631.475.0361 F. 518.621.7655

www.BBSARCHITECTURE.com


66-04-07-06-0-005-012 DISTRICT GREENBURGH CSD PROJECT PH. I - DW CAP. IMPROVEMENTS R.J. BAILEY E.S.

DWG TITLE SECOND FLOOR DEMOLITION PLAN

SCALE: AS NOTED

DATE: MAY 2022 BID PICK-UP: MAY 27, 2022 FILE No: 21-290

E1.02C

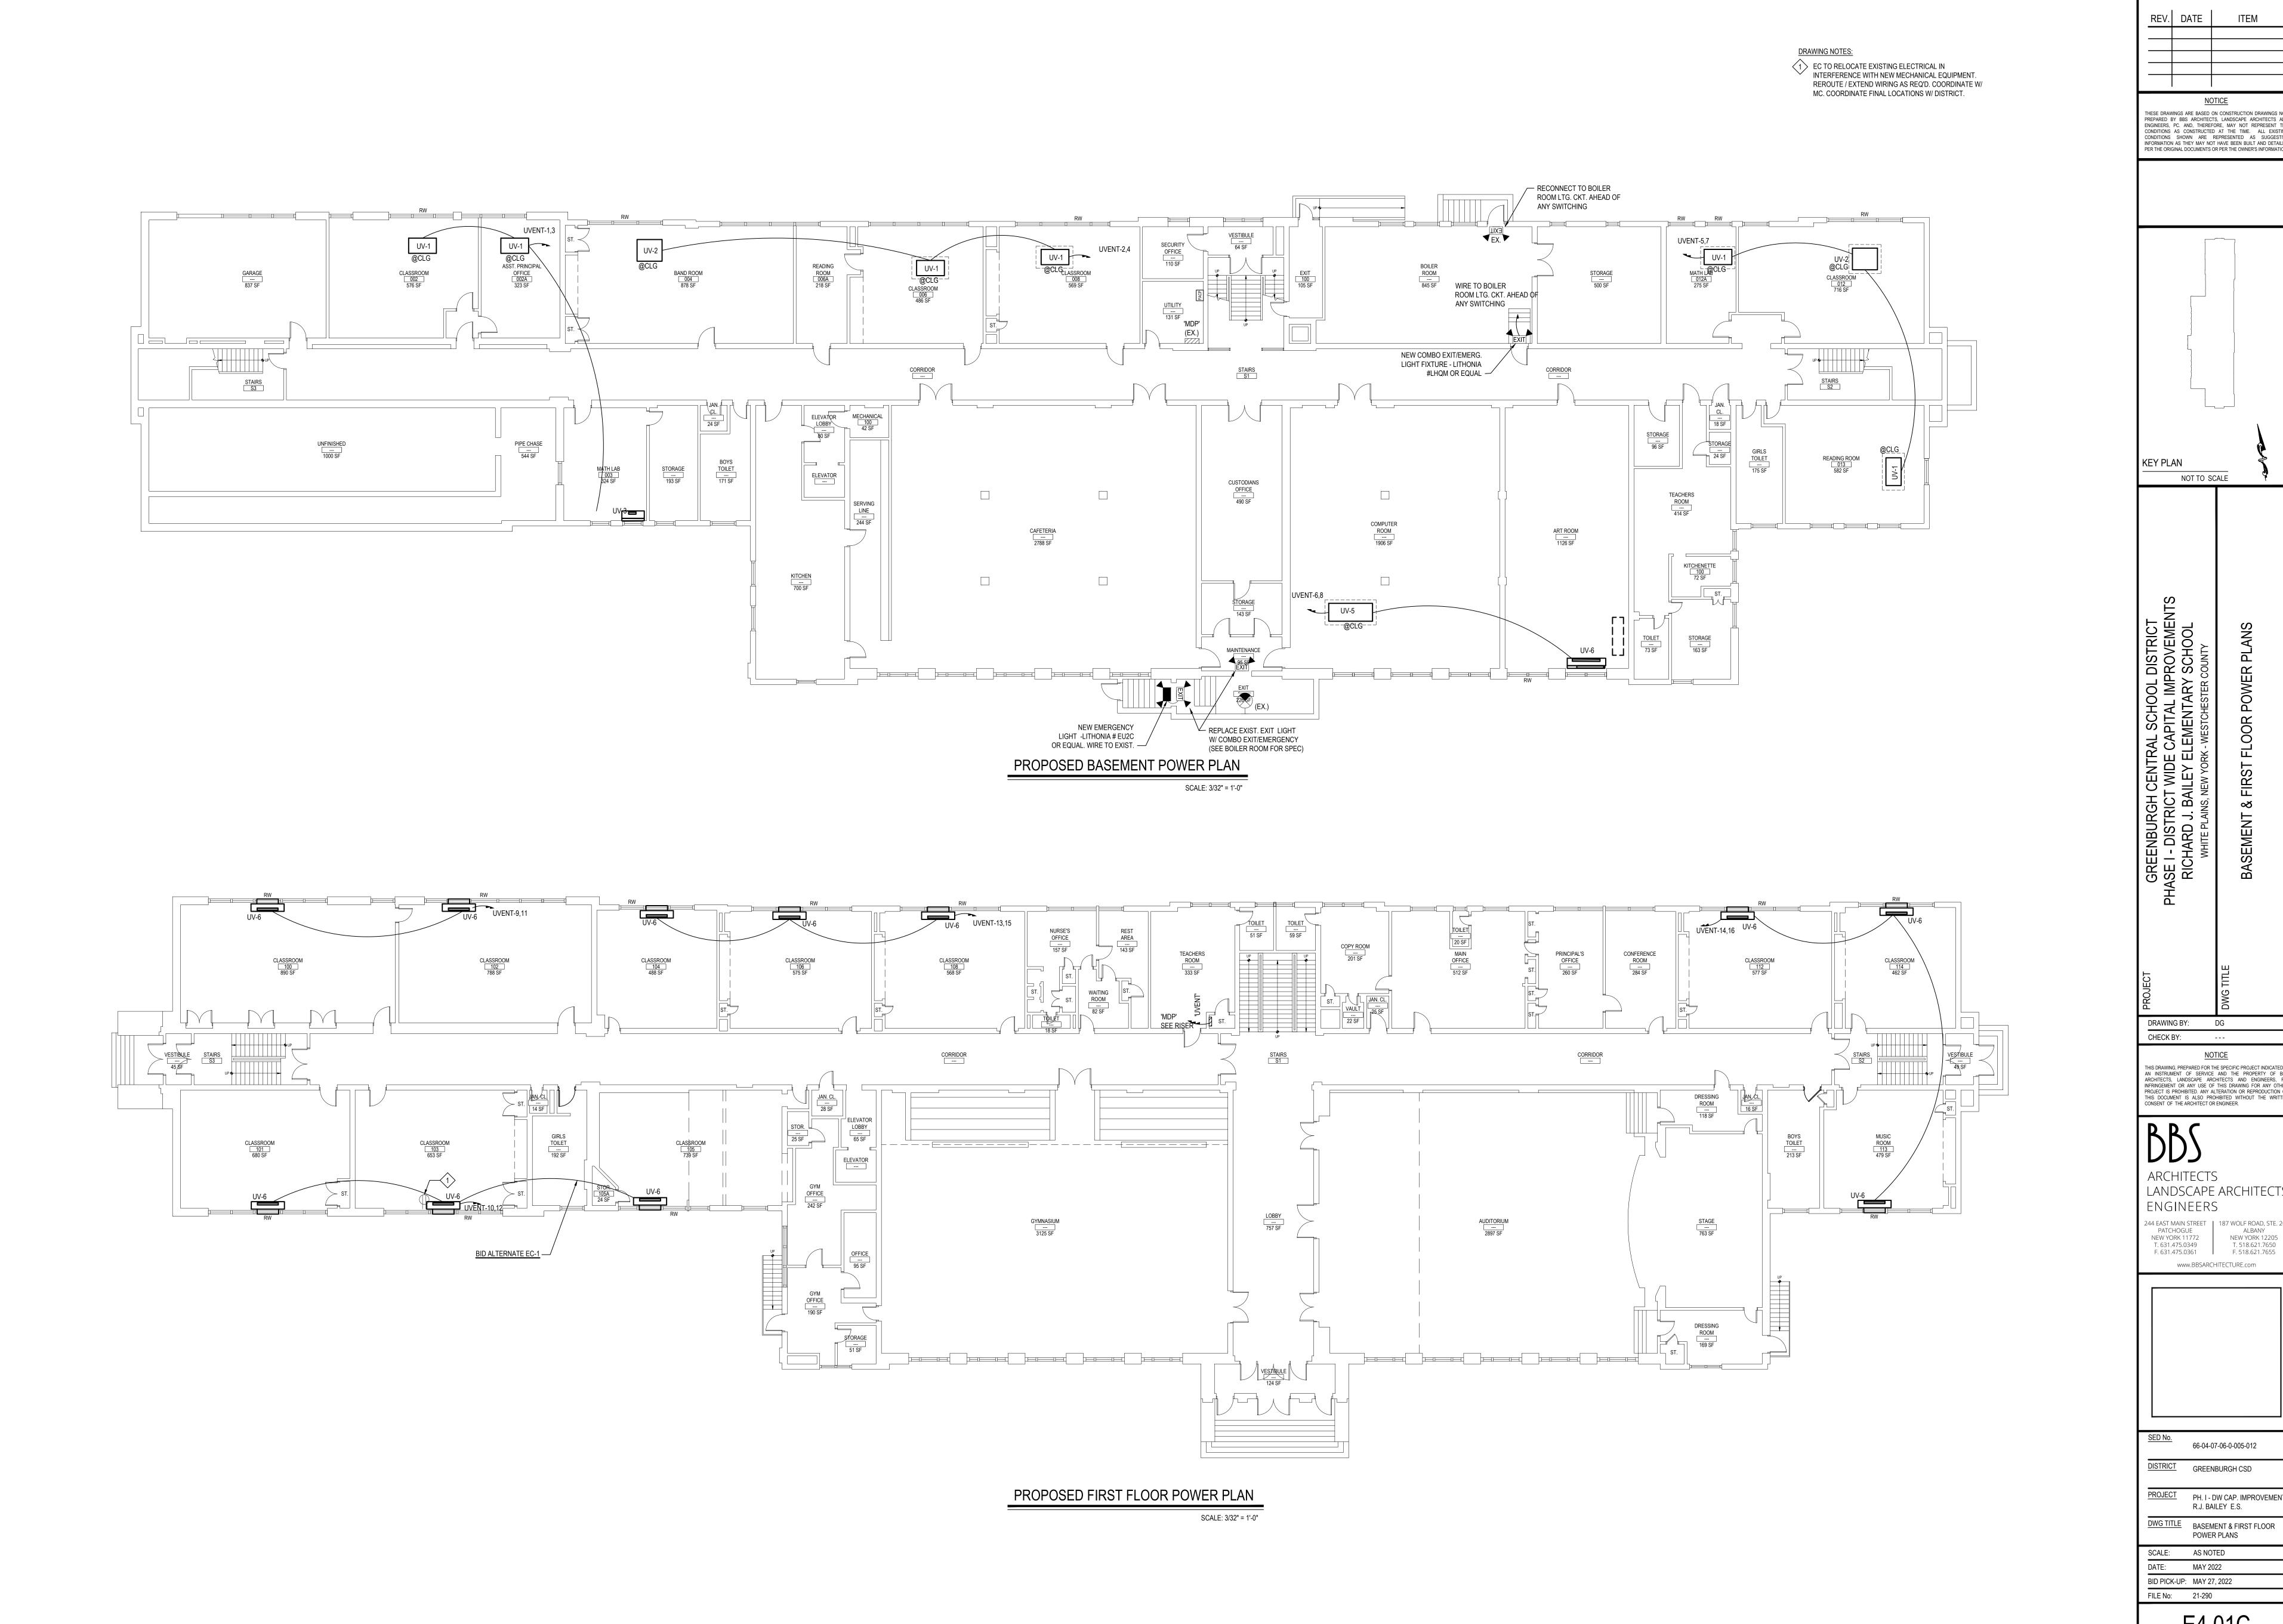


<u>NOTICE</u> THESE DRAWINGS ARE BASED ON CONSTRUCTION DRAWINGS NOT PREPARED BY BBS ARCHITECTS, LANDSCAPE ARCHITECTS AND ENGINEERS, PC. AND, THEREFORE, MAY NOT REPRESENT THE CONDITIONS AS CONSTRUCTED AT THE TIME. ALL EXISTING CONDITIONS SHOWN ARE REPRESENTED AS SUGGESTIVE INFORMATION AS THEY MAY NOT HAVE BEEN BUILT AND DETAILED PER THE ORIGINAL DOCUMENTS OR PER THE OWNER'S INFORMATION. NOT TO SCALE DRAWING BY: DG <u>NOTICE</u> THIS DRAWING, PREPARED FOR THE SPECIFIC PROJECT INDICATED IS AN INSTRUMENT OF SERVICE AND THE PROPERTY OF BBS ARCHITECTS, LANDSCAPE ARCHITECTS AND ENGINEERS, PC. INFRINGEMENT OR ANY USE OF THIS DRAWING FOR ANY OTHER PROJECT IS PROHIBITED. ANY ALTERATION OR REPRODUCTION OF THIS DOCUMENT IS ALSO PROHIBITED WITHOUT THE WRITTEN CONSENT OF THE ARCHITECT OR ENGINEER. ARCHITECTS LANDSCAPE ARCHITECTS ENGINEERS 244 EAST MAIN STREET | 187 WOLF ROAD, STE. 20 ALBANY ALBANY NEW YORK 12205 T. 518.621.7650 F. 631.475.0361 F. 518.621.7655 www.BBSARCHITECTURE.com

66-04-07-06-0-005-012 DISTRICT GREENBURGH CSD

PROJECT PH. I - DW CAP. IMPROVEMENTS R.J. BAILEY E.S.


SCALE: AS NOTED

E4.01C

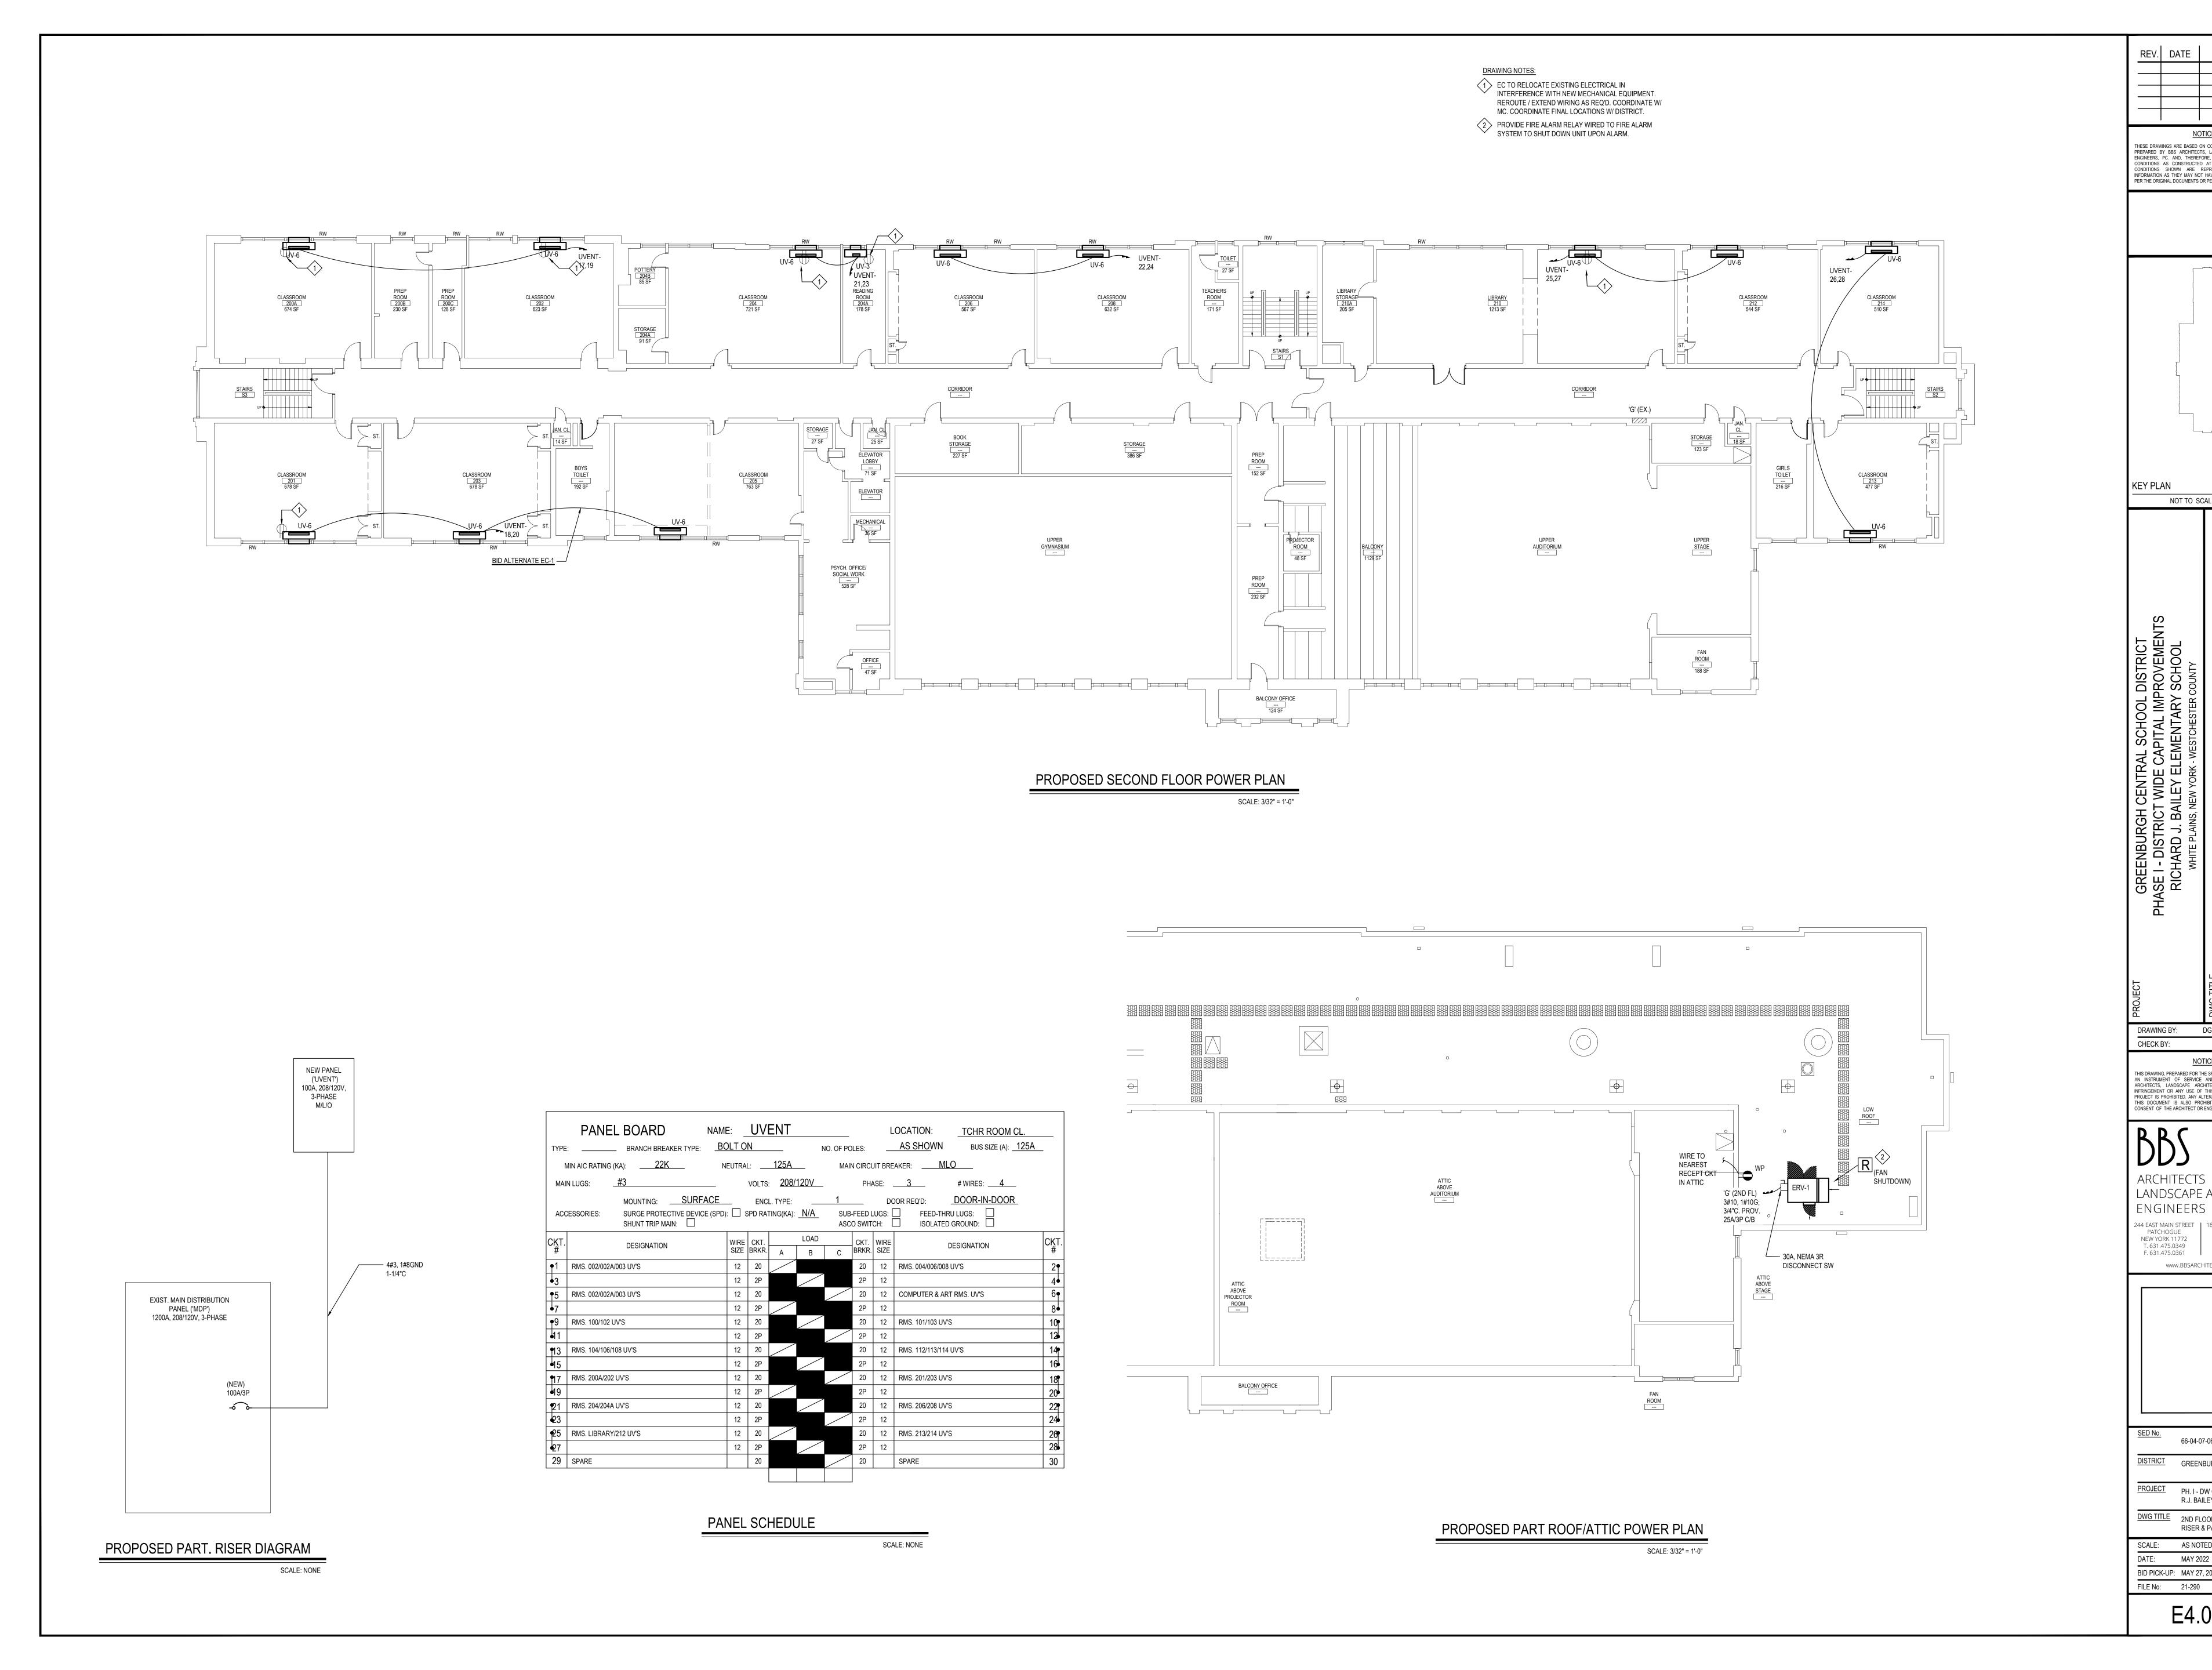

<u>NOTICE</u> THESE DRAWINGS ARE BASED ON CONSTRUCTION DRAWINGS NOT PREPARED BY BBS ARCHITECTS, LANDSCAPE ARCHITECTS AND ENGINEERS, PC. AND, THEREFORE, MAY NOT REPRESENT THE CONDITIONS AS CONSTRUCTED AT THE TIME. ALL EXISTING CONDITIONS SHOWN ARE REPRESENTED AS SUGGESTIVE INFORMATION AS THEY MAY NOT HAVE BEEN BUILT AND DETAILED PER THE ORIGINAL DOCUMENTS OR PER THE OWNER'S INFORMATION. KEY PLAN NOT TO SCALE DRAWING BY: DG CHECK BY: THIS DRAWING, PREPARED FOR THE SPECIFIC PROJECT INDICATED IS AN INSTRUMENT OF SERVICE AND THE PROPERTY OF BBS ARCHITECTS, LANDSCAPE ARCHITECTS AND ENGINEERS, PC. INFRINGEMENT OR ANY USE OF THIS DRAWING FOR ANY OTHER PROJECT IS PROHIBITED. ANY ALTERATION OR REPRODUCTION OF THIS DOCUMENT IS ALSO PROHIBITED WITHOUT THE WRITTEN CONSENT OF THE ARCHITECT OR ENGINEER. ARCHITECTS LANDSCAPE ARCHITECTS ENGINEERS 244 EAST MAIN STREET | 187 WOLF ROAD, STE. 20 ALBANY NEW YORK 11772 NEW YORK 12205 F. 631.475.0361 F. 518.621.7655 www.BBSARCHITECTURE.com 66-04-07-06-0-005-012 DISTRICT GREENBURGH CSD PROJECT PH. I - DW CAP. IMPROVEMENTS R.J. BAILEY E.S. DWG TITLE 2ND FLOOR & ROOF PWR PLANS RISER & PANEL SCHEDULE SCALE: AS NOTED BID PICK-UP: MAY 27, 2022

E4.02C

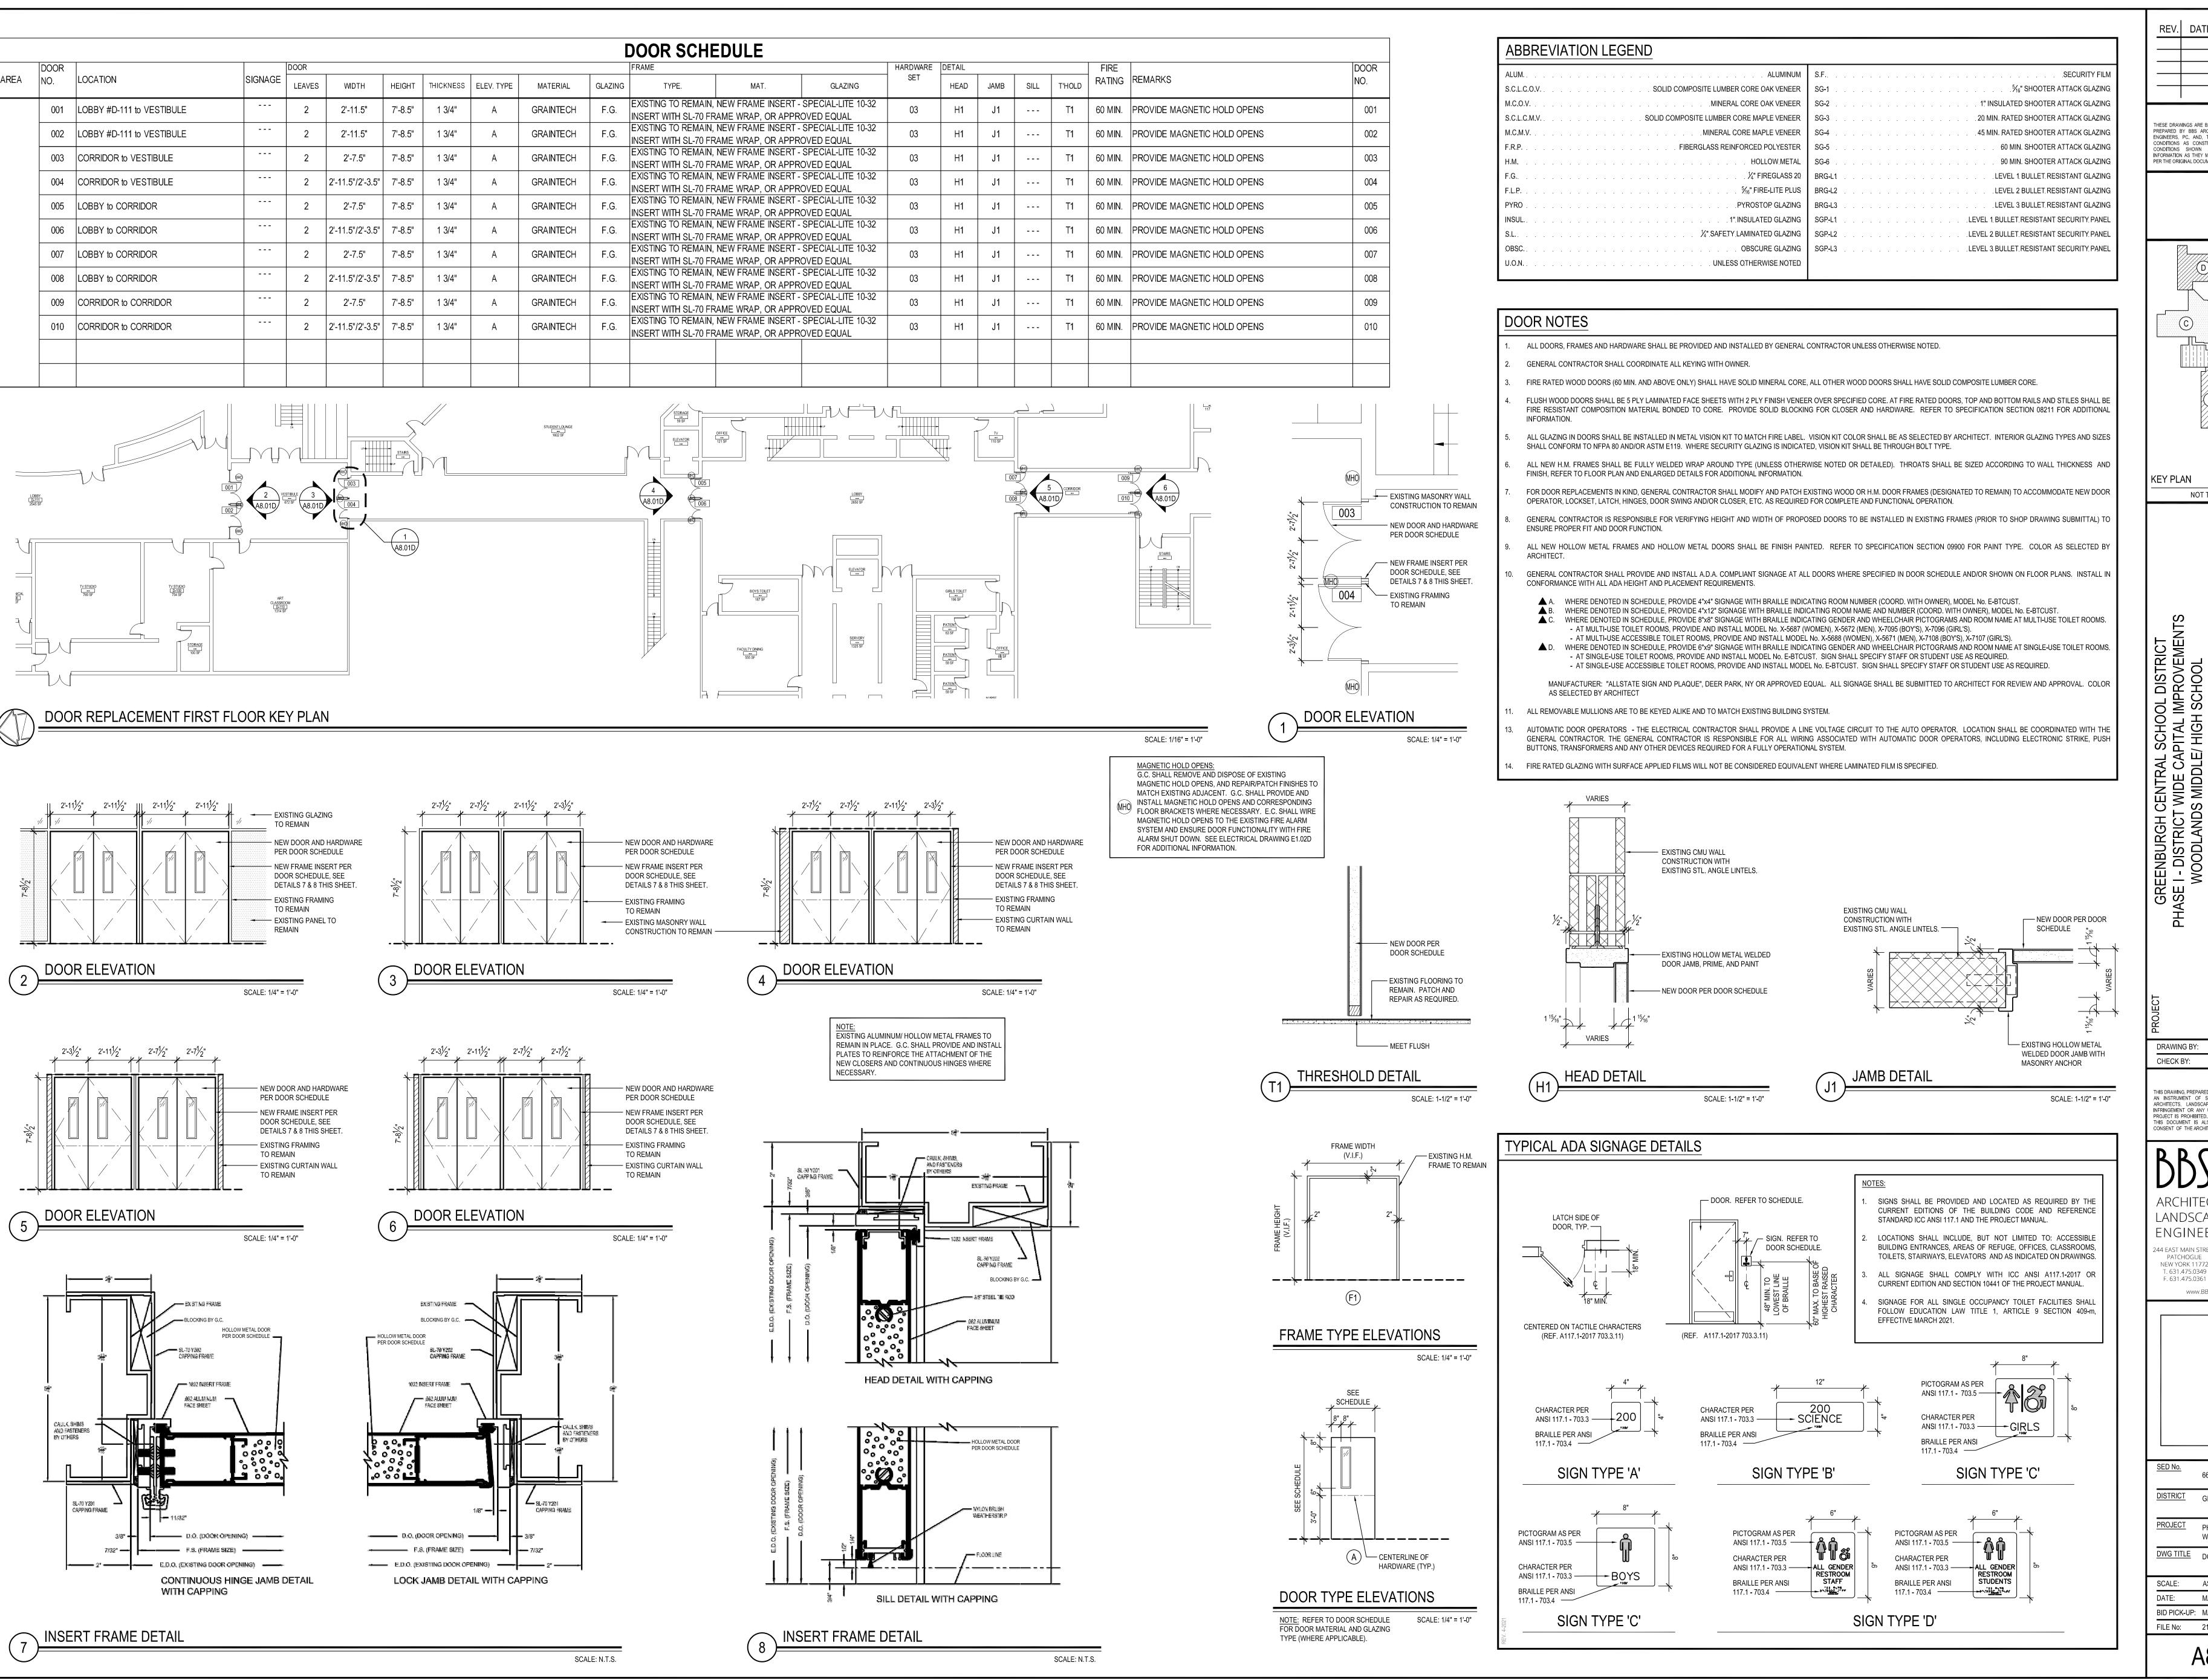

REV. DATE

ESE DRAWINGS ARE BASED ON CONSTRUCTION DRAWINGS NO EPARED BY BBS ARCHITECTS, LANDSCAPE ARCHITECTS AN FORMATION AS THEY MAY NOT HAVE BEEN BUILT AND DETAILE

KEY PLAN NOT TO SCALE

S.E.S. CHECK BY: J.W.W. THIS DRAWING, PREPARED FOR THE SPECIFIC PROJECT INDICATED IS AN INSTRUMENT OF SERVICE AND THE PROPERTY OF BBS ARCHITECTS, LANDSCAPE ARCHITECTS AND ENGINEERS, FINFRINGEMENT OR ANY USE OF THIS DRAWING FOR ANY OTH PROJECT IS PROHIBITED. ANY ALTERATION OR REPRODUCTION OF THIS DOCUMENT IS ALSO PROHIBITED WITHOUT THE WRITTEN ONSENT OF THE ARCHITECT OR ENGINEER.

ARCHITECTS

LANDSCAPE ARCHITECTS ENGINEERS


187 WOLF ROAD, STE. 20 PATCHOGUE NEW YORK 11772 NEW YORK 12205 T. 518.621.7650 F. 518.621.7655 F. 631.475.0361 www.BBSARCHITECTURE.com


SED No. 66-04-07-06-0-007-022 DISTRICT GREENBURGH CSD

<u>PROJECT</u> PH. I - DW CAP. IMPROVEMENTS WOODLANDS M.S./H.S. DWG TITLE DOOR SCHEDULE

SCALE: AS NOTED DATE: MAY 2022 BID PICK-UP: MAY 27, 2022 FILE No: 21-291

A8.01D

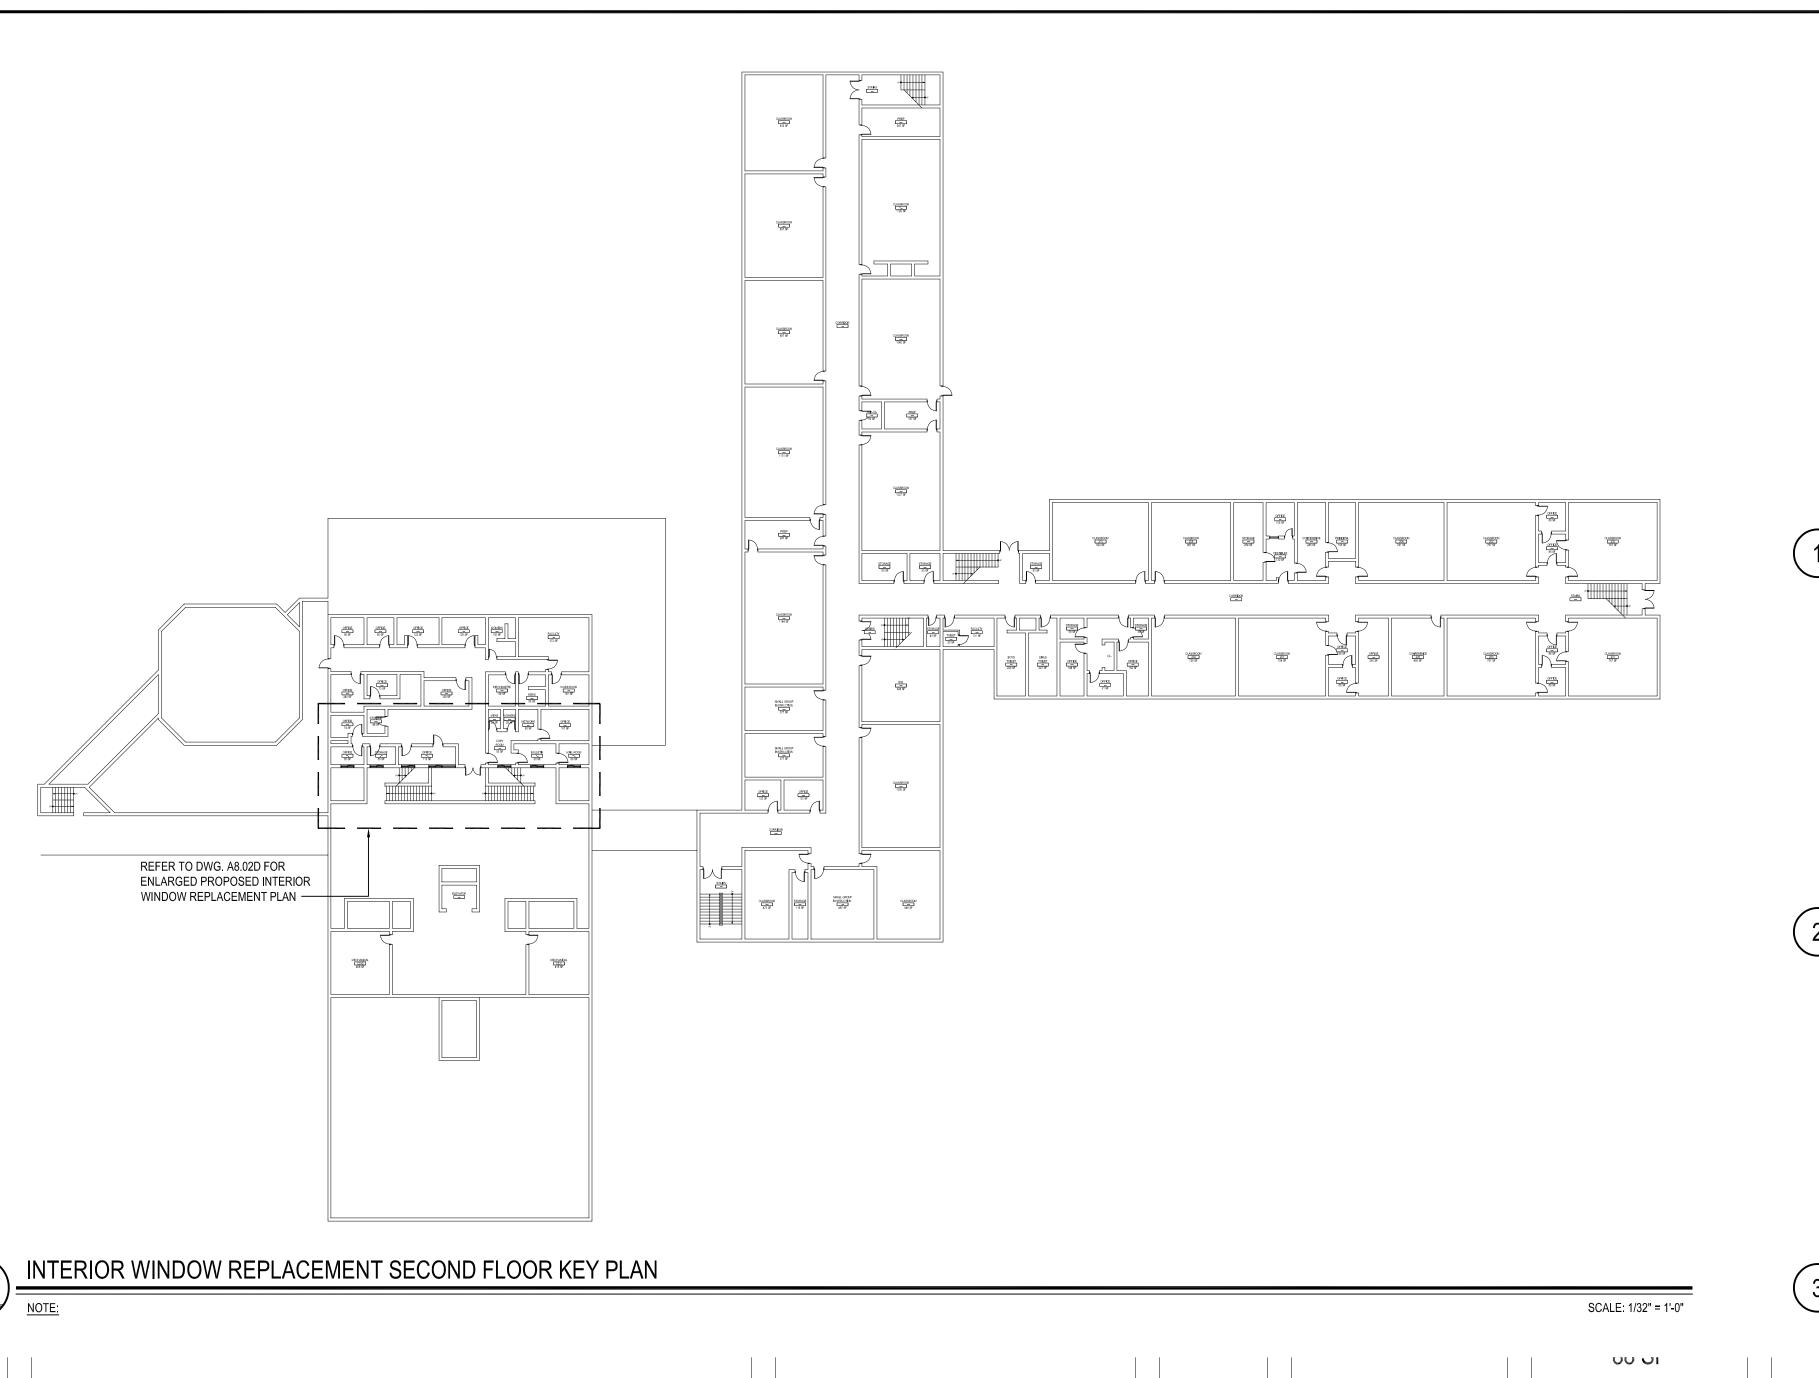


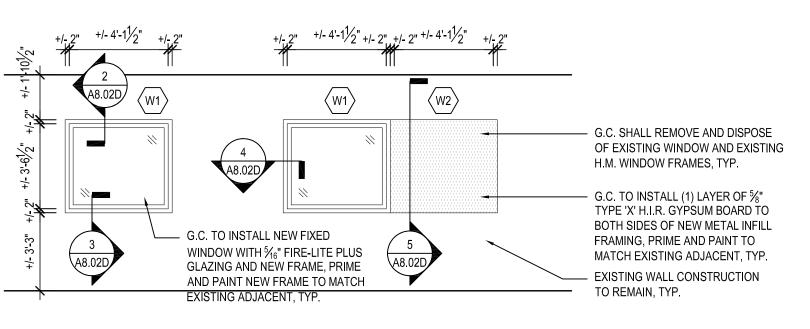



TYPICAL WINDOW REPLACEMENT ELEVATION

SCALE: 1/4" = 1'-0"

SCALE: 6" = 1'-0"

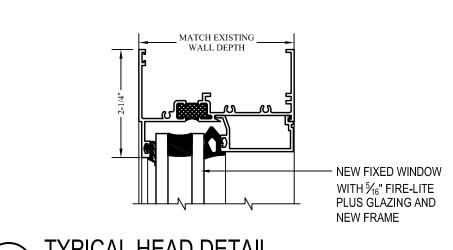

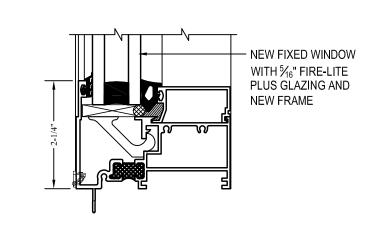

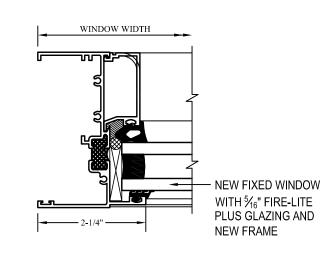

\_\_\_ GYP. BD. METAL STUD INFILL PARTITION

EXIST. TO REMAIN

NEW INFILL

**EXISTING PARTITION TO REMAIN - VERIFY** 

SECURE TOP OF NEW PARTITION TO

EXISTING PARTITION CONSTRUCTION -

CONSTRUCTION TYPE AND SIZE IN FIELD -

NEW GYP. BD. METAL STUD FRAMED INFILL

EXISTING ADJACENT SURFACES FOR NEW

CONSTRUCTION TO ALIGN WITH EXISTING

AT 16" O.C. MAX. - SIZE AS APPROPRIATE TO

MATCH EXIST. PARTITION THICKNESS ----

SECURE BASE OF NEW PARTITION

UL U419 / STC 49, NON-BEARING

INTERIOR PARTITION, GRAPHIC

SIMILAR AS SHOWN

TO EXISTING FLOOR CONSTRUCTION -

ONE (1) LAYER OF GYP. BD. (EACH SIDE). GYPSUM

PANEL CORE COMPOSITION SHALL MAINTAIN THE EXISTING FIRE RATING (WHERE APPLICABLE) — 20GA. MIN. HOT-DIP GALV. STEEL FRAMING

PARTITION. PATCH AND MATCH ALL

FOR A SEAMLESS TRANSITION —

PRE-ABATEMENT WORK NOTES:

1. THE CONTRACTOR SHALL DETERMINE EXACT FINAL LOCATIONS OF PERSONAL AND WASTE DECONTAMINATION ENCLOSURES, PICK UP AREA FOR REFUSE AND ASBESTOS DEBRIS. THESE LOCATIONS SHALL BE REVIEWED AND PROPERLY APPROVED BY THE DISTRICT PRIOR TO COMMENCEMENT OF WORK. THIS CONTRACTOR SHALL ESTABLISH, LABEL AND MAINTAIN PROPER EXITS AND WAYS OF DEPARTURE WITHIN EACH WORK AREA FOR NORMAL AND EMERGENCY USE BY WORKERS DURING ALL ABATEMENT.

POST-ABATEMENT WORK NOTES:

1. THE CONTRACTOR SHALL, UPON COMPLETION OF REMOVALS, PROVIDE WRITTEN DOCUMENTATION THAT THE PROJECT WORK AREAS ARE COMPLETELY FREE OF ALL HAZARDOUS

2. THE CONTRACTOR SHALL PROVIDE RECORDS OF ALL HAZARDOUS MATERIALS REMOVED FROM

# ABATEMENT NOTES

REMOVE FROM THE AREAS INDICATED: ALL ASBESTOS CONTAINING ELBOWS TO FIBERGLASS PIPE INSULATION WITH CANVAS WRAP, AT ALL LOCATIONS BASED ON THIS PROJECT. LOCATED IN MECHANICAL ROOMS. REMOVAL SHALL BE IN COMPLIANCE WITH CODE RULE 56 AND

REMOVE FROM THE AREAS INDICATED: ALL ASBESTOS CONTAINING ELBOWS TO FIBERGLASS PIPE INSULATION WITH TAR CONTAINING WRAP, AT ALL LOCATIONS BASED ON THIS PROJECT. LOCATED IN MECHANICAL ROOMS. REMOVAL SHALL BE IN COMPLIANCE WITH CODE RULE 56 AND

REMOVE FROM THE AREAS INDICATED: ALL ASBESTOS CONTAINING DUCT INSULATION, AT ALL LOCATIONS BASED ON THIS PROJECT, LOCATED IN CAFETERIA MECHANICAL ROOM #1, REMOVAL SHALL BE IN COMPLIANCE WITH CODE RULE 56 AND SPECIFICATIONS.

REFER TO ENVIROSCIENCE CONSULTANTS, REPORT FOR PROJECT # 21819, CONTAINED WITHIN THE PROJECT MANUAL, FOR ALL PRECONSTRUCTION SURVEY, BULK SAMPLING AND ANALYSIS OF SUSPECT/ASSUMED ASBESTOS CONSTRUCTION MATERIALS. G.C. TO COORDINATE WITH ENVIROSCIENCE FOR PROJECT-SPECIFIC ABATEMENT & DISPOSAL PROTOCOL REQUIRED.

# LEAD CONTAINING NOTES

NONE OF THE BUILDING MATERIALS AFFECTED BY THE SCOPE OF WORK WERE FOUND TO BE LEAD CONTAINING. PLEASE SEE TEST RESULTS AND REPORT BY ENVIROSCIENCE CONSULTANTS, REPORT FOR PROJECT # 21819, CONTAINED WITHIN THE PROJECT MANUAL. FOR ALL PRECONSTRUCTION SURVEY, BULK SAMPLING AND ANALYSIS OF SUSPECT/ASSUMED LEAD CONTAINING CONSTRUCTION MATERIALS.

### GENERAL PARTITION TYPE NOTES:

AND FIRE SAFING JOINT FILLER AT PARTITION TO SLAB/DECK JUNCTION.

TO CODE COMPLIANCE DRAWINGS FOR ADDITIONAL INFORMATION.

CONTRACTOR SHALL BE RESPONSIBLE FOR VERIFYING ALL EXISTING CONDITIONS IN FIELD

. ALL PARTITIONS SHALL EXTEND TO UNDERSIDE OF A FLOOR SLAB OR ROOF DECK UNLESS OTHERWISE NOTED. 2. AT ALL PARTITIONS THAT ARE DESIGNATED TO BE FIRE RATED PARTITIONS; PROVIDE CONTINUOUS SMOKE

AND FIRESTOPPING SEALANT AT TOPS OF PARTITIONS; AT ALL PENETRATIONS THROUGH RATED PARTITIONS;

- REFER TO CODE COMPLIANCE DRAWINGS FOR LOCATIONS OF ALL FIRE RATED PARTITIONS/ASSEMBLIES AND ADDITIONAL FIRE RATING INFORMATION.
- ALL PARTITIONS SHALL BE FINISHED AS SCHEDULED. ALL FINISHES SHALL BE CONTINUOUS AT ALL PARTITION
- FACES UNLESS NOTED OTHERWISE. REFER TO A9-SERIES FOR ADDITIONAL FINISH INFORMATION. . ALL NEW PARTITIONS SHALL BE PREPPED, PRIMED AND PAINTED, PER SPECIFICATION SECTION 09900.
- 6. REFER TO THE PROJECT MANUAL FOR CONTROL AND EXPANSION JOINT REQUIREMENTS FOR ALL MASONRY
- WALL CONSTRUCTION, GYP. BD. WALL CONSTRUCTION, GYP. BD. LAMINATION, AND PLASTER SURFACING. REFER TO SPECIFICATIONS FOR GYPSUM BOARD TYPE DESIGNATIONS AND APPLICABLE LOCATIONS (GYP. BD.
- WHERE METAL STUD FRAMED PARTITIONS ARE SCHEDULED TO RECEIVE NEW TILE FINISHES; THE CONTRACTOR SHALL PROVIDE GYPSUM WALL BOARD TYPE II AT THE LOCATIONS TO RECEIVE TILE (ONLY) IN LIEU OF THE SCHEDULED GYP. BD. TYPE FOR A SUITABLE WALL FINISH SUBSTRATE. REFER TO A-9 SERIES FOR
- ADDITIONAL INFORMATION. ALL NEW OPENINGS IN METAL STUD PARTITIONS, INCLUDING BUT NOT LIMITED TO DOORS AND WINDOWS, SHALL RECEIVE THE APPROPRIATE HEADER AS DESIGNED BY THE LIGHT GAUGE FRAMING MANUFACTURER.
- ). WHERE EXISTING OPENINGS IN EXISTING PARTITIONS ARE SCHEDULED TO BE INFILLED, THE NEW INFILL CONSTRUCTION SHALL MAINTAIN AND MATCH THE EXISTING PARTITION'S FIRE RATING FOR CONTINUITY OF FIRE AND SMOKE PROTECTION - CONTRACTOR TO VERIFY IN FIELD (1-HR MIN. RATING AT CORRIDORS). REFER
- . AT ALL LOCATIONS WHERE EXISTING PARTITIONS ARE SCHEDULED TO BE PATCHED OR INFILLED; ALL NEW CONSTRUCTION/FINISHES SHALL MATCH THE EXISTING ADJACENT SURFACES IN KIND - CONTRACTOR TO V.I.F.
- 12. AT ALL LOCATIONS WHERE NEW WORK IS SCHEDULED, THE CONTRACTOR SHALL PROVIDE SOLID BLOCKING, LATERAL BRACING, AND ADDITIONAL FRAMING AS REQUIRED TO SECURE NEW PARTITIONS TO THE STRUCTURE ABOVE AND TO ACCOMMODATE ALL NEW WALL MOUNTED FIXTURES, ACCESSORIES, EQUIPMENT, ETC.
- 13. WHERE PARTITION TYPES ARE NOT SPECIFICALLY IDENTIFIED IN PLAN, IT IS THE INTENT THAT THE GRAPHICALLY INDICATED WALL TYPE SHALL BE CONTIGUOUS UNTIL INTERRUPTED BY ANOTHER SPECIFIED

PAINT TYPES		
TYPE P1:	PAINT BY SHERWIN WILLIAMS: DTM ALKYD SEMI-GLOSS ENAMEL COLOR: TO BE SELECTED BY ARCHITEC (H.M. WINDOW FRAMES)	

LL DIMENSIONS GIVEN ARE +/- AND ARE TO BE VERIFIED IN THE FIELD BY THE GENERAL CONTRACTOR PRIOR TO FABRICATION AND INSTALLATION OF NEW PANELS. CONTRACTOR SHALL SUBMIT SHOP DRAWINGS FOR APPROVAL BY ARCHITECT PRIOR TO FABRICATION AND INSTALLATION OF NEW WORK.

# **DEMOLITION and REMOVAL NOTES**

- THE GENERAL CONTRACTOR IS RESPONSIBLE FOR ALL DEMOLITION AND REMOVALS, UNLESS NOTED OTHERWISE. MECHANICAL, PLUMBING AND ELECTRICAL CONTRACTORS SHALL BE RESPONSIBLE FOR ALL DISCONNECTS. G.C. TO COORDINATE DEMOLITION WITH M.C., P.C., AND E.C. REFER TO M.E.P. SERIES DEMOLITION DRAWINGS FOR ADDITIONAL INFORMATION AND DEMOLITION SCOPE BY GENERAL CONTRACTOR NOT SHOWN THIS DRAWING. TYPICAL FOR ALL AREAS OF INTERIOR DEMOLITION AND / OR RECONSTRUCTION.
- TOOTHED-IN TO MATCH ADJACENT.

ALL OPENINGS IN EXISTING INTERIOR AND EXTERIOR WALLS SHALL BE PATCHED AS REQUIRED AND MASONRY

- G.C. SHALL PATCH, REPLACE, OR REPAIR DAMAGE CAUSED TO EXIST. FLOOR, WALLS, ROOF, ETC. SHOWN TO REMAIN AS A RESULT OF DEMOLITION TO PRIOR CONDITION OR MATCH ADJACENT NEW CONSTRUCTION.
- I. G.C. SHALL VERIFY ALL REMOVALS W/ OWNERS REPRESENTATIVE/OWNER, AND M.C., P.C., OR E.C. PRIOR TO COMMENCEMENT.
- NOTED WALL REMOVALS SHALL INCLUDE ALL DOORS, WINDOWS AND FRAMES WHERE SHOWN.

KEY PLAN NOT TO SCALE OTHERWISE, NEW INFILL PARTITION FINISHES (EACH SIDE) SHALL MATCH

WHERE TILE IS SCHEDULED AT GYP. BD. PARTITIONS, REFER TO GENERAL

REFER TO GENERAL PARTITION TYPE NOTE 10 THIS SHEET FOR ADDITIONAL

PARTITION TYPE NOTE 8 THIS SHEET.

INFILL PARTITION REQUIREMENTS.

ACOUSTICAL FIBERGLASS

OF STEEL FRAMING - V.I.F.

UNFACED BATT INSULATION.

THICKNESS TO FILL ENTIRE WIDTH

UNLESS NOTED OR SCHEDULED

THE EXISTING PARTITION FINISHES

COVERING, WALL TILE, CEILING TRIM,

MOLDINGS, ETC. - VERIFY IN FIELD

IN KIND, INCLUDING BUT NOT

LIMITED TO: WALL BASE, WALL

ALL BASE AND TOP TRACK RUNNERS SHALL BE HOT-DIP GALV. STEEL 20GA MIN. FASTENED AT 24" O.C. MAX.

REV. DATE

THESE DRAWINGS ARE BASED ON CONSTRUCTION DRAWINGS NOT PREPARED BY BBS ARCHITECTS, LANDSCAPE ARCHITECTS AND CONDITIONS AS CONSTRUCTED AT THE TIME. ALL EXISTIN CONDITIONS AS CONTROLLE AND INME. AS SUGGESTIVE INFORMATION AS THEY MAY NOT HAVE BEEN BUILT AND DETAILED PER THE ORIGINAL DOCUMENTS OR PER THE OWNER'S INFORMATION

DRAWING BY: S.E.S. CHECK BY: J.W.W.

THIS DRAWING, PREPARED FOR THE SPECIFIC PROJECT INDICATED IS AN INSTRUMENT OF SERVICE AND THE PROPERTY OF BBS ARCHITECTS, LANDSCAPE ARCHITECTS AND ENGINEERS, P. INFRINGEMENT OR ANY USE OF THIS DRAWING FOR ANY OTHE PROJECT IS PROHIBITED. ANY ALTERATION OR REPRODUCTION OF THIS DOCUMENT IS ALSO PROHIBITED WITHOUT THE WRITTEN ONSENT OF THE ARCHITECT OR ENGINEER.

LANDSCAPE ARCHITECTS ENGINEERS

4 EAST MAIN STREET | 187 WOLF ROAD, STE. 205 NEW YORK 11772 NEW YORK 12205 F. 518.621.7655

www.BBSARCHITECTURE.com

66-04-07-06-0-007-022 DISTRICT GREENBURGH CSD <u>PROJECT</u> PH. I - DW CAP. IMPROVEMENTS WOODLANDS M.S./H.S.

DWG TITLE DEMO AND PROPOSED WINDOW REPLACEMENTS SCALE: AS NOTED DATE: MAY 2022 BID PICK-UP: MAY 27, 2022


FILE No: 21-291

A8.02D


OFFICE 48 SF	MENS WOMENS 26 SF NETWORK 68 SF	OFFICE 167 SF
OFFICE  65 SF  W  W  WI  WI  WI  WI  WI  AND FRAME TO BE REMOVED BY ITS ENTIRETY. INSTALL NEW FRAME WINDOW WITH ME PROLUCE MUSTAL WINDOW WITH ME PRELIE PLUS BUSINES GLAZING WITH NEW PROLUCE WINDOW WITH ME PROLUCE MUSTAL WINDOW WITH ME PRELIE PLUS BUSINES WINDOW WITH ME PRELIE PLUS BUSI	COPY ROOM 95 SF  BULLETIN 90 SF w1 +/- 4'-5\/_2" M.O. V.I.F.	MAIL ROOM   69 SF  W1   EXISTING SLIDER WINDOW SYSTEM AND FRAME TO BE REMOVED IN ITS ENTIRETY. INSTALL NEW FIXED WINDOW WITH 5/6" FIRE-LITE PLUS GLAZING WITH NEW HOLLOW METAL FRAME, PRIME AND PAINT TO MATCH EXISTING ADJACENT.
WINDOW TYPE: SLIDER DIMENSIONS: 4'-5½" x 3'-10½"  WINDOW TYPE: FIXED DIMENSIONS: 4'-5½" x 3'-10½"		

ENLARGED PROPOSED INTERIOR WINDOW REPLACEMENT PLAN

SCALE: 1/4" = 1'-0"

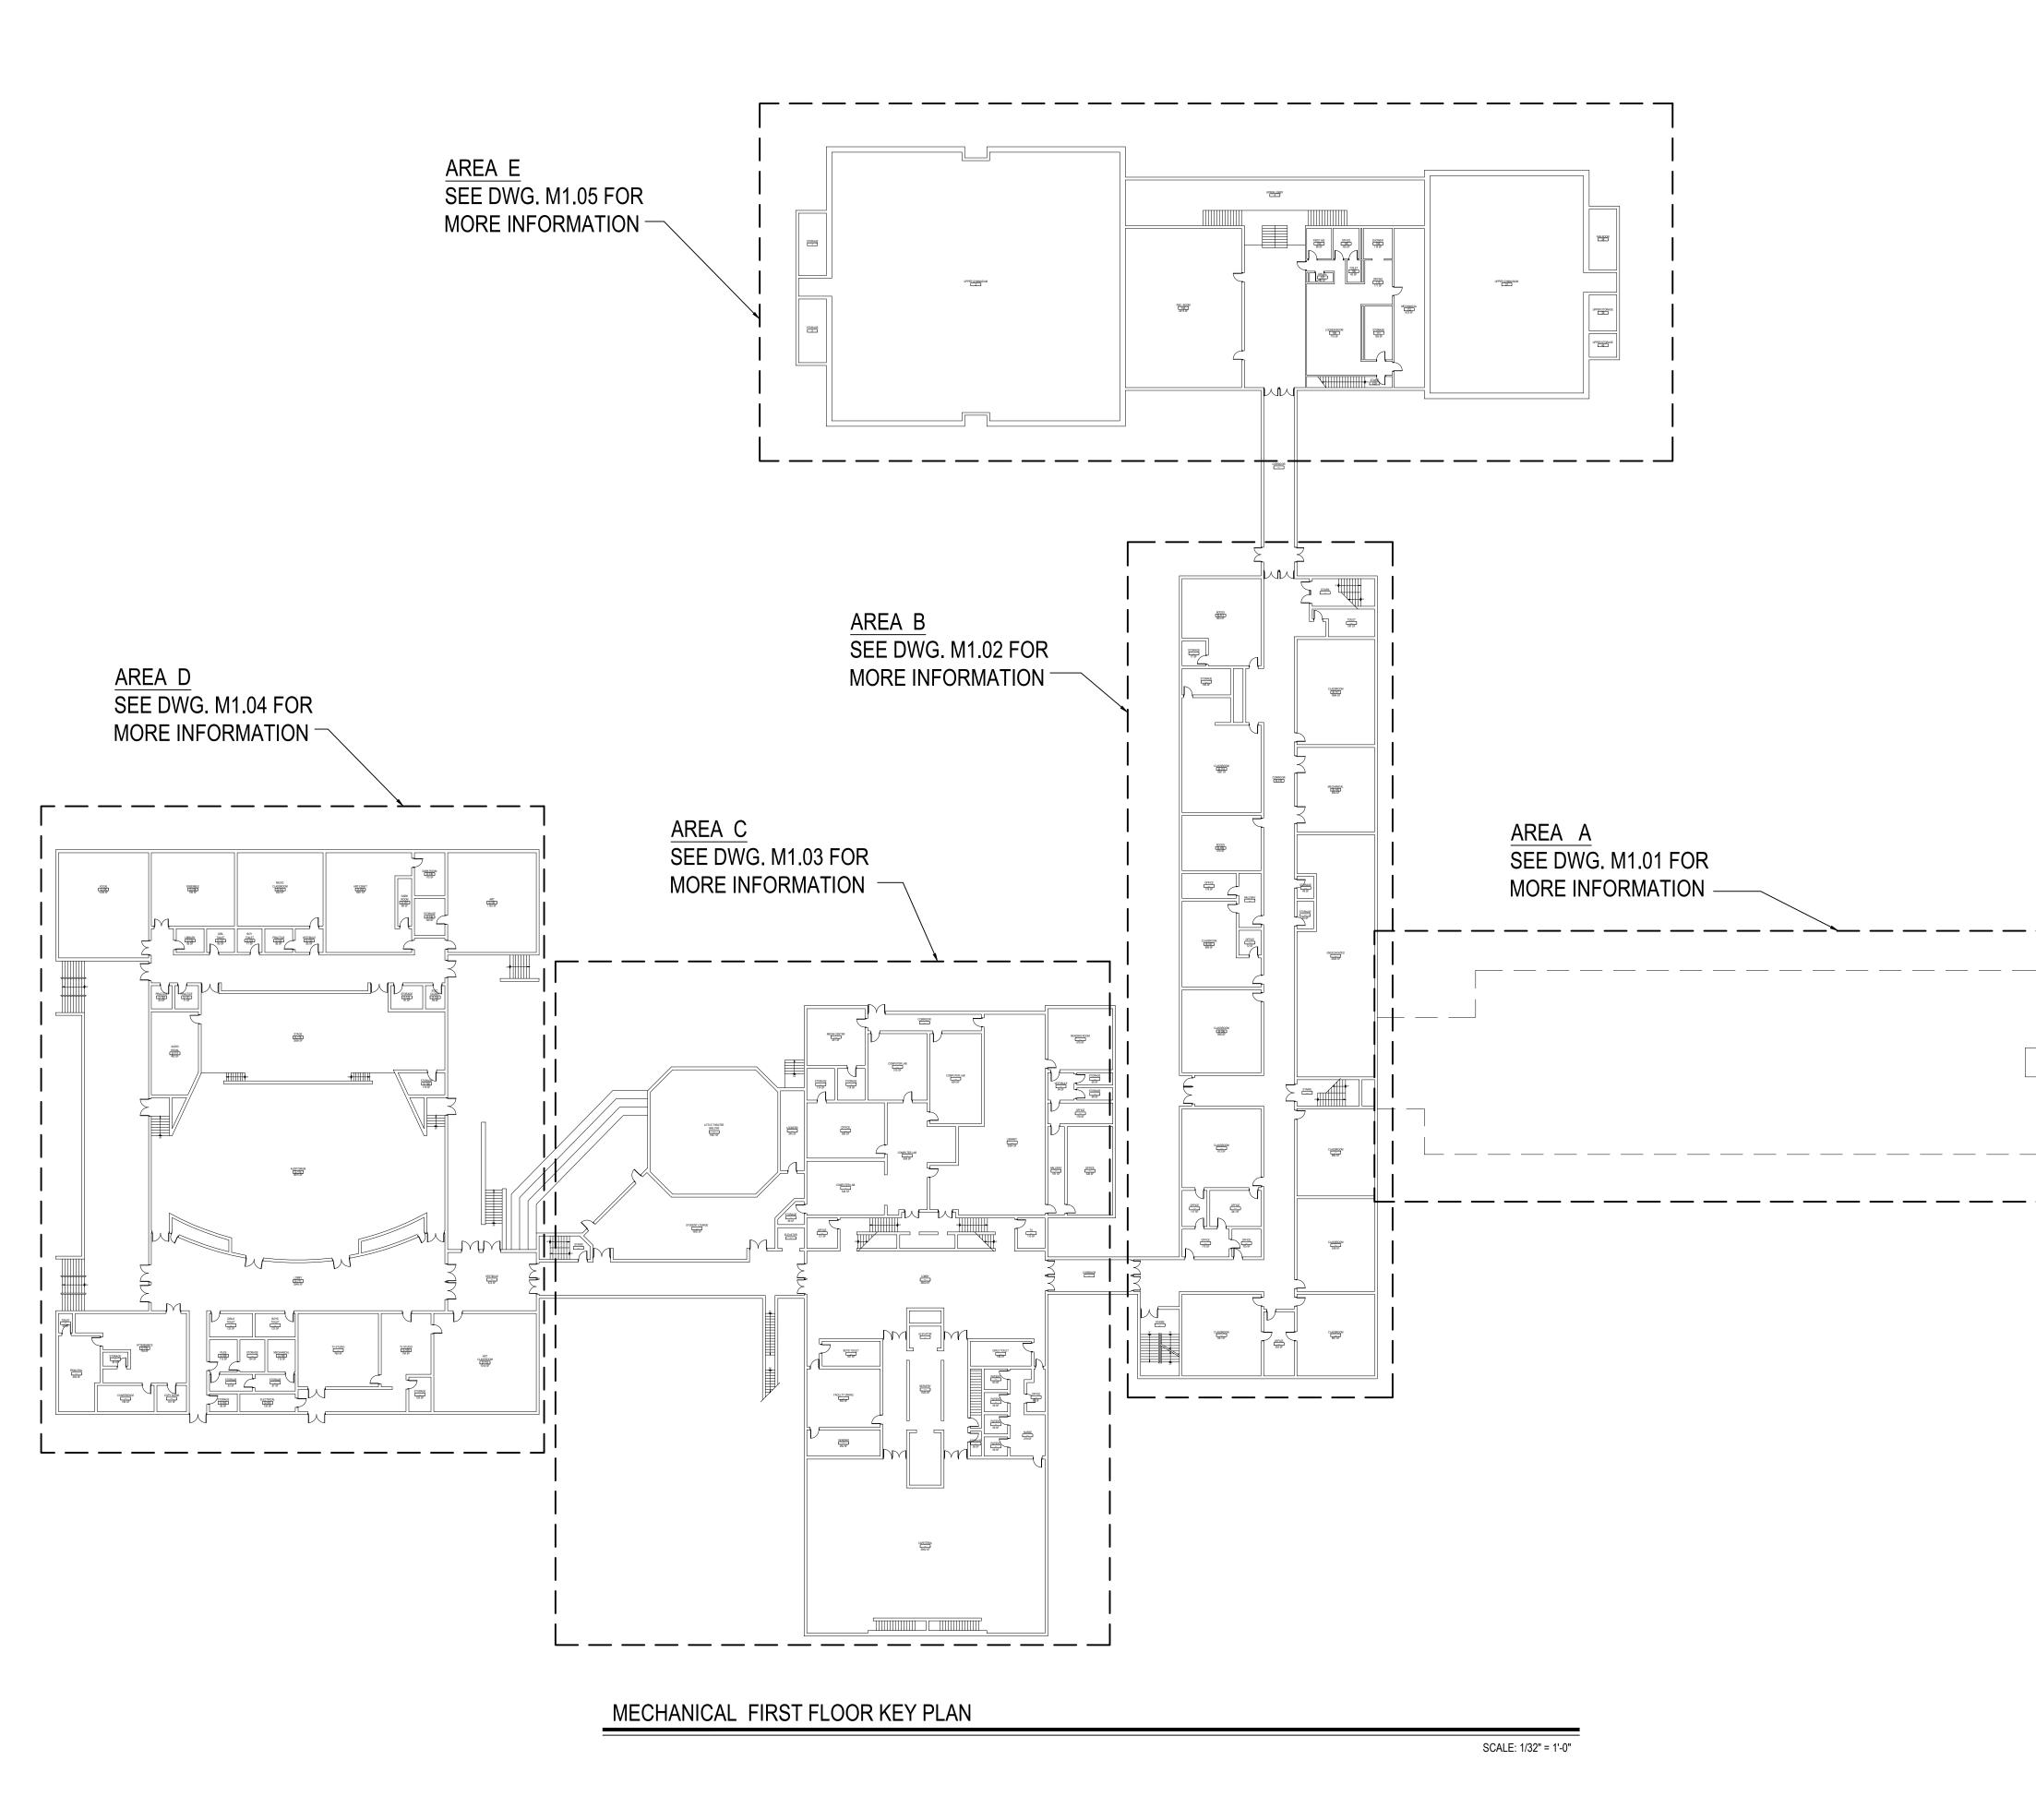

# MECHANICAL LEGEND, SYMBOLS, AND ABBREVIATIONS

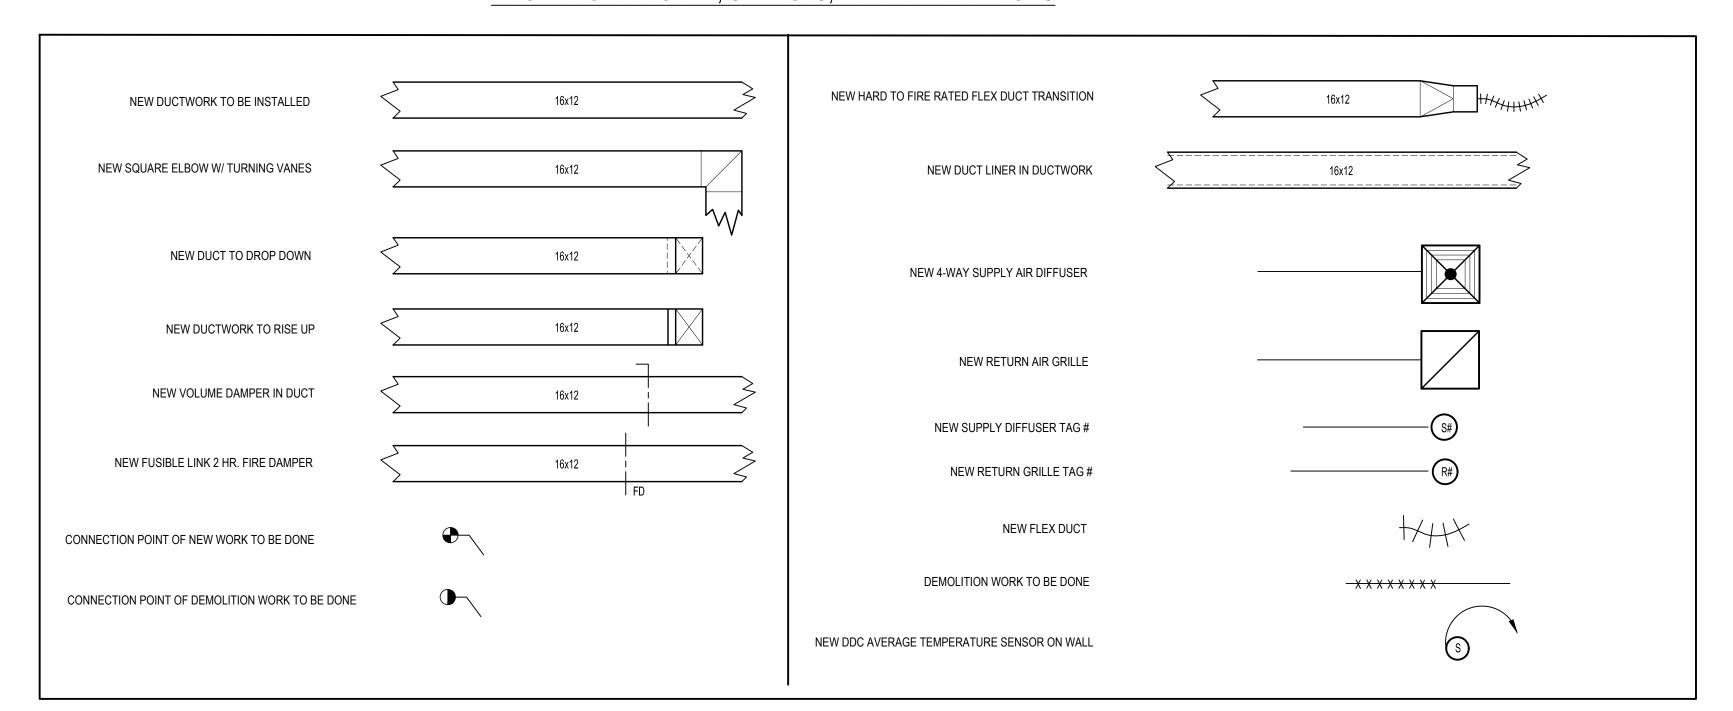

#### **GENERAL NOTES**

- 1. REMOVAL & RELOCATION OF CERTAIN EXISTING WORK SHALL BE NECESSARY FOR THE PERFORMANCE OF THE NEW WORK SHOWN HEREIN. ALL EXISTING CONDITIONS ARE NOT COMPLETELY DETAILED ON THE DRAWINGS. THE CONTRACTOR SHALL SURVEY THE SITE & MAKE ALL NECESSARY CHANGES BASED ON EXISTING CONDITIONS AS REQUIRED FOR PROPER DEMOLITION OF EXISTING WORK & SHALL INCLUDE ALL MATERIALS & LABOR FOR SAME IN HIS BID PRICE. NO ALLOWANCE WILL BE MADE FOR FAILURE TO DO SO.
- PRIOR TO SUBMITTING A BID, THE CONTRACTOR SHALL VISIT THE PREMISES OF THE PROPOSED WORK & SHALL CAREFULLY EXAMINE THE ENGINEERING DRAWINGS, EXISTING CONDITIONS & LIMITATIONS THEREOF. VERIFY ACTUAL LOCATIONS WHERE THE NEW PIPING WILL BE ROUTED, COORDINATE WITH NEW & EXISTING WORK & PROVIDE CLEARANCE W/ BUILDING STRUCTURE, OTHER SERVICES, ETC.. THE CONTRACTOR SHALL INCLUDE ALL COSTS WHATSOEVER WHICH ARE INCURRED AS A RESULT OF LIMITATIONS OF THE EXISTING & NEW CONDITIONS. LATER CLAIMS FOR EXTRA LABOR, EQUIPMENT, MATERIALS, ETC. REQUIRED DUE TO DIFFICULTIES WHICH COULD HAVE BEEN FORESEEN WILL NOT BE CONSIDERED AS EXTRA WORK.
- INSTALL WORK SO AS TO BE READILY ACCESSIBLE FOR OPERATING, MAINTENANCE & REPAIR. MINOR DEVIATIONS FROM DRAWINGS MAY BE MADE TO ACCOMPLISH THIS, BUT CHANGES OF MAGNITUDE WHICH INVOLVE EXTRA COST SHALL NOT BE MADE WITHOUT APPROVAL.
- INVESTIGATE EACH SPACE THROUGH WHICH EQUIPMENT MUST BE MOVED. WHEN NECESSARY, EQUIPMENT SHALL BE SHIPPED FROM MANUFACTURER IN CRATED SECTIONS OF SIZE SUITABLE FOR MOVING THROUGH AREAS AVAILABLE. ASCERTAIN FROM BUILDING OWNER AT WHAT TIMES OF DAY EQUIPMENT MAY BE MOVED THROUGH THE BUILDING.
- COORDINATE THE EXACT SIZE & LOCATION OF NEW OPENINGS WITH EXISTING STRUCTURE. PATCH / INSULATE AS REQUIRED. CONTRACTOR SHALL FIRESTOP ALL PENETRATIONS FROM NEW PIPING, CONDUIT, DUCTWORK, ETC. THROUGH EXISTING OR NEW FIRE/ SMOKE BARRIERS. REFER TO SPECIFICATION SECTION 15511 FOR FURTHER DETAILS.
- IT IS THE INTENT OF THIS CONTRACT FOR REMAINING SYSTEMS TO BE LEFT IN GOOD WORKING ORDER, READY FOR OPERATION. COORDINATE ANY REQUIRED SYSTEM SHUTDOWNS WITH OWNER 48 HOURS IN ADVANCE. EXISTING SYSTEM SHUTDOWNS WILL NOT BE PERMITTED IF THEY INTERFERE WITH THE DAILY OPERATIONS OF THE BUILDING. CONTRACTOR WILL BE REQUIRED TO TAKE PROPER PRECAUTIONS AGAINST DAMAGING OR DISRUPTING BUILDING SYSTEMS, WIRING, PIPING OR CONTROL TUBING. ANY DAMAGE TO THESE ITEMS SHALL BE REPAIRED AT THE CONTRACTOR'S COST AS A PART OF THIS CONTRACT.
- THE CONTRACTOR SHALL REPAIR / RESTORE TO ORIGINAL CONDITION ANY EXISTING EQUIPMENT OR MATERIALS DAMAGED IN THE PROCESS OF INSTALLATION, OR DEMOLITION TO THE SATISFACTION OF THE OWNER'S REPRESENTATIVE. CONTRACTOR SHALL MAKE REPAIRS USING THE SAME OR EQUIVALENT MATERIALS. WORK WILL BE PERFORMED AT THE CONTRACTOR'S COST.
- CONTRACTOR SHALL INCUR ANY COSTS OR BURDENS ASSOCIATED WITH LOST OR STOLEN EQUIPMENT /
- DURING THE LIFE OF THE CONTRACT PERIOD, CONTRACTOR SHALL REMOVE ALL RUBBISH / EXCESS MATERIAL ACCUMULATED AS A RESULT OF HIS OPERATIONS ON A DAILY BASIS. ALL AREAS / EQUIPMENT AFFECTED UNDER THIS CONTRACT SHALL BE KEPT CLEAN OF DUST / DEBRIS. ALL AREAS SHALL RECEIVE A FINAL CLEANING PRIOR TO FINAL ACCEPTANCE BY THE OWNER.
- 10. PROVIDE FOR LEGAL REMOVAL / DISPOSAL OF ALL RUBBISH / DEBRIS FROM THE BUILDING & SITE. PROTECT ALL WORK NOT SLATED FOR DEMOLITION.
- 11. THIS CONTRACTOR SHALL COORDINATE HIS WORK WITH ALL OTHER TRADES PRIOR TO SCHEDULING THE WORK. WORK SHALL BE PERFORMED IN PROPER SEQUENCE, AS AGREED TO BY ALL TRADES. ANY COSTS INCURRED BY THE OWNER DUE TO IMPROPER SEQUENCING OF WORK WILL BE PAID FOR BY THIS CONTRACTOR.
- 12. CONTRACTOR SHALL OBTAIN ALL PERMITS, PAY ALL FEES, CONNECTION CHARGES, ETC. ASSOCIATED WITH THE WORK UNDER THEIR CONTRACT.
- 13. PAINT / TOUCH UP ALL SURFACES MARRED AS A RESULT OF THE PERFORMANCE OF THE CONTRACT WORK.
- 14. THE MECHANICAL CONTRACTOR SHALL REFER TO / REVIEW ALL OTHER TRADE DRAWINGS IN THE BID PACKAGE & SHALL BE RESPONSIBLE FOR / PERFORM ALL WORK INDICATED AS (M.C.) MECHANICAL WORK AS A PART OF THE BASE BID UNLESS SPECIFICALLY NOTED OTHERWISE.
- 5. SUBSTITUTED EQUIPMENT OF GREATER OR LARGER POWER, DIMENSIONS, CAPACITIES & RATINGS MAY BE FURNISHED PROVIDED THAT SAID EQUIPMENT IS APPROVED IN WRITING PRIOR TO ORDER. ANY CONNECTING MECHANICAL SERVICES, ELECTRICAL SERVICES, BASES, STRUCTURAL APPURTENANCES, ETC. REQUIRED TO BE INCREASED DUE TO THE USE OF SAID EQUIPMENT WILL BE PAID FOR IN FULL BY THE MECHANICAL CONTRACTOR, INCLUDING ANY ADDITIONAL REQUIRED ENGINEERING FEES.
- 16. EACH PIECE OF EQUIPMENT SHALL BE PROVIDED WITH A PERMANENT TYPE LAMINATED, BLACK FINISH, WHITE CORE, PHENOLIC NAMEPLATE. NAMEPLATES SHOULD INDICATE THE NAME & NUMBER OF THE UNIT, UNIT VOLTAGE, & ANY INTERLOCK REFERENCE. STARTERS / DISCONNECT SWITCHES SHOULD ALSO BE EQUIPPED WITH AN IDENTICAL NAMEPLATE WITH THE SAME INFORMATION.
- 17. "ATTIC STOCK" UPON COMPLETION OF THE PROJECT, MECHANICAL CONTRACTOR SHALL COMPLETELY REMOVE / DISPOSE OF FILTERS USED DURING CONSTRUCTION & START-UP PROCEDURES. INSTALL NEW FILTERS IN ALL EQUIPMENT, MERV-8 OR BETTER UPON TURN OVER OF THE PROJECT TO THE OWNER. IN ADDITION, PROVIDE (2) COMPLETE SETS OF FILTERS FOR EACH PEICE OF EQUIPMENT & TURN OVER TO OWNER.
- 18. MECHANICAL CONTRACTOR SHALL PROVIDE (1) SPARE MOTOR FOR EACH SIZE MOTOR USED ON THE PROJECT. IN INSTANCES WHERE MORE THAN TEN OF THE SAME MOTOR ARE USED, MECHANICAL CONTRACTOR SHALL PROVIDE (1) SPARE MOTOR FOR EVERY TEN MOTORS OF A GIVEN SIZE USED ON THE PROJECT.
- 19. MAINTENANCE MANUAL: UPON COMPLETION OF THE PROJECT, THE MECHANICAL CONTRACTOR SHALL PROVIDE A BINDER CONTAINING THE OPERATIONS & MAINTENANCE MANUALS FOR EACH NEW PEICE OF EQUIPMENT INSTALLED UNDER THIS PROJECT. THE FIRST SECTION OF THE MAINTENANCE MANUAL SHALL CONTAIN A LIST OF EACH PEICE OF EQUIPMENT, COMPLETE WITH INFORMATION SHOWING APPROPRIATE REPLACEMENT FILTER SIZES / TYPES, APPROPRIATE REPLACEMENT BELT SPECIFICATIONS, REPLACEMENT MOTOR SPECIFICATIONS, REPLACEMENT BEARING SPECIFICATIONS, VOLTAGES OF UNIT, ETC. THIS SHALL SERVE AS A WRITTEN DATABASE DESCRIBING ALL MAINTENANCE INFORMATION FOR EACH NEW PEICE OF EQUIPMENT USED.

CONTROLS SUBCONTRACTOR , UNDER CONTRACT TO MECHANICAL CONTRACTOR

#### FIRE STOPPING NOTES

- 1. ALL PENETRATIONS RELATED TO MECHANICAL WORK THROUGH FIRE RATED WALLS, FLOORS OR OTHER STRUCTURES SHALL BE FIRE STOPPED AS REQUIRED TO MAINTAIN THE RATING OF THE WALL BY MECHANICAL CONTRACTOR. IT IS ASSUMED THAT ALL WALLS IN THE CONSTRUCTION CARRY A MINIMUM FIRE RATING OF 1 HR. IT SHOULD BE ASSUMED THAT ALL MACHINE ROOM WALLS / BOILER ROOM WALLS / ELECTRIC ROOM WALLS CARRY A RATING OF 2 HR. MECHANICAL CONTRACTOR SHALL BE RESPONSIBLE FOR A COMPLETE REVIEW OF THE ARCHITECTURAL DRAWINGS IN ORDER TO DETERMINE FIRE RATINGS OF ALL WALLS / PARTITIONS RELATED TO WORK UNDER THIS CONTRACT.
- 2. MECHANICAL CONTRACTOR SHALL REVIEW THE COMPLETE ARCHITECTURAL SET OF DRAWINGS IN ORDER TO DETERMINE WHERE DUCT PENETRATIONS THROUGH RATED BARRIERS. DUCTS PENETRATING SAID RATED BARRIERS SHALL BE EQUIPPED WITH A UL LISTED FUSIBLE LINK TYPE FIRE DAMPER, RATED FOR SERVICE FOR WHICH IT IS BEING USED. FIRE DAMPERS SHALL BE PROVIDED & INSTALLED BY THE MECHANICAL CONTRACTOR, COMPLETE W/ DUCT ACCESS DOORS DIRECTLY ADJACENT TO THE DAMPER, POSITIONED FOR EASY REPLACEMENT OF THE LINK.
- 3. MECHANICAL CONTRACTOR SHALL REVIEW THE COMPLETE ARCHITECTURAL SET OF DRAWINGS IN ORDER TO DETERMINE WHERE DUCT PENETRATIONS THROUGH RATED BARRIERS OCCUR BETWEEN SEPARATE SMOKE ZONES. DUCTS PENETRATING SAID FIRE / SMOKE BARRIERS SHALL BE EQUIPPED WITH A ULLISTED COMBINATION FIRE / SMOKE DAMPER, RATED FOR SERVICE FOR WHICH IT IS BEING USED. FIRE / SMOKE DAMPERS SHALL BE PROVIDED & INSTALLED BY THE MECHANICAL CONTRACTOR, COMPLETE W/ DUCT ACCESS DOORS DIRECTLY ADJACENT TO THE DAMPER. DAMPER ACTUATOR & RELATED WIRING SHALL BE PROVIDED & INSTALLED BY THE ELECTRICAL CONTRACTOR. COORDINATE DAMPER INSTALLATIONS W/ E.C. TO VERIFY PROPER CLEARANCES TO ASSURE PROPER DAMPER OPERATION.
- MECHANICAL CONTRACTOR SHALL PROVIDE A FULL SET OF AS-BUILT DRAWINGS, SHOWING EACH DAMPER LOCATION, TYPE OF DAMPER, ACCESS DOOR LOCATIONS, ETC.
   CONTRACTOR SHALL REFER TO SPECIFICATION SECTION 15511 FOR FURTHER DETAILS REGARDING FIRESTOPPING MATERIALS & METHODS.
- CONTRACTOR SHALL SUBMIT SHOP DRAWINGS OF PRODUCTS TO BE USED. FIRESTOP MATERIALS OTHER THAN THE PRODUCTS SPECIFIED SHALL INCLUDE FULL TECHNICAL DATA WITH SHOP DRAWINGS TO DEMONSTRATE EQUALITY WITH THE SPECIFIED FIRESTOPPING MATERIALS.

#### GENERAL INSTRUMENTATION NOTES

- 1. AT A MINIMUM, PROVIDE THERMOMETERS / WELLS AT THE FOLLOWING LOCATIONS:
- AT INLETS & OUTLET OF EACH THREE WAY VALVE (UNIT VENTILATORS / CABINET UNIT HEATER INSTALLATIONS EXCEPTED).
- AT INLET & OUTLET OF EACH HYDRONIC BOILER, CHILLER OR COOLING TOWER.

  AT INLET & OUTLET OF EACH HYDRONIC COIL IN AIR HANDLING UNITS & BUILT-UP CENTRAL SYSTEMS.
- AT A MINIMUM, PROVIDE LIQUID FILLED PRESSURE GAUGES / WELLS AT THE FOLLOWING LOCATIONS:

  AT SUCTION & DISCHARGE OF EACH PUMP.
- FOR EACH MAKEUP WATER LINE.
  BEFORE & AFTER ALL PRESSURE REDUCING VALVES.
- AT ACCESSIBLE HIGH POINT OF ALL HYDRONIC PIPING SYSTEMS.
   AT ALL EXPANSION / COMPRESSION TANKS.

#### PIPING SYSTEMS AND EQUIPMENT VENTING NOTES

- 1. MECHANICAL CONTRACTOR WILL BE RESPONSIBLE FOR THE PROPER VENTING OF ALL NEWLY INSTALLED HYDRONIC PIPING SYSTEMS. AUTOMATIC AIR VENTS SHALL BE INSTALLED AT EVERY HIGH POINT IN THE PIPING SYSTEM WHERE AIR CAN COLLECT. PROVIDE COCK IN RISER PRIOR TO AUTOMATIC AIR VENT. NEW AIR VENTS SHALL BE "TACO" #HY-VENT OR EQUIVALENT.
- 2. MECHANICAL CONTRACTOR SHALL PROVIDE & INSTALL NEW AUTOMATIC AIR VENT FOR EACH AIR HANDLING UNIT COIL OR DUCT MOUNTED COIL. INSTALL SHUT-OFF COCK PRIOR TO VENT TIE-IN.
- MECHANICAL CONTRACTOR SHALL PROVIDE NEW MANUAL AIR VENTS FOR ALL UNIT VENTILATOR COILS, CONVECTORS, FAN COIL UNITS, FIN TUBE RADIATORS, ETC. MANUAL VENTS SHALL BE "TACO" #417 COIN VENT OR EQUIVALENT. PROVIDE SHUT-OFF COCK PRIOR TO VENT. AIM COIN VENT DISCHARGE IN AN APPROPRIATE MANNER AS TO FACILITATE THE CAPTURE OF BLEED WATER WHILE PERFORMING SYSTEM BLEEDING OPERATIONS.

### ELECTRICAL WORK UNDER MECHANICAL CONTRACT

- 1. MECHANICAL CONTRACTOR SHALL PROVIDE ALL STARTERS & DISCONNECT SWITCHES REQUIRED FOR ALL NEW MECHANICAL EQUIPMENT. STARTER / DISCONNECT SWITCH INSTALLATION TO BE PERFORMED UNDER THE ELECTRICAL CONTRACT. COORDINATE WORK W/ ELECTRICAL CONTRACTOR PRIOR TO START OF WORK.
- POWER WIRING REQUIRED FOR CONTROLS SHALL BE PERFORMED UNDER THE MECHANICAL CONTRACT UNLESS SPECIFICALLY NOTED OTHERWISE ON THE ELECTRICAL DRAWINGS. MECHANICAL CONTRACTOR SHALL OBTAIN THE SERVICES OF A LICENSED ELECTRICIAN (PER NEC REQUIREMENTS) TO PERFORM ALL ELECTRICAL WORK.

# DUCTWORK NOTES

- PROVIDE ALL NEW DUCTWORK AS SHOWN AND SPECIFIED UNDER SPECIFICATION SECTION 015891, AND IN CONFORMANCE WITH 'SMACNA' SPECIFICATIONS.
- 2. IF A DUCT ELBOW IS SHOWN TO BE RADIUSED, THEN RADIUSED ELBOWS SHALL BE INSTALLED. SQUARE ELBOWS MAY NOT BE SUBSTITUTED WHERE RADIUSED ELBOWS ARE SHOWN. WHERE SQUARE ELBOWS ARE SHOWN, TURNING VANES SHALL BE INSTALLED UPON APPROVAL BY THE ENGINEER.
- 3. PROVIDE DUCT LINING IN ALL DUCTWORK THAT IS CONVEYING BELOW AMBIENT TEMPERATURE AIR & IS NOT INSULATED. PROVIDE LINING IN SUPPLY & RETURN AIR DUCTWORK FROM AIR HANDLING EQUIPMENT TO 20 FEET AWAY FROM THE UNIT(S). IN ADDITION, INCLUDE LINING IN ANY OTHER DUCT SPECIFICALLY SHOWN OR SPECIFIED TO BE EQUIPPED WITH LINING. REFER TO SPECIFICATION SECTION 15891 & 15290 FOR FURTHER INFORMATION.
- 4. WHERE FLEXIBLE DUCTWORK IS USED, LENGTHS MAY NOT EXCEED 4 FEET TOTAL IN ANY ONE RUN OF FLEXIBLE DUCTWORK. FLEXIBLE DUCTWORK SHALL BE RATED IN ACCORDANCE WITH UL 181, CLASS 1. REFER TO SPECIFICATION SECTION 15891 FOR FURTHER INFORMATION.
- MECHANICAL CONTRACTOR SHALL PROVIDE A BUTTERFLY TYPE VOLUME DAMPER WITH LOCKING QUADRANT HANDLE PRIOR TO EACH AIR OUTLET SHOWN. INSTALL DAMPER AT LEAST 5 FEET AWAY FROM AIR OUTLET WHEREVER POSSIBLE.
- 6. MECHANICAL CONTRACTOR SHALL PROVIDE FLEXIBLE DUCT CONNECTIONS WHERE DUCT SYSTEMS CONNECT TO EQUIPMENT. REFER TO SPECIFICATION SECTION 15891 FOR FURTHER INFORMATION.

# TESTING and BALANCING NOTES

- 1. MECHANICAL CONTRACTOR WILL BE REQUIRED TO PERFORM ALL EQUIPMENT & SYSTEM TESTING / BALANCING REQUIRED UNDER THIS CONTRACT. PROVIDE A FULL REPORT DETAILING ALL DESIGN & ACTUAL CONDITIONS FOR ALL AIR & HYDRONIC SYSTEMS SHOWN ON THE DRAWINGS. REFER TO SPECIFICATION SECTIONS 15990 & 15997 FOR FURTHER DETAILS.
- 2. UPON NOTICE OF COMPLETION OF WORK BY THE CONTRACTOR, OWNER WILL OBTAIN THE SERVICES OF AN INDEPENDENT TESTING & BALANCING CONTRACTOR TO VERIFY THE RESULTS OF THE TESTING & BALANCING REPORT SUBMISSION. INDEPENDENT TESTING AGENCY SHALL SELECT A RANDOM NUMBER OF MEASUREMENTS TO BE CHECKED. MEASUREMENTS WILL BE CHECKED IN THE SAME MANNER AS ORIGINALLY MEASURED. NUMBER OF VERIFICATION MEASUREMENTS SHALL BE APPROXIMATELY 25% OF THE TOTAL MEASUREMENTS FOR THE PROJECT.
- IF MORE THAN 10% OF THE VERIFICATION TESTING SHOWS DEVIATIONS OF 10% OR MORE / SOUND LEVEL OF 2dB DIFFERENT THAN THAT ORIGINALLY MEASURED, THE ORIGINAL REPORT WILL BE REJECTED. ALL SYSTEMS WILL THEN BE REQUIRED TO BE COMPLETELY RE-TESTED, WITH A SECOND REPORT SUBMITTED. IN THE EVENT THAT THE ORIGINAL REPORT IS REJECTED, ALL SYSTEMS SHALL BE READJUSTED & TESTED, NEW CERTIFIED REPORTS SUBMITTED, AND NEW VERIFICATION TESTS MADE, AT NO ADDITIONAL COST TO THE OWNER. THE CONTRACTOR WILL BE RESPONSIBLE FOR ALL COSTS INVOLVED WITH THE VERIFICATION TESTS.

CONTRACTOR ABBREVIATIONS:

M.C. = MECHANICAL CONTRACTOR

C.C. = CONTROLS CONTRACTOR


R.C. = CERTIFIED ROOFING CONTRACTOR

P.C. = PLUMBING CONTRACTOR E.C. = ELECTRICAL CONTRACTOR

REV. DATE

THESE DRAWINGS ARE BASED ON CONSTRUCTION DRAWINGS NO PREPARED BY BBS ARCHITECTS, LANDSCAPE ARCHITECTS AN ENGINEERS, PC. AND, THEREFORE, MAY NOT REPRESENT THE CONDITIONS AS CONSTRUCTED AT THE TIME. ALL EXISTIN CONDITIONS SHOWN ARE REPRESENTED AS SUGGESTIN INFORMATION AS THEY MAY NOT HAVE BEEN BUILT AND DETAILE PER THE ORIGINAL DOCUMENTS OR PER THE OWNER'S INFORMATION.

NOTICE

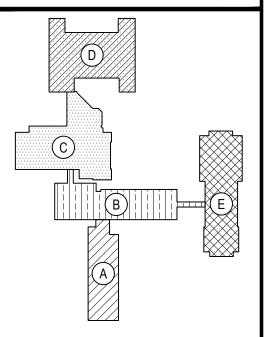

KEY PLAN

NOT TO SCALE

ICT WIDE CAPITAL IMPROVEMENTS
INDS MIDDLE/ HIGH SCHOOL
E, NEW YORK - WESTCHESTER COUNTY
GENERAL NOTES AND SYMBOLS

WOOD HARTSI MECHANIC,

DRAWING BY: DS

CHECK BY: DS

NOTICE

THIS DRAWING, PREPARED FOR THE SPECIFIC PROJECT INDICATED IS AN INSTRUMENT OF SERVICE AND THE PROPERTY OF BES ARCHITECTS, LANDSCAPE ARCHITECTS AND ENGINEERS, PC INFRINGEMENT OR ANY USE OF THIS DRAWING FOR ANY OTHER PROJECT IS PROHIBITED. ANY ALTERATION OR REPRODUCTION OF THIS DOCUMENT IS ALSO PROHIBITED WITHOUT THE WRITTEN CONSENT OF THE ARCHITECT OR ENGINEER.




ARCHITECTS
LANDSCAPE ARCHITECTS

ENGINEERS

244 EAST MAIN STREET
PATCHOGUE
NEW YORK 11772
T. 631.475.0349
F. 631.475.0361
PATCHOGUE
ALBANY
NEW YORK 12205
T. 518.621.7650
F. 518.621.7655

www.BBSARCHITECTURE.com

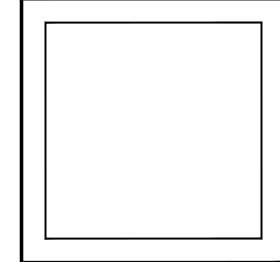

SED No. 66-04-07-06-0-007-022

DISTRICT GREENBURGH CSD

PROJECT PH. I - DW CAP. IMPROVEMENT WOODLANDS M.S./H.S.


DWG TITLE MECHANICAL GENERAL NOTES AND SYMBOLS


SCALE: AS NOTED

DATE: MAY 2022

M0.01D

BID PICK-UP: MAY 27, 2022

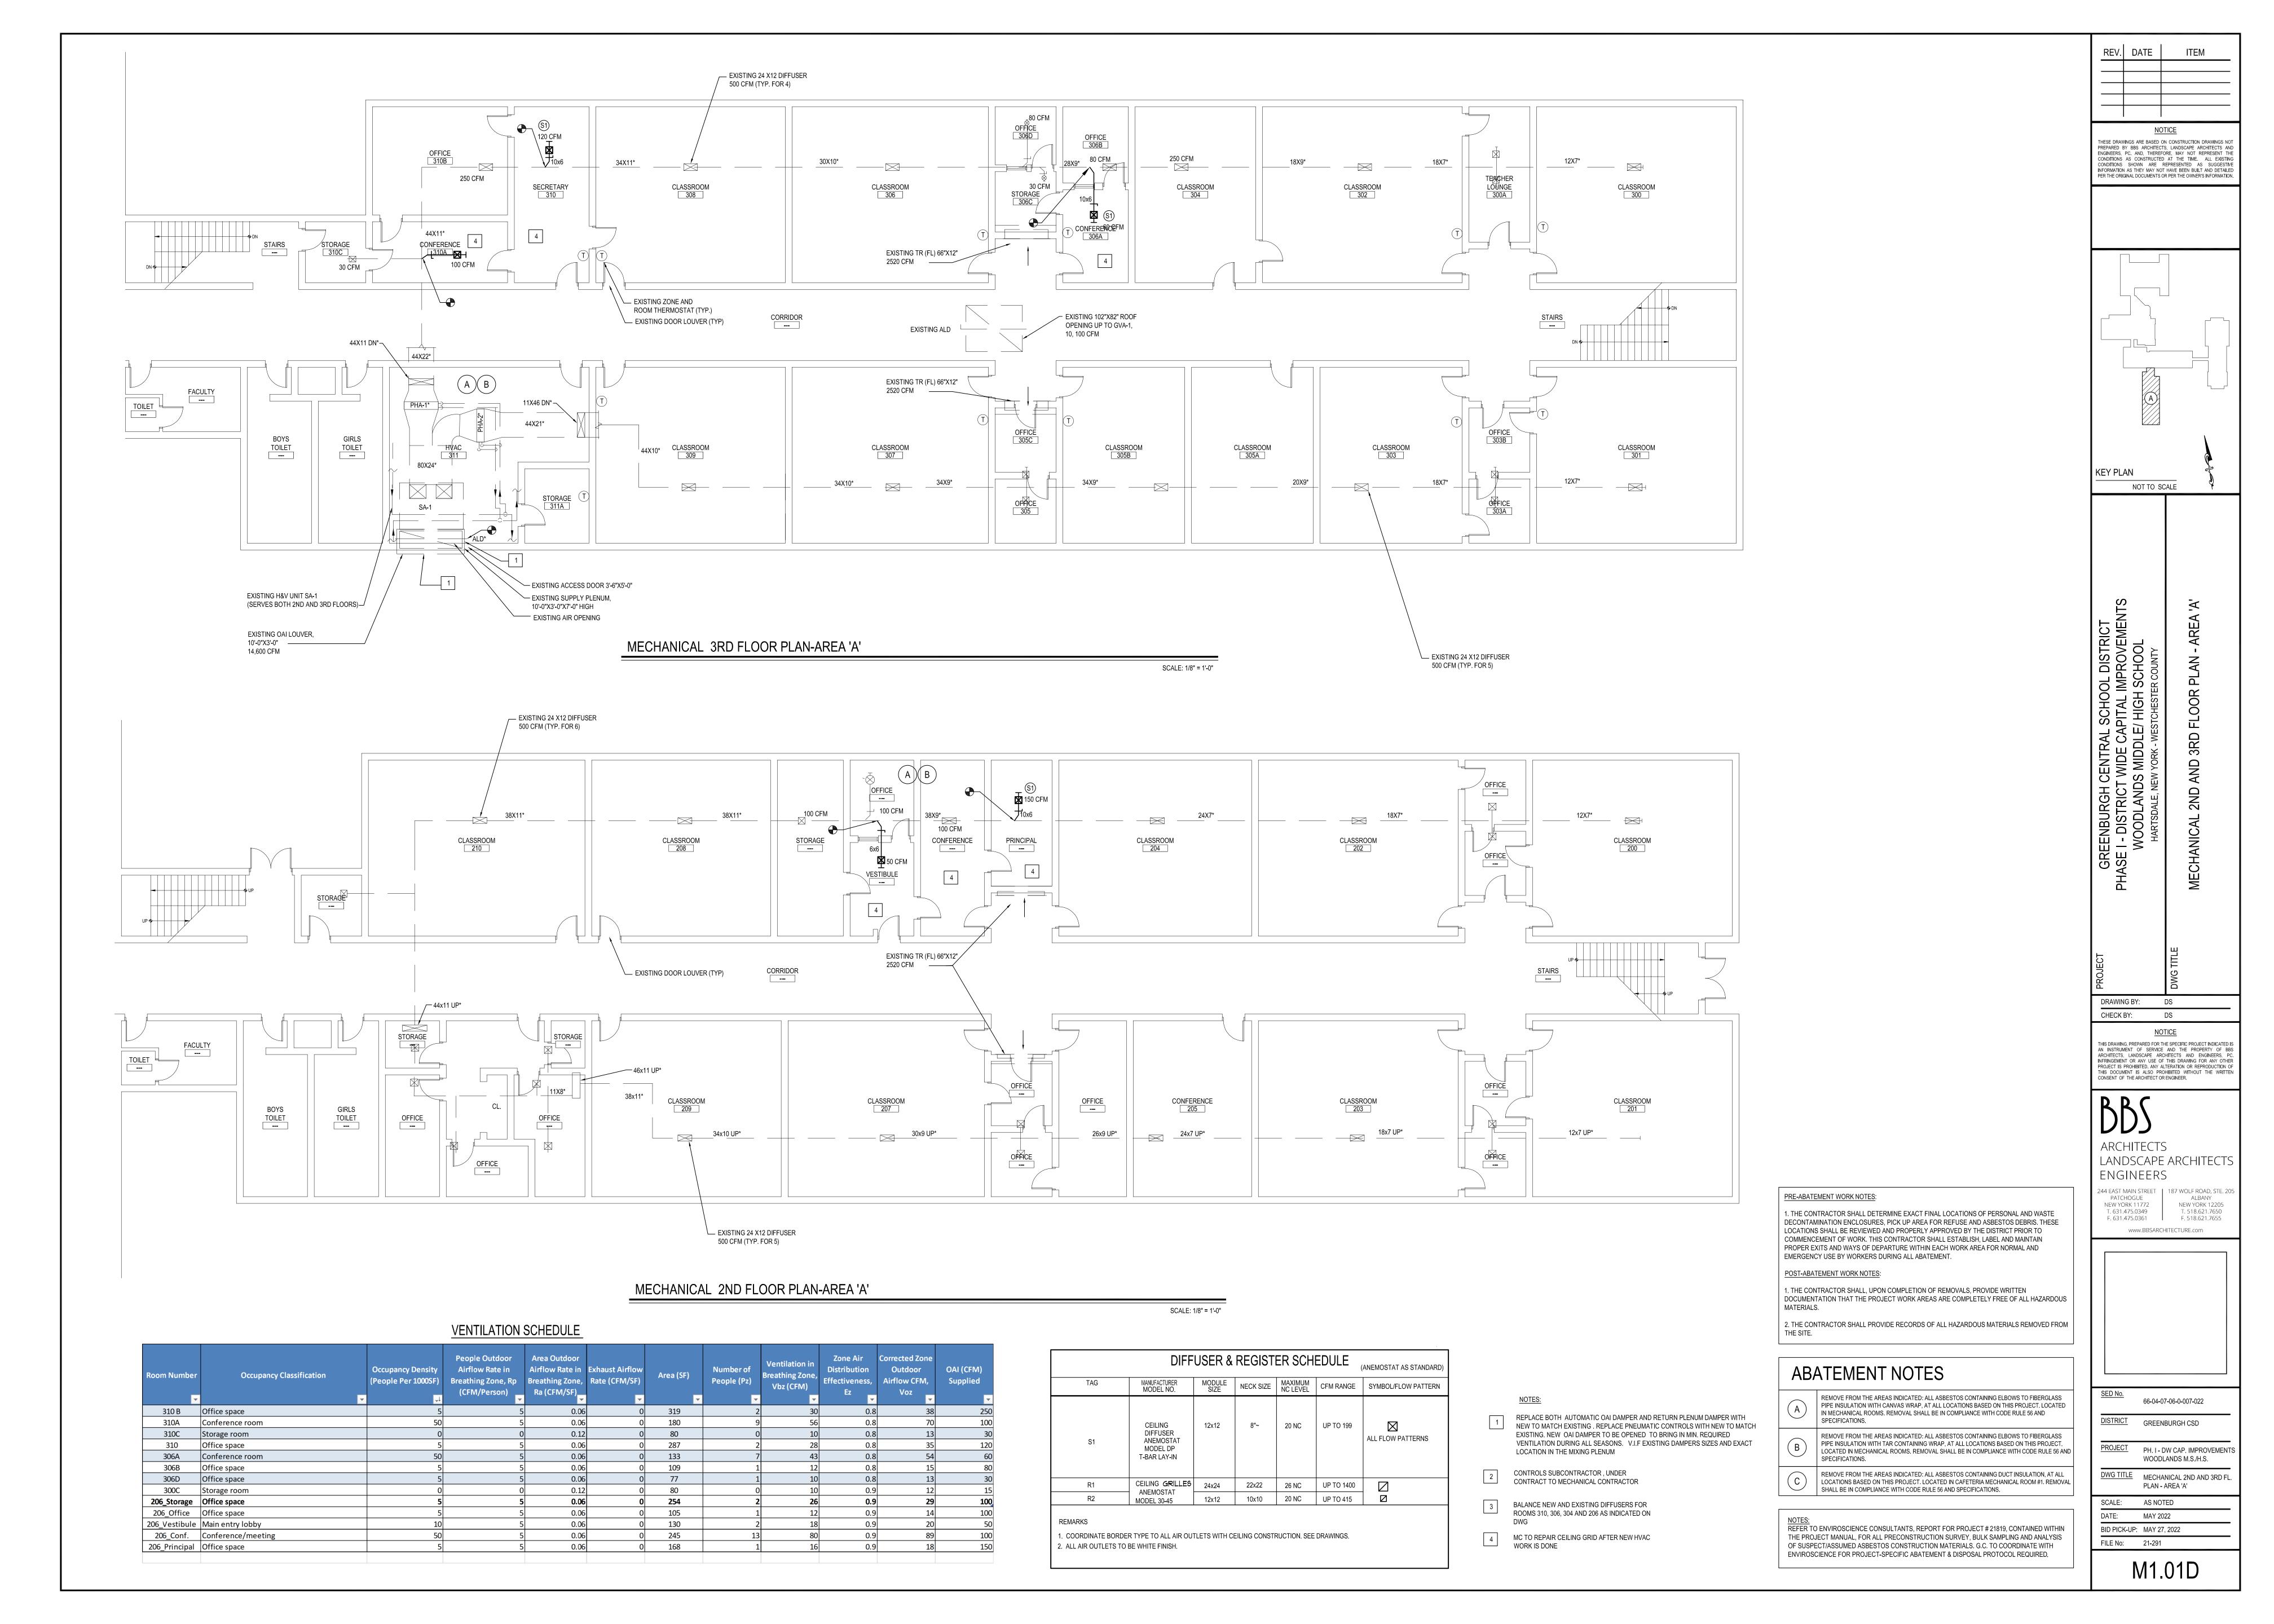

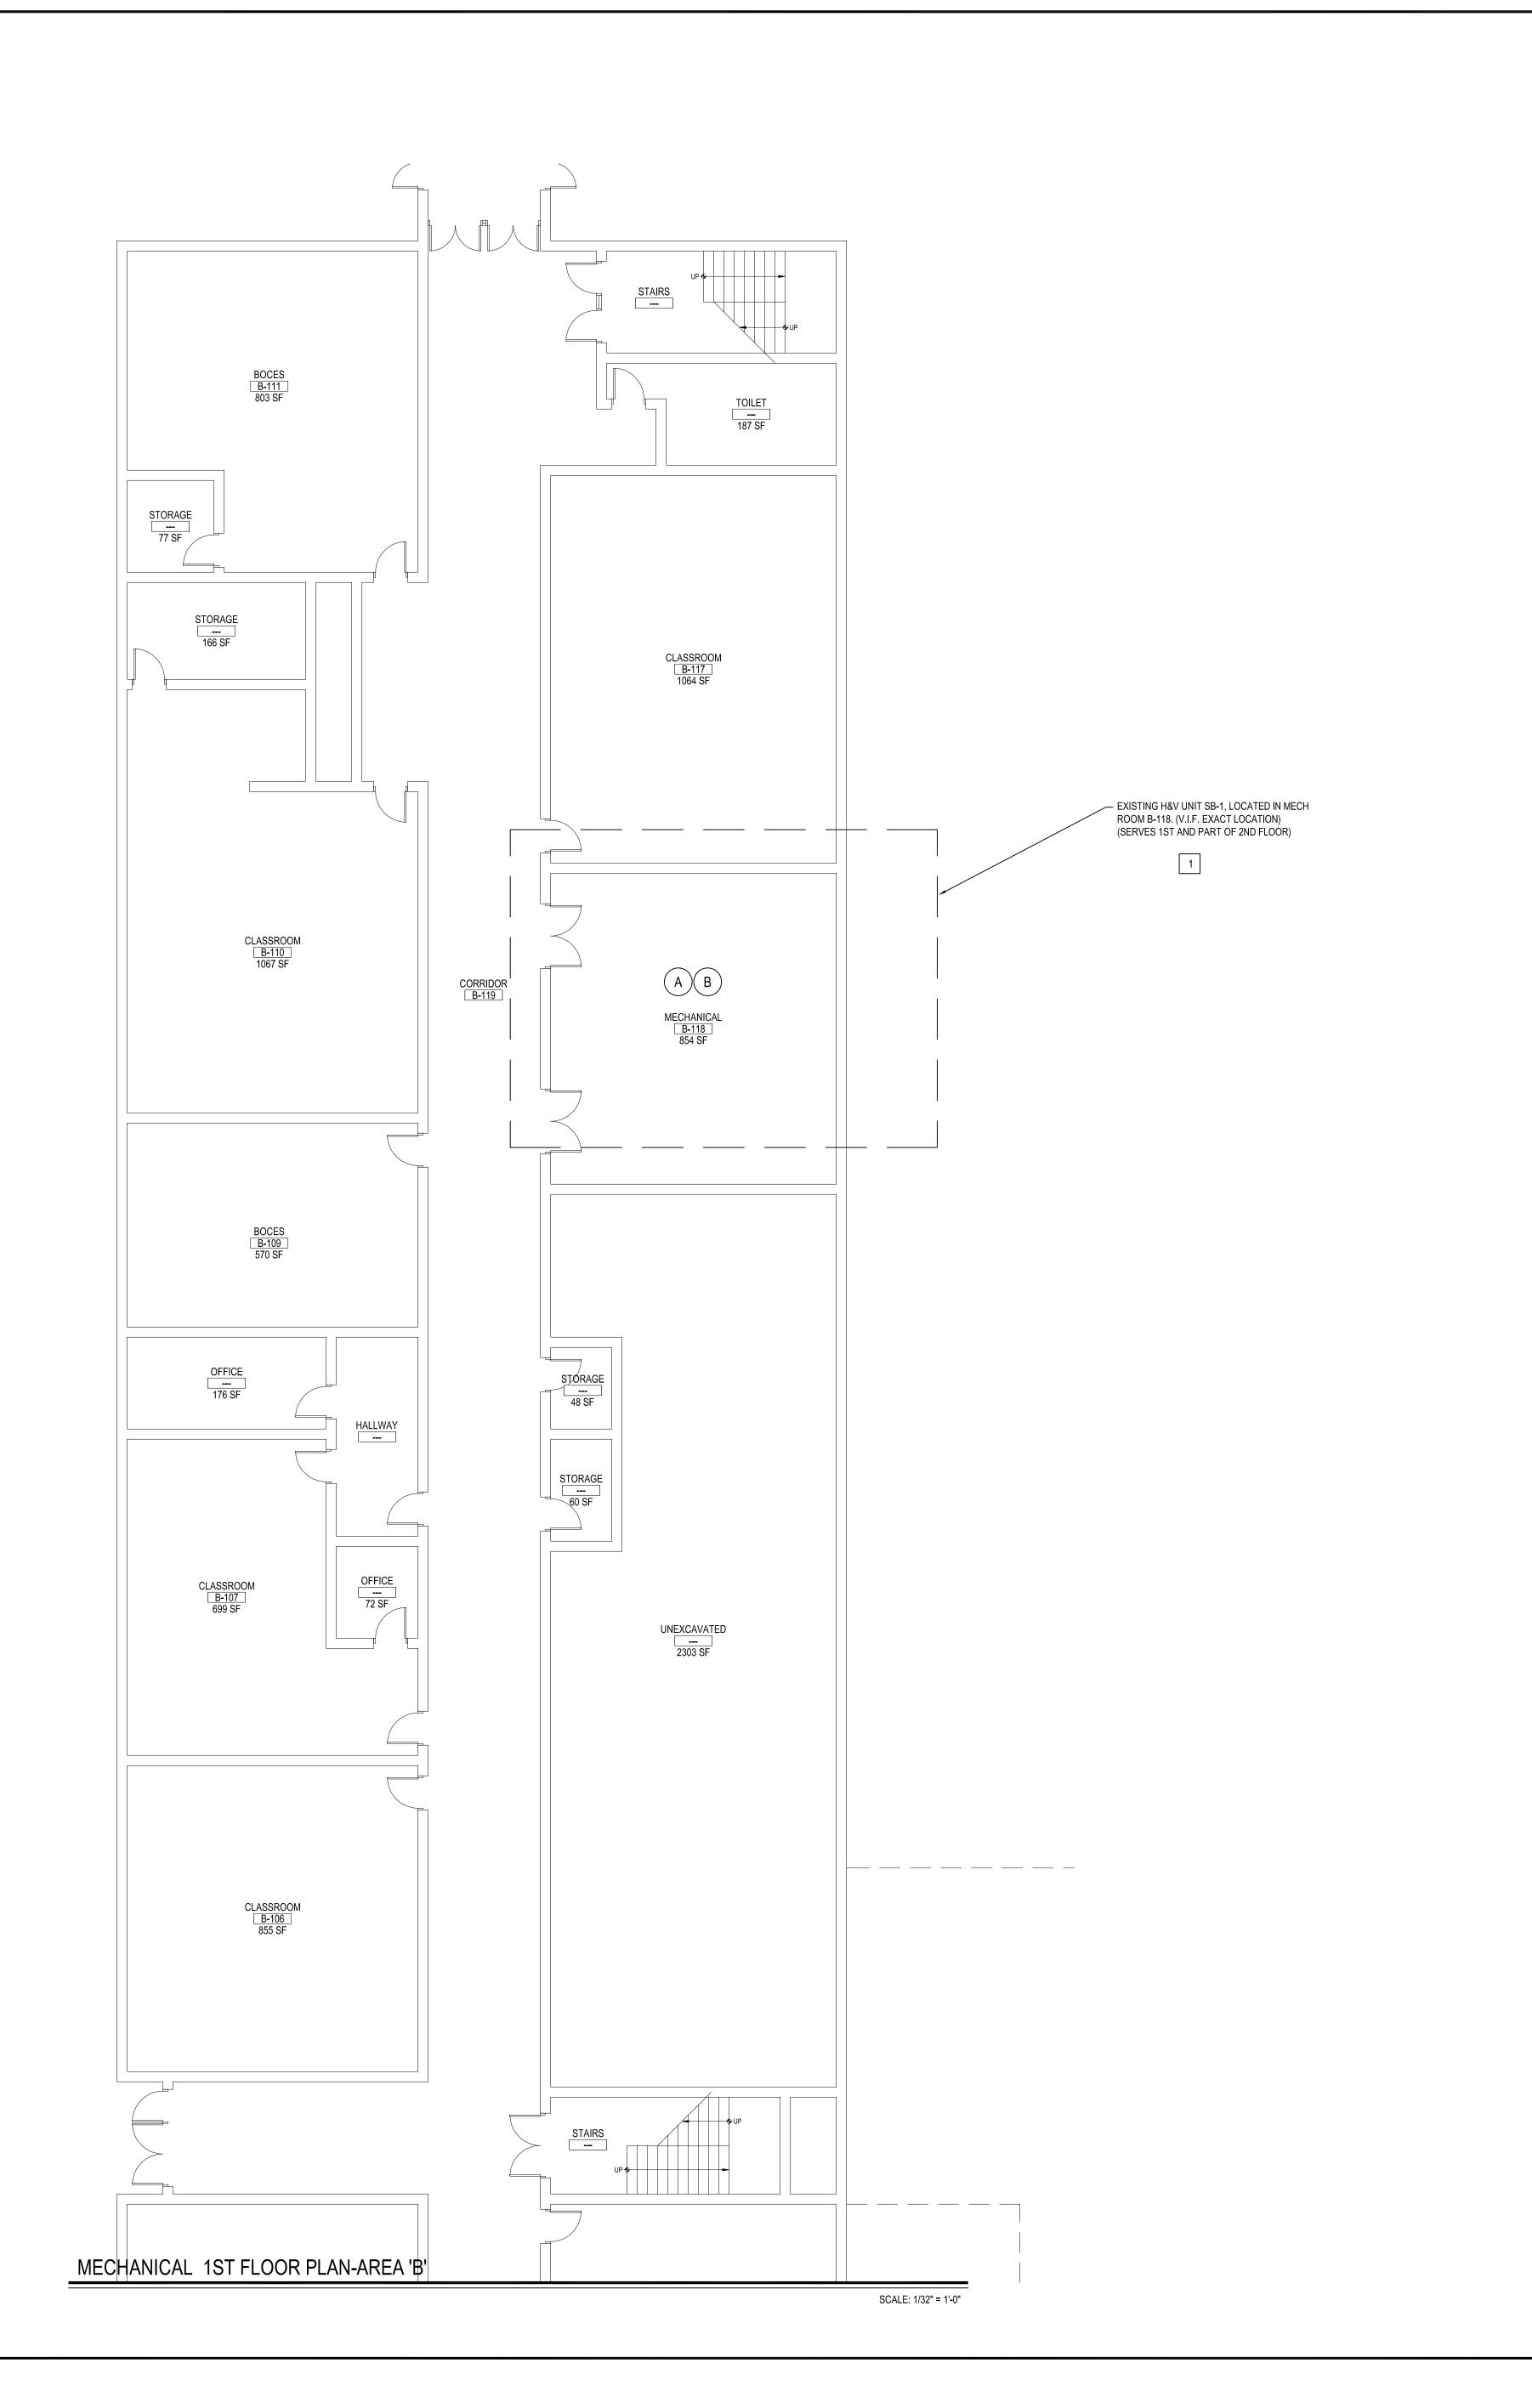

PRE-ABATEMENT WORK NOTES:

1. THE CONTRACTOR SHALL DETERMINE EXACT FINAL LOCATIONS OF PERSONAL AND WASTE DECONTAMINATION ENCLOSURES, PICK UP AREA FOR REFUSE AND ASBESTOS DEBRIS. THESE LOCATIONS SHALL BE REVIEWED AND PROPERLY APPROVED BY THE DISTRICT PRIOR TO COMMENCEMENT OF WORK. THIS CONTRACTOR SHALL ESTABLISH, LABEL AND MAINTAIN PROPER EXITS AND WAYS OF DEPARTURE WITHIN EACH WORK AREA FOR NORMAL AND EMERGENCY USE BY WORKERS DURING ALL ABATEMENT.

#### POST-ABATEMENT WORK NOTES:

NOTES:

- V.I.F EXISTING OAI DMAPER EXACT LOCATION IN THE MIXING

INSPECT OAI DAMPER BLADES FOR FREE , UNHINDERED

MOVEMENT. REMOVE RUST FROM DAMPER'S BLADES IF

- TEST DAMPER WITH ACTUATOR UNPLUGGED, TO ENSURE DAMPER

- CHECK SEALS FOR TIGHT CLOSURE , REPLACE WORN SEALS WITH

- REPLACE ANY WORN OR RUSTED BUSHING AND PINS.

- APPLY APPROVED LUBRICANTS TO ALL METALLIC PARTS - REPLACE IF NECESSARY PNEUMATIC ACTUATOR WITH NEW TO

OAI DAMPER TO BE OPENED TO BRING IN MIN. REQUIRED VENTILATION IN ALL SEASONS.

CONTROLS SUBCONTRACTOR, UNDER

CONTRACT TO MECHANICAL CONTRACTOR

PLENUM /OUTSIDE WALL.

WORKS ON ITS OWN,

MATCH EXISTING.

NECESSARY

NEW ONES,

1. THE CONTRACTOR SHALL, UPON COMPLETION OF REMOVALS, PROVIDE WRITTEN DOCUMENTATION THAT THE PROJECT WORK AREAS ARE COMPLETELY FREE OF ALL HAZARDOUS

2. THE CONTRACTOR SHALL PROVIDE RECORDS OF ALL HAZARDOUS MATERIALS REMOVED FROM

# ABATEMENT NOTES

- REMOVE FROM THE AREAS INDICATED: ALL ASBESTOS CONTAINING ELBOWS TO FIBERGLASS PIPE INSULATION WITH CANVAS WRAP, AT ALL LOCATIONS BASED ON THIS PROJECT, LOCATED IN MECHANICAL ROOMS. REMOVAL SHALL BE IN COMPLIANCE WITH CODE RULE 56 AND SPECIFICATIONS.
- REMOVE FROM THE AREAS INDICATED: ALL ASBESTOS CONTAINING ELBOWS TO FIBERGLASS PIPE INSULATION WITH TAR CONTAINING WRAP, AT ALL LOCATIONS BASED ON THIS PROJECT. LOCATED IN MECHANICAL ROOMS. REMOVAL SHALL BE IN COMPLIANCE WITH CODE RULE 56 AND
- REMOVE FROM THE AREAS INDICATED: ALL ASBESTOS CONTAINING DUCT INSULATION, AT ALL

LOCATIONS BASED ON THIS PROJECT. LOCATED IN CAFETERIA MECHANICAL ROOM #1. REMOVAL

REFER TO ENVIROSCIENCE CONSULTANTS, REPORT FOR PROJECT # 21819, CONTAINED WITHIN THE PROJECT MANUAL, FOR ALL PRECONSTRUCTION SURVEY, BULK SAMPLING AND ANALYSIS OF SUSPECT/ASSUMED ASBESTOS CONSTRUCTION MATERIALS. G.C. TO COORDINATE WITH

ENVIROSCIENCE FOR PROJECT-SPECIFIC ABATEMENT & DISPOSAL PROTOCOL REQUIRED.

SHALL BE IN COMPLIANCE WITH CODE RULE 56 AND SPECIFICATIONS.

<u>NOTICE</u>

THESE DRAWINGS ARE BASED ON CONSTRUCTION DRAWINGS NOT PREPARED BY BBS ARCHITECTS, LANDSCAPE ARCHITECTS AND ENGINEERS, PC. AND, THEREFORE, MAY NOT REPRESENT THE CONDITIONS AS CONSTRUCTED AT THE TIME. ALL EXISTING CONDITIONS SHOWN ARE REPRESENTED AS SUGGESTIVE INFORMATION AS THEY MAY NOT HAVE BEEN BUILT AND DETAILED PER THE ORIGINAL DOCUMENTS OR PER THE OWNER'S INFORMATION.

REV. DATE

KEY PLAN NOT TO SCALE

<u>NOTICE</u> THIS DRAWING, PREPARED FOR THE SPECIFIC PROJECT INDICATED IS AN INSTRUMENT OF SERVICE AND THE PROPERTY OF BBS ARCHITECTS, LANDSCAPE ARCHITECTS AND ENGINEERS, PC. INFRINGEMENT OR ANY USE OF THIS DRAWING FOR ANY OTHER PROJECT IS PROHIBITED. ANY ALTERATION OR REPRODUCTION OF THIS DOCUMENT IS ALSO PROHIBITED WITHOUT THE WRITTEN CONSENT OF THE ARCHITECT OR ENGINEER.

LANDSCAPE ARCHITECTS


ENGINEERS 244 EAST MAIN STREET | 187 WOLF ROAD, STE. 209 PATCHOGUE | ALBANY NEW YORK 12205 T. 518.621.7650 NEW YORK 11772


F. 631.475.0361 F. 518.621.7655 www.BBSARCHITECTURE.com

66-04-07-06-0-007-022 DISTRICT GREENBURGH CSD PROJECT PH. I - DW CAP. IMPROVEMENTS WOODLANDS M.S./H.S.

DWG TITLE MECHANICAL 1ST FL. PLAN - AREA 'B' SCALE: AS NOTED

> BID PICK-UP: MAY 27, 2022 FILE No: 21-291 M1.02D

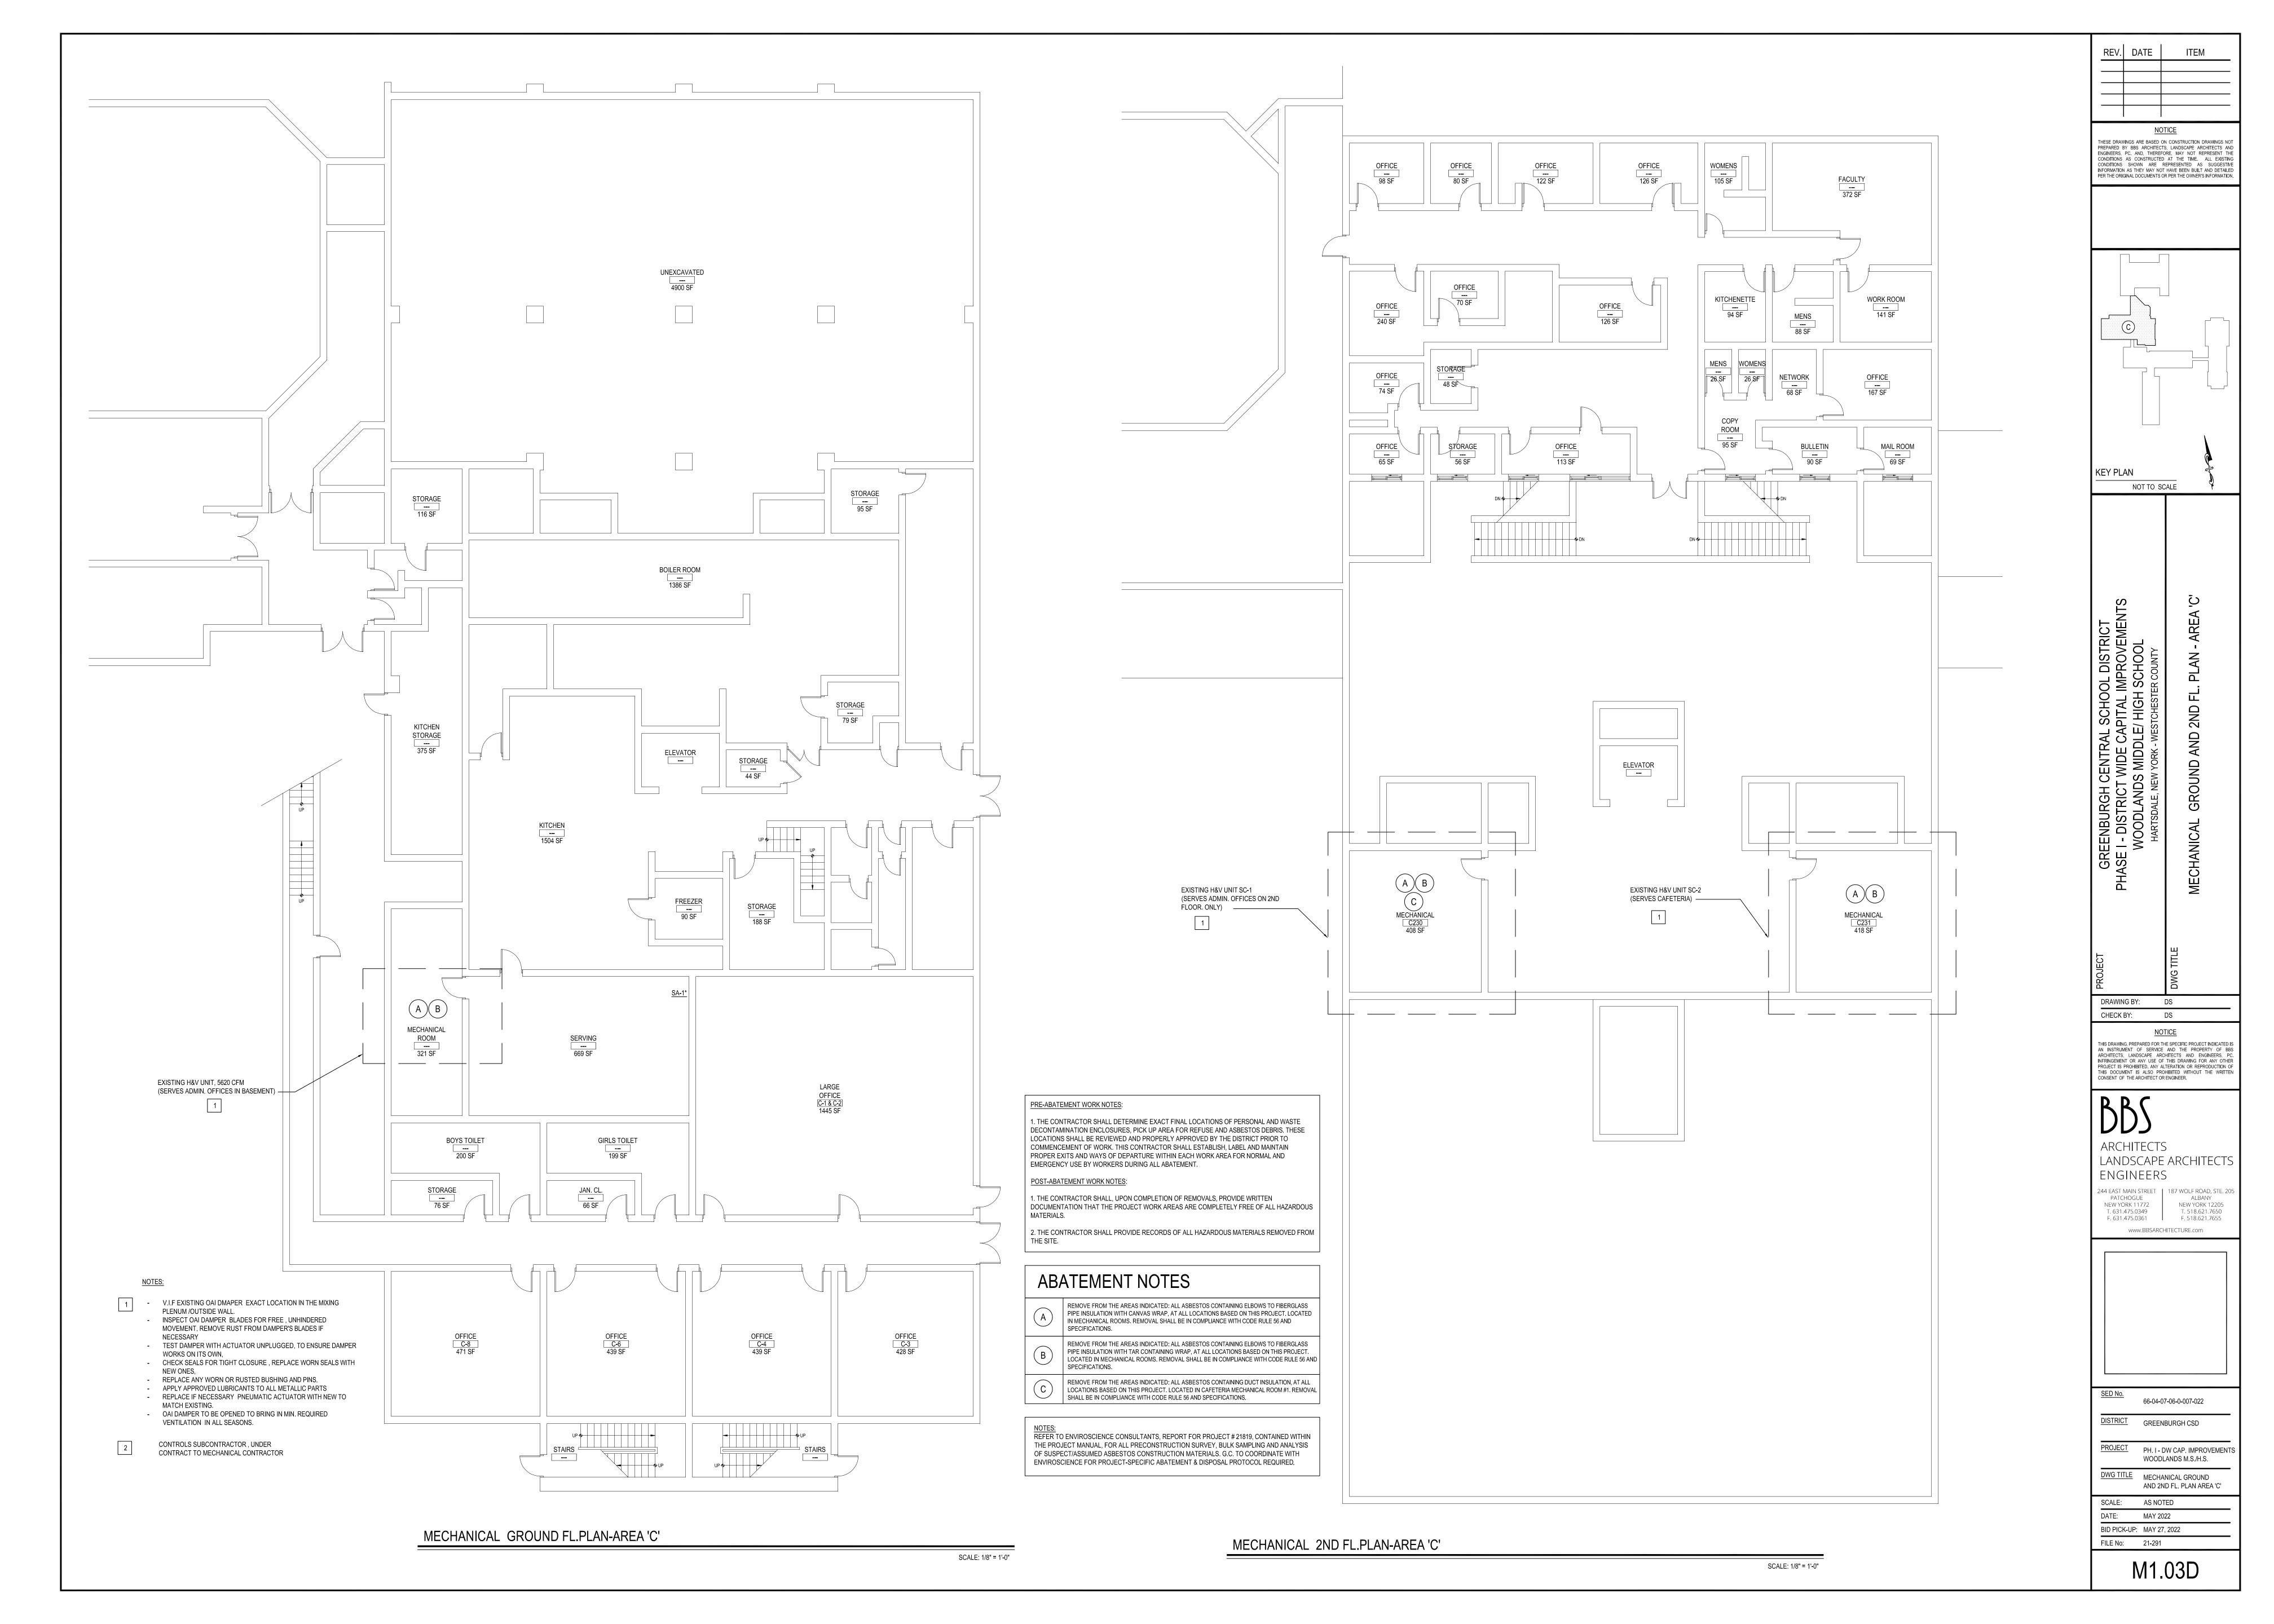

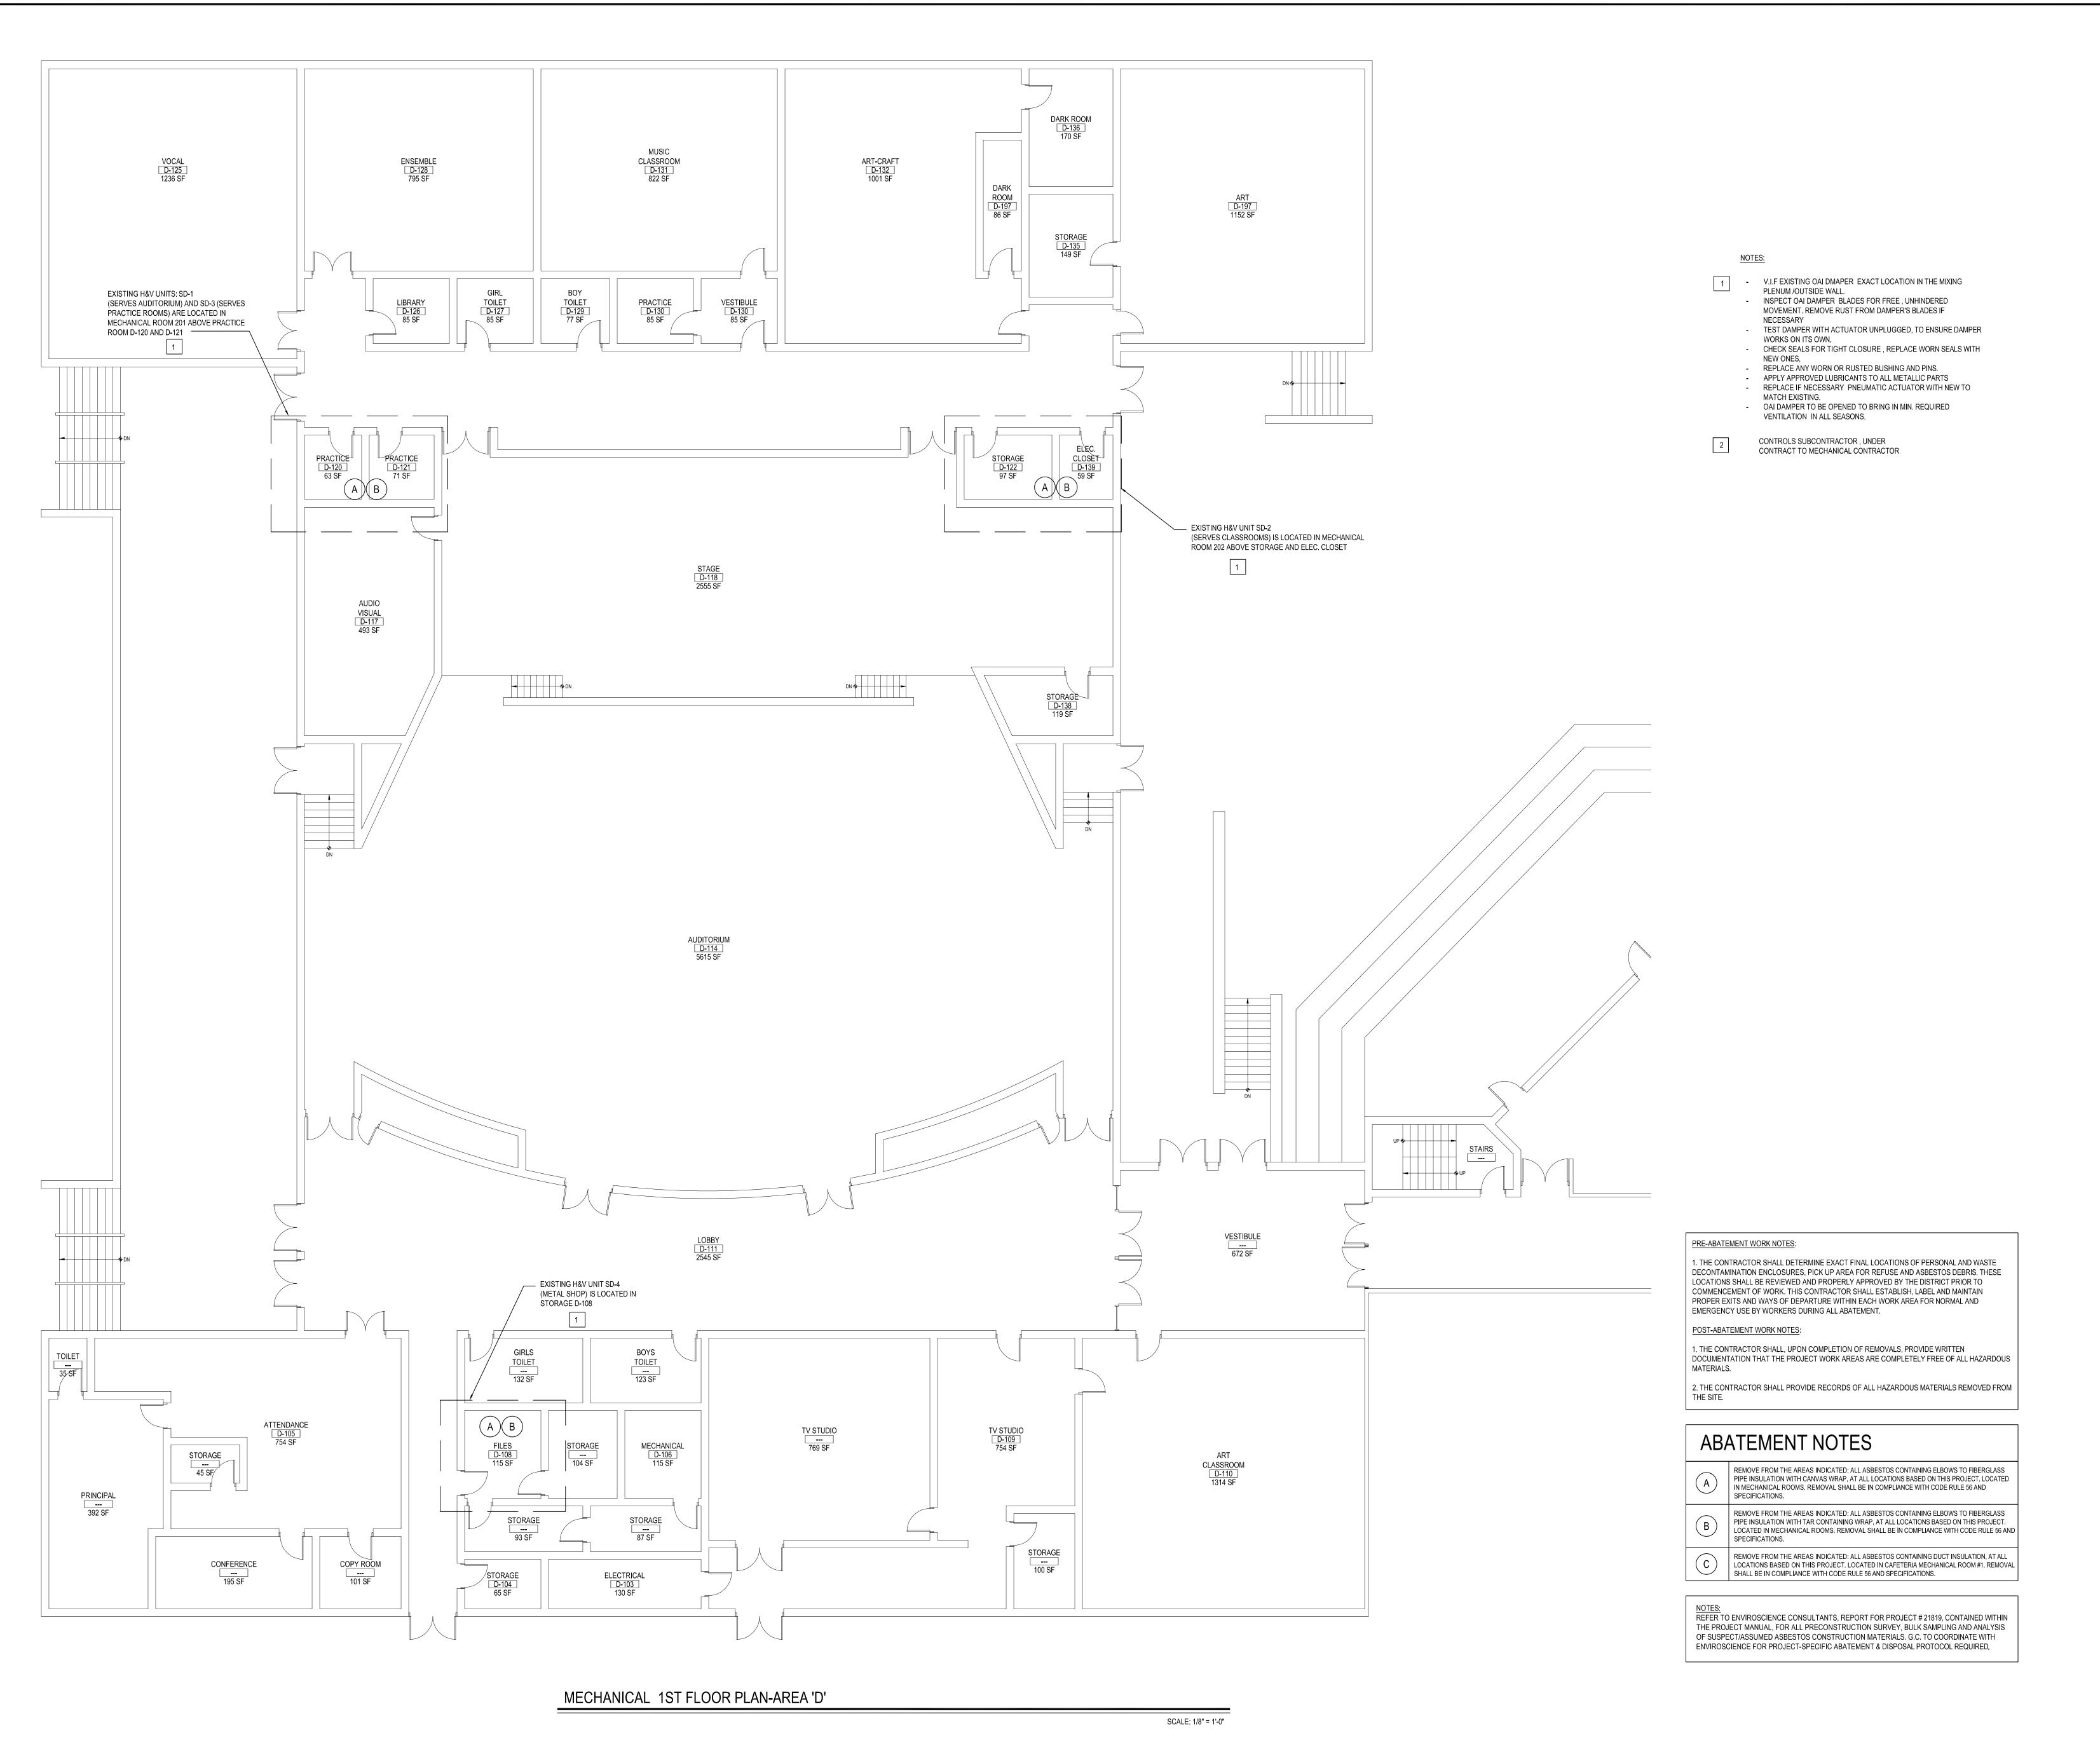

REV. DATE NOTICE

THESE DRAWINGS ARE BASED ON CONSTRUCTION DRAWINGS NOT PREPARED BY BBS ARCHITECTS, LANDSCAPE ARCHITECTS AND ENGINEERS, PC. AND, THEREFORE, MAY NOT REPRESENT THE CONDITIONS AS CONSTRUCTED AT THE TIME. ALL EXISTING CONDITIONS SHOWN ARE REPRESENTED AS SUGGESTIVE INFORMATION AS THEY MAY NOT HAVE BEEN BUILT AND DETAILED PER THE ORIGINAL DOCUMENTS OR PER THE OWNER'S INFORMATION.

KEY PLAN NOT TO SCALE

CHECK BY: DS

<u>NOTICE</u>

THIS DRAWING, PREPARED FOR THE SPECIFIC PROJECT INDICATED IS AN INSTRUMENT OF SERVICE AND THE PROPERTY OF BBS ARCHITECTS, LANDSCAPE ARCHITECTS AND ENGINEERS, PC. INFRINGEMENT OR ANY USE OF THIS DRAWING FOR ANY OTHER PROJECT IS PROHIBITED. ANY ALTERATION OR REPRODUCTION OF THIS DOCUMENT IS ALSO PROHIBITED WITHOUT THE WRITTEN CONSENT OF THE ARCHITECT OR ENGINEER.

ARCHITECTS

LANDSCAPE ARCHITECTS ENGINEERS 244 EAST MAIN STREET | 187 WOLF ROAD, STE. 205 PATCHOGUE | ALBANY

NEW YORK 11772 NEW YORK 12205 T. 631.475.0349 T. 518.621.7650 F. 631.475.0361 F. 518.621.7655

www.BBSARCHITECTURE.com


66-04-07-06-0-007-022


DISTRICT GREENBURGH CSD PROJECT PH. I - DW CAP. IMPROVEMENTS WOODLANDS M.S./H.S.

DWG TITLE MECHANICAL 1ST FLOOR PLAN - AREA 'D'

SCALE: AS NOTED DATE: MAY 2022 BID PICK-UP: MAY 27, 2022 FILE No: 21-291

M1.04D

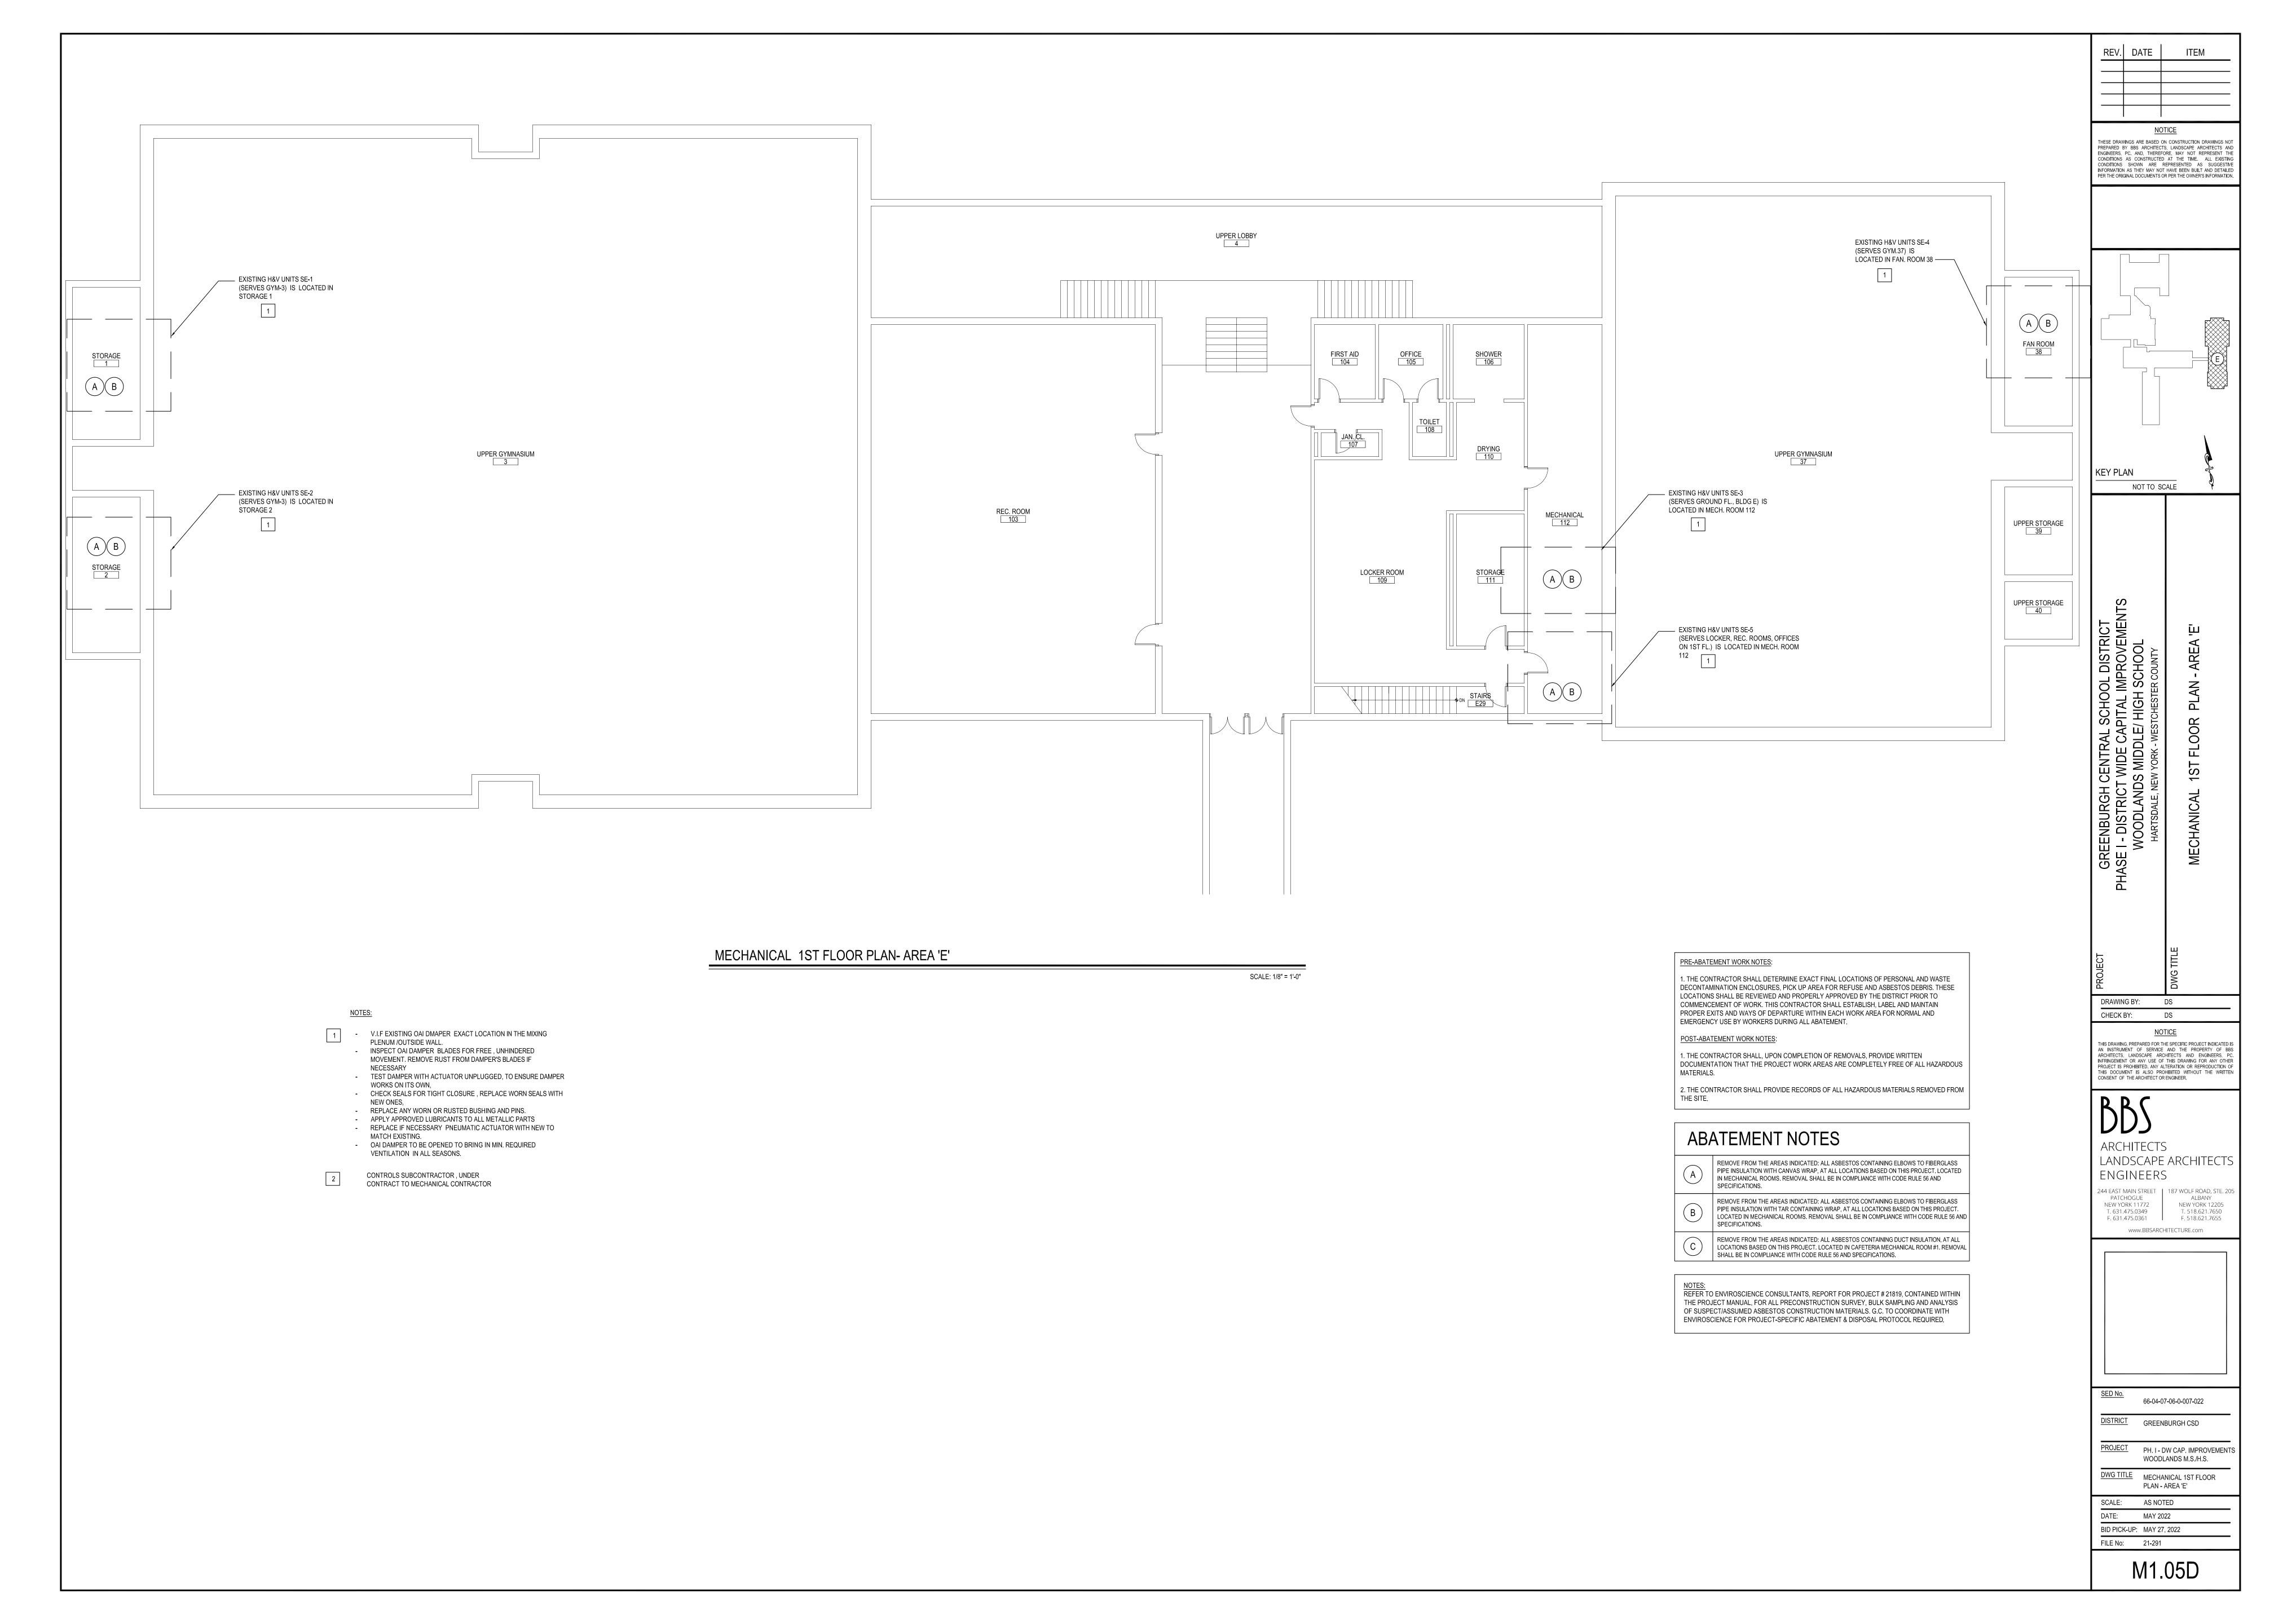

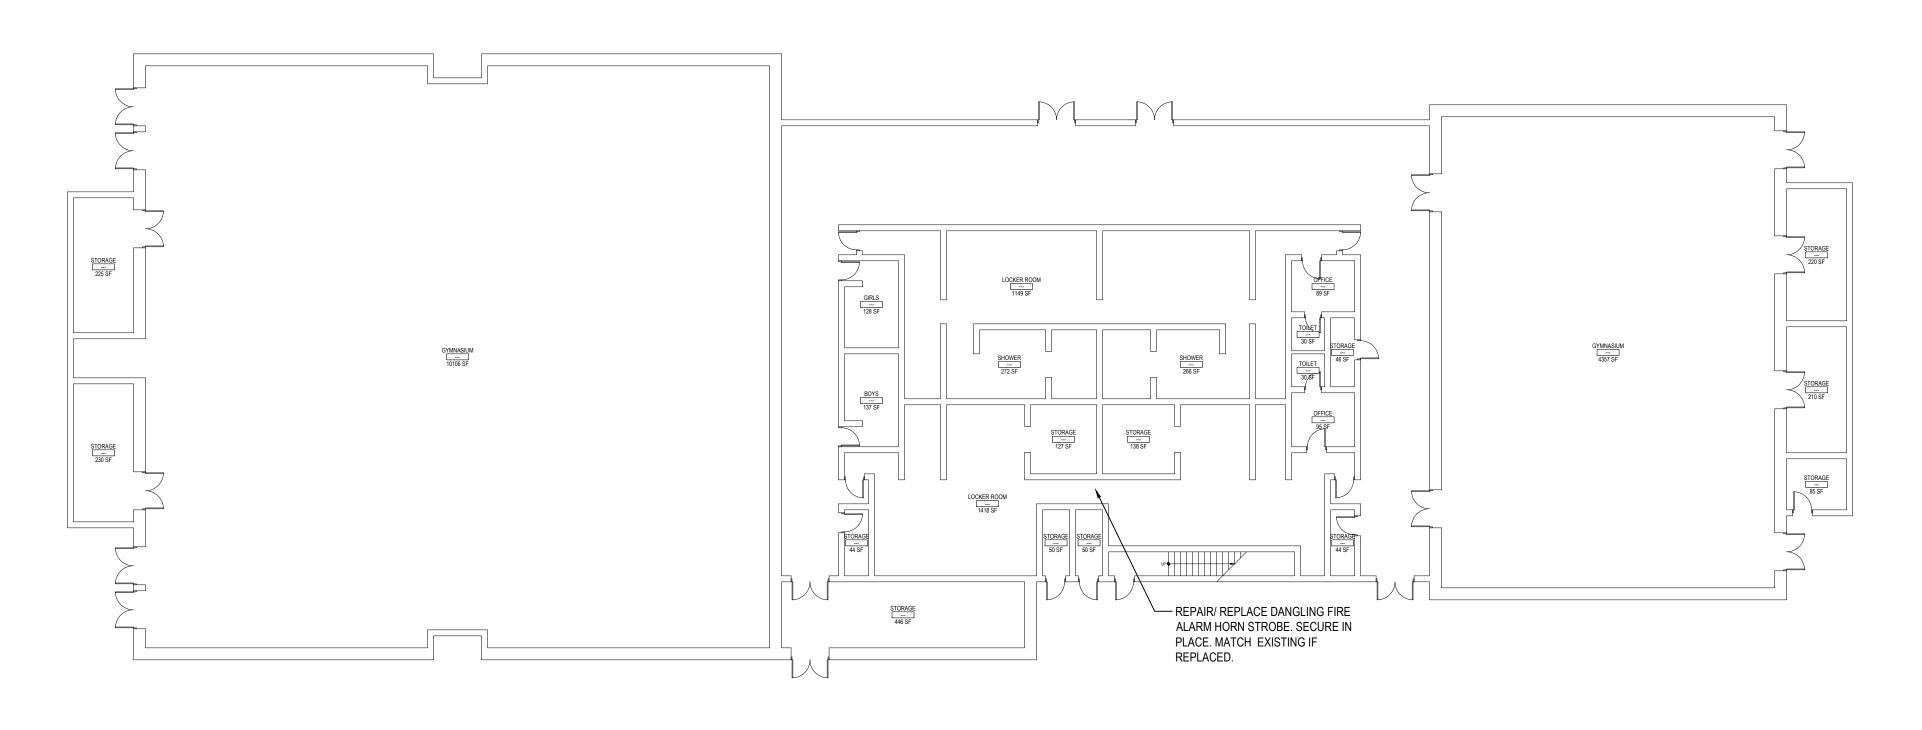

# PART GROUND FLOOR KEY PLAN

SEE E1.02D FOR DRAWING NOTES:

SCALE: 1/16" = 1'-0"

# IN LOCATIONS WHERE SIMILAR DEVICES ARE MOUNTED AT THE SAME HEIGHT. DEVICES SHALL BE PROPERLY "GANGED" AND SHALL HAVE A SINGLE COVER IN LOCATIONS WHERE DIFFERENT DEVICES ARE MOUNTED AT DIFFERENT HEIGHTS WITHIN FOUR FEET OF ONE ANOTHER, DEVICES SHALL BE MOUNTED SUCH THAT THEY HAVE A COMMON CENTERLINE. IF THERE ARE THREE OR MORE DEVICES, THE CONTRACTOR SHALL REQUEST A DETAIL FROM THE 80" TO BOTTOM, OR AT SHALLOW CEILING INSTALLATIONS, WITHIN 6" OF FINISHED CEILING. VERIFY WITH ENGINEER. IN TOILET ROOMS WITH BACK SPLASH AT VANITY, MOUNT CENTER AT 4" ABOVE BACK SPLASH. IF NO BACK SPLASH, MOUNT 4" ABOVE COUNTER. IF NO COUNTER, MOUNT AT 42" AFF.COORDINATE WITH ARCHITECTURAL PLANS. REFER TO ELEVATIONS AND FURNITURE PLANS. RECEPTACLE IN PLAN WITH THE NOTATION 'AC' INDICATES MOUNTING HEIGHT OF 4" ABOVE COUNTER OR 4" ABOVE BACK SPLASH. COORDINATE WITH ARCHITECTURAL PLANS. REFER TO ELEVATIONS AND FURNITURE PLANS. . MOUNT AT 7'-6" ABOVE CLOSEST FLOOR LEVEL (LANDINGS, STEPPED FLOORS, ETC.) UNLESS OTHERWISE NOTED. **DEVICE MOUNTING HEIGHT DETAIL** SCALE: N.T.S.

#### **GENERAL CONSTRUCTION NOTES**

1. ALL WORK SHALL BE DONE IN ACCORDANCE WITH THE 2017 EDITION OF THE NEC, APPLICABLE LOCAL CODES, STATE CODES, SCHOOL WORKING RULES AND SCHEDULE DIRECTIVES, AND THE ENGINEER'S SPECIFICATIONS.

2. THE VOLTAGE CHARACTERISTIC OF THIS SCHOOL IS 120/208VAC, 4 WIRE, 3PH, GROUNDED NEUTRAL, WYE. ALL EQUIPMENT SHALL BE COMPATIBLE WITH THESE CHARACTERISTICS.

3. THE DRAWINGS SHOW SCHEMATICALLY, THE APPROXIMATE LOCATION OF ALL EQUIPMENT, CONDUITS, DEVICES, ETC. THE EXACT LOCATION OF WHICH SHALL BE SUBJECT TO APPROVAL BY THE ARCHITECT/OWNER WHO RESERVES THE RIGHT TO MAKE PRIOR TO INSTALLATION. ANY REASONABLE CHANGES IN LOCATION INDICATED WITHOUT EXTRA COST TO THE OWNER. CONTRACTOR SHALL VERIFY ALL INDICATED OR APPROXIMATED DIMENSIONS DRAWN OR DENOTED.

4. DIVISION 16 CONTRACTOR SHALL EXAMINE THE SITE TO VERIFY WORK TO BE PERFORMED AS SHOWN ON DRAWINGS AND SPECIFICATIONS BEFORE SUBMITTING HIS BID. ANY DISCREPANCY BETWEEN DRAWINGS/SPECIFICATIONS AND ACTUAL FIELD CONDITIONS SHALL BE BROUGHT TO ARCHITECT/ENGINEERS ATTENTION BEFORE BID SUBMITTAL. ANY FIELD CONDITION FOUND AFTER BID APPROVAL WHICH HAMPERS AND/OR PREVENTS ANY WORK TO BE PERFORMED AS SHOWN ON DRAWINGS AND SPECIFICATIONS SHALL BE THE RESPONSIBILITY OF THE DIVISION 16 CONTRACTOR. THE DIVISION 16 CONTRACTOR SHALL BID THE HIGHER SPECIFICATION FOR ANY DISCREPANCY BETWEEN DRAWINGS AND SPECIFICATIONS.

5. DIVISION 16 CONTRACTOR SHALL PROVIDE ALL LABOR SERVICE MATERIALS, EQUIPMENT, AND RELATED ITEMS TO COMPLETE THE WORK OF THIS DIVISION, AS REQUIRED BY THE NATIONAL ELECTRIC CODE, AND ALL STATE AND LOCAL AUTHORITIES HAVING JURISDICTION.

6. DIVISION 16 CONTRACTOR SHALL PROVIDE ALL ELECTRICAL HARDWARE SHOWN ON THESE DRAWINGS AND RELATED DETAIL MATERIALS NOT SPECIFICALLY SHOWN OR SPECIFIED. ALL NEW ELECTRICAL MATERIAL AND EQUIPMENT SHALL CONFORM TO THE STANDARDS AND BEAR THE INSPECTION LABEL OF THE UNDERWRITERS LABORATORIES AND SHALL BE APPROVED FOR USE BY ALL LOCAL AUTHORITIES HAVING JURISDICTION.

7. THE DIVISION 16 CONTRACTOR SHALL REFER TO ALL OTHER DRAWINGS IN BID PACKAGE AND PERFORM THE WORK (INCLUDE IN HIS BID) INDICATED AS ELECTRICAL CONTRACTOR (E.C.) WORK. CONTRACTOR TO COORDINATE ALL LOCATIONS WITH GENERAL CONTRACTOR AND OTHER TRADES.

8. ELECTRICAL CONTRACTOR SHALL COORDINATE WITH THE MECHANICAL CONTRACTOR FOR ALL MECHANICAL EQUIPMENT REQUIRING ELECTRICAL POWER. THE EC IS RESPONSIBLE TO INSTALL ALL MOTOR STARTERS AND ASSOCIATED POWER WIRING. THE LOCATIONS OF MOTOR STARTERS SHALL BE DETERMINED BY THE CONTRACTOR IN THE FIELD AND SUBMITTED TO THE ENGINEER FOR APPROVAL UNLESS IT IS SPECIFIED ON THE DRAWINGS. THE EC SHALL REFER TO THE MECHANICAL EQUIPMENT SCHEDULES & NOTES AND INCLUDE IN HIS BID PRICE ALL ELECTRICAL WORK ASSOCIATED WITH THEIR INSTALLATION, AND THE REMOVAL OF ANY STARTERS/DISCONNECTS NO LONGER REQUIRED.

9. ALL WORK SHALL BE IN ACCORDANCE WITH MANUFACTURER'S RECOMMENDATIONS AND DIRECTIVES OF THE

10. ALL ELECTRICAL WORK SHALL BE PERFORMED BY A LICENSED ELECTRICAL CONTRACTOR WHO SHALL OBTAIN AN APPROVED ELECTRICAL INSPECTION CERTIFICATE FROM THE LOCAL AHJ AND PAY ASSOCIATED FEE. SUBMIT A PHOTOCOPY OF THIS CERTIFICATE TO THE ENGINEER WITH FINAL PAYMENT APPLICATION. SUBMIT A COPY OF THIS CERTIFICATE TO THE OWNER.

11. DIVISION 16 CONTRACTOR SHALL GUARANTEE ALL MATERIALS AND THEIR INSTALLATION TO BE FREE OF DEFECTS FOR A PERIOD AS DEFINED IN THE PROJECT MANUAL.

12. IF ADDITIONAL POLE POSITIONS ARE REQUIRED FOR NEW CIRCUITS IN EXISTING PANELS SERVICING RENOVATED AREAS, REMOVE (3) ADJACENT 1 POLE BREAKERS PROVIDE AND INSTALL 3P, 60A BREAKER FOR SUB FEED TO A SURFACE MOUNTED 100A, 3PH, 18 POLE SUB PANEL AND ESTABLISH OVERFLOW CIRCUITS IN NEW SUB PANEL, EACH WITH A 1P, 20A BREAKER. PROVIDE (3) 1P, 20A BREAKERS FOR DISCONNECTED CIRCUITS IN MAIN PANEL AND RECONNECT THEM IN SUB PANEL. SUB PANEL FEED TO BE 3#6 + 1#6(N) + 1#10(G)

13. IT IS EXPECTED THAT STRUCTURAL DEMOLITION BY THE GENERAL CONTRACTOR WILL CAUSE VARIOUS ELECTRIC SUPPLIES, OF VARIOUS VOLTAGES AND PURPOSES, TO BE CUT AND RENDER SOME DEVICES TEMPORARILY INACTIVE. IT IS THE ELECTRICAL CONTRACTOR'S RESPONSIBILITY TO RECONSTRUCT AND RECONNECT SUCH ELECTRIC SOURCES UPON COMPLETION. NOTE THAT MOST REINSTALLED ITEMS WILL BE IN DIFFERENT LOCATIONS FROM THE REMOVAL LOCATION. THE ELECTRICAL CONTRACTOR SHALL MAKE ALL REQUIRED CIRCUIT EXTENSIONS OR MODIFICATIONS TO PROVIDE SERVICE TO A REINSTALLED ITEM AS RELOCATED. NOTE THAT THIS REQUIREMENT ALSO APPLIES TO THE ROOMS AND ELECTRICAL ITEMS WITHIN THAT ARE NOMINALLY NOT IN CONTRACT. SUCH RESTORATION OF SERVICE, IF NEEDED, IS SPECIFICALLY IN THE ELECTRICAL CONTRACTOR'S CONTRACT.

14. THE ELECTRICAL CONTRACTOR SHALL PROVIDE TEMPORARY LIGHTING AND POWER TO ALL TRADES FOR THE DURATION OF THE PROJECT. SERVICE SHALL BE SUPPLIED TO CONTRACTOR'S CONSTRUCTION TRAILERS WHERE SUCH IS REQUESTED. USE THE EXISTING POWER PANELS FOR SUCH SUPPLY. POWER COSTS WILL BE PAID BY THE OWNER. ALL CONSTRUCTION POWER RECEPTACLES SHALL BE GFI PROTECTED.

15. IT SHALL BE THE ELECTRICAL CONTRACTOR'S RESPONSIBILITY TO PROTECT ALL ELECTRICAL DEVICES FROM DAMAGES DURING CONSTRUCTION. THIS INCLUDES DEVICES WHICH ARE EITHER INDICATED TO REMAIN, AND/OR TO BE REMOVED AND REINSTALLED THROUGHOUT ALL CONSTRUCTION AREAS. DEVICES SHALL INCLUDE BUT WILL NOT BE LIMITED TO: SMOKE DETECTORS, EMERGENCY LIGHTS, EXIT SIGNS, OCCUPANCY SENSORS, SPEAKERS, LIGHT FIXTURES, SWITCHES, RECEPTACLES, ETC. IN THE EVENT OF DAMAGES INCURRED DUE TO CONSTRUCTION ACTIVITIES, THE ELECTRICAL CONTRACTOR SHALL BE RESPONSIBLE TO REPLACE ANY DAMAGED DEVICES AT NO ADDITIONAL COST TO OWNER.

16. THE INDICATED SOURCE OF EXISTING CIRCUITS MAY NOT BE KNOWN OR HAS NOT BEEN VERIFIED. IT IS THE DIVISION 16 CONTRACTOR'S RESPONSIBILITY TO TRACE OUT, LOCATE AND VERIFY THE DISCONNECTING MEANS OF EXISTING CIRCUIT(S) TO BE IMPACTED BY THE WORK. SAFE OFF THE CIRCUIT(S0 AS REQUIRED TO SAFELY PERFORM THE WORK, AND RE-ENERGIZE UPON COMPLETION. UPDATE PANEL DIRECTORIES UPON

17. WHERE EXISTING FIRE ALARM SYSTEMS ARE MODIFIED DURING THE COURSE OF THE PROJECT, PROVIDE OWNER WITH UPDATED COMPLETION RECORD DOCUMENTATION PER NFPA 72, ARTICLE 10.18. INCLUDE COPY OF UPDATED SITE SPECIFIC SOFTWARE. ANY ADDITIONAL DEVICES SHALL BE MAPPED INTO THE SYSTEM WITH THE APPROPRIATE ADDRESSES/LABELS.

18. FURNISH AND INSTALL ALL INDICATED LIGHTING FIXTURES AND MOUNTING HARDWARE AS REQUIRED FOR A COMPLETE INSTALLATION. NOTE ALL LIGHT FIXTURES SHALL BE SUPPORTED FROM BUILDING STRUCTURE. UTILIZING CEILING FRAMING ALONE IS NOT ACCEPTABLE. NEW LIGHTING FIXTURES (OTHER THAN THEATRICAL EQUIPMENT) SHALL NOT BE DAISY CHAINED. RE-USE OF AN EXISTING LIGHTING CKT INCLUDES HOME RUN WIRING OR WIRING UP TO THE SWITCH. ANY WIRING DOWNSTREAM OF THE SWITCH IS SUBJECT TO REPLACEMENT/REARRANGEMENT. EC SHALL ALLOW FOR THIS IN THE BID PRICE.

19. UNLESS OTHERWISE NOTED ON THE PLANS BRANCH CIRCUIT HOMERUNS OF 100 FT OR LESSSHALL BE 2#12, 1#12G, 3/4"C OR EQUIVALENT. HOMERUNS. HOMERUNS LONGR THAN 100 FT SHALL BE 2#10, 1#10G; 3/4" OR

20. ALL BRANCH CIRCUIT WIRING TO BE 1#12+1#12(N)+1#12(G)-3/4" EMT, OR STEEL JACKETED MC CABLE (WHERE CODE PERMITTED), UNLESS OTHERWISE SPECIFIED ON DRAWINGS. ALUMINUM JACKETED MC CABLE IS NOT

21. RUN BRANCH CIRCUITS IN DROPPED CEILINGS, VOIDS, & CHASES. ALL DEVICES & CONDUITS ON NEW CONSTRUCTION MUST BE RECESSED. FOR EXISTING SURFACES: MECHANICAL/WORK SPACES-CONDUITS MAY BE SURFACE MOUNTED. EXISTING PUBLIC/FINISHED AREAS- CONDUITS SHALL BE CONCEALED WHEREVER POSSIBLE (IN HUNG CEILINGS, VOIDS/CHASES, FLOOR BELOW OR BEHIND WALLS) ALL WIRING THAT CANNOT BE CONCEALED IN MUST BE RUN IN FINISHED SURFACE RACEWAY SUCH AS WIREMOLD, COLOR PER ARCHITECT. USE OF ADHESIVE IS PROHIBITED, SURFACE RACEWAY MUST BE SECURED USING MECHANICALLY FASTENED

22. ANY LIGHT FIXTURES INSTALLED IN GYMNASIUMS OR OTHER AREAS SUBJECT TO IMPACT OR PHYSICAL DAMAGE SHALL BE MOUNTED WITH SAFETY CHAINS AND SECURED TO STRUCTURE.

23. EMERGENCY AND EXIT LIGHTING FIXTURES SHALL BE WIRED TO THE LOCAL AREA WIRING CIRCUIT AHEAD

24. NEW CIRCUIT BREAKERS INSTALLED IN EXSITING PANELS SHALL BE LISTED FOR USE IN THE INTENDED PANEL AND SHALL MEET OR EXCEED THE AIC RATING OF THE PANEL.

25. SEE SPEC. SECTION 16100 BASIC MATERIALS AND METHODS FOR COMPLETE NOTES ON INSTALLATION, MISCELLANEOUS MATERIALS AND ELECTRICAL DEVICES.

# FIRE STOP NOTES

- ALL CONDUIT AND CABLE PENETRATIONS THROUGH FIRE RATED WALLS, FLOORS OR OTHER STRUCTURES
- THE FIRE STOP MATERIALS SHALL BE HILTI TYPE FS-657 FIRE BLOCK, FS-ONE SEALANT, CP-672 JOINT SPRAY, CP-601S ELASTOMERIC SEALANT, 6P-606 FLEXIBLE SEALANT, CP-643 OR CP-642 COLLAR, CP-618 PUTTY STICK, OR FS-635 TROWEL ABLE COMPOUND, AS SUITABLE.
- CONTRACTOR SHALL SUBMIT SHOP DRAWINGS OF PRODUCTS SPECIFIED OR EQUAL.
- FIRE STOP MATERIALS OTHER THAN HILTI SHALL INCLUDE FULL TECHNICAL DATA WITH SHOP DRAWINGS TO DEMONSTRATE EQUALITY WITH THE SPECIFIED FIRE STOPS AND STATEMENT FROM MANUFACTURER THAT THEY MEET OR EXCEED THE PRODUCTS SPECIFIED HERE.
- ALL SYSTEMS SHALL HAVE THEIR OWN SLEEVE THROUGH FIRE RATED WALLS. IE FIRE ALARM, PUBLIC ADDRESS, TELEPHONE, DATA, POWER AND LIGHTING.

ABBRE	VIATIONS
Α	
AC	
ACT	
AFF	
AFG	
BC	
<u>C</u>	
CB	
.CKT	
.CM	
DC	
DH	
DISC	
EC	ELECTRICAL CONTRACTOR
EM	EMERGENCY
EMT	
ETR	
EX	
FA	
FMC	
FT	
GFÇI, GFI	
G, GND	
GRS	
HD	
JG	
JN	
KW	
LFMC	LIQUID TIGHT FLEXIBLE METAL CONDUIT
MAX	
MC.	
MCB	
MDP	
MH	
MIN	
MLQ	
MTD	
МТН	
N	
NEÇ	
NEMA	NATIONAL ELECTRICAL MANUFACTURES ASSOCIATION
NIC	NOT IN CONTRACT
NL	NIGHT,LIGHT
NT\$	
PA	
PC	
PV	
PVÇ	
REÇ	
REQ'D.	
RL	
SCH	
SM	
SPD	
SQ	
SWBD	
SWG	
TSP	
TV\$S	TRANSIENT VOLTAGE SURGE SUPPRESSION
.TYP	
UC	
UG	
UTP	
UWS	
.V	
VFD	
.w	
WG.	
WM	
	MEATIED DDOOL
WP.	

# EXISTING FIRE ALARM SYSTEM NOTES

- DIVISION 16 CONTRACTOR SHALL EXTEND THE EXISTING FIRE ALARM SYSTEM TO PROVIDE COVERAGE FOR THE NEW AREAS AND/OR DEVICES AND INTEGRATE THEM INTO THE SYSTEM. . NEW DEVICES SHALL BE COMPATIBLE WITH THE EXISTING FIRE ALARM PANEL WHICH IS TO REMAIN. ALL NEW DEVICES SHALL BE INSTALLED PER ADA REQUIREMENTS AND FULLY INTEGRATED INTO THE SYSTEM. THE CONTRACTOR SHALL PROVIDE THE ITEMS ON THE DRAWING AND ALL RELATED EXPANSION, ADAPTIVE, AND CONNECTING
- ALL FIRE ALARM WORK SHALL BE PERFORMED BY MANUFACTURER CERTIFIED TECHNICIANS.
- WIRING, REPROGRAMMING AND DEVICES FOR A FULLY FUNCTIONING SYSTEM. DIVISION 16 CONTRACTOR SHALL OBTAIN ALL REQUIRED PERMITS AND APPROVALS FOR THIS PROJECT
- SHALL CONTAIN A SYSTEM RISER DIAGRAM. DIVISION 16 CONTRACTOR TO PROTECT OR TEMPORARILY DISCONNECT / RECONNECT EXISTING FIRE ALARM DEVICES TO ACCOMMODATE NEW CONSTRUCTION AS REQUIRED. COORDINATE WITH GENERAL CONTRACTOR. WHERE PLANS CALL FOR EXISTING DEVICE TO BE RELOCATED, EXTEND WIRING AS

AND PAY RELATED FEES. HE SHALL SUBMIT SHOP DRAWINGS ON ALL HARDWARE. THE SHOP DRAWINGS

- ALL NEW FIRE ALARM DEVICES SHALL BE OF THE SAME MANUFACTURER AND COMPATIBLE WITH THE FIRE
- PROVIDE ADAPTIVE HARDWARE TO POWER THE HORN STROBES, STROBES AND MAGNETIC DOOR
- ALL WORK SHALL BE IN ACCORDANCE WITH SYSTEM MANUFACTURER SPECIFICATIONS, LATEST EDITION
- OF NEC, ANY LOCAL, STATE CODES, AND ENGINEERING SPECIFICATIONS. ALL WIRING SHALL BE AS SPECIFIED BY SYSTEM MANUFACTURER AND PLENUM RATED.
- DIVISION 16 CONTRACTOR SHALL PROVIDE ANY ADDITIONAL EQUIPMENT, SYSTEM MODULES, POWER SUPPLIES ETC. NEEDED TO HAVE A COMPLETE AND OPERATIONAL SYSTEM. PROVIDE NEW REMOTE ANNUNCIATOR PANEL(S) WHERE INDICATED INCLUDING UPDATED GRAPHIC MAPS. UPDATED MAPS SHALL ALSO INDICATE THE LOCATIONS OF ALL AREA OF RESCUE ASSISTANCE (REFUGE) CALL STATIONS. SUBMIT PROPOSED MAPS FOR APPROVAL.
- . THE DIVISION 16 CONTRACTOR SHALL FIELD SELECT THE PROPER OUTPUT SETTINGS OF FIRE ALARM HORNS AND STROBES TO MEET THE MINIMUM CODE PERFORMANCE REQUIREMENTS TO SUIT THE AREAS
- PROVIDE AS-BUILT DRAWINGS <u>AND COPY OF UPDATED SITE SPECIFIC SYSTEM SOFTWARE INCLUDING PASSWORDS</u> TO THE DISTRICT AT NO ADDITIONAL CHARGE.

		REV.	DATE	ITEM
MPERAGE OR AMPS				
ERNATING CURRENT.		-		
BOVE COUNTER TOP.			N/	OTICE
VE FINISHED FLOOR		THESE DRAV		OTICE ON CONSTRUCTION DRAWINGS
VE FINISHED GRADE		PREPARED I ENGINEERS,	BY BBS ARCHITE( PC. AND, THERE	CTS, LANDSCAPE ARCHITECTS FORE, MAY NOT REPRESENT
BELOW CEILING		CONDITIONS	SHOWN ARE	ED AT THE TIME. ALL EXIS REPRESENTED AS SUGGES OT HAVE BEEN BUILT AND DETA
CONDUIT				OR PER THE OWNER'S INFORMA
ÇIRCUIT BREAKER				
CIRCUIT				
CEILING MOUNTED				
DIRECT CURRENT.				
. DOOR HOLDER				
. DISCONNECT.				
RICAL CONTRACTOR				
. EMERGENCY.				
AL METALLIC TUBING		_		
XISTING TO REMAIN				
EXISTING		(	<u>C</u>	
FIRE ALARM				
BLE METAL CONDUIT			В	)
FEET.				
ERAL CONTRACTOR				
RCUIT,INTERRUPTER			(A)	
ANIZED RIGID STEEL			V	
HAND DRYER ISOLATED GROUND				/
INCHES				<b>A</b>
	<b>.</b>	1		■

NOT TO SCALE

KEY PLAN


DG

THIS DRAWING, PREPARED FOR THE SPECIFIC PROJECT INDICATED IS AN INSTRUMENT OF SERVICE AND THE PROPERTY OF BBS ARCHITECTS, LANDSCAPE ARCHITECTS AND ENGINEERS, PC. INFRINGEMENT OR ANY USE OF THIS DRAWING FOR ANY OTH PROJECT IS PROHIBITED. ANY ALTERATION OR REPRODUCTION OF THIS DOCUMENT IS ALSO PROHIBITED WITHOUT THE WRITTEN CONSENT OF THE ARCHITECT OR ENGINEER.



LANDSCAPE ARCHITECTS ENGINEERS 187 WOLF ROAD, STE. 205 NEW YORK 11772 NEW YORK 12205 T. 631.475.0349

F. 631.475.0361 F. 518.621.7655 www.BBSARCHITECTURE.com

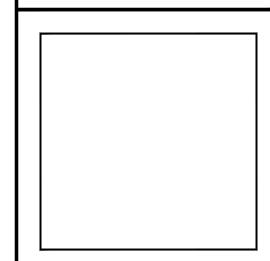

66-04-07-06-0-007-022


DISTRICT GREENBURGH CSD PROJECT PH. I - DW CAP. IMPROVEMENT WOODLANDS M.S./H.S.


DWG TITLE ELECTRICAL NOTES & PLANS SCALE: AS NOTED DATE: MAY 2022


BID PICK-UP: MAY 27, 2022

FILE No: 21-291

E1.01D

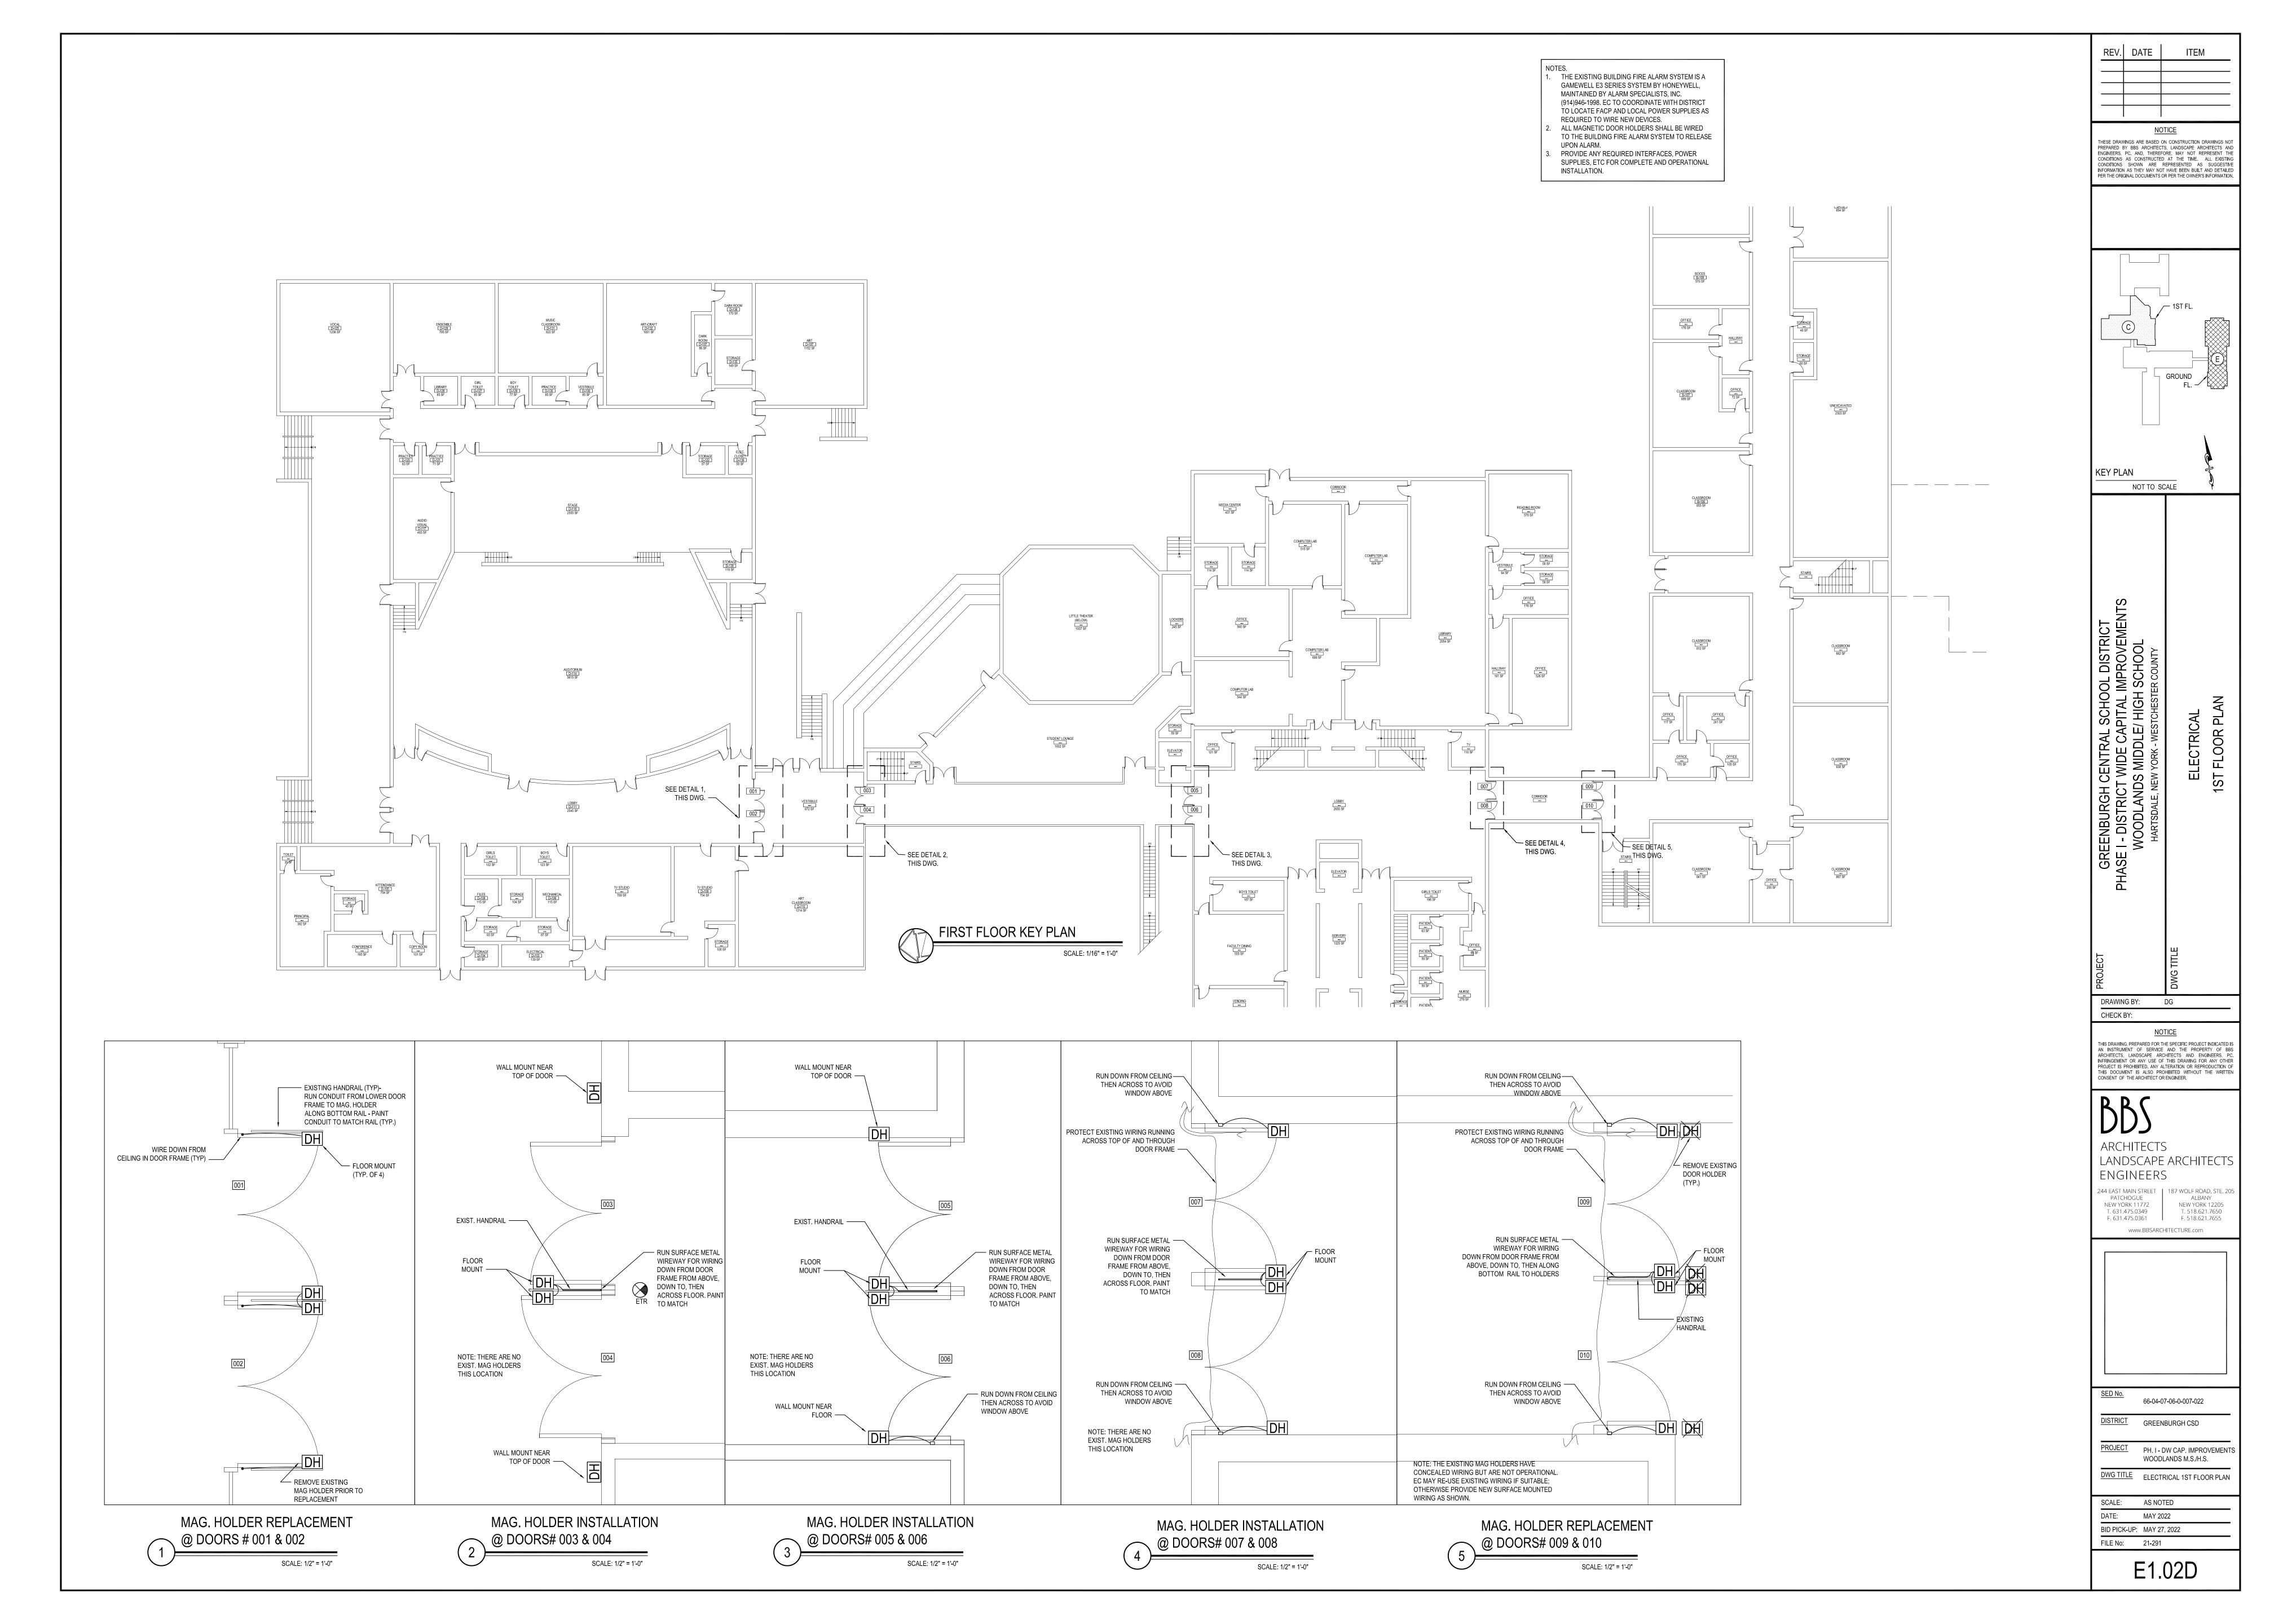

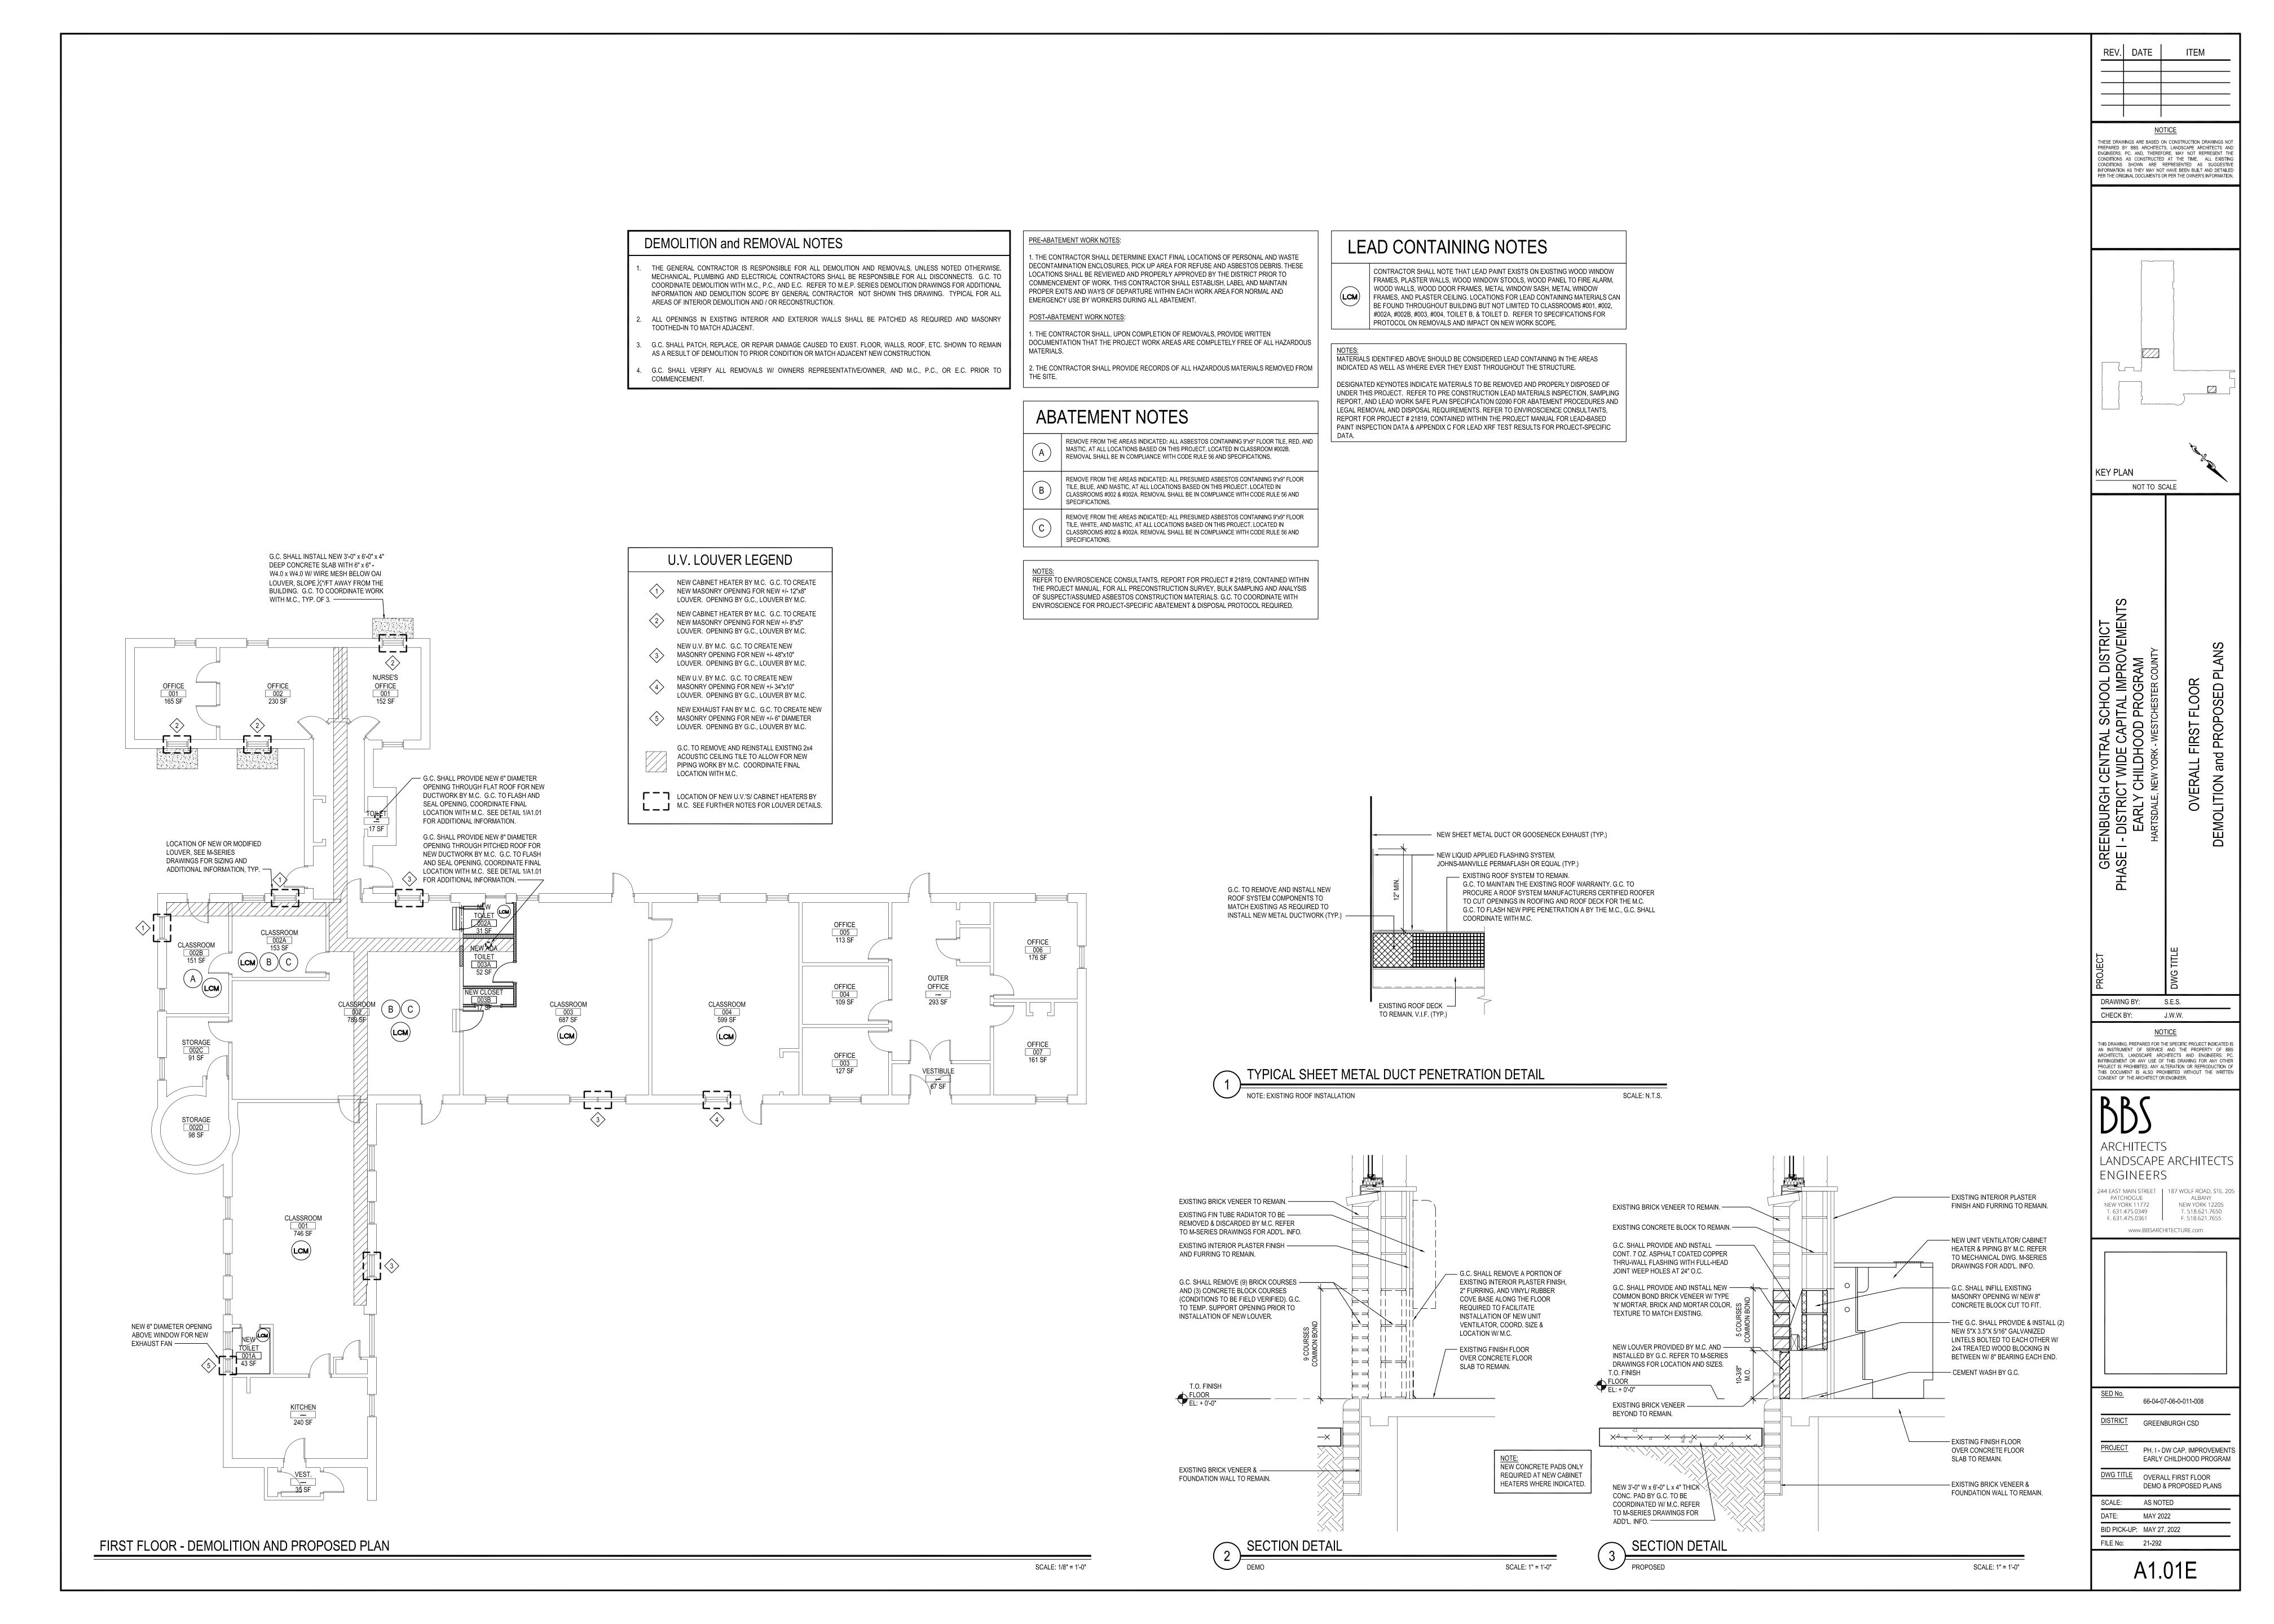

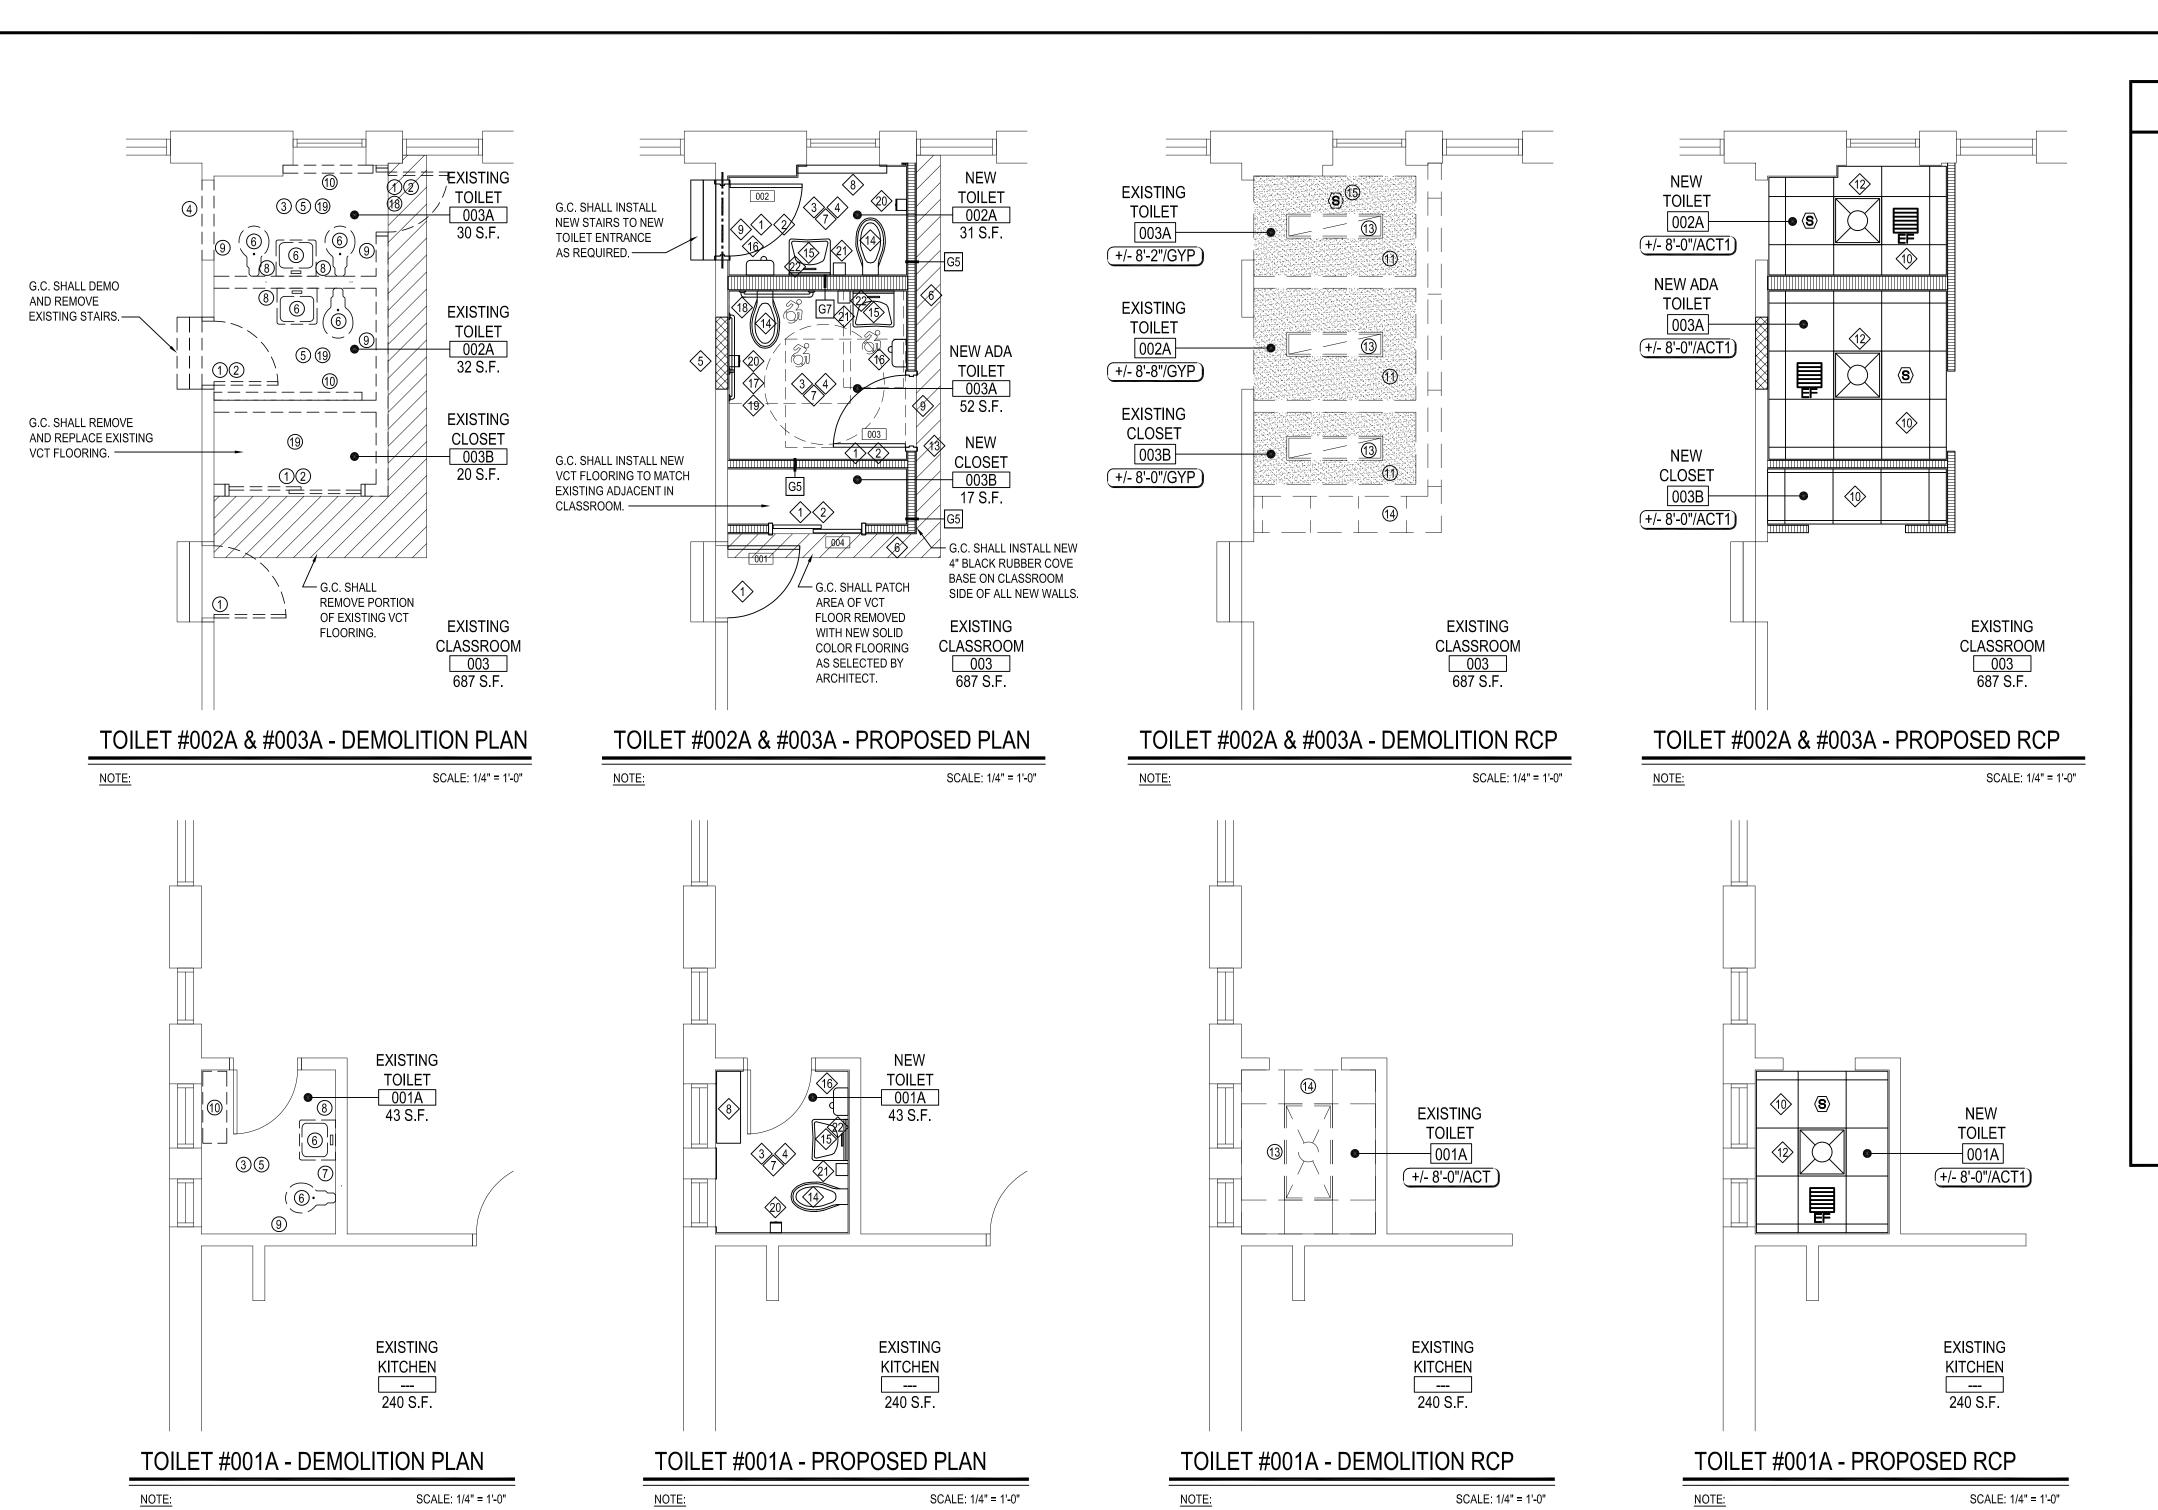

## **DEMOLITION AND REMOVAL KEYED NOTES:**

- (ALL CONTRACTORS SHALL REFER TO ASBESTOS, LEAD AND PCB ABATEMENT PLANS AND ASSOCIATED TESTING REPORTS IN SPECIFICATIONS PRIOR TO ANY REMOVALS)
- G.C. SHALL REMOVE EXISTING DOOR AND HARDWARE. TURN OVER TO OWNER OR DISPOSE OF AS DIRECTED BY OWNER.
- (2) G.C. SHALL REMOVE EXISTING TOILET ROOM DOOR FRAME.
- THROUGHOUT EXISTING TOILET ROOM G.C. SHALL REMOVE AND DISPOSE OF EXISTING CERAMIC WALL TILE WAINSCOT
- IN LOCATIONS WHERE THE EXISTING WALLS ARE TO REMAIN AND RECEIVE NEW FINISHES, G.C. SHALL PATCH AND PREP EXISTING WALL BOARD, PLASTER AND OR C.M.U. SURFACES - READY TO RECEIVE NEW FINISHES. G.C. SHALL REMOVE AND DISPOSE OF EXISTING MASONRY WALLS IN THEIR ENTIRETY. G.C. SHALL PATCH/REPAIR
- ADJACENT WALLS, CEILINGS, AND FLOORS TO MATCH EXISTING ADJACENT. IN LOCATIONS WHERE THERE IS EXISTING SECTION OF WALL ABOVE TO REMAIN OR THERE IS EXISTING STRUCTURE ABOVE THAT IS SUPPORTED BY THE REMOVED WALL BELOW - G.C. SHALL SHORE-UP AND TEMPORARILY SUPPORT EXISTING WALL/STRUCTURE ABOVE - G.C. SHALL PROVIDE AND INSTALL NEW STEEL LINTEL AT NEW/WIDENED DOOR MO'S AND INSTALL NEW CMU WALL IN WIDTH AND COURSING TO MATCH EXISTING. REFER TO PROPOSED PLANS FOR ADDITIONAL INFORMATION.
- THROUGHOUT EXISTING TOILET ROOM EXISTING CERAMIC FLOOR TILE & BASE TO BE COMPLETELY REMOVED AND DISPOSED OF. PROVIDE NEW MUDSET CERAMIC FLOOR TILE AND NEW INTEGRAL BASE, TYPICAL, ENTIRE ROOM PROVIDE
- THROUGHOUT EXISTING TOILET ROOMS G.C. SHALL REMOVE AND DISPOSE OF ALL EXISTING PLUMBING FIXTURES (SINKS, URINALS, WATER CLOSETS, FAUCETS, FLUSHOMETERS, ETC.) IN THEIR ENTIRETY. P.C. SHALL DISCONNECT, ADJUST/CUT BACK ALL PLUMBING PIPING. G.C. TO COORDINATE WITH P.C., REFER TO PLUMBING DRAWINGS FOR

POSITIVE PITCH TO FLOOR DRAINS.

- THROUGHOUT ALL EXISTING TOILET ROOMS G.C. SHALL REMOVE PART OF EXISTING WET WALLS AS REQUIRED TO ALLOW PLUMBING CONTRACTOR TO MODIFY PLUMBING AND INSTALL NEW FIXTURE CARRIERS. G.C TO COORDINATE WITH P.C. FOR LOCATIONS PRIOR TO DEMO. G.C. TO INFILL ALL OPENINGS AFTER P.C. HAS COMPLETED. INFILL OPENINGS WITH CMU TO MATCH EXISTING, TOOTH-IN NEW MASONRY. G.C. TO TEMPORARILY SHORE OPENINGS AS REQUIRED.
- THROUGHOUT EXISTING TOILET ROOM G.C. TO REMOVE ALL EXISTING HAND SOAP DISPENSERS AND TURN OVER TO OWNER OR DISPOSE OF AS DIRECTED BY THE OWNER.
- THROUGHOUT EXISTING TOILET ROOM G.C. TO REMOVE ALL EXISTING TOILET PAPER DISPENSERS AND TURN OVER TO OWNER OR DISPOSE OF AS DIRECTED BY THE OWNER.
- THROUGHOUT EXISTING TOILET ROOMS EXISTING RADIATOR COVERS TO REMAIN. G.C. TO REMOVE PREP AND PAINT AND REINSTALL, COLOR BY ARCHITECT.
- THROUGHOUT EXISTING TOILET ROOMS G.C. TO REMOVE ALL EXISTING PLASTER CEILINGS IN THEIR ENTIRETY. REFER TO ELECTRICAL AND MECHANICAL DRAWINGS FOR ADDITIONAL INFORMATION.
- THROUGHOUT EXISTING TOILET ROOM EXISTING CEILING VENTILATION GRILLES ARE TO REMOVED AND NEW ONES INSTALLED. REFER TO MECHANICAL DRAWINGS FOR ADDITIONAL INFORMATION.

THROUGHOUT EXISTING TOILET ROOM - G.C. TO REMOVE ALL EXISTING SURFACE MOUNTED OR LAY-IN LIGHT FIXTURES

THROUGHOUT EXISTING TOILET ROOMS - G.C. SHALL REMOVE AND DISPOSE OF ALL EXISTING CEILING GRID AND CEILING

- AND TURN OVER TO OWNER OR DISPOSE OF AS DIRECTED BY THE OWNER. E.C. TO DISCONNECT PRIOR TO THEIR REMOVALS (REFER TO REFLECTED CEILING PLANS & ELECTRICAL DRAWINGS FOR ADDITIONAL INFORMATION).
- TILES. REFER TO REFLECTED CEILING PLANS & ELECTRICAL DRAWINGS FOR ADDITIONAL INFORMATION. THROUGHOUT EXISTING TOILET ROOMS - EXISTING CEILING MOUNTED ELECTRICAL DEVICES (SMOKE DETECTORS, OCCUPANCY SENSORS, VAPE SENSORS, FIRE ALARM DEVICES, ETC. ARE TO BE REMOVED AND REPLACED WITH NEW
- (16) EXISTING THERMOSTAT TO REMAIN, REFER TO MECHANICAL DRAWINGS FOR ADDITIONAL INFORMATION.
- EXISTING FLOOR DRAIN TO REMAIN, REFER TO PLUMBING DRAWINGS FOR ADDITIONAL INFORMATION.
- THROUGHOUT EXISTING TOILET ROOMS G.C. TO REMOVE EXISTING MARBLE DOOR SADDLES AND REPLACE WITH NEW. REFER TO TOILET ROOM FINISHED FLOOR PLANS FOR ADDITIONAL INFORMATION.
- PRIOR TO COMMENCEMENT OF WORK, THE OWNER SHALL REMOVE ALL FREE STANDING SHELVING/ EQUIPMENT/ ETC.

#### **DEMOLITION and REMOVAL NOTES**

REFER TO ELECTRICAL DRAWINGS FOR ADDITIONAL INFORMATION.


THE GENERAL CONTRACTOR IS RESPONSIBLE FOR ALL DEMOLITION AND REMOVALS, UNLESS NOTED OTHERWISE MECHANICAL, PLUMBING AND ELECTRICAL CONTRACTORS SHALL BE RESPONSIBLE FOR ALL DISCONNECTS. G.C. TO COORDINATE DEMOLITION WITH M.C., P.C., AND E.C. REFER TO M.E.P. SERIES DEMOLITION DRAWINGS FOR ADDITIONAL INFORMATION AND DEMOLITION SCOPE BY GENERAL CONTRACTOR NOT SHOWN THIS DRAWING. TYPICAL FOR ALL AREAS OF INTERIOR DEMOLITION AND / OR RECONSTRUCTION.

- ALL OPENINGS IN EXISTING INTERIOR AND EXTERIOR WALLS SHALL BE PATCHED AS REQUIRED AND MASONRY TOOTHED-IN TO MATCH ADJACENT.
- G.C. SHALL PATCH, REPLACE, OR REPAIR DAMAGE CAUSED TO EXIST. FLOOR, WALLS, ROOF, ETC. SHOWN TO REMAIN
- G.C. SHALL VERIFY ALL REMOVALS W/ OWNERS REPRESENTATIVE/OWNER, AND M.C., P.C., OR E.C. PRIOR TO
- NOTED WALL REMOVALS SHALL INCLUDE ALL DOORS, WINDOWS AND FRAMES WHERE SHOWN


AS A RESULT OF DEMOLITION TO PRIOR CONDITION OR MATCH ADJACENT NEW CONSTRUCTION.

# FLUORESCENT BULB NOTE

ALL EXISTING FLUORESCENT BULBS TO BE REMOVED SHALL BE CONSIDERED HAZARDOUS WASTE AND SHOULD BE HANDLED AND DISPOSED OF IN ACCORDANCE WITH THE NEW YORK STATE DEPARTMENT OF ENVIRONMENTAL CONSERVATION (DEC) & UNITED STATES ENVIRONMENTAL PROTECTION AGENCY (EPA) RULES, REGULATIONS & GUIDELINES.

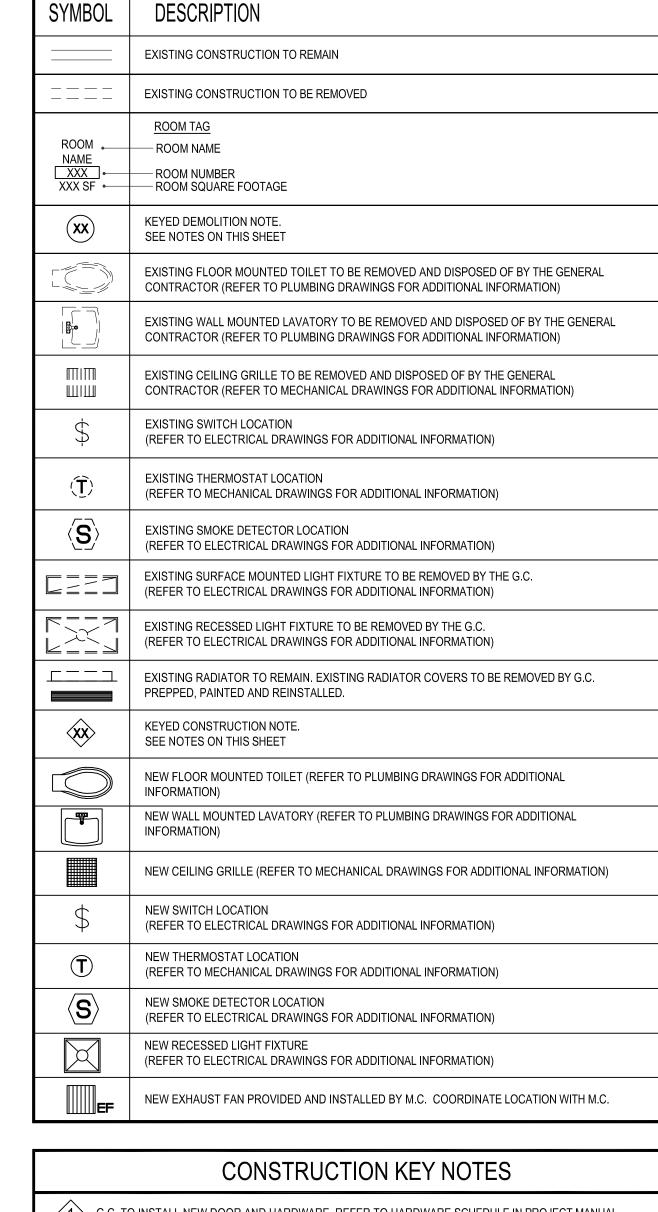

SYMBOL LEGEND

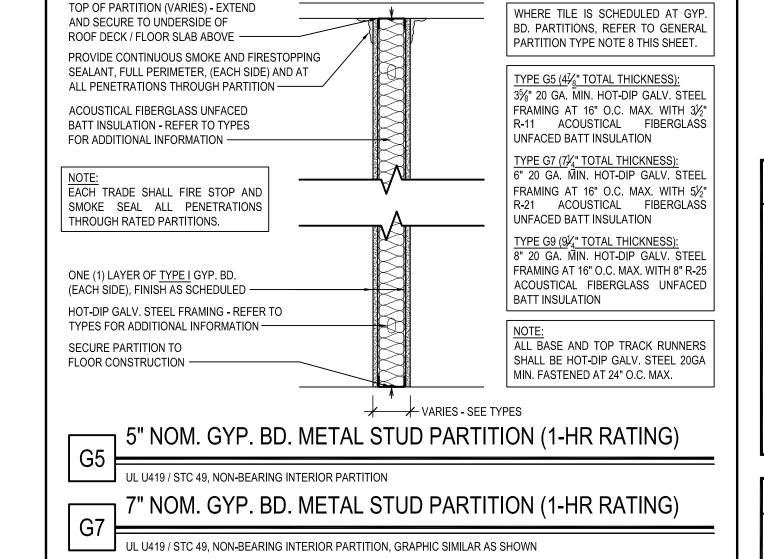

9" NOM. GYP. BD. METAL STUD PARTITION (1-HR RATING)

UL U419 / STC 49, NON-BEARING INTERIOR PARTITION, GRAPHIC SIMILAR AS SHOWN

# **REFLECTED CEILING NOTES:**

- CEILING PLANS MAY NOT INDICATE ALL MECHANICAL AND/OR ELECTRICAL CEILING ITEMS, REFER TO MECHANICAL AND ELECTRICAL DRAWINGS FOR ADDITIONAL INFORMATION.
- CEILING GRID SHALL BE ARRANGED TO BE SPACED EQUALLY IN EACH DIRECTION W/ NO TILE LESS THAN 6" UNLESS OTHERWISE REQUIRED.
- UNLESS OTHERWISE NOTED, ALL SOFFITS AND WINDOW POCKETS SHALI BE TYPE-X GYP. BD. OVER 18GA. COLD FORMED FRAMING AT 16" O.C.. REFER TO TYPICAL DETAILS.
- ALL AREAS NOTED AS 'OPEN' AND/OR 'NO CEILING (CLG)' SHALL BE PAINTED. (INCLUDING DECK, STRUCTURE, DUCTWORK, ETC.) REFER TO CEILING TYPES NOTES FOR ADDITIONAL INFORMATION

# CEILING TYPES

ACOUSTIC CEILING TILE BY "ARMSTRONG" SIZE: 24" X 24" X 7/8", NRC RATING .80 STYLE: #1445 ULTIMA HEALTH ZONE HIGH NRC, SQUARE LAY IN

CEILING GRID BY "ARMSTRONG", 15/16" PRELUDE, U.O.N. NOTE: ALL CEILING TILE & GRID TO BE WHITE UNLESS OTHERWISE NOTED.

PROVIDE NEW MARBLE SADDLE AT ALL TOILET ROOM DOORS. PROVIDE BEVELED SADDLE TO MEET ADA REQUIREMENTS. ALL NEW V.C.T. FLOORING TO BE INSTALLED THROUGHOUT ENTIRE FLOOR AREA AS SHOWN UNLESS OTHERWISE NOTED.

GENERAL CONTRACTOR SHALL PATCH ALL AREAS OF FLOOR DAMAGED

GENERAL CONTRACTOR SHALL FLASH PATCH ALL FLOORS IN THEIR

ACCORDANCE WITH MANUFACTURERS SPECIFICATIONS. PRIOR TO

(PLANI/PATCH PLUS) BY 'MAPEI' OR ARCHITECT APPROVED EQUAL.

ENTIRETY WHERE MASTIC REMOVAL HAS OCCURRED WITH

GENERAL CONTRACTOR SHALL PERFORM A BOND TEST IN

# CEILING NOTE:

NOTES

ADVISORY SPECIFICATIONS FOR WATER CLOSETS SERVING CHILDREN AGES 3-12

WATER CLOSET - SIDE VIEW

BY THE REMOVAL OF MASTIC.

INSTALLATION OF NEW FLOORING.

ALL TOILET ROOM CEILINGS ARE TO BE SIMILAR OR EQUAL TO ARMSTRONG #1445 ULTIMA HEALTH ZONE HIGH NRC CEILING TILE. THIS TILE IS TREATED WITH HUMIGUARD PLUS FOR DURABILITY, WORKABILITY AND WATER-RESISTANCE. THE TILE CARRIES A 30-YEAR WARRANTY AGAINST SAG, MOLD, MILDEW AND GROWTH.

#### 12" x 12" GLAZED PORCELAIN FLOOR TILE BY DALTILE STYLE: HARMONIST COLOR: TO BE SELECTED BY ARCHITECT 6" x 6" CERAMIC WALL TILE BY DALTILE STYLE: COLOR WHEEL-CLASSIC COLOR: TO BE SELECTED BY ARCHITECT (TOILET WALL FIELD TILE) 6" ACCENT BAND 1" x 1" AMERICAN OLEAN COLOR APPEAL GLASS MOSAICS COLOR: TO BE SELECTED BY ARCHITECT (TOILET WALL ACCENT TILE) 6" ACCENT BAND 1" x 1" AMERICAN OLEAN COLOR APPEAL GLASS MOSAICS COLOR: TO BE SELECTED BY ARCHITECT (TOILET WALL ACCENT TILE) **CERAMIC COVE BASE:** TYPE CTCB1: 6" X 6" CERAMIC TILE FLAT TOP COVE BASE BY DALTILE STYLE: SEMI GLOSS A-3601 COLOR: TO BE SELECTED BY ARCHITECT

(TOILET COVE BASE)

AGES 5 THROUGH 8 AGES 9 THROUGH 12

PORCELAIN / CERAMIC TILE TYPES

#### COLOR: TO BE SELECTED BY ARCHITECT AS MANUFACTURED BY MAPEI OR EQUAL, UNSANDED, COLOR: TO BE SELECTED BY ARCHITECT PAINT TYPES PAINT BY SHERWIN WILLIAMS: DTM ALKYD SEMI-GLOSS ENAMEL COLOR: TO BE SELECTED BY ARCHITECT (HM DOOR FRAMES/ RADIATOR COVERS

PAINT BY SHERWIN WILLIAMS:

SEMI-GLOSS ENAMEL FINISH

(TOILET ROOMS)

COLOR: TO BE SELECTED BY ARCHITECT

FLOOR GROUT: AS MANUFACTURED BY MAPEI OR EQUAL, SANDED,

4" RUBBER COVE BASE BY "JOHNSONITE"

COLOR: PEWTER CG38

BASE TYPES

GROUT TYPES

# TOILET FIXTURE MOUNTING HEIGHTS

- AT ALL STUDENT OCCUPIED TOILET FACILITIES (i.e. CLASSROOM TOILET ROOMS) - ALL TOILET FIXTURES, GRAB BARS, ACCESSORIES, ETC. SHALL BE MOUNTED AT THE "CHILD" HEIGHT RANGES AS INDICATED ON THE TYPICAL TOILET ROOM MOUNTING
- THE CHILD DIMENSIONS GIVEN APPLY FOR CHILDREN BETWEEN THE AGES OF 6 AND 12 YEARS. FOR KINDERGARTEN CHILDREN -THE BOTTOM END OF THE RANGES SHOULD BE USED AS A MAXIMUM.
- BARS, ACCESSORIES, ETC. SHALL BE MOUNTED AT THE "ADULT" HEIGHT RANGES AS INDICATED ON THE TYPICAL TOILET ROOM MOUNTING DETAILS. THE TOP HEIGHT OF ALL GRAB BAR MUST BE THE SAME WITHIN


AT ALL ADULT USE TOILET FACILITIES, ALL TOILET FIXTURES, GRAB

EACH STALL/ROOM. THE CHILD MOUNTING HEIGHT LIMITS APPLY FOR ADA AND NON-ADA

# TYPICAL TOILET ROOM MOUNTING STANDARDS


ADVISORY SPECIFICATIONS FOR WATER CLOSETS SERVING CHILDREN AGES 3-12


TYPICAL ADA ACCESSIBLE STALL DIMENSIONS

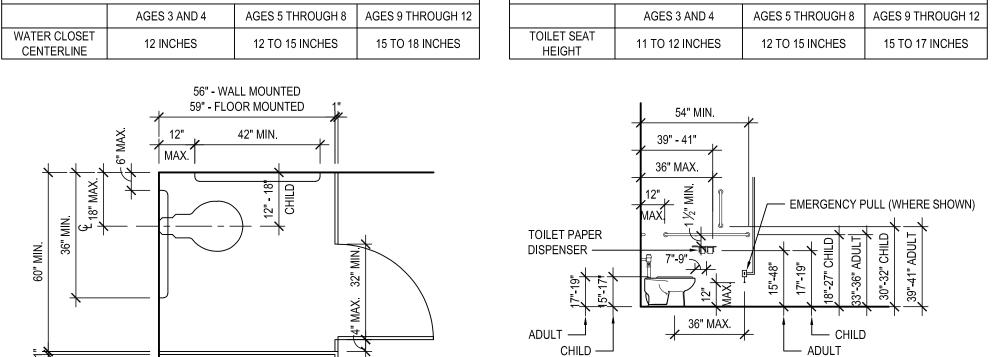


14 INCHES 14 TO 17 INCHES 17 TO 19 INCHES HEIGHT NOTE: THE GRAB BAR SHALL BE MIN. OF 36" LONG UNLESS THERE ARE SPECIFIC SPACE LIMITATIONS. ADULT ---CHILD -

ADVISORY SPECIFICATIONS FOR WATER CLOSETS SERVING CHILDREN AGES 3-12

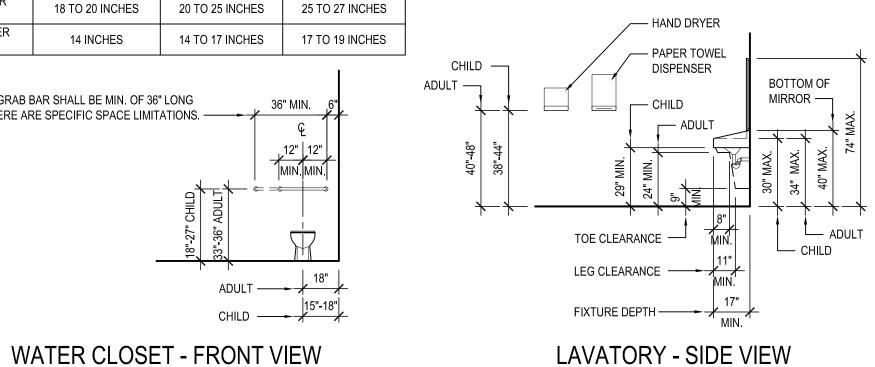

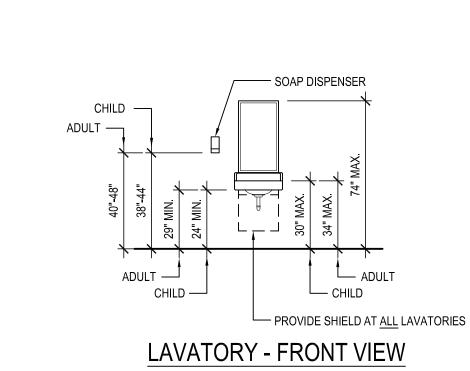

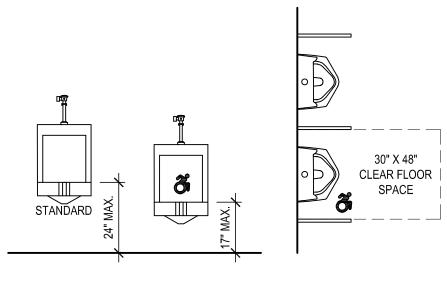

URINAL ADA ACCESSIBLE DIMENSIONS

A2.01E

(1) G.C. TO INSTALL NEW DOOR AND HARDWARE. REFER TO HARDWARE SCHEDULE IN PROJECT MANUAL. <2> G.C. TO INSTALL NEW DOOR FRAME. REFER TO DOOR SCHEDULE FOR ADDITIONAL INFO. THROUGHOUT ENTIRE TOILET ROOM - G.C. SHALL PROVIDE AND INSTALL NEW FLOOR TILE AND CERAMIC  $\stackrel{3}{>}$  TILE COVE BASE. REFER TO FINISH PLANS AND FINISH NOTES FOR ADDITIONAL INFO. THROUGHOUT EXISTING TOILET ROOM - G.C. SHALL INSTALL NEW CERAMIC WALL TILE TO A HEIGHT OF 4'-0" A.F.F. REFER TO FINISH PLANS AND FINISH NOTES FOR ADDITIONAL INFO. C.C. SHALL INSTALL NEW MASONRY TO MATCH EXISTING WALLS AS REQUIRED TO INFILL OR PATCH EXISTING WALLS THROUGHOUT THE PROJECT AREAS. REFER TO FINISH NOTES FOR ADDITIONAL INFO. NEW PARTITION WALL - 3 5/8" OR 6" (SEE WALL TAG AND PARTITION TYPE) 20 GA. STEEL STUDS AT 16" O.C  $^{f 0}$  WITH (1 LAYER OF \$" TYPE 'X' H.I.R. MOISTURE RESISTANT GYPSUM BOARD \$\$" CEMENT BOARD ON TOILET ROOM SIDE ONLY, AND (1) LAYER OF 1/8" TYPE 'X' H.I.R. GYPSUM BOARD ON SIDE OTHER THAN TOILET ROOM. PROVIDE FIBERGLASS ACOUSTIC SOUND BATTS BETWEEN STUDS (ENTIRE WALL). RUN WALL FULL HEIGHT AND SECURE TO ROOF/FLOOR DECK. TAPE/SPACKLE/PRIME/PAINT. SEE TOILET ROOM TILE WAINSCOT & SUBSTRATE NOTE AND FINISH NOTES FOR ADDITIONAL INFO. G.C. TO LAMINATE NEW 5/8" TYPE 'X' H.I.R. MOISTURE RESISTANT GYPSUM BOARD TO ALL TOILET ROOM WALLS. PREP TO RECEIVE WAINSCOT WALL TILE AND/OR PAINT. REFER TO FINISH NOTES FOR ADD. INFO. G.C. TO LAMINATE NEW ¾" TYPE 'X' H.I.R. MOISTURE RESISTANT GYPSUM BOARD TO ALL TOILET ROOM (8) G.C. TO PREP, PRIME AND PAINT EXISTING RADIATOR COVERS THROUGHOUT THE PROJECT AREAS. REFER TO FINISH NOTES FOR ADDITIONAL INFO. G.C. TO PROVIDE AND INSTALL NEW FLUSH MARBLE THRESHOLD. G.C. TO INSTALL NEW ACOUSTIC LAY-IN TILE AND GRID SYSTEM AS SPECIFIED AT 8'-0" A.F.F., G.C. TO COORDINATE WITH THE ELECTRICAL CONTRACTOR. G.C. TO INSTALL NEW LAY-IN EGG CRATE MECHANICAL GRILLE, G.C. TO COORDINATE WITH THE M.C. THIS DRAWING, PREPARED FOR THE SPECIFIC PROJECT INDICATED IS AN INSTRUMENT OF SERVICE AND THE PROPERTY OF BBS ARCHITECTS, LANDSCAPE ARCHITECTS AND ENGINEERS, INFRINGEMENT OR ANY USE OF THIS DRAWING FOR ANY OTH (12) ELECTRICAL CONTRACTOR TO INSTALL NEW LAY-IN LIGHT FIXTURES AS SPECIFIED. REFER TO ELECTRICAL PROJECT IS PROHIBITED. ANY ALTERATION OR REPRODUCTION C THIS DOCUMENT IS ALSO PROHIBITED WITHOUT THE WRITTE SERIES OF DRAWINGS FOR ADDITIONAL INFO. ELECTRICAL CONTRACTOR TO COORDINATE WITH THE G.C. ONSENT OF THE ARCHITECT OR ENGINEER. NEW ADA DOOR OPERATOR SWITCHES BY G.C., E.C. TO WIRE. REFER TO ELECTRICAL DRAWINGS FOR ADDITIONAL INFO. P.C. TO FURNISH AND INSTALL NEW ADA ACCESSIBLE WATER CLOSET AND FLUSHOMETER. (15) P.C. TO FURNISH AND INSTALL NEW ADA ACCESSIBLE LAVATORY AND FAUCET. **ARCHITECTS** (16) E.C. TO FURNISH AND INSTALL NEW ADA ACCESSIBLE HAND DRYER. E.C. TO COORDINATE LOCATION WITH G.C. LANDSCAPE ARCHITECTS (17) G.C. TO FURNISH AND INSTALL NEW 18" VERTICAL GRAB BAR  $\langle 18 
angle$  G.C. TO FURNISH AND INSTALL NEW 36" GRAB BAR. (19) G.C. TO FURNISH AND INSTALL NEW 42" GRAB BAR. (20) G.C. TO FURNISH AND INSTALL NEW TOILET PAPER DISPENSER.  $\langle 21 \rangle$  G.C. TO FURNISH AND INSTALL NEW SOAP DISPENSER.  $\langle 22 \rangle$  G.C. TO FURNISH AND INSTALL NEW MIRROR.

KEY PLAN

NOT TO SCALE

REV. DATE

ESE DRAWINGS ARE BASED ON CONSTRUCTION DRAWINGS NO

FPARED BY BBS ARCHITECTS LANDSCAPE ARCHITECTS AN

INDITIONS AS CONSTRUCTED AT THE TIME. ALL EXISTIN

FORMATION AS THEY MAY NOT HAVE BEEN BUILT AND DETAILE

ER THE ORIGINAL DOCUMENTS OR PER THE OWNER'S INFORMATIO

ENGINEERS 87 WOLF ROAD, STE. 20 NEW YORK 11772 NEW YORK 12205 F. 631.475.0361 F. 518.621.7655 www.BBSARCHITECTURE.com

S.E.S.

J.W.W.

66-04-07-06-0-011-008


DISTRICT GREENBURGH CSD PH. I - DW CAP. IMPROVEMENTS EARLY CHILDHOOD PROGRAM


SCALE: AS NOTED MAY 2022 BID PICK-UP: MAY 27, 2022 FILE No: 21-292


PLANS & NOTES

DWG TITLE DEMO & PROPOSED

										DOO	R SCH	<b>IEDULE</b>									
AREA	DOOR	LOCATION	SIGNAGE	DOOR							FRAME			HARDWARE SE	T DETAIL				FIRE	REMARKS	DOOR
AREA	NO.	LOCATION	SIGNAGE	LEAVES	WIDTH	HEIGHT	THICKNESS	ELEV. TYPE	MAT.	GLAZING	TYPE.	MAT.	GLAZING		HEAD	JAMB	SILL	T'HOLD	RATING	REIWARNS	NO.
	001	CLASSROOM #002 to CLASSROOM #003		1	3'-0"	7'-0"	1 3/4"	Α	SCLCOV		Е	EXISTING TO RE	MAIN	01A	H1	J1		T1			001
<u> </u>	002	CLASSROOM #002 to NEW TOILET #002A		1	3'-0"	7'-0"	1 3/4"	Α	SCLCOV		F1	H.M.		04	H2	J2		T2			002
▼	003	CLASSROOM #003 to NEW ADA TOILET #003A		1	3'-0"	7'-0"	1 3/4"	Α	SCLCOV		F1	H.M.		04	H3	J3		T2			003
RE	004	CLASSROOM #003 to NEW CLOSET #003B		2	2'-0"	7'-0"	1 3/4"	Α	SCLCOV		F1	H.M.		05	H3	J3		T1		SLIDING CLOSET DOORS	004

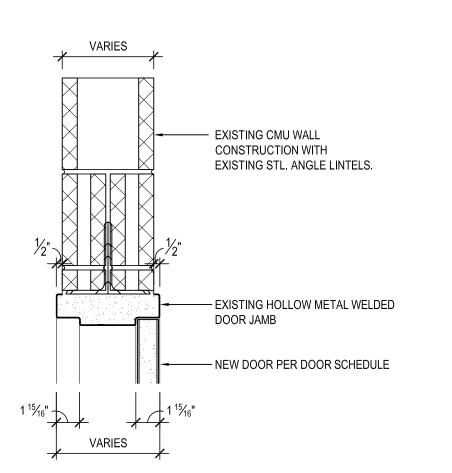

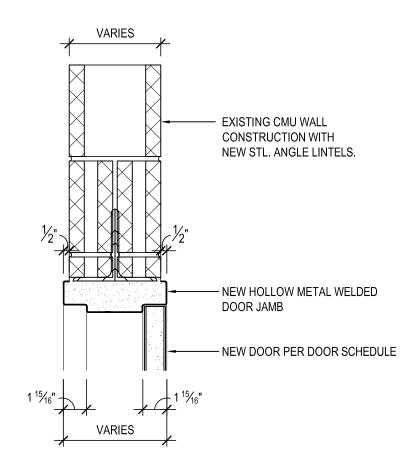

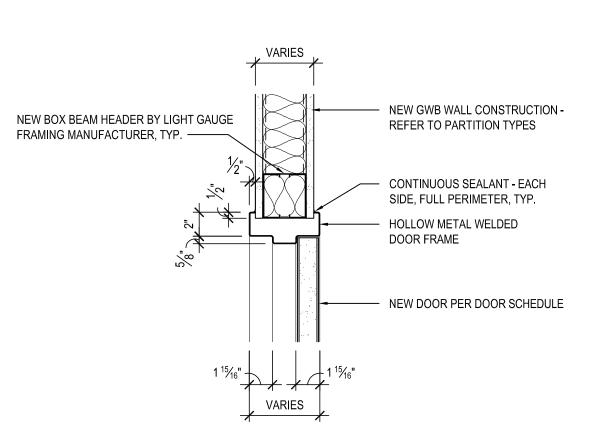











SCALE: 1-1/2" = 1'-0"

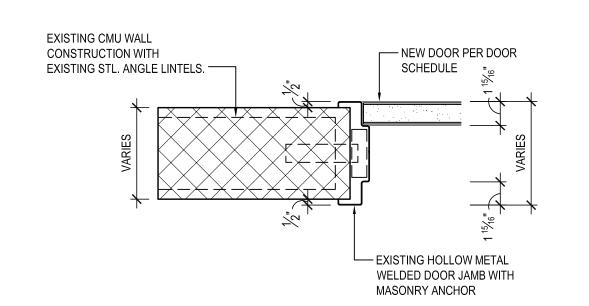

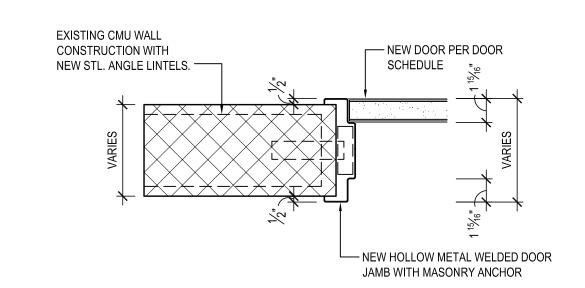


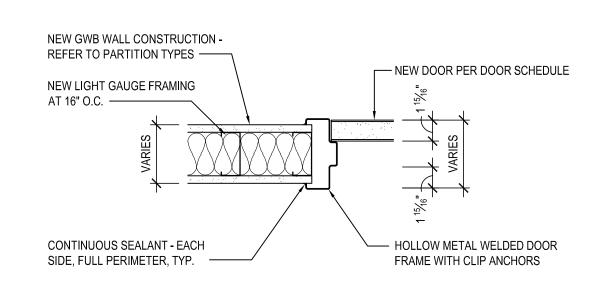


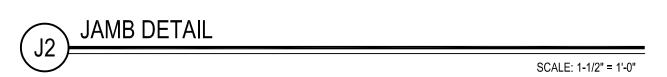



SCALE: 1-1/2" = 1'-0"

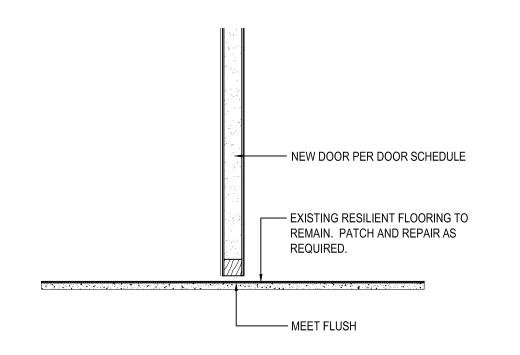


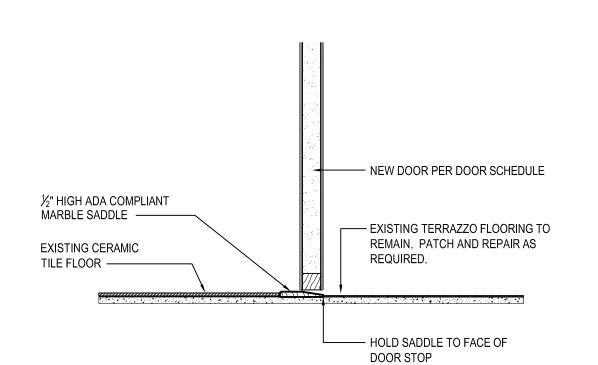




A117.1-2009


SCALE: 1-1/2" = 1'-0"

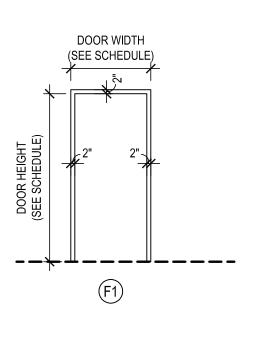

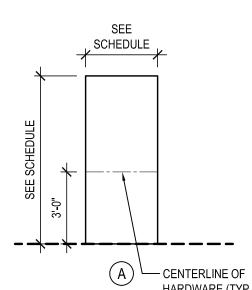

SCALE: 1-1/2" = 1'-0"

FRAME TYPE ELEVATIONS NOTE: REFER TO DOOR SCHEDULE FOR DOOR FRAME MATERIAL.

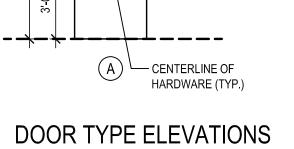

NOTE: REFER TO DOOR SCHEDULE FOR DOOR SCALE: 1/4" = 1'-0" MATERIAL AND GLAZING TYPE (WHERE APPLICABLE).


ABBREVIATION LEGEND	
ALUM	S.F
S.C.L.C.O.V	SG-1
M.C.O.V	SG-2
S.C.L.C.M.V SOLID COMPOSITE LUMBER CORE MAPLE VENEER	SG-3
M.C.M.V	SG-4
F.R.P	SG-5
H.M	SG-6
F.G	BRG-L1
F.L.P	BRG-L2
PYRO	BRG-L3
INSUL	SGP-L1 LEVEL 1 BULLET RESISTANT SECURITY PANEL
S.L	SGP-L2 LEVEL 2 BULLET RESISTANT SECURITY PANEL
OBSC OBSCURE GLAZING	SGP-L3 LEVEL 3 BULLET RESISTANT SECURITY PANEL
U.O.N	


#### **DOOR NOTES**

- ALL DOORS, FRAMES AND HARDWARE SHALL BE PROVIDED AND INSTALLED BY GENERAL CONTRACTOR UNLESS OTHERWISE NOTED.
- GENERAL CONTRACTOR SHALL COORDINATE ALL KEYING WITH OWNER.
- FIRE RATED WOOD DOORS (60 MIN. AND ABOVE ONLY) SHALL HAVE SOLID MINERAL CORE, ALL OTHER WOOD DOORS SHALL HAVE SOLID COMPOSITE LUMBER CORE.
- FLUSH WOOD DOORS SHALL BE 5 PLY LAMINATED FACE SHEETS WITH 2 PLY FINISH VENEER OVER SPECIFIED CORE. AT FIRE RATED DOORS, TOP AND BOTTOM RAILS AND STILES SHALL BE FIRE RESISTANT COMPOSITION MATERIAL BONDED TO CORE. PROVIDE SOLID BLOCKING FOR CLOSER AND HARDWARE. REFER TO SPECIFICATION SECTION 08211 FOR ADDITIONAL
- ALL GLAZING IN DOORS SHALL BE INSTALLED IN METAL VISION KIT TO MATCH FIRE LABEL. VISION KIT COLOR SHALL BE AS SELECTED BY ARCHITECT. INTERIOR GLAZING TYPES AND SIZES SHALL CONFORM TO NFPA 80 AND/OR ASTM E119. WHERE SECURITY GLAZING IS INDICATED, VISION KIT SHALL BE THROUGH BOLT TYPE.
- ALL NEW H.M. FRAMES SHALL BE FULLY WELDED WRAP AROUND TYPE (UNLESS OTHERWISE NOTED OR DETAILED). THROATS SHALL BE SIZED ACCORDING TO WALL THICKNESS AND FINISH, REFER TO FLOOR PLAN AND ENLARGED DETAILS FOR ADDITIONAL INFORMATION.
- FOR DOOR REPLACEMENTS IN KIND, GENERAL CONTRACTOR SHALL MODIFY AND PATCH EXISTING WOOD OR H.M. DOOR FRAMES (DESIGNATED TO REMAIN) TO ACCOMMODATE NEW DOOR OPERATOR, LOCKSET, LATCH, HINGES, DOOR SWING AND/OR CLOSER, ETC. AS REQUIRED FOR COMPLETE AND FUNCTIONAL OPERATION.
- GENERAL CONTRACTOR IS RESPONSIBLE FOR VERIFYING HEIGHT AND WIDTH OF PROPOSED DOORS TO BE INSTALLED IN EXISTING FRAMES (PRIOR TO SHOP DRAWING SUBMITTAL) TO ENSURE PROPER FIT AND DOOR FUNCTION.
- ALL NEW HOLLOW METAL FRAMES AND HOLLOW METAL DOORS SHALL BE FINISH PAINTED. REFER TO SPECIFICATION SECTION 09900 FOR PAINT TYPE. COLOR AS SELECTED BY
- GENERAL CONTRACTOR SHALL PROVIDE AND INSTALL A.D.A. COMPLIANT SIGNAGE AT ALL DOORS WHERE SPECIFIED IN DOOR SCHEDULE AND/OR SHOWN ON FLOOR PLANS. INSTALL IN CONFORMANCE WITH ALL ADA HEIGHT AND PLACEMENT REQUIREMENTS.
- A. WHERE DENOTED IN SCHEDULE, PROVIDE 4"x4" SIGNAGE WITH BRAILLE INDICATING ROOM NUMBER (COORD. WITH OWNER), MODEL No. E-BTCUST. ▲ B. WHERE DENOTED IN SCHEDULE, PROVIDE 4"x12" SIGNAGE WITH BRAILLE INDICATING ROOM NAME AND NUMBER (COORD. WITH OWNER), MODEL No. E-BTCUST.
- ▲ C. WHERE DENOTED IN SCHEDULE, PROVIDE 8"x8" SIGNAGE WITH BRAILLE INDICATING GENDER AND WHEELCHAIR PICTOGRAMS AND ROOM NAME AT MULTI-USE TOILET ROOMS. - AT MULTI-USE TOILET ROOMS, PROVIDE AND INSTALL MODEL No. X-5687 (WOMEN), X-5672 (MEN), X-7095 (BOY'S), X-7096 (GIRL'S). - AT MULTI-USE ACCESSIBLE TOILET ROOMS, PROVIDE AND INSTALL MODEL No. X-5688 (WOMEN), X-5671 (MEN), X-7108 (BOY'S), X-7107 (GIRL'S).
- ▲ D. WHERE DENOTED IN SCHEDULE, PROVIDE 6"x9" SIGNAGE WITH BRAILLE INDICATING GENDER AND WHEELCHAIR PICTOGRAMS AND ROOM NAME AT SINGLE-USE TOILET ROOMS. - AT SINGLE-USE TOILET ROOMS, PROVIDE AND INSTALL MODEL No. E-BTCUST. SIGN SHALL SPECIFY STAFF OR STUDENT USE AS REQUIRED. - AT SINGLE-USE ACCESSIBLE TOILET ROOMS, PROVIDE AND INSTALL MODEL No. E-BTCUST. SIGN SHALL SPECIFY STAFF OR STUDENT USE AS REQUIRED.


MANUFACTURER: "ALLSTATE SIGN AND PLAQUE", DEER PARK, NY OR APPROVED EQUAL. ALL SIGNAGE SHALL BE SUBMITTED TO ARCHITECT FOR REVIEW AND APPROVAL. COLOR AS SELECTED BY ARCHITECT


- ALL REMOVABLE MULLIONS ARE TO BE KEYED ALIKE AND TO MATCH EXISTING BUILDING SYSTEM.
- AUTOMATIC DOOR OPERATORS THE ELECTRICAL CONTRACTOR SHALL PROVIDE A LINE VOLTAGE CIRCUIT TO THE AUTO OPERATOR. LOCATION SHALL BE COORDINATED WITH THE GENERAL CONTRACTOR. THE GENERAL CONTRACTOR IS RESPONSIBLE FOR ALL WIRING ASSOCIATED WITH AUTOMATIC DOOR OPERATORS, INCLUDING ELECTRONIC STRIKE, PUSH BUTTONS, TRANSFORMERS AND ANY OTHER DEVICES REQUIRED FOR A FULLY OPERATIONAL SYSTEM.
- FIRE RATED GLAZING WITH SURFACE APPLIED FILMS WILL NOT BE CONSIDERED EQUIVALENT WHERE LAMINATED FILM IS SPECIFIED.

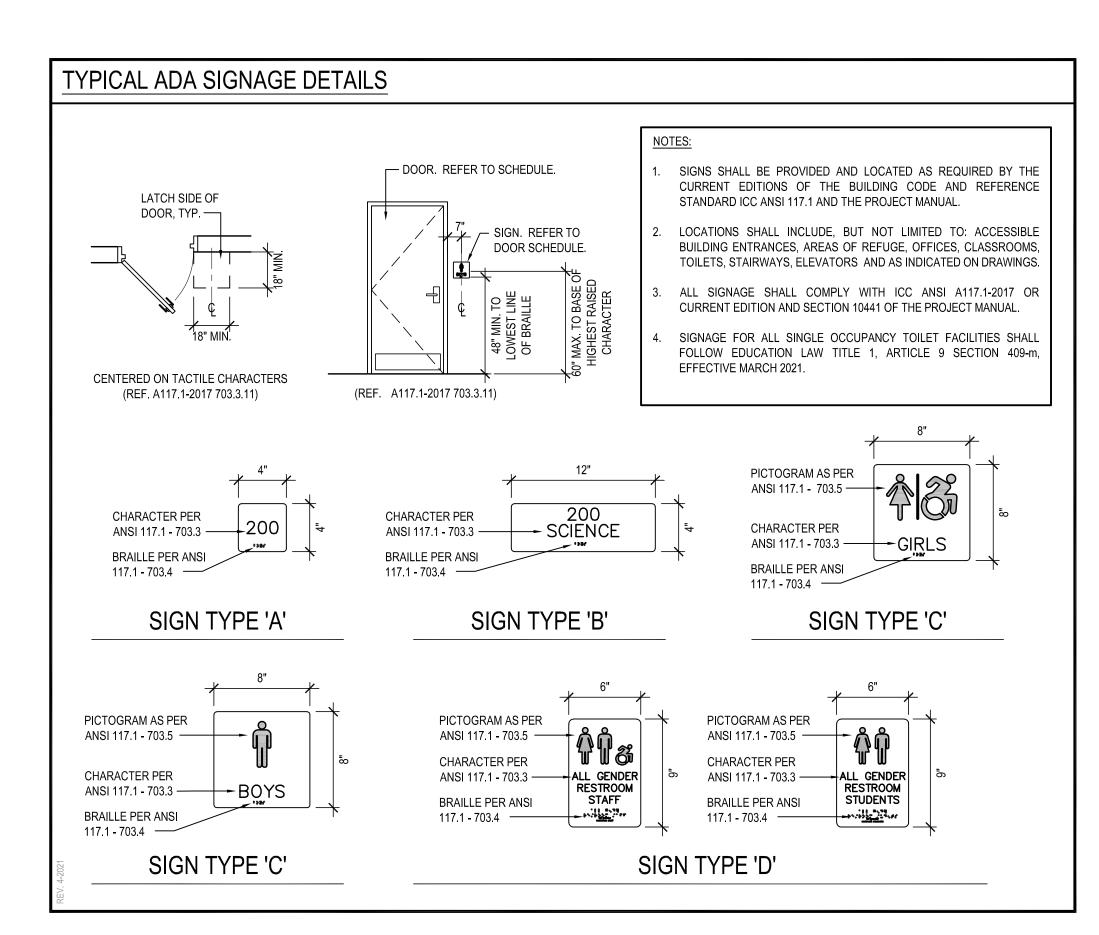


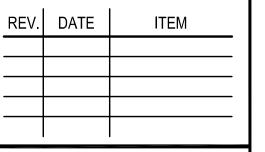

THESE DRAWINGS ARE BASED ON CONSTRUCTION DRAWINGS NOT PREPARED BY BBS ARCHITECTS, LANDSCAPE ARCHITECTS AND ONDITIONS AS CONSTRUCTED AT THE TIME. ALL EXISTIN INFORMATION AS THEY MAY NOT HAVE BEEN BUILT AND DETAILE

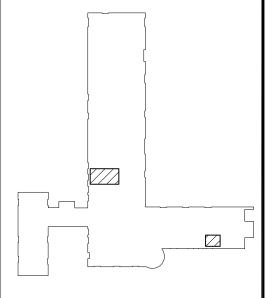

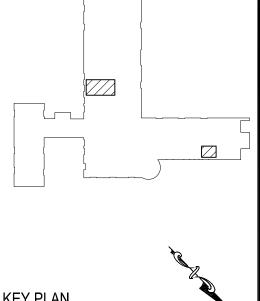

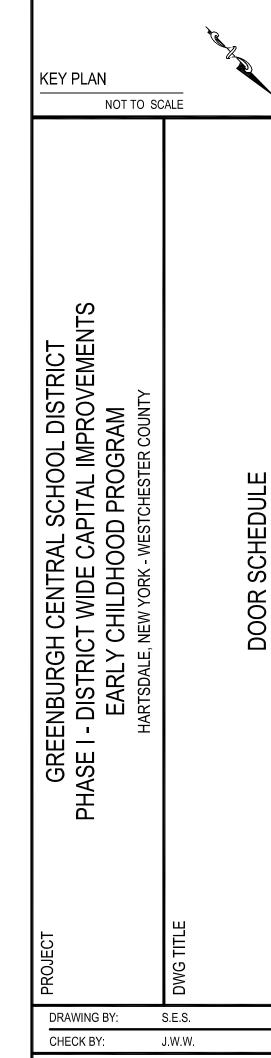


THIS DRAWING, PREPARED FOR THE SPECIFIC PROJECT INDICATED IS AN INSTRUMENT OF SERVICE AND THE PROPERTY OF BBS ARCHITECTS, LANDSCAPE ARCHITECTS AND ENGINEERS, PINFRINGEMENT OR ANY USE OF THIS DRAWING FOR ANY OTHE PROJECT IS PROHIBITED. ANY ALTERATION OR REPRODUCTION OF THIS DOCUMENT IS ALSO PROHIBITED WITHOUT THE WRITTEN CONSENT OF THE ARCHITECT OR ENGINEER.



LANDSCAPE ARCHITECTS ENGINEERS 4 EAST MAIN STREET | 187 WOLF ROAD, STE. 205 PATCHOGUE



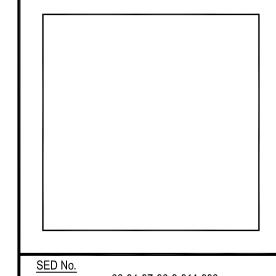


66-04-07-06-0-011-008 DISTRICT GREENBURGH CSD PROJECT PH. I - DW CAP. IMPROVEMENTS EARLY CHILDHOOD PROGRAM DWG TITLE DOOR SCHEDULE

SCALE: AS NOTED BID PICK-UP: MAY 27, 2022 FILE No: 21-292

A8.01E

#### MECHANICAL LEGEND, SYMBOLS, AND ABBREVIATIONS

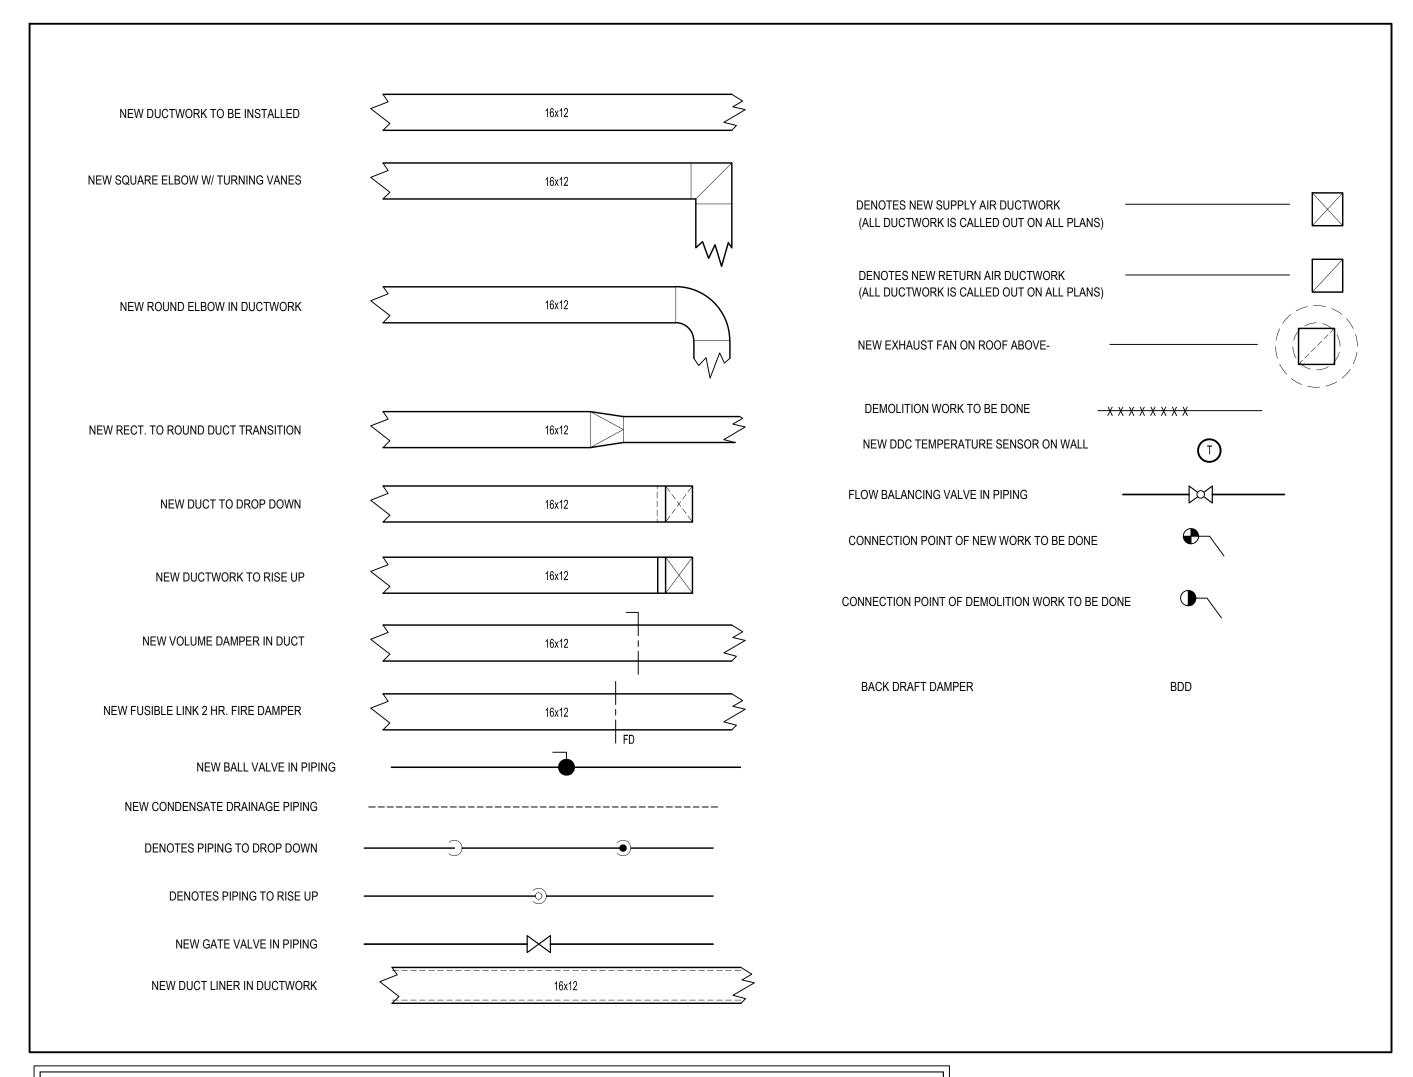

CONTRACTOR ABBREVIATIONS:

M.C. = MECHANICAL CONTRACTOR

C.C. = CONTROLS CONTRACTOR

P.C. = PLUMBING CONTRACTOR E.C. = ELECTRICAL CONTRACTOR

R.C. = CERTIFIED ROOFING CONTRACTOR

# VENTILATION SCHEDULE

Room Number	Occupancy Classification	Occupancy Density (People Per 1000SF)	People Outdoor Airflow Rate in Breathing Zone, Rp (CFM/Person)	Area Outdoor Airflow Rate in Breathing Zone, Ra (CFM/SF)	Exhaust Airflow Rate (CFM/SF)	Area (SF)	Number of People (Pz)	Ventilation in Breathing Zone, Vbz (CFM)	Distribution	Corrected Zone Outdoor Airflow CFM, Voz	OAI (CFM) Supplied
_001	Classroom (ages 5-8)	25	10	0.12	0	746	19	280	0.9	312	320
_002	Classroom (ages 5-8)	25	10	0.12	0	746	19	280	0.9	312	320
_003	Classroom (ages 5-8)	25	10	0.12	0	674	17	251	0.9	279	280
_004	Classroom (ages 5-8)	25	10	0.12	0	599	15	222	0.9	247	250
_002A	Classroom (ages 5-8)	25	10	0.12	0	155	4	59	0.9	66	70
_002B	Classroom (ages 5-8)	25	10	0.12	0	151	4	59	0.9	66	70
Office-001	Office space	5	5	0.06	0	165	1	15	0.8	19	30
Office-002	Office space	5	5	0.06	0	230	2	24	0.8	30	30
Nurse Office	Office space	5	5	0.06	0	152	1	15	0.8	19	30

#### GENERAL NOTES

- 1. REMOVAL & RELOCATION OF CERTAIN EXISTING WORK SHALL BE NECESSARY FOR THE PERFORMANCE OF THE NEW WORK SHOWN HEREIN. ALL EXISTING CONDITIONS ARE NOT COMPLETELY DETAILED ON THE DRAWINGS. THE CONTRACTOR SHALL SURVEY THE SITE & MAKE ALL NECESSARY CHANGES BASED ON EXISTING CONDITIONS AS REQUIRED FOR PROPER DEMOLITION OF EXISTING WORK & SHALL INCLUDE ALL MATERIALS & LABOR FOR SAME IN HIS BID PRICE. NO ALLOWANCE WILL BE MADE FOR FAILURE TO DO SO.
- PRIOR TO SUBMITTING A BID, THE CONTRACTOR SHALL VISIT THE PREMISES OF THE PROPOSED WORK & SHALL CAREFULLY EXAMINE THE ENGINEERING DRAWINGS, EXISTING CONDITIONS & LIMITATIONS THEREOF. VERIFY ACTUAL LOCATIONS WHERE THE NEW PIPING WILL BE ROUTED, COORDINATE WITH NEW & EXISTING WORK & PROVIDE CLEARANCE W/ BUILDING STRUCTURE, OTHER SERVICES, ETC.. THE CONTRACTOR SHALL INCLUDE ALL COSTS WHATSOEVER WHICH ARE INCURRED AS A RESULT OF LIMITATIONS OF THE EXISTING & NEW CONDITIONS. LATER CLAIMS FOR EXTRA LABOR, EQUIPMENT, MATERIALS, ETC. REQUIRED DUE TO DIFFICULTIES WHICH COULD HAVE BEEN FORESEEN WILL NOT BE CONSIDERED AS EXTRA WORK.
- 3. INSTALL WORK SO AS TO BE READILY ACCESSIBLE FOR OPERATING, MAINTENANCE & REPAIR. MINOR DEVIATIONS FROM DRAWINGS MAY BE MADE TO ACCOMPLISH THIS, BUT CHANGES OF MAGNITUDE WHICH INVOLVE EXTRA COST SHALL NOT BE MADE WITHOUT APPROVAL.
- INVESTIGATE EACH SPACE THROUGH WHICH EQUIPMENT MUST BE MOVED. WHEN NECESSARY, EQUIPMENT SHALL BE SHIPPED FROM MANUFACTURER IN CRATED SECTIONS OF SIZE SUITABLE FOR MOVING THROUGH AREAS AVAILABLE. ASCERTAIN FROM BUILDING OWNER AT WHAT TIMES OF DAY EQUIPMENT MAY BE MOVED THROUGH THE BUILDING.
- COORDINATE THE EXACT SIZE & LOCATION OF NEW OPENINGS WITH EXISTING STRUCTURE. PATCH / INSULATE AS REQUIRED. CONTRACTOR SHALL FIRESTOP ALL PENETRATIONS FROM NEW PIPING, CONDUIT, DUCTWORK, ETC. THROUGH EXISTING OR NEW FIRE/ SMOKE BARRIERS. REFER TO SPECIFICATION SECTION 15511 FOR FURTHER DETAILS.
- IT IS THE INTENT OF THIS CONTRACT FOR REMAINING SYSTEMS TO BE LEFT IN GOOD WORKING ORDER, READY FOR OPERATION. COORDINATE ANY REQUIRED SYSTEM SHUTDOWNS WITH OWNER 48 HOURS IN ADVANCE. EXISTING SYSTEM SHUTDOWNS WILL NOT BE PERMITTED IF THEY INTERFERE WITH THE DAILY OPERATIONS OF THE BUILDING. CONTRACTOR WILL BE REQUIRED TO TAKE PROPER PRECAUTIONS AGAINST DAMAGING OR DISRUPTING BUILDING SYSTEMS, WIRING, PIPING OR CONTROL TUBING. ANY DAMAGE TO THESE ITEMS SHALL BE REPAIRED AT THE CONTRACTOR'S COST AS A PART OF THIS CONTRACT.
- 7. THE CONTRACTOR SHALL REPAIR / RESTORE TO ORIGINAL CONDITION ANY EXISTING EQUIPMENT OR MATERIALS DAMAGED IN THE PROCESS OF INSTALLATION, OR DEMOLITION TO THE SATISFACTION OF THE OWNER'S REPRESENTATIVE. CONTRACTOR SHALL MAKE REPAIRS USING THE SAME OR EQUIVALENT MATERIALS. WORK WILL BE PERFORMED AT THE CONTRACTOR'S COST.
- CONTRACTOR SHALL INCUR ANY COSTS OR BURDENS ASSOCIATED WITH LOST OR STOLEN EQUIPMENT /
- 9. DURING THE LIFE OF THE CONTRACT PERIOD, CONTRACTOR SHALL REMOVE ALL RUBBISH / EXCESS MATERIAL ACCUMULATED AS A RESULT OF HIS OPERATIONS ON A DAILY BASIS. ALL AREAS / EQUIPMENT AFFECTED UNDER THIS CONTRACT SHALL BE KEPT CLEAN OF DUST / DEBRIS. ALL AREAS SHALL RECEIVE A FINAL CLEANING PRIOR TO FINAL ACCEPTANCE BY THE OWNER.
- 0. PROVIDE FOR LEGAL REMOVAL / DISPOSAL OF ALL RUBBISH / DEBRIS FROM THE BUILDING & SITE. PROTECT ALL WORK NOT SLATED FOR DEMOLITION.
- I. THIS CONTRACTOR SHALL COORDINATE HIS WORK WITH ALL OTHER TRADES PRIOR TO SCHEDULING THE WORK. WORK SHALL BE PERFORMED IN PROPER SEQUENCE, AS AGREED TO BY ALL TRADES. ANY COSTS INCURRED BY THE OWNER DUE TO IMPROPER SEQUENCING OF WORK WILL BE PAID FOR BY THIS CONTRACTOR.
- . CONTRACTOR SHALL OBTAIN ALL PERMITS, PAY ALL FEES, CONNECTION CHARGES, ETC. ASSOCIATED WITH THE WORK UNDER THEIR CONTRACT.
- 13. PAINT / TOUCH UP ALL SURFACES MARRED AS A RESULT OF THE PERFORMANCE OF THE CONTRACT WORK.
- 14. THE MECHANICAL CONTRACTOR SHALL REFER TO / REVIEW ALL OTHER TRADE DRAWINGS IN THE BID PACKAGE & SHALL BE RESPONSIBLE FOR / PERFORM ALL WORK INDICATED AS (M.C.) MECHANICAL WORK AS A PART OF THE BASE BID UNLESS SPECIFICALLY NOTED OTHERWISE.
- 15. SUBSTITUTED EQUIPMENT OF GREATER OR LARGER POWER, DIMENSIONS, CAPACITIES & RATINGS MAY BE FURNISHED PROVIDED THAT SAID EQUIPMENT IS APPROVED IN WRITING PRIOR TO ORDER. ANY CONNECTING MECHANICAL SERVICES, ELECTRICAL SERVICES, BASES, STRUCTURAL APPURTENANCES, ETC. REQUIRED TO BE INCREASED DUE TO THE USE OF SAID EQUIPMENT WILL BE PAID FOR IN FULL BY THE MECHANICAL CONTRACTOR, INCLUDING ANY ADDITIONAL REQUIRED ENGINEERING FEES.
- 16. EACH PIECE OF EQUIPMENT SHALL BE PROVIDED WITH A PERMANENT TYPE LAMINATED, BLACK FINISH, WHITE CORE, PHENOLIC NAMEPLATE. NAMEPLATES SHOULD INDICATE THE NAME & NUMBER OF THE UNIT, UNIT VOLTAGE, & ANY INTERLOCK REFERENCE. STARTERS / DISCONNECT SWITCHES SHOULD ALSO BE EQUIPPED WITH AN IDENTICAL NAMEPLATE WITH THE SAME INFORMATION.
- 17. "ATTIC STOCK" UPON COMPLETION OF THE PROJECT, MECHANICAL CONTRACTOR SHALL COMPLETELY REMOVE / DISPOSE OF FILTERS USED DURING CONSTRUCTION & START-UP PROCEDURES. INSTALL NEW FILTERS IN ALL EQUIPMENT, MERV-8 OR BETTER UPON TURN OVER OF THE PROJECT TO THE OWNER. IN ADDITION, PROVIDE (2) COMPLETE SETS OF FILTERS FOR EACH PEICE OF EQUIPMENT & TURN OVER TO OWNER.
- 18. MECHANICAL CONTRACTOR SHALL PROVIDE (1) SPARE MOTOR FOR EACH SIZE MOTOR USED ON THE PROJECT. IN INSTANCES WHERE MORE THAN TEN OF THE SAME MOTOR ARE USED, MECHANICAL CONTRACTOR SHALL PROVIDE (1) SPARE MOTOR FOR EVERY TEN MOTORS OF A GIVEN SIZE USED ON THE
- 19. MAINTENANCE MANUAL: UPON COMPLETION OF THE PROJECT, THE MECHANICAL CONTRACTOR SHALL PROVIDE A BINDER CONTAINING THE OPERATIONS & MAINTENANCE MANUALS FOR EACH NEW PEICE OF EQUIPMENT INSTALLED UNDER THIS PROJECT. THE FIRST SECTION OF THE MAINTENANCE MANUAL SHALL CONTAIN A LIST OF EACH PEICE OF EQUIPMENT, COMPLETE WITH INFORMATION SHOWING APPROPRIATE REPLACEMENT FILTER SIZES / TYPES, APPROPRIATE REPLACEMENT BELT SPECIFICATIONS, REPLACEMENT MOTOR SPECIFICATIONS, REPLACEMENT BEARING SPECIFICATIONS, VOLTAGES OF UNIT, ETC. THIS SHALL SERVE AS A WRITTEN DATABASE DESCRIBING ALL MAINTENANCE INFORMATION FOR EACH NEW PEICE OF EQUIPMENT USED.

#### FIRE STOPPING NOTES

- 1. ALL PENETRATIONS RELATED TO MECHANICAL WORK THROUGH FIRE RATED WALLS, FLOORS OR OTHER STRUCTURES SHALL BE FIRE STOPPED AS REQUIRED TO MAINTAIN THE RATING OF THE WALL BY MECHANICAL CONTRACTOR. IT IS ASSUMED THAT ALL WALLS IN THE CONSTRUCTION CARRY A MINIMUM FIRE RATING OF 1 HR. IT SHOULD BE ASSUMED THAT ALL MACHINE ROOM WALLS / BOILER ROOM WALLS / ELECTRIC ROOM WALLS CARRY A RATING OF 2 HR. MECHANICAL CONTRACTOR SHALL BE RESPONSIBLE FOR A COMPLETE REVIEW OF THE ARCHITECTURAL DRAWINGS IN ORDER TO DETERMINE FIRE RATINGS OF ALL WALLS / PARTITIONS RELATED TO WORK UNDER THIS CONTRACT.
- 2. MECHANICAL CONTRACTOR SHALL REVIEW THE COMPLETE ARCHITECTURAL SET OF DRAWINGS IN ORDER TO DETERMINE WHERE DUCT PENETRATIONS THROUGH RATED BARRIERS. DUCTS PENETRATING SAID RATED BARRIERS SHALL BE EQUIPPED WITH A UL LISTED FUSIBLE LINK TYPE FIRE DAMPER, RATED FOR SERVICE FOR WHICH IT IS BEING USED. FIRE DAMPERS SHALL BE PROVIDED & INSTALLED BY THE MECHANICAL CONTRACTOR, COMPLETE W/ DUCT ACCESS DOORS DIRECTLY ADJACENT TO THE DAMPER, POSITIONED FOR EASY REPLACEMENT OF THE LINK.
- 3. MECHANICAL CONTRACTOR SHALL REVIEW THE COMPLETE ARCHITECTURAL SET OF DRAWINGS IN ORDER TO DETERMINE WHERE DUCT PENETRATIONS THROUGH RATED BARRIERS OCCUR BETWEEN SEPARATE SMOKE ZONES. DUCTS PENETRATING SAID FIRE / SMOKE BARRIERS SHALL BE EQUIPPED WITH A UL LISTED COMBINATION FIRE / SMOKE DAMPER, RATED FOR SERVICE FOR WHICH IT IS BEING USED. FIRE / SMOKE DAMPERS SHALL BE PROVIDED & INSTALLED BY THE MECHANICAL CONTRACTOR, COMPLETE W/ DUCT ACCESS DOORS DIRECTLY ADJACENT TO THE DAMPER. DAMPER ACTUATOR & RELATED WIRING SHALL BE PROVIDED & INSTALLED BY THE ELECTRICAL CONTRACTOR. COORDINATE DAMPER INSTALLATIONS W/ E.C. TO VERIFY PROPER CLEARANCES TO ASSURE PROPER DAMPER OPERATION.
- MECHANICAL CONTRACTOR SHALL PROVIDE A FULL SET OF AS-BUILT DRAWINGS, SHOWING EACH DAMPER LOCATION, TYPE OF DAMPER, ACCESS DOOR LOCATIONS, ETC.
   CONTRACTOR SHALL REFER TO SPECIFICATION SECTION 15511 FOR FURTHER DETAILS REGARDING FIRESTOPPING MATERIALS & METHODS.
- 6. CONTRACTOR SHALL SUBMIT SHOP DRAWINGS OF PRODUCTS TO BE USED. FIRESTOP MATERIALS OTHER THAN THE PRODUCTS SPECIFIED SHALL INCLUDE FULL TECHNICAL DATA WITH SHOP DRAWINGS TO DEMONSTRATE EQUALITY WITH THE SPECIFIED FIRESTOPPING MATERIALS.

#### GENERAL INSTRUMENTATION NOTES

- 1. AT A MINIMUM, PROVIDE THERMOMETERS / WELLS AT THE FOLLOWING LOCATIONS:
- AT INLETS & OUTLET OF EACH THREE WAY VALVE (UNIT VENTILATORS / CABINET UNIT HEATER
- INSTALLATIONS EXCEPTED).
   AT INLET & OUTLET OF EACH HYDRONIC BOILER, CHILLER OR COOLING TOWER.
- AT INLET & OUTLET OF EACH HYDRONIC COIL IN AIR HANDLING UNITS & BUILT-UP CENTRAL SYSTEMS.
- 2. AT A MINIMUM, PROVIDE LIQUID FILLED PRESSURE GAUGES / WELLS AT THE FOLLOWING LOCATIONS:
- AT SUCTION & DISCHARGE OF EACH PUMP. FOR EACH MAKEUP WATER LINE.
- BEFORE & AFTER ALL PRESSURE REDUCING VALVES.
   AT ACCESSIBLE HIGH POINT OF ALL HYDRONIC PIPING SYSTEMS.
- AT ACCESSIBLE HIGH POINT OF ALL HYDRONIC PIPING SYSTEM
   AT ALL EXPANSION / COMPRESSION TANKS.

#### PIPING SYSTEMS AND EQUIPMENT VENTING NOTES

- MECHANICAL CONTRACTOR WILL BE RESPONSIBLE FOR THE PROPER VENTING OF ALL NEWLY INSTALLED HYDRONIC PIPING SYSTEMS. AUTOMATIC AIR VENTS SHALL BE INSTALLED AT EVERY HIGH POINT IN THE PIPING SYSTEM WHERE AIR CAN COLLECT. PROVIDE COCK IN RISER PRIOR TO AUTOMATIC AIR VENT. NEW AIR VENTS SHALL BE "TACO" #HY-VENT OR EQUIVALENT.
- 2. MECHANICAL CONTRACTOR SHALL PROVIDE & INSTALL NEW AUTOMATIC AIR VENT FOR EACH AIR HANDLING UNIT COIL OR DUCT MOUNTED COIL. INSTALL SHUT-OFF COCK PRIOR TO VENT TIE-IN.
- 3. MECHANICAL CONTRACTOR SHALL PROVIDE NEW MANUAL AIR VENTS FOR ALL UNIT VENTILATOR COILS, CONVECTORS, FAN COIL UNITS, FIN TUBE RADIATORS, ETC. MANUAL VENTS SHALL BE "TACO" #417 COIN VENT OR EQUIVALENT. PROVIDE SHUT-OFF COCK PRIOR TO VENT. AIM COIN VENT DISCHARGE IN AN APPROPRIATE MANNER AS TO FACILITATE THE CAPTURE OF BLEED WATER WHILE PERFORMING SYSTEM BLEEDING OPERATIONS.

## ELECTRICAL WORK UNDER MECHANICAL CONTRACT

- 1. MECHANICAL CONTRACTOR SHALL PROVIDE ALL STARTERS & DISCONNECT SWITCHES REQUIRED FOR ALL NEW MECHANICAL EQUIPMENT. STARTER / DISCONNECT SWITCH INSTALLATION TO BE PERFORMED UNDER THE ELECTRICAL CONTRACT. COORDINATE WORK W/ ELECTRICAL CONTRACTOR PRIOR TO START OF WORK
- 2. POWER WIRING REQUIRED FOR CONTROLS SHALL BE PERFORMED UNDER THE MECHANICAL CONTRACT UNLESS SPECIFICALLY NOTED OTHERWISE ON THE ELECTRICAL DRAWINGS. MECHANICAL CONTRACTOR SHALL OBTAIN THE SERVICES OF A LICENSED ELECTRICIAN (PER NEC REQUIREMENTS) TO PERFORM ALL ELECTRICAL WORK.

## **DUCTWORK NOTES**

- PROVIDE ALL NEW DUCTWORK AS SHOWN AND SPECIFIED UNDER SPECIFICATION SECTION 015891, AND IN CONFORMANCE WITH 'SMACNA' SPECIFICATIONS.
- IF A DUCT ELBOW IS SHOWN TO BE RADIUSED, THEN RADIUSED ELBOWS SHALL BE INSTALLED. SQUARE ELBOWS MAY NOT BE SUBSTITUTED WHERE RADIUSED ELBOWS ARE SHOWN. WHERE SQUARE ELBOWS ARE SHOWN, TURNING VANES SHALL BE INSTALLED UPON APPROVAL BY THE ENGINEER.
- PROVIDE DUCT LINING IN ALL DUCTWORK THAT IS CONVEYING BELOW AMBIENT TEMPERATURE AIR & IS NOT INSULATED. PROVIDE LINING IN SUPPLY & RETURN AIR DUCTWORK FROM AIR HANDLING EQUIPMENT TO 20 FEET AWAY FROM THE UNIT(S). IN ADDITION, INCLUDE LINING IN ANY OTHER DUCT SPECIFICALLY SHOWN OR SPECIFIED TO BE EQUIPPED WITH LINING. REFER TO SPECIFICATION SECTION 15891 & 15290 FOR FURTHER INFORMATION.
- WHERE FLEXIBLE DUCTWORK IS USED, LENGTHS MAY NOT EXCEED 4 FEET TOTAL IN ANY ONE RUN OF FLEXIBLE DUCTWORK. FLEXIBLE DUCTWORK SHALL BE RATED IN ACCORDANCE WITH UL 181, CLASS 1. REFER TO SPECIFICATION SECTION 15891 FOR FURTHER INFORMATION.
- 5. MECHANICAL CONTRACTOR SHALL PROVIDE A BUTTERFLY TYPE VOLUME DAMPER WITH LOCKING QUADRANT HANDLE PRIOR TO EACH AIR OUTLET SHOWN. INSTALL DAMPER AT LEAST 5 FEET AWAY FROM AIR OUTLET WHEREVER POSSIBLE.
- MECHANICAL CONTRACTOR SHALL PROVIDE FLEXIBLE DUCT CONNECTIONS WHERE DUCT SYSTEMS CONNECT TO EQUIPMENT. REFER TO SPECIFICATION SECTION 15891 FOR FURTHER INFORMATION.

# TESTING and BALANCING NOTES


- MECHANICAL CONTRACTOR WILL BE REQUIRED TO PERFORM ALL EQUIPMENT & SYSTEM TESTING / BALANCING REQUIRED UNDER THIS CONTRACT. PROVIDE A FULL REPORT DETAILING ALL DESIGN & ACTUAL CONDITIONS FOR ALL AIR & HYDRONIC SYSTEMS SHOWN ON THE DRAWINGS. REFER TO SPECIFICATION SECTIONS 15990 & 15997 FOR FURTHER DETAILS.
- 2. UPON NOTICE OF COMPLETION OF WORK BY THE CONTRACTOR, OWNER WILL OBTAIN THE SERVICES OF AN INDEPENDENT TESTING & BALANCING CONTRACTOR TO VERIFY THE RESULTS OF THE TESTING & BALANCING REPORT SUBMISSION. INDEPENDENT TESTING AGENCY SHALL SELECT A RANDOM NUMBER OF MEASUREMENTS TO BE CHECKED. MEASUREMENTS WILL BE CHECKED IN THE SAME MANNER AS ORIGINALLY MEASURED. NUMBER OF VERIFICATION MEASUREMENTS SHALL BE APPROXIMATELY 25% OF THE TOTAL MEASUREMENTS FOR THE PROJECT.
- IF MORE THAN 10% OF THE VERIFICATION TESTING SHOWS DEVIATIONS OF 10% OR MORE / SOUND LEVEL OF 2dB DIFFERENT THAN THAT ORIGINALLY MEASURED, THE ORIGINAL REPORT WILL BE REJECTED. ALL SYSTEMS WILL THEN BE REQUIRED TO BE COMPLETELY RE-TESTED, WITH A SECOND REPORT SUBMITTED. IN THE EVENT THAT THE ORIGINAL REPORT IS REJECTED, ALL SYSTEMS SHALL BE READJUSTED & TESTED, NEW CERTIFIED REPORTS SUBMITTED, AND NEW VERIFICATION TESTS MADE, AT NO ADDITIONAL COST TO THE OWNER. THE CONTRACTOR WILL BE RESPONSIBLE FOR ALL COSTS INVOLVED WITH THE VERIFICATION TESTS.

# REV. DATE ITEM

NOTICE

HESE DRAWINGS ARE BASED ON CONSTRUCTION DRAWINGS NOT REPARED BY BBS ARCHITECTS, LANDSCAPE ARCHITECTS AND GINEERS, PC. AND, THEREFORE, MAY NOT REPRESENT THE DAIL EXISTING AS CONSTRUCTED AT THE TIME. ALL EXISTING

NFORMATION AS THEY MAY NOT HAVE BEEN BUILT AND DETAILI ER THE ORIGINAL DOCUMENTS OR PER THE OWNER'S INFORMATIO

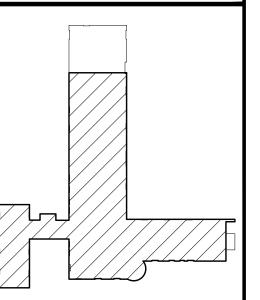

KEY PLAN

NOT TO SCALE

MENTS

PHASE I - DISTRICT WIDE CAPITAL IMPROVEM
EARLY CHILDHOOD PROGRAM
HARTSDALE, NEW YORK - WESTCHESTER COUNTY
MECHANICAL GENERAL NOTES, SYMBOLS AND I

DRAWING BY: DS

CHECK BY: DS

NOTICE

THIS DRAWING, PREPARED FOR THE SPECIFIC PROJECT INDICATED IS AN INSTRUMENT OF SERVICE AND THE PROPERTY OF BBS ARCHITECTS, LANDSCAPE ARCHITECTS AND ENGINEERS, PC. INFRINGEMENT OR ANY USE OF THIS DRAWING FOR ANY OTHER PROJECT IS PROHIBITED. ANY ALTERATION OR REPRODUCTION OF THIS DOCUMENT IS ALSO PROHIBITED WITHOUT THE WRITTEN CONSENT OF THE ARCHITECT OR ENGINEER.

BBS ARCHITECTS

LANDSCAPE ARCHITECTS
ENGINEERS

244 EAST MAIN STREET | 187 WOLF ROAD, STE. 20
PATCHOGUE | ALBANY
NEW YORK 11772 | NEW YORK 12205

T. 631.475.0349 T. 518.621.7650 F. 631.475.0361 F. 518.621.7655 www.BBSARCHITECTURE.com

 SED No.
 66-04-07-06-0-011-008

 DISTRICT
 GREENBURGH CSD

PROJECT PH. I - DW CAP. IMPROVEMENTS EARLY CHILDHOOD PROGRAM

<u>DWG TITLE</u> MECHANICAL GENERAL NOTES,

SYMBOLS AND LEGEND


SCALE: AS NOTED

DATE: MAY 2022

BID PICK-UP: MAY 27, 2022

FILE No: 21-292

M0.01E | of ---

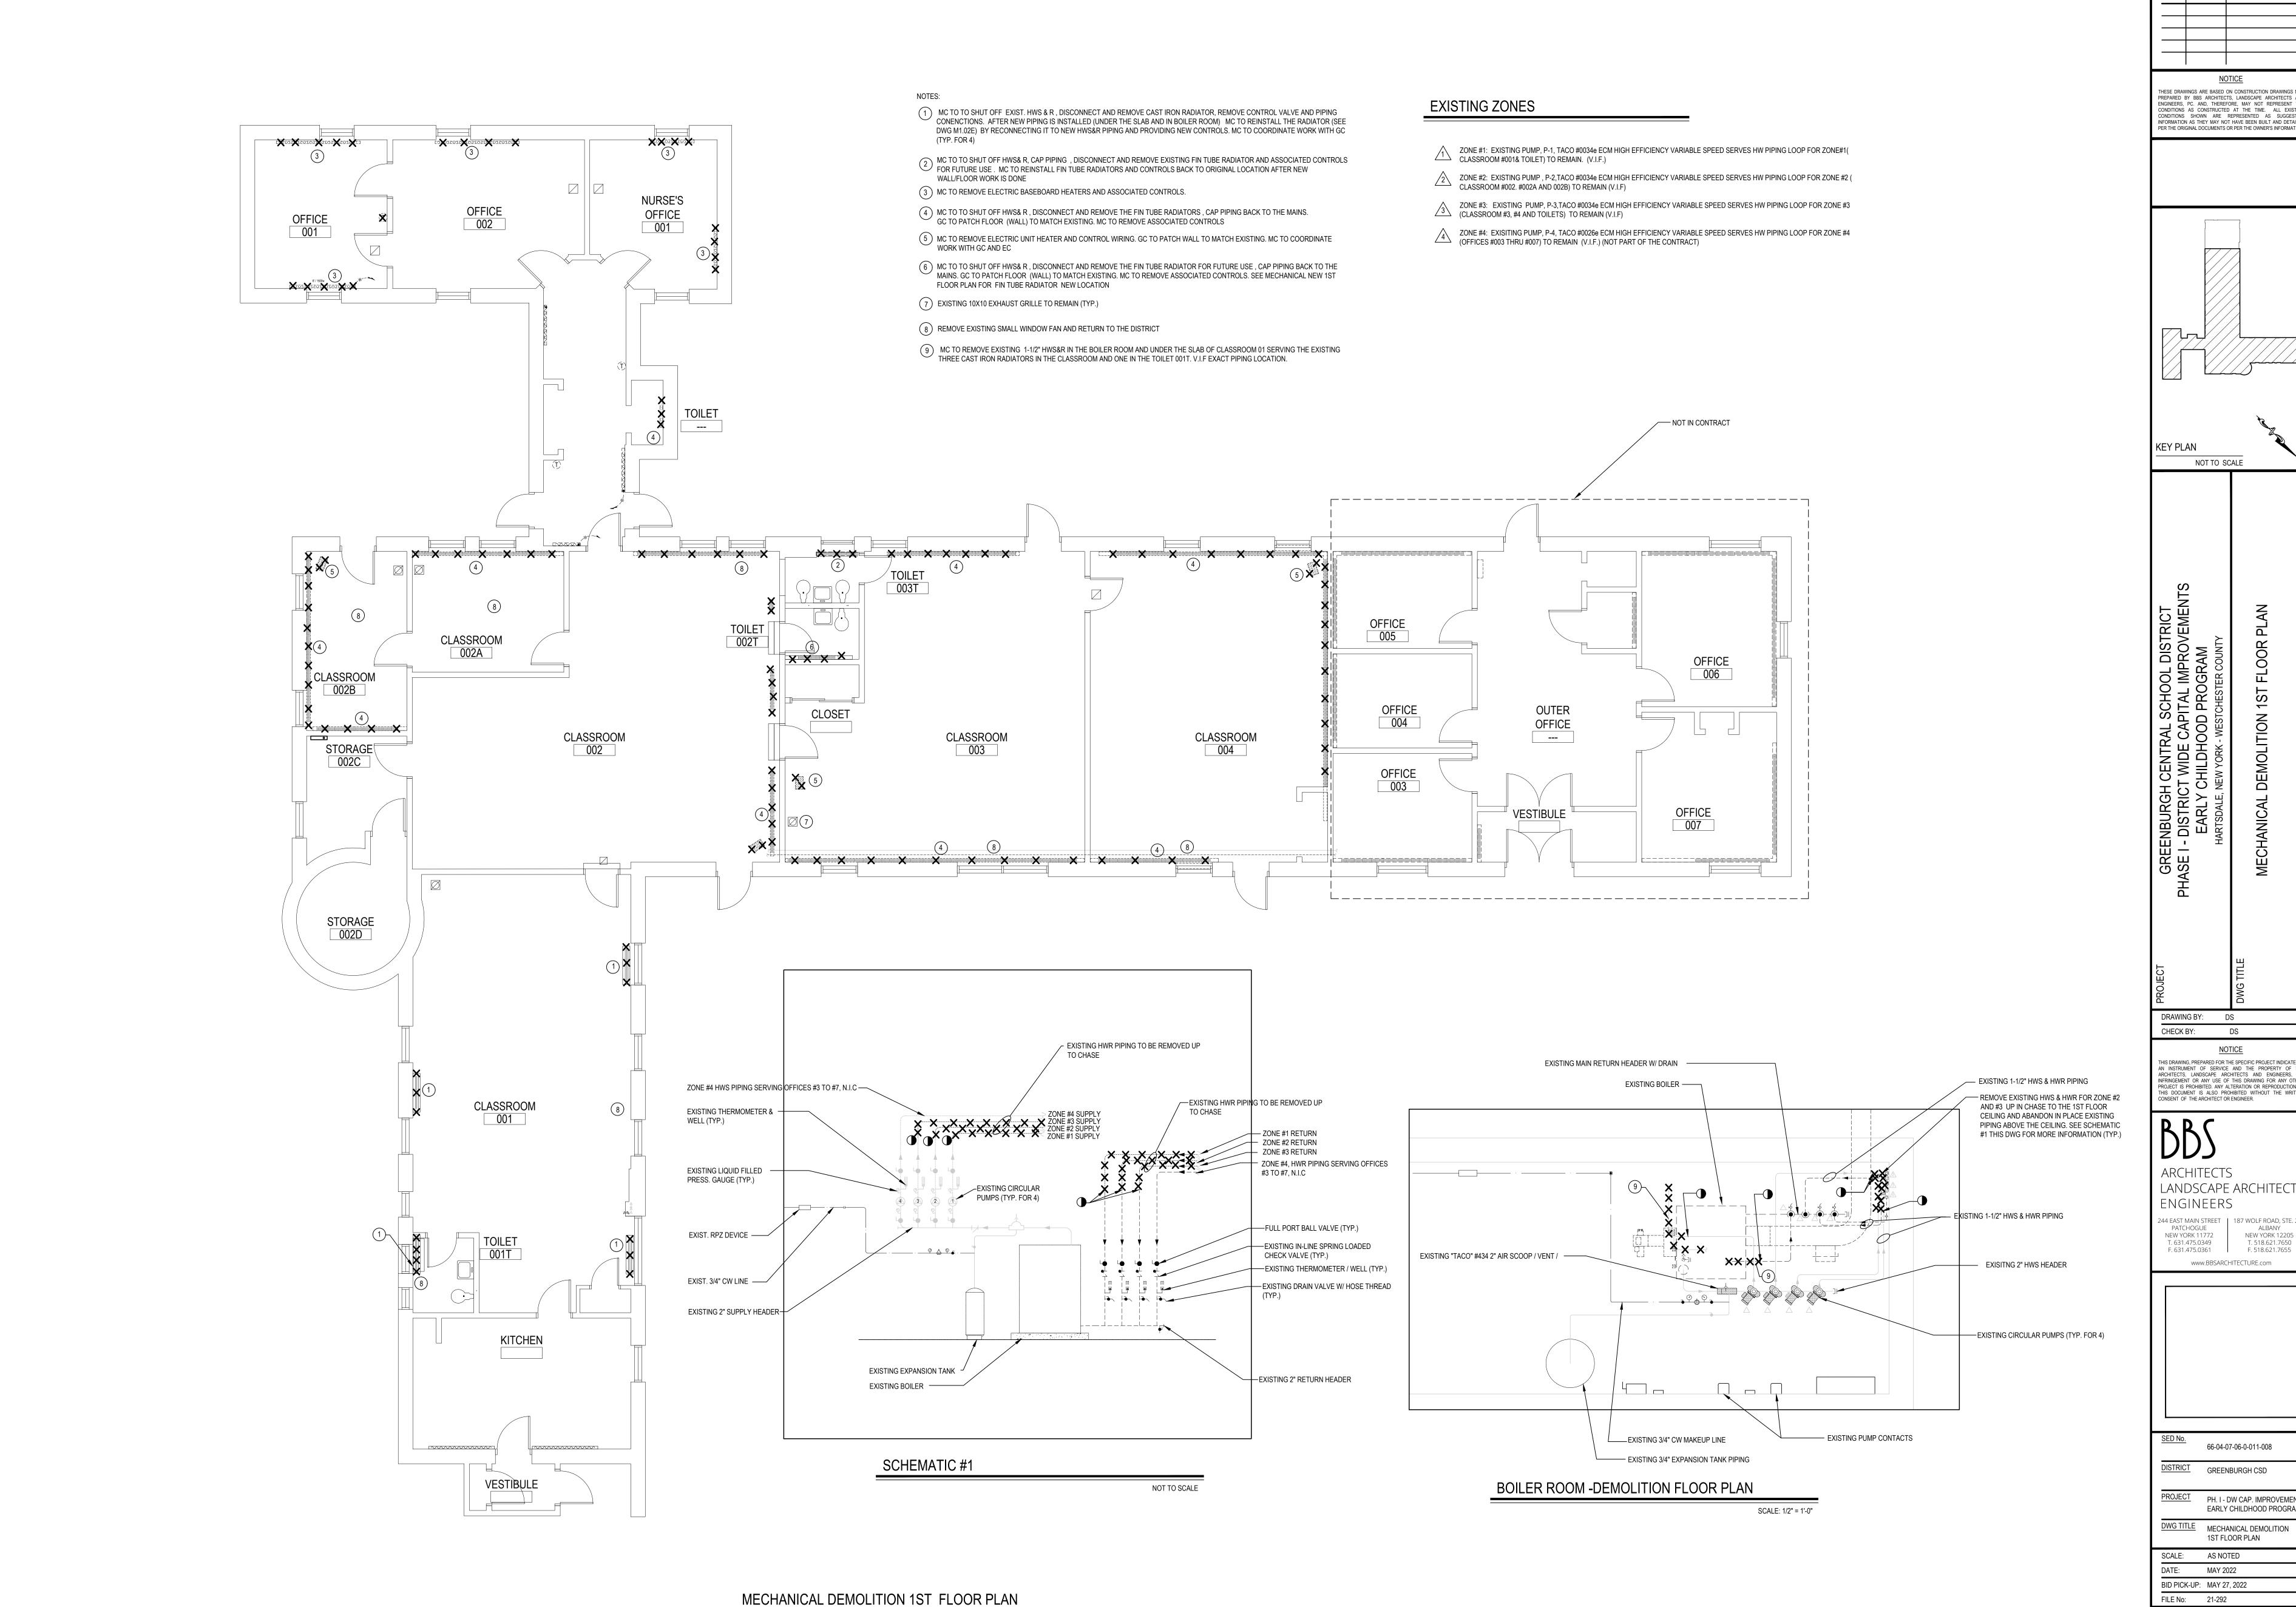

REV. DATE NOTICE HESE DRAWINGS ARE BASED ON CONSTRUCTION DRAWINGS NOT PREPARED BY BBS ARCHITECTS, LANDSCAPE ARCHITECTS AND ENGINEERS, PC. AND, THEREFORE, MAY NOT REPRESENT THE CONDITIONS AS CONSTRUCTED AT THE TIME. ALL EXISTING CONDITIONS SHOWN ARE REPRESENTED AS SUGGESTIVE INFORMATION AS THEY MAY NOT HAVE BEEN BUILT AND DETAILED NOT TO SCALE

DS

<u>NOTICE</u> THIS DRAWING, PREPARED FOR THE SPECIFIC PROJECT INDICATED IS AN INSTRUMENT OF SERVICE AND THE PROPERTY OF BBS ARCHITECTS, LANDSCAPE ARCHITECTS AND ENGINEERS, PC. INFRINGEMENT OR ANY USE OF THIS DRAWING FOR ANY OTHER PROJECT IS PROHIBITED. ANY ALTERATION OR REPRODUCTION OF THIS DOCUMENT IS ALSO PROHIBITED WITHOUT THE WRITTEN CONSENT OF THE ARCHITECT OR ENGINEER.

LANDSCAPE ARCHITECTS


187 WOLF ROAD, STE. 20 ALBANY NEW YORK 12205 T. 518.621.7650 F. 518.621.7655 www.BBSARCHITECTURE.com

66-04-07-06-0-011-008 DISTRICT GREENBURGH CSD

PROJECT PH. I - DW CAP. IMPROVEMENTS EARLY CHILDHOOD PROGRAM

1ST FLOOR PLAN SCALE: AS NOTED

M1.01E | of ---

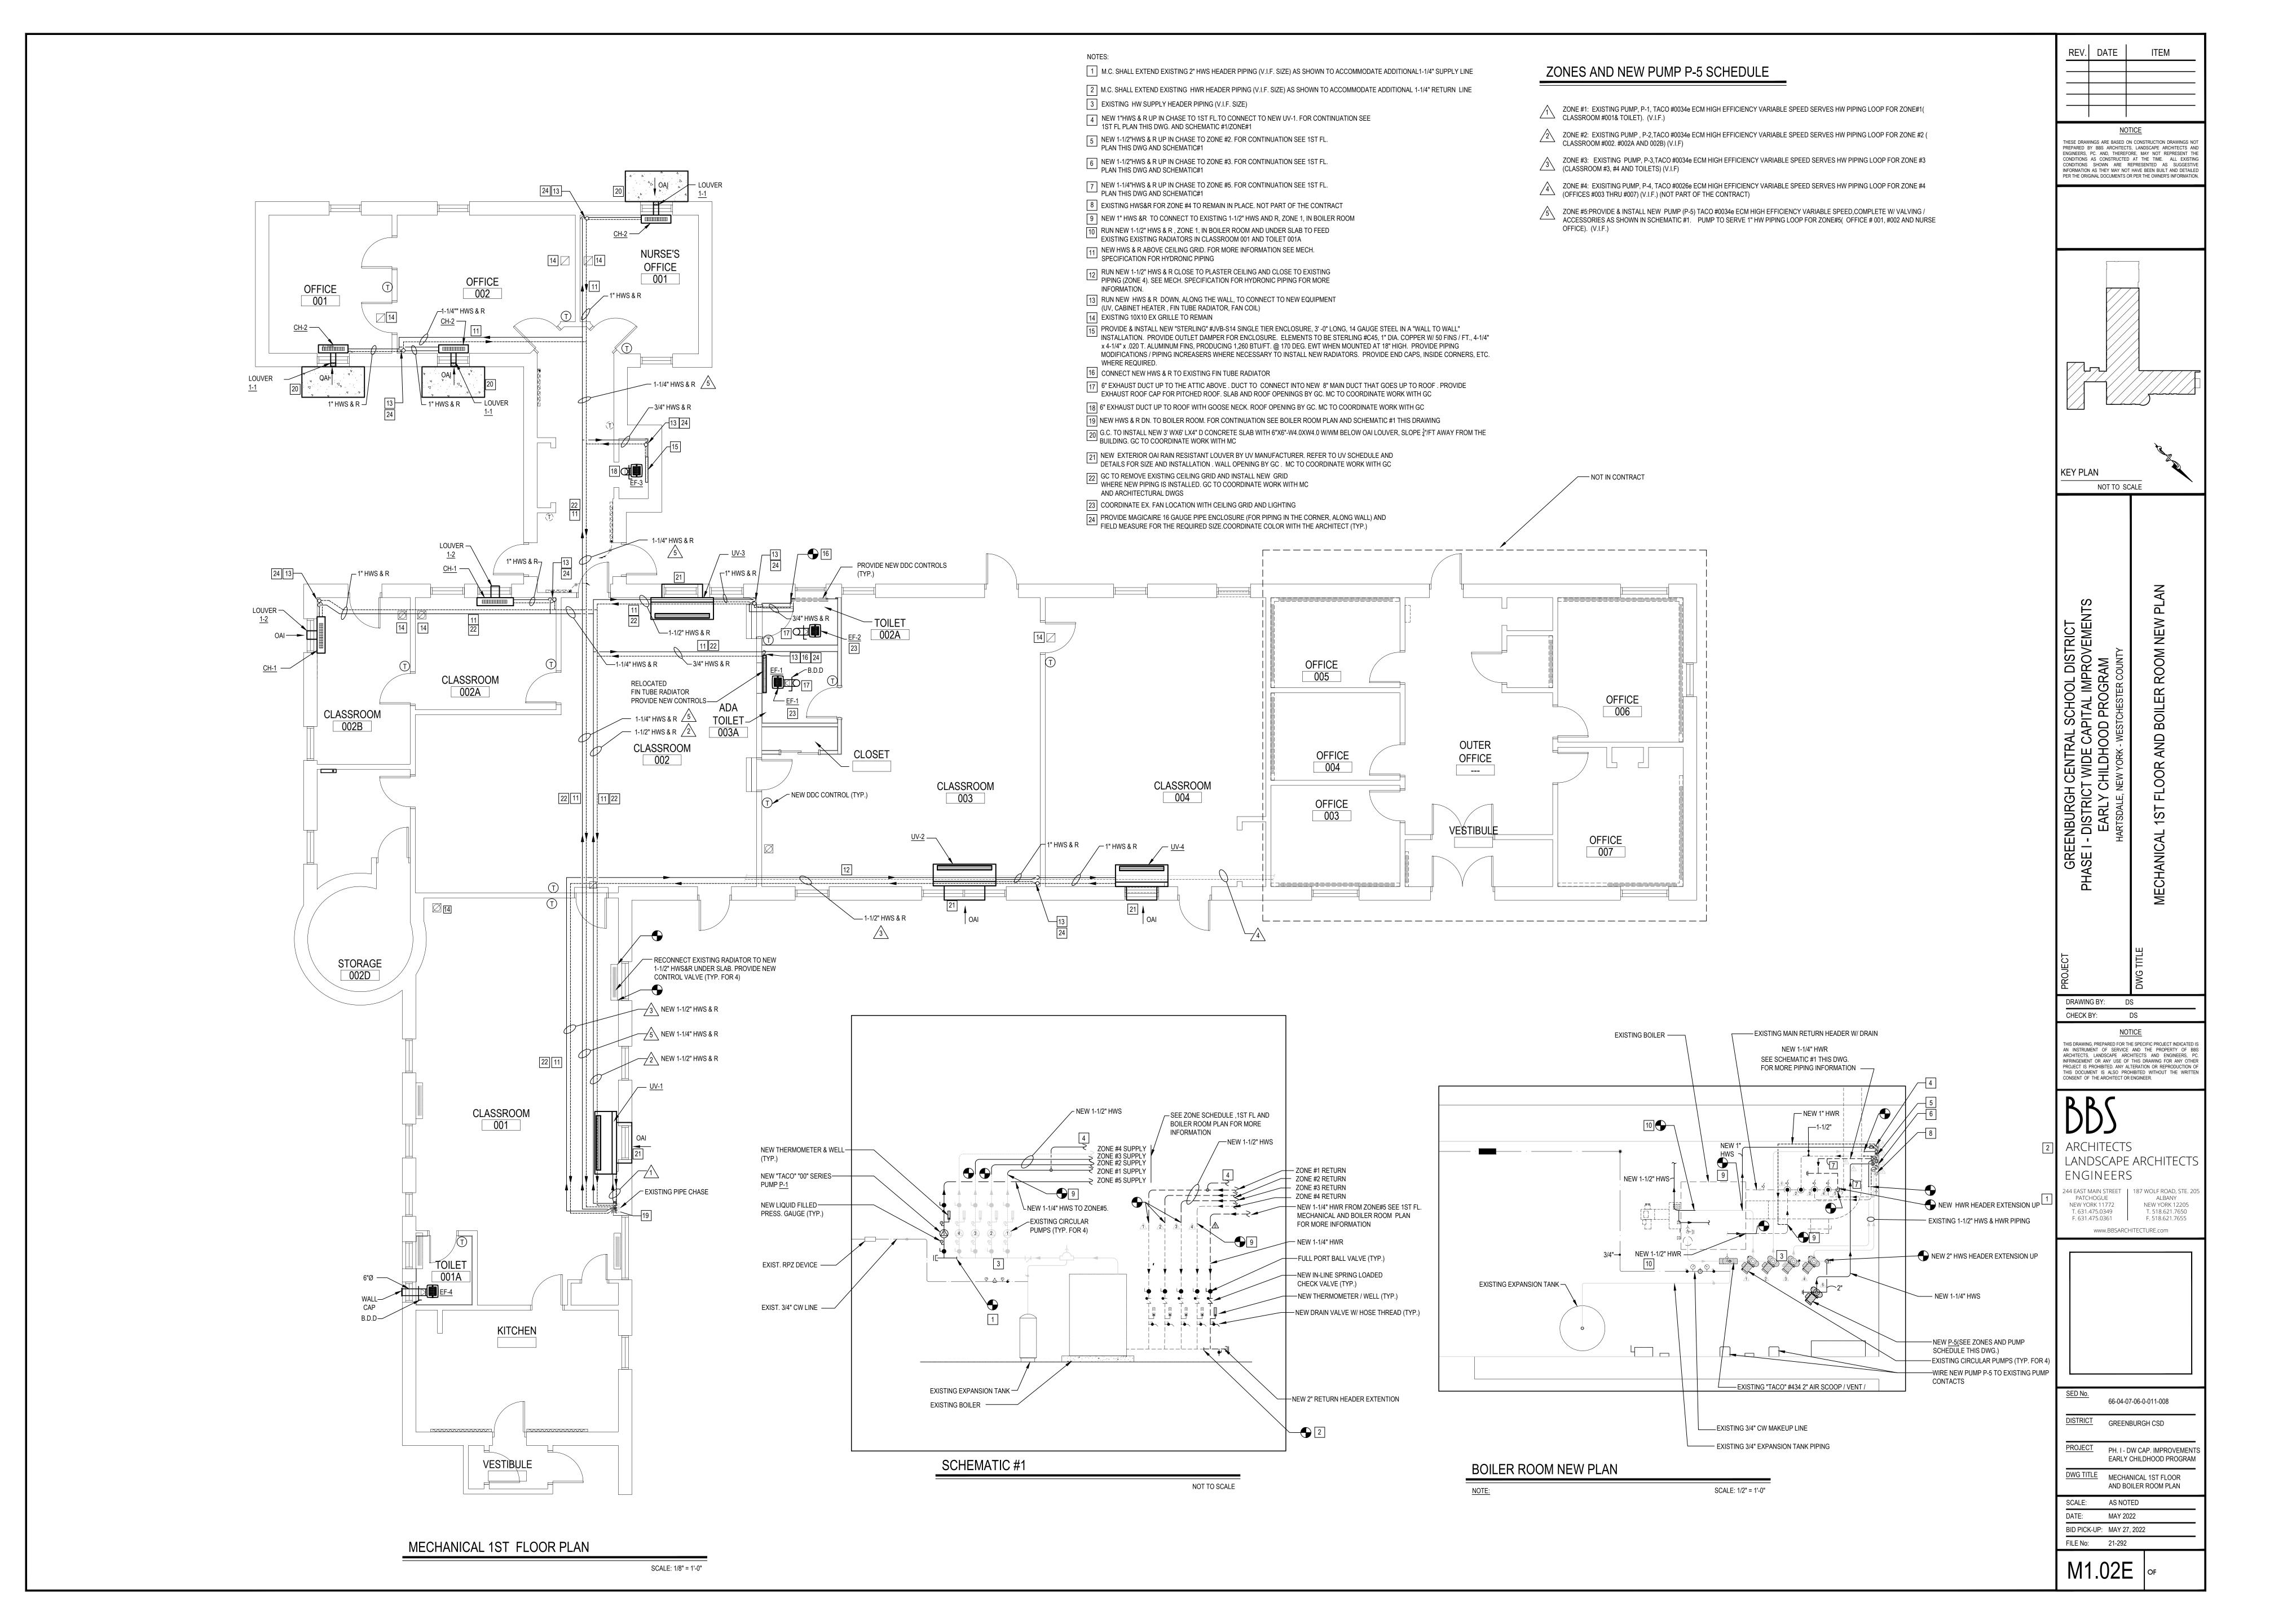

#### CABINET UNIT HEATER SCHEDULE

(STERLING AS STANDARD)

Manufactuer	MagicAire	MagicAire
Performance Details	MAUVF3	MAUVF2
Arrangement	Vertical Floor Mounted	Vertical Floor Mounte
Base Unit Size	MAUV-3	MAUV-2
Tag	UV-1, UV-2 & UV-3	UV-4
Quantity	3	1
Altitude	0	0
Configuration	4 Pipe	4 Pipe
Nominal Airflow (CFM)	1000	750
OA (CFM)	UV-3 = 280, UV-1 & 2 = 315	UV-4=250
External Static Pressure ESP (IWG)	0.1	0.1

Heating Coil	2 Row Hot Water Coil - Left Hand	2 Row Hot Water Coil - Left H
Rows	2	2
EAT Dry Bulb (F)	47	47
LAT Dry Bulb (F)	100.93	101.16
Total Capacity (BTU/hr)	60659	46227
EWT (F)	180	180
LWT (F)	148.86	152.88
GPM	4	3.5
WPD (ft w.g.)	1.516	0.963
Heating Fluid	Water	Water
Electrical Data	ECM	ECM
Voltage 1 (V1)	120	120
Phase	1	1
Frequency	60	60
Motor HP	1/3	1/3
Motor FLA (at V1)	4	3.7
Unit MCA (at V1)	5	4.6
Unit MOPD (at V1)	15	15
LOUVER SIZE	48"x10"	34"x10"
NOTES:		

1. All temperature controls to be field supplied and installed by ATC contractor.


2. Architect to select unit color from vendor color chart. 3. MC to coordinate pipe hand connections with vendor.


4. Provide MERV 13 filters


5. REFER TO ATC SPECIFICATION SECTION 15903 FOR FURTHER DETAILS REGARDING UNIT TEMPERATURE CONTROLS. REFER TO DWGS. #M6.02 FOR PIPING / INSTALLATION

DETAILS. PROVIDE NEW CLEAR ANODIZED LOUVER.

6. CONTROLS UBCONTRACTOR, UNDER CONTRACT TO MECHANICAL CONTRACTOR 7. PROVIDE NEW CLEAR ANODIZED OAI LOUVER.

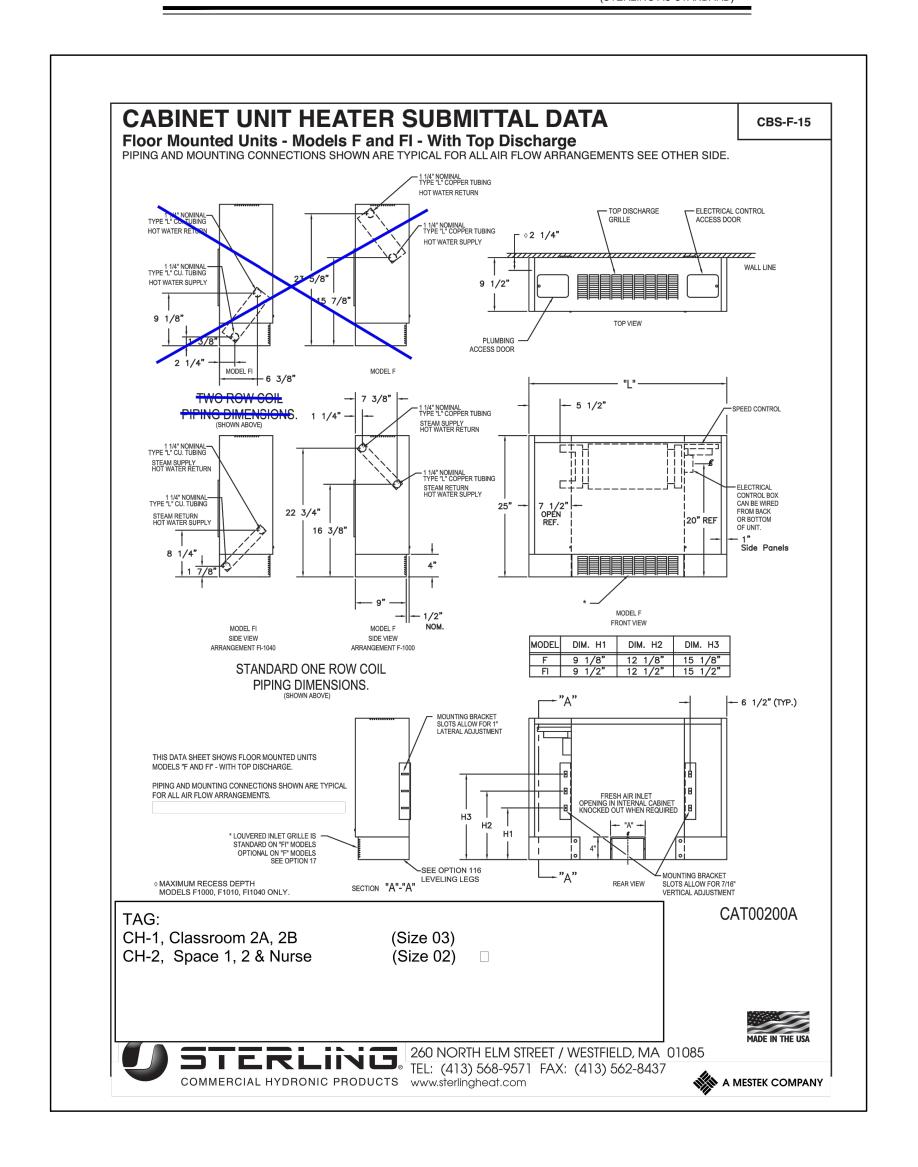

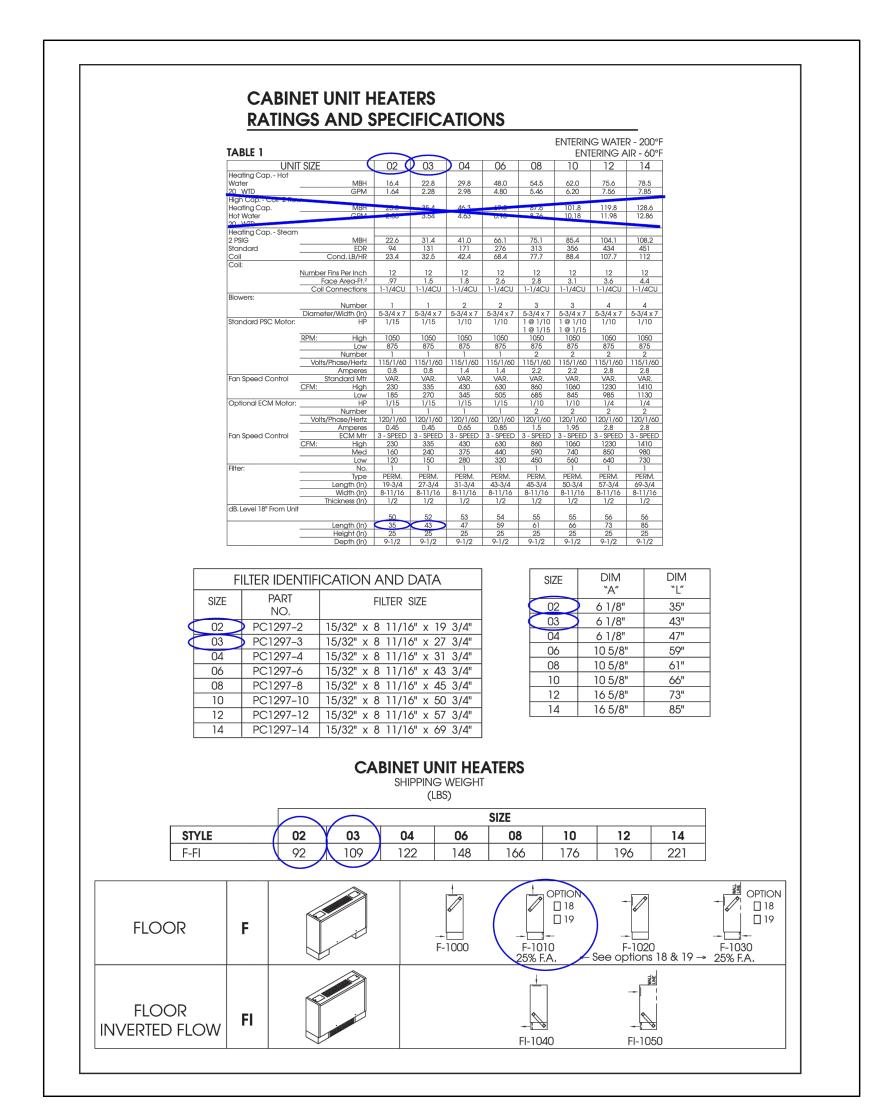


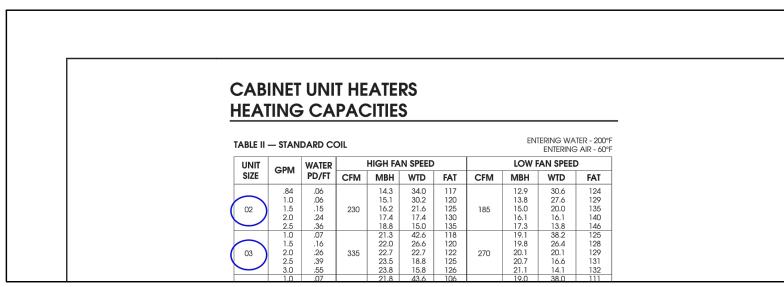


	EXHAUST FAN SCHEDULE GR										GREENHECK AS STD.
						INPUT			WEIGHT	OPTIONS AND	
TAG	SERVICE	MODEL	CFM	ESP	FAN RPM	(W)	SONES	VOLT/PH	(LBS)	ACCESSORIES	NOTES
EF-1	ADA TOILET 003A	SP-B110	70	0.75	888	80.0	3.0	115/1	12.0	1,2,3,4,5	
EF-2	TOILET 002A	SP-B110	70	0.75	888	80.0	3.0	115/1	12.0	1,2,3,4,5	
EF-3	TOILET CORRIDOR	SP-B110	70	0.5	777	80.0	2.0	115/1	12.0	1,2,3,4,5	
EF-4	TOILET 001A	SP-B110	70	0.5	777	80.0	2.0	115/1	12.0	1,2,3,4,5	
OPTIONS /	ACCESSORIES:					•					

2. UL-507 LISTING 3. ISOLATION KIT 4. FRANKLIN CONTROLS MODEL BAS-1P STARTER WITH HOA 5. MOTOR WITH THERMAL OVERLOAD

1. SOLID STATE SPEED CONTROL

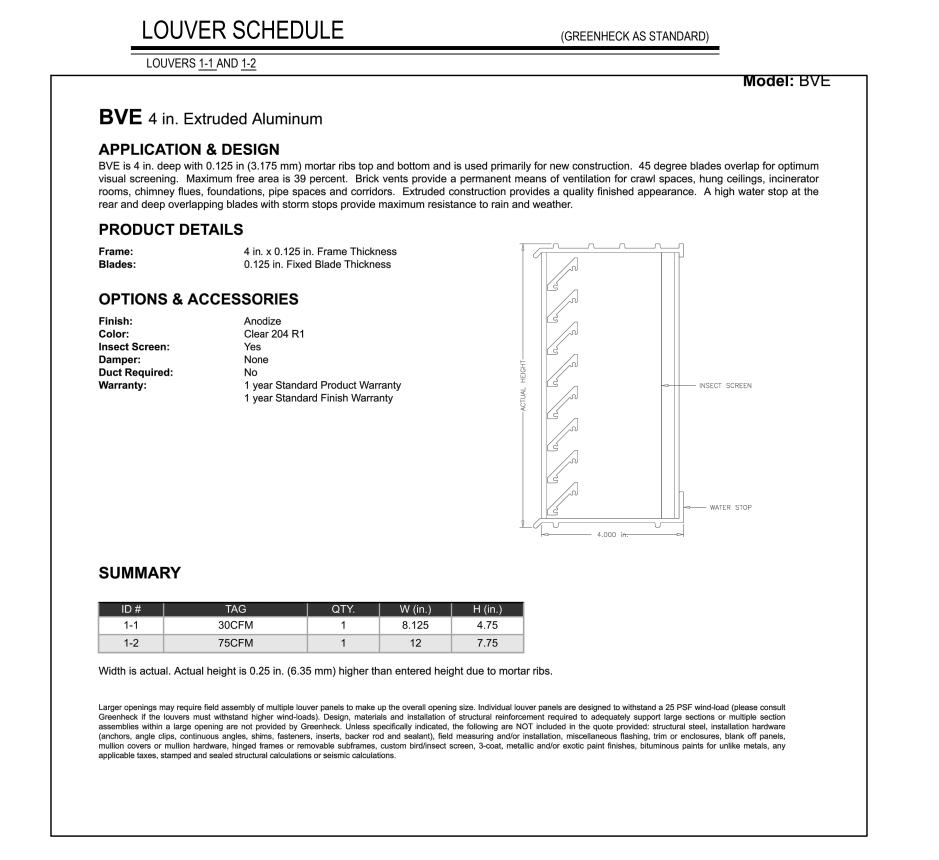

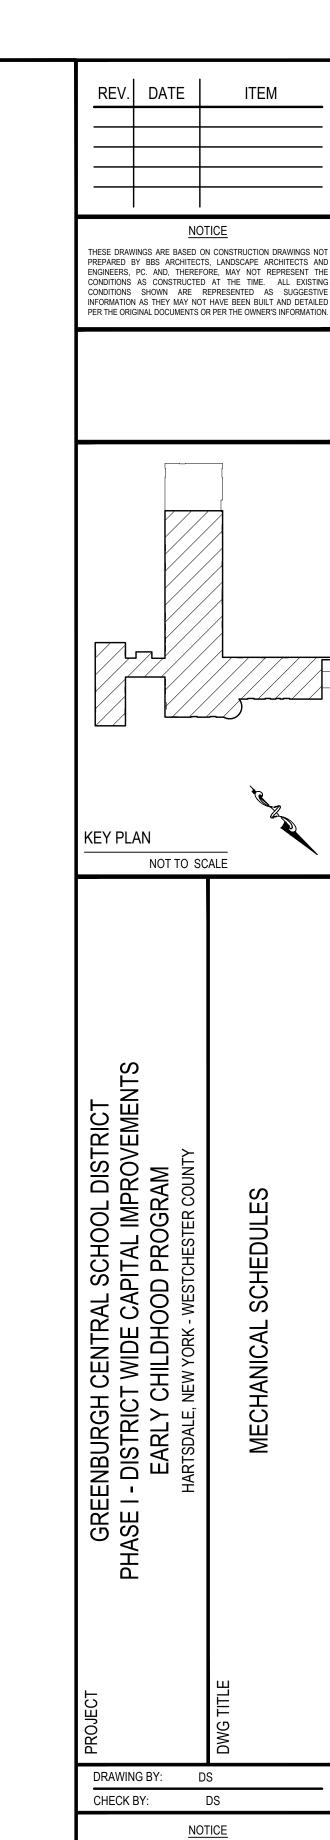

THIS DRAWING, PREPARED FOR THE SPECIFIC PROJECT INDICATED IS AN INSTRUMENT OF SERVICE AND THE PROPERTY OF BBS ARCHITECTS, LANDSCAPE ARCHITECTS AND ENGINEERS, PC. INFRINGEMENT OR ANY USE OF THIS DRAWING FOR ANY OTHER PROJECT IS PROHIBITED. ANY ALTERATION OR REPRODUCTION OF THIS DOCUMENT IS ALSO PROHIBITED WITHOUT THE WRITTEN CONSENT OF THE ADOLUTECT OR ENGINEER.

LANDSCAPE ARCHITECTS

244 EAST MAIN STREET | 187 WOLF ROAD, STE. 20

www.BBSARCHITECTURE.com

66-04-07-06-0-011-008

PROJECT PH. I - DW CAP. IMPROVEMENTS

SCHEDULES

M6.01E of ---

EARLY CHILDHOOD PROGRAM

DISTRICT GREENBURGH CSD

DWG TITLE MECHANICAL

SCALE: AS NOTED DATE: MAY 2022 BID PICK-UP: MAY 27, 2022

FILE No: 21-292

NEW YORK 12205 T. 518.621.7650


F. 518.621.7655

CONSENT OF THE ARCHITECT OR ENGINEER.

ENGINEERS

F. 631.475.0361

PATCHOGUE NEW YORK 11772

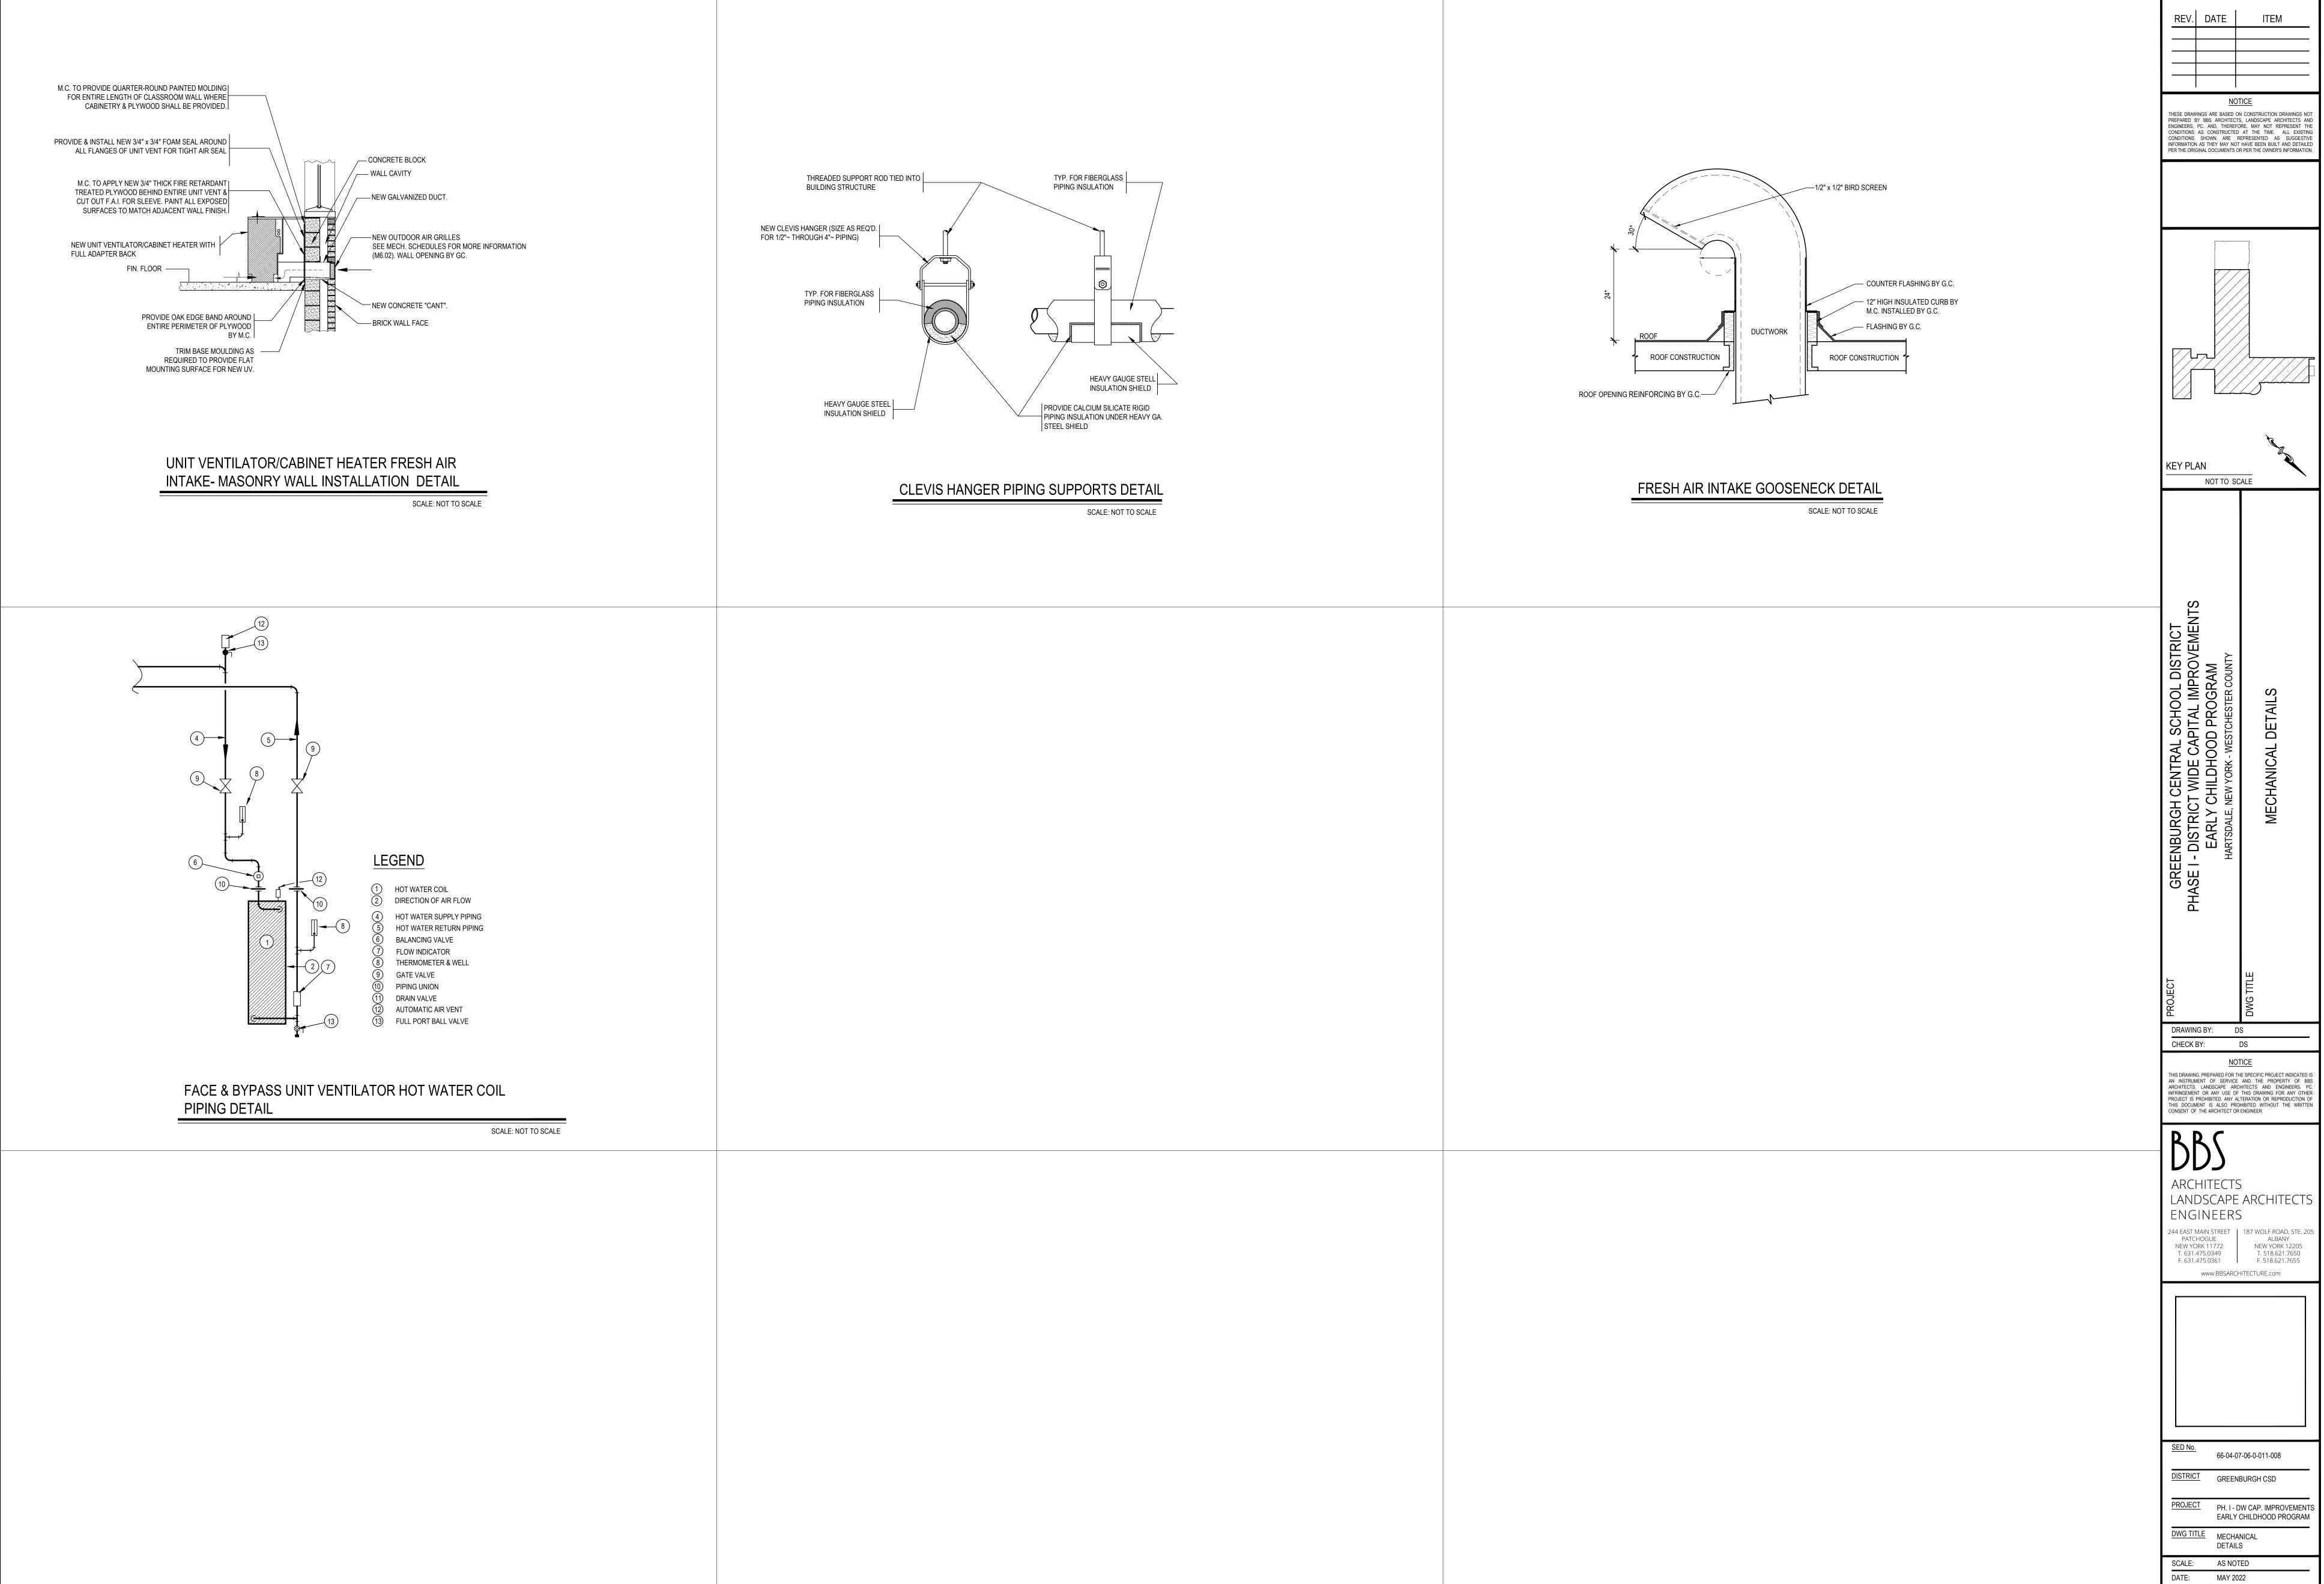

<u>NOTICE</u> THESE DRAWINGS ARE BASED ON CONSTRUCTION DRAWINGS NOT PREPARED BY BBS ARCHITECTS, LANDSCAPE ARCHITECTS AND ENGINEERS, PC. AND, THEREFORE, MAY NOT REPRESENT THE CONDITIONS AS CONSTRUCTED AT THE TIME. ALL EXISTING CONDITIONS SHOWN ARE REPRESENTED AS SUGGESTIVE INFORMATION AS THEY MAY NOT HAVE BEEN BUILT AND DETAILED PER THE ORIGINAL DOCUMENTS OR PER THE OWNER'S INFORMATION. KEY PLAN NOT TO SCALE DRAWING BY: DS CHECK BY: DS <u>NOTICE</u> THIS DRAWING, PREPARED FOR THE SPECIFIC PROJECT INDICATED IS AN INSTRUMENT OF SERVICE AND THE PROPERTY OF BBS ARCHITECTS, LANDSCAPE ARCHITECTS AND ENGINEERS, PC. INFRINGEMENT OR ANY USE OF THIS DRAWING FOR ANY OTHER PROJECT IS PROHIBITED. ANY ALTERATION OR REPRODUCTION OF THIS DOCUMENT IS ALSO PROHIBITED WITHOUT THE WRITTEN CONSENT OF THE ARCHITECT OR ENGINEER. ARCHITECTS LANDSCAPE ARCHITECTS ENGINEERS 244 EAST MAIN STREET PATCHOGUE ALBANY
NEW YORK 11772 NEW YORK 12205
T. 631.475.0349 T. 518.621.7650
F. 631.475.0361 F. 518.621.7655 www.BBSARCHITECTURE.com

66-04-07-06-0-011-008


DETAILS

M6.02E | ∘ - - -

BID PICK-UP: MAY 27, 2022

FILE No: 21-292

REV. DATE

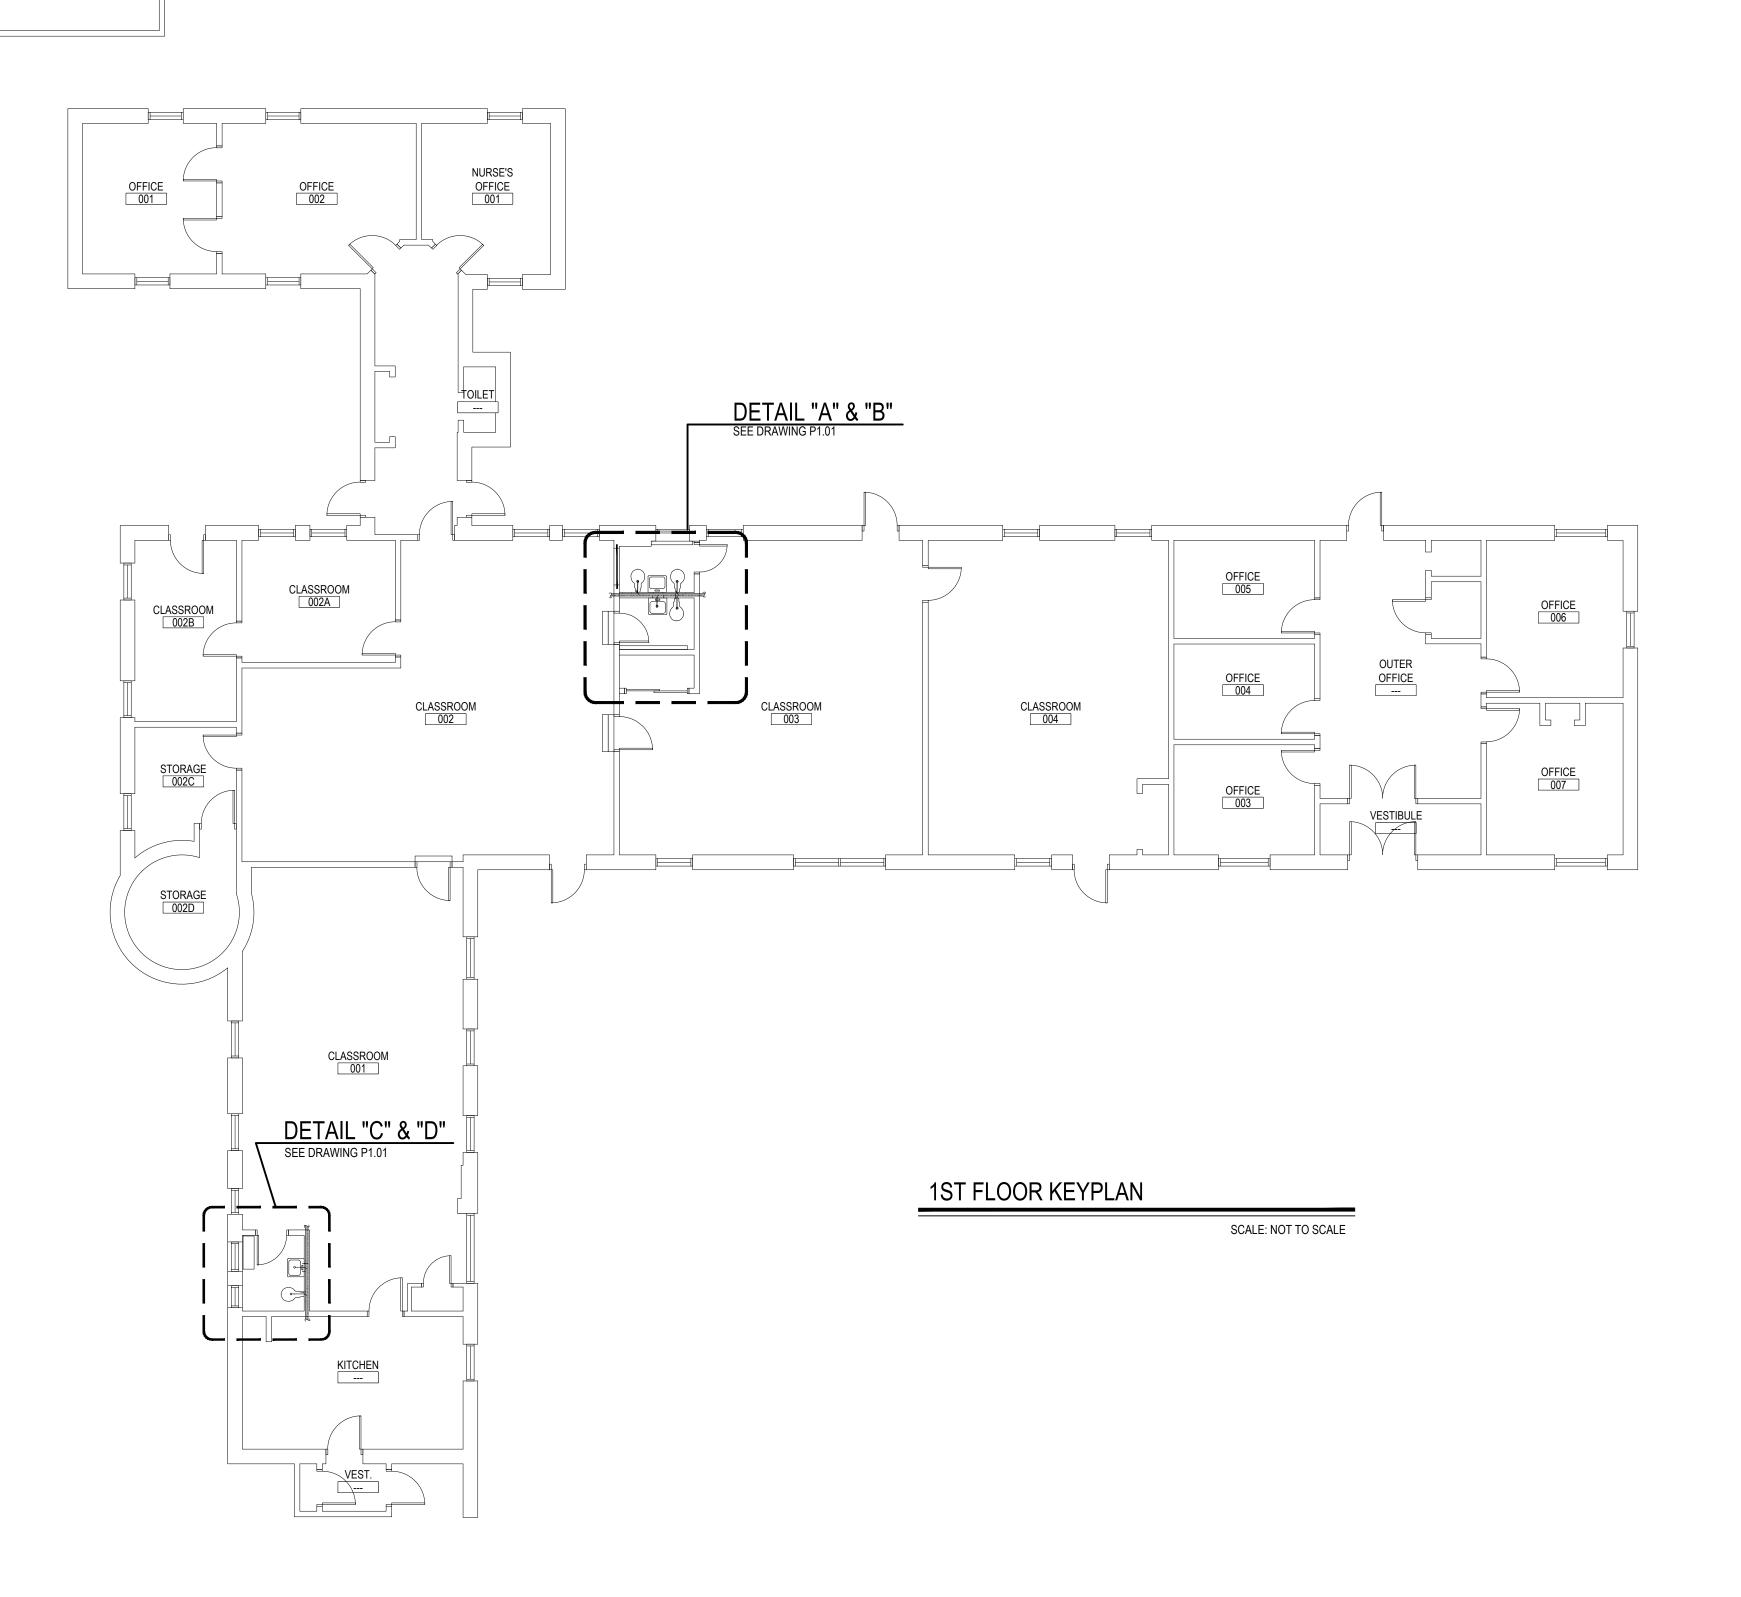

	PLUMBING FIXTURE SCHEDULE								
ITEM No.	FIXTURE	TRAP	VENT	COLD WATER	HOT WATER	TEMPERED WATER	DESCRIPTION		
P-1 (HC)	WATER CLOSET PHYSICALLY HANDICAPPED (CHILDREN)	4"	2"	1"	_		FURNISH AND INSTALL AMERICAN STANDARD MADERA YOUTH FLOWISE, 14" HEIGHT, ELONGATED BOWL NO. 2599.001, TOP SPUD, FLOOR MOUNTED. THE TOP OF WATER CLOSET SEAT SHALL BE 15" ABOVE FINISHED FLOOR FOR HANDICAPPED ACCESSIBILITY. PROVIDE AND INSTALL AMERICAN STANDARD BATTERY POWERED AND SENSOR OPERATED SELECTRONIC FLUSHOMETER MODEL 6065.121.002 LOW CONSUMPTION (1.28 G.P.F.) AND ALL NECESSARY SUPPORTS AND CONNECTIONS. FURNISH SEAT, HEAVY DUTY OPEN FRONT LESS COVER MODEL 5901. COLOR TO BE WHITE.		
P-1	WATER CLOSET (CHILDREN)	4"	2"	1"			FURNISH AND INSTALL AMERICAN STANDARD MADERA YOUTH FLOWISE, 14" HEIGHT, ELONGATED BOWL NO. 2599.001, TOP SPUD, FLOOR MOUNTED. PROVIDE AND INSTALL AMERICAN STANDARD BATTERY POWERED AND SENSOR OPERATED SELECTRONIC FLUSHOMETER MODEL 6065.121.002 LOW CONSUMPTION (1.28 G.P.F.) AND ALL NECESSARY SUPPORTS AND CONNECTIONS. FURNISH SEAT, HEAVY DUTY OPEN FRONT LESS COVER MODEL 5901. COLOR TO BE WHITE.		
P-2 (HC)	LAVATORY PHYSICALLY HANDICAPPED (CHILDREN)	1-1/2"	1-1/2"	1/2"	1/2"	1/2"	FURNISH AND INSTALL AMERICAN STANDARD LUCERNE WHITE VITREOUS CHINA WALL HUNG LAVATORY MODEL 0355.012 WITH FRONT OVERFLOW, FAUCET LEDGE, "D" SHAPED BOWL, SELF-DRAINAGE DECK AREA WITH CONTOURED BACK AND SIDE SPLASH SHIELDS AND BRACKET SUPPORT. RIM OF LAVATORY SHALL BE 30" ABOVE FINISHED FLOOR FOR HANDICAPPED ACCESSIBILITY. FURNISH AND INSTALL WITH AMERICAN STANDARD INNSBROOK SELECTRONIC ELECTRONIC PROXIMITY LAVATORY FAUCET MODEL 6053.205 BATTERY POWERED FAUCET (0.5 GPM) WITH AMERICAN STANDARD MODEL 605XTMV1070 THERMOSTATIC MIXING VALVE, GRID STRAINER AND TRUEBRO MODEL 2018-AS-L LAV SHIELD ENCLOSURE. FURNISH AND INSTALL LAVATORY WITH ZURN MODEL Z1231-EZ CONCEALED ARM CARRIER.		
P-2	LAVATORY (CHILDREN)	1-1/2"	1-1/2"	1/2"	1/2"	1/2"	FURNISH AND INSTALL AMERICAN STANDARD LUCERNE WHITE VITREOUS CHINA WALL HUNG LAVATORY MODEL 0355.012 WITH FRONT OVERFLOW, FAUCET LEDGE, "D" SHAPED BOWL, SELF-DRAINAGE DECK AREA WITH CONTOURED BACK AND SIDE SPLASH SHIELDS AND BRACKET SUPPORT. RIM OF LAVATORY SHALL BE 30" ABOVE FINISHED FLOOR FOR HANDICAPPED ACCESSIBILITY. FURNISH AND INSTALL WITH AMERICAN STANDARD INNSBROOK SELECTRONIC ELECTRONIC PROXIMITY LAVATORY FAUCET MODEL 6053.205 BATTERY POWERED FAUCET (0.5 GPM) WITH AMERICAN STANDARD MODEL 605XTMV1070 THERMOSTATIC MIXING VALVE, GRID STRAINER AND TRUEBRO MODEL 2018-AS-L LAV SHIELD ENCLOSURE. FURNISH AND INSTALL LAVATORY WITH ZURN MODEL Z1231-EZ CONCEALED ARM CARRIER.		

#### PLUMBING NOTES

- 1. PLUMBING CONTRACTOR TO SHUT-OFF & DISCONNECT HOT & COLD WATER SUPPLIES, SANITARY WASTE LINES & VENT PIPING. GENERAL CONTRACTOR TO REMOVE ALL PLUMBING FIXTURES AS INDICATED ON DRAWINGS.
- 2. ALL HOT WATER, COLD WATER, SANITARY & VENT PIPING TO EXISTING PLUMBING FIXTURES SHALL BE COMPLETELY REMOVED BACK AS INDICATED ON DRAWINGS. PLUMBING CONTRACTOR SHALL BE RESPONSIBLE TO REPLACE ANY PIPE INSULATION.

#### 1. PLUMBING CONTRACTOR SHALL PROVIDE AND INSTALL NEW FIXTURES AS SHOWN IN PLUMBING FIXTURE SCHEDULE.

- 2. PLUMBING CONTRACTOR SHALL INSTALL NEW PIPING WITH CONNECTIONS TO MAIN PIPING FOR EACH NEW FIXTURE.
- PLUMBING CONTRACTOR SHALL CONNECT NEW VENT PIPING TO EXISTING VENTS OR NEW VENTS.
- 4. SEE GENERAL NOTES AND PLUMBING SPECIFICATIONS SECTION 15A FOR MORE DETAIL.
- 5. DEMOLITION AND RECONSTRUCTION OF PLUMBING WALLS BY GENERAL CONTRACTOR. PLUMBING CONTRACTOR TO COORDINATE WITH GENERAL CONTRACTOR.
- 6. IN ALL INSTANCES WHERE NEW FIXTURES ARE PROPOSED THE PLUMBING CONTRACTOR SHALL PERFORM ALL DEMOLITION REQUIRED FOR REMOVAL OF EXISTING FIXTURE CARRIERS AND INSTALL NEW FIXTURE CARRIERS. GENERAL CONTRACTOR. SHALL THEN BUILD OR PATCH WALLS AS REQUIRED, INCLUDING NEW TILE FINISHES. UPON COMPLETION OF MASONRY / TILE THE PLUMBING CONTRACTOR SHALL INSTALL NEW FIXTURES PER SPECIFICATIONS.
- 7. REFER TO ARCHITECTURAL DRAWINGS FOR DIMENSIONAL LOCATIONS OF NEW PLUMBING FIXTURES.

#### LEAD-FREE FIXTURE COMPLIANCE NOTE

#### EPA 67.4 NOTE:

- 1. THE PLUMBING CONTRACTOR SHALL PROVIDE AND INSTALL NEW AND/OR REPLACEMENT PLUMBING FIXTURES. THE RESPECTIVE FIXTURES MUST ADHERE TO THE "LEAD-FREE" DIVISION 15A SPECIFICATIONS OUTLINING THE INSTALLATION MEANS AND METHODS AS WELL AS THE FIXTURE ITSELF BEING "LEAD FREE." THE CONTRACTOR SHALL PROVIDE THE REQUIRED SUBMITTALS FOR ALL FIXTURES AND BUILDING MATERIALS PRIOR TO THE FIXTURE INSTALLATION, AND CONFIRM ON THE JOBSITE THAT THE FIXTURE ADHERES TO "LEAD-FREE"
- a. FOLLOWING THE POTABLE FIXTURE INSTALLATION. THE P.C. SHALL REMOVE ALL FILTERS AND STRAINERS AND FLUSH THE FIXTURE OF DEBRIS FROM THE SYSTEM.
- 2. FOLLOWING THE COMPLETION OF THE P.C. WORK SCOPE, THE OWNER SHALL HAVE THE WATER CONDITIONS TESTED FOR LEAD CONTAMINANTS BY A THIRD-PARTY TESTING FIRM TO REGULATION 67.4 OF THE DEPARTMENT OF HEALTH REGULATIONS AS PART OF SECTION 1417 OF THE FEDERAL SAFE WATER ACT TO DETERMINE THEM AS "LEAD-FREE" COMPLIANT, AND NYSED GUIDELINES OF LESS THAN 15PPB.
- 3. IF A FIXTURE DOES NOT COMPLY WITH SUB-PART REGULATION 67.4 OF THE DOH SECTION 1417 OF THE FEDERAL SAFE WATER ACT, THE P.C. SHALL PROVIDE A REPLACEMENT FIXTURE AT NO ADDITIONAL COST, TO THEN REPEAT THE INSTALLATION AND TESTING REQUIREMENTS. THE P.C. SHALL ABSORB THE FEE FOR THE FIRST LEAD TESTING PROCEDURE AS WELL AS THE FOLLOWING CONFIRMATION PROCEDURES AT NO ADDITIONAL COST TO THE OWNER.

	LEGEND				
	CW - COLD WATER LINE				
	HW - HOT WATER LINE				
sw	SW - SANITARY WASTE LINE				
ST	ST - STORM DRAIN				
	HWR - HOT WATER RETURN				
V	V - VENT LINE				
TW	TW - TEMPERED WATER LINE				
——-G——	GAS LINE PIPING				
×-×-×-×	DEMO PIPE				
————II co	CLEAN OUT IN HUNG CEILING				
DPCO	DECK PLATE CLEAN OUT				
WPCO	WALL PLATE CLEAN OUT				
<b>——</b>	BALL VALVE				
<b>\Phi</b>	POINT OF CONNECTION				
O UP	PIPE RUNNING UP				
ND C	PIPE RUNNING DOWN				
<del></del>	NEW GAS COCK IN PIPING				

#### **GENERAL NOTES**

- 1. PLUMBING CONTRACTOR SHALL VISIT THE SITE PRIOR TO SUBMITTING HIS BID AND PERFORM ALL INVESTIGATION WORK BEFORE SUBMITTING A BID ON THE PLUMBING WORK.
- 2. CONNECT ALL HOT WATER, COLD WATER, VENT, AND WASTE PIPING AS REQUIRED INCLUDING PIPING, VALVES, TAPS, ESCUTCHEONS, SLEEVES, ACCESS DOORS, CLEANOUTS, PIPE HANGERS,
- 3. PROVIDE AND INSTALL PLUMBING FIXTURES INCLUDING ALL CUTTING AND PATCHING AS REQUIRED INCLUDING WASTE, VENT, AND WATER SUPPLY CONNECTIONS AND FITTINGS (ALL TRAPS TO HAVE CLEANOUTS).
- 4. ALL WORK SHALL BE IN ACCORDANCE WITH STATE AND LOCAL BUILDING CODES. CONTRACTOR SHALL BE RESPONSIBLE FOR OBTAINING ALL NECESSARY PERMITS AND PAYING RELATED FEES.
- 5. PLUMBING CONTRACTOR SHALL COORDINATE HIS WORK WITH ALL OTHER TRADES PRIOR TO
- 6. INTERIOR DOMESTIC WATER PIPING SHALL BE TYPE "L" COPPER. UNDERGROUND DOMESTIC WATER PIPING SHALL BE TYPE "K" COPPER FOR UP TO 2" AND DUCTILE IRON OVER 2". WASTE PIPING SHALL BE SERVICE WEIGHT CAST IRON SOIL PIPE, HUB AND SPIGOT UNDERGROUND, AND NO HUB INSIDE BUILDING. STORM DRAIN PIPING SHALL BE NO HUB CAST IRON SOIL PIPE INSIDE BUILDING. VENT

#### PIPING SHALL BE NO HUB CAST IRON. 7. PIPE INSULATION SHALL BE AS FOLLOWS:

MINIMUM PIPE INSULATION SCHEDULE									
FLUID	LESS THAN 1-1/2"	GREATER THAN 1-1/2"							
TEMPERED WATER	1-1/2"	2"							
COLD WATER	1-1/2"	1-1/2"							
HOT WATER	1-1/2"	2"							


- 8. ALL WORK SHALL BE PROPERLY TESTED AND CLEANED. PROVIDE ONE YEAR WARRANTY FROM DATE OF ACCEPTED COMPLETION ON ALL PARTS AND LABOR.
- 9. ALL EXPOSED METALWORK ON PLUMBING FIXTURES SHALL BE CHROME PLATED.
- 10. PROVIDE SHUTOFF VALVE ON WATER SUPPLY BRANCH TO EACH INDIVIDUAL FIXTURE IN AN ACCESSIBLE LOCATION.
- 11. ALL WORK SHALL BE IN ACCORDANCE WITH MANUFACTURER'S RECOMMENDATIONS.
- 12. WHERE DISSIMILAR METALS ARE CONNECTED, PROVIDE AN APPROVED MAKE OF NON-GALVANIC ISOLATOR, DIELECTRIC UNION OR FLANGES.
- 13. PROVIDE AND INSTALL BOLT CAPS ON ALL TOILETS.
- 14. RUN LOCAL HORIZONTAL DRAINAGE PIPING AT A GRADE OF 1/4-INCH PER FOOT WHEREVER POSSIBLE, BUT NO LESS THAN 1/8-INCH PER FOOT; HOUSE DRAINS AT 1/8-INCH PER FOOT UNLESS OTHERWISE NOTED AND OUTSIDE UNDERGROUND DRAINAGE PIPING AS INDICATED OR REQUIRED
- 15. RUN VENT PIPING WITH LONG TURN ELBOWS AT CHANGES IN DIRECTION, GRADE TO DRAIN OUT CONDENSATION, AND CONNECT AT BASE TO PREVENT ACCUMULATION OF RUST.
- 16. PROVIDE CLEANOUTS (FULL SIZE UP TO 4-INCHES AND AT LEAST HALF-SIZE FOR LARGER PIPES WITH 4-INCH MINIMUM), WHERE INDICATED, APPROXIMATELY EVERY 50 FEET ON HORIZONTAL DRAINAGE PIPING, AT CHANGES IN DIRECTION, AT BASE OF LEADERS, SOIL, AND WASTE STACKS,
- 17. PLUMBING CONTRACTOR SHALL BE RESPONSIBLE FOR ALL CORE DRILLING THRU WALLS, FLOORS AND CUTTING & PATCHING AS REQUIRED TO FACILITATE INSTALLATION OF PIPES AND PLUMBING
- 18. PLUMBING CONTRACTOR TO PROVIDE AND INSTALL NEW VENTS FROM FIXTURES UP TO ROOF AS SHOWN.
- 19. ALL FLOOR TRAPS SHALL BE INSTALLED WITH PRIMER TAPPING FOR WATER CONNECTION TO TRAP
- 20. P.C. SHALL PROVIDE AND INSTALL PIPE INSULATION ON ALL DOMESTIC COLD WATER SUPPLY, HOT WATER SUPPLY, HOT WATER SUPPLY (RECIRCULATION LINE) AND ROOF DRAIN PIPING THAT IS EXPOSED ABOVE CEILINGS OR IN CRAWL SPACE AND PIPE CHASES.

#### FIRE STOP NOTES


- 1. ALL PIPING PENETRATIONS THROUGH FIRE RATED WALLS, FLOORS OR OTHER STRUCTURES SHALL BE FIRE STOPPED BY PLUMBING CONTRACTOR.
- 2. THE FIRE STOP MATERIALS SHALL BE HILTI TYPE FS-657 FIRE BLOCK, FS-ONE SEALANT, CP-672 JOINT SPRAY, CP-601S ELASTOMERIC SEALANT, 6P-606 FLEXIBLE SEALANT, CP-643 OR CP-642 COLLAR, CP-618 PUTTY STICK OR FS-635 TROWEL ABLE COMPOUND, AS SUITABLE.
- 3. CONTRACTOR SHALL SUBMIT SHOP DRAWINGS OF PRODUCTS TO BE USED.
- 4. FIRESTOP MATERIALS OTHER THAN HILTI SHALL INCLUDE FULL TECHNICAL DATA WITH SHOP DRAWINGS TO DEMONSTRATE EQUALITY WITH THE SPECIFIED FIRE STOPS.

REV.	DATE	ITEM

<u>NOTICE</u> HESE DRAWINGS ARE BASED ON CONSTRUCTION DRAWINGS NOT REPARED BY BBS ARCHITECTS, LANDSCAPE ARCHITECTS AN CONDITIONS AS CONSTRUCTED AT THE TIME. ALL EXISTING CONDITIONS SHOWN ARE REPRESENTED AS SUGGESTIVE INFORMATION AS THEY MAY NOT HAVE BEEN BUILT AND DETAILED PER THE ORIGINAL DOCUMENTS OR PER THE OWNER'S INFORMATION

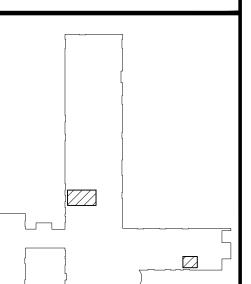



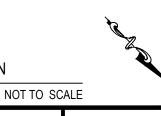


KEY PLAN NOT TO SCALE DRAWING BY: CHECK BY:

NOTICE THIS DRAWING, PREPARED FOR THE SPECIFIC PROJECT INDICATED IS AN INSTRUMENT OF SERVICE AND THE PROPERTY OF BBS ARCHITECTS, LANDSCAPE ARCHITECTS AND ENGINEERS, PC. INFRINGEMENT OR ANY USE OF THIS DRAWING FOR ANY OTHER PROJECT IS PROHIBITED. ANY ALTERATION OR REPRODUCTION O THIS DOCUMENT IS ALSO PROHIBITED WITHOUT THE WRITTE CONSENT OF THE ARCHITECT OR ENGINEER.



LANDSCAPE ARCHITECTS ENGINEERS

244 EAST MAIN STREET | 187 WOLF ROAD, STE. 20 NEW YORK 11772 NEW YORK 12205 T. 518.621.7650 F. 631.475.0361 F. 518.621.7655

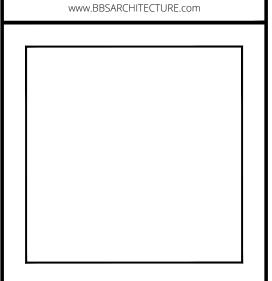


66-04-07-06-0-011-008


DISTRICT GREENBURGH CSD PROJECT PH. I - DW CAP. IMPROVEMENTS EARLY CHILDHOOD PROGRAM

DWG TITLE PLUMBING GENERAL NOTES, SCHEDULE AND KEY PLAN

SCALE: AS NOTED BID PICK-UP: MAY 27, 2022 FILE No: 21-292


P0.01E | oF - - -

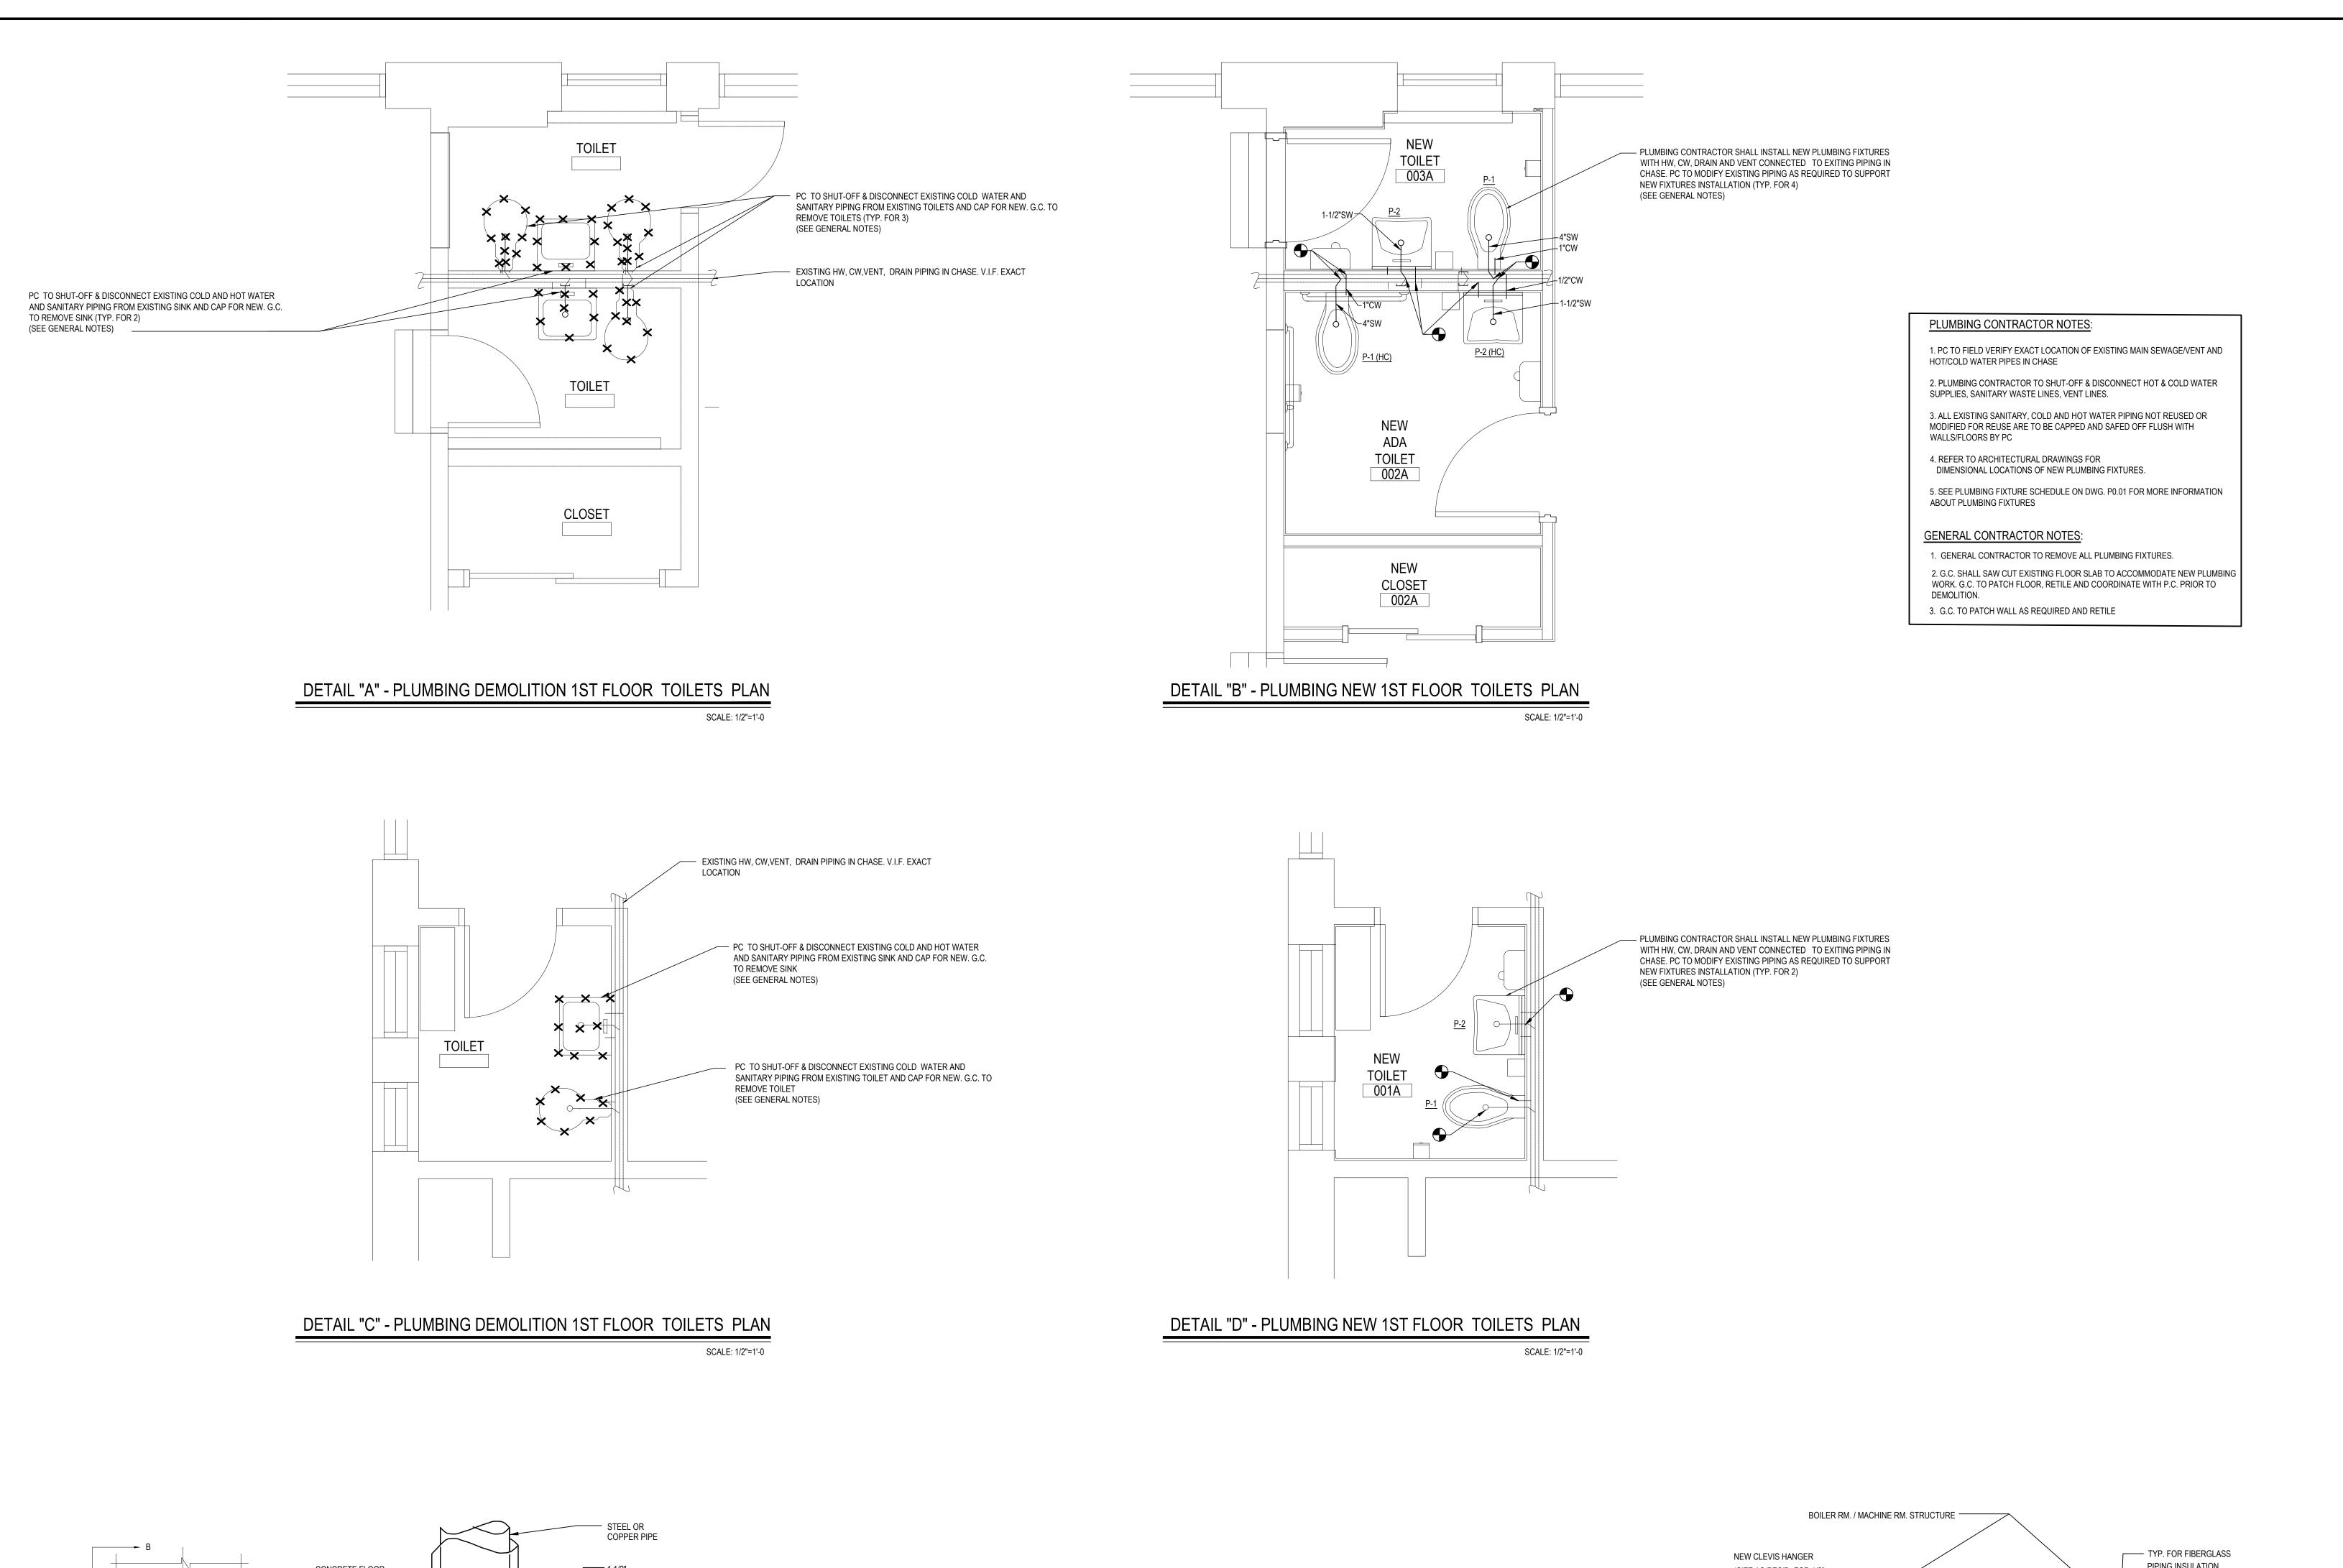

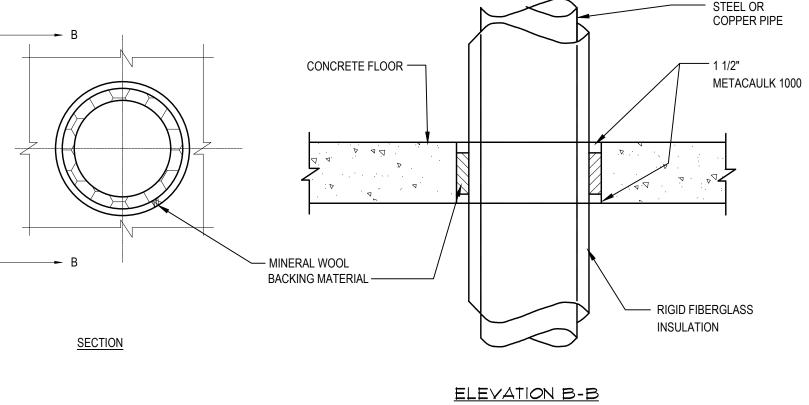


PIPING FLOOR PENETRATION DETAIL

SCALE: NOT TO SCALE

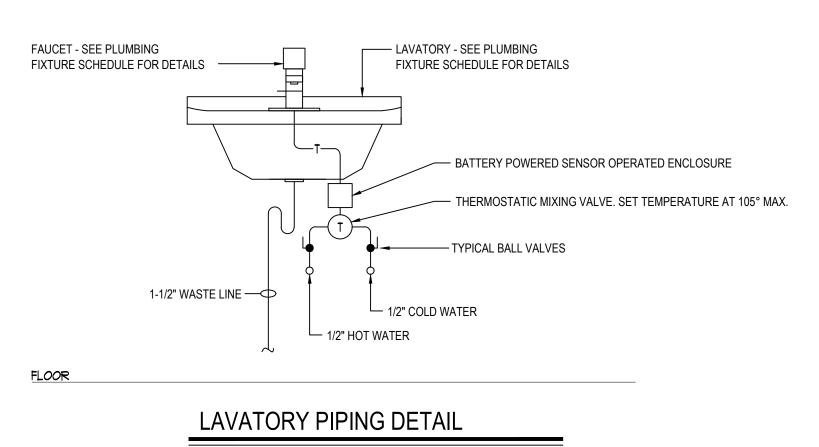

SCALE: NOT TO SCALE

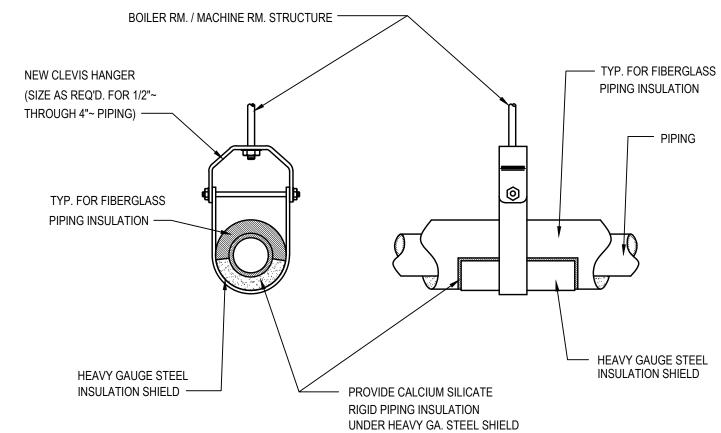

CLAVIS HANGER PIPING SUPPORT DETAIL

SCALE: NOT TO SCALE

KEY PLAN  NOT TO SO	ALE
GREENBURGH CENTRAL SCHOOL DISTRICT PHASE I - DISTRICT WIDE CAPITAL IMPROVEMENTS EARLY CHILDHOOD PROGRAM HARTSDALE, NEW YORK - WESTCHESTER COUNTY	E PLUMBING DEMOLITION AND NEW PART PLANS AND DETAILS
PROJECT	DWG TITLE
DRAWING BY: D	S DS
THIS DRAWING, PREPARED FOR TH AN INSTRUMENT OF SERVICE ARCHITECTS, LANDSCAPE ARC INFRINGEMENT OR ANY USE OF PROJECT IS PROHIBITED. ANY AL	E SPECIFIC PROJECT INDICATED IS AND THE PROPERTY OF BBS HITECTS AND ENGINEERS, PC. THIS DRAWING FOR ANY OTHER TERATION OR REPRODUCTION OF HIBITED WITHOUT THE WRITTEN

REV. DATE

<u>NOTICE</u>

THESE DRAWINGS ARE BASED ON CONSTRUCTION DRAWINGS NOT PREPARED BY BBS ARCHITECTS, LANDSCAPE ARCHITECTS AND ENGINEERS, PC. AND, THEREFORE, MAY NOT REPRESENT THE CONDITIONS AS CONSTRUCTED AT THE TIME. ALL EXISTING CONDITIONS SHOWN ARE REPRESENTED AS SUGGESTIVE INFORMATION AS THEY MAY NOT HAVE BEEN BUILT AND DETAILED PER THE ORIGINAL DOCUMENTS OR PER THE OWNER'S INFORMATION.

F. 631.475.0361 F. 518.621.7655
www.BBSARCHITECTURE.com

LANDSCAPE ARCHITECTS

NEW YORK 12205 T. 518.621.7650

ARCHITECTS

ENGINEERS

NEW YORK 11772

 SED No.
 66-04-07-06-0-011-008

 DISTRICT
 GREENBURGH CSD

PROJECT
PH. I - DW CAP. IMPROVEMENTS
EARLY CHILDHOOD PROGRAM

DWG TITLE
PLUMBING DEMOLITION AND
NEW PART PLAN AND DETAILS

SCALE: AS NOTED

DATE: MAY 2022

BID PICK-UP: MAY 27, 2022

FILE No: 21-292

P1.01E | ∘ - - -

#### GENERAL CONSTRUCTION NOTES

- 1. ALL WORK SHALL BE DONE IN ACCORDANCE WITH THE LATEST EDITIONS OF THE NEC, APPLICABLE LOCAL CODES, STATE CODES, SCHOOL WORKING RULES AND SCHEDULE DIRECTIVES, AND THE ENGINEER'S SPECIFICATIONS.
- 2. THE VOLTAGE CHARACTERISTIC OF THIS SCHOOL IS 120/208VAC, 4 WIRE, 3PH, GROUNDED NEUTRAL, WYE. ALL EQUIPMENT SHALL BE COMPATIBLE WITH THESE CHARACTERISTICS.
- 3. THE DRAWINGS SHOW SCHEMATICALLY, THE APPROXIMATE LOCATION OF ALL EQUIPMENT, CONDUITS, DEVICES, ETC. THE EXACT LOCATION OF WHICH SHALL BE SUBJECT TO APPROVAL BY THE ARCHITECT/OWNER WHO RESERVES THE RIGHT TO MAKE PRIOR TO INSTALLATION, ANY REASONABLE CHANGES IN LOCATION INDICATED WITHOUT EXTRA COST TO THE OWNER. CONTRACTOR SHALL VERIFY ALL INDICATED OR APPROXIMATED DIMENSIONS DRAWN OR DENOTED.
- 4. DIVISION 16 CONTRACTOR SHALL EXAMINE THE SITE TO VERIFY WORK TO BE PERFORMED AS SHOWN ON DRAWINGS AND SPECIFICATIONS BEFORE SUBMITTING HIS BID. ANY DISCREPANCY BETWEEN DRAWINGS/SPECIFICATIONS AND ACTUAL FIELD CONDITIONS SHALL BE BROUGHT TO ARCHITECT/ENGINEERS ATTENTION BEFORE BID SUBMITTAL. ANY FIELD CONDITION FOUND AFTER BID APPROVAL WHICH HAMPERS AND/OR PREVENTS ANY WORK TO BE PERFORMED AS SHOWN ON DRAWINGS AND SPECIFICATIONS SHALL BE THE RESPONSIBILITY OF THE DIVISION 16 CONTRACTOR. THE DIVISION 16 CONTRACTOR SHALL BID THE HIGHER SPECIFICATION FOR ANY DISCREPANCY BETWEEN DRAWINGS AND SPECIFICATIONS.
- 5. DIVISION 16 CONTRACTOR SHALL PROVIDE ALL LABOR SERVICE MATERIALS, EQUIPMENT, AND RELATED ITEMS TO COMPLETE THE WORK OF THIS DIVISION, AS REQUIRED BY THE NATIONAL ELECTRIC CODE, AND ALL STATE AND LOCAL AUTHORITIES HAVING JURISDICTION.
- 6. DIVISION 16 CONTRACTOR SHALL PROVIDE ALL ELECTRICAL HARDWARE SHOWN ON THESE DRAWINGS AND RELATED DETAIL MATERIALS NOT SPECIFICALLY SHOWN OR SPECIFIED. ALL NEW ELECTRICAL MATERIAL AND EQUIPMENT SHALL CONFORM TO THE STANDARDS AND BEAR THE INSPECTION LABEL OF THE UNDERWRITERS LABORATORIES AND SHALL BE APPROVED FOR USE BY ALL LOCAL AUTHORITIES HAVING JURISDICTION.
- 7. THE DIVISION 16 CONTRACTOR SHALL REFER TO ALL OTHER DRAWINGS IN BID PACKAGE AND PERFORM THE WORK (INCLUDE IN HIS BID) INDICATED AS ELECTRICAL CONTRACTOR (E.C.) WORK. CONTRACTOR TO COORDINATE ALL LOCATIONS WITH GENERAL CONTRACTOR AND OTHER TRADES.
- 8. ELECTRICAL CONTRACTOR SHALL COORDINATE WITH THE MECHANICAL CONTRACTOR FOR ALL MECHANICAL EQUIPMENT REQUIRING ELECTRICAL POWER. THE EC IS RESPONSIBLE TO INSTALL ALL MOTOR STARTERS AND ASSOCIATED POWER WIRING. THE LOCATIONS OF MOTOR STARTERS SHALL BE DETERMINED BY THE CONTRACTOR IN THE FIELD AND SUBMITTED TO THE ENGINEER FOR APPROVAL UNLESS IT IS SPECIFIED ON THE DRAWINGS. THE EC SHALL REFER TO THE MECHANICAL EQUIPMENT SCHEDULES & NOTES AND INCLUDE IN HIS BID PRICE ALL ELECTRICAL WORK ASSOCIATED WITH THEIR INSTALLATION, AND THE REMOVAL OF ANY STARTERS/DISCONNECTS NO LONGER REQUIRED.
- 9. ALL WORK SHALL BE IN ACCORDANCE WITH MANUFACTURER'S RECOMMENDATIONS AND DIRECTIVES OF THE
- 10. ALL ELECTRICAL WORK SHALL BE PERFORMED BY A LICENSED ELECTRICAL CONTRACTOR WHO SHALL OBTAIN AN APPROVED ELECTRICAL INSPECTION CERTIFICATE FROM THE LOCAL AHJ AND PAY ASSOCIATED FEE. SUBMIT A PHOTOCOPY OF THIS CERTIFICATE TO THE ENGINEER WITH FINAL PAYMENT APPLICATION. SUBMIT A COPY OF THIS CERTIFICATE TO THE OWNER.
- 11. DIVISION 16 CONTRACTOR SHALL GUARANTEE ALL MATERIALS AND THEIR INSTALLATION TO BE FREE OF DEFECTS FOR A PERIOD AS DEFINED IN THE PROJECT MANUAL.
- 12. IF ADDITIONAL POLE POSITIONS ARE REQUIRED FOR NEW CIRCUITS IN EXISTING PANELS SERVICING RENOVATED AREAS, REMOVE (3) ADJACENT 1 POLE BREAKERS PROVIDE AND INSTALL 3P, 60A BREAKER FOR SUB FEED TO A SURFACE MOUNTED 100A, 3PH, 18 POLE SUB PANEL AND ESTABLISH OVERFLOW CIRCUITS IN NEW SUB PANEL, EACH WITH A 1P, 20A BREAKER. PROVIDE (3) 1P, 20A BREAKERS FOR DISCONNECTED CIRCUITS IN MAIN PANEL AND RECONNECT THEM IN SUB PANEL. SUB PANEL FEED TO BE 3#6 + 1#6(N) + 1#10(G) IN 1"C.
- 13. IT IS EXPECTED THAT STRUCTURAL DEMOLITION BY THE GENERAL CONTRACTOR WILL CAUSE VARIOUS ELECTRIC SUPPLIES, OF VARIOUS VOLTAGES AND PURPOSES, TO BE CUT AND RENDER SOME DEVICES TEMPORARILY INACTIVE. IT IS THE ELECTRICAL CONTRACTOR'S RESPONSIBILITY TO RECONSTRUCT AND RECONNECT SUCH ELECTRIC SOURCES UPON COMPLETION. NOTE THAT MOST REINSTALLED ITEMS WILL BE IN DIFFERENT LOCATIONS FROM THE REMOVAL LOCATION. THE ELECTRICAL CONTRACTOR SHALL MAKE ALL REQUIRED CIRCUIT EXTENSIONS OR MODIFICATIONS TO PROVIDE SERVICE TO A REINSTALLED ITEM AS RELOCATED. NOTE THAT THIS REQUIREMENT ALSO APPLIES TO THE ROOMS AND ELECTRICAL ITEMS WITHIN THAT ARE NOMINALLY NOT IN CONTRACT. SUCH RESTORATION OF SERVICE, IF NEEDED, IS SPECIFICALLY IN THE ELECTRICAL CONTRACTOR'S CONTRACT.
- 14. THE ELECTRICAL CONTRACTOR SHALL PROVIDE TEMPORARY LIGHTING AND POWER TO ALL TRADES FOR THE DURATION OF THE PROJECT. SERVICE SHALL BE SUPPLIED TO CONTRACTOR'S CONSTRUCTION TRAILERS WHERE SUCH IS REQUESTED. USE THE EXISTING POWER PANELS FOR SUCH SUPPLY. POWER COSTS WILL BE PAID BY THE OWNER. ALL CONSTRUCTION POWER RECEPTACLES SHALL BE GFI PROTECTED.
- 15. IT SHALL BE THE ELECTRICAL CONTRACTOR'S RESPONSIBILITY TO PROTECT ALL ELECTRICAL DEVICES FROM DAMAGES DURING CONSTRUCTION. THIS INCLUDES DEVICES WHICH ARE EITHER INDICATED TO REMAIN, AND/OR TO BE REMOVED AND REINSTALLED THROUGHOUT ALL CONSTRUCTION AREAS. DEVICES SHALL INCLUDE BUT WILL NOT BE LIMITED TO: SMOKE DETECTORS, EMERGENCY LIGHTS, EXIT SIGNS, OCCUPANCY SENSORS, SPEAKERS, LIGHT FIXTURES, SWITCHES, RECEPTACLES, ETC. IN THE EVENT OF DAMAGES INCURRED DUE TO CONSTRUCTION ACTIVITIES, THE ELECTRICAL CONTRACTOR SHALL BE RESPONSIBLE TO REPLACE ANY DAMAGED DEVICES AT NO ADDITIONAL COST TO OWNER.
- 16. THE INDICATED SOURCE OF EXISTING CIRCUITS MAY NOT BE KNOWN OR HAS NOT BEEN VERIFIED. IT IS THE DIVISION 16 CONTRACTOR'S RESPONSIBILITY TO TRACE OUT, LOCATE AND VERIFY THE DISCONNECTING MEANS OF EXISTING CIRCUIT(S) TO BE IMPACTED BY THE WORK. SAFE OFF THE CIRCUIT(S) AS REQUIRED TO SAFELY PERFORM THE WORK, AND RE-ENERGIZE UPON COMPLETION. UPDATE PANEL DIRECTORIES UPON
- 17. WHERE EXISTING FIRE ALARM SYSTEMS ARE MODIFIED DURING THE COURSE OF THE PROJECT, PROVIDE OWNER WITH UPDATED COMPLETION RECORD DOCUMENTATION PER NFPA 72, ARTICLE 10.18. INCLUDE COPY OF UPDATED SITE SPECIFIC SOFTWARE. ANY ADDITIONAL DEVICES SHALL BE MAPPED INTO THE SYSTEM WITH THE APPROPRIATE ADDRESSES/LABELS.

COMPLETION.

- 18. FURNISH AND INSTALL ALL INDICATED LIGHTING FIXTURES AND MOUNTING HARDWARE AS REQUIRED FOR A COMPLETE INSTALLATION. NOTE ALL LIGHT FIXTURES SHALL BE SUPPORTED FROM BUILDING STRUCTURE. UTILIZING CEILING FRAMING ALONE IS NOT ACCEPTABLE. NEW LIGHTING FIXTURES (OTHER THAN THEATRICAL EQUIPMENT) SHALL NOT BE DAISY CHAINED. RE-USE OF AN EXISTING LIGHTING CKT INCLUDES HOME RUN WIRING OR WIRING UP TO THE SWITCH. ANY WIRING DOWNSTREAM OF THE SWITCH IS SUBJECT TO REPLACEMENT/REARRANGEMENT. EC SHALL ALLOW FOR THIS IN THE BID PRICE.
- 19. ALL WIRING TO BE 1#12+1#12(N)+1#12(G)-3/4" EMT, OR STEEL JACKETED MC CABLE (WHERE CODE PERMITTED), UNLESS OTHERWISE SPECIFIED ON DRAWINGS. ALUMINUM JACKETED MC CABLE IS NOT ACCEPTABLE.
- 20. RUN BRANCH CIRCUITS IN DROPPED CEILINGS, VOIDS, & CHASES. ALL DEVICES & CONDUITS ON NEW CONSTRUCTION MUST BE RECESSED. FOR EXISTING SURFACES: MECHANICAL/WORK SPACES-CONDUITS MAY BE SURFACE MOUNTED. EXISTING PUBLIC/FINISHED AREAS- CONDUITS SHALL BE CONCEALED WHEREVER POSSIBLE (IN HUNG CEILINGS, VOIDS/CHASES, FLOOR BELOW OR BEHIND WALLS) ALL WIRING THAT CANNOT BE CONCEALED IN MUST BE RUN IN FINISHED SURFACE RACEWAY SUCH AS WIREMOLD, COLOR PER ARCHITECT. USE OF ADHESIVE IS PROHIBITED, SURFACE RACEWAY MUST BE SECURED USING MECHANICALLY FASTENED
- 21. ANY LIGHT FIXTURES INSTALLED IN GYMNASIUMS OR OTHER AREAS SUBJECT TO IMPACT OR PHYSICAL

DAMAGE SHALL BE MOUNTED WITH SAFETY CHAINS AND SECURED TO STRUCTURE.

22. SEE SPEC. SECTION 16100 BASIC MATERIALS AND METHODS FOR COMPLETE NOTES ON INSTALLATION, MISCELLANEOUS MATERIALS AND ELECTRICAL DEVICES.

#### DEMOLITION NOTES

- THE ITEMS SPECIFICALLY SHOWN ON THE DEMOLITION DRAWINGS ARE TO BE ADDRESSED BY THE ELECTRICAL CONTRACTOR. THE ITEMS ARE TO BE TREATED AS NOTED AND RANGE FROM DIRECT REMOVAL AND DISPOSAL TO REMOVAL, STORAGE AND REINSTALLATION
- 2. MANY OTHER ELECTRIC ITEMS EXIST THAT ARE NOT SHOWN INCLUDING, BUT ARE NOT LIMITED TO, SWITCHES, RECEPTACLES, FLOOR OUTLETS, LOW VOLTAGE JACKS, LOW VOLTAGE DEVICES AND WIRING, TELEPHONE PUNCH DOWN BLOCKS, AND OUT OF SERVICE ITEMS. ALL SUCH ITEMS SHALL BE PERMANENTLY DE-ENERGIZED, DISCONNECTED, AND OTHERWISE MADE SAFE FOR DEMOLITION BY NON-ELECTRICAL CONTRACTORS. THE ELECTRICAL CONTRACTOR IS RESPONSIBLE FOR ASSURING THAT ALL ELECTRIC DEVICES SCHEDULED FOR DEMOLITION, OF ANY VOLTAGE OR FUNCTION, ARE SAFE AND ADVISE THE OTHER CONTRACTORS.
- 3. AFTER THE ELECTRICAL CONTRACTOR HAS DISCONNECTED ELECTRIC SUPPLIES TO ITEMS TO BE DEMOLISHED, HE SHALL ADVISE THE GENERAL CONTRACTOR OF ANY ELECTRIC ITEMS TO BE RETAINED FOR FUTURE USE AND THEREFOR NOT TO BE DEMOLISHED. THE GENERAL CONTRACTOR SHALL THEN PERFORM ALL WORK ZONE DEMOLITION. THIS MATTER APPLIES TO ALL ELECTRIC ITEMS, OF ANY VOLTAGE OR PURPOSE.
- 4. THE SPECIAL/SPECIFIC ITEMS SHOWN ON THE DRAWING FOR ELECTRICAL CONTRACTOR TO ACT ON WERE FOUND BY SURVEY. NUMEROUS LOCATIONS WERE BLOCKED BY FURNITURE, ETC. AND ADDITIONAL EQUAL TYPE ITEMS MAY BE PRESENT. THE ELECTRICAL CONTRACTOR SHALL ALLOW FOR THIS IN HIS BID PRICE AND ATTEND TO THOSE EQUAL OR SIMILAR DEVICES AS MAY BE DISCOVERED.
- 5. REMOVAL ITEMS THAT ARE LISTED AS TO BE TURNED OVER TO OWNER'S INVENTORY SHALL BE DISCUSSED WITH THE DISTRICT BUILDINGS AND GROUNDS MANAGER. THOSE ITEMS THAT THE OWNER DECLINES SHALL THEN BE DISPOSED OF BY THE CONTRACTOR IN THE MANOR OF OTHER PERMANENT REMOVALS. ANY PCB BEARING FLUORESCENT FIXTURES SHALL BE DISPOSED OF PER REGULATIONS.
- 6. RETAIN EXISTING RECEPTACLES IN WALLS THAT WILL NOT BE IN CONFLICT WITH NEW CONSTRUCTION. RETAIN LIGHT SWITCH LOCATIONS THAT WILL NOT BE IN CONFLICT WITH NEW CONSTRUCTION. INSTALL BLANKING PLATE COVERS OVER THE UNUSED PORTION OF GANG BOXES HAVING MORE GANG POSITIONS THAN NEEDED FOR NEW SWITCHES.
- 7. LIGHT FIXTURES ARE TO BE REMOVED AS GENERAL, NON ELECTRIC, CONTRACTOR DEMOLITION. ELECTRICAL CONTRACTOR IS RESPONSIBLE TO SAFE OFF LIGHTING CIRCUITS FOR REMOVAL BY OTHERS. NO SPECIFIC QUANTITIES OR LOCATIONS ARE SHOWN. RETURN WHATEVER QUANTITY, IF ANY, OF THESE TO OWNER'S INVENTORY IF HE SO SPECIFIES OR THEY ARE OTHERWISE TO BE DISPOSED OF. ELECTRICAL CONTRACTOR SHALL EXAMINE FIXTURES FOR PRESENCE OF PCB'S AND SPECIAL DISPOSAL.
- 8. THE ELECTRICAL CONTRACTOR SHALL COVER ALL BACK BOXES IN THE WALL THAT BECOME EXPOSED DUE TO DEVICE REMOVALS. THIS INSTRUCTION ALSO APPLIES TO EXPOSED ELECTRICAL BACK BOXES AS MAY EXIST AT THE SITE PRIOR TO THIS PROJECT. THE COVER SHALL BE BRUSHED ALUMINUM WITH CHAMFERED EDGES AND COVER THE HOLE COMPLETELY WITH AT LEAST 3/4" EXTRA MARGIN ON ALL SIDES. MOUNT THE COVER WITH SCREWS TO MATCH THE ORIGINAL PATTERN.
- 9. IT IS EXPECTED THAT STRUCTURAL DEMOLITION BY THE GENERAL CONTRACTOR WILL CAUSE VARIOUS ELECTRIC SUPPLIES, OF VARIOUS VOLTAGES AND PURPOSES, TO BE CUT AND RENDER SOME DEVICES TEMPORARILY INACTIVE. IT IS THE ELECTRICAL CONTRACTOR'S RESPONSIBILITY TO RECONSTRUCT AND RECONNECT SUCH ELECTRIC SOURCES WHEN THE NEW STRUCTURE IS BUILT. NOTE THAT MOST REINSTALLED ITEMS WILL BE IN DIFFERENT LOCATIONS FROM THE REMOVAL LOCATION. THE ELECTRICAL CONTRACTOR SHALL MAKE ALL REQUIRED CIRCUIT EXTENSIONS OR MODIFICATIONS TO PROVIDE SERVICE TO A REINSTALLED ITEM AS RELOCATED. PROVIDE ALL REQUIRED CIRCUIT EXTENSIONS AS REQUIRED TO RESTORE SERVICE TO DEVICES. NOTE THAT THIS REQUIREMENT ALSO APPLIES TO THE ROOMS AND ELECTRICAL ITEMS WITHIN THAT ARE NOMINALLY NOT IN CONTRACT. SUCH RESTORATION OF SERVICE, IF NEEDED, IS SPECIFICALLY IN THE ELECTRICAL CONTRACTOR'S CONTRACT.
- 10. IT SHALL BE THE ELECTRICAL CONTRACTOR'S RESPONSIBILITY TO PROTECT ALL ELECTRICAL DEVICES, FROM DAMAGES DURING CONSTRUCTION, WHICH ARE EITHER INDICATED TO REMAIN, AND/OR TO BE REMOVED AND REINSTALLED THROUGHOUT ALL CONSTRUCTION AREAS. DEVICES SHALL INCLUDE BUT WILL NOT BE LIMITED TO: SMOKE DETECTORS, EMERGENCY LIGHTS, EXIT SIGNS, OCCUPANCY SENSORS, SPEAKERS, LIGHT FIXTURES, SWITCHES, RECEPTACLE, ETC. IN THE EVENT OF DAMAGES INCURRED DUE TO CONSTRUCTION ACTIVITIES, THE ELECTRICAL CONTRACTOR SHALL BE RESPONSIBLE TO REPLACE ANY DAMAGED DEVICES AT NO ADDITIONAL COST TO OWNER.
- ALL SYSTEM ASSOCIATED WITH THE DEVICES SCHEDULED TO BE REMOVED, STORED AND PROTECTED SHALL BE TESTED BY THE MANUFACTURER'S CERTIFIED TESTING VENDOR PRIOR TO ANY DEMOLITION ACTIVITY. ANY DEVICE WHICH FAILS THE TEST SHALL BE REPLACED WITH A FORM, FIT AND FUNCTION COMPONENT PER UNIT PRICES, AND SUCH DEVICES ARE NOT INCLUDED IN THIS RESPONSIBILITY STATEMENT. BUT ALSO SUCH INSTALLATION SHALL BE IN THE ELECTRICAL CONTRACTOR'S BASE BID. THE ELECTRICAL CONTRACTOR SHALL RE-TEST ALL SUCH SYSTEM COMPONENTS BY A MANUFACTURER CERTIFIED TESTING VENDOR OF SUCH SYSTEM OF ALL PREVIOUSLY TESTED SYSTEM COMPONENTS AFTER ALL WORK BY ALL TRADES HAS BEEN COMPLETED, AND ALL SYSTEM COMPONENTS HAVE BEEN INSTALLED. ANY COMPONENT WHICH FAILS SHALL BE REPLACED, AND PROGRAMMED IF NECESSARY BY THE ELECTRICAL CONTRACTOR. ALL SUCH REPLACEMENT AND PROGRAMMING COSTS SHALL BE ELECTRICAL CONTRACTOR'S RESPONSIBILITY. ALL COSTS ASSOCIATED WITH THE TESTING OF AFFECTED SYSTEM SUCH AS BUT NOT LIMITED TO FIRE ALARM, PUBLIC ADDRESS, INTERCOM, TELEPHONE, AND SECURITY SYSTEMS SHALL BE THE RESPONSIBILITY OF THE ELECTRICAL CONTRACTOR. ALL EQUIPMENT, DEVICES, WIRING AND THEIR ASSOCIATED MATERIAL SPECIFIED TO REMAIN, WHICH IS NOT STORED AND PROTECTED, SHALL BE PROTECTED DURING THE DEMOLITION ACTIVITIES, AND ALL TRADES SHALL BE INFORMED OF SUCH COMPONENTS. ANY OF SUCH COMPONENTS WHICH BECOME DAMAGED DURING DEMOLITION SHALL BE REPLACED FORM, FIT AND FUNCTION BY THE ELECTRICAL CONTRACTOR AT HIS
- 12. EC IS RESPONSIBLE TO RESTORE AND COMPLETE SURFACES CAUSED BY THE REMOVAL OF DEVICES, CONDUITS, ETC. ALL FINISHES TO MATCH ADJACENT AREAS.

# FIRE STOP NOTES

- ALL CONDUIT AND CABLE PENETRATIONS THROUGH FIRE RATED WALLS, FLOORS OR OTHER STRUCTURES
- 2. THE FIRE STOP MATERIALS SHALL BE HILTI TYPE FS-657 FIRE BLOCK, FS-ONE SEALANT, CP-672 JOINT
- SPRAY, CP-601S ELASTOMERIC SEALANT, 6P-606 FLEXIBLE SEALANT, CP-643 OR CP-642 COLLAR, CP-618 PUTTY STICK, OR FS-635 TROWEL ABLE COMPOUND, AS SUITABLE.
- 3. CONTRACTOR SHALL SUBMIT SHOP DRAWINGS OF PRODUCTS SPECIFIED OR <u>EQUAL</u>.

ADDRESS, TELEPHONE, DATA, POWER AND LIGHTING.

4. FIRE STOP MATERIALS OTHER THAN HILTI SHALL INCLUDE FULL TECHNICAL DATA WITH SHOP DRAWINGS TO DEMONSTRATE EQUALITY WITH THE SPECIFIED FIRE STOPS AND STATEMENT FROM MANUFACTURER THAT THEY MEET OR EXCEED THE PRODUCTS SPECIFIED HERE.

ALL SYSTEMS SHALL HAVE THEIR OWN SLEEVE THROUGH FIRE RATED WALLS. IE FIRE ALARM, PUBLIC

	<u>EVIATIONS</u>
Α	
AC	
ACT	
NFF	
G	
C	
3	
KT	
M	
C	
Н	
ISC	
.C	
М.	
MŢ	
TŖ	
(	EXISTIN
١	
MC	
Γ	
C	
FCI, GFI .	
, GND .	
R\$	
D	
V	
MC	LIQUID TIGHT FLEXIBLE METAL CONDUI
AX	
IC	
CB	
DP	
H	
IN	
LO	
TD	
ТН	
EÇ	NATIONAL ELECTRICAL COD
EMA	NATIONAL ELECTRICAL MANUFACTURES ASSOCIATIO
IIC	
NL	
T\$	
<b>A</b>	
C	
VÇ	
EÇ	
REQ'D	
L	
СН	
М	
PD	
SQ.	
WBD	
SW.G	
SP	
V\$S	
TYP	
JC	
JG	
ITP	
UWS	
JWS	
UWS	
JWS	UNTWISTE  VOLTAGE OR VOLT  VARIABLE FREQUENCY DRIV  WATTAGE OR WATT
UTP	

FIRE ALARM SYMBOL LEGEND			
SYMBOL	DESCRIPTION		
FACP	FIRE ALARM CONTROL PANEL. PROVIDE BUILDING SHATTERPROOF FRAMED SCHOOL GRAPHIC PAPER MAP WITHIN SIGHT OF PANEL.		
RAP	REMOTE ANNUNCIATOR PANEL. PROVIDE BUILDING SHATTERPROOF FRAMED SCHOOL GRAPHIC PAPER MAP WITHIN SIGHT OF PANEL.		
RCC	REMOTE COMMAND CENTER.		
F	MANUAL PULL STATION WITH STI STOPPER PROTECTIVE SHIELD WITHOUT ALARM (OR SIMILAR).		
<b>⟨≥</b> ⟩xx	SMOKE DETECTOR WITH BASE.  CO = SMOKE AND CARBON MONOXIDE COMBINATION DETECTOR LED = REMOTE LED INDICATOR		
<b>(\$</b> )	DUCT DETECTOR WITH HOUSING AND REMOTE LED INDICATOR.		
<b>O</b>	CARBON MONOXIDE DETECTOR WITH SOUNDER BASE.		
<b>(I</b> ) <sub>xx</sub>	HEAT DETECTOR. FIXED TEMPERATE OF RISE UNLESS OTHERWISE NOTED. (NONE) = 135°F 195°F		
Ē	WALL MOUNT SPEAKER / STROBE NOTIFICATION DEVICE. THE STROBE CANDELA IS 15 cd UNLESS OTHERWISE INDICATED ON DRAWING.		
\rightarrow{\rightarrow{F}}	WALL MOUNT SPEAKER NOTIFICATION DEVICE.		
Œ	WALL MOUNT STROBE NOTIFICATION DEVICE. THE STROBE CANDELA IS 15 0 UNLESS OTHERWISE INDICATED ON DRAWING.		
	CEILING MOUNT SPEAKER / STROBE NOTIFICATION DEVICE. THE STROBE CANDELA IS 15 cd UNLESS OTHERWISE INDICATED ON DRAWING.		
\$	CEILING MOUNT SPEAKER NOTIFICATION DEVICE.		
Ē	CEILING MOUNT STROBE NOTIFICATION DEVICE. THE STROBE CANDELA IS 1 cd UNLESS OTHERWISE INDICATED ON DRAWING.		
DН	ELECTROMAGNETIC HOLD OPEN DEVICE. VOLTAGE TO MATCH SYSTEM.		
R	FIRE ALARM RELAY.		
ANSUL	HOOD FIRE SUPPRESSION SYSTEM.		

SYMBOL	DESCRIPTION
Φ	TAMPER-RESISTANT DUPLEX ELECTRICAL OUTLET FOR CONVENIENCE POWER WITH 302/304 STAINLESS STEEL FACEPLATE, NEMA 5-20R.
#	TAMPER-RESISTANT DOUBLE DUPLEX ELECTRICAL OUTLET FOR CONVENIENCE POWER WITH 302/304 STAINLESS STEEL FACEPLATE, N. 5-20R.
P	TAMPER-RESISTANT GROUND FAULT INTERRUPTED DUPLEX ELECTRIC OUTLET FOR CONVENIENCE POWER WITH 302/304 STAINLESS STEEL FACEPLATE, NEMA 5-20R.
φ	TAMPER-RESISTANT SINGLE ELECTRICAL OUTLET FOR CONVENIENCE POWER WITH 302/304 STAINLESS STEEL FACEPLATE, NEMA 5-20R.
φ	TAMPER-RESISTANT SPECIAL PURPOSE SINGLE ELECTRICAL OUTLET CONVENIENCE POWER WITH 302/304 STAINLESS STEEL FACEPLATE, 25 NEMA 6-20R.
φ	TWIST-LOCK SINGLE ELECTRICAL OUTLET FOR CONVENIENCE POWER 302/304 STAINLESS STEEL FACEPLATE, 125V, 30A, NEMA L5-30R.
Φ	TAMPER-RESISTANT USB CHARGER DUPLEX ELECTRICAL OUTLET FOR CONVENIENCE POWER WITH 302/304 STAINLESS STEEL FACEPLATE, N 5-20R.
	DATA & POWER SURFACE RACEWAY - NUMBER OF TRIANGLES INDICAT NUMBER OF DATA DROPS - PROVIDE (2) DUPLEX RECEPTACLES PER D DROP.
	POWER CORD REEL, NEMA 5-20R.
P	FIRE RATED POWER FEED POKE-THROUGH.
FB	FLOOR BOX.
WB	MULTIPLE SERVICE WALL BOX.
J	JUNCTION BOX, SIZE AS REQUIRE.
(HP)	MOTOR, HORSEPOWER AS INDICATED.
	UN-FUSED DISCONNECT SWITCH.
F	FUSED DISCONNECT SWITCH.
HD	HAND DRYER.
	PANEL.
3E	TRANSFORMER.
\$	SWITCH:  LOWER CASE LETTER INDICATES SWITCHING DESIGNATION  UPPER CASE LETTER(S) OR NUMBER SUBSCRIPTS:  (NONE) = SINGLE POLE, 20 A, HEAVY DUTY SPEC GRADE SWITCH  K = KEY SWITCH D = DIMMER SWITCH  3 = TREE WAY SWITCH 4 = FOUR WAY SWITCH  MC = MOMENTARY CONTACT SWITCH  LV = LOW VOLTAGE BUTTON SWITCH  EF = COMMERCIAL GRADE EXHAUST FAN SWITCH
© (S ES	CEILING MOUNTED OCCUPANCY/ VACANCY/ DAYLIGHT SENSOR, LOW VOLTAGE, DUAL TECHNOLOGY, COMPLETE W/ POWER PACK(S) AS REC
(W) (W)	WALL MOUNTED OCCUPANCY/ VACANCY, LOW VOLTAGE, DUAL TECHNOLOGY, COMPLETE W/ POWER PACK(S) AS REQUIRED.
\$%	DUAL TECHNOLOGY SINGLE LEVEL OCCUPANCY SENSING WALL SWITC
PC	PHOTOCELL.
RC	ROOM CONTROLLER.

AIR			
ED.			2' X 4' RECESSED EMERGENCY LIGHTING FIXTURE. WITH 90 MINUTES EMERGENCY BATTERY PACK.
IVE ITS.		$\boxtimes$	2' X 2' RECESSED LIGHTING FIXTURE.
RD.		X	2' X 2' RECESSED EMERGENCY LIGHTING FIXTURE. WITH 90 MINUTES EMERGENCY BATTERY PACK.
OF, IER		$\triangleright$	1' X 4' RECESSED LIGHTING FIXTURE.
LI			1' X 4' RECESSED EMERGENCY LIGHTING FIXTURE. WITH 90 MINUTES EMERGENCY BATTERY PACK.
			2' X 4' SURFACE MOUNT LIGHTING FIXTURE.
			2' X 4' SURFACE MOUNT EMERGENCY LIGHTING FIXTURE. WITH 90 MINUTES EMERGENCY BATTERY PACK.
MED			2' X 2' SURFACE MOUNT LIGHTING FIXTURE.
			2' X 2' SURFACE MOUNT EMERGENCY LIGHTING FIXTURE. WITH 90 MINUTES EMERGENCY BATTERY PACK.
JΤ	M	1' X 4' SURFACE MOUNT LIGHTING FIXTURE.	
			1' X 4' SURFACE MOUNT EMERGENCY LIGHTING FIXTURE. WITH 90 MINUTES EMERGENCY BATTERY PACK.
		•	1' X 4' PENDANT LIGHTING FIXTURE.
		91111	1' X 4' PENDANT EMERGENCY LIGHTING FIXTURE. WITH 90 MINUTES EMERGENCY BATTERY PACK.
ED.		0	RECESSED DOWN LIGHTING FIXTURE.
		Ø	RECESSED DOWN EMERGENCY LIGHTING FIXTURE. WITH 90 MINUTES EMERGENCY BATTERY PACK.
		8	SURFACE MOUNT DOWN LIGHTING FIXTURE.
_			EXTERIOR WALL MOUNT LIGHTING FIXTURE.
15 cc			EXTERIOR POLE LIGHTING FIXTURE.
E		<b>20100</b>	EXIT SIGN.
			EMERGENCY WALL PACK LIGHTING FIXTURE.
IS 15		EXIT	EXIT SIGN/EMERGENCY COMBO WALL PACK LIGHTING FIXTURE.
			NOTE: SYMBOLS AND ABBREVIATIONS ON THIS DRAWING ARE FOR REFERENCE ONLY, AND MAY NOT BE USED IN THE FOLLOWING DOCUMENTS.

LIGHTING LEGEND

SYMBOL

DESCRIPTION

2' X 4' RECESSED LIGHTING FIXTURE.


REV. DATE <u>NOTICE</u> HESE DRAWINGS ARE BASED ON CONSTRUCTION DRAWINGS NO REPARED BY BBS ARCHITECTS. LANDSCAPE ARCHITECTS AND CONDITIONS AS CONSTRUCTED AT THE TIME. ALL EXISTI INFORMATION AS THEY MAY NOT HAVE BEEN BUILT AND DETAILE KEY PLAN NOT TO SCALE DRAWING BY: DG CHECK BY: NOTICE THIS DRAWING, PREPARED FOR THE SPECIFIC PROJECT INDICATED IS AN INSTRUMENT OF SERVICE AND THE PROPERTY OF BBS ARCHITECTS, LANDSCAPE ARCHITECTS AND ENGINEERS, P INFRINGEMENT OR ANY USE OF THIS DRAWING FOR ANY OTHE PROJECT IS PROHIBITED. ANY ALTERATION OR REPRODUCTION OF THIS DOCUMENT IS ALSO PROHIBITED WITHOUT THE WRITTEN ONSENT OF THE ARCHITECT OR ENGINEER. LANDSCAPE ARCHITECTS ENGINEERS 44 EAST MAIN STREET | 187 WOLF ROAD, STE. 205 PATCHOGUE NEW YORK 11772 NEW YORK 12205 T. 631.475.0349 F. 518.621.7655 F. 631.475.0361 www.BBSARCHITECTLIRE.com 66-04-07-06-0-011-008 DISTRICT GREENBURGH CSD PROJECT PH. I - DW CAP. IMPROVEMENT EARLY CHILDHOOD PROGRAM DWG TITLE ELECTRICAL NOTES & SCALE: AS NOTED BID PICK-UP: MAY 27, 2022

DATE: MAY 2022

BID PICK-UP: MAY 27, 2022

FILE No: 21-292


E0.01E

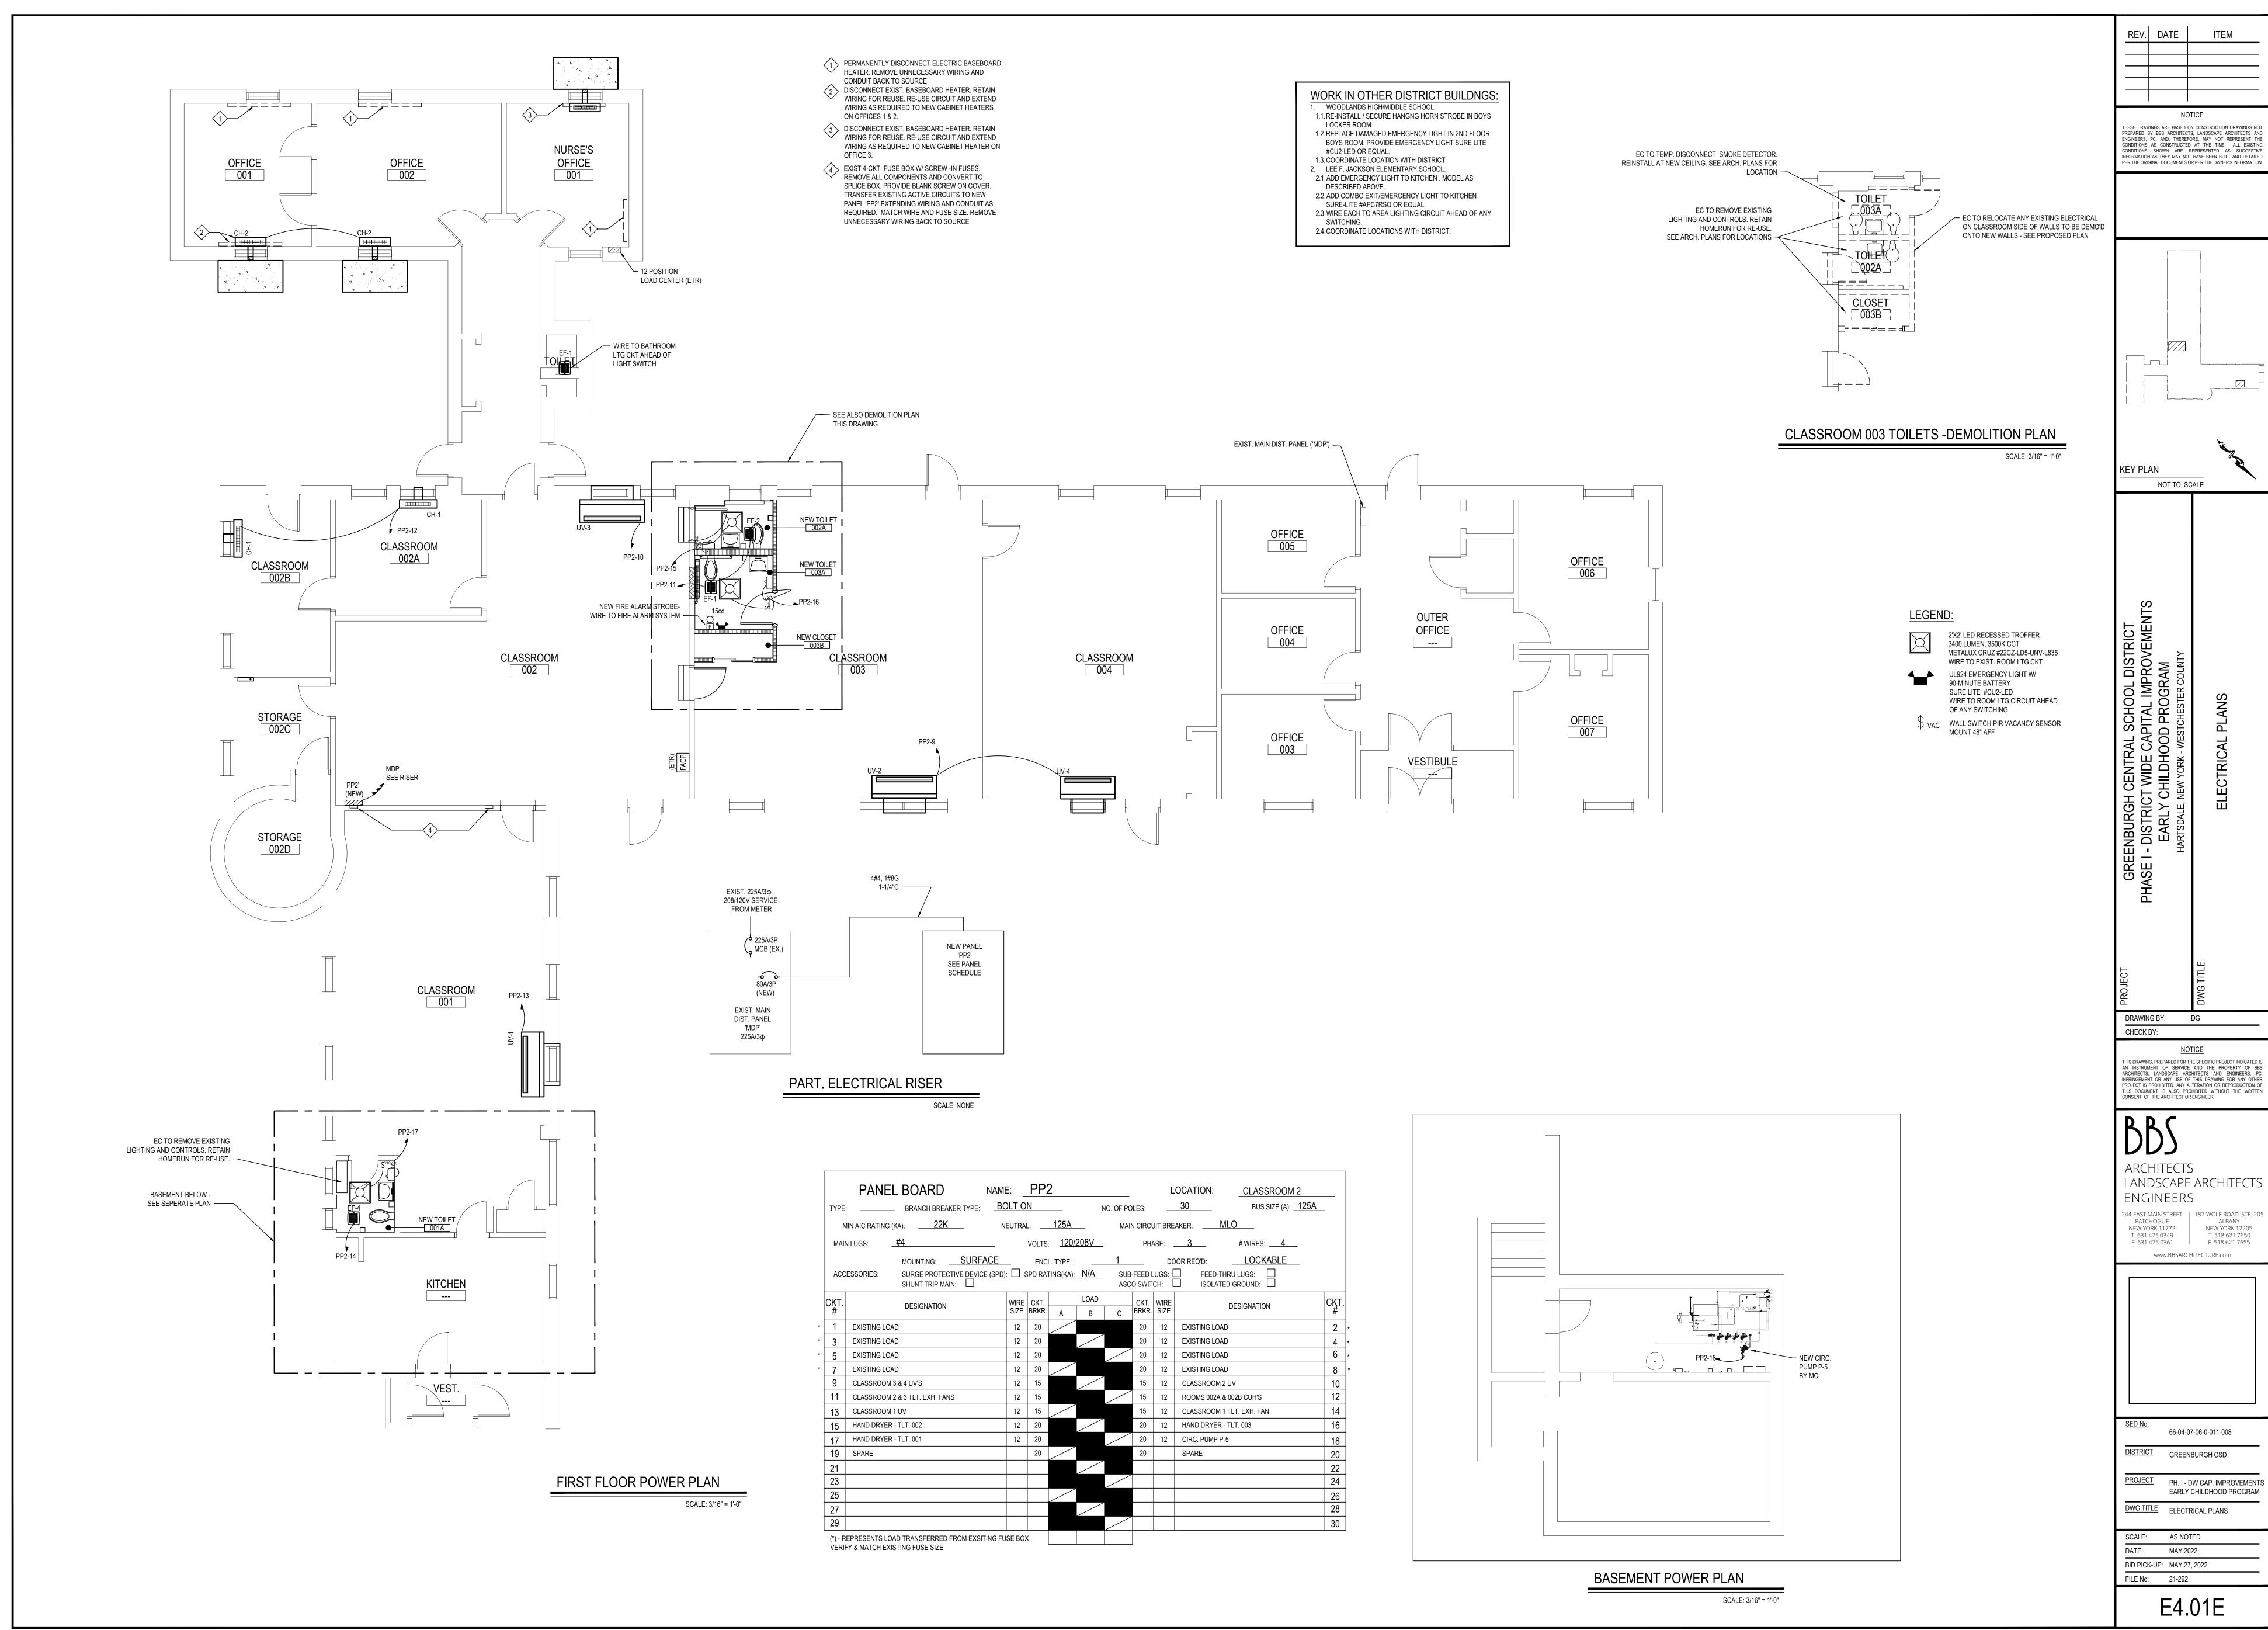

THESE DRAWINGS ARE BASED ON CONSTRUCTION DRAWINGS NOT PREPARED BY BBS ARCHITECTS, LANDSCAPE ARCHITECTS AND ENGINEERS, PC. AND, THEREFORE, MAY NOT REPRESENT THE CONDITIONS AS CONSTRUCTED AT THE TIME. ALL EXISTING CONDITIONS SHOWN ARE REPRESENTED AS SUGGESTIVE INFORMATION AS THEY MAY NOT HAVE BEEN BUILT AND DETAILED PER THE ORIGINAL DOCUMENTS OR PER THE OWNER'S INFORMATION.

THIS DRAWING, PREPARED FOR THE SPECIFIC PROJECT INDICATED IS AN INSTRUMENT OF SERVICE AND THE PROPERTY OF BBS ARCHITECTS, LANDSCAPE ARCHITECTS AND ENGINEERS, PC. INFRINGEMENT OR ANY USE OF THIS DRAWING FOR ANY OTHER

LANDSCAPE ARCHITECTS 244 EAST MAIN STREET | 187 WOLF ROAD, STE. 20 ALBANY

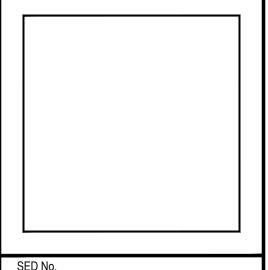

DWG TITLE ELECTRICAL PLANS