PLUMBING SYMBOL LIST

<u>IDENTIFIER</u>	DESCRIPTION
CW	DOMESTIC COLD WATER
W	WASTE PIPING (ABOVE SLAB)
	WASTE PIPING (UNDER SLAB)
s	SANITARY PIPING (ABOVE SLAB)
	SANITARY PIPING (UNDER SLAB)
V	SANITARY VENT PIPING
•	FIELD CONNECT
•	FIELD DISCONNECT
F#)	REFER TO SUPPLEMENTAL FIGURE INDICATED BY NUMBER (I.E. F2 REFERS TO FIGURE 2)
XXX	— EQUIPMENT TAG — EQUIPMENT NUMBER
XXX X-XXX	— DETAIL TAG/CALL OUT TAG — PLUMBING SHEET NUMBER

PIPING ELEMENTS/VALVING

BACKFLOW PREVENTER (DOUBLE CHECK VALVE ASSEMBLY)

———O PIPE RISING UP —

TEE OUTLET DOWN

——O— TEE OUTLET UP

── VALVE IN RISE OR DROP

IN BOX W/VACUUM BREAKER

NFHB >+-- NON FREEZE HOSE BIBB

—⊸ō— BALL VALVE CAP ON END OF PIPE - CO⊢ CLEANOUT

FD⊠—— FLOOR DRAIN ——⋈— GATE VALVE HB Ş+--- HOSE BIBB

SCOPE OF WORK

PLUMBING SCOPE OF WORK INCLUDES, BUT IS NOT LIMITED TO:

1. REMOVAL OF EXISTING WATER SERVICE.

2. THE INSTALLATION OF NEW PLUMBING FIXTURES AND ALL ASSOCIATED PIPING AND ACCESSORIES.

3. THE INSTALLATION OF NEW SANITARY AND DOMESTIC WATER SERVICES.

NOTE: THIS SCOPE OF WORK DESCRIPTION IS PROVIDED TO GIVE AN OVERALL "MACRO" DESCRIPTION OF THIS PROJECT .P.C. IS RESPONSIBLE TO REVIEW ALL ENGINEERING & ARCHITECTURAL DRAWINGS & VISIT THE SITE IF NEEDED, PRIOR TO SUBMISSION OF BID.

CODE REFERENCE

2020 NEW YORK STATE BUILDING CODE 2020 NEW YORK STATE MECHANICAL CODE 2020 NEW YORK STATE PLUMBING CODE 2020 NEW YORK STATE ENERGY CONSERVATION CODE

SECTION 704

DRAINAGE PIPING INSTALLATION

704.1 SLOPE OF HORIZONTAL DRAINAGE PIPING.

HORIZONTAL DRAINAGE PIPING SHALL BE INSTALLED IN UNIFORM ALIGNMENT AT UNIFORM SLOPES. THE MINIMUM SLOPE OF HORIZONTAL DRAINAGE PIPE SHALL BE IN ACCORDANCE WITH TABLE 704.1. **TABLE 704.1** CLODE OF HODIZONTAL DRAINAGE DIDE

SLOPE OF HORIZONTAL DRAINAGE PIPE				
SIZE	MINIMUM SLOPE			
(INCHES)	(INCH PER FOOT)			
2 1/2 OR LESS	1/4			
3 TO 6	1/8			
8 OR LARGER	1/16			

LEED NOTES

1. ALL ADHESIVES, SEALANTS, PAINTS & COATINGS APPLIED TO THE INTERIOR OF THE BUILDING (WITHIN THE WEATHER PROOFING SYSTEM, INCLUDING WALL CAVITIES) MUST NOT EXCEED THE LEED VOC LIMITS. PROVIDE A VOC SUBMITTAL AND MSDS FOR ALL ADHESIVES, SEALANTS, PAINTS AND COATINGS TO BE APPLIED.

PLUMBING GENERAL NOTES:

- ALL PLUMBING WORK UNDER THIS CONTRACT SHALL CONFORM TO THE LATEST EDITION OF THE PLUMBING CODE OF NEW YORK STATE (PC-NYS), THE NEW YORK STATE ENERGY CODE, AND THE REQUIREMENTS OF THE UTILITY AND THE LOCAL
- 2. ALL MATERIALS SHALL BE NEW UNLESS NOTED OTHERWISE
- THE PLUMBING CONTRACTOR SHALL ASSUME RESPONSIBILITY FOR ALL LABOR AND MATERIALS SUPPLIED AND INSTALLED UNDER THIS CONTRACT AND SHALL GUARANTEE THE WORK PERFORMED UNDER THIS CONTRACT FOR A PERIOD OF ONE
- PLUMBING CONTRACTOR SHALL CONSULT WITH, COOPERATE AND COORDINATE WITH TRADES DURING PERFORMANCE OF THIS WORK.
- THE PLUMBING CONTRACTOR SHALL PREPARE AND FILE ALL REQUIRED PLANS AND PERMITS WITH THE LOCAL AUTHORITIES. PC SHALL PAY THE FILING FEES AS REQUIRED. PC SHALL OBTAIN ALL APPROVALS AND SHALL PAY FOR ALL WORK MANNER IN CONFORMANCE WITH THE CODES AND AUTHORITIES HAVING
- THE PLUMBING CONTRACTOR SHALL PERFORM ALL TESTS AND ARRANGE FOR ALL INSPECTIONS FOR WORK UNDER HIS CONTRACT AS REQUIRED BY LAW AND SHALL SUPPLY ALL CERTIFICATES OF INSURANCE AS REQUIRED BY THE LAW AND THE
- THE PLUMBING CONTRACTOR SHALL MAKE ALL FINAL CONNECTIONS TO ALL
- PLUMBING CONTRACTOR SHALL VISIT THE SITE & BECOME FAMILIAR WITH THE EXISTING CONDITIONS, INCLUDING THE SIZE OF CONNECTIONS, ROUGHING DIMENSIONS, ETC. BEFORE SUBMITTING A QUOTATION FOR THE WORK.
- PLUMBING CONTRACTOR SHALL PERFORM ALL CUTTING, EXCAVATION, BACKFILLING, ROUGH & FINISH PATCHING AS PER THE SPECIFICATIONS AS REQUIRED FOR THE INSTALLATION OF THE WORK, UNLESS NOTED OTHERWISE.
- INSTALLED IN ACCORDANCE WITH THE MANUFACTURER'S INSTRUCTIONS.
- OPERATIONAL.
- 13. ALL NEW PLUMBING FIXTURES SHALL BE INSTALLED WITH ANGLE STOP VALVES IN
- 14. ALL NEW EXPOSED WATER AND WASTE PIPING SERVING THE FIXTURES SHALL BE CHROME PLATED AND SHALL HAVE CHROME PLATED ESCUTCHEONS RIGIDLY ATTACHED TO THE PIPING AT THE POINT OF WALL OR FLOOR PENETRATIONS.
- 15. PLUMBING CONTRACTOR SHALL SUBMIT SHOP DRAWINGS FOR ALL NEW PLUMBING FIXTURES AND EQUIPMENT TO BE SUPPLIED AND INSTALLED UNDER THIS CONTRACT FOR APPROVAL BEFORE INSTALLATION OF SAME.
- 16. WATERPROOF PIPE SLEEVES SHALL BE INSTALLED AT ALL PENETRATIONS THROUGH EXTERIOR WALLS. PIPE SLEEVES SHALL BE INSTALLED AT ALL WALL PENETRATIONS
- WATER HAMMER ELIMINATORS (APPROVED FIELD FABRICATED OR MANUFACTURED) SHALL BE INSTALLED AT ALL RUN OUTS IN HOT AND/OR COLD WATER LINES SERVING TOILET ROOMS AND OTHER AREAS WHICH INCORPORATE "RAPID - ACTION" VALVES
- 18. ALL PIPING SHALL BE TESTED AT A MINIMUM PRESSURE OF 1-1/2 TIMES THE MAXIMUM OPERATING PRESSURE UNLESS OTHERWISE NOTED ON THE DOCUMENTS OR THE PLUMBING CODE AND IN ACCORDANCE WITH THE UTILITY REQUIREMENTS.
- 19. ALL REMOVALS PERFORMED UNDER THIS CONTRACT SHALL INCLUDE REMOVAL OF
- 20. ALL LAVATORIES DESIGNED FOR USE BY PERSONS CONFINED TO WHEELCHAIRS SHALL HAVE THE HOT & COLD WATER SERVICES, AS WELL AS THE TRAP, RECESSED &
- 21. REFER TO THE ARCHITECTURAL PLANS FOR ALL STRUCTURAL DIMENSIONS.
- 24. ALL WATER SERVICE PIPING WITHIN THE BUILDING IS TO BE INSULATED IN
- 25. ALL PLUMBING FIXTURES TO BE INSTALLED AS PER FACTORY RECOMMENDATIONS.
- 26. ALL PLUMBING FIXTURES TO BE TRAPPED, VENTED AND PROVIDED WITH AIR SHOCKS
- 27. PLUMBING FIXTURES SHALL COMPLY WITH "WATER CONSERVATION" REQUIREMENT AS DETAILED IN THE NYS-PC.
- AUTHORITY AND HAVE OWNER FILL OUT APPLICATION UPON COMPLETION OF PLUMBING ROUGH-IN INSPECTION.
- SHALL BE INSULATED.

- 32. ALL PLUMBING FIXTURES TO HAVE ISOLATION VALVES.
- ENSURE A TEMPERATURE RANGE OF 110°F TO 120°F AT THE INDIVIDUAL FIXTURE OUTPUT. P.C. MUST ENSURE A TEMPERATURE OF 120° F MAXIMUM AT THE FIXTURES TO PREVENT SCALDING.
- 35. BUILDING SANITARY DEMAND & SIZING IS CALCULATED FROM NYS-PC SECTIONS 709
- 36. ALL DFU CALCULATIONS ARE BASED OFF OF TABLE 709.1 OF THE NYS-PC.
- 37. ALL SANITARY WATER PIPING SHALL BE PITCHED IN ACCORDANCE WITH NYS-PC SECTION 704 BASED ON TABLE 704.1 SLOPE OF HORIZONTAL DRAINAGE PIPE.
- 38. ALL VENT SIZING IS BASED OFF OF SECTION 916 OF THE NYS PLUMBING CODE.
- 39. ALL PLUMBING EQUIPMENT SHALL BE INSTALLED PER MANUFACTURER'S

ABBREVIATIONS:

CO

CW DCV

DPCO

FFD

HWR

LAV

U.O.N.

UR

WC

MC

TYP.

WFU

ACCESS DOOR

CLEAN OUT

COLD WATER

FIELD CONNECT

FLOOR DRAIN

FIXTURE UNIT

HOT WATER

LAVATORY

JANITOR'S SINK

NORMALLY CLOSED

NYS-PC NEW YORK STATE PLUMBING CODE

THERMOSTATIC MIXING VALVE

UNLESS OTHERWISE NOTED

PLUMBING CONTRACTOR

MECHANICAL CONTRACTOR

NORMALLY OPEN

ROOF DRAIN

STORM DRAIN

WATER CLOSET

VERIFY IN FIELD

WALL CLEAN OUT

WATER FIXTURE UNITS

THE ABBREVIATIONS ARE SHOWN FOR GENERAL

ABBREVIATION ON THIS LIST DOES NOT IMPLY ITS USE ON THIS PROJECT. REFER TO DRAWINGS FOR

REFERENCE ONLY. THE PRESENCE OF AN

SANITARY

URINAL

VENT

TYPICAL

EXISTING

SPECIFIC ABBREVIATIONS USED.

DEMO

BACKFLOW PREVENTER

DOUBLE CHECK VALVE

DRAINAGE FIXTURE UNIT

DECK PLATE CLEAN OUT

FUNNEL FLOOR DRAIN

HOT WATER RETURN

IN ACCORDANCE WITH

INDIRECT WASTE FUNNEL DRAIN

- WATER COMPANY.
- (1) YEAR FROM THE DATE OF ACCEPTANCE OF THIS WORK.
- THE GENERAL CONTRACTOR, MECHANICAL CONTRACTOR, SPRINKLER CONTRACTOR, ELECTRICAL CONTRACTOR, ETC. IN ORDER TO MINIMIZE INTERFERENCES BETWEEN
- PERMITS, INSPECTIONS AND SIGN-OFFS AS REQUIRED TO EXECUTE THIS WORK IN A JURISDICTION.
- OWNER. REFER TO SECTION 107 (INSPECTIONS) OF THE PC-NYS.
- PLUMBING EQUIPMENT REGARDLESS WHETHER ILLUSTRATED HEREIN WITHOUT ANY ADDITIONAL COSTS TO THE OWNER.
- 10. ALL CONNECTIONS TO NEW AND/OR EXISTING EQUIPMENT SHALL BE SIZED AND
- 11. IT IS THE INTENT OF THIS CONTRACT THAT THE COMPLETED WORK BE FULLY
- 12. ALL PIPE HANGERS AND SUPPORTS SHALL BE INSTALLED AT INTERVALS AND BE FABRICATED OF MATERIALS AS REQUIRED BY THE PC-NYS.
- THE SUPPLY LINES SERVING THE FIXTURE.

- THROUGH INTERIOR WALLS AND FLOORS.
- SUCH AS FLUSHOMETERS, SOLENOID VALVES, ETC.
- ALL DEBRIS AND DISPOSAL AT AN APPROPRIATE SITE.
- INSULATED IN ACCORDANCE WITH ADA REQUIREMENTS.
- 22. ALL WORK TO BE COORDINATED WITH OTHER TRADES.
- 23. ALL PIPING PENETRATIONS TO BE SEALED AROUND WITH "NELSON" FIRE SEAL.
- ACCORDANCE WITH ALL NEW YORK STATE PLUMBING CODE (NYS-PC) AND NYS

- 28. GC IS RESPONSIBLE TO SUBMIT APPLICATION AND TAP FEES TO LOCAL WATER
- 29. ALL WATER AND HORIZONTAL STORM DRAIN PIPING INCLUDING ROOF DRAIN BODY
- 30. FLOOR DRAINS AND FLOOR CLEAN-OUTS SHALL BE SET LEVEL WITH FINISHED
- 31. ALL PIPE DIMENSIONS ARE INSIDE CLEAR.
- 33. P.C. IS RESPONSIBLE TO ADJUST HOT WATER HEATER (WH) TEMPERATURE TO
- 34. BUILDING DOMESTIC WATER DEMAND & SIZING IS CALCULATED FROM NYS-PC SECTION 603, 604 & APPENDIX E.
- AND 710.

FLOOR DRAIN SCHEDULE				
TAG	TYPE	MANUFACTURER	MODEL	SERVICE
FD-1	ADJUSTABLE	ZURN	FD-2320-R5	ALL SPACES
NOTES:				
1. PROVIDE THE FOLLOW	NG FOR FD-1; CHORME PLATED STR	AINER ASSEMBLY, 6" NICKEL HEAD ASSI	EMBLY, AND VANDAL PROOF.	

CLEANOUT SCHEDULE					
TAG	TYPE	MANUFACTURER	MODEL		
СО	ADJUSTABLE DECK PLATE CLEAN OUT	WATTS	CO-1200-R		

DOUBLE CHECK VALVE SCHEDULE						
TAG	MANUFACTURER	MODEL	LOCATION	SIZE (IN)	PRESSURE DROP (PSI)	
DCV-1	WATTS	LF007M1QT-S	SPRINKLER ROOM	2	6	
NOTES:						
1. PRO	1. PROVIDE STRAINER FOR DOUBLE CHECK VALVE.					
2. LEAD	2. LEAD FREE					

2. PROVIDE BARRIER-TYPE TRAP SEAL PROTECTION DEVICE ZURN Z1072 OR APPROVED EQUAL.

TAG	TYPE	MANUFACTURER	MODEL
NFHB	WALL HYDRANT	ZURN	Z1320XL

WALL HYDRANT SCHEDULE

PLUMBING DRAWING LIST					
SHEET NO.	SHEET NAME	REVISON NO.	REVISION DATE		
CXA-P-01	PLUMBING NOTES, SYMBOLS, ABBREVIATIONS AND DRAWING LIST	0	-		
CXA-P-21	PLUMBING FIRST FLOOR CONSTRUCTION PLAN	0	a .		
CXA-P-81	PLUMBING DETAILS	0	-		

LiRo Engineers, Inc.

ONSULTANT SEAL

| MADE | APP'D

REQUIREMENTS/SPECIFICATIONS.

REVISION

CONTRACTOR

AS BUILT - CHANGES AS NOTED

PROJECT COORDINATOR

AS BUILT - NO CHANGES

RECORD DRAWING CERTIFICATION


DEPARTMENT OF PUBLIC WORKS AND TRANSPORTATION DIVISION OF ENGINEERING **INFRASTRUCTURE REHABILITATION - PHASE 3**

PLAYLAND PARK, RYE, NEW YORK

CROSS AXIS BUILDING A

WESTCHESTER COUNTY, NEW YORK

22-523 CXA-P-01 DWG NO.: **155 of 664 AS INDICATED** 08/23/2022 PLUMBING NOTES, SYMBOLS, ABBREVIATIONS AND DRAWING LIST 1-118-P-904-0

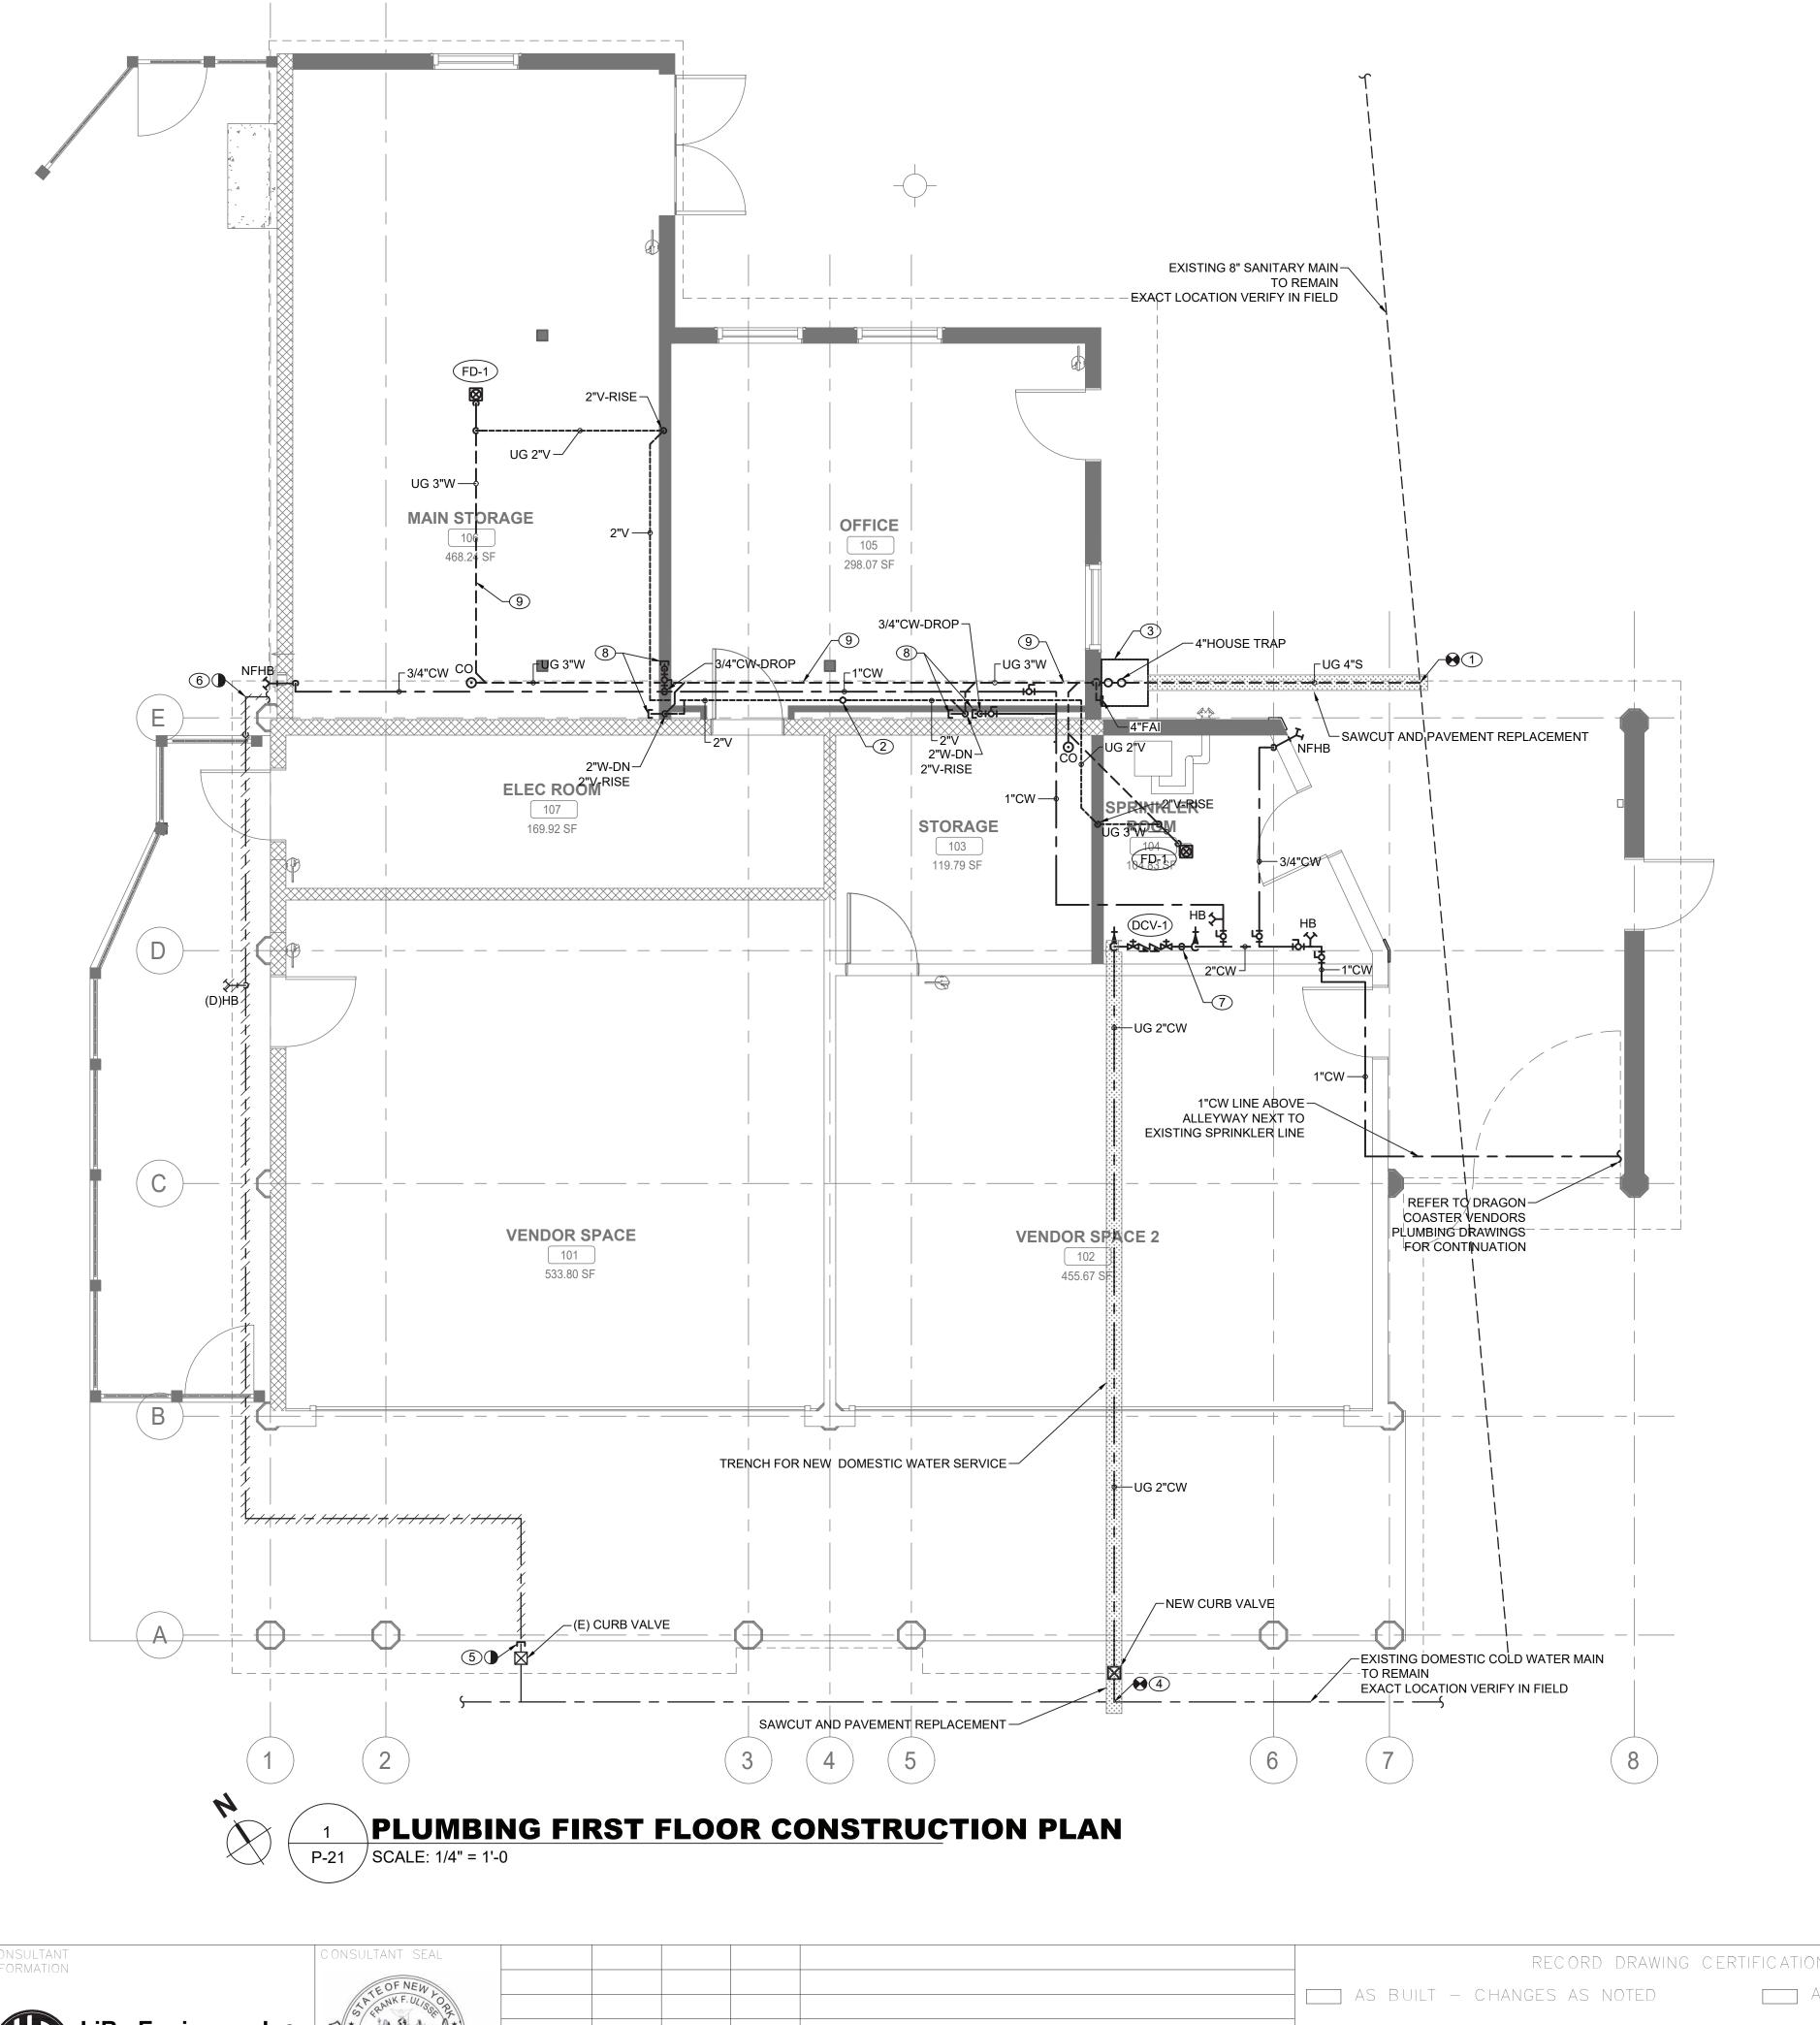

PLUMBING CONSTRUCTION NOTES:


- ① CONNECT NEW 4" SANITARY SERVICE TO EXISTING SEWER MAIN LOCATED AT CROSS-AXIS ALLEY WEST. CONTRACTOR TO VERIFY THE INVERT, SIZE, AND MATERIAL OF THE EXISTING SEWER PIPING TO FACILITATE NEW SANITARY SERVICE CONNECTION.
- 2 PROVIDE NEW 4" VENT THRU ROOF.
- 3 PROVIDE NEW 4"HOUSE TRAP IN PIT. PROVIDE ACCESS DOOR FOR MAINTENANCE. PROVIDE 4" FRESH AIR INTAKE THRU EXTERIOR WALL. TERMINATE VENT WITH INSECT SCREEN. HOUSE TRAP SHALL BE PROTECTED FROM FREEZING.
- (4) CONNECT NEW 2" DOMESTIC COLD WATER SERVICE TO EXISTING WATER MAIN LOCATED AT CROSS-AXIS ALLEY WEST. PROVIDE CURB VALVE WITH VALVE BOX.
- (5) CUT AND PERMANENTLY CAP EXISTING WATER SERVICE BELOW GROUND. ABANDON IN PLACE EXISTING WATER SERVICE PIPING, REMOVE PORTIONS OF PIPING THAT EXPOSED OR IN CONFLICT WITH NEW CONSTRUCTION.
- 6 REMOVE EXISTING WATER LINE UP TO PLUMBING FIXTURES LOCATED WITHIN DRAGON COASTER VENDOR SPACE
- 7 PROVIDE A COMPRESSED AIR CONNECTION FOR WINTERIZING.
- 8 PROVIDE 2"W AND 3/4"CW STUB-UP FOR FUTURE SINK WITHIN NEW WALL. CONNECTION SHALL BE ACCESSIBLE AFTER CONSTRUCTION.
- COORDINATE LOCATION OF NEW UNDERGROUND PIPING WITH STRUCTURAL ELEMENTS. PROVIDE REQUIRED SLEEVES AND SUPPORTS.

GENERAL NOTES:


DEMOLITION AND CONSTRUCTION WORK.

1. COORDINATE WITH FACILITY PRIOR TO SHUTDOWN OF WATER DISTRIBUTION SYSTEM FOR ANY

- 2. PROVIDE DRAIN VALVES AT BOTTOM FOR EACH BRANCH. PROVIDE ACCESS PANELS TO ALL VALVES ABOVE CEILING AND BEHIND WALLS.
- 3. INSTALL NEW WATER PIPING WITH PROPER SLOPES TO AVOID WATER TRAPS DURING WINTER SEASON.
- 4. CONTRACTOR TO COORDINATE WITH FACILITY WHEN WORKING AROUND OR ABOVE THE RIDE COMPONENTS, AND PROVIDE ALL NECESSARY MEASURES TO PROTECT THESE COMPONENTS PER THE REQUIREMENTS OF THE FACILITY.
- 5. UPON COMPLETION, SYSTEM SHALL BE TESTED FOR PROPER OPERATION.
- 6. SEWER CROSSING WATER MAINS, CONDUITS, OR OTHER UTILITY SHALL BE MINIMUM 18" CLEARANCE BETWEEN THE OUTSIDE OF THE UTILITY AND OUTSIDE OF THE SEWER. THE CROSSINGS SHALL BE ARRANGED SO THAT THE SEWER JOINTS WILL BE EQUIDISTANT AND AS FAR AS POSSIBLE FROM THE WATER MAIN JOINTS.

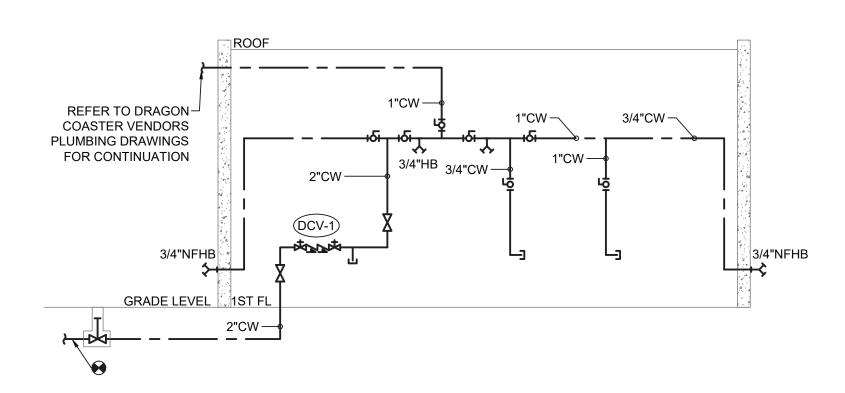

2 DOMESTIC WATER RISER DIAGRAM P-21 SCALE: NOT TO SCALE

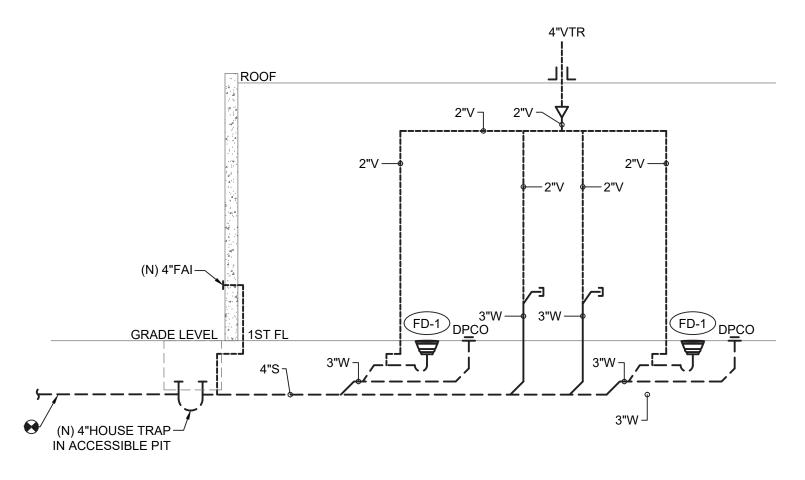

3 SANITARY RISER DIAGRAM
P-21 SCALE: NOT TO SCALE

CONSULTANT INFORMATION RECORD DRAWING CERTIFICATION WESTCHESTER COUNTY, NEW YORK NUMBER 22-523 AS BUILT - NO CHANGES DEPARTMENT OF PUBLIC WORKS AND TRANSPORTATION CXA-P-21 DIVISION OF ENGINEERING DWG NO.: **156 of 664** LiRo Engineers, Inc.

A LiRo Group Company CONTRACTOR PROJECT COORDINATOR **AS INDICATED INFRASTRUCTURE REHABILITATION - PHASE 3** PLAYLAND PARK, RYE, NEW YORK 08/23/2022 **CROSS AXIS BUILDING A** DATE MADE APP'D
BY
BY 1-118-P-905-0 REVISION PLUMBING FIRST FLOOR CONSTRUCTION PLAN

