

MECHANICAL GENERAL NOTES	
1.	ALL WORK AND MATERIALS SHALL BE PURCHASED AND INSTALLED IN ACCORDANCE WITH ALL NATIONAL & NEW YORK STATE CODES AND REGULATIONS (AS WELL AS ALL APPLICABLE LOCAL CODES & REGULATIONS). THE CONTRACTOR SHALL BE RESPONSIBLE TO ENSURE THAT ALL HVAC WORK IS PROVIDED AND INSTALLED IN STRICT ACCORDANCE WITH SEISMIC REQUIREMENTS.
2.	DO NOT SCALE FROM THESE DRAWINGS.
3.	THE EXACT MOUNTING HEIGHTS AND LOCATIONS OF ALL HVAC EQUIPMENT SHALL BE FIELD VERIFIED AND COORDINATED WITH ALL OTHER MECHANICAL, ELECTRICAL, PLUMBING, FIRE SPRINKLER, ARCHITECTURAL AND STRUCTURAL SYSTEMS. DURING SHOP DRAWINGS SUBMISSIONS, SHOW ALL MOUNTING HEIGHTS OF DUCTWORK, UNITS, ETC.
4.	VERIFY ALL EQUIPMENT VOLTAGES WITH THE ELECTRICAL DESIGN PRIOR TO ORDERING EQUIPMENT.
5.	PROVIDE PHASE LOSS PROTECTION FOR ALL POLY-PHASE MOTOR DEVICES.
6.	DUCTWORK SHALL BE CONSTRUCTED OF GALVANIZED SHEET STEEL IN STRICT COMPLIANCE WITH THE LATEST EDITION OF THE ASHRAE, NFPA, AND SMACNA GUIDE RECOMMENDATIONS. ALL DUCTS TO HAVE PITTSBURGH TYPE LOCK FOR LONGITUDINAL SEAMS AND DRIVE SLIP / "S" SLIP FOR TRANSVERSE JOINTS. "DUCT-MATE" JOINT SYSTEM IS ACCEPTABLE IN LIEU OF PRIOR SEAM SYSTEMS. SIZES AS SHOWN INDICATE INSIDE CLEAR DIMENSIONS OF THE AIR PASSAGE. DUCTWORK SHALL BE FULLY INSULATED AS PER APPLICABLE CODES AND WRITTEN SPECIFICATIONS.
7.	DUCT SIZES MUST BE VERIFIED FOR CLEARANCES AT THE JOB SITE PRIOR TO FABRICATION. DIMENSIONS MAY BE CHANGED TO ACCOMMODATE CONSTRUCTION AS LONG AS EFFECTIVE CROSS-SECTIONAL AREA IS MAINTAINED. DUCT TRANSITIONS SHALL BE CONSTRUCTED WITH A SLOPE OF 1" TO 4". ALL DEVIATIONS FROM ORIGINAL CONTRACT DRAWINGS SHALL BE REVIEWED BY ENGINEER DURING THE SHOP DRAWING PROCESS.
8.	PROVIDE MANUAL BALANCING DAMPERS AS REQUIRED TO PROPERLY BALANCE EACH INDIVIDUAL AIR DISTRIBUTION SYSTEM. IF THE LOCATION OF THE BALANCING DAMPER IS NOT DEFINED ON THE DRAWINGS, THE FOLLOWING MINIMUMS STANDARDS SHALL GOVERN. ALL SUPPLY, RETURN, AND EXHAUST MAIN BRANCHES FROM TRUNKS, EACH SPLIT AND ALL SUB-BRANCHES FROM MAIN SHALL INCORPORATE BALANCING DAMPERS.
9.	PROVIDE FLEXIBLE CONNECTORS AT ALL DUCT CONNECTIONS TO VIBRATING EQUIPMENT. THESE CONNECTORS SHALL BE INSTALLED IN CLOSE PROXIMITY TO SUCH EQUIPMENT.
10.	PROVIDE FIRE DAMPERS WITH RATED ACCESS DOORS AT ALL DUCT PENETRATIONS, RATED FIRE, RATED WALL, SMOKE AND FIRE STOPPING, SHAFT, FLOORS, RATED CEILINGS AND PARTITIONS AS REQUIRED TO MAINTAIN ARCHITECTURAL FIRE RATINGS. REFER TO THE ARCHITECTURAL PLANS AND SPECIFICATIONS FOR LOCATIONS AND FIRE RATING REQUIREMENTS. CONTRACTOR MUST FULLY REVIEW ALL ARCHITECTURAL AND ENGINEERING DRAWINGS AND VISIT THE SITE PRIOR TO SUBMITTING THE BID. NO EXTRAS WILL BE ALLOWED.
11.	ALL ACCESS DOORS REQUIRED IN GENERAL CONSTRUCTION ARE TO BE PROVIDED AND INSTALLED BY THE CONTRACTOR. IT IS THE RESPONSIBILITY OF THE CONTRACTOR TO IDENTIFY SIZE, TYPE AND LOCATION OF SUCH DOORS FOR PROPER ACCESS TO ALL CONCEALED HVAC EQUIPMENT, VALVES AND OTHER RELATED EQUIPMENT. THE CONTRACTOR SHALL IDENTIFY THESE REQUIREMENTS ON A COORDINATED SHOP DRAWING PRIOR TO SYSTEM FABRICATION AND INSTALLATION.
12.	ALL CEILING MOUNTED EQUIPMENT MUST BE SUPPORTED DIRECTLY FROM BUILDING STRUCTURE WITH COMBINATION SPRING AND NEOPRENE-IN-SHEAR HANGERS AND ROD. PROVIDE SUPPLEMENTARY STEEL AS REQUIRED TO ADEQUATELY SUPPORT THE LOAD.
13.	THE CONTRACTOR MUST CONTRACT AN INDEPENDENT NEBB CERTIFIED AIR BALANCING & TESTING COMPANY TO PERFORM THE AIR BALANCING WORK AND ASSOCIATED SYSTEM AIR BALANCING REPORT. ALL WORK SHALL BE PERFORMED IN STRICT COMPLIANCE WITH ALL APPLICABLE CODES, REGULATIONS, PLANS AND WRITTEN SPECIFICATIONS. SUBMIT THE FINAL AIR BALANCE REPORT TO THE ENGINEER FOR REVIEW AND APPROVAL PRIOR TO SUBSTANTIAL COMPLETION OF THE PROJECT, AS DETERMINED BY THE AND OWNER/CLIENT. THE AIR BALANCE REPORT MUST INCLUDE ALL SUPPLY, RETURN, & EXHAUST AIR TERMINALS, FRESH AIR (OUTSIDE AIR) INTAKE AND VENTILATION EXHAUST CFM RATES FOR ALL UNITS. ALSO INCLUDE ACTUAL SUPPLY & RETURN AIR VELOCITY & STATIC PRESSURE READINGS ALONG WITH ALL MOTOR AMPERAGES FOR ALL UNITS.
14.	THE CONTRACTOR IS TO INCLUDE IN THEIR BID ALL LOW VOLTAGE CONTROL WIRING, THERMOSTATS, RELAYS, TRANSFORMERS, STARTERS ETC FOR A COMPLETE OPERATING CONTROL SYSTEM AS DESCRIBED IN THE SEQUENCE OF OPERATIONS. THE CONTRACTOR IS ALSO RESPONSIBLE FOR LINE VOLTAGE CONTROL FOR EXHAUST FANS CONTROLLED FROM LIGHT SWITCH AND THERMOSTATS. ALL CONTROL WIRING IN THE AREAS THAT DO NOT HAVE DROPPED CEILINGS THE CONTRACTOR MUST PROVIDE ALL CONTROL WIRING CONDUIT, IN AREAS OF DROPPED CEILING PLENUM RATED CONTROL WIRING CAN BE RUN EXPOSED ABOVE CEILING.
15.	ALL MECHANICAL EQUIPMENT SHALL BE INSTALLED PER MANUFACTURER'S REQUIREMENTS/SPECIFICATIONS.

CODE REFERENCE
2020 NEW YORK STATE BUILDING CODE 2020 NEW YORK STATE MECHANICAL CODE 2020 NEW YORK STATE ENERGY CONSERVATION CODE

MECHANICAL DEMOLITION NOTES	
1.	CONTRACTOR SHALL BE RESPONSIBLE FOR DEMOLITION OF MECHANICAL EQUIPMENT AND MATERIAL RELATING TO THEIR RESPECTIVE TRADE.
2.	THE CONTRACTOR SHALL REMOVE, RELOCATE, REPLACE, ADJUST, ADAPT AND MODIFY EXISTING EQUIPMENT AND/OR SYSTEMS AS REQUIRED WHEN SUCH WORK IS UNCOVERED AND FOUND TO INTERFERE WITH COMPLETION OF WORK IN THIS CONTRACT OR OTHER CONTRACT WORK.
3.	EXECUTE THE DEMOLITION IN CAREFUL AND ORDERLY MANNER WITH THE LEAST POSSIBLE DISTURBANCE TO THE PUBLIC, EGRESS OR THE FUNCTIONING OF THE EXISTING BUILDING.
4.	TAKE NECESSARY PRECAUTIONS TO PREVENT DUST AND DIRT FROM RISING BY WETTING DEMOLISHED DEBRIS. EXCESSIVE USE OF WATER WILL NOT BE PERMITTED.
5.	PRIOR TO DEMOLITION, CONTRACTOR SHALL REVIEW WITH OWNER ALL MATERIALS TO BE REMOVED, SHOULD THE OWNER WANT TO KEEP ANY MATERIALS THE CONTRACTOR SHALL REMOVE AND DELIVER THE PARTS TO THE OWNER ON THE SITE WHERE SO DIRECTED. OTHERWISE ALL DEMOLISHED OR REMOVED MATERIALS SHALL BECOME THE PROPERTY OF THE CONTRACTOR AND SHALL BE REMOVED FROM THE SITE AND BE DISPOSED OF IN A LEGAL MANNER.
6.	DEMOLITION SHALL INCLUDE REMOVAL OF ALL PARTS AND PIECES IN THEIR ENTIRETY BACK TO POINTS INDICATED OR IF NOT INDICATED BACK TO THEIR POINT OF SOURCE.
7.	WHERE CONDITIONS PROHIBIT TOTAL REMOVAL OF THE WORK, THE REMAINING PORTION SHALL BE CUT FLUSH WITH THE SURROUNDING SURFACE AND BE CAPPED, PLUGGED OR SEALED AND THE SURROUNDING SURFACE SHALL BE REFINISHED IN AN APPROVED MANNER.
9.	DO NOT REMOVE EXISTING STRUCTURAL WORK. DO NOT REMOVE OPERATIONAL ELEMENTS AND SAFETY-RELATED COMPONENTS IN A MANNER RESULTING IN A REDUCTION OF CAPACITIES TO PERFORM IN THE MANNER INTENDED OR RESULTING IN DECREASED OPERATIONAL LIFE, INCREASED MAINTENANCE, OR DECREASED SAFETY.
10.	REMOVALS, DISCONNECTIONS, AND RELOCATIONS SHALL BE PERFORMED BY WORKMEN SKILLED IN THE TRADE INVOLVED AND SHALL BE EMPLOYED BY A CONTRACTOR LICENSED IN THE TRADE INVOLVED. ALL WORK SHALL BE DONE IN ACCORDANCE WITH ACCEPTED TRADE PRACTICES.
11.	PROVIDE ADEQUATE TEMPORARY SUPPORT FOR WORK TO REMAIN, TO PREVENT FAILURE. DO NOT ENDANGER OTHER WORK.
12.	PROTECTION: PROVIDE ADEQUATE PROTECTION WHERE REQUIRED FOR THE PRESENT BUILDING AND ITS CONTENTS. TEMPORARY DUSTPROOF BARRIERS AND BARRICADES SHALL BE ERECTED WHERE REQUIRED FOR PROTECTION OF PERSONNEL, PROTECTION FROM DUST AND DIRT, FOR SECURITY, FIRE AND WEATHER PROTECTIVE REASONS.
13.	CONTRACTOR SHALL TAKE EVERY PRECAUTION AGAINST FIRE BY EMPLOYING FIRE DEPARTMENT TYPE HOSES AND PORTABLE FIRE EXTINGUISHERS AS REQUIRED BY OSHA AND/OR THE OWNER'S INSURANCE UNDERWRITER.
14.	BEFORE STARTING DEMOLITION OPERATIONS, PROVIDE THE NECESSARY PROTECTIVE DEVICES, WHERE REQUIRED, AND IN STRICT ACCORDANCE WITH OSHA RULES AND REGULATIONS.
14.	USE TEMPORARY ENCLOSURES, OR OTHER SUITABLE METHODS TO LIMIT DUST AND DIRT RISING AND SCATTERING TO LOWEST PRACTICAL LEVEL. COMPLY WITH GOVERNING REGULATIONS PERTAINING TO ENVIRONMENTAL PROTECTION.
15.	FIELD VERIFY DEMOLITION REQUIREMENTS AND EXISTING CONDITIONS. DEMOLITION NOTES ARE INDICATED IN NOTE FORM.
16.	CONTRACTOR SHALL ESTABLISH A PATH OF TRAVEL AND TIME SCHEDULE FOR THE REMOVAL OF ALL DEBRIS AND WASTE, AND HAVE THIS APPROVED BY OWNER. CONTRACTOR IS TO ENSURE THAT ALL CORRIDORS AND PUBLIC AREAS BE KEPT FREE OF OBSTRUCTIONS, DEBRIS, AND ARE TO BE BROOM SWEEP CLEAN AT ALL TIMES.
17.	CONTRACTOR SHALL VISIT THE SITE AND BECOME INFORMED AS TO THE CONDITION OF THE PREMISES AND THE EXTENT AND CHARACTER OF WORK REQUIRED. NO ADDITIONAL COMPENSATION WILL BE APPROVED DUE TO FIELD CONDITIONS.

NYSECC ENERGY COMPLIANCE STATEMENT:
PER SECTION C101.7 OF THE 2020 NYSECC HISTORIC BUILDINGS ARE EXEMPT FROM THE REQUIREMENTS OF THE ENERGY CODE.

HVAC SYMBOL LIST	
IDENTIFIER	DESCRIPTION
	NEW DUCTWORK OR PIPING
	EXISTING DUCTWORK OR PIPING TO BE REMOVED
	EXISTING DUCTWORK OR PIPING TO REMAIN
	DOUBLE-LINE AND SINGLE-LINE RECTANGULAR DUCT. FIRST NUMBER INDICATES SIDE IN VIEW IN INCHES, SECOND NUMBER INDICATES SIDE IN DEPTH IN INCHES
	FLEXIBLE DUCTWORK
	REGULAR SUPPLY AIR DUCT (UP AND DOWN)
	REGULAR RETURN AIR DUCT (UP AND DOWN)
	REGULAR EXHAUST AIR DUCT (UP AND DOWN)
	REGULAR OUTSIDE AIR DUCT (UP AND DOWN)
	VOLUME DAMPER
	BACKDRAFT DAMPER
	MOTOR OPERATED DAMPER
	EQUIPMENT TAG EQUIPMENT NUMBER
	DETAIL TAG/CALL OUT TAG MECHANICAL SHEET NUMBER
	THERMOSTAT
	EXHAUST GRILLE
	REFER TO SUPPLEMENTAL FIGURE INDICATED BY NUMBER (I.E. F2 REFERS TO FIGURE 2)



HVAC ABBREVIATIONS	
IDENTIFIER	DESCRIPTION
AC	DIRECT EXPANSION AIR CONDITION UNIT
CFM	CUBIC FEET PER MINUTE
COND	CONDENSATE
CU	CONDENSING UNIT
CUH	CABINET UNIT HEATER
DB	DRY BULB
DN	DOWN
EA	EXHAUST AIR
EF	EXHAUST FAN
EG	EXHAUST GRILLE
EUH	ELECTRIC UNIT HEATER
EER	ENERGY EFFICIENCY RATIO
EG	EXHAUST GRILLE
FAI	FRESH AIR INTAKE
GC	GENERAL CONTRACTOR
MBH	THOUSAND BTU PER HOUR
PC	PLUMBING CONTRACTOR
RG	RETURN GRILLE
RTU	ROOFTOP UNIT
SA	SUPPLY AIR
SD	SUPPLY DIFFUSER
TYP.	TYPICAL
VIF	VERIFY IN FIELD

SCOPE OF WORK
DEMOLITION 1. REMOVE ONE (1) EXISTING THRU WALL AC UNIT AS INDICATED. 2. REMOVE ONE (1) EXISTING WALL MOUNTED PROPELLER FAN AS INDICATED. 3. REMOVE ONE (1) EXISTING ELECTRIC UNIT HEATERS AND ASSOCIATED SUPPORTS, WIRING AND ACCESSORIES.
CONSTRUCTION 1. PROVIDE ONE (1) NEW WALL MOUNTED ELECTRIC UNIT HEATERS AS INDICATED.

MECHANICAL DRAWING LIST			
SHEET NO.	SHEET NAME	REVISION NO.	REVISION DATE
CXD-M-01	MECHANICAL NOTES, SYMBOLS, & LEGENDS	0	-
CXD-M-11	MECHANICAL 1ST FLOOR DEMOLITION PLAN	0	-
CXD-M-21	MECHANICAL 1ST FLOOR CONSTRUCTION PLAN	0	-
CXD-M-61	MECHANICAL SCHEDULES, DETAILS AND CONTROLS	0	-

TABLE 1: ENERGY CODE ANALYSIS TABLE FOR MECHANICAL SYSTEMS							
(PER 2020 NYS ENERGY CODE)							
ITEM DESCRIPTION			PROPOSED VALUE	MINIMUM EFFECENCY	CODE PRECRIPTION VALUE AND CITATION	CITATION	SUPPORTING DOCUMENTATION
	UNIT TAG	EQUIPMENT TYPE					
HVAC SYSTEM CONTROLS	ALL HEATING COOLING EQUIPMENT	THERMOSTATIC CONTROLS	DIGITAL THERMOSTATS	-	THERMOSTATIC CONTROLS FOR HVAC SYSTEM	C403.2.6	MECHANICAL SCHEDULES AND PLANS

TABLE 2: ENERGY CODE COMPLIANCE INSPECTIONS FOR MECHANICAL SYSTEMS					
(IIB - MECHANICAL AND SERVICE WATER HEATING INSPECTIONS)					
	INSPECTION TEST	FREQUENCY	REFERENCE STANDARDS	INSPECTION DESCRIPTION	ECC CITATION
IIB3	HVAC AND SERVICE WATER HEATING EQUIPMENT	PRIOR TO FINAL MECHANICAL AND CONSTRUCTION INSPECTION	APPROVED CONSTRUCTION DOCUMENTS	EQUIPMENT SIZING, EFFICIENCIES AND OTHER PERFORMANCE FACTORS OF ALL MAJOR EQUIPMENT UNITS, AS DETERMINED BY THE APPLICANT OF RECORD, AND NO LESS THAN 15% OF MINOR EQUIPMENT UNITS, SHALL BE VERIFIED BY VISUAL INSPECTION AND, WHERE NECESSARY, REVIEW OF MANUFACTURER'S DATA. POOL HEATERS AND COVERS SHALL BE VERIFIED BY VISUAL INSPECTION	NYSECC C403.2, C404.2, C404.7, C406.2
IIB4	HVAC AND SERVICE WATER HEATING SYSTEM CONTROLS	AFTER INSTALLATION AND PRIOR TO FINAL ELECTRICAL AND CONSTRUCTION INSPECTION, EXCEPT THAT FOR CONTROLS WITH SEASONALLY DEPENDENT FUNCTIONALITY, SUCH TESTING SHALL BE PERFORMED BEFORE SIGN-OFF FOR ISSUANCE OF A FINAL CERTIFICATE OF OCCUPANCY	APPROVED CONSTRUCTION DOCUMENTS INCLUDING CONTROL SYSTEM NARRATIVES	NO LESS THAN 20% OF EACH TYPE OF REQUIRED CONTROLS AND ECONOMIZERS SHALL BE VERIFIED BY VISUAL INSPECTION AND TESTED FOR FUNCTIONALITY AND PROPER OPERATION. SUCH CONTROLS SHALL INCLUDE, BUT ARE NOT LIMITED TO, THERMOSTATIC AND ECONOMIZER CONTROLS	NYSECC C403.2.4, C403.2.5.1, C403.2.11, C403.3, C403.4, C404.3, C404.6, C404.7


CONSULTANT INFORMATION  LiRo Engineers, Inc. A LiRo Group Company Syosset, N.Y. 516-214-8157[T]	CONSULTANT SEAL 							RECORD DRAWING CERTIFICATION		WESTCHESTER COUNTY, NEW YORK DEPARTMENT OF PUBLIC WORKS AND TRANSPORTATION DIVISION OF ENGINEERING		CONTRACT NUMBER 22-523	SHEET NUMBER CXD-M-01
								<input type="checkbox"/> AS BUILT – CHANGES AS NOTED <input type="checkbox"/> AS BUILT – NO CHANGES		DWG NO.: 227 of 664		SCALE: AS INDICATED	
								CONTRACTOR		INFRASTRUCTURE REHABILITATION - PHASE 3 PLAYLAND PARK, RYE, NEW YORK CROSS AXIS BUILDING D		DATE: 08/23/2022	
		REVISION NUMBER	DATE	MADE BY	APP'D BY	REVISION		NAME SIGNATURE	PROJECT COORDINATOR SIGNATURE	MECHANICAL NOTES, SYMBOLS AND LEGENDS		DPW FILE NUMBER 1-118-M-976-0	REV. NO. 0

GENERAL NOTES:



- 1. RETURN REMOVED EXISTING EQUIPMENT TO OWNER IF IT IS IN WORKING CONDITION.
- 2. CONTRACTOR TO COORDINATE WITH FACILITY WHEN WORKING AROUND OR ABOVE THE RIDE COMPONENTS, AND PROVIDE ALL NECESSARY MEASURES TO PROTECT THESE COMPONENTS PER THE REQUIREMENTS OF THE FACILITY.

MECHANICAL DEMOLITION NOTES:

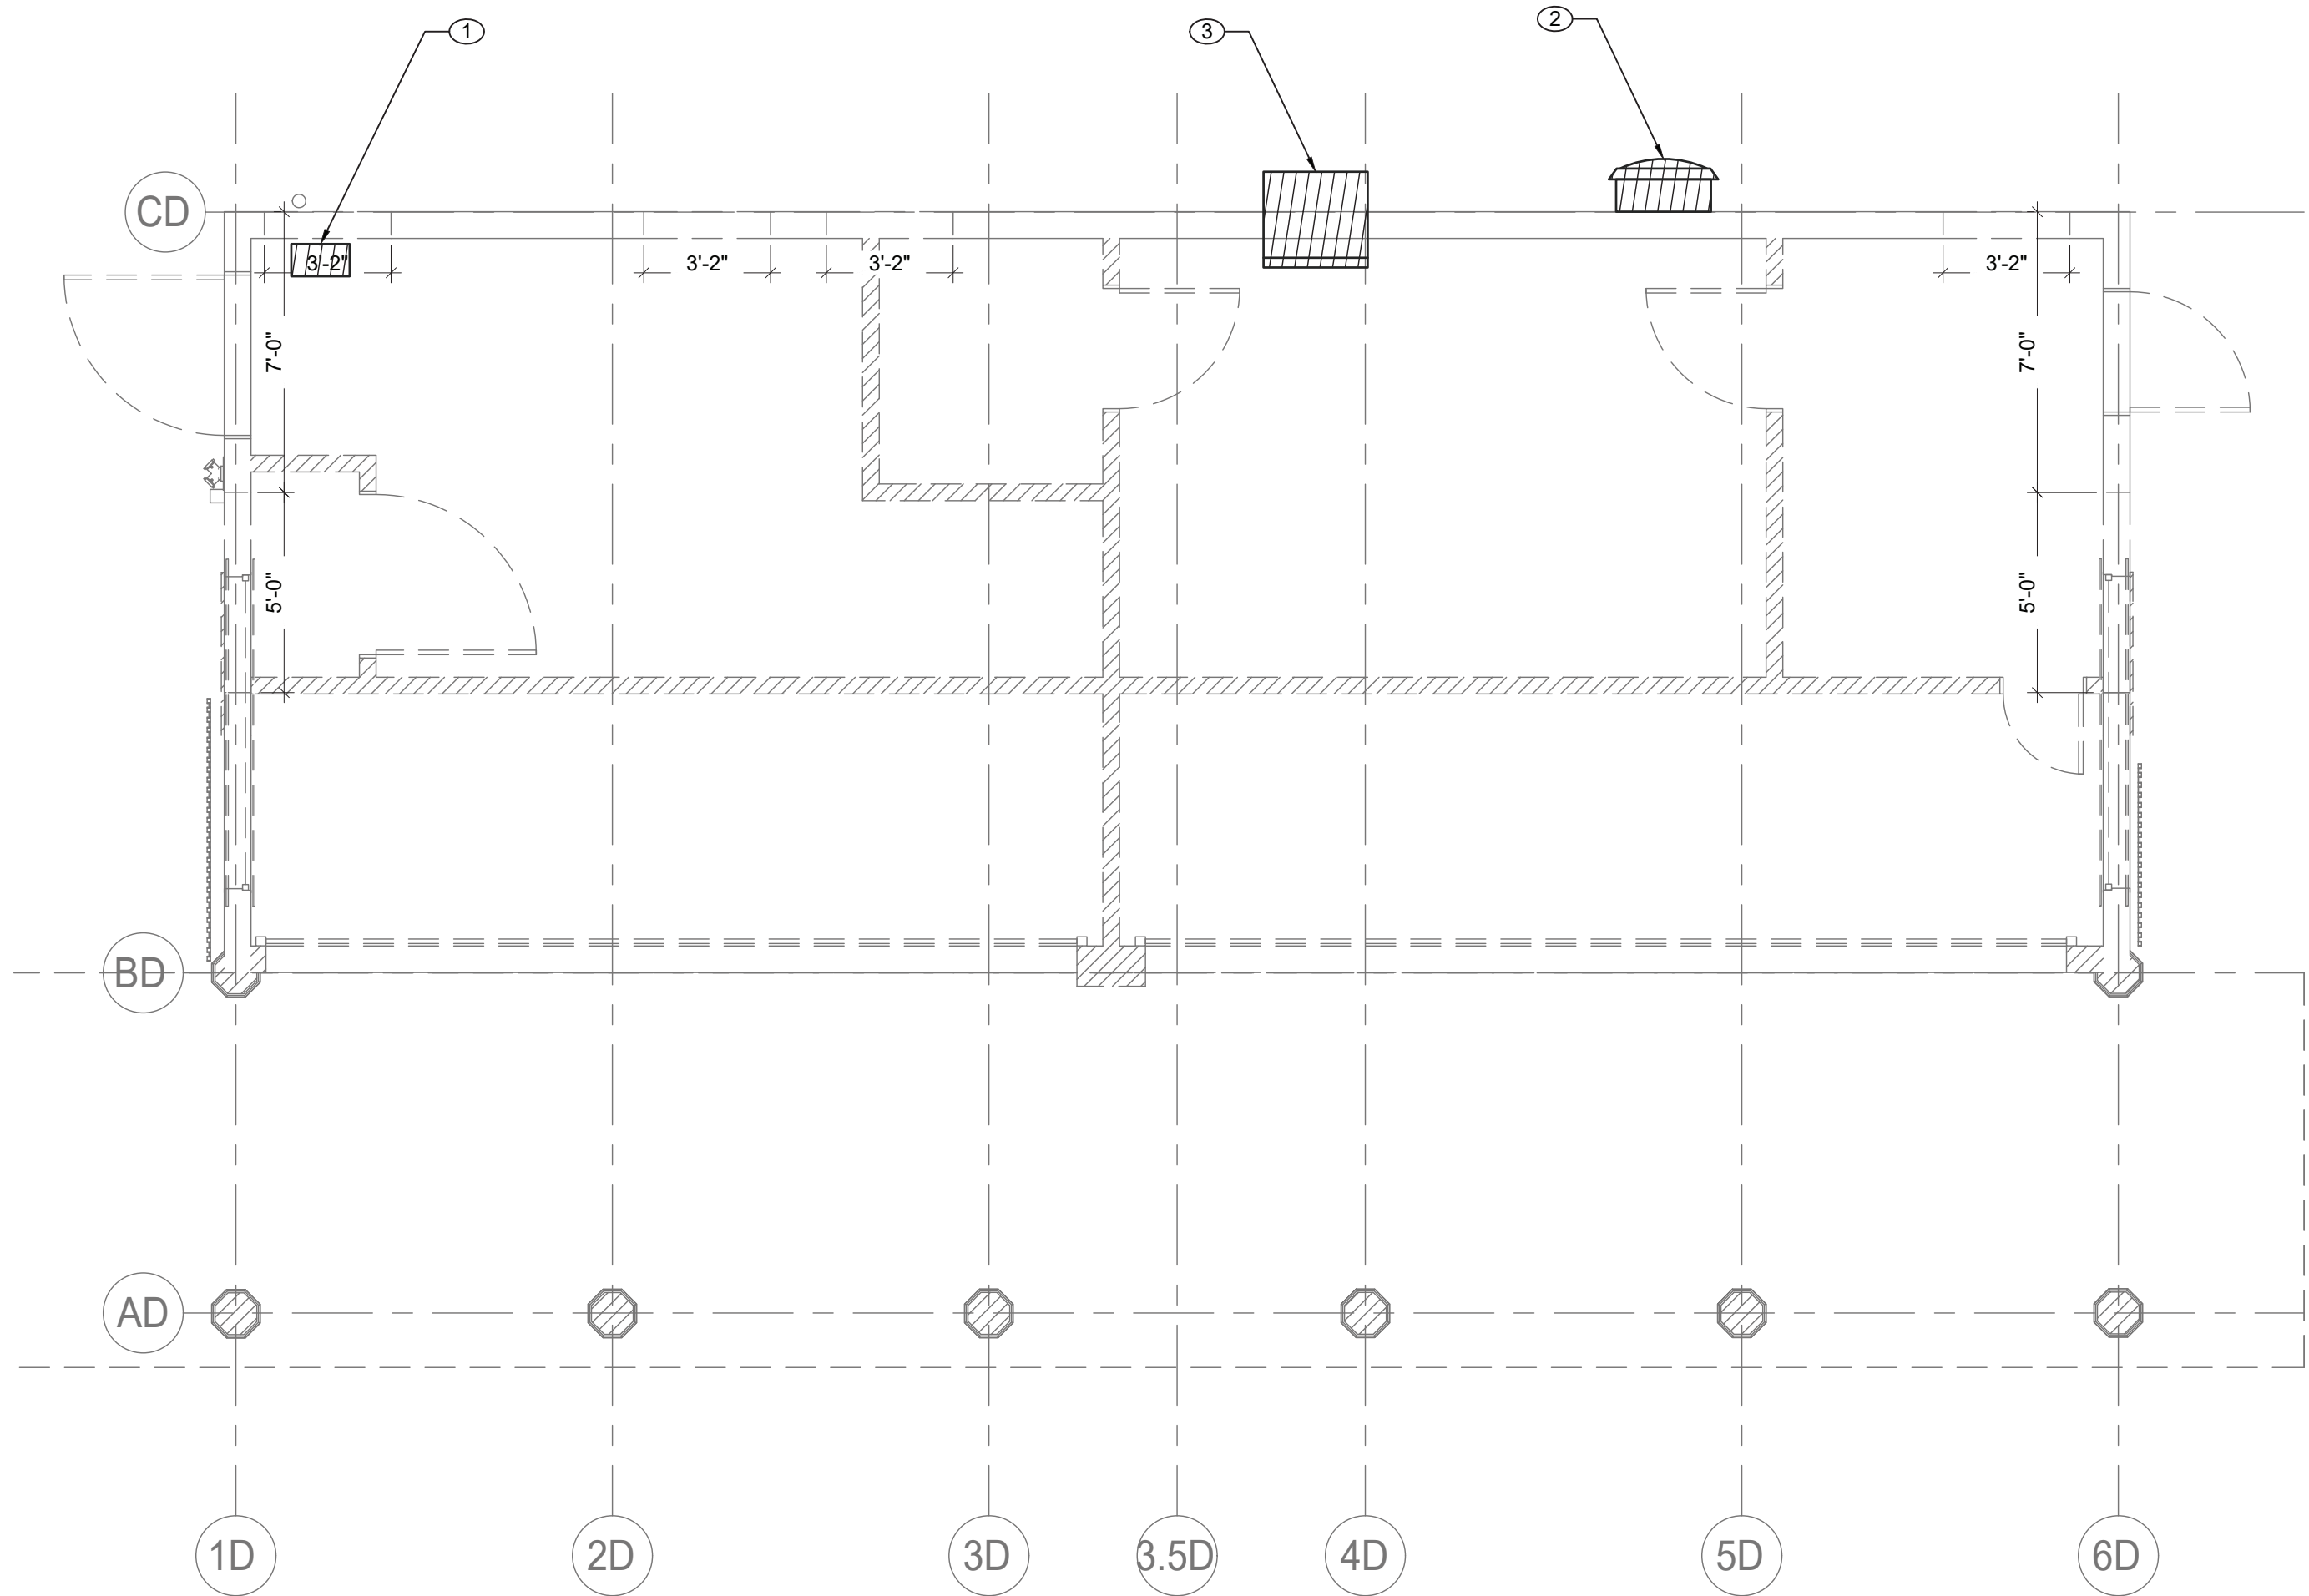- ① DEMOLISH EXISTING ELECTRIC UNIT HEATERS AND ASSOCIATED SUPPORTS, WIRING AND ACCESSORIES. COORDINATE REMOVAL OF ELECTRICAL POWER AND WIRING WITH ELECTRICAL CONTRACTOR.
- ② DEMOLISH EXISTING WALL MOUNTED PROPELLER FAN. COORDINATE REMOVAL OF ELECTRICAL POWER AND WIRING WITH ELECTRICAL CONTRACTOR.COORDINATE WITH GC TO SEAL EXISTING WALL PENETRATION.
- ③ REMOVE EXISTING THRU WALL AC UNIT. IF NO LONGER IN WORKING CONDITION, DISPOSAL SHALL BE IN ACCORDANCE WITH EPA REQUIREMENTS. COORDINATE WITH GC TO SEAL EXISTING WALL PENETRATION.



 **MECHANICAL FIRST FLOOR DEMOLITION PLAN**
SCALE: 1/4" = 1'-0


CONSULTANT INFORMATION  LiRo Engineers, Inc. A LiRo Group Company Syosset, N.Y. 516-214-8157[T]		CONSULTANT SEAL 		RECORD DRAWING CERTIFICATION <input type="checkbox"/> AS BUILT – CHANGES AS NOTED <input type="checkbox"/> AS BUILT – NO CHANGES						WESTCHESTER COUNTY, NEW YORK DEPARTMENT OF PUBLIC WORKS AND TRANSPORTATION DIVISION OF ENGINEERING INFRASTRUCTURE REHABILITATION - PHASE 3 PLAYLAND PARK, RYE, NEW YORK CROSS AXIS BUILDING D MECHANICAL FIRST FLOOR DEMOLITION		CONTRACT NUMBER 22-523		SHEET NUMBER CXD-M-11			
				CONTRACTOR NAME _____ SIGNATURE _____ TITLE _____ DATE _____								PROJECT COORDINATOR NAME _____ SIGNATURE _____ TITLE _____ DATE _____		DWG NO.: 228 of 664		SCALE: AS INDICATED	
REVISION NUMBER		DATE		MADE BY		APP'D BY		REVISION						DPW FILE NUMBER 1-118-M-977-0		REV. NO. 0	

GENERAL NOTES:

1. CONTRACTOR TO COORDINATE WITH FACILITY WHEN WORKING AROUND OR ABOVE THE RIDE COMPONENTS, AND PROVIDE ALL NECESSARY MEASURES TO PROTECT THESE COMPONENTS PER THE REQUIREMENTS OF THE FACILITY.
2. UPON COMPLETION, SYSTEM SHALL BE TESTED FOR PROPER OPERATION.

MECHANICAL CONSTRUCTION NOTES:

- ① PROVIDE NEW ELECTRIC WALL MOUNTED UNIT HEATER. COORDINATE INSTALL HEIGHT IN FIELD.

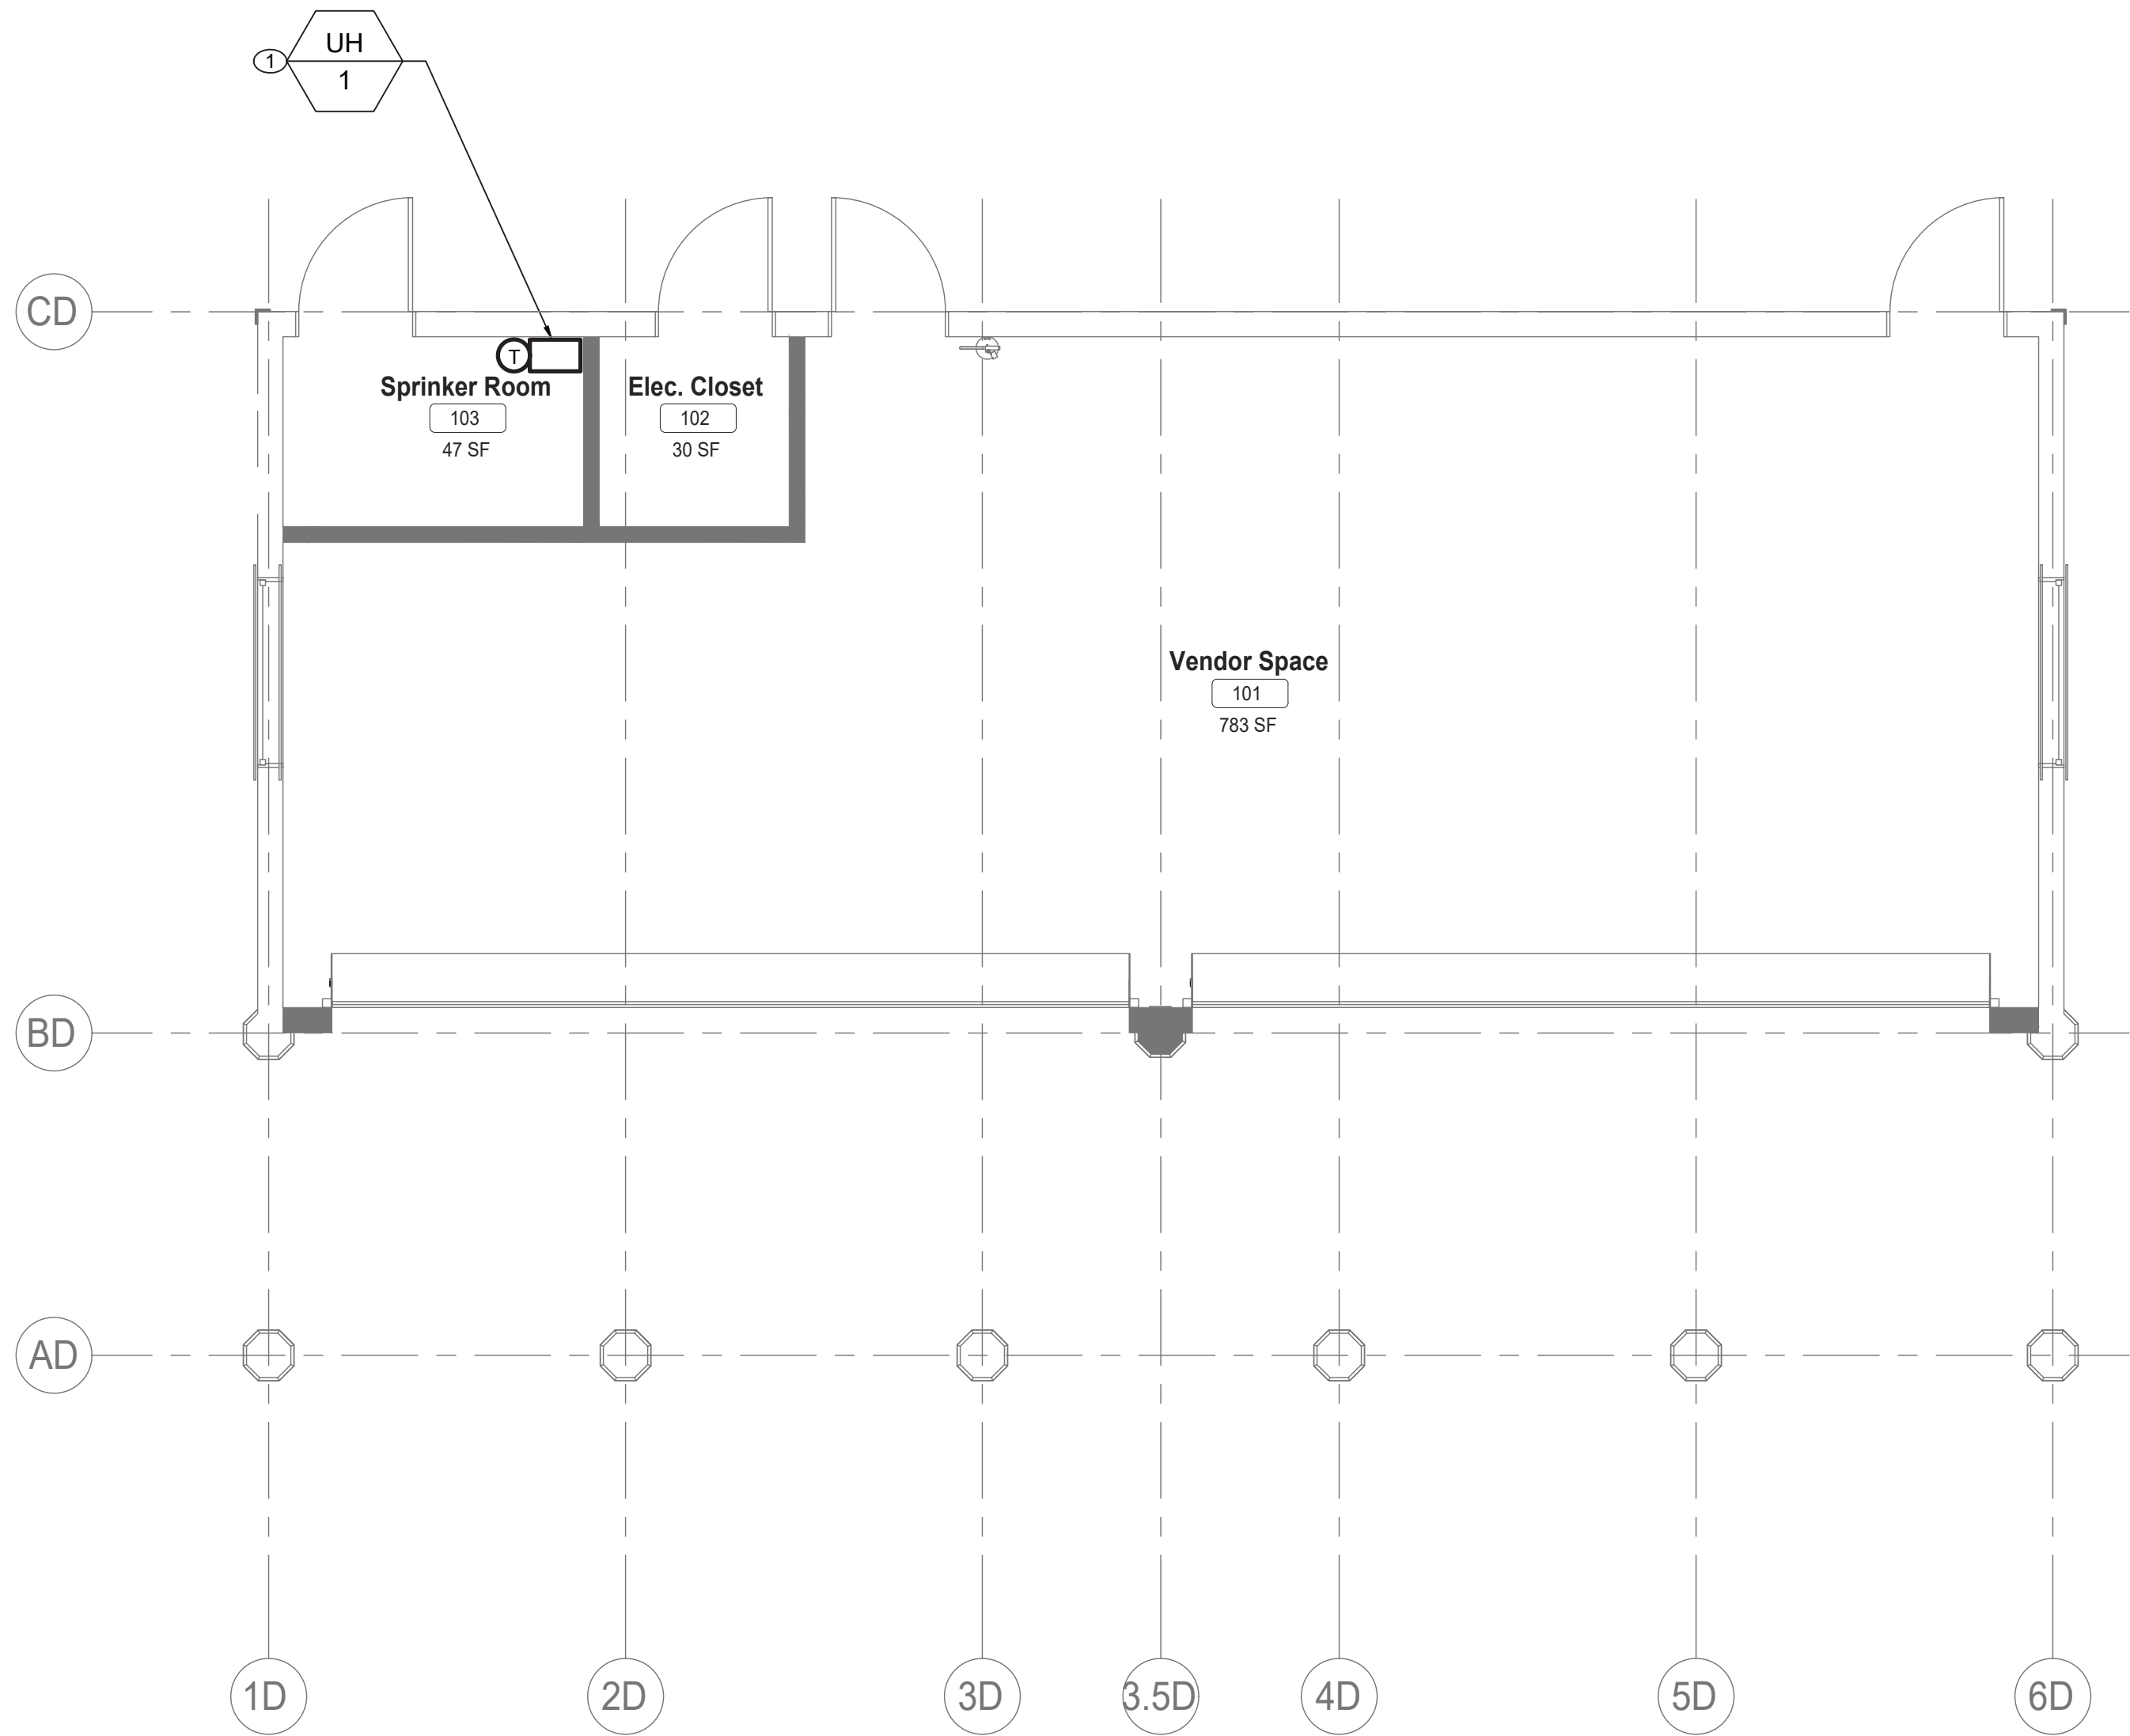

MECHANICAL FIRST FLOOR CONSTRUCTION PLAN
SCALE: 1/4" = 1'-0

CONSULTANT
INFORMATION



LiRo Engineers, Inc.
A LiRo Group Company
Syosset, N.Y. 516-214-8157[T]

CONSULTANT SEAL



REVISION NUMBER	DATE	MADE BY	APP'D BY	REVISION

RECORD DRAWING CERTIFICATION

☐ AS BUILT – CHANGES AS NOTED ☐ AS BUILT – NO CHANGES

CONTRACTOR		PROJECT COORDINATOR	
NAME	_____	NAME	_____
SIGNATURE	_____	SIGNATURE	_____
TITLE	_____ DATE _____	TITLE	_____ DATE _____

WESTCHESTER COUNTY, NEW YORK
DEPARTMENT OF PUBLIC WORKS AND TRANSPORTATION
DIVISION OF ENGINEERING


INFRASTRUCTURE REHABILITATION - PHASE 3
PLAYLAND PARK, RYE, NEW YORK
CROSS AXIS BUILDING D
MECHANICAL FIRST FLOOR CONSTRUCTION PLAN

CONTRACT NUMBER 22-523	SHEET NUMBER CXD-M-21
DWG NO.: 229 of 664	
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DPW FILE NUMBER 1-118-M-978-0	REV. NO. 0


ELECTRIC UNIT HEATER SCHEDULE							
TAG	MANUFACTURER	MODEL	SERVICE	TYPE	KW	AMPS	V-PH-HZ
UH-1	TRANE	UHEC-031A0C0	103 SPRINKLER ROOM	WALL HUNG	3.3	15.9	208-1-60


NOTES:

1. PROVIDE UNIT MOUNTED 2-STAGE THERMOSTAT, REFER TO CONTROLS

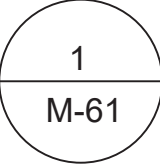

SCALE: NOT TO SCALE

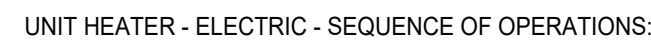

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SCALE: NOT TO SCALE