


1 CXE - BUILDING AXONOMETRIC




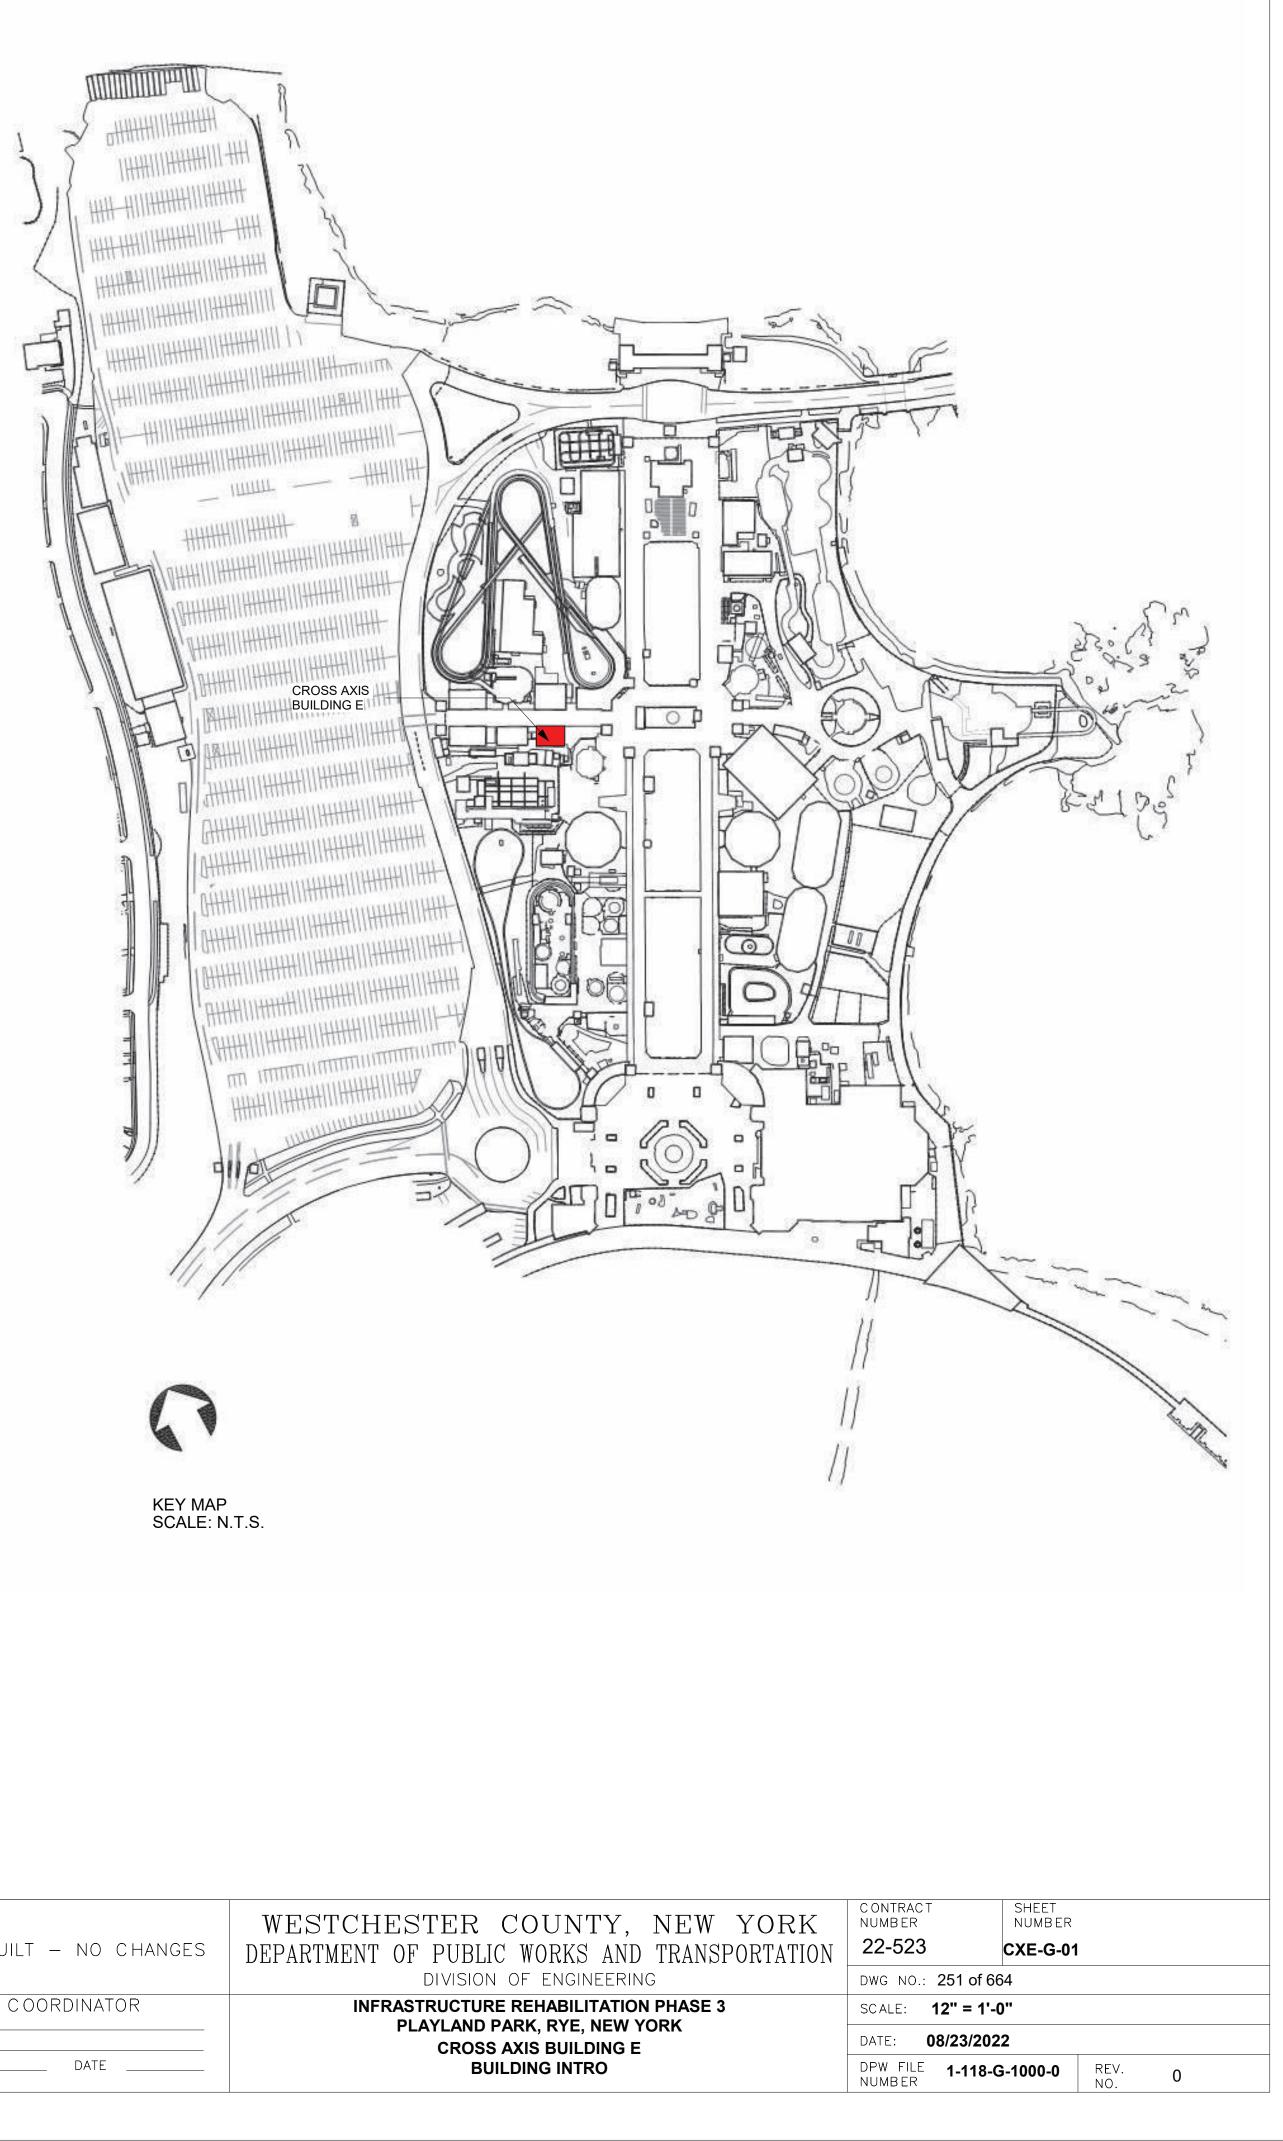

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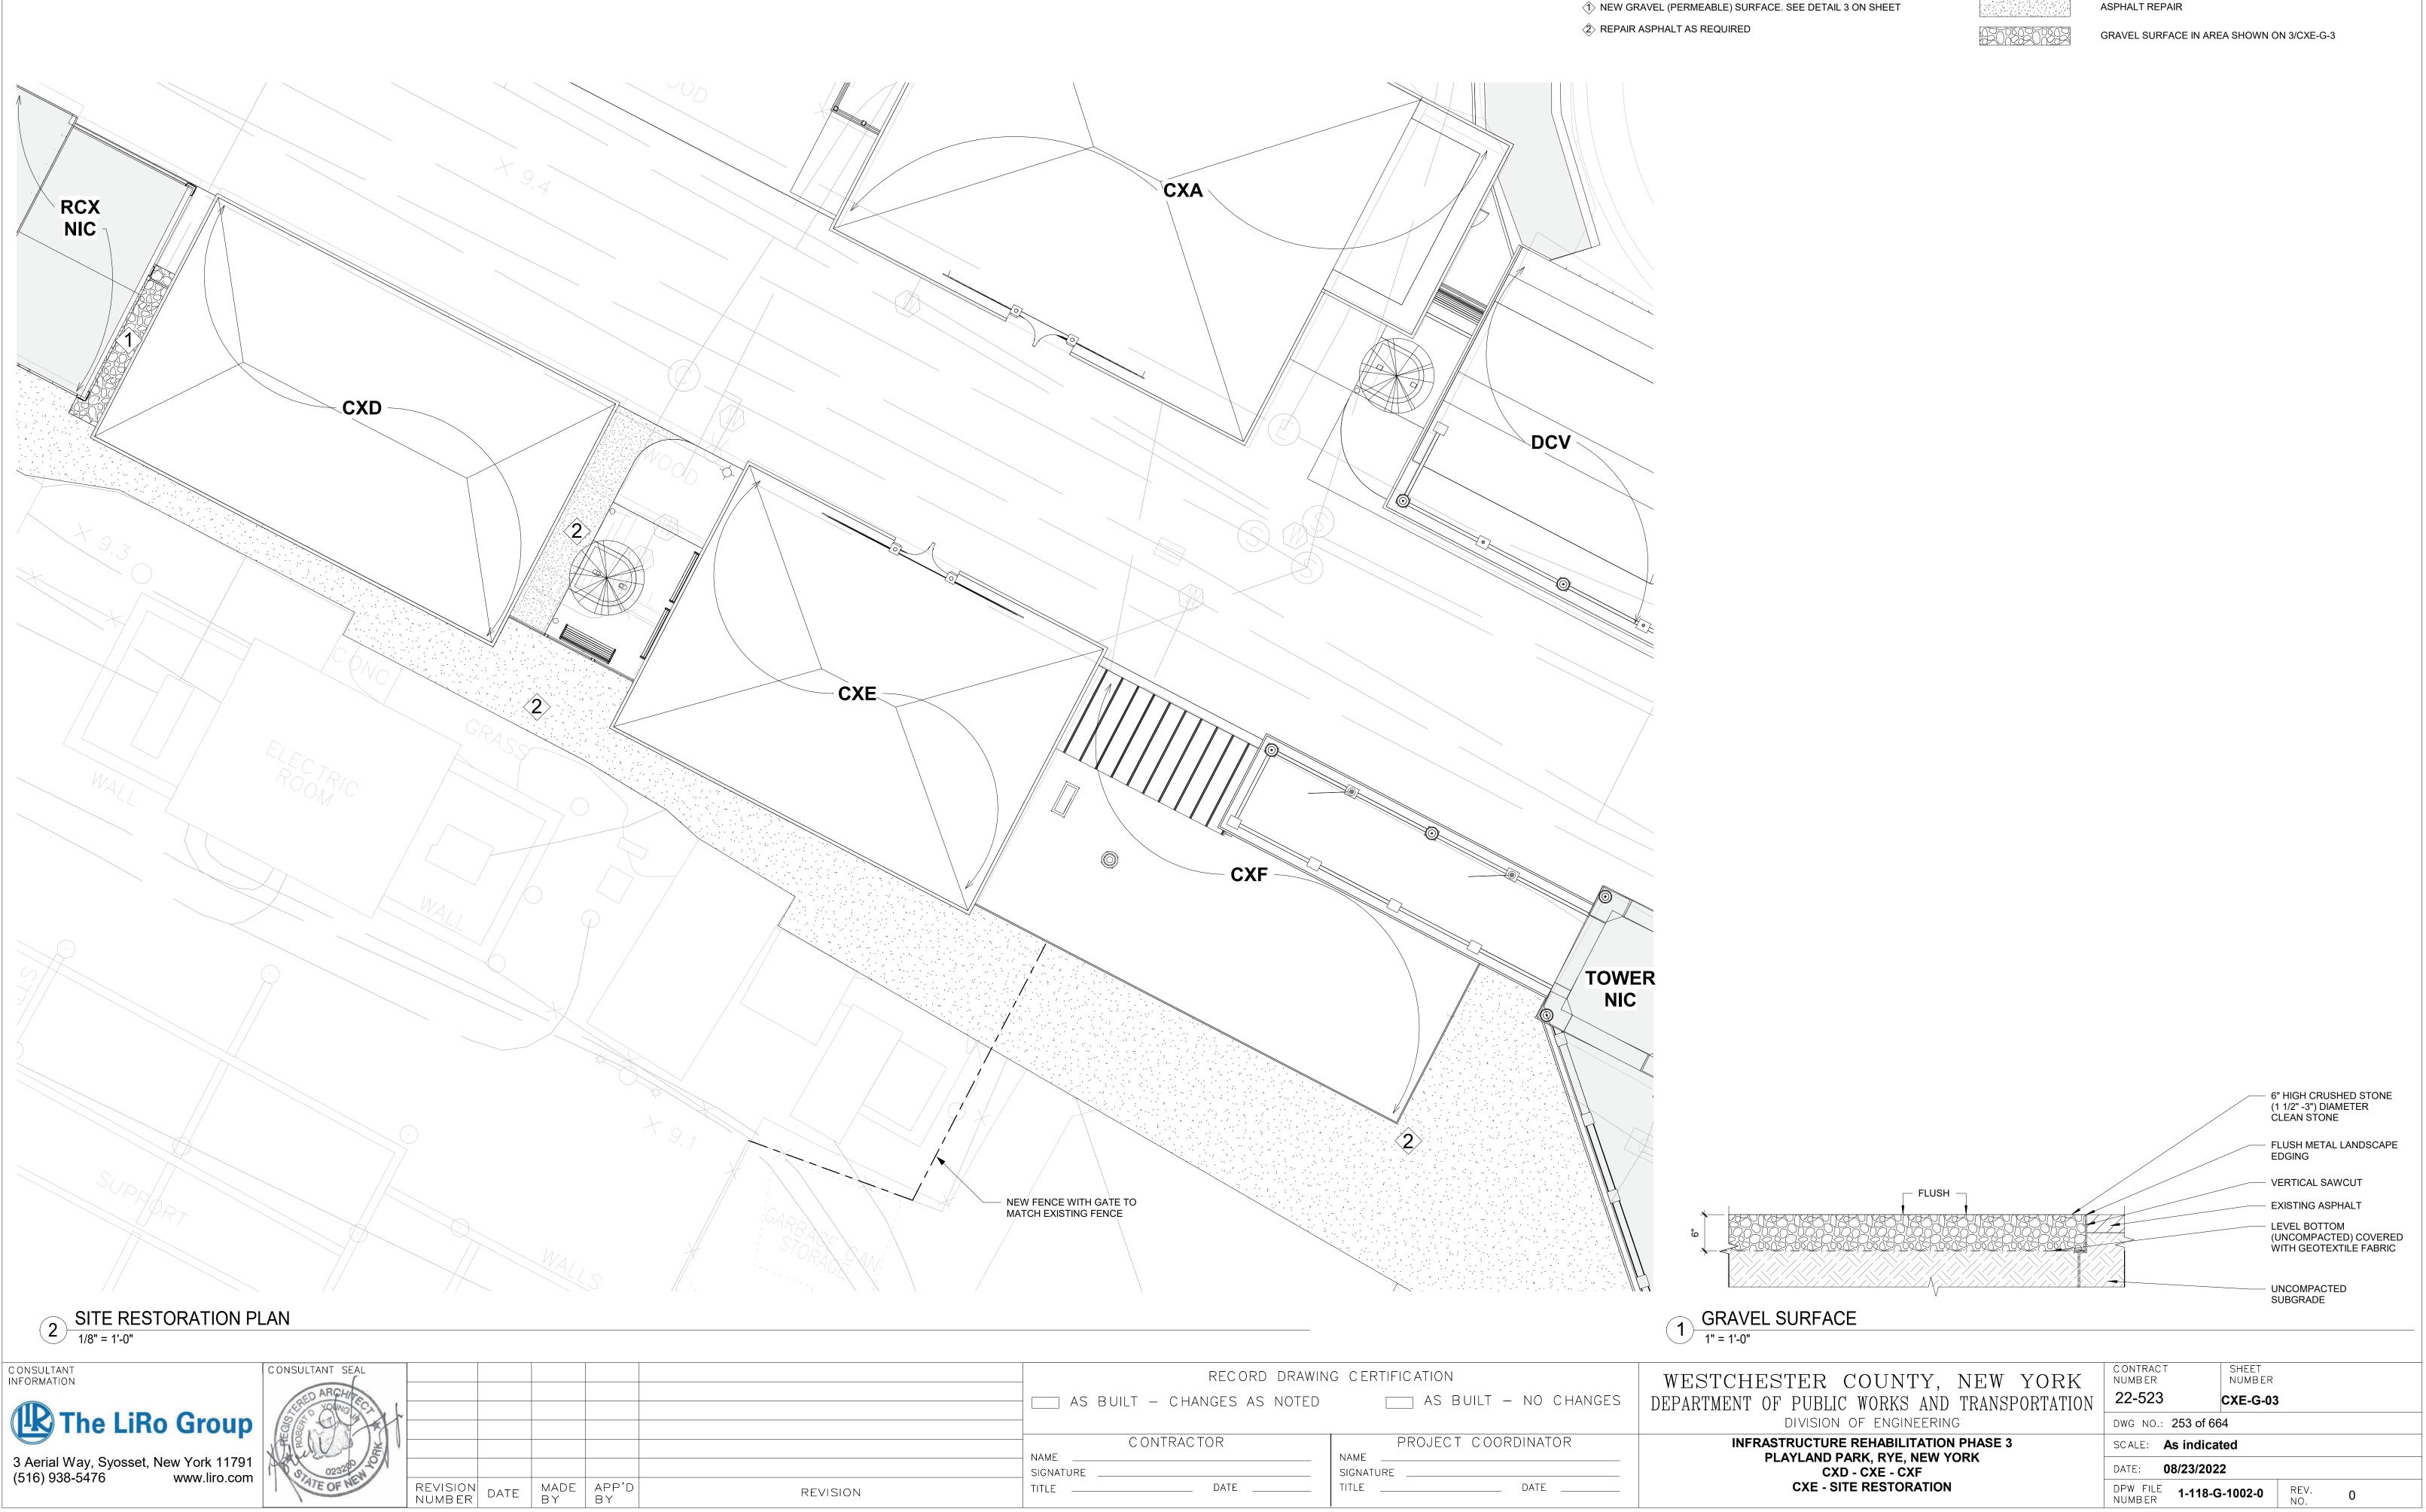
NUMBER

	WOOD FRAME WALLS, ABOVE GROUND	MIN R-20	
	ATTIC AND OTHER ROOFS	MIN R-38	
	UNHEATED SLABS	MIN R-10 FOR 24" BELO	
	OPAQUE SWINGING DOOR	MAX U-0.37	
	GARAGE DOOR	MAX U-0.31	
	OPERABLE FENESTRATION	MAX U-0.45	
ADDITION TO MEET PRESCRIPTIVE METHOD C502.2 IN 2020 NYS EC			

	RECORD DRAWIN	G CERTIFICATION	WESTCHESTER COUNTY, NEW YORK	CONTRACT SHEET NUMBER NUMBER
	AS BUILT - CHANGES AS NOTED	AS BUILT – NO CHANGES	DEPARTMENT OF PUBLIC WORKS AND TRANSPORTATION	22-523 CXE-G-02
			DIVISION OF ENGINEERING	DWG NO.: 252 of 664
	CONTRACTOR	PROJECT COORDINATOR	INFRASTRUCTURE REHABILITATION PHASE 3	SCALE: As indicated
	NAME	NAME	PLAYLAND PARK, RYE, NEW YORK CROSS AXIS BUILDING E	DATE: 08/23/2022
REVISION	TITLE DATE	TITLE DATE	CXE & CXF - LIFE SAFETY PLANS	DPW FILE 1-118-G-1001-0 REV. 0 NUMBER NO. 0 0

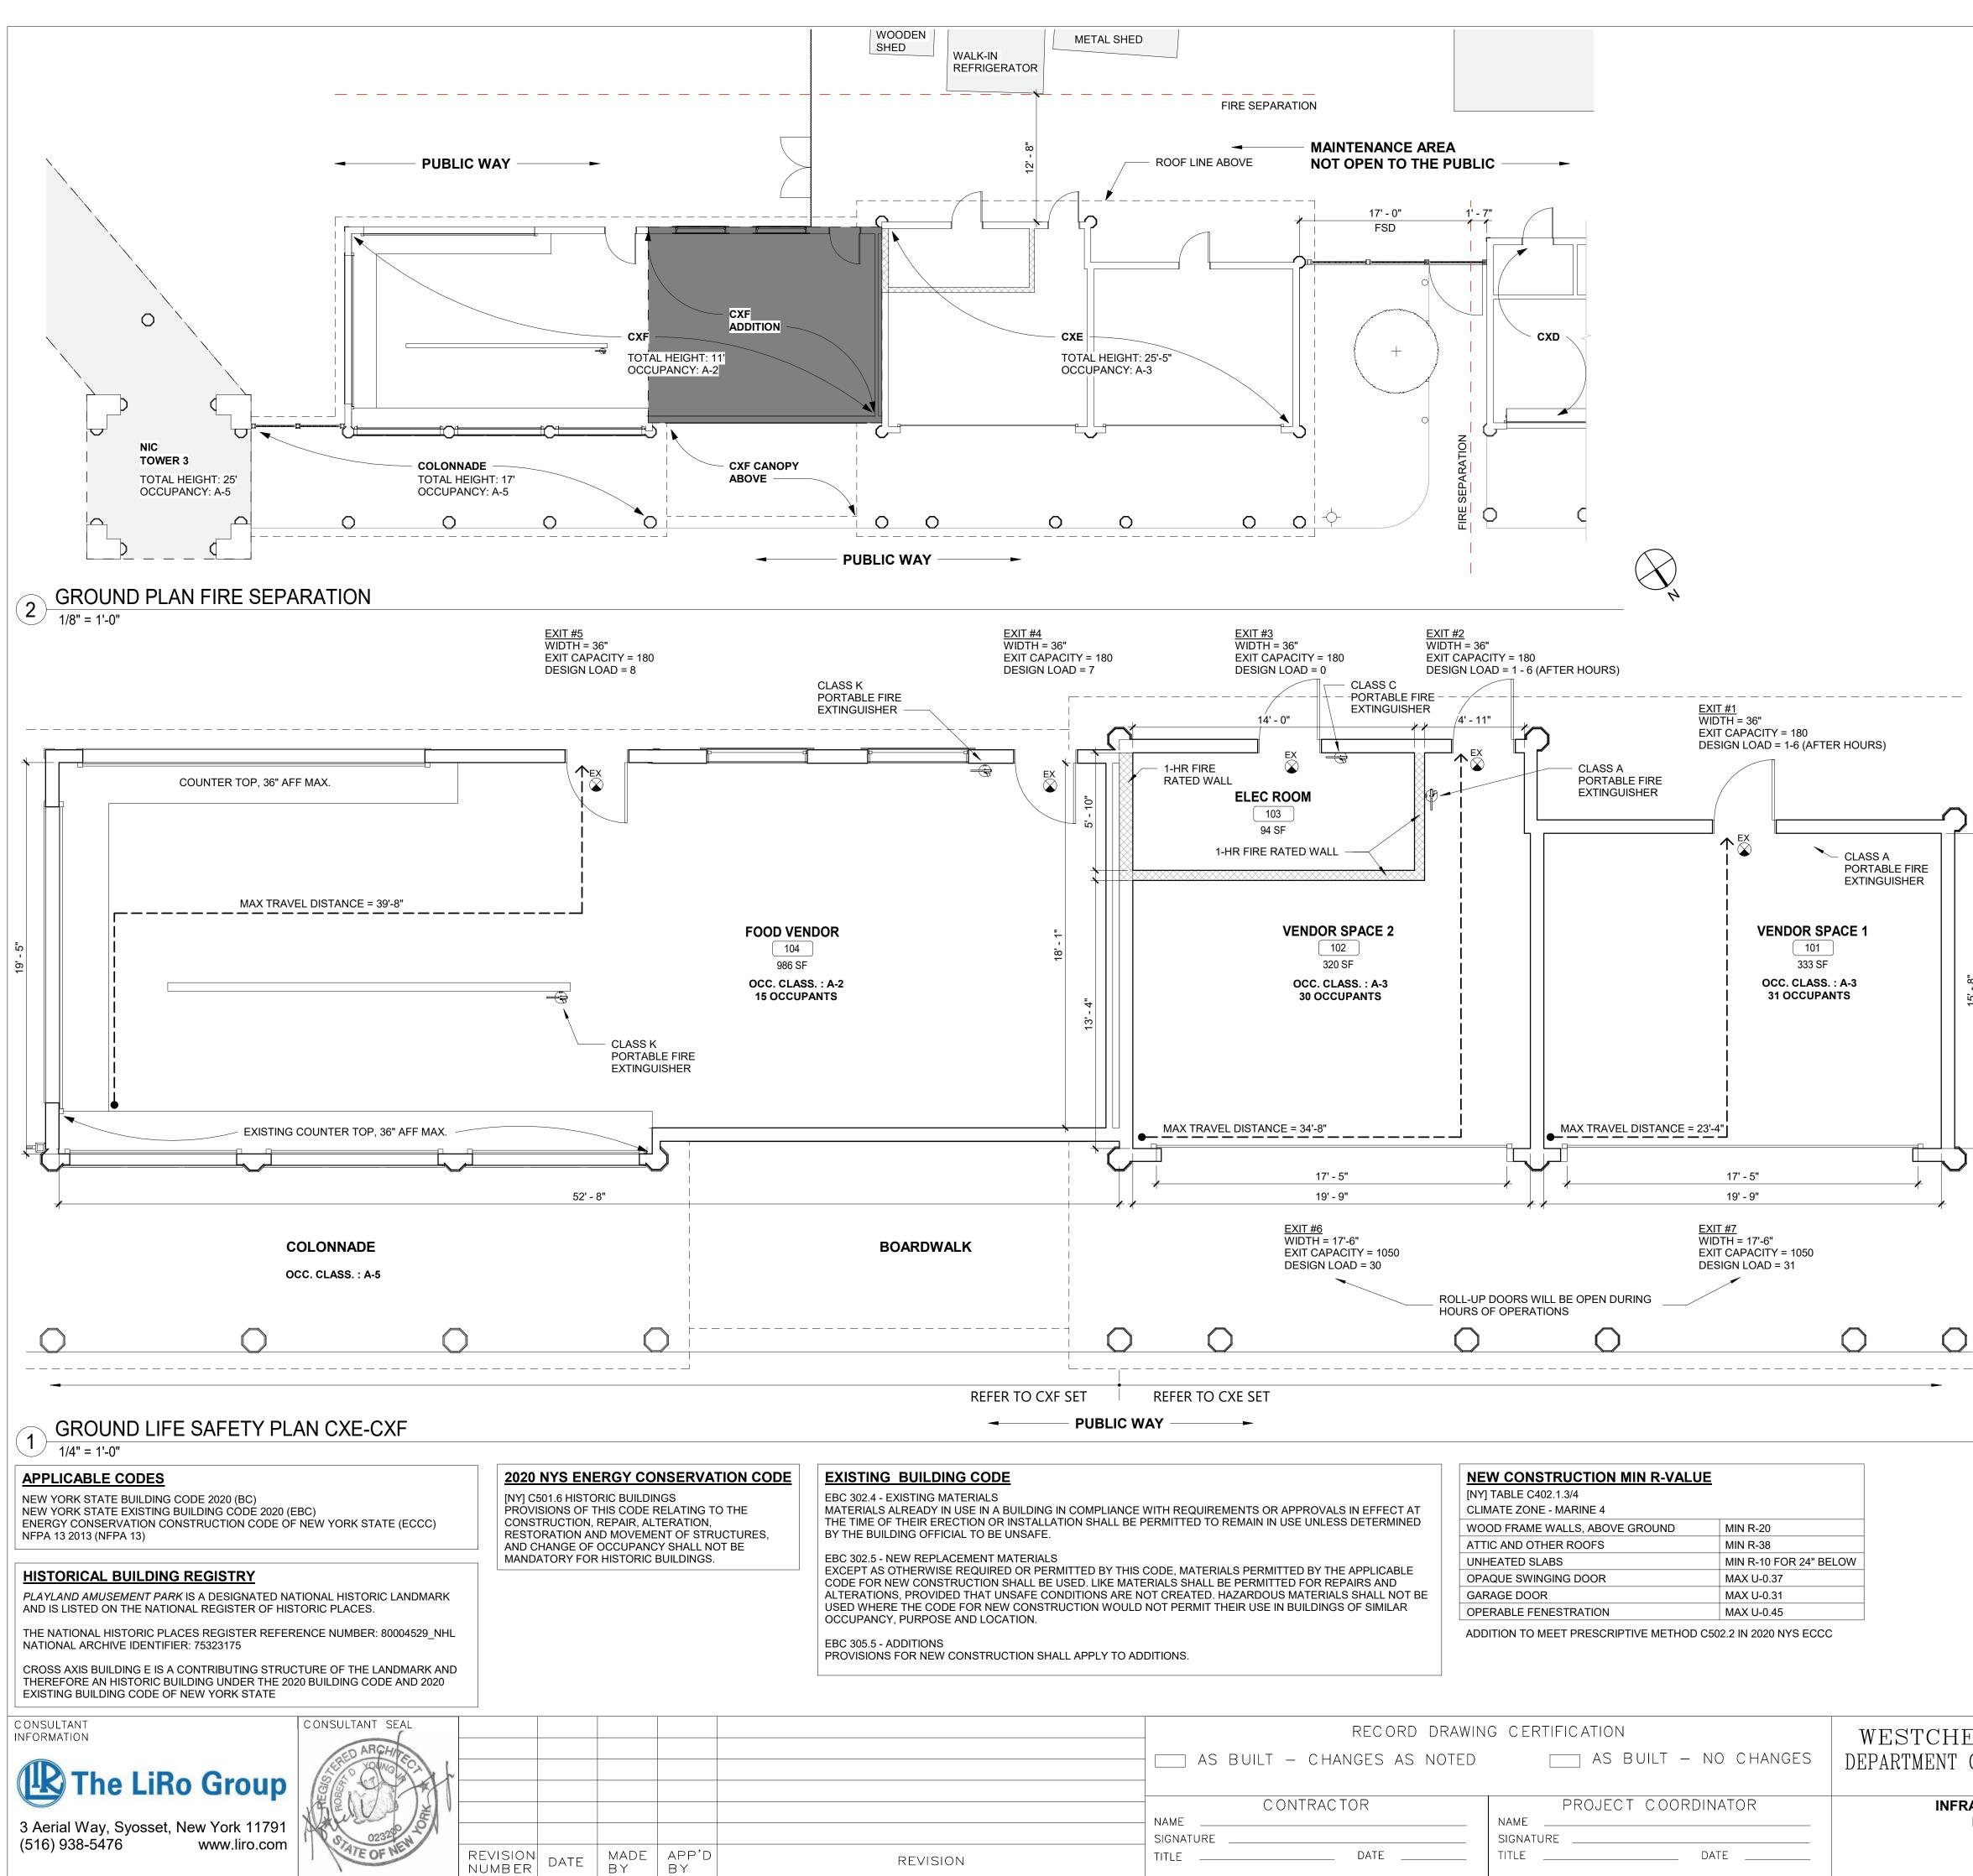CODE ANALYSIS 2020 Building code of New York State

Construction Type (Tbl 601)	V B	(Fully Sprinklered)
Occupancy Classification	A-3 (CXE)	Arcade
	A-2 (CXF)	Food Vendor
Number of Stories (Tbl 504.4)	1	< 2 (max. allowable)
Height (ft) (Tbl 504.3)	25.4'	< 60 (max. allowable)
Building Area (sf) (Tbl 506.2)	1,795	< 24,000 (max. allowable)
	1,,,,,,,,,,,,,,,,,,,,,,,,,,,,,,,,,,,,,,	
Fire-Resistance Rating Requirements (Tbl 601)	Required	Existing
Primary Structure Frame	0	0
(including Columns, Girders, Trusses)		
Bearing Walls		
Exterior (Tbl 602)	2	
Fire separation distance > = 10 ft	0	0
Interior	0	0
Nonbearing Walls and Partitions		
Exterior (Tbl 602)		
Fire separation distance > = 10 ft	0	0
Interior	0	0
Floor Construction		
Including supporting beam and joists	0	0
Roof Construction		0
Including supporting beam and joists	0	0
Allowable Area of Openings (BC 705.8)		
Fire separation distance 15 > 10 ft (Unprotected, Sprinklered)	45%	12%
Fire separation distance > 20 ft (Unprotected, Sprinklered)	No limit	
,		
Interior Finishes Class (BC 803)		
Wall and Ceiling	С	
Floors - Radiant Flux	Class II	
Portable Fire Extinguishers (BC 906)	Required	Provided
Fire Hazard	Class A	Class A
	Class K	Class K
Hazard Occupancy	Ordinary	
	and the	
Minimum rated single extinguisher	2-A	Class K
Maximum floor area per unit of A	1,500 sf	333 sf
Maximum floor area for extinguisher	11,250 sf	493 sf
Maximum distance of travel to extinguisher	75'	35'
Number of Type 2-A extinguishers required	Required	Provided
First Floor	2	4
	2	
Means of Egress		
Max. Floor Area Allowances per Occupant (Tbl 1004.5) (sf)		
Amusement arcades	11 gross	
Kitchens, commercial	200 gross	
Occupant Load		
Vendor #1 (333 sf)	31	
Vendor #2 (320 sf)	30	
Food Vendor (986 sf)	15 (designed load)	
Elec. Room (95 sf)	0 (not occupiable)	
Egress Width per Occupant (BC 1005)		
Other Egress Components	0.2	
Egress Width Required (inches)	6.2	DC Dress into al
Vendor #1* Vendor #2*	6.2	36 Provided
Vendor #2*	6	36 Provided 72 Provided
Food Vendor *Note: Poll up doors will be open during business bours	3	12 Provided
*Note: Roll-up doors will be open during business hours		
Single Exits (BC 1006.3.3[2])	Minimum	Provided
First Story above or below grade plane (A Occupancy) in compliance		1
		-
with Tbl 1006.2.1. Occupant load < 49 per space		
with Tbl 1006.2.1. Occupant load < 49 per space	Dormittad	Dronocod
with Tbl 1006.2.1. Occupant load < 49 per space Maximum Common Path of Egress Travel (Tbl 1006.2.1)	Permitted	Proposed
with Tbl 1006.2.1. Occupant load < 49 per space	Permitted 75'	0'
with Tbl 1006.2.1. Occupant load < 49 per space Maximum Common Path of Egress Travel (Tbl 1006.2.1) A Occupancy with Sprinkler System		
with Tbl 1006.2.1. Occupant load < 49 per space Maximum Common Path of Egress Travel (Tbl 1006.2.1)		



SHEET NOTES

PROVIDE PROTECTION PLAN FOR APPROVAL

RESTORATION KEY NOTES

	AS BUILT – CHANGES AS NOTED	AS BUILT - NO CHANGES	DEP
	CONTRACTOR NAMESIGNATURE	PROJECT COORDINATOR NAME SIGNATURE	
REVISION	TITLE DATE	TITLE DATE	

-PROVIDE PROTECTION FOR EXISTING FEATURES TO REMAIN.


-SCHEDULE AND COMPLETE WORK AS REQUIRED TO GIVE THE SITE IMPROVEMENT CONTRACTORS ACCESS TO THEIR JOBSITE

(1) NEW GRAVEL (PERMEABLE) SURFACE. SEE DETAIL 3 ON SHEET

CONSTRUCTION NOTES

-REPLACE ALL PLANTED MATTER DISTURBED DURING CONSTRUCTION UNLESS STATED OTHERWISE. -REPAIR ALL DAMAGED PARK PROPERTY INCURRED DURING CONSTRUCTION. -REPAIR ASPHALT AS REQUIRED -REPAIR SOD AS REQUIRED

RESTORATION LEGEND

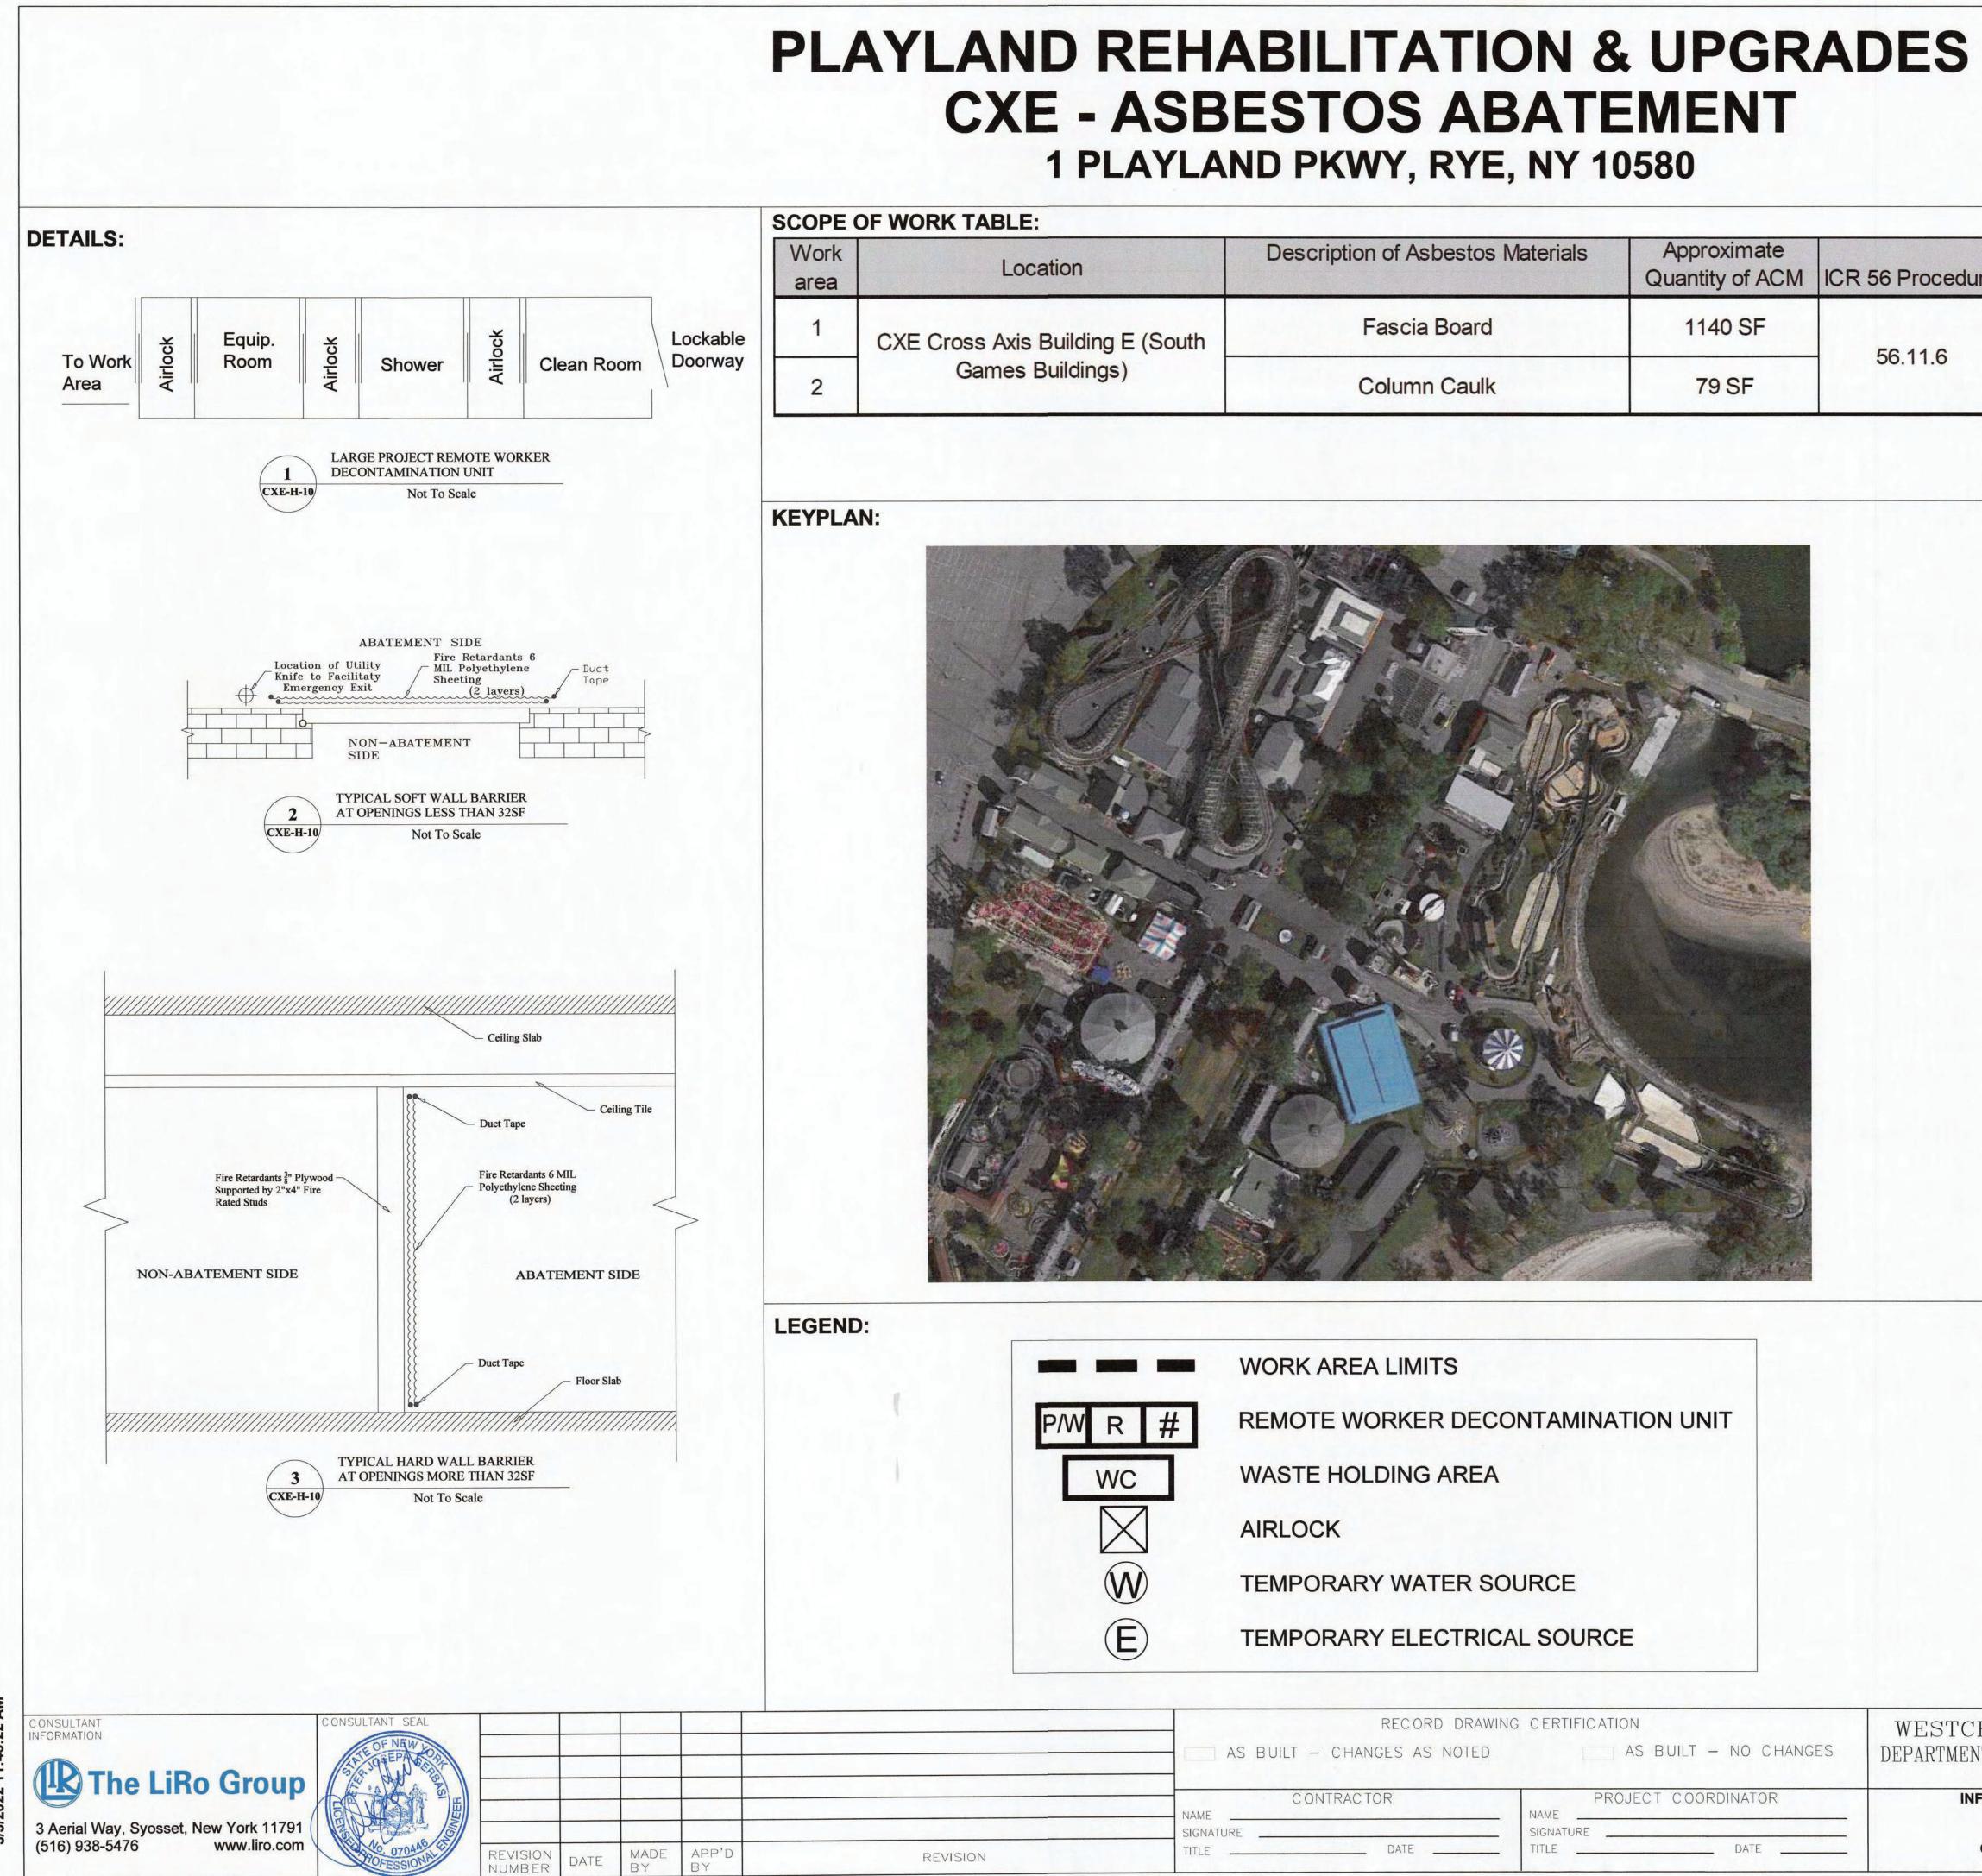


Location	Description of Asbestos Materials	Approximate Quantity of ACM	ICR 56 Proc			
CXE Cross Axis Building E (South	South Fascia Board 1140		50.11			
Games Buildings)	Column Caulk	79 SF	- 56.11.0			

	RECORD DRAWIN	RECORD DRAWING CERTIFICATION WES T - CHANGES AS NOTED AS BUILT - NO CHANGES DEPART CONTRACTOR PROJECT COORDINATOR NAME SIGNATURE	
	AS BUILT - CHANGES AS NOTED	AS BUILT - NO CHANGES	A CONTRACTOR OF A CONTRACTOR O
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	SIGNATURE		
REVISION	TITLE DATE	TITLE DATE	and the second

PROJECT NOTES:	
responsible for verifying quantiti performed. Failure to do so sh	of all conditions of the Project and is es and locations of all Work to be all not relieve the Contractor of its d materials necessary to perform the
Documents and all governing co	odes, rules, and regulations. Where ect Documents and applicable codes, tringent shall apply.
3. All abatement work shall be coord Abatement may be phased with o	dinated with General Contractor work; ther contract work.
Asbestos abatement activities in preparation, gross removal ac removal, etc. may need to be p nights and weekends). In addit required to perform the work ide	uired and approved by the Owner. cluding, but not limited to, work area ctivities, cleaning activities, waste erformed during 'off-hours' (including tion, multiple mobilizations may be ntified in this project. The Contractor II Work with the facility and Owner's
	coordinate with facility representative ge at the entranceway that redirects a of the abatement.
	tape to extend the limits of the active, the public and other non-abatement
phases of the abatement with the	ible for defining and coordinating the facility and DPW, as well as securing mits, and any necessary NYS DOL
decontamination units, routes of	ractor shall coordinate locations of egress, temporary water and power er locations with the Owner and the
9. The Contractor may need to sup they cannot be provided by facility	ply temporary power/water sources if y.
work area(s) under this co	upply any and all scaffolding for the ontract. Scaffolding structure and cordance with local, state and federal
11. The Contractor is to protect any a for abatement.	and all exposed surfaces not targeted
12. The Contractor shall request and with any work info from the own require protection.	d receive in writing prior to preceding ner regarding surfaces/materials that
13. Regular waste generated by the be stored securely using a closed	abatement work of this contract shall waste container.
HESTER COUNTY, NEW YORK T OF PUBLIC WORKS AND TRANSPORTATION	CONTRACT SILEET NUMBER NUMBER 22-523 CXE-H-10
DIVISION OF ENGINEERING	DWG NO.: SCALE: 254 OF NOT TO SCALE


PLAYLAND PARK, RYE, NEW YORK **CROASS AXIS BUILDING E GENERAL ASBESTOS ABATEMENT NOTES**

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22-523	CXE-H-	10		
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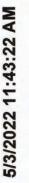


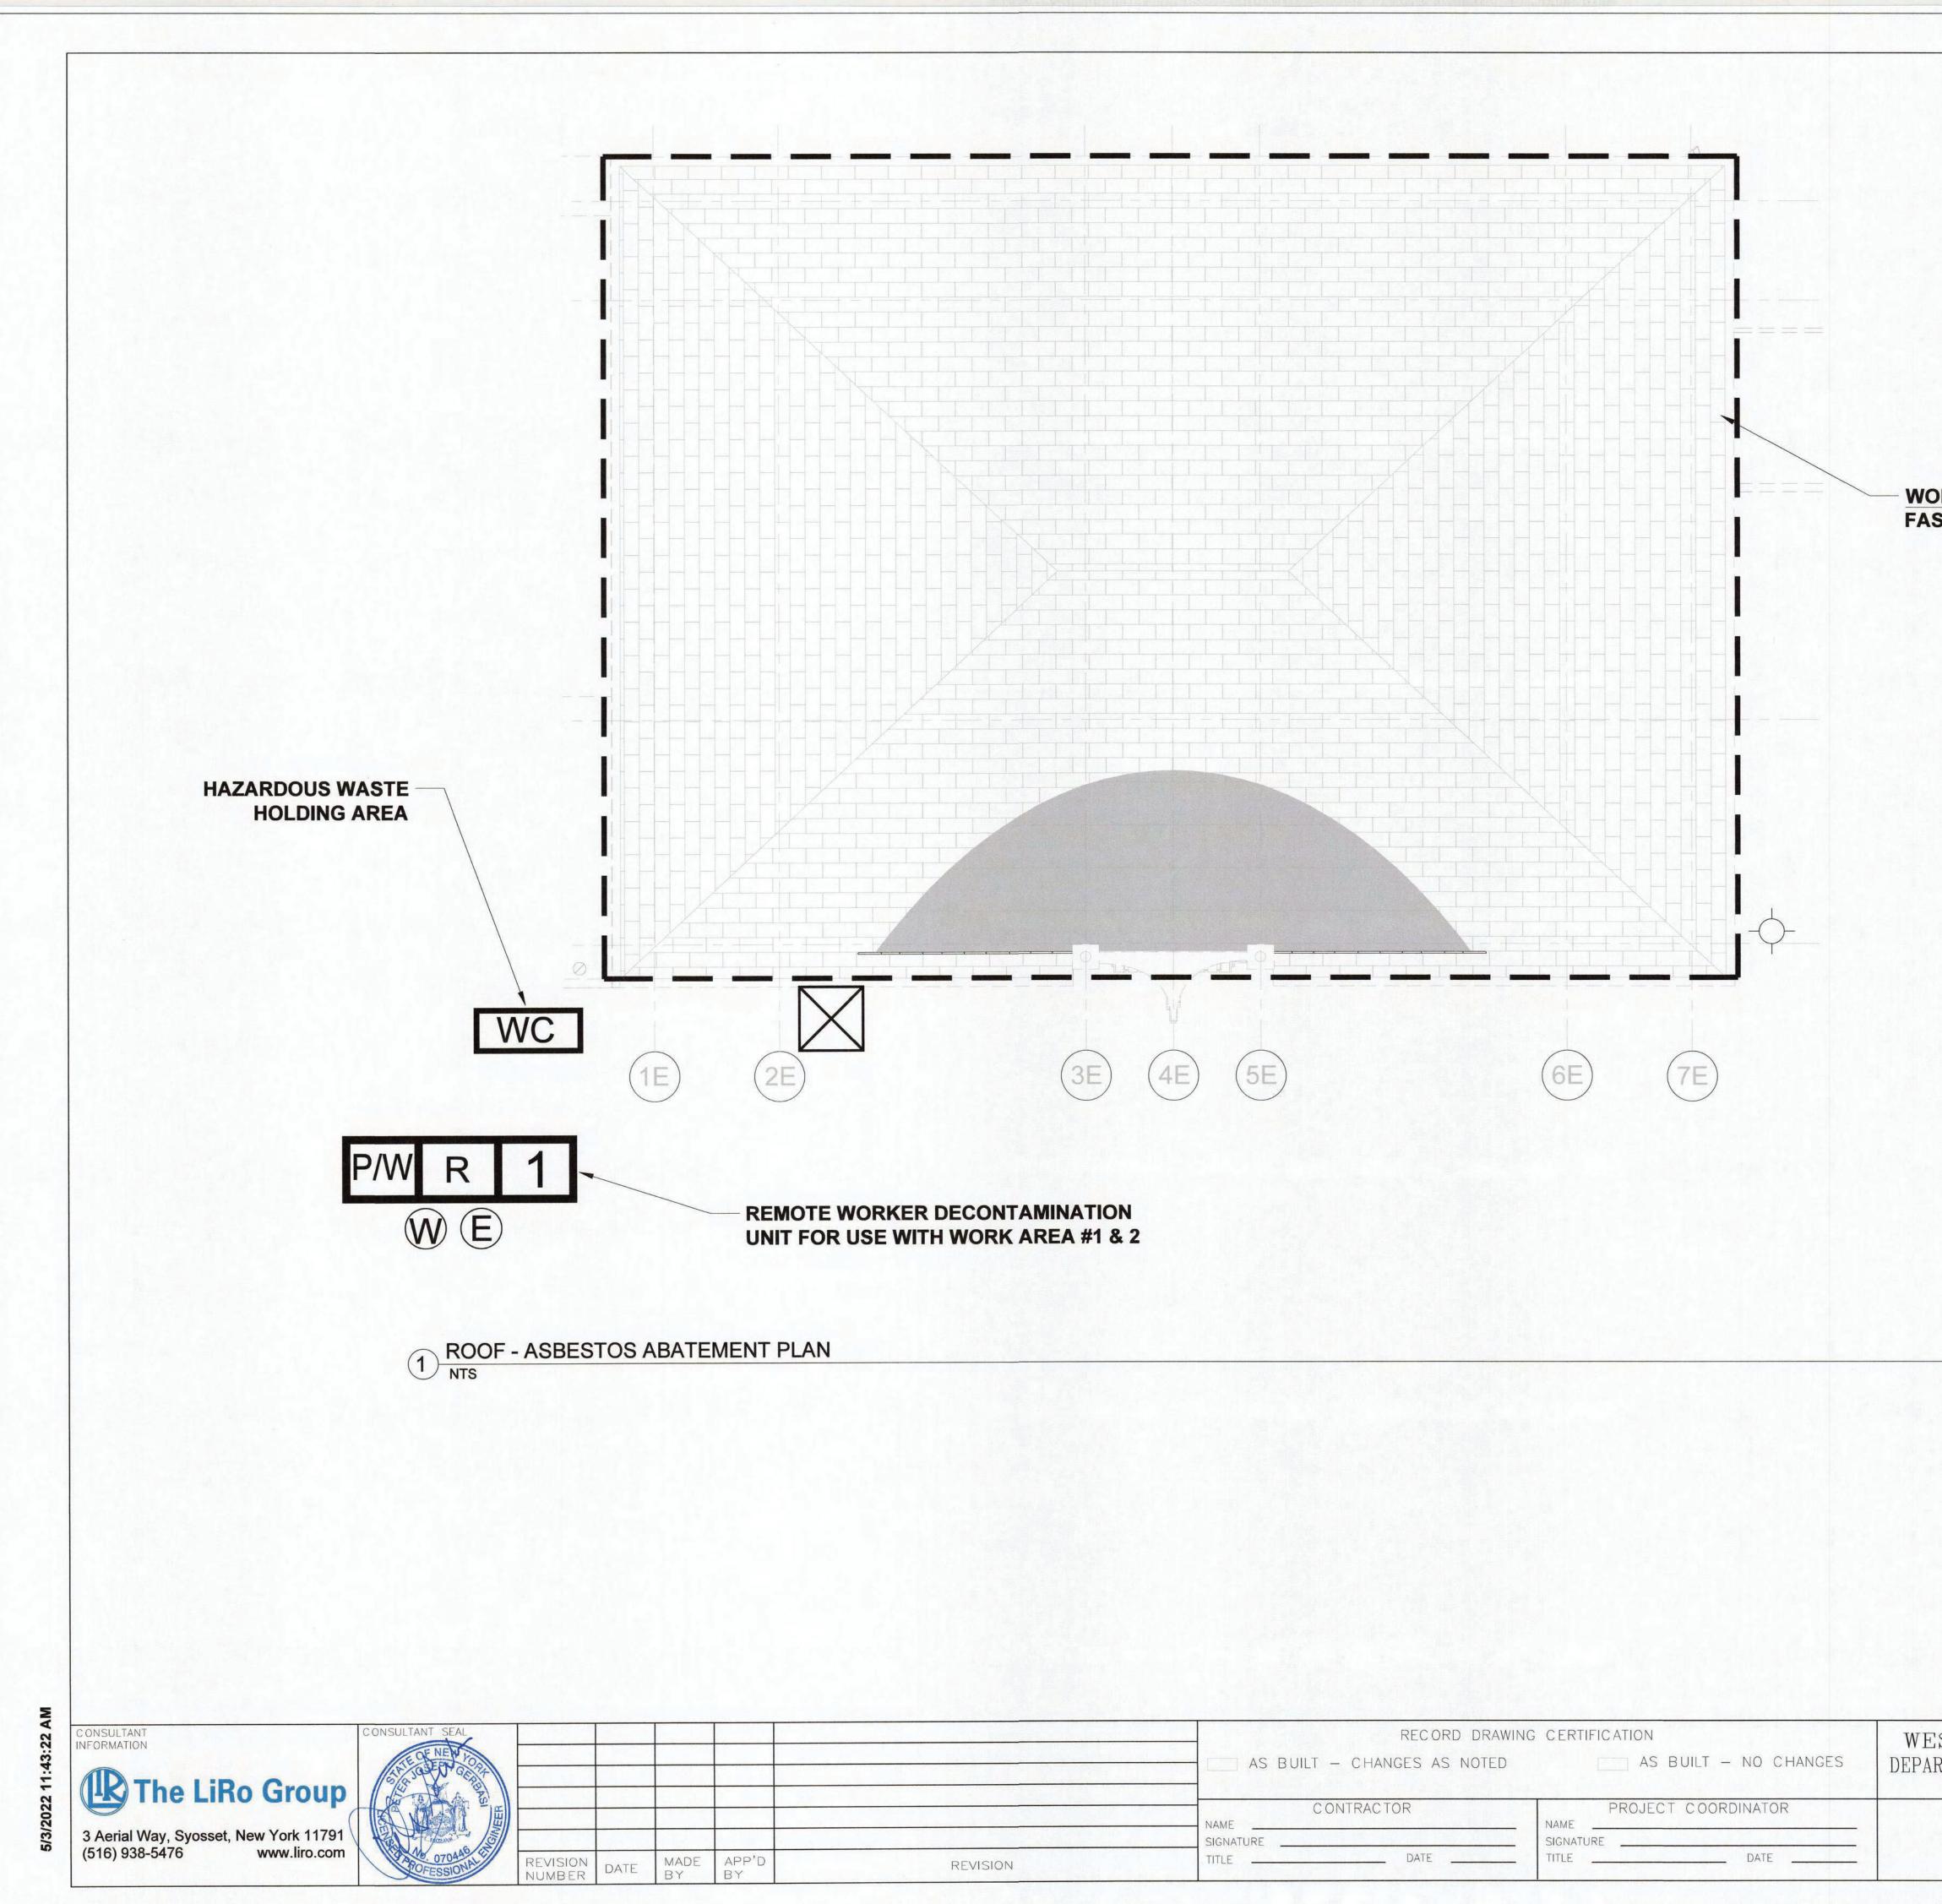WORK AREA #1 FASCIA BOARD

STCHESTER COUNTY, NEW YORK RTMENT OF PUBLIC WORKS AND TRANSPORTATION	CONTRACT NUMBER 22-523	SLIEET NUMBER CXE-H-11
DIVISION OF ENGINEERING	DWG NO .:	
INFRASTRUCTURE REHABILITATION - PHASE 3	SCALE: 255 of	NOT TO SCALE
PLAYLAND PARK, RYE, NEW YORK CROSS AXIS BUILDING E	DATE:	08/23/2022
ROOF - ASBESTOS ABATEMENT PLAN	DPW FILE 1-118-G-1	004-0 REV. 0

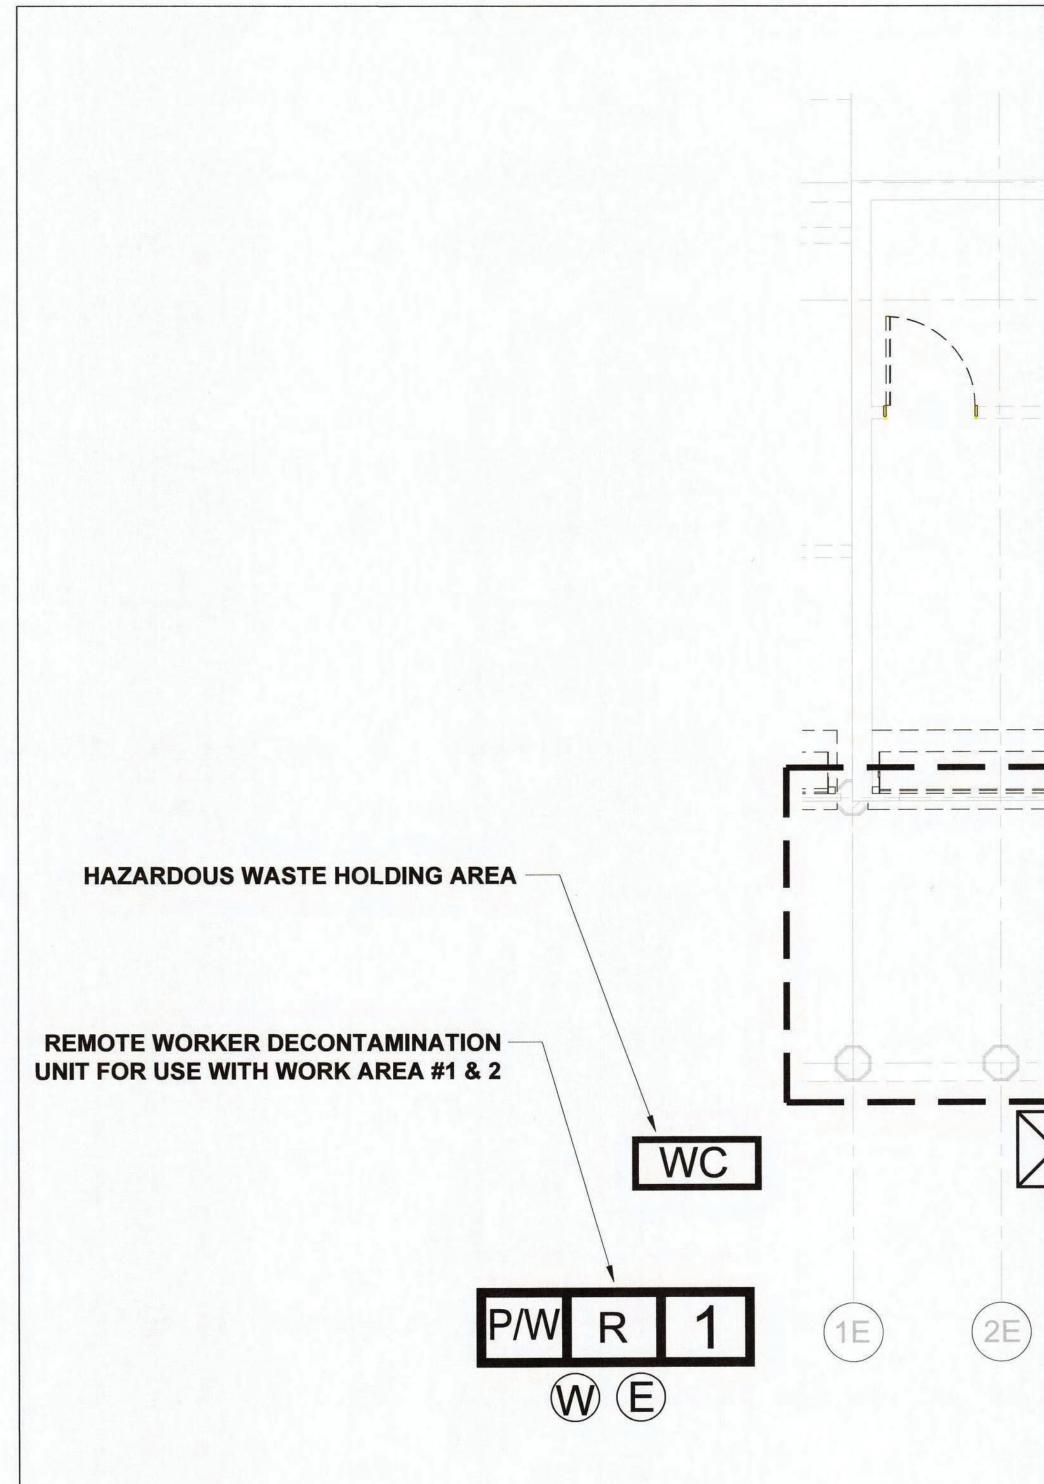

1 GROUND FLOOR - ASBESTOS ABATEMENT F








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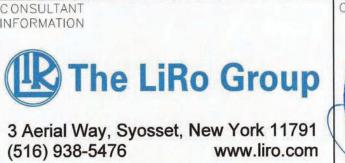
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			WESTCHESTER COUNTY, NEW YORK	CONTRACT SLIEET NUMBER NUMBER 22-523 CXE-H-12
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	CONTRACTOR NAME SIGNATURE	PROJECT COORDINATOR NAME SIGNATURE	INFRASTRUCTURE REHABILITATION - PHASE 3 PLAYLAND PARK, RYE, NEW YORK CROSS AXIS BUILDING E	SCALE: 256 of 664 TO SCALE DATE: 08/23/2022
REVISION	TITLE DATE	TITLE DATE	GROUND FLOOR - ASBESTOS ABATEMENT PLAN	DPW FILE 1-118-G-1005-0 REV. 0 NUMBER 0 NO. 0

WORK AREA #2 COLUMN CAULK



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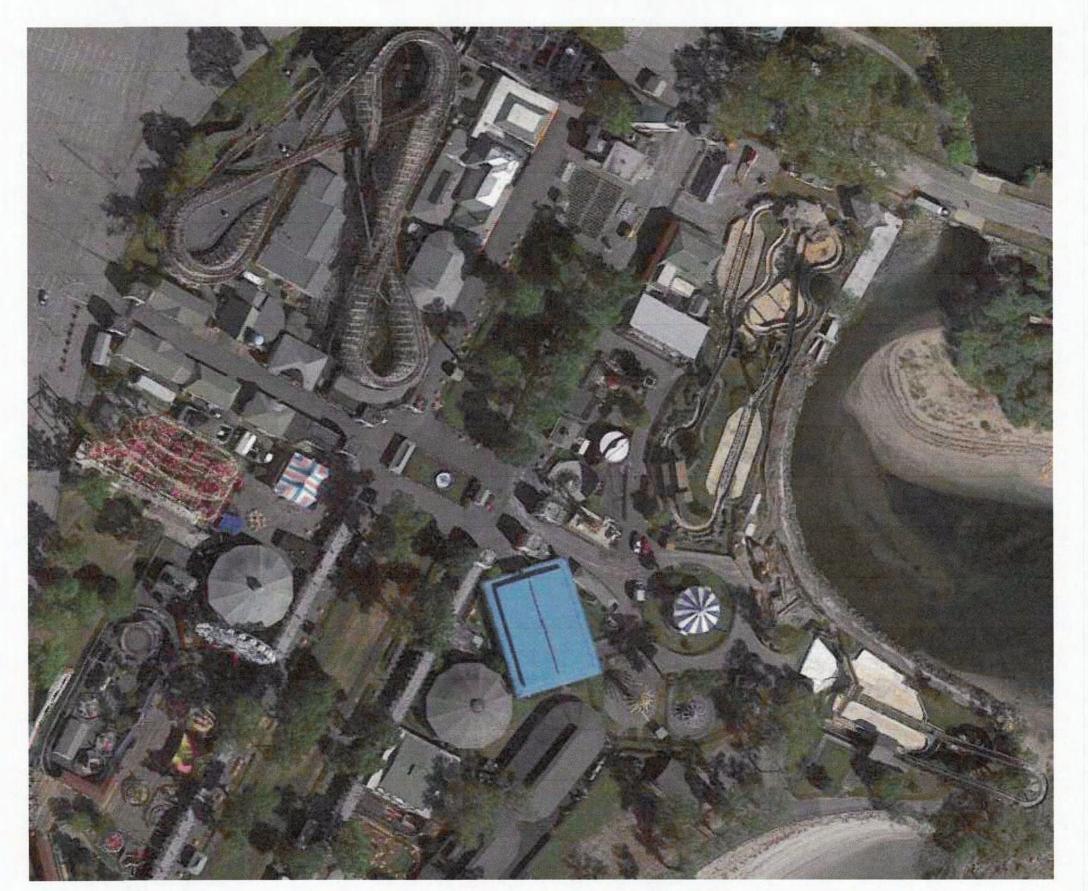

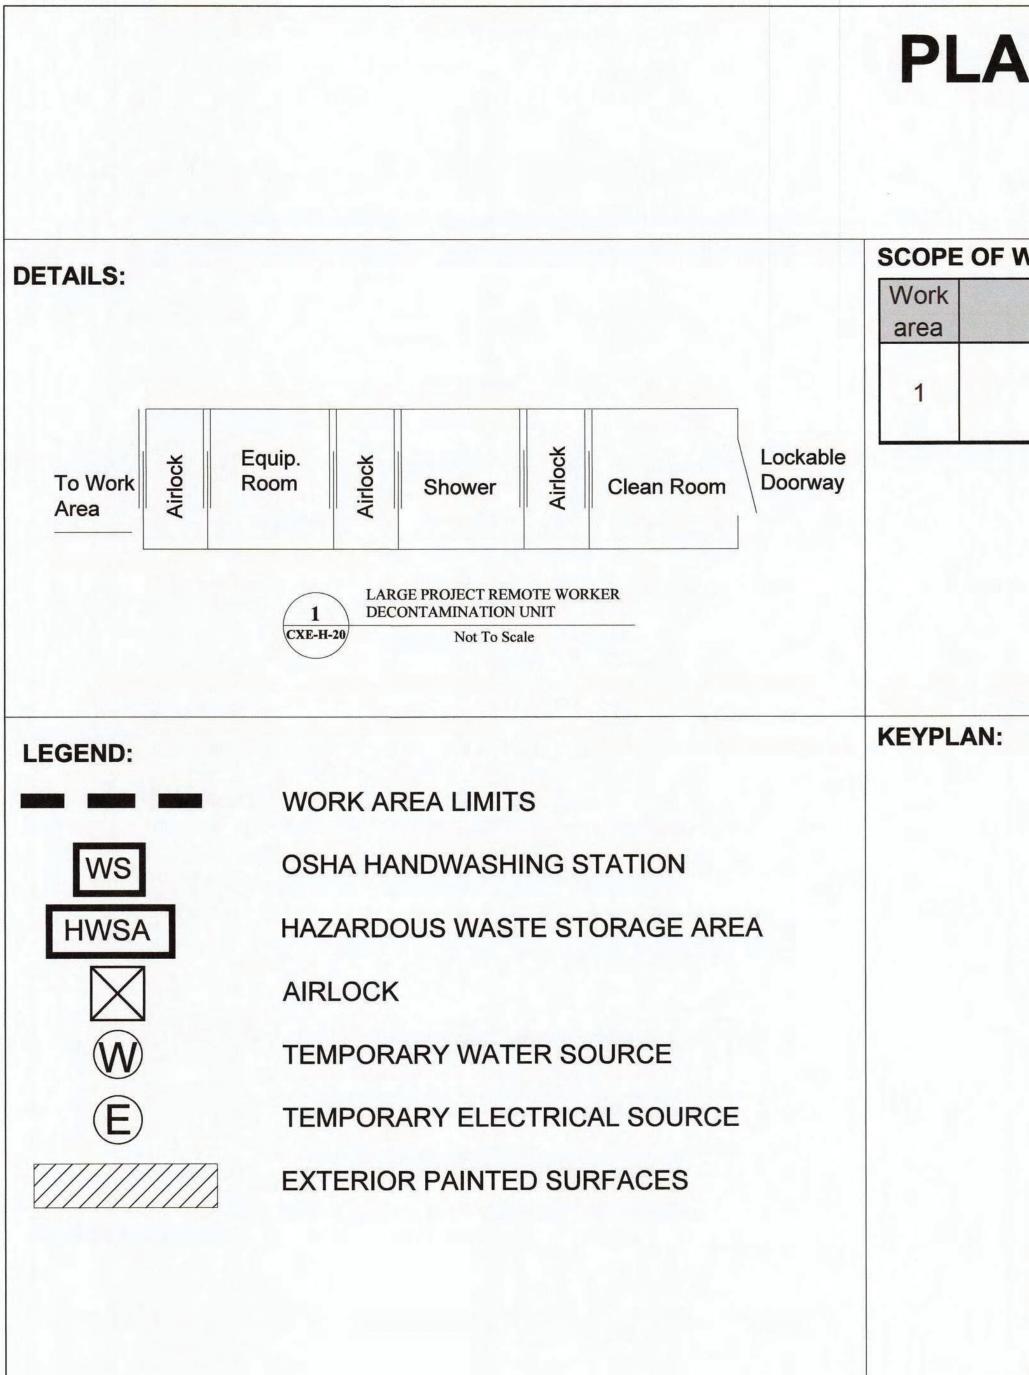
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PLAYLAND REHABILITATION & UPGRADE CXE - LEAD REMEDIATION 1 PLAYLAND PKWY, RYE, NY 10580

SCOPE OF WORK TABLE:

Location	Description	Material	Quantity	Procedu
Exterior	Entire Building	Painted Surfaces	600 SF	Manual W Scraping/Che Strip



		RECORD DRA	WING CERTIFICATION		WES
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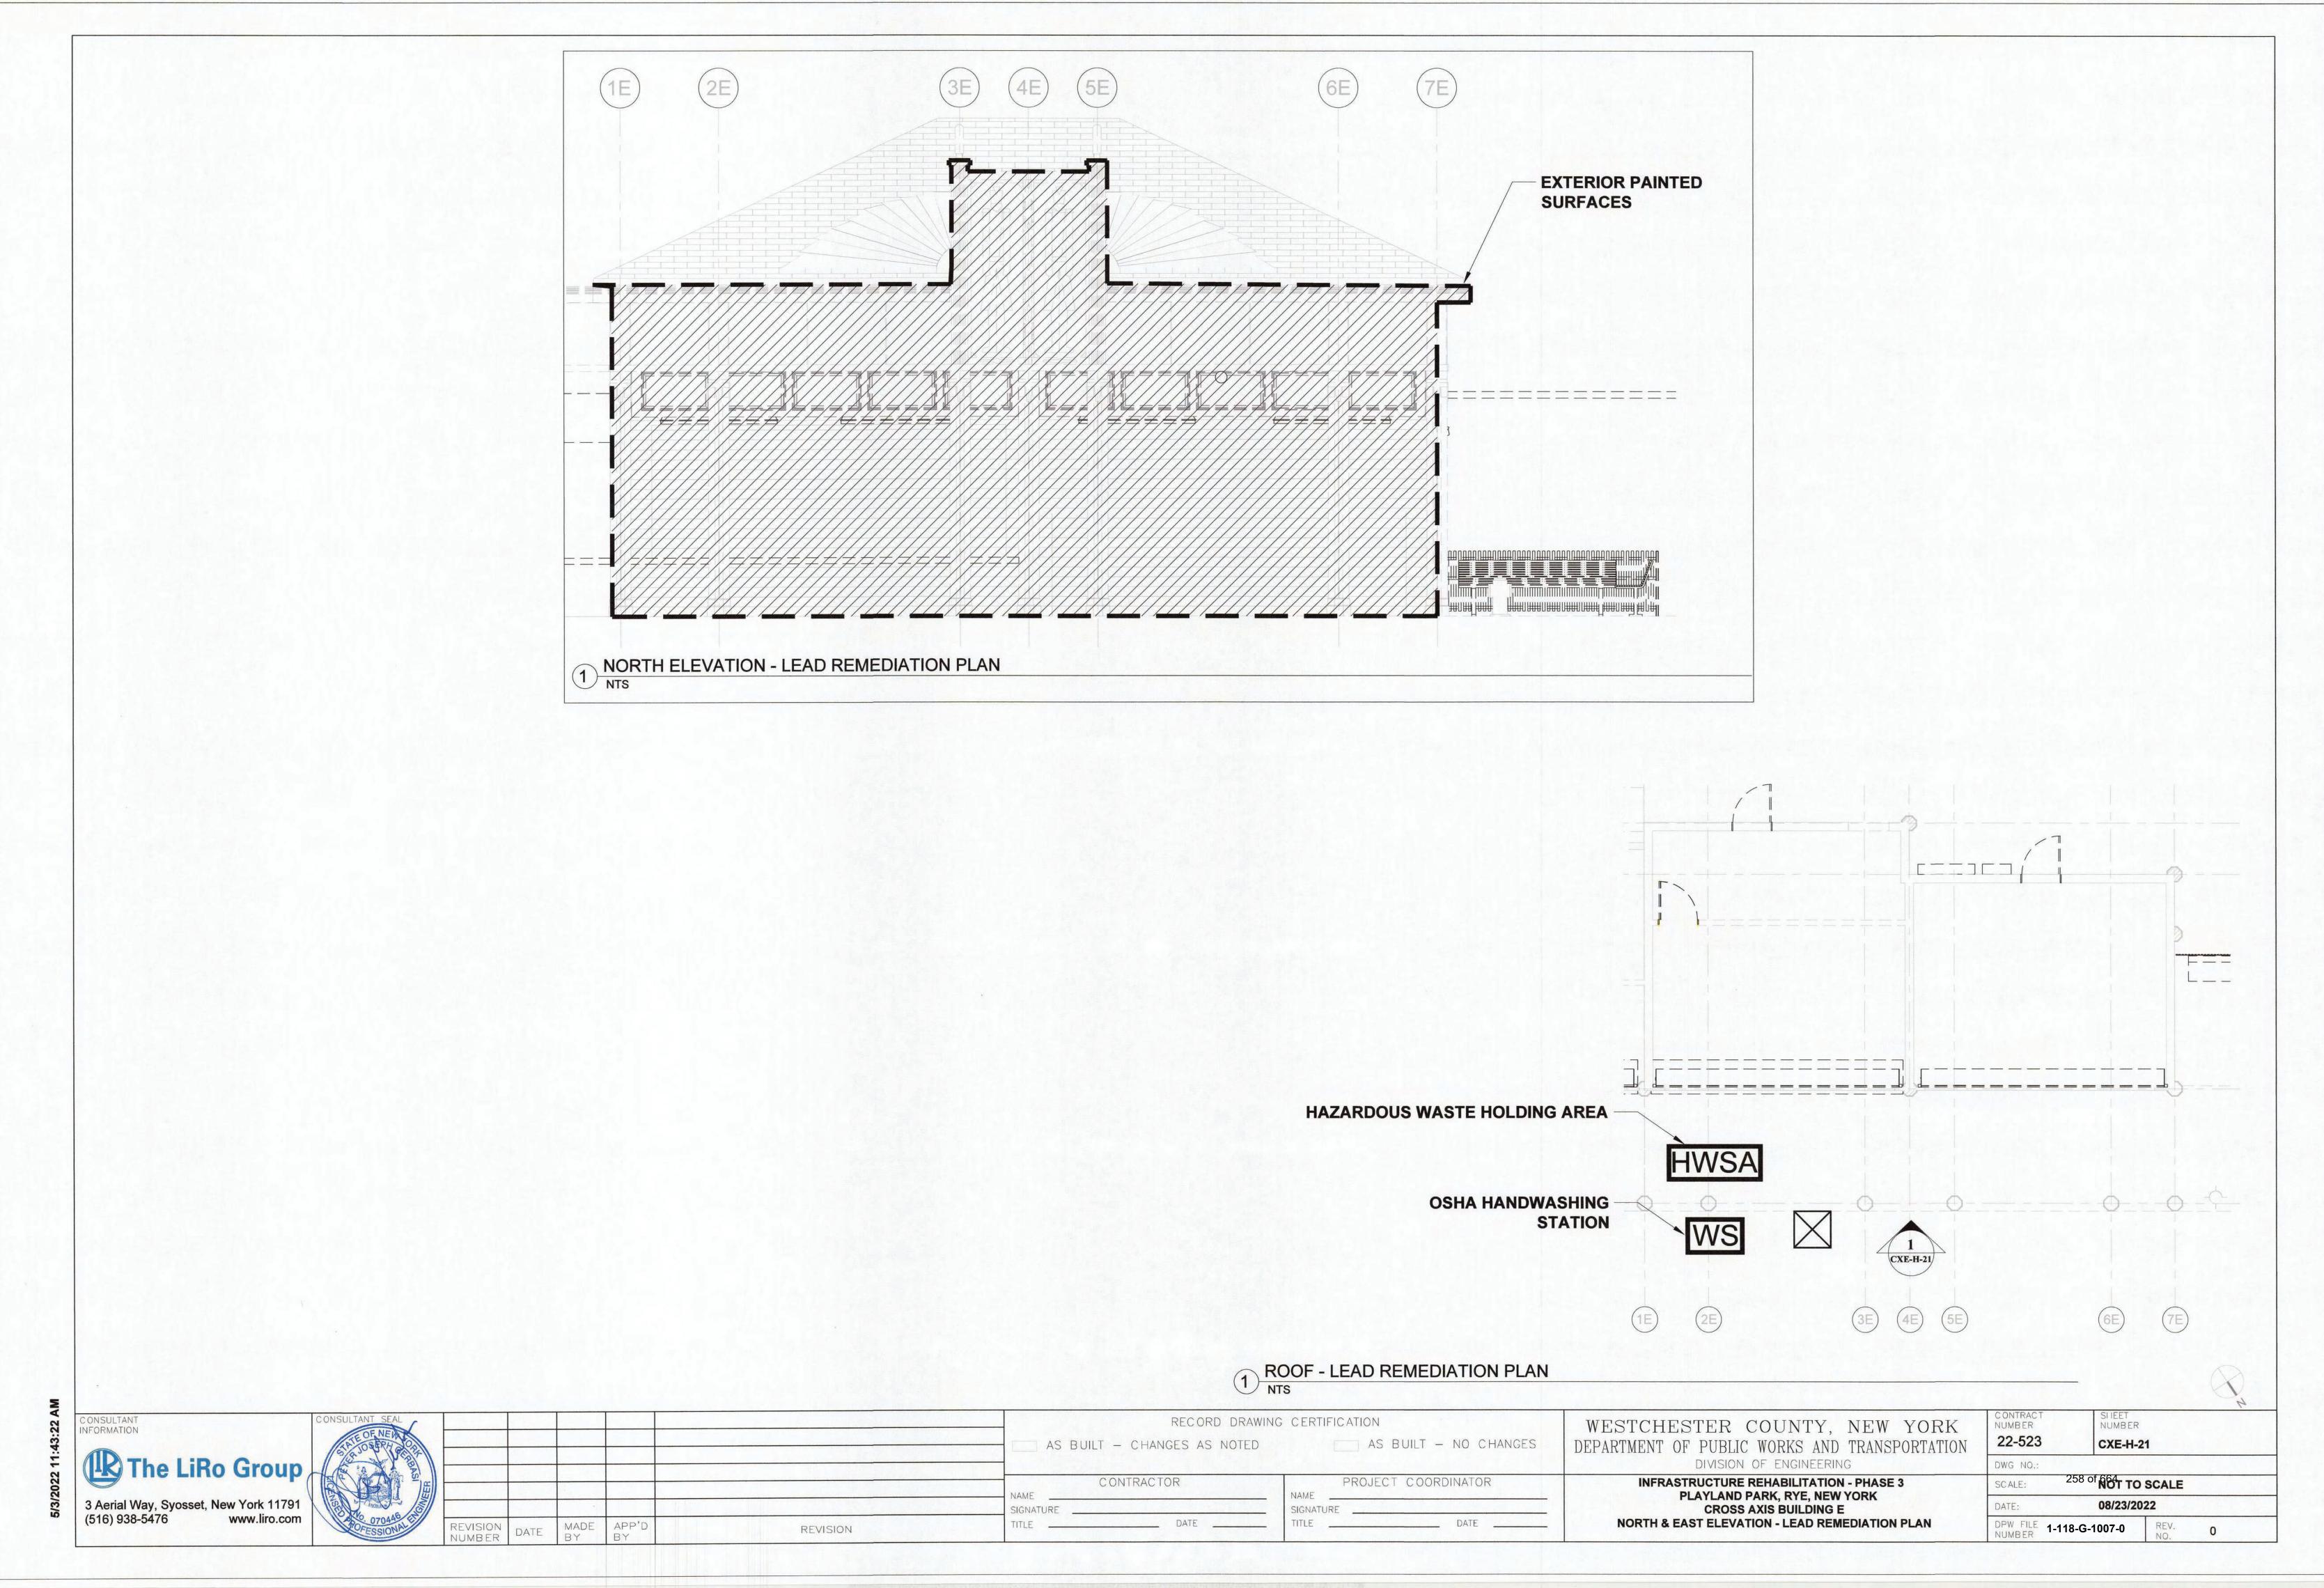
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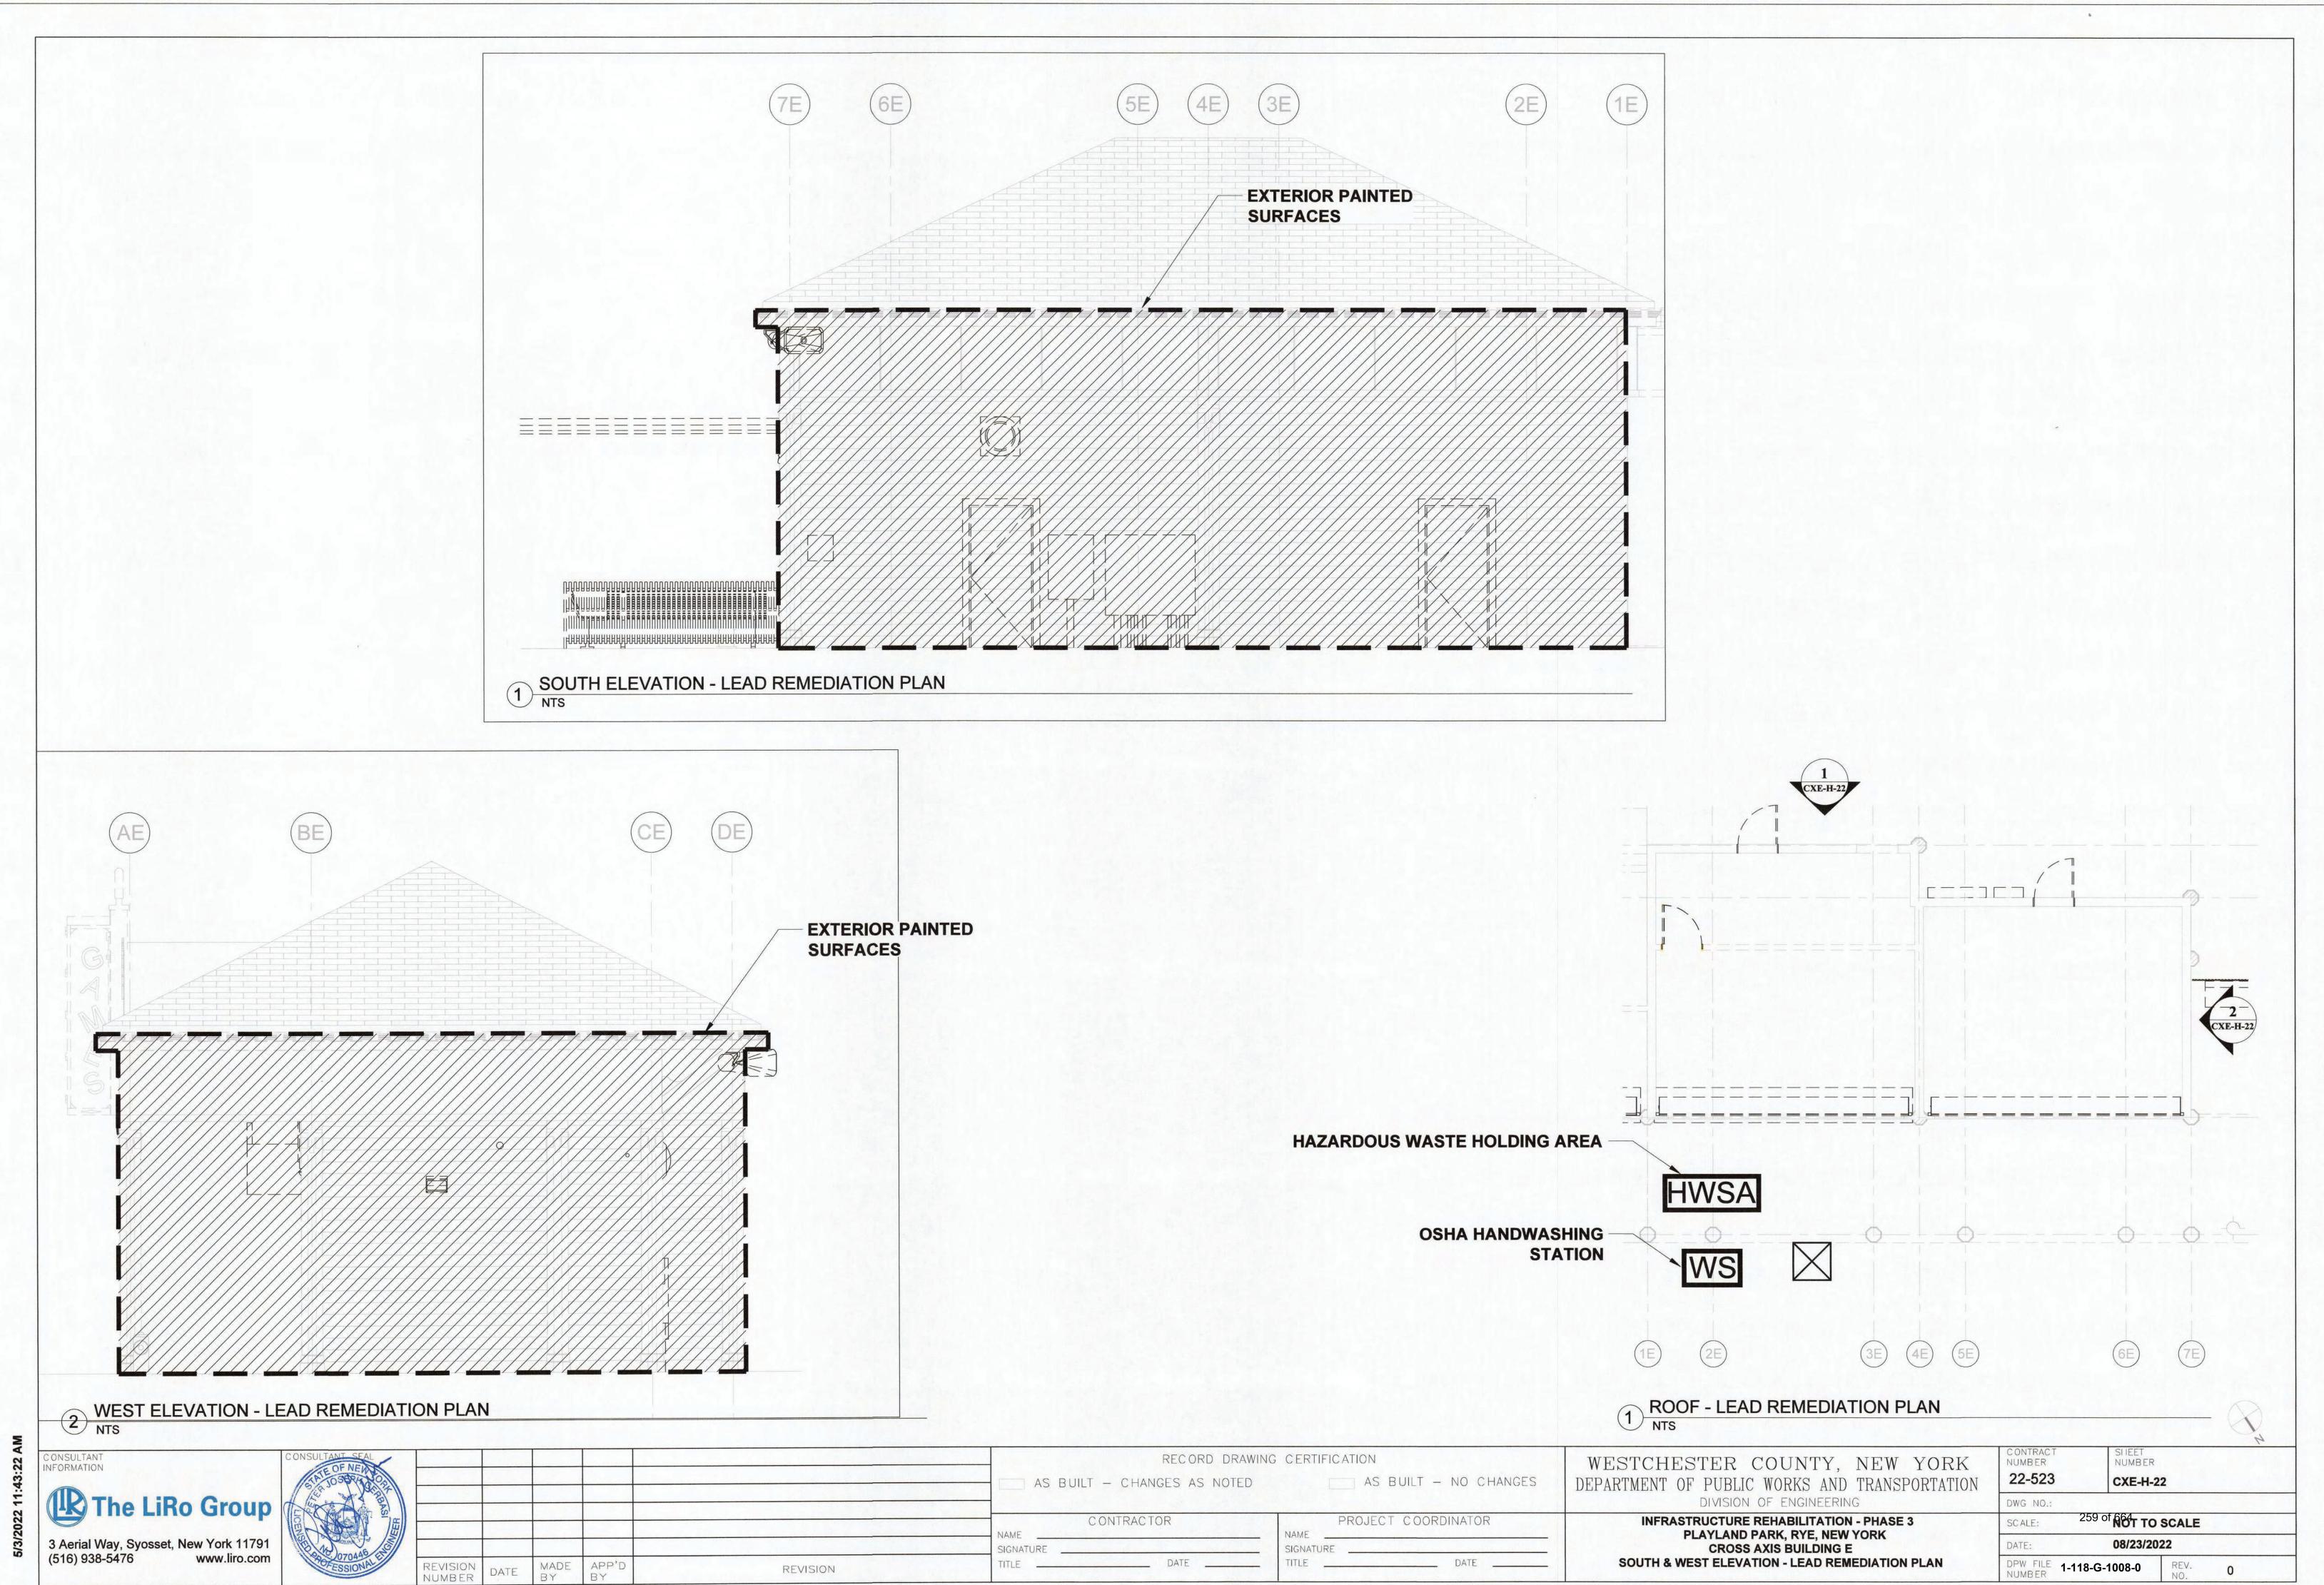
PROJECT NOTES:

- All layers of coating shall be considered as LBP and removed down to the substrates. Substrates coated with LBP and targeted for demolition may be removed and disposed of solid structure waste following TCLP testing.
- 2. Substrates coated with LBP and targeted for refurbish and recoating shall be abated using manual wet scraping or chemical stripping procedures, localized testing of chemical strapping products shall proceed broader use and only after approval by the DPW Environmental Consultant.
- 3. The abatement contractor shall separate paint chips and contaminated dust/particulate generated by the abatement from other project waste streams including worker personal protective equipment and plastic sheeting. All waste other than lead paint chips and contaminated dust/particulate shall be TCLP tested prior to disposal.
- 4. Waste generated by the work of this method shall be stored on site in a NYSDEC compliant Hazardous and Waste Storage Area and transported under manifest to the disposal site.
- 5. The contractor shall prepare a project specific work plan and project specific HASP for the work of this contract.
- LBP remediation shall be consistent with guidelines from SSPC and work shall comply with the OSHA regulations including using of decontamination units and hand wash stations.
- The contractor may propose alternate LBP removal procedures however, use of alternate procedures will require approval by DPW Environmental Consultant; the abatement contractor is responsible with maintaining the physical conditions and integrity of the targeted substrates, and the surrounding structures during abatement work.
- 8. The Contractor shall request and receive in writing prior to preceding with any work info from the owner regarding surfaces/materials that require protection.


STCHESTER COUNTY, NEW YORK RTMENT OF PUBLIC WORKS AND TRANSPORTATION	C ONTRACT NUMBERSI IEET NUMBER22-523CXE-H-20		
DIVISION OF ENGINEERING	DWG NO .:		
INFRASTRUCTURE REHABILITATION - PHASE 3	SCALE: 257 of NOT TO SCALE		
PLAYLAND PARK, RYE, NEW YORK CROSS AXIS BUILDING E	DATE: 08/23/2022		
GENERAL LEAD REMEDIATION NOTES	DPW_FILE 1-118-G-1006-0 REV. 0 NUMBER 0 0 0		



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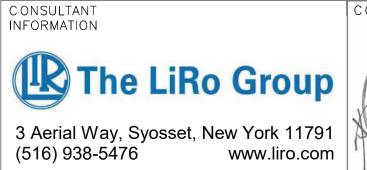


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	CONTRACTOR	PF	ROJECT COORDINATOR			
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GROUND FLOOR DEMOLITION PLAN CXE 1/4" = 1'-0"

CONSULTANT

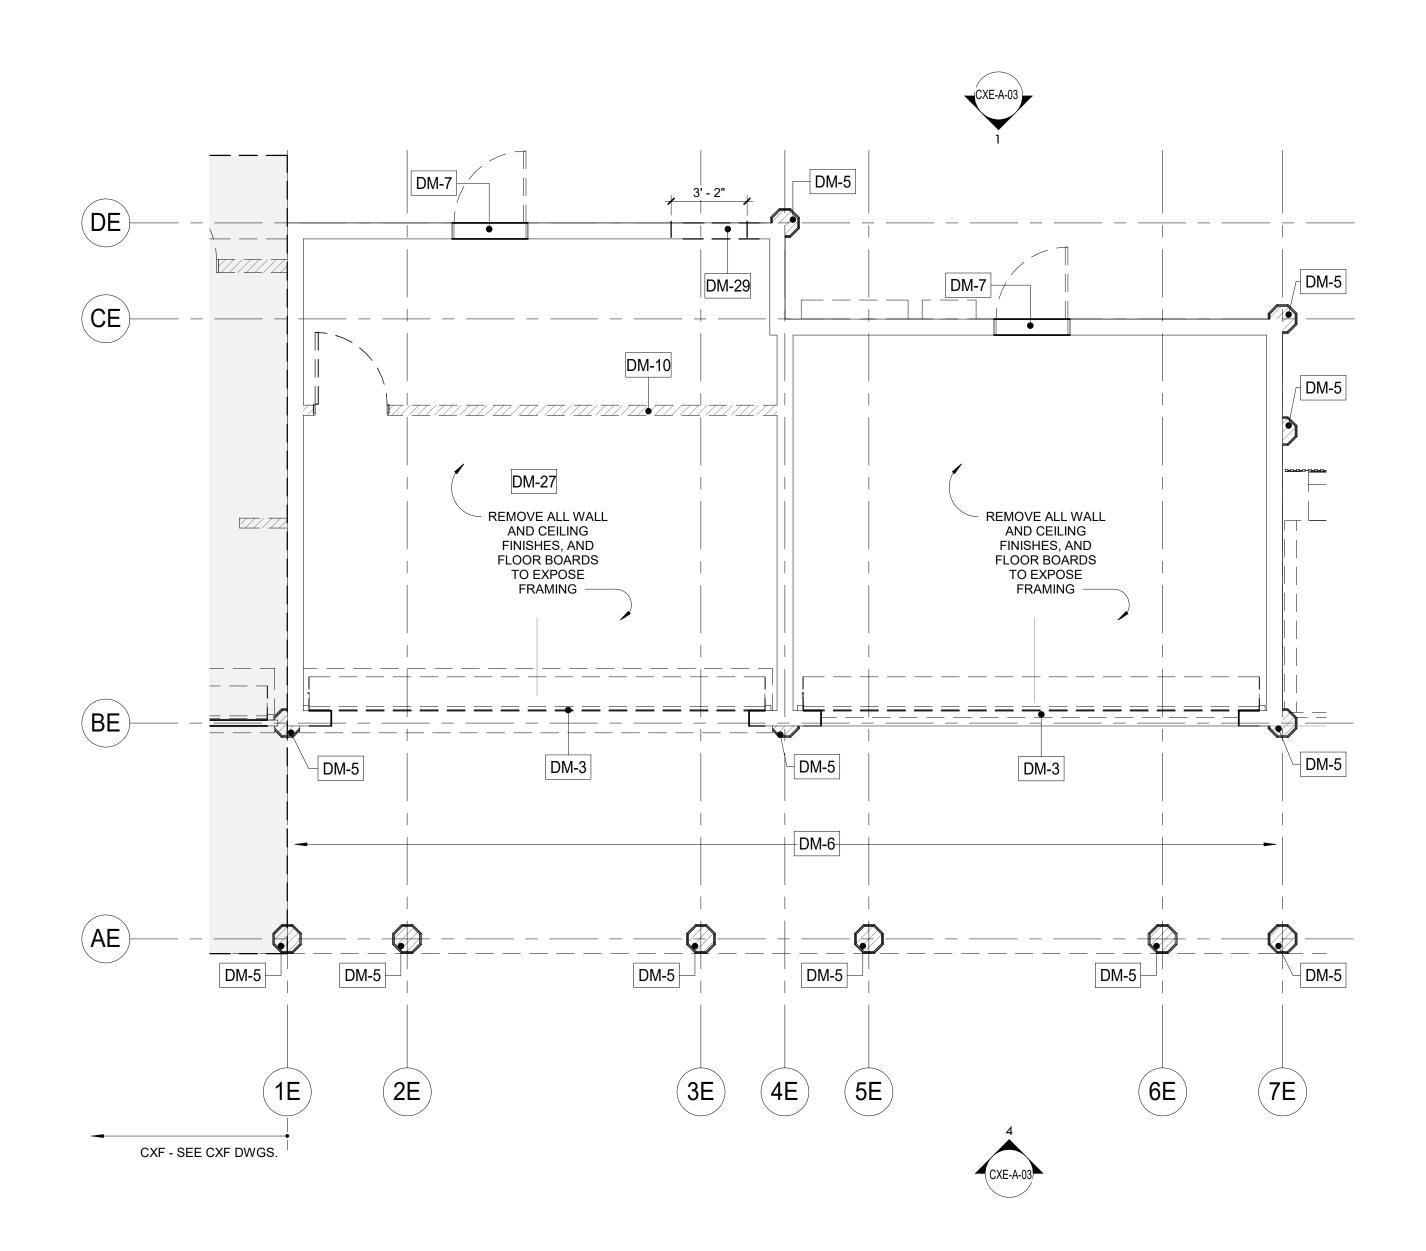



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	RECORD DRAWIN	NG CERTIFICATION	WESTCHESTEF
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	CONTRACTOR NAMESIGNATURE	PROJECT COORDINATOR NAME SIGNATURE	INFRASTRUCT PLAYLAN CRO
REVISION	TITLE DATE	TITLE DATE	CXE - GROUN

DEMOLITION NOTES:

- THE GENERAL CONTRACTOR SHALL VISIT THE SITE AND FAMILIARIZE HIM/HERSELF WITH EXISTING CONDITIONS AND REQUIREMENTS OF THE WORK. THE GENERAL CONTRACTOR SHALL FIELD VERIFY EXACT QUANTITIES OF ALL ITEMS TO BE REMOVED.
- 2. THE CONTRACTOR SHALL PHOTOGRAPH AND DOCUMENT EXISTING HISTORIC DECORATIVE TRIMS INCLUDING SIZES AND PROFILES PRIOR TO ENVIRONMENTAL REMEDIATION WORK START.
- ITEMS TO BE REMOVED / DEMOLISHED AS INDICATED ON THE DRAWINGS ARE INTENDED TO SHOW THE GENERAL SCOPE OF THE DEMOLITION WORK. THE DRAWINGS DO NOT REPRESENT IN DETAIL ALL ITEMS OR SITUATIONS THAT MAY BE ENCOUNTERED DURING THE DEMOLITION. IT IS THE CONTRACTOR'S RESPONSIBILITY TO REMOVE, PROTECT, AND MAKE CORRECTIONS AS REQUIRED TO ACHIEVE DRAWING INTENT. THE GENERAL CONTRACTOR SHALL NOTIFY ARCHITECT OF ANY STRUCTURAL NONCONFORMITY TO PLANS AND SPECIFICATIONS.
- 4. PLAYLAND RESERVES THE RIGHT TO REVIEW ALL MATERIALS DESIGNATED FOR REMOVAL AND TO RETAIN OWNERSHIP OF SUCH MATERIALS. IF PLAYLAND RETAINS ANY MATERIAL THE CONTRACTOR SHALL MAKE ARRANGEMENTS WITH THE PLAYLAND'S SUPERINTENDENT TO HAVE THOSE MATERIALS REMOVED AND STORED OFF SITE AT NO ADDITIONAL COST.
- DEMOLITION OF THE EXISTING BUILDING SHALL INCLUDE REMOVAL OF THE EXISTING FOUNDATIONS FOR THEIR ENTIRE DEPTH TO ACCOMMODATE INSTALLATION OF NEW FOUNDATIONS.
 THE CONTRACTOR SHALL USE EXTREME CAUTION IN AREAS OF DEMOLITION WHICH MAY DISTURB EXISTING STRUCTURES. TEMPORARY SHORING, BARRICADES, DUST PARTITIONS, ETC. SHALL BE
- PROVIDED AS REQUIRED TO PROTECT ALL EXISTING STRUCTURES AND PROPERTY.7. SEE STRUCTURAL, ELECTRICAL, SPRINKLER, AND PLUMBING DRAWINGS FOR RELATED DEMOLITION
- WORK. 8. VERIFY LOCATION OF EXISTING STRUCTURES AND SHORE UP ROOF/FLOOR ABOVE AS REQUIRED BEFORE REMOVING WALL.
- REMOVAL OF ALL CEILINGS AND MOUNTED ITEMS THROUGHOUT THE CONTRACT AREA INCLUDE ANCHORING HARDWARE, AND MISCELLANEOUS FASTENINGS, ETC.
- WALLS SHALL BE REMOVED AS INDICATED ON DEMOLITION PLANS. ALL UTILITIES IN WALL SHALL BE CUT TO BELOW SLAB OR ABOVE THE CEILING.
 REMOVE ALL EXISTING ELECTRICAL AND PLUMBING LINES NOT TO BE RE-USED. CAP PLUMBING
- LINES AS REQUIRED. ELECTRICAL WIRING SHALL BE DISCONNECTED BACK TO THE NEAREST ACTIVE LOCATION. ALL ABANDONED COMMUNICATION CABLES (DATA, TELEPHONE, FIRE ALARM, AND AUDIO/VIDEO CABLES) SHALL BE REMOVED TO SOURCE IF NOT TAGGED FOR FUTURE USE.
- 12. DEMOLITION PROCEDURES ARE THE SOLE RESPONSIBILITY OF THE GENERAL CONTRACTOR OF THIS CONTRACT. CONTRACTOR TO "CUT OFF" ALL NECESSARY UTILITIES REQUIRED TO OBTAIN DESIRED RESULTS. CONTRACTOR TO OBTAIN "SHUT OFF" APPROVALS FROM PLAYLAND PRIOR TO SCHEDULED DEMOLITION.
- 13. THE GENERAL CONTRACTOR SHALL PATCH AND REPAIR ALL EXISTING CONSTRUCTION DISTURBED BY THE WORK AND PREPARE FOR NEW FINISH AS SHOWN ON THE INTERIOR ELEVATIONS.
- THE EXISTING WOOD FLOOR SHALL BE CLEANED TO ALLOW FOR THE APPLICATION OF NEW FLOOR COATING.
- 15. THE GENERAL CONTRACTOR SHALL BE RESPONSIBLE FOR THE CLEANING UP AND HAULING AWAY OF ALL TRASH AND DEBRIS ON A REGULAR BASIS DURING THE CONSTRUCTION PERIOD.
- ALL DEBRIS REMOVED FROM THE SITE SHALL BE DISPOSED OF IN A LEGAL MANNER.
 EXISTING EXITS SHALL REMAIN FULLY ACCESSIBLE AND UNOBSTRUCTED DURING THE PROGRESS OF THE WORK.

DEMOLITION LEGEND

	<u></u>	77777		
	DM	DEMOLITION KEY NOTES		
		SHINGLES TO BE REMOVE	=D	
		SBS MODIFIED BITUMEN 1	O BE REMOVED	
	N	IC INDICATES N.I.C.		
	DEMO	KEYNOTES		
	DEIVIC DM-3	REMOVE ROLL DOWN DOOR AND AS	SOCIATED HARDWARE	
	DM-5	AS REFERENCE IN ORDER TO REPL	ICATE TRIMS TO MATCH	EAST ONE COLUMN ENCLOSURE TO USE
	DM-6	INDICATED. COORDINATE WITH STR REMOVE EXISTING WOOD DECKING FLOOR JOISTS TO REMAIN AS NEED	. (COORDINATE EXTENT	
	DM-7 DM-10	REMOVE EXISTING DOOR & FRAME. REMOVE INTERIOR PARTITION.		
	DM-10 DM-27 DM-29	REMOVE EXISTING FLOORING.		S REQUIRED TO CREATE A DOOR OPENING.
	DIM 20	SEE ELEVATIONS FOR EXTENT.		
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4			CONTRACT	SHEET
		Y, NEW YORK	NUMBER	NUMBER
ENT OF PUBLIC WOF division of ei		ND TRANSPORTATION	22-523 DWG NO.: 260 of 6	CXE-A-01
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PLAYLAND PARK, R	YE, NE	W YORK		


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DPW FILE **1-118-A-1009-0** REV. NUMBER NO.

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CROSS AXIS BUILDING E


CXE - GROUND FLOOR DEMOLITION PLAN



ROOF PLAN DEMOLITION CXE 1/4" = 1'-0"

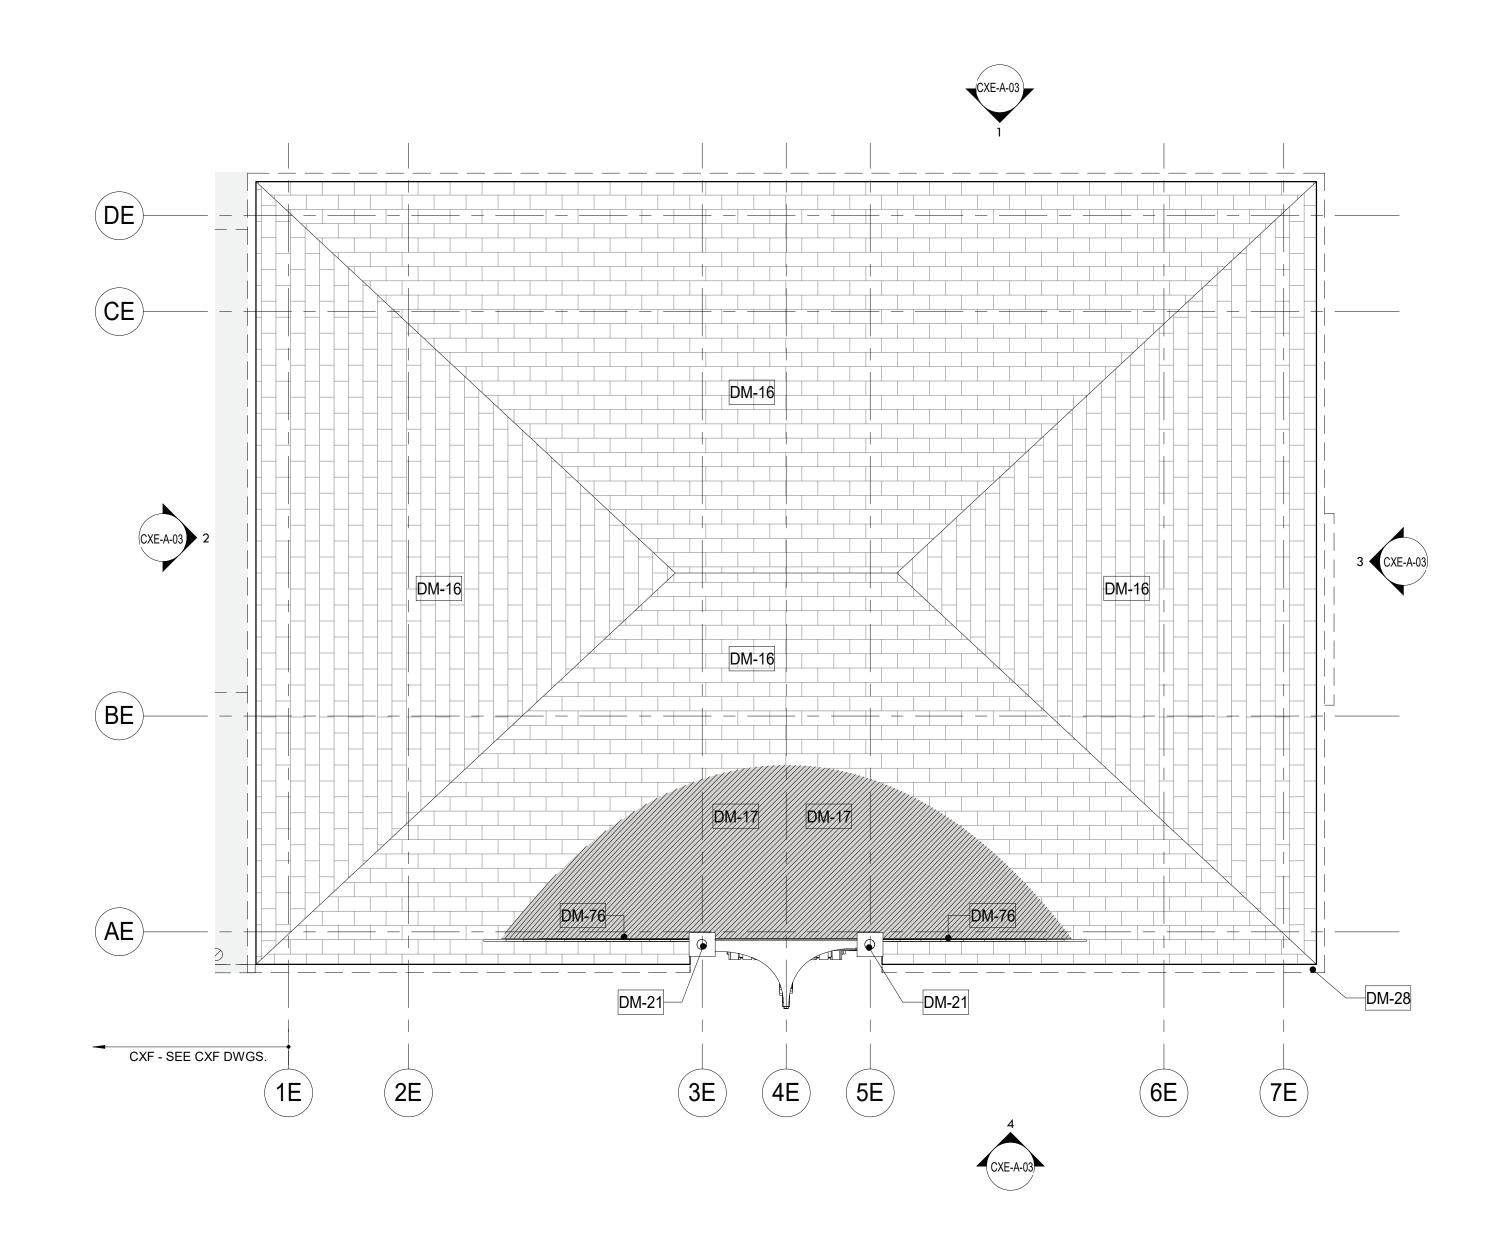



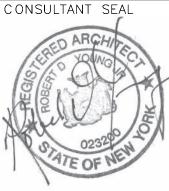

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WESTCHESTEF	G CERTIFICATION	RECORD DRAWING	
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INFRASTRUCT PLAYLAN CRO	PROJECT COORDINATOR NAME SIGNATURE	CONTRACTOR NAME	
CXE - R	TITLE DATE	TITLE DATE	REVISION

DEMOLITION NOTES:


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- 12. DEMOLITION PROCEDURES ARE THE SOLE RESPONSIBILITY OF THE GENERAL CONTRACTOR OF THIS CONTRACT. CONTRACTOR TO "CUT OFF" ALL NECESSARY UTILITIES REQUIRED TO OBTAIN DESIRED RESULTS. CONTRACTOR TO OBTAIN "SHUT OFF" APPROVALS FROM PLAYLAND PRIOR TO SCHEDULED DEMOLITION.
- 13. THE GENERAL CONTRACTOR SHALL PATCH AND REPAIR ALL EXISTING CONSTRUCTION DISTURBED
- BY THE WORK AND PREPARE FOR NEW FINISH AS SHOWN ON THE INTERIOR ELEVATIONS. 14. THE EXISTING WOOD FLOOR SHALL BE CLEANED TO ALLOW FOR THE APPLICATION OF NEW FLOOR COATING.
- 15. THE GENERAL CONTRACTOR SHALL BE RESPONSIBLE FOR THE CLEANING UP AND HAULING AWAY OF ALL TRASH AND DEBRIS ON A REGULAR BASIS DURING THE CONSTRUCTION PERIOD.
- 16. ALL DEBRIS REMOVED FROM THE SITE SHALL BE DISPOSED OF IN A LEGAL MANNER. 17. EXISTING EXITS SHALL REMAIN FULLY ACCESSIBLE AND UNOBSTRUCTED DURING THE PROGRESS OF THE WORK.

	DEMOLITION	I LEGEND			
		INDICATES DEMOLITION			
	DM - #	DEMOLITION KEY NOTES			
		SHINGLES TO BE REMOVE	D		
		SBS MODIFIED BITUMEN T	O BE REMOVED		
	NIC	INDICATES N.I.C.			
	REPLACDM-17REMOVE REPLACDM-21CAREFUDM-28REMOVEDM-76CAREFU	E EXISTING ROOFING SHINGL E DAMAGED SHEATHING TO E EXISTING ROOFING MEMBF E EXISTING DAMAGED SHEA LLY REMOVE FINIAL LIGHTS E EXISTING GUTTER, FASCIA	MATCH EXISTING. CC RANES, UNDERLAYME THING TO MATCH EXI (H6) FOR REFURBISH , AND SOFFITS.	AND ANY ROTTED WOOD SH ORDINATE WITH A/E. NT AND ANY ROTTED WOOD S STING. COORDINATE WITH A/ MENT AND REINSTALLATION PR RESTORATION/ REPLICATI	SHEATHING. /E.
ESTCHESTER COU	JNTY, N	EW YORK	C ONTRAC T NUMB ER	SHEET NUMBER	
ARTMENT OF PUBLIC WO	RKS AND TI		22-523	CXE-A-02	
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PLAYLAND PARK, RIE, NEW TORK **CROSS AXIS BUILDING E CXE - ROOF DEMOLITION PLAN**


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DEMOLITION NOTES:

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	CONTRACTOR	PROJECT COORDINATOR	
	NAME	NAME	
	SIGNATURE	SIGNATURE	
REVISION	TITLE DATE	TITLE DATE	

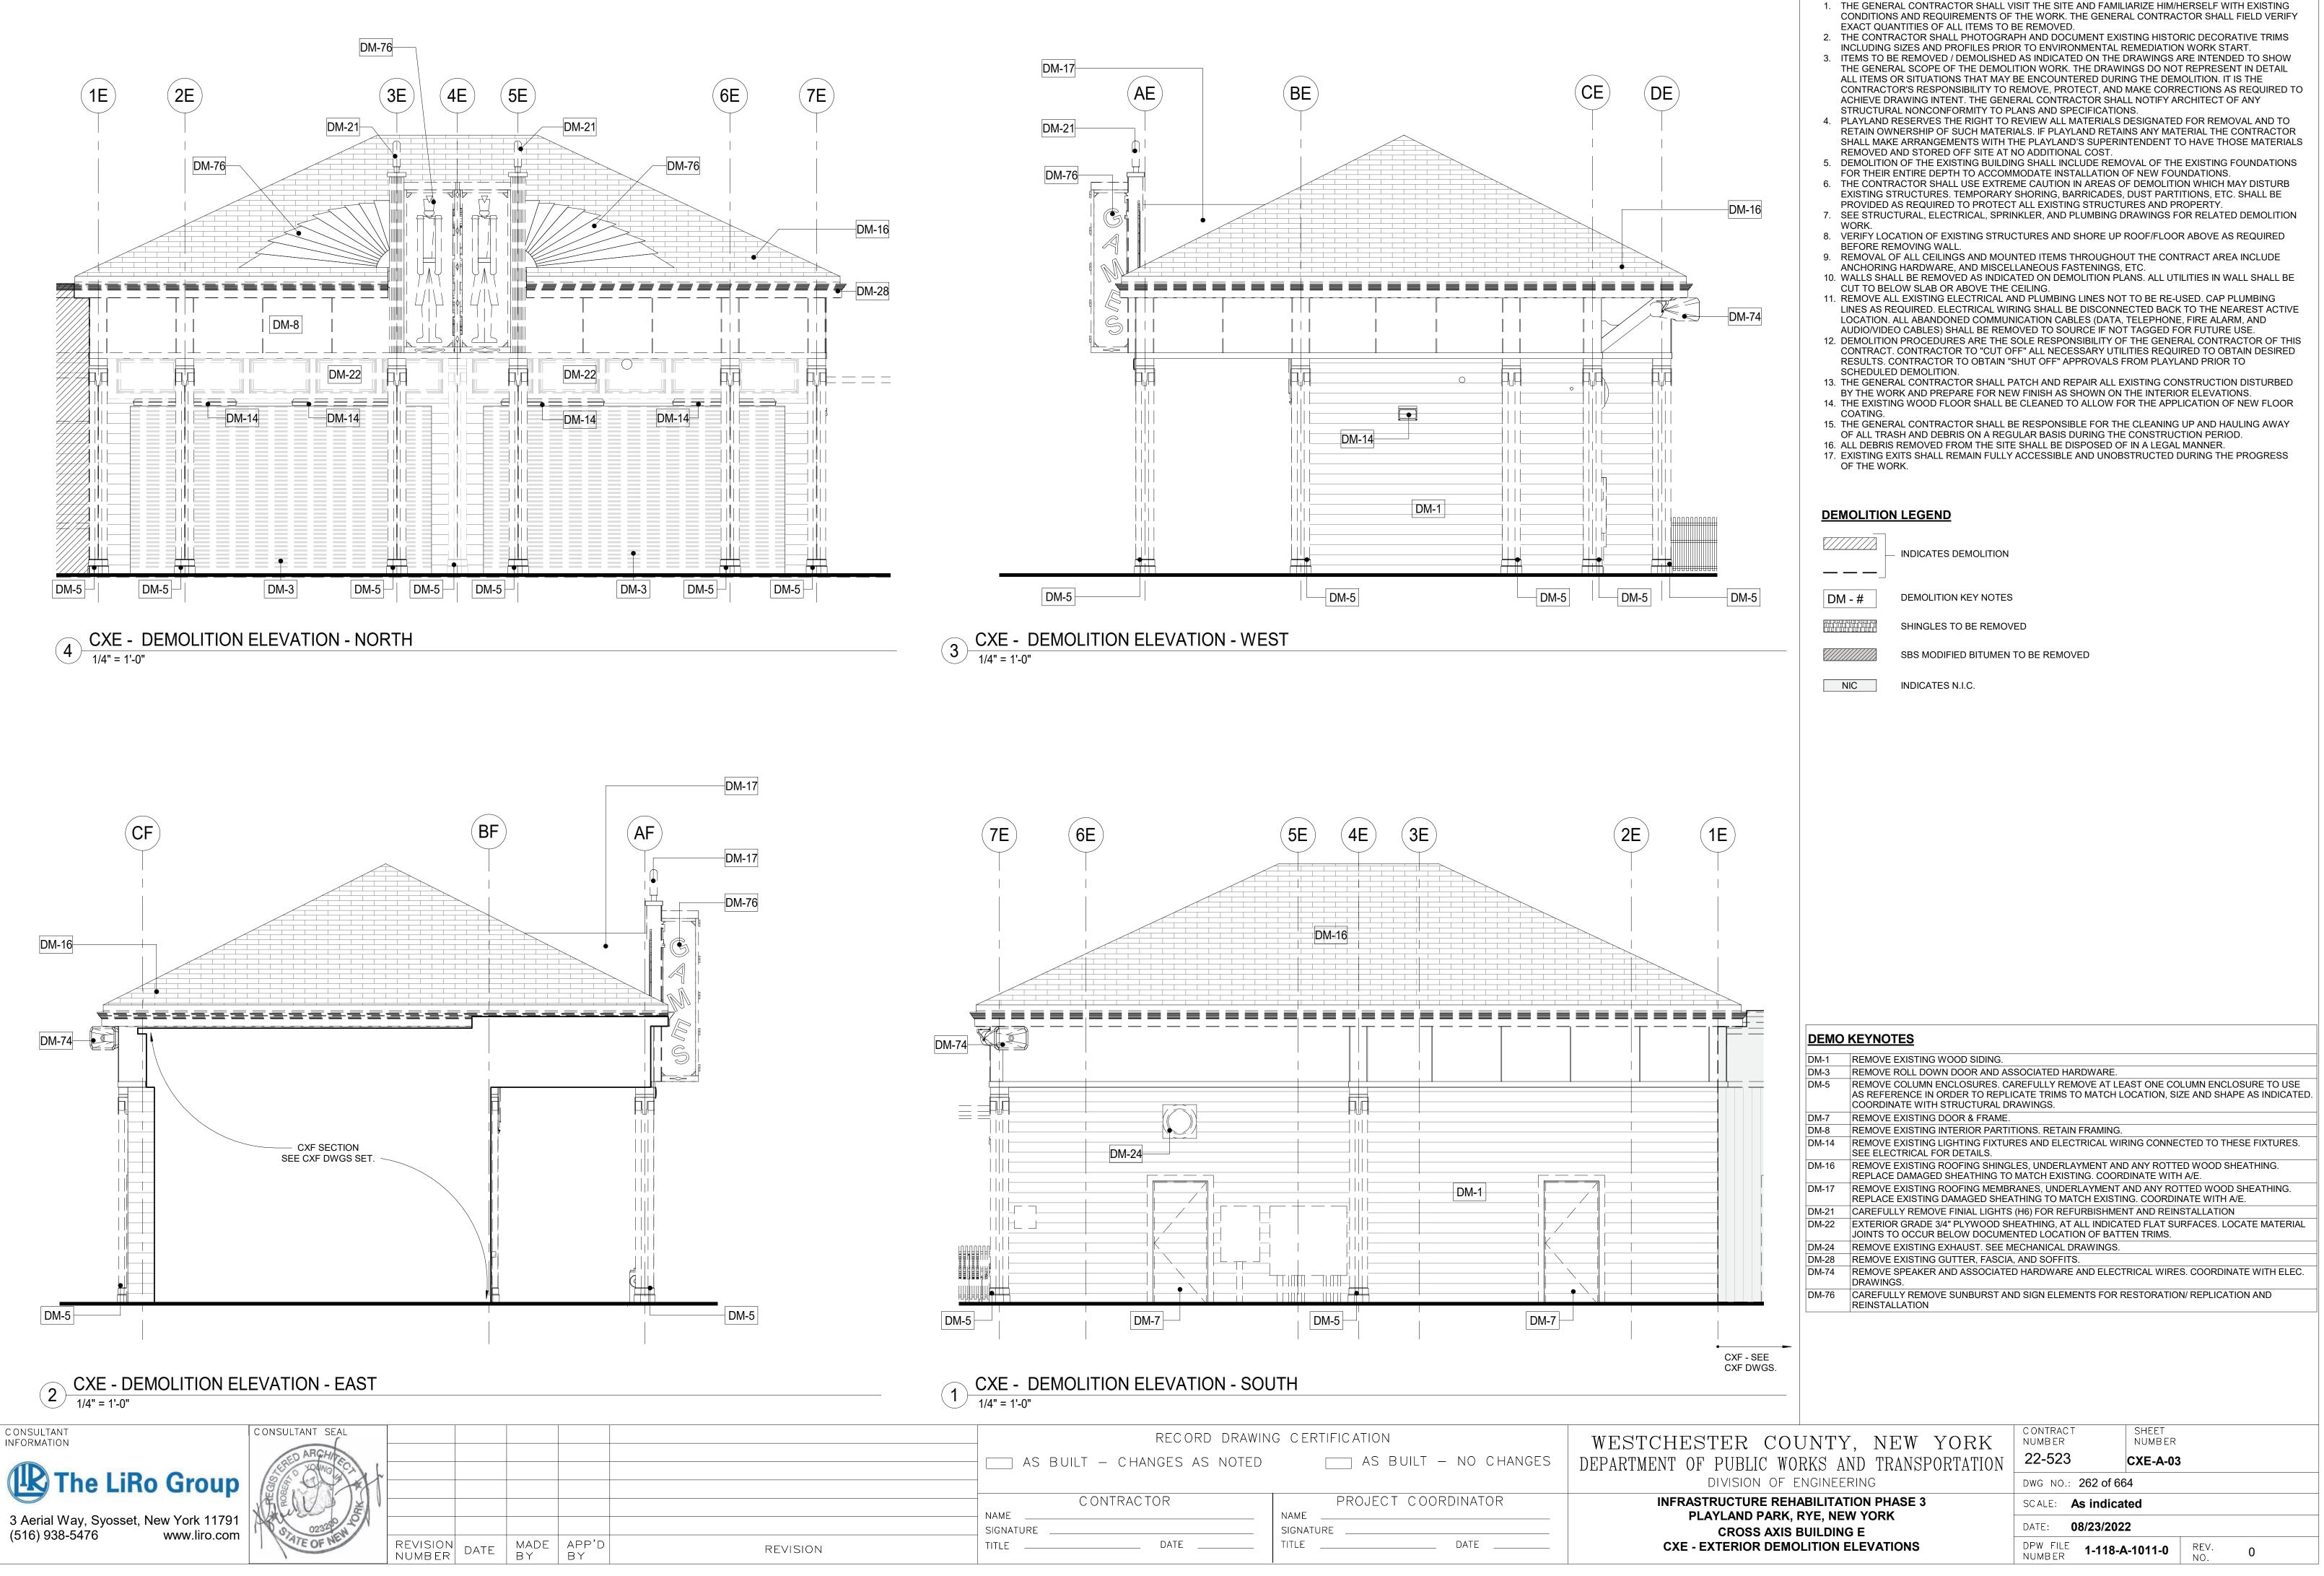

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	RECORD DRAWIN	NG CERTIFICATION	WESTCHESTER
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	CONTRACTOR NAMESIGNATURE	PROJECT COORDINATOR NAME SIGNATURE	INFRASTRUCTUR PLAYLAND
REVISION	TITLE DATE	TITLE DATE	CROS CXE -


DEMOLITION NOTES:

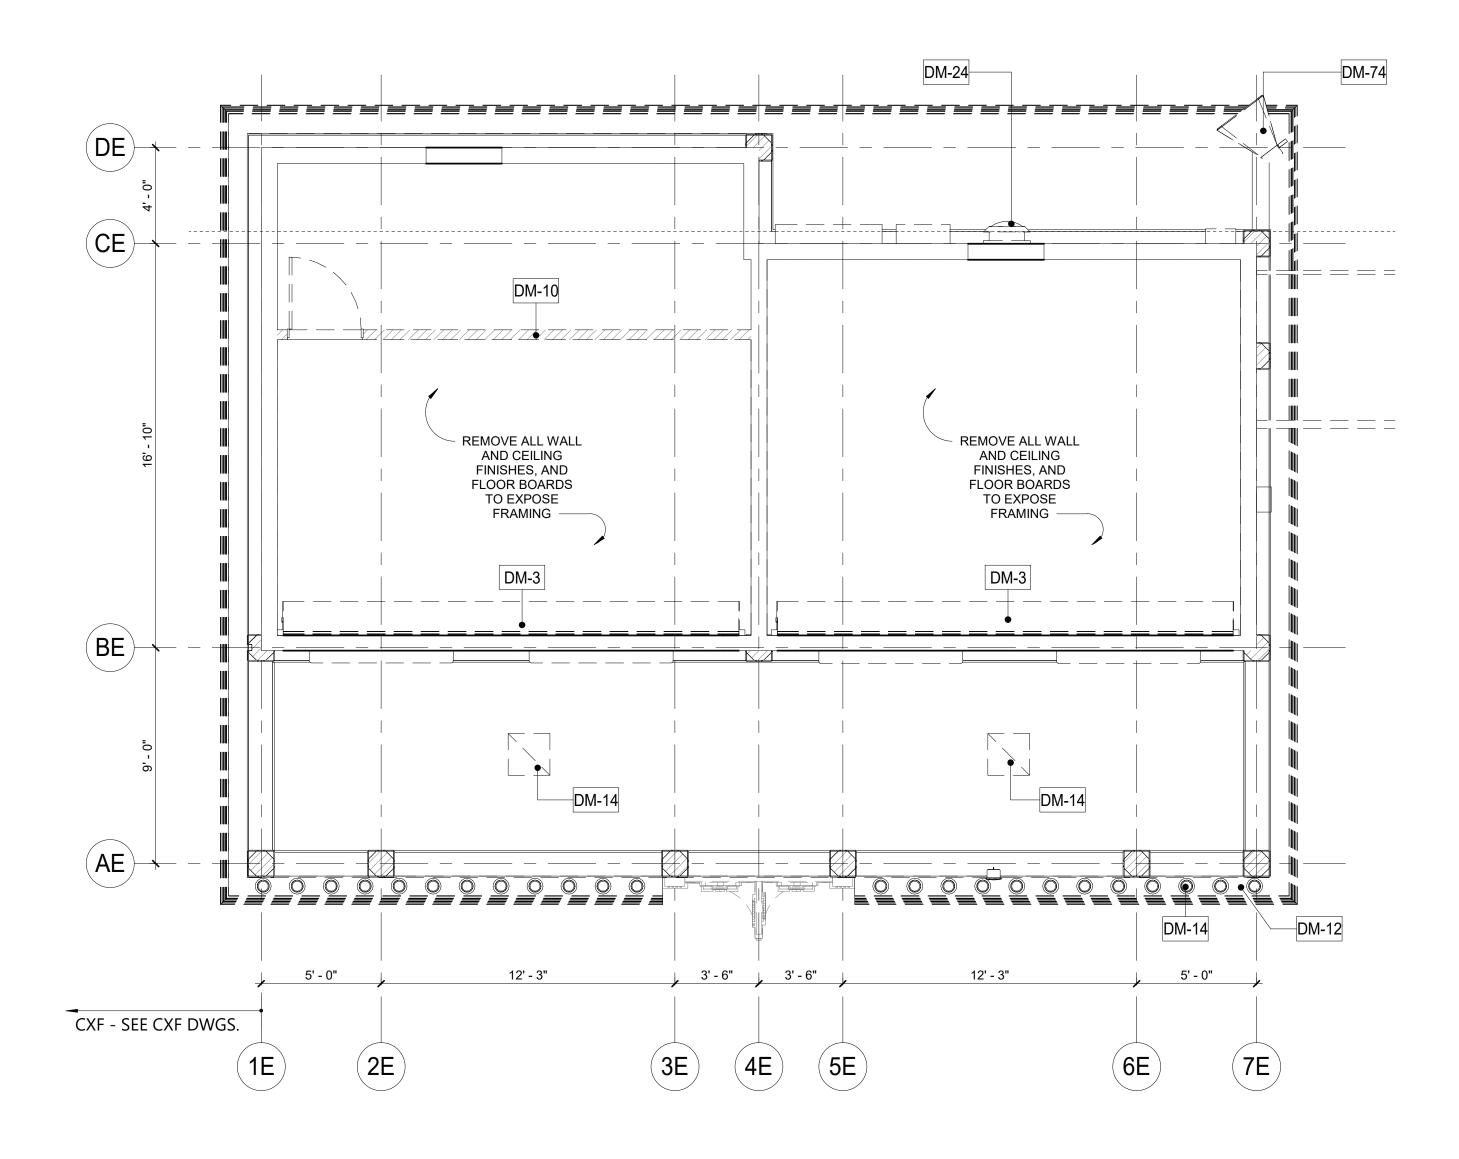- 1. THE GENERAL CONTRACTOR SHALL VISIT THE SITE AND FAMILIARIZE HIM/HERSELF WITH EXISTING CONDITIONS AND REQUIREMENTS OF THE WORK. THE GENERAL CONTRACTOR SHALL FIELD VERIFY EXACT QUANTITIES OF ALL ITEMS TO BE REMOVED.
- 2. THE CONTRACTOR SHALL PHOTOGRAPH AND DOCUMENT EXISTING HISTORIC DECORATIVE TRIMS
- INCLUDING SIZES AND PROFILES PRIOR TO ENVIRONMENTAL REMEDIATION WORK START. ITEMS TO BE REMOVED / DEMOLISHED AS INDICATED ON THE DRAWINGS ARE INTENDED TO SHOW 3 THE GENERAL SCOPE OF THE DEMOLITION WORK. THE DRAWINGS DO NOT REPRESENT IN DETAIL ALL ITEMS OR SITUATIONS THAT MAY BE ENCOUNTERED DURING THE DEMOLITION. IT IS THE CONTRACTOR'S RESPONSIBILITY TO REMOVE, PROTECT, AND MAKE CORRECTIONS AS REQUIRED TO
- ACHIEVE DRAWING INTENT. THE GENERAL CONTRACTOR SHALL NOTIFY ARCHITECT OF ANY STRUCTURAL NONCONFORMITY TO PLANS AND SPECIFICATIONS. PLAYLAND RESERVES THE RIGHT TO REVIEW ALL MATERIALS DESIGNATED FOR REMOVAL AND TO RETAIN OWNERSHIP OF SUCH MATERIALS. IF PLAYLAND RETAINS ANY MATERIAL THE CONTRACTOR SHALL MAKE ARRANGEMENTS WITH THE PLAYLAND'S SUPERINTENDENT TO HAVE THOSE MATERIALS
- REMOVED AND STORED OFF SITE AT NO ADDITIONAL COST. 5. DEMOLITION OF THE EXISTING BUILDING SHALL INCLUDE REMOVAL OF THE EXISTING FOUNDATIONS
- FOR THEIR ENTIRE DEPTH TO ACCOMMODATE INSTALLATION OF NEW FOUNDATIONS. 6. THE CONTRACTOR SHALL USE EXTREME CAUTION IN AREAS OF DEMOLITION WHICH MAY DISTURB EXISTING STRUCTURES. TEMPORARY SHORING, BARRICADES, DUST PARTITIONS, ETC. SHALL BE PROVIDED AS REQUIRED TO PROTECT ALL EXISTING STRUCTURES AND PROPERTY.
- 7. SEE STRUCTURAL, ELECTRICAL, SPRINKLER, AND PLUMBING DRAWINGS FOR RELATED DEMOLITION WORK.
- 8. VERIFY LOCATION OF EXISTING STRUCTURES AND SHORE UP ROOF/FLOOR ABOVE AS REQUIRED BEFORE REMOVING WALL.
- 9. REMOVAL OF ALL CEILINGS AND MOUNTED ITEMS THROUGHOUT THE CONTRACT AREA INCLUDE ANCHORING HARDWARE, AND MISCELLANEOUS FASTENINGS, ETC.
- 10. WALLS SHALL BE REMOVED AS INDICATED ON DEMOLITION PLANS. ALL UTILITIES IN WALL SHALL BE CUT TO BELOW SLAB OR ABOVE THE CEILING. 11. REMOVE ALL EXISTING ELECTRICAL AND PLUMBING LINES NOT TO BE RE-USED. CAP PLUMBING
- LINES AS REQUIRED. ELECTRICAL WIRING SHALL BE DISCONNECTED BACK TO THE NEAREST ACTIVE LOCATION. ALL ABANDONED COMMUNICATION CABLES (DATA, TELEPHONE, FIRE ALARM, AND AUDIO/VIDEO CABLES) SHALL BE REMOVED TO SOURCE IF NOT TAGGED FOR FUTURE USE.
- 12. DEMOLITION PROCEDURES ARE THE SOLE RESPONSIBILITY OF THE GENERAL CONTRACTOR OF THIS CONTRACT. CONTRACTOR TO "CUT OFF" ALL NECESSARY UTILITIES REQUIRED TO OBTAIN DESIRED RESULTS. CONTRACTOR TO OBTAIN "SHUT OFF" APPROVALS FROM PLAYLAND PRIOR TO SCHEDULED DEMOLITION.
- 13. THE GENERAL CONTRACTOR SHALL PATCH AND REPAIR ALL EXISTING CONSTRUCTION DISTURBED BY THE WORK AND PREPARE FOR NEW FINISH AS SHOWN ON THE INTERIOR ELEVATIONS.
- 14. THE EXISTING WOOD FLOOR SHALL BE CLEANED TO ALLOW FOR THE APPLICATION OF NEW FLOOR COATING.
- 15. THE GENERAL CONTRACTOR SHALL BE RESPONSIBLE FOR THE CLEANING UP AND HAULING AWAY OF ALL TRASH AND DEBRIS ON A REGULAR BASIS DURING THE CONSTRUCTION PERIOD. 16. ALL DEBRIS REMOVED FROM THE SITE SHALL BE DISPOSED OF IN A LEGAL MANNER.
- 17. EXISTING EXITS SHALL REMAIN FULLY ACCESSIBLE AND UNOBSTRUCTED DURING THE PROGRESS OF THE WORK.

CXE - RCP DEMO PLAN

	DEMOLITION	<u>N LEGEND</u>		
		INDICATES DEMOLITION		
	 DM - #	DEMOLITION KEY NOTES		
		SHINGLES TO BE REMOV	ED	
		SBS MODIFIED BITUMEN	TO BE REMOVED	
	NIC	INDICATES N.I.C.		
	DM-10 REMOVE	ROLL DOWN DOOR AND AS INTERIOR PARTITION.		TER LIGHTING IS TO BE REMOVED.
	COORDI	NATE WITH ELECTRICAL DR	AWINGS.	IRING CONNECTED TO THESE FIXTURES.
	DM-24 REMOVE	CTRICAL FOR DETAILS. EXISTING EXHAUST. SEE M		
	DM-74 REMOVE DRAWIN		D HARDWARE AND ELEC	CTRICAL WIRES. COORDINATE WITH ELEC.
			CONTRACT	SHEET
CHESTER COU ENT OF PUBLIC WOI			NUMBER 22-523	NUMBER CXE-A-04
DIVISION OF E	NGINEERING		DWG NO.: 263 of 6	64
INFRASTRUCTURE REHA PLAYLAND PARK, F			SCALE: As indica	
CROSS AXIS E			DATE: 08/23/202	22


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1 GROUND FLOOR PLAN CXE
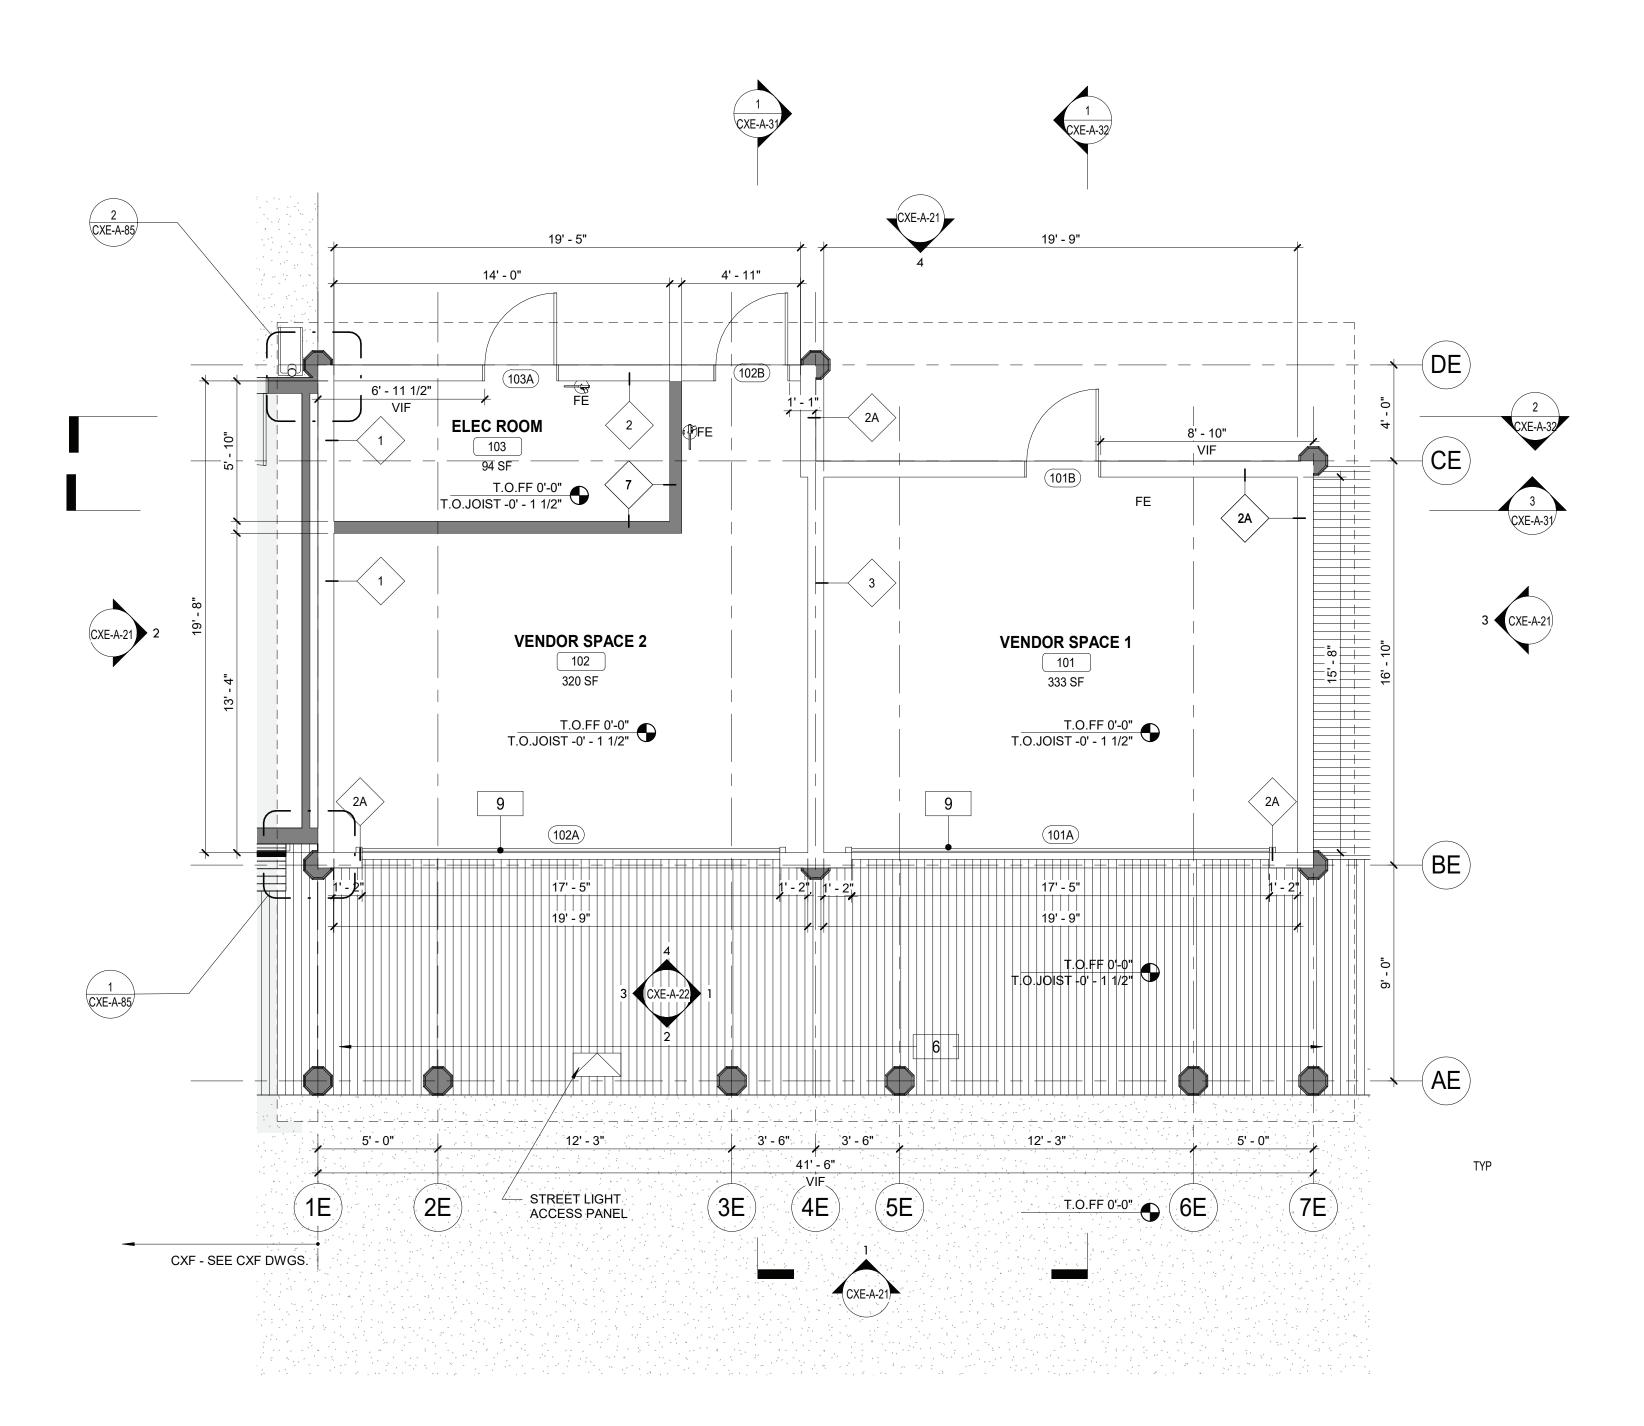
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	RECORD DRAWING	G CERTIFICATION	WESTCHESTER COUNTY, NEW YORK	CONTRACT SHEET NUMBER NUMBER
	AS BUILT – CHANGES AS NOTED	AS BUILT - NO CHANGES	DEPARTMENT OF PUBLIC WORKS AND TRANSPORTATION	22-523 CXE-A-11
			DIVISION OF ENGINEERING	DWG NO.: 264 of 664
	C ONTRAC TOR	PROJECT COORDINATOR	INFRASTRUCTURE REHABILITATION PHASE 3	SCALE: As indicated
	SIGNATURE	SIGNATURE	PLAYLAND PARK, RYE, NEW YORK CROSS AXIS BUILDING E	DATE: 08/23/2022
REVISION	TITLE DATE	TITLE DATE	CXE - GROUND FLOOR PLAN	DPW FILE 1-118-A-1013-0 REV. 0

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FLOOR PLAN NOTES:


- 1. DIMENSIONS ARE TO FACE OF GYPSUM WALL BOARD, GRID LINES, OR CENTERLINE OF COLUMN. ALL ELEVATIONS ARE NOTED FROM FINISH FLOOR ELEVATIONS.
- PROVIDE DRYWALL TRIM AT ALL EXPOSED EDGES AND CORNERS.
 MINIMUM DIMENSION FROM ANY CORNER OR WALL TO FRAMING STUD AT DOOR JAMB OPENING SUBJURE AT LUNCO.
- SHALL BE 4" U.N.O.PROVIDE FIRE RETARDANT WOOD BLOCKING FOR ANY WALL MOUNTED EQUIPMENT OR
- ACCESSORIES. COORDINATE ALL BLOCKING REQUIREMENTS NECESSARY WITH OTHER TRADES.
 5. THE CONTRACTOR SHALL VERIFY DIMENSIONS OF THE EXISTING SPACE AND OF ANY EXISTING CONSTRUCTION TO REMAIN BY ACTUAL MEASUREMENT BEFORE ANY WORK IS PERFORMED. IF ANY MEASUREMENTS DIFFER FROM DIMENSIONS SHOWN ON PLAN, GC IS TO NOTIFY THE ARCHITECT IMMEDIATELY. THE CONTRACTOR SHALL BE RESPONSIBLE FOR CORRECTING ANY AND ALL DISCREPANCIES FOUND AFTER THE WORK IS PERFORMED, AT NO ADDITIONAL EXPENSE TO THE OWNER.
- THE GC SHALL PROVIDE CAULK JOINTS WHERE GYP BD MEETS THE FLOOR OR ROOF DECK.
 THE GC SHALL BE RESPONSIBLE FOR COORDINATING WITH OWNER ON ALL WORK TO BE PERFORMED BY THE OWNER. ANY POTENTIAL CONFLICTS OR DELAYS CAUSED BY THE OWNER'S SUBCONTRACTORS MUST BE DOCUMENTED IN WRITING TO THE OWNER BEFORE THE DELAY IS ACTUALLY INCURRED FOR IT TO BE CONSIDERED. OTHERWISE THE GC WILL BE RESPONSIBLE FOR MEETING THE SCHEDULE AS OUTLINED IN THE CONTRACT.
- 8. THE CONTRACTOR TO VERIFY ALL FINISHED DIMENSIONS. FIELD CONDITIONS ALTERING ANY DIMENSIONS SHOULD BE BROUGHT TO THE ATTENTION OF THE OWNER AND ARCHITECT.
- THE CONTRACTOR SHALL SUPPLY ALL MATERIAL, LABOR, AND COORDINATION REQUIRED FOR THEINSTALLATION OF ALL OWNER-SUPPLIED ITEMS AS DESCRIBED IN THE DOCUMENTS, U.N.O.
 THE CONTRACTOR IS RESPONSIBLE FOR ALL FLOOR AND WALL PENETRATIONS FOR ELECTRICAL AND MECHANICAL WORK. ALL SUCH OPENING SHALL BE FRAMED AND REINFORCED.
- FLOOR SURFACES SHALL BE LEVELED TO ASSURE SMOOTH SURFACE FOR FINISH FLOOR INSTALLATION.
 INSTALLATION.
- THE CONTRACTOR. TO COORDINATE ALL UTILITY STUB-UPS AND LOCATION OF ALL EQUIPMENT PRIOR TO INSTALLING ANY ONE ITEM.
 PROVIDE PAINTED ACCESS PANELS IN WALLS & CEILING AT CONCEALED ITEMS SUCH AS VALVES, ONTROLS, SWITCHES OR ANY OTHER ITEMS THAT REQUIRES ACCESS. GC O DETERMINE ACCESS ANEL LOCATION W/ ARCHITECT PRIOR TO INSTALLATION.


PLAN LEGEND:

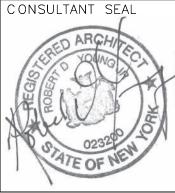	NEW IPE WOOD DECK	101	DOOR TAG
	NEW CONSTRUCTION	$\langle 1i \rangle$	WINDOW TAG
NIC	NOT IN CONTRACT	FE 🕳	FIRE EXTINGUISHER
#	KEY NOTES	FD 🔯	FLOOR DRAIN
1 i	WALL TAG		

CONSTRUCTION KEYNOTES

INSTALL NEW IPE DECKING. SEE STRUCTURAL FOR DETAILS. (CXE-S-05/1) PROVIDE AND INSTALL ROLL DOWN DOOR. SEE DETAILS AND SCHEDULE.

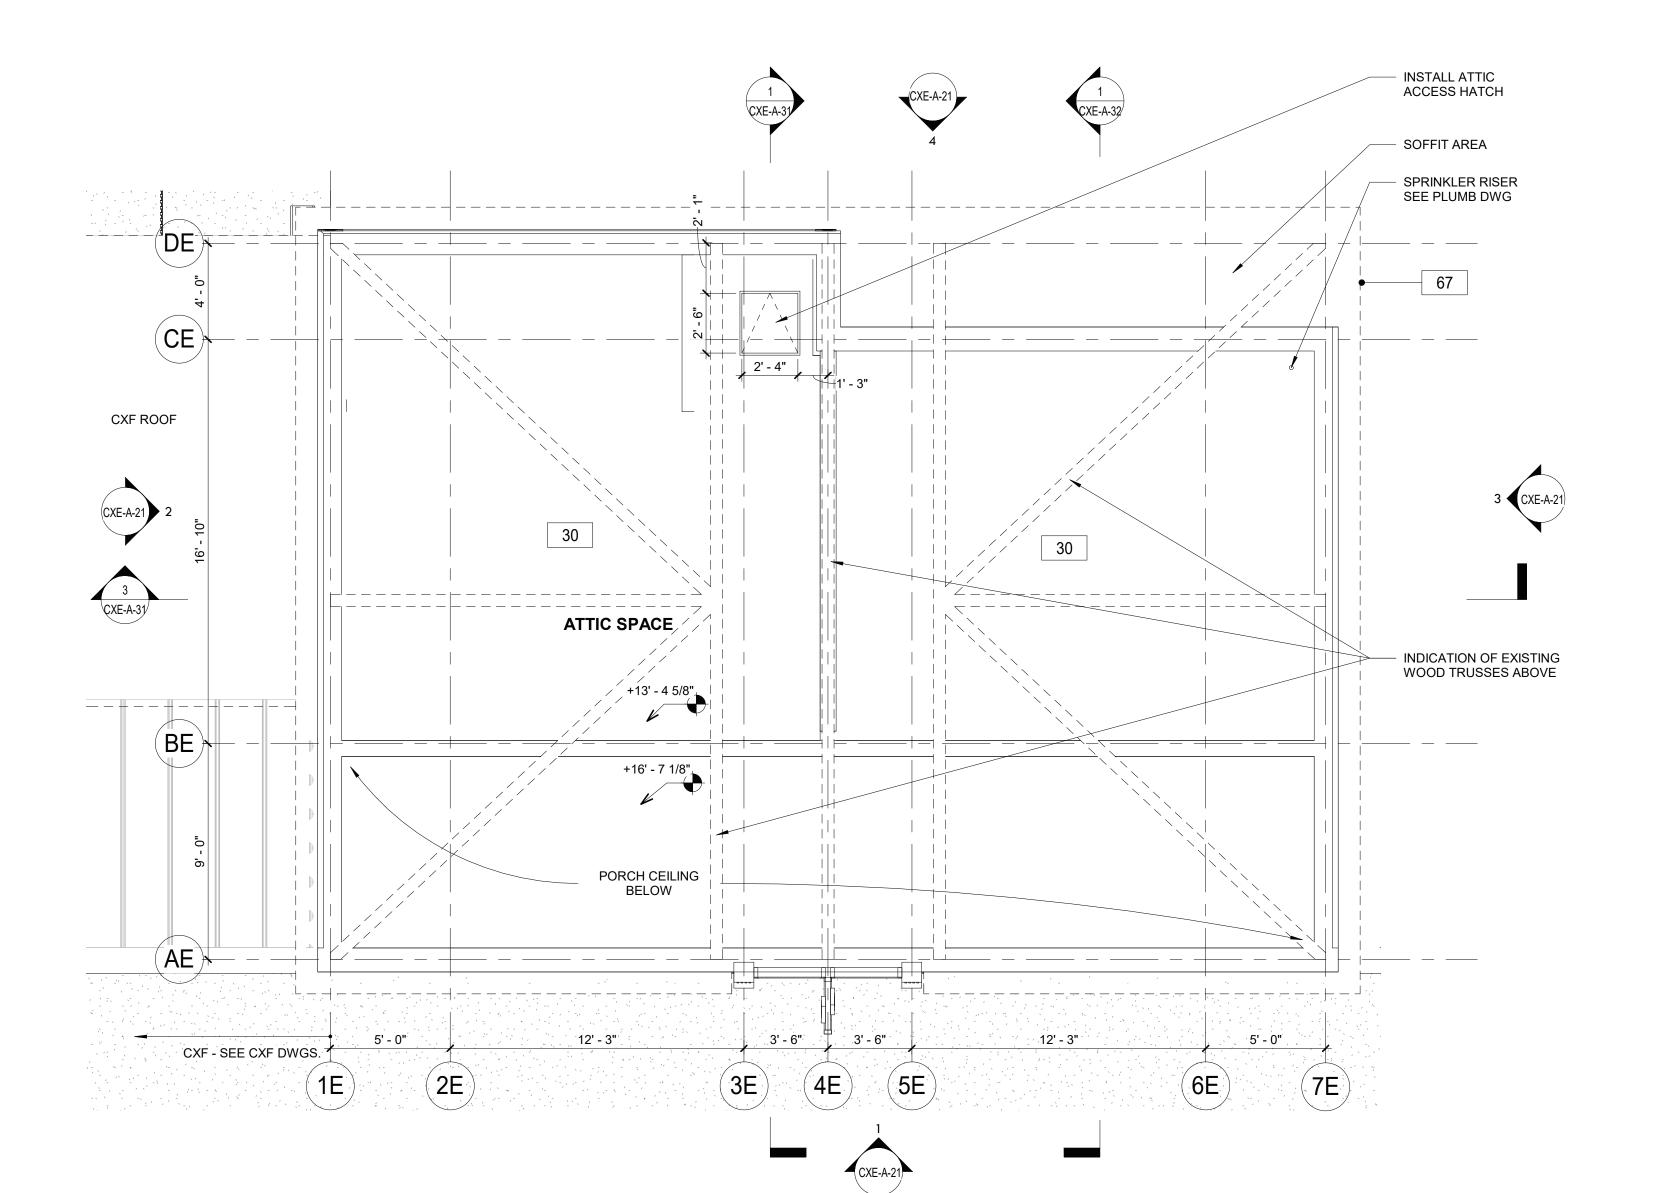

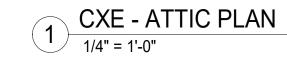

CONSULTANT INFORMATION





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	RECORD DRAWIN	WESTCHESTER	
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	CONTRACTOR NAME	PROJECT COORDINATOR NAME SIGNATURE	INFRASTRUCTU PLAYLAND CROS
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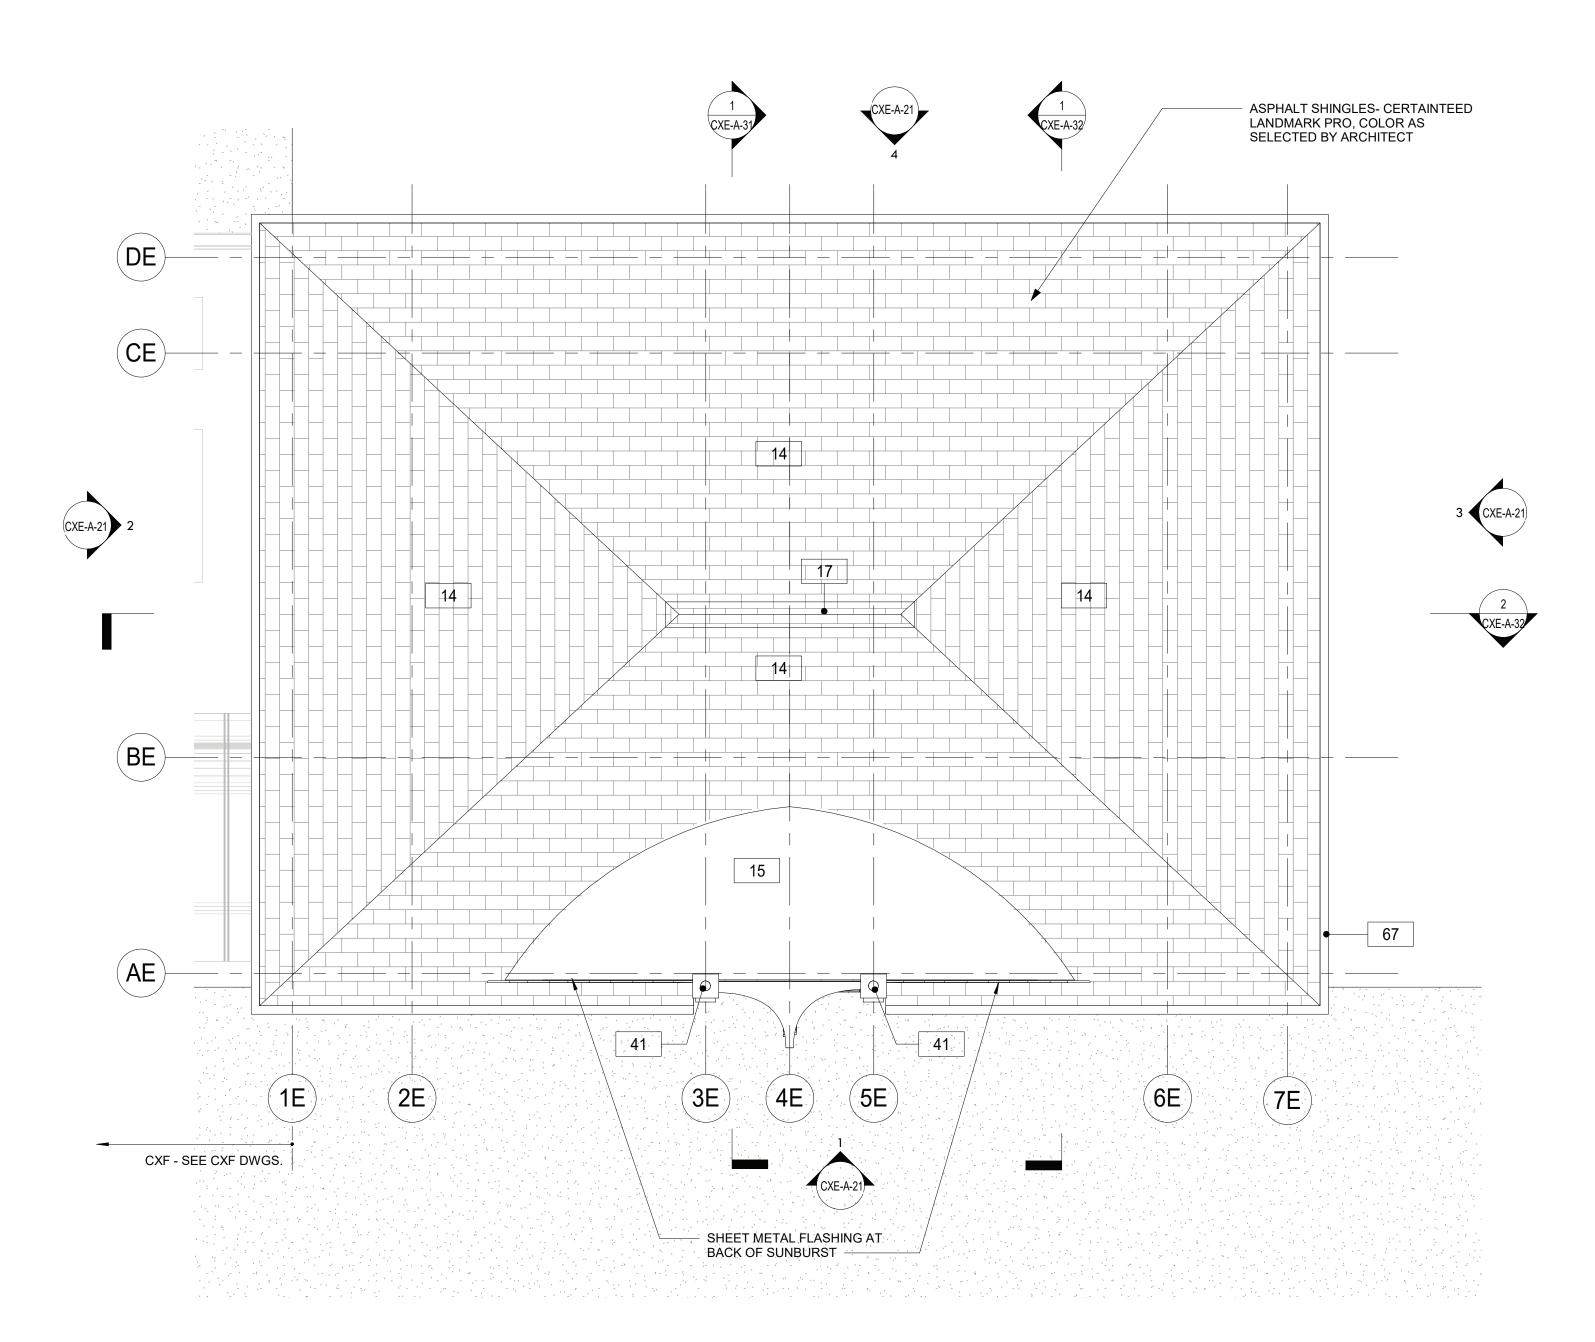
FLOOR PLAN NOTES:


- 1. DIMENSIONS ARE TO FACE OF GYPSUM WALL BOARD, GRID LINES, OR CENTERLINE OF COLUMN. ALL ELEVATIONS ARE NOTED FROM FINISH FLOOR ELEVATIONS.
- PROVIDE DRYWALL TRIM AT ALL EXPOSED EDGES AND CORNERS.
 MINIMUM DIMENSION FROM ANY CORNER OR WALL TO FRAMING STUD AT DOOR JAMB OPENING
- SHALL BE 4" U.N.O. 4. PROVIDE FIRE RETARDANT WOOD BLOCKING FOR ANY WALL MOUNTED EQUIPMENT OR
- ACCESSORIES. COORDINATE ALL BLOCKING REQUIREMENTS NECESSARY WITH OTHER TRADES.
 THE CONTRACTOR SHALL VERIFY DIMENSIONS OF THE EXISTING SPACE AND OF ANY EXISTING CONSTRUCTION TO REMAIN BY ACTUAL MEASUREMENT BEFORE ANY WORK IS PERFORMED. IF ANY MEASUREMENTS DIFFER FROM DIMENSIONS SHOWN ON PLAN, GC IS TO NOTIFY THE ARCHITECT IMMEDIATELY. THE CONTRACTOR SHALL BE RESPONSIBLE FOR CORRECTING ANY AND ALL DISCREPANCIES FOUND AFTER THE WORK IS PERFORMED, AT NO ADDITIONAL EXPENSE TO THE OWNER.
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 THE CONTRACTOR. TO COORDINATE ALL UTILITY STUB-UPS AND LOCATION OF ALL EQUIPMENT
- PRIOR TO INSTALLING ANY ONE ITEM.
 13. PROVIDE PAINTED ACCESS PANELS IN WALLS & CEILING AT CONCEALED ITEMS SUCH AS VALVES, ONTROLS, SWITCHES OR ANY OTHER ITEMS THAT REQUIRES ACCESS. GC O DETERMINE ACCESS ANEL LOCATION W/ ARCHITECT PRIOR TO INSTALLATION.

PLAN LEGEND:			
		101	DOOR TAG
NEW CONSTRUCTION	<	$\langle 1i \rangle$	WINDOW TAG
NIC NOT IN CONTRACT	FE ==		FIRE EXTINGUISHER
# KEY NOTES	FD	\otimes	FLOOR DRAIN
1i WALL TAG			
CONSTRUCTION KEYNOTES			
30 NEW 2x6 WOOD FLOOR.67 NEW FASCIA BOARD AND SOFFIT.			
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ENT OF PUBLIC WORKS AND TRANSPORTATION	22-523		XE-A-12
DIVISION OF ENGINEERING	DWG NO.: 265 (of 664	
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PLAYLAND PARK, RYE, NEW YORK CROSS AXIS BUILDING E	DATE: 08/23/	/2022	

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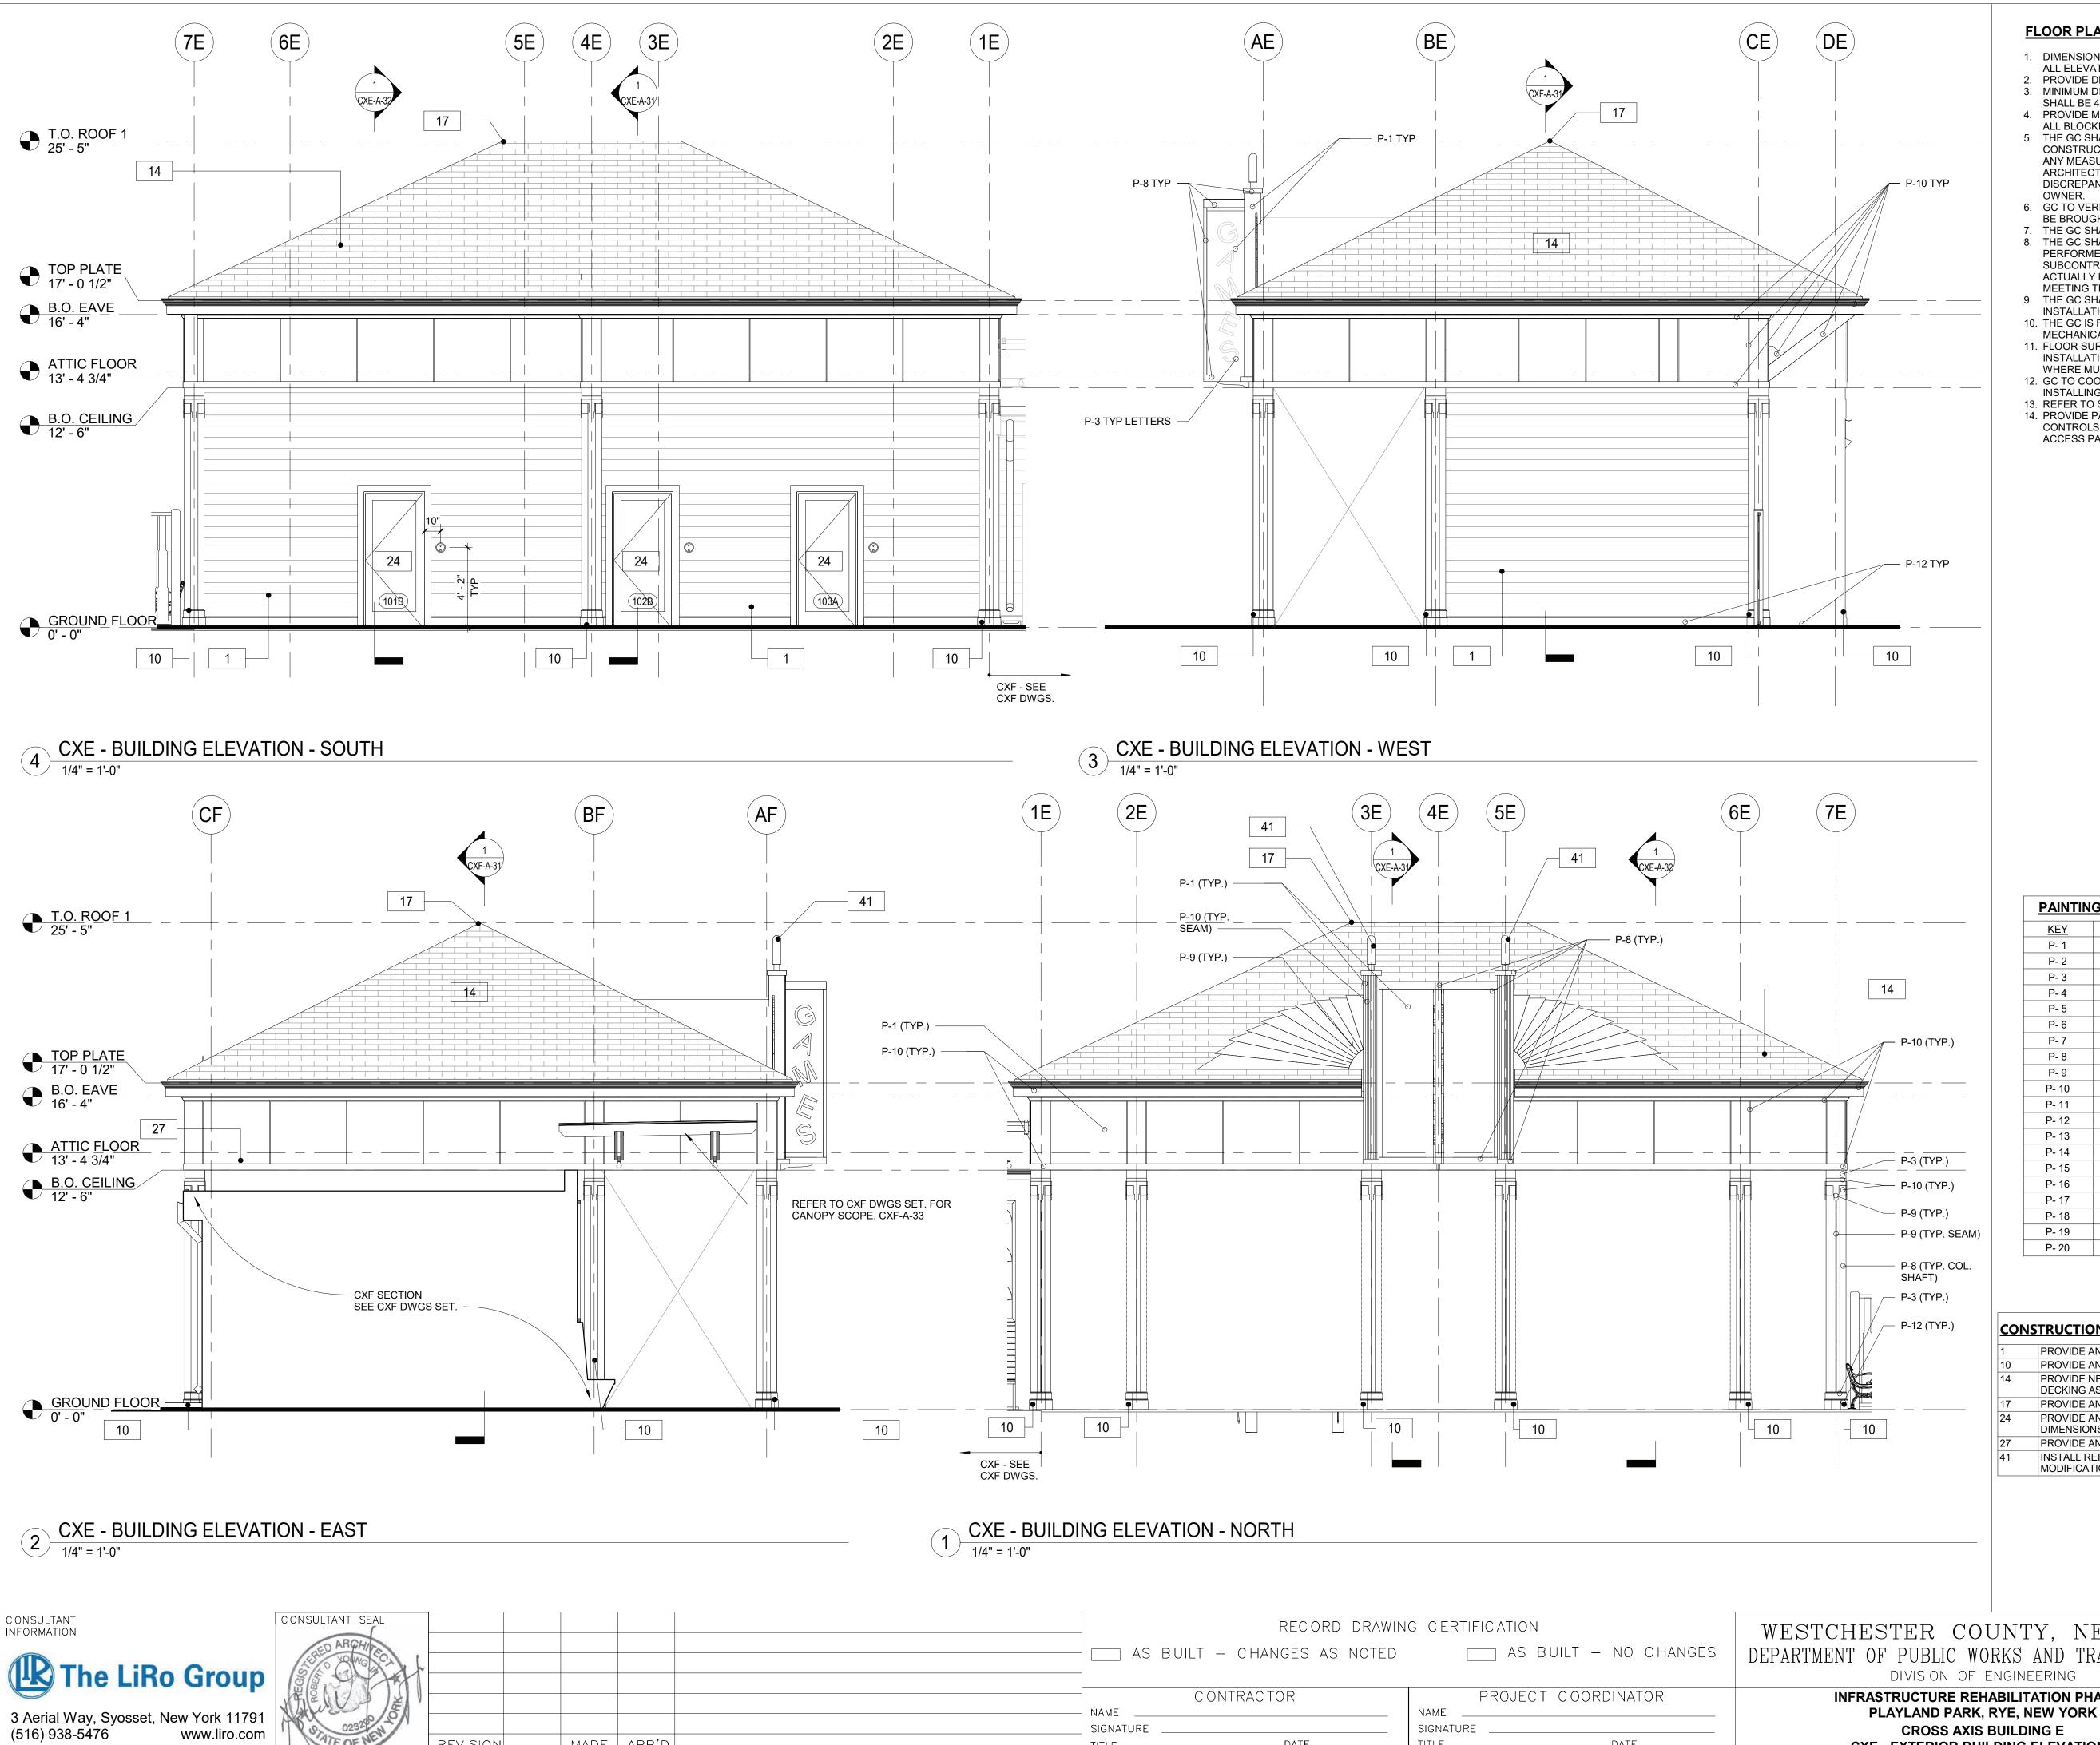
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	CONTRACTOR	PROJECT COORDINATOR	INFRASTRUC PLAYLA
REVISION	SIGNATURE DATE	SIGNATURE TITLE	CF

FLOOR PLAN NOTES:

- DIMENSIONS ARE TO FACE OF GYPSUM WALL BOARD, GRID LINES, OR CENTERLINE OF COLUMN. ALL ELEVATIONS ARE NOTED FROM FINISH FLOOR ELEVATIONS.
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- SHALL BE 4" U.N.O. 4. PROVIDE FIRE RETARDANT WOOD BLOCKING FOR ANY WALL MOUNTED EQUIPMENT OR
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- 8. THE CONTRACTOR TO VERIFY ALL FINISHED DIMENSIONS. FIELD CONDITIONS ALTERING ANY DIMENSIONS SHOULD BE BROUGHT TO THE ATTENTION OF THE OWNER AND ARCHITECT.
- THE CONTRACTOR SHALL SUPPLY ALL MATERIAL, LABOR, AND COORDINATION REQUIRED FOR THEINSTALLATION OF ALL OWNER-SUPPLIED ITEMS AS DESCRIBED IN THE DOCUMENTS, U.N.O.
 THE CONTRACTOR IS RESPONSIBLE FOR ALL FLOOR AND WALL PENETRATIONS FOR ELECTRICAL
- AND MECHANICAL WORK. ALL SUCH OPENING SHALL BE FRAMED AND REINFORCED. 11. FLOOR SURFACES SHALL BE LEVELED TO ASSURE SMOOTH SURFACE FOR FINISH FLOOR
- INSTALLATION. 12. THE CONTRACTOR. TO COORDINATE ALL UTILITY STUB-UPS AND LOCATION OF ALL EQUIPMENT PRIOR TO INSTALLING ANY ONE ITEM.
- 13. PROVIDE PAINTED ACCESS PANELS IN WALLS & CEILING AT CONCEALED ITEMS SUCH AS VALVES, ONTROLS, SWITCHES OR ANY OTHER ITEMS THAT REQUIRES ACCESS. GC O DETERMINE ACCESS ANEL LOCATION W/ ARCHITECT PRIOR TO INSTALLATION.

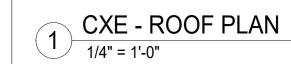	PLAN LEGEND:		
		101	DOOR TAG
		$\langle 1i \rangle$	WINDOW TAG
	NIC NOT IN CONTRACT	FE - 🕀	FIRE EXTINGUISHER
	# KEY NOTES	FD 🔯	FLOOR DRAIN
	1i WALL TAG		
	CONSTRUCTION KEYNOTES		
	14 PROVIDE NEW ASPHALT SHINGLE RO DECKING AS REQUIRED (COORDINAT		D REPLACE IN KIND EXISTING
	15PROVIDE AND INSTALL SBS MODIFIED17PROVIDE AND INSTALL RIDGE VENT A	D BITUMEN ROOFING AND U	NDERLAYMENT.
	41 INSTALL REFURBISHED FINIAL LIGHTS MODIFICATIONS TO H6 LIGHTS DURIN	S (H6). ARCHITECT TO APPR	OVE FINISH AND ANY NEEDED
	67 NEW FASCIA BOARD AND SOFFIT.		
\frown			
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4		CONTRACT	SHEET
	UNTY, NEW YORK	NUMBER	NUMBER
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DIVISION OF E	ENGINEERING ABILITATION PHASE 3	DWG NO.: 266 of 664	d
PLAYLAND PARK,	RYE, NEW YORK	SCALE: As indicate	u
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FLOOR PLAN GENERAL NOTES

- 1. DIMENSIONS ARE TO FACE OF GYPSUM WALL BOARD, GRID LINES, OR CENTERLINE OF COLUMN. ALL ELEVATIONS ARE NOTED FROM FINISH FLOOR ELEVATIONS.
- PROVIDE DRYWALL TRIM AT ALL EXPOSED EDGES AND CORNERS. MINIMUM DIMENSION FROM ANY CORNER OR WALL TO FRAMING STUD AT DOOR JAMB OPENING 3.
- SHALL BE 4" (U.N.O.). 4. PROVIDE METAL BLOCKING FOR ANY WALL MOUNTED EQUIPMENT OR ACCESSORIES. COORDINATE
- ALL BLOCKING REQUIREMENTS NECESSARY WITH OTHER TRADES. THE GC SHALL VERIFY DIMENSIONS OF THE EXISTING SPACE AND OF ANY EXISTING CONSTRUCTION TO REMAIN BY ACTUAL MEASUREMENT BEFORE ANY WORK IS PERFORMED. IF

ANY MEASUREMENTS DIFFER FROM DIMENSIONS SHOWN ON PLAN, GC IS TO NOTIFY THE ARCHITECT IMMEDIATELY. THE GC SHALL BE RESPONSIBLE FOR CORRECTING ANY AND ALL DISCREPANCIES FOUND AFTER THE WORK IS PERFORMED, AT NO ADDITIONAL EXPENSE TO THE OWNER. 6. GC TO VERIFY ALL FINISHED DIMENSIONS. FIELD CONDITIONS ALTERING ANY DIMENSIONS SHOULD

- BE BROUGHT TO THE ATTENTION OF THE OWNER AND ARCHITECT. 7. THE GC SHALL PROVIDE CAULK JOINTS WHERE GYP. BD. MEETS THE FLOOR OR ROOF DECK.
- 8. THE GC SHALL BE RESPONSIBLE FOR COORDINATING WITH OWNER ON ALL WORK TO BE PERFORMED BY THE OWNER. ANY POTENTIAL CONFLICTS OR DELAYS CAUSED BY THE OWNER'S SUBCONTRACTORS MUST BE DOCUMENTED IN WRITING TO THE OWNER BEFORE THE DELAY IS ACTUALLY INCURRED FOR IT TO BE CONSIDERED. OTHERWISE THE GC WILL BE RESPONSIBLE FOR MEETING THE SCHEDULE AS OUTLINED IN THE CONTRACT.
- 9. THE GC SHALL SUPPLY ALL MATERIAL, LABOR, AND COORDINATION REQUIRED FOR THE INSTALLATION OF ALL OWNER-SUPPLIED ITEMS AS DESCRIBED IN THE DOCUMENTS, U.N.O. 10. THE GC IS RESPONSIBLE FOR ALL FLOOR AND WALL PENETRATIONS FOR ELECTRICAL AND MECHANICAL WORK. ALL SUCH OPENING SHALL BE FRAMED AND REINFORCED.
- 11. FLOOR SURFACES SHALL BE LEVELED TO ASSURE SMOOTH SURFACE FOR FINISH FLOOR INSTALLATION. GC SHALL ALSO PAY SPECIAL ATTENTION THAT ALL WALL SURFACES ARE SMOOTH WHERE MURALS WILL BE DIRECTLY APPLIED TO WALL.
- 12. GC TO COORDINATE ALL UTILITY STUB-UPS AND LOCATION OF ALL EQUIPMENT PRIOR TO INSTALLING ANY ONE ITEM. 13. REFER TO SHEET CXE-A-80 FOR PARTITION TYPE INFORMATION.
- 14. PROVIDE PAINTED ACCESS PANELS IN WALLS & CEILING AT CONCEALED ITEMS SUCH AS VALVES, CONTROLS, SWITCHES OR ANY OTHER ITEMS THAT REQUIRES ACCESS. GC TO DETERMINE ACCESS PANEL LOCATION W/ ARCHITECT PRIOR TO INSTALLATION.

PAINTIN	<u>G SCHEDULE</u>		
KEY	COLOR	MANUFACTURER	REMARKS
P- 1	MYSTICAL POWERS #901	BENJAMIN MOORE	
P- 2	HERITAGE RED #HC-181	BENJAMIN MOORE	
P- 3	NEW YORK STATE OF MIND #805	BENJAMIN MOORE	
P- 4	LAZY SUNDAY #803	BENJAMIN MOORE	
P- 5	DEEP JUNGLE #595	BENJAMIN MOORE	
P- 6	LUCK OF THE IRISH #588	BENJAMIN MOORE	
P- 7	MAJOLICA GREEN #0013	SHERWIN WILLIAMS	
P- 8	ANTELOPE CANYON #125	BENJAMIN MOORE	
P- 9	FORSYTHIA #6907	SHERWIN WILLIAMS	
P- 10	CAPE BLUE #1642	BENJAMIN MOORE	
P- 11	WHITE SNOW #9541	SHERWIN WILLIAMS	
P- 12	TRICORN BLACK #6258	SHERWIN WILLIAMS	
P- 13	READY MIX WHITE	BENJAMIN MOORE	INTERIOR USE ONLY
P- 14	STUCCO PAINT TO MATCH P-1	KEIM	
P- 15	VAN DEUSEN BLUE #HC-156	BENJAMIN MOORE	
P- 16	#RAL9001	-	TYP. ROLL UP DOOR
P- 17	FLORIDA BEACHES #900	BENJAMIN MOORE	
P- 18	PIRATES COVE PEACH #903	BENJAMIN MOORE	
P- 19	JADITE #6459	SHERWIN WILLIAMS	
P- 20	DECISIVE YELLOW #6902	SHERWIN WILLIAMS	

CONSTRUCTION KEYNOTES


1 PROVIDE AND INSTALL NEW 1x8 MILLE	ED YELLOW PINE - TO	ONGUE AND GROOVE - NO BEVEL					
10 PROVIDE AND INSTALL COLUMN ENCL	PROVIDE AND INSTALL COLUMN ENCLOSURES. SEE DETAILS.						
	PROVIDE NEW ASPHALT SHINGLE ROOFING, UNDERLAYMENT, AND REPLACE IN KIND EXISTING DECKING AS REQUIRED (COORDINATE WITH STRUCTURAL).						
17 PROVIDE AND INSTALL RIDGE VENT A	T ROOF HIPS.						
24 PROVIDE AND INSTALL NEW DOOR AN DIMENSIONS PRIOR TO ORDERING NE		NG OPENING. CONTRACTOR TO V.I.F. ALL					
27 PROVIDE AND INSTALL STEP FLASHIN	IG WHERE SLOPE RC	OFS MEET VERTICAL WALLS.					
	FURBISHED FINIAL LIGHTS (H6). ARCHITECT TO APPROVE FINISH AND ANY NEEDED ONS TO H6 LIGHTS DURING REFURBISHMENT.						
	CONTRACT	SHEET					
UNTY, NEW YORK	NUMBER	NUMBER					
RKS AND TRANSPORTATION	22-523	CXE-A-21					
ENGINEERING	DWG NO.: 267 of 664						
ABILITATION PHASE 3	SCALE: As indicated						

DATE: **08/23/2022**

DPW FILE **1-118-A-1016-0** REV. NO.

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CROSS AXIS BUILDING E CXE - EXTERIOR BUILDING ELEVATIONS

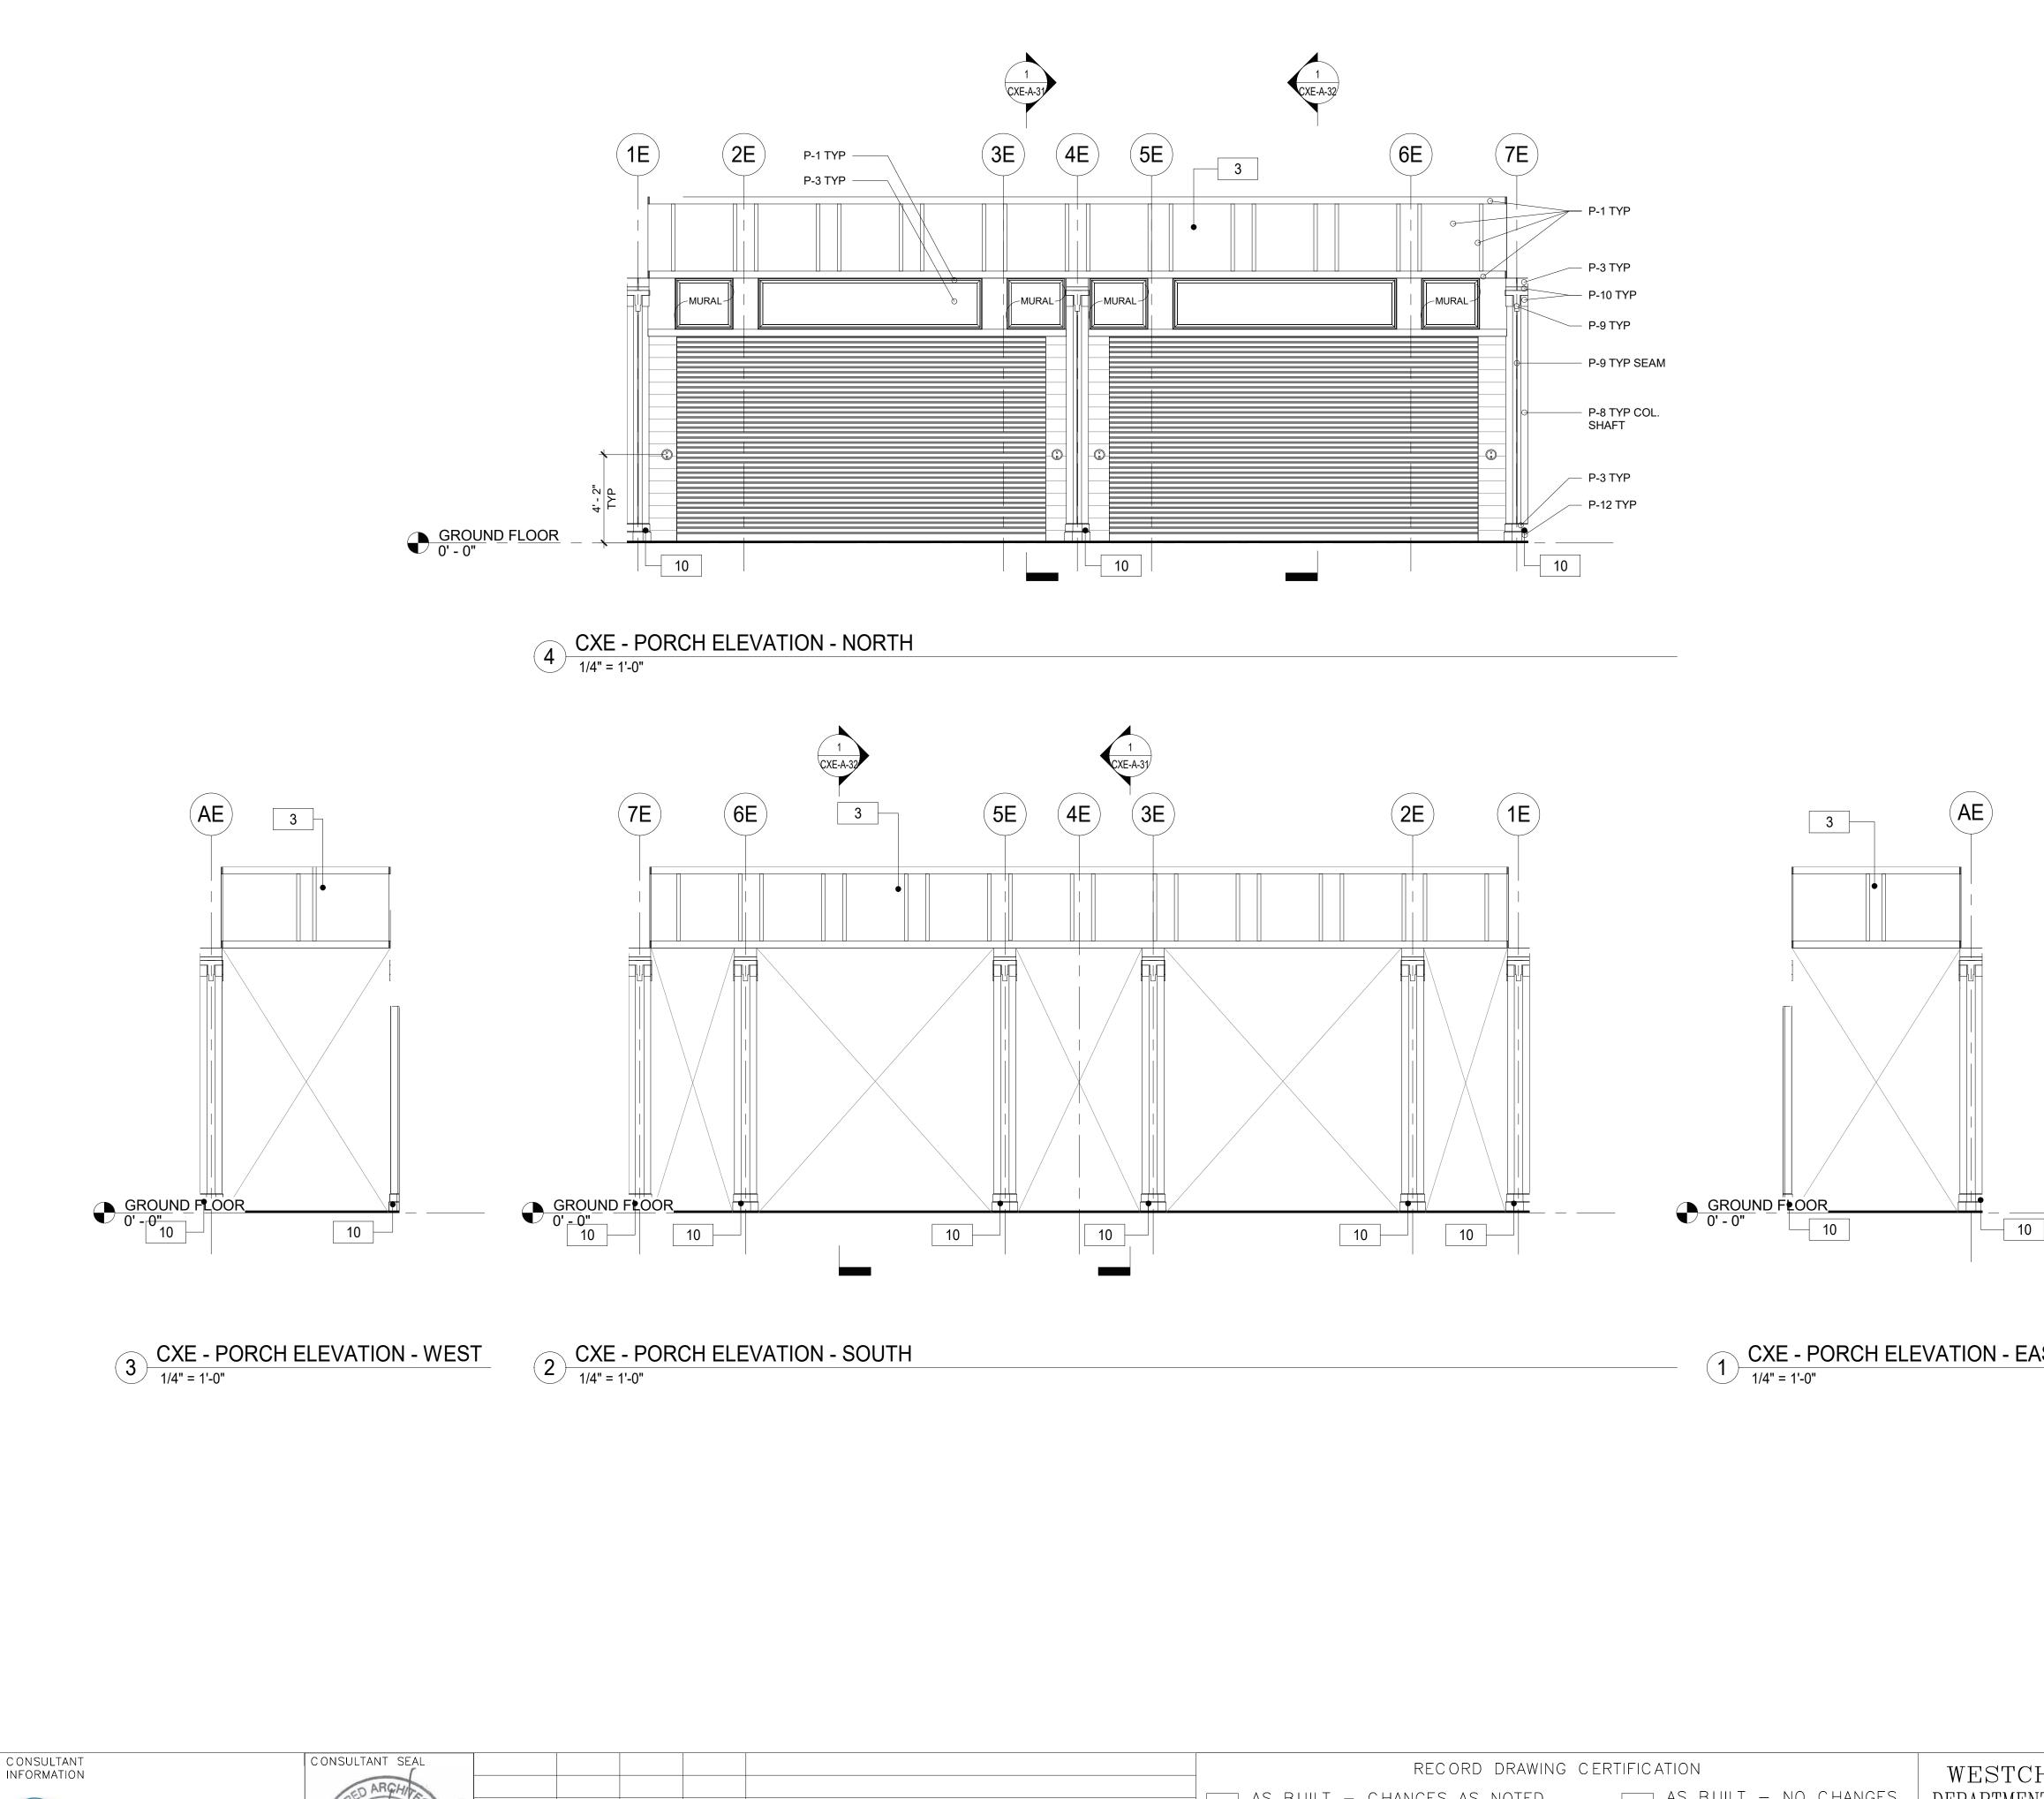

C ONSULTANT INFORMATION	CONSULTANT SEAL						RECORD DRAV	WING CERTIFICATION	1	WESTCHESTER
R The LiRo Group	Steel AHGHINES					AS BUILT	- CHANGES AS NOTE	D AS	BUILT – NO CHANGES	DEPARTMENT OF PUBLIC
	18/2012					C (ONTRACTOR	PROJEC	T COORDINATOR	
3 Aerial Way, Syosset, New York 11791 (516) 938-5476 www.liro.com	02320 H					SIGNATURE		_ SIGNATURE		PLAYLAND F CROSS
	ATE OF NE	REVISION NUMBER	DATE MAD BY	E APP'D BY	REVISION	TITLE	DATE	_ TITLE	DATE	CXE - EXTERIOR BU

1 CXE - PORCH ELEVATION - EAST

FLOOR PLAN GENERAL NOTES

- 1. DIMENSIONS ARE TO FACE OF GYPSUM WALL BOARD, GRID LINES, OR CENTERLINE OF COLUMN. ALL ELEVATIONS ARE NOTED FROM FINISH FLOOR ELEVATIONS.
- 2. PROVIDE DRYWALL TRIM AT ALL EXPOSED EDGES AND CORNERS.
- 3. MINIMUM DIMENSION FROM ANY CORNER OR WALL TO FRAMING STUD AT DOOR JAMB OPENING SHALL BE 4" U.N.O. 4. PROVIDE METAL BLOCKING FOR ANY WALL MOUNTED EQUIPMENT OR ACCESSORIES. COORDINATE
- ALL BLOCKING REQUIREMENTS NECESSARY WITH OTHER TRADES. 5. THE GC SHALL VERIFY DIMENSIONS OF THE EXISTING SPACE AND OF ANY EXISTING CONSTRUCTION TO REMAIN BY ACTUAL MEASUREMENT BEFORE ANY WORK IS PERFORMED. IF
- ANY MEASUREMENTS DIFFER FROM DIMENSIONS SHOWN ON PLAN, GC IS TO NOTIFY THE ARCHITECT IMMEDIATELY. THE GC SHALL BE RESPONSIBLE FOR CORRECTING ANY AND ALL DISCREPANCIES FOUND AFTER THE WORK IS PERFORMED, AT NO ADDITIONAL EXPENSE TO THE OWNER. 6. GC TO VERIFY ALL FINISHED DIMENSIONS. FIELD CONDITIONS ALTERING ANY DIMENSIONS SHOULD
- BE BROUGHT TO THE ATTENTION OF THE OWNER AND ARCHITECT. 7. THE GC SHALL PROVIDE CAULK JOINTS WHERE GYP. BD. MEETS THE FLOOR OR ROOF DECK.
- 8. THE GC SHALL BE RESPONSIBLE FOR COORDINATING WITH OWNER ON ALL WORK TO BE PERFORMED BY THE OWNER. ANY POTENTIAL CONFLICTS OR DELAYS CAUSED BY THE OWNER'S SUBCONTRACTORS MUST BE DOCUMENTED IN WRITING TO THE OWNER BEFORE THE DELAY IS ACTUALLY INCURRED FOR IT TO BE CONSIDERED. OTHERWISE THE GC WILL BE RESPONSIBLE FOR MEETING THE SCHEDULE AS OUTLINED IN THE CONTRACT.
- 9. THE GC SHALL SUPPLY ALL MATERIAL, LABOR, AND COORDINATION REQUIRED FOR THE INSTALLATION OF ALL OWNER-SUPPLIED ITEMS AS DESCRIBED IN THE DOCUMENTS, U.N.O. 10. THE GC IS RESPONSIBLE FOR ALL FLOOR AND WALL PENETRATIONS FOR ELECTRICAL AND
- MECHANICAL WORK. ALL SUCH OPENING SHALL BE FRAMED AND REINFORCED. 11. FLOOR SURFACES SHALL BE LEVELED TO ASSURE SMOOTH SURFACE FOR FINISH FLOOR
- INSTALLATION. GC SHALL ALSO PAY SPECIAL ATTENTION THAT ALL WALL SURFACES ARE SMOOTH WHERE MURALS WILL BE DIRECTLY APPLIED TO WALL. 12. GC TO COORDINATE ALL UTILITY STUB-UPS AND LOCATION OF ALL EQUIPMENT PRIOR TO
- INSTALLING ANY ONE ITEM. 13. REFER TO SHEET CXE-A-80 FOR PARTITION TYPE INFORMATION. 14. PROVIDE PAINTED ACCESS PANELS IN WALLS & CEILING AT CONCEALED ITEMS SUCH AS VALVES,
- CONTROLS, SWITCHES OR ANY OTHER ITEMS THAT REQUIRES ACCESS. GC TO DETERMINE ACCESS PANEL LOCATION W/ ARCHITECT PRIOR TO INSTALLATION.




CXE - EXTERIOR BUILDING PORCH ELEVATIONS

	OUNEDOLL		
KEY	COLOR	MANUFACTURER	REMARKS
P- 1	MYSTICAL POWERS #901	BENJAMIN MOORE	
P- 2	HERITAGE RED #HC-181	BENJAMIN MOORE	
P- 3	NEW YORK STATE OF MIND #805	BENJAMIN MOORE	
P- 4	LAZY SUNDAY #803	BENJAMIN MOORE	
P- 5	DEEP JUNGLE #595	BENJAMIN MOORE	
P- 6	LUCK OF THE IRISH #588	BENJAMIN MOORE	
P- 7	MAJOLICA GREEN #0013	SHERWIN WILLIAMS	
P- 8	ANTELOPE CANYON #125	BENJAMIN MOORE	
P- 9	FORSYTHIA #6907	SHERWIN WILLIAMS	
P- 10	CAPE BLUE #1642	BENJAMIN MOORE	
P- 11	WHITE SNOW #9541	SHERWIN WILLIAMS	
P- 12	TRICORN BLACK #6258	SHERWIN WILLIAMS	
P- 13	READY MIX WHITE	BENJAMIN MOORE	INTERIOR USE ONLY
P- 14	STUCCO PAINT TO MATCH P-1	KEIM	
P- 15	VAN DEUSEN BLUE #HC-156	BENJAMIN MOORE	
P- 16	#RAL9001	-	TYP. ROLL UP DOOR
P- 17	FLORIDA BEACHES #900	BENJAMIN MOORE	
P- 18	PIRATES COVE PEACH #903	BENJAMIN MOORE	
P- 19	JADITE #6459	SHERWIN WILLIAMS	
P- 20	DECISIVE YELLOW #6902	SHERWIN WILLIAMS	

	CONS	STRUCTION KEYNOTES			
	3	REPLICATE TRIMS TO MATCH DOCUMI COLORS AS SCHEDULED.	ENTED TRIM, LOCATI	ONS, SIZE AND SHAPE. FINISH PAINT	
	10	PROVIDE AND INSTALL COLUMN ENCL	OSURES. SEE DETAI	LS.(CXE-A-83)	
CHESTER COI	JNT	Y, NEW YORK	C ONTRAC T NUMB ER	SHEET NUMBER	
		AND TRANSPORTATION	22-523	CXE-A-22	
DIVISION OF E	INGINE	ERING	DWG NO.: 268 of 664		
			SCALE: As inc	licated	
PLAYLAND PARK, CROSS AXIS I	•		DATE: 08/23/	2022	

DPW FILE **1-118-A-1017-0** REV. NO.

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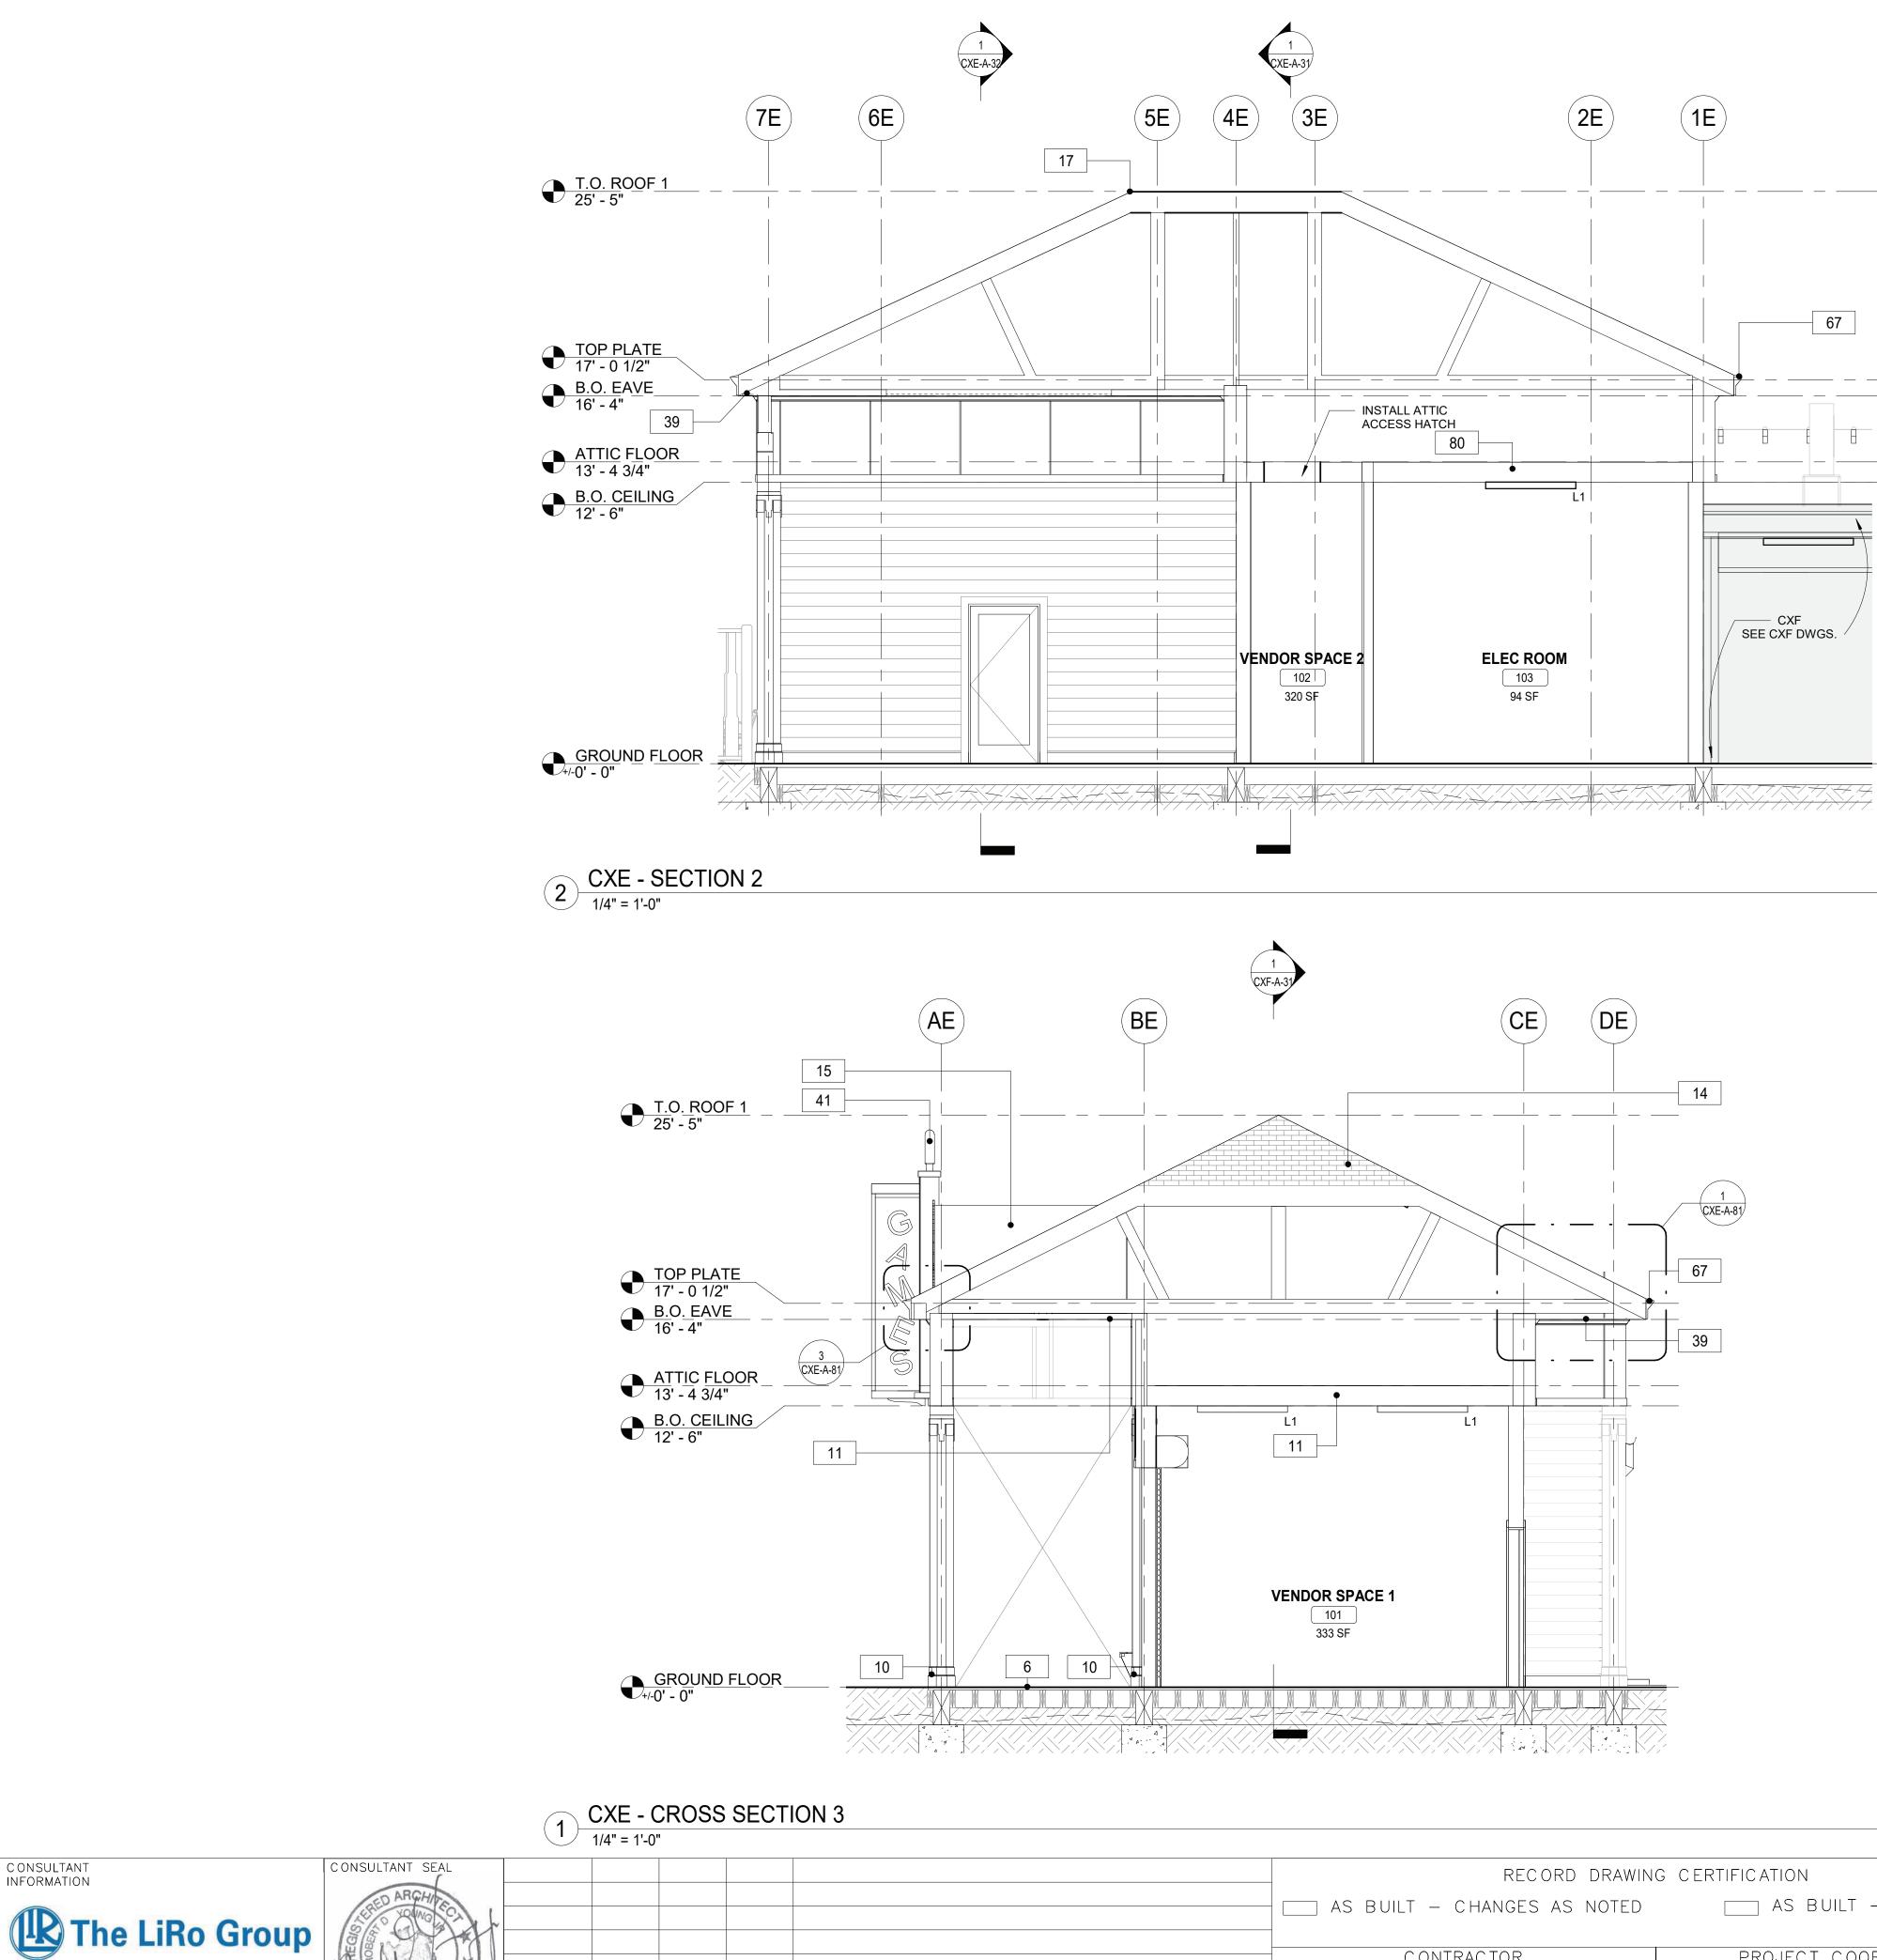


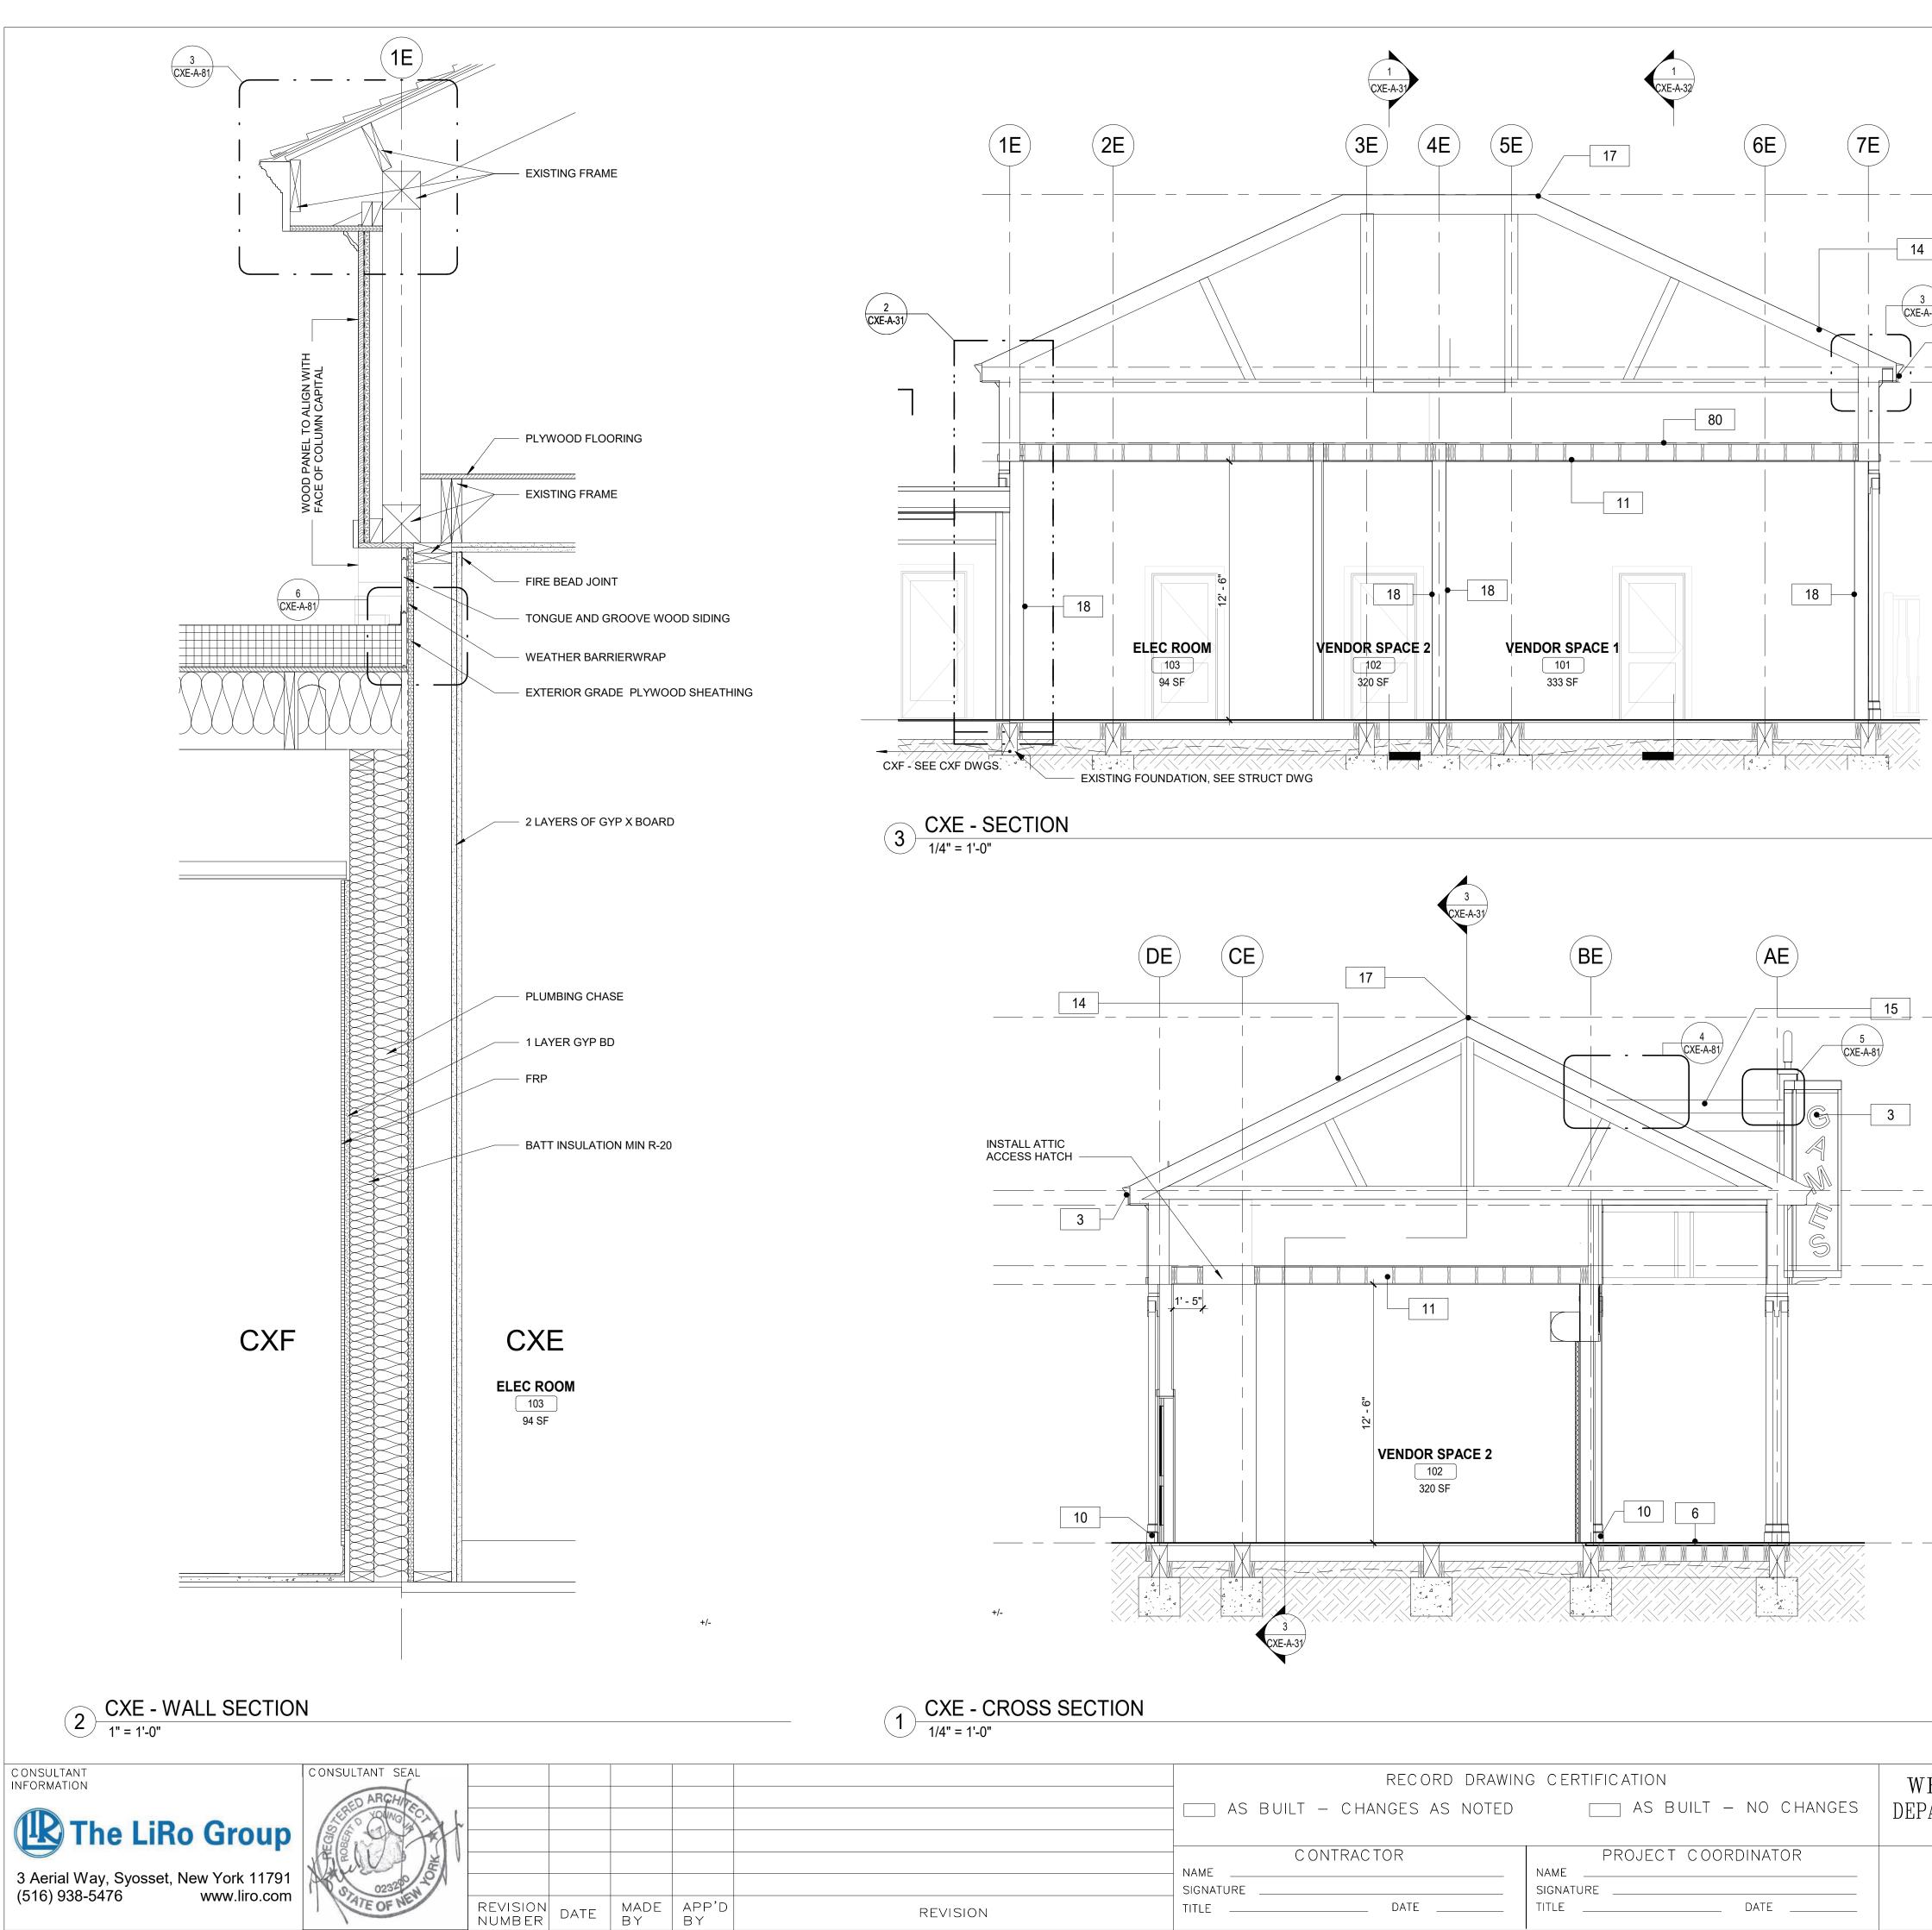	RECORD DRAWING CERTIFICATION				
	AS BUILT – CHANGES AS NOTED	AS BUILT - NO CHANGES	DEPAF		
	CONTRACTOR	PROJECT COORDINATOR			
REVISION	SIGNATURE DATE	SIGNATURE DATE			

	FLOOR PLAN GENERAL NOTES	<u>5</u>
$ \begin{array}{c} 1.0. \ ROOF 1 \\ 25' - 5'' \\ \end{array} $ $ \begin{array}{c} 1 \\ 67 \\ \end{array} $ $ \begin{array}{c} 10P \ PLATE \\ 17' - 0 \ 1/2'' \\ \end{array} $ $ \begin{array}{c} B.0. \ EAVE \\ 16' - 4'' \\ \end{array} $ $ \begin{array}{c} B.0. \ EAVE \\ 16' - 4'' \\ \end{array} $ $ \begin{array}{c} B.0. \ EAVE \\ 13' - 4 \ 3/4'' \\ \end{array} $ $ \begin{array}{c} B.0. \ CEILING \\ 12' - 6'' \\ \end{array} $	 DIMENSIONS ARE TO FACE OF GYPSI ALL ELEVATIONS ARE NOTED FROM I 2. PROVIDE DRYWALL TRIM AT ALL EXP MINIMUM DIMENSION FROM ANY COF SHALL BE 4" (U.N.O.). PROVIDE METAL BLOCKING FOR ANY ALL BLOCKING REQUIREMENTS NECH THE GC SHALL VERIFY DIMENSIONS OF CONSTRUCTION TO REMAIN BY ACTU ANY MEASUREMENTS DIFFER FROM ARCHITECT IMMEDIATELY. THE GC SI DISCREPANCIES FOUND AFTER THE OWNER. GC TO VERIFY ALL FINISHED DIMENS BE BROUGHT TO THE ATTENTION OF THE GC SHALL PROVIDE CAULK JOIN THE GC SHALL BE RESPONSIBLE FOF PERFORMED BY THE OWNER. ANY PA SUBCONTRACTORS MUST BE DOCUM ACTUALLY INCURRED FOR IT TO BE OF MEETING THE SCHEDULE AS OUTLIN THE GC SHALL SUPPLY ALL MATERIA INSTALLATION OF ALL OWNER-SUPP THE GC IS RESPONSIBLE FOR ALL FL MECHANICAL WORK. ALL SUCH OPEN FLOOR SURFACES SHALL BE LEVELE INSTALLATION. GC SHALL ALSO PAY WHERE MURALS WILL BE DIRECTLY AND UNSTALLATION. GC SHALL ALSO PAY WHERE MURALS WILL BE DIRECTLY AND SUBCATUALLY INCURRED FOR ALL FL MECHANICAL WORK. ALL SUCH OPEN FLOOR SURFACES SHALL BE LEVELE INSTALLATION. GC SHALL ALSO PAY WHERE MURALS WILL BE DIRECTLY AND SUBCAT ANY ONE ITEM. REFER TO SHEET CXE-A-80 FOR PAR H. PROVIDE PAINTED ACCESS PANELS INCIDE 	UM WALL BOARD, GRID LINES, OR CENTERLINE OF COLUMN. FINISH FLOOR ELEVATIONS. 'OSED EDGES AND CORNERS. RNER OR WALL TO FRAMING STUD AT DOOR JAMB OPENING 'WALL MOUNTED EQUIPMENT OR ACCESSORIES. COORDINATE ESSARY WITH OTHER TRADES. OF THE EXISTING SPACE AND OF ANY EXISTING JAL MEASUREMENT BEFORE ANY WORK IS PERFORMED. IF DIMENSIONS SHOWN ON PLAN, GC IS TO NOTIFY THE HALL BE RESPONSIBLE FOR CORRECTING ANY AND ALL WORK IS PERFORMED, AT NO ADDITIONAL EXPENSE TO THE FIONS. FIELD CONDITIONS ALTERING ANY DIMENSIONS SHOULD 'THE OWNER AND ARCHITECT. ITS WHERE GYP. BD. MEETS THE FLOOR OR ROOF DECK. R COORDINATING WITH OWNER ON ALL WORK TO BE OTENTIAL CONFLICTS OR DELAYS CAUSED BY THE OWNER'S MENTED IN WRITING TO THE OWNER BEFORE THE DELAY IS CONSIDERED. OTHERWISE THE GC WILL BE RESPONSIBLE FOR ED IN THE CONTRACT. AL, LABOR, AND COORDINATION REQUIRED FOR THE 'LIED ITEMS AS DESCRIBED IN THE DOCUMENTS, U.N.O. .OOR AND WALL PENETRATIONS FOR ELECTRICAL AND NING SHALL BE FRAMED AND REINFORCED. DO ASSURE SMOOTH SURFACE FOR FINISH FLOOR SPECIAL ATTENTION THAT ALL WALL SURFACES ARE SMOOTH APPLIED TO WALL. JB-UPS AND LOCATION OF ALL EQUIPMENT PRIOR TO 'TITION TYPE INFORMATION. IN WALLS & CEILING AT CONCEALED ITEMS SUCH AS VALVES, ER ITEMS THAT REQUIRES ACCESS. GC TO DETERMINE
GROUND FLOOR		
+/- 0' - 0"	CONSTRUCTION KEYNOTES	JMENTED TRIM, LOCATIONS, SIZE AND SHAPE. FINISH PAINT
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	11PROVIDE AND INSTALL T1-11 CEILIN12PROVIDE DROP CEILING AND ALL HARD	IG. ANGERS/ ACCESSORIES.
	DECKING AS REQUIRED (COORDINA15PROVIDE AND INSTALL SBS MODIFIE	ED BITUMEN ROOFING AND UNDERLAYMENT.
	17PROVIDE AND INSTALL RIDGE VENT18PROVIDE NEW WALL FINISHES. SEE67NEW FASCIA BOARD AND SOFFIT.	
	80 NEW 3/4" PLYWOOD FLOOR	
<u>T.O. ROOF 1</u> 25' - 5"		
<u>TOP PLATE</u> 17' - 0 1/2"		
<u>B.O. EAVE</u> 16' - 4"		
ATTIC FLOOR 13' - 4 3/4"		
<u>B.O. CEILING</u> 12' - 6"		
0' - 0"		
		CONTRACT SHEET
	UNTY, NEW YORK ORKS AND TRANSPORTATION	NUMBER NUMBER 22-523 CXE-A-31
DIVISION OF E	ENGINEERING	DWG NO.: 269 of 664
INFRASTRUCTURE REH PLAYLAND PARK,	RYE, NEW YORK	SCALE: As indicated DATE: 08/23/2022
CROSS AXIS CXE - BUILDIN		DPW FILE 1-118-A-1018-0 REV. 0

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C ONSULTANT INFORMATION	CONSULTANT SEAL					_		RECORD DRAW	VING CERTIFICAT	ION	WESTCHESTER COUNTY, NEW YORK	C ONTRAC T NUMB ER	SHEET NUMBER
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The LiRo Group	36.5	1				-					DIVISION OF ENGINEERING	DWG NO.: 270	of 664
	AFIRAL A	1				-	CONTRAC	CTOR	PROJ	JECT COORDINATOR	INFRASTRUCTURE REHABILITATION PHASE 3	SCALE: 1/4"	= 1'-0"
3 Aerial Way, Syosset, New York 11791 (516) 938-5476 www.liro.com	02320 N					– NAME _ SIGNATURE			_ NAME _ SIGNATURE		PLAYLAND PARK, RYE, NEW YORK CROSS AXIS BUILDING E	DATE: 08/23	3/2022
(010) 000-0-10 www.mo.com	TE OF NE	REVISION NUMBER DATE	MADE BY	APP'D By	REVISION	TITLE		DATE	TITLE	DATE	CXE - BUILDING SECTIONS	DPW FILE NUMBER 1-1	118-A-1019-0 REV. 0

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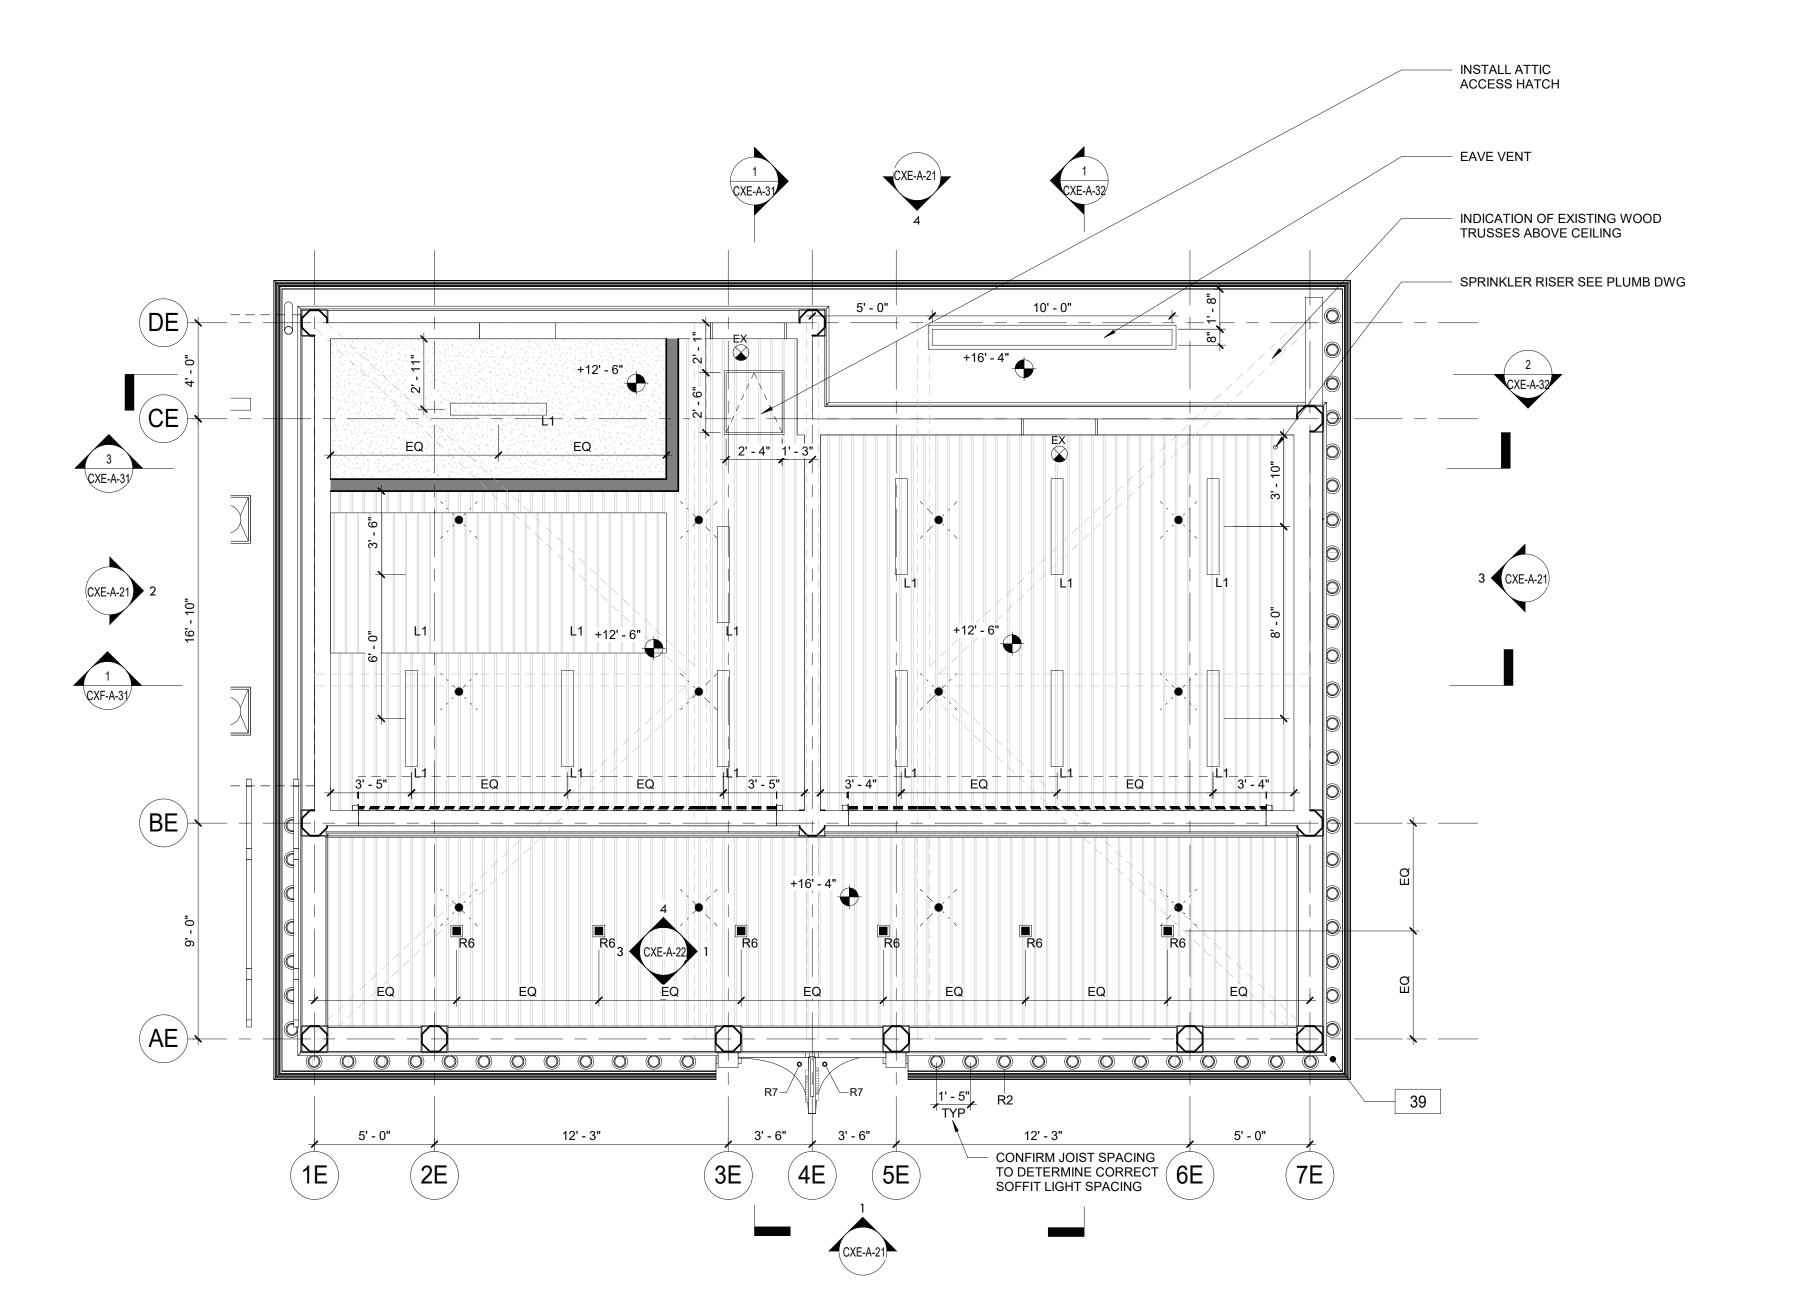


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- CONTROLS, SWITCHES OR ANY OTHER ITEMS THAT REQUIRES ACCESS. GC TO DETERMINE ACCESS PANEL LOCATION W/ ARCHITECT PRIOR TO INSTALLATION.

CONSTRUCTION KEYNOTES

6	INSTALL NEW IPE DECKING. SEE STRUCTURAL FOR DETAILS.
10	PROVIDE AND INSTALL COLUMN ENCLOSURES. SEE DETAILS.
11	PROVIDE AND INSTALL T1-11 CEILING.
14	PROVIDE NEW ASPHALT SHINGLE ROOFING, UNDERLAYMENT, AND REPLACE IN KIND EXISTING DECKING AS REQUIRED (COORDINATE WITH STRUCTURAL).
15	PROVIDE AND INSTALL SBS MODIFIED BITUMEN ROOFING AND UNDERLAYMENT.
17	PROVIDE AND INSTALL RIDGE VENT AT ROOF HIPS.
39	NEW SOFFIT WITH RECESSED LIGHTS AS INDICATED ON RCP
41	INSTALL REFURBISHED FINIAL LIGHTS (H6). ARCHITECT TO APPROVE FINISH AND ANY NEEDED MODIFICATIONS TO H6 LIGHTS DURING REFURBISHMENT.
67	NEW FASCIA BOARD AND SOFFIT.
80	NEW 3/4" PLYWOOD FLOOR



CXE - GROUND RCP 1/4" = 1'-0"






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it						AS BUILT – CHANGES AS NOTED) — AS BUILT – NO CHANGE	
						CONTRACTOR NAMESIGNATURE	PROJECT COORDINATOR	_
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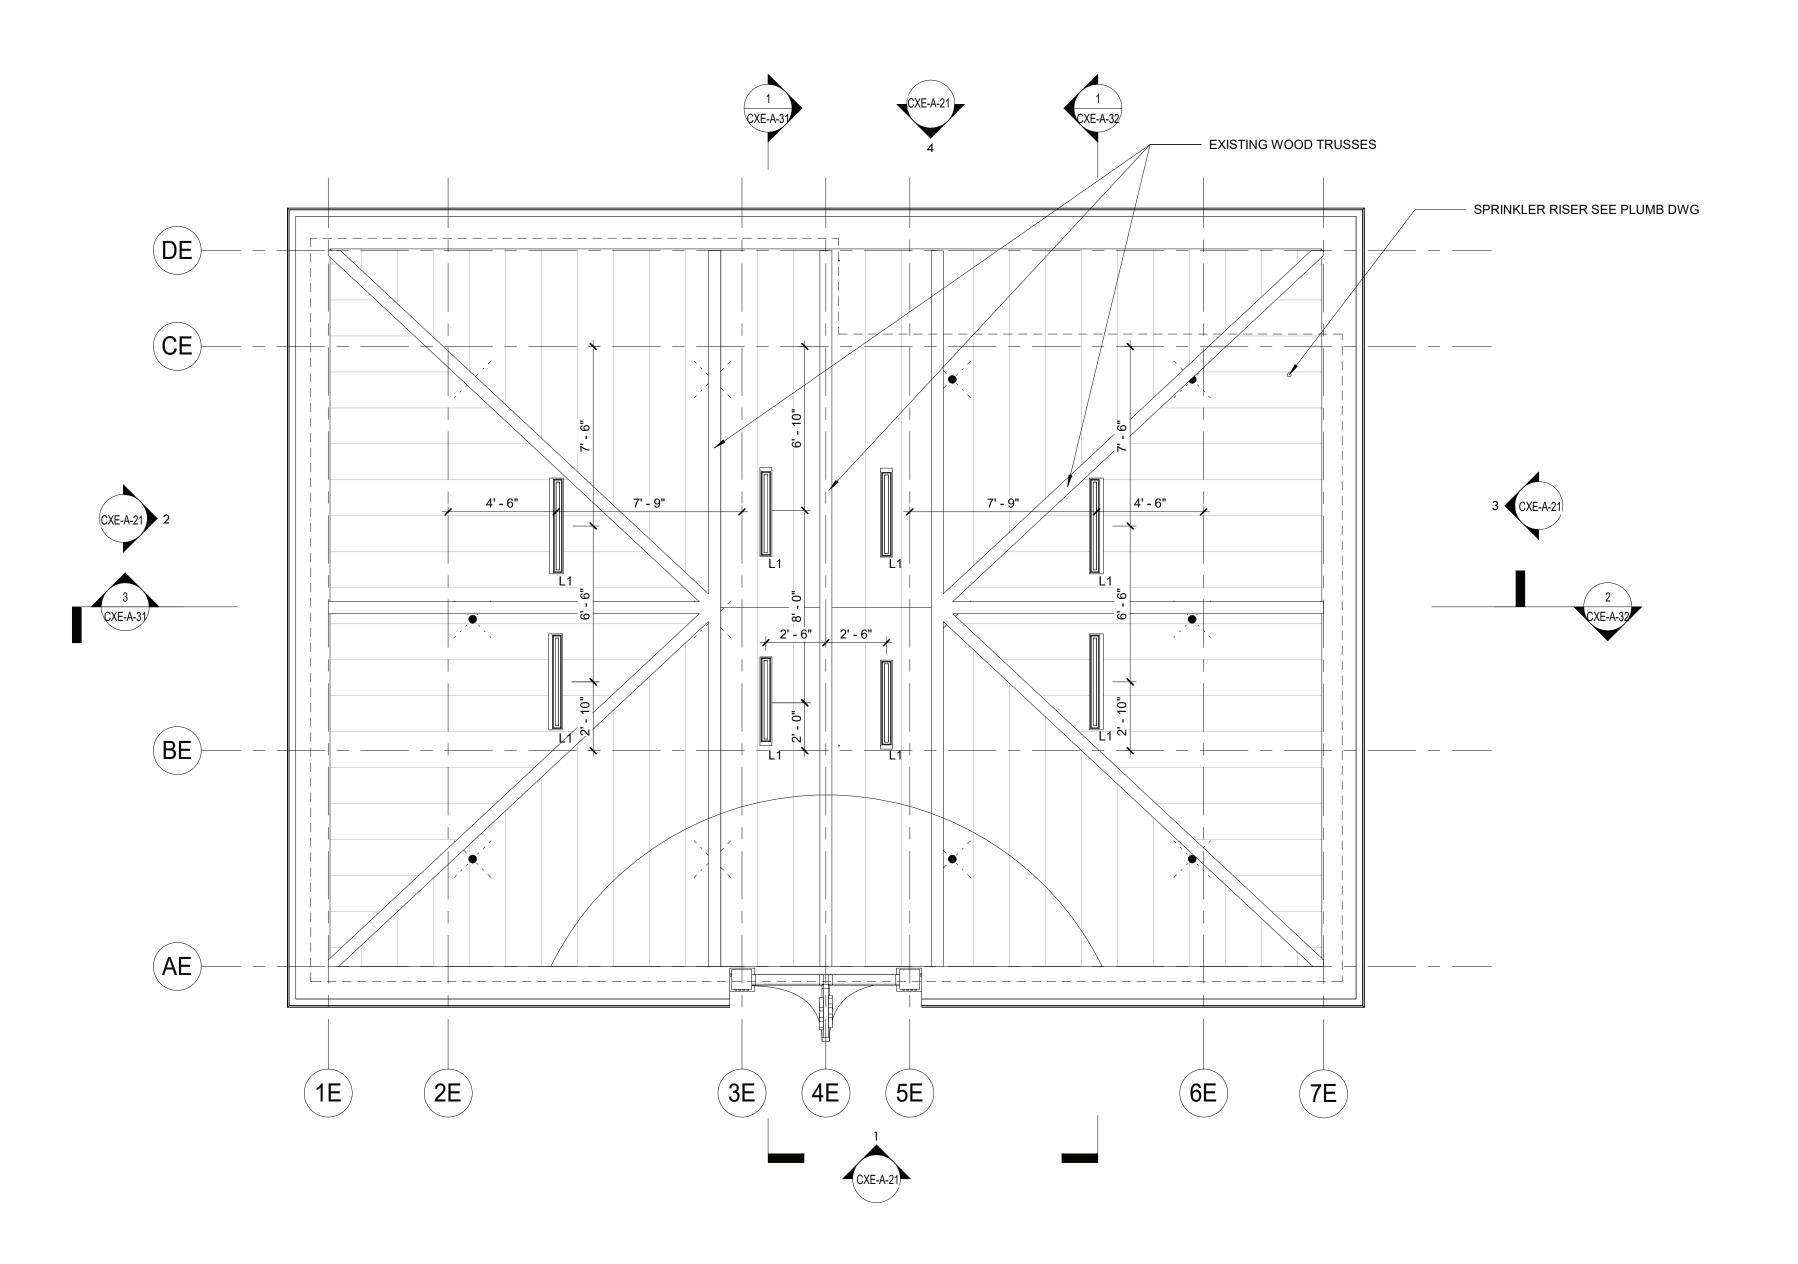
|--|

- 1. CONTRACTOR SHALL PROVIDE THE NECESSARY FRAMING OR BRIDGING FOR ALL LIGHT FIXTURES,
- DIFFUSERS, RETURNS, ETC., AS WELL AS REQUIRED CUTOUTS.
- 2. CONTRACTOR SHALL NOTIFY THE ARCHITECT OF ANY POSSIBLE INTERFERENCES BEFORE PROCEEDING WITH CEILING INSTALLATION. 3. CEILING CONSTRUCTION SHALL NOT BE CLOSED IN UNTIL THE CONSTRUCTION MANAGER AND
- AUTHORITIES HAVING JURISDICTION HAVE HAD AN OPPORTUNITY TO INSPECT THE AREA AND ASCERTAIN THAT ALL DUCTWORK, PLUMBING, ELECTRICAL CONDUITS AND LINES HAVE BEEN INSTALLED PROPERLY.
- 4. FASCIAS OR ANY BREAK IN THE CEILING HEIGHTS CREATED BY THE INSTALLATION AND/OR ALTERATION OF HEATING, VENTILATING, A/C OR MECHANICAL DUCTS, PIPING OR OTHER EQUIPMENT SHALL BE FORMED OF GYPSUM WALLBOARD ON FURRING CHANNELS.
- 5. THE CEILING PANEL JOINTS SHALL BE ALIGNED PERFECTLY WITH LIGHTING FIXTURES. 6. ALL JOINTS IN THE PANEL SHALL BE SQUARE, LEVEL AND PERFECTLY ALIGNED WITH EACH OTHER AND WITH BUILDING FIXTURES.
- 7. CONTRACTOR SHALL PROVIDE CUTOUTS AND OTHER SPECIAL PROVISIONS IN ACOUSTICAL WORK AS REQUIRED FOR LIGHTING FIXTURES, REGISTERS, DIFFUSERS AND OTHER INSERTED ITEMS. GENERAL CONSTRUCTION CONTRACTOR SHALL INSTALL ACCESS PANELS IN GYPSUM DRYWALL CEILINGS FOR ACCESS TO AIR CONDITIONING, PLUMBING, TELEPHONE & ELECTRICAL CONTROL
- EQUIPMENT REQUIRING ACCESS. 8. IN GENERAL, WITHIN EACH AREA, CEILING WORK REQUIREMENTS SHALL BE EXECUTED IN SUCH A MANNER AS TO PROVIDE CONTINUOUS MATCHED AND ALIGNED CEILINGS. THE FINAL CEILING INSTALLATION SHALL BE FREE OF ALL VISUAL DEFECTS.

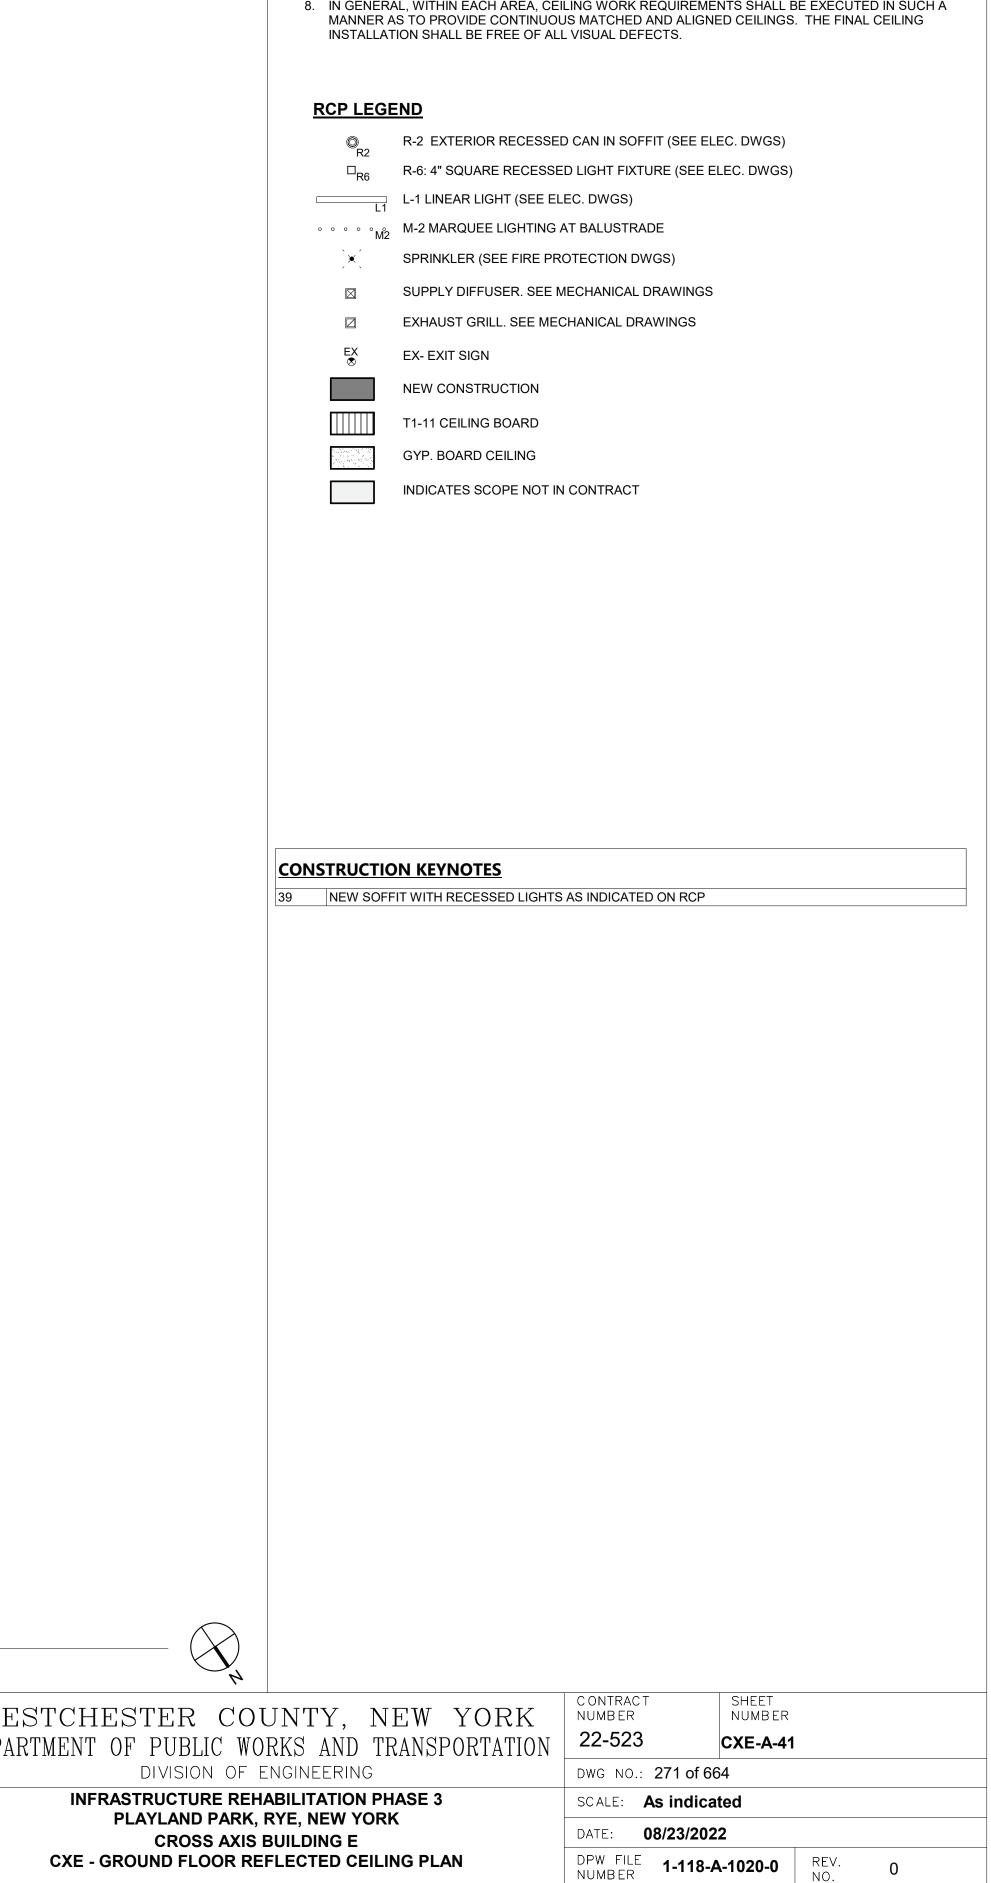

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CXE - GROUND FLOOR REFLECTED CEILING PLAN



1 CXE - ATTIC PLAN 1/4" = 1'-0"

CONSULTANT INFORMATION



CONSULTANT SEAL		
ED ARCHINA		
ALL COMPANY		
VEIELL E		
0232 N		
ATE OF NEW	REVISION NUMBER	DATE

I	DATE	MADE B Y	APP'D By	

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	RECORD DRAWI	NG CERTIFICATION	WESTCHESTER COUNTY, NEW YORK	CONTRACT SHEET NUMBER NUMBER
	AS BUILT – CHANGES AS NOTED	AS BUILT – NO CHANGES	DEPARTMENT OF PUBLIC WORKS AND TRANSPORTATION	22-523 CXE-A-42
			DIVISION OF ENGINEERING	DWG NO.: 272 of 664
	C ONTRAC TOR	PROJECT COORDINATOR	INFRASTRUCTURE REHABILITATION PHASE 3	SCALE: As indicated
	SIGNATURE	SIGNATURE	PLAYLAND PARK, RYE, NEW YORK CROSS AXIS BUILDING E	DATE: 08/23/2022
REVISION	TITLE DATE	TITLE DATE	CXE - ATTIC REFLECTED CEILING PLAN	DPW FILE 1-118-A-1021-0 REV. 0 NO.


GENERAL REFLECTED CEILING PLAN NOTES

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 2. CONTRACTOR SHALL NOTIFY THE ARCHITECT OF ANY POSSIBLE INTERFERENCES BEFORE PROCEEDING WITH CEILING INSTALLATION.
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- 4. FASCIAS OR ANY BREAK IN THE CEILING HEIGHTS CREATED BY THE INSTALLATION AND/OR ALTERATION OF HEATING, VENTILATING, A/C OR MECHANICAL DUCTS, PIPING OR OTHER EQUIPMENT SHALL BE FORMED OF GYPSUM WALLBOARD ON FURRING CHANNELS.
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- IN GENERAL, WITHIN EACH AREA, CEILING WORK REQUIREMENTS SHALL BE EXECUTED IN SUCH A MANNER AS TO PROVIDE CONTINUOUS MATCHED AND ALIGNED CEILINGS. THE FINAL CEILING INSTALLATION SHALL BE FREE OF ALL VISUAL DEFECTS.
 CEILING BOARD OVER VENDOR SPACES SHOULD BE MOISTURE RESISTANT, PRESSURE TREATED WOOD

RCP LEGEND


EX

- R-2 EXTERIOR RECESSED CAN IN SOFFIT (SEE ELEC. DWGS)
- R-6: 4" SQUARE RECESSED LIGHT FIXTURE (SEE ELEC. DWGS)
- L-1 LINEAR LIGHT (SEE ELEC. DWGS)
- SPRINKLER (SEE FIRE PROTECTION DWGS)
- SUPPLY DIFFUSER. SEE MECHANICAL DRAWINGS
- Z EXHAUST GRILL. SEE MECHANICAL DRAWINGS
 - EX- EXIT SIGN
 - NEW CONSTRUCTION
 - T1-11 CEILING BOARD
 - GYP. BOARD CEILING
 - INDICATES SCOPE NOT IN CONTRACT

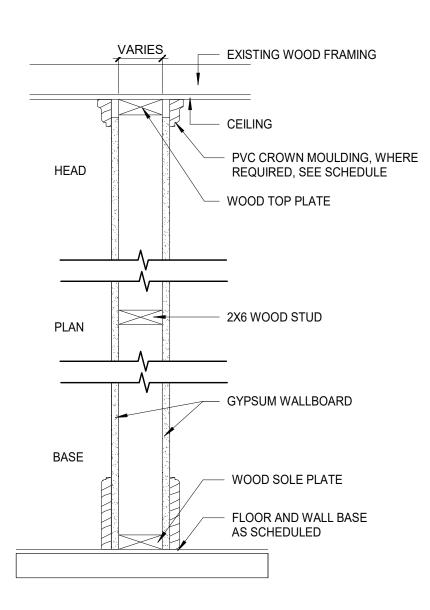



NO RATING 1 LAYER 5/8" IMPACT & MOLD-RESISTANT GYP. BD. TO CEILING, ON EACH SIDE

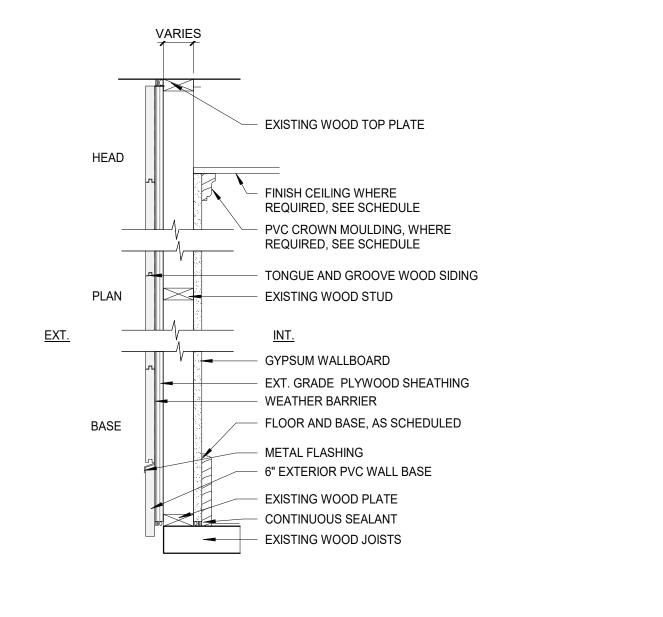



NO RATING


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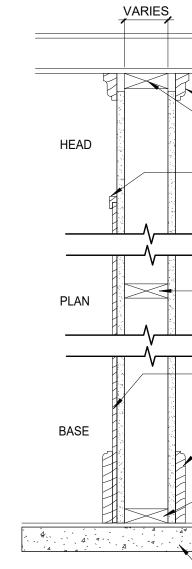
1 LAYER 5/8" IMPACT & MOLD-RESISTANT GYP. BD. AND 5/8" MOLD-RESISTANT GYP. BD. TO CEILING ON THE INTERIOR SIDE. 8' HIGH" BEADBOARD ON INTERIOR SIDE WITH PVC BEADBOARD CAP (NOT SHOWN)





REVISION NUMBER	DATE	MADE BY	APP'D By	



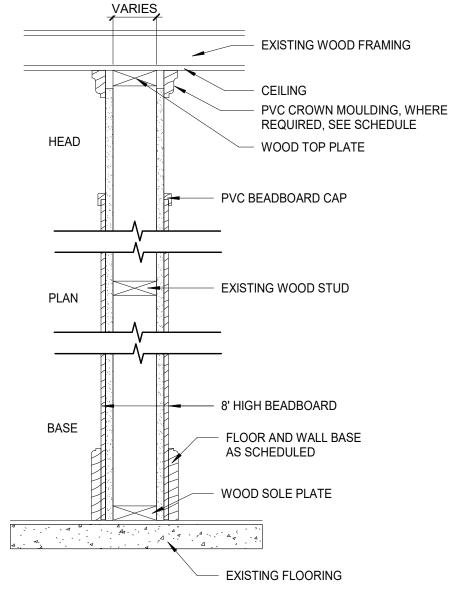


		G CERTIFICATION	WESTCHESTER COUNTY, NEW YORK	CONTRACT SHEET NUMBER NUMBER
	AS BUILT – CHANGES AS NOTED	AS BUILT – NO CHANGES	DEPARTMENT OF PUBLIC WORKS AND TRANSPORTATION DIVISION OF ENGINEERING	22-523 CXE-A-80 DWG NO.: 273 of 664
	CONTRACTOR NAME	PROJECT COORDINATOR NAME	INFRASTRUCTURE REHABILITATION PHASE 3 PLAYLAND PARK, RYE, NEW YORK CROSS AXIS BUILDING E	SCALE: 1 1/2" = 1'-0" DATE: 08/23/2022
REVISION	TITLE DATE	TITLE DATE	PARTITION TYPES	DPW FILE 1-118-A-1022-0 REV. 0 NUMBER 0







1	e.	
		EXISTING WOOD FRAMING
		CEILING PVC CROWN MOULDING, WHERE REQUIRED, SEE SCHEDULE WOOD TOP PLATE PVC BEADBOARD CAP
		- 2x6 WOOD STUD -
		- 8' HIGH BEADBOARD
		FLOOR AND WALL BASE AS SCHEDULED
		WOOD SOLE PLATE
1		

- EXISTING FLOORING

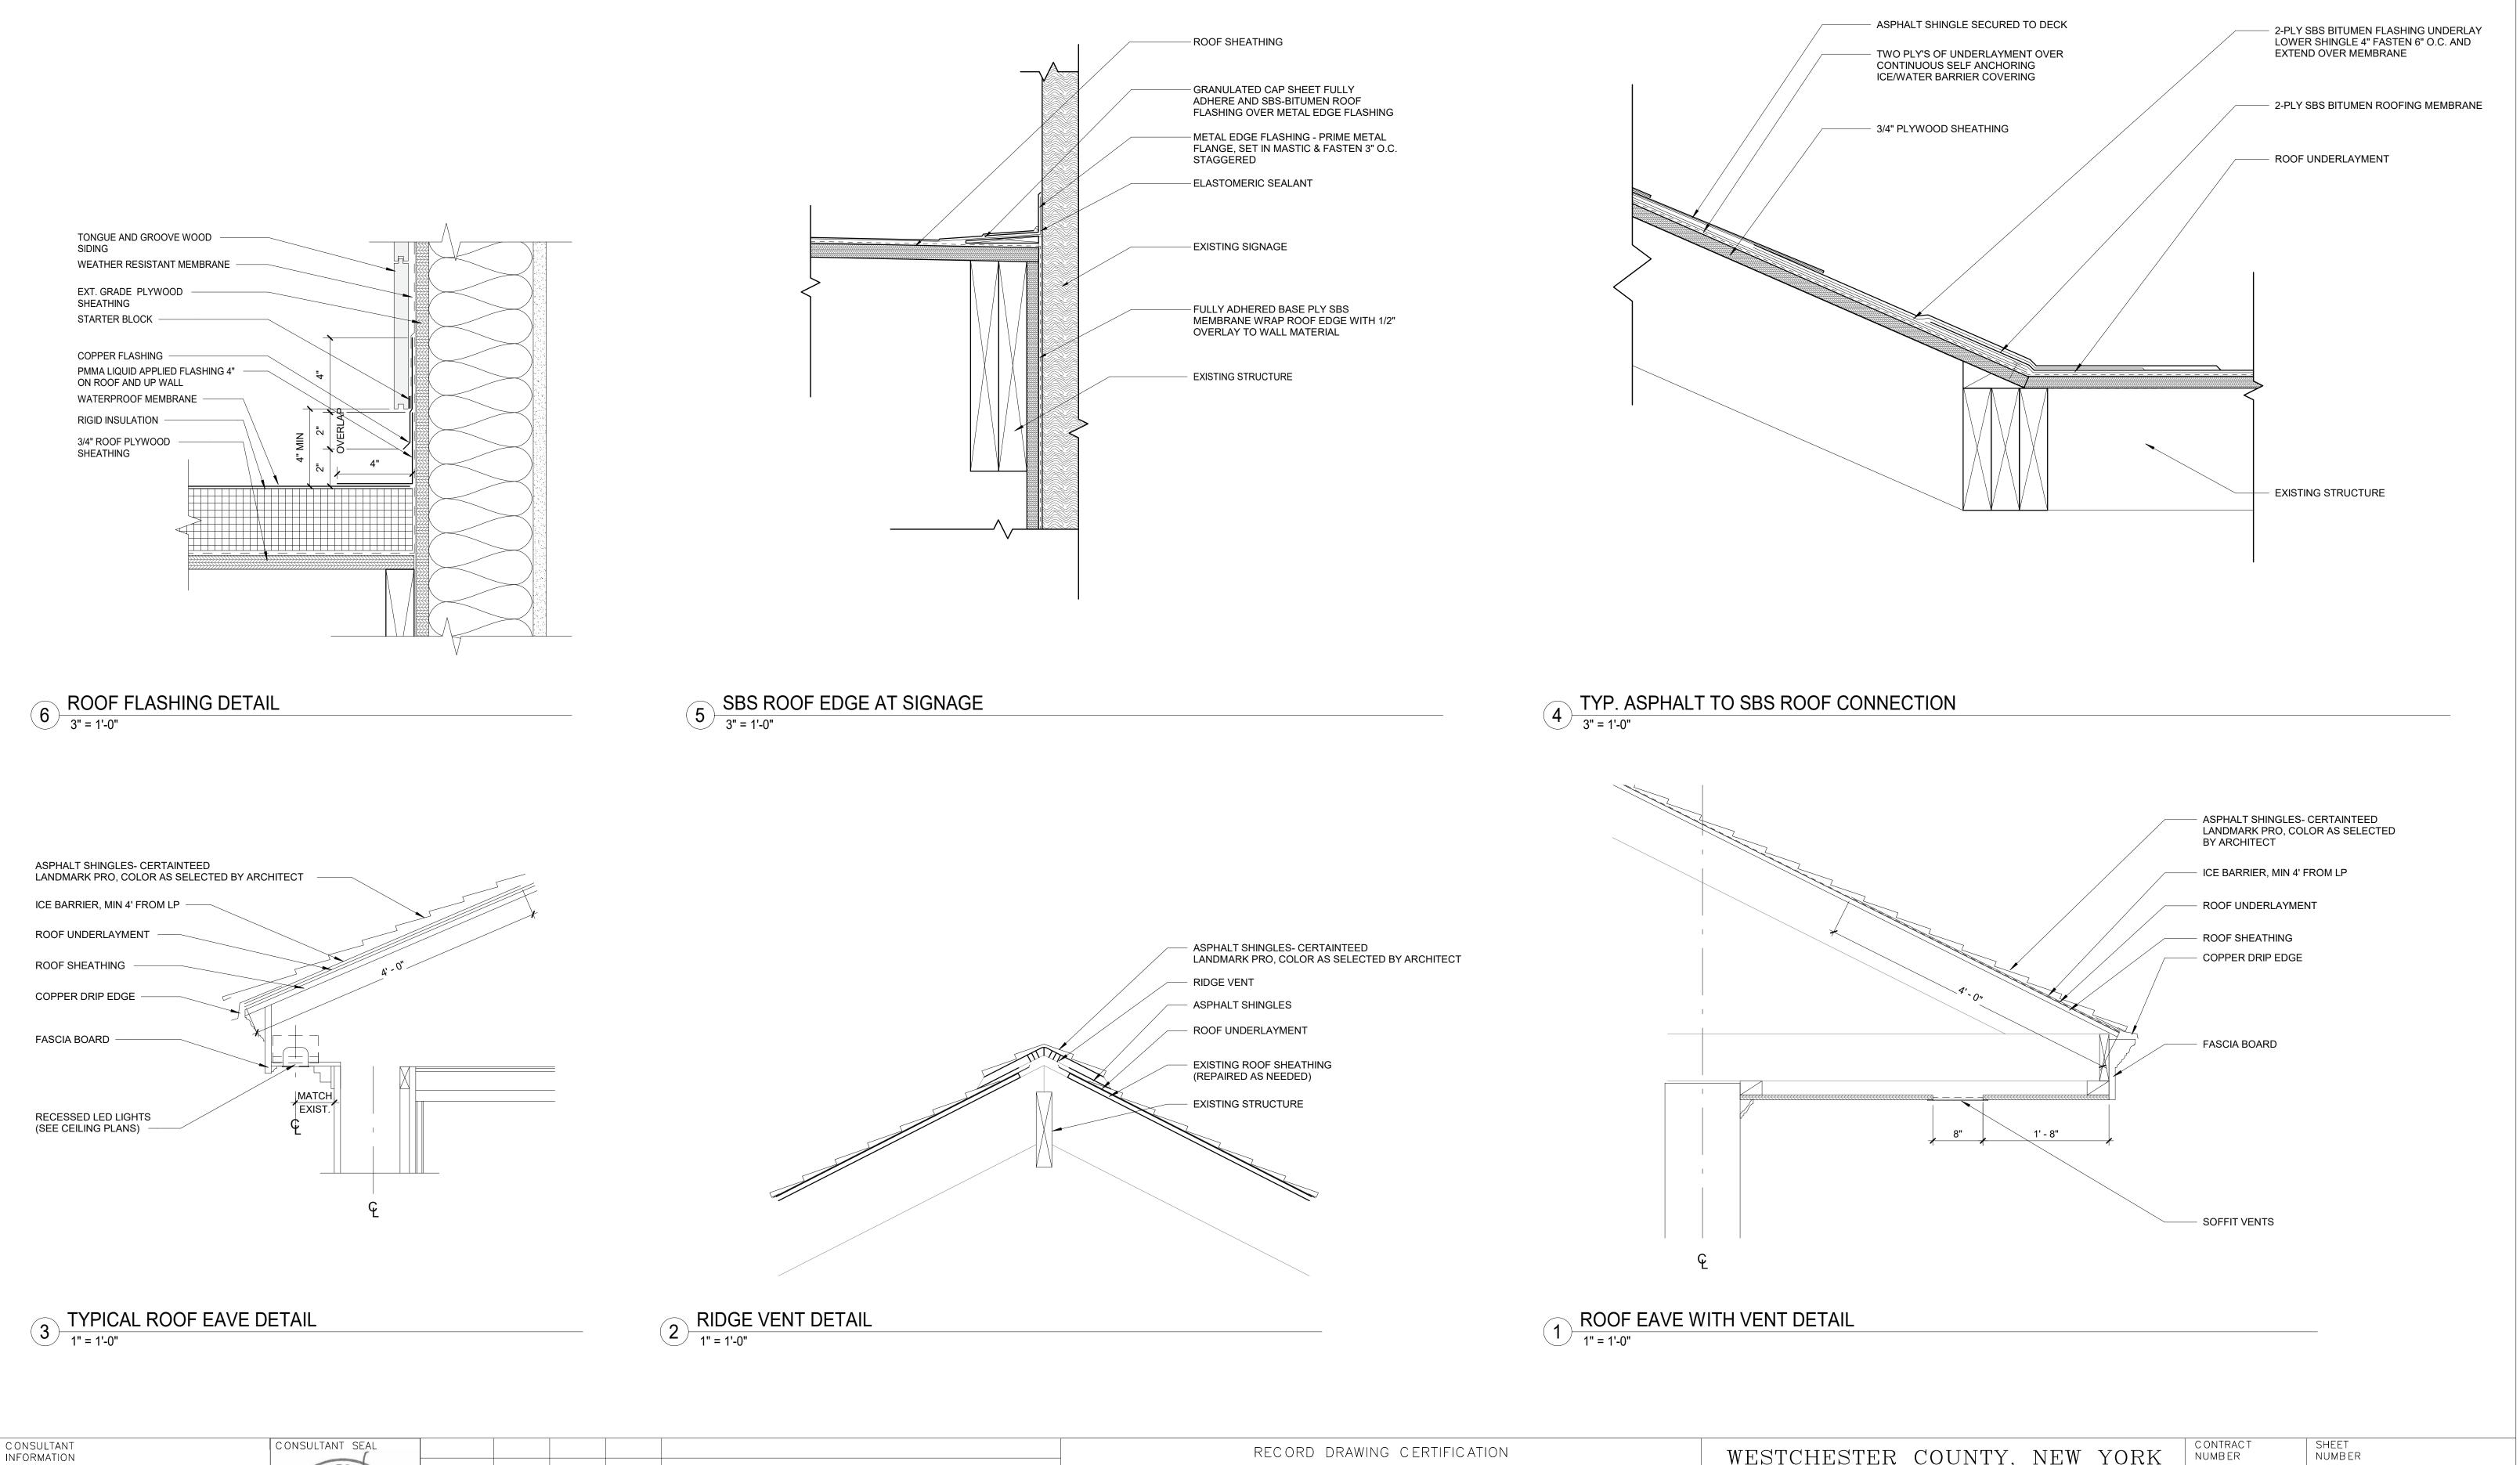

	C ONTRAC TOR	PROJECT COORDINATOR	DIVISION OF ENGINEERING INFRASTRUCTURE REHABILITATION PHASE 3	DWG NO.: 274 of 664 SCALE: As indicated		
REVISION	NAME	NAME	PLAYLAND PARK, RYE, NEW YORK CROSS AXIS BUILDING E ROOF DETAILS	SCALE: AS indicated DATE: 08/23/2022 DPW_FILE 1-118-A-1023-0 NUMBER 0		

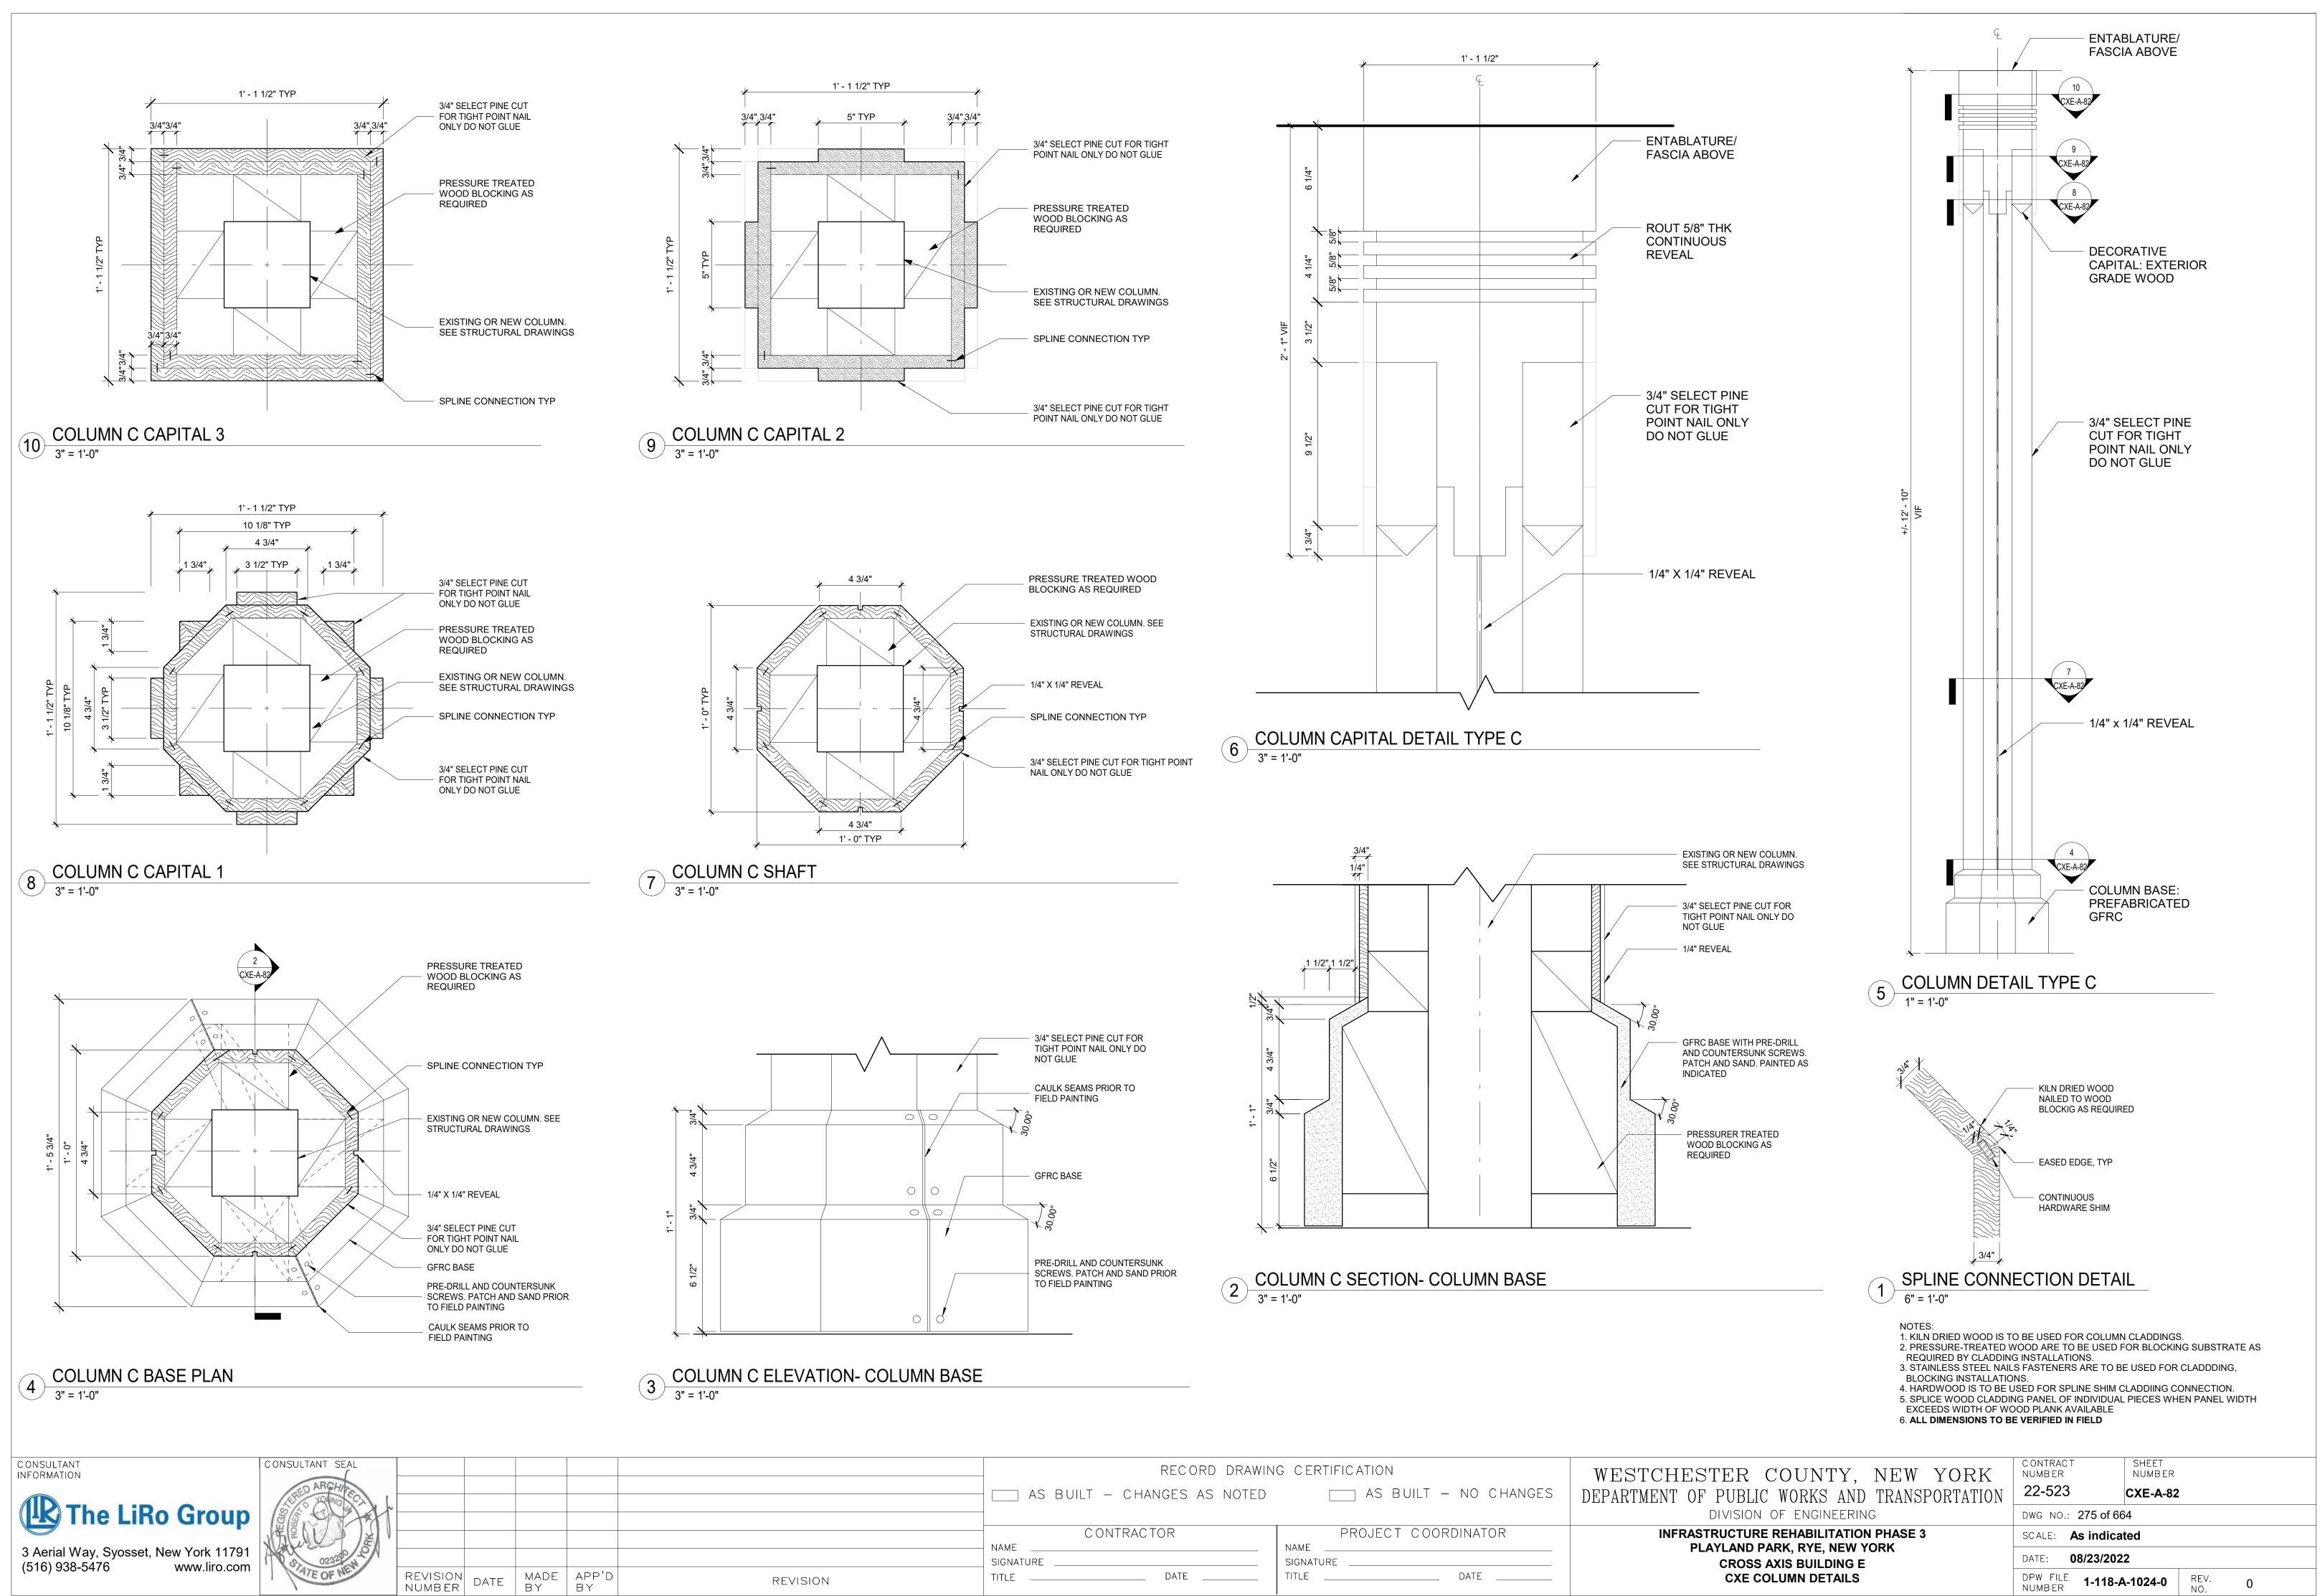

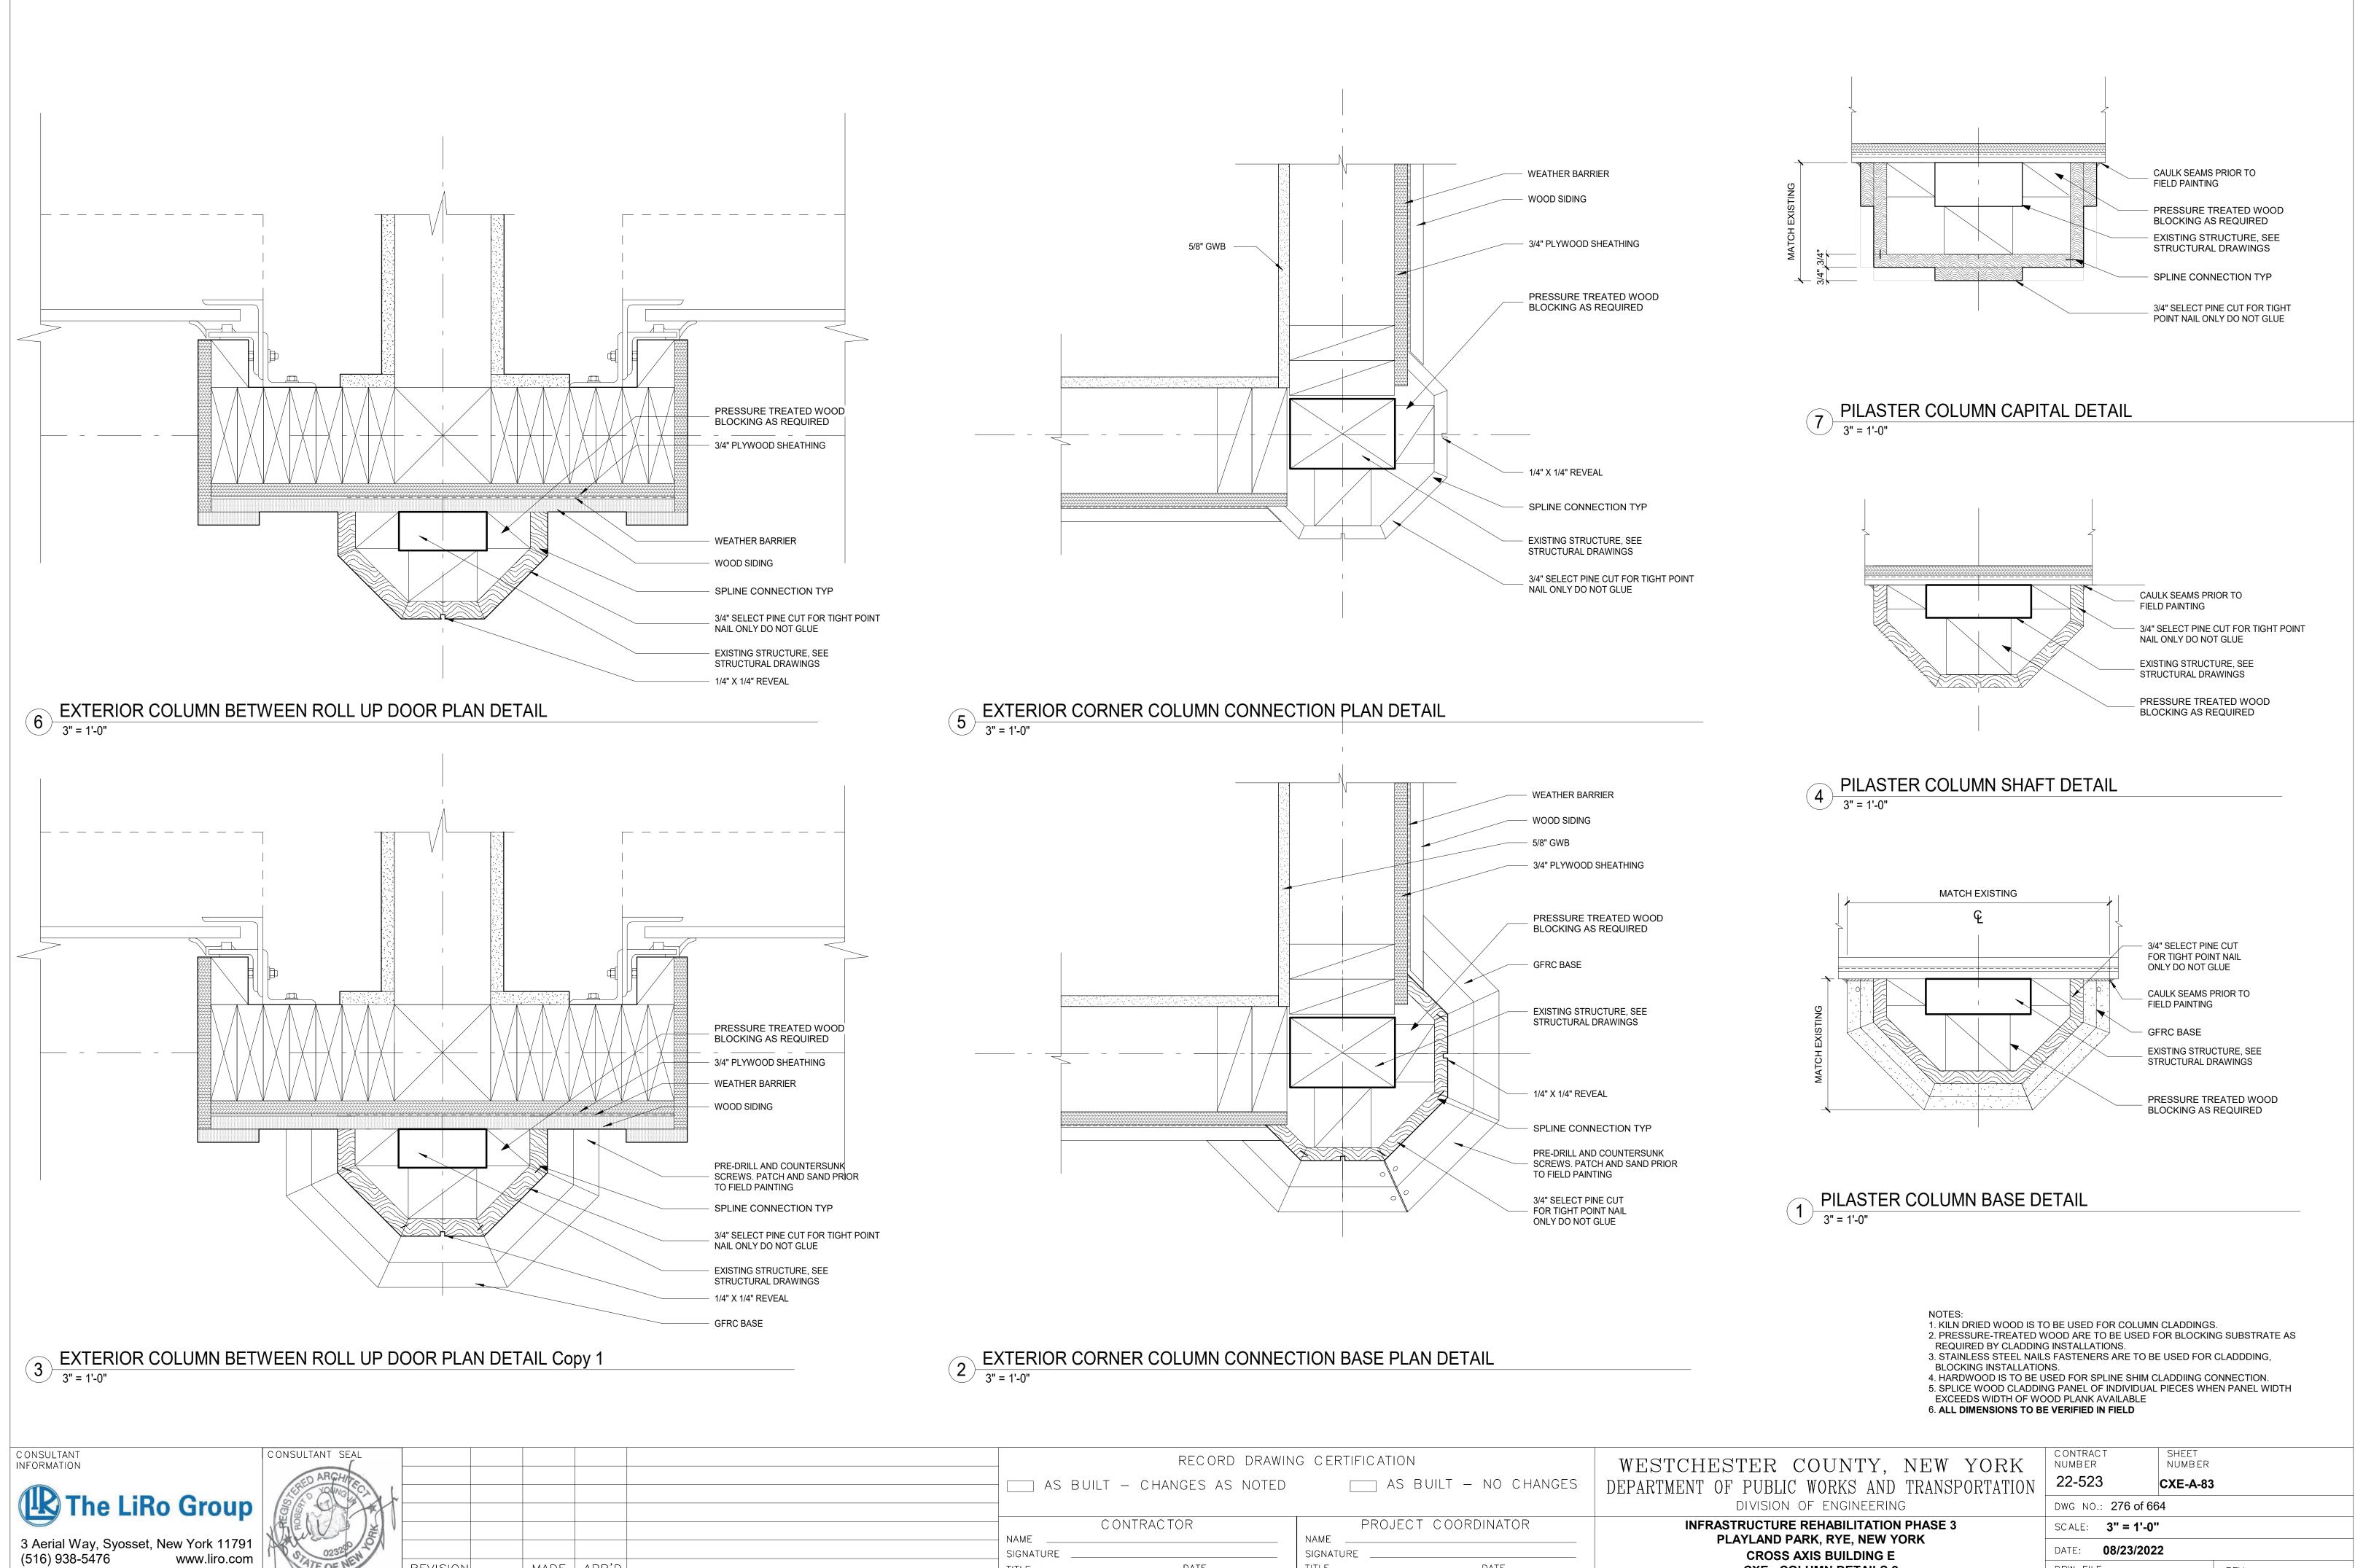

REVISION DATE

NUMBER

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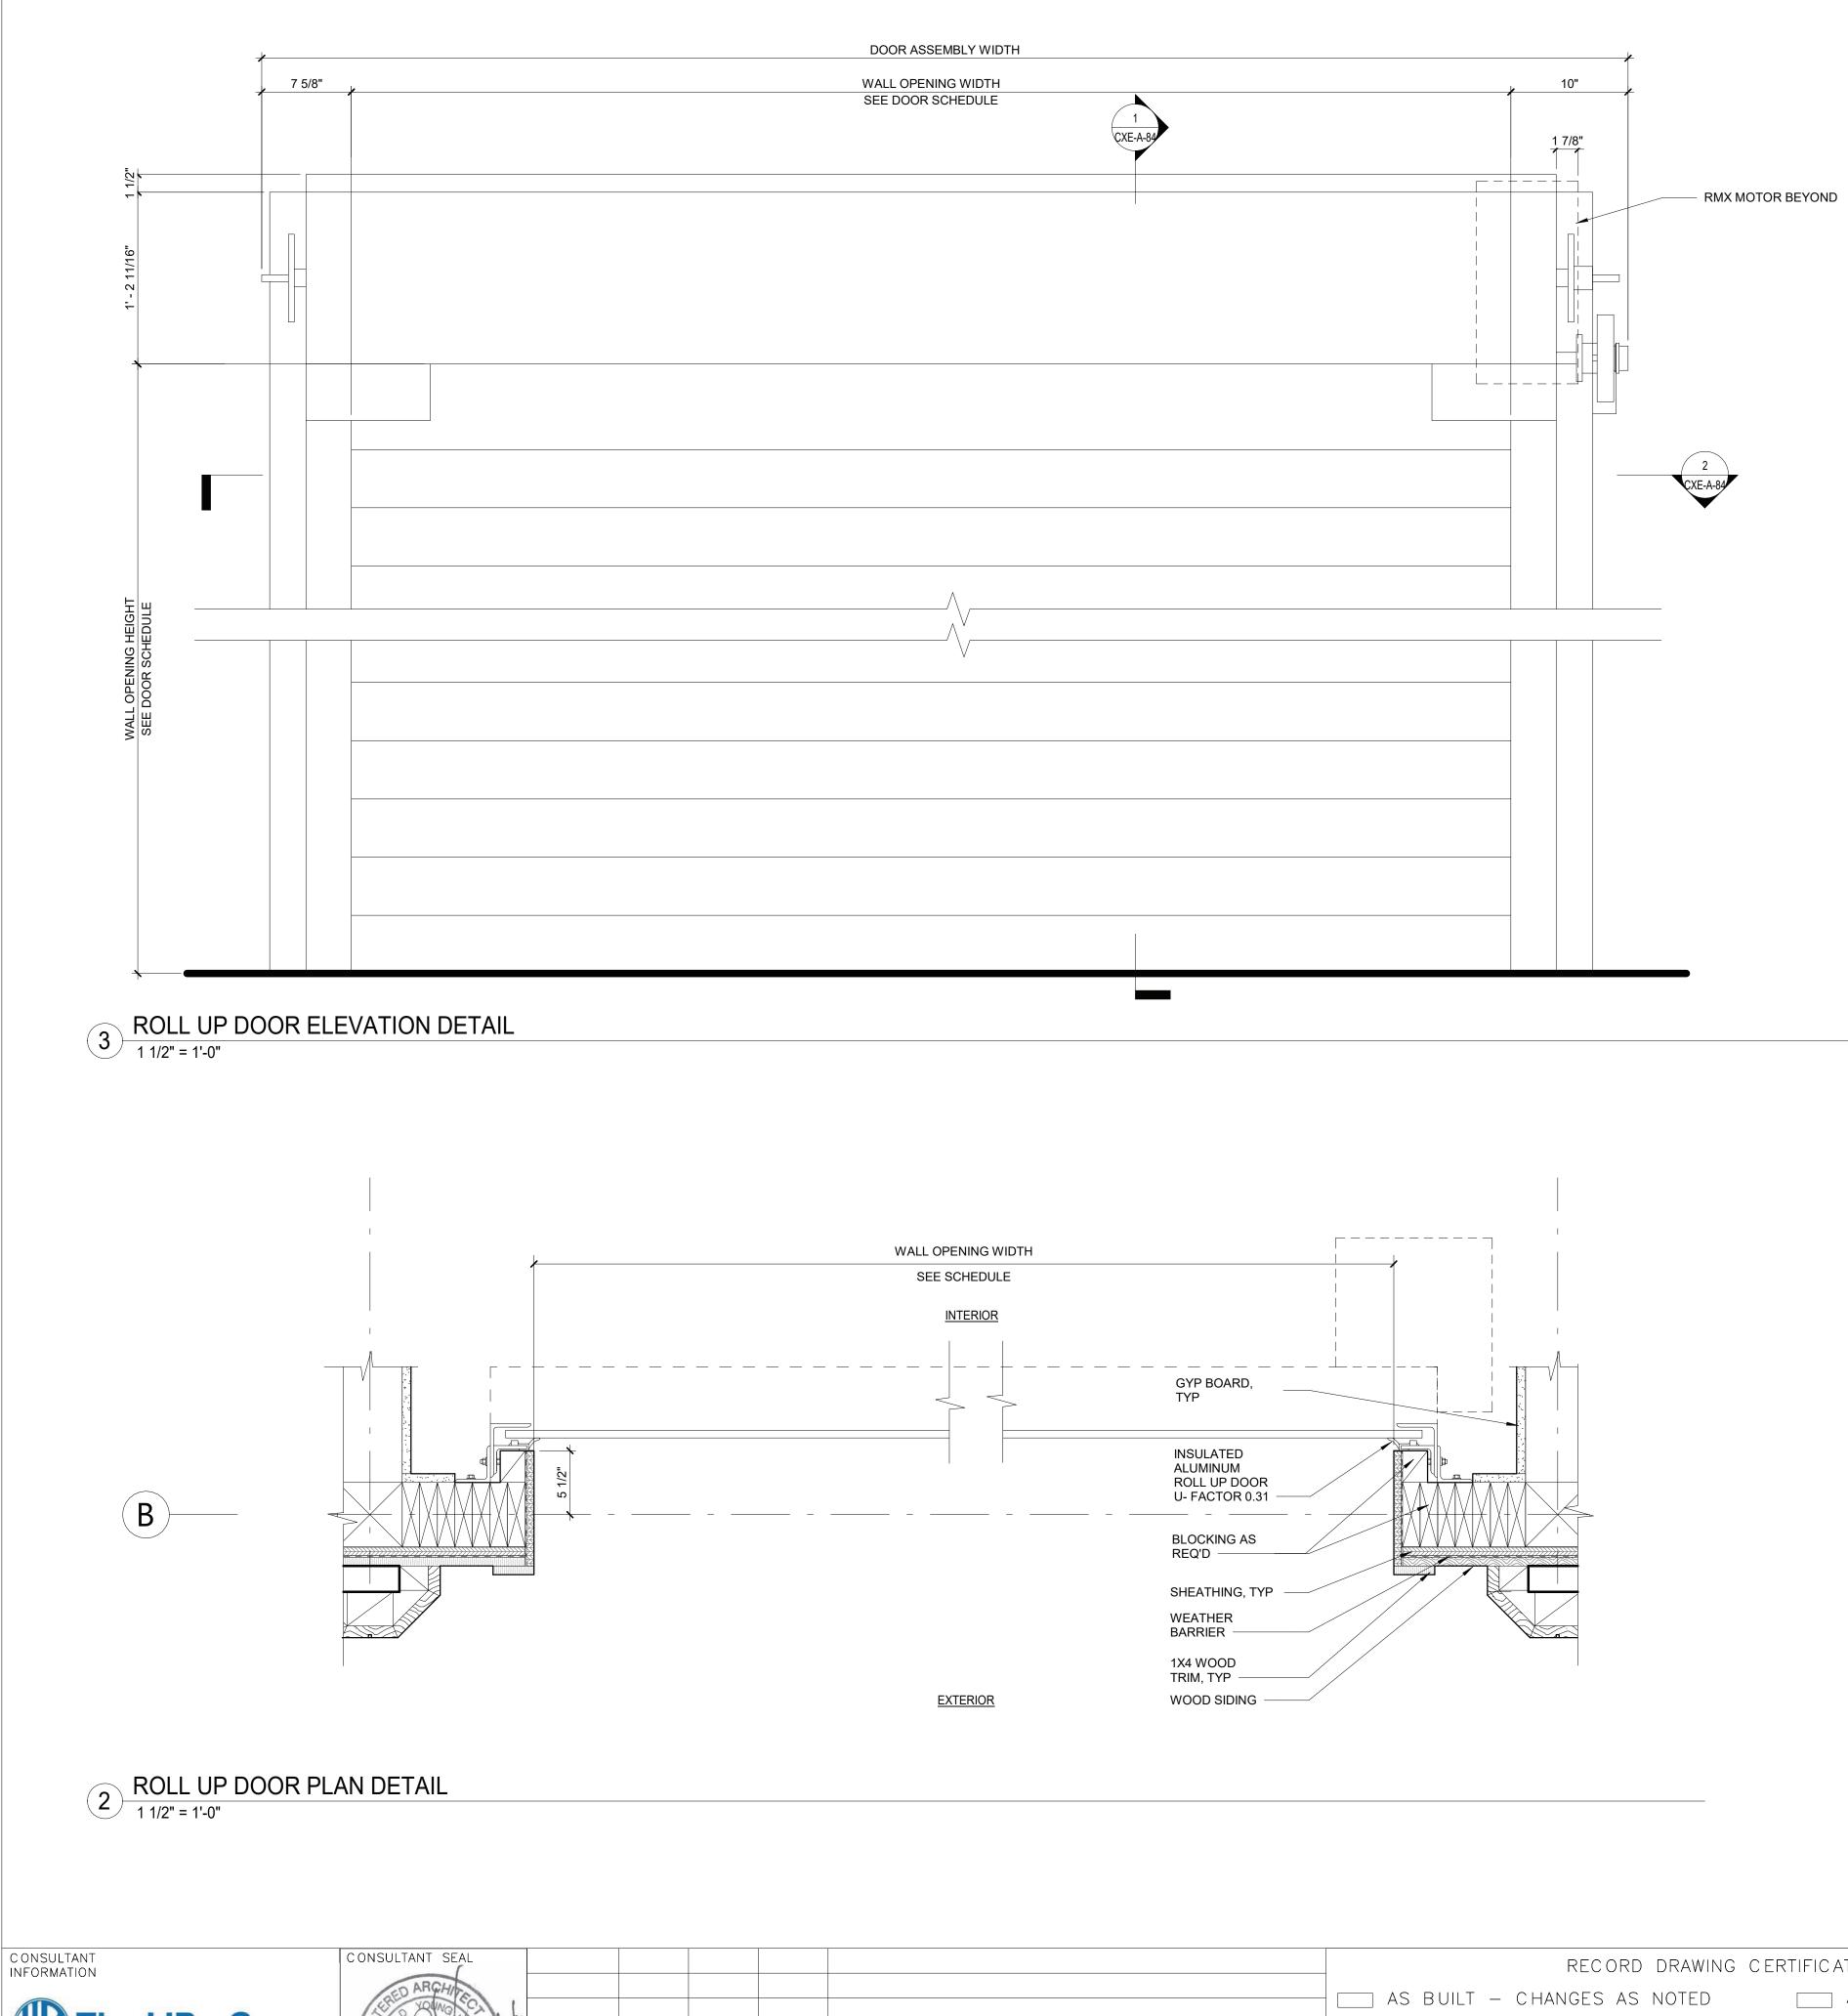
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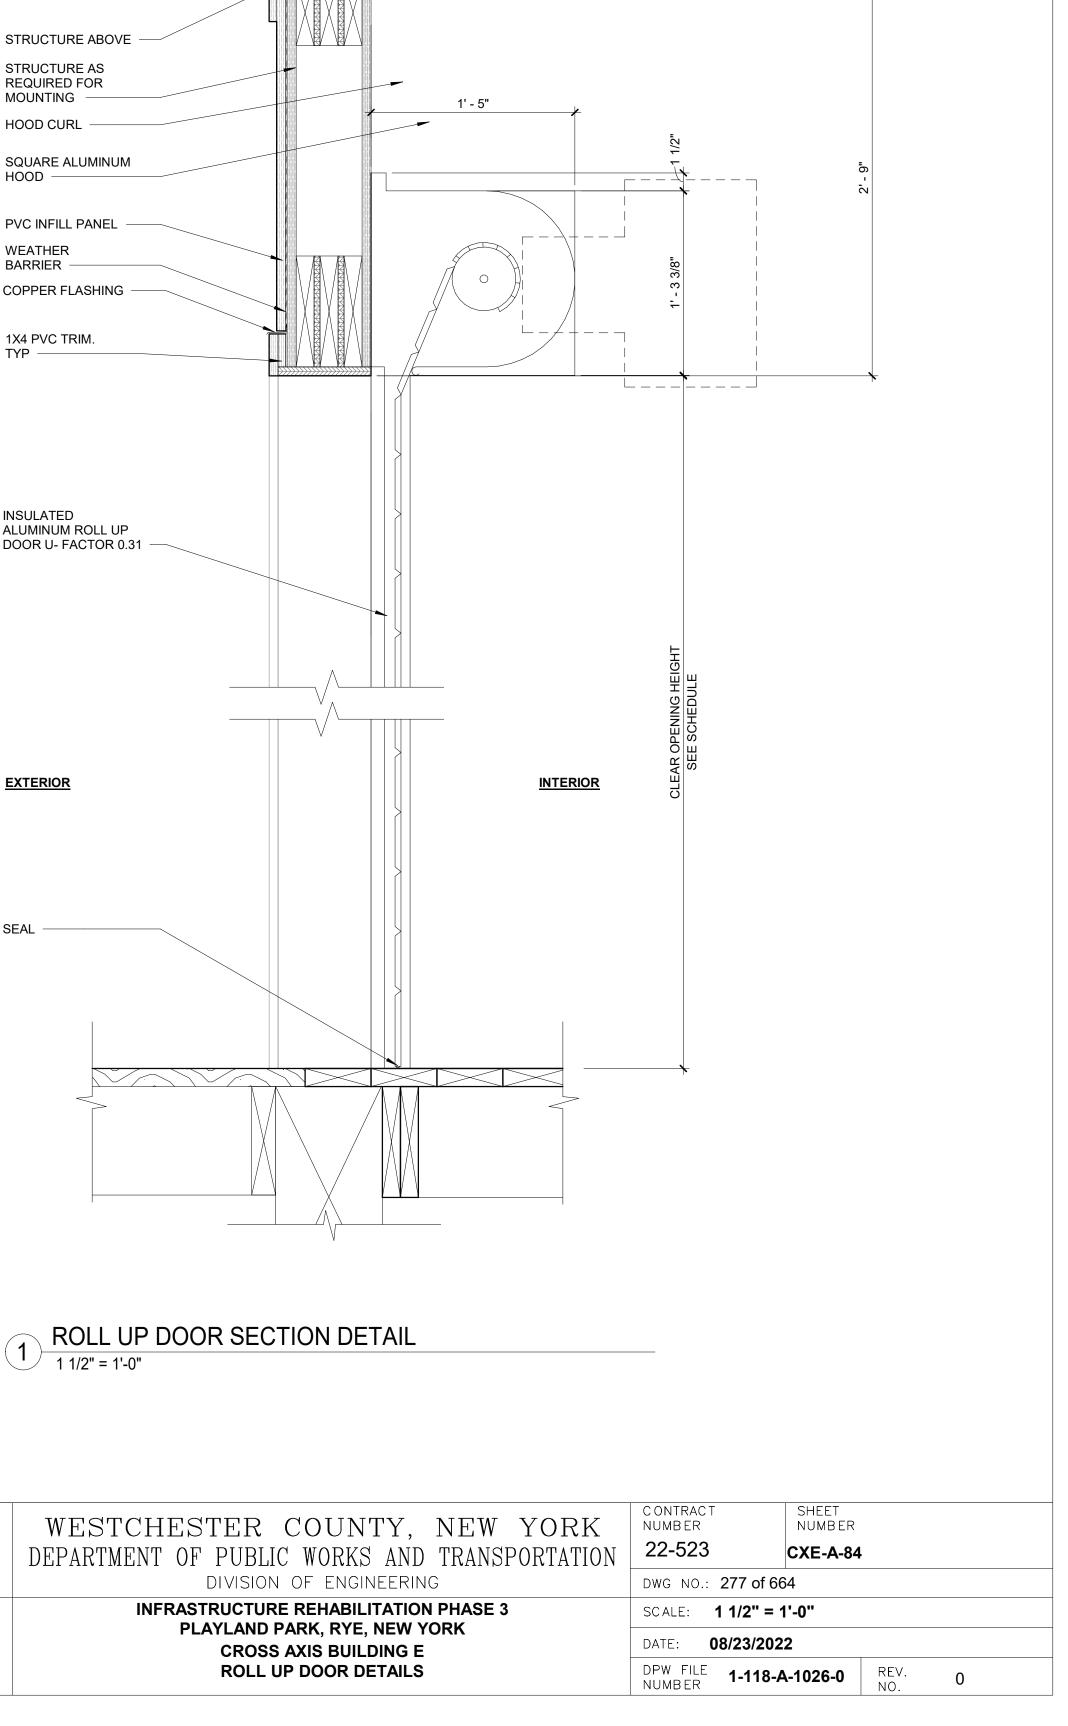
CROSS AXIS BUILDING E CXE - COLUMN DETAILS 2


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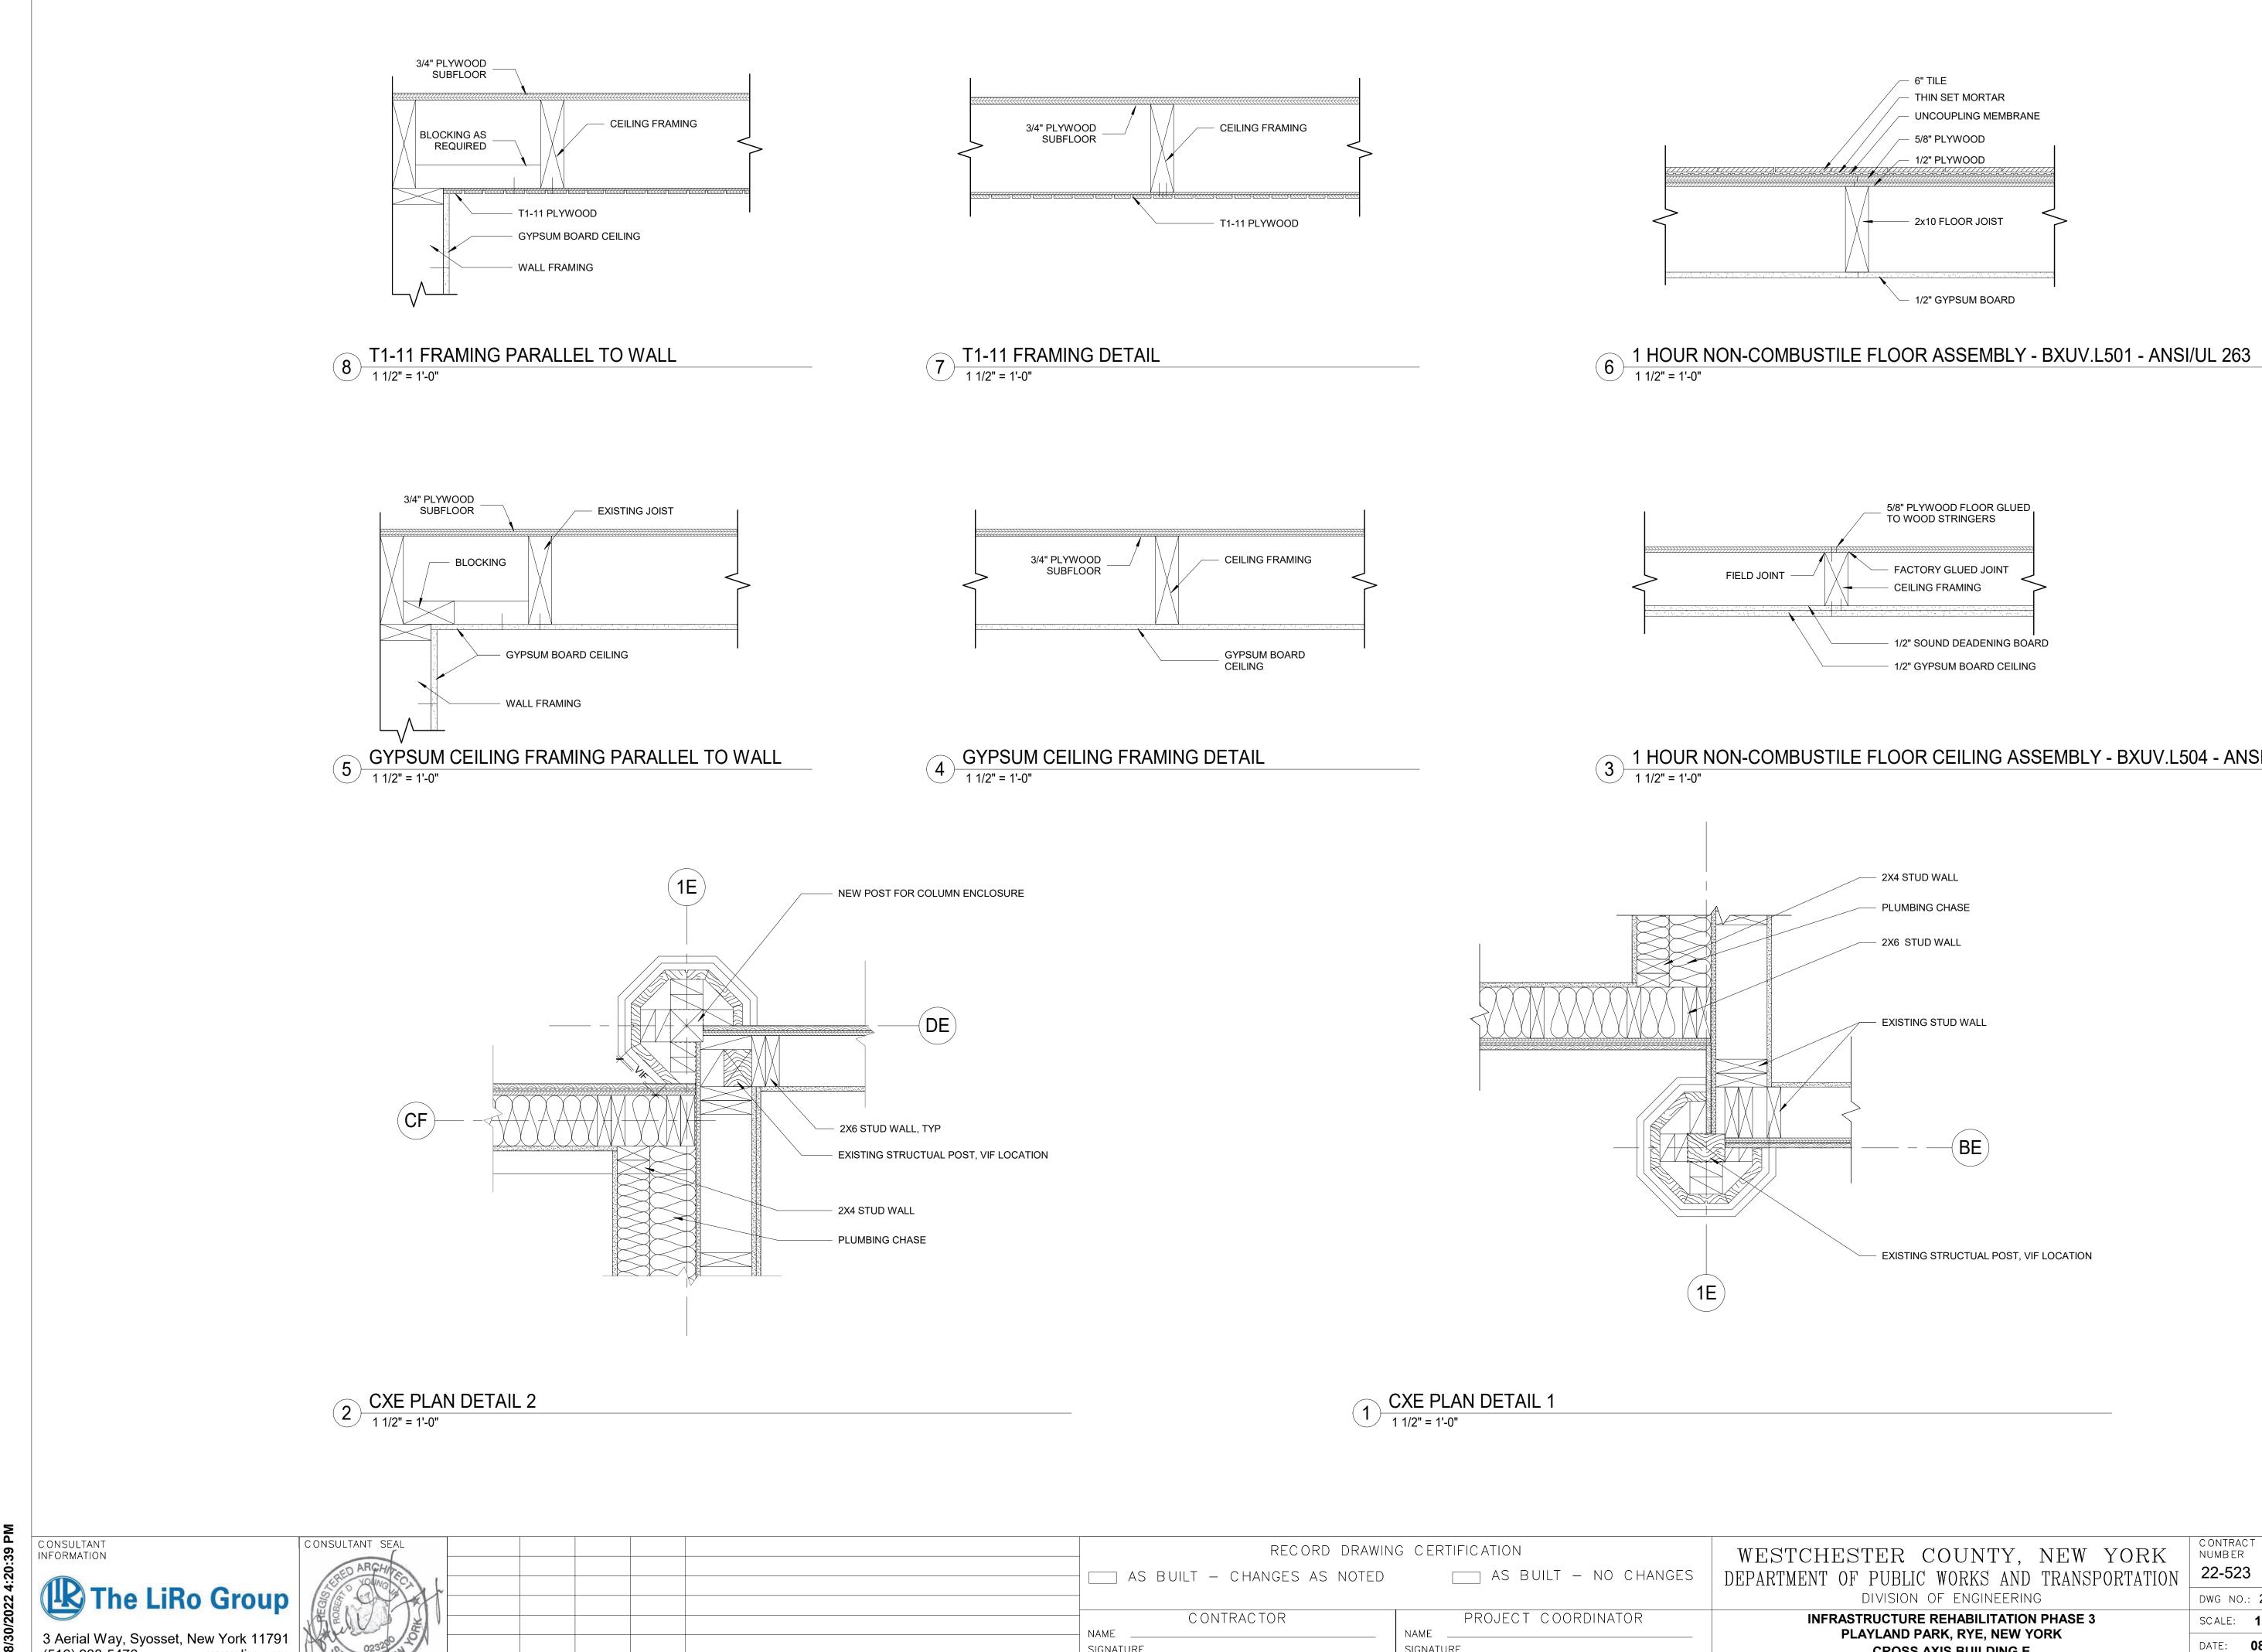


The LiRo Group 3 Aerial Way, Syosset, New York 11791 (516) 938-5476 www.liro.com MADE APP'D By By REVISION NUMBER DATE





		RECORD DRAWI	NG CERTIFICATIO	Ν	WE
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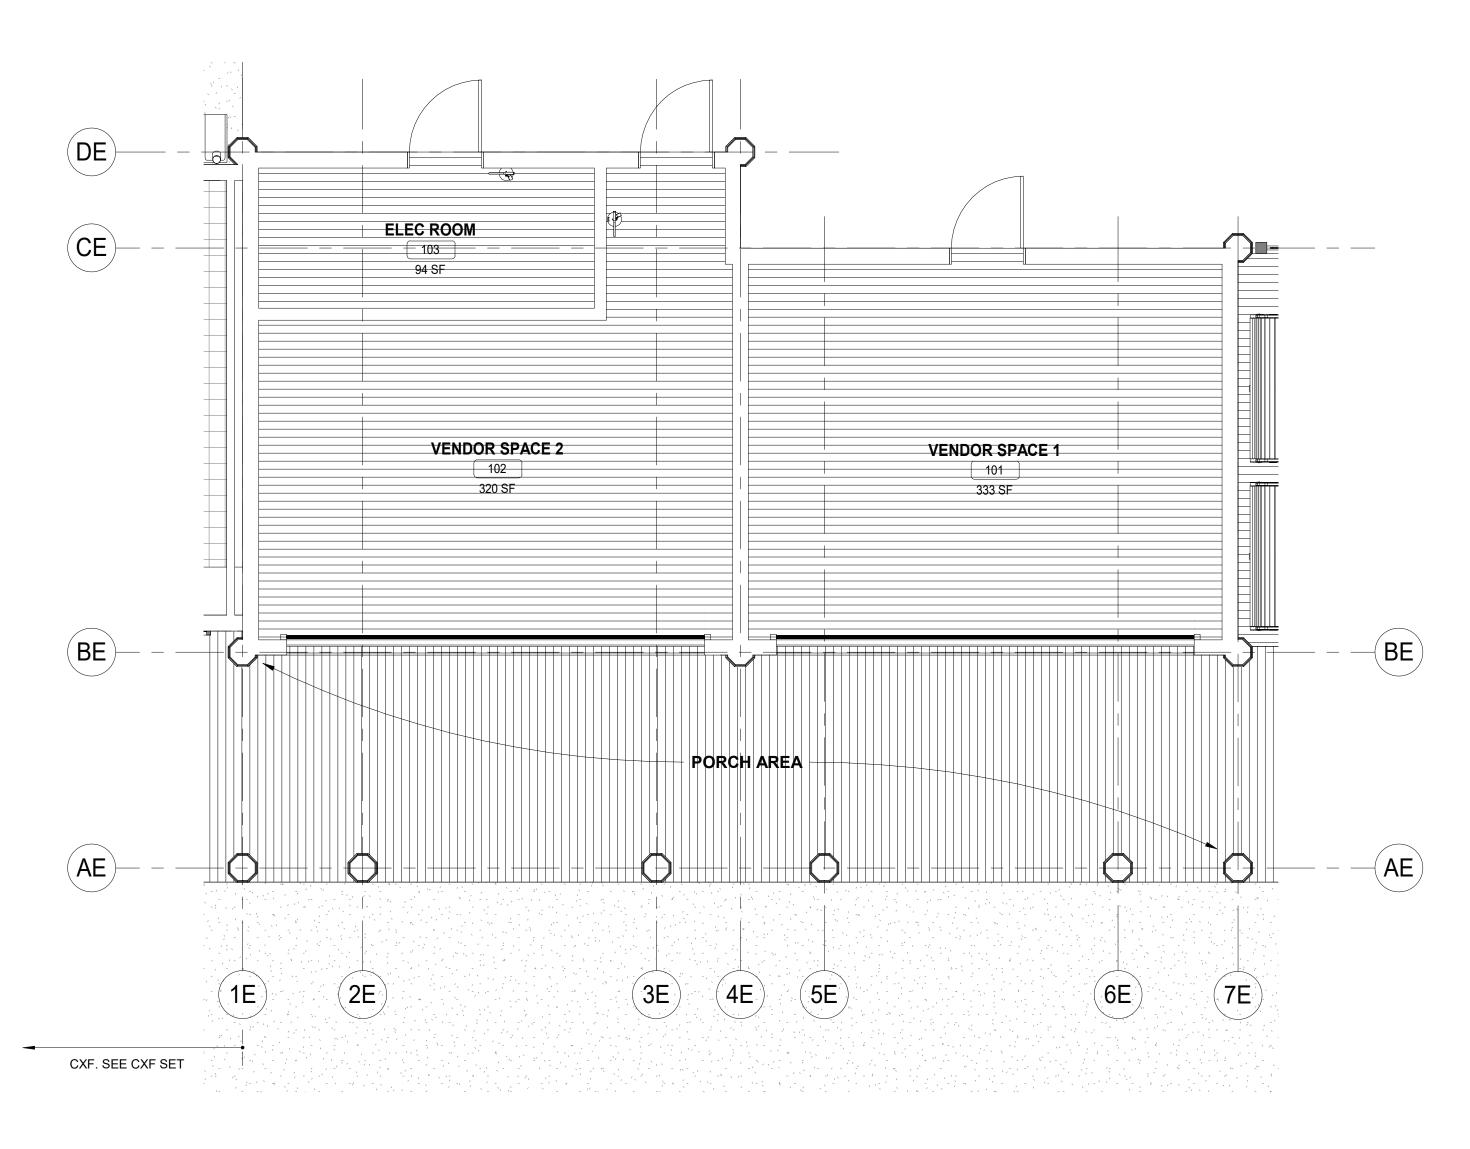
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		G CERTIFICATION	WESTCHESTER COUNTY, NEW YORK DEPARTMENT OF PUBLIC WORKS AND TRANSPORTATION	CONTRACTSHEETNUMBERNUMBER22-523CXE-A-85
			DIVISION OF ENGINEERING	DWG NO.: 278 of 664
	CONTRACTOR NAME	PROJECT COORDINATOR NAME	INFRASTRUCTURE REHABILITATION PHASE 3 PLAYLAND PARK, RYE, NEW YORK CROSS AXIS BUILDING E	SCALE: 1 1/2" = 1'-0" DATE: 08/23/2022
REVISION	TITLE DATE	TITLE DATE	DETAILS	DPW FILE 1-118-A-1027-0 REV. 0 NO.

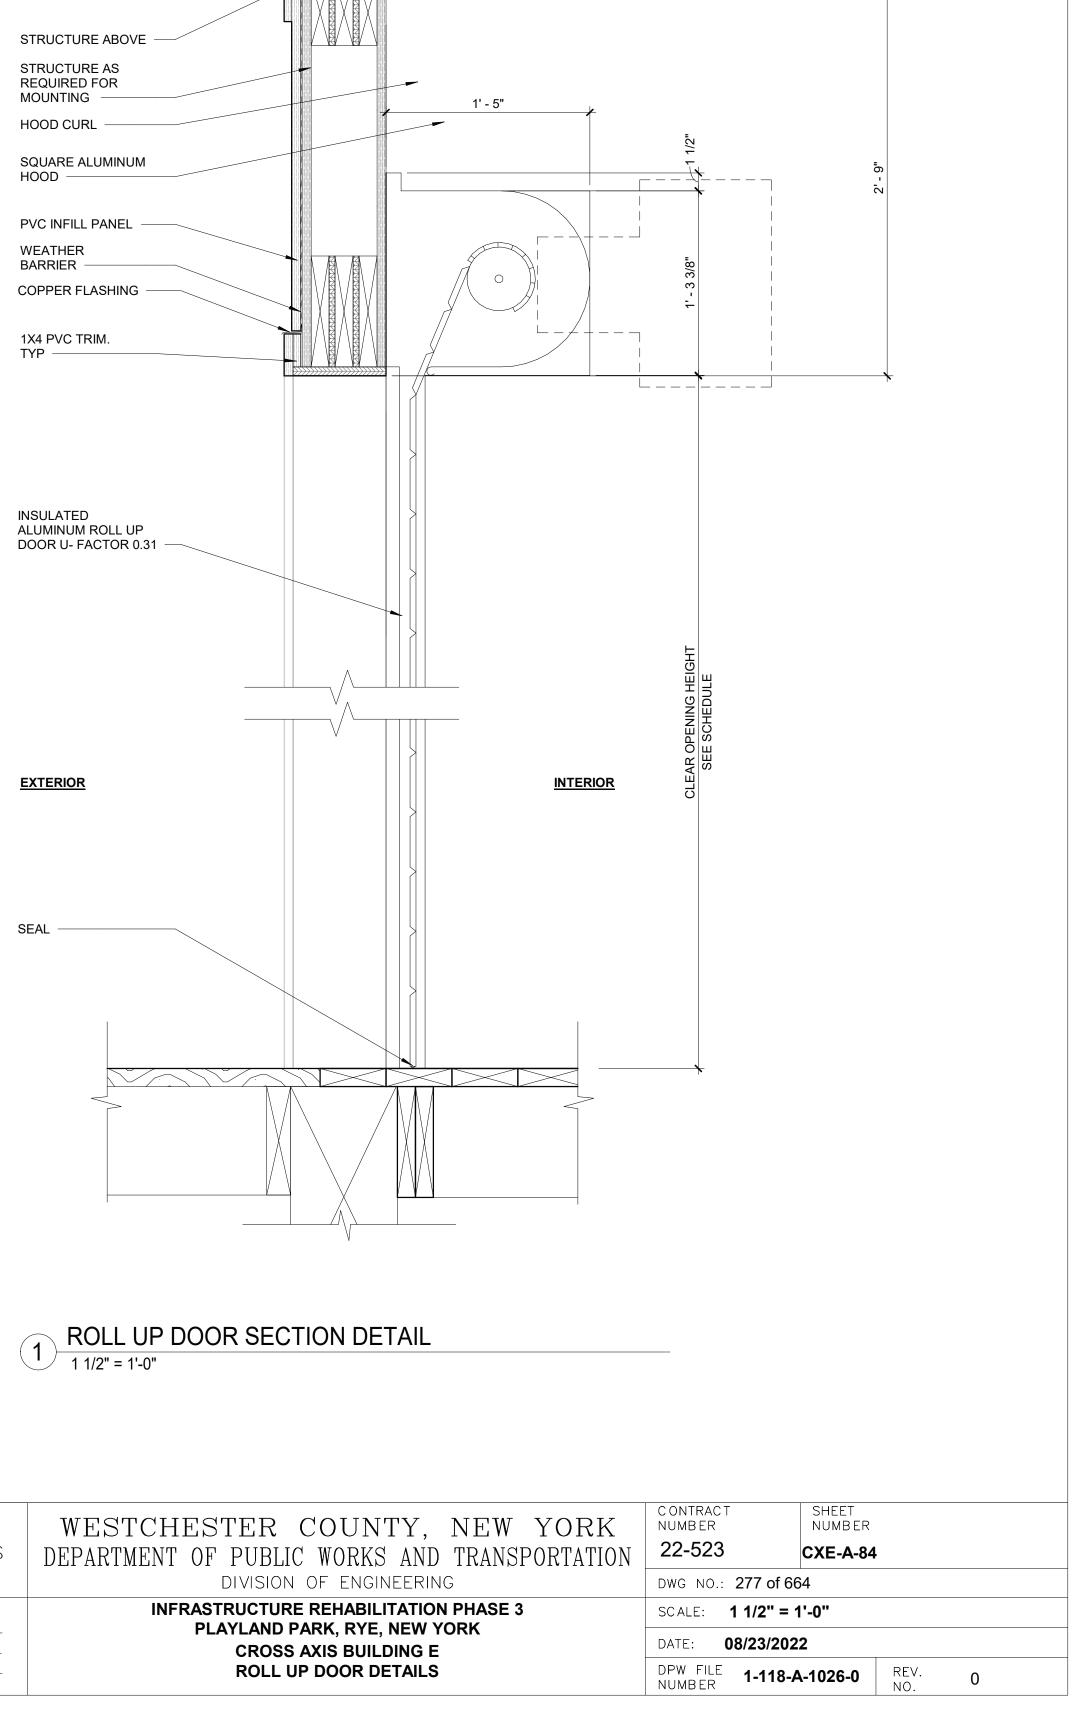1 HOUR NON-COMBUSTILE FLOOR CEILING ASSEMBLY - BXUV.L504 - ANSI/UL 263



1 CXE FINISH PLAN 1/4" = 1'-0"

FINISH SCHEDULE										
ROOM #	ROOM NAME	FLOORS	WALLS	CEILING	DOORS AND TRIM	WALL BASE				
101	VENDOR SPACE 1	WD-1	P-13	P-13	SEE DOOR SCHEDULE (CXE-A-92)	WB-1				
102	VENDOR SPACE 2	WD-1	P-13	P-13	SEE DOOR SCHEDULE (CXE-A-92)	WB-1				
104	ELECTRICAL ROOM	WD-1	P-13	P-13	SEE DOOR SCHEDULE (CXE-A-92)	WB-1				
-	PORCH AREA	WD-2	-	P-10	-	-				
PAINT (FOR PAINT TYPE AND SYSTEMS, SEE SPECIFICATIONS)										
P-13 MFR: BENJAMIN MOORE - COLOR: READY MIX WHITE										
CEILING										
P-13 MFR: BENJAMIN MOORE - COLOR: READY MIX WHITE										
P-10 MFR: BENJAMIN MOORE - COLOR: CAPE BLUE										
FLOORING	<u>.</u>									
WD-1 2X6 WOOD BOARD TO MATCH IN KIND WITH EXISTING FLOOR										
WD-2 IPE WOOD DECK										
WALL BAS	E (FOR WALL BASE DETAILS,	SEE CXE-A-XX)								
WB-1	1 x 6 WOOD BASE									
WB-2	QUARRY TILE BASE TO MATCH IN KIN	D WITH ADJACEN	NT (N.I.C. SPAC	E)						
THRESHO	LD (FOR THRESHOLD DETAILS	SEE CXE_A_02)								
TR-1	EXTERIOR DOOR SILL									

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					RECORD DRA'	WING CERTIFICAT	ON	WESTCHESTER COUNTY, NEW YORK	C ONTRACT NUMB ER	SHEET NUMBER
				AS BUILT	– CHANGES AS NOTE	ED A	S BUILT – NO CHANGES	DEPARTMENT OF PUBLIC WORKS AND TRANSPORTATION	22-523	CXE-A-91
r								DIVISION OF ENGINEERING	DWG NO.: 279 of 664	4
V				СС	ONTRACTOR	PRO	ECT COORDINATOR	INFRASTRUCTURE REHABILITATION PHASE 3	SCALE: As indicate	ed
				NAME 		NAME SIGNATURE		PLAYLAND PARK, RYE, NEW YORK CROSS AXIS BUILDING E	DATE: 08/23/2022	2
	REVISION NUMBER DATE	MADE APP'D By By	REVISION	TITLE	DATE	_ TITLE	DATE	FINISH PLAN AND FINISH SCHEDULE	DPW FILE NUMBER 1-118-A	-1028-0 REV. 0

FINISH LEGEND:

NIC I ITEMS NOT IN CONTRACT

QUARRY TILE FLOORING


FINISH PLAN NOTES:

- 1. INDICATES TYPICAL FINISHES WITHIN ROOM, U.N.O. SEE SHEET CXE-A-91 FOR MATERIAL AND
- COLOR SCHEDULE. 2. ALL FLOORING COVERING MATERIALS TO BE INSTALLED PER MANUFACTURER'S STANDARD DETAILS AND SPECIFICATIONS. VERIFY WITH MANUFACTURER PRIOR INSTALLATION.
- THE G.C. IS RESPONSIBLE FOR PROVIDING A SMOOTH LEVEL FLOOR SURFACE THAT MEETS MANUFACTURERS INSTALLATION SPECIFICATIONS PRIOR TO THE INSTALLATION OF ALL FLOORING MATERIALS.
- THE FLOORING SUB-CONTRACTOR IS RESPONSIBLE FOR VERIFYING THAT THE CONDITION OF THE BASE FLOOR MEETS THE INSTALLATION SPECIFICATIONS PRIOR TO THE INSTALLATION OF THE NEW FLOORING MATERIAL.
- ALL MATERIAL TRANSITIONS AN DOOR THRESHOLDS TO TAKE PLACE AT DOOR CENTERLINE U.N.O.
 ALL DIMENSIONS ARE TO CENTERLINE OF TRANSITION BETWEEN FLOORING MATERIALS OR FINISH COLOR OF SAME MATERIAL. PLANS DO NOT SHOW ALL TILES OF SAME MATERIALS. CONTRACTOR TO START TILES AT POINT AS INDICATED ON PLANS.
- 7. THE GENERAL CONTRACTOR SHALL BE RESPONSIBLE FOR PROPER PREPARATION OF ALL NEW AND EXISTING SURFACES IN A SATISFACTORY MANNER TO RECEIVE NEW FINISHES. THIS INCLUDES THE DEMOLITION AND REMOVAL OF NECESSARY ITEMS. TOUCH- UP AND/ OR REFINISH OF SURFACES DAMAGED BY SUBSEQUENT WORK SHALL BE PERFORMED IN CONFORMANCE WITH THE MANUFACTURER'S RECOMMENDED INSTALLATION METHODS.
- 8. ALL SURFACES WHICH ARE TO RECEIVE A PAINT FINISH SHALL BE PRIMED AND FINISHED IN ACCORDANCE WITH THE WRITTEN SPECIFICATIONS.
- 9. ALL JOINTS IN GYPSUM BOARD WALLS SHALL BE FINISHED WITH PAPER TAPE 2" WIDE AND THREE COATS OF VINYL, DRY OR PREMIXED JOINT COMPOUND. ALL OUTSIDE CORNERS SHALL BE FINISHED WITH METAL CORNER BEADS, TAPED AND SPACKLED. ALL AREAS TO BE PAINTED SHALL BE SANDED SMOOTH. JUST PRIOR TO THE APPLICATION OF THE FIRST COAT OF PAINT, WIPE SANDED SURFACES WITH A DAMP CLOTH IN ORDER TO LAY FLAT ANY NAP WHICH MAY HAVE FORMED IN SANDING.
- THE PAINT CONTRACTOR SHALL REMOVE ALL HARDWARE, SWITCH COVERS, ETC. PRIOR TO PAINTING AND BE RESPONSIBLE FOR THE REINSTALLATION AFTER PAINTING IS COMPLETED.
 FINISH FLOORING INSTALLATION SHALL BE IN CONFORMANCE WITH THE MANUFACTURER'S
- RECOMMENDED INSTALLATION GUIDELINES. COORDINATE THE INSTALLATION WITH OTHER TRADES, SUCH AS ELECTRICAL. 12. ALL JOINTS BETWEEN MATERIALS TO BE TIGHT AND CONSTRUCTED IN A NEAT WORKMANLIKE
- MANNER. 13. ALL FINISHES SHALL BE TOUCHED UP TO CORRECT ANY IMPERFECTIONS AFTER INSTALLATION. FIXTURE CONTRACTOR SHALL PROVIDE TO THE GENERAL CONTRACTOR ALL MATERIALS FOR TOUCH UP WORK.
- 14. THE INTENT OF THE FINISH SPECIFICATIONS IS TO PROVIDE A SATISFACTORY FINISH TO ALL PARTS OF THE WORK. COVER ALL SURFACES THOROUGHLY. IF THE SPECIFIED NUMBER OF COATS DOES NOT ACCOMPLISH THE INTENT, THE GENERAL CONTRACTOR SHALL BE RESPONSIBLE FOR THE APPLICATION OF ADDITIONAL COATS OF THE SPECIFIED MATERIAL TO GIVE SATISFACTORY COVERAGE, AT NO ADDITIONAL COST TO OWNER.
- 15. CLEAN ALL GLASS SURFACES WITH LIQUID GLASS CLEANER AT PROJECT COMPLETION.
 16. REFERENCE SPECIFICATIONS FOR COMPLETE FINISH DOCUMENTATION AND MANUFACTURER INSTALLATION AND MAINTENANCE DOCUMENTATION.


PAINTI	NG SCHEDULE		
<u>KEY</u>	COLOR	MANUFACTURER	REMARKS
P- 1	MYSTICAL POWERS #901	BENJAMIN MOORE	
P- 2	HERITAGE RED #HC-181	BENJAMIN MOORE	
P- 3	NEW YORK STATE OF MIND #805	BENJAMIN MOORE	
P- 4	LAZY SUNDAY #803	BENJAMIN MOORE	
P- 5	DEEP JUNGLE #595	BENJAMIN MOORE	
P- 6	LUCK OF THE IRISH #588	BENJAMIN MOORE	
P- 7	MAJOLICA GREEN #0013	SHERWIN WILLIAMS	
P- 8	ANTELOPE CANYON #125	BENJAMIN MOORE	
P- 9	FORSYTHIA #6907	SHERWIN WILLIAMS	
P- 10	CAPE BLUE #1642	BENJAMIN MOORE	
P- 11	WHITE SNOW #9541	SHERWIN WILLIAMS	
P- 12	TRICORN BLACK #6258	SHERWIN WILLIAMS	
P- 13	READY MIX WHITE	BENJAMIN MOORE	INTERIOR USE ONL
P- 14	STUCCO PAINT TO MATCH P-1	KEIM	
P- 15	VAN DEUSEN BLUE #HC-156	BENJAMIN MOORE	
P- 16	#RAL9001	-	TYP. ROLL UP DOO
P- 17	FLORIDA BEACHES #900	BENJAMIN MOORE	
P- 18	PIRATES COVE PEACH #903	BENJAMIN MOORE	
P- 19	JADITE #6459	SHERWIN WILLIAMS	
P- 20	DECISIVE YELLOW #6902	SHERWIN WILLIAMS	

									DOOR SCHED	ULE - CXE					
DOOR								DO	OR			FRAME			
BUILDING	DOOR NUMBER	DOOR TYPE	WIDTH	HEIGHT	DOOR THICKNESS	DOOR MATERIAL	GLASS	EXTERIOR FINISH	INTERIOR FINISH	FRAME TYPE	MATERIAL	EXTERIOR	INTERIOR	HDWR SET	REMARKS
CXE	101A	С	17' - 5"	11' - 2"		ALUM	NO	PAINT, P-16	PAINT, P-16	-	-	-	-	4.0	
CXE	101B	В	3' - 0"	7' - 0"	1 3/4"	WOOD	NO	PAINT, P-1	PAINT, P-13	2	WD.	PAINT, P-10	PAINT, P-13	9.0	STOREFRONT LOCK SET, X-2 SIGN
CXE	102A	С	17' - 5"	11' - 2"		ALUM	NO	PAINT, P-16	PAINT, P-16	-	-	-	-	4.0	
CXE	102B	В	3' - 0"	7' - 0"	1 3/4"	WOOD	NO	PAINT, P-1	PAINT, P-13	2	WD.	PAINT, P-10	PAINT, P-13	9.0	STOREFRONT LOCK SET, X-2 SIGN
CXE	103A	В	3' - 0"	7' - 0"	1 3/4"	WOOD	NO	PAINT, P-1	PAINT, P-13	2	WD.	PAINT, P-10	PAINT, P-13	11.0	STOREFRONT LOCK SET, A-3 SIGN

NOTE: GC TO CONFIRM DOOR SIZES IN FIELD PRIOR TO ORDERING

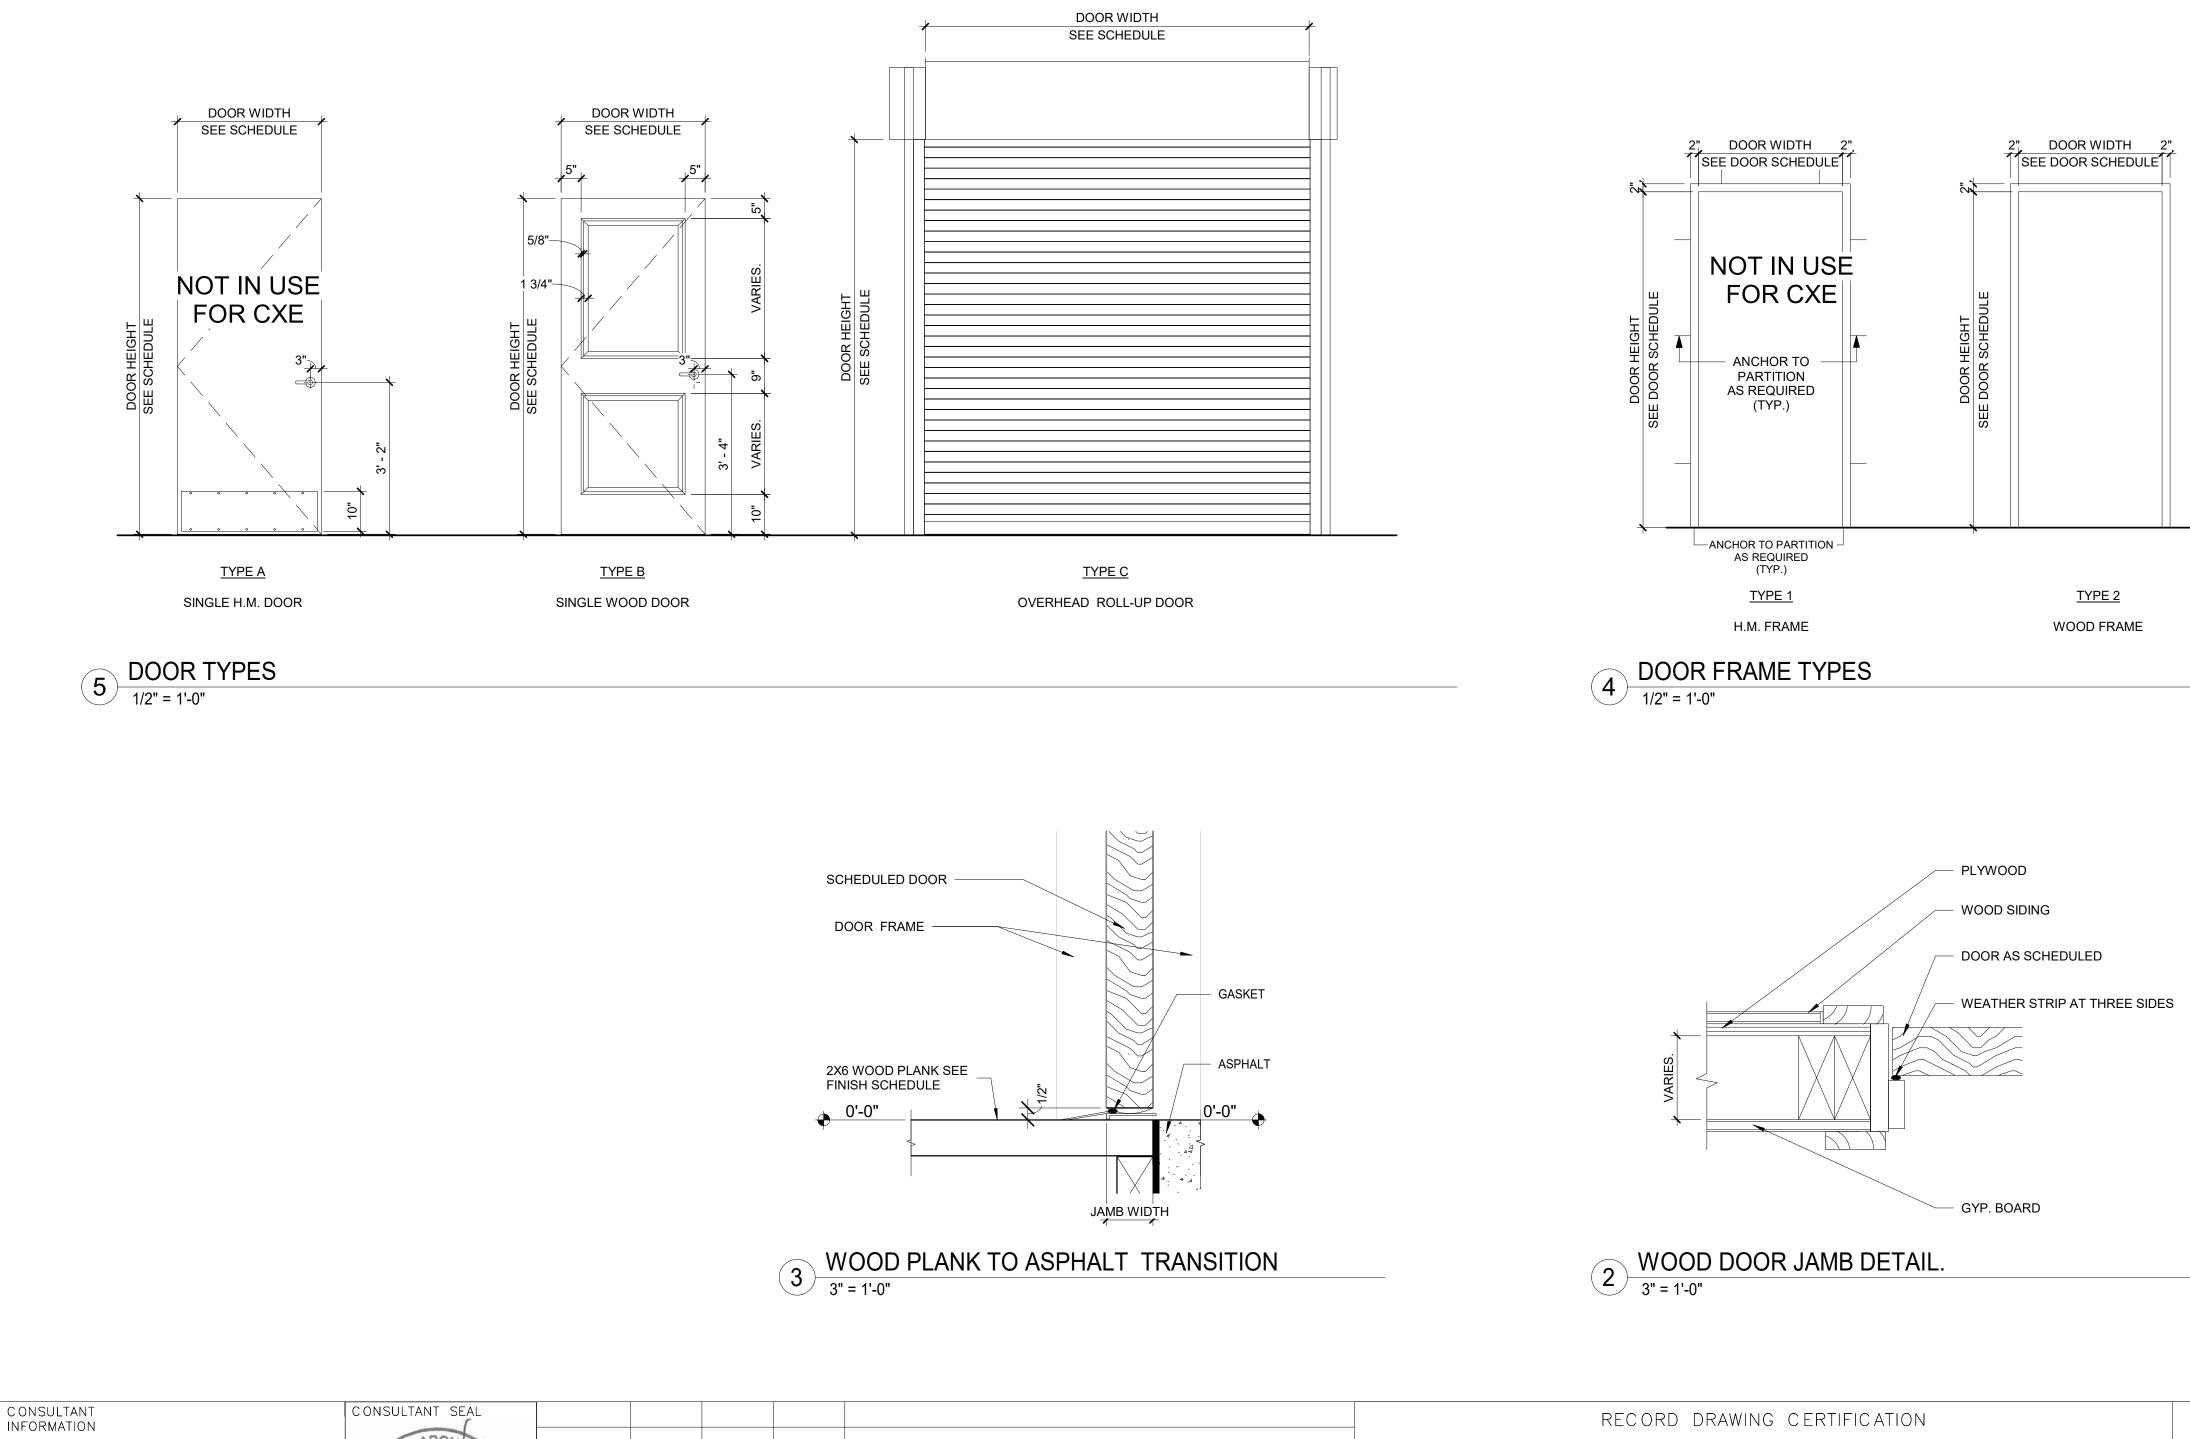


3 Aerial Way, Syosset, New York 11791 (516) 938-5476 www.liro.com REVISION NUMBER DATE MADE BY APP'D BY	INFORMATION	ARGH				
3 Aerial Way, Syosset, New York 11791 (516) 938-5476 www.liro.com REVISION DATE MADE APP'D	The LiDe Crown	ALL COMONS				
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	(516) 938-5476 www.liro.com	ATE OF NEW	REVISION NUMBER	DATE		

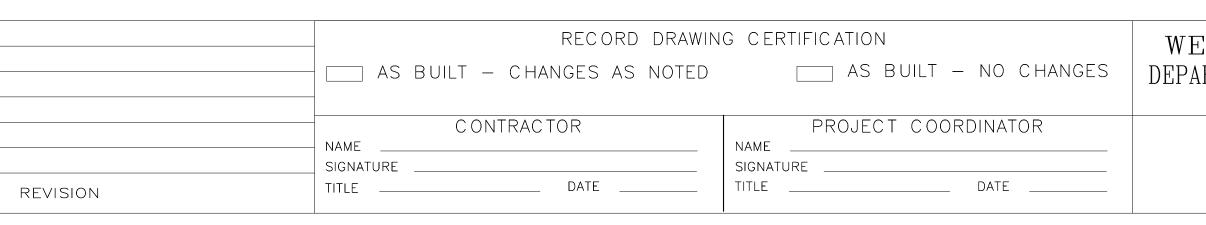


GENERAL DOOR SCHEDULE NOTES:


- 1. REFER TO CXE-A-92 SHEET FOR DOOR SILL & TRANSITION DETAILS. SILL TRANSITION INFORMATION IS INDICATED ON FINISH PLAN UNLESS OTHERWISE NOTED.
- 2. REFER TO SHEET CXE-A-91 FOR FINISH SCHEDULE AND LEGEND. 3. THE CONTRACTOR SHALL EXAMINE THE DRAWINGS, SCHEDULE AND
- SPECIFICATIONS AND FURNISH PROPER HARDWARE FOR ALL OPENINGS WHETHER LISTED OR NOT. COMPLETE SHOP DRAWINGS SHALL BE PROVIDED FOR APPROVAL PRIOR TO PURCHASE.
- 4. ALL EXIT DOORS SHALL BE OPENABLE FROM THE EGRESS SIDE WITHOUT THE USE OF A KEY OR SPECIAL KNOWLEDGE.
- VERIFY DIMENSIONS OF EXISTING OPENINGS AND DOORS BEFORE ORDERING.
 THE CONTRACTOR SHALL COORDINATE & VERIFY LOCATION OF RECESSED FLOOR CLOSERS, PIVOTS, ETC. WITH EXISTING FLOOR SLABS AND OTHER FIELD CONDITIONS PRIOR TO ORDERING TO ENSURE PROPER CLEARANCES & DEPTHS ARE ALLOWED.

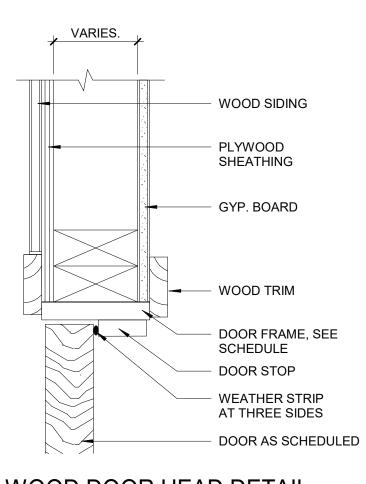



ESTCHESTER COUNTY, NEW YORK RTMENT OF PUBLIC WORKS AND TRANSPORTATION	CONTRACT NUMBERSHEET NUMBER22-523CXE-A-92
DIVISION OF ENGINEERING	DWG NO.: 280 of 664
INFRASTRUCTURE REHABILITATION PHASE 3	SCALE: As indicated
PLAYLAND PARK, RYE, NEW YORK CROSS AXIS BUILDING E	DATE: 08/23/2022
DOOR SCHEDULE AND DOOR DETAILS	DPW FILE 1-118-A-1029-0 REV. 0

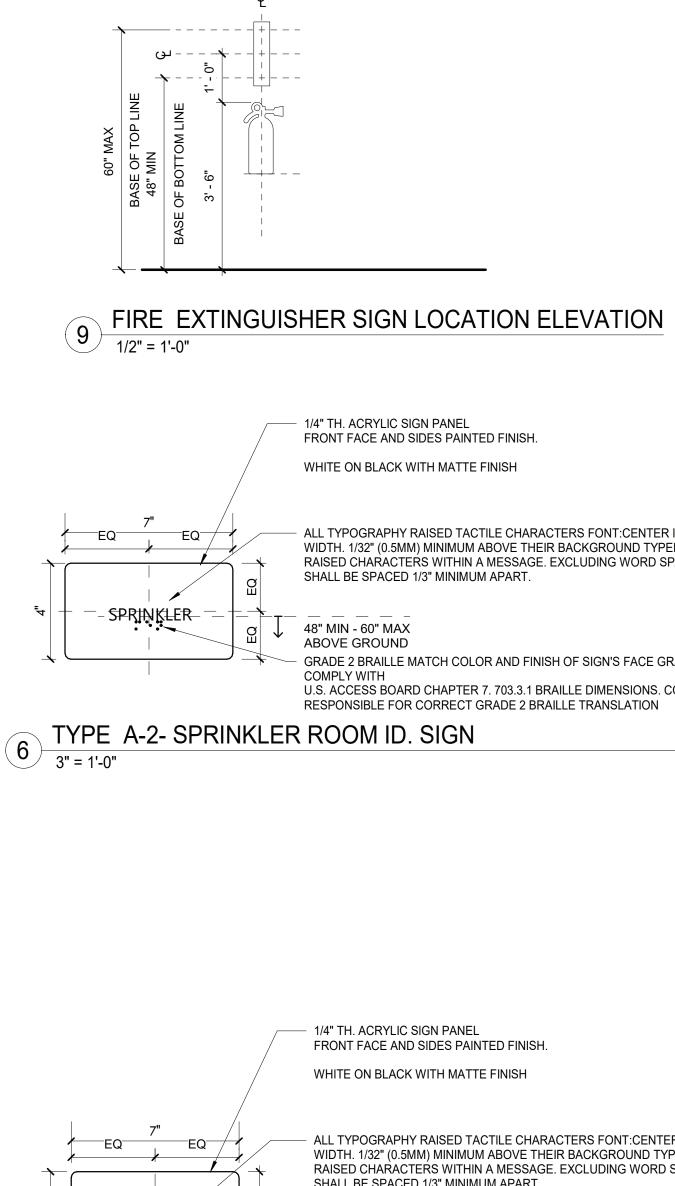

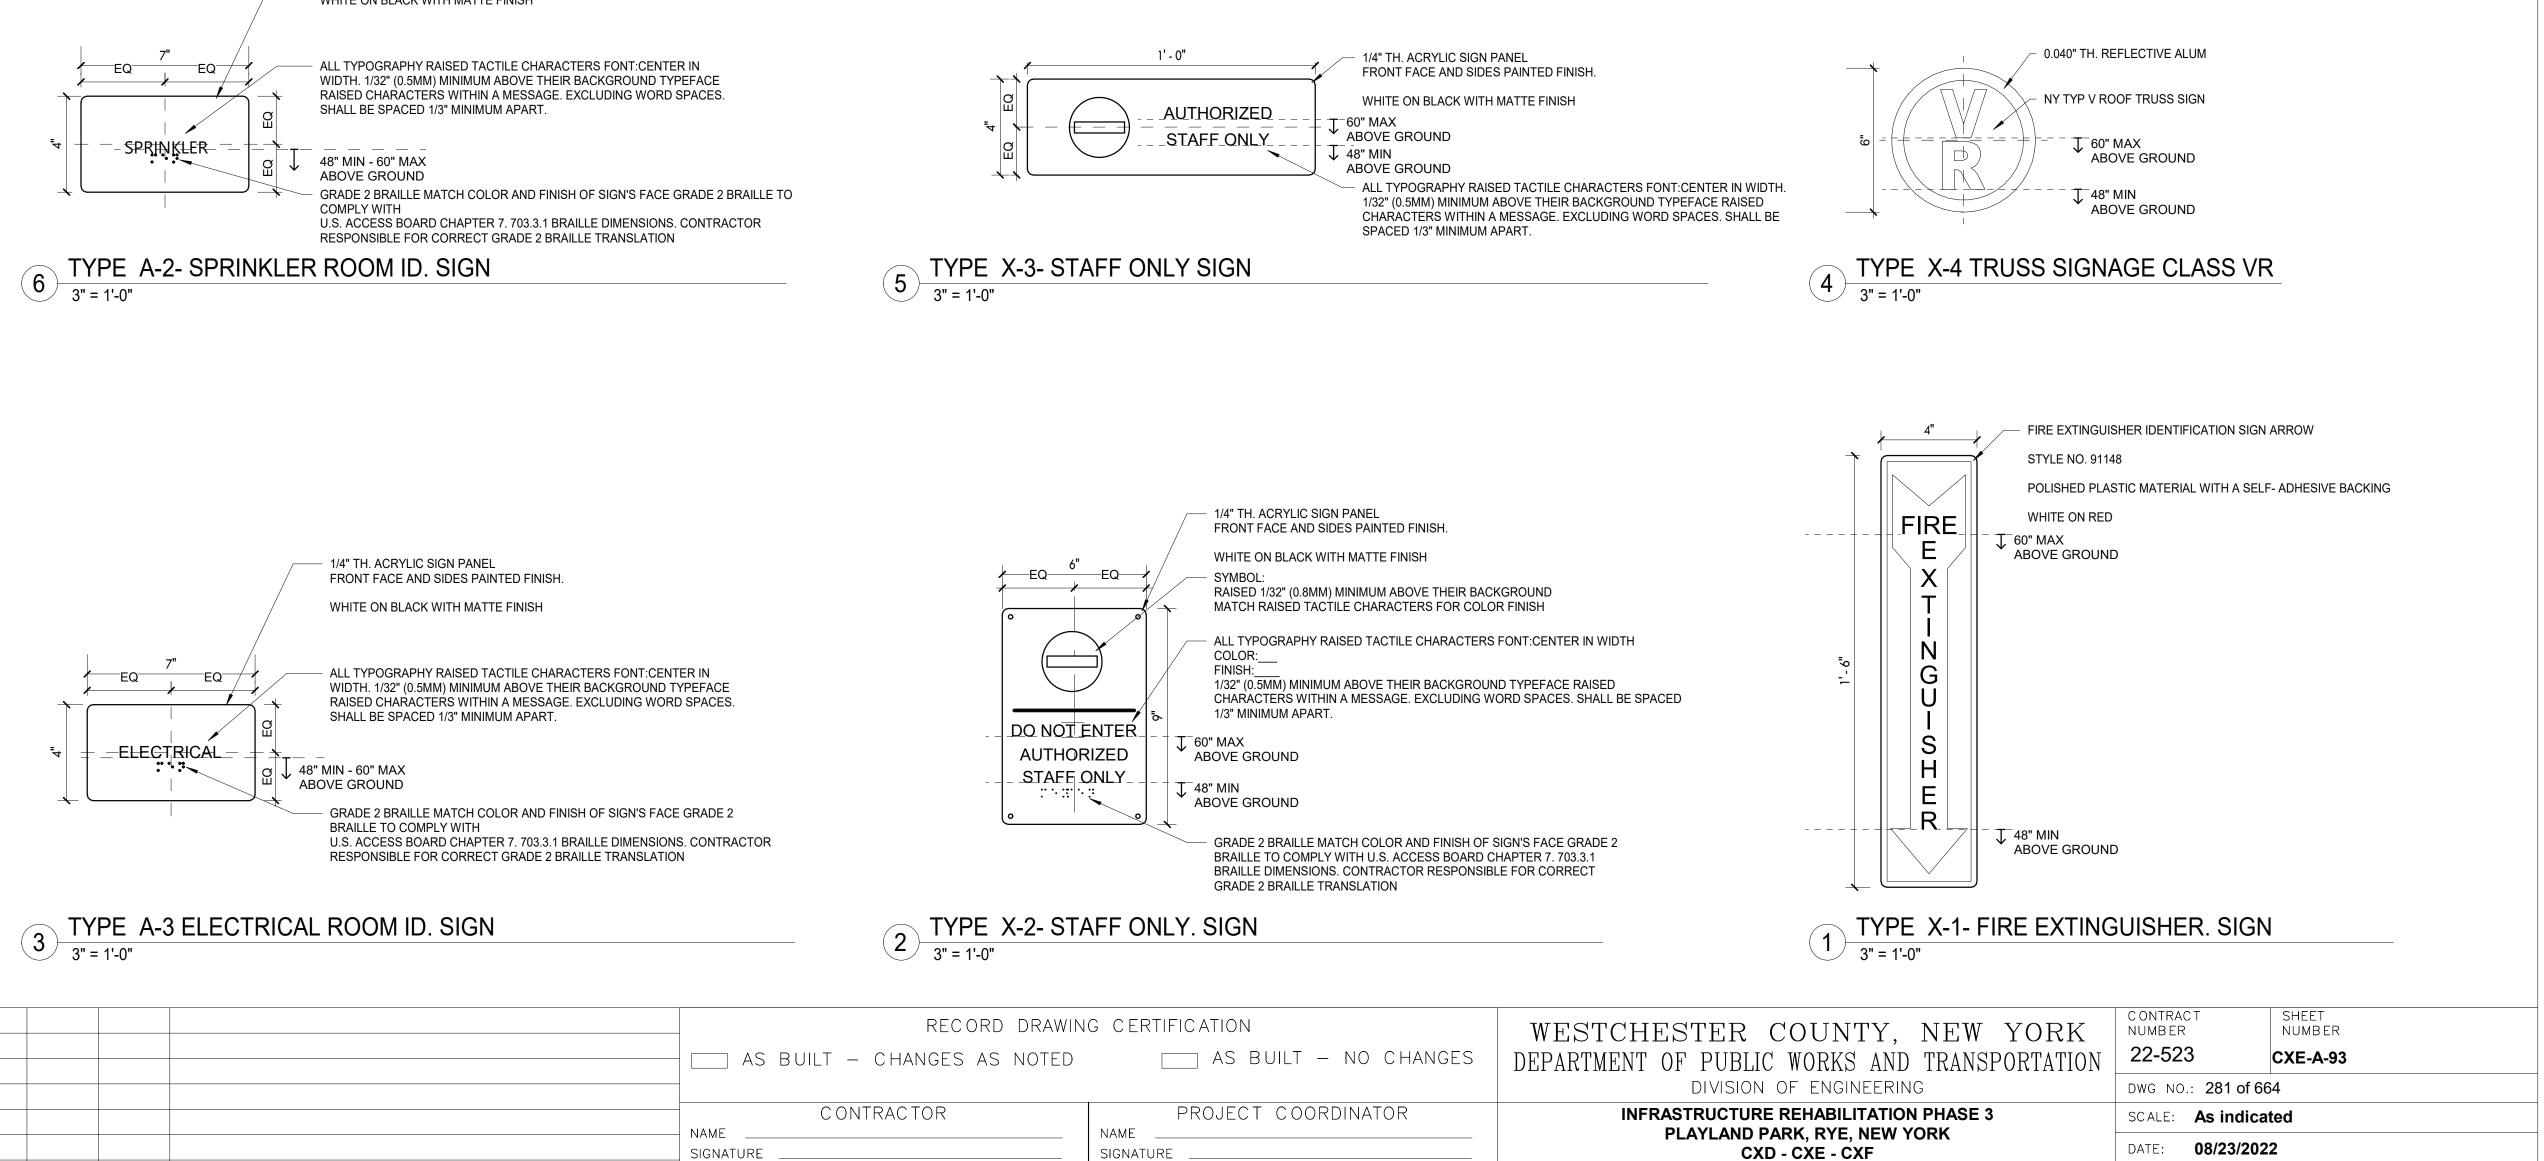


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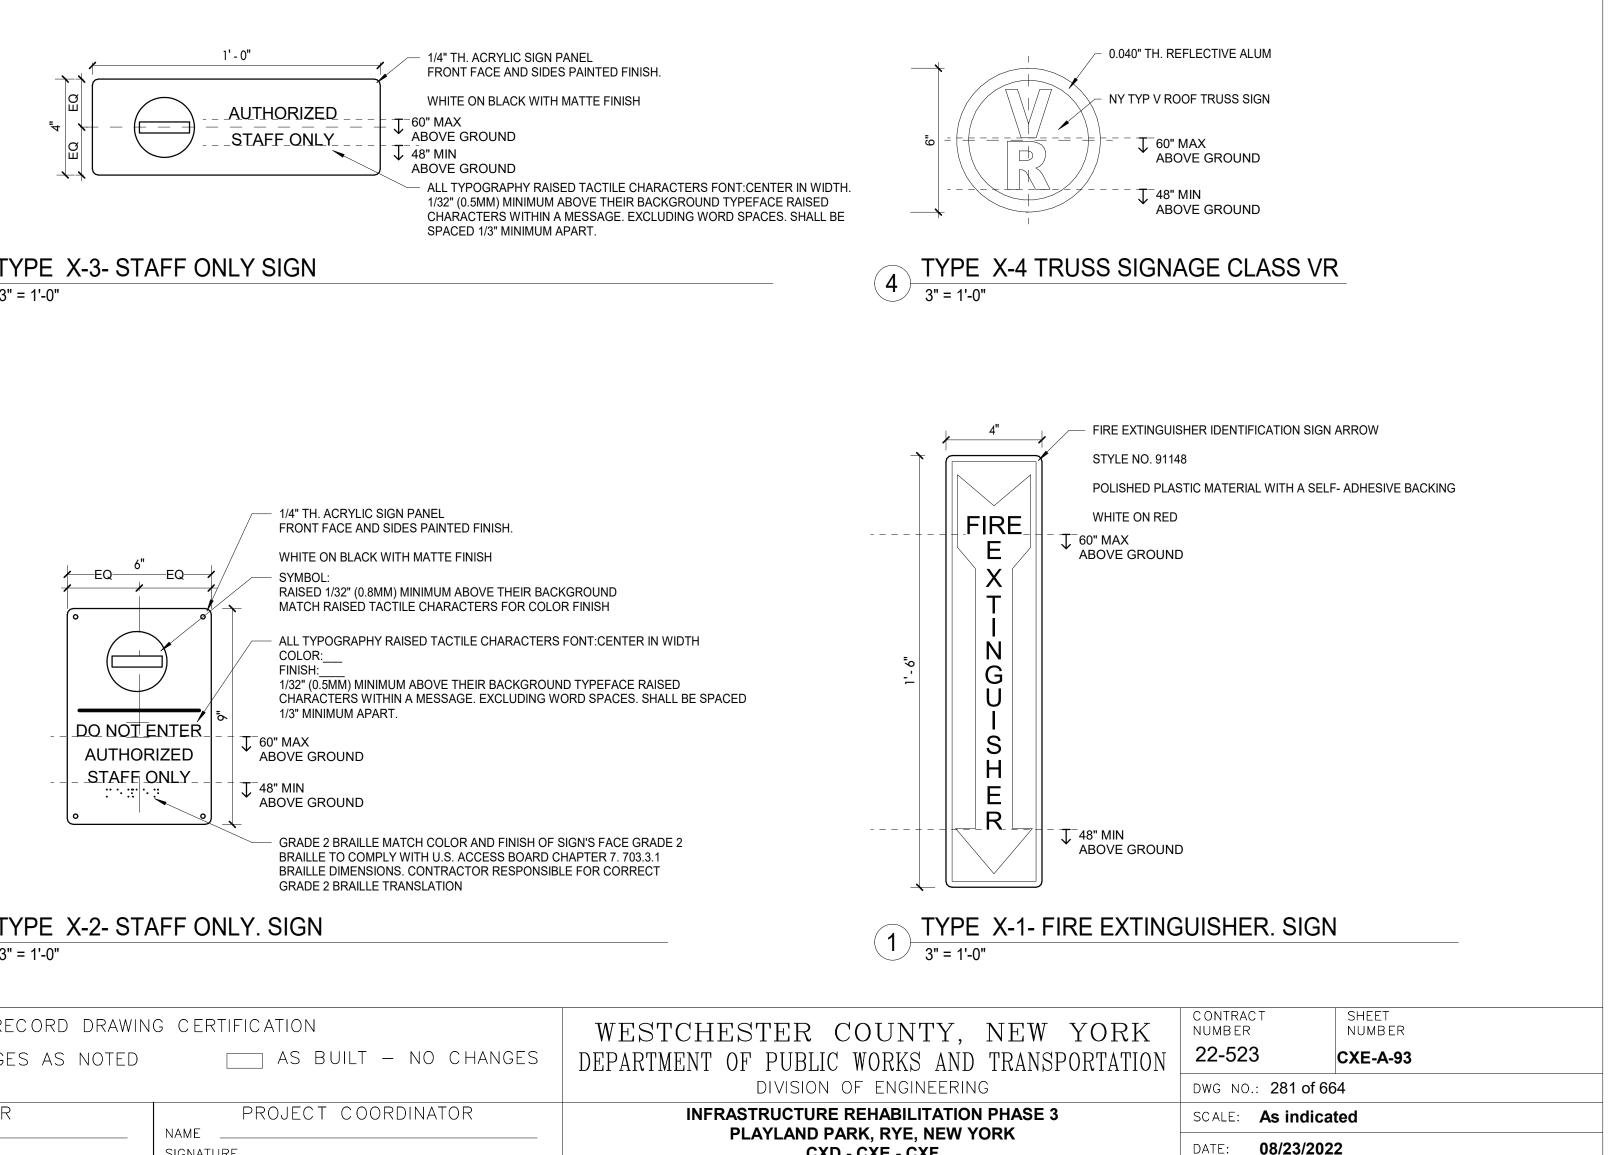


1/4" TH. ACRYLIC SIGN PANEL FRONT FACE AND SIDES PAINTED FINISH.

WHITE ON BLACK WITH MATTE FINISH

REVISION

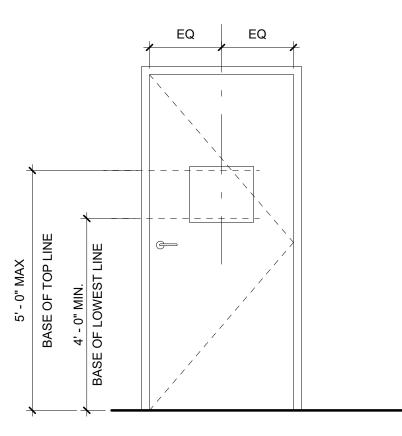SIGN LOCATION ELEVATION - TYPICAL DOOR CONDITION 2 (8) 1/2" = 1'-0"



SIGNAGE TYPES AND DETAILS




SIGNATURE
TITLE

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TITLE

SIGNAGE GENERAL NOTES

- 1. ALL PANEL SIGNAGE SHALL BE WALL MOUNTED AT 48" MIN AND 60" MAX ABOVE THE ADJACENT FINISHED FLOOR MEASURED FROM THE BASELINE OF THE CHARACTERS AND IN COMPLIANCE WITH THE LATEST ADOPTED VERSION OF ICC/ANSI-A117.1 REQUIREMENTS.
- 2. SIGNAGE SHOWN HERE MAY NOT BE INCLUSIVE OF ALL TYPES OF SIGNAGE REQUIRED FOR THIS PROJECT. REFER TO DRAWINGS AND SPECIFICATIONS FOR ALL ADDITIONAL SIGNAGE
- REQUIREMENTS NOT SHOWN HERE. 3. MOUNT SIGN SO THAT A PERSON CAN APPROACH WITHIN 3" AND AVOID DOOR SWING AND
- PROTRUDING OBJECTS 4. SIGNS SHALL BE LOCATED ON THE WALL ADJACENT TO THE LATCH SIDE OF DOOR, UON.



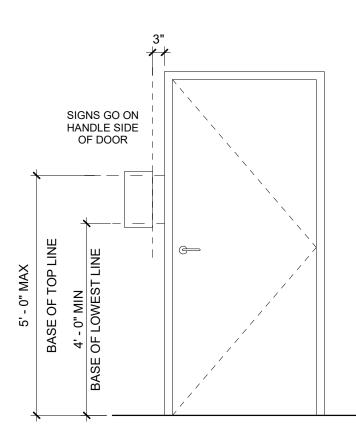

SIGN LOCATION ELEVATION - TYPICAL DOOR CONDITION (7 1/2" = 1'-0"

DPW FILE **1-118-A-1030-0** REV. NO.


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<u>GENE</u> G–1	THESE NOTES ARE GENERAL AND SUPPLEMENTAL TO THE SPECIFICATIONS. THESE NOTES APPLY TO THE ENTIRE PROJECT UNLESS MODIFIED OR NOTED				
G-2	WHEN REFERRED TO OR WHEN NO MORE RESTRICTIVE OR DIFFERENT DETAILS				
G-3	ARE SHOWN ON THE DRAWINGS. DESIGN WAS IN ACCORDANCE WITH AND CONSTRUCTION SHALL COMPLY WITH THE PROVISIONS OF THE NEW YORK STATE BUILDING CODE (NYSBC). THE DESIGN LOADS AND OTHER DESIGN VALUES GIVEN BELOW WERE USED FOR DESIGN OF STRUCTURES UON ON THE DRAWINGS.				
G-4	DESIGN LOADS FOR NEW ELEMENTS: LIVE LOADS: CROSS AXIS BUILDING E: ROOF: FLOOR: 60 PSF 100 PSF				
	SNOW LOADS: GROUND SNOW LOAD, $Pg = 30 PSF$ $Pf= 21 PSF$ $SNOW EXPOSURE FACTOR,$ $SNOW LOAD IMPORTANCE FACTOR,$ $H = 1.1$ $Ct = 1.0$				
	WIND DESIGN: BASIC WIND SPEED, BUILDING CATEGORY: $V = 126$ MPH II WIND EXPOSURE CATEGORY: NTERNAL PRESSURE COEFFICIENT, GCpi = ± 0.18				
	SEISMIC DESIGN:SPECTRAL RESPONSE COEFFICIENTS:SDS =0.296SD1 =0.096SITE CLASS:BSEISMIC DESIGN CATEGORY:CSEISMIC IMPORTANCE FACTOR:I = 1.25BASIC SEISMIC FORCE RESISTING SYSTEM ISAS SHOWN ON DRAWINGSDESIGN BASE SHEAR, V = AS SHOWN ON DRAWINGSANALYSIS PROCEDURE IS EQUIVALENT LATERAL FORCEMETHOD, UON.RESPONSE MODIFICATION FACTOR, R:CROSS AXIS BUILDING E:R = 7				
	LOADS INDICATED ABOVE REFLECT DESIGN LOADS FOR ANY NEW OR REHABILITATED STRUCTURAL ELEMENTS. THEY SHOULD NOT BE TAKEN AS DESIGN LOADS FOR THE STRUCTURE AS A WHOLE.				
G-5	ALL DIMENSIONS INDICATED (*) ARE TO BE VERIFIED EITHER BY FIELD MEASUREMENTS FOR EXISTING STRUCTURES OR BY SHOP DRAWINGS FOR EQUIPMENT FURNISHED. STRUCTURAL DIMENSIONS NOT SHOWN BUT CONTROLLED BY OR RELATED TO EQUIPMENT SHALL BE VERIFIED BY THE CONTRACTOR WITH THE MANUFACTURER PRIOR TO CONSTRUCTION.				
G-6	STRUCTURAL DRAWINGS SHALL BE USED IN COORDINATION WITH THE DRAWINGS OF ALL OTHER DISCIPLINES AND MANUFACTURER'S SHOP DRAWINGS.				
G-7	IF A CONFLICT IS FOUND BETWEEN DIFFERENT PORTIONS OF THE CONTRACT DOCUMENTS, THE CONTRACTOR SHALL NOTIFY THE ENGINEER IMMEDIATELY. CONTINUED CONSTRUCTION OF THE AREA IN CONFLICT SHALL BE AT THE CONTRACTOR'S OWN RISK UNTIL THE CONFLICT IS RESOLVED BY THE ENGINEER.				
G-8	WHENEVER ONE MEMBER IS FASTENED TO ANOTHER WITH FASTENINGS (BOLTS, WELDS, ETC.) SET AT A UNIFORM SPACING, THERE SHALL BE A MINIMUM OF TWO FASTENINGS PER PIECE CONNECTED AND THE FIRST AND LAST FASTENINGS SHALL BE LOCATED NOT TO EXCEED 0.25 OF FASTENER SPACING FROM EACH END.				
G-9	STRUCTURES HAVE BEEN DESIGNED FOR OPERATIONAL LOADS ON THE COMPLETED STRUCTURE. DURING CONSTRUCTION, THE STRUCTURES SHALL BE PROTECTED BY BRACING AND TEMPORARY SUPPORTS WHEREVER EXCESSIVE CONSTRUCTION LOADS MAY OCCUR. OVERSTRESSING OF ANY STRUCTURAL ELEMENT IS PROHIBITED.				
G-10	NO BACKFILL SHALL BE PLACED AGAINST ANY WALL UNLESS ALL SUPPORTING ELEMENTS OF THE STRUCTURE HAVE BEEN CONSTRUCTED AND HAVE REACHED THE SPECIFIED MINIMUM CONCRETE STRENGTH.				
G—11	THE CONTRACTOR IS RESPONSIBLE FOR VERIFYING ALL EXISTING INFORMATION IN THE FIELD AS REQUIRED FOR NEW WORK.				
<u>Foun</u>	DATIONS				
F—1	DESIGN ASSUMPTIONS: A) ALLOWABLE BEARING PRESSURE: 1. SOUND ROCK – 8 TSF, 2. OVERBURDEN – 1 TSF.				
	B) GROUNDWATER: EXISTING GROUNDWATER ELEVATIONS VARY ACROSS SITE.				
F-2	GRAVITY UNDER DRAINS SHALL BE PROVIDED TO PERMANENTLY LOWER GROUNDWATER.				
F-3 F-4	CONCRETE GENERAL NOTES APPLY TO FOUNDATIONS. MINIMUM DEPTH FROM ADJACENT FINISHED GRADE TO BOTTOM OF FOUNDATION, 4'-0"				
F-5	FOUNDATIONS BEARING ON ROCK SHALL BE CONSTRUCTED SUCH THAT ROCK SURFACE IS LEVEL, UNLESS APPROVED BY ENGINEER.				
F-6	COMPACTED SELECT GRANULAR FILL 12 INCHES THICK MINIMUM, SHALL BE PLACED BELOW ALL CONCRETE FOUNDATIONS UNLESS DIRECTLY BEARING ON SOUND ROCK.				

S-1 DETAIL, FABRICATE, AND ERECT STRUCTURA AISC SPECIFICATION FOR STRUCTURAL STEE DESIGN AND LRFD DESIGN (LRFD MANUAL C CURRENT EDITION). S-2 STEEL MATERIAL: A) STRUCTURAL TUBING, ASTM A 500, B) STRUCTURAL PIPE, ASTM A 53, GR C) PLATES AND ANGLES, ASTM A 36 D) STRUCTURAL W SHAPES, ASTM A 50 KSI). E) STRUCTURAL S, M, & H SHAPES A S-3 PROVIDE MIN 3/4" DIAMETER ASTM A 325 FULLY TIGHTENED TYPE N CONNECTIONS FO S-4 PROVIDE TYPICAL STEEL BEAM CONNECTION THAN THE TOTAL UNIFORM LOAD CAPACITY FOR ALLOWABLE LOADS OF BEAMS UNLESS S-5 CAST IN PLACE ANCHOR BOLTS FOR STRUC TO ASTM A307 UON. S-6 DO NOT PAINT STEEL SURFACES WHICH ARE ENCASED IN CONCRETE. S–7 STAINLESS STEEL SHALL BE TYPE 316 FOR 316L FOR WELDED CONSTRUCTIONS. S-8 ALUMINUM SHALL BE ALLOY 6061-T6. S-9 ALL GROOVE AND BUTT WELDS SHALL BE F S-10 FILLET WELD SIZES SHALL BE THE MINIMUM FOR PLATE SIZES TO BE CONNECTED AND ENTIRE JOINT CONTACT LENGTH, BUT NOT L S-11 DETAIL, FABRICATE, AND ERECT ALUMINUM ALUMINUM ASSOCIATION CONSTRUCTION MAN S-12 ALL BOLTS, ANCHOR BOLTS, AND CONCRETE ALUMINUM SHALL BE TYPE 316 STAINLESS S-13 ALUMINUM SHALL BE ISOLATED FROM CONTA DISSIMILAR METALS. EXCAVATION E-1 CONTRACTOR SHALL PERFORM ALL EXCAVA STATE, LOCAL AND FEDERAL REQUIREMENTS EXCAVATION REQUIREMENTS. E-2 TEMPORARY SHEETING AND BRACING IS NOT

- DRAWINGS. ALL EXCAVATIONS WITH A POTEN PROVIDED WITH EXCAVATION PROTECTION S OSHA 1926. SLOPING AND BENCHING WHICH SLATED TO REMAIN ACCESSIBLE OR THAT M FOOTINGS AND STRUCTURES SHALL NOT BE
- ENGINEER REGISTERED IN THE STATE OF NE TEMPORARY SHEETING AND BRACING AND R CONTRACTOR TO SUBMIT SUCH PLANS TO E E-4 CONTRACTOR SHALL BE RESPONSIBLE FOR
- EXCAVATIONS. E-5 ALL EXCAVATED MATERIALS SHALL BE REMO

by: BCRE Designec -A-04.dwg] ts: ---9:46 AM dwg] [BCR-02 Comment ugust 2022 1 Frsg-svLogo.

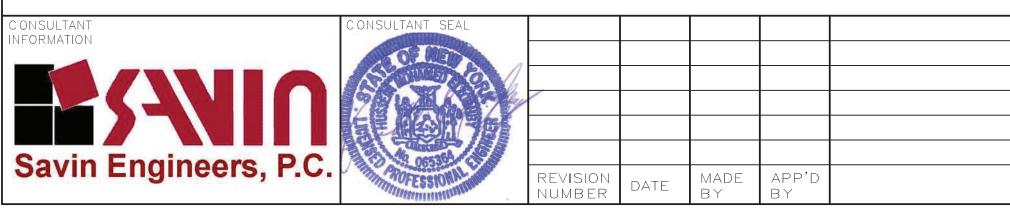

5–1	DETAIL, FABRICATE, AND ERECT STRUCTURAL STEEL IN ACCORDANCE WITH AISC SPECIFICATION FOR STRUCTURAL STEEL BUILDINGS, ALLOWABLE STRESS DESIGN AND LRFD DESIGN (LRFD MANUAL OF STEEL CONSTRUCTION, CURRENT EDITION).
-2	 STEEL MATERIAL: A) STRUCTURAL TUBING, ASTM A 500, GRADE B. B) STRUCTURAL PIPE, ASTM A 53, GRADE B. C) PLATES AND ANGLES, ASTM A 36 UNO. D) STRUCTURAL W SHAPES, ASTM A 992 (MIN. YIELD STRENGTH OF 50 KSI). E) STRUCTURAL S, M, & H SHAPES ASTM A572 GRADE 50.
5–3	PROVIDE MIN 3/4" DIAMETER ASTM A 325 HIGH STRENGTH BOLTS WITH FULLY TIGHTENED TYPE N CONNECTIONS FOR STRUCTURAL STEEL UON.
5-4	PROVIDE TYPICAL STEEL BEAM CONNECTIONS FOR A CAPACITY NOT LESS THAN THE TOTAL UNIFORM LOAD CAPACITY TABULATED IN THE AISC TABLES FOR ALLOWABLE LOADS OF BEAMS UNLESS NOTED OTHERWISE.
S-5	CAST IN PLACE ANCHOR BOLTS FOR STRUCTURAL STEEL SHALL CONFORM TO ASTM A307 UON.
S-6	DO NOT PAINT STEEL SURFACES WHICH ARE TO BE WELDED OR ARE TO BE ENCASED IN CONCRETE.
S-7	STAINLESS STEEL SHALL BE TYPE 316 FOR BOLTED CONSTRUCTIONS AND 316L FOR WELDED CONSTRUCTIONS.
S-8	ALUMINUM SHALL BE ALLOY 6061-T6.
S-9	ALL GROOVE AND BUTT WELDS SHALL BE FULL PENETRATION.
6–10	FILLET WELD SIZES SHALL BE THE MINIMUM SIZE REQUIRED BY AISC CODE FOR PLATE SIZES TO BE CONNECTED AND SHALL BE APPLIED TO THE ENTIRE JOINT CONTACT LENGTH, BUT NOT LESS THAN 3/16".
S—11	DETAIL, FABRICATE, AND ERECT ALUMINUM IN ACCORDANCE WITH THE ALUMINUM ASSOCIATION CONSTRUCTION MANUAL CURRENT EDITION.
S-12	ALL BOLTS, ANCHOR BOLTS, AND CONCRETE ANCHORS CONNECTING ALUMINUM SHALL BE TYPE 316 STAINLESS STEEL UON.
S–13	ALUMINUM SHALL BE ISOLATED FROM CONTACT WITH CONCRETE OR DISSIMILAR METALS.
EXCA	VATION
E—1	CONTRACTOR SHALL PERFORM ALL EXCAVATION IN ACCORDANCE WITH STATE, LOCAL AND FEDERAL REQUIREMENTS INCLUDING OSHA BRACING AND EXCAVATION REQUIREMENTS.
E-2	TEMPORARY SHEETING AND BRACING IS NOT SHOWN ON CONTRACT DRAWINGS. ALL EXCAVATIONS WITH A POTENTIAL FOR CAVE-IN SHALL BE PROVIDED WITH EXCAVATION PROTECTION SYSTEMS IN ACCORDANCE WITH OSHA 1926. SLOPING AND BENCHING WHICH WILL ENCROACH ON AREAS SLATED TO REMAIN ACCESSIBLE OR THAT MAY ENCROACH ON EXISTING FOOTINGS AND STRUCTURES SHALL NOT BE PERMITTED.
E-3	CONTRACTOR SHALL ENGAGE THE SERVICES OF A LICENSED PROFESSIONAL ENGINEER REGISTERED IN THE STATE OF NEW YORK TO DESIGN ALL TEMPORARY SHEETING AND BRACING AND RELATED APPURTENANCES. CONTRACTOR TO SUBMIT SUCH PLANS TO ENGINEER FOR INFORMATION.
E-4	CONTRACTOR SHALL BE RESPONSIBLE FOR DEWATERING OF OPEN EXCAVATIONS.

<u>TIMBER</u>

- T-1 ALL WOOD FRAMING MEMBERS INCLUDING, BUT NOT LIMITED TO, WALL STUDS AND JOISTS, ARE INTENDED TO ACT AS A SYSTEM AS DETAILED IN THE STRUCTURAL DRAWINGS AND ONCE CONSTRUCTION IS COMPLETE. IT IS THE RESPONSIBILITY OF THE CONTRACTOR TO ENSURE SAFETY AND STABILITY OF WOOD FRAMING SYSTEMS (I.E. TEMPORARY BRACING IF REQUIRED) DURING CONSRTUCTION AS A RESULT OF CONSTRUCTION METHODS AND SEQUENCES.
- T-2 ALL TIMBER BELOW FLOOR DECKING SHALL BE PRESSURE-TREATED SOUTHERN PINE LUMBER.
- T-3 STORAGE OF ALL LUMBER AND TIMBER ON SITE SHALL BE KEPT OFF GROUND, UNDER COVER AND PROTECTED FROM DAMAGE.
- T-4 ALL DIMENSIONAL LUMBER SHALL BE CERTIFIED BY THE SUPPLIER IN WRITING TO BE KILN DRIED.
- T-5 STRUCTURE SHALL NOT BE ENCLOSED UNLESS LUMBER MOISTURE CONTENT HAS BEEN VERIFIED TO BE AT OR BELOW 15%. ANY SIGNS OF MOLD SHALL BE REMOVED AND TREATED IN ACCORDANCE WITH PROJECT SPECIFICATIONS OR INDUSTRY STANDARDS.
- T-6 ALL LUMBER IN CONTACT WITH THE GROUND OR CONCRETE SHALL BE PRESSURE TREATED.
- T–7 FASTENERS FOR PRESERVATIVE TREATED AND FIRE RETARDANT TREATED WOOD SHALL BE OF HOT DIPPED ZINC COATED GALVANIZED STEEL OR STAINLESS STEEL AND SHALL FOLLOW CURRENT SIMPSON GUIDELINES BASED ON WEATHER EXPOSURE. WHERE STAINLESS STEEL CONNECTORS OR HOT DIPPED GALVANIZED CONNECTORS ARE SPECIFIED IN THE DRAWINGS, STAINLESS STEEL OR HOT DIPPED GALVANIZED FASTENERS SHALL BE USED TO MATCH CONNECTOR TYPE.
- T–8 ALL PLATES AND LEDGERS SHALL BE FASTENED WITH A MINIMUM (3) ANCHORS PER PIECE UNLESS NOTED OTHERWISE.
- T–9 ALL METAL HARDWARE AND FRAMING ACCESSORIES SHALL BE MANUFACTURED BY SIMPSON STRONG-TIE COMPANY. ALL ITEMS SHALL BE INSTALLED PER THE SIMPSON'S INSTALLATION REQUIREMENTS. ALL NAIL HOLES SHALL BE FILLED WITH THE RECOMMENDED FASTENER UNLESS NOTED OTHERWISE ON THE DRAWING.
- T-10 HOLES FOR BOLTS SHALL BE DRILLED WITH A BIT OF THE SAME NOMIMAL DIAMETER AS THE BOLT + 1/16". LEAD HOLES FOR LAG SCREWS SHALL BE BORED PER NDS 11.1.3.
- T-11 ALL BOLTS, CARRIAGE BOLTS, LAG SCREWS, EXPANSION BOLTS AND EPOXY BOLTS SHALL BE INSTALLED WITH STANDARD CUT WASHERS UNDER THE BOLT HEAD AND NUTS THAT BEAR DIRECTLY ON THE WOOD. ALL NUTS SHALL BE TIGHTENED AT THE TIME OF INSTALLATION AND RE-TIGHTENED IF NECESSARY, DUE TO WOOD SHRINKAGE, PRIOR TO CLOSE OUT OR COMPLETION OF THE PROJECT. BOLTS AND LAG SCREWS SHALL CONFORM TO ANSI/ASME STANDARD B18.2.1. WOOD SCREWS SHALL CONFORM TO B18.6.1. ALL BOLTS SHALL CONFORM TO ASTM A307 GRADE A UNLESS NOTED OTHERWISE.
- T-12 CUTTING AND NOTCHING OF SAWN LUMBER RAFTERS AND STUDS SHALL BE IN CONFORMANCE WITH THE FOLLOWING CRITERIA:
 - A. JOISTS NOTCHES AT THE ENDS OF JOISTS SHALL NOT EXCEED 1/5 OF THE JOIST DEPTH. HOLES IN JOISTS SHALL NOT BE WITHIN 21/3 INCHES OF THE TOP OR BOTTOM OF THE JOIST, AND THE DIAMETER OF ANY SUCH HOLE SHALL NOT EXCEED 1/4 THE DEPTH OF THE JOIST. NOTCHES IN THE TOP OR BOTTOM OF THE JOISTS SHALL NOT EXCEED 1/6 THE DEPTH AND SHALL NOT BE LOCATED IN THE MIDDLE OF THE THIRD SPAN.
 - B. RAFTERS NOTCHES AT THE ENDS OF RAFTERS OR CEILING JOISTS SHALL NOT EXCEED 1/5 OF THE DEPTH. NOTCHES IN THE TOP OR BOTTOM OF THE RAFTER OR CEILING JOIST SHALL NOT EXCEED 1/6 THE DEPTH AND SHALL NOT BE LOCATED IN THE MIDDLE 1/3 OF THE SPAN. EXCEPT THAT A NOTCH NOT EXCEEDING 1/3 OF THE DEPTH IS PERMITTED IN THE TOP OF THE RAFTERS OR CEILING JOIST NOT FURTHER FROM THE FACE OF THE SUPPORT THAN THE DEPTH OF THE MEMBER. HOLES BORED IN RAFTERS OR CEILING JOISTS SHALL NOT BE WITHIN $2\frac{1}{2}$ " INCHES OF THE TOP AND BOTTOM AND THEIR DIAMETER SHALL NOT EXCEED 1/4 THE DEPTH OF THE MEMBER.
 - C. WALL STUDS A MAXIMUM OF $2\frac{1}{4}$ " DIAMETER NEATLY BORED HOLE MAY BE PLACED IN THE CENTER OF ALL BEARING 2x6 STUDS WITH NO ADDITIONAL REINFORCEMENT REQUIRED.

SPECIAL INSPECTIONS (CROSS AXIS BUILDING E)

- S-1 SPECIAL INSPECTION SHALL COMPLY WITH SPECIFICATIONS.
- S-2 SPECIAL INSPECTION WILL BE PERFORMED IN ACCORDANCE WITH CHAPTER 17 OF THE NYS BUILDING CODE.
- S-3 SPECIAL INSPECTION WILL BE PERFORMED ON THE FOLLOWING STRUCTURAL SYSTEMS:
 - A) WOOD CONSTRUCTION (1705.4).

RECORD DRAWING CERTIFICATION WES DEPAR AS BUILT – CHANGES AS NOTED AS BUILT – NO CHANGES CONTRACTOR PROJECT COORDINATOR JAME JAME -SIGNATURE _____ SIGNATURE _____ TITLE _____ DATE _____ TITLE _____ DATE _____ REVISION

DEMOLITION

<u>LEGEND</u>


D-5

EXISTING REINFORCED CONCRETE WALL OR STRUCTURE TO BE DEMOLISHED

SAW CUT LINE – FULL DEPTH UNLESS NOTED OTHERWISE

DRAWINGS.

)—1	CONTRACTOR IS ALERTED THAT LI APPROXIMATE. ACTUAL LIMITS SHA STRUCTURE. CONTRACTOR TO CO- PROCEDURE PER SPECIFICATIONS.
)-2	ALL ITEMS SHOWN ARE EXISTING T
)-3	FOR ADDITIONAL DEMOLITION REQU
)—4	ALL EXISTING CONCRETE TO BE DE NOTED OTHERWISE. REINFORCING S

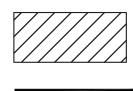

IMITS OF DEMOLITION SHOWN IS ALL BETHE MINIMUM REQUIRED FOR NEW -ORDINATE AND SUBMIT DEMOLITION

TO REMAIN UNLESS NOTED OTHERWISE. UIREMENTS SEE SPECIFICATIONS (024116).

EMOLISHED IS STEEL REINFORCED UNLESS STEEL NOT SHOWN FOR CLARITY.

FOR ADDITIONAL DEMOLITION NOT SHOWN, SEE G, A, M, E, H, AND P

STCHESTER COUNTY, NEW YORK RTMENT OF PUBLIC WORKS AND TRANSPORTATION	CONTRACT NUMBERSHEET NUMBER22-523CXE-S-01		
DIVISION OF ENGINEERING	DWG NO.:		
INFRASTRUCTURE REHABILITATION - PHASE 3	SCALE: AS SHOWN ⁶⁴		
PLAYLAND PARK, RYE, NEW YORK CROSS AXIS BUILDING E	DATE: 8/23/ 2022		
STRUCTURAL NOTES	DPW FILE NUMBER 1-118-S-1031-0 REV. NO. 0		

STRUCTURAL ABBREVIATIONS

GAUGE

GRADE

GRATING

HEIGHT

HORIZONTAL

HIGH POINT

INSIDE DIAMETER

INSIDE FACE

JUNCTION BOX

LENGTH/ANGLE

LINEAR FEET

LONG LEG HORIZONTAL

LONG LEG VERTICAL

LOW WATER LEVEL

MANUFACTURER

MISCELLANEOUS

MASONRY OPENING MODIFY/MODIFIED

NOT APPLICABLE NOT IN CONTRACT

MILLION GALLONS

MILLION GALLONS PER DAY

LIVE LOAD

LOCATION

LOW POINT LOUVER

MASONRY

MATERIAL

MAXIMUM MECHANICAL

MANHOLE

MOUNTÉD

NORTH

NUMBER

NOMINAL

NOT TO SCALE

OUTSIDE DIAMETER

ON CENTER

MINIMUM

METAL

JUNCTION

INCH

INCLUDE

INTERIOR

INVERT

JOIST

JOINT

LONG

HOLLOW STRUCTURAL STEEL

GALVANIZE

GRADE BEAM

GA

GB

GALV

All inquiries regarding this drawing(s) or pr Bureau of Engineering Design and Constru 10946 AM Designed by: ----Drav Rev#: be

C ON SULTANT INFORMATION	CONSULTANT SEAL					
CONSULTANT INFORMATION Savin Engineers, P.C.	AND AND	/				
Savin Engineers, P.C.	PROFESSIONAL CONTRACTOR	REVISION NUMBER	DATE	MADE B Y	APP'D By	

CONC CONST CONT CONTR CP CLJ CTR CY	CONCRETE CONSTRUCTION CONTINUOUS CONTRACTOR CONCRETE PLANK CONTROL JOINT CENTER CUBIC YARD	LOO LP LVR LWL MAS MATL MAX MECH
DET DIA (Ø) DIAG DIM DIST DN DO DP DWG DWL	DETAIL DIAMETER DIAGONAL DIMENSION DISTANCE DOWN DITTO DEEP DRAWING DOWEL	MET MFR MG MGD MH MIN MISC MO MOD MTD
E EA EF EL ELEV	EAST EACH EACH FACE ELEVATION ELEVATOR	N NA NIC NO NOM NTS
ENGR EMB ENCL ENT EQ EQPT EW EXIST	ENGINEER EMBEDMENT ENCLOSURE ENTRANCE EQUAL EQUIPMENT EACH WAY EXISTING	OC OD OF OPNG OPP OT OVHD
EXP EXP JT EXT	EXPANSION EXPANSION JOINT EXTERIOR	PAR PC
FAB FD FDN FFL FIN FLR FT FTG F&C	FABRICATE FLOOR DRAIN FOUNDATION FINISH FLOOR FINISH FLOOR FEET FOOTING FRAME&COVER	PCO PI PL PREFAB PSF PSI PT PTN PVMT
F&G	FRAME&GRATE	QTY

AB

ADDL

ADH

ADJ AFF

AGG

AL ALT

APPROX

ARCH

AVG

BLDG

BM BOF BOS BOT BRG

ΒT

С ТО С

CANT

CJ

CL CLR CMU CO

COL

ANCHOR BOLT

ADJUSTABLE/ADJACENT

ABOVE FINISHED FLOOR

ADDITIONAL

AGGREGATE

ALUMINUM

ALTERNATE

AVERAGE

BUILDING

BOTTOM

BEARING

CHANNEL

CLEAR

CANTILEVER

CENTER LINE

CLEAN OUT

COLUMN

BOLT

BORING

APPROXIMATE

ARCHITECTURAL

BEAM/BENCH MARK

BOTTÓM OF FOOTING

BOTTOM OF STEEL

CENTER TO CENTER

CONSTRUCTION JOINT

CONCRETE MASONRY UNIT


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B R RTG		
GT ORZ P SS		
)		
I ICL IT IV		
B CT T		
. G		
- _H _V DC VR WL		
AS ATL AX ECH ET FR GD H ISC OD TD		
A IC O OM TS		
C D F PNG PP T VHD		
AR C CO		

OUTSIDE FACE OPENING OPPOSITE OPEN TRUSS OVERHEAD PARALLEL POINT OF CURVE/PIECE PILE CUT OFF POINT OF INTERSECTION PLATE/PROPERTY LINE PREFABRICATED POUNDS PER SQUARE FOOT POUNDS PER SQUARE INCH POINT OF TANGENCY PARTITION PAVEMENT

QUANTITY

<u>SYMBOLS</u>



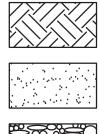















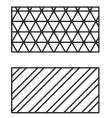

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TITLE _____ DATE _____

TITLE _____ DATE _____

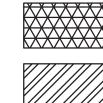

WELDED WIRE FABRIC YARD YEAR

RISER

RADIUS

REMOVE

ROOF

SOUTH

SCHEDULE

SECTION

SHEET

SIMILAR

SQUARE

STATION

STAIR

STANDARD

STIFFENER

STRUCTURAL

SUBSTITUTE

SYMMETRICAL

TOP AND BOTTOM

TOUNGE AND GROOVE

TOP OF CURB/CONCRETE

TOP OF MASONRY/MANHOLE

UNLESS NOTED OTHERWISE

WEST/WIDTH/WIDE FLANGE

WATERPROOF/WALL PIPE

WALL PENETRATING TYPE

STIRRUP

STEEL

TREAD

TANGENT

THICK

TEMPERATURE

TOP OF DECK

TOP OF WALL

TYPICAL

VERTICAL

WITH

WITHOUT

WEIGHT

REVISION

WATER LEVEL

WATER SURFACE

TOP OF FOOTING

TOP OF SLAB/STEEL

SQUARE FEET

STEEL JOIST

SPECIFICATION

STAINLESS STEEL

REQUIRED

ROOF DRAIN

REINFORCEMENT

ROUGH OPENING

RECTANGULAR

REINFORCED CONCRETE PIPE

WELDED WIRE FABRIC BLANKET INSULATION STEEL

UNDISTURBED EARTH

COMPACTED BACKFILL

CONCRETE BLOCK

FINISHED WOOD

CONCRETE

BRICK


SELECT GRANULAR FILL MATERIAL

DENOTES MOMENT CONNECTION


ROUGH WOOD RIGID INSULATION REINFORCED STEEL IN CONCRETE


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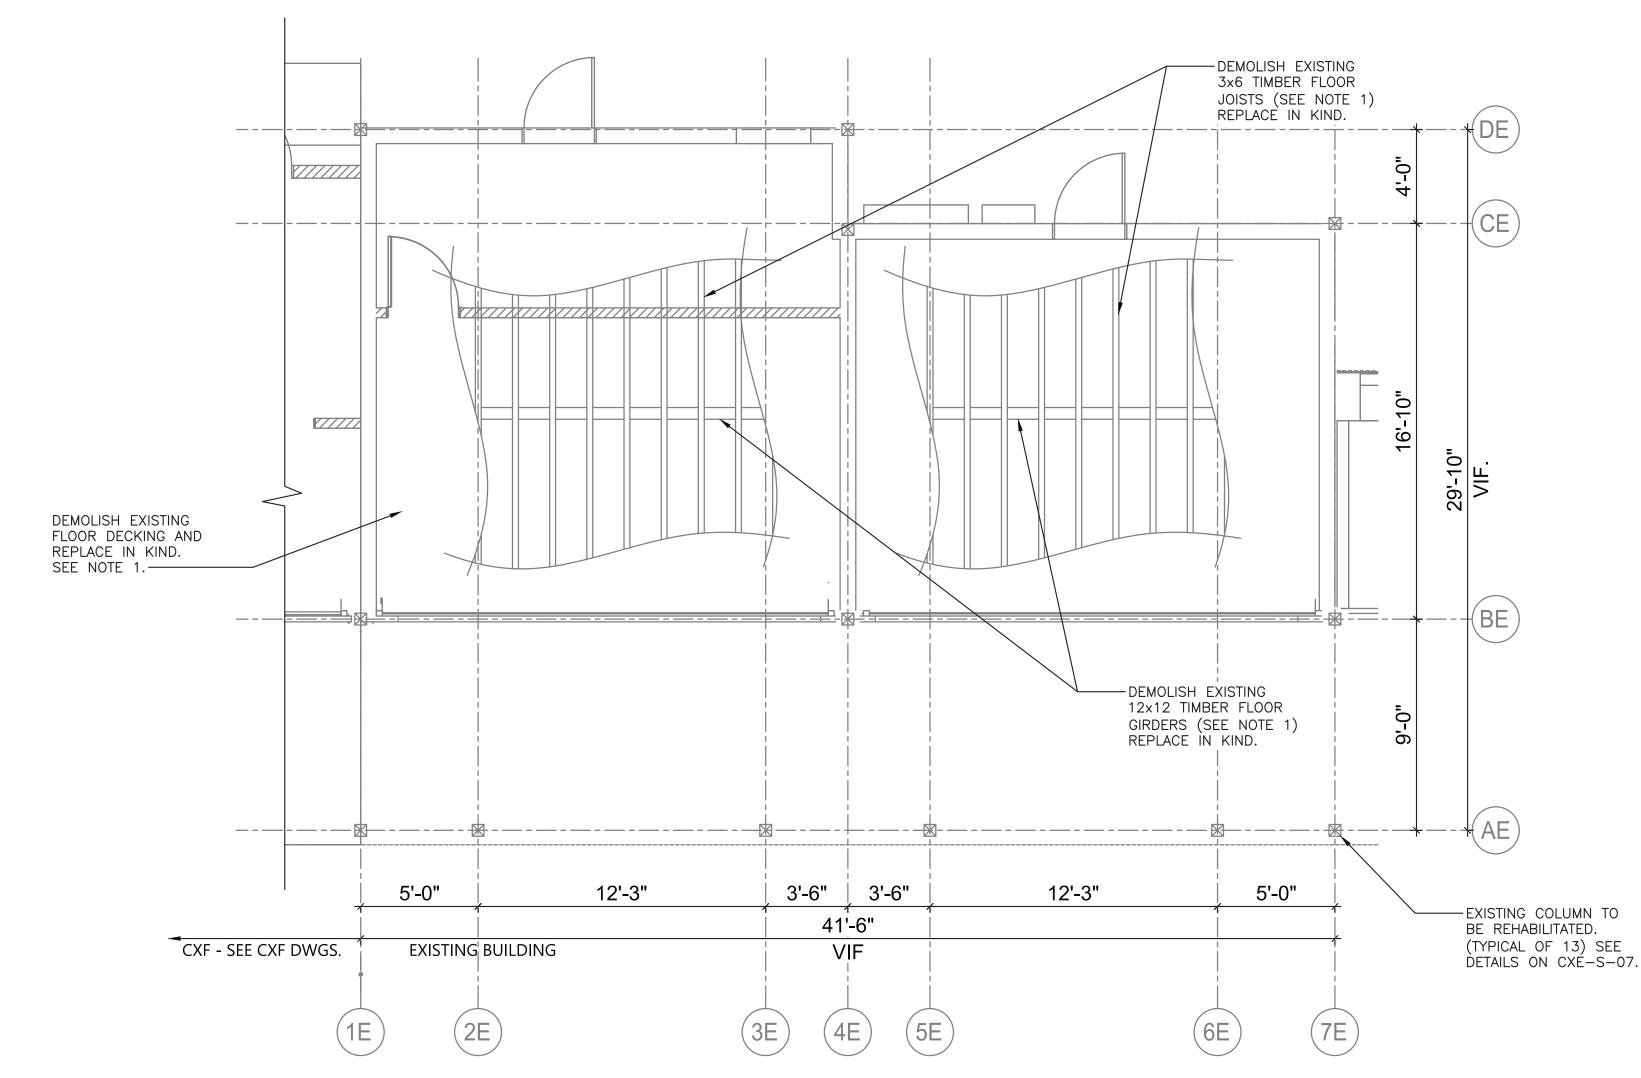
ESTCHESTER COUNTY, NEW YORK	CONTRACT SHEET NUMBER NUMBER
ARTMENT OF PUBLIC WORKS AND TRANSPORTATION	22-523 CXE-S-02
DIVISION OF ENGINEERING	DWG NO.:
INFRASTRUCTURE REHABILITATION - PHASE 3 PLAYLAND PARK, RYE, NEW YORK	SCALE: AS SHOWN ⁶⁴
CROSS AXIS BUILDING E	DATE: 8/23/ 2022
STRUCTURAL ABBREVIATIONS AND SYMBOLS	DPW FILE 1-118-S-1032-0 REV. NO. 0

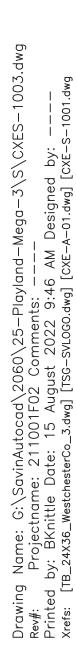


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CXE-S-07.

DEMOLITION - GROUND FLOOR PLAN 1/4" = 1'-0"

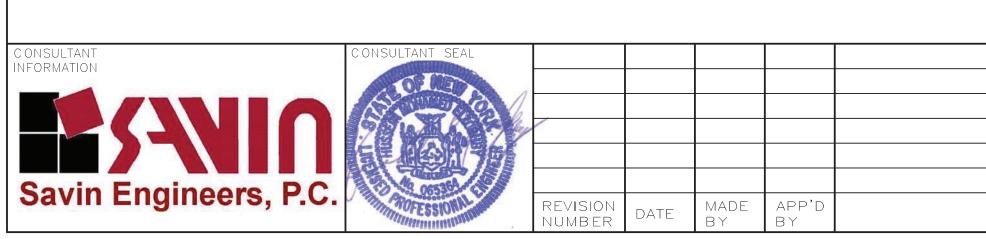
	RECORD DRAWING CERTIFICATION				
	AS BUILT – CHANGES AS NOTED	AS BUILT – NO CHANGES	DEPART		
	CONTRACTOR	PROJECT COORDINATOR			
	SIGNATURE	SIGNATURE			
REVISION	TITLE DATE	TITLE DATE			

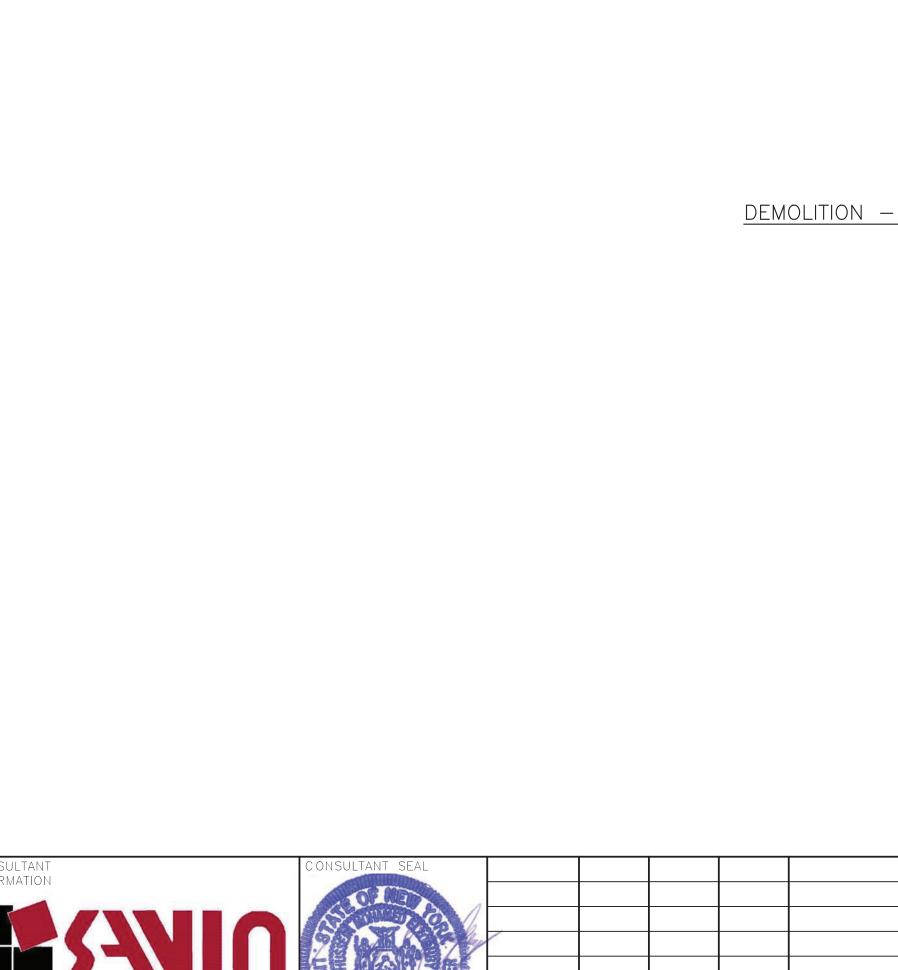1. REHABILITATION OF THE CROSS AXIS BUILDING E INCLUDES VARIOUS ELEMENTS SLATED FOR REMOVAL AND REPLACEMENT IN-KIND FOR DETERIORATED MEMBERS. CONTRACTOR IS TO ALERT THE ENGINEER 6 WEEKS PRIOR TO START OF REHABILITATION WORK TO PERFORM FIELD INSPECTION OF THE REPAIR ITEMS IDENTIFIED BELOW. UPON COMPLETION OF THE FIELD INSPECTION WORK, THE ENGINEER WILL PROVIDE TO THE CONTRACTOR IN WRITING THE DEFINED LIMITS OF REPLACEMENT WORK. REHABILITATION WORK FOR VARIOUS ELEMENTS SHALL BE PERFORMED PER DETAILS AND SEQUENCES AS OUTLINED ON DRAWINGS, CXE-S-03, CXE-S-04, CXE-S-05, CXE-S-06 & CXE-S-07. FOR THE PURPOSES OF BIDDING, CONTRACTOR SHALL INCLUDE IN THEIR BID THE QUANTITIES FOR EACH ELEMENT AS MENTIONED BELOW.

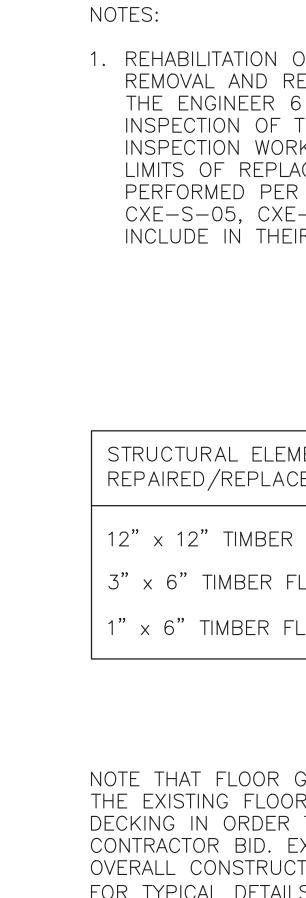MENTS TO BE	QUANTITY	UNITS	REMARKS
R FLOOR GIRDERS	4	EA	APPROXIMATELY 21 FT LONG EACH
FLOOR JOISTS	20	EA	APPROXIMATELY 22 FT LONG EACH
FLOOR DECKING	530	SF	

NOTE THAT FLOOR GIRDERS AND FLOOR JOIST LOCATIONS MAY BE ANYWHERE WITHIN THE LIMITS OF THE EXISTING FLOOR DECKING. COSTS FOR REMOVAL AND REINSTALLATION OF EXISTING FLOOR DECKING IN ORDER TO ACCESS GIRDERS AND JOISTS SHALL BE DEEMED INCLUDED IN THE CONTRACTOR BID. EXECUTIONS OF THE ABOVE REHABILITATING WORK SHALL BE COORDINATED WITH OVERALL CONSTRUCTION SEQUENCE AND PHASING. SEE SPECIFICATION. FOR TYPICAL DETAILS OF FLOOR/GIRDER FRAMING AND CONNECTIONS, SEE DRAWING CXE-S-06 &

		SCALE: $1/4" = 1'-0"$	
STCHESTER COUNTY, NEW YORK	C ONTRAC T NUMBER	SHEET NUMBER	
TMENT OF PUBLIC WORKS AND TRANSPORTATION	22-523	CXE-S-03	
DIVISION OF ENGINEERING	DWG NO.:		
INFRASTRUCTURE REHABILITATION - PHASE 3	SCALE: AS SHOWN ⁶⁴		
PLAYLAND PARK, RYE, NEW YORK CROSS AXIS BUILDING E	DATE: 8/23/ 2022		
DEMOLITION - GROUND FLOOR PLAN	DPW FILE NUMBER 1-118-S-	-1033-0 REV. NO. 0	

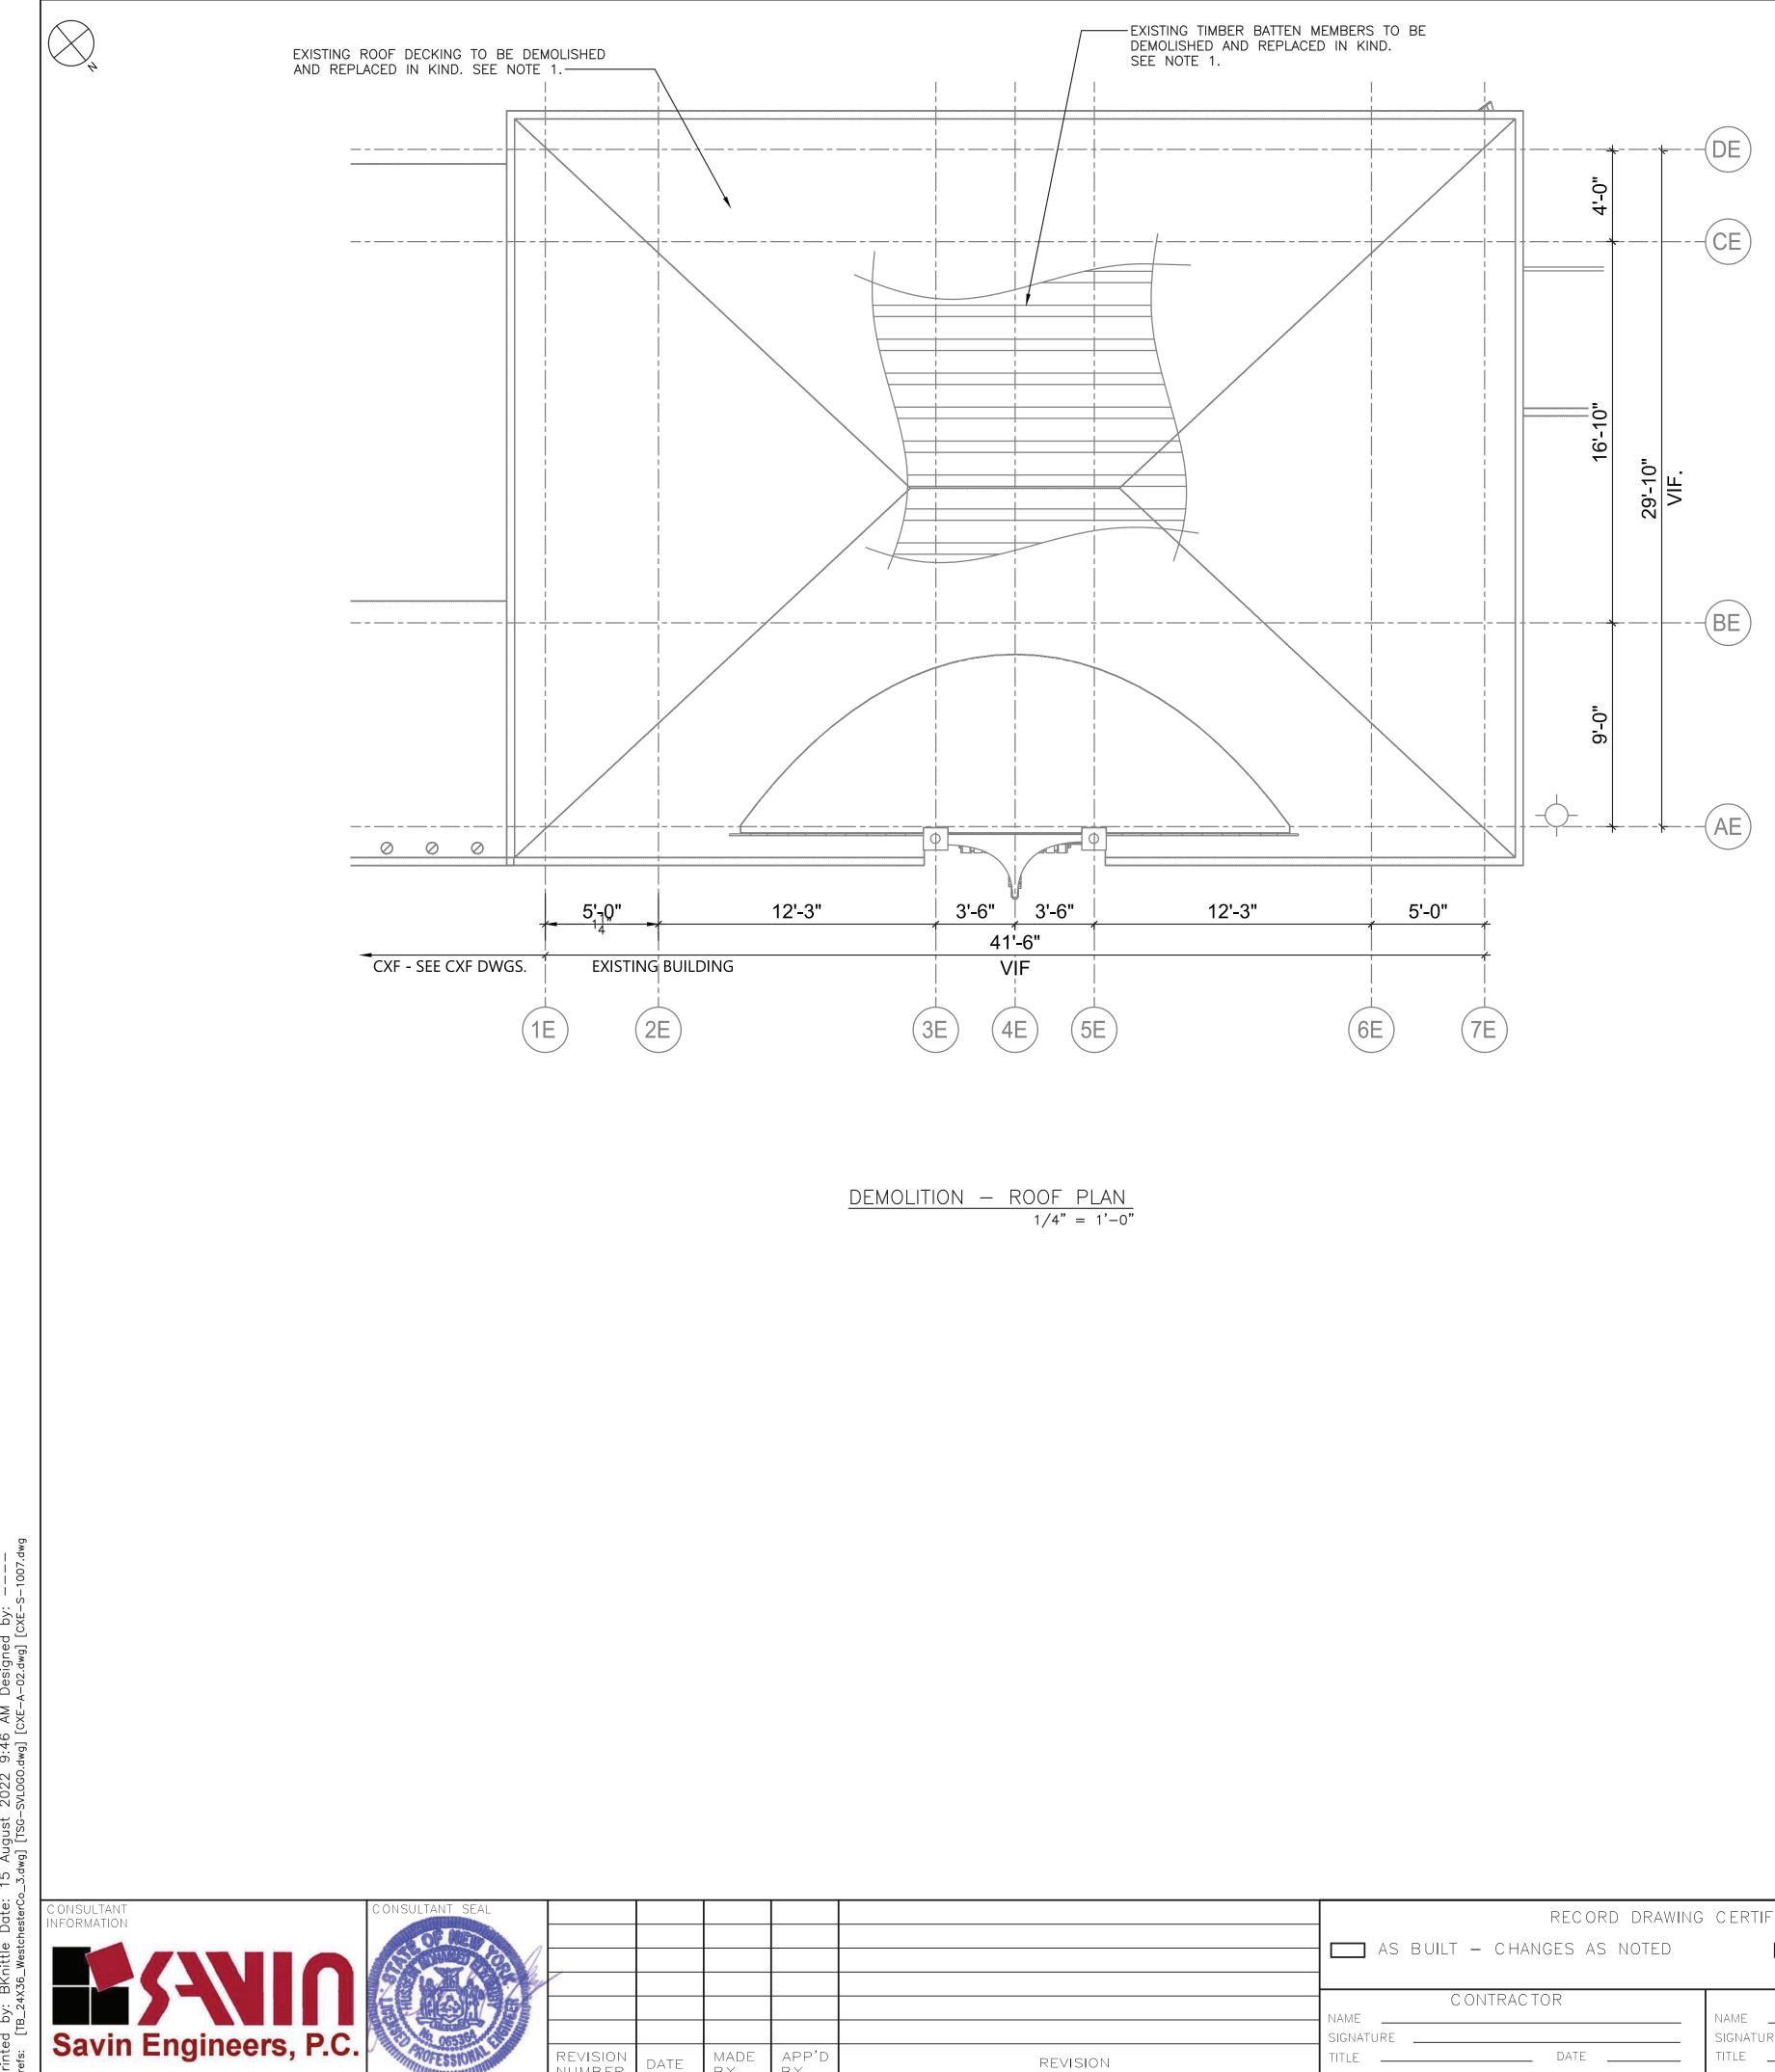

REVISION NUMBER

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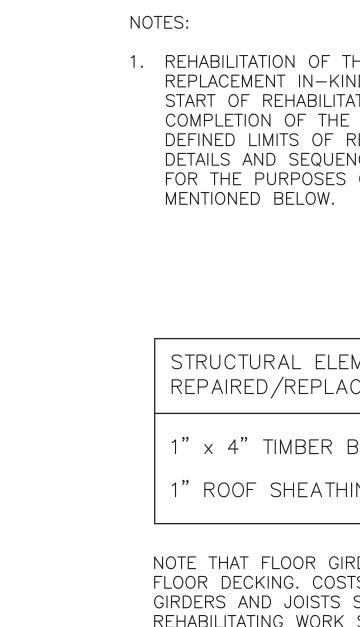
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F02 Comments: ----August 2022 9:46 AM Designed by: --Alfrsc-SvLoGo.dwg] [CXE-A-02.dwg] [CXE-S--2110011 ite: 15 /



SPECIFICATION.

	RE	RECORD DRAWING CERTIFICATION		
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	C ONTRAC TOR	NAME	PROJECT COORDINATOR	
	SIGNATURE	SIGNATURE		_
REVISION	TITLE D/	ATE TITLE	DATE	-


1. REHABILITATION OF THE CROSS AXIS BUILDING E INCLUDES VARIOUS ELEMENTS SLATED FOR REMOVAL AND REPLACEMENT IN-KIND FOR DETERIORATED MEMBERS. CONTRACTOR IS TO ALERT THE ENGINEER 6 WEEKS PRIOR TO START OF REHABILITATION WORK TO PERFORM FIELD INSPECTION OF THE REPAIR ITEMS IDENTIFIED BELOW. UPON COMPLETION OF THE FIELD INSPECTION WORK, THE ENGINEER WILL PROVIDE TO THE CONTRACTOR IN WRITING THE DEFINED LIMITS OF REPLACEMENT WORK. REHABILITATION WORK FOR VARIOUS ELEMENTS SHALL BE PERFORMED PER DETAILS AND SEQUENCES AS OUTLINED ON DRAWINGS, CXE-S-03, CXE-S-04, CXE-S-05, CXE-S-06 & CXE-S-07. FOR THE PURPOSES OF BIDDING, CONTRACTOR SHALL INCLUDE IN THEIR BID THE QUANTITIES FOR EACH ELEMENT AS

EMENTS TO BE ACED	QUANTITY	UNITS	REMARKS
BATTEN MEMBER	10	ΕA	APPROXIMATELY 10 FT LONG EACH
HING	100	SF	

NOTE THAT FLOOR GIRDERS AND FLOOR JOIST LOCATIONS MAY BE ANYWHERE WITHIN THE LIMITS OF THE EXISTING FLOOR DECKING. COSTS FOR REMOVAL AND REINSTALLATION OF EXISTING FLOOR DECKING IN ORDER TO ACCESS GIRDERS AND JOISTS SHALL BE DEEMED INCLUDED IN THE CONTRACTOR BID. EXECUTIONS OF THE ABOVE REHABILITATING WORK SHALL BE COORDINATED WITH OVERALL CONSTRUCTION SEQUENCE AND PHASING. SEE

STCHESTER COUNTY, NEW YORK	CONTRACT SHEET NUMBER NUMBER		
TMENT OF PUBLIC WORKS AND TRANSPORTATION	22-523 CXE-S-04		
DIVISION OF ENGINEERING	DWG NO.:		
INFRASTRUCTURE REHABILITATION - PHASE 3	SCALE: AS SHOWN ⁶⁴		
PLAYLAND PARK, RYE, NEW YORK CROSS AXIS BUILDING E	DATE: 8/23/ 2022		
DEMOLITION - ROOF PLAN	DPW FILE NUMBER 1-118-S-1034-0 REV. NO. 0		

SCALE: 1/4" = 1'-0"

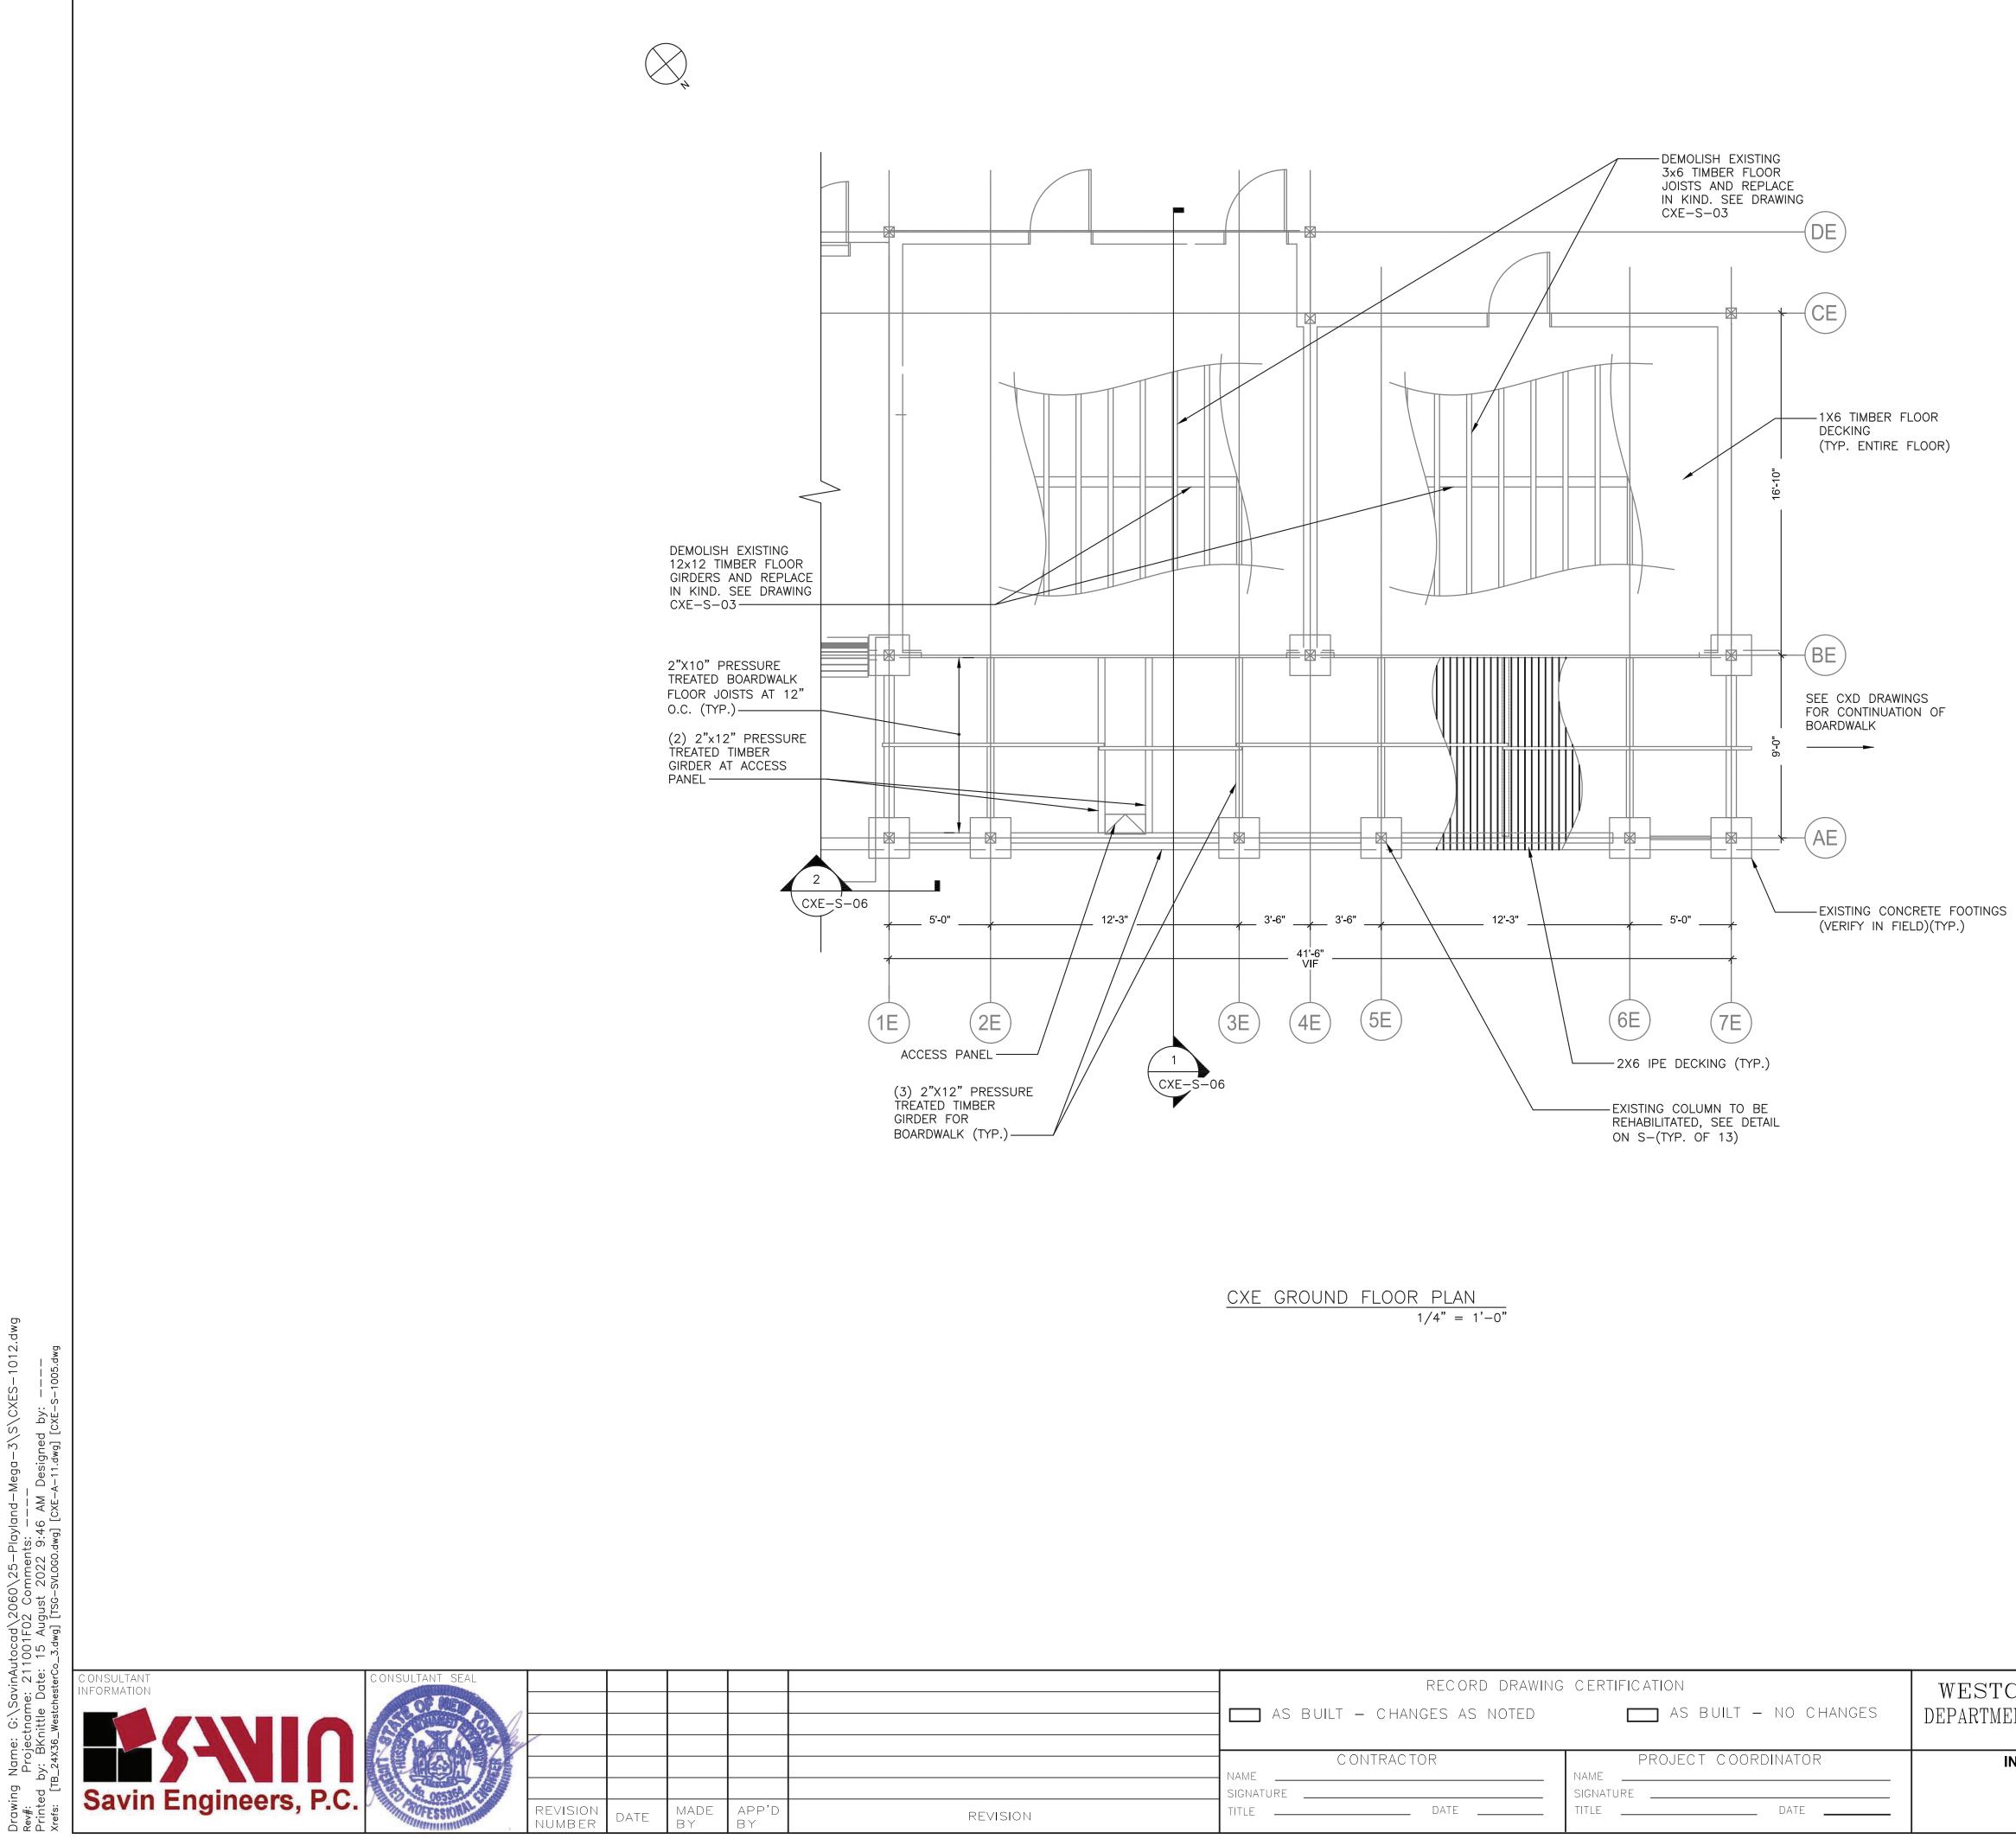

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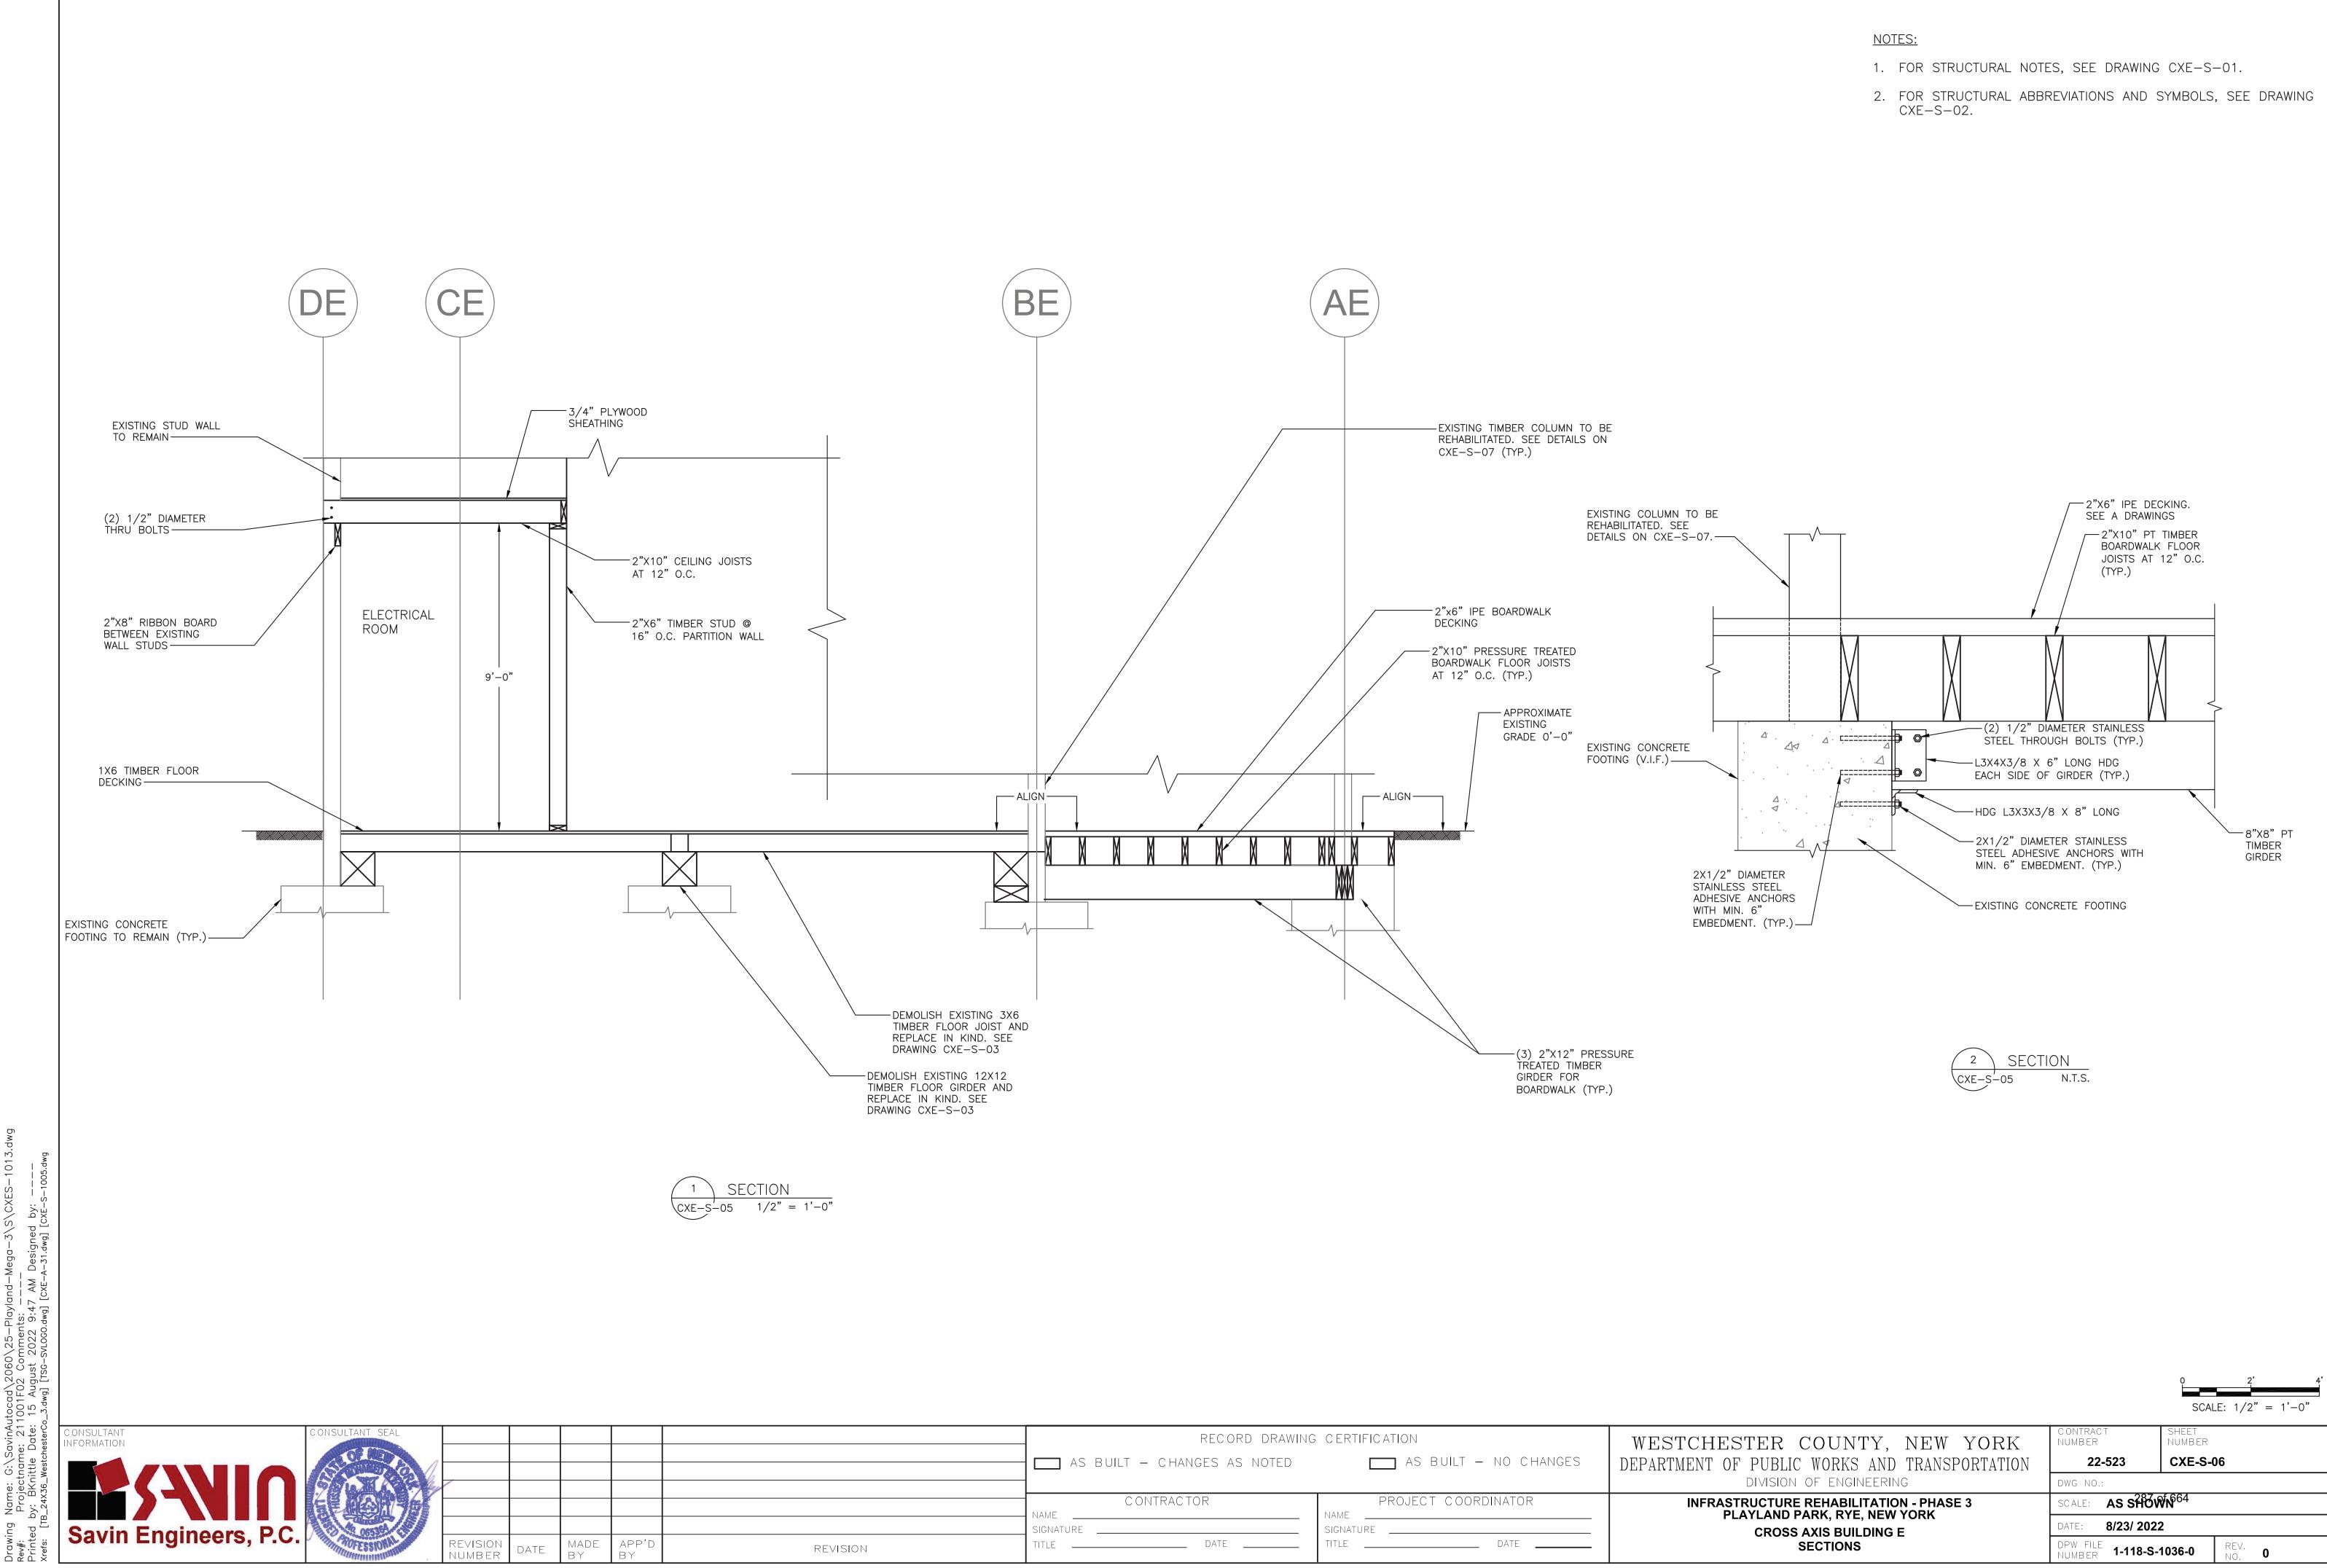
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	RECORD DRAWING CERTIFICATION		
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	C ONTRAC TOR	PROJECT COORDINATOR	
REVISION	SIGNATURE DATE	SIGNATURE DATE	
	·		<u>-</u>

NOTES:

- 1. FOR STRUCTURAL NOTES, SEE DRAWING CXE-S-01.
- 2. FOR STRUCTURAL ABBREVIATIONS AND SYMBOLS, SEE DRAWING CXE-S-02.


		SCALE: $1/4" = 1'-0"$	
STCHESTER COUNTY, NEW YORK	C ONTRAC T NUMB ER	SHEET NUMBER	
TMENT OF PUBLIC WORKS AND TRANSPORTATION	22-523	CXE-S-05	
DIVISION OF ENGINEERING	DWG NO.:		
INFRASTRUCTURE REHABILITATION - PHASE 3	SCALE: AS SHOWN ⁶⁶⁴		
PLAYLAND PARK, RYE, NEW YORK CROSS AXIS BUILDING E	DATE: 8/23/ 2022		
GROUND FLOOR PLAN	DPW FILE NUMBER 1-118-S-	1035-0 REV. 0	



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	RECORD DRAWING	CERTIFICATION	WES
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	CONTRACTOR	PROJECT COORDINATOR	
	SIGNATURE DATE	SIGNATURE DATE	
REVISION			



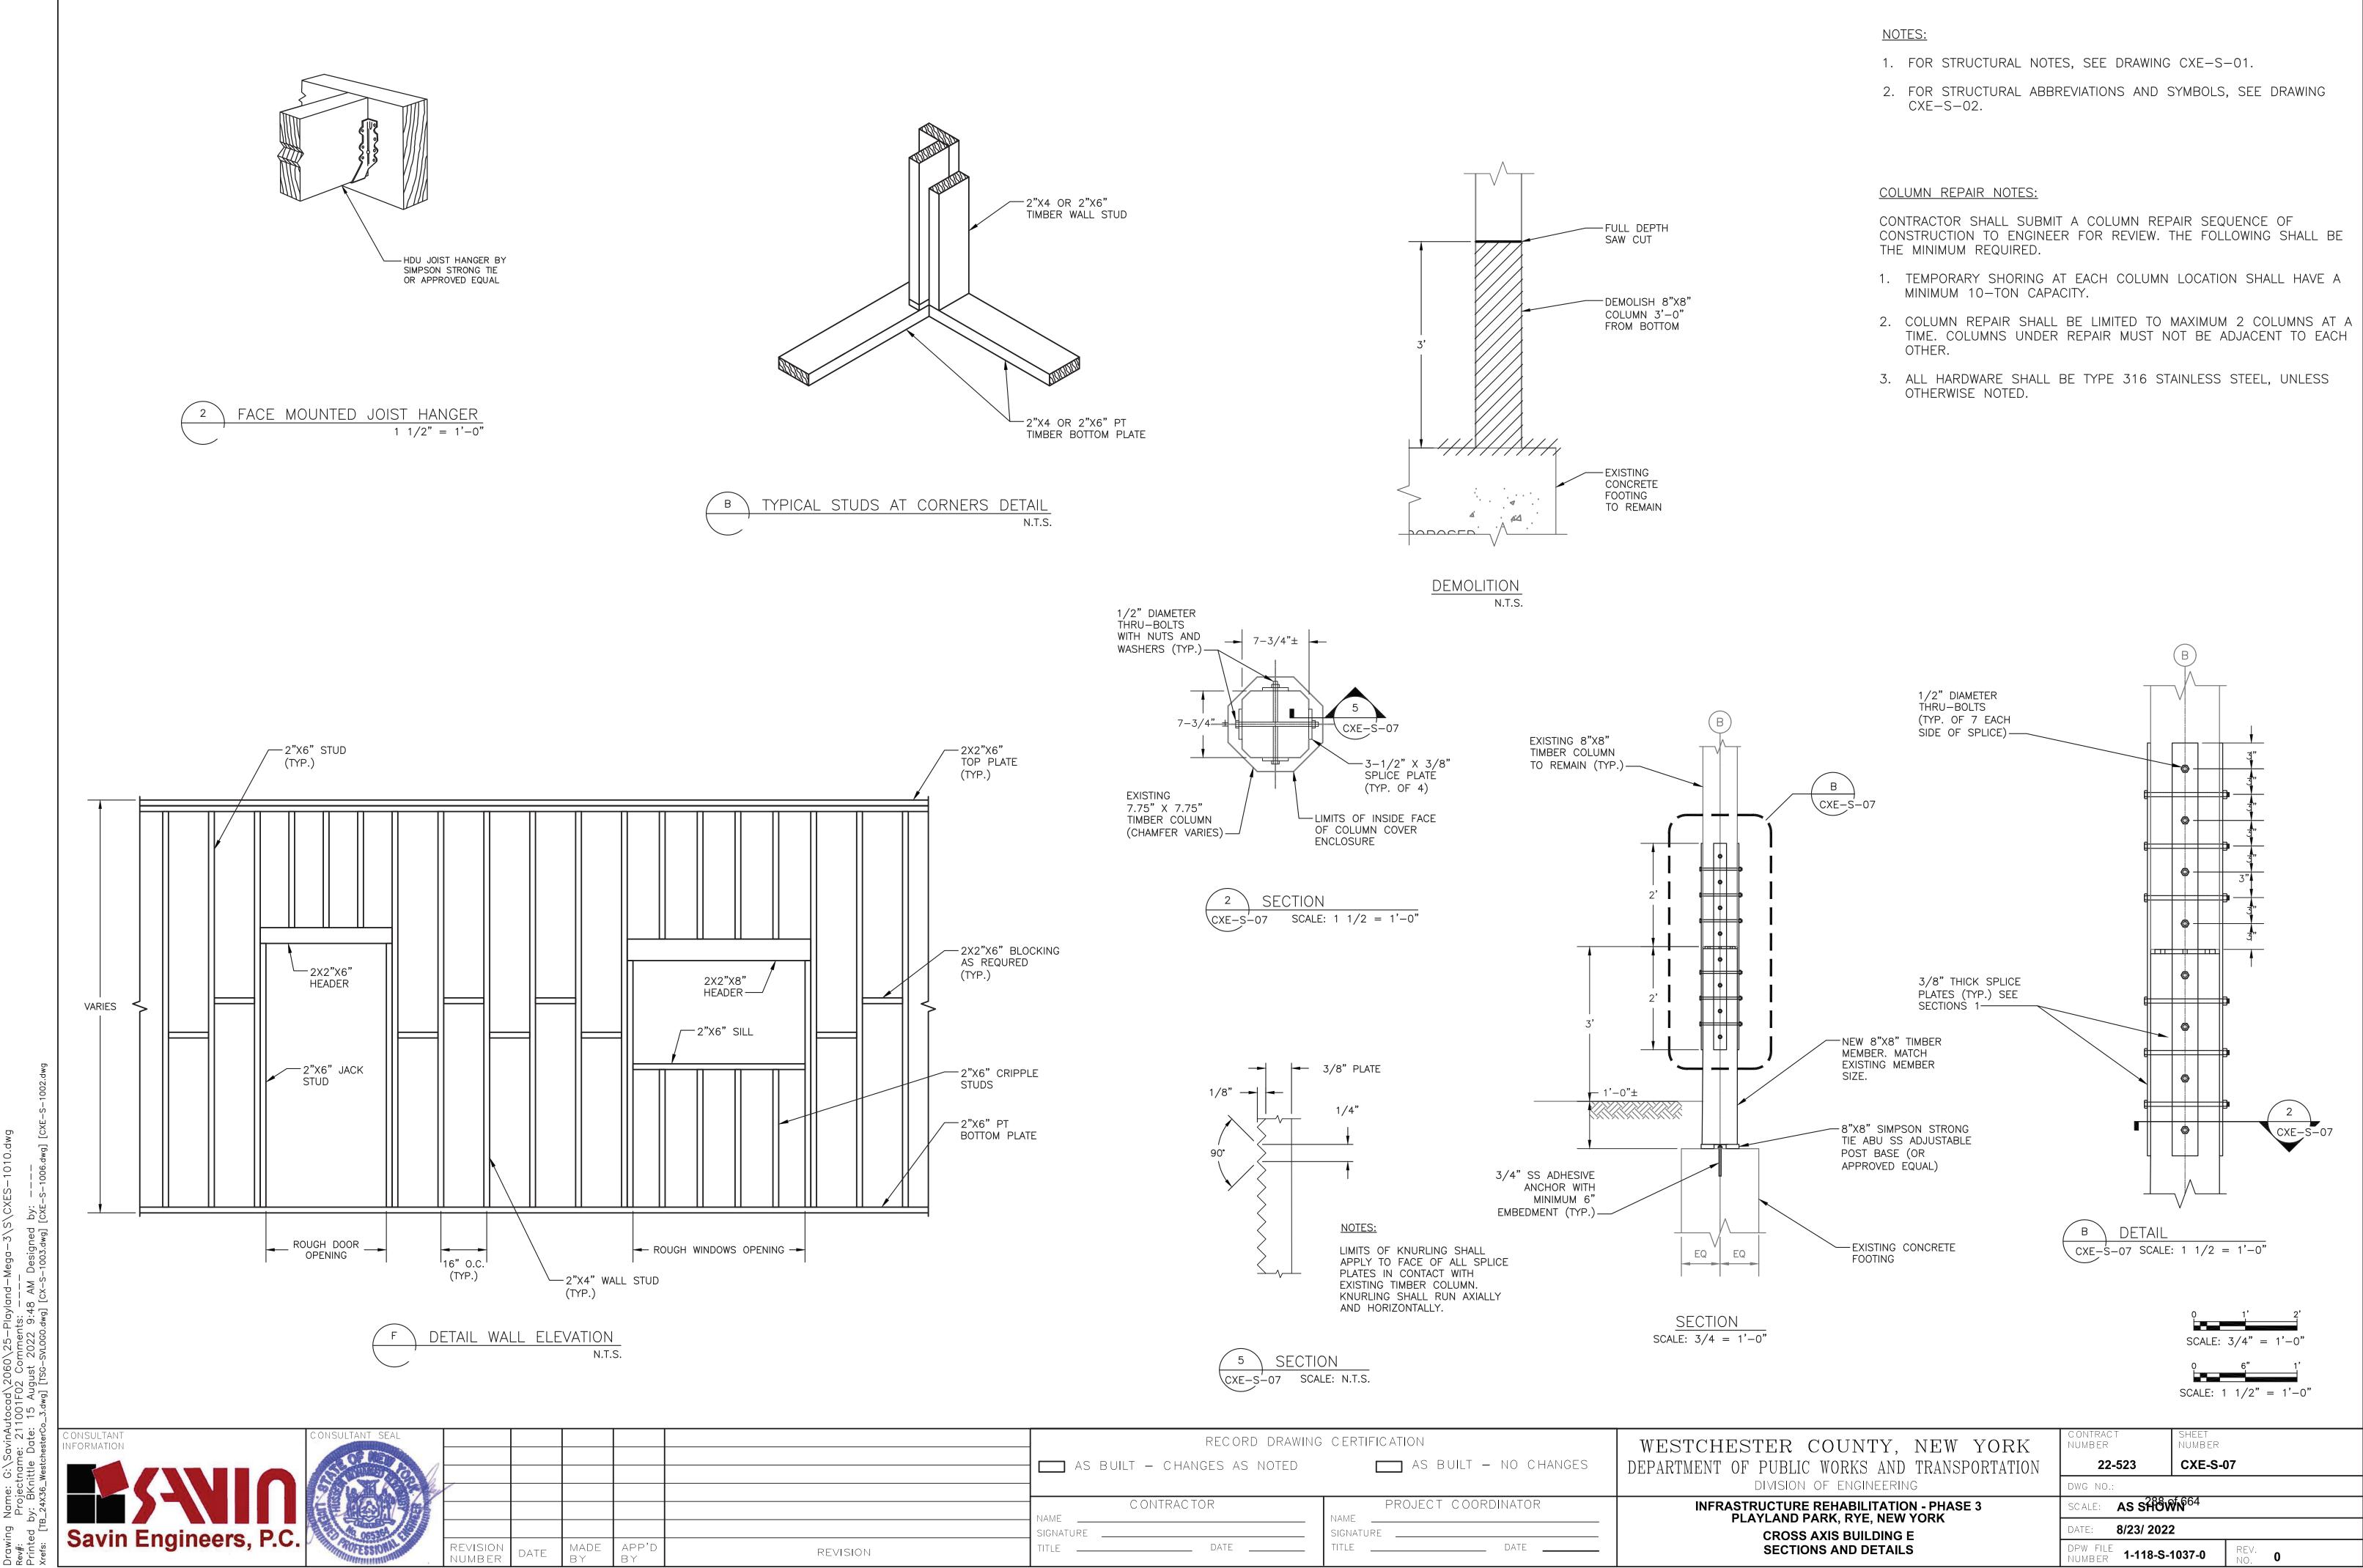

	RECORD DRAWING	CERTIFICATION	WES
	AS BUILT – CHANGES AS NOTED	AS BUILT – NO CHANGES	DEPART
REVISION	CONTRACTOR NAME SIGNATURE DATE	PROJECT COORDINATOR NAME SIGNATURE TITLE DATE	
	1	1	<u> </u>

FIRE PROTECTION SAFETY NOTES:

1. SPECIAL PRECAUTION SHALL BE TAKEN BY THE CONTRACTOR SO THAT EQUIPMENT OF THIS APPLICATION AND ITS INSTALLATION WILL NOT AFFECT THE FOLLOWING: EGRESS TO AND FROM THE BUILDING. FIRE SAFETY OR CREATE A FIRE HAZARD. STRUCTURAL SAFETY OF THE BUILDING, ACCUMULATION OF DUST AND DEBRIS. (THE CONTRACTOR SHALL LEAVE THE SITE BROOM CLEANED EACH DAY.)

FIRE PROTECTION GENERAL NOTES:

1. DIMENSIONS, LOCATIONS AND SIZES INDICATED ON THE PLANS AND THE ELEVATION ARE APPROXIMATE AND SHALL BE VERIFIED BY FIELD INSPECTION BY THE CONTRACTOR.

2. SOME EXISTING PIPE AND EQUIPMENT IS SHOWN FOR CLARIFICATION OF THIS CONTRACT, BUT MUST BE PROTECTED BY THE CONTRACTOR.

3. NO WORK SHALL BE INITIATED UNTIL A WORK PERMIT IS OBTAINED BY THE CONTRACTOR AND A SAFETY PLAN IS SUBMITTED AND IS APPROVED.

4. CONTRACTOR IS RESPONSIBLE FOR OBTAINING ALL PERMITS, EQUIPMENT USE PERMITS, ALL INSPECTION APPROVALS, AND LETTER OF COMPLETION FROM THE DEPARTMENT OF BUILDINGS FOR WORK UNDER THIS CONTRACT AS APPLICABLE.

5. ANY EXISTING MATERIALS, PIPING, ETC., NOT INDICATED FOR DEMOLITION WHICH ARE REMOVED BY THE CONTRACTOR IN ORDER TO INSTALL NEW WORK SHALL BE REINSTALLED BY THE CONTRACTOR. IF EXISTING WORK IS DAMAGED IT SHALL BE REPLACED AT THE CONTRACTOR'S EXPENSE. ALL SURFACES OR FINISHES THAT ARE DAMAGED OR OTHERWISE AFFECTED BY WORK OF THIS CONTRACT SHALL BE PATCHED, REPAIRED, PAINTED OR REPLACED TO MATCH THE PRE-EXISTING CONDITION AND THE NEW WORK.

6. CONTRACTOR MAY PROPOSE ALTERNATE ROUTING IN DIFFICULT AREAS WHERE REPLACEMENT IN KIND IS NOT PRACTICAL. ANY AND ALL ALTERNATE ROUTING IS SUBJECT TO PRIOR REVIEW AND APPROVAL BY THE ENGINEER.

7. A FIRE WATCH SHALL BE PROVIDED WHEN SPRINKLER COVERAGE IS IMPACTED TO MAINTAIN BUILDING OPERATIONS OR AS REQUIRED.

FIRE PROTECTION SYMBOL LIST

	- FS DRY— — NEW DRY SPRINKLER PIPING
	DRY(E) — EXISTING TO REMAIN DRY SPRINKLER PIPING
0	NEW UPRIGHT SPRINKLER HEAD
0	EXISTING UPRIGHT SPRINKLER HEAD
•	NEW CONCEALED PENDENT SPRINKLER HEAD-ORDINARY TEMPERATURE
	SPRINKLER DRY PIPE VALVE
L d	FIRE HOSE CABINET
<u>~</u>	SIAMESE CONNECTION
1Z	CHECK VALVE
1Z •Zĭ	CHECK VALVE W/ ALARM
	WATER MOTOR ALARM BELL
8	PIPE RISER
Ģ	PIPE DROP
0-	PIPE UP
	POINT OF CONNECTION
	POINT OF DISCONNECTION
[]p	PREACTION 6" BELL
R	SOLENOID VALVE
本	OS & Y VALVE
	REVISION SYMBOL
F#	REFER TO SUPPLEMENTAL FIGURE INDICATED BY NUMBER (I.E. F2 REFERS TO FIGURE 2)
	EQUIPMENT TAG
	EQUIPMENT NUMBER
X X-XXX	

SHOP DWGS/EQUIPMENT SUBMITTALS

THE CONTRACTOR MUST SUBMIT ANY EQUIPMENT ALTERNATES 2 WEEKS PRIOR TO BIDS DUE FOR REVIEW AND COMMENTS. ALTERNATES MUST BE ACCEPTED BY LIRO ENGINEERS, INC., THE ARCHITECT, AND THE OWNER PRIOR TO INCLUSION IN BID. THE CONTRACTOR IS RESPONSIBLE TO COORDINATE EQUIPMENT ALTERNATES WITH OTHER TRADES AND MAKE ADJUSTMENTS TO THE MECHANICAL SYSTEMS, AS REQUIRED, TO ACCOMMODATE THESE NEW ALTERNATES.

THE CONTRACTOR IS RESPONSIBLE TO SUBMIT ALL OF THE FOLLOWING ITEMS FOR REVIEW/APPROVAL BY NO MORE THAN 3 WEEKS AFTER THE CONTRACTOR'S CONTRACT/BID HAS BEEN AWARDED. ALL SUBMITTALS MUST BE SENT TOGETHER AS A SINGLE PACKAGE WITH MANUFACTURER'S SPECIFIC MODELS AND SPECIFICATIONS OUTLINED TO MATCH THE SCHEDULED REQUIREMENTS. EACH SUBMITTAL MUST BE LABELED WITH THE UNIT DESIGNATION USED WITHIN THIS DRAWING SET. IF THE SUBMITTAL PACKAGE IS FOUND TO BE INCOMPLETE UPON RECEIPT, THE PACKAGE WILL BE HELD AND WILL NOT BE REVIEWED UNTIL THE REMAINDER OF THE PACKAGE IS RECEIVED. SIX (6) HARD COPIES OF THE SUBMITTAL PACKAGE MUST BE SENT TO LIRO ENGINEERS, INC. DIGITAL SHOP DRAWING SUBMISSIONS ARE ACCEPTABLE.

SCOPE OF WORK:

1. THE INSTALLATION OF NEW DRY FS EQUIPMENT. . PROPOSED FIRE SPRINKLER HEAD LOCATIONS AND PIPING ARE AS NOTED ON PLAT EXACT PIPING FROM THE FIRE SPRINKLER MAIN TO ALL HEADS IS TO BE COORDINATE AND HYDRAULICALLY CALCULATED BY THE F.S.C. & SUBMITTED TO THE ENGINEER FC APPROVAL.

NOTE: THIS SCOPE OF WORK DESCRIPTION IS PROVIDED TO GIVE AN OVERALL "MACI DESCRIPTION OF THIS PROJECT. F.S.C. IS RESPONSIBLE TO REVIEW ALL ENGINEERIN AND ARCHITECTURAL DRAWINGS AND VISIT THE SITE IF NEEDED, PRIOR TO SUBMISSION OF BID.

SPRINKLER HEAD SCHEDU DESCRIPTION

	MANUFACIURER	WODEL	SORIF HON	
0	RELIABLE	F1FR	 DINARY UPR NKLER HEAI	
	ABBREVIA	TION	DRAWI	NG
ACV	ALARM CHECK	VALVE		
B.O.I	P. BOTTOM OF PIP	Ϋ́Ε	#	
-				

(E)	EXISTING TO REMAIN		
.S.C.	FIRE SPRINKLER CONTRACTOR		
P.C	PLUMBING CONTRACTOR		
TYP	TYPICAL		
W/	WITH		
NYS	NEW YORK STATE		

U/P UNDERGROUND PIPING

W WATER

DESIGN CRITERIA

1. AREA OF APPLICATION = 1950 SQ. FT

- 2. OCCUPANCY CLASSIFICATION = ORDINARY HAZARD GROUP 2
- 3. MAXIMUM COVERAGE PER SPRINKLER HEAD = 130 SQ. FT
- 4. DESIGN DENSITY = 0.20 GPM/SQ. FT
- 5. NUMBER OF SPRINKLER HEADS WITHIN AREA OF APPLICATION = 26
- 6. "K" FACTOR OF SPRINKLER HEADS = 5.6
- 7. DESIGN CRITERIA REQUIREMENTS BASED ON: - 2020 BUILDING CODE OF NEW YORK STATE - 2016 NFPA 13

ORDINARY HAZARD PIPE SCHEDULE

	STEEL	С	OPPER
11N. 1 1/4 IN. 1 1/2IN. 2 IN. 2 1/2 IN. 3 IN. 3 1/2 IN. 4 IN. 5 IN. 6 IN. 8 IN.	2 SPRINKLERS 3 SPRINKLERS 5 SPRINKLERS 10 SPRINKLERS 20 SPRINKLERS 40 SPRINKLERS 100 SPRINKLERS 160 SPRINKLERS 275 SPRINKLERS SEE SECTION 8.2	1IN. 1 1/4 IN. 1 1/2IN. 2 IN. 2 1/2 IN. 3 IN. 3 1/2 IN. 4 IN. 5 IN. 6 IN. 8 IN.	2 SPRINKLERS 3 SPRINKLERS 5 SPRINKLERS 12 SPRINKLERS 25 SPRINKLERS 45 SPRINKLERS 75 SPRINKLERS 115 SPRINKLERS 180 SPRINKLERS 300 SPRINKLERS SEE SECTION 8.2

FOR SI UNITS, 1 IN. = 25.4 MM.

MAX DISTANCE BETWEEN HANGERS (FT.-IN.)

	NOMINAL PIPE SIZE (IN.)					
	3/4	1	1 1/4	1 1/2	2	2 1/
STEEL PIPE EXCEPT THREADED LIGHTWALL	N/A	12-0	12-0	15-0	15-0	15-(
THREADED LIGHTWALL STEEL PIPE	N/A	12-0	12-0	12-0	12-0	12-(
COPPER TUBE	8-0	8-0	10-0	10-0	12-0	12-(

CODE REFER

2020 NEW YORK STATE BUILDING CODE 2016 NFPA 13

ONSULTANT VFORMATION



REVISION NUMBER	DATE	MADE B Y	APP'D By	

ULE					
	K-FACTOR	QUANTITY			
IT	5.6	31			
NO	NOTATIONS				
RAV	VING NOTE T	ГАВ			
RISEF	R DESIGNAT	ION			

POINT OF CONNECTION

POINT OF DISCONNECTION



/2	3	3 1/2	4	5	6	8
0	15-0	15-0	15-0	15-0	15-0	15-0
0	12-0	N/A	N/A	N/A	N/A	N/A
0	12-0	15-0	15-0	15-0	15-0	15-0

REN	ICE	

FIRE PROTECTION NOTES

┦		
AN AP PIF CO ET(FU	THE DRAWINGS SHOW THE LAYOUT OF THE SYSTEM AND INDICATE THE APPROXIMATE LOCATIONS OF EQUIPMENT D PIPING. CONTRACTOR IS CAUTIONED NOT TO SCALE THE DRAWINGS. THE PIPING SHALL BE RUN PROXIMATELY IN THE AREAS AS INDICATED ON THE DRAWINGS, [HOWEVER, TO THE ARRANGEMENT OF THE PING SYSTEMS AS MAY BE REFERENCED WITH WORK OF OTHER TRADES]. CONTRACTOR SHALL REVIEW AND ORDINATE WITH STRUCTURAL, ELECTRICAL AND MECHANICAL DRAWINGS. PARTITIONS, STRUCTURAL MEMBERS, C. ARE DESIGNED TO BE FURRED OR CLOSED IN AND TO INCLUDE ROUGH-IN PIPING. CONTRACTOR SHALL RNISH ALL OFFSETS, ADDITIONAL FITTINGS, ETC. WHETHER SHOWN ON DRAWINGS OR NOT, AS REQUIRED TO	
2.0	ET INSTALLATION CONDITIONS. CONTRACTOR IS TO COMPLY WITH LATEST NFPA AND N.Y.S. CODES, AND COORDINATE HIS WORK WITH OTHER	
3. (ADES AND MAKE NECESSARY ADJUSTMENTS.	
4. (RVEY. CONTRACTOR IS TO REPORT ANY CONDITION REQUIRING CHANGES FROM PLANS TO ENGINEER PRIOR TO	
	ARTING WORK. BRANCH LINES AND MAINS (1 1/2" OR LESS) - SCHEDULE 40 FM APPROVED	
6. E	BRANCH LINES AND MAINS (2" OR LARGER) - THINWALL (THICKNESS LESS THEN SCHEDULE 40 MORE THEN HEDULE 10 & FM APPROVED)	
7.0	CONTRACTOR IS TO PERFORM A HYDROSTATIC TEST FOR 2 HRS. @ 200 PSI WITH NO LEAKAGE AND PROVIDE A ST CERTIFICATE TO ENGINEER	
8. (CONTRACTOR IS TO EMPLOY EXPERIENCED WORKMEN WHO ARE TO FAMILIARIZE THEMSELVES WITH THE	
	ILDING AND OBSERVE SAFETY REQUIREMENTS. CONTRACTOR TO ADJUST HEAD LOCATION TO COORDINATE WITH LIGHTS, DUCTS, ETC.	
10.	PERMIT FROM LOCAL AUTHORITY, TO BE OBTAINED BY CONTRACTOR.	
	ALL WORK TO BE APPROVED BY OWNERS ENGINEER, STATE AUTHORITIES HAVING JURISDICTION AND MUNICIPAL RE, PLUMBING, BUILDING AND WATER DEPARTMENTS.	
	U.L. AND/OR FM APPROVED EQUIPMENT TO BE USED.	
14.	WORK TO BE IN ACCORDANCE WITH MUNICIPAL WATER DEPT. RULES SYSTEM IS TO BE MAINTAINED AND TESTED BY THE OWNER OR HIS AGENT IN ACCORDANCE WITH APPLICABLE	
	CAL AND STATE CODES AND IN CONFORMANCE WITH NFPA 13A, LATEST EDITION. IF BUILDING OCCUPANCY OR CONSTRUCTION CHANGES, THE SPRINKLER SYSTEM IS TO BE UPDATED	
_	CORDINGLY BY THE OWNER OR HIS AGENT.	
PE	THE ENGINEER IS NOT RETAINED FOR SUPERVISION.	
18.	THE INSTALLATION OF THIS SYSTEM WILL REQUIRE THE CLOSING OF ONE OR MORE FIRE PROTECTION CONTROL	
TH	LVES. THESE VALVE CLOSURES SHOULD BE CLOSELY COORDINATED WITH THE OWNERS WHO SHOULD CONTACT E LOCAL FIRE DEPARTMENT, INSURANCE INTERESTS, ETC. PRIOR TO VALVE CLOSURES.	
	ACTUAL DESIGN DENSITY MAY EXCEED STANDARDS, HOWEVER, IT IS A MINIMUM TO BE USED BY THE INTRACTOR.	
	ALL ALARMS RELATING TO THE SPRINKLER SYSTEM SHOULD BE ACTIVATED UPON PLACING THE SPRINKLER STEM IN SERVICE.	
	THE INSTALLATION COMPONENTS, SIZING, SPACING, MATERIALS LOCATION CLEARANCES, POSITION AND TYPE SYSTEM SHALL CONFORM TO NFPA 13 AND NYS UNIFORM FIRE PREVENTION BUILDING CODE LATEST EDITION.	
	SPRINKLERS SHALL BE PROTECTED AGAINST FREEZING AND INJURY AS PER NFPA CODE.	
	INSPECTION AND TESTS OF SPRINKLER SYSTEM SHALL BE CONDUCTED AS SPECIFIED IN NFPA CODE. WATER SUPPLY TEST PIPES AND GAUGES SHALL BE PROVIDED AS SPECIFIED IN CHAPTER 2-9 OF NPPA 13.	
FIT	PIPING SPECIFICATIONS, PIPE SCHEDULES, SYSTEM TEST PIPES, PROTECTION AGAINST CORROSION, DAMAGE TINGS, VALVES, HANGERS, SPRINKLERS, GUARDS AND SHIELDS SHALL BE IN ACCORDANCE WITH CHAPTER 3 AND APTER 8 OF NFPA 13, LATEST EDITION. PIPING SHALL BE PAINTED TO PREVENT CORROSION.	
	STOCK OF EXTRA SPRINKLERS WILL BE FURNISHED AS PER CHAPTER 3 OF NFPA 13 (REQUIRED FOR EACH MPERATURE RATING).	
	SPRINKLER ALARMS WILL BE IN ACCORDANCE WITH NFPA 13. SPACING, LOCATION AND POSITION OF SPRINKLERS SHALL BE IN ACCORDANCE WITH CHAPTER 4 OF NFPA 13.	
	ALL PIPING PASSING THROUGH WALLS SHALL COMPLY WITH NFPA FOR FIRE PROOFING.	
	DISTANCE OF SPRINKLERS FROM HEAT SOURCES SHALL BE IN ACCORDANCE WITH TABLE 3-16.6.3 OF NFPA 13.	
_	PROVIDE WATER SUPPLY LETTER WITH FLOW TEST DATA. ALL PIPES PASSING THROUGH FOUNDATION WALLS TO BE PROTECTED.	
33.	ALL VALVES SHALL BE IDENTIFIED AS REQUIRED BY NFPA 13.	
	DRAINAGE TO CONFORM TO CHAPTER 3-11 OF NFPA 13. A ONE PIECE REDUCING FITTING OF GOOD DESIGN SHOULD BE USED WHEREVER A CHANGE IS MADE IN THE SIZE	
OF	PIPE AS PER SECTION 3-12.2.7 OF NFPA 13.	
&Y	ALL VALVES ON CONNECTIONS TO WATER SUPPLIES AND IN SUPPLY TO SPRINKLERS SHALL BE APPROVED O.S. . OR APPROVED INDICATOR TYPE WITH TAMPER SWITCHES.	
	DRAIN VALVES AND TEST VALVES SHALL BE APPROVED TYPE AS PER SECTION 3-14.1.2 OF NFPA 13. HANGERS SHALL BE OF A TYPE APPROVED FOR USE WITH THE PIPE OR TUBE INVOLVED, SPRINKLER PIPING	
SH	OULD BE SUPPORTED BY ADJUSTABLE HANGERS PER NFPA 13, SECTION 3-15.	
CO	NNECTIONS CONSISTING OF A CAPPED NIPPLE 4" LONG ON THE END OF THE CROSS MAIN, AS PER SECTION 3- 8.2 NFPA 13.	
	SPRINKLER SHALL BE AN APPROVED TYPE AS PER SECTION 3-16 OF NFPA 13.	
	TEMPERATURE RATING SHALL COMPLY WITH SEC. 3-16.6 OF NFPA 13. CLEARANCES BETWEEN SPRINKLERS AND STORAGE OR PARTITIONS AS PER NFPA 13, SECTION 4-2.5	
43.	SPACING AND LOCATION OF SPRINKLER SHALL COMPLY WITH CHAPTER 4 NFPA 13.	
	CONTRACTOR TO COORDINATE HIS WORK WITH OTHER TRADES. ONLY EXPERIENCED SPRINKLER MECHANICS TO WORK ON THE SYSTEM.	
	ALL PIPING TO BE A MINIMUM OF 1" UNLESS OTHERWISE NOTED.	
	PROVIDE SHOP DRAWINGS WITH HYDRAULIC CALCULATIONS FOR REVIEW TO LOCAL FIRE MARSHALL AND SURANCE UNDERWRITER AND ENGINEER FOR APPROVAL PRIOR TO INSTALLATION.	SHEE
48.	ALL FIRE PROTECTION EQUIPMENT SHALL BE INSTALLED PER MANUFACTURER'S QUIREMENTS/SPECIFICATIONS.	CXE-F
49.	ALL FIRE PROTECTION EQUIPMENT SHALL BE MOUNTED ON MINIMUM 6" HIGH CONCRETE PAD UNLESS	CXE-F
50.	HERWISE NOTED (PAVER AND CINDER BLOCK IS NOT ACCEPTABLE). PERMIT IS REQUIRED PRIOR TO INSTALLATION, TO INCLUDE SIGNED AND SEALED SHOP DRAWINGS, HYDRAULIC	CXE-F
	LCULATION, SHOP DRAWINGS, MANUFACTURERS INFORMATION ON HEADS AND APPLIANCES, COMPLIANCE WITH PA 13 AND SECTION 903 2020 NYSBC/FC.	
	RECORD DRAWING CERTIFICATION	
	AS BUILT – CHANGES AS NOTED AS BUILT – NO CHAN	NGES
	CONTRACTOR PROJECT COORDINATOR	

SIGNATURE _____


SIGNATURE _____

10.	SHEET NAME		REVISO NO.		DATE	
01	FIRE PROTECTION NOTES, SYMBOLS, ABBREVIATIONS, AND DRAWING L	IST	0		5 -	
11	1 FIRE PROTECTION GROUND FLOOR AND ATTIC DEMOLITION PLAN				(3 <u>11</u>	
21	FIRE PROTECTION GROUND FLOOR AND ATTIC CONSTRUCTION RCP		0			
81	FIRE PROTECTION DETAILS		0			
	ESTCHESTER COUNTY, NEW YORK ARTMENT OF PUBLIC WORKS AND TRANSPORTATION division of engineering	CONTRACT NUMBER 22-523 Dwg No.: 289 of 66	SHEET NUMBER CXE-FP-0	1		
INFRASTRUCTURE REHABILITATION - PHASE 3 PLAYLAND PARK, RYE, NEW YORK CROSS AXIS BUILDING E FIRE PROTECTION NOTES, SYMBOLS, ABBREVIATIONS & DWG LIST		SCALE: AS INDICA				
		DPW FILE Number 1-118-F	P-1038-0	REV. NO.	0	

REVISON

REVISION

FIRE PROTECTION DRAWING LIST

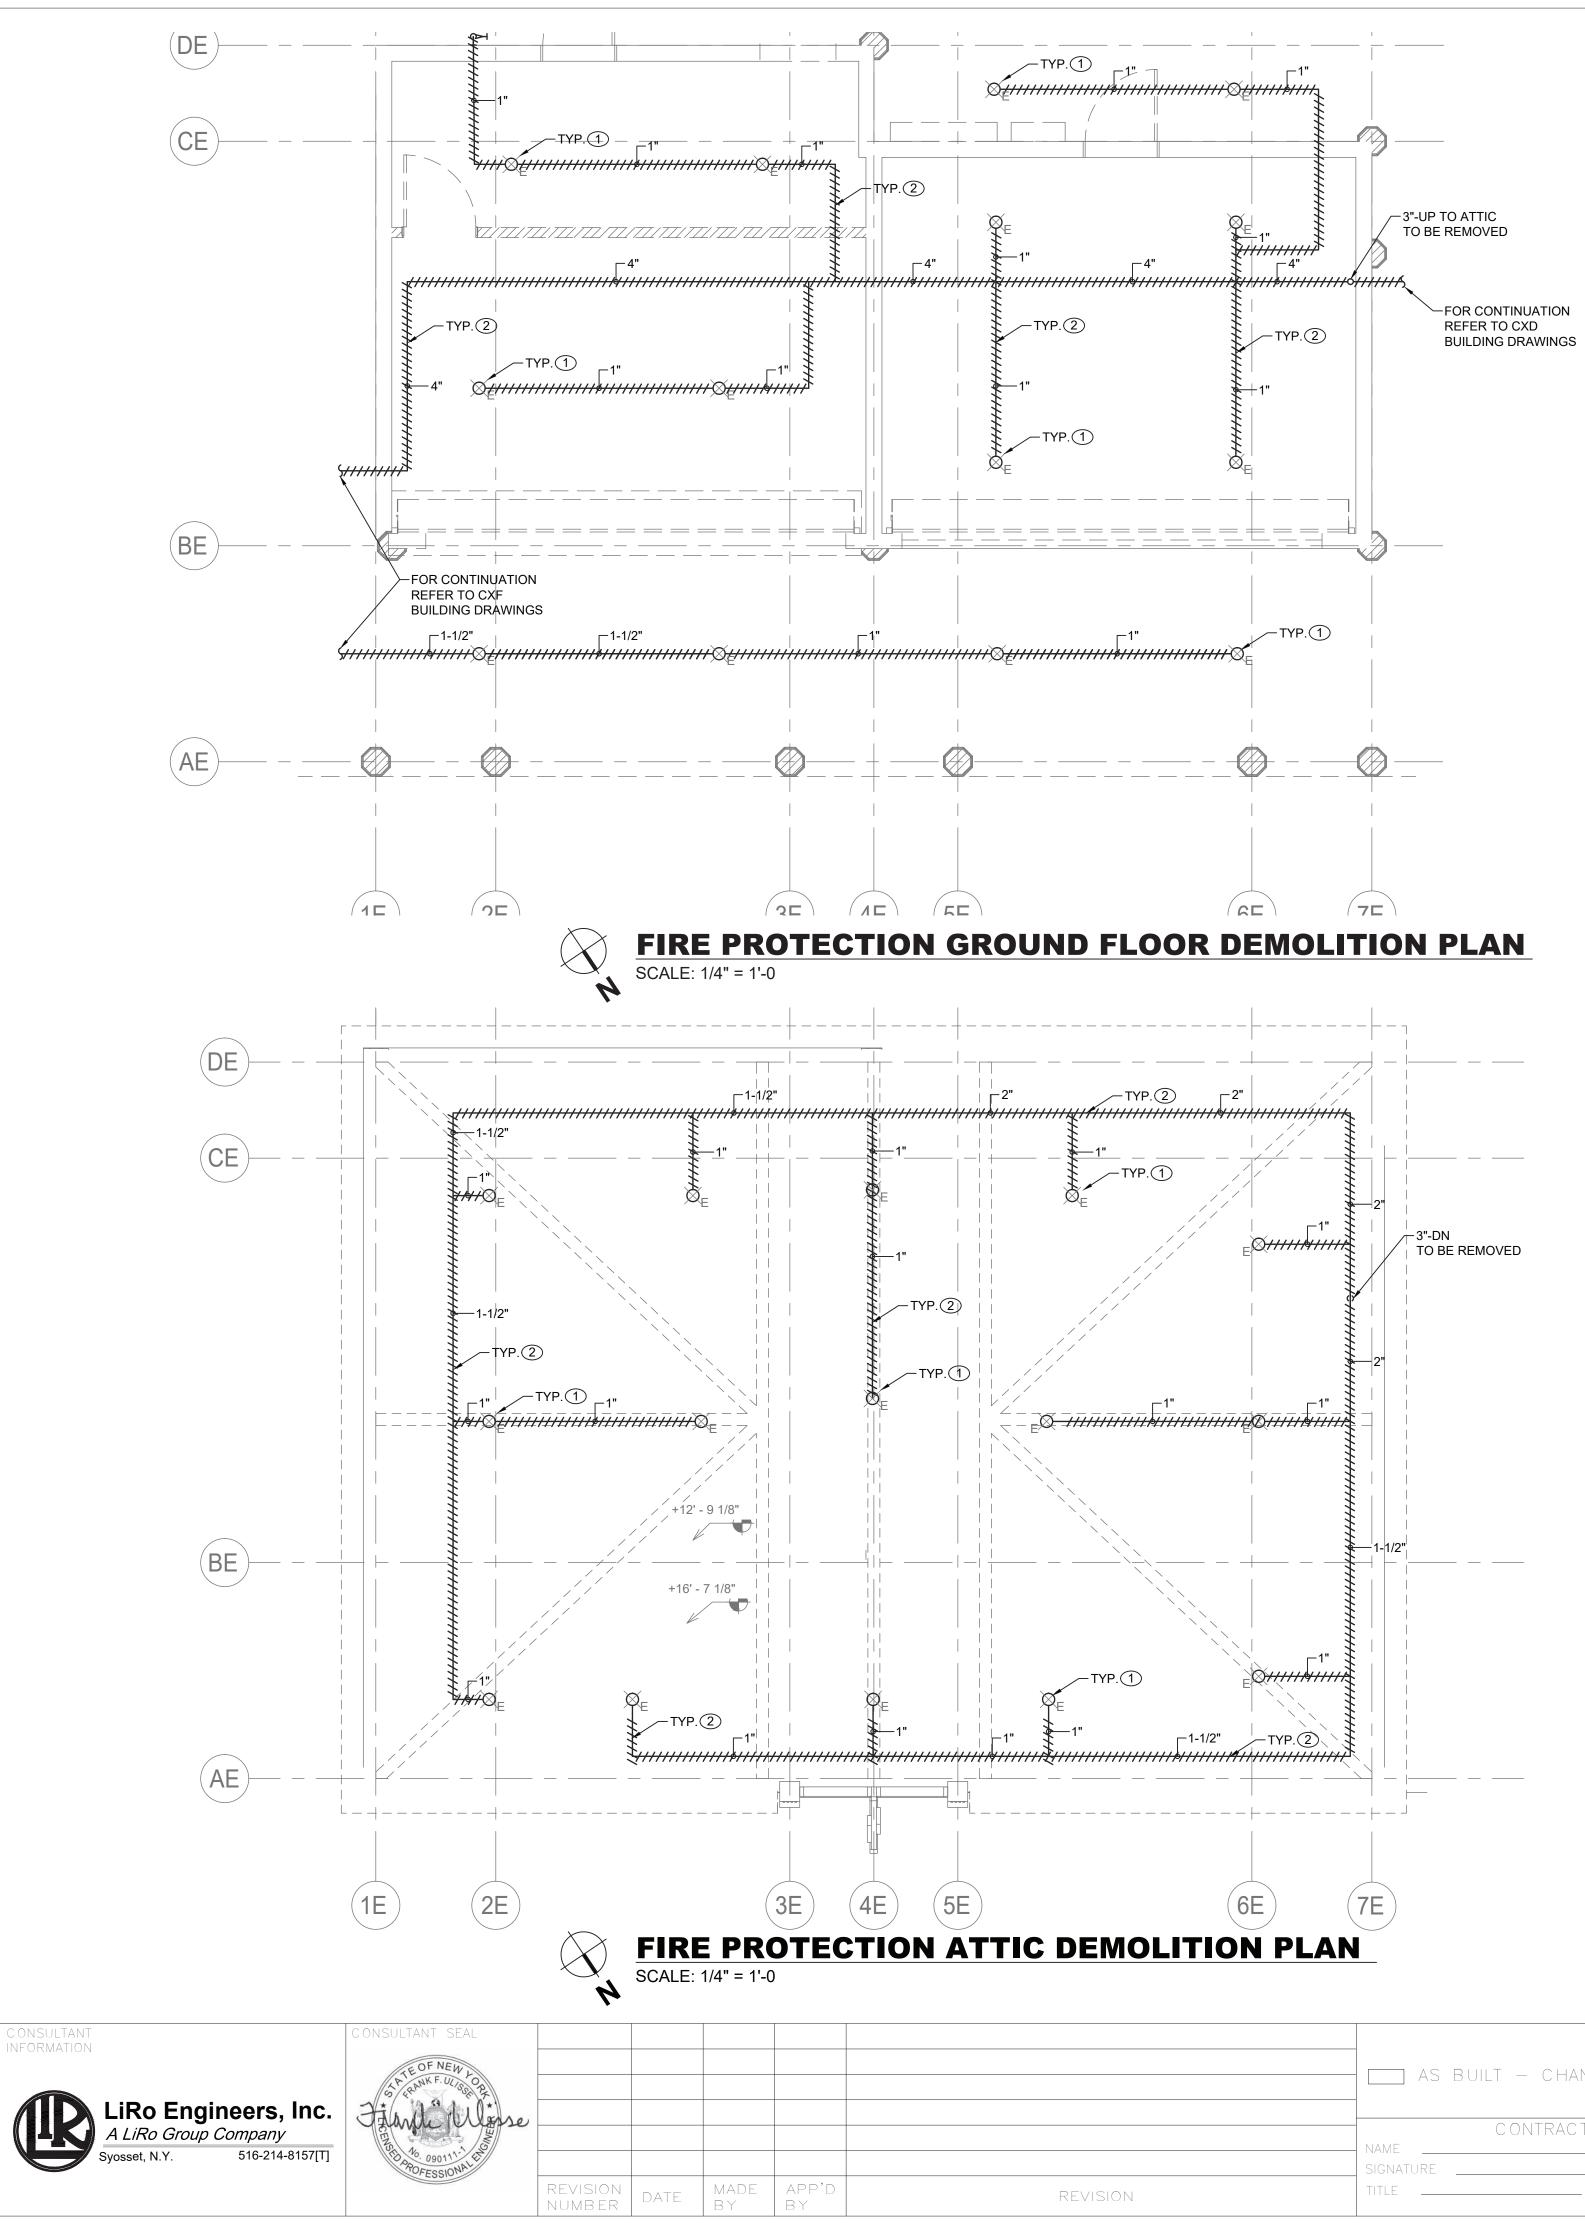

		RECORD DRAWING CERTIFICATION			
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	C ONTRAC	TOR	PROJEC	CT COORDINATOR	
	SIGNATURE		SIGNATURE		
REVISION	TITLE	_ DATE	TITLE	DATE	

SPRINKLER DEMOLITION NOTES:

(1) DEMOLISH ALL EXISTING SPRINKLER HEADS WITHIN THE CXE BUILDING.

(2) DEMOLISH ALL EXISTING DRY SPRINKLER PIPING WITHIN THE CXE BUILDING INCLUDING ATTIC SPACE.


GENERAL NOTES:

1. COORDINATE WITH FACILITY PRIOR TO SHUTDOWN OF FIRE PROTECTION SYSTEM FOR ANY DEMOLITION AND CONSTRUCTION WORK.

2. CONTRACTOR SHALL PROVIDE FIRE WATCH AS NEEDED FOR THE DEPENDENT BUILDINGS BY THE DEMOLITION AND CONSTRUCTION WORK WHILE SPRINKLER COVERAGE IS IMPACTED.

3. CONTRACTOR TO COORDINATE WITH FACILITY WHEN WORKING AROUND OR ABOVE THE RIDE COMPONENTS, AND PROVIDE ALL NECESSARY MEASURES TO PROTECT THESE COMPONENTS PER THE REQUIREMENTS OF THE FACILITY.

STCHESTER COUNTY, NEW YORK	C ONTRAC T NUMB ER	SHEET NUMBER
RTMENT OF PUBLIC WORKS AND TRANSPORTATION	22-523	CXE-FP-11
DIVISION OF ENGINEERING	DWG NO.: 290 of 66	64
INFRASTRUCTURE REHABILITATION - PHASE 3	SCALE: AS INDICA	TED
PLAYLAND PARK, RYE, NEW YORK CROSS AXIS BUILDING E	DATE: 08/23/2022	
FIRE PROTECTION GROUND FLOOR AND ATTIC DEMOLITION PLAN	DPW FILE NUMBER 1-118-FF	P-1039-0 REV. 0

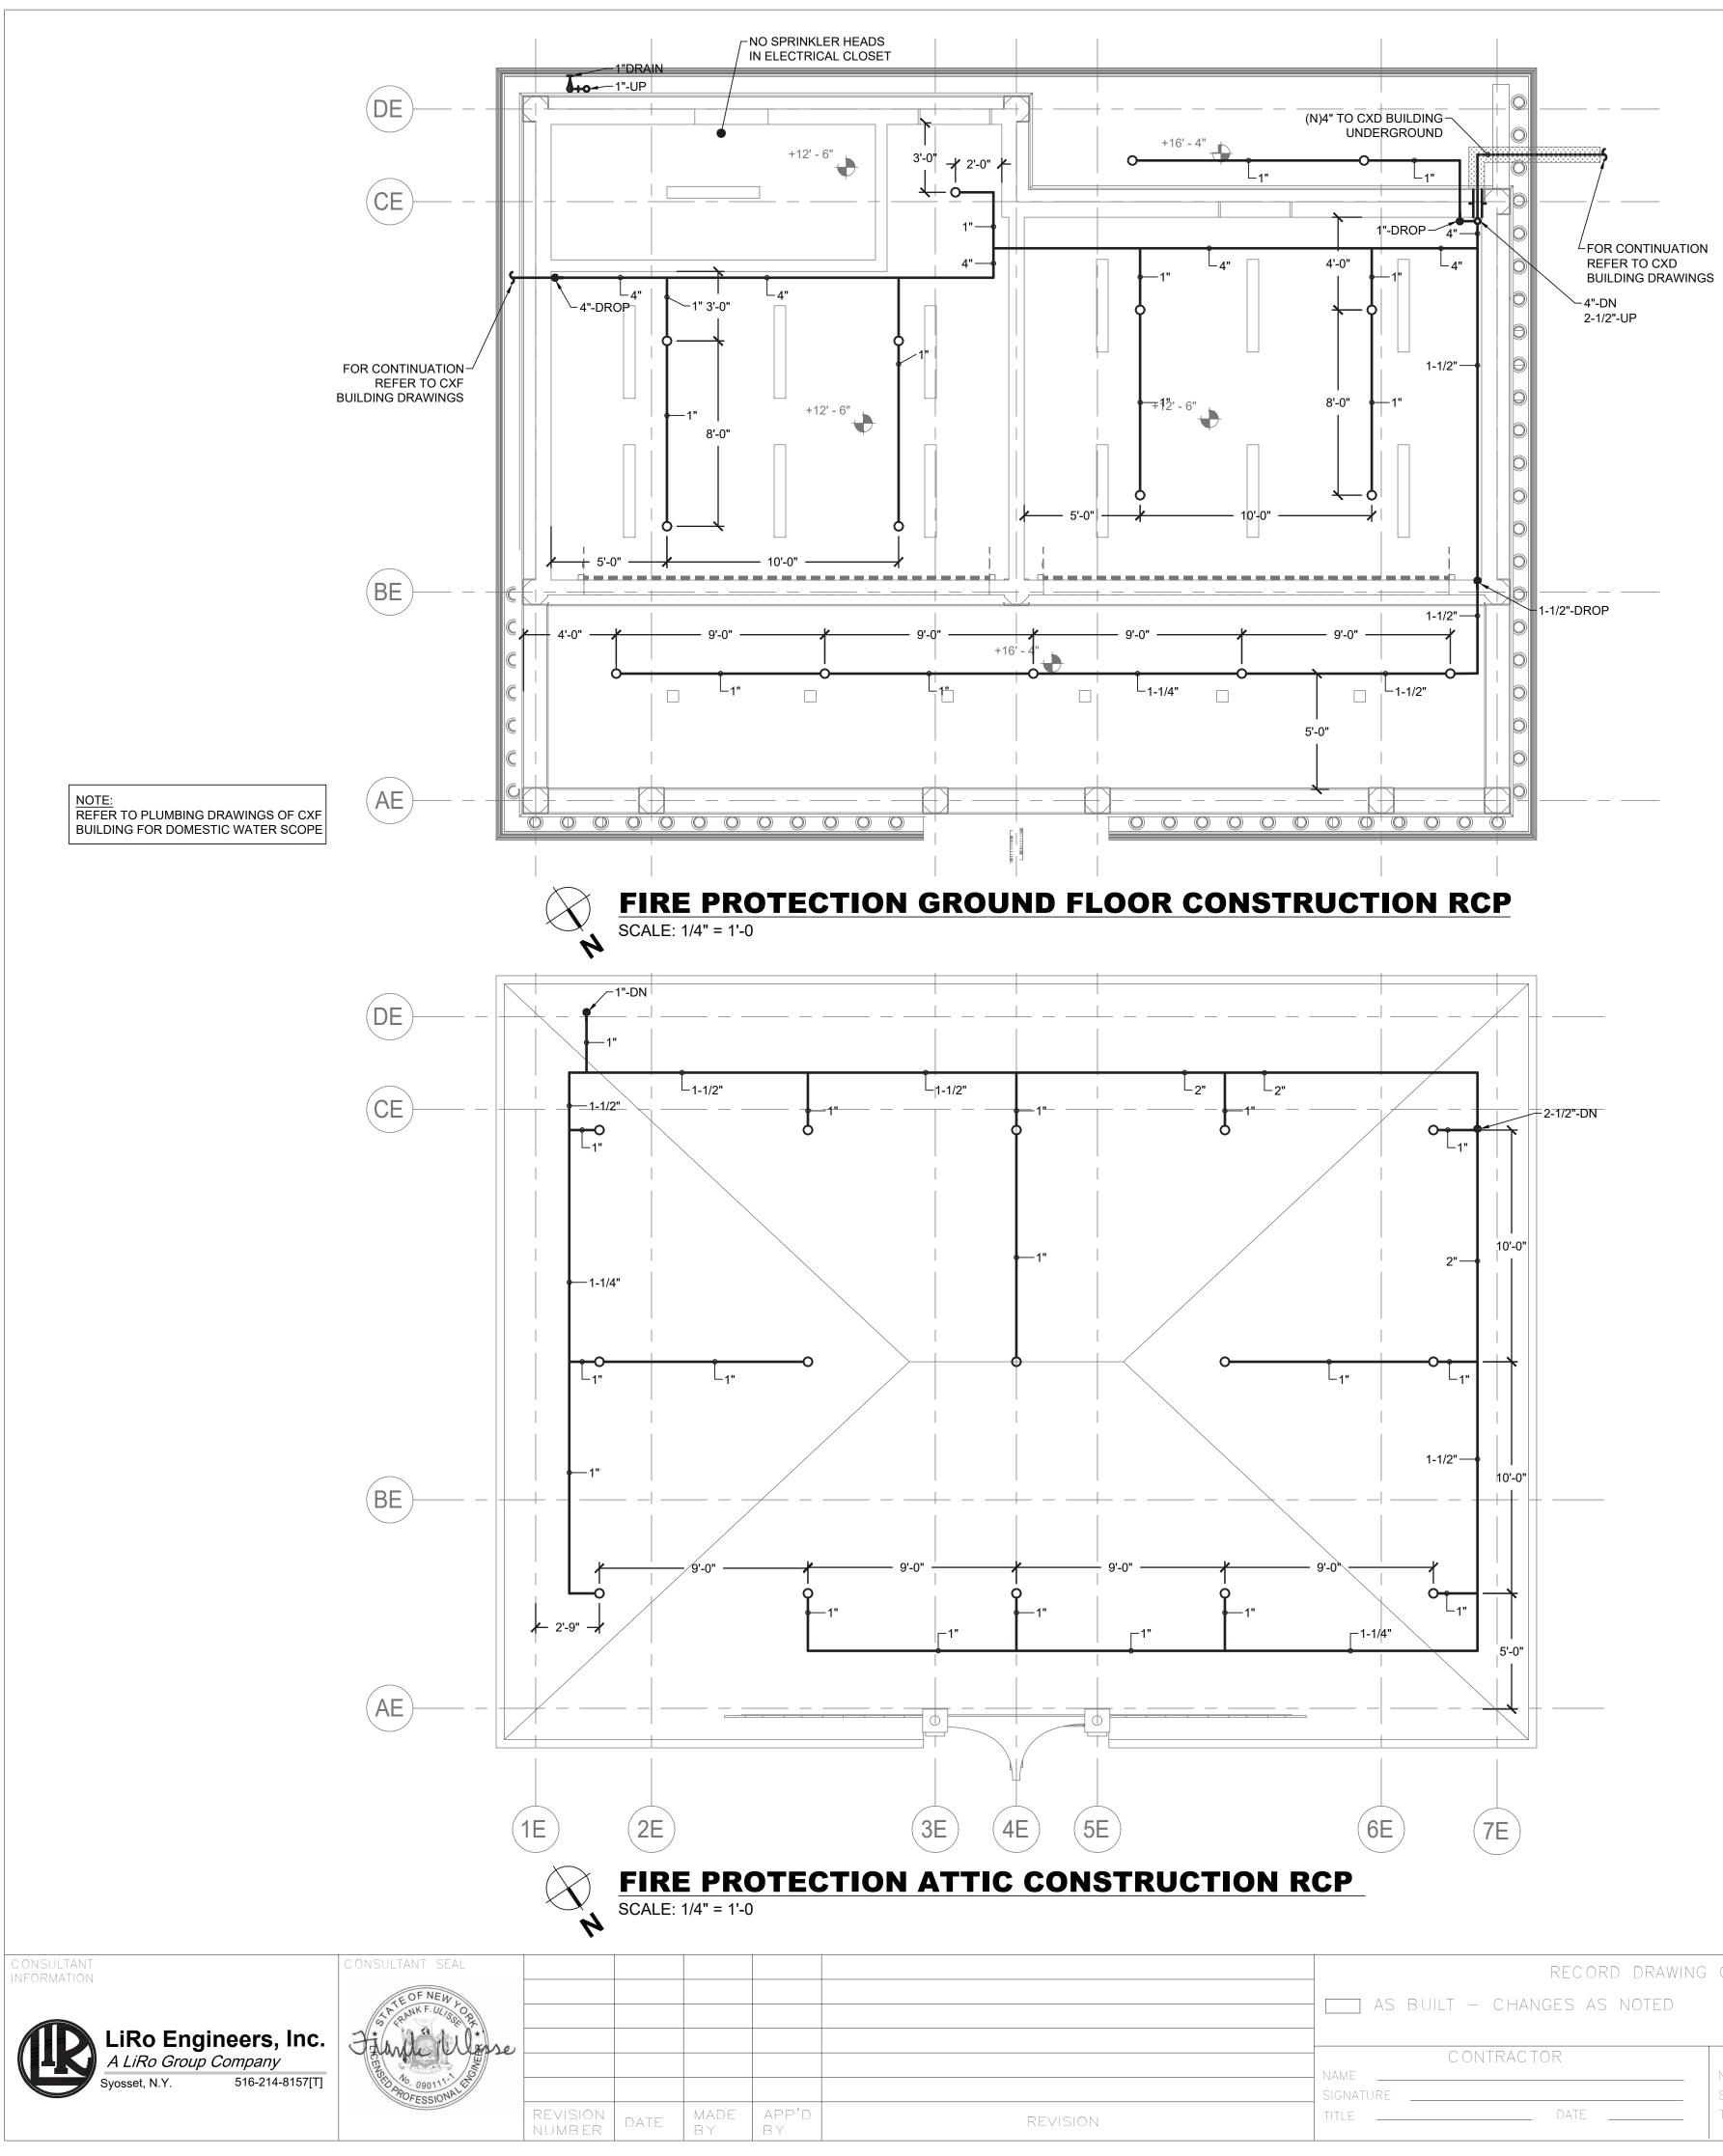


	RECORD	RECORD DRAWING CERTIFICATION			
	AS BUILT – CHANGES AS	NOTED AS BUILT -	NO CHANGES DEPAR		
	CONTRACTOR	PROJECT COORD	INATOR		
	SIGNATURE	SIGNATURE			
REVISION	TITLE DATE	TITLE	DATE		

GENERAL NOTES:

- 1. ALL DISTRIBUTION PIPING, SHALL BE PAINTED. REFER TO SPECIFICATION FOR PAINT TYPE AND APPLICATION PROCEDURE.
- 2. COORDINATE WITH FACILITY PRIOR TO SHUTDOWN OF FIRE PROTECTION SYSTEM FOR ANY DEMOLITION AND CONSTRUCTION WORK.
- 3. CONTRACTOR SHALL PROVIDE FIRE WATCH AS NEEDED FOR ALL AFFECTED BUILDINGS WHILE SPRINKLER COVERAGE IS IMPACTED.
- 4. CONTRACTOR TO COORDINATE WITH FACILITY WHEN WORKING AROUND OR ABOVE THE RIDE COMPONENTS, AND PROVIDE ALL NECESSARY MEASURES TO PROTECT THESE COMPONENTS PER THE REQUIREMENTS OF THE FACILITY.
- 5. UPON COMPLETION, SYSTEM SHALL BE TESTED FOR PROPER OPERATION.
- 6. PROVIDE REQUIRED PITCH AND DRAINS FOR DRY SPRINKLER PIPING FOR FULL WATER REMOVAL FROM THE SYSTEM.

ESTCHESTER COUNTY, NEW YORK ARTMENT OF PUBLIC WORKS AND TRANSPORTATION	contract number 22-523	SHEET NUMBER CXE-FP-21
DIVISION OF ENGINEERING	DWG NO.: 291 of 66	64
INFRASTRUCTURE REHABILITATION - PHASE 3	SCALE: AS INDICA	ATED
PLAYLAND PARK, RYE, NEW YORK CROSS AXIS BUILDING E	DATE: 08/23/2022	
FIRE PROTECTION GROUND FL. AND ATTIC CONSTRUCTION RCP	DPW FILE NUMBER 1-118-FF	P-1040-0 REV. 0

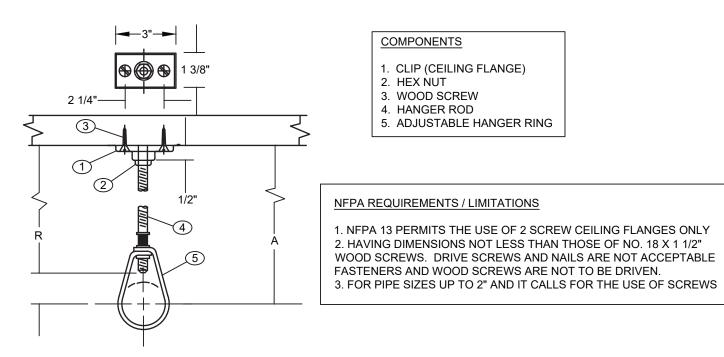

DESIGN DATA FOR CLIP HANGERS

NOMINAL PIPE	MINIMUM A DIMENSION	HANGER TAKEOUT	ROD DIAMETER	FASTENERS	
SIZE	INCHES	INCHES	INCHES	QTY	ITEMS
1/2	3 3/4	-1 1/4	3/8	1 2 1	3/8" CEILING FLANGE (CLIP) NO. 18 X 1 1/2" FLAT HEAD WOOD SCREWS 3/8" HEX NUT
3/4 1 1 1/4 1 1/2 2	3 3/4 3 3/4 4 4 4 1/4	-1 1/4 -1 1/4 -1 1/2 -1 1/2 -1 3/4			SEE ABOVE " " " " " "




CONSULTANT INFORMATION







REVISION NUMBER	DATE	MADE B Y	APP'D By	

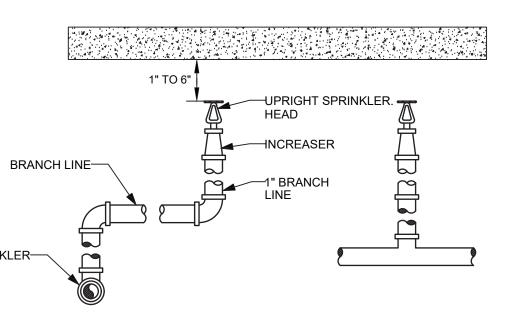


² UPRIGHT SPRINKLER DETAIL

FP-81 / SCALE: NOT TO SCALE

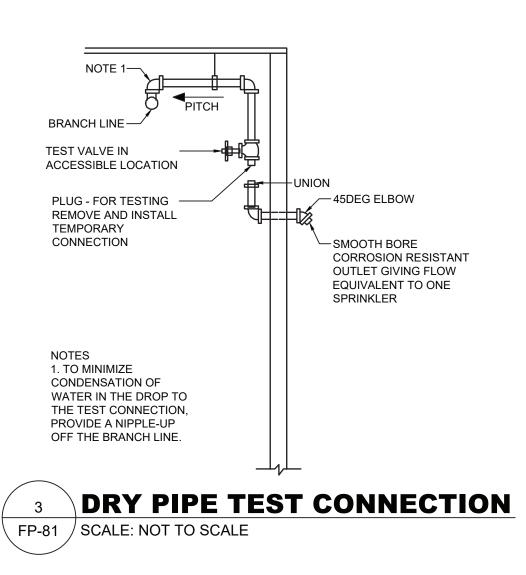

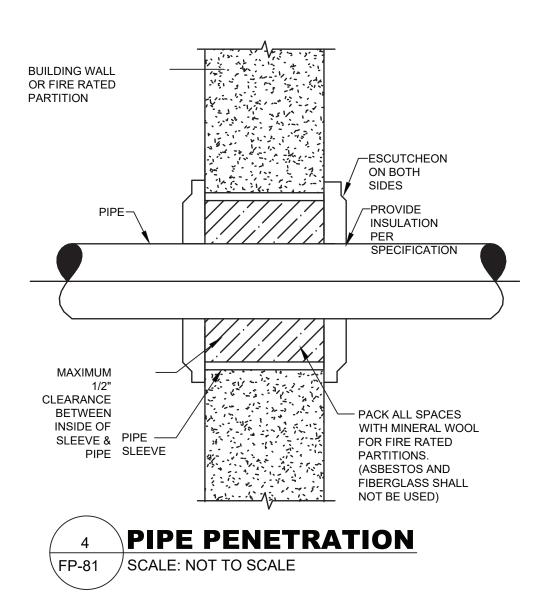

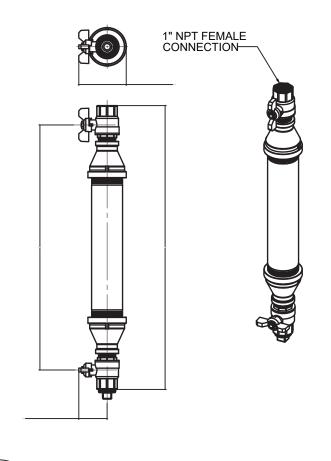



REVISION	TITLE DATE	TITLE DATE	FIRE PROTECTION DETAILS	DPW FILE 1-118-FP-1041-0 REV NO.	· 0
	SIGNATURE	SIGNATURE	PLAYLAND PARK, RYE, NEW YORK CROSS AXIS BUILDING E	DATE: 08/23/2022	
	C ONTRAC TOR	PROJECT COORDINATOR	INFRASTRUCTURE REHABILITATION - PHASE 3	SCALE: AS INDICATED	
			DIVISION OF ENGINEERING	DWG NO.: 292 of 664	
	AS BUILT – CHANGES AS	NOTED AS BUILT – NO CHANGES	DEPARTMENT OF PUBLIC WORKS AND TRANSPORTATION	22-523 CXE-FP-81	
	RECORD	DRAWING CERTIFICATION	WESTCHESTER COUNTY, NEW YORK	CONTRACT SHEET NUMBER NUMBER	

ECHANICAL GENERAL NOTES	MECHANICAL DEMOLITIC
ALL WORK AND MATERIALS SHALL BE PURCHASED AND INSTALLED IN ACCORDANCE WITH ALL NATIONAL & NEW YORK STATE CODES AND REGULATIONS (AS WELL AS ALL APPLICABLE LOCAL CODES & REGULATIONS). THE CONTRACTOR SHALL BE RESPONSIBLE TO ENSURE THAT ALL HVAC WORK	1. CONTRACTOR SHALL BE RESPONSIBLE FOR DEMOLITION OF M EQUIPMENT AND MATERIAL RELATING TO THEIR RESPECTIVE TR 2. THE CONTRACTOR SHALL REMOVE, RELOCATE, REPLACE, ADJ
IS PROVIDED AND INSTALLED IN STRICT ACCORDANCE WITH SEISMIC REQUIREMENTS.	MODIFY EXISTING EQUIPMENT AND/OR SYSTEMS AS REQUIRED V UNCOVERED AND FOUND TO INTERFERE WITH COMPLETION OF V CONTRACT OR OTHER CONTRACT WORK.
DO NOT SCALE FROM THESE DRAWINGS.	3. EXECUTE THE DEMOLITION IN CAREFUL AND ORDERLY MANNE
SHALL BE FIELD VERIFIED AND COORDINATED WITH ALL OTHER MECHANICAL, ELECTRICAL, PLUMBING, FIRE SPRINKLER, ARCHITECTURAL AND STRUCTURAL SYSTEMS. DURING SHOP DRAWINGS SUBMISSIONS, SHOW ALL MOUNTING	 POSSIBLE DISTURBANCE TO THE PUBLIC, EGRESS OR THE FUNC EXISTING BUILDING. 4. TAKE NECESSARY PRECAUTIONS TO PREVENT DUST AND DIRT
VERIFY ALL EQUIPMENT VOLTAGES WITH THE ELECTRICAL DESIGN PRIOR TO	5. PRIOR TO DEMOLISHED DEBRIS. EXCESSIVE USE OF WATER WILL
ORDERING EQUIPMENT. PROVIDE PHASE LOSS PROTECTION FOR ALL POLY-PHASE MOTOR DEVICES.	TO BE REMOVED, SHOULD THE OWNER WANT TO KEEP ANY MAT CONTRACTOR SHALL REMOVE AND DELIVER THE PARTS TO THE WHERE SO DIRECTED. OTHERWISE ALL DEMOLISHED OR REMOV BECOME THE PROPERTY OF THE CONTRACTOR AND SHALL BE R
DUCTWORK SHALL BE CONSTRUCTED OF GALVANIZED SHEET STEEL IN STRICT COMPLIANCE WITH THE LATEST EDITION OF THE ASHRAE, NFPA, AND SMACNA GUIDE RECOMMENDATIONS. ALL DUCTS TO HAVE PITTSBURGH TYPE LOCK FOR LONGITUDINAL SEAMS AND DRIVE SLIP / "S" SLIP FOR TRANSVERSE JOINTS.	SITE AND BE DISPOSED OF IN A LEGAL MANNER. 6. DEMOLITION SHALL INCLUDE REMOVAL OF ALL PARTS AND PIE ENTIRETY BACK TO POINTS INDICATED OR IF NOT INDICATED
"DUCT-MATE" JOINT SYSTEM IS ACCEPTABLE IN LIEU OF PRIOR SEAM SYSTEMS. SIZES AS SHOWN INDICATE INSIDE CLEAR DIMENSIONS OF THE AIR PASSAGE. DUCTWORK SHALL BE FULLY INSULATED AS PER APPLICABLE CODES AND WRITTEN SPECIFICATIONS.	BACK TO THEIR POINT OF SOURCE. 7. WHERE CONDITIONS PROHIBIT TOTAL REMOVAL OF THE WORK PORTION SHALL BE CUT FLUSH WITH THE SURROUNDING SURFA
DUCT SIZES MUST BE VERIFIED FOR CLEARANCES AT THE JOB SITE PRIOR TO FABRICATION. DIMENSIONS MAY BE CHANGED TO ACCOMMODATE CONSTRUCTION AS LONG AS EFFECTIVE CROSS-SECTIONAL AREA IS	 PLUGGED OR SEALED AND THE SURROUNDING SURFACE SHALL APPROVED MANNER. 9. DO NOT REMOVE EXISTING STRUCTURAL WORK. DO NOT REM
TO 4". ALL DEVIATIONS FROM ORIGINAL CONTRACT DRAWINGS SHALL BE REVIEWED BY ENGINEER DURING THE SHOP DRAWING PROCESS.	OPERATIONAL ELEMENTS AND SAFETY-RELATED COMPONENTS MANNER RESULTING IN A REDUCTION OF CAPACITIES TO PERFO INTENDED OR RESULTING IN DECREASED OPERATIONAL LIFE, IN MAINTENANCE, OR DECREASED SAFETY.
EACH INDIVIDUAL AIR DISTRIBUTION SYSTEM. IF THE LOCATION OF THE BALANCING DAMPER IS NOT DEFINED ON THE DRAWINGS, THE FOLLOWING MINIMUMS STANDARDS SHALL GOVERN. ALL SUPPLY, RETURN, AND EXHAUST MAIN BRANCHES FROM TRUNKS, EACH SPLIT AND ALL SUB- BRANCHES FROM	10. REMOVALS, DISCONNECTIONS, AND RELOCATIONS SHALL BE PERFORMED BY WORKMEN SKILLED IN THE TRADE INVOLVED AN BY A CONTRACTOR LICENSED IN THE TRADE INVOLVED. ALL WO ACCORDANCE WITH ACCEPTED TRADE PRACTICES.
MAIN SHALL INCORPORATE BALANCING DAMPERS. PROVIDE FLEXIBLE CONNECTORS AT ALL DUCT CONNECTIONS TO VIBRATING EQUIPMENT. THESE CONNECTORS SHALL BE INSTALLED IN CLOSE PROXIMITY	11. PROVIDE ADEQUATE TEMPORARY SUPPORT FOR WORK TO R FAILURE. DO NOT ENDANGER OTHER WORK.
TO SUCH EQUIPMENT. PROVIDE FIRE DAMPERS WITH RATED ACCESS DOORS AT ALL DUCT PENETRATIONS THROUGH FIRE RATED WALLS, SMOKE AND FIRE STOPPING, SHAFT, FLOORS, RATED CEILINGS AND PARTITIONS AS REQUIRED TO MAINTAIN	12. PROTECTION: PROVIDE ADEQUATE PROTECTION WHERE REC PRESENT BUILDING AND ITS CONTENTS. TEMPORARY DUSTPROC BARRICADES SHALL BE ERECTED WHERE REQUIRED FOR PROTE PROTECTION FROM DUST AND DIRT, FOR SECURITY, FIRE AND WEATHER PROTECTIVE REASONS.
ARCHITECTURAL FIRE RATINGS. REFER TO THE ARCHITECTURAL PLANS AND SPECIFICATIONS FOR LOCATIONS AND FIRE RATING REQUIREMENTS. CONTRACTOR MUST FULLY REVIEW ALL ARCHITECTURAL AND ENGINEERING DRAWINGS AND VISIT THE SITE PRIOR TO SUBMITTING THE BID. NO EXTRAS	13. CONTRACTOR SHALL TAKE EVERY PRECAUTION AGAINST FIR DEPARTMENT TYPE HOSES AND PORTABLE FIRE EXTINGUISHERS OSHA AND/OR THE OWNER'S INSURANCE UNDERWRITER.
ALL ACCESS DOORS REQUIRED IN GENERAL CONSTRUCTION ARE TO BE PROVIDED AND INSTALLED BY THE CONTRACTOR. IT IS THE RESPONSIBILITY	14. BEFORE STARTING DEMOLITION OPERATIONS, PROVIDE THE NECESSARY PROTECTIVE DEVICES, WHERE REQUIRED, AND IN S WITH OSHA RULES AND REGULATIONS.
FOR PROPER ACCESS TO ALL CONCEALED HVAC EQUIPMENT, VALVES AND OTHER RELATED EQUIPMENT. THE CONTRACTOR SHALL IDENTIFY THESE REQUIREMENTS ON A COORDINATED SHOP DRAWING PRIOR TO SYSTEM	14. USE TEMPORARY ENCLOSURES, OR OTHER SUITABLE METHO DIRT RISING AND SCATTERING TO LOWEST PRACTICAL LEVEL. C GOVERNING REGULATIONS PERTAINING TO ENVIRONMENTAL PR
ALL CEILING MOUNTED EQUIPMENT MUST BE SUPPORTED DIRECTLY FROM	15. FIELD VERIFY DEMOLITION REQUIREMENTS AND EXISTING CONOTES ARE INDICATED IN NOTE FORM.
HANGERS AND ROD. PROVIDE SUPPLEMENTARY STEEL AS REQUIRED TO ADEQUATELY SUPPORT THE LOAD.	16. CONTRACTOR SHALL ESTABLISH A PATH OF TRAVEL AND TIME REMOVAL OF ALL DEBRIS AND WASTE, AND HAVE THIS APPROVE CONTRACTOR IS TO ENSURE THAT ALL CORRIDORS AND PUBLIC OF OBSTRUCTIONS, DEBRIS, AND ARE TO BE BROOM SWEPT CLE
BALANCING & TESTING COMPANY TO PERFORM THE AIR BALANCING WORK AND ASSOCIATED SYSTEM AIR BALANCING REPORT. ALL WORK SHALL BE PERFORMED IN STRICT COMPLIANCE WITH ALL APPLICABLE CODES, REGULATIONS, PLANS AND WRITTEN SPECIFICATIONS. SUBMIT THE FINAL AIR	17. CONTRACTOR SHALL VISIT THE SITE AND BECOME INFORMED OF THE PREMISES AND THE EXTENT AND CHARACTER OF WORK ADDITIONAL COMPENSATION WILL BE APPROVED DUE TO FIELD (
SUBSTANTIAL COMPLETION OF THE PROJECT, AS DETERMINED BY THE AND OWNER/CLIENT. THE AIR BALANCE REPORT MUST INCLUDE ALL SUPPLY, RETURN, & EXHAUST AIR TERMINALS, FRESH AIR (OUTSIDE AIR) INTAKE AND VENTILATION EXHAUST CFM RATES FOR ALL UNITS. ALSO INCLUDE ACTUAL	NYSECC ENERGY COMPI
SUPPLY & RETURN AIR VELOCITY & STATIC PRESSURE READINGS ALONG WITH ALL MOTOR AMPERAGES FOR ALL UNITS.	STATEMENT:
THE CONTRACTOR IS TO INCLUDE IN THEIR BID ALL LOW VOLTAGE CONTROL WIRING, THERMOSTATS, RELAYS, TRANSFORMERS, STARTERS ETC FOR A COMPLETE OPERATING CONTROL SYSTEM AS DESCRIBED IN THE SEQUENCE OF OPERATIONS, THE CONTRACTOR IS ALSO RESPONSIBLE FOR LINE VOLTAGE CONTROL FOR EXHAUST FANS CONTROLLED FROM LIGHT SWITCH AND THERMOSTATS. ALL CONTROL WIRING IN THE AREAS THAT DO NOT HAVE DROPPED CEILINGS THE CONTRACTOR MUST PROVIDE ALL CONTROL WIRING CONDUIT. IN AREAS OF DROPPED CEILING PLENUM RATED CONTROL WIRING CAN BE RUN EXPOSED ABOVE CEILING	PER SECTION C101.7 OF THE 2020 NYSECC HISTORIC BUILDINGS THE REQUIREMENTS OF THE ENERGY CODE.
ALL MECHANICAL EQUIPMENT SHALL BE INSTALLED PER MANUFACTURER'S REQUIREMENTS/SPECIFICATIONS.	
CODE REFERENCE	
NEW YORK STATE BUILDING CODE	
A PERTER A CONTRACT DE CONTRACT DE CONTRACTOR A	ACCORDANCE WITH ALL NATIONAL & NEW YORK STATE CODES AND REGULATIONS (IS WIELL & SALL APPLICABLE LOCAL CODES & REGULATIONS), FHE CONTRACTOR SHALL BE RESPONSIBLE TO ENSURE THAT ALL HVAC WORK IS PROVIDED AND INSTALLED IN STRICT ACCORDANCE WITH SEISMIC REGUREMENTS. DO NOT SCALE FROM THESE DRAWINGS. THE EXACT MOUNTING HEIGHTS AND LOCATIONS OF ALL HVAC EQUIPMENT SHALL BE FIELD VERIFIED AND COORDINATED WITH ALL OTHER MECHANICAL, ELCRIRCAL, PUMBING, FREE SPRINKLER, ARCHITECTURAL AND STRUCTURAL SYSTEMS. DURING SHOP DRAWINGS SUBMISSIONS. SHOW ALL MOUNTING HEIGHTS OF DURING SHOP DRAWING SUBMISSIONS. SHOW ALL MOUNTING HEIGHTS OF DURING SHOP DRAWINGS SUBMISSIONS. SHOW ALL MOUNTING HEIGHTS OF DURING. THE SHIFT AND ALL MOUNTING HEIGHTS OF DURING. THE ASH MARK AND STRUCTED SOMELMACE WITH THE LATEST EDITION OF THE ASHRAE. INFPA, AND SMACNA ONCOURD FHASE LOSS PROTECTION FOR ALL POLY-PHASE MOTOR DEVICES. DUCTWORK SHALL BE CONSTRUCTED OF GALVANIZED SHEET STEEL IN STRUCT COMPLIANCE WITH THE LATEST EDITION OF THE ASHRAE. INFPA, AND SMACNA ONCOURT UNAL SHAS AND DRIVE LIPP 17% SUBMISSIONS OF THE ARP PASSAGE. DUCTWORK SHALL BE FULLY INSULATED AS PER APPLICABLE CODES AND WITTEN SPECIFICATIONS. DUCT STANSTOND ON MAY BE OF ARAPCILCABLE CODES AND WITTEN SPECIFICATIONS. DUCT STANSTOND SHALL BE CONSTRUCTED WITH A SLOPE OF 17 TO 4". ALL DEVIATIONS MAY BE CHANGED TO ACCOMMONATE HIS UNITANED. DUCT TRANSITIONS SHALL BE CONSTRUCTED WITH A SLOPE OF 17 TO 4". ALL DEVIATIONS MAY BE CHANGED TO ACCOMMONATE HIS UNITANED. DUCT TRANSITIONS SHALL BE CONSTRUCTED WITH A SLOPE OF 17 TO 4". ALL DEVIATIONS MAY BE CHANGED TO ACCOMMONATE HIS WITH AND AND HISTRIEUTION SYSTEM. IF THE LOCATION OF THE CARANING MANUTE BE SUPPORTED DRAWINGS SHALL BE EVERTIME ON TREAL DRAWING CONTRACT ANA SLOPE CONTRACTOR MUST TRANSITIES

CONSULTANT INFORMATION



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ED AS TO THE CONDITION RK REQUIRED. NO D CONDITIONS.

LIANCE

S ARE EXEMPT FROM

HVAC S	YMBOL LIST
IDENTIFIER	DESCRIPTION
22	NEW DUCTWORK OR PIPING
\$++++++++5	EXISTING DUCTWORK OR PIPING TO BE REMOVED
۶	EXISTING DUCTWORK OR PIPING TO REMAIN
24X12 5 24X12 5 24X12 5	DOUBLE-LINE AND SINGLE-LINE RECTANGULAR DUCT, FIRST NUMBER INDICATES SIDE IN VIEW IN INCHES, SECOND NUMBER INDICATES SIDE IN DEPTH IN INCHES
·····	FLEXIBLE DUCTWORK
	REGULAR SUPPLY AIR DUCT (UP AND DOWN)
	REGULAR RETURN AIR DUCT (UP AND DOWN)
	REGULAR EXHAUST AIR DUCT (UP AND DOWN)
	REGULAR OUTSIDE AIR DUCT (UP AND DOWN)
VD	VOLUME DAMPER
— — — BD	BACKDRAFT DAMPER
<u>Bar</u>	MOTOR OPERATED DAMPER
XXX XX	— EQUIPMENT TAG — EQUIPMENT NUMBER
XXX X-XXX	 DETAIL TAG/CALL OUT TAG MECHANICAL SHEET NUMBER
T	THERMOSTAT
	EXHAUST GRILLE
F#	REFER TO SUPPLEMENTAL FIGURE INDICATED BY NUMBER (I.E. F2 REFERS TO FIGURE 2)

HVAC ABBREVIATIONS

	DESCRIPTION
AC	DIRECT EXPANSION AIR CONDITION UNIT
CFM	CUBIC FEET PER MINUTE
COND	CONDENSATE
CU	CONDENSING UNIT
CUH	CABINET UNIT HEATER
DB	DRY BULB
DN	DOWN
EA	EXHAUST AIR
EF	EXHAUST FAN
EG	EXHAUST GRILLE
EUH	ELECTRIC UNIT HEATER
EER	ENERGY EFFICIENCY RATIO
EG	EXHAUST GRILLE
FAI	FRESH AIR INTAKE
GC	GENERAL CONTRACTOR
MBH	THOUSAND BTU PER HOUR
PC	PLUMBING CONTRACTOR
RG	RETURN GRILLE
RGL	REFRIGERANT GAS LINE
RLL	REFRIGERANT LIQUID LINE
RTU	ROOFTOP UNIT
SA	SUPPLY AIR
SD	SUPPLY DIFFUSER
TYP.	TYPICAL
VIF	VERIFY IN FIELD


SCOPE OF WORK

DEMOLITION 1. REMOVE ONE (1) EXISTING WALL MOUNTED FAN AS INDICATED ON PLANS.

		GCERTIFICATION	WESTCHESTER COUNTY, NEW YORK
	AS BUILT – CHANGES AS NOTED	AS BUILT – NO CHANGES	DEPARTMENT OF PUBLIC WORKS AND TRANSPORTATION Division of engineering
REVISION	CONTRACTOR NAMESIGNATUREDATE	PROJECT COORDINATOR NAME SIGNATURE TITLE DATE	INFRASTRUCTURE REHABILITATION - PHASE 3 PLAYLAND PARK, RYE, NEW YORK CROSS AXIS BUILDING E MECHANICAL NOTES, SYMBOLS AND LEGENDS

MECHANICAL DRAWING LIST				
SHEET NO.	SHEET NAME	REVISON NO.	REVISION DATE	
CXE-M-01	MECHANICAL NOTES, SYMBOLS & LEGENDS	0		
CXE-M-11	MECHANICAL 1ST FLOOR DEMOLITION PLAN	0	-	

C ONTRAC T NUMB ER	SHEET NUMBER			
22-523	CXE-M-01			
DWG NO.: 293 of 664				
SCALE: AS INDICATED				
DATE: 08/23/2022				
DPW FILE NUMBER 1-118-M-4	1042-0 REV. 0			

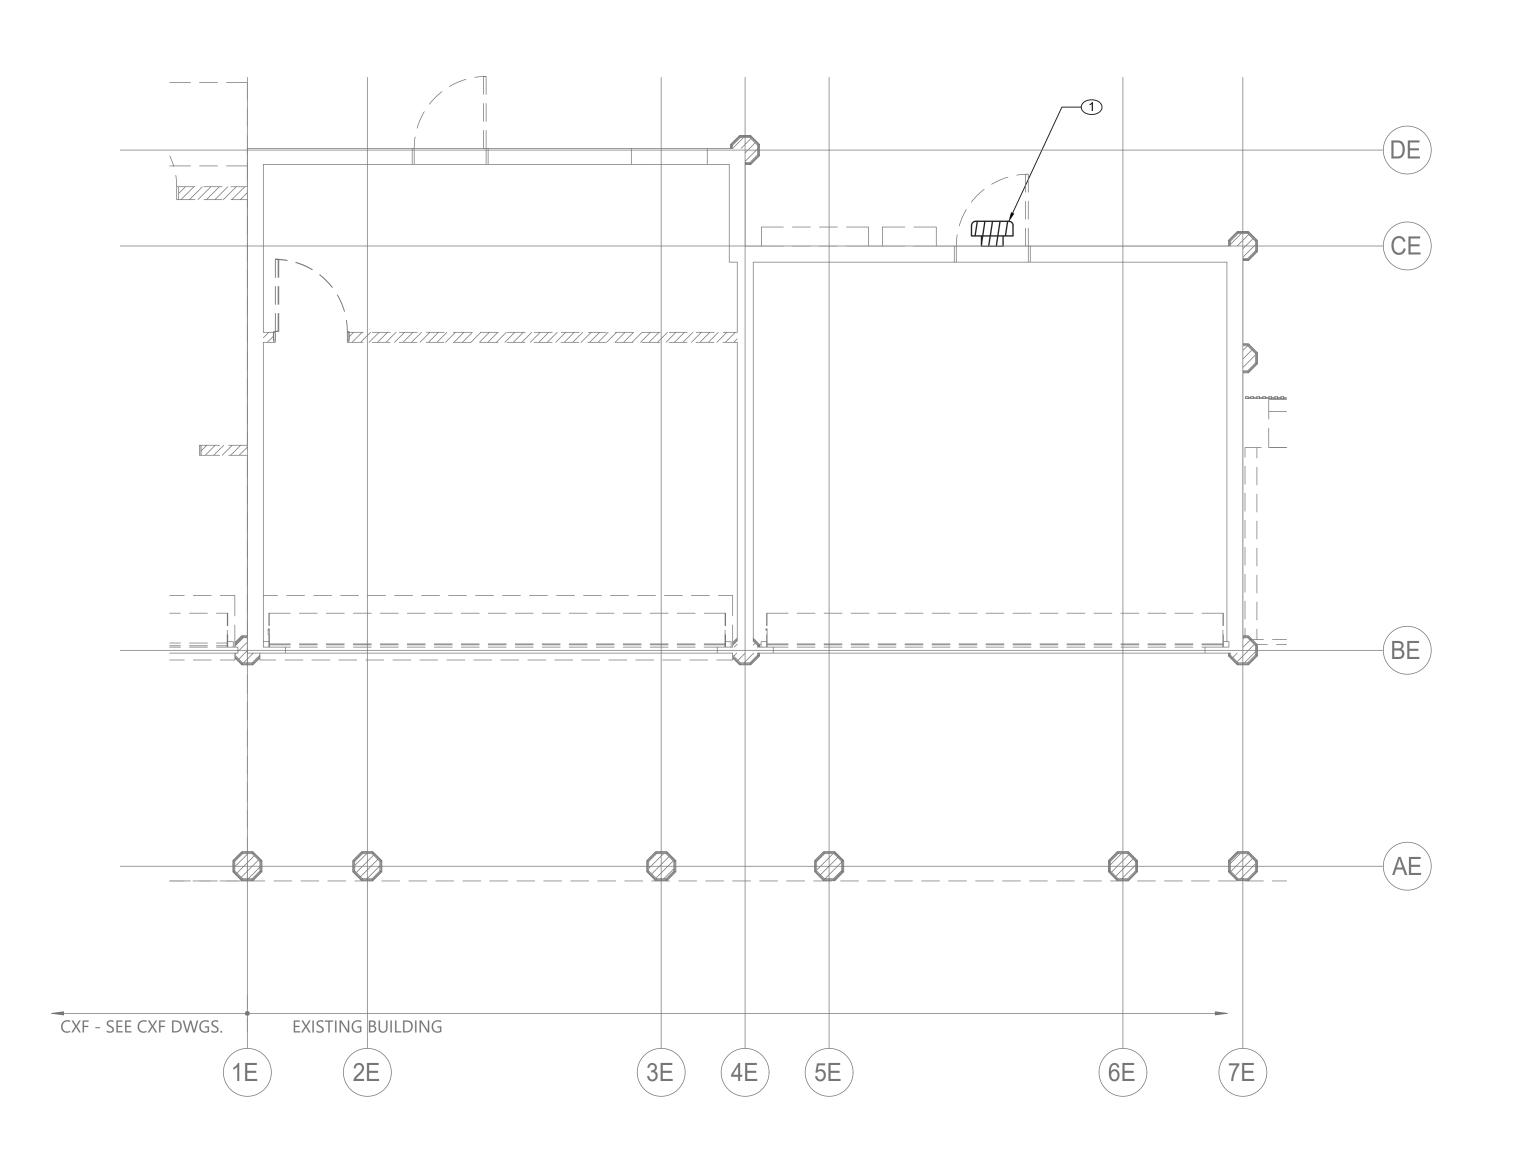



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LiRo Engineers, Inc. A LiRo Group Company	HANNE ULSON					
Syosset, N.Y. 516-214-8157[T]	TO NO. 090111-1 ES	REVISION NUMBER	DATE	MADE By	APP'D BY	F

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	CONTRACTOR NAME	PROJECT COORDINATOR	
REVISION	TITLE DATE	TITLE DATE	

GENERAL NOTES:

1. RETURN REMOVED EXISTING EQUIPMENT TO OWNER IF IT IS IN WORKING CONDITION.

2. CONTRACTOR TO COORDINATE WITH FACILITY WHEN WORKING AROUND OR ABOVE THE RIDE COMPONENTS, AND PROVIDE ALL NECESSARY MEASURES TO PROTECT THESE COMPONENTS PER THE REQUIREMENTS OF THE FACILITY.

MECHANICAL DEMOLITION NOTES:

1 DEMOLISH EXISTING WALL MOUNTED PROPELLER FAN. COORDINATE REMOVAL OF ELECTRICAL POWER AND WIRING WITH ELECTRICAL CONTRACTOR. COORDINATE WITH GC TO SEAL EXISTING WALL PENETRATION.

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INFRASTRUCTURE REHABILITATION - PHASE 3
PLAYLAND PARK, RYE, NEW YORK
CROSS AXIS BUILDING E
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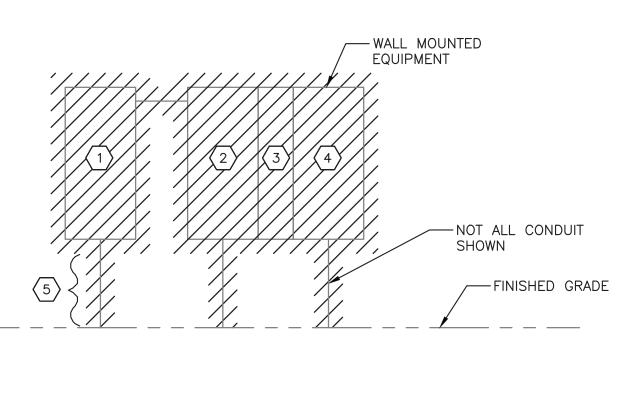
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22-523	CXE-M-11	
DWG NO.: 294 of 66	64	
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DATE: 08/23/2022		
DPW FILE NUMBER 1-118-M-	1043-0 REV.	0

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	RECORD DRAWING		WEST DEPARTN
REVISION	CONTRACTOR NAME	PROJECT COORDINATOR NAME	


NOTES:

- 1. FOR ADDITIONAL NOTES, ABBREVIATIONS AND SYMBOLS, SEE DRAWING GE-E-01.
- 2. CONTRACTOR IS ADVISED THAT LOCATED ON THE SOUTH EXTERIOR ARE FOUR VERY OLD FUSED PANELBOARDS. ALL SHALL BE DISCONNECTED AND REMOVED.
- 3. ACTUAL FEEDER CIRCUITS ARE UNKNOWN AT THIS TIME. CONTRACTOR SHALL TRACE OUT ALL FEEDER CIRCUITS (UNDERGROUND), VERIFY POWER SOURCE (EITHER FROM LOCAL TRANSFORMER OR FROM QUAD #4 ELECTRICAL BUILDING. BE ADVISED PANELS ARE 20 FEET FROM TRANSFORMER AND 35 FEET FROM BUILDING. ONCE VERIFIED, ALL FEEDER CIRCUITS SHALL BE DISCONNECTED AND REMOVED. UNLESS NOTED OTHERWISE, ABANDON UNDERGROUND CONDUIT IN PLACE.
- 4. THERE ARE APPROXIMATELY 25 DISTRIBUTION CIRCUITS ASSOCIATED WITH PANEL "ARRAY". 90% ARE NO LONGER USED. HOWEVER, THERE COULD BE "LIVE" CIRCUITS THAT WILL NEED TO BE REPOWERED VIA NEW ELECTRICAL PANELS LOCATED IN THE NEW ELECTRICAL CLOSET. SEE DRAWING CXE-E-05 FOR ADDITIONAL INFORMATION.
- 5. CONTRACTOR SHALL DISCONNECT AND REMOVE ALL EXPOSED CONDUIT, JUNCTION BOXES, LIGHTS, ETC., MOUNTED TO BUILDING. ASSUME 100' OF CONDUIT.
- 6. CONTRACTOR IS ADVISED THAT THIS BUILDING DEMOLITION SHALL BE COORDINATED WITH BUILDING CXF.

<u>KEY NOTES:</u>

- DISCONNECT AND REMOVE 250A-208Y/120 VOLT PANELBOARD
- 2 DISCONNECT AND REMOVE 200A-240 VOLT (DELTA) PANELBOARD.
- 3 DISCONNECT AND REMOVE SMALL PANEL AND ASSOCIATED RECEPTACLE. RATINGS UNKNOWN.
- $\langle 4 \rangle$ disconnect and remove 400a-208y/120 volt PANELBOARD.
- $(5) \pm 18$ DISTRIBUTION CIRCUITS AND WIRE TO BE DISCONNECTED AND REMOVED. REMOVE CONDUITS TO 18" BELOW GROUND.

STCHESTER COUNTY, NEW YORK	CONTRACT SHEET NUMBER NUMBER
TMENT OF PUBLIC WORKS AND TRANSPORTATION	22-523 CXE-E-01
DIVISION OF ENGINEERING	DWG NO.:
INFRASTRUCTURE REHABILITATION - PHASE 3 PLAYLAND PARK, RYE, NEW YORK	SCALE: AS SHOWN ⁶⁴
CROSS AXIS BUILDING E	DATE: 8/23/2022
ONE LINE DIAGRAM - DEMOLITION	DPW FILE 1-118-E-1044-0 REV. NO. 0

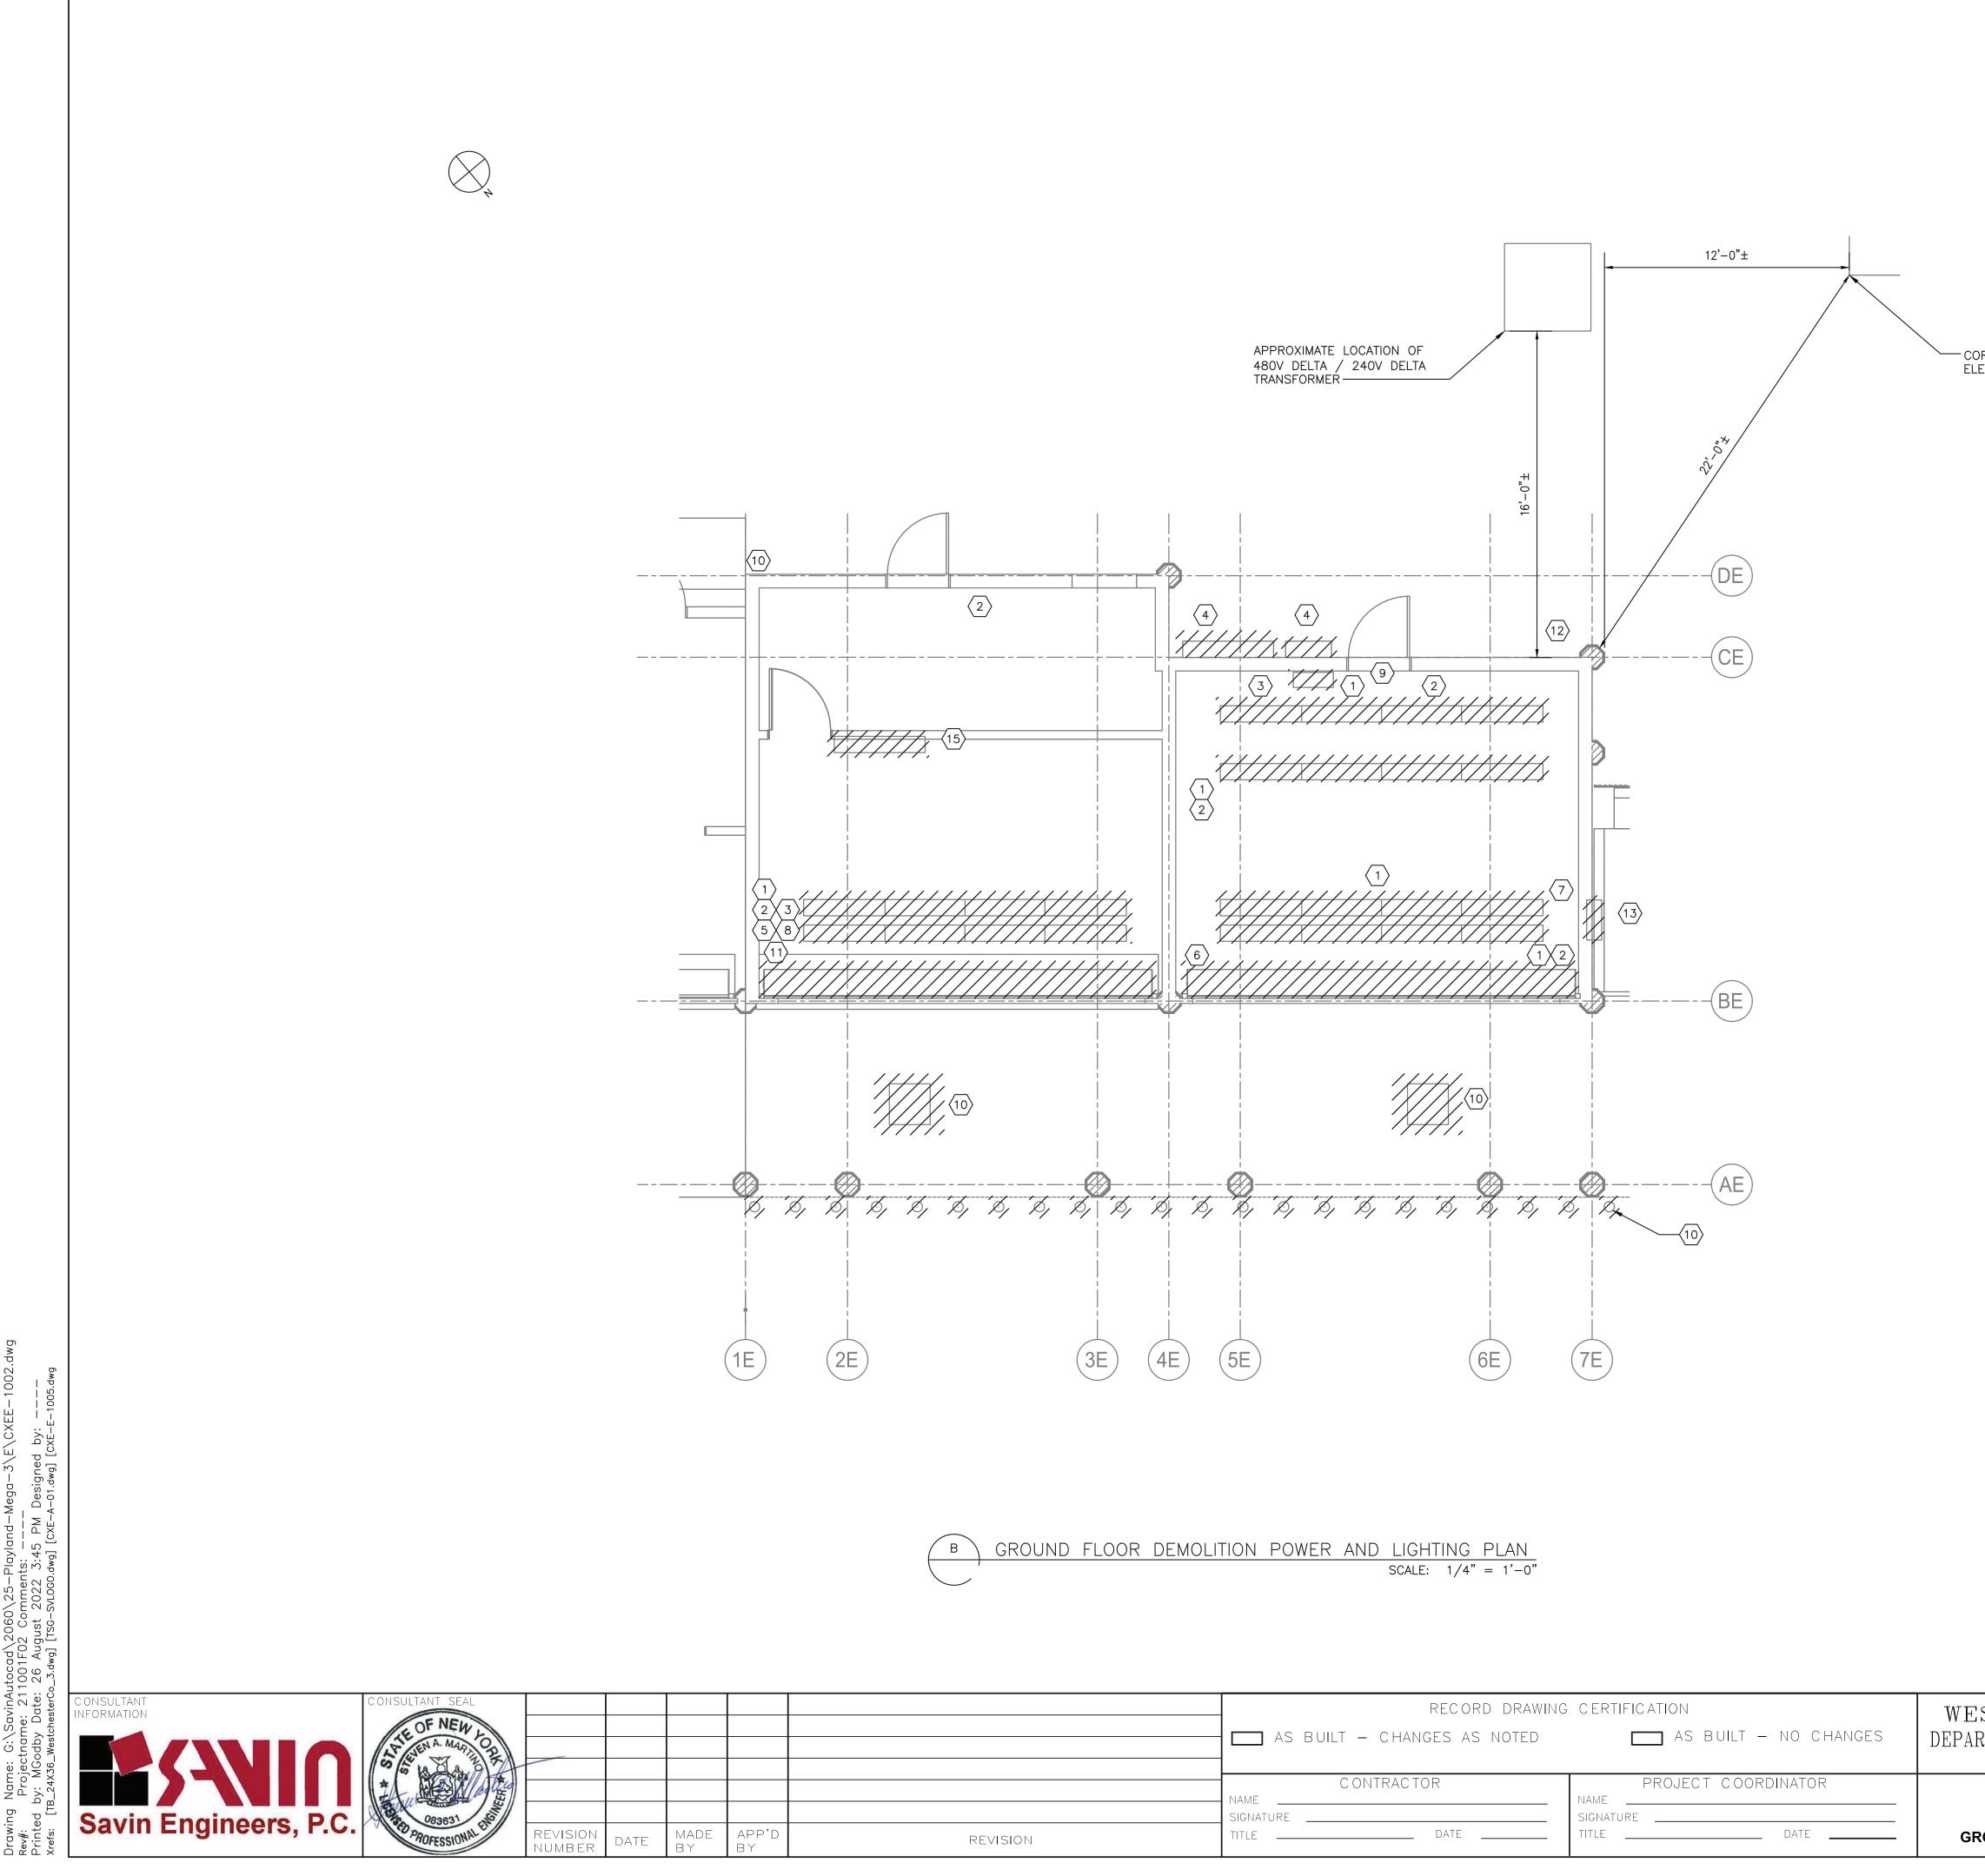

	CONTRACTOR NAME	PROJECT COORDINATOR			
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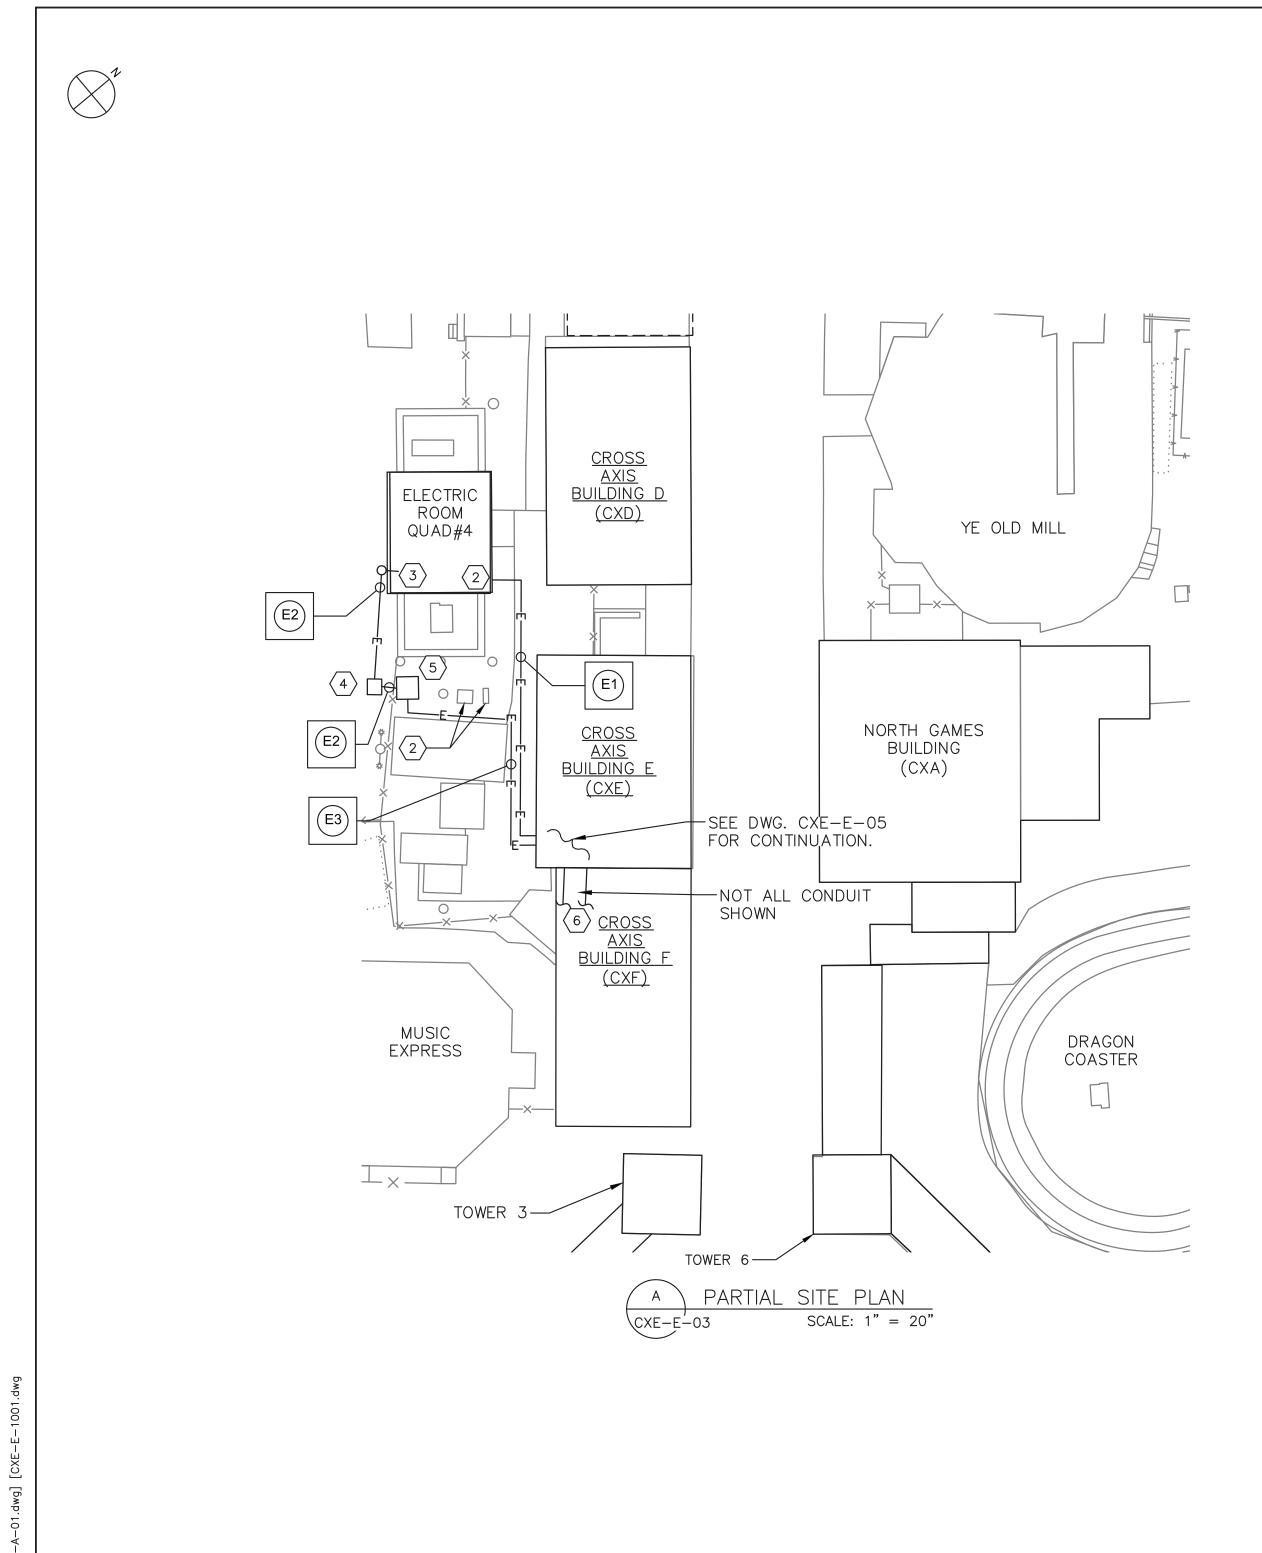
- 1. FOR ADDITIONAL NOTES, ABBREVIATIONS AND SYMBOLS, SEE DRAWING GE-E-01.
- 2. ALL REMOVED EQUIPMENT SHALL BE RETURNED TO OWNER UPON REQUEST. OTHERWISE ALL REMOVED MATERIAL SHALL BE LEGALLY DISPOSED OF.
- 3. DISCONNECT AND REMOVE ALL ELECTRICAL EQUIPMENT, LIGHTING, POWER CONDUIT AND WIRE BACK TO SOURCE. REMOVE ALL PANELBOARDS.
- 4. ALL ASSOCIATED CIRCUITING TO BE DEMOLISHED FOR RECEPTACLES AND LIGHTING FIXTURES SHALL ASSUME TO BE 3/4" CONDUIT WITH 2#12 & 1#12G, UNLESS OTHERWISE NOTED.
- 5. CONTRACTOR SHALL DEMOLISH ALL EXISTING JUNCTION BOXES AND ALL ASSOCIATED CONDUITS, WIRES AND APPURTENANCES. FOR BIDDING PURPOSES ASSUME 600 FEET 1"C, 3#12 & 1#12G.
- 6. ARRAY OF MULTIPLE EXISTING, POOR CONDITION POWER PANELS TO BE DISCONNECTED AND REMOVED. SEE DRAWING CXE-E-01 FOR MORE INFORMATION.
- 7. MOTOR FOR ROLLING DOOR. CONTRACTOR SHALL DISCONNECT AND REMOVE THE MOTOR AND ALL ASSOCIATED CONDUIT AND WIRE BACK TO SOURCE.
- 8. DISPOSITION OF EXISTING CCTV/DATA/COMMUNICATIONS SHALL BE BY OTHERS. THIS INCLUDES BOTH INCOMING AND OUTGOING CONDUIT AND CABLES.

	DEMOLITION LEGEND
1	RECEPTACLE
2	LIGHT SWITCH
3	24 CKT PANEL "CR-AX3"
4	EXISITNG PANEL ARRAY (SEE NOTE 6)
5	4 CKT PUSHMATIC PANEL
6	ROLLING DOOR MOTOR (SEE NOTE 7)
7	4 CKT PUSHMATIC PANEL (RECESSED IN WALL)
8	GENERAL DUTY SAFETY SWITCH (30A)
9	EXHAUST FAN
10	EXTERIOR LIGHT
11	12 CIRCUIT PANEL (BASKETBALL GAME)
12	COMMUNICATIONS BOX (SEE NOTE 8)
13	FLOODLIGHT

SCALE: 1/4" = 1'

STCHESTER COUNTY, NEW YORK	C ONTRAC T NUMB ER	SHEET NUMBER		
TMENT OF PUBLIC WORKS AND TRANSPORTATION	22-523	CXE-E-0	02	
DIVISION OF ENGINEERING	DWG NO.:			
INFRASTRUCTURE REHABILITATION - PHASE 3	SCALE: AS SHOW	¥ № ⁶⁶⁴		
PLAYLAND PARK, RYE, NEW YORK CROSS AXIS BUILDING E	DATE: 8/23/2022			
OUND FLOOR DEMOLITION - POWER AND LIGHTING PLAN	DPW FILE NUMBER 1-118-E-	1045-0	REV. No. O	

CORNER OF QUAD #4 ELECTRICAL BUILDING



	DUCTBANK SCHEDULE				
NAME	FROM	то	CONDUIT SIZE	CABLE	REMARKS
E1	208Y/120V SWITCHBOARD	PANEL CXE-PP1	2"C	4#2 & 1#8 GND	
E2	480Y/277V SWITCHBOARD	CXF TRANSFORMER	3 1/2"C	3-350 KCMIL & 1#4 GND	
E3	CXF TRANSFORMER	PANEL CXF-PP1	2 SETS OF 3 1/2"C	4-350KCMIL & 1#2 GND (EACH)	VIA DISCONNECT SWITCH
	1				



REVISION NUMBER	DATE	MADE B Y	APP'D By	

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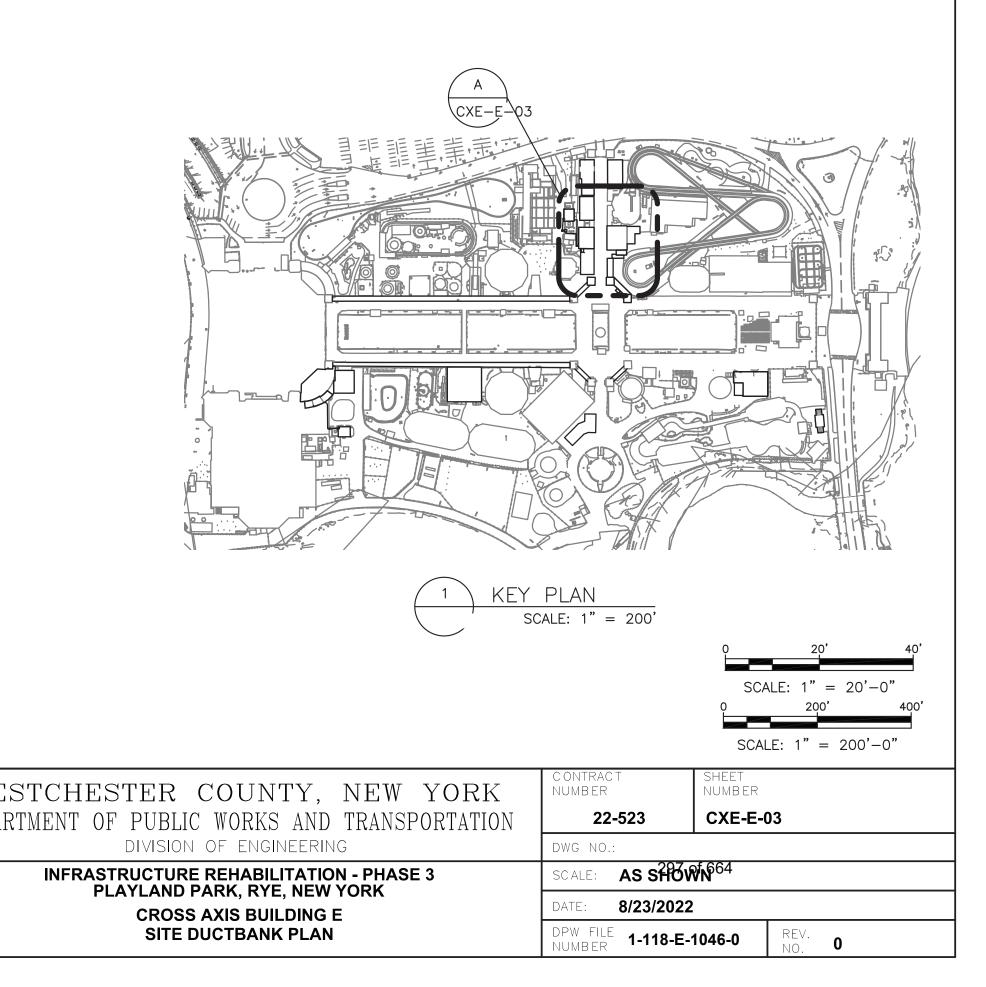
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	CONTRACTOR NAME	PROJECT COORDINATOR		
REVISION	TITLE DATE	TITLE DATE		


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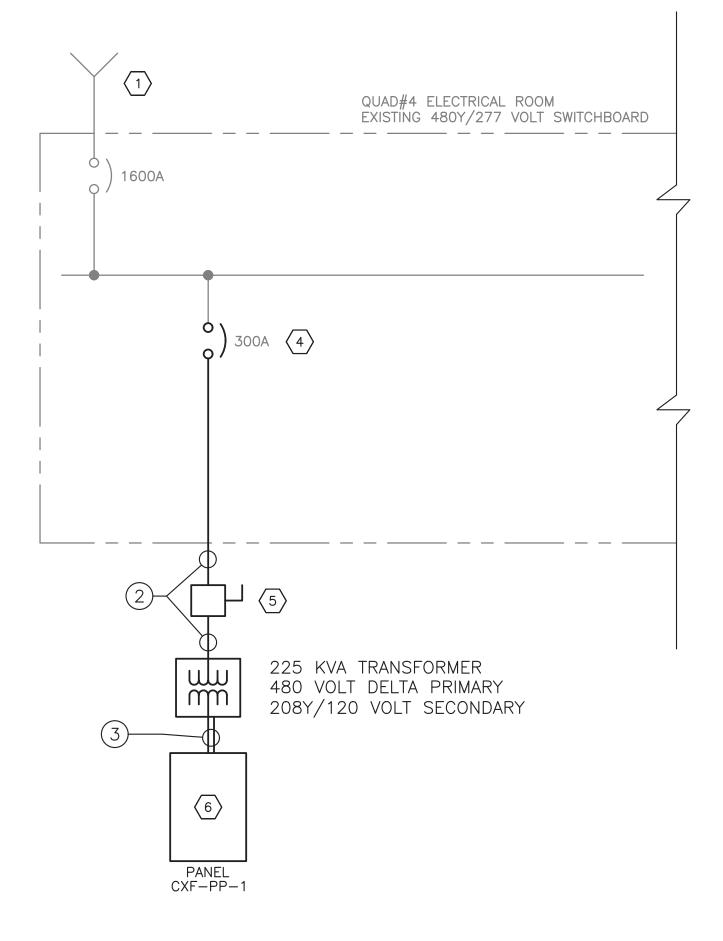
- 1. FOR ADDITIONAL NOTES, ABBREVIATIONS AND SYMBOLS, SEE DRAWING GE-E-01.
- 2. FOR PANEL SCHEDULES, SEE DRAWING CXE-E-09.
- 3. CONTRACTOR SHALL COORDINATE WITH THE CONSTRUCTION MANAGER AND STANDARD AMUSEMENTS FOR EXACT LOCATION OF NEW CXF TRANSFORMER AND ASSOCIATED DISCONNECT SWITCH.

<u>KEY NOTES:</u>

- (1) LOCATION OF EXTERIOR, PAD-MOUNTED ELECTRICAL EQUIPMENT PREVIOUSLY USED FOR "SPIDER" RIDE AND X-AXIS POWER.
- INTERNAL TO QUAD #4 ELECTRICAL ROOM, EXTEND WITH NEW 2" CONDUIT WITH 4#2 & 1#8 GND TO 208Y/120 VOLT SWITCHBOARD. MODIFY EXISTING SWITCHBOARD TO ACCEPT A 100 AMP, 3 POLE CIRCUIT BREAKER FOR NEW PANEL CXE-PP1.
- (3) INTERNAL TO QUAD #4 ELECTRICAL ROOM, EXTEND WITH NEW 3 1/2" CONDUIT WITH 3-350 KCMIL & 1#4 GND TO NEW 480Y/277 VOLT SWITCHBOARD. MODIFY EXISTING SWITCHBOARD TO ACCEPT A 300 AMP, 3 POLE CIRCUIT BREAKER FOR NEW PANEL CXF-PP1.
- 4 400 AMP FUSED DISCONNECT SWITCH (FUSED AT 300 AMPS) IN NEMA 3R ENCLOSURE. PROVIDE CONCRETE PAD FOUNDATION AND CHANNEL FRAME SUPPORT. CHANNEL SHALL BE STAINLESS STEEL (304).
- 5 225 KVA CXF TRANSFORMER WITH 480 VOLT DELTA PRIMARY AND 208Y/120 VOLT, 3 PHASE, 4-WIRE SECONDARY. TRANSFORMER SHALL BE SUITABLE FOR OUTDOOR USE. MOUNT TRANSFORMER ON PROPERLY SIZED CONCRETE HOUSEKEEPING PAD. PAD SHALL BE MINIMUM 8" THICK AND 4000 PSI CONCRETE.
- 6 CONTRACTOR IS ADVISED THAT EXISTING PANELS PP-TW2 & 3, TW2-RP AND TW3-RP SHALL BE RELOCATED FROM THE CXF BUILDING. EXTENDING CONDUITS SHALL RUN UNDER THE NEW CXF STRUCTURE AND STUB UP INTO THE NEW ELECTRICAL ROOM LOCATED IN THE CXE BUILDING. SEE CROSS AXIS BUILDING F ELECTRICAL DRAWINGS.





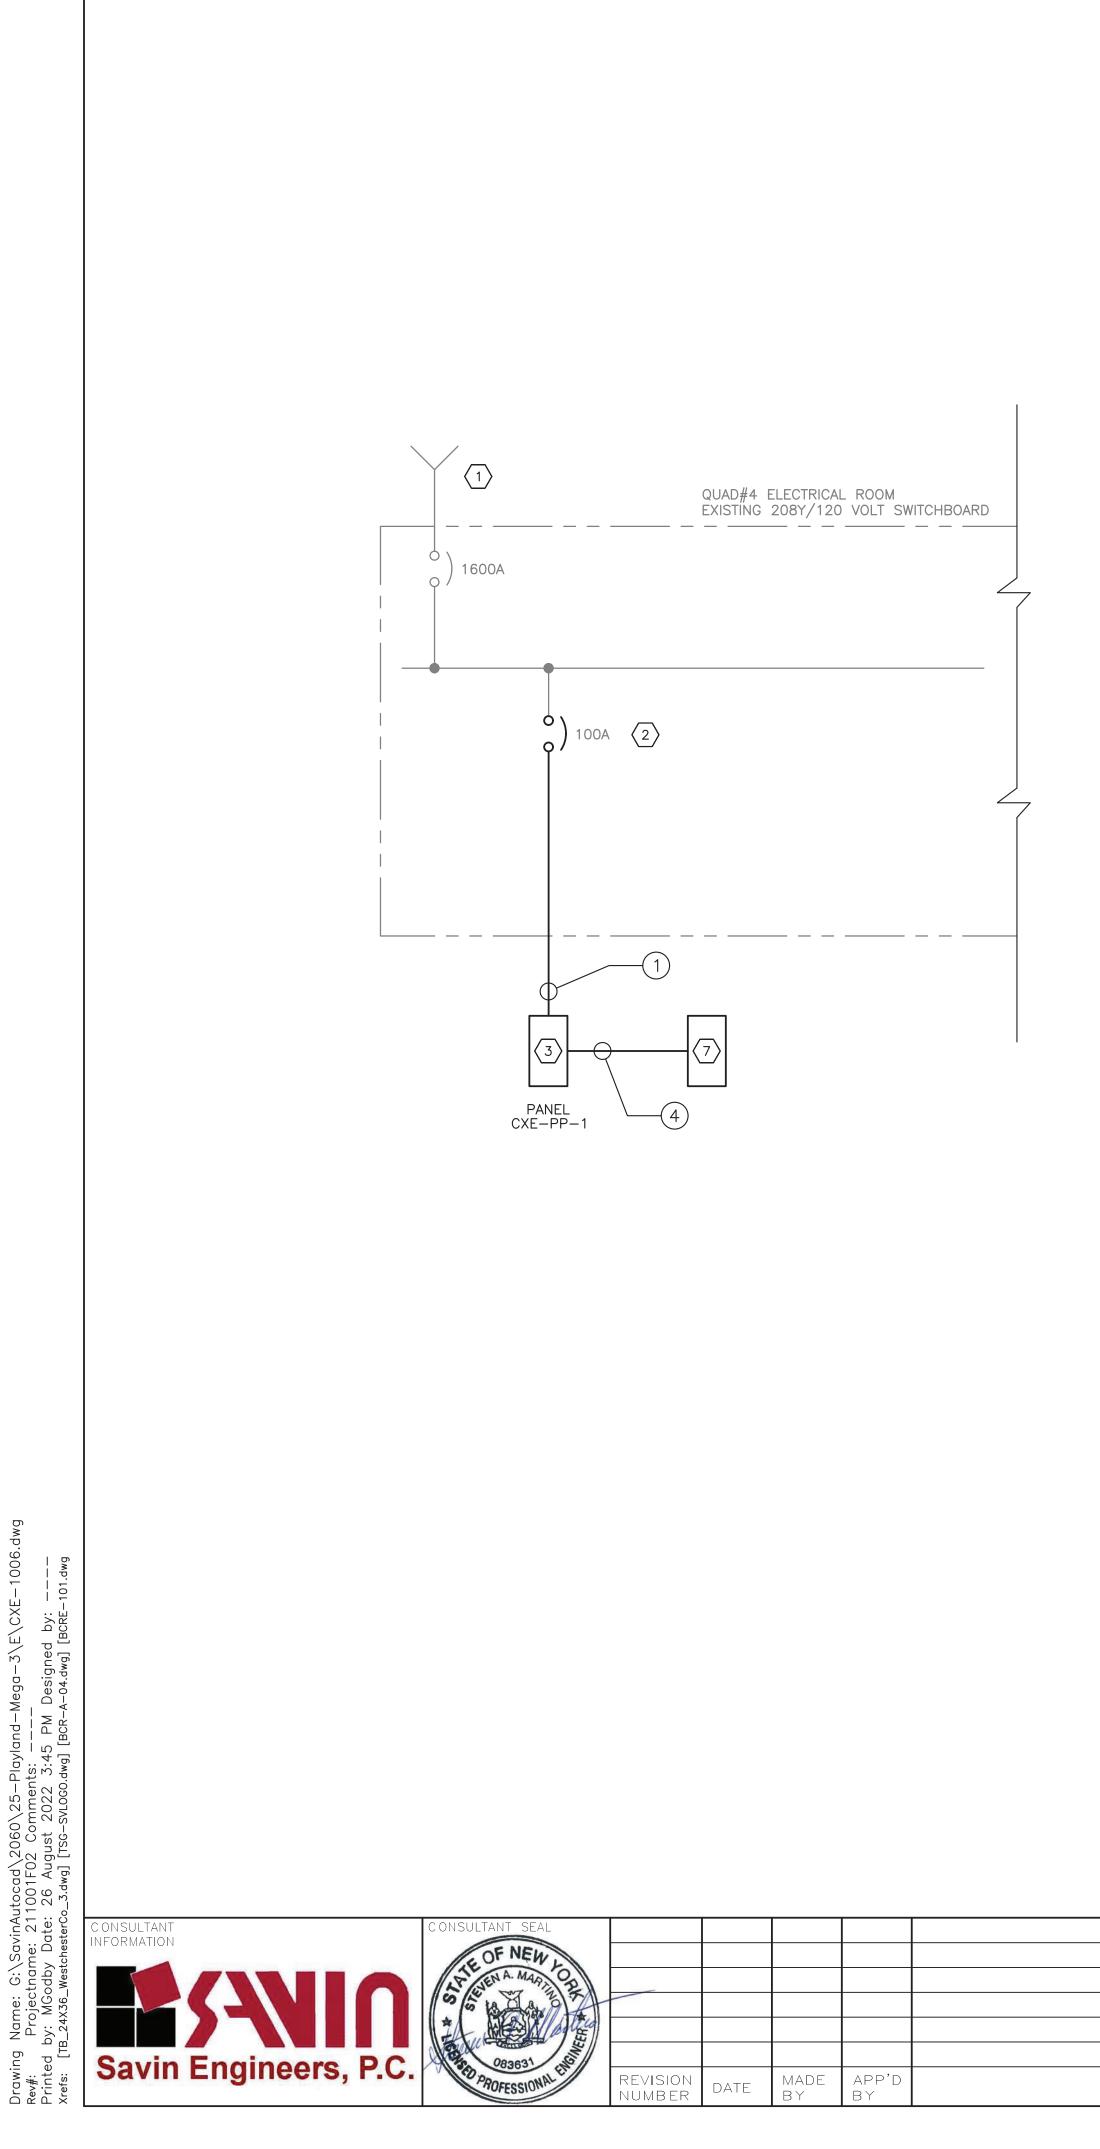

ONE LINE DIAGRAMS N.T.S.

	RECORD DRAWING CERTIFICATION			
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	CONTRACTOR	PROJECT COORDINATOR		
REVISION	SIGNATURE DATE	SIGNATURE DATE		
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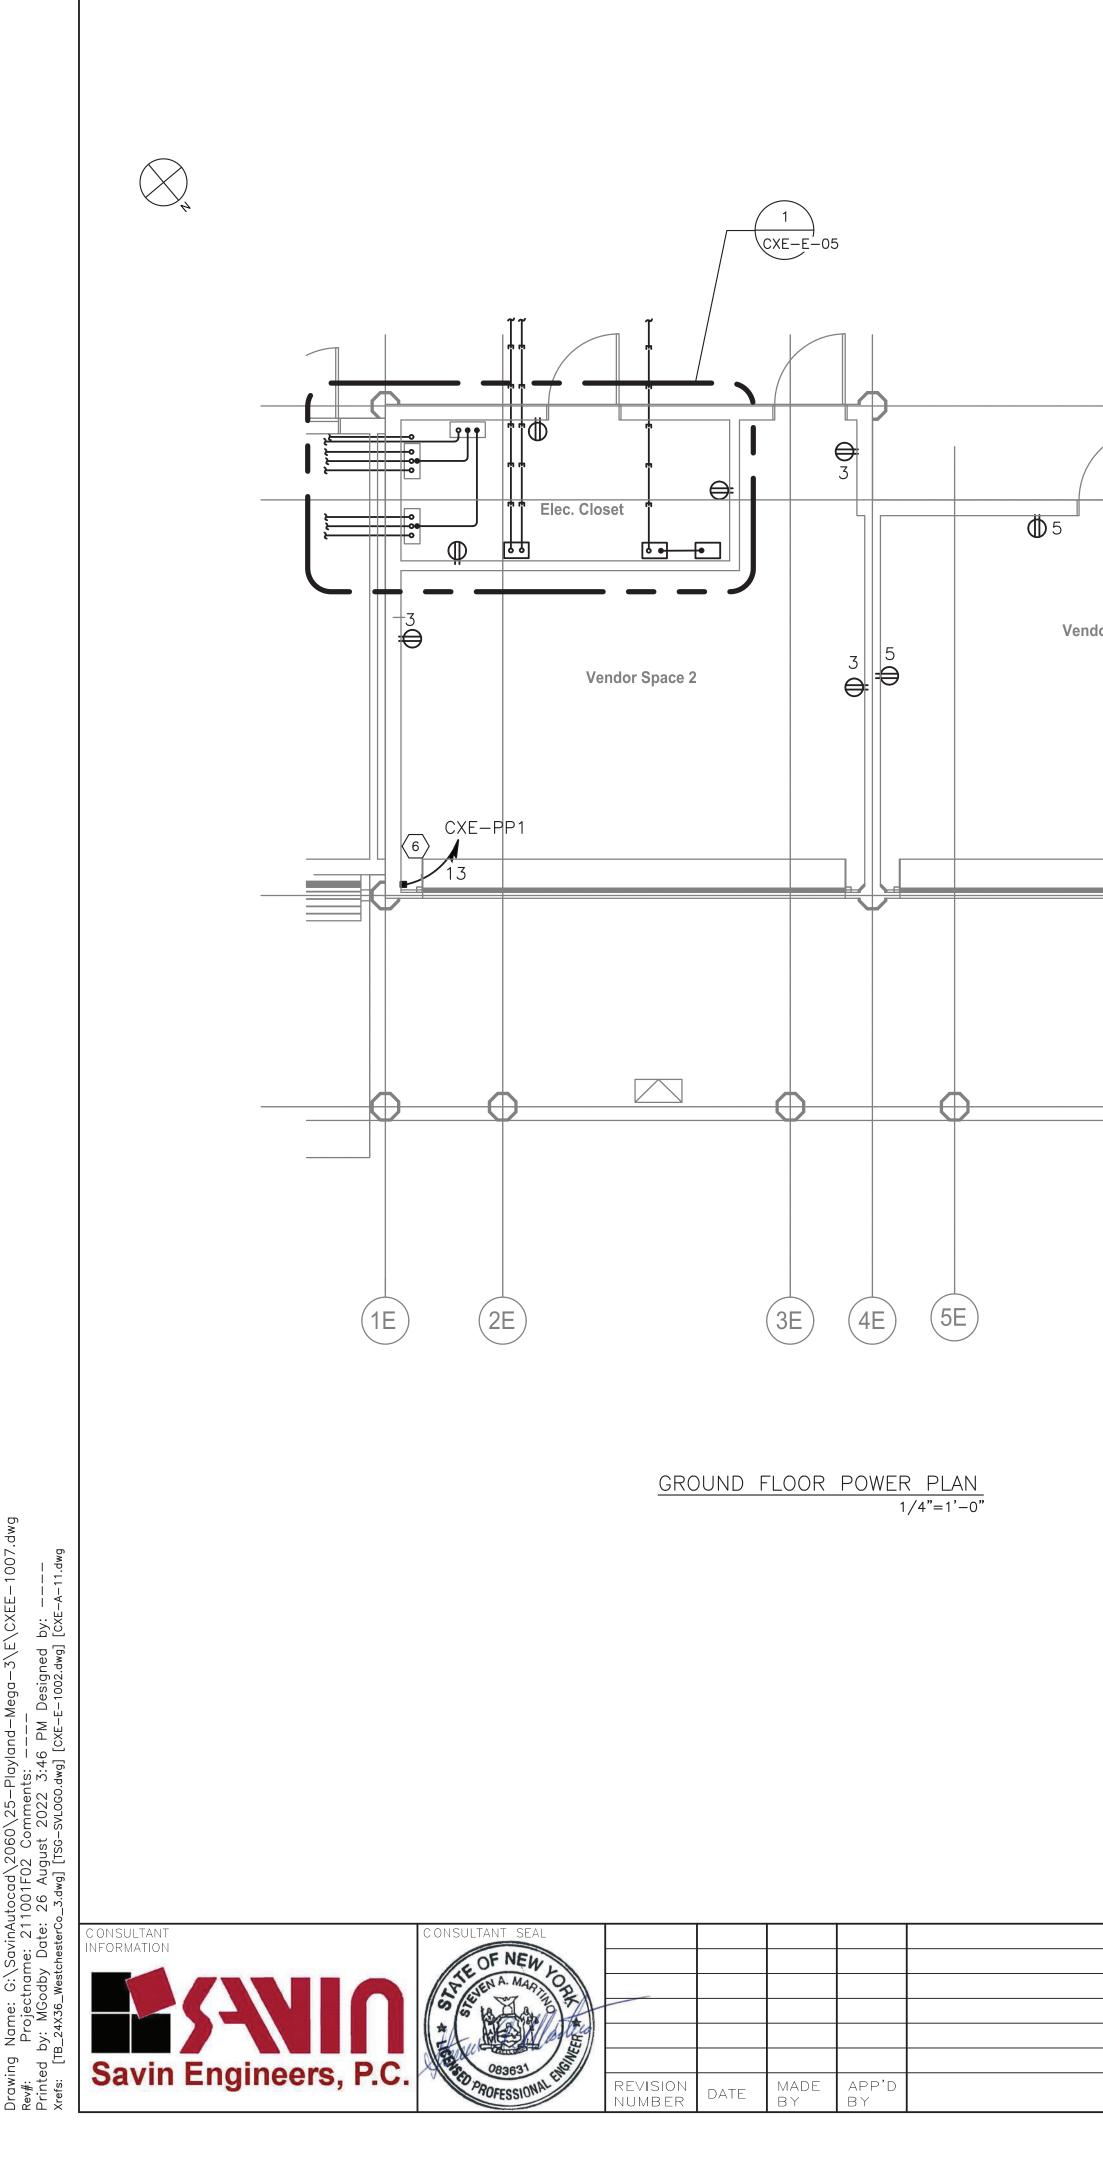
- 1. FOR ADDITIONAL NOTES, ABBREVIATIONS AND SYMBOLS, SEE DRAWING GE-E-01.
- CONTRACTOR IS ADVISED THAT PANELS SHOWN WILL BE LOCATED IN THE CXE BUILDING ELECTRICAL ROOM. IN ADDITION TO THESE PANELS THERE WILL BE 3 OTHER PANELS RELOCATED TO THIS ROOM AS WELL. SEE CROSS AXIS BUILDING F DRAWINGS FOR ADDITIONAL INFORMATION.

<u>KEY NOTES:</u>

- $\langle 1 \rangle$ incoming feeder
- 2 NEW 100 AMP, 3-POLE CIRCUIT BREAKER
- $\langle 3 \rangle$ NEW 208Y/120 VOLT, 3-PHASE, 4-WIRE PANEL WITH 125 AMP MAINS AND 100 AMP MAIN CIRCUIT BREAKER
- $\langle 4 \rangle$ provide and install New 300 AMP, 3-pole breaker
- $\overline{5}$ NEW DISCONNECT SWITCH (NEMA 3R ENCLOSURE)
- 6 NEW 208Y/120 VOLT, 3-PHASE, 4-WIRE PANEL WITH 600 AMP MAINS AND 600 AMP MAIN CIRCUIT BREAKER
- $\langle 7 \rangle$ NEW RELAY PANEL CXE-RP.

	CONDUIT AND WIRE LEGEND
NO.	DESCRIPTION
1	2"C, 4#2 & 1#8 GND
2	3 1/2"C, 3-350 KMCL & 1#4 GND
3	2 SETS OF 3 1/2"C, 4-350 KMCL & 1#2 GND
4	2"C, 14#12 & 6#12 GNDS

STCHESTER COUNTY, NEW YORK	CONTRACT SHEET NUMBER NUMBER
TMENT OF PUBLIC WORKS AND TRANSPORTATION	22-523 CXE-E-04
DIVISION OF ENGINEERING	DWG NO.:
INFRASTRUCTURE REHABILITATION - PHASE 3 PLAYLAND PARK, RYE, NEW YORK	SCALE: AS SHOWN ⁶⁴
CROSS AXIS BUILDING E	DATE: 8/23/2022
ONE LINE DIAGRAMS	DPW FILE 1-118-E-1047-0 REV. NO. 0



NOT REQUIRED AT THIS TIME. (DE) WITH 125 AMP MAINS AND 100 AMP MAIN CIRCUIT LOADS IN THE CXE BUILDING. (CE)AND CXF BUILDINGS. $\langle 6 \rangle$ Approximate location of motor for New Roll-UP Vendor Space 1 CIRCUIT MOTOR FROM PANEL CXE-PP-1. NUMBER **⊖** ROLL-UP DOOR MOTOR LOCATION. (\nearrow) RELOCATED CXE-PP1 PP-TW2 & 3-6 STUB AND CAP 4" SPARE CONDUIT -----15 (BE) CONDUIT INSTALLED UNDER BUILDING GRADE BEAMS TO POWER HANDHOLE (AE) TO RP HANDHOLE SEE CXF BUILDING DRAWINGS FOR CONTINUATION (SEE NOTE 2) TO RP HANDHOLE \bigcirc ¹ (6E) (7E)

> ELECTRICAL ROOM POWER PLAN CXE-E-05


					SCALE: $1/2" = 1'-0"$ 0 4' 8' SCALE: $1/4" = 1'-0"$
	RECORD DRAWIN AS BUILT – CHANGES AS NOTED	G CERTIFICATION	WESTCHESTER COUNTY, NEW YORK DEPARTMENT OF PUBLIC WORKS AND TRANSPORTATION	C ONTRAC T NUMB ER 22-523	sheet Number CXE-E-05
	CONTRACTOR	PROJECT COORDINATOR	DIVISION OF ENGINEERING INFRASTRUCTURE REHABILITATION - PHASE 3 PLAYLAND PARK, RYE, NEW YORK	DWG NO.: SCALE: AS STION	
REVISION	SIGNATUREDATE	SIGNATURE DATE	CROSS AXIS BUILDING E GROUND FLOOR - POWER PLAN	DATE: 8/23/2022 DPW FILE NUMBER 1-118-E-	

KEY NOTES:

- (1) RELOCATED 200 AMP PANEL PP-TW2 & 3. CONTRACTOR SHALL EXTEND ALL DISTRIBUTION CIRCUITS PRESENTLY CONNECTED TO THIS PANEL. CONTRACTOR SHALL TRACE OUT EACH CIRCUIT AND PLAN FOR ALL REQUIRED RECONNECTIONS. SEE DRAWING CXE-E-08 FOR PANEL SCHEDULE.
- $\langle 2 \rangle$ Relocated Relay panels TW2-RP and TW3-RP. See CXF DRAWINGS FOR ADDITIONAL INFORMATION.
- $\langle 3 \rangle$ NEW 208Y/120 VOLT, 3 PHASE, 4-WIRE PANEL CXF-PP1 WITH 600 AMP MAINS AND 600 AMP MAIN BREAKER. THIS PANEL WILL BE USED TO SUPPLY NEW KITCHEN LOADS FOR THE CXF BUILDING. KITCHEN LOADS WILL BE DETERMINED BY STANDARD AMUSEMENTS. DISTRIBUTION CIRCUITS ARE
- $\langle 4 \rangle$ NEW 208Y/120 VOLT, 3 PHASE 4-WIRE PANEL CXE-PP1 BREAKER. THIS PANEL WILL BE USED FOR ALL ELECTRICAL
- $\langle 5 \rangle$ New Relay panel CXE-RP. This relay panel shall be USED FOR ALL NEW EXTERIOR LIGHTING FOR BOTH CXE
- DOOR. CONTRACTOR SHALL CONFIRM MOTOR LOCATION IN THE FIELD PRIOR TO INSTALLATION. CONTRACTOR SHALL DESIGNATORS INDICATE CIRCUIT NUMBERS. CONTRACTOR SHALL PROVIDE 30 AMP, 2-POLE DISCONNECT SWITCH AT

NOTES:


- 1. FOR ADDITIONAL NOTES, ABBREVIATIONS AND SYMBOLS, SEE DRAWING GE-E-01.
- 2. CONTRACTOR IS ADVISED THAT THERE ARE 3 EXITING PANELS (ONE POWER AND TWO RELAY) THAT NEED TO BE RELOCATED TO THE CXE ELECTRICAL ROOM. THIS INCLUDES ALL ASSOCIATED CONDUIT AND WIRE BOTH FOR POWER AND DISTRIBUTION CIRCUITS THE INTENT IS TO RELOCATE SAID EQUIPMENT AN PROVIDE NEW CONDUIT AND WIRE FOR CONNECTION TO EXISTING CIRCUITS. FOR ADDITIONAL INFORMATION, SEE CROSS AXIS BUILDING F DRAWINGS. CONTRACTOR SHALL COORDINATE THE REQUIREMENT OF RELOCATING THESE PANELS WITH THE CONSTRUCTION PHASING OF BOTH CXE AND CXF BUILDINGS.
- 3. ALL RECEPTACLE DESIGNATORS ARE POWERED VIA PANEL CXE-PP-1, UNLESS OTHERWISE NOTED.
- 4. ALL CIRCUITS SHOWN ON THE DRAWING BUT NOT SPECIFICALLY CALLED OUT ON THE CONDUIT AND WIRE LEGEND SHALL BE 3/4" CONDUIT, 2#12 & 1#12 GND.
- 5. FOR PANEL SCHEDULES, SEE DRAWING CXE-E-09.
- 6. CONTRACTOR SHALL ASSUME THAT TWO ADDITIONAL CIRCUITS WILL BE NEEDED FOR EQUIPMENT NOT AS YET SHOWN. ASSUME A TOTAL OF 100 FEET OF 3/4" CONDUIT WITH 3 #12 AWG.

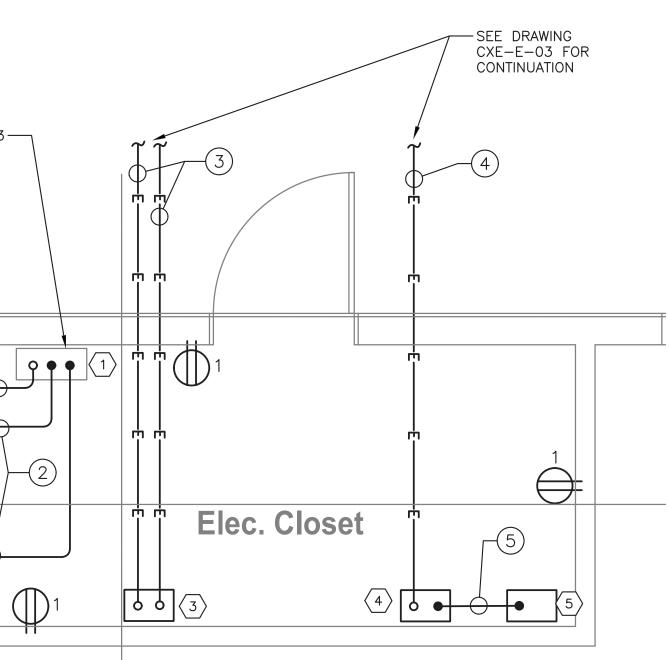

SCALE: 1/2" = 1'-0"

CONDUIT AND WIRE LEGEND DESCRIPTION NO.

1	4"C, 4–250 KCMIL & 1#2 GND (OR MATCH EXISTING)
2	2"C, 18#10 & 9#10 GNDS (OR MATCH EXISTING)
3	2 SETS OF 3 1/2"C, 4-350 KCMIL & 1#2 GND
4	2"C, 4#2 & 1#8 GND
5	2"C, 18#12 & 7#12 GNDS

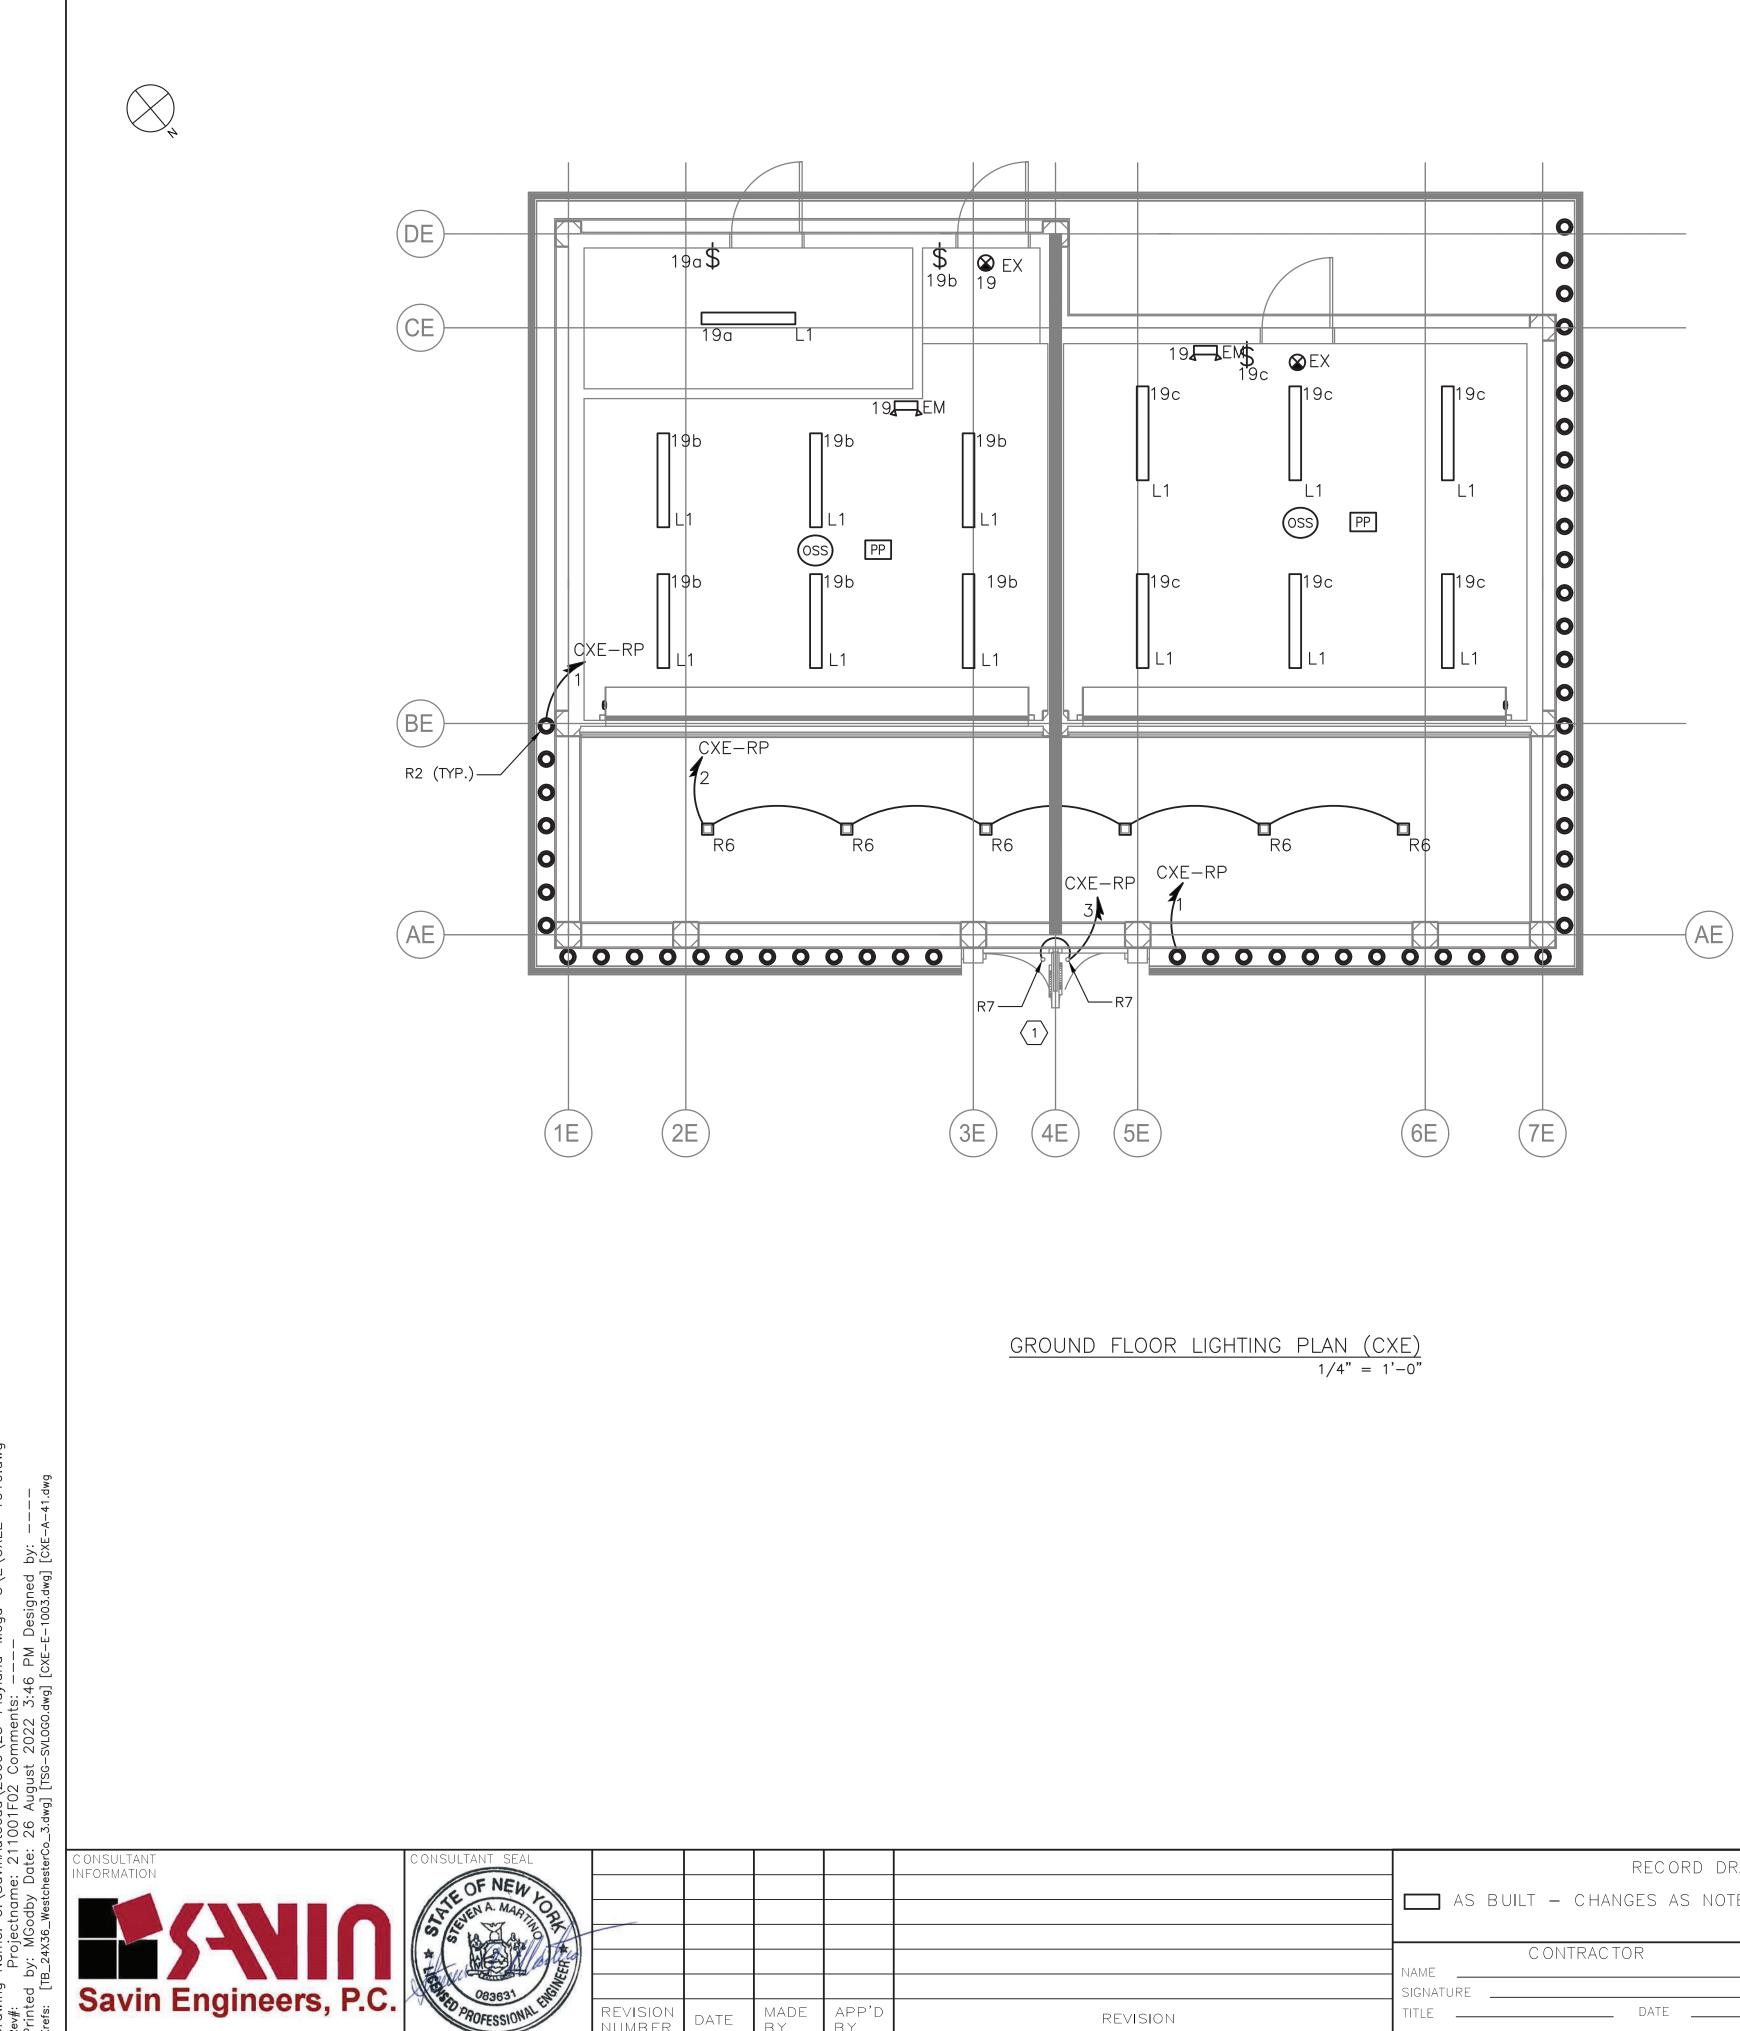

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REVISION NUMBER MADE DATE $\exists \forall$

	RECORD DRAWING	RECORD DRAWING CERTIFICATION			
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	CONTRACTOR	PROJECT COORDINATOR			
	SIGNATURE	SIGNATURE			
REVISION	TITLE DATE	TITLE DATE			

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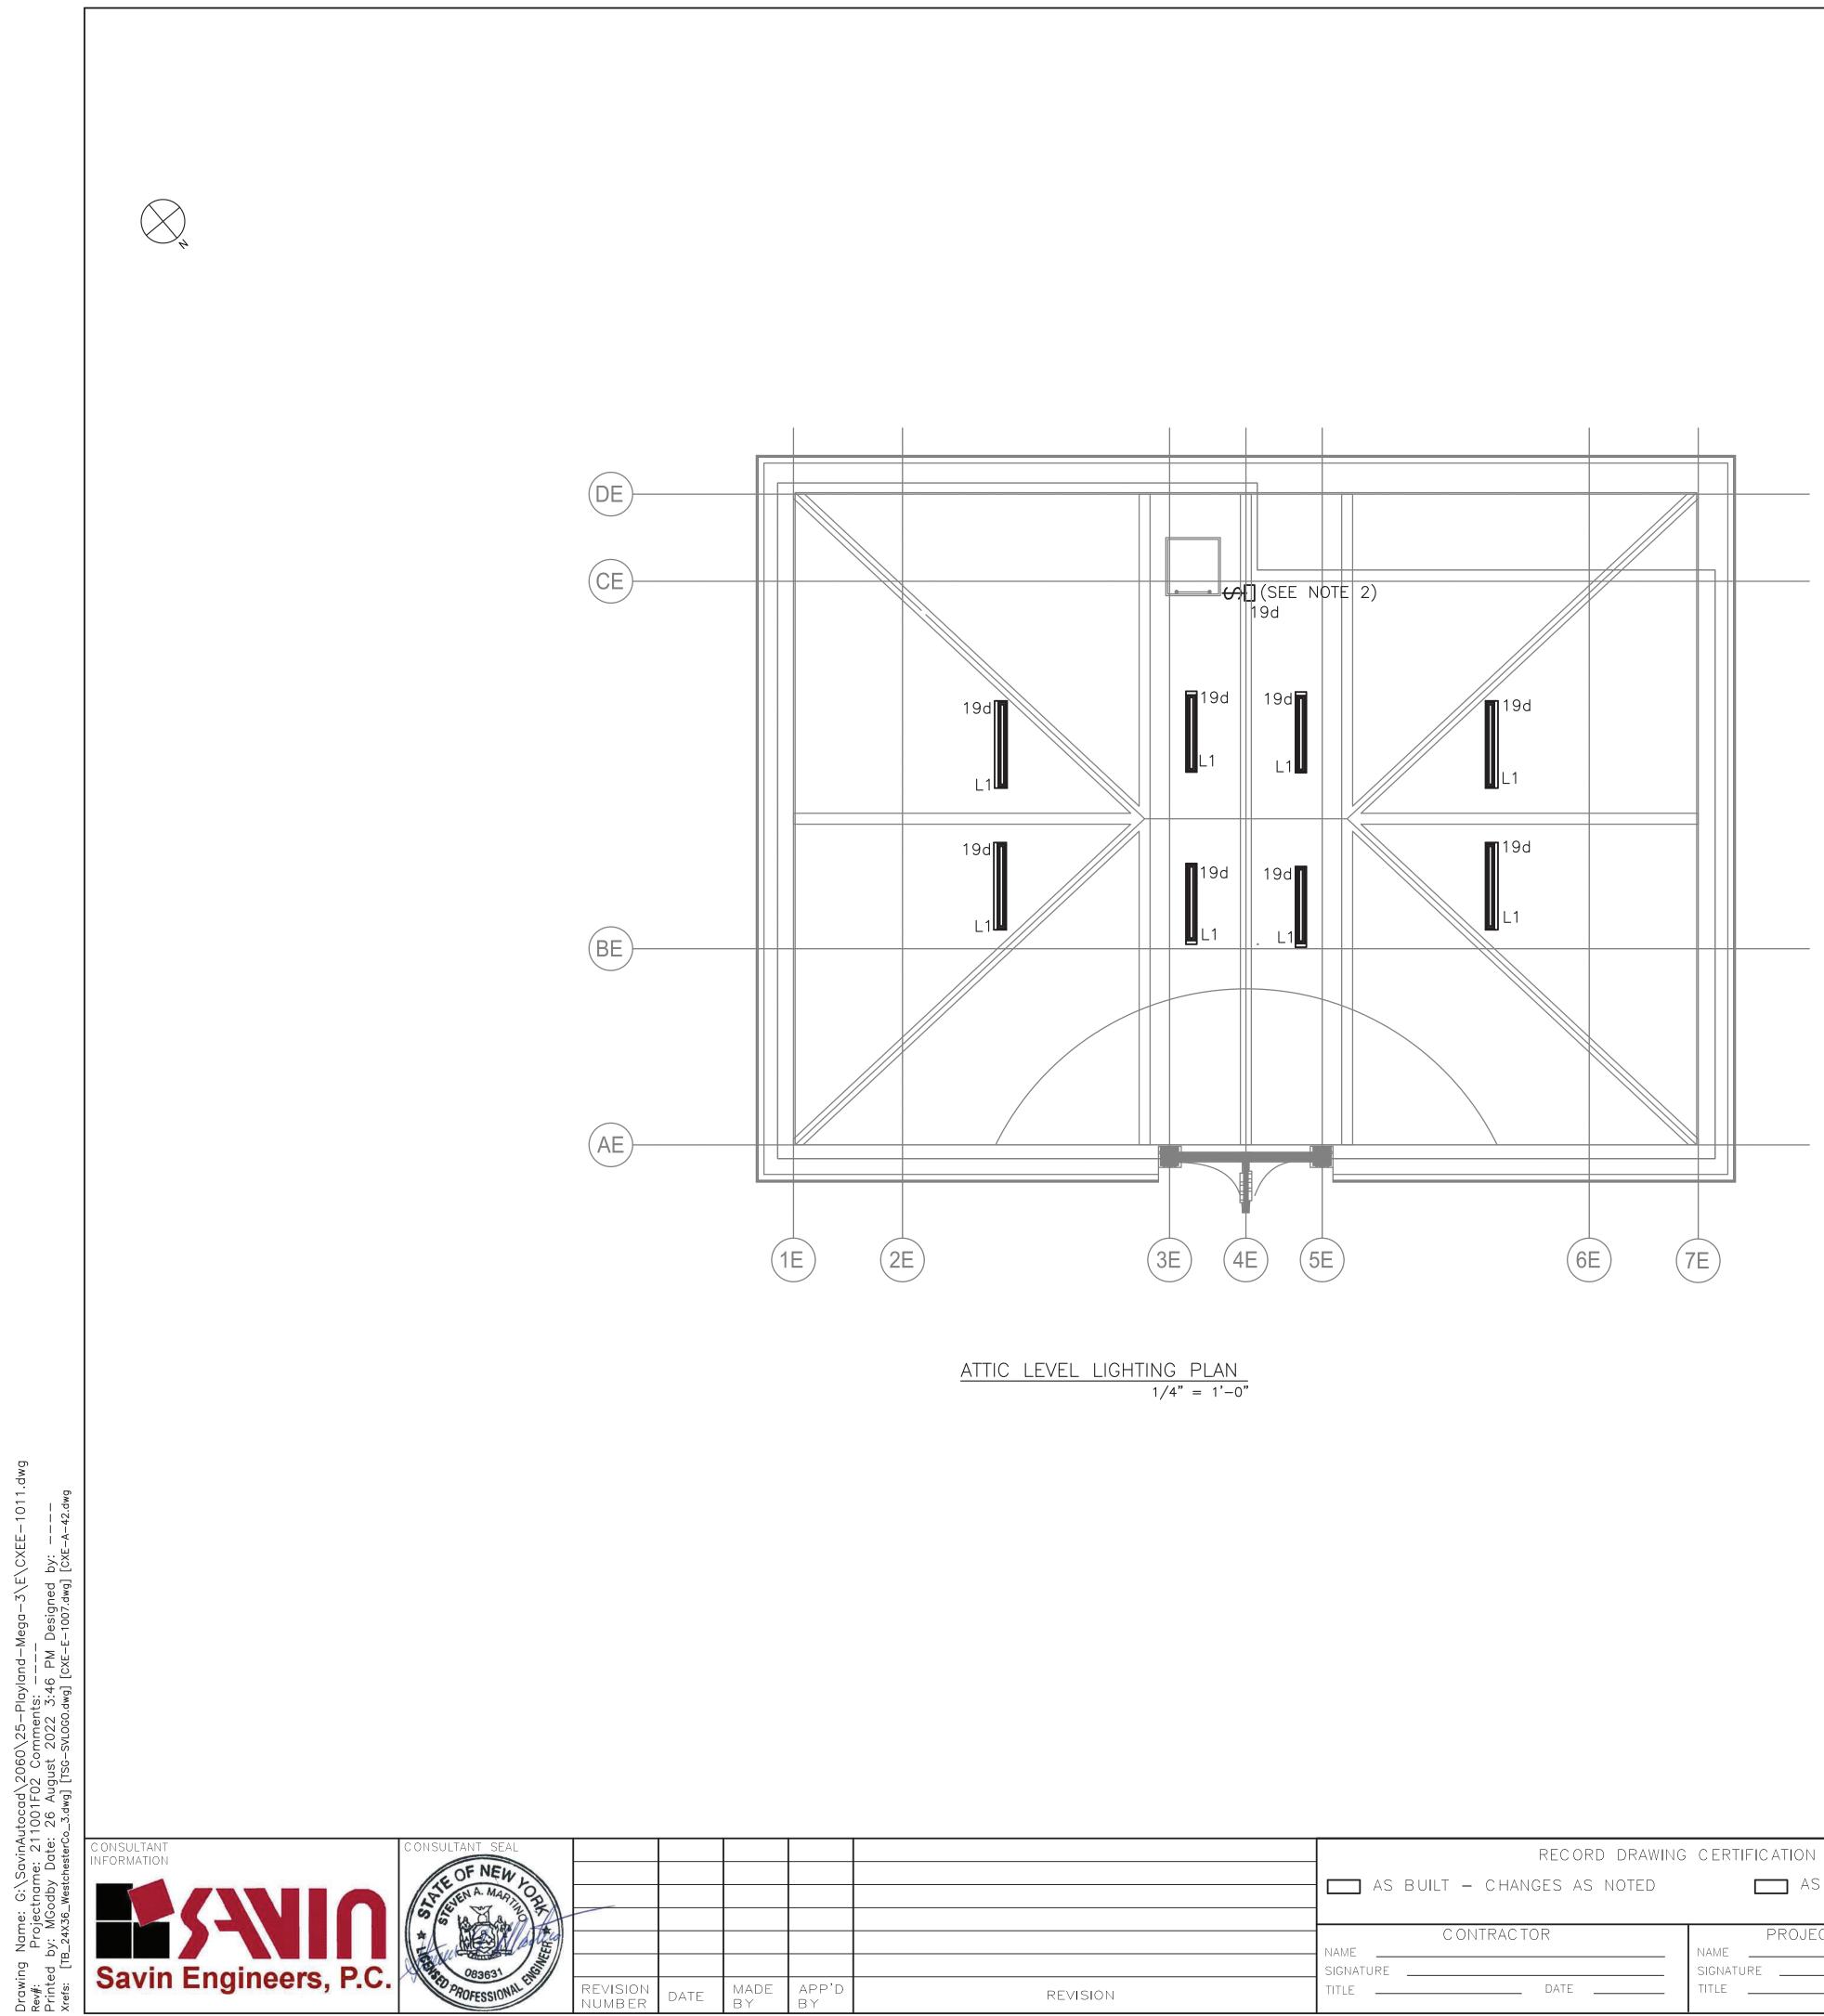
- 1. FOR ADDITIONAL NOTES, ABBREVIATIONS AND SYMBOLS, SEE DRAWING GE-E-01.
- 2. ALL INTERIOR LIGHTING IS POWERED VIA PANEL CXE-PP1, UNLESS NOTED OTHERWISE. CONTRACTOR SHALL CIRCUIT LIGHTING FIXTURES WITH 3/4" CONDUIT WITH 2#12 & 1#12GND.
- 3. EXIT SIGNS SHALL BE WIRED TO THE UN-SWITCHED LEG OF THE DESIGNATED CIRCUIT.
- 4. EMERGENCY FIXTURES SHALL BE WIRED TO THE UN-SWITCHED LEG OF THE DESIGNATED CIRCUIT.
- 5. ALL EXTERIOR LIGHTING SHALL BE CIRCUITED TO RELAY PANEL CXE-RP. CONTRACTOR SHALL CIRCUIT LIGHTING FIXTURES WITH 3/4" CONDUIT WITH 2#10 & 1#10GND, UNLESS NOTED OTHERWISE. CONTRACTOR SHALL DAISY-CHAIN ALL EXTERIOR LIGHT FIXTURES WITH SAME CIRCUIT NUMBER BACK TO RELAY PANEL CXE-RP.
- 6. FOR LIGHTING PANEL SCHEDULE, REFER TO DRAWING CXE-E-09.
- 7. NUMBER DESIGNATORS NEXT TO FIXTURES AND/OR CONTROLS INDICATE CIRCUIT NUMBERS.
- 8. ALL LIGHTING CONTROL COMPONENTS SHALL BE FROM A SINGLE MANUFACTURER, AND MUST BE FROM THE SAME MANUFACTURER FOR ALL BUILDINGS WITHIN THE CONTRACT AND AS PROVIDED ELSEWHERE AT THE PLAYLAND FACILITY.
- 9. LIGHTING CONTROLS SELECTED SHALL HAVE THE CAPABILITY TO BE CONNECTED TO A MASTER HEAD-END SYSTEM (FUTURE CONTRACT).
- 10. ALL OUTDOOR LIGHTING SHALL BE POWERED VIA RELAY PANEL CXE-RP. RELAY PANEL SHALL BE EQUIPPED WITH BOTH A BUILT-IN TIME CLOCK AND A PHOTOSENSOR CONTROL.

KEY NOTES:

(1) R7 LIGHT FIXTURES SHALL BE CONNECTED INTO THE SAME CIRCUIT USED FOR POWERING THE REFURBISHED FINIAL LIGHTS. SEE ARCHITECTURAL DRAWINGS FOR ADDITIONAL INFORMATION.

STCHESTER COUNTY, NEW YORK	CONTRACT SHEET NUMBER NUMBER
RTMENT OF PUBLIC WORKS AND TRANSPORTATION	22-523 CXE-E-06
DIVISION OF ENGINEERING	DWG NO.:
INFRASTRUCTURE REHABILITATION - PHASE 3	SCALE: AS SHOWN ⁶⁴
PLAYLAND PARK, RYE, NEW YORK CROSS AXIS BUILDING E	DATE: 8/23/2022
GROUND FLOOR - LIGHTING PLAN	DPW FILE NUMBER 1-118-E-1049-0 REV. NO. 0

SCALE: 1/4" = 1'-0"




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	CONTRACTOR	PROJECT COORDINATOR	1					
	SIGNATURE DATE	SIGNATURE DATE						
REVISION	TITLE DATE							
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NOTES:

- 1. FOR ADDITIONAL NOTES, ABBREVIATIONS AND SYMBOLS, SEE DRAWING GE-E-01.
- 2. MOUNT ATTIC LIGHT SWITCH AT TOP OF ATTIC ACCESS HATCH.

	SCALE: $1/4" = 1'-0"$	
STCHESTER COUNTY, NEW YORK	CONTRACT SHEET NUMBER NUMBER	
RTMENT OF PUBLIC WORKS AND TRANSPORTATION division of engineering	22-523 CXE-E-07	-
INFRASTRUCTURE REHABILITATION - PHASE 3 PLAYLAND PARK, RYE, NEW YORK	SCALE: AS SHOWN ⁶⁴	_
CROSS AXIS BUILDING E	DATE: 8/23/2022	
ATTIC LEVEL - LIGHTING PLAN	DPW FILE 1-118-E-1050-0 REV. 0	

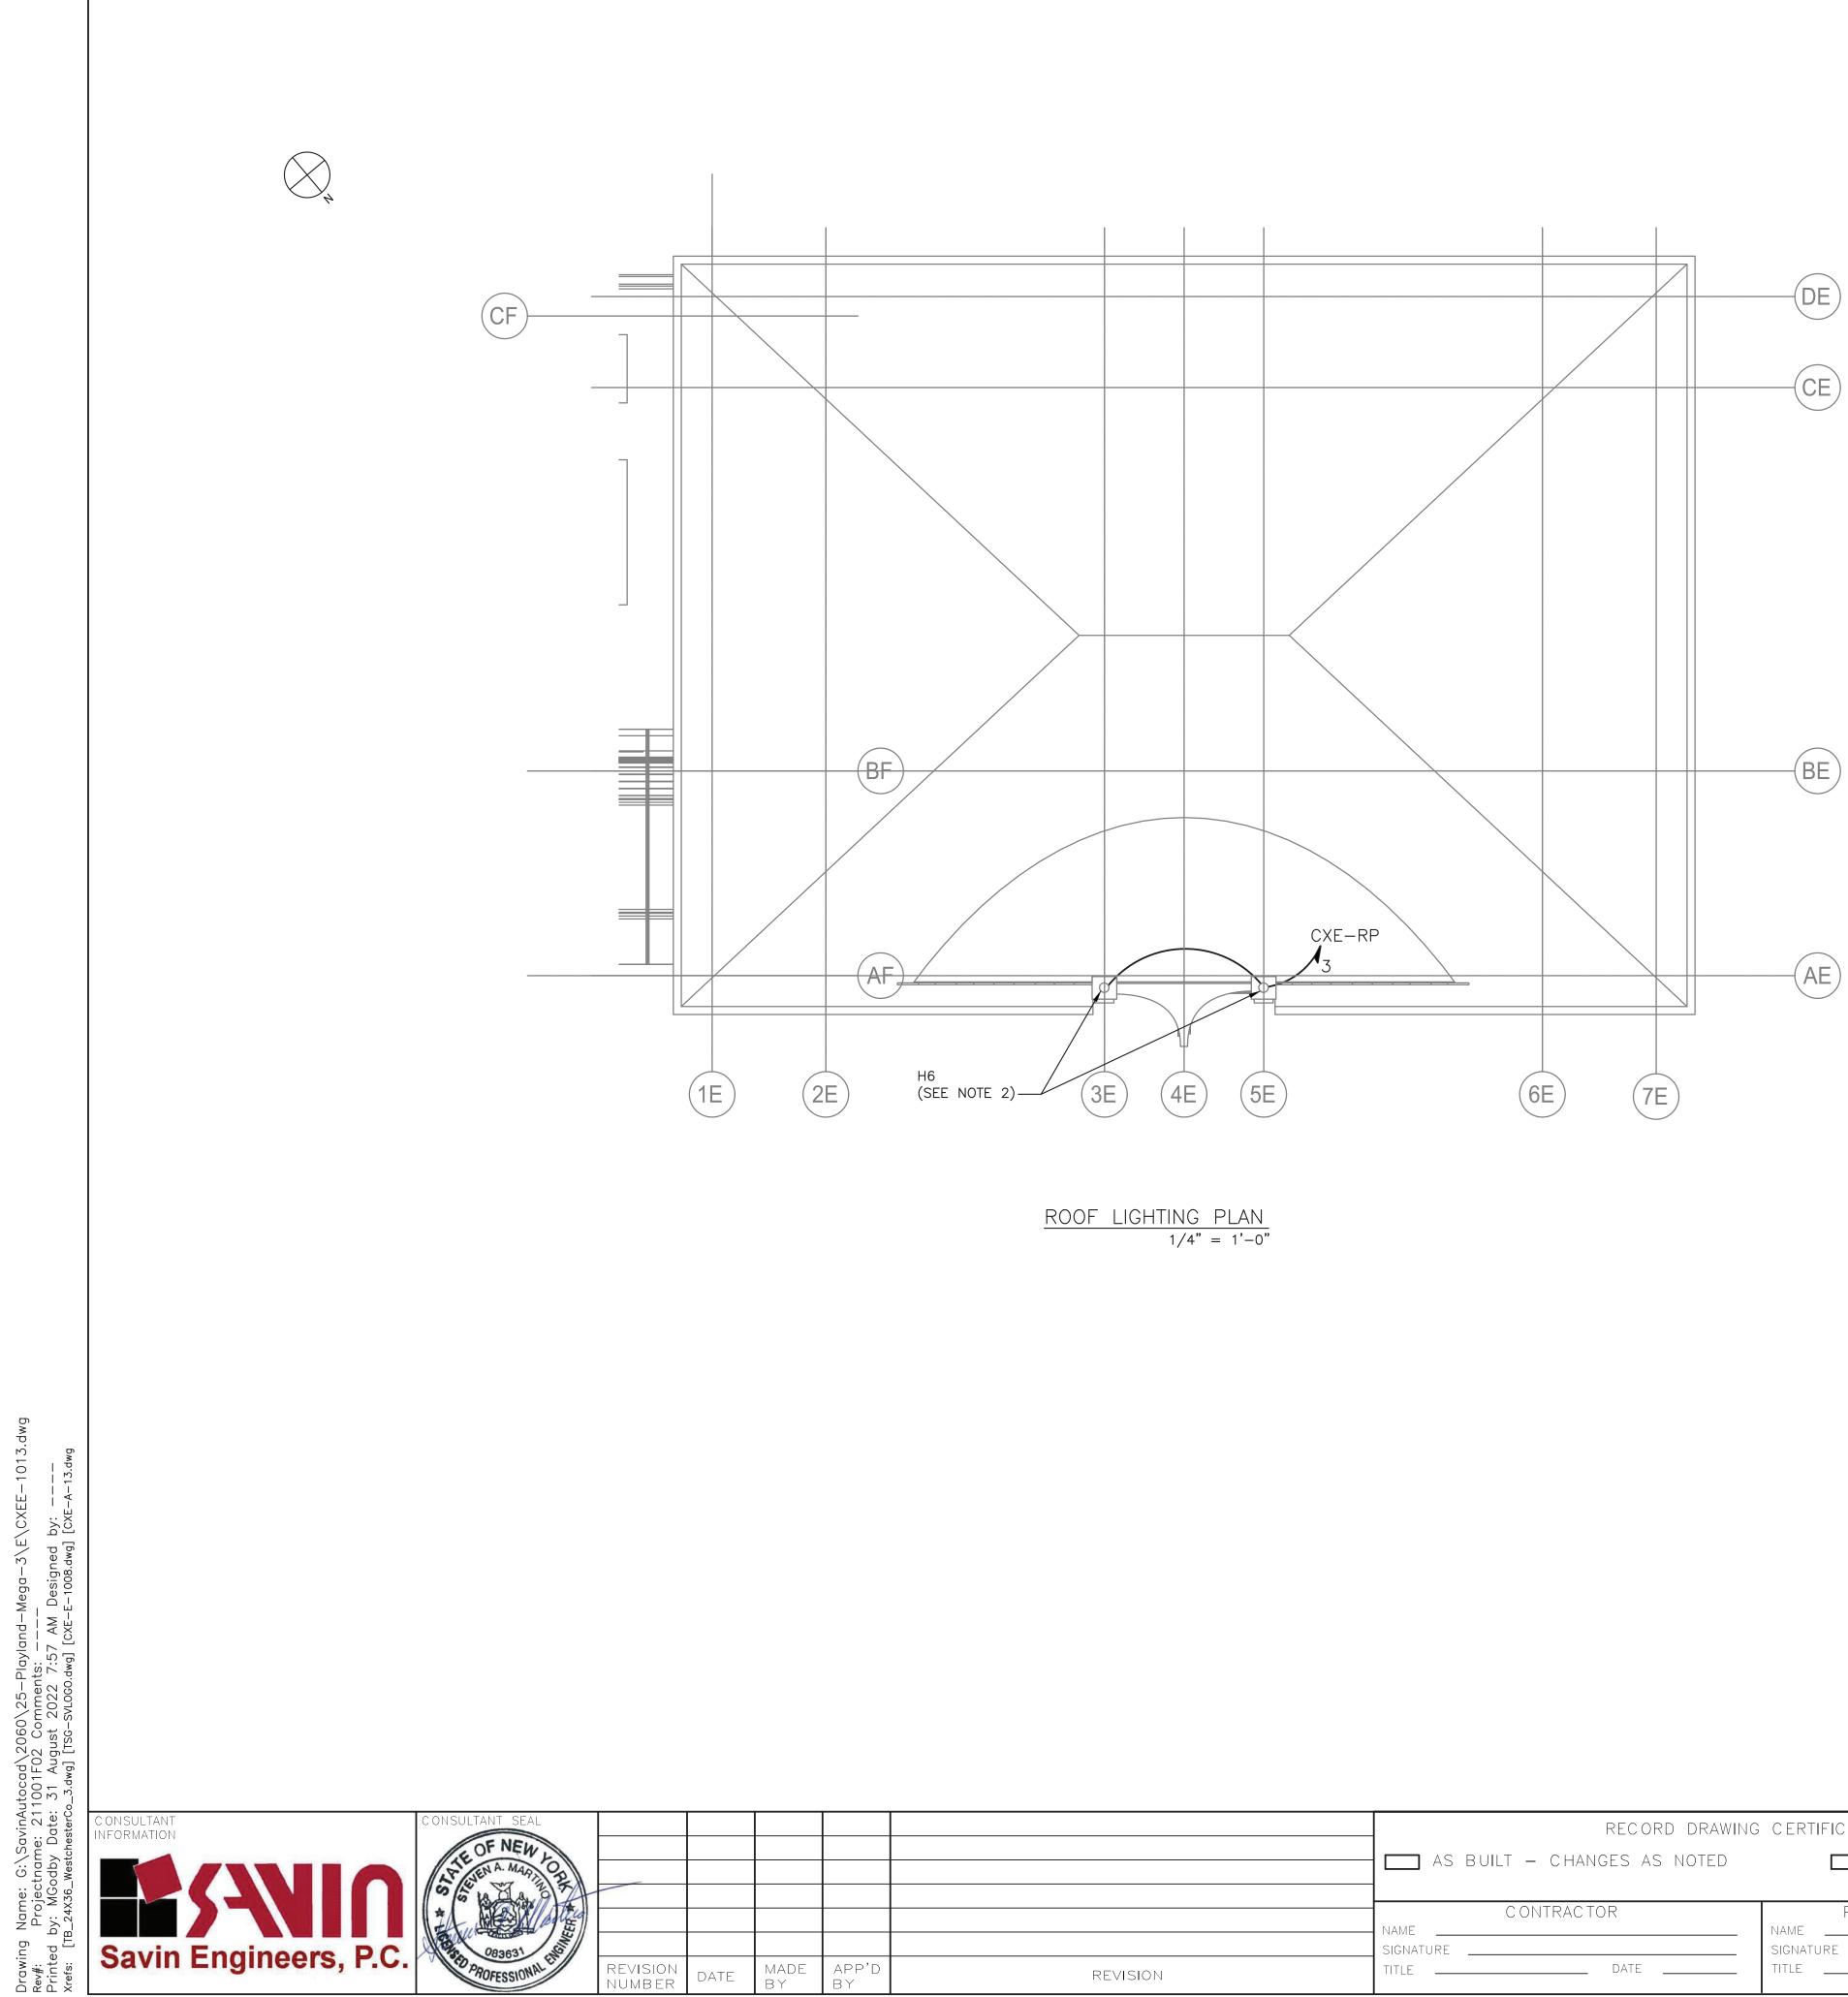

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NOTES:

- 1. FOR ADDITIONAL NOTES, ABBREVIATIONS AND SYMBOLS, SEE DRAWING GE-E-01.
- 2. HISTORIC FINIAL LIGHTS TO BE REFURBISHED AND REINSTALLED UNDER THIS CONTRACT. CONTRACTOR SHALL RE-INSTALL THESE UNITS. REFER TO ARCHITECTURAL DRAWINGS FOR MORE INFORMATION.

		SCALE: $1/4" = 1'-0"$
TCHESTER COUNTY, NEW YORK	C ONTRAC T NUMB ER	SHEET NUMBER
MENT OF PUBLIC WORKS AND TRANSPORTATION	22-523	CXE-E-08
DIVISION OF ENGINEERING	DWG NO.:	
INFRASTRUCTURE REHABILITATION - PHASE 3	SCALE: AS SHO	WN ⁶⁶⁴
PLAYLAND PARK, RYE, NEW YORK CROSS AXIS BUILDING E	DATE: 8/23/202	2
F PLAN - LIGHTING AND LIGHTNING PROTECTION PLAN	DPW FILE NUMBER 1-118-E	-1051-0 REV. NO. 0

	PANELBOARD: CXE-PP1						LOCATION	ELECTI	RICAL R	OOM		
Ι	NEMA RATING			3	POLE	S	MOUNTING	G: SURFA	CE			
125	AMP BUS RATING	100 AMP MAIN BRE	EAKER	42	KA SI	HORT CI	RCUIT RATING					
208Y/I20	VOLTS	3 PHASE 4 V	VIRE					LECTR	RONIC C	GRADE :	NO	
		LO	AD KVA	BREAKER	N N			L	OAD KV	VA	BREAKER	
CIRCUIT	DESCRIPTION		PHASE PHASE	E AMPS /	NOTES	CIRCUIT	DESCRIPTION	PHASE	PHASE	PHASE	AMPS /	
NO.		A	B C	POLES	Ž	NO.		A	В	C	POLES	ž
Ι	RECEPTACLES	0.2		20/I		2	CXE - EXTERIOR SOFFITS	0.2			20/1	
3	RECEPTACLES		0.2	20/I		4	CXE - PORCH LIGHTING		0.2		20/I	
5	RECEPTACLES		0.2	20/1		6	CXE - GAMES SIGNAGE LIGHTING			0.2	20/1	
7	FIRE ALARM	0.1		20/I		8	CXF - EXTERIOR SOFFITS	0.2			20/1	
9	COM CABINET		0.1	20/1		10	CXF - CANOPY LIGHTING		0.2		20/1	
11	SPARE		-	20/1		12	CXF - COLONNADE LIGHTING			0.5	20/1	
13	ROLL-UP DOOR	1.2		20/1		14	SPARE	-			20/1	
15	ROLL-UP DOOR		1.2	20/1		16	SPARE		-		20/1	
I 7	SPARE		-	20/I		18	SPARE			-	20/I	
19	BUILDING LIGHTING	0.5		20/1		20	RELAY PANEL CXE-RP POWER (120V)	0.6			20/1	
21	SPARE		-	20/I		22	SPARE		_		20/1	
23	SPARE		-	20/1		24	SPARE			-	20/1	
25	SPACE					26	SPACE					
27	SPACE					28	SPACE					
29	SPACE					30	SPACE					
31	SPACE					32	SPACE					
33	SPACE					34	SPACE					
35	SPACE					36	SPACE					
37	SPACE					38	SPACE					
39	SPACE					40	SPACE					
41	SPACE					42	SPACE					
	TOTAL PHASE KVA THIS SIDE	2	1.5 0.2				TOTAL PHASE KVA THIS SIDE	1	0.4	0.7		
			I				TOTAL KVA PER PHASE	3	1.9	0.9		
							TOTAL THREE PHASE KVA		5.8			
NOT	TES:					NOTES (I				
1.						5.						
2.						6.						
3.						7.						
4.												

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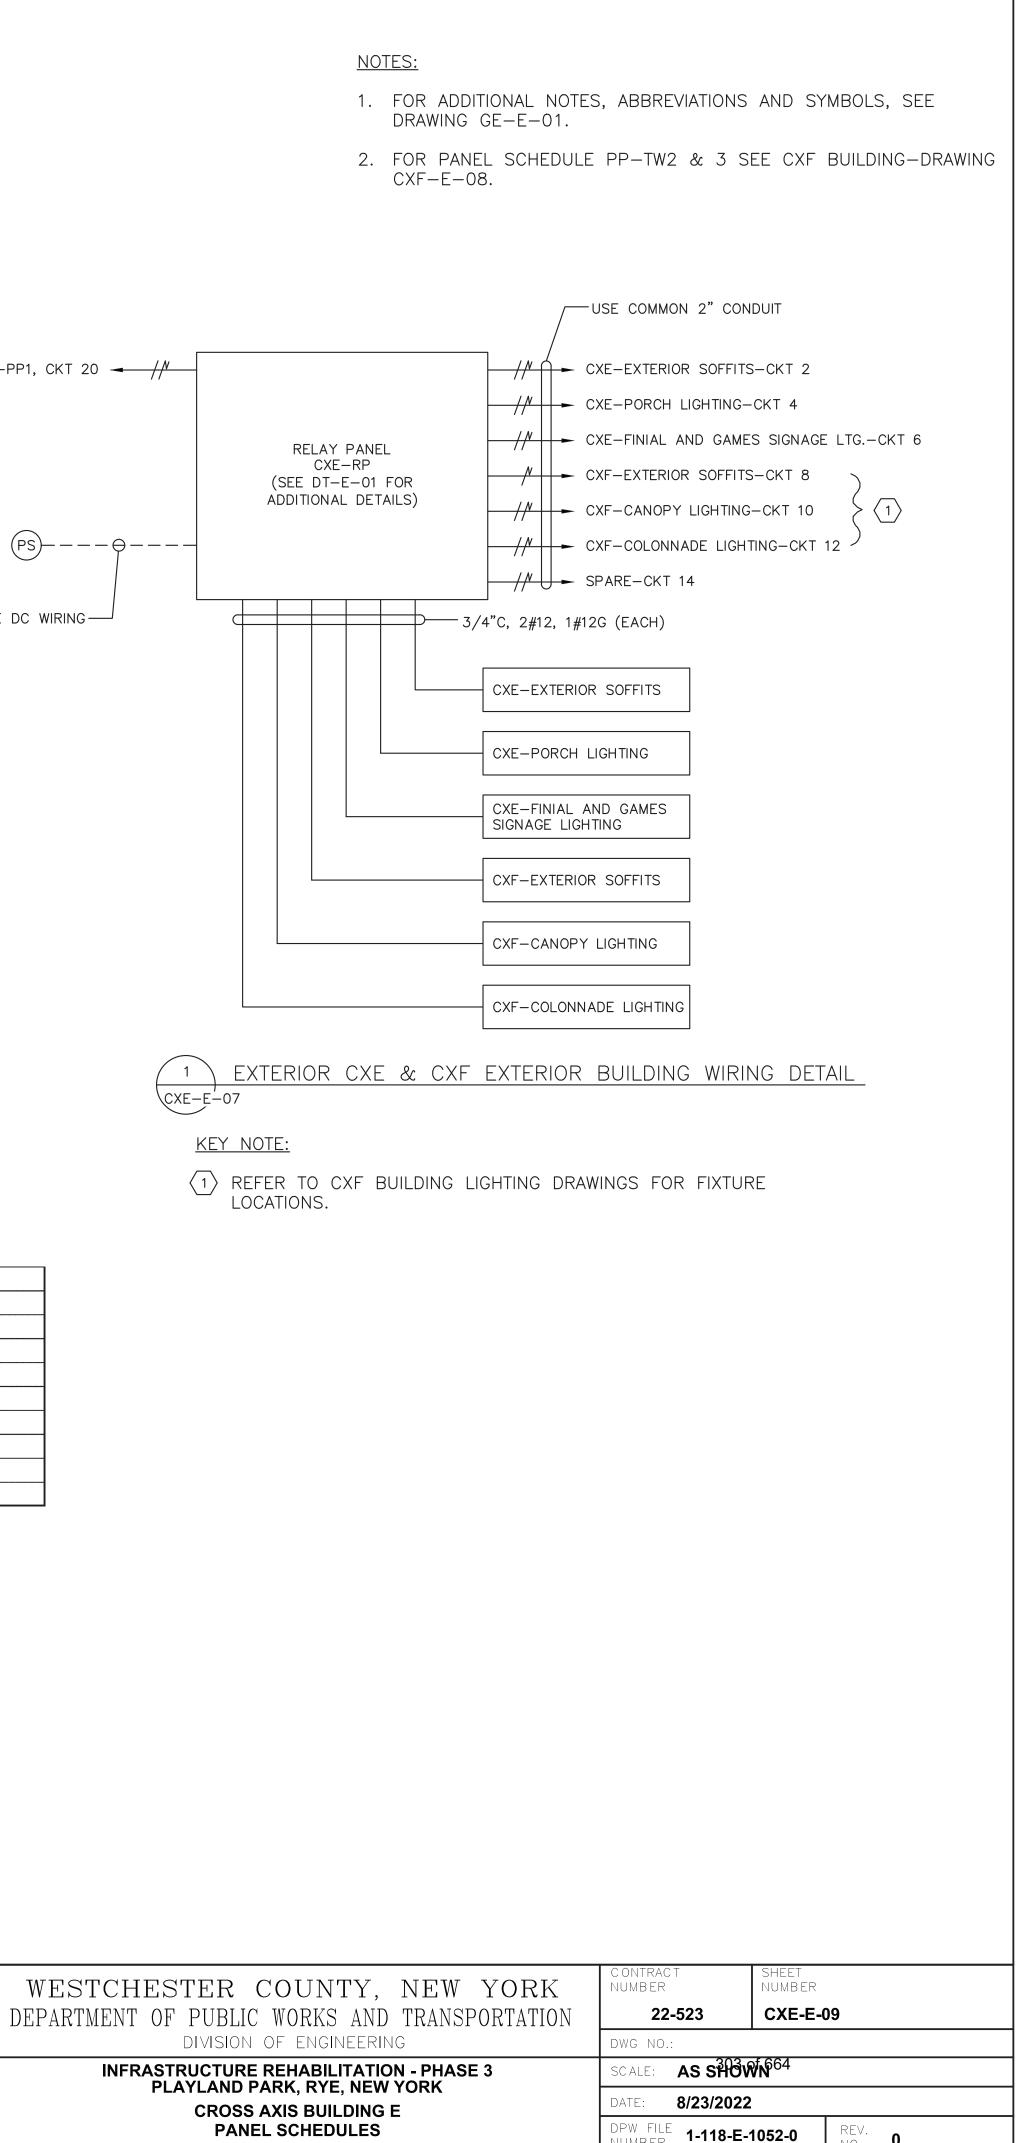
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	REVISION NUMBER	DATE	MADE By	APP'D By	

RELAY PANEL POWER { CXE-PP1, CKT 20 - //

3/4"C, 3#14 LOW VOLTAGE DC WIRING

LOCATION: CXE ELECTRICAL CLOSET						
DESCRIPTION	NOTES					
CXE-EXTERIOR SOFFITS						
CXE-PORCH LIGHTING						
CXE-FINIAL AND GAMES SIGNAGE LIGHTING						
CXF-EXTERIOR SOFFITS						
CXF-CANOPY LIGHTING						
CXF-COLONNADE LIGHTING						
SPARE						
SPARE						
	DESCRIPTION CXE-EXTERIOR SOFFITS CXE-PORCH LIGHTING CXE-FINIAL AND GAMES SIGNAGE LIGHTING CXF-EXTERIOR SOFFITS CXF-CANOPY LIGHTING CXF-COLONNADE LIGHTING SPARE					

	RECORD DRAWING CERTIFICATION							
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	CONTRACTOR	PROJECT COORDINATOR						
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DPW FILE NUMBER **1-118-E-1052-0**

REV. No. **0**

FIRE ALARM GENERAL NOTES:

- THE FIRE ALARM AND SMOKE DETECTION SYSTEM SHALL BE INSTALLED IN COMPLIANCE WITH THE NATIONAL FIRE PREVENTION CODE (NFPA 72 - 2016), NATIONAL LIFE SAFETY CODE (NFPA 101 - 2018), NATIONAL ELECTRICAL CODE (NFPA 70 - 2017), 2020 NEW YORK STATE BUILDING CODE, AND ALL LOCAL MUNICIPAL CODES HAVING JURISDICTION.
- 2. THE FIRE ALARM AND SMOKE DETECTION SYSTEM SHALL BE MAINTAINED AND TESTED IN COMPLIANCE WITH NFPA 72.
- 3. A CONTINUOUS FIRE WATCH SHALL BE PROVIDED IF THERE IS FIRE SYSTEM IMPAIRMENT.
- 4. ALL FIRE ALARM STROBES SHALL BE SYNCHRONIZED AND SHALL REMAIN FLASHING AFTER SYSTEM SILENCE FUNCTION.
- 5. CONTRACTOR TO UPDATE ALL NECESSARY CORRESPONDING FIRE ALARM SIGNALS WHEN PERFORMING ANY MODIFICATION TO THE BUILDING, WHERE APPLICABLE, MAKE SURE THE SAME UPDATES ARE COORDINATED AND TRANSMITTED TO THE CENTRAL STATION.
- 6. HORNS WILL SOUND A TEMPORAL 3-SIGNALING RHYTHM PER NFPA 72.
- 7. EXACT PLACEMENT OF DEVICES TO BE VERIFIED IN FIELD.
- 8. ALL SMOKE DETECTORS SHALL BE INSTALLED A MINIMUM OF 36" FROM ANY HVAC SUPPLY OR RETURN REGISTER.
- 9. FIRE ALARM WIRING SHALL BE INSTALLED IN A MINIMUM OF 3/4" RIGID GALVANIZED CONDUIT OR BY NEW YORK STATE BUILDING CODE APPROVED WIRING METHODS.
- 10. WALL MOUNTED HORNS AND VISUAL FIRE ALARMS (STROBES) SHALL BE MOUNTED NOT LESS THAN 6'-8" AND NOT GREATER THAN 8'-0" A.F.F. WHERE LOCAL CONDITIONS ARE TOO LOW TO PERMIT THE REQUIRED MINIMUM INSTALLATION HEIGHT, INSTALL THE STROBES AT 6" BELOW THE CEILING.
- 11. MANUAL PULL STATIONS SHALL BE MOUNTED AT 4'-0" A.F.F. AND SHALL BE INSTALLED WITHIN 5'-0" OF EXIT DOOR.
- 12. WIRING SHALL BE INSTALLED IN ACCORDANCE WITH NFPA 70 AND AS RECOMMENDED BY THE MANUFACTURER OF THE FIRE ALARM SYSTEM.
- 13. ALL EQUIPMENT AND COMPONENTS SHALL BE NEW AND SHALL BE TESTED AND LISTED BY A NATIONALLY RECOGNIZED APPROVALS AGENCY.
- 14. ALL EQUIPMENT SHALL BE ATTACHED TO WALLS AND CEILING/FLOOR ASSEMBLIES AND SHALL BE HELD FIRMLY IN PLACE. FASTENERS AND SUPPORTS SHALL BE ADEQUATE TO SUPPORT REQUIRED LOAD.
- 15. ALL FIELD WIRING SHALL BE ELECTRICALLY SUPERVISED FOR OPEN CIRCUIT AND GROUND FAULTS.
- 16. ALL BOXES AND CABINETS SHALL BE UL LISTED FOR THEIR USE AND PURPOSE.
- 17. DIALER OR ALARM COMMUNICATOR TRANSMITTER SHALL TRANSMIT ALL POINTS AS THEY ARE REPORTED TO THE HOST PANEL.
- 18. ALL DEVICES SHALL BE COMPATIBLE WITH EXISTING SYSTEM (EST3 BY EDWARDS). FIRE ALARM PRODUCTS SHALL BE APPROVED BY THE ENGINEER OR OWNER.
- 19. ALL PENETRATIONS SHALL BE FIRE PROOFED AS REQUIRED.

FIRE ALARM CONSTRUCTION NOTES:

- ELECTRICIAN SHALL COORDINATE WITH THE FIRE ALARM VENDOR TO PRODUCE A SEPARATE FIXED PRICE TO PERFORM THE SCOPE OF WORK CONTAINED ON THESE DRAWINGS IN CONNECTION WITH THE FIRE ALARM SYSTEM. THESE DRAWINGS ARE PROVIDED FOR BID PURPOSES ONLY AND TO ILLUSTRATE THE SCOPE OF WORK INTENT OF THIS PROJECT.
- 2. ELECTRICIAN SHALL OBTAIN SEPARATE PERMIT FOR FIRE ALARM PRIOR TO INSTALLATION.
- PRIOR TO SUBMISSION OF THE FIRE ALARM SYSTEM BID, THE FIRE ALARM VENDOR IS RESPONSIBLE TO REVIEW ALL DRAWINGS (I.E., MECHANICAL/HVAC, ELECTRICAL, PLUMBING, FIRE SPRINKLER, AND ARCHITECTURAL). UPON SUBMISSION OF THE FIRE ALARM BID. THE FIRE ALARM VENDOR CERTIFIES THAT ALL DRAWINGS HAVE BEEN REVIEWED, THE SITE HAS BEEN VISITED/INSPECTED (IF APPLICABLE), AND THAT ALL LOCAL FIRE DEPARTMENT REQUIRED ITEMS ARE FULLY UNDERSTOOD AND INCLUDED IN THE BID PRICE (NO CHANGE ORDERS ALLOWED).
- FIRE ALARM VENDOR MUST ADHERE TO NFPA 72, NFPA 101, AND ALL LOCAL CODES AND AUTHORITIES HAVING JURISDICTION. THE ENTIRE SYSTEM MUST BE DESIGNED IN ACCORDANCE WITH THESE AUTHORITIES HAVING JURISDICTION.
- FIRE ALARM VENDOR SHALL INCLUDE THE COST OF THE ENGINEERING FEE, PROGRAMMING CHARGE, NEW EQUIPMENT, CONNECTION & TESTING, TROUBLESHOOTING, ATTENDANCE AT THE FIRE ALARM INSPECTION, ETC. AS PART OF THE TOTAL PRICE.
- FIRE ALARM VENDOR MUST SUBMIT APPROVED, SIGNED AND SEALED DESIGN/BUILD DRAWINGS TO THE ENGINEER AND OWNER, INCLUDING: FIRE ALARM RISER DIAGRAM, LAYOUT, EQUIPMENT LIST, SPECIFICATIONS PRIOR TO START OF INSTALLATION. INSTALLATION OF THE NEW FIRE ALARM SYSTEM SHALL NOT PROCEED PRIOR TO WRITTEN APPROVAL BY THE ENGINEER.
- FIRE ALARM VENDOR SHALL SUBMIT SHOP DRAWINGS IN COMPLIANCE WITH NFPA 72, 2020 NEW YORK STATE BUILDING CODE, AND 2020 NEW YORK STATE FIRE CODE SECTION 907.1.1.
- 8. ALL FIRE ALARM CABLES AND WIRING MUST BE PLENUM RETURN RATED CABLES.

SCOPE OF WORK:

- 1. DEMOLISH EXISTING FIRE ALARM DEVICES AND ASSOCIATED WIRING BACK TO SOURCE.
- 2. INSTALL NEW FIRE ALARM DEVICES AS PER DRAWINGS. PROVIDE ALL NECESSARY WIRING, CONNECTIONS, CONDUIT, AND FITTINGS.
- 3. NEW FIRE ALARM DEVICES AND SIGNAL WIRING SHALL BE CONNECTED TO THE EXISTING "QUAD 4" FIRE ALARM PANEL.
- . NEW FIRE ALARM SYSTEM SHALL BE INSPECTED BY A THIRD PARTY INSPECTION AGENCY CERTIFIED BY WESTCHESTER COUNTY. ELECTRICIAN SHALL INCLUDE INSPECTION IN BASE BID SCOPE AND COORDINATE WITH INSPECTION AGENCY TO CERTIFY THE SYSTEM.
- ELECTRICIAN SHALL COORDINATE WITH THE FIRE ALARM VENDOR (OPEN SYSTEMS METRO) TO RE-PROGRAM AND TEST THE CENTRAL FIRE ALARM SYSTEM IN THE PLAYLAND MAIN ADMINISTRATION BUILDING FOLLOWING THE INSTALLATION OF NEW SYSTEM AND DEVICES.
- ELECTRICIAN SHALL COORDINATE WITH THE FIRE ALARM CENTRAL MONITORING PROVIDER (STATEWIDE MONITORING) TO TEST AND VERIFY CENTRAL MONITORING OF PARKWIDE SYSTEM FOLLOWING THE INSTALLATION OF NEW SYSTEM AND DEVICES.

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INFORMATION	



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- THE SITE CONDITIONS.

- 5. FUSE CUT OUT BOX SHALL COMPLY WITH THE NATIONAL ELECTRICAL CODE AND HAVE A REMOVABLE SOLID COPPER
- NEUTRAL BAR.
- CONDUCTOR.

SYMBOL

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IRE ALARM SYSTEM RISER NOTES:

LOCATION OF DEVICES AND EQUIPMENT ARE APPROXIMATE. FINAL LOCATIONS MUST BE DETERMINED ACCORDING TO

2. VISUAL FIRE ALARMS (STROBES) SHALL HAVE MINIMUM 5'-0" CLEARANCE FROM ANY OBSTRUCTIONS, SHALL BE FIELD ADJUSTABLE, AND SHALL BE RATED AT 75 CANDELA MINIMUM, UNLESS OTHERWISE NOTED. ALL STROBES SHALL BE SYNCHRONIZED AT LINE OF SIGHT.

3. WALL MOUNTED HORNS AND VISUAL FIRE ALARMS (STROBES) SHALL BE MOUNTED NOT LESS THAN 6'-8" AND NOT GREATER THAN 8'-0" A.F.F. WHERE LOCAL CONDITIONS ARE TOO LOW TO PERMIT THE REQUIRED MINIMUM INSTALLATION HEIGHT, INSTALL THE STROBES AT 6" BELOW THE CEILING.

4. MANUAL PULL STATIONS SHALL BE MOUNTED AT 4'-0" A.F.F. AND SHALL BE INSTALLED WITHIN 5'-0" OF EXIT DOOR.

6. ALL CONDUITS AND CONTROL PANELS SHALL BE GROUNDED TO BUILDING STEEL/GROUND GRID WITH A MINIMUM #8

RISER DIAGRAM ON THIS DRAWING IS FOR DESIGN PURPOSE ONLY. FIRE ALARM CONTRACTOR SHALL PROVIDE A COMPLETE RISER DIAGRAM WITH ACTUAL FIELD WIRING REQUIRED.

8. EACH FIRE ALARM INITIATING AND INDICATING CIRCUIT SHALL BE ELECTRICALLY SUPERVISED.

9. EACH VISUAL FIRE ALARM CIRCUIT SHALL CONTAIN AT LEAST 20% SPARE CAPACITY.

10. ALL CONTROL PANELS, FUSE CUTOUTS, TROUBLE BELLS, ALARM BELLS AND SILENCE SWITCHES SHALL BE PROPERLY LABELED WITH MINIMUM 1/4" HIGH LETTERS.

11. WIRING FOR AUDIBLE AND VISUAL ALARM NOTIFICATION DEVICES SHALL BE ARRANGED SO THAT A LOSS OF A PORTION OF THE WIRING ON A FLOOR WILL NOT RENDER MORE THAN 60% OF THE DEVICES OF EACH TYPE INOPERATIVE, AND THE DEVICES SHALL BE SO CONNECTED TO THE CIRCUITRY (i.e., BY MEANS OF ALTERNATE CIRCUITS) AS TO MAINTAIN AT LEAST PARTIAL AUDIBILITY/VISIBILITY THROUGHOUT THE ENTIRE FLOOR.

12. THE FIRE ALARM CONTROL PANEL SHALL BE PROVIDED WITH A KEY SWITCH. DURING DAILY TESTS, THE KEY SWITCH SHALL BE USED TO BYPASS THE CIRCUITS THAT CONTROL DAMPERS AND FAN SHUTDOWN.

13. THE DAMPERS AND FAN BYPASS FUNCTION SHALL BE AUTOMATICALLY RESTORED TO BE NORMAL UN-SHUNTED CONDITION WITHIN FORTY-FIVE MINUTES, IF NOT DONE SO MANUALLY BEFORE FORTY-FIVE MINUTES.

14. PERFORM FIRE ALARM SYSTEM TESTING PER THE 2020 NEW YORK STATE FIRE CODE AND NFPA 72.

_	DESCRIPTION
	FIRE ALARM SUB PANEL
	SMOKE DETECTOR
	HEAT DETECTOR
	MANUAL FIRE ALARM PULL STATION
	FIRE ALARM WALL MOUNTED HORN/STROBE # = CANDELA RATING
	FUSED CUT OUT SWITCH/FUSED LOCKABLE DISCONNECT SWITCH
	WALL MOUNTED STROBE # = CANDELA RATING
	FLOW SWITCH CONNECTED TO FIRE ALARM SYSTEM
	SPRINKLER VALVE TAMPER SWITCH CONNECTED TO FIRE ALARM SYSTEM
	DUCT MOUNTED SMOKE DETECTOR
	FIRE ALARM INTERFACE RELAY FOR HVAC FAN SHUTDOWN

NG TO REMAIN

NG TO BE RELOCATED

NG AS SHOWN IN NEW LOCATION

ARM CONTROL PANEL

CUT OUT


ARM CONTROL UNIT

ROTECTION

ROOFTOP UNIT

SPRINKLER WEATHERPROOF

EXISTING TO BE DEMOLISHED

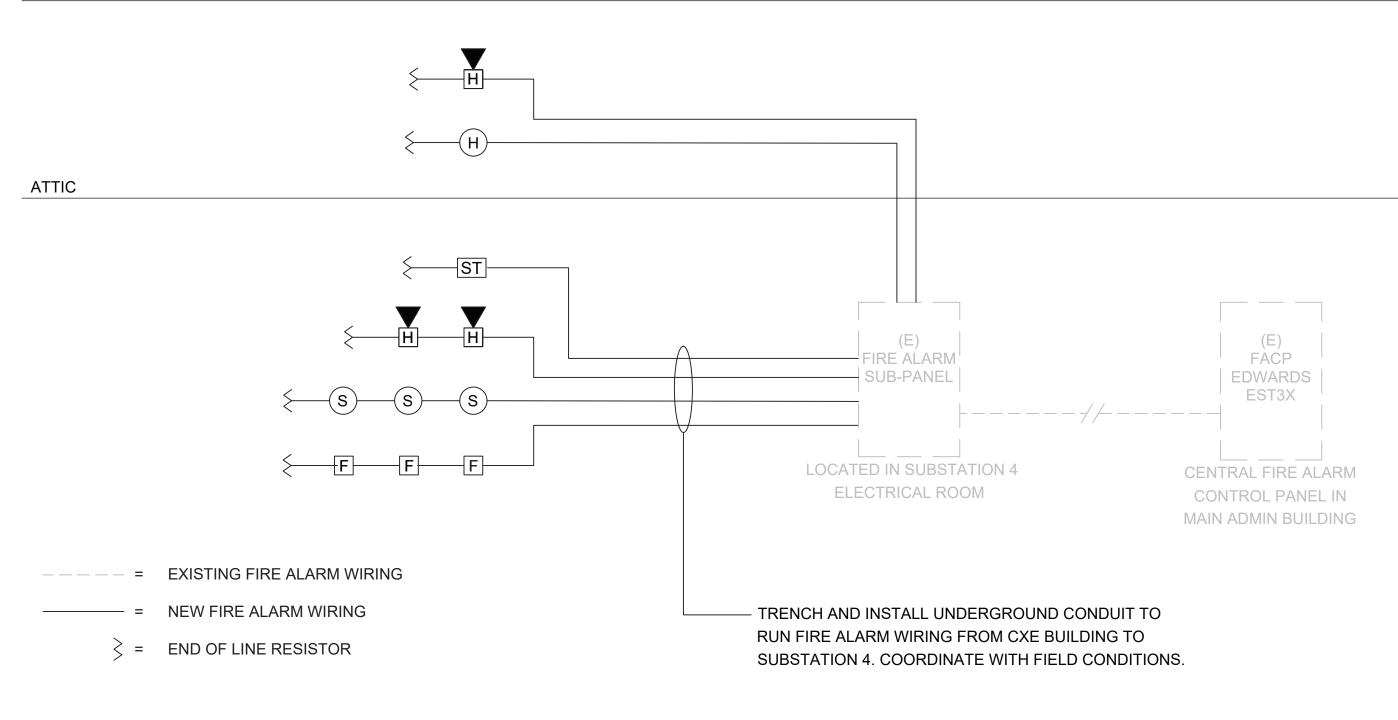

GROUND FLOOR

NOTES

- 1. WIRING SHOWN ON RISER IS DIAGRAMMATICAL. PROVIDE NEW FIRE ALARM CABLE AS REQUIRED AND INSTALL WIRING LOOPS AS BEST SUITED FOR FIELD CONDITIONS.
- 2. THE BUILDING IS FULLY SPRINKLERED.



		Contro	ol Unit	Annun	ciation					1	lotificati	on				Su	ipp.
	ACTUATE COMMON ALARM SIGNAL	ACTUATE AUDIBLE ALARM SIGNAL	INDICATE COMMON SUPERVISORY STATUS	ACTUATE AUDIBLE SUPERVISORY SIGNAL	INDICATE COMMON TROBLE SIGNAL	ACTUATE AUDIBLE COMMON TROUBLE SIGNAL	ACTIVATE HORNS AND STROBES THROUGHOUT THE PROTECTED AREA	DISPLAY/PRINT CHANGE OF STATUS	TRANSMIT AUTOMATIC ALARM SIGNAL TO SUPERVISING STATION	TRANSMIT MANUAL ALARM SIGNAL TO SUPERVISING STATION	TRANSMIT WATERFLOW ALARM SIGNAL TO SUPERVISING STATION	TRANSMIT SUPERVISORY SIGNAL TO SUPERVISING STATION	TRANSMIT CO ALARM SIGNAL TO SUPERVISING STATION	TRANSMIT TROUBLE SIGNAL TO SUPERVISING STATION	ACTIVATE TEMPORAL 4 SIGNAL ON ACTIVATED CO DETECTOR SOUNDER BASES	DAUT DOWN CO PRODUCING EQUIPMENT	SHUT DOWN FANS/AIR HANDLING UNITS
	A	B	С	D	E	F	G	H	I	J	K		M	N	0		Q
1 ACTIVATION OF MANUAL PULL STATION 2 ACTIVATION OF SMOKE DETECTOR	X	X					X	X		X							
	X	X					X	X	X								X
	X	X					X	X	X								X
	X	X					X	X	X								X
	X	X	X				X	X			X						X
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9 FIRE ALARM SYSTEM WIRING FAILURE					^			X						X			


SYSTEM OUTPUTS



		RECORD DRAWIN	G CERTIFICATION		WESTCHESTER COUNTY, NEW YORK			
	AS BUILT -	- CHANGES AS NOTED	AS AS	BUILT – NO CHANGES	DEPARTMENT OF PUBLIC WORKS AND TRANSPORTATION Division of engineering			
	C ONTRACTOR		PROJECT COORDINATOR		INFRASTRUCTURE REHABILITATION - PHASE 3 PLAYLAND PARK, RYE, NEW YORK			
REVISION	SIGNATURE TITLE	DATE	SIGNATURE TITLE	DATE	CROSS AXIS BUILDING E FIRE ALARM NOTES, SYMBOLS, LEGEND, AND RISER DIAGRAM			

C ONTRAC T NUMB ER	SHEET NUMBER			
22-523	CXE-F/	A-01		
DWG NO.: 304 of 66	4			
SCALE: As indica	ted			
DATE: 08/23/2022				
DPW FILE 1-118-FA	-1053-0	REV.	0	

FIRE ALARM SEQUENCE OF OPERATIONS MATRIX

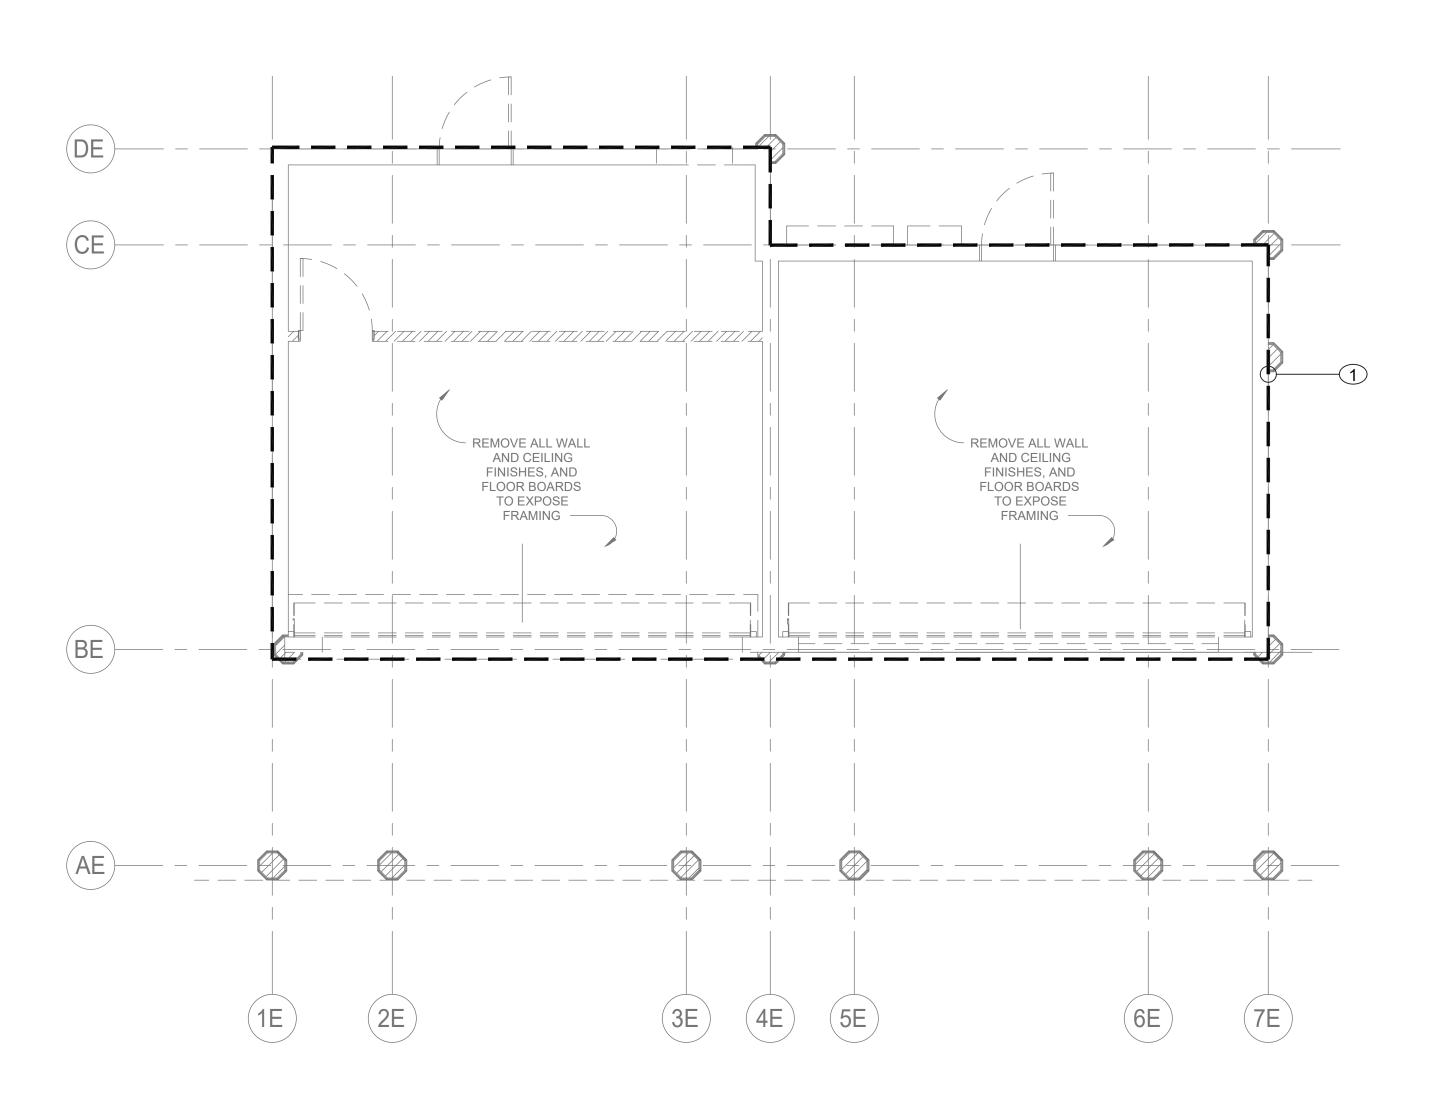




C ONSULTANT INFORMATION	CONSULTANT SEAL					
LiRo Engineers, Inc. <i>A LiRo Group Company</i> Syosset, N.Y. 516-214-8157[T]	HANNE ULGON OP					
	PROFESSIONAL ET	REVISION NUMBER	DATE	MADE B Y	APP'D By	

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ESTCHESTER COUNTY, NEW YORK	CONTRACT SHEET NUMBER NUMBER				
ARTMENT OF PUBLIC WORKS AND TRANSPORTATION	22-523 CXE-FA-11				
DIVISION OF ENGINEERING	DWG NO.: 305 of 664				
INFRASTRUCTURE REHABILITATION - PHASE 3	SCALE: As indicated				
PLAYLAND PARK, RYE, NEW YORK CROSS AXIS BUILDING E	DATE: 08/23/2022				
FIRE ALARM FIRST FLOOR DEMOLITION PLAN	DPW FILE 1-118-FA-1054-0 REV. 0				



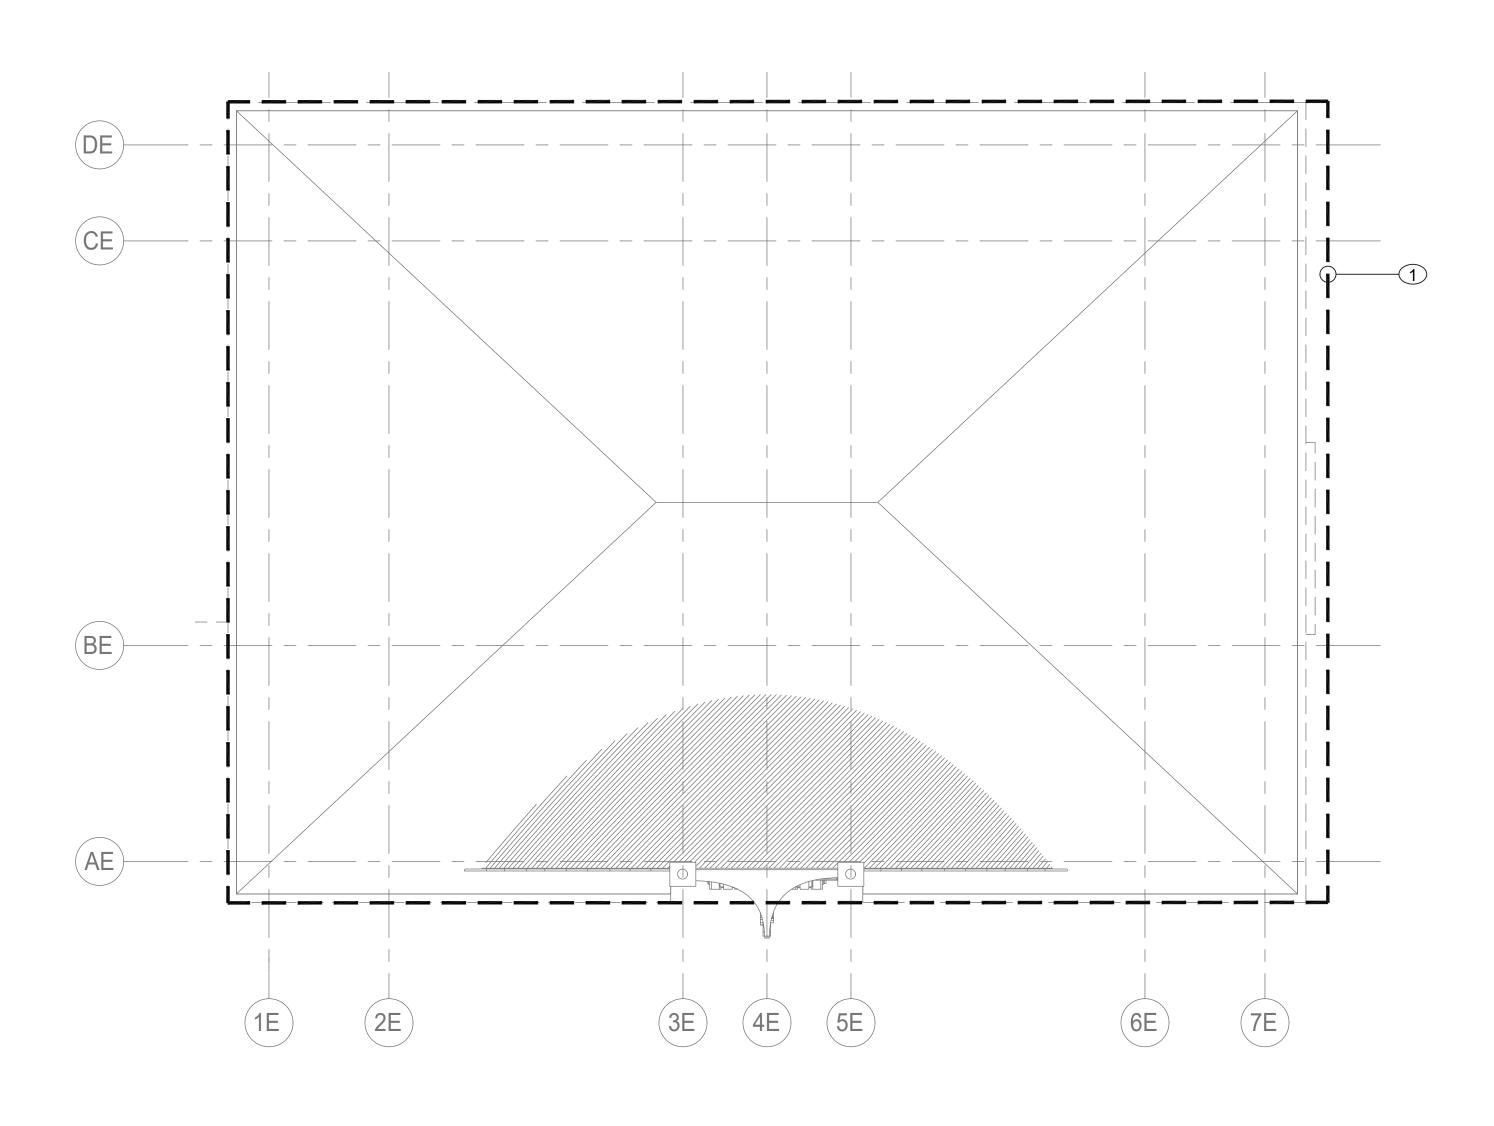


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ESTCHESTER COUNTY, NEW YORK	CONTRACT SHEET NUMBER NUMBER				
PARTMENT OF PUBLIC WORKS AND TRANSPORTATION	22-523 CXE-FA-12				
DIVISION OF ENGINEERING	DWG NO.: 306 of 664				
INFRASTRUCTURE REHABILITATION - PHASE 3	SCALE: As indicated				
PLAYLAND PARK, RYE, NEW YORK CROSS AXIS BUILDING E	DATE: 08/23/2022				
FIRE ALARM ATTIC DEMOLITION PLAN	DPW FILE 1-118-FA-1055-0 REV. 0				





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REVISION	TITLE	DATE	TITLE	DATE	

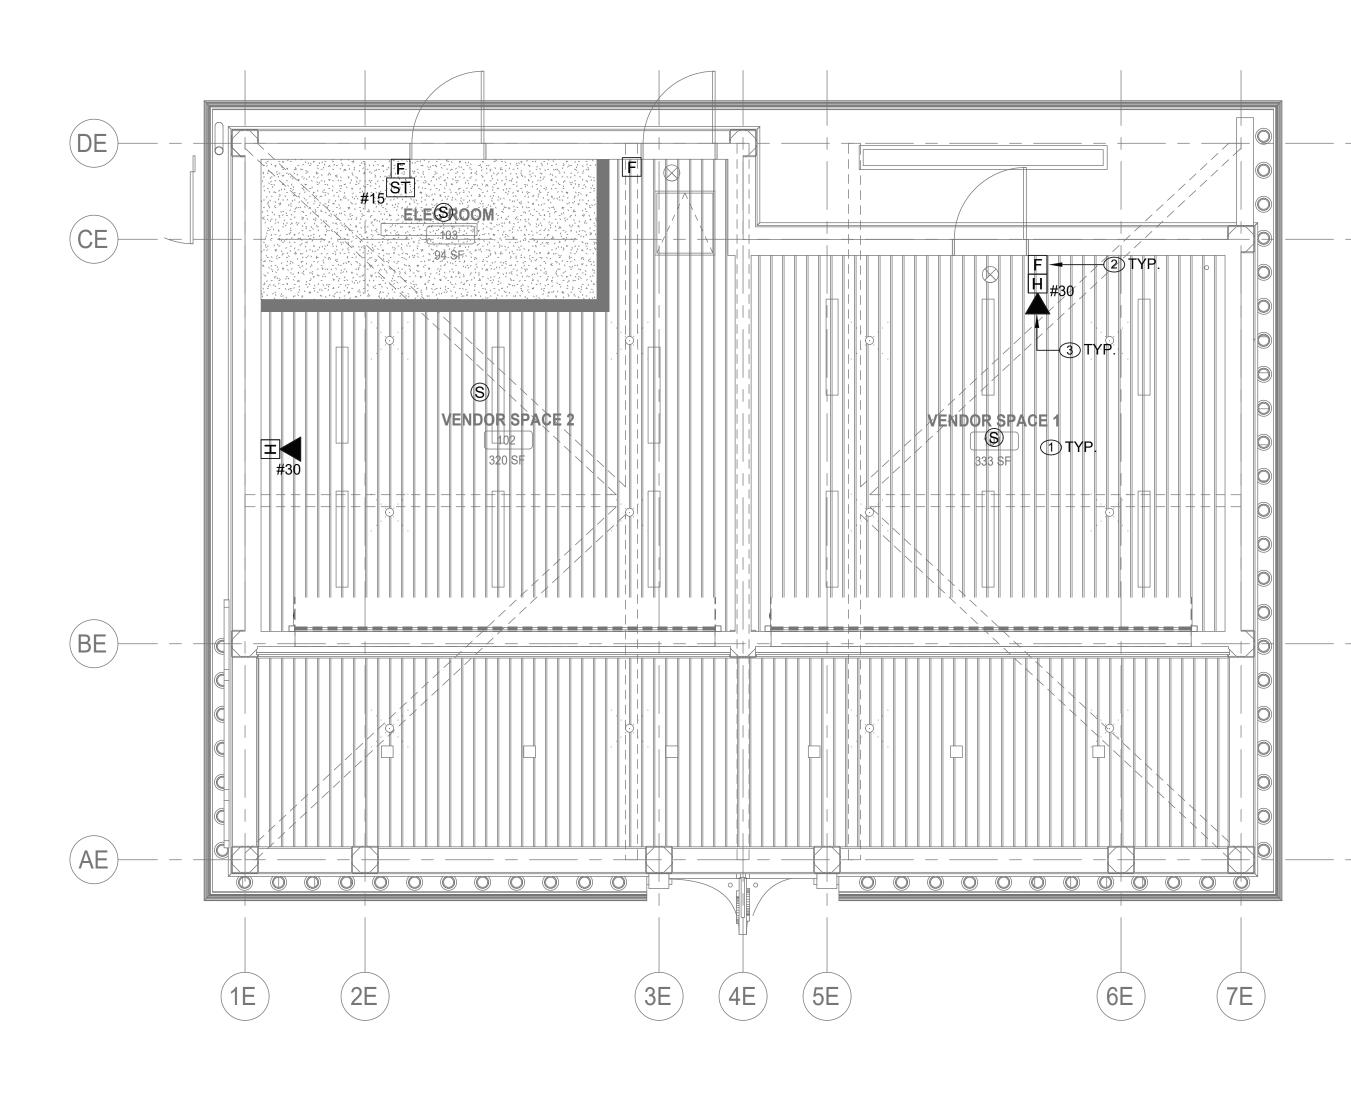FIRE ALARM CONSTRUCTION NOTES:

(1) CONNECT NEW FIRE ALARM DEVICES TO EXISTING FIRE ALARM CONTROL PANEL IN SUBSTATION 4 ELECTRICAL ROOM.


2 NEW MANUAL PULL STATIONS SHALL BE INSTALLED AT 4'-0" ABOVE FINISHED FLOOR AT EACH BUILDING EXIT (MAX. DISTANCE OF 5'-0" FROM EXIT).

(3) FIRE ALARM STROBES AND HORN STROBES SHALL BE FIELD ADJUSTABLE AND SET CANDELA RATING INDICATED ON PLAN. FIRE ALARM STROBES AND HORN STROBES SHALL BE INSTALLED AT 7'-4" ABOVE FINISHED FLOOR UNLESS OTHERWISE NOTED.


FIRE ALARM GENERAL NOTES:

- . REFER TO DRAWING FA-001.00 FOR SYMBOLS, ABBREVIATIONS, AND NOTES. LAYOUT OF FIRE ALARM DEVICES ON THIS PLAN IS DIAGRAMMATIC; EXACT LOCATIONS OF DEVICES AND CONDUIT SHALL BE COORDINATED WITH FIELD CONDITIONS, ARCHITECTURAL REQUIREMENTS, AND MANUFACTURER RECOMMENDATIONS.
- 2. ALL DEVICES AND EQUIPMENT SHOWN ON THIS PLAN ARE NEW, UNLESS OTHERWISE NOTED.
- 3. INSTALL NEW FIRE ALARM SYSTEM IN STRICT ACCORDANCE WITH NFPA-72 AND NFPA-90A REQUIREMENTS.
- 4. CONTRACTOR SHALL INSTALL NEW FIRE ALARM SYSTEM AS INDICATED AND PROVIDE ALL NECESSARY WIRING, CONDUIT, AND APPARATUSES.
- 5. ALL VISUAL NOTIFICATION DEVICES IN THE SAME SPACE SHALL BE SYNCHRONIZED IN ACCORDANCE WITH NFPA-72.
- 6. COORDINATE INSTALLATION WITH FIRE ALARM SYSTEM VENDOR AND MANUFACTURER REQUIREMENTS.
- 7. COORDINATE FIRE ALARM DEVICES WITH ARCHITECTURAL FINISHES. CONCEAL CONDUIT IN FINISHED WALLS AND FLUSH MOUNT DEVICES WHERE POSSIBLE.
- 8. CONTRACTOR SHALL TEST THE FIRE ALARM SYSTEM AFTER COMPLETION OF INSTALLATION. FIRE ALARM SYSTEM SHALL BE TESTED AND VERIFIED TO BE WORKING PROPERLY PRIOR TO INSPECTION BY THE AUTHORITY HAVING JURISDICTION.
- 9. FOLLOWING INSTALLATION, CONTRACTOR SHALL PATCH, PAINT, AND RESTORE ALL WALLS AND CEILINGS TO MATCH EXISTING OR DESIRED NEW CONDITION.
- 10. FIRESTOP ALL FIRE-RATED FLOOR OR WALL PENETRATIONS TO MAINTAIN ORIGINAL FIRE RATING TO FULL DEPTH OF OPENING.
- 11. CONTRACTOR SHALL PROVIDE SLEEVE FOR CONDUIT PENETRATIONS THROUGH WALL AND CEILING FLOORS.

ESTCHESTER COUNTY, NEW YORK	NUMBER NUMBER
ARTMENT OF PUBLIC WORKS AND TRANSPORTATION	22-523 CXE-FA-21
DIVISION OF ENGINEERING	DWG NO.: 307 of 664
INFRASTRUCTURE REHABILITATION - PHASE 3	SCALE: As indicated
PLAYLAND PARK, RYE, NEW YORK CROSS AXIS BUILDING E	DATE: 08/23/2022
FIRE ALARM FIRST FLOOR PLAN	DPW FILE 1-118-FA-1056-0 REV. 0 NO.

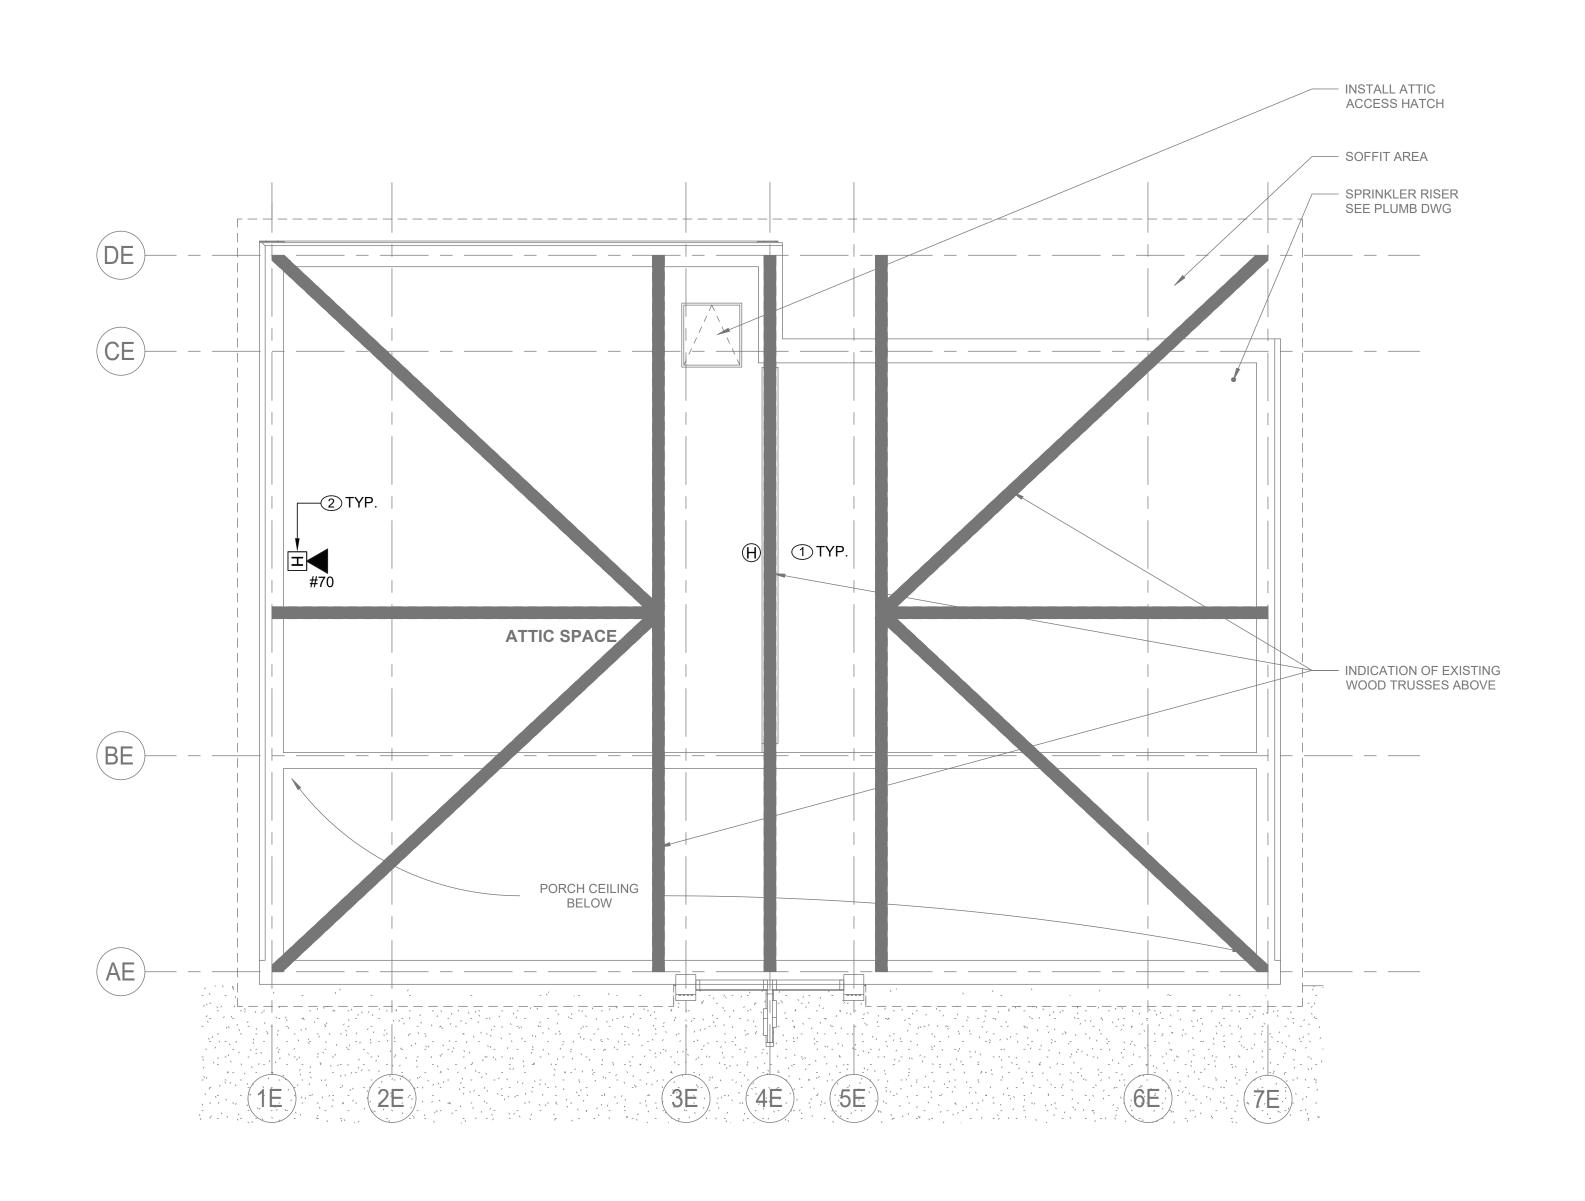

FIRE ALARM ATTIC PLAN SCALE: 1/4" = 1'-0"

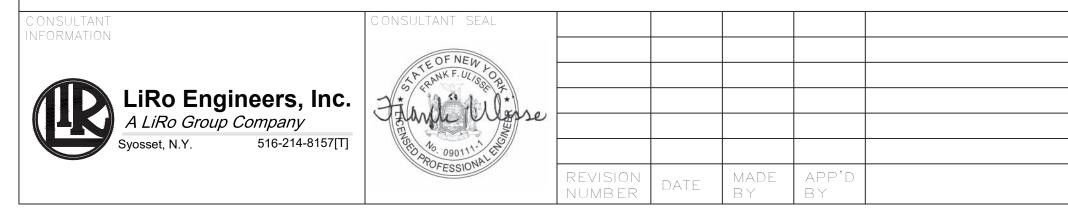

	RECORD DRAWING	G CERTIFICATION	WESTCHESTER COUNTY, NEW YORK	C ONTRACT NUMB ER	SHEET NUMBER
	AS BUILT – CHANGES AS NOTED	AS BUILT – NO CHANGES	DEPARTMENT OF PUBLIC WORKS AND TRANSPORTATION	22-523	CXE-FA-22
			DIVISION OF ENGINEERING	DWG NO.: 308 of 6	64
	CONTRACTOR	PROJECT COORDINATOR	INFRASTRUCTURE REHABILITATION - PHASE 3	SCALE: As indica	ated
	SIGNATURE	SIGNATURE	PLAYLAND PARK, RYE, NEW YORK CROSS AXIS BUILDING E	DATE: 08/23/2022	2
REVISION	TITLE DATE	TITLE DATE	FIRE ALARM ATTIC PLAN	DPW FILE 1-118-F	A-1057-0 REV. 0


FIRE ALARM CONSTRUCTION NOTES:

1 CONNECT NEW FIRE ALARM DEVICES TO EXISTING FIRE ALARM CONTROL PANEL IN SUBSTATION 4 ELECTRICAL ROOM.

2 FIRE ALARM STROBES AND HORN STROBES SHALL BE FIELD ADJUSTABLE AND SET CANDELA RATING INDICATED ON PLAN. FIRE ALARM STROBES AND HORN STROBES SHALL BE INSTALLED AT 7'-4" ABOVE FINISHED FLOOR UNLESS OTHERWISE NOTED.

FIRE ALARM GENERAL NOTES:

- 1. REFER TO DRAWING FA-001.00 FOR SYMBOLS, ABBREVIATIONS, AND NOTES. LAYOUT OF FIRE ALARM DEVICES ON THIS PLAN IS DIAGRAMMATIC; EXACT LOCATIONS OF DEVICES AND CONDUIT SHALL BE COORDINATED WITH FIELD CONDITIONS, ARCHITECTURAL REQUIREMENTS, AND MANUFACTURER RECOMMENDATIONS.
- 2. ALL DEVICES AND EQUIPMENT SHOWN ON THIS PLAN ARE NEW, UNLESS OTHERWISE NOTED.
- 3. INSTALL NEW FIRE ALARM SYSTEM IN STRICT ACCORDANCE WITH NFPA-72 AND NFPA-90A REQUIREMENTS.
- 4. CONTRACTOR SHALL INSTALL NEW FIRE ALARM SYSTEM AS INDICATED AND PROVIDE ALL NECESSARY WIRING, CONDUIT, AND APPARATUSES.
- 5. ALL VISUAL NOTIFICATION DEVICES IN THE SAME SPACE SHALL BE SYNCHRONIZED IN ACCORDANCE WITH NFPA-72.
- 6. COORDINATE INSTALLATION WITH FIRE ALARM SYSTEM VENDOR AND MANUFACTURER REQUIREMENTS.
- 7. COORDINATE FIRE ALARM DEVICES WITH ARCHITECTURAL FINISHES. CONCEAL CONDUIT IN FINISHED WALLS AND FLUSH MOUNT DEVICES WHERE POSSIBLE.
- 8. CONTRACTOR SHALL TEST THE FIRE ALARM SYSTEM AFTER COMPLETION OF INSTALLATION. FIRE ALARM SYSTEM SHALL BE TESTED AND VERIFIED TO BE WORKING PROPERLY PRIOR TO INSPECTION BY THE AUTHORITY HAVING JURISDICTION.
- 9. FOLLOWING INSTALLATION, CONTRACTOR SHALL PATCH, PAINT, AND RESTORE ALL WALLS AND CEILINGS TO MATCH EXISTING OR DESIRED NEW CONDITION.
- 10. FIRESTOP ALL FIRE-RATED FLOOR OR WALL PENETRATIONS TO MAINTAIN ORIGINAL FIRE RATING TO FULL DEPTH OF OPENING.
- 11. CONTRACTOR SHALL PROVIDE SLEEVE FOR CONDUIT PENETRATIONS THROUGH WALL AND CEILING FLOORS.

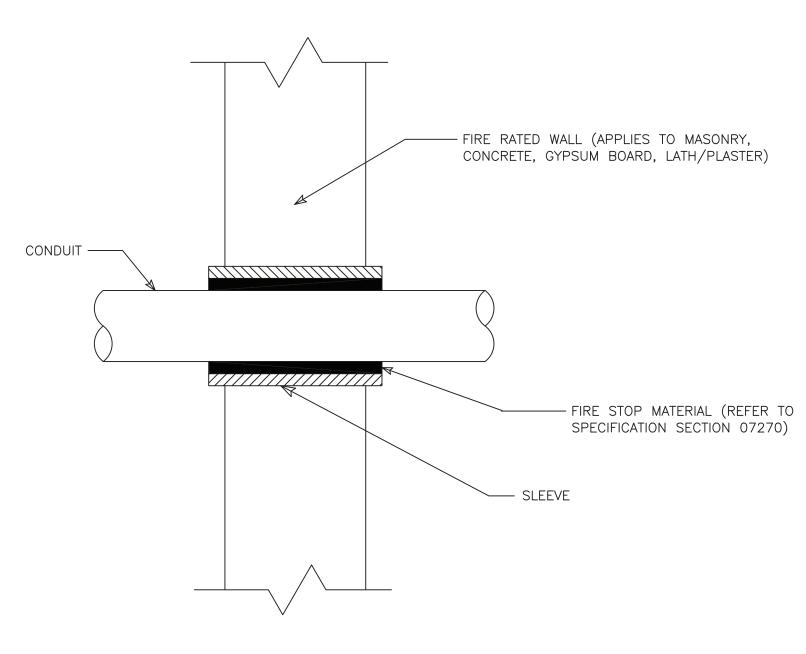




CONDUIT PENETRATION THRU FIRE RATED WALL

CONSULTANT INFORMATION





REVISION NUMBER	DATE	MADE B Y	APP'D By	

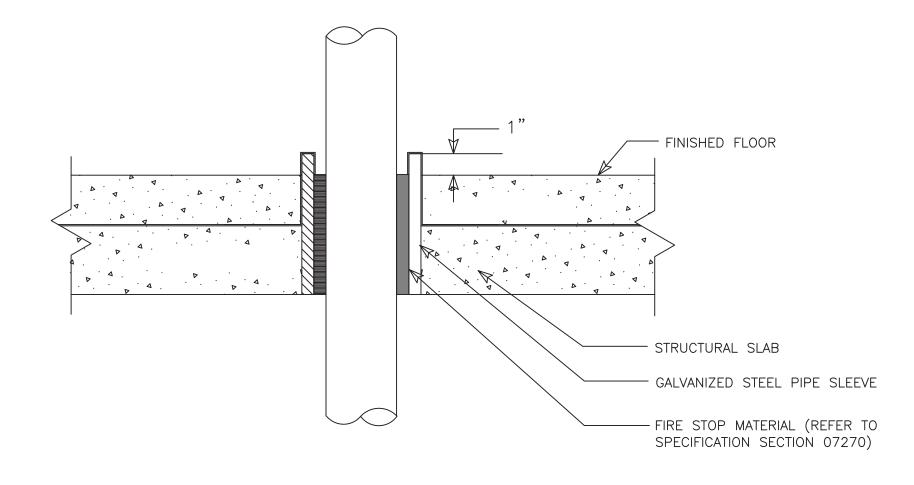



CONDUIT PENETRATION THRU FLOOR SLAB

	RECORD DRAWING	G CERTIFICATION	WESTCHESTER COUNTY, NEW YORK	C ONTRAC T NUMB ER	SHEET NUMBER
	AS BUILT – CHANGES AS NOTED	AS BUILT – NO CHANGES	DEPARTMENT OF PUBLIC WORKS AND TRANSPORTATION	22-523	CXE-FA-81
			DIVISION OF ENGINEERING	DWG NO.: 309 c	of 664
	CONTRACTOR	PROJECT COORDINATOR	INFRASTRUCTURE REHABILITATION - PHASE 3	SCALE: As inc	dicated
		signature	PLAYLAND PARK, RYE, NEW YORK CROSS AXIS BUILDING E	DATE: 08/23/2	022
ON	TITLE DATE	TITLE DATE	FIRE ALARM DETAILS	DPW FILE 1-118 NUMBER 1-118	8-FA-1058-0 REV. 0

GENERAL NOTES:

- 1. DIMENSIONS INDICATED ON THE DRAWINGS ARE APPROXIMATE AND SUBJECT TO REVISIONS AS PER ACTUAL FIELD CONDITIONS.
- 2. CONTRACTOR SHALL COMPLY WITH ALL NYSDEC PERMIT REQUIREMENTS AND ANY OTHER STATE, COUNTY, CITY OR TOWN AGENCY HAVING JURISDICTION. REFER TO THE CONTRACT SPECIFICATIONS FOR PERMIT REQUIREMENTS.
- 3. CONTRACTOR SHALL TAKE ALL PRECAUTIONS TO MAINTAIN UTILITY SERVICE TO AND FROM BUILDINGS AND PARK AREAS.
- 4. ANY UTILITIES SHOWN ON THE PLANS ARE FOR INFORMATION ONLY AND HAVE BEEN OBTAINED FROM AVAILABLE SOURCES. THE EXISTENCE AND LOCATION OF ANY UTILITIES INDICATED ON THE PLANS ARE NOT GUARANTEED AND SHALL BE INVESTIGATED AND VERIFIED IN THE FIELD BY THE CONTRACTOR BEFORE STARTING WORK. THE CONTRACTOR SHALL HAVE ALL EXISTING UTILITIES FIELD STAKED BEFORE STARTING WORK BY CALLING DIG SAFELY NEW YORK AT 1-800-962-7962. EXCAVATION IN THE VICINITY OF UNDERGROUND UTILITIES SHALL BE DUG BY HAND. THE CONTRACTOR WILL BE HELD RESPONSIBLE FOR ANY DAMAGE TO EXISTING UTILITIES. NO SEPARATE PAYMENT SHALL BE MADE FOR THIS WORK.
- 5. THE CONTRACTOR WILL BE REQUIRED TO PROVIDE PRIVATE UTILITY MARKOUTS FOR ALL UTILITIES IN THE WORK AREAS. THE CONTRACTOR SHALL SUBMIT THE PROPOSED UTILITY SUB-CONTRACTOR FOR APPROVAL.
- 6. THE CONTRACTOR SHALL OBTAIN AND HAVE ON THE JOB SITE, AT ALL TIMES, ALL PERMITS AS REQUIRED BY THE STATE, COUNTY, CITY, TOWN/VILLAGE OR ANY OTHER PERMITTING AGENCY. THE CONTRACTOR SHALL BEAR ALL COSTS OF OBTAINING THESE PERMITS.
- 7. CONTRACTOR SHALL REMOVE ALL DEBRIS AND EXCESS CONSTRUCTION MATERIALS TO THE SATISFACTION OF THE OWNER AND ENGINEER. THE CONTRACTOR SHALL BE RESPONSIBLE FOR THE REMOVAL AND LEGAL DISPOSAL OF ALL MATERIALS RESULTING FROM THE CONTRACT.
- 8. CONTRACTOR SHALL COORDINATE ALL CONSTRUCTION ACTIVITIES WITH THE OWNER AND ENGINEER TO MINIMIZE INTERRUPTIONS TO NORMAL PARK OPERATIONS.
- 9. CONTRACTOR SHALL SUBMIT A DETAILED WORK PLAN INCLUDING SEQUENCE OF OPERATIONS PRIOR TO COMMENCING WORK AND SHALL BE SUBJECT TO APPROVAL OF THE OWNER/ENGINEER.
- 10. THE CONTRACTOR SHALL NOTIFY THE OWNER AND THE ENGINEER A MINIMUM OF SEVENTY-TWO (72) HOURS PRIOR TO THE START OF CONSTRUCTION. IN ADDITION, IF WORK SHOULD BE STOPPED AND RESTARTED FOR ANY REASON, THE CONTRACTOR SHALL GIVE THE ENGINEER A MINIMUM OF SEVENTY-TWO (72) HOURS NOTICE.
- 11. ITEMS SUSTAINING DAMAGE DURING CONSTRUCTION AS A RESULT OF THE CONTRACTOR'S OPERATIONS SHALL BE REPAIRED AND/OR REPLACED TO THE SATISFACTION AND APPROVAL OF THE OWNER AT THE CONTRACTORS EXPENSE. ANY DAMAGE SHALL BE REPAIRED AT NO ADDITIONAL COST TO THE OWNER.
- 12. ALL NECESSARY PRECAUTIONS SHALL BE TAKEN TO PRESERVE THE MATERIAL BELOW AND BEYOND THE LINES OF ALL EXCAVATION IN THE SOUNDEST POSSIBLE CONDITION. ANY DAMAGE TO THE WORK DUE TO THE CONTRACTOR'S OPERATIONS SHALL BE REPAIRED AT THE EXPENSE OF AND BY THE CONTRACTOR.
- 13.NO MATERIALS OF ANY KIND SHALL BE USED UNTIL IT HAS BEEN INSPECTED AND ACCEPTED BY THE ENGINEER; ALL MATERIALS REJECTED SHALL BE IMMEDIATELY REMOVED FROM THE WORK SITE AND SHALL NOT BE OFFERED FOR INSPECTION AGAIN.
- 14. ANY MATERIALS OR WORKMANSHIP FOUND AT ANY TIME TO BE DEFECTIVE SHALL BE REMEDIED AT ONCE, REGARDLESS OF PREVIOUS INSPECTION, THE INSPECTION AND OBSERVATION OF WORK BY THE ENGINEER IS INTENDED TO AID THE CONTRACTOR IN APPLYING LABOR AND MATERIAL TO AND IN ACCORDANCE WITH THE SPECIFICATION, BUT SUCH INSPECTION SHALL NOT RELEASE THE CONTRACTOR FROM ANY CONTRACT OBLIGATIONS.
- 15. THE CONTRACTOR SHALL CONDUCT THE WORK IN A SAFE MANNER SO AS TO POSE NO DANGER OR HAZARDS TO PERSONS OR PROPERTY. WHERE NECESSARY, TEMPORARY SHIELDS OR OTHER PROTECTIVE DEVICES MUST BE UTILIZED. THE CONTRACTOR ASSUMES FULL RESPONSIBILITY AND EXPENSE OF ANY AND ALL SAFETY MEASURES. THE USE OF EXPLOSIVES IS STRICTLY PROHIBITED. THE CONTRACTOR SHALL COMPLY WITH ALL OSHA AND NEW YORK STATE DEPARTMENT OF LABOR REQUIREMENTS.
- 16. RESED ALL AREAS WHERE WORK OCCURS AND/OR WHERE CONTRACTOR DAMAGES EXISTING GRASS. COMPLY WITH THE SPECIFICATIONS. STAGING AREAS SHALL BE RESTORED TO ORIGINAL CONDITION AND SHALL BE SEEDED FOLLOWING COMPLETION OF ALL PHYSICAL WORK.
- 17. THE CONTRACTOR SHALL HAVE A COMPETENT REPRESENTATIVE PRESENT WHO SHALL RESPOND TO ANY OUESTIONS OR REQUESTS OF THE ENGINEER IN THE PROSECUTION AND COMPLETION OF THE WORK IN CONFORMITY WITH THIS CONTRACT, AND SHALL HAVE FULL AUTHORITY TO SUPPLY LABOR AND MATERIAL IMMEDIATELY. THE CONTRACTOR SHALL ALSO HAVE A COMPETENT REPRESENTATIVE AVAILABLE TO RECEIVE TELEPHONE MESSAGES AND PROVIDE A REASONABLE REPLY AS SOON AS POSSIBLE, BUT NO LATER THAN 24 HOURS.
- 18. NEITHER THE OWNER OR ENGINEER SHALL BE RESPONSIBLE FOR THE MEANS AND METHODS CHOSEN BY THE CONTRACTOR TO COMPLETE THE WORK.
- 19. THE CONTRACTOR SHALL HAVE FULL RESPONSIBILITY FOR SITE SAFETY AND THE SAFETY OF THE CONTRACTOR'S WORK FORCE.
- 20.BACKFILL AT ALL EXCAVATIONS SHALL BE PLACED IN 6" LIFTS AND SHALL ACHIEVE A COMPACTION NOT LESS THAN 95 PERCENT OF STANDARD PROCTOR MAXIMUM DENSITY. UNDER THE TERMS OF THE CONTRACT, THE CONTRACTOR SHALL PERFORM FIELD TESTS BY AN APPROVED LABORATORY TO ASSURE THIS COMPACTION RATE AT VARYING DEPTHS. THE CONTRACTOR SHALL BEAR ALL COSTS FOR TESTING AND ANY DELAYS THAT RESULT FROM SUCH TESTING.
- 21.THE CONTRACTOR SHALL ADJUST ALL MANHOLE FRAMES AND COVERS, VALVE COVERS, WATERVALVE BOXES, DRAINAGE INLETS, ETC. AS NECESSARY TO MEET THE SURFACE OF NEW PAVEMENT OR WALKWAY AS REQUIRED TO ALLOW POSITIVE DRAINAGE. NO SEPARATE PAYMENT WILL BE MADE FOR THIS WORK UNLESS OTHERWISE NOTED IN THE CONTRACT DOCUMENTS. THE CONTRACTOR SHALL COORDINATE THIS ACTIVITY WITH THE RELATED UTILITY COMPANIES, IF APPLICABLE. WARPING OF THE PAVEMENT SURFACE TO MEET THESE ITEMS WILL NOT BE PERMITTED.
- 22.ALL EXISTING SIGNS IN THE CONTRACT AREA ARE TO REMAIN INTACT. SIGNS DAMAGED SHALL BE REPLACED AT THE CONTRACTOR'S EXPENSE. ANY SIGNS THAT REQUIRE RESETTING SHALL BE PLACED IN A FINAL POSITION DETERMINED BY THE OWNER. NO SEPARATE PAYMENT SHALL BE MADE FOR THIS WORK. THE CONTRACTOR SHALL BE HELD RESPONSIBLE FOR SIGNS DAMAGED BY HIS OPERATIONS. THE CONTRACTOR SHALL BE RESPONSIBLE FOR ALL DAMAGES TO BURIED AND OVERHEAD UTILITIES LOCATED ON PUBLIC AND PRIVATE PROPERTY. THE CONTRACTOR SHALL BE RESPONSIBLE FOR ALL DAMAGES TO FACILITIES ON PUBLIC AND PRIVATE PROPERTY, SUCH AS, LANDSCAPING, DRIVEWAYS, CURBS, PAVEMENT, SIDEWALK, ETC.
- 23. CONTRACTOR IS RESPONSIBLE TO COORDINATE AND VERIFY THE EXTENT OF ALL DEMOLITION WITH THE ENGINEER PRIOR TO PERFORMING THE WORK.
- 24.CONTRACTOR SHALL RESTORE STAGING AREA BACK TO ITS ORIGINAL CONDITION INCLUDING GRADING, SEEDING ETC. EXISTING TREES, UTILITIES, LIGHT POLES, STONE, SIDEWALK, CURB, ETC. SHALL BE PROTECTED AND REPLACED IF DAMAGED. PROVIDE ELECTRICAL POWER, WATER, TELEPHONE, ETC. AS SPECIFIED FOR THE ENGINEERS TRAILER WHICH SHALL BE LOCATED IN THE STAGING AREA.

SURVEY NOTES

- 1. HORIZONTAL COORDINATES SHOWN HEREON REFER TO THE NORTH AMERICAN DATUM OF 1983 (NAD83), NEW YORK STATE PLANE COORDINATE SYSTEM, NEW YORK EAST ZONE 3101.
- 2. VERTICAL ELEVATIONS SHOWN HEREON REFER TO THE NORTH AMERICAN VERTICAL DATUM OF 1988 (NAVD88) WHICH IS BASED ON THE UNITED STATES COAST & GEODETIC SURVEY MEAN SEA LEVEL AT SANDY HOOK, NEW JERSEY.
- 3. LOCATION OF UTILITIES AS SHOWN ARE BASED UPON MAP TITLED "PARTIAL TOPOGRAPHICAL AND UTILITY SURVEY OF RYE PLAYLAND PARK" BY LKB LAST UPDATED SEPTEMBER 8, 2017.

4. LOCATIONS OF UNDERGROUND UTILITIES SHOWN ON THIS SURVEY ARE APPROXIMATE. RLT

- ENGINEERING, GEOLOGY, AND LAND SURVEYING, P.C., CANNOT GUARANTEE THE LOCATION OF UNDERGROUND UTILITIES AND STRUCTURES. THE STANDARD OF CARE USED BY RLT ENGINEERING GEOLOGY, AND LAND SURVEYING, P.C. TO LOCATE THE UTILITIES IS REASONABLE AND CONSISTENT WITH THE LOCAL STANDARD OF CARE USED TO LOCATE THE UNDERGROUND UTILITIES. LOCATIONS AND SIZE ARE BASED ON UTILITY MARK-OUTS, AS-BUILT MAPS AND OTHER VISIBLE SURFACE EVIDENCE OBSERVED IN THE COURSE OF THIS SURVEY. PRIOR TO EXCAVATION OR CONSTRUCTION THE LOCATION, SIZE AND TYPE OF ALL UNDERGROUND UTILITY LOCATIONS MUST BE VERIFIED BY THE RESPECTIVE UTILITY COMPANY.
- 5. THE SUBJECT PROPERTY OF RYE PLAYLAND PARK FALLS WITHIN FEMA FLOOD ZONES AE (EL 12), AE (EL 13), VE (EL 14), VE (EL 15), VE (EL 16), VE (EL 17) AS SHOWN ON THE FEMA FLOOD INSURANCE RATE MAP COMMUNITY PANEL #36119C0358 F EFFECTIVE DATE SEPTEMBER 28, 2007 AND FEMA FLOOD INSURANCE RATE MAP COMMUNITY PANEL #36119C0356 F EFFECTIVE DATE SEPTEMBER 28, 2007. FEMA ELEVATIONS REFER TO NAVD88."

DEMOLITION NOTES:

- 1. ALL REQUIRED DEMOLITION PERMITS MUST BE OBTAINED FROM ALL REQUIRED AGENCIES PRIOR TO COMMENCEMENT OF WORK.
- 2. ANY ASBESTOS REMOVAL MUST BE DONE BY A CERTIFIED ASBESTOS REMOVAL CONTRACTOR.
- 3. ALL UTILITY COMPANIES MUST BE NOTIFIED A MINIMUM OF 48 HOURS IN ADVANCE OF DEMOLITION.
- 4. FOR ALL UTILITIES, CONTRACTOR SHALL VERIFY DISCONNECT PRIOR TO DEMOLITION.
- 5. PROPER FENCING OR PUBLIC PROTECTION DEVICES MUST BE CONSTRUCTED AND MAINTAINED AROUND THE PERIMETER OF THE SITE AT ALL TIMES DURING DEMOLITION PHASE.
- 6. IT IS THE CONTRACTOR'S RESPONSIBILITY TO CONTROL DUST, DIRT, AND DEBRIS DURING DEMOLITION AND CONSTRUCTION PHASES.
- 7. IF SUSPICIOUS AND/OR HAZARDOUS MATERIAL IS ENCOUNTERED DURING DEMOLITION / CONSTRUCTION, ALL WORK SHALL STOP AND THE COUNTY DEPARTMENT OF HEALTH AND THE NEW YORK STATE DEPARTMENT OF ENVIRONMENTAL CONSERVATION SHALL BE NOTIFIED IMMEDIATELY. WORK SHALL NOT RESUME UNTIL THE CONTRACTOR HAS OUTLINED APPROPRIATE ACTION FOR DEALING WITH THE WASTE MATERIAL.
- 8. WHERE EXISTING CURB, GUTTER, SIDEWALK OR WALK IS TO BE REMOVED, IT SHALL BE SAW CUT OR REMOVED AT THE NEAREST JOINT.
- 9. THE CONTRACTOR SHALL PERFORM DAILY CLEANUP OPERATIONS WHICH INCLUDE SWEEPING OF THE ROADWAYS, REMOVAL OF DEBRIS (CUPS, PAPER BAGS, CANS, ETC.), REMOVAL OF EXCESS CONSTRUCTION MATERIALS. ALL TO THE SATISFACTION OF THE OWNER.
- 10.THE CONTRACTOR SHALL CONFORM TO ALL STATE AND LOCAL RULES, REGULATIONS AND LAWS WHICH SHALL GOVERN THE HAULING AND DISPOSING OF TREES, SHRUBS, STUMPS, ROOTS, RUBBISH, DEBRIS AND OTHER MATTER
- 11.NO TREES, SHRUBS, ROOTS, BRANCHES, WOOD, CONCRETE OR OTHER DEBRIS SHALL BE BURIED IN FILLS, EMBANKMENTS OR STOCK PILES.
- 12.NO CLEARED MATTER, DEBRIS SHALL BE STORED AT THE CONSTRUCTION SITE.
- 13.CONTRACTOR SHALL GUARANTEE THAT WORK PERFORMED UNDER THIS CONTRACT WILL NOT PERMANENTLY DAMAGE TREES, SHRUBS, TURF OR PLANTS DESIGNATED TO REMAIN, OR OTHER ADJACENT WORK OR FACILITIES. IF DAMAGE RESULTING FROM CONTRACTOR'S OPERATIONS APPEARS DURING THE PERIOD UP TO 24 MONTHS AFTER COMPLETION OF THE PROJECT, THE CONTRACTOR SHALL REPLACE DAMAGED ITEMS AT HIS EXPENSE
- 14.DAMAGE TO ANY EXISTING ITEMS, NOT SHOWN IN CONTRACT DOCUMENTS TO BE REMOVED, SUCH AS PAVEMENT, GRASSED AREAS, UTILITIES, STRUCTURES OR OTHER FACILITIES SHALL BE REPAIRED BY THE CONTRACTOR IMMEDIATELY AT HIS OWN EXPENSE TO THE SATISFACTION OF THE ENGINEER AND OWNER. ALL ASPHALT PAVEMENTS, GRASSED AREAS AND LANDSCAPING THAT ARE DAMAGED OR DISTURBED SHALL BE RESTORED IN ACCORDANCE WITH APPLICABLE SECTIONS ON THE CONTRACT SPECIFICATIONS.
- 15.EXCEPT AS NOTED BELOW, CONTRACTOR SHALL REMOVE FROM THE SITE AND SATISFACTORILY DISPOSE OF ALL TREES, SHRUBS, ROOTS, BRUSH, MASONRY, RUBBISH, SCRAP, DEBRIS, PAVEMENT, CURBS. FENCES AND MISCELLANEOUS OTHER ITEMS NOT COVERED UNDER OTHER SECTIONS AS SHOWN, SPECIFIED OR OTHERWISE REQUIRED TO PERMIT CONSTRUCTION OF NEW WORK.
- 16.BURNING OF MATERIAL IS EXPRESSLY FORBIDDEN.
- 17.TREES AND SHRUBS TO BE SAVED:
- A. TREES AND SHRUBS WHICH ARE TO REMAIN SHALL BE PROTECTED BY FENCES, BARRICADES, WRAPPING OR OTHER MEANS OF PROTECTION. EQUIPMENT STORAGE, MATERIAL STOCKPILES, ETC., SHALL NOT BE PERMITTED WITHIN TREE BRANCH SPREAD
- B. PROTECT ALL OTHER TREES AND SHRUBS FROM DEFACEMENT, INJURY AND DESTRUCTION. PRESERVE TREES WITHIN THE CONTRACT LIMITS THAT ARE SO DELINEATED ON THE PLANS OR AS MARKED IN THE FIELD BY THE ENGINEER. ALSO, ALL TO BE SAVED SHALL BE PROTECTED IN ACCORDANCE WITH THE CONTRACT DOCUMENTS
- C. DO NOT CUT ROOTS UNNECESSARILY: HANDWORK OR OTHER METHODS SHALL BE IMPLEMENTED TO PREVENT DAMAGE TO ROOTS WHICH EXTEND INTO GRADING LIMITS OR LIMITS OF EXCAVATION. DISTURB ROOTS AS LITTLE AS POSSIBLE WHEN TUNNELING UNDER TREES. BACKFILLING AROUND TREE ROOTS SHALL BE DONE IMMEDIATELY AFTER COMPLETION OF CONSTRUCTION IN THE VICINITY OF TREES.
- D. THE CONTRACTOR SHALL BE RESPONSIBLE FOR THE PROTECTION OF ALL VEGETATION FROM DAMAGE RESULTING FROM EMISSIONS FROM MOTORIZED EQUIPMENT.
- E. CONTRACTOR SHALL BE VIGILANT OF ANY OVERHEAD UTILITY LINES WHEN USING AERIAL EQUIPMENT FOR TREE TRIMMING OPERATIONS.
- F. DURING WORKING OPERATION, PROTECT THE TRUNK, FOLIAGE, AND ROOT SYSTEM OF ALL TREES TO BE SAVED WITH BOARDS OR OTHER GUARDS AND AS REQUIRED TO PREVENT DAMAGE, INJURY AND DEFACEMENT. DO NOT PILE EXCAVATED MATERIAL ADJACENT TO THE BASE OF ANY TREES. DO NOT ALLOW RUNDER TO ACCUMULATE AROUND BASE OF TREES. DO NOT FASTEN OR ATTACH ROPES, CABLE OR GUY WIRES TO TREES WITHOUT PERMISSION OF THE ENGINEER. WHEN SUCH PERMISSION IS GRANTED. PROTECT THE TREE BEFORE MAKING FASTENING OR ATTACHMENTS BY PROVIDING BURLAP WRAPPING AND SOFTWOOD CLEATS. THE CONTRACTOR SHALL BE HELD RESPONSIBLE FOR DAMAGE RESULTING FROM THESE ACTIONS. USE OF AXES OR CLIMBING SPURS FOR TRIMMING WILL NOT BE PERMITTED. PROVIDE CLIMBING ROPES DURING TRIMMING.
- G. REMOVE SHRUBS TO BE SAVED, TAKING A SUFFICIENT EARTH BALL AT THE ROOTS TO MAINTAIN THE SHRUB. TEMPORARILY REPLANT IF REQUIRED, AND REPLACE AT THE COMPLETION OF CONSTRUCTION IN CONDITION EQUALING THE ORIGINAL.
- H. TREE AND SHRUB REPAIR WHERE REQUIRED SHALL BE PERFORMED BY A TREE SURGEON.
- I. TREES AND SHRUBS INTENDED TO REMAIN WHICH ARE DAMAGED BEYOND REPAIR BY CONSTRUCTION. SHALL BE REPLACED BY THE CONTRACTOR AT NO EXPENSE TO THE OWNER.

SITE NOTES:

- 1. THE CONTRACTOR SHALL PERFORM ALL WORK IN COMPLIANCE WITH TITLE 29 OF FEDERAL REGULATIONS, PART 1926, SAFETY AND HEALTH REGULATIONS FOR CONSTRUCTION(OSHA). 2. HIGHWAY DRAINAGE ALONG ALL ROADS AND PRIVATE DRIVES SHALL BE KEPT CLEAN OF MUD,
- DEBRIS ETC. AT ALL TIMES.
- 3. REFER TO ARCHITECTURAL DRAWINGS FOR BUILDING INFORMATION.
- 4. THE CONTRACTOR SHALL CONSULT THE DESIGN ENGINEER BEFORE DEVIATING FROM THESE PLANS. 5. IN ALL TRENCH EXCAVATIONS, CONTRACTOR MUST LAY THE TRENCH SIDE SLOPES BACK TO A SAFE
- SLOPE, USE A TRENCH SHIELD OR PROVIDE SHEETING AND BRACING IF REQUIRED. 6. THE CONTRACTOR SHALL TAKE PRECAUTIONS TO MAINTAIN A MINIMUM OF 2' OF COVER OVER ALL EXISTING AND NEW STORM AND SANITARY PIPES DURING CONSTRUCTION.
- 7. ALL EXISTING SURFACE APPURTENANCES (I.E. WATER VALVES, CATCH BASIN FRAMES AND GRATES, MANHOLE COVERS) WITHIN THE PROJECT LIMITS SHALL BE ADJUSTED TO FINISHED GRADE.
- 8. UNLESS COVERED BY THE CONTRACT SPECIFICATIONS OR AS NOTED ON THE PLANS, ALL WORK SHALL CONFORM TO THE NEW YORK STATE DEPARTMENT OF TRANSPORTATION STANDARD SPECIFICATIONS DATED JANUARY 1, 2020 AND ANY SUBSEQUENT APPENDICES.

INFORMATION	CONSULTANT SEAL					
LiRo Engineers, Inc. <i>A LiRo Group Company</i> Mineola, N.Y. 516-746-2350[T]	K CONSTRUCTION OF THE REAL OF					
	Page 059134 TESSIONAL ENGINE	REVISION NUMBER	DATE	MADE BY	APP'D By	

UTILITY NOTES:

- 1. APPROXIMATE LOCATION OF KNOWN UTILITY STRUCTURES AND FACILITIES THAT MAY BE ENCOUNTERED WITHIN AND ADJACENT TO THE LIMITS OF WORK ARE SHOWN ON THE PLANS. THE ACCURACY AND COMPLETENESS OF THIS INFORMATION IS NOT GUARANTEED BY THE ENGINEER. THE CONTRACTOR IS ADVISED TO VERIFY IN FIELD ALL THE FACTS CONCERNING THE UTILITY LOCATIONS AND OTHER CONSTRUCTION OBSTACLES PRIOR TO CONSTRUCTION OF ANY DISCREPANCIES WHICH MAY AFFECT PROJECT DESIGN AND/OR SCOPE.
- 2. ALL ABANDONED WATER LINES SHALL BE CUT AND CAPPED IN ACCORDANCE WITH WESTCHESTER COUNTY REQUIREMENTS.
- 3. TRENCH DETAILS ARE INTENDED TO PROVIDE INFORMATION REGARDING BACKFILLING MATERIALS AND GENERAL MATERIAL DEPTHS ONLY. THE CONTRACTOR SHALL BE RESPONSIBLE FOR THE MEANS AND METHODS OF CONSTRUCTION AND SHALL PROVIDE APPROPRIATE SAFETY MEASURES. SHEETING AND BRACING AS NECESSARY. SHEFTING CONDITIONS ARE TO BE DESIGNED BY A NEW YORK STATE LICENSED PROFESSIONAL ENGINEER AND SUBMITTED TO THE DESIGN ENGINEER FOR APPROVAL. TH DESIGN ENGINEER ASSUMES NO RESPONSIBILITY OR LIABILITY FOR FIELD CONDITIONS, TRENCHING OR BACKFILLING OPERATIONS DURING CONSTRUCTION. THE CONTRACTOR SHALL COMPLY WITH ALL APPLICABLE OSHA STANDARDS AND DETAILS FOR TRENCH EXCAVATION.
- 4. CONTRACTOR SHALL BE RESPONSIBLE FOR DEWATERING AND PRECLUDING PONDING OF WATER IN ALL AREAS. DEWATERING OPERATIONS SHALL BE IN ACCORDANCE WITH NYSDEC REGULATIONS, THE PROJECT STORMWATER POLLUTION PREVENTION PLAN AND WESTCHESTER COUNTY.
- 5. THE CONTRACTOR SHALL COMPLY WITH THE LATEST OSHA CONFINED SPACE ENTRY REQUIREMENTS (29 CFR PART 1910).
- 6. THE CONTRACTOR SHALL COMPLY WITH THE LATEST REVISED OSHA SHEETING REQUIREMENTS (29 CFR PART 1926.650, 651, 652).
- 7. ALL EXISTING UTILITIES THAT ARE TO REMAIN IN SERVICE AND THAT INTERFERE WITH THE WORK SHALL BE RELOCATED UNLESS OTHERWISE SHOWN.
- 8. ALL ABANDONED PIPES SHALL BE PLUGGED, REMOVED, CRUSHED OR FILLED WITH A SUITABLE MATERIAL AS DIRECTED BY THE ENGINEERS, ABANDONED PIPES 12" INSIDE DIAMETER AND LARGER MUST BE REMOVED, FILLED OR CRUSHED IN PLACE. SMALLER PIPES SHALL BE PLUGGED AND ABANDONED IN PLACE UNLESS OTHERWISE DIRECTED BY THE ENGINEER.
- 9. THE CONTRACTOR SHALL CONTACT THE UTILITY COMPANIES TO DETERMINE THEIR SCHEDULE FOR PERFORMING UTILITY RELOCATION AND INSTALLATION WORK. THE CONTRACTOR SHALL SCHEDULE THEIR WORK ACCORDINGLY IN ORDER TO NOT INTERFERE WITH THE WORK OF THE UTILITY COMPANIES
- 10. TRENCHES SHALL BE BACKFILLED WITHOUT DELAY. OPEN TRENCHES SHALL BE TEMPORARILY SUPPORTED AND STEEL PLATED WHEN WORK IS NOT IN PROGRESS. CONTRACTOR MUST ENSURE NO TRENCHES ARE LEFT OPEN OVERNIGHT. THE CONTRACTOR IS RESPONSIBLE FOR THE DESIGN AND INSTALLATION OF STEEL PLATES THAT ARE CAPABLE OF SAFELY SUPPORTING THE SUBJECTED LOADS. 11. THE CONTRACTOR SHALL BE RESPONSIBLE FOR PROVIDING TEMPORARY LIGHTING WITHIN THE LIMITS
- OF CONSTRUCTION AND FOR ALL AREAS WHERE WHERE EXISTING STREET AND AREA LIGHTING SHUT-DOWN IS REQUIRED TO INSTALL NEW LIGHTING AND ELECTRICAL SERVICE. 12. ALL CMP PIPES SHALL FOLLOW NYSDOT SECTION 602-2 AND 707.02, BE HELICAL BITUMINOUS
- COATED, SHALL HAVE GASKETED AND BANDED JOINTS AND BE OF THE FOLLOWING PIPE GAUGES UNLESS OTHERWISE SPECIFIED. 10" TO 21" - 14 GAUGE
- 24" TO 30" 12 GAUGE 30"TO 60"- 10 GAUGE
- 13. IN INSTANCES WHERE THE STORM SEWER CROSSES THE SANITARY SEWER A CRUSHED STONE ENCASEMENT SHALL BE PROVIDED AROUND THE SANITARY SEWER UP TO THE STORM SEWER-COMPACT WITH APPROVED EQUIPMENT
- 14. ALL CATCH BASINS AND STORM MANHOLES WITHIN PAVEMENT TO BE CONSTRUCTED TO WITHSTAND H-20 LOADING.
- 15. ALL EXISTING CATCH BASINS WITHIN WORK LIMITS TO BE CLEANED OF ANY DEBRIS OR SILT.

GRADING NOTES:


- 1. REMOVE AND STOCKPILE TOPSOIL AS DIRECTED BY THE CONSTRUCTION MANAGER. REPLACE TOPSOIL TO A MINIMUM 4" DEPTH. ALL DISTURBED AREAS TO BE HYDROSEEDED AS DIRECTED BY THE CONSTRUCTION MANAGER.
- 2 CONTRACTOR SHALL BE RESPONSIBLE FOR THE MAINTENANCE AND REMOVAL OF TEMPORARY SEDIMENTATION CONTROLS, INCLUDING SILT SINK AND SILT FENCE. EROSION CONTROL MEASURES SHALL NOT BE REMOVED BEFORE VEGETATION HAS OCCURRED COMPLETELY.
- 3. ALL SILT FENCE TO BE REPLACED WHENEVER THEY BECOME CLOGGED OR INOPERABLE AND SHALL BE REPLACED AS DIRECTED BY THE ENGINEER.
- 4. THE CONTRACTOR SHALL BE RESPONSIBLE FOR RESTORATION OF TOPSOIL TO ALL DISTURBED AREAS. IT IS THE CONTRACTOR'S RESPONSIBILITY TO MAINTAIN EROSION CONTROL MEASURES AT ALL TIMES.
- 5. EROSION CONTROL MEASURES WILL BE IMPLEMENTED IN ACCORDANCE WITH THE NEW YORK STATE GUIDELINES FOR URBAN EROSION SEDIMENT CONTROL MANUAL, WESTCHESTER COUNTY HEALTH DEPARTMENT, AND THE CITY OF RYE REQUIREMENTS.
- 6. ALL INLETS TO THE STORM SEWER SHALL HAVE STONE DROP INLET PROTECTION. THE CONTRACTOR SHALL BE RESPONSIBLE FOR MAINTAINING THE BEST MANAGEMENT PRACTICES (BMP'S) UNTIL GROUND COVER IS ESTABLISHED.
- 7. SILT FENCE, JUTE MESH, AND/OR EROSION CONTROL BLANKETS WILL BE USED ON STEEP SLOPES AND WHEREVER NECESSARY TO CONTROL EROSION AND SILTATION OF EXISTING DRAINAGE SYSTEMS AS ORDERED BY THE ENGINEER OR SPECIFIED ON PLANS.
- 8. THE CONTRACTOR SHALL DESIGNATE A MEMBER OF HIS/HER FIRM TO BE RESPONSIBLE TO MONITOR EROSION CONTROL, EROSION CONTROL STRUCTURES, TREE PROTECTION AND PRESERVATION THROUGHOUT CONSTRUCTION.
- 9. ALL DISTURBED AREAS SHALL BE PROTECTED FROM EROSION EITHER BY MULCH OR TEMPORARY SEEDING WITHIN 2 WEEKS OF DISTURBANCE.

SOIL EROSION AND SEDIMENT CONTROL NOTES:


- 1. ALL SOIL EROSION AND SEDIMENT CONTROL PRACTICES TO BE INSTALLED PRIOR TO ANY SOIL DISTURBANCE, OR IN THEIR PROPER SEQUENCE, AND MAINTAINED UNTIL PERMANENT PROTECTION IS ESTABLISHED. CONTRACTOR SHALL COMPLY WITH ALL REQUIREMENTS OF THE STORMWATER POLLUTION PREVENTION PLAN.
- 2. ANY DISTURBED AREAS THAT WILL NOT RECEIVE PERMANENT RESTORATION WITHIN TEN (10) DAYS AFTER FINAL GRADING, AND NOT SUBJECT TO CONSTRUCTION TRAFFIC, WILL IMMEDIATELY RECEIVE A TEMPORARY COVER. THE DISTURBED AREAS WILL BE MULCHED WITH STRAW, OR EQUIVALENT MATERIAL AT A RATE OF TWO (2) TONS PER ACRE, ACCORDING TO STATE STANDARDS.
- 3. PERMANENT VEGETATION TO BE SEEDED OR SODDED ON ALL EXPOSED AREAS WITHIN TEN (10) DAYS AFTER FINAL GRADING. MULCH WILL BE USED AS NECESSARY FOR PROTECTION UNTIL SEEDING IS ESTABLISHED.
- 4. ALL WORK TO BE DONE IN ACCORDANCE WITH THE STANDARDS FOR SOIL EROSION AND SEDIMENT CONTROL IN THE STATE OF NEW YORK.
- 5. A SUB-BASE COURSE DETAIL WILL BE APPLIED IMMEDIATELY FOLLOWING ROUGH GRADING AND INSTALLATION OF IMPROVEMENTS IN ORDER TO STABILIZE ROADS, DRIVEWAYS PARKING AREAS AND SIDEWALKS. IN AREAS WHERE NO UTILITIES ARE PRESENT, THE SUB-BASE SHALL BE INSTALLED WITHIN 15 DAYS OF THE PRELIMINARY GRADING.
- 6. IMMEDIATELY FOLLOWING INITIAL DISTURBANCE OR ROUGH GRADING, ALL CRITICAL AREAS SUBJECT TO EROSION (I.E.; STEEP SLOPES AND ROADWAY EMBANKMENTS) WILL RECEIVE A TEMPORARY COVER OF STRAW MULCH OR A SUITABLE EQUIVALENT AT A RATE OF TWO (2) TONS PER ACRE, ACCORDING TO NYS STANDARDS.
- 7. ANY STEEP SLOPES RECEIVING PIPELINE INSTALLATION WILL BE BACKFILLED AND STABILIZED DAILY, AS THE INSTALLATION PROCEEDS (I.E.; SLOPES GREATER THAN 3:1).
- 8. IN ACCORDANCE WITH THE STANDARDS FOR PERMANENT VEGETATIVE COVER FOR SOIL STABILIZATION, ANY SOIL HAVING A pH OF 4 OR LESS OR CONTAINING IRON SULFIDES SHALL BE COVERED WITH A MINIMUM OF 12 INCHES OF SOIL HAVING A pH OF 5 OR GREATER PRIOR TO SEEDBED PREPARATION.
- 9. WESTCHESTER COUNTY AND THE ENGINEER, SHALL BE NOTIFIED 72 HOURS IN ADVANCE OF ANY LAND DISTURBING ACTIVITY.
- 10. AT THE TIME WHEN THE SITE PREPARATION FOR PERMANENT VEGETATIVE STABILIZATION IS GOING TO BE ACCOMPLISHED. ANY SOIL THAT WILL NOT PROVIDE A SUITABLE ENVIRONMENT TO SUPPORT ADEQUATE VEGETATIVE GROUND COVER. SHALL BE REMOVED OR TREATED IN SUCH A WAY THAT WILL PERMANENTLY ADJUST THE SOIL CONDITIONS AND RENDER IT SUITABLE FOR VEGETATIVE COVER. IF THE REMOVAL OR TREATMENT OF THE SOIL WILL NOT PROVIDE SUITABLE CONDITIONS, NON-VEGETATIVE MEANS OF PERMANENT GROUND STABILIZATION WILL HAVE TO BE EMPLOYED
- 11. THE CONTRACTOR SHALL TAKE NECESSARY MEASURES TO MAINTAIN DUST CONTROL. DIRT HAUL ROADS SHALL BE SPRINKLED WITH WATER OR GIVEN A SURFACE OF CRUSHED STONES OR WOOD CHIPS AS REQUIRED. VEHICLES SHALL BE CLEANED, AS NECESSARY, PRIOR TO USING PUBLIC STREETS. PAVED ROADS SHALL BE SPRINKLED WITH WATER.
- 12. ALL SOIL EROSION AND SEDIMENT CONTROL DEVICES SHALL BE LOCATED IN THE FIELD AS REQUIRED OR AT THE DIRECTION OF THE ENGINEER. THE CONTRACT DRAWING ARE NOT INTENDED TO SHOW THE LOCATION AND DETAILS FOR ALL SUCH DEVICES BUT ARE TO BE USED AS A REASONABLE
- 13. ANY CHANGES TO THE SOIL AND SEDIMENT CONTROL PLANS WILL REQUIRE THE SUBMISSION OF REVISED SOIL EROSION AND SEDIMENT CONTROL PLANS TO WESTCHESTER COUNTY AND THE ENGINEER. THE REVISED PLANS MUST BE PREPARED BY THE CONTRACTOR AND MUST MEET ALL CURRENT NYS SOIL EROSION AND SEDIMENT CONTROL PRACTICES.
- 14. CONTRACTOR SHALL OBTAIN ALL REQUIRED SEDIMENT CONTROL PERMITS.
- 15. UPON COMPLETION OF CONSTRUCTION WORK AND AFTER FINAL GRADING AND WHEN PERMANENT STABILIZATION HAS BEEN ESTABLISHED, STRAW BALES, SILT FENCES AND ALL OTHER SOIL PLAN APPURTENANCES WILL BE REMOVED AND DISPOSED OF BY THE CONTRACTOR, UNLESS ORDERED TO REMAIN BY THE ENGINEER.
- 16. ALL EXCESS EXCAVATED MATERIAL, EXCEPT FOR TOP SOIL, WILL BE REMOVED FROM THE SITE BY THE CONTRACTOR IN ACCORDANCE WITH THE CONTRACT DOCUMENTS.
- 17. CONDUIT OUTLETS AND CATCH BASIN INLETS MUST BE PROTECTED PRIOR TO START OF CONSTRUCTION.
- 18. THE CONTRACTOR SHALL PROVIDE A DETAILED SEQUENCE OF CONSTRUCTION OPERATIONS FOR REVIEW AND SUBMITTAL TO WESTCHESTER COUNTY AND THE ENGINEER.
- 19. THE CONTRACTOR SHALL MEET ENGINEER ON-SITE TO DEFINE THOSE AREAS WHICH WILL REQUIRE SOIL EROSION AND SEDIMENT CONTROL FACILITIES, DISCUSS THEIR CONSTRUCTION AND THEREAFTER PROVIDE DETAILED PLANS FOR REVIEW OF SUCH FACILITIES BY WESTCHESTER COUNTY AND THE FNGINFFR.
- 20. ALL SOIL EROSION AND SEDIMENT CONTROL PRACTICES SHALL BE IN PLACE WHERE POSSIBLE PRIOR TO, OR IMMEDIATELY FOLLOWING SITE AND ACCESS CLEARING.
- 21. ALL SOIL FROSION AND SEDIMENT CONTROL PRACTICES SHALL BE LEFT IN PLACE AND MAINTAINED: INCLUDING SILT AND SEDIMENT REMOVAL, UNTIL CONSTRUCTION IS COMPLETED, AREA STABILIZED AND
- 22. CONTRACTOR SHALL CONFINE SOIL DISTURBANCE ACTIVITY TO THE AREAS CONTAINED WITHIN THE "LIMIT OF DISTURBANCE" LINES EXCEPT AS DIRECTED BY THE ENGINEER AND IN ACCORDANCE AND COORDINATION WITH ADJACENT CONTRACTS. SUCH ACTIVITY SHALL SHALL ESSENTIALLY CONSIST OF CLEARING, GRUBBING, GRADING AND CONSTRUCTION IN AREAS DEFINED AS BUILDINGS, PIPELINE, PARKING AREAS, DRIVES AND WALKWAYS OR AS MAY BE REQUIRED DUE TO GRADE CHANGES OR RETAINING WALLS.
- 23. ALL DEWATERING OPERATIONS MUST DISCHARGE DIRECTLY INTO A SEDIMENT FILTER AREA. SEDIMENT FILTER SHALL BE INSTALLED IN ACCORDANCE WITH THE CONTRACT DOCUMENTS AND THE DETAILS OF DESIGN AND CONSTRUCTION SHALL PREPARED AND SUBMITTED BY THE CONTRACTOR TO THE ENGINEER, AND ALL OTHER PERTINENT AGENCIES FOR REVIEW.
- 24. SOIL STABILIZATION METHODS SHALL BE UNDERTAKEN COINCIDENTALLY WITH ALL SITE IMPROVEMENTS AND CONTINUE DURING THE CONSTRUCTION ACTIVITY PERIOD.
- 25. THE LIMITS OF FENCING FOR TREE PROTECTION WILL BE DETERMINED IN THE FIELD PRIOR TO CONSTRUCTION AND WILL INCLUDE THE TREE CANOPY.
- 26. COMPLY WITH GENERAL PERMIT GP-0-20-001. AS OUTLINED IN THE STORM WATER PREVENTION PLAN (SWPPP).

	RECORD DRAWING	CERTIFICATION	WF
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	CONTRACTOR	PROJECT COORDINATOR	
REVISION	NAME	NAME	

VESTCHESTER COUNTY, NEW YORK PARTMENT OF PUBLIC WORKS AND TRANSPORTATION CXE-C-01 22-523 DIVISION OF ENGINEERING 310 of 664 INFRASTRUCTURE REHABILITATION PHASE 3 1"=10' PLAYLAND PARK, RYE, NEW YORK 08/23/2022 CROSS AXIS BUILDING E **GENERAL NOTES** 1-118-C-1059-0

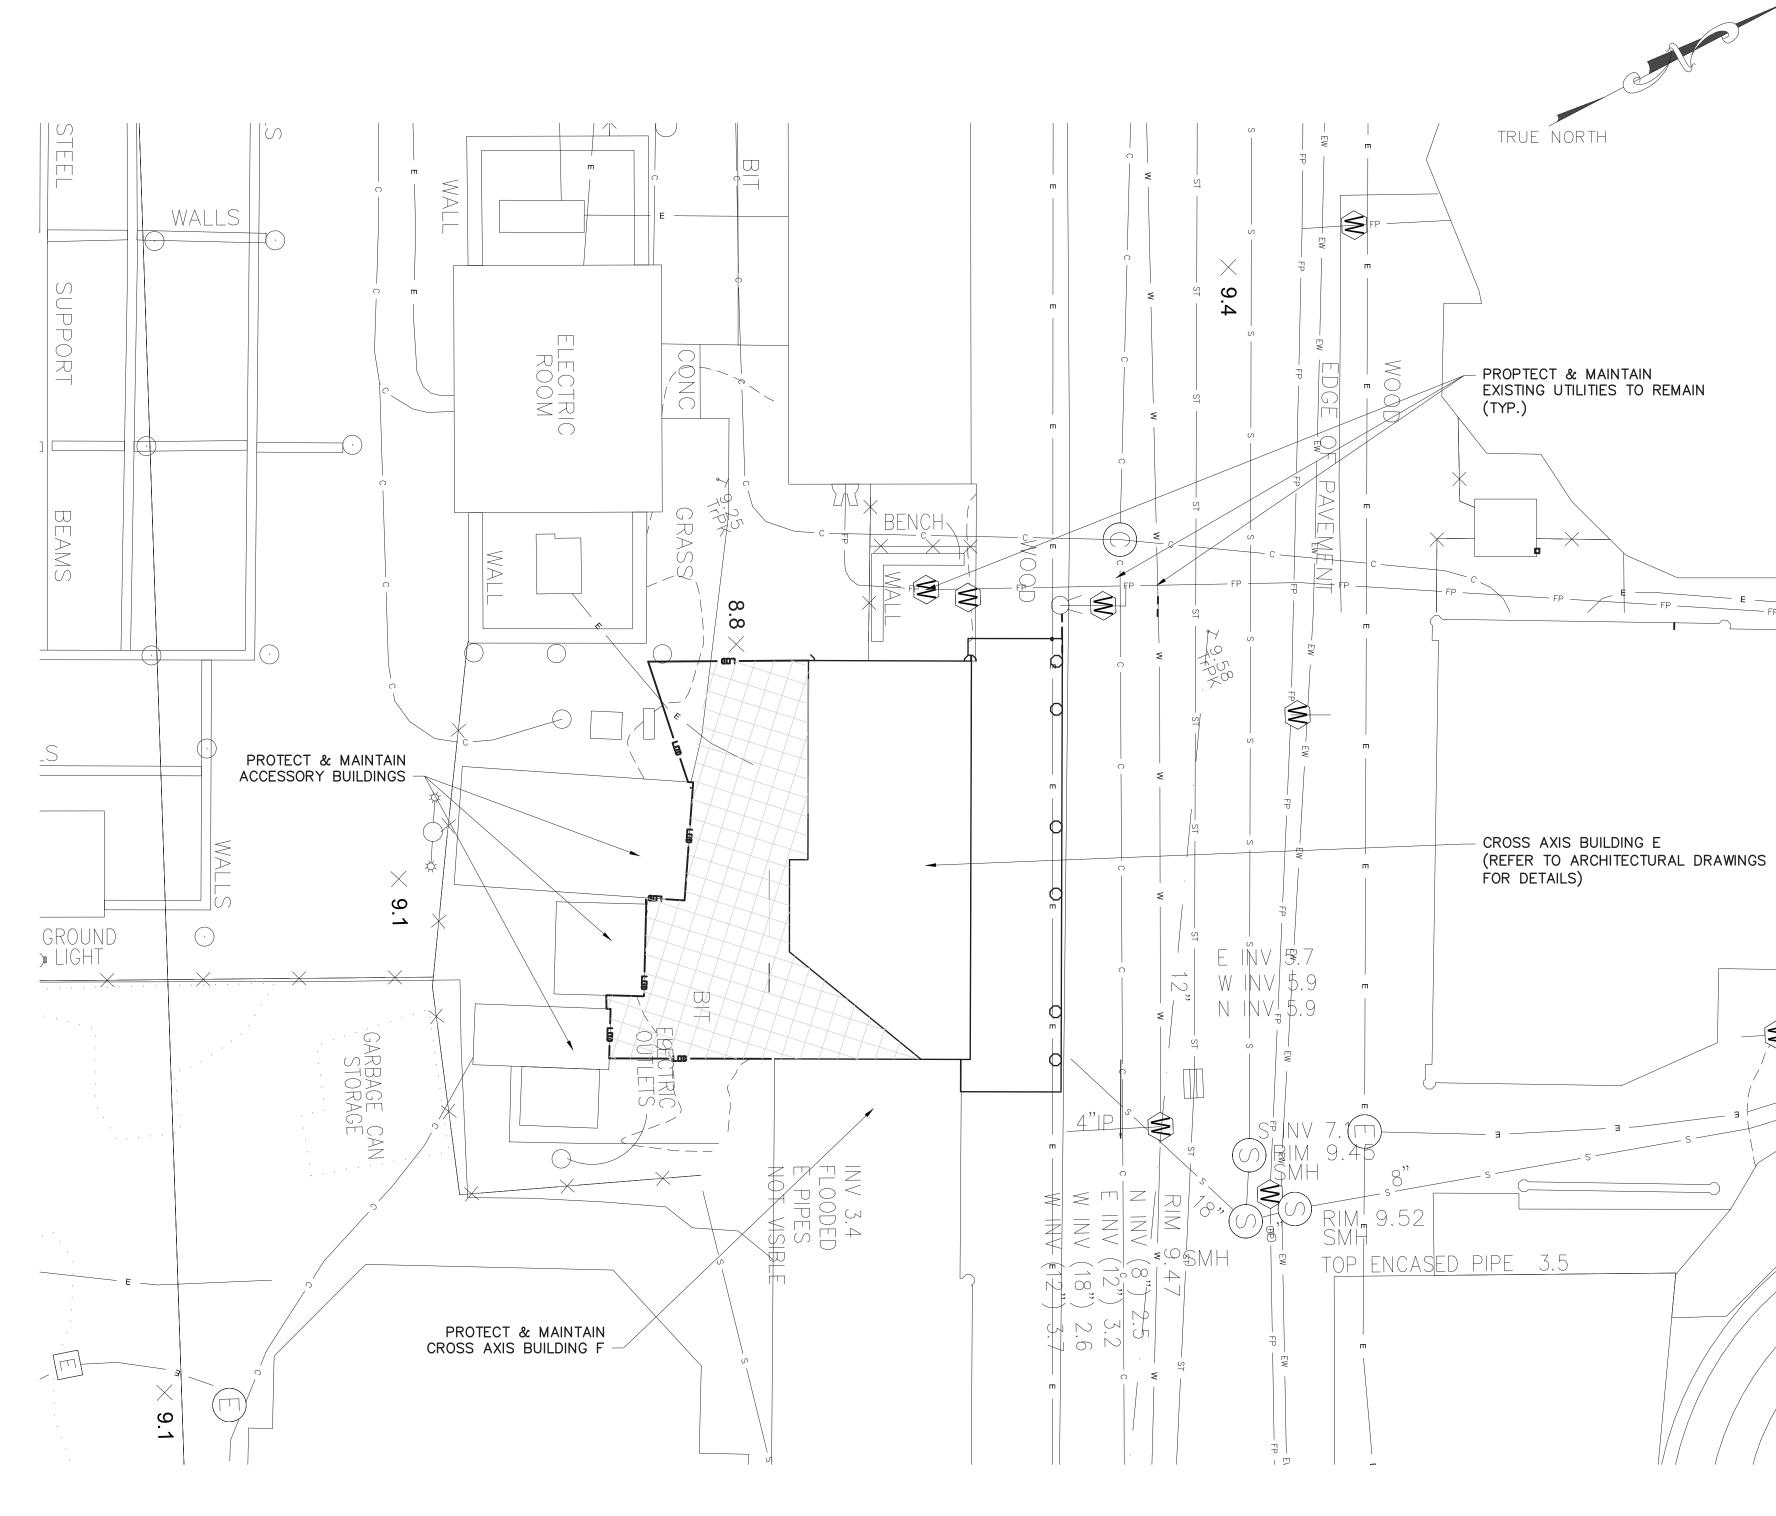

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EXISTING LEGEND 0 POST \odot UTILITY POLE ── OR ⊖─⊖ SIGN HANDICAP PARKING Ġ. GROUND LIGHT \diamond LIGHT POLE ¢ ·----• UTILITY POLE WITH LIGHT ◯─≫ LIGHT POLE (SINGLE LIGHT) \$—⊖—\$ LIGHT POLE (DOUBLE LIGHT) *~* LIGHT POLE (MULTI LIGHT) *** BOAT TIE-OFF CLEAT ----⊕ or ⊞ or ⊟ catch basin TRENCH DRAIN Μ MAILBOX \otimes UNKNOWN MANHOLE C OR C COMMUNICATIONS BOX/HAND HOLE E ELECTRIC HAND HOLE EB ELECTRIC BOX GM GAS METER IB IRRIGATION BOX U UNKNOWN UTILITY BOX/HAND HOLE \bigcirc COMMUNICATION MANHOLE DORD DRAINAGE MANHOLE (E) ELECTRIC MANHOLE S or S SEWER MANHOLE ST STORM SEWER MANHOLE SEWER CLEANOUT \propto HYDRANT \mathcal{M} SIAMESE CONNECTION 🕖 OR 💟 UNKNOWN VALVE $\langle W \rangle$ WATER VALVE $\langle \mathbb{G} \rangle$ GAS VALVE WS WATER SPIGOT OR FOUNTAIN MONITORING WELL DECIDUOUS BUSH EVERGREEN BUSH Σ<u>`</u>Σ 8 DECIDUOUS TREE EVERGREEN TREE N'S STUMP ۲ HEDGE ROW TREELINE BRUSHLINE v v v v RETAINING WALL GUIDE RAIL STONE WALL WATERLINE UNDERGROUND COMMUNICATION UNDERGROUND PROPANE UNDERGROUND ELECTRICAL UNDERGROUND STREET LIGHTING EXISTING MAJOR CONTOUR — — 9 — — EXISTING MINOR CONTOUR PROPOSED LEGEND: ---- SAW CUTTING ASPHALT CONCRETE LIMITS OF DISTURBANCE LIMITS OF PAVEMENT REMOVAL (MILLING & EXCAVATION)
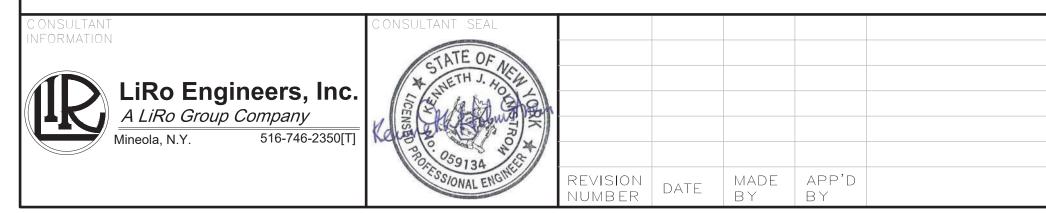
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AREA OF ASPHALT PAVEMENT REMOVAL (FULL DEPTH & EXCAVATION)


DRAINAGE STRUCTURE INLET PROTECTION

NOTES:

- 1. PAVEMENT REMOVAL, MILLING AND EXCAVATION, MATERIAL SHALL NOT BE STOCKPILED ON SITE.
- 2. EXISTING GRADES, PIPE LOCATIONS, SIZES, MATERIAL, INVERTS AND OTHER EXISTING CONDITIONS ARE SHOWN ON THE DRAWINGS FROM AVAILABLE AS-BUILT DRAWINGS AND FIELD SURVEY BY OTHERS. IT SHALL BE THE RESPONSIBILITY OF THE CONTRACTOR TO VERIFY ALL EXISTING CONDITIONS.
- 3. THE CONTRACTOR SHALL TAKE PROPER PRECAUTIONS NOT TO DAMAGE ANY EXISTING SITE CONDITIONS SPECIFICALLY EXCLUDED FROM THE CONTRACT AND WILL BE HELD SOLELY RESPONSIBLE FOR ANY DAMAGE OCCURRING DURING THE COURSE OF THE WORK DURING CONSTRUCTION. THE CONTRACTOR SHALL, AT THEIR OWN EXPENSE, MAKE ALL REPAIRS REQUIRED TO RESTORE ANY DAMAGED AREAS TO ORIGINAL CONDITIONS.

ESTCHESTER COUNTY, NEW YORK ARTMENT OF PUBLIC WORKS AND TRANSPORTATION DIVISION OF ENGINEERING


INFRASTRUCTURE REHABILITATION PHASE 3 PLAYLAND PARK, RYE, NEW YORK CROSS AXIS BUILDING E EXISTING CONDITIONS/DEMOLITION PLAN

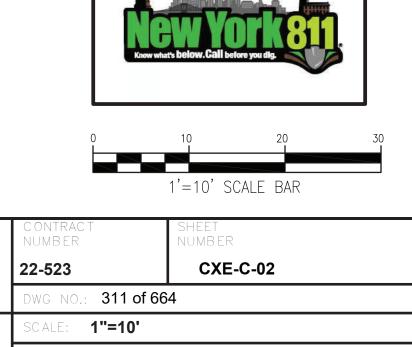

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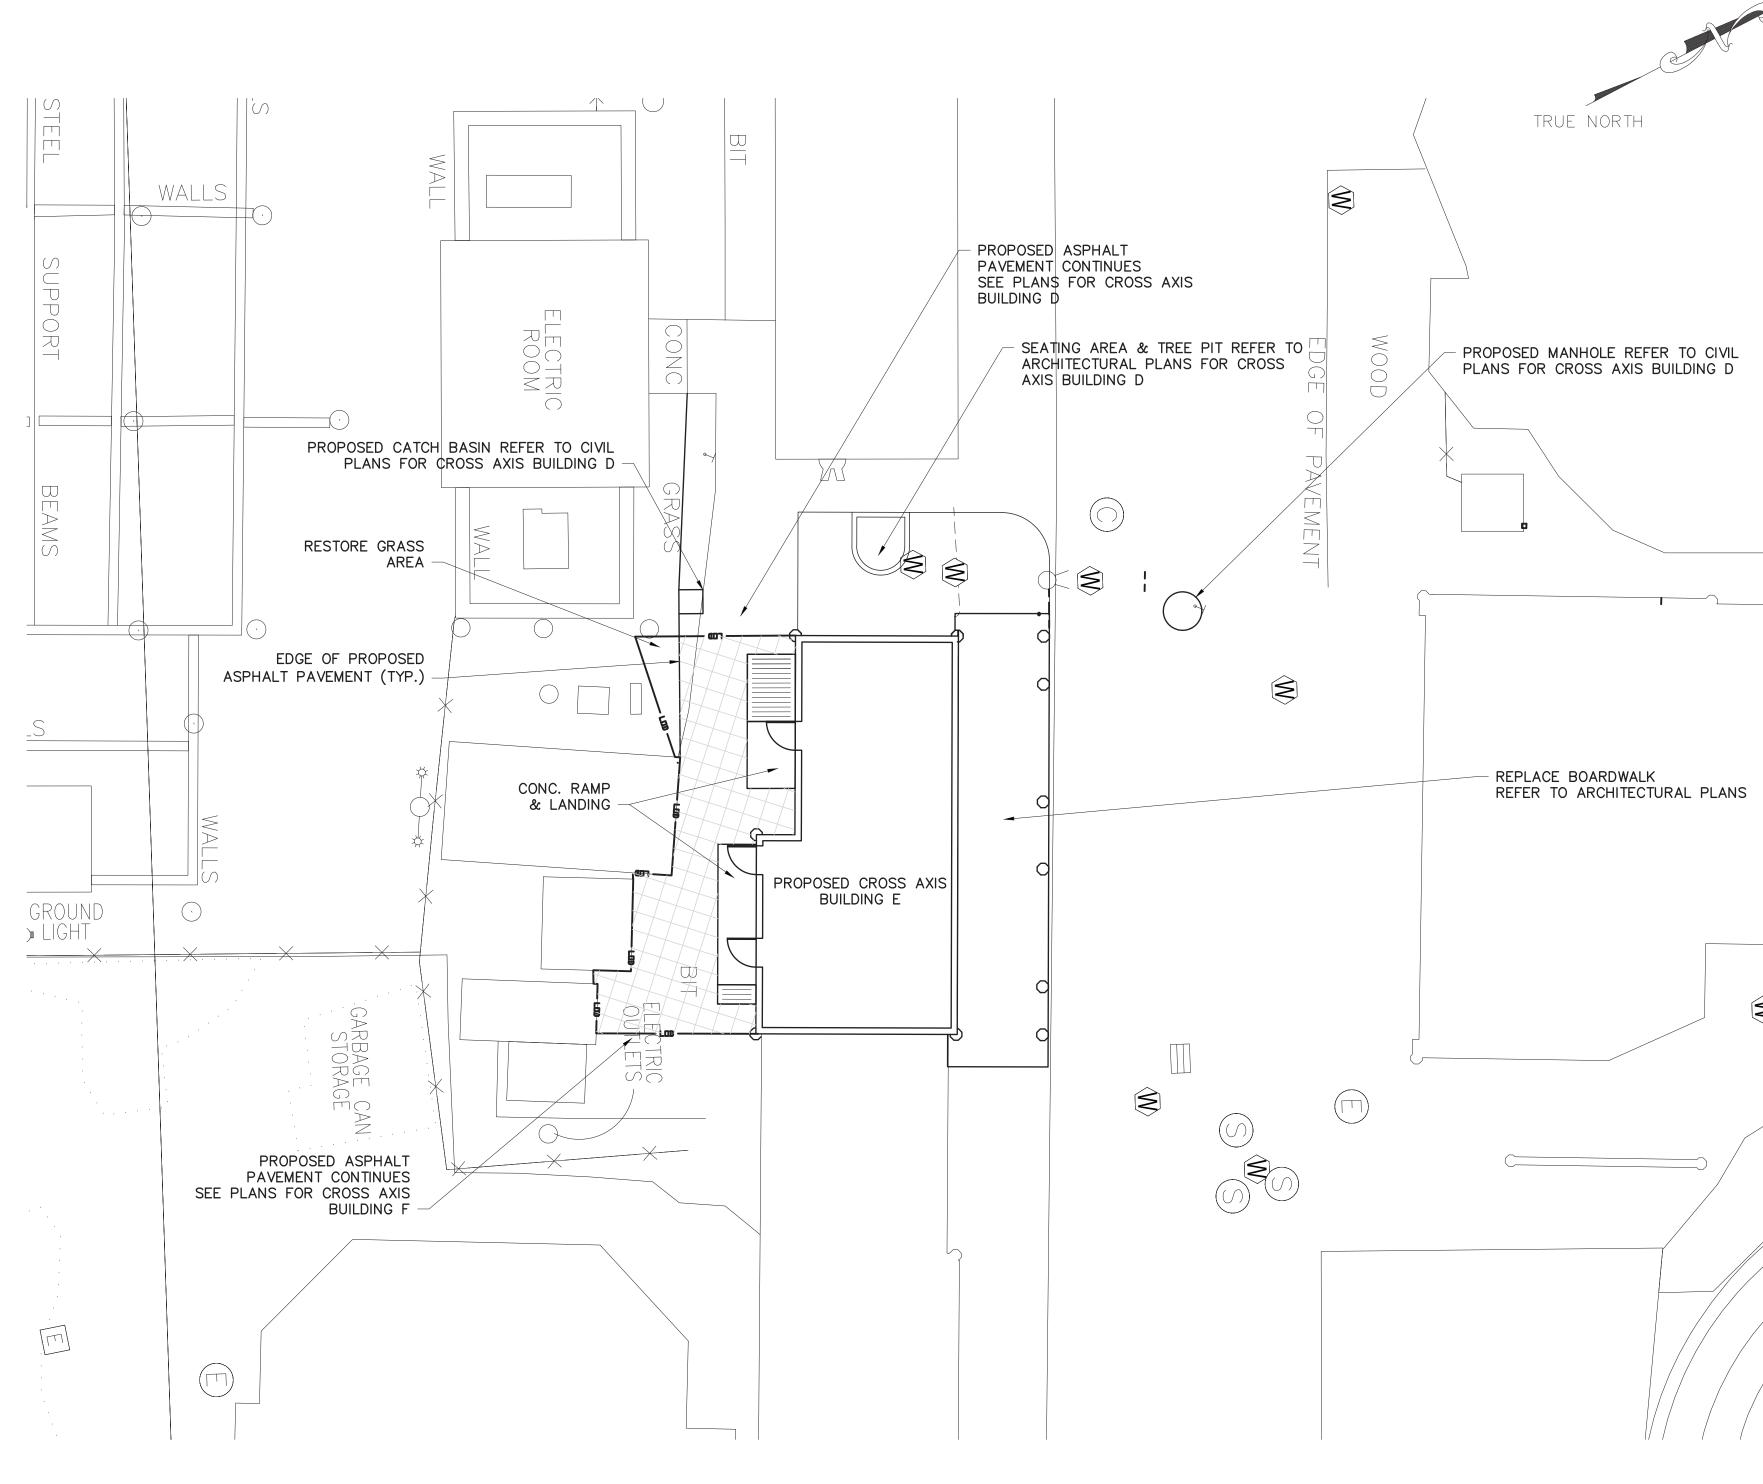
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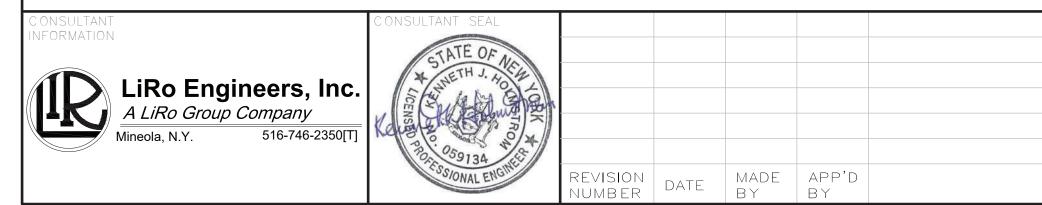


KEY MAP

NOT TO SCALE

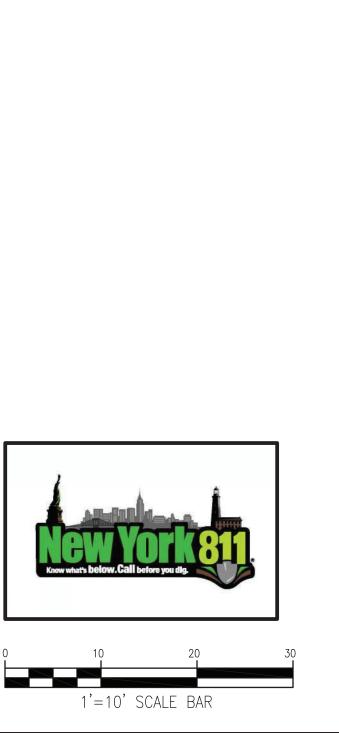


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	-		DIVISION OF ENGINEERING	DWG NO.: 312 of 664		
	C ONTRAC TOR	PROJECT COORDINATOR	INFRASTRUCTURE REHABILITATION PHASE 3	SCALE: 1"=10'		
	SIGNATURE	SIGNATURE	PLAYLAND PARK, RYE, NEW YORK CROSS AXIS BUILDING E	DATE: 08/23/2022		
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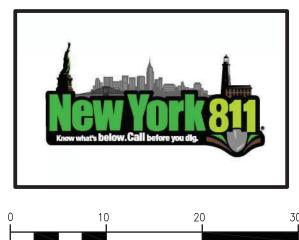
HANDICAP PARKING GROUND LIGHT LIGHT POLE UTILITY POLE WITH LIGHT LIGHT POLE (SINGLE LIGHT) LIGHT POLE (DOUBLE LIGHT) LIGHT POLE (MULTI LIGHT) BOAT TIE-OFF CLEAT TRENCH DRAIN UNKNOWN MANHOLE C OR C COMMUNICATIONS BOX/HAND HOLE ELECTRIC HAND HOLE ELECTRIC BOX GAS METER IRRIGATION BOX UNKNOWN UTILITY BOX/HAND HOLE COMMUNICATION MANHOLE DRAINAGE MANHOLE ELECTRIC MANHOLE SEWER MANHOLE STORM SEWER MANHOLE SEWER CLEANOUT SIAMESE CONNECTION UNKNOWN VALVE WATER VALVE GAS VALVE WATER SPIGOT OR FOUNTAIN MONITORING WELL DECIDUOUS BUSH EVERGREEN BUSH DECIDUOUS TREE EVERGREEN TREE

PROPOSED LEGEND:


______X _____ MOVABLE CONSTRUCTION FENCE ---- SAW CUTTING ASPHALT CONCRETE LIMITS OF DISTURBANCE ------ LIMITS OF PAVEMENT REMOVAL AREA OF FULL DEPTH ASPHALT PAVEMENT

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DRAINAGE STRUCTURE INLET PROTECTION

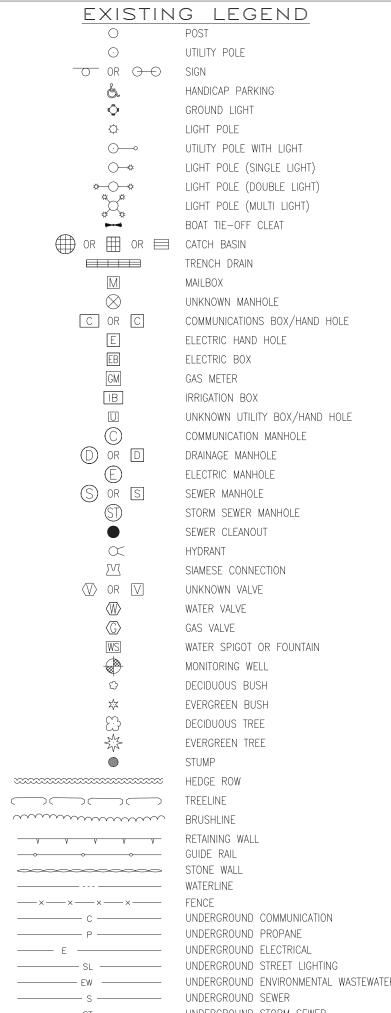

1'=10' SCALE BAR

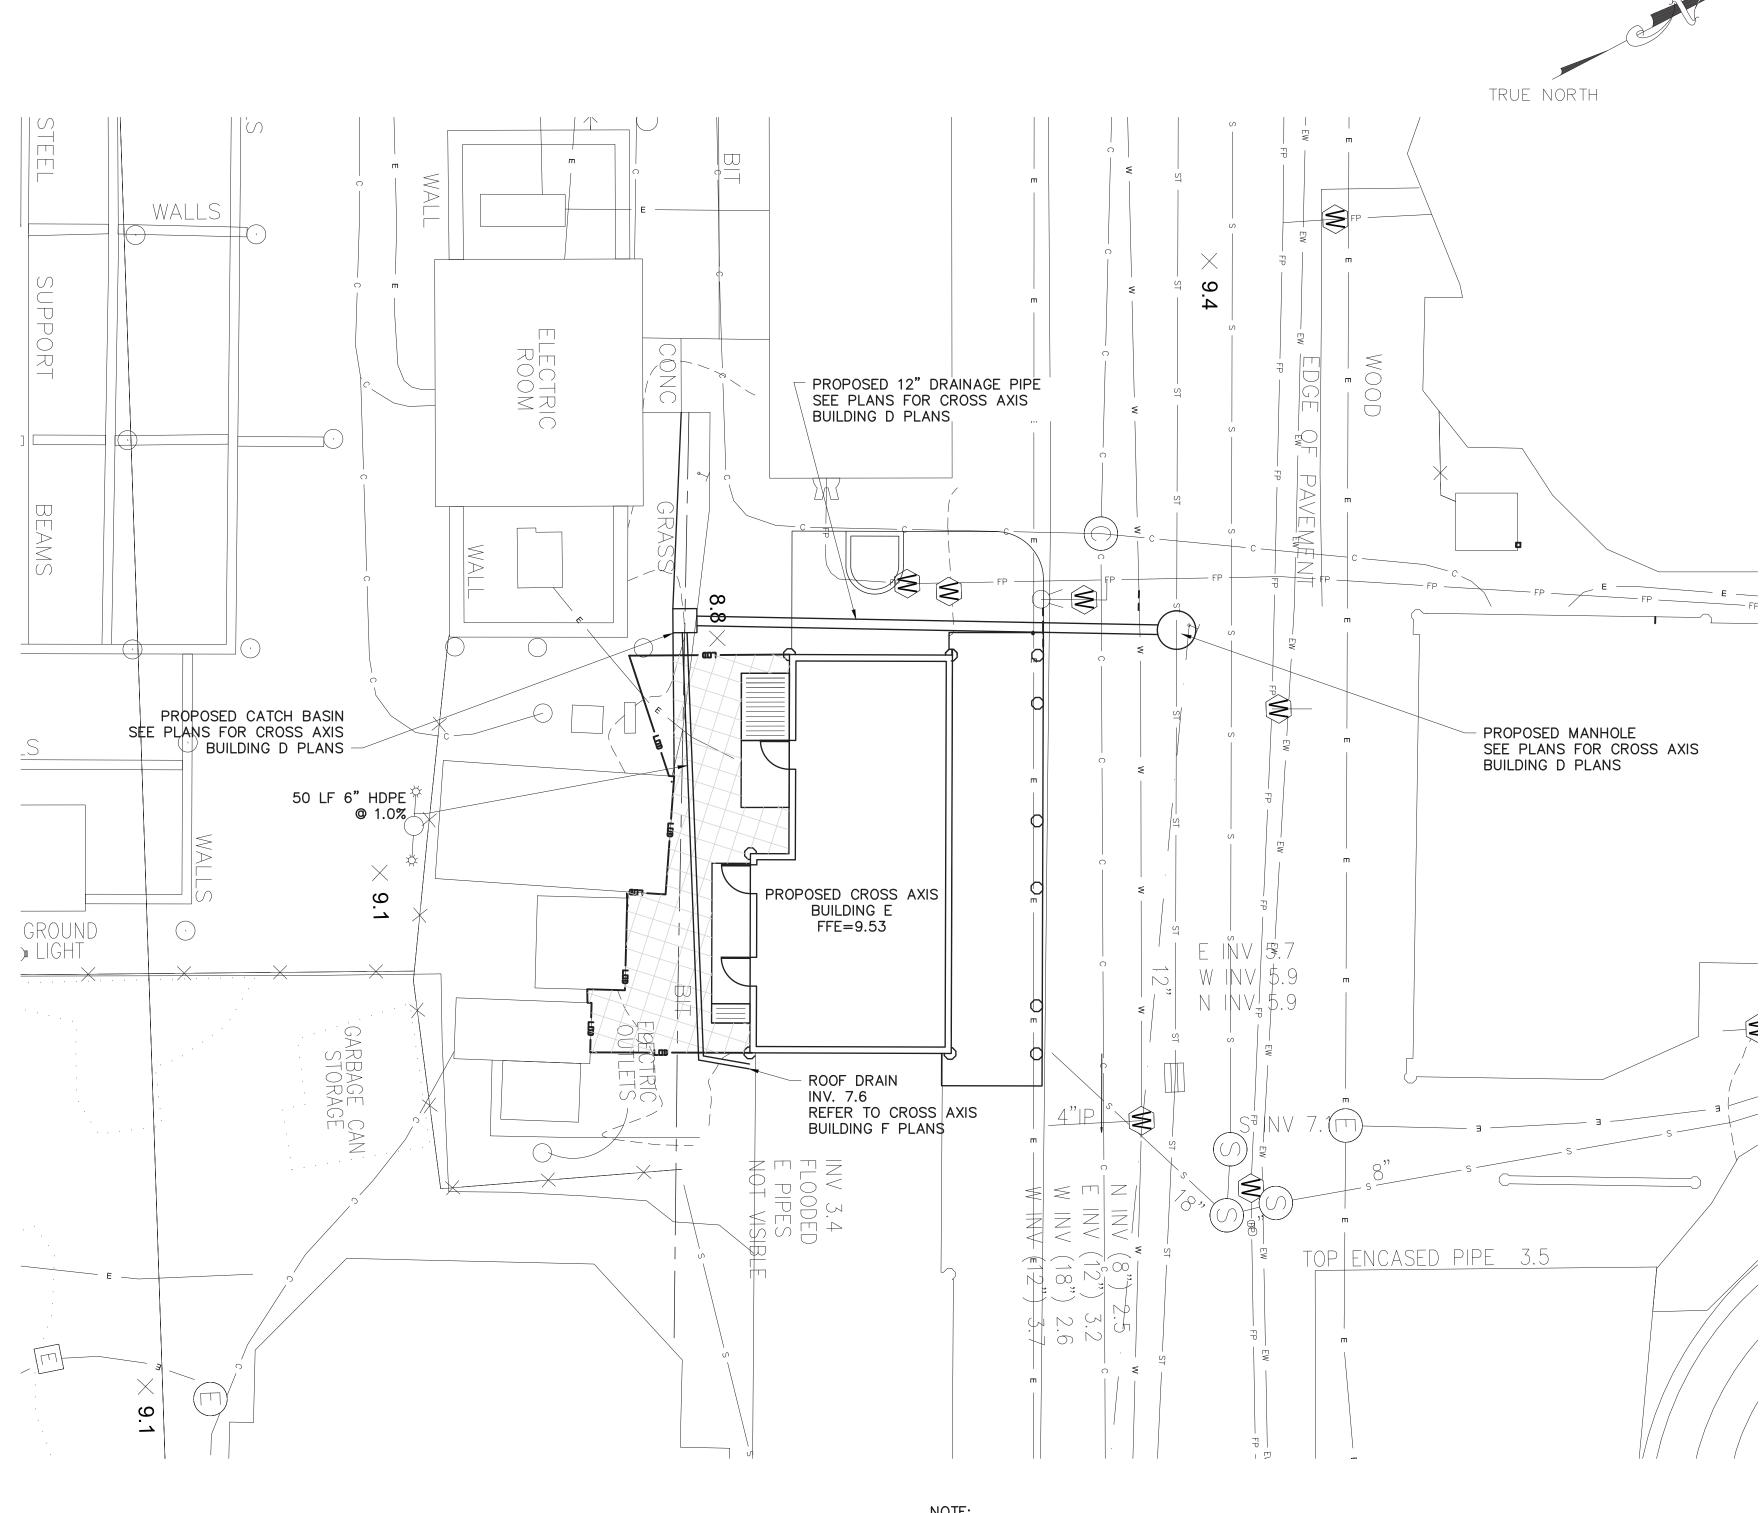

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<u>NOTE:</u> NO WATER AND SEWER SUPPLY NEEDED FOR THIS BUILDING. SEE FIRE PROTECTION PLAN FOR DETAILS


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	C ONTRAC TOR	PROJECT COORDINATOR	INFRASTRUCTURE REHABILITATION PHASE 3	SCALE: 1"=10' DATE: 08/23/2022	
	NAME SIGNATURE	signature	PLAYLAND PARK, RYE, NEW YORK CROSS AXIS BUILDING E		
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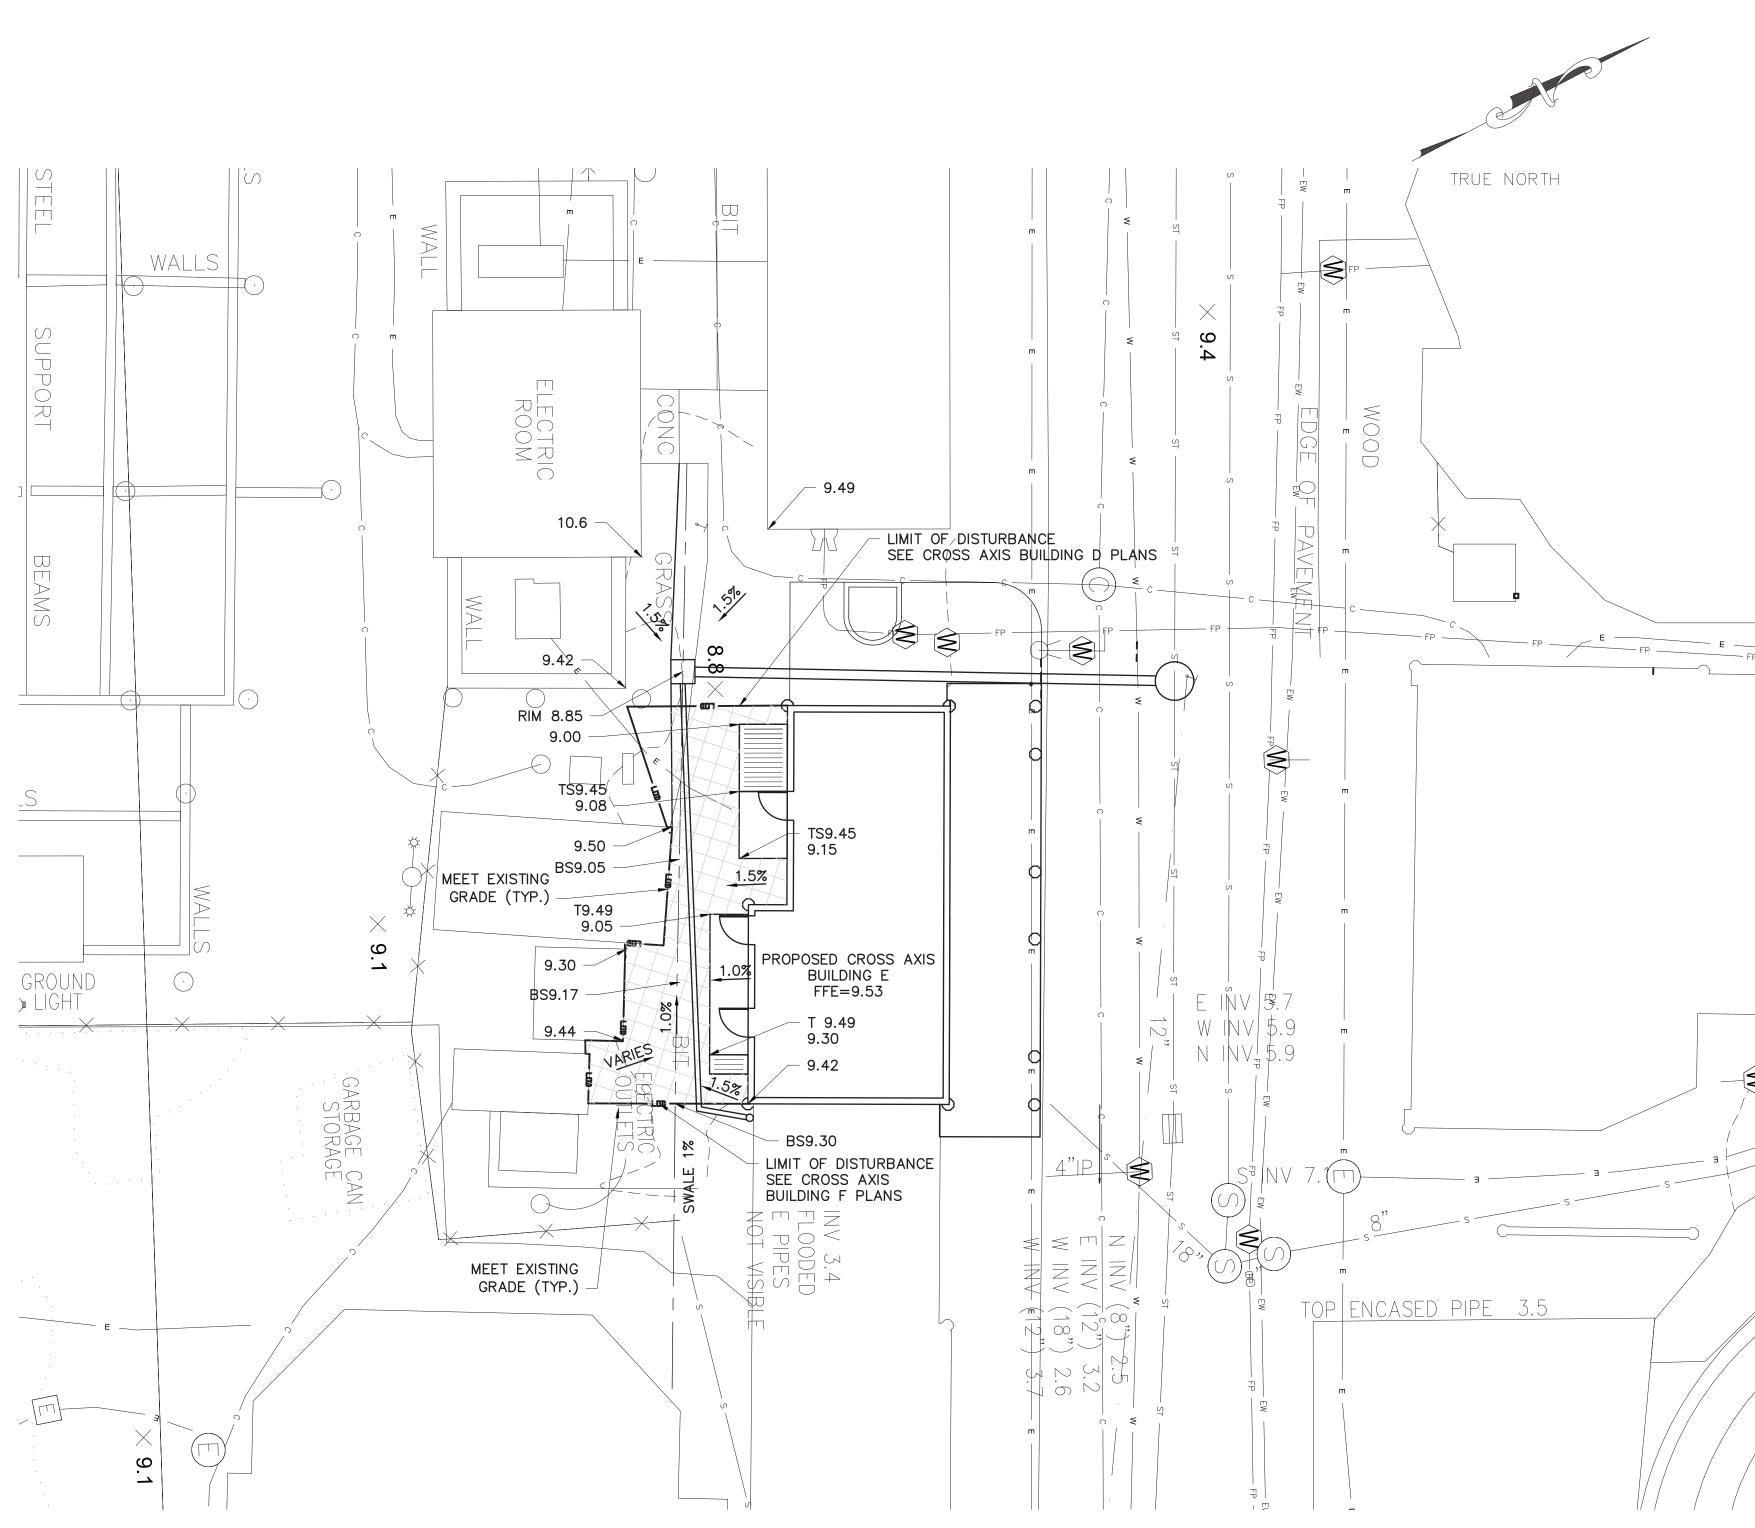
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	UNDERGROUND ENVIRONMENTAL WASTEWAT
	UNDERGROUND SEWER
	UNDERGROUND STORM SEWER
	UNDERGROUND WATER UNDERGROUND FIRE PROTECTION
	UNDERGROUND FIRE PRUIEUHUN


PROPOSED LEGEND:

	SAW CUTTING ASPHALT CONCRETE
LOD	LIMITS OF DISTURBANCE
	LIMITS OF PAVEMENT REMOVAL (MILLING & EXCAVATION)
v	PROPOSED WATER LINE
	PROPOSED CATCH BASIN
	PROPOSED STORM PIPE
\bigcirc	PROPOSED SANITARY MANHOLE
s	PROPOSED SANITARY PIPE
UGE	PROPOSED UNDERGROUND ELECTRIC



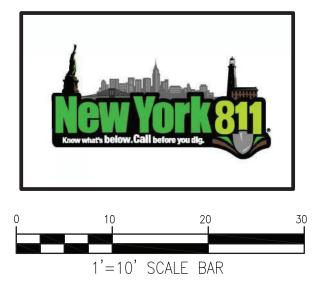

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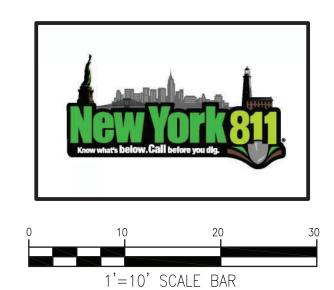
EXISTING LEGEND POST \bigcirc • UTILITY POLE O OR O SIGN HANDICAP PARKING Ġ. GROUND LIGHT \diamond LIGHT POLE ¢ UTILITY POLE WITH LIGHT ·---• ◯─≫ *___* LIGHT POLE (MULTI LIGHT) *** BOAT TIE-OFF CLEAT 💮 or 🖽 or 🚍 catch basin TRENCH DRAIN Μ MAILBOX \otimes UNKNOWN MANHOLE C OR C COMMUNICATIONS BOX/HAND HOLE ELECTRIC HAND HOLE E EB ELECTRIC BOX GM GAS METER IB IRRIGATION BOX U \bigcirc COMMUNICATION MANHOLE D OR D DRAINAGE MANHOLE E ELECTRIC MANHOLE S OR S SEWER MANHOLE ST STORM SEWER MANHOLE SEWER CLEANOUT \propto HYDRANT M SIAMESE CONNECTION ⟨V⟩ OR [V] UNKNOWN VALVE $\langle W \rangle$ WATER VALVE G GAS VALVE WS MONITORING WELL DECIDUOUS BUSH EVERGREEN BUSH Σ,Z 8 DECIDUOUS TREE 2,2 EVERGREEN TREE STUMP HEDGE ROW TREELINE BRUSHLINE v v v v v Retaining Wall STONE WALL ----- WATERLINE UNDERGROUND COMMUNICATION UNDERGROUND PROPANE ------ e -------- UNDERGROUND ELECTRICAL UNDERGROUND STREET LIGHTING UNDERGROUND SEWER UNDERGROUND WATER — W -_v 415.50

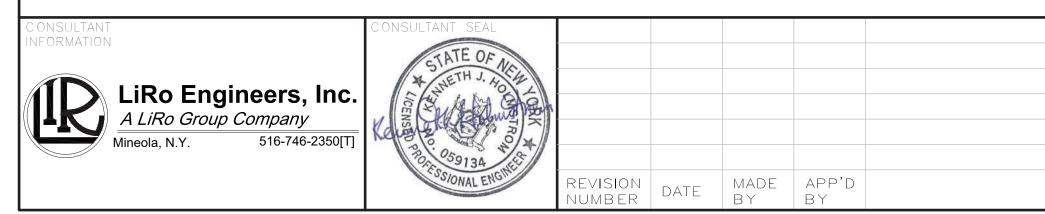LIGHT POLE (SINGLE LIGHT) LIGHT POLE (DOUBLE LIGHT) UNKNOWN UTILITY BOX/HAND HOLE WATER SPIGOT OR FOUNTAIN UNDERGROUND FIRE PROTECTION EXISTING SPOT ELEVATION EXISTING TOP OF GRATE ELEVATION


PROPOSED LEGEND:

TG=415.50

	SAW CUTTING ASPHALT CONCRETE
Loo	LIMITS OF DISTURBANCE
	PROPOSED MAJOR CONTOUR
	PROPOSED MINOR CONTOUR
9.30	PROPOSED SPOT ELEVATION
BS9.30	PROPOSED BOTTOM SWALE
TS9.30 —	TOP OF SLAB
	PROPOSED INLET PROTECTION



ESTCHESTER COUNTY, NEW YORK JMBER IUMBER 22-523 ARTMENT OF PUBLIC WORKS AND TRANSPORTATION CXE-C-05 DIVISION OF ENGINEERING .: **314 of 664 INFRASTRUCTURE REHABILITATION PHASE 3** 1"=10' PLAYLAND PARK, RYE, NEW YORK 08/23/2022 CROSS AXIS BUILDING E GRADING AND EROSION CONTROL PLAN 1-118-C-1063-0 0

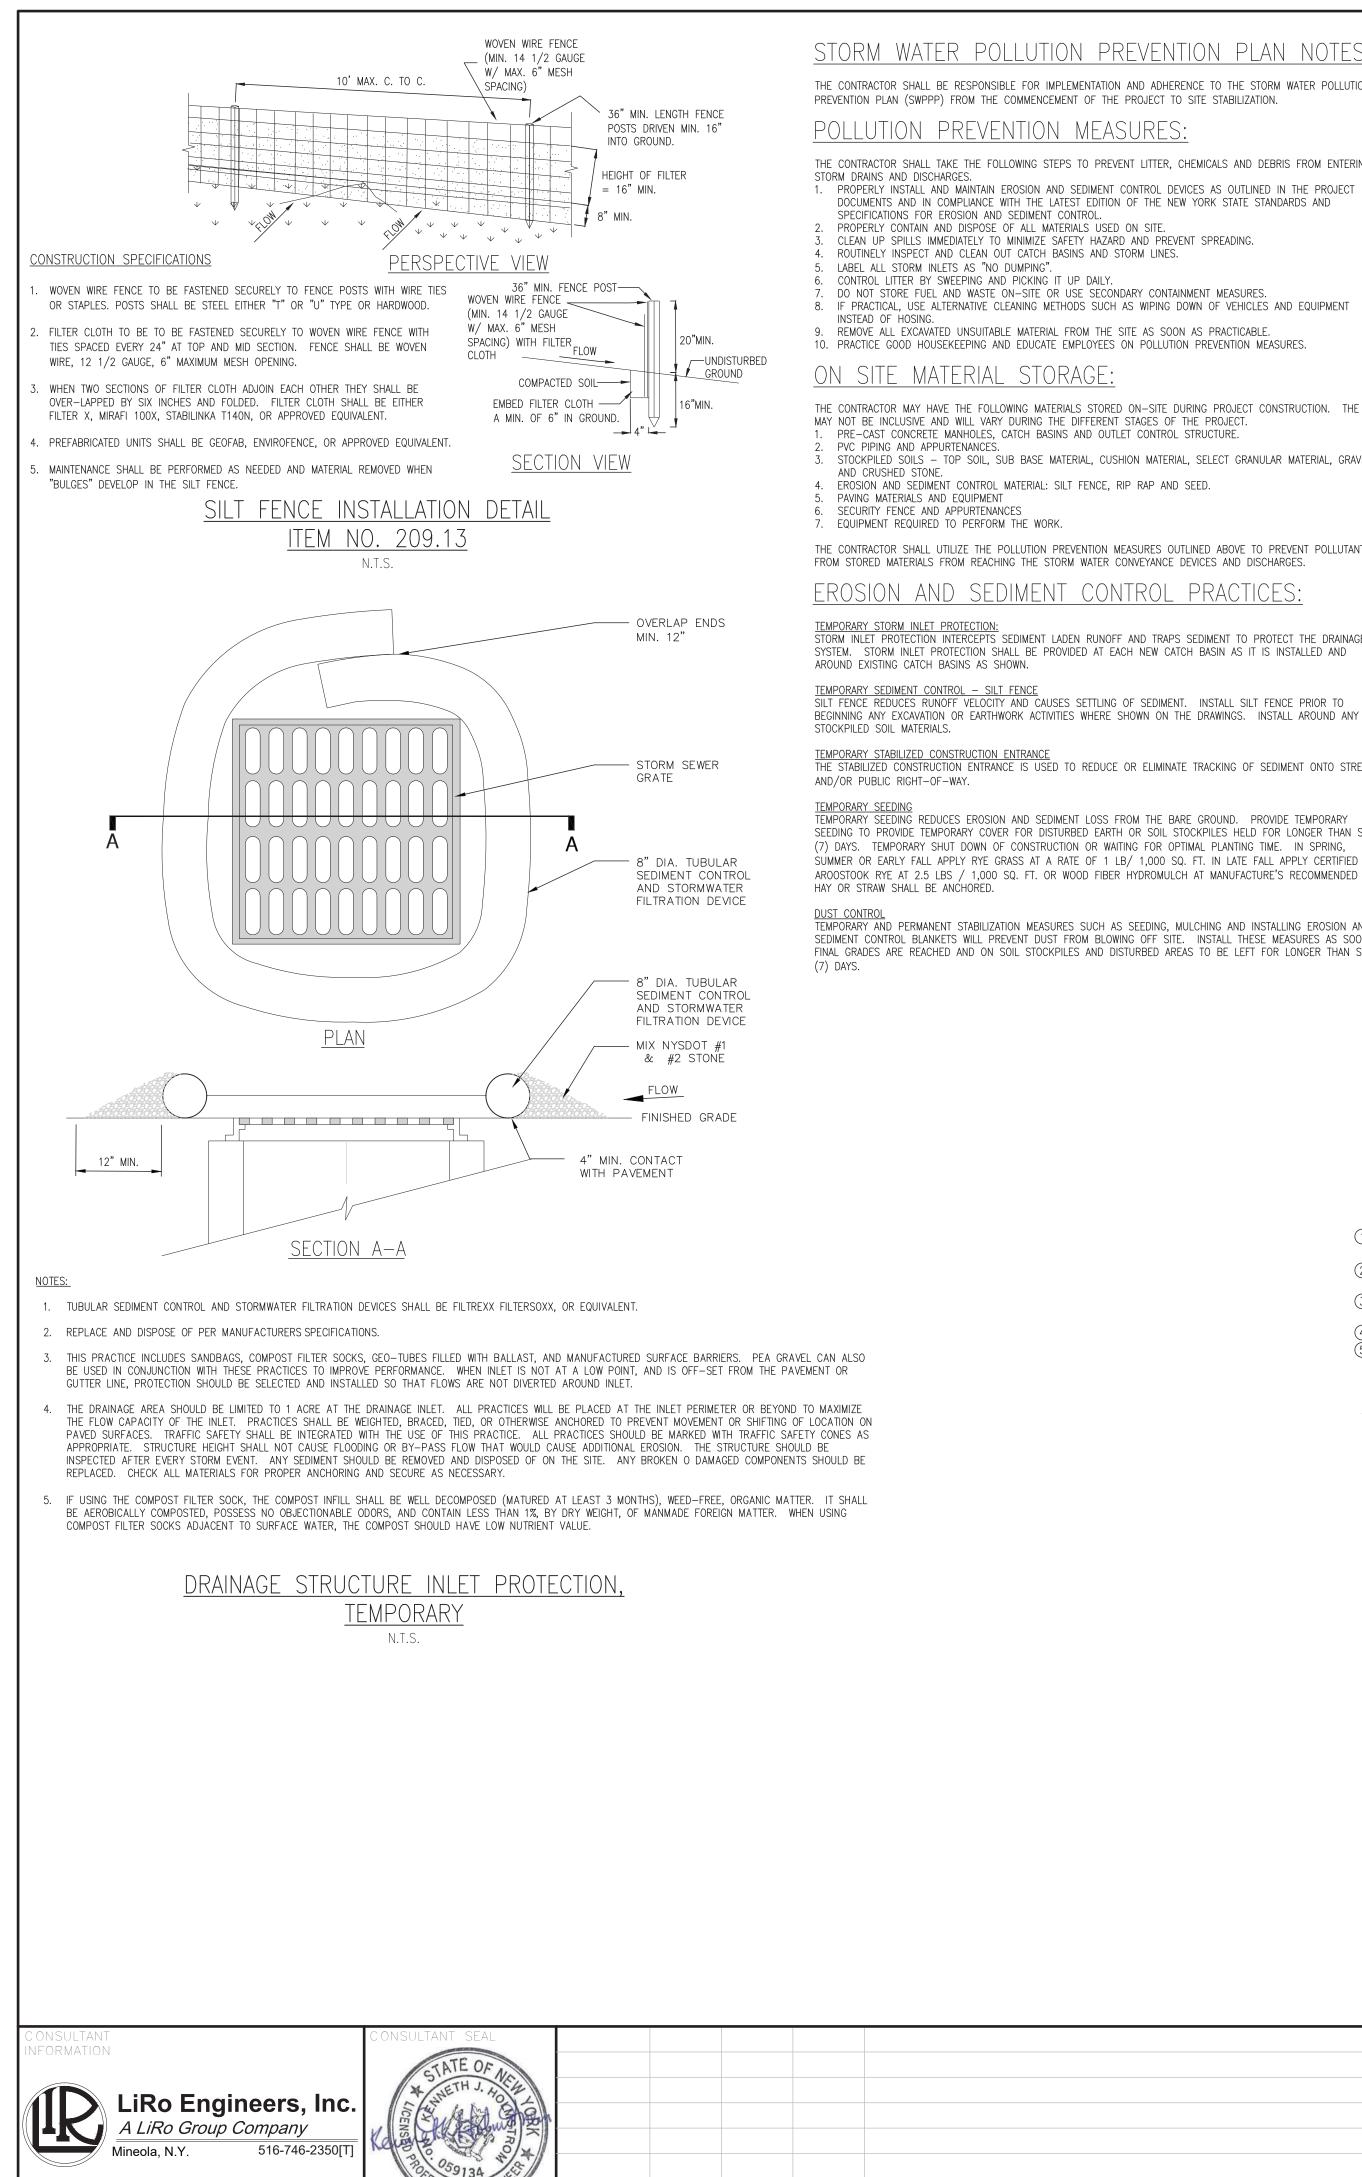

REVISION DATE MADE APP'D

STORM WATER POLLUTION PREVENTION PLAN NOTES: THE CONTRACTOR SHALL BE RESPONSIBLE FOR IMPLEMENTATION AND ADHERENCE TO THE STORM WATER POLLUTION

THE CONTRACTOR SHALL TAKE THE FOLLOWING STEPS TO PREVENT LITTER, CHEMICALS AND DEBRIS FROM ENTERING

DOCUMENTS AND IN COMPLIANCE WITH THE LATEST EDITION OF THE NEW YORK STATE STANDARDS AND

8. IF PRACTICAL, USE ALTERNATIVE CLEANING METHODS SUCH AS WIPING DOWN OF VEHICLES AND EQUIPMENT 9. REMOVE ALL EXCAVATED UNSUITABLE MATERIAL FROM THE SITE AS SOON AS PRACTICABLE. 10. PRACTICE GOOD HOUSEKEEPING AND EDUCATE EMPLOYEES ON POLLUTION PREVENTION MEASURES.

THE CONTRACTOR MAY HAVE THE FOLLOWING MATERIALS STORED ON-SITE DURING PROJECT CONSTRUCTION. THE LIST

STOCKPILED SOILS - TOP SOIL, SUB BASE MATERIAL, CUSHION MATERIAL, SELECT GRANULAR MATERIAL, GRAVEL

THE CONTRACTOR SHALL UTILIZE THE POLLUTION PREVENTION MEASURES OUTLINED ABOVE TO PREVENT POLLUTANTS FROM STORED MATERIALS FROM REACHING THE STORM WATER CONVEYANCE DEVICES AND DISCHARGES.

STORM INLET PROTECTION INTERCEPTS SEDIMENT LADEN RUNOFF AND TRAPS SEDIMENT TO PROTECT THE DRAINAGE

BEGINNING ANY EXCAVATION OR EARTHWORK ACTIVITIES WHERE SHOWN ON THE DRAWINGS. INSTALL AROUND ANY

THE STABILIZED CONSTRUCTION ENTRANCE IS USED TO REDUCE OR ELIMINATE TRACKING OF SEDIMENT ONTO STREETS

TEMPORARY SEEDING REDUCES EROSION AND SEDIMENT LOSS FROM THE BARE GROUND. PROVIDE TEMPORARY SEEDING TO PROVIDE TEMPORARY COVER FOR DISTURBED EARTH OR SOIL STOCKPILES HELD FOR LONGER THAN SEVEN (7) DAYS. TEMPORARY SHUT DOWN OF CONSTRUCTION OR WAITING FOR OPTIMAL PLANTING TIME. IN SPRING, SUMMER OR EARLY FALL APPLY RYE GRASS AT A RATE OF 1 LB/ 1,000 SQ. FT. IN LATE FALL APPLY CERTIFIED AROOSTOOK RYE AT 2.5 LBS / 1,000 SQ. FT. OR WOOD FIBER HYDROMULCH AT MANUFACTURE'S RECOMMENDED RATE.

TEMPORARY AND PERMANENT STABILIZATION MEASURES SUCH AS SEEDING, MULCHING AND INSTALLING EROSION AND SEDIMENT CONTROL BLANKETS WILL PREVENT DUST FROM BLOWING OFF SITE. INSTALL THESE MEASURES AS SOON AS FINAL GRADES ARE REACHED AND ON SOIL STOCKPILES AND DISTURBED AREAS TO BE LEFT FOR LONGER THAN SEVEN

PHASING OF EROSION AND SEDIMENT CONTROL PRACTICES:

- 1. PRIOR TO COMMENCING ANY CONSTRUCTION ACTIVITIES ON THE SITE, THE CONTRACTOR SHALL MEET WITH THE OWNERS REPRESENTATIVE AND DESIGNER TO DISCUSS THE STORM WATER POLLUTION PREVENTION PLAN. PRIOR TO COMMENCING ANY EXCAVATION PROCEDURES, INSTALL SILT FENCE AS SHOWN ON THE PLANS.
- INSTALL STABILIZED CONSTRUCTION ENTRANCE. 4. AS THE NEW CATCH BASINS ARE INSTALLED, PROVIDE TEMPORARY INLET PROTECTION.
- 5. AS SOIL MATERIAL IS EXCAVATED OR STOCKPILED, PROVIDE A SILT FENCE ENCLOSURE AROUND THE PILE. IF THE PILE IS TO REMAIN FOR LONGER THAN SEVEN (7) DAYS, TEMPORARILY SEED THE PILE. 6. DO NOT LEAVE DISTURBED AREAS NOT TO BE COVERED BY IMPERVIOUS SURFACE BARE FOR LONGER THAN SEVEN (7) DAYS, ROUGH GRADE THE AREAS AND TEMPORARILY SEED.
- AFTER FINAL GRADING OF VEGETATED AREAS. PROVIDE PERMANENT SEEDING. 8. UPON FINAL STABILIZATION OF THE SITE, REMOVE ALL TEMPORARY EROSION AND SEDIMENT CONTROL DEVICES. INSPECT ALL PERMANENT EROSION AND SEDIMENT CONTROL AND STORM WATER MANAGEMENT DEVICES. REPLACE ANY FAILING OR UNSATISFACTORY MEASURES. CLEAN ALL STORMWATER CATCH BASINS AND PIPING.

EROSION AND SEDIMENT CONTROL AND STORMWATER CONTROL DEVICE MAINTENANCE:

CONSTRUCTION DURATION ALL EROSION AND SEDIMENT CONTROL DEVICES SHALL BE INSPECTED WEEKLY.

- SILT FENCE SHALL BE REPLACED WHEN TORN, IS BULGING OR NO LONGER MEETING THE INSTALLATION DETAILS. THE STABILIZED CONSTRUCTION ENTRANCE SHALL BE MAINTAINED IN A CONDITION TO PREVENT TRACKING OF
- SEDIMENT ON TO ROADS AND PUBLIC RIGHTS-OF-WAY. INSPECT TOP DRESSING AND PROVIDE ADDITIONAL AGGREGATE AS NECESSARY. 3. DRAINAGE STRUCTURES AND PIPING SHALL BE CHECKED FOR CLOGGING AND SEDIMENT ACCUMULATION AND CLEANED IF REQUIRED.

PROJECT COMPLETION AT THE PROJECT COMPLETION AND PRIOR TO PROJECT CLOSE OUT, THE CONTRACTOR SHALL INSPECT ALL PERMANENT EROSION AND CONTROL AND STORMWATER MANAGEMENT PRACTICES.

ACCEPTABLE VEGETATION ESTABLISHMENT IN ACCORDANCE WITH SPECIFICATIONS. 2. DRAINAGE STRUCTURES AND PIPING SHALL BE CHECKED FOR CLOGGING AND SEDIMENT ACCUMULATION AND CLEANED IF REQUIRED.


MAINTENANCE OF PERMANENT STORMWATER MANAGEMENT PRACTICES

1. DRAINAGE STRUCTURES AND PIPING SHALL BE CHECKED FOR CLOGGING AND SEDIMENT ACCUMULATION AND

SITE ASSESSMENT AND INSPECTIONS

CLEANED IF REQUIRED.

COMPLY WILL ALL CONDITIONS INCLUDED IN THE SPDES PERMIT, PART III.D.3 THROUGH PART III.D.5. THE REQUIREMENTS IN THESE SUBSECTIONS OF THE SPDES PERMIT TAKE PRECEDENCE OVER NOTES ON THIS DRAWING AND ON THE EROSION AND SEDIMENT CONTROL PLAN WHERE CONTRADICTIONS BETWEEN THESE DRAWINGS AND THE SPDES PERMIT MAY ARISE.

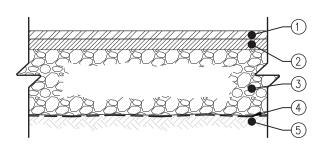

1 2" TOP COURSE, 12.5 F2 TOP COURSE HMA, 80 SERIES COMPACTION NYSDOT ITEM 402.128204

2" BINDER COURSE, 25 F9 BINDER COURSE HMA, 80 SERIES COMPACTION NYSDOT ITEM 402.258904

(3) 4" SUBBASE COURSE, SUBBASE COURSE, TYPE 2 NYSDOT ITEM 304.12

(4) GEOTEXTILE SEPARATION NYSDOT ITEM 207.21

5 COMPACTED SUBGRADE

NOTES:


1. COMPACT SUBGRADE TO A MODIFIED PROCTOR DENSITY OF 95% 2. SUBBASE COURSE SHALL HAVE NO MORE THAN (7%) SEVEN PERCENT

BY WEIGHT FINER THAN NO. 200 SIEVE. 3. IMPRINTED PATTERN SHOWN IS FOR GRAPHICAL REPRESENTATIONS


ONLY. ALL IMPRINTING/PATTERNING LAYOUTS AND POSITIONING SHALL BE APPROVED BY THE PROJECT ENGINEER PRIOR TO ACTUAL CONSTRUCTION.

ASPHALT PAVEMENT SECTION N.T.S.

	REC	RECORD DRAWING CERTIFICATION				
	AS BUILT – CHANGES	AS NOTED	_ AS BUILT – NO CHANGES	DEPAR		
	C ONTRAC TOR NAME	P NAME	ROJECT COORDINATOR			
	SIGNATURE	SIGNATURE				
REVISION	TITLE DATE	TITLE	DATE			
				•		

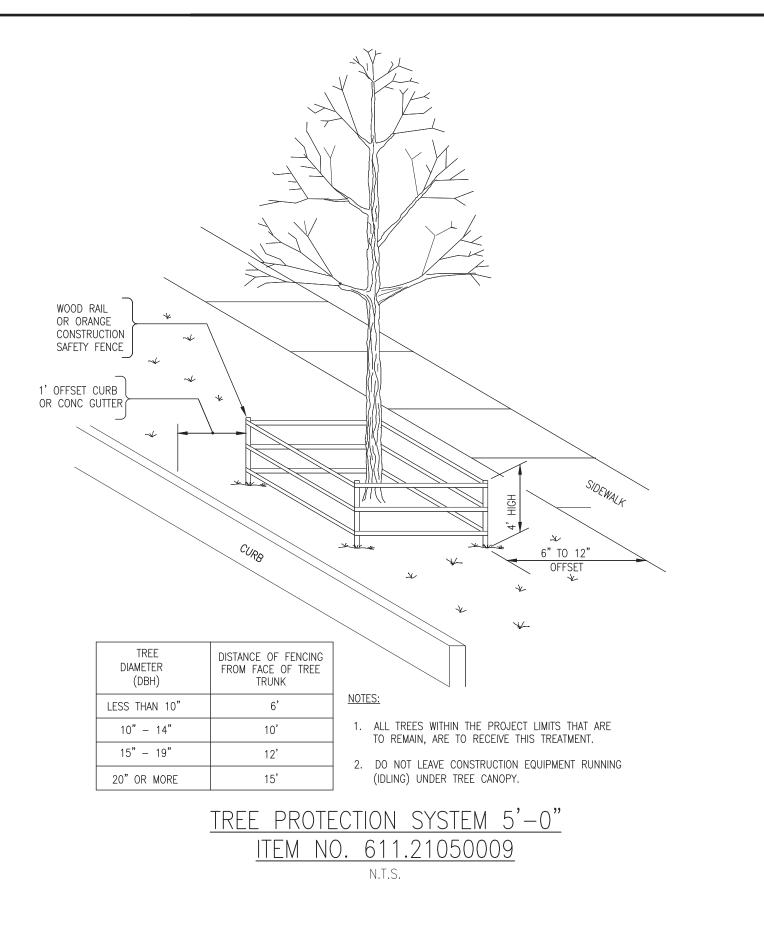

ESTCHESTER COUNTY, NEW YORK ARTMENT OF PUBLIC WORKS AND TRANSPORTATION	CONTRACT SHEET NUMBER NUMBER 22-523 CXE-C-06
DIVISION OF ENGINEERING	DWG NO.: 315 of 664
INFRASTRUCTURE REHABILITATION PHASE 3	SCALE: AS NOTED
PLAYLAND PARK, RYE, NEW YORK CROSS AXIS BUILDING E	DATE: 08/23/2022
CIVIL DETAILS 1	DPW FILE 1-118-C-1064-0 REV. NUMBER 0

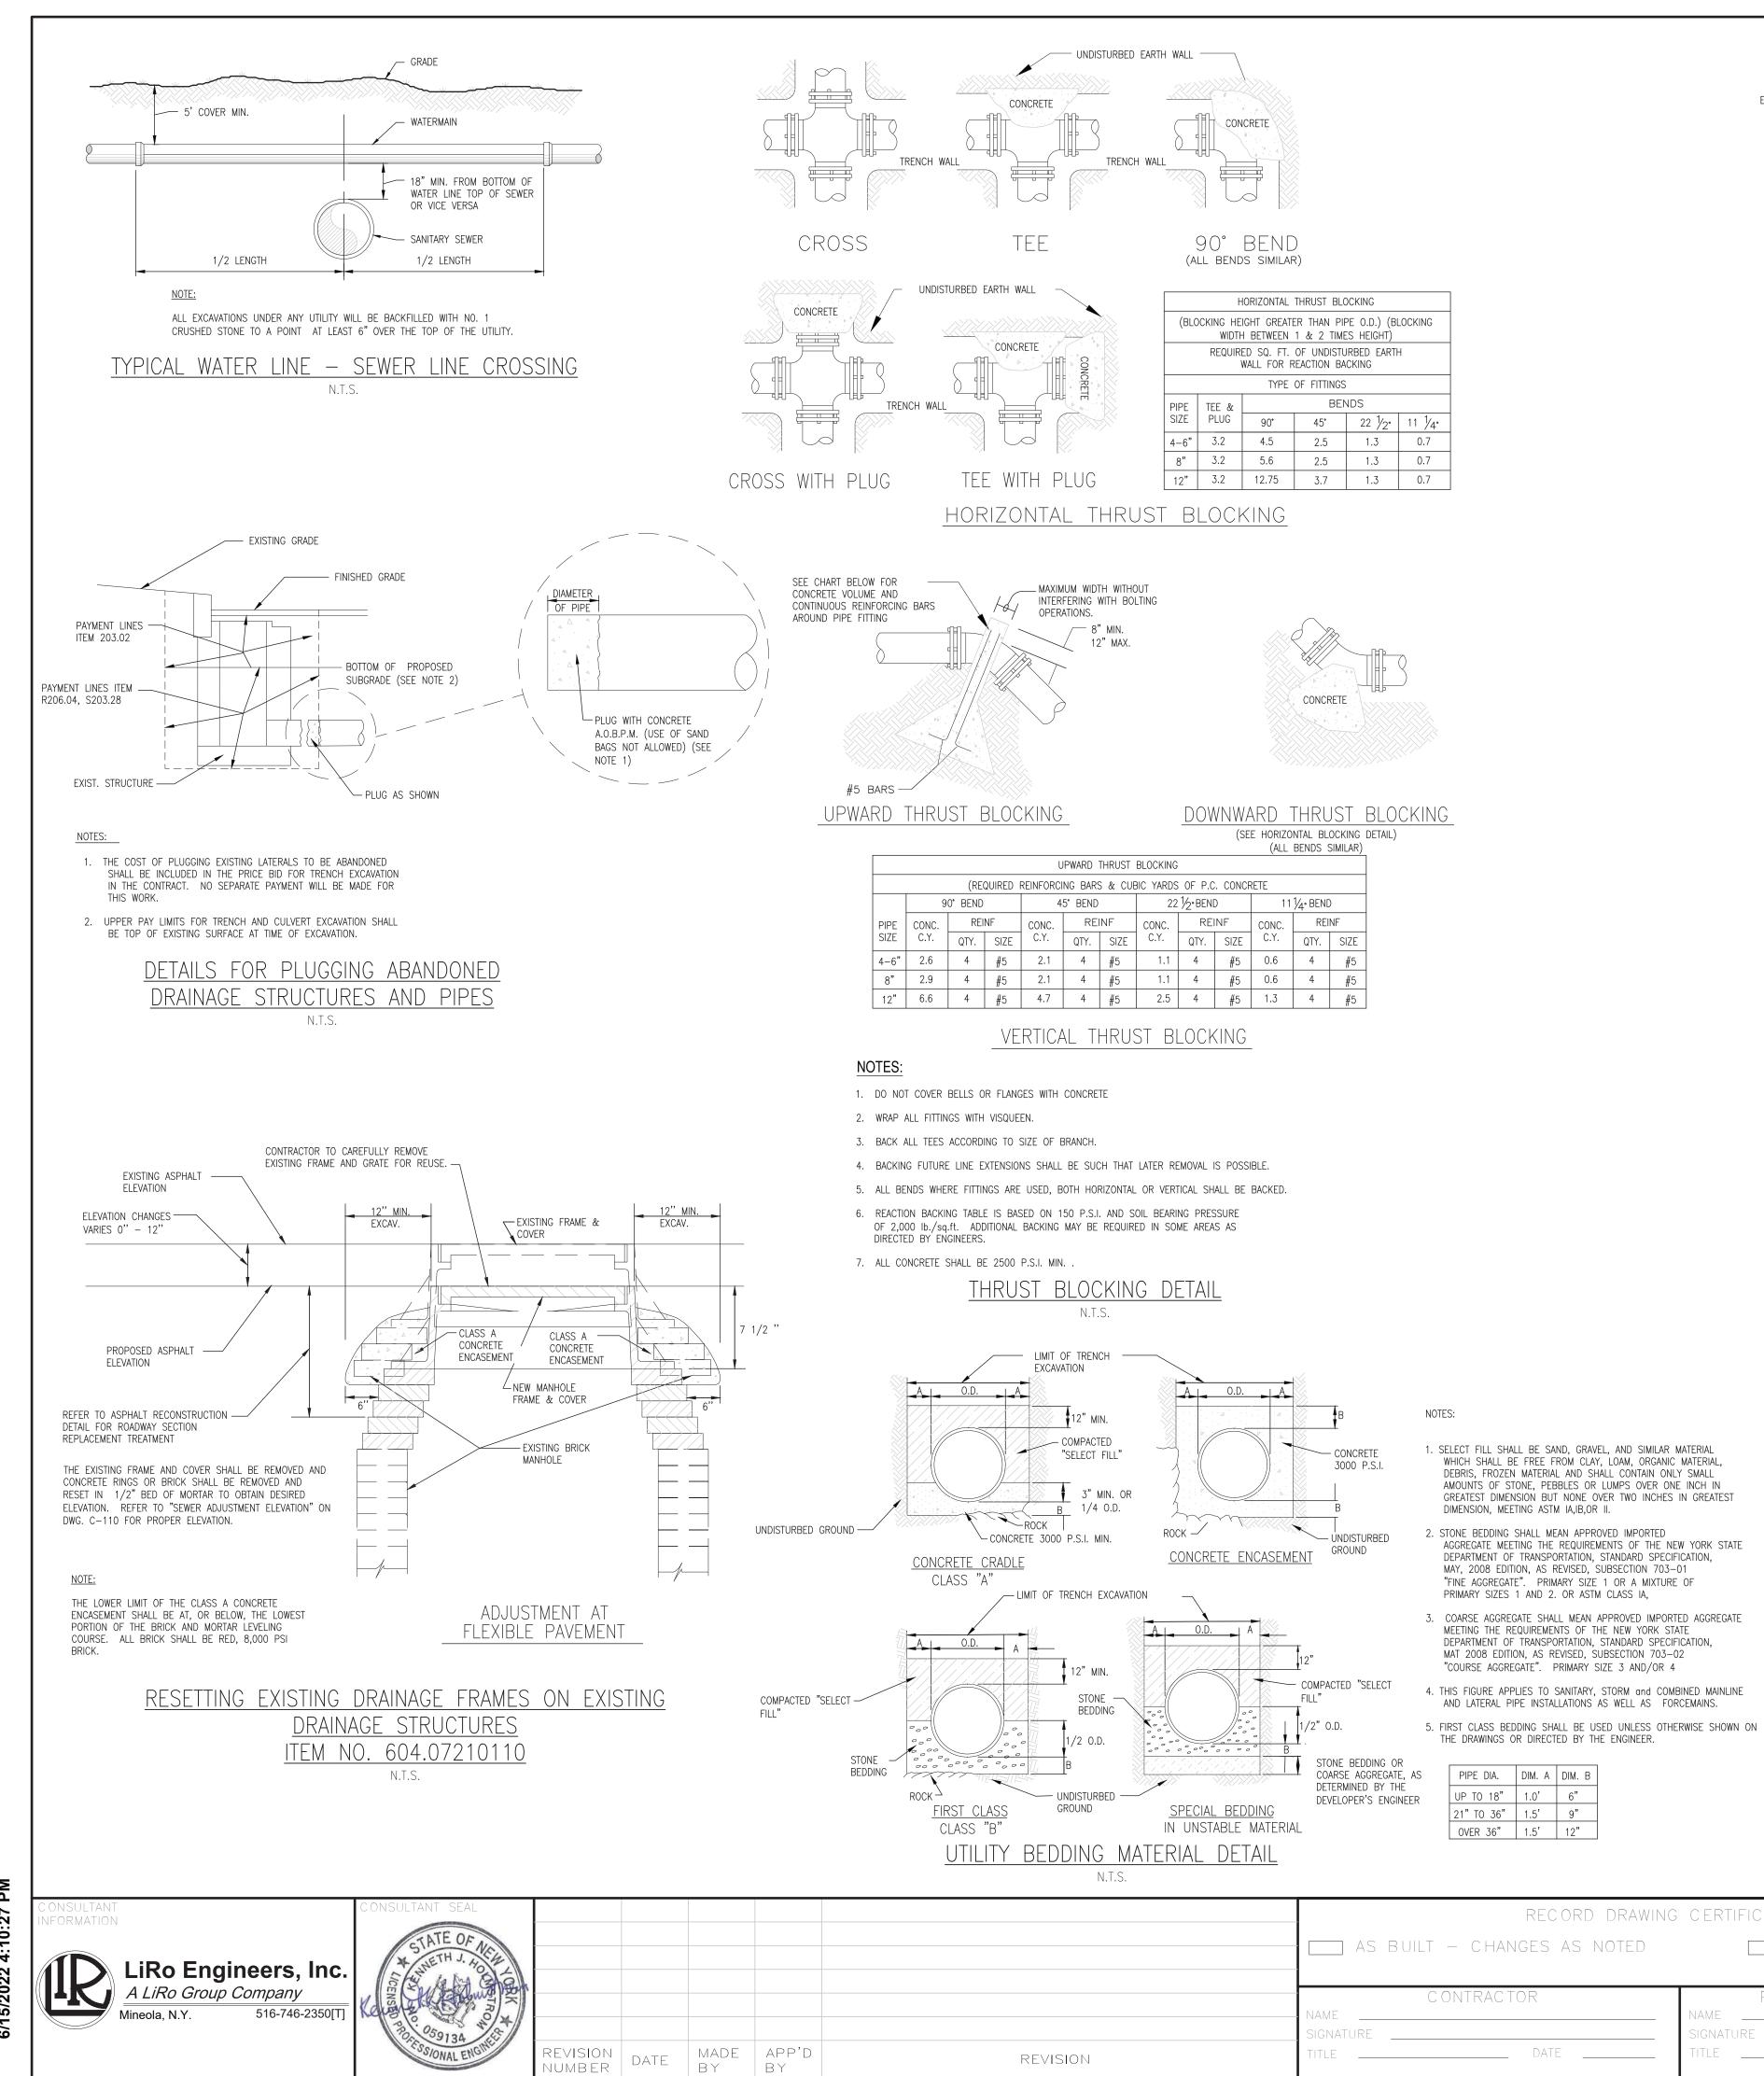


BY BY

	(ALL BENDS SIMILAR)								
UPWARD THRUST BLOCKING									
IRED REINFORCING BARS & CUBIC YARDS OF P.C. CONCRETE									
	45° BEND 22 1/2° BEND 11 1/4° BEND)
	CONC.	REI	EINF CONC. REINF		CONC.	REINF			
SIZE	C.Y.	QTY.	SIZE	C.Y.	QTY.	SIZE	C.Y.	QTY.	SIZE
# 5	2.1	4	# 5	1.1	4	# 5	0.6	4	# 5
# 5	2.1	4	# 5	1.1	4	# 5	0.6	4	# 5
# 5	4.7	4	# 5	2.5	4	# 5	1.3	4	# 5

- 1. SELECT FILL SHALL BE SAND, GRAVEL, AND SIMILAR MATERIAL WHICH SHALL BE FREE FROM CLAY, LOAM, ORGANIC MATERIAL, DEBRIS, FROZEN MATERIAL AND SHALL CONTAIN ONLY SMALL AMOUNTS OF STONE, PEBBLES OR LUMPS OVER ONE INCH IN GREATEST DIMENSION BUT NONE OVER TWO INCHES IN GREATEST
- AGGREGATE MEETING THE REQUIREMENTS OF THE NEW YORK STATE DEPARTMENT OF TRANSPORTATION, STANDARD SPECIFICATION, MAY, 2008 EDITION, AS REVISED, SUBSECTION 703-01 "FINE AGGREGATE". PRIMARY SIZE 1 OR A MIXTURE OF
- 3. COARSE AGGREGATE SHALL MEAN APPROVED IMPORTED AGGREGATE MEETING THE REQUIREMENTS OF THE NEW YORK STATE DEPARTMENT OF TRANSPORTATION, STANDARD SPECIFICATION, MAT 2008 EDITION, AS REVISED, SUBSECTION 703-02 "COURSE AGGREGATE". PRIMARY SIZE 3 AND/OR 4
- 4. THIS FIGURE APPLIES TO SANITARY, STORM and COMBINED MAINLINE AND LATERAL PIPE INSTALLATIONS AS WELL AS FORCEMAINS.
- THE DRAWINGS OR DIRECTED BY THE ENGINEER.

— 1"I,D, SLEEVES EXISTING WATERMAIN TYPICAL CONCRETE -THRUST BLOCK FOR 45° WATERMAIN -BEND

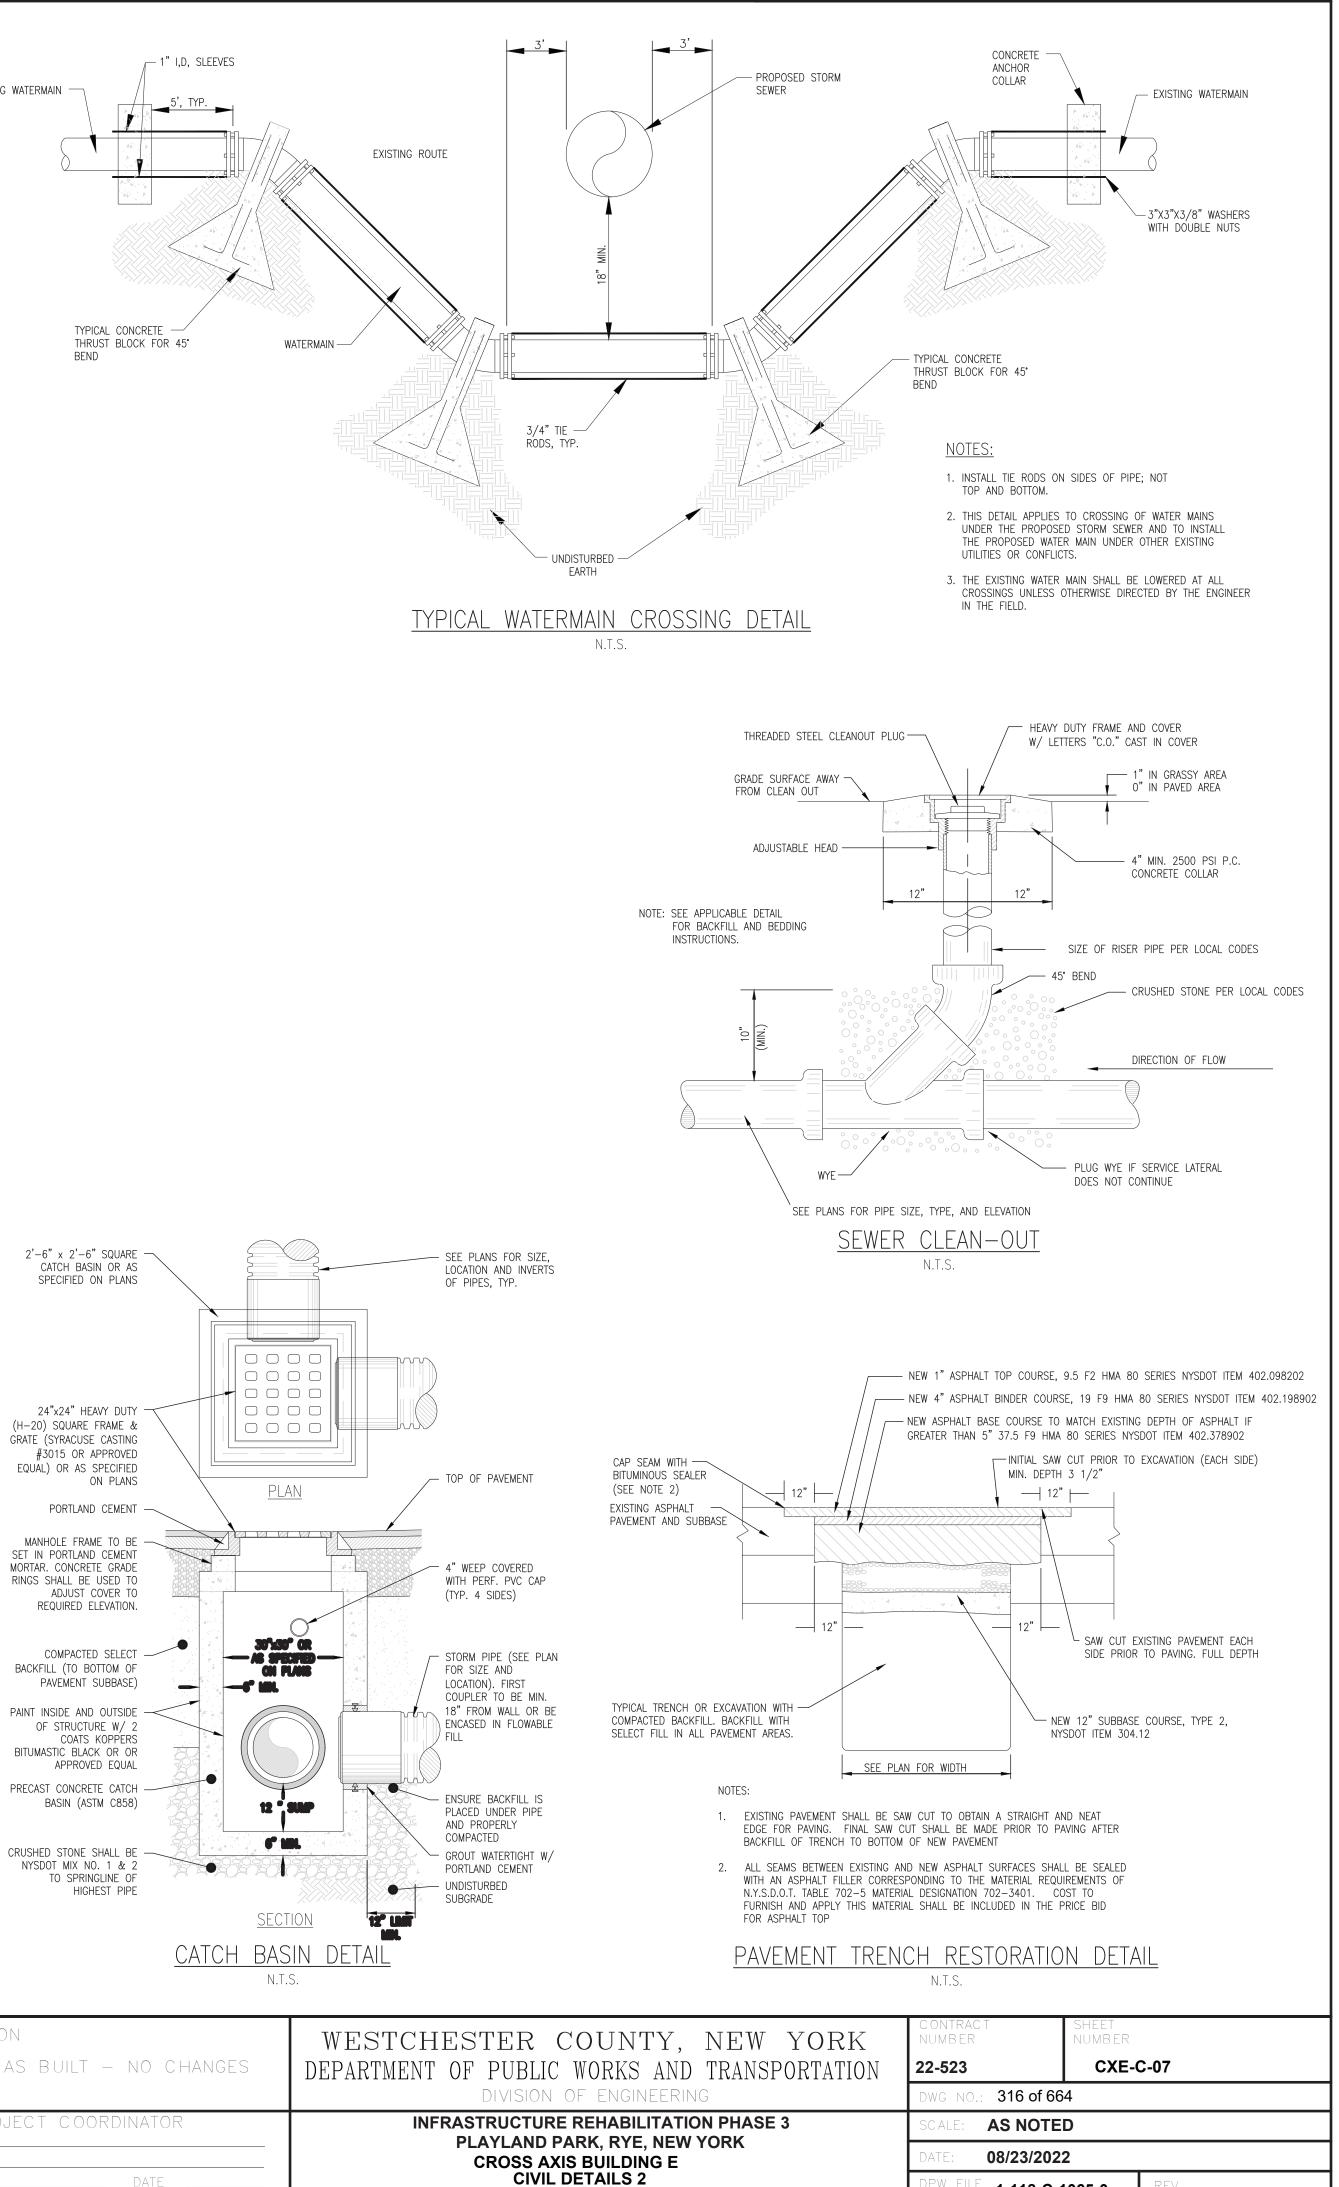

1-118-C-1065-0

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		RECORD DRAWING	CERTIFICATION		WES
	as built – cha	NGES AS NOTED		s built – no changes	DEPAR
	CONTRAC	TOR		ECT COORDINATOR	
	NAME		NAME SIGNATURE		
REVISION	TITLE	DATE	TITLE	DATE	