1.	ALL WORK AND MATERIALS SHALL BE PURCHASED AND INSTALLED IN ACCORDANCE WITH ALL NATIONAL & NEW YORK STATE CODES AND RECULATIONS (AS WELL AS ALL APPLICABLE LOCAL CODES & RECULATIONS)	1. CONTRACTOR SHALL BE RESPONSIBLE FOR DEMOLI EQUIPMENT AND MATERIAL RELATING TO THEIR RESP
	REGULATIONS (AS WELL AS ALL APPLICABLE LOCAL CODES & REGULATIONS). THE CONTRACTOR SHALL BE RESPONSIBLE TO ENSURE THAT ALL HVAC WORK IS PROVIDED AND INSTALLED IN STRICT ACCORDANCE WITH SEISMIC REQUIREMENTS.	2. THE CONTRACTOR SHALL REMOVE, RELOCATE, REF MODIFY EXISTING EQUIPMENT AND/OR SYSTEMS AS R UNCOVERED AND FOUND TO INTERFERE WITH COMPL
2.	DO NOT SCALE FROM THESE DRAWINGS.	CONTRACT OR OTHER CONTRACT WORK. 3. EXECUTE THE DEMOLITION IN CAREFUL AND ORDER
3.	THE EXACT MOUNTING HEIGHTS AND LOCATIONS OF ALL HVAC EQUIPMENT SHALL BE FIELD VERIFIED AND COORDINATED WITH ALL OTHER MECHANICAL, ELECTRICAL, PLUMBING, FIRE SPRINKLER, ARCHITECTURAL AND STRUCTURAL SYSTEMS. DURING SHOP DRAWINGS SUBMISSIONS, SHOW ALL MOUNTING	POSSIBLE DISTURBANCE TO THE PUBLIC, EGRESS OR EXISTING BUILDING.4. TAKE NECESSARY PRECAUTIONS TO PREVENT DUST
4	HEIGHTS OF DUCTWORK, UNITS, ETC.	WETTING DEMOLISHED DEBRIS. EXCESSIVE USE OF W 5. PRIOR TO DEMOLITION, CONTRACTOR SHALL REVIE
ч. 5.	ORDERING EQUIPMENT. PROVIDE PHASE LOSS PROTECTION FOR ALL POLY-PHASE MOTOR DEVICES.	TO BE REMOVED, SHOULD THE OWNER WANT TO KEEF CONTRACTOR SHALL REMOVE AND DELIVER THE PAR WHERE SO DIRECTED. OTHERWISE ALL DEMOLISHED BECOME THE PROPERTY OF THE CONTRACTOR AND S
6.	DUCTWORK SHALL BE CONSTRUCTED OF GALVANIZED SHEET STEEL IN STRICT COMPLIANCE WITH THE LATEST EDITION OF THE ASHRAE, NFPA, AND SMACNA GUIDE RECOMMENDATIONS. ALL DUCTS TO HAVE PITTSBURGH TYPE LOCK FOR LONGITUDINAL SEAMS AND DRIVE SLIP / "S" SLIP FOR TRANSVERSE JOINTS. "DUCT-MATE" JOINT SYSTEM IS ACCEPTABLE IN LIEU OF PRIOR SEAM SYSTEMS.	 SITE AND BE DISPOSED OF IN A LEGAL MANNER. 6. DEMOLITION SHALL INCLUDE REMOVAL OF ALL PAR ENTIRETY BACK TO POINTS INDICATED OR IF NOT INDI BACK TO THEIR POINT OF SOURCE.
	SIZES AS SHOWN INDICATE INSIDE CLEAR DIMENSIONS OF THE AIR PASSAGE. DUCTWORK SHALL BE FULLY INSULATED AS PER APPLICABLE CODES AND WRITTEN SPECIFICATIONS.	7. WHERE CONDITIONS PROHIBIT TOTAL REMOVAL OF PORTION SHALL BE CUT FLUSH WITH THE SURROUNDI PLUGGED OR SEALED AND THE SURROUNDING SURFA
7.	DUCT SIZES MUST BE VERIFIED FOR CLEARANCES AT THE JOB SITE PRIOR TO FABRICATION. DIMENSIONS MAY BE CHANGED TO ACCOMMODATE CONSTRUCTION AS LONG AS EFFECTIVE CROSS-SECTIONAL AREA IS MAINTAINED. DUCT TRANSITIONS SHALL BE CONSTRUCTED WITH A SLOPE OF 1" TO 4". ALL DEVIATIONS FROM ORIGINAL CONTRACT DRAWINGS SHALL BE REVIEWED BY ENGINEER DURING THE SHOP DRAWING PROCESS.	APPROVED MANNER. 9. DO NOT REMOVE EXISTING STRUCTURAL WORK. DO OPERATIONAL ELEMENTS AND SAFETY-RELATED COM MANNER RESULTING IN A REDUCTION OF CAPACITIES INTENDED OR RESULTING IN DECREASED OPERATION.
8.	PROVIDE MANUAL BALANCING DAMPERS AS REQUIRED TO PROPERLY BALANCE EACH INDIVIDUAL AIR DISTRIBUTION SYSTEM. IF THE LOCATION OF THE BALANCING DAMPER IS NOT DEFINED ON THE DRAWINGS, THE FOLLOWING MINIMUMS STANDARDS SHALL GOVERN. ALL SUPPLY, RETURN, AND EXHAUST	MAINTENANCE, OR DECREASED SAFETY. 10. REMOVALS, DISCONNECTIONS, AND RELOCATIONS PERFORMED BY WORKMEN SKILLED IN THE TRADE INVOLVED BY A CONTRACTOR LICENSED IN THE TRADE INVOLVED
9.	MAIN BRANCHES FROM TRUNKS, EACH SPLIT AND ALL SUB- BRANCHES FROM MAIN SHALL INCORPORATE BALANCING DAMPERS. PROVIDE FLEXIBLE CONNECTORS AT ALL DUCT CONNECTIONS TO VIBRATING EQUIPMENT. THESE CONNECTORS SHALL BE INSTALLED IN CLOSE PROXIMITY	ACCORDANCE WITH ACCEPTED TRADE PRACTICES. 11. PROVIDE ADEQUATE TEMPORARY SUPPORT FOR W FAILURE. DO NOT ENDANGER OTHER WORK.
10.	TO SUCH EQUIPMENT. PROVIDE FIRE DAMPERS WITH RATED ACCESS DOORS AT ALL DUCT PENETRATIONS THROUGH FIRE RATED WALLS, SMOKE AND FIRE STOPPING, SHAFT, FLOORS, RATED CEILINGS AND PARTITIONS AS REQUIRED TO MAINTAIN	12. PROTECTION: PROVIDE ADEQUATE PROTECTION V PRESENT BUILDING AND ITS CONTENTS. TEMPORARY BARRICADES SHALL BE ERECTED WHERE REQUIRED F PROTECTION FROM DUST AND DIRT, FOR SECURITY, F WEATHER PROTECTIVE REASONS.
	ARCHITECTURAL FIRE RATINGS. REFER TO THE ARCHITECTURAL PLANS AND SPECIFICATIONS FOR LOCATIONS AND FIRE RATING REQUIREMENTS. CONTRACTOR MUST FULLY REVIEW ALL ARCHITECTURAL AND ENGINEERING DRAWINGS AND VISIT THE SITE PRIOR TO SUBMITTING THE BID. NO EXTRAS	13. CONTRACTOR SHALL TAKE EVERY PRECAUTION AC DEPARTMENT TYPE HOSES AND PORTABLE FIRE EXTIN OSHA AND/OR THE OWNER'S INSURANCE UNDERWRIT
11.	WILL BE ALLOWED. ALL ACCESS DOORS REQUIRED IN GENERAL CONSTRUCTION ARE TO BE PROVIDED AND INSTALLED BY THE CONTRACTOR. IT IS THE RESPONSIBILITY OF THE CONTRACTOR TO IDENTIFY SIZE, TYPE AND LOCATION OF SUCH DOORS	14. BEFORE STARTING DEMOLITION OPERATIONS, PRO NECESSARY PROTECTIVE DEVICES, WHERE REQUIRED WITH OSHA RULES AND REGULATIONS.
	FOR PROPER ACCESS TO ALL CONCEALED HVAC EQUIPMENT, VALVES AND OTHER RELATED EQUIPMENT. THE CONTRACTOR SHALL IDENTIFY THESE REQUIREMENTS ON A COORDINATED SHOP DRAWING PRIOR TO SYSTEM FABRICATION AND INSTALLATION.	14. USE TEMPORARY ENCLOSURES, OR OTHER SUITAE DIRT RISING AND SCATTERING TO LOWEST PRACTICAL GOVERNING REGULATIONS PERTAINING TO ENVIRONM
12.	ALL CEILING MOUNTED EQUIPMENT MUST BE SUPPORTED DIRECTLY FROM BUILDING STRUCTURE WITH COMBINATION SPRING AND NEOPRENE-IN-SHEAR	15. FIELD VERIFY DEMOLITION REQUIREMENTS AND EX NOTES ARE INDICATED IN NOTE FORM.
13.	HANGERS AND ROD. PROVIDE SUPPLEMENTARY STEEL AS REQUIRED TO ADEQUATELY SUPPORT THE LOAD. THE CONTRACTOR MUST CONTRACT AN INDEPENDENT NEBB CERTIFIED AIR	16. CONTRACTOR SHALL ESTABLISH A PATH OF TRAVE REMOVAL OF ALL DEBRIS AND WASTE, AND HAVE THIS CONTRACTOR IS TO ENSURE THAT ALL CORRIDORS AN OF OBSTRUCTIONS, DEBRIS, AND ARE TO BE BROOM
	BALANCING & TESTING COMPANY TO PERFORM THE AIR BALANCING WORK AND ASSOCIATED SYSTEM AIR BALANCING REPORT. ALL WORK SHALL BE PERFORMED IN STRICT COMPLIANCE WITH ALL APPLICABLE CODES, REGULATIONS, PLANS AND WRITTEN SPECIFICATIONS. SUBMIT THE FINAL AIR BALANCE REPORT TO THE ENGINEER FOR REVIEW AND APPROVAL PRIOR TO	17. CONTRACTOR SHALL VISIT THE SITE AND BECOME OF THE PREMISES AND THE EXTENT AND CHARACTER ADDITIONAL COMPENSATION WILL BE APPROVED DUE
	SUBSTANTIAL COMPLETION OF THE PROJECT, AS DETERMINED BY THE AND OWNER/CLIENT. THE AIR BALANCE REPORT MUST INCLUDE ALL SUPPLY, RETURN, & EXHAUST AIR TERMINALS, FRESH AIR (OUTSIDE AIR) INTAKE AND VENTILATION EXHAUST CFM RATES FOR ALL UNITS. ALSO INCLUDE ACTUAL SUPPLY & RETURN AIR VELOCITY & STATIC PRESSURE READINGS ALONG WITH ALL MOTOR AMPERAGES FOR ALL UNITS.	NYSECC ENERGY CO STATEMEN
14.	THE CONTRACTOR IS TO INCLUDE IN THEIR BID ALL LOW VOLTAGE CONTROL	PER SECTION C101.7 OF THE 2020 NYSECC HISTORIC I
	WIRING, THERMOSTATS, RELAYS, TRANSFORMERS, STARTERS ETC FOR A COMPLETE OPERATING CONTROL SYSTEM AS DESCRIBED IN THE SEQUENCE OF OPERATIONS, THE CONTRACTOR IS ALSO RESPONSIBLE FOR LINE VOLTAGE CONTROL FOR EXHAUST FANS CONTROLLED FROM LIGHT SWITCH AND THERMOSTATS. ALL CONTROL WIRING IN THE AREAS THAT DO NOT HAVE DROPPED CEILINGS THE CONTRACTOR MUST PROVIDE ALL CONTROL WIRING CONDUIT. IN AREAS OF DROPPED CEILING PLENUM RATED CONTROL WIRING	THE REQUIREMENTS OF THE ENERGY CODE.
15.	CAN BE RUN EXPOSED ABOVE CEILING. ALL MECHANICAL EQUIPMENT SHALL BE INSTALLED PER MANUFACTURER'S REQUIREMENTS/SPECIFICATIONS.	
	CODE REFERENCE	
2020	D NEW YORK STATE BUILDING CODE D NEW YORK STATE MECHANICAL CODE D NEW YORK STATE ENERGY CONSERVATION CODE	

CONSULTANT INFORMATION



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ON NOTES

MECHANICAL RADE.

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IRT FROM RISING BY ILL NOT BE PERMITTED. OWNER ALL MATERIALS ATERIALS THE HE OWNER ON THE SITE IOVED MATERIALS SHALL E REMOVED FROM THE

PIECES IN THEIR

DRK, THE REMAINING RFACE AND BE CAPPED, ILL BE REFINISHED IN AN

EMOVE 'S IN A FORM IN THE MANNER INCREASED

AND SHALL BE EMPLOYED ORK SHALL BE DONE IN

REMAIN, TO PREVENT

REQUIRED FOR THE ROOF BARRIERS AND DECTION OF PERSONNEL,

IRE BY EMPLOYING FIRE ERS AS REQUIRED BY

STRICT ACCORDANCE

HODS TO LIMIT DUST AND COMPLY WITH PROTECTION. CONDITIONS. DEMOLITION

TIME SCHEDULE FOR THE DVED BY OWNER. LIC AREAS BE KEPT FREE CLEAN AT ALL TIMES.

IED AS TO THE CONDITION ORK REQUIRED. NO LD CONDITIONS.

PLIANCE

GS ARE EXEMPT FROM

HVAC S	YMBOL LIST			
IDENTIFIER	DESCRIPTION			
<u>} </u>	NEW DUCTWORK OR PIPING			
\$+++++++>	EXISTING DUCTWORK OR PIPING TO BE REMOVED			
ک۲	EXISTING DUCTWORK OR PIPING TO REMAIN			
24X12 5 24X12 5 24X12 5 24X12	DOUBLE-LINE AND SINGLE-LINE RECTANGULAR DUCT, FIRST NUMBER INDICATES SIDE IN VIEW IN INCHES, SECOND NUMBER INDICATES SIDE IN DEPTH IN INCHES			
·····	FLEXIBLE DUCTWORK			
	REGULAR SUPPLY AIR DUCT (UP AND DOWN)			
	REGULAR RETURN AIR DUCT (UP AND DOWN)			
	REGULAR EXHAUST AIR DUCT (UP AND DOWN)			
	REGULAR OUTSIDE AIR DUCT (UP AND DOWN)			
VD	VOLUME DAMPER			
— — — BD	BACKDRAFT DAMPER			
- (\$)	MOTOR OPERATED DAMPER			
XXX XX	— EQUIPMENT TAG — EQUIPMENT NUMBER			
XXX X-XXX	 DETAIL TAG/CALL OUT TAG MECHANICAL SHEET NUMBER 			
Ū	THERMOSTAT			
	EXHAUST GRILLE			
F#	REFER TO SUPPLEMENTAL FIGURE INDICATED BY NUMBER (I.E. F2 REFERS TO FIGURE 2)			

HVAC ABBREVIATIONS

IDENTIFIER	DESCRIPTION
AC CFM COND CU CUH DB DN EA EF EG EUH EER EG FAI GC MBH PC RG RGL RLL RTU SA SD TYP.	DESCRIPTION DIRECT EXPANSION AIR CONDITION UNIT CUBIC FEET PER MINUTE CONDENSATE CONDENSING UNIT CABINET UNIT HEATER DRY BULB DOWN EXHAUST AIR EXHAUST FAN EXHAUST GRILLE ELECTRIC UNIT HEATER ENERGY EFFICIENCY RATIO EXHAUST GRILLE FRESH AIR INTAKE GENERAL CONTRACTOR THOUSAND BTU PER HOUR PLUMBING CONTRACTOR RETURN GRILLE REFRIGERANT GAS LINE REFRIGERANT GAS LINE REFRIGERANT LIQUID LINE ROOFTOP UNIT SUPPLY AIR SUPPLY AIR SUPPLY DIFFUSER TYPICAL
VIF	VERIFY IN FIELD


SCOPE OF WORK

DEMOLITION
1. REMOVE ONE (1) EXISTING WALL MOUNTED FAN AS INDICATED ON PLANS.

	AS BUILT – CHANGES AS NOTED		DEPARTMENT OF PUBLIC WORKS AND TRANSPORTATION Division of engineering
	CONTRACTOR NAMESIGNATURE	PROJECT COORDINATOR	INFRASTRUCTURE REHABILITATION - PHASE 3 PLAYLAND PARK, RYE, NEW YORK
REVISION	TITLE DATE	TITLE DATE	CROSS AXIS BUILDING E MECHANICAL NOTES, SYMBOLS AND LEGENDS

MECHANICAL DRAWING LIST						
SHEET NO.	SHEET NAME	REVISON NO.	REVISION DATE			
CXE-M-01	MECHANICAL NOTES, SYMBOLS & LEGENDS	0				
CXE-M-11	MECHANICAL 1ST FLOOR DEMOLITION PLAN	0	-			

C ONTRAC T NUMB ER	SHEET NUMBER					
22-523	CXE-M-01					
DWG NO.: 293 of 66	4					
SCALE: AS INDICATED						
DATE: 08/23/2022						
DPW FILE NUMBER 1-118-M-	1042-0 REV. 0					

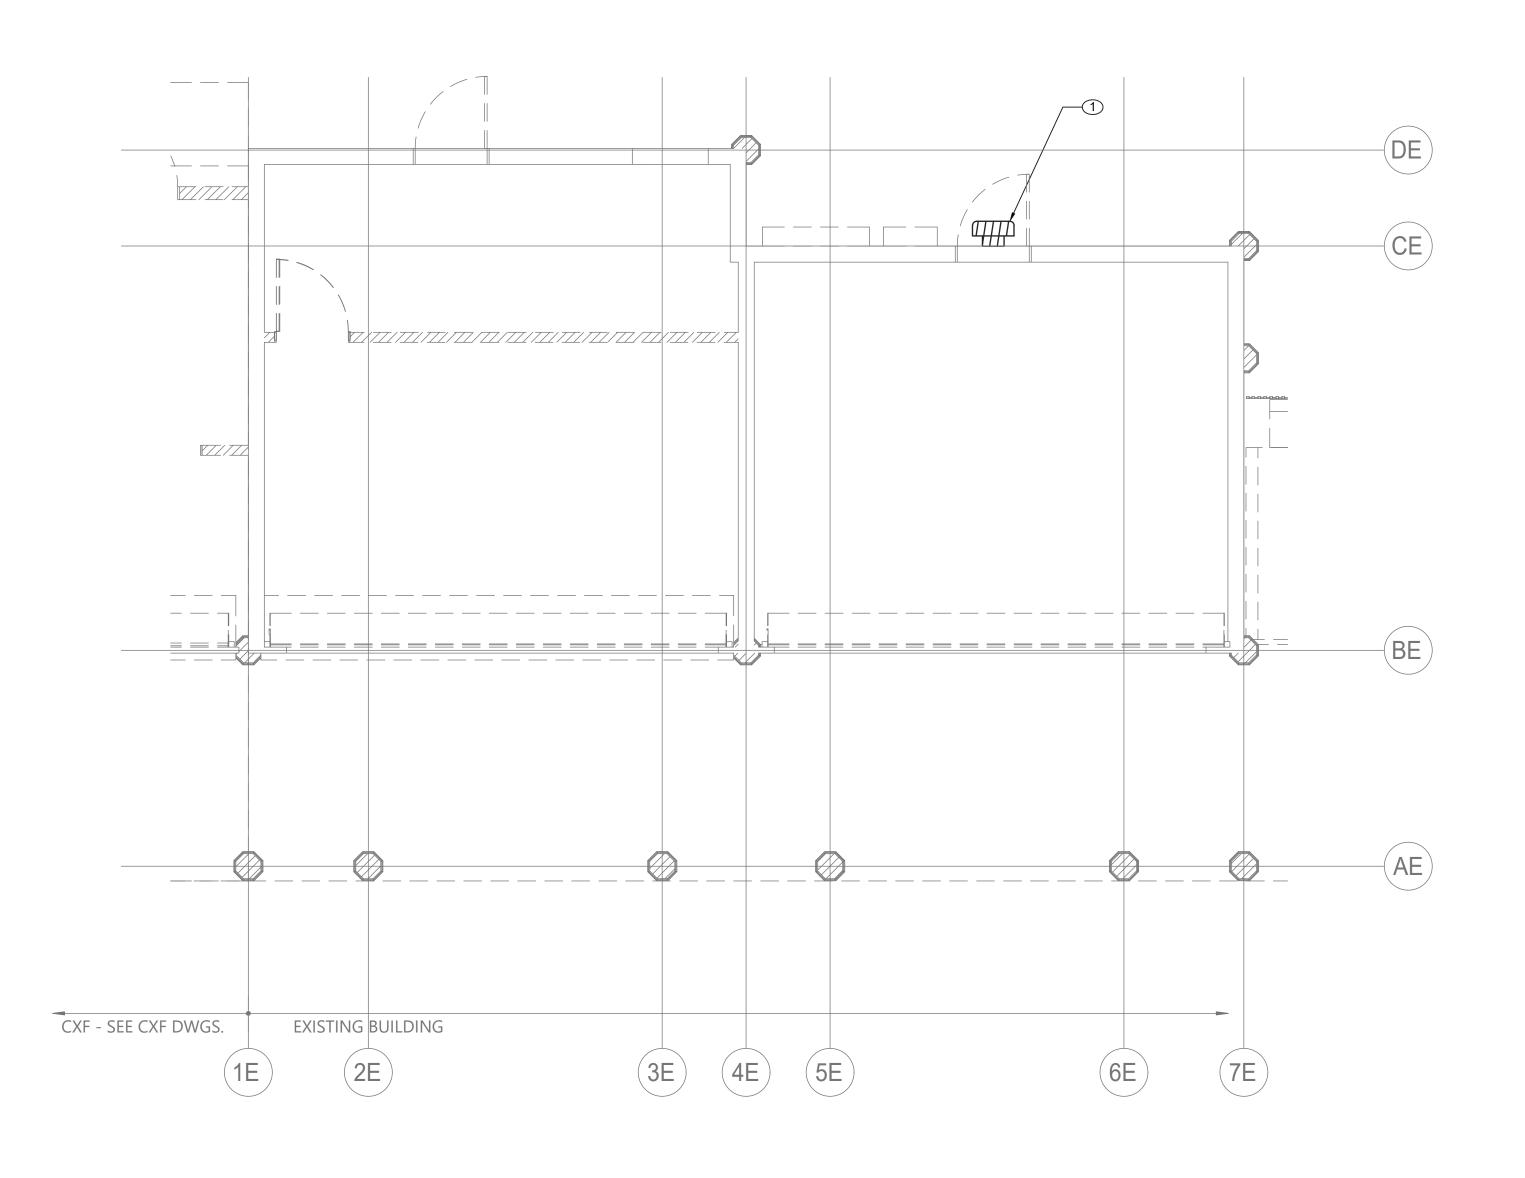



CONSULTANT INFORMATION LIRO Engineers, Inc. A LiRo Group Company Syosset, N.Y. 516-214-8157[T]	CONSULTANT SEAL					
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	RECORD DRAWIN	G CERTIFICATION	WES
	AS BUILT – CHANGES AS NOTED	AS BUILT – NO CHANGES	DEPAR
	CONTRACTOR NAME	PROJECT COORDINATOR	
REVISION	TITLE DATE	TITLE DATE	

GENERAL NOTES:

1. RETURN REMOVED EXISTING EQUIPMENT TO OWNER IF IT IS IN WORKING CONDITION.

2. CONTRACTOR TO COORDINATE WITH FACILITY WHEN WORKING AROUND OR ABOVE THE RIDE COMPONENTS, AND PROVIDE ALL NECESSARY MEASURES TO PROTECT THESE COMPONENTS PER THE REQUIREMENTS OF THE FACILITY.

MECHANICAL DEMOLITION NOTES:

(1) DEMOLISH EXISTING WALL MOUNTED PROPELLER FAN. COORDINATE REMOVAL OF ELECTRICAL POWER AND WIRING WITH ELECTRICAL CONTRACTOR. COORDINATE WITH GC TO SEAL EXISTING WALL PENETRATION.

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RTMENT	0F	PUBLI(C W	ORKS	AND	TRANSI	PORTATION
		DIVISION	OF	ENGIN	IEERIN	G	

INFRASTRUCTURE REHABILITATION - PHASE 3 PLAYLAND PARK, RYE, NEW YORK CROSS AXIS BUILDING E MECHANICALFIRST FLOOR DEMOLITION PLAN

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22-523	CXE-M-11				
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DATE: 08/23/2022					

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