


## **RESTAURANT KITCHEN**



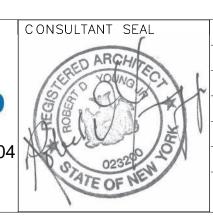

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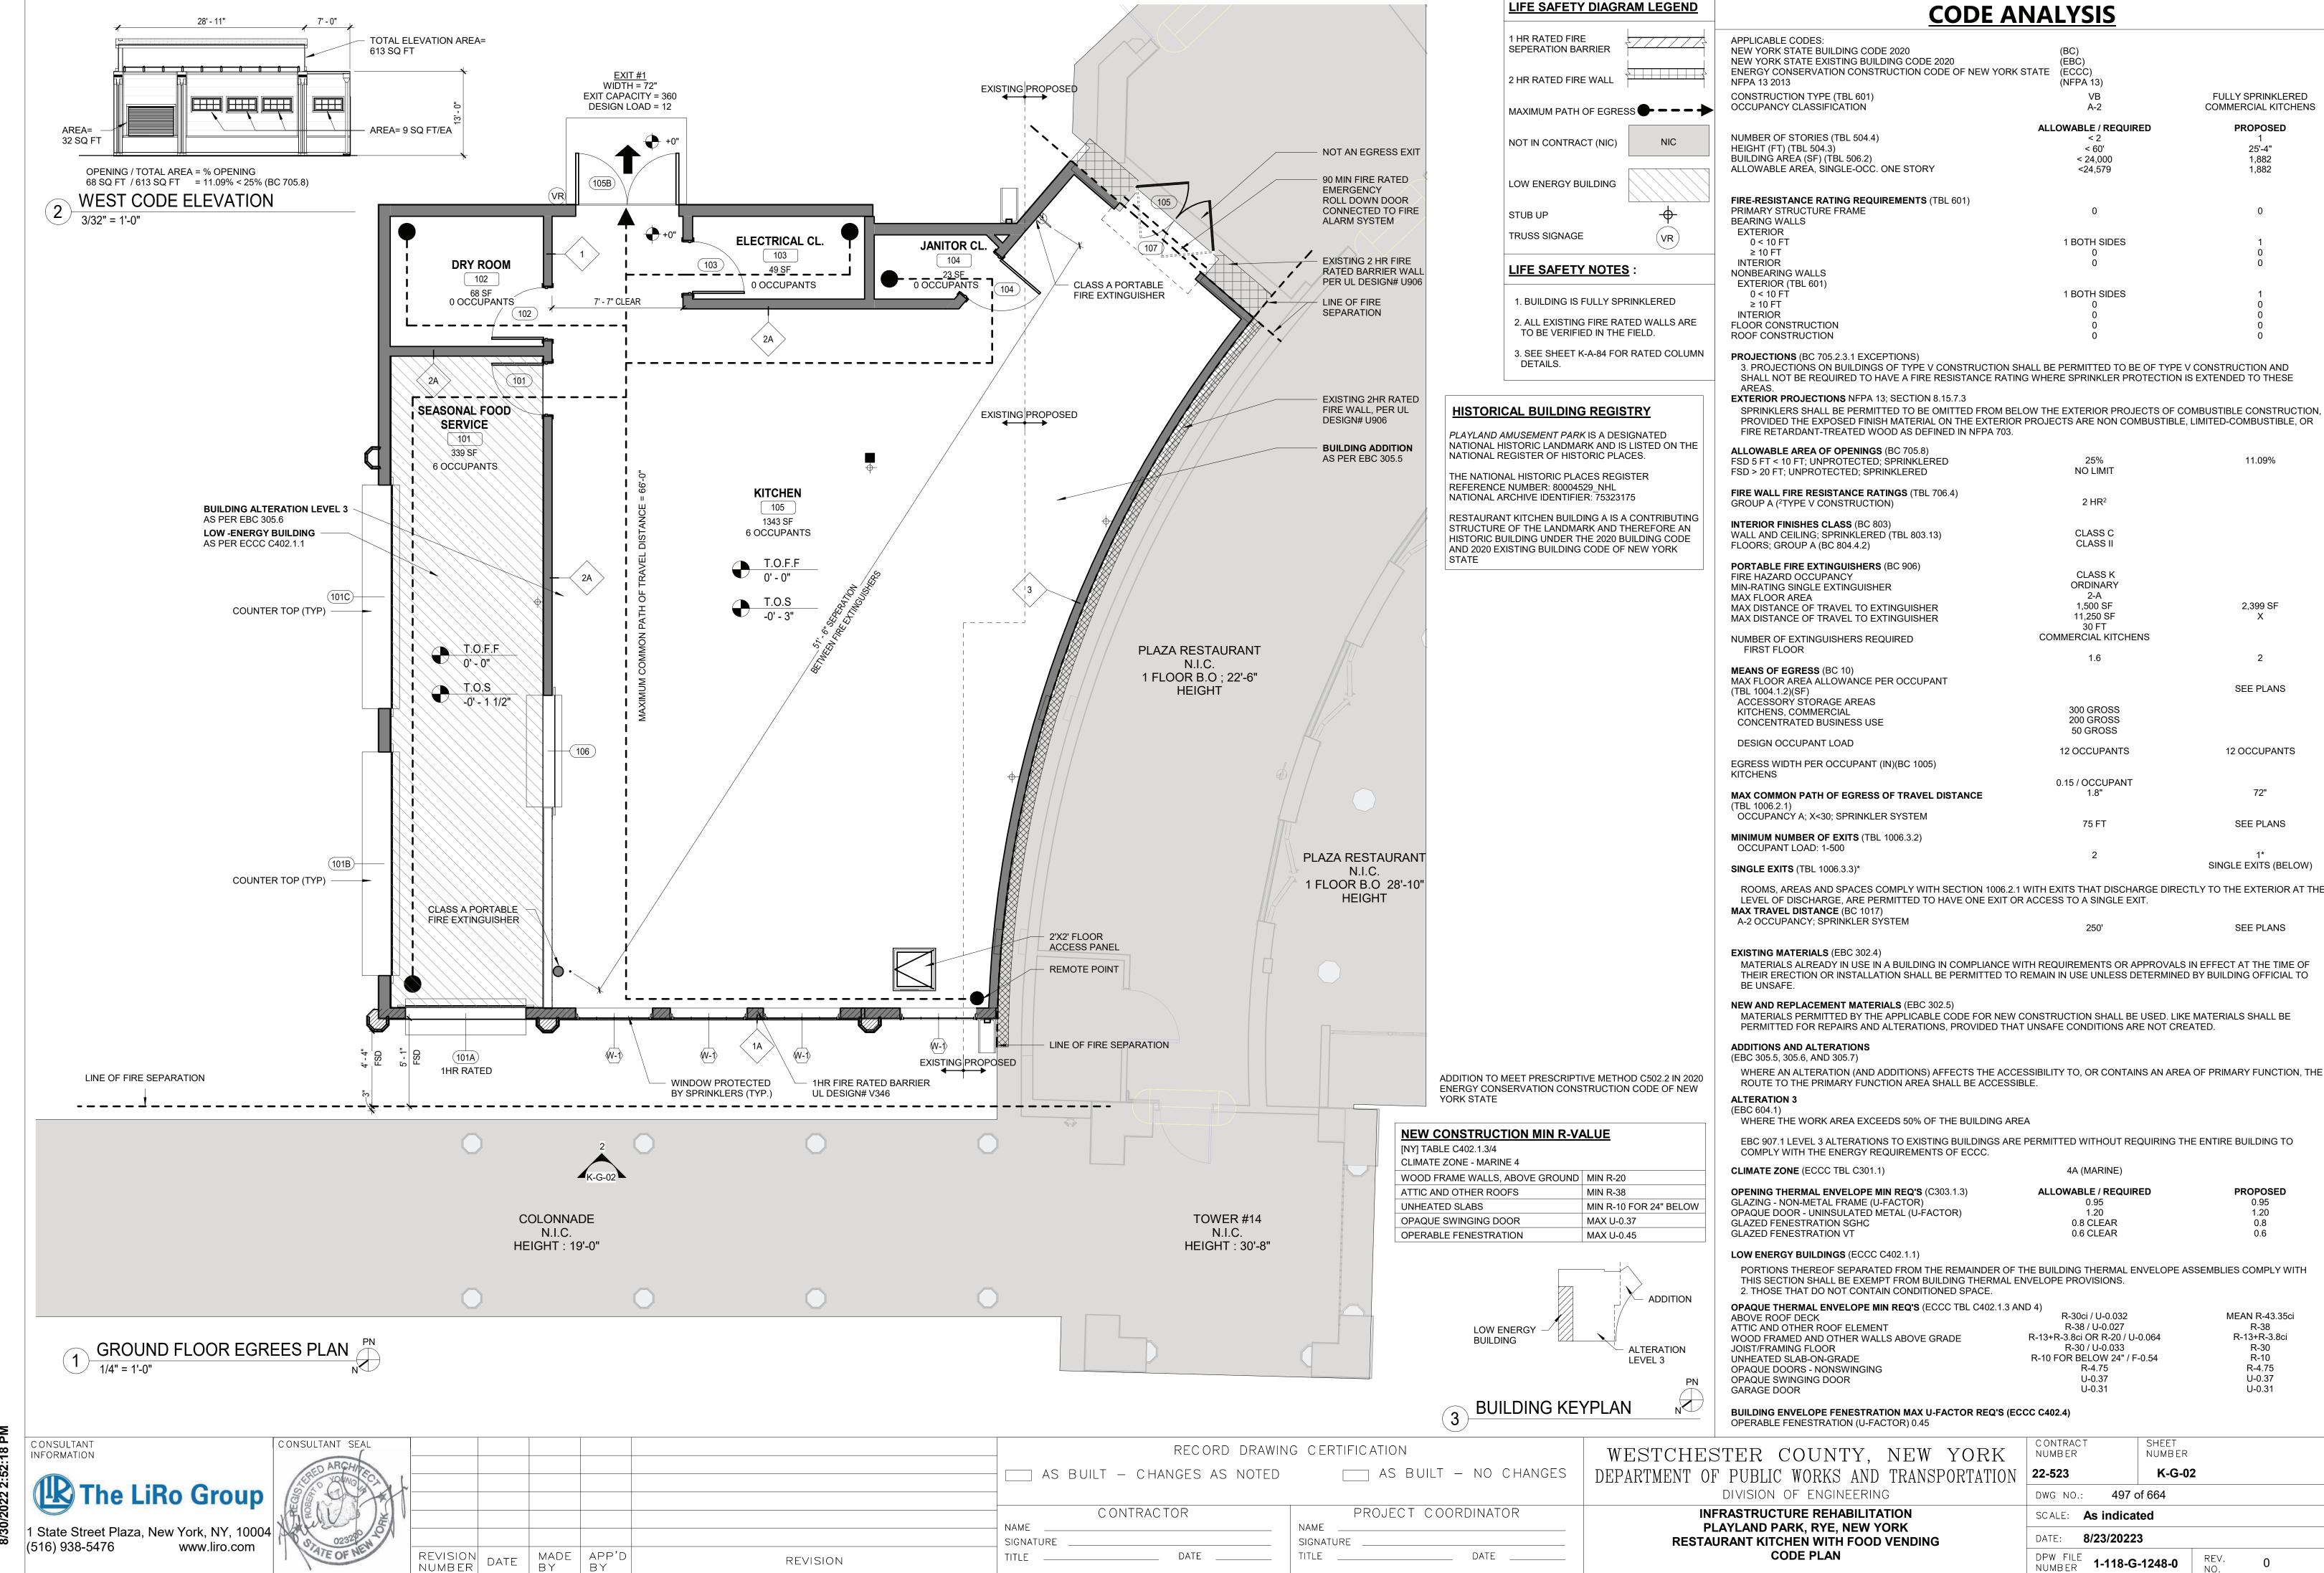
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	REVISION NUMBER	DATE	MADE BY	APP'D BY	REVISION	TITLE

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CONTRACTOR	PROJECT COORDINATOR
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WESTCHESTER COUNTY, NEW YORK DEPARTMENT OF PUBLIC WORKS AND TRANSPORTATION DIVISION OF ENGINEERING

INFRASTRUCTURE REHABILITATION
PLAYLAND PARK, RYE, NEW YORK
RESTAURANT KITCHEN WITH FOOD VENDING
BUILDING 3D VIEW


K	CONTRACT NUMBER	SHEET NUMBER			
ION	22-523	K-G-0	1		
	DWG NO.: 496 (	of 664			
	SCALE: 12" = 1'-0	)"			
	DATE: <b>8/23/2022</b>	3			
	DPW FILE 1-118-G	-1247-0	REV. NO.	0	





# PLAYLAND REHABILITATION & UPGRADES RESTAURANT KITCHEN - ASBESTOS ABATEMENT


1 PLAYLAND PKWY, RYE, NY 10580



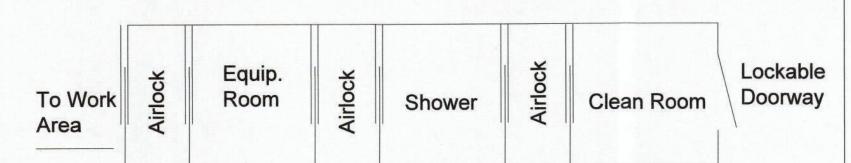

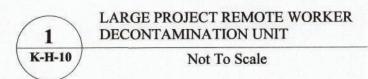

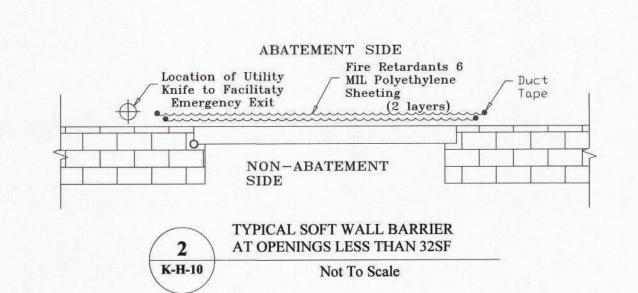


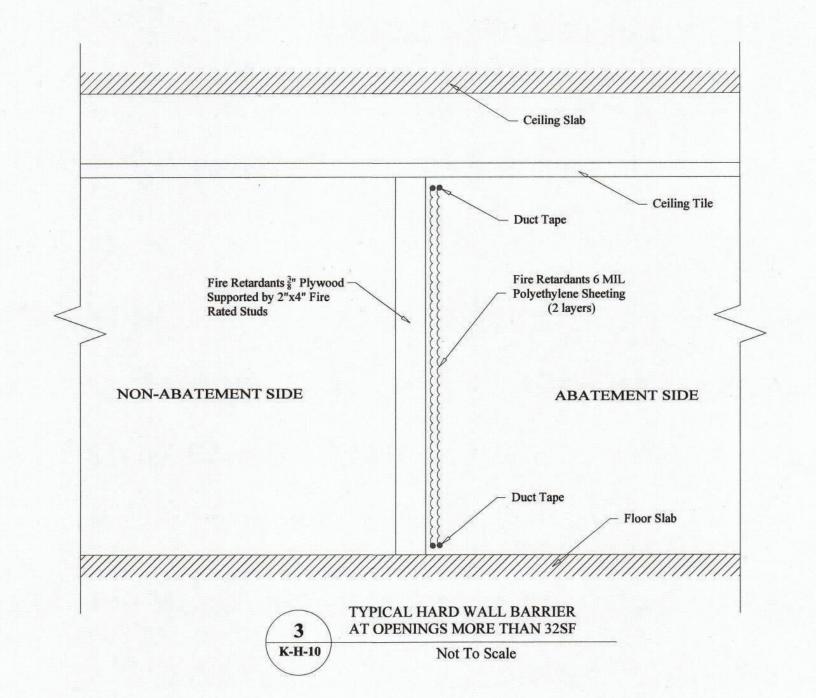


#### SCOPE OF WORK TABLE:

/ork rea	Location	Description of Asbestos Materials	Approximate  Quantity of ACM	ICR 56 Procedure
1	K - Restaurant Kitchen Exterior - North	Transite Siding	440 SF	56.11.6
2	K - Restaurant Kitchen Exterior - East	Transite Siding	440 SF	56.11.6

#### **KEYPLAN:**

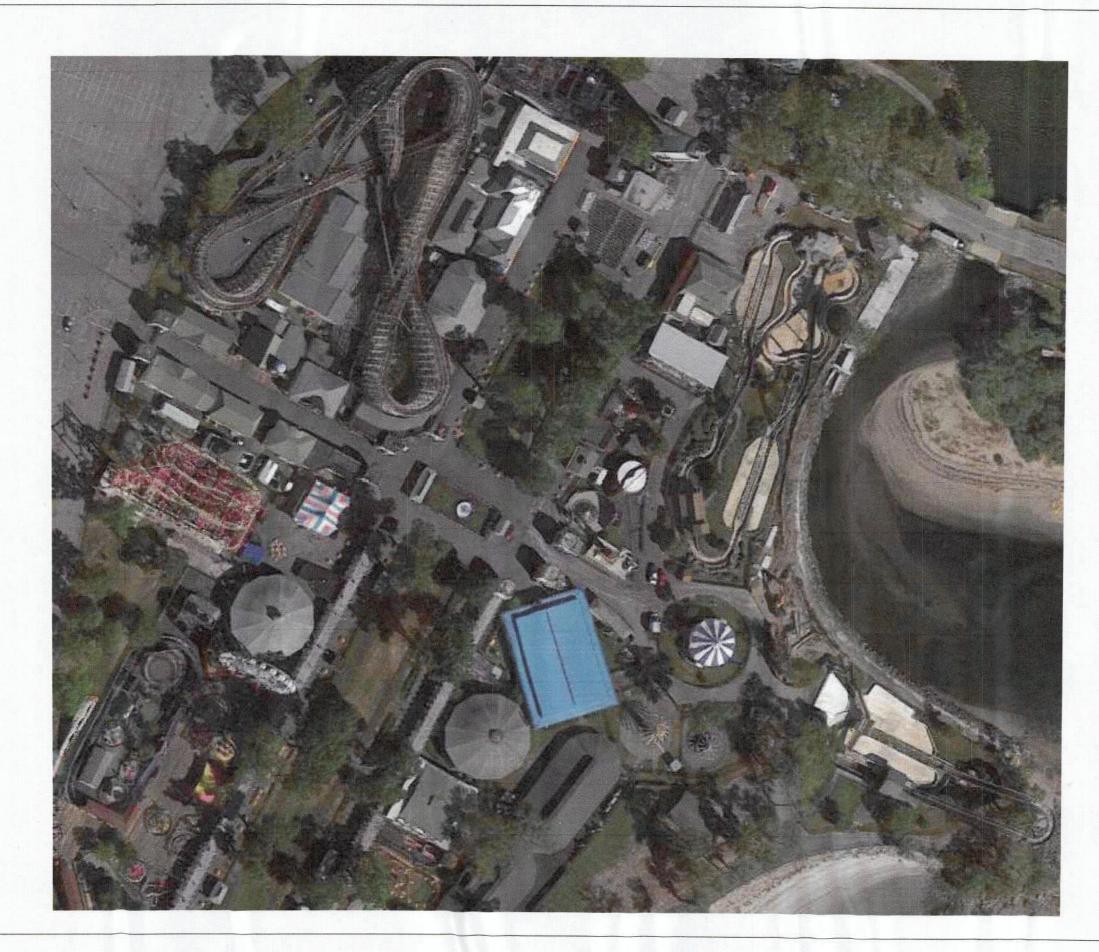

#### LEGEND:

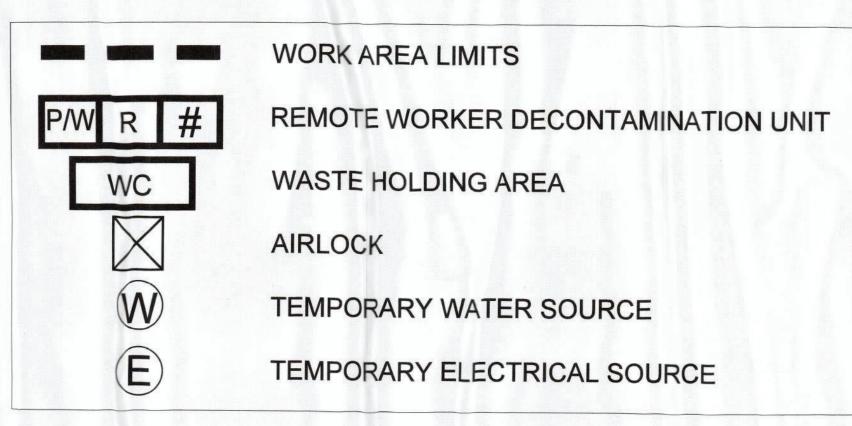


### **PROJECT NOTES:**

- 1. The Contractor shall be aware of all conditions of the Project and is responsible for verifying quantities and locations of all Work to be performed. Failure to do so shall not relieve the Contractor of its obligation to furnish all labor and materials necessary to perform the Work.
- All Work shall be performed in strict accordance with the Project Documents and all governing codes, rules, and regulations. Where conflicts occur between the Project Documents and applicable codes, rules, and regulations, the more stringent shall apply.
- All abatement work shall be coordinated with General Contractor work;
   Abatement may be phased with other contract work.
- 4. Working hours shall be as required and approved by the Owner. Asbestos abatement activities including, but not limited to, work area preparation, gross removal activities, cleaning activities, waste removal, etc. may need to be performed during 'off-hours' (including nights and weekends). In addition, multiple mobilizations may be required to perform the work identified in this project. The Contractor shall coordinate and schedule all Work with the facility and Owner's representative.
- The Contractor shall prepare and coordinate with facility representative the posting of appropriate signage at the entranceway that redirects park occupants away from the area of the abatement.
- 6. The Contractor shall use barrier tape to extend the limits of the active, regulated work areas closed to the public and other non-abatement trades.
- The Contractor shall be responsible for defining and coordinating the phases of the abatement with the facility and DPW, as well as securing any site specific variances, permits, and any necessary NYS DOL approvals.
- 8. The asbestos abatement Contractor shall coordinate locations of decontamination units, routes of egress, temporary water and power connections and waste container locations with the Owner and the Facility.
- The Contractor may need to supply temporary power/water sources if they cannot be provided by facility.
- 10. The General Contractor shall supply any and all scaffolding for the work area(s) under this contract. Scaffolding structure and maintenance shall be in strict accordance with local, state and federal safety requirements.
- 11. The Contractor is to protect any and all exposed surfaces not targeted for abatement.
- 12. The Contractor shall request and receive in writing prior to preceding with any work info from the owner regarding surfaces/materials that require protection.
- 13. Regular waste generated by the abatement work of this contract shall be stored securely using a closed waste container.

The LiRo Group

3 Aerial Way, Syosset, New York 11791
(516) 938-5476 www.liro.com

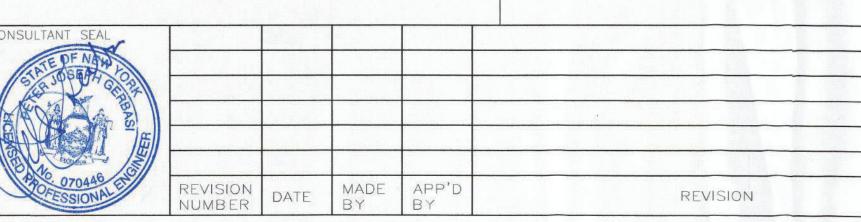

RECORD DRAWING CERTIFICATION

AS BUILT - CHANGES AS NOTED

CONTRACTOR

AME

IGNATURE

DATE

DATE

RECORD DRAWING CERTIFICATION

AS BUILT - NO CHANGES

PROJECT COORDINATOR

NAME

SIGNATURE

TITLE

DATE

DATE

WESTCHESTER COUNTY, NEW YORK
DEPARTMENT OF PUBLIC WORKS AND TRANSPORTATION
DIVISION OF ENGINEERING

INFRASTRUCTURE REHABILITATION - PHASE 3
PLAYLAND PARK, RYE, NEW YORK

RESTAURANT KITCHEN

**GENERAL ASBESTOS ABATEMENT NOTES** 

CONTRACT NUMBER

22-523

K-H-10

DWG NO.:

498 of 664

NOT TO SCALE

DATE:


08/23/2022

DPW FILE NUMBER

1-118-G-1247-0

REV. NO.

0

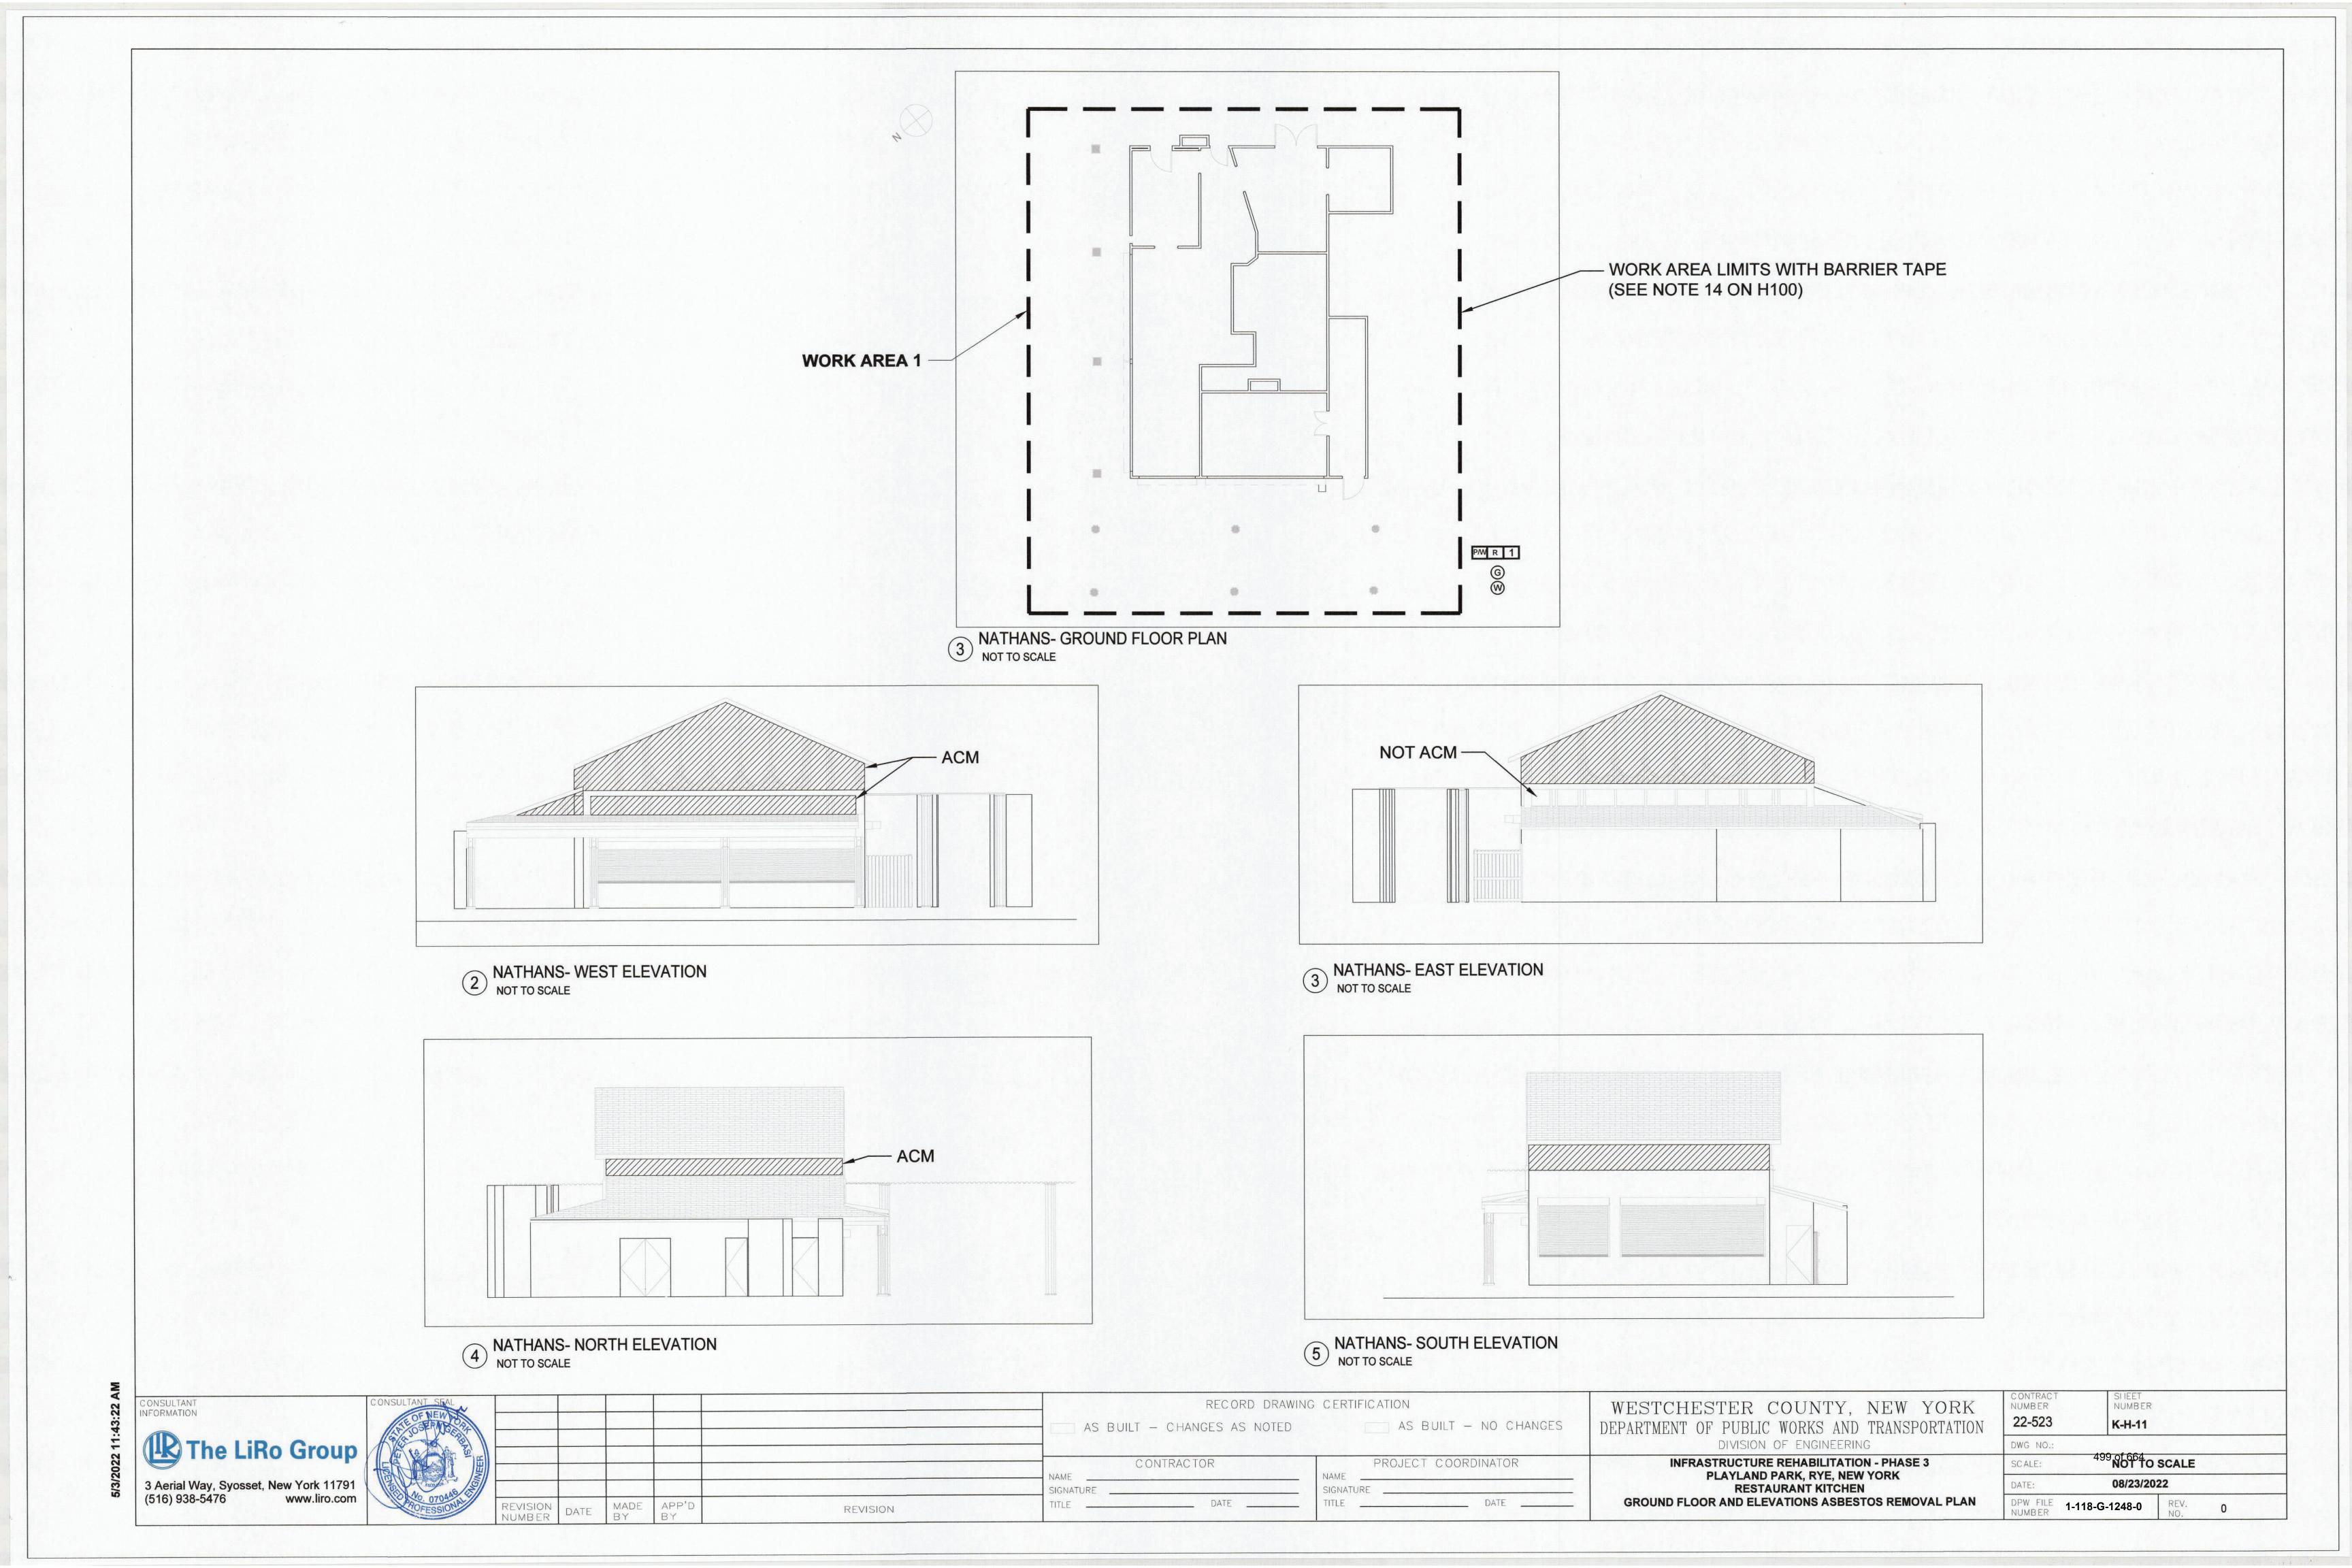

# PLAYLAND REHABILITATION & UPGRADES RESTAURANT KITCHEN - LEAD REMEDIATION

1 PLAYLAND PKWY, RYE, NY 10580

DETAILS:

To Work Area Equip. Room Shower Shower Clean Room Doorway

**DECONTAMINATION UNIT** 

LARGE PROJECT REMOTE WORKER

Not To Scale

#### SCOPE OF WORK TABLE:

Work Area	Location	Description	Material	Quantity	Procedure
		West Floration	Soffit (Beige Coating)	90 SF	
		West Elevation	Wood Columns (Beige, Orange & Green Coating)	48 SF (4 at 12 SF each)	
			Wall Paint (Beige Coating)	300 SF	
1	Main	East Elevation	Soffit (Beige Coating)	50 SF	Manual Wet Scrape /
	Nathan's	Edot Elevation	Window Frame (Beige Coating)	30 LF	Chemical Strip
			Wood Pilaster (Beige, Orange & Green Coating)	48 SF (4 at 12 SF each)	
		North, South, West East Elevation	Eave (Beige Coating)	168 SF	

**KEYPLAN:** 

LEGEND:

**WORK AREA LIMITS** 

WS HWSA **OSHA HANDWASHING STATION** 

HAZARDOUS WASTE STORAGE AREA

 $\boxtimes$ 

AIRLOCK

TEMPORARY WATER SOURCE




TEMPORARY ELECTRICAL SOURCE



CORNICE / FASCIA ELEMENTS

WALL CLADDING / TRIM ELEMENTS


COLUMNS

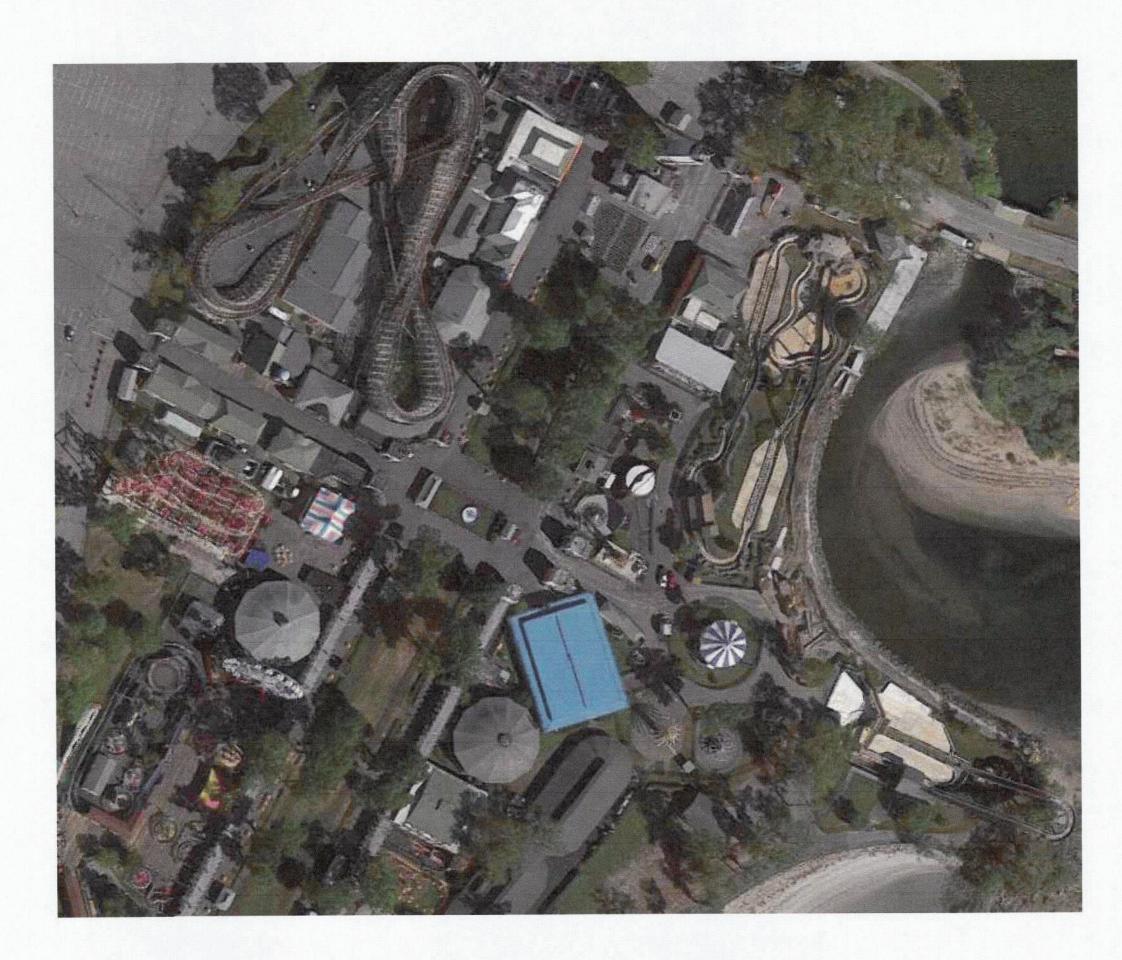

#### **PROJECT NOTES:**

- All layers of coating shall be considered as LBP and removed down to the substrates. Substrates coated with LBP and targeted for demolition may be removed and disposed of solid structure waste following TCLP testing.
- Substrates coated with LBP and targeted for refurbish and recoating shall be abated using manual wet scraping or chemical stripping procedures, localized testing of chemical strapping products shall proceed broader use and only after approval by the DPW Environmental Consultant.
- 3. The abatement contractor shall separate paint chips and contaminated dust/particulate generated by the abatement from other project waste streams including worker personal protective equipment and plastic sheeting. All waste other than lead paint chips and contaminated dust/particulate shall be TCLP tested prior to disposal.
- 4. Waste generated by the work of this method shall be stored on site in a NYSDEC compliant Hazardous and Waste Storage Area and transported under manifest to the disposal site.
- The contractor shall prepare a project specific work plan and project specific HASP for the work of this contract.
- 6. LBP remediation shall be consistent with guidelines from SSPC and work shall comply with the OSHA regulations including using of decontamination units and hand wash stations.
- 7. The contractor may propose alternate LBP removal procedures however, use of alternate procedures will require approval by DPW Environmental Consultant; the abatement contractor is responsible with maintaining the physical conditions and integrity of the targeted substrates, and the surrounding structures during abatement work.
- 8. The Contractor shall request and receive in writing prior to preceding with any work info from the owner regarding surfaces/materials that require protection.



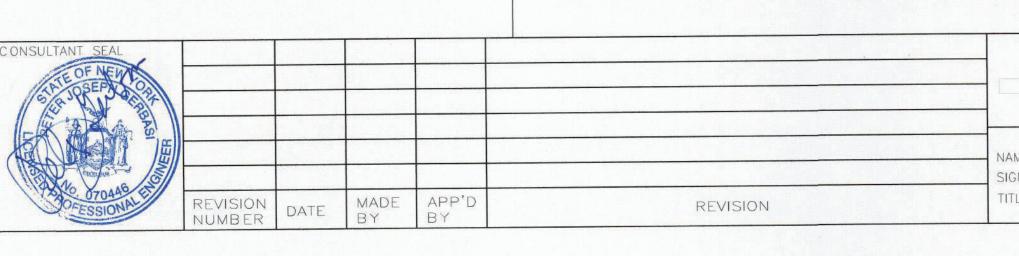

RECORD DRAWING CERTIFICATION

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CONTRACTOR PROJECT COORDINATOR

NAME

SIGNATURE

DATE


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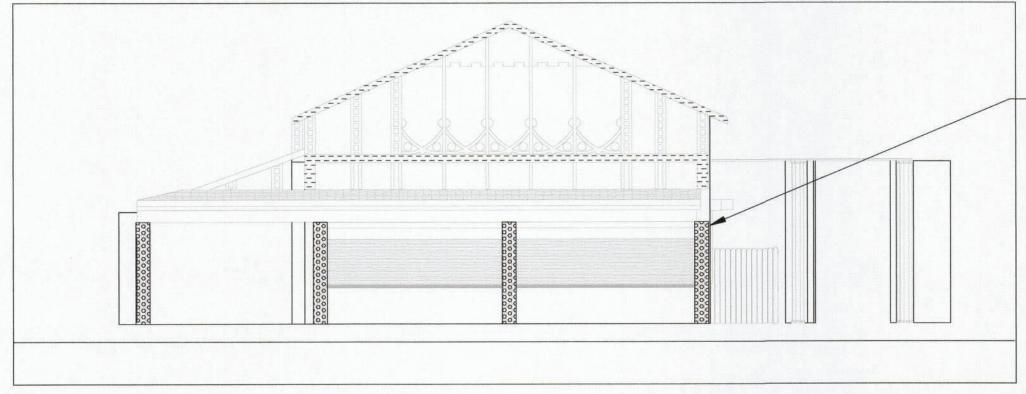
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WESTCHESTER COUNTY, NEW YORK
DEPARTMENT OF PUBLIC WORKS AND TRANSPORTATION
DIVISION OF ENGINEERING
INFRASTRUCTURE REHABILITATION - PHASE 3


INFRASTRUCTURE REHABILITATION - PHASE 3
PLAYLAND PARK, RYE, NEW YORK
RESTAURANT KITCHEN
GENERAL LEAD REMEDIATION NOTES

DPW FILE NUMBER 1-1	18-G-1249-0	REV.	0			
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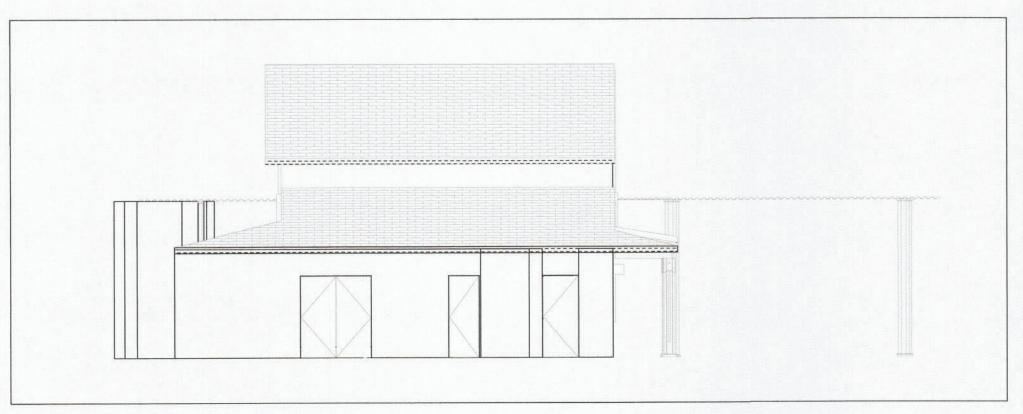


PILASTER (TYPICAL)

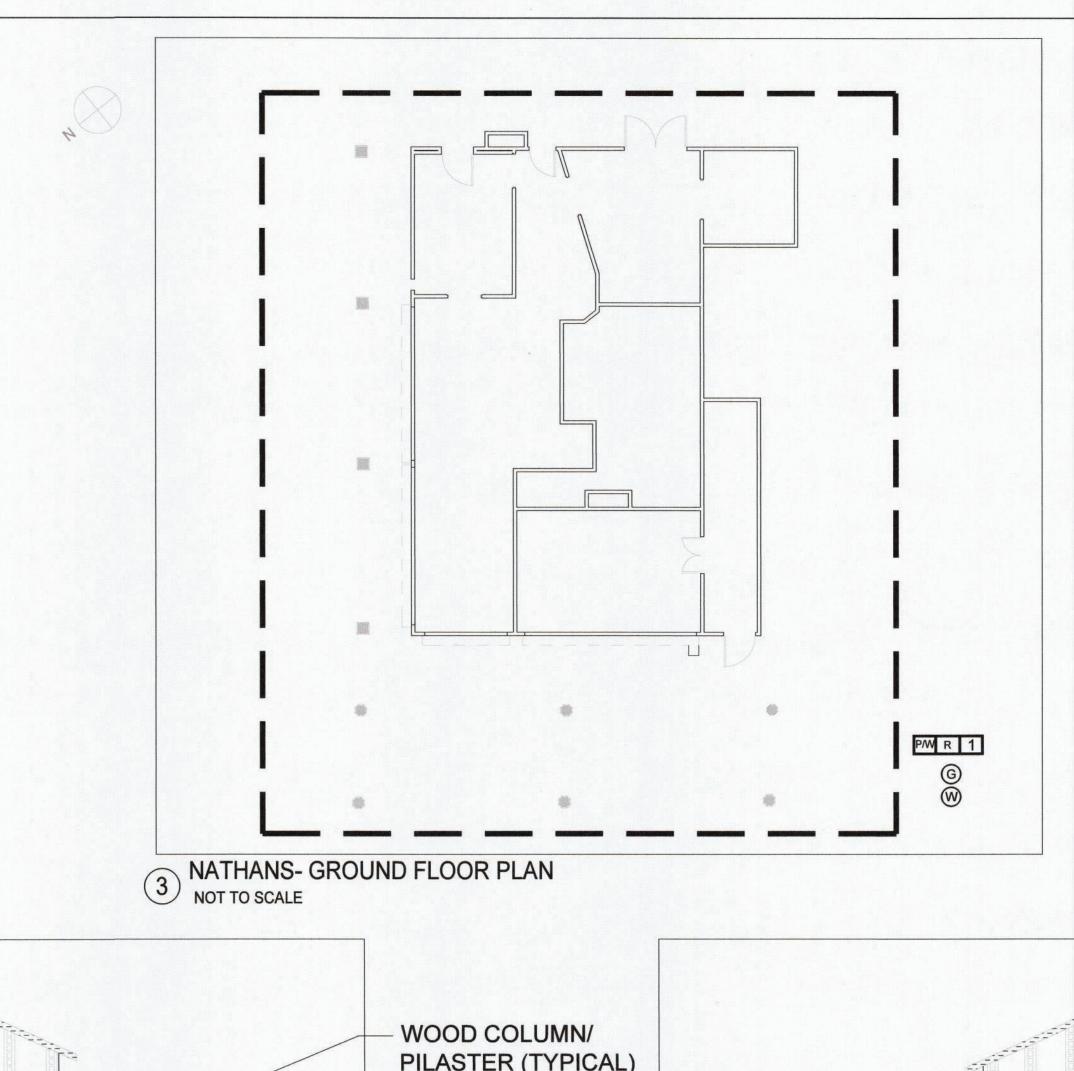

2 NATHANS- WEST ELEVATION NOT TO SCALE

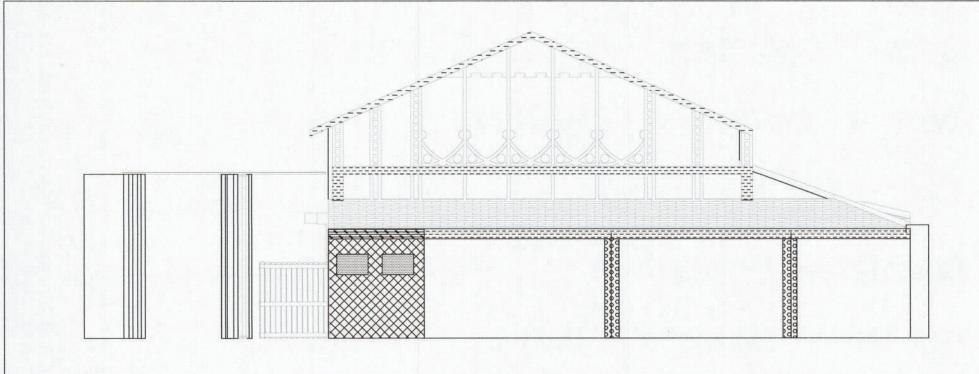3 NATHANS- EAST ELEVATION NOT TO SCALE




5 NATHANS- SOUTH ELEVATION NOT TO SCALE

PROJECT COORDINATOR

4 NATHANS- NORTH ELEVATION NOT TO SCALE

CONSULTANT INFORMATION 3 Aerial Way, Syosset, New York 11791 (516) 938-5476 www.liro.com

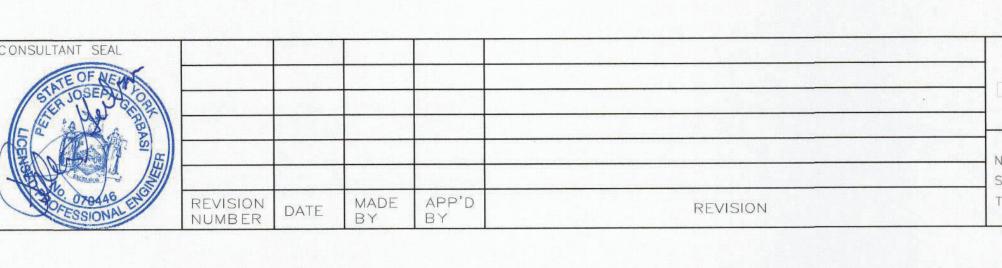

RECORD DRAWING CERTIFICATION


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CONTRACTOR

WESTCHESTER COUNTY, NEW YORK DEPARTMENT OF PUBLIC WORKS AND TRANSPORTATION DIVISION OF ENGINEERING

INFRASTRUCTURE REHABILITATION - PHASE 3
PLAYLAND PARK, RYE, NEW YORK
RESTAURANT KITCHEN GROUND FLOOR AND ELEVATION LEAD REMEDIATION PLAN

	DPW FILE NUMBER	1-118-G-1250-0	REV.	0		
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	CONTRACT NUMBER	SHEET NUMBER				

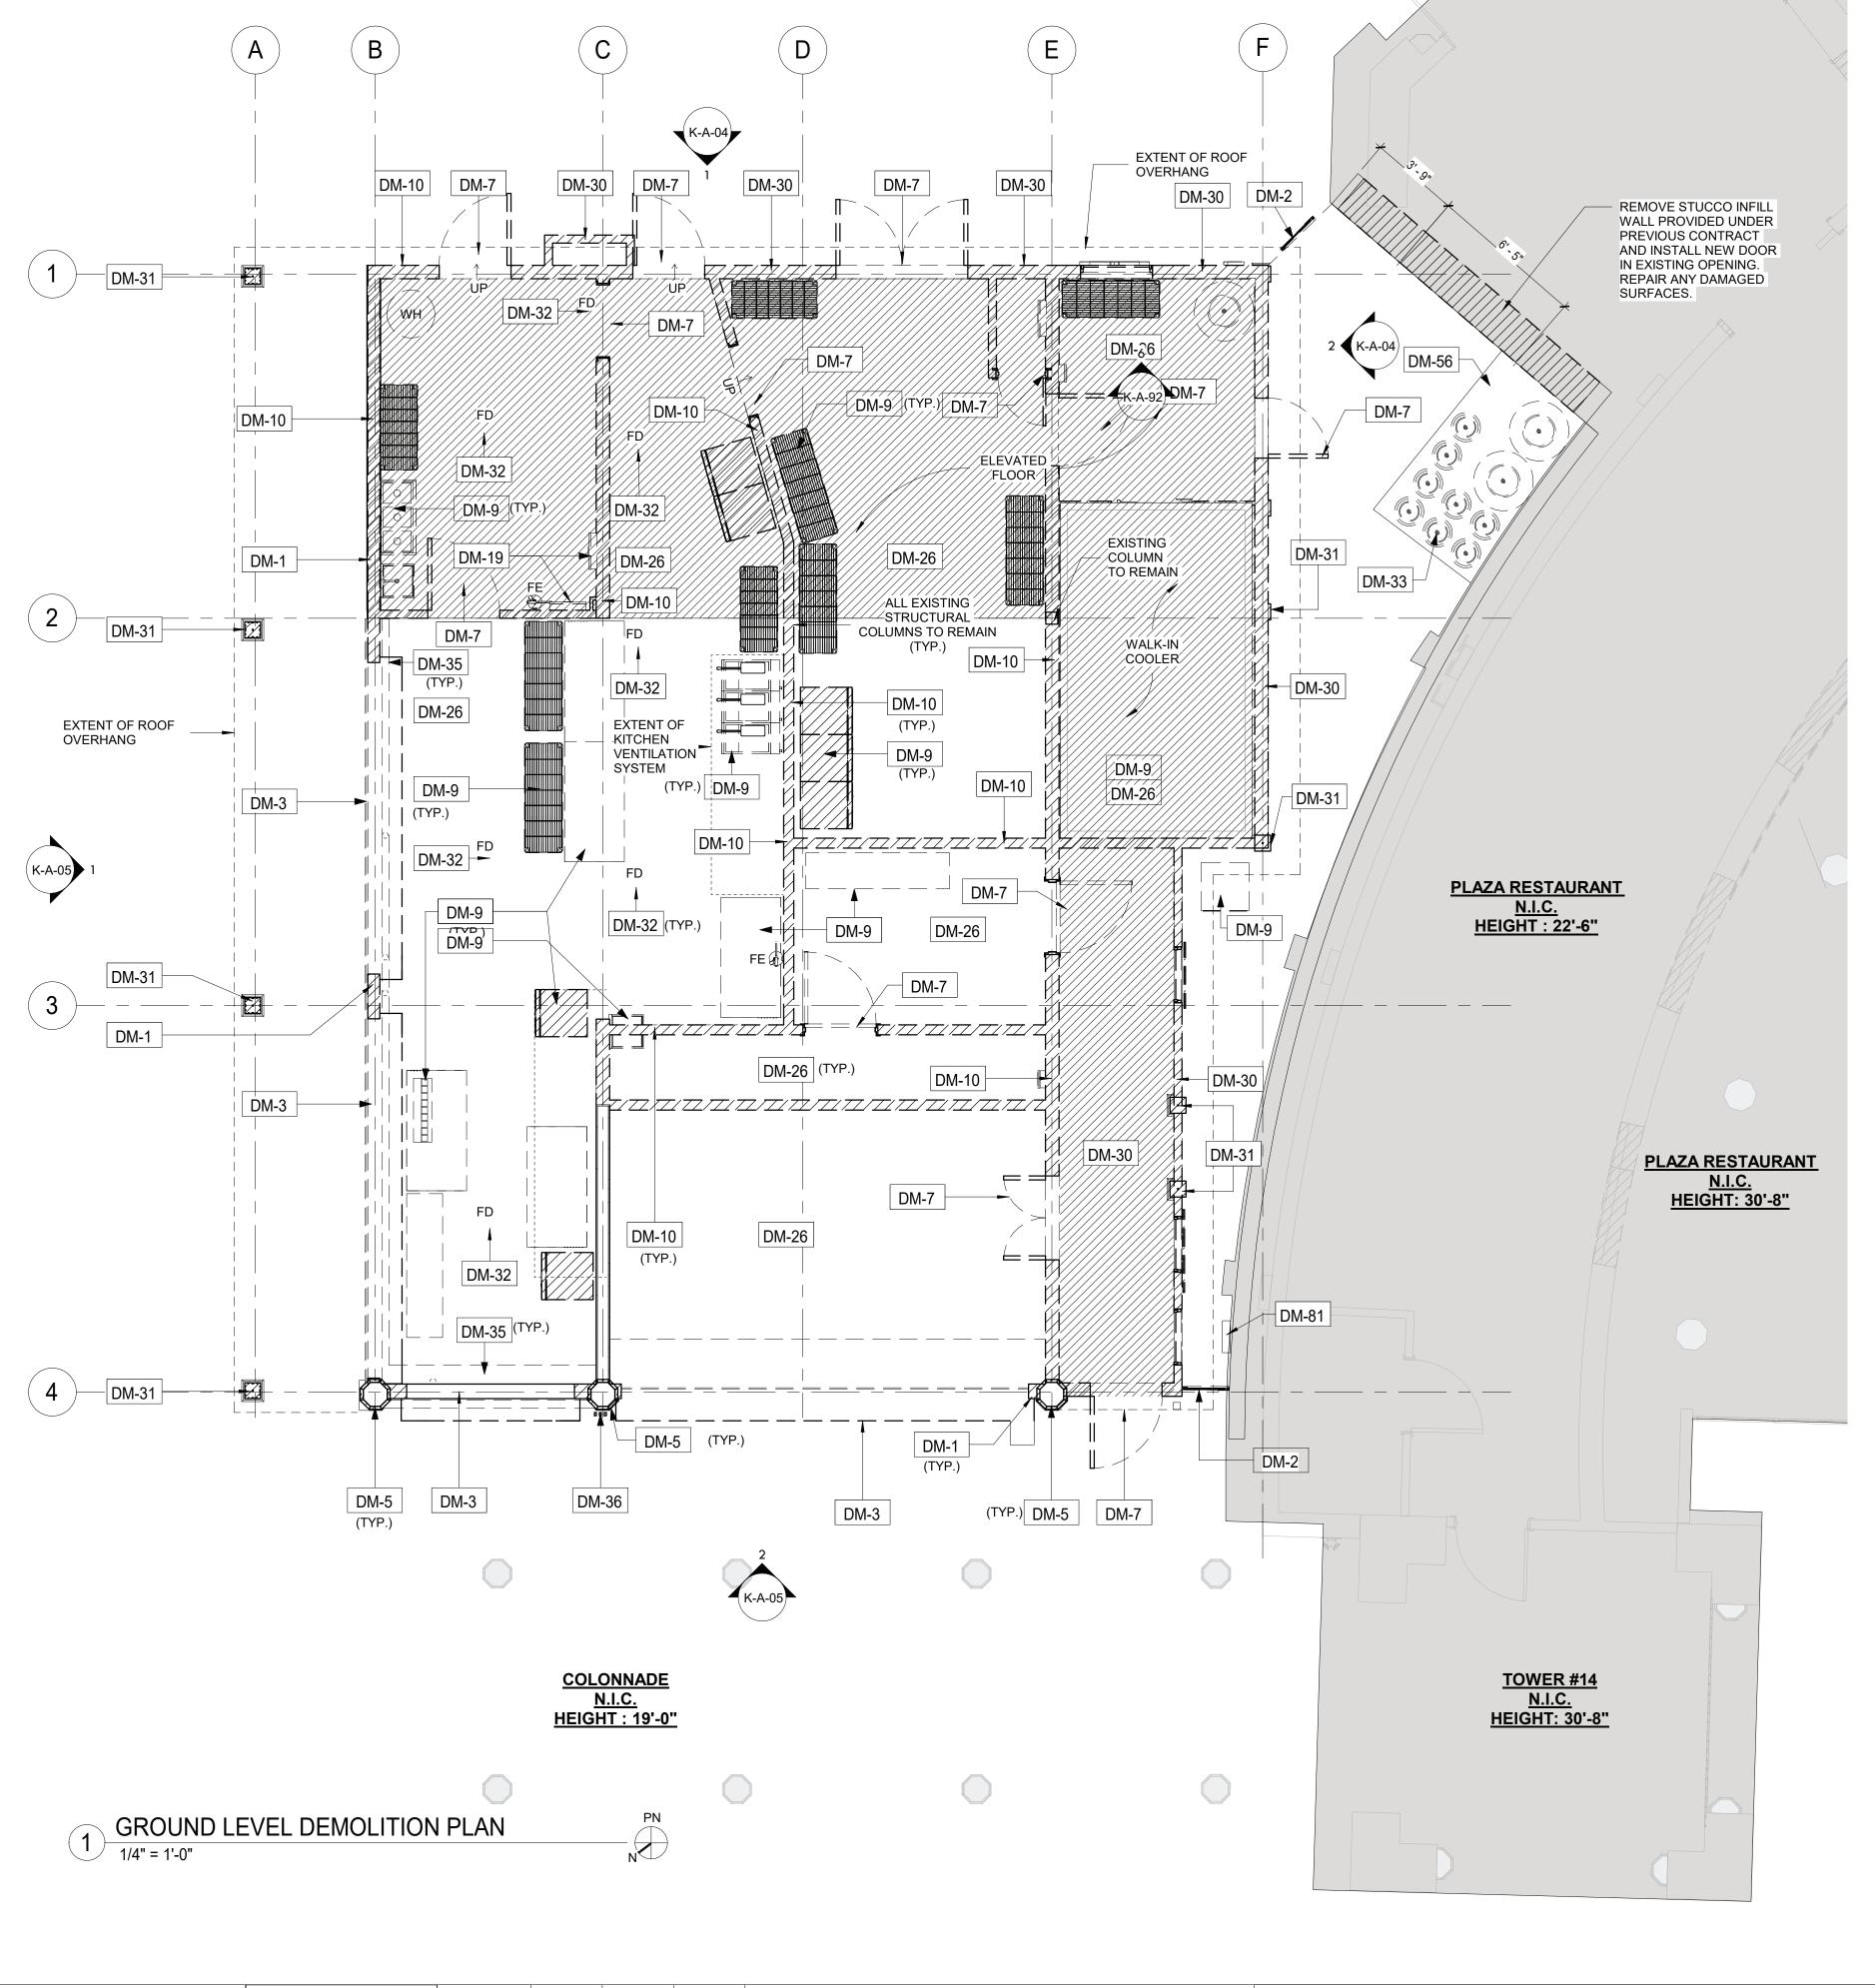

REVISION

**DEMOLITION GENERAL NOTES** 

- 1. ALL DEMOLITION AND REMOVAL WORK INCLUDES, BUT IS NOT LIMITED TO THE WORK INDICATED, NOTED, SPECIFIED, AND COORDINATED WITH WORK OF ALL OTHER TRADES, AS INDICATED ELSEWHERE, AND AS
- REQUIRED TO ACCOMODATE CONSTRUCTION. 2. PRIOR TO STARTING WORK, CONTRACTOR TO MAKE A THOROUGH EXAMINATION OF THE PORTIONS OF THE STRUCTURE IN WHICH THE WORK IS TO BE PERFORMED INCLUDING, BUT NOT LIMITED TO THE WORK AT ADJOINING OR UNDERLYING LOCATIONS. REPORT TO THE ARCHITECT ANY AND ALL CONDITIONS WHICH MAY INTERFERE WITH OR OTHERWISE PREVENT THE PROPER EXECUTION AND COMPLETION OF THE WORK. WORK
- ARCHITECT. 3. DASHED LINES INDICATE WALLS, FIXTURES, EQUIPMENT, ETC. TO BE REMOVED AND DISPOSED OF BY G.C. 4. ANY QUESTIONS ON SCOPE OF DEMOLITION MUST BE DIRECTED TO THE ARCHITECT PRIOR TO BID. SHOULD QUESTIONS OR DISCREPANCIES ARISE, THE CONTRACTOR SHALL NOTIFY THE ARCHITECT, IN WRITING, PRIOR TO

SHALL NOT START UNTIL SUCH CONDITIONS HAVE BEEN EXAMINED AND MUTUALLY AGREED UPON WITH THE

PROCEEDING WITH DEMOLITION. 5. ALL DIMENSIONS, LOCATIONS AND/OR ELEVATIONS OF EXISTING CONSTRUCTION CONDITIONS ARE

APPROXOMATE. CONTRACTOR TO VERIFIED EXISTING CONDITIONS PRIOR TO THE START OF WORK.

- 6. CONTRACTOR(S) ARE RESPONSIBLE FOR SHORING, BRACING AND UNDERPINNING RELATED TO THE DEMOLITION, REMOVAL OR CUTTING OF AN WALL, PARTITION, OR ANY OTHER LOAD-BEARING OR STRUCTURAL ELEMENT. 7. ALTER AND RESTORE EXISTING WALLS, PARTITIONS, COLUMNS, CEILING AND FLOORS, AND THEIR RESPECTIVE FINISHED SURFACES TO ACCOMMODATE NEW CONSTRUCTION AND FINISHES, IN ACCORDANCE WITH DRAWINGS
- AND SPECIFICATIONS. 8. IMMEDIATELY NOTIFY THE OWNER'S REPRESENTATIVES OF ANY HAZARDOUS MATERIALS ENCOUNTERED DURING DEMOLITION/REMOVAL
- 9. CONTAINERIZED DEMOLITION DEBRIS SHALL BE TCLP TESTED TO CONFIRM WASTE MAY BE DISPOSED OF AS
- 10. ALL ITEMS SCHEDULED FOR DEMOLITION SHALL BE REMOVED FROM THE SITE UNLESS OTHERWISE NOTED.
- CONTRACTOR SHALL BE RESPONSIBLE FOR CLEANING OF SITE ON A DAILY BASIS. 11. REFER TO ELECTRICAL, MECHANICAL, STRUCTURAL, PLUMBING, ETC. DEMOLITION DRAWINGS FOR ADDITIONAL

12. PATCH AND REPAIR SURFACES (FLOOR, WALL, CEILING) DAMAGED IN PREPARATION FOR NEW EQUIPMENT AND FINISHES.

#### **DEMOLITION LEGEND**


Value



Keynote Text

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DM-1	REMOVE EXISTING WOOD SIDING.
DM-2	REMOVE EXISTING GATE.
DM-3	REMOVE ROLL DOWN DOOR AND ASSOCIATED HARDWARE.
DM-5	REMOVE COLUMN ENCLOSURES. CAREFULLY REMOVE AT LEAST ONE COLUMN ENCLOSURE TO USE AS REFERENCE IN ORDER TO REPLICATE TRIMS TO MATCH LOCATION, SIZE AND SHAPE AS INDICATED. COORDINATE WITH STRUCTURAL DRAWINGS.
DM-7	REMOVE EXISTING DOOR & FRAME.
DM-9	CONTRACTOR TO REMOVE ANY REMAINING EQUIPMENT AND BUILDING CONTENT. CONTENT MAY INCLUDE BUT NOT LIMITED TO REFRIGERATOR, STORAGE, RACKS, AC UNITS, GAMES ETC.
DM-10	REMOVE INTERIOR PARTITION.
DM-19	DISCONNECT AND REMOVE EXISTING SUSPENDED EQUIPMENT SUCH AS CAMERAS, SPEAKERS, ETC. SEE ELECTRICAL DRAWINGS FOR DETAILS.
DM-26	REMOVE EXISTING FLOOR AND CONCRETE SLAB ON GRADE. SEE STRUCTURAL DRAWINGS.
DM-30	EXISTING STRUCTURE TO BE REMOVED IN ITS ENTIRETY. SEE PLANS FOR EXTENT OF REMOVAL.
DM-31	REMOVE EXISTING COLUMN.
DM-32	REMOVE EXISTING FLOOR DRAIN. REFER TO PLUMBING DRAWINGS.
DM-33	REMOVE GAS SERVICE TO BUILDING. EXISTING TANKS TO BE REMOVED.
DM-35	REMOVE COUNTER AND ALL RELATED COMPONENTS.
DM-36	CAREFULLY REMOVE AND RELOCATE EXISTING WIRING, CONDUITS. SEE ELECTRICAL DRAWINGS.
DM-56	REMOVE EXISTING CONCRETE PAD.
DM-81	EXISTING DATA/ TELEPHONE COMMUNICATION CABLES TO BE SUPPORTED

DURING CONSTRUCTION AND RELOCATED AS INDICATED.

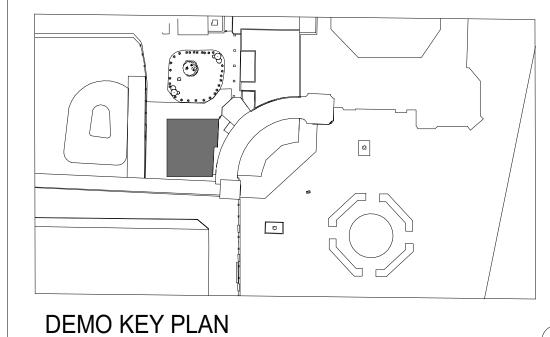

CONTRAC WESTCHESTER COUNTY, NEW YORK 22-523 DEPARTMENT OF PUBLIC WORKS AND TRANSPORTATION

SHEET NUMBER K-A-01 502 of 664 DWG NO.: SCALE: **As indicated** DATE: **8/23/2022** 

DPW FILE NUMBER 1-118-A-1251-0 REV. NO.

CONSULTANT INFORMATION The LiRo Group 1 State Street Plaza, New York, NY, 10004 (516) 938-5476 www.liro.com

CONSULTANT SEAL MADE APP'D BY BY REVISION NUMBER

AS BUILT - CHANGES AS NOTED CONTRACTOR

SIGNATURE

PROJECT COORDINATOR

\_\_\_\_ AS BUILT - NO CHANGES

RECORD DRAWING CERTIFICATION


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NAME

SIGNATURE \_\_\_\_

**INFRASTRUCTURE REHABILITATION** PLAYLAND PARK, RYE, NEW YORK **RESTAURANT KITCHEN WITH FOOD VENDING** 

DIVISION OF ENGINEERING

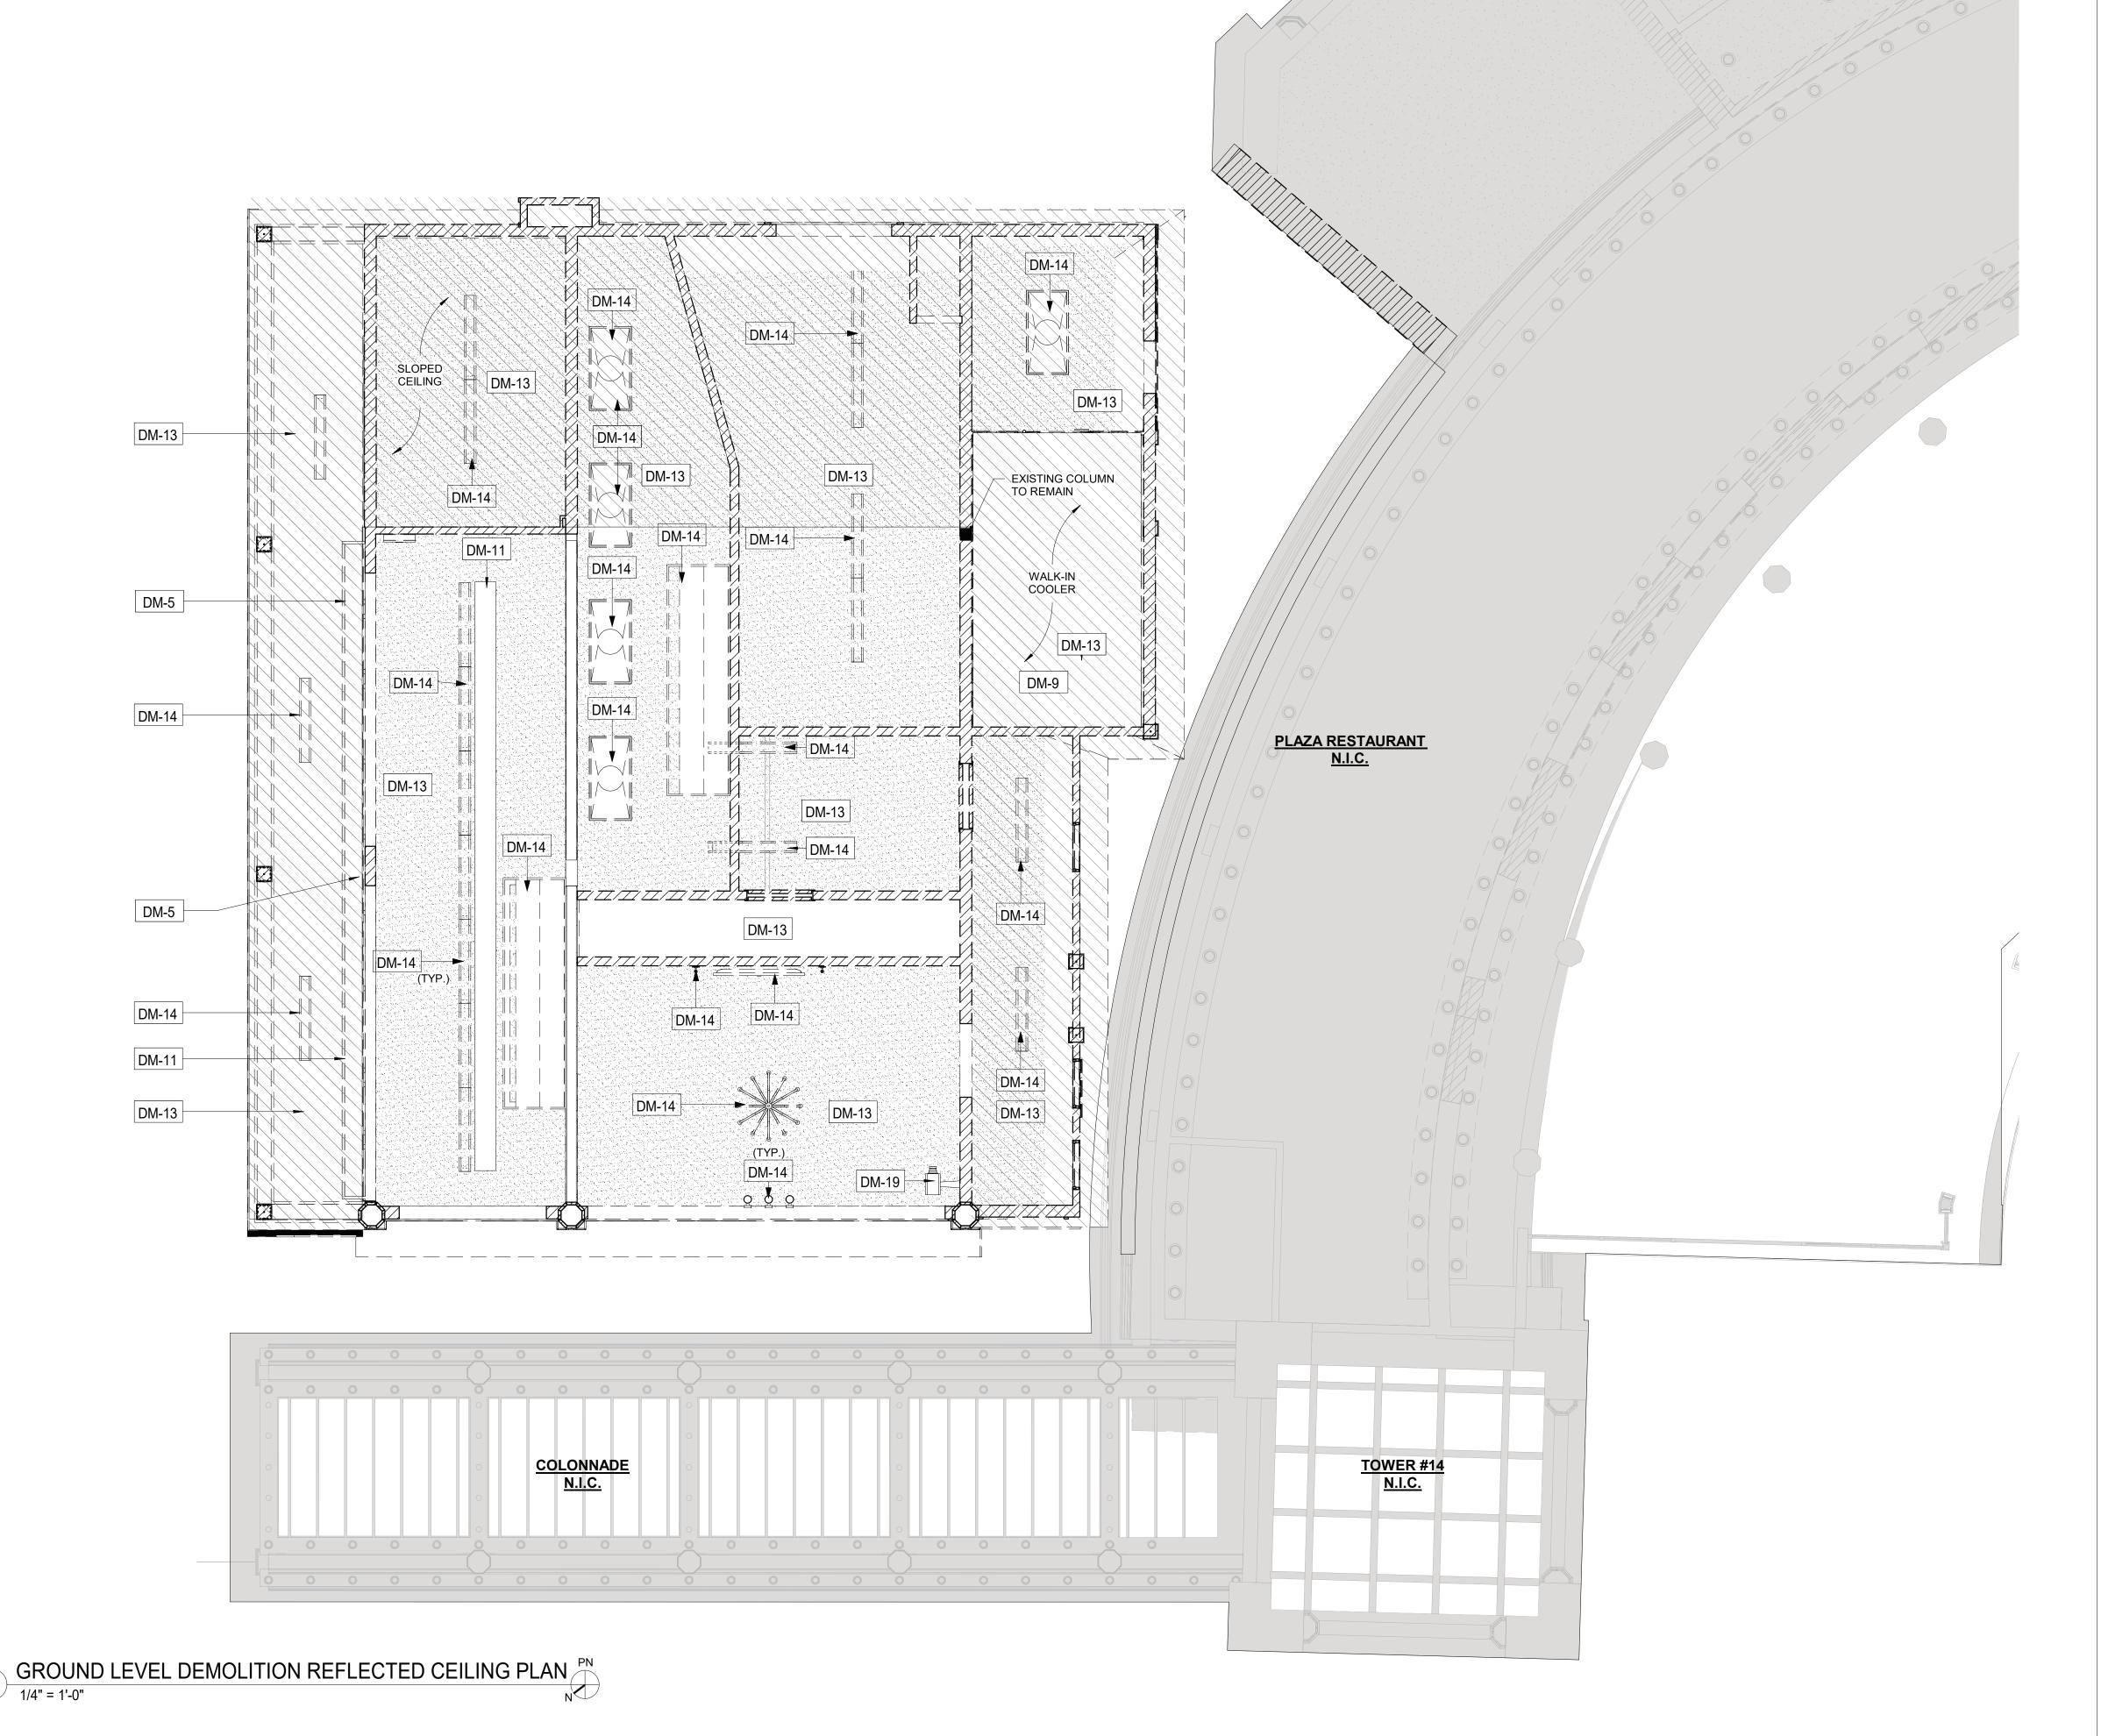


#### **DEMOLITION RCP GENERAL NOTES**

- 1. ALL DEMOLITION AND REMOVAL WORK INCLUDES, BUT IS NOT LIMITED TO THE WORK INDICATED, NOTED, SPECIFIED, AND COORDINATED WITH WORK OF ALL OTHER TRADES, AS INDICATED ELSEWHERE, AND AS
- 2. PRIOR TO STARTING WORK, CONTRACTOR TO MAKE A THOROUGH EXAMINATION OF THE PORTIONS OF THE STRUCTURE IN WHICH THE WORK IS TO BE PERFORMED INCLUDING, BUT NOT LIMITED TO THE WORK AT INTERFERE WITH OR OTHERWISE PREVENT THE PROPER EXECUTION AND COMPLETION OF THE WORK. WORK
- 4. ANY QUESTIONS ON SCOPE OF DEMOLITION MUST BE DIRECTED TO THE ARCHITECT PRIOR TO BID. SHOULD
- APPROXOMATE. CONTRACTOR TO VERIFIED EXISTING CONDITIONS PRIOR TO THE START OF WORK. 6. CONTRACTOR(S) ARE RESPONSIBLE FOR SHORING, BRACING AND UNDERPINNING RELATED TO THE
- 7. ALTER AND RESTORE EXISTING WALLS, PARTITIONS, COLUMNS, CEILING AND FLOORS, AND THEIR RESPECTIVE FINISHED SURFACES TO ACCOMMODATE NEW CONSTRUCTION AND FINISHES, IN ACCORDANCE WITH DRAWINGS
- 8. IMMEDIATELY NOTIFY THE OWNER'S REPRESENTATIVES OF ANY HAZARDOUS MATERIALS ENCOUNTERED DURING DEMOLITION/REMOVAL.
- 9. CONTAINERIZED DEMOLITION DEBRIS SHALL BE TCLP TESTED TO CONFIRM WASTE MAY BE DISPOSED OF AS 10. ALL ITEMS SCHEDULED FOR DEMOLITION SHALL BE REMOVED FROM THE SITE UNLESS OTHERWISE NOTED.
- CONTRACTOR SHALL BE RESPONSIBLE FOR CLEANING OF SITE ON A DAILY BASIS. 11. REFER TO ELECTRICAL, MECHANICAL, STRUCTURAL, PLUMBING, ETC. DEMOLITION DRAWINGS FOR ADDITIONAL
- 12. PATCH AND REPAIR SURFACES (FLOOR, WALL, CEILING) DAMAGED IN PREPARATION FOR NEW EQUIPMENT AND

#### **DEMOLITION LEGEND**



Value Keynote Text REMOVE COLUMN ENCLOSURES. CAREFULLY REMOVE AT LEAST ONE COLUMN ENCLOSURE TO USE AS REFERENCE IN ORDER TO REPLICATE TRIMS TO MATCH LOCATION, SIZE AND SHAPE AS INDICATED. COORDINATE WITH STRUCTURAL DRAWINGS. CONTRACTOR TO REMOVE ANY REMAINING EQUIPMENT AND BUILDING CONTENT. CONTENT MAY INCLUDE BUT NOT LIMITED TO REFRIGERATOR, STORAGE, RACKS, AC UNITS, GAMES ETC. DM-11 | CAREFULLY REMOVE AND RETURN TO OWNER ALL EXISTING SIGNAGE AND LETTERING. COORDINATE SIGNAGE REMOVAL WITH OWNER PRIOR TO REMOVAL OF ANY SIGNAGE. DM-13 REMOVE EXISTING CEILING AND ALL ACCESSORIES AND EQUIPMENT DM-14 REMOVE EXISTING LIGHTING FIXTURES AND ELECTRICAL WIRING CONNECTED TO THESE FIXTURES. SEE ELECTRICAL FOR DETAILS. DM-19 DISCONNECT AND REMOVE EXISTING SUSPENDED EQUIPMENT SUCH AS CAMERAS, SPEAKERS, ETC. SEE ELECTRICAL DRAWINGS FOR DETAILS. DM-54 CONTRACTOR TO CAREFULLY REMOVE, STORE AND CATALOG EXISTING "LANTERN" STYLE FIXTURE FOR REPLICATION. (TO BE UPDATED)

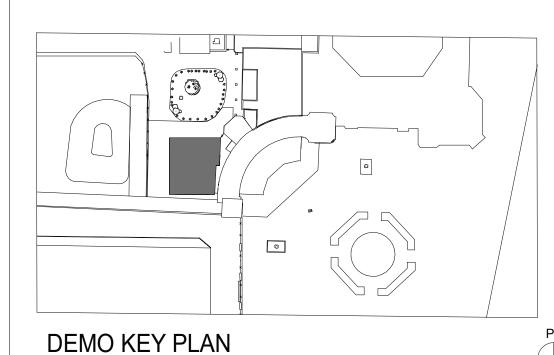

WESTCHESTER COUNTY, NEW YORK DEPARTMENT OF PUBLIC WORKS AND TRANSPORTATION DIVISION OF ENGINEERING

22-523 K-A-02 DWG NO.: 503 of 664 SCALE: **As indicated** DATE: **8/23/20223** DPW FILE NUMBER **1-118-A-1252-0** 

SHEET NUMBER

CONSULTANT INFORMATION 1 State Street Plaza, New York, NY, 10004 (516) 938-5476 www.liro.com

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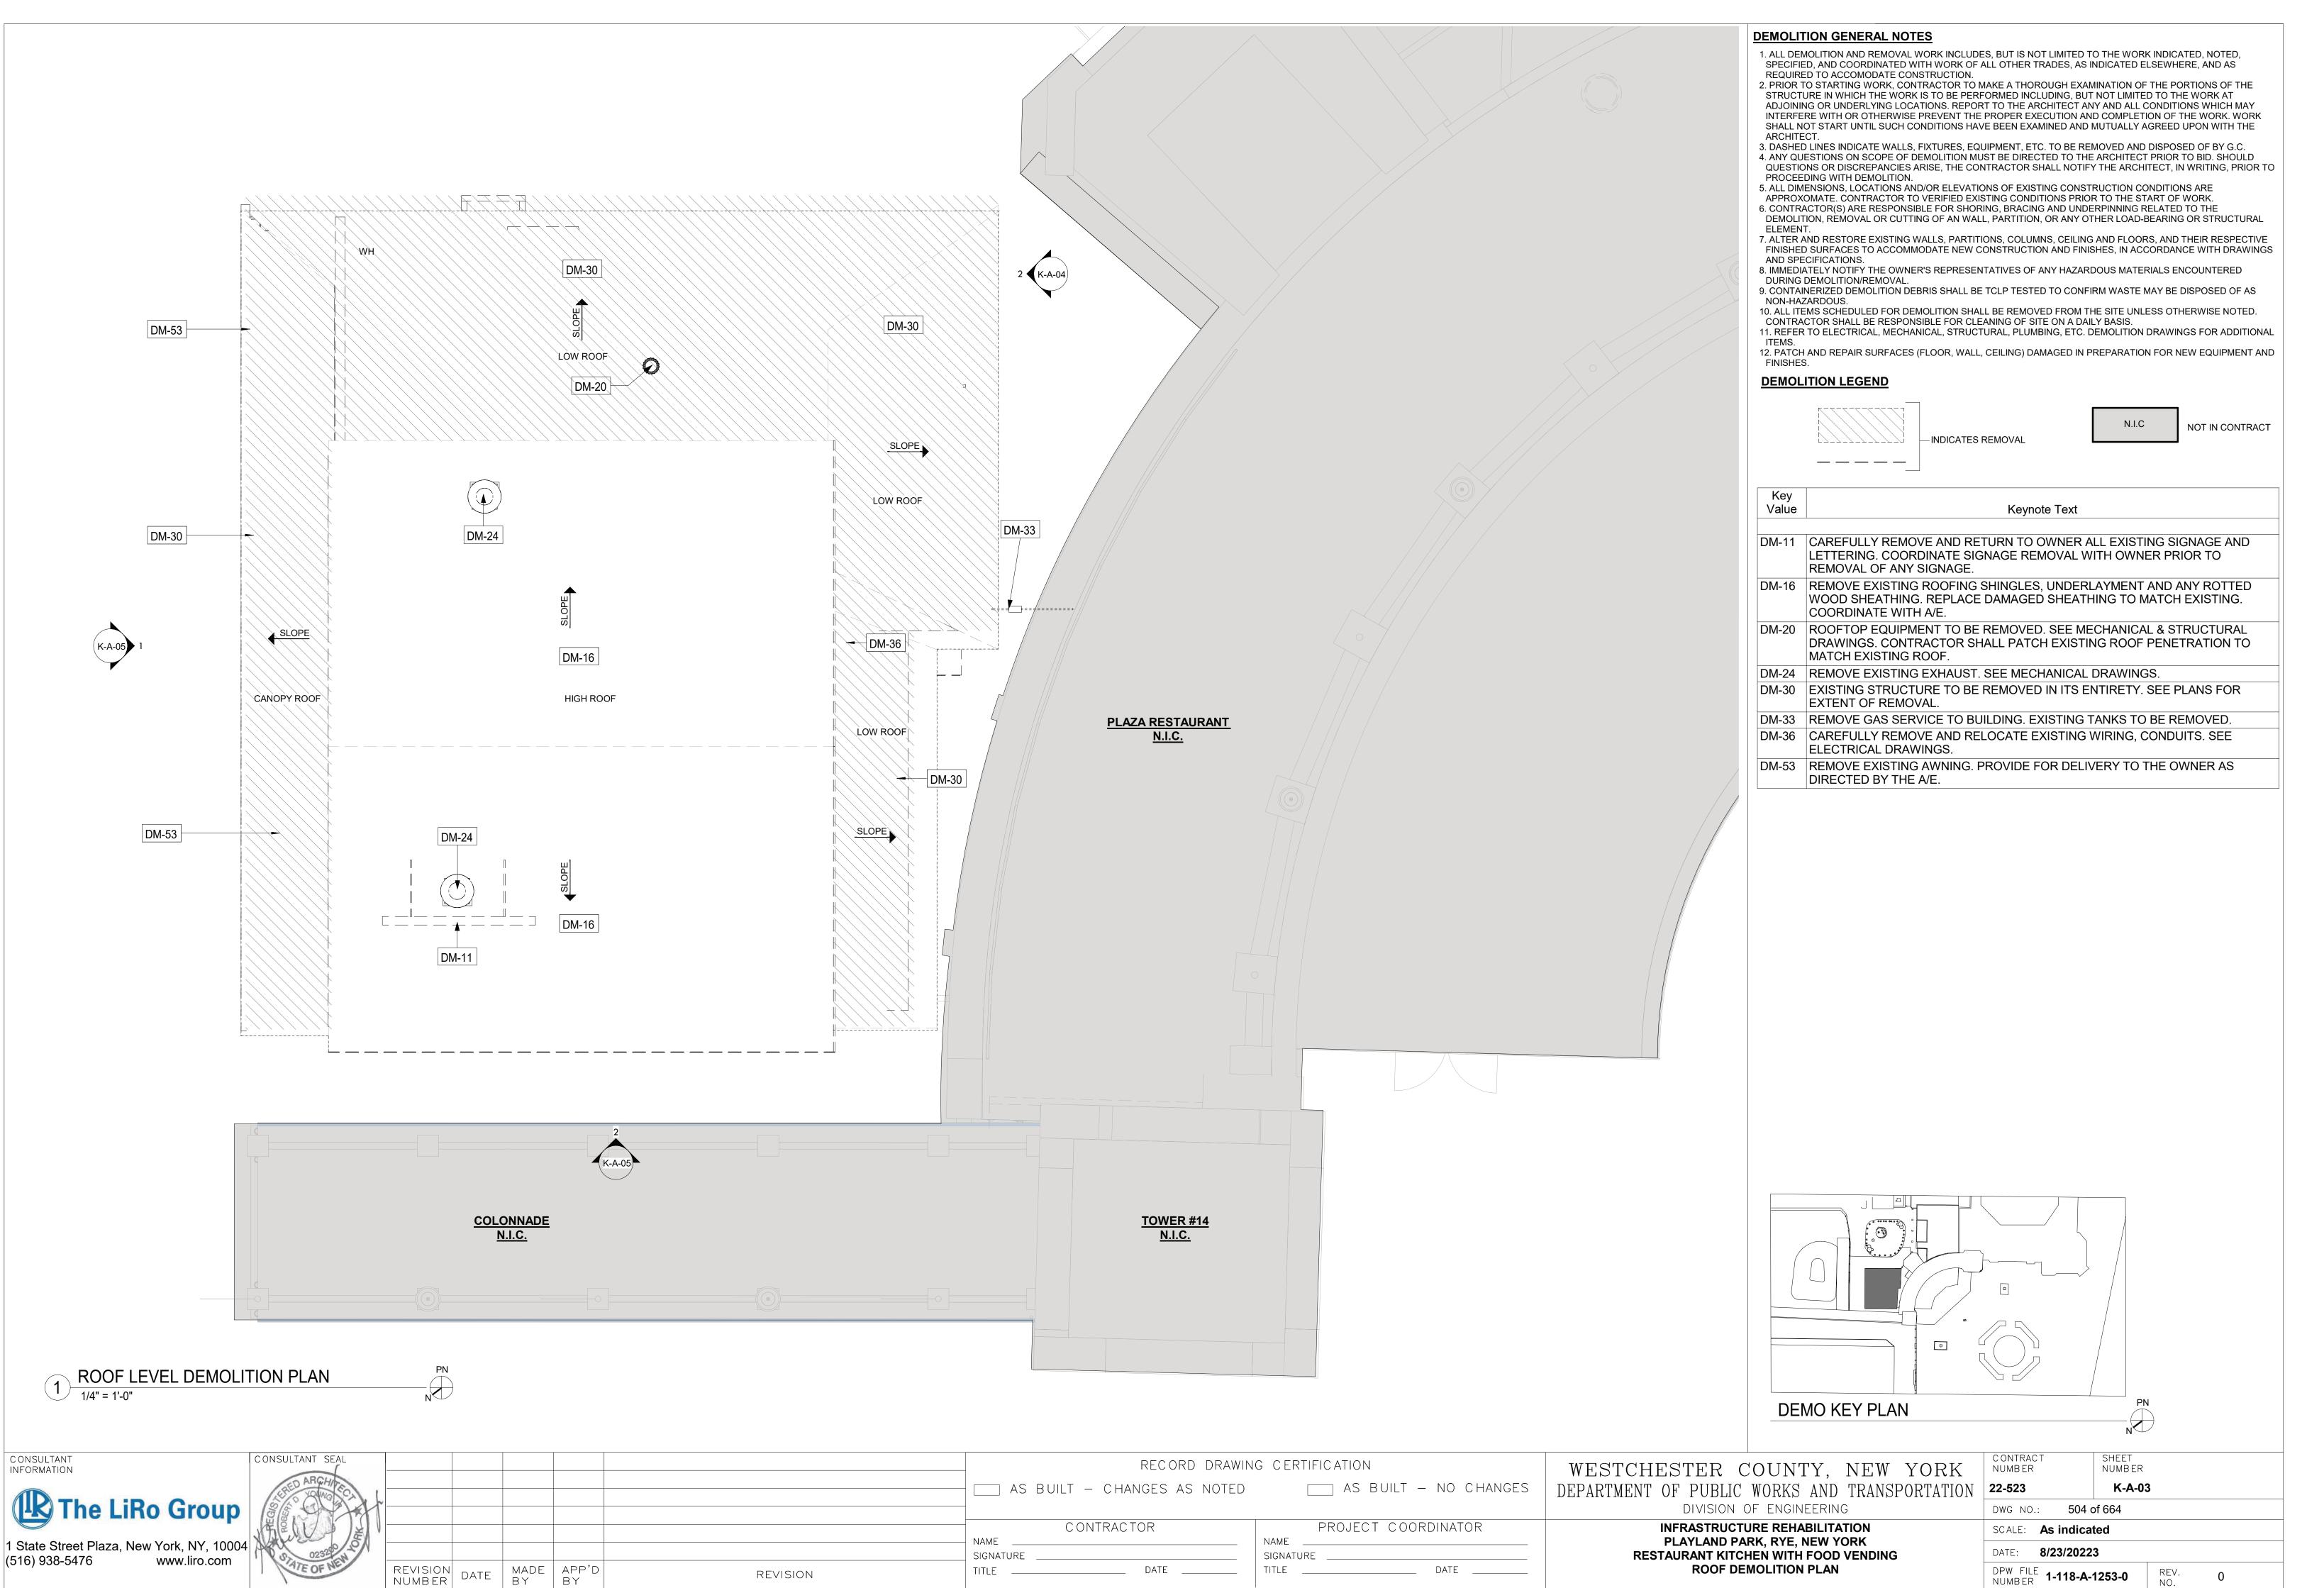
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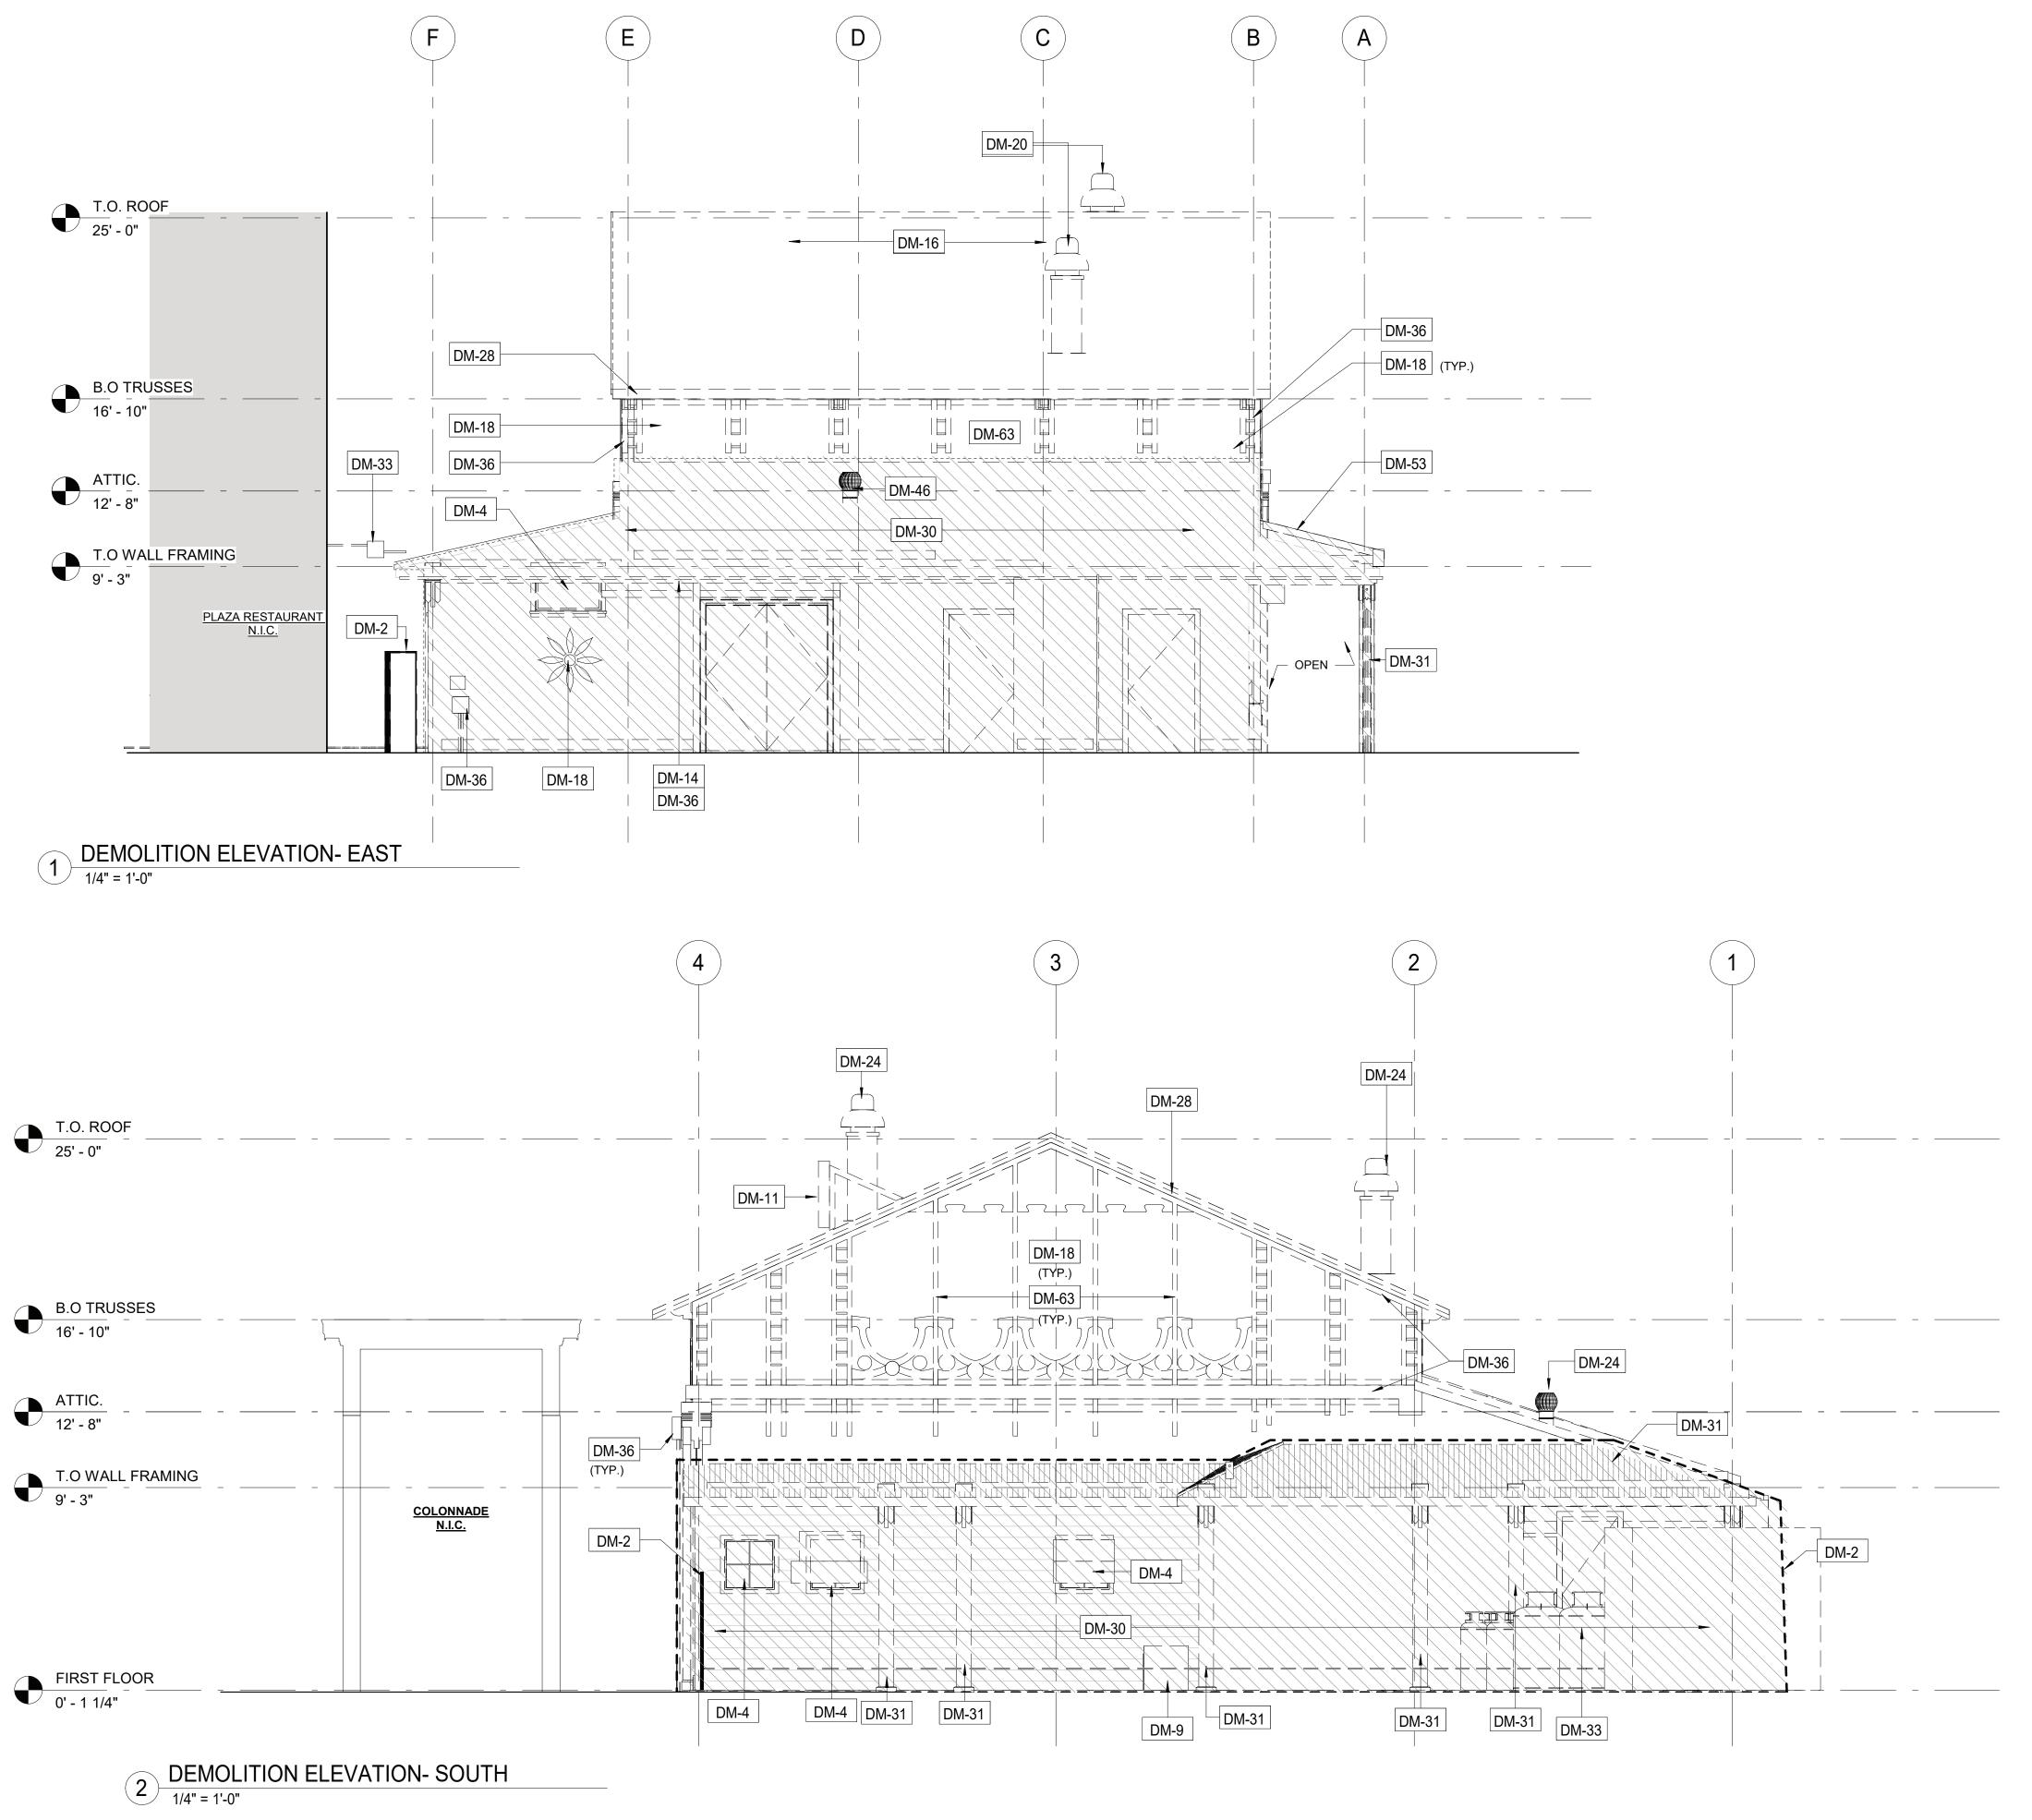
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DATE \_\_\_\_

RECORD DRAWING CERTIFICATION





REVISION

RECORD DRAWING CERTIFICATION

NAME

SIGNATURE

AS BUILT - CHANGES AS NOTED

CONTRACTOR

DATE

SIGNATURE

\_\_\_ AS BUILT - NO CHANGES

PROJECT COORDINATOR

#### **DEMOLITION GENERAL NOTES**

- 1. ALL DEMOLITION AND REMOVAL WORK INCLUDES, BUT IS NOT LIMITED TO THE WORK INDICATED, NOTED, SPECIFIED, AND COORDINATED WITH WORK OF ALL OTHER TRADES, AS INDICATED ELSEWHERE, AND AS REQUIRED TO ACCOMODATE CONSTRUCTION.
- 2. PRIOR TO STARTING WORK, CONTRACTOR TO MAKE A THOROUGH EXAMINATION OF THE PORTIONS OF THE STRUCTURE IN WHICH THE WORK IS TO BE PERFORMED INCLUDING, BUT NOT LIMITED TO THE WORK AT ADJOINING OR UNDERLYING LOCATIONS. REPORT TO THE ARCHITECT ANY AND ALL CONDITIONS WHICH MAY INTERFERE WITH OR OTHERWISE PREVENT THE PROPER EXECUTION AND COMPLETION OF THE WORK. WORK SHALL NOT START UNTIL SUCH CONDITIONS HAVE BEEN EXAMINED AND MUTUALLY AGREED UPON WITH THE
  - 3. DASHED LINES INDICATE WALLS, FIXTURES, EQUIPMENT, ETC. TO BE REMOVED AND DISPOSED OF BY G.C. 4. ANY QUESTIONS ON SCOPE OF DEMOLITION MUST BE DIRECTED TO THE ARCHITECT PRIOR TO BID. SHOULD
  - QUESTIONS OR DISCREPANCIES ARISE, THE CONTRACTOR SHALL NOTIFY THE ARCHITECT, IN WRITING, PRIOR TO PROCEEDING WITH DEMOLITION.
  - 5. ALL DIMENSIONS, LOCATIONS AND/OR ELEVATIONS OF EXISTING CONSTRUCTION CONDITIONS ARE APPROXOMATE. CONTRACTOR TO VERIFIED EXISTING CONDITIONS PRIOR TO THE START OF WORK.
  - 6. CONTRACTOR(S) ARE RESPONSIBLE FOR SHORING, BRACING AND UNDERPINNING RELATED TO THE
  - DEMOLITION, REMOVAL OR CUTTING OF AN WALL, PARTITION, OR ANY OTHER LOAD-BEARING OR STRUCTURAL
  - 7. ALTER AND RESTORE EXISTING WALLS, PARTITIONS, COLUMNS, CEILING AND FLOORS, AND THEIR RESPECTIVE FINISHED SURFACES TO ACCOMMODATE NEW CONSTRUCTION AND FINISHES, IN ACCORDANCE WITH DRAWINGS AND SPECIFICATIONS.
  - 8. IMMEDIATELY NOTIFY THE OWNER'S REPRESENTATIVES OF ANY HAZARDOUS MATERIALS ENCOUNTERED DURING DEMOLITION/REMOVAL
  - 9. CONTAINERIZED DEMOLITION DEBRIS SHALL BE TCLP TESTED TO CONFIRM WASTE MAY BE DISPOSED OF AS
  - NON-HAZARDOUS. 10. ALL ITEMS SCHEDULED FOR DEMOLITION SHALL BE REMOVED FROM THE SITE UNLESS OTHERWISE NOTED.
  - CONTRACTOR SHALL BE RESPONSIBLE FOR CLEANING OF SITE ON A DAILY BASIS. 11. REFER TO ELECTRICAL, MECHANICAL, STRUCTURAL, PLUMBING, ETC. DEMOLITION DRAWINGS FOR ADDITIONAL
  - 12. PATCH AND REPAIR SURFACES (FLOOR, WALL, CEILING) DAMAGED IN PREPARATION FOR NEW EQUIPMENT AND
  - FINISHES.

#### **DEMOLITION LEGEND**



Key Value	Keynote Text
DM 0	DEMOVE EVICTING CATE
DM-2	REMOVE EXISTING GATE.
DM-4	REMOVE EXISTING WINDOW & FRAME.
DM-9	CONTRACTOR TO REMOVE ANY REMAINING EQUIPMENT AND BUILDING CONTENT. CONTENT MAY INCLUDE BUT NOT LIMITED TO REFRIGERATOR, STORAGE, RACKS, AC UNITS, GAMES ETC.
DM-11	CAREFULLY REMOVE AND RETURN TO OWNER ALL EXISTING SIGNAGE AND LETTERING. COORDINATE SIGNAGE REMOVAL WITH OWNER PRIOR TO REMOVAL OF ANY SIGNAGE.
DM-14	REMOVE EXISTING LIGHTING FIXTURES AND ELECTRICAL WIRING CONNECTED TO THESE FIXTURES. SEE ELECTRICAL FOR DETAILS.
DM-16	REMOVE EXISTING ROOFING SHINGLES, UNDERLAYMENT AND ANY ROTTED WOOD SHEATHING. REPLACE DAMAGED SHEATHING TO MATCH EXISTING. COORDINATE WITH A/E.
DM-18	REMOVE EXISTING PANELS & TRIMS.
DM-20	ROOFTOP EQUIPMENT TO BE REMOVED. SEE MECHANICAL & STRUCTURAL DRAWINGS. CONTRACTOR SHALL PATCH EXISTING ROOF PENETRATION TO MATCH EXISTING ROOF.
DM-24	REMOVE EXISTING EXHAUST. SEE MECHANICAL DRAWINGS.
DM-28	REMOVE EXISTING GUTTER, FASCIA, AND SOFFITS.
DM-30	EXISTING STRUCTURE TO BE REMOVED IN ITS ENTIRETY. SEE PLANS FOR EXTENT OF REMOVAL.
DM-31	REMOVE EXISTING COLUMN.
DM-33	REMOVE GAS SERVICE TO BUILDING. EXISTING TANKS TO BE REMOVED.
DM-36	CAREFULLY REMOVE AND RELOCATE EXISTING WIRING, CONDUITS. SEE ELECTRICAL DRAWINGS.
DM-46	EXISTING ELECTRICAL EQUIPMENT TO BE PROTECTED DURING CONSTRUCTION.
DM-53	REMOVE EXISTING AWNING. PROVIDE FOR DELIVERY TO THE OWNER AS DIRECTED BY THE A/E.
DM-63	CONTRACTOR TO CAREFULLY DOCUMENT AND REMOVE ALL EXISTING FACAD MATERIALS AND TRIM.

CONSULTANT INFORMATION


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MADE APP'D BY BY

REVISION NUMBER



#### **DEMOLITION GENERAL NOTES**

EXAMINED AND MUTUALLY AGREED UPON WITH THE ARCHITECT.

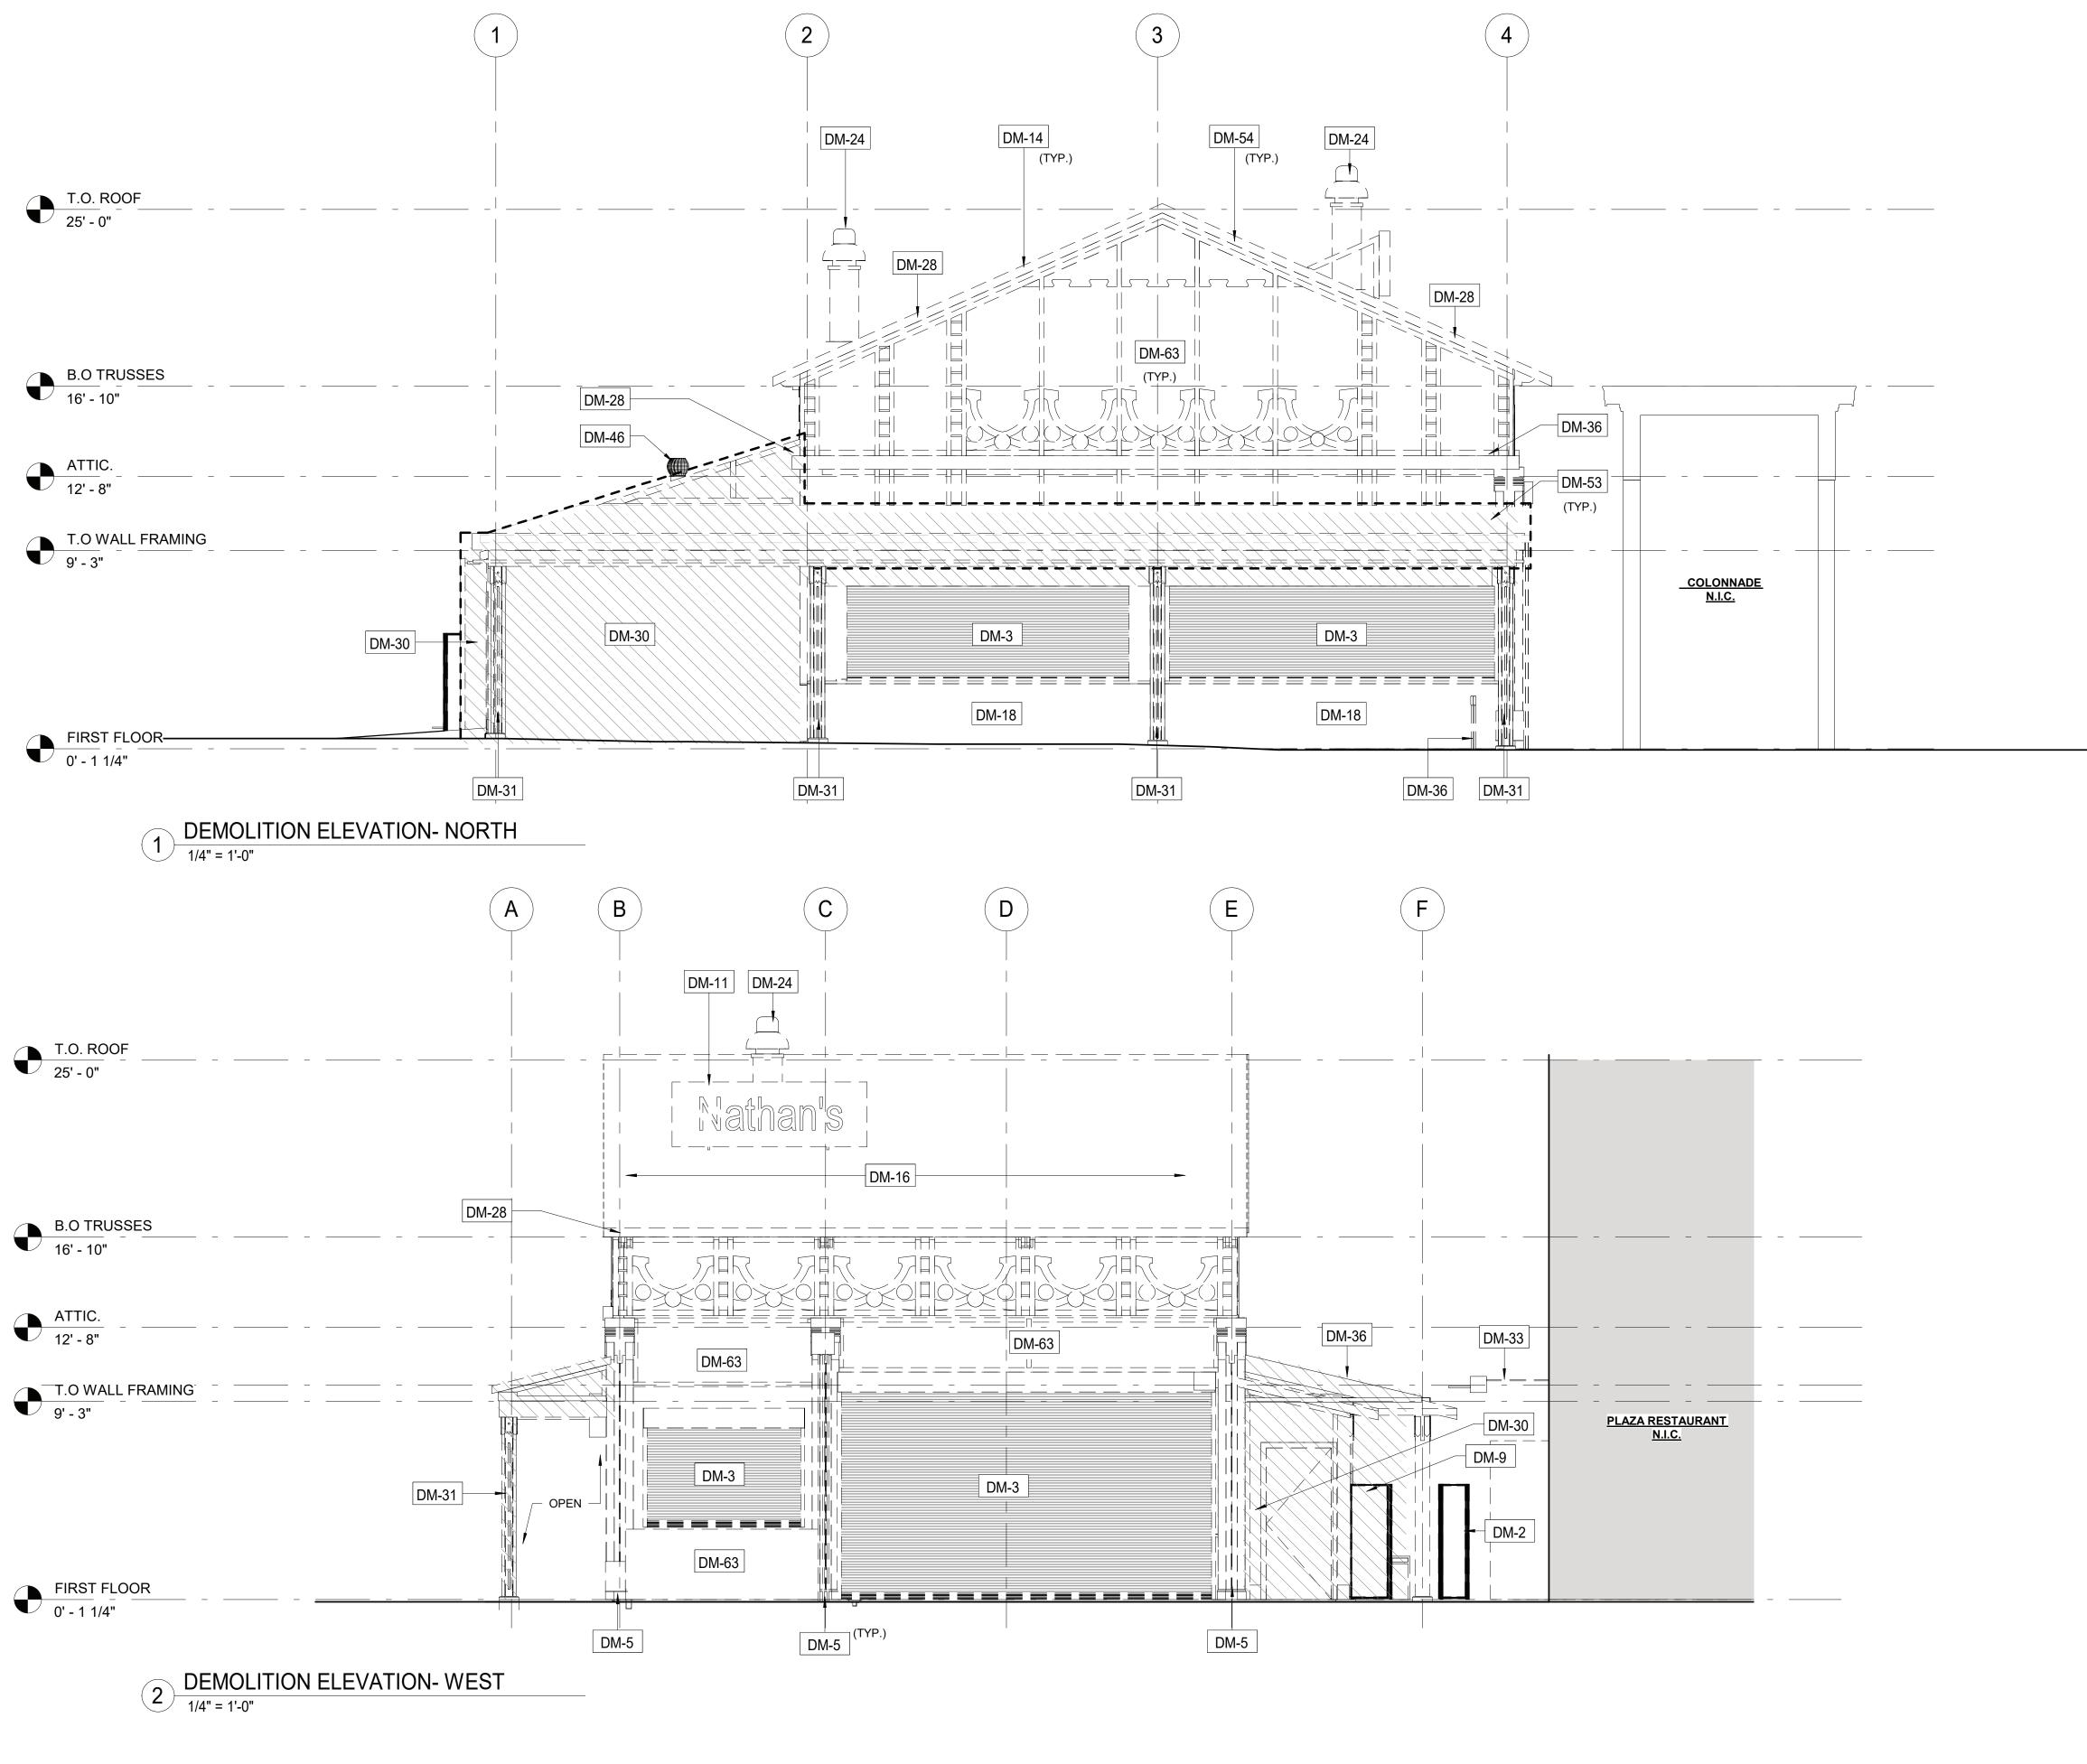- 1. ALL DEMOLITION AND REMOVAL WORK INCLUDES, BUT IS NOT LIMITED TO THE WORK INDICATED, NOTED, SPECIFIED, AND COORDINATED WITH WORK OF ALL OTHER TRADES, AS INDICATED ELSEWHERE, AND AS REQUIRED TO ACCOMODATE
- CONSTRUCTION.

  2. PRIOR TO STARTING WORK, CONTRACTOR TO MAKE A THOROUGH EXAMINATION OF THE PORTIONS OF THE STRUCTURE IN WHICH THE WORK IS TO BE PERFORMED INCLUDING, BUT NOT LIMITED TO THE WORK AT ADJOINING OR UNDERLYING LOCATIONS. REPORT TO THE ARCHITECT ANY AND ALL CONDITIONS WHICH MAY INTERFERE WITH OR OTHERWISE PREVENT THE PROPER EXECUTION AND COMPLETION OF THE WORK. WORK SHALL NOT START UNTIL SUCH CONDITIONS HAVE BEEN
- 3. DASHED LINES INDICATE WALLS, FIXTURES, EQUIPMENT, ETC. TO BE REMOVED AND DISPOSED OF BY G.C.
  4. ANY QUESTIONS ON SCOPE OF DEMOLITION MUST BE DIRECTED TO THE ARCHITECT PRIOR TO BID. SHOULD QUESTIONS
- OR DISCREPANCIES ARISE, THE CONTRACTOR SHALL NOTIFY THE ARCHITECT, IN WRITING, PRIOR TO PROCEEDING WITH DEMOLITIONS.
- 5. ALL DIMENSIONS, LOCATIONS AND/OR ELEVATIONS OF EXISTING CONSTRUCTION CONDITIONS ARE APPROXOMATE. CONTRACTOR TO VERIFIED EXISTING CONDITIONS PRIOR TO THE START OF WORK.
- CONTRACTOR TO VERIFIED EXISTING CONDITIONS PRIOR TO THE START OF WORK.
  6. CONTRACTOR(S) ARE RESPONSIBLE FOR SHORING, BRACING AND UNDERPINNING RELATED TO THE DEMOLITION,
- REMOVAL OR CUTTING OF AN WALL, PARTITION, OR ANY OTHER LOAD-BEARING OR STRUCTURAL ELEMENT.
  7. ALTER AND RESTORE EXISTING WALLS, PARTITIONS, COLUMNS, CEILING AND FLOORS, AND THEIR RESPECTIVE FINISHED SURFACES TO ACCOMMODATE NEW CONSTRUCTION AND FINISHES, IN ACCORDANCE WITH DRAWINGS AND
- SPECIFICATIONS.

  8. IMMEDIATELY NOTIFY THE OWNER'S REPRESENTATIVES OF ANY HAZARDOUS MATERIALS ENCOUNTERED DURING DEMOLITION/REMOVAL.
- 9. CONTAINERIZED DEMOLITION DEBRIS SHALL BE TCLP TESTED TO CONFIRM WASTE MAY BE DISPOSED OF AS NON-
- HAZARDOUS.
  10. ALL ITEMS SCHEDULED FOR DEMOLITION SHALL BE REMOVED FROM THE SITE UNLESS OTHERWISE NOTED. CONTRACTOR
- SHALL BE RESPONSIBLE FOR CLEANING OF SITE ON A DAILY BASIS.

  11. REFER TO ELECTRICAL, MECHANICAL, STRUCTURAL, PLUMBING, ETC. DEMOLITION DRAWINGS FOR ADDITIONAL ITEMS.

#### 12. PATCH AND REPAIR SURFACES (FLOOR, WALL, CEILING) DAMAGED IN PREPARATION FOR NEW EQUIPMENT AND FINISHES.

#### **DEMOLITION LEGEND**




Key Value	Keynote Text
DM-2	REMOVE EXISTING GATE.
DM-3	REMOVE ROLL DOWN DOOR AND ASSOCIATED HARDWARE.
DM-5	REMOVE COLUMN ENCLOSURES. CAREFULLY REMOVE AT LEAST ONE COLUMN ENCLOSURE TO USE AS REFERENCE IN ORDER TO REPLICATE TRIMS TO MATCH LOCATION, SIZE AND SHAPE AS INDICATED. COORDINATE WITH STRUCTURAL DRAWINGS.
DM-9	CONTRACTOR TO REMOVE ANY REMAINING EQUIPMENT AND BUILDING CONTENT. CONTENT MAY INCLUDE BUT NOT LIMITED TO REFRIGERATOR, STORAGE, RACKS, AC UNITS, GAMES ETC.
DM-11	CAREFULLY REMOVE AND RETURN TO OWNER ALL EXISTING SIGNAGE AND LETTERING. COORDINATE SIGNAGE REMOVAL WITH OWNER PRIOR TO REMOVAL OF ANY SIGNAGE.
DM-14	REMOVE EXISTING LIGHTING FIXTURES AND ELECTRICAL WIRING CONNECTED TO THESE FIXTURES. SEE ELECTRICAL FOR DETAILS.
DM-16	REMOVE EXISTING ROOFING SHINGLES, UNDERLAYMENT AND ANY ROTTED WOOD SHEATHING. REPLACE DAMAGED SHEATHING TO MATCH EXISTING. COORDINATE WITH A/E.
DM-18	REMOVE EXISTING PANELS & TRIMS.
DM-24	REMOVE EXISTING EXHAUST. SEE MECHANICAL DRAWINGS.
DM-28	REMOVE EXISTING GUTTER, FASCIA, AND SOFFITS.
DM-30	EXISTING STRUCTURE TO BE REMOVED IN ITS ENTIRETY. SEE PLANS FOR EXTENT OF REMOVAL.
DM-31	REMOVE EXISTING COLUMN.
DM-33	REMOVE GAS SERVICE TO BUILDING. EXISTING TANKS TO BE REMOVED.
DM-36	CAREFULLY REMOVE AND RELOCATE EXISTING WIRING, CONDUITS. SEE ELECTRICAL DRAWINGS.
DM-46	EXISTING ELECTRICAL EQUIPMENT TO BE PROTECTED DURING CONSTRUCTION.
DM-53	REMOVE EXISTING AWNING. PROVIDE FOR DELIVERY TO THE OWNER AS DIRECTED BY THE A/E.
DM-54	CONTRACTOR TO CAREFULLY REMOVE, STORE AND CATALOG EXISTING "LANTERN" STYLE FIXTURE FOR REPLICATION. (TO BE UPDATED)
DM-63	CONTRACTOR TO CAREFULLY DOCUMENT AND REMOVE ALL EXISTING FACADE MATERIALS AND TRIM.


CONSULTANT INFORMATION

The LiRo Group

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DATE

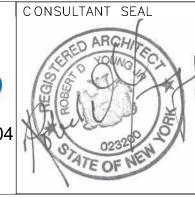PROJECT COORDINATOR

SIGNATURE \_\_

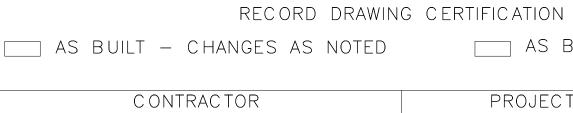WESTCHESTER COUNTY, NEW YORK
DEPARTMENT OF PUBLIC WORKS AND TRANSPORTATION
DIVISION OF ENGINEERING
INFRASTRUCTURE REHABILITATION

INT OF PUBLIC WORKS AND TRANSPORTATION
DIVISION OF ENGINEERING

INFRASTRUCTURE REHABILITATION
PLAYLAND PARK, RYE, NEW YORK
RESTAURANT KITCHEN WITH FOOD VENDING
EXTERIOR DEMOLITION ELEVATIONS

CONTRACT NUMBER

YON 22-523 K-A-05


DWG NO.: 506 of 664


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DATE: 8/23/20223

DPW FILE NUMBER

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**FLOOR PLAN GENERAL NOTES** 

1. ALL METAL STUDS 20 GA- TYPICAL NON-LOAD BEARING PARTITIONS. SEE USG STEEL- FRAMED DRYWALL SYSTEMS " LIMITING HEIGHT"- STEEL STUD ASSEMBLIES CHART. USE THE L/240 ALLOWABLE DEFLECTION FIGURES ONLY.

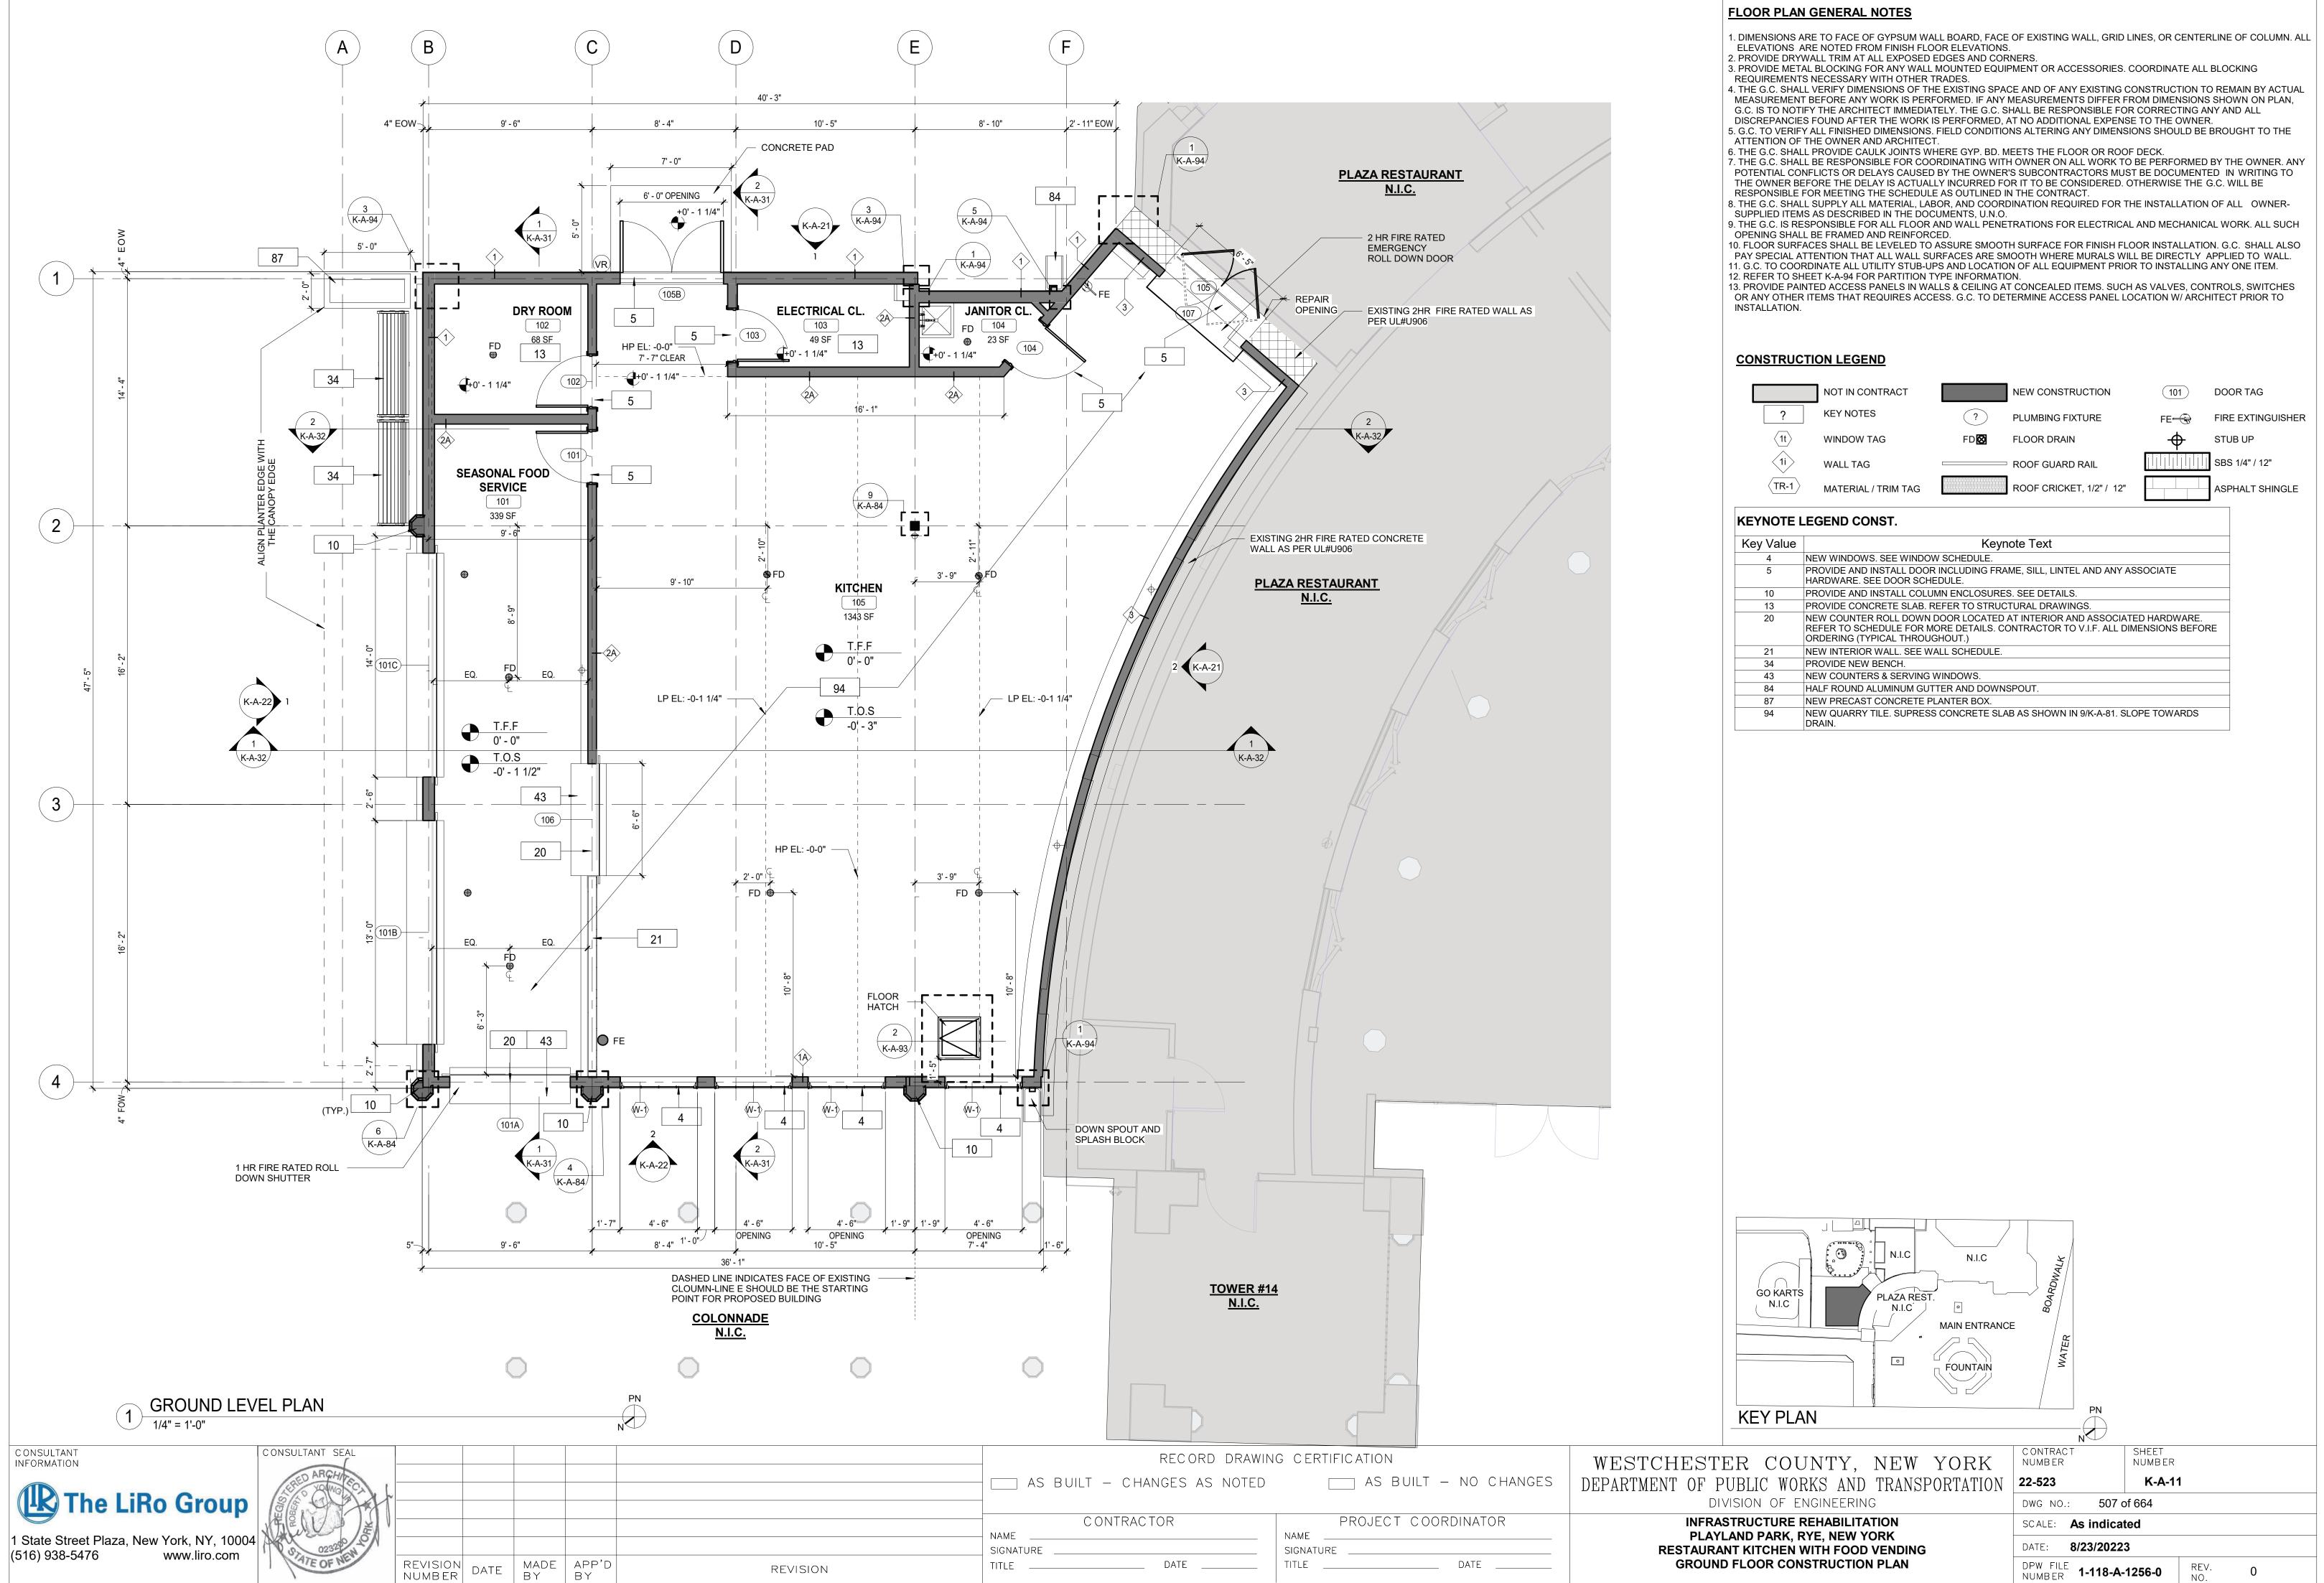2. DIMENSIONS ARE TO FACE OF GYPSUM WALL BOARD, EXISTING WALL, GRID LINES, OR CENTERLINE OF COLUMN. ALL

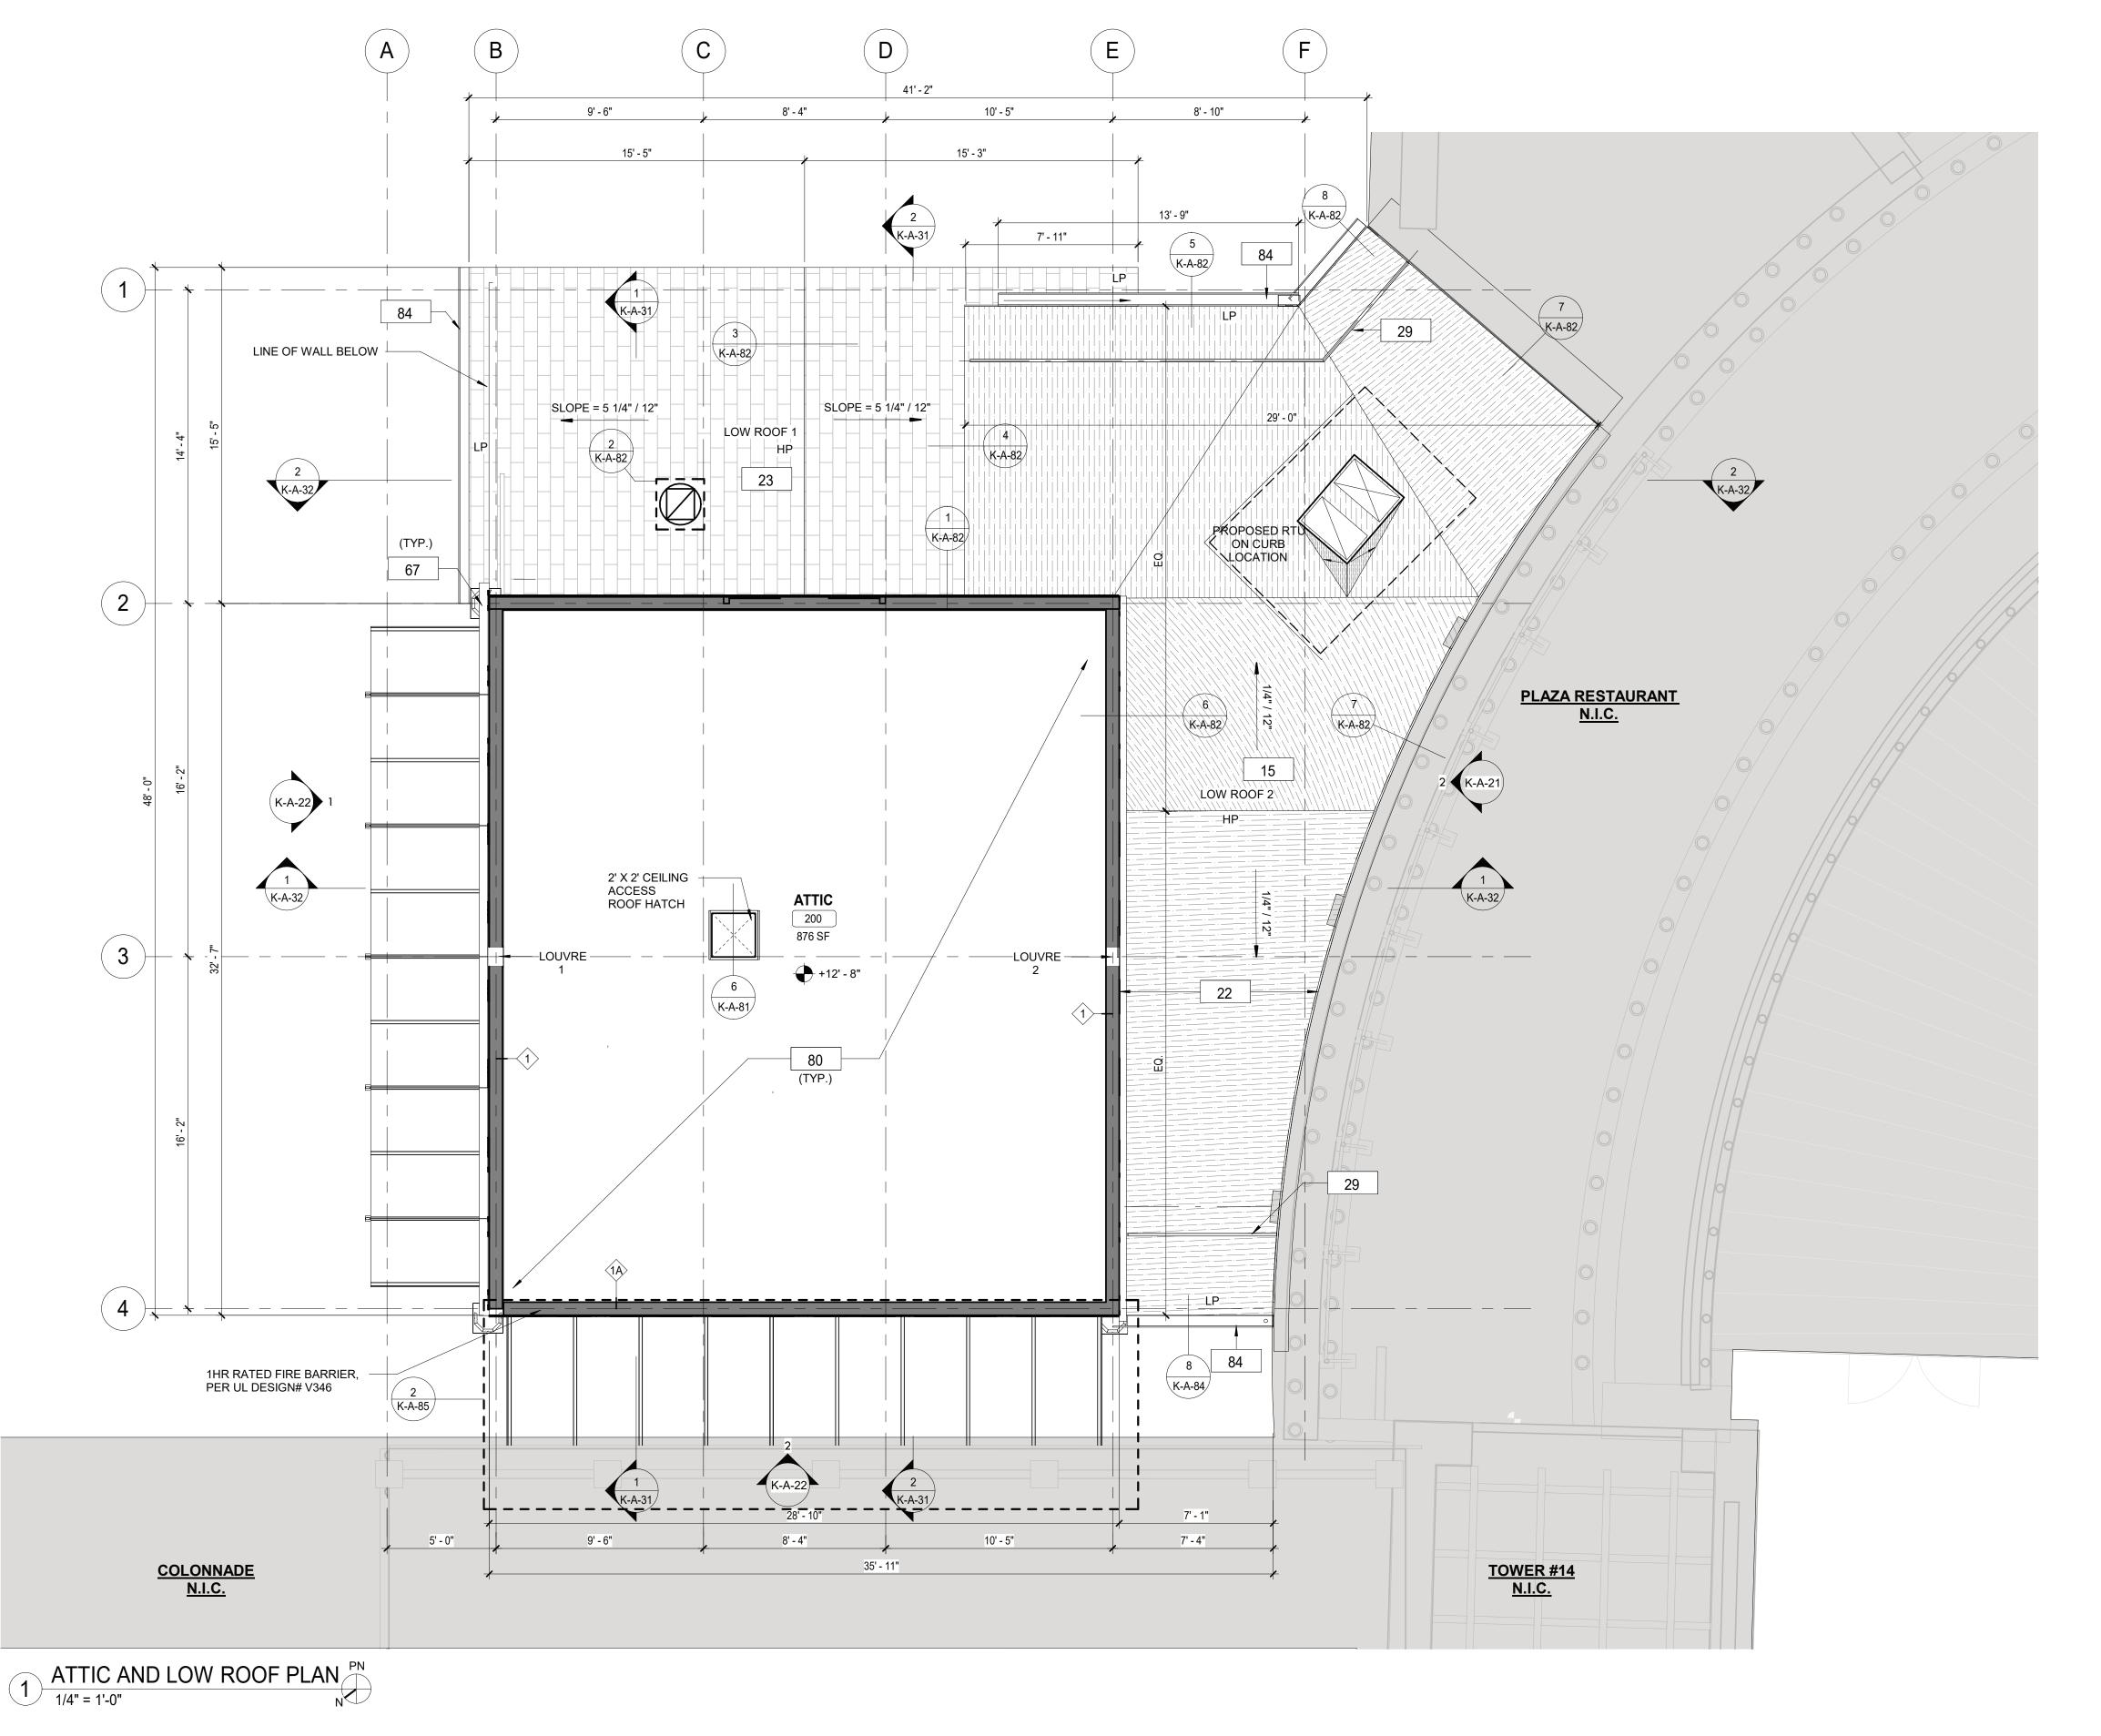ELEVATIONS ARE NOTED FROM FINISH FLOOR ELEVATIONS.

3. PROVIDE DRYWALL TRIM AT ALL EXPOSED EDGES AND CORNERS.
4. MINIMUM DIMENSION FROM ANY CORNER OR WALL TO FRAMING STUD AT DOOR JAMB OPENING SHALL BE 4" (U.O.N.).
5. PROVIDE METAL BLOCKING FOR ANY WALL MOUNTED EQUIPMENT OR ACCESSORIES. COORDINATE ALL BLOCKING

5. PROVIDE METAL BLOCKING FOR ANY WALL MOUNTED EQUIPMENT OR ACCESSORIES. COORDINATE ALL BLOCKING REQUIREMENTS NECESSARY WITH OTHER TRADES.

6. THE G.C. SHALL VERIFY DIMENSIONS OF THE EXISTING SPACE AND OF ANY EXISTING CONSTRUCTION TO REMAIN BY ACTUAL MEASUREMENT BEFORE ANY WORK IS PERFORMED. IF ANY MEASUREMENTS DIFFER FROM DIMENSIONS SHOWN ON PLAN, G.C. IS TO NOTIFY THE ARCHITECT IMMEDIATELY. THE G.C. SHALL BE RESPONSIBLE FOR CORRECTING ANY AND ALL DISCREPANCIES FOUND AFTER THE WORK IS PERFORMED, AT NO ADDITIONAL EXPENSE TO THE OWNER.

7. G.C. TO VERIFY ALL FINISHED DIMENSIONS. FIELD CONDITIONS ALTERING ANY DIMENSIONS SHOULD BE BROUGHT TO THE ATTENTION OF THE OWNER AND ARCHITECT.

8. THE G.C. SHALL PROVIDE CAULK JOINTS WHERE GYP. BD. MEETS THE FLOOR OR ROOF DECK.

9. THE G.C. SHALL BE RESPONSIBLE FOR COORDINATING WITH OWNER ON ALL WORK TO BE PERFORMED BY THE OWNER. ANY POTENTIAL CONFLICTS OR DELAYS CAUSED BY THE OWNER'S SUBCONTRACTORS MUST BE DOCUMENTED IN WRITING TO THE OWNER BEFORE THE DELAY IS ACTUALLY INCURRED FOR IT TO BE CONSIDERED. OTHERWISE THE G.C. WILL BE RESPONSIBLE FOR MEETING THE SCHEDULE AS OUTLINED IN THE CONTRACT.

10. THE G.C. SHALL SUPPLY ALL MATERIAL, LABOR, AND COORDINATION REQUIRED FOR THE INSTALLATION OF ALL OWNER-SUPPLIED ITEMS AS DESCRIBED IN THE DOCUMENTS, U.N.O.

11. THE G.C. IS RESPONSIBLE FOR ALL FLOOR AND WALL PENETRATIONS FOR ELECTRICAL AND MECHANICAL WORK. ALL SUCH OPENING SHALL BE FRAMED AND REINFORCED.


12. FLOOR SURFACES SHALL BE LEVELED TO ASSURE SMOOTH SURFACE FOR FINISH FLOOR INSTALLATION. G.C. SHALL ALSO PAY SPECIAL ATTENTION THAT ALL WALL SURFACES ARE SMOOTH WHERE MURALS WILL BE DIRECTLY APPLIED TO WALL.

13. G.C. TO COORDINATE ALL UTILITY STUB-UPS AND LOCATION OF ALL EQUIPMENT PRIOR TO INSTALLING ANY ONE ITEM.

14. REFER TO SHEET K-A-94 FOR PARTITION TYPE INFORMATION.


15. PROVIDE PAINTED ACCESS PANELS IN WALLS & CEILING AT CONCEALED ITEMS. SUCH AS VALVES, CONTROLS, SWITCHES OR ANY OTHER ITEMS THAT REQUIRES ACCESS. G.C. TO DETERMINE ACCESS PANEL LOCATION W/ ARCHITECT PRIOR TO INSTALLATION.

#### **CONSTRUCTION LEGEND**

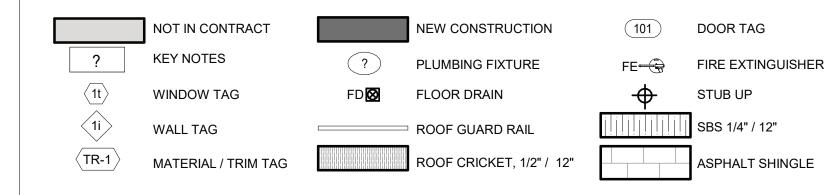

### KEYNOTE LEGEND CONST.

Key Value	Keynote Text
15	PROVIDE AND INSTALL SBS MODIFIED BITUMEN ROOFING AND UNDERLAYMENT.
22	PROVIDE NEW FLASHING ALONG EXISTING WALL AND ROOF CONNECTION.
23	NEW ROOF WITH BATT INSULATION (R-38 MIN) PACKED BETWEEN JOISTS. PROVIDE AND INSTALL SHINGLES, UNDERLAYMENT SHEATHING AND FLASHING SYSTEM.
29	PROVIDE AND INSTALL NEW OSHA COMPLIANT GUARD RAIL.
80	NEW 3/4" PLYWOOD FLOOR
84	HALF ROUND ALUMINUM GUTTER AND DOWNSPOUT.

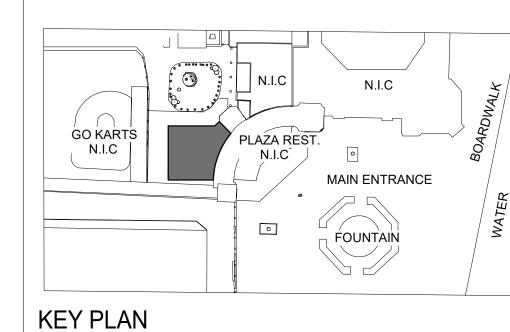

WESTCHESTER COUNTY, NEW YORK
DEPARTMENT OF PUBLIC WORKS AND TRANSPORTATION
DIVISION OF ENGINEERING
INFRASTRUCTURE REHABILITATION

CONTRACT NUMBER

22-523 K-A-12


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SCALE: As indicated

DATE: 8/23/20223

DPW FILE NUMBER 1-118-A-1257-0 REV. NO. 0





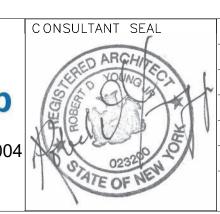

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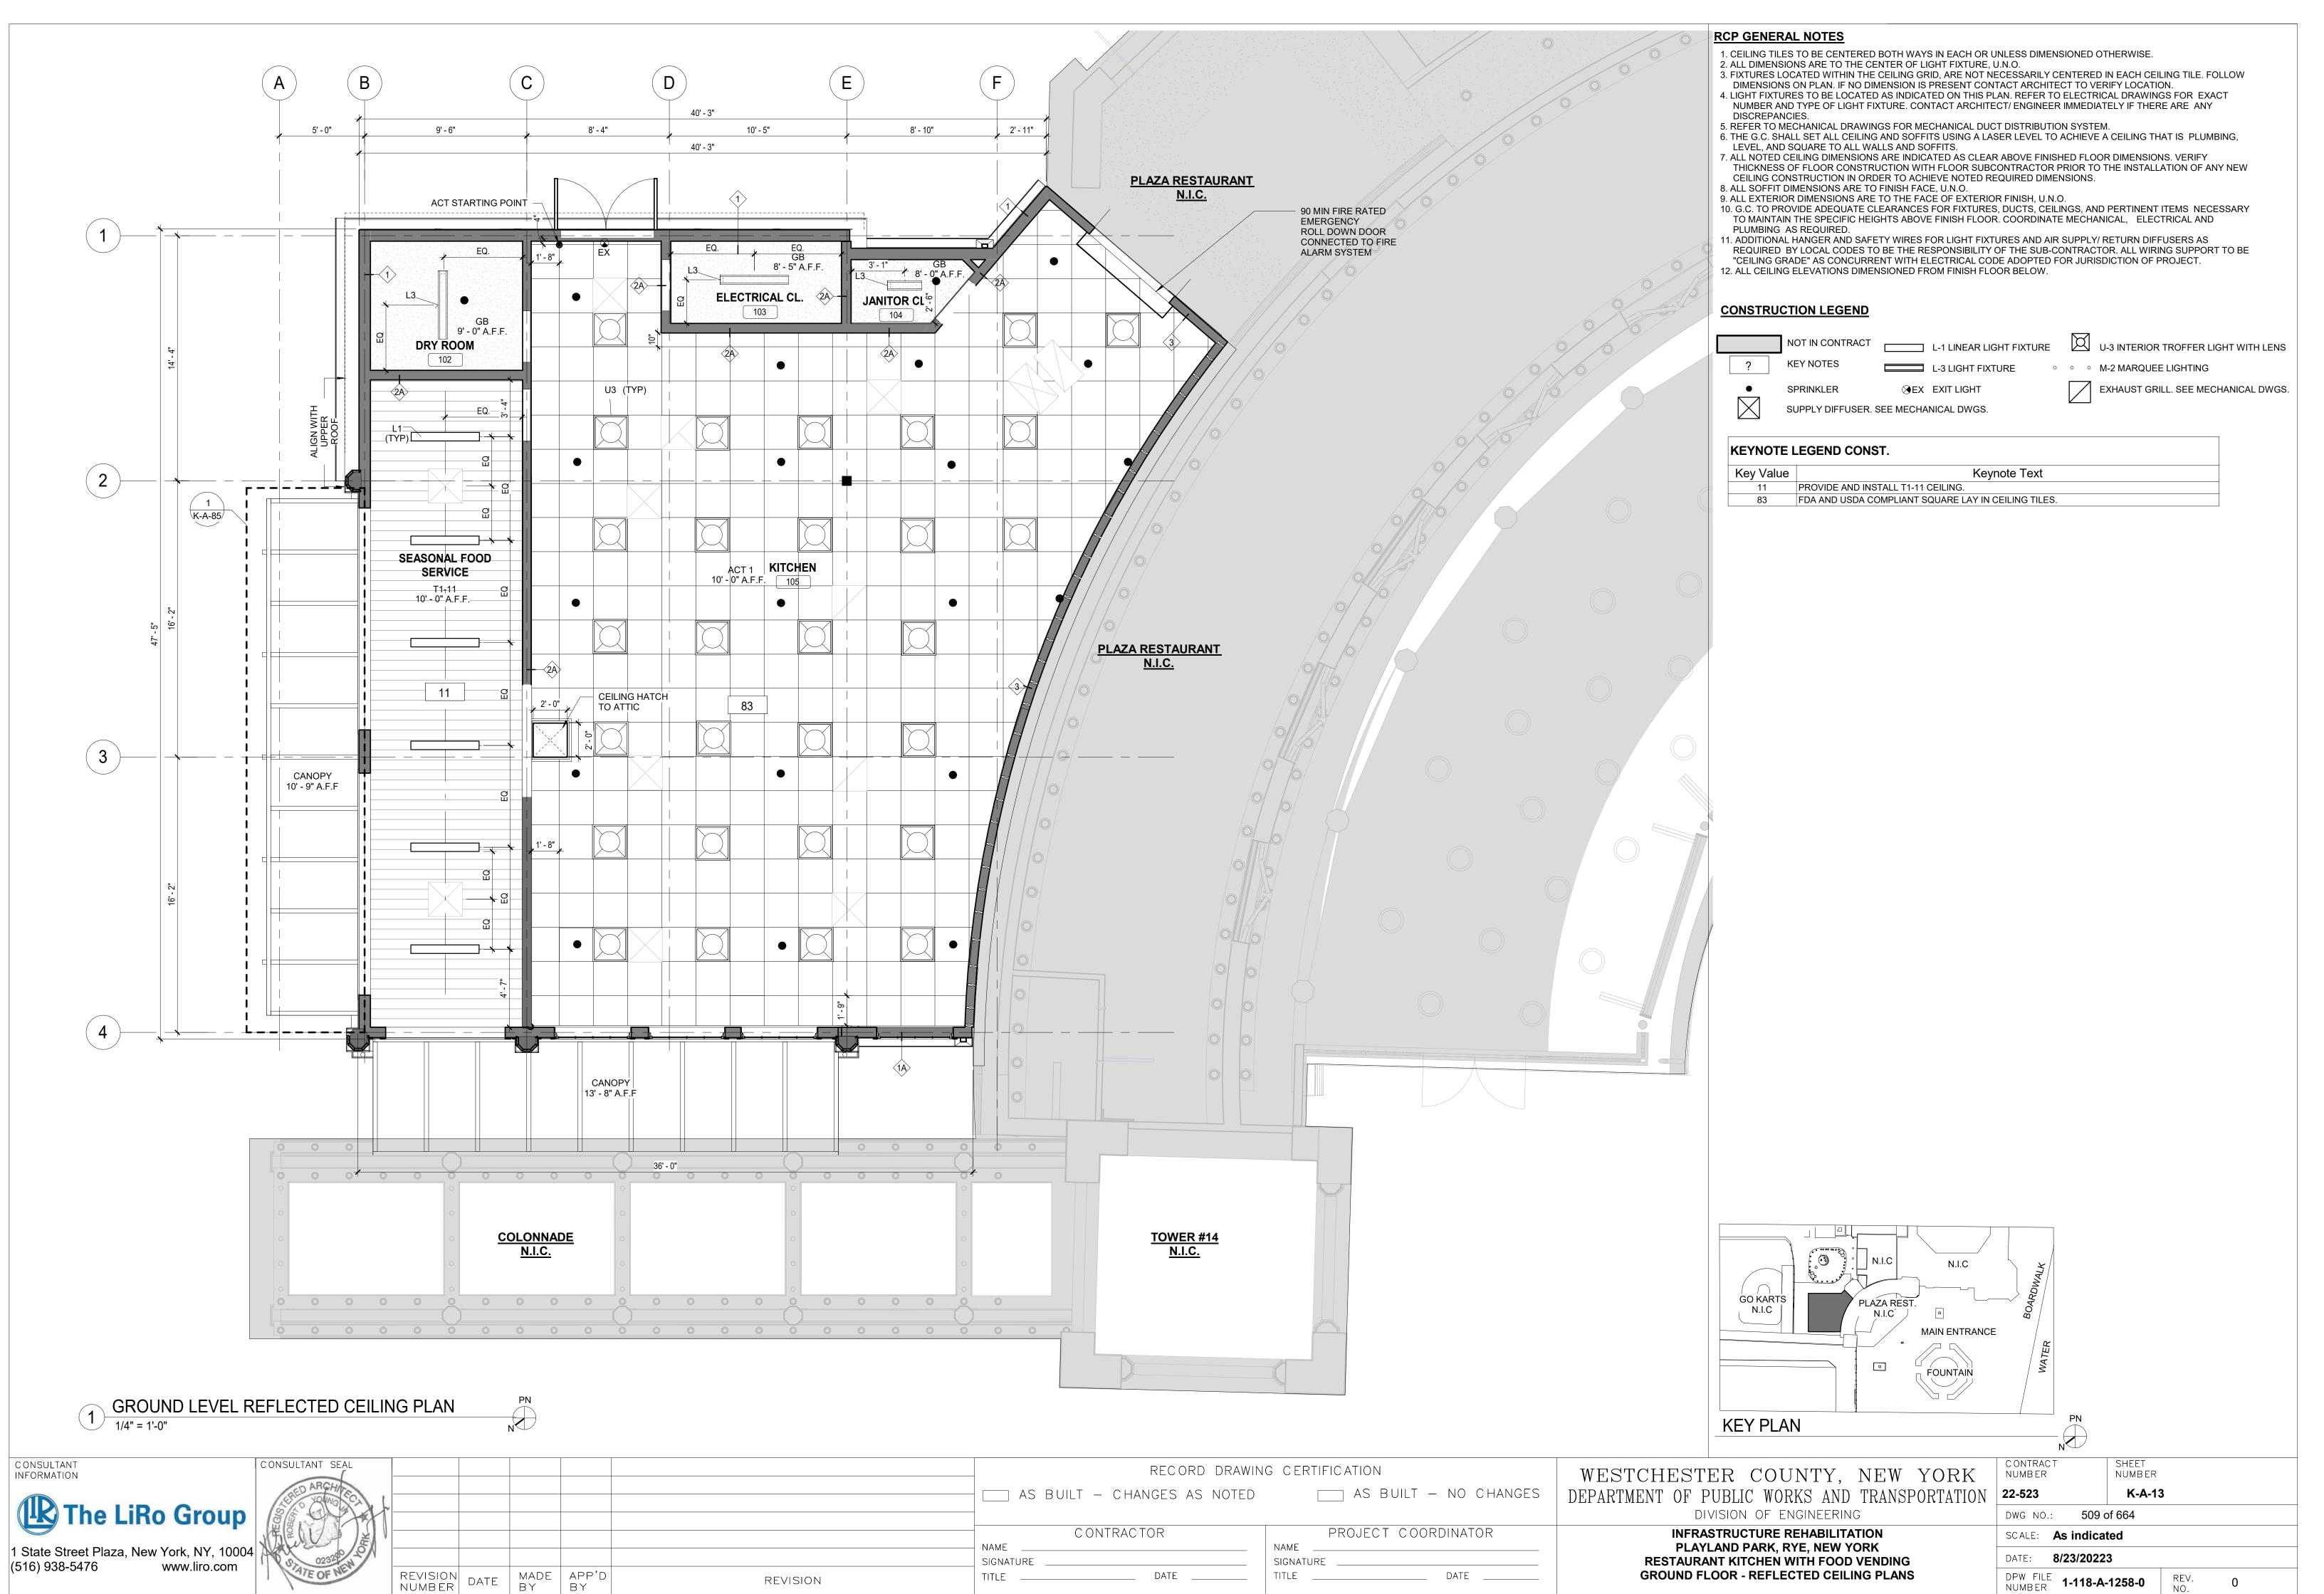
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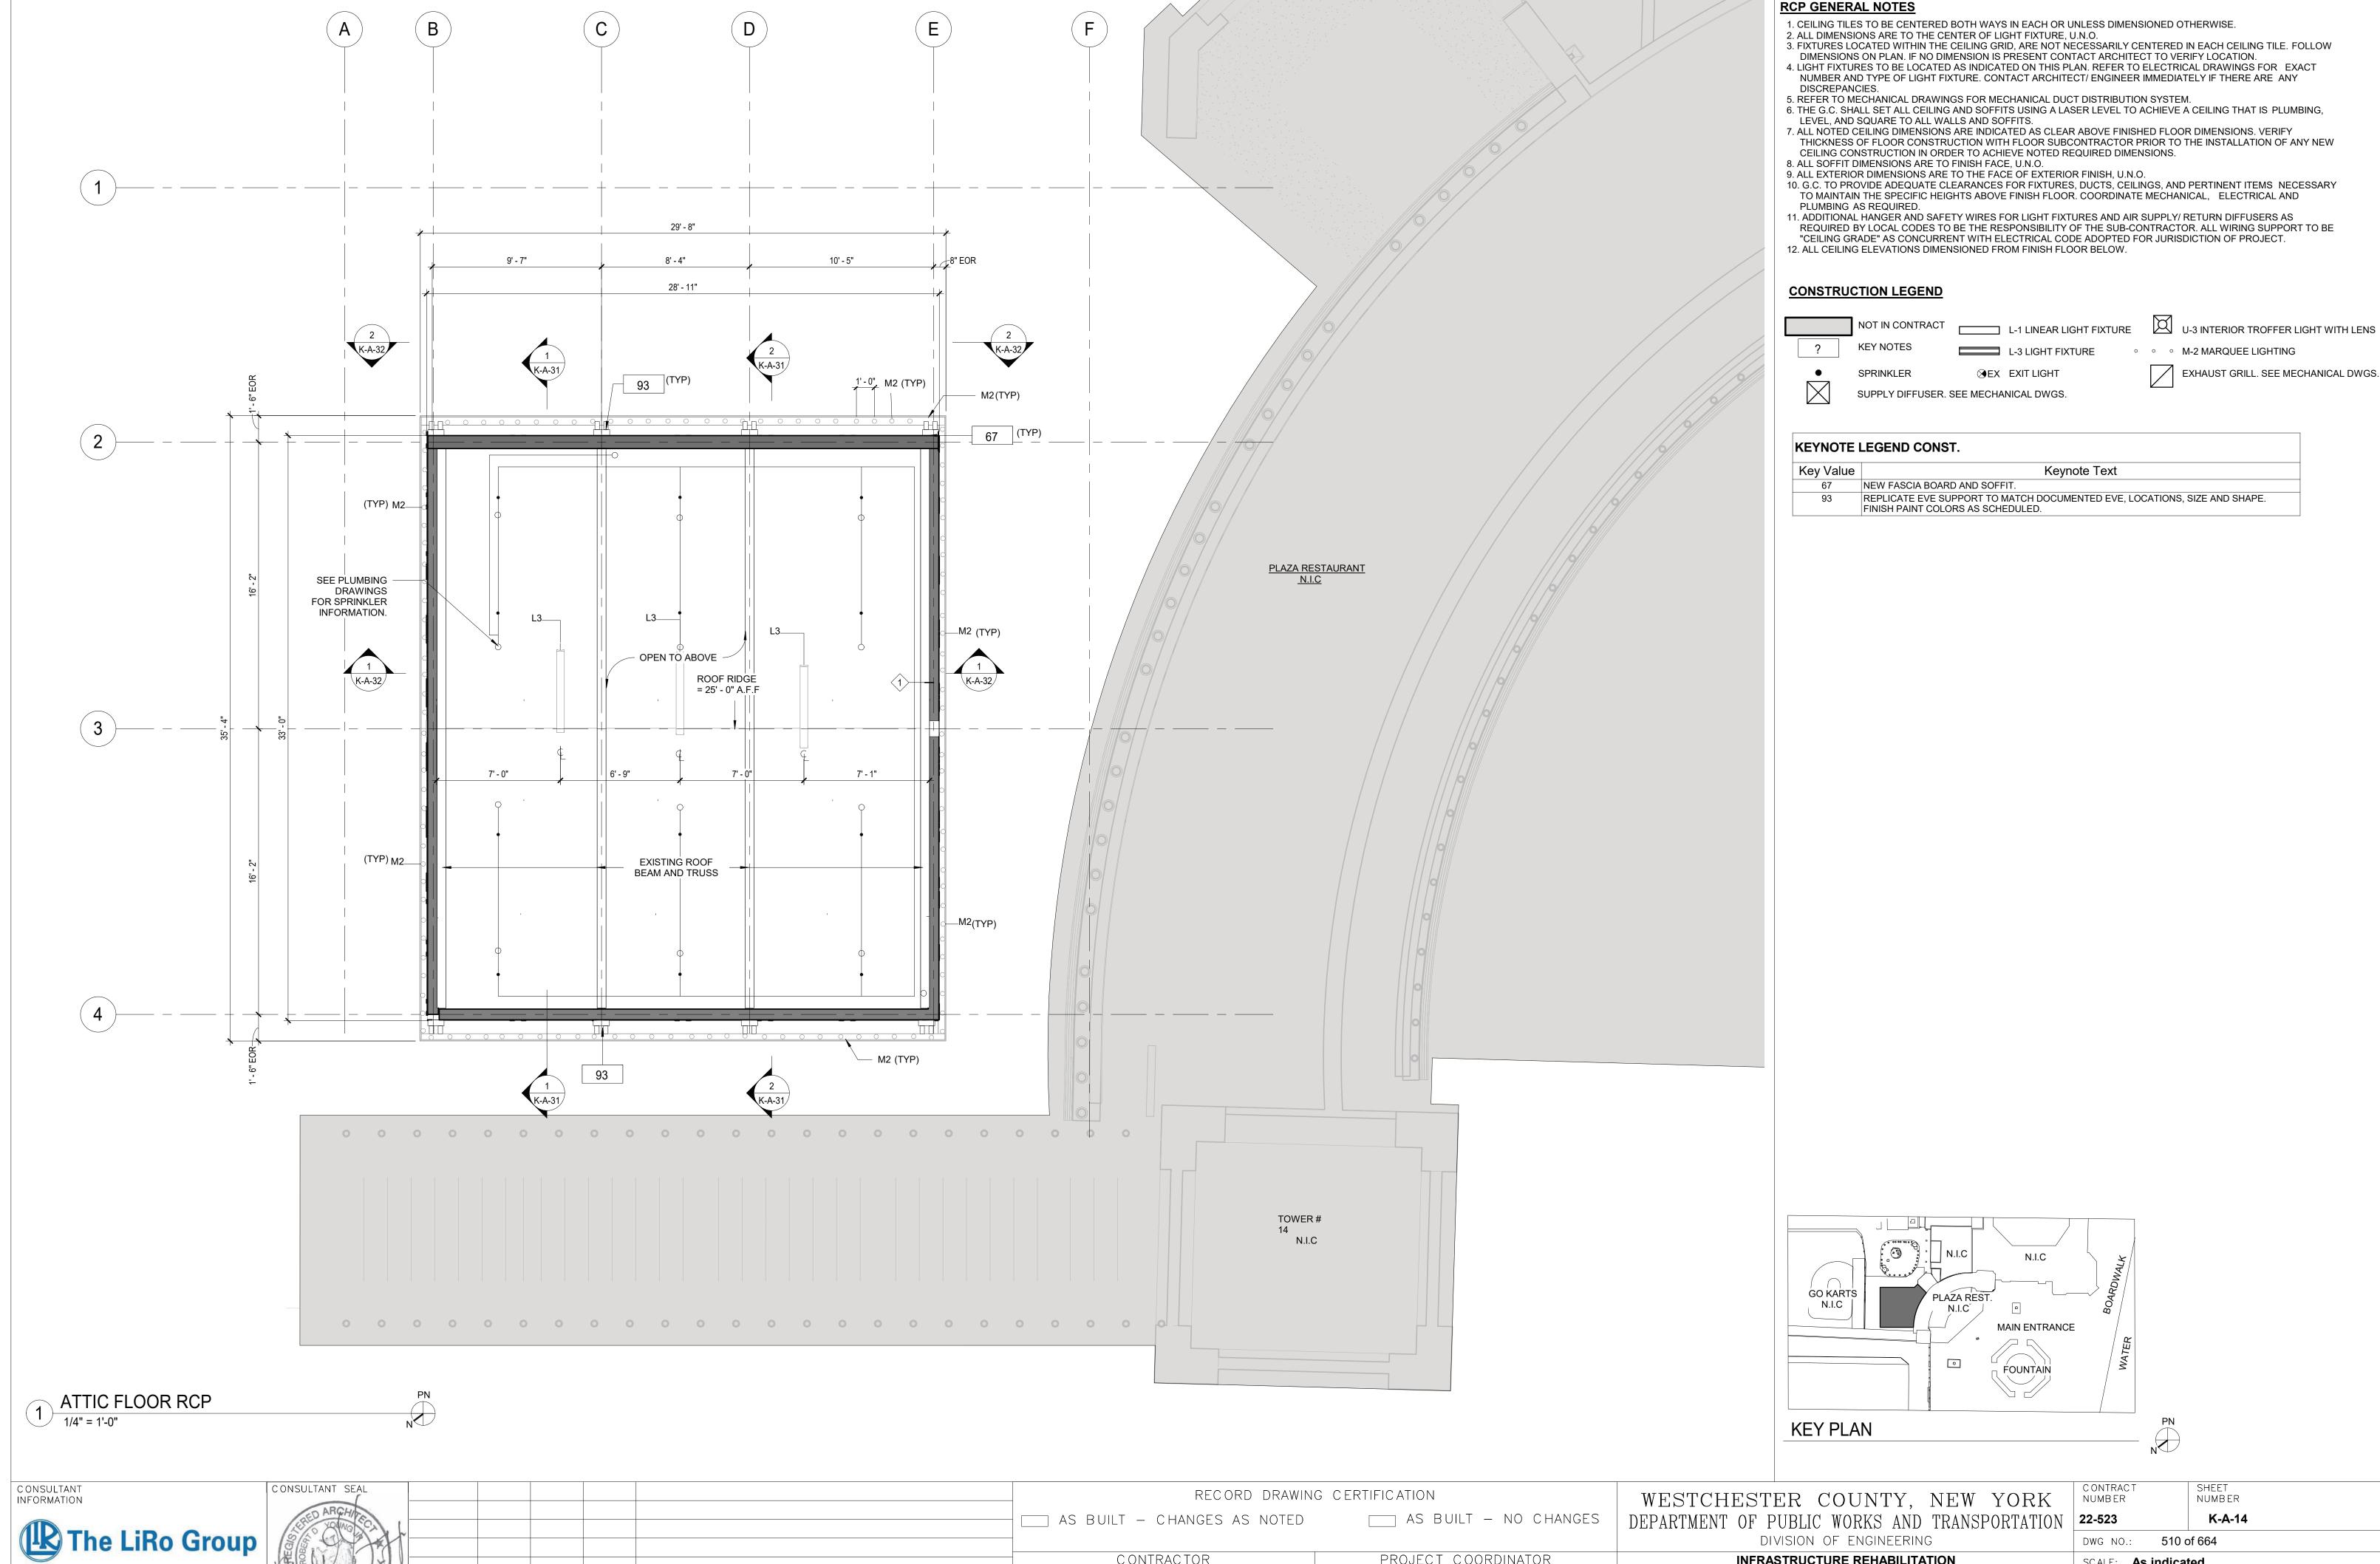
CONTRACTOR PROJECT COORDINATOR

NAME NAME SIGNATURE SIGNATURE

DATE \_\_\_\_

PLAYLAND PARK, RYE, NEW YORK
RESTAURANT KITCHEN WITH FOOD VENDING
ATTIC AND LOW ROOF CONSTRUCTION PLAN





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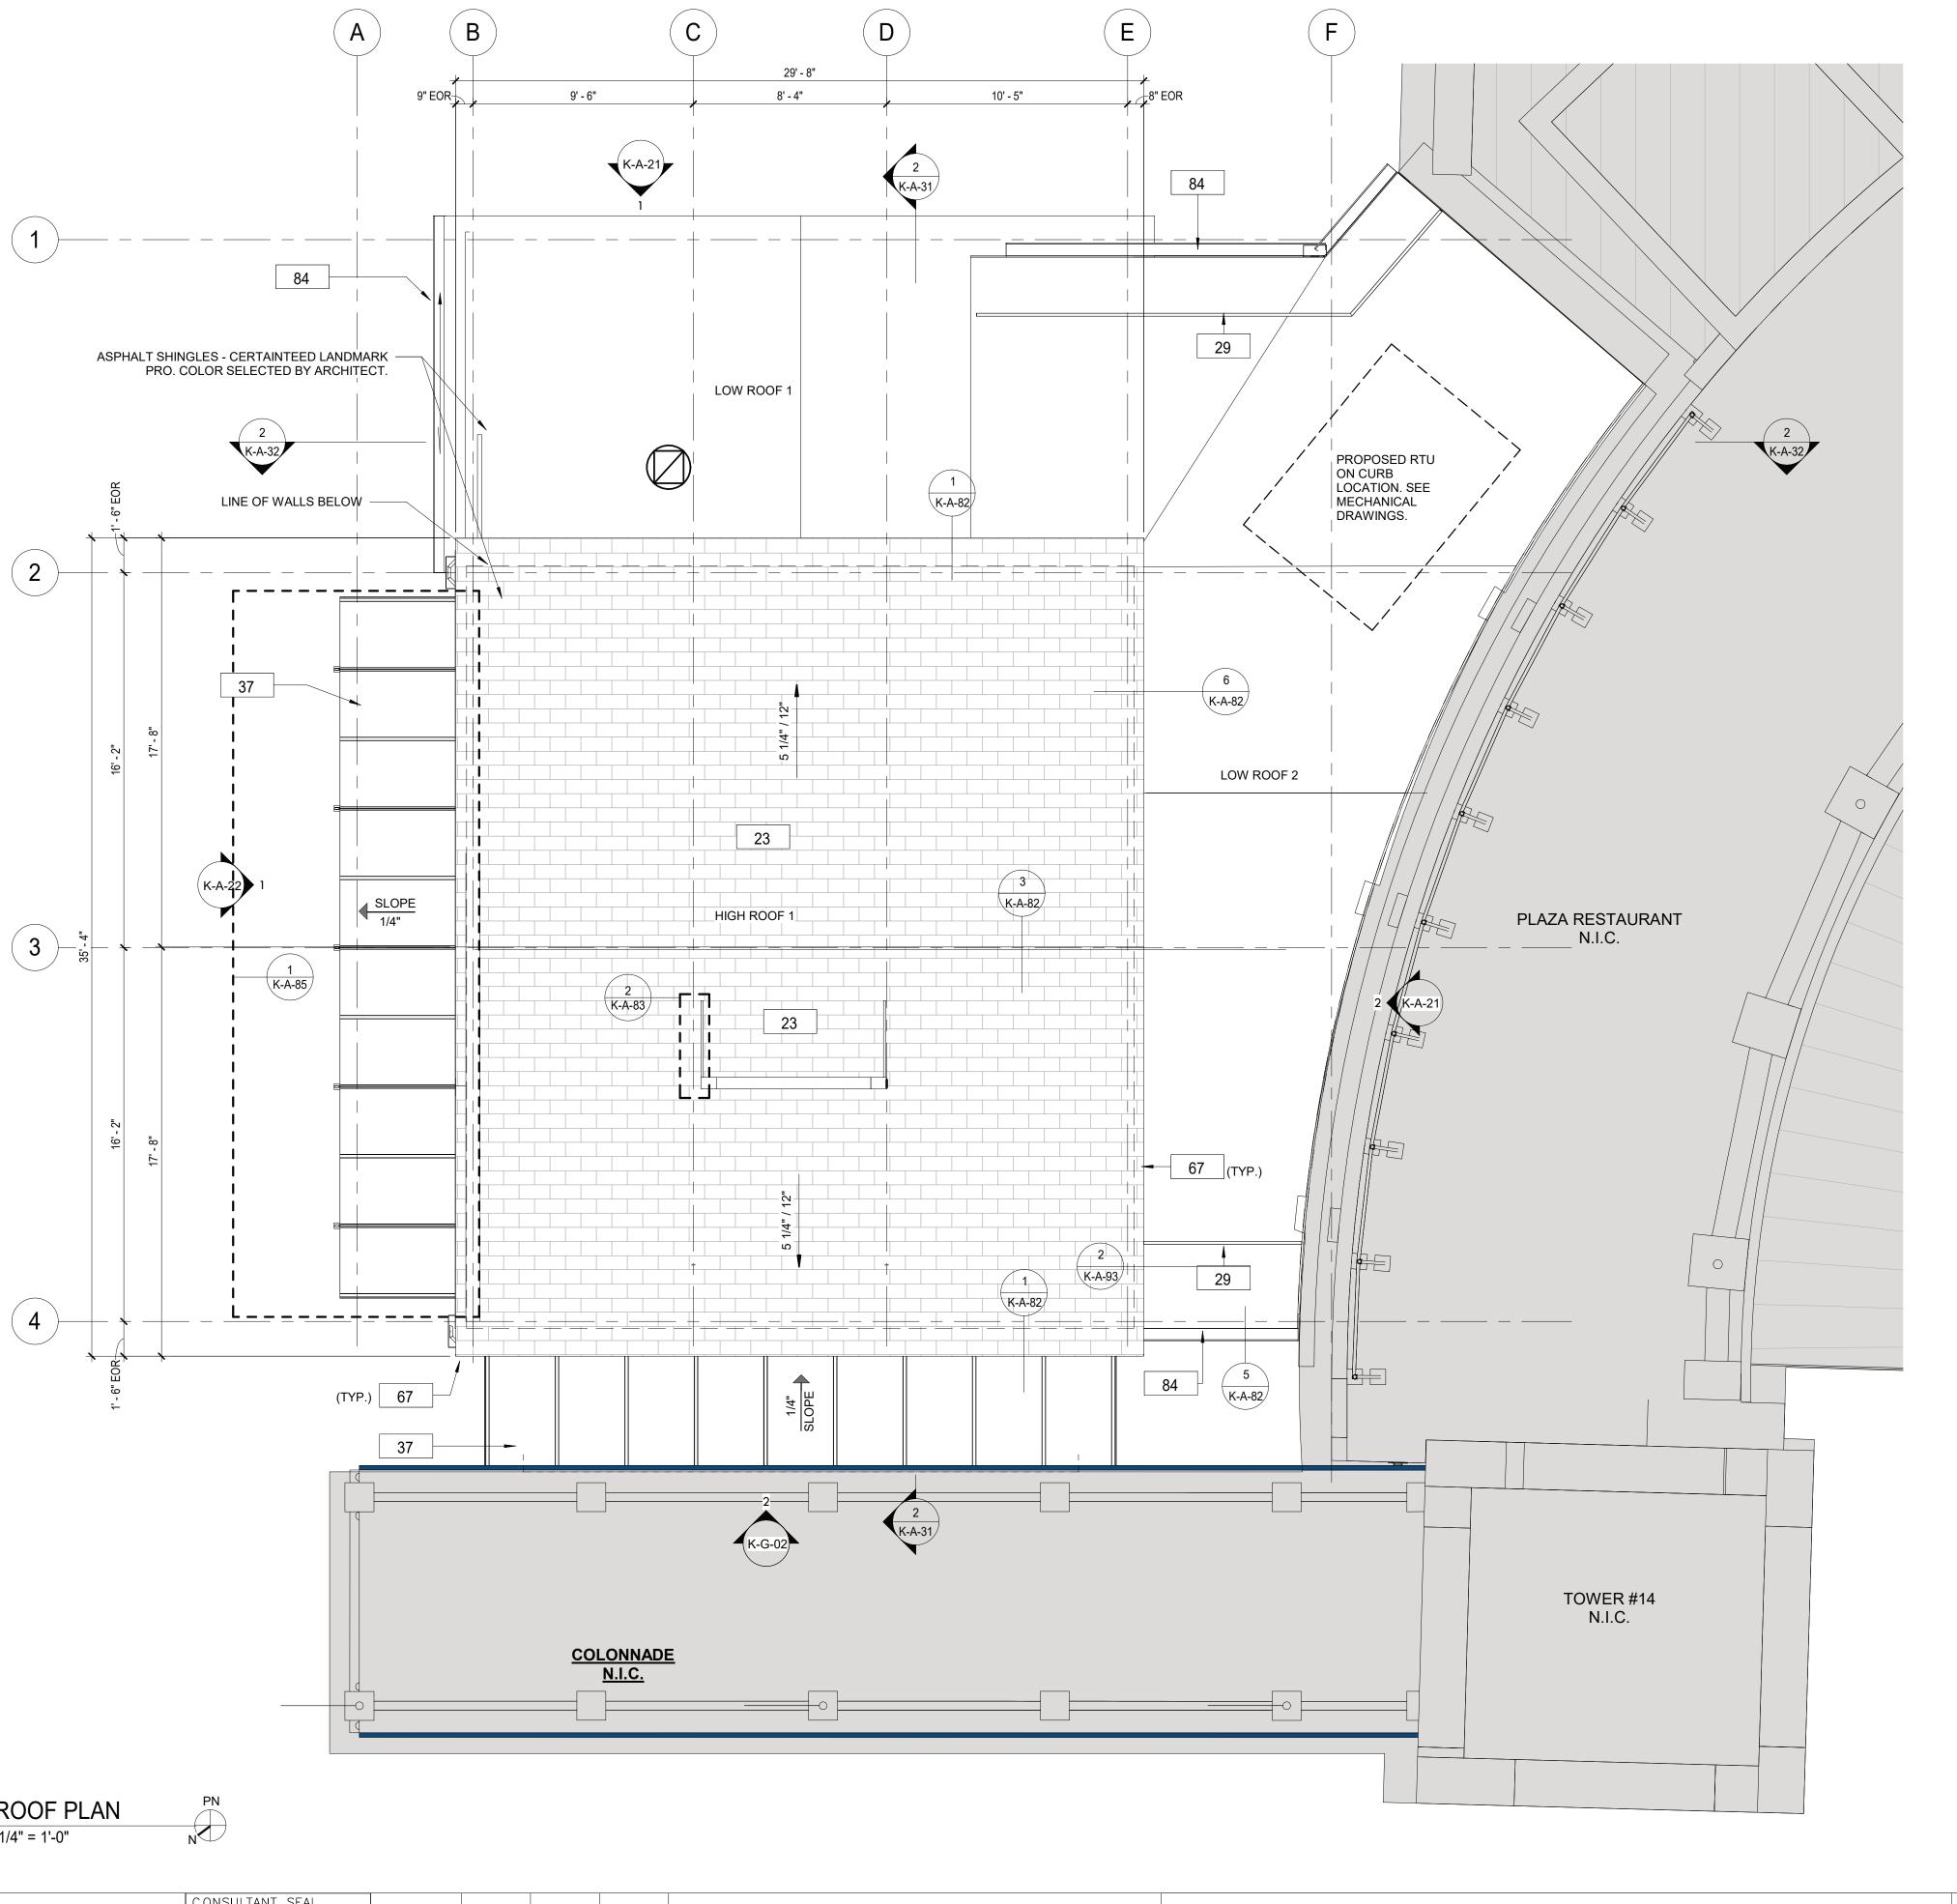
CONTRACTOR

\_\_\_\_\_ DATE \_\_\_\_

PROJECT COORDINATOR NAME SIGNATURE \_\_\_\_

**INFRASTRUCTURE REHABILITATION** PLAYLAND PARK, RYE, NEW YORK RESTAURANT KITCHEN WITH FOOD VENDING ATTIC REFLECTED CEILING PLAN

_	CONTRACT NUMBER	SHEET NUMB ER			
)N	22-523	K-A-14	4		
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	SCALE: As indicat	ted			
	DATE: <b>8/23/20223</b>				
	DPW FILE NUMBER 1-118-A-1	1259-0	REV. NO.	0	



1. PROVIDE LEVEL ROOF CURB FOR ALL MECHANICAL EQUIPMENT 8 INCHES ABOVE HIGHEST FINISHED ROOF

3. REFER TO MECHANICAL DRAWINGS FOR ALL ROOF TOP MOUNTED EQUIPMENT LOCATIONS, SIZE &

SPECIFICATIONS.

4. REFER TO PLUMBING, MECHANICAL, & ELECTRICAL DRAWINGS FOR ANY ADDITIONAL ROOF PENERATIONS

AND DETAILS.

5. ROOFING SYSTEM AND ACCESSORIES INSTALLATION AND DETAILS ARE FOR DESIGN INTENT. ROOF INSTALLATION SHALL BE IN CONFORMANCE WITH MANUFACTURERS.


6. REFER TO SHEET K-A-82FOR TYPICAL ROOF DETAILS. 7. SEE STRUCTURAL DRAWINGS FOR RTU OPENING FRAMING & REINFORCING. 9. LOW ROOF 1 AND LOW ROOF 2 REFER TO SHEET K-A-12.

#### **CONSTRUCTION LEGEND**

	NOT IN CONTRACT		NEW CONSTRUCTION	101	DOOR TAG
?	KEY NOTES	?	PLUMBING FIXTURE	FE <del>-</del>	FIRE EXTINGUISHER
$\langle 1t \rangle$	WINDOW TAG	FD <b>⊠</b>	FLOOR DRAIN	<del>+</del>	STUB UP
<del>1</del> i	WALL TAG		ROOF GUARD RAIL		SBS 1/4" / 12"
⟨TR-1⟩	MATERIAL / TRIM TAG		ROOF CRICKET, 1/2" / 12"		ASPHALT SHINGLE

KEYNOTE LEGEND CONST.					
Key Value	Keynote Text				
23	NEW ROOF WITH BATT INSULATION (R-38 MIN) PACKED BETWEEN JOISTS. PROVIDE AND INSTALL SHINGLES, UNDERLAYMENT SHEATHING AND FLASHING SYSTEM.				
29	PROVIDE AND INSTALL NEW OSHA COMPLIANT GUARD RAIL.				
37	NEW CANOPY, SEE DETAILS.				
67	NEW FASCIA BOARD AND SOFFIT.				

HALF ROUND ALUMINUM GUTTER AND DOWNSPOUT.

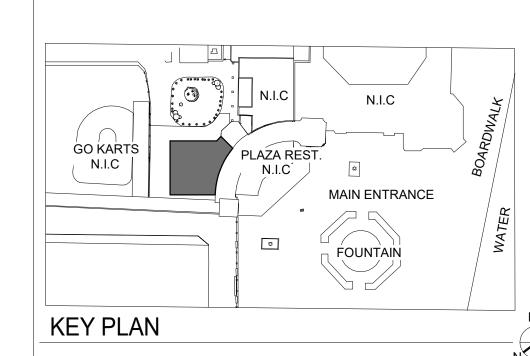

CONSULTANT INFORMATION The LiRo Group 1 State Street Plaza, New York, NY, 10004 (516) 938-5476 www.liro.com

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MADE APP'D BY BY

REVISION NUMBER DATE

RECORD DRAWING CERTIFICATION AS BUILT - CHANGES AS NOTED CONTRACTOR NAME SIGNATURE SIGNATURE \_\_\_\_

REVISION


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DATE \_\_\_\_

WESTCHESTER COUNTY, NEW YORK DEPARTMENT OF PUBLIC WORKS AND TRANSPORTATION DIVISION OF ENGINEERING

**INFRASTRUCTURE REHABILITATION** PLAYLAND PARK, RYE, NEW YORK RESTAURANT KITCHEN WITH FOOD VENDING ROOF CONSTRUCTION PLAN

CONTRACT NUMBER SHEET NUMBER 22-523 K-A-15 DWG NO.: 511 of 664 SCALE: **As indicated** DATE: **8/23/20223** DPW FILE NUMBER 1-118-A-1260-0 REV. NO.

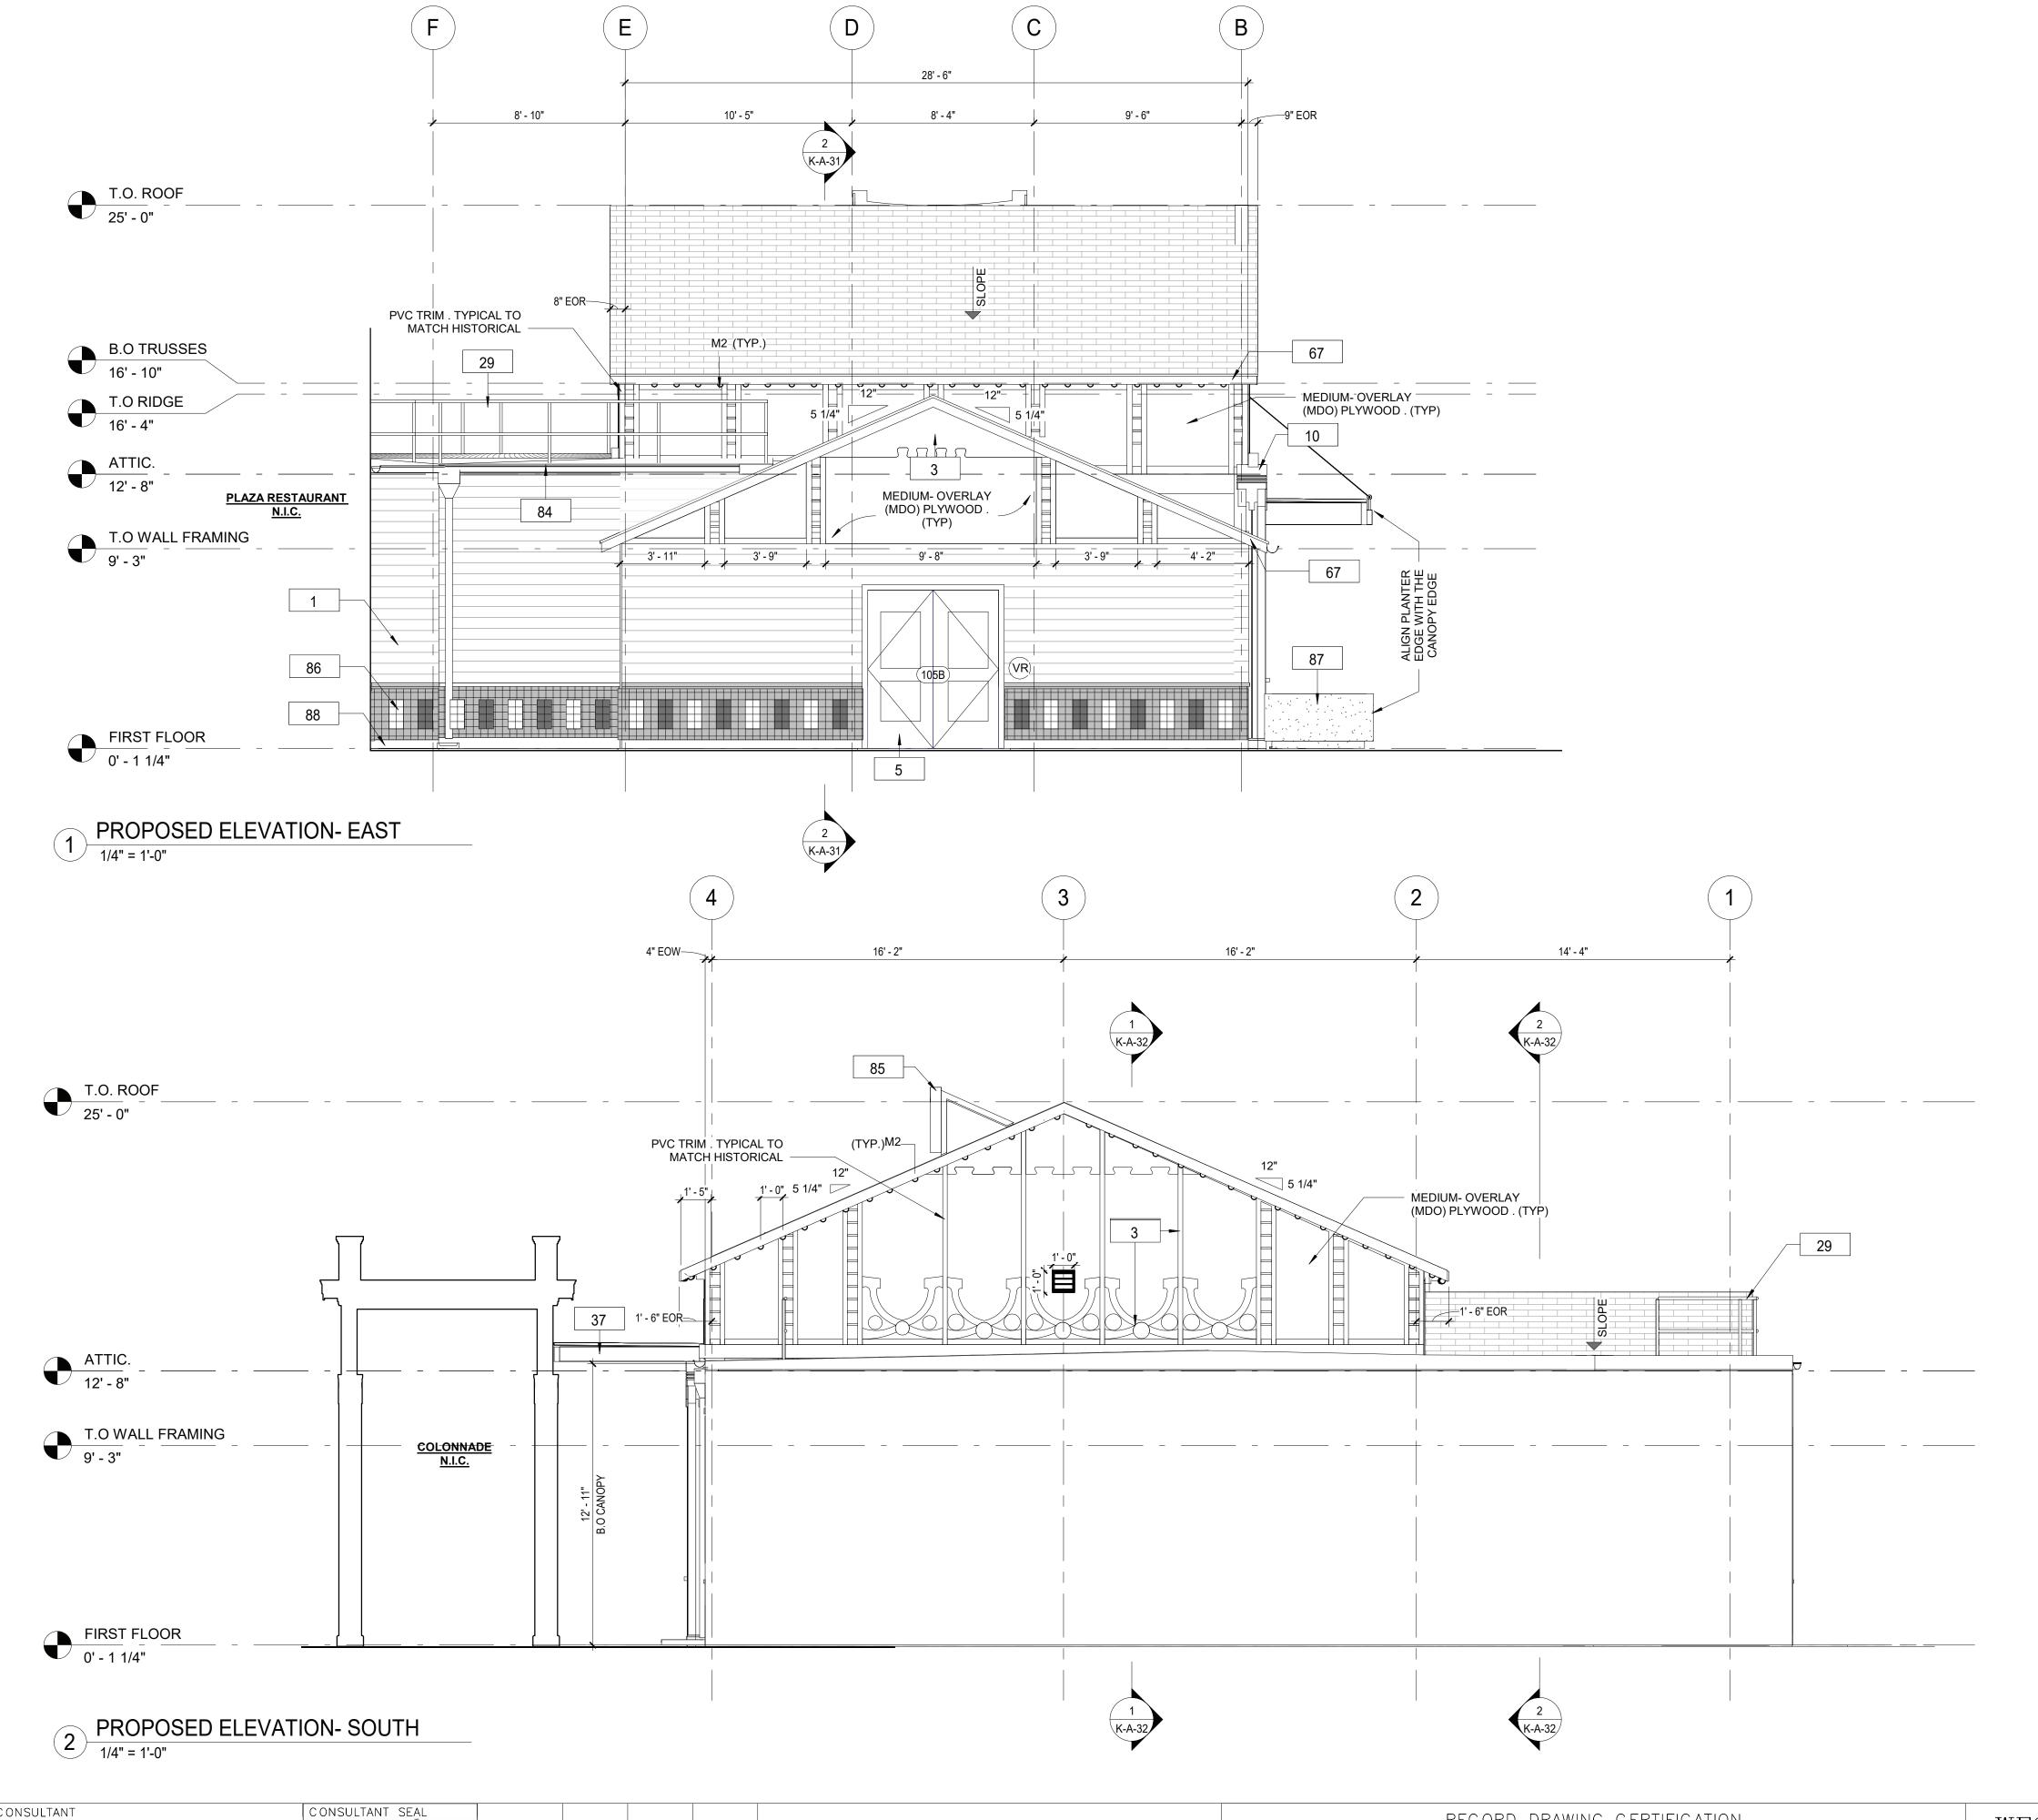

- 1. THE ARCHITECT DOES NOT CERTIFY DIMENSIONS OR CONDITIONS OF EXISTING CONSTRUCTION. GENERAL CONTRACTOR SHALL NOTIFY ARCHITECT IMMEDIATELY OF ANY DISCREPANCY BETWEEN DRAWINGS AND EXISTING CONDITIONS. IN ADDITION, CONTRACTOR SHALL NOTIFY THE ARCHITECT OF ANY DEFECTIVE CONSTRUCTION UNCOVERED DURING CONSTRUCTION.
- 2. CONTRACTOR SHALL KEEP WORK SITE FREE FROM DEBRIS AND ACCUMULATED REFUSE, AND SHALL HAVE SOLE RESPONSIBILITY FOR PROTECTING ALL DANGEROUS AREAS FROM ENTRY BY UNAUTHORIZED PARTIES. ALL CONSTRUCTION SCRAPS, DIRT, AND DEBRIS SHALL BE REMOVED FROM THE PREMISES DAILY. SITE SHALL BE LEFT BROOM CLEAN AT THE END OF EACH WORKING DAY. AT THE COMPLETION OF THE WORK, HE PREMISES SHALL BE LEFT IN A BROOM CLEAN CONDITION
  - CONDITION.
    3. MATERIALS UTILIZED SHALL BE AS SPECIFIED ON THE DRAWINGS OR IN THE JOB SPECIFICATIONS, OR, IF GENERIC, IN COMPLIANCE WITH ASTM, NEW YORK CODE, OR OTHER GENERALLY ACCEPTED STANDARDS.
- ALL EXITS SHALL BE KEPT READILY ACCESSIBLE AND UNOBSTRUCTED AT ALL TIMES.
   THE G.C. SHALL VERIFY DIMENSIONS OF THE EXISTING SPACE AND OF ANY EXISTING CONSTRUCTION TO REMAIN BY ACTUAL MEASUREMENT BEFORE ANY WORK IS PERFORMED. IF ANY MEASUREMENTS DIFFER FROM DIMENSIONS SHOWN ON PLAN, G.C. IS TO NOTIFY THE ARCHITECT IMMEDIATELY. THE G.C. SHALL BE RESPONSIBLE FOR CORRECTING ANY AND ALL
- DISCREPANCIES FOUND AFTER THE WORK IS PERFORMED, AT NO ADDITIONAL EXPENSE TO THE OWNER.
  6. G.C. TO VERIFY ALL FINISHED DIMENSIONS. FIELD CONDITIONS ALTERING ANY DIMENSIONS SHOULD BE BROUGHT TO THE ATTENTION OF THE OWNER AND ARCHITECT.
- 7. THE G.C. SHALL BE RESPONSIBLE FOR COORDINATING WITH OWNER ON ALL WORK TO BE PERFORMED BY THE OWNER. ANY POTENTIAL CONFLICTS OR DELAYS CAUSED BY THE OWNER'S SUBCONTRACTORS MUST BE DOCUMENTED IN WRITING TO THE OWNER BEFORE THE DELAY IS ACTUALLY INCURRED FOR IT TO BE CONSIDERED. OTHERWISE THE G.C. WILL BE RESPONSIBLE FOR MEETING THE SCHEDULE AS OUTLINED IN THE CONTRACT.

#### CONSTRUCTION LEGEND

	NOT IN CONTRACT		NEW CONSTRUCTION	101	DOOR TAG
?	KEY NOTES	?	PLUMBING FIXTURE	FE <del></del>	FIRE EXTINGUISHER
$\langle 1t \rangle$	WINDOW TAG	FD█	FLOOR DRAIN	<del>     </del>	STUB UP
<del>1</del> i	WALL TAG		ROOF GUARD RAIL		SBS 1/4" / 12"
⟨TR-1⟩	MATERIAL / TRIM TAG		ROOF CRICKET, 1/2" / 12"		ASPHALT SHINGLE

Key Value	Keynote Text
1	PROVIDE AND INSTALL NEW 1x8 MILLED YELLOW PINE - TONGUE AND GROOVE - NO BEVEL
3	REPLICATE TRIMS TO MATCH DOCUMENTED TRIM, LOCATIONS, SIZE AND SHAPE. FINISH PAINT COLORS AS SCHEDULED.
5	PROVIDE AND INSTALL DOOR INCLUDING FRAME, SILL, LINTEL AND ANY ASSOCIATE HARDWARE. SEE DOOR SCHEDULE.
10	PROVIDE AND INSTALL COLUMN ENCLOSURES. SEE DETAILS.
29	PROVIDE AND INSTALL NEW OSHA COMPLIANT GUARD RAIL.
37	NEW CANOPY, SEE DETAILS.
67	NEW FASCIA BOARD AND SOFFIT.
84	HALF ROUND ALUMINUM GUTTER AND DOWNSPOUT.
85	NEW ROOF MOUNTED SIGN. SEE DETAILS
86	NEW CERAMIC TILES.
87	NEW PRECAST CONCRETE PLANTER BOX.
88	NEW PVC BASEBOARD.

RECORD DRAWING CERTIFICATION

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AS BUILT - CHANGES AS NOTED

AS BUILT - NO CHANGES

CONTRACTOR

NAME

SIGNATURE

TITLE

DATE

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DATE

REVISION

RECORD DRAWING CERTIFICATION

CONTRACTOR

NAME

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WESTCHESTER COUNTY, NEW YORK DEPARTMENT OF PUBLIC WORKS AND TRANSPORTATION DIVISION OF ENGINEERING

INFRASTRUCTURE REHABILITATION
PLAYLAND PARK, RYE, NEW YORK
RESTAURANT KITCHEN WITH FOOD VENDING
EXTERIOR BUILDING ELEVATIONS - EAST AND SOUTH

CONTRACT NUMBER

TION

22-523

CONTRACT NUMBER

NUMBER

K-A-21

DWG NO.: 512 of 664


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DATE: 8/23/20223

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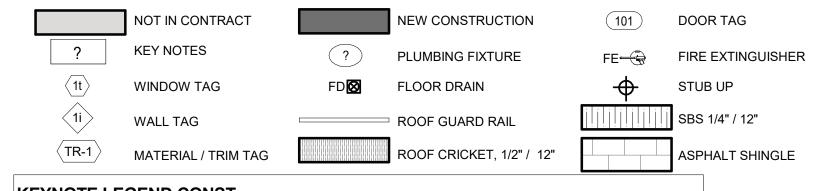


1. THE ARCHITECT DOES NOT CERTIFY DIMENSIONS OR CONDITIONS OF EXISTING CONSTRUCTION. CONTRACTOR SHALL NOTIFY ARCHITECT IMMEDIATELY OF ANY DISCREPANCY BETWEEN DRAWINGS AND EXISTING CONDITIONS. IN ADDITION,


CONTRACTOR SHALL NOTIFY THE ARCHITECT OF ANY DEFECTIVE CONSTRUCTION UNCOVERED DURING CONSTRUCTION.

- 2. CONTRACTOR SHALL KEEP WORK SITE FREE FROM DEBRIS AND ACCUMULATED REFUSE, AND SHALL HAVE SOLE RESPONSIBILITY FOR PROTECTING ALL DANGEROUS AREAS FROM ENTRY BY UNAUTHORIZED PARTIES. ALL CONSTRUCTION SCRAPS, DIRT, AND DEBRIS SHALL BE REMOVED FROM THE PREMISES DAILY. SITE SHALL BE LEFT BROOM CLEAN AT THE END OF EACH WORKING DAY. AT THE COMPLETION OF THE WORK, HE PREMISES SHALL BE LEFT IN A BROOM CLEAN CONDITION
- 3. ALL WORK TO BE PERFORMED IN A WORKMANLIKE FASHION. MATERIALS UTILIZED SHALL BE AS SPECIFIED ON THE DRAWINGS OR IN THE JOB SPECIFICATIONS, OR, IF GENERIC, IN COMPLIANCE WITH ASTM, NEW YORK CODE, OR OTHER GENERALLY ACCEPTED STANDARDS.
- 4. WHERE EXISTING EQUIPMENT OR CONSTRUCTION IS REMOVED OR ALTERED, ALL REMAINING SURFACES AND FINISHES AFFECTED SHALL BE PATCHED AND FINISHED TO MATCH ADJACENT CONSTRUCTION/PRE- EXISTING CONDITION.
  5. ALL EXITS SHALL BE KEPT READILY ACCESSIBLE AND UNOBSTRUCTED AT ALL TIMES. ALL EXITS SHALL BE KEPT READILY
- ACCESSIBLE AND UNOBSTRUCTED AT ALL TIMES.
  6. ALL INFILLED OPENINGS TO BE FLUSH WITH EXISTING MASONRY WALL SURFACES, EXTERIOR OF NEW AND OLD TO BE FLUSH AND MATCH WITH EXISTING ADJACENT WALL SYSTEM.
- 7. THE G.C. SHALL VERIFY DIMENSIONS OF THE EXISTING SPACE AND OF ANY EXISTING CONSTRUCTION TO REMAIN BY ACTUAL MEASUREMENT BEFORE ANY WORK IS PERFORMED. IF ANY MEASUREMENTS DIFFER FROM DIMENSIONS SHOWN ON PLAN, G.C. IS TO NOTIFY THE ARCHITECT IMMEDIATELY. THE G.C. SHALL BE RESPONSIBLE FOR CORRECTING ANY AND ALL DISCREPANCIES FOUND AFTER THE WORK IS PERFORMED, AT NO ADDITIONAL EXPENSE TO THE OWNER.
- 8. G.C. TO VERIFY ALL FINISHED DIMENSIONS. FIELD CONDITIONS ALTERING ANY DIMENSIONS SHOULD BE BROUGHT TO THE ATTENTION OF THE OWNER AND ARCHITECT.
- 9. THE G.C. SHALL BE RESPONSIBLE FOR COORDINATING WITH OWNER ON ALL WORK TO BE PERFORMED BY THE OWNER. ANY POTENTIAL CONFLICTS OR DELAYS CAUSED BY THE OWNER'S SUBCONTRACTORS MUST BE DOCUMENTED IN WRITING TO THE OWNER BEFORE THE DELAY IS ACTUALLY INCURRED FOR IT TO BE CONSIDERED. OTHERWISE THE G.C. WILL BE RESPONSIBLE FOR MEETING THE SCHEDULE AS OUTLINED IN THE CONTRACT.
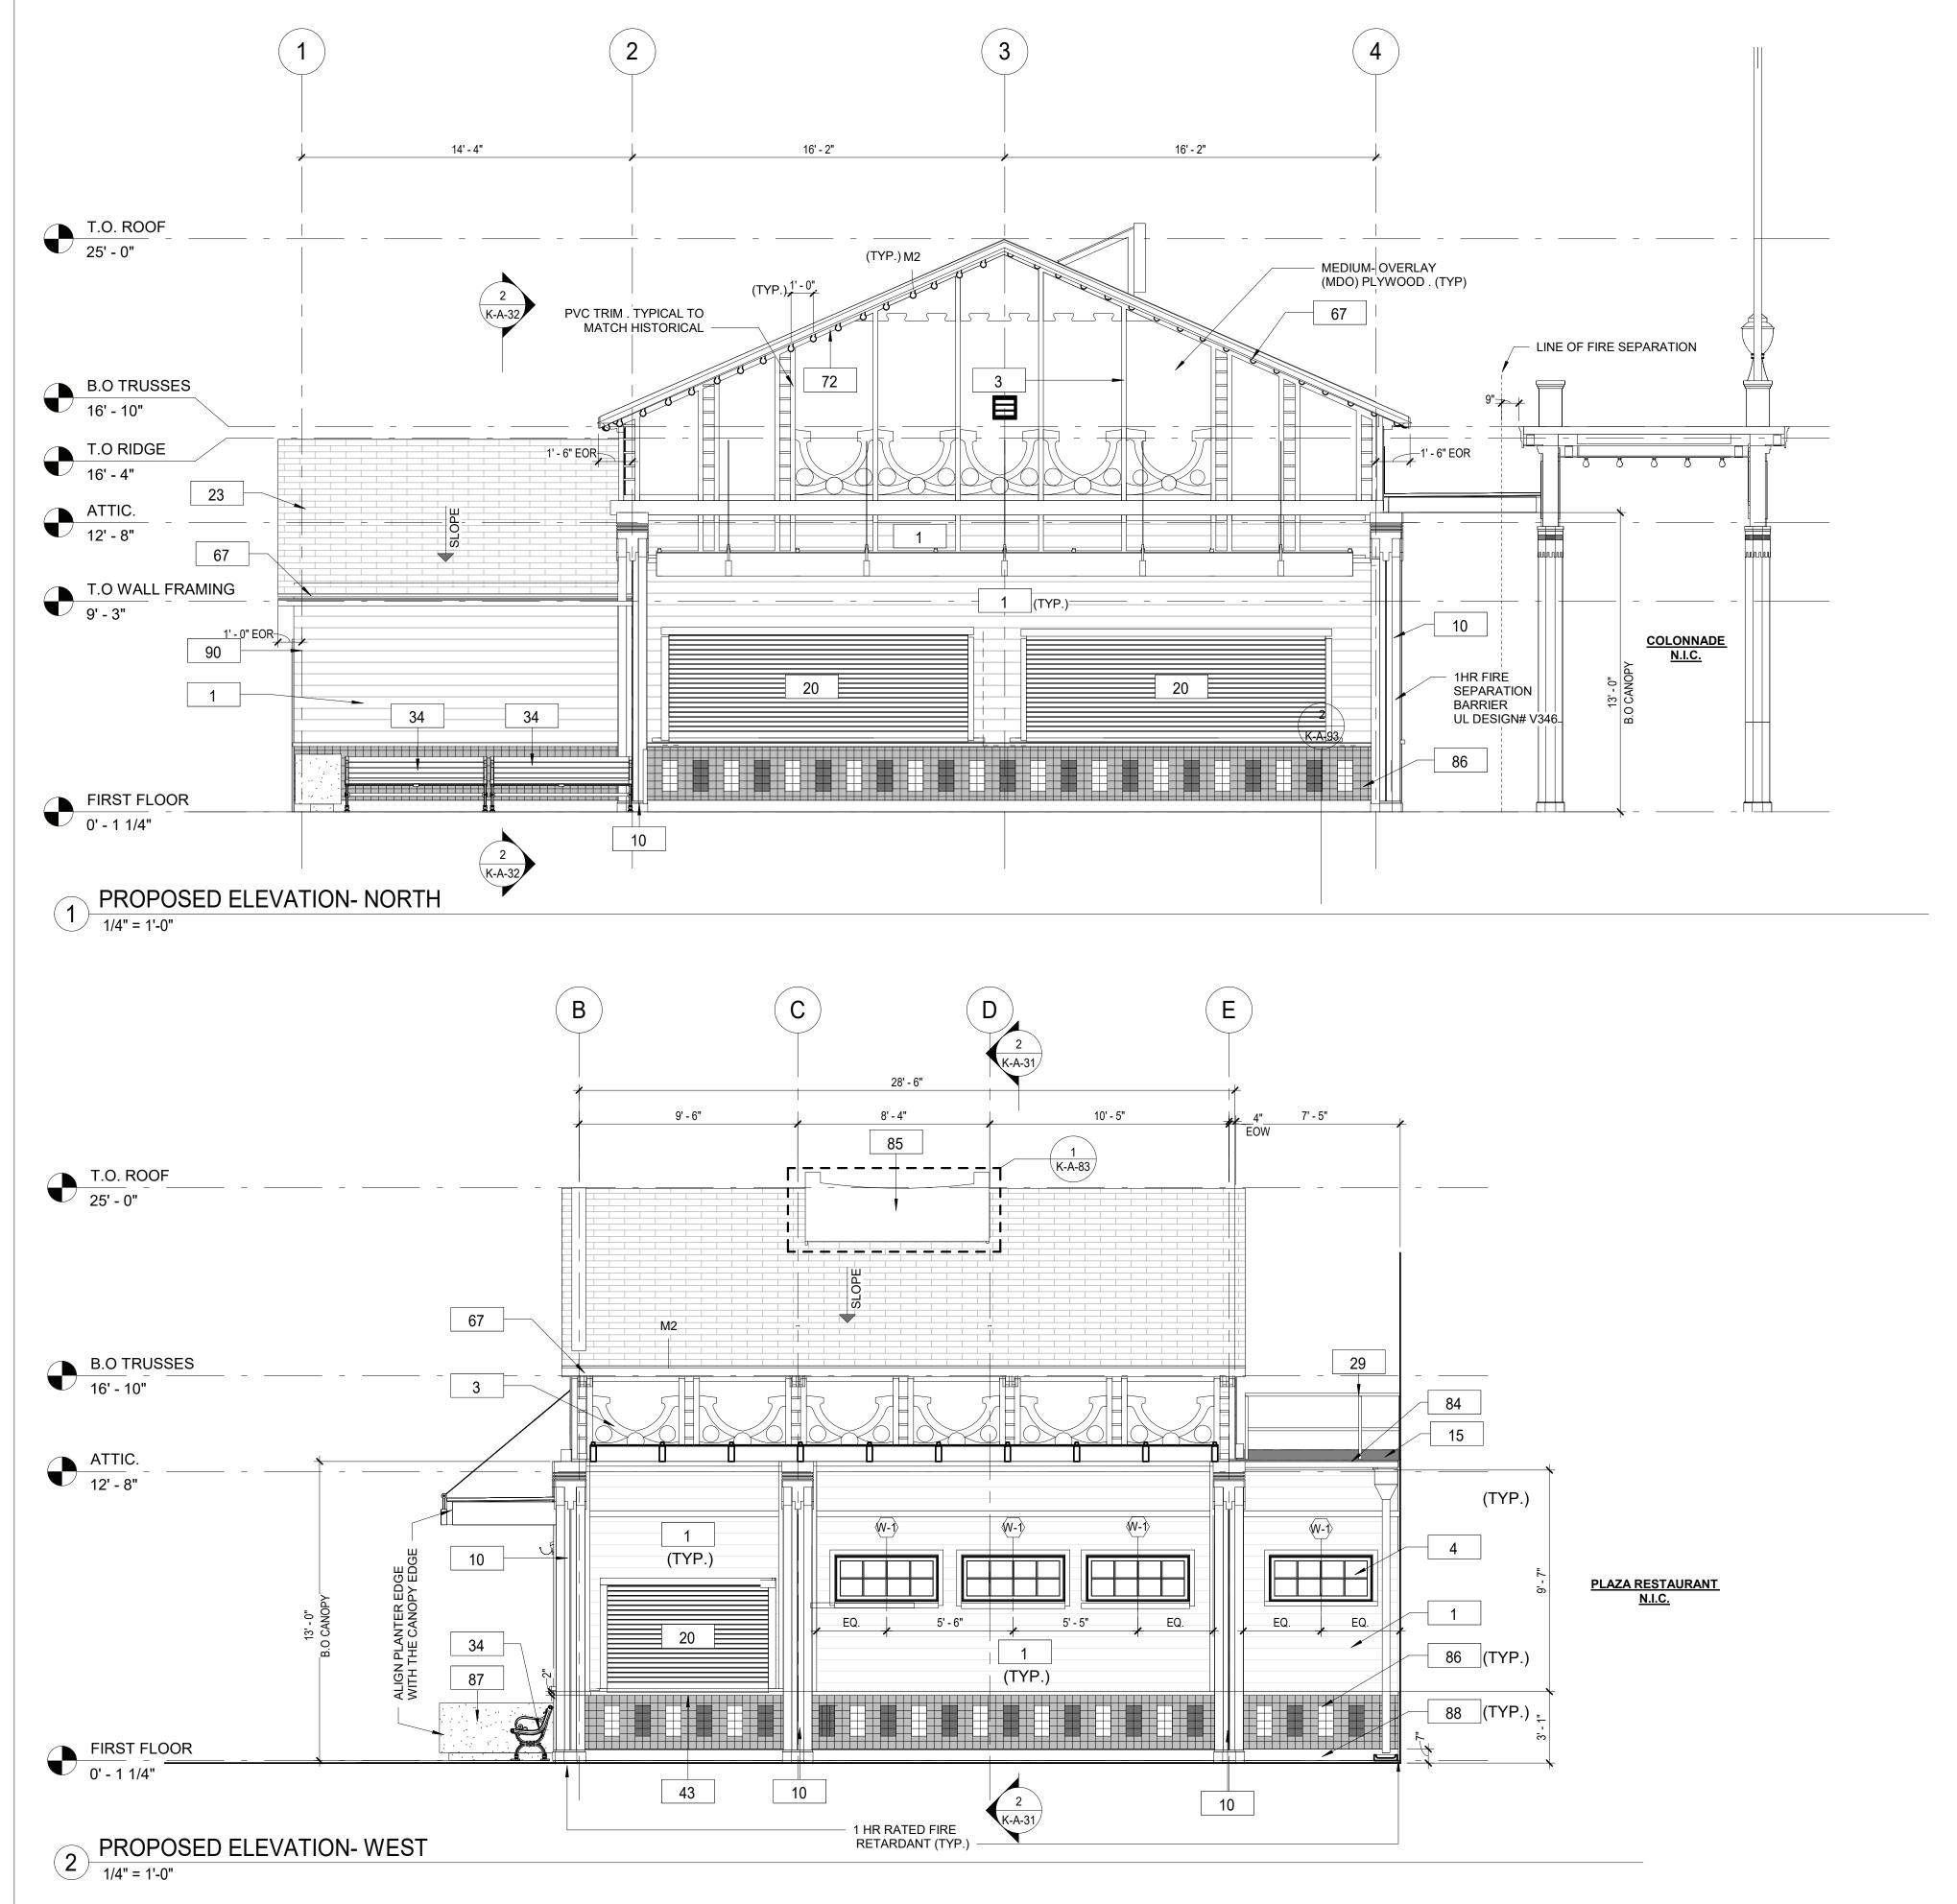
#### CONSTRUCTION LEGEND



Key Value	Keynote Text
1	PROVIDE AND INSTALL NEW 1x8 MILLED YELLOW PINE - TONGUE AND GROOVE - NO BEVEL
3	REPLICATE TRIMS TO MATCH DOCUMENTED TRIM, LOCATIONS, SIZE AND SHAPE. FINISH PAIN COLORS AS SCHEDULED.
4	NEW WINDOWS. SEE WINDOW SCHEDULE.
10	PROVIDE AND INSTALL COLUMN ENCLOSURES. SEE DETAILS.
15	PROVIDE AND INSTALL SBS MODIFIED BITUMEN ROOFING AND UNDERLAYMENT.
20	NEW COUNTER ROLL DOWN DOOR LOCATED AT INTERIOR AND ASSOCIATED HARDWARE. REFER TO SCHEDULE FOR MORE DETAILS. CONTRACTOR TO V.I.F. ALL DIMENSIONS BEFORE ORDERING (TYPICAL THROUGHOUT.)
23	NEW ROOF WITH BATT INSULATION (R-38 MIN) PACKED BETWEEN JOISTS. PROVIDE AND INSTALL SHINGLES, UNDERLAYMENT SHEATHING AND FLASHING SYSTEM.
29	PROVIDE AND INSTALL NEW OSHA COMPLIANT GUARD RAIL.
34	PROVIDE NEW BENCH.
43	NEW COUNTERS & SERVING WINDOWS.
67	NEW FASCIA BOARD AND SOFFIT.
72	NEW LIGHT FIXTURES TO BE INSTALLED (SEE ELECTRICAL DRAWINGS).
84	HALF ROUND ALUMINUM GUTTER AND DOWNSPOUT.
85	NEW ROOF MOUNTED SIGN. SEE DETAILS
86	NEW CERAMIC TILES.
87	NEW PRECAST CONCRETE PLANTER BOX.
88	NEW PVC BASEBOARD.
90	NEW OUTSIDE CORNER MOULDING.

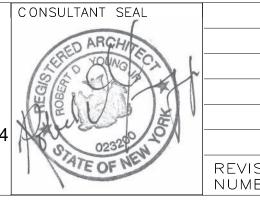

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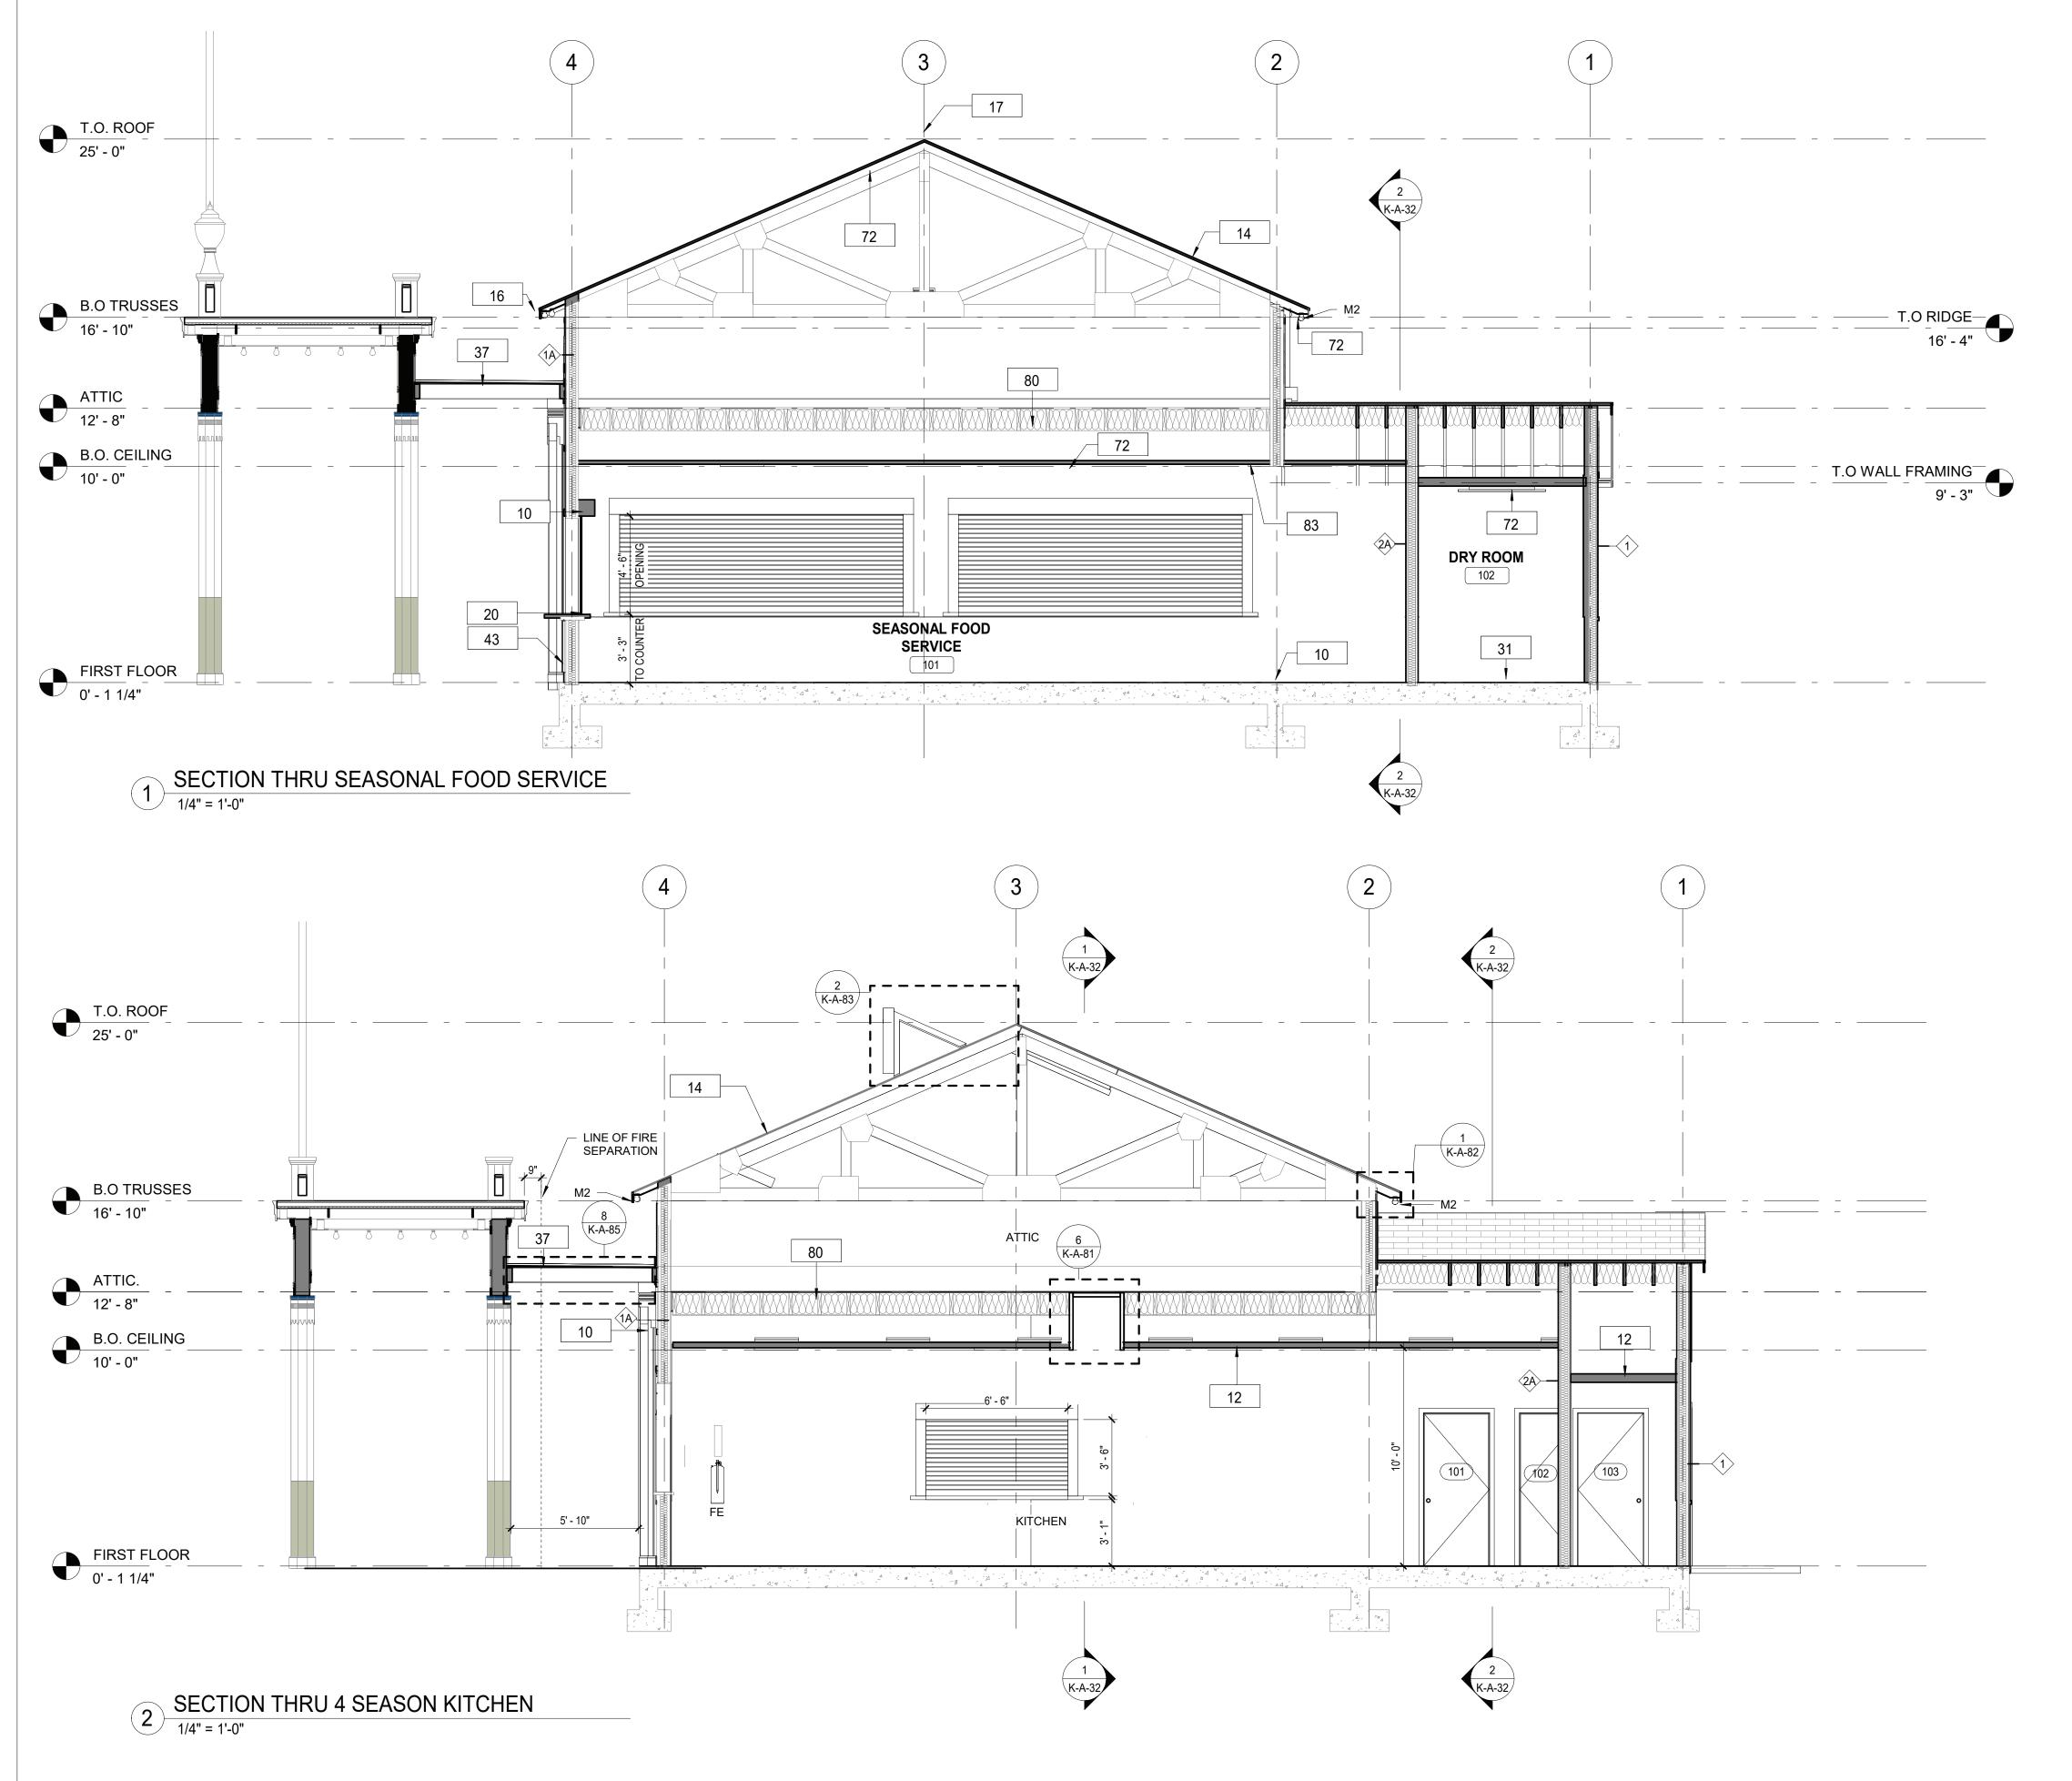
PROJECT COORDINATOR

NAME \_\_\_\_\_\_
SIGNATURE \_\_\_\_\_

WESTCHESTER COUNTY, NEW YORK
DEPARTMENT OF PUBLIC WORKS AND TRANSPORTATION
DIVISION OF ENGINEERING

INFRASTRUCTURE REHABILITATION
PLAYLAND PARK, RYE, NEW YORK
RESTAURANT KITCHEN WITH FOOD VENDING
EXTERIOR BUILDING ELEVATIONS - NORTH AND WEST

	CONTRACT NUMBER	SHEET NUMBER			
N	22-523	K-A-22	2		
	DWG NO.: 513 c	of 664			
	SCALE: 1/4" = 1'-	0"			
	DATE: <b>8/23/2022</b>	3			
	DPW FILE NUMBER 1-118-A-1	262-0	REV. NO.	0	
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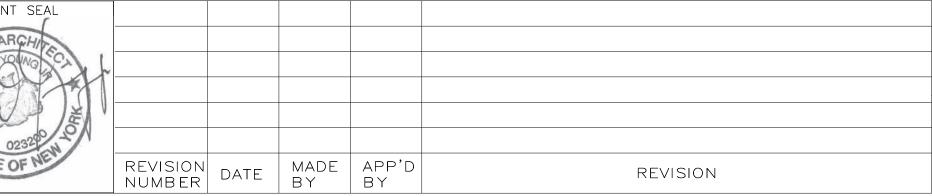
- 1. THE ARCHITECT DOES NOT CERTIFY DIMENSIONS OR CONDITIONS OF EXISTING CONSTRUCTION. CONTRACTOR SHALL NOTIFY ARCHITECT IMMEDIATELY OF ANY DISCREPANCY BETWEEN DRAWINGS AND EXISTING CONDITIONS. IN ADDITION, CONTRACTOR SHALL NOTIFY THE ARCHITECT OF ANY DEFECTIVE CONSTRUCTION UNCOVERED DURING CONSTRUCTION. 2. CONTRACTOR SHALL KEEP WORK SITE FREE FROM DEBRIS AND ACCUMULATED REFUSE, AND SHALL HAVE SOLE RESPONSIBILITY FOR PROTECTING ALL DANGEROUS AREAS FROM ENTRY BY UNAUTHORIZED PARTIES. ALL CONSTRUCTION
- OF EACH WORKING DAY. AT THE COMPLETION OF THE WORK, HE PREMISES SHALL BE LEFT IN A BROOM CLEAN CONDITION. 3. ALL WORK TO BE PERFORMED IN A WORKMANLIKE FASHION. MATERIALS UTILIZED SHALL BE AS SPECIFIED ON THE DRAWINGS OR IN THE JOB SPECIFICATIONS, OR, IF GENERIC, IN COMPLIANCE WITH ASTM, NEW YORK CODE, OR OTHER GENERALLY ACCEPTED STANDARDS.
- 4. WHERE EXISTING EQUIPMENT OR CONSTRUCTION IS REMOVED OR ALTERED, ALL REMAINING SURFACES AND FINISHES AFFECTED SHALL BE PATCHED AND FINISHED TO MATCH ADJACENT CONSTRUCTION/PRE- EXISTING CONDITION. 5. ALL EXITS SHALL BE KEPT READILY ACCESSIBLE AND UNOBSTRUCTED AT ALL TIMES. ALL EXITS SHALL BE KEPT READILY ACCESSIBLE AND UNOBSTRUCTED AT ALL TIMES.
- 6. ALL INFILLED OPENINGS TO BE FLUSH WITH EXISTING MASONRY WALL SURFACES, EXTERIOR OF NEW AND OLD TO BE FLUSH AND MATCH WITH EXISTING ADJACENT WALL SYSTEM. 7. THE G.C. SHALL VERIFY DIMENSIONS OF THE EXISTING SPACE AND OF ANY EXISTING CONSTRUCTION TO REMAIN BY ACTUAL MEASUREMENT BEFORE ANY WORK IS PERFORMED. IF ANY MEASUREMENTS DIFFER FROM DIMENSIONS SHOWN ON PLAN,
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#### **CONSTRUCTION LEGEND**

	NOT IN CONTRACT
?	KEY NOTES
<u></u>	WINDOW TAG
101	DOOR TAG

Key Value	Keynote Text
10	PROVIDE AND INSTALL COLUMN ENCLOSURES. SEE DETAILS.
12	PROVIDE DROP CEILING AND ALL HANGERS/ ACCESSORIES.
14	PROVIDE NEW ASPHALT SHINGLE ROOFING, UNDERLAYMENT, AND REPLACE IN KIND EXISTING DECKING AS REQUIRED (COORDINATE WITH STRUCTURAL).
16	PROVIDE AND INSTALL ALUMINUM METAL DRIP EDGE, DOWNSPOUT AND GUTTER AT PERIMETER OF ROOF.
17	PROVIDE AND INSTALL RIDGE VENT AT ROOF HIPS.
20	NEW COUNTER ROLL DOWN DOOR LOCATED AT INTERIOR AND ASSOCIATED HARDWARE. REFER TO SCHEDULE FOR MORE DETAILS. CONTRACTOR TO V.I.F. ALL DIMENSIONS BEFORE ORDERING (TYPICAL THROUGHOUT.)
31	NEW CONCRETE PAD FOUNDATION. SEE STRUCTURAL DRAWINGS.
37	NEW CANOPY, SEE DETAILS.
43	NEW COUNTERS & SERVING WINDOWS.
72	NEW LIGHT FIXTURES TO BE INSTALLED (SEE ELECTRICAL DRAWINGS).
80	NEW 3/4" PLYWOOD FLOOR
83	FDA AND USDA COMPLIANT SQUARE LAY IN CEILING TILES.








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WESTCHESTER COUNTY, NEW YORK DEPARTMENT OF PUBLIC WORKS AND TRANSPORTATION DIVISION OF ENGINEERING **INFRASTRUCTURE REHABILITATION** 

SHEET NUMBER 22-523 K-A-31 DWG NO.: 514 of 664 SCALE: 1/4" = 1'-0" PLAYLAND PARK, RYE, NEW YORK DATE: **8/23/20223 RESTAURANT KITCHEN WITH FOOD VENDING BUILDING SECTIONS** DPW FILE NUMBER **1-118-A-1263-0** REV. NO.



REVISION

MADE APP'D BY BY

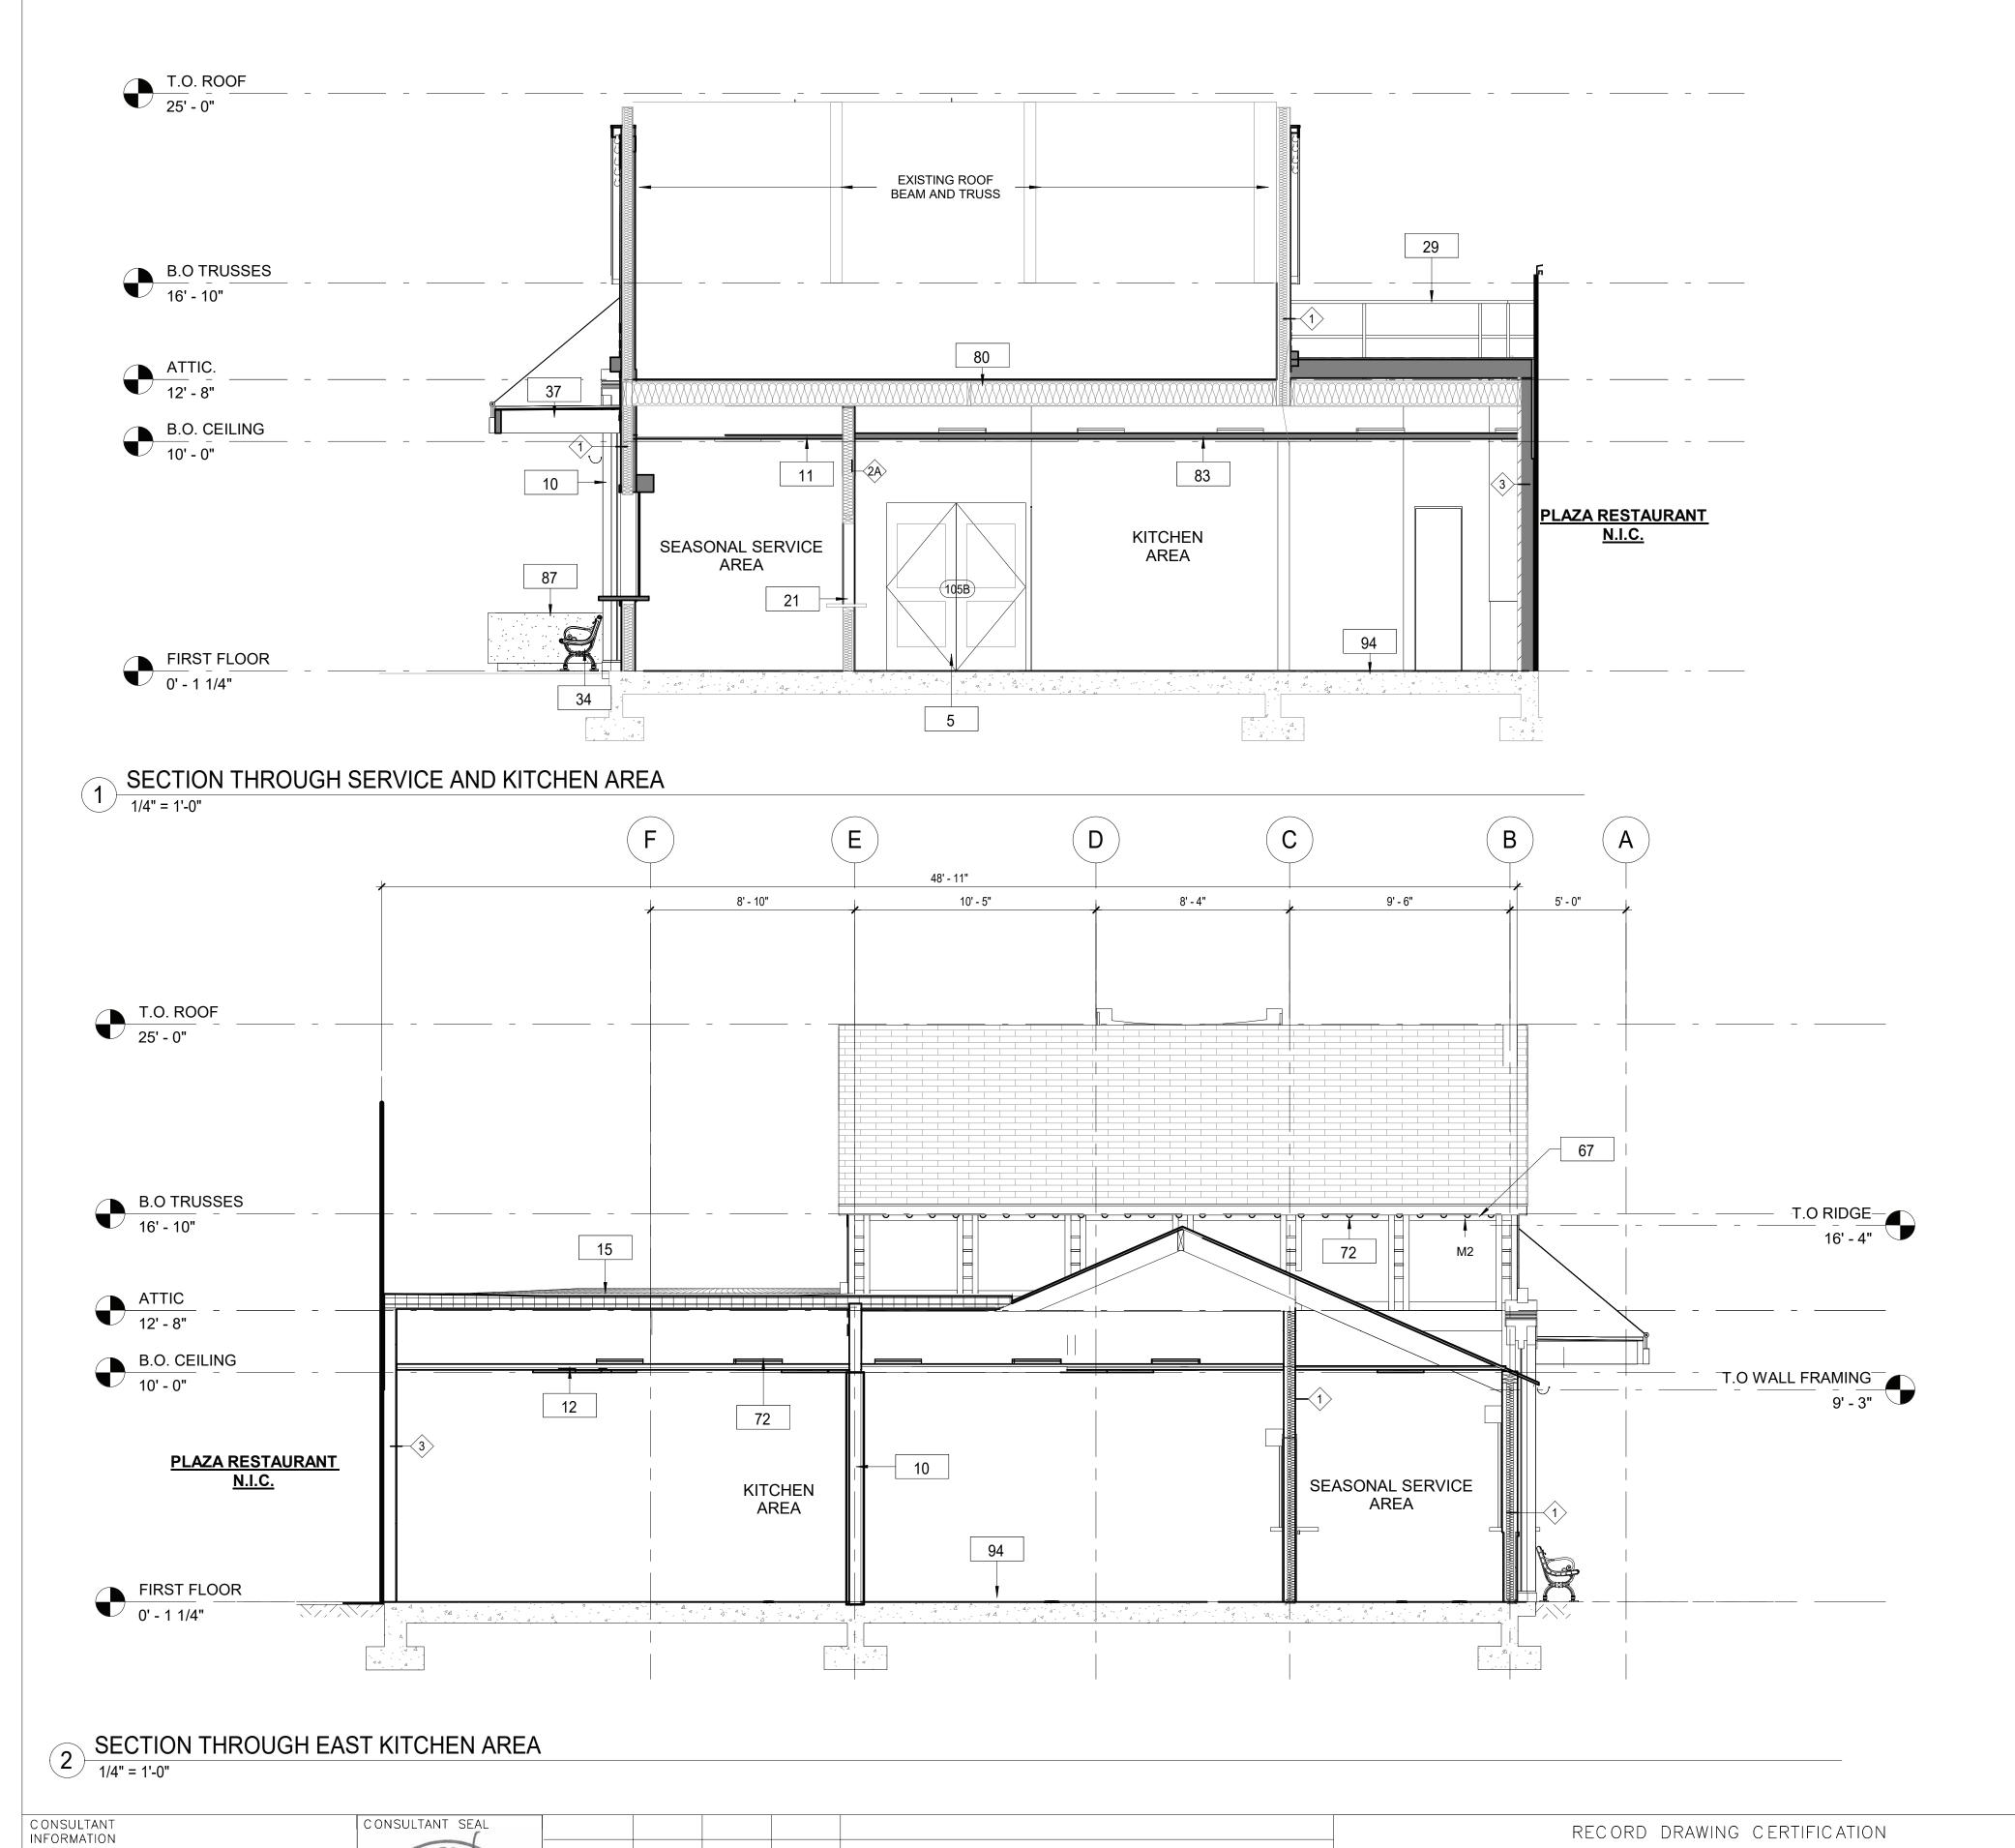REVISION NUMBER

RECORD DRAWING CERTIFICATION

NAME

SIGNATURE \_\_\_\_

AS BUILT - CHANGES AS NOTED

CONTRACTOR

DATE \_\_\_

SIGNATURE

\_\_\_\_ AS BUILT - NO CHANGES

PROJECT COORDINATOR

**CONSTRUCTION GENERAL NOTES** 

1. THE ARCHITECT DOES NOT CERTIFY DIMENSIONS OR CONDITIONS OF EXISTING CONSTRUCTION. CONTRACTOR SHALL NOTIFY ARCHITECT IMMEDIATELY OF ANY DISCREPANCY BETWEEN DRAWINGS AND EXISTING CONDITIONS. IN ADDITION, CONTRACTOR SHALL NOTIFY THE ARCHITECT OF ANY DEFECTIVE CONSTRUCTION UNCOVERED DURING CONSTRUCTION.

2. CONTRACTOR SHALL KEEP WORK SITE FREE FROM DEBRIS AND ACCUMULATED REFUSE, AND SHALL HAVE SOLE RESPONSIBILITY FOR PROTECTING ALL DANGEROUS AREAS FROM ENTRY BY UNAUTHORIZED PARTIES. ALL CONSTRUCTION SCRAPS, DIRT, AND DEBRIS SHALL BE REMOVED FROM THE PREMISES DAILY. SITE SHALL BE LEFT BROOM CLEAN AT THE END OF EACH WORKING DAY. AT THE COMPLETION OF THE WORK, HE PREMISES SHALL BE LEFT IN A BROOM CLEAN

3. ALL WORK TO BE PERFORMED IN A WORKMANLIKE FASHION. MATERIALS UTILIZED SHALL BE AS SPECIFIED ON THE DRAWINGS OR IN THE JOB SPECIFICATIONS, OR, IF GENERIC, IN COMPLIANCE WITH ASTM, NEW YORK CODE, OR OTHER GENERALLY ACCEPTED STANDARDS.

4. WHERE EXISTING EQUIPMENT OR CONSTRUCTION IS REMOVED OR ALTERED, ALL REMAINING SURFACES AND FINISHES AFFECTED SHALL BE PATCHED AND FINISHED TO MATCH ADJACENT CONSTRUCTION/PRE- EXISTING CONDITION. 5. ALL EXITS SHALL BE KEPT READILY ACCESSIBLE AND UNOBSTRUCTED AT ALL TIMES. ALL EXITS SHALL BE KEPT READILY

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7. THE G.C. SHALL VERIFY DIMENSIONS OF THE EXISTING SPACE AND OF ANY EXISTING CONSTRUCTION TO REMAIN BY ACTUAL MEASUREMENT BEFORE ANY WORK IS PERFORMED. IF ANY MEASUREMENTS DIFFER FROM DIMENSIONS SHOWN ON PLAN, G.C. IS TO NOTIFY THE ARCHITECT IMMEDIATELY. THE G.C. SHALL BE RESPONSIBLE FOR CORRECTING ANY AND ALL

DISCREPANCIES FOUND AFTER THE WORK IS PERFORMED, AT NO ADDITIONAL EXPENSE TO THE OWNER.


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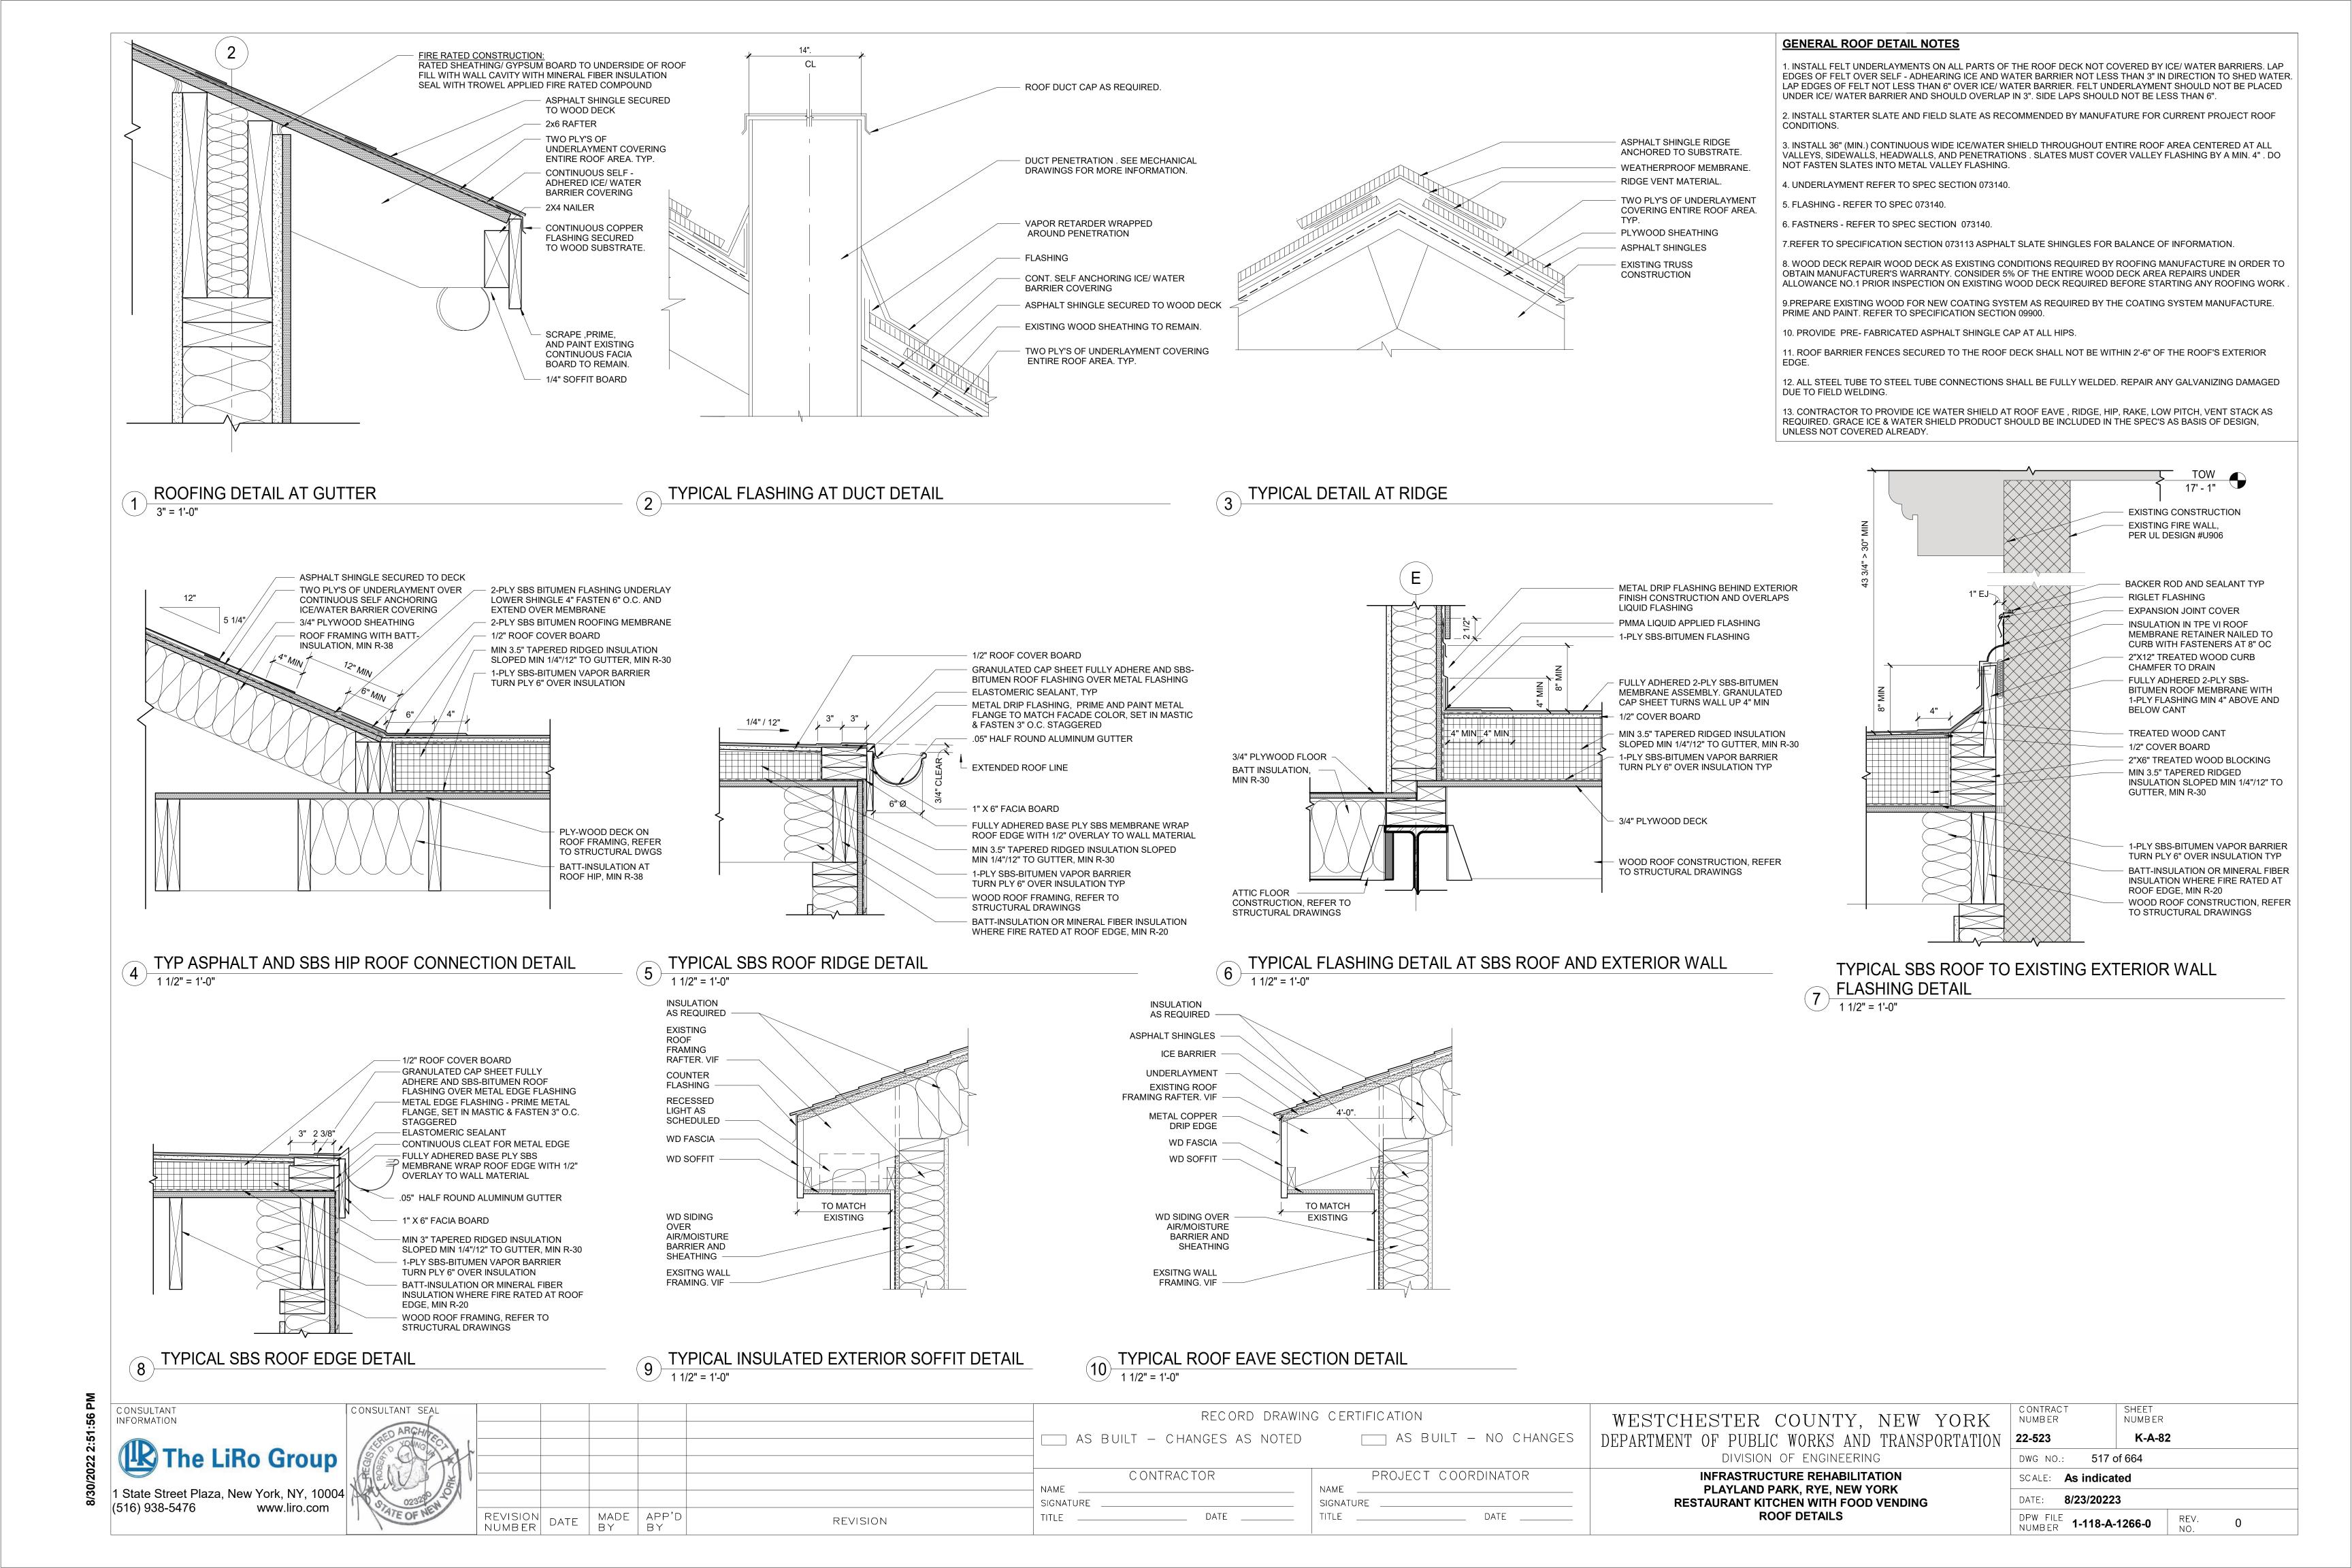
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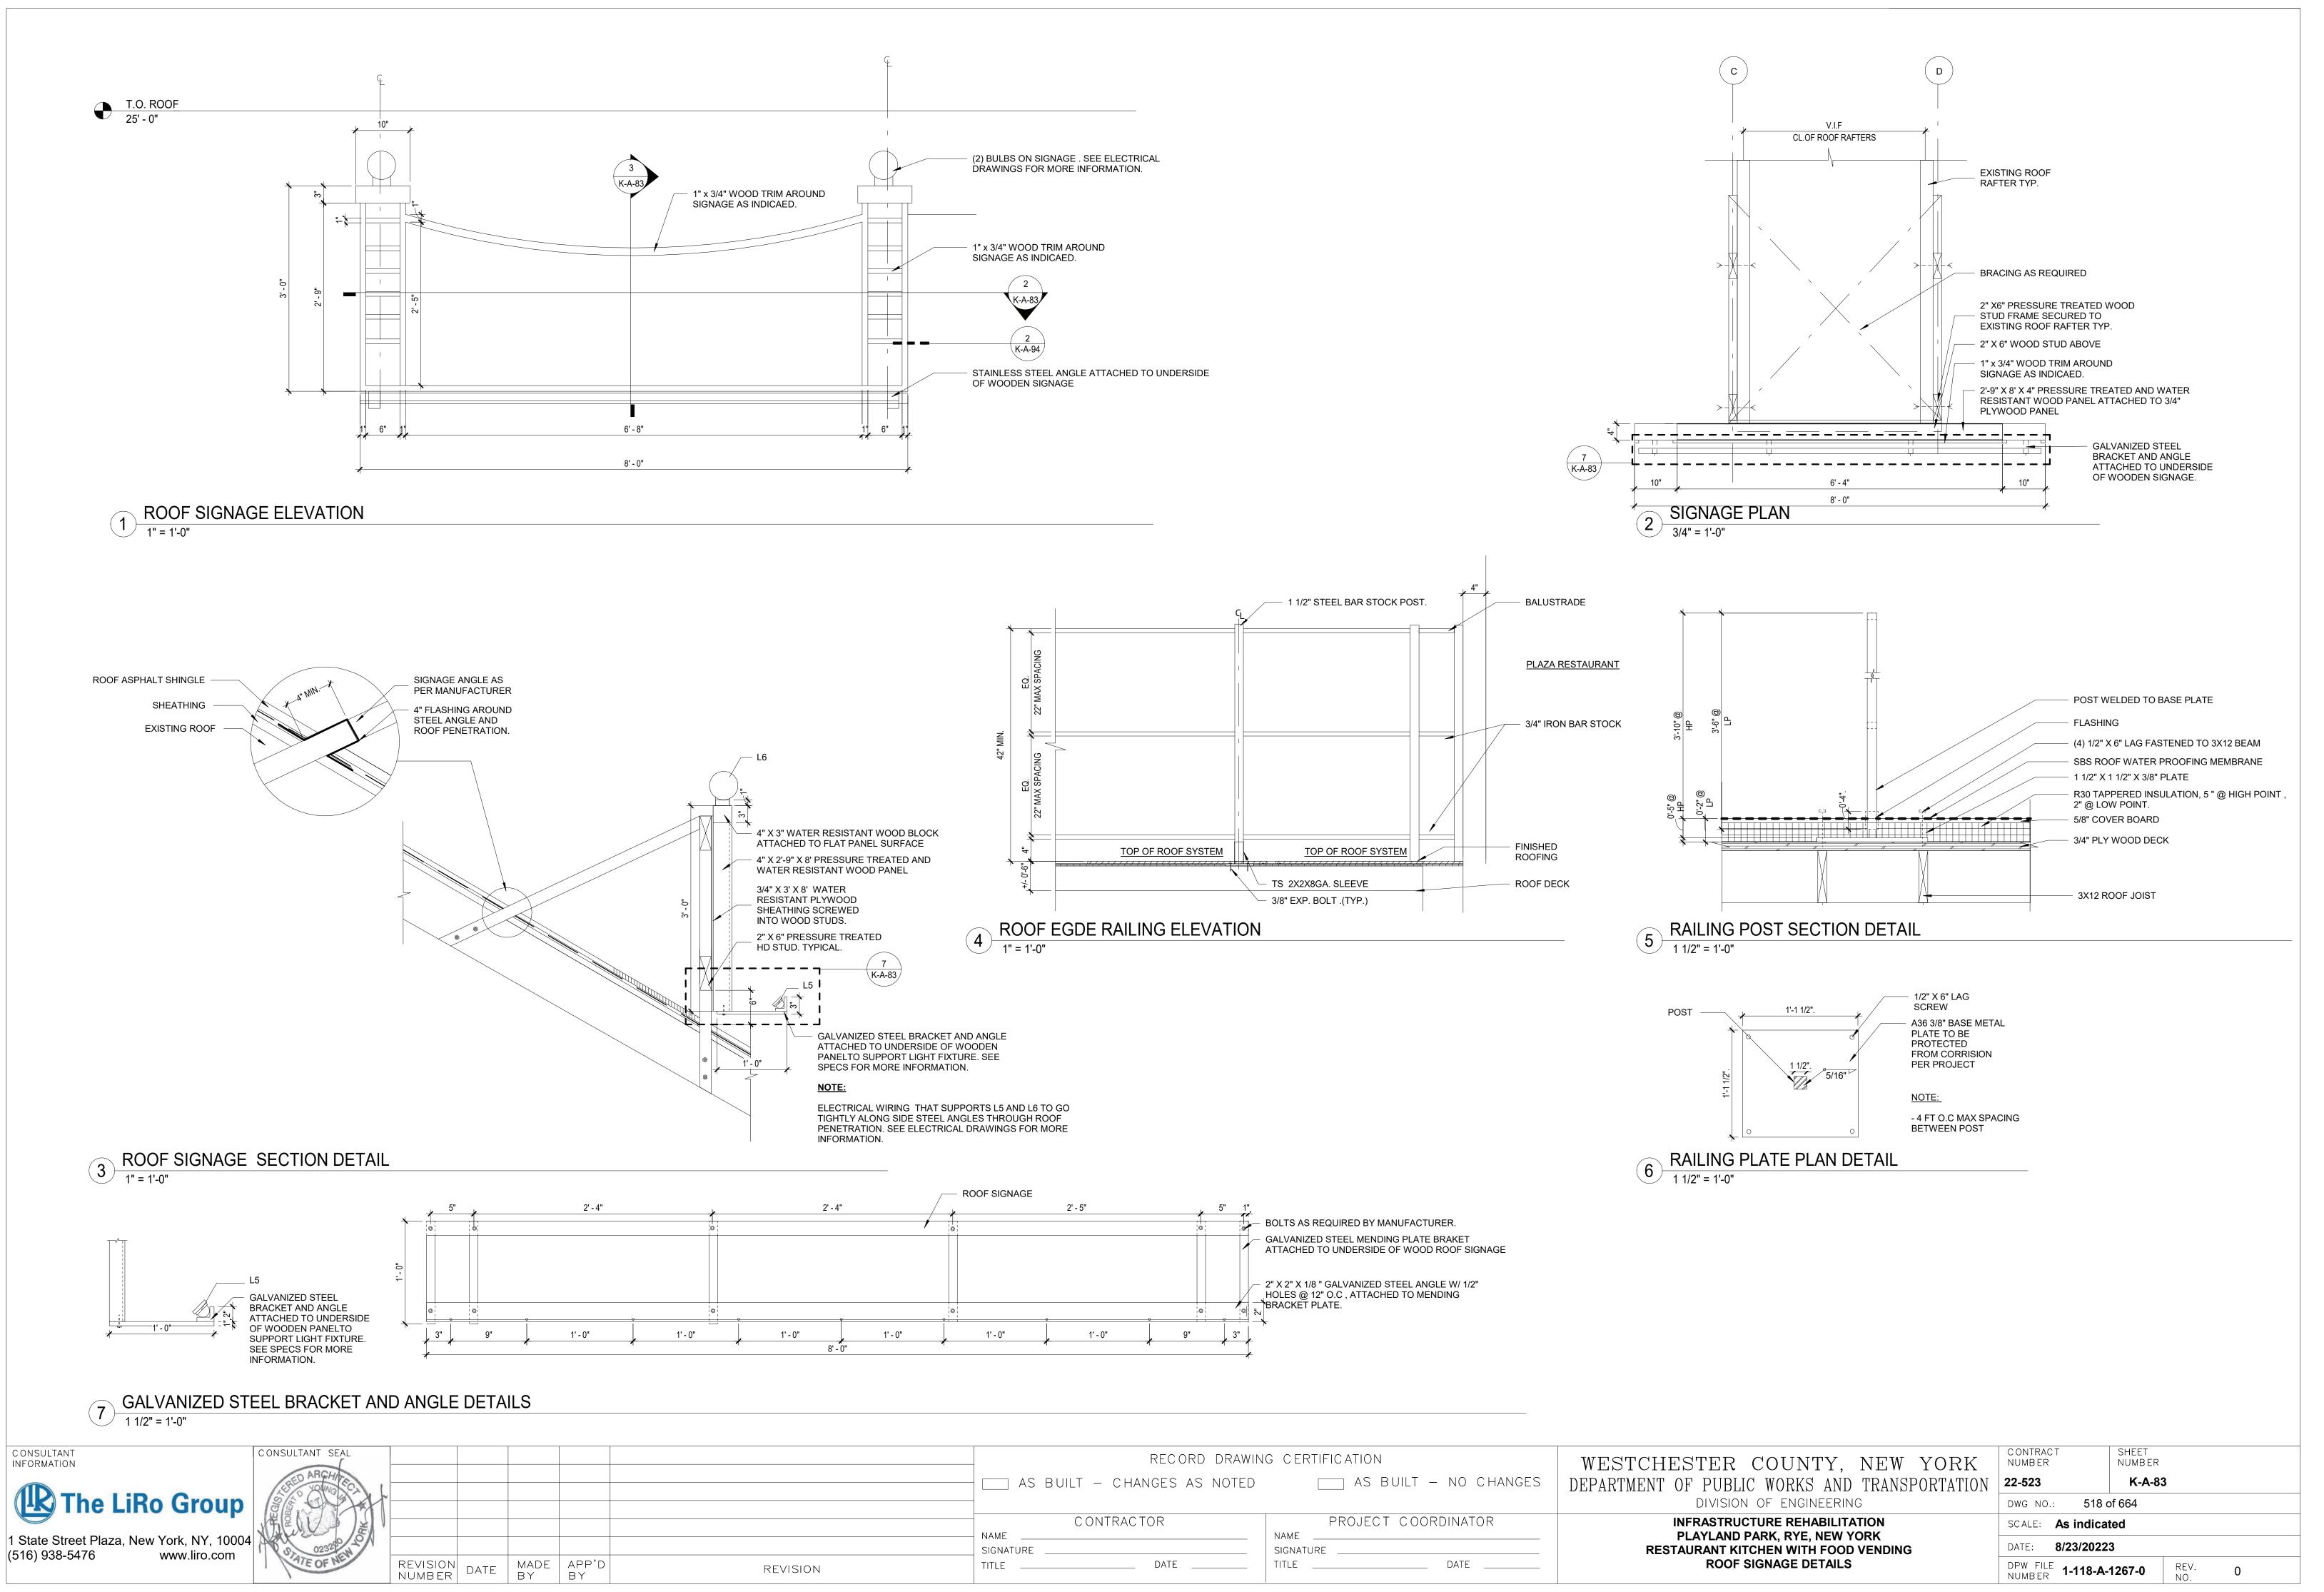
#### **CONSTRUCTION LEGEND**


	NOT IN CONTRACT
?	KEY NOTES
<u></u>	WINDOW TAG
<u> 101</u>	DOOR TAG


Key Value	Keynote Text
5	PROVIDE AND INSTALL DOOR INCLUDING FRAME, SILL, LINTEL AND ANY ASSOCIATE HARDWARE. SEE DOOR SCHEDULE.
10	PROVIDE AND INSTALL COLUMN ENCLOSURES. SEE DETAILS.
11	PROVIDE AND INSTALL T1-11 CEILING.
12	PROVIDE DROP CEILING AND ALL HANGERS/ ACCESSORIES.
15	PROVIDE AND INSTALL SBS MODIFIED BITUMEN ROOFING AND UNDERLAYMENT.
21	NEW INTERIOR WALL. SEE WALL SCHEDULE.
29	PROVIDE AND INSTALL NEW OSHA COMPLIANT GUARD RAIL.
34	PROVIDE NEW BENCH.
37	NEW CANOPY, SEE DETAILS.
67	NEW FASCIA BOARD AND SOFFIT.
72	NEW LIGHT FIXTURES TO BE INSTALLED (SEE ELECTRICAL DRAWINGS).
80	NEW 3/4" PLYWOOD FLOOR
83	FDA AND USDA COMPLIANT SQUARE LAY IN CEILING TILES.
87	NEW PRECAST CONCRETE PLANTER BOX.
94	NEW QUARRY TILE. SUPRESS CONCRETE SLAB AS SHOWN IN 9/K-A-81. SLOPE TOWARDS DRAIN.






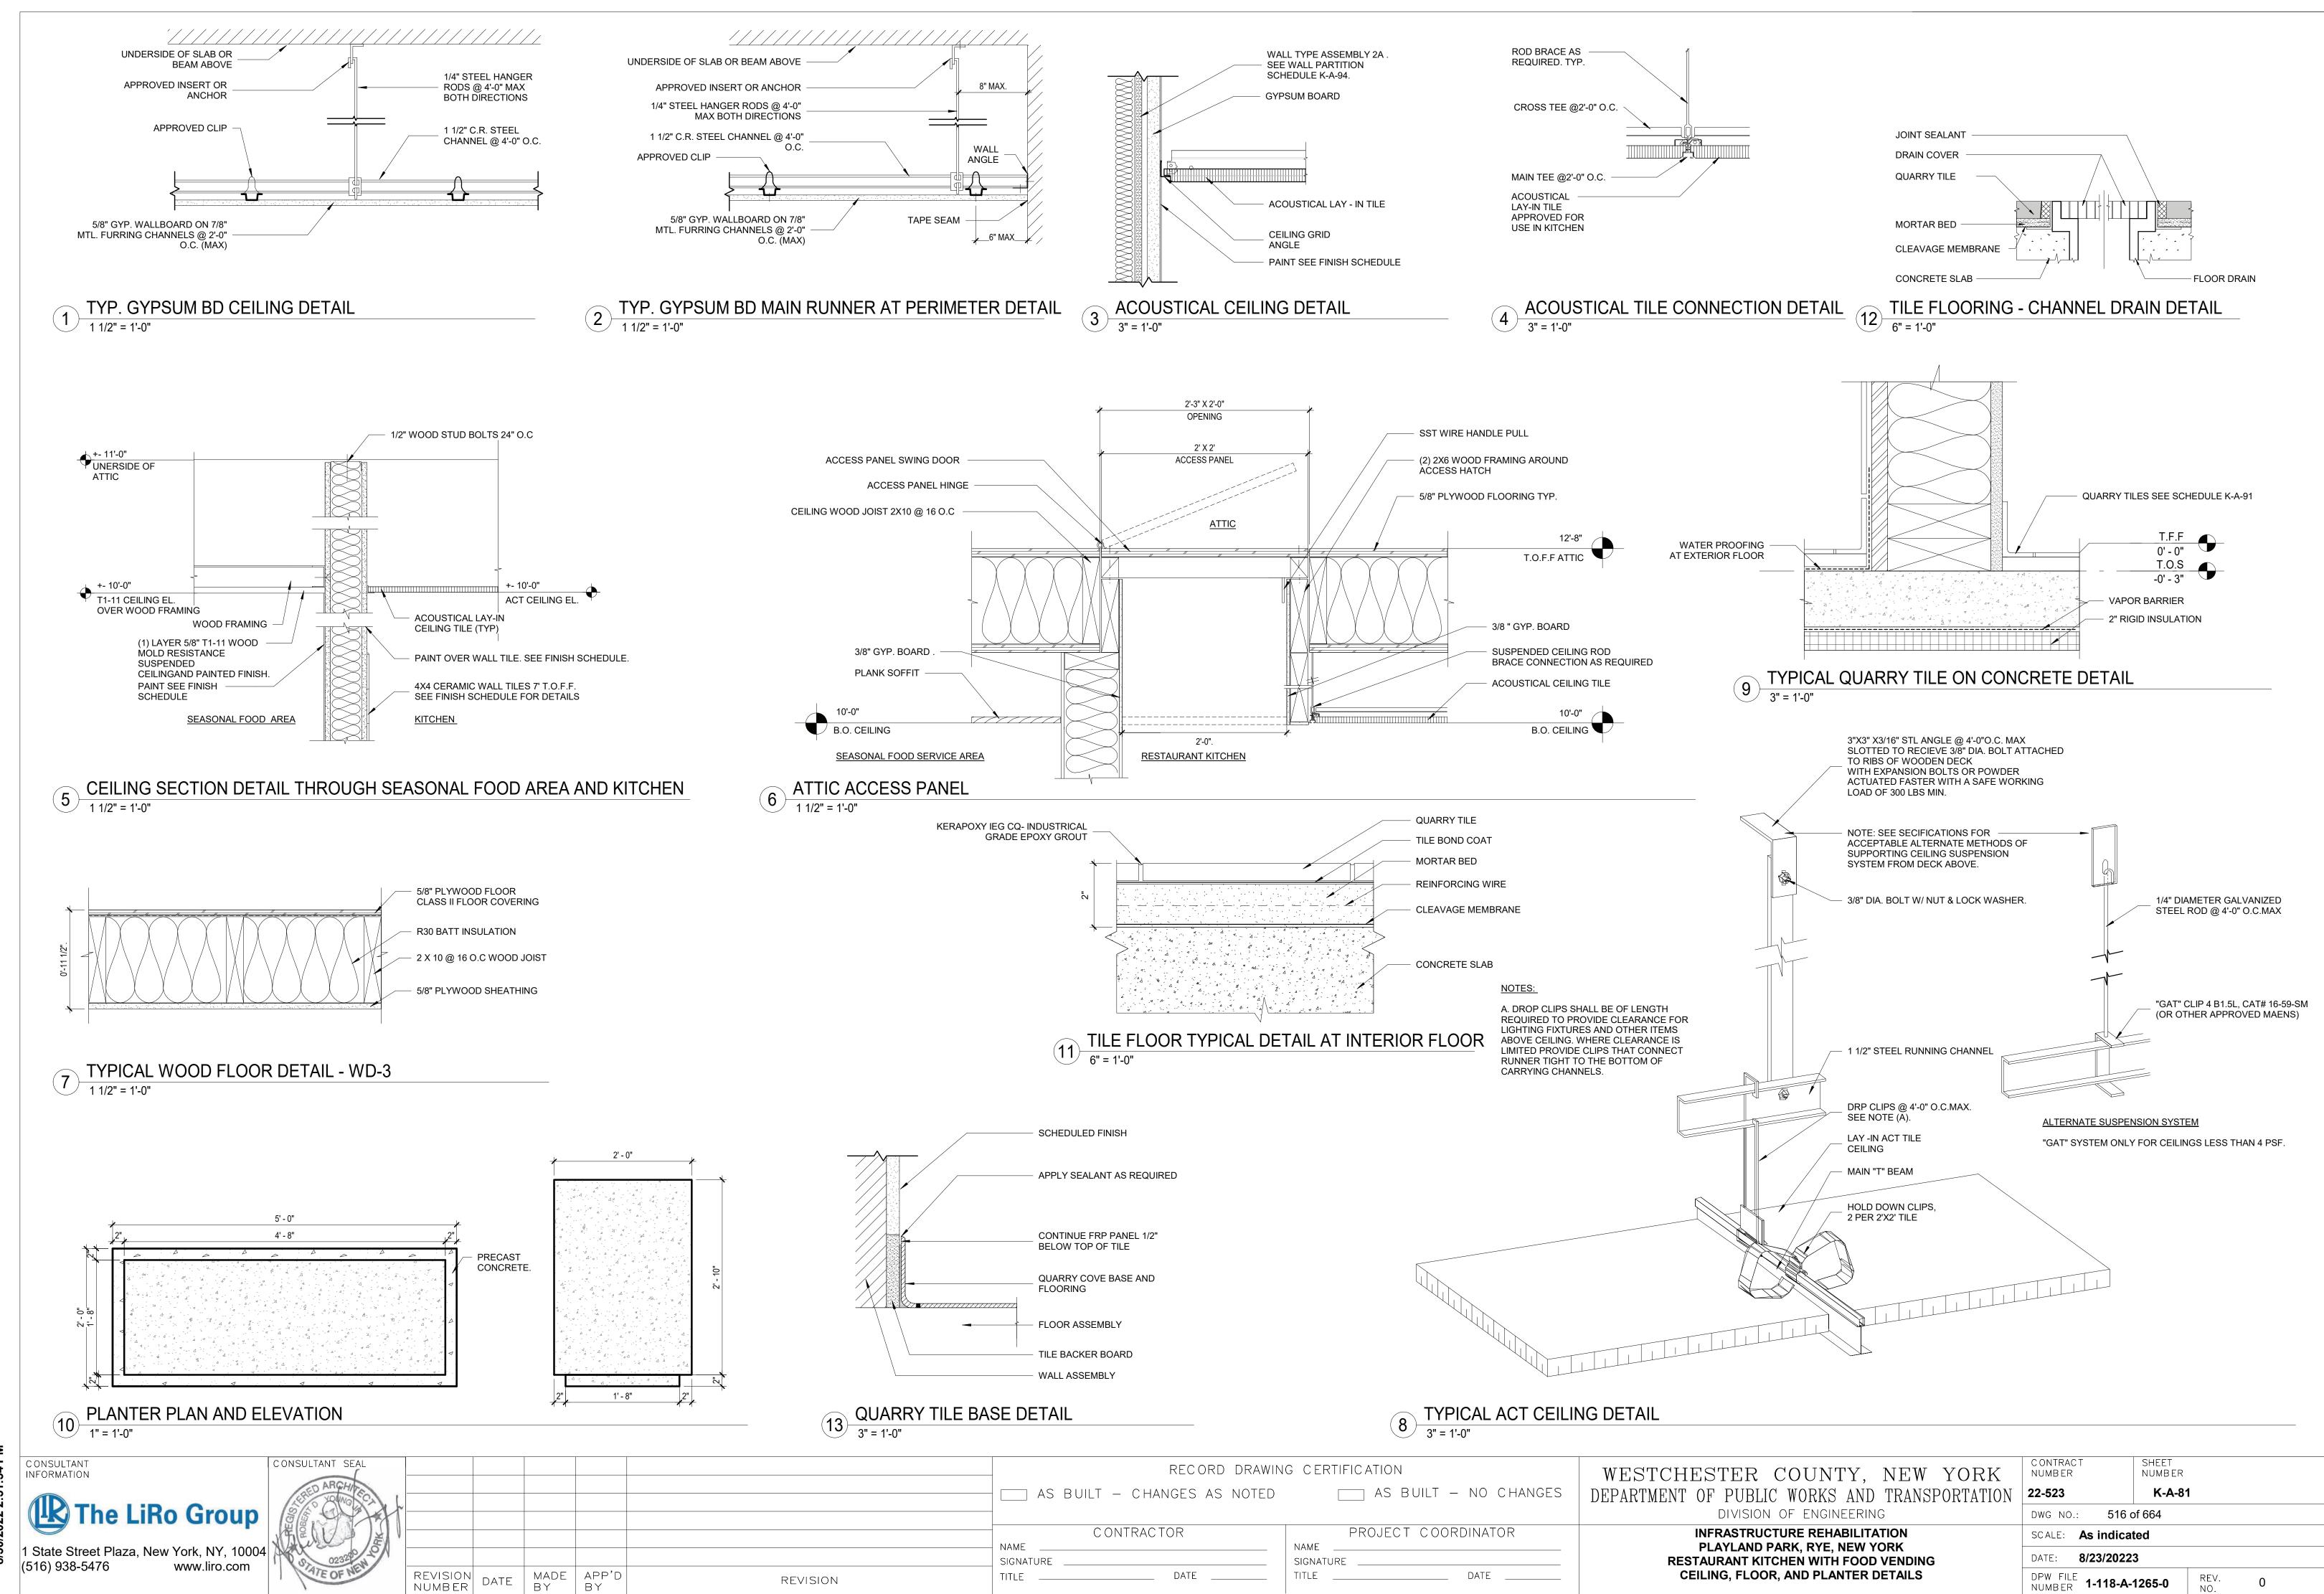

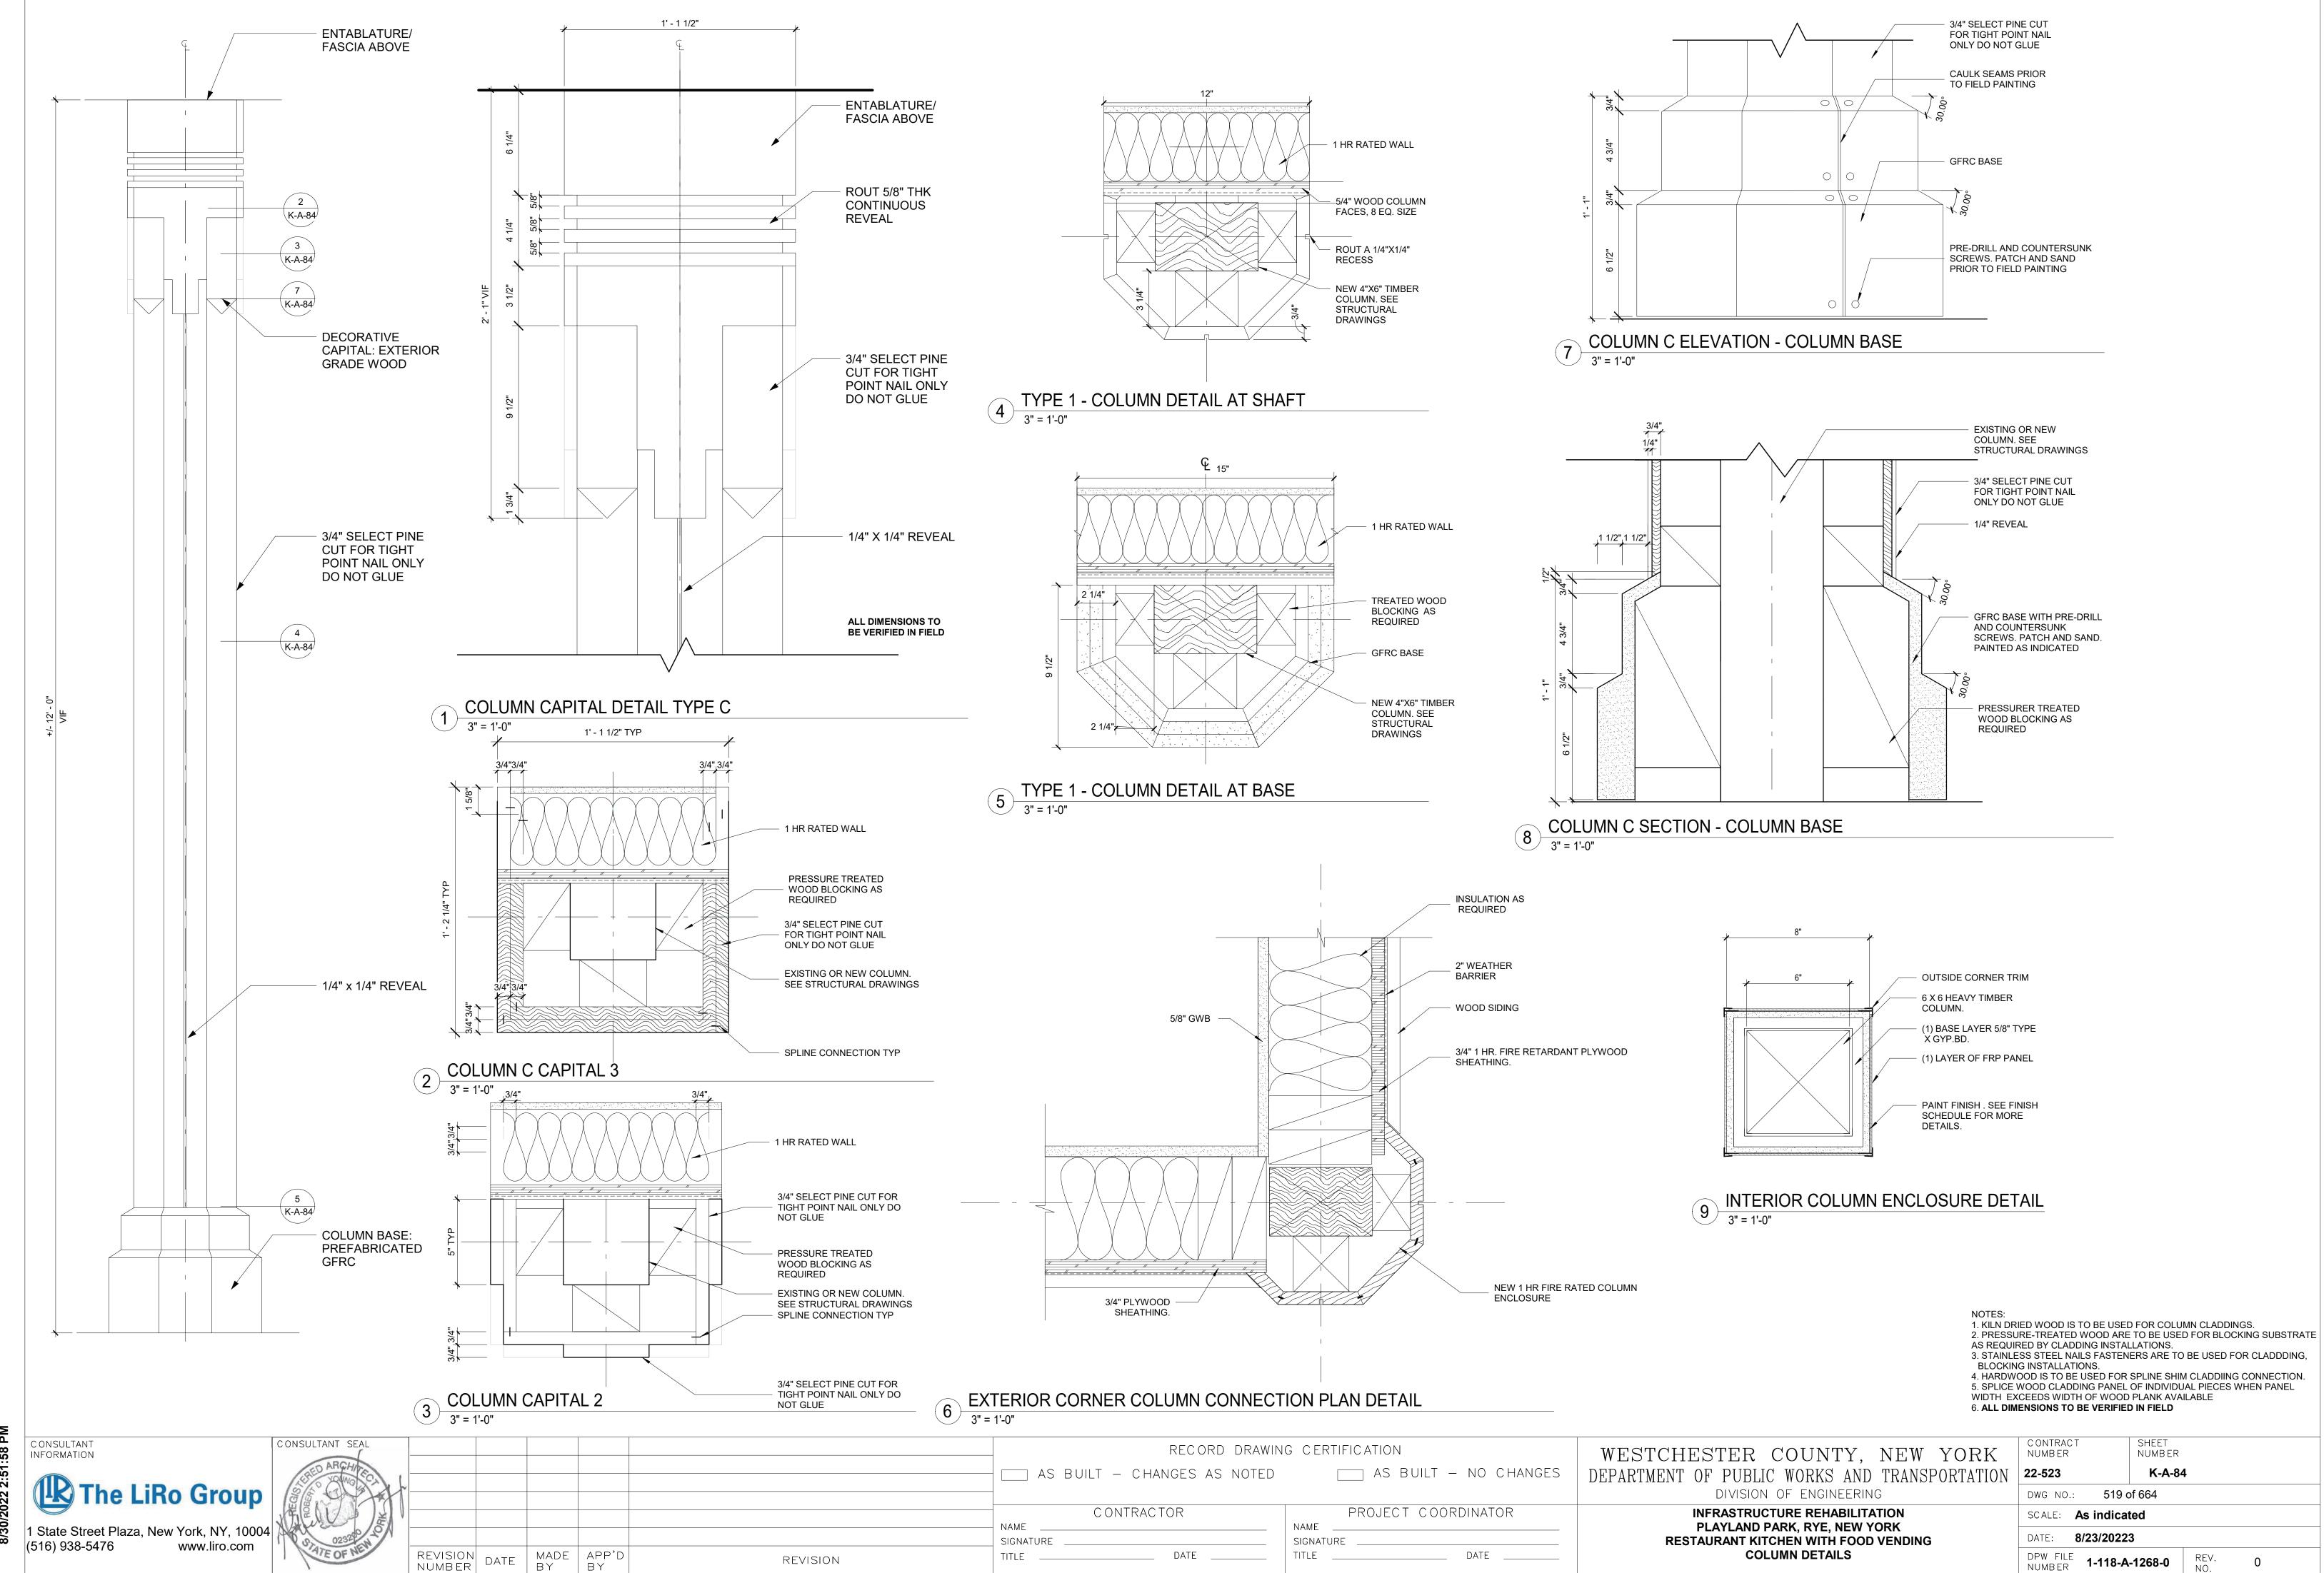

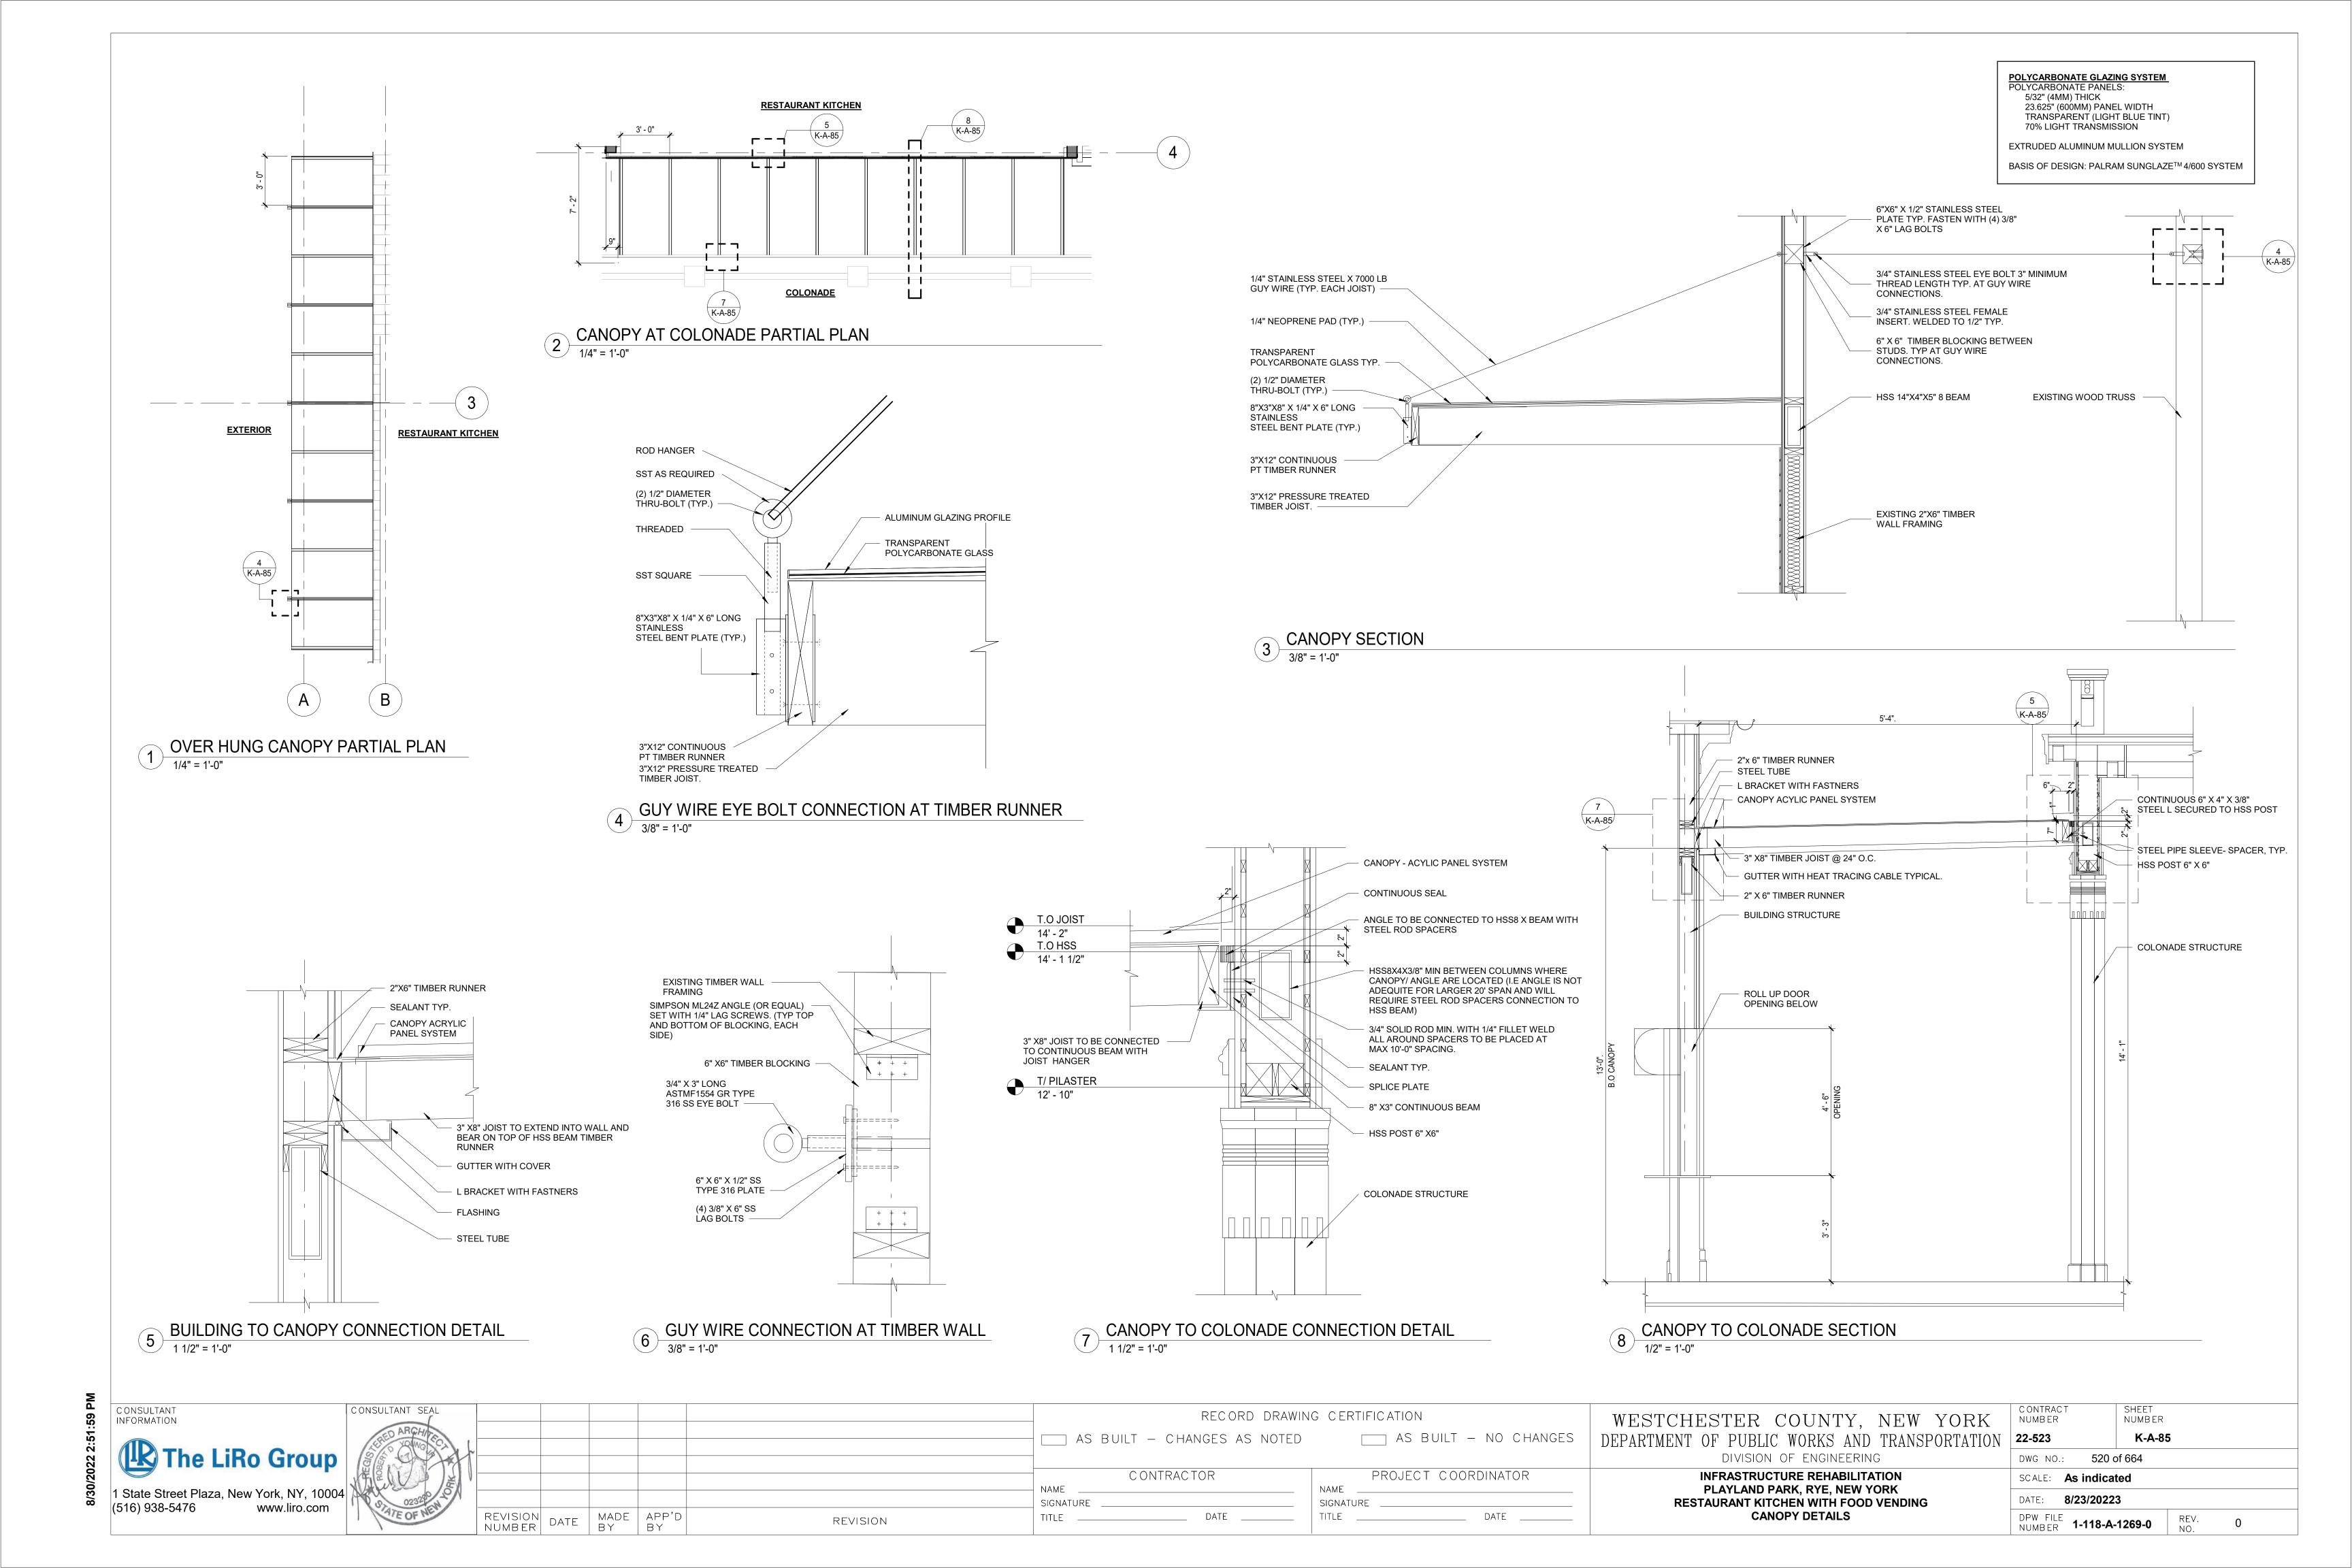

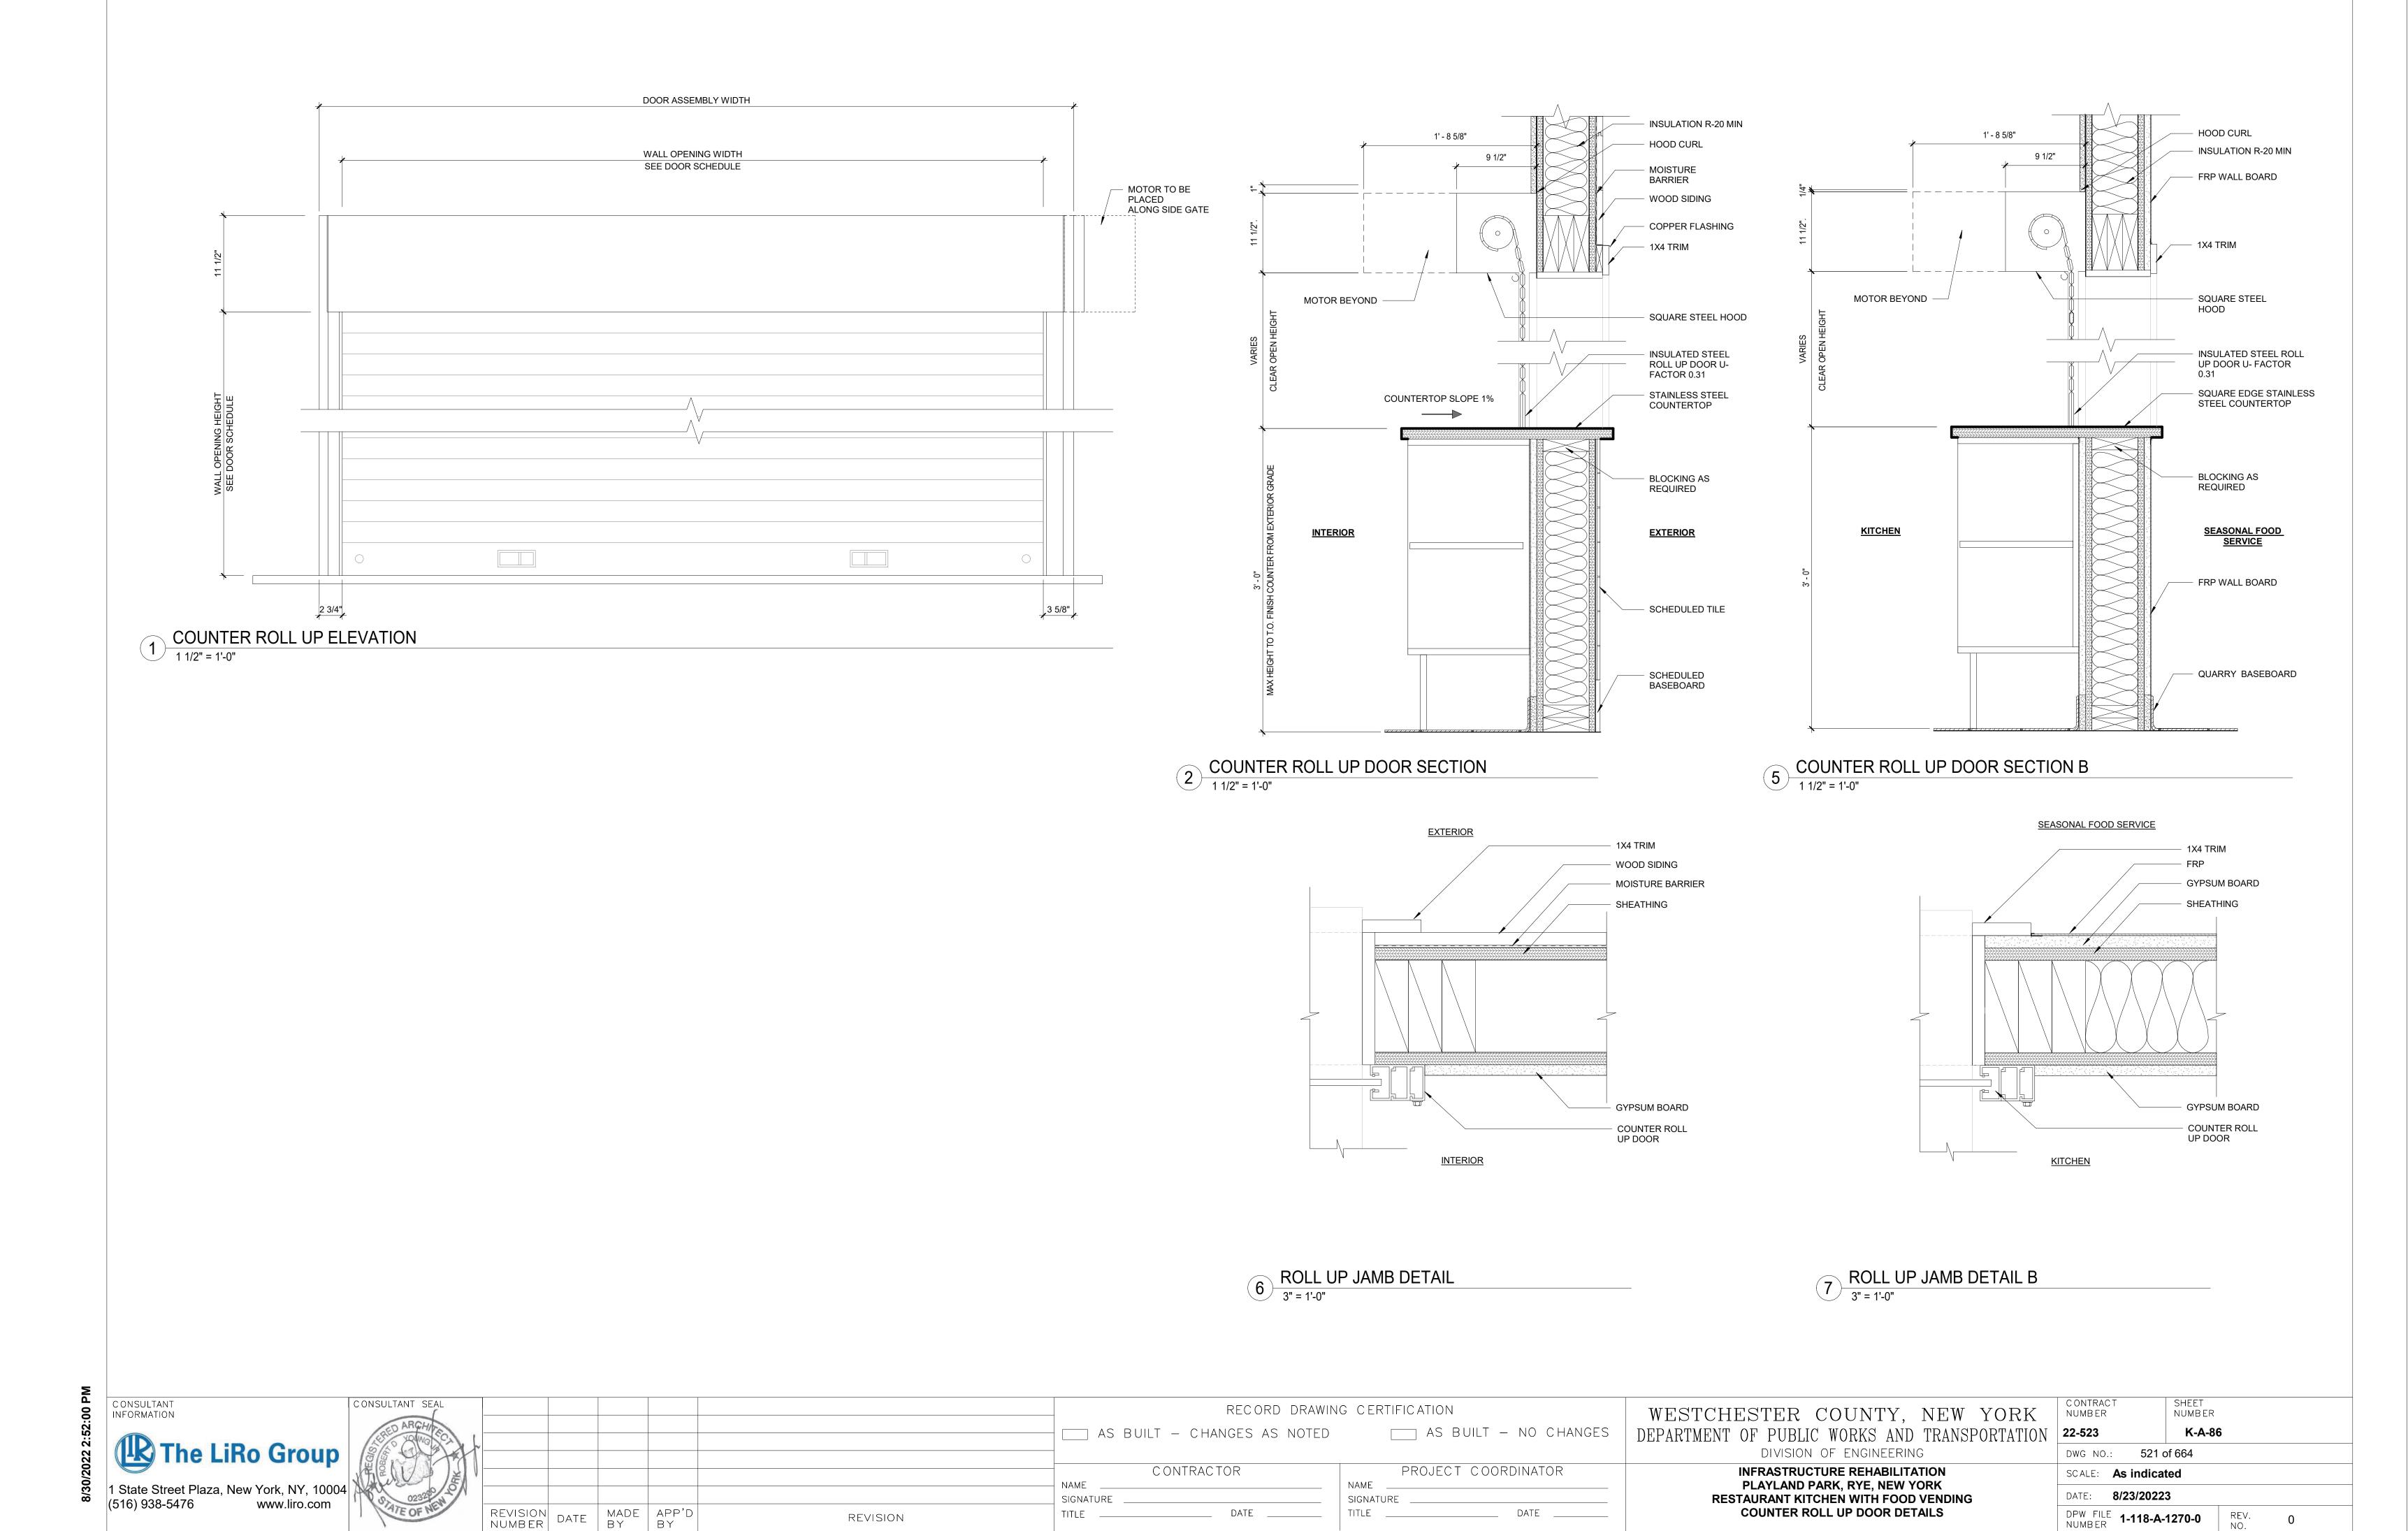




FIRE EXTINGUISHER

STYLE NO. 91148

WHITE ON RED

IDENTIFICATION SIGN ARROW


POLISHED PLASTIC MATERIAL WITH A SELF- ADHESIVE BACKING

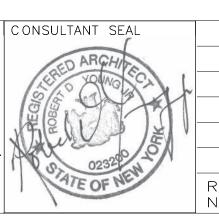

1 FIRE EXTINGUISHER SIGN LOCATION
1/2" = 1'-0"


FIRE

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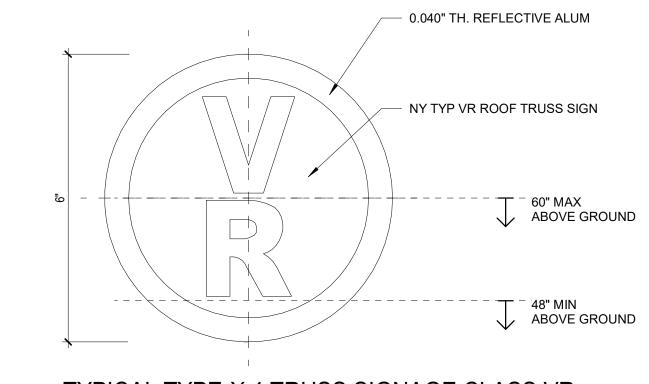


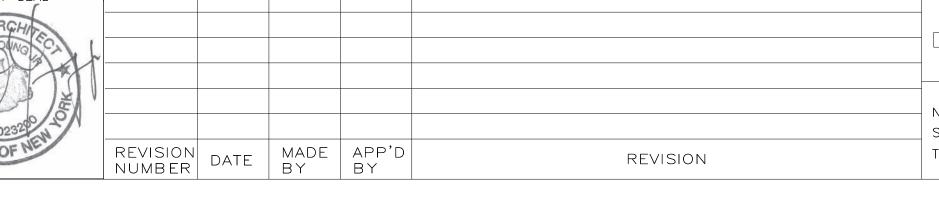TYPE X-1 FIRE EXTINGUISHER SIGN
6" = 1'-0"



5 TYPE X-2 STAFF ONLY (RESTRICTED AREA ) SIGN 6" = 1'-0"

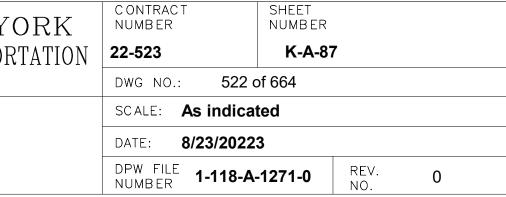SIGNS GO ON HANDLE SIDE OF DOOR



EQ

GRADE 2 BRAILLE MATCH COLOR AND FINISH OF SIGN'S FACE GRADE 2 BRAILLE TO COMPLY WITH U.S. ACCESS BOARD CHAPTER 7. 703.3.1 BRAILLE DIMENSIONS. CONTRACTOR RESPONSIBLE FOR CORRECT GRADE 2 BRAILLE TRANSLATION

EQ

1/4" TH. ACRYLIC SIGN — PANEL FRONT FACE AND SIDES PAINTED FINISH. COLOR:\_\_\_\_ FINISH:\_\_\_\_

ALL TYPOGRAPHY RAISED TACTILE
CHARACTERS FONT:CENTER IN WIDTH
COLOR:\_\_\_
FINISH:\_\_
1/32" (0.5MM) MINIMUM ABOVE THEIR
BACKGROUND TYPEFACE RAISED
CHARACTERS WITHIN A MESSAGE.

EXCLUDING WORD SPACES. SHALL BE SPACED 1/3" MINIMUM APART.

TYPE A-1 ELECTRICAL CLOSET SIGN
6" = 1'-0"

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1/4" TH. ACRYLIC SIGN PANEL FRONT FACE AND SIDES	-	EQ EQ
PAINTED FINISH.  COLOR: FINISH: SYMBOL:		0
RAISED 1/32" (0.8MM) MINIMUM ABOVE THEIR BACKGROUND MATCH RAISED TACTILE CHARACTERS FOR COLOR FINISH	21/2"	
-∞	2" 5/8"	NO
	1/2"5/8"1/2"	ADMITTANCE_
ALL TYPOGRAPHY RAISED TACTILE CHARACTERS FONT:CENTER IN		STAFF ONLY
WIDTH COLOR: FINISH: 1/32" (0.5MM) MINIMUM ABOVE	11/8"	
THEIR BACKGROUND TYPEFACE RAISED CHARACTERS WITHIN A MESSAGE. EXCLUDING WORD SPACES. SHALL BE SPACED 1/3" MINIMUM APART.		GRADE 2 BRAILLE MATCH COLOR AND FINISH OF SIGN'S FACE GRADE 2 BRAILLE TO COMPLY WITH U.S. ACCESS BOARD CHAPTER 7. 703.3.1 BRAILLE DIMENSIONS

SIGN LOCATION ELEVATION TYPICAL DOOR CONDITION

1/2" = 1'-0"

TO COMPLY WITH U.S. ACCESS BOARD CHAPTER 7. 703.3.1 BRAILLE DIMENSIONS. CONTRACTOR RESPONSIBLE FOR CORRECT GRADE 2 BRAILLE TRANSLATION

	1
	TYPE-X 4 TRUSS SIGNAGE CLASS
6" = 1'-0"	

	AS BUILL — CHANGES AS NOTED	
	CONTRACTOR	
	— NAME	
	SIGNATURE	5
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ΕD	AS BUILI — NO CHANGES	
	PROJECT COORDINATOR  NAME  SIGNATURE	
_	TITLE DATE	


DIVISION (	OF ENGINEERING
	JRE REHABILITATION
	RK, RYE, NEW YORK HEN WITH FOOD VENDING
SIGNA	GE DETAILS

CHESTER COUNTY, NEW YORK	NUMBER NUMBER
MENT OF PUBLIC WORKS AND TRANSPORTATION	22-523 K-A-87
DIVISION OF ENGINEERING	DWG NO.: <b>522 of 664</b>
INFRASTRUCTURE REHABILITATION	SCALE: As indicated
PLAYLAND PARK, RYE, NEW YORK RESTAURANT KITCHEN WITH FOOD VENDING	DATE: <b>8/23/20223</b>
SIGNAGE DETAILS	DPW FILE 1-118-A-1271-0 REV. 0


							WINDOW SCI	HEDULE					
Mark	WINDOW TYPE	BUILDING	LEVEL	WIDTH	ROUGH WIDTH	HEIGHT	ROUGH HEIGHT	SILL HEIGHT	WINDOW MATERIAL	Finish	EXTERIOR TRIM	INTERIOR TRIM	REMARKS
005	W-1	RESTAURANT KITCHEN	FIRST FLOOR	4' - 6"	4' - 6 3/4"	2' - 0"	2' - 0 3/4"	6' - 11"	ALUMINUM	Black Powder Coat	P-2	P-13	1" INSULATED GLASS UNIT
006	W-1	RESTAURANT KITCHEN	FIRST FLOOR	4' - 6"	4' - 6 3/4"	2' - 0"	2' - 0 3/4"	6' - 11"	ALUMINUM	Black Powder Coat	P-2	P-13	1" INSULATED GLASS UNIT
007	W-1	RESTAURANT KITCHEN	FIRST FLOOR	4' - 6"	4' - 6 3/4"	2' - 0"	2' - 0 3/4"	6' - 11"	ALUMINUM	Black Powder Coat	P-2	P-13	1" INSULATED GLASS UNIT
800	W-1	RESTAURANT KITCHEN	FIRST FLOOR	4' - 6"	4' - 6 3/4"	2' - 0"	2' - 0 3/4"	6' - 11"	ALUMINUM	Black Powder Coat	P-2	P-13	1" INSULATED GLASS UNIT

NOTES:
- ALL COLOR TO BE APPROVED BY ARCHITECT

- ALL COLOR TO BE APPROVED BY ARCHITECT
- ALL DIMENSIONS TO BE VERIFIED IN FIELD PRIOR TO FABRICATION

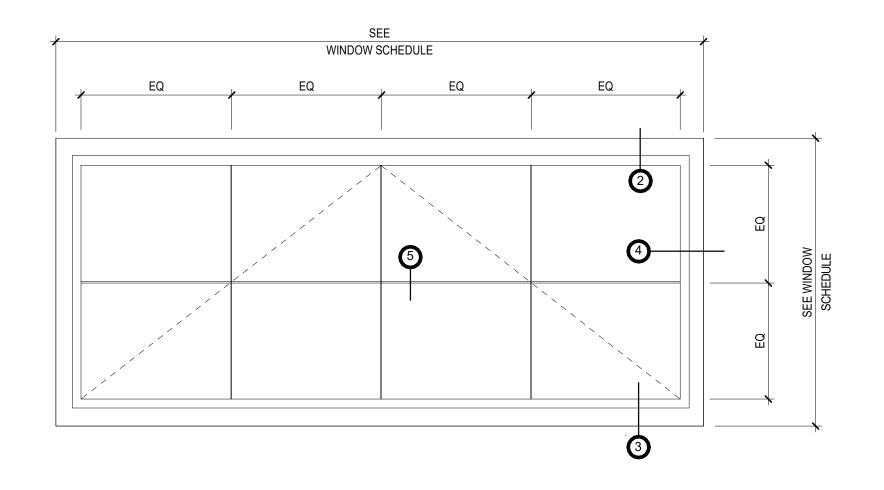

1 AWNING WINDOW ELEVATION W-1

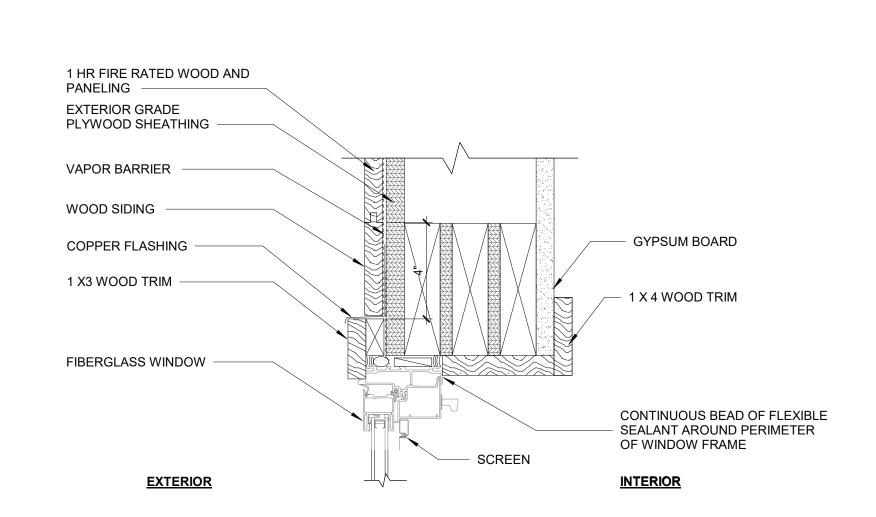

FIBERGLASS WINDOW

CONTINUOUS BEAD OF FLEXIBLE SEALANT AROUND PERIMETER OF WINDOW FRAME

INTERIOR

INTERIOR

GYPSUM BOARD


WOOD SIDING

3 AWNING WINDOW SILL DETAIL
3" = 1'-0"

WATER RESISTIVE BARRIER

EXTERIOR GRADE PLYWOOD SHEATHING

2 AWNING WINDOW HEAD DEATIL
3" = 1'-0"

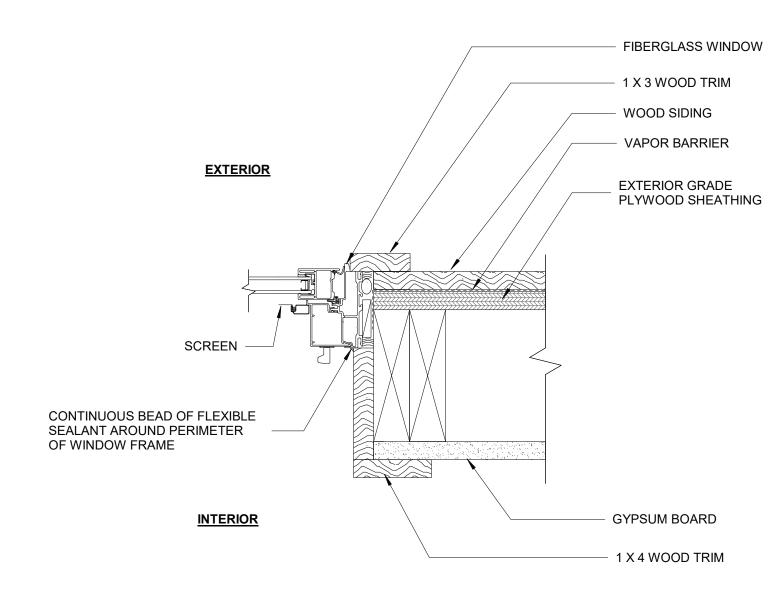


4 AWNING WINDOW JAMB DETAIL
3" = 1'-0"





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P-4 — P-12 SEE FINISH SCHEDULE AT K-A-91

COLUMN FINISH

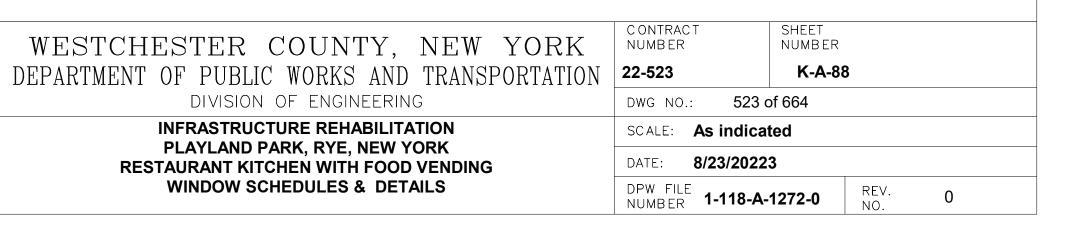GROUND LEVEL FINISH FLOOR PLAN 3/16" = 1'-0"

2 ATTIC FINISH PLAN
3/16" = 1'-0"

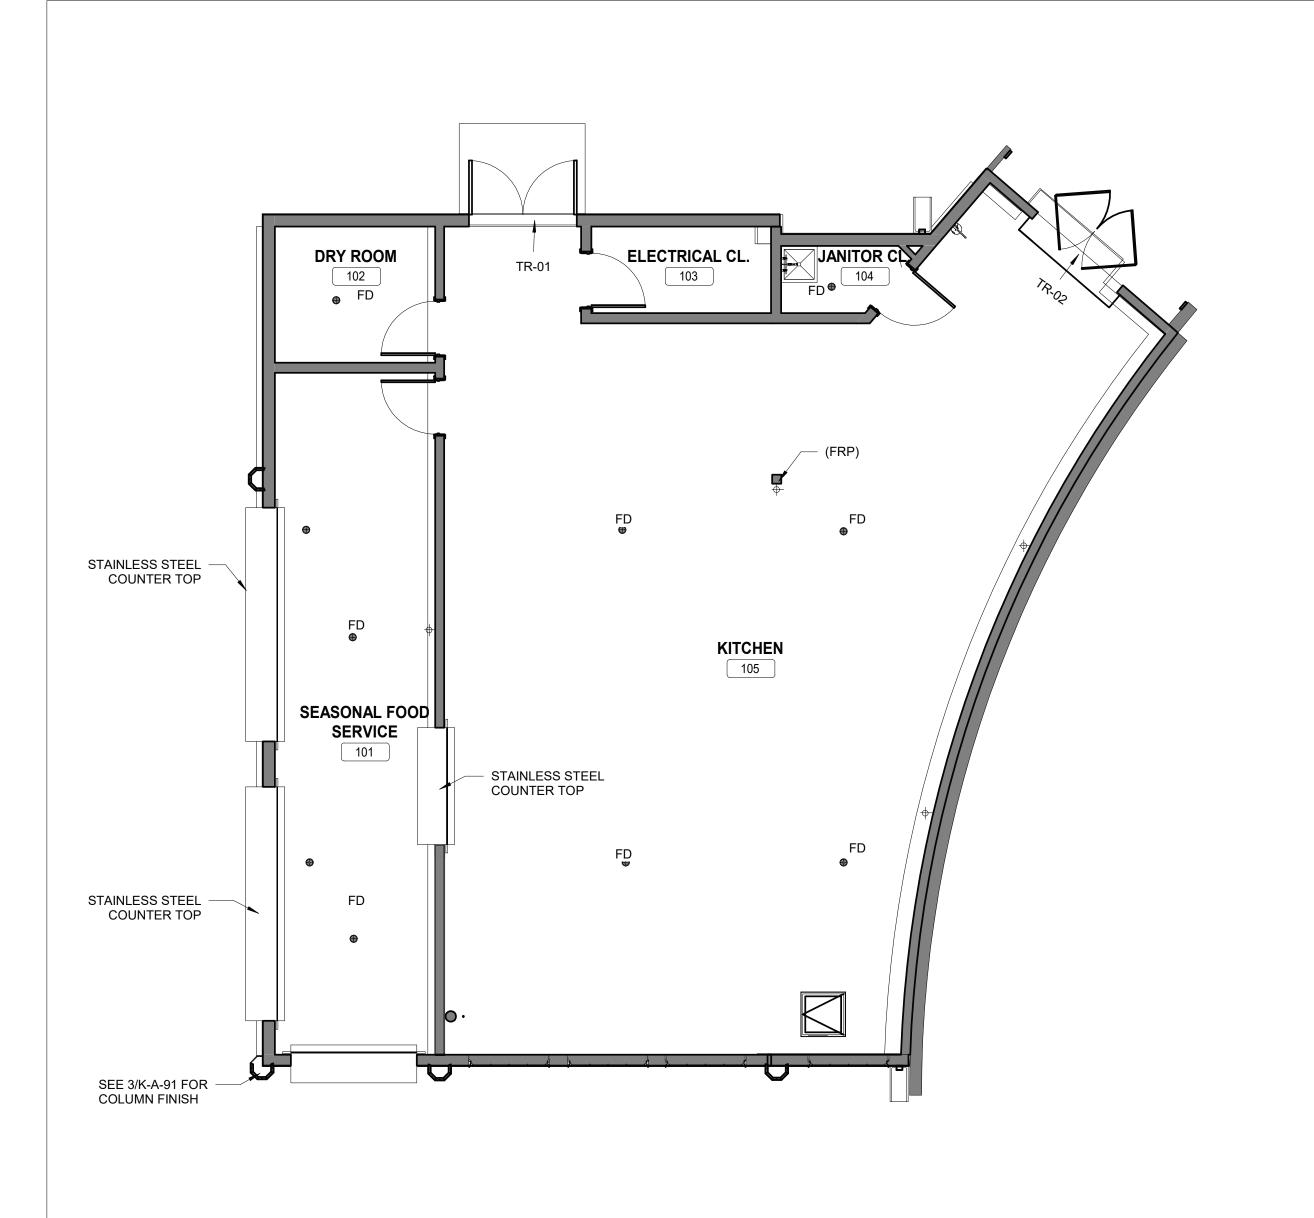**FINISH SCHEDULE** 
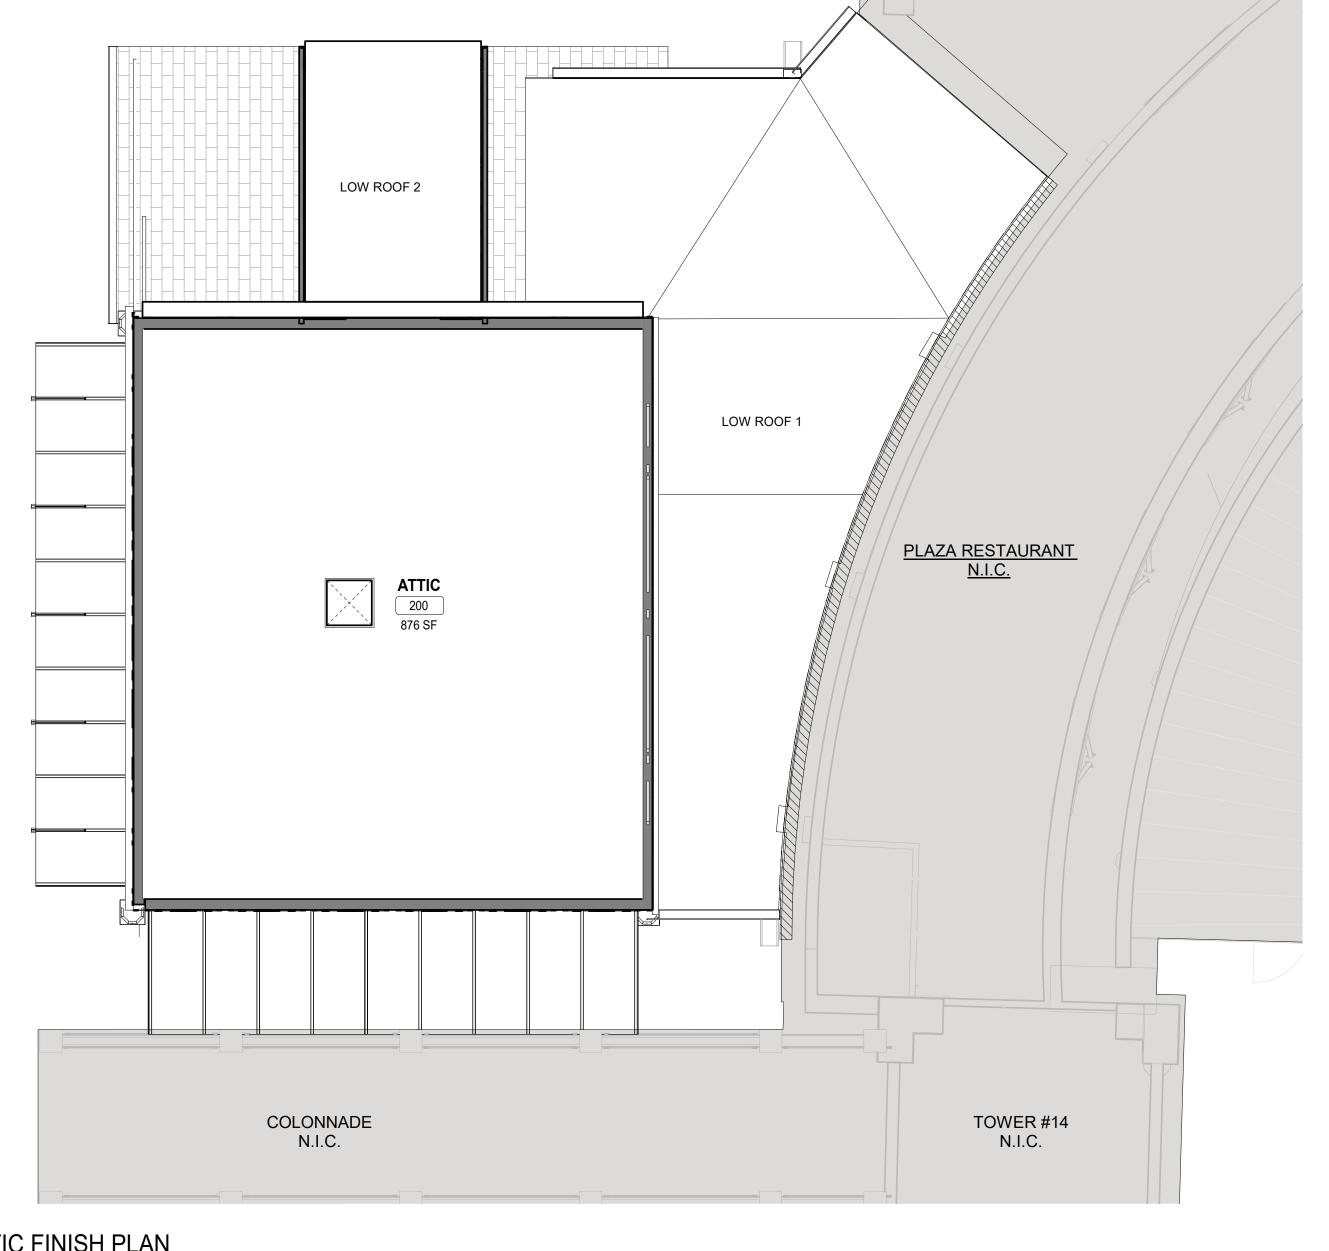
<b>FINISH LEGEND:</b>		

QUARRY TILE FLOORING

1. INDICATES TYPICAL FINISHES WITHIN ROOM, U.O.N. SEE FINISH SCHEDULE FOR MORE INFORMATION. 2. ALL FLOORING COVERING MATERIALS TO BE INSTALLED PER MANUFACTURER'S STANDARD DETAILS AND ITEMS NOT IN CONTRACT SPECIFICATIONS. VERIFY WITH MANUFACTURER PRIOR INSTALLATION.

**FINISH PLAN NOTES:** 

3. THE G.C. IS RESPONSIBLE FOR PROVIDING A SMOOTH LEVEL FLOOR SURFACE THAT MEETS MANUFACTURERS INSTALLATION SPECIFICATIONS PRIOR TO THE INSTALLATION OF ALL FLOORING MATERIALS. 4. THE FLOORING SUB-CONTRACTOR IS RESPONSIBLE FOR VERIFYING THAT THE CONDITION OF THE BASE FLOOR

MEETS THE INSTALLATION SPECIFICATIONS PRIOR TO THE INSTALLATION OF THE NEW FLOORING MATERIAL. 5. ALL MATERIAL TRANSITIONS AN DOOR THRESHOLDS TO TAKE PLACE AT DOOR CENTERLINE U.N.O. 6. ALL DIMENSIONS ARE TO CENTERLINE OF TRANSITION BETWEEN FLOORING MATERIALS OR FINISH COLOR OF

SAME MATERIAL. PLANS DO NOT SHOW ALL TILES OF SAME MATERIALS. CONTRACTOR TO START TILES AT POINT AS INDICATED ON PLANS. 7. THE GENERAL CONTRACTOR SHALL BE RESPONSIBLE FOR PROPER PREPARATION OF ALL NEW AND EXISTING SURFACES IN A SATISFACTORY MANNER TO RECEIVE NEW FINISHES. THIS INCLUDES THE DEMOLITION AND REMOVAL OF NECESSARY ITEMS. TOUCH- UP AND/ OR REFINISH OF SURFACES DAMAGED BY SUBSEQUENT WORK SHALL BE PERFORMED IN CONFORMANCE WITH THE MANUFACTURER'S RECOMMENDED INSTALLATION

8. ALL SURFACES WHICH ARE TO RECEIVE A PAINT FINISH SHALL BE PRIMED AND FINISHED IN ACCORDANCE WITH

THE WRITTEN SPECIFICATIONS. 9. ALL JOINTS IN GYPSUM BOARD WALLS SHALL BE FINISHED WITH PAPER TAPE 2" WIDE AND THREE COATS OF VINYL, DRY OR PREMIXED JOINT COMPOUND. ALL OUTSIDE CORNERS SHALL BE FINISHED WITH METAL CORNER BEADS, TAPED AND SPACKLED. ALL AREAS TO BE PAINTED SHALL BE SANDED SMOOTH. JUST PRIOR TO THE APPLICATION OF THE FIRST COAT OF PAINT, WIPE SANDED SURFACES WITH A DAMP CLOTH IN ORDER TO LAY

FLAT ANY NAP WHICH MAY HAVE FORMED IN SANDING. 10. THE PAINT CONTRACTOR SHALL REMOVE ALL HARDWARE, SWITCH COVERS, ETC. PRIOR TO PAINTING AND BE RESPONSIBLE FOR THE REINSTALLATION AFTER PAINTING IS COMPLETED.

11. FINISH FLOORING INSTALLATION SHALL BE IN CONFORMANCE WITH THE MANUFACTURER'S RECOMMENDED INSTALLATION GUIDELINES. COORDINATE THE INSTALLATION WITH OTHER TRADES, SUCH AS ELECTRICAL. 12. ALL JOINTS BETWEEN MATERIALS TO BE TIGHT AND CONSTRUCTED IN A NEAT WORKMANLIKE MANNER. 13. ALL FINISHES SHALL BE TOUCHED UP TO CORRECT ANY IMPERFECTIONS AFTER INSTALLATION. FIXTURE CONTRACTOR SHALL PROVIDE TO THE GENERAL CONTRACTOR ALL MATERIALS FOR TOUCH UP WORK.

14. THE INTENT OF THE FINISH SPECIFICATIONS IS TO PROVIDE A SATISFACTORY FINISH TO ALL PARTS OF THE WORK. COVER ALL SURFACES THOROUGHLY. IF THE SPECIFIED NUMBER OF COATS DOES NOT ACCOMPLISH THE INTENT, THE GENERAL CONTRACTOR SHALL BE RESPONSIBLE FOR THE APPLICATION OF ADDITIONAL COATS OF THE SPECIFIED MATERIAL TO GIVE SATISFACTORY COVERAGE, AT NO ADDITIONAL COST TO OWNER.

15. CLEAN ALL GLASS SURFACES WITH LIQUID GLASS CLEANER AT PROJECT COMPLETION. 16. REFERENCE SPECIFICATIONS FOR COMPLETE FINISH DOCUMENTATION AND MANUFACTURER INSTALLATION AND MAINTENANCE DOCUMENTATION.

	PAINTING SCH	EDULE	
<u>KEY</u>	COLOR	MANUFACTURER	<u>REMARKS</u>
P- 1	MYSTICAL POWERS #901	BENJAMIN MOORE	
P- 2	HERITAGE RED #HC-181	BENJAMIN MOORE	
P- 3	NEW YORK STATE OF MIND #805	BENJAMIN MOORE	
P- 4	LAZY SUNDAY #803	BENJAMIN MOORE	
P- 5	DEEP JUNGLE #595	BENJAMIN MOORE	
P- 6	LUCK OF THE IRISH #588	BENJAMIN MOORE	
P- 7	MAJOLICA GREEN #0013	SHERWIN WILLIAMS	
P- 8	ANTELOPE CANYON #125	BENJAMIN MOORE	
P- 9	FORSYTHIA #6907	SHERWIN WILLIAMS	
P- 10	CAPE BLUE #1642	BENJAMIN MOORE	
P- 11	WHITE SNOW #9541	SHERWIN WILLIAMS	
P- 12	TRICORN BLACK #6258	SHERWIN WILLIAMS	
P- 13	READY MIX WHITE	BENJAMIN MOORE	INTERIOR USE ONLY
P- 14	STUCCO PAINT TO MATCH P-1	KEIM	
P- 15	VAN DEUSEN BLUE #HC-156	BENJAMIN MOORE	
P- 16	#RAL9001	-	TYP. ROLL UP DOOF
P- 17	FLORIDA BEACHES #900	BENJAMIN MOORE	
P- 18	PIRATES COVE PEACH #903	BENJAMIN MOORE	
P- 19	JADITE #6459	SHERWIN WILLIAMS	
P- 20	DECISIVE YELLOW #6902	SHERWIN WILLIAMS	

REVISION

NUMBER

DATE

MADE APP'D BY

ROOM#		ROOM NAME	FLOOF	RS WALLS	CEILING	DOORS /	AND TRIM	WALL BASE
101	SEAS	SONAL SERVICE AREA	QT-1	FRP	T1-11	11 SEE DOOR SCHEDULE (K-A-9		-93) WB-2
102		DRY ROOM	QT-1	FRP	GYP	SEE DOOR SC	HEDULE (K-A-	-93) WB-2
103	EL	ECTRICAL CLOSET	QT-1	GYP/P-13	GYP	SEE DOOR SC	HEDULE (K-A-	-93) WB-2
104	J	ANITORS CLOSET	QT-1	GYP-P-13/ CT-4	GYP	SEE DOOR SC	HEDULE (K-A-	-93) WB-2
105		KITCHEN	QT-1	FRP	ACT	SEE DOOR SC	HEDULE (K-A-	-93) WB-2
201		ATTIC	WD-3	-	-	SEE DOOR SC	HEDULE (K-A	-93) -
•					MATERIAL	SCHEDULE		
	KEY	MATERIAL		MANUFACTURI	<u>ER</u>	FINISH COLOR	SIZE	REMARKS
	CT-1	CERAMIC TILE		DATILE; LINEAR COLO	OR WHEEL	AZURE -QH44	4" X 4"	
WALLS	CT-2	CERAMIC TILE		DATILE; LINEAR COLO	OR WHEEL	ATLANTIS -QH43	4" X 4"	
VVALLS	CT-3	CERAMIC TILE		DATILE; LINEAR COLO	OR WHEEL	ALMOND - QH02	4" X 4"	
	CT-4	CERAMIC TILE		DATILE; LINEAR COL	OR WHEEL	ARCTIC WHITE -GLOSSY	6" X 18"	PROVIDE EDGE PROTECTION ON ALL OUTSIDE WALL CORNERS
	FRP	FIBERGLASS REINFORCED	PANEL	-		WHITE		
FLOODING	QT-1	QUARRY TILE		DATILE; QUARRY TEX	XTURES	SAHARA SAND-0T08(2)	6"X6"X1/2"	COVE BASE TO MATCH ON WALL BASE (WB-2)
<u>FLOORING</u>	WD-3	PLYWOOD PANEL		-		EXTERIOR GRADE		
	ACT	ACOUSTICAL CEILING TIL	E	-		-	24"X24"X3/4"	FDA AND USDA COMPLIANT SQUARE LAY IN TILES.
<u>CEILING</u>	GYP	GYPSUM BOARD		-		-	5/8"	
	T1-11	T1-11 PLYWOOD SIDING	G	-		PREMIUM GRADE SIDING	4'X8'X11/32"	
WALLBASE	WB-2	QUARRY TILE COVE BAS	E	DATILE; QUARRY TEX	XTURES	SAHARA SAND-0T08(2)	6"X6"X1/2"	
	TR-01	EXTERIOR DOOR SILL		-		-		
THRESHOLD	TR-02	QUARRY TO CONCRETE	Ē	-		-		
<u>GROUT</u>	GR-01	GROUT		MAPEI; TRADIT	IONAL	27- SILVER		
RAILING	R-01	PAINT		IVPPAINTS; RA	L 7004	SIGNAL GREY		

INFORMATION 1 State Street Plaza, New York, NY, 1000<sup>2</sup> (516) 938-5476 www.liro.com

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	C ONTRAC TOR		PROJECT COOR	DINATOR

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NAME

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TITLE \_\_\_\_

DATE \_\_\_\_


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\_\_\_ DATE \_\_\_\_\_

WESTCHESTER COUNTY, NEW YORK	CONTRACT SHEET NUMBER NUMBER
DEPARTMENT OF PUBLIC WORKS AND TRANSPORTATION	22-523 K-A-91
DIVISION OF ENGINEERING	DWG NO.: <b>524 of 664</b>
INFRASTRUCTURE REHABILITATION	SCALE: As indicated
PLAYLAND PARK, RYE, NEW YORK RESTAURANT KITCHEN WITH FOOD VENDING	DATE: <b>8/23/20223</b>
FINISHES & MATERIAL SCHEDULE	DPW FILE NUMBER 1-118-A-1273-0 REV. NO. 0



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MADE APP'D BY BY

DATE

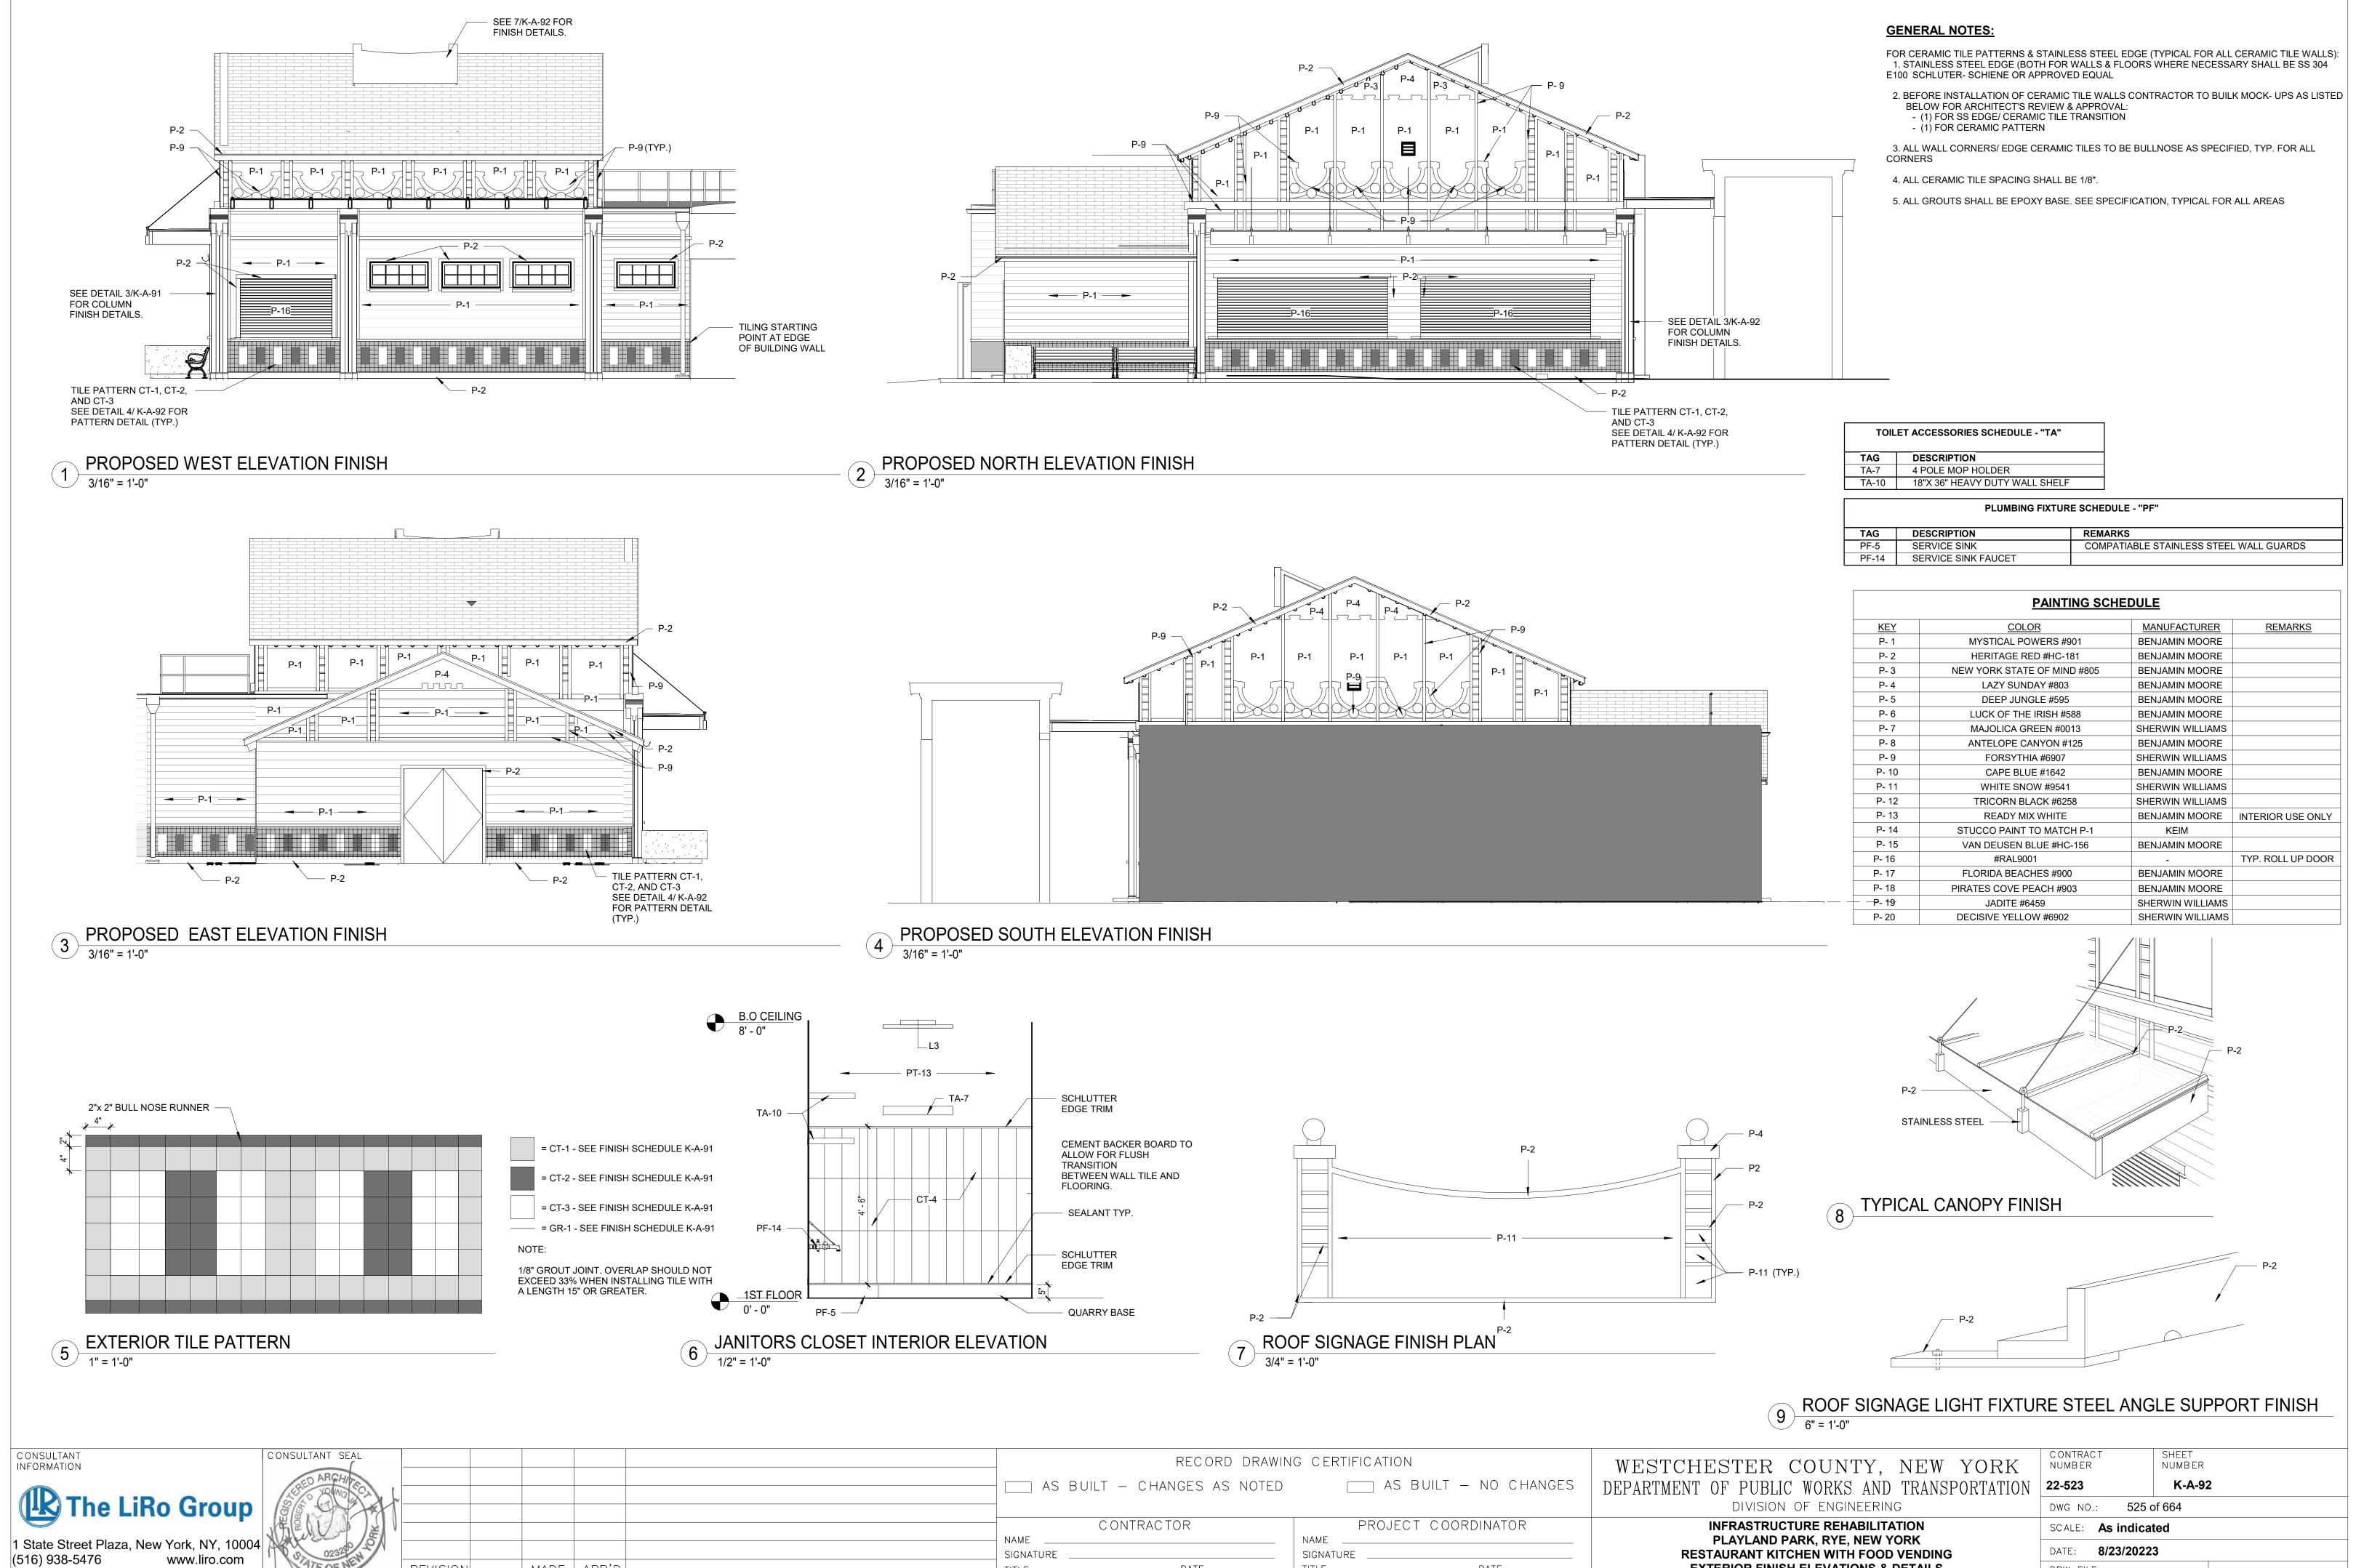
NUMBER


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\_\_\_ DATE \_\_\_

**EXTERIOR FINISH ELEVATIONS & DETAILS** 

DPW FILE **1-118-A-1274-0** REV. NO.



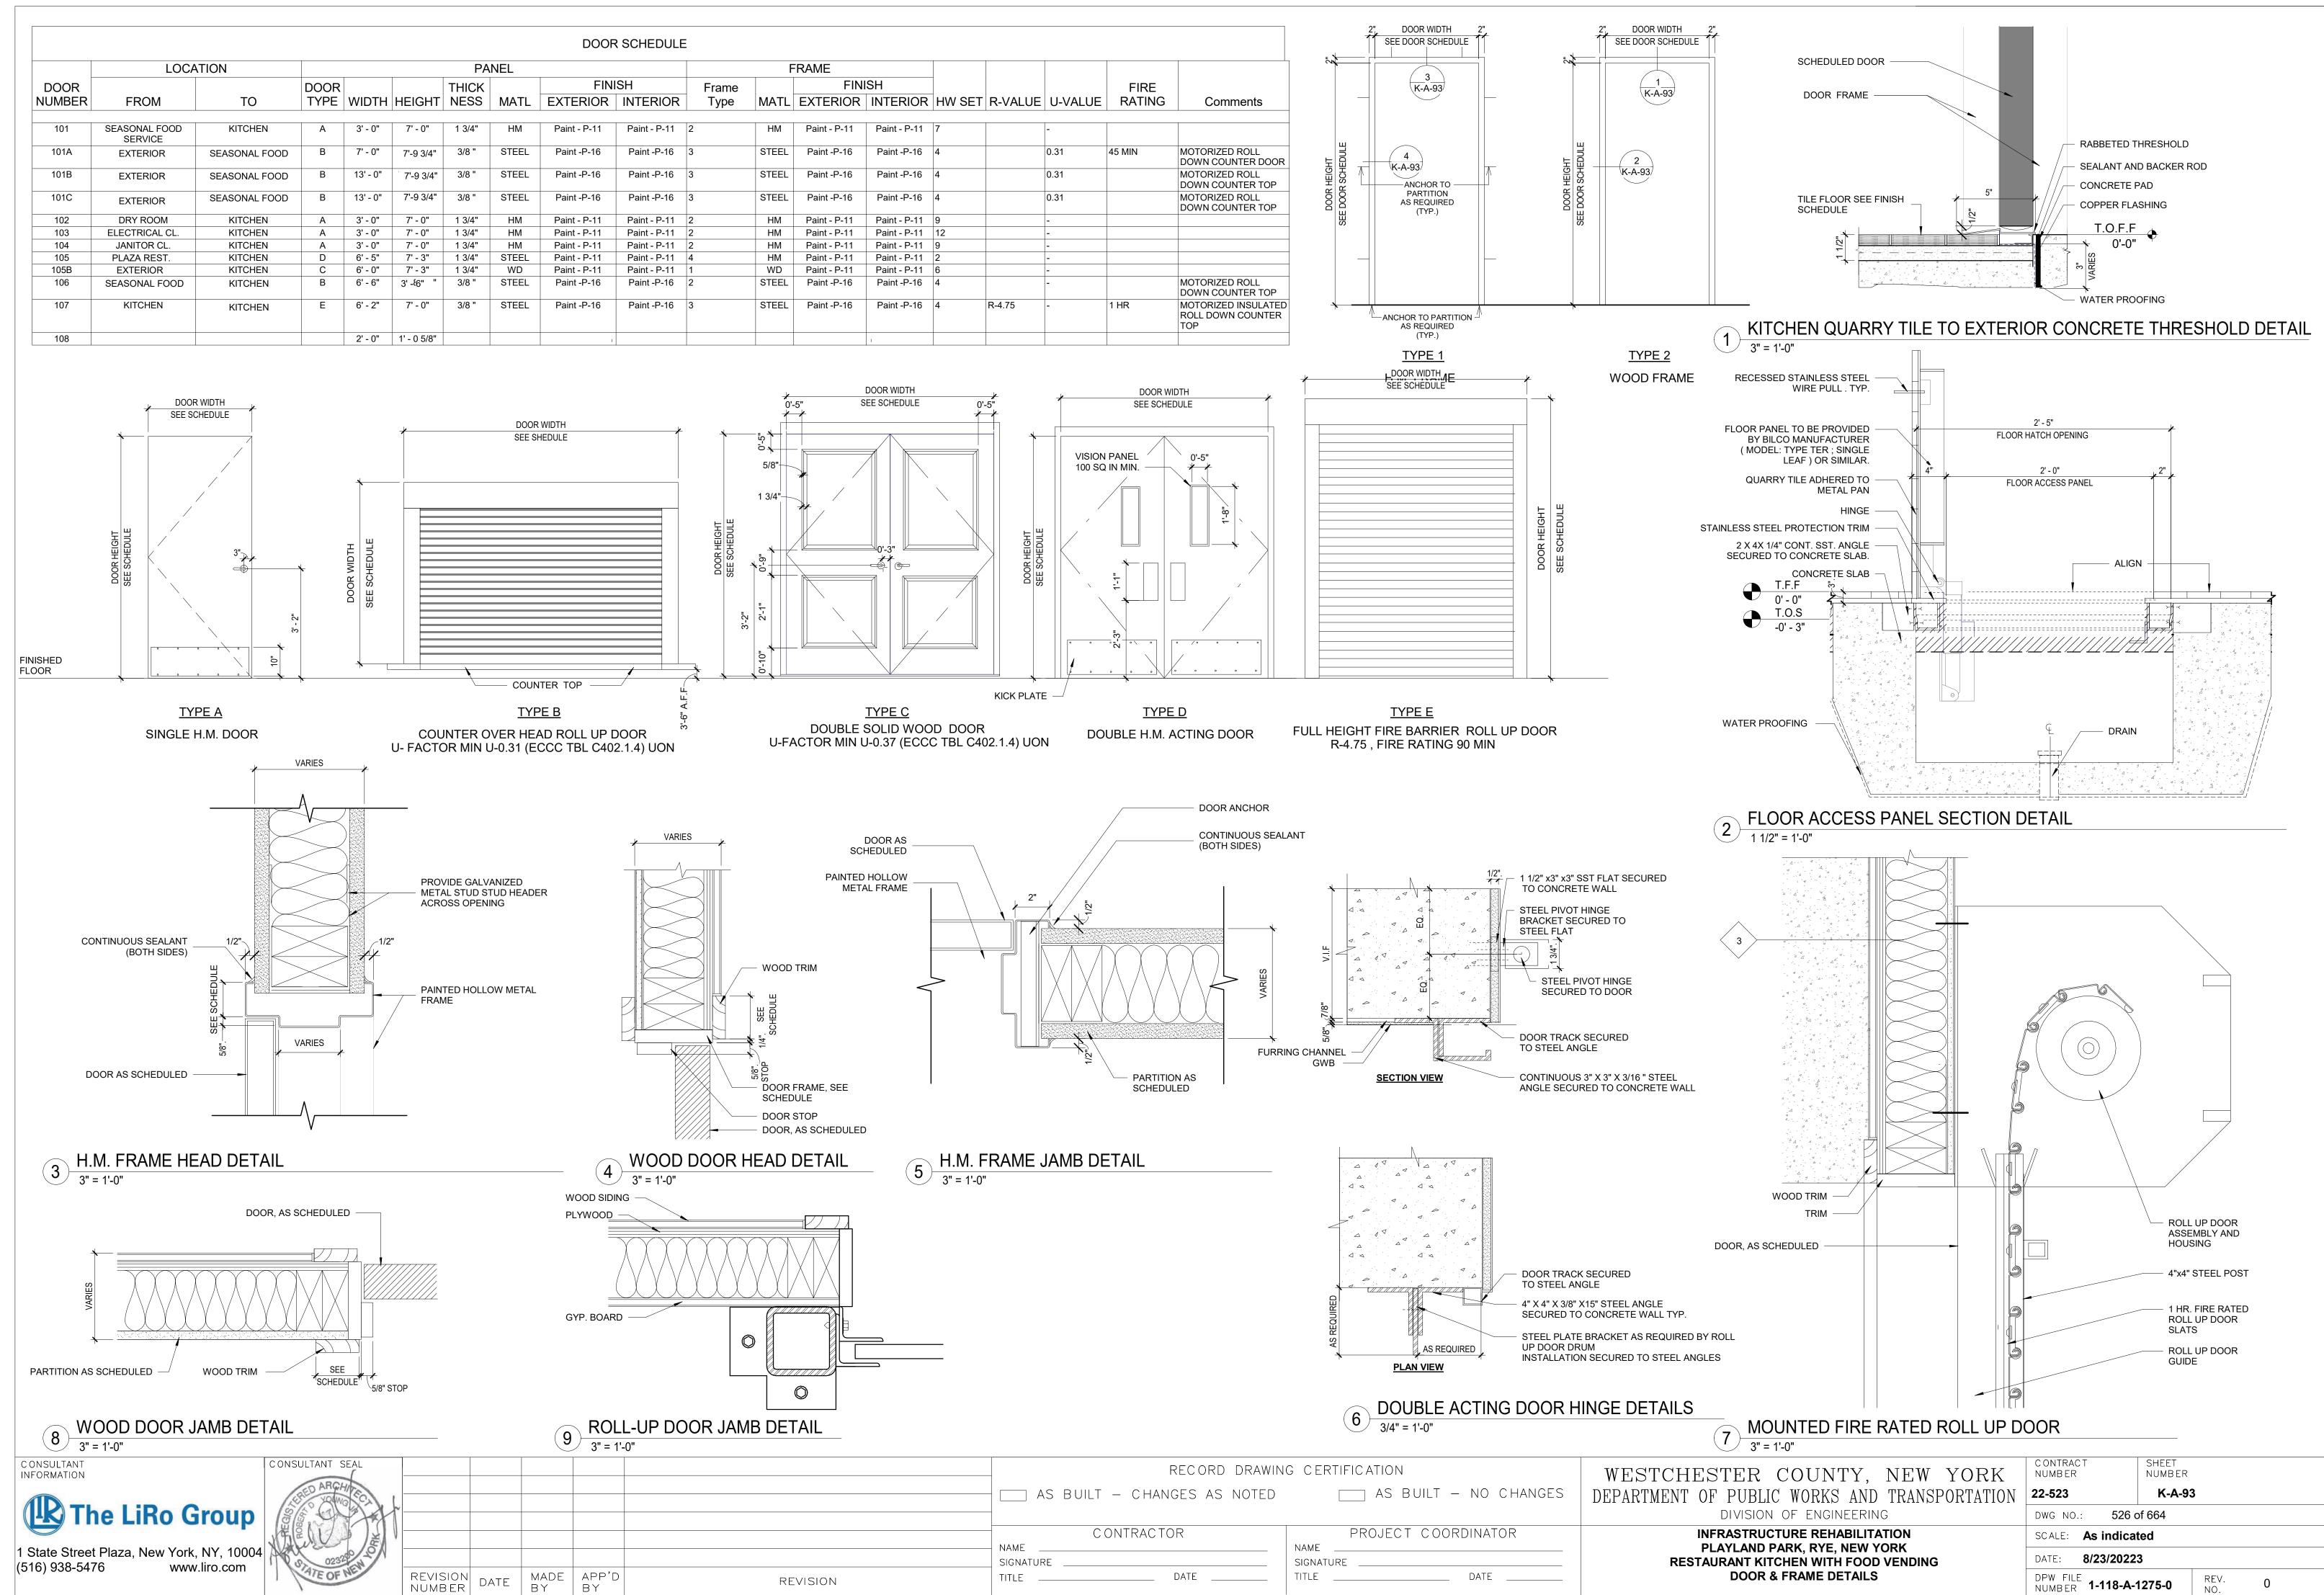
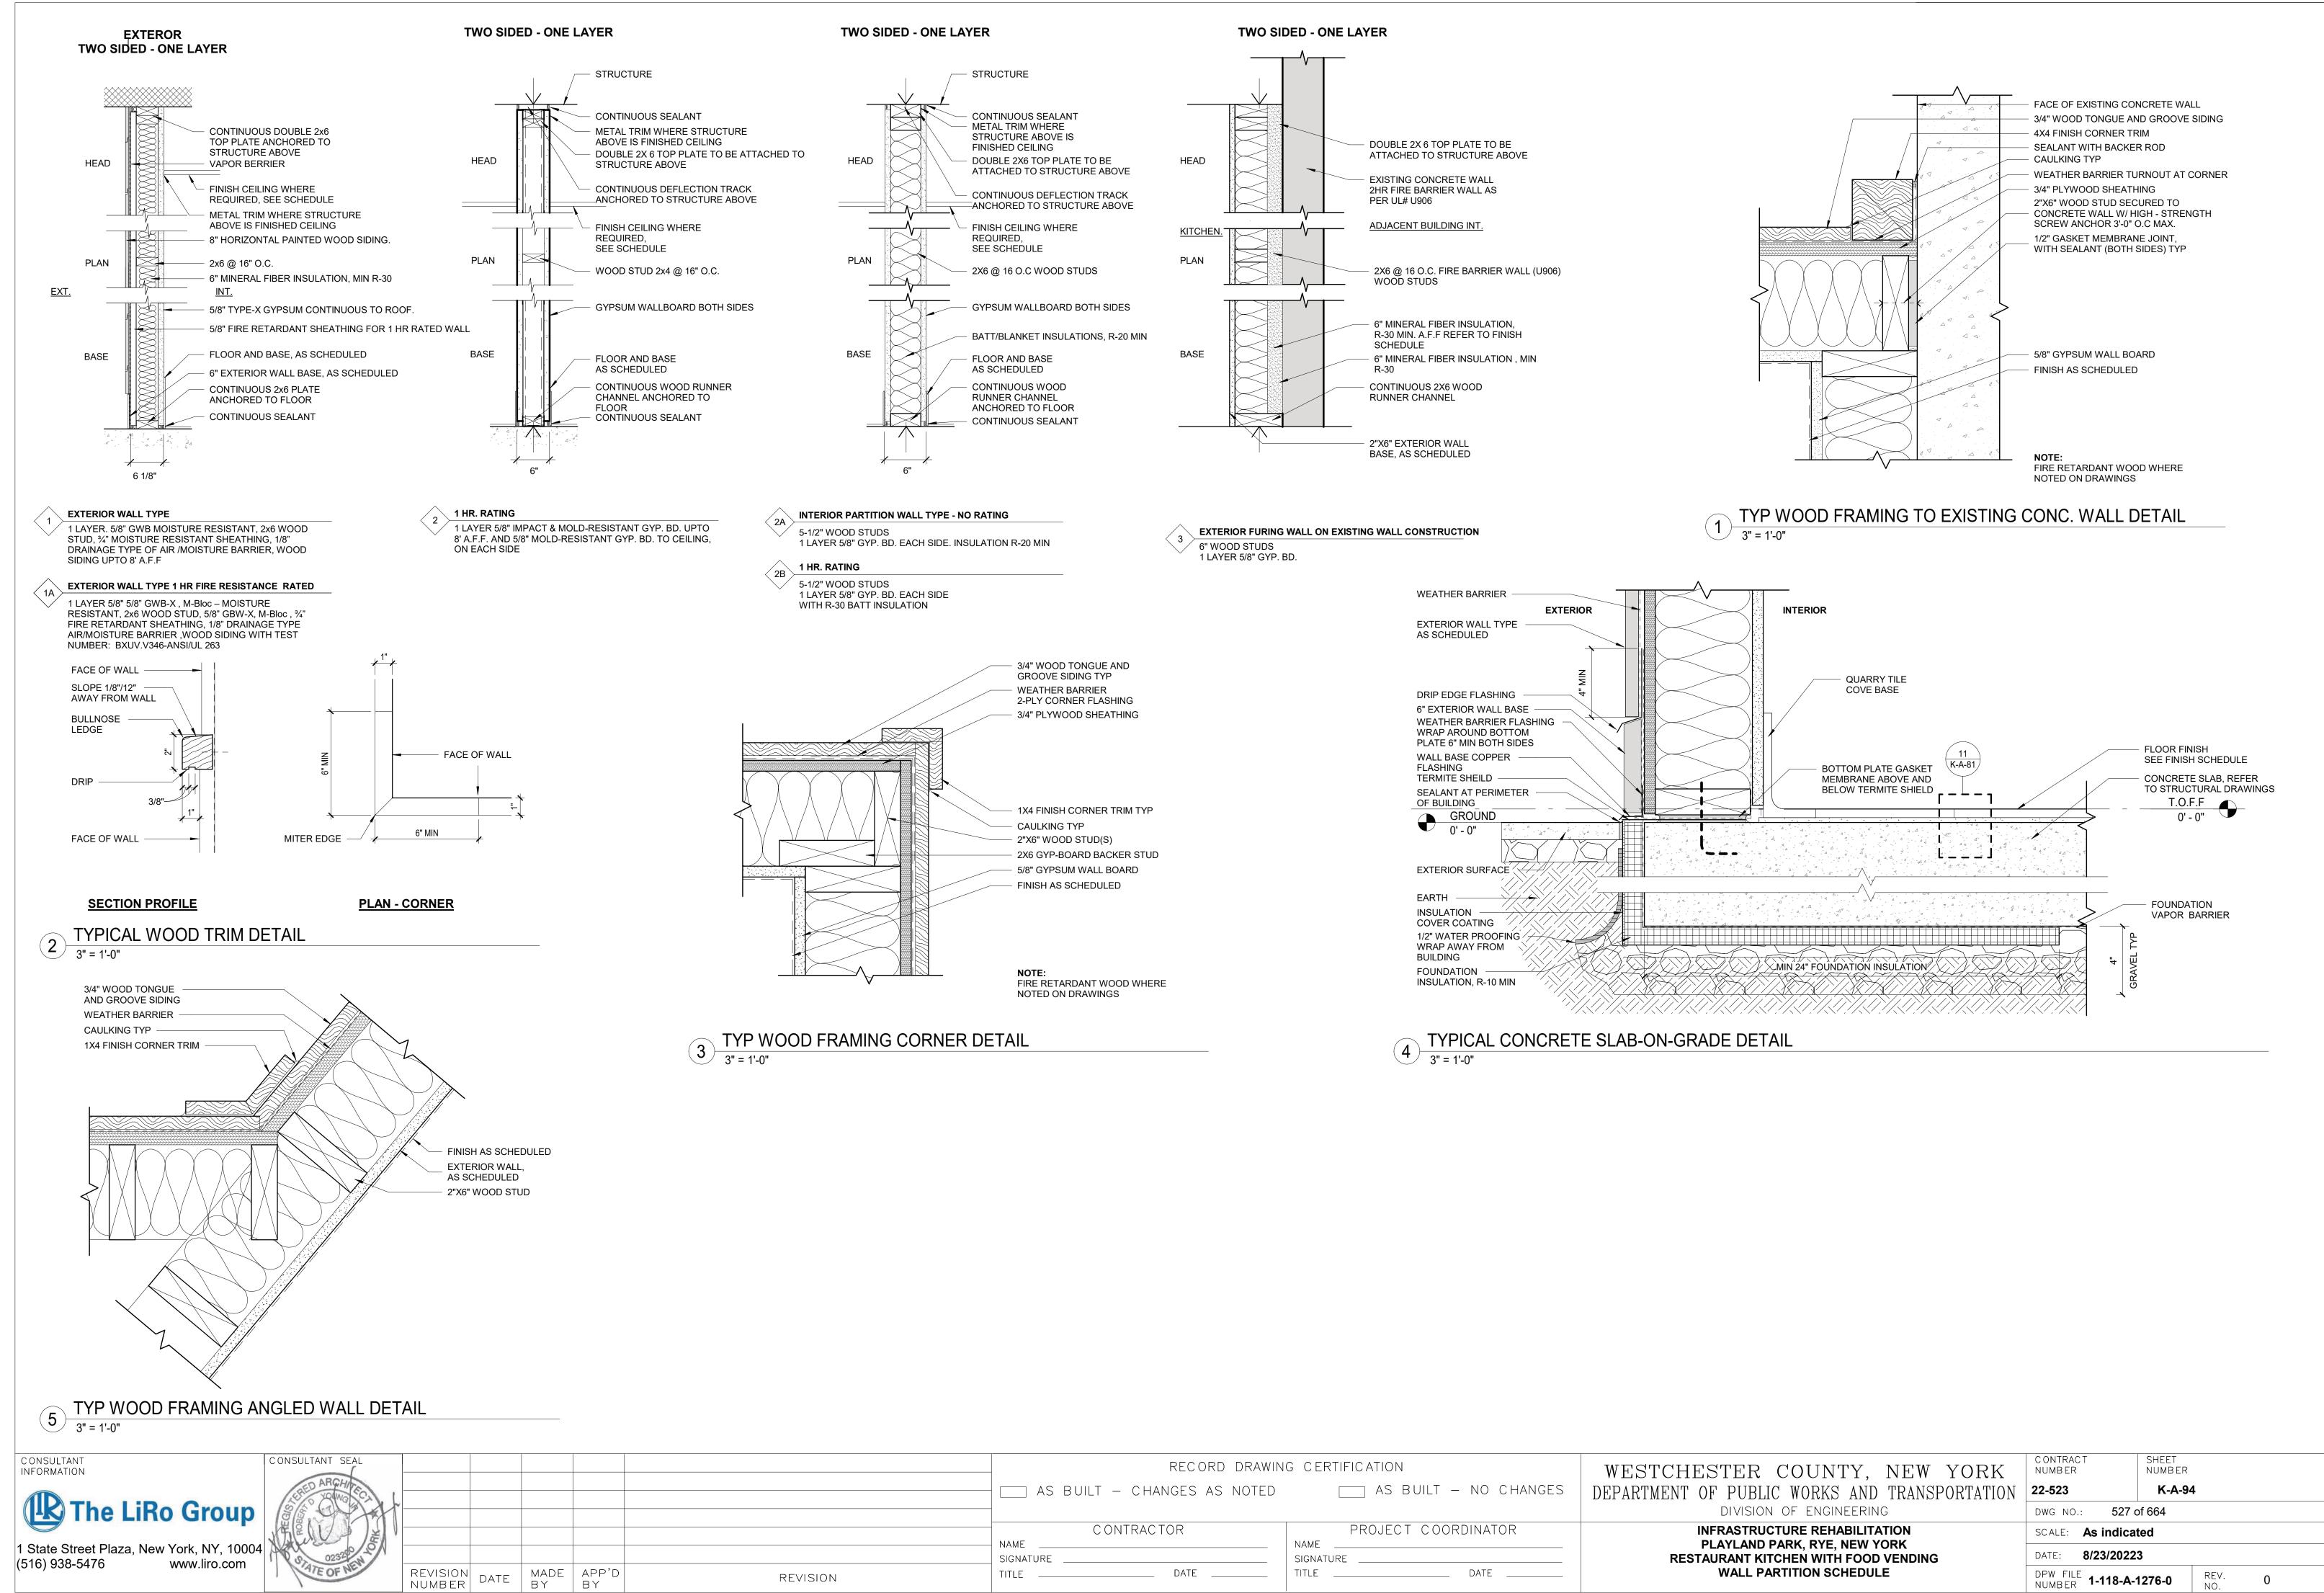
#### STRUCTURAL NOTES

#### **GENERAL**

- THESE NOTES ARE GENERAL AND SUPPLEMENTAL TO THE SPECIFICATIONS. THESE NOTES APPLY TO THE ENTIRE PROJECT UNLESS MODIFIED OR NOTED OTHERWISE IN THE CONTRACT DOCUMENTS.
- STANDARD DETAILS, SHOWN ON DRAWINGS K-S-11 AND K-S-12 SHALL BE USED WHEN REFERRED TO OR WHEN NO MORE RESTRICTIVE OR DIFFERENT DETAILS ARE SHOWN ON THE DRAWINGS.
- G-3 DESIGN WAS IN ACCORDANCE WITH AND CONSTRUCTION SHALL COMPLY WITH THE PROVISIONS OF THE NEW YORK STATE BUILDING CODE (NYSBC). THE DESIGN LOADS AND OTHER DESIGN VALUES GIVEN BELOW WERE USED FOR DESIGN OF STRUCTURES UON ON THE DRAWINGS.
- G-4 DESIGN LOADS FOR NEW ELEMENTS: LIVE LOADS:

RESTAURANT KITCHEN WITH FOOD VENDING: ALL FLOORS U.O.N.: FLOOR.: 60 PSF SNOW LOADS: GROUND SNOW LOAD, Pq = 30 PSFPf= 21 PSF ROOF SNOW LOAD, SNOW EXPOSURE FACTOR, Ce = 0.9SNOW LOAD IMPORTANCE FACTOR, 1 = 1.1

Ct = 1.0

V = 126 MPH

WIND DESIGN: BASIC WIND SPEED.

THERMAL FACTOR,

BUILDING CATEGORY: WIND EXPOSURE CATEGORY: INTERNAL PRESSURE COEFFICIENT,  $GCpi = \pm 0.18$ 

SEISMIC DESIGN:

SPECTRAL RESPONSE COEFFICIENTS: SDS = SD1 = 0.096 SITE CLASS: SEISMIC DESIGN CATEGORY: SEISMIC IMPORTANCE FACTOR: I = 1.25BASIC SEISMIC FORCE RESISTING SYSTEM IS AS SHOWN ON DRAWINGS DESIGN BASE SHEAR, V = AS SHOWN ON DRAWINGS ANALYSIS PROCEDURE IS EQUIVALENT LATERAL FORCE METHOD, UON.

RESPONSE MODIFICATION FACTOR, R: RESTAURANT KITCHEN WITH FOOD VENDING: R = 7LOADS INDICATED ABOVE REFLECT DESIGN LOADS FOR ANY NEW OR

DESIGN LOADS FOR THE STRUCTURE AS A WHOLE. G-5 ALL DIMENSIONS INDICATED (\*) ARE TO BE VERIFIED EITHER BY FIELD MEASUREMENTS FOR EXISTING STRUCTURES OR BY SHOP DRAWINGS FOR EQUIPMENT FURNISHED. STRUCTURAL DIMENSIONS NOT SHOWN BUT

CONTROLLED BY OR RELATED TO EQUIPMENT SHALL BE VERIFIED BY THE

REHABILITATED STRUCTURAL ELEMENTS. THEY SHOULD NOT BE TAKEN AS

STRUCTURAL DRAWINGS SHALL BE USED IN COORDINATION WITH THE DRAWINGS OF ALL OTHER DISCIPLINES AND MANUFACTURER'S SHOP DRAWINGS.

CONTRACTOR WITH THE MANUFACTURER PRIOR TO CONSTRUCTION.

- IF A CONFLICT IS FOUND BETWEEN DIFFERENT PORTIONS OF THE CONTRACT DOCUMENTS, THE CONTRACTOR SHALL NOTIFY THE ENGINEER IMMEDIATELY. CONTINUED CONSTRUCTION OF THE AREA IN CONFLICT SHALL BE AT THE CONTRACTOR'S OWN RISK UNTIL THE CONFLICT IS RESOLVED BY THE
- WHENEVER ONE MEMBER IS FASTENED TO ANOTHER WITH FASTENINGS (BOLTS, WELDS, ETC.) SET AT A UNIFORM SPACING, THERE SHALL BE A MINIMUM OF TWO FASTENINGS PER PIECE CONNECTED AND THE FIRST AND LAST FASTENINGS SHALL BE LOCATED NOT TO EXCEED 0.25 OF FASTENER SPACING FROM EACH END.
- STRUCTURES HAVE BEEN DESIGNED FOR OPERATIONAL LOADS ON THE COMPLETED STRUCTURE. DURING CONSTRUCTION, THE STRUCTURES SHALL BE PROTECTED BY BRACING AND TEMPORARY SUPPORTS WHEREVER EXCESSIVE CONSTRUCTION LOADS MAY OCCUR. OVERSTRESSING OF ANY STRUCTURAL ELEMENT IS PROHIBITED.
- G-10 NO BACKFILL SHALL BE PLACED AGAINST ANY WALL UNLESS ALL SUPPORTING ELEMENTS OF THE STRUCTURE HAVE BEEN CONSTRUCTED AND HAVE REACHED THE SPECIFIED MINIMUM CONCRETE STRENGTH.
- G-11 THE CONTRACTOR IS RESPONSIBLE FOR VERIFYING ALL EXISTING INFORMATION IN THE FIELD AS REQUIRED FOR NEW WORK.

#### **FOUNDATIONS**

- F-1 DESIGN ASSUMPTIONS: A) ALLOWABLE BEARING PRESSURE: 1. SOUND ROCK - 8 TSF, 2. OVERBURDEN - 1 TSF.
  - B) GROUNDWATER: EXISTING GROUNDWATER ELEVATIONS VARY ACROSS
- F-2 GRAVITY UNDER DRAINS SHALL BE PROVIDED TO PERMANENTLY LOWER GROUNDWATER.
- CONCRETE GENERAL NOTES APPLY TO FOUNDATIONS.
- MINIMUM DEPTH FROM ADJACENT FINISHED GRADE TO BOTTOM OF FOUNDATION, 4'-0"
- FOUNDATIONS BEARING ON ROCK SHALL BE CONSTRUCTED SUCH THAT ROCK SURFACE IS LEVEL, UNLESS APPROVED BY ENGINEER.
- COMPACTED SELECT GRANULAR FILL 12 INCHES THICK MINIMUM, SHALL BE PLACED BELOW ALL CONCRETE FOUNDATIONS UNLESS DIRECTLY BEARING ON SOUND ROCK.

#### STRUCTURAL METALS

S-1 DETAIL, FABRICATE, AND ERECT STRUCTURAL STEEL IN ACCORDANCE WITH AISC SPECIFICATION FOR STRUCTURAL STEEL BUILDINGS, ALLOWABLE STRESS DESIGN AND LRFD DESIGN (LRFD MANUAL OF STEEL CONSTRUCTION, CURRENT EDITION).

S-2 STEEL MATERIAL:

A) STRUCTURAL TUBING, ASTM A 500, GRADE B.

B) STRUCTURAL PIPE, ASTM A 53, GRADE B. C) PLATES AND ANGLES, ASTM A 36 UNO.

- D) STRUCTURAL W SHAPES, ASTM A 992 (MIN. YIELD STRENGTH OF
- E) STRUCTURAL S, M, & H SHAPES ASTM A572 GRADE 50. F) F) COLD FORMED STEEL.
- PROVIDE MIN 3/4" DIAMETER ASTM A 325 HIGH STRENGTH BOLTS WITH FULLY TIGHTENED TYPE N CONNECTIONS FOR STRUCTURAL STEEL UON.
- PROVIDE TYPICAL STEEL BEAM CONNECTIONS FOR A CAPACITY NOT LESS THAN THE TOTAL UNIFORM LOAD CAPACITY TABULATED IN THE AISC TABLES FOR ALLOWABLE LOADS OF BEAMS UNLESS NOTED OTHERWISE.
- S-5 CAST IN PLACE ANCHOR BOLTS FOR STRUCTURAL STEEL SHALL CONFORM TO ASTM A307 UON.
- S-6 DO NOT PAINT STEEL SURFACES WHICH ARE TO BE WELDED OR ARE TO BE ENCASED IN CONCRETE.
- STAINLESS STEEL SHALL BE TYPE 316 FOR BOLTED CONSTRUCTIONS AND 316L FOR WELDED CONSTRUCTIONS.
- S-8 ALUMINUM SHALL BE ALLOY 6061-T6.
- S-9 ALL GROOVE AND BUTT WELDS SHALL BE FULL PENETRATION.
- S-10 FILLET WELD SIZES SHALL BE THE MINIMUM SIZE REQUIRED BY AISC CODE FOR PLATE SIZES TO BE CONNECTED AND SHALL BE APPLIED TO THE ENTIRE JOINT CONTACT LENGTH, BUT NOT LESS THAN 3/16".
- S-11 DETAIL, FABRICATE, AND ERECT ALUMINUM IN ACCORDANCE WITH THE ALUMINUM ASSOCIATION CONSTRUCTION MANUAL CURRENT EDITION.
- S-12 ALL BOLTS, ANCHOR BOLTS, AND CONCRETE ANCHORS CONNECTING ALUMINUM SHALL BE TYPE 316 STAINLESS STEEL UON.
- S-13 ALUMINUM SHALL BE ISOLATED FROM CONTACT WITH CONCRETE OR DISSIMILAR METALS.
- E-1 CONTRACTOR SHALL PERFORM ALL EXCAVATION IN ACCORDANCE WITH STATE, LOCAL AND FEDERAL REQUIREMENTS INCLUDING OSHA BRACING AND EXCAVATION REQUIREMENTS.
- E-2 TEMPORARY SHEETING AND BRACING IS NOT SHOWN ON CONTRACT DRAWINGS. ALL EXCAVATIONS WITH A POTENTIAL FOR CAVE-IN SHALL BE PROVIDED WITH EXCAVATION PROTECTION SYSTEMS IN ACCORDANCE WITH OSHA 1926. SLOPING AND BENCHING WHICH WILL ENCROACH ON AREAS SLATED TO REMAIN ACCESSIBLE OR THAT MAY ENCROACH ON EXISTING FOOTINGS AND STRUCTURES SHALL NOT BE PERMITTED.
- CONTRACTOR SHALL ENGAGE THE SERVICES OF A LICENSED PROFESSIONAL ENGINEER REGISTERED IN THE STATE OF NEW YORK TO DESIGN ALL TEMPORARY SHEETING AND BRACING AND RELATED APPURTENANCES. CONTRACTOR TO SUBMIT SUCH PLANS TO ENGINEER FOR INFORMATION.
- CONTRACTOR SHALL BE RESPONSIBLE FOR DEWATERING OF OPEN
- E-5 ALL EXCAVATED MATERIALS SHALL BE REMOVED FROM SITE TO A FACILITY AS REQUIRED BY STATE, LOCAL FEDERAL LAW.

- T-1 ALL WOOD FRAMING MEMBERS INCLUDING, BUT NOT LIMITED TO, WALL STUDS AND JOISTS, ARE INTENDED TO ACT AS A SYSTEM AS DETAILED IN THE STRUCTURAL DRAWINGS AND ONCE CONSTRUCTION IS COMPLETE. IT IS THE RESPONSIBILITY OF THE CONTRACTOR TO ENSURE SAFETY AND STABILITY OF WOOD FRAMING SYSTEMS (I.E. TEMPORARY BRACING IF REQUIRED) DURING CONSRTUCTION AS A RESULT OF CONSTRUCTION METHODS AND SEQUENCES.
- T-2 ALL TIMBER BELOW FLOOR DECKING SHALL BE PRESSURE—TREATED SOUTHERN PINE LUMBER.
- T-3 STORAGE OF ALL LUMBER AND TIMBER ON SITE SHALL BE KEPT OFF GROUND, UNDER COVER AND PROTECTED FROM DAMAGE.
- T-4 ALL DIMENSIONAL LUMBER SHALL BE CERTIFIED BY THE SUPPLIER IN WRITING TO BE KILN DRIED.
- T-5 STRUCTURE SHALL NOT BE ENCLOSED UNLESS LUMBER MOISTURE CONTENT HAS BEEN VERIFIED TO BE AT OR BELOW 15%. ANY SIGNS OF MOLD SHALL BE REMOVED AND TREATED IN ACCORDANCE WITH PROJECT SPECIFICATIONS OR INDUSTRY STANDARDS.
- T-6 ALL LUMBER IN CONTACT WITH THE GROUND OR CONCRETE SHALL BE PRESSURE TREATED.
- T-7 FASTENERS FOR PRESERVATIVE TREATED AND FIRE RETARDANT TREATED WOOD SHALL BE OF HOT DIPPED ZINC COATED GALVANIZED STEEL OR STAINLESS STEEL AND SHALL FOLLOW CURRENT SIMPSON GUIDELINES BASED ON WEATHER EXPOSURE. WHERE STAINLESS STEEL CONNECTORS OR HOT DIPPED GALVANIZED CONNECTORS ARE SPECIFIED IN THE DRAWINGS, STAINLESS STEEL OR HOT DIPPED GALVANIZED FASTENERS SHALL BE USED TO MATCH CONNECTOR TYPE.
- T-8 ALL PLATES AND LEDGERS SHALL BE FASTENED WITH A MINIMUM (3) ANCHORS PER PIECE UNLESS NOTED OTHERWISE.
- T-9 ALL METAL HARDWARE AND FRAMING ACCESSORIES SHALL BE MANUFACTURED BY SIMPSON STRONG-TIE COMPANY. ALL ITEMS SHALL BE INSTALLED PER THE SIMPSON'S INSTALLATION REQUIREMENTS. ALL NAIL HOLES SHALL BE FILLED WITH THE RECOMMENDED FASTENER UNLESS NOTED OTHERWISE ON THE DRAWING.
- T-10 HOLES FOR BOLTS SHALL BE DRILLED WITH A BIT OF THE SAME NOMIMAL DIAMETER AS THE BOLT + 1/16". LEAD HOLES FOR LAG SCREWS SHALL BE BORED PER NDS 11.1.3.
- T-11 ALL BOLTS, CARRIAGE BOLTS, LAG SCREWS, EXPANSION BOLTS AND EPOXY BOLTS SHALL BE INSTALLED WITH STANDARD CUT WASHERS UNDER THE BOLT HEAD AND NUTS THAT BEAR DIRECTLY ON THE WOOD. ALL NUTS SHALL BE TIGHTENED AT THE TIME OF INSTALLATION AND RE-TIGHTENED IF NECESSARY, DUE TO WOOD SHRINKAGE, PRIOR TO CLOSE OUT OR COMPLETION OF THE PROJECT. BOLTS AND LAG SCREWS SHALL CONFORM TO ANSI/ASME STANDARD B18.2.1. WOOD SCREWS SHALL CONFORM TO B18.6.1. ALL BOLTS SHALL CONFORM TO ASTM A307 GRADE A UNLESS NOTED OTHERWISE.
- T-12 CUTTING AND NOTCHING OF SAWN LUMBER RAFTERS AND STUDS SHALL BE IN CONFORMANCE WITH THE FOLLOWING CRITERIA:
  - A. JOISTS NOTCHES AT THE ENDS OF JOISTS SHALL NOT EXCEED 1/5 OF THE JOIST DEPTH. HOLES IN JOISTS SHALL NOT BE WITHIN 21/2 INCHES OF THE TOP OR BOTTOM OF THE JOIST, AND THE DIAMETER OF ANY SUCH HOLE SHALL NOT EXCEED 1/4 THE DEPTH OF THE JOIST. NOTCHES IN THE TOP OR BOTTOM OF THE JOISTS SHALL NOT EXCEED 1/6 THE DEPTH AND SHALL NOT BE LOCATED IN THE MIDDLE OF THE THIRD SPAN.
  - B. RAFTERS NOTCHES AT THE ENDS OF RAFTERS OR CEILING JOISTS SHALL NOT EXCEED 1/5 OF THE DEPTH. NOTCHES IN THE TOP OR BOTTOM OF THE RAFTER OR CEILING JOIST SHALL NOT EXCEED 1/6 THE DEPTH AND SHALL NOT BE LOCATED IN THE MIDDLE 1/3 OF THE SPAN. EXCEPT THAT A NOTCH NOT EXCEEDING 1/3 OF THE DEPTH IS PERMITTED IN THE TOP OF THE RAFTERS OR CEILING JOIST NOT FURTHER FROM THE FACE OF THE SUPPORT THAN THE DEPTH OF THE MEMBER. HOLES BORED IN RAFTERS OR CEILING JOISTS SHALL NOT BE WITHIN 21/2" INCHES OF THE TOP AND BOTTOM AND THEIR DIAMETER SHALL NOT EXCEED 1/4 THE DEPTH OF THE MEMBER.
  - C. WALL STUDS A MAXIMUM OF  $2\frac{1}{4}$ " DIAMETER NEATLY BORED HOLE MAY BE PLACED IN THE CENTER OF ALL BEARING 2x6 STUDS WITH NO ADDITIONAL REINFORCEMENT REQUIRED.

SPECIAL INSPECTIONS—RESTAURANT KITCHEN WITH FOOD VENDING

- S-1 SPECIAL INSPECTION SHALL COMPLY WITH SPECIFICATIONS.
- S-2 SPECIAL INSPECTION WILL BE PERFORMED IN ACCORDANCE WITH CHAPTER 17 OF THE NYS BUILDING CODE.
- SPECIAL INSPECTION WILL BE PERFORMED ON THE FOLLOWING STRUCTURAL
  - A) STRUCTURAL STEEL CONSTRUCTION (1705.5).
  - B) WOOD CONSTRUCTION (1705.4).
  - C) CONCRETE CONSTRUCTION (1705.3).
- D) SOILS (1705.6).
- E) DRIVEN DEEP FOUNDATIONS (1705.7)
- F) WIND RESISTANCE (1705.11)
- G) SEISMIC RESISTANCE (1705.12).

#### CONCRETE (EXCEPT PRECAST)


- C-1 CONCRETE STRENGTH CLASSES (28-DAY COMPRESSIVE STRENGTH): CLASS A (5000 PSI) STRUCTURES, REINFORCED DUCT BANKS, AND PIPE ENCASEMENT. FOR CONCRETE WALLS GREATER THAN 2 FEET THICK FOLLOW ACI RECOMMENDATIONS FOR MASS CONCRETE. CLASS D (2500 PSI) SIDEWALKS, CURBS AND GUTTERS, CONCRETE FILL, THRUST BLOCKS, UNREINFORCED DUCT BANKS AND PIPE ENCASEMENT, FENCE POST EMBEDMENT.
- C-2 REINFORCEMENT: ASTM A615, GRADE 60, OR ASTM A706, GRADE 60 WHERE REINFORCEMENT IS TO BE WELDED.
- C-3 CONCRETE COVER FOR REINFORCING: A) SURFACES CAST AGAINST SUBGRADE 3" MIN. B) FORMED SURFACES IN CONTACT WITH SOIL OR LIQUID 2" MIN. C) SURFACES NOT IN CONTACT WITH WEATHER, SOIL, OR LIQUID 1 1/2" MIN.
- C-4 CONSTRUCTION JOINTS & CONTROL JOINTS SHALL BE LOCATED AS SHOWN ON THE DRAWINGS. WHERE NOT SHOWN, CONSTRUCTION JOINTS SHALL BE LOCATED AT NO MORE THAN 30 FEET ON CENTER. JOINT LOCATIONS SHALL BE AS APPROVED BY THE
- C-5 EQUIPMENT SUPPORTS, ANCHORAGES, OPENINGS, RECESSES AND REVEALS NOT SHOWN ON THE STRUCTURAL DRAWINGS BUT REQUIRED BY OTHER DISCIPLINES, SHALL BE PROVIDED FOR PRIOR TO PLACING CONCRETE.
- C-6 SPLICES SHALL BE CLASS 'B' CONFORMING TO THE PROVISIONS OF ACI 318 UNLESS NOTED OTHERWISE.
- C-7 AT ALL TYPICAL CURBS, EQUIPMENT PADS, AND PIPE SUPPORT PIERS, REINFORCING DOWELS SHOWN MAY BE REPLACED WITH MATCHING DOWELS SET IN EPOXY IN DRILLED HOLES AS SPECIFIED. DOWELS LOCATED CLOSER THAN 3" FROM ANY EDGE OF CONCRETE SHALL NOT BE REPLACED WITH DRILLED DOWELS.
- C-8 DRILLED EPOXY DOWELS (WHERE DOWELS ARE SHOWN TO BE PLACED INTO HARDENED CONCRETE): A) THE HOLE DIAMETER SHALL BE NO LARGER THAN 1/8" GREATER THAN THE DIAMETER OF THE REINFORCING BAR AT THE
  - DEFORMATIONS. B) THE DEPTH OF EMBEDMENT SHALL BE 12 BAR DIAMETERS, UNLESS SHOWN OTHERWISE.
  - C) ADJUST THE DOWEL LOCATIONS AS NEEDED TO AVOID DRILLING THROUGH ANY REINFORCING BARS.IF THE DOWEL LOCATION NEEDS TO BE MODIFIED, CONTACT THE ENGINEER.
- C-9 SLABS WITH SLOPING SURFACES SHALL HAVE THE INDICATED SLAB THICKNESS MAINTAINED AS THE MINIMUM. SLAB BOTTOMS CAN EITHER SLOPE WITH THE TOP SURFACE OR BE LEVEL. REINFORCEMENT IN SLABS WITH SLOPING SURFACES SHALL BE PLACED AT THE REQUIRED CLEARANCE FROM THE SLAB SURFACE.
- C-10 SLOPES SHOWN ON SLAB SURFACES BY FLOW ARROWS SHALL BE 1.0 PERCENT UNLESS NOTED OTHERWISE.
- C-11 WHERE HORIZONTAL CONSTRUCTION JOINTS, LOCATED ABOVE THE FOUNDATION SLAB, EXTEND BEYOND WHERE NEEDED, THEY SHALL BE TERMINATED AT A VERTICAL CONSTRUCTION JOINT APPROVED BY
- C-12 DOWELS, ANCHOR BOLTS, PIPES, WATERSTOPS AND OTHER EMBEDDED ITEMS SHALL BE HELD SECURELY IN POSITION WHILE CONCRETE IS BEING PLACED.
- C-13 CONDUITS AND OTHER SIMILAR ITEMS EMBEDDED IN OR PENETRATING THROUGH CONCRETE SHALL BE SPACED ON CENTER NOT LESS THAN 3 TIMES THEIR OUTSIDE DIMENSION, BUT NOT LESS THAN 2 1/2" CLEAR IN CLASS 45F CONCRETE OR 2" CLEAR IN CLASS 45 CONCRETE. SUCH ITEMS SHALL NOT EXCEED 1/3 OF THE MEMBER THICKNESS.
- C-14 REINFORCING BARS AND ACCESSORIES SHALL NOT BE IN CONTACT WITH ANY METAL PIPE, PIPE FLANGE, METAL CONDUIT, OR OTHER METAL PARTS EMBEDDED IN CONCRETE. A MINIMUM CLEARANCE OF 2 INCHES SHALL BE PROVIDED.
- C-15 ALL JOINTS WHICH ARE IN MEMBERS IN CONTACT WITH LIQUID OR BELOW GRADE SHALL HAVE A WATERSTOP. CONSTRUCTION JOINTS SHALL HAVE A 6" PVC FLATSTRIP WATERSTOP. EXPANSION JOINTS SHALL HAVE A 9" PVC CENTERBULB WATERSTOP.
- C-16 IN VERTICAL JOINTS, WATERSTOP SHALL STOP NO LESS THAN 18" ABOVE THE MAXIMUM WATER SURFACE OR 18" ABOVE GRADE, WHICHEVER IS HIGHER.
- C-17 AT JOINT INTERSECTIONS, WATERSTOPS SHALL BE CONNECTED SO AS TO FORM A COMPLETE SEAL USING CONNECTION PIECES AS
- C-18 ALL EXPOSED CORNERS SHALL HAVE A 3/4" CHAMFER OR A 1/2" RADIUS TOOLED CORNER.

#### DEMOLITION

EXISTING REINFORCED CONCRETE WALL OR STRUCTURE TO BE DEMOLISHED

SAW CUT LINE - FULL DEPTH

UNLESS NOTED OTHERWISE

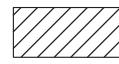

CONTRACTOR IS ALERTED THAT LIMITS OF DEMOLITION SHOWN IS APPROXIMATE. ACTUAL LIMITS SHALL BETHE MINIMUM REQUIRED FOR NEW STRUCTURE. CONTRACTOR TO CO-ORDINATE AND SUBMIT DEMOLITION PROCEDURE PER SPECIFICATIONS.


- D-2 ALL ITEMS SHOWN ARE EXISTING TO REMAIN UNLESS NOTED OTHERWISE.
- D-3 FOR ADDITIONAL DEMOLITION REQUIREMENTS SEE SPECIFICATIONS (024116).
- ALL EXISTING CONCRETE TO BE DEMOLISHED IS STEEL REINFORCED UNLESS NOTED OTHERWISE. REINFORCING STEEL NOT SHOWN FOR CLARITY.
- FOR ADDITIONAL DEMOLITION NOT SHOWN, SEE G, A, M, E, H, AND P DRAWINGS

#### PILE NOTES

- P-1 PILES SHALL BE DESIGNED AND INSTALLED BY A QUALIFIED PILE CONTRACTOR IN ACCORDANCE WITH THE BORED-IN PILE SPECIFICATIONS AND SUBJECT TO THE REQUIREMENTS LISTED HEREIN.
- THE CONTRACTOR SHALL ENGAGE A LICENSED PROFESSIONAL ENGINEER REGISTERED IN THE STATE OF NEW YORK TO DESIGN PILE AND SUBMIT THE DESIGN TO THE ENGINEER FOR APPROVAL.
- THE BORED-IN PILE SHALL BE MINIMUM 9 5/8" WITH 0,545" WALL THICKNESS AND DESIGNED AND INSTALLED FOR ULTIMATE LOAD IN COMPRESSION = 60 TONS ALLOWABLE LOAD IN COMPRESSION = 30 TONS.
- P-4 ALL BORED-IN PILES SHALL BE GROUTED WITH A MINIMUM 28 DAY COMPRESSIVE STRENGTH OF 4000 PSI.
- P-5 ALL BORED-IN PILES SHALL HAVE FULL LENGTH 1-1/4" Ø THREADBARS. THE THREADBARS SHALL CONFORM TO THE REQUIREMENTS OF ASTM A722, GRADE 150 AS MANUFACTURED BY DYWIDAG OR APPROVED EQUAL, UNLESS NOTED OTHERWISE. PROVIDE BEARING PLATES AND NUTS IN ACCORDANCE WITH THE THREADBAR MANUFACTURER'S RECOMMENDATIONS.
- P-6 PROVIDE CENTRALIZERS FOR THREADBARS AT 10 FEET MAXIMUM VERTICAL
- P-7 CUT OFF THE ELEVATIONS OF THE BORED-IN PILES AS SHOWN ON DRAWINGS.
- ALL BORED-IN PILES SHALL BE INSTALLED WITH A MAXIMUM LATERAL TOLERANCE OF THREE INCHES.
- P-9 DRILLING OPERATION SHALL BE PERFORMED IN THE PRESENCE OF THE ENGINEER.
- P-10 ONE (1) STATIC AXIAL COMPRESSION LOAD TEST WILL BE REQUIRED.
- P-11 THE INSTALLATION METHOD USED FOR THE SUCCESSFUL COMPLETION OF LOAD TESTING SHALL BE USED FOR ALL THE PRODUCTION PILES.
- P-12 THE CONTRACTOR SHALL SUBMIT A STATIC AXIAL LOAD TESTING PROGRAM CONSISTING OF ONE (1) COMPRESSION TEST SHOWING PROPOSED PILE LOAD TEST LOCATIONS FOR APPROVAL OF THE ENGINEER.
- P-13 COMPRESSION LOAD TESTING SHALL CONFORM TO ASTM D1143 AND THE PROJECT SPECIFICATIONS. UPLIFT LOAD TESTING SHALL CONFORM TO THE PROJECT SPECIFICATIONS AND ASTM D3689.
- P-14 A MINIMUM PERIOD OF TWO (2) WEEKS SHALL ELAPSE FROM THE INSTALLATION OF THE TEST PILE TO THE COMMENCEMENT OF THE LOAD
- P-15 TWO (2) TELLTALE RODS SHALL BE INSTALLED IN THE LOAD TEST PILE. THE BOTTOM END OF ONE TELLTALE ROD SHALL BE AT THE BOTTOM OF THE TEST PILE, AND THE BOTTOM END OF THE OTHER ROD SHALL BE TERMINATED MIDWAY BETWEEN PILE CUT-OFF AND PILE TIP. THE TELLTALE SHALL CONSIST OF A STEEL SOUNDING ROD EXTENDED TO AN ELEVATION DESIGNATED BY THE ENGINEER. THE TELLTALES SHALL BE PROTECTED BY A STEEL TUBE EMBEDDED IN GROUT. THE TELLTALE SHALL BE CENTERED IN THE TUBE IN A MANNER TO AVOID FRICTION BETWEEN THE TELLTALE AND
- P-16 THE LOADING PROCEDURE FOR STATIC AXIAL COMPRESSION TEST SHALL BE IN ACCORDANCE WITH NEW YORK STATE BUILDING CODE.
- P-17 MEASUREMENTS OF MOVEMENT OF THE PILE BUTT, TELLTALES, REFERENCE BEAMS, ETC. SHALL BE TAKEN BY LICENSED SURVEYOR (REGISTERED IN THE STATE OF NEW YORK) ENGAGED BY THE OWNER.
- P-18 MONITORING OF LOAD TEST SHALL BE PERFORMED BY A PROFESSIONAL ENGINEER REGISTERED IN THE STATE OF NEW YORK AND HIRED BY THE

IUMBER

P-19 THE DIAL GAUGES FOR MONITORING THE MOVEMENT OF THE PILE SHALL HAVE A MINIMUM TRAVEL OF THREE (3) INCHES AND SHALL BE AT LEAST THREE (3) INCHES IN DIAMETER.

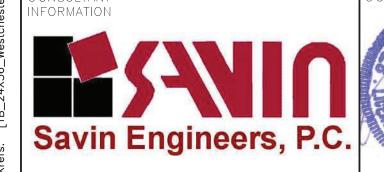

SIGNATURE REVISION REVISION IUMBER

AS BUILT - CHANGES AS NOTED

\_\_\_\_\_ DATE \_\_\_\_\_

CONTRACTOR

RECORD DRAWING CERTIFICATION

AS BUILT - NO CHANGES PROJECT COORDINATOR SIGNATURE

\_\_\_\_\_ DATE \_\_\_\_\_

DIVISION OF ENGINEERING **INFRASTRUCTURE REHABILITATION - PHASE 3** PLAYLAND PARK, RYE, NEW YORK RESTAURANT KITCHEN WITH FOOD VENDING

WESTCHESTER COUNTY, NEW YORK

DEPARTMENT OF PUBLIC WORKS AND TRANSPORTATION

STRUCTURAL NOTES

K-S-01 22-523

DWG NO. SCALE: AS SHOWN of 664 8/23/2022 DPW FILE **1-118-S-1277-0** NUMBER

NUMBER

GAUGE

GRADE

GRATING

GALVANIZE

GRADE BEAM

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GB

GR

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OPP OT

		<u> 21400</u>
AB ADDL ADH ADJ AFF AGG AL ALT APPROX ARCH AVG	ANCHOR BOLT ADDITIONAL ADHESIVE ADJUSTABLE/ADJACENT ABOVE FINISHED FLOOR AGGREGATE ALUMINUM ALTERNATE APPROXIMATE ARCHITECTURAL AVERAGE	
B BLDG BM BOF BOS BOT BRG BT	BORING BUILDING BEAM/BENCH MARK BOTTOM OF FOOTING BOTTOM OF STEEL BOTTOM BEARING BOLT	
C C TO C CANT CJ CL CLR CMU CO COL CONC	CHANNEL CENTER TO CENTER CANTILEVER CONSTRUCTION JOINT CENTER LINE CLEAR CONCRETE MASONRY UNIT CLEAN OUT COLUMN CONCRETE CONCRETE	

CONTINUOUS

CONTRACTOR

CENTER

DETAIL

DIAMETER

DIAGONAL

DIMENSION

DISTANCE

DOWN

DITTO

DEEP

DRAWING

DOWEL

EAST

EACH

EACH FACE

ELEVATION

ELEVATOR

ENGINEER

EMBEDMENT

ENCLOSURE

ENTRANCE

EQUIPMENT

EACH WAY

EXPANSION

EXTERIOR

FABRICATE

FLOOR DRAIN

FOUNDATION

FINISH FLOOR

FRAME&COVER FRAME&GRATE

FINISH

FLOOR

FEET

FOOTING

EXPANSION JOINT

**EXISTING** 

EQUAL

CUBIC YARD

CONCRETE PLANK

CONTROL JOINT

CONT

CP

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DIM DIST

DN DO DP

DWG

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**EXIST** 

EXP JT

EXP

FD FDN FFL

FLR

FTG F&C

DIA (Ø)

CONTR

HGT HEIGHT HORIZONTAL HORZ HIGH POINT HSS HOLLOW STRUCTURAL STEEL INSIDE DIAMETER INSIDE FACE INCH INCL INCLUDE INT INTERIOR INV INVERT JOIST JUNCTION BOX JUNCTION JOINT LENGTH/ANGLE LINEAR FEET LONG LIVE LOAD LLH LONG LEG HORIZONTAL LONG LEG VERTICAL LLV LOC LOCATION LOW POINT LVR LOUVER LWL LOW WATER LEVEL MAS MASONRY MATERIAL MATL MAX MAXIMUM MECH MECHANICAL MET METAL MFR MANUFACTURER MG MILLION GALLONS MGD MILLION GALLONS PER DAY MH MANHOLE MIN MINIMUM MISC MISCELLANEOUS MO MASONRY OPENING MOD MODIFY/MODIFIED

MOUNTÉD

NOT APPLICABLE

NOT TO SCALE

OUTSIDE FACE

ON CENTER

OPENING

OPPOSITE

OVERHEAD

PARALLEL

PARTITION

PAVEMENT

QUANTITY

PILE CUT OFF

PREFABRICATED

OPEN TRUSS

NOT IN CONTRACT

OUTSIDE DIAMETER

POINT OF CURVE/PIECE

POINT OF INTERSECTION

PLATE/PROPERTY LINE

POINT OF TANGENCY

POUNDS PER SQUARE FOOT POUNDS PER SQUARE INCH

NORTH

NUMBER

NOMINAL

SJ SPEC SQ SS STA STD STR STIF STIR STL STRUC SUB SYM T&B T&G TAN TEMP THK TOC TOD TOF TOM TOS TOW TYP UNO VERT W/0 WPT WWF YD

RISER

RADIUS

REINFORCEMENT

ROUGH OPENING

RECTANGULAR

REMOVE

REQUIRED

ROOF

SOUTH

SCHEDULE

SQUARE FEET

STEEL JOIST

SPECIFICATION

STAINLESS STEEL

SECTION

SHEET

SIMILAR

SQUARE

STATION STANDARD

STAIR

STIFFENER

STRUCTURAL

SUBSTITUTE

TANGENT

THICK

TEMPERATURE

TOP OF DECK

TOP OF WALL

TYPICAL

VERTICAL

WITH

YARD

YEAR

WITHOUT

WATER LEVEL

WATER SURFACE

WELDED WIRE FABRIC

TOP OF FOOTING

TOP OF SLAB/STEEL

SYMMETRICAL

TOP AND BOTTOM

TOUNGE AND GROOVE

TOP OF CURB/CONCRETE

TOP OF MASONRY/MANHOLE

UNLESS NOTED OTHERWISE

WEST/WIDTH/WIDE FLANGE

WATERPROOF/WALL PIPE

WALL PENETRATING TYPE

STIRRUP

STEEL

REINFORCED CONCRETE PIPE

RAD

RCP

RD REINF RECT

REM

REQD

SCHED SECT SF

SHT

SIM

RO

<u>SYMBOLS</u>

UNDISTURBED EARTH

COMPACTED BACKFILL



SELECT GRANULAR FILL MATERIAL



CONCRETE BLOCK





FINISHED WOOD






CONCRETE



ROUGH WOOD




RIGID INSULATION

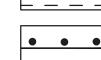

REINFORCED STEEL IN CONCRETE



WELDED WIRE FABRIC

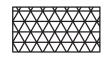



BLANKET INSULATION




STEEL



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						CONTRACTOR
						NAME
						SIGNATURE
	REVISION NUMBER	DATE	MADE BY	APP'D BY	REVISION	TITLE DATE




AS BUILT — NO CHANGES PROJECT COORDINATOR

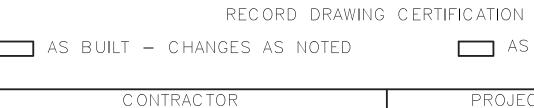DEPARTMENT OF PUBLIC WORKS AND TRANSPORTATION DIVISION OF ENGINEERING **INFRASTRUCTURE REHABILITATION - PHASE 3** PLAYLAND PARK, RYE, NEW YORK RESTAURANT KITCHEN WITH FOOD VENDING

STRUCTURAL ABBREVIATIONS AND SYMBOLS

WESTCHESTER COUNTY, NEW YORK


NUMBER	NUMBER					
22-523	K-S-02					
DWG NO.:						
SCALE: AS SHO	29 of 664					
DATE: <b>8/23/2022</b>						
DPW FILE 1-118-S-	1278-0	REV. NO.	0			

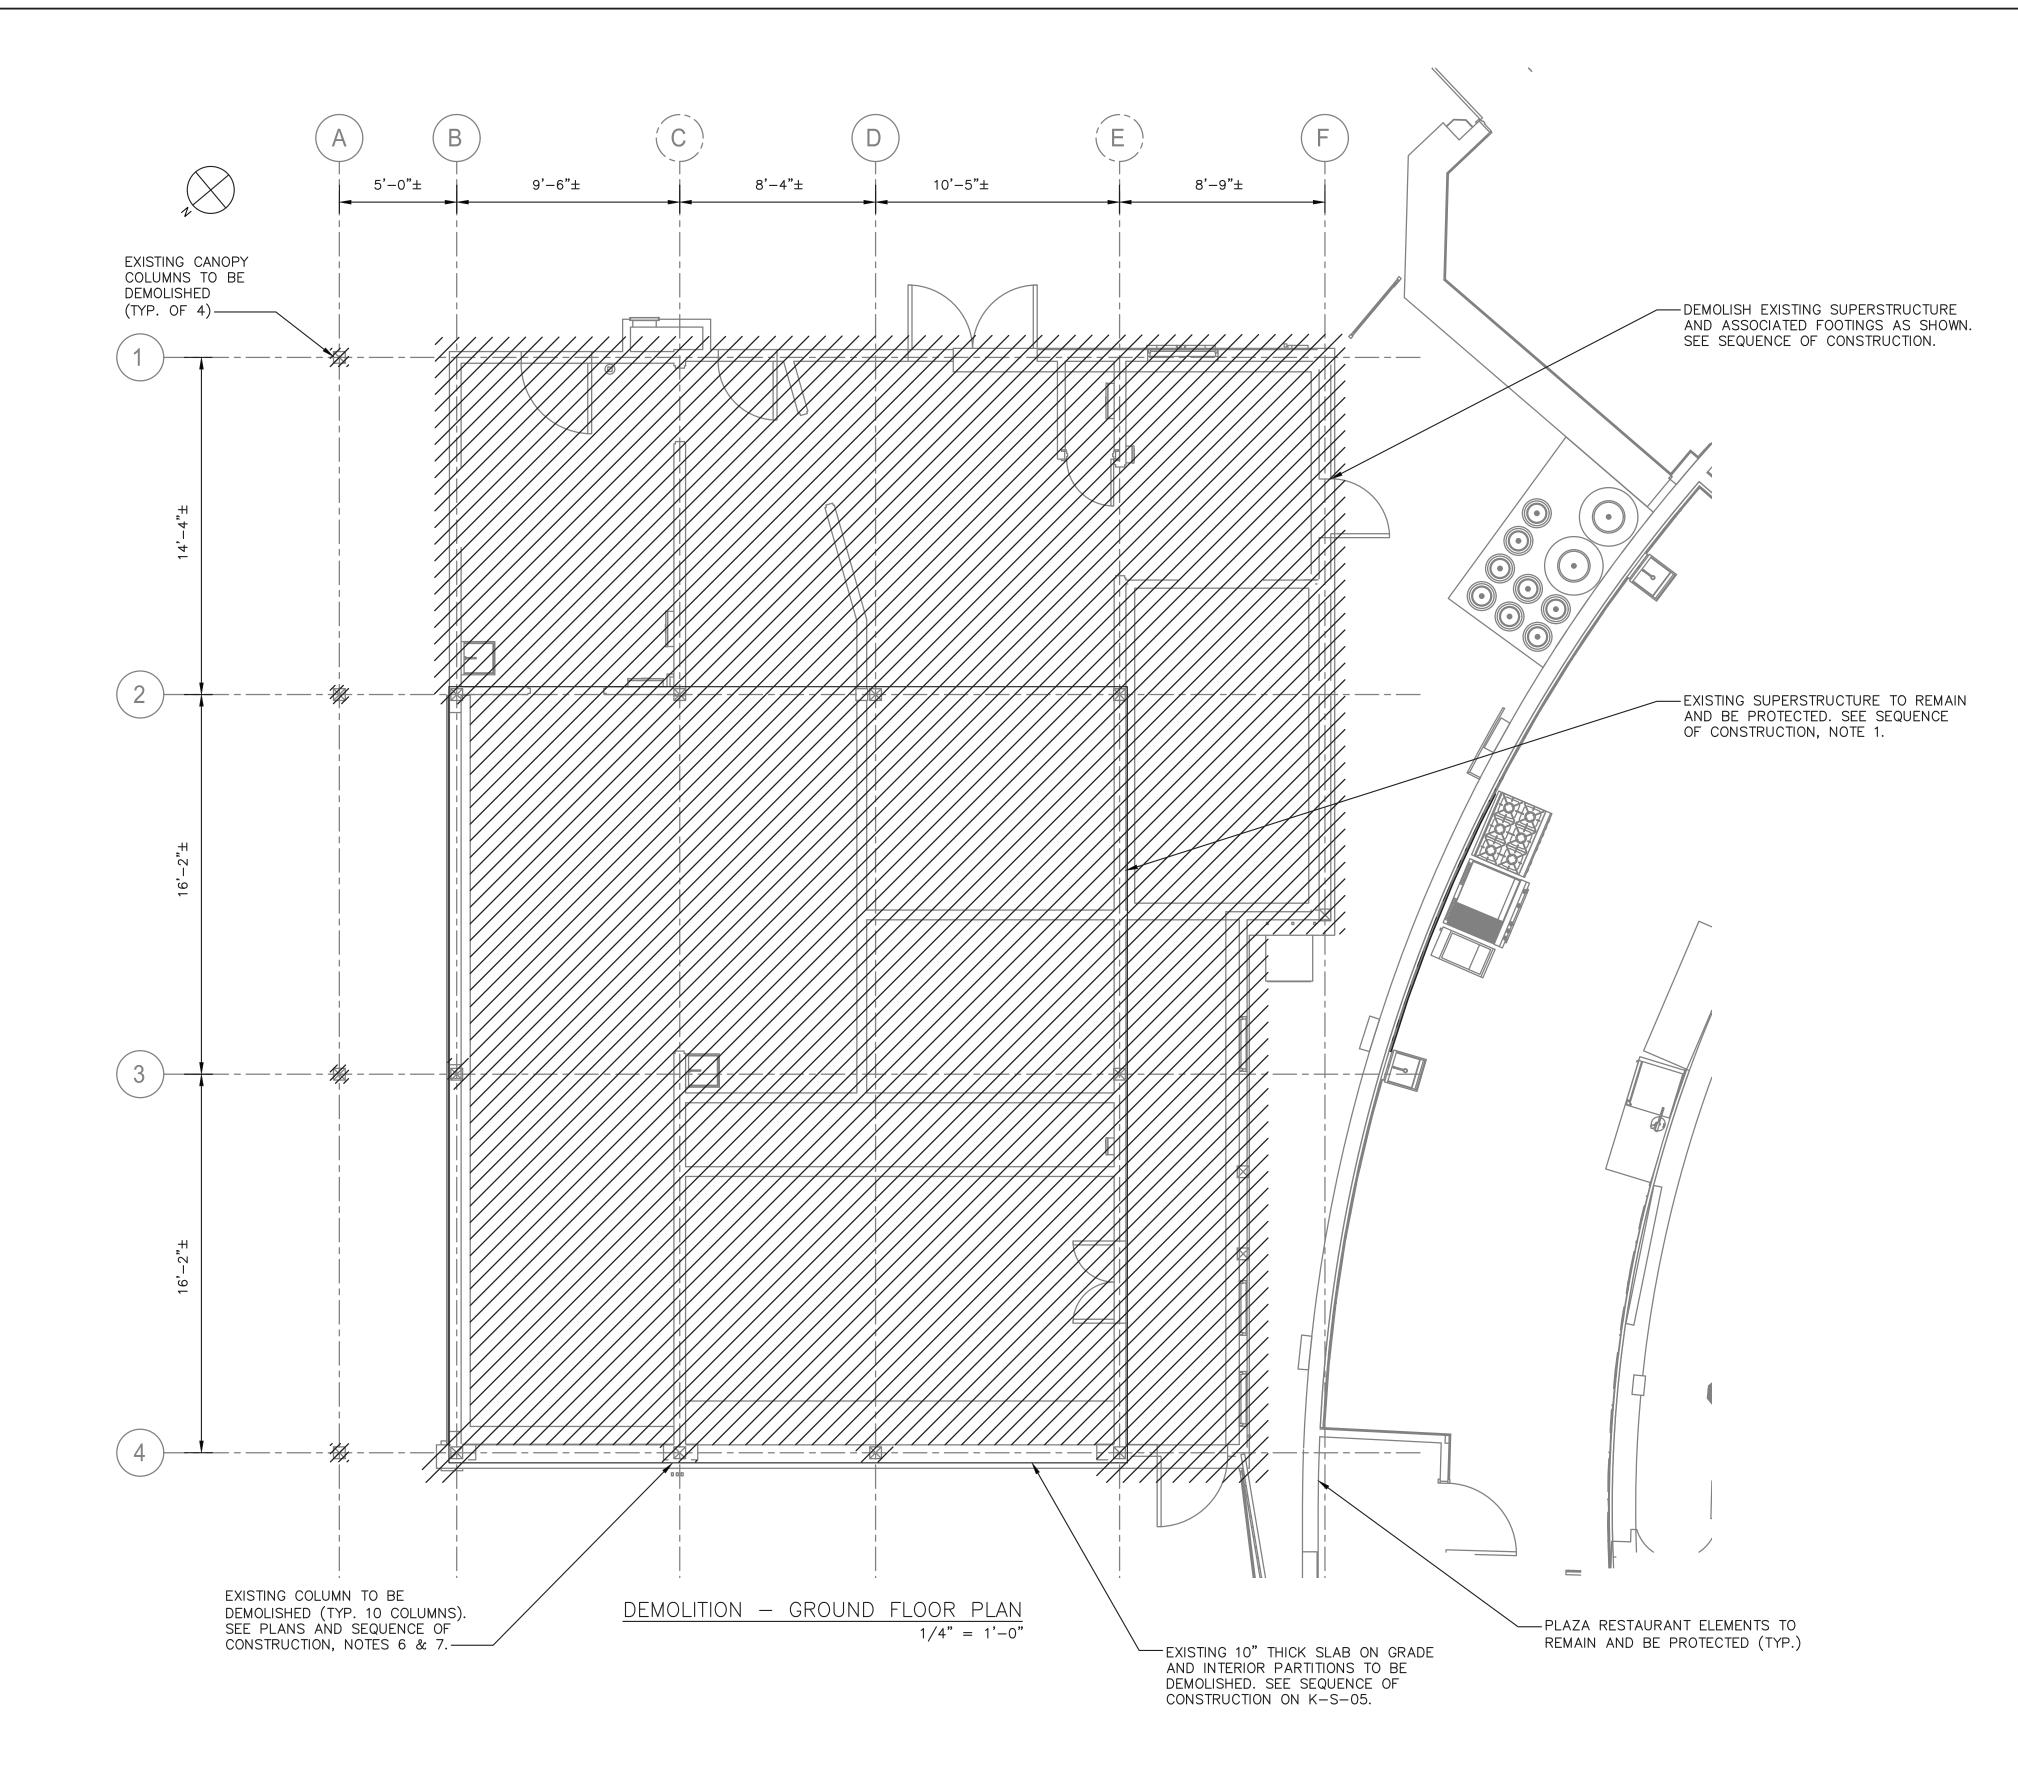

#### NOTES:

- 1. FOR STRUCTURAL NOTES, SEE DRAWING K-S-01.
- 2. FOR STRUCTURAL ABBREVIATIONS AND SYMBOLS, SEE DRAWING K-S-02.
- SEE K-S-05 FOR SHORING PLAN AND SEQUENCE OF CONSTRUCTION.

CONSULTANT SEAL INFORMATION			RECORD DRAWING	C ERTIFIC ATION	WESTCHESTER COUNTY, NEW YORK	C ONTRACT NUMB ER	SHEET NUMBER
			AS BUILT — CHANGES AS NOTED	AS BUILT - NO CHANGES	DEPARTMENT OF PUBLIC WORKS AND TRANSPORTATION	22-523	K-S-03
	Charles I and the Control of the Con		-		DIVISION OF ENGINEERING	DWG NO.:	
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Savin Engineers PC			SIGNATURE	SIGNATURE	PLAYLAND PARK, RYE, NEW YORK RESTAURANT KITCHEN WITH FOOD VENDING	DATE: <b>8/23/2022</b>	2
Savin Engineers, P.C.	REVISION DATE MADE APP'D	REVISION	TITLE DATE	TITLE DATE	DEMOLITION - GROUND FLOOR PLAN	DPW FILE 1-118-S-	5-1279-0 REV. <b>0</b>

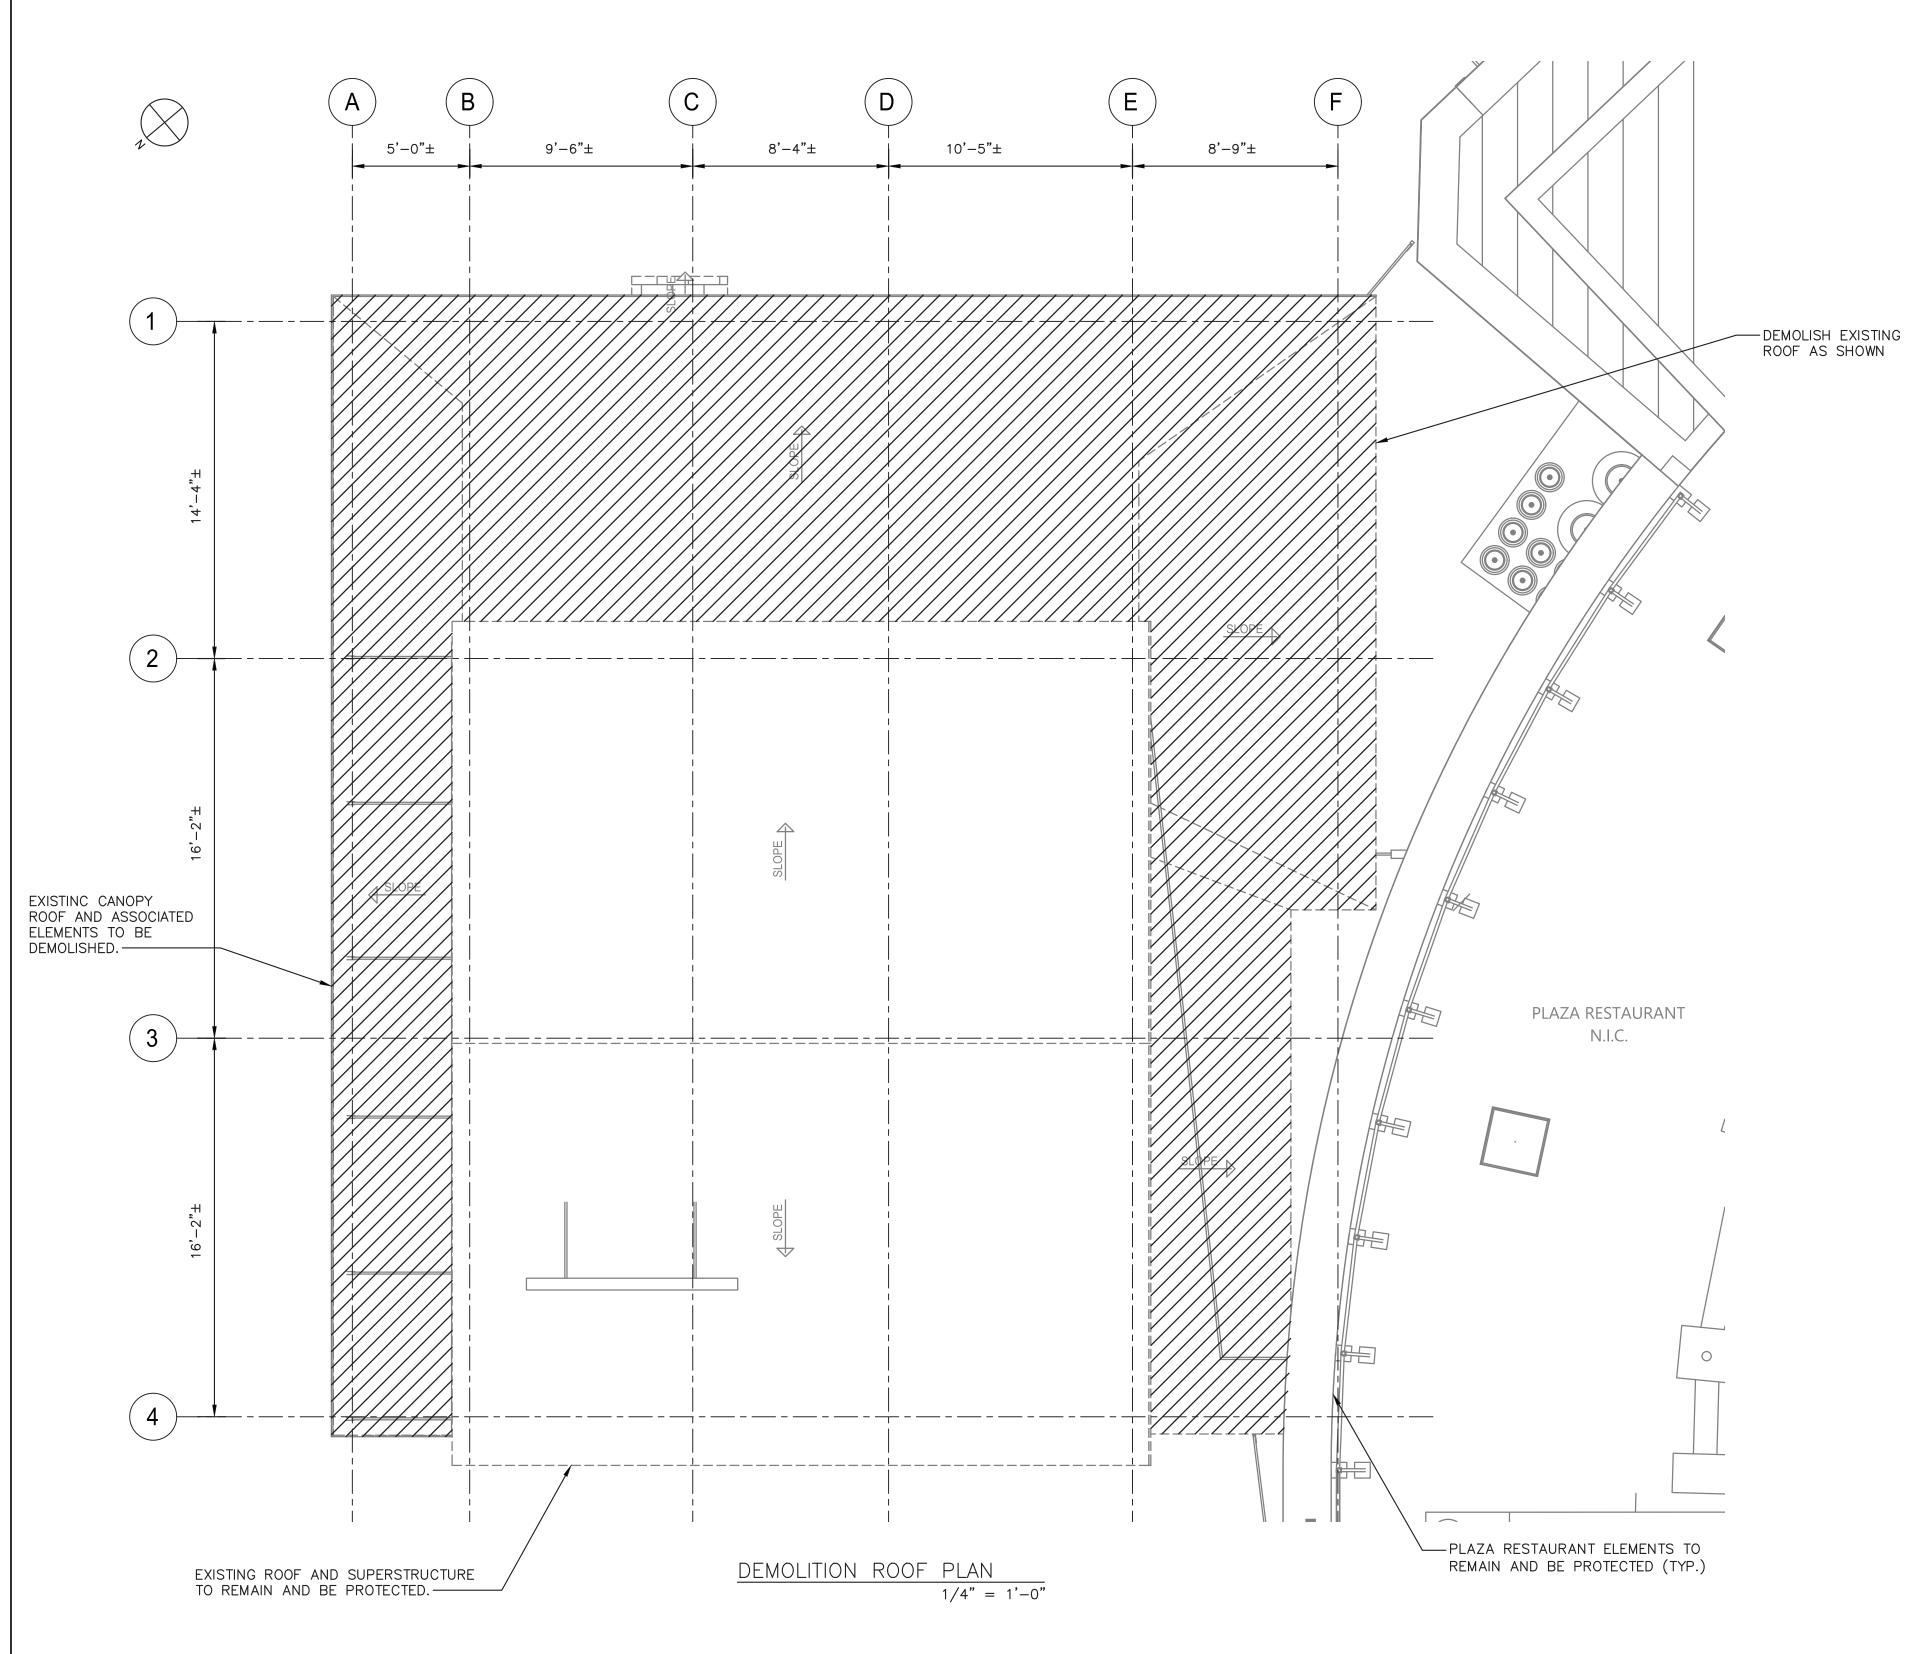

NOTES:

- 1. FOR STRUCTURAL NOTES, SEE DRAWING K-S-01.
- 2. FOR STRUCTURAL ABBREVIATIONS AND SYMBOLS, SEE DRAWING K-S-02.

C ONSULTANT INFORMATION	ONSULTANT SEAL			RECORD DRAW  AS BUILT — CHANGES AS NOTED	ING CERTIFICATION  AS BUILT — NO CHANGES	WESTCHESTER COUNTY, NEW YORK DEPARTMENT OF PUBLIC WORKS AND TRANSPORTATION	CONTRACT NUMBER 22-523	SHEET NUMBER <b>K-S-04</b>
				CONTRACTOR	PROJECT COORDINATOR	INFRASTRUCTURE REHABILITATION - PHASE 3 PLAYLAND PARK, RYE, NEW YORK	DWG NO.: SCALE: <b>AS SHO</b>	<b>o₩N</b> of 664
Savin Engineers, P.C.	OFESSIONA MINIMARIAN MARIANTANA	REVISION DATE MADE APP'D BY	REVISION	SIGNATURE DATE	SIGNATURE DATE	RESTAURANT KITCHEN WITH FOOD VENDING DEMOLITION - ROOF PLAN	DATE: <b>8/23/20</b> DPW FILE 1-118-	-S-1280-0 REV. NO. 0


- 1. FOR STRUCTURAL NOTES, SEE DRAWING K-S-01.
- 2. FOR STRUCTURAL ABBREVIATIONS AND SYMBOLS, SEE DRAWING K-S-02.
- 3. TEMPORARY SHORING SHALL BEAR ON ASPHALT, CONCRETE OR SUBSURFACE.

### SEQUENCE OF CONSTRUCTION:


- 1. DEMOLISH EXISTING SUPERSTRUCTURE AS SHOWN AND EXISTING INTERIOR SLAB ON GRADE. SEE K-S-03 AND K-S-04.
- 2. INSTALL ALL MICROPILES AS SHOWN ON K-S-06. CONTRACTOR IS ALERTED OF SPACE RESTRICTIONS AND SHALL INCLUDE IN THEIR BID THE USE OF A SMALL PROFILE MICROPILE DRILL RIG.
- 3. INSTALL TEMPORARY SHORING AROUND PERIMETER OF SUPERSTRUCTURE TO REMAIN.
- 4. EXCAVATE AND COMPLETE FOUNDATION WORK AND UNDERPINNING.
- 5. INSTALL TEMPORARY SHORING FOR COLUMN REPLACEMENT.
- 6. DEMOLISH EXISTING COLUMNS.
- 7. INSTALL NEW COLUMNS AND COMPLETE INSTALLATION OF STRUCTURAL STEEL FRAMING. SEE PLANS.
- 8. REMOVE ALL TEMPORARY SHORING.
- 9. COMPLETE INSTALLATION OF SLAB ON GRADE FOR EXISTING SUPERSTRUCTURE.

10. COMPLETE REMAINDER OF CONTRACT WORK.

SCALE: 1/4" = 1'-0"

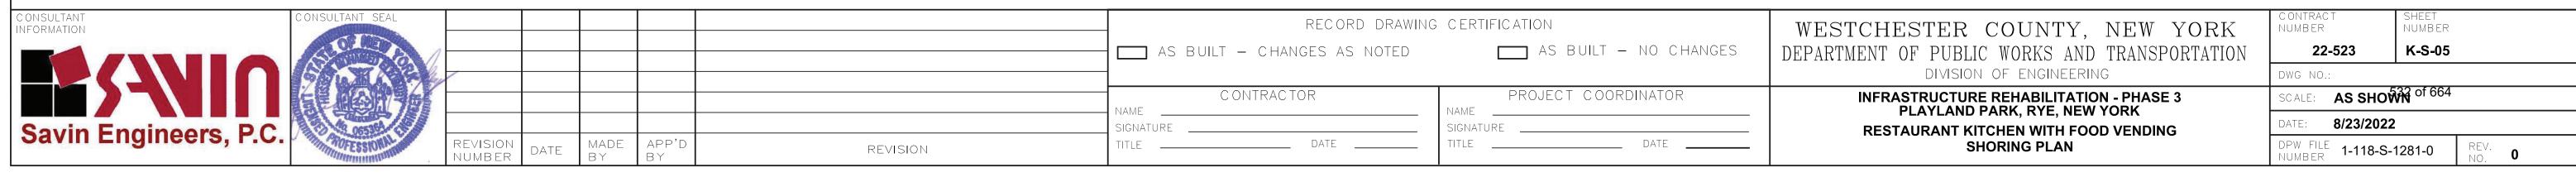



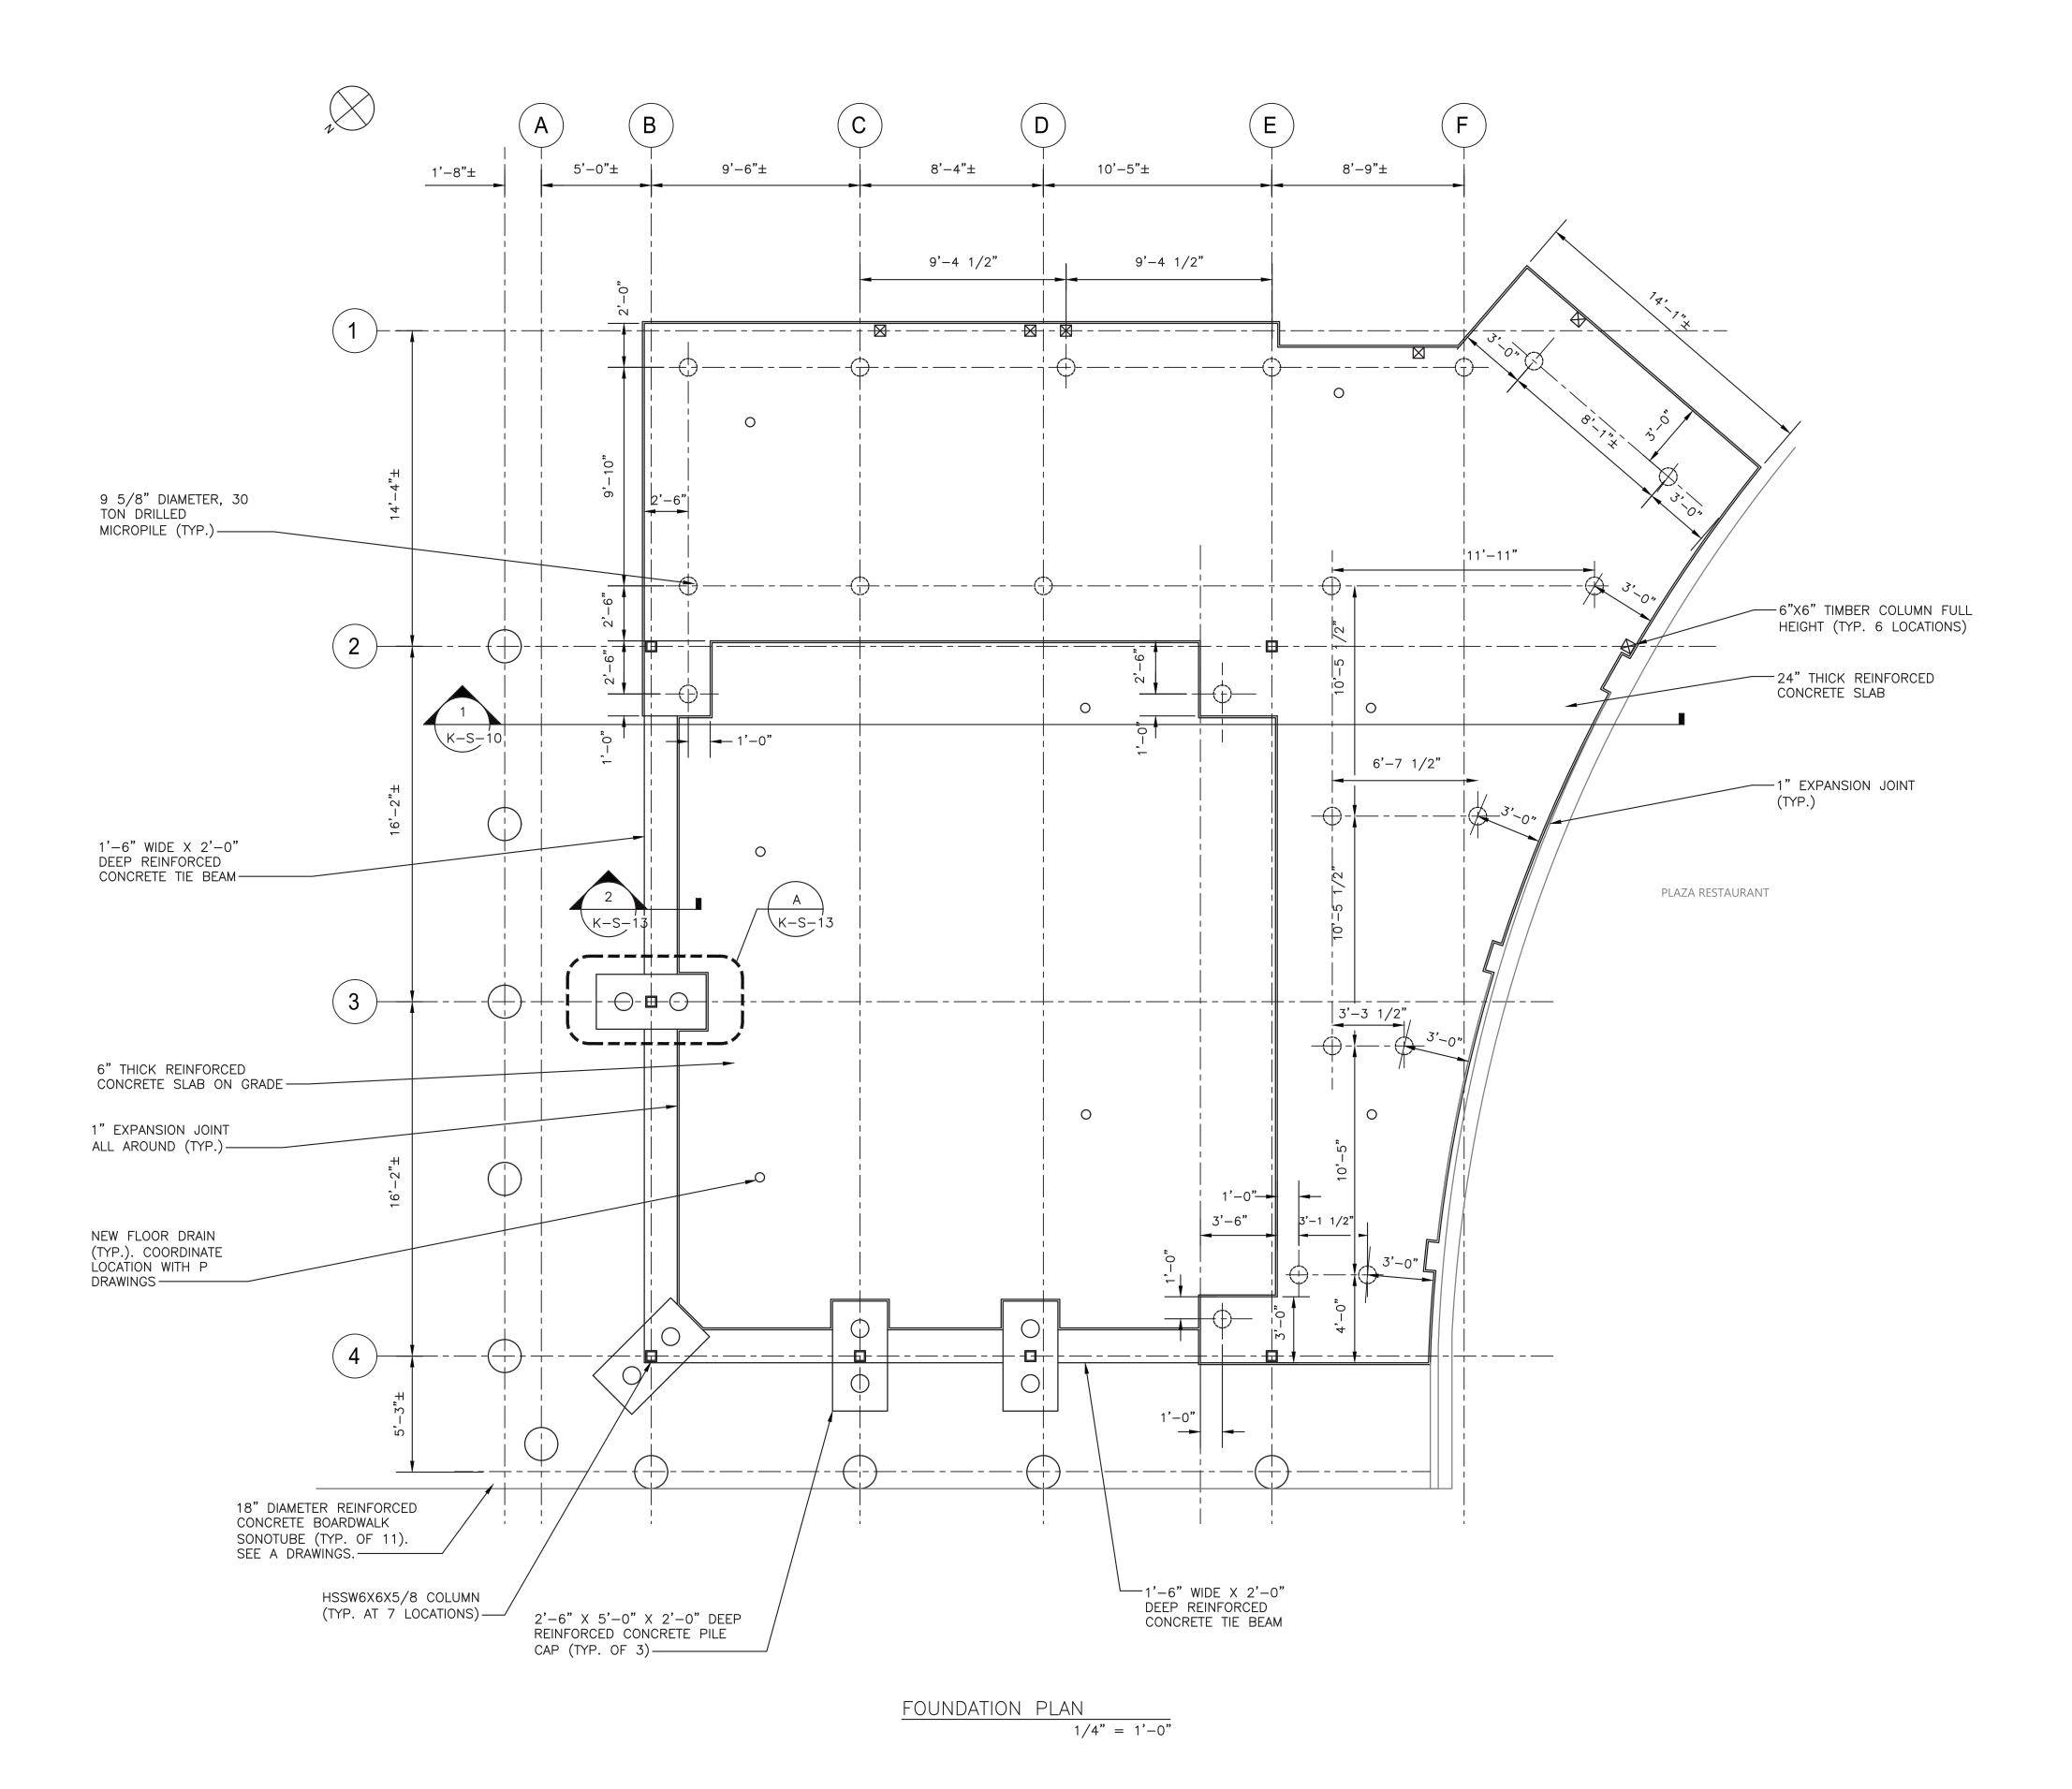

- 1. FOR STRUCTURAL NOTES, SEE DRAWING K-S-01.
- 2. FOR STRUCTURAL ABBREVIATIONS AND SYMBOLS, SEE DRAWING K-S-02.
- 3. CONTRACTOR SHALL FIELD VERIFY LOCATION IF EXISTING SANITARY LINE PRIOR TO PILE DRILLING OPERATIONS AND SURVEY EXISTING ELEVATIONS. SEE PLUMBING DRAWINGS.

CONSULTANT INFORMATION RECORD DRAWING CERTIFICATION AS BUILT — NO CHANGES AS BUILT — CHANGES AS NOTED CONTRACTOR PROJECT COORDINATOR Savin Engineers, P.C. REVISION NUMBER TITLE \_\_\_\_\_ DATE \_\_\_\_ REVISION

CONTRACT NUMBER WESTCHESTER COUNTY, NEW YORK DEPARTMENT OF PUBLIC WORKS AND TRANSPORTATION DWG NO.: **INFRASTRUCTURE REHABILITATION - PHASE 3** 

DIVISION OF ENGINEERING

PLAYLAND PARK, RYE, NEW YORK

RESTAURANT KITCHEN WITH FOOD VENDING

**FOUNDATION PLAN** 

SHEET NUMBER K-S-06 22-523 SCALE: **AS SHOWN** of 664 DATE: **8/23/2022** DPW FILE **1-118-S-1282-0** NUMBER

K-S-02.

1. FOR STRUCTURAL NOTES, SEE DRAWING K-S-01.


2. FOR STRUCTURAL ABBREVIATIONS AND SYMBOLS, SEE DRAWING

GROUND FLOOR PLAN

1/4" = 1'-0"

CONTRACT NUMBER SHEET NUMBER RECORD DRAWING CERTIFICATION WESTCHESTER COUNTY, NEW YORK AS BUILT — NO CHANGES AS BUILT — CHANGES AS NOTED K-S-07 DEPARTMENT OF PUBLIC WORKS AND TRANSPORTATION 22-523 DIVISION OF ENGINEERING DWG NO.: SCALE: AS SHOWN of 664 CONTRACTOR PROJECT COORDINATOR **INFRASTRUCTURE REHABILITATION - PHASE 3** PLAYLAND PARK, RYE, NEW YORK Savin Engineers, P.C. DATE: **8/23/2022** RESTAURANT KITCHEN WITH FOOD VENDING REVISION NUMBER TITLE \_\_\_\_\_ DATE \_\_\_\_ **GROUND FLOOR PLAN** DPW FILE 1-118-S-1283-0 REVISION

Projectname: 211001F02 Comments: ———
by: JCastro Date: 19 August 2022 1:07 PM Designed by: ———

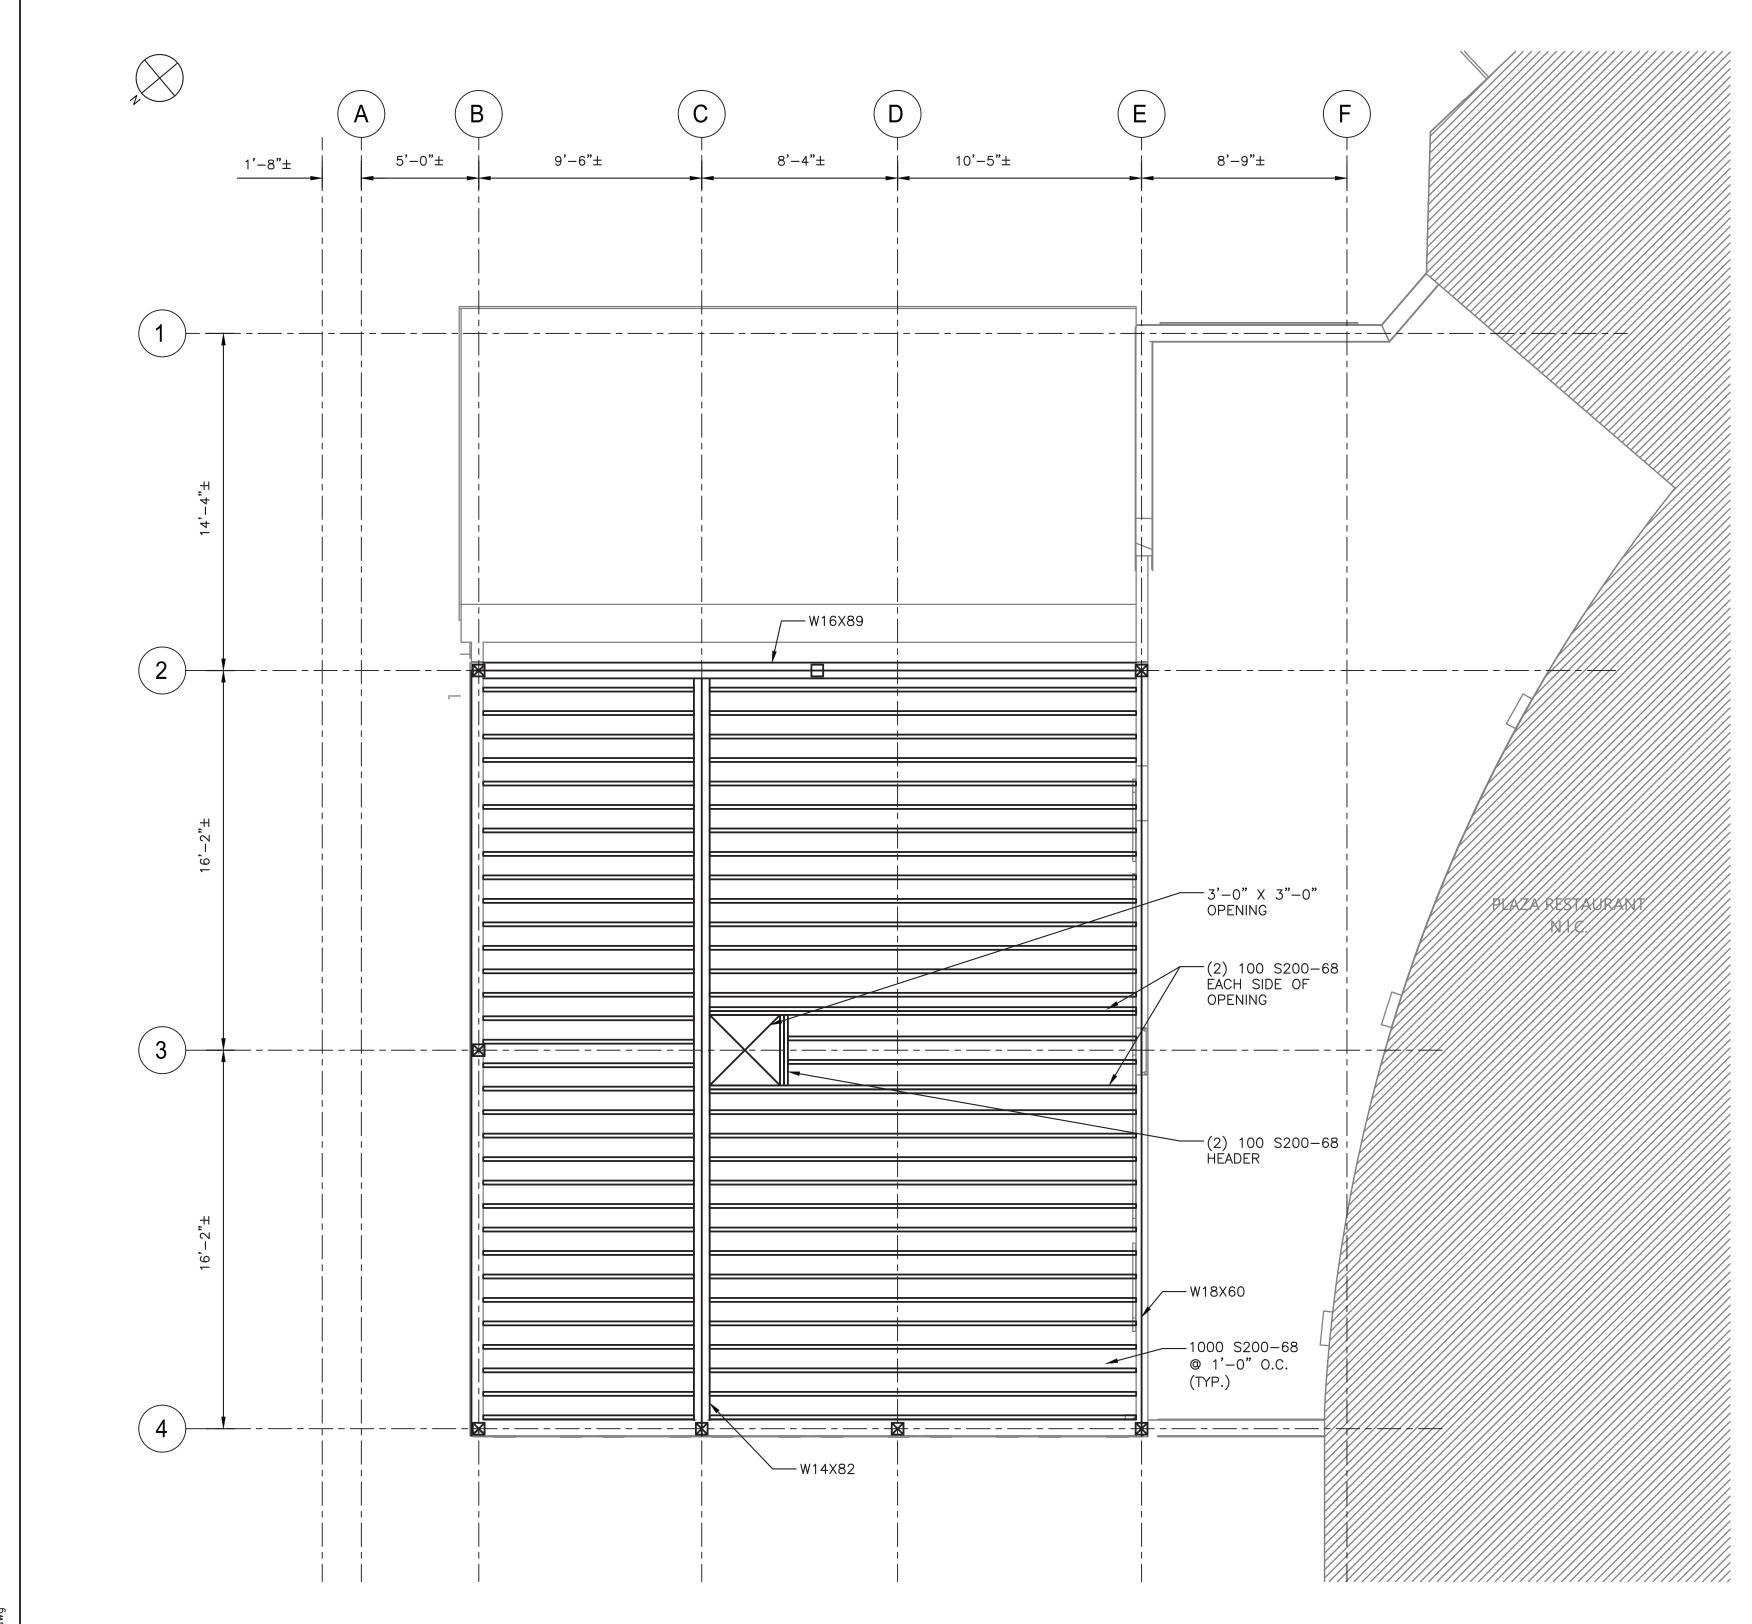

CEILING FRAMING PLAN

1/4" = 1'-0"

Savin Engineers, P.C.

CONSULTANT SEAL

REVISION DATE MADE BY BY REVISION

RECORD DRAWING CERTIFICATION

AS BUILT — CHANGES AS NOTED

AS

CONTRACTOR

TITLE \_\_\_\_\_ DATE \_\_\_\_\_

PROJECT COORDINATOR

INFRASTRUCTURE REHABILITATION - PHASE 3
PLAYLAND PARK, RYE, NEW YORK
RESTAURANT KITCHEN WITH FOOD VENDING
CEILING FRAMING PLAN

WESTCHESTER COUNTY, NEW YORK

DEPARTMENT OF PUBLIC WORKS AND TRANSPORTATION

CONTRACT NUMBER

22-523 K-S-08

DWG NO.:

SCALE: AS SHOWN of 664

DATE: 8/23/2022

DPW FILE NUMBER 1-118-S-1284-0 REV. NO. 0


ame: 211001F02 Comments: ———
ro Date: 19 August 2022 1:08 PM Designed by: ———
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NOTES:

1. FOR STRUCTURAL NOTES, SEE DRAWING K-S-01.

2. FOR STRUCTURAL ABBREVIATIONS AND SYMBOLS, SEE DRAWING K-S-02.



- 1. FOR STRUCTURAL NOTES, SEE DRAWING K-S-01.
- 2. FOR STRUCTURAL ABBREVIATIONS AND SYMBOLS, SEE DRAWING K-S-02.

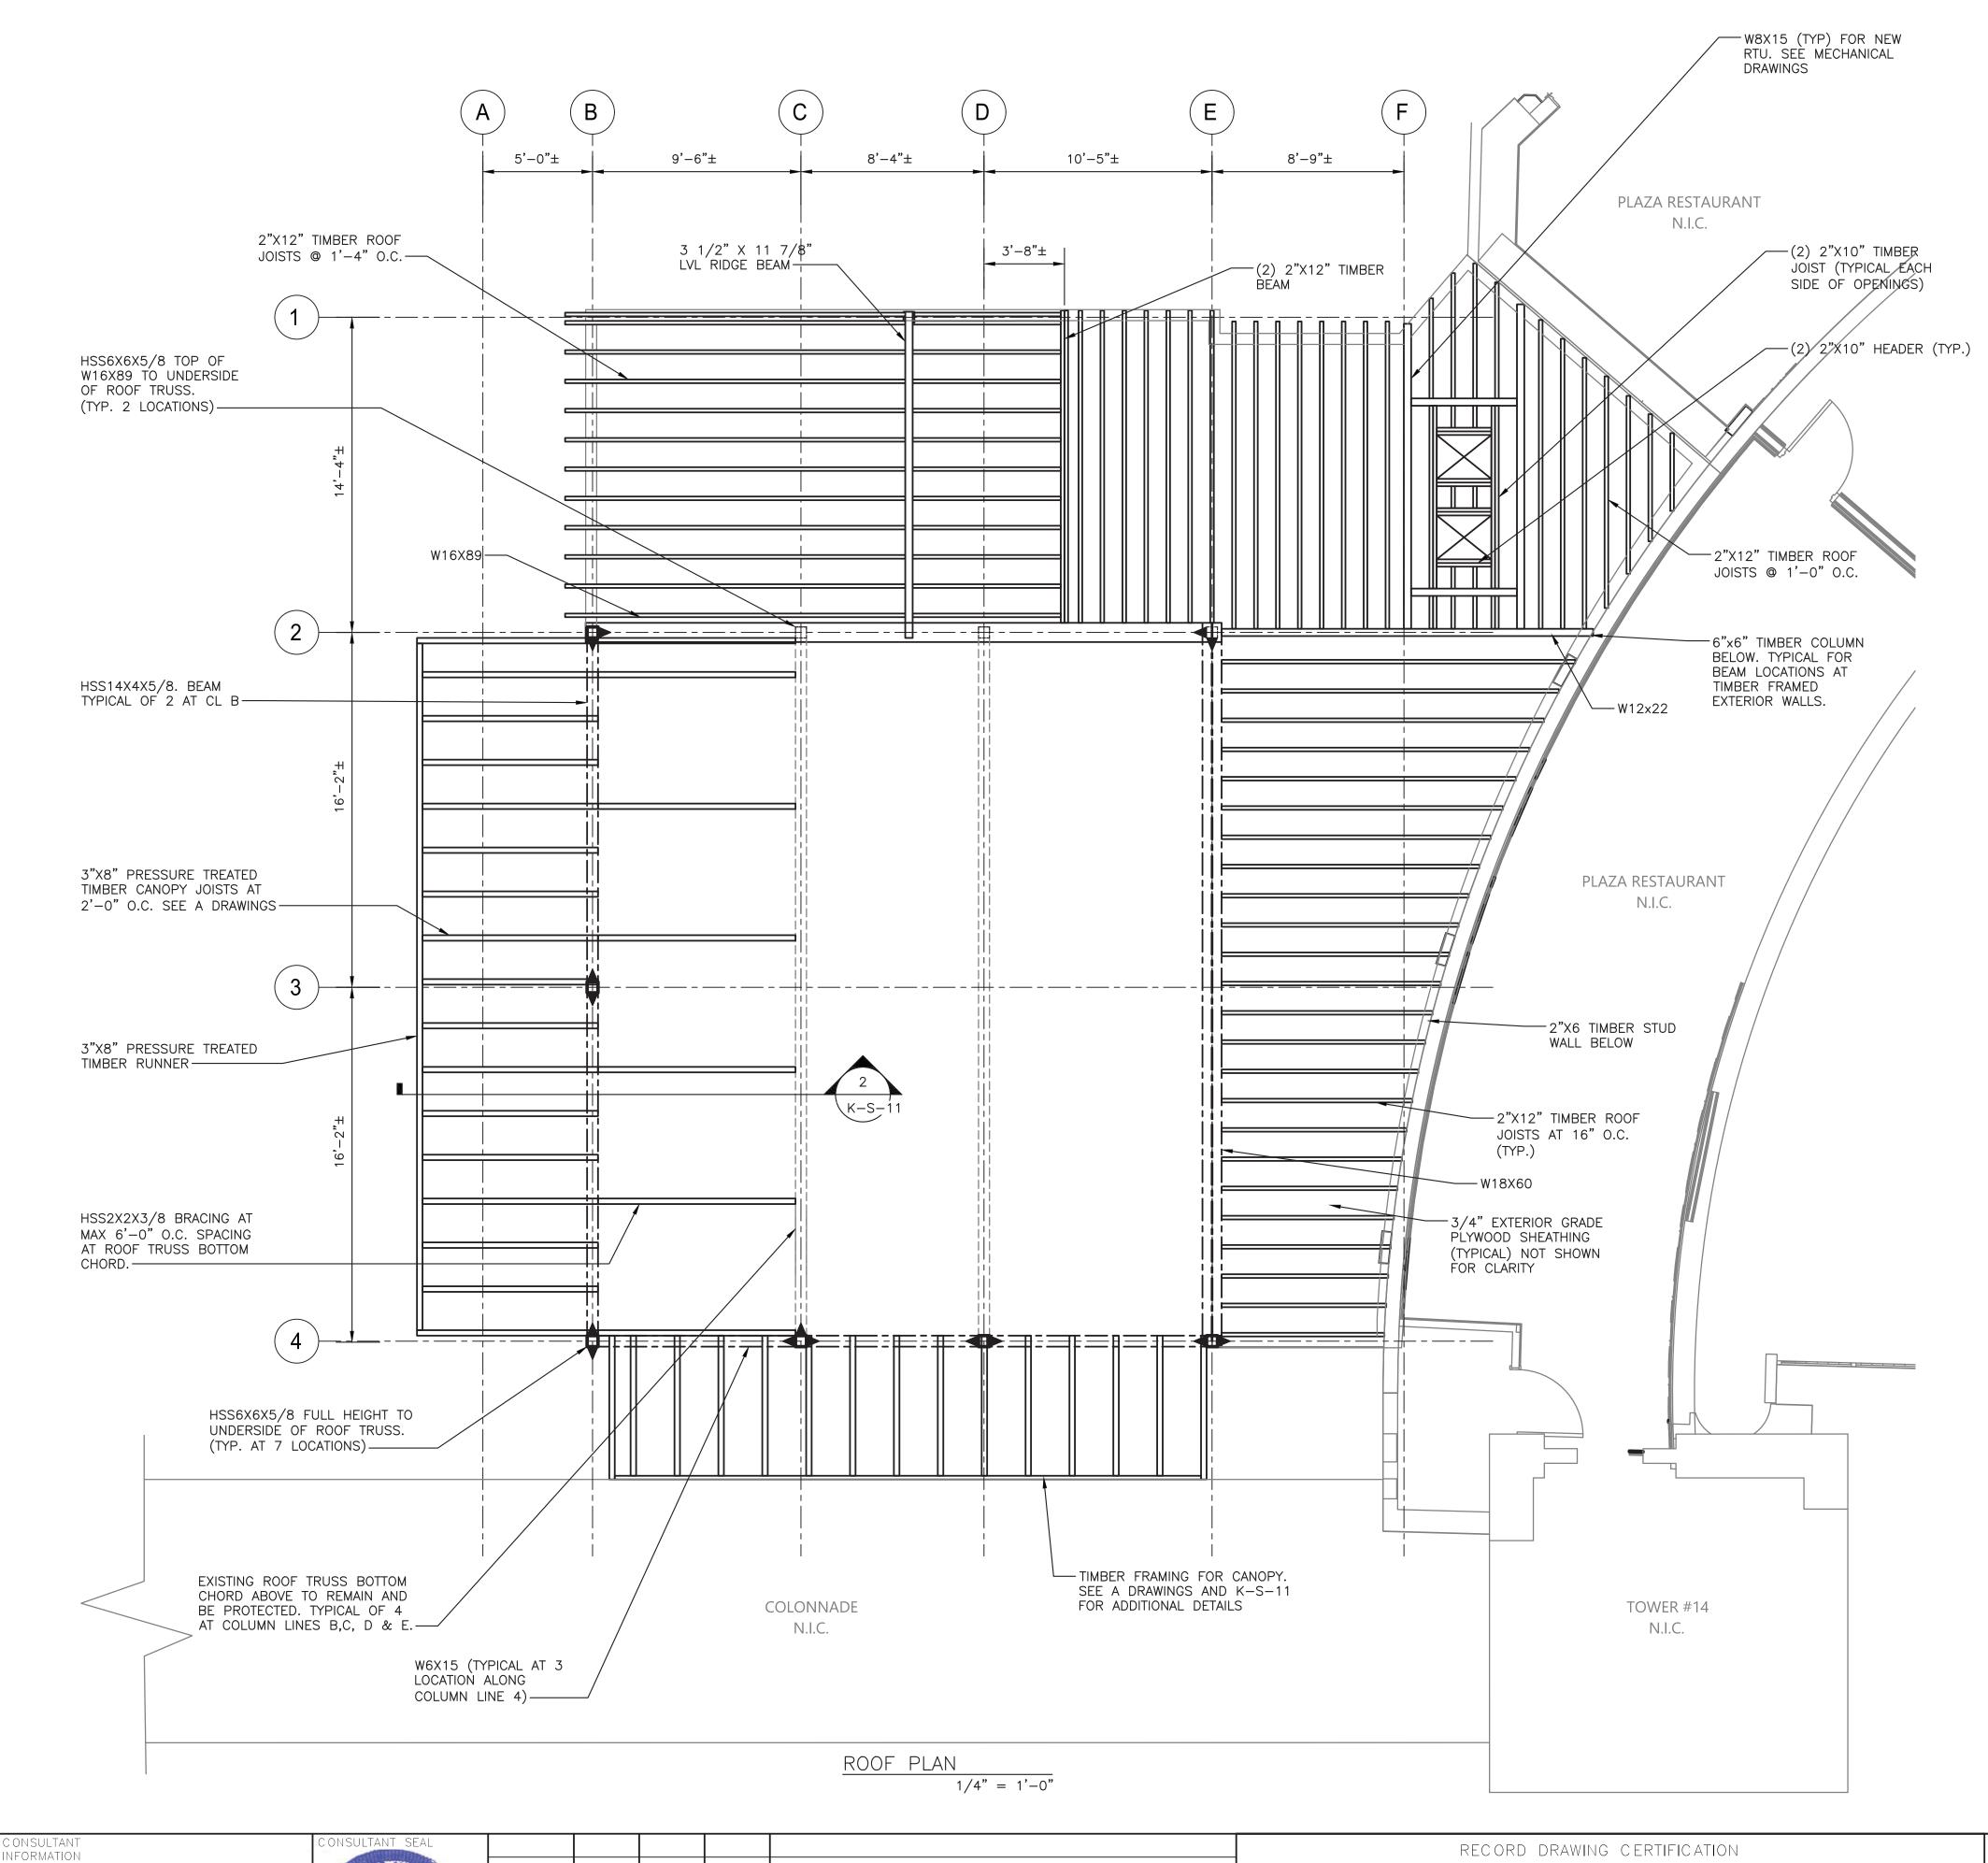Drawing Name: G:\SavinAutocad\2060\25—Playland—Mega—3\S\KS—1013.dwg Rev#: Projectname: 211001F02 Comments: ——— Printed by: JCastro Date: 19 August 2022 1:08 PM Designed by: ———

Savin Engineers, P.C.

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DEPARTMENT OF PUBLIC WORKS AND TRANSPORTATION DIVISION OF ENGINEERING

INFRASTRUCTURE REHABILITATION - PHASE 3 PLAYLAND PARK, RYE, NEW YORK

RESTAURANT KITCHEN WITH FOOD VENDING ROOF PLAN

WESTCHESTER COUNTY, NEW YORK

CONTRACT NUMBER

22-523 K-S-09


DWG NO.:

SCALE: AS SHOWN of 664

DATE: 8/23/2022

DPW FILE NUMBER 1-118-S-1285-0 REV. NO. 0

- 1. FOR STRUCTURAL NOTES, SEE DRAWING K-S-01.
- 2. FOR STRUCTURAL ABBREVIATIONS AND SYMBOLS, SEE DRAWING K-S-02.

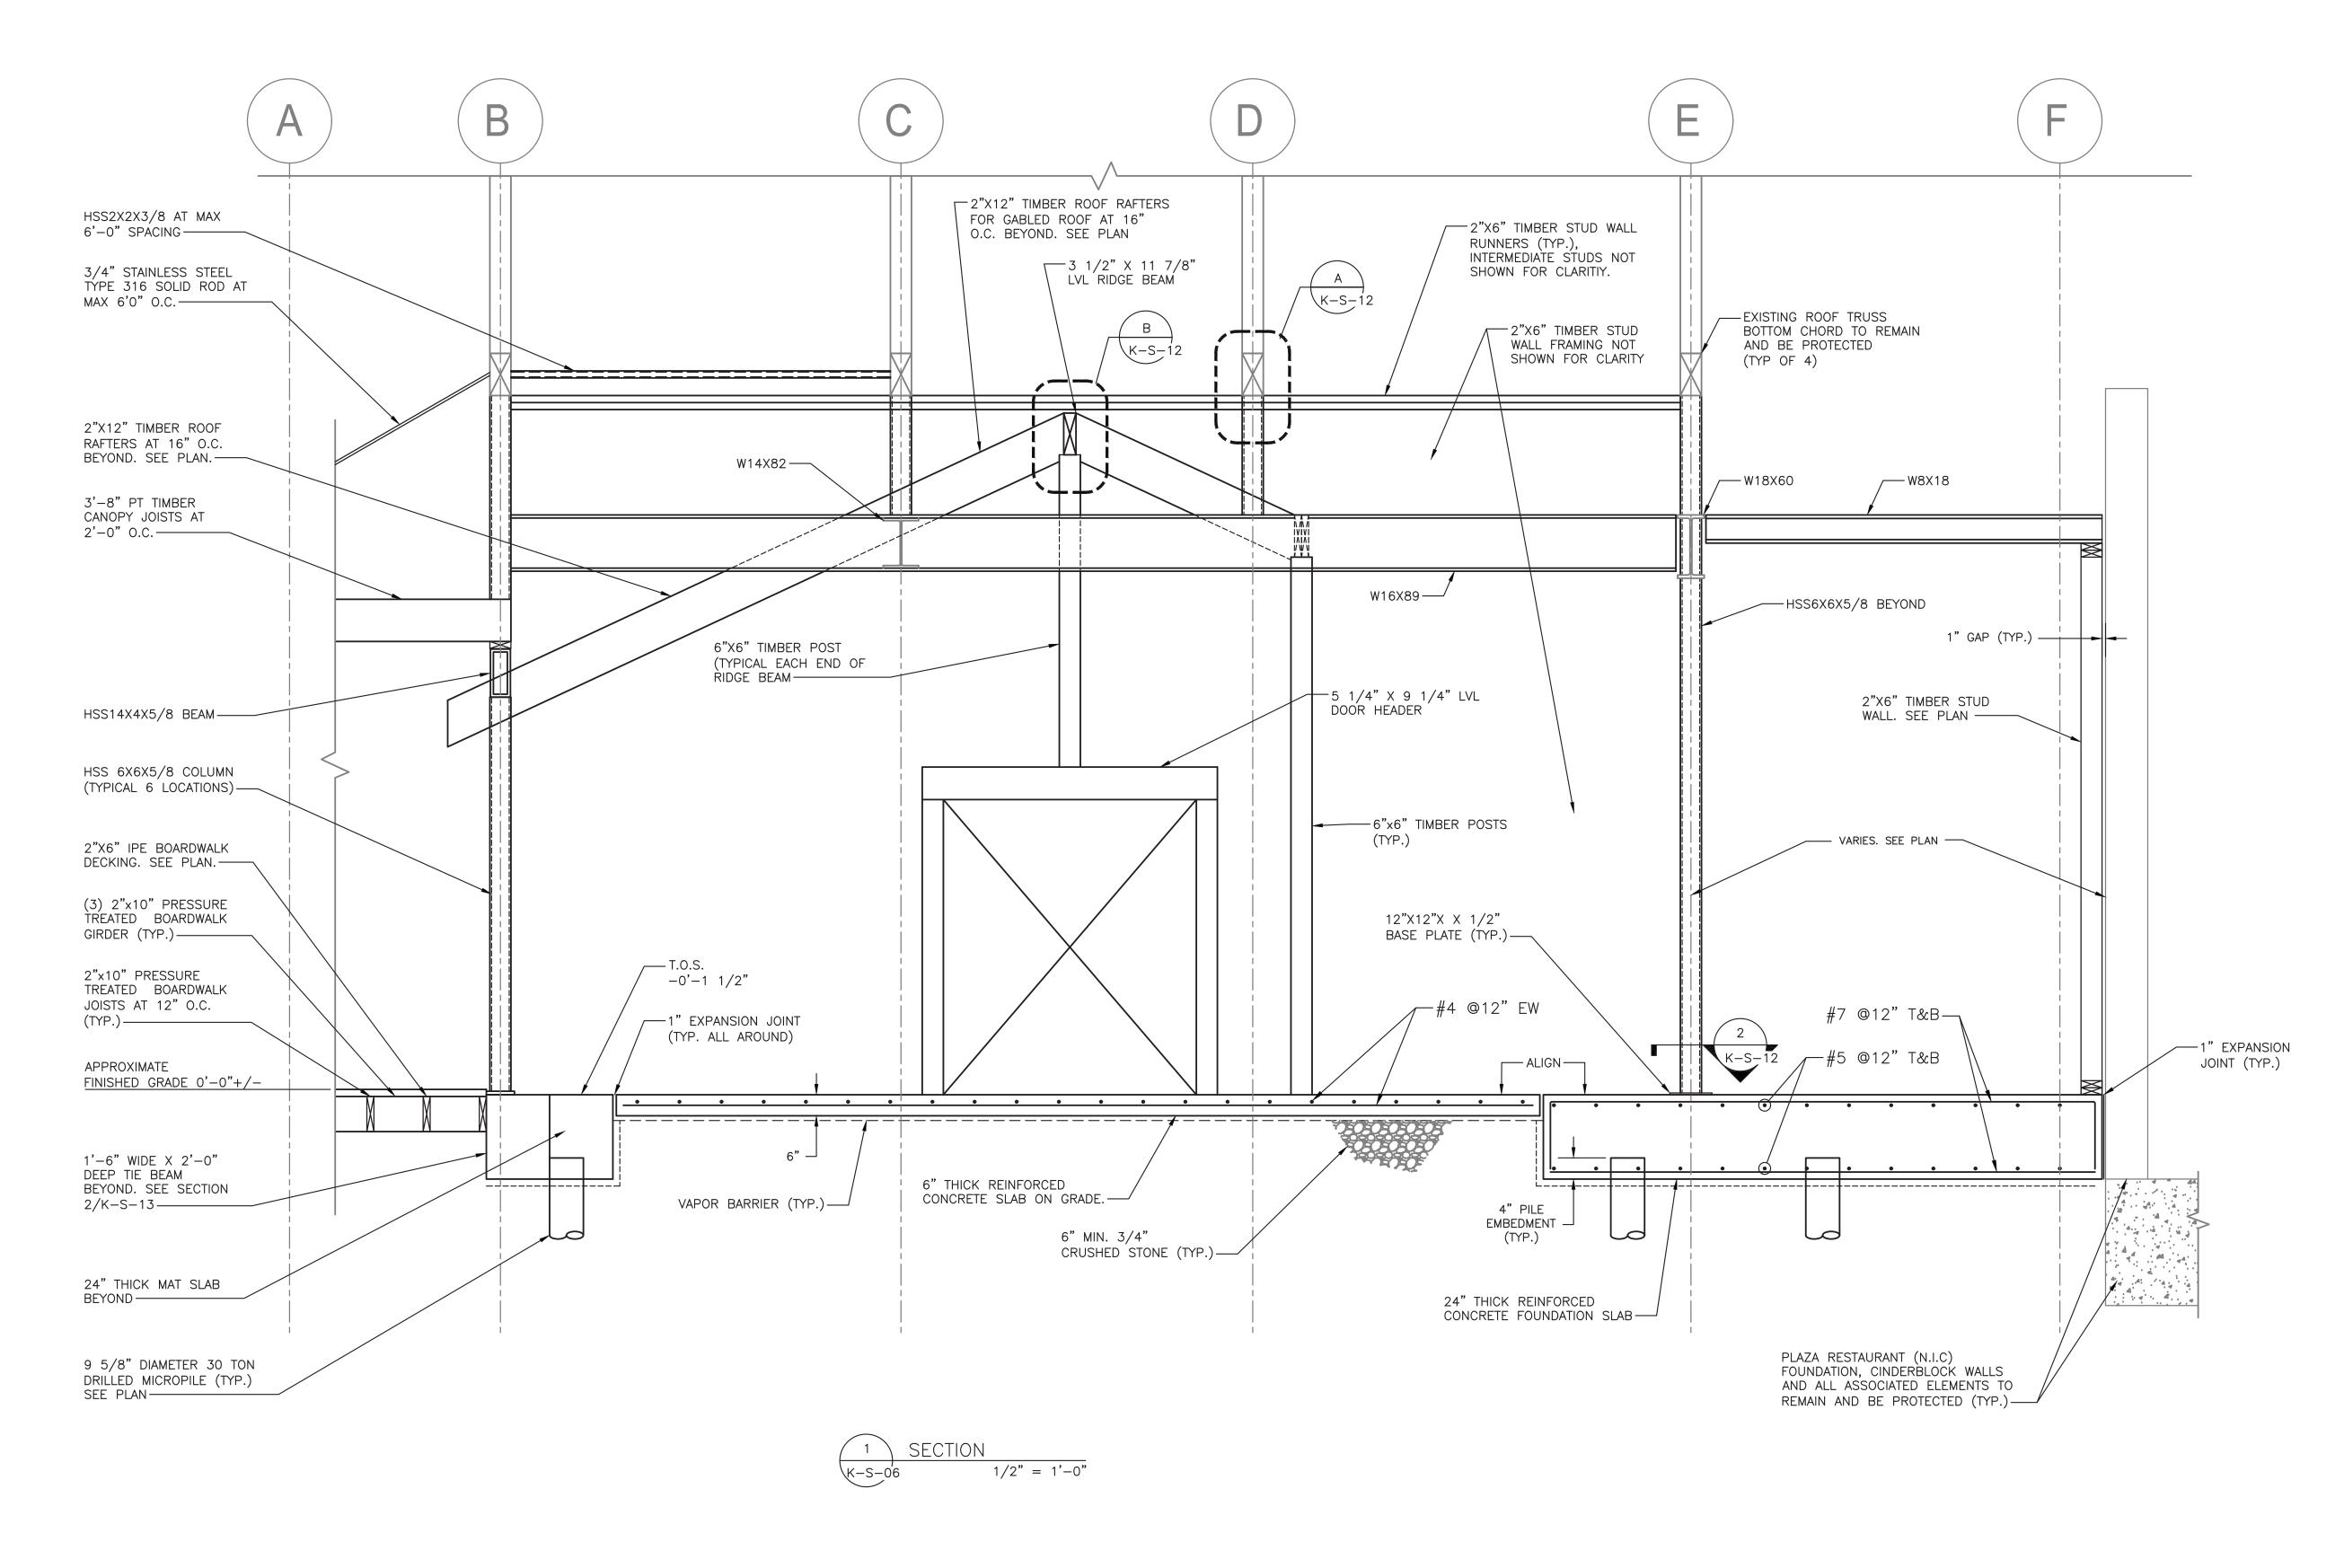

Drawnig Name: G. (SavinAutoCaa (2000 (23—Flayland—Mega—) (3 (N3—1012.awg) Rev#: Projectname: 211001F02 Comments: ———— Printed by: JCastro Date: 19 August 2022 1:08 PM Designed by: ———— Xrefs: [TB\_24X36\_WestchesterCo\_3.dwg] [TSG—SVLOGO.dwg] [K-S—1003.dwg] [K-S—1019.dwg

CONSULTANT INFORMATION

CONSULTANT INFORMATION

Savin Engineers, P.C.

CONSULTANT SEAL

REVISION DATE MADE BY BY REVISION

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CONTRACTOR

\_\_\_\_\_ DATE \_\_\_\_

RECORD DRAWING CERTIFICATION

PROJECT COORDINATOR

DEPARTMENT OF PUBLIC WORKS AND TRANSPORTATION DIVISION OF ENGINEERING

INFRASTRUCTURE REHABILITATION - PHASE 3 PLAYLAND PARK, RYE, NEW YORK

RESTAURANT KITCHEN WITH FOOD VENDING SECTION

WESTCHESTER COUNTY, NEW YORK

CONTRACT NUMBER


22-523 K-S-10

DWG NO.:

SCALE: AS SHOWN of 664

DATE: 8/23/2022

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CONTRACTOR
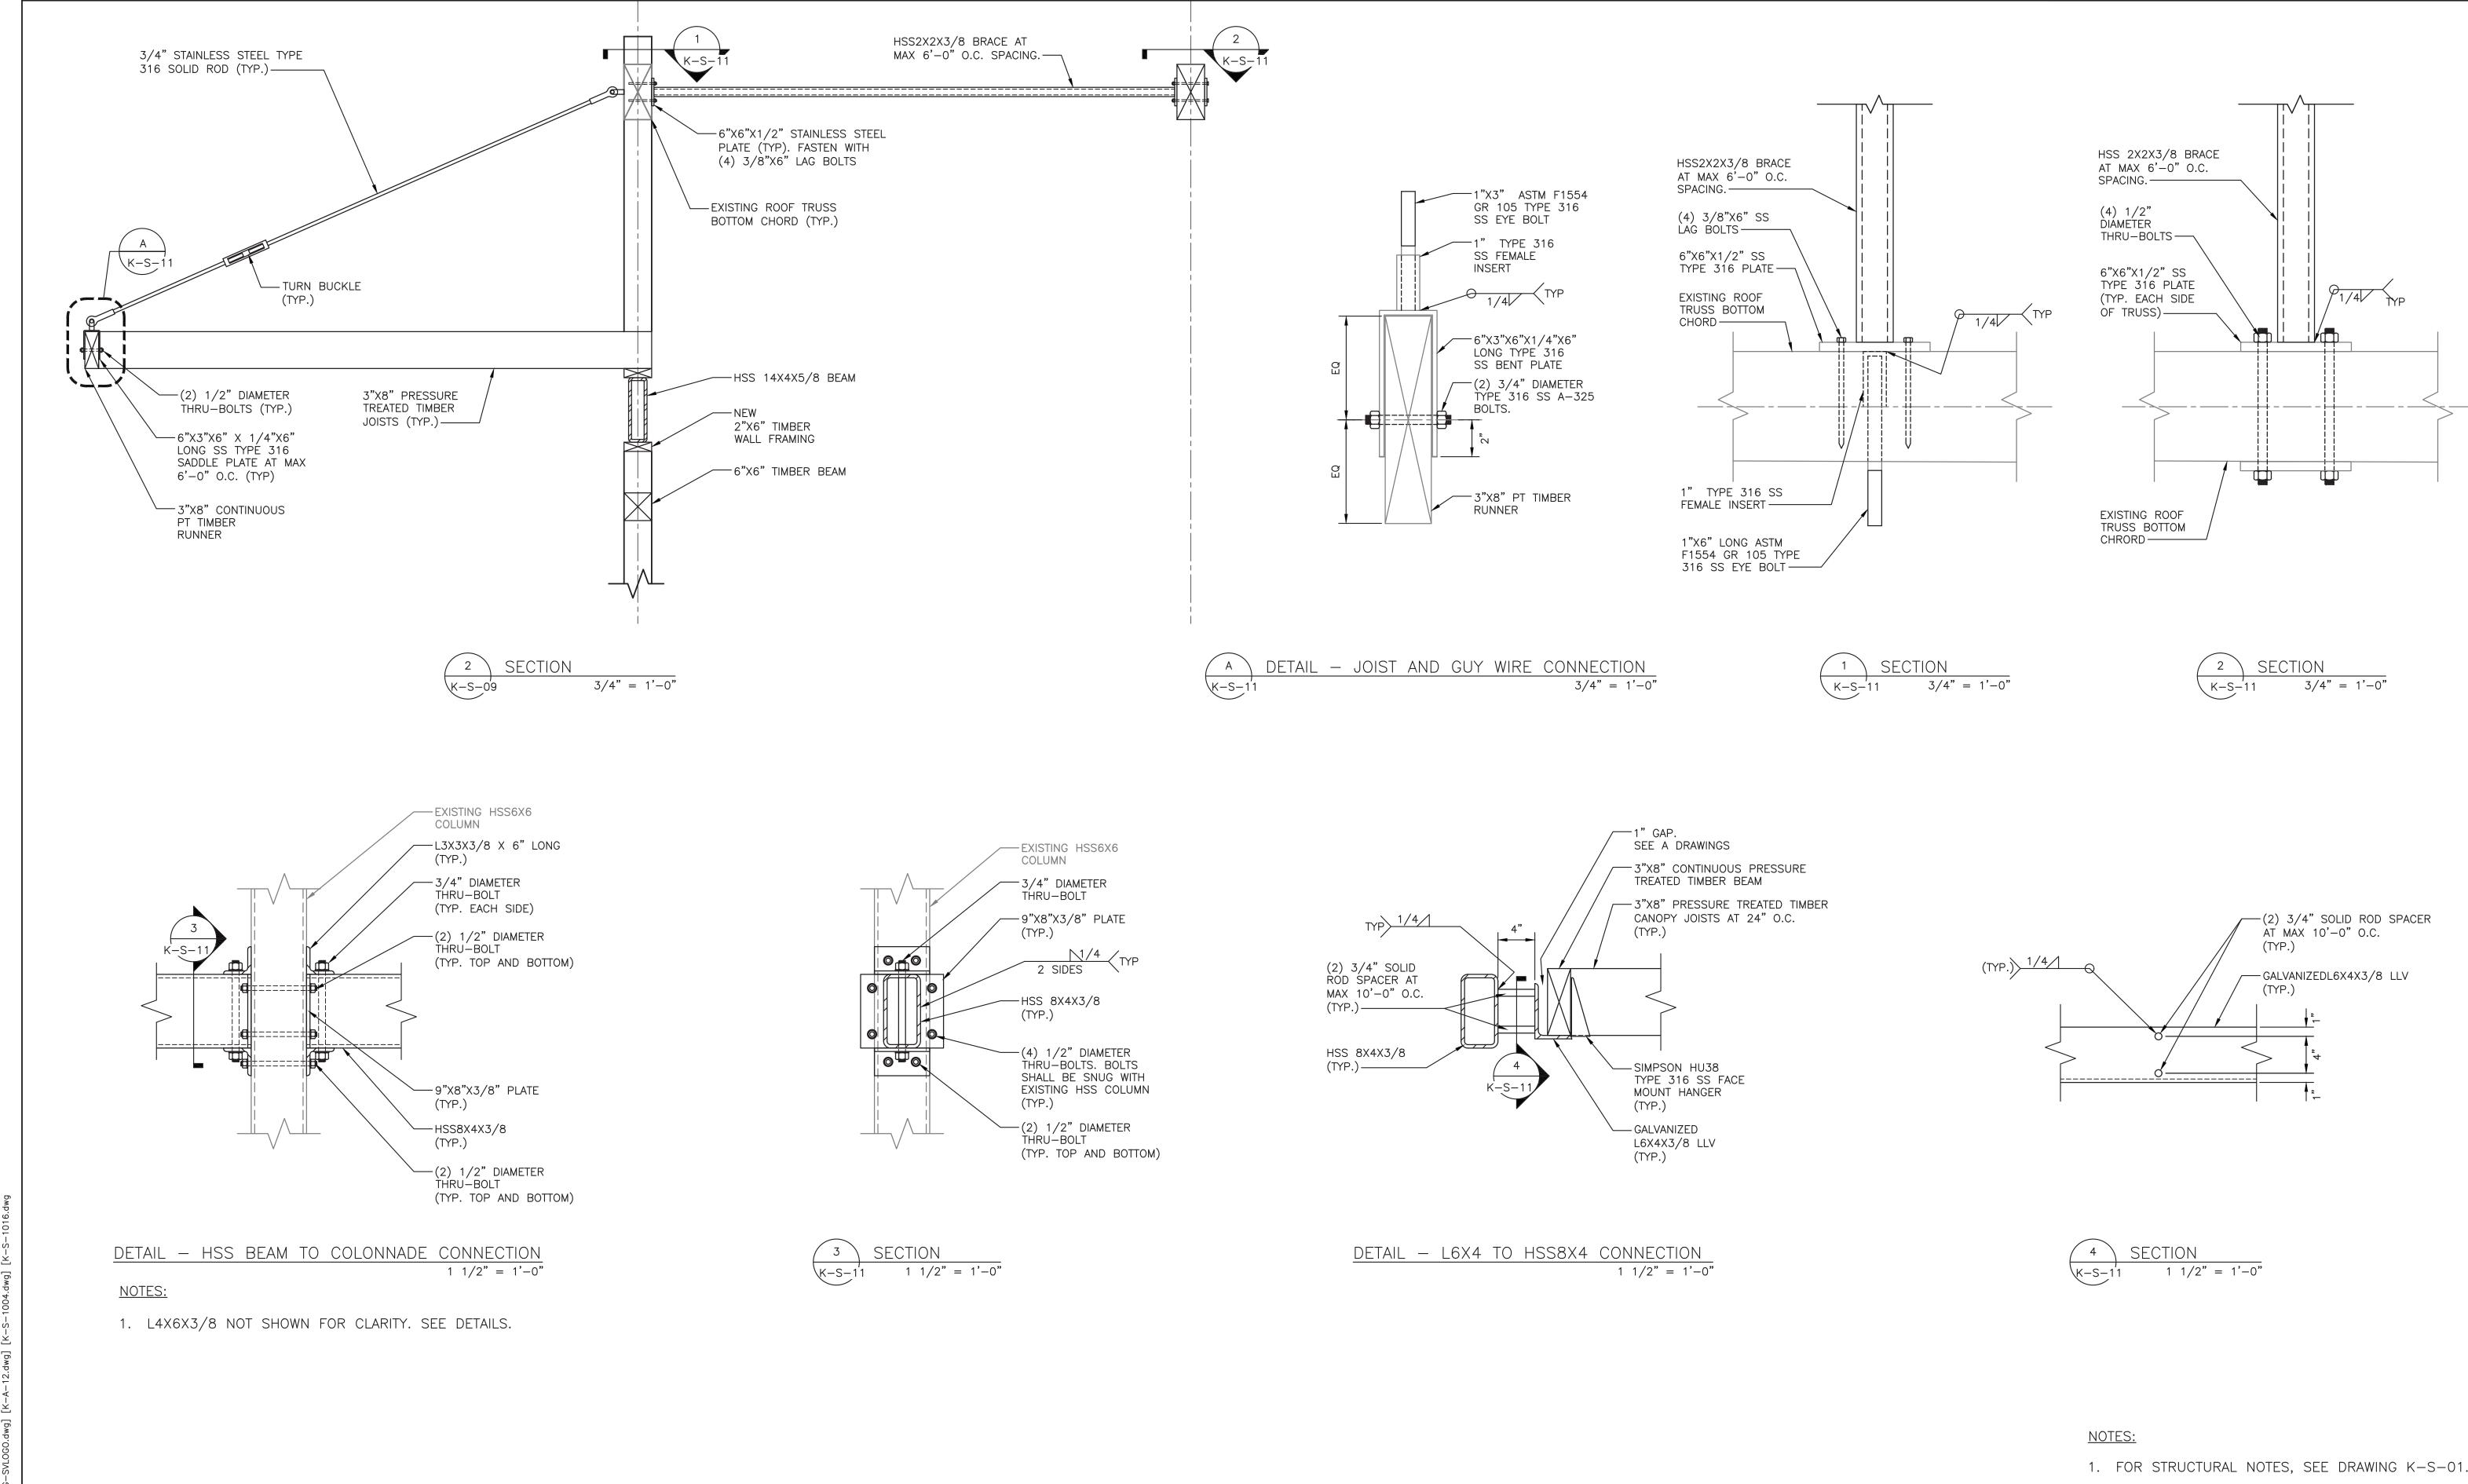
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RECORD DRAWING CERTIFICATION

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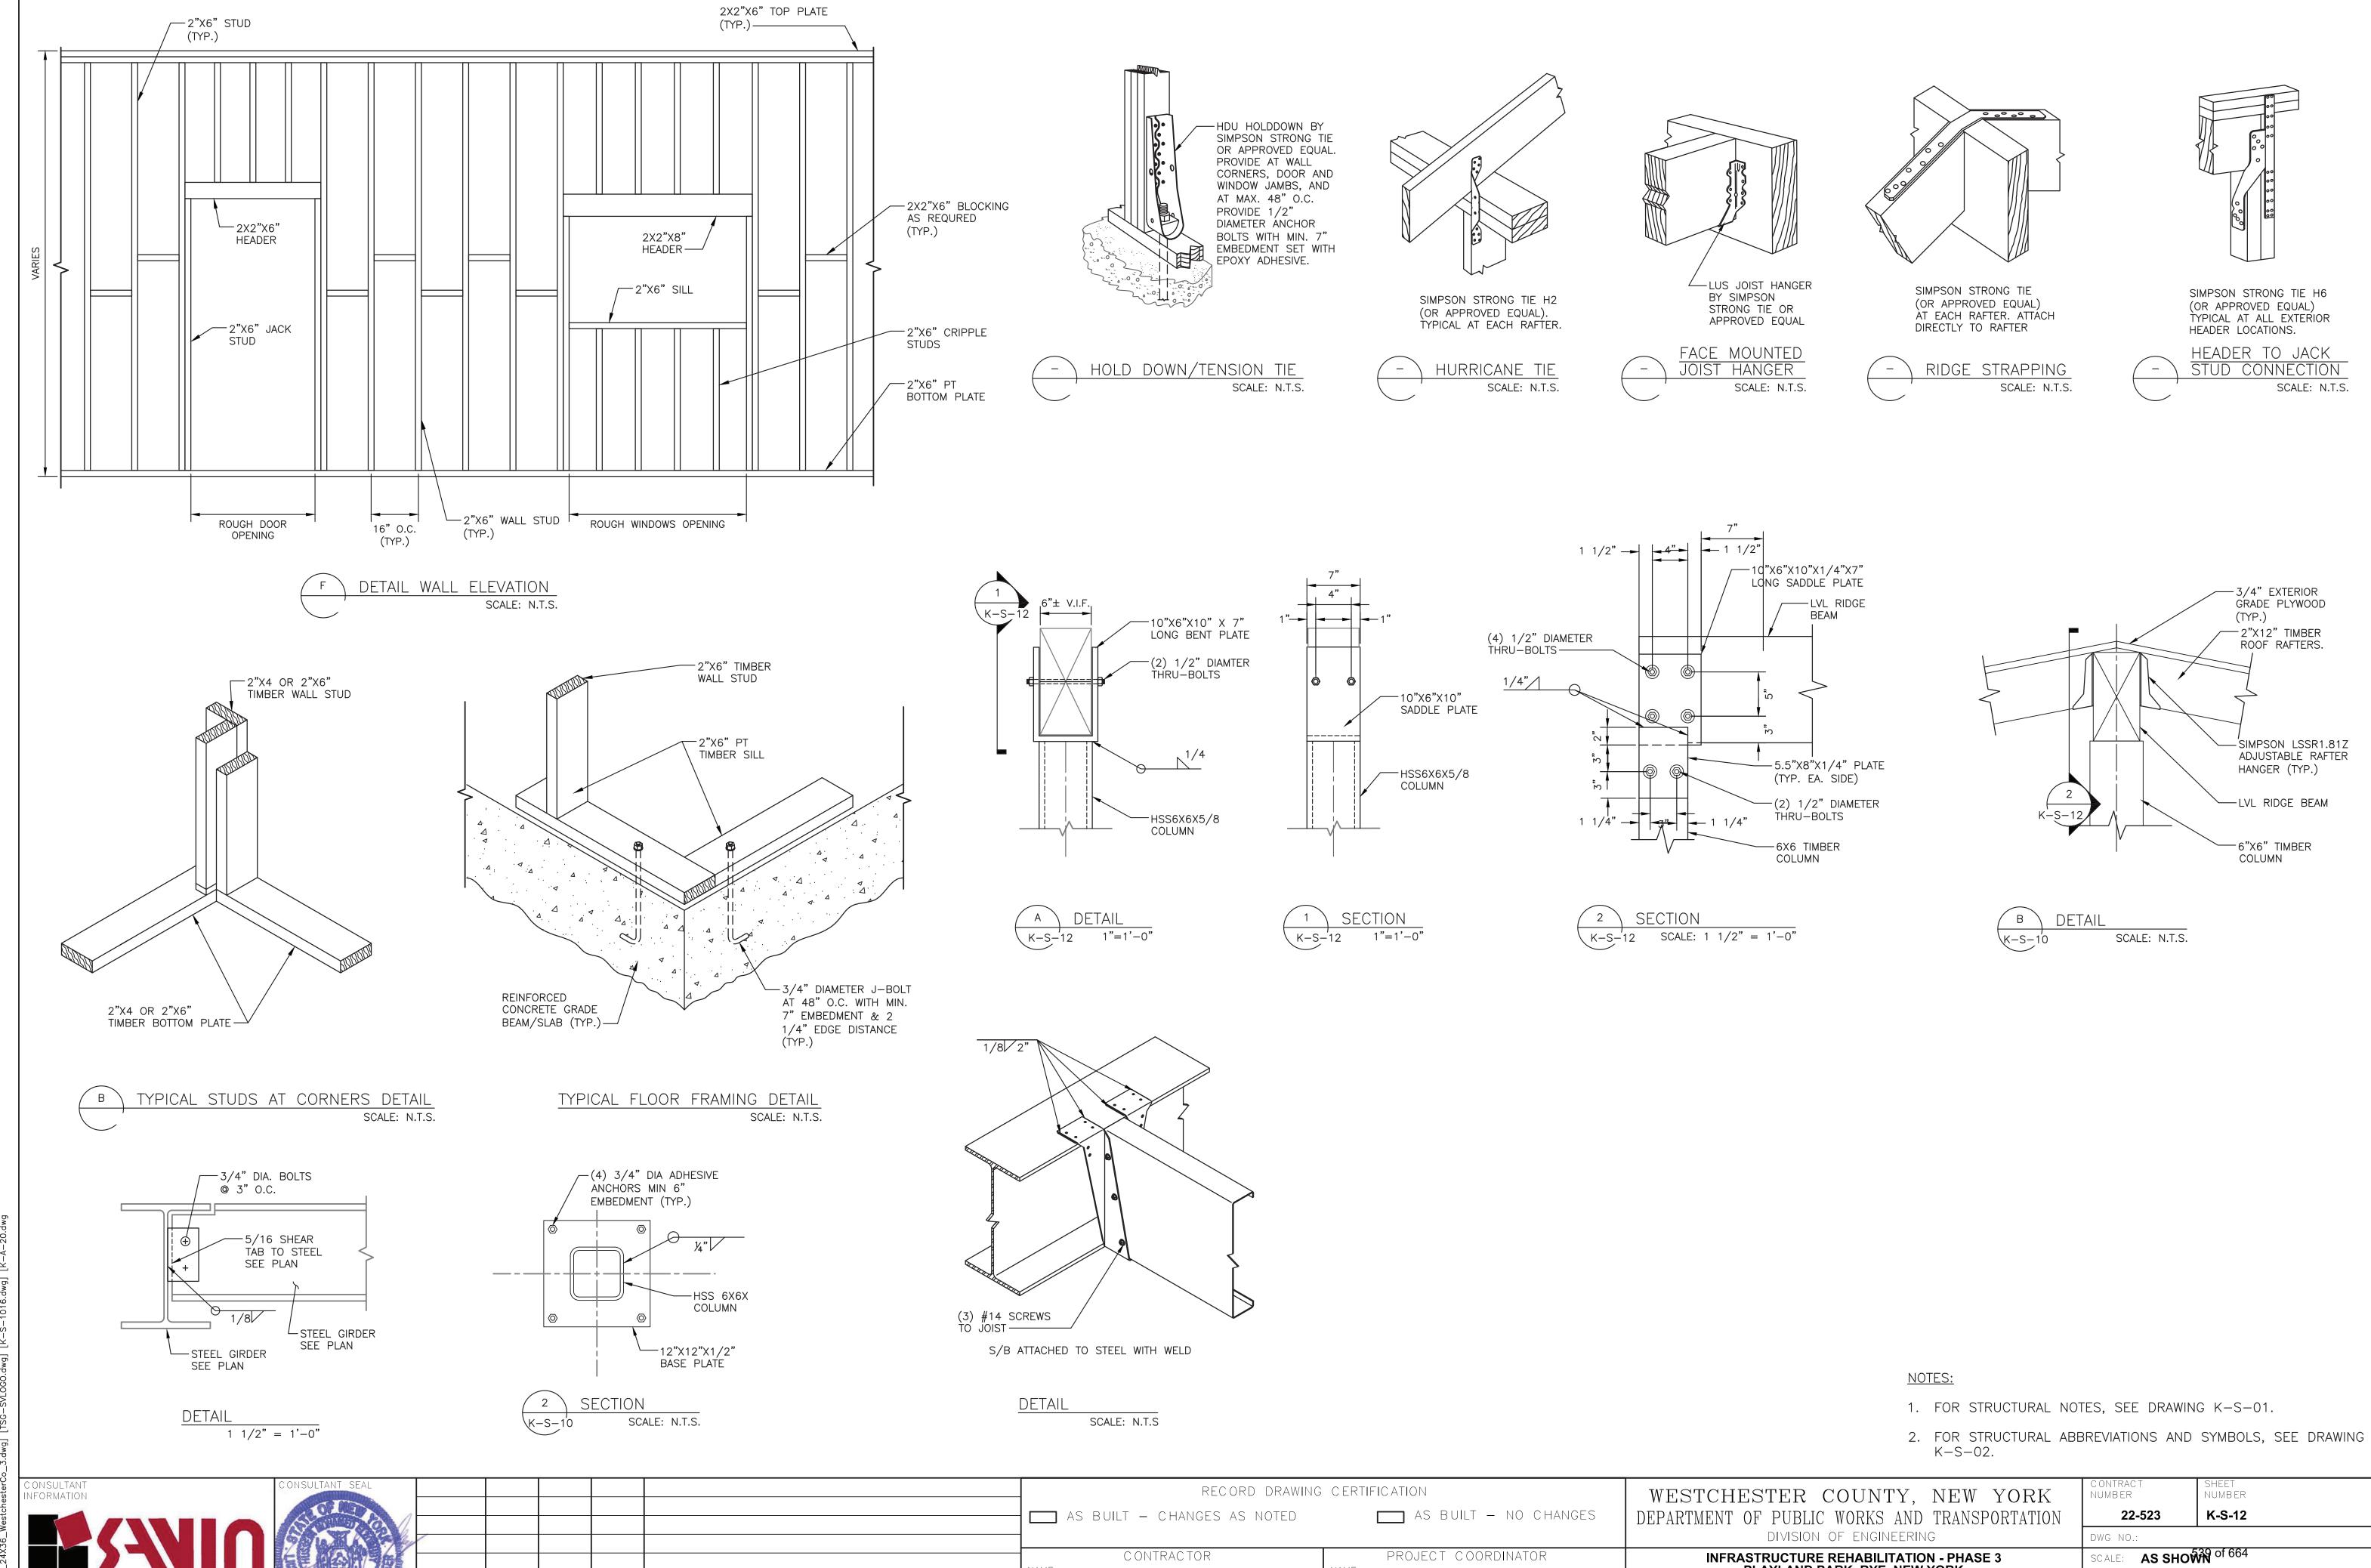
PROJECT COORDINATOR

WESTCHESTER COUNTY, NEW YORK DEPARTMENT OF PUBLIC WORKS AND TRANSPORTATION DIVISION OF ENGINEERING

**INFRASTRUCTURE REHABILITATION - PHASE 3** PLAYLAND PARK, RYE, NEW YORK RESTAURANT KITCHEN WITH FOOD VENDING SECTION AND DETAILS

CONTRACT NUMBER	SHEET NUMBER					
22-523	K-S-11					
DWG NO.:						
SCALE: AS SHO	38 of 664					
DATE: <b>8/23/2022</b>						
DPW FILE 1-118-S-	1287-0	REV. NO.	0			

2. FOR STRUCTURAL ABBREVIATIONS AND SYMBOLS, SEE DRAWING K-S-02.



\_\_\_\_\_ DATE \_\_\_

REVISION

PLAYLAND PARK, RYE, NEW YORK

RESTAURANT KITCHEN WITH FOOD VENDING

**SECTIONS AND DETAILS** 


DATE: **8/23/2022** 


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Drawing Name: G:\SavinAutocad\2060\25—Playland—Mega—3\S\KS—1006.dv Rev#: Projectname: 211001F02 Comments: ——— Printed by: JCastro Date: 19 August 2022 1:09 PM Designed by: ———

Savin Engineers, P.C.

REVISION NUMBER



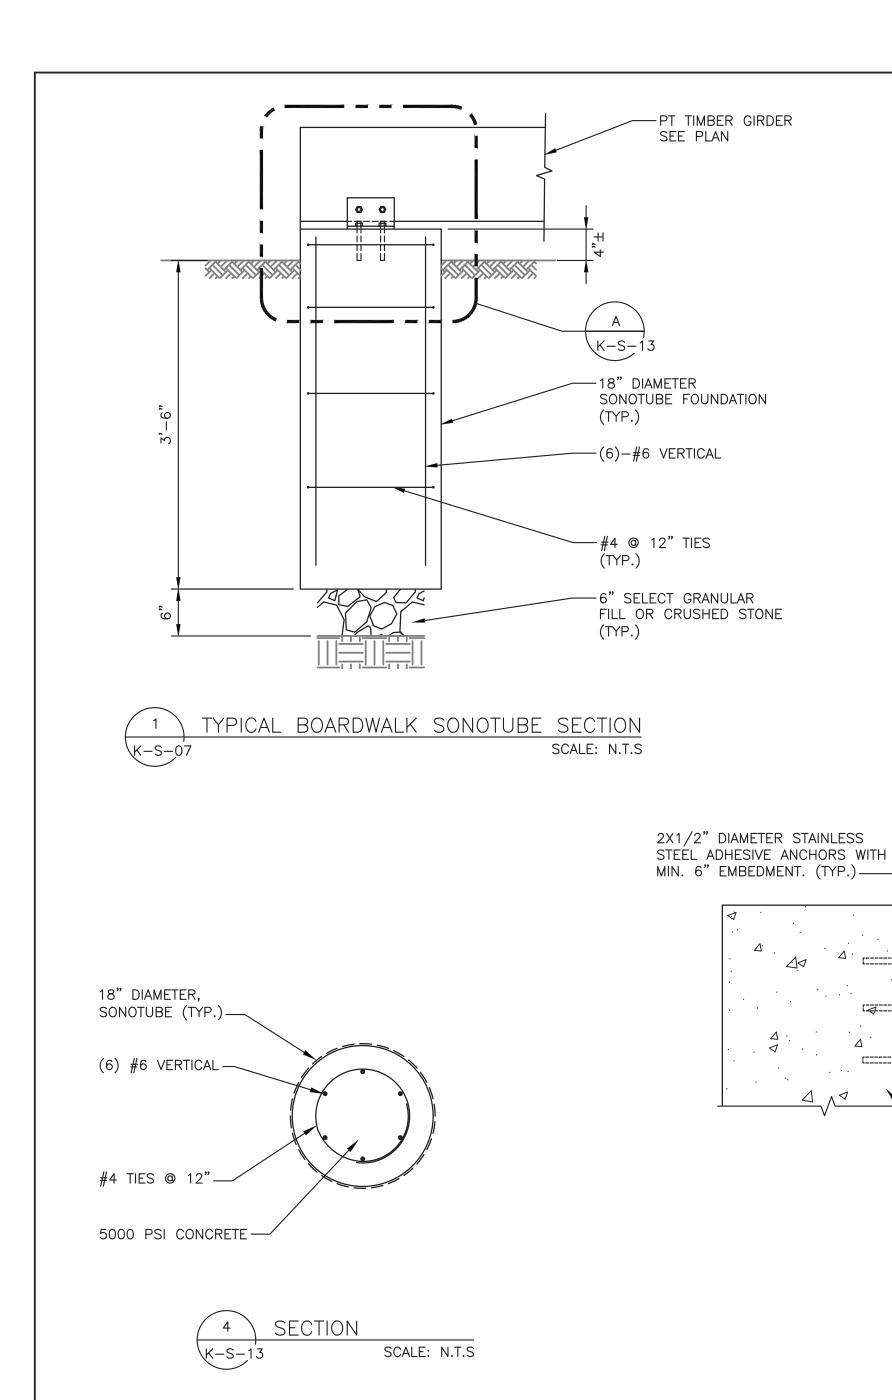

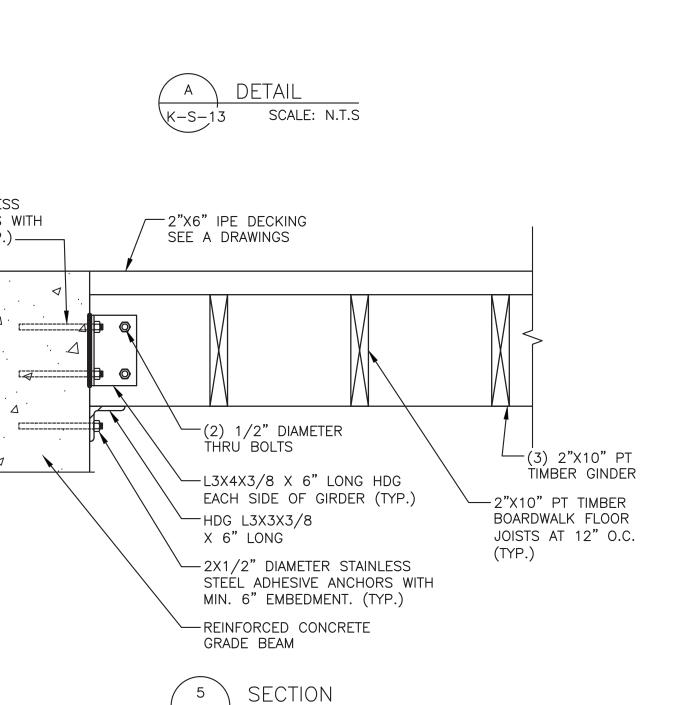SCALE: N.T.S

REVISION

O O

--- TIMBER GIRDER

— SS TYPE 316 L4X3X3/8

-(2) 1/2" DIAMETER SS TYPE 316

THRU-BOLTS (TYP.)

-1(4) 1/2" DIAMETER SS TYPE 316 ADHESIVE ANCHORS


EMBEDMENT (TYP.)

WITH MIN 4"

(TYP EACH SIDE OF GIRDER)

1 1/4" DIAMETER

THREADED ROD (TYP.)

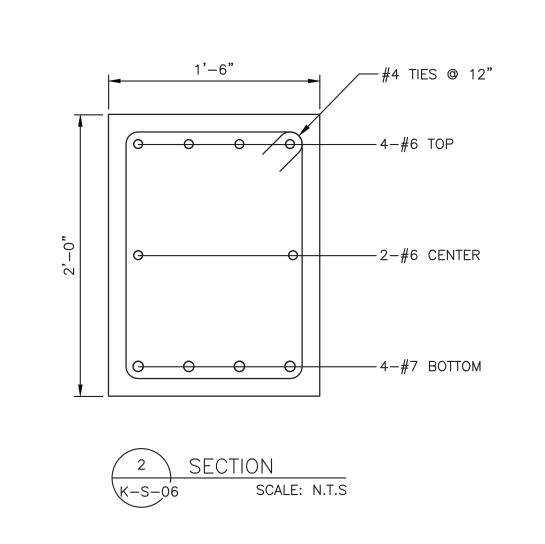

W/CONC. COVER \*

7"

9"

11"

1'-0"

1'-2"

1'-4"

1'-6"

1'-7"

TYPICAL PILE HEAD DETAIL

----DOUBLE NUT (TYP.)

— 8"X8"X1/2" PLATE (TYP.)

- CONCRETE PILE CAP


(TYP.)

SCALE: N.T.S

-FULLY GROUTED

30-TON STEEL MICROPILE

9 5/8" DIAMETER

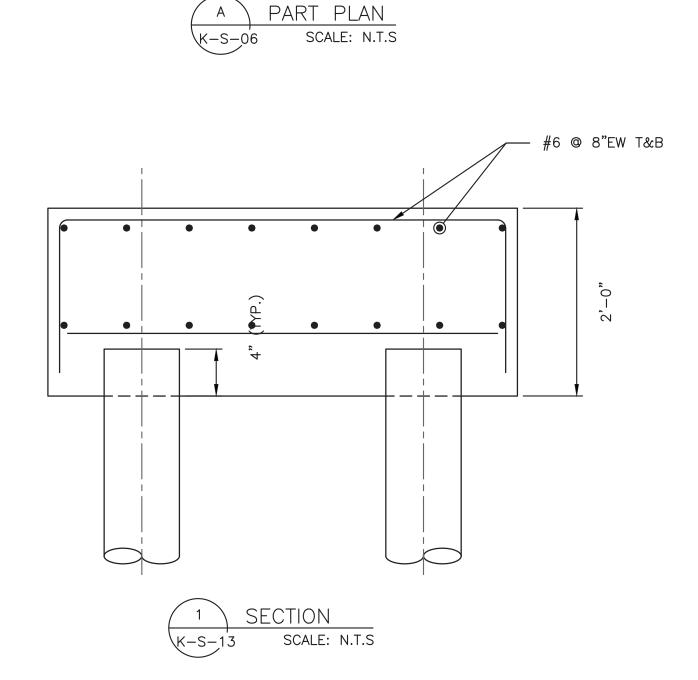

1. FOR STRUCTURAL NOTES, SEE DRAWING K-S-01.

2. FOR STRUCTURAL ABBREVIATIONS AND SYMBOLS, SEE DRAWING

5'-0"

3'-0"

1'-0"

9 5/8" DIAMETER 30 TON

MICROPILE (TYP.) -

PILE

K-S-13

1'-0"

PILE

			BASIC DEVELOP	MENT LENGTH AND	SPLICE LENGTH			
			F	OR BARS IN TENSIO	N			
fy = 60,000 psi				fc	= 4000 psi OR GRE	ATER, NORMAL WEIGHT (	CONCRETE	
	BASIC DEVELOPME	ENT LENGTH ** I d				CLASS B SPLICE LI	ENGTH ** 1.3 x l d	
CLEAR SPA	ACING > 3"	CLEAR SP.	ACING < 3"	BAR SIZE	CLEAR SPA	ACING > 3"	CLEAR SP.	ACING < 3"
BASIC	TOP *	BASIC	TOP *		BASIC	TOP *	BASIC	TOP *
1'-0"	1'-4"	1'-9"	2'-2"	#3	1'-4"	1'-9"	2'-2"	2'-11"
1'-4"	1'-8"	2'-2"	2'-9"	#4	1'-8"	2'-2"	2'-9"	3'-7"
1'-8"	2'-2"	2'-10"	3'-7"	#5	2'-2"	2'-10"	3'-7"	4'-8"
2'-0"	2'-6"	3'-3"	4'-2"	#6	2'-6"	3'-3"	4'-2"	5'-5"
3'-6"	4'-7"	5'-11"	7'-7"	#7	4'-7"	5'-11"	7'-7"	9'-11"
4'-0"	5'-2"	6'-9"	8'-8"	#8	5'-2"	6'-9"	8'-8"	11'-4"
4'-6"	5'-10"	7'-7"	9'-10"	#9	5'-10"	7'-7"	9'-9"	12'-9"
5'-0"	6'-5"	8'-6"	11'-10"	#10	6'-5"	8'-6"	11'-0"	13'-7"
5'-7"	7'-4"	9'-5"	12'-6"	#11	7'-4"	9'-5"	12'-6"	14'-9"

MADE

* TOP REINFORCEMENT IS HORIZONTAL REINFORCEMENT SO PLACED THAT MORE THAN 12 INCHES OF FRESH CONCRETE IS CAST IN THE MEMBER BELOW THE REINFORCEMENT
** LENGTHS SHOWN IN CHART SHALL BE MODIFIED WHERE REQUIRED TO CONFORM TO THE PROVISIONS OF ACI 318, SECTION 12.2

REVISION NUMBER

\*\*\* UNCOATED REINFORCEMENT

\* SIDE COVER NORMAL TO PLANE OF HOOK AT LEAST 2 1/2"; AND FOR 90° HOOK, END COVER BEYOND

DEVELOPMENT LENGTH OF STANDARD HOOKS

FOR BARS IN TENSION

fy = 60,000 psi fc = 4000 psi OR GREATER, NORMAL WEIGHT CONCRETE

BASIC

8"

10"

1'-0"

1'-3"

1'-5"

1'-7"

1'-10"

2'-1"

2'-3"

\*\* UNCOATED REINFORCEMENT

BAR SIZE #3

#4

#5

#6 #7

#8

#9

#10

#11

RECORD DRAWING	CERTIFICATION
AS BUILT — CHANGES AS NOTED	AS BUILT - NO CHANGES

CONTRACT NUMBER	SHEET NUMBER			
22-523	K-S-13			
DWG NO.:				
SCALE: AS SHO	40 of 664			
DATE: <b>8/23/2022</b>				
DPW FILE 1-118-S-	1289-0	REV.	0	

OUTSIDE END OF HOOK AT LEAST 2".

RECORD DRAWING  AS BUILT — CHANGES AS NOTED	CERTIFICATION  AS BUILT — NO CHANGES	WESTCHESTER COUNTY, NEW YORK DEPARTMENT OF PUBLIC WORKS AND TRANSPORTATION DIVISION OF ENGINEERING
CONTRACTOR NAME	PROJECT COORDINATOR	INFRASTRUCTURE REHABILITATION - PHASE 3 PLAYLAND PARK, RYE, NEW YORK
SIGNATURE DATE	SIGNATURE DATE	RESTAURANT KITCHEN WITH FOOD VENDING SECTIONS AND DETAILS

DEVELOPMENT LENGTH, I dh

Savin Engineers, P.C.

19 19 4X36\_

T OF PUBLIC WORKS AND TRANSPORTATION FRASTRUCTURE REHABILITATION - PHASE 3 ESTAURANT KITCHEN WITH FOOD VENDING SECTIONS AND DETAILS

NOTES:

K-S-02.

### **FIRE PROTECTION SAFETY NOTES:**

1. SPECIAL PRECAUTION SHALL BE TAKEN BY THE CONTRACTOR SO THAT EQUIPMENT OF THIS APPLICATION AND ITS INSTALLATION WILL NOT AFFECT THE FOLLOWING: EGRESS TO AND FROM THE BUILDING. FIRE SAFETY OR CREATE A FIRE HAZARD. STRUCTURAL SAFETY OF THE BUILDING, ACCUMULATION OF DUST AND DEBRIS. (THE CONTRACTOR SHALL LEAVE THE SITE BROOM CLEANED EACH DAY.)

### FIRE PROTECTION GENERAL NOTES:

1. DIMENSIONS, LOCATIONS AND SIZES INDICATED ON THE PLANS AND THE ELEVATION ARE APPROXIMATE AND SHALL BE VERIFIED BY FIELD INSPECTION BY THE CONTRACTOR.

3. NO WORK SHALL BE INITIATED UNTIL A WORK PERMIT IS OBTAINED BY THE CONTRACTOR AND A SAFETY PLAN IS SUBMITTED AND IS APPROVED.

CONTRACT, BUT MUST BE PROTECTED BY THE CONTRACTOR.

2. SOME EXISTING PIPE AND EQUIPMENT IS SHOWN FOR CLARIFICATION OF THIS

4. CONTRACTOR IS RESPONSIBLE FOR OBTAINING ALL PERMITS, EQUIPMENT USE PERMITS, ALL INSPECTION APPROVALS, AND LETTER OF COMPLETION FROM THE DEPARTMENT OF BUILDINGS FOR WORK UNDER THIS CONTRACT AS APPLICABLE.

5. ANY EXISTING MATERIALS, PIPING, ETC., NOT INDICATED FOR DEMOLITION WHICH ARE REMOVED BY THE CONTRACTOR IN ORDER TO INSTALL NEW WORK SHALL BE REINSTALLED BY THE CONTRACTOR. IF EXISTING WORK IS DAMAGED IT SHALL BE REPLACED AT THE CONTRACTOR'S EXPENSE. ALL SURFACES OR FINISHES THAT ARE DAMAGED OR OTHERWISE AFFECTED BY WORK OF THIS CONTRACT SHALL BE PATCHED, REPAIRED, PAINTED OR REPLACED TO MATCH THE PRE-EXISTING CONDITION AND THE

6. CONTRACTOR MAY PROPOSE ALTERNATE ROUTING IN DIFFICULT AREAS WHERE REPLACEMENT IN KIND IS NOT PRACTICAL. ANY AND ALL ALTERNATE ROUTING IS SUBJECT TO PRIOR REVIEW AND APPROVAL BY THE ENGINEER.

7. A FIRE WATCH SHALL BE PROVIDED WHEN SPRINKLER COVERAGE IS IMPACTED TO MAINTAIN BUILDING OPERATIONS OR AS REQUIRED.

### FIRE PROTECTION SYMBOL LIST

	FS DRY— — NEW DRY SPRINKLER PIPING
	DRY(E) — EXISTING TO REMAIN DRY SPRINKLER PIPING
0	NEW UPRIGHT SPRINKLER HEAD
O <sub>E</sub>	EXISTING UPRIGHT SPRINKLER HEAD
•	NEW CONCEALED PENDENT SPRINKLER HEAD-ORDINARY TEMPERATURE
\$	SPRINKLER DRY PIPE VALVE
Ц	FIRE HOSE CABINET
<b>&gt;</b>	SIAMESE CONNECTION
1Z	CHECK VALVE
₽,	CHECK VALVE W/ ALARM
$\Diamond$	WATER MOTOR ALARM BELL
8	PIPE RISER
<del>c-</del>	PIPE DROP
0-	PIPE UP
•	POINT OF CONNECTION
	POINT OF DISCONNECTION
	PREACTION 6" BELL
	SOLENOID VALVE
፟፟	OS & Y VALVE
<u>/</u> #\	REVISION SYMBOL
F#)	REFER TO SUPPLEMENTAL FIGURE INDICATED BY NUMBER (I.E. F2 REFERS TO FIGURE 2)
/xxx	EQUIPMENT TAG
X	EQUIPMENT NUMBER
X	DETAIL TAG/ CALL OUT TAG
X-XXX	FIRE PROTECTION SHEET NUMBER

# SHOP DWGS/EQUIPMENT **SUBMITTALS**

THE CONTRACTOR MUST SUBMIT ANY EQUIPMENT ALTERNATES 2 WEEKS PRIOR TO BIDS DUE FOR REVIEW AND COMMENTS. ALTERNATES MUST BE ACCEPTED BY LIRO ENGINEERS, INC., THE ARCHITECT, AND THE OWNER PRIOR TO INCLUSION IN BID. THE CONTRACTOR IS RESPONSIBLE TO COORDINATE EQUIPMENT ALTERNATES WITH OTHER TRADES AND MAKE ADJUSTMENTS TO THE MECHANICAL SYSTEMS, AS REQUIRED, TO ACCOMMODATE THESE NEW ALTERNATES.

THE CONTRACTOR IS RESPONSIBLE TO SUBMIT ALL OF THE FOLLOWING ITEMS FOR REVIEW/APPROVAL BY NO MORE THAN 3 WEEKS AFTER THE CONTRACTOR'S CONTRACT/BID HAS BEEN AWARDED. ALL SUBMITTALS MUST BE SENT TOGETHER AS A SINGLE PACKAGE WITH MANUFACTURER'S SPECIFIC MODELS AND SPECIFICATIONS

OUTLINED TO MATCH THE SCHEDULED REQUIREMENTS. EACH SUBMITTAL MUST BE LABELED WITH THE UNIT DESIGNATION USED WITHIN THIS DRAWING SET. IF THE SUBMITTAL PACKAGE IS FOUND TO BE INCOMPLETE UPON RECEIPT, THE PACKAGE WILL BE HELD AND WILL NOT BE REVIEWED UNTIL THE REMAINDER OF THE PACKAGE IS RECEIVED. SIX (6) HARD COPIES OF THE SUBMITTAL PACKAGE MUST BE SENT TO LIRO ENGINEERS, INC. DIGITAL SHOP DRAWING SUBMISSIONS ARE ACCEPTABLE.

### **SCOPE OF WORK:**

1. THE INSTALLATION OF NEW DRY FS EQUIPMENT.

PROPOSED FIRE SPRINKLER HEAD LOCATIONS AND PIPING ARE AS NOTED ON PLANS. EXACT PIPING FROM THE FIRE SPRINKLER MAIN TO ALL HEADS IS TO BE COORDINATED AND HYDRAULICALLY CALCULATED BY THE F.S.C. & SUBMITTED TO THE ENGINEER FOR APPROVAL.

NOTE: THIS SCOPE OF WORK DESCRIPTION IS PROVIDED TO GIVE AN OVERALL "MACRO" DESCRIPTION OF THIS PROJECT. F.S.C. IS RESPONSIBLE TO REVIEW ALL ENGINEERING AND ARCHITECTURAL DRAWINGS AND VISIT THE SITE IF NEEDED, PRIOR TO SUBMISSION OF BID.

SPRINKLER HEAD SCHEDULE										
MANUFACTURER	MODEL	DESCRIPTION	K-FACTOR	QUANTITY						
RELIABLE	F1FR	DRY ORDINARY UPRIGHT SPRINKLE HEAD	5.6	15						
RELIABLE	F1FR	WET ORDINARY CONCEALED SPRINKLE HEAD	5.6	24						
TYCO	DS1	DRY ORDINARY SIDEWALL SPRINKLE HEAD	5.6	4						
	RELIABLE	MANUFACTURER MODEL RELIABLE F1FR RELIABLE F1FR	MANUFACTURER MODEL DESCRIPTION  RELIABLE F1FR DRY ORDINARY UPRIGHT SPRINKLE HEAD  RELIABLE F1FR WET ORDINARY CONCEALED SPRINKLE HEAD  TYCO DS1 DRY ORDINARY SIDEWALL	RELIABLE F1FR DRY ORDINARY UPRIGHT SPRINKLE HEAD 5.6  RELIABLE F1FR WET ORDINARY CONCEALED SPRINKLE HEAD 5.6  TYCO DS1 DRY ORDINARY SIDEWALL 5.6						

	ABBREVIATION			DRAWING NOTATIONS				
ACV	ALARM CHECK VALVE							
B.O.P.	BOTTOM OF PIPE		#	DRAWING NOTE TAB				
(E)	EXISTING TO REMAIN			RISER DESIGNATION				
F.S.C.	FIRE SPRINKLER CONTRACTOR		•	POINT OF CONNECTION				
P.C	PLUMBING CONTRACTOR			TOWN OF CONNECTION				
TYP	TYPICAL			POINT OF DISCONNECTION				
W/	WITH							
NYS	NEW YORK STATE							

## **DESIGN CRITERIA**

1. AREA OF APPLICATION = 1950 SQ. FT

U/P UNDERGROUND PIPING

W | WATER

- 2. OCCUPANCY CLASSIFICATION = ORDINARY HAZARD GROUP 2
- 3. MAXIMUM COVERAGE PER SPRINKLER HEAD = 130 SQ. FT
- 4. DESIGN DENSITY = 0.20 GPM/SQ. FT

- 2016 NFPA 13

- 5. NUMBER OF SPRINKLER HEADS WITHIN AREA OF APPLICATION = 26
- 6. "K" FACTOR OF SPRINKLER HEADS = 5.6

7. DESIGN CRITERIA REQUIREMENTS BASED ON: - 2020 BUILDING CODE OF NEW YORK STATE

# ORDINARY HAZARD PIPE **SCHEDULE**

STEEL	COPPER
11N. 2 SPRINKLERS 1 1/4 IN. 3 SPRINKLERS 1 1/2IN. 5 SPRINKLERS 2 IN. 10 SPRINKLERS 2 1/2 IN. 20 SPRINKLERS 3 IN. 40 SPRINKLERS 3 1/2 IN. 65 SPRINKLERS 4 IN. 100 SPRINKLERS 5 IN. 160 SPRINKLERS 6 IN. 275 SPRINKLERS 8 IN. SEE SECTION 8.2	1 IN.       2 SPRINKLERS         1 1/4 IN.       3 SPRINKLERS         1 1/2IN.       5 SPRINKLERS         2 IN.       12 SPRINKLERS         2 1/2 IN.       25 SPRINKLERS         3 IN.       45 SPRINKLERS         3 1/2 IN.       75 SPRINKLERS         4 IN.       115 SPRINKLERS         5 IN.       180 SPRINKLERS         6 IN.       300 SPRINKLERS         8 IN.       SEE SECTION 8.2

FOR SI UNITS, 1 IN. = 25.4 MM.

# **MAX DISTANCE BETWEEN HANGERS (FT.-IN.)**

NOMINAL PIPE SIZE (IN.)												
	3/4	1	1 1/4	1 1/2	2	2 1/2	3	3 1/2	4	5	6	8
STEEL PIPE EXCEPT HREADED LIGHTWALL	N/A	12-0	12-0	15-0	15-0	15-0	15-0	15-0	15-0	15-0	15-0	15-0
HREADED LIGHTWALL STEEL PIPE	N/A	12-0	12-0	12-0	12-0	12-0	12-0	N/A	N/A	N/A	N/A	N/A
COPPER TUBE	8-0	8-0	10-0	10-0	12-0	12-0	12-0	15-0	15-0	15-0	15-0	15-0

**CODE REFERENCE** 

# 2020 NEW YORK STATE BUILDING CODE

2016 NFPA 13

### FIRE PROTECTION NOTES

1. THE DRAWINGS SHOW THE LAYOUT OF THE SYSTEM AND INDICATE THE APPROXIMATE LOCATIONS OF EQUIPMENT AND PIPING. CONTRACTOR IS CAUTIONED NOT TO SCALE THE DRAWINGS. THE PIPING SHALL BE RUN APPROXIMATELY IN THE AREAS AS INDICATED ON THE DRAWINGS, [HOWEVER, TO THE ARRANGEMENT OF THE PIPING SYSTEMS AS MAY BE REFERENCED WITH WORK OF OTHER TRADES]. CONTRACTOR SHALL REVIEW AND COORDINATE WITH STRUCTURAL, ELECTRICAL AND MECHANICAL DRAWINGS. PARTITIONS, STRUCTURAL MEMBERS, ETC. ARE DESIGNED TO BE FURRED OR CLOSED IN AND TO INCLUDE ROUGH-IN PIPING. CONTRACTOR SHALL FURNISH ALL OFFSETS, ADDITIONAL FITTINGS, ETC. WHETHER SHOWN ON DRAWINGS OR NOT, AS REQUIRED TO MEET INSTALLATION CONDITIONS.

2. CONTRACTOR IS TO COMPLY WITH LATEST NFPA AND N.Y.S. CODES, AND COORDINATE HIS WORK WITH OTHER TRADES AND MAKE NECESSARY ADJUSTMENTS.

3. CONTRACTOR IS TO PREPARE SHOP DRAWINGS FOR ENGINEERS REVIEW AFTER MAKING A COMPLETE FIELD

4. CONTRACTOR IS TO REPORT ANY CONDITION REQUIRING CHANGES FROM PLANS TO ENGINEER PRIOR TO STARTING WORK.

5. BRANCH LINES AND MAINS (1 1/2" OR LESS) - SCHEDULE 40 FM APPROVED

6. BRANCH LINES AND MAINS (2" OR LARGER) - THINWALL (THICKNESS LESS THEN SCHEDULE 40 MORE THEN SCHEDULE 10 & FM APPROVED)

7. CONTRACTOR IS TO PERFORM A HYDROSTATIC TEST FOR 2 HRS. @ 200 PSI WITH NO LEAKAGE AND PROVIDE A TEST CERTIFICATE TO ENGINEER

8. CONTRACTOR IS TO EMPLOY EXPERIENCED WORKMEN WHO ARE TO FAMILIARIZE THEMSELVES WITH THE

BUILDING AND OBSERVE SAFETY REQUIREMENTS. 9. CONTRACTOR TO ADJUST HEAD LOCATION TO COORDINATE WITH LIGHTS, DUCTS, ETC.

10. PERMIT FROM LOCAL AUTHORITY, TO BE OBTAINED BY CONTRACTOR.

11. ALL WORK TO BE APPROVED BY OWNERS ENGINEER, STATE AUTHORITIES HAVING JURISDICTION AND MUNICIPAL FIRE, PLUMBING, BUILDING AND WATER DEPARTMENTS.

12. U.L. AND/OR FM APPROVED EQUIPMENT TO BE USED.

13. WORK TO BE IN ACCORDANCE WITH MUNICIPAL WATER DEPT. RULES

14. SYSTEM IS TO BE MAINTAINED AND TESTED BY THE OWNER OR HIS AGENT IN ACCORDANCE WITH APPLICABLE LOCAL AND STATE CODES AND IN CONFORMANCE WITH NFPA 13A, LATEST EDITION.

15. IF BUILDING OCCUPANCY OR CONSTRUCTION CHANGES, THE SPRINKLER SYSTEM IS TO BE UPDATED

ACCORDINGLY BY THE OWNER OR HIS AGENT.

16. CONTRACTOR IS TO NEATLY CUT AND PATCH IN A FIRST CLASS WORKMANLIKE MANNER, ALL HOLES AND PENETRATIONS IN WALLS, CEILINGS, FLOORS, PARTITIONS, ETC.

17. THE ENGINEER IS NOT RETAINED FOR SUPERVISION.

18. THE INSTALLATION OF THIS SYSTEM WILL REQUIRE THE CLOSING OF ONE OR MORE FIRE PROTECTION CONTROL VALVES. THESE VALVE CLOSURES SHOULD BE CLOSELY COORDINATED WITH THE OWNERS WHO SHOULD CONTACT THE LOCAL FIRE DEPARTMENT, INSURANCE INTERESTS, ETC. PRIOR TO VALVE CLOSURES.

19. ACTUAL DESIGN DENSITY MAY EXCEED STANDARDS, HOWEVER, IT IS A MINIMUM TO BE USED BY THE CONTRACTOR.

20. ALL ALARMS RELATING TO THE SPRINKLER SYSTEM SHOULD BE ACTIVATED UPON PLACING THE SPRINKLER SYSTEM IN SERVICE.

21. THE INSTALLATION COMPONENTS, SIZING, SPACING, MATERIALS LOCATION CLEARANCES, POSITION AND TYPE OF SYSTEM SHALL CONFORM TO NFPA 13 AND NYS UNIFORM FIRE PREVENTION BUILDING CODE LATEST EDITION.

22. SPRINKLERS SHALL BE PROTECTED AGAINST FREEZING AND INJURY AS PER NFPA CODE.

23. INSPECTION AND TESTS OF SPRINKLER SYSTEM SHALL BE CONDUCTED AS SPECIFIED IN NFPA CODE.

24. WATER SUPPLY TEST PIPES AND GAUGES SHALL BE PROVIDED AS SPECIFIED IN CHAPTER 2-9 OF NPPA 13. 25. PIPING SPECIFICATIONS, PIPE SCHEDULES, SYSTEM TEST PIPES, PROTECTION AGAINST CORROSION, DAMAGE

FITTINGS, VALVES, HANGERS, SPRINKLERS, GUARDS AND SHIELDS SHALL BE IN ACCORDANCE WITH CHAPTER 3 AND CHAPTER 8 OF NFPA 13, LATEST EDITION. PIPING SHALL BE PAINTED TO PREVENT CORROSION.

26. STOCK OF EXTRA SPRINKLERS WILL BE FURNISHED AS PER CHAPTER 3 OF NFPA 13 (REQUIRED FOR EACH TEMPERATURE RATING).

27. SPRINKLER ALARMS WILL BE IN ACCORDANCE WITH NFPA 13.

28. SPACING, LOCATION AND POSITION OF SPRINKLERS SHALL BE IN ACCORDANCE WITH CHAPTER 4 OF NFPA 13.

29. ALL PIPING PASSING THROUGH WALLS SHALL COMPLY WITH NFPA FOR FIRE PROOFING.

30. DISTANCE OF SPRINKLERS FROM HEAT SOURCES SHALL BE IN ACCORDANCE WITH TABLE 3-16.6.3 OF NFPA 13.

31. PROVIDE WATER SUPPLY LETTER WITH FLOW TEST DATA.

32. ALL PIPES PASSING THROUGH FOUNDATION WALLS TO BE PROTECTED.

33. ALL VALVES SHALL BE IDENTIFIED AS REQUIRED BY NFPA 13. 34. DRAINAGE TO CONFORM TO CHAPTER 3-11 OF NFPA 13.

35. A ONE PIECE REDUCING FITTING OF GOOD DESIGN SHOULD BE USED WHEREVER A CHANGE IS MADE IN THE SIZE OF PIPE AS PER SECTION 3-12.2.7 OF NFPA 13.

36. ALL VALVES ON CONNECTIONS TO WATER SUPPLIES AND IN SUPPLY TO SPRINKLERS SHALL BE APPROVED O.S. &Y. OR APPROVED INDICATOR TYPE WITH TAMPER SWITCHES.

37. DRAIN VALVES AND TEST VALVES SHALL BE APPROVED TYPE AS PER SECTION 3-14.1.2 OF NFPA 13.

38. HANGERS SHALL BE OF A TYPE APPROVED FOR USE WITH THE PIPE OR TUBE INVOLVED, SPRINKLER PIPING SHOULD BE SUPPORTED BY ADJUSTABLE HANGERS PER NFPA 13, SECTION 3-15.

39. PROVISIONS SHOULD BE MADE TO FACILITATE FLUSHING SYSTEM PIPING BY PROVIDING FLUSHING CONNECTIONS CONSISTING OF A CAPPED NIPPLE 4" LONG ON THE END OF THE CROSS MAIN, AS PER SECTION 3-8.2

40. SPRINKLER SHALL BE AN APPROVED TYPE AS PER SECTION 3-16 OF NFPA 13.

41. TEMPERATURE RATING SHALL COMPLY WITH SEC. 3-16.6 OF NFPA 13.

42. CLEARANCES BETWEEN SPRINKLERS AND STORAGE OR PARTITIONS AS PER NFPA 13, SECTION 4-2.5

43. SPACING AND LOCATION OF SPRINKLER SHALL COMPLY WITH CHAPTER 4 NFPA 13.

44. CONTRACTOR TO COORDINATE HIS WORK WITH OTHER TRADES.

45. ONLY EXPERIENCED SPRINKLER MECHANICS TO WORK ON THE SYSTEM.

46. ALL PIPING TO BE A MINIMUM OF 1" UNLESS OTHERWISE NOTED.

47. PROVIDE SHOP DRAWINGS WITH HYDRAULIC CALCULATIONS FOR REVIEW TO LOCAL FIRE MARSHALL AND


INSURANCE UNDERWRITER AND ENGINEER FOR APPROVAL PRIOR TO INSTALLATION.

48. ALL FIRE PROTECTION EQUIPMENT SHALL BE INSTALLED PER MANUFACTURER'S REQUIREMENTS/SPECIFICATIONS.

49. ALL FIRE PROTECTION EQUIPMENT SHALL BE MOUNTED ON MINIMUM 6" HIGH CONCRETE PAD UNLESS OTHERWISE NOTED (PAVER AND CINDER BLOCK IS NOT ACCEPTABLE).

50. PERMIT IS REQUIRED PRIOR TO INSTALLATION, TO INCLUDE SIGNED AND SEALED SHOP DRAWINGS, HYDRAULIC CALCULATION, SHOP DRAWINGS, MANUFACTURERS INFORMATION ON HEADS AND APPLIANCES, COMPLIANCE WITH NFPA 13 AND SECTION 903 2020 NYSBC/FC.

### FIRE PROTECTION DRAWING LIST REVISION SHEET REVISON SHEET NAME DATE K-FP-01 FIRE PROTECTION NOTES, SYMBOLS, ABBREVIATIONS, AND DRAWING LIST K-FP-11 | FIRE PROTECTION GROUND FLOOR DEMOLITION PLAN K-FP-21 | FIRE PROTECTION GROUND FLOOR AND ATTIC CONSTRUCTION RCP -K-FP-81 FIRE PROTECTION DETAILS

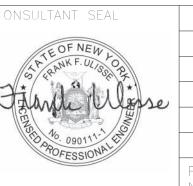

ט						NAME SIGNA
	REVISION NUMBER	DATE	MADE BY	APP'D BY	REVISION	TITLE


AS BUILT - NO CHANGES THE AS BUILT - CHANGES AS NOTED PROJECT COORDINATOR CONTRACTOR \_\_\_\_\_ DATE \_\_\_\_

RECORD DRAWING CERTIFICATION

**INFRASTRUCTURE REHABILITATION - PHASE 3** PLAYLAND PARK, RYE, NEW YORK RESTAURANT KITCHEN WITH FOOD VENDING

WESTCHESTER COUNTY, NEW YORK

22-523 DEPARTMENT OF PUBLIC WORKS AND TRANSPORTATION K-FP-01 DIVISION OF ENGINEERING 541 of 664 **AS INDICATED** 08/23/2022 1-118-FP-1290-0 FIRE PROTECTION NOTES, SYMBOLS, ABBREVIATIONS & DWG LIST

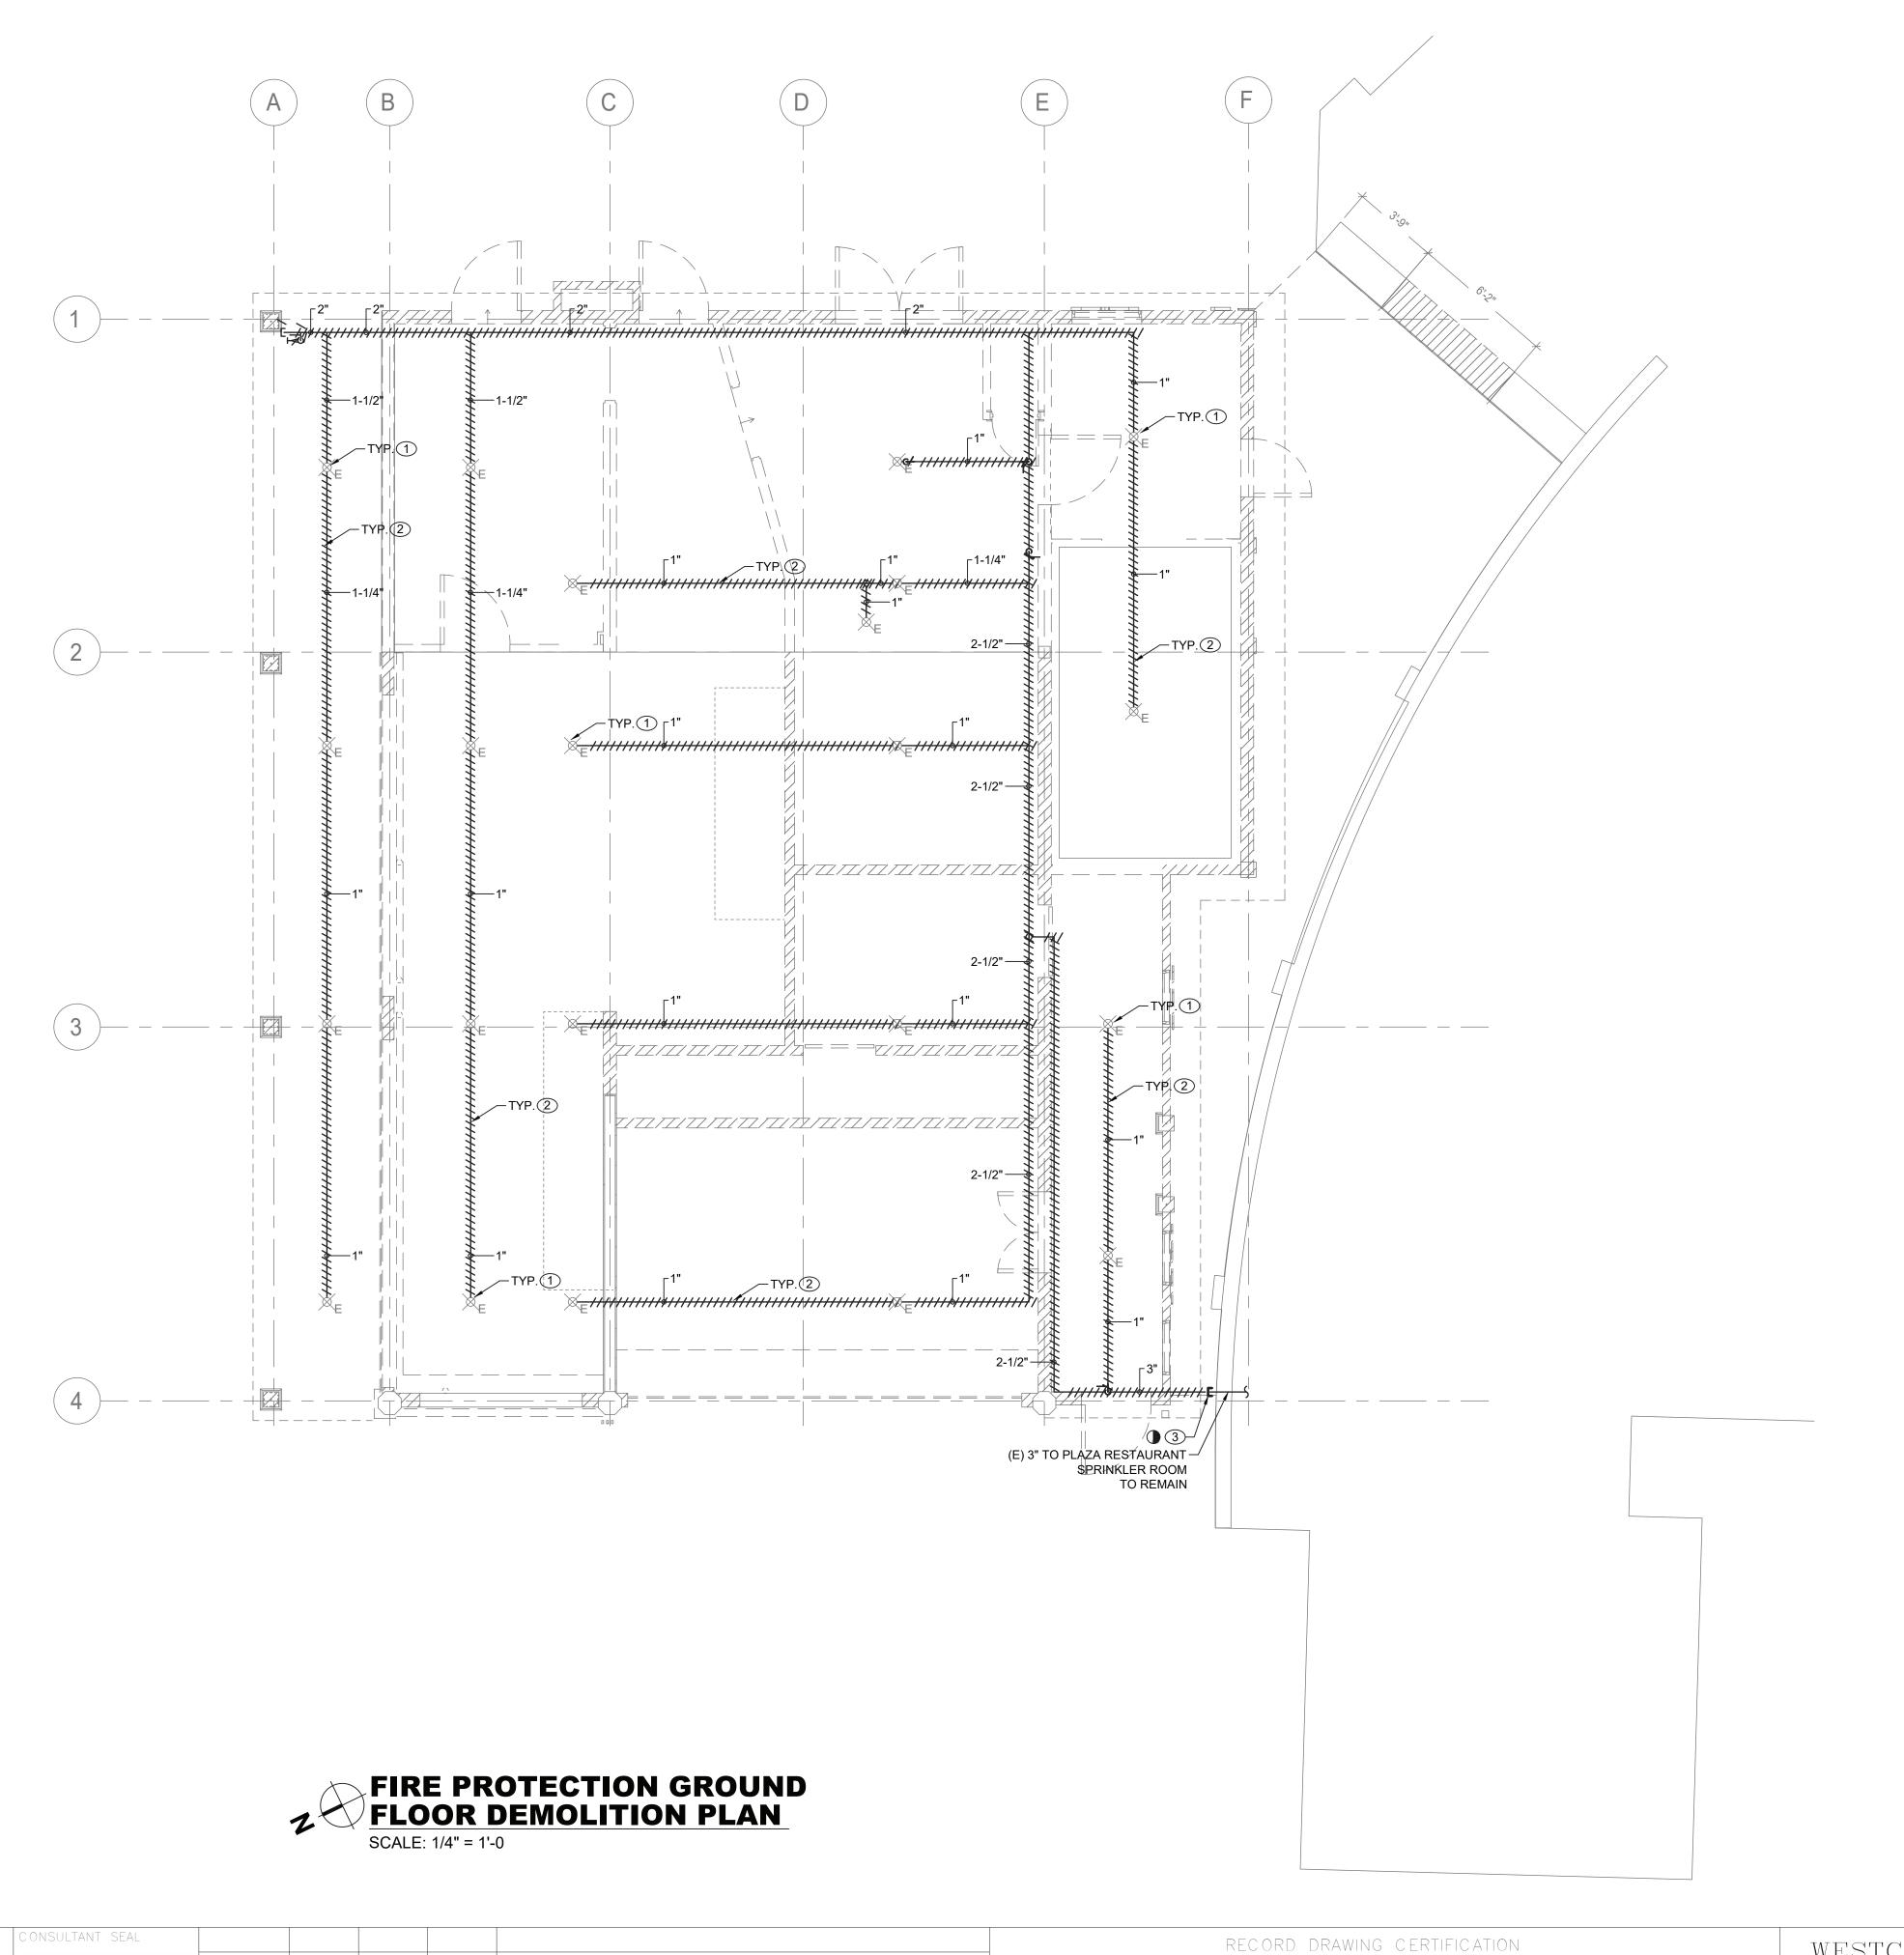

AS BUILT — CHANGES AS NOTED

CONTRACTOR

PROJECT COORDINATOR

CONSULTANT INFORMATION

LiRo Engineers, Inc.

A LiRo Group Company

Syosset, N.Y. 516-214-8157[T]

REVISION DATE MADE APP'D BY

REVISION

SHEET NUMBER WESTCHESTER COUNTY, NEW YORK 22-523 K-FP-11 \_\_\_\_ AS BUILT — NO CHANGES DEPARTMENT OF PUBLIC WORKS AND TRANSPORTATION DIVISION OF ENGINEERING 542 of 664 DWG NO.: **AS INDICATED INFRASTRUCTURE REHABILITATION - PHASE 3** PLAYLAND PARK, RYE, NEW YORK 08/23/2022 RESTAURANT KITCHEN WITH FOOD VENDING DPW FILE 1-118-FP-1291-0 NUMBER FIRE PROTECTION GROUND FLOOR DEMOLITION PLAN

**SPRINKLER DEMOLITION NOTES:** 

DEMOLISH ALL EXISTING DRY SPRINKLER PIPING WITHIN THE NATHAN'S BUILDING INCLUDING

③ CUT AND TEMPORARY CAP EXISTING 3" DRY SPRINKLER LINE FOR FUTURE RECONNECTION.

**GENERAL NOTES:** 

1. COORDINATE WITH FACILITY PRIOR TO SHUTDOWN OF FIRE PROTECTION SYSTEM FOR ANY

DEMOLITION AND CONSTRUCTION WORK WHILE SPRINKLER COVERAGE IS IMPACTED.

2. CONTRACTOR SHALL PROVIDE FIRE WATCH AS NEEDED FOR THE DEPENDENT BUILDINGS BY THE


3. CONTRACTOR TO COORDINATE WITH FACILITY WHEN WORKING AROUND OR ABOVE THE RIDE COMPONENTS, AND PROVIDE ALL NECESSARY MEASURES TO PROTECT THESE COMPONENTS PER

1 DEMOLISH ALL EXISTING SPRINKLER HEADS WITHIN THE NATHAN'S BUILDING.

2 ATTIC SPACE.

DEMOLITION AND CONSTRUCTION WORK.

THE REQUIREMENTS OF THE FACILITY.

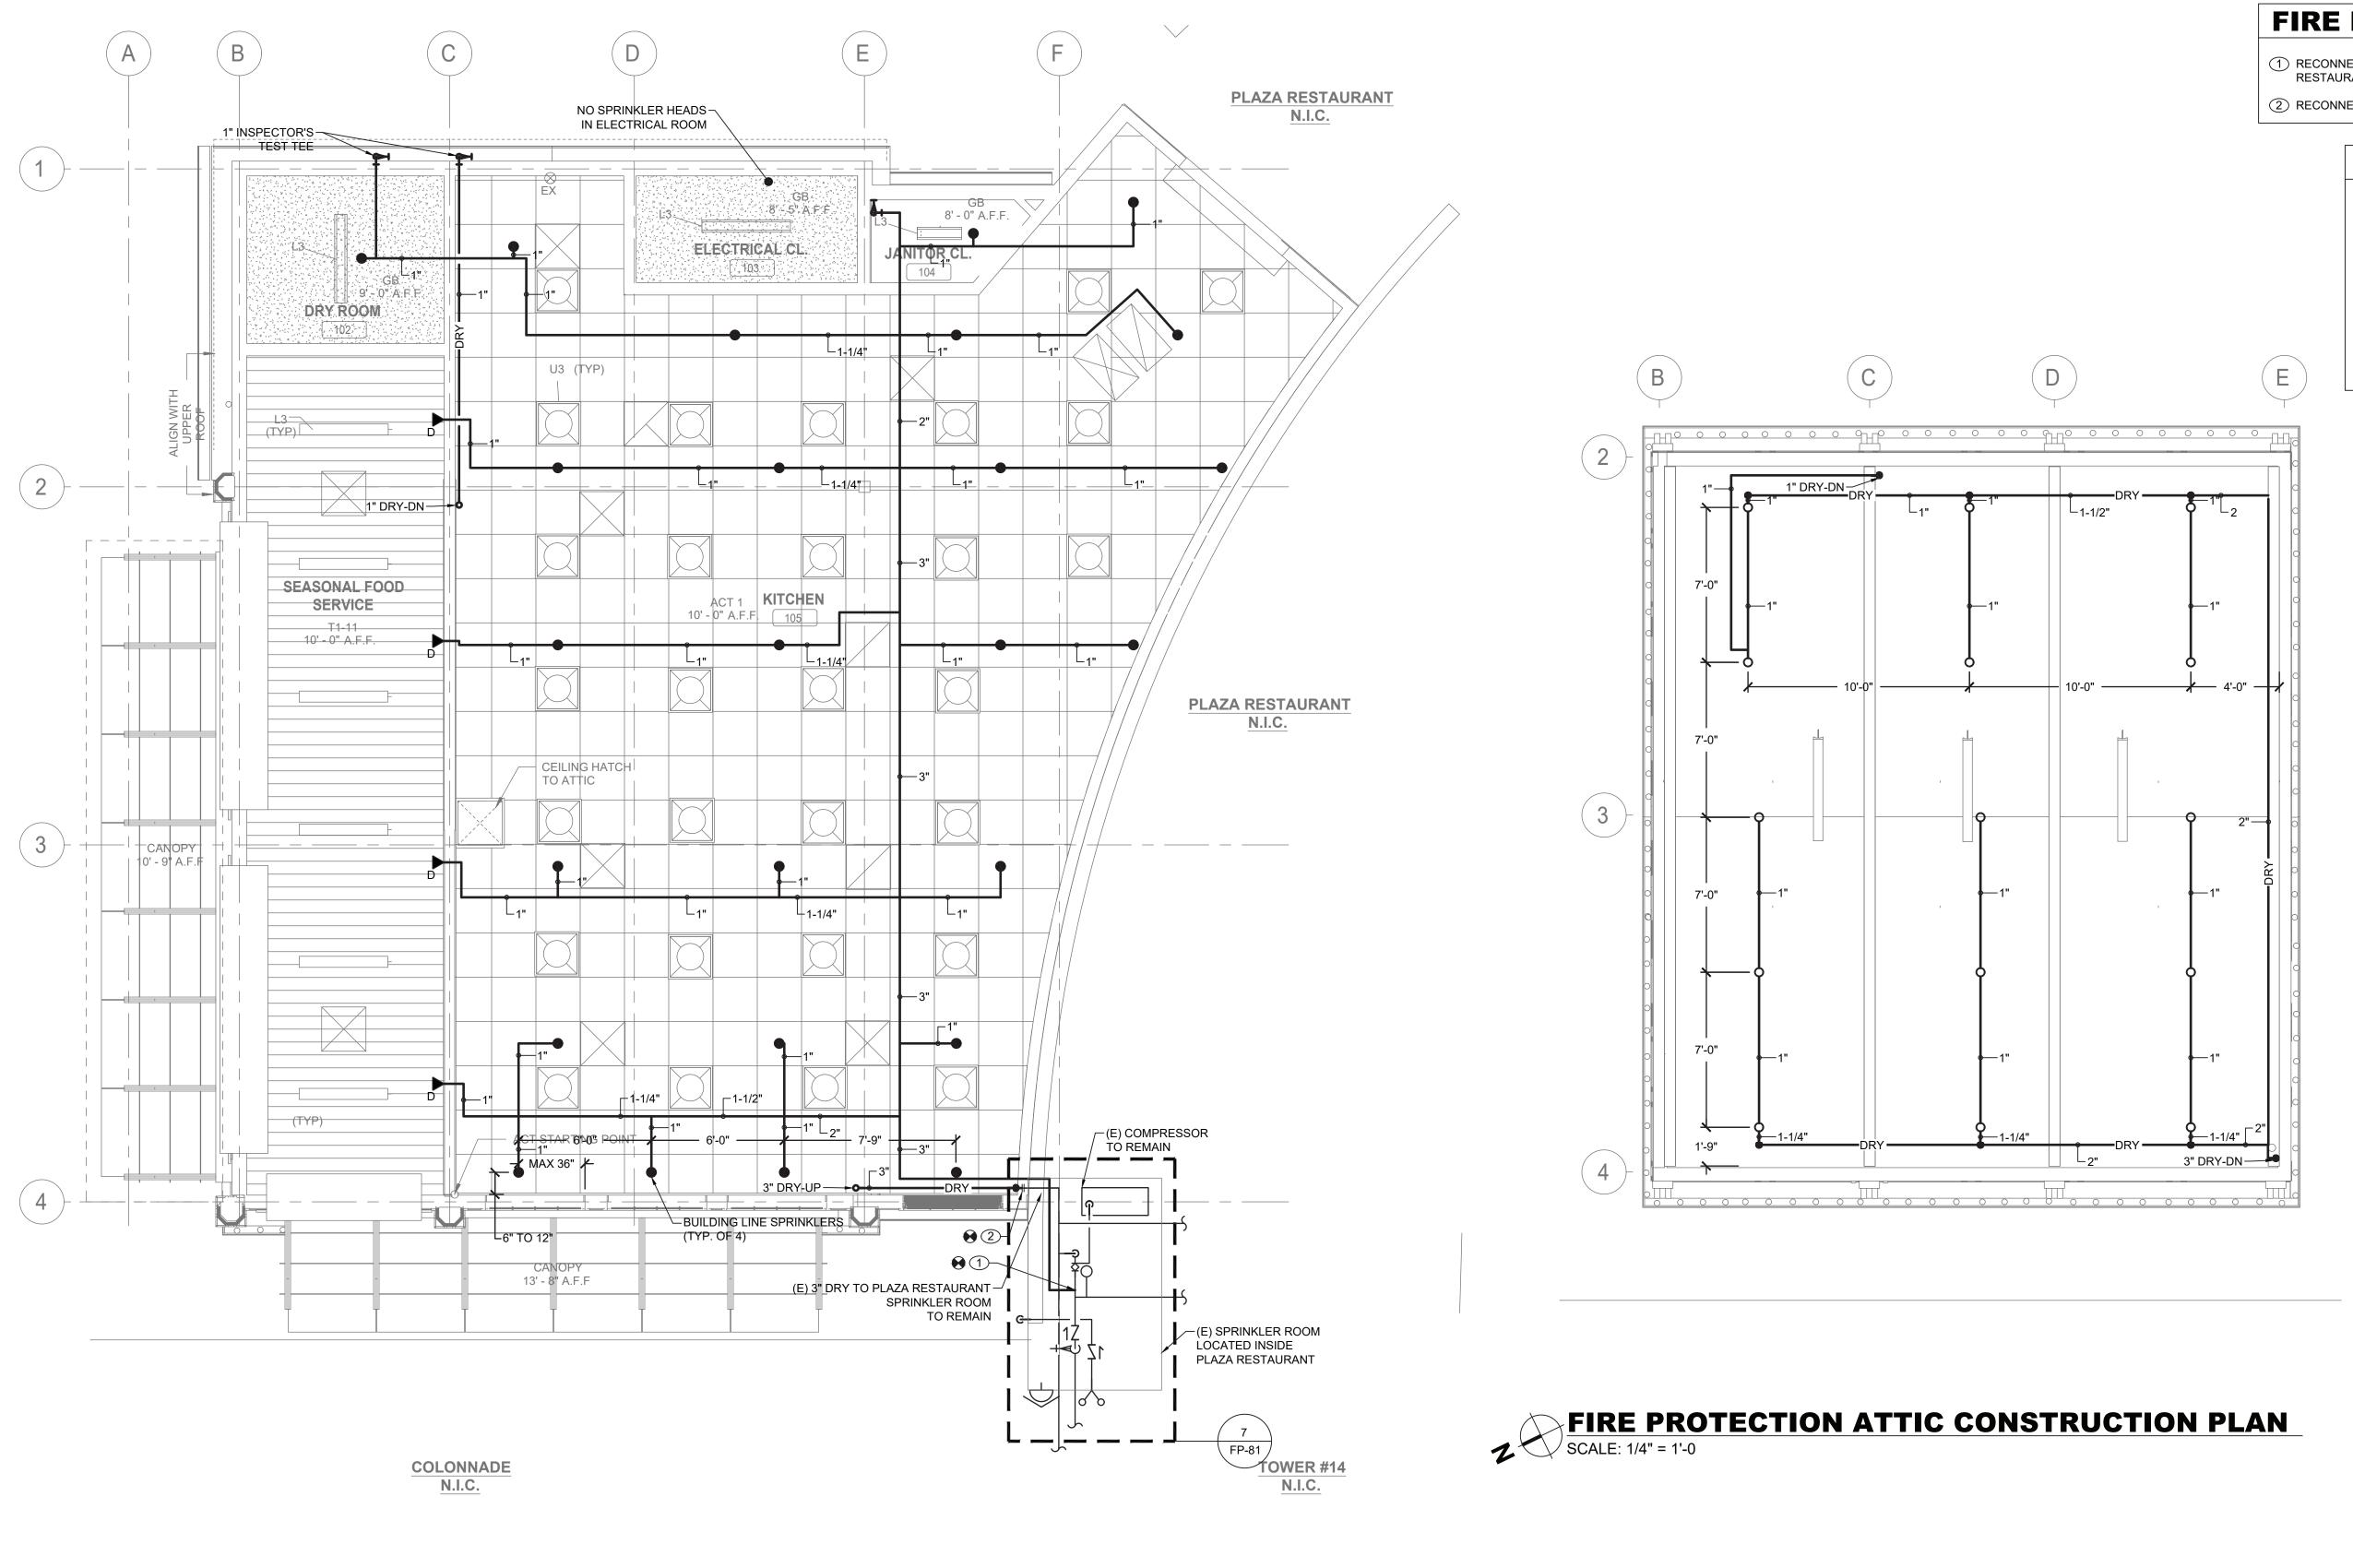

FIRE PROTECTION GROUND

FLOOR CONSTRUCTION RCP
SCALE: 1/4" = 1'-0

### FIRE PROTECTION CONSTRUCTION NOTES:


- 1 RECONNECT NEW 3" WET SPRINKLER LINE TO EXISTING 6" LINE WITHIN SPRINKLER ROOM OF PLAZA RESTAURANT.
- 2 RECONNECT NEW 3" DRY SPRINKLER LINE WITH EXISTING.

## **GENERAL NOTES:**

- 1. ALL DISTRIBUTION PIPING, SHALL BE PAINTED AS DIRECTED BY ARCHITECT. REFER TO SPECIFICATION FOR PAINT TYPE AND APPLICATION PROCEDURE.
- 2. COORDINATE WITH FACILITY PRIOR TO SHUTDOWN OF FIRE PROTECTION SYSTEM FOR ANY DEMOLITION AND CONSTRUCTION WORK.
- 3. CONTRACTOR SHALL PROVIDE FIRE WATCH AS NEEDED FOR ALL AFFECTED BUILDINGS WHILE SPRINKLER COVERAGE IS IMPACTED.
- 4. CONTRACTOR TO COORDINATE WITH FACILITY WHEN WORKING AROUND OR ABOVE THE RIDE COMPONENTS, AND PROVIDE ALL NECESSARY MEASURES TO PROTECT THESE COMPONENTS PER THE REQUIREMENTS OF THE FACILITY.
- 5. UPON COMPLETION, SYSTEM SHALL BE TESTED FOR PROPER OPERATION.

CONSULTANT INFORMATION CONSULTANT SEAL SHEET NUMBER RECORD DRAWING CERTIFICATION WESTCHESTER COUNTY, NEW YORK \_\_\_\_ AS BUILT — NO CHANGES 22-523 K-FP-21 AS BUILT - CHANGES AS NOTED DEPARTMENT OF PUBLIC WORKS AND TRANSPORTATION DIVISION OF ENGINEERING 543 of 664 LiRo Engineers, Inc.

A LiRo Group Company PROJECT COORDINATOR CONTRACTOR **AS INDICATED INFRASTRUCTURE REHABILITATION - PHASE 3** PLAYLAND PARK, RYE, NEW YORK 08/23/2022 RESTAURANT KITCHEN WITH FOOD VENDING REVISION DATE MADE APP'D BY FIRE PROTECTION GROUND FLOOR AND ATTIC CONSTRUCTION RCP REVISION

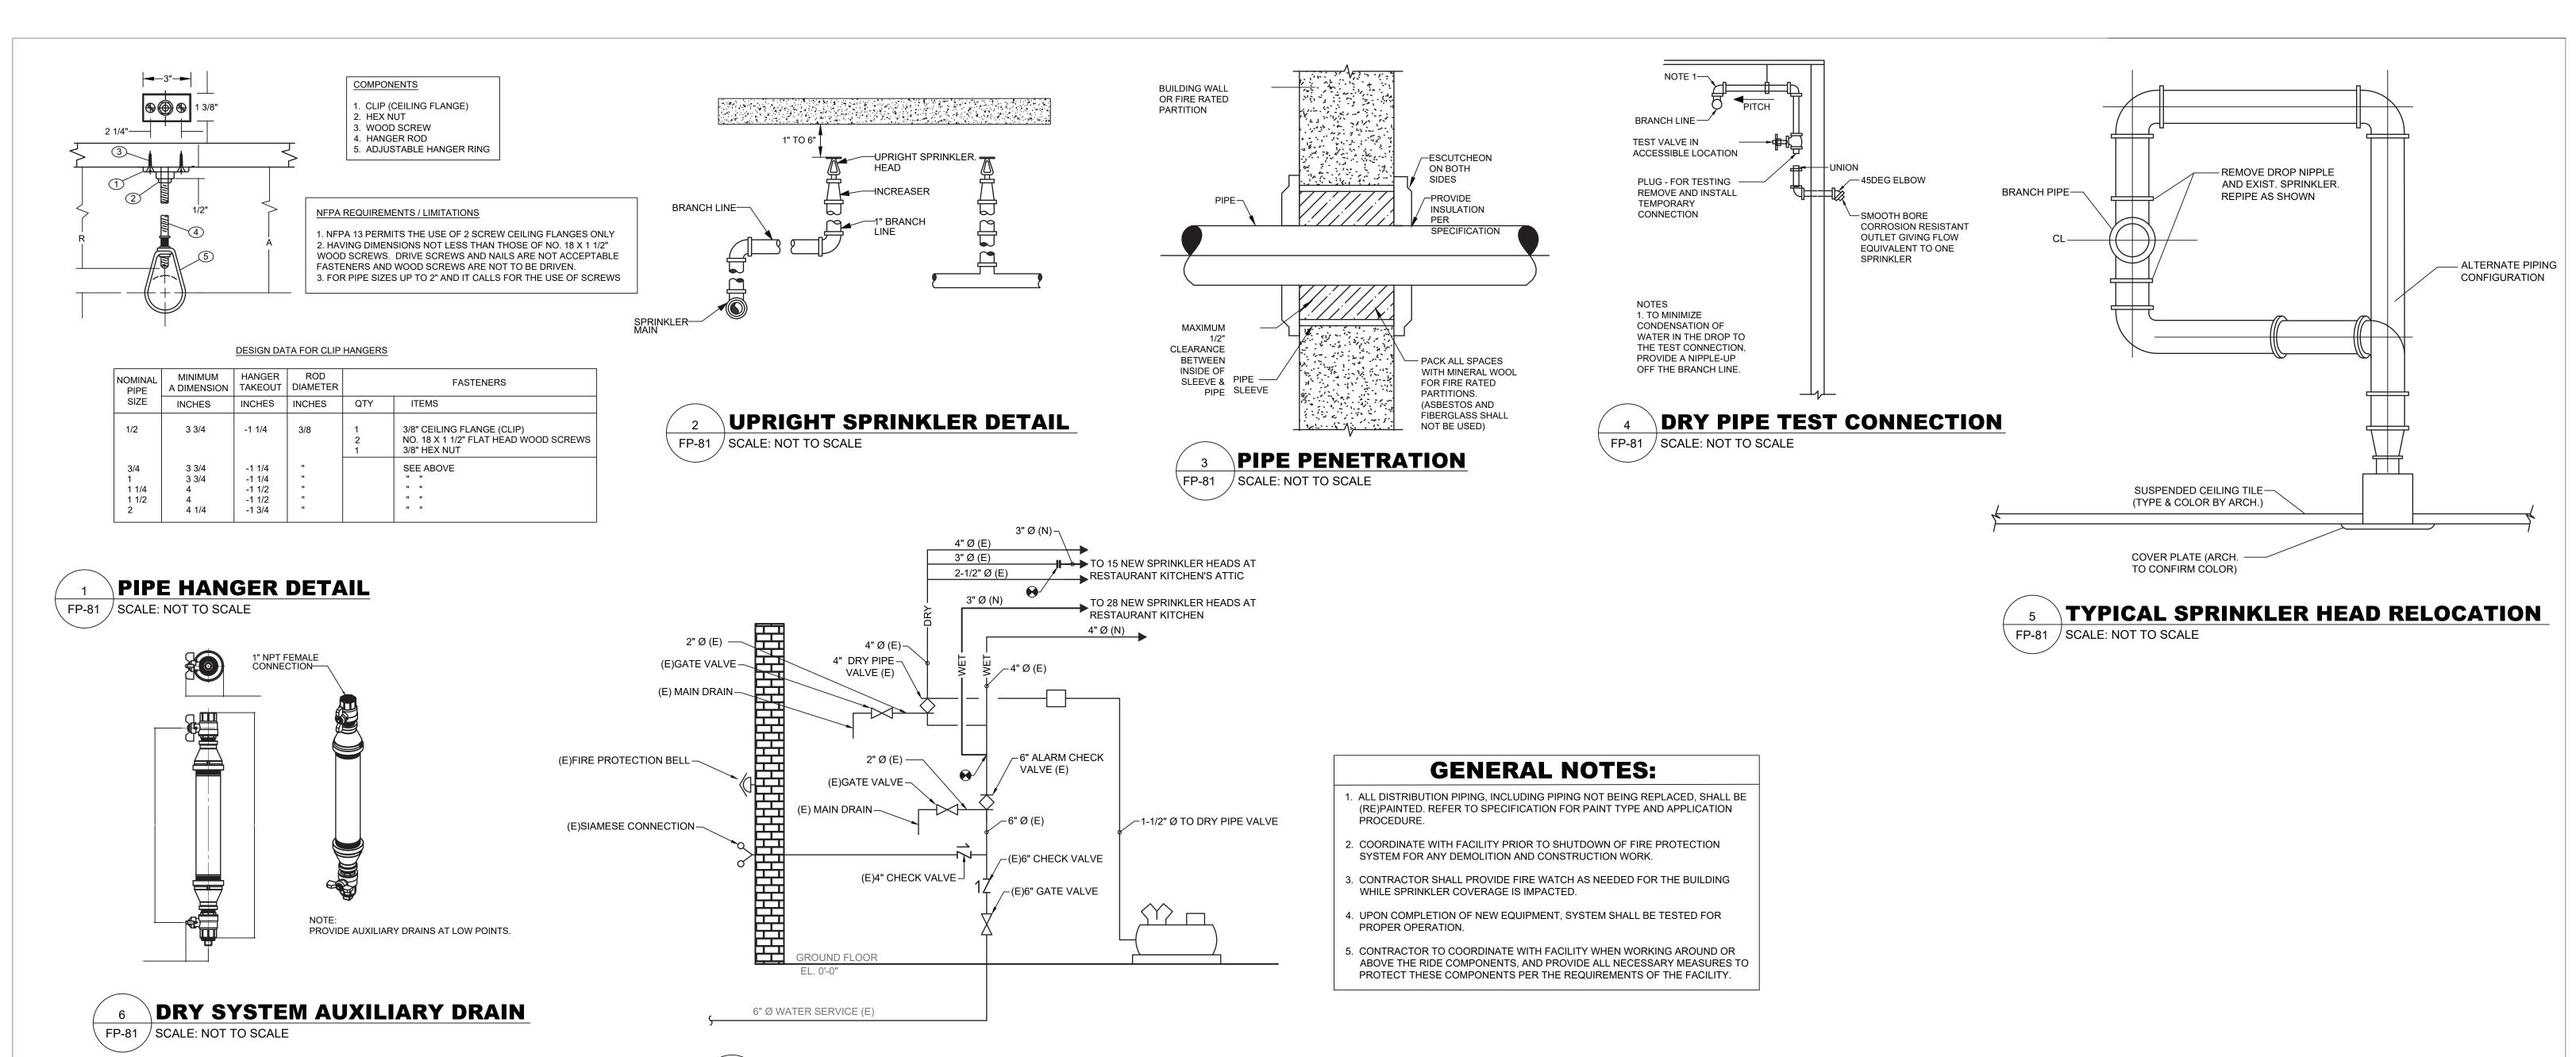

7 PLAZA RESTAURANT SPRINKLER ROOM RISER - CONSTRUCTION
FP-81 SCALE: NOT TO SCALE



# **PLUMBING SYMBOL LIST**

<u>IDENTIFIER</u>	DESCRIPTION
CW	DOMESTIC COLD WATER
W	WASTE PIPING (ABOVE SLAB)
	WASTE PIPING (UNDER SLAB)
s	SANITARY PIPING (ABOVE SLAB)
S	SANITARY PIPING (UNDER SLAB)
V	SANITARY VENT PIPING
•	FIELD CONNECT
•	FIELD DISCONNECT
F#)	REFER TO SUPPLEMENTAL FIGURE INDICATED BY NUMBER (I.E. F2 REFERS TO FIGURE 2)
XXX	— EQUIPMENT TAG — EQUIPMENT NUMBER
XXX X-XXX	— DETAIL TAG/CALL OUT TAG — PLUMBING SHEET NUMBER

### PIPING ELEMENTS/VALVING

── VALVE IN RISE OR DROP

IN BOX W/VACUUM BREAKER

NFHB >+-- NON FREEZE HOSE BIBB

BACKFLOW PREVENTER (DOUBLE CHECK VALVE ASSEMBLY)

———O PIPE RISING UP — 

☐ TEE OUTLET DOWN —⊸ნ— BALL VALVE ——O— TEE OUTLET UP CAP ON END OF PIPE

- CO⊢ CLEANOUT FD ─ FLOOR DRAIN ——⋈— GATE VALVE HB Ş+--- HOSE BIBB

### **SCOPE OF WORK**

PLUMBING SCOPE OF WORK INCLUDES, BUT IS NOT LIMITED TO:

1. REMOVAL OF EXISTING WATER SERVICE.

2. THE INSTALLATION OF NEW PLUMBING FIXTURES AND ALL ASSOCIATED PIPING AND ACCESSORIES.

3. THE INSTALLATION OF NEW SANITARY AND DOMESTIC WATER SERVICES.

NOTE: THIS SCOPE OF WORK DESCRIPTION IS PROVIDED TO GIVE AN OVERALL "MACRO" DESCRIPTION OF THIS PROJECT .P.C. IS RESPONSIBLE TO REVIEW ALL ENGINEERING & ARCHITECTURAL DRAWINGS & VISIT THE SITE IF NEEDED, PRIOR TO SUBMISSION OF BID.

### **CODE REFERENCE**

2020 NEW YORK STATE BUILDING CODE 2020 NEW YORK STATE MECHANICAL CODE 2020 NEW YORK STATE PLUMBING CODE 2020 NEW YORK STATE ENERGY CONSERVATION CODE

### **SECTION 704**

## **DRAINAGE PIPING INSTALLATION**

704.1 SLOPE OF HORIZONTAL DRAINAGE PIPING.

HORIZONTAL DRAINAGE PIPING SHALL BE INSTALLED IN UNIFORM ALIGNMENT AT UNIFORM SLOPES. THE MINIMUM SLOPE OF HORIZONTAL DRAINAGE PIPE SHALL BE IN ACCORDANCE WITH TABLE 704.1. **TABLE 704.1** CLODE OF HODIZONTAL DRAINAGE DIDE

SLOPE OF HORIZONTAL	DRAINAGE PIPE
SIZE	MINIMUM SLOPE
(INCHES)	(INCH PER FOOT)
2 1/2 OR LESS	1/4
3 TO 6	1/8
8 OR LARGER	1/16

### **LEED NOTES**

1. ALL ADHESIVES, SEALANTS, PAINTS & COATINGS APPLIED TO THE INTERIOR OF THE BUILDING (WITHIN THE WEATHER PROOFING SYSTEM, INCLUDING WALL CAVITIES) MUST NOT EXCEED THE LEED VOC LIMITS. PROVIDE A VOC SUBMITTAL AND MSDS FOR ALL ADHESIVES, SEALANTS, PAINTS AND COATINGS TO BE APPLIED.

### **PLUMBING GENERAL NOTES:**

- ALL PLUMBING WORK UNDER THIS CONTRACT SHALL CONFORM TO THE LATEST EDITION OF THE PLUMBING CODE OF NEW YORK STATE (PC-NYS), THE NEW YORK STATE ENERGY CODE, AND THE REQUIREMENTS OF THE UTILITY AND THE LOCAL WATER COMPANY.
- 2. ALL MATERIALS SHALL BE NEW UNLESS NOTED OTHERWISE
- 3. THE PLUMBING CONTRACTOR SHALL ASSUME RESPONSIBILITY FOR ALL LABOR AND MATERIALS SUPPLIED AND INSTALLED UNDER THIS CONTRACT AND SHALL GUARANTEE THE WORK PERFORMED UNDER THIS CONTRACT FOR A PERIOD OF ONE (1) YEAR FROM THE DATE OF ACCEPTANCE OF THIS WORK.
- PLUMBING CONTRACTOR SHALL CONSULT WITH, COOPERATE AND COORDINATE WITH THE GENERAL CONTRACTOR, MECHANICAL CONTRACTOR, SPRINKLER CONTRACTOR, ELECTRICAL CONTRACTOR, ETC. IN ORDER TO MINIMIZE INTERFERENCES BETWEEN
- THE PLUMBING CONTRACTOR SHALL PREPARE AND FILE ALL REQUIRED PLANS AND PERMITS WITH THE LOCAL AUTHORITIES. PC SHALL PAY THE FILING FEES AS REQUIRED. PC SHALL OBTAIN ALL APPROVALS AND SHALL PAY FOR ALL WORK MANNER IN CONFORMANCE WITH THE CODES AND AUTHORITIES HAVING
- THE PLUMBING CONTRACTOR SHALL PERFORM ALL TESTS AND ARRANGE FOR ALL SUPPLY ALL CERTIFICATES OF INSURANCE AS REQUIRED BY THE LAW AND THE
- PLUMBING CONTRACTOR SHALL VISIT THE SITE & BECOME FAMILIAR WITH THE EXISTING CONDITIONS, INCLUDING THE SIZE OF CONNECTIONS, ROUGHING
- PLUMBING CONTRACTOR SHALL PERFORM ALL CUTTING, EXCAVATION, BACKFILLING, ROUGH & FINISH PATCHING AS PER THE SPECIFICATIONS AS REQUIRED FOR THE
- 10. ALL CONNECTIONS TO NEW AND/OR EXISTING EQUIPMENT SHALL BE SIZED AND
- 11. IT IS THE INTENT OF THIS CONTRACT THAT THE COMPLETED WORK BE FULLY
- 13. ALL NEW PLUMBING FIXTURES SHALL BE INSTALLED WITH ANGLE STOP VALVES IN
- 14. ALL NEW EXPOSED WATER AND WASTE PIPING SERVING THE FIXTURES SHALL BE
- 15. PLUMBING CONTRACTOR SHALL SUBMIT SHOP DRAWINGS FOR ALL NEW PLUMBING FIXTURES AND EQUIPMENT TO BE SUPPLIED AND INSTALLED UNDER THIS CONTRACT
- 16. WATERPROOF PIPE SLEEVES SHALL BE INSTALLED AT ALL PENETRATIONS THROUGH EXTERIOR WALLS. PIPE SLEEVES SHALL BE INSTALLED AT ALL WALL PENETRATIONS
- WATER HAMMER ELIMINATORS (APPROVED FIELD FABRICATED OR MANUFACTURED) SHALL BE INSTALLED AT ALL RUN OUTS IN HOT AND/OR COLD WATER LINES SERVING TOILET ROOMS AND OTHER AREAS WHICH INCORPORATE "RAPID - ACTION" VALVES
- 18. ALL PIPING SHALL BE TESTED AT A MINIMUM PRESSURE OF 1-1/2 TIMES THE MAXIMUM OPERATING PRESSURE UNLESS OTHERWISE NOTED ON THE DOCUMENTS OR THE
- 19. ALL REMOVALS PERFORMED UNDER THIS CONTRACT SHALL INCLUDE REMOVAL OF
- 20. ALL LAVATORIES DESIGNED FOR USE BY PERSONS CONFINED TO WHEELCHAIRS SHALL HAVE THE HOT & COLD WATER SERVICES, AS WELL AS THE TRAP, RECESSED &
- 21. REFER TO THE ARCHITECTURAL PLANS FOR ALL STRUCTURAL DIMENSIONS.
- 23. ALL PIPING PENETRATIONS TO BE SEALED AROUND WITH "NELSON" FIRE SEAL.
- 24. ALL WATER SERVICE PIPING WITHIN THE BUILDING IS TO BE INSULATED IN
- 25. ALL PLUMBING FIXTURES TO BE INSTALLED AS PER FACTORY RECOMMENDATIONS.
- 26. ALL PLUMBING FIXTURES TO BE TRAPPED, VENTED AND PROVIDED WITH AIR SHOCKS
- AS DETAILED IN THE NYS-PC.
- 28. GC IS RESPONSIBLE TO SUBMIT APPLICATION AND TAP FEES TO LOCAL WATER AUTHORITY AND HAVE OWNER FILL OUT APPLICATION UPON COMPLETION OF PLUMBING ROUGH-IN INSPECTION.
- SHALL BE INSULATED.
- 30. FLOOR DRAINS AND FLOOR CLEAN-OUTS SHALL BE SET LEVEL WITH FINISHED
- 32. ALL PLUMBING FIXTURES TO HAVE ISOLATION VALVES.
- 35. BUILDING SANITARY DEMAND & SIZING IS CALCULATED FROM NYS-PC SECTIONS 709
- 36. ALL DFU CALCULATIONS ARE BASED OFF OF TABLE 709.1 OF THE NYS-PC.
- 37. ALL SANITARY WATER PIPING SHALL BE PITCHED IN ACCORDANCE WITH NYS-PC
- 38. ALL VENT SIZING IS BASED OFF OF SECTION 916 OF THE NYS PLUMBING CODE.
- 39. ALL PLUMBING EQUIPMENT SHALL BE INSTALLED PER MANUFACTURER'S

CW DCV

DFU

DPCO

HWR

IWFD

JS

U.O.N.

UR

WC

MC

TYP.

NYS-PC NEW YORK STATE PLUMBING CODE

THERMOSTATIC MIXING VALVE

UNLESS OTHERWISE NOTED

PLUMBING CONTRACTOR

MECHANICAL CONTRACTOR

**ROOF DRAIN** 

STORM DRAIN

WATER CLOSET

VERIFY IN FIELD

WALL CLEAN OUT

WATER FIXTURE UNITS

THE ABBREVIATIONS ARE SHOWN FOR GENERAL

ABBREVIATION ON THIS LIST DOES NOT IMPLY ITS USE ON THIS PROJECT. REFER TO DRAWINGS FOR

REFERENCE ONLY. THE PRESENCE OF AN

SANITARY

URINAL

**VENT** 

TYPICAL

**EXISTING** 

SPECIFIC ABBREVIATIONS USED.

DEMO

- TRADES DURING PERFORMANCE OF THIS WORK.
- PERMITS, INSPECTIONS AND SIGN-OFFS AS REQUIRED TO EXECUTE THIS WORK IN A JURISDICTION.
- INSPECTIONS FOR WORK UNDER HIS CONTRACT AS REQUIRED BY LAW AND SHALL OWNER. REFER TO SECTION 107 (INSPECTIONS) OF THE PC-NYS.
- THE PLUMBING CONTRACTOR SHALL MAKE ALL FINAL CONNECTIONS TO ALL PLUMBING EQUIPMENT REGARDLESS WHETHER ILLUSTRATED HEREIN WITHOUT ANY ADDITIONAL COSTS TO THE OWNER.
- DIMENSIONS, ETC. BEFORE SUBMITTING A QUOTATION FOR THE WORK.
- INSTALLATION OF THE WORK, UNLESS NOTED OTHERWISE.
- INSTALLED IN ACCORDANCE WITH THE MANUFACTURER'S INSTRUCTIONS.
- OPERATIONAL.
- 12. ALL PIPE HANGERS AND SUPPORTS SHALL BE INSTALLED AT INTERVALS AND BE FABRICATED OF MATERIALS AS REQUIRED BY THE PC-NYS.
- THE SUPPLY LINES SERVING THE FIXTURE.
- CHROME PLATED AND SHALL HAVE CHROME PLATED ESCUTCHEONS RIGIDLY ATTACHED TO THE PIPING AT THE POINT OF WALL OR FLOOR PENETRATIONS.
- FOR APPROVAL BEFORE INSTALLATION OF SAME.
- THROUGH INTERIOR WALLS AND FLOORS.
- SUCH AS FLUSHOMETERS, SOLENOID VALVES, ETC.
- PLUMBING CODE AND IN ACCORDANCE WITH THE UTILITY REQUIREMENTS.
- ALL DEBRIS AND DISPOSAL AT AN APPROPRIATE SITE.
- INSULATED IN ACCORDANCE WITH ADA REQUIREMENTS.
- 22. ALL WORK TO BE COORDINATED WITH OTHER TRADES.
- ACCORDANCE WITH ALL NEW YORK STATE PLUMBING CODE (NYS-PC) AND NYS

- 27. PLUMBING FIXTURES SHALL COMPLY WITH "WATER CONSERVATION" REQUIREMENT
- 29. ALL WATER AND HORIZONTAL STORM DRAIN PIPING INCLUDING ROOF DRAIN BODY

- 31. ALL PIPE DIMENSIONS ARE INSIDE CLEAR.

REQUIREMENTS/SPECIFICATIONS.

- 33. P.C. IS RESPONSIBLE TO ADJUST HOT WATER HEATER (WH) TEMPERATURE TO ENSURE A TEMPERATURE RANGE OF 110°F TO 120°F AT THE INDIVIDUAL FIXTURE OUTPUT. P.C. MUST ENSURE A TEMPERATURE OF 120° F MAXIMUM AT THE FIXTURES TO PREVENT SCALDING.
- 34. BUILDING DOMESTIC WATER DEMAND & SIZING IS CALCULATED FROM NYS-PC SECTION 603, 604 & APPENDIX E.
- AND 710.
- SECTION 704 BASED ON TABLE 704.1 SLOPE OF HORIZONTAL DRAINAGE PIPE.

BBREVIATIONS:					PLUME	BING FIX	KTURE SCH	<b>EDUL</b>	.E	
ACCESS DOOR						SERVICE				
BACKFLOW PREVENTER	MARK	DESCRIPTION								
CLEAN OUT	WANK	DESCRIP HON	•	TRAP	s/W	V CI	w Tw	HW	ITEM	MAN
COLD WATER										
DOUBLE CHECK VALVE									Hebri Para Halle Co. Ja	
DRAINAGE FIXTURE UNIT	PF-5	SERVICE SINF	<	3"	3"	2" 1/3	2" -	1/2"	FAUCET DRAIN TRI	, I
DECK PLATE CLEAN OUT									DRAIN I KI	VI
FIELD CONNECT	NOTES:			<u> </u>	V.		<u> </u>			3
FLOOR DRAIN		F ALL REQUIRED HANG	FRS MOUNTII	NG BRACKETS AND	HARDWARF FOR	A COMPLETE INST	ALLATION PER MANUFACT	LIRES INSTRIL	CTIONS	
FUNNEL FLOOR DRAIN	1.110010	E ALL REGOINED HAIVO	Ens, Moonth	TO DIVICKE 13, AIVE	IARDWARETOR	A COM LETE INST	ALLATION TEN MANOTACI	OILS IIVS IIVO	CHONS.	
FIXTURE UNIT										
HOT WATER		EL	ECTR	IC DOME	STIC F	IOT WA	TER HEATE	R SC	HEDL	JLE
HOT WATER RETURN	4.5		¥	T		0700405	0700405 W4750 7540	ELECT	BICAL	DIMENSIO
IN ACCORDANCE WITH	TAG	MANUFACTURER	MODEL	LOCATION	<b>HEATER KW</b>	STORAGE CAPACITY GAL.	STORAGE WATER TEMP	0.00 (COV.2000.000)	DATE OF THE PARTY	Commence of the Commence of th
INDIRECT WASTE FUNNEL DRAIN	OR RESERVATE. OR	THE STOCKER PROTOCOCKER STOCKER OF THE STOCKER OF T	to Nation Verified Organi I Part - Make a	U WENGERSON WENNESS OF THE STREET OF THE STR	Acc as	CAPACITY GAL.	SETPOINT (DEG F)	V-PH-HZ	AMPS	HxD (IN)
LAVATORY	WH-1	BRADFORD WHITE	LE120L3-3	JANITOR CLOSET	1.5	19	140	120-1-60	12.5	24.75x18
JANITOR'S SINK	NOTES:									
NORMALLY CLOSED										
NORMALLY OPEN	8								2	

TAG	TYPE	MANUFACTURER	MODEL	SERVICE
FD-1	ADJUSTABLE	ZURN	FD-2320-R5	ALL SPACES

TAG	MANUFACTURER	MODEL	LOCATION	SIZE (IN)	PRESSURE DROP (PSI)			
RPZ-1	WATTS	LF009-S	SPRINKLER ROOM	2	10			
NOTES:								

	WALL HYDRA	ANT SCHEDULE	
TAG	TYPE	MANUFACTURER	MODEL
NFHB	WALL HYDRANT	ZURN	Z1320XL

	PLUMBING DRAWING LIST		
SHEET NO.	SHEET NAME	REVISON NO.	REVISION DATE
K-P-01	PLUMBING NOTES, SYMBOLS, ABBREVIATIONS AND DRAWING LIST	0	
K-P-21	PLUMBING GROUND FLOOR DEMOLITION PLAN	0	_
K-P-21	PLUMBING GROUND FLOOR CONSTRUCTION PLAN	0	-
K-P-81	PLUMBING DETAILS	0	=

LiRo Engineers, Inc.



| MADE | APP'D REVISION AS BUILT - CHANGES AS NOTED

CONTRACTOR

RECORD DRAWING CERTIFICATION

PROJECT COORDINATOR

AS BUILT - NO CHANGES

WESTCHESTER COUNTY, NEW YORK DEPARTMENT OF PUBLIC WORKS AND TRANSPORTATION DIVISION OF ENGINEERING

BASED ON:

MANUFACTURER

MUSTEE

DIMENSION APPROX. SHIPPING

HxD (IN)

12.5 24.75x18

WEIGHT (LBS)

REMARKS

FAUCET

**AMERICAN** 

STANDARD


8344.212

MODEL

63M

22-523 K-P-01 545 of 664 **AS INDICATED** 08/23/2022 1-118-P-1294-0

**INFRASTRUCTURE REHABILITATION - PHASE 3** PLAYLAND PARK, RYE, NEW YORK RESTAURANT KITCHEN WITH FOOD VENDING PLUMBING NOTES, SYMBOLS, ABBREVIATIONS AND DRAWING LIST

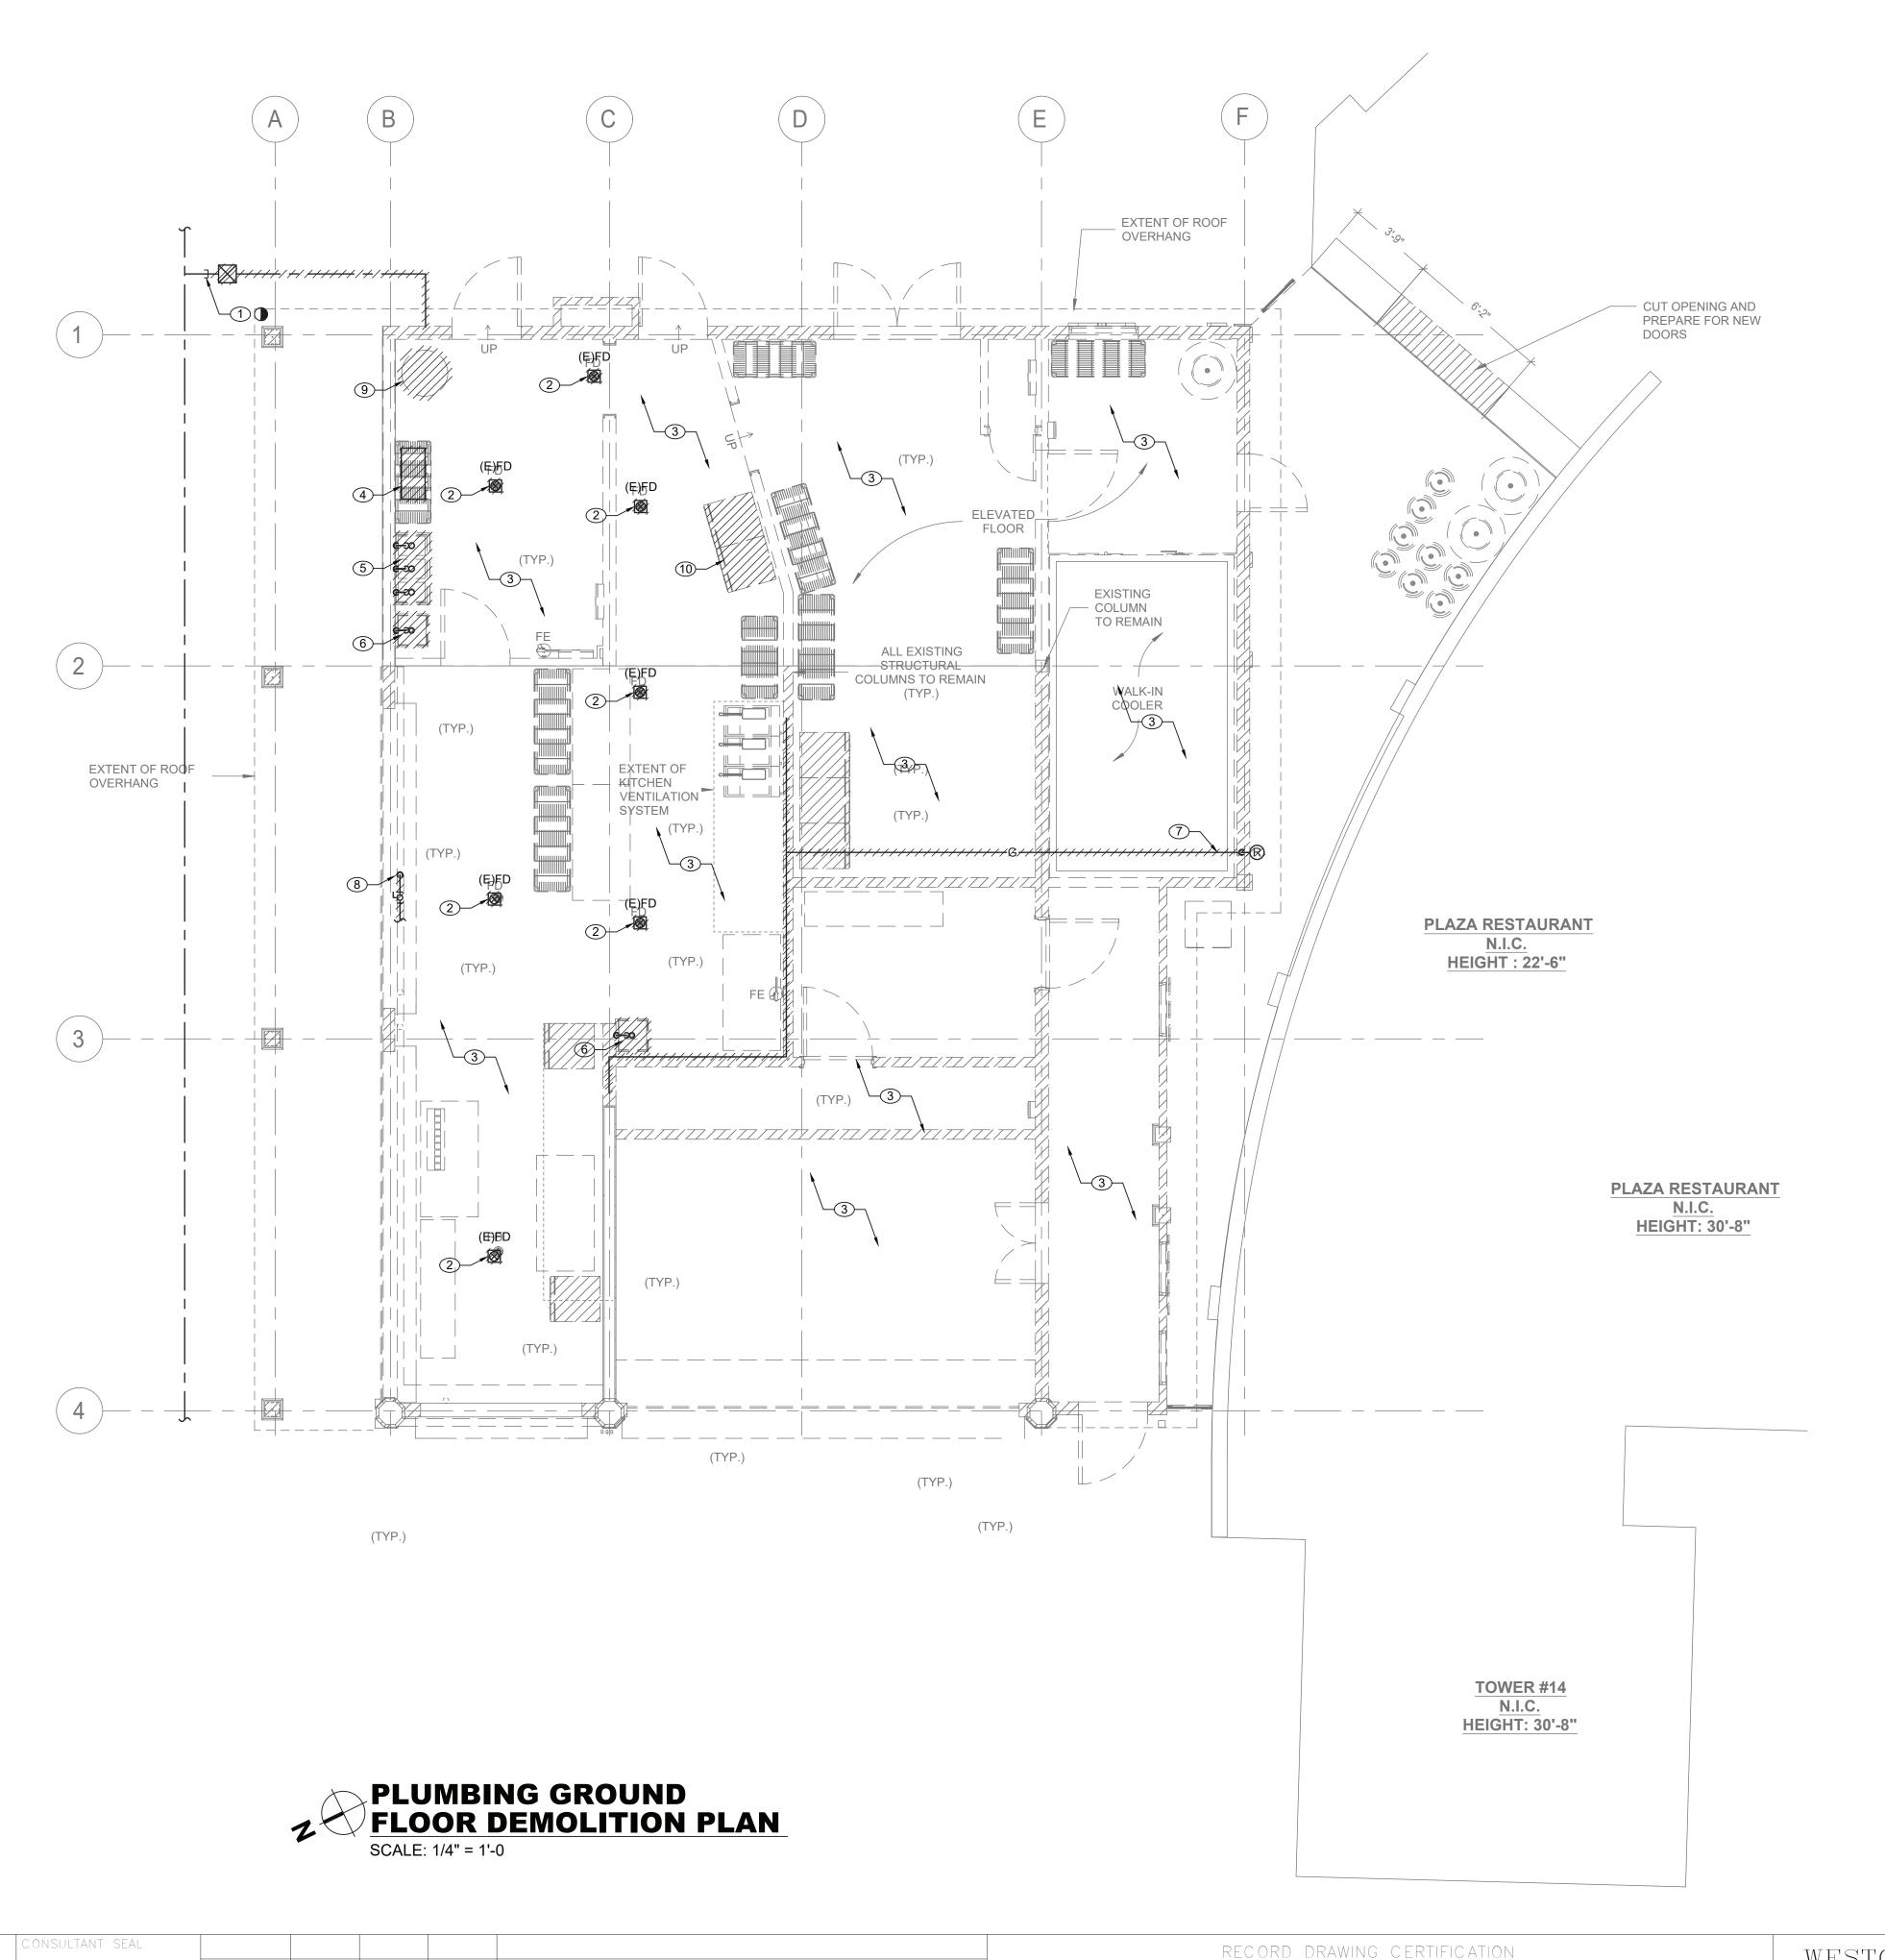

CONSULTANT INFORMATION

LiRo Engineers, Inc.

A LiRo Group Company

Syosset, N.Y. 516-214-8157[T]


### SHEET NUMBER WESTCHESTER COUNTY, NEW YORK 22-523 \_\_\_\_ AS BUILT — NO CHANGES K-P-11 AS BUILT - CHANGES AS NOTED DEPARTMENT OF PUBLIC WORKS AND TRANSPORTATION DIVISION OF ENGINEERING 546 of 664 DWG NO.: PROJECT COORDINATOR CONTRACTOR **AS INDICATED INFRASTRUCTURE REHABILITATION - PHASE 3** PLAYLAND PARK, RYE, NEW YORK 08/23/2022 **RESTAURANT KITCHEN WITH FOOD VENDING** REVISION DATE MADE APP'D BY DPW FILE 1-118-P-1295-0 NUMBER REVISION PLUMBING GROUND FLOOR DEMOLITION PLAN

### **PLUMBING DEMOLITION NOTES:**

- CONTRACTOR CUT AND CAP UNDERGROUND EXISTING DOMESTIC WATER SERVICE OUTSIDE OF AREA OF WORK. REMOVE EXISTING CURB VALVE.
- 2 REMOVE EXISTING FLOOR DRAIN WITH ALL ASSOCIATED PIPING. CUT AND CAP EXISTING SANITARY PIPING BELOW FINISH FLOOR.
- 3 CONTRACTOR TO REMOVE ALL PLUMBING FIXTURES, EQUIPMENT, PIPING AND VALVES. ABANDON EXISTING UNDERGROUND PIPING IN PLACE. SANITARY PIPING SHALL NOT HAVE UNVENTED DEAD ENDS LONGER THAN TWO FEET. REMOVE UNDERGROUND PIPING THAT IN CONFLICT WITH NEW CONSTRUCTION.
- 4 REMOVE EXISTING GREASE INTERCEPTOR WITH ALL ASSOCIATED PIPING.
- 5 REMOVE EXISTING 3-COMPARTMENT SINK WITH ALL ASSOCIATED PIPING.
- 6 REMOVE EXISTING SINK WITH ALL ASSOCIATED PIPING.
- 7 DISCONNECT EXISTING PROPANE LINE FROM PROPANE EQUIPMENT AND REMOVE ALL PROPANE PIPING INCLUDING VALVES AND REGULATOR. REMOVE PROPANE EQUIPMENT.
- 8 REMOVE ALL EXISTING DOMESTIC WATER PIPING ABOVE FINISH FLOOR AND ABONDON BELOW FINISH FLOOR
- 9 REMOVE EXISTING ELECTRIC WATER HEATER WITH ALL ASSOCIATED PIPING.
- (10) REMOVE EXISTING ICE MAKING MACHINE WITH ALL ASSOCIATED PIPING.

## **GENERAL NOTES:**

- 1. ALL EXISTING PIPING ARE SHOWN AS A REFERENCE ONLY. CONTRACTOR SHALL FIELD VERIFY LOCATIONS AND SIZES FOR ALL EXISTING SERVICES PRIOR TO DEMOLITION.
- 2. COORDINATE WITH FACILITY PRIOR TO SHUTDOWN OF DOMESTIC WATER SYSTEM FOR ANY DEMOLITION AND CONSTRUCTION WORK.

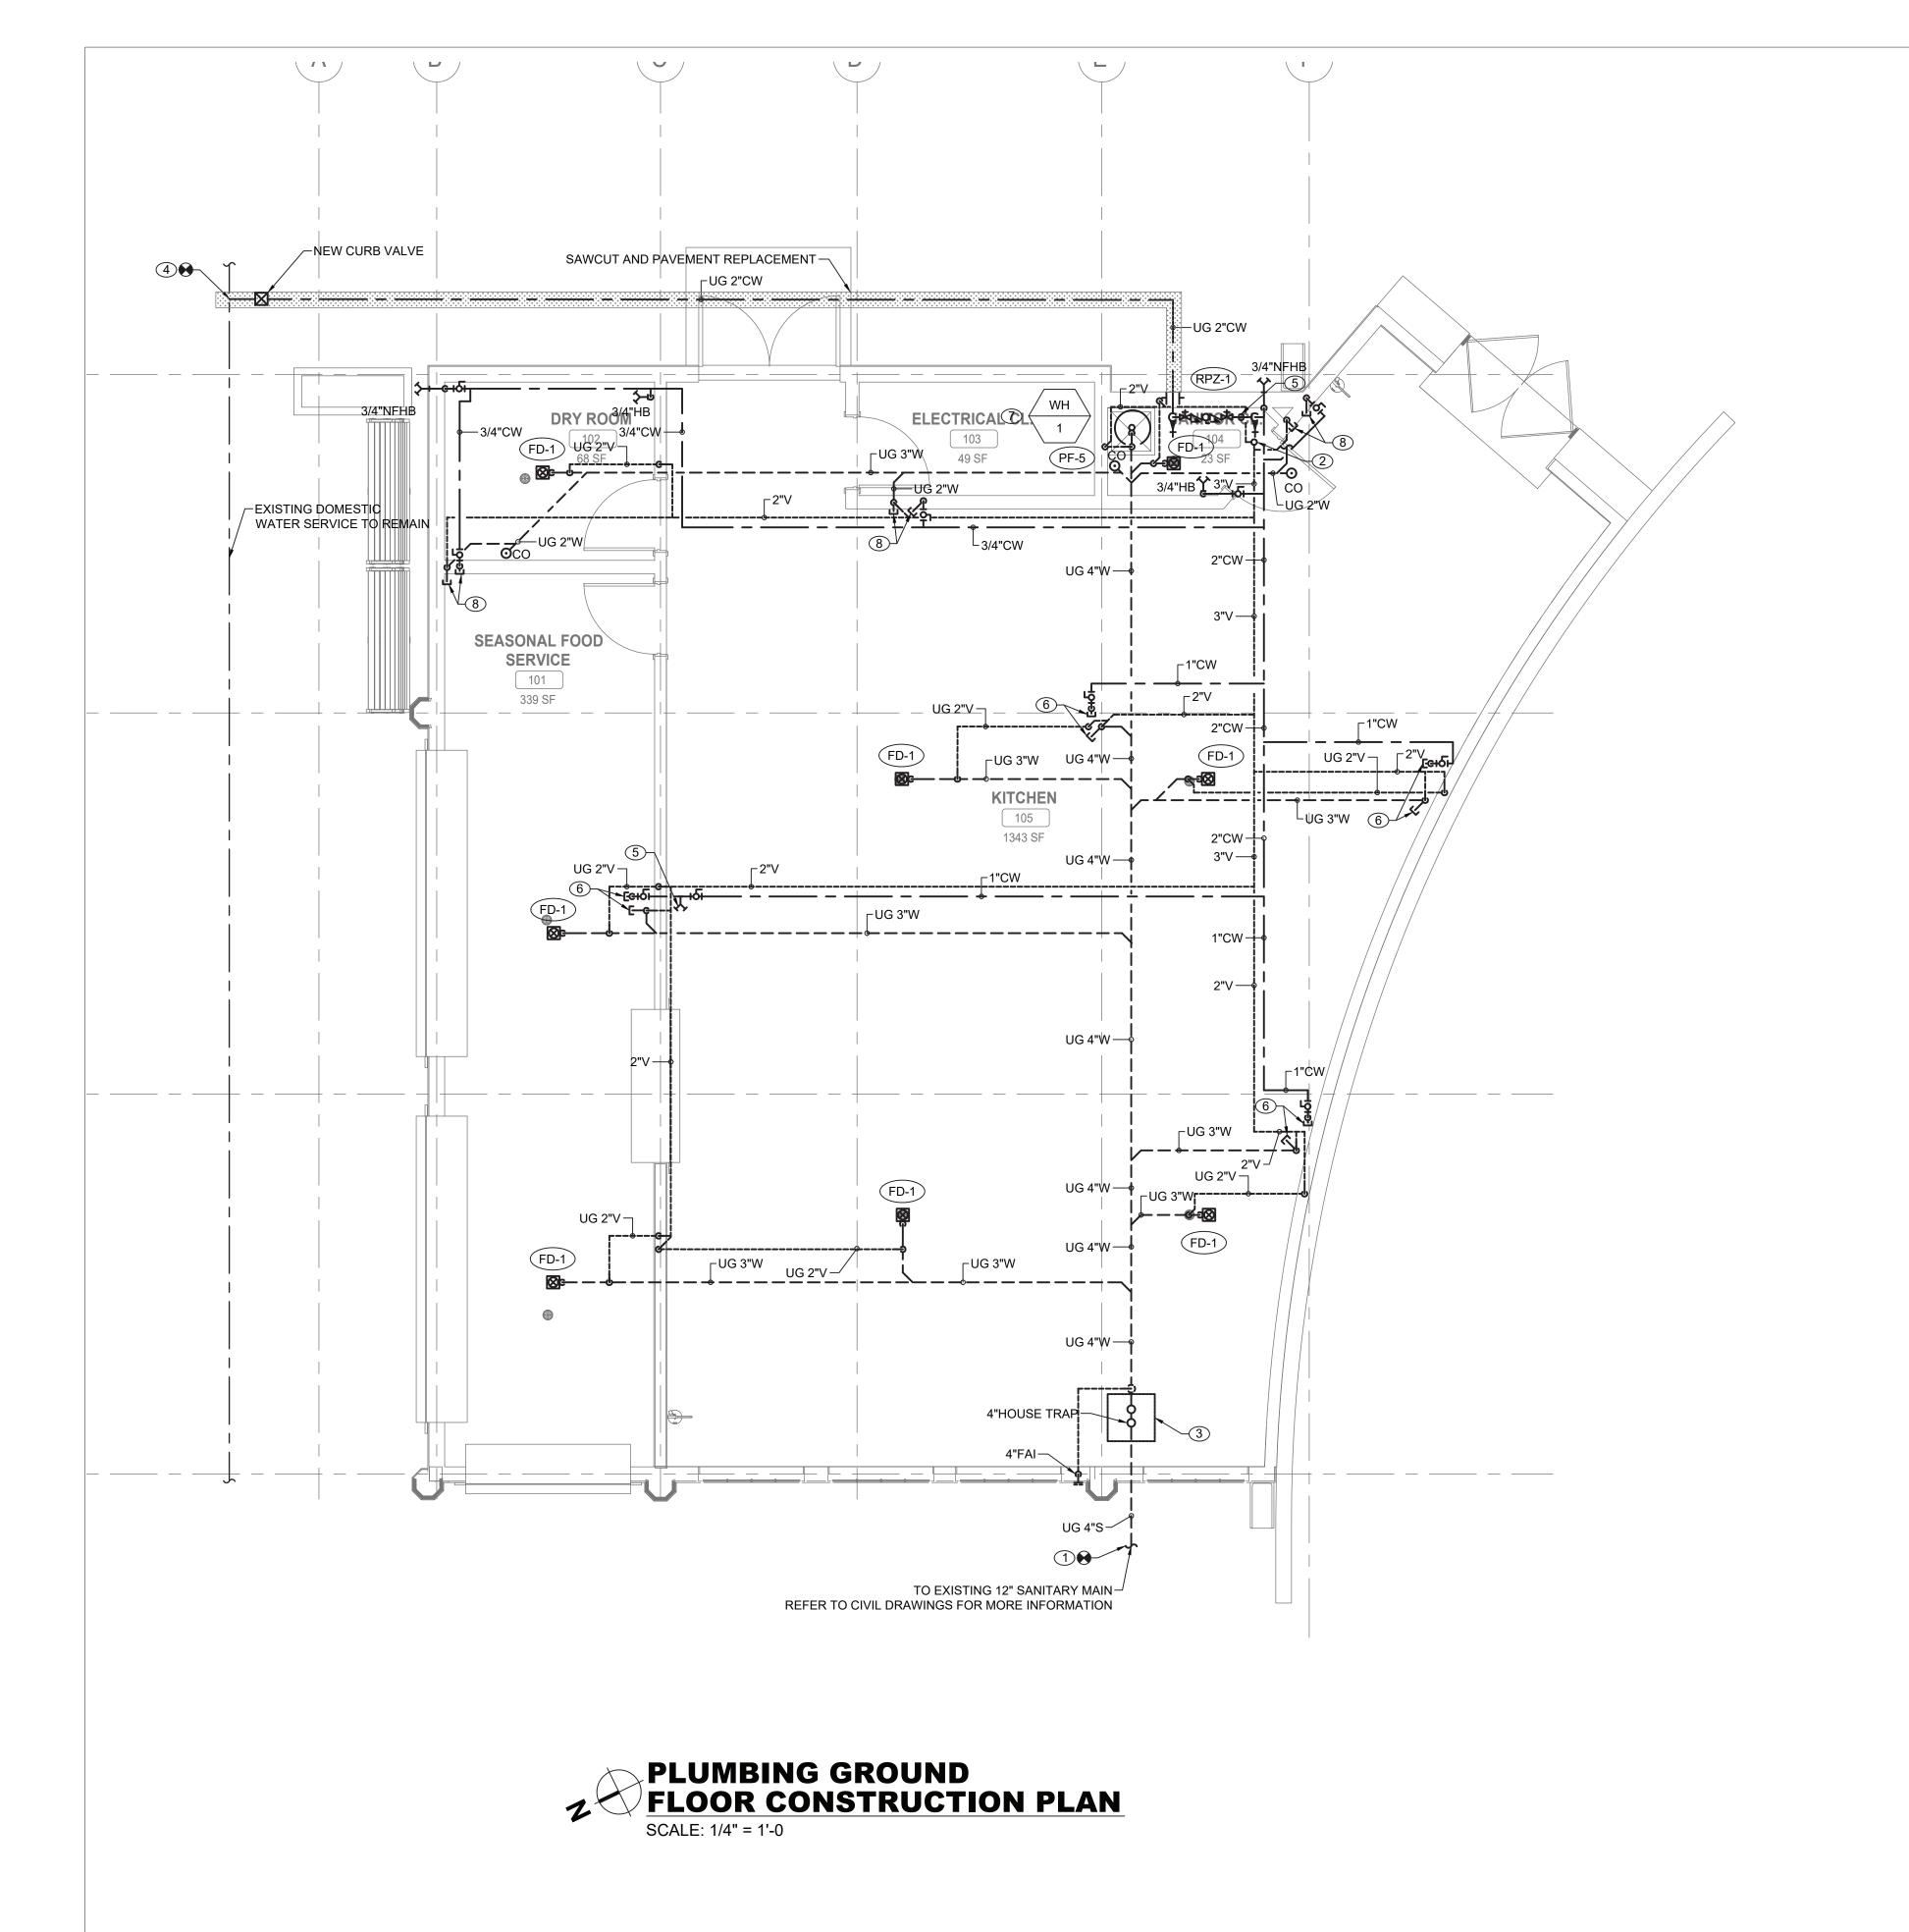


### **PLUMBING CONSTRUCTION NOTES:**


- 1 CONNECT NEW 4" SANITARY SERVICE TO SEWER MAIN. CONTRACTOR TO VERIFY THE INVERT, SIZE, AND MATERIAL OF THE SEWER SERVICE TO FACILITATE NEW SANITARY SERVICE CONNECTION. COORDINATE CONNECTION WITH CIVIL DRAWINGS
- 2 PROVIDE NEW 4" VENT THRU ROOF.
- 3 PROVIDE NEW 4"HOUSE TRAP IN PIT. PROVIDE ACCESS DOOR FOR MAINTENANCE. PROVIDE 4" FRESH AIR INTAKE THRU EXTERIOR WALL. TERMINATE VENT WITH INSECT SCREEN. HOUSE TRAP SHALL BE PROTECTED FROM FREEZING.
- (4) CONNECT NEW 2" DOMESTIC COLD WATER SERVICE TO EXISTING WATER MAIN. PROVIDE NEW CURB VALVE.
- (5) PROVIDE A COMPRESSED AIR CONNECTION FOR WINTERIZING.
- 6 PROVIDE 3"W AND 1"CW STUB-UP FOR FUTURE KITCHEN FIXTURES EXPOSED NEXT TO THE WALL. CONNECTIONS SHALL BE ACCESSIBLE AFTER CONSTRUCTION.
- 7 PROVIDE NEW MOP SINK WITH P-TRAP, FAUCET, SHUTOFF VALVES AND ALL ASSOCIATED PIPING. INSTALL NEW STORAGE TYPE ELECTRIC DOMESTIC WATER HEATER FOR MOP SINK NEEDS. INSTALL WATER HEATER ABOVE MOP SINK AS HIGH AS POSSIBLE ON BRACKETS TO KEEP REQUIRED CLEARANCES FOR MAINTENANCE. PROVIDE DRIP PAN WITH DRAIN PIPING.
- 8 PROVIDE 2"W AND 3/4"CW STUB-UP FOR FUTURE KITCHEN FIXTURES INSIDE THE WALL. CONNECTIONS SHALL BE ACCESSIBLE AFTER CONSTRUCTION.

# **GENERAL NOTES:**

- 1. COORDINATE WITH FACILITY PRIOR TO SHUTDOWN OF WATER DISTRIBUTION SYSTEM FOR ANY DEMOLITION AND CONSTRUCTION WORK.
- 2. PROVIDE DRAIN VALVES AT BOTTOM FOR EACH BRANCH. PROVIDE ACCESS PANELS TO ALL VALVES ABOVE CEILING AND BEHIND WALLS.
- 3. INSTALL NEW WATER PIPING WITH PROPER SLOPES TO AVOID WATER TRAPS DURING WINTER SEASON.
- 4. CONTRACTOR TO COORDINATE WITH FACILITY WHEN WORKING AROUND OR ABOVE THE RIDE COMPONENTS, AND PROVIDE ALL NECESSARY MEASURES TO PROTECT THESE COMPONENTS PER THE REQUIREMENTS OF THE FACILITY.
- 5. UPON COMPLETION, SYSTEM SHALL BE TESTED FOR PROPER OPERATION.
- 6. SEWER CROSSING WATER MAINS, CONDUITS, OR OTHER UTILITY SHALL BE MINIMUM 18" CLEARANCE BETWEEN THE OUTSIDE OF THE UTILITY AND OUTSIDE OF THE SEWER. THE CROSSINGS SHALL BE ARRANGED SO THAT THE SEWER JOINTS WILL BE EQUIDISTANT AND AS FAR AS POSSIBLE FROM THE WATER MAIN JOINTS.

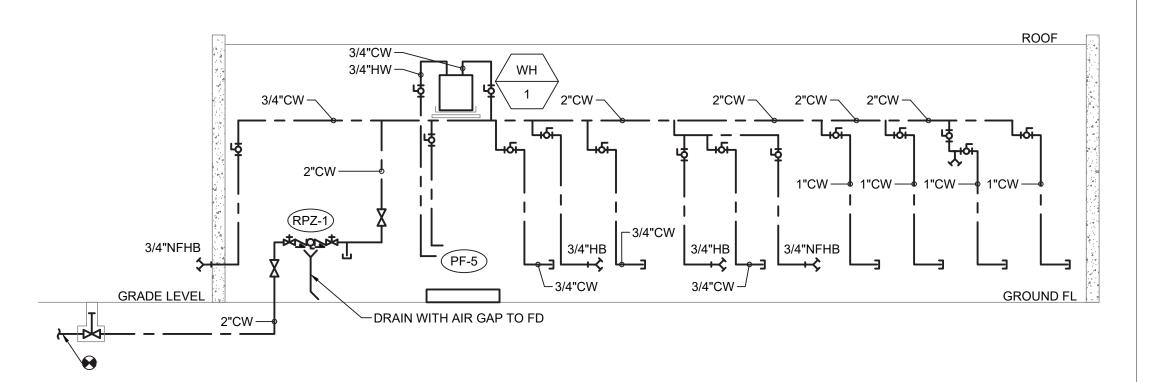


# 1 DOMESTIC WATER RISER DIAGRAM P-21 SCALE: NOT TO SCALE

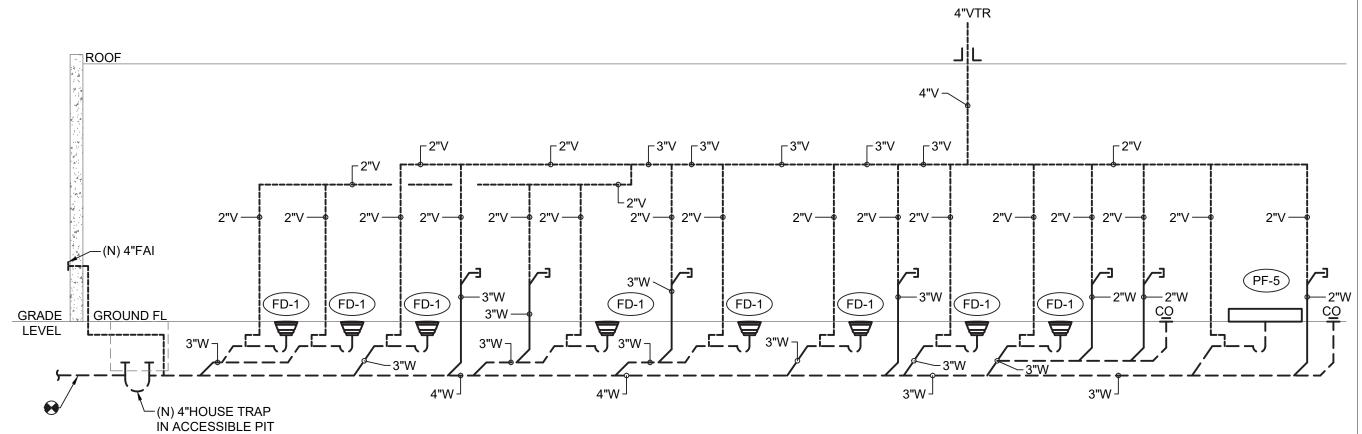

# 2 SANITARY RISER DIAGRAM P-21 SCALE: NOT TO SCALE

CONSULTANT INFORMATION CONSULTANT SEAL RECORD DRAWING CERTIFICATION WESTCHESTER COUNTY, NEW YORK NUMBER 22-523 AS BUILT - NO CHANGES DEPARTMENT OF PUBLIC WORKS AND TRANSPORTATION AS BUILT — CHANGES AS NOTED K-P-21 DIVISION OF ENGINEERING 547 of 664 LiRo Engineers, Inc. PROJECT COORDINATOR CONTRACTOR **AS INDICATED INFRASTRUCTURE REHABILITATION - PHASE 3** PLAYLAND PARK, RYE, NEW YORK 08/23/2022 RESTAURANT KITCHEN WITH FOOD VENDING DATE MADE APP'D
BY BY DPW FILE 1-118-P-1296-0 REVISION PLUMBING GROUND FLOOR CONSTRUCTION PLAN

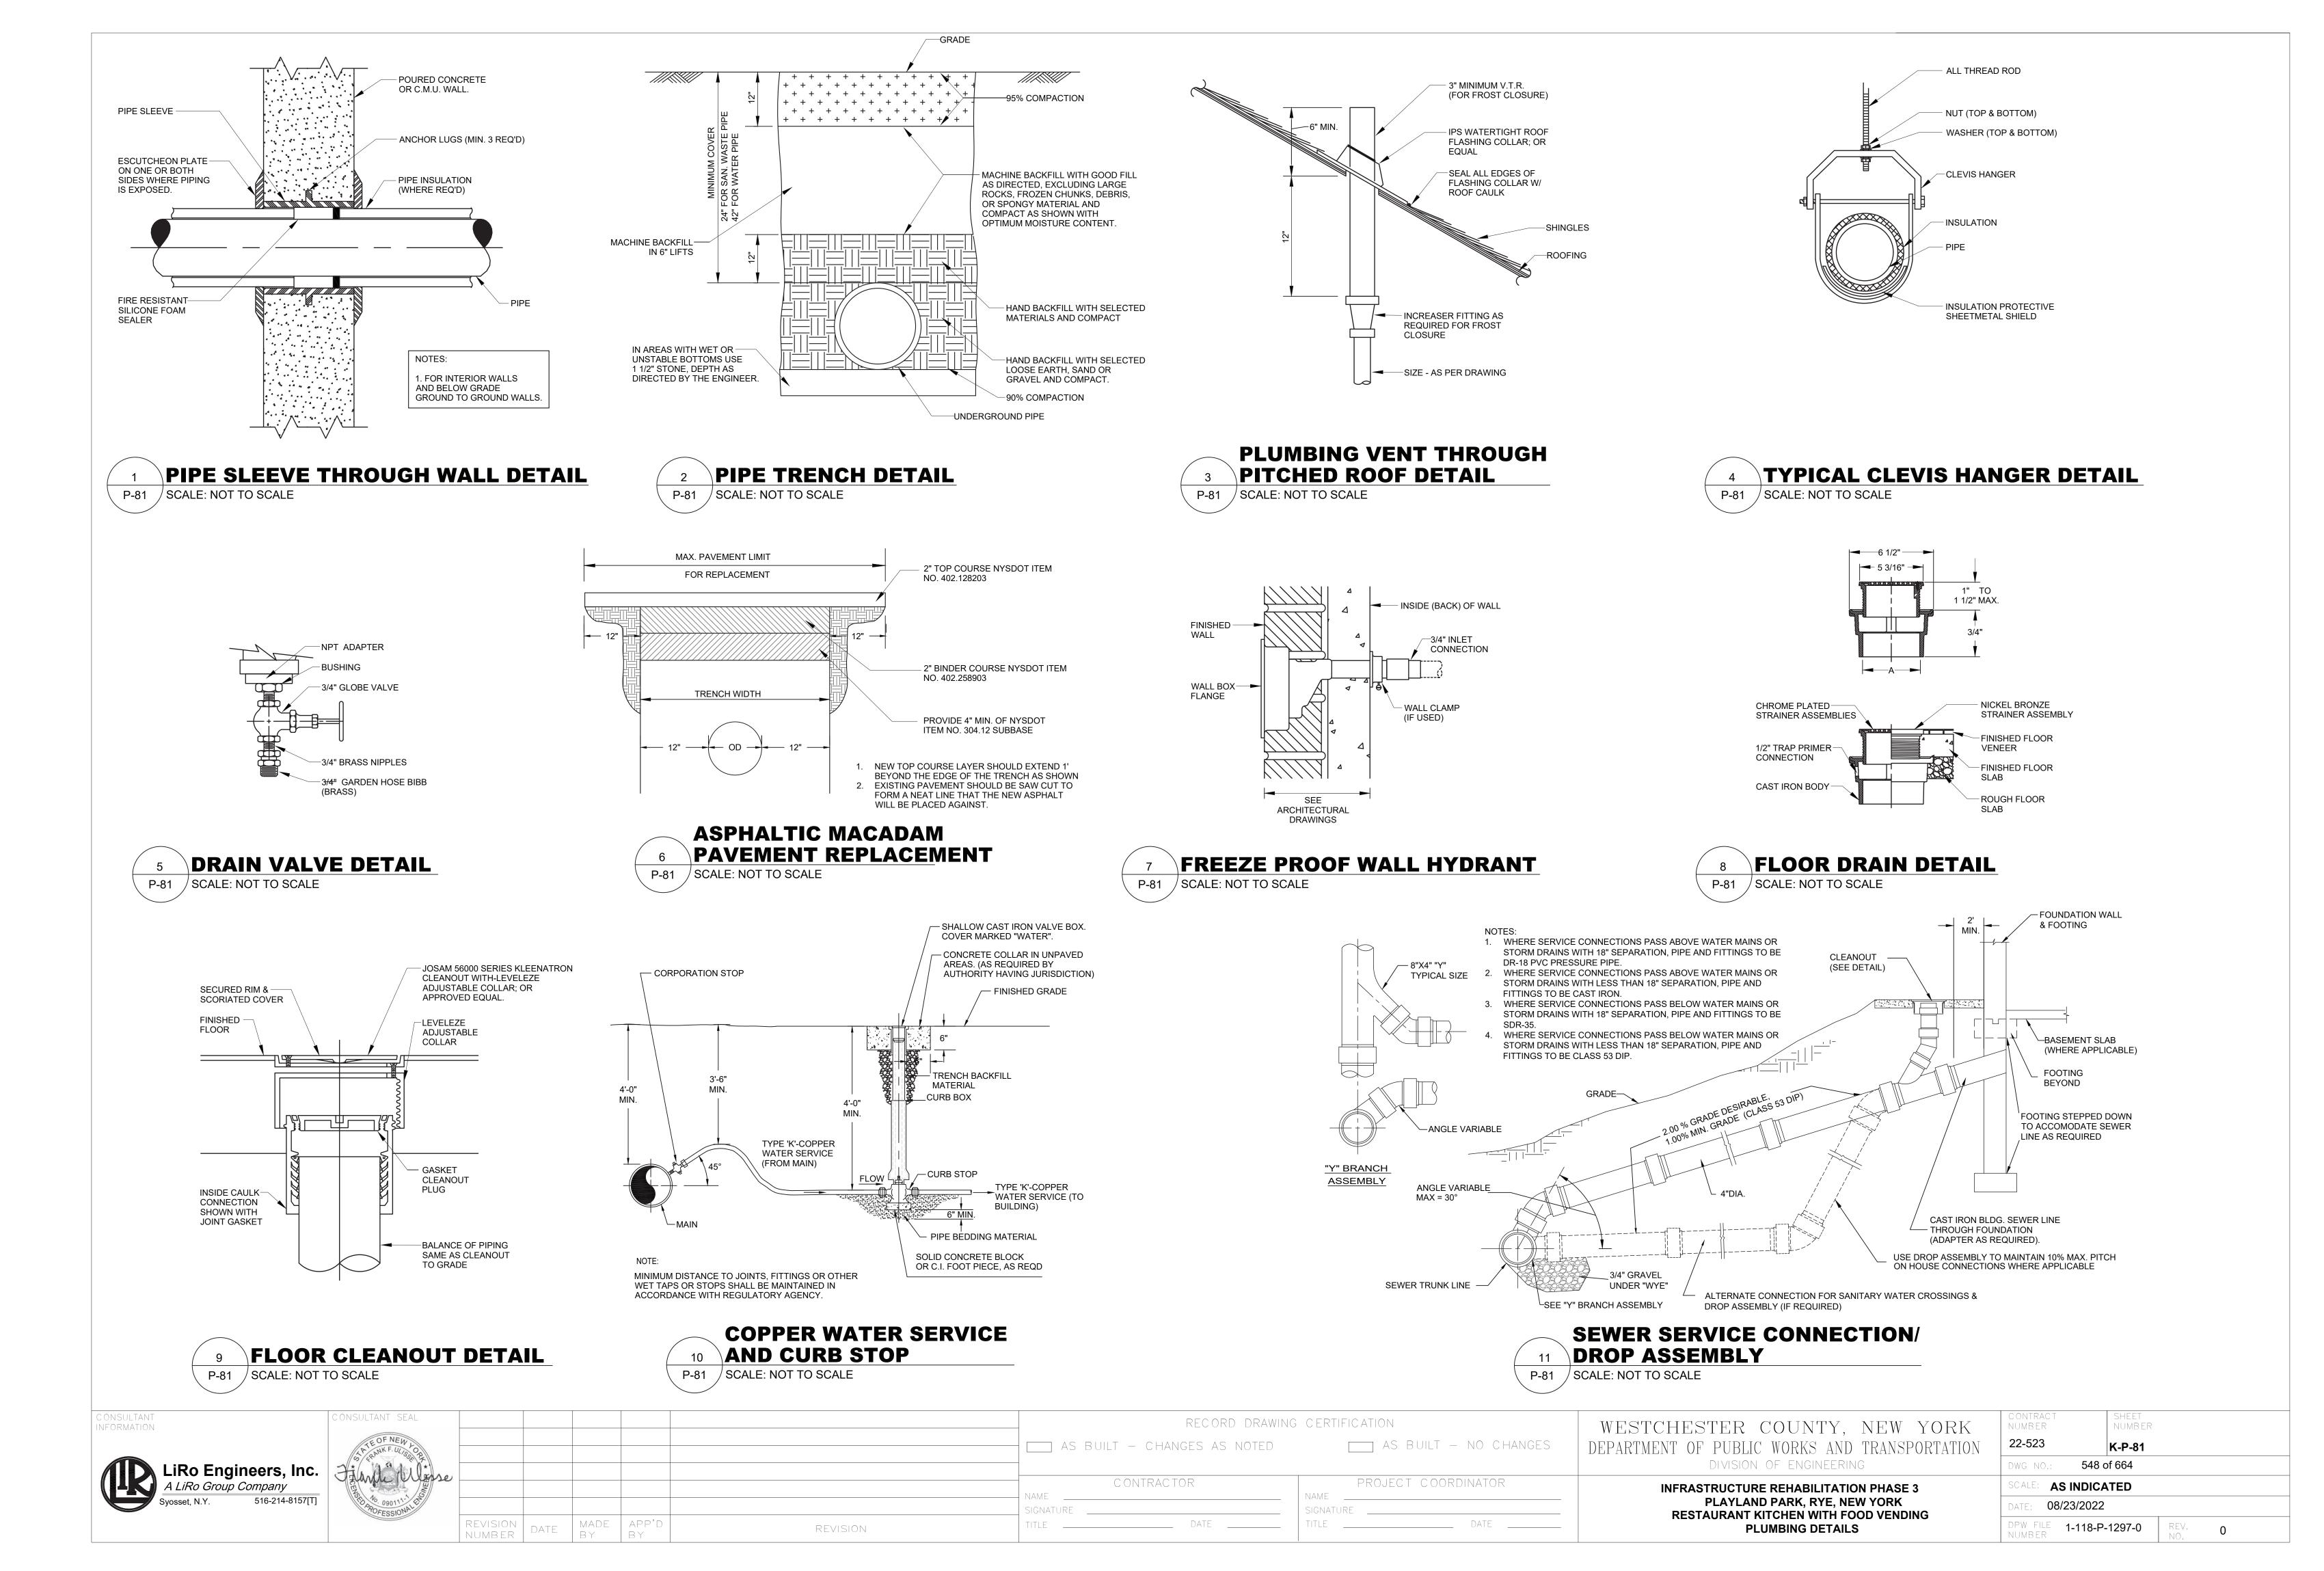

### **MECHANICAL GENERAL NOTES**

- ALL WORK AND MATERIALS SHALL BE PURCHASED AND INSTALLED IN ACCORDANCE WITH ALL NATIONAL & NEW YORK STATE CODES AND REGULATIONS (AS WELL AS ALL APPLICABLE LOCAL CODES & REGULATIONS). THE CONTRACTOR SHALL BE RESPONSIBLE TO ENSURE THAT ALL HVAC WORK IS PROVIDED AND INSTALLED IN STRICT ACCORDANCE WITH SEISMIC REQUIREMENTS.
- 2. DO NOT SCALE FROM THESE DRAWINGS.
- 3. THE EXACT MOUNTING HEIGHTS AND LOCATIONS OF ALL HVAC EQUIPMENT SHALL BE FIELD VERIFIED AND COORDINATED WITH ALL OTHER MECHANICAL, ELECTRICAL, PLUMBING, FIRE SPRINKLER, ARCHITECTURAL AND STRUCTURAL SYSTEMS. DURING SHOP DRAWINGS SUBMISSIONS, SHOW ALL MOUNTING HEIGHTS OF DUCTWORK, UNITS, ETC.
- VERIFY ALL EQUIPMENT VOLTAGES WITH THE ELECTRICAL DESIGN PRIOR TO ORDERING EQUIPMENT.
- . PROVIDE PHASE LOSS PROTECTION FOR ALL POLY-PHASE MOTOR DEVICES.
- DUCTWORK SHALL BE CONSTRUCTED OF GALVANIZED SHEET STEEL IN STRICT COMPLIANCE WITH THE LATEST EDITION OF THE ASHRAE, NFPA, AND SMACNA GUIDE RECOMMENDATIONS. ALL DUCTS TO HAVE PITTSBURGH TYPE LOCK FOR LONGITUDINAL SEAMS AND DRIVE SLIP / "S" SLIP FOR TRANSVERSE JOINTS. "DUCT-MATE" JOINT SYSTEM IS ACCEPTABLE IN LIEU OF PRIOR SEAM SYSTEMS. SIZES AS SHOWN INDICATE INSIDE CLEAR DIMENSIONS OF THE AIR PASSAGE. DUCTWORK SHALL BE FULLY INSULATED AS PER APPLICABLE CODES AND WRITTEN SPECIFICATIONS.
- DUCT SIZES MUST BE VERIFIED FOR CLEARANCES AT THE JOB SITE PRIOR TO FABRICATION. DIMENSIONS MAY BE CHANGED TO ACCOMMODATE CONSTRUCTION AS LONG AS EFFECTIVE CROSS-SECTIONAL AREA IS MAINTAINED. DUCT TRANSITIONS SHALL BE CONSTRUCTED WITH A SLOPE OF 1 TO 4". ALL DEVIATIONS FROM ORIGINAL CONTRACT DRAWINGS SHALL BE REVIEWED BY ENGINEER DURING THE SHOP DRAWING PROCESS.
- PROVIDE MANUAL BALANCING DAMPERS AS REQUIRED TO PROPERLY BALANCE EACH INDIVIDUAL AIR DISTRIBUTION SYSTEM. IF THE LOCATION OF THE BALANCING DAMPER IS NOT DEFINED ON THE DRAWINGS, THE FOLLOWING MINIMUMS STANDARDS SHALL GOVERN. ALL SUPPLY, RETURN, AND EXHAUST MAIN BRANCHES FROM TRUNKS, EACH SPLIT AND ALL SUB- BRANCHES FROM MAIN SHALL INCORPORATE BALANCING DAMPERS.
- PROVIDE FLEXIBLE CONNECTORS AT ALL DUCT CONNECTIONS TO VIBRATING EQUIPMENT. THESE CONNECTORS SHALL BE INSTALLED IN CLOSE PROXIMITY TO SUCH EQUIPMENT.
- 10. PROVIDE FIRE DAMPERS WITH RATED ACCESS DOORS AT ALL DUCT PENETRATIONS THROUGH FIRE RATED WALLS, SMOKE AND FIRE STOPPING, SHAFT, FLOORS, RATED CEILINGS AND PARTITIONS AS REQUIRED TO MAINTAIN ARCHITECTURAL FIRE RATINGS. REFER TO THE ARCHITECTURAL PLANS AND SPECIFICATIONS FOR LOCATIONS AND FIRE RATING REQUIREMENTS. CONTRACTOR MUST FULLY REVIEW ALL ARCHITECTURAL AND ENGINEERING DRAWINGS AND VISIT THE SITE PRIOR TO SUBMITTING THE BID. NO EXTRAS WILL BE ALLOWED.
- 11. ALL ACCESS DOORS REQUIRED IN GENERAL CONSTRUCTION ARE TO BE PROVIDED AND INSTALLED BY THE CONTRACTOR. IT IS THE RESPONSIBILITY OF THE CONTRACTOR TO IDENTIFY SIZE, TYPE AND LOCATION OF SUCH DOORS FOR PROPER ACCESS TO ALL CONCEALED HVAC EQUIPMENT, VALVES AND OTHER RELATED EQUIPMENT. THE CONTRACTOR SHALL IDENTIFY THESE REQUIREMENTS ON A COORDINATED SHOP DRAWING PRIOR TO SYSTEM FABRICATION AND INSTALLATION.
- 12. ALL CEILING MOUNTED EQUIPMENT MUST BE SUPPORTED DIRECTLY FROM BUILDING STRUCTURE WITH COMBINATION SPRING AND NEOPRENE-IN-SHEAR HANGERS AND ROD. PROVIDE SUPPLEMENTARY STEEL AS REQUIRED TO ADEQUATELY SUPPORT THE LOAD.
- 13. THE CONTRACTOR MUST CONTRACT AN INDEPENDENT NEBB CERTIFIED AIR BALANCING & TESTING COMPANY TO PERFORM THE AIR BALANCING WORK AND ASSOCIATED SYSTEM AIR BALANCING REPORT. ALL WORK SHALL BE PERFORMED IN STRICT COMPLIANCE WITH ALL APPLICABLE CODES. REGULATIONS, PLANS AND WRITTEN SPECIFICATIONS. SUBMIT THE FINAL AIR BALANCE REPORT TO THE ENGINEER FOR REVIEW AND APPROVAL PRIOR TO SUBSTANTIAL COMPLETION OF THE PROJECT, AS DETERMINED BY THE AND OWNER/CLIENT. THE AIR BALANCE REPORT MUST INCLUDE ALL SUPPLY, RETURN. & EXHAUST AIR TERMINALS. FRESH AIR (OUTSIDE AIR) INTAKE AND VENTILATION EXHAUST CFM RATES FOR ALL UNITS. ALSO INCLUDE ACTUAL SUPPLY & RETURN AIR VELOCITY & STATIC PRESSURE READINGS ALONG WITH ALL MOTOR AMPERAGES FOR ALL UNITS.
- 14. THE CONTRACTOR IS TO INCLUDE IN THEIR BID ALL LOW VOLTAGE CONTROL WIRING, THERMOSTATS, RELAYS, TRANSFORMERS, STARTERS ETC FOR A COMPLETE OPERATING CONTROL SYSTEM AS DESCRIBED IN THE SEQUENCE OF OPERATIONS, THE CONTRACTOR IS ALSO RESPONSIBLE FOR LINE VOLTAGE CONTROL FOR EXHAUST FANS CONTROLLED FROM LIGHT SWITCH AND THERMOSTATS. ALL CONTROL WIRING IN THE AREAS THAT DO NOT HAVE DROPPED CEILINGS THE CONTRACTOR MUST PROVIDE ALL CONTROL WIRING CONDUIT. IN AREAS OF DROPPED CEILING PLENUM RATED CONTROL WIRING CAN BE RUN EXPOSED ABOVE CEILING.
- 15. ALL MECHANICAL EQUIPMENT SHALL BE INSTALLED PER MANUFACTURER'S REQUIREMENTS/SPECIFICATIONS.

### **CODE REFERENCE**

2020 NEW YORK STATE BUILDING CODE 2020 NEW YORK STATE MECHANICAL CODE 2020 NEW YORK STATE ENERGY CONSERVATION CODE

### MECHANICAL DEMOLITION NOTES

1. CONTRACTOR SHALL BE RESPONSIBLE FOR DEMOLITION OF MECHANICAL EQUIPMENT AND MATERIAL RELATING TO THEIR RESPECTIVE TRADE.

2. THE CONTRACTOR SHALL REMOVE, RELOCATE, REPLACE, ADJUST, ADAPT AND MODIFY EXISTING EQUIPMENT AND/OR SYSTEMS AS REQUIRED WHEN SUCH WORK IS UNCOVERED AND FOUND TO INTERFERE WITH COMPLETION OF WORK IN THIS CONTRACT OR OTHER CONTRACT WORK.

3. EXECUTE THE DEMOLITION IN CAREFUL AND ORDERLY MANNER WITH THE LEAST POSSIBLE DISTURBANCE TO THE PUBLIC. EGRESS OR THE FUNCTIONING OF THE EXISTING BUILDING.

4. TAKE NECESSARY PRECAUTIONS TO PREVENT DUST AND DIRT FROM RISING BY WETTING DEMOLISHED DEBRIS. EXCESSIVE USE OF WATER WILL NOT BE PERMITTED.

5. PRIOR TO DEMOLITION, CONTRACTOR SHALL REVIEW WITH OWNER ALL MATERIALS TO BE REMOVED, SHOULD THE OWNER WANT TO KEEP ANY MATERIALS THE CONTRACTOR SHALL REMOVE AND DELIVER THE PARTS TO THE OWNER ON THE SITE WHERE SO DIRECTED. OTHERWISE ALL DEMOLISHED OR REMOVED MATERIALS SHALL BECOME THE PROPERTY OF THE CONTRACTOR AND SHALL BE REMOVED FROM THE SITE AND BE DISPOSED OF IN A LEGAL MANNER.

6. DEMOLITION SHALL INCLUDE REMOVAL OF ALL PARTS AND PIECES IN THEIR ENTIRETY BACK TO POINTS INDICATED OR IF NOT INDICATED BACK TO THEIR POINT OF SOURCE.

7. WHERE CONDITIONS PROHIBIT TOTAL REMOVAL OF THE WORK, THE REMAINING PORTION SHALL BE CUT FLUSH WITH THE SURROUNDING SURFACE AND BE CAPPED, PLUGGED OR SEALED AND THE SURROUNDING SURFACE SHALL BE REFINISHED IN AN APPROVED MANNER.

9. DO NOT REMOVE EXISTING STRUCTURAL WORK. DO NOT REMOVE OPERATIONAL ELEMENTS AND SAFETY-RELATED COMPONENTS IN A MANNER RESULTING IN A REDUCTION OF CAPACITIES TO PERFORM IN THE MANNER INTENDED OR RESULTING IN DECREASED OPERATIONAL LIFE, INCREASED MAINTENANCE, OR DECREASED SAFETY.

10. REMOVALS, DISCONNECTIONS, AND RELOCATIONS SHALL BE

BY A CONTRACTOR LICENSED IN THE TRADE INVOLVED. ALL WORK SHALL BE DONE IN ACCORDANCE WITH ACCEPTED TRADE PRACTICES. 11. PROVIDE ADEQUATE TEMPORARY SUPPORT FOR WORK TO REMAIN, TO PREVENT

PERFORMED BY WORKMEN SKILLED IN THE TRADE INVOLVED AND SHALL BE EMPLOYED

FAILURE. DO NOT ENDANGER OTHER WORK.

12. PROTECTION: PROVIDE ADEQUATE PROTECTION WHERE REQUIRED FOR THE PRESENT BUILDING AND ITS CONTENTS. TEMPORARY DUSTPROOF BARRIERS AND BARRICADES SHALL BE ERECTED WHERE REQUIRED FOR PROTECTION OF PERSONNEL PROTECTION FROM DUST AND DIRT, FOR SECURITY, FIRE AND WEATHER PROTECTIVE REASONS.

13. CONTRACTOR SHALL TAKE EVERY PRECAUTION AGAINST FIRE BY EMPLOYING FIRE DEPARTMENT TYPE HOSES AND PORTABLE FIRE EXTINGUISHERS AS REQUIRED BY OSHA AND/OR THE OWNER'S INSURANCE UNDERWRITER.

14. BEFORE STARTING DEMOLITION OPERATIONS, PROVIDE THE NECESSARY PROTECTIVE DEVICES, WHERE REQUIRED, AND IN STRICT ACCORDANCE WITH OSHA RULES AND REGULATIONS.

14. USE TEMPORARY ENCLOSURES, OR OTHER SUITABLE METHODS TO LIMIT DUST AND DIRT RISING AND SCATTERING TO LOWEST PRACTICAL LEVEL. COMPLY WITH GOVERNING REGULATIONS PERTAINING TO ENVIRONMENTAL PROTECTION.

15. FIELD VERIFY DEMOLITION REQUIREMENTS AND EXISTING CONDITIONS. DEMOLITION NOTES ARE INDICATED IN NOTE FORM.

16. CONTRACTOR SHALL ESTABLISH A PATH OF TRAVEL AND TIME SCHEDULE FOR THE REMOVAL OF ALL DEBRIS AND WASTE, AND HAVE THIS APPROVED BY OWNER. CONTRACTOR IS TO ENSURE THAT ALL CORRIDORS AND PUBLIC AREAS BE KEPT FREE OF OBSTRUCTIONS, DEBRIS, AND ARE TO BE BROOM SWEPT CLEAN AT ALL TIMES.

17. CONTRACTOR SHALL VISIT THE SITE AND BECOME INFORMED AS TO THE CONDITION OF THE PREMISES AND THE EXTENT AND CHARACTER OF WORK REQUIRED. NO ADDITIONAL COMPENSATION WILL BE APPROVED DUE TO FIELD CONDITIONS.

# **NYSECC ENERGY COMPLIANCE STATEMENT:**

PER SECTION C101.7 OF THE 2020 NYSECC HISTORIC BUILDINGS ARE EXEMPT FROM THE REQUIREMENTS OF THE ENERGY CODE.

### **HVAC SYMBOL LIST**

<u>IDENTIFIER</u>	DESCRIPTION
Z	NEW DUCTWORK OR PIPING
5///////5	EXISTING DUCTWORK OR PIPING TO BE REMOVED
۶	EXISTING DUCTWORK OR PIPING TO REMAIN
24X12	DOUBLE-LINE AND SINGLE-LINE RECTANGULAR DUCT, FIRST NUMBER INDICATES SIDE IN VIEW IN INCHES, SECOND NUMBER INDICATES SIDE IN DEPTH IN INCHES
www	FLEXIBLE DUCTWORK

REGULAR SUPPLY AIR DUCT (UP AND DOWN)

> REGULAR RETURN AIR DUCT (UP AND DOWN) REGULAR EXHAUST AIR DUCT

(UP AND DOWN) REGULAR OUTSIDE AIR DUCT (UP AND DOWN) VOLUME DAMPER  $\neg \lor D$ --- BD BACKDRAFT DAMPER MOTOR OPERATED DAMPER <u>-</u>₩₩-

- EQUIPMENT TAG EQUIPMENT NUMBER  $\langle xxx \rangle$ DETAIL TAG/CALL OUT TAG X-XXX MECHANICAL SHEET NUMBER THERMOSTAT

**EXHAUST GRILLE** (F#) FIGURE INDICATED BY NUMBER

(I.E. F2 REFERS TO FIGURE 2)

# **HVAC ABBREVIATIONS**

<u>IDENTIFIER</u>	DESCRIPTION
AC	DIRECT EXPANSION AIR CONDITION UNIT
CFM	CUBIC FEET PER MINUTE
COND	CONDENSATE
CU	CONDENSING UNIT
CUH	CABINET UNIT HEATER
DB	DRY BULB
DN	DOWN
EA	EXHAUST AIR
EF	EXHAUST FAN
EG	EXHAUST GRILLE
EUH	ELECTRIC UNIT HEATER
EER	ENERGY EFFICIENCY RATIO
EG	EXHAUST GRILLE
FAI	FRESH AIR INTAKE
GC	GENERAL CONTRACTOR
MBH	THOUSAND BTU PER HOUR
PC	PLUMBING CONTRACTOR
RG	RETURN GRILLE
RGL	REFRIGERANT GAS LINE
RLL	REFRIGERANT LIQUID LINE
RTU	ROOFTOP UNIT
SA	SUPPLY AIR
SD	SUPPLY DIFFUSER
TYP.	TYPICAL
VIF	VERIFY IN FIELD

### **SCOPE OF WORK**

REMOVE TWO (2) EXISTING RANGE HOODS AS INDICATED.

CONTROLS AND ACCESSORIES.

- REMOVE TWO (2) EXISTING FLUES AS INDICATED. REMOVE TWO (2) EXISTING CEILING VENTILATION GRILLES AS INDICATED.
- REMOVE ONE (1) EXISTING RELIEF VENT AS INDICATED. REMOVE TWO (2) EXISTING ROOFTOP FANS AND ASSOCIATED DUCTWORK,

### CONSTRUCTION

**DEMOLITION** 

- PROVIDE ONE (1) NEW ROOFTOP AIR HANDLING UNIT RTU-1. PROVIDE DUCTWORK TO NEW SPACES AS INDICATED.
- PROVIDE ONE (1) NEW OUTDOOR SPLIT CONDENSER AIR CONDITIONER UNIT AS INDICATED
- 3. PROVIDE TWO (2) NEW CEILING RECESSED INDOOR AIR CONDITIONER UNITS
- AS INDICTED 4. PROVIDE ONE (1) NEW PACKAGED TERMINAL AIR CONDITIONER UNIT AS INDICATED
- PROVIDE ONE (1) NEW GENERAL KITCHEN/TRASH ROOM EXHAUST FAN ON
- ROOF AND ASSOCIATED DUCTWORK AS INDICATED. PROVIDE ONE (1) NEW ATTIC EXHAUST FAN AS INDICATED. PROVIDE ONE (1) NEW WALL MOUNTED ELECTRIC UNIT HEATER AS
- 8. PROVIDE TWO (2) NEW RAIN RESISTANT LOUVERS AS INDICATED.

ALL HEATING COOLING

EQUIPMENT

SHUTOFF DAMPERS

DUCT LEAKAGE

**HVAC SYSTEM** 

CONTROLS

	MECHANICAL DRA	WING LIST	
SHEET NO.	SHEET NAME	REVISON NO.	REVISION DATE
K-M-01	MECHANICAL NOTES, SYMBOLS & LEGENDS	0	-
K-M-11	MECHANICAL 1ST FLOOR DEMOLITION PLAN	0	-
K-M-12	MECHANICAL ROOF DEMOLITION PLAN	0	-
K-M-21	MECHANICAL 1ST FLOOR CONSTRUCTION PLAN	0	-
K-M-22	MECHANICAL ATTIC FLOOR CONSTRUCTION PLAN	0	-
K-M-23	MECHANICAL ROOF CONSTRUCTION PLAN	0	-
K-M-61	MECHANICAL SCHEDULES	0	-
K-M-81	MECHANICAL DETAILS 1 OF 2	0	-
K-M-82	MECHANICAL DETAILS 2 OF 2	0	-
K-M-91	MECHANICAL CONTROLS	0	-

THERMOSTATIC CONTROLS FOR HVAC SYSTEM | C403.2.6 | MECHANICAL SCHEDULES AND PLANS

C403.7.7

MECHANICAL SCHEDULES AND PLANS

PER C403 MECHANICAL DWGS. & SPECS

BACKDRAFT DAMPER INSTALLED AT EXHAUST

**OPENINGS** 

SMACNA HVAC DUCT LEAKAGE TEST

### **MECHANICAL VENTILATION SCHEDULE** MECH CODE REQUIREMENTS SPACE DETAILS DESIGN # OF FIXT MIN DESIGN ACTUAL ACTUAL ACTUAL AREA # OA / SQ OA PER (TOILET/URI EXH EXH (FT2) PEOPLE FT PERSON NALS/SLOP CFWSQFT CFWFIXTURE NET OA OA FLOW ROOM SA FLOW RA FLOW EA FLOW (CFM) (CFM) SINK) 105 KITCHEN 1347 27 0.12 7.5 0.7 943 1000 2400 1400 1000 102 DRY ROOM 67 0.12 100 100 1. NEW YORK STATE MECHANICAL CODE

NATURAL VENTILATION SCHEDULE  SPACE DETAILS DESIGN							
SPACE DE	TAILS			DESIGN		_	
ROOM	AREA (SF)	4% FLOOR AREA (SF)	WINDOW FREE AREA (SF)	DOOR AREA (SF)	TOTAL OPENABLE AREA (SF)	NOTES	
101 SEASONAL FOOD SERVICE	343	14	-	156	156	1,2	
NOTES:			1				
1. NEW YORK STATE MECHANICA	L CODE.						
2. NATURAL VENTILATION OF AN (	OCCUPIED SPA	CE SHALL BE T	THROUGH WIN	DOWS, DOORS	S, LOUVERS, AN	D OTHER	
OPENINGS TO THE OUTDOORS	. THE MINIMUM	OPENABLE AF	REA TO THE O	UTDOORS SHA	LL BE 4 PERCEN	NT OF THE	
FLOOR AREA BEING VENTILATE	ED.						

THERMOSTATIC CONTROLS

### (PER 2020 NYS ENERGY CODE) ITEM DESCRIPTION CITATION PROPOSED VALUE MINIMUM EFFECIENCY CODE PRECRIBED VALUE AND CITATION SUPPORTING DOCUMENTATION **EQUIPMENT TYPE UNIT TAG** MINIMUM EFFICIENCY REQUIREMENTS: HVAC EQUIPMENT ELECTRICALLY OPERATED UNITARY AIR CONDITIONERS AND CONDENSING UNITS > 65,000 C403.2.3(1) SINGLE PACKAGED UNIT SEER= 12.6 SEER=11.2 MECHANICAL SCHEDULES PERFORMANCE Btu/H < 135,000 Btu/h MINIMUM EFFICIENCY REQUIREMENTS: ELECTRICALLY OPERATED UNITARY AIR HVAC EQUIPMENT HSPF = 11.2 HSPF = 8.2 CONDITIONERS AND CONDENSING UNITS < 65,000 C403.2.3(1) SPLIT SYSTEM HEAT PUMP MECHANICAL SCHEDULES AC-1,AC-2, CU-1 PERFORMANCE SEER= 14.0 SEER= 15.0

DIGITAL THERMOSTATS

GRAVITY/BACKDRAFT DAMPERS PROVIDED IN

LIEU OF MOTORIZED DAMPER MOTORIZED


DAMPERS PER EXCEPTIONS 1

SMACNA HVAC DUCT LEAKAGE TEST

TABLE 1: ENERGY CODE ANALYSIS TABLE FOR MECHANICAL SYSTEMS

	TABLE 2: ENERGY CODE COMPLIANCE INSPECTIONS FOR MECHANICAL SYSTEMS  (IIB - MECHANICAL AND SERVICE WATER HEATING INSPECTIONS)											
	INSPECTION TEST	FREQUENCY	REFERENCE STANDARDS	INSPECTION DESCRIPTION	ECC CITATION							
IIB2	SHUT-OFF DAMPERS	AS REQUIRED DURING INSTALLATION	APPROVED CONSTRUCTION DOCUMENTS	DAMPERS FOR STAIR AND ELEVATOR SHAFT VENTS AND OTHER OUTDOOR AIR INTAKES AND EXHAUST OPENINGS INTEGRAL TO THE BUILDING ENVELOPE SHALL BE VISUALLY INSPECTED TO VERIFY THAT SUCH DAMPERS, EXCEPT WHERE PERMITTED TO BE GRAVITY DAMPERS, COMPLY WITH APPROVED CONSTRUCTION DRAWINGS. MANUFACTURER'S LITERATURE SHALL BE REVIEWED TO VERIFY THAT THE PRODUCT HAS BEEN TESTED AND FOUND TO MEET THE STANDARD.	NYSECC C403.2.4.4, C403.7.7, OR ASHRAE 90.1 6.4.3.4							
IIB3	HVAC AND SERVICE WATER HEATING EQUIPMENT	PRIOR TO FINAL MECHANICAL AND CONSTRUCTION INSPECTION	APPROVED CONSTRUCTION DOCUMENTS	EQUIPMENT SIZING, EFFICIENCIES AND OTHER PERFORMANCE FACTORS OF ALL MAJOR EQUIPMENT UNITS, AS DETERMINED BY THE APPLICANT OF RECORD, AND NO LESS THAN 15% OF MINOR EQUIPMENT UNITS, SHALL BE VERIFIED BY VISUAL INSPECTION AND, WHERE NECESSARY, REVIEW OF MANUFACTURER'S DATA. POOL HEATERS AND COVERS SHALL BE VERIFIED BY VISUAL INSPECTION	NYSECC C403.2, C404.2, C404.7, C406.2							
IIB4	HVAC AND SERVICE WATER HEATING SYSTEM CONTROLS	AFTER INSTALLATION AND PRIOR TO FINAL ELECTRICAL AND CONSTRUCTION INSPECTION, EXCEPT THAT FOR CONTROLS WITH SEASONALLY DEPENDENT FUNCTIONALITY, SUCH TESTING SHALL BE PERFORMED BEFORE SIGN-OFF FOR ISSUANCE OF A FINAL CERTIFICATE OF OCCUPANCY	APPROVED CONSTRUCTION DOCUMENTS INCLUDING CONTROL SYSTEM NARRATIVES	NO LESS THAN 20% OF EACH TYPE OF REQUIRED CONTROLS AND ECONOMIZERS SHALL BE VERIFIED BY VISUAL INSPECTION AND TESTED FOR FUNCTIONALITY AND PROPER OPERATION. SUCH CONTROLS SHALL INCLUDE, BUT ARE NOT LIMITED TO, THERMOSTATIC AND ECONOMIZER CONTROLS	NYSECC C403.2.4, C403.2.5.1, C403.2.11, C403.3, C403.4, C404.3, C404.6, C404.7							
IIB6	HVAC DUCT LEAKAGE TESTING	PRIOR TO CLOSING CEILINGS AND WALLS AND PRIOR TO FINAL CONSTRUCTION INSPECTION	APPROVED CONSTRUCTION DOCUMENTS; NYC MECHANICAL CODE	WHERE THE AIR HANDLER AND/OR SOME DUCTWORK IS IN UNCONDITIONED SPACE, DUCT-LEAKAGE TESTING SHALL BE PERFORMED EITHER AFTER ROUGH-IN OR POST-CONSTRUCTION TO ENSURE COMPLIANCE WITH ECC R403.3.3 AND R403.3.4. NOT LESS THAN 20% OF SUCH DUCTWORK SHALL BE TESTED	NYSECC C403							

CONSULTANT	CONSULTANT SEAL							CONTRACT	SHEET
CONSULTANT NFORMATION	TEOF NEW LOOK				RECORD DRAWING  AS BUILT — CHANGES AS NOTED	AS BUILT — NO CHANGES	WESTCHESTER COUNTY, NEW YORK DEPARTMENT OF PUBLIC WORKS AND TRANSPORTATION	NUMBER <b>22-523</b>	NUMBER K-M-01
LiRo Engineers, Inc.  A LiRo Group Company	Finde Wise				CONTRACTOR	PROJECT COORDINATOR	DIVISION OF ENGINEERING  INFRASTRUCTURE REHABILITATION - PHASE 3	DWG NO.:	549 of 664  INDICATED
Syosset, N.Y. 516-214-8157[T]	10 090111 ES	REVISION MADE	APP'D		NAME	NAME SIGNATURE DATE	PLAYLAND PARK, RYE, NEW YORK RESTAURANT KITCHEN WITH FOOD VENDING	DATE: 08/2	23/2022
		NUMBER DATE BY	BY	REVISION	THE	DATE.	MECHANICAL NOTES, SYMBOLS AND LEGENDS	NUMBER 1-	-118-M-1298-0 REV. NO. 0

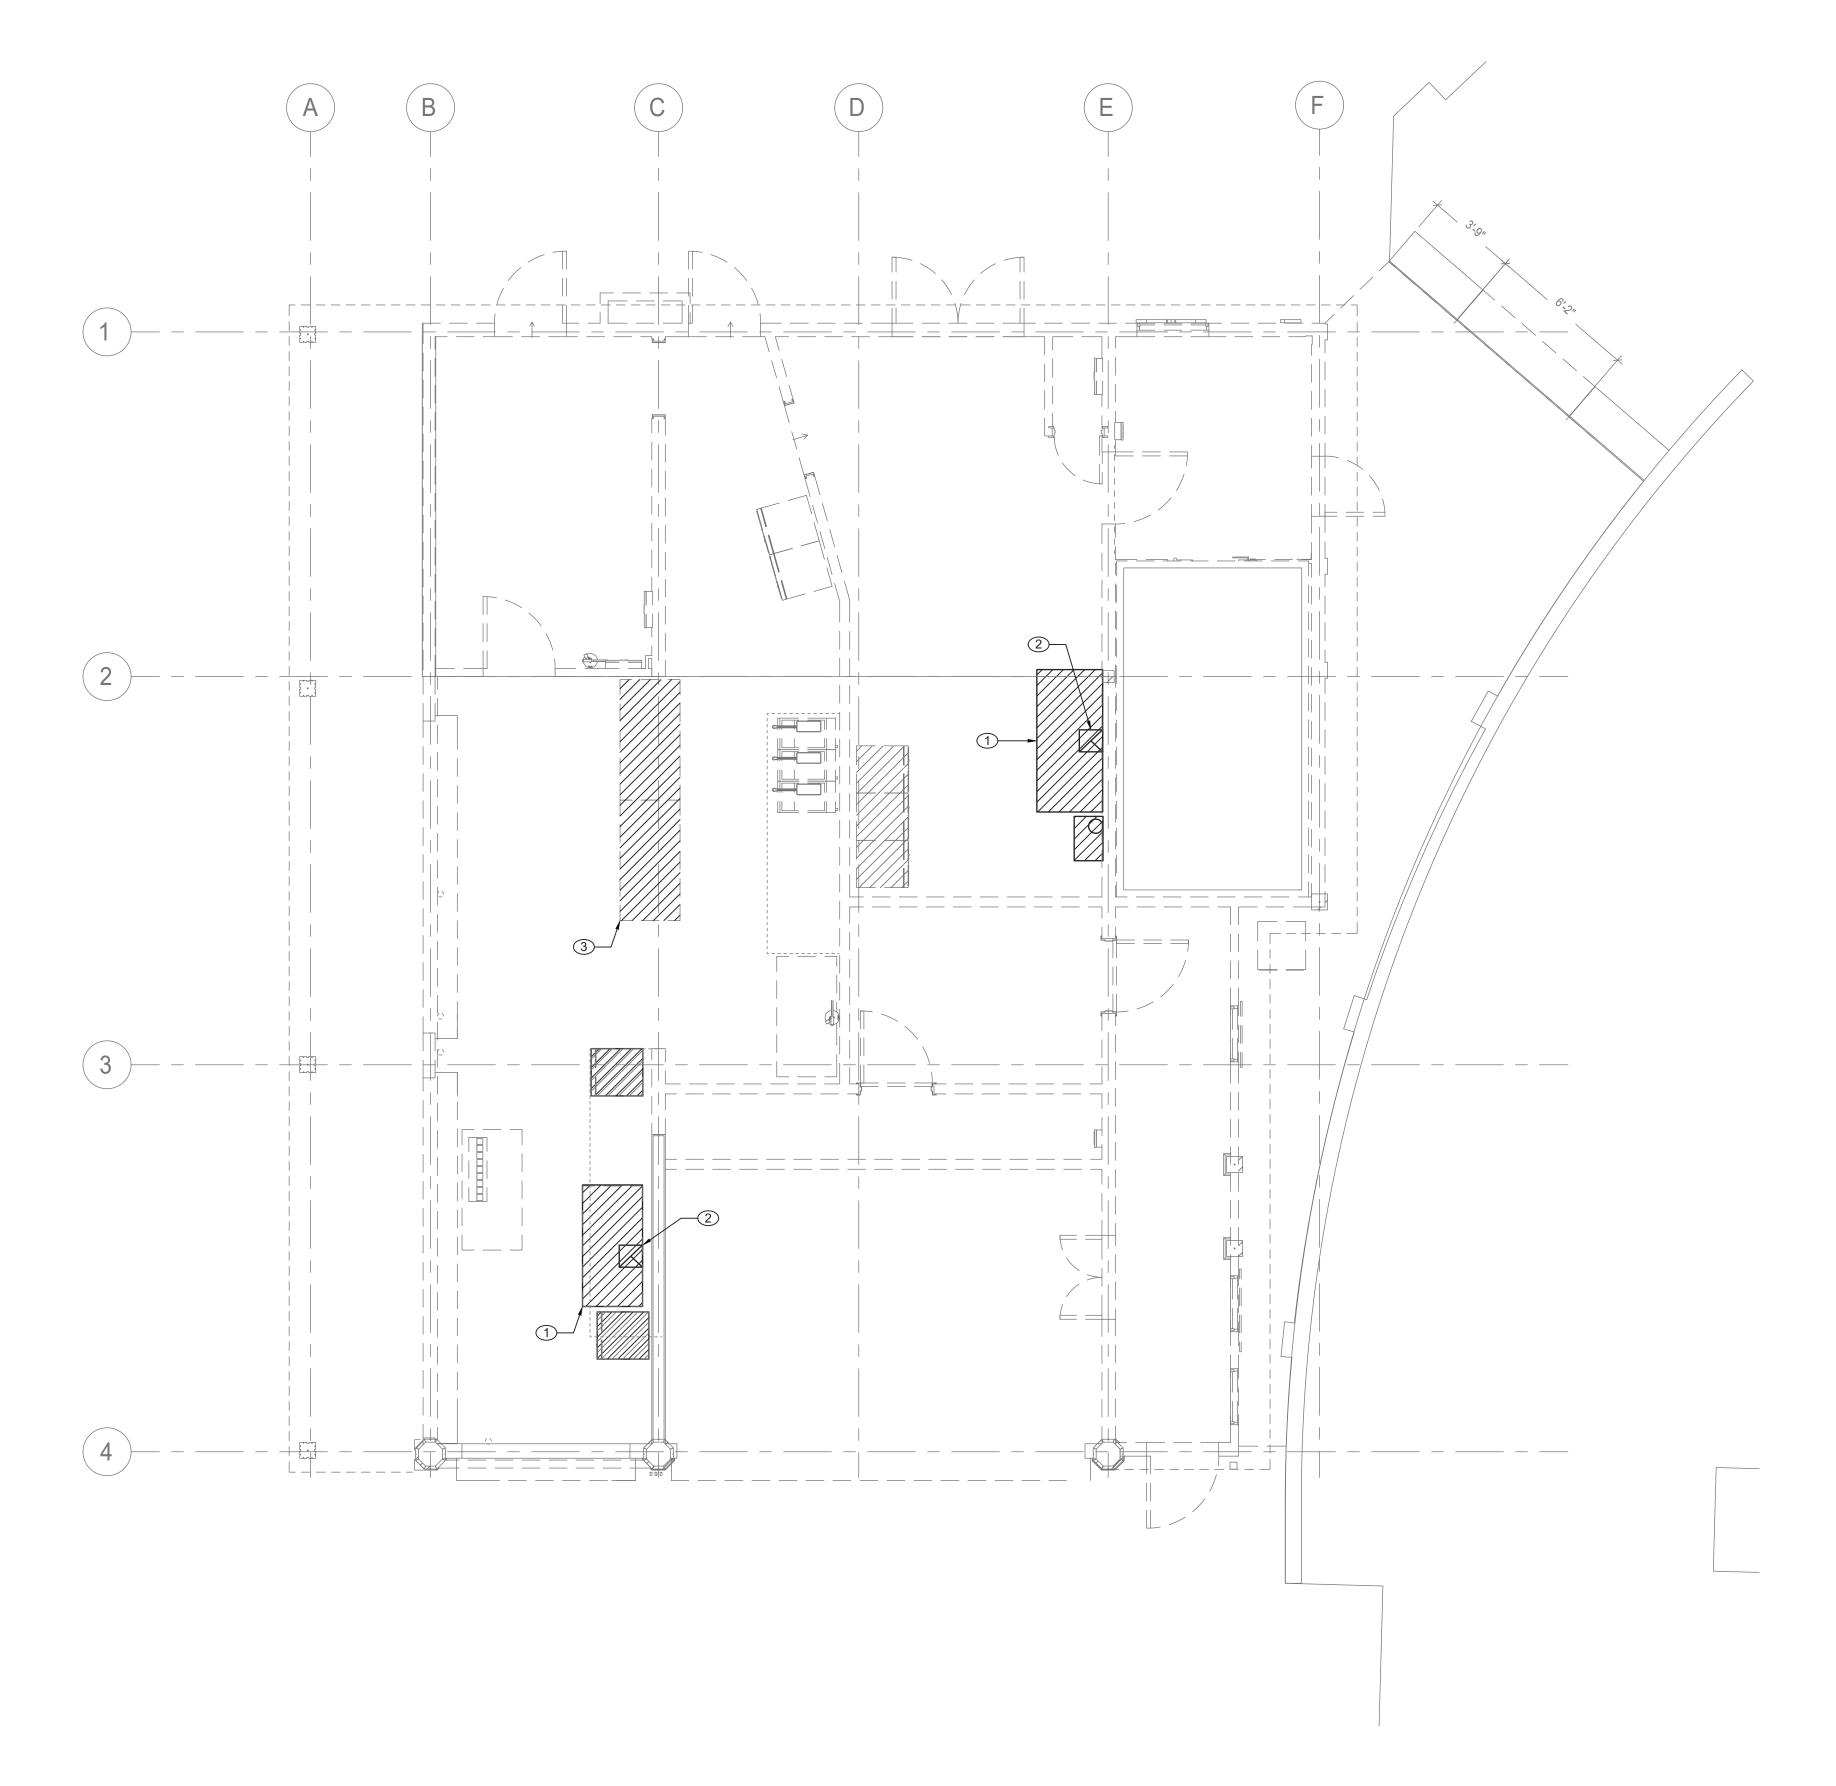

# MECHANICAL FIRST FLOOR DEMOLITION PLAN SCALE: 1/4" = 1'-0"

LiRo Engineers, Inc.

A LiRo Group Company

Syosset, N.Y. 516-214-8157[I]

REVISION DATE MADE BY BY

REVISION

NUMBER DATE BY

REVISION

RECORD DRAWING CERTIFICATION

AS BUILT - CHANGES AS NOTED

CONTRACTOR

PROJECT COORDINATOR

WESTCHESTER COUNTY, NEW YORK
DEPARTMENT OF PUBLIC WORKS AND TRANSPORTATION
DIVISION OF ENGINEERING

INFRASTRUCTURE REHABILITATION - PHASE 3
PLAYLAND PARK, RYE, NEW YORK

RESTAURANT KITCHEN WITH FOOD VENDING

MECHANICAL FIRST FLOOR DEMOLITION PLAN

CONTRACT NUMBER

22-523 K-M-11

DWG NO.: 550 of 664

SCALE: AS INDICATED

DATE: 08/23/2022


DPW FILE 1-118-M-1299-0 REV. NO. 0

## **GENERAL NOTES:**

- 1. RETURN REMOVED EXISTING EQUIPMENT TO OWNER IF IT IS IN WORKING CONDITION.
- 2. CONTRACTOR TO COORDINATE WITH FACILITY WHEN WORKING AROUND OR ABOVE THE RIDE COMPONENTS, AND PROVIDE ALL NECESSARY MEASURES TO PROTECT THESE COMPONENTS PER THE REQUIREMENTS OF THE FACILITY.

# **MECHANICAL DEMOLITION NOTES:**

- 1 REMOVE EXISTING RANGE HOOD AND ASSOCIATED DUCTWORK AND PIPING. DEMOLISH EXISTING ANSUL FIRE PROTECTION SYSTEM AND ASSOCIATED CONTROLS. COORDINATE REMOVAL OF ANSUL SYSTEM WITH FIRE PROTECTION CONTRACTOR AND OWNER.
- 2 REMOVE EXISTING FLUE VENT FOR OVEN. COORDINATE WITH GC TO SEAL EXISTING WALL PENETRATION. PROVIDE FIRE STOPPING TO MATCH EXISTING.
- 3 REMOVE EXISTING CEILING VENTILATION GRILLES.

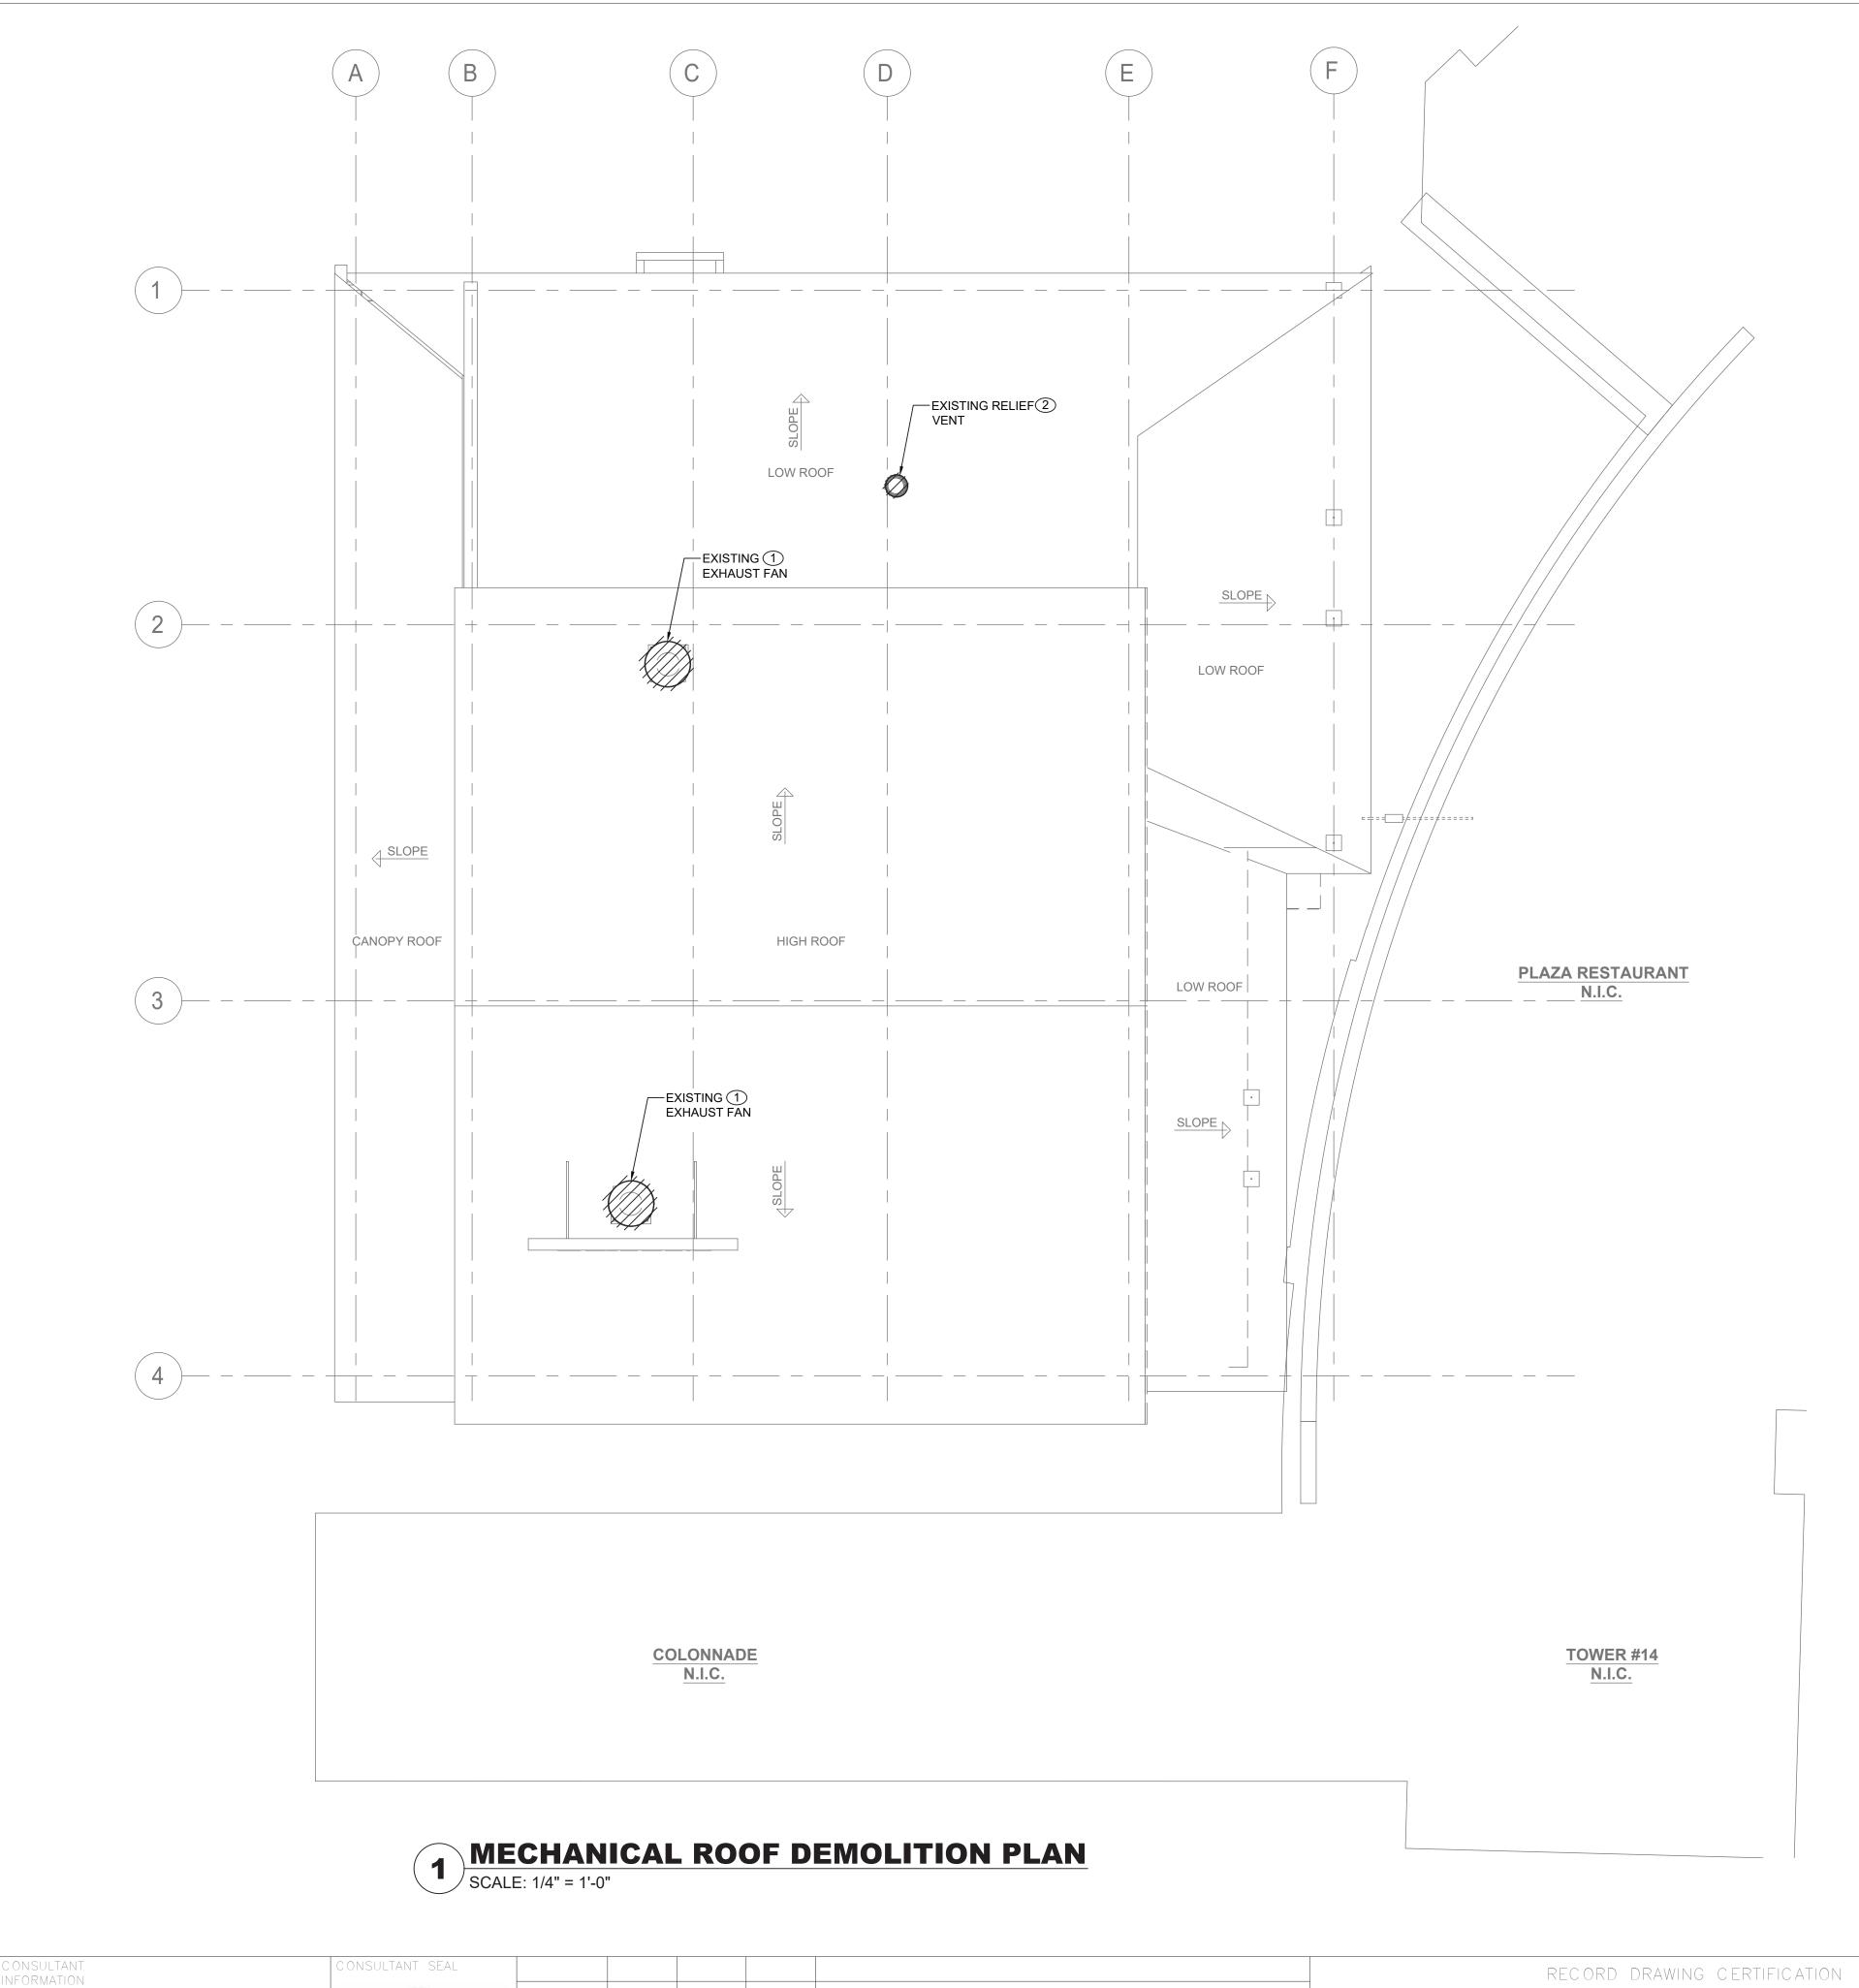


### CONSULTANT SEAL SHEET NUMB ER RECORD DRAWING CERTIFICATION WESTCHESTER COUNTY, NEW YORK 22-523 K-M-12 \_\_\_\_ AS BUILT — NO CHANGES \_\_\_\_ AS BUILT — CHANGES AS NOTED DEPARTMENT OF PUBLIC WORKS AND TRANSPORTATION DIVISION OF ENGINEERING 551 of 664 LiRo Engineers, Inc. A LiRo Group Company Syosset, N.Y. 516-214-8157[T] PROJECT COORDINATOR CONTRACTOR AS INDICATED **INFRASTRUCTURE REHABILITATION - PHASE 3** PLAYLAND PARK, RYE, NEW YORK 08/23/2022 RESTAURANT KITCHEN WITH FOOD VENDING MADE APP'D MECHANICAL ROOF DEMOLITION PLAN DPW FILE 1-118-M-1300-0 NUMBER REVISION

## **GENERAL NOTES:**

- 1. RETURN REMOVED EXISTING EQUIPMENT TO OWNER IF IT IS IN WORKING CONDITION.
- 2. CONTRACTOR TO COORDINATE WITH FACILITY WHEN WORKING AROUND OR ABOVE THE RIDE COMPONENTS, AND PROVIDE ALL NECESSARY MEASURES TO PROTECT THESE COMPONENTS PER THE REQUIREMENTS OF THE FACILITY.

# **MECHANICAL DEMOLITION NOTES:**

- ① DEMOLISH EXISTING EXHAUST FAN AND ASSOCIATED CONTROLS, DUCTWORK AND ACCESSORIES. COORDINATE REMOVAL OF ELECTRICAL POWER AND WIRING WITH ELECTRICAL CONTRACTOR. CONTRACTOR SHALL PATCH EXISTING ROOF PENETRATION TO MATCH EXISTING ROOF.
- ② DEMOLISH EXISTING RELIEF VENT. CONTRACTOR SHALL PATCH EXISTING ROOF PENETRATION TO MATCH EXISTING ROOF.

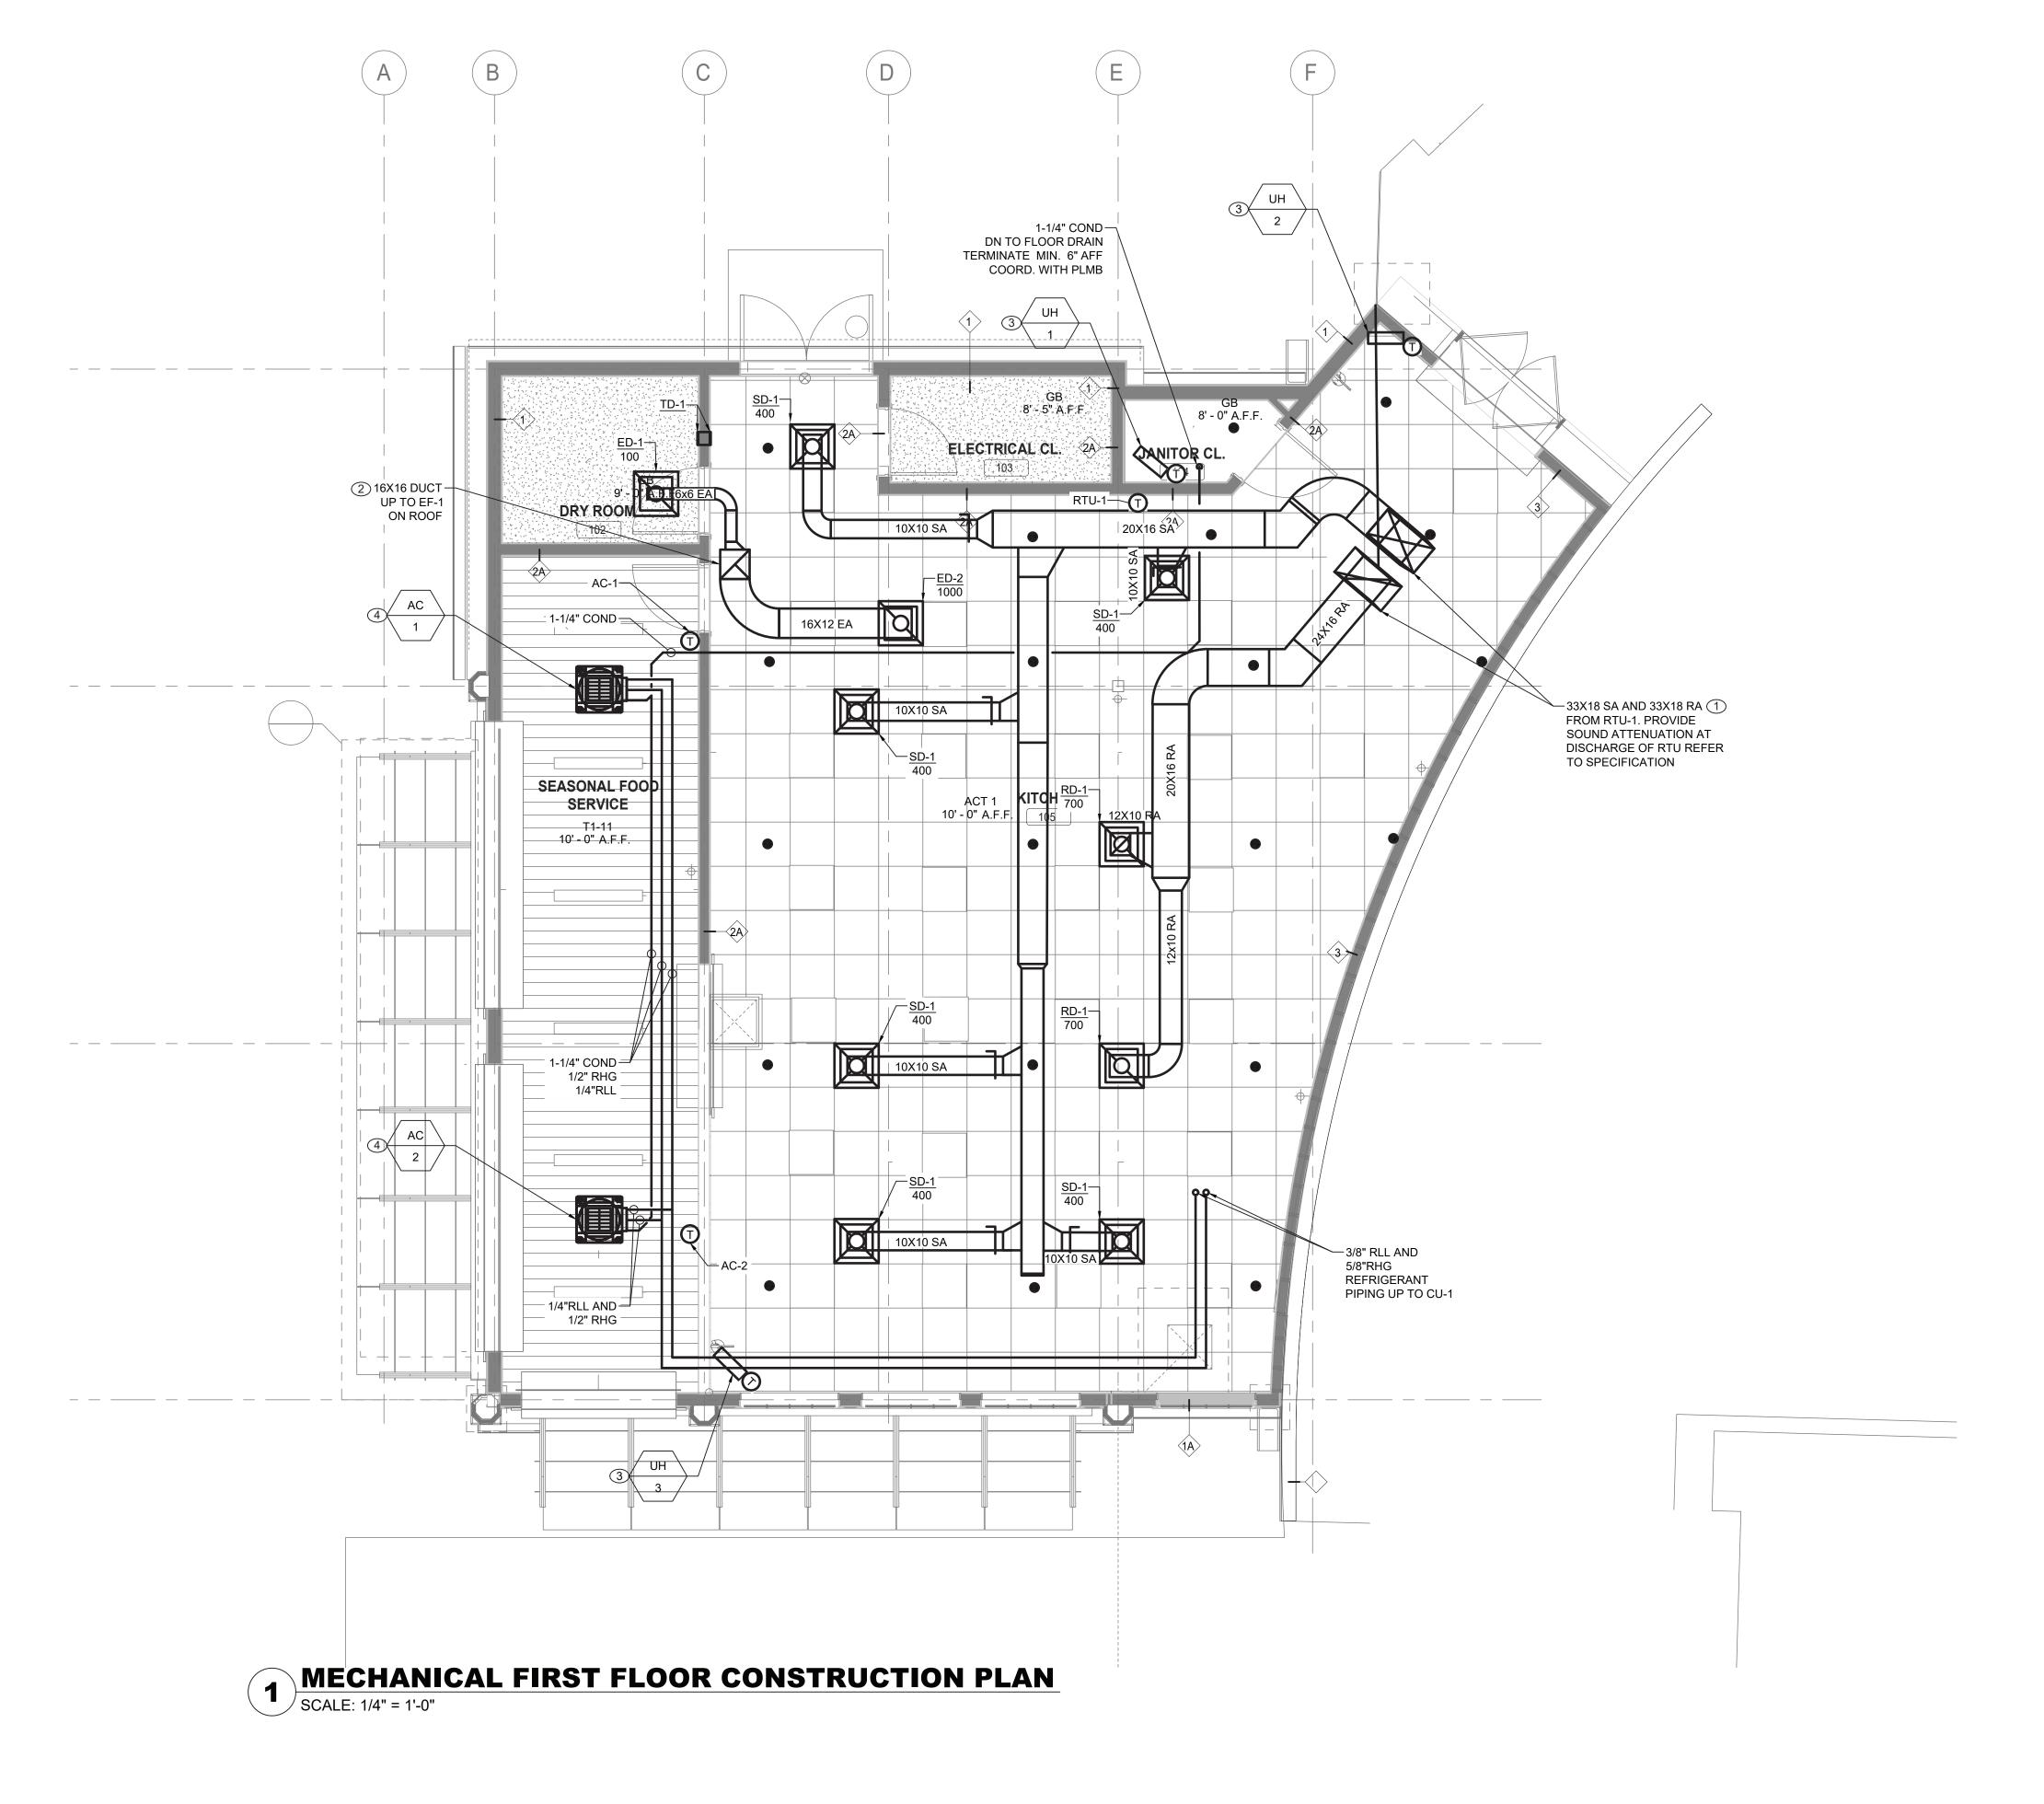

REVISION

RECORD DRAWING CERTIFICATION

AS BUILT - CHANGES AS NOTED

CONTRACTOR

\_\_\_\_ AS BUILT — NO CHANGES

PROJECT COORDINATOR

CONSULTANT INFORMATION

LiRo Engineers, Inc.

A LiRo Group Company

Syosset, N.Y. 516-214-8157[T]

CONSULTANT SEAL

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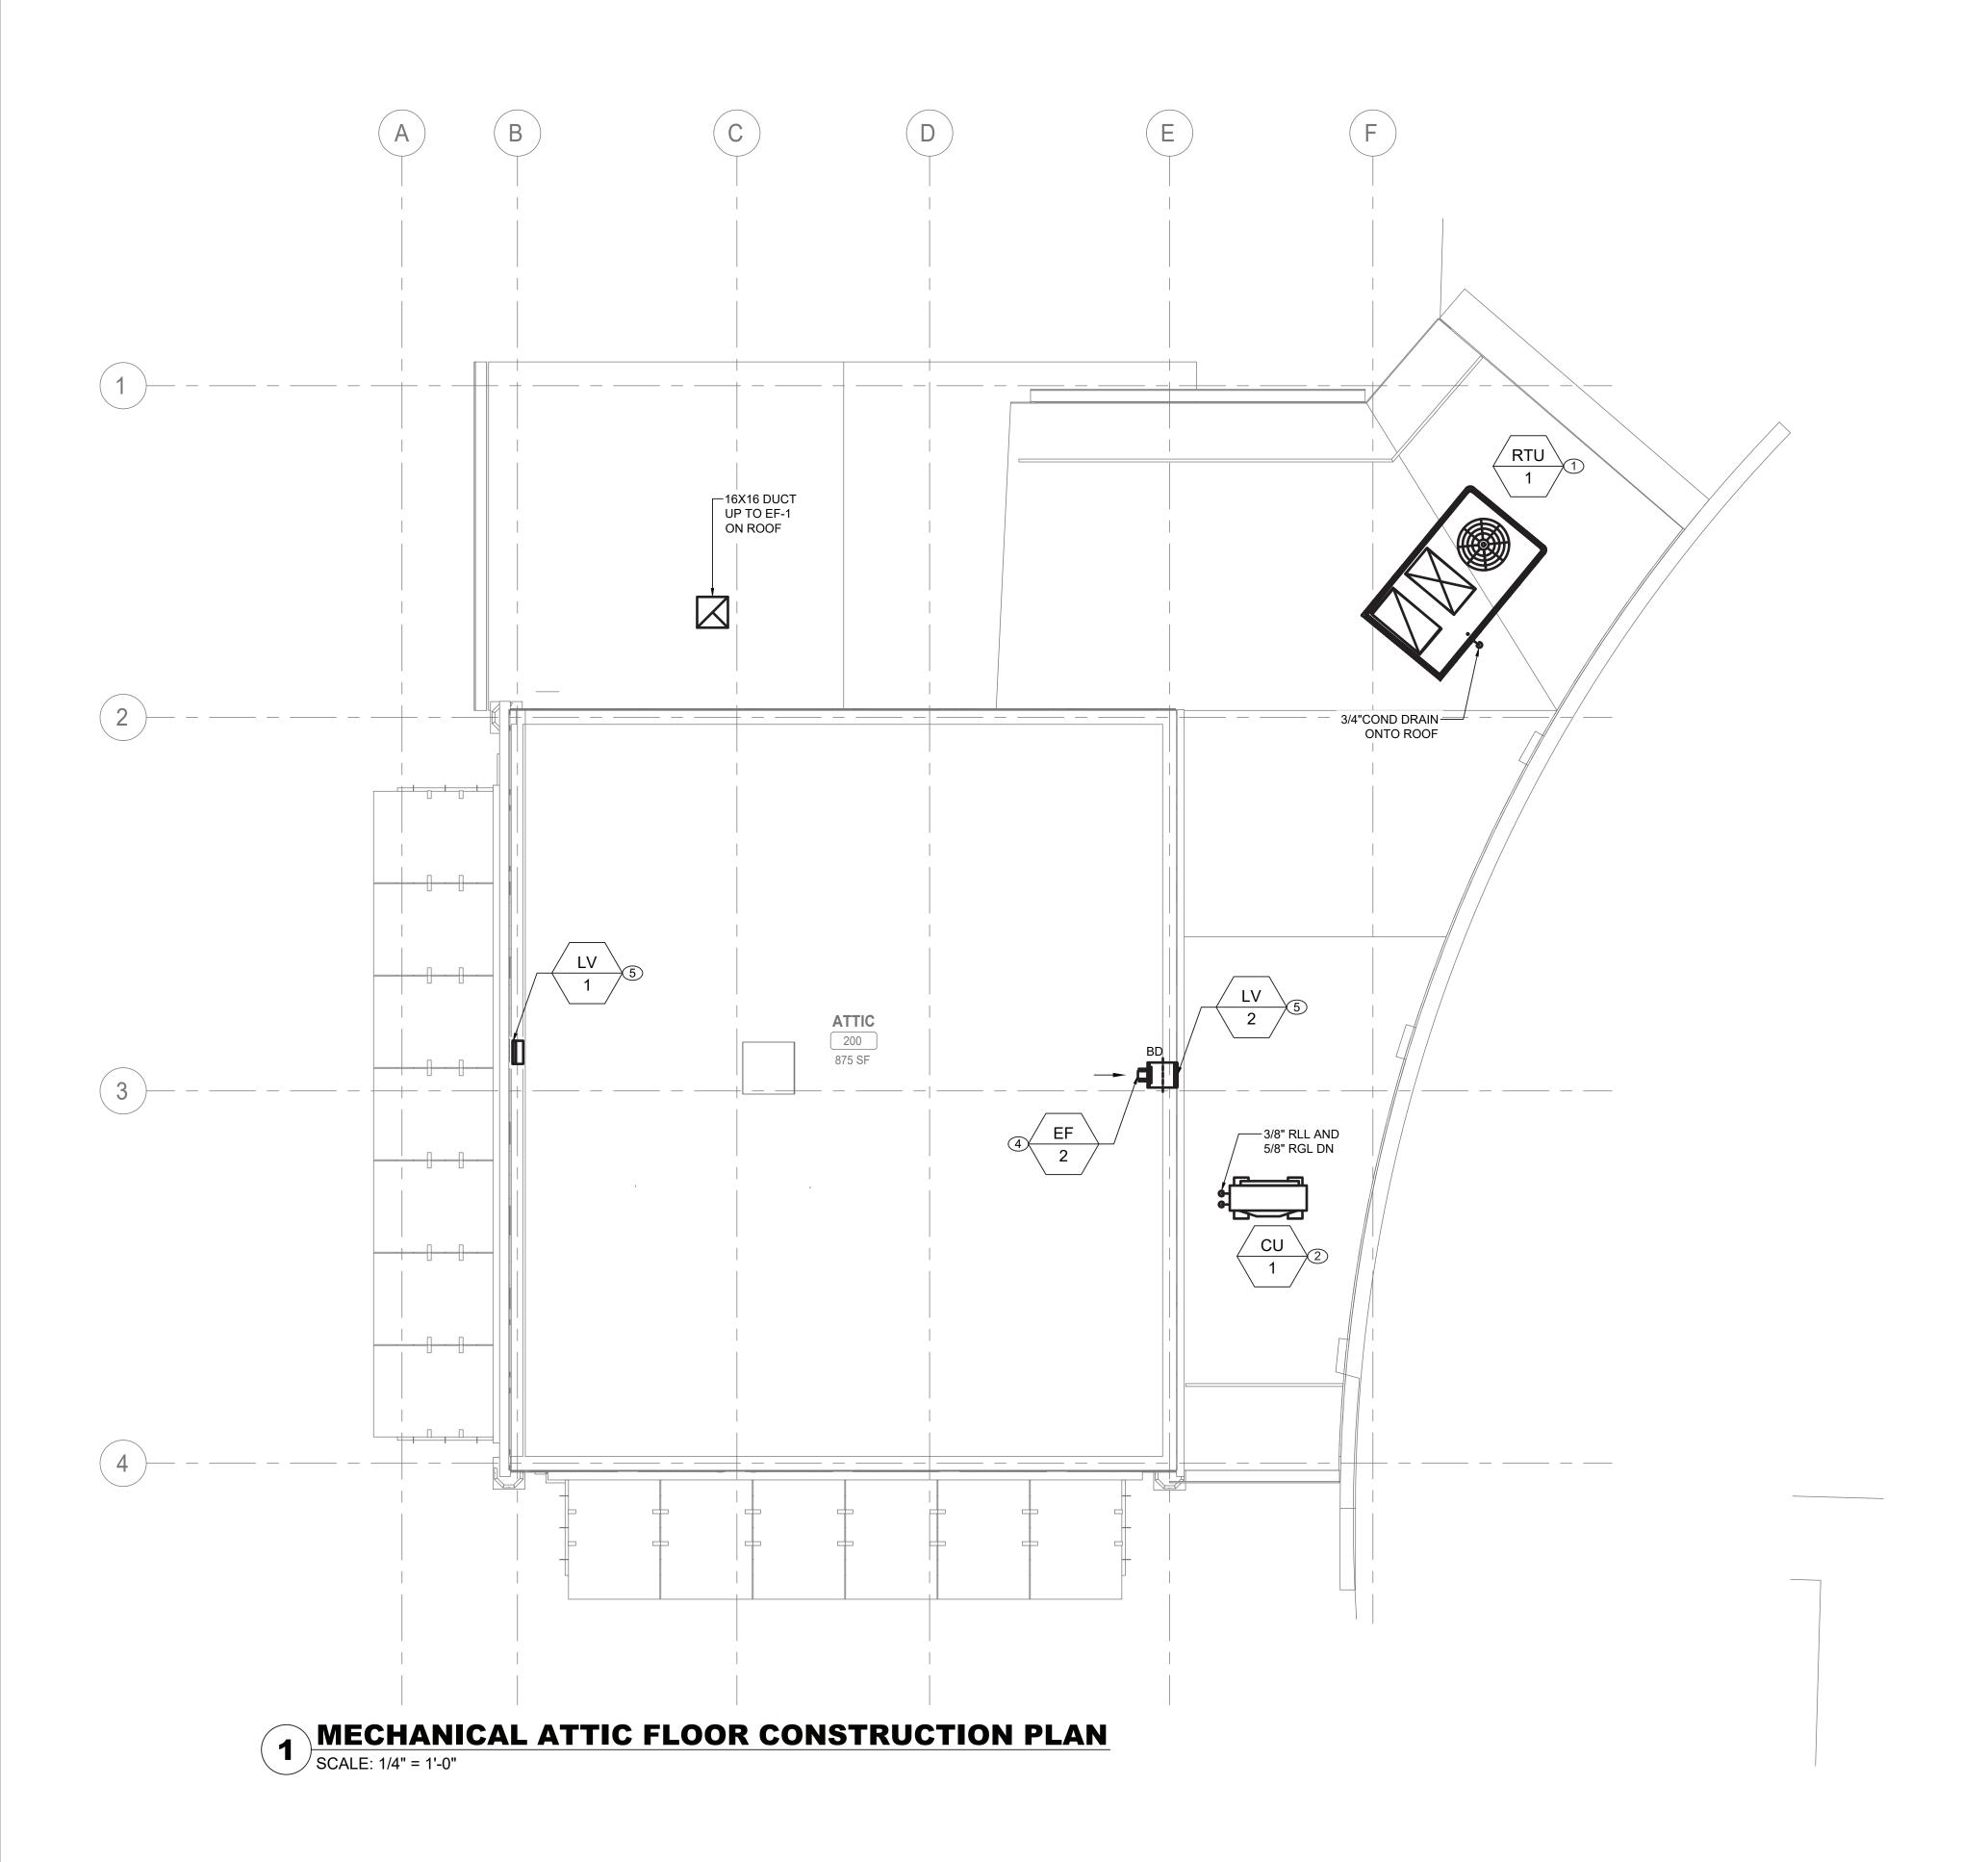
### **GENERAL NOTES:**

- 1. CONTRACTOR TO COORDINATE WITH FACILITY WHEN WORKING AROUND OR ABOVE THE RIDE COMPONENTS, AND PROVIDE ALL NECESSARY MEASURES TO PROTECT THESE COMPONENTS PER THE REQUIREMENTS OF THE FACILITY.
- 2. UPON COMPLETION, SYSTEM SHALL BE TESTED FOR PROPER OPERATION.

## **MECHANICAL CONSTRUCTION NOTES:**

- 1 PROVIDE SUPPLY AND RETURN DUCTWORK FROM ROOFTOP UNIT RTU-1 AND ROUTE ALONG INDICATED PATH. PROVIDE INSULATION TO ALL SUPPLY DUCTWORK. PROVIDE VOLUME DAMPERS AND SUPPLY DIFFUSERS/GRILLES AND BALANCE TO INDICATED VALUES.
- 2 PROVIDE EXHAUST DUCTWORK FROM KITCHEN UP TO ROOFTOP EXHAUST FAN AS INDICATED.
- 3 PROVIDE NEW WALL MOUNTED ELECTRIC UNIT HEATER. COORDINATE INSTALL HEIGHT IN FIELD.
- 4 PROVIDE NEW CEILING MOUNTED INDOOR UNITS AC-1 AND AC-2 AS SHOWN. COORDINATE ELECTRICAL POWER AND WIRING WITH ELECTRICAL DRAWINGS.

CONTRACT NUMBER SHEET NUMBER WESTCHESTER COUNTY, NEW YORK 22-523 K-M-21 DEPARTMENT OF PUBLIC WORKS AND TRANSPORTATION 552 of 664 DIVISION OF ENGINEERING DWG NO.: **AS INDICATED INFRASTRUCTURE REHABILITATION - PHASE 3** PLAYLAND PARK, RYE, NEW YORK 08/23/2022 RESTAURANT KITCHEN WITH FOOD VENDING DPW FILE 1-118-M-1301-0 NUMBER MECHANICAL FIRST FLOOR CONSTRUCTION PLAN




### CONSULTANT INFORMATION SHEET NUMBER CONSULTANT SEAL RECORD DRAWING CERTIFICATION WESTCHESTER COUNTY, NEW YORK 22-523 \_\_\_\_ AS BUILT — NO CHANGES K-M-22 AS BUILT — CHANGES AS NOTED DEPARTMENT OF PUBLIC WORKS AND TRANSPORTATION DIVISION OF ENGINEERING 553 of 664 LiRo Engineers, Inc. A LiRo Group Company Syosset, N.Y. 516-214-8157[T] PROJECT COORDINATOR CONTRACTOR AS INDICATED **INFRASTRUCTURE REHABILITATION - PHASE 3** PLAYLAND PARK, RYE, NEW YORK 08/23/2022 RESTAURANT KITCHEN WITH FOOD VENDING MADE APP'D BY BY DPW FILE **1-118-M-1302-0** NUMBER REVISION MECHANICAL ATTIC FLOOR CONSTRUCTION PLAN

## **GENERAL NOTES:**

- 1. CONTRACTOR TO COORDINATE WITH FACILITY WHEN WORKING AROUND OR ABOVE THE RIDE COMPONENTS, AND PROVIDE ALL NECESSARY MEASURES TO PROTECT THESE COMPONENTS PER THE REQUIREMENTS OF THE FACILITY.
- 2. UPON COMPLETION, SYSTEM SHALL BE TESTED FOR PROPER OPERATION.

### **MECHANICAL CONSTRUCTION NOTES:**

- 1 PROVIDE SUPPLY AND RETURN DUCTWORK FROM ROOFTOP UNIT RTU-1 AND ROUTE ALONG INDICATED PATH. PROVIDE INSULATION TO ALL SUPPLY DUCTWORK. PROVIDE VOLUME DAMPERS AND SUPPLY DIFFUSERS/GRILLES AND BALANCE TO INDICATED VALUES. PLACE UNIT ON NEW ROOF CURB AS SHOWN ON K-M-82.
- 2 PROVIDE NEW OUTDOOR SPLIT CONDENSER AIR CONDITIONER UNIT ON ROOF AS SHOWN. COORDINATE ELECTRICAL POWER AND WIRING WITH ELECTRICAL DRAWINGS. PLACE UNIT ON EQUIPMENT RAILS AS SHOWN ON K-M-81
- 3 PROVIDE NEW PACKAGED TERMINAL AIR CONDITIONER UNIT. COORDINATE ELECTRICAL POWER AND WIRING WITH ELECTRICAL DRAWINGS.
- 4 PROVIDE NEW EXHAUST FAN AS SCHEDULED. COORDINATE ELECTRICAL POWER AND WIRING WITH ELECTRICAL CONTRACTOR. INSTALL EF-2 AT 6'0" ABOVE ATTIC FLOOR TO CENTER.
- 5 PROVIDE NEW RAIN RESISTANT LOUVERS AS SCHEDULED. INSTALL LV-1 AND LV-2 AT 6'0" ABOVE ATTIC FLOOR TO CENTER.

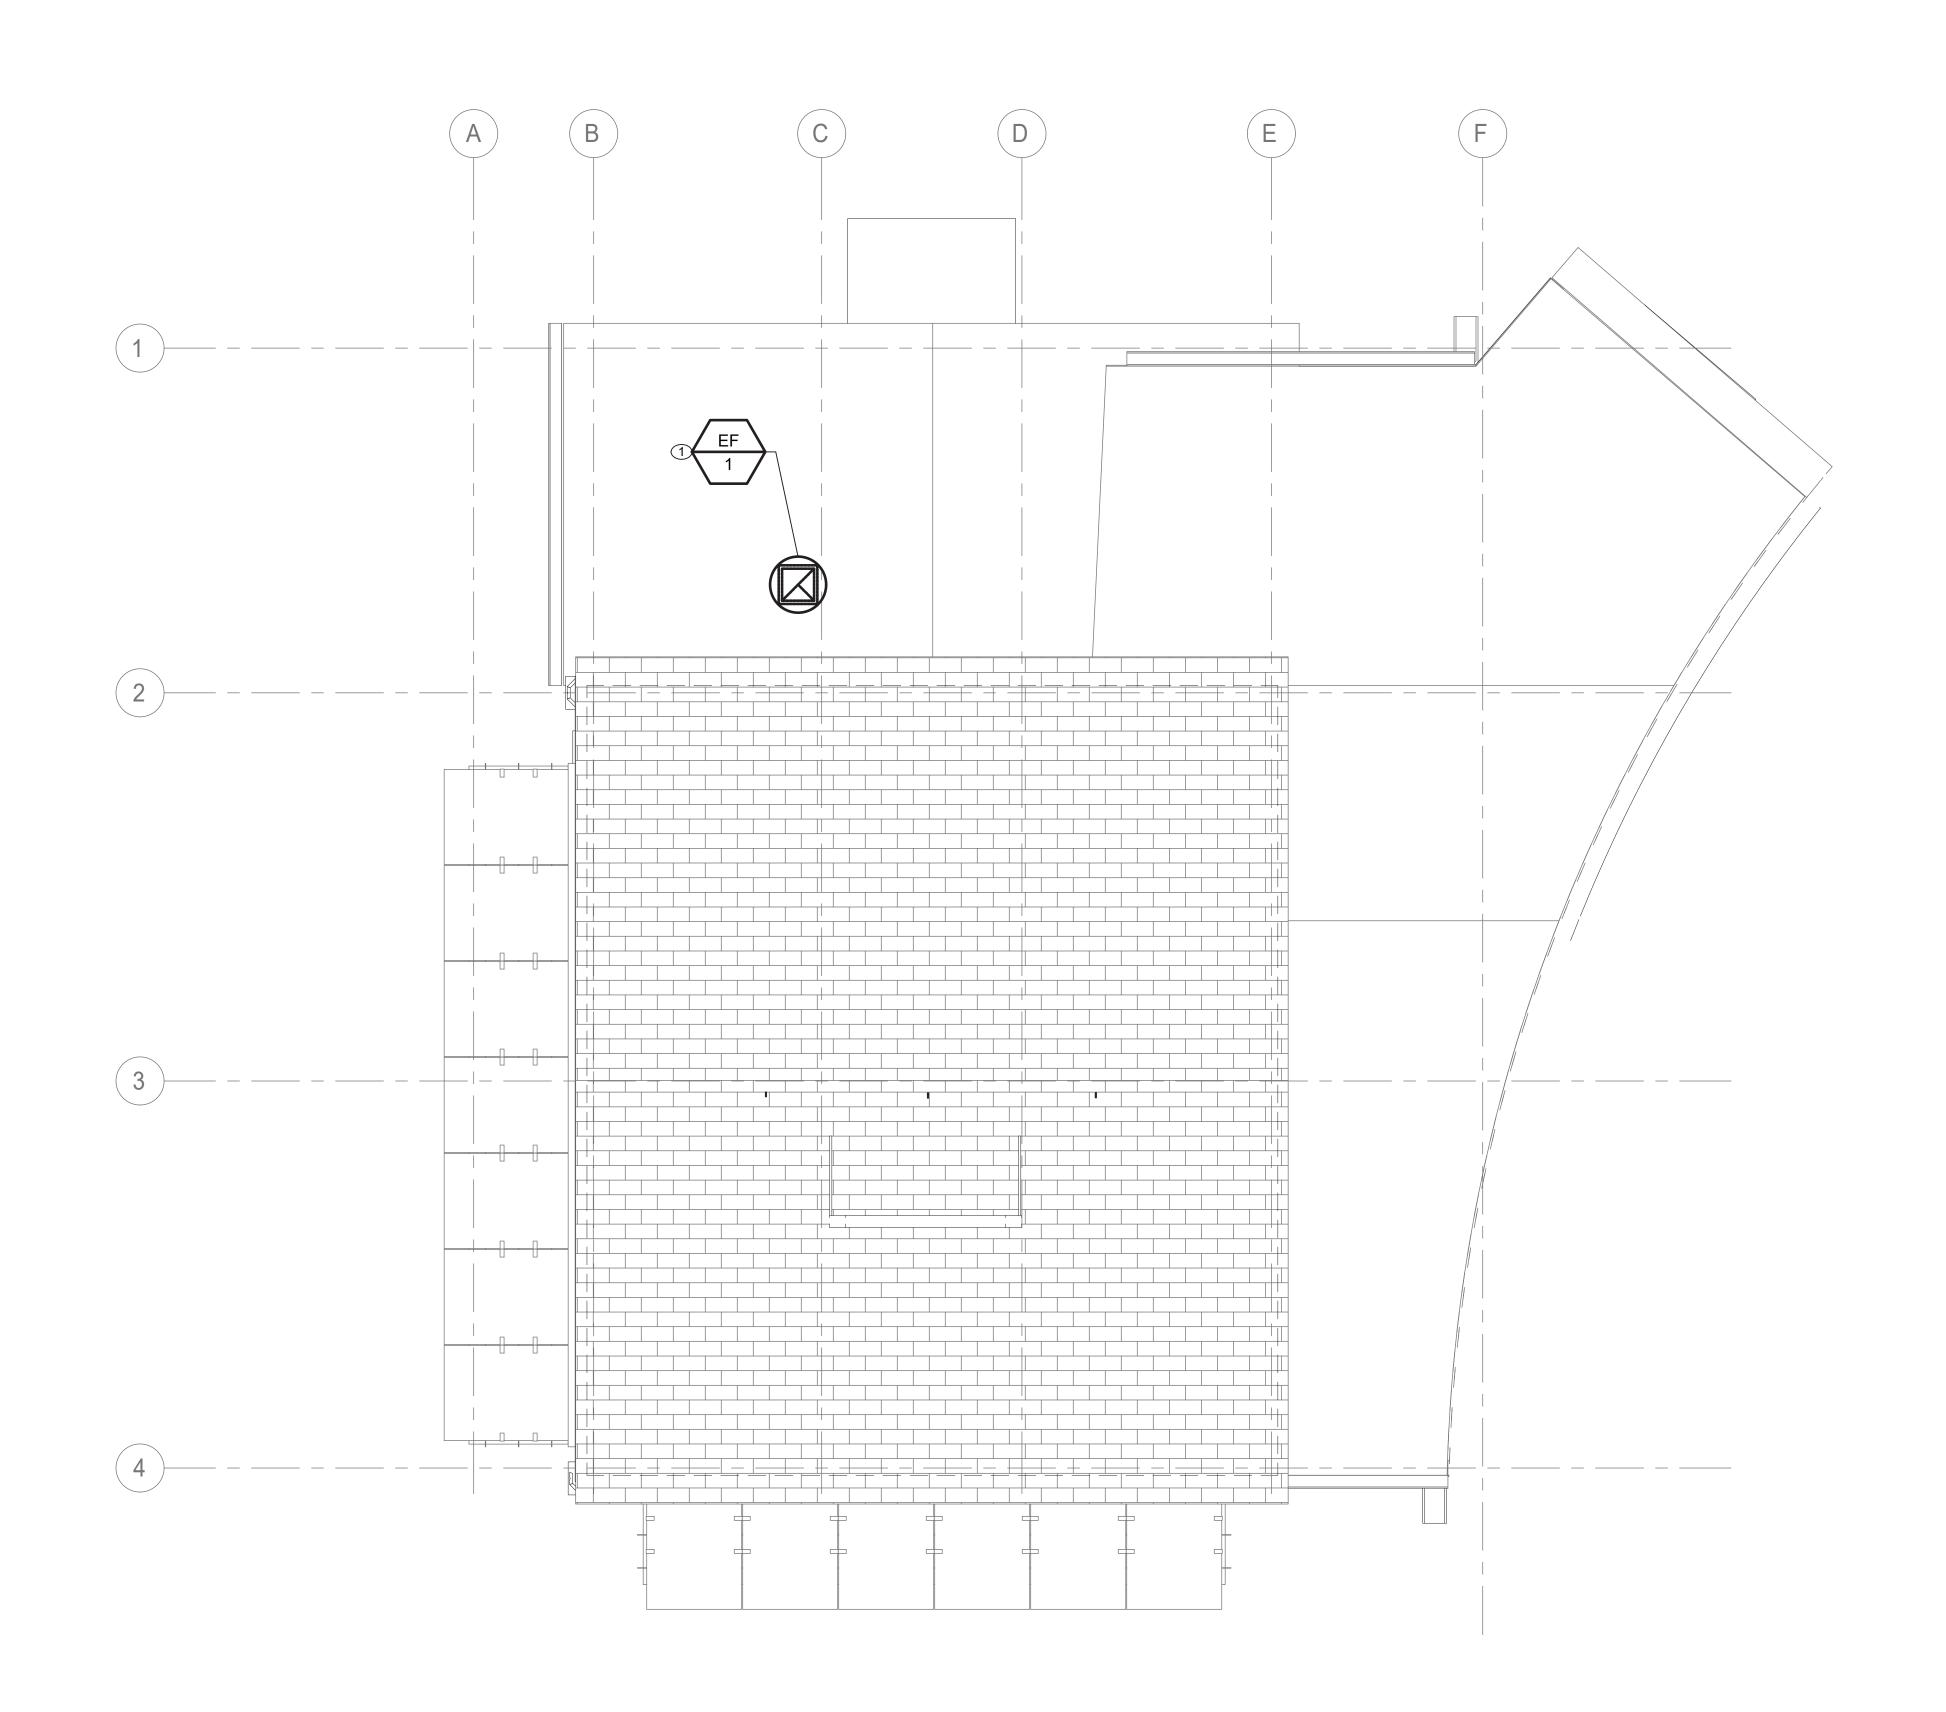

# MECHANICAL ROOF CONSTRUCTION PLAN SCALE: 1/4" = 1'-0"

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	Syosset, N.Y.	516-214-8157[T]	//3

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	REVISION NUMBER	DATE	MADE BY	APP'D BY	REVISION	J

# RECORD DRAWING CERTIFICATION AS BUILT — CHANGES AS NOTED \_\_\_\_\_ AS

CONTRACTOR

AS BUILT — NO CHANGES

PROJECT COORDINATOR

WESTCHESTER COUNTY, NEW YORK
DEPARTMENT OF PUBLIC WORKS AND TRANSPORTATION
DIVISION OF ENGINEERING

INFRASTRUCTURE REHABILITATION - PHASE 3

RTATION 22-523

DWG NO.:

SCALE: A

CONTRACT
NUMBER

22-523

K-M-23

554 of 664

DWG NO.:

SCALE: AS INDICATED

INFRASTRUCTURE REHABILITATION - PHASE 3
PLAYLAND PARK, RYE, NEW YORK
RESTAURANT KITCHEN WITH FOOD VENDING
MECHANICAL ROOF CONSTRUCTION PLAN

**GENERAL NOTES:** 

REQUIREMENTS OF THE FACILITY.

MANUFACTURER WARRANTY.

1. CONTRACTOR TO COORDINATE WITH FACILITY WHEN WORKING AROUND OR ABOVE THE RIDE

**MECHANICAL CONSTRUCTION NOTES:** 

1 PROVIDE NEW EXHAUST FAN AS SCHEDULED. COORDINATE ELECTRICAL POWER AND WIRING WITH ELECTRICAL DRAWINGS. ENSURE ALL WORK IMPACTING ROOF IS DONE IN ACCORDANCE WITH ROOFING

2. UPON COMPLETION, SYSTEM SHALL BE TESTED FOR PROPER OPERATION.

COMPONENTS, AND PROVIDE ALL NECESSARY MEASURES TO PROTECT THESE COMPONENTS PER THE

DATE: 08/23/2022

DPW FILE 1-118-M-1303-0

### ROOFTOP AIR CONDITIONING UNIT SCHEDULE HEATING COMPRESSOR SUPPLY FAN DX COOLING CONDENSER ELECTRICAL **OPERATING** DIMENSIONS NOM. CAP. MIN. OA OA AIR ESP MOTOR (IN) BHP TOTAL SENSIBLE EAT EAT LAT LAT CAP. CAP. DB WB DB WB CAP. (MBH) (°F) (°F) (°F) (°F) (°F) (MBH) LOCATION LxWxH NOTES TAG MANUFACTURER MODEL WEIGHT MER REFRIG AMB. TEMP FAN TYPE/QTY MCA MOCP V-PH-HZ (±LBS) (FT) V TYPE (°F) (CFM) (MBH) (°F) (°F) (°F) 2" 13 R-410A THC092F3RNA ROOF 7.5 1100 2400 0.50 0.55 87.5 70.4 80.2 64.3 54.4 52.1 36.0 122.9 0.72 | 12.60 | 104 | 110 | 208-3-60 | TRANE SCROLL/2 1228 7.4X4.4X3.9 1,2,3,4 PLEATED NOTES:

REVISION

1. PROVIDE DOWNFLOW SUPPLY AND RETURN UNIT CONFIGURATION, OVERSIZE SUPPLY FAN MOTOR, MOTORIZED OUTSIDE AIR DAMPER, NON-FUSED DISCONNECT, ECONOMIZER, ECONOMIZER HOOD, BAROMETRIC RELIEF HOOD AND 14" ROOF CURB.

2. FACTORY CONTROLS TO BE PROVIDED BY MANUFACTURER.

3. PROVIDE WITH MERV 13 FILTERS AND OPTION FOR UV LIGHT FILTRATION KIT.

4. INSTALL AND SIZE REFRIGERANT PIPING PER MANUFACTURER'S SPECIFICATION.

4. PROVIDE DIGITAL CONTROLLER WITH DISPLAY CAPABLE OF DEMAND CONTROL VENTILATION AND ECONOMIZER MODE. CONTRACTOR TO PROVIDE TRANSFORMER AND POWER AS REQUIRED.

	DUCTLESS SPLIT SYSTEM HEAT PUMP SCHEDULE														
	ASSOCIATED	mountain and a				SUPPLY FAN	COOLIN	NG	HE	ATING	ELE	ECTRICAL			
UNIT TAG (INDOOR)	OUTDOOR UNIT	MANUFACTURER	MODEL	LOCATION/SERVICE	REFRIGERANT	CFM	TOTAL/SENS. (MBH)	EAT DB/WB	мвн	EAT/LAT DB	VPHCY.	MCA	МОСР	WEIGHT	NOTES
AC-1	CU-1	MITSUBISHI	PLFY-P18NFMU-E	SEASONAL FOOD SERVICE	R410A	460	18.0/18.0	81/66	20.0	68/90	208-1-60	0.50	15	31.3	1,2,3,4
AC-2	CU-1	MITSUBISHI	PLFY-P18NFMU-E	SEASONAL FOOD SERVICE	R410A	460	18.0/18.0	81/66	20.0	68/90	208-1-60	0.50	15	31.3	1,2,3,4
NOTES:		th st				<u> </u>	<u>-</u> -		!	•		•	<u>.</u>		-
1. UNIT CAPACITY INDICA	ATED AS SIZING CRITE	RIA.													
2. PROVIDE UNIT WITH V	VIRED WALL MOUNTE	D THERMOSTAT.													
3. PROVIDE ALL INDOOF	R UNIT WITH INTREGAT	ED CONDENSATE PUM	IP												

UNIT TAG (OUTDOOR)	MANUFACTURER	MODEL	NOMINAL COOLING (BTU/HR)	NOMINAL HEATING (BTU/HR)	SERVICE	SEER	СОР	VPHCY.	MCA	МОСР	WEIGHT	NOTES
CU-1	MITSUBISHI	PUMY-P36NKMU3-BS	36000	42000	SEASONAL FOOD SERVICE	22.3	4	208-1-60	29.0	44.0	271.0	1,2

		FAN S	CHE	DUL
 · · · · · · · · · · · · · · · · · · ·				

TAG	MANUFACTURER	MODEL	LOCATION	SERVICE	TYPE	DRIVE	AIR FLOW	TSP		ELECT	RICAL	2	OPERATING WEIGHT	DIMENSIONS Dx H	NOTES
IAG	MANOT ACTORER	MODEL	LOCATION	SERVICE		DICIVE	(CFM)	(IN. WG)	HP	BHP	RPM	V-PH-HZ	(±LBS)	(IN)	NOTES
EF-1	GREENHECK	G-130-VG	ROOF	KITCHEN / TRASH RM	CENTRIFUGAL	DIRECT	1100	0.25	0.25	0.09	906	115-1-60	24	19x 19	1,2,3,4,5
EF-2	GREENHECK	SE1-8-440-VG	ATTIC	ATTIC	AXIAL	DIRECT	50	0.05	0.07	0.00	638	115-1-60	16	13X13	1,2,3,4,6

NOTES:

1. PROVIDE ALL CONTACTS, RELAYS, AND DEVICES NECESSARY FOR BMS CONTROL OF FANS PER SEQUENCE OF OPERATIONS.

2. PROVIDE THERMAL OVERLOAD FOR ALL SINGLE PHASE MOTORS.

3. PROVIDE SALT WATER RESISTANT HI-PRO POLYESTER COATING FOR ALL FANS.

4. FAN SHALL BE FURNISHED WITH NON FUSED DISCONNECT.

5. PROVIDE 12" ROOF CURBS FOR ALL ROOF MOUNTED FANS. INCLUDE 1.5" INSULATION ON CURB.

6. PROVIDE WALL HOUSING.

2. PROVIDE UNIT WITH 16" ROOF STAND.

ELECTRIC UNIT HEATER SCHEDULE													
TAG	MANUFACTURER	MODEL	SERVICE	TYPE	кw	AMPS	V-PH-HZ	NOTES					
UH-1	TRANE	UHEC-031A0C0	WATER SERVICES RM	WALL HUNG	3.3	15.9	208-1-60	1					
UH-2	TRANE	UHEC051AACA	KITCHEN	WALL HUNG	5	24.1	208-1-60	1					
UH-3	TRANE	UHEC051AACA	KITCHEN	WALL HUNG	5	24.1	208-1-60	1					
NOTES:	1				1								

	LOUVER SCHEDULE											
TAG	MANUFACTURER	MODEL	SERVICE	LOCATION	MATERIAL	FINISH TYPE	WIDTH (INCH)	HEIGHT (INCH)	FREE AIR VELOCITY (FPM)	PRESSURE DROP (IN. WG)	MINIMUM FREE AREA (SQUARE FEET)	NOTES
LV-1	GREENHECK	ESD-635	EXHAUST	ATTIC	ALUMINUM	BAKED ENAMEL	12	12	-	-	0.19	2
LV-2	GREENHECK	ESD-635	EXHAUST	ATTIC	ALUMINUM	BAKED ENAMEL	12	12	263	0.05	0.19	1
NOTES:					•							
1. PROVI	DE WITH ALUMINUM	BIRD SCREE	N AND BACKDE	RAFT DAMPERS.								
2. PROVII	DE WITH ALUMINUM	BIRD SCREE	N ONLY.									


	AIR INLET / OUTLET SCHEDULE											
TAG	MANUFACTURER	MODEL	SERVICE	NECK SIZE (IN)	FACE SIZE (IN)	MOUNTING	CFM	MAX PD (wg)	MAX VELOCITY	MAX NC	NOTES	
SD-1	TITUS	TMS	GENERAL SUPPLY	12	24x24	LAY-IN / GYP	321-425	0.10	600	30	1, 2, 3	
RD-1	TITUS	50F	GENERAL RETURN	14X14	24x24	LAY-IN / GYP	528-732	0.05	600	30	1, 3	
ED-1	TITUS	50F	GENERAL EXHAUST	6X6	24x24	LAY-IN / GYP	0-95	0.05	600	30	1, 3	
ED-2	TITUS	50F	GENERAL EXHAUST	16X16	24X24	LAY-IN / GYP	732-972	0.50	600	30	1, 3	
TG-1	TITUS	SG-LFF	TRANSFER	-	6X6	WALL MOUNTED	70	0.03	400	-	1	
NOTES:	•		<u> </u>	•						Ti-		
1. COORDIN	IATE AND CONFIRM CEI	LING AND/OR W	/ALL MOUNT (T-BAR, SURF	ACE, REINFOR	CEMENT, ETC) V	VITH ARCHITECTURA	AL RCP AND V	VALL CONSTR	RUCTION BEFO	RE ORDERI	NG.	


3. INTEGRAL VOLUME DAMPERS NOT ACCEPTABLE. VOLUME DAMPERS PROVIDED BY MECHANICAL CONTRACTOR ON ALL RUN-OUTS. EXCEPTIONS REQUIRE APPROVAL WHEN REQUIRED.

CONSULTANT INFORMATION SHEET NUMBER CONSULTANT SEAL RECORD DRAWING CERTIFICATION WESTCHESTER COUNTY, NEW YORK NUMBER 22-523 K-M-61 \_\_\_\_ AS BUILT — CHANGES AS NOTED \_\_\_\_ AS BUILT — NO CHANGES DEPARTMENT OF PUBLIC WORKS AND TRANSPORTATION DIVISION OF ENGINEERING 555 of 664 DWG NO.: CONTRACTOR PROJECT COORDINATOR SCALE: **AS INDICATED INFRASTRUCTURE REHABILITATION - PHASE 3** PLAYLAND PARK, RYE, NEW YORK 08/23/2022 **RESTAURANT KITCHEN WITH FOOD VENDING** DATE MADE APP'D BY DPW FILE 1-118-M-1304-0 NUMBER MECHANICAL SCHEDULES

1. PROVIDE UNIT MOUNTED 2 STAGE THERMOSTAT.


2. PROVIDE WITH MOLDED INSULATION BLANKET.

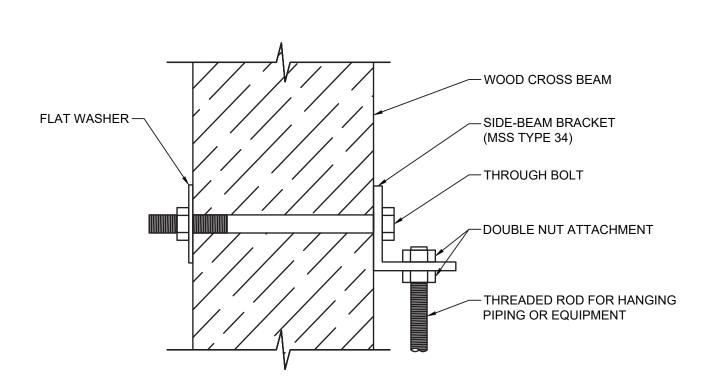

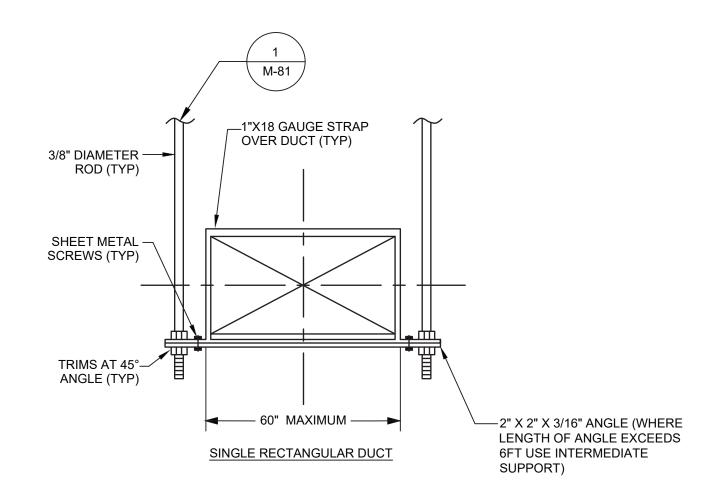


# MECHANICAL ANCHORING DETAIL M-81 / SCALE: NOT TO SCALE


# MECHANICAL DUCT HANGER DETAIL / SCALE: NOT TO SCALE

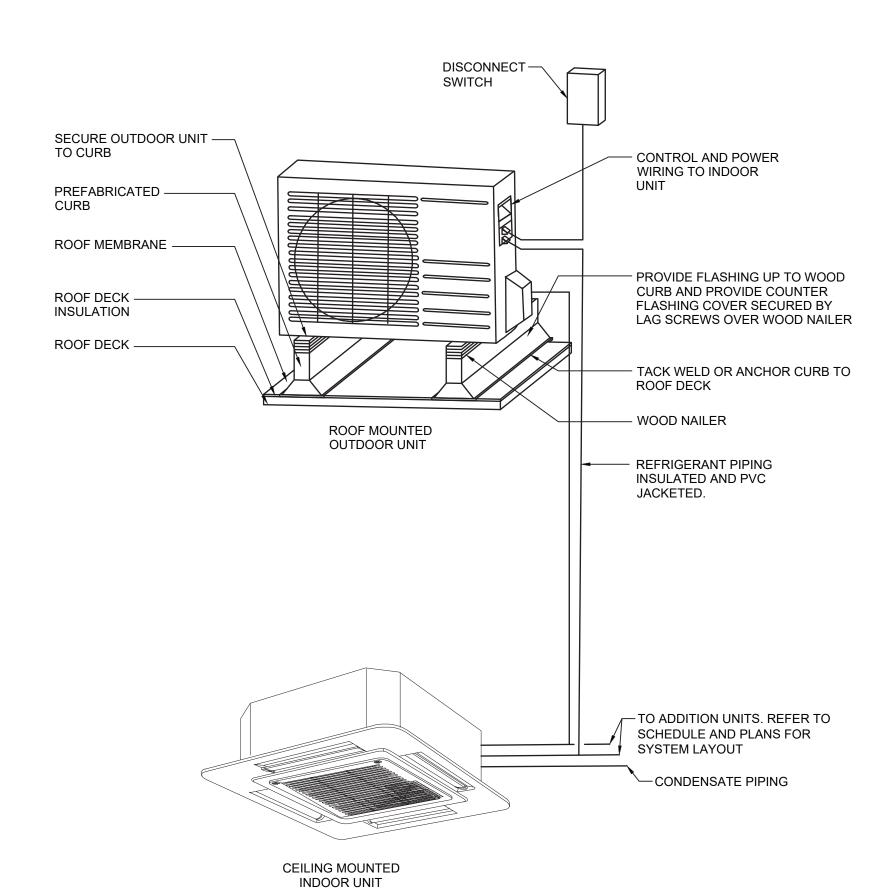



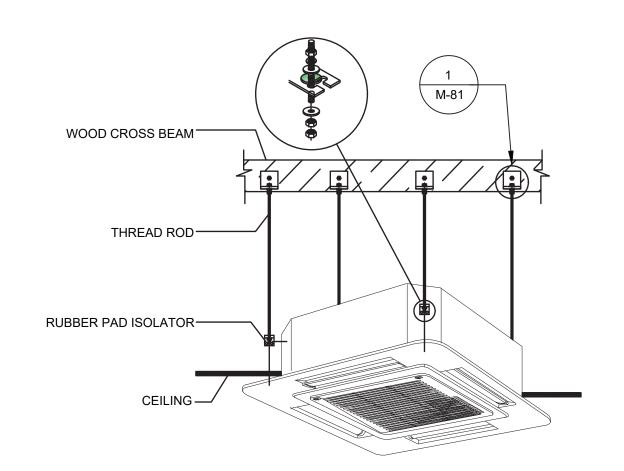


SPLIT CEILING CASSETTE MOUNTING DETAIL M-81 / SCALE: NOT TO SCALE

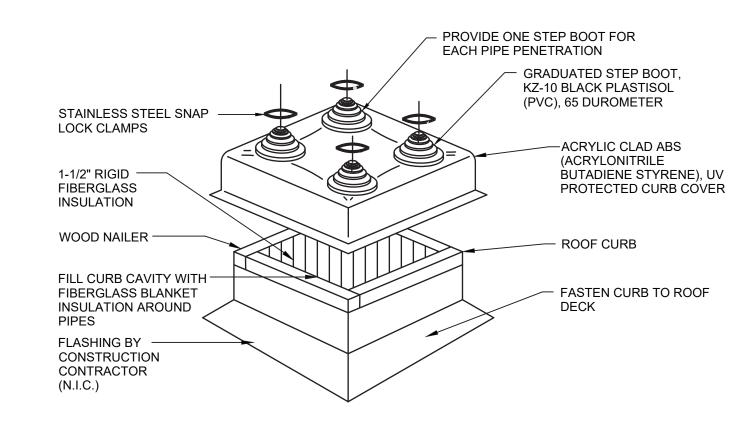



MECHANICAL REFRIG. PENETRATION DETAIL SCALE: NOT TO SCALE

TITLE \_\_\_\_\_ DATE \_\_\_

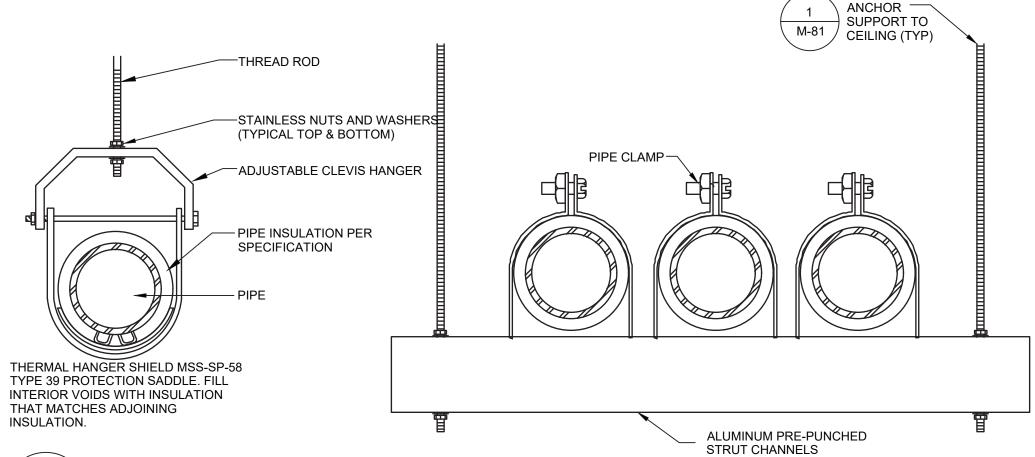


MECHANICAL PIPE HANGER DETAIL M-81 / SCALE: NOT TO SCALE

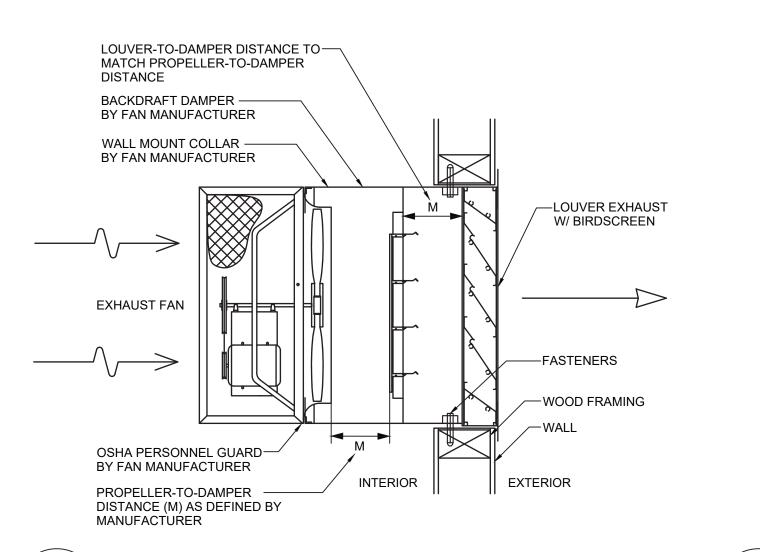

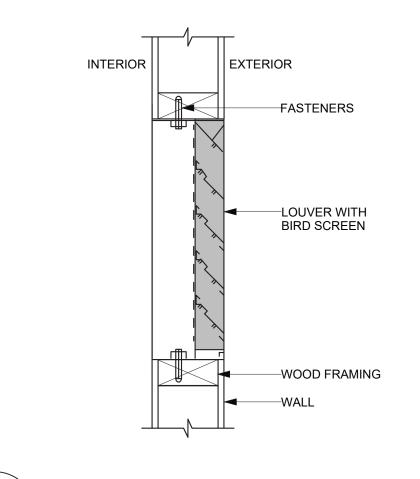

**PROPELLER FAN DETAIL** M-81 / SCALE: NOT TO SCALE

**MECHANICAL LOUVER** M-81 / SCALE: NOT TO SCALE

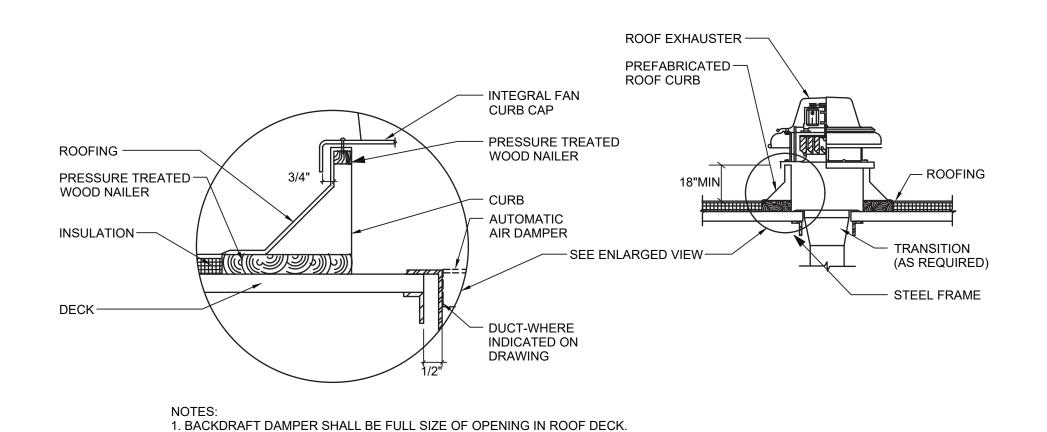

MECHANICAL ROOF FAN DETAIL M-81 / SCALE: NOT TO SCALE

CONSULTANT LiRo Engineers, Inc.

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	REVISION NUMBER	DATE	MADE BY	APP'D BY	REVISION

RECORD DRAWING CERTIFICATION AS BUILT - NO CHANGES AS BUILT — CHANGES AS NOTED CONTRACTOR PROJECT COORDINATOR

RESTAURANT KITCHEN WITH FOOD VENDING


WESTCHESTER COUNTY, NEW YORK DEPARTMENT OF PUBLIC WORKS AND TRANSPORTATION DIVISION OF ENGINEERING **INFRASTRUCTURE REHABILITATION - PHASE 3** 


PLAYLAND PARK, RYE, NEW YORK

**MECHANICAL DETAILS 1 OF 2** 

NUMBER 22-523 K-M-81 08/23/2022

556 of 664 **AS INDICATED** 1-118-M-1305-0

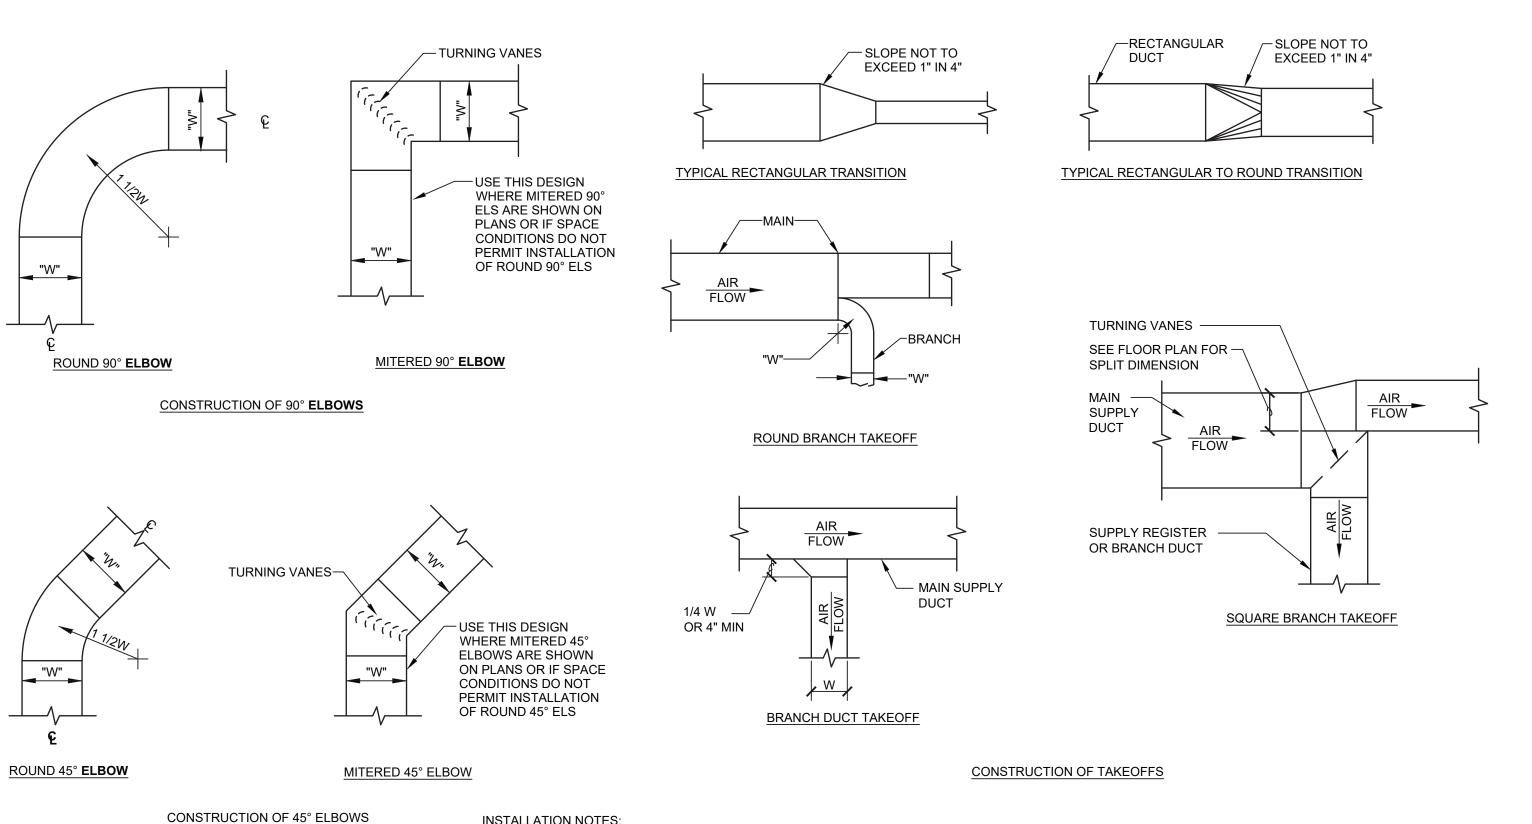

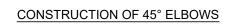

ACTING

### **INSTALLATION NOTES:**

DETAILED BY SMACNA.

1. ALL DUCT TRANSITIONS SHALL BE CONSTRUCTED AND INSTALLED AS

2. ALL DUCTS SHALL BE CONSTRUCTED AND ERECTED IN A NEAT AND WORKABLE MANNER.

3. DUCTS SHALL BE CONSTRUCTED OF THE WEIGHTS, GAUGES AND MATERIAL SPECIFIED.

4. THE DIMENSION SHOWN FOR ALL DUCTS SHOWN IN PLAN GIVE THE WIDTH 12. FLEXIBLE FABRIC CONNECTIONS (OR EQUAL) SHOULD BE USED ON BOTH FIRST AND THEN THE HEIGHT.

5. DUCT RISERS SHOULD BE SUPPORTED BY ANGLES AT EVERY FLOOR.

6. AIR TURN SHALL BE INSTALLED IN ALL ABRUPT ELBOWS TO PREVENT TURBULENCE.

7. DUCTS SHALL BE SECURELY ATTACHED TO THE BUILDING CONSTRUCTION IN AN APPROVED MANNER.

8. DIVERGING TRANSITION PIECES SHALL BE MADE AS GRADUAL AS

9. INSTALL FIRE DAMPERS IN ACCORDANCE WITH UL 555.

10. ACCESS PANELS SHOULD BE PLACED BEFORE AND/OR AFTER EQUIPMENT INSTALLED IN THE DUCT.


11. DUCT AREA SHOULD NOT BE DECREASED MORE THAN 10 PERCENT WHEN OBSTRUCTIONS CANNOT BE AVOIDED, AND THEN A STREAMLINED FITTING

INLETS AND OUTLETS OF ALL FANS AND AIR HANDLING UNIT.

13. JOINTS AND SEAMS OF SUPPLY DUCTS SHALL BE FASTENED SECURELY AND MADE AIR TIGHT.

14. VANES SHORTER THAN 36" SHALL BE SINGLE WALL, WITH A 2" RADIUS AND 1 1/2" SPACING. VANES LARGER THAN 36" AND SHORTER THAN 48" SHALL BE DOUBLE WALL, WITH A 2" OUTER RADIUS, 1" INNER RADIUS, AND 2 1/8" SPACING. VANES LONGER THAN 48" SHALL BE DOUBLE WALL, WITH A 4 1/2" OUTER RADIUS, 2 1/4" INNER RADIUS, AND 3 1/4" SPACING. NO TURNING

VANES SHALL INCLUDE A TRAILING EDGE.

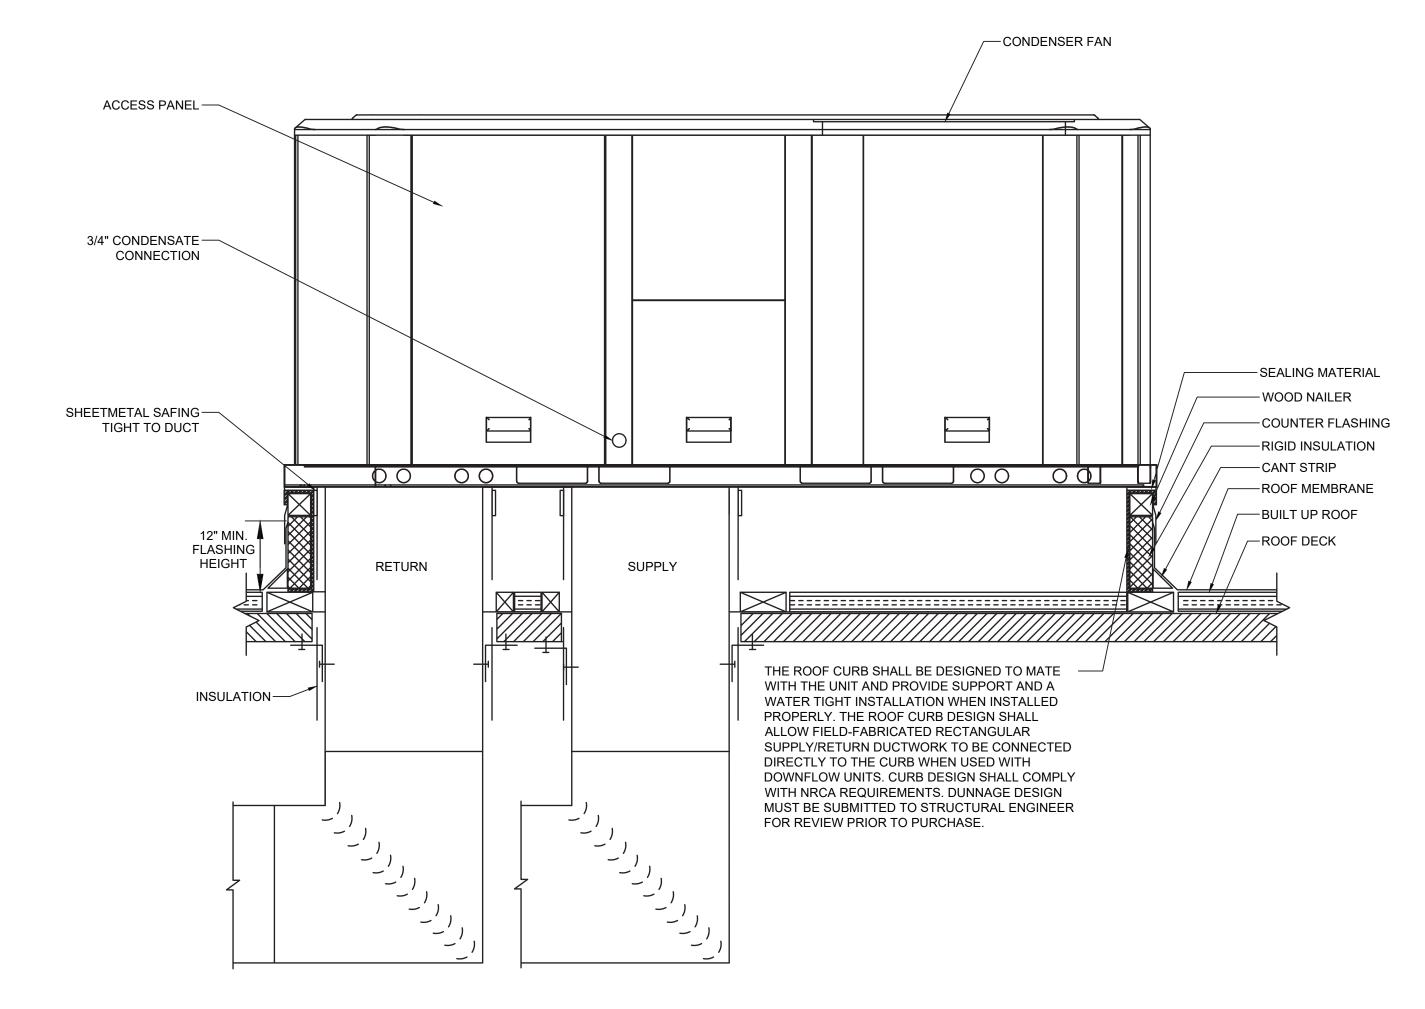


# **ROOF TOP UNIT (RTU) DETAIL** M-82 / SCALE: NOT TO SCALE

# MECHANICAL DUCT CONSTRUCTION DETAIL M-82 / SCALE: NOT TO SCALE

-OPERATING SHAFT

FOR QUADRANT OR

MOTOR

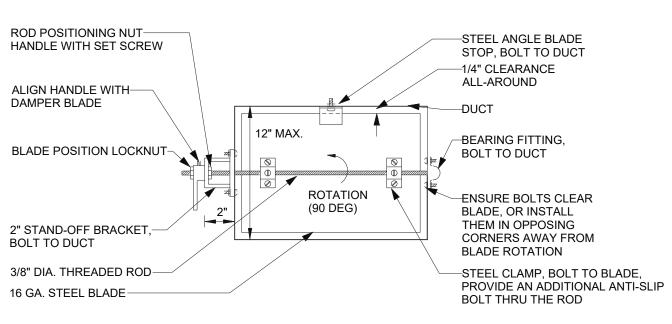


CONNECTION-

TYPICAL VOLUME DAMPER

LINKAGE

1. DAMPERS FOR ROUND DUCTS SHALL BE SIMILAR TO THE DAMPER SHOWN ABOVE. 2. ENSURE THAT FULL 90 DAMPER BLADE MOVEMENT IS UNOBSTRUCTED. 3. FOR DUCT HEIGHTS MORE THAN 12", PROVIDE FACTORY-FABRICATED OPPOSED BLADE DAMPERS.

# MECHANICAL VOLUME DAMPER DETAIL M-82 / SCALE: NOT TO SCALE

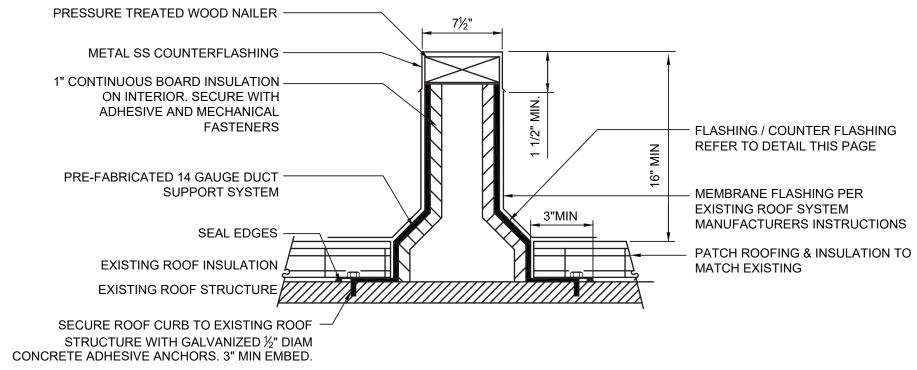

1. ALL EXPOSED METAL OR WELDS SUSCEPTIBLE TO RUSTING TO BE


PAINTED WITH COLD GALVANIZED COATING 2. CONTRACTOR TO INSTALL MEMBRANE FLASHING PER EXISTING ROOFING SYSTEM MANUFACTURER'S INSTRUCTIONS AND TO MEET

ANY EXISTING ROOF WARRANTY REQUIREMENTS. 3. CONTRACTOR TO VERIFY IN THE FIELD ALL EXISTING ROOF CONDITIONS AND DIMENSIONS PRIOR TO STARTING WORK.

4. MAINTAIN ROOF IN WEATHER TIGHT CONDITION DURING ENTIRE 5. CONTRACTOR TO PROVIDE TEMPORARY PROTECTION OF THE ROOF


WITHIN THE AREA OF WORK THROUGHOUT CONSTRUCTION. 6. ANCHOR CONDENSER TO SUPPORTS WITH ½" STAINLESS STEEL


## MECHANICAL EQUIP RAILS DETAIL M-81 / SCALE: NOT TO SCALE

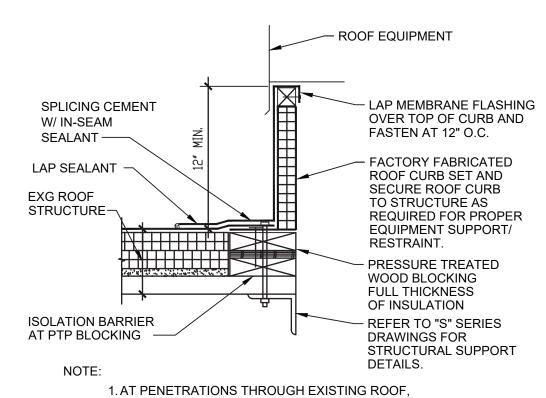

FLASH INTO EXISTING ROOF SYSTEM AND PATCH TO MATCH AS REQUIRED BY ROOF SYSTEM MANUFACTURER.

## **ROOF CURB DETAIL** M-82 / SCALE: NOT TO SCALE

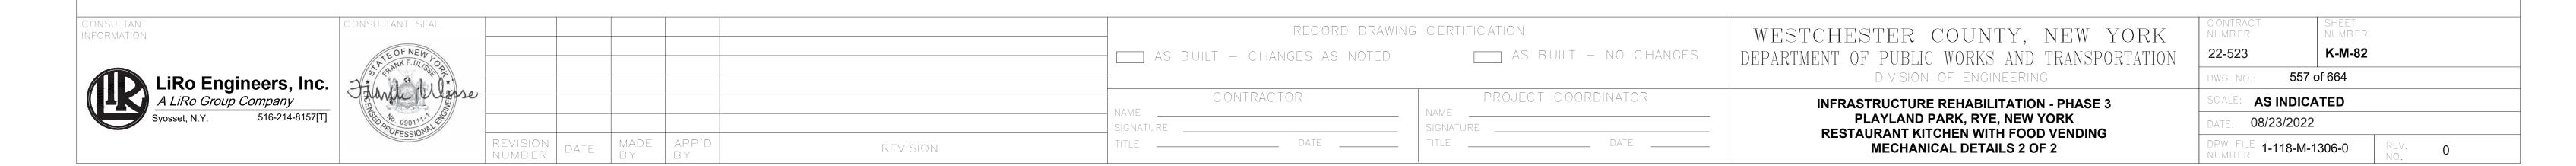

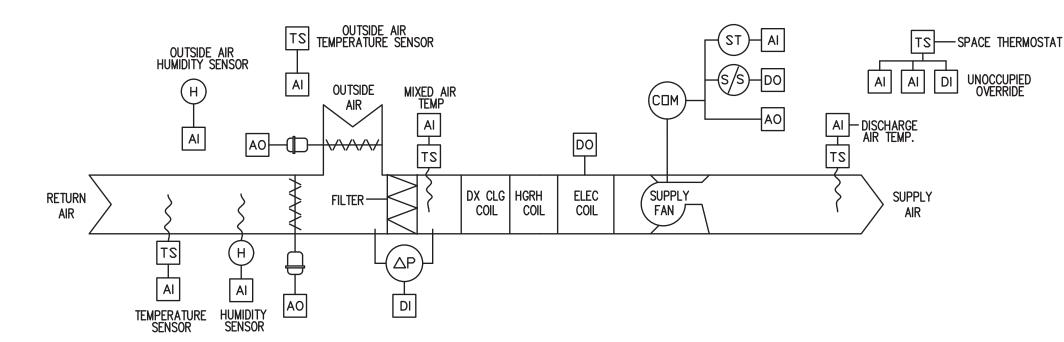

### ROOFTOP UNIT - ELECTRIC HEATING COIL AND DX COOLING - SEQUENCE OF OPERATIONS:

### 1. GENERAL:

- a. SUPPLY FAN AND ASSOCIATED EXHAUST FANS SHALL RUN CONTINUOUSLY. THE SUPPLY FAN SHALL RUN AT THE FREQUENCY DETERMINED BY THE BALANCING CONTRACTOR. THE RTU SYSTEMS CONSISTS OF SUPPLY FANS W/ EC MOTOR CONTROLLER, BAROMETRIC (PASSIVE) RELIEF, RETURN AIR DAMPERS, ECONOMIZER, DAMPERS, DX COOLING COIL, HOT-GAS REHEAT COIL, AND GAS-FIRED HEATING COIL.
- b. THE RTU SYSTEM IS DESIGNED TO PROVIDE VENTILATION, HEATING AND COOLING SUPPLY AIR, AND MAKEUP FOR GENERAL KITCHEN EXHAUST TO A SINGLE ZONE. FUTURE KITCHEN HOOD MAKEUP AIR TO BE PROVIDED BY RESTAURANT VENDOR WITH DEDICATED SYSTEMS.
- c. THE RTU SYSTEM IS PROVIDED AS A PACKAGED SYSTEM, WITH MANUFACTURER PROVIDED UNIT CONTROLLER.
   d. THE CONTROL CONTRACTOR SHALL REVIEW MANUFACTURER SHOP DRAWINGS AND CONTROL DEVICE INSTALLATION, FURNISH AND INSTALL ALL REMAINING CONTROL DEVICES AND FIELD INSTALLED ACCESSORIES TO PERFORM THE SEQUENCES INDICATED. REFER TO EQUIPMENT SCHEDULES AND DETAILS FOR DEVICES INCLUDED WITH THE EQUIPMENT.

### 2. OCCUPIED MODE:

- a. SUPPLY FAN AND ASSOCIATED EXHAUST FANS SHALL RUN CONTINUOUSLY (SINGLE ZONE VAV).
- b. THE OUTSIDE AIR DAMPER SHALL OPEN TO THE POSITION REQUIRED TO MAINTAIN THE MINIMUM OUTSIDE AIR QUANTITY INDICATED. OUTSIDE AIR DAMPER
- SHALL NEVER BE POSITIONED BELOW THIS MINIMUM POSITION EXCEPT IN CASE OF ALARM.

  c. HEATING: WHEN THE SPACE TEMPERATURE IS AT OR BELOW THE HEATING SETPOINT, THE ELECTRIC COIL SHALL MODULATE TO MAINTAIN SPACE HEATING
- SETPOINT SUBJECT TO A DISCHARGE HIGH LIMIT OF 100 DEG. F (ADJUSTABLE) AND DISCHARGE LOW LIMIT OF 70 DEG. F (ADJUSTABLE).

  d. FREE COOLING: WHEN THE SPACE TEMPERATURE RISES 3 DEG. F (ADJUSTABLE) ABOVE THE SPACE HEATING SETPOINT, AND THE OUTSIDE AIR ENTHALPY IS
- LOWER THAN THE SPACE ENTHALPY, THE OUTSIDE AIR DAMPER SHALL MODULATE OPEN AND THE ASSOCIATED RELIEF DAMPER SHALL OPEN TO MAINTAIN THE OCCUPIED SETPOINT. THIS SHALL BE DONE SUBJECT TO LOW LIMIT OF 55 DEG. F (ADJUSTABLE) AND WITH THE ELECTRIC HEATING COIL DISABLED.

  e. COOLING: WHEN THE SPACE TEMPERATURE IS 3 DEG. F (ADJUSTABLE) ABOVE THE COOLING SETPOINT, AND THE OUTSIDE AIR CANNOT COOL THE SPACE, THE

# RESPECTIVE CONDENSING UNIT SHALL BE CYCLED WITH THE ELECTRIC HEATING COIL DISABLED TO MAINTAIN SPACE TEMPERATURE. USE 5 DEG. F (ADJUSTABLE) DEADBAND BETWEEN HEATING AND COOLING SETPOINTS.

### 3. ECONOMIZER OPERATION

- a. ECONOMIZER OPERATION IS ENABLED WHEN OUTDOOR AIR ENTHALPY IS LESS THAN RETURN AIR ENTHALPY.
- b. THE OUTSIDE AIR AND RETURN AIR DAMPERS SHALL MODULATE AS REQUIRED TO OPTIMIZE SUPPLY AIR TEMPERATURE SETPOINT VIA FREE COOLING. THIS IS TYPICALLY A FULLY OPEN OUTSIDE AIR DAMPER DURING SUMMER MONTHS, AND PARTIALLY OPEN OUTSIDE AIR AND RETURN AIR DAMPERS DURING WINTER MONTHS.
- c. IF ECONOMIZER MODE CAN NOT FULLY PROVIDE THE REQUIRED DISCHARGE AIR TEMPERATURE, THE DX COOLING COIL SHALL SUPPLEMENT AS REQUIRED.

### 4. UNOCCUPIED MODE:

- a. THE SUPPLY AND ASSOCIATED EXHAUST FAN SHALL BE OFF.
- b. THE OUTSIDE AIR DAMPER AND THE ASSOCIATED RELIEF AIR HOOD DAMPER SHALL BE FULLY CLOSED AND THE RETURN AIR DAMPER SHALL BE FULLY OPEN.
- c. ON DROP IN SPACE TEMPERATURE BELOW THE UNOCCUPIED HEATING SETPOINT, CYCLE THE FAN ON AND ELECTRICAL COIL SHALL OPERATE AT THE FULL RATE TO MAINTAIN REDUCED SPACE TEMPERATURE. USE 5 DEG. F (ADJUSTABLE) DEADBAND TO MINIMIZE SHORT CYCLING.
- d. A TIMED LOCAL OVERRIDE CONTROL SHALL ALLOW AN OCCUPANT TO OVERRIDE THE SCHEDULE AND PLACE THE UNIT IN OCCUPIED MODE FOR 1 HOUR (ADJUSTABLE). AT EXPIRATION OF THIS TIME, CONTROL OF THE UNIT SHALL AUTOMATICALLY RETURN TO THE SCHEDULE.


### 5. WARM-UP MODE:

- a. THE UNIT SHALL START PER AN OPTIMUM START PROGRAM.
- b. THE OUTSIDE AIR DAMPER AND THE ASSOCIATED RELIEF HOOD DAMPER SHALL BE FULLY CLOSED, THE RETURN AIR DAMPER SHALL BE FULLY OPEN, AND THE ASSOCIATED EXHAUST FAN SHALL BE OFF.
- c. THE SUPPLY FAN SHALL RUN AND THE ELECTRIC HEATING COIL SHALL MODULATE TO MAINTAIN OCCUPIED SETPOINT.

### 6. SAFETIES:

- a. DIFFERENTIAL PRESSURE ACROSS THE AIR FILTERS SHALL GENERATE AN ALARM AT UNIT CONTROLLER WHENEVER THE DIFFERENTIAL PRESSURE EXCEEDS IT'S
- b. IF THE DISCHARGE AIR TEMPERATURE DROPS BELOW 35 DEG F (ADJUSTABLE), THE SUPPLY FAN SHALL TURN OFF AND SHALL BE LOCKED OUT, AND AN ALARM
- SHALL BE ACTIVATED.
  c. IF THE DISCHARGE AIR TEMPERATURE RISES ABOVE 120 DEG. F (ADJUSTABLE), THE ELECTRIC HEATING COIL SHALL TURN OFF AND AN ALARM SHALL BE

# 1 ROOFTOP UNIT - ELECTRIC COIL AND DX COOLING M-91 SCALE: NOT TO SCALE

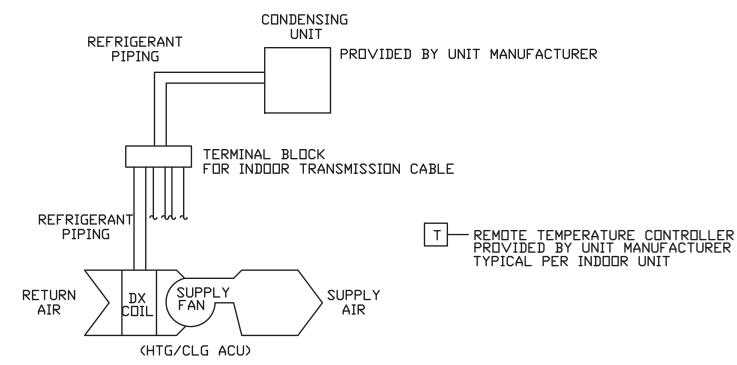

### MULTIPLE DUCTLESS SPLIT SYSTEMS - HEATING AND COOLING - SEQUENCE OF OPERATIONS:

- 1. UNITS SHALL BE CONTROLLED WITH UNIT PROVIDED THERMOSTATS AND CONNECTED TO CONTROLLER.
- 2. GENERATE AN ALARM AT CONTROLLER WHEN THE TEMPERATURE GOES ABOVE OR BELOW ROOM TEMPERATURE RANGE (ADJUSTABLE).

TS SPACE

UNIT HEATER - ELECTRIC - SEQUENCE OF OPERATIONS:

SHORT CYCLING.

M-91 / SCALE: NOT TO SCALE

1. ON DROP IN SPACE TEMPERATURE BELOW OCCUPIED HEATING SETPOINT,


VALVE CLOSES. USE 5 DEG. F (ADJUSTABLE) DEADBAND TO MINIMIZE

**UNIT HEATER - ELECTRIC** 

CYCLE THE FAN ON AND MODULATE (2 STAGE) ELECTRIC COIL TO MAINTAIN

SPACE OCCUPIED SETPOINT, FAN SHALL HAVE DELAYED SHUT OFF AFTER



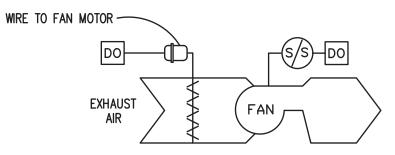


### EXHAUST FAN - CONSTANT SPEED - SEQUENCE OF OPERATIONS:

INTERLOCK THE OPERATION OF THE EXHAUST FANS AND AUTOMATIC DAMPERS WITH THEIR RESPECTIVE HEATING AND COOLING EQUIPMENT, RTU-1.

- 1. OCCUPIED MODE:
- a. THE EXHAUST FAN SHALL RUN CONTINUOUSLY AND THE AUTOMATIC AIR DAMPER SHALL OPEN.
- 3. UNOCCUPIED MODE:
- a. THE EXHAUST FAN SHALL BE OFF AND THE AUTOMATIC AIR DAMPER SHALL BE CLOSED.
- 4. WARM-UP MODE:
- a. THE EXHAUST FAN SHALL BE OFF AND THE AUTOMATIC AIR DAMPER SHALL BE CLOSED.



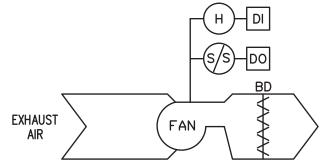

### EXHAUST FAN - CONSTANT SPEED - SEQUENCE OF OPERATIONS:

GENERAL: EACH EXHAUST FAN CONSISTS OF FAN, BACKDRAFT DAMPER, AND EC MOTOR CONTROLLER

- 1. OCCUPIED MODE:
- a. THE EXHAUST FAN SHALL RUN WHEN THE RELATIVE HUMIDITY IN THE SPACE SERVED EXCEEDS 60 PERCENT.
- 3. UNOCCUPIED MODE:
- a. THE EXHAUST FAN SHALL RUN WHEN THE RELATIVE HUMIDITY IN THE SPACE SERVED EXCEEDS 60 PERCENT.
- 4. WARM-UP MODE:
- a. THE EXHAUST FAN SHALL RUN WHEN THE RELATIVE HUMIDITY IN THE SPACE SERVED

5 ATTIC EXHAUST FAN - CONSTANT SPEED
M-91 SCALE: NOT TO SCALE

