

RESTAURANT KITCHEN

8/30/2022 2:52:14 PM

CONSULTANT
INFORMATION



1 State Street Plaza, New York, NY, 10004
(516) 938-5476
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CONSULTANT SEAL



REVISION NUMBER	DATE	MADE BY	APP'D BY	REVISION

RECORD DRAWING CERTIFICATION

☐ AS BUILT – CHANGES AS NOTED ☐ AS BUILT – NO CHANGES

CONTRACTOR

NAME _____
SIGNATURE _____
TITLE _____ DATE _____

PROJECT COORDINATOR

NAME _____
SIGNATURE _____
TITLE _____ DATE _____

WESTCHESTER COUNTY, NEW YORK
DEPARTMENT OF PUBLIC WORKS AND TRANSPORTATION

DIVISION OF ENGINEERING

INFRASTRUCTURE REHABILITATION
PLAYLAND PARK, RYE, NEW YORK
RESTAURANT KITCHEN WITH FOOD VENDING
BUILDING 3D VIEW

CONTRACT
NUMBER

22-523

SHEET
NUMBER

K-G-01


DWG NO.: 496 of 664

SCALE: 12" = 1'-0"


DATE: 8/23/20223

DPW FILE
NUMBER 1-118-G-1247-0

REV.
NO. 0

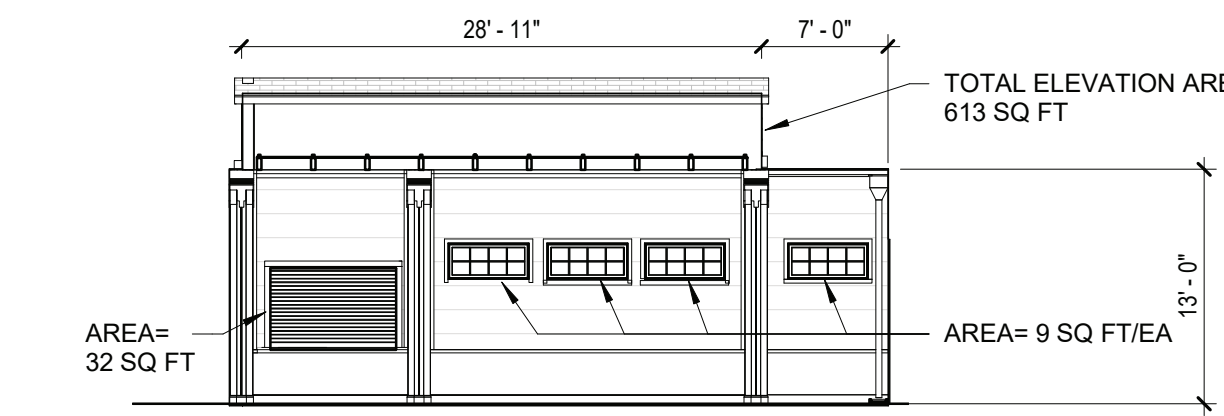


WEST CODE ELEVATION
3/32" = 1'-0"

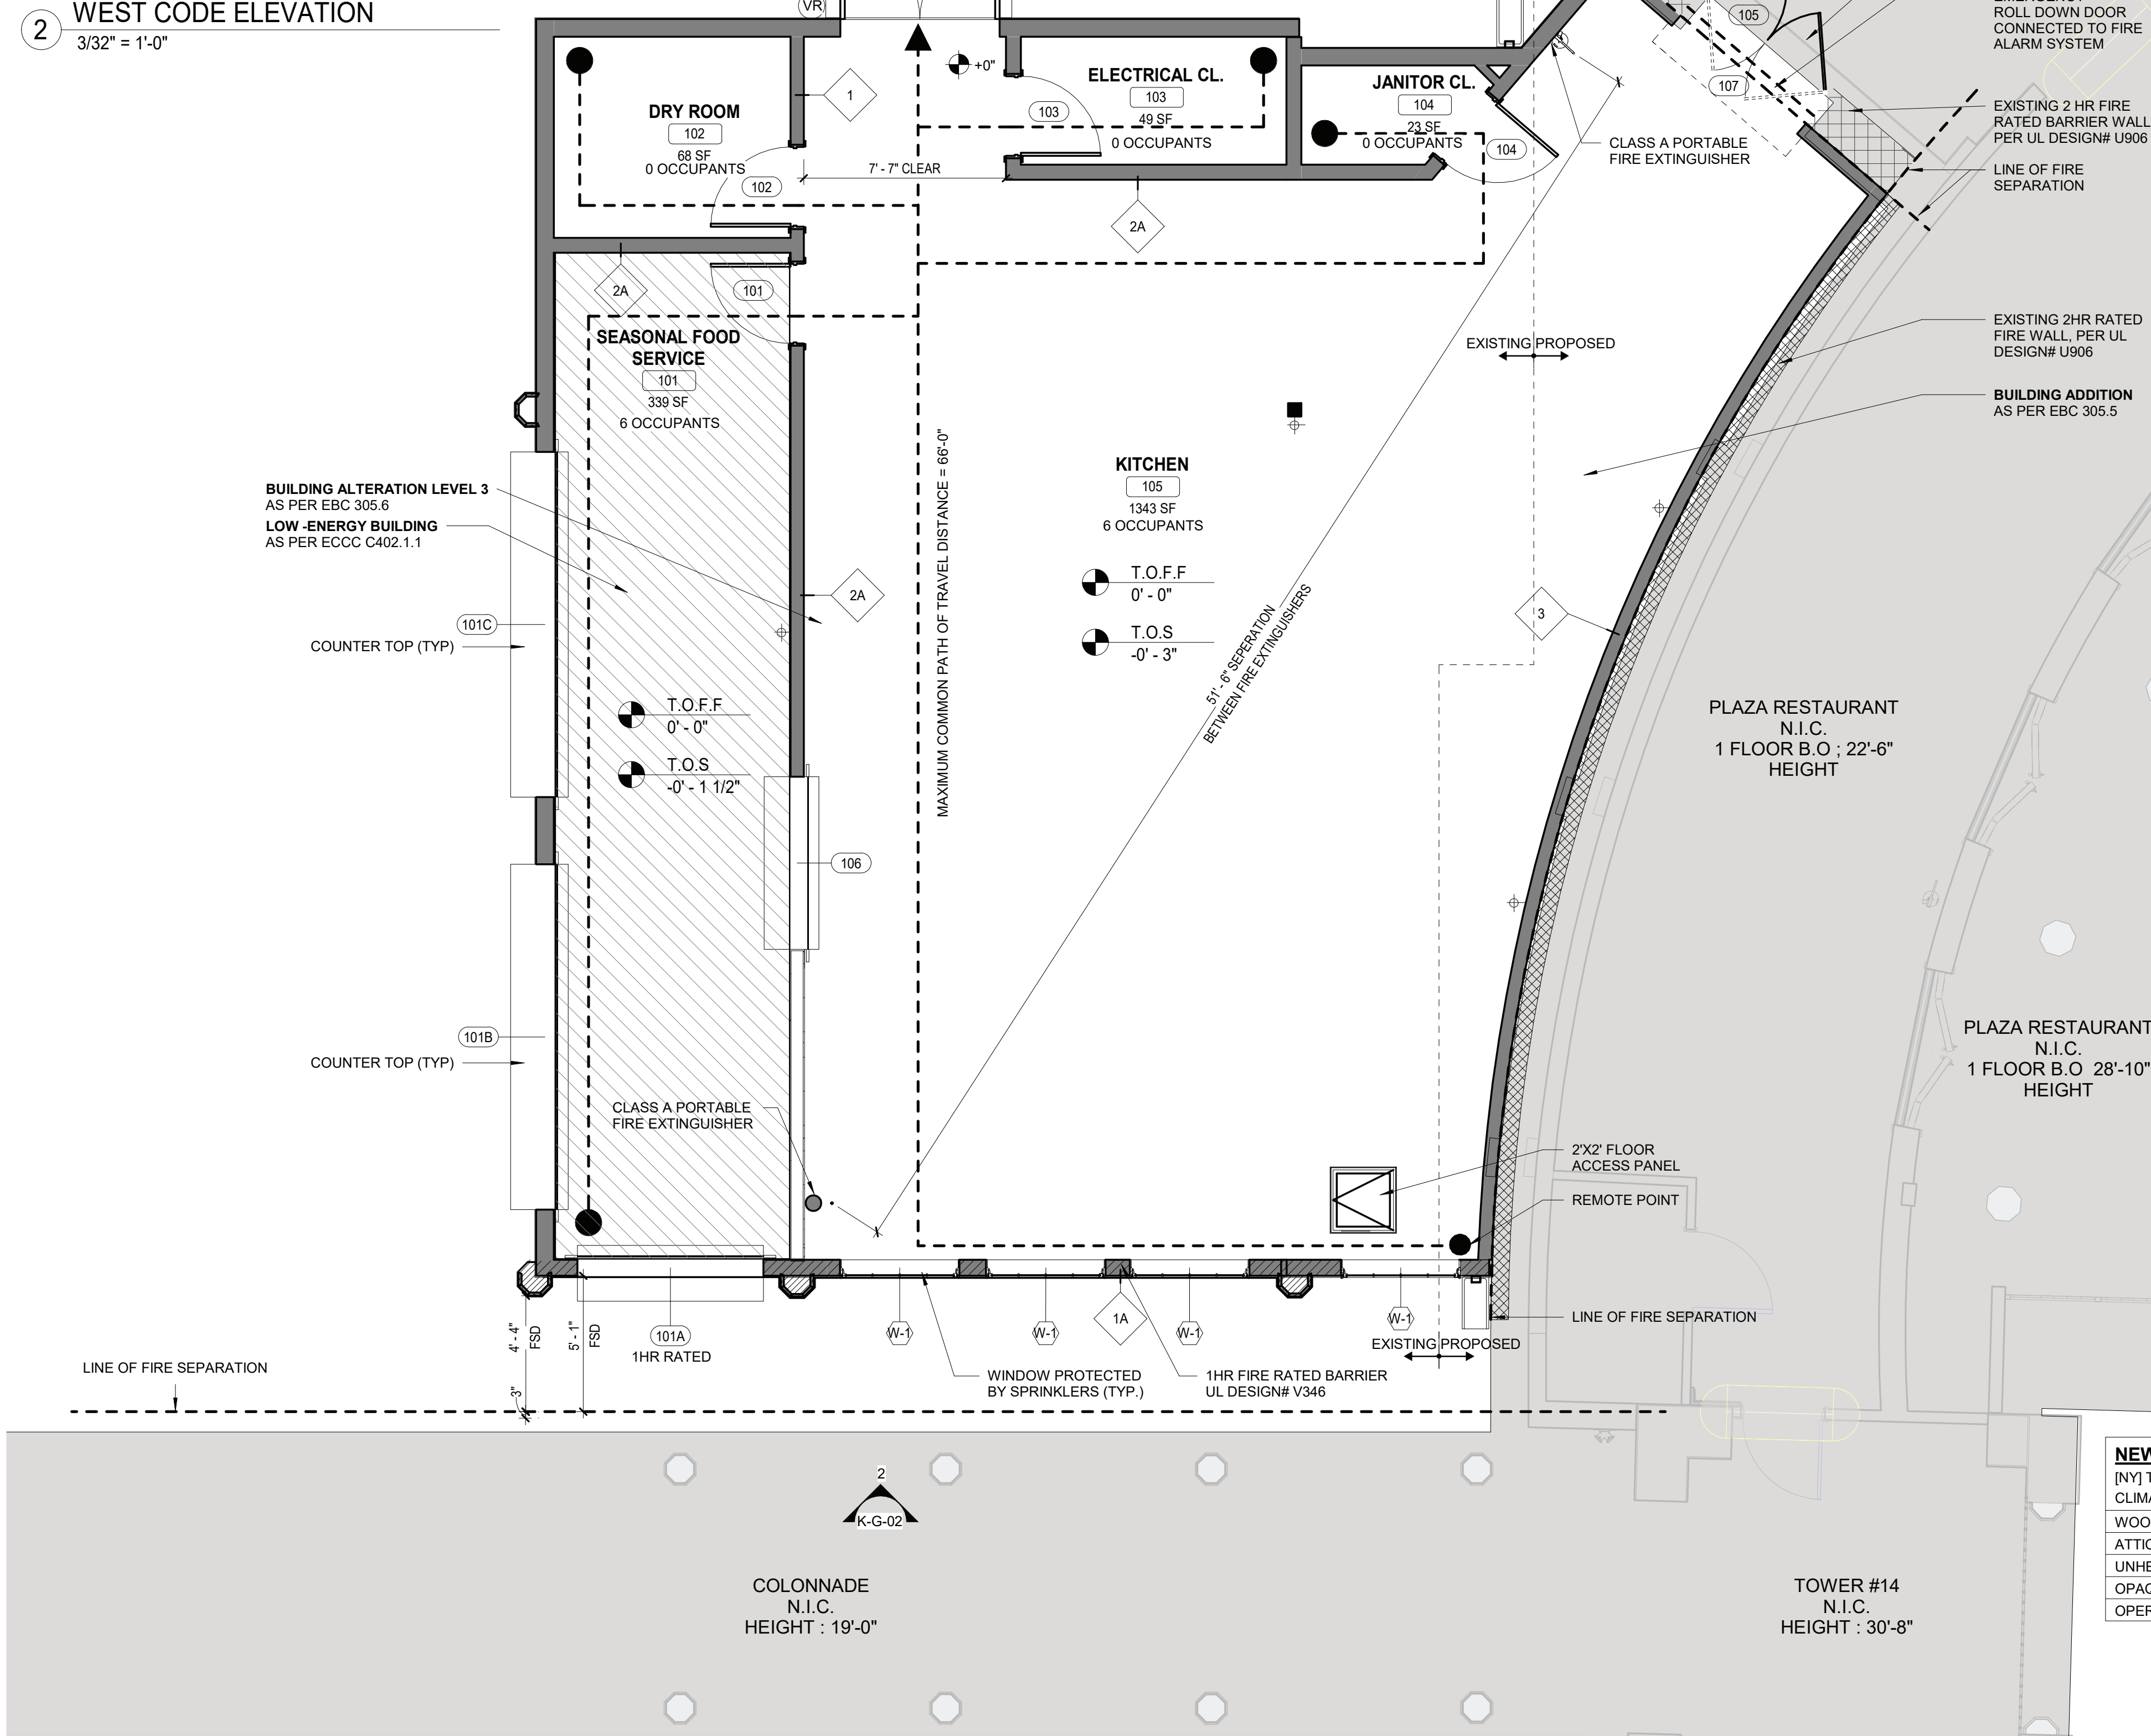

GROUND FLOOR EGRES PLAN
1/4" = 1'-0"

LIFE SAFETY DIAGRAM LEGEND

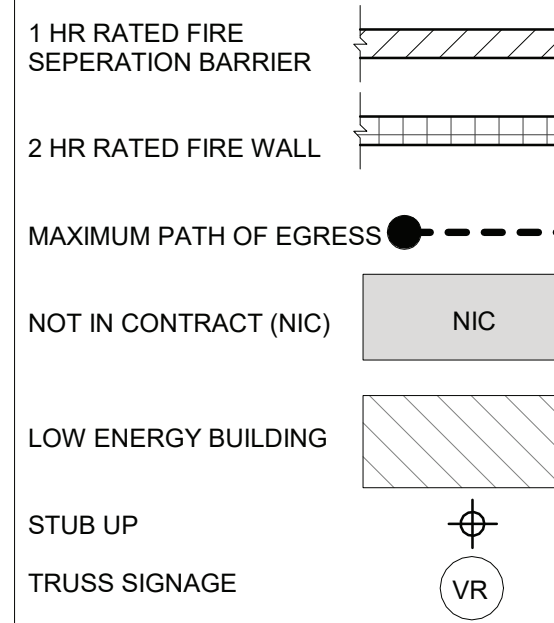

LIFE SAFETY NOTES :

1. BUILDING IS FULLY SPRINKLERED
2. ALL EXISTING FIRE RATED WALLS ARE TO BE VERIFIED IN THE FIELD.
3. SEE SHEET K-A-84 FOR RATED COLUMN DETAILS.

HISTORICAL BUILDING REGISTRY

PLAYLAND AMUSEMENT PARK IS A DESIGNATED NATIONAL HISTORIC LANDMARK AND IS LISTED ON THE NATIONAL REGISTER OF HISTORIC PLACES.


THE NATIONAL HISTORIC PLACES REGISTER
REFERENCE NUMBER: 80004529 NHL
NATIONAL ARCHIVE IDENTIFIER: 75323175

RESTAURANT KITCHEN BUILDING A IS A CONTRIBUTING STRUCTURE OF THE LANDMARK AND THEREFORE AN HISTORIC BUILDING UNDER THE 2020 BUILDING CODE AND 2020 EXISTING BUILDING CODE OF NEW YORK STATE

ADDITION TO MEET PRESCRIPTIVE METHOD C502.2 IN 2020 ENERGY CONSERVATION CONSTRUCTION CODE OF NEW YORK STATE

NEW CONSTRUCTION MIN R-VALUE

[NY] TABLE C402.1.3/4 CLIMATE ZONE - MARINE 4	
WOOD FRAME WALLS, ABOVE GROUND	MIN R-20
ATTIC AND OTHER ROOFS	MIN R-38
UNHEATED SLABS	MIN R-10 FOR 24" BELOW
OPAQUE SWINGING DOOR	MAX U-0.37
OPERABLE FENESTRATION	MAX U-0.45

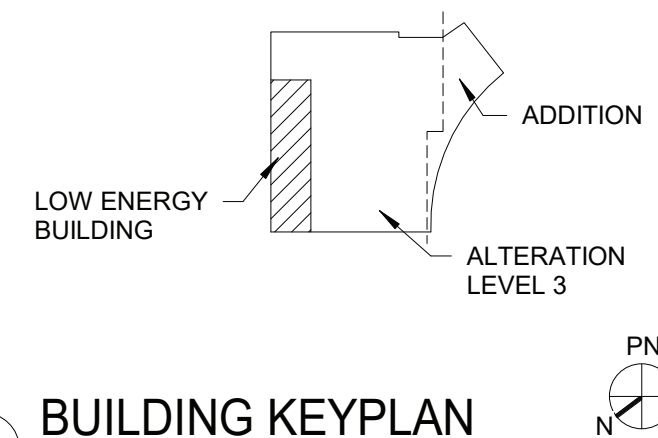

BUILDING KEYPLAN

CODE ANALYSIS

APPLICABLE CODES: NEW YORK STATE BUILDING CODE 2020 (BC) NEW YORK STATE EXISTING BUILDING CODE 2020 (EBC) ENERGY CONSERVATION CONSTRUCTION CODE OF NEW YORK STATE (ECCC) NFPA 13 2013 (NFPA 13) CONSTRUCTION TYPE (TBL 601) VB OCCUPANCY CLASSIFICATION A-2 FULLY SPRINKLERED COMMERCIAL KITCHENS		
NUMBER OF STORIES (TBL 504.4) HEIGHT (FT) (TBL 504.3) BUILDING AREA (SF) (TBL 506.2) ALLOWABLE AREA, SINGLE-OCC. ONE STORY	ALLOWABLE / REQUIRED < 2 < 60' < 24,000 < 24,579	PROPOSED 1 25'-4" 1,882 1,882
FIRE-RESISTANCE RATING REQUIREMENTS (TBL 601)		
PRIMARY STRUCTURE FRAME BEARING WALLS	0	0
EXTERIOR 0 < 10 FT ≥ 10 FT	1 BOTH SIDES 0 0	1 0 0
INTERIOR NONBEARING WALLS EXTERIOR (TBL 601) 0 < 10 FT ≥ 10 FT	1 BOTH SIDES 0 0 0	1 0 0 0
FLOOR CONSTRUCTION ROOF CONSTRUCTION	0 0	0 0
PROJECTIONS (BC 705.2.3.1 EXCEPTIONS)		
3. PROJECTIONS ON BUILDINGS OF TYPE V CONSTRUCTION SHALL BE PERMITTED TO BE OF TYPE V CONSTRUCTION AND SHALL NOT BE REQUIRED TO HAVE A FIRE RESISTANCE RATING WHERE SPRINKLER PROTECTION IS EXTENDED TO THESE AREAS.		
EXTERIOR PROJECTIONS NFPA 13; SECTION 8.15.7.3		
SPRINKLERS SHALL BE PERMITTED TO BE OMITTED FROM BELOW THE EXTERIOR PROJECTS OF COMBUSTIBLE CONSTRUCTION, PROVIDED THE EXPOSED FINISH MATERIAL ON THE EXTERIOR PROJECTS ARE NON COMBUSTIBLE, LIMITED-COMBUSTIBLE, OR FIRE RETARDANT-TREATED WOOD AS DEFINED IN NFPA 703.		
ALLOWABLE AREA OF OPENINGS (BC 705.8) FSD 5 FT < 10 FT; UNPROTECTED; SPRINKLERED FSD > 20 FT; UNPROTECTED; SPRINKLERED	25% NO LIMIT	11.09%
FIRE WALL, FIRE RESISTANCE RATINGS (TBL 706.4) GROUP A (TYPE V CONSTRUCTION)	2 HR ²	
INTERIOR FINISHES CLASS (BC 803) WALL AND CEILING; SPRINKLERED (TBL 803.13) FLOORS; GROUP A (BC 804.4.2)	CLASS C CLASS II	
PORTABLE FIRE EXTINGUISHERS (BC 906) FIRE HAZARD OCCUPANCY MIN-RATING SINGLE EXTINGUISHER MAX FLOOR AREA MAX DISTANCE OF TRAVEL TO EXTINGUISHER MAX DISTANCE OF TRAVEL TO EXTINGUISHER	CLASS K ORDINARY 2-A 1,500 SF 11,250 SF 30 FT	2,399 SF X
NUMBER OF EXTINGUISHERS REQUIRED FIRST FLOOR	COMMERCIAL KITCHENS 1.6	2
MEANS OF EGRESS (BC 10) MAX FLOOR AREA ALLOWANCE PER OCCUPANT (TBL 1004.1.2)(SF) ACCESSORY STORAGE AREAS KITCHENS, COMMERCIAL CONCENTRATED BUSINESS USE	300 GROSS 200 GROSS 50 GROSS	SEE PLANS
DESIGN OCCUPANT LOAD	12 OCCUPANTS	12 OCCUPANTS
EGRESS WIDTH PER OCCUPANT (IN)(BC 1005) KITCHENS	0.15 / OCCUPANT 1.8"	72"
MAX COMMON PATH OF EGRESS OF TRAVEL DISTANCE (TBL 1006.2.1) OCCUPANCY A; X<30; SPRINKLER SYSTEM	75 FT	SEE PLANS
MINIMUM NUMBER OF EXITS (TBL 1006.3.2) OCCUPANT LOAD: 1-500	2	1" SINGLE EXITS (BELOW)
SINGLE EXITS (TBL 1006.3.3)"		
ROOMS, AREAS AND SPACES COMPLY WITH SECTION 1006.2.1 WITH EXITS THAT DISCHARGE DIRECTLY TO THE EXTERIOR AT THE LEVEL OF DISCHARGE. ARE PERMITTED TO HAVE ONE EXIT OR ACCESS TO A SINGLE EXIT.		
MAX TRAVEL DISTANCE (BC 1017) A-2 OCCUPANCY; SPRINKLER SYSTEM	250'	SEE PLANS

EXISTING MATERIALS (EBC 302.4)
MATERIALS ALREADY IN USE IN A BUILDING IN COMPLIANCE WITH REQUIREMENTS OR APPROVALS IN EFFECT AT THE TIME OF THEIR ERECTION OR INSTALLATION SHALL BE PERMITTED TO REMAIN IN USE UNLESS DETERMINED BY BUILDING OFFICIAL TO BE UNSAFE.

NEW AND REPLACEMENT MATERIALS (EBC 302.5)
MATERIALS PERMITTED BY THE APPLICABLE CODE FOR NEW CONSTRUCTION SHALL BE USED. LIKE MATERIALS SHALL BE PERMITTED FOR REPAIRS AND ALTERATIONS, PROVIDED THAT UNSAFE CONDITIONS ARE NOT CREATED.

ADDITIONS AND ALTERATIONS (EBC 305.5, 305.6, AND 305.7)
WHERE AN ALTERATION (AND ADDITIONS) AFFECTS THE ACCESSIBILITY TO, OR CONTAINS AN AREA OF PRIMARY FUNCTION, THE ROUTE TO THE PRIMARY FUNCTION AREA SHALL BE ACCESSIBLE.

ALTERATION 3 (EBC 604.1)
WHERE THE WORK AREA EXCEEDS 50% OF THE BUILDING AREA

EBC 907.1 LEVEL 3 ALTERATIONS TO EXISTING BUILDINGS ARE PERMITTED WITHOUT REQUIRING THE ENTIRE BUILDING TO COMPLY WITH THE ENERGY REQUIREMENTS OF ECCC.

CLIMATE ZONE (ECCC TBL C301.1)	4A (MARINE)	
OPENING THERMAL ENVELOPE MIN REQ'S (C303.1.3)	ALLOWABLE / REQUIRED	PROPOSED
GLAZING - NON-METAL FRAME (U-FACTOR)	0.95	0.95
OPAQUE DOOR - UNINSULATED METAL (U-FACTOR)	1.20	1.20
GLAZED FENESTRATION SHGC	0.8 CLEAR	0.8
GLAZED FENESTRATION VT	0.6 CLEAR	0.6

LOW ENERGY BUILDINGS (ECCC C402.1.1)
PORTIONS THEREOF SEPARATED FROM THE REMAINDER OF THE BUILDING THERMAL ENVELOPE ASSEMBLIES COMPLY WITH THIS SECTION SHALL BE EXEMPT FROM BUILDING THERMAL ENVELOPE PROVISIONS.
2. THOSE THAT DO NOT CONTAIN CONDITIONED SPACE.


OPAQUE THERMAL ENVELOPE MIN REQ'S (ECCC TBL C402.1.3 AND 4) ABOVE ROOF DECK ATTIC AND OTHER ROOF ELEMENT WOOD FRAMED AND OTHER WALLS ABOVE GRADE JOIST/FRAMING FLOOR UNHEATED SLAB-ON-GRADE OPAQUE DOORS - NONSWINGING OPAQUE SWINGING DOOR GARAGE DOOR	R-30ci / U-0.032 R-38 / U-0.027 R-13+R-3.8ci OR R-20 / U-0.064 R-30 / U-0.033 R-10 FOR BELOW 24" / F-0.54 R-4.75 U-0.37 U-0.31	MEAN R-43.35ci R-38 R-13+R-3.8ci R-30 R-10 R-4.75 U-0.37 U-0.31
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BUILDING ENVELOPE FENESTRATION MAX U-FACTOR REQ'S (ECCC C402.4)
OPERABLE FENESTRATION (U-FACTOR) 0.45


CONSULTANT INFORMATION 1 State Street Plaza, New York, NY, 10004 (516) 938-5476 www.liro.com		CONSULTANT SEAL 	REVISION DATE MADE BY APP'D BY REVISION				RECORD DRAWING CERTIFICATION <input type="checkbox"/> AS BUILT - CHANGES AS NOTED <input type="checkbox"/> AS BUILT - NO CHANGES		CONTRACTOR NAME SIGNATURE TITLE		PROJECT COORDINATOR NAME SIGNATURE TITLE		WESTCHESTER COUNTY, NEW YORK DEPARTMENT OF PUBLIC WORKS AND TRANSPORTATION DIVISION OF ENGINEERING INFRASTRUCTURE REHABILITATION PLAYLAND PARK, RYE, NEW YORK RESTAURANT KITCHEN WITH FOOD VENDING CODE PLAN		CONTRACT NUMBER 22-523	SHEET NUMBER K-G-02
DWG NO.: 497 of 664		SCALE: As indicated		DATE: 8/23/20223		DPW FILE NUMBER 1-118-G-1248-0		REV. NO. 0								

PLAYLAND REHABILITATION & UPGRADES
RESTAURANT KITCHEN - ASBESTOS ABATEMENT
1 PLAYLAND PKWY, RYE, NY 10580


DETAILS:

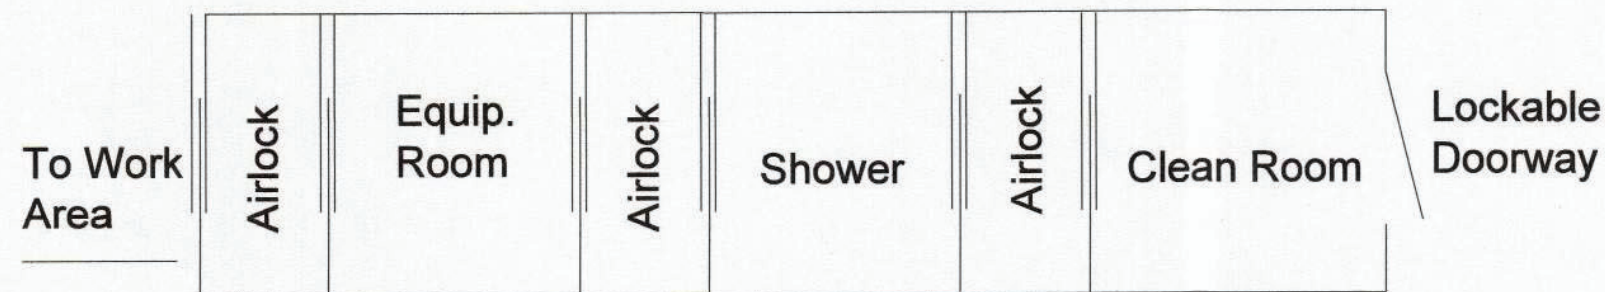

1
K-H-10
LARGE PROJECT REMOTE WORKER
DECONTAMINATION UNIT
Not To Scale

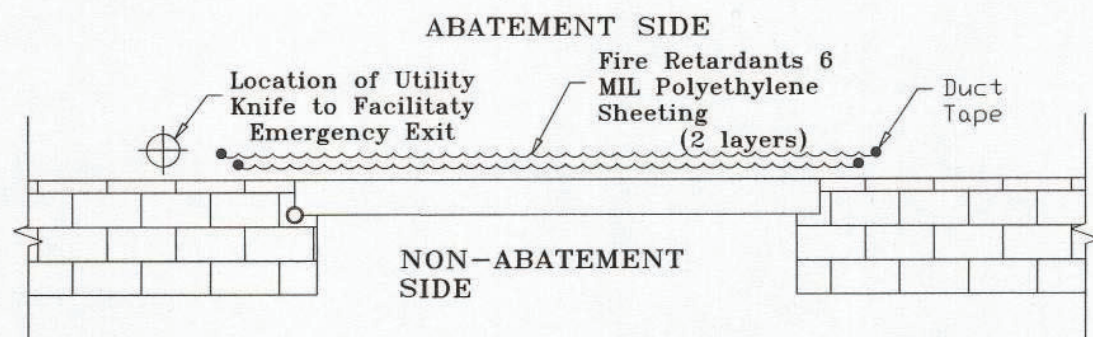

2
K-H-10
TYPICAL SOFT WALL BARRIER
AT OPENINGS LESS THAN 32SF
Not To Scale

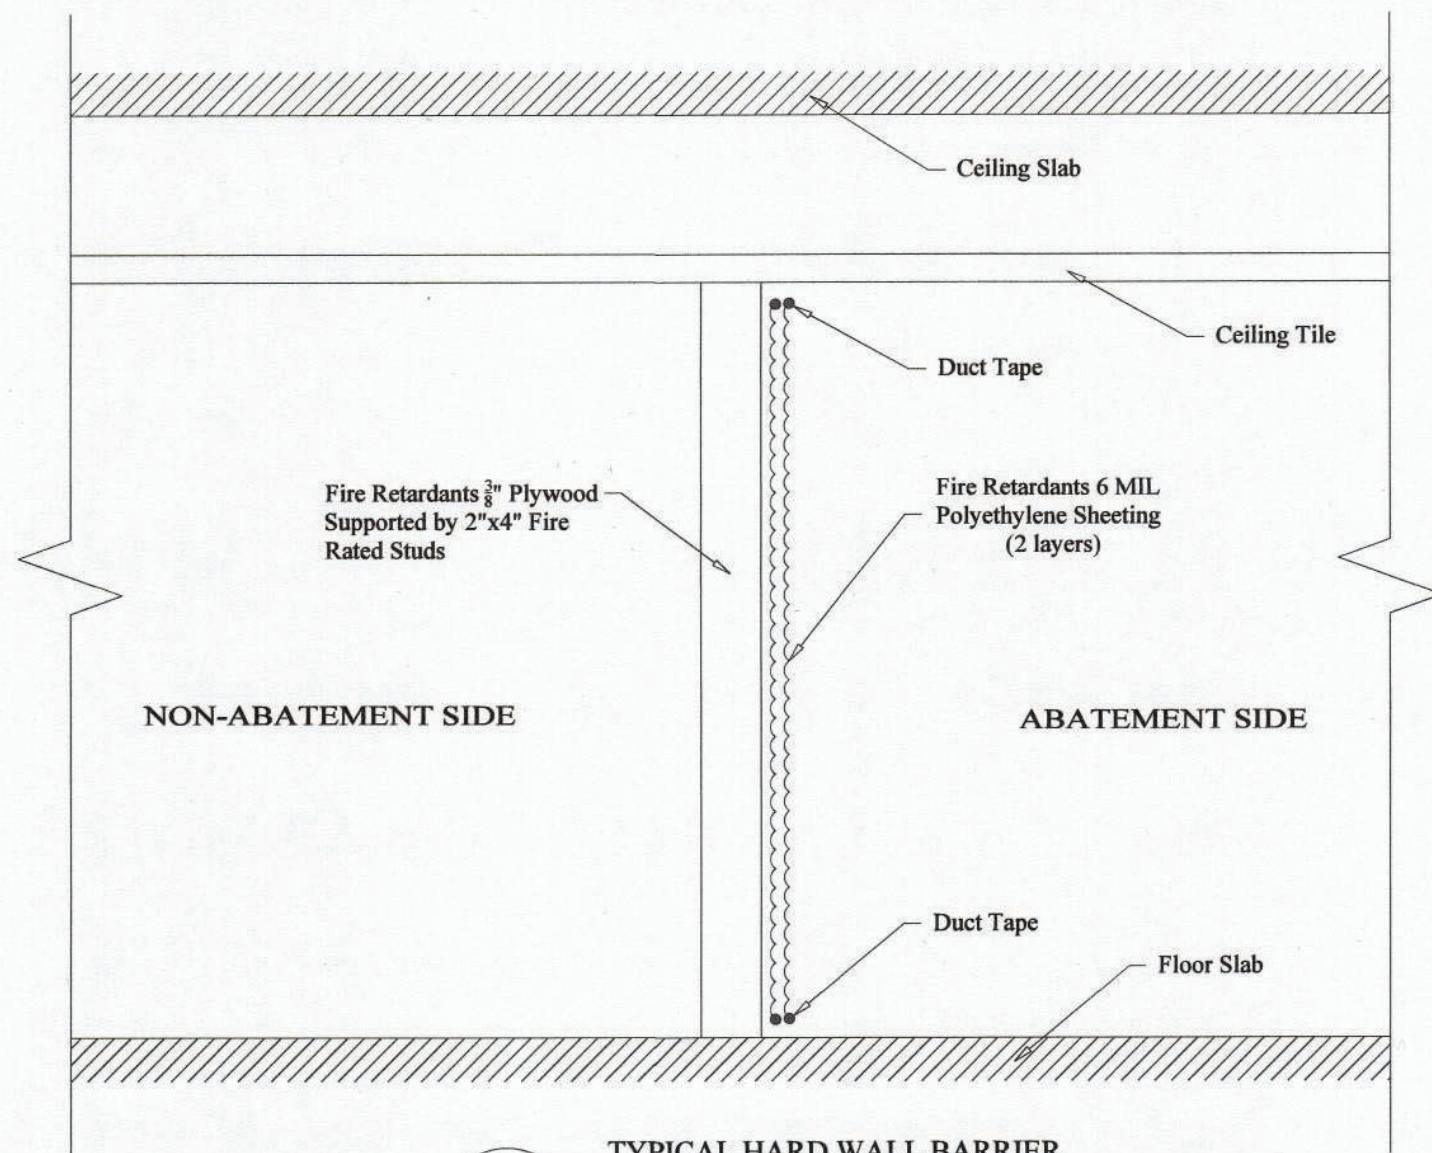

3
K-H-10
TYPICAL HARD WALL BARRIER
AT OPENINGS MORE THAN 32SF
Not To Scale

SCOPE OF WORK TABLE:

Work area	Location	Description of Asbestos Materials	Approximate Quantity of ACM	ICR 56 Procedure
1	K - Restaurant Kitchen Exterior - North	Transite Siding	440 SF	56.11.6
2	K - Restaurant Kitchen Exterior - East	Transite Siding	440 SF	56.11.6

KEYPLAN:



LEGEND:

	WORK AREA LIMITS
	REMOTE WORKER DECONTAMINATION UNIT
	WASTE HOLDING AREA
	AIRLOCK
	TEMPORARY WATER SOURCE
	TEMPORARY ELECTRICAL SOURCE


PROJECT NOTES:

1. The Contractor shall be aware of all conditions of the Project and is responsible for verifying quantities and locations of all Work to be performed. Failure to do so shall not relieve the Contractor of its obligation to furnish all labor and materials necessary to perform the Work.
2. All Work shall be performed in strict accordance with the Project Documents and all governing codes, rules, and regulations. Where conflicts occur between the Project Documents and applicable codes, rules, and regulations, the more stringent shall apply.
3. All abatement work shall be coordinated with General Contractor work; Abatement may be phased with other contract work.
4. Working hours shall be as required and approved by the Owner. Asbestos abatement activities including, but not limited to, work area preparation, gross removal activities, cleaning activities, waste removal, etc. may need to be performed during 'off-hours' (including nights and weekends). In addition, multiple mobilizations may be required to perform the work identified in this project. The Contractor shall coordinate and schedule all Work with the facility and Owner's representative.
5. The Contractor shall prepare and coordinate with facility representative the posting of appropriate signage at the entranceway that redirects park occupants away from the area of the abatement.
6. The Contractor shall use barrier tape to extend the limits of the active, regulated work areas closed to the public and other non-abatement trades.
7. The Contractor shall be responsible for defining and coordinating the phases of the abatement with the facility and DPW, as well as securing any site specific variances, permits, and any necessary NYS DOL approvals.
8. The asbestos abatement Contractor shall coordinate locations of decontamination units, routes of egress, temporary water and power connections and waste container locations with the Owner and the Facility.
9. The Contractor may need to supply temporary power/water sources if they cannot be provided by facility.
10. The General Contractor shall supply any and all scaffolding for the work area(s) under this contract. Scaffolding structure and maintenance shall be in strict accordance with local, state and federal safety requirements.
11. The Contractor is to protect any and all exposed surfaces not targeted for abatement.
12. The Contractor shall request and receive in writing prior to preceding with any work info from the owner regarding surfaces/materials that require protection.
13. Regular waste generated by the abatement work of this contract shall be stored securely using a closed waste container.

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CONSULTANT INFORMATION

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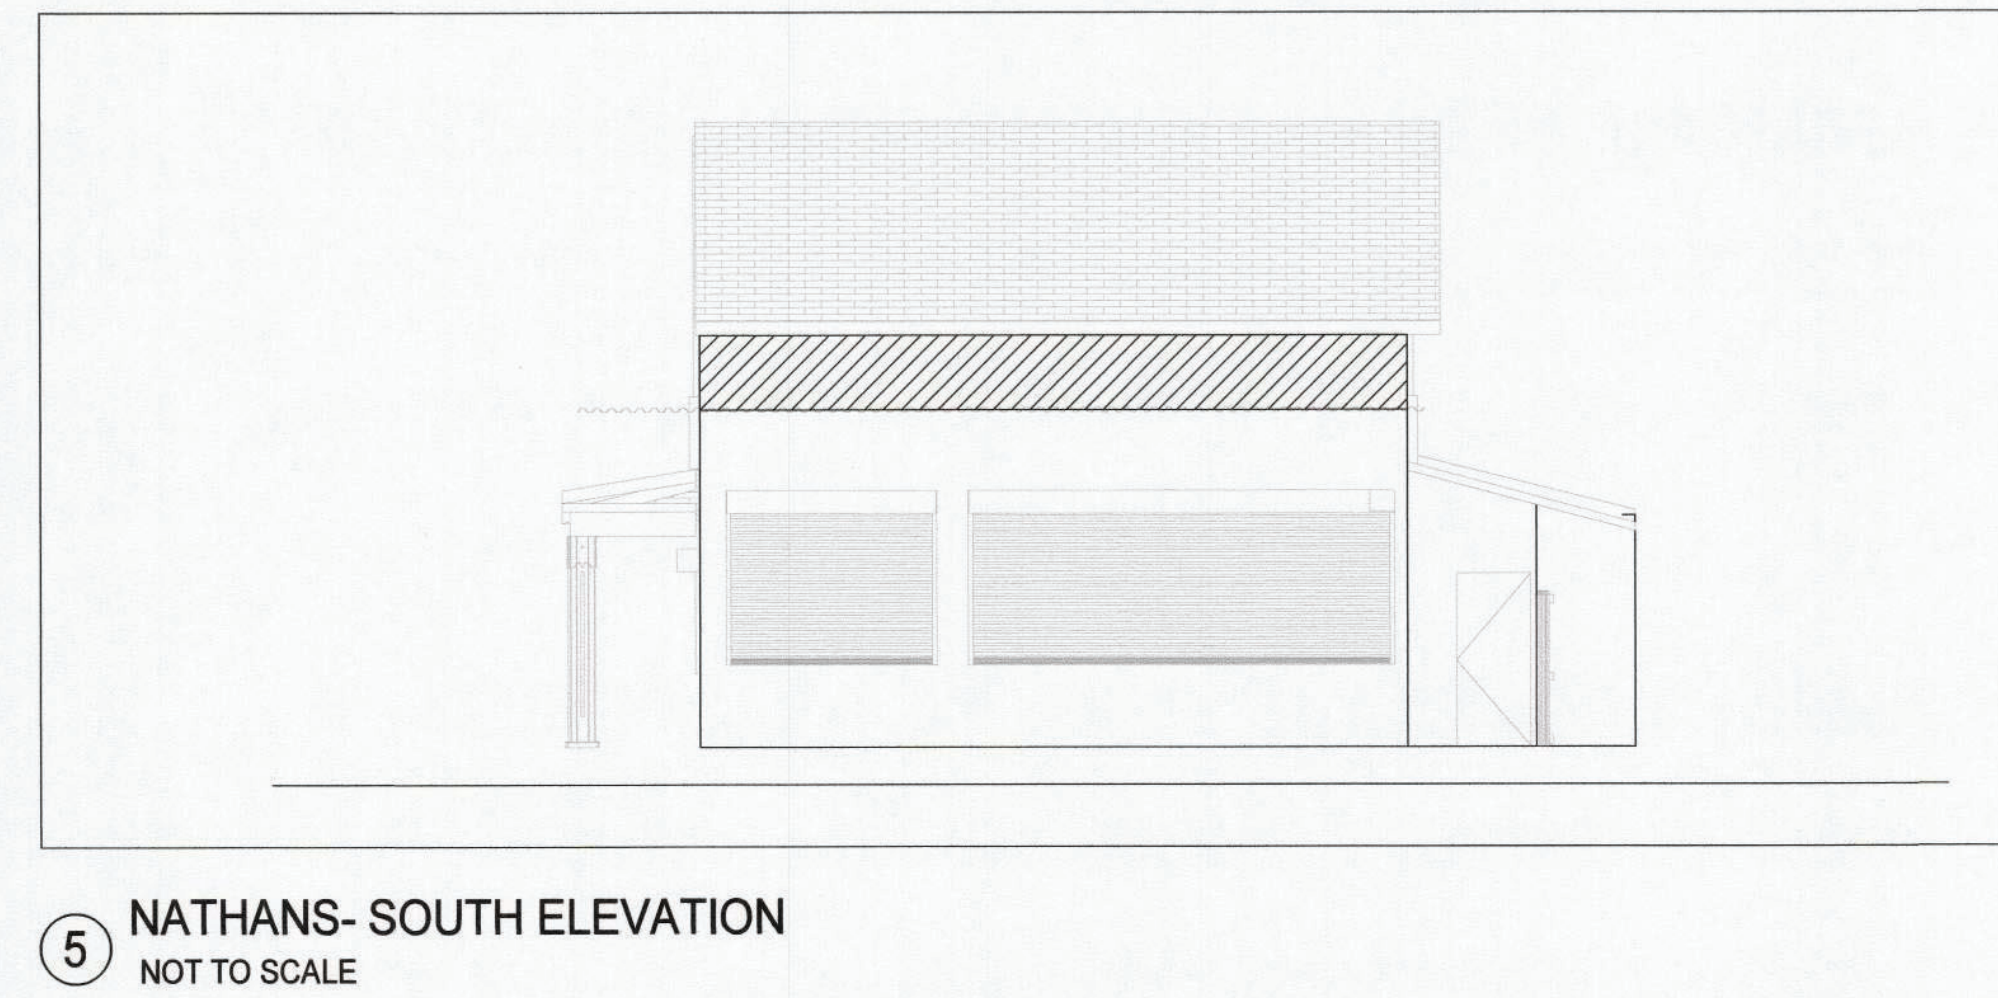
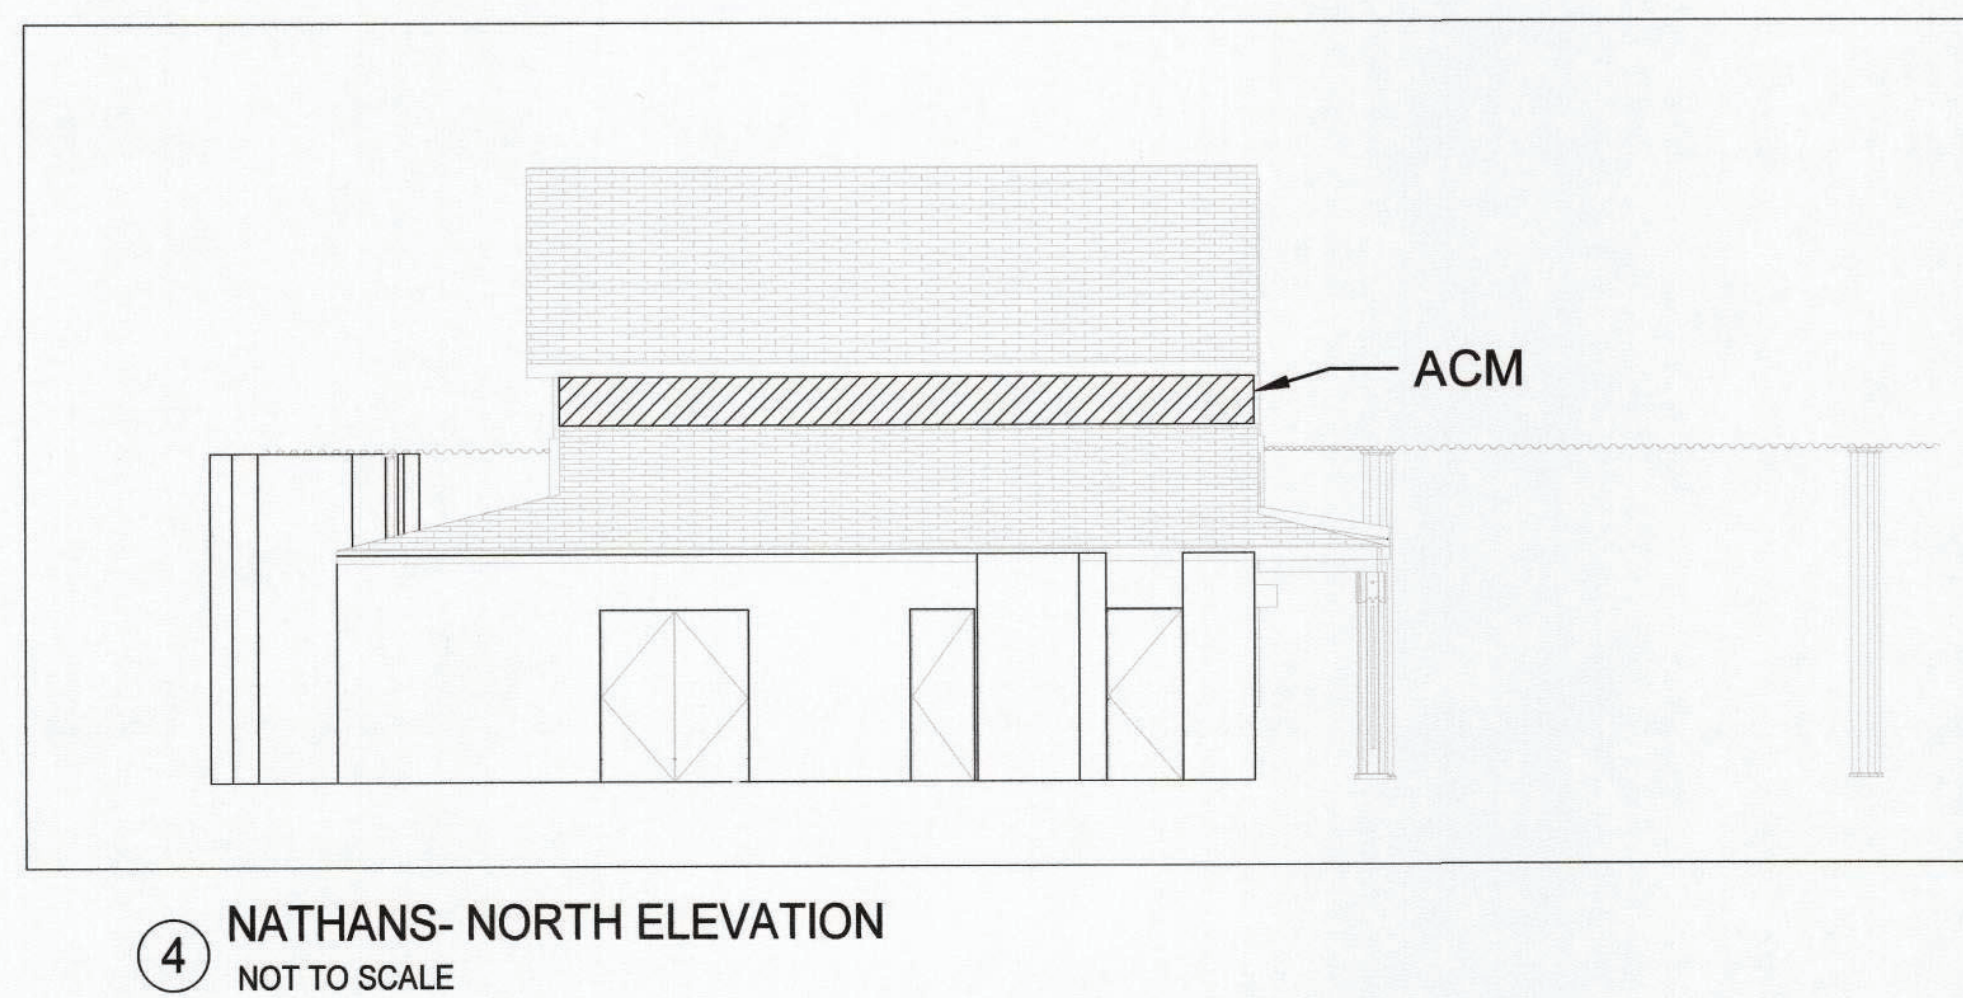
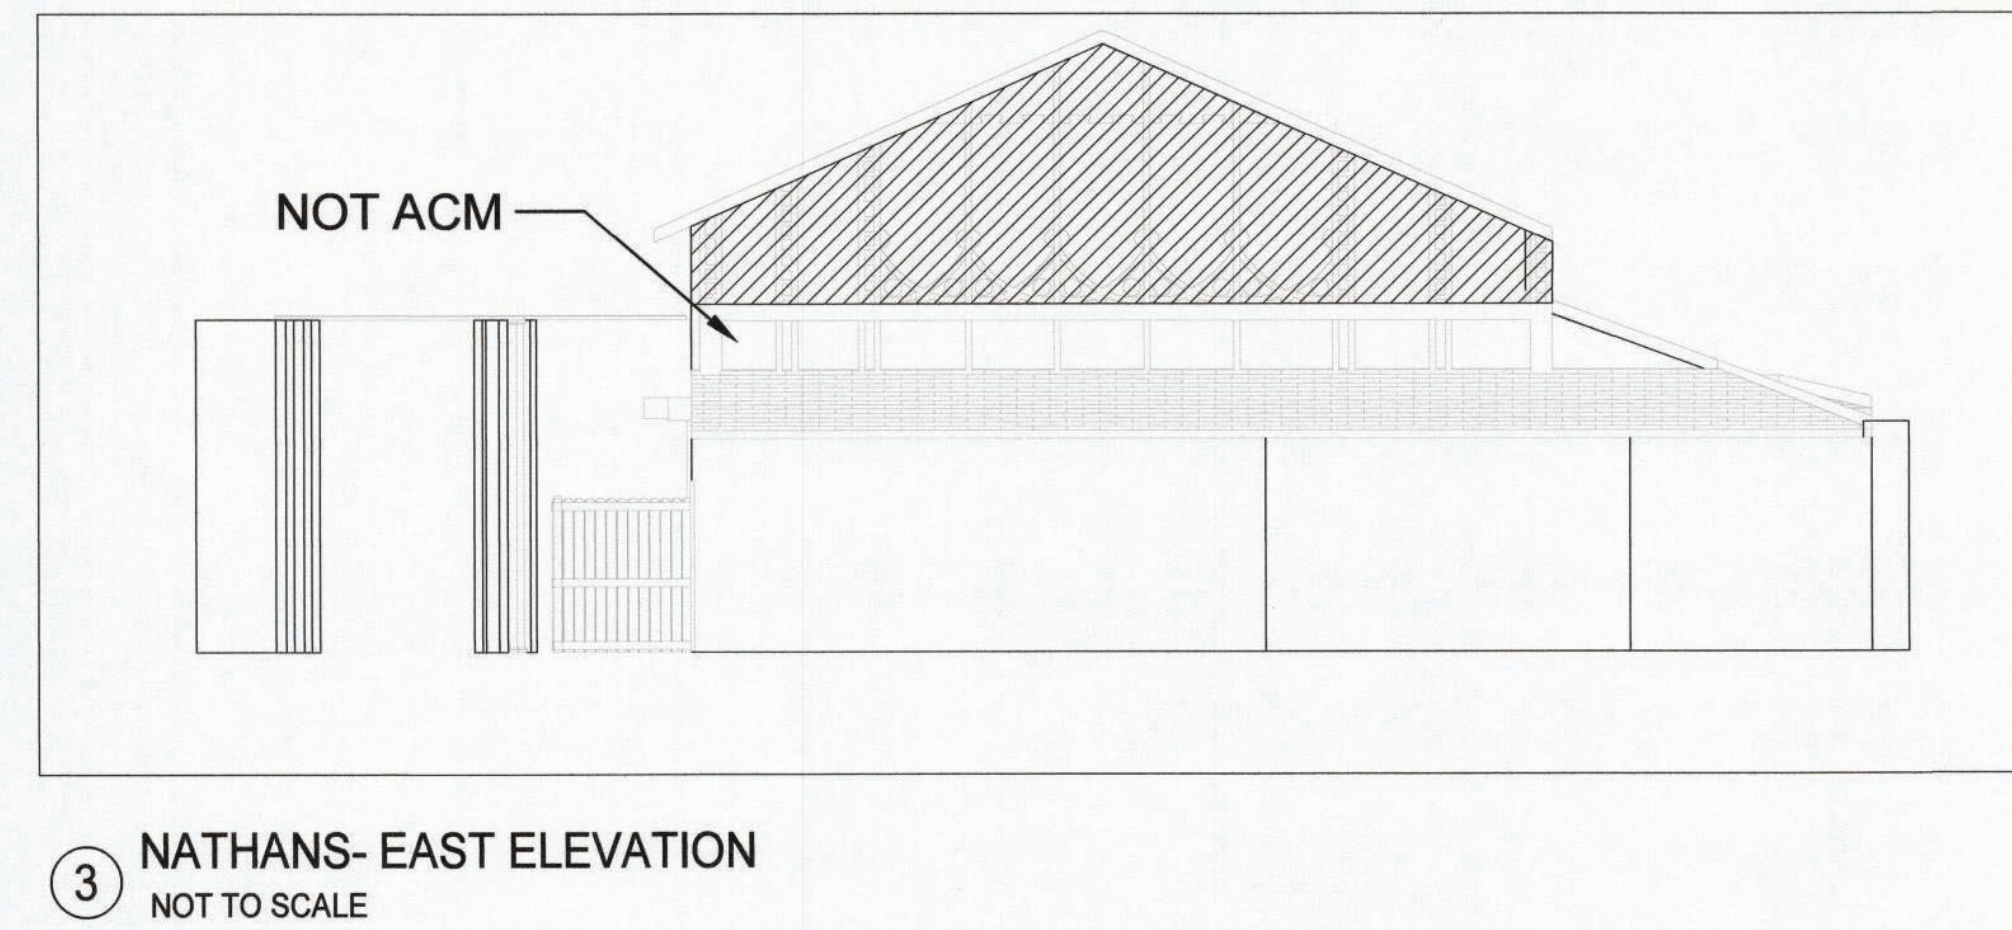
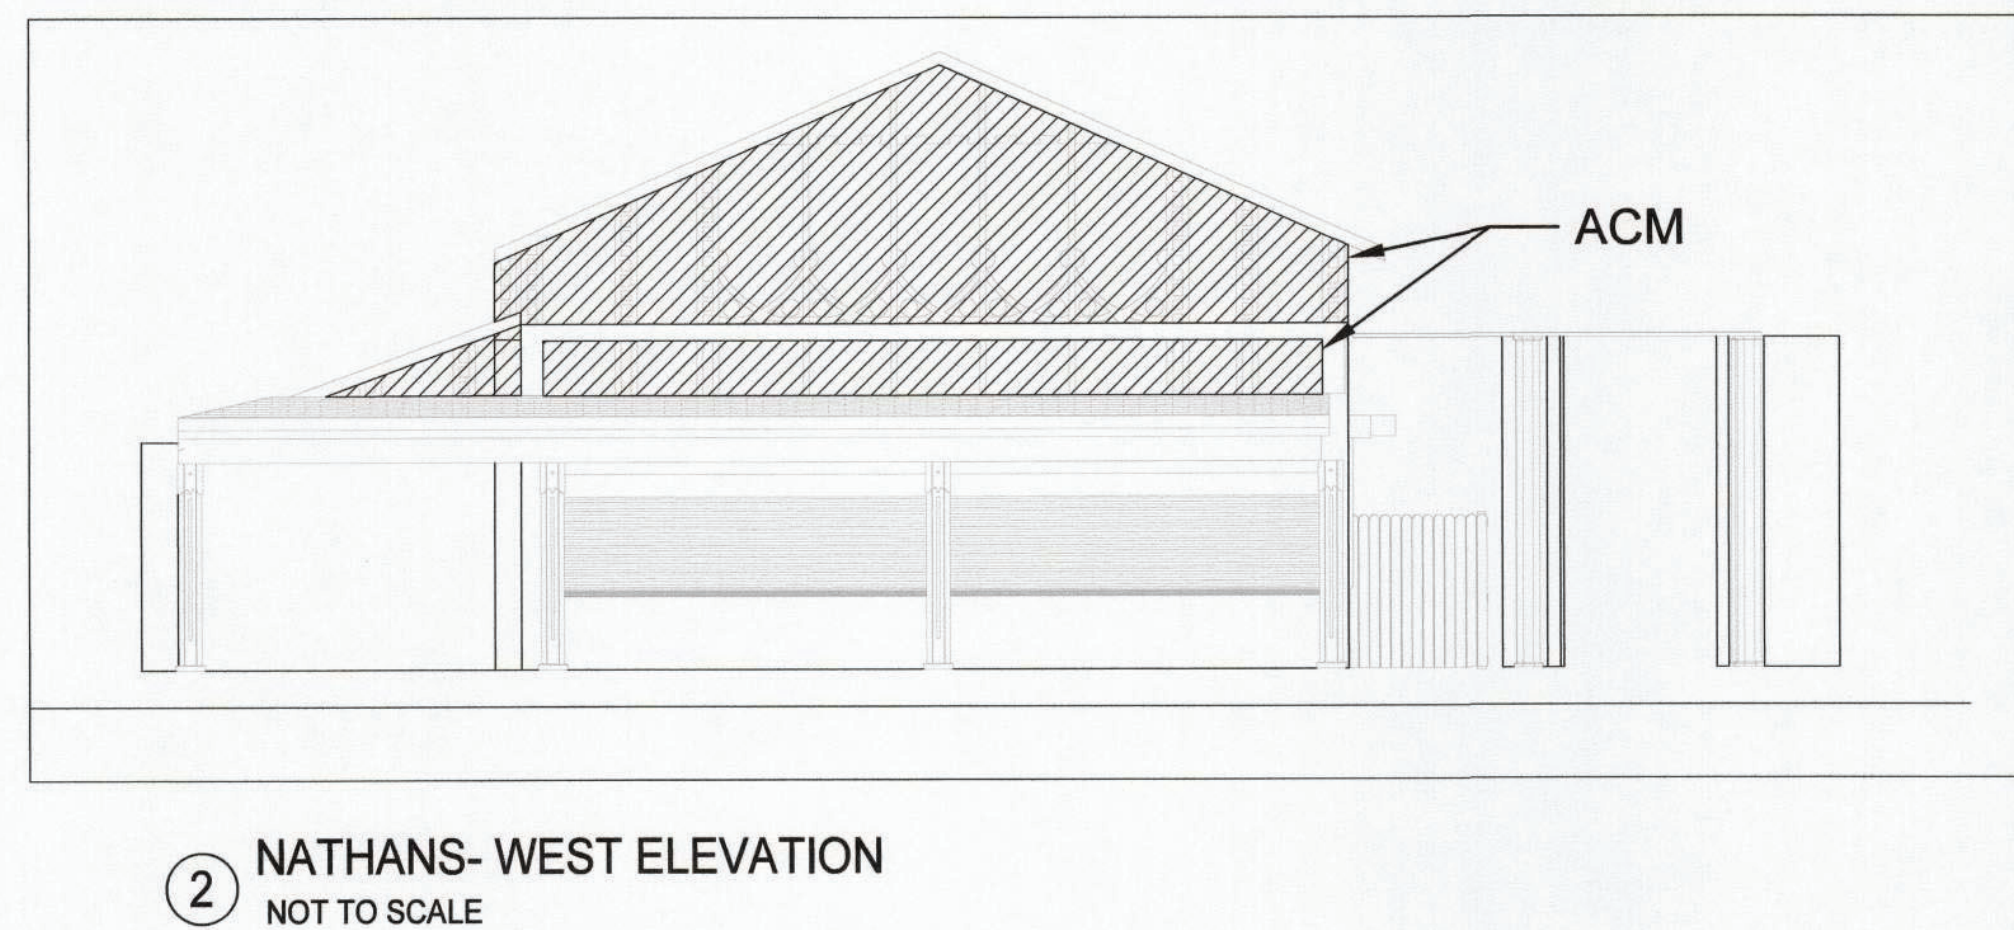
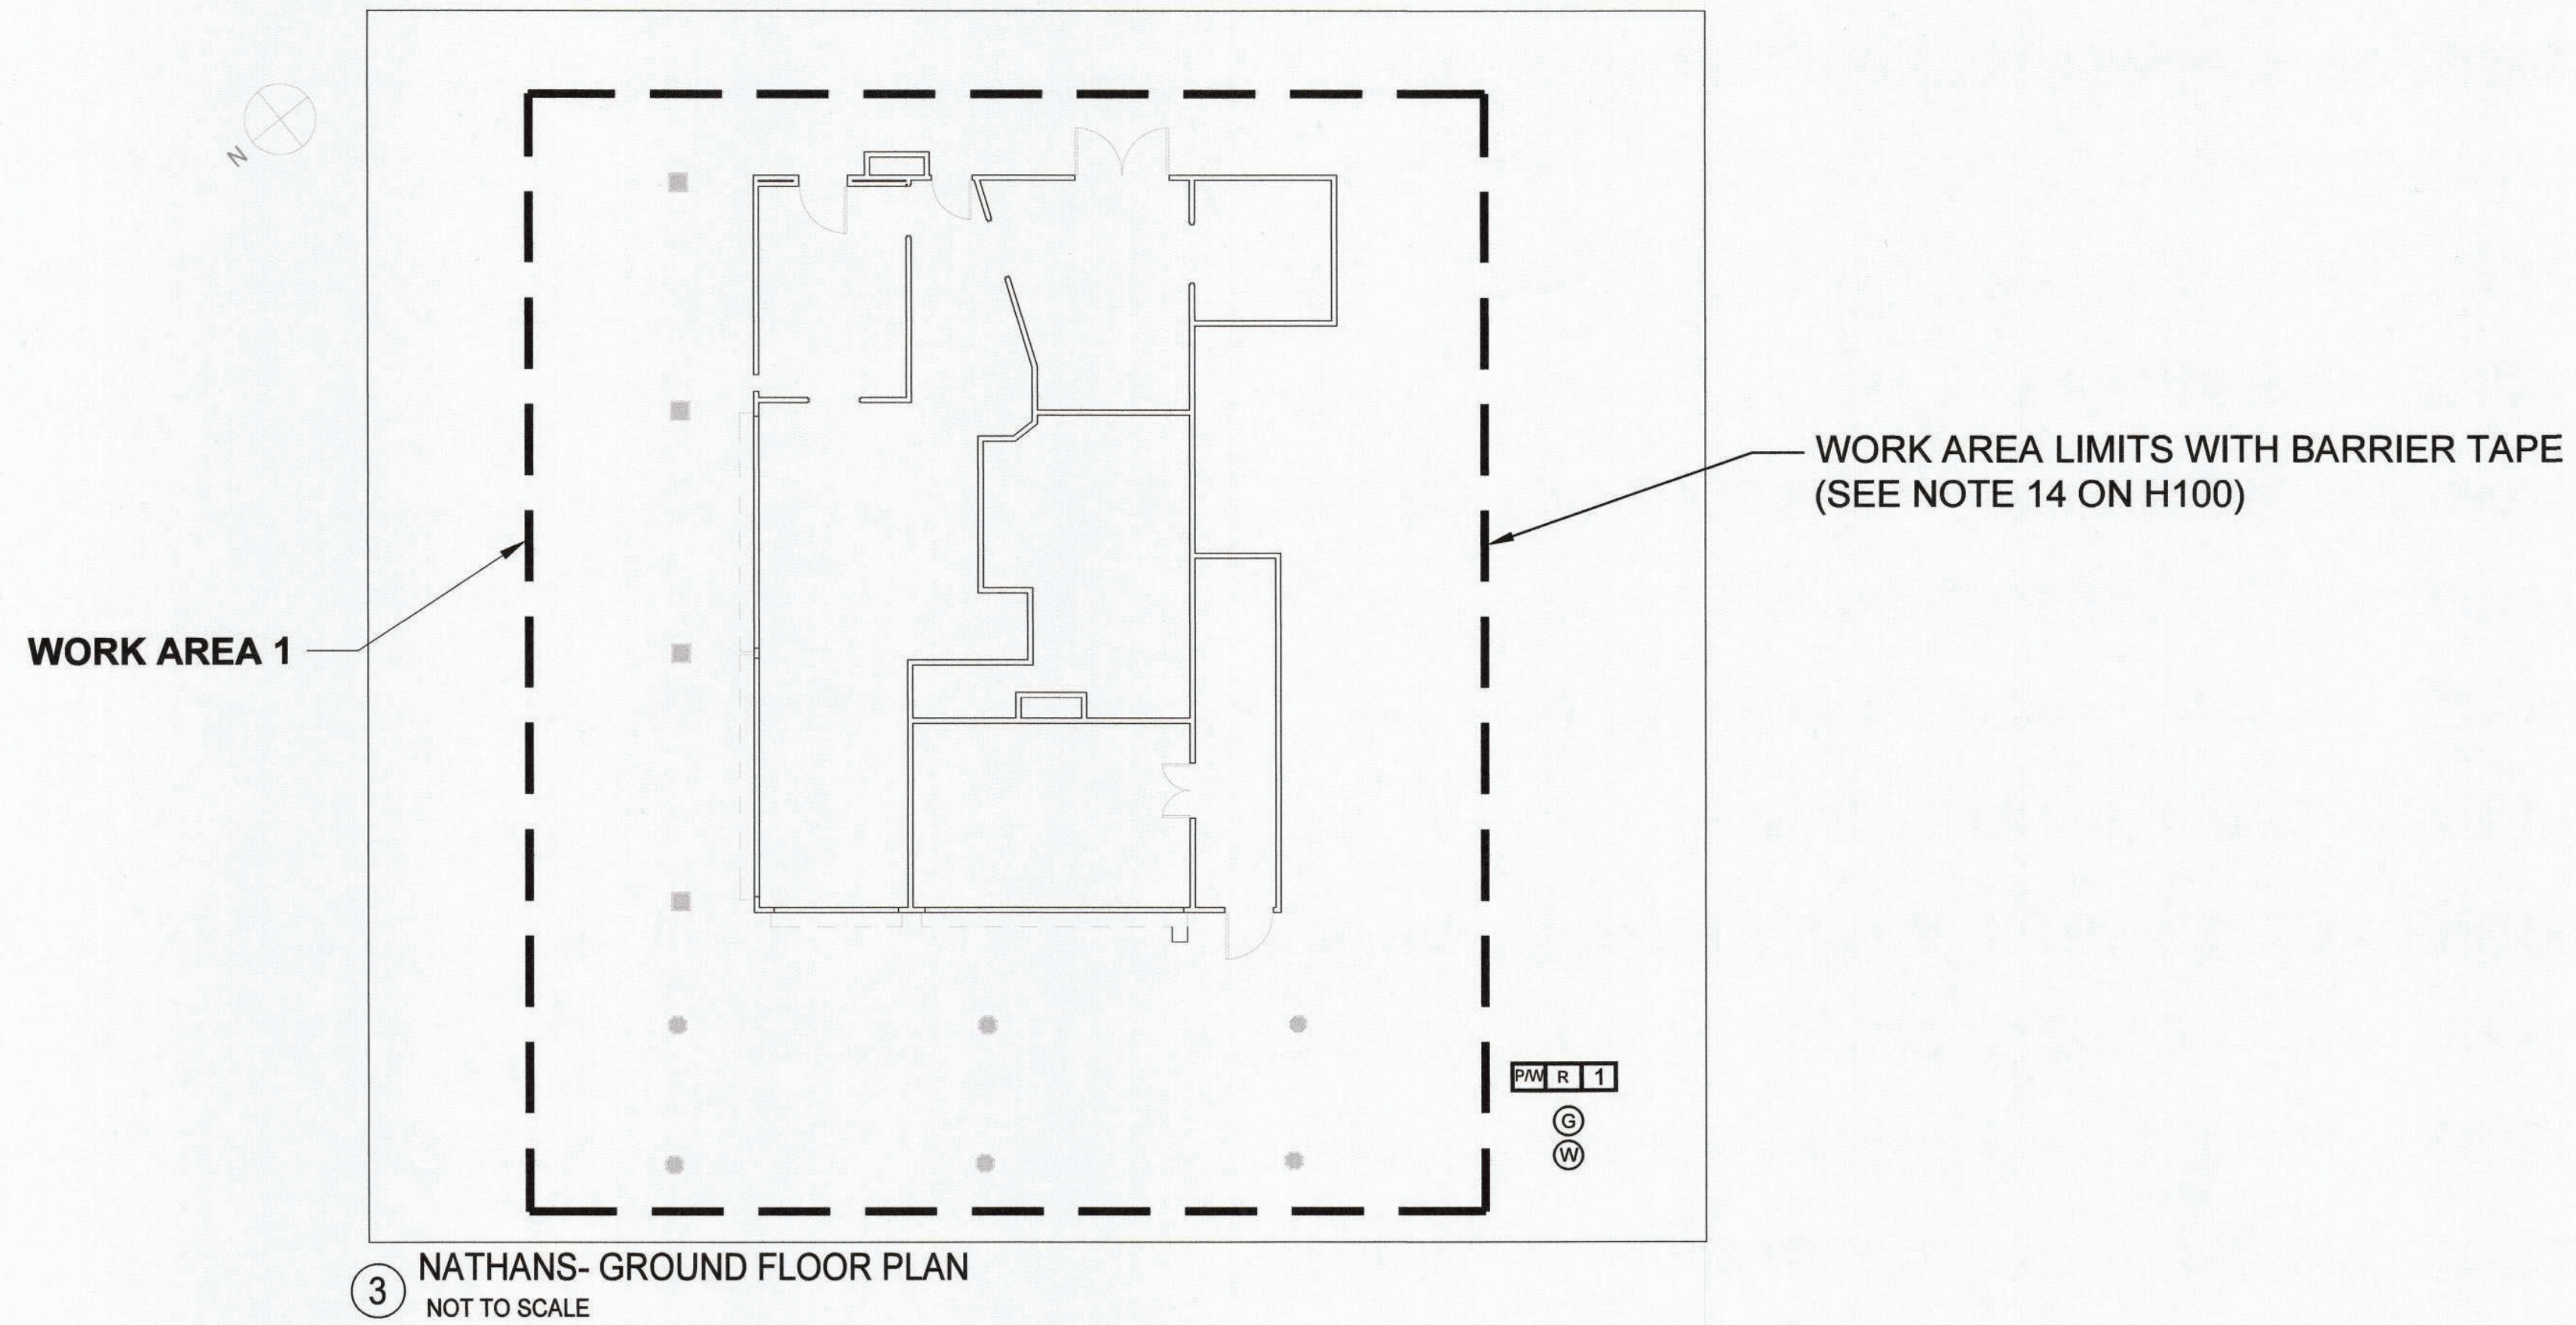


REVISION NUMBER	DATE	MADE BY	APP'D BY	REVISION

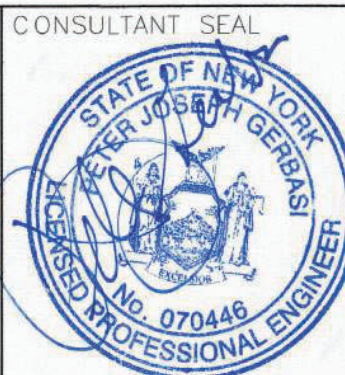RECORD DRAWING CERTIFICATION	
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CONTRACTOR	
NAME	PROJECT COORDINATOR
SIGNATURE	SIGNATURE
TITLE	TITLE
DATE	DATE

WESTCHESTER COUNTY, NEW YORK
DEPARTMENT OF PUBLIC WORKS AND TRANSPORTATION
DIVISION OF ENGINEERING
INFRASTRUCTURE REHABILITATION - PHASE 3
PLAYLAND PARK, RYE, NEW YORK
RESTAURANT KITCHEN
GENERAL ASBESTOS ABATEMENT NOTES

CONTRACT NUMBER 22-523	SHEET NUMBER K-H-10
DWG NO.: 498 of 664	SCALE: NOT TO SCALE
DATE: 08/23/2022	REV. NO. 0
DPW FILE NUMBER 1-118-G-1247-0	



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CONSULTANT
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The LiRo Group

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WESTCHESTER COUNTY, NEW YORK
DEPARTMENT OF PUBLIC WORKS AND TRANSPORTATION
DIVISION OF ENGINEERING

**INFRASTRUCTURE REHABILITATION - PHASE 3
PLAYLAND PARK, RYE, NEW YORK
RESTAURANT KITCHEN**


GROUND FLOOR AND ELEVATIONS ASBESTOS REMOVAL PLAN

CONTRACT NUMBER 22-523	SHEET NUMBER K-H-11
DWG NO.: 499 of 664	SCALE: NOT TO SCALE
DATE: 08/23/2022	REV. NO. 0
DPW FILE NUMBER 1-118-G-1248-0	

PLAYLAND REHABILITATION & UPGRADES RESTAURANT KITCHEN - LEAD REMEDIATION

1 PLAYLAND PKWY, RYE, NY 10580

DETAILS:

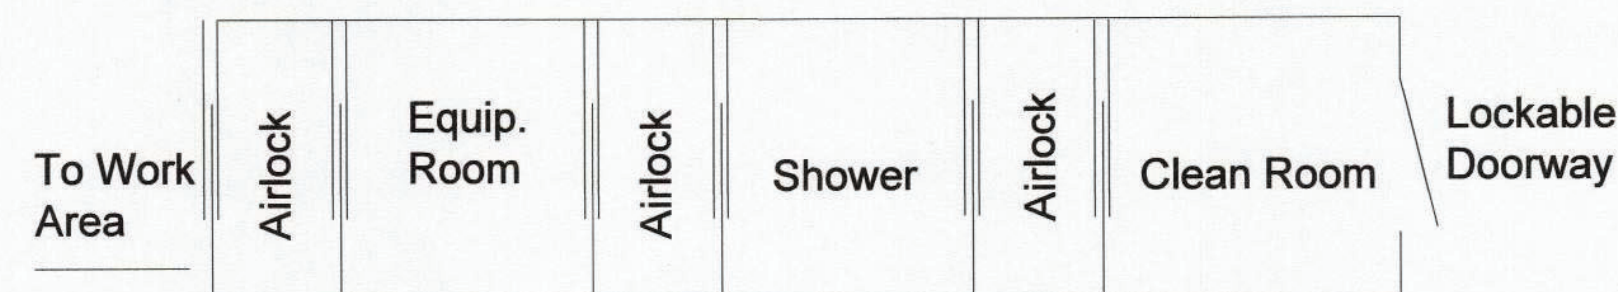

1
K-H-20
LARGE PROJECT REMOTE WORKER
DECONTAMINATION UNIT
Not To Scale

LEGEND:

	WORK AREA LIMITS
	OSHA HANDWASHING STATION
	HAZARDOUS WASTE STORAGE AREA
	AIRLOCK
	TEMPORARY WATER SOURCE
	TEMPORARY ELECTRICAL SOURCE
	CORNICE / FASCIA ELEMENTS
	WALL CLADDING / TRIM ELEMENTS
	COLUMNS

SCOPE OF WORK TABLE:


Work Area	Location	Description	Material	Quantity	Procedure
1	Main Nathan's	West Elevation	Soffit (Beige Coating)	90 SF	Manual Wet Scrape / Chemical Strip
			Wood Columns (Beige, Orange & Green Coating)	48 SF (4 at 12 SF each)	
		East Elevation	Wall Paint (Beige Coating)	300 SF	
			Soffit (Beige Coating)	50 SF	
			Window Frame (Beige Coating)	30 LF	
			Wood Pilaster (Beige, Orange & Green Coating)	48 SF (4 at 12 SF each)	
		North, South, West East Elevation	Eave (Beige Coating)	168 SF	

PROJECT NOTES:


- All layers of coating shall be considered as LBP and removed down to the substrates. Substrates coated with LBP and targeted for demolition may be removed and disposed of solid structure waste following TCLP testing.
- Substrates coated with LBP and targeted for refurbish and recoating shall be abated using manual wet scraping or chemical stripping procedures, localized testing of chemical strapping products shall proceed broader use and only after approval by the DPW Environmental Consultant.
- The abatement contractor shall separate paint chips and contaminated dust/particulate generated by the abatement from other project waste streams including worker personal protective equipment and plastic sheeting. All waste other than lead paint chips and contaminated dust/particulate shall be TCLP tested prior to disposal.
- Waste generated by the work of this method shall be stored on site in a NYSDEC compliant Hazardous and Waste Storage Area and transported under manifest to the disposal site.
- The contractor shall prepare a project specific work plan and project specific HASP for the work of this contract.
- LBP remediation shall be consistent with guidelines from SSPC and work shall comply with the OSHA regulations including using of decontamination units and hand wash stations.
- The contractor may propose alternate LBP removal procedures however, use of alternate procedures will require approval by DPW Environmental Consultant; the abatement contractor is responsible with maintaining the physical conditions and integrity of the targeted substrates, and the surrounding structures during abatement work.
- The Contractor shall request and receive in writing prior to preceding with any work info from the owner regarding surfaces/materials that require protection.

KEYPLAN:



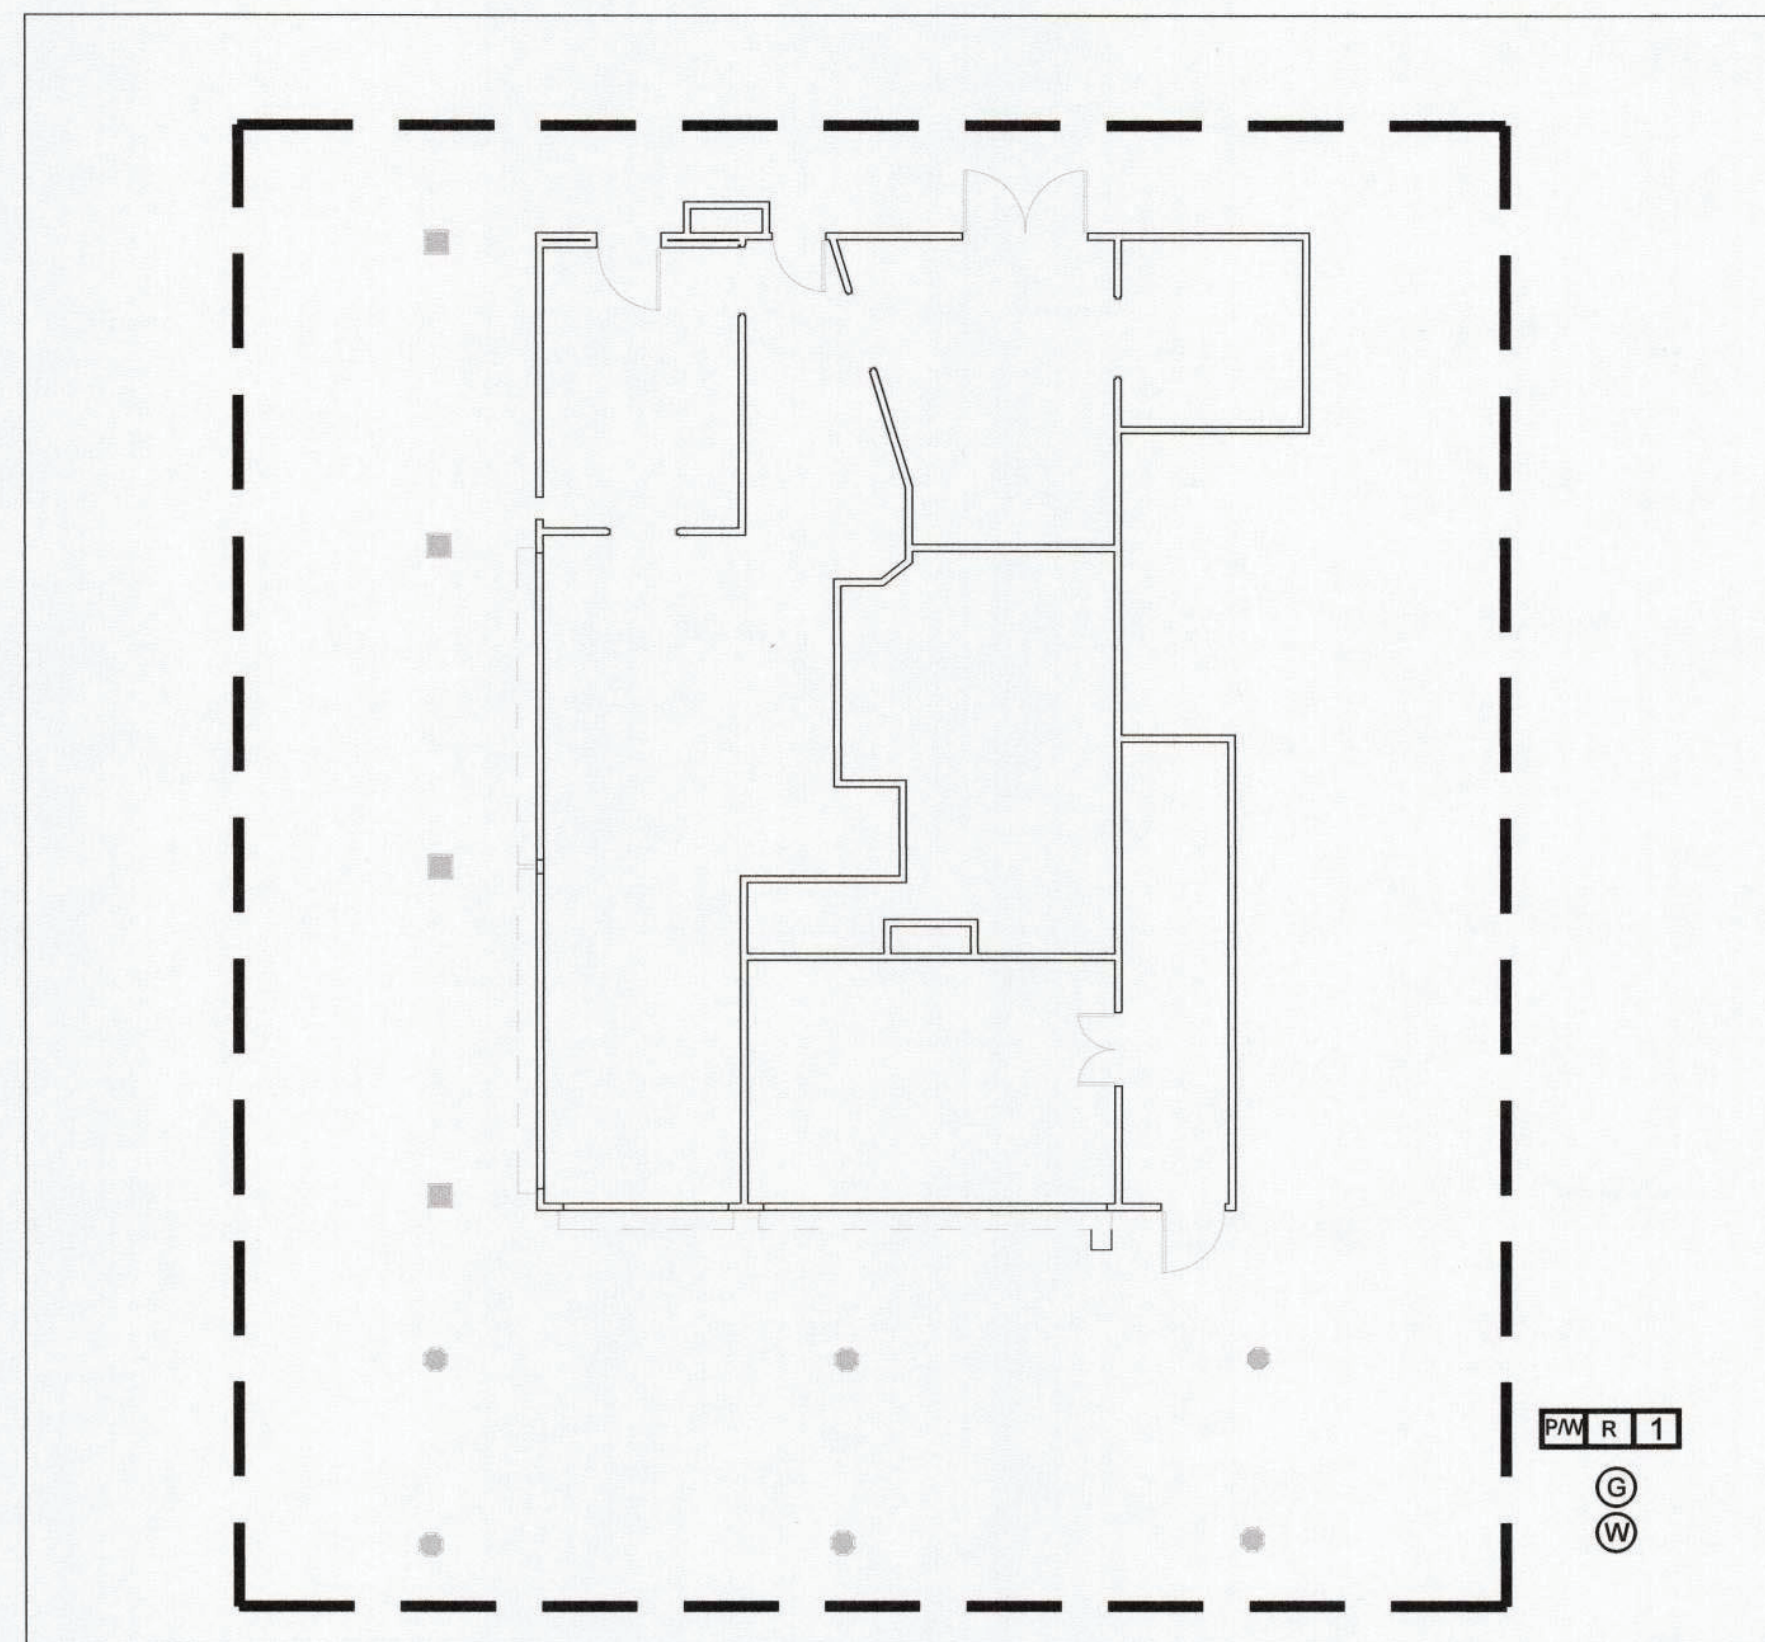


③ NATHANS- GROUND FLOOR PLAN
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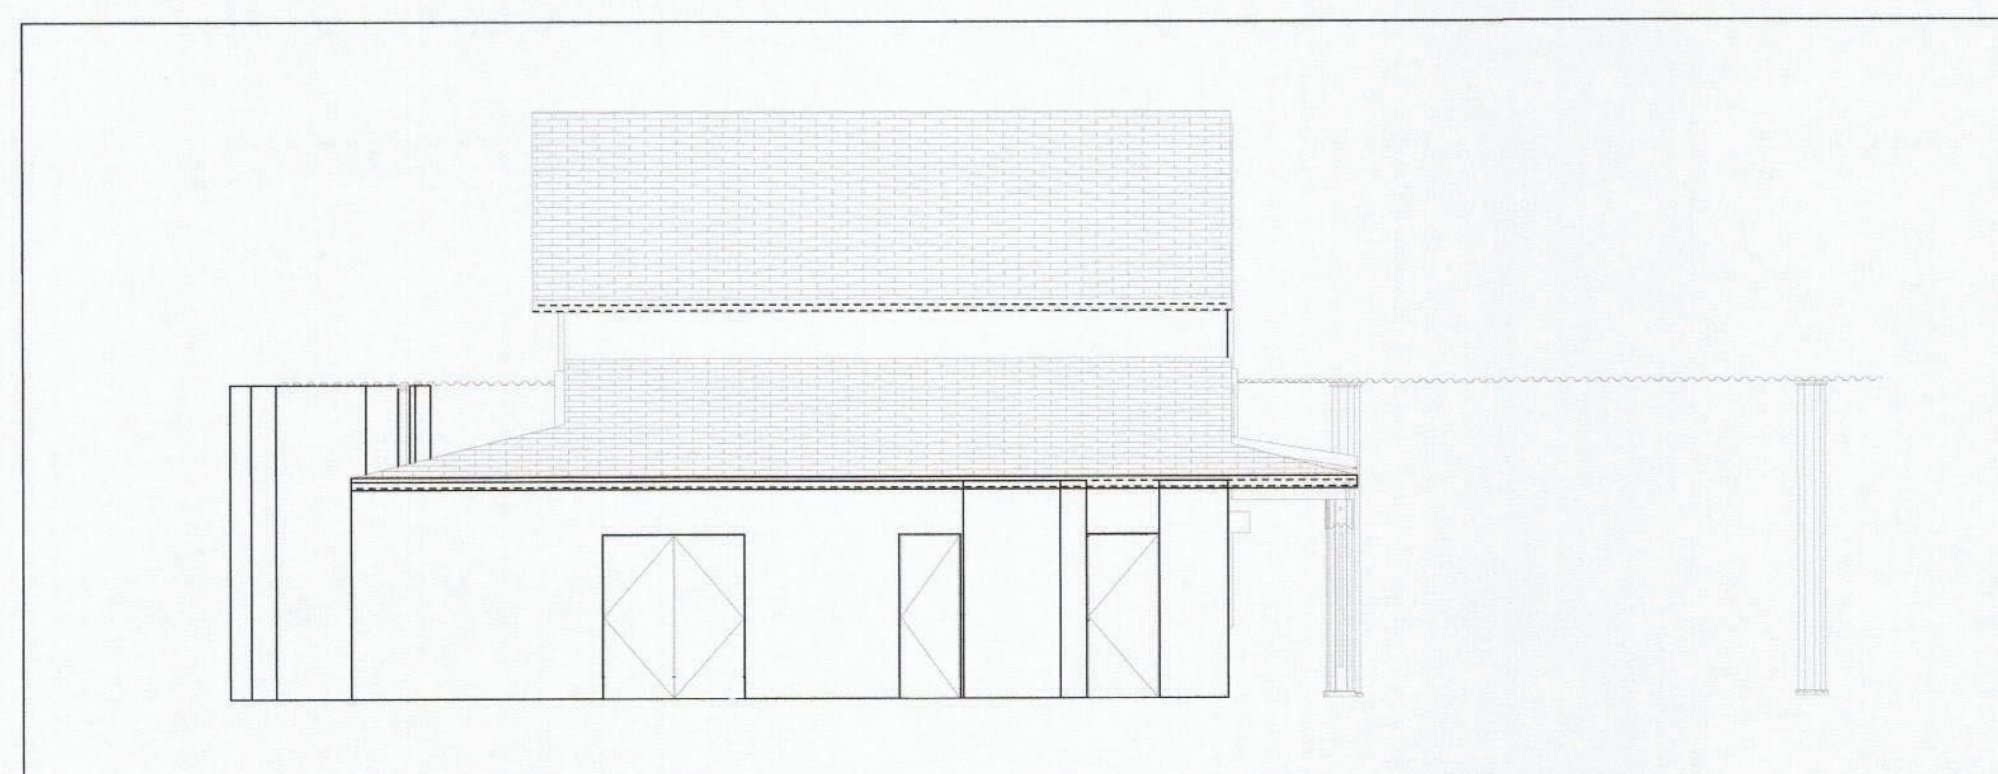


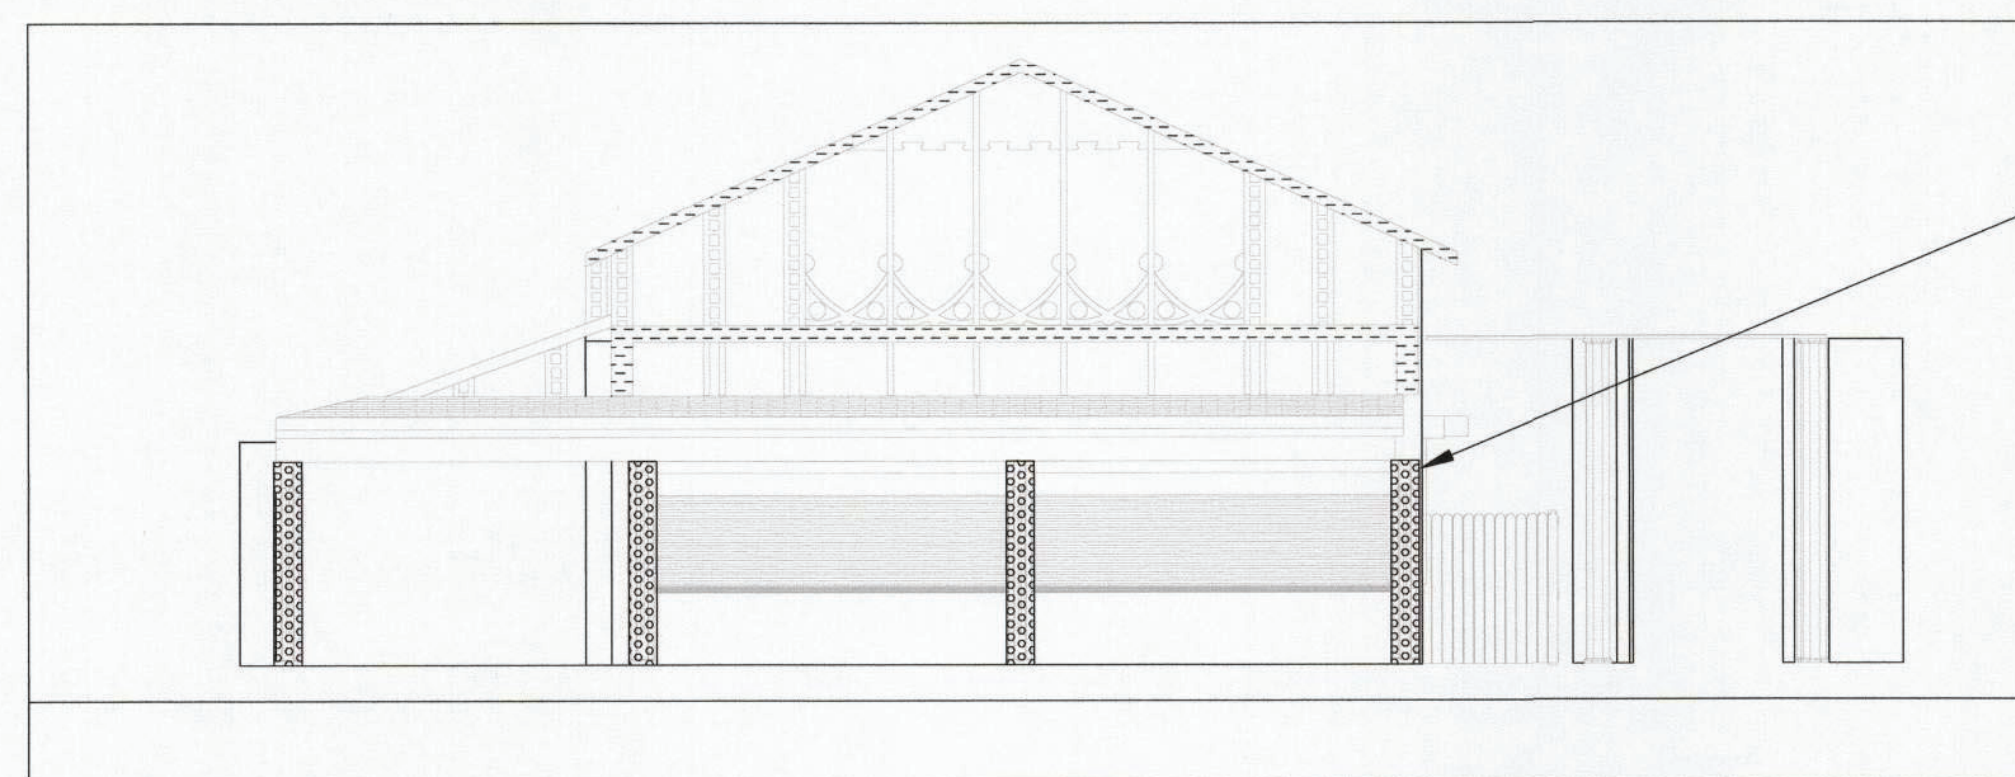WOOD COLUMN/
PILASTER (TYPICAL)


② NATHANS- WEST ELEVATION
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③ NATHANS- EAST ELEVATION
NOT TO SCALE

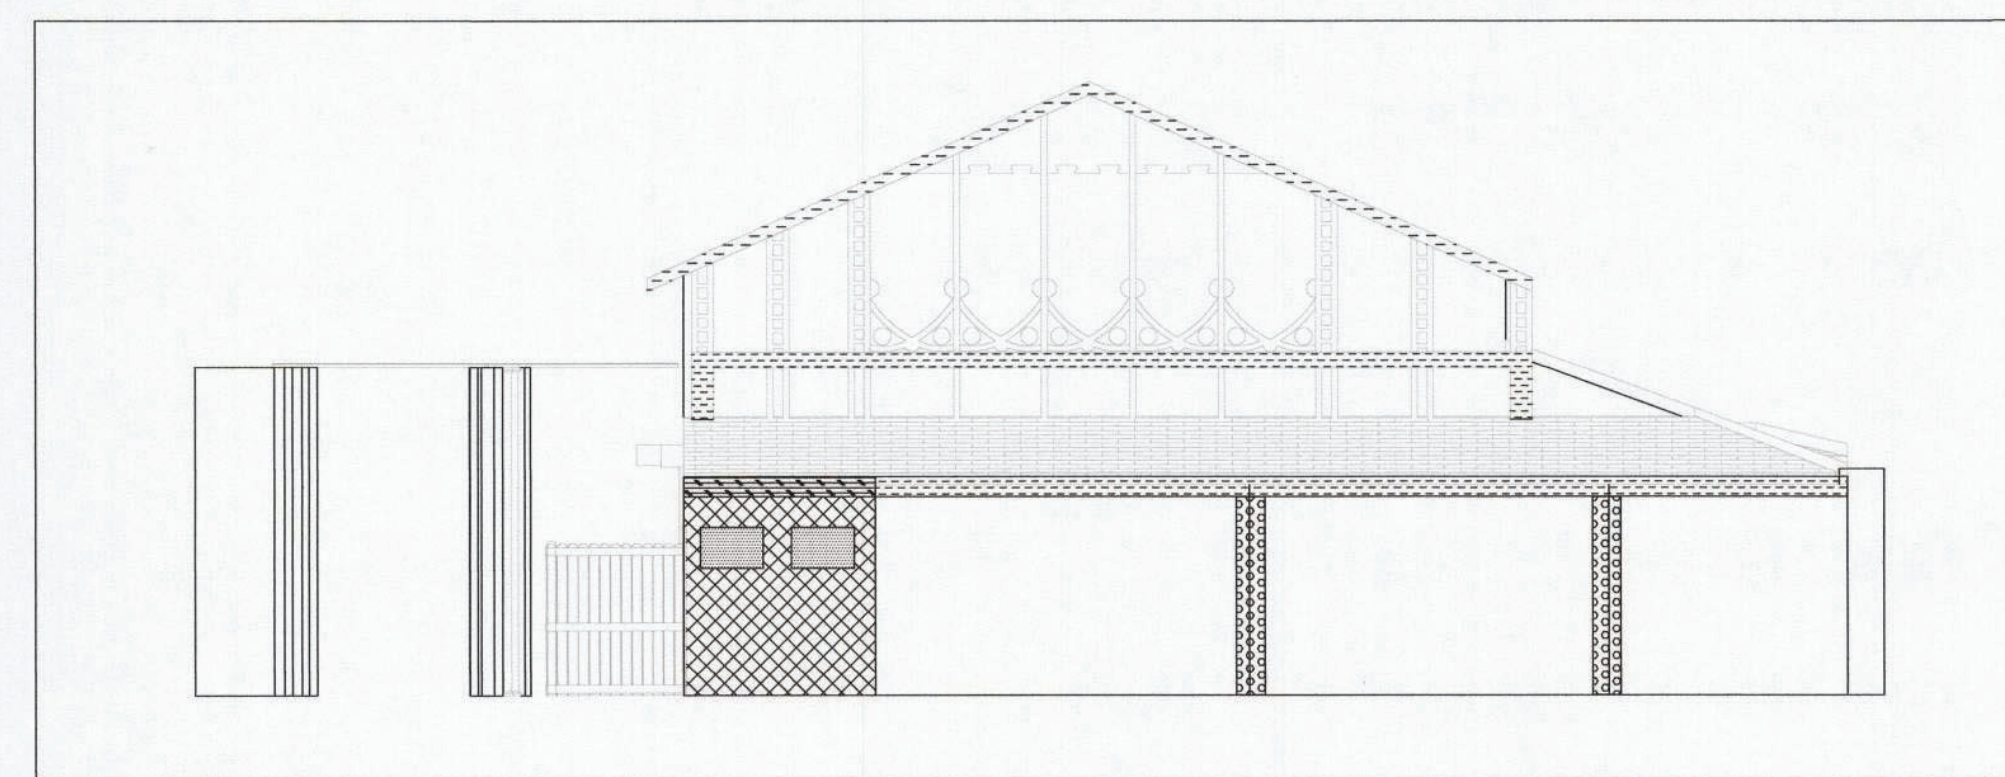


④ NATHANS- NORTH ELEVATION
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⑤ NATHANS- SOUTH ELEVATION
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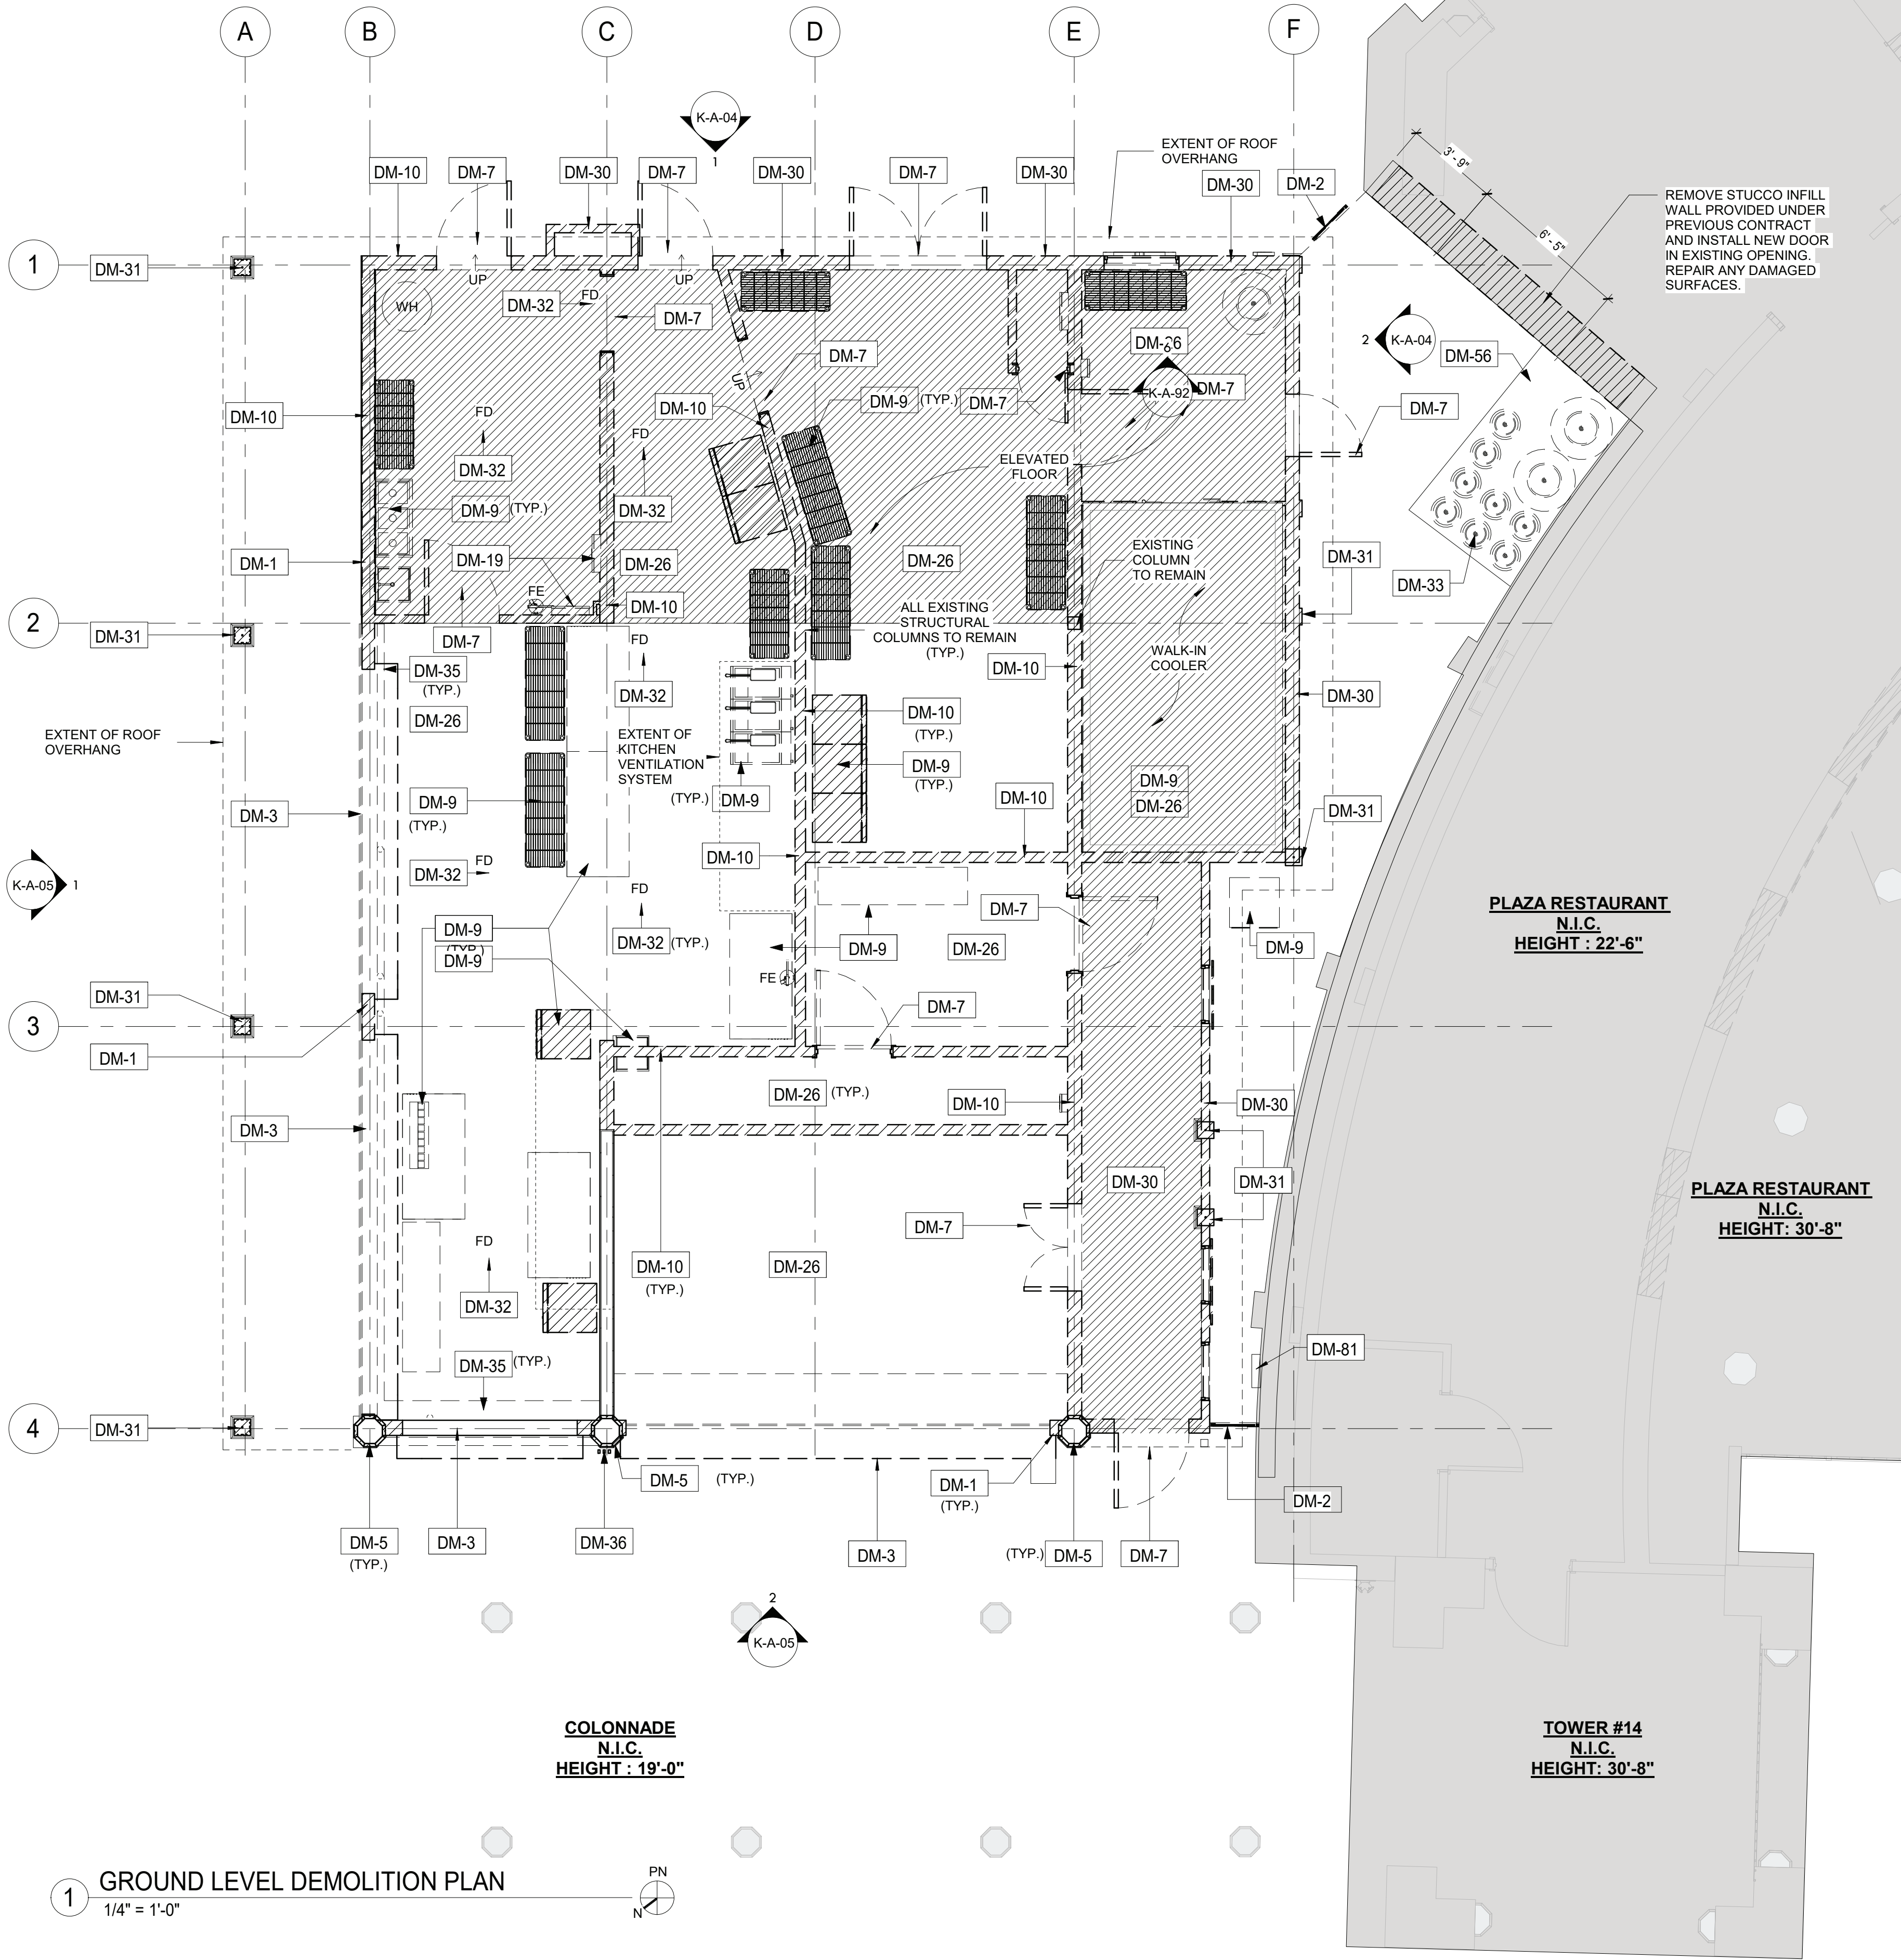

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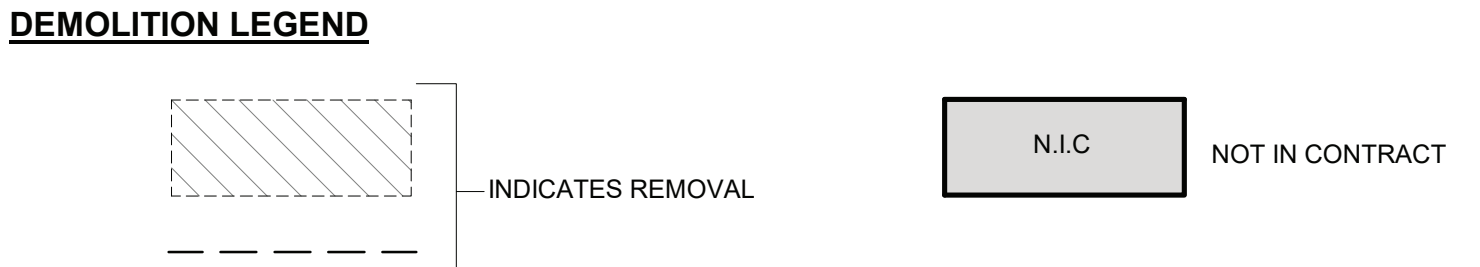
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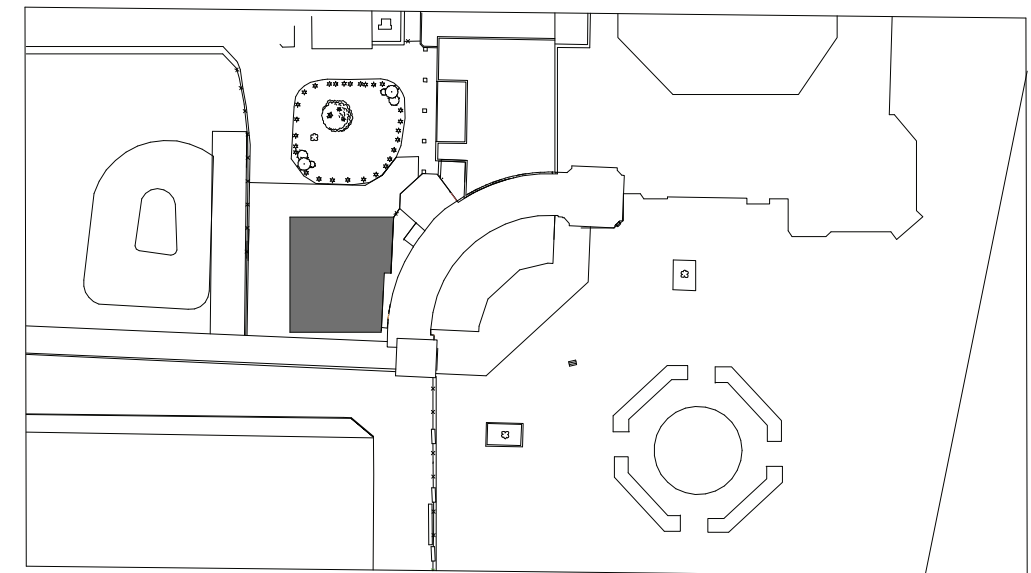
WESTCHESTER COUNTY, NEW YORK DEPARTMENT OF PUBLIC WORKS AND TRANSPORTATION DIVISION OF ENGINEERING		CONTRACT NUMBER 22-523	SHEET NUMBER K-H-21
INFRASTRUCTURE REHABILITATION - PHASE 3 PLAYLAND PARK, RYE, NEW YORK RESTAURANT KITCHEN GROUND FLOOR AND ELEVATION LEAD REMEDIATION PLAN		DWG. NO.: SCALE: DATE: DPW FILE NUMBER	501 of 664 NOT TO SCALE 08/23/2022 1-118-G-1250-0 REV. NO. 0




- DEMOLITION GENERAL NOTES**
- ALL DEMOLITION AND REMOVAL WORK INCLUDES, BUT IS NOT LIMITED TO THE WORK INDICATED, NOTED, SPECIFIED, AND COORDINATED WITH WORK OF ALL OTHER TRADES, AS INDICATED ELSEWHERE, AND AS REQUIRED TO ACCOMMODATE CONSTRUCTION.
 - PRIOR TO STARTING WORK, CONTRACTOR TO MAKE A THOROUGH EXAMINATION OF THE PORTIONS OF THE STRUCTURE IN WHICH THE WORK IS TO BE PERFORMED INCLUDING, BUT NOT LIMITED TO THE WORK AT ADJOINING OR UNDERLYING LOCATIONS, REPORT TO THE ARCHITECT ANY AND ALL CONDITIONS WHICH MAY INTERFERE WITH OR OTHERWISE PREVENT THE PROPER EXECUTION AND COMPLETION OF THE WORK. WORK SHALL NOT START UNTIL SUCH CONDITIONS HAVE BEEN EXAMINED AND MUTUALLY AGREED UPON WITH THE ARCHITECT.
 - DASHED LINES INDICATE WALLS, FIXTURES, EQUIPMENT, ETC. TO BE REMOVED AND DISPOSED OF BY G.C.
 - ANY QUESTIONS OR DISCREPANCIES ARISING FROM THIS DRAWING MUST BE DIRECTED TO THE ARCHITECT PRIOR TO BID. SHOULD QUESTIONS OR DISCREPANCIES ARISE, THE CONTRACTOR SHALL NOTIFY THE ARCHITECT, IN WRITING, PRIOR TO PROCEEDING WITH DEMOLITION.
 - ALL DIMENSIONS, LOCATIONS AND/OR ELEVATIONS OF EXISTING CONSTRUCTION CONDITIONS ARE APPROXIMATE. CONTRACTOR TO VERIFY EXISTING CONDITIONS PRIOR TO THE START OF WORK.
 - CONTRACTOR(S) ARE RESPONSIBLE FOR SHORING, BRACING AND UNDERPINNING RELATED TO THE DEMOLITION, REMOVAL OR CUTTING OF AN WALL, PARTITION, OR ANY OTHER LOAD-BEARING OR STRUCTURAL ELEMENT.
 - ALTER AND RESTORE EXISTING WALLS, PARTITIONS, COLUMNS, CEILING AND FLOORS, AND THEIR RESPECTIVE FINISHED SURFACES TO ACCOMMODATE NEW CONSTRUCTION AND FINISHES, IN ACCORDANCE WITH DRAWINGS AND SPECIFICATIONS.
 - IMMEDIATELY NOTIFY THE OWNER'S REPRESENTATIVES OF ANY HAZARDOUS MATERIALS ENCOUNTERED DURING DEMOLITION/REMOVAL.
 - CONTAINERIZED DEMOLITION DEBRIS SHALL BE TCLP TESTED TO CONFIRM WASTE MAY BE DISPOSED OF AS NON-HAZARDOUS.
 - ALL ITEMS SCHEDULED FOR DEMOLITION SHALL BE REMOVED FROM THE SITE UNLESS OTHERWISE NOTED. CONTRACTOR SHALL BE RESPONSIBLE FOR CLEANING OF SITE ON A DAILY BASIS.
 - REFER TO ELECTRICAL, MECHANICAL, STRUCTURAL, PLUMBING, ETC. DEMOLITION DRAWINGS FOR ADDITIONAL ITEMS.
 - PATCH AND REPAIR SURFACES (FLOOR, WALL, CEILING) DAMAGED IN PREPARATION FOR NEW EQUIPMENT AND FINISHES.

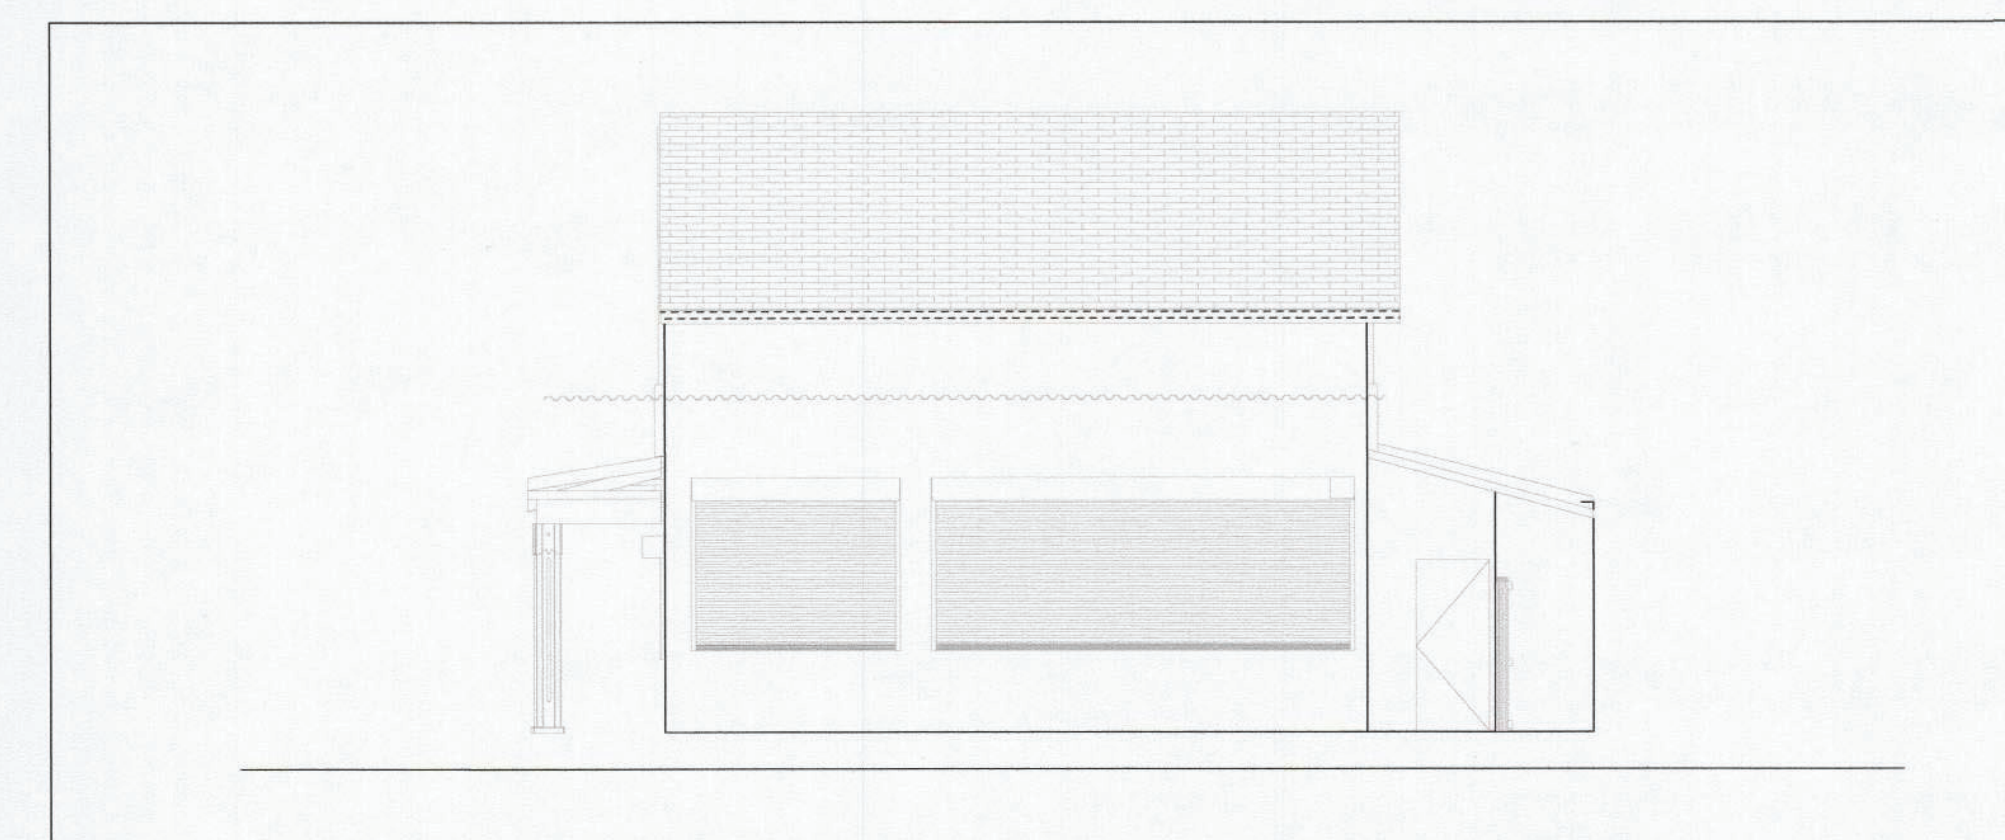

Key Value	Keynote Text
DM-1	REMOVE EXISTING WOOD SIDING.
DM-2	REMOVE EXISTING GATE.
DM-3	REMOVE ROLL DOWN DOOR AND ASSOCIATED HARDWARE.
DM-5	REMOVE COLUMN ENCLOSURES. CAREFULLY REMOVE AT LEAST ONE COLUMN ENCLOSURE TO USE AS REFERENCE IN ORDER TO REPLICATE TRIMS TO MATCH LOCATION, SIZE AND SHAPE AS INDICATED. COORDINATE WITH STRUCTURAL DRAWINGS.
DM-7	REMOVE EXISTING DOOR & FRAME.
DM-9	CONTRACTOR TO REMOVE ANY REMAINING EQUIPMENT AND BUILDING CONTENT. CONTENT MAY INCLUDE BUT NOT LIMITED TO REFRIGERATOR, STORAGE, RACKS, AC UNITS, GAMES ETC.
DM-10	REMOVE INTERIOR PARTITION.
DM-19	DISCONNECT AND REMOVE EXISTING SUSPENDED EQUIPMENT SUCH AS CAMERAS, SPEAKERS, ETC. SEE ELECTRICAL DRAWINGS FOR DETAILS.
DM-26	REMOVE EXISTING FLOOR AND CONCRETE SLAB ON GRADE. SEE STRUCTURAL DRAWINGS.
DM-30	EXISTING STRUCTURE TO BE REMOVED IN ITS ENTIRETY. SEE PLANS FOR EXTENT OF REMOVAL.
DM-31	REMOVE EXISTING COLUMN.
DM-32	REMOVE EXISTING FLOOR DRAIN. REFER TO PLUMBING DRAWINGS.
DM-33	REMOVE GAS SERVICE TO BUILDING. EXISTING TANKS TO BE REMOVED.
DM-35	REMOVE COUNTER AND ALL RELATED COMPONENTS.
DM-36	CAREFULLY REMOVE AND RELOCATE EXISTING WIRING, CONDUITS. SEE ELECTRICAL DRAWINGS.
DM-56	REMOVE EXISTING CONCRETE PAD.
DM-81	EXISTING DATA/ TELEPHONE COMMUNICATION CABLES TO BE SUPPORTED DURING CONSTRUCTION AND RELOCATED AS INDICATED.

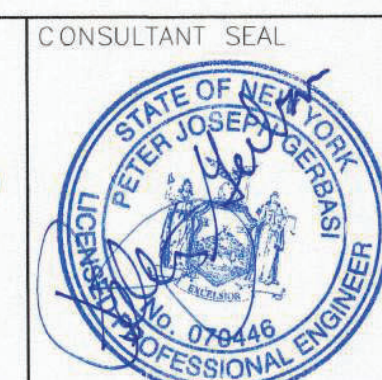

DEMO KEY PLAN

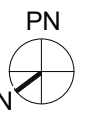

8/30/2022 2:50:56 PM

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REVISION NUMBER	DATE	MADE BY	APP'D BY	REVISION

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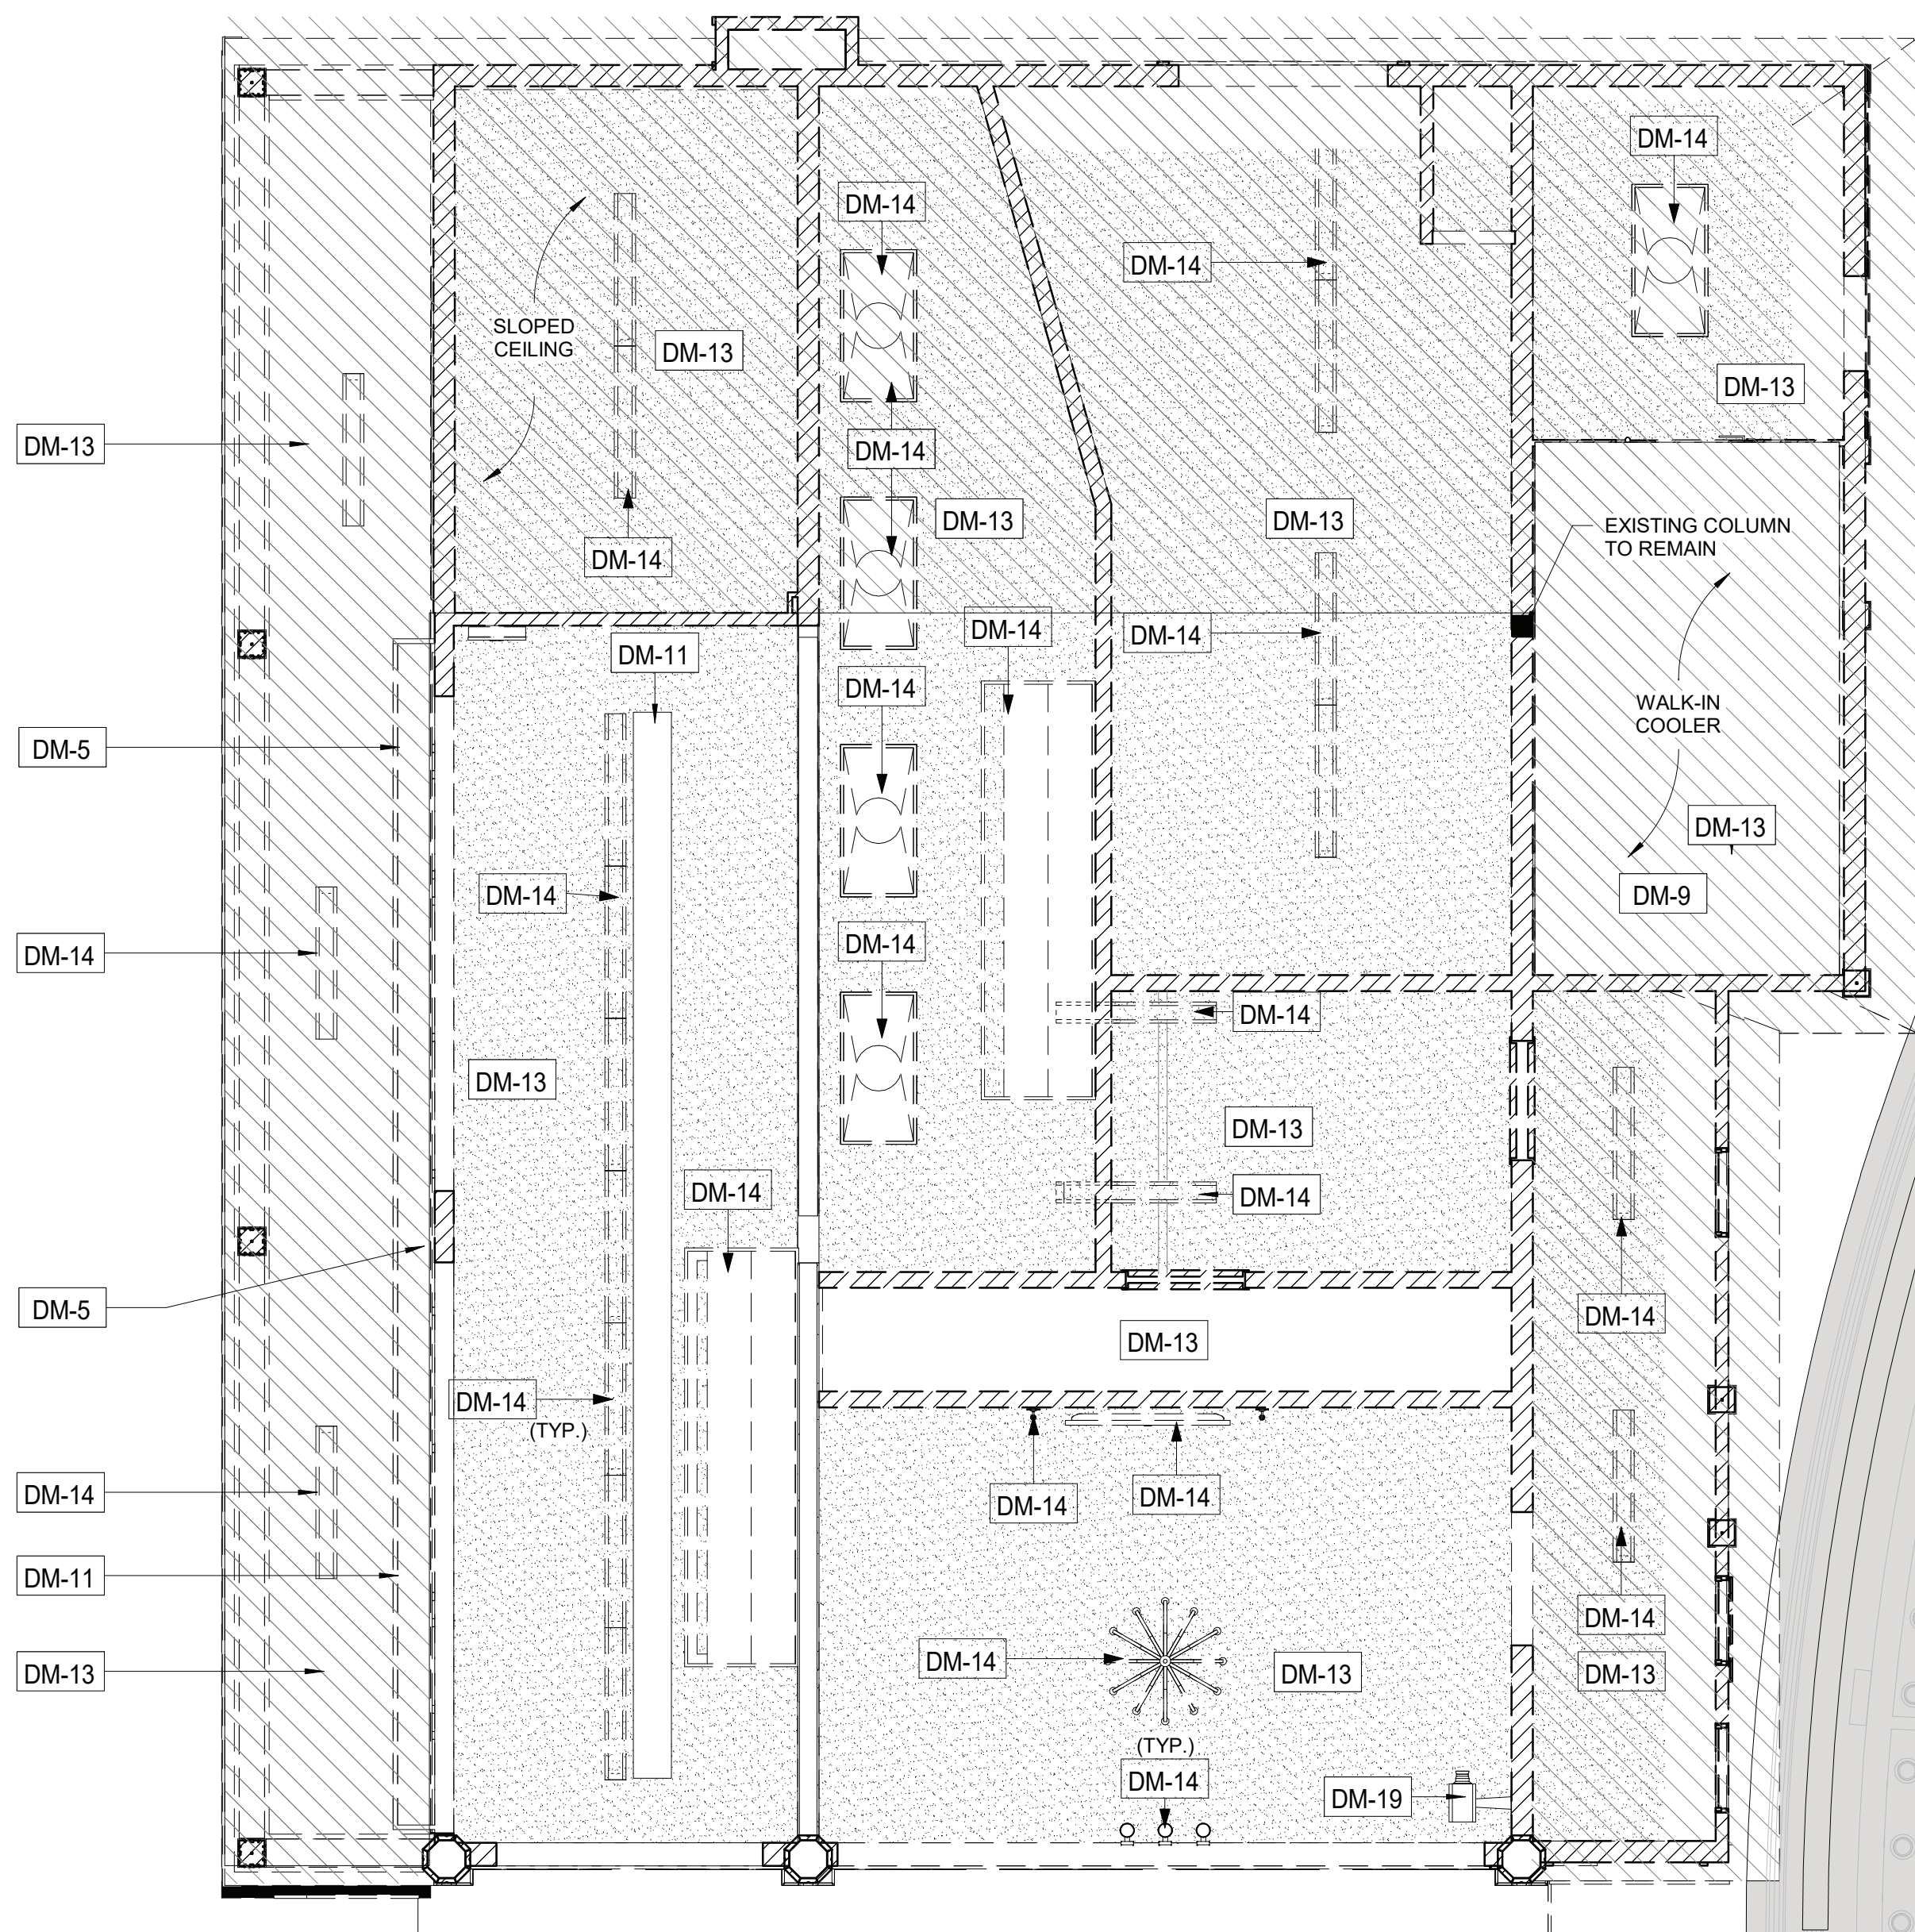
☐ AS BUILT – CHANGES AS NOTED ☐ AS BUILT – NO CHANGES

CONTRACTOR		PROJECT COORDINATOR	
NAME		NAME	
SIGNATURE		SIGNATURE	
TITLE		TITLE	

WESTCHESTER COUNTY, NEW YORK
DEPARTMENT OF PUBLIC WORKS AND TRANSPORTATION
DIVISION OF ENGINEERING

INFRASTRUCTURE REHABILITATION
PLAYLAND PARK, RYE, NEW YORK
RESTAURANT KITCHEN WITH FOOD VENDING
GROUND FLOOR DEMOLITION PLAN

CONTRACT NUMBER	SHEET NUMBER
22-523	K-A-01
DWG NO.:	502 of 664
SCALE:	As indicated
DATE:	8/23/2022
DPW FILE NUMBER	REV. NO.
1-118-A-1251-0	0



PLAZA RESTAURANT
N.I.C.


COLONNADE
N.I.C.

TOWER #14
N.I.C.


DEMOLITION RCP GENERAL NOTES

1. ALL DEMOLITION AND REMOVAL WORK INCLUDES, BUT IS NOT LIMITED TO THE WORK INDICATED, NOTED, SPECIFIED, AND COORDINATED WITH WORK OF ALL OTHER TRADES, AS INDICATED ELSEWHERE, AND AS REQUIRED TO ACCOMMODATE CONSTRUCTION.
2. PRIOR TO STARTING WORK, CONTRACTOR TO MAKE A THOROUGH EXAMINATION OF THE PORTIONS OF THE STRUCTURE IN WHICH THE WORK IS TO BE PERFORMED INCLUDING, BUT NOT LIMITED TO THE WORK AT ADJOINING OR UNDERLYING LOCATIONS. REPORT TO THE ARCHITECT ANY AND ALL CONDITIONS WHICH MAY INTERFERE WITH OR OTHERWISE PREVENT THE PROPER EXECUTION AND COMPLETION OF THE WORK. WORK SHALL NOT START UNTIL SUCH CONDITIONS HAVE BEEN EXAMINED AND MUTUALLY AGREED UPON WITH THE ARCHITECT.
3. DASHED LINES INDICATE WALLS, FIXTURES, EQUIPMENT, ETC. TO BE REMOVED AND DISPOSED OF BY G.C.
4. ANY QUESTIONS ON SCOPE OF DEMOLITION MUST BE DIRECTED TO THE ARCHITECT PRIOR TO BID. SHOULD QUESTIONS OR DISCREPANCIES ARISE, THE CONTRACTOR SHALL NOTIFY THE ARCHITECT, IN WRITING, PRIOR TO PROCEEDING WITH DEMOLITION.
5. ALL DIMENSIONS, LOCATIONS AND/OR ELEVATIONS OF EXISTING CONSTRUCTION CONDITIONS ARE APPROXIMATE. CONTRACTOR TO VERIFIED EXISTING CONDITIONS PRIOR TO THE START OF WORK.
6. CONTRACTOR(S) ARE RESPONSIBLE FOR SHORING, BRACING AND UNDERPINNING RELATED TO THE DEMOLITION, REMOVAL OR CUTTING OF AN WALL, PARTITION, OR ANY OTHER LOAD-BEARING OR STRUCTURAL ELEMENT.
7. ALTER AND RESTORE EXISTING WALLS, PARTITIONS, COLUMNS, CEILING AND FLOORS, AND THEIR RESPECTIVE FINISHED SURFACES TO ACCOMMODATE NEW CONSTRUCTION AND FINISHES, IN ACCORDANCE WITH DRAWINGS AND SPECIFICATIONS.
8. IMMEDIATELY NOTIFY THE OWNER'S REPRESENTATIVES OF ANY HAZARDOUS MATERIALS ENCOUNTERED DURING DEMOLITION/REMOVAL.
9. CONTAINERIZED DEMOLITION DEBRIS SHALL BE TCPL TESTED TO CONFIRM WASTE MAY BE DISPOSED OF AS NON-HAZARDOUS.
10. ALL ITEMS SCHEDULED FOR DEMOLITION SHALL BE REMOVED FROM THE SITE UNLESS OTHERWISE NOTED. CONTRACTOR SHALL BE RESPONSIBLE FOR CLEANING OF SITE ON A DAILY BASIS.
11. REFER TO ELECTRICAL, MECHANICAL, STRUCTURAL, PLUMBING, ETC. DEMOLITION DRAWINGS FOR ADDITIONAL ITEMS.
12. PATCH AND REPAIR SURFACES (FLOOR, WALL, CEILING) DAMAGED IN PREPARATION FOR NEW EQUIPMENT AND FINISHES.

DEMOLITION LEGEND

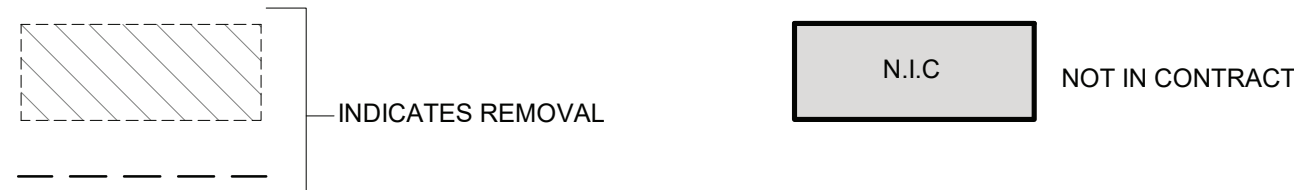

Key Value	Keynote Text
DM-5	REMOVE COLUMN ENCLOSURES. CAREFULLY REMOVE AT LEAST ONE COLUMN ENCLOSURE TO USE AS REFERENCE IN ORDER TO REPLICATE TRIMS TO MATCH LOCATION, SIZE AND SHAPE AS INDICATED. COORDINATE WITH STRUCTURAL DRAWINGS.
DM-9	CONTRACTOR TO REMOVE ANY REMAINING EQUIPMENT AND BUILDING CONTENT. CONTENT MAY INCLUDE BUT NOT LIMITED TO REFRIGERATOR, STORAGE, RACKS, AC UNITS, GAMES ETC.
DM-11	CAREFULLY REMOVE AND RETURN TO OWNER ALL EXISTING SIGNAGE AND LETTERING. COORDINATE SIGNAGE REMOVAL WITH OWNER PRIOR TO REMOVAL OF ANY SIGNAGE.
DM-13	REMOVE EXISTING CEILING AND ALL ACCESSORIES AND EQUIPMENT.
DM-14	REMOVE EXISTING LIGHTING FIXTURES AND ELECTRICAL WIRING CONNECTED TO THESE FIXTURES. SEE ELECTRICAL FOR DETAILS.
DM-19	DISCONNECT AND REMOVE EXISTING SUSPENDED EQUIPMENT SUCH AS CAMERAS, SPEAKERS, ETC. SEE ELECTRICAL DRAWINGS FOR DETAILS.
DM-54	CONTRACTOR TO CAREFULLY REMOVE, STORE AND CATALOG EXISTING "LANTERN" STYLE FIXTURE FOR REPLICATION. (TO BE UPDATED)

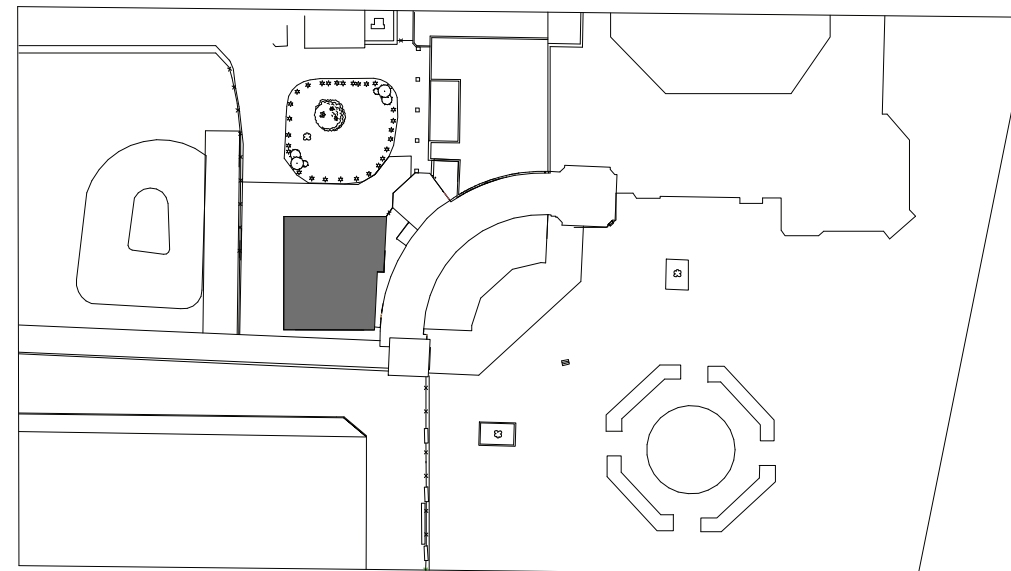

DEMO KEY PLAN

1 GROUND LEVEL DEMOLITION REFLECTED CEILING PLAN
1/4" = 1'-0"

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CONTRACTOR		PROJECT COORDINATOR	
NAME		NAME	
SIGNATURE		SIGNATURE	
TITLE		TITLE	

WESTCHESTER COUNTY, NEW YORK
DEPARTMENT OF PUBLIC WORKS AND TRANSPORTATION
DIVISION OF ENGINEERING

INFRASTRUCTURE REHABILITATION
PLAYLAND PARK, RYE, NEW YORK
RESTAURANT KITCHEN WITH FOOD VENDING
GROUND FLOOR DEMOLITION- REFLECTED CEILING PLANS

CONTRACT NUMBER	SHEET NUMBER
22-523	K-A-02
DWG NO.:	503 of 664
SCALE:	As indicated
DATE:	8/23/20223
DPW FILE NUMBER	1-118-A-1252-0
REV. NO.	0

- DEMOLITION GENERAL NOTES**
1. ALL DEMOLITION AND REMOVAL WORK INCLUDES, BUT IS NOT LIMITED TO THE WORK INDICATED, NOTED, SPECIFIED, AND COORDINATED WITH WORK OF ALL OTHER TRADES, AS INDICATED ELSEWHERE, AND AS REQUIRED TO ACCOMMODATE CONSTRUCTION.
 2. PRIOR TO STARTING WORK, CONTRACTOR TO MAKE A THOROUGH EXAMINATION OF THE PORTIONS OF THE STRUCTURE IN WHICH THE WORK IS TO BE PERFORMED INCLUDING, BUT NOT LIMITED TO THE WORK AT ADJOINING OR UNDERLYING LOCATIONS. REPORT TO THE ARCHITECT ANY AND ALL CONDITIONS WHICH MAY INTERFERE WITH OR OTHERWISE PREVENT THE PROPER EXECUTION AND COMPLETION OF THE WORK. WORK SHALL NOT START UNTIL SUCH CONDITIONS HAVE BEEN EXAMINED AND MUTUALLY AGREED UPON WITH THE ARCHITECT.
 3. DASHED LINES INDICATE WALLS, FIXTURES, EQUIPMENT, ETC. TO BE REMOVED AND DISPOSED OF BY G.C.
 4. ANY QUESTIONS ON SCOPE OF DEMOLITION MUST BE DIRECTED TO THE ARCHITECT PRIOR TO BID. SHOULD QUESTIONS OR DISCREPANCIES ARISE, THE CONTRACTOR SHALL NOTIFY THE ARCHITECT, IN WRITING, PRIOR TO PROCEEDING WITH DEMOLITION.
 5. ALL DIMENSIONS, LOCATIONS AND/OR ELEVATIONS OF EXISTING CONSTRUCTION CONDITIONS ARE APPROXIMATE. CONTRACTOR TO VERIFIED EXISTING CONDITIONS PRIOR TO THE START OF WORK.
 6. CONTRACTOR(S) ARE RESPONSIBLE FOR SHORING, BRACING AND UNDERPINNING RELATED TO THE DEMOLITION, REMOVAL OR CUTTING OF AN WALL, PARTITION, OR ANY OTHER LOAD-BEARING OR STRUCTURAL ELEMENT.
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 8. IMMEDIATELY NOTIFY THE OWNER'S REPRESENTATIVES OF ANY HAZARDOUS MATERIALS ENCOUNTERED DURING DEMOLITION/REMOVAL.
 9. CONTAINERIZED DEMOLITION DEBRIS SHALL BE TCLP TESTED TO CONFIRM WASTE MAY BE DISPOSED OF AS NON-HAZARDOUS.
 10. ALL ITEMS SCHEDULED FOR DEMOLITION SHALL BE REMOVED FROM THE SITE UNLESS OTHERWISE NOTED. CONTRACTOR SHALL BE RESPONSIBLE FOR CLEANING OF SITE ON A DAILY BASIS.
 11. REFER TO ELECTRICAL, MECHANICAL, STRUCTURAL, PLUMBING, ETC. DEMOLITION DRAWINGS FOR ADDITIONAL ITEMS.
 12. PATCH AND REPAIR SURFACES (FLOOR, WALL, CEILING) DAMAGED IN PREPARATION FOR NEW EQUIPMENT AND FINISHES.


DEMOLITION LEGEND

INDICATES REMOVAL

N.I.C.

NOT IN CONTRACT

Key Value	Keynote Text
DM-11	CAREFULLY REMOVE AND RETURN TO OWNER ALL EXISTING SIGNAGE AND LETTERING. COORDINATE SIGNAGE REMOVAL WITH OWNER PRIOR TO REMOVAL OF ANY SIGNAGE.
DM-16	REMOVE EXISTING ROOFING SHINGLES, UNDERLAYMENT AND ANY ROTTED WOOD SHEATHING. REPLACE DAMAGED SHEATHING TO MATCH EXISTING. COORDINATE WITH A/E.
DM-20	ROOFTOP EQUIPMENT TO BE REMOVED. SEE MECHANICAL & STRUCTURAL DRAWINGS. CONTRACTOR SHALL PATCH EXISTING ROOF PENETRATION TO MATCH EXISTING ROOF.
DM-24	REMOVE EXISTING EXHAUST. SEE MECHANICAL DRAWINGS.
DM-30	EXISTING STRUCTURE TO BE REMOVED IN ITS ENTIRETY. SEE PLANS FOR EXTENT OF REMOVAL.
DM-33	REMOVE GAS SERVICE TO BUILDING. EXISTING TANKS TO BE REMOVED.
DM-36	CAREFULLY REMOVE AND RELOCATE EXISTING WIRING, CONDUITS. SEE ELECTRICAL DRAWINGS.
DM-53	REMOVE EXISTING AWNING. PROVIDE FOR DELIVERY TO THE OWNER AS DIRECTED BY THE A/E.

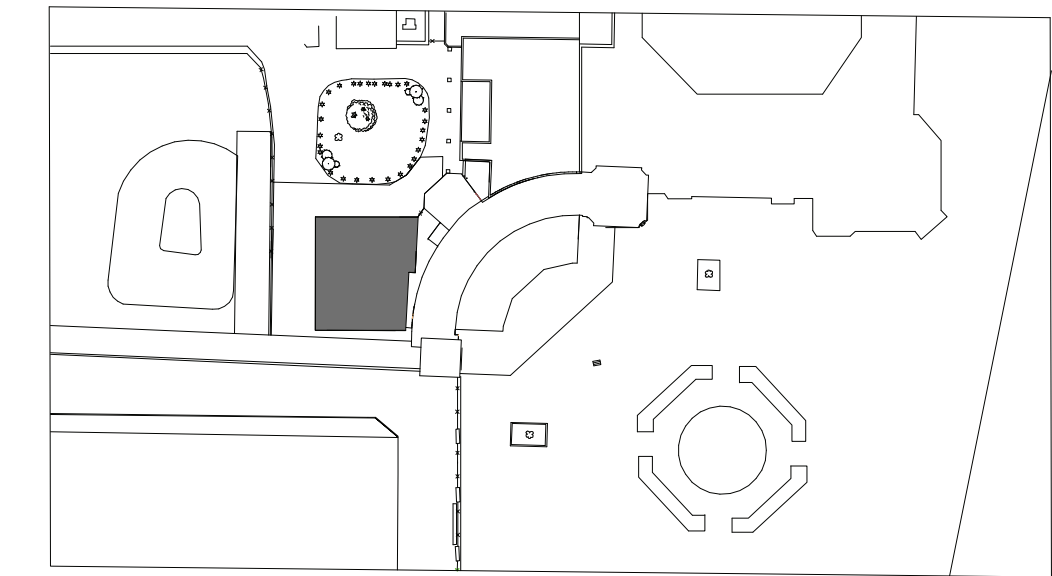

DEMO KEY PLAN

1 ROOF LEVEL DEMOLITION PLAN
1/4" = 1'-0"

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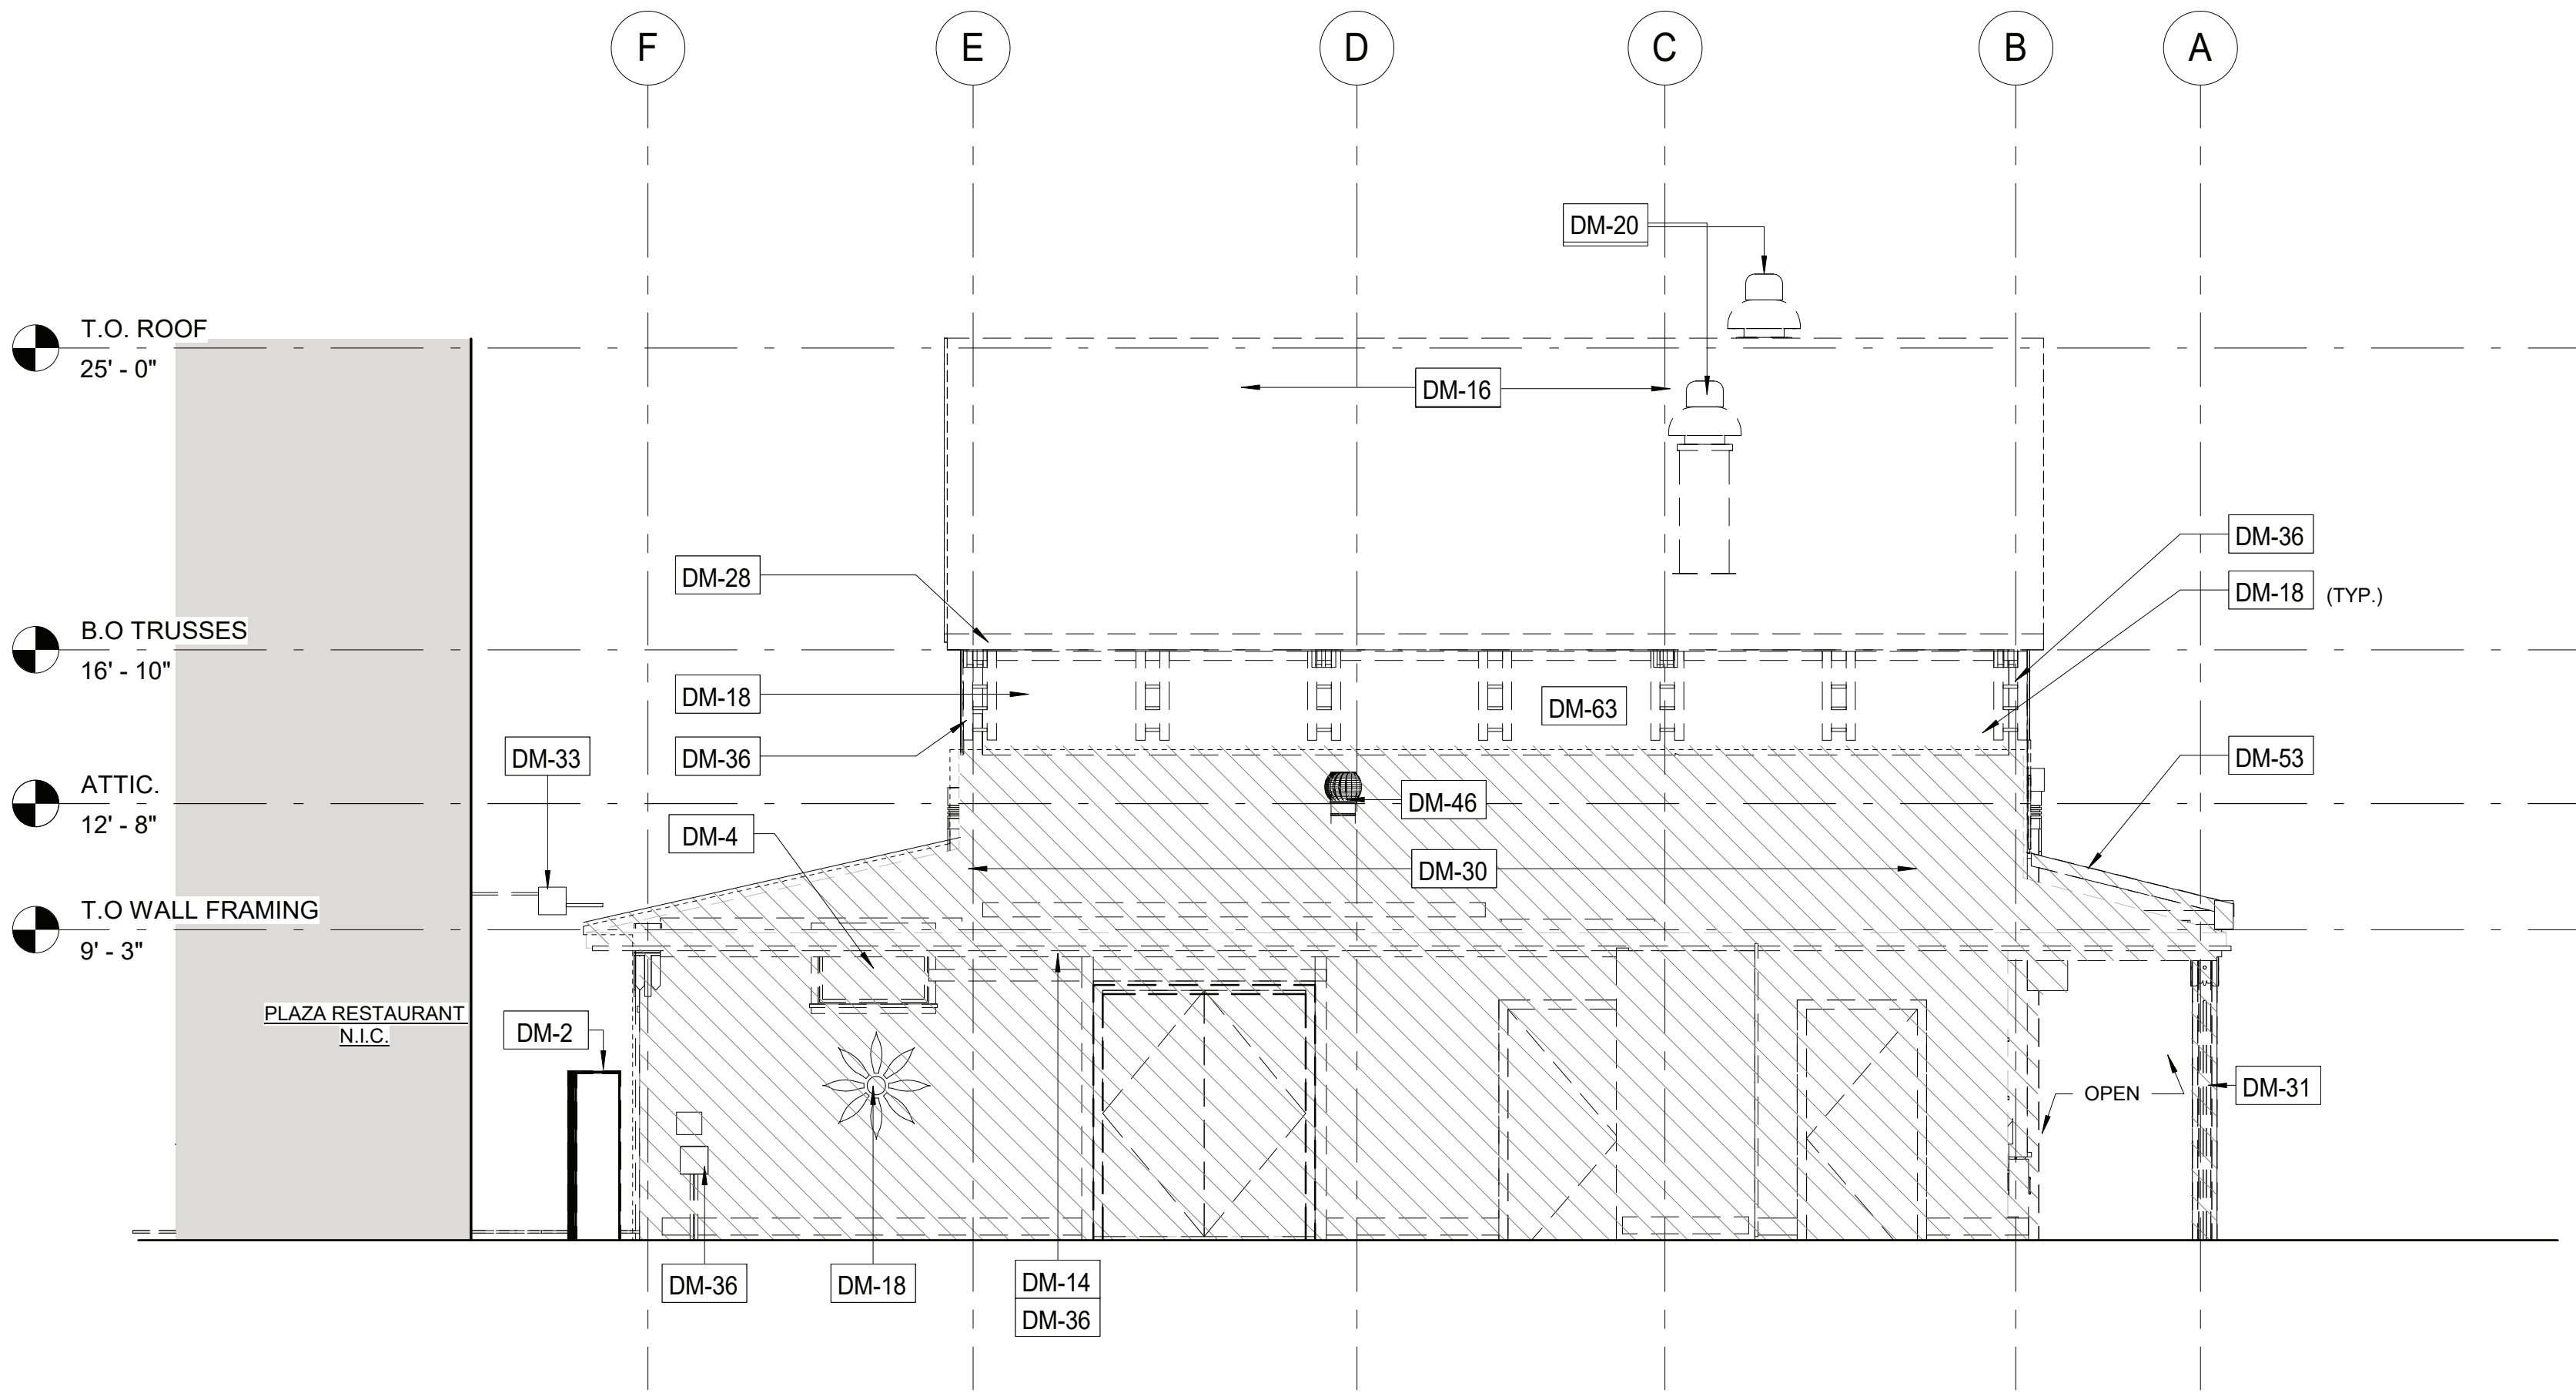
REVISION NUMBER	DATE	MADE BY	APP'D BY	REVISION

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NAME _____	NAME _____		
SIGNATURE _____	SIGNATURE _____		
TITLE _____	TITLE _____		
DATE _____	DATE _____		


WESTCHESTER COUNTY, NEW YORK
DEPARTMENT OF PUBLIC WORKS AND TRANSPORTATION
DIVISION OF ENGINEERING

INFRASTRUCTURE REHABILITATION
PLAYLAND PARK, RYE, NEW YORK
RESTAURANT KITCHEN WITH FOOD VENDING
ROOF DEMOLITION PLAN

CONTRACT NUMBER 22-523	SHEET NUMBER K-A-03
DWG NO.: 504 of 664	
SCALE: As indicated	
DATE: 8/23/20223	
DPW FILE NUMBER 1-118-A-1253-0	REV. NO. 0



1 DEMOLITION ELEVATION- EAST
1/4" = 1'-0"

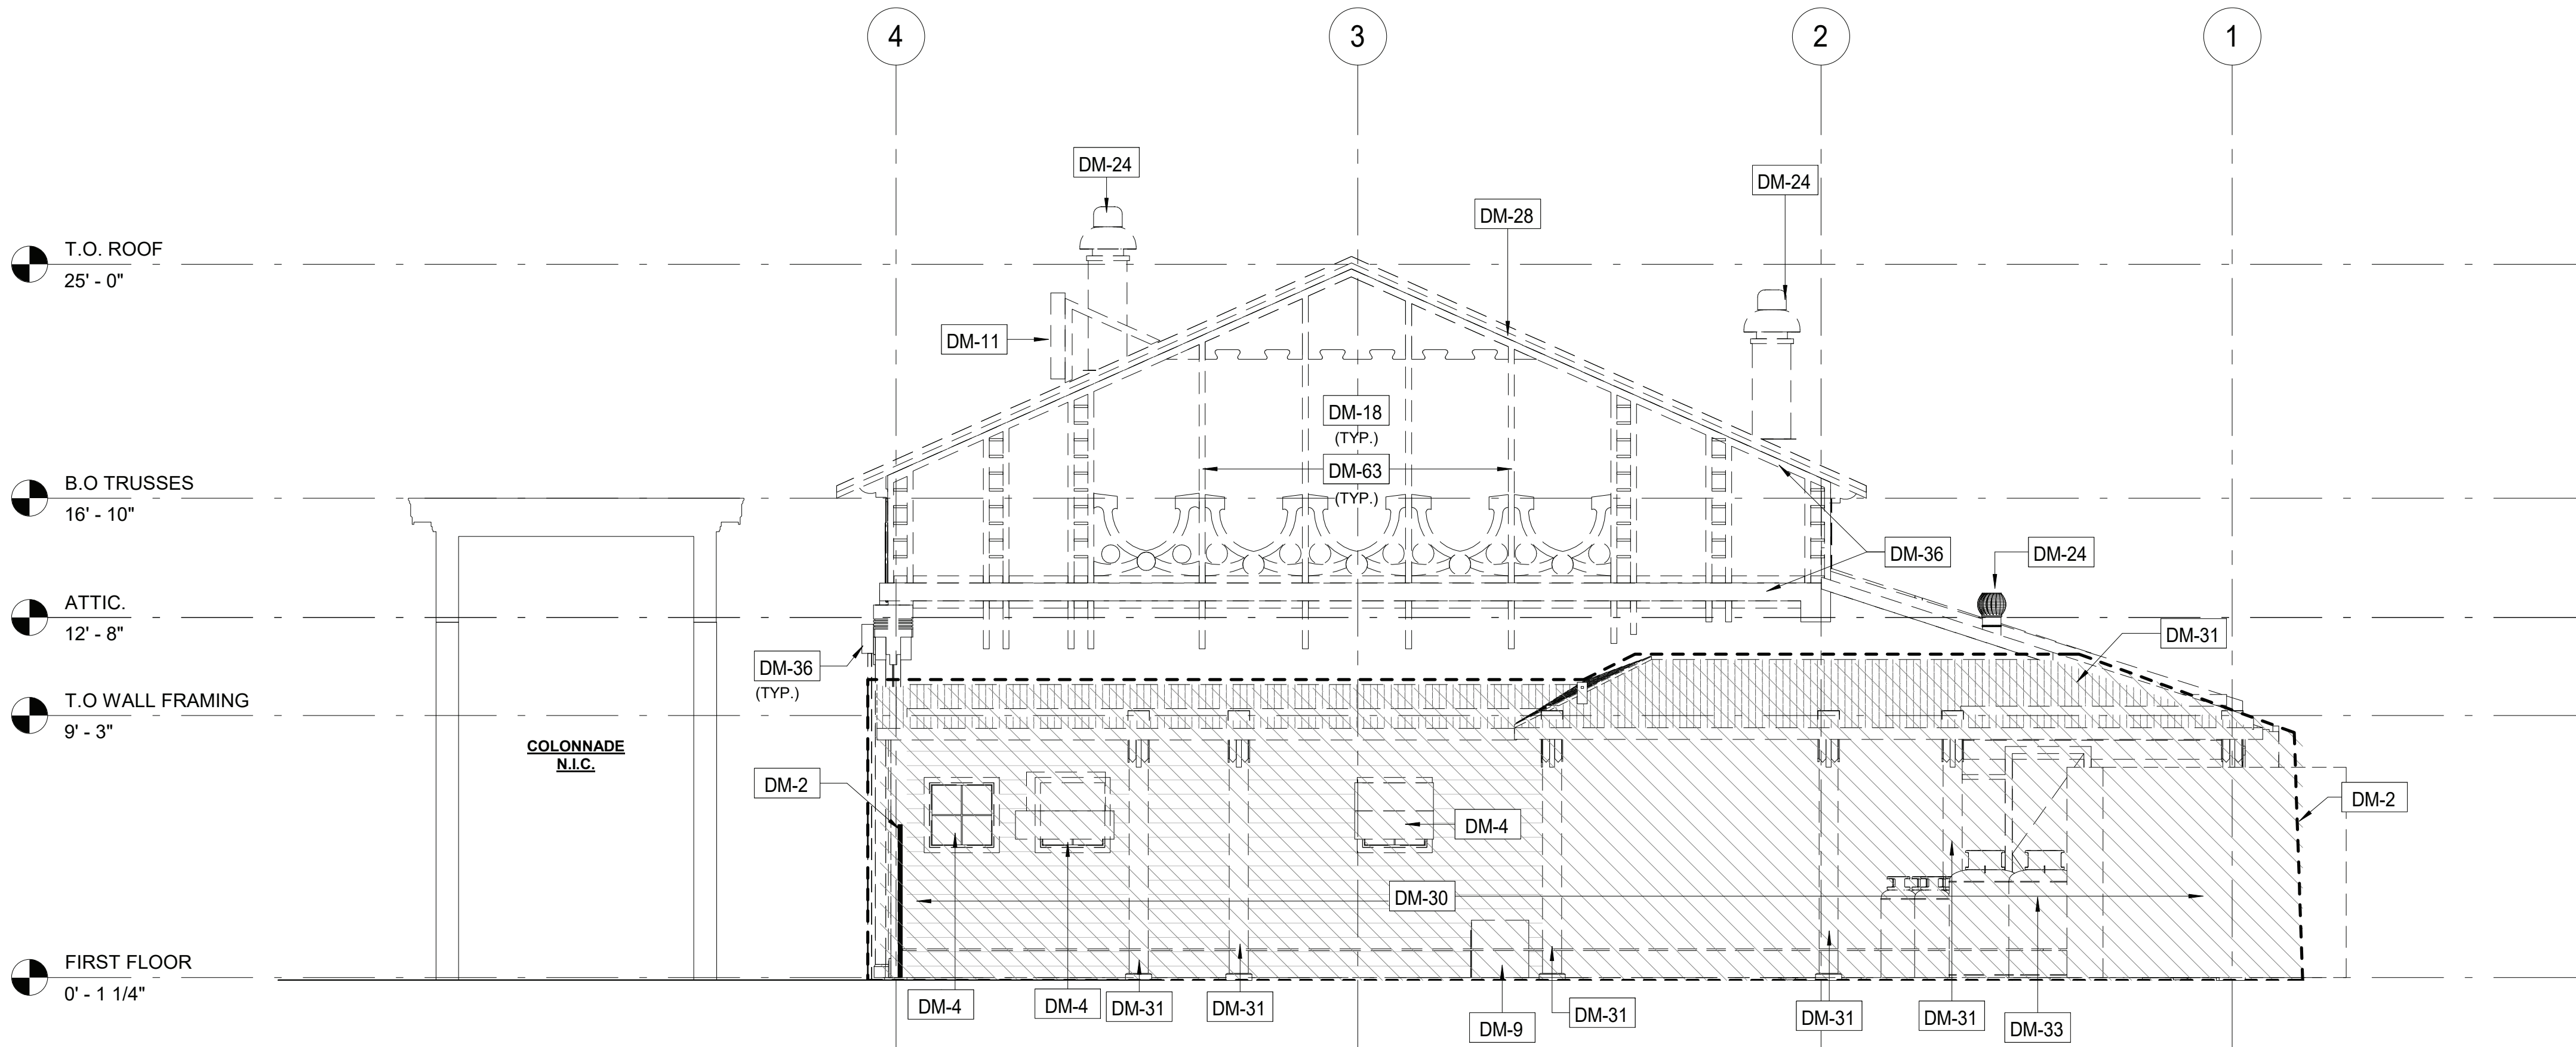


2 DEMOLITION ELEVATION- SOUTH
1/4" = 1'-0"

DEMOLITION GENERAL NOTES

1. ALL DEMOLITION AND REMOVAL WORK INCLUDES, BUT IS NOT LIMITED TO THE WORK INDICATED, NOTED, SPECIFIED, AND COORDINATED WITH WORK OF ALL OTHER TRADES, AS INDICATED ELSEWHERE, AND AS REQUIRED TO ACCOMMODATE CONSTRUCTION.
2. PRIOR TO STARTING WORK, CONTRACTOR TO MAKE A THOROUGH EXAMINATION OF THE PORTIONS OF THE STRUCTURE IN WHICH THE WORK IS TO BE PERFORMED INCLUDING, BUT NOT LIMITED TO THE WORK AT ADJOINING OR UNDERLYING LOCATIONS. REPORT TO THE ARCHITECT ANY AND ALL CONDITIONS WHICH MAY INTERFERE WITH OR OTHERWISE PREVENT THE PROPER EXECUTION AND COMPLETION OF THE WORK. WORK SHALL NOT START UNTIL SUCH CONDITIONS HAVE BEEN EXAMINED AND MUTUALLY AGREED UPON WITH THE ARCHITECT.
3. DASHED LINES INDICATE WALLS, FIXTURES, EQUIPMENT, ETC. TO BE REMOVED AND DISPOSED OF BY G.C.
4. ANY QUESTIONS ON SCOPE OF DEMOLITION MUST BE DIRECTED TO THE ARCHITECT PRIOR TO BID. SHOULD QUESTIONS OR DISCREPANCIES ARISE, THE CONTRACTOR SHALL NOTIFY THE ARCHITECT, IN WRITING, PRIOR TO PROCEEDING WITH DEMOLITION.
5. ALL DIMENSIONS, LOCATIONS AND/OR ELEVATIONS OF EXISTING CONSTRUCTION CONDITIONS ARE APPROXIMATE. CONTRACTOR TO VERIFY EXISTING CONDITIONS PRIOR TO THE START OF WORK.
6. CONTRACTOR(S) ARE RESPONSIBLE FOR SHORING, BRACING AND UNDERPINNING RELATED TO THE DEMOLITION, REMOVAL OR CUTTING OF AN WALL, PARTITION, OR ANY OTHER LOAD-BEARING OR STRUCTURAL ELEMENT.
7. ALTER AND RESTORE EXISTING WALLS, PARTITIONS, COLUMNS, CEILING AND FLOORS, AND THEIR RESPECTIVE FINISHED SURFACES TO ACCOMMODATE NEW CONSTRUCTION AND FINISHES, IN ACCORDANCE WITH DRAWINGS AND SPECIFICATIONS.
8. IMMEDIATELY NOTIFY THE OWNER'S REPRESENTATIVES OF ANY HAZARDOUS MATERIALS ENCOUNTERED DURING DEMOLITION/REMOVAL.
9. CONTAINERIZED DEMOLITION DEBRIS SHALL BE TCLP TESTED TO CONFIRM WASTE MAY BE DISPOSED OF AS NON-HAZARDOUS.
10. ALL ITEMS SCHEDULED FOR DEMOLITION SHALL BE REMOVED FROM THE SITE UNLESS OTHERWISE NOTED. CONTRACTOR SHALL BE RESPONSIBLE FOR CLEANING OF SITE ON A DAILY BASIS.
11. REFER TO ELECTRICAL, MECHANICAL, STRUCTURAL, PLUMBING, ETC. DEMOLITION DRAWINGS FOR ADDITIONAL ITEMS.
12. PATCH AND REPAIR SURFACES (FLOOR, WALL, CEILING) DAMAGED IN PREPARATION FOR NEW EQUIPMENT AND FINISHES.

DEMOLITION LEGEND

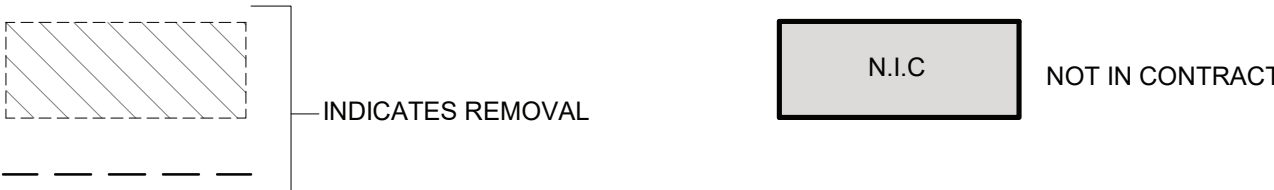

Key Value	Keynote Text
DM-2	REMOVE EXISTING GATE.
DM-4	REMOVE EXISTING WINDOW & FRAME.
DM-9	CONTRACTOR TO REMOVE ANY REMAINING EQUIPMENT AND BUILDING CONTENT. CONTENT MAY INCLUDE BUT NOT LIMITED TO REFRIGERATOR, STORAGE, RACKS, AC UNITS, GAMES ETC.
DM-11	CAREFULLY REMOVE AND RETURN TO OWNER ALL EXISTING SIGNAGE AND LETTERING. COORDINATE SIGNAGE REMOVAL WITH OWNER PRIOR TO REMOVAL OF ANY SIGNAGE.
DM-14	REMOVE EXISTING LIGHTING FIXTURES AND ELECTRICAL WIRING CONNECTED TO THESE FIXTURES. SEE ELECTRICAL FOR DETAILS.
DM-16	REMOVE EXISTING ROOFING SHINGLES, UNDERLAYMENT AND ANY ROTTED WOOD SHEATHING. REPLACE DAMAGED SHEATHING TO MATCH EXISTING. COORDINATE WITH A/E.
DM-18	REMOVE EXISTING PANELS & TRIMS.
DM-20	ROOFTOP EQUIPMENT TO BE REMOVED. SEE MECHANICAL & STRUCTURAL DRAWINGS. CONTRACTOR SHALL PATCH EXISTING ROOF PENETRATION TO MATCH EXISTING ROOF.
DM-24	REMOVE EXISTING EXHAUST. SEE MECHANICAL DRAWINGS.
DM-28	REMOVE EXISTING GUTTER, FASCIA, AND SOFFITS.
DM-30	EXISTING STRUCTURE TO BE REMOVED IN ITS ENTIRETY. SEE PLANS FOR EXTENT OF REMOVAL.
DM-31	REMOVE EXISTING COLUMN.
DM-33	REMOVE GAS SERVICE TO BUILDING. EXISTING TANKS TO BE REMOVED.
DM-36	CAREFULLY REMOVE AND RELOCATE EXISTING WIRING, CONDUITS. SEE ELECTRICAL DRAWINGS.
DM-46	EXISTING ELECTRICAL EQUIPMENT TO BE PROTECTED DURING CONSTRUCTION.
DM-53	REMOVE EXISTING AWNING. PROVIDE FOR DELIVERY TO THE OWNER AS DIRECTED BY THE A/E.
DM-63	CONTRACTOR TO CAREFULLY DOCUMENT AND REMOVE ALL EXISTING FACADE MATERIALS AND TRIM.

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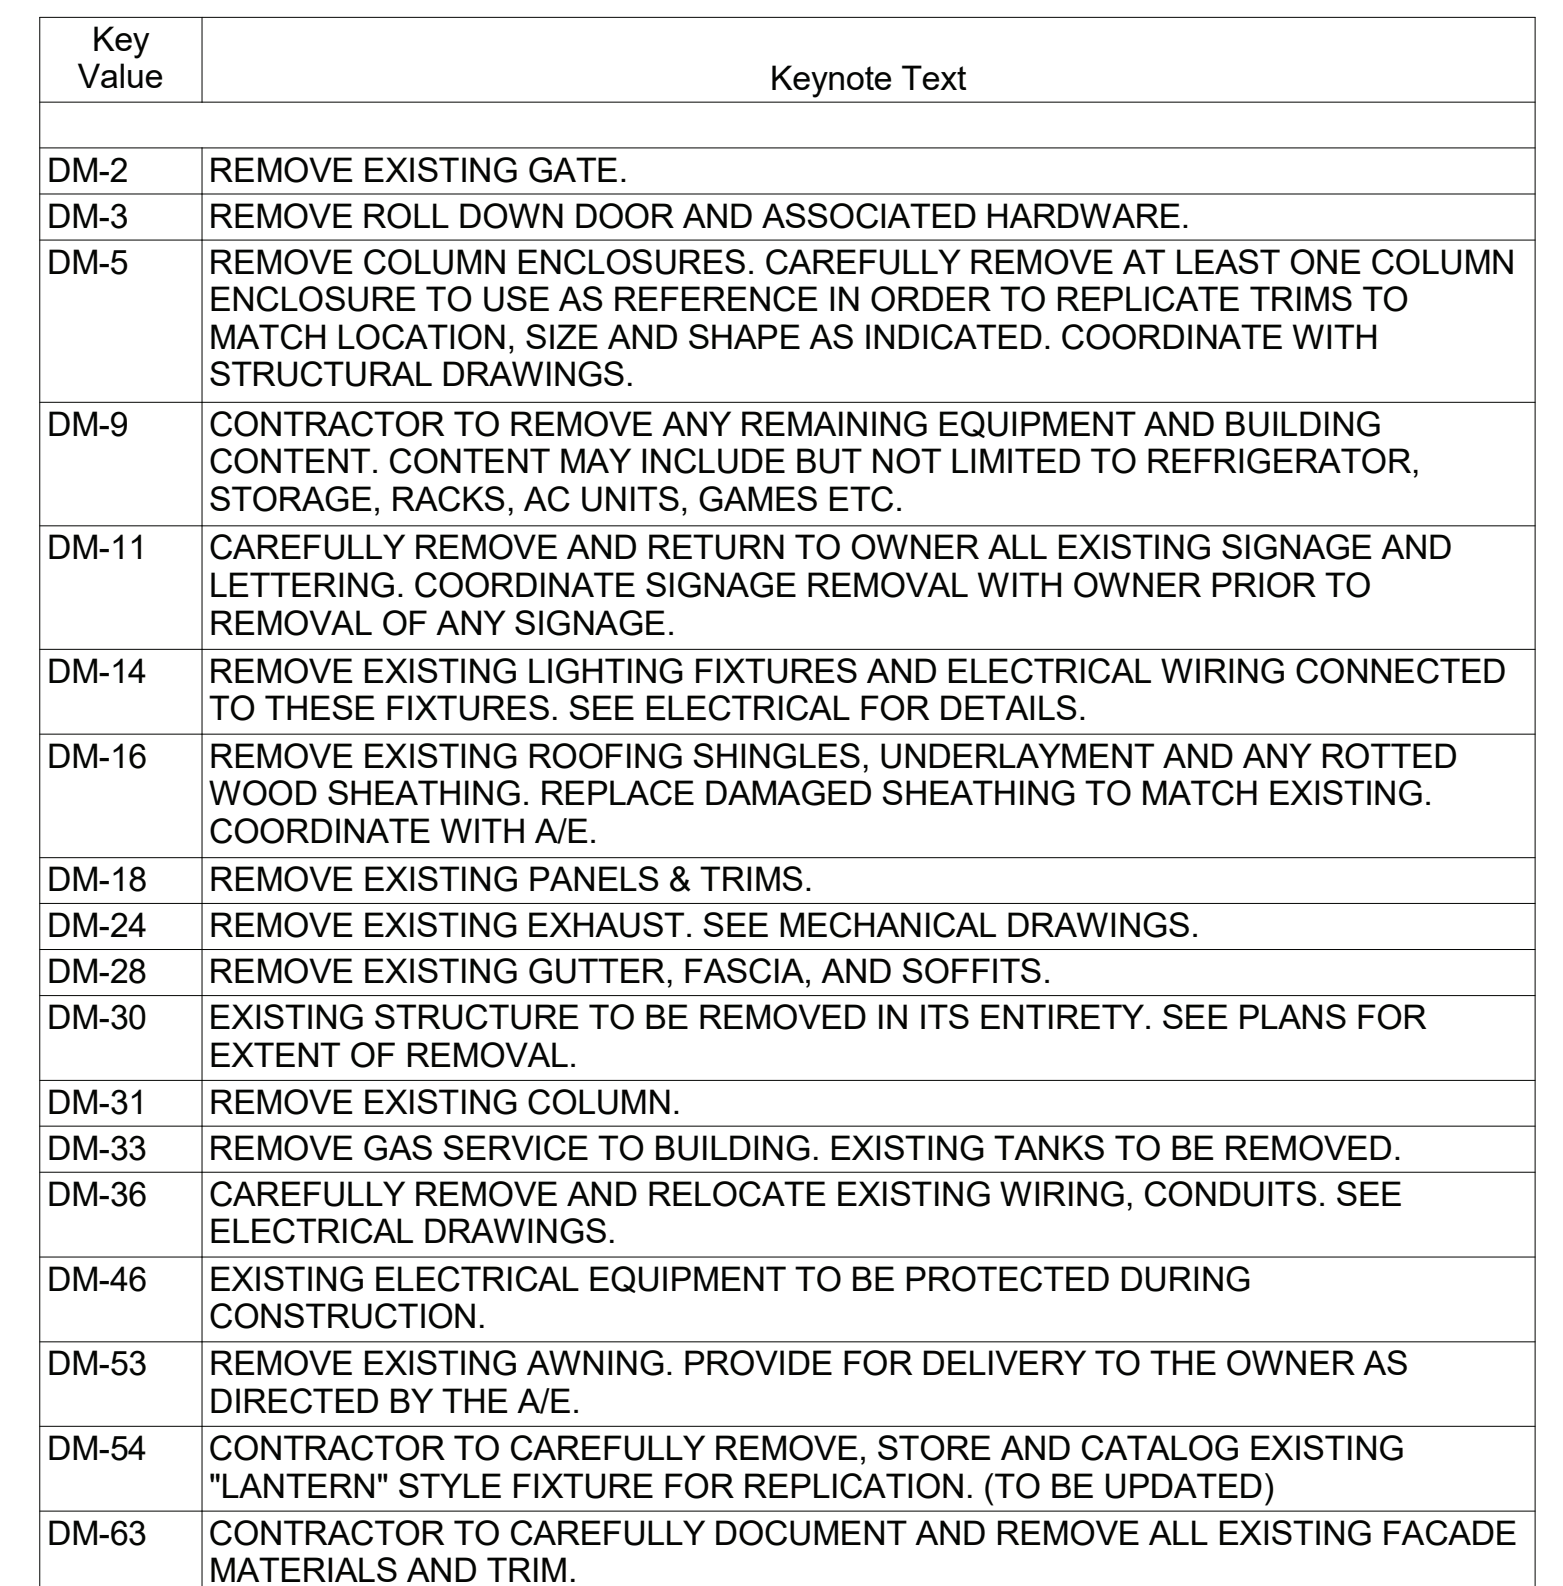
☐ AS BUILT - CHANGES AS NOTED ☐ AS BUILT - NO CHANGES

CONTRACTOR		PROJECT COORDINATOR	
NAME		NAME	
SIGNATURE		SIGNATURE	
TITLE		TITLE	
DATE		DATE	

WESTCHESTER COUNTY, NEW YORK
DEPARTMENT OF PUBLIC WORKS AND TRANSPORTATION
DIVISION OF ENGINEERING

INFRASTRUCTURE REHABILITATION
PLAYLAND PARK, RYE, NEW YORK
RESTAURANT KITCHEN WITH FOOD VENDING
EXTERIOR DEMOLITION ELEVATIONS

CONTRACT NUMBER	SHEET NUMBER
22-523	K-A-04
DWG NO.:	505 of 664
SCALE:	1/4" = 1'-0"
DATE:	8/23/20223
DPW FILE NUMBER	REV. NO.
1-118-A-1254-0	0



CONTRACT NUMBER 22-523		SHEET NUMBER K-A-05	
DWG NO.: 506 of 664			
SCALE: 1/4" = 1'-0"			
DATE: 8/23/2023			
DPW FILE NUMBER 1-118-A-1255-0		REV.	0

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RECORD DRAWING CERTIFICATION

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CONTRACTOR

NAME _____
SIGNATURE _____
TITLE _____ DATE _____

PROJECT COORDINATOR

NAME _____
SIGNATURE _____
TITLE _____ DATE _____

WESTCHESTER COUNTY, NEW YORK
DEPARTMENT OF PUBLIC WORKS AND TRANSPORTATION
DIVISION OF ENGINEERING

INFRASTRUCTURE REHABILITATION
PLAYLAND PARK, RYE, NEW YORK
RESTAURANT KITCHEN WITH FOOD VENDING
GROUND FLOOR CONSTRUCTION PLAN

CONTRACT NUMBER 22-523	SHEET NUMBER K-A-11
DWG NO.: 507 of 664	SCALE: As indicated
DATE: 8/23/20223	REV. NO. 0
DPW FILE NUMBER 1-118-A-1256-0	

FLOOR PLAN GENERAL NOTES


- DIMENSIONS ARE TO FACE OF GYPSUM WALL BOARD, FACE OF EXISTING WALL, GRID LINES, OR CENTERLINE OF COLUMN. ALL ELEVATIONS ARE NOTED FROM FINISH FLOOR ELEVATIONS.
- PROVIDE DRYWALL TRIM AT ALL EXPOSED EDGES AND CORNERS.
- PROVIDE METAL BLOCKING FOR ANY WALL MOUNTED EQUIPMENT OR ACCESSORIES. COORDINATE ALL BLOCKING REQUIREMENTS NECESSARY WITH OTHER TRADES.
- THE G.C. SHALL VERIFY DIMENSIONS OF THE EXISTING SPACE AND OF ANY EXISTING CONSTRUCTION TO REMAIN BY ACTUAL MEASUREMENT BEFORE ANY WORK IS PERFORMED. IF ANY MEASUREMENTS DIFFER FROM DIMENSIONS SHOWN ON PLAN, G.C. IS TO NOTIFY THE ARCHITECT IMMEDIATELY. THE G.C. SHALL BE RESPONSIBLE FOR CORRECTING ANY AND ALL DISCREPANCIES FOUND AFTER THE WORK IS PERFORMED, AT NO ADDITIONAL EXPENSE TO THE OWNER.
- G.C. TO VERIFY ALL FINISHED DIMENSIONS. FIELD CONDITIONS ALTERING ANY DIMENSIONS SHOULD BE BROUGHT TO THE ATTENTION OF THE OWNER AND ARCHITECT.
- THE G.C. SHALL PROVIDE CAULK JOINTS WHERE GYP. BD. MEETS THE FLOOR OR ROOF DECK.
- THE G.C. SHALL BE RESPONSIBLE FOR COORDINATING WITH OWNER ON ALL WORK TO BE PERFORMED BY THE OWNER. ANY POTENTIAL CONFLICTS OR DELAYS CAUSED BY THE OWNER'S SUBCONTRACTORS MUST BE DOCUMENTED IN WRITING TO THE OWNER BEFORE THE DELAY IS ACTUALLY INCURRED FOR IT TO BE CONSIDERED. OTHERWISE THE G.C. WILL BE RESPONSIBLE FOR MEETING THE SCHEDULE AS OUTLINED IN THE CONTRACT.
- THE G.C. SHALL SUPPLY ALL MATERIAL, LABOR, AND COORDINATION REQUIRED FOR THE INSTALLATION OF ALL OWNER-SUPPLIED ITEMS AS DESCRIBED IN THE DOCUMENTS, U.N.O.
- THE G.C. IS RESPONSIBLE FOR ALL FLOOR AND WALL PENETRATIONS FOR ELECTRICAL AND MECHANICAL WORK. ALL SUCH OPENINGS SHALL BE FRAMED AND REINFORCED.
- FLOOR SURFACES SHALL BE LEVELED TO ASSURE SMOOTH SURFACE FOR FINISH FLOOR INSTALLATION. G.C. SHALL ALSO PAY SPECIAL ATTENTION THAT ALL WALL SURFACES ARE SMOOTH WHERE MURALS WILL BE DIRECTLY APPLIED TO WALL.
- G.C. TO COORDINATE ALL UTILITY STUB-UPS AND LOCATION OF ALL EQUIPMENT PRIOR TO INSTALLING ANY ONE ITEM.
- REFER TO SHEET K-A-94 FOR PARTITION TYPE INFORMATION.
- PROVIDE PAINTED ACCESS PANELS IN WALLS & CEILING AT CONCEALED ITEMS, SUCH AS VALVES, CONTROLS, SWITCHES OR ANY OTHER ITEMS THAT REQUIRES ACCESS. G.C. TO DETERMINE ACCESS PANEL LOCATION W/ ARCHITECT PRIOR TO INSTALLATION.

CONSTRUCTION LEGEND



	NOT IN CONTRACT		NEW CONSTRUCTION		DOOR TAG
	KEY NOTES		PLUMBING FIXTURE		FIRE EXTINGUISHER
	WINDOW TAG		FLOOR DRAIN		STUB UP
	WALL TAG		ROOF GUARD RAIL		SBS 1/4" / 12"
	MATERIAL / TRIM TAG		ROOF CRICKET, 1/2" / 12"		ASPHALT SHINGLE

KEYNOTE LEGEND CONST.


Key Value	Keynote Text
4	NEW WINDOWS. SEE WINDOW SCHEDULE.
5	PROVIDE AND INSTALL DOOR INCLUDING FRAME, SILL, LINTEL AND ANY ASSOCIATE HARDWARE. SEE DOOR SCHEDULE.
10	PROVIDE AND INSTALL COLUMN ENCLOSURES. SEE DETAILS.
13	PROVIDE CONCRETE SLAB. REFER TO STRUCTURAL DRAWINGS.
20	NEW COUNTER ROLL DOWN DOOR LOCATED AT INTERIOR AND ASSOCIATED HARDWARE. REFER TO SCHEDULE FOR MORE DETAILS. CONTRACTOR TO V.I.F. ALL DIMENSIONS BEFORE ORDERING (TYPICAL THROUGHOUT).
21	NEW INTERIOR WALL. SEE WALL SCHEDULE.
34	PROVIDE NEW BENCH.
43	NEW COUNTERTOPS & SERVING WINDOWS.
84	HALF ROUND ALUMINUM GUTTER AND DOWNSPOUT.
87	NEW PRECAST CONCRETE PLANTER BOX.
94	NEW QUARRY TILE. SUPPRESS CONCRETE SLAB AS SHOWN IN 9/K-A-81. SLOPE TOWARDS DRAIN.

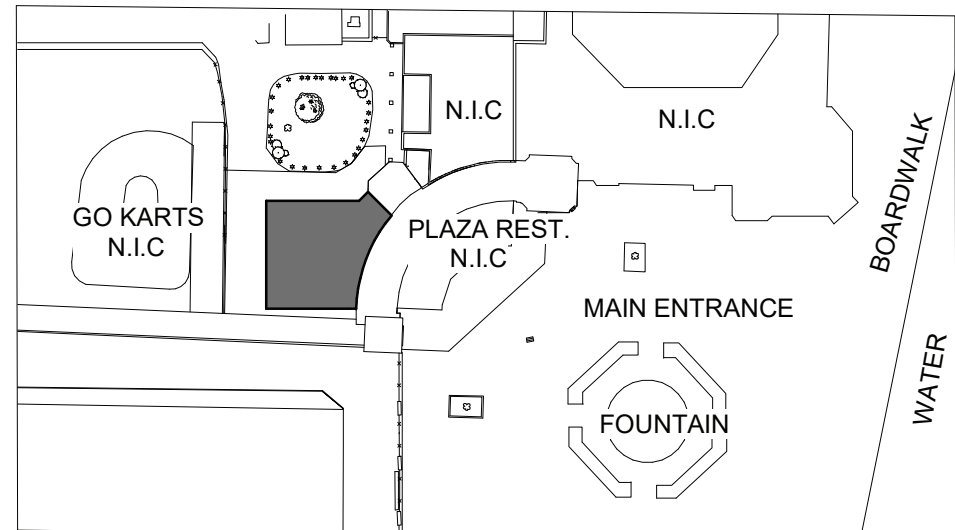

KEY PLAN

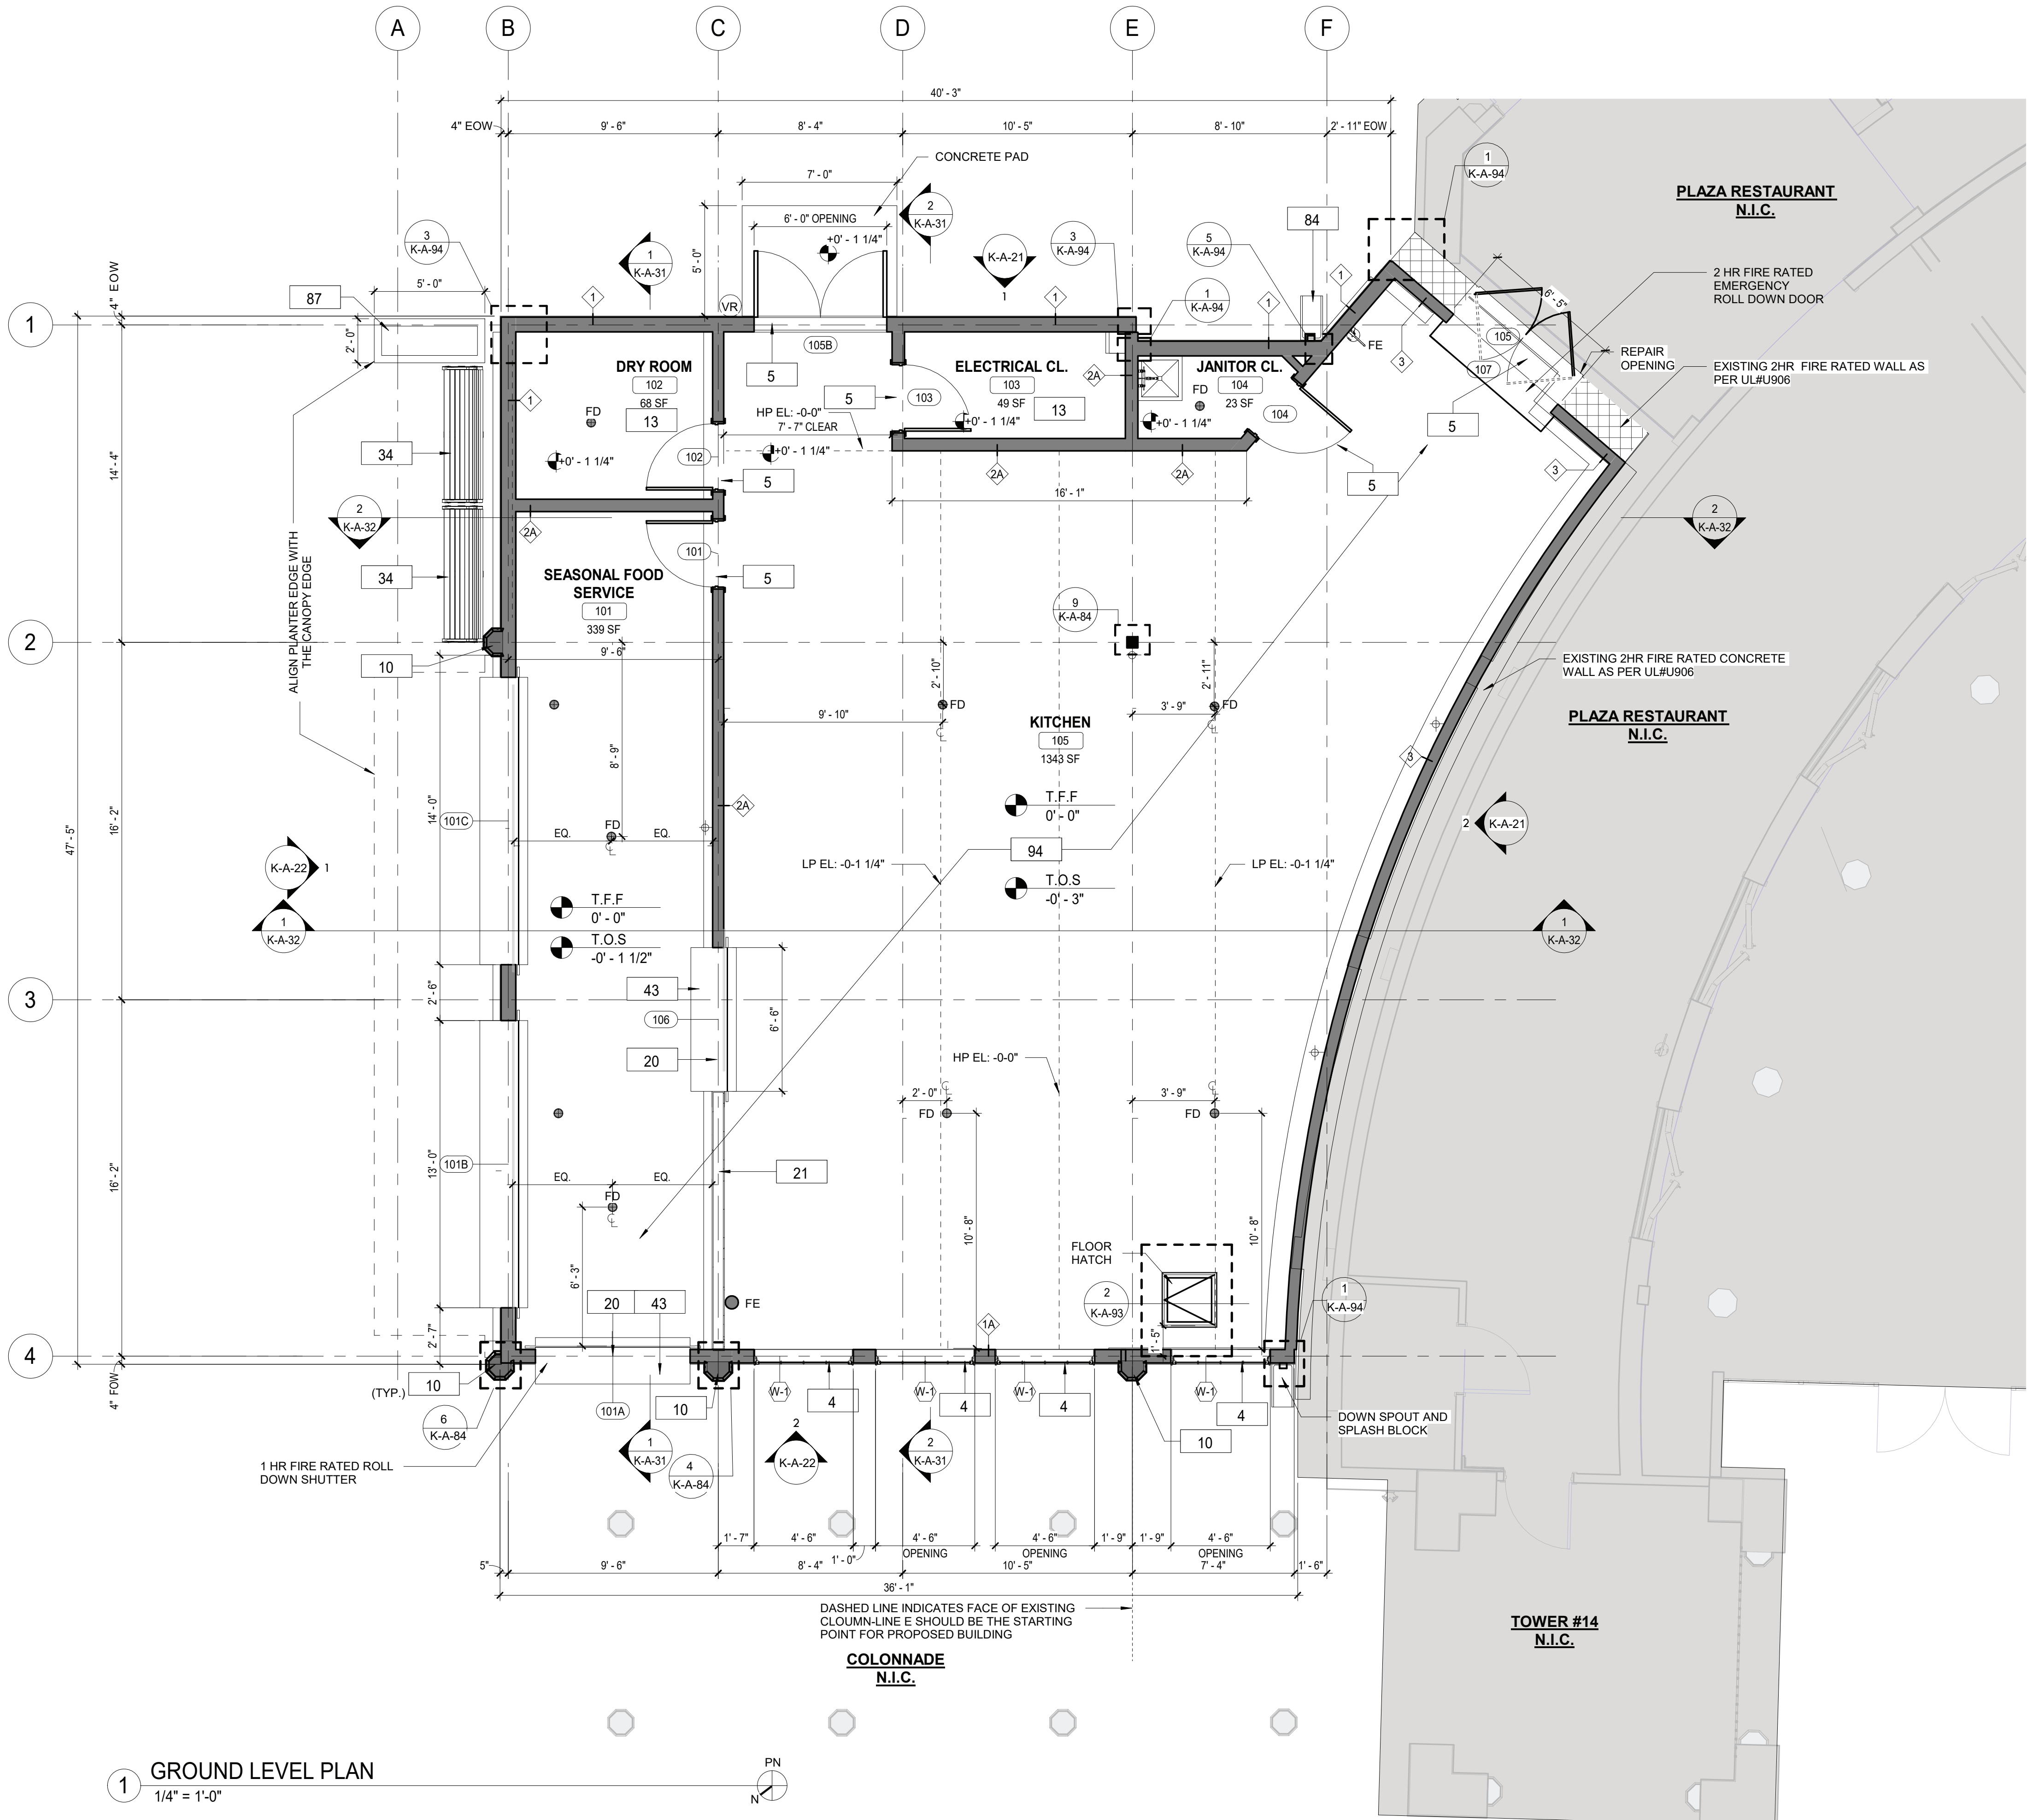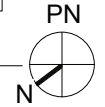


1 GROUND LEVEL PLAN
1/4" = 1'-0"

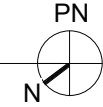



Key Value	Keynote Text
15	PROVIDE AND INSTALL SBS MODIFIED BITUMEN ROOFING AND UNDERLAYMENT.
22	PROVIDE NEW FLASHING ALONG EXISTING WALL AND ROOF CONNECTION.
23	NEW ROOF WITH BATT INSULATION (R-30 MIN) ABOVE EXISTING JOISTS, PROVIDE AND INSTALL SHINGLES, UNDERLAYMENT SHEATHING AND FLASHING SYSTEM.
29	PROVIDE AND INSTALL NEW OSHA COMPLIANT GUARD RAIL.
80	NEW 3/4" PLYWOOD FLOOR.
84	HALF ROUND ALUMINUM GUTTER AND DOWNSPOUT.



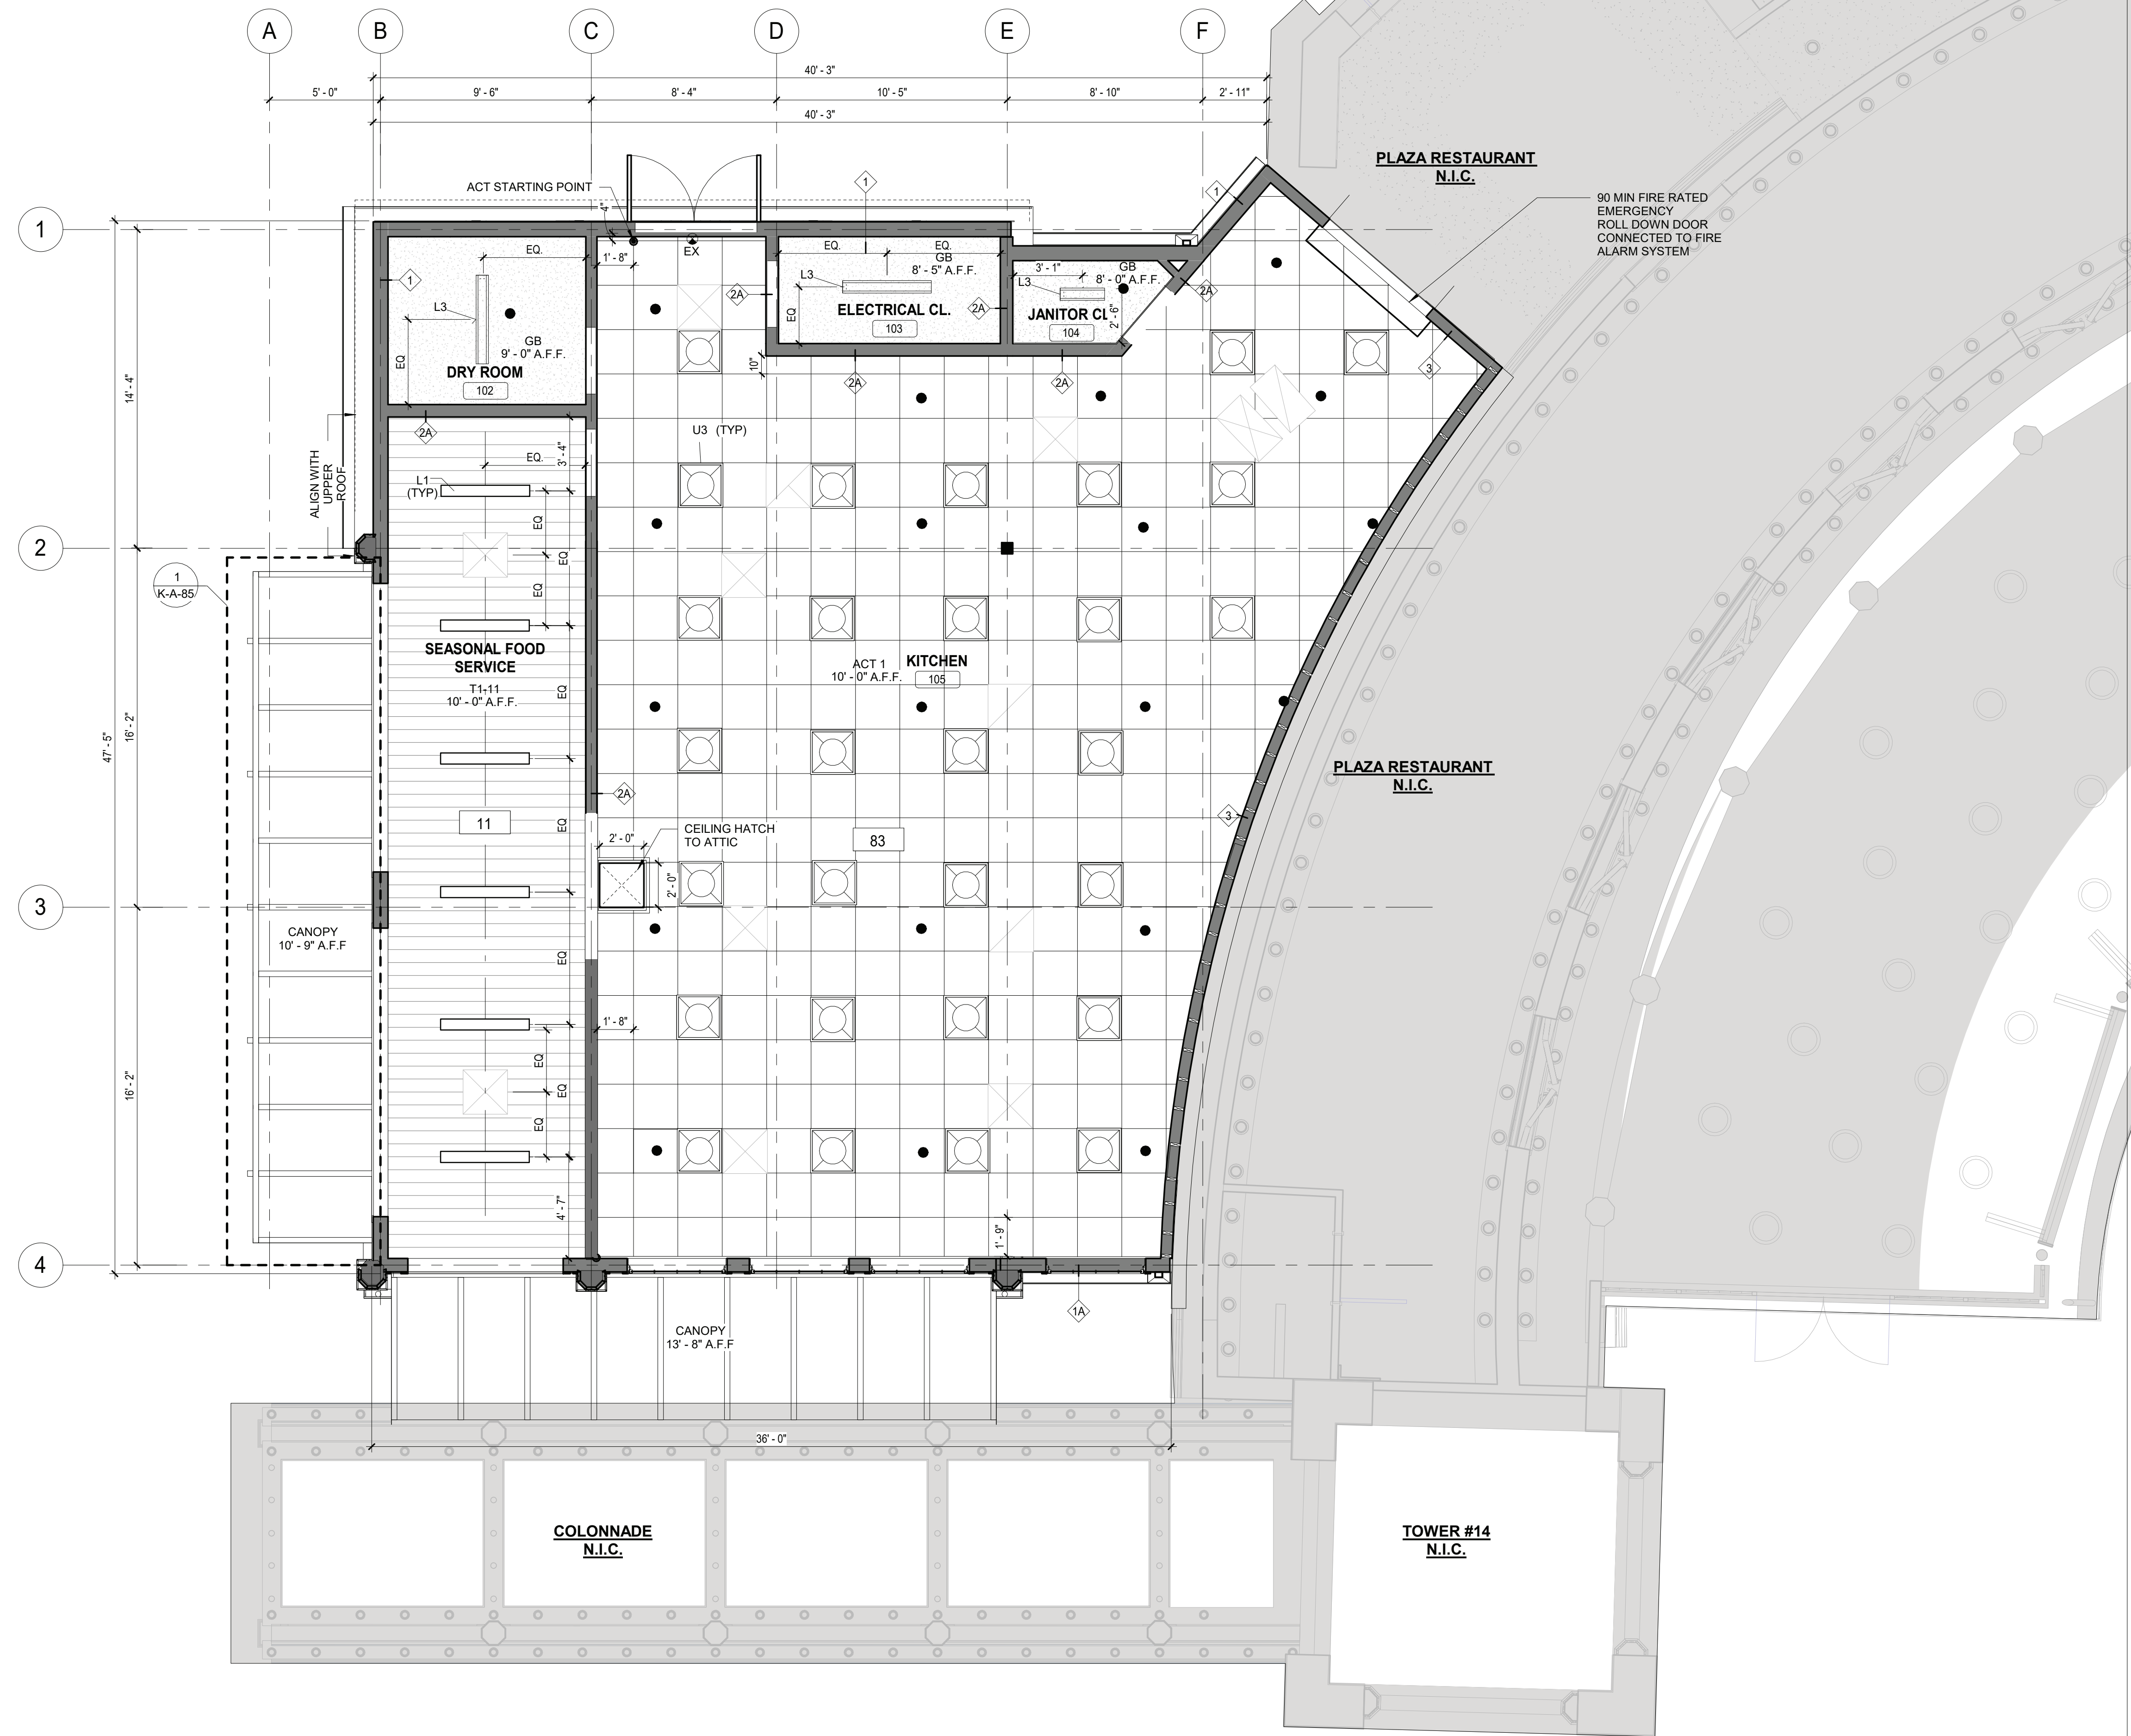

1 GROUND LEVEL REFLECTED CEILING PLAN
1/4" = 1'-0"

RCP GENERAL NOTES


1. CEILING TILES TO BE CENTERED BOTH WAYS IN EACH OR UNLESS DIMENSIONED OTHERWISE.
2. ALL DIMENSIONS ARE TO THE CENTER OF LIGHT FIXTURE, U.N.O.
3. FIXTURES LOCATED WITHIN THE CEILING GRID, ARE NOT NECESSARILY CENTERED IN EACH CEILING TILE. FOLLOW DIMENSIONS ON PLAN. IF NO DIMENSION IS PRESENT CONTACT ARCHITECT TO VERIFY LOCATION.
4. LIGHT FIXTURES TO BE LOCATED AS INDICATED ON THIS PLAN. REFER TO ELECTRICAL DRAWINGS FOR EXACT NUMBER AND TYPE OF LIGHT FIXTURE. CONTACT ARCHITECT/ENGINEER IMMEDIATELY IF THERE ARE ANY DISCREPANCIES.
5. REFER TO MECHANICAL DRAWINGS FOR MECHANICAL DUCT DISTRIBUTION SYSTEM.
6. THE G.C. SHALL SET ALL CEILING AND SOFFITS USING A LASER LEVEL TO ACHIEVE A CEILING THAT IS PLUMBING, LEVEL, AND SQUARE TO ALL WALLS AND SOFFITS.
7. ALL NOTED CEILING DIMENSIONS ARE INDICATED AS CLEAR ABOVE FINISHED FLOOR DIMENSIONS. VERIFY THICKNESS OF FLOOR CONSTRUCTION WITH FLOOR SUBCONTRACTOR PRIOR TO THE INSTALLATION OF ANY NEW CEILING CONSTRUCTION IN ORDER TO ACHIEVE NOTED REQUIRED DIMENSIONS.
8. ALL SOFFIT DIMENSIONS ARE TO FINISH FACE, U.N.O.
9. ALL EXTERIOR DIMENSIONS ARE TO THE FACE OF EXTERIOR FINISH, U.N.O.
10. G.C. TO PROVIDE ADEQUATE CLEARANCES FOR FIXTURES, DUCTS, CEILINGS, AND PERTINENT ITEMS NECESSARY TO MAINTAIN THE SPECIFIC HEIGHTS ABOVE FINISH FLOOR. COORDINATE MECHANICAL, ELECTRICAL AND PLUMBING AS REQUIRED.
11. ADDITIONAL HANGER AND SAFETY WIRES FOR LIGHT FIXTURES AND AIR SUPPLY/RETURN DIFFUSERS AS REQUIRED BY LOCAL CODES TO BE THE RESPONSIBILITY OF THE SUB-CONTRACTOR. ALL WIRING SUPPORT TO BE "CEILING GRADE" AS CONCURRENT WITH ELECTRICAL CODE ADOPTED FOR JURISDICTION OF PROJECT.
12. ALL CEILING ELEVATIONS DIMENSIONED FROM FINISH FLOOR BELOW.

CONSTRUCTION LEGEND


	NOT IN CONTRACT		U-3 INTERIOR TROFFER LIGHT WITH LENS
	KEY NOTES		M-2 MARQUEE LIGHTING
	SPRINKLER		EXHAUST GRILL. SEE MECHANICAL DWGS.
	SUPPLY DIFFUSER. SEE MECHANICAL DWGS.		

KEYNOTE LEGEND CONST.

Key Value	Keynote Text
11	PROVIDE AND INSTALL T1-11 CEILING.
83	FDA AND USDA COMPLIANT SQUARE LAY IN CEILING TILES.

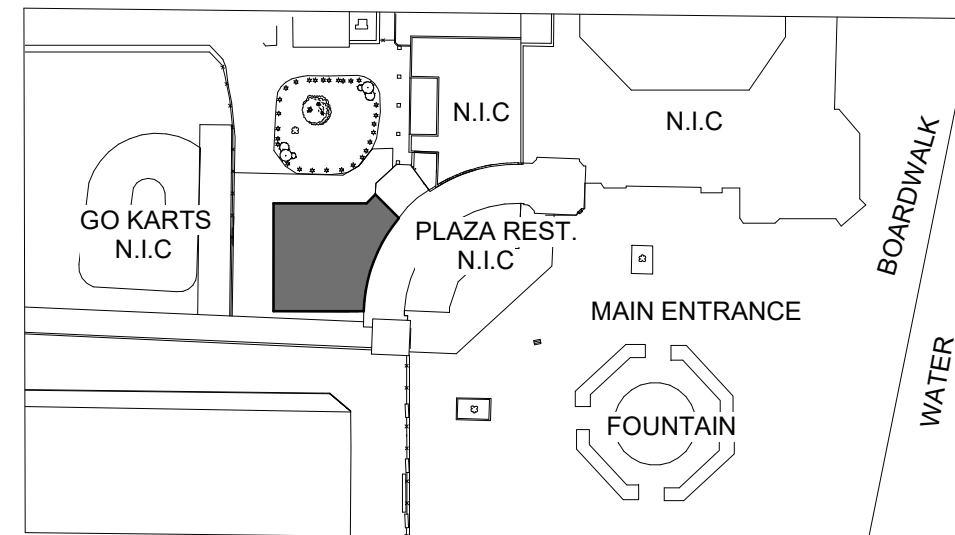


KEY PLAN

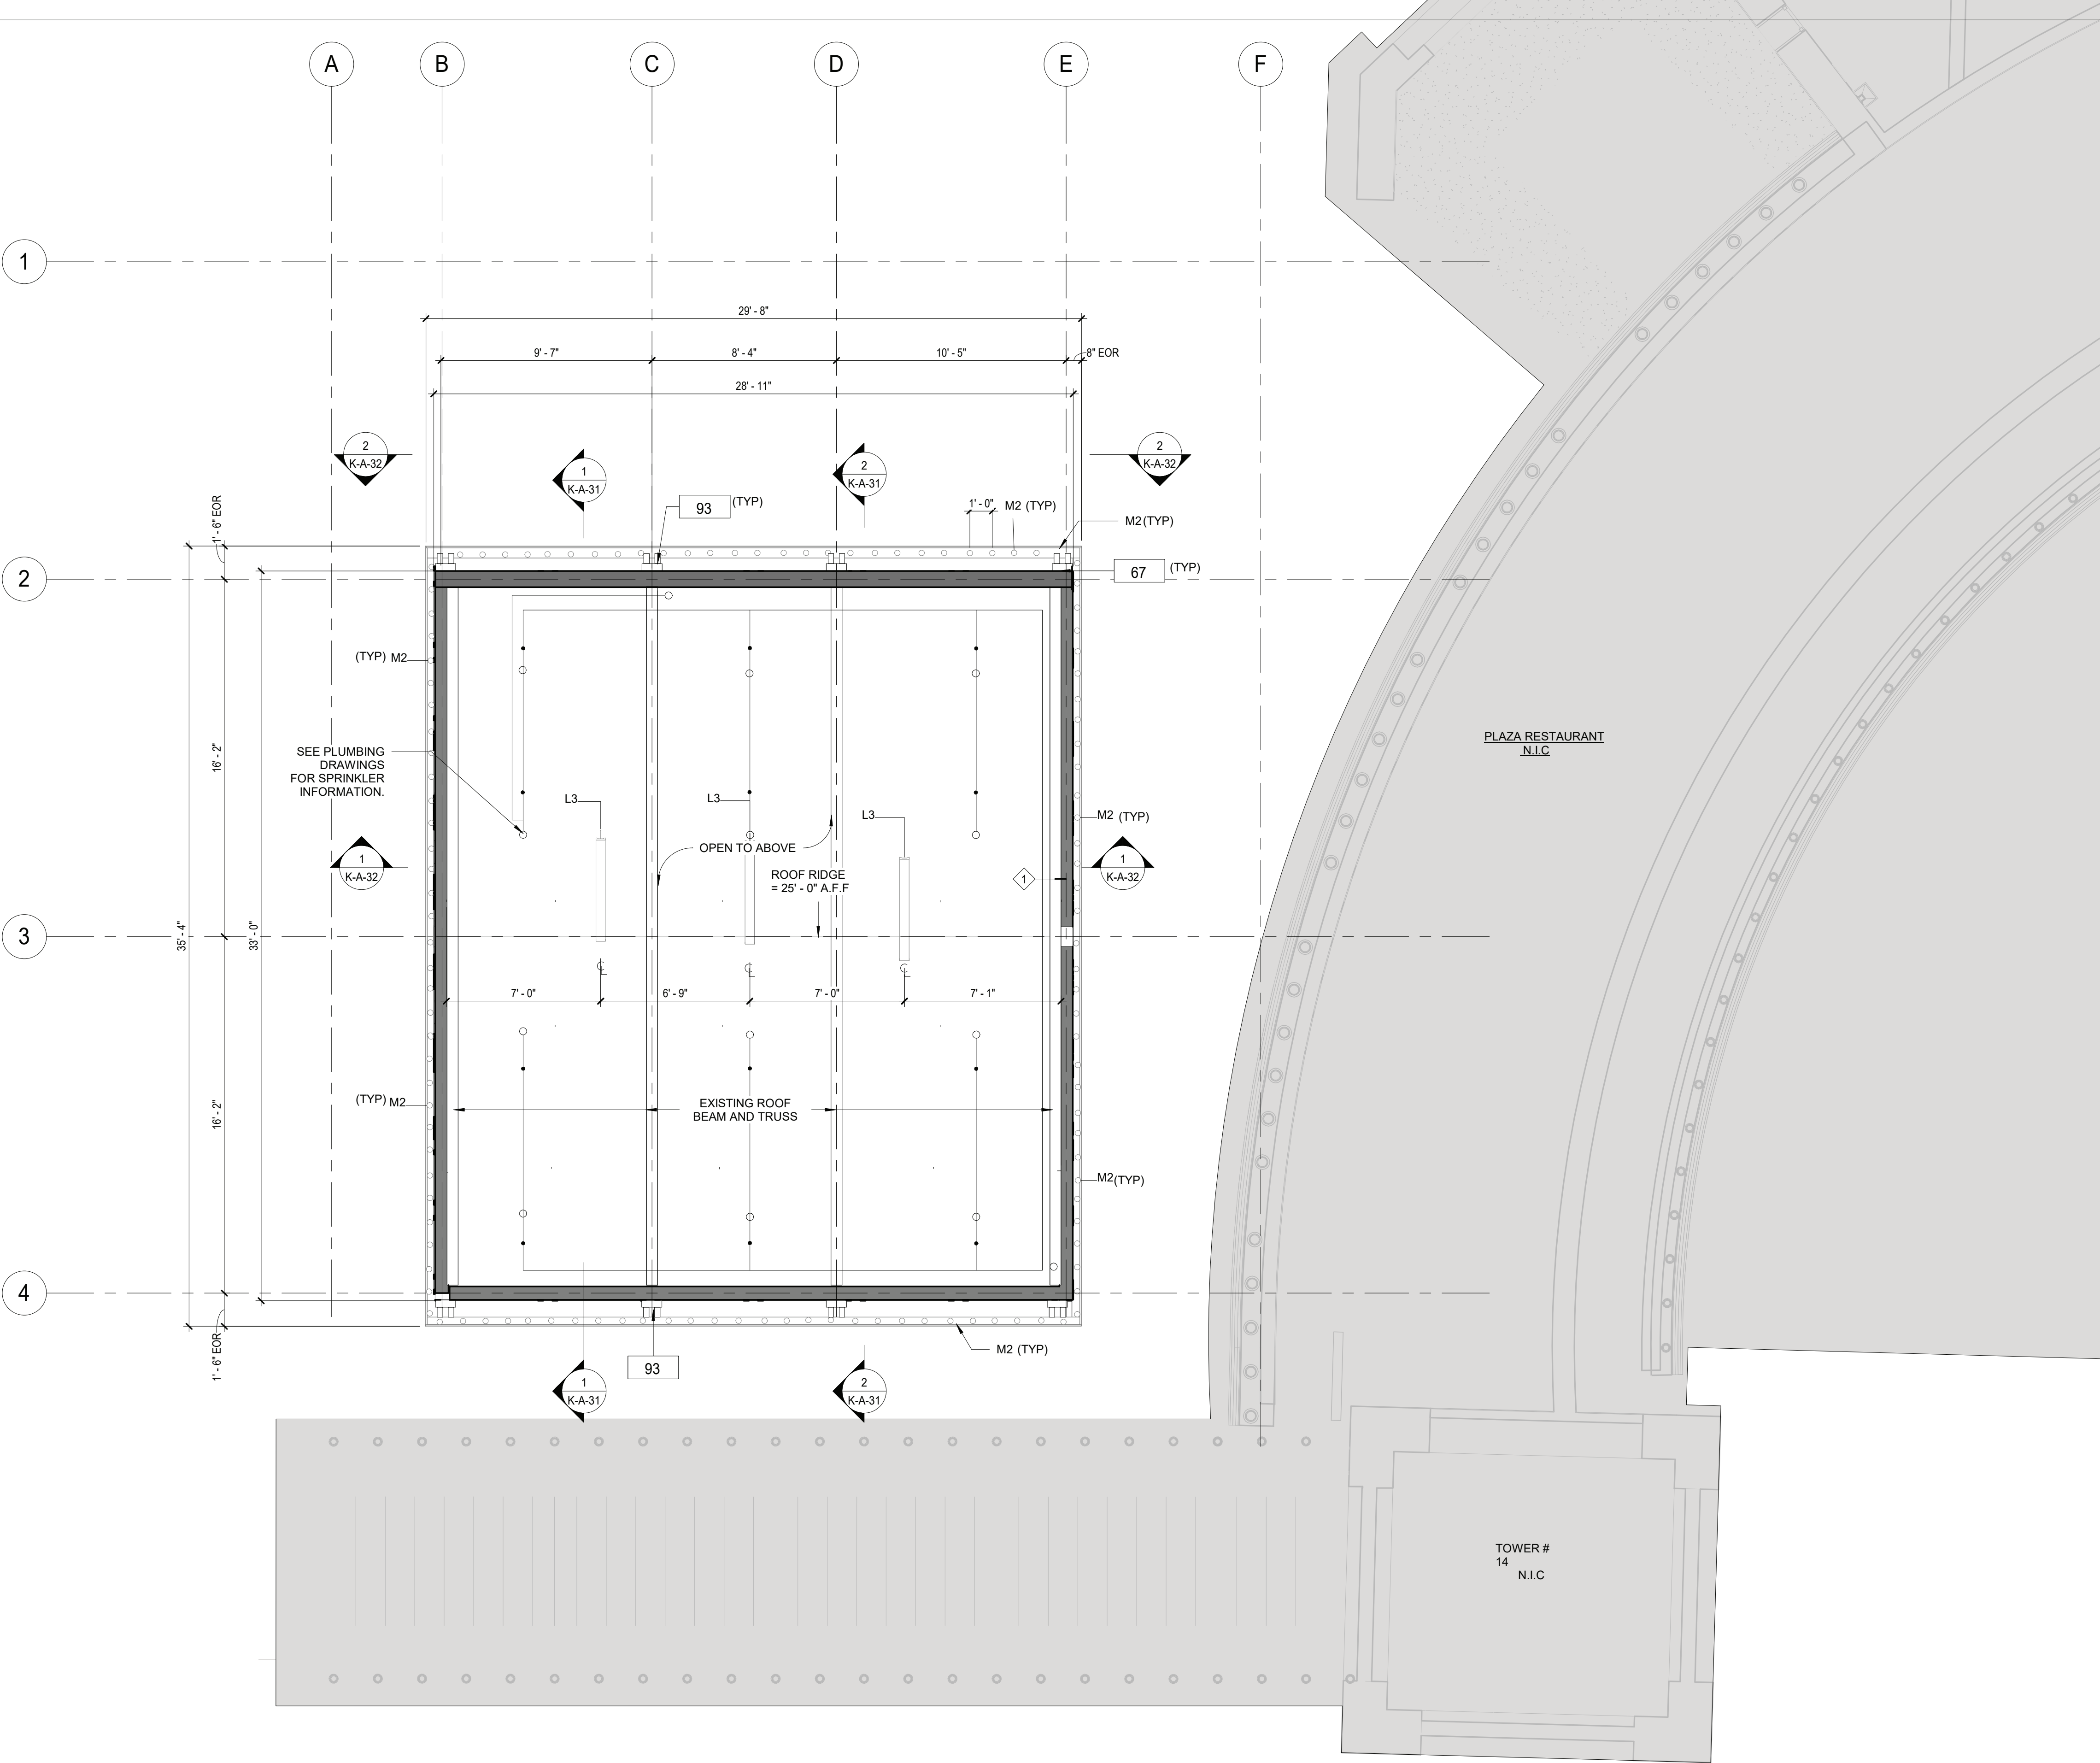

- RCP GENERAL NOTES**
1. CEILING TILES TO BE CENTERED BOTH WAYS IN EACH OR UNLESS DIMENSIONED OTHERWISE.
 2. ALL DIMENSIONS ARE TO THE CENTER OF LIGHT FIXTURE, U.N.O.
 3. FIXTURES LOCATED WITHIN THE CEILING GRID, ARE NOT NECESSARILY CENTERED IN EACH CEILING TILE. FOLLOW DIMENSIONS ON PLAN. IF NO DIMENSION IS PRESENT CONTACT ARCHITECT TO VERIFY LOCATION.
 4. LIGHT FIXTURES TO BE LOCATED AS INDICATED ON THIS PLAN. REFER TO ELECTRICAL DRAWINGS FOR EXACT NUMBER AND TYPE OF LIGHT FIXTURE. CONTACT ARCHITECT/ENGINEER IMMEDIATELY IF THERE ARE ANY DISCREPANCIES.
 5. REFER TO MECHANICAL DRAWINGS FOR MECHANICAL DUCT DISTRIBUTION SYSTEM.
 6. THE G.C. SHALL SET ALL CEILING AND SOFFITS USING A LASER LEVEL TO ACHIEVE A CEILING THAT IS PLUMBING, LEVEL, AND SQUARE TO ALL WALLS AND SOFFITS.
 7. ALL NOTED CEILING DIMENSIONS ARE INDICATED AS CLEAR ABOVE FINISHED FLOOR DIMENSIONS. VERIFY THICKNESS OF FLOOR CONSTRUCTION WITH FLOOR SUBCONTRACTOR PRIOR TO THE INSTALLATION OF ANY NEW CEILING CONSTRUCTION IN ORDER TO ACHIEVE NOTED REQUIRED DIMENSIONS.
 8. ALL SOFFIT DIMENSIONS ARE TO FINISH FACE, U.N.O.
 9. ALL EXTERIOR DIMENSIONS ARE TO THE FACE OF EXTERIOR FINISH, U.N.O.
 10. G.C. TO PROVIDE ADEQUATE CLEARANCES FOR FIXTURES, DUCTS, CEILINGS, AND PERTINENT ITEMS NECESSARY TO MAINTAIN THE SPECIFIC HEIGHTS ABOVE FINISH FLOOR. COORDINATE MECHANICAL, ELECTRICAL AND PLUMBING AS REQUIRED.
 11. ADDITIONAL HANGER AND SAFETY WIRES FOR LIGHT FIXTURES AND AIR SUPPLY/RETURN DIFFUSERS AS REQUIRED BY LOCAL CODES TO BE THE RESPONSIBILITY OF THE SUB-CONTRACTOR. ALL WIRING SUPPORT TO BE "CEILING GRADE" AS CONCURRENT WITH ELECTRICAL CODE ADOPTED FOR JURISDICTION OF PROJECT.
 12. ALL CEILING ELEVATIONS DIMENSIONED FROM FINISH FLOOR BELOW.


- CONSTRUCTION LEGEND**
- | | | | | | |
|--|---------------------------------------|--|--------------------------|--|--------------------------------------|
| | NOT IN CONTRACT | | L-1 LINEAR LIGHT FIXTURE | | U-3 INTERIOR TROFFER LIGHT WITH LENS |
| | KEY NOTES | | L-3 LIGHT FIXTURE | | M-2 MARQUEE LIGHTING |
| | SPRINKLER | | EX EXIT LIGHT | | EXHAUST GRILL. SEE MECHANICAL DWGS. |
| | SUPPLY DIFFUSER. SEE MECHANICAL DWGS. | | | | |

KEYNOTE LEGEND CONST.	
Key Value	Keynote Text
67	NEW FASCIA BOARD AND SOFFIT.
93	REPLICATE EVE SUPPORT TO MATCH DOCUMENTED EVE, LOCATIONS, SIZE AND SHAPE. FINISH PAINT COLORS AS SCHEDULED.

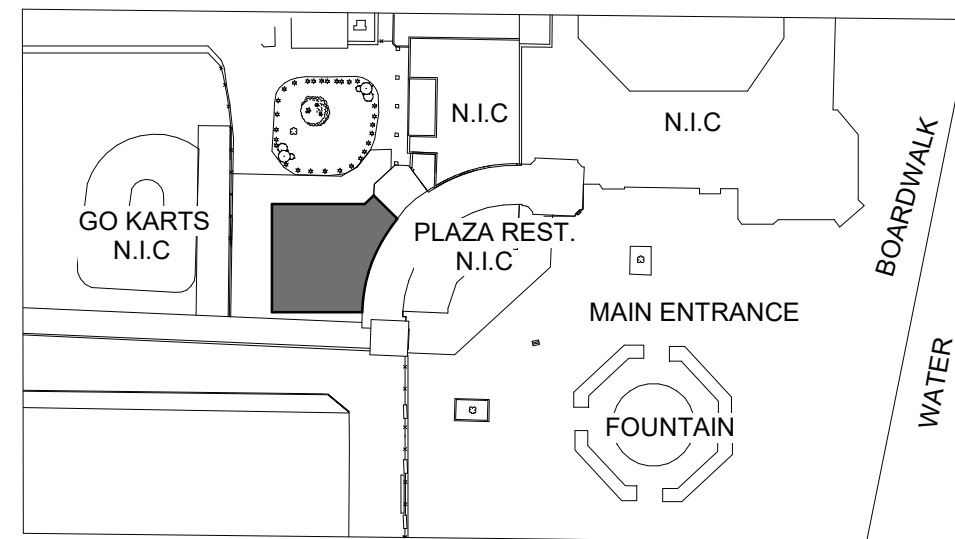


KEY PLAN

1 ATTIC FLOOR RCP
1/4" = 1'-0"

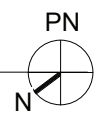

CONSULTANT INFORMATION

1 State Street Plaza, New York, NY, 10004
(516) 938-5476
www.liro.com

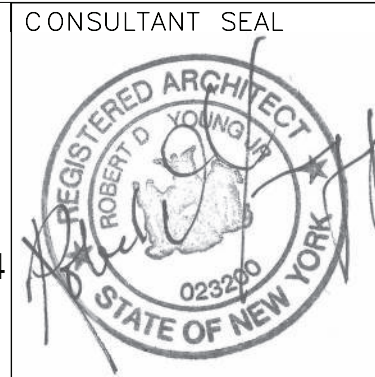

REVISION NUMBER	DATE	MADE BY	APP'D BY	REVISION

RECORD DRAWING CERTIFICATION			
<input type="checkbox"/> AS BUILT – CHANGES AS NOTED	<input type="checkbox"/> AS BUILT – NO CHANGES		
CONTRACTOR		PROJECT COORDINATOR	
NAME _____	NAME _____	SIGNATURE _____	SIGNATURE _____
TITLE _____	TITLE _____	DATE _____	DATE _____

WESTCHESTER COUNTY, NEW YORK
DEPARTMENT OF PUBLIC WORKS AND TRANSPORTATION
DIVISION OF ENGINEERING
**INFRASTRUCTURE REHABILITATION
PLAYLAND PARK, RYE, NEW YORK
RESTAURANT KITCHEN WITH FOOD VENDING
ATTIC REFLECTED CEILING PLAN**

CONTRACT NUMBER 22-523	SHEET NUMBER K-A-14
DWG NO.: 510 of 664	SCALE: As indicated
DATE: 8/23/20223	REV. NO. 0
DPW FILE NUMBER 1-118-A-1259-0	

8/30/2022 2:51:40 PM

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CONSULTANT
INFORMATION



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REVISION NUMBER	DATE	MADE BY	APP'D BY	REVISION

RECORD DRAWING CERTIFICATION

☐ AS BUILT – CHANGES AS NOTED ☐ AS BUILT – NO CHANGES

CONTRACTOR

NAME _____
SIGNATURE _____
TITLE _____ DATE _____

PROJECT COORDINATOR

NAME _____
SIGNATURE _____
TITLE _____ DATE _____

WESTCHESTER COUNTY, NEW YORK
DEPARTMENT OF PUBLIC WORKS AND TRANSPORTATION
DIVISION OF ENGINEERING
**INFRASTRUCTURE REHABILITATION
PLAYLAND PARK, RYE, NEW YORK
RESTAURANT KITCHEN WITH FOOD VENDING
ROOF CONSTRUCTION PLAN**

CONTRACT
NUMBER

22-523

SHEET
NUMBER

K-A-15

DWG NO.: 511 of 664

SCALE: As indicated

DATE: 8/23/20223

DPW FILE
NUMBER 1-118-A-1260-0

REV.
NO. 0

CONSTRUCTION GENERAL NOTES


1. PROVIDE LEVEL ROOF CURB FOR ALL MECHANICAL EQUIPMENT 8 INCHES ABOVE HIGHEST FINISHED ROOF SURFACE.
3. REFER TO MECHANICAL DRAWINGS FOR ALL ROOF TOP MOUNTED EQUIPMENT LOCATIONS, SIZE & SPECIFICATIONS.
4. REFER TO PLUMBING, MECHANICAL, & ELECTRICAL DRAWINGS FOR ANY ADDITIONAL ROOF PENETRATIONS AND DETAILS.
5. ROOFING SYSTEM AND ACCESSORIES INSTALLATION AND DETAILS ARE FOR DESIGN INTENT. ROOF INSTALLATION SHALL BE IN CONFORMANCE WITH MANUFACTURERS.
6. REFER TO SHEET K-A-82FOR TYPICAL ROOF DETAILS.
7. SEE STRUCTURAL DRAWINGS FOR RTU OPENING FRAMING & REINFORCING.
9. LOW ROOF 1 AND LOW ROOF 2 REFER TO SHEET K-A-12.

CONSTRUCTION LEGEND


	NOT IN CONTRACT		NEW CONSTRUCTION		DOOR TAG
	KEY NOTES		PLUMBING FIXTURE		FIRE EXTINGUISHER
	WINDOW TAG		FLOOR DRAIN		STUB UP
	WALL TAG		ROOF GUARD RAIL		SBS 1/4" / 12"
	MATERIAL / TRIM TAG		ROOF CRICKET, 1/2" / 12"		ASPHALT SHINGLE

KEYNOTE LEGEND CONST.

Key Value	Keynote Text
23	NEW ROOF WITH BATT INSULATION (R-38 MIN) PACKED BETWEEN JOISTS. PROVIDE AND INSTALL SHINGLES, UNDERLAYMENT SHEATHING AND FLASHING SYSTEM.
29	PROVIDE AND INSTALL NEW OSHA COMPLIANT GUARD RAIL.
37	NEW CANOPY, SEE DETAILS.
67	NEW FASCIA BOARD AND SOFFIT.
84	HALF ROUND ALUMINUM GUTTER AND DOWNSPOUT.

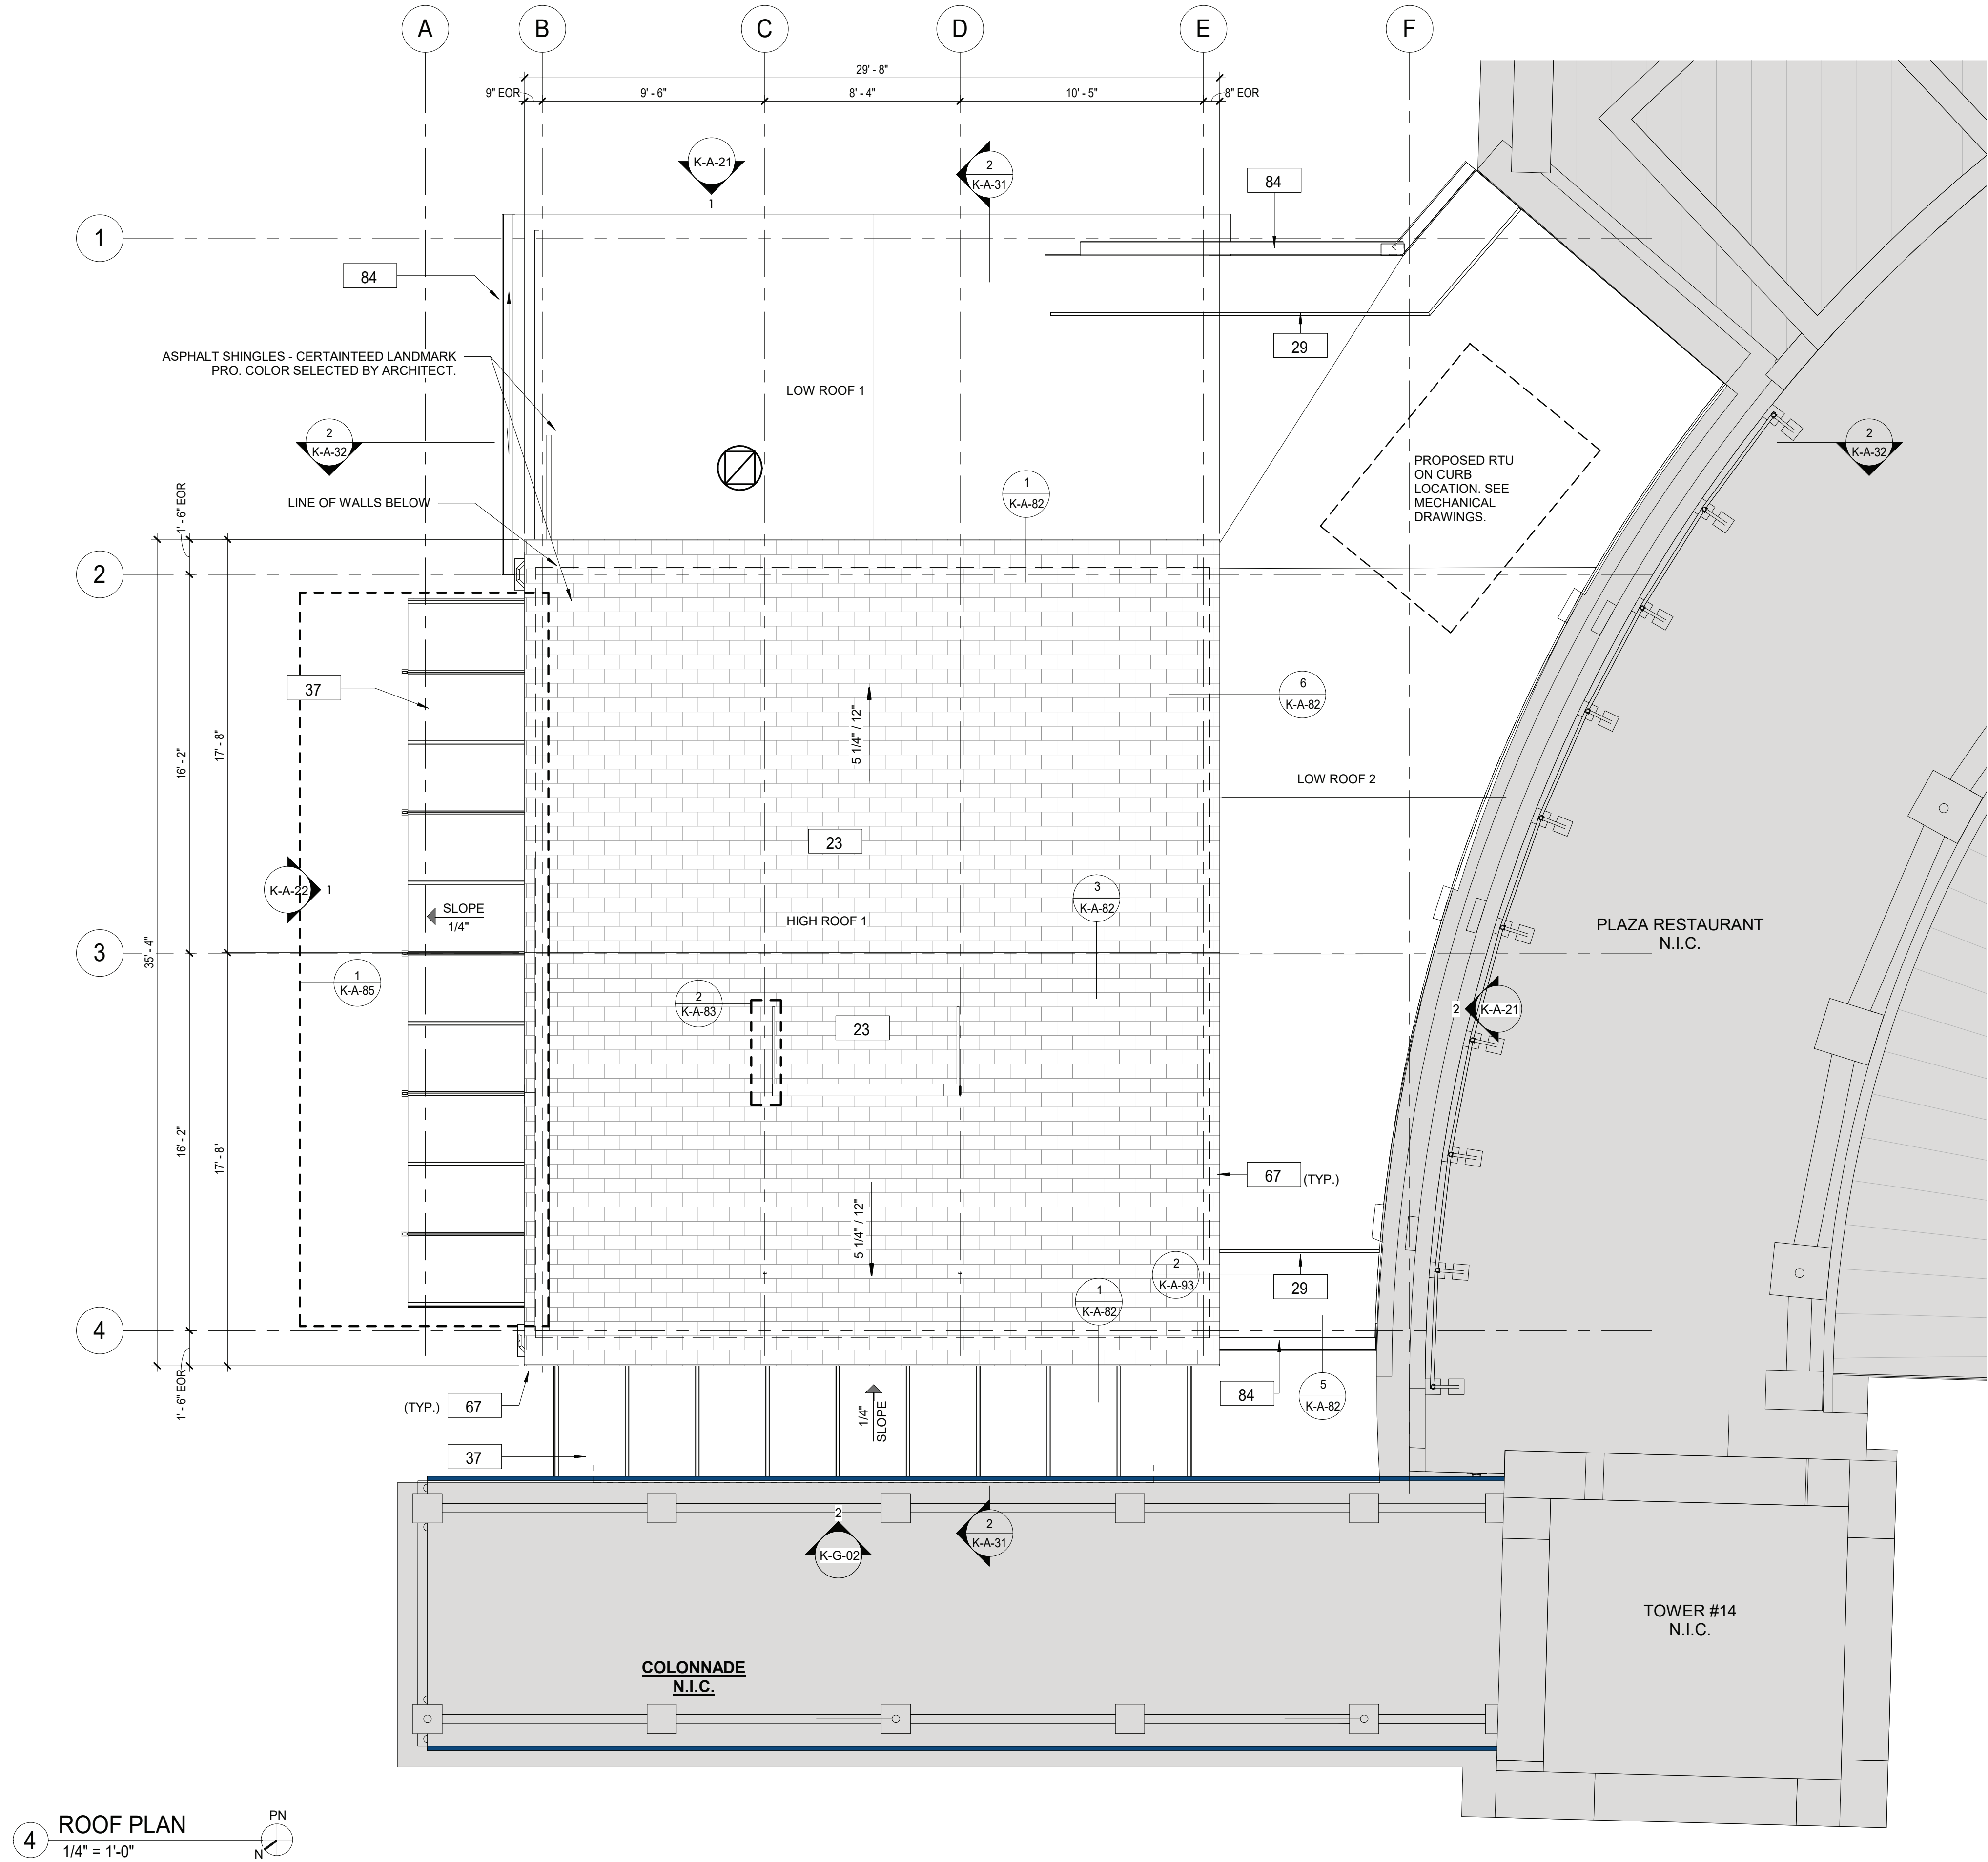

4 ROOF PLAN
1/4" = 1'-0"

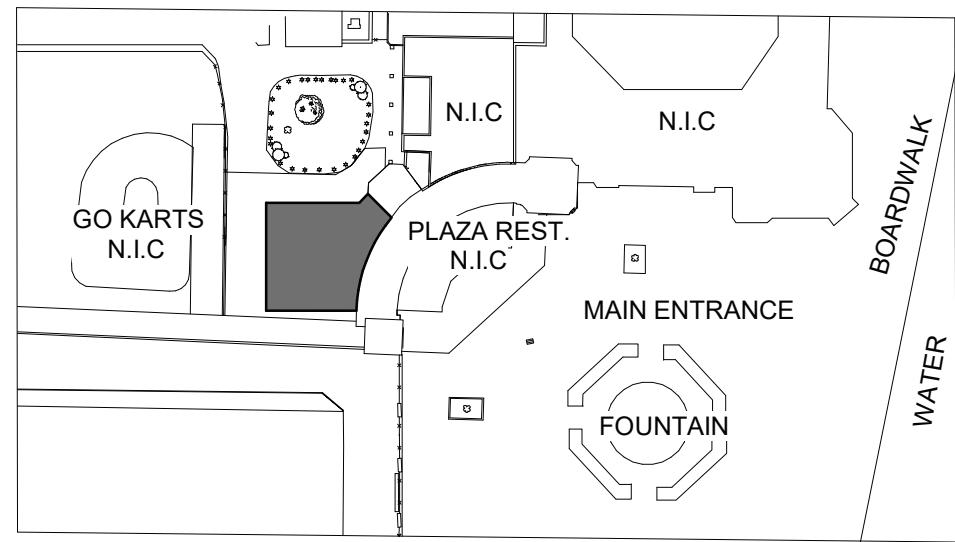

KEY PLAN

CONSTRUCTION GENERAL NOTES

1. THE ARCHITECT DOES NOT CERTIFY DIMENSIONS OR CONDITIONS OF EXISTING CONSTRUCTION. GENERAL CONTRACTOR SHALL NOTIFY ARCHITECT IMMEDIATELY OF ANY DISCREPANCY BETWEEN DRAWINGS AND EXISTING CONDITIONS. IN ADDITION, CONTRACTOR SHALL NOTIFY THE ARCHITECT OF ANY DEFECTIVE CONSTRUCTION UNCOVERED DURING CONSTRUCTION.

2. CONTRACTOR SHALL KEEP WORK SITE FREE FROM DEBRIS AND ACCUMULATED REFUSE, AND SHALL HAVE SOLE RESPONSIBILITY FOR PROTECTING ALL DANGEROUS AREAS FROM ENTRY BY UNAUTHORIZED PARTIES. ALL CONSTRUCTION SCRAPS, DIRT, AND DEBRIS SHALL BE REMOVED FROM THE PREMISES DAILY. SITE SHALL BE LEFT BROOM CLEAN AT THE END OF EACH WORKING DAY. AT THE COMPLETION OF THE WORK, HE PREMISES SHALL BE LEFT IN A BROOM CLEAN CONDITION.

3. MATERIALS UTILIZED SHALL BE AS SPECIFIED ON THE DRAWINGS OR IN THE JOB SPECIFICATIONS, OR, IF GENERIC, IN COMPLIANCE WITH ASTM, NEW YORK CODE, OR OTHER GENERALLY ACCEPTED STANDARDS.

4. ALL EXITS SHALL BE KEPT READILY ACCESSIBLE AND UNOBSTRUCTED AT ALL TIMES.

5. THE G.C. SHALL VERIFY DIMENSIONS OF THE EXISTING SPACE AND OF ANY EXISTING CONSTRUCTION TO REMAIN BY ACTUAL MEASUREMENT BEFORE ANY WORK IS PERFORMED. IF ANY MEASUREMENTS DIFFER FROM DIMENSIONS SHOWN ON PLAN, G.C. IS TO NOTIFY THE ARCHITECT IMMEDIATELY. THE G.C. SHALL BE RESPONSIBLE FOR CORRECTING ANY AND ALL DISCREPANCIES FOUND AFTER THE WORK IS PERFORMED, AT NO ADDITIONAL EXPENSE TO THE OWNER.

6. G.C. TO VERIFY ALL FINISHED DIMENSIONS. FIELD CONDITIONS ALTERING ANY DIMENSIONS SHOULD BE BROUGHT TO THE ATTENTION OF THE OWNER AND ARCHITECT.


7. THE G.C. SHALL BE RESPONSIBLE FOR COORDINATING WITH OWNER ON ALL WORK TO BE PERFORMED BY THE OWNER. ANY POTENTIAL CONFLICTS OR DELAYS CAUSED BY THE OWNER'S SUBCONTRACTORS MUST BE DOCUMENTED IN WRITING TO THE OWNER BEFORE THE DELAY IS ACTUALLY INCURRED FOR IT TO BE CONSIDERED. OTHERWISE THE G.C. WILL BE RESPONSIBLE FOR MEETING THE SCHEDULE AS OUTLINED IN THE CONTRACT.

CONSTRUCTION LEGEND


	NOT IN CONTRACT		NEW CONSTRUCTION		DOOR TAG
	KEY NOTES		PLUMBING FIXTURE		FIRE EXTINGUISHER
	WINDOW TAG		FLOOR DRAIN		STUB UP
	WALL TAG		ROOF GUARD RAIL		SBS 1/4" / 12"
	MATERIAL / TRIM TAG		ROOF CRICKET, 1/2" / 12"		ASPHALT SHINGLE

KEYNOTE LEGEND CONST.

Key Value	Keynote Text
1	PROVIDE AND INSTALL NEW 1x8 MILLED YELLOW PINE - TONGUE AND GROOVE - NO BEVEL
3	REPLICATE TRIMS TO MATCH DOCUMENTED TRIM, LOCATIONS, SIZE AND SHAPE. FINISH PAINT COLORS AS SCHEDULED.
5	PROVIDE AND INSTALL DOOR INCLUDING FRAME, SILL, LINTEL AND ANY ASSOCIATE HARDWARE. SEE DOOR SCHEDULE.
10	PROVIDE AND INSTALL COLUMN ENCLOSURES. SEE DETAILS.
29	PROVIDE AND INSTALL NEW OSHA COMPLIANT GUARD RAIL.
37	NEW CANOPY, SEE DETAILS.
67	NEW FASCIA BOARD AND SOFFIT.
84	HALF ROUND ALUMINUM GUTTER AND DOWNSPOUT.
85	NEW ROOF MOUNTED SIGN. SEE DETAILS
86	NEW CERAMIC TILES.
87	NEW PRECAST CONCRETE PLANTER BOX.
88	NEW PVC BASEBOARD.

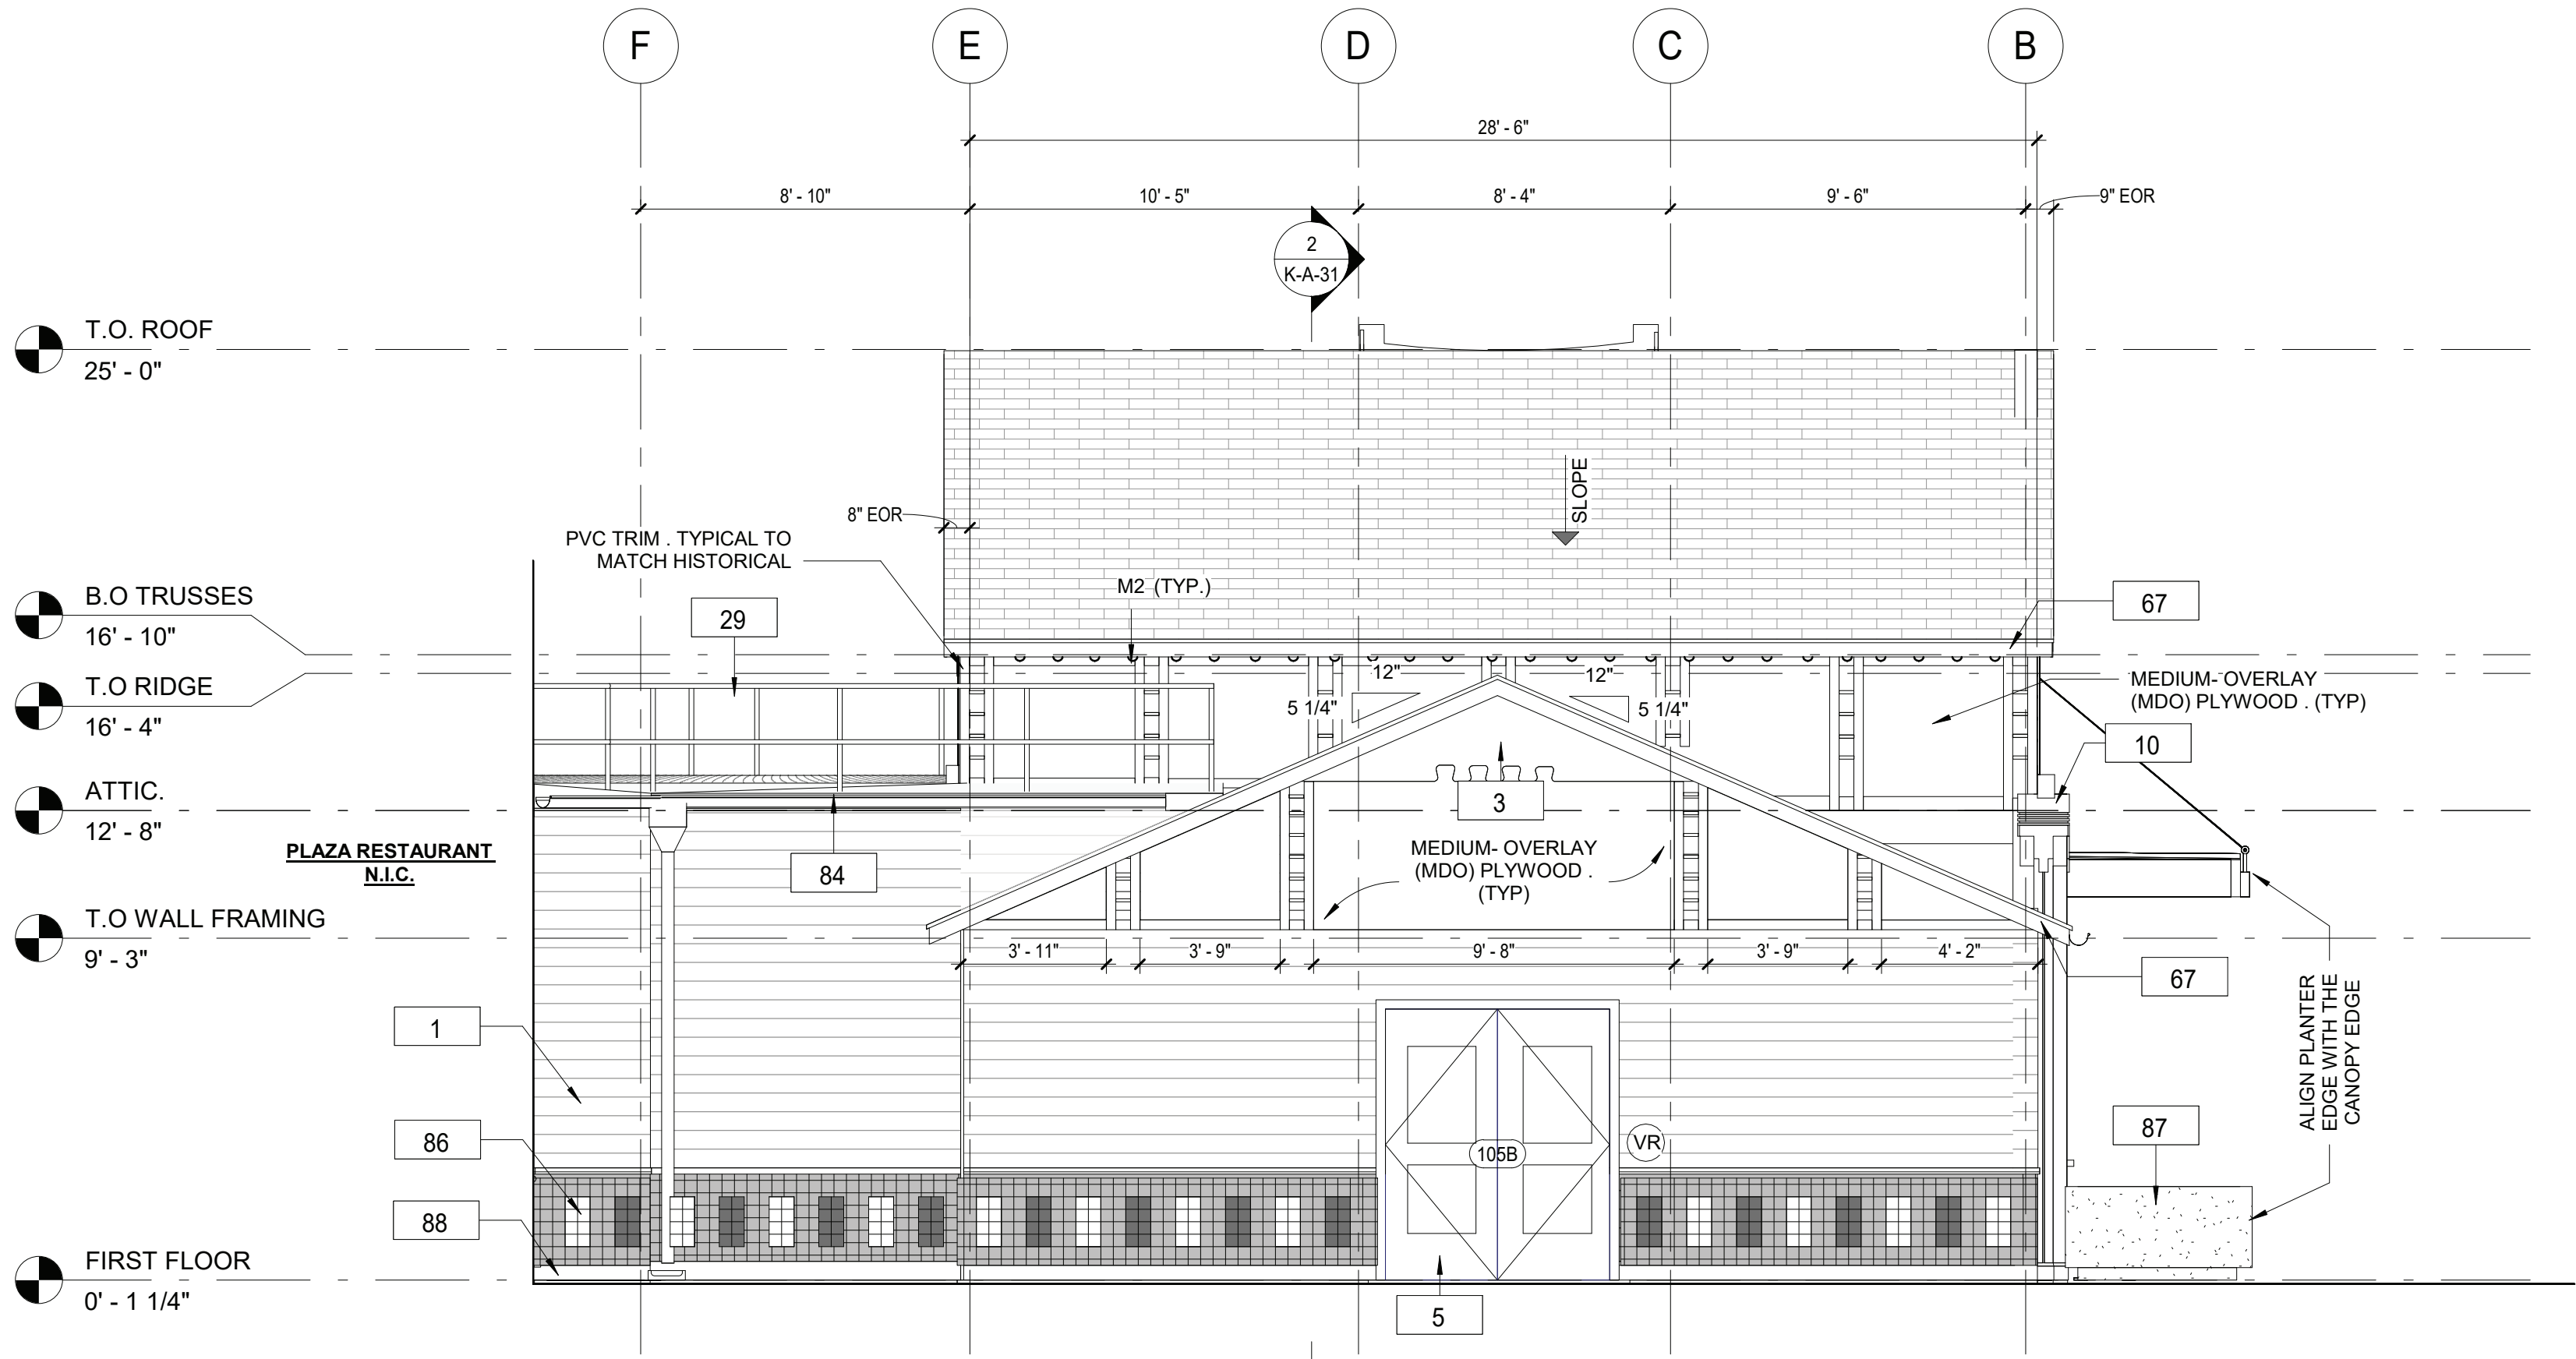

1 PROPOSED ELEVATION- EAST
1/4" = 1'-0"

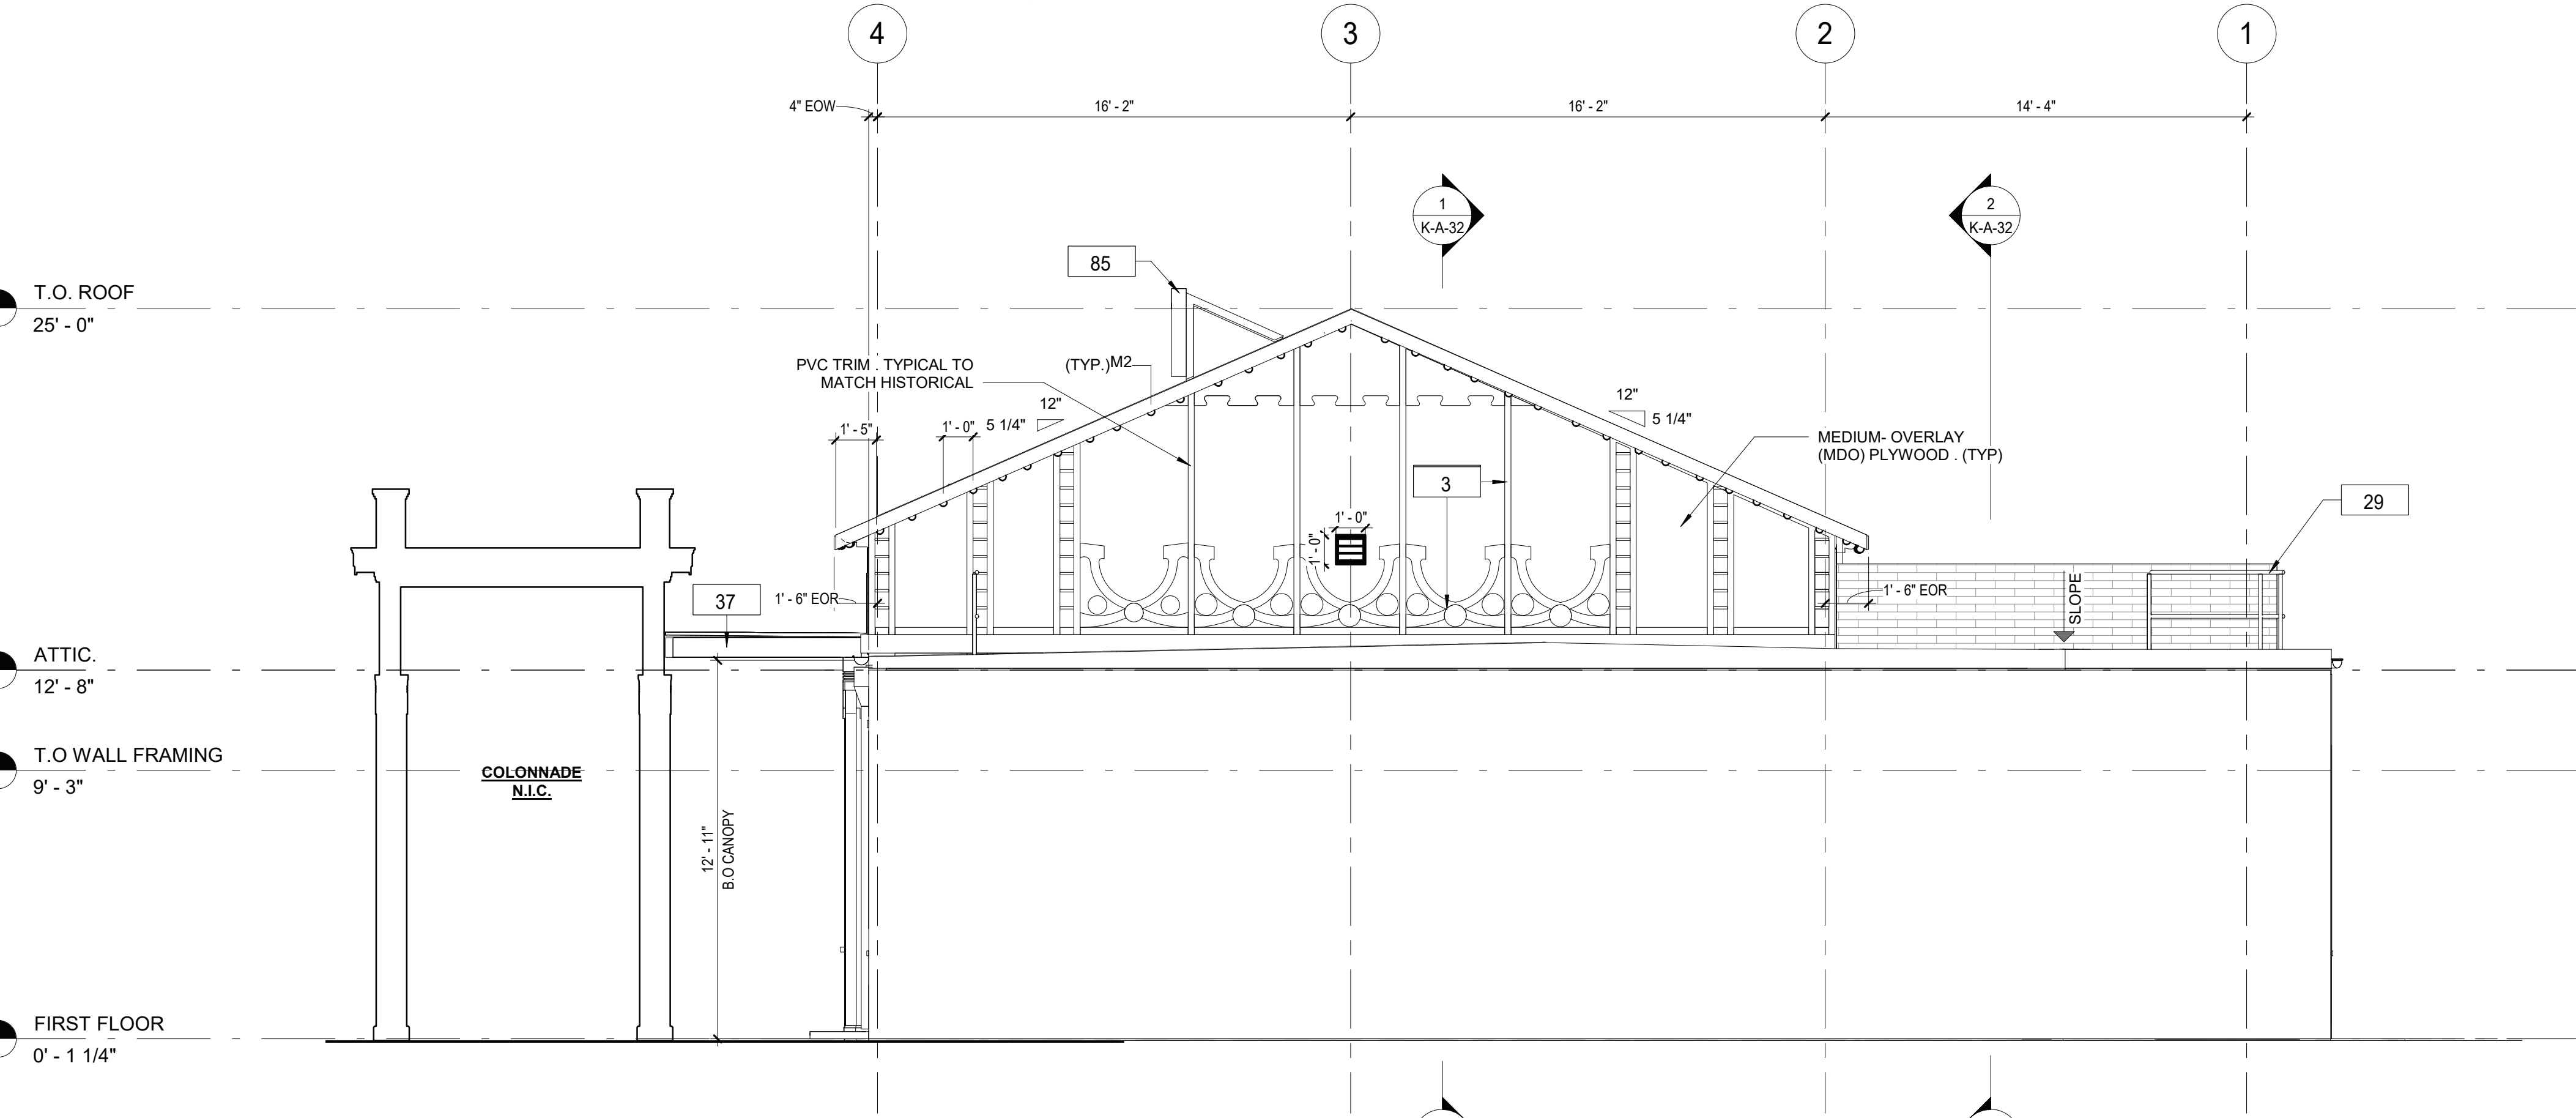

2 PROPOSED ELEVATION- SOUTH
1/4" = 1'-0"

CONSULTANT INFORMATION

The LiRo Group

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REVISION NUMBER	DATE	MADE BY	APP'D BY	REVISION

RECORD DRAWING CERTIFICATION


☐ AS BUILT – CHANGES AS NOTED ☐ AS BUILT – NO CHANGES

CONTRACTOR		PROJECT COORDINATOR	
NAME	SIGNATURE	NAME	SIGNATURE
TITLE	DATE	TITLE	DATE


WESTCHESTER COUNTY, NEW YORK
DEPARTMENT OF PUBLIC WORKS AND TRANSPORTATION
DIVISION OF ENGINEERING

INFRASTRUCTURE REHABILITATION
PLAYLAND PARK, RYE, NEW YORK
RESTAURANT KITCHEN WITH FOOD VENDING
EXTERIOR BUILDING ELEVATIONS - EAST AND SOUTH

CONTRACT NUMBER 22-523	SHEET NUMBER K-A-21
DWG NO.: 512 of 664	SCALE: 1/4" = 1'-0"
DATE: 8/23/20223	REV. NO. 0
DPW FILE NUMBER 1-118-A-1261-0	

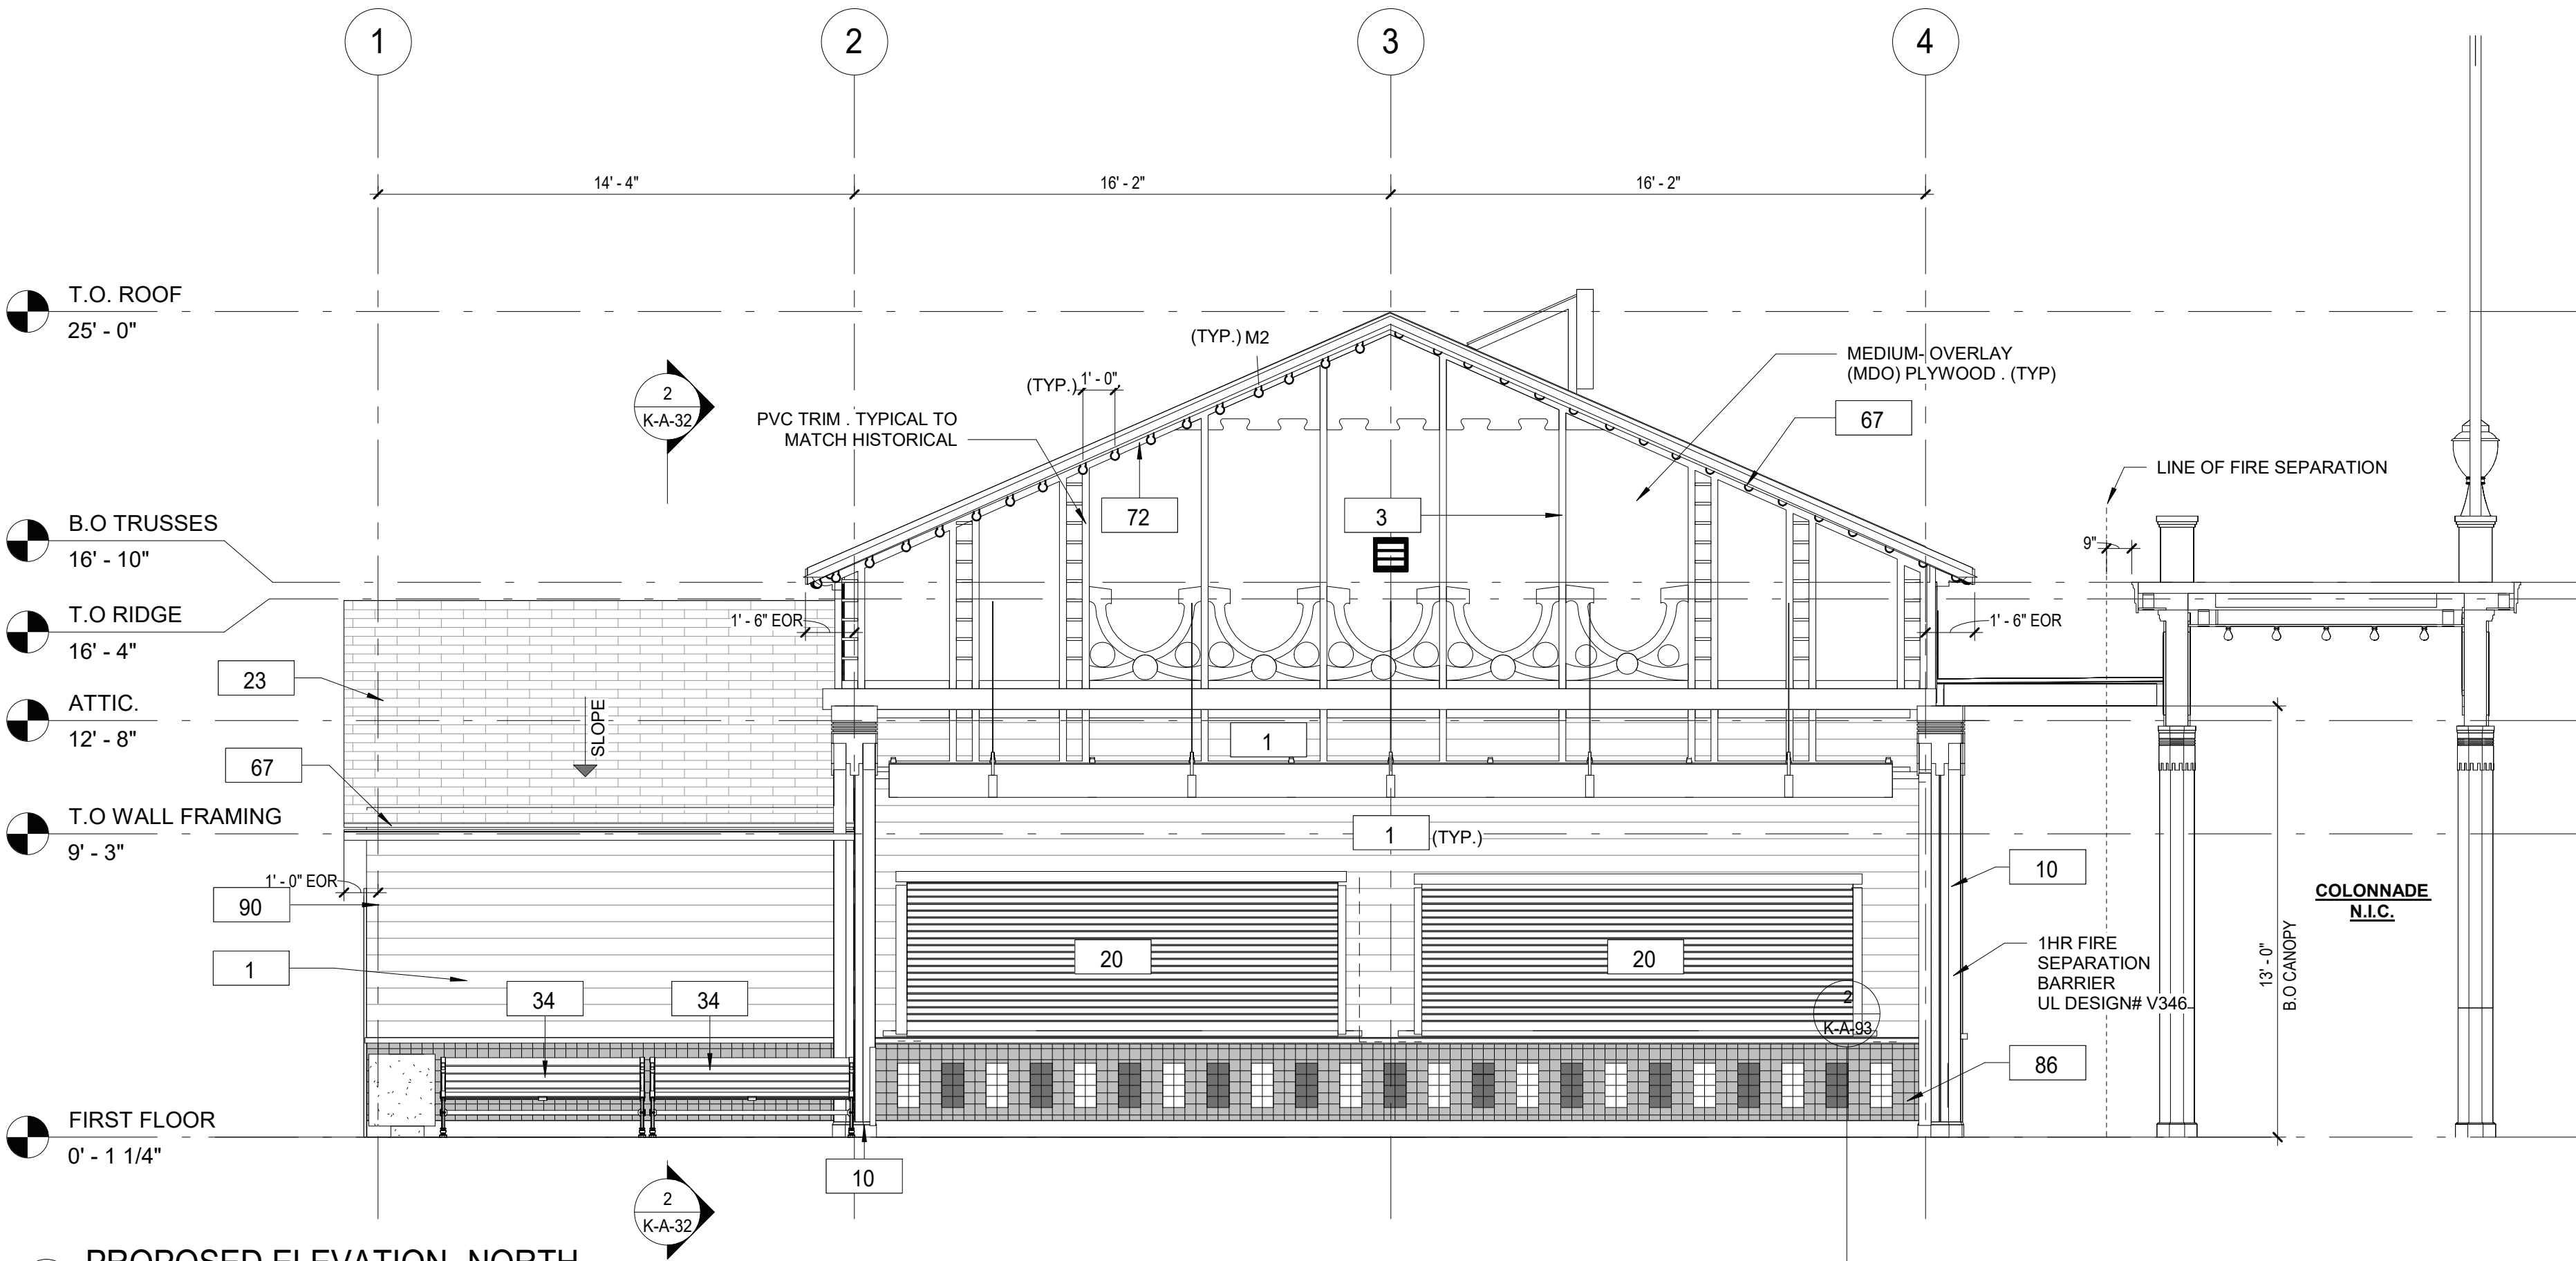

1 PROPOSED ELEVATION- NORTH
1/4" = 1'-0"

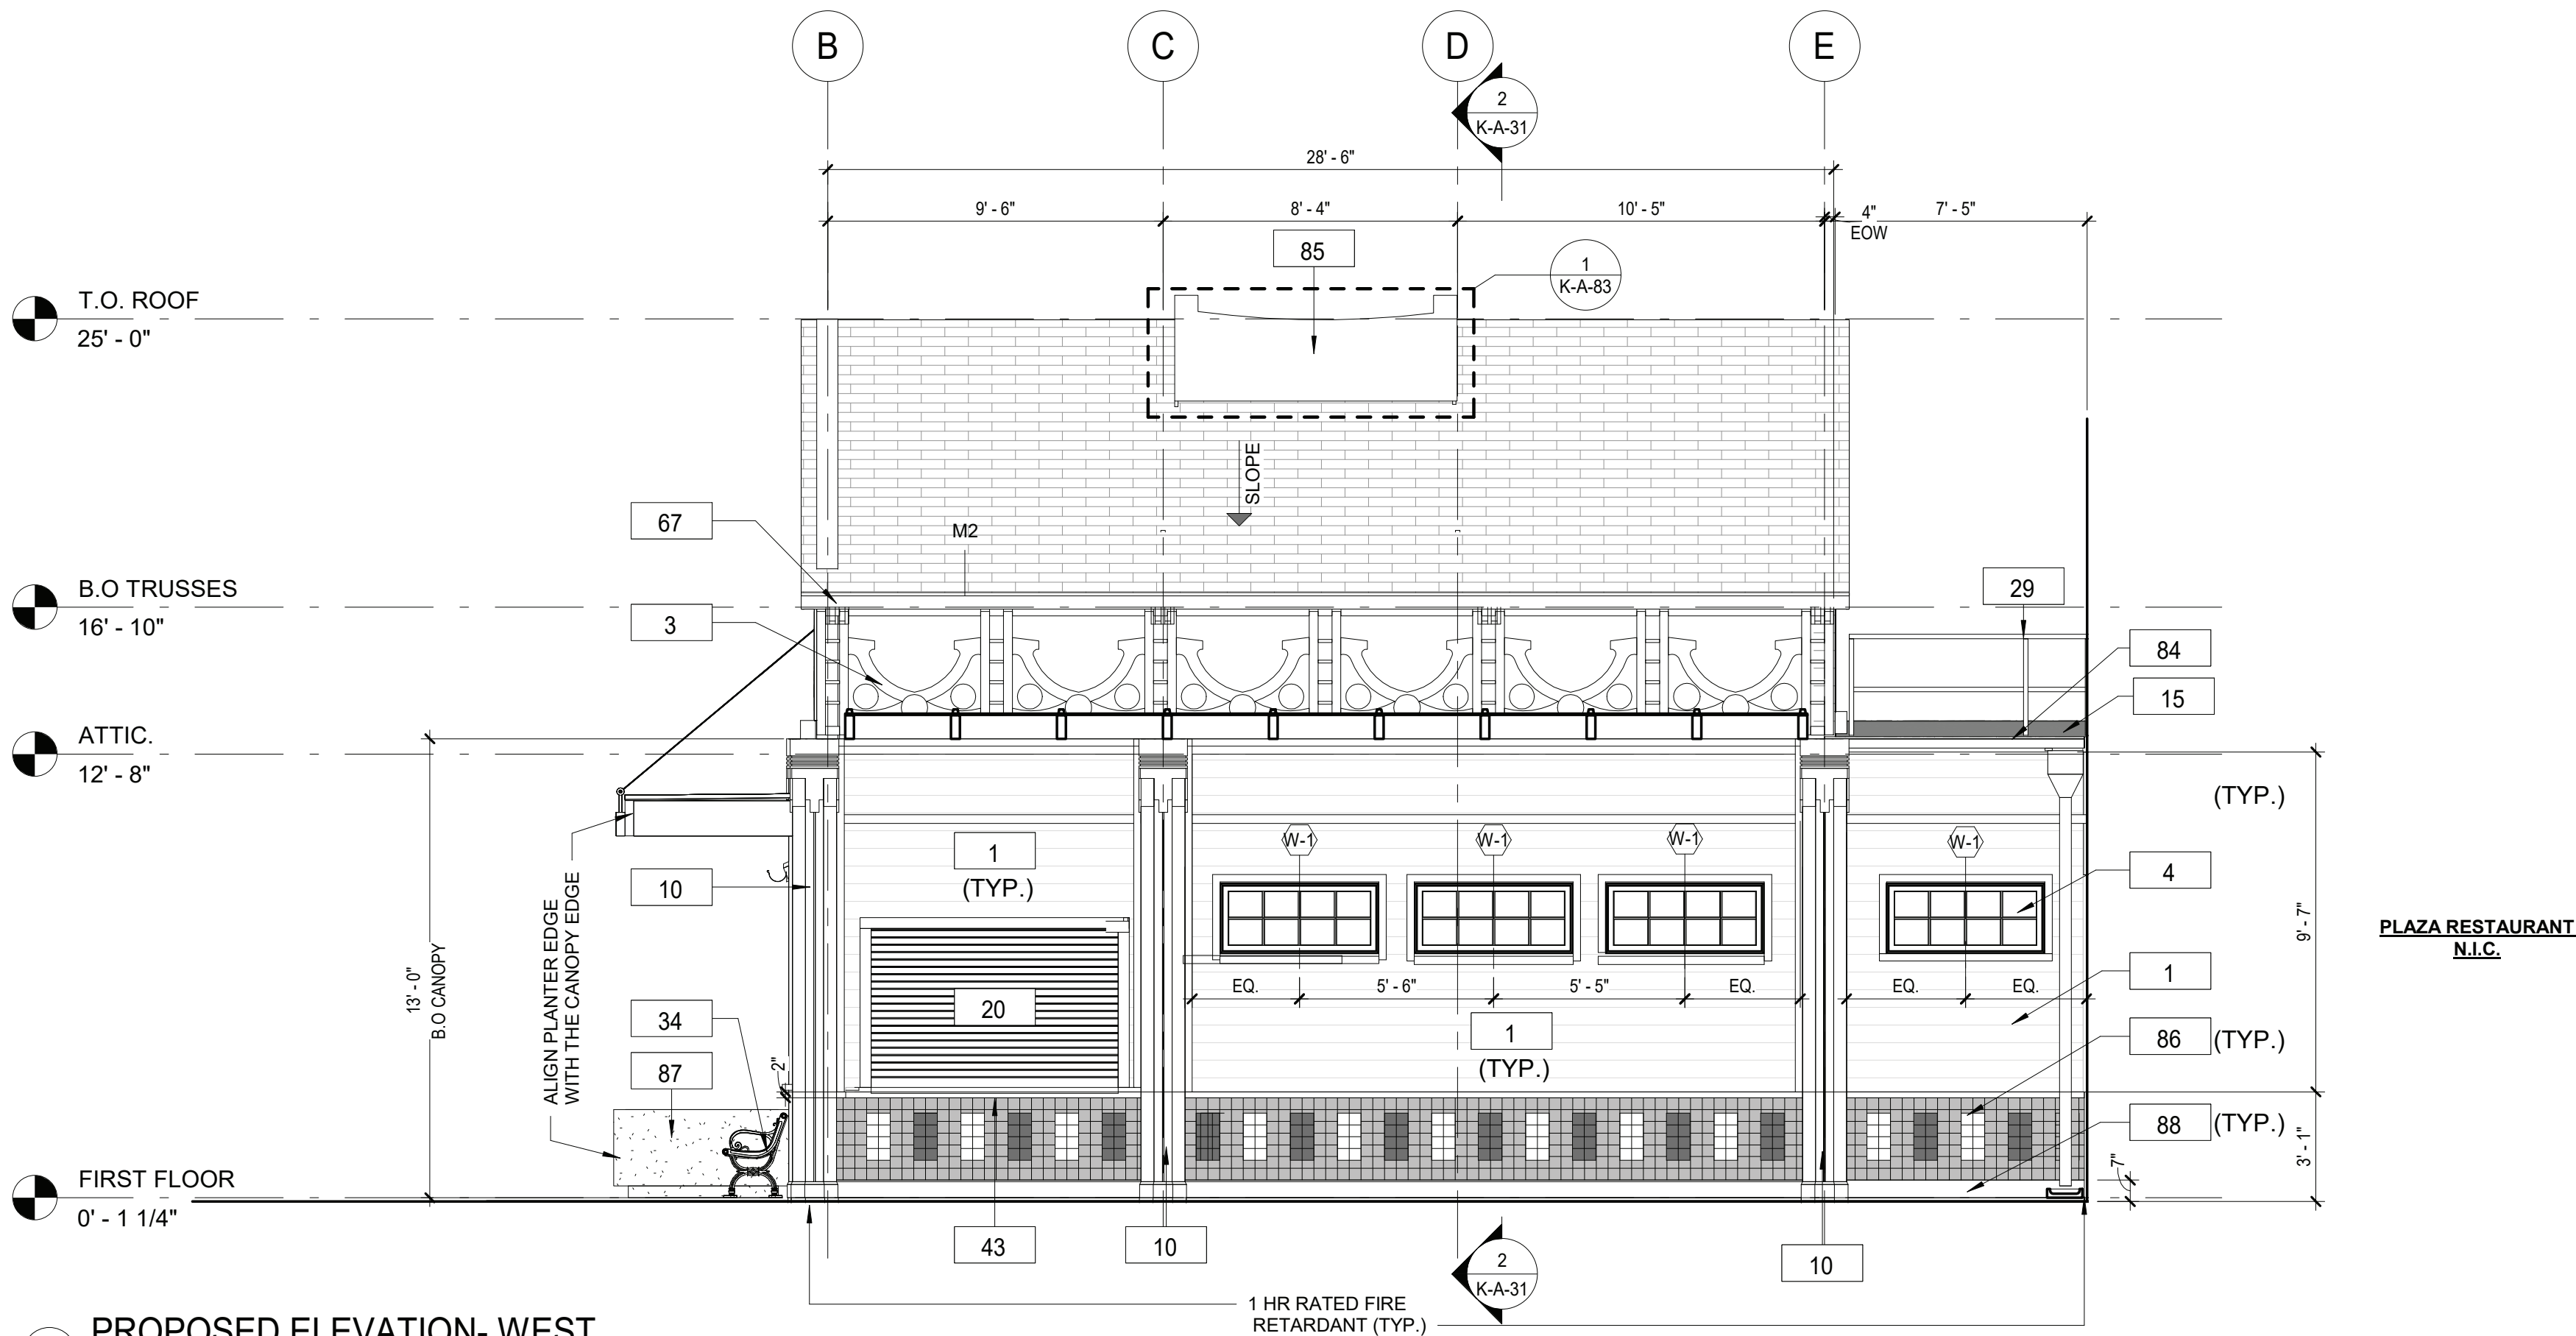

2 PROPOSED ELEVATION- WEST
1/4" = 1'-0"

CONSTRUCTION GENERAL NOTES

1. THE ARCHITECT DOES NOT CERTIFY DIMENSIONS OR CONDITIONS OF EXISTING CONSTRUCTION. CONTRACTOR SHALL NOTIFY ARCHITECT IMMEDIATELY OF ANY DISCREPANCY BETWEEN DRAWINGS AND EXISTING CONDITIONS. IN ADDITION, CONTRACTOR SHALL NOTIFY THE ARCHITECT OF ANY DEFECTIVE CONSTRUCTION UNCOVERED DURING CONSTRUCTION.
2. CONTRACTOR SHALL KEEP WORK SITE FREE FROM DEBRIS AND ACCUMULATED REFUSE, AND SHALL HAVE SOLE RESPONSIBILITY FOR PROTECTING ALL DANGEROUS AREAS FROM ENTRY BY UNAUTHORIZED PARTIES. ALL CONSTRUCTION SCRAPS, DIRT, AND DEBRIS SHALL BE REMOVED FROM THE PREMISES DAILY. SITE SHALL BE LEFT BROOM CLEAN AT THE END OF EACH WORKING DAY. AT THE COMPLETION OF THE WORK, HE PREMISES SHALL BE LEFT IN A BROOM CLEAN CONDITION.
3. ALL WORK TO BE PERFORMED IN A WORKMANLIKE FASHION. MATERIALS UTILIZED SHALL BE AS SPECIFIED ON THE DRAWINGS OR IN THE JOB SPECIFICATIONS, OR, IF GENERIC, IN COMPLIANCE WITH ASTM, NEW YORK CODE, OR OTHER GENERALLY ACCEPTED STANDARDS.
4. WHERE EXISTING EQUIPMENT OR CONSTRUCTION IS REMOVED OR ALTERED, ALL REMAINING SURFACES AND FINISHES AFFECTED SHALL BE PATCHED AND FINISHED TO MATCH ADJACENT CONSTRUCTION/PRE- EXISTING CONDITION.
5. ALL EXITS SHALL BE KEPT READILY ACCESSIBLE AND UNOBSTRUCTED AT ALL TIMES. ALL EXITS SHALL BE KEPT READILY ACCESSIBLE AND UNOBSTRUCTED AT ALL TIMES.
6. ALL INFILLED OPENINGS TO BE FLUSH WITH EXISTING MASONRY WALL SURFACES, EXTERIOR OF NEW AND OLD TO BE FLUSH AND MATCH WITH EXISTING ADJACENT WALL SYSTEM.
7. THE G.C. SHALL VERIFY DIMENSIONS OF THE EXISTING SPACE AND OF ANY EXISTING CONSTRUCTION TO REMAIN BY ACTUAL MEASUREMENT BEFORE ANY WORK IS PERFORMED. IF ANY MEASUREMENTS DIFFER FROM DIMENSIONS SHOWN ON PLAN, G.C. IS TO NOTIFY THE ARCHITECT IMMEDIATELY. THE G.C. SHALL BE RESPONSIBLE FOR CORRECTING ANY AND ALL DISCREPANCIES FOUND AFTER THE WORK IS PERFORMED, AT NO ADDITIONAL EXPENSE TO THE OWNER.
8. G.C. TO VERIFY ALL FINISHED DIMENSIONS. FIELD CONDITIONS ALTERING ANY DIMENSIONS SHOULD BE BROUGHT TO THE ATTENTION OF THE OWNER AND ARCHITECT.
9. THE G.C. SHALL BE RESPONSIBLE FOR COORDINATING WITH OWNER ON ALL WORK TO BE PERFORMED BY THE OWNER. ANY POTENTIAL CONFLICTS OR DELAYS CAUSED BY THE OWNER'S SUBCONTRACTORS MUST BE DOCUMENTED IN WRITING TO THE OWNER BEFORE THE DELAY IS ACTUALLY INCURRED FOR IT TO BE CONSIDERED. OTHERWISE THE G.C. WILL BE RESPONSIBLE FOR MEETING THE SCHEDULE AS OUTLINED IN THE CONTRACT.

CONSTRUCTION LEGEND

	NOT IN CONTRACT		NEW CONSTRUCTION		DOOR TAG
	KEY NOTES		PLUMBING FIXTURE		FIRE EXTINGUISHER
	WINDOW TAG		FLOOR DRAIN		STUB UP
	WALL TAG		ROOF GUARD RAIL		SBS 1/4" / 12"
	MATERIAL / TRIM TAG		ROOF CRICKET, 1/2" / 12"		ASPHALT SHINGLE

KEYNOTE LEGEND CONST.

Key Value	Keynote Text
1	PROVIDE AND INSTALL NEW 1x8 MILLED YELLOW PINE - TONGUE AND GROOVE - NO BEVEL
3	REPLICATE TRIMS TO MATCH DOCUMENTED TRIM, LOCATIONS, SIZE AND SHAPE. FINISH PAINT COLORS AS SCHEDULED.
4	NEW WINDOWS. SEE WINDOW SCHEDULE.
10	PROVIDE AND INSTALL COLUMN ENCLOSURES. SEE DETAILS.
15	PROVIDE AND INSTALL SBS MODIFIED BITUMEN ROOFING AND UNDERLAYMENT.
20	NEW COUNTER ROLL DOWN DOOR LOCATED AT INTERIOR AND ASSOCIATED HARDWARE. REFER TO SCHEDULE FOR MORE DETAILS. CONTRACTOR TO V.I.F. ALL DIMENSIONS BEFORE ORDERING (TYPICAL THROUGHOUT.)
23	NEW ROOF WITH BATT INSULATION (R-38 MIN) PACKED BETWEEN JOISTS. PROVIDE AND INSTALL SHINGLES, UNDERLAYMENT SHEATHING AND FLASHING SYSTEM.
29	PROVIDE AND INSTALL NEW OSHA COMPLIANT GUARD RAIL.
34	PROVIDE NEW BENCH.
43	NEW COUNTERS & SERVING WINDOWS.
67	NEW FASCIA BOARD AND SOFFIT.
72	NEW LIGHT FIXTURES TO BE INSTALLED (SEE ELECTRICAL DRAWINGS).
84	HALF ROUND ALUMINUM GUTTER AND DOWNSPOUT.
85	NEW ROOF MOUNTED SIGN. SEE DETAILS
86	NEW CERAMIC TILES.
87	NEW PRECAST CONCRETE PLANTER BOX.
88	NEW PVC BASEBOARD.
90	NEW OUTSIDE CORNER MOULDING.

8/30/2022 2:51:48 PM

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INFORMATION



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CONSULTANT SEAL



REVISION NUMBER	DATE	MADE BY	APP'D BY	REVISION

RECORD DRAWING CERTIFICATION

☐ AS BUILT - CHANGES AS NOTED ☐ AS BUILT - NO CHANGES

CONTRACTOR

NAME
SIGNATURE
TITLE

PROJECT COORDINATOR

NAME
SIGNATURE
TITLE

WESTCHESTER COUNTY, NEW YORK
DEPARTMENT OF PUBLIC WORKS AND TRANSPORTATION
DIVISION OF ENGINEERING

INFRASTRUCTURE REHABILITATION
PLAYLAND PARK, RYE, NEW YORK
RESTAURANT KITCHEN WITH FOOD VENDING
EXTERIOR BUILDING ELEVATIONS - NORTH AND WEST

CONTRACT
NUMBER

22-523

SHEET
NUMBER

K-A-22

DWG NO.: 513 of 664

SCALE: 1/4" = 1'-0"


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DPW FILE
NUMBER 1-118-A-1262-0


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NO. 0



Key Value	Keynote Text
10	PROVIDE AND INSTALL COLUMN ENCLOSURES. SEE DETAILS.
12	PROVIDE DROP CEILING AND ALL HANGERS/ACCESSORIES.
14	PROVIDE NEW ASPHALT SHINGLE ROOFING UNDERLAYMENT, AND REPLACE IN KIND EXISTING DECKING AS REQUIRED (COORDINATE WITH STRUCTURAL).
16	PROVIDE AND INSTALL ALUMINUM METAL DRIP EDGE, DOWNSPOUT AND GUTTER AT PERIMETER OF ROOF.
17	PROVIDE AND INSTALL RIDGE VENT AT ROOF HIPS.
20	NEW COUNTER ROLL DOWN DOOR LOCATED AT INTERIOR AND ASSOCIATED HARDWARE. REFER TO SCHEDULE FOR MORE DETAILS. CONTRACTOR TO V.I.F. ALL DIMENSIONS BEFORE ORDERING (TYPICAL THROUGHOUT).
31	NEW CONCRETE PAD FOUNDATION. SEE STRUCTURAL DRAWINGS.
37	NEW CANOPY. SEE DETAILS.
43	NEW COUNTERS & SERVING WINDOWS.
72	NEW LIGHT FIXTURES TO BE INSTALLED (SEE ELECTRICAL DRAWINGS).
80	NEW 3/4" PLYWOOD FLOOR
83	FDA AND USDA COMPLIANT SQUARE LAY IN CEILING TILES.

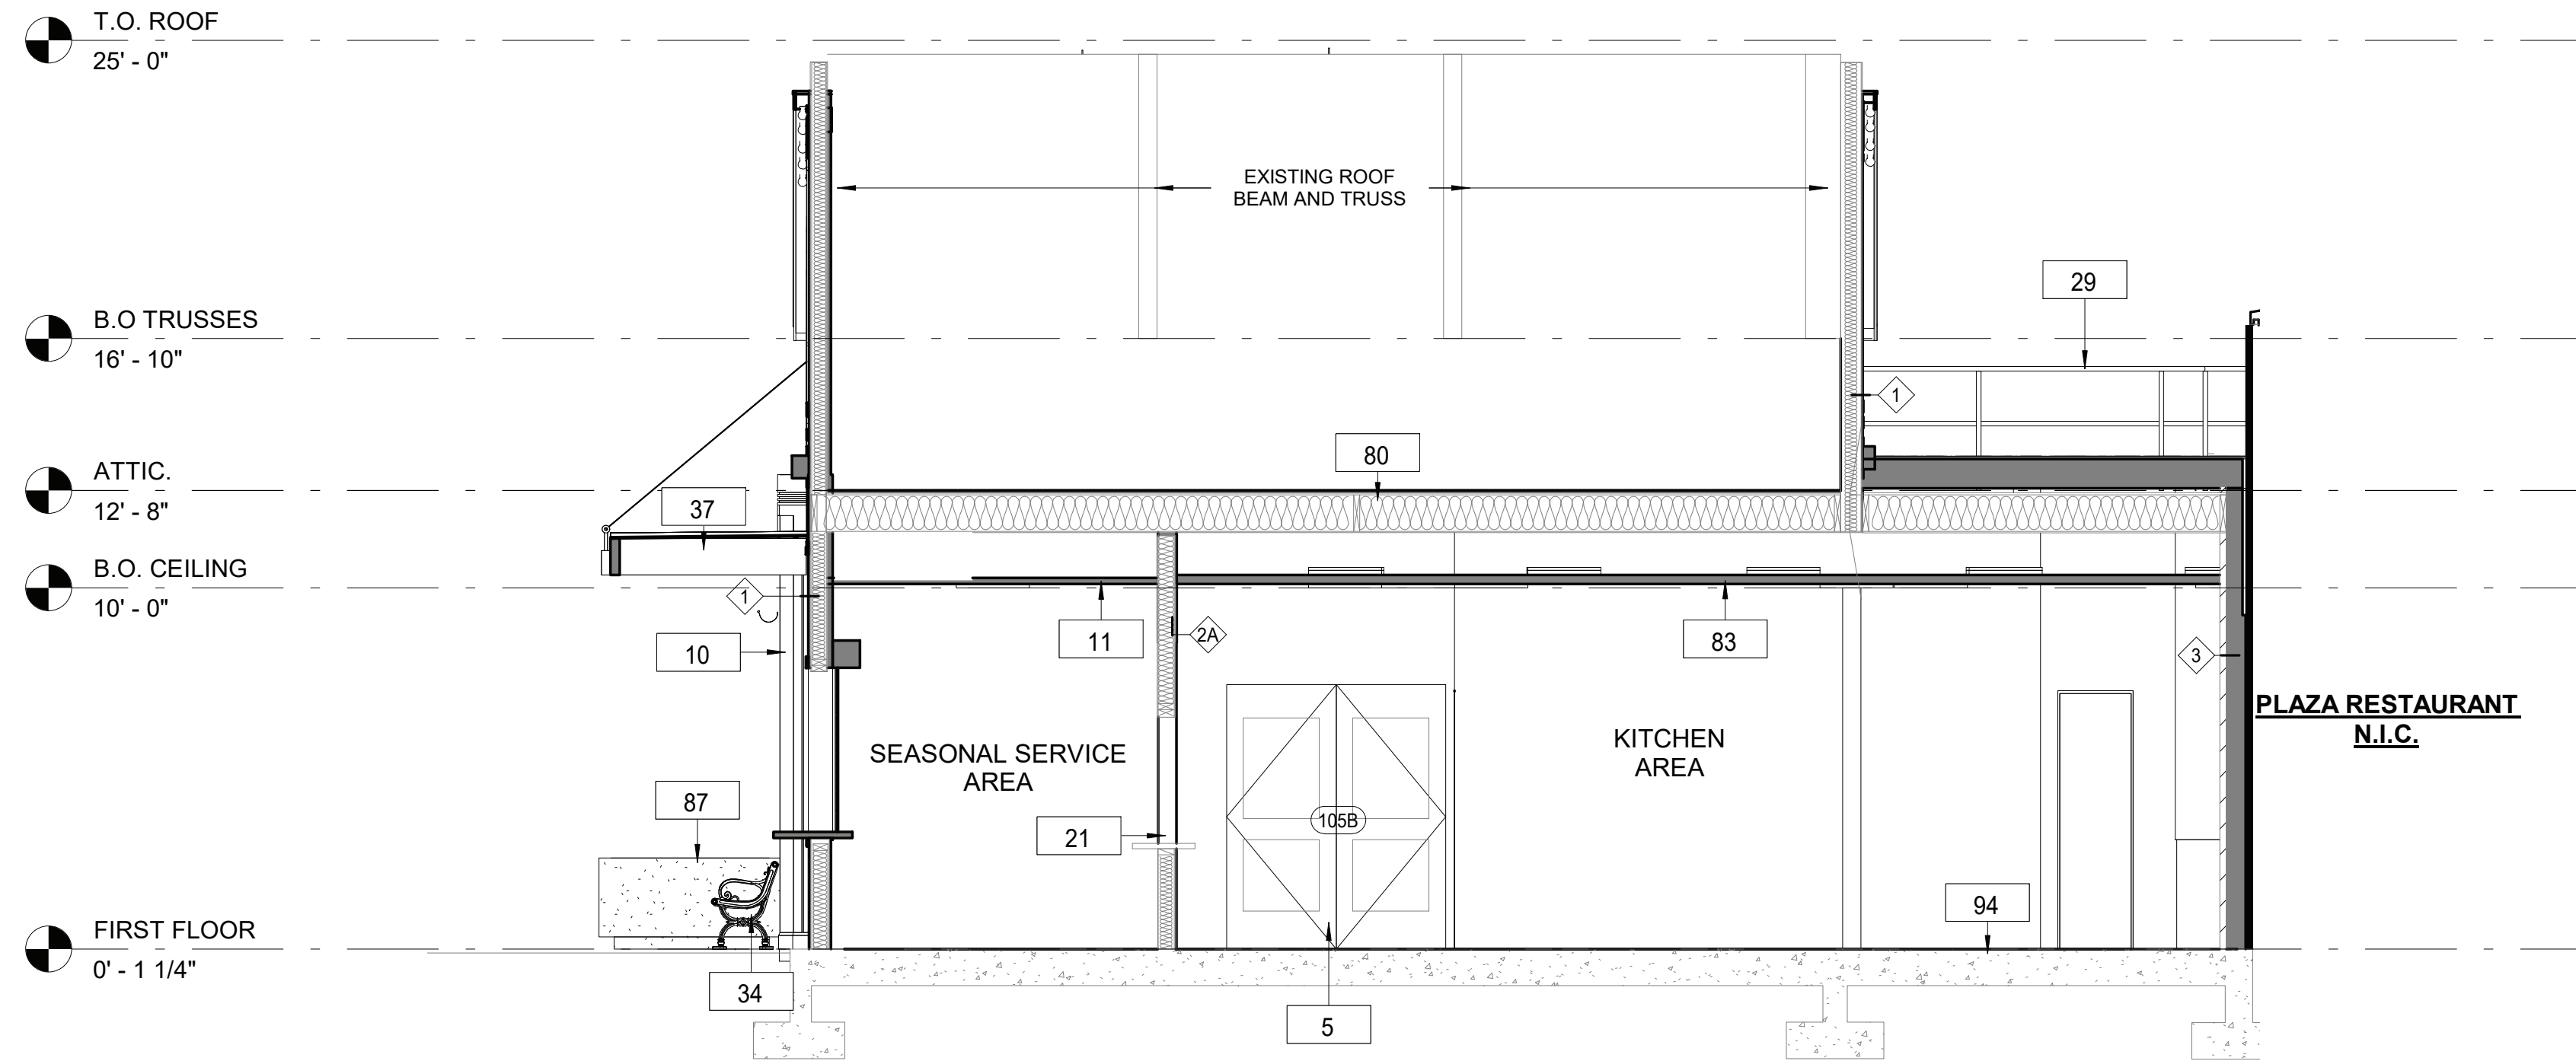

1 SECTION THROUGH SERVICE AND KITCHEN AREA
1/4" = 1'-0"

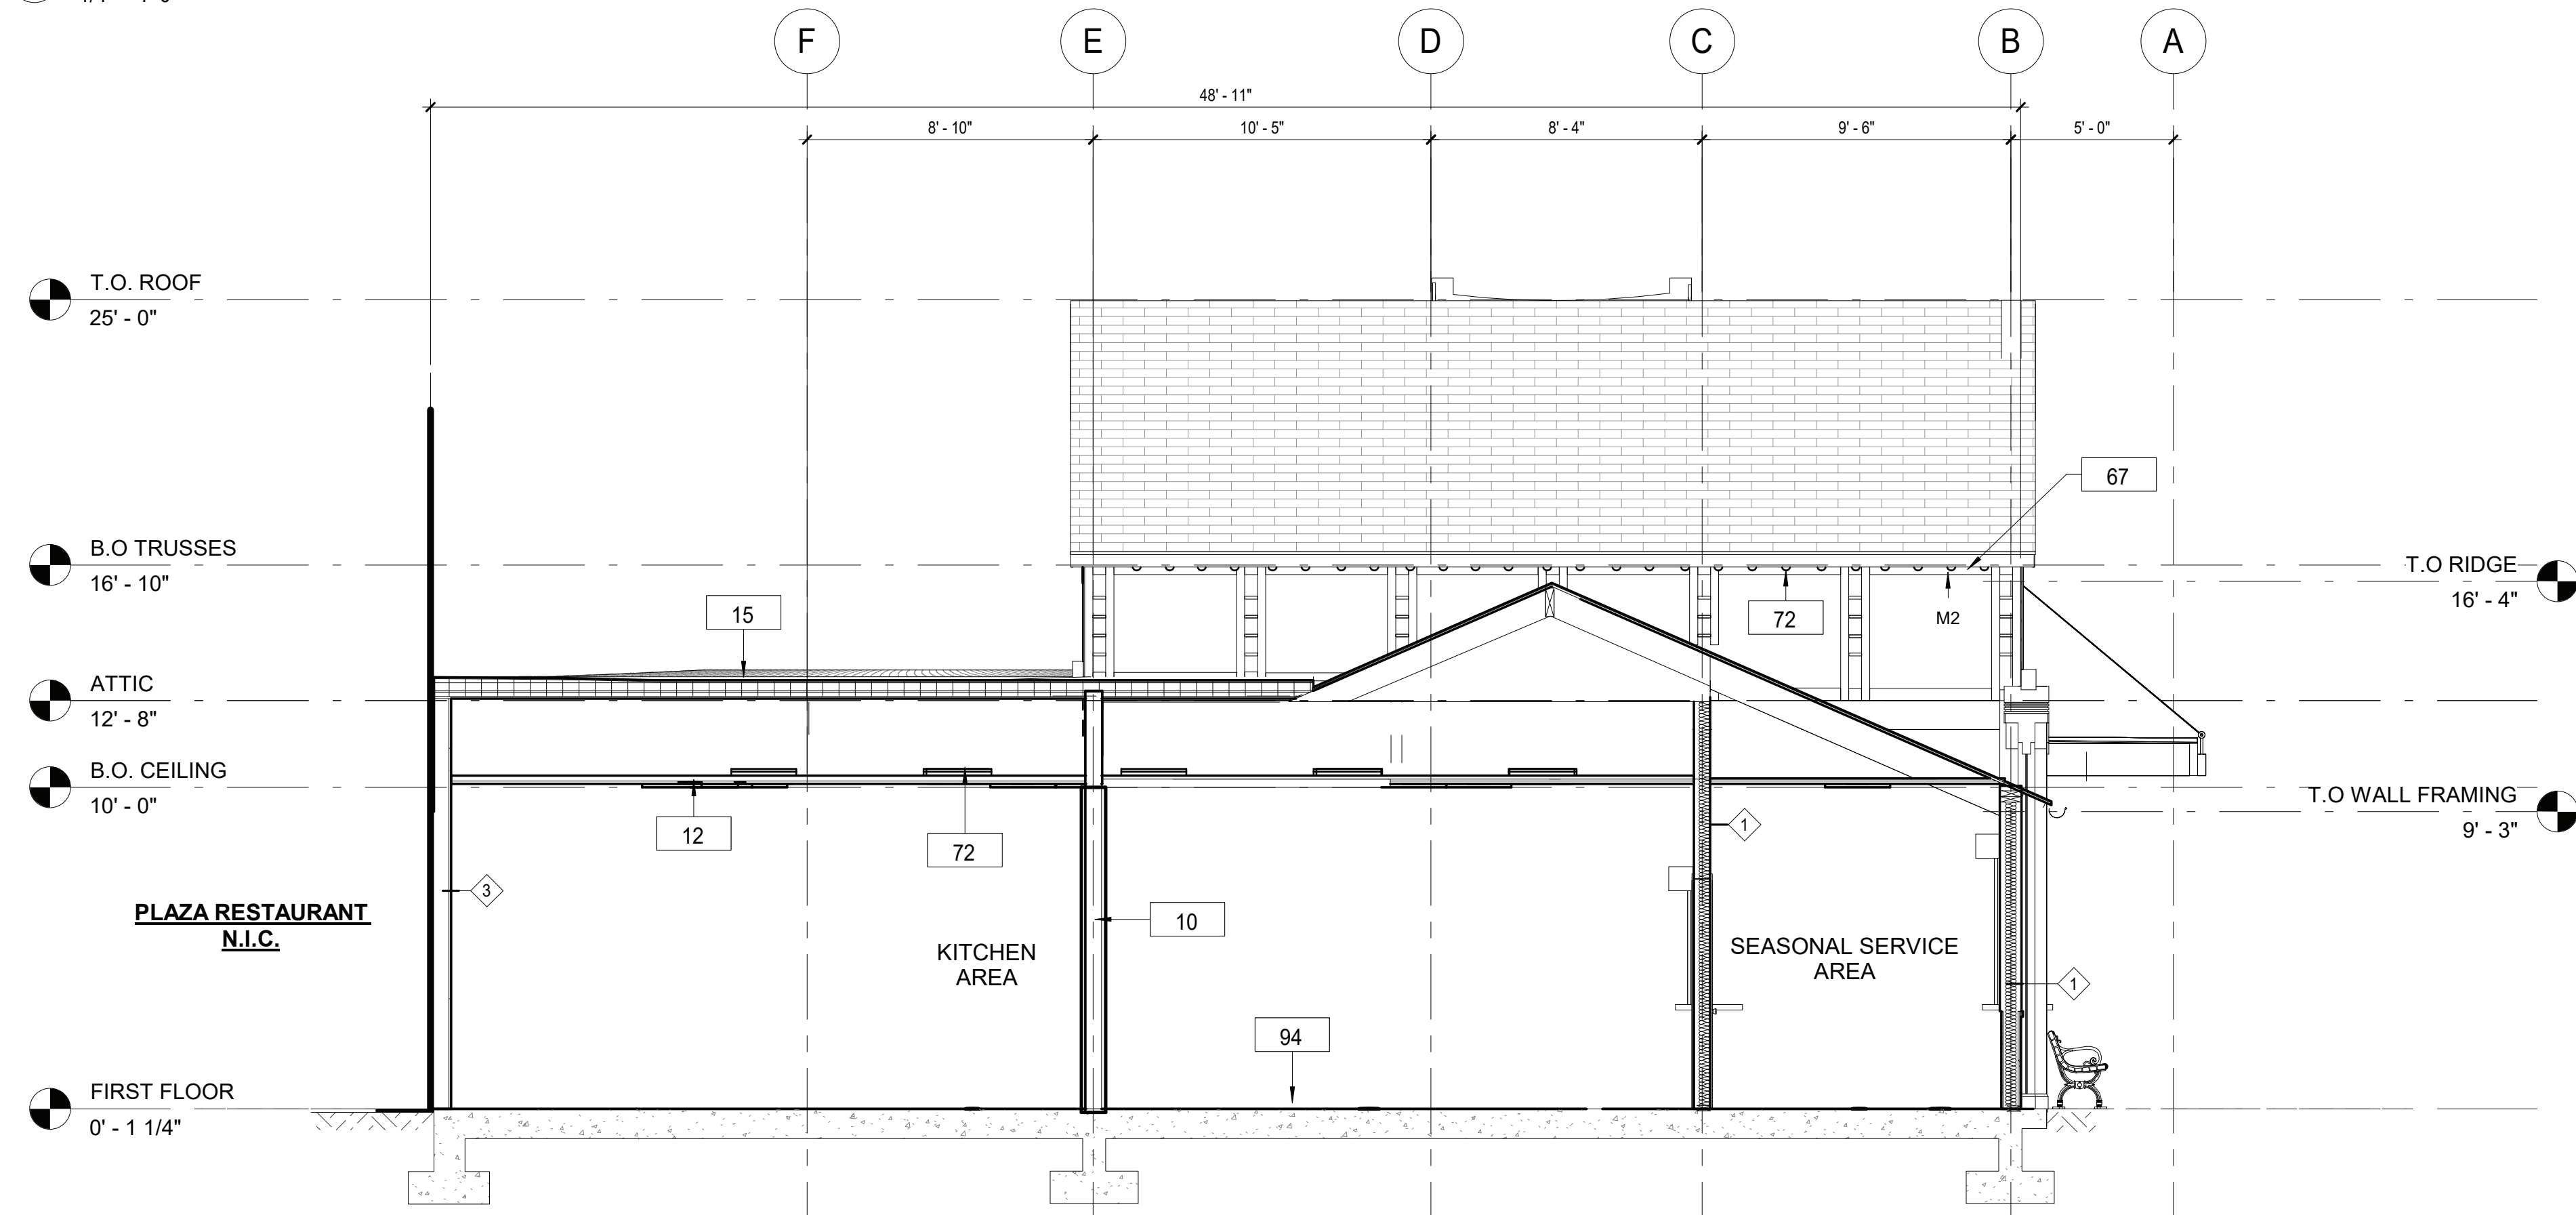

2 SECTION THROUGH EAST KITCHEN AREA
1/4" = 1'-0"

- CONSTRUCTION GENERAL NOTES**
1. THE ARCHITECT DOES NOT CERTIFY DIMENSIONS OR CONDITIONS OF EXISTING CONSTRUCTION. CONTRACTOR SHALL NOTIFY ARCHITECT IMMEDIATELY OF ANY DISCREPANCY BETWEEN DRAWINGS AND EXISTING CONDITIONS. IN ADDITION, CONTRACTOR SHALL NOTIFY THE ARCHITECT OF ANY DEFECTIVE CONSTRUCTION UNCOVERED DURING CONSTRUCTION.
 2. CONTRACTOR SHALL KEEP WORK SITE FREE FROM DEBRIS AND ACCUMULATED REFUSE, AND SHALL HAVE SOLE RESPONSIBILITY FOR PROTECTING ALL DANGEROUS AREAS FROM ENTRY BY UNAUTHORIZED PARTIES. ALL CONSTRUCTION SCRAPS, DIRT, AND DEBRIS SHALL BE REMOVED FROM THE PREMISES DAILY. SITE SHALL BE LEFT BROOM CLEAN AT THE END OF EACH WORKING DAY. AT THE COMPLETION OF THE WORK, THE PREMISES SHALL BE LEFT IN A BROOM CLEAN CONDITION.
 3. ALL WORK TO BE PERFORMED IN A WORKMANLIKE FASHION. MATERIALS UTILIZED SHALL BE AS SPECIFIED ON THE DRAWINGS OR IN THE JOB SPECIFICATIONS, OR, IF GENERIC, IN COMPLIANCE WITH ASTM, NEW YORK CODE, OR OTHER GENERALLY ACCEPTED STANDARDS.
 4. WHERE EXISTING EQUIPMENT OR CONSTRUCTION IS REMOVED OR ALTERED, ALL REMAINING SURFACES AND FINISHES AFFECTED SHALL BE PATCHED AND FINISHED TO MATCH ADJACENT CONSTRUCTION/PRE- EXISTING CONDITION.
 5. ALL EXITS SHALL BE KEPT READILY ACCESSIBLE AND UNOBSTRUCTED AT ALL TIMES. ALL EXITS SHALL BE KEPT READILY ACCESSIBLE AND UNOBSTRUCTED AT ALL TIMES.
 6. ALL INFILLED OPENINGS TO BE FLUSH WITH EXISTING MASONRY WALL SURFACES, EXTERIOR OF NEW AND OLD TO BE FLUSH AND MATCH WITH EXISTING ADJACENT WALL SYSTEM.
 7. THE G.C. SHALL VERIFY DIMENSIONS OF THE EXISTING SPACE AND OF ANY EXISTING CONSTRUCTION TO REMAIN BY ACTUAL MEASUREMENT BEFORE ANY WORK IS PERFORMED. IF ANY MEASUREMENTS DIFFER FROM DIMENSIONS SHOWN ON PLAN, G.C. IS TO NOTIFY THE ARCHITECT IMMEDIATELY. THE G.C. SHALL BE RESPONSIBLE FOR CORRECTING ANY AND ALL DISCREPANCIES FOUND AFTER THE WORK IS PERFORMED, AT NO ADDITIONAL EXPENSE TO THE OWNER.
 8. G.C. TO VERIFY ALL FINISHED DIMENSIONS. FIELD CONDITIONS ALTERING ANY DIMENSIONS SHOULD BE BROUGHT TO THE ATTENTION OF THE OWNER AND ARCHITECT.
 9. THE G.C. SHALL BE RESPONSIBLE FOR COORDINATING WITH OWNER ON ALL WORK TO BE PERFORMED BY THE OWNER. ANY POTENTIAL CONFLICTS OR DELAYS CAUSED BY THE OWNER'S SUBCONTRACTORS MUST BE DOCUMENTED IN WRITING TO THE OWNER BEFORE THE DELAY IS ACTUALLY INCURRED FOR IT TO BE CONSIDERED. OTHERWISE THE G.C. WILL BE RESPONSIBLE FOR MEETING THE SCHEDULE AS OUTLINED IN THE CONTRACT.

CONSTRUCTION LEGEND

	NOT IN CONTRACT
	KEY NOTES
	WINDOW TAG
	DOOR TAG

KEYNOTE LEGEND CONST.


Key Value	Keynote Text
5	PROVIDE AND INSTALL DOOR INCLUDING FRAME, SILL, LINTEL AND ANY ASSOCIATE HARDWARE. SEE DOOR SCHEDULE.
10	PROVIDE AND INSTALL COLUMN ENCLOSURES. SEE DETAILS.
11	PROVIDE AND INSTALL T1-11 CEILING.
12	PROVIDE DROP CEILING AND ALL HANGERS/ ACCESSORIES.
15	PROVIDE AND INSTALL SBS MODIFIED BITUMEN ROOFING AND UNDERLAYMENT.
21	NEW INTERIOR WALL. SEE WALL SCHEDULE.
29	PROVIDE AND INSTALL NEW OSHA COMPLIANT GUARD RAIL.
34	PROVIDE NEW BENCH.
37	NEW CANOPY. SEE DETAILS.
67	NEW FASCIA BOARD AND SOFFIT.
72	NEW LIGHT FIXTURES TO BE INSTALLED (SEE ELECTRICAL DRAWINGS).
80	NEW 3/4" PLYWOOD FLOOR
83	FDA AND USDA COMPLIANT SQUARE LAY IN CEILING TILES.
87	NEW PRECAST CONCRETE PLANTER BOX.
94	NEW QUARRY TILE. SUPPRESS CONCRETE SLAB AS SHOWN IN 9/K-A-81. SLOPE TOWARDS DRAIN.

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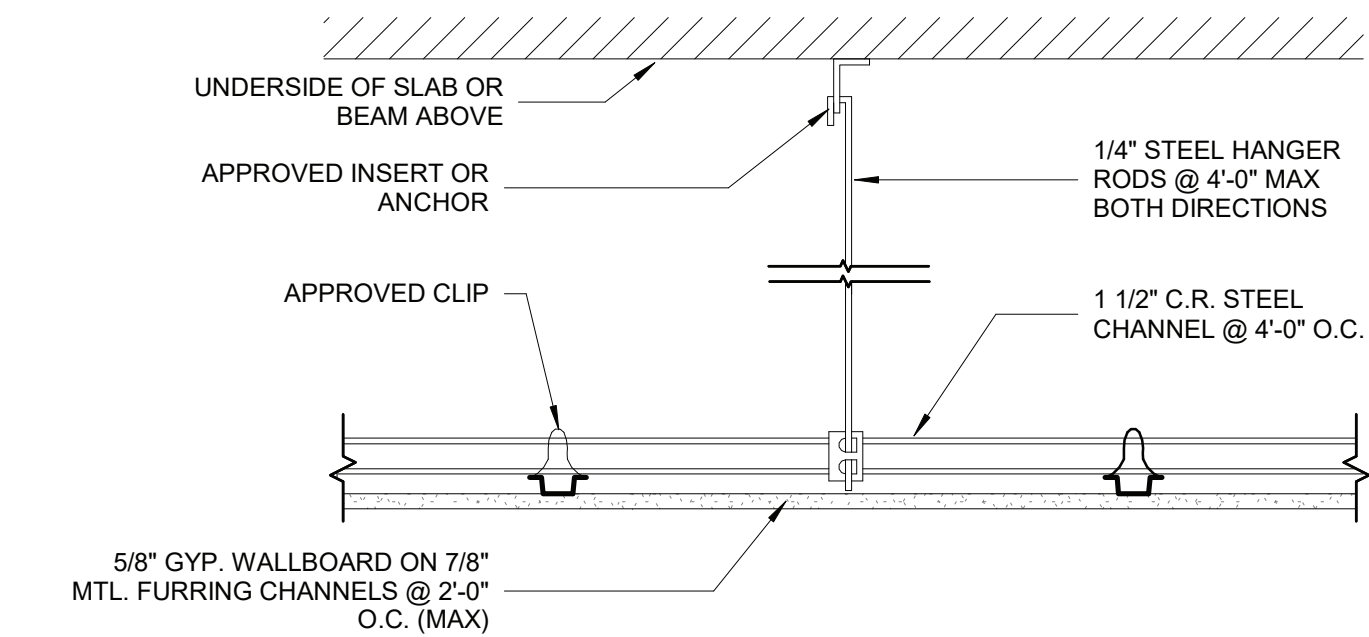
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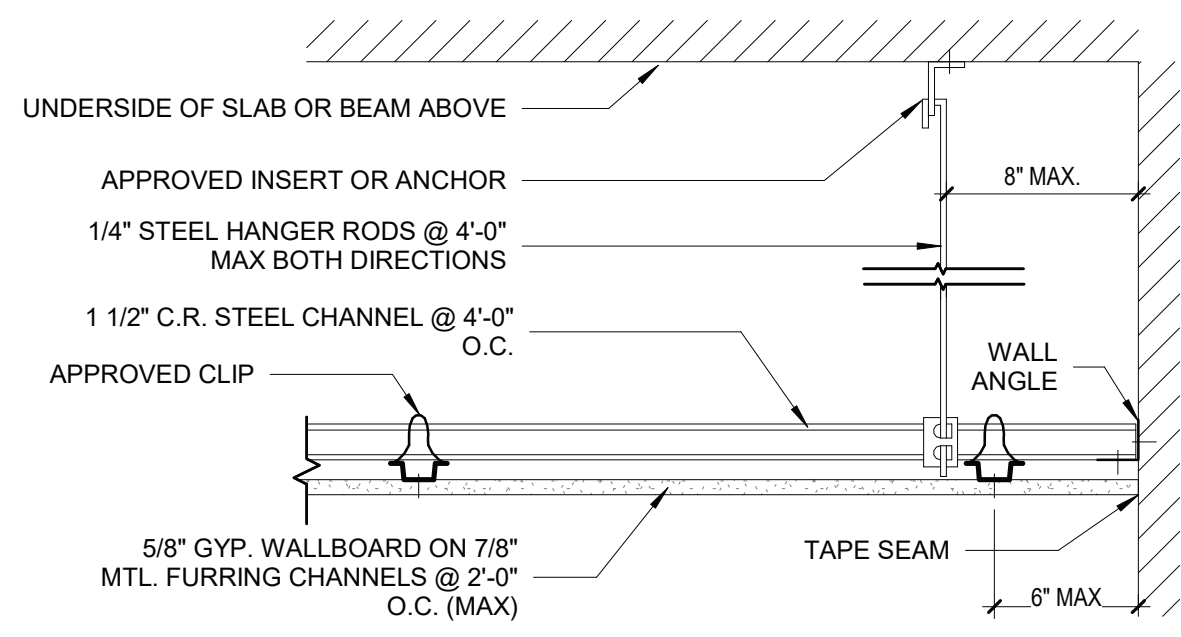
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CONTRACTOR	PROJECT COORDINATOR
NAME _____	NAME _____
SIGNATURE _____	SIGNATURE _____
TITLE _____	TITLE _____
DATE _____	DATE _____


WESTCHESTER COUNTY, NEW YORK DEPARTMENT OF PUBLIC WORKS AND TRANSPORTATION DIVISION OF ENGINEERING INFRASTRUCTURE REHABILITATION PLAYLAND PARK, RYE, NEW YORK RESTAURANT KITCHEN WITH FOOD VENDING BUILDING SECTIONS 2	CONTRACT NUMBER 22-523	SHEET NUMBER K-A-32
	DWG NO.: 515 of 664	
	SCALE: 1/4" = 1'-0"	
	DATE: 8/23/20223	
	DPW FILE NUMBER 1-118-A-1264-0	REV. NO. 0




1 TYP. GYPSUM BD CEILING DETAIL
1 1/2" = 1'-0"

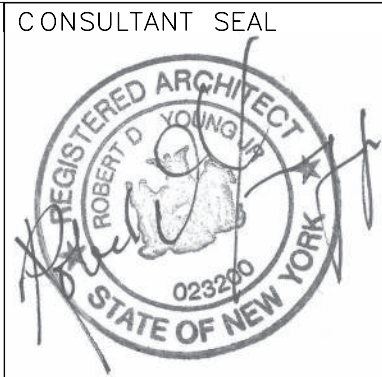


2 TYP. GYPSUM BD MAIN RUNNER AT PERIMETER DETAIL
1 1/2" = 1'-0"

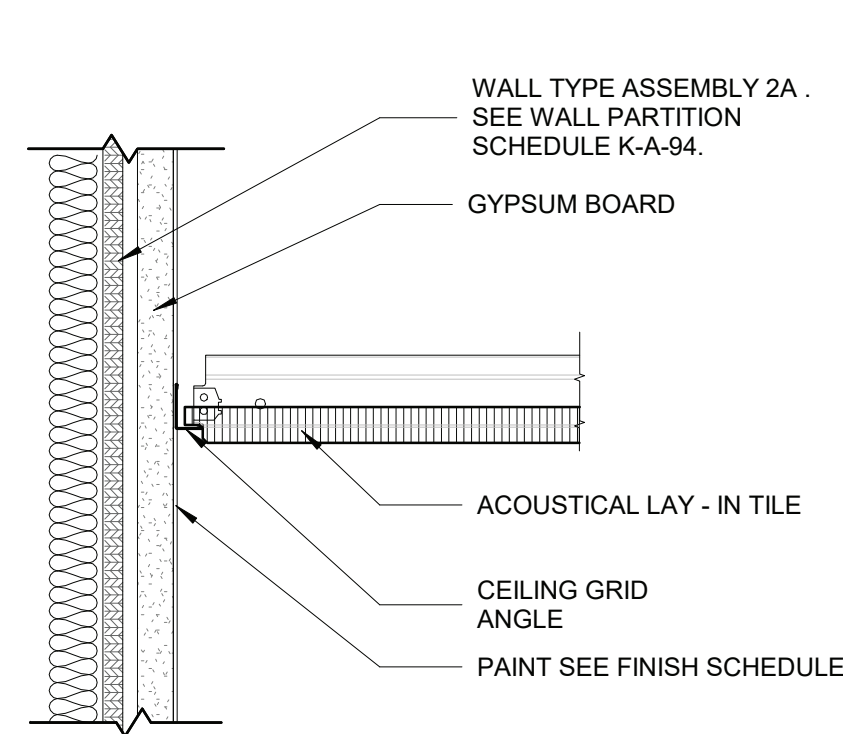


3 ACOUSTICAL CEILING DETAIL
3" = 1'-0"

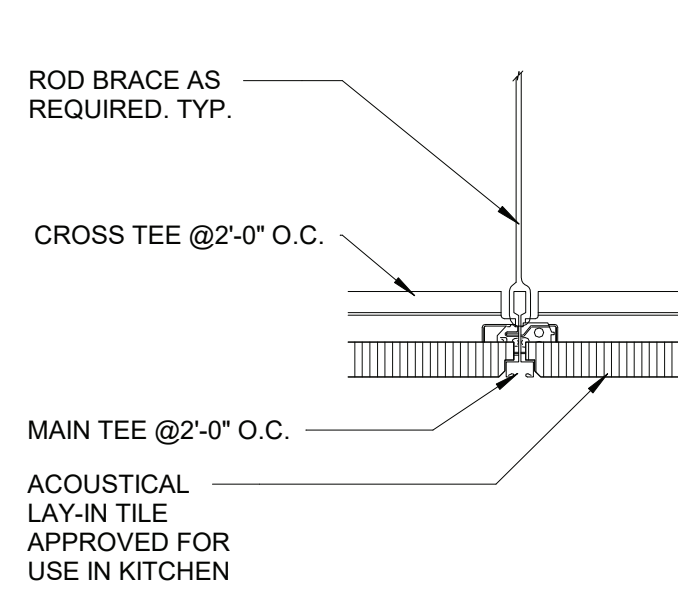


4 ACOUSTICAL TILE CONNECTION DETAIL
3" = 1'-0"

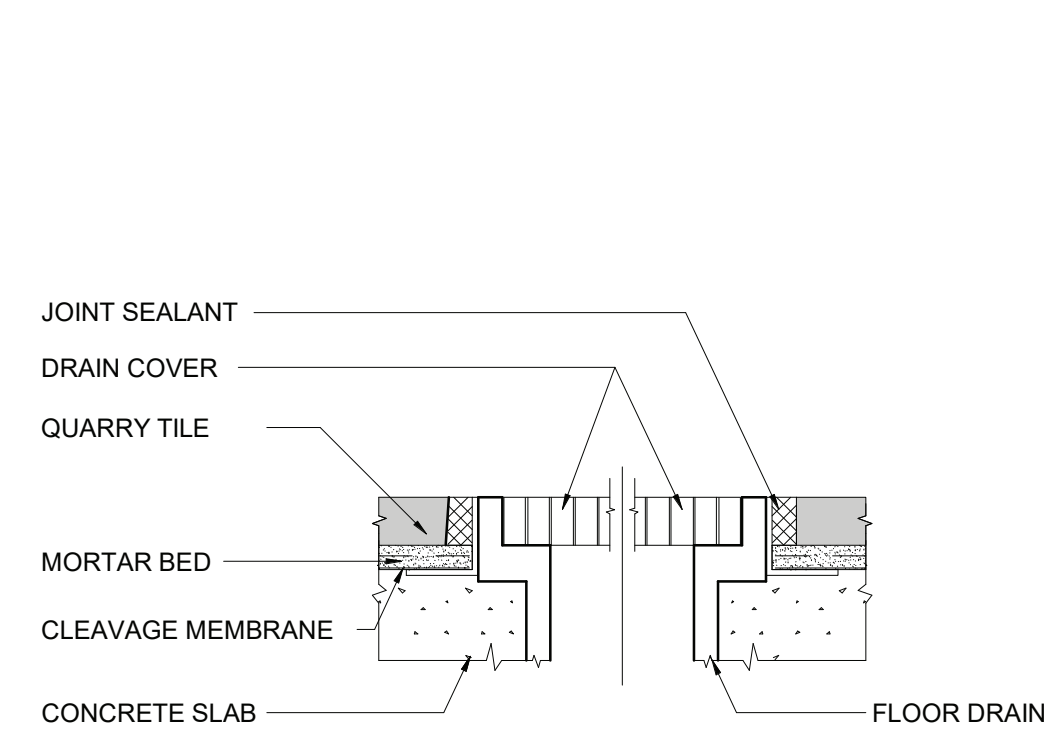


12 TILE FLOORING - CHANNEL DRAIN DETAIL
6" = 1'-0"

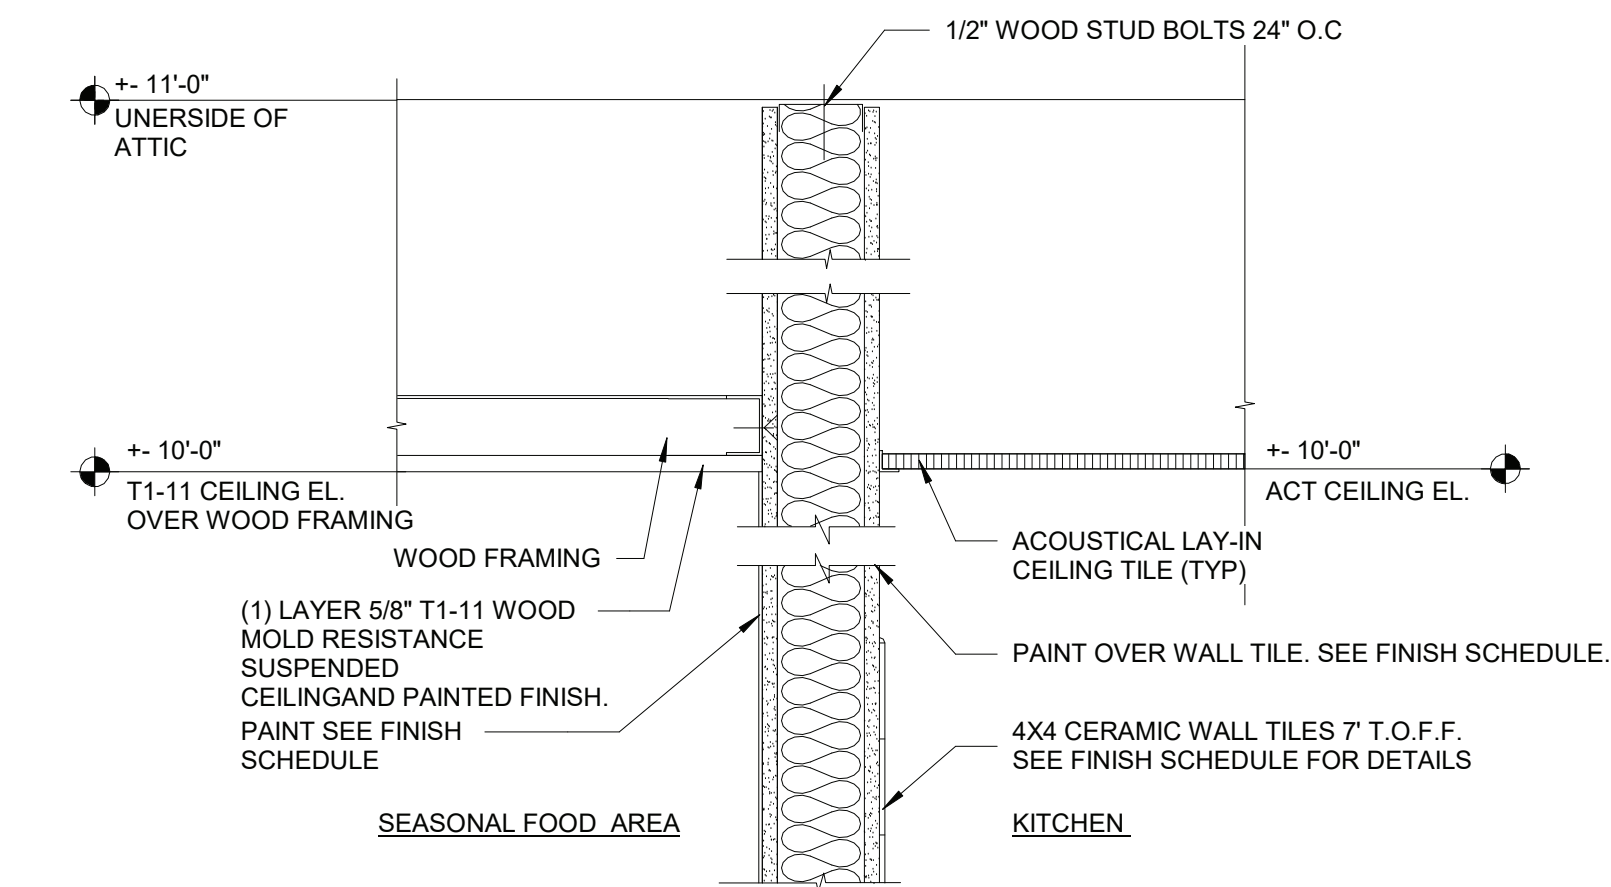


5 CEILING SECTION DETAIL THROUGH SEASONAL FOOD AREA AND KITCHEN
1 1/2" = 1'-0"

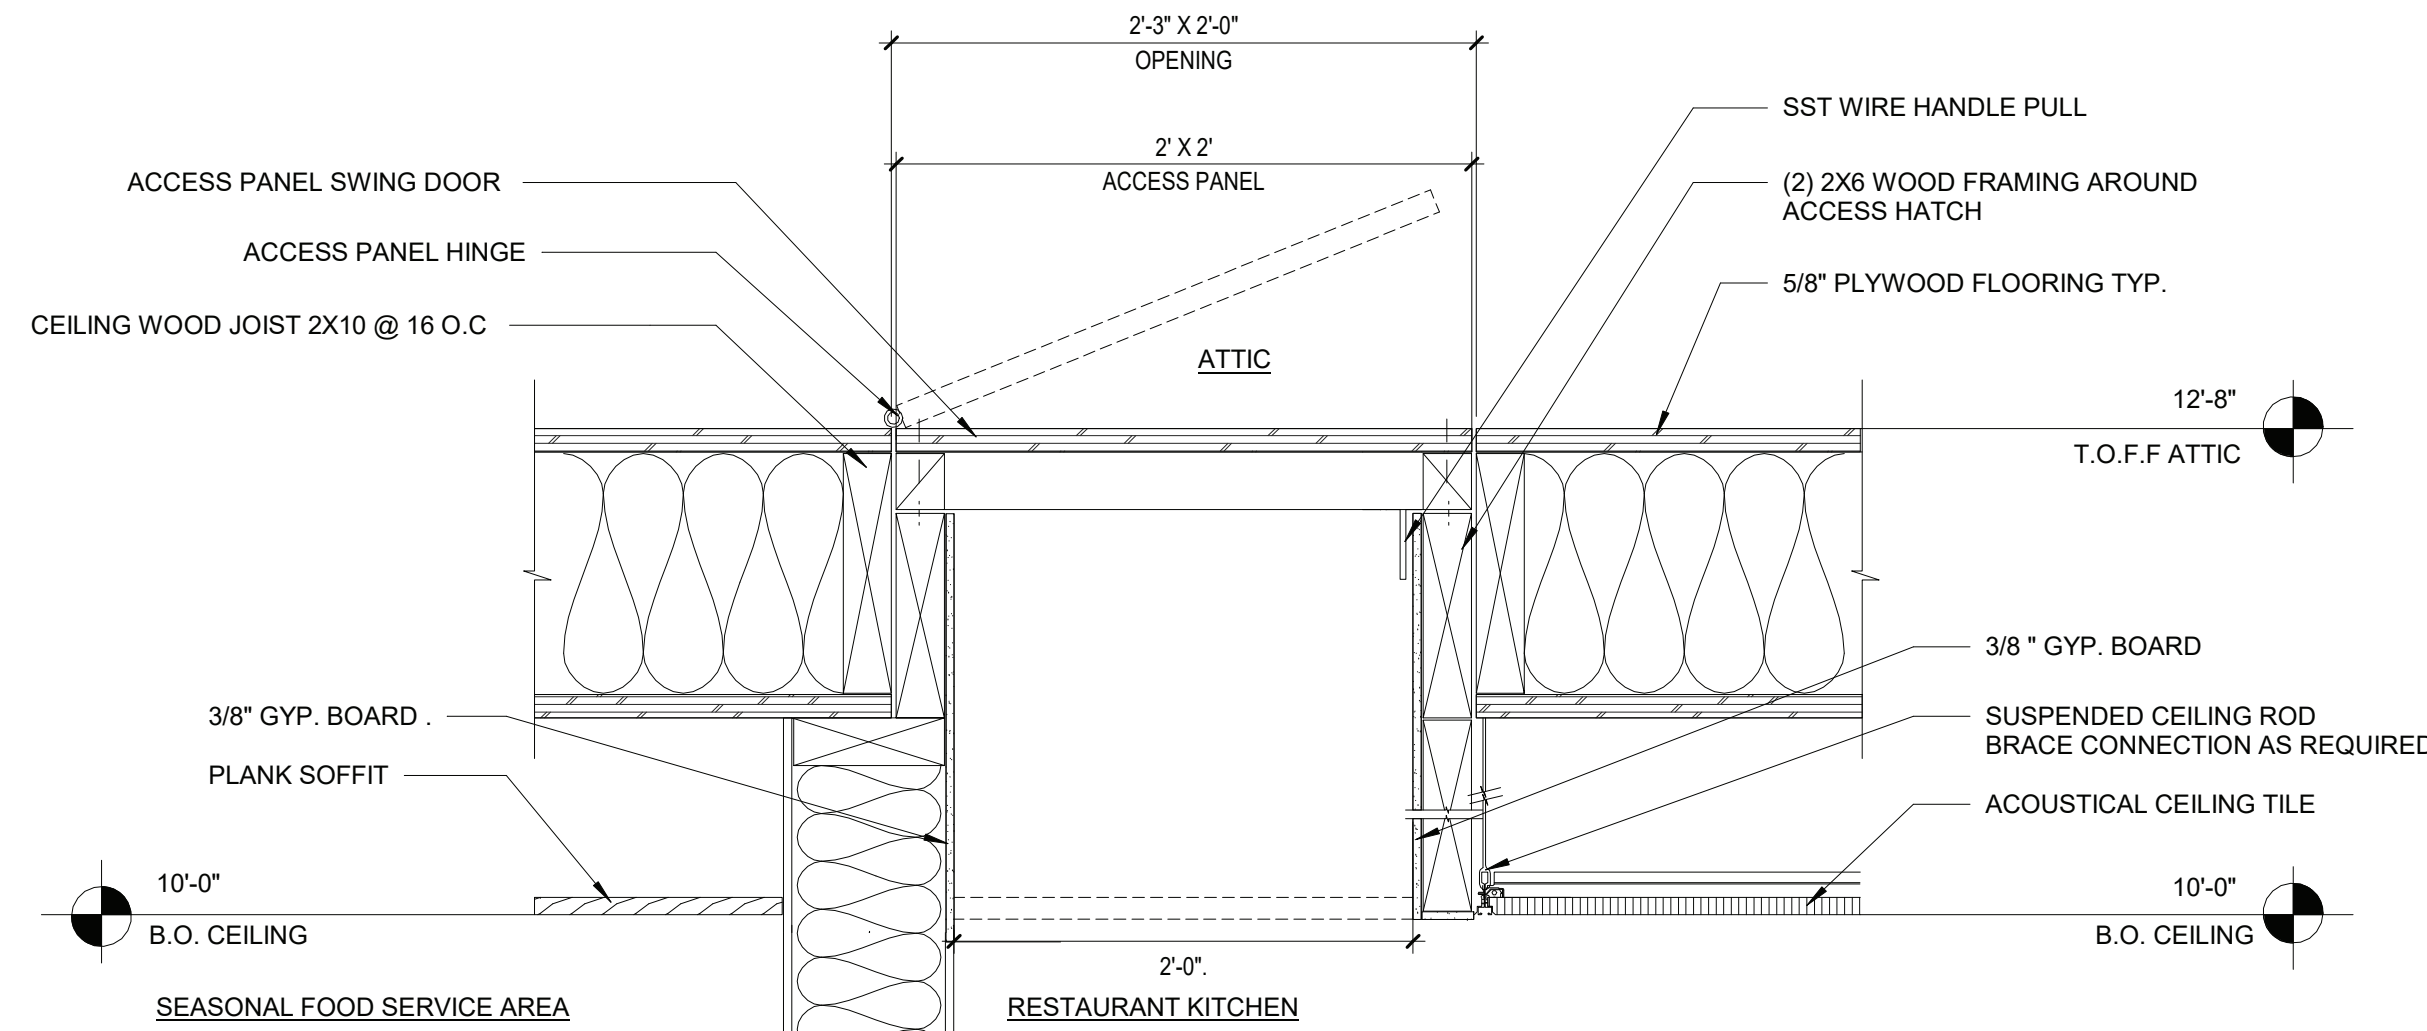


6 ATTIC ACCESS PANEL
1 1/2" = 1'-0"

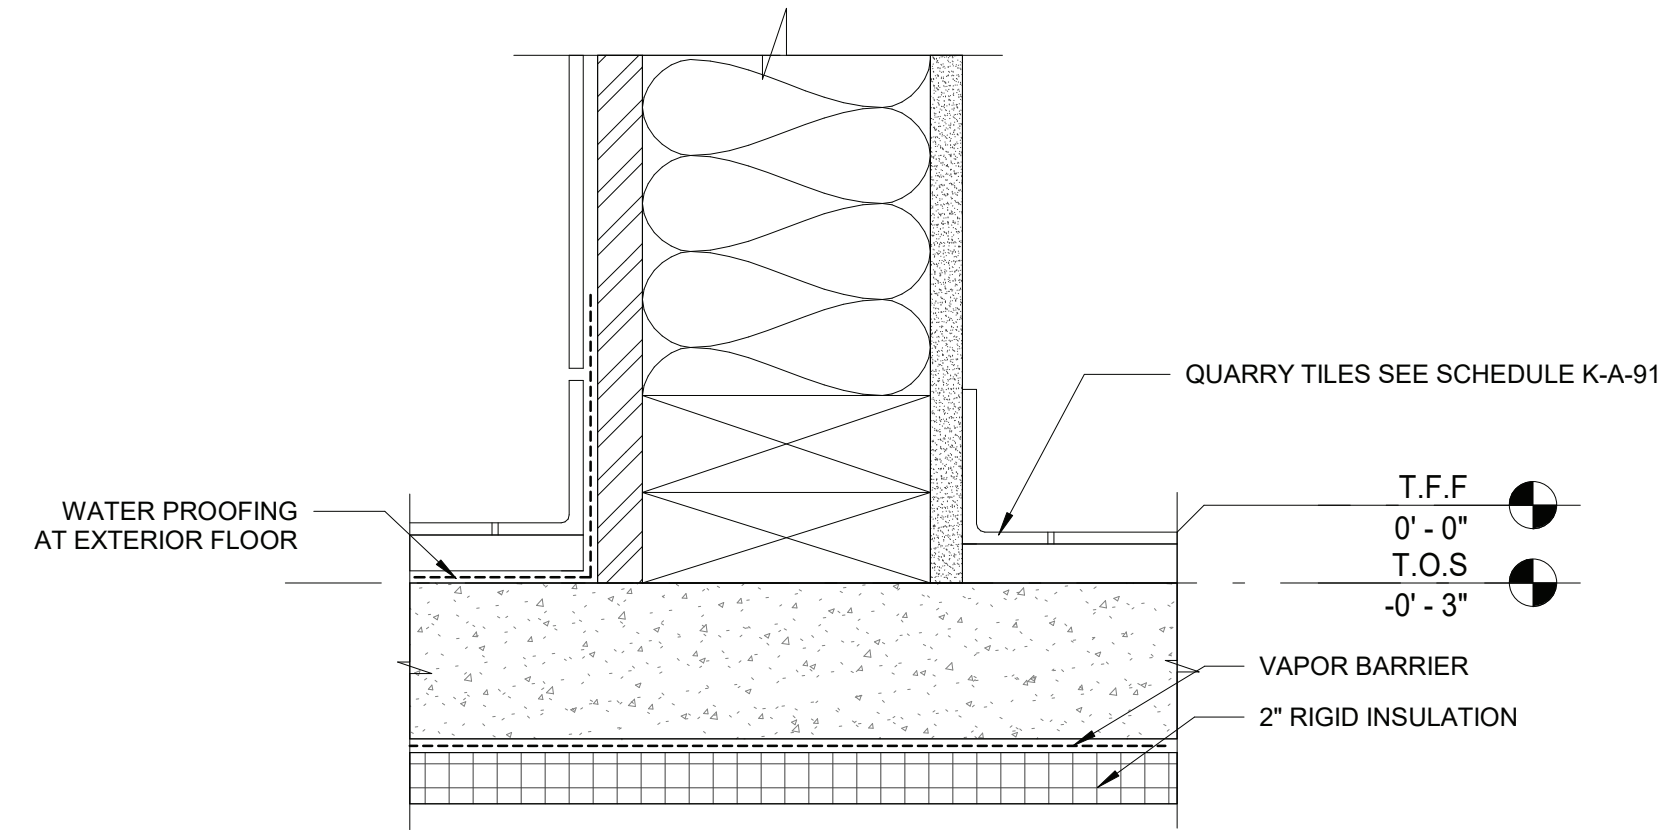

9 TYPICAL QUARRY TILE ON CONCRETE DETAIL
3" = 1'-0"

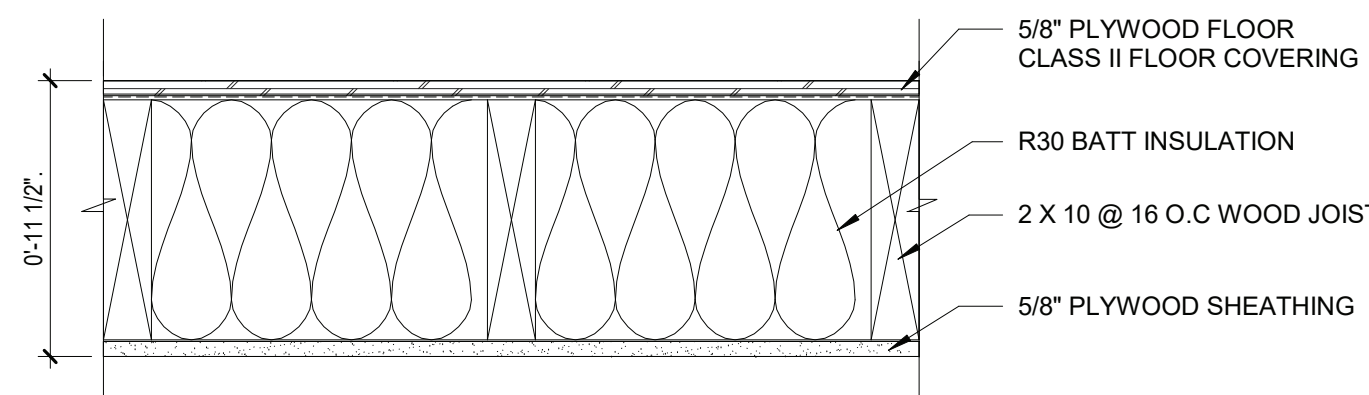


7 TYPICAL WOOD FLOOR DETAIL - WD-3
1 1/2" = 1'-0"

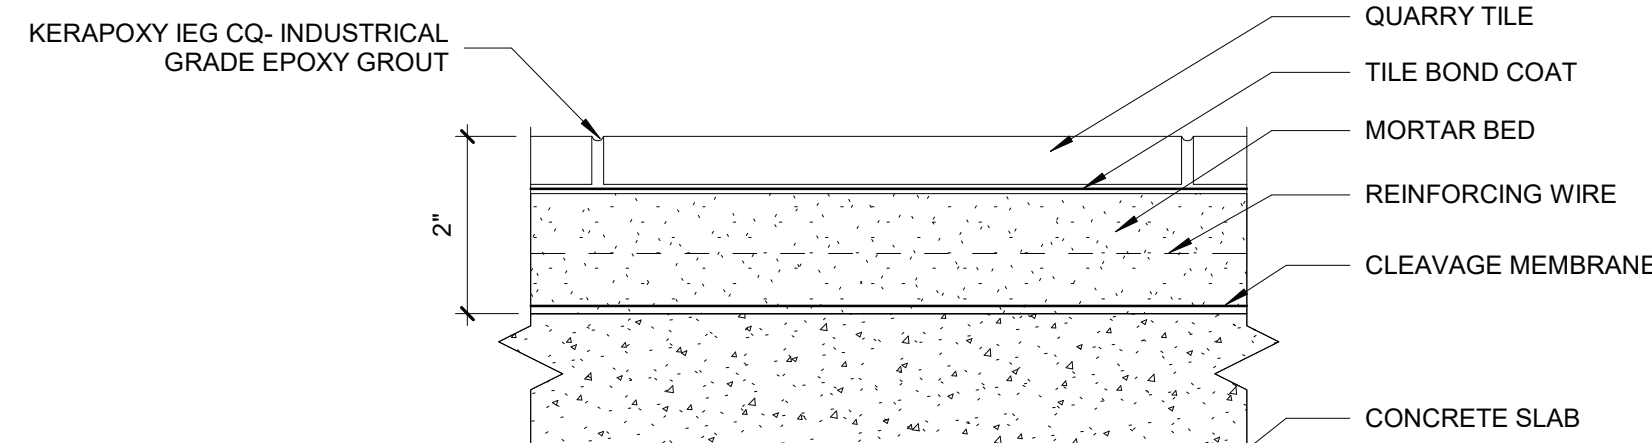


11 TILE FLOOR TYPICAL DETAIL AT INTERIOR FLOOR
6" = 1'-0"


NOTES:
A. DROP CLIPS SHALL BE OF LENGTH REQUIRED TO PROVIDE CLEARANCE FOR LIGHTING FIXTURES AND OTHER ITEMS ABOVE CEILING. WHERE CLEARANCE IS LIMITED PROVIDE CLIPS THAT CONNECT RUNNER TIGHT TO THE BOTTOM OF CARRYING CHANNELS.

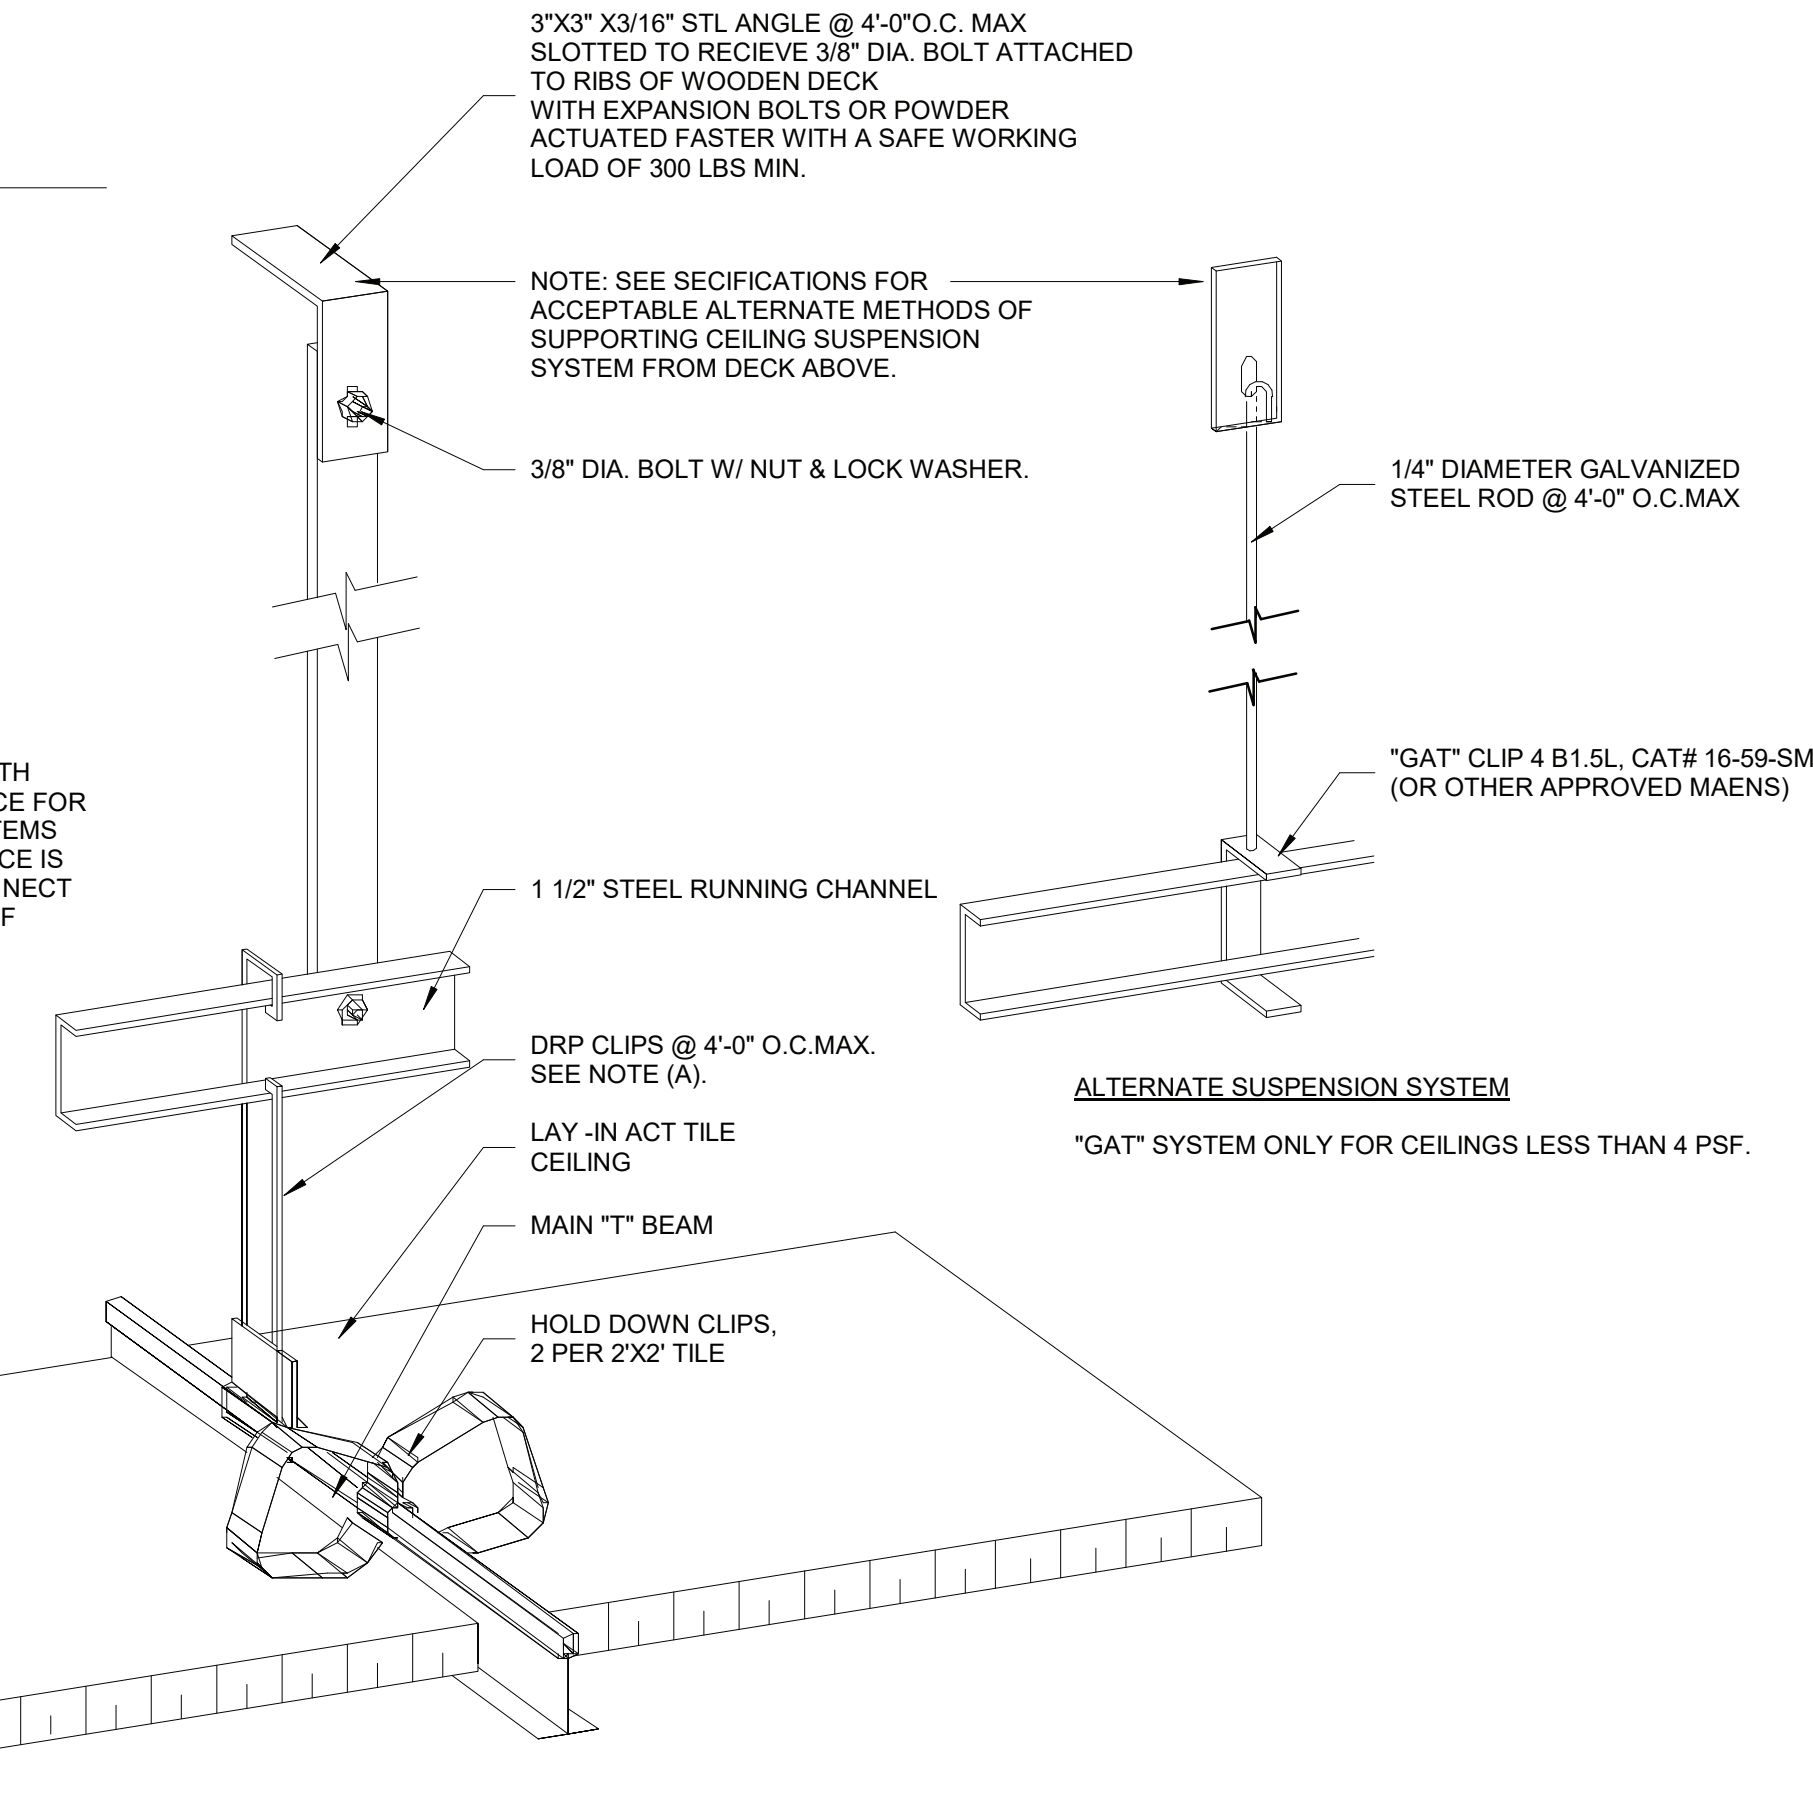

8 TYPICAL ACT CEILING DETAIL
3" = 1'-0"

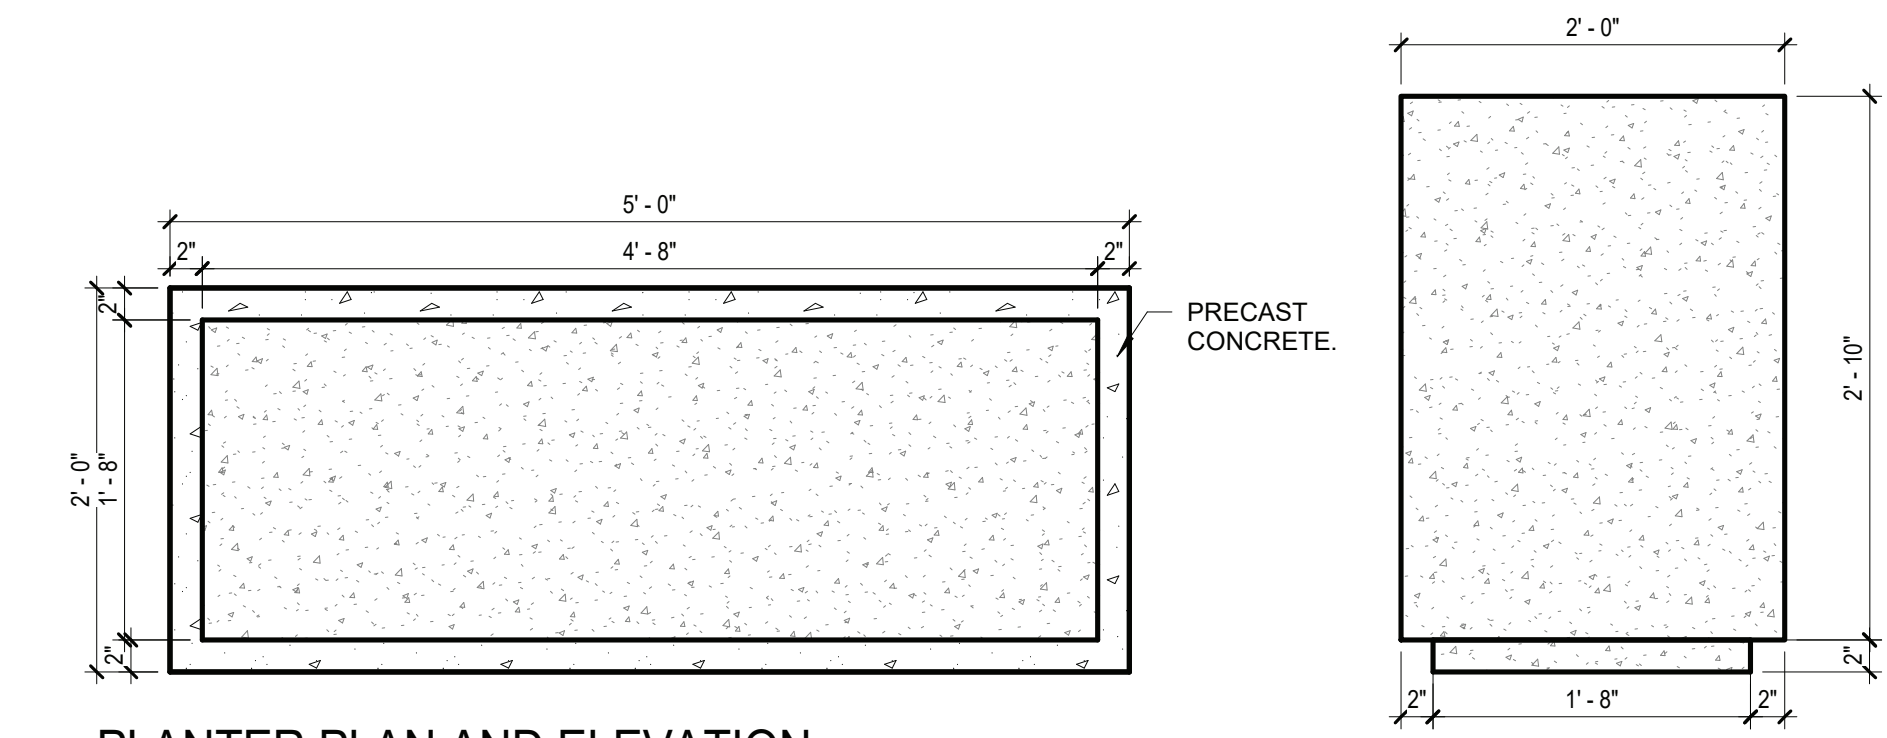

10 PLANTER PLAN AND ELEVATION
1" = 1'-0"

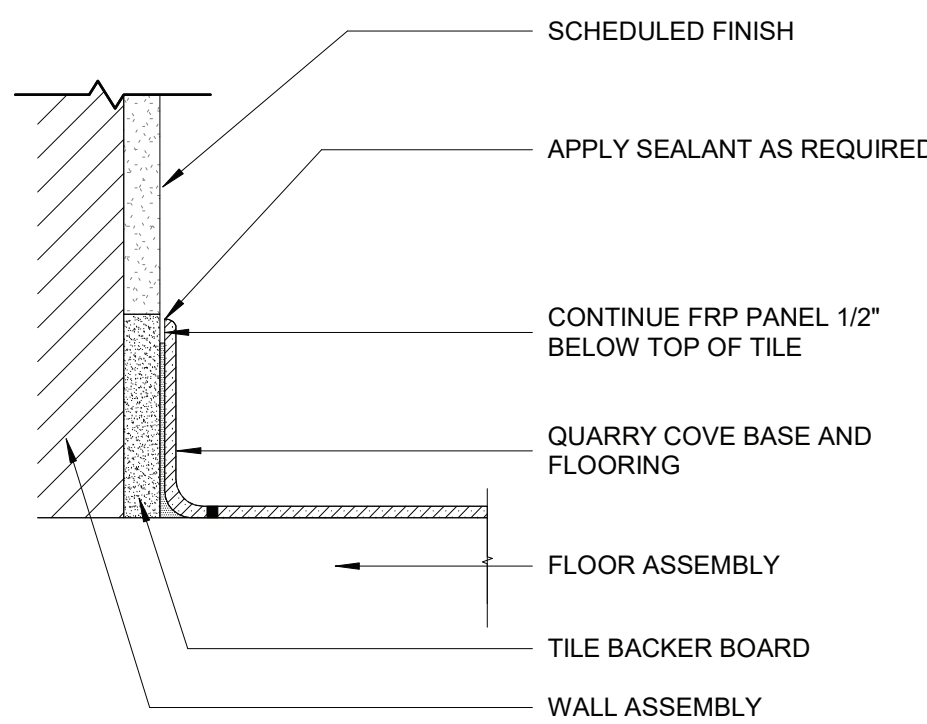

13 QUARRY TILE BASE DETAIL
3" = 1'-0"

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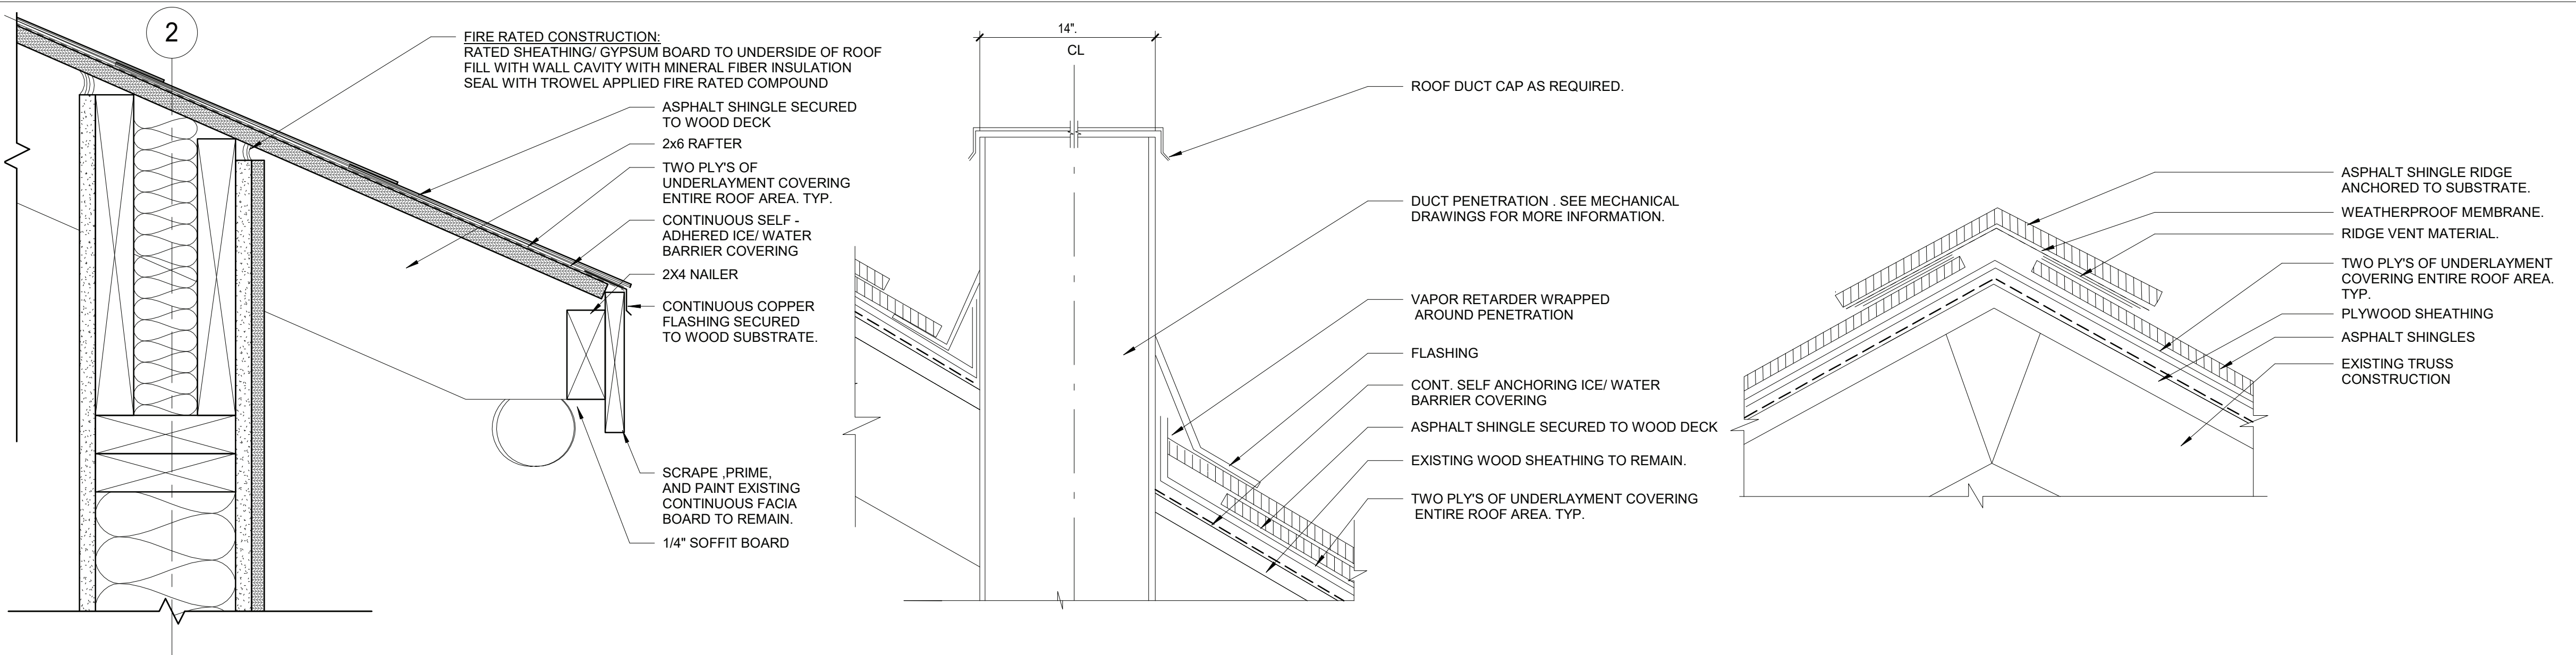
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CONTRACTOR		PROJECT COORDINATOR	
NAME		NAME	
SIGNATURE		SIGNATURE	
TITLE		TITLE	

WESTCHESTER COUNTY, NEW YORK
DEPARTMENT OF PUBLIC WORKS AND TRANSPORTATION
DIVISION OF ENGINEERING

INFRASTRUCTURE REHABILITATION
PLAYLAND PARK, RYE, NEW YORK
RESTAURANT KITCHEN WITH FOOD VENDING
CEILING, FLOOR, AND PLANTER DETAILS


CONTRACT NUMBER	SHEET NUMBER
22-523	K-A-81
DWG NO.:	516 of 664
SCALE:	As indicated
DATE:	8/23/20223
DPW FILE NUMBER	REV. NO.
1-118-A-1265-0	0




GENERAL ROOF DETAIL NOTES

1. INSTALL FELT UNDERLAYMENTS ON ALL PARTS OF THE ROOF DECK NOT COVERED BY ICE/ WATER BARRIERS. LAP EDGES OF FELT OVER SELF - ADHEARING ICE AND WATER BARRIER NOT LESS THAN 3" IN DIRECTION TO SHED WATER. LAP EDGES OF FELT NOT LESS THAN 6" OVER ICE/ WATER BARRIER. FELT UNDERLAYMENT SHOULD NOT BE PLACED UNDER ICE/ WATER BARRIER AND SHOULD OVERLAP IN 3". SIDE LAPS SHOULD NOT BE LESS THAN 6".
2. INSTALL STARTER SLATE AND FIELD SLATE AS RECOMMENDED BY MANUFACTURE FOR CURRENT PROJECT ROOF CONDITIONS.
3. INSTALL 36" (MIN.) CONTINUOUS WIDE ICE/WATER SHIELD THROUGHOUT ENTIRE ROOF AREA CENTERED AT ALL VALLEYS, SIDEWALLS, HEADWALLS, AND PENETRATIONS. SLATES MUST COVER VALLEY FLASHING BY A MIN. 4". DO NOT FASTEN SLATES INTO METAL VALLEY FLASHING.
4. UNDERLAYMENT REFER TO SPEC SECTION 073140.
5. FLASHING - REFER TO SPEC 073140.
6. FASTNERS - REFER TO SPEC SECTION 073140.
7. REFER TO SPECIFICATION SECTION 073113 ASPHALT SLATE SHINGLES FOR BALANCE OF INFORMATION.
8. WOOD DECK REPAIR WOOD DECK AS EXISTING CONDITIONS REQUIRED BY ROOFING MANUFACTURE IN ORDER TO OBTAIN MANUFACTURER'S WARRANTY. CONSIDER 5% OF THE ENTIRE WOOD DECK AREA REPAIRS UNDER ALLOWANCE NO. 1 PRIOR INSPECTION ON EXISTING WOOD DECK REQUIRED BEFORE STARTING ANY ROOFING WORK.
9. PREPARE EXISTING WOOD FOR NEW COATING SYSTEM AS REQUIRED BY THE COATING SYSTEM MANUFACTURE. PRIME AND PAINT. REFER TO SPECIFICATION SECTION 09900.
10. PROVIDE PRE- FABRICATED ASPHALT SHINGLE CAP AT ALL HIPs.
11. ROOF BARRIER FENCES SECURED TO THE ROOF DECK SHALL NOT BE WITHIN 2'-6" OF THE ROOF'S EXTERIOR EDGE.
12. ALL STEEL TUBE TO STEEL TUBE CONNECTIONS SHALL BE FULLY WELDED. REPAIR ANY GALVANIZING DAMAGED DUE TO FIELD WELDING.
13. CONTRACTOR TO PROVIDE ICE WATER SHIELD AT ROOF EAVE, RIDGE, HIP, RAKE, LOW PITCH, VENT STACK AS REQUIRED. GRACE ICE & WATER SHIELD PRODUCT SHOULD BE INCLUDED IN THE SPEC'S AS BASIS OF DESIGN, UNLESS NOT COVERED ALREADY.


1 ROOFING DETAIL AT GUTTER
3" = 1'-0"

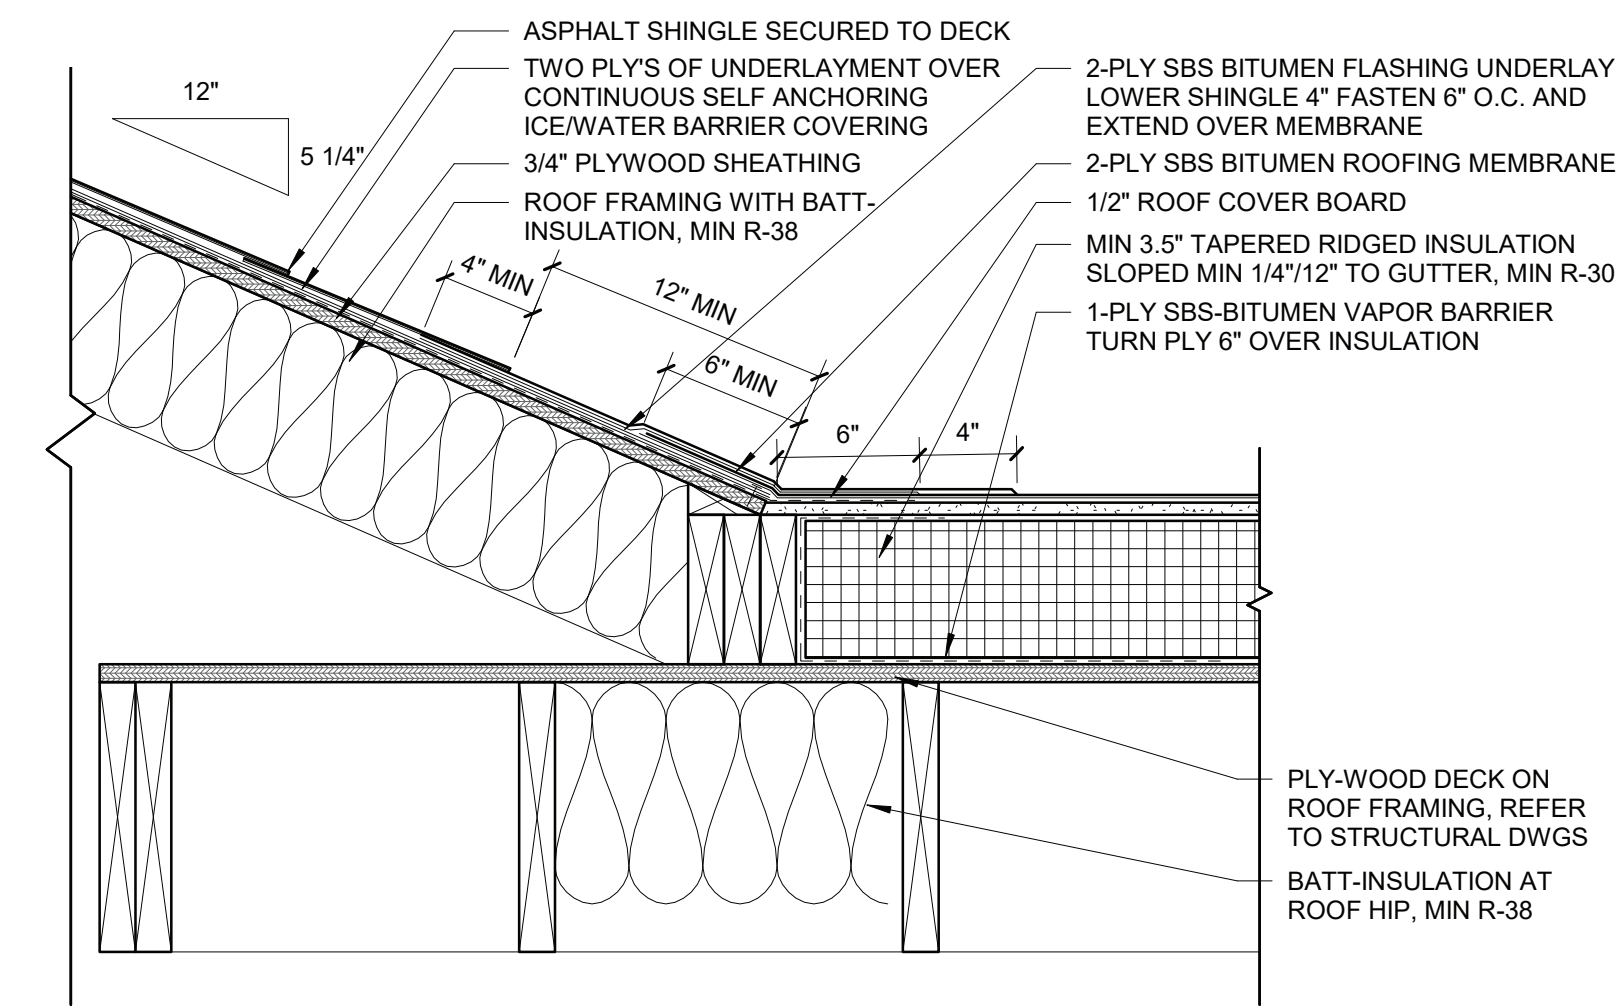


2 TYPICAL FLASHING AT DUCT DETAIL
3" = 1'-0"

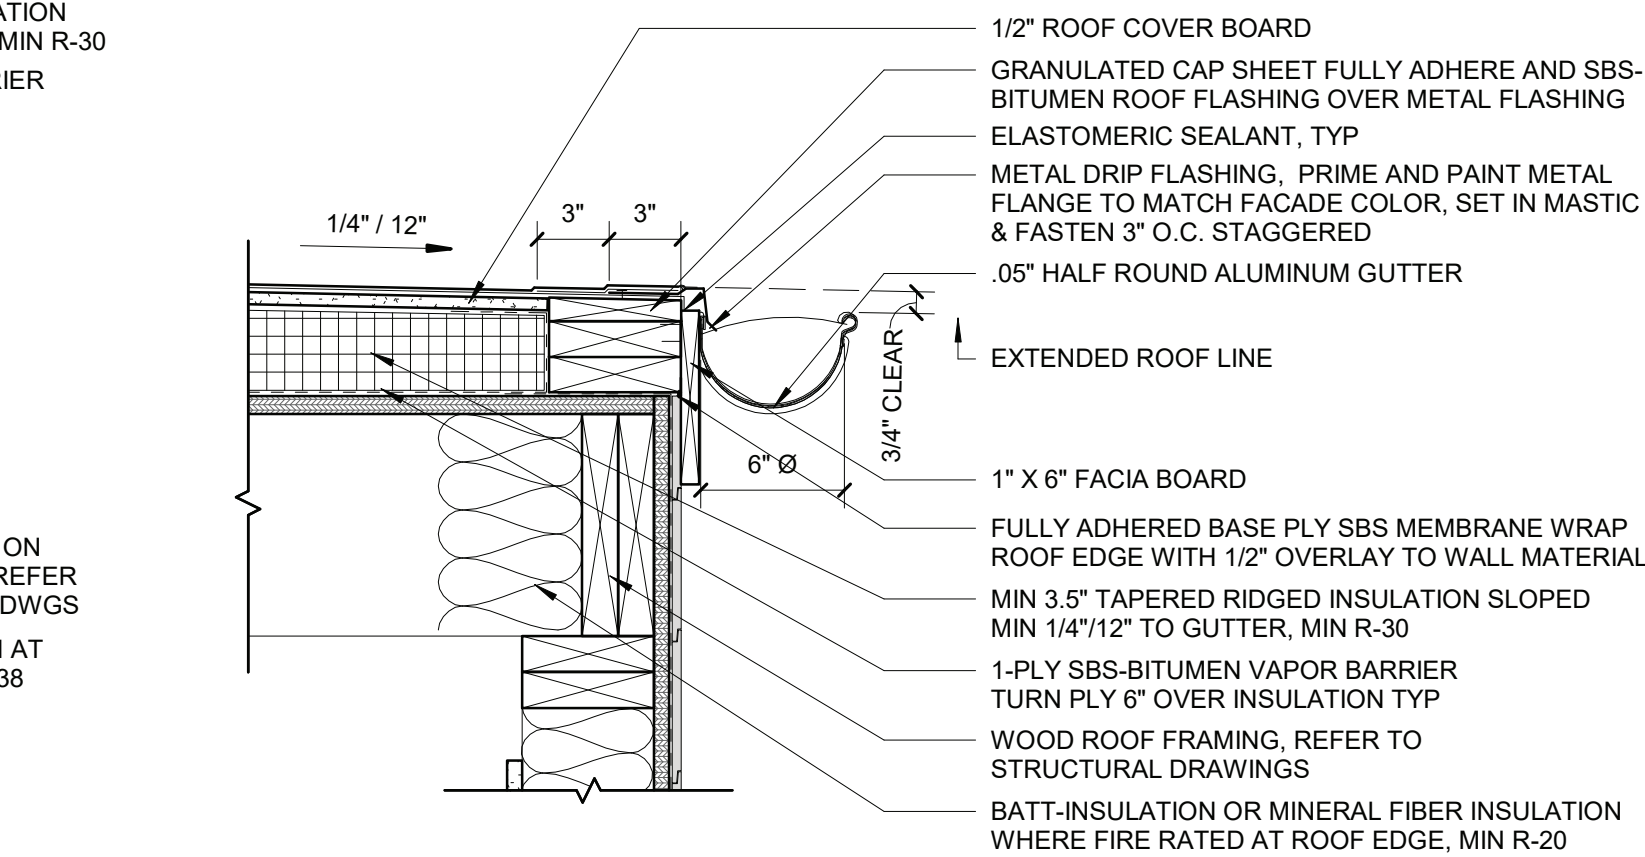


3 TYPICAL DETAIL AT RIDGE
3" = 1'-0"

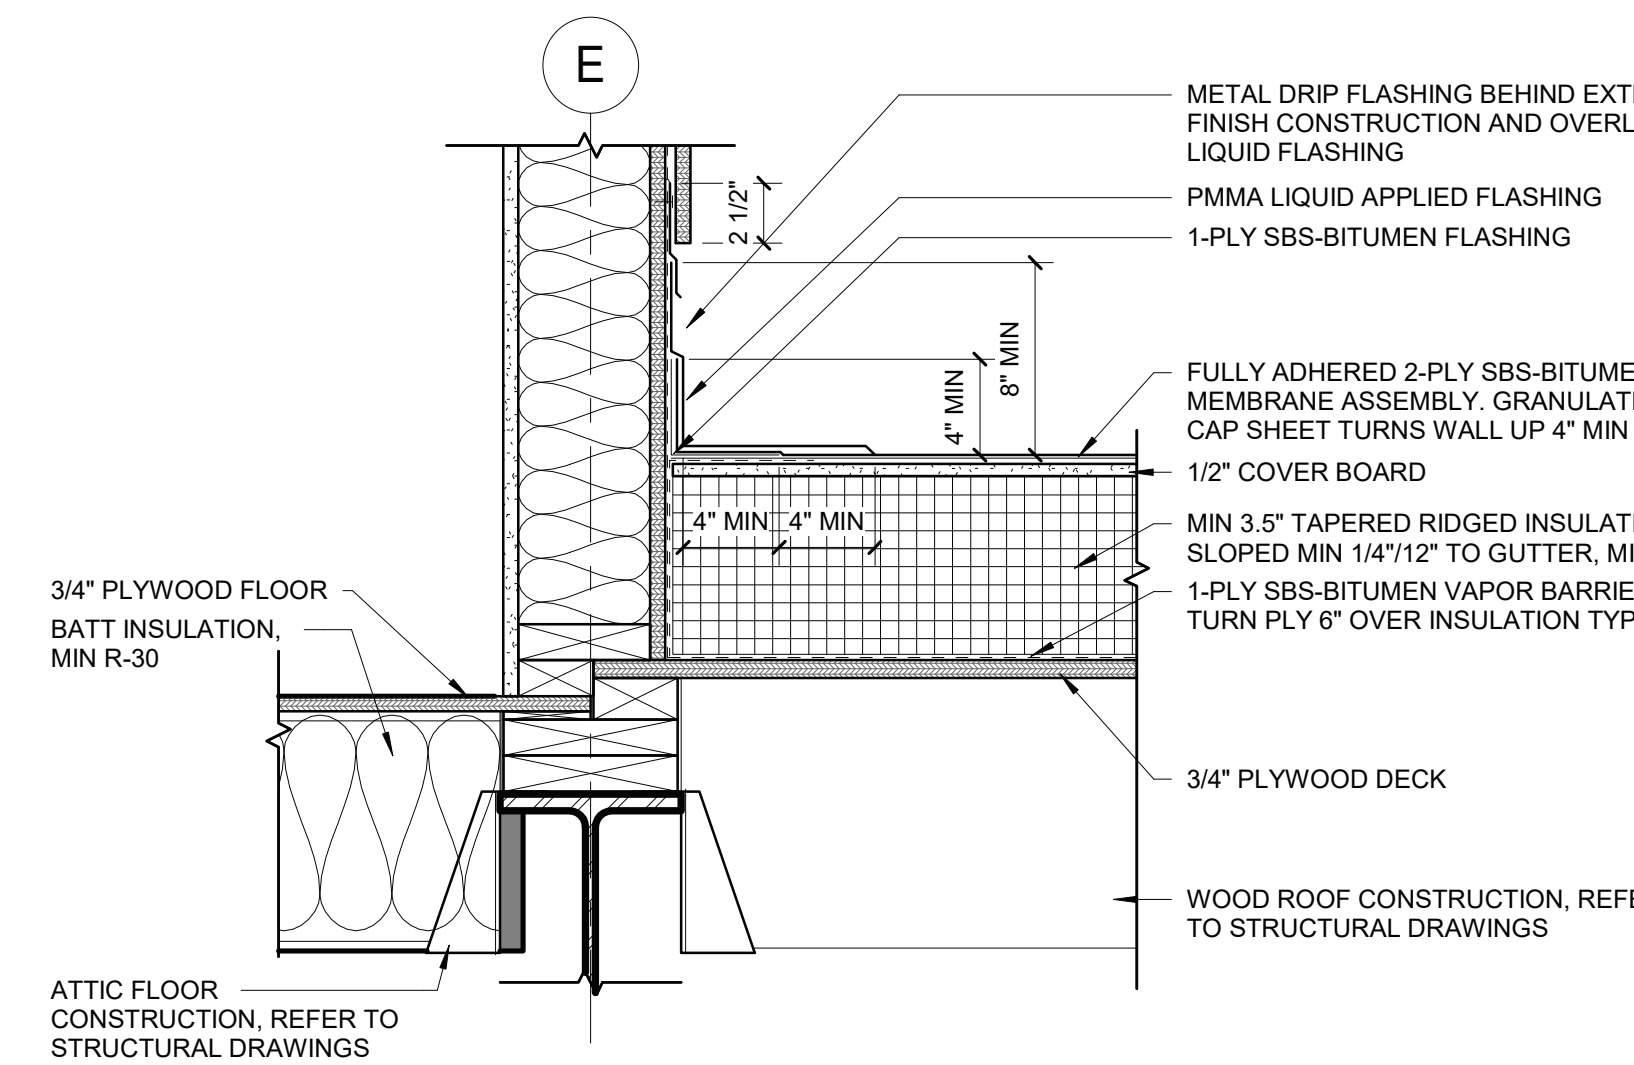


4 TYP ASPHALT AND SBS HIP ROOF CONNECTION DETAIL
1 1/2" = 1'-0"

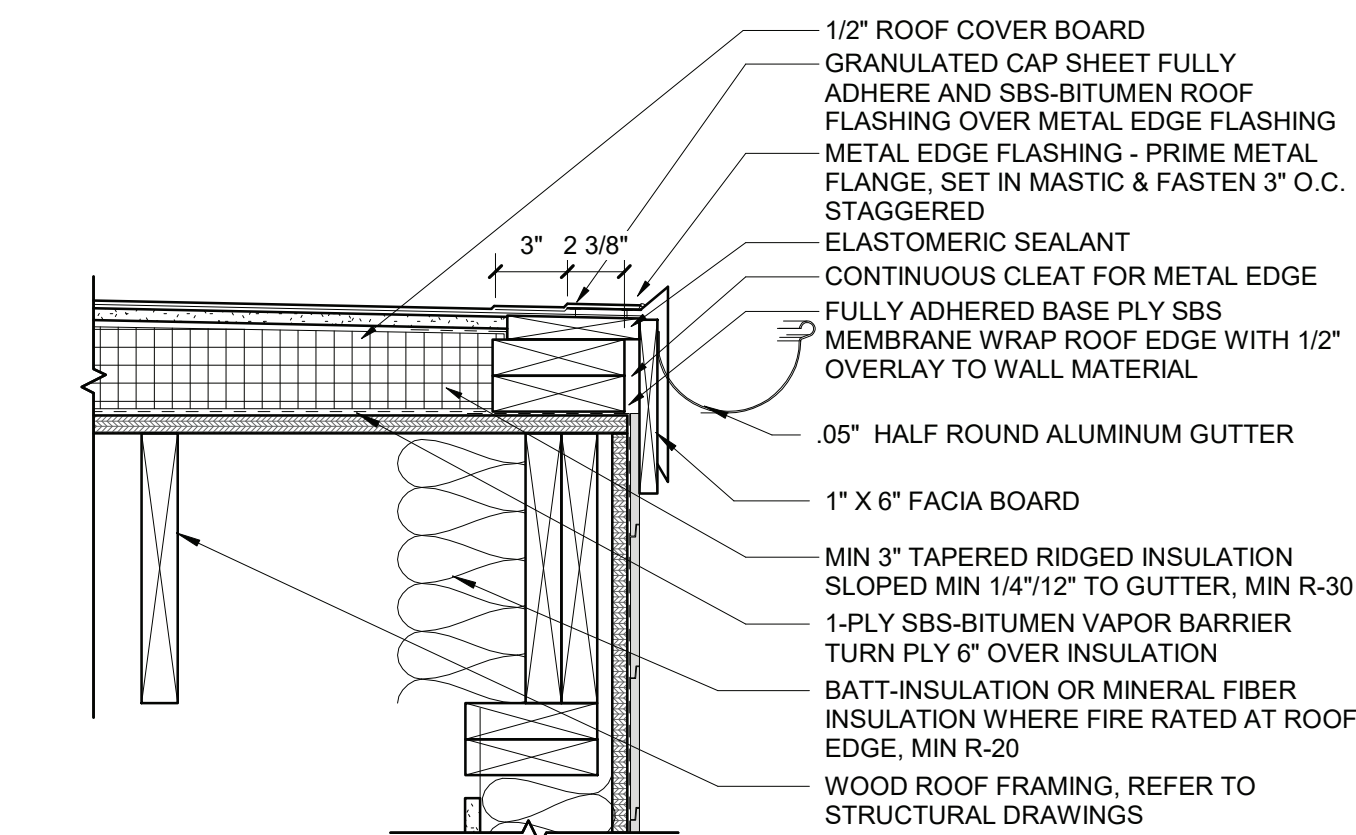


5 TYPICAL SBS ROOF RIDGE DETAIL
1 1/2" = 1'-0"

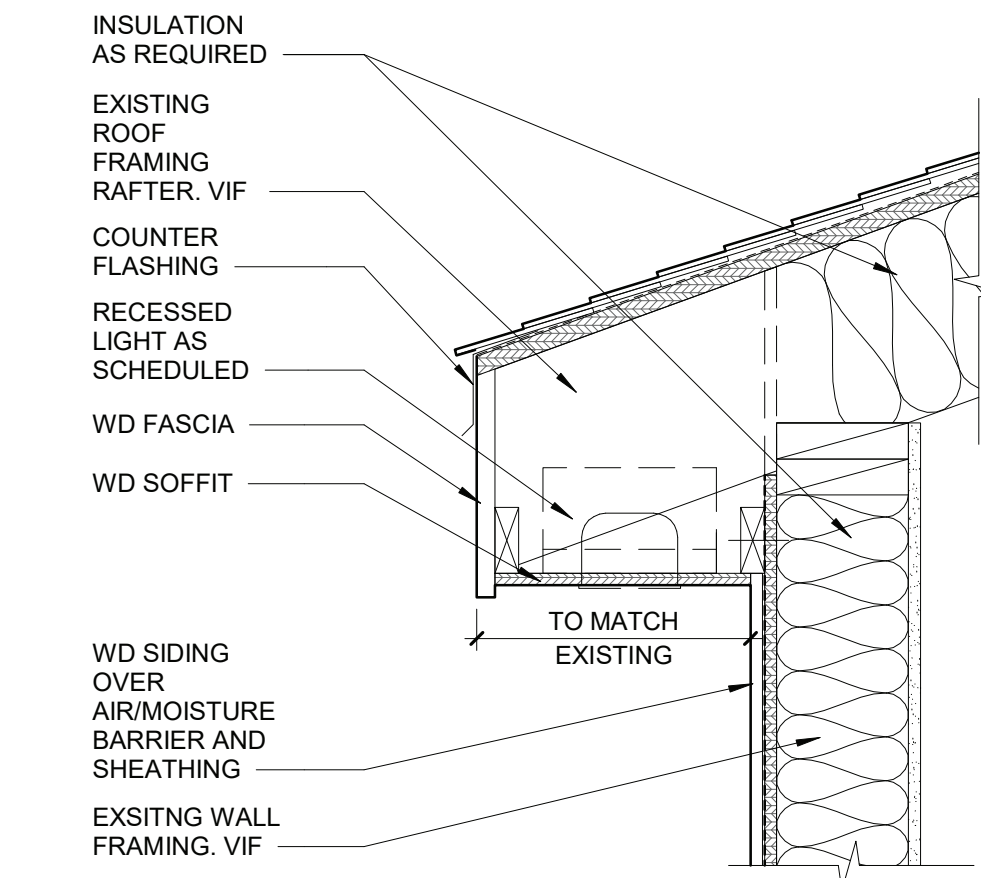

6 TYPICAL FLASHING DETAIL AT SBS ROOF AND EXTERIOR WALL
1 1/2" = 1'-0"

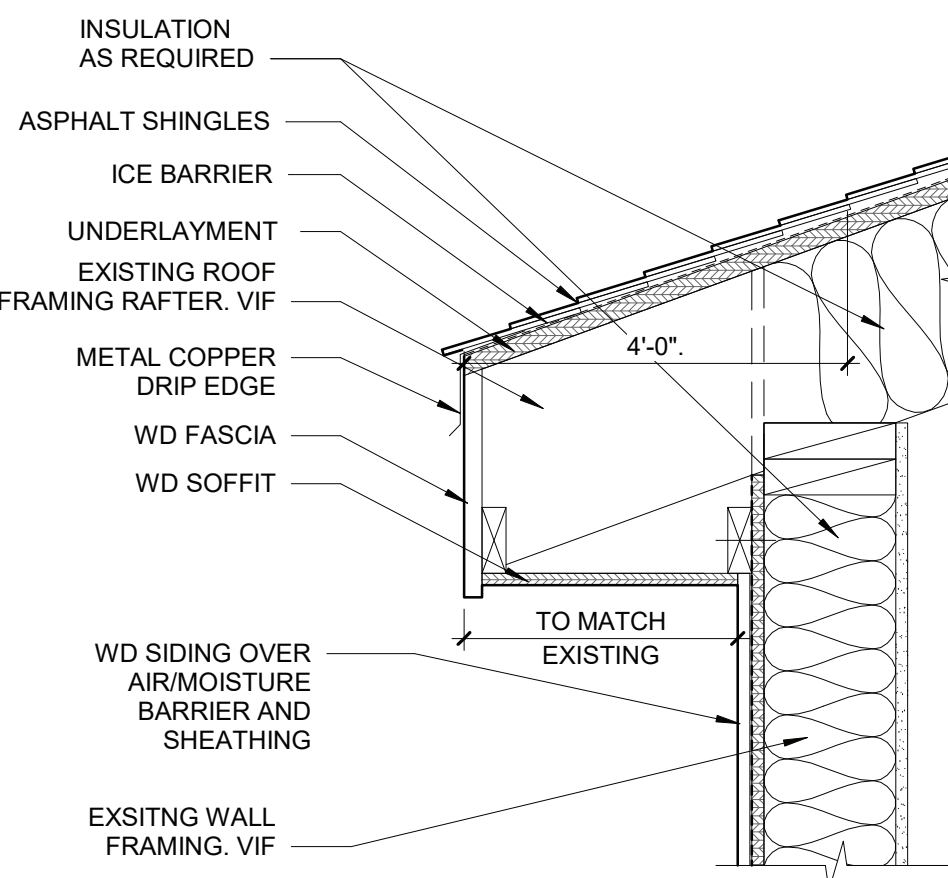


7 TYPICAL SBS ROOF TO EXISTING EXTERIOR WALL FLASHING DETAIL
1 1/2" = 1'-0"

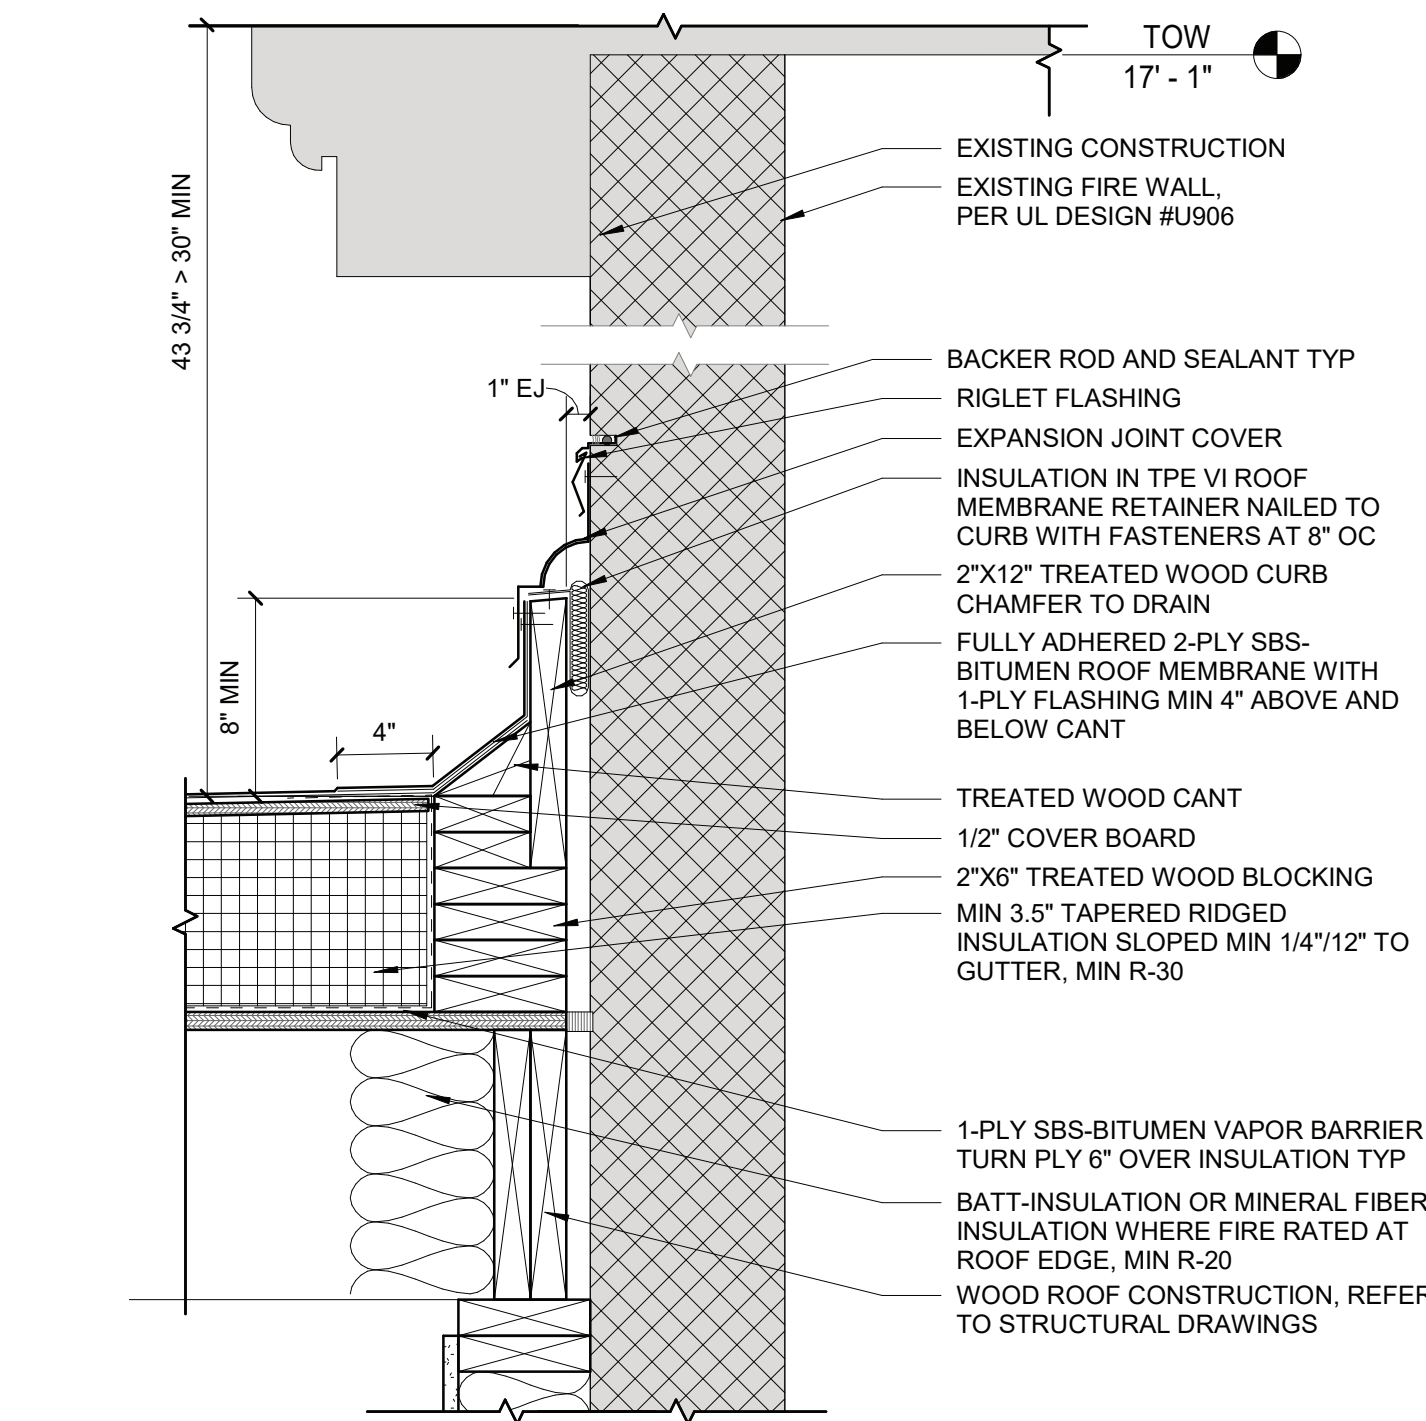


8 TYPICAL SBS ROOF EDGE DETAIL
3" = 1'-0"



9 TYPICAL INSULATED EXTERIOR SOFFIT DETAIL
1 1/2" = 1'-0"

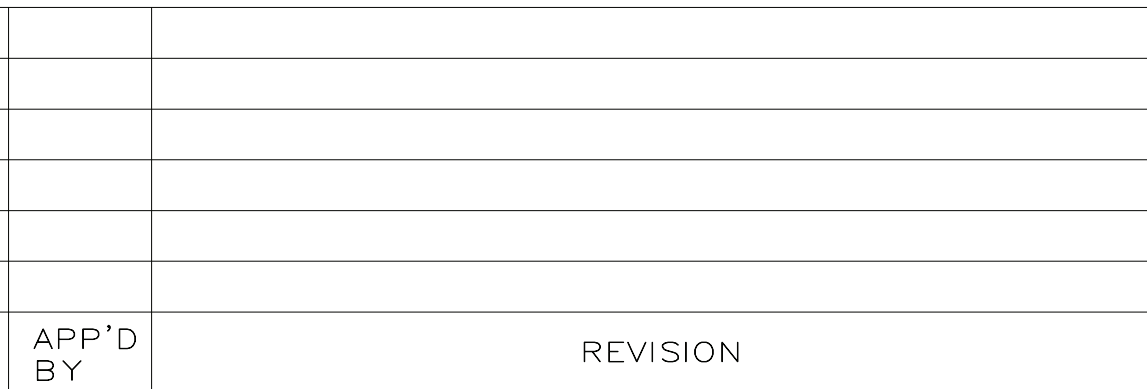

10 TYPICAL ROOF EAVE SECTION DETAIL
1 1/2" = 1'-0"

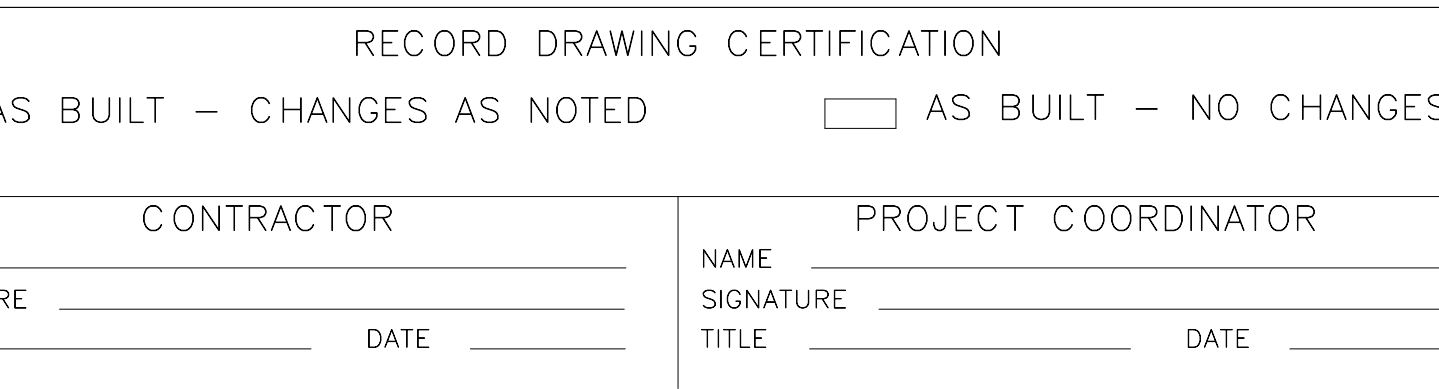

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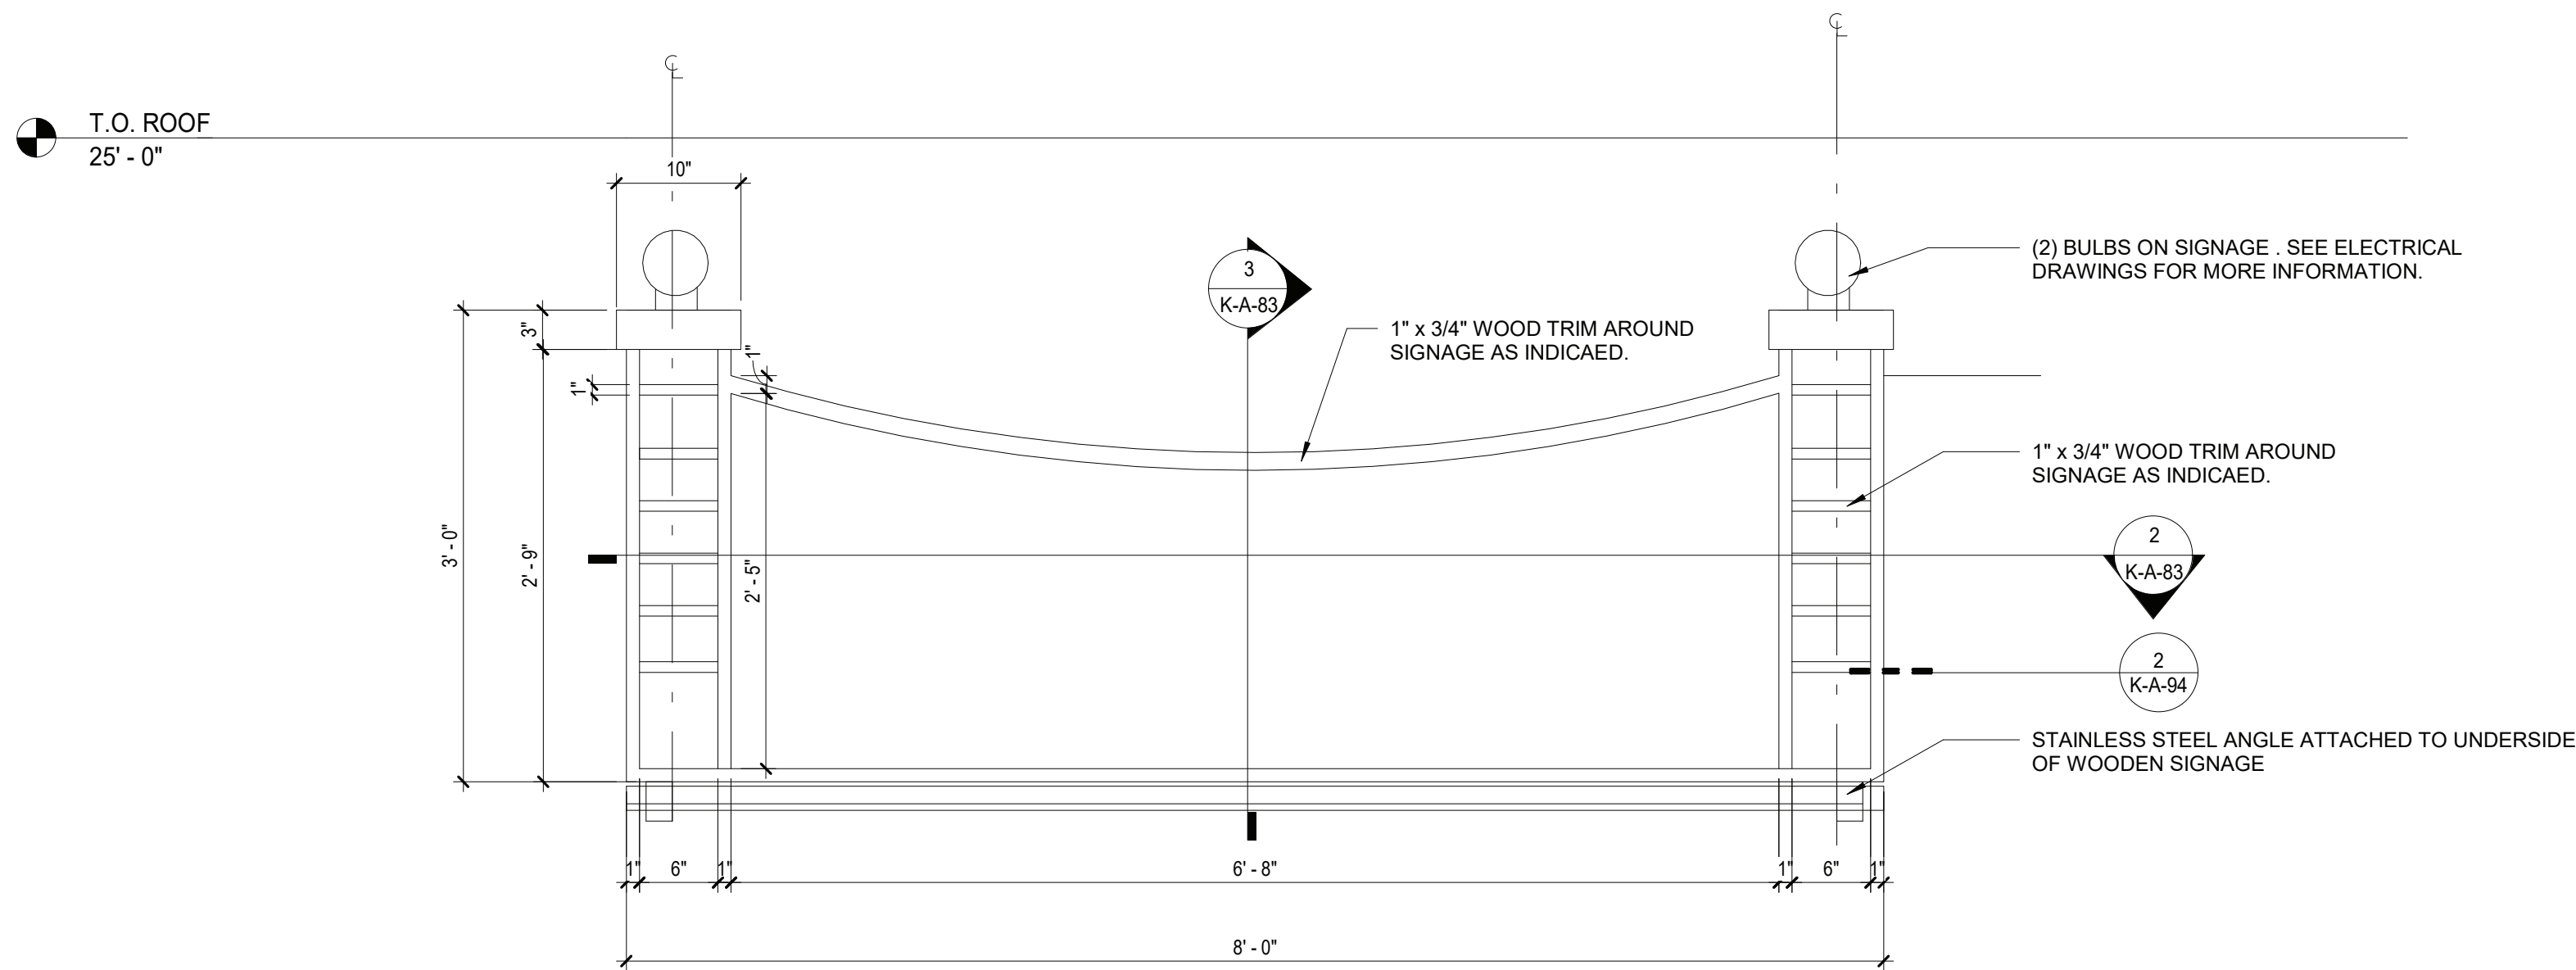
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NAME		NAME	
SIGNATURE		SIGNATURE	
TITLE		TITLE	


WESTCHESTER COUNTY, NEW YORK
DEPARTMENT OF PUBLIC WORKS AND TRANSPORTATION
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INFRASTRUCTURE REHABILITATION
PLAYLAND PARK, RYE, NEW YORK
RESTAURANT KITCHEN WITH FOOD VENDING
ROOF DETAILS


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SCALE:	As indicated
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1-118-A-1266-0	0




1 ROOF SIGNAGE ELEVATION
1" = 1'-0"

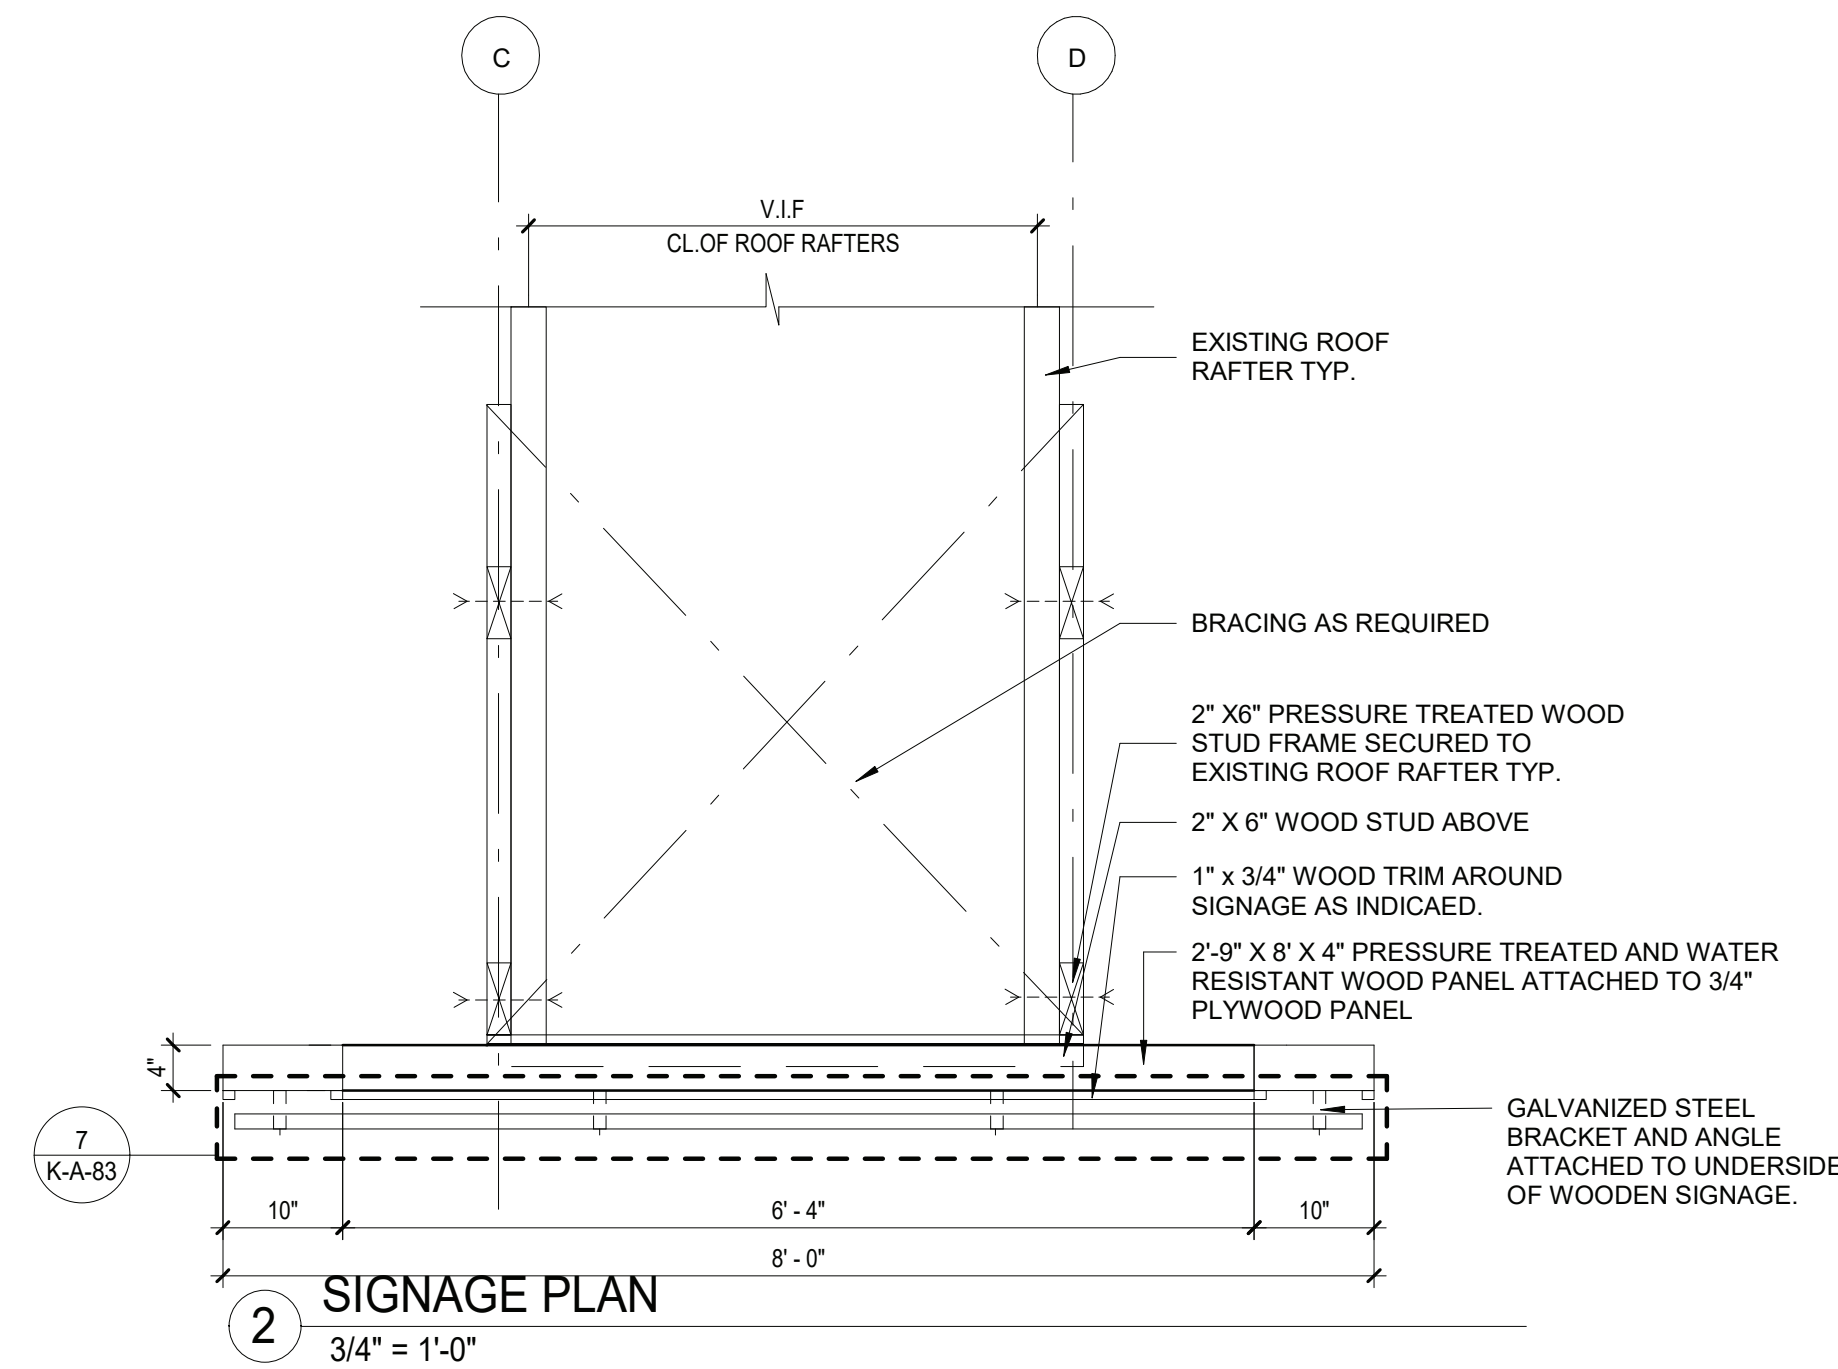


2 SIGNAGE PLAN
3/4" = 1'-0"

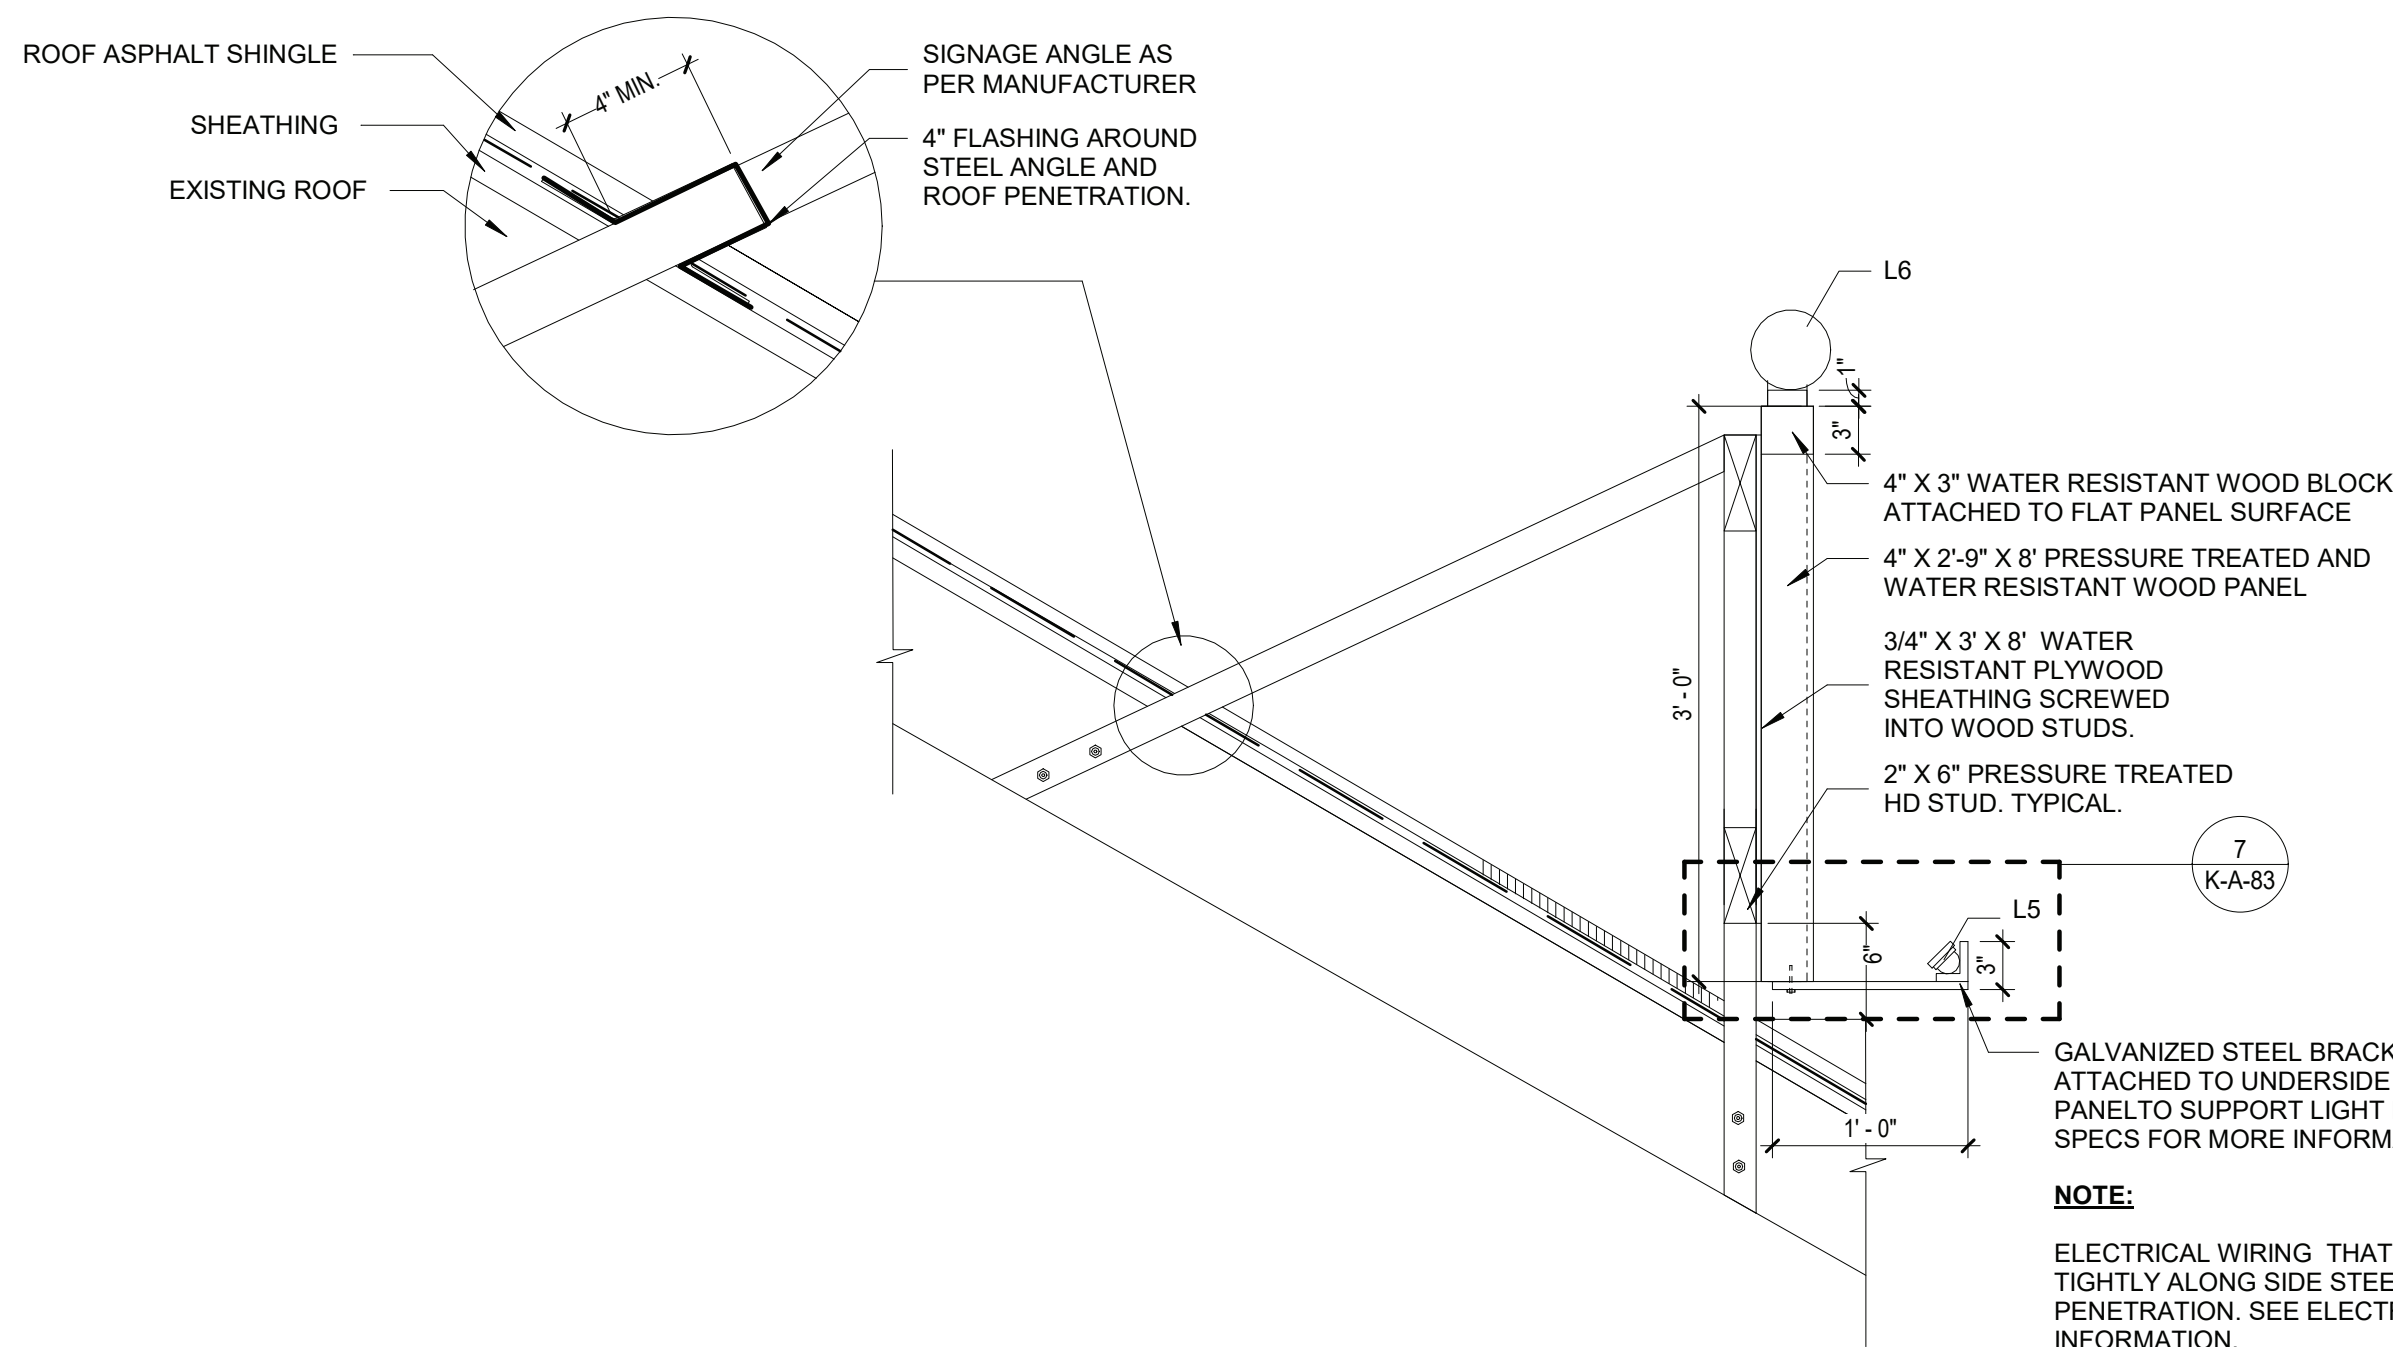


3 ROOF SIGNAGE SECTION DETAIL
1" = 1'-0"

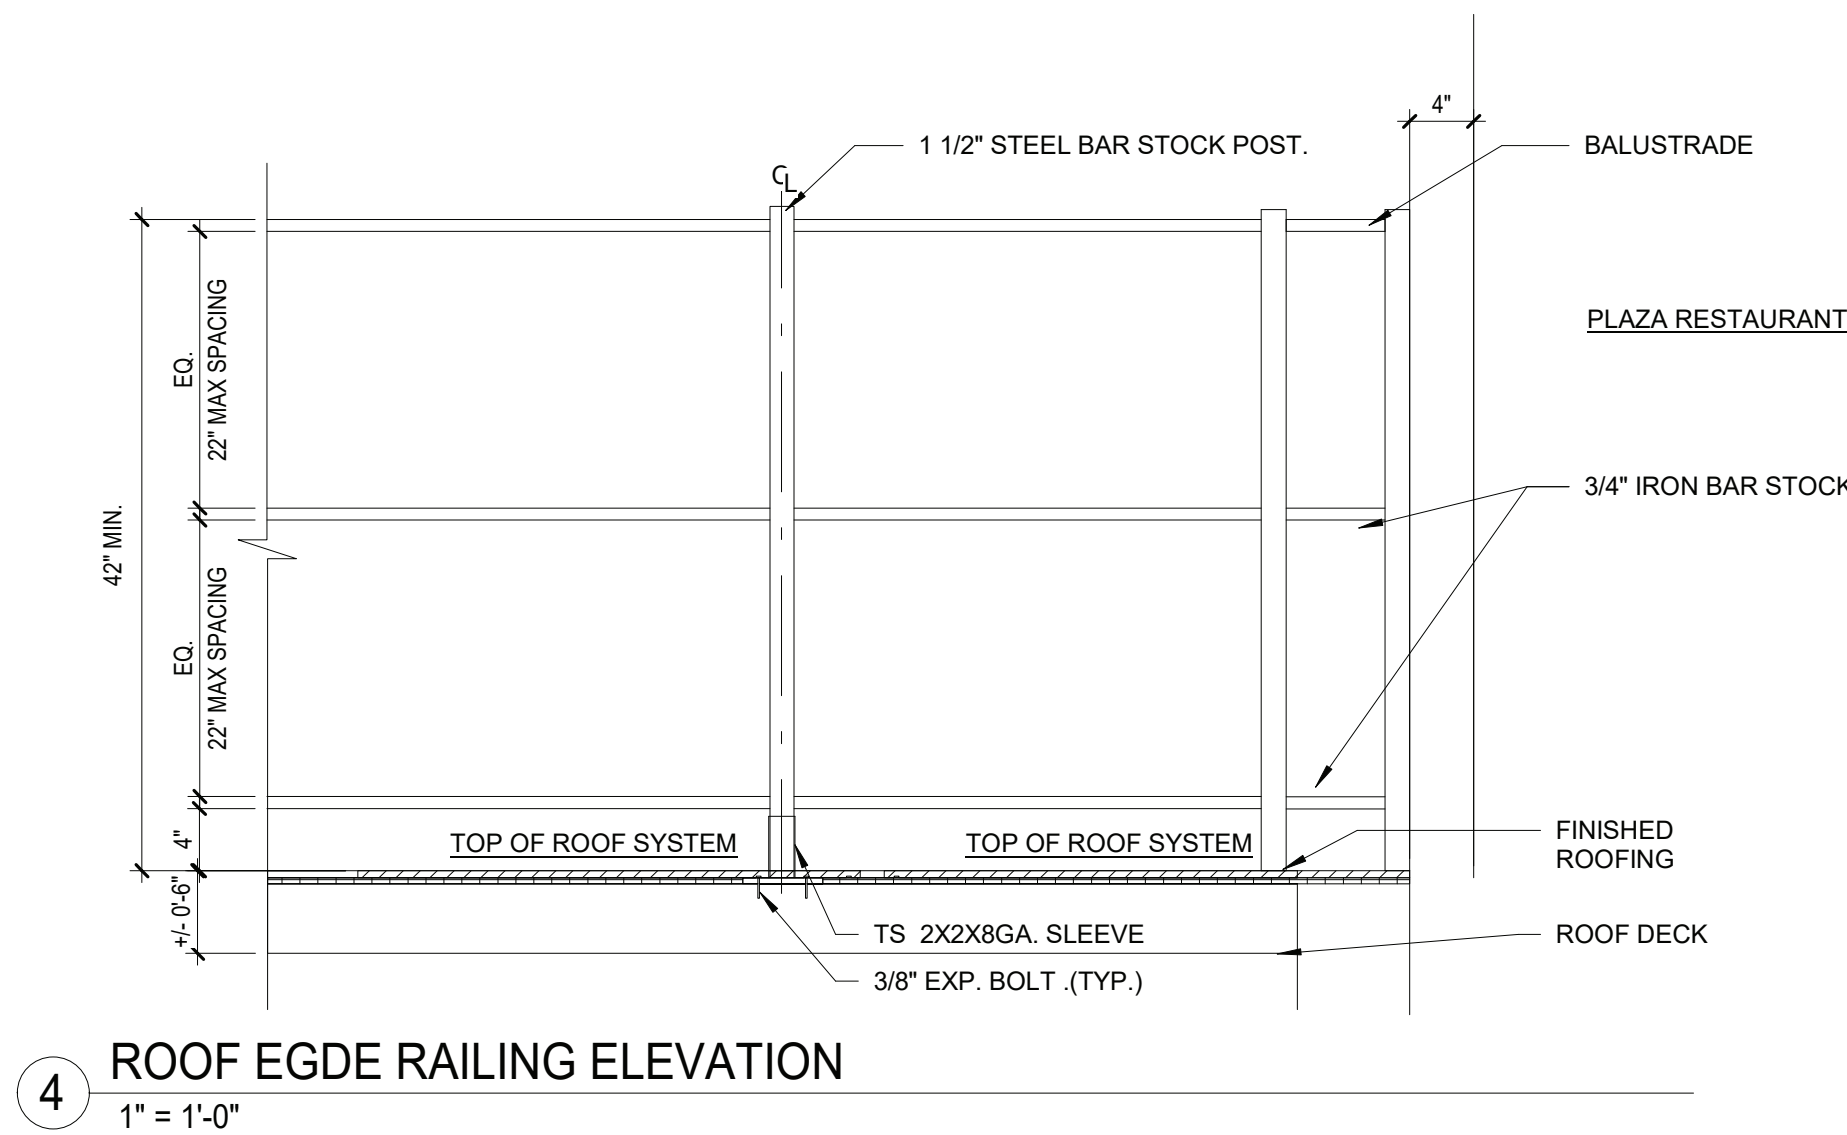


4 ROOF EGDE RAILING ELEVATION
1" = 1'-0"

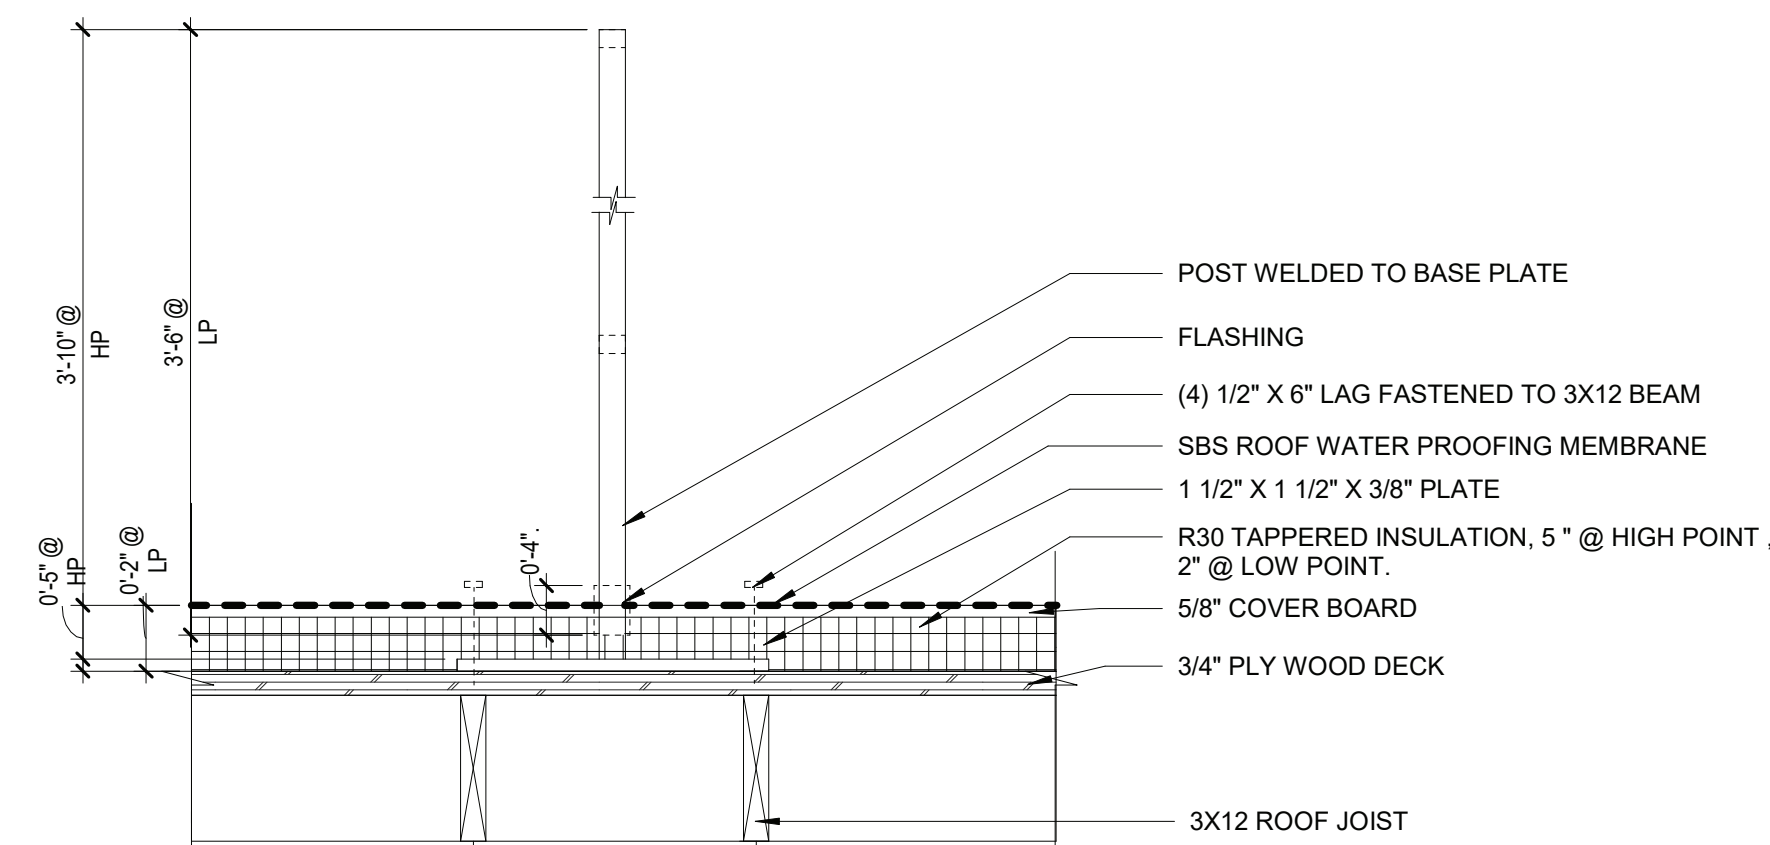


5 RAILING POST SECTION DETAIL
1 1/2" = 1'-0"

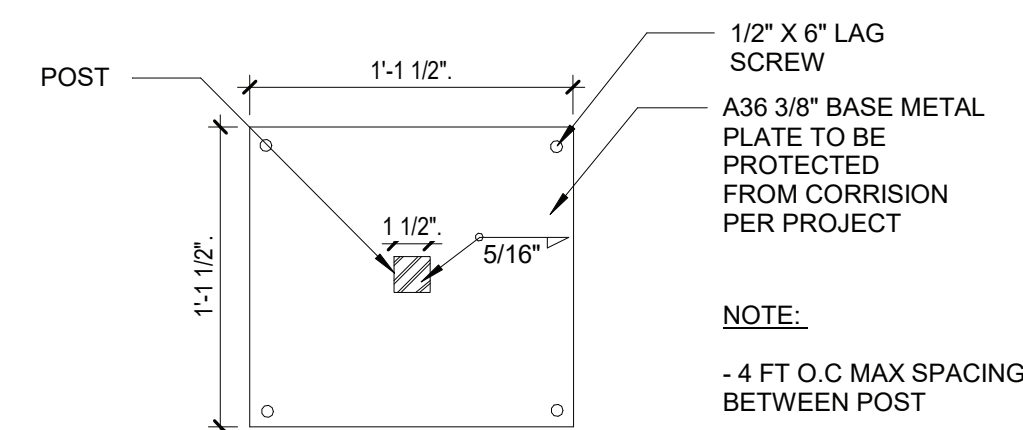


6 RAILING PLATE PLAN DETAIL
1 1/2" = 1'-0"

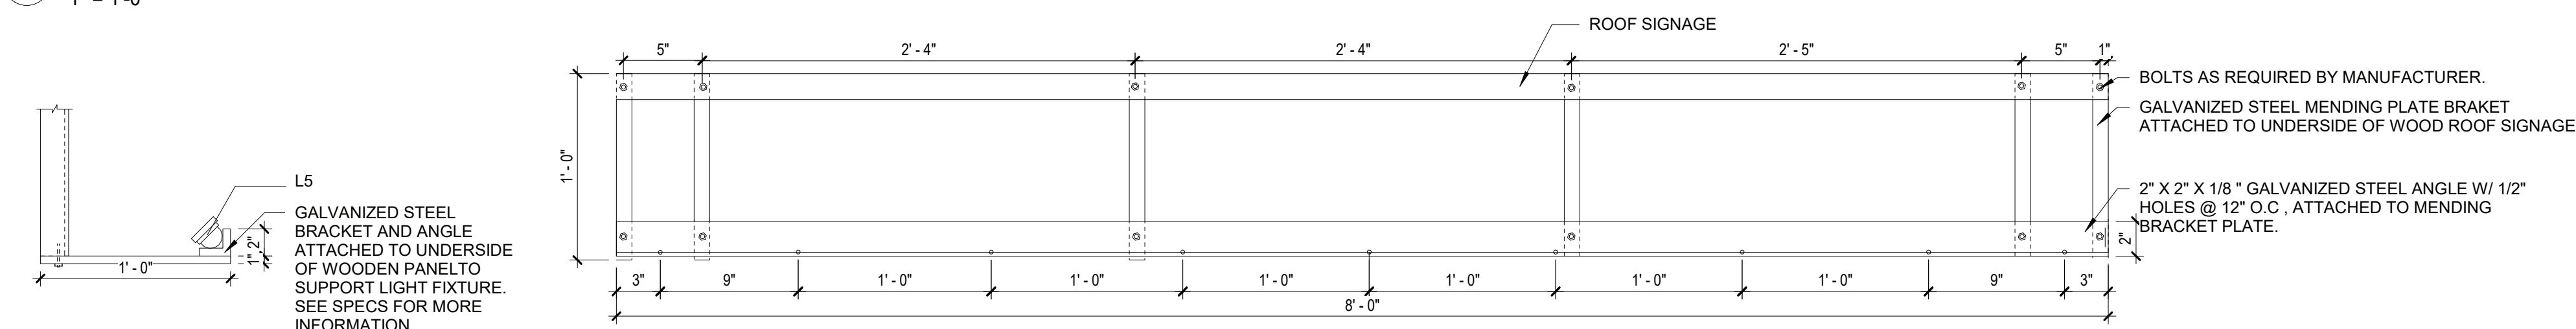


7 GALVANIZED STEEL BRACKET AND ANGLE DETAILS
1 1/2" = 1'-0"

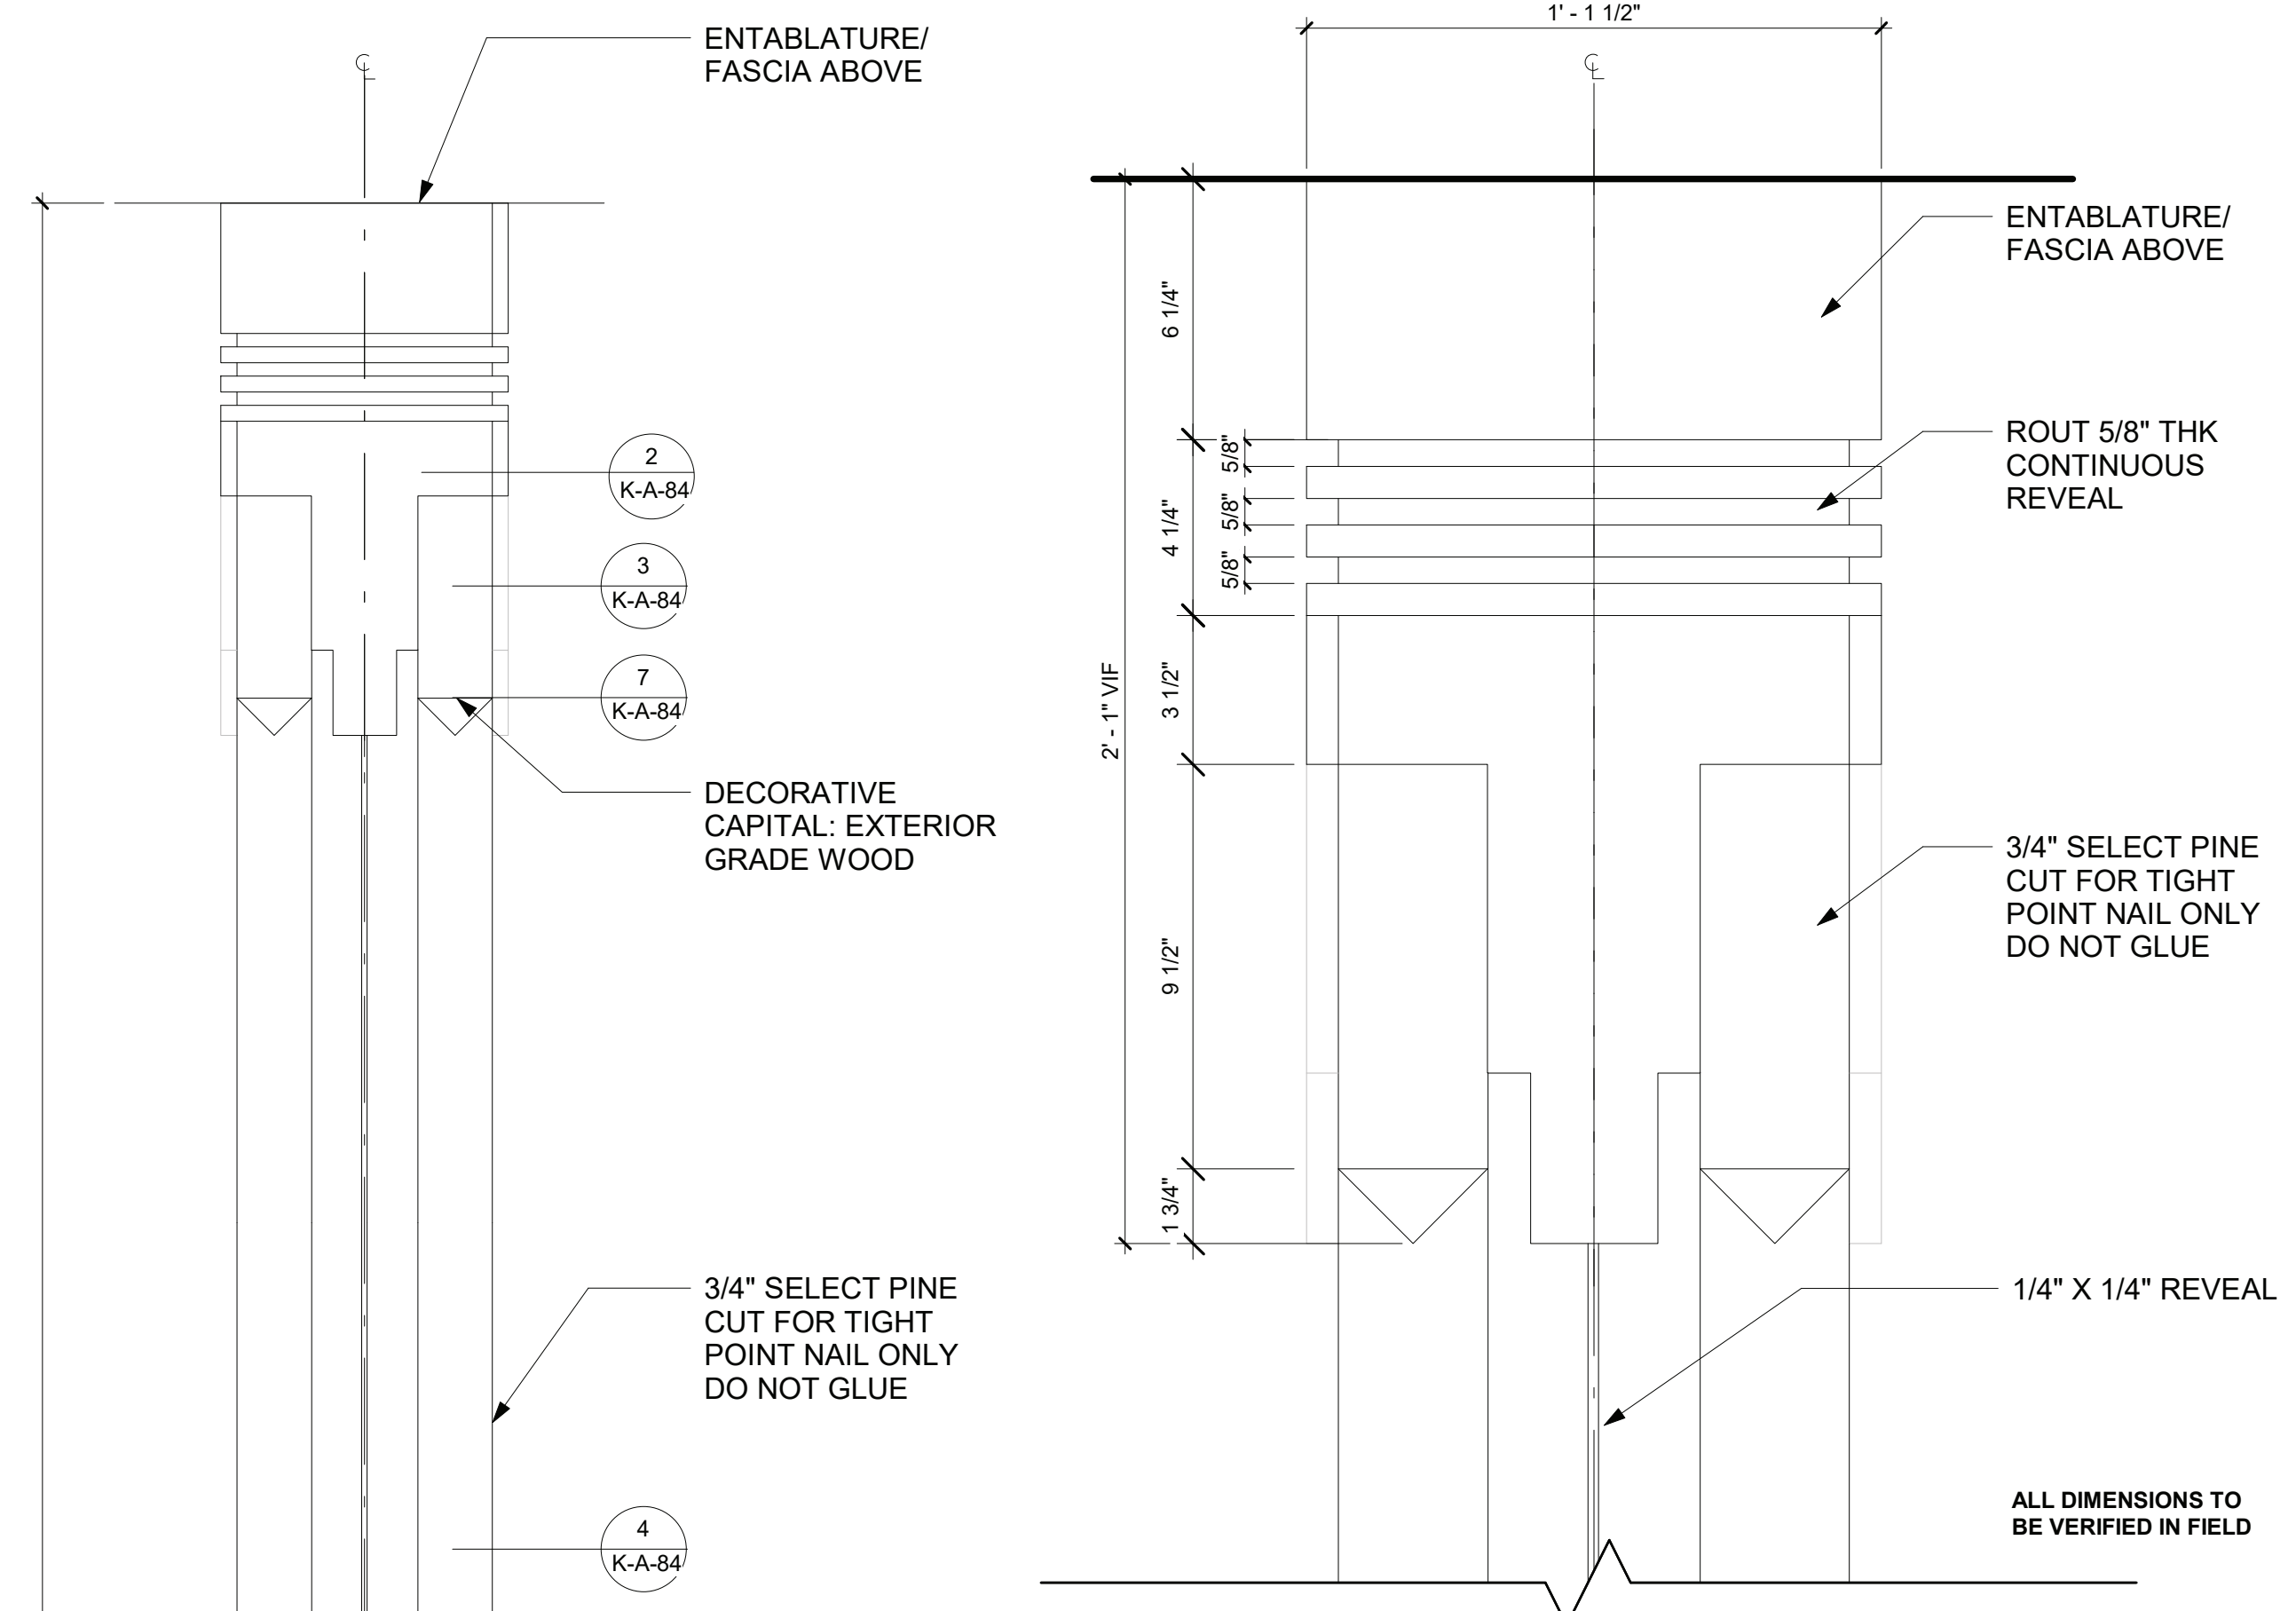


1 COLUMN CAPITAL DETAIL TYPE C
3" = 1'-0"

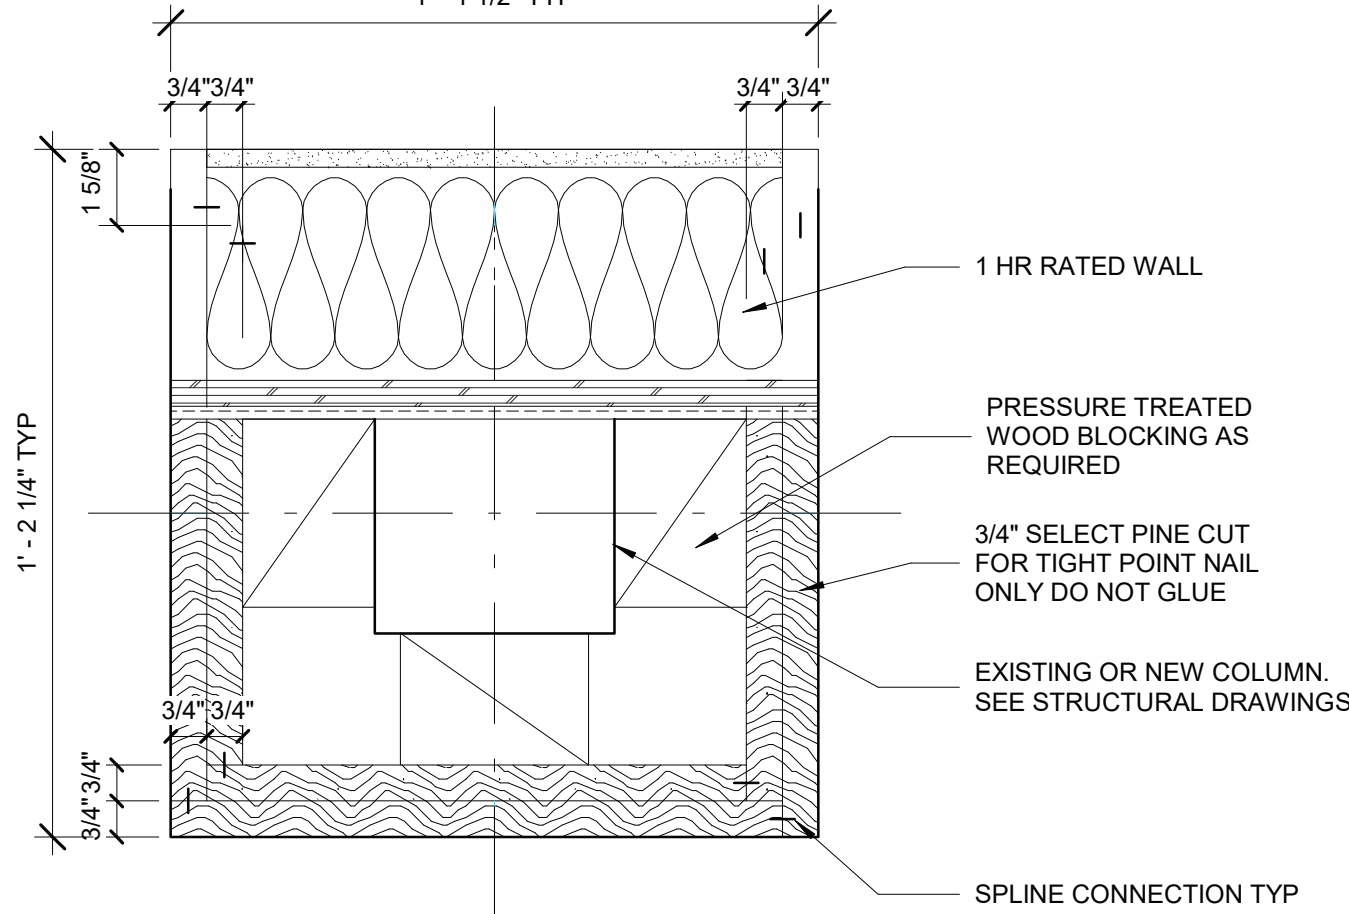


2 COLUMN C CAPITAL 3
3" = 1'-0"

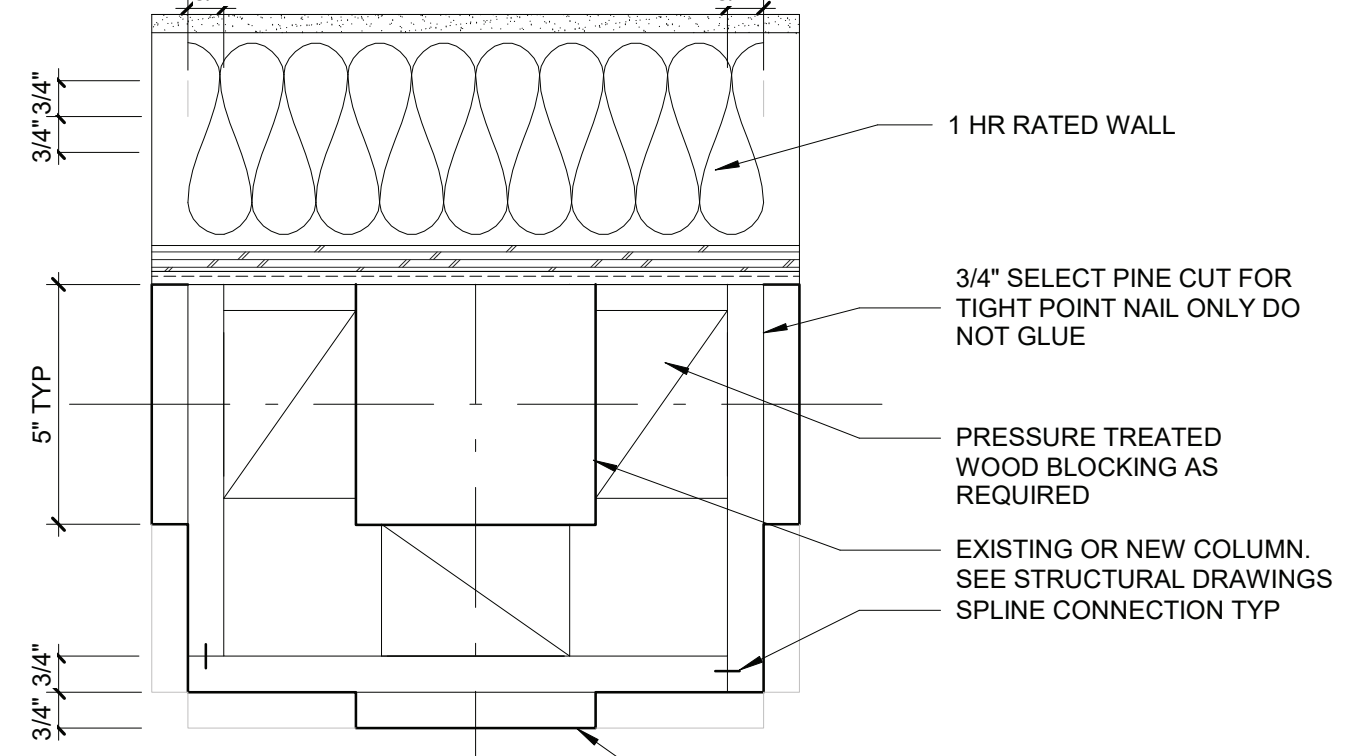


3 COLUMN CAPITAL 2
3" = 1'-0"

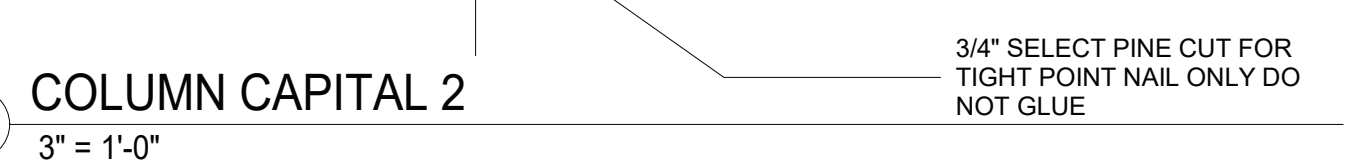


4 TYPE 1 - COLUMN DETAIL AT SHAFT
3" = 1'-0"

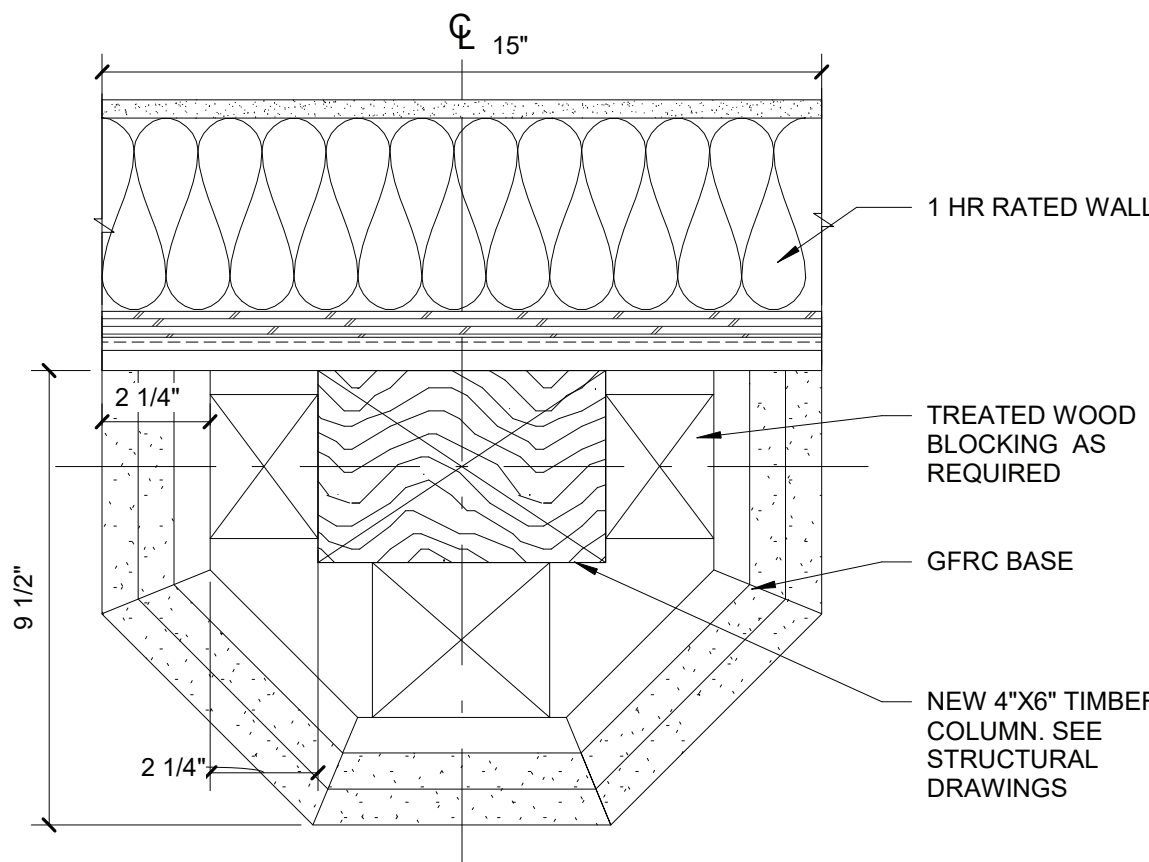


5 TYPE 1 - COLUMN DETAIL AT BASE
3" = 1'-0"

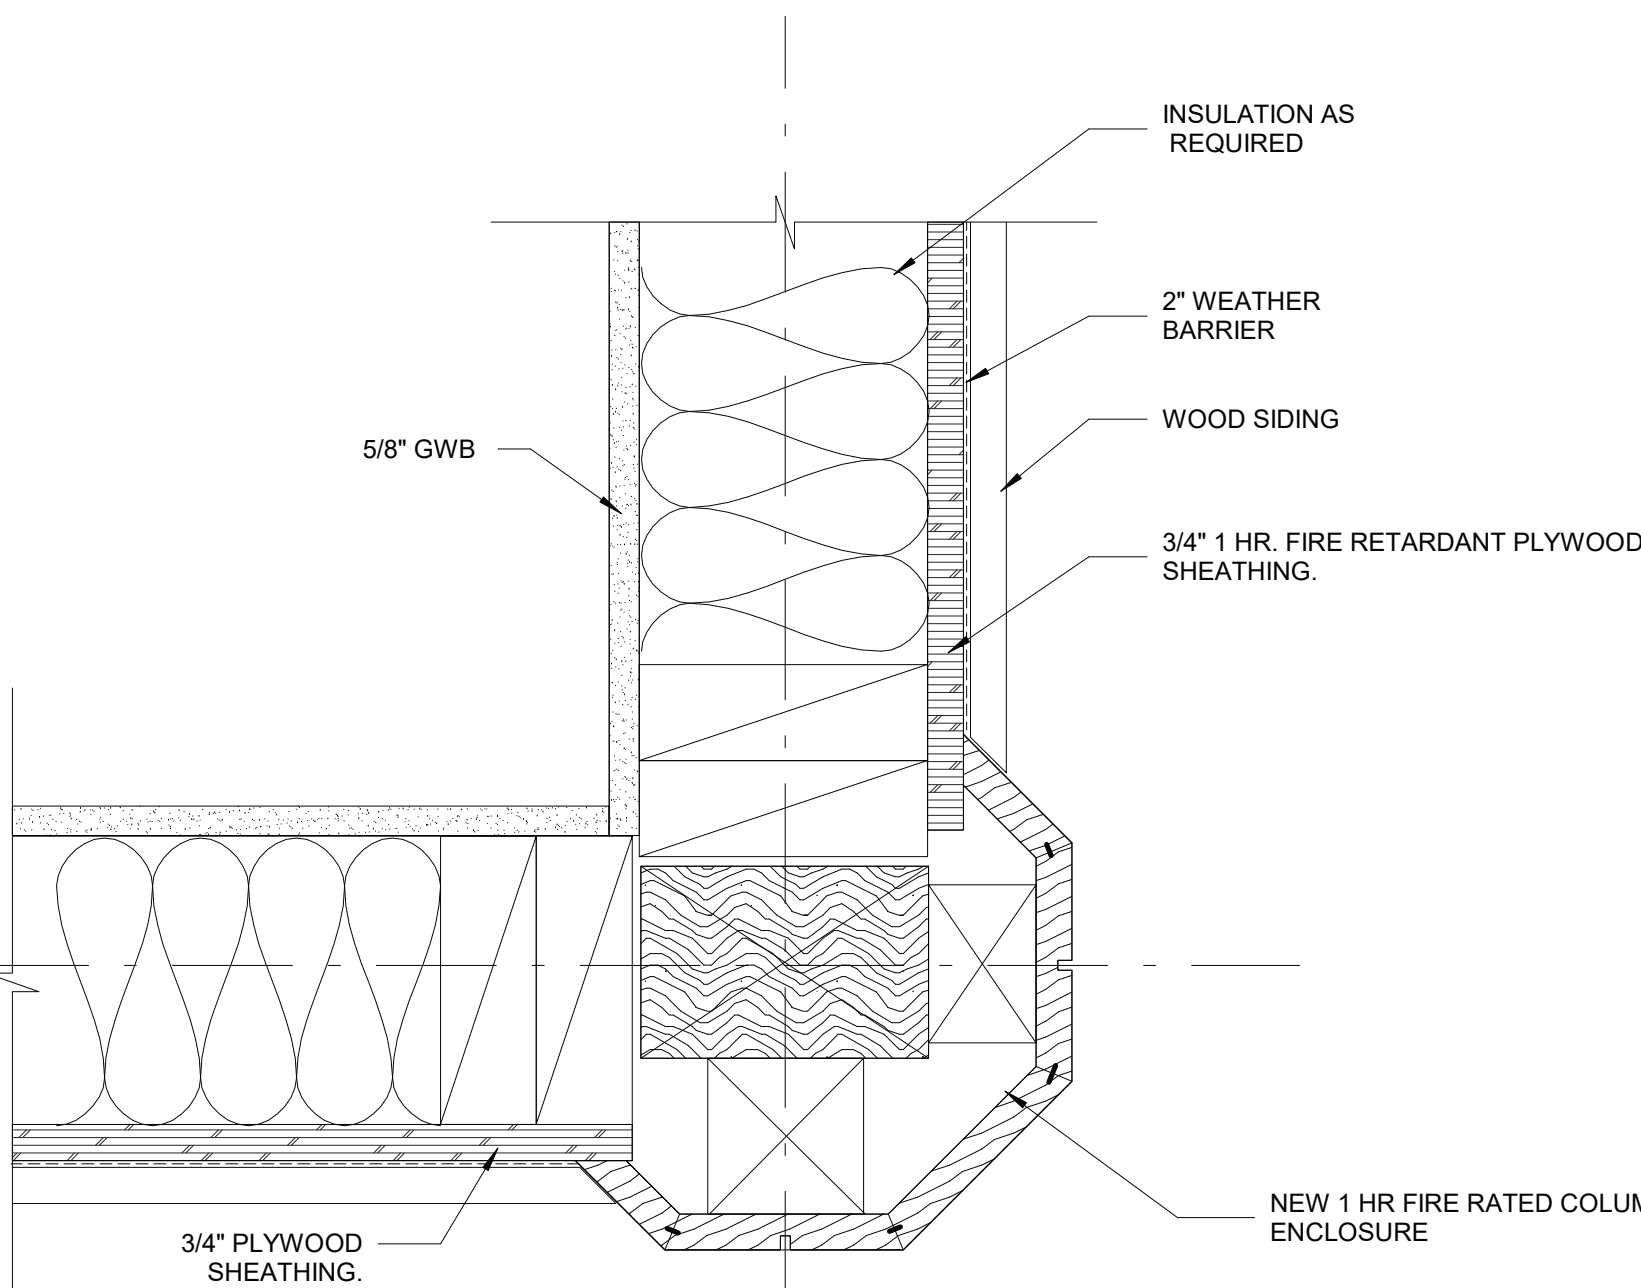


6 EXTERIOR CORNER COLUMN CONNECTION PLAN DETAIL
3" = 1'-0"

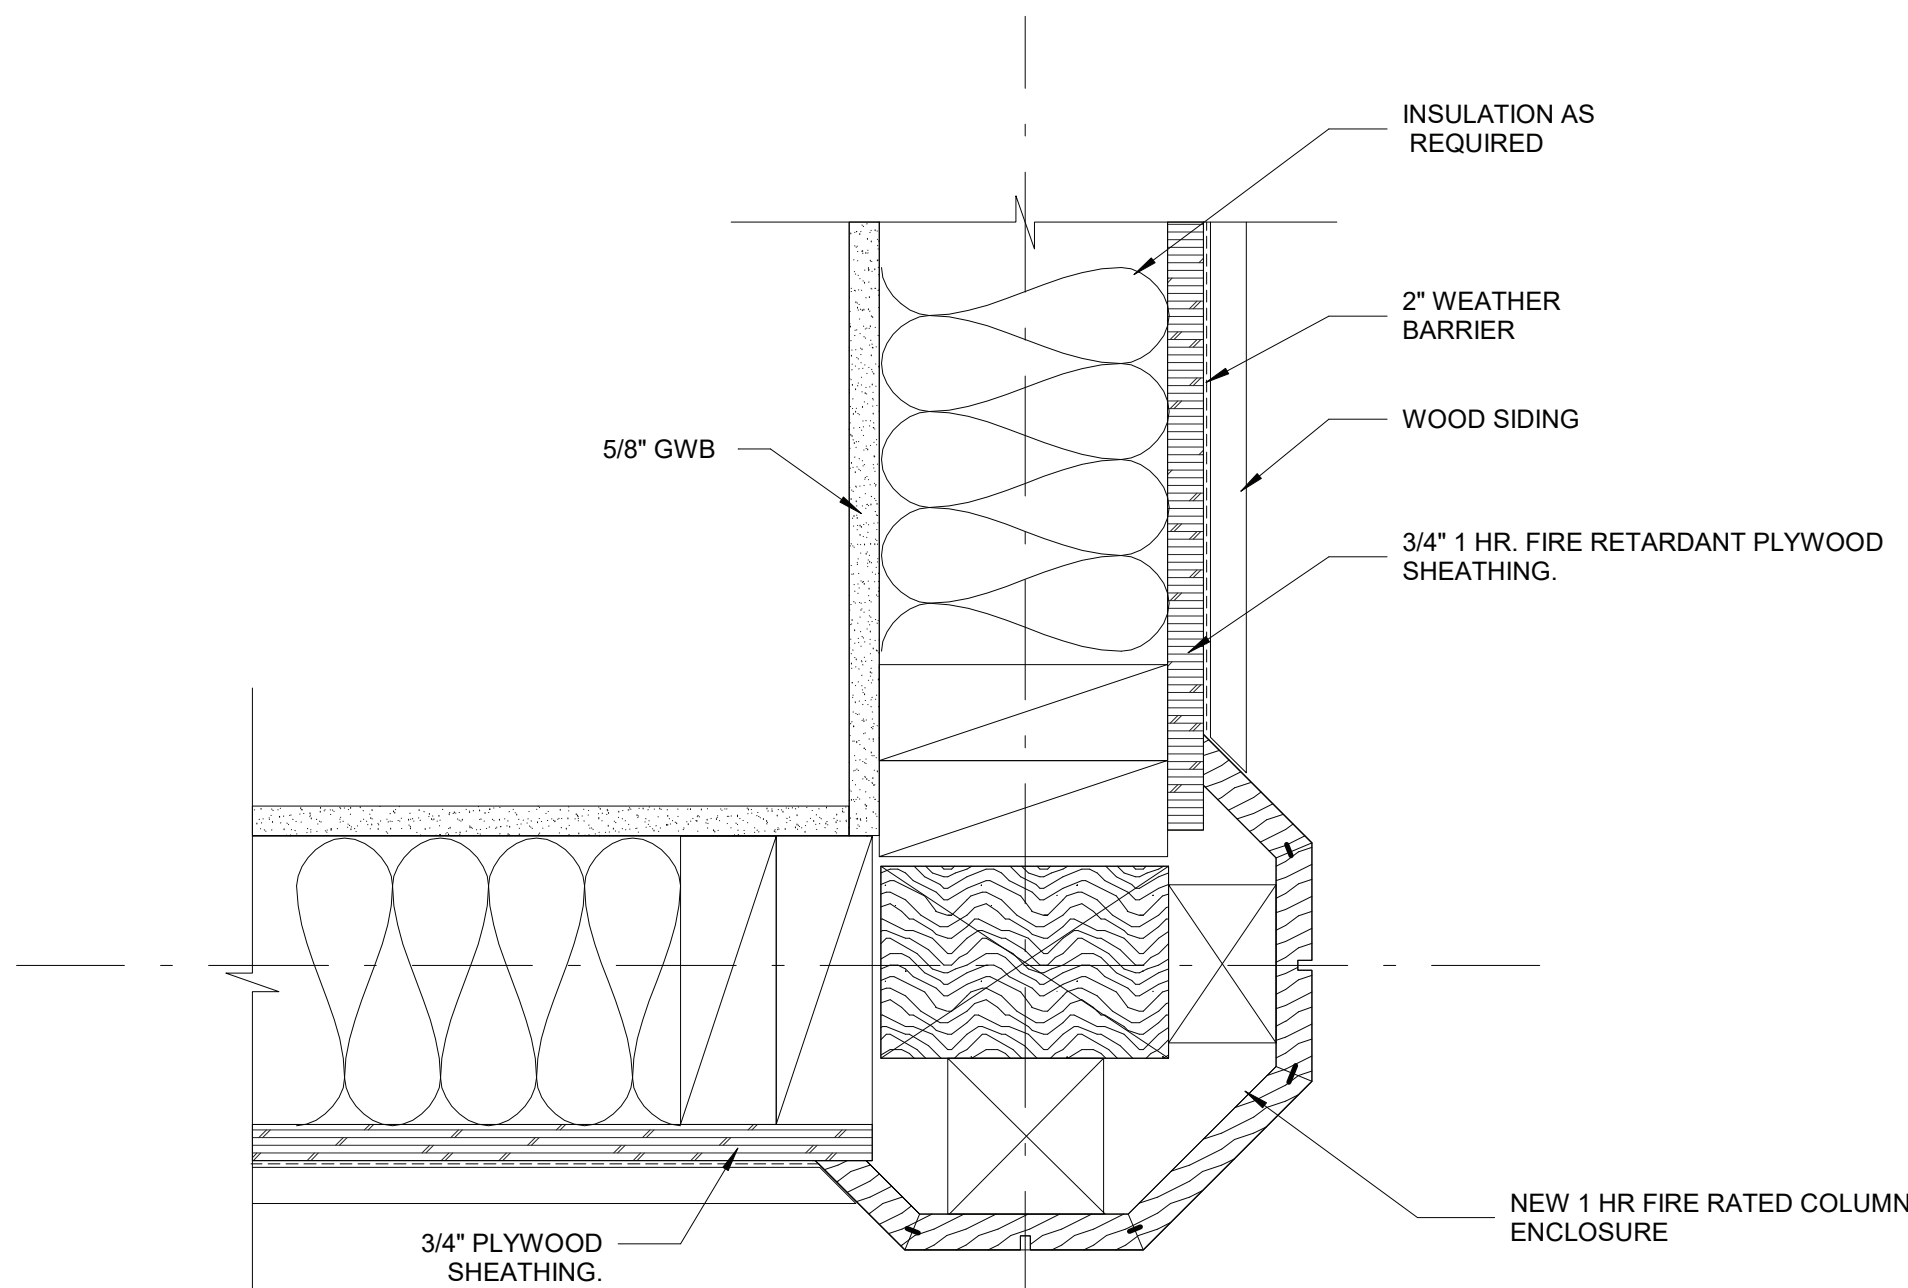


7 COLUMN C ELEVATION - COLUMN BASE
3" = 1'-0"

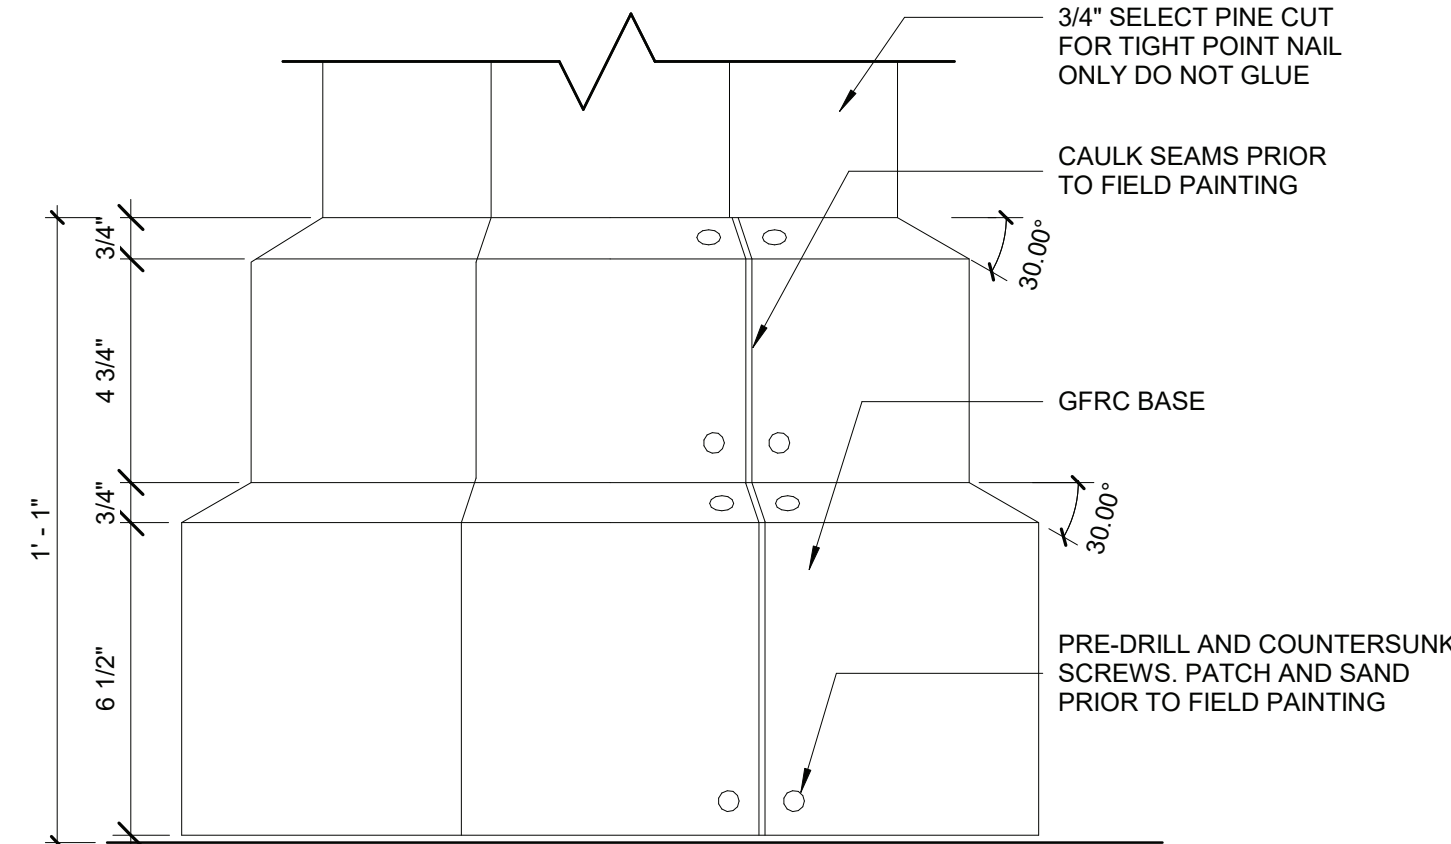

8 COLUMN C SECTION - COLUMN BASE
3" = 1'-0"

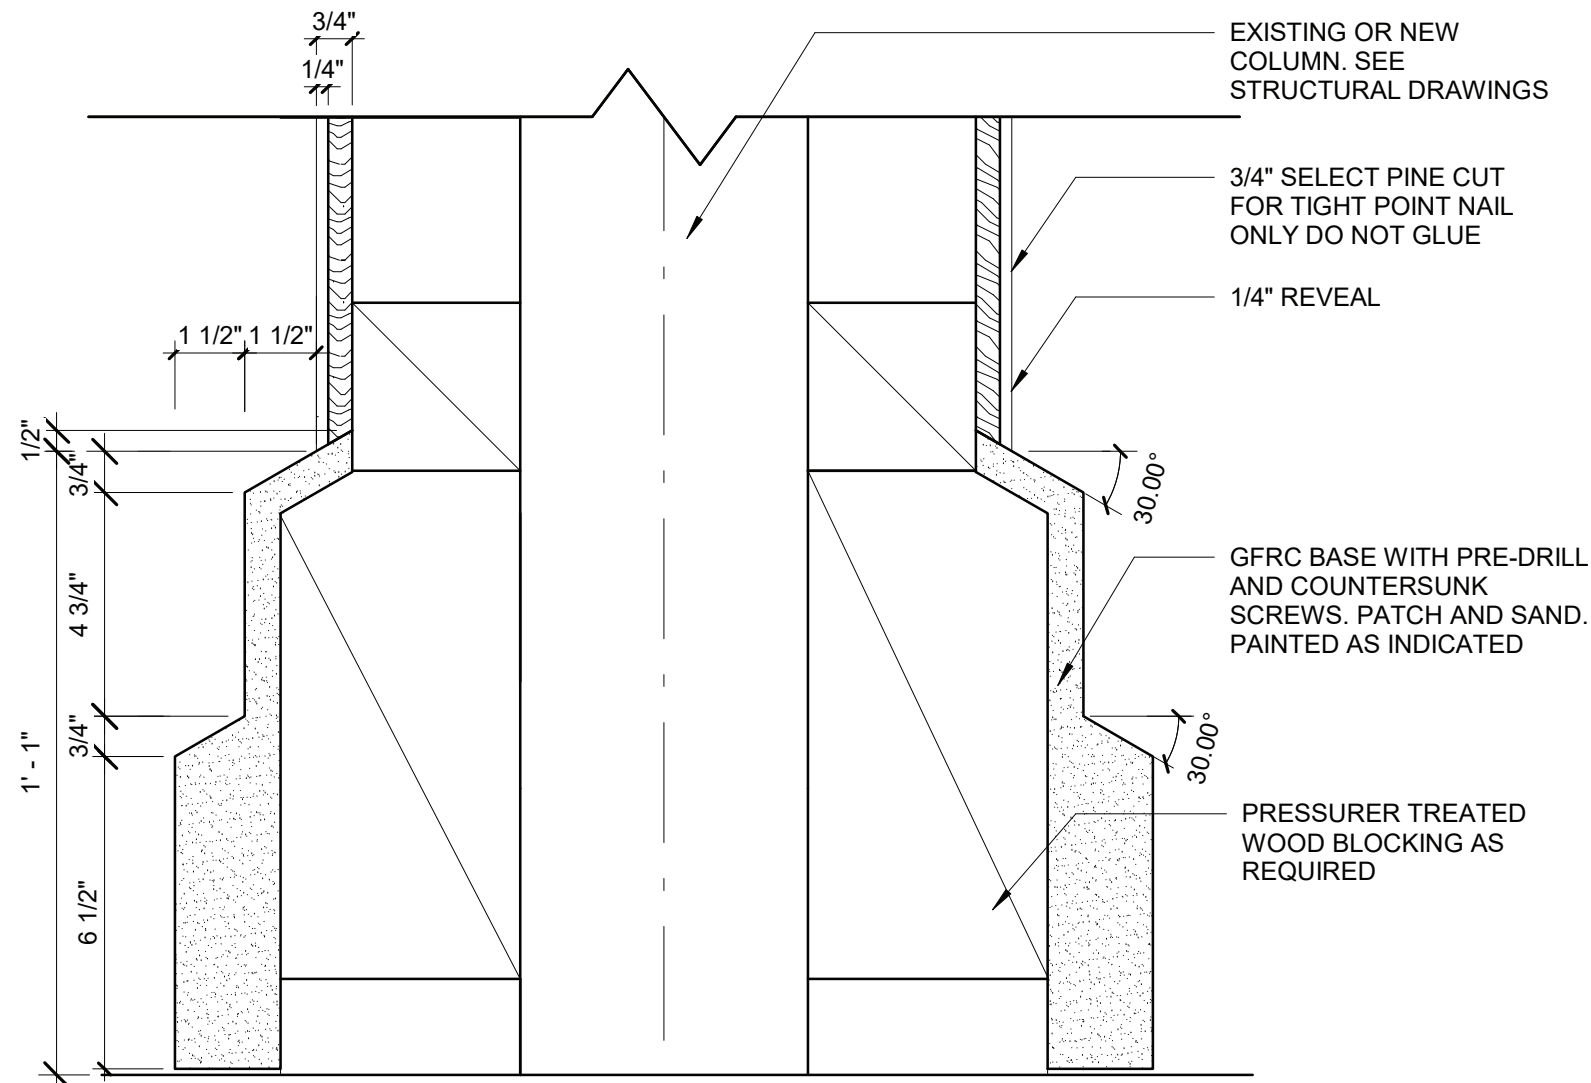

9 INTERIOR COLUMN ENCLOSURE DETAIL
3" = 1'-0"

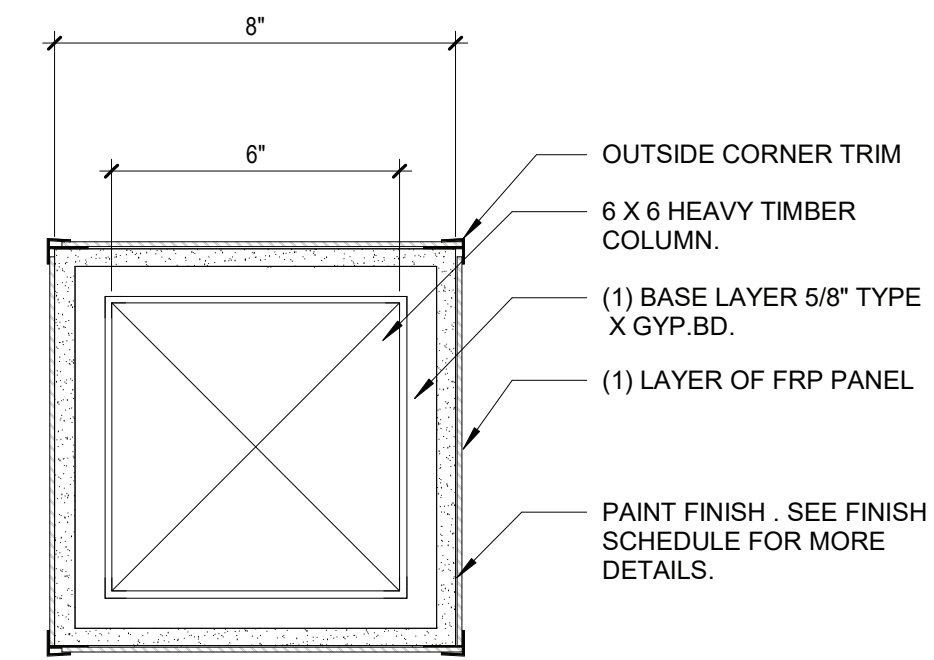

- NOTES:
1. KILN DRIED WOOD IS TO BE USED FOR COLUMN CLADDINGS.
 2. PRESSURE-TREATED WOOD ARE TO BE USED FOR BLOCKING SUBSTRATE AS REQUIRED BY CLADDING INSTALLATIONS.
 3. STAINLESS STEEL NAILS FASTENERS ARE TO BE USED FOR CLADDING, BLOCKING INSTALLATIONS.
 4. HARDWOOD IS TO BE USED FOR SPLINE SHIM CLADDING CONNECTION.
 5. SPLICE WOOD CLADDING PANEL OF INDIVIDUAL PIECES WHEN PANEL WIDTH EXCEEDS WIDTH OF WOOD PLANK AVAILABLE
 6. ALL DIMENSIONS TO BE VERIFIED IN FIELD

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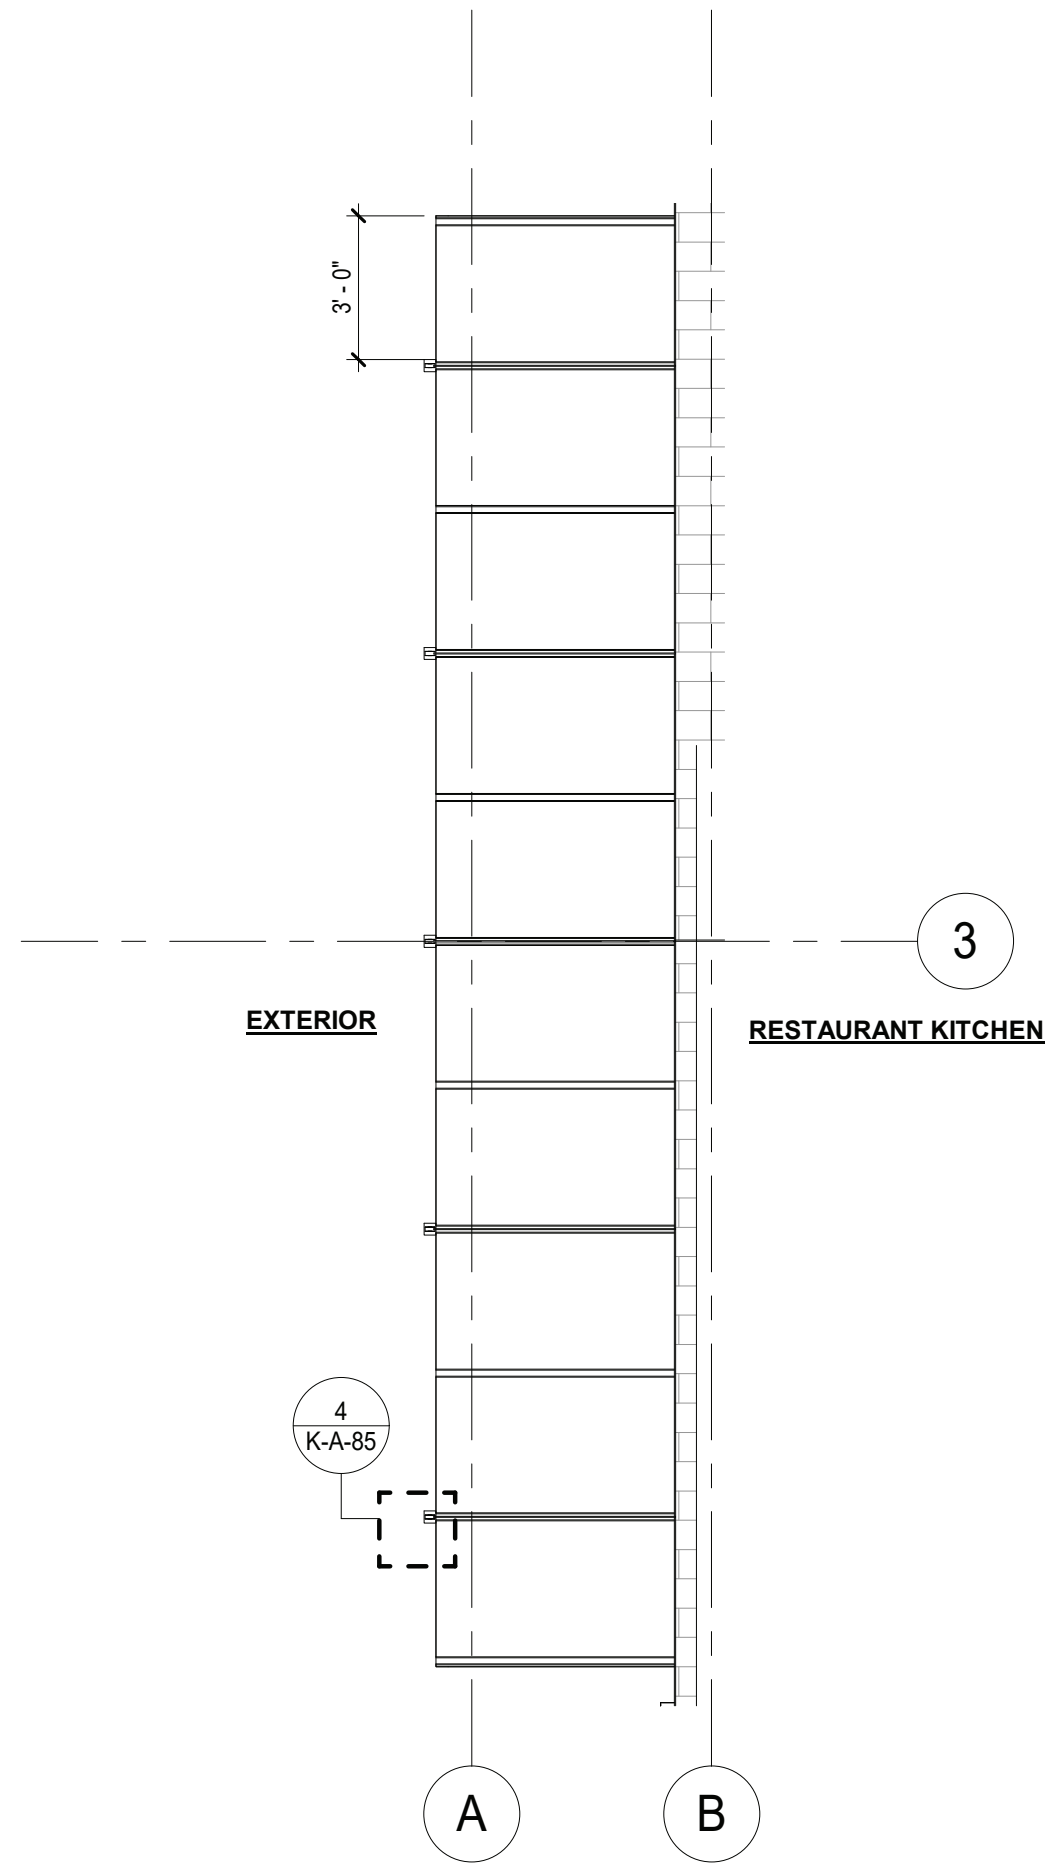


REVISION NUMBER	DATE	MADE BY	APP'D BY	REVISION


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CONTRACTOR		PROJECT COORDINATOR	
NAME		NAME	
SIGNATURE		SIGNATURE	
TITLE		TITLE	
DATE		DATE	

WESTCHESTER COUNTY, NEW YORK
DEPARTMENT OF PUBLIC WORKS AND TRANSPORTATION
DIVISION OF ENGINEERING
**INFRASTRUCTURE REHABILITATION
PLAYLAND PARK, RYE, NEW YORK
RESTAURANT KITCHEN WITH FOOD VENDING
COLUMN DETAILS**


CONTRACT NUMBER 22-523	SHEET NUMBER K-A-84
DWG NO.: 519 of 664	SCALE: As indicated
DATE: 8/23/20223	REV. NO. 0
DPW FILE NUMBER 1-118-A-1268-0	




1 OVER HUNG CANOPY PARTIAL PLAN
1/4" = 1'-0"

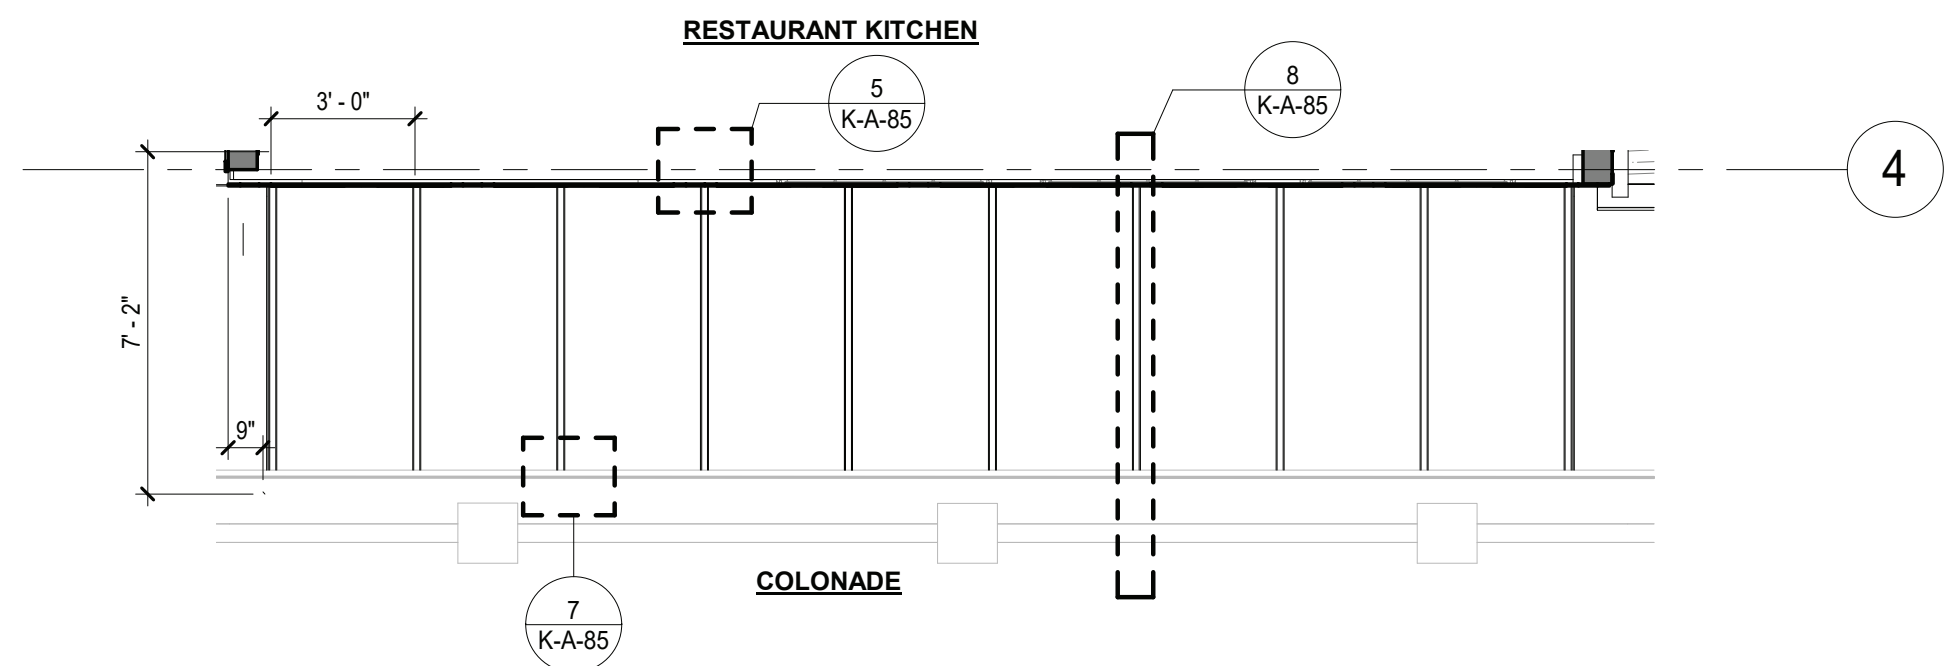


2 CANOPY AT COLNADE PARTIAL PLAN
1/4" = 1'-0"

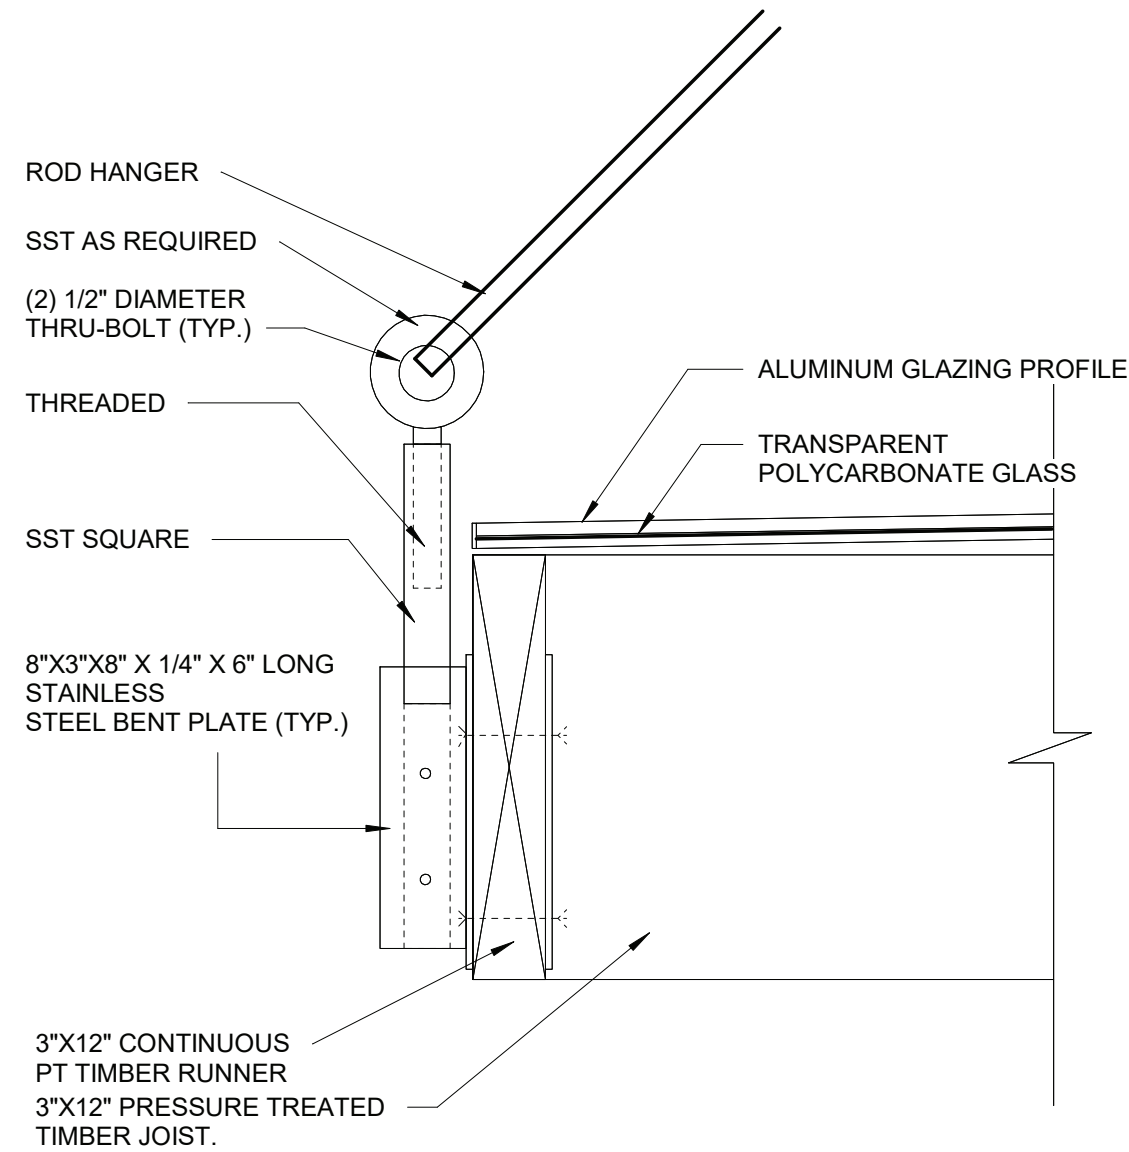


4 GUY WIRE EYE BOLT CONNECTION AT TIMBER RUNNER
3/8" = 1'-0"

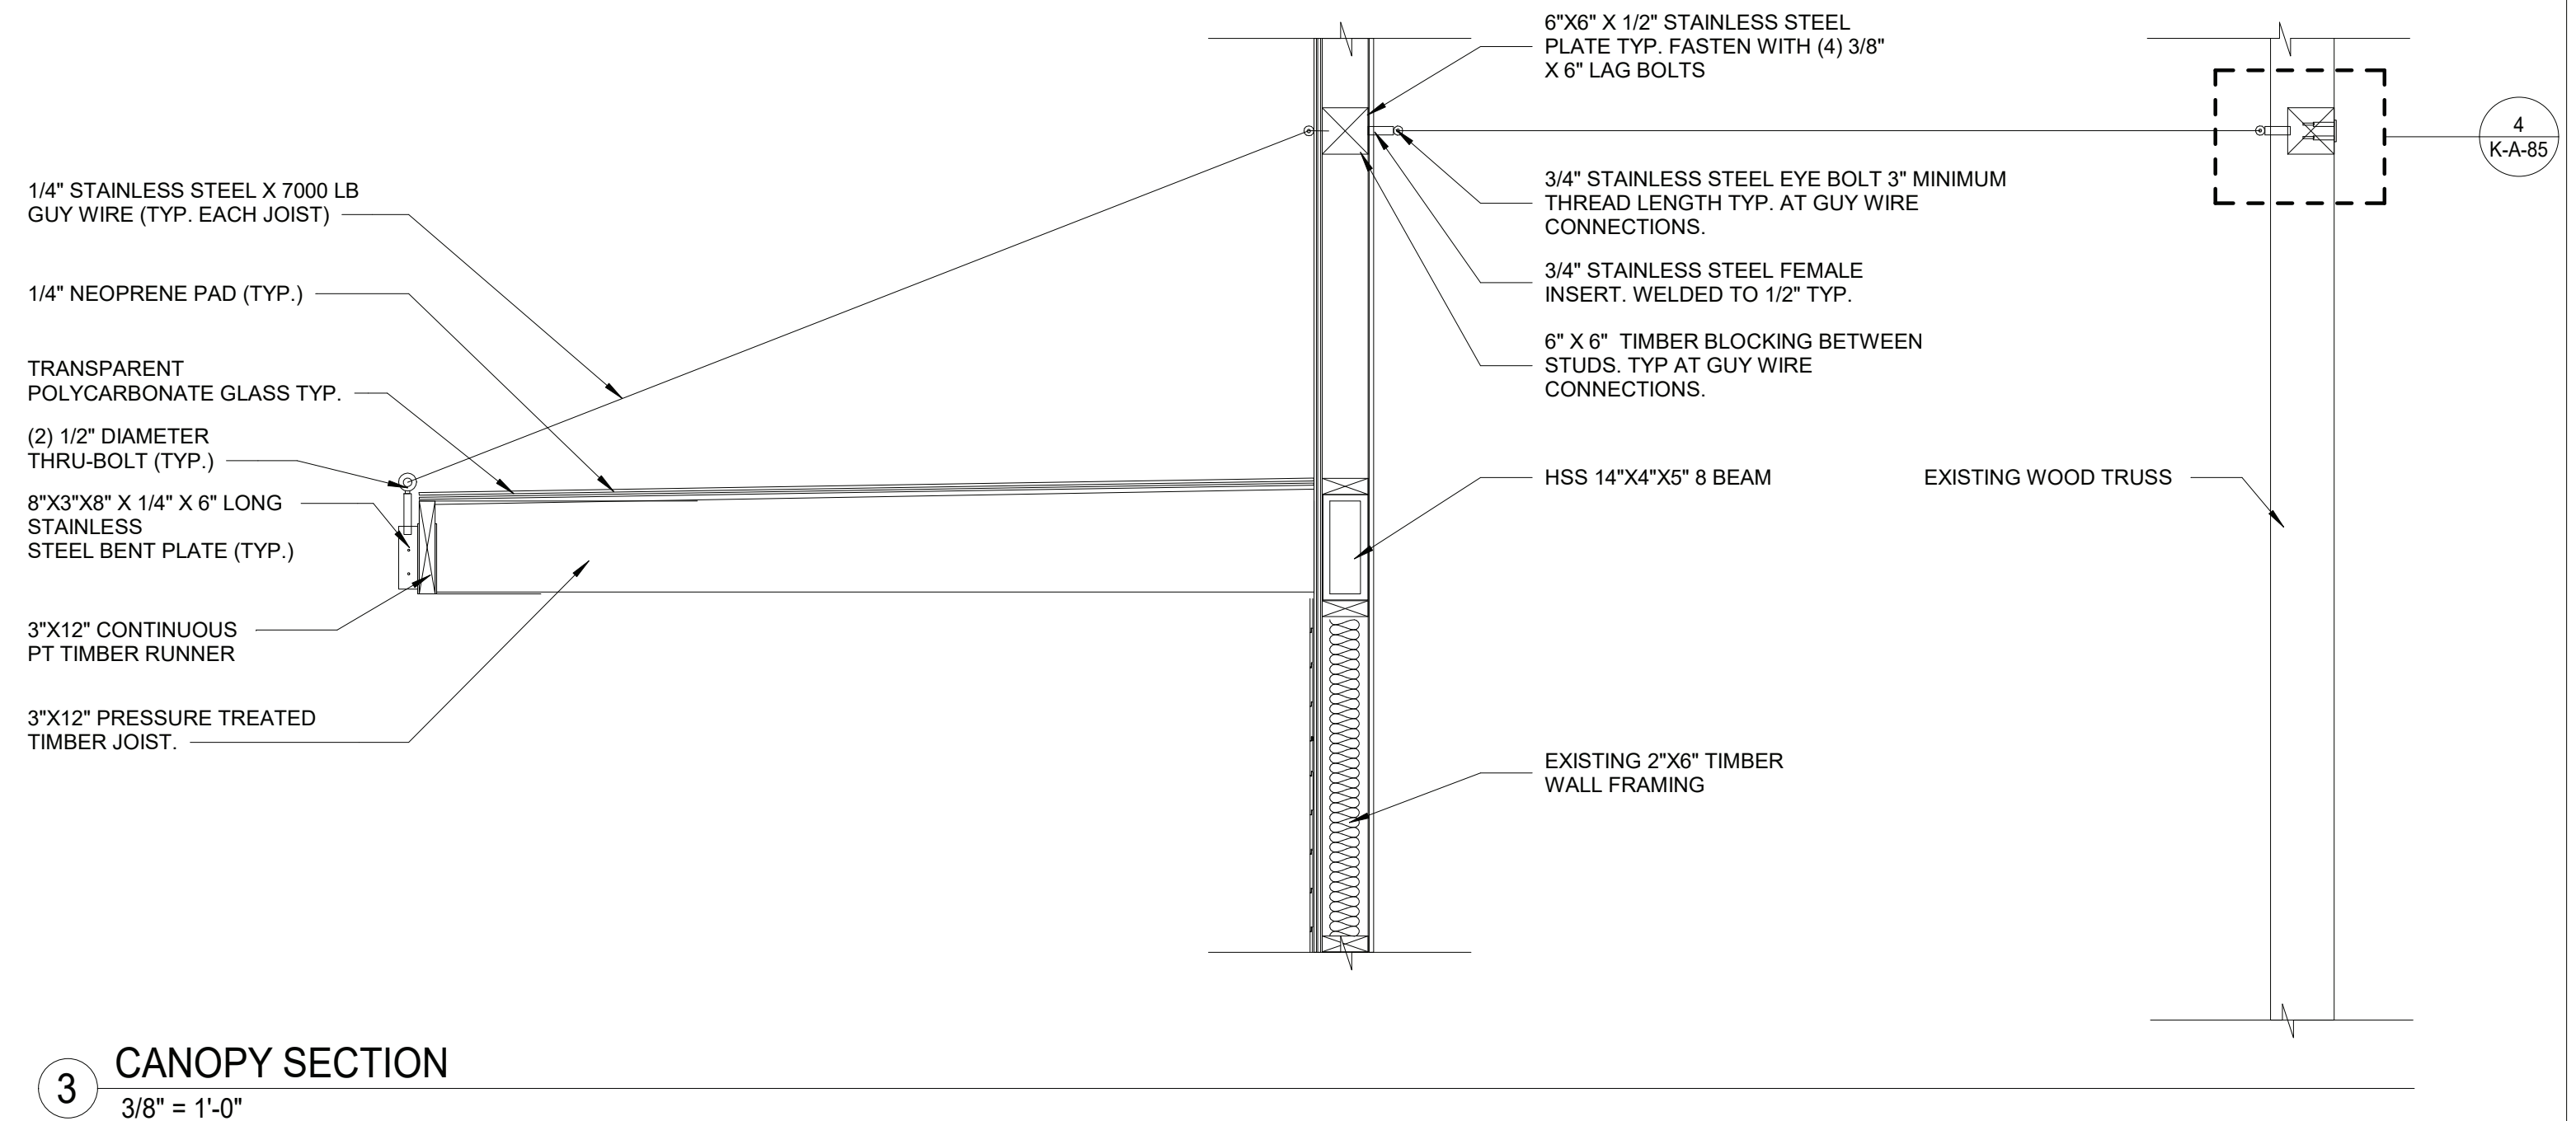


3 CANOPY SECTION
3/8" = 1'-0"

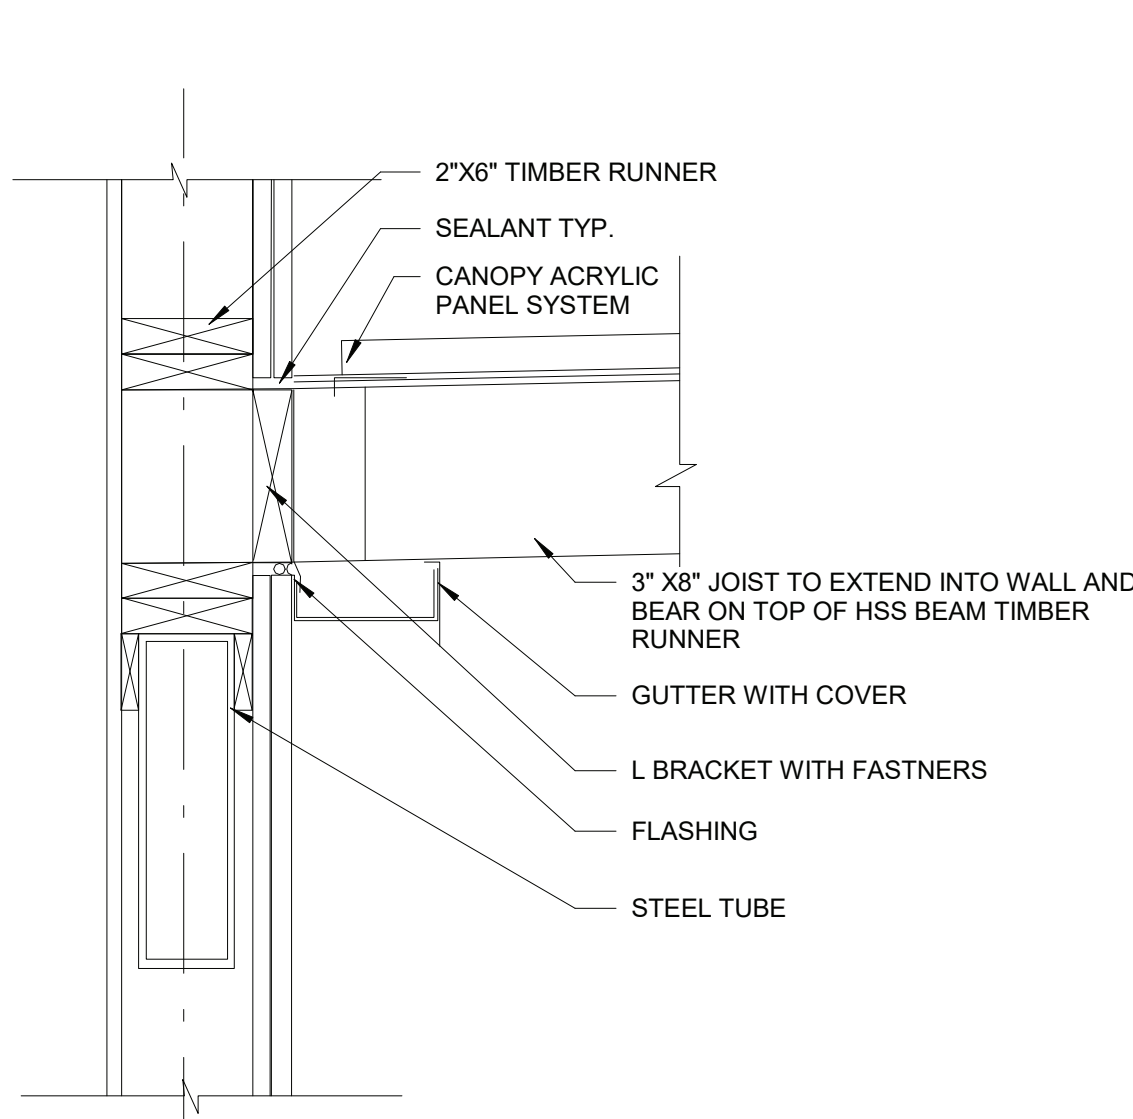


5 BUILDING TO CANOPY CONNECTION DETAIL
1 1/2" = 1'-0"

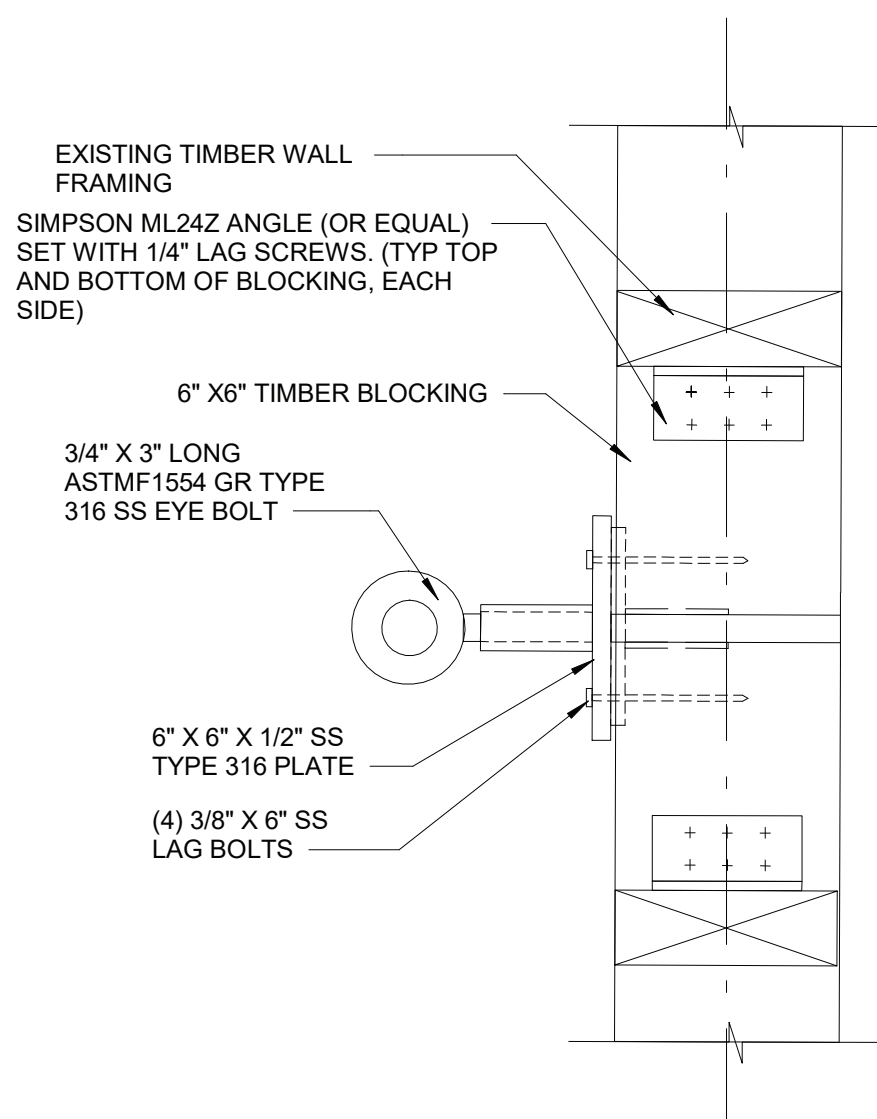

6 GUY WIRE CONNECTION AT TIMBER WALL
3/8" = 1'-0"

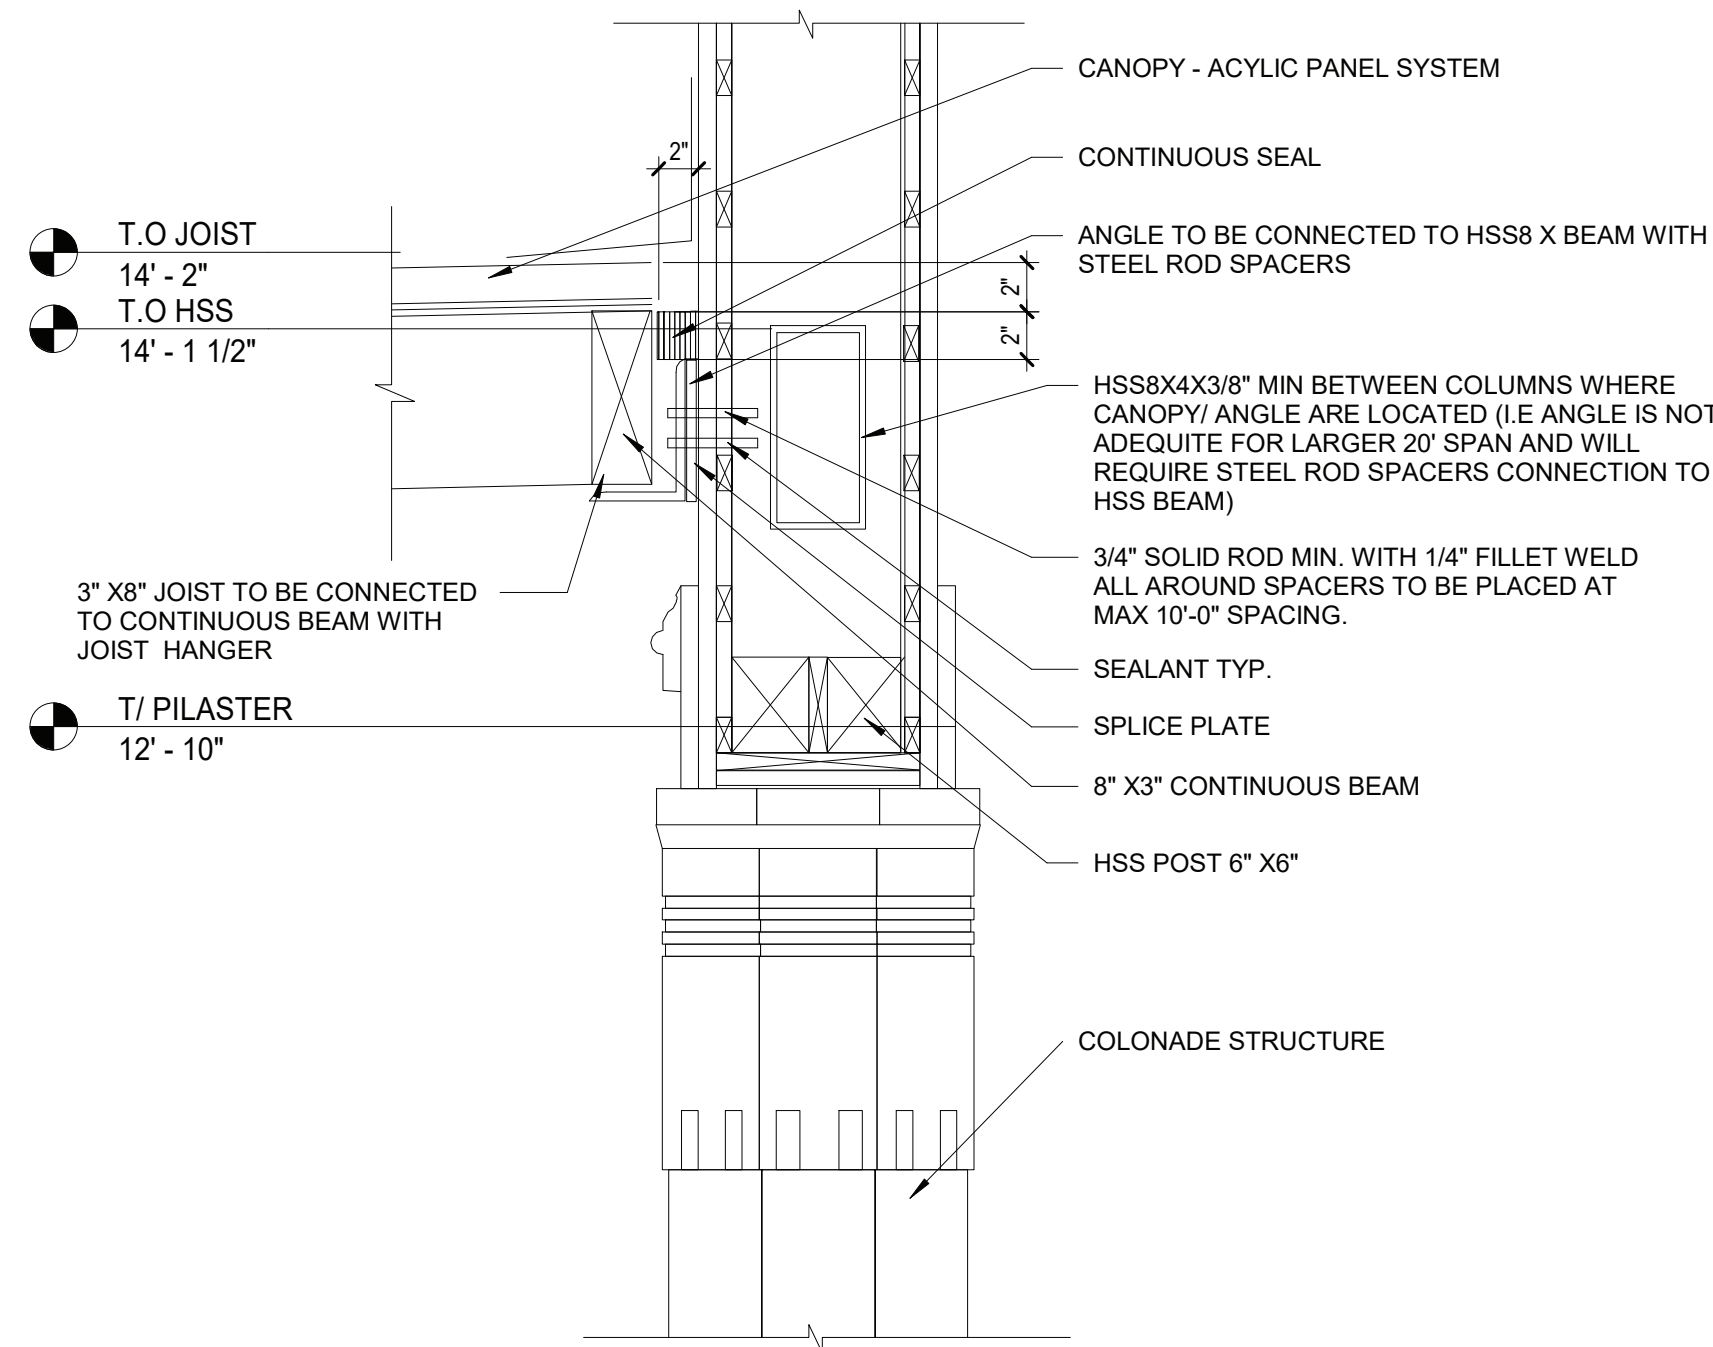

7 CANOPY TO COLNADE CONNECTION DETAIL
1 1/2" = 1'-0"

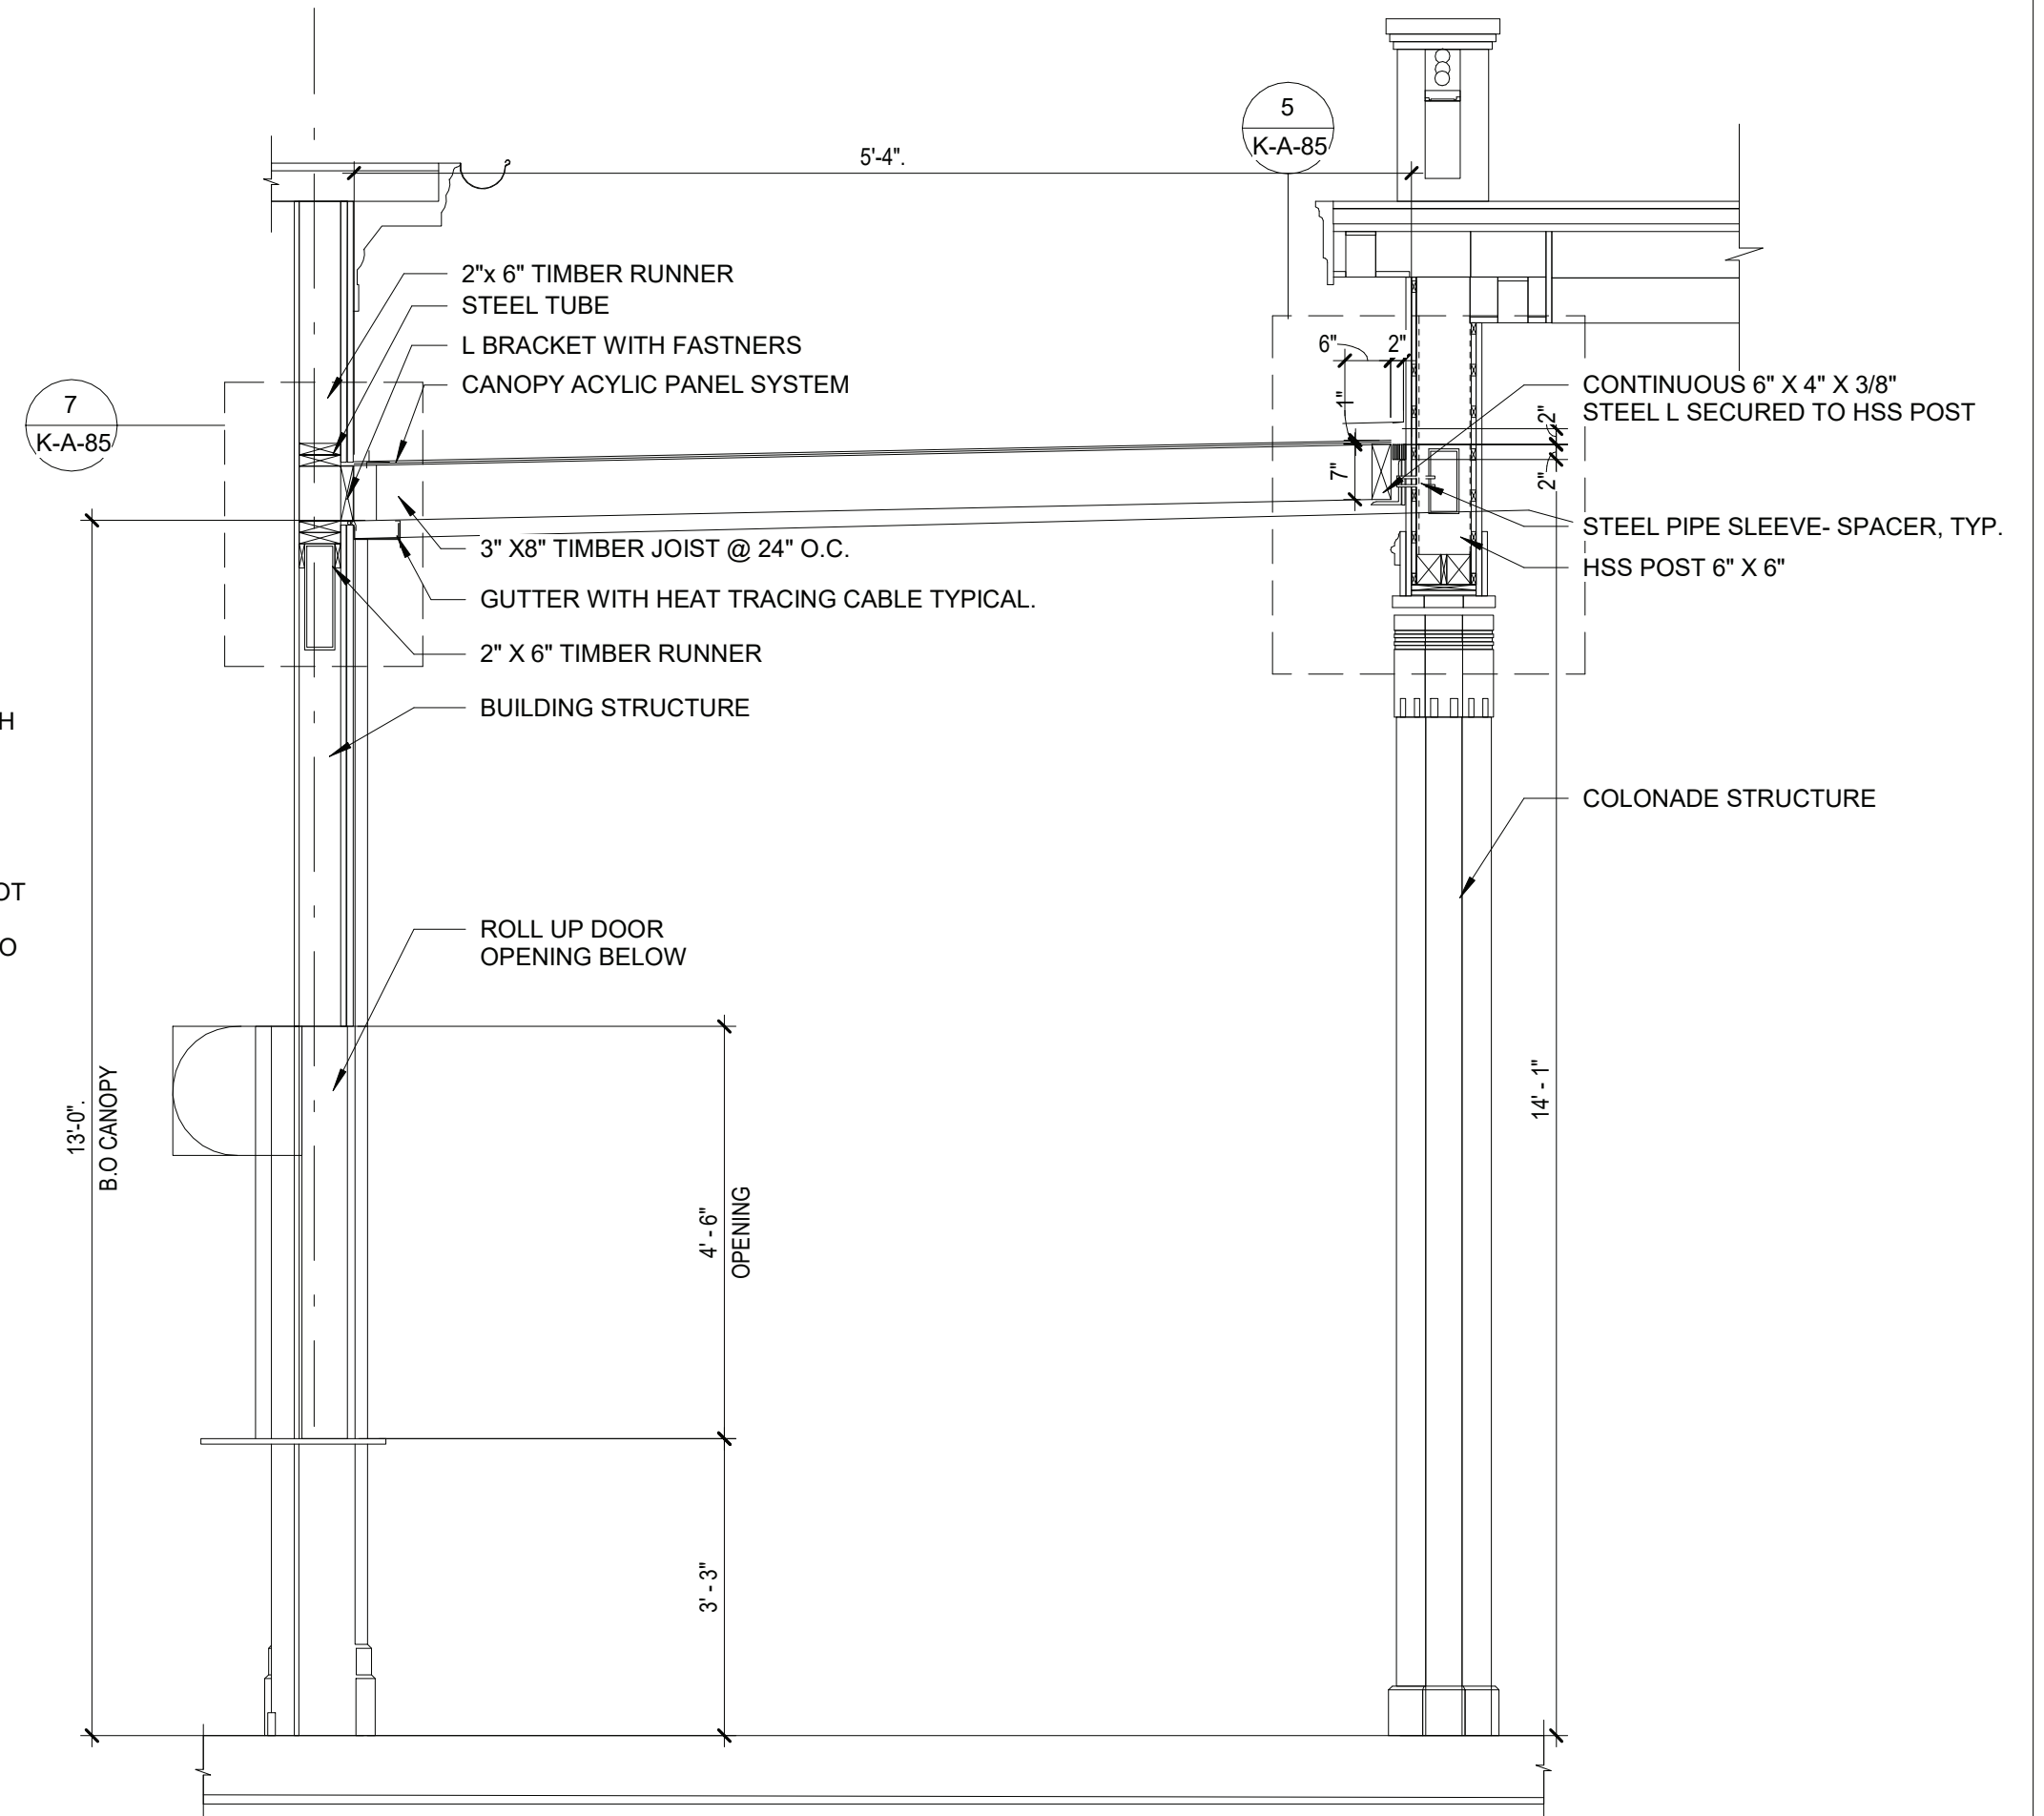

8 CANOPY TO COLNADE SECTION
1/2" = 1'-0"

POLYCARBONATE GLAZING SYSTEM
POLYCARBONATE PANELS:
5/32" (4MM) THICK
23.625" (600MM) PANEL WIDTH
TRANSPARENT (LIGHT BLUE TINT)
70% LIGHT TRANSMISSION
EXTRUDED ALUMINUM MULLION SYSTEM
BASIS OF DESIGN: PALRAM SUNGLAZE™ 4/600 SYSTEM

8/30/2022 2:51:59 PM

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CONTRACTOR

NAME
SIGNATURE
TITLE

PROJECT COORDINATOR

NAME
SIGNATURE
TITLE

WESTCHESTER COUNTY, NEW YORK
DEPARTMENT OF PUBLIC WORKS AND TRANSPORTATION
DIVISION OF ENGINEERING

INFRASTRUCTURE REHABILITATION
PLAYLAND PARK, RYE, NEW YORK
RESTAURANT KITCHEN WITH FOOD VENDING
CANOPY DETAILS

CONTRACT
NUMBER

22-523

SHEET
NUMBER

K-A-85


DWG NO.: 520 of 664

SCALE: As indicated


DATE: 8/23/20223

DPW FILE
NUMBER 1-118-A-1269-0


REV.
NO. 0

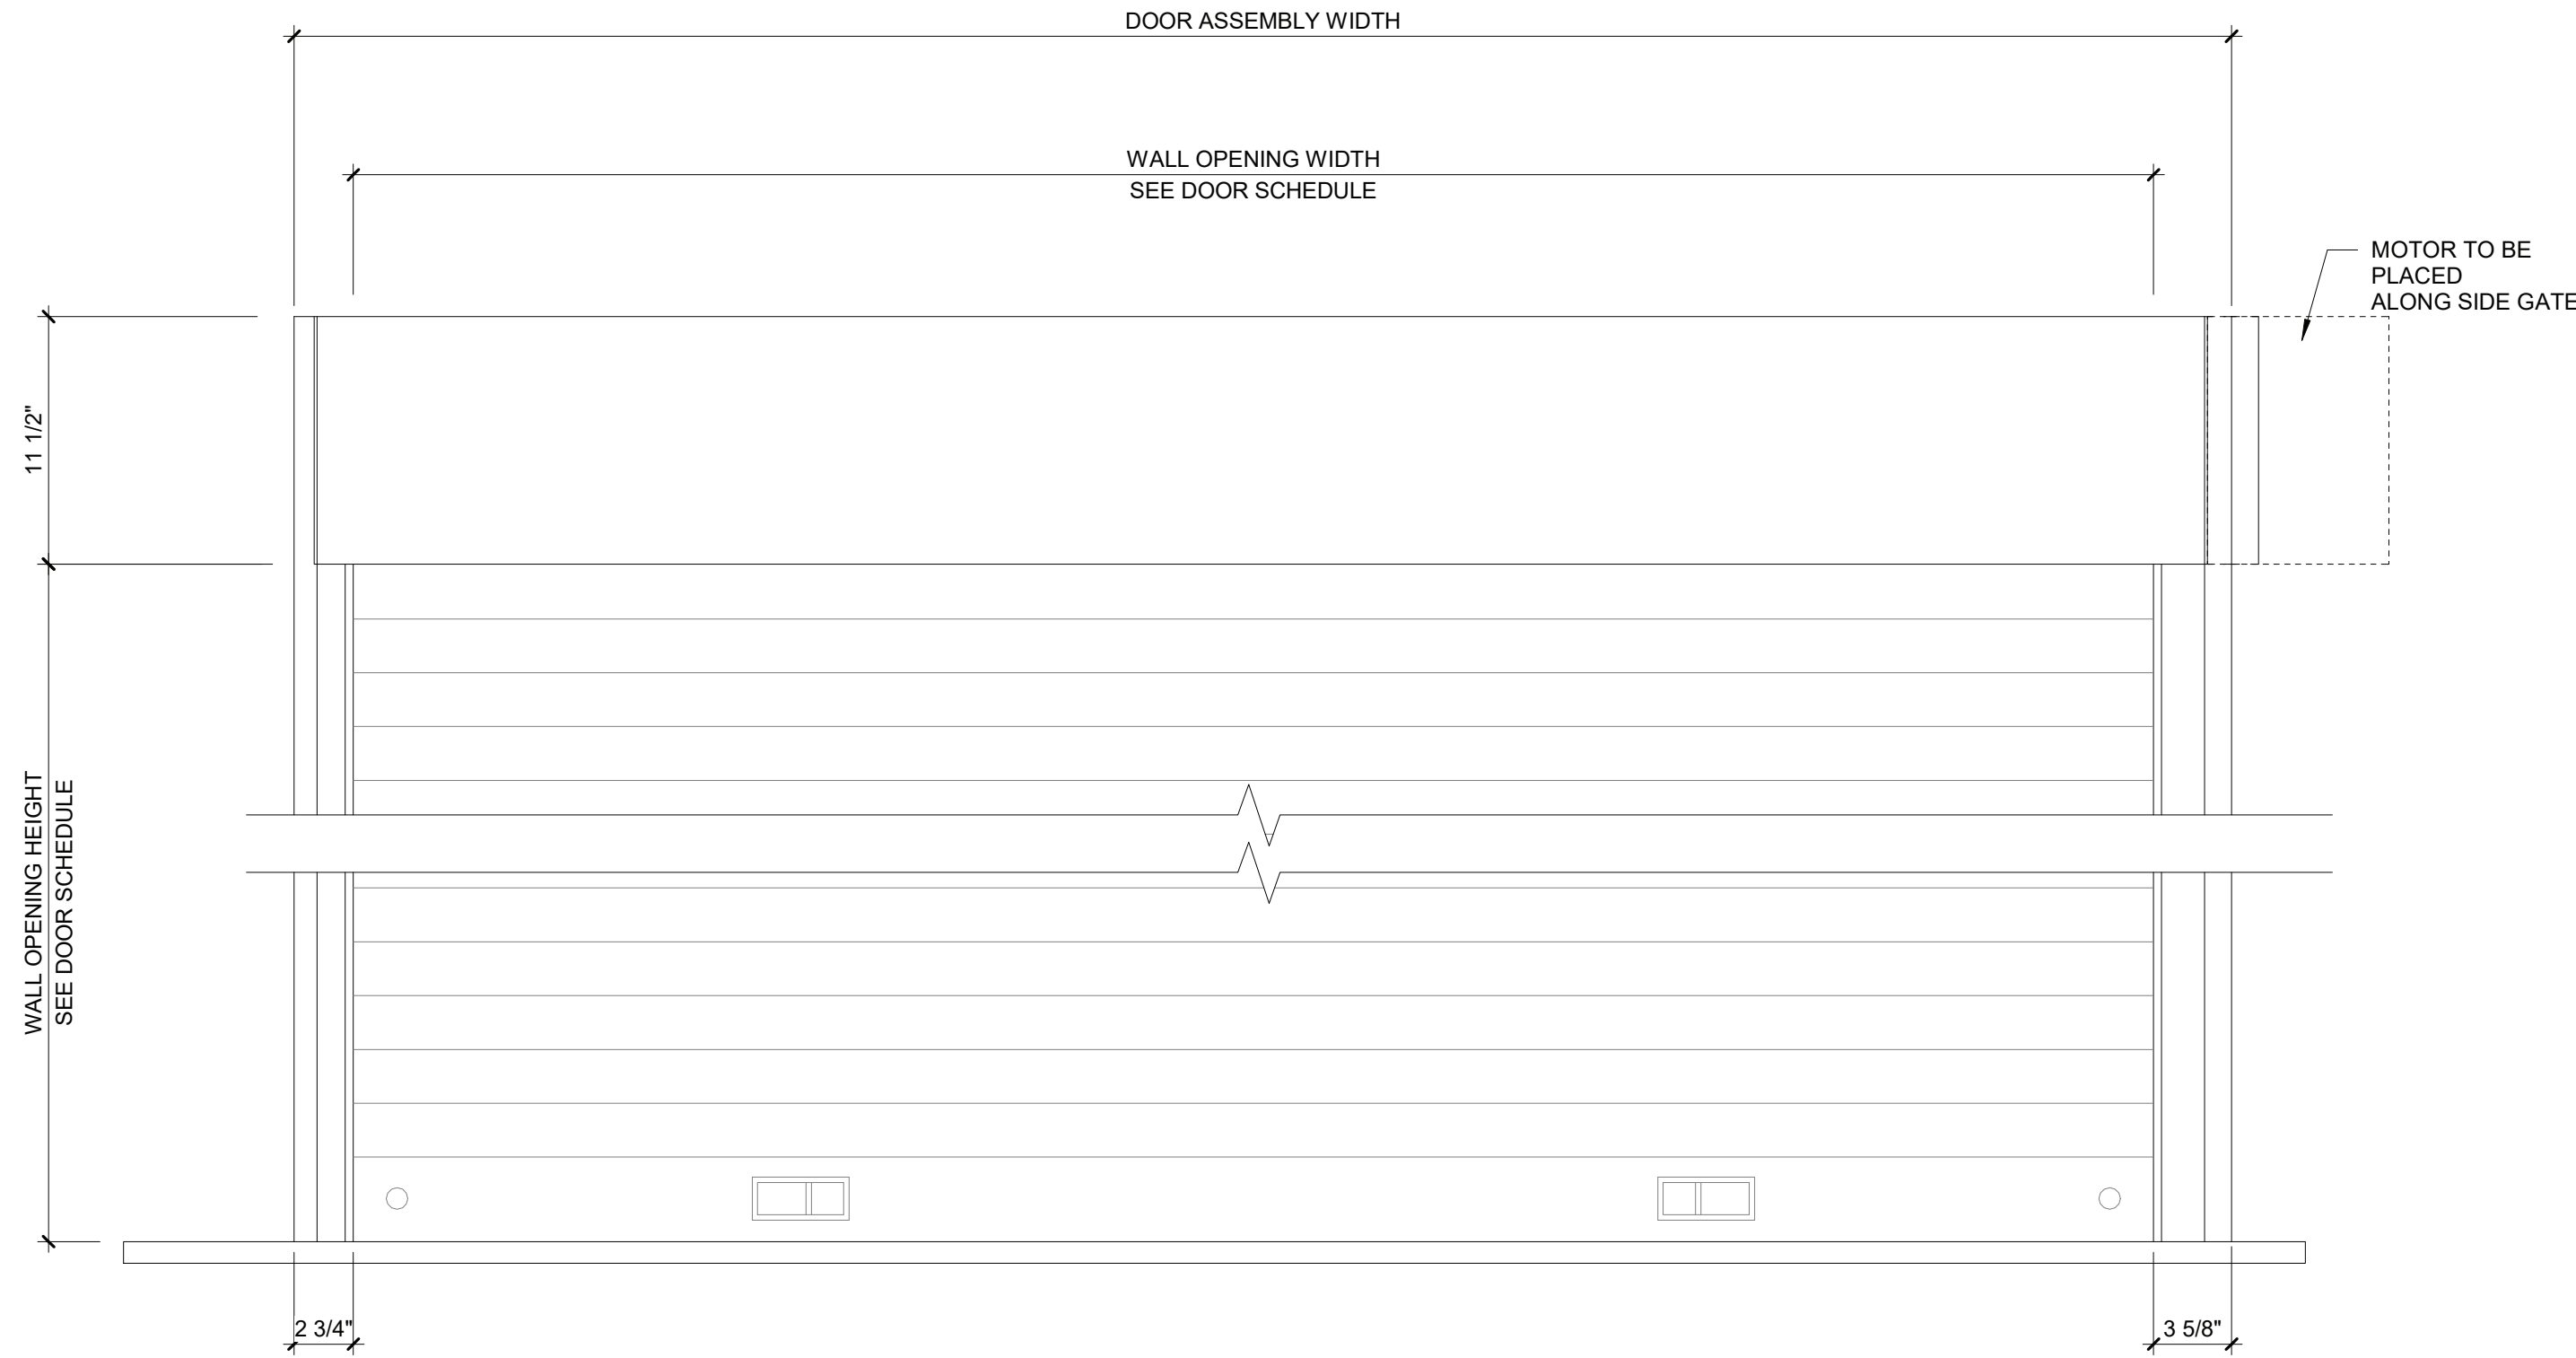


1 COUNTER ROLL UP ELEVATION
1 1/2" = 1'-0"

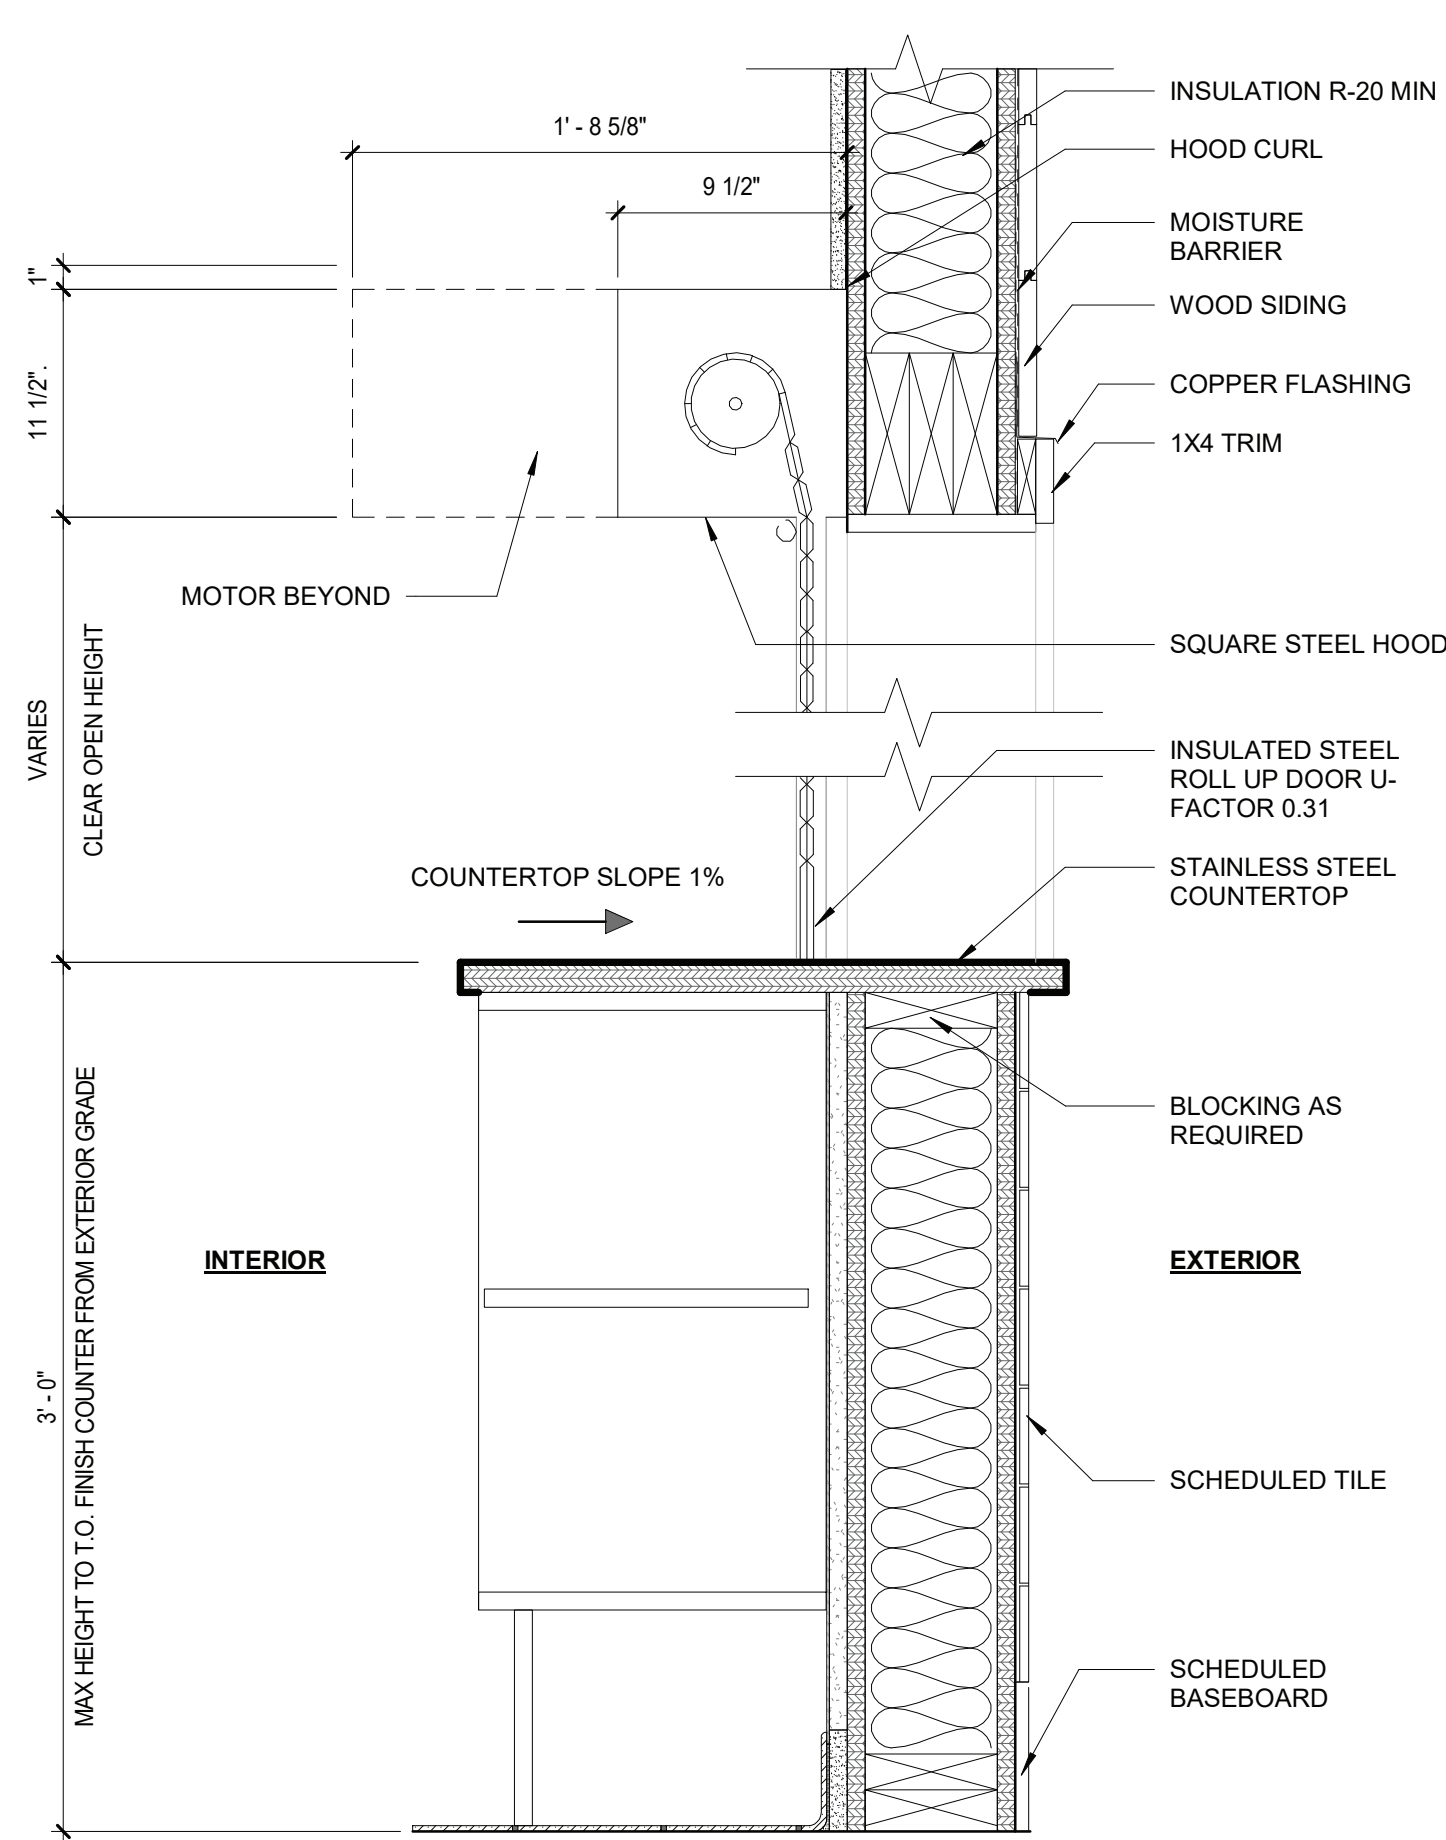


2 COUNTER ROLL UP DOOR SECTION
1 1/2" = 1'-0"

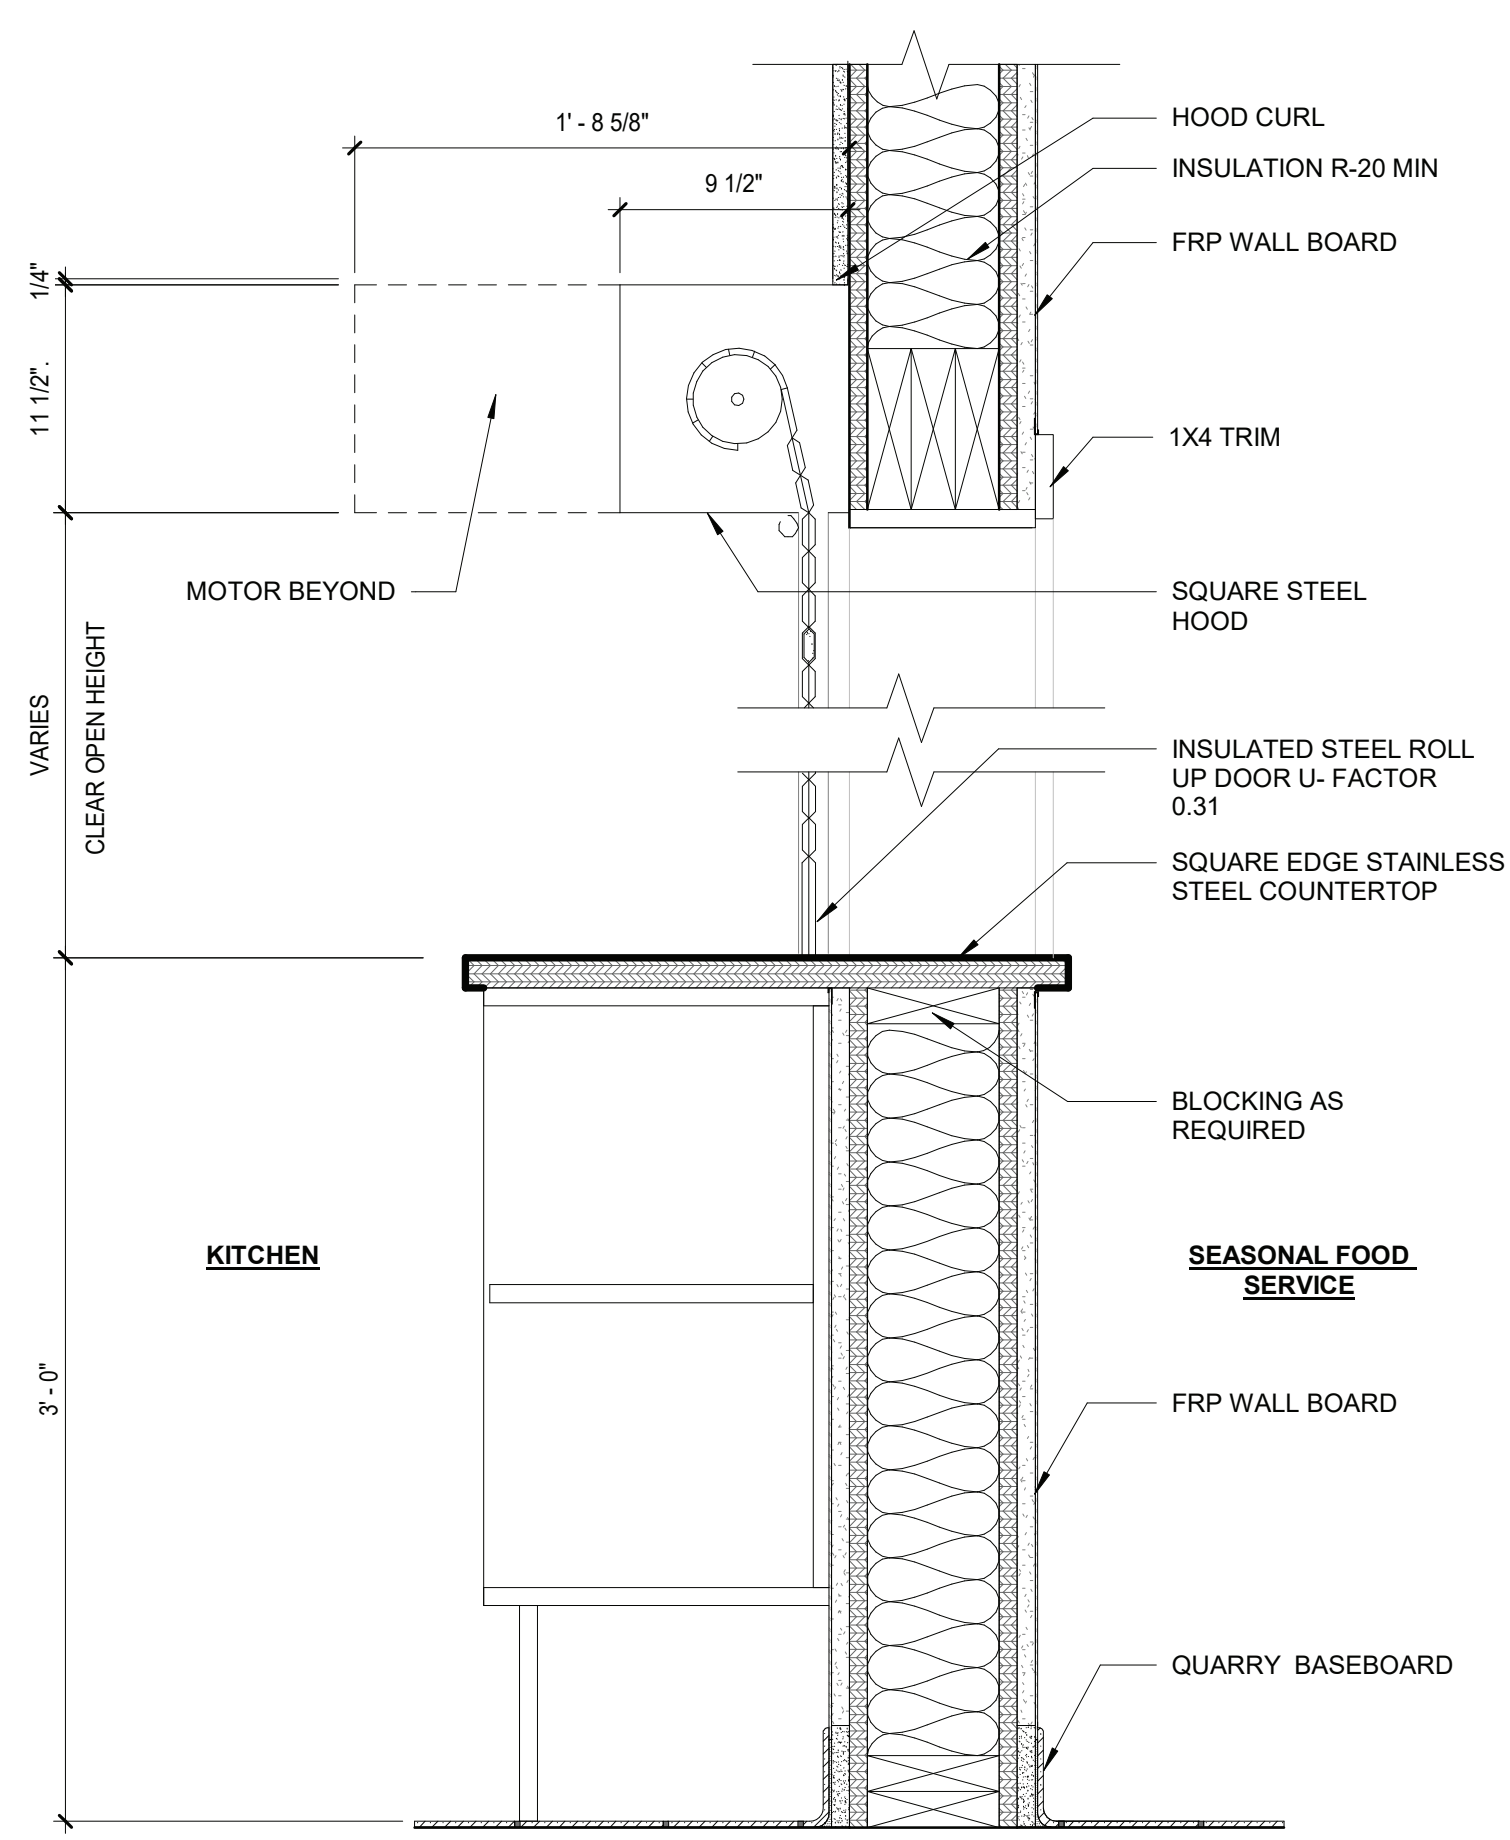

5 COUNTER ROLL UP DOOR SECTION B
1 1/2" = 1'-0"

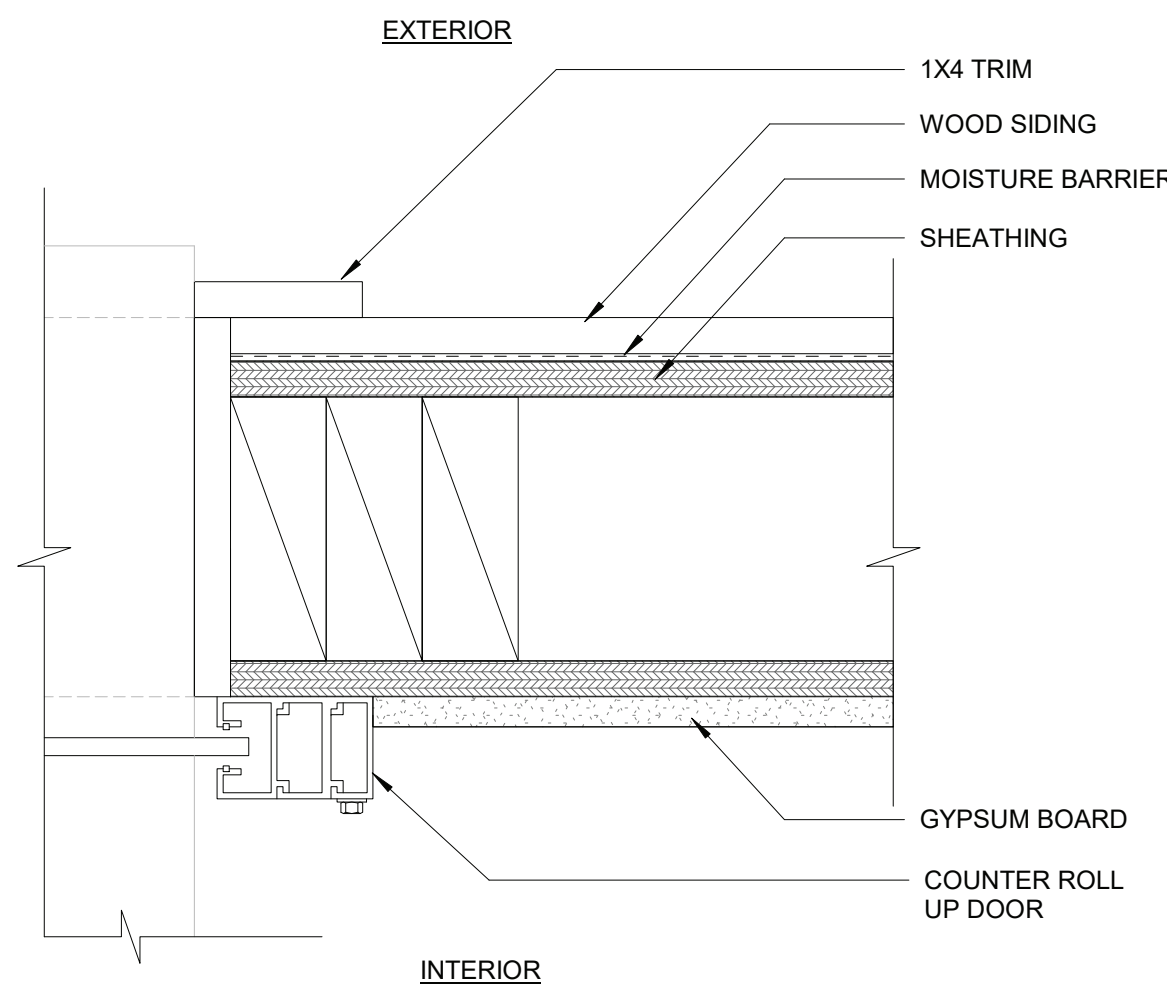

6 ROLL UP JAMB DETAIL
3" = 1'-0"

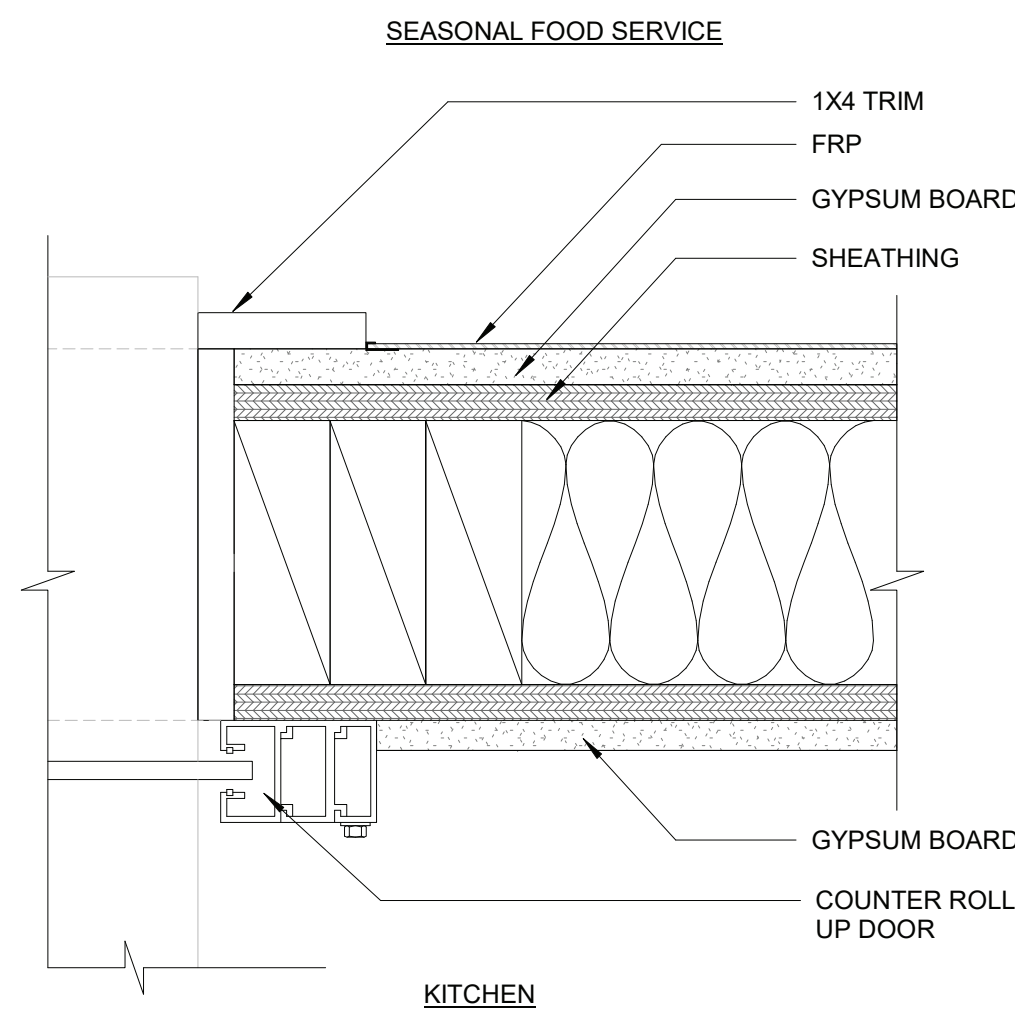

7 ROLL UP JAMB DETAIL B
3" = 1'-0"

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REVISION NUMBER	DATE	MADE BY	APP'D BY	REVISION

RECORD DRAWING CERTIFICATION

☐ AS BUILT – CHANGES AS NOTED

☐ AS BUILT – NO CHANGES

CONTRACTOR

NAME _____
SIGNATURE _____
TITLE _____ DATE _____

PROJECT COORDINATOR

NAME _____
SIGNATURE _____
TITLE _____ DATE _____

WESTCHESTER COUNTY, NEW YORK
DEPARTMENT OF PUBLIC WORKS AND TRANSPORTATION
DIVISION OF ENGINEERING

INFRASTRUCTURE REHABILITATION
PLAYLAND PARK, RYE, NEW YORK
RESTAURANT KITCHEN WITH FOOD VENDING
COUNTER ROLL UP DOOR DETAILS

CONTRACT
NUMBER

22-523

SHEET
NUMBER

K-A-86


DWG NO.: 521 of 664

SCALE: As indicated


DATE: 8/23/20223

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NUMBER 1-118-A-1270-0


REV.
NO. 0

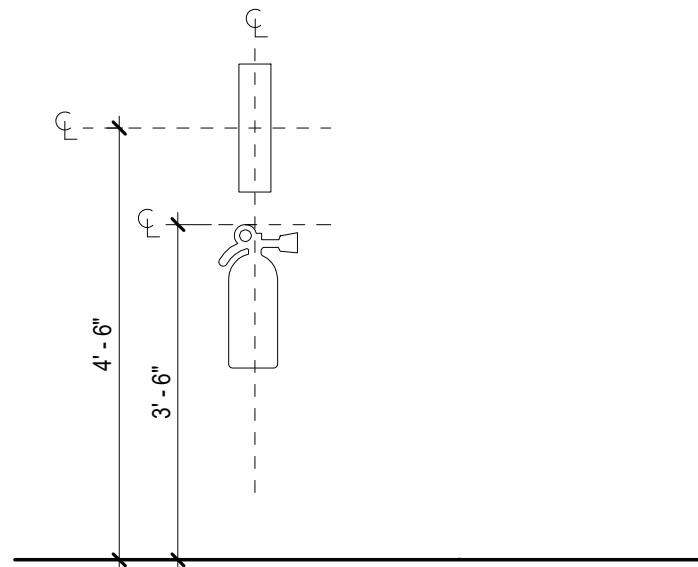


1 FIRE EXTINGUISHER SIGN LOCATION
1/2" = 1'-0"

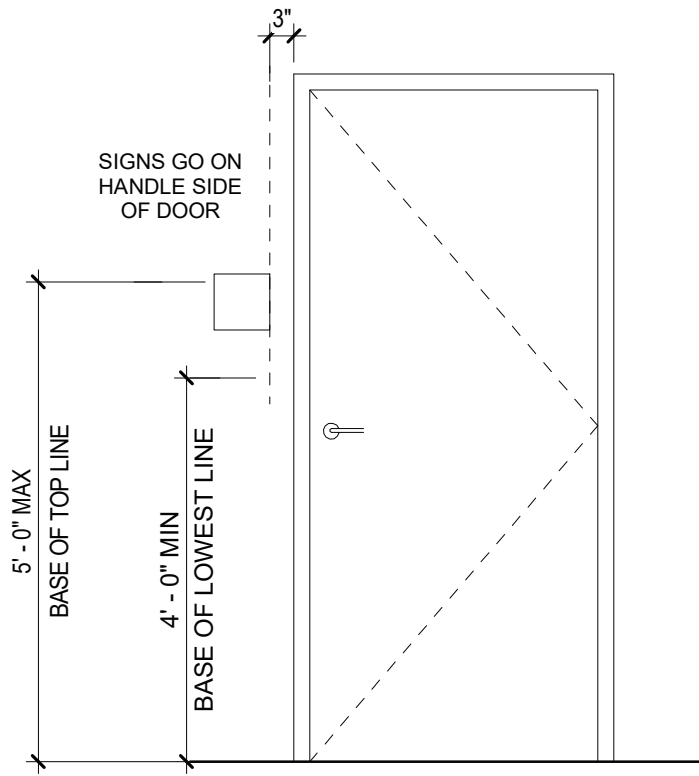


2 SIGN LOCATION ELEVATION TYPICAL DOOR CONDITION
1/2" = 1'-0"

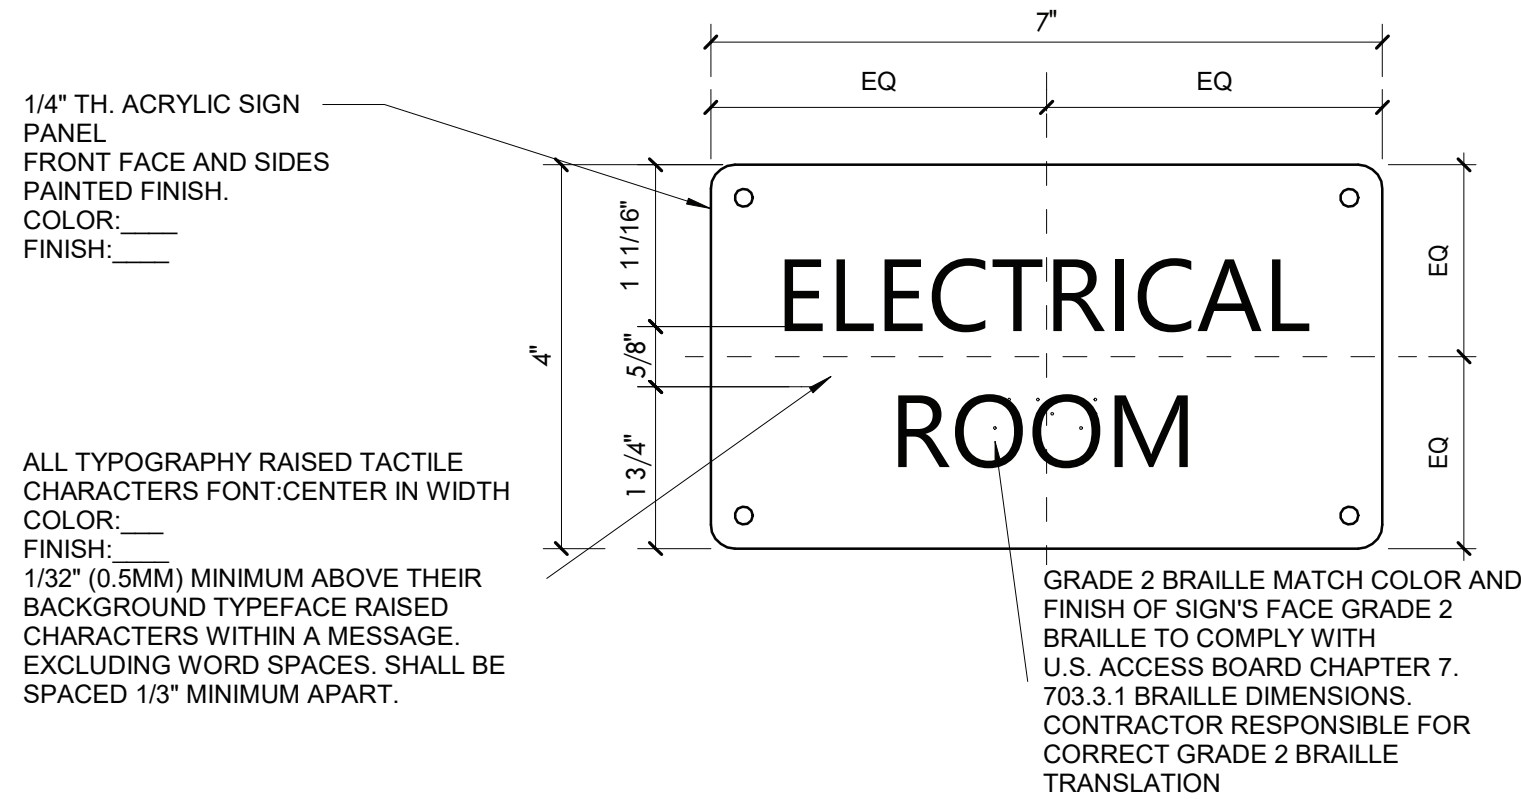


3 TYPE A-1 ELECTRICAL CLOSET SIGN
6" = 1'-0"

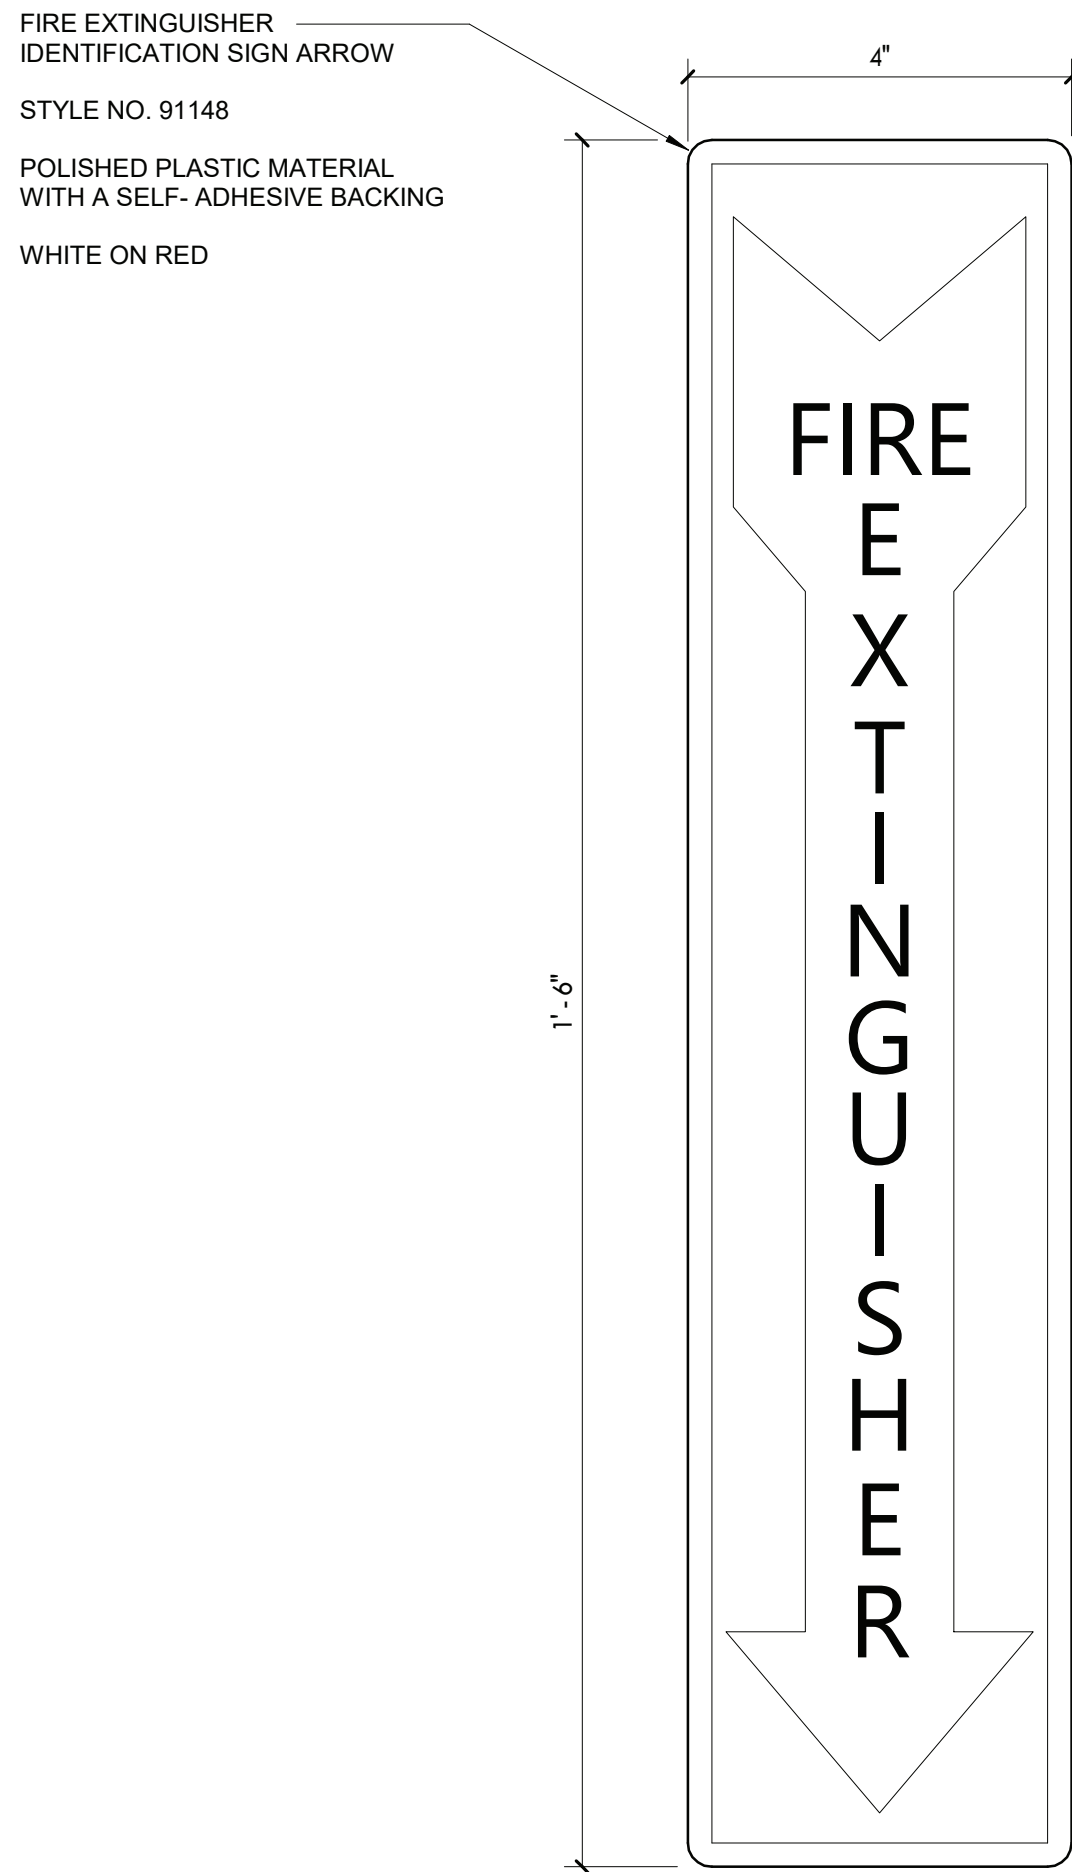

4 TYPE X-1 FIRE EXTINGUISHER SIGN
6" = 1'-0"

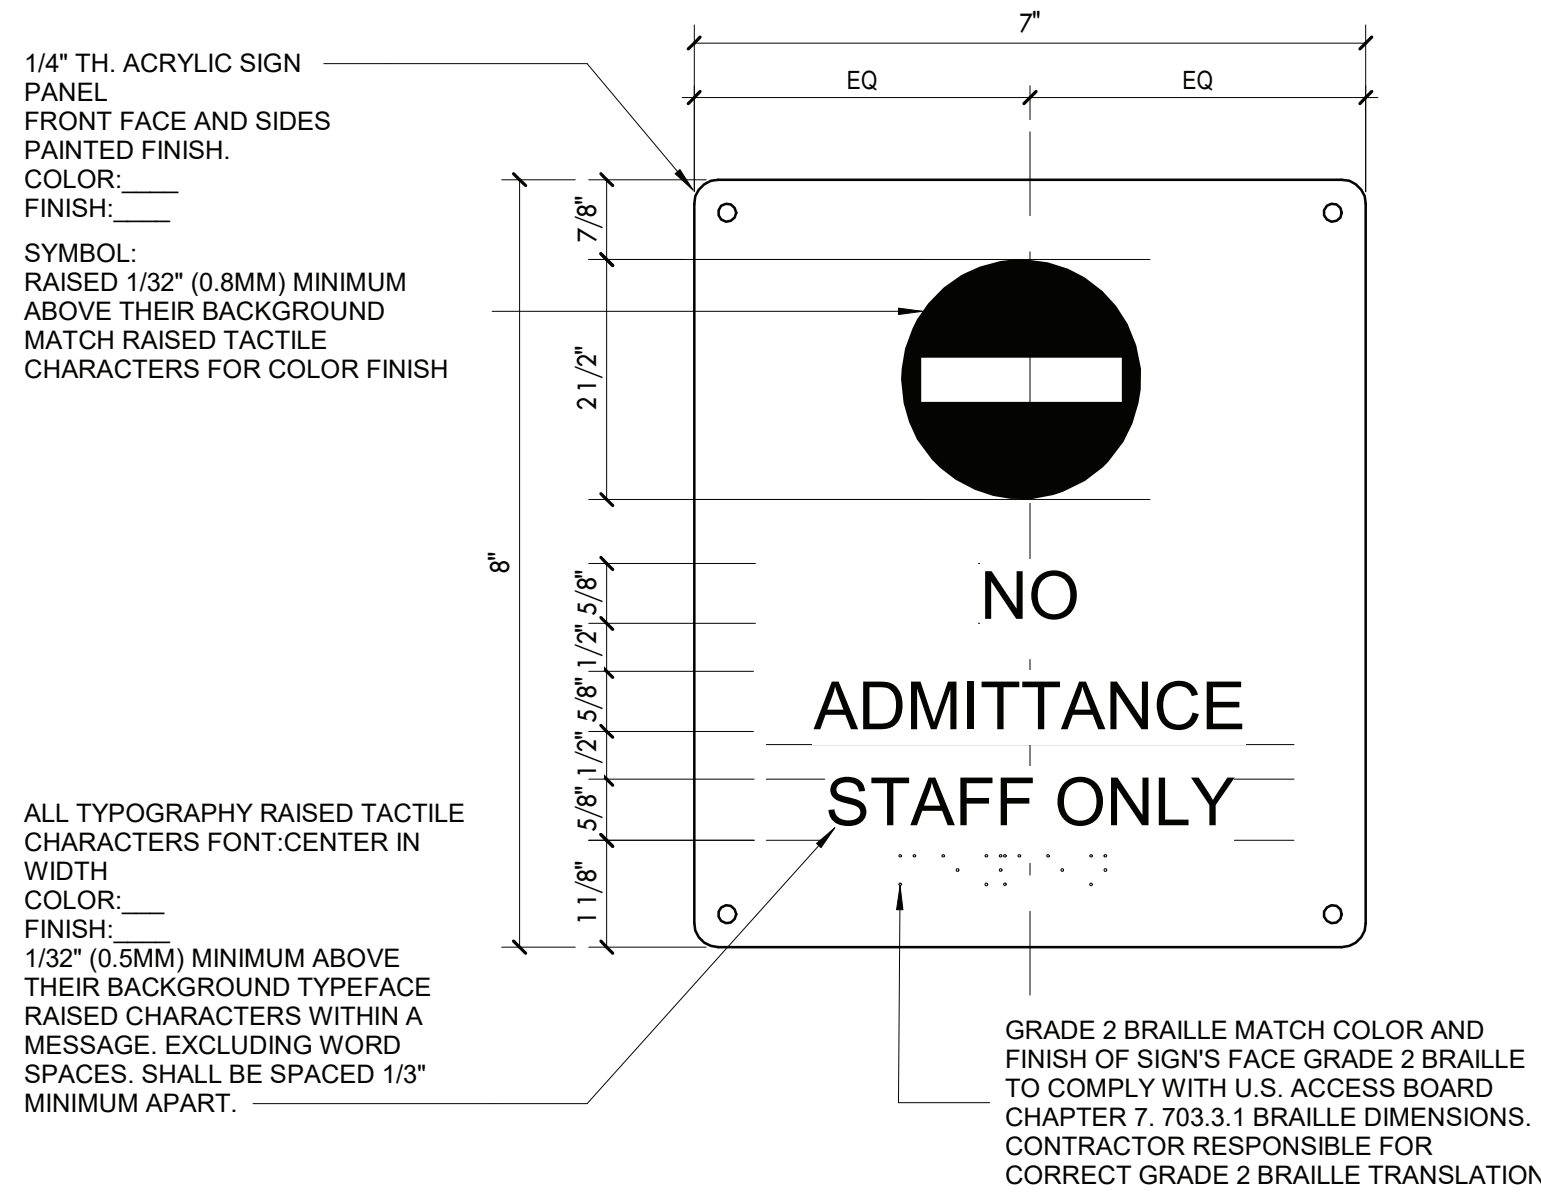

5 TYPE X-2 STAFF ONLY (RESTRICTED AREA) SIGN
6" = 1'-0"

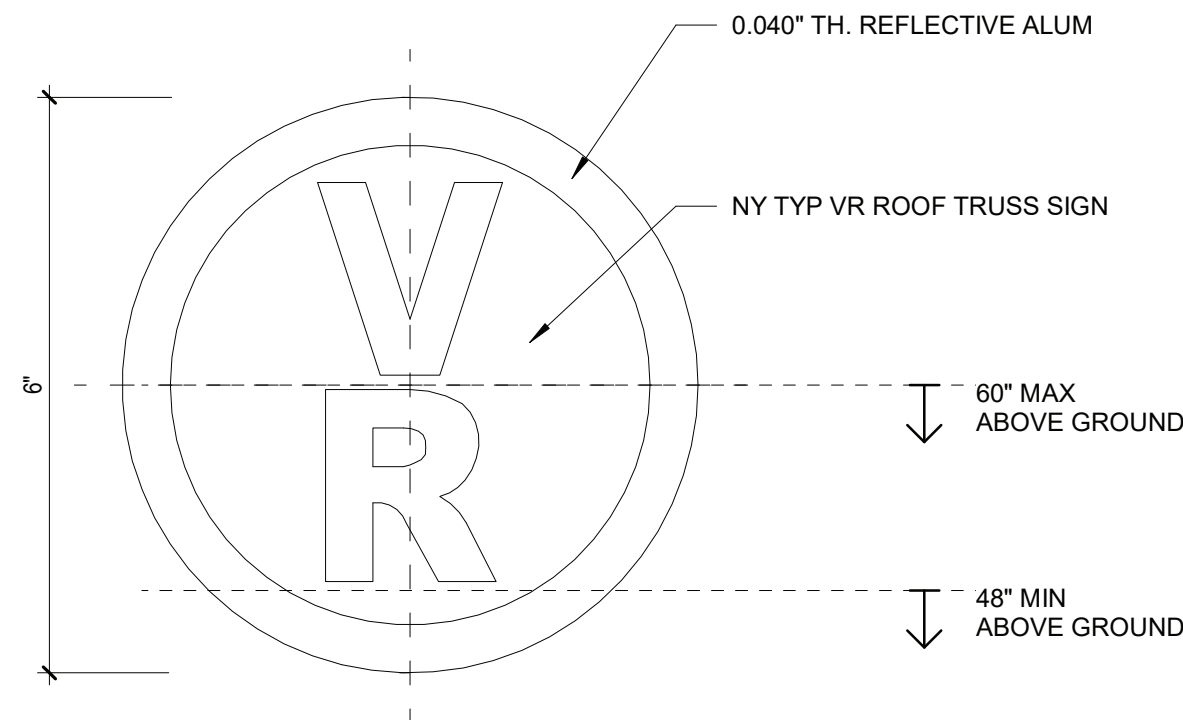

7 TYPICAL TYPE-X 4 TRUSS SIGNAGE CLASS VR
6" = 1'-0"

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CONSULTANT
INFORMATION



The LiRo Group

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NUMBER

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CONTRACTOR

NAME _____

SIGNATURE _____

TITLE _____ DATE _____

PROJECT COORDINATOR

NAME _____

SIGNATURE _____

TITLE _____ DATE _____

WESTCHESTER COUNTY, NEW YORK
DEPARTMENT OF PUBLIC WORKS AND TRANSPORTATION

DIVISION OF ENGINEERING

**INFRASTRUCTURE REHABILITATION
PLAYLAND PARK, RYE, NEW YORK
RESTAURANT KITCHEN WITH FOOD VENDING
SIGNAGE DETAILS**

CONTRACT
NUMBER

22-523

SHEET
NUMBER

K-A-87

DWG NO.: 522 of 664

SCALE: **As indicated**


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DPW FILE
NUMBER **1-118-A-1271-0**


REV.
NO. **0**

WINDOW SCHEDULE													
Mark	WINDOW TYPE	BUILDING	LEVEL	WIDTH	ROUGH WIDTH	HEIGHT	ROUGH HEIGHT	SILL HEIGHT	WINDOW MATERIAL	Finish	EXTERIOR TRIM	INTERIOR TRIM	REMARKS
005	W-1	RESTAURANT KITCHEN	FIRST FLOOR	4' - 6"	4' - 6 3/4"	2' - 0"	2' - 0 3/4"	6' - 11"	ALUMINUM	Black Powder Coat	P-2	P-13	1" INSULATED GLASS UNIT
006	W-1	RESTAURANT KITCHEN	FIRST FLOOR	4' - 6"	4' - 6 3/4"	2' - 0"	2' - 0 3/4"	6' - 11"	ALUMINUM	Black Powder Coat	P-2	P-13	1" INSULATED GLASS UNIT
007	W-1	RESTAURANT KITCHEN	FIRST FLOOR	4' - 6"	4' - 6 3/4"	2' - 0"	2' - 0 3/4"	6' - 11"	ALUMINUM	Black Powder Coat	P-2	P-13	1" INSULATED GLASS UNIT
008	W-1	RESTAURANT KITCHEN	FIRST FLOOR	4' - 6"	4' - 6 3/4"	2' - 0"	2' - 0 3/4"	6' - 11"	ALUMINUM	Black Powder Coat	P-2	P-13	1" INSULATED GLASS UNIT


NOTES:
- ALL COLOR TO BE APPROVED BY ARCHITECT
- ALL DIMENSIONS TO BE VERIFIED IN FIELD PRIOR TO FABRICATION

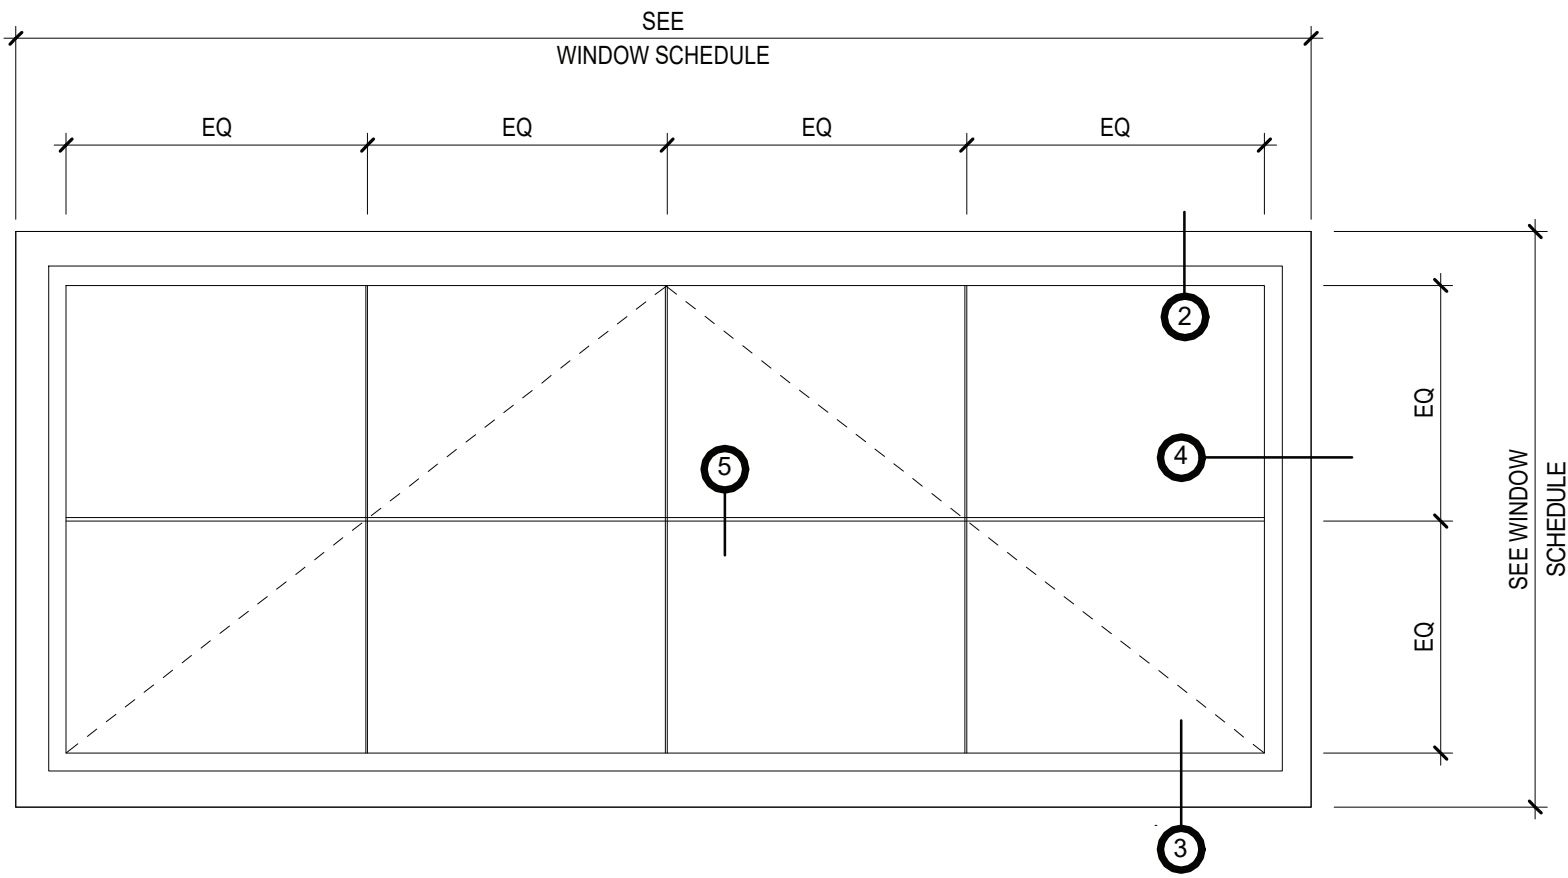


1 AWNING WINDOW ELEVATION W-1
1 1/2" = 1'-0"

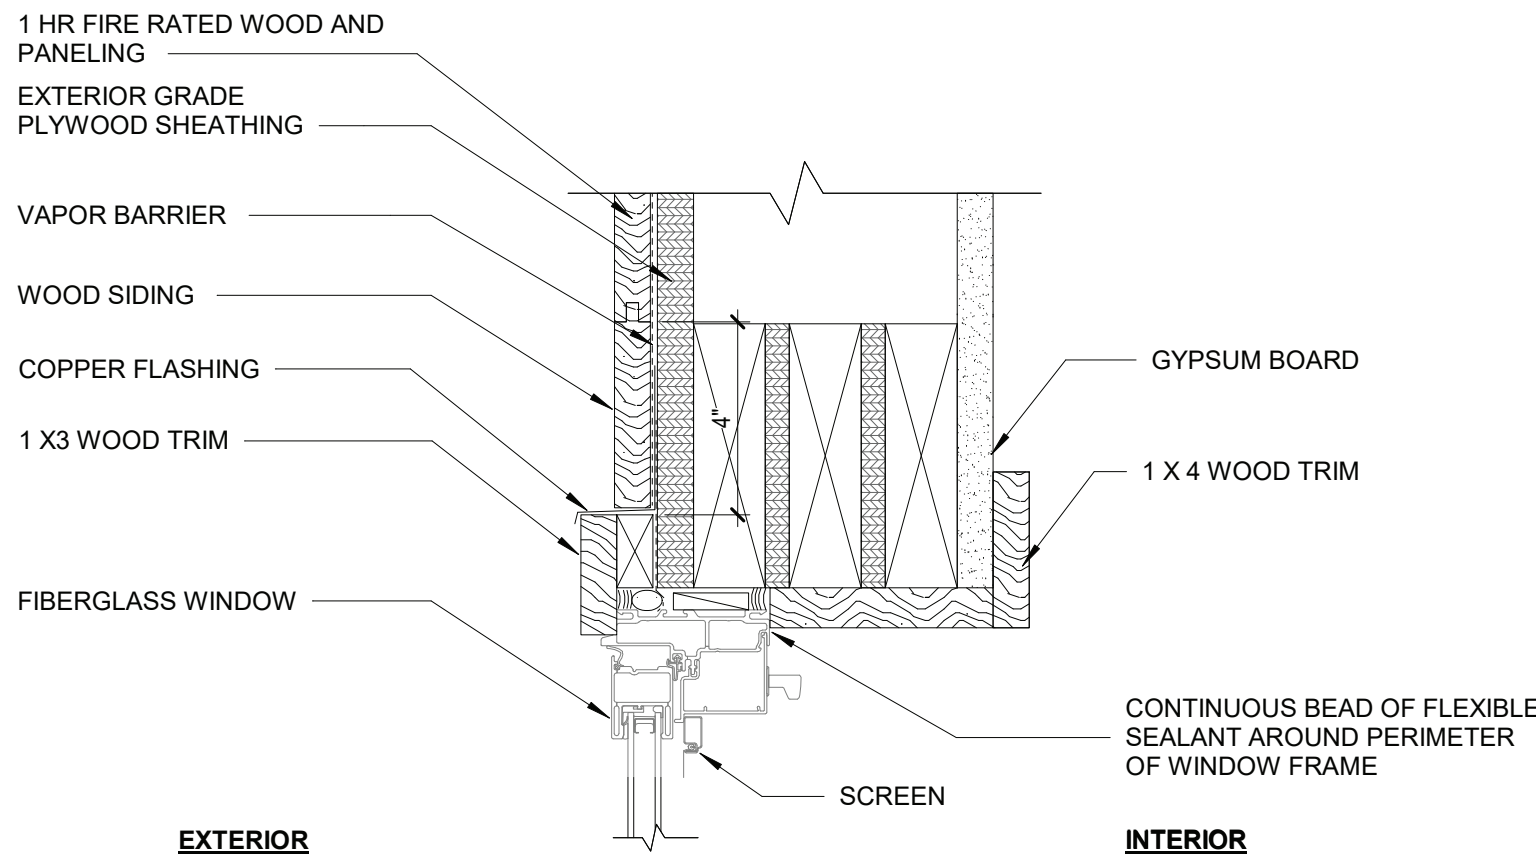

2 AWNING WINDOW HEAD DEATIL
3" = 1'-0"

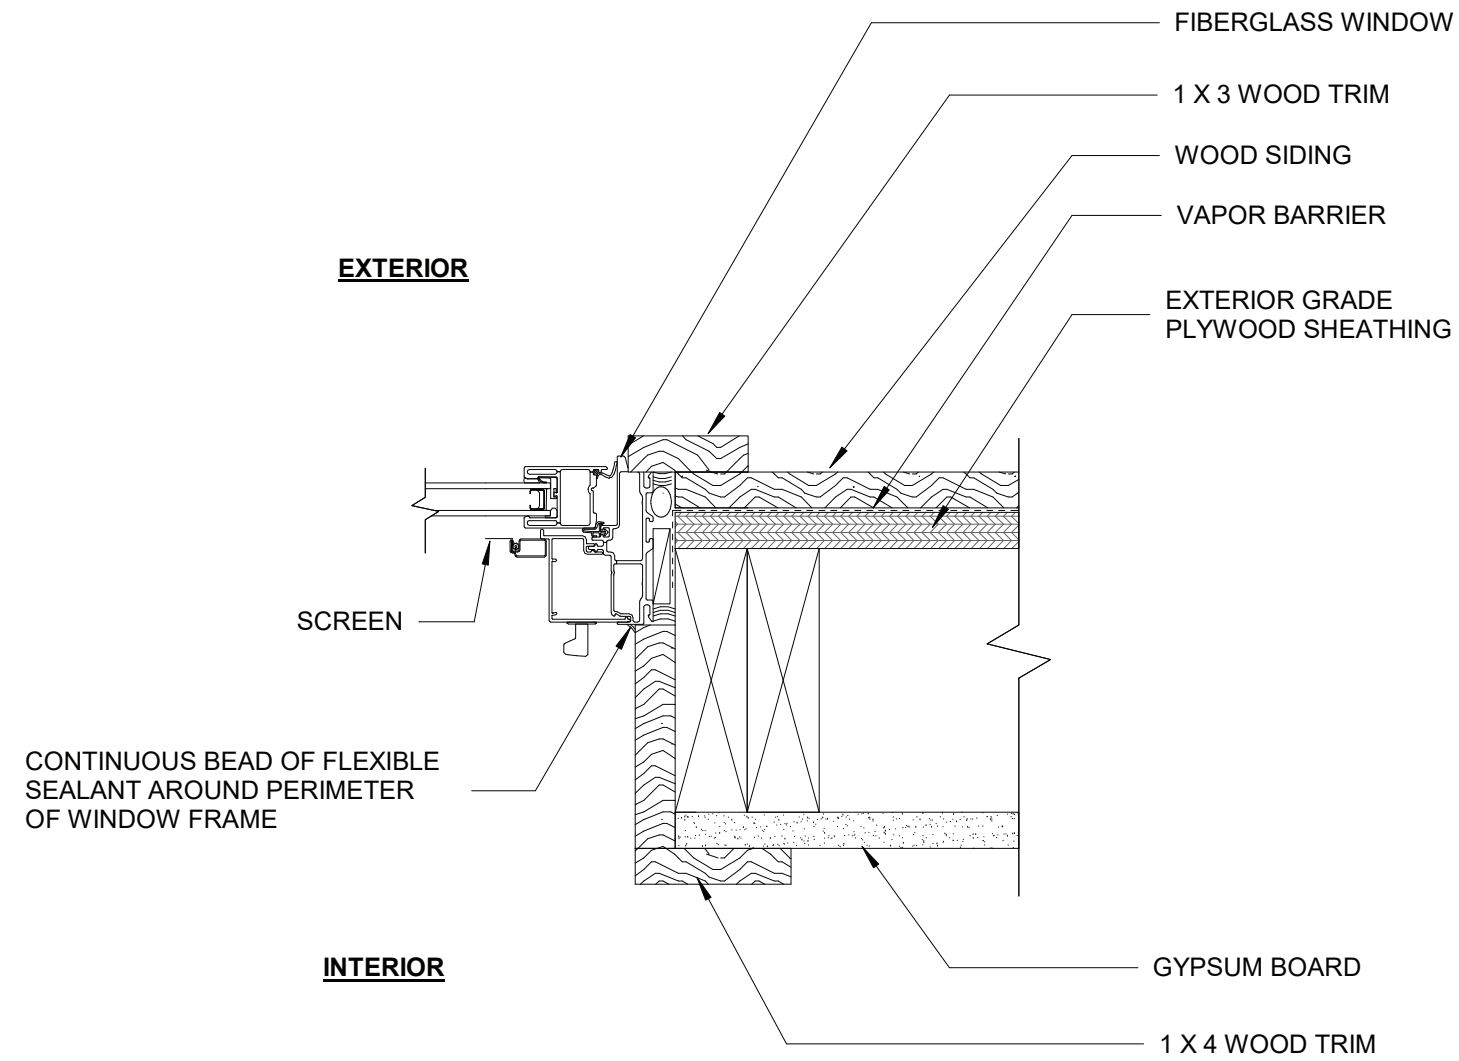

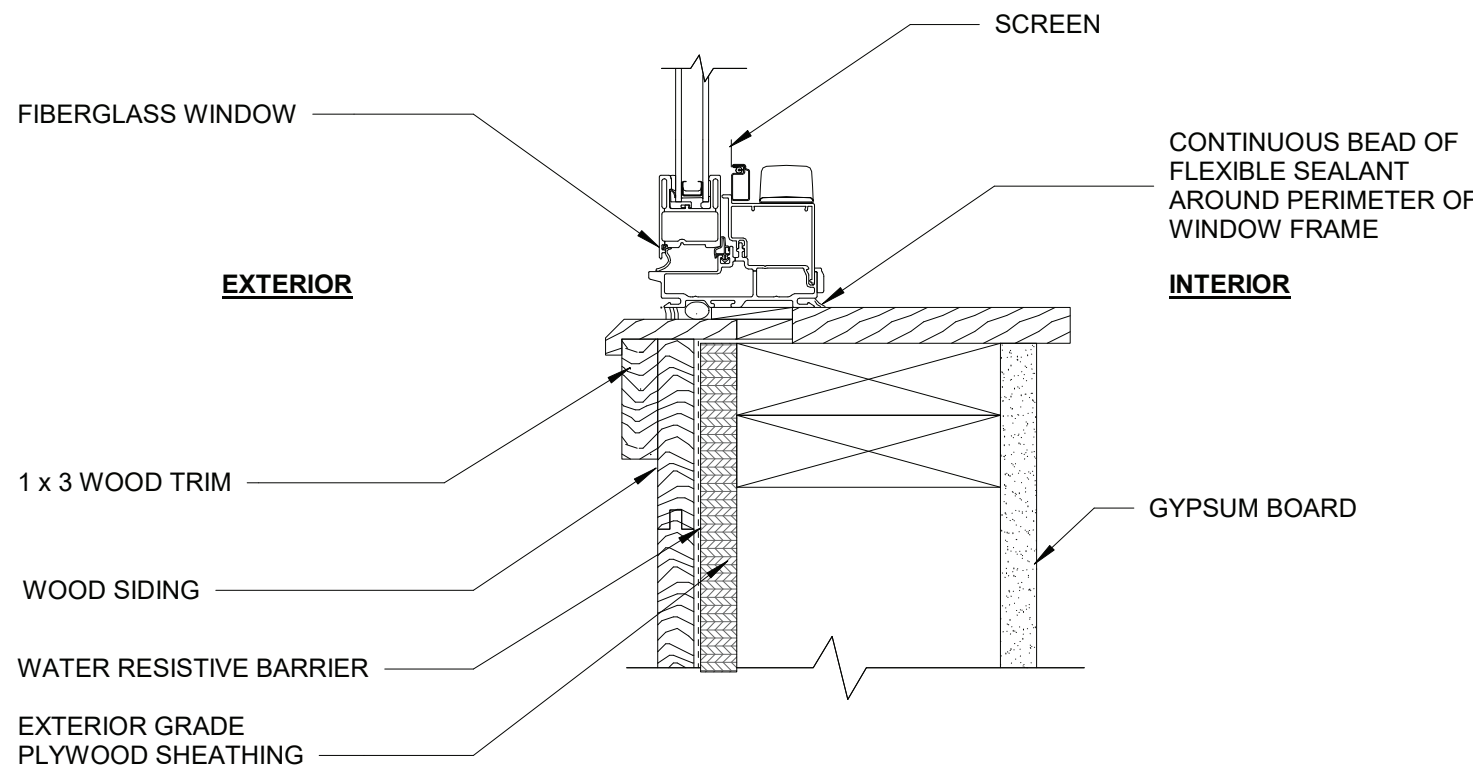


4 AWNING WINDOW JAMB DETAIL
3" = 1'-0"



3 AWNING WINDOW SILL DETAIL
3" = 1'-0"

8/30/2022 2:52:01 PM

<div>CONSULTANT INFORMATION</div> <div></div> <div>1 State Street Plaza, New York, NY, 10004 (516) 938-5476 www.liro.com</div>	<div>CONSULTANT SEAL</div> <div></div>							RECORD DRAWING CERTIFICATION		WESTCHESTER COUNTY, NEW YORK DEPARTMENT OF PUBLIC WORKS AND TRANSPORTATION DIVISION OF ENGINEERING		CONTRACT NUMBER 22-523	SHEET NUMBER K-A-88	
									<input type="checkbox"/> AS BUILT – CHANGES AS NOTED <input type="checkbox"/> AS BUILT – NO CHANGES		INFRASTRUCTURE REHABILITATION PLAYLAND PARK, RYE, NEW YORK RESTAURANT KITCHEN WITH FOOD VENDING WINDOW SCHEDULES & DETAILS		DWG NO.: 523 of 664	
									CONTRACTOR		PROJECT COORDINATOR		SCALE: As indicated	
		REVISION NUMBER	DATE	MADE BY	APP'D BY	REVISION	NAME		SIGNATURE		SIGNATURE		DATE: 8/23/20223	

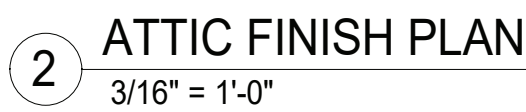

(FOR PAINT TYPE AND SYSTEMS, SEE SPECIFICATIONS)

FINISH LEGEND:

FINISH PLAN NOTES:

2. INDICATES TYPICAL FINISHES WITHIN ROOM. U.O.N SEE FINISH SCHEDULE FOR MORE INFORMATION.
3. ALL FLOORING COVERING MATERIALS TO BE INSTALLED PER MANUFACTURER'S STANDARD DETAILS AND SPECIFICATIONS. VERIFY WITH MANUFACTURER PRIOR INSTALLATION.
4. THE U.O.N IS RESPONSIBLE FOR PROVIDING A FACTORY LEVEL FINISH SURFACE THAT MEETS MANUFACTURERS INSTALLATION SPECIFICATIONS PRIOR TO THE INSTALLATION OF ALL FLOORING MATERIALS.
5. THE FLOORING SUB-CONTRACTOR IS RESPONSIBLE FOR VERIFYING THAT THE CONDITION OF THE BASE FLOOR MEETS THE INSTALLATION SPECIFICATIONS PRIOR TO THE INSTALLATION OF THE NEW FLOORING MATERIAL.
6. ALL MATERIAL TRANSITIONS AN DOOR THRESHOLDS TO TAKE PLACE AT DOOR CENTERLINE U.O.N.O.
7. ALL TRANSITION RISES TO CENTERLINE OF TRANSITION BETWEEN FLOORING MATERIALS OR FINISH COLOR OF SAME MATERIAL PLANS IF NOT SHOW ALL TILES OF SAME MATERIALS. CONTRACTOR TO START TILES AT POINT AS INDICATED ON PLANS.
7. THE GENERAL CONTRACTOR SHALL BE RESPONSIBLE FOR PROPER PREPARATION OF ALL NEW AND EXISTING SURFACES IN A SATISFACTORY MANNER TO RECEIVE NEW FINISHES. THIS INCLUDES THE DEMOLITION AND REMOVAL OF NECESSARY ITEMS. TOUCH- UP AND/ OR REFINISH OF SURFACES DAMAGED BY SUBSEQUENT WORK SHALL BE PERFORMED IN CONFORMANCE WITH THE MANUFACTURER'S RECOMMENDED INSTALLATION METHODS.
8. ALL SURFACES WHICH ARE TO RECEIVE A PAINT FINISH SHALL BE PRIMED AND FINISHED IN ACCORDANCE WITH THE WRITTEN SPECIFICATIONS.
9. ALL JOINTS IN GYMnasium WALLS SHALL BE FINISHED WITH PAPER TAPE 2" WIDE AND THREE COATS OF VINYL PRIMER JOINT COMPOUND. ALL OUTSIDE CORNERS SHALL BE FINISHED WITH METAL CORNER BEADS, TAPED AND SPACKLED. ALL AREAS TO BE PAINTED SHALL BE SANDED SMOOTH. JUST PRIOR TO THE APPLICATION OF THE FIRST COAT OF PAINT, WIDE SANDED SURFACES WITH A DAMP CLOTH IN ORDER TO LAY FLAT ANY NAP WHICH MAY HAVE FORMED IN SANDING.
10. THE PAINT CONTRACTOR SHALL REMOVE ALL HARDWARE, SWITCH COVERS, ETC. PRIOR TO PAINTING AND BE RESPONSIBLE FOR THE REINSTALLATION OF THE SAME WHEN THE PAINT IS COMPLETED.
11. FINISH FLOORING INSTALLATION SHALL BE IN CONFORMANCE WITH THE MANUFACTURER'S RECOMMENDED INSTALLATION GUIDELINES. COORDINATE THE INSTALLATION WITH OTHER TRADES, SUCH AS ELECTRICAL.
12. ALL JOINTS BETWEEN MATERIALS TO BE TIGHT AND CONSTRUCTED IN A NEAT WORKMANLIKE MANNER.
13. ALL FINISHES SHALL BE TOUCHED UP TO CORRECT ANY IMPERFECTIONS AFTER INSTALLATION. FIXTURES SHALL BE PROVIDED BY THE GENERAL CONTRACTOR. ALL MATERIALS TO BE TOUCH UP WORK.
14. THE INTENT OF THE FINISH SPECIFICATIONS IS TO PROVIDE A SATISFACTORY FINISH TO ALL PARTS OF THE WORK. COVER ALL SURFACES THOROUGHLY. IF THE SPECIFIED NUMBER OF COATS DOES NOT ACCOMPLISH THE INTENT, THE GENERAL CONTRACTOR SHALL BE RESPONSIBLE FOR THE APPLICATION OF ADDITIONAL COATS OF THE SPECIFIED MATERIAL TO GIVE SATISFACTORY COVERAGE, AT NO ADDITIONAL COST TO OWNER.
15. GLASS SURFACES SHALL BE PROTECTED BY A GENERAL CONTRACTOR'S PROTECTIVE MATERIAL.
16. REFERENCE SPECIFICATIONS FOR COMPLETE FINISH DOCUMENTATION AND MANUFACTURER INSTALLATION AND MAINTENANCE DOCUMENTATION.














1. STAINLESS STEEL EDGE (BOTH FOR WALLS & FLOORS WHERE NECESSARY SHALL BE SS 304 E100 SCHLUTER- SCHIENE OR APPROVED EQUAL
2. BEFORE INSTALLATION OF CERAMIC TILE WALLS CONTRACTOR TO BULK MOCK- UPS AS LISTED BELOW FOR ARCHITECT'S REVIEW & APPROVAL:
 - (1) FOR SS EDGE/ CERAMIC TILE TRANSITION
 - (1) FOR CERAMIC PATTERN
3. ALL WALL CORNERS/ EDGE CERAMIC TILES TO BE BULLNOSE AS SPECIFIED, TYP. FOR ALL CORNERS
4. ALL CERAMIC TILE SPACING SHALL BE 1/8".
5. ALL GROUTS SHALL BE EPOXY BASE. SEE SPECIFICATION, TYPICAL FOR ALL AREAS

PLUMBING FIXTURE SCHEDULE - "PF"		
TAG	DESCRIPTION	REMARKS
PF-5	SERVICE SINK	COMPATIBLE STAINLESS STEEL WALL GUARDS
PF-14	SERVICE SINK FAUCET	

3 PROPOSED EAST ELEVATION FINISH
3/16" = 1'-0"



DOOR SCHEDULE																		
DOOR NUMBER	LOCATION		DOOR TYPE	PANEL						FRAME				HW SET	R-VALUE	U-VALUE	FIRE RATING	Comments
	FROM	TO		WIDTH	HEIGHT	THICK NESS	MATL	FINISH		Frame Type	MATL	FINISH						
								EXTERIOR	INTERIOR			EXTERIOR	INTERIOR					
101	SEASONAL FOOD SERVICE	KITCHEN	A	3' - 0"	7' - 0"	1 3/4"	HM	Paint - P-11	Paint - P-11	2		HM	Paint - P-11	Paint - P-11	7	-		
101A	EXTERIOR	SEASONAL FOOD	B	7' - 0"	7'-9 3/4"	3/8 "	STEEL	Paint -P-16	Paint -P-16	3		STEEL	Paint -P-16	Paint -P-16	4	0.31	45 MIN	MOTORIZED ROLL DOWN COUNTER DOOR
101B	EXTERIOR	SEASONAL FOOD	B	13' - 0"	7'-9 3/4"	3/8 "	STEEL	Paint -P-16	Paint -P-16	3		STEEL	Paint -P-16	Paint -P-16	4	0.31		MOTORIZED ROLL DOWN COUNTER TOP
101C	EXTERIOR	SEASONAL FOOD	B	13' - 0"	7'-9 3/4"	3/8 "	STEEL	Paint -P-16	Paint -P-16	3		STEEL	Paint -P-16	Paint -P-16	4	0.31		MOTORIZED ROLL DOWN COUNTER TOP
102	DRY ROOM	KITCHEN	A	3' - 0"	7' - 0"	1 3/4"	HM	Paint - P-11	Paint - P-11	2		HM	Paint - P-11	Paint - P-11	9	-		
103	ELECTRICAL CL.	KITCHEN	A	3' - 0"	7' - 0"	1 3/4"	HM	Paint - P-11	Paint - P-11	2		HM	Paint - P-11	Paint - P-11	12	-		
104	JANITOR CL.	KITCHEN	A	3' - 0"	7' - 0"	1 3/4"	HM	Paint - P-11	Paint - P-11	2		HM	Paint - P-11	Paint - P-11	9	-		
105	PLAZA REST.	KITCHEN	D	6' - 5"	7' - 3"	1 3/4"	STEEL	Paint - P-11	Paint - P-11	4		HM	Paint - P-11	Paint - P-11	2	-		
105B	EXTERIOR	KITCHEN	C	6' - 0"	7' - 3"	1 3/4"	WD	Paint - P-11	Paint - P-11	1		WD	Paint - P-11	Paint - P-11	6	-		
106	SEASONAL FOOD	KITCHEN	B	6' - 6"	3'-46" "	3/8 "	STEEL	Paint -P-16	Paint -P-16	2		STEEL	Paint -P-16	Paint -P-16	4	-		MOTORIZED ROLL DOWN COUNTER TOP
107	KITCHEN	KITCHEN	E	6' - 2"	7' - 0"	3/8 "	STEEL	Paint -P-16	Paint -P-16	3		STEEL	Paint -P-16	Paint -P-16	4	R-4.75	-	1 HR
108				2' - 0"	1' - 0 5/8"													MOTORIZED INSULATED ROLL DOWN COUNTER TOP

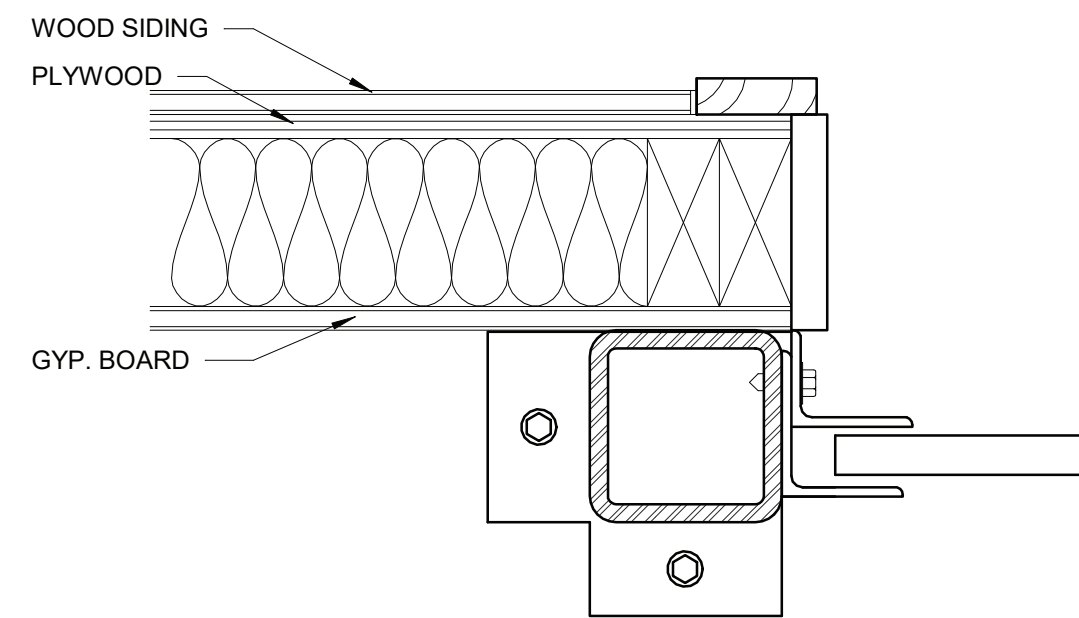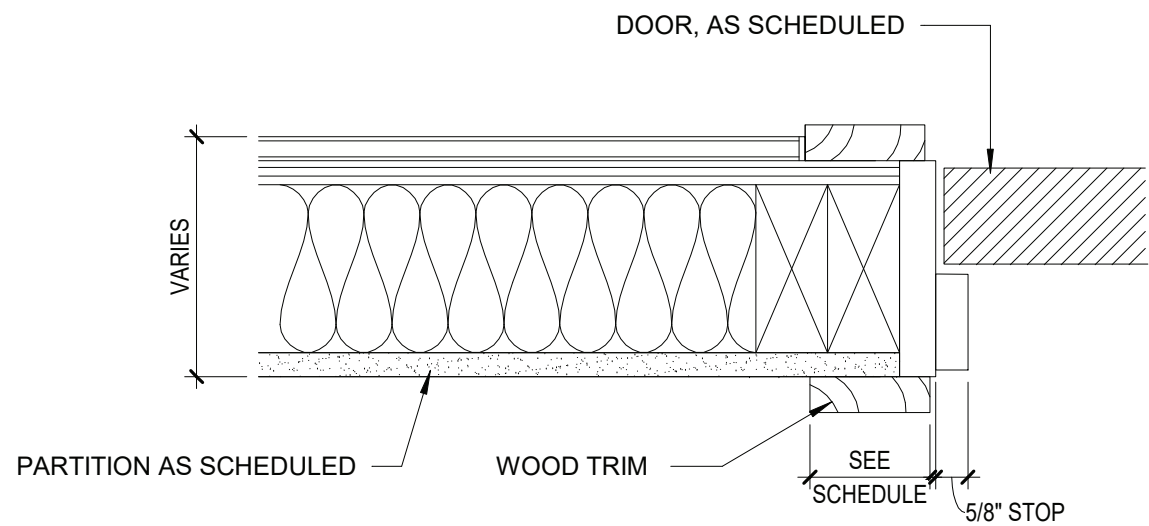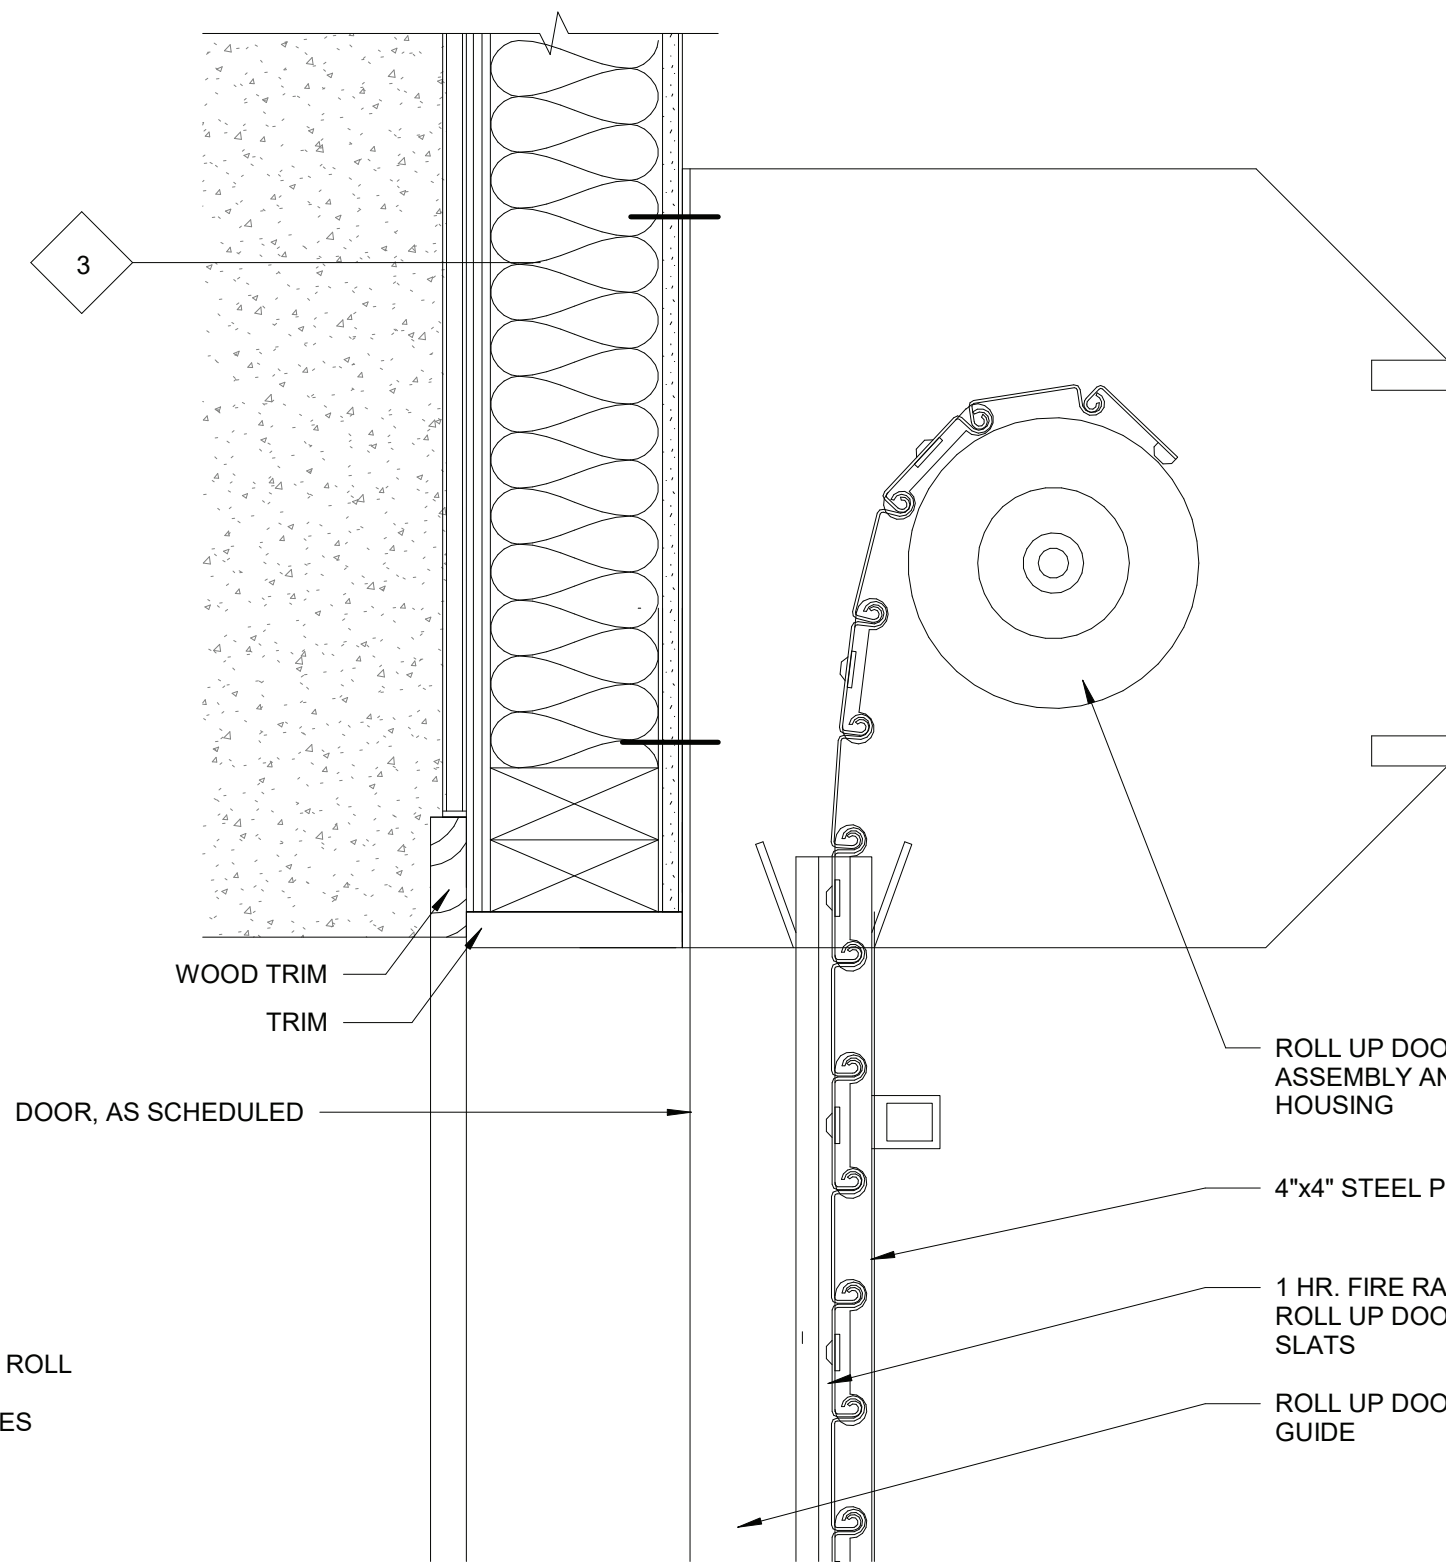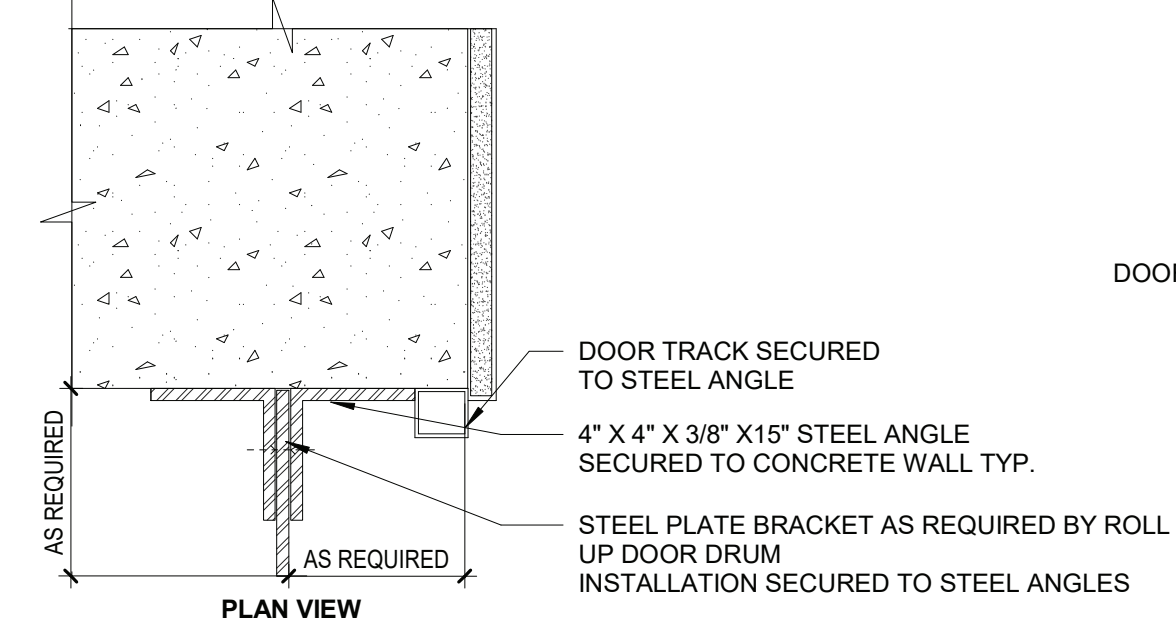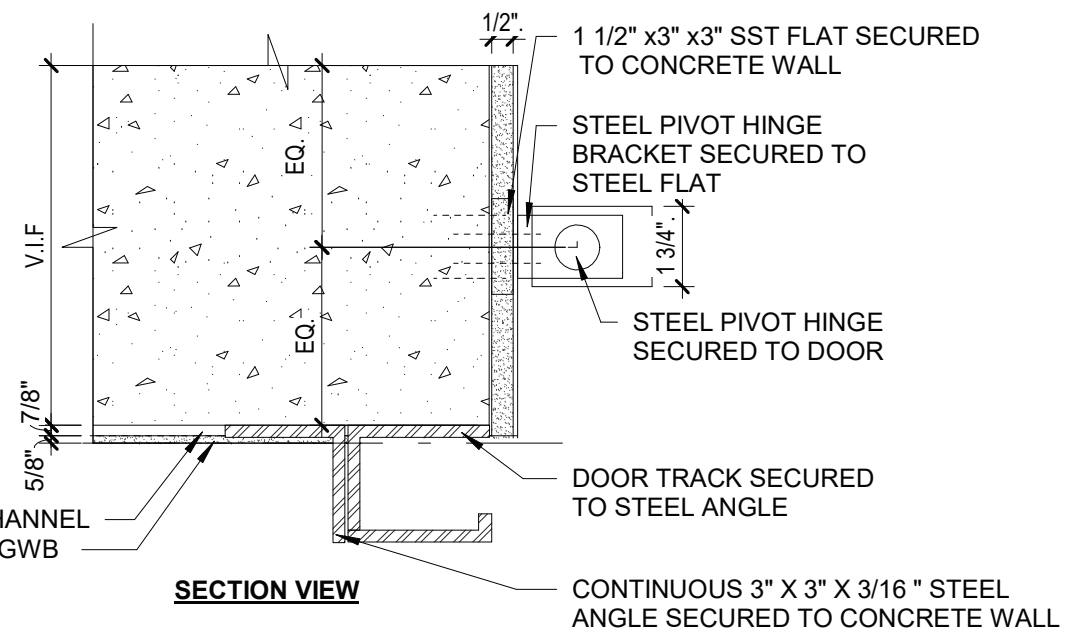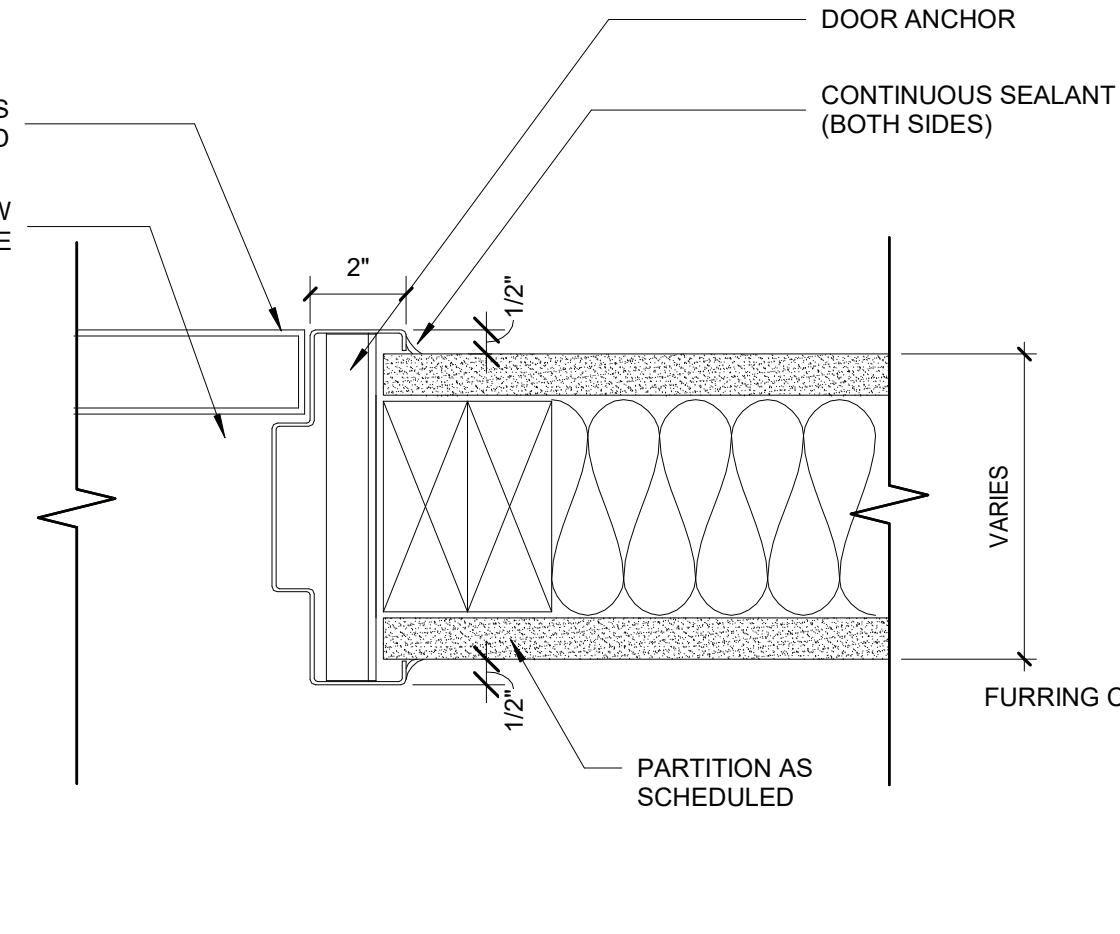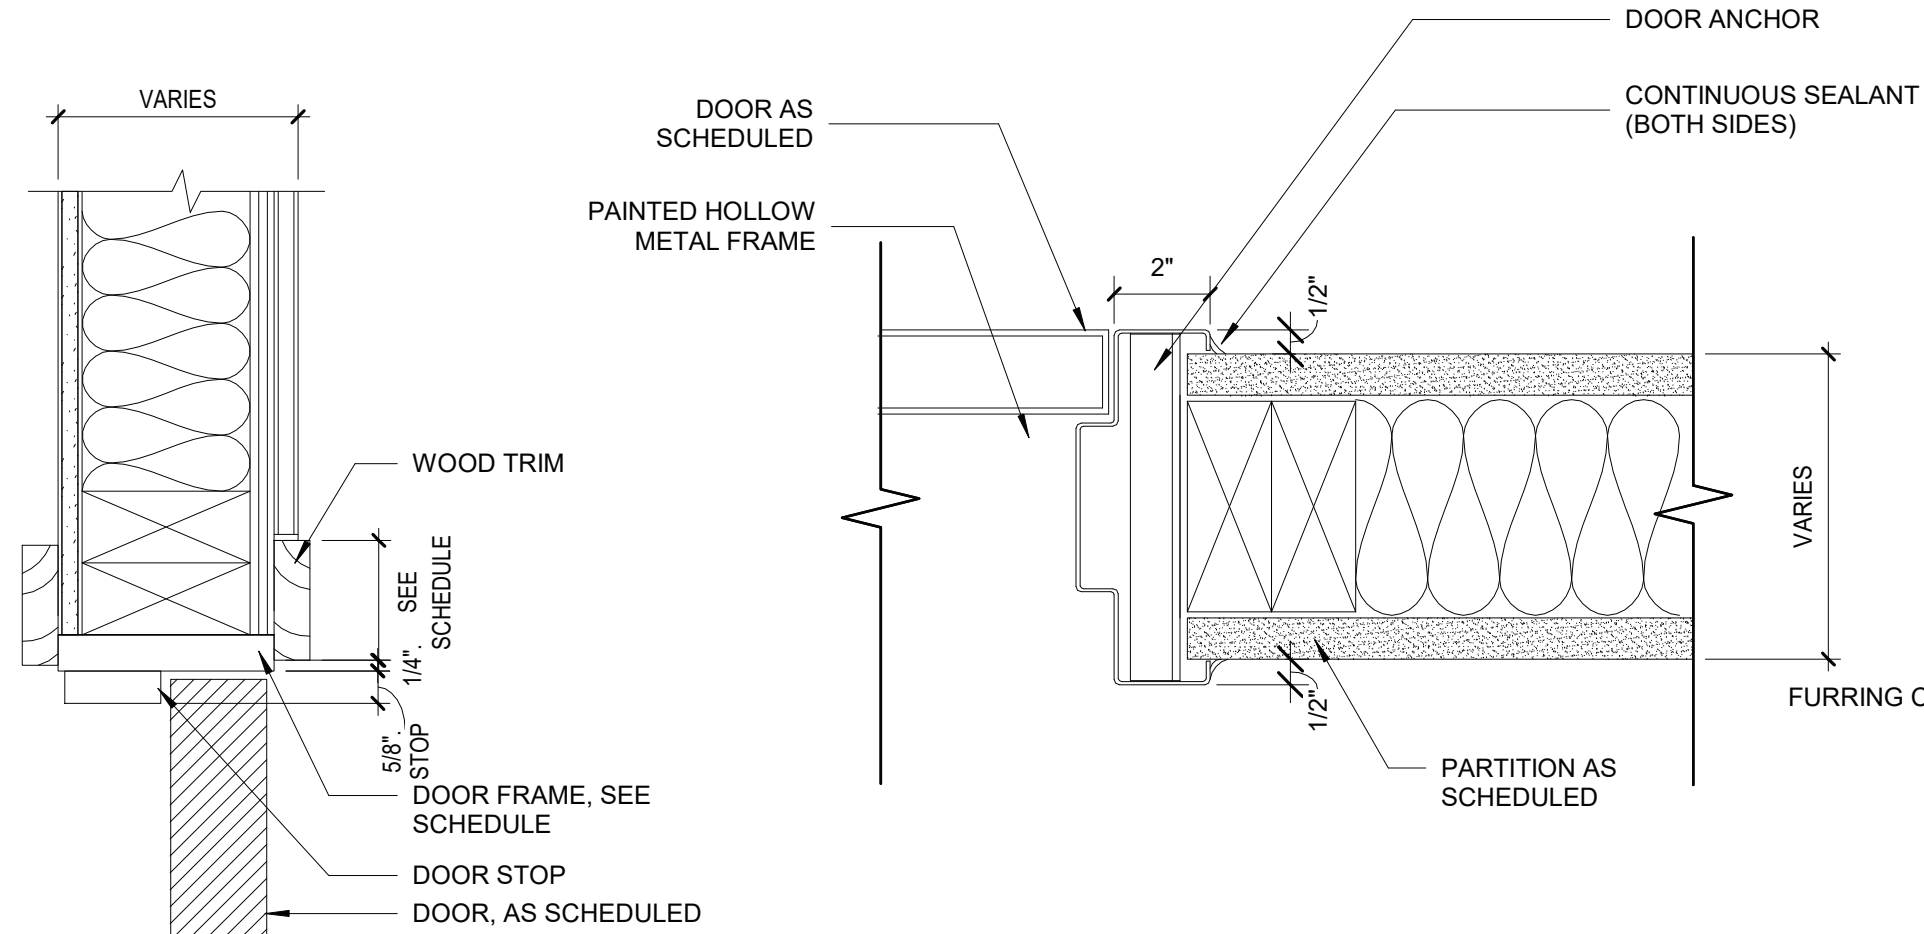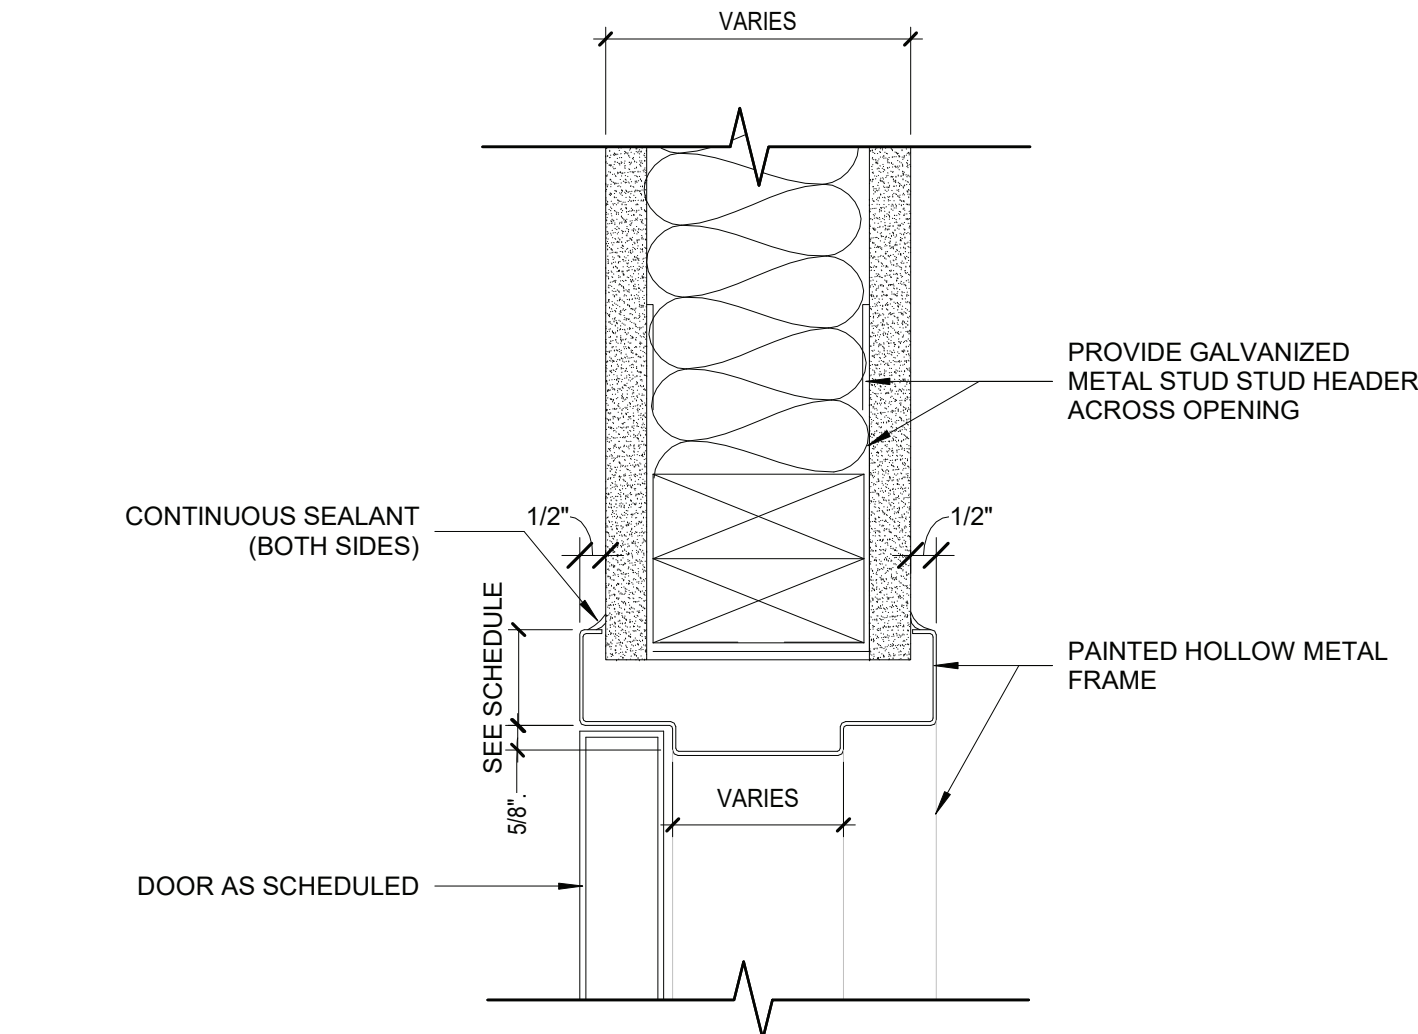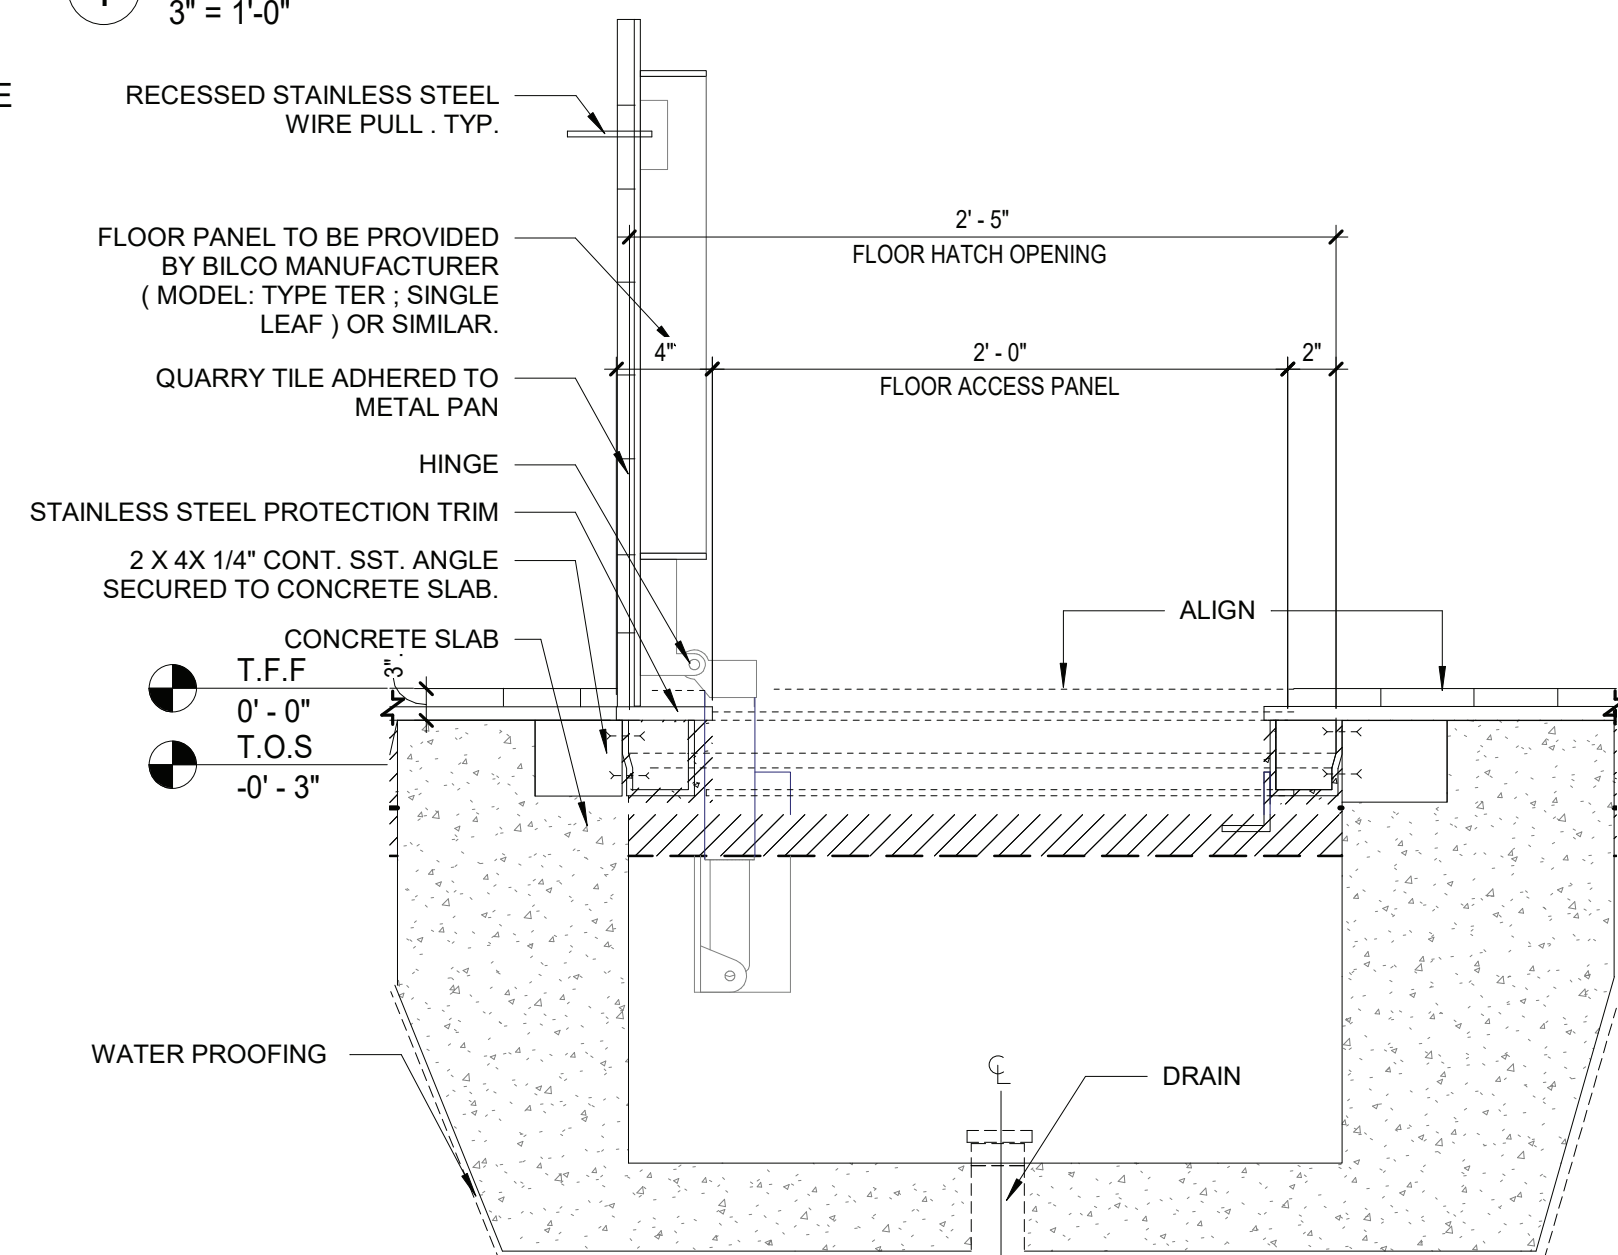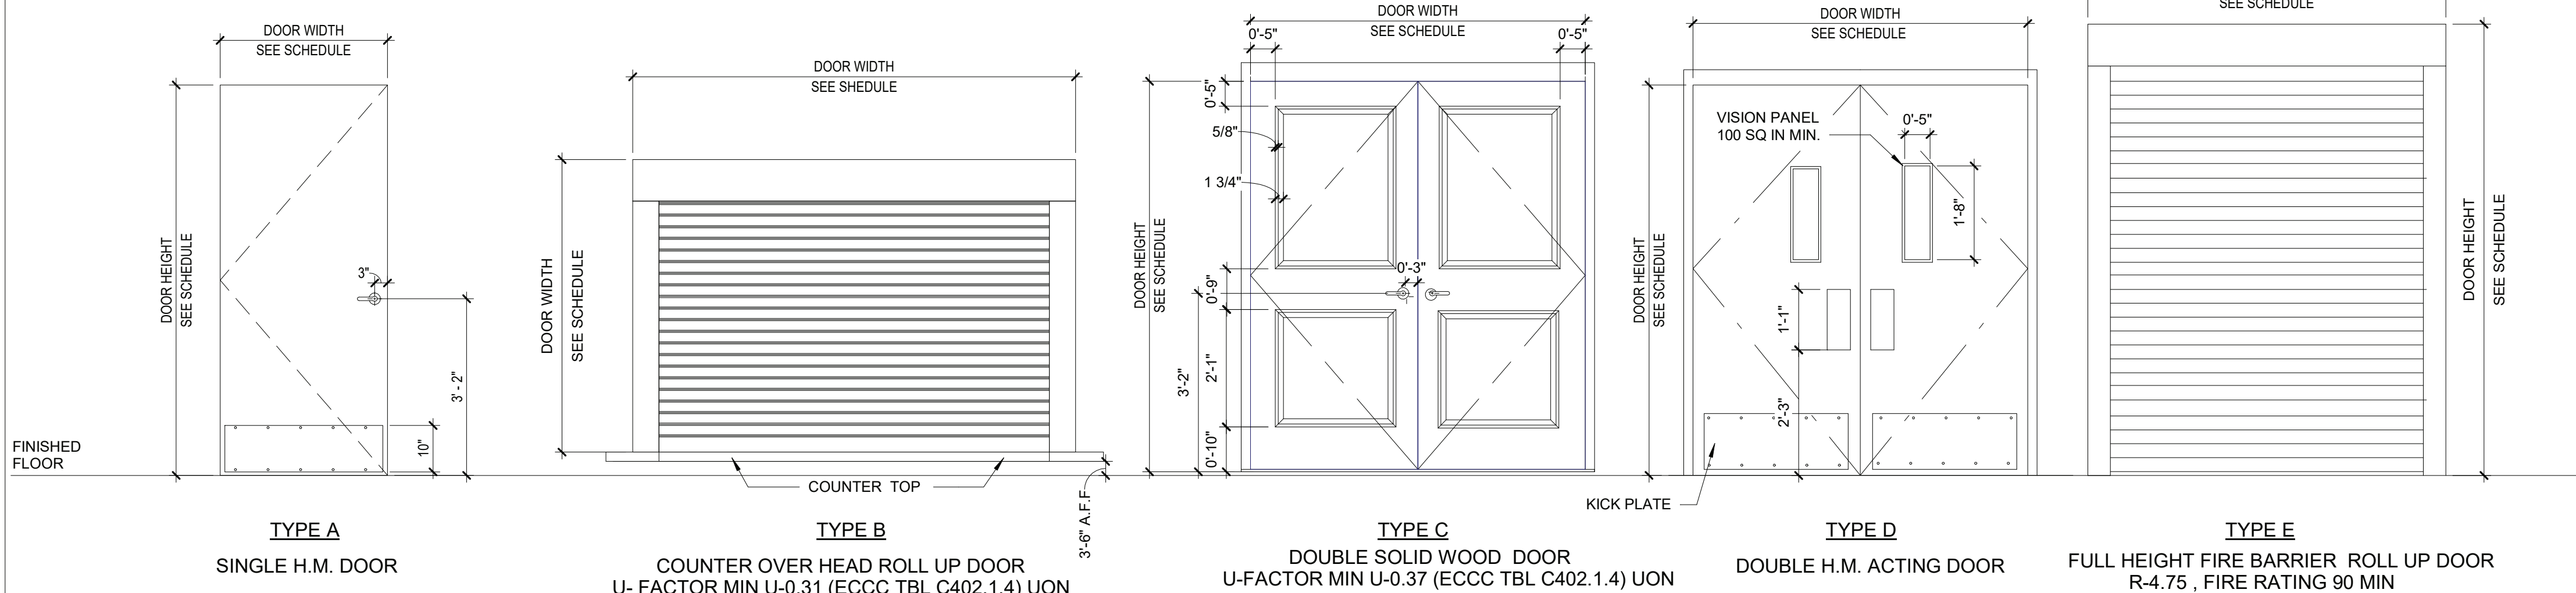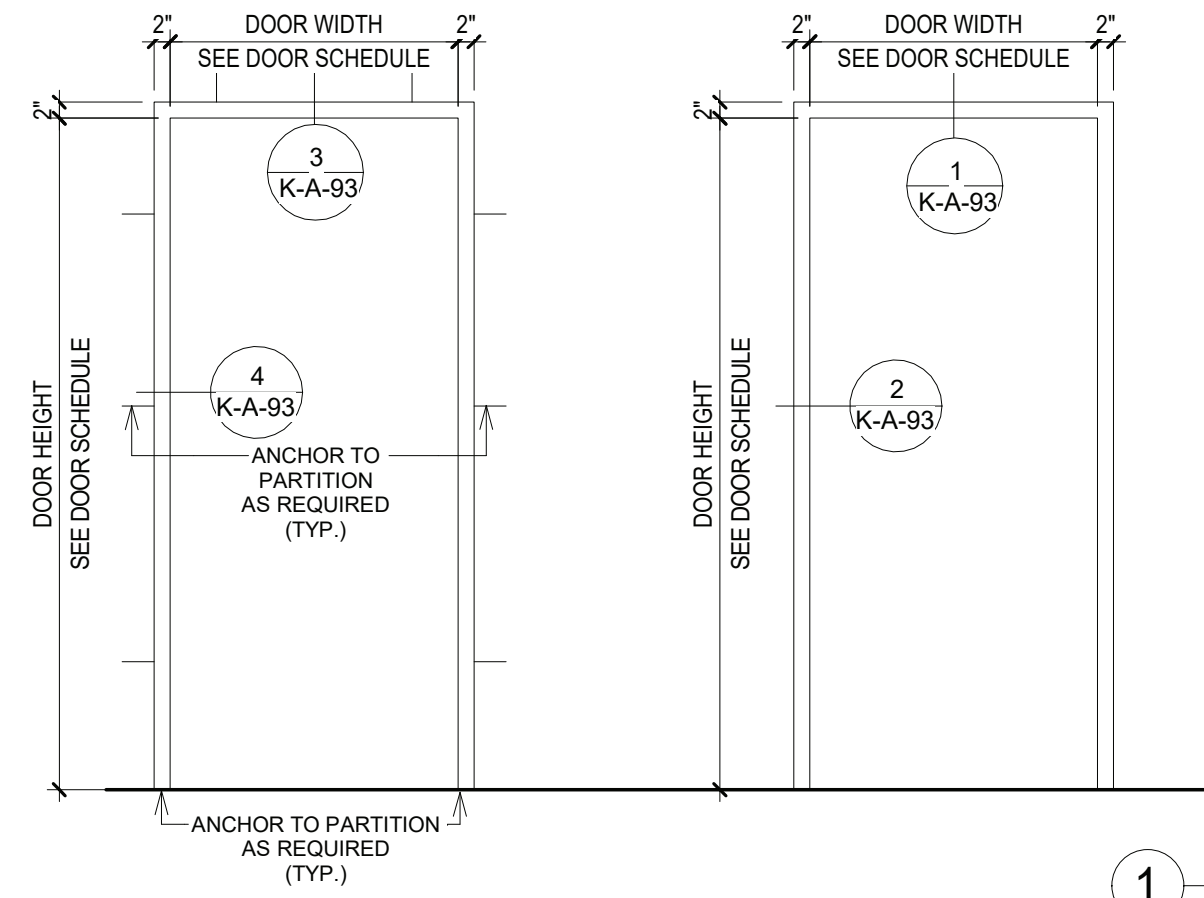

HEAD

CONTINUOUS DOUBLE 2x6 TOP PLATE ANCHORED TO STRUCTURE ABOVE

VAPOR BARRIER

FINISH CEILING WHERE REQUIRED, SEE SCHEDULE

METAL TRIM WHERE STRUCTURE ABOVE IS FINISHED CEILING

8" HORIZONTAL PAINTED WOOD SIDING.

PLAN

2x6 @ 16" O.C.

6" MINERAL FIBER INSULATION, MIN R-30

INT.

5/8" TYPE-X GYPSUM CONTINUOUS TO ROOF

5/8" FIRE RETARDANT SHEATHING FOR 1

BASE

FLOOR AND BASE, AS SCHEDULED

6" EXTERIOR WALL BASE, AS SCHEDULED

CONTINUOUS 2x6 PLATE ANCHORED TO FLOOR

CONTINUOUS SEALANT

6 1/8"

STRUCTURE

CONTINUOUS SEALANT

METAL TRIM WHERE STRUCTURE ABOVE IS FINISHED CEILING

DOUBLE 2X 6 TOP PLATE TO BE ATTACHED TO STRUCTURE ABOVE

CONTINUOUS DEFLECTION TRACK ANCHORED TO STRUCTURE ABOVE

HEAD

FINISH CEILING WHERE REQUIRED, SEE SCHEDULE

PLAN

WOOD STUD 2x4 @ 16" O.C.

GYPSUM WALLBOARD BOTH SIDES

WALL

BASE

FLOOR AND BASE AS SCHEDULED

CONTINUOUS WOOD RUNNER CHANNEL ANCHORED TO FLOOR

CONTINUOUS SEALANT

6"

STRUCTURE

CONTINUOUS SEALANT

METAL TRIM WHERE STRUCTURE ABOVE IS FINISHED CEILING

DOUBLE 2X6 TOP PLATE TO BE ATTACHED TO STRUCTURE ABOVE

CONTINUOUS DEFLECTION TRACK ANCHORED TO STRUCTURE ABOVE

FINISH CEILING WHERE REQUIRED, SEE SCHEDULE

2X6 @ 16 O.C WOOD STUDS

GYPSUM WALLBOARD BOTH SIDES

BATT/BLANKET INSULATIONS, R-20 MIN

FLOOR AND BASE AS SCHEDULED

CONTINUOUS WOOD RUNNER CHANNEL ANCHORED TO FLOOR

CONTINUOUS SEALANT

6"

HEAD

PLAN

BASE

HEAD

DOUBLE 2X6 TOP PLATE TO BE ATTACHED TO STRUCTURE ABOVE

EXISTING CONCRETE WALL

2HR FIRE BARRIER WALL AS PER UL# U906

KITCHEN

PLAN

2X6 @ 16 O.C. FIRE BARRIER WALL (U906) WOOD STUDS

BASE

6" MINERAL FIBER INSULATION, R-30 MIN. A.F.F. REFER TO FINISH SCHEDULE

6" MINERAL FIBER INSULATION, MIN R-30

CONTINUOUS 2X6 WOOD RUNNER CHANNEL

2"X6" EXTERIOR WALL BASE, AS SCHEDULED

ADJACENT BUILDING INT.

FACE OF EXISTING CONCRETE WALL
 3/4" WOOD TONGUE AND GROOVE SIDING
 4X4 FINISH CORNER TRIM
 SEALANT WITH BACKER ROD
 CAULKING TYP
 WEATHER BARRIER TURNOUT AT CORNER
 3/4" PLYWOOD SHEATHING
 2"x6" WOOD STUD SECURED TO CONCRETE WALL W/ HIGH - STRENGTH SCREW ANCHOR 3'-0" O.C. MAX.
 1/2" GASKET MEMBRANE JOINT, WITH SEALANT (BOTH SIDES) TYP
 5/8" GYPSUM WALL BOARD
 FINISH AS SCHEDULED

NOTE:

1 LAYER. 5/8" GWB MOISTURE RESISTANT, 2x6 WOOD STUD, 3/4" MOISTURE RESISTANT SHEATHING, 1/8" DRAINAGE TYPE OF AIR /MOISTURE BARRIER, WOOD SIDING UPTO 8' A.F.F


1 LAYER 5/8" IMPACT & MOLD-RESISTANT GYP. BD. UPTO
8' A.F.F. AND 5/8" MOLD-RESISTANT GYP. BD. TO CEILING
ON EACH SIDE

5-1/2" WOOD STUDS
1 LAYER 5/8" GYP. BD. EACH SIDE. INSULATION R-20 MIN


6" WOOD STUDS
1 LAYER 5/8" GYP. BD.

① $3'' = 1' - 0''$


1 LAYER 5/8" 5/8" GWB-X, M-Bloc – MOISTURE
RESISTANT, 2x6 WOOD STUD, 5/8" GBW-X, M-Bloc, 3/4"
FIRE RETARDANT SHEATHING, 1/8" DRAINAGE TYPE
AIR/MOISTURE BARRIER, WOOD SIDING WITH TEST
NUMBER: BXUV.V346-ANSI/UL 263

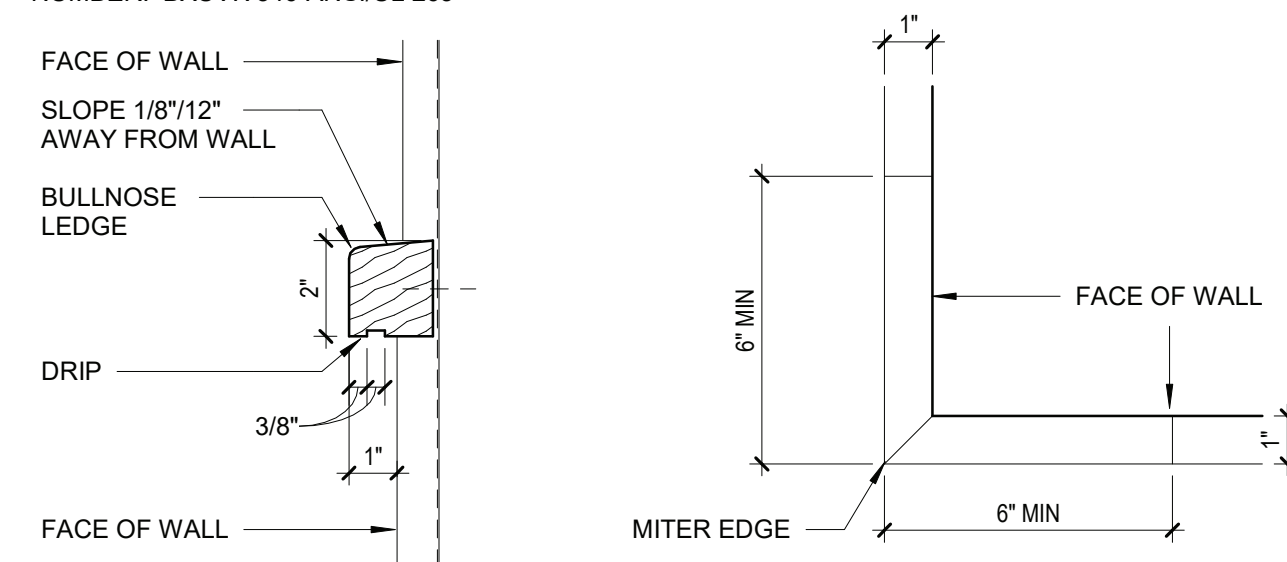


2 $3'' = 1'-0''$

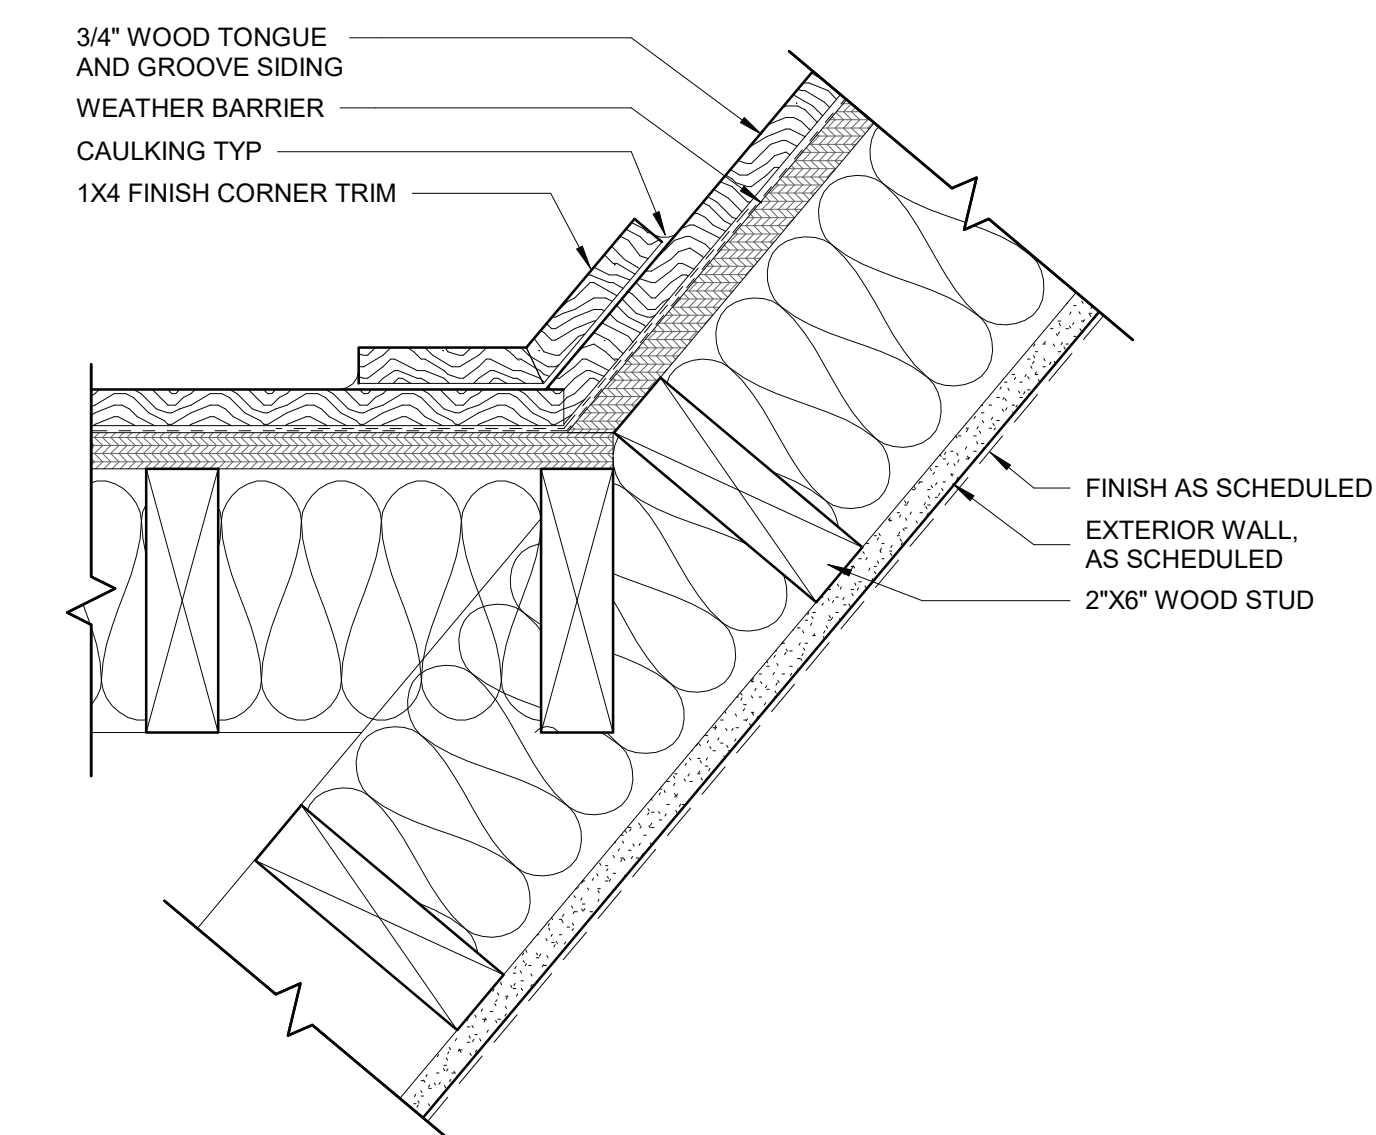

5 $3'' = 1'-0''$

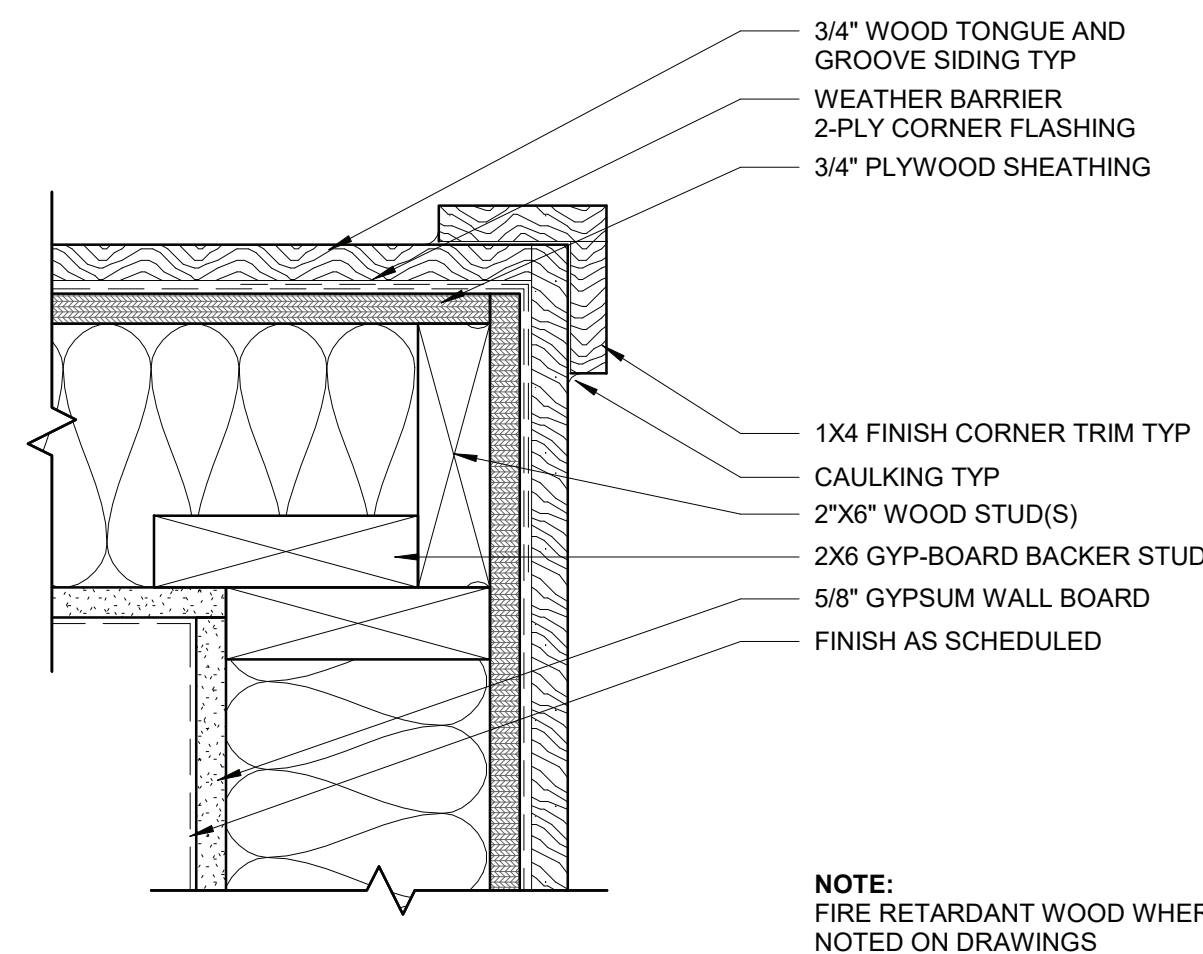

3 $3'' = 1'-0''$

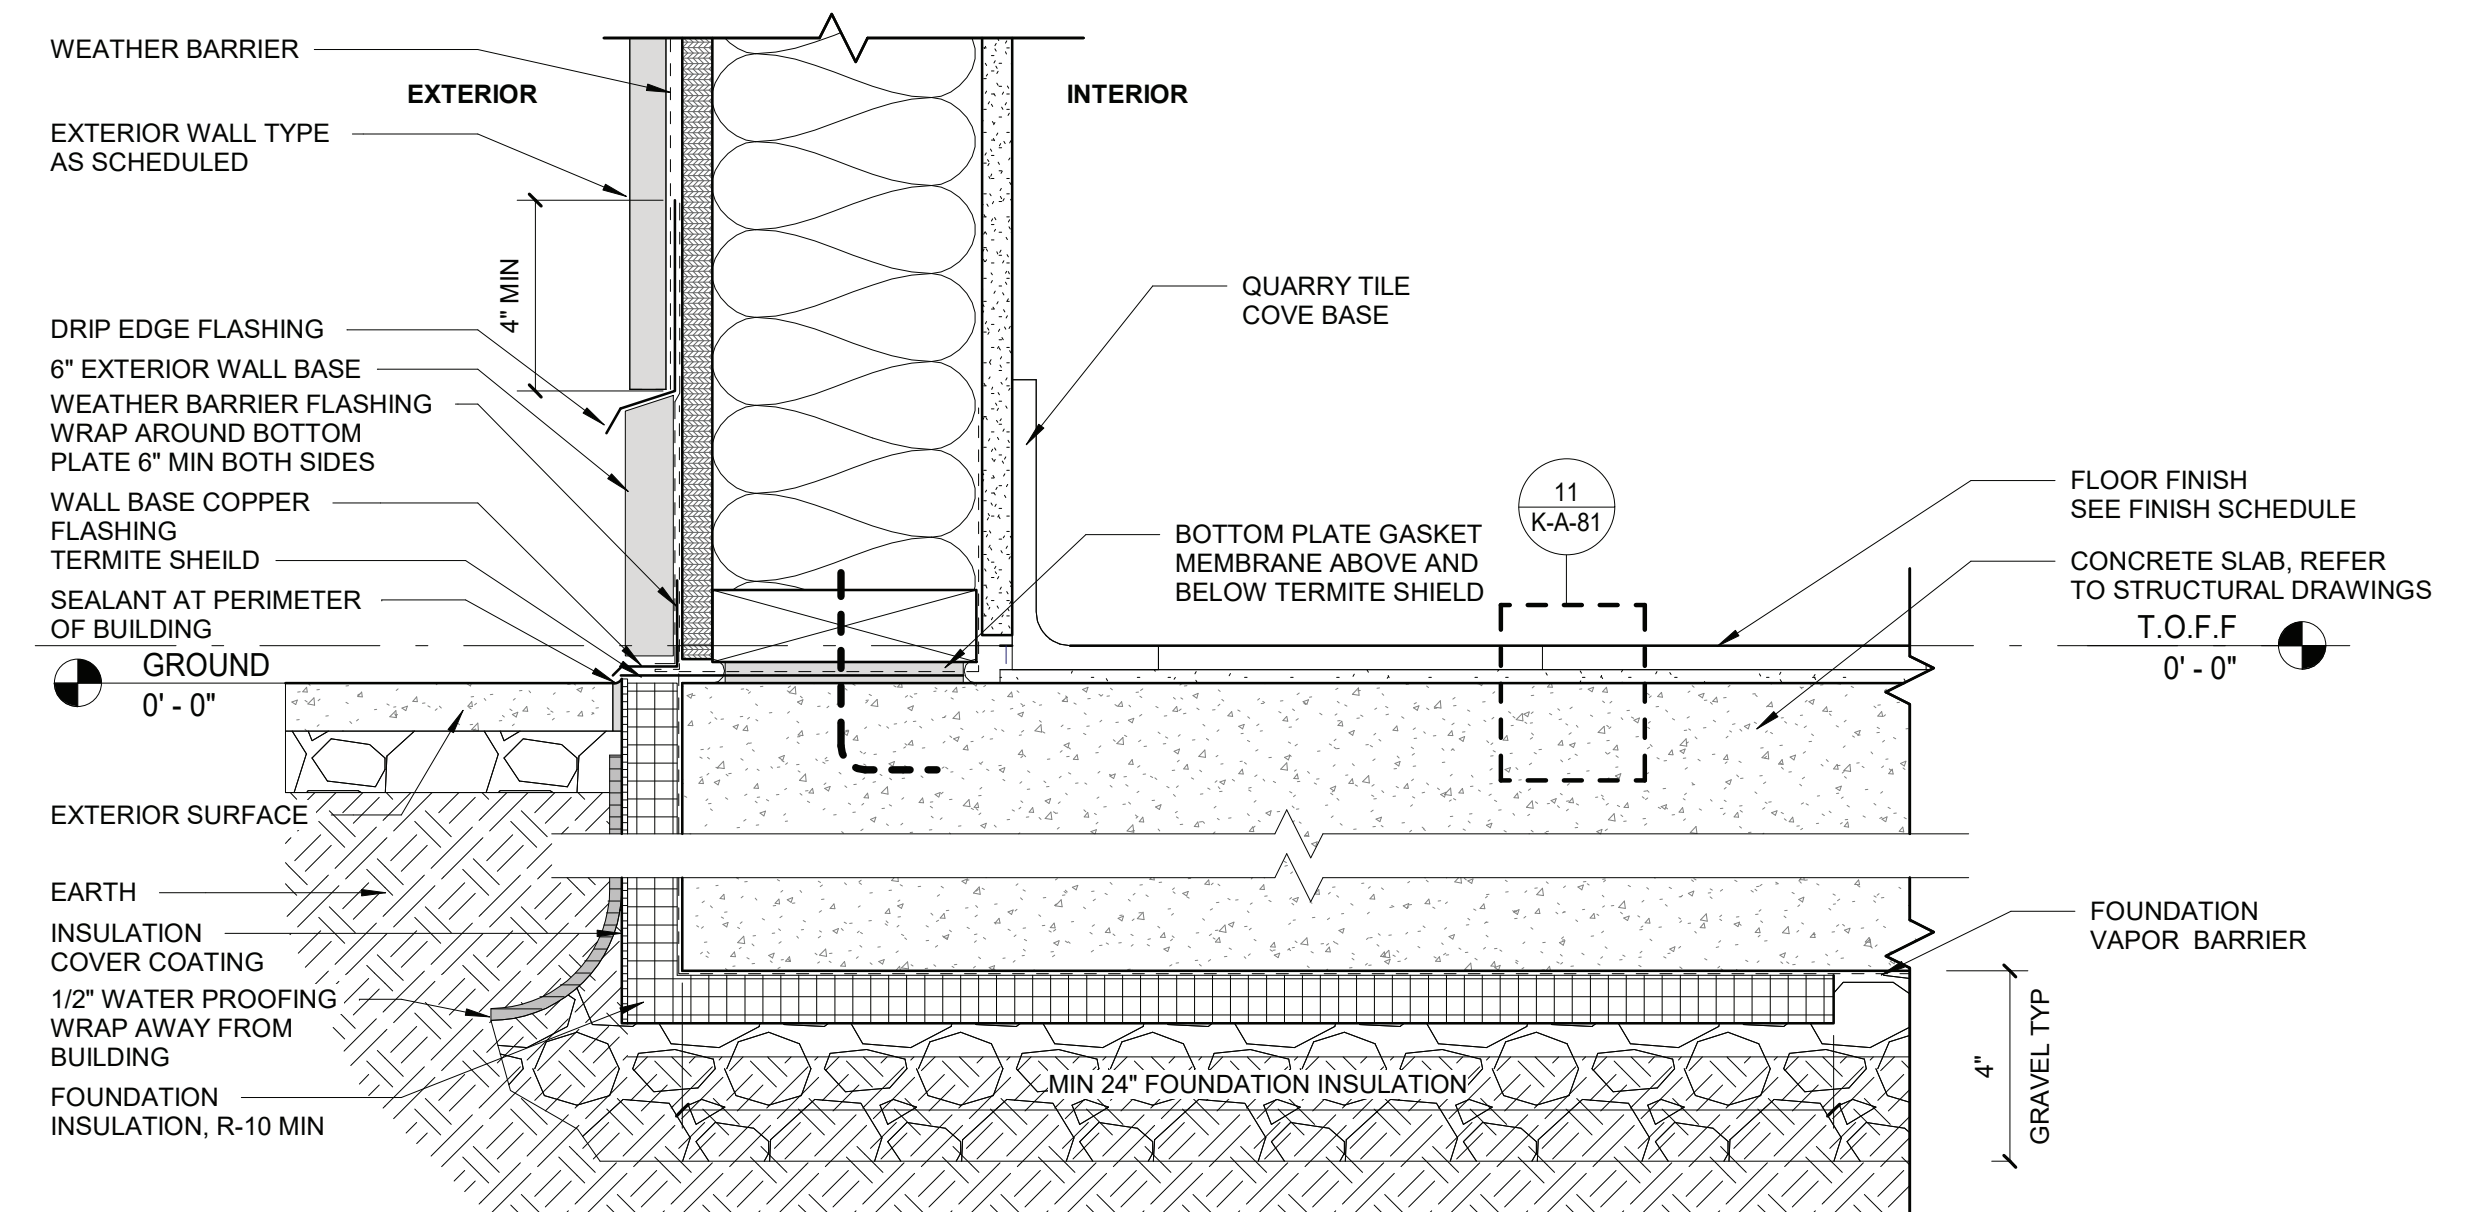

4 $3'' = 1'-0''$

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Printed by: JCastro Date: 19 August 2022 1:06 PM
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STRUCTURAL NOTES

GENERAL

- G-1 THESE NOTES ARE GENERAL AND SUPPLEMENTAL TO THE SPECIFICATIONS. THESE NOTES APPLY TO THE ENTIRE PROJECT UNLESS MODIFIED OR NOTED OTHERWISE IN THE CONTRACT DOCUMENTS.
- G-2 STANDARD DETAILS, SHOWN ON DRAWINGS K-S-11 AND K-S-12 SHALL BE USED WHEN REFERRED TO OR WHEN NO MORE RESTRICTIVE OR DIFFERENT DETAILS ARE SHOWN ON THE DRAWINGS.
- G-3 DESIGN WAS IN ACCORDANCE WITH AND CONSTRUCTION SHALL COMPLY WITH THE PROVISIONS OF THE NEW YORK STATE BUILDING CODE (NYSBC). THE DESIGN LOADS AND OTHER DESIGN VALUES GIVEN BELOW WERE USED FOR DESIGN OF STRUCTURES UON ON THE DRAWINGS.
- G-4 DESIGN LOADS FOR NEW ELEMENTS:
LIVE LOADS:
RESTAURANT KITCHEN WITH FOOD VENDING:
ALL FLOORS U.O.N.: 100 PSF
FLOOR.: 60 PSF
SNOW LOADS:
GROUND SNOW LOAD, Pg = 30 PSF
ROOF SNOW LOAD, P_{rf} = 21 PSF
SNOW EXPOSURE FACTOR, Ce = 0.9
SNOW LOAD IMPORTANCE FACTOR, I = 1.1
THERMAL FACTOR, Ct = 1.0
WIND DESIGN:
BASIC WIND SPEED, V = 126 MPH
BUILDING CATEGORY: II
WIND EXPOSURE CATEGORY: D
INTERNAL PRESSURE COEFFICIENT, GC_{pi} = ±0.18
SEISMIC DESIGN:
SPECTRAL RESPONSE COEFFICIENTS:
SDS = 0.296
SD1 = 0.096
SITE CLASS: B
SEISMIC DESIGN CATEGORY: C
SEISMIC IMPORTANCE FACTOR: I = 1.25
BASIC SEISMIC FORCE RESISTING SYSTEM IS AS SHOWN ON DRAWINGS
DESIGN BASE SHEAR, V = AS SHOWN ON DRAWINGS
ANALYSIS PROCEDURE IS EQUIVALENT LATERAL FORCE METHOD, UON.
RESPONSE MODIFICATION FACTOR, R: R = 7
RESTAURANT KITCHEN WITH FOOD VENDING:
LOADS INDICATED ABOVE REFLECT DESIGN LOADS FOR ANY NEW OR REHABILITATED STRUCTURAL ELEMENTS. THEY SHOULD NOT BE TAKEN AS DESIGN LOADS FOR THE STRUCTURE AS A WHOLE.
- G-5 ALL DIMENSIONS INDICATED (*) ARE TO BE VERIFIED EITHER BY FIELD MEASUREMENTS FOR EXISTING STRUCTURES OR BY SHOP DRAWINGS FOR EQUIPMENT FURNISHED. STRUCTURAL DIMENSIONS NOT SHOWN BUT CONTROLLED BY OR RELATED TO EQUIPMENT SHALL BE VERIFIED BY THE CONTRACTOR WITH THE MANUFACTURER PRIOR TO CONSTRUCTION.
- G-6 STRUCTURAL DRAWINGS SHALL BE USED IN COORDINATION WITH THE DRAWINGS OF ALL OTHER DISCIPLINES AND MANUFACTURER'S SHOP DRAWINGS.
- G-7 IF A CONFLICT IS FOUND BETWEEN DIFFERENT PORTIONS OF THE CONTRACT DOCUMENTS, THE CONTRACTOR SHALL NOTIFY THE ENGINEER IMMEDIATELY. CONTINUED CONSTRUCTION OF THE AREA IN CONFLICT SHALL BE AT THE CONTRACTOR'S OWN RISK UNTIL THE CONFLICT IS RESOLVED BY THE ENGINEER.
- G-8 WHENEVER ONE MEMBER IS FASTENED TO ANOTHER WITH FASTENINGS (BOLTS, WELDS, ETC.) SET AT A UNIFORM SPACING, THERE SHALL BE A MINIMUM OF TWO FASTENINGS PER PIECE CONNECTED AND THE FIRST AND LAST FASTENINGS SHALL BE LOCATED NOT TO EXCEED 0.25 OF FASTENER SPACING FROM EACH END.
- G-9 STRUCTURES HAVE BEEN DESIGNED FOR OPERATIONAL LOADS ON THE COMPLETED STRUCTURE. DURING CONSTRUCTION, THE STRUCTURES SHALL BE PROTECTED BY BRACING AND TEMPORARY SUPPORTS WHEREVER EXCESSIVE CONSTRUCTION LOADS MAY OCCUR. OVERSTRESSING OF ANY STRUCTURAL ELEMENT IS PROHIBITED.
- G-10 NO BACKFILL SHALL BE PLACED AGAINST ANY WALL UNLESS ALL SUPPORTING ELEMENTS OF THE STRUCTURE HAVE BEEN CONSTRUCTED AND HAVE REACHED THE SPECIFIED MINIMUM CONCRETE STRENGTH.
- G-11 THE CONTRACTOR IS RESPONSIBLE FOR VERIFYING ALL EXISTING INFORMATION IN THE FIELD AS REQUIRED FOR NEW WORK.

FOUNDATIONS

- F-1 DESIGN ASSUMPTIONS:
A) ALLOWABLE BEARING PRESSURE: 1. SOUND ROCK – 8 TSF, 2. OVERBURDEN – 1 TSF.
B) GROUNDWATER: EXISTING GROUNDWATER ELEVATIONS VARY ACROSS SITE.
- F-2 GRAVITY UNDER DRAINS SHALL BE PROVIDED TO PERMANENTLY LOWER GROUNDWATER.
- F-3 CONCRETE GENERAL NOTES APPLY TO FOUNDATIONS.
- F-4 MINIMUM DEPTH FROM ADJACENT FINISHED GRADE TO BOTTOM OF FOUNDATION, 4'-0"
- F-5 FOUNDATIONS BEARING ON ROCK SHALL BE CONSTRUCTED SUCH THAT ROCK SURFACE IS LEVEL, UNLESS APPROVED BY ENGINEER.
- F-6 COMPACTED SELECT GRANULAR FILL 12 INCHES THICK MINIMUM, SHALL BE PLACED BELOW ALL CONCRETE FOUNDATIONS UNLESS DIRECTLY BEARING ON SOUND ROCK.

STRUCTURAL METALS

- S-1 DETAIL, FABRICATE, AND ERECT STRUCTURAL STEEL IN ACCORDANCE WITH AISC SPECIFICATION FOR STRUCTURAL STEEL BUILDINGS, ALLOWABLE STRESS DESIGN AND LRFD DESIGN (LRFD MANUAL OF STEEL CONSTRUCTION, CURRENT EDITION).
- S-2 STEEL MATERIAL:
A) STRUCTURAL TUBING, ASTM A 500, GRADE B.
B) STRUCTURAL PIPE, ASTM A 53, GRADE B.
C) PLATES AND ANGLES, ASTM A 36 UNO.
D) STRUCTURAL W SHAPES, ASTM A 992 (MIN. YIELD STRENGTH OF 50 KSI).
E) STRUCTURAL S, M, & H SHAPES ASTM A572 GRADE 50.
F) COLD FORMED STEEL.
- S-3 PROVIDE MIN 3/4" DIAMETER ASTM A 325 HIGH STRENGTH BOLTS WITH FULLY TIGHTENED TYPE N CONNECTIONS FOR STRUCTURAL STEEL UON.
- S-4 PROVIDE TYPICAL STEEL BEAM CONNECTIONS FOR A CAPACITY NOT LESS THAN THE TOTAL UNIFORM LOAD CAPACITY TABULATED IN THE AISC TABLES FOR ALLOWABLE LOADS OF BEAMS UNLESS NOTED OTHERWISE.
- S-5 CAST IN PLACE ANCHOR BOLTS FOR STRUCTURAL STEEL SHALL CONFORM TO ASTM A307 UON.
- S-6 DO NOT PAINT STEEL SURFACES WHICH ARE TO BE WELDED OR ARE TO BE ENCASED IN CONCRETE.
- S-7 STAINLESS STEEL SHALL BE TYPE 316 FOR BOLTED CONSTRUCTIONS AND 316L FOR WELDED CONSTRUCTIONS.
- S-8 ALUMINUM SHALL BE ALLOY 6061-T6.
- S-9 ALL GROOVE AND BUTT WELDS SHALL BE FULL PENETRATION.
- S-10 FILLET WELD SIZES SHALL BE THE MINIMUM SIZE REQUIRED BY AISC CODE FOR PLATE SIZES TO BE CONNECTED AND SHALL BE APPLIED TO THE ENTIRE JOINT CONTACT LENGTH, BUT NOT LESS THAN 3/16".
- S-11 DETAIL, FABRICATE, AND ERECT ALUMINUM IN ACCORDANCE WITH THE ALUMINUM ASSOCIATION CONSTRUCTION MANUAL CURRENT EDITION.
- S-12 ALL BOLTS, ANCHOR BOLTS, AND CONCRETE ANCHORS CONNECTING ALUMINUM SHALL BE TYPE 316 STAINLESS STEEL UON.
- S-13 ALUMINUM SHALL BE ISOLATED FROM CONTACT WITH CONCRETE OR DISSIMILAR METALS.

EXCAVATION

- E-1 CONTRACTOR SHALL PERFORM ALL EXCAVATION IN ACCORDANCE WITH STATE, LOCAL AND FEDERAL REQUIREMENTS INCLUDING OSHA BRACING AND EXCAVATION REQUIREMENTS.
- E-2 TEMPORARY SHEETING AND BRACING IS NOT SHOWN ON CONTRACT DRAWINGS. ALL EXCAVATIONS WITH A POTENTIAL FOR CAVE-IN SHALL BE PROVIDED WITH EXCAVATION PROTECTION SYSTEMS IN ACCORDANCE WITH OSHA 1926. SLOPING AND BENCHING WHICH WILL ENCR OACH ON AREAS SLATED TO REMAIN ACCESSIBLE OR THAT MAY ENCR OACH ON EXISTING FOOTINGS AND STRUCTURES SHALL NOT BE PERMITTED.
- E-3 CONTRACTOR SHALL ENGAGE THE SERVICES OF A LICENSED PROFESSIONAL ENGINEER REGISTERED IN THE STATE OF NEW YORK TO DESIGN ALL TEMPORARY SHEETING AND BRACING AND RELATED APPURTENANCES. CONTRACTOR TO SUBMIT SUCH PLANS TO ENGINEER FOR INFORMATION.
- E-4 CONTRACTOR SHALL BE RESPONSIBLE FOR DEWATERING OF OPEN EXCAVATIONS.
- E-5 ALL EXCAVATED MATERIALS SHALL BE REMOVED FROM SITE TO A FACILITY AS REQUIRED BY STATE, LOCAL FEDERAL LAW.

TIMBER

- T-1 ALL WOOD FRAMING MEMBERS INCLUDING, BUT NOT LIMITED TO, WALL STUDS AND JOISTS, ARE INTENDED TO ACT AS A SYSTEM AS DETAILED IN THE STRUCTURAL DRAWINGS AND ONCE CONSTRUCTION IS COMPLETE. IT IS THE RESPONSIBILITY OF THE CONTRACTOR TO ENSURE SAFETY AND STABILITY OF WOOD FRAMING SYSTEMS (I.E. TEMPORARY BRACING IF REQUIRED) DURING CONSTRUCTION AS A RESULT OF CONSTRUCTION METHODS AND SEQUENCES.
- T-2 ALL TIMBER BELOW FLOOR DECKING SHALL BE PRESSURE-TREATED SOUTHERN PINE LUMBER.
- T-3 STORAGE OF ALL LUMBER AND TIMBER ON SITE SHALL BE KEPT OFF GROUND, UNDER COVER AND PROTECTED FROM DAMAGE.
- T-4 ALL DIMENSIONAL LUMBER SHALL BE CERTIFIED BY THE SUPPLIER IN WRITING TO BE KILN DRIED.
- T-5 STRUCTURE SHALL NOT BE ENCLOSED UNLESS LUMBER MOISTURE CONTENT HAS BEEN VERIFIED TO BE AT OR BELOW 15%. ANY SIGNS OF MOLD SHALL BE REMOVED AND TREATED IN ACCORDANCE WITH PROJECT SPECIFICATIONS OR INDUSTRY STANDARDS.
- T-6 ALL LUMBER IN CONTACT WITH THE GROUND OR CONCRETE SHALL BE PRESSURE TREATED.
- T-7 FASTENERS FOR PRESERVATIVE TREATED AND FIRE RETARDANT TREATED WOOD SHALL BE OF HOT DIPPED ZINC COATED GALVANIZED STEEL OR STAINLESS STEEL AND SHALL FOLLOW CURRENT SIMPSON GUIDELINES BASED ON WEATHER EXPOSURE. WHERE STAINLESS STEEL CONNECTORS OR HOT DIPPED GALVANIZED CONNECTORS ARE SPECIFIED IN THE DRAWINGS, STAINLESS STEEL OR HOT DIPPED GALVANIZED FASTENERS SHALL BE USED TO MATCH CONNECTOR TYPE.
- T-8 ALL PLATES AND LEDGERS SHALL BE FASTENED WITH A MINIMUM (3) ANCHORS PER PIECE UNLESS NOTED OTHERWISE.
- T-9 ALL METAL HARDWARE AND FRAMING ACCESSORIES SHALL BE MANUFACTURED BY SIMPSON STRONG-TIE COMPANY. ALL ITEMS SHALL BE INSTALLED PER THE SIMPSON'S INSTALLATION REQUIREMENTS. ALL NAIL HOLES SHALL BE FILLED WITH THE RECOMMENDED FASTENER UNLESS NOTED OTHERWISE ON THE DRAWING.
- T-10 HOLES FOR BOLTS SHALL BE DRILLED WITH A BIT OF THE SAME NOMINAL DIAMETER AS THE BOLT + 1/16". LEAD HOLES FOR LAG SCREWS SHALL BE BORED PER NDS 11.1.3.
- T-11 ALL BOLTS, CARRIAGE BOLTS, LAG SCREWS, EXPANSION BOLTS AND EPOXY BOLTS SHALL BE INSTALLED WITH STANDAR D CUT WASHERS UNDER THE BOLT HEAD AND NUTS THAT BEAR DIRECTLY ON THE WOOD. ALL NUTS SHALL BE TIGHTENED AT THE TIME OF INSTALLATION AND RE-TIGHTENED IF NECESSARY, DUE TO WOOD SHRINKAGE, PRIOR TO CLOSE OUT OR COMPLETION OF THE PROJECT. BOLTS AND LAG SCREWS SHALL CONFORM TO ANSI/ASME STANDARD B18.2.1. WOOD SCREWS SHALL CONFORM TO B18.6.1. ALL BOLTS SHALL CONFORM TO ASTM A307 GRADE A UNLESS NOTED OTHERWISE.
- T-12 CUTTING AND NOTCHING OF SAWN LUMBER RAFTERS AND STUDS SHALL BE IN CONFORMANCE WITH THE FOLLOWING CRITERIA:
A. JOISTS NOTCHES AT THE ENDS OF JOISTS SHALL NOT EXCEED 1/5 OF THE JOIST DEPTH. HOLES IN JOISTS SHALL NOT BE WITHIN 2½ INCHES OF THE TOP OR BOTTOM OF THE JOIST, AND THE DIAMETER OF ANY SUCH HOLE SHALL NOT EXCEED 1/4 THE DEPTH OF THE JOIST. NOTCHES IN THE TOP OR BOTTOM OF THE JOISTS SHALL NOT EXCEED 1/8 THE DEPTH AND SHALL NOT BE LOCATED IN THE MIDDLE OF THE THIRD SPAN.
B. RAFTERS NOTCHES AT THE ENDS OF RAFTERS OR CEILING JOISTS SHALL NOT EXCEED 1/5 OF THE DEPTH. NOTCHES IN THE TOP OR BOTTOM OF THE RAFTER OR CEILING JOIST SHALL NOT EXCEED 1/6 THE DEPTH AND SHALL NOT BE LOCATED IN THE MIDDLE 1/3 OF THE SPAN. EXCEPT THAT A NOTCH NOT EXCEEDING 1/3 OF THE DEPTH IS PERMITTED IN THE TOP OF THE RAFTERS OR CEILING JOIST NOT FURTHER FROM THE FACE OF THE SUPPORT THAN THE DEPTH OF THE MEMBER. HOLES BORED IN RAFTERS OR CEILING JOISTS SHALL NOT BE WITHIN 2½ INCHES OF THE TOP AND BOTTOM AND THEIR DIAMETER SHALL NOT EXCEED 1/4 THE DEPTH OF THE MEMBER.
C. WALL STUDS A MAXIMUM OF 2¼" DIAMETER NEATLY BORED HOLE MAY BE PLACED IN THE CENTER OF ALL BEARING 2x6 STUDS WITH NO ADDITIONAL REINFORCEMENT REQUIRED.

SPECIAL INSPECTIONS-RESTAURANT KITCHEN WITH FOOD VENDING

- S-1 SPECIAL INSPECTION SHALL COMPLY WITH SPECIFICATIONS.
- S-2 SPECIAL INSPECTION WILL BE PERFORMED IN ACCORDANCE WITH CHAPTER 17 OF THE NYS BUILDING CODE.
- S-3 SPECIAL INSPECTION WILL BE PERFORMED ON THE FOLLOWING STRUCTURAL SYSTEMS:
A) STRUCTURAL STEEL CONSTRUCTION (1705.5).
B) WOOD CONSTRUCTION (1705.4).
C) CONCRETE CONSTRUCTION (1705.3).
D) SOILS (1705.6).
E) DRIVEN DEEP FOUNDATIONS (1705.7)
F) WIND RESISTANCE (1705.11).
G) SEISMIC RESISTANCE (1705.12).


CONCRETE (EXCEPT PRECAST)

- C-1 CONCRETE STRENGTH CLASSES (28-DAY COMPRESSIVE STRENGTH): CLASS A (5000 PSI) STRUCTURES, REINFORCED DUCT BANKS, AND PIPE ENCASEMENT. FOR CONCRETE WALLS GREATER THAN 2 FEET THICK FOLLOW ACI RECOMMENDATIONS FOR MASS CONCRETE. CLASS D (2500 PSI) SIDEWALKS, CURBS AND GUTTERS, CONCRETE FILL, THRUST BLOCKS, UNREINFORCED DUCT BANKS AND PIPE ENCASEMENT, FENCE POST EMBEDMENT.
- C-2 REINFORCEMENT: ASTM A615, GRADE 60, OR ASTM A706, GRADE 60 WHERE REINFORCEMENT IS TO BE WELDED.
- C-3 CONCRETE COVER FOR REINFORCING:
A) SURFACES CAST AGAINST SUBGRADE 3" MIN.
B) FORMED SURFACES IN CONTACT WITH SOIL OR LIQUID 2" MIN.
C) SURFACES NOT IN CONTACT WITH WEATHER, SOIL, OR LIQUID 1 1/2" MIN.
- C-4 CONSTRUCTION JOINTS & CONTROL JOINTS SHALL BE LOCATED AS SHOWN ON THE DRAWINGS. WHERE NOT SHOWN, CONSTRUCTION JOINTS SHALL BE LOCATED AT NO MORE THAN 30 FEET ON CENTER. JOINT LOCATIONS SHALL BE AS APPROVED BY THE ENGINEER.
- C-5 EQUIPMENT SUPPORTS, ANCHORAGES, OPENINGS, RECESSES AND REVEALS NOT SHOWN ON THE STRUCTURAL DRAWINGS BUT REQUIRED BY OTHER DISCIPLINES, SHALL BE PROVIDED FOR PRIOR TO PLACING CONCRETE.
- C-6 SPLICES SHALL BE CLASS 'B' CONFORMING TO THE PROVISIONS OF ACI 318 UNLESS NOTED OTHERWISE.
- C-7 AT ALL TYPICAL CURBS, EQUIPMENT PADS, AND PIPE SUPPORT PIERS, REINFORCING DOWELS SHOWN MAY BE REPLACED WITH MATCHING DOWELS SET IN EPOXY IN DRILLED HOLES AS SPECIFIED. DOWELS LOCATED CLOSER THAN 3" FROM ANY EDGE OF CONCRETE SHALL NOT BE REPLACED WITH DRILLED DOWELS.
- C-8 DRILLED EPOXY DOWELS (WHERE DOWELS ARE SHOWN TO BE PLACED INTO HARDENED CONCRETE):
A) THE HOLE DIAMETER SHALL BE NO LARGER THAN 1/8" GREATER THAN THE DIAMETER OF THE REINFORCING BAR AT THE DEFORMATIONS.
B) THE DEPTH OF EMBEDMENT SHALL BE 12 BAR DIAMETERS, UNLESS SHOWN OTHERWISE.
C) ADJUST THE DOWEL LOCATIONS AS NEEDED TO AVOID DRILLING THROUGH ANY REINFORCING BARS.IF THE DOWEL LOCATION NEEDS TO BE MODIFIED, CONTACT THE ENGINEER.
- C-9 SLABS WITH SLOPING SURFACES SHALL HAVE THE INDICATED SLAB THICKNESS MAINTAINED AS THE MINIMUM. SLAB BOTTOMS CAN EITHER SLOPE WITH THE TOP SURFACE OR BE LEVEL. REINFORCEMENT IN SLABS WITH SLOPING SURFACES SHALL BE PLACED AT THE REQUIRED CLEARANCE FROM THE SLAB SURFACE.
- C-10 SLOPES SHOWN ON SLAB SURFACES BY FLOW ARROWS SHALL BE 1.0 PERCENT UNLESS NOTED OTHERWISE.
- C-11 WHERE HORIZONTAL CONSTRUCTION JOINTS, LOCATED ABOVE THE FOUNDATION SLAB, EXTEND BEYOND WHERE NEEDED, THEY SHALL BE TERMINATED AT A VERTICAL CONSTRUCTION JOINT APPROVED BY THE ENGINEER.
- C-12 DOWELS, ANCHOR BOLTS, PIPES, WATERSTOPS AND OTHER EMBEDDED ITEMS SHALL BE HELD SECURELY IN POSITION WHILE CONCRETE IS BEING PLACED.
- C-13 CONDUITS AND OTHER SIMILAR ITEMS EMBEDDED IN OR PENETRATING THROUGH CONCRETE SHALL BE SPACED ON CENTER NOT LESS THAN 3 TIMES THEIR OUTSIDE DIMENSION, BUT NOT LESS THAN 2 1/2" CLEAR IN CLASS 45F CONCRETE OR 2" CLEAR IN CLASS 45 CONCRETE. SUCH ITEMS SHALL NOT EXCEED 1/3 OF THE MEMBER THICKNESS.
- C-14 REINFORCING BARS AND ACCESSORIES SHALL NOT BE IN CONTACT WITH ANY METAL PIPE, PIPE FLANGE, METAL CONDUIT, OR OTHER METAL PARTS EMBEDDED IN CONCRETE. A MINIMUM CLEARANCE OF 2 INCHES SHALL BE PROVIDED.
- C-15 ALL JOINTS WHICH ARE IN MEMBERS IN CONTACT WITH LIQUID OR BELOW GRADE SHALL HAVE A WATERSTOP. CONSTRUCTION JOINTS SHALL HAVE A 6" PVC FLATSTRIP WATERSTOP, EXPANSION JOINTS SHALL HAVE A 9" PVC CENTERBULB WATERSTOP.
- C-16 IN VERTICAL JOINTS, WATERSTOP SHALL STOP NO LESS THAN 18" ABOVE THE MAXIMUM WATER SURFACE OR 18" ABOVE GRADE, WHICHEVER IS HIGHER.
- C-17 AT JOINT INTERSECTIONS, WATERSTOPS SHALL BE CONNECTED SO AS TO FORM A COMPLETE SEAL USING CONNECTION PIECES AS NEEDED.
- C-18 ALL EXPOSED CORNERS SHALL HAVE A 3/4" CHAMFER OR A 1/2" RADIUS TOOLED CORNER.

DEMOLITION

LEGEND

EXISTING REINFORCED CONCRETE WALL OR STRUCTURE TO BE DEMOLISHED

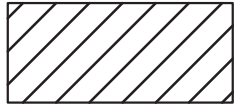


SAW CUT LINE – FULL DEPTH UNLESS NOTED OTHERWISE

- D-1 CONTRACTOR IS ALERTED THAT LIMITS OF DEMOLITION SHOWN IS APPROXIMATE. ACTUAL LIMITS SHALL BE THE MINIMUM REQUIRED FOR NEW STRUCTURE. CONTRACTOR TO CO-ORDINATE AND SUBMIT DEMOLITION PROCEDURE PER SPECIFICATIONS.
- D-2 ALL ITEMS SHOWN ARE EXISTING TO REMAIN UNLESS NOTED OTHERWISE.
- D-3 FOR ADDITIONAL DEMOLITION REQUIREMENTS SEE SPECIFICATIONS (024116).
- D-4 ALL EXISTING CONCRETE TO BE DEMOLISHED IS STEEL REINFORCED UNLESS NOTED OTHERWISE. REINFORCING STEEL NOT SHOWN FOR CLARITY.
- D-5 FOR ADDITIONAL DEMOLITION NOT SHOWN, SEE G, A, M, E, H, AND P DRAWINGS.

PILE NOTES

- P-1 PILES SHALL BE DESIGNED AND INSTALLED BY A QUALIFIED PILE CONTRACTOR IN ACCORDANCE WITH THE BORED-IN PILE SPECIFICATIONS AND SUBJECT TO THE REQUIREMENTS LISTED HEREIN.
- P-2 THE CONTRACTOR SHALL ENGAGE A LICENSED PROFESSIONAL ENGINEER REGISTERED IN THE STATE OF NEW YORK TO DESIGN PILE AND SUBMIT THE DESIGN TO THE ENGINEER FOR APPROVAL.
- P-3 THE BORED-IN PILE SHALL BE MINIMUM 9 5/8"Ø WITH 0.545" WALL THICKNESS AND DESIGNED AND INSTALLED FOR ULTIMATE LOAD IN COMPRESSION = 60 TONS ALLOWABLE LOAD IN COMPRESSION = 30 TONS.
- P-4 ALL BORED-IN PILES SHALL BE GROUTED WITH A MINIMUM 28 DAY COMPRESSIVE STRENGTH OF 4000 PSI.
- P-5 ALL BORED-IN PILES SHALL HAVE FULL LENGTH 1-1/4" Ø THREADBARS. THE THREADBARS SHALL CONFORM TO THE REQUIREMENTS OF ASTM A722, GRADE 150 AS MANUFACTURED BY DYWIDAG OR APPROVED EQUAL, UNLESS NOTED OTHERWISE. PROVIDE BEARING PLATES AND NUTS IN ACCORDANCE WITH THE THREADBAR MANUFACTURER'S RECOMMENDATIONS.
- P-6 PROVIDE CENTRALIZERS FOR THREADBARS AT 10 FEET MAXIMUM VERTICAL SPACING.
- P-7 CUT OFF THE ELEVATIONS OF THE BORED-IN PILES AS SHOWN ON DRAWINGS.
- P-8 ALL BORED-IN PILES SHALL BE INSTALLED WITH A MAXIMUM LATERAL TOLERANCE OF THREE INCHES.
- P-9 DRILLING OPERATION SHALL BE PERFORMED IN THE PRESENCE OF THE ENGINEER.
- P-10 ONE (1) STATIC AXIAL COMPRESSION LOAD TEST WILL BE REQUIRED.
- P-11 THE INSTALLATION METHOD USED FOR THE SUCCESSFUL COMPLETION OF LOAD TESTING SHALL BE USED FOR ALL THE PRODUCTION PILES.
- P-12 THE CONTRACTOR SHALL SUBMIT A STATIC AXIAL LOAD TESTING PROGRAM CONSISTING OF ONE (1) COMPRESSION TEST SHOWING PROPOSED PILE LOAD TEST LOCATIONS FOR APPROVAL OF THE ENGINEER.
- P-13 COMPRESSION LOAD TESTING SHALL CONFORM TO ASTM D1143 AND THE PROJECT SPECIFICATIONS. UPLIFT LOAD TESTING SHALL CONFORM TO THE PROJECT SPECIFICATIONS AND ASTM D3689.
- P-14 A MINIMUM PERIOD OF TWO (2) WEEKS SHALL ELAPSE FROM THE INSTALLATION OF THE TEST PILE TO THE COMMENCEMENT OF THE LOAD TEST.
- P-15 TWO (2) TELLTALE RODS SHALL BE INSTALLED IN THE LOAD TEST PILE. THE BOTTOM END OF ONE TELLTALE ROD SHALL BE AT THE BOTTOM OF THE TEST PILE, AND THE BOTTOM END OF THE OTHER ROD SHALL BE TERMINATED MIDWAY BETWEEN PILE CUT-OFF AND PILE TIP. THE TELLTALE SHALL CONSIST OF A STEEL SOUNDING ROD EXTENDED TO AN ELEVATION DESIGNATED BY THE ENGINEER. THE TELLTALES SHALL BE PROTECTED BY A STEEL TUBE EMBEDDED IN GROUT. THE TELLTALE SHALL BE CENTERED IN THE TUBE IN A MANNER TO AVOID FRICTION BETWEEN THE TELLTALE AND THE TUBE.
- P-16 THE LOADING PROCEDURE FOR STATIC AXIAL COMPRESSION TEST SHALL BE IN ACCORDANCE WITH NEW YORK STATE BUILDING CODE.
- P-17 MEASUREMENTS OF MOVEMENT OF THE PILE BUTT, TELLTALES, REFERENCE BEAMS, ETC. SHALL BE TAKEN BY LICENSED SURVEYOR (REGISTERED IN THE STATE OF NEW YORK) ENGAGED BY THE OWNER.
- P-18 MONITORING OF LOAD TEST SHALL BE PERFORMED BY A PROFESSIONAL ENGINEER REGISTERED IN THE STATE OF NEW YORK AND HIRED BY THE OWNER.
- P-19 THE DIAL GAUGES FOR MONITORING THE MOVEMENT OF THE PILE SHALL HAVE A MINIMUM TRAVEL OF THREE (3) INCHES AND SHALL BE AT LEAST THREE (3) INCHES IN DIAMETER.

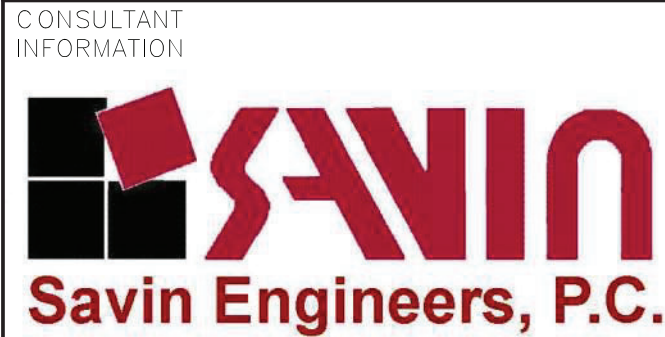

REVISION NUMBER	DATE	MADE BY	APP'D BY	REVISION

RECORD DRAWING CERTIFICATION			
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CONTRACTOR		PROJECT COORDINATOR	
NAME _____	NAME _____	SIGNATURE _____	SIGNATURE _____
TITLE _____	TITLE _____	DATE _____	DATE _____

WESTCHESTER COUNTY, NEW YORK
DEPARTMENT OF PUBLIC WORKS AND TRANSPORTATION
DIVISION OF ENGINEERING
INFRASTRUCTURE REHABILITATION - PHASE 3
PLAYLAND PARK, RYE, NEW YORK
RESTAURANT KITCHEN WITH FOOD VENDING
STRUCTURAL NOTES

CONTRACT NUMBER	SHEET NUMBER
22-523	K-S-01
DWG NO.: 22-523	523 of 664
SCALE: AS SHOWN	
DATE: 8/23/2022	
DPW FILE NUMBER 1-118-S-1277-0	REV. NO. 0

Drawing Name: C:\SavinAutocad\2060\25-Playland-Mega-3\5\VS-1007.dwg
Revised: 8/23/2022
Project: Infrastructure Rehabilitation - Phase 3
Drawing: Structural Abbreviations and Symbols
Scale: AS SHOWN
Printed: 8/23/2022 4:06 PM
Designed by: ---

STRUCTURAL ABBREVIATIONS


AB	ANCHOR BOLT
ADDL	ADDITIONAL
ADH	ADHESIVE
ADJ	ADJUSTABLE/ADJACENT
AFF	ABOVE FINISHED FLOOR
AGG	AGGREGATE
AL	ALUMINUM
ALT	ALTERNATE
APPROX	APPROXIMATE
ARCH	ARCHITECTURAL
AVG	AVERAGE
B	BORING
BLDG	BUILDING
BM	BEAM/BENCH MARK
BOF	BOTTOM OF FOOTING
BOS	BOTTOM OF STEEL
BOT	BOTTOM
BRG	BEARING
BT	BOLT
C	CHANNEL
C TO C	CENTER TO CENTER
CANT	CANTILEVER
CJ	CONSTRUCTION JOINT
CL	CENTER LINE
CLR	CLEAR
CMU	CONCRETE MASONRY UNIT
CO	CLEAN OUT
COL	COLUMN
CONC	CONCRETE
CONST	CONSTRUCTION
CONT	CONTINUOUS
CONTR	CONTRACTOR
CP	CONCRETE PLANK
CLJ	CONTROL JOINT
CTR	CENTER
CY	CUBIC YARD
DET	DETAIL
DIA (ø)	DIAMETER
DIAG	DIAGONAL
DIM	DIMENSION
DIST	DISTANCE
DN	DOWN
DO	DITTO
DP	DEEP
DWG	DRAWING
DWL	DOWEL
E	EAST
EA	EACH
EF	EACH FACE
EL	ELEVATION
ELEV	ELEVATOR
ENGR	ENGINEER
EMB	EMBEDMENT
ENCL	ENCLOSURE
ENT	ENTRANCE
EQ	EQUAL
EQPT	EQUIPMENT
EW	EACH WAY
EXIST	EXISTING
EXP	EXPANSION
EXP JT	EXPANSION JOINT
EXT	EXTERIOR
FAB	FABRICATE
FD	FLOOR DRAIN
FDN	FOUNDATION
FFL	FINISH FLOOR
FIN	FINISH
FLR	FLOOR
FT	FEET
FTG	FOOTING
F&C	FRAME&COVER
F&G	FRAME&GRATE

GA	GAUGE
GALV	GALVANIZE
GB	GRADE BEAM
GR	GRADE
GRTG	GRATING
HGT	HEIGHT
HORZ	HORIZONTAL
HP	HIGH POINT
HSS	HOLLOW STRUCTURAL STEEL
ID	INSIDE DIAMETER
IF	INSIDE FACE
IN	INCH
INCL	INCLUDE
INT	INTERIOR
INV	INVERT
J	JOIST
JB	JUNCTION BOX
JCT	JUNCTION
JT	JOINT
L	LENGTH/ANGLE
LF	LINEAR FEET
LG	LONG
LL	LIVE LOAD
LLH	LONG LEG HORIZONTAL
LLV	LONG LEG VERTICAL
LOC	LOCATION
LP	LOW POINT
LVR	LOUVER
LWL	LOW WATER LEVEL
MAS	MASONRY
MATL	MATERIAL
MAX	MAXIMUM
MECH	MECHANICAL
MET	METAL
MFR	MANUFACTURER
MG	MILLION GALLONS
MGD	MILLION GALLONS PER DAY
MH	MANHOLE
MIN	MINIMUM
MISC	MISCELLANEOUS
MO	MASONRY OPENING
MOD	MODIFY/MODIFIED
MTD	MOUNTED
N	NORTH
NA	NOT APPLICABLE
NIC	NOT IN CONTRACT
NO	NUMBER
NOM	NOMINAL
NTS	NOT TO SCALE
OC	ON CENTER
OD	OUTSIDE DIAMETER
OF	OUTSIDE FACE
OPNG	OPENING
OPP	OPPOSITE
OT	OPEN TRUSS
OVHD	OVERHEAD
PAR	PARALLEL
PC	POINT OF CURVE/PIECE
PCO	PILE OUT OFF
PI	POINT OF INTERSECTION
PL	PLATE/PROPERTY LINE
PREFAB	PREFABRICATED
PSF	POUNDS PER SQUARE FOOT
PSI	POUNDS PER SQUARE INCH
PT	POINT OF TANGENCY
PTN	PARTITION
PVMT	PAVEMENT
QTY	QUANTITY


R	RISER
RAD	RADIUS
RCP	REINFORCED CONCRETE PIPE
RD	ROOF DRAIN
REINF	REINFORCEMENT
RECT	RECTANGULAR
REM	REMOVE
REQD	REQUIRED
RF	ROOF
RO	ROUGH OPENING
S	SOUTH
SCHED	SCHEDULE
SECT	SECTION
SF	SQUARE FEET
SHT	SHEET
SIM	SIMILAR
SJ	STEEL JOIST
SPEC	SPECIFICATION
SQ	SQUARE
SS	STAINLESS STEEL
STA	STATION
STD	STANDARD
STR	STAIR
STIF	STIFFENER
STIR	STIRRUP
STL	STEEL
STRUC	STRUCTURAL
SUB	SUBSTITUTE
SYM	SYMMETRICAL
T	TREAD
T&B	TOP AND BOTTOM
T&G	TOUNGE AND GROOVE
TAN	TANGENT
TEMP	TEMPERATURE
THK	THICK
TOC	TOP OF CURB/CONCRETE
TOD	TOP OF DECK
TOF	TOP OF FOOTING
TOM	TOP OF MASONRY/MANHOLE
TOS	TOP OF SLAB/STEEL
TOW	TOP OF WALL
TYP	TYPICAL
UNO	UNLESS NOTED OTHERWISE
VERT	VERTICAL
W	WEST/WIDTH/WIDE FLANGE
W/	WITH
W/O	WITHOUT
WL	WATER LEVEL
WP	WATERPROOF/WALL PIPE
WPT	WALL PENETRATING TYPE
WS	WATER SURFACE
WT	WEIGHT
WWF	WELDED WIRE FABRIC
YD	YARD
YR	YEAR

SYMBOLS



	UNDISTURBED EARTH
	COMPACTED BACKFILL
	SELECT GRANULAR FILL MATERIAL
	CONCRETE BLOCK
	BRICK
	FINISHED WOOD
	CONCRETE
	ROUGH WOOD
	RIGID INSULATION
	REINFORCED STEEL IN CONCRETE
	WELDED WIRE FABRIC
	BLANKET INSULATION
	STEEL
	DENOTES MOMENT CONNECTION

<div>CONSULTANT INFORMATION</div> <div></div>	<div>CONSULTANT SEAL</div> <div></div>				<div>REVISION</div> <div>DATE</div> <div>MADE BY</div> <div>APP'D BY</div> <div>REVISION</div>				<div>RECORD DRAWING CERTIFICATION</div> <div><input type="checkbox"/> AS BUILT - CHANGES AS NOTED <input type="checkbox"/> AS BUILT - NO CHANGES</div> <div><div>CONTRACTOR</div><div>NAME _____ SIGNATURE _____ TITLE _____ DATE _____</div><div>PROJECT COORDINATOR</div><div>NAME _____ SIGNATURE _____ TITLE _____ DATE _____</div></div>				<div>WESTCHESTER COUNTY, NEW YORK</div> <div>DEPARTMENT OF PUBLIC WORKS AND TRANSPORTATION</div> <div>DIVISION OF ENGINEERING</div> <div>INFRASTRUCTURE REHABILITATION - PHASE 3</div> <div>PLAYLAND PARK, RYE, NEW YORK</div> <div>RESTAURANT KITCHEN WITH FOOD VENDING</div> <div>STRUCTURAL ABBREVIATIONS AND SYMBOLS</div>				<div>CONTRACT NUMBER</div> <div>22-523</div> <div>SHEET NUMBER</div> <div>K-S-02</div>	
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									<div>SCALE:</div> <div>AS SHOWN</div>									
									<div>DATE:</div> <div>8/23/2022</div>									
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Xrefs: [TB-24436-WestchesterCo_3.dwg] [TSC-SYMBOL.dwg] [K-S-1001.dwg]

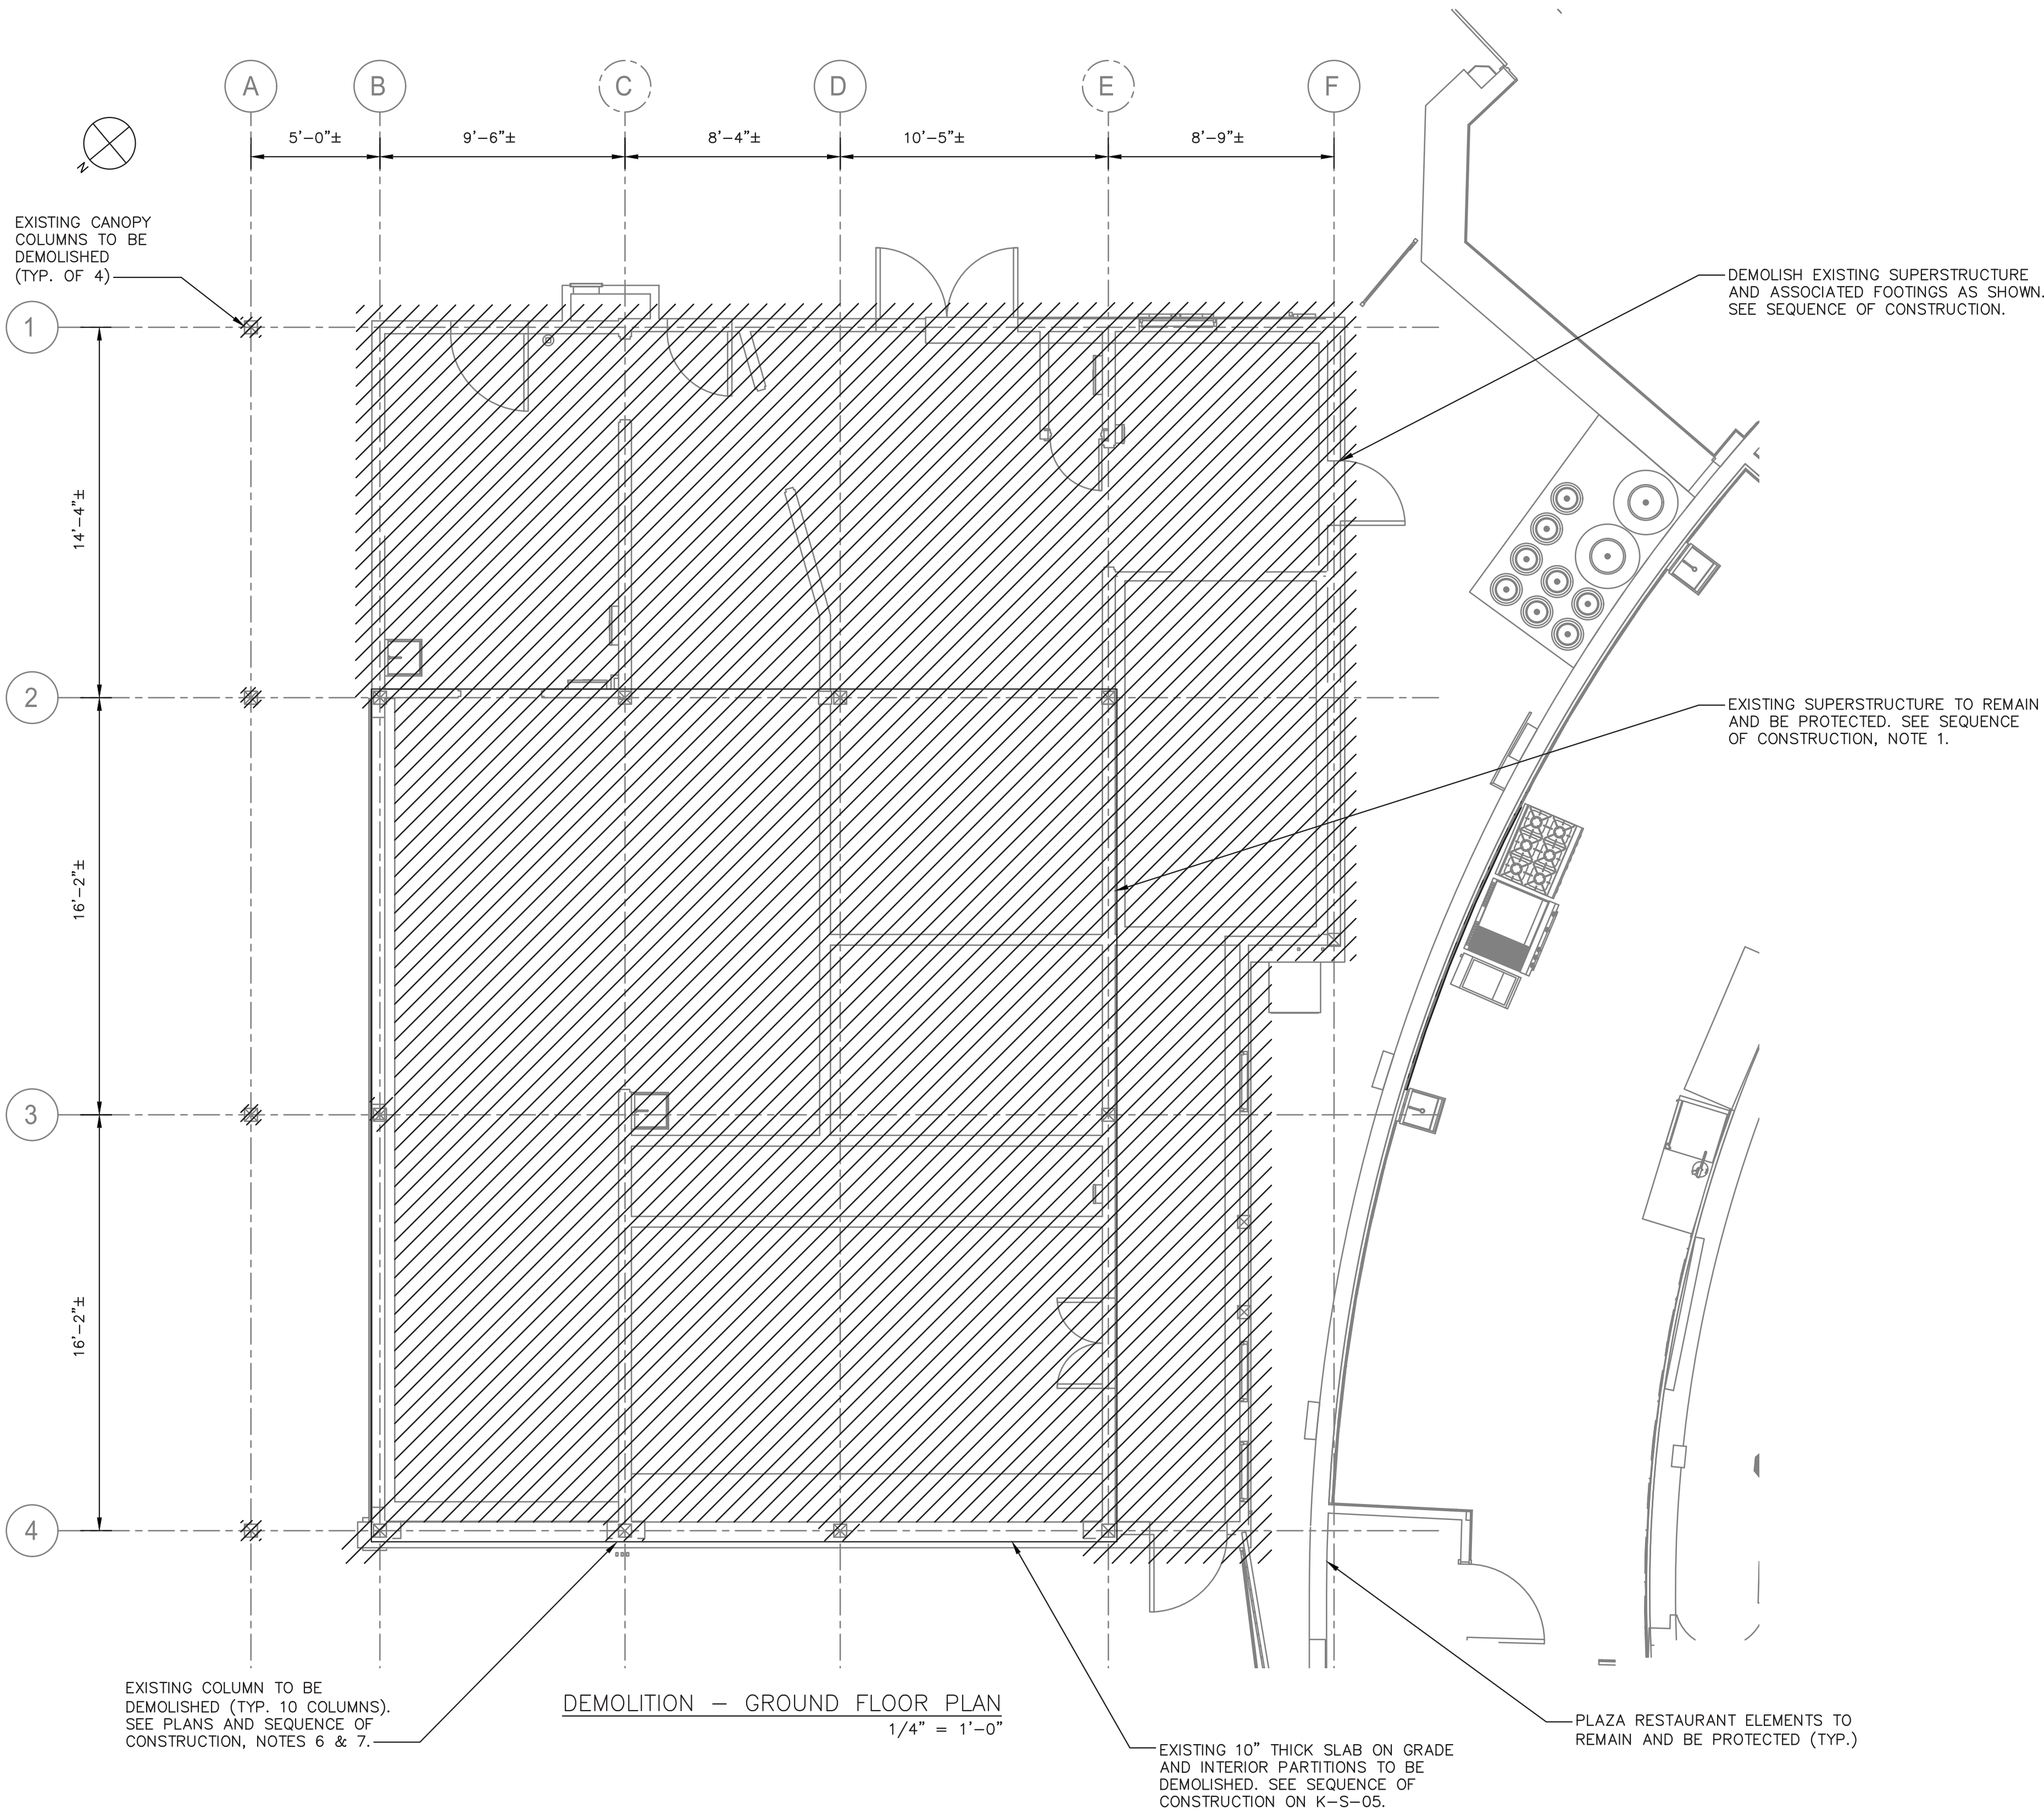

- NOTES:
1. FOR STRUCTURAL NOTES, SEE DRAWING K-S-01.
 2. FOR STRUCTURAL ABBREVIATIONS AND SYMBOLS, SEE DRAWING K-S-02.
 3. SEE K-S-05 FOR SHORING PLAN AND SEQUENCE OF CONSTRUCTION.

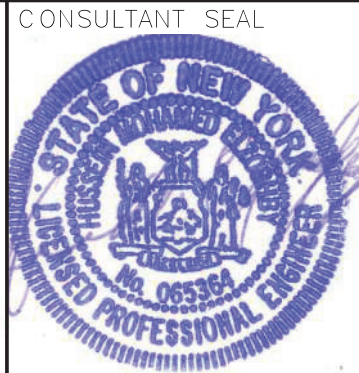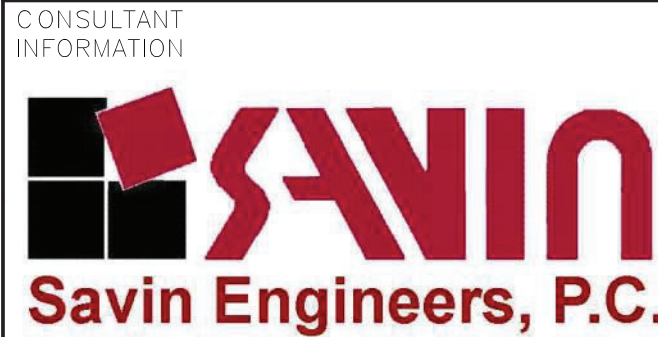


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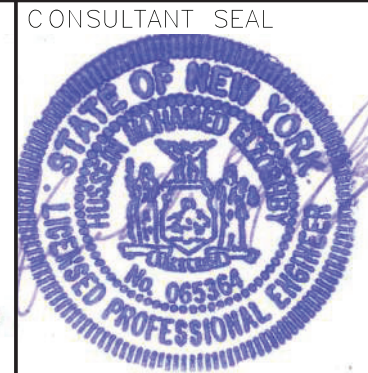
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INFRASTRUCTURE REHABILITATION - PHASE 3 PLAYLAND PARK, RYE, NEW YORK RESTAURANT KITCHEN WITH FOOD VENDING DEMOLITION - GROUND FLOOR PLAN	
CONTRACT NUMBER 22-523	SHEET NUMBER K-S-03
DWG NO.: 523 of 664	
SCALE: AS SHOWN	
DATE: 8/23/2022	
DPW FILE NUMBER 1-118-S-1279-0	REV. NO. 0

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CONSULTANT
INFORMATION



Savin
Engineers, P.C.



REVISION NUMBER	DATE	MADE BY	APP'D BY	REVISION

RECORD DRAWING CERTIFICATION

☐ AS BUILT - CHANGES AS NOTED ☐ AS BUILT - NO CHANGES


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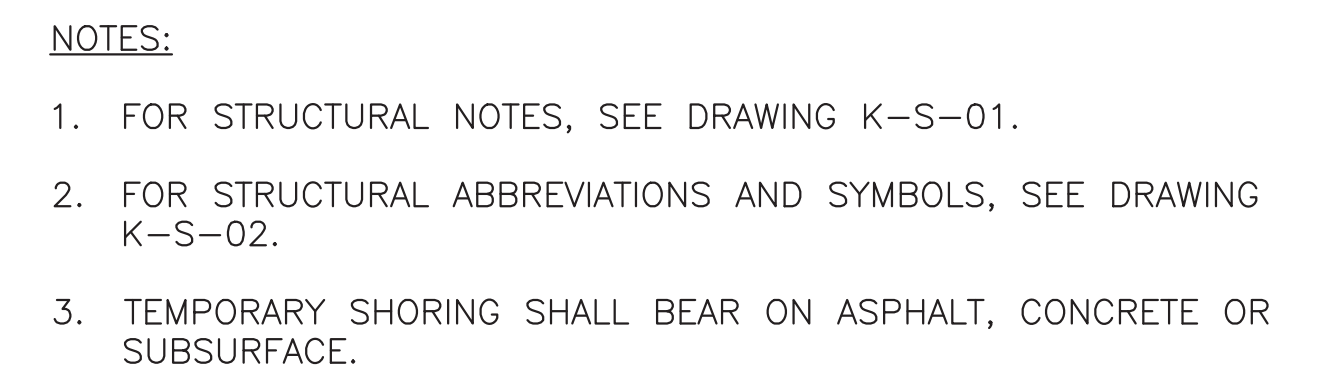
WESTCHESTER COUNTY, NEW YORK
DEPARTMENT OF PUBLIC WORKS AND TRANSPORTATION
DIVISION OF ENGINEERING

INFRASTRUCTURE REHABILITATION - PHASE 3
PLAYLAND PARK, RYE, NEW YORK
RESTAURANT KITCHEN WITH FOOD VENDING
DEMOLITION - ROOF PLAN

CONTRACT NUMBER 22-523	SHEET NUMBER K-S-04
DWG NO.: 531 of 664	SCALE: AS SHOWN
DATE: 8/23/2022	REV. NO. 0
DPW FILE NUMBER 1-118-S-1280-0	

- NOTES:
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 - FOR STRUCTURAL ABBREVIATIONS AND SYMBOLS, SEE DRAWING K-S-02.



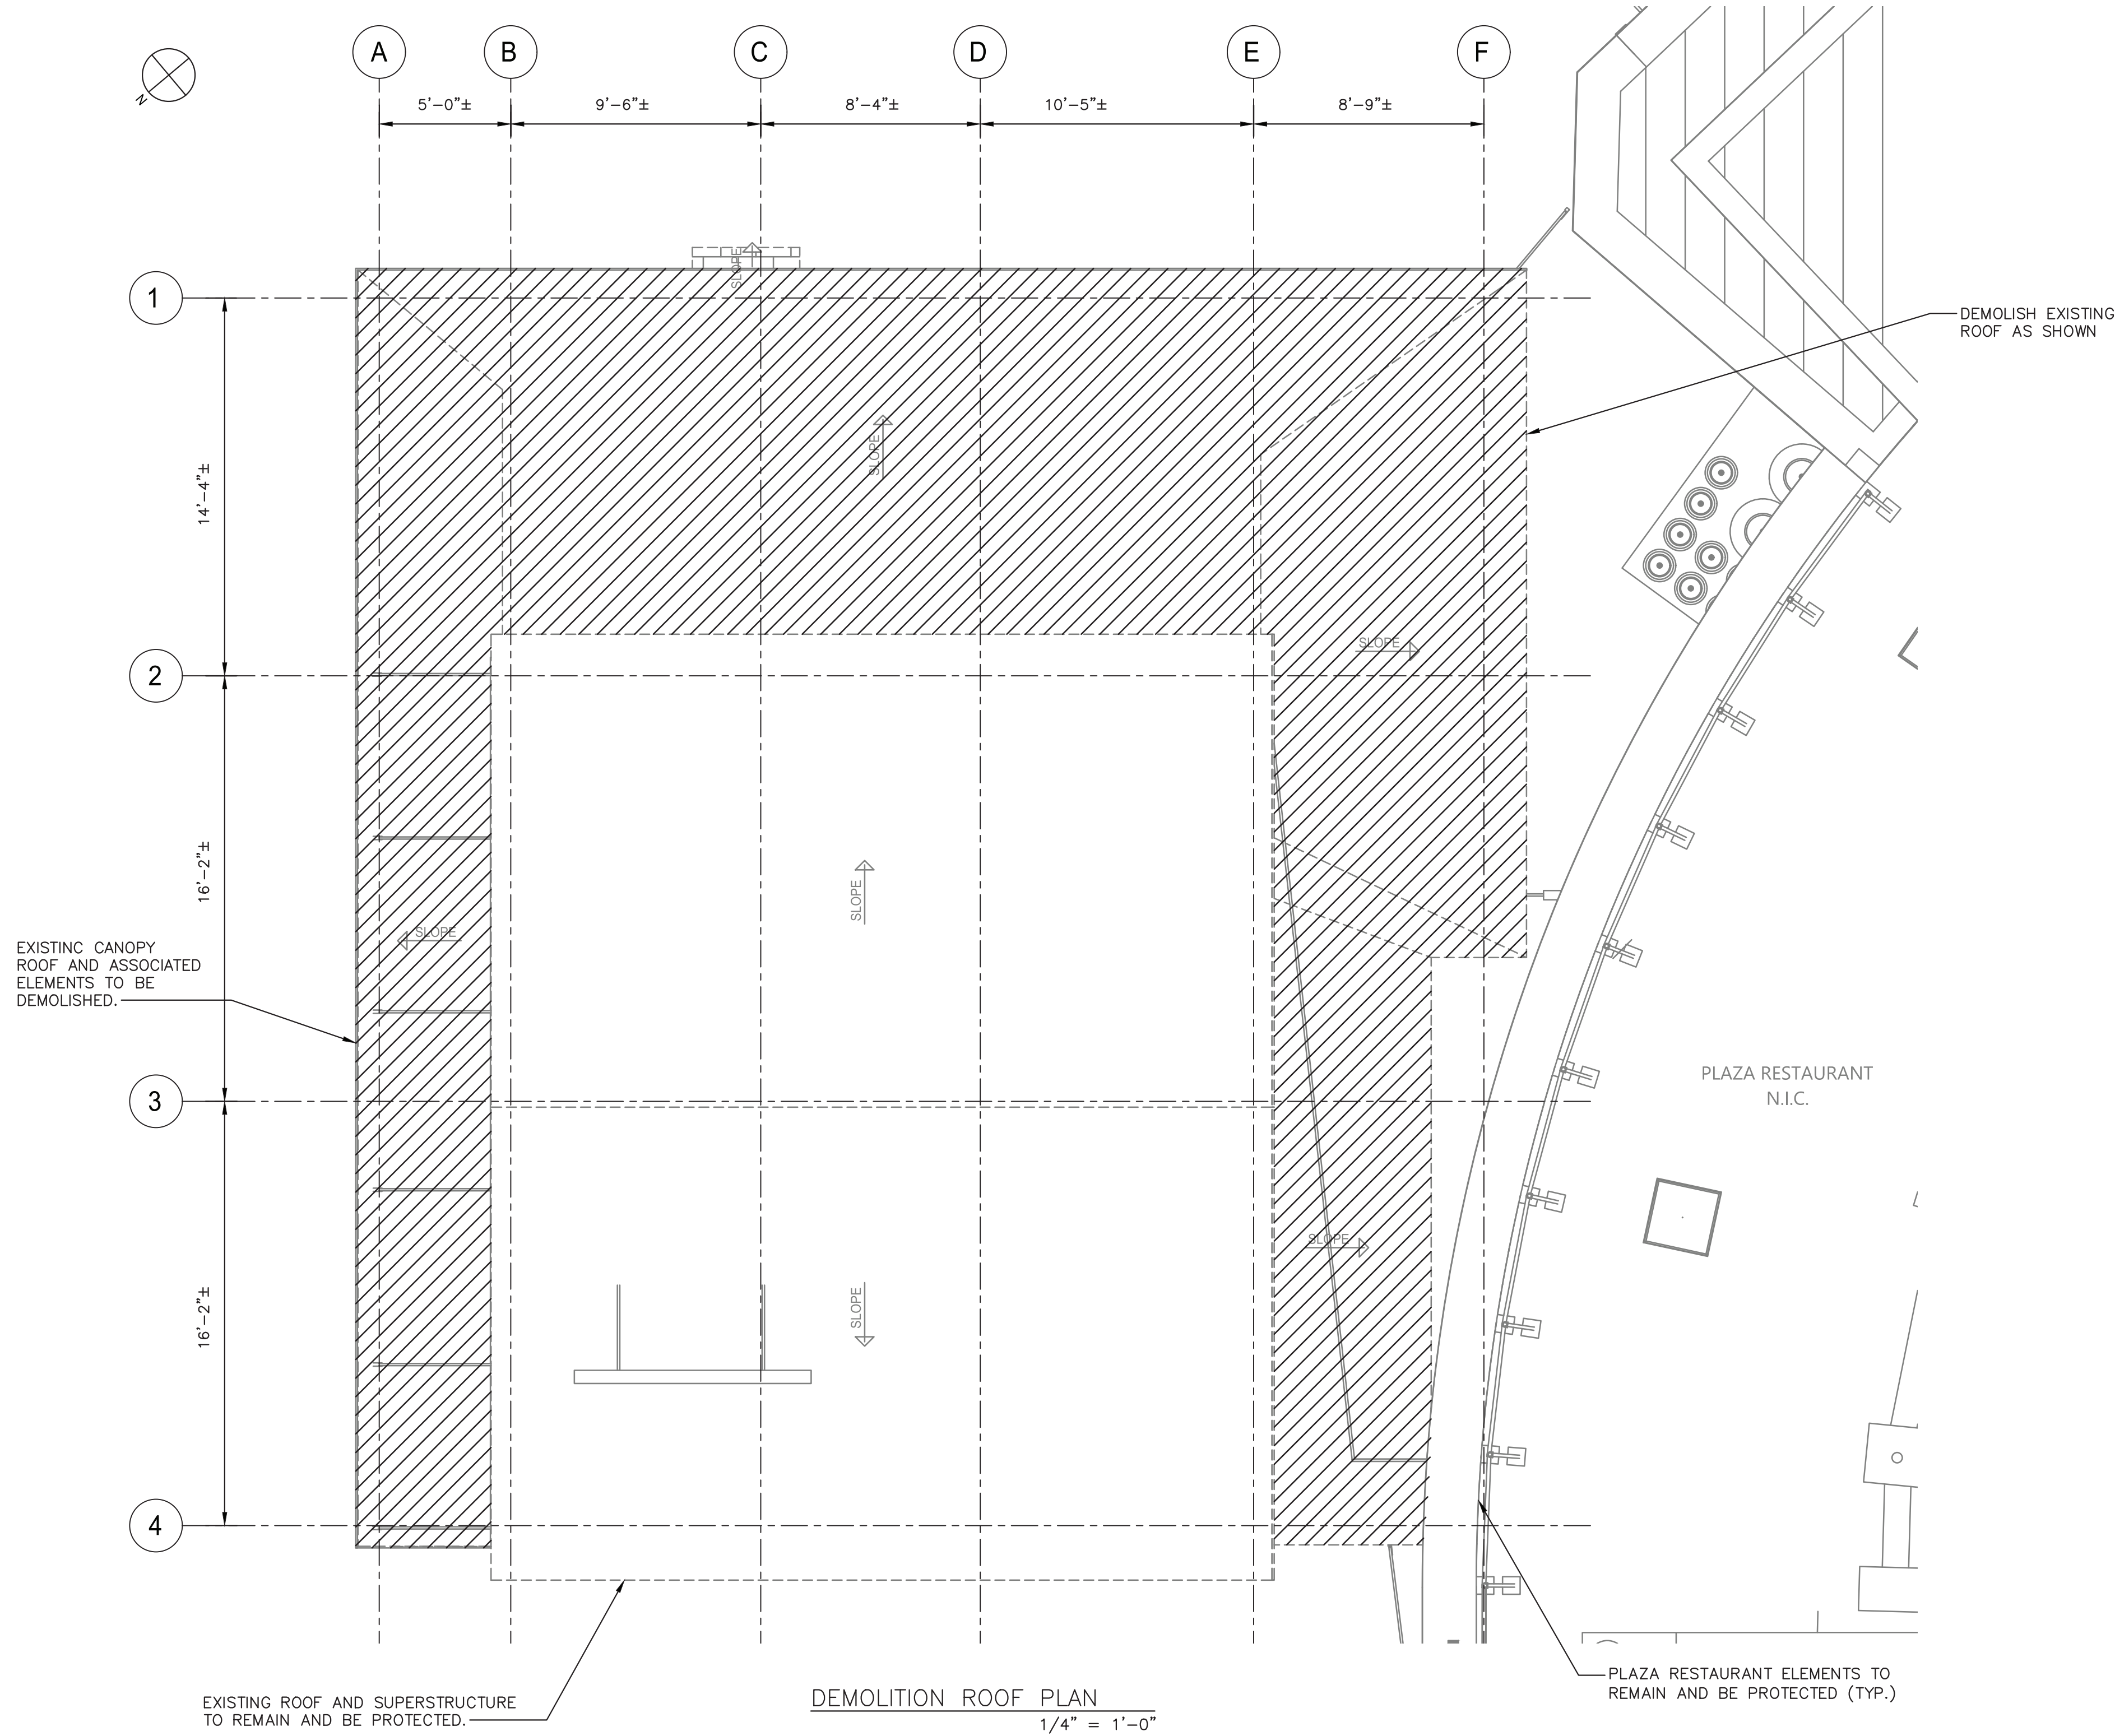


1. DEMOLISH EXISTING SUPERSTRUCTURE AS SHOWN AND EXISTING INTERIOR SLAB ON GRADE. SEE K-S-03 AND K-S-04.
2. INSTALL ALL MICROPILES AS SHOWN ON K-S-06. CONTRACTOR IS ALERTED OF SPACE RESTRICTIONS AND SHALL INCLUDE IN THEIR BID THE USE OF A SMALL PROFILE MICROPILE DRILL RIG.
3. INSTALL TEMPORARY SHORING AROUND PERIMETER OF SUPERSTRUCTURE TO REMAIN.
4. EXCAVATE AND COMPLETE FOUNDATION WORK AND UNDERPINNING.
5. INSTALL TEMPORARY SHORING FOR COLUMN REPLACEMENT.
6. DEMOLISH EXISTING COLUMNS.
7. INSTALL NEW COLUMNS AND COMPLETE INSTALLATION OF STRUCTURAL STEEL FRAMING. SEE PLANS.
8. REMOVE ALL TEMPORARY SHORING.
9. COMPLETE INSTALLATION OF SLAB ON GRADE FOR EXISTING SUPERSTRUCTURE.
10. COMPLETE REMAINDER OF CONTRACT WORK.

— TEMPORARY SHORING FOR UNDERPINNING BY CONTRACTOR. SEE SEQUENCE OF CONSTRUCTION, NOTE 3.

— EXISTING SUPERSTRUCTURE TO
REMAIN AND BE PROTECTED.
SEE SEQUENCE OF
CONSTRUCTION NOTE 1.

PLAZA RESTAURANT ELEMENTS
TO REMAIN AND BE PROTECTED
(TYP.)

- NOTES:
- FOR STRUCTURAL NOTES, SEE DRAWING K-S-01.
 - FOR STRUCTURAL ABBREVIATIONS AND SYMBOLS, SEE DRAWING K-S-02.
 - CONTRACTOR SHALL FIELD VERIFY LOCATION IF EXISTING SANITARY LINE PRIOR TO PILE DRILLING OPERATIONS AND SURVEY EXISTING ELEVATIONS. SEE PLUMBING DRAWINGS.

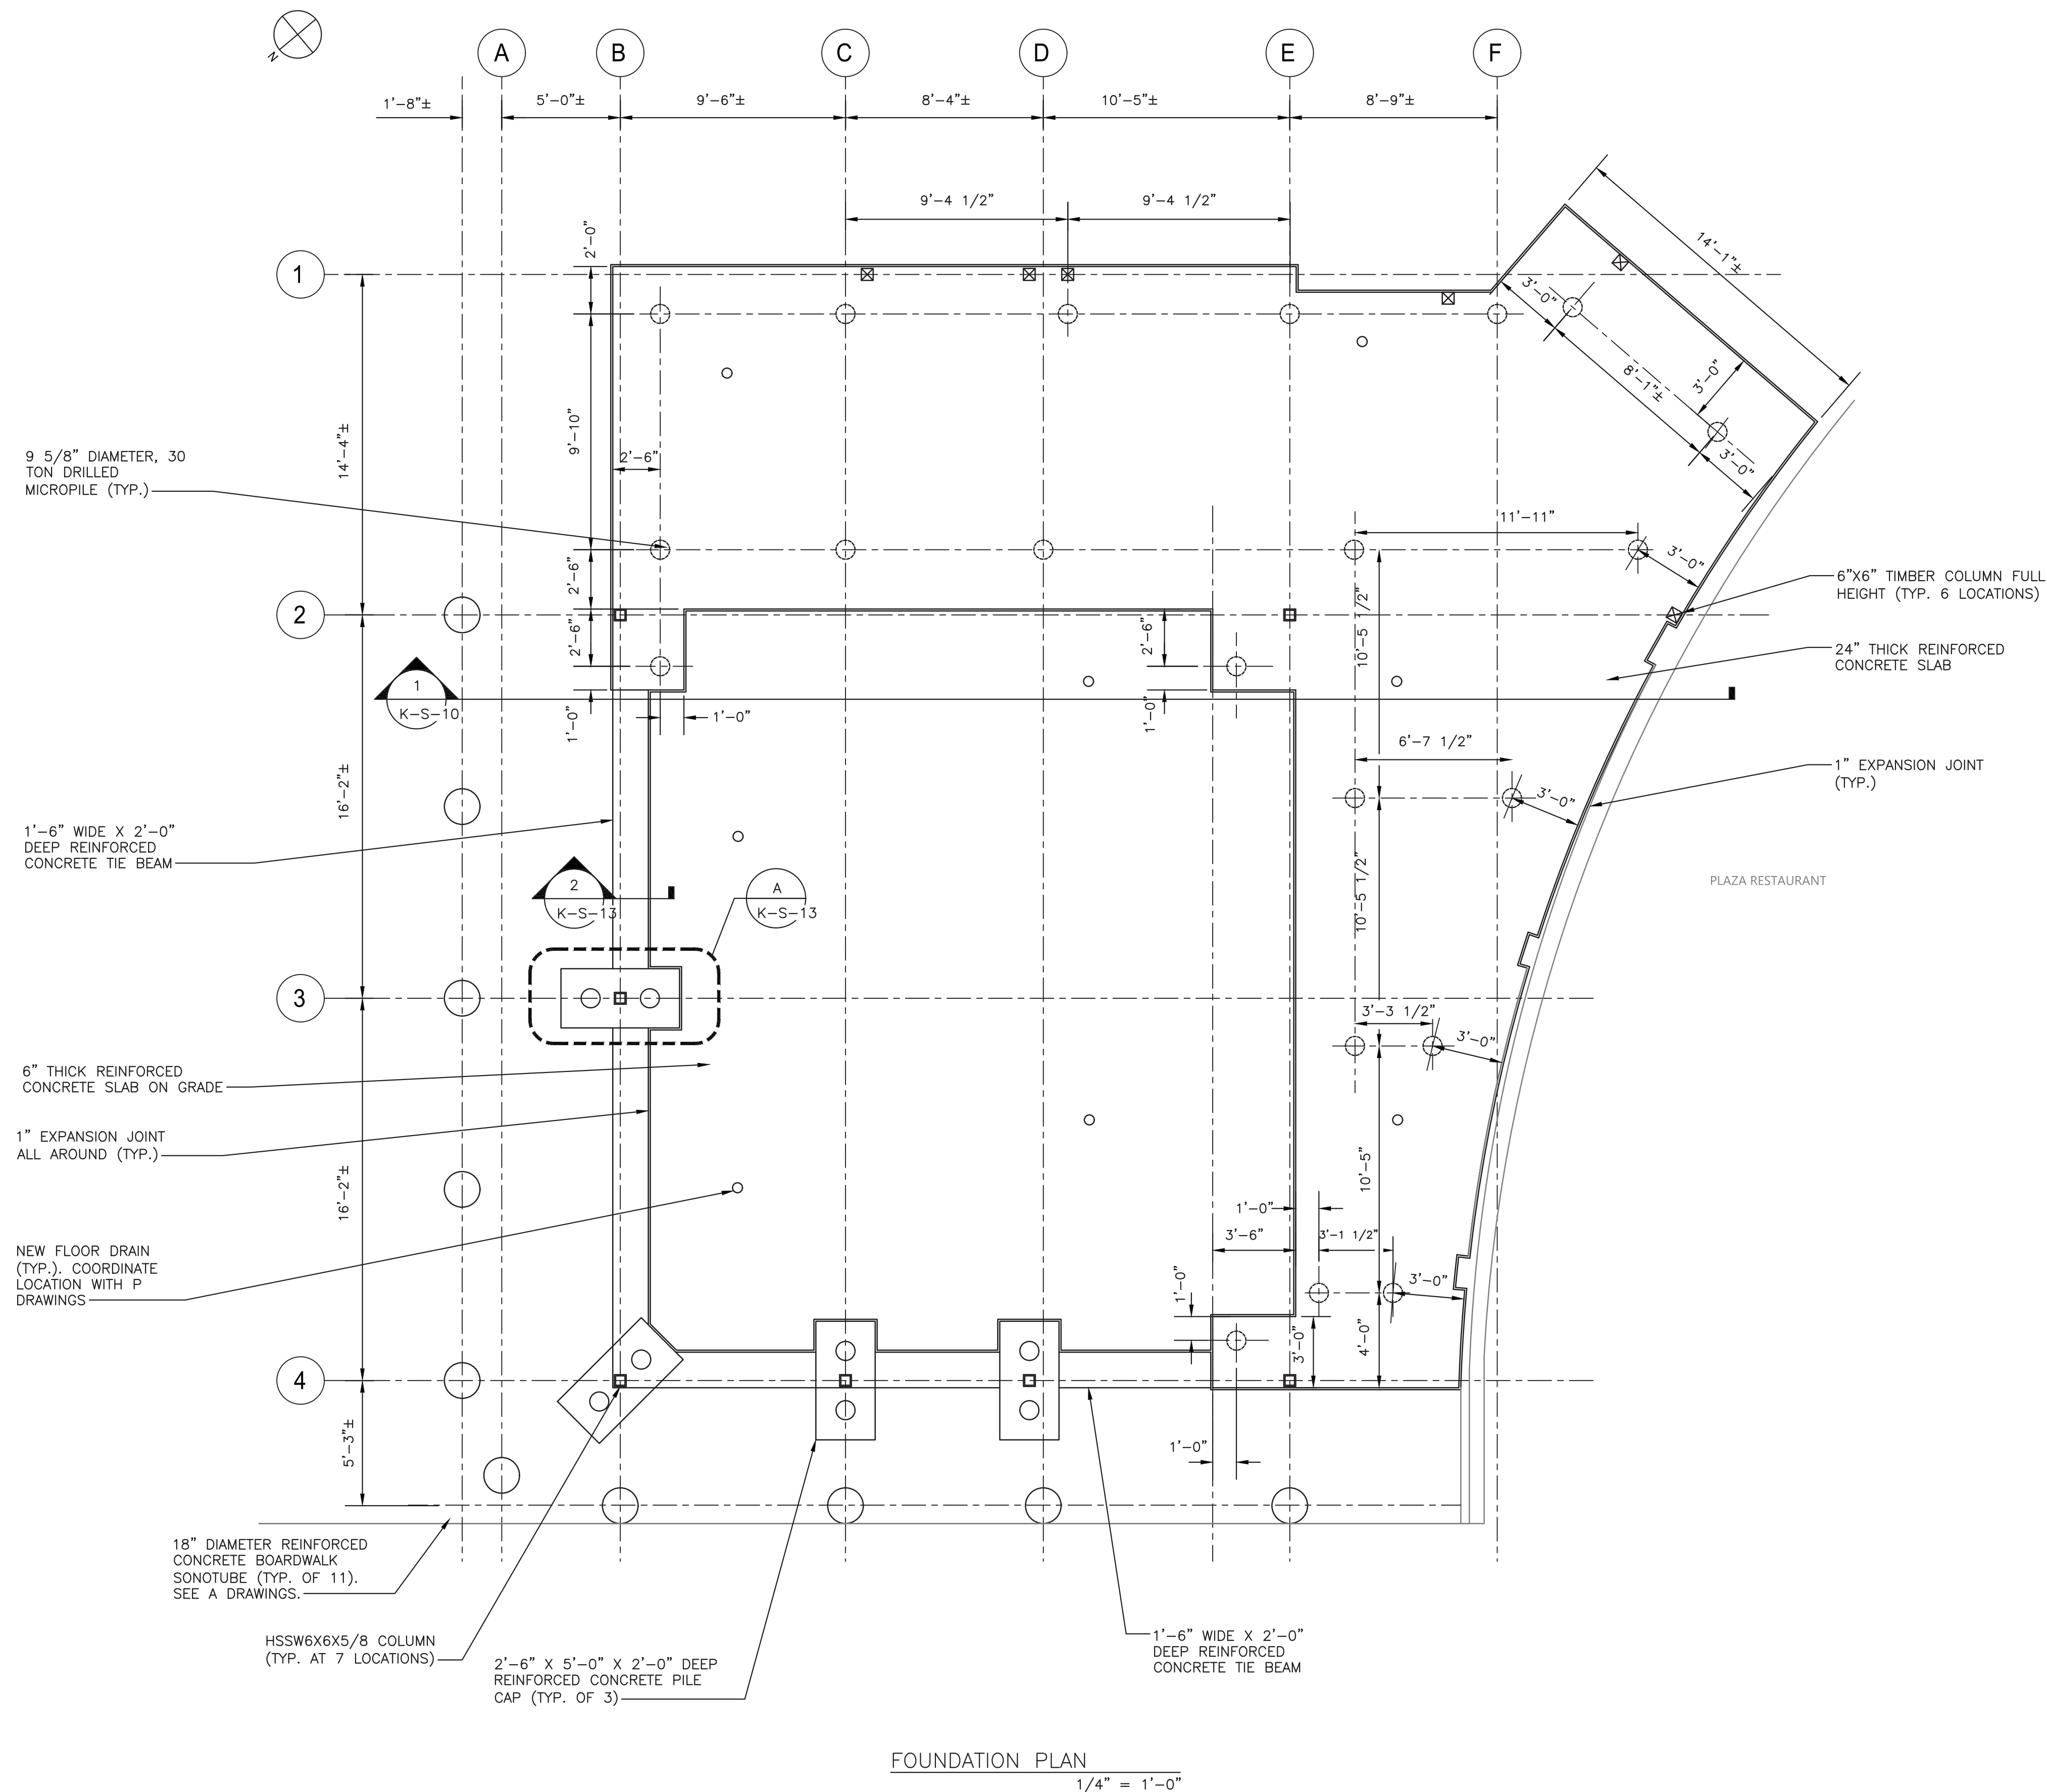

FOUNDATION PLAN
1/4" = 1'-0"


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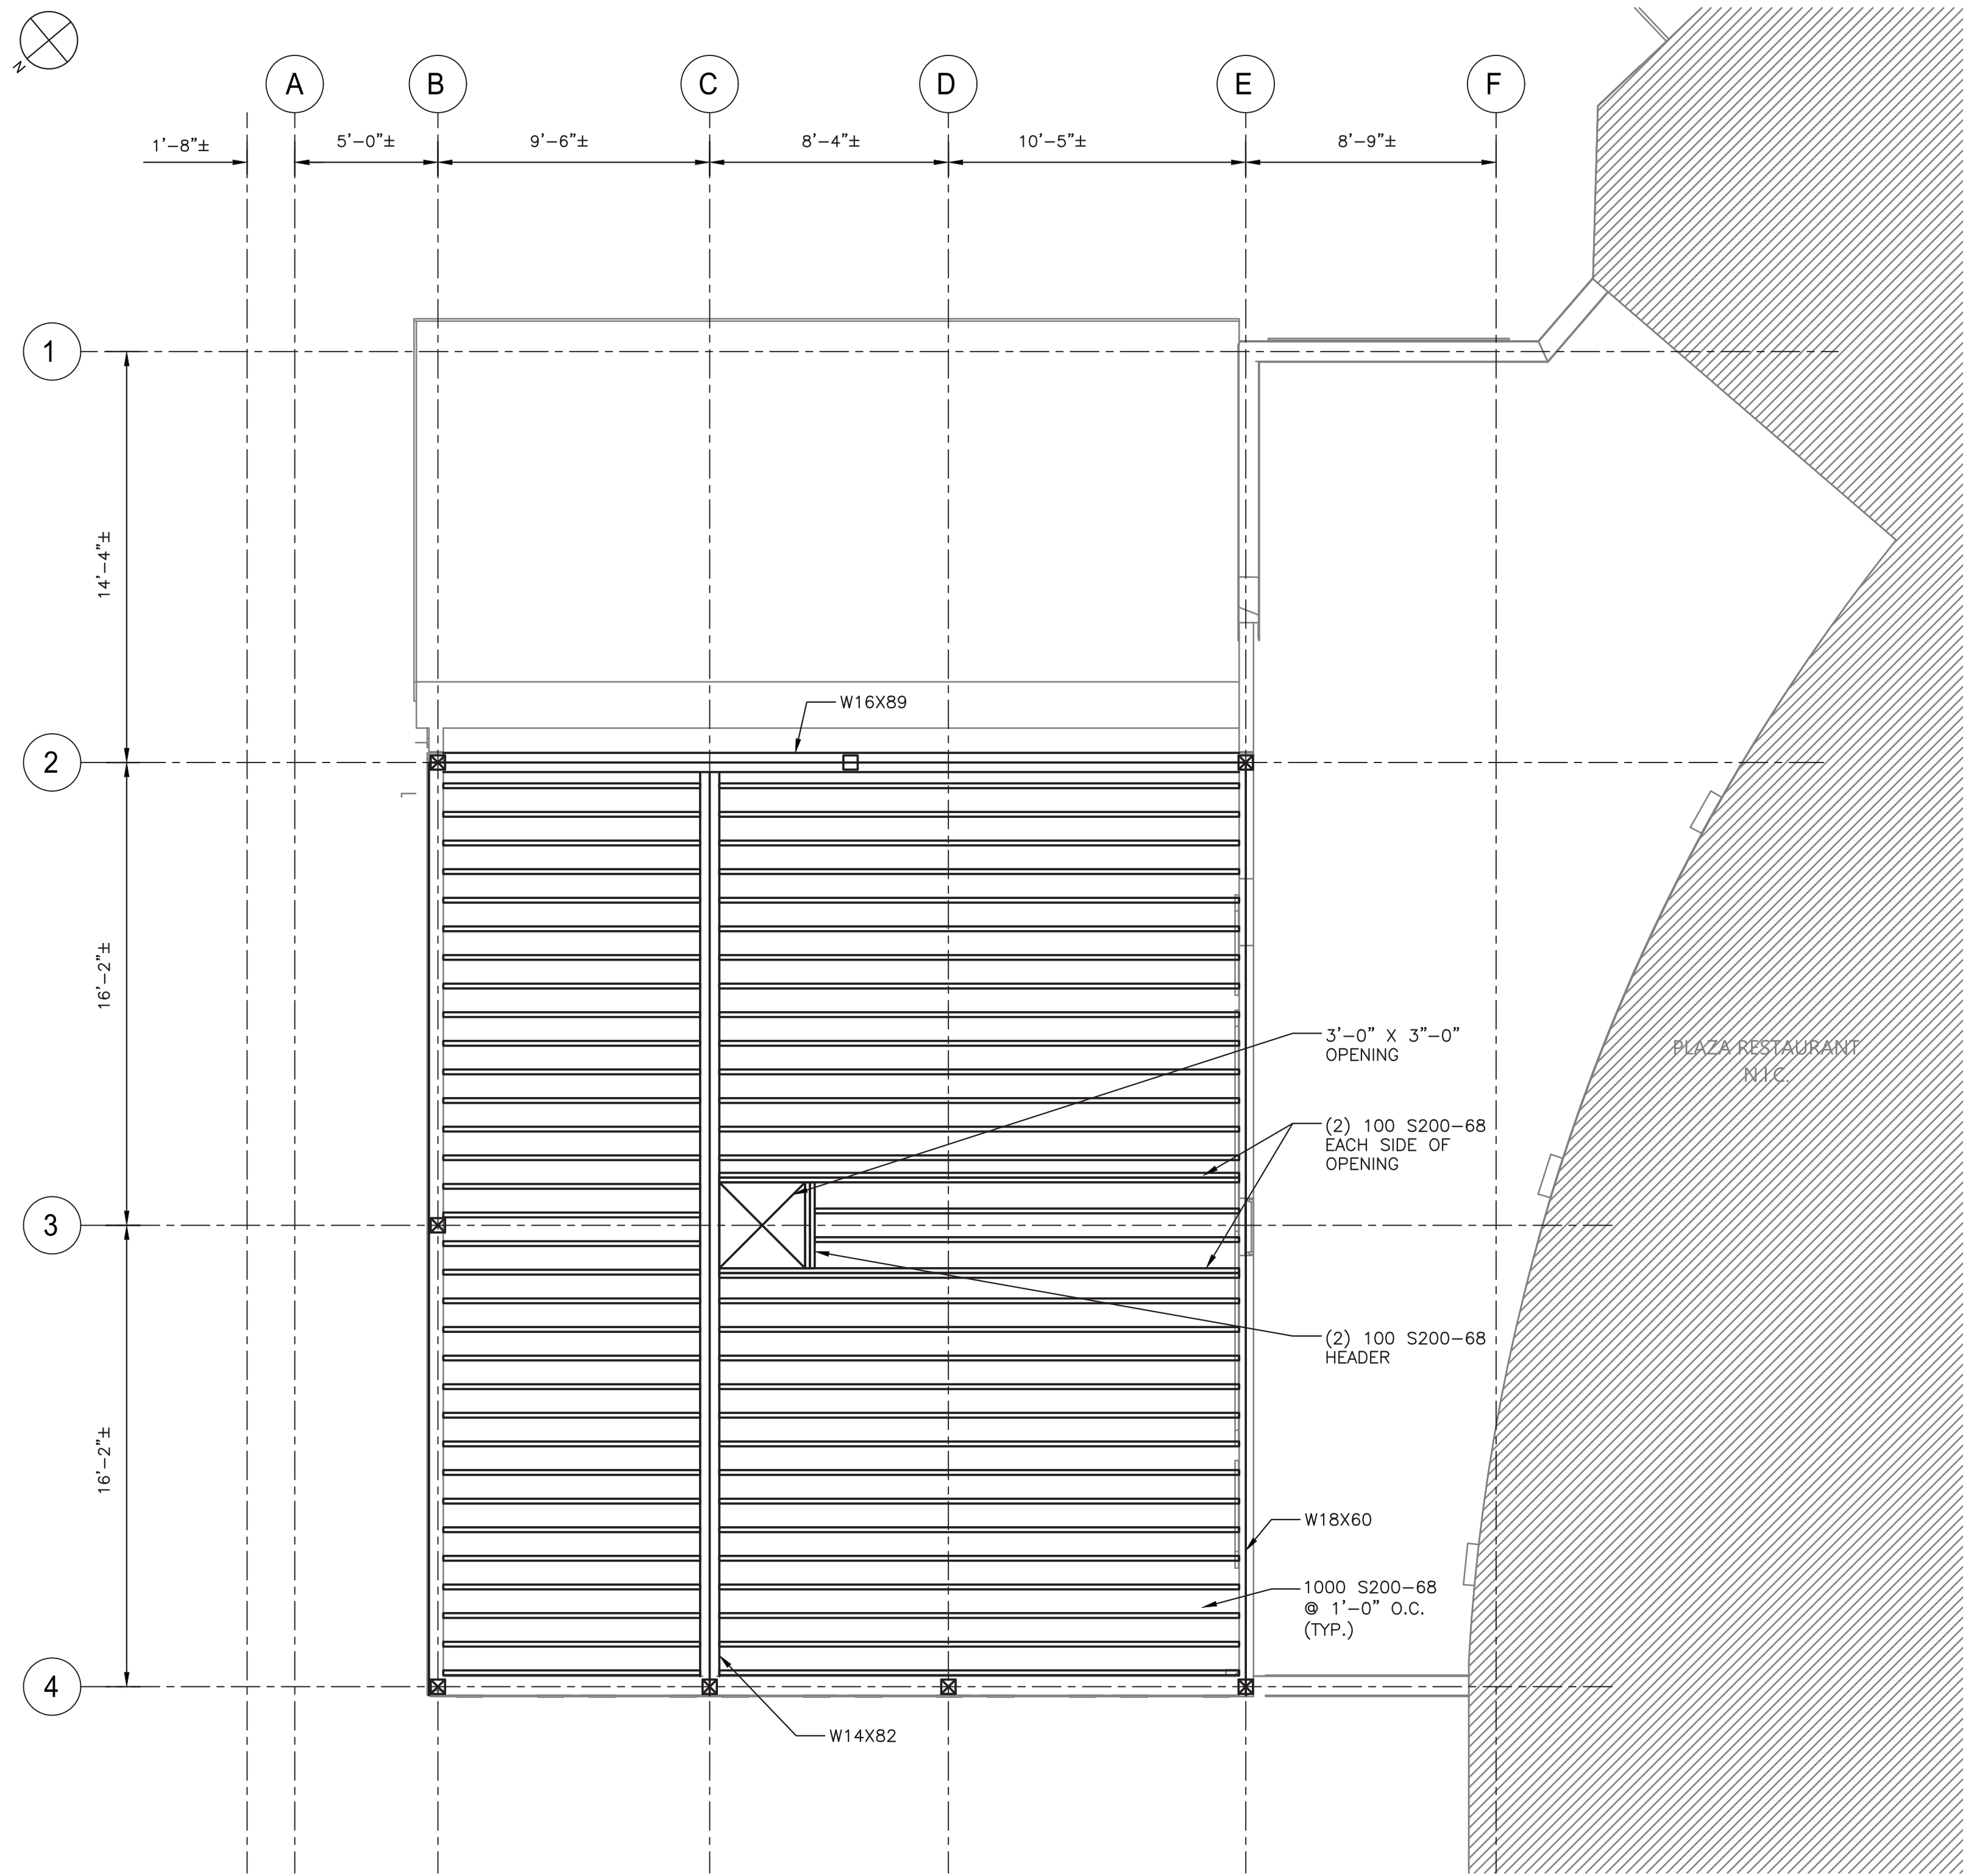


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TITLE _____	TITLE _____	TITLE _____	TITLE _____
DATE _____	DATE _____	DATE _____	DATE _____

WESTCHESTER COUNTY, NEW YORK DEPARTMENT OF PUBLIC WORKS AND TRANSPORTATION DIVISION OF ENGINEERING		CONTRACT NUMBER 22-523	SHEET NUMBER K-S-06
INFRASTRUCTURE REHABILITATION - PHASE 3 PLAYLAND PARK, RYE, NEW YORK RESTAURANT KITCHEN WITH FOOD VENDING FOUNDATION PLAN		DWG NO.: 523 of 664	SCALE: AS SHOWN
		DATE: 8/23/2022	
		DPW FILE NUMBER 1-118-S-1282-0	REV. NO. 0




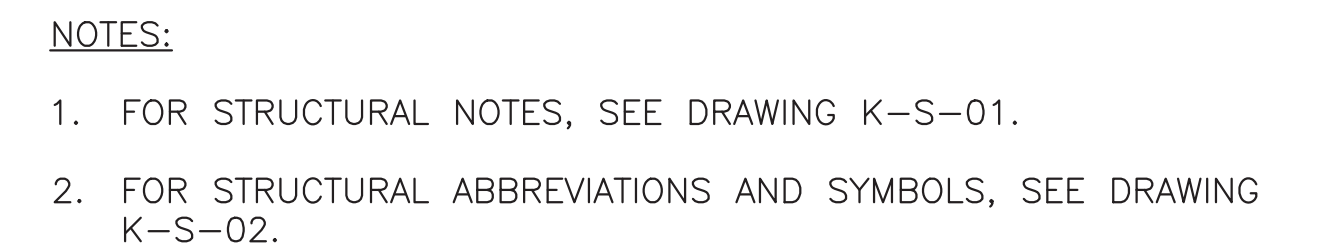

CEILING FRAMING PLAN
1/4" = 1'-0"

- NOTES:
1. FOR STRUCTURAL NOTES, SEE DRAWING K-S-01.
 2. FOR STRUCTURAL ABBREVIATIONS AND SYMBOLS, SEE DRAWING K-S-02.

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Revision: 211001F02 C
Printed by: JCastro Date: 19 August 2022 1:08 PM Designed by: ---
Xrefs: [TB-24436-WestchesterCo_3.dwg] [TSC-SYMBOL.dwg] [K-S-1007.dwg]

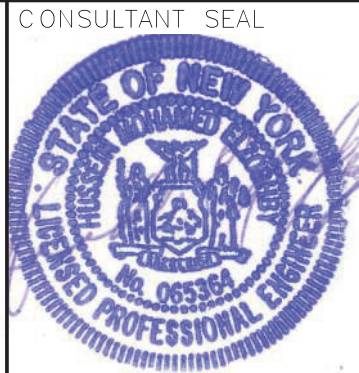

REVISION NUMBER	DATE	MADE BY	APP'D BY	REVISION

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DATE _____	DATE _____	DATE _____	DATE _____

WESTCHESTER COUNTY, NEW YORK DEPARTMENT OF PUBLIC WORKS AND TRANSPORTATION DIVISION OF ENGINEERING		CONTRACT NUMBER 22-523	SHEET NUMBER K-S-08
INFRASTRUCTURE REHABILITATION - PHASE 3 PLAYLAND PARK, RYE, NEW YORK RESTAURANT KITCHEN WITH FOOD VENDING CEILING FRAMING PLAN		DWG NO.: 523 of 664 SCALE: AS SHOWN	DATE: 8/23/2022
DPW FILE NUMBER 1-118-S-1284-0		REV. NO. 0	

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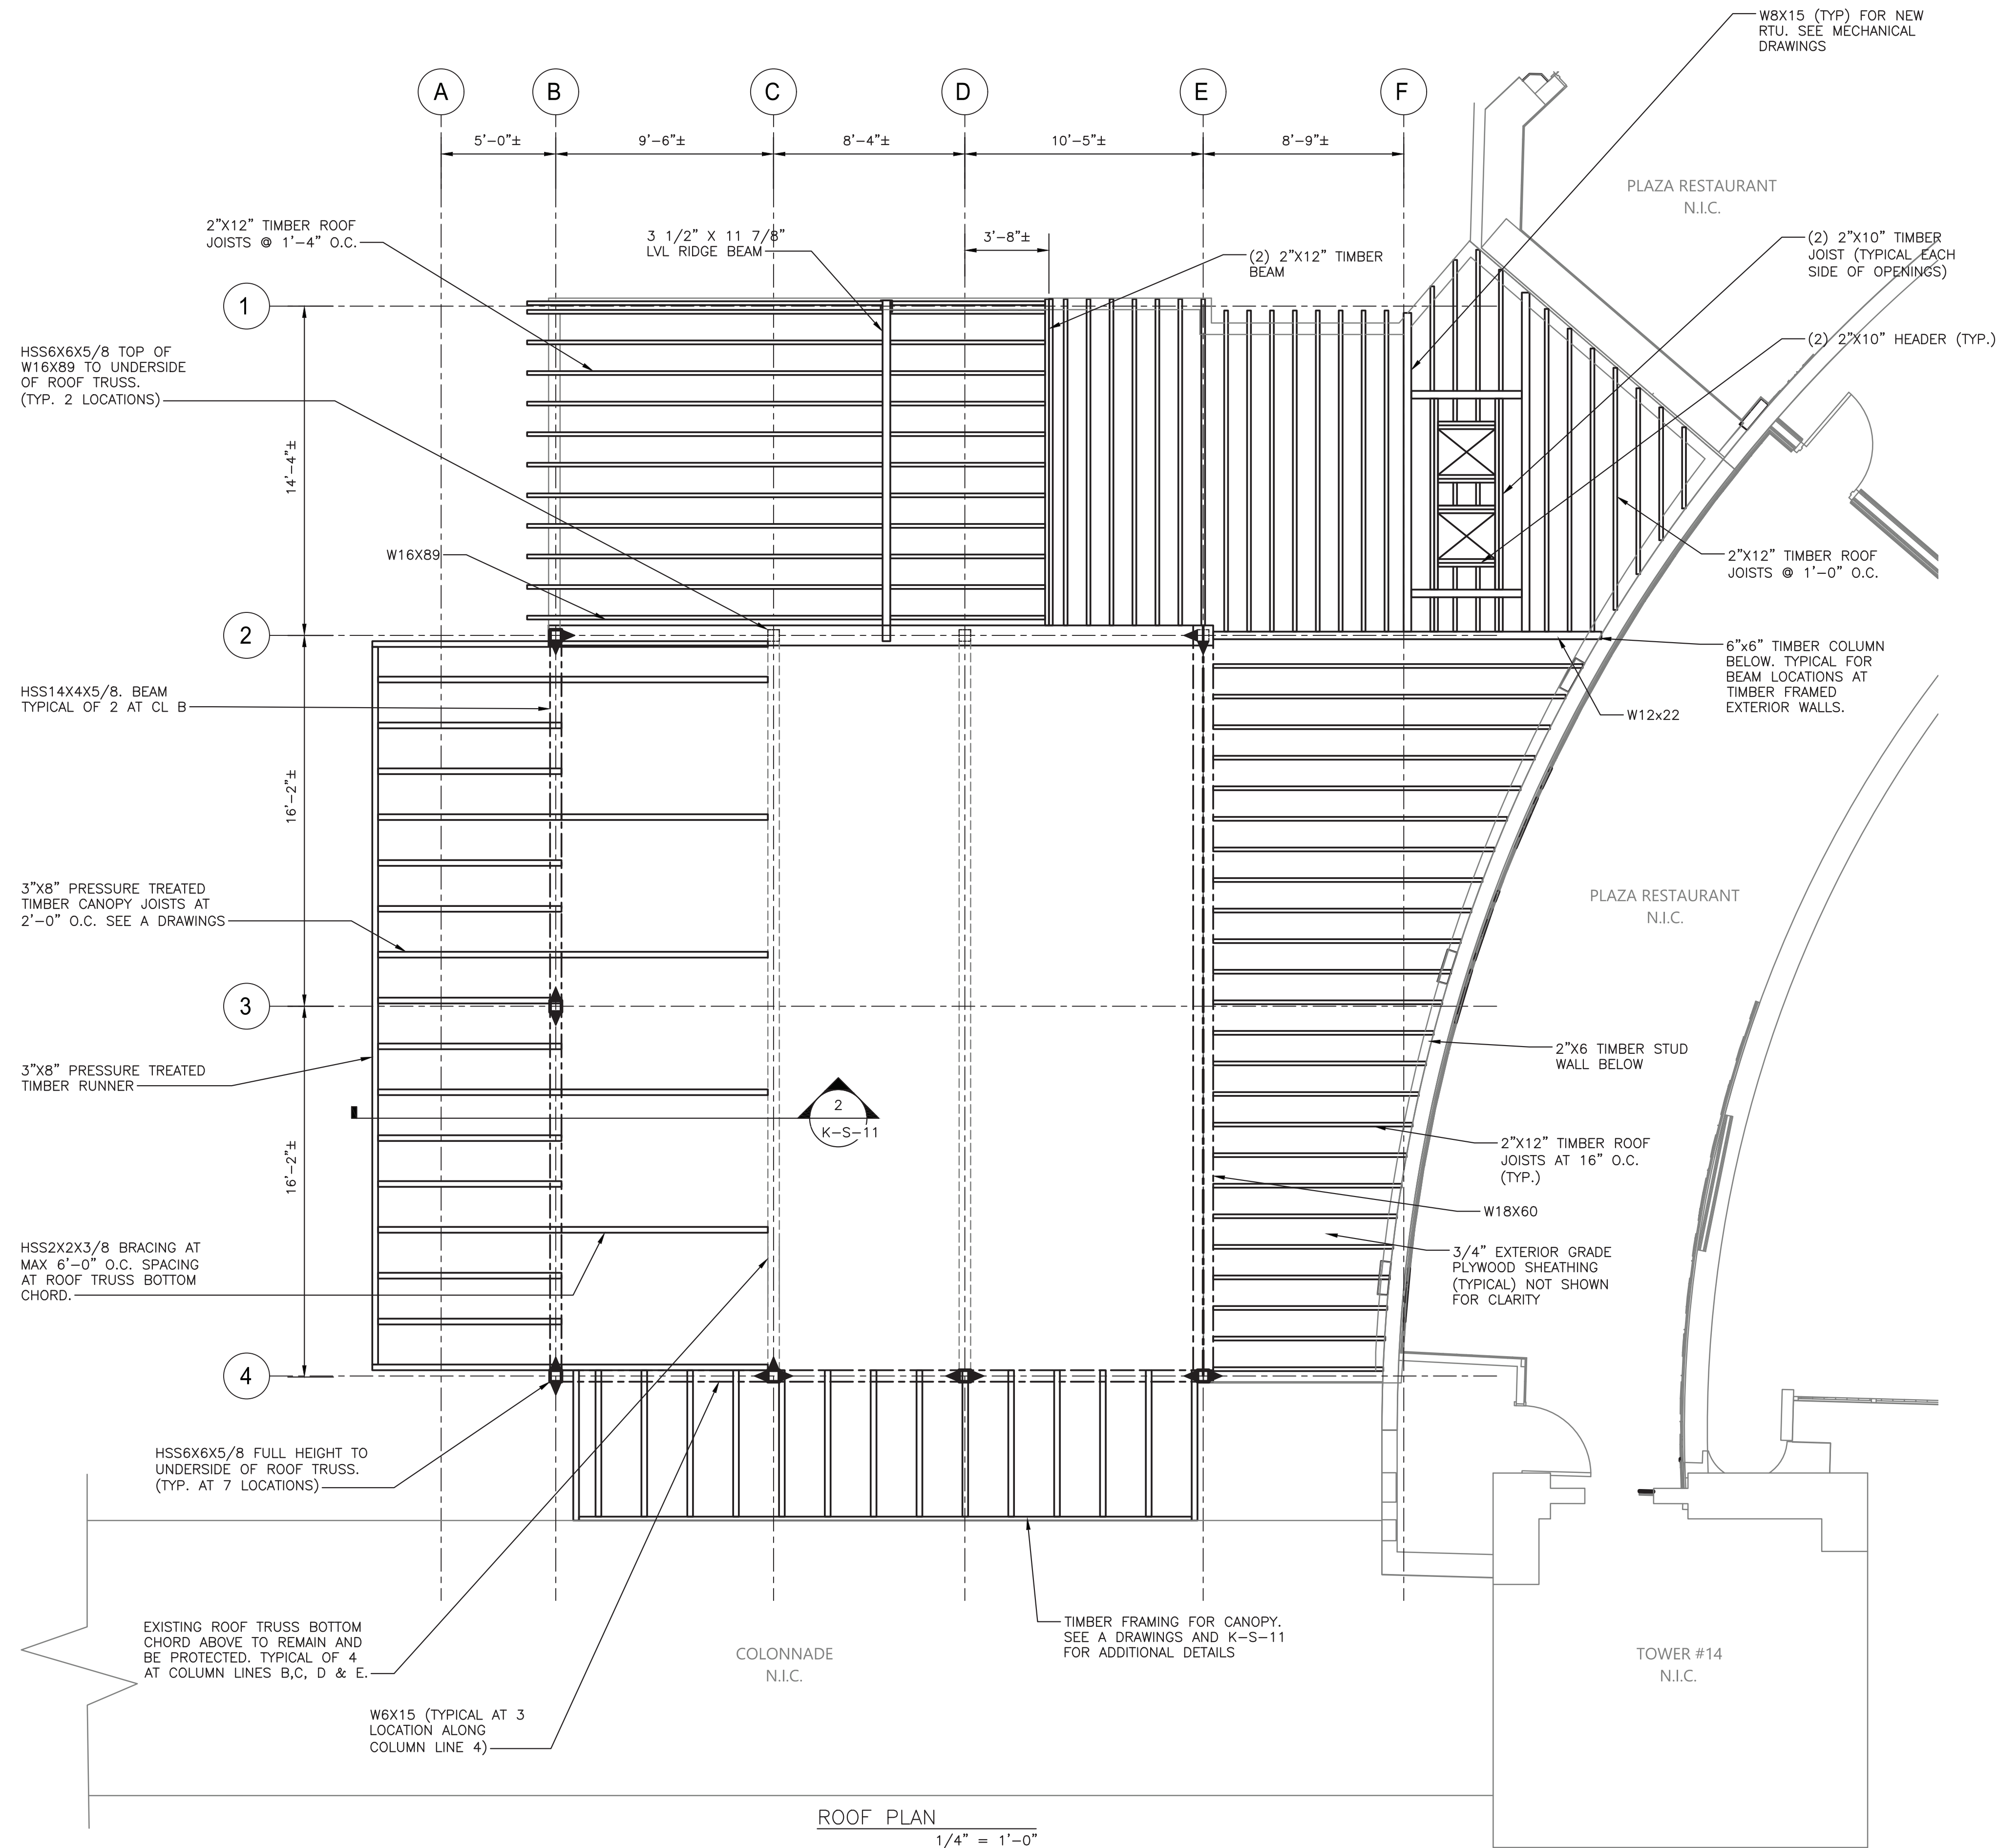


REVISION NUMBER	DATE	MADE BY	APP'D BY	REVISION

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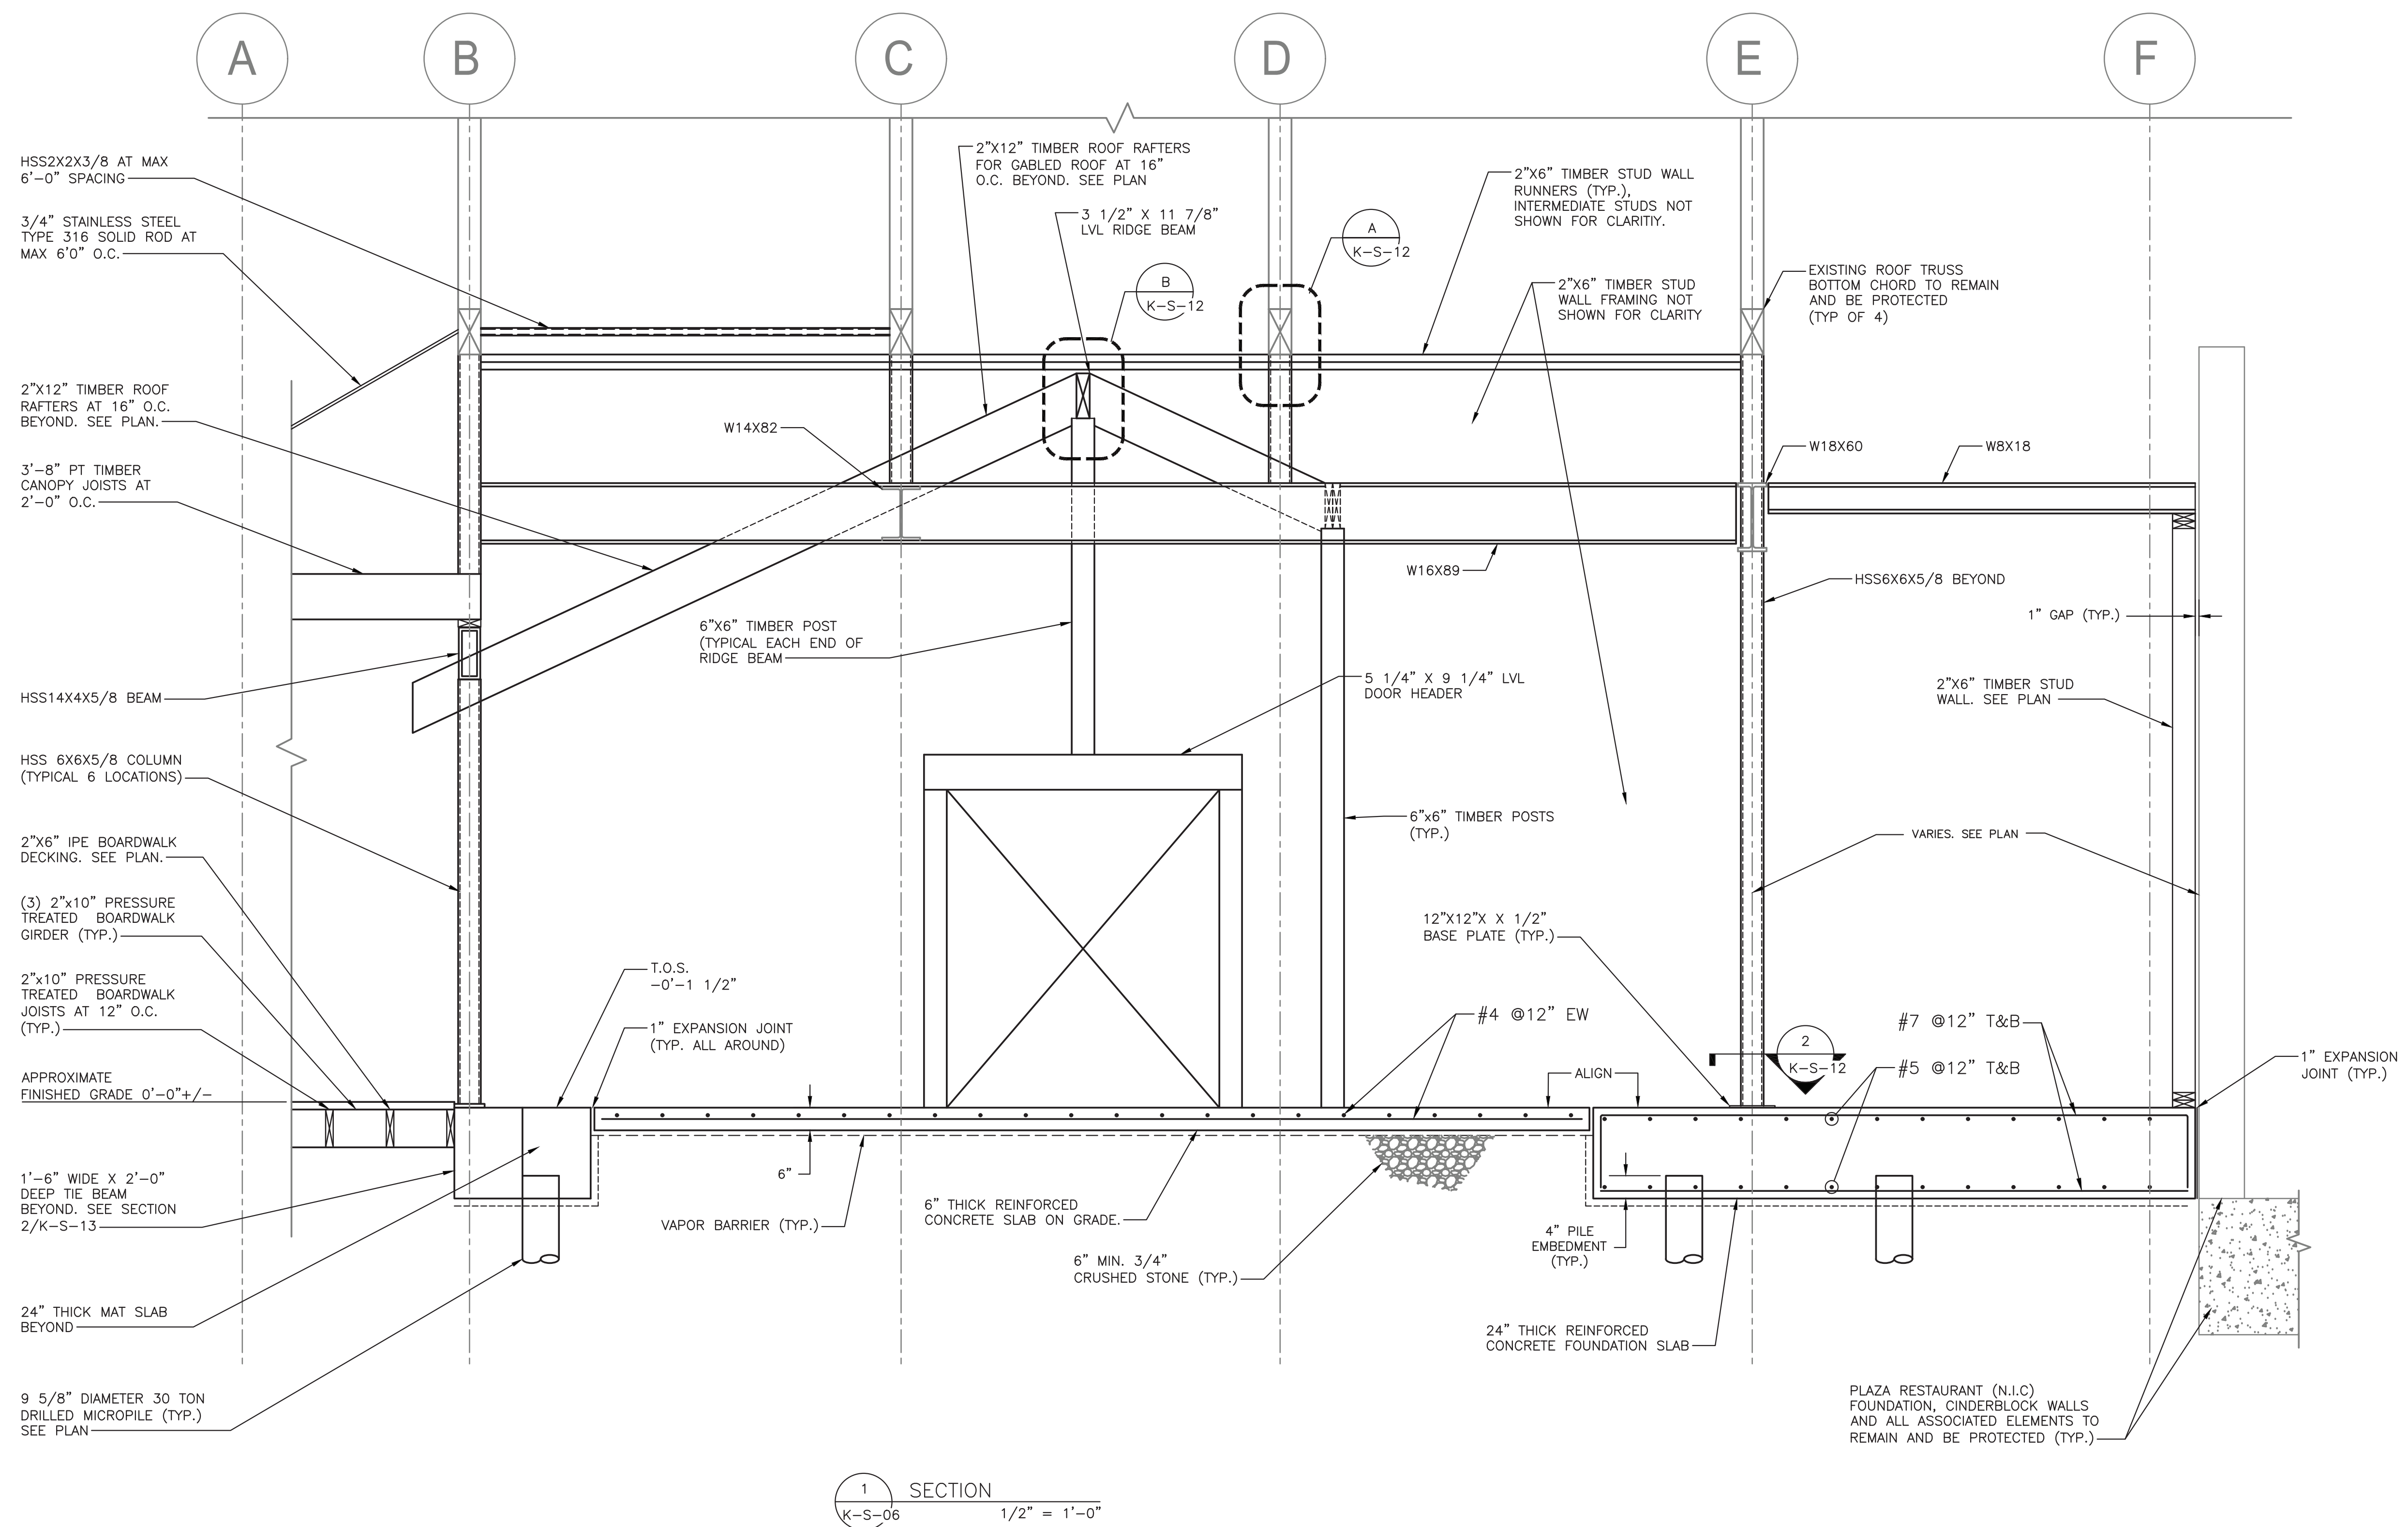
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INFRASTRUCTURE REHABILITATION - PHASE 3 PLAYLAND PARK, RYE, NEW YORK RESTAURANT KITCHEN WITH FOOD VENDING ROOF PLAN	

CONTRACT NUMBER 22-523	SHEET NUMBER K-S-09
DWG NO.: 523 of 664	
SCALE: AS SHOWN	
DATE: 8/23/2022	
DPW FILE NUMBER 1-118-S-1285-0	REV. NO. 0




- NOTES:
- FOR STRUCTURAL NOTES, SEE DRAWING K-S-01.
 - FOR STRUCTURAL ABBREVIATIONS AND SYMBOLS, SEE DRAWING K-S-02.

- NOTES:
- FOR STRUCTURAL NOTES, SEE DRAWING K-S-01.
 - FOR STRUCTURAL ABBREVIATIONS AND SYMBOLS, SEE DRAWING K-S-02.



1 SECTION
K-S-06 1/2" = 1'-0"

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REVISION NUMBER	DATE	MADE BY	APP'D BY	REVISION

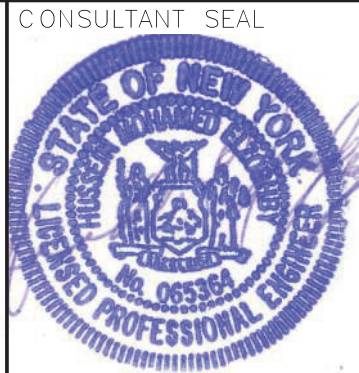
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NAME _____	NAME _____	NAME _____	NAME _____
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TITLE _____	TITLE _____	TITLE _____	TITLE _____
DATE _____	DATE _____	DATE _____	DATE _____

WESTCHESTER COUNTY, NEW YORK
DEPARTMENT OF PUBLIC WORKS AND TRANSPORTATION
DIVISION OF ENGINEERING


INFRASTRUCTURE REHABILITATION - PHASE 3
PLAYLAND PARK, RYE, NEW YORK
RESTAURANT KITCHEN WITH FOOD VENDING SECTION

CONTRACT NUMBER 22-523	SHEET NUMBER K-S-10
DWG NO.: 537 of 664	SCALE: AS SHOWN
DATE: 8/23/2022	REV. NO. 0
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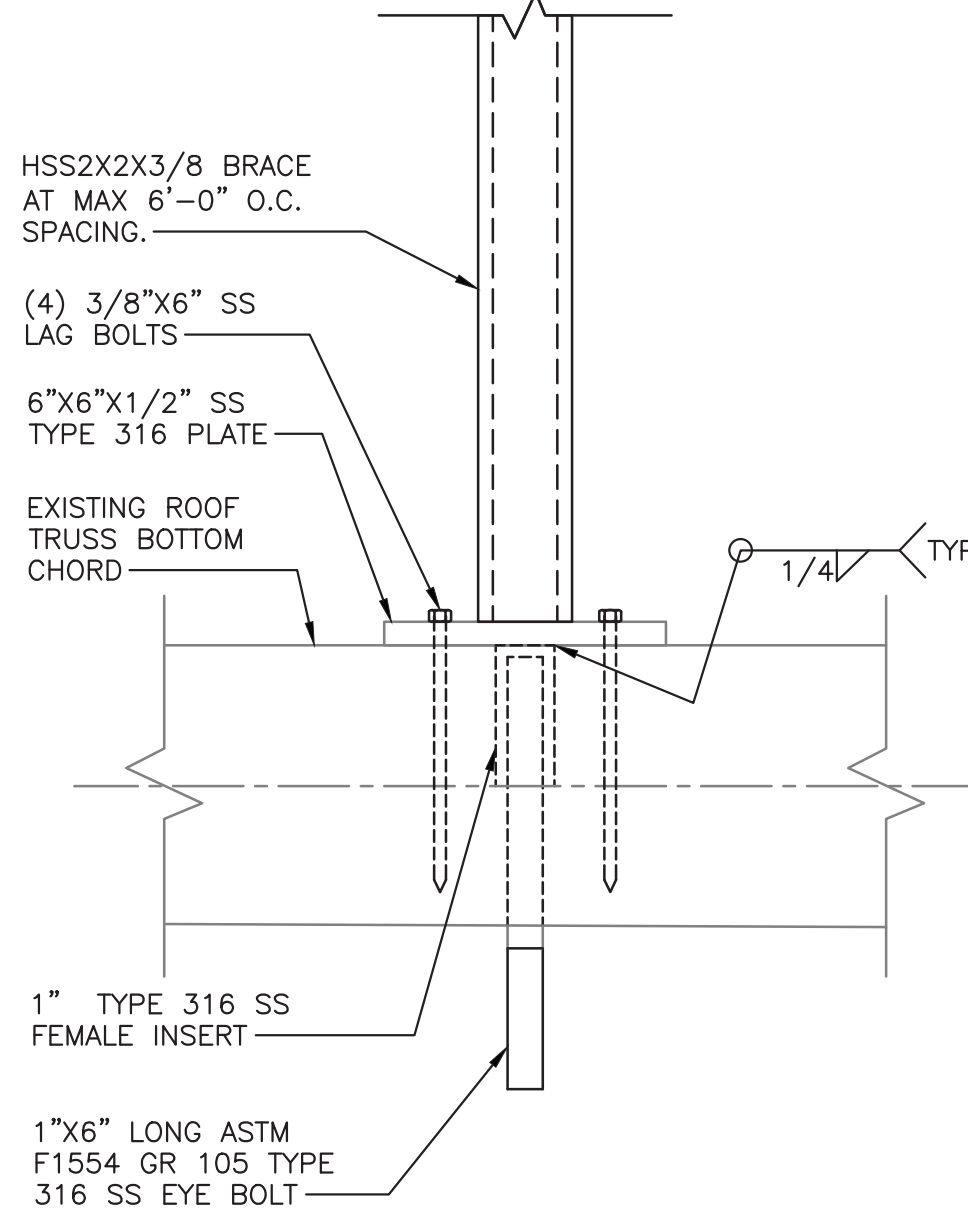
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Revised by: JCastro Date: 19 August 2022 1:08 PM Designed by: ----
Printed by: JCastro Date: 19 August 2022 1:08 PM
Xrefs: [TB-24436-WestchesterCo_3.dwg] [TSC-SVLogo.dwg] [K-A-12.dwg] [K-S-1004.dwg] [K-S-1016.dwg]

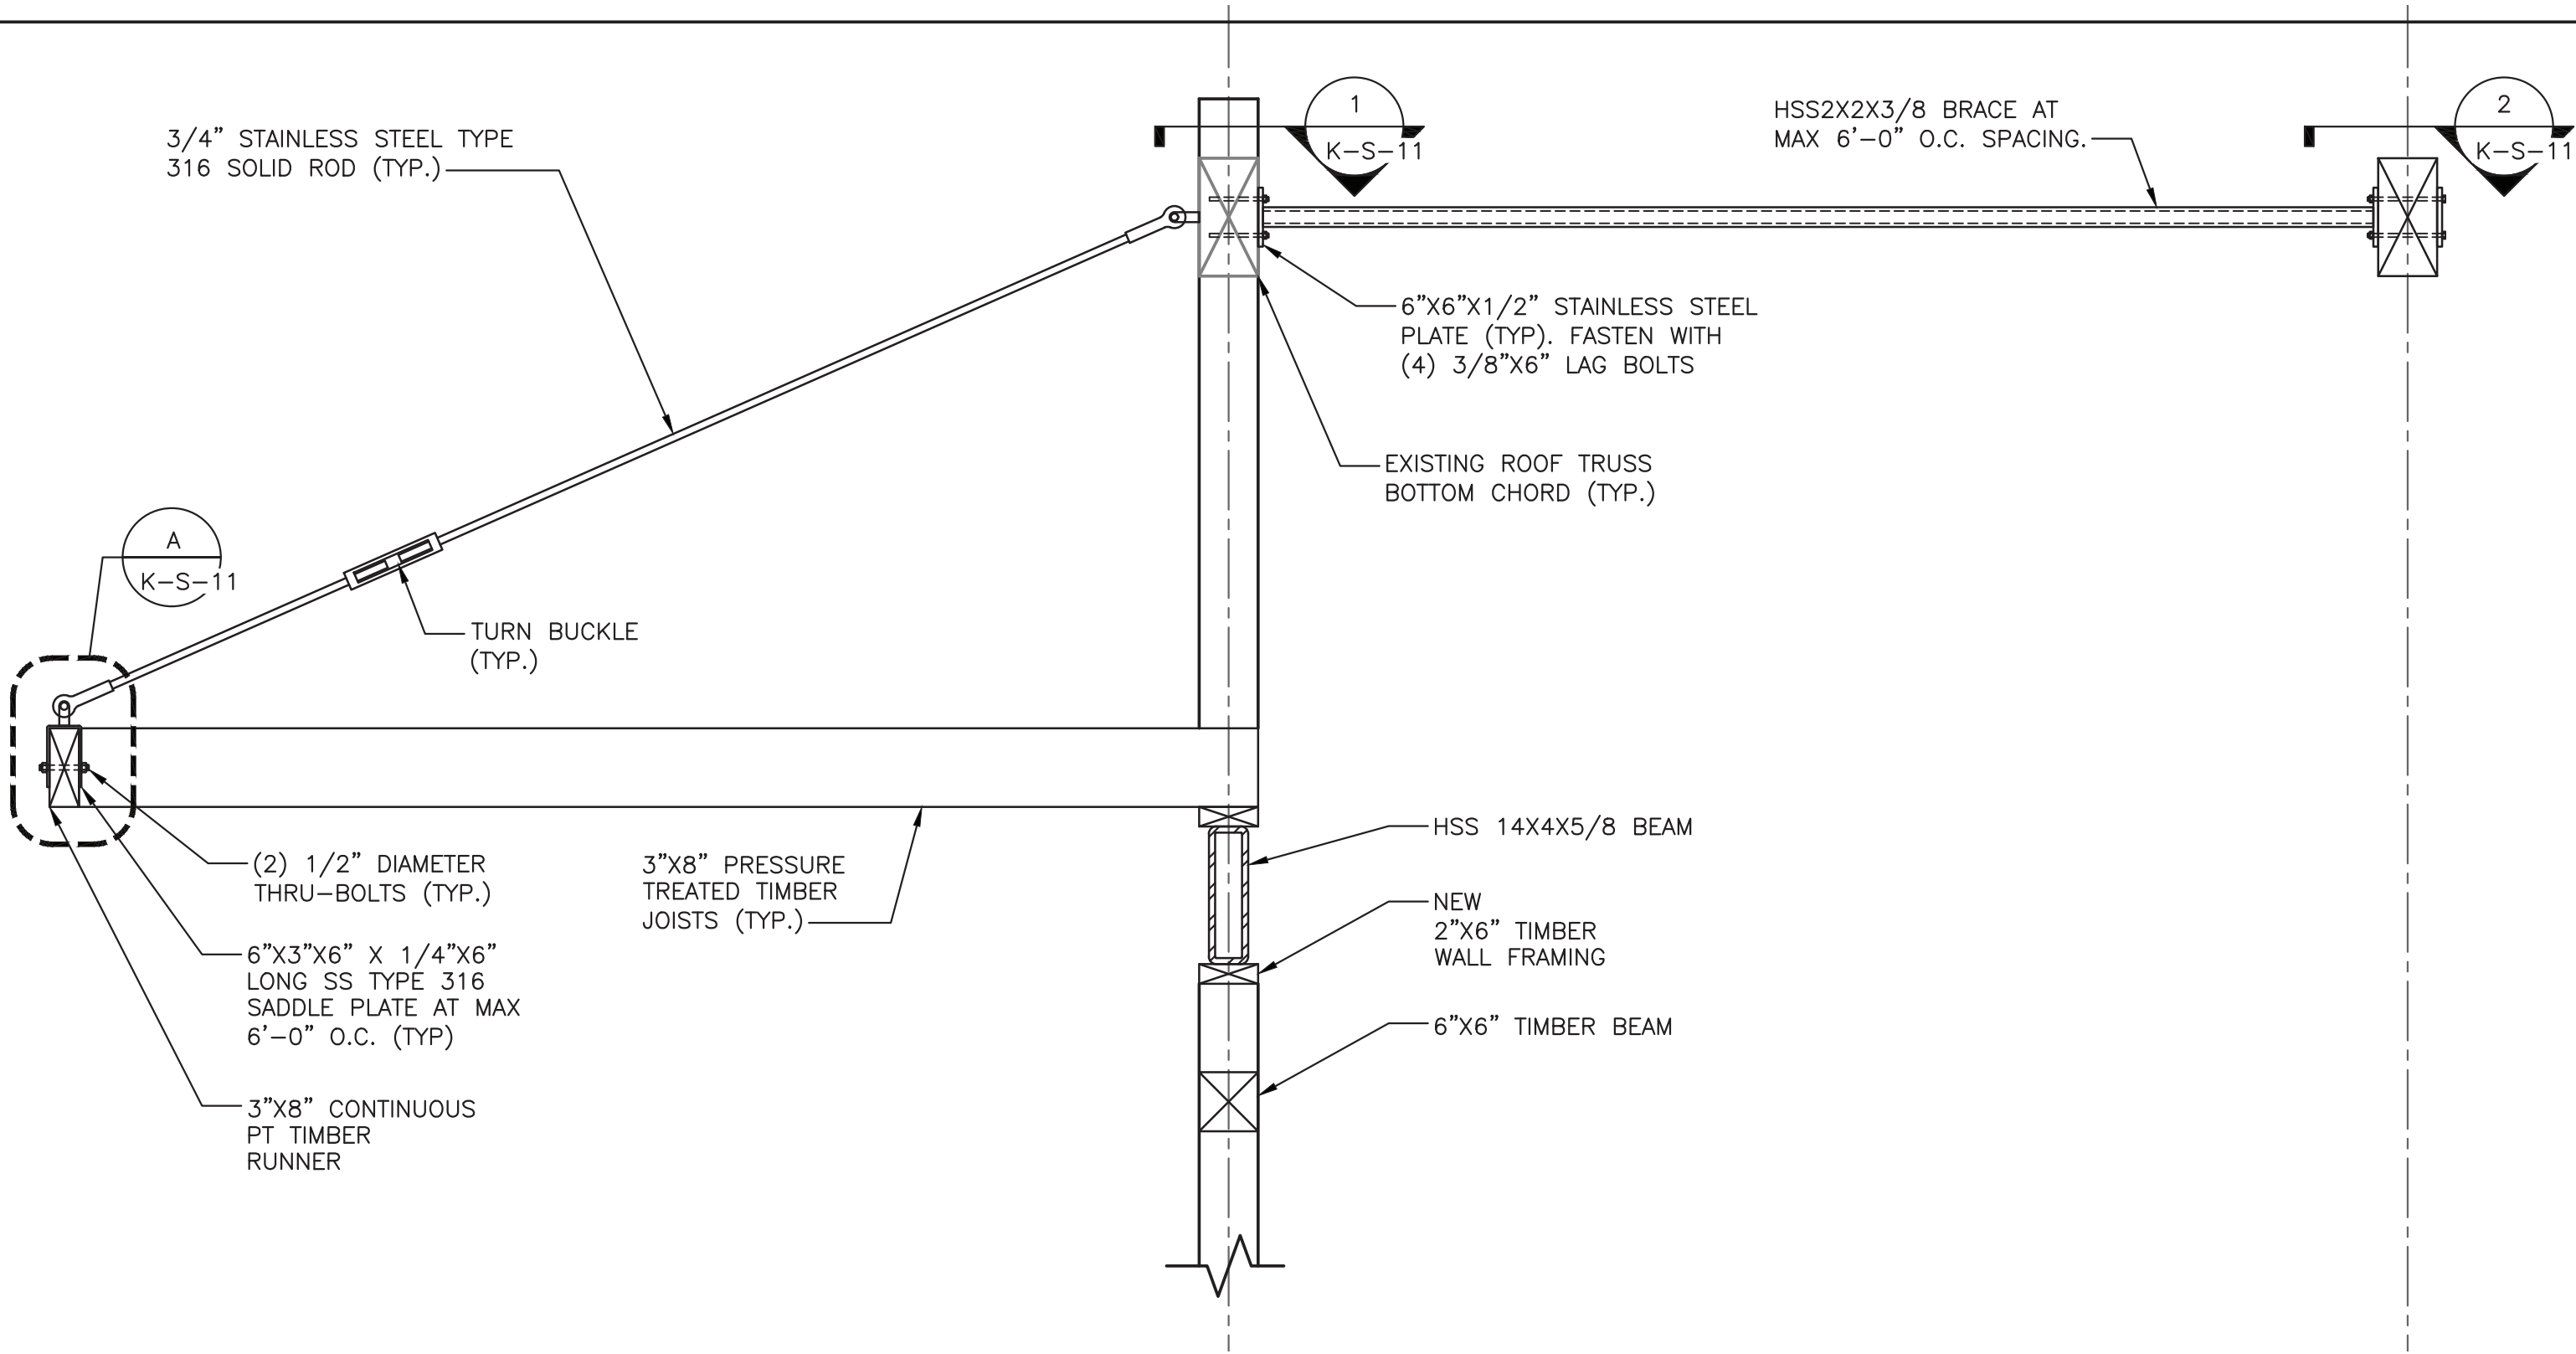


2 SECTION
K-S-09 3/4" = 1'-0"

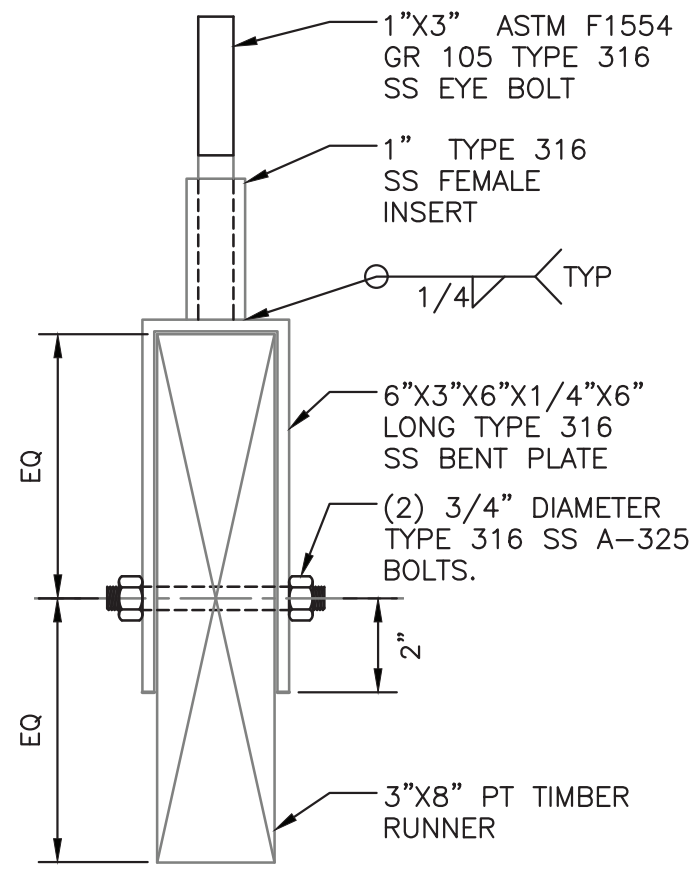


A DETAIL - JOIST AND GUY WIRE CONNECTION
K-S-11 3/4" = 1'-0"




1 SECTION
K-S-11 3/4" = 1'-0"

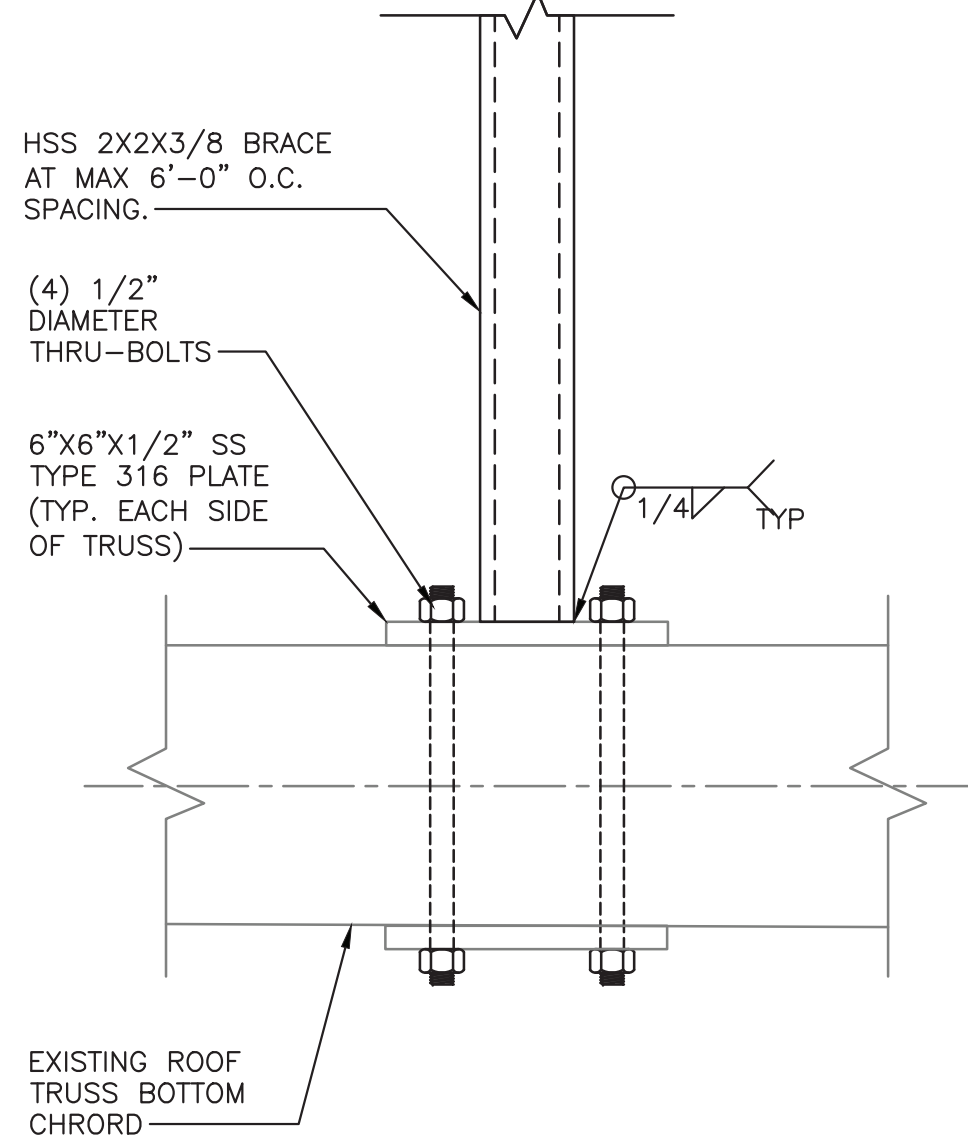


2 SECTION
K-S-11 3/4" = 1'-0"

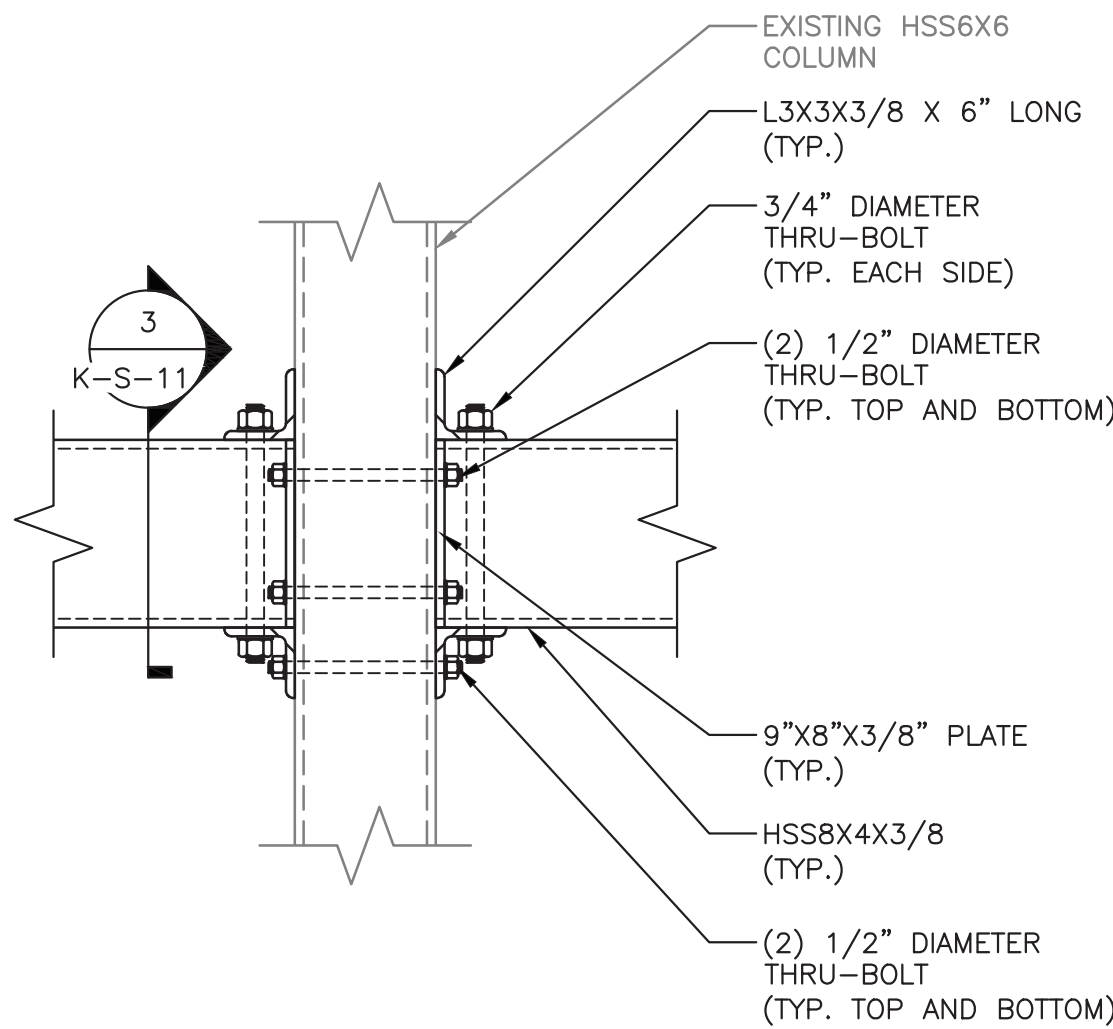


DETAIL - HSS BEAM TO COLONNADE CONNECTION
K-S-11 1 1/2" = 1'-0"

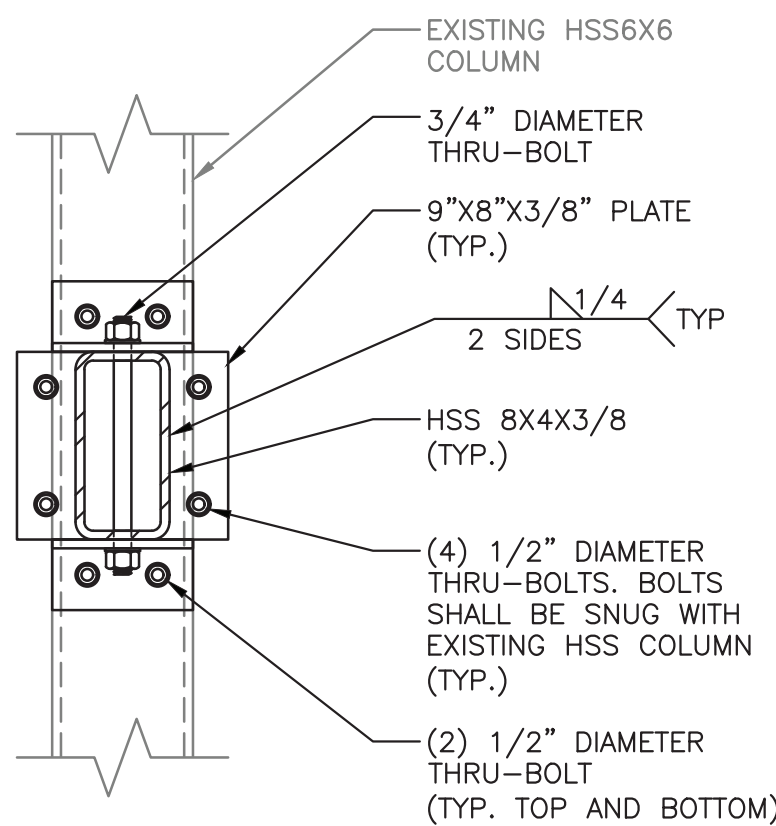

3 SECTION
K-S-11 1 1/2" = 1'-0"

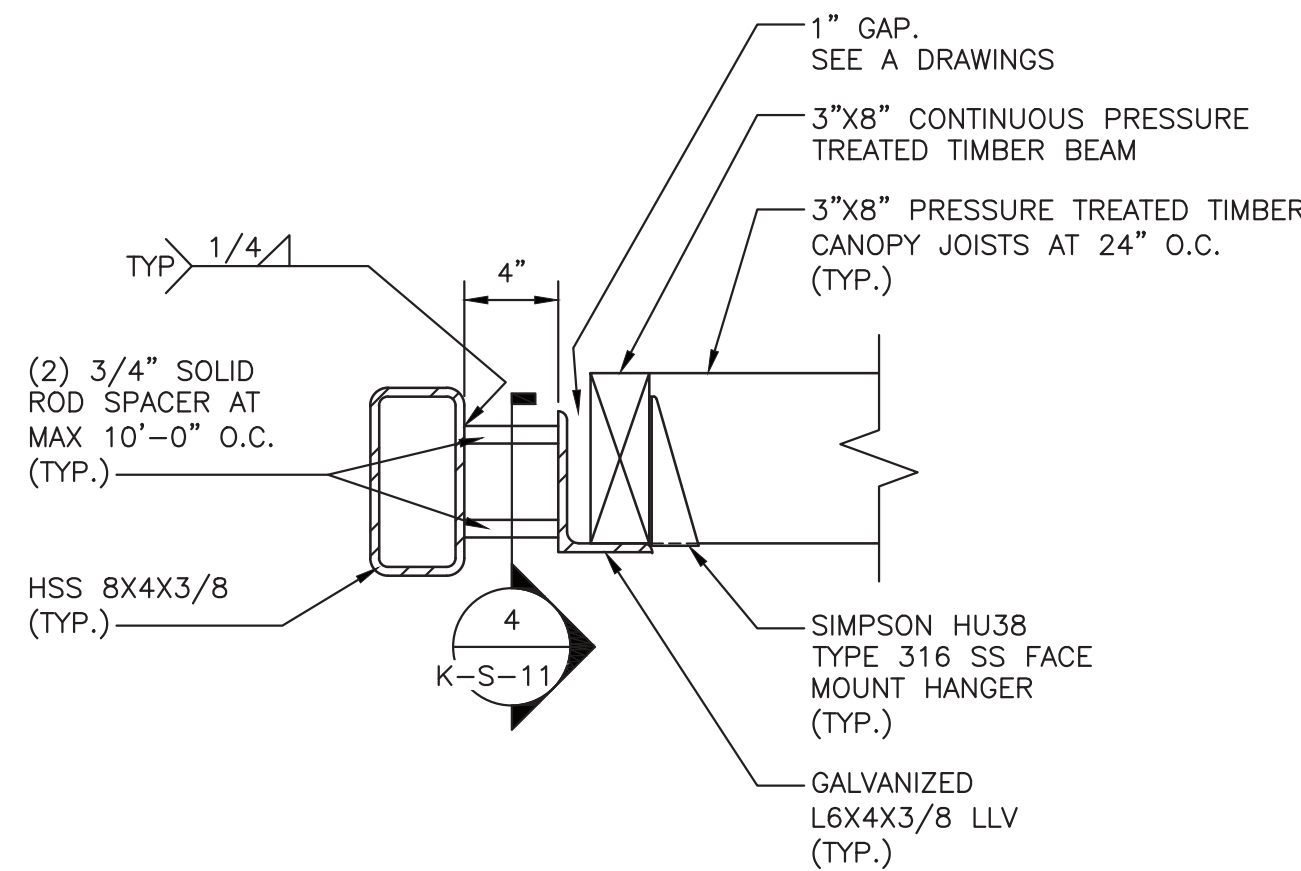

DETAIL - L6X4 TO HSS8X4 CONNECTION
K-S-11 1 1/2" = 1'-0"

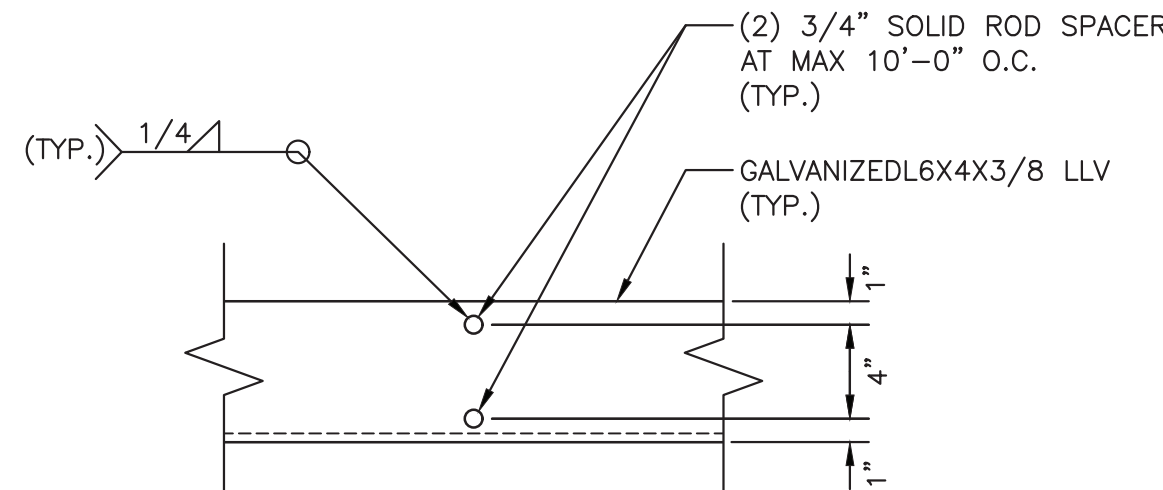


4 SECTION
K-S-11 1 1/2" = 1'-0"

NOTES:

1. L4X6X3/8 NOT SHOWN FOR CLARITY. SEE DETAILS.

NOTES:

1. FOR STRUCTURAL NOTES, SEE DRAWING K-S-01.
2. FOR STRUCTURAL ABBREVIATIONS AND SYMBOLS, SEE DRAWING K-S-02.

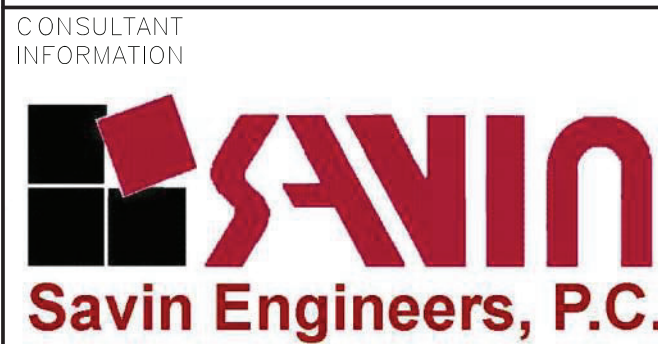


REVISION NUMBER	DATE	MADE BY	APP'D BY	REVISION


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CONTRACTOR		PROJECT COORDINATOR	
NAME		NAME	
SIGNATURE		SIGNATURE	
TITLE		TITLE	

WESTCHESTER COUNTY, NEW YORK	
DEPARTMENT OF PUBLIC WORKS AND TRANSPORTATION	
DIVISION OF ENGINEERING	
INFRASTRUCTURE REHABILITATION - PHASE 3	
PLAYLAND PARK, RYE, NEW YORK	
RESTAURANT KITCHEN WITH FOOD VENDING	
SECTION AND DETAILS	


CONTRACT NUMBER	22-523	SHEET NUMBER	K-S-11
DWG NO.:	523 of 664	SCALE:	AS SHOWN
DATE:	8/23/2022	REV. NO.	0
DPW FILE NUMBER	1-118-S-1287-0		

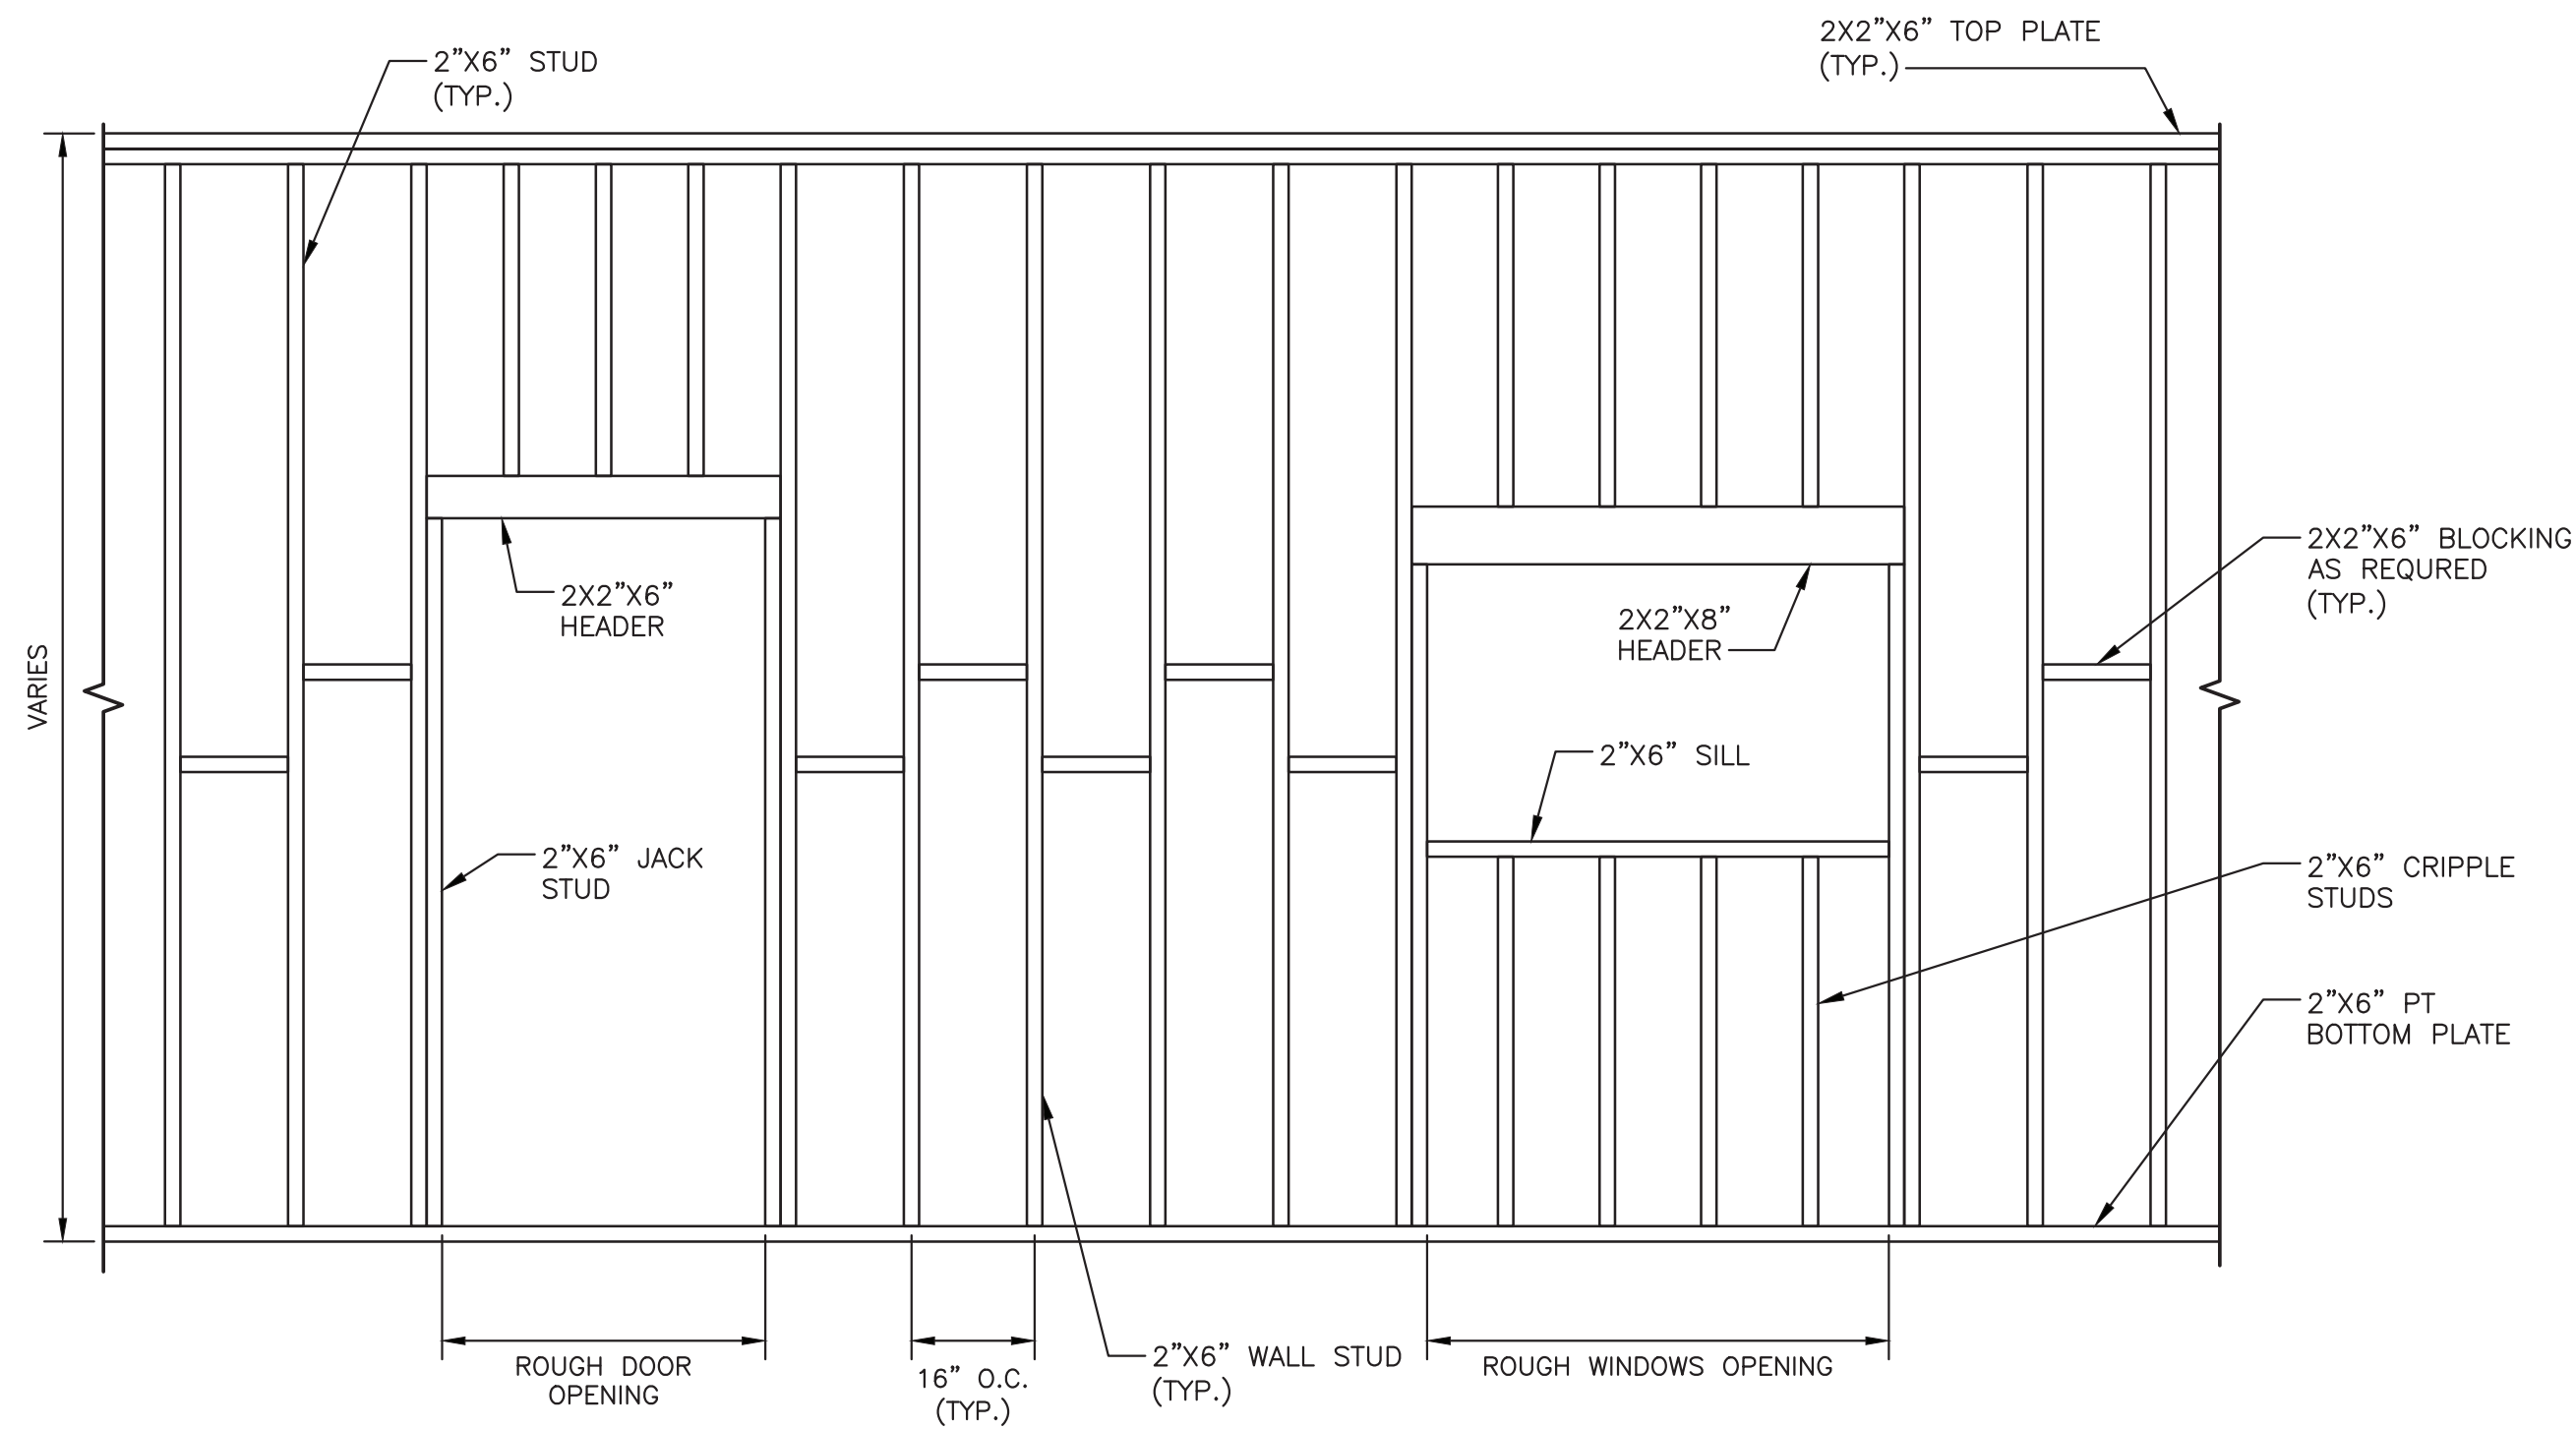


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DETAIL WALL ELEVATION
SCALE: N.T.S.

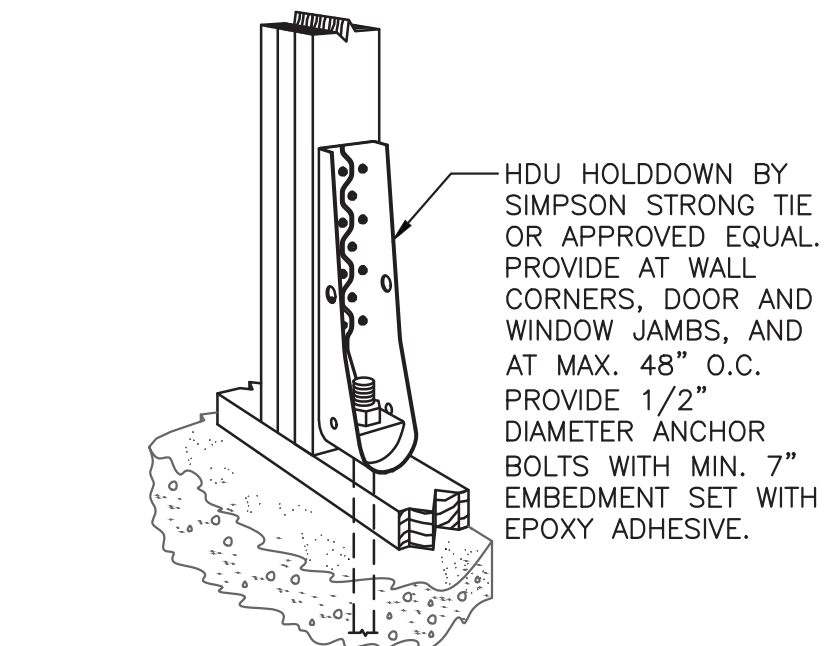


-
HOLD DOWN/TENSION TIE
SCALE: N.T.S.

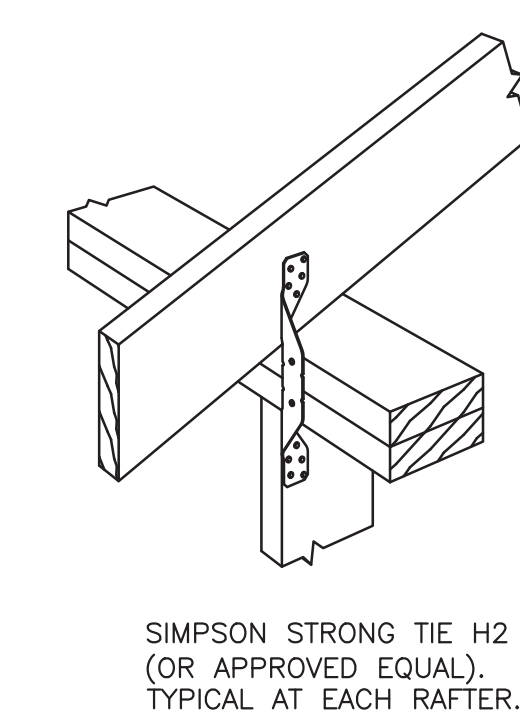


-
HURRICANE TIE
SCALE: N.T.S.

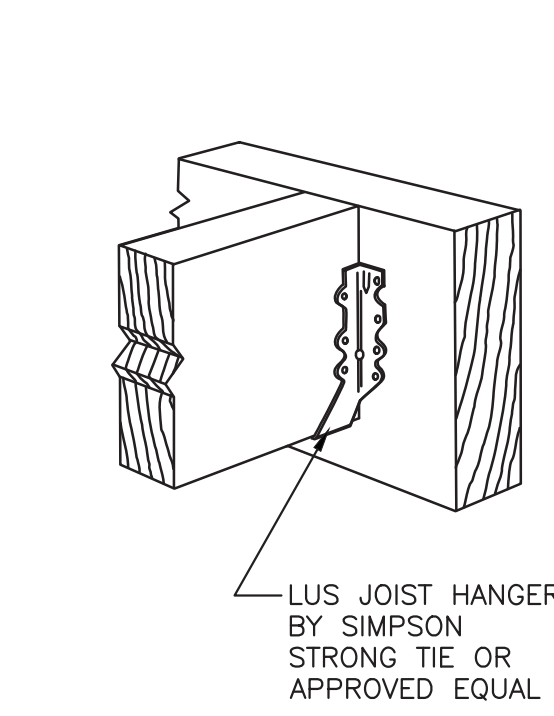


-
FACE MOUNTED JOIST HANGER
SCALE: N.T.S.

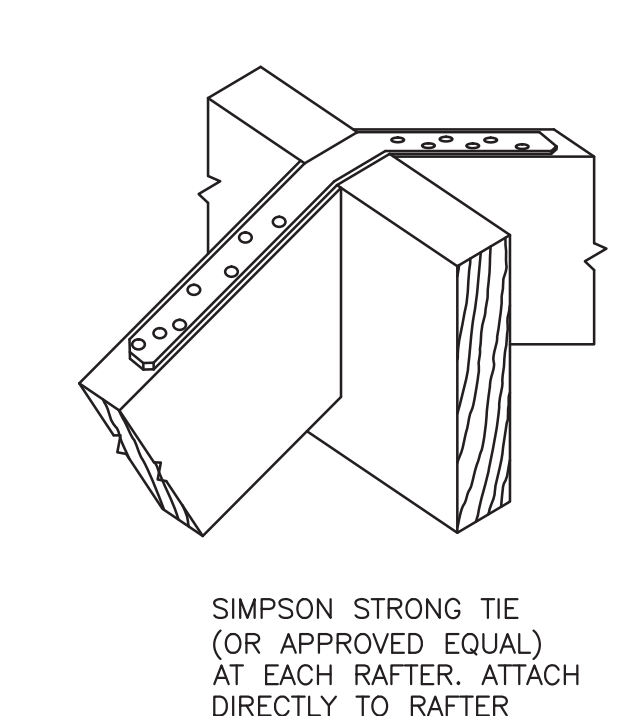


-
RIDGE STRAPPING
SCALE: N.T.S.

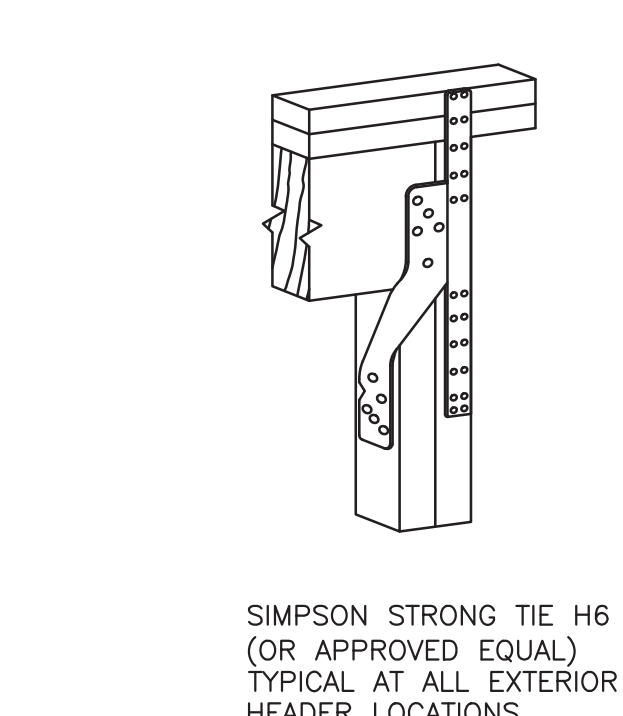


-
HEADER TO JACK STUD CONNECTION
SCALE: N.T.S.

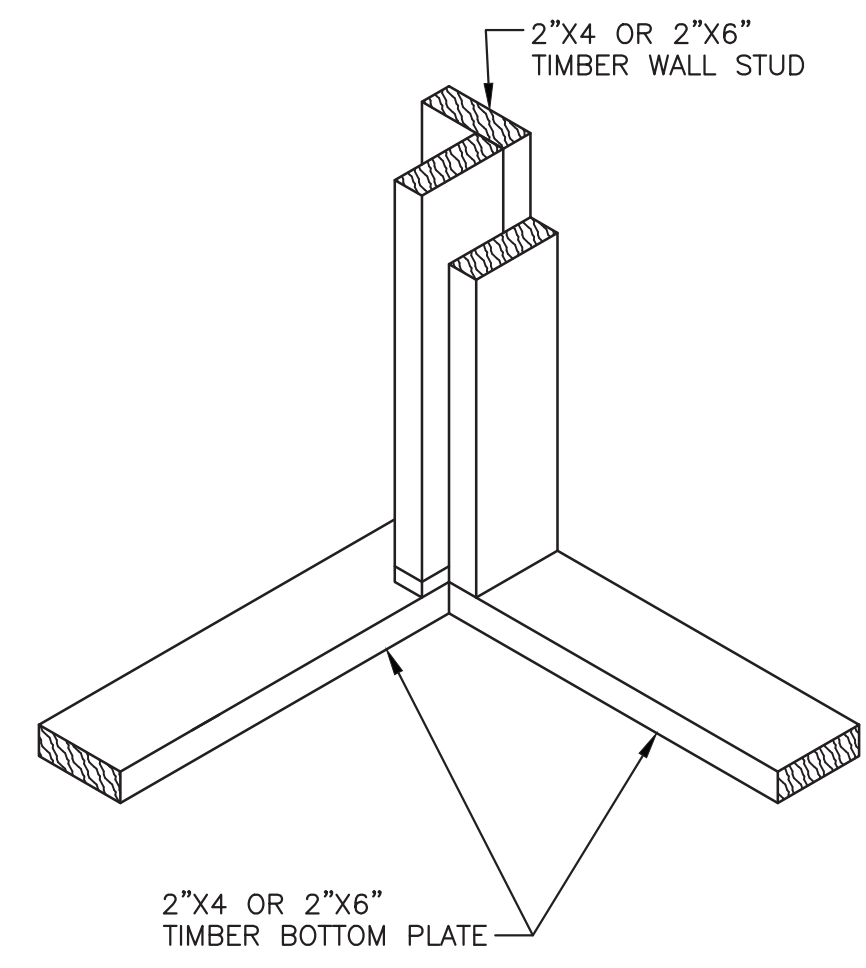


B
TYPICAL STUDS AT CORNERS DETAIL
SCALE: N.T.S.

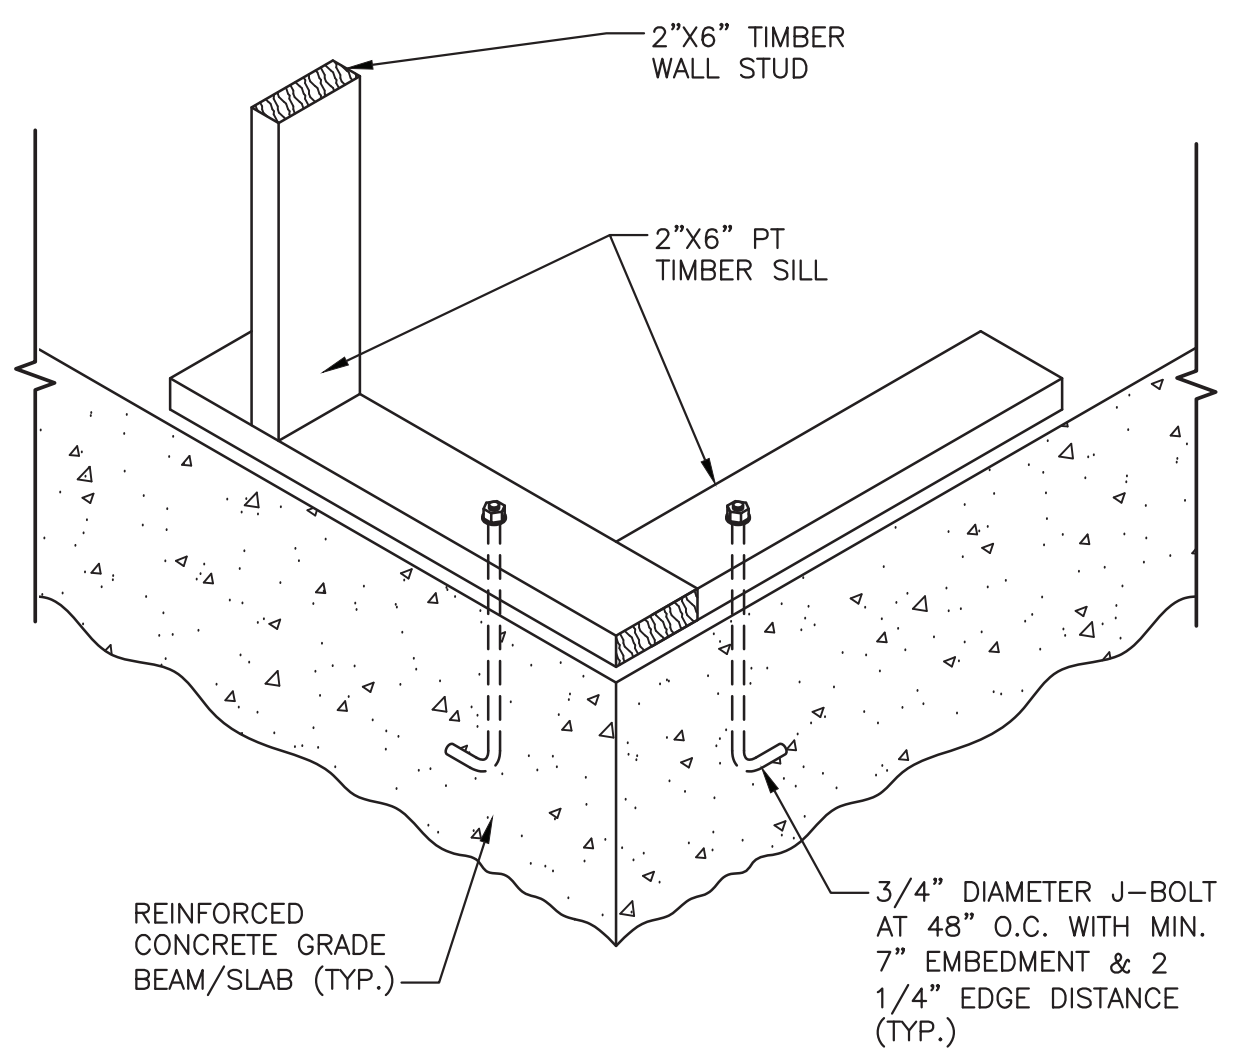


TYPICAL FLOOR FRAMING DETAIL
SCALE: N.T.S.

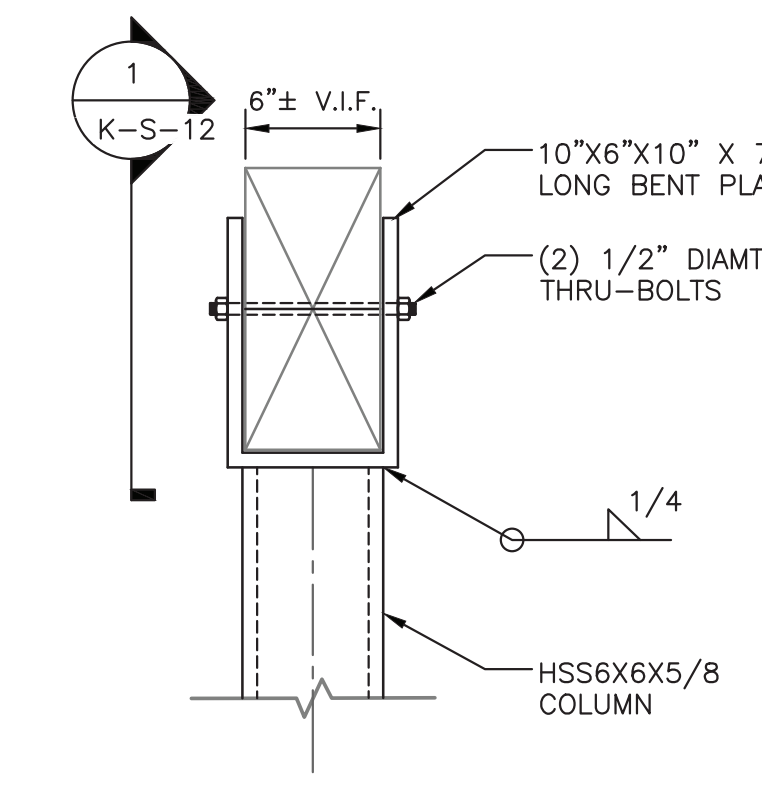


A
DETAIL
K-S-12 1"=1'-0"

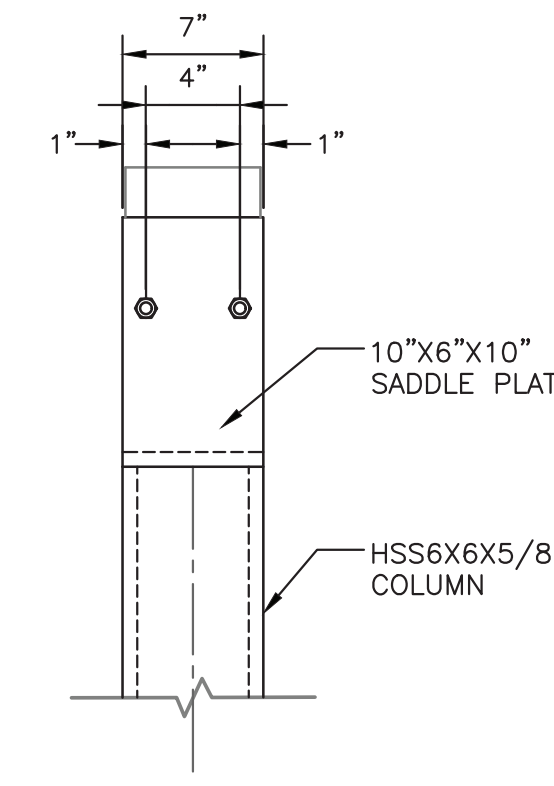


1
SECTION
K-S-12 1"=1'-0"

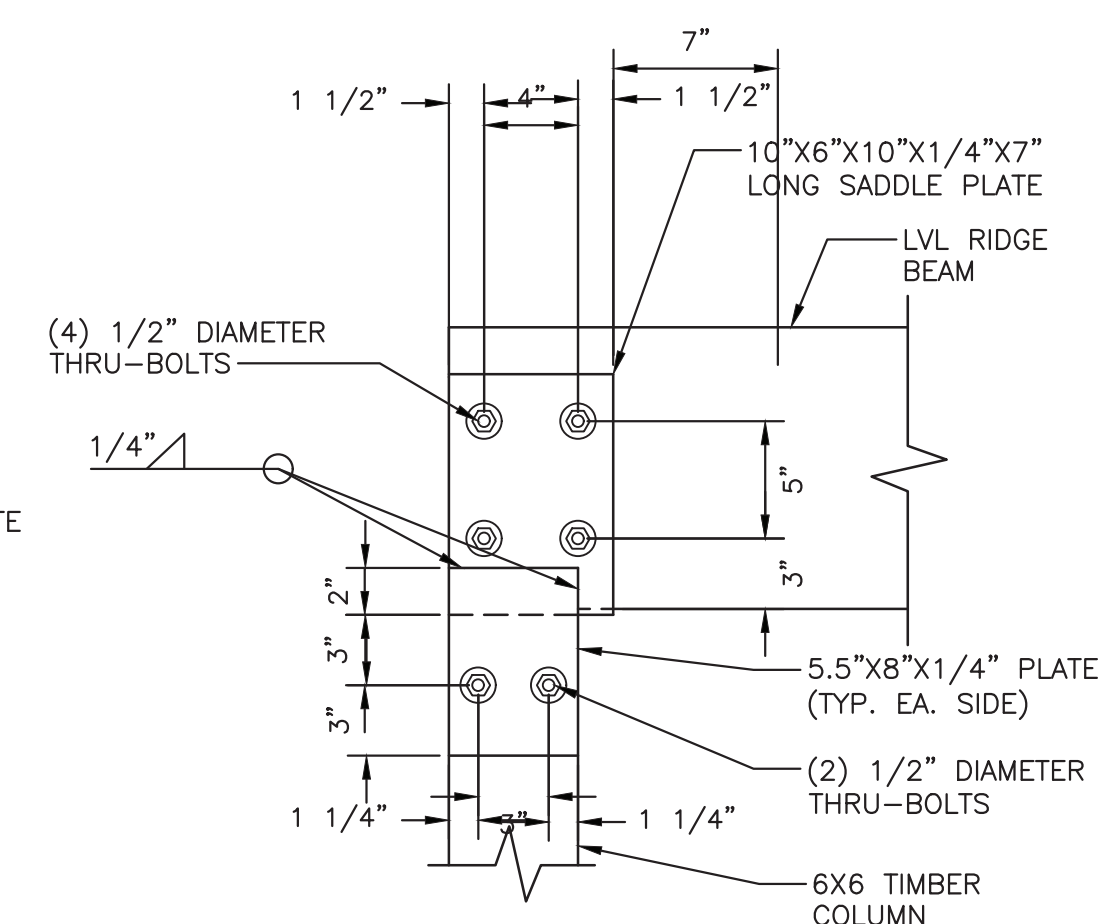


2
SECTION
K-S-12 SCALE: 1 1/2" = 1'-0"

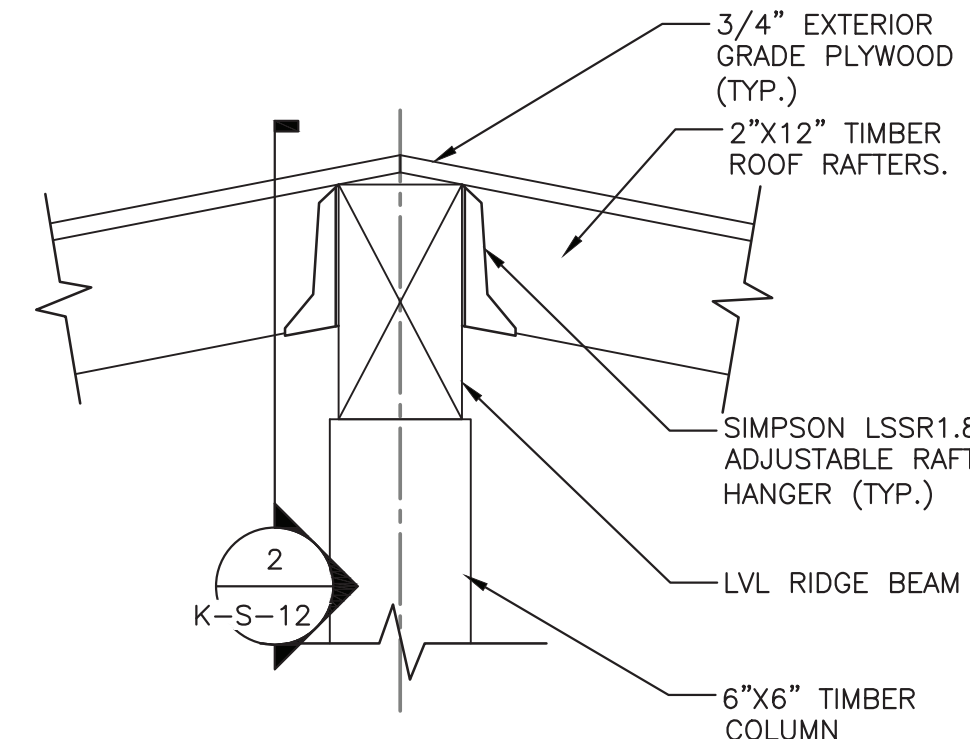


B
DETAIL
K-S-10 SCALE: N.T.S.

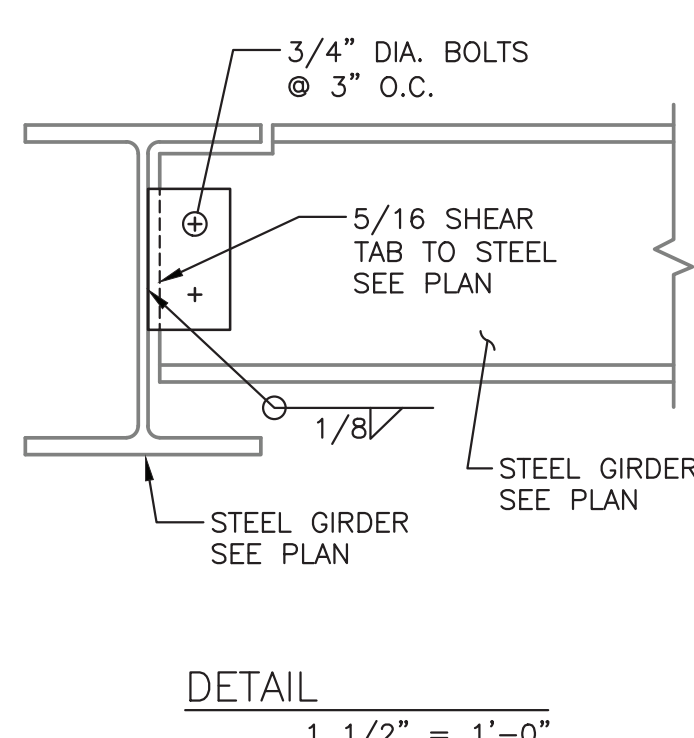

DETAIL
1 1/2" = 1'-0"

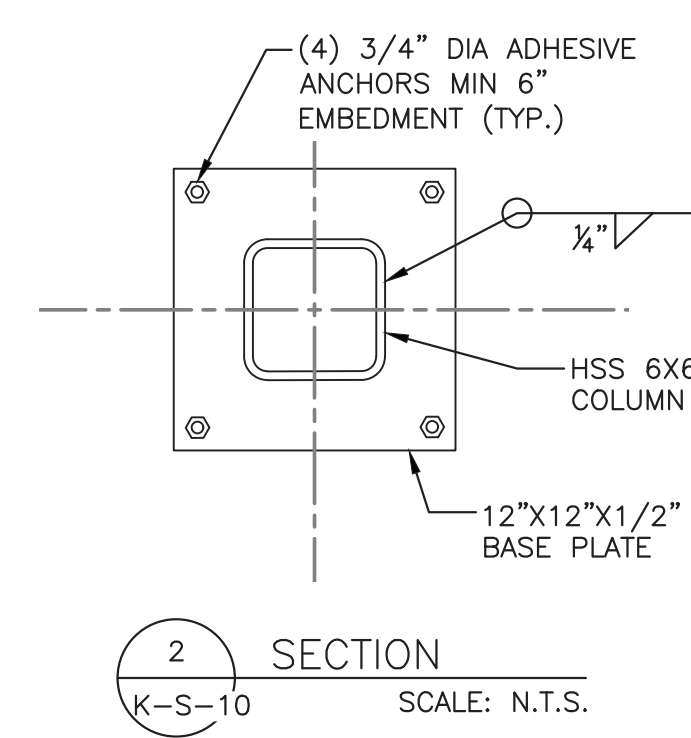


2
SECTION
K-S-10 SCALE: N.T.S.

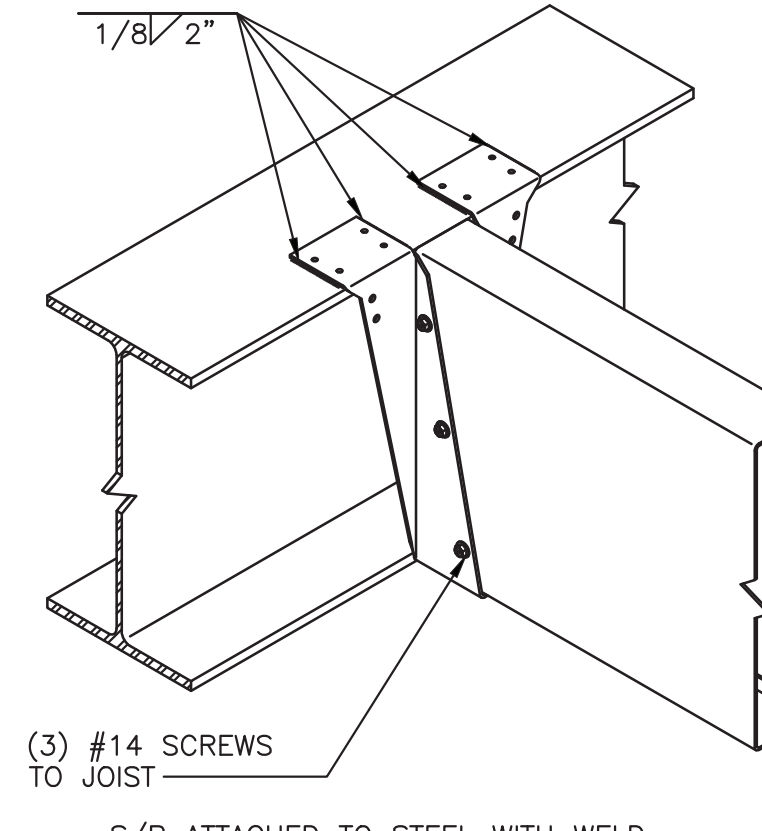

DETAIL
SCALE: N.T.S.

- NOTES:
- FOR STRUCTURAL NOTES, SEE DRAWING K-S-01.
 - FOR STRUCTURAL ABBREVIATIONS AND SYMBOLS, SEE DRAWING K-S-02.

Drawing Name: C:\Savin\Autocad\2060\25-Playland-Mega-3\K-S-1006.dwg
Revised by: JCastro Date: 21 August 2022 1:09 PM Designed by: ---
Printed by: JCastro Date: 19 August 2022 1:09 PM
xrefs: [TB-24436_WestchesterCo_3.dwg] [TSC-SYMBOL.dwg] [K-S-1016.dwg] [K-A-20.dwg]

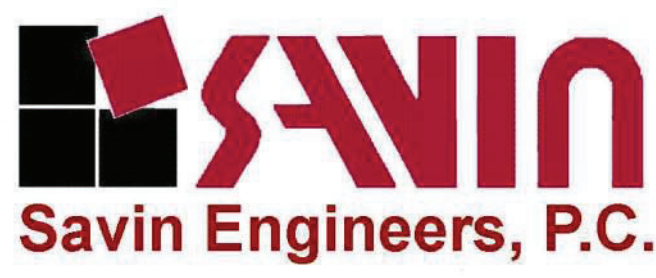


REVISION NUMBER	DATE	MADE BY	APP'D BY	REVISION

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CONTRACTOR		PROJECT COORDINATOR	
NAME	SIGNATURE	NAME	SIGNATURE
TITLE	DATE	TITLE	DATE


WESTCHESTER COUNTY, NEW YORK
DEPARTMENT OF PUBLIC WORKS AND TRANSPORTATION
DIVISION OF ENGINEERING
INFRASTRUCTURE REHABILITATION - PHASE 3
PLAYLAND PARK, RYE, NEW YORK
RESTAURANT KITCHEN WITH FOOD VENDING
SECTIONS AND DETAILS

CONTRACT NUMBER	SHEET NUMBER
22-523	K-S-12
DWG NO.:	SCALE: AS SHOWN
DATE: 8/23/2022	REV. NO. 0
DPW FILE NUMBER 1-118-S-1288-0	


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Revised By: J. Castro Date: 19 August 2022 1:09 PM Designed by: ---
Printed by: J. Castro Date: 19 August 2022 1:09 PM
Xrefs: [TSC-S4000.dwg] [TB_24X36_WebsterCo_3.dwg] [K-S-01000.dwg] [K-S-010010.dwg]

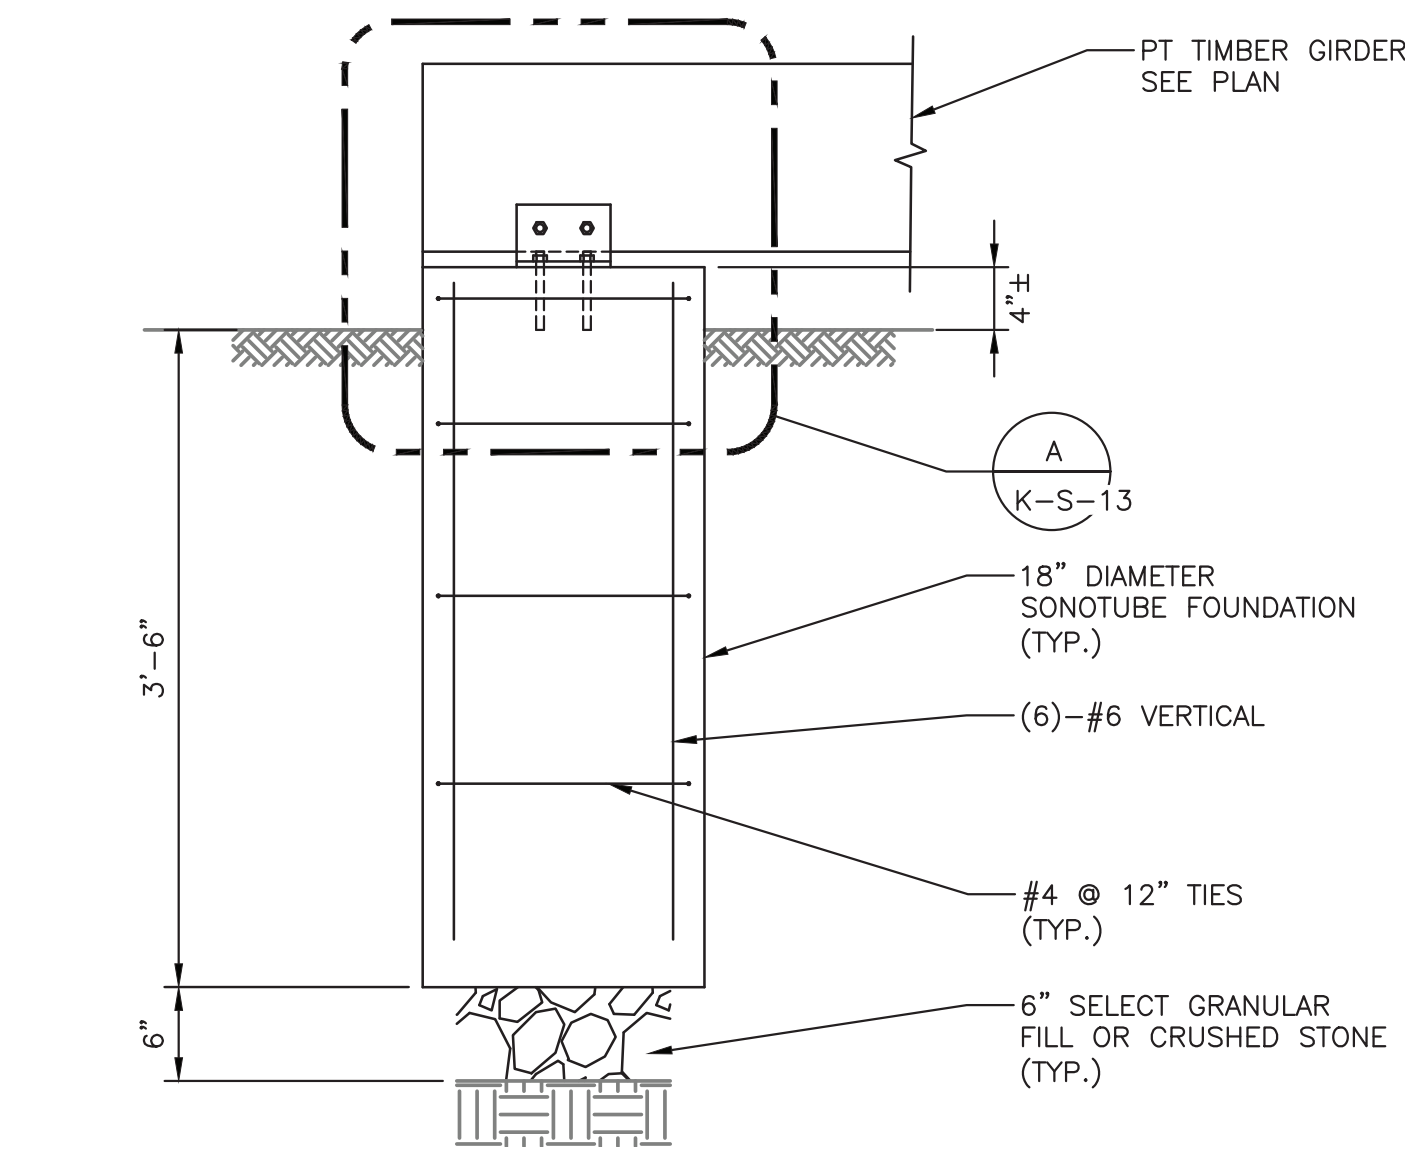


1 TYPICAL BOARDWALK SONOTUBE SECTION
K-S-07 SCALE: N.T.S.

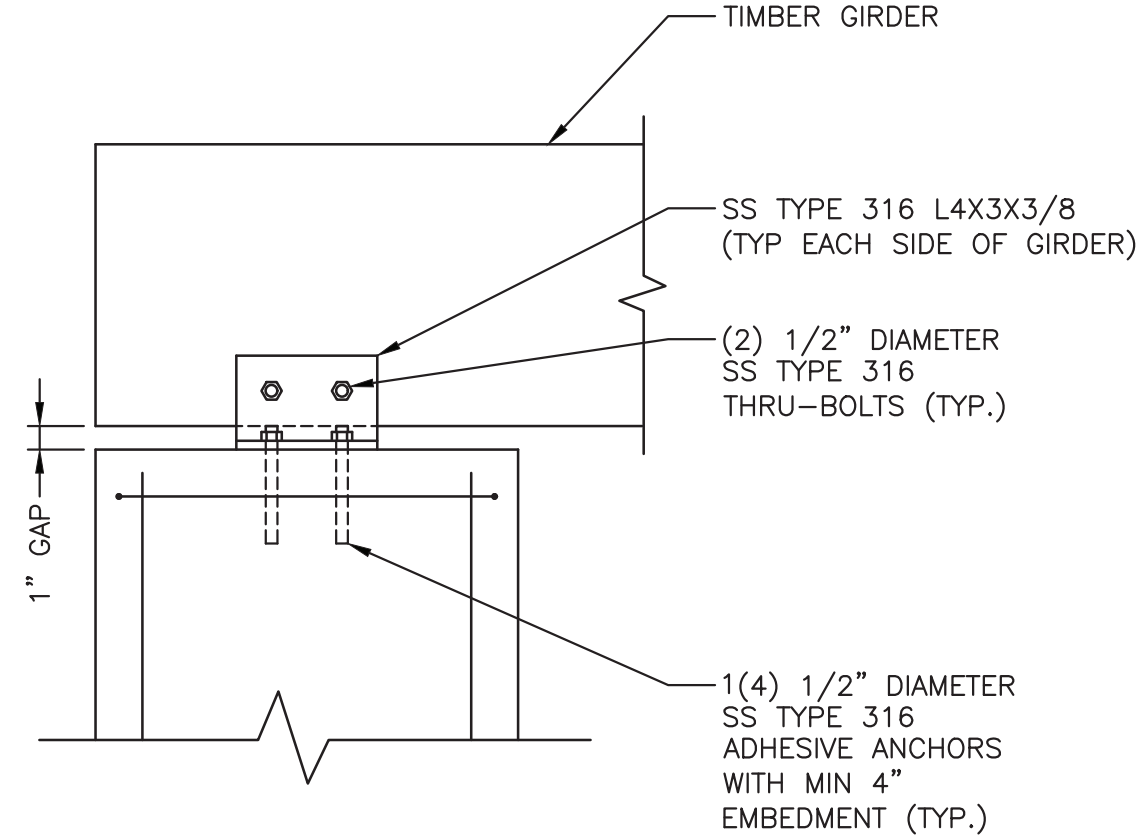


A DETAIL
K-S-13 SCALE: N.T.S.

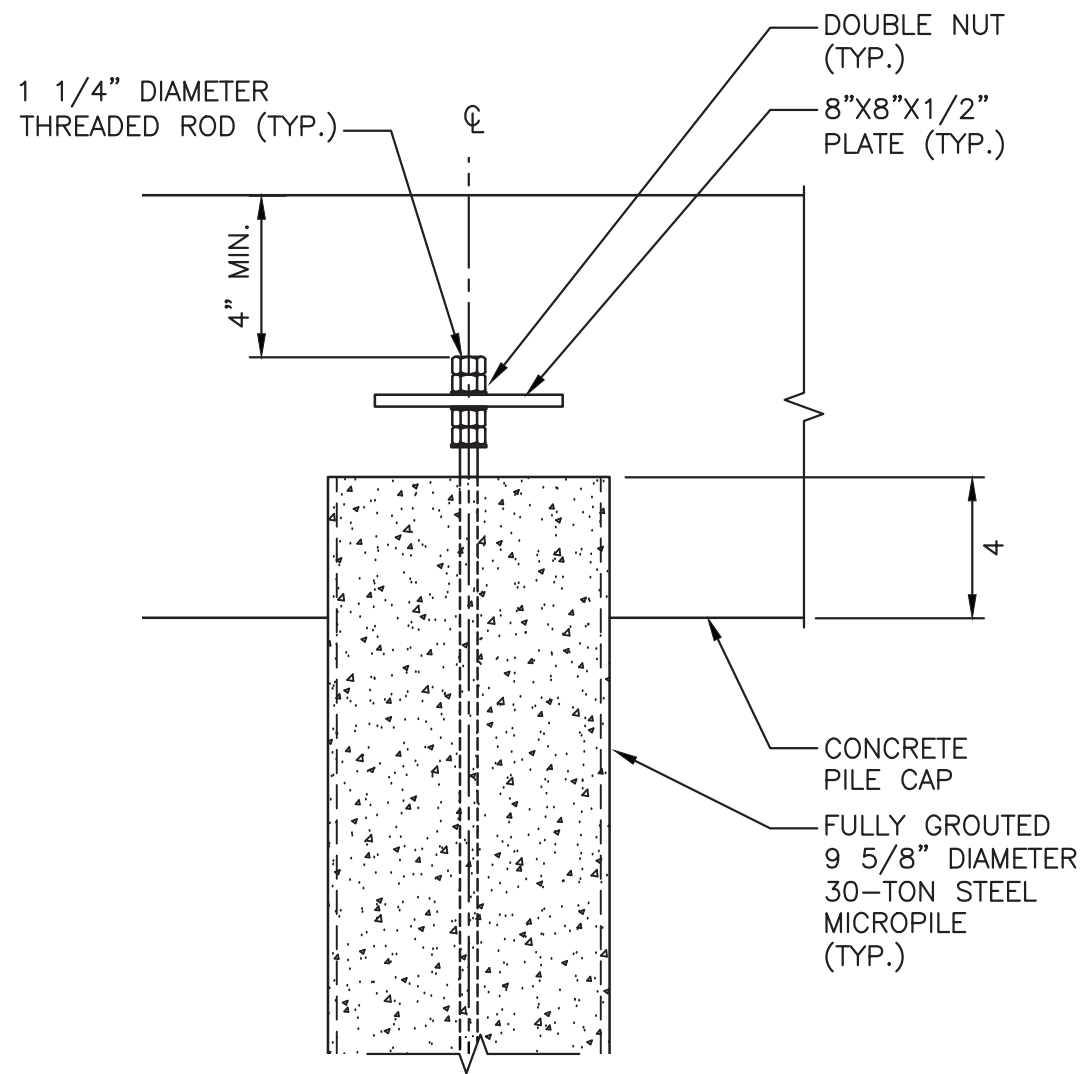


A TYPICAL PILE HEAD DETAIL
D-S-501 SCALE: N.T.S.

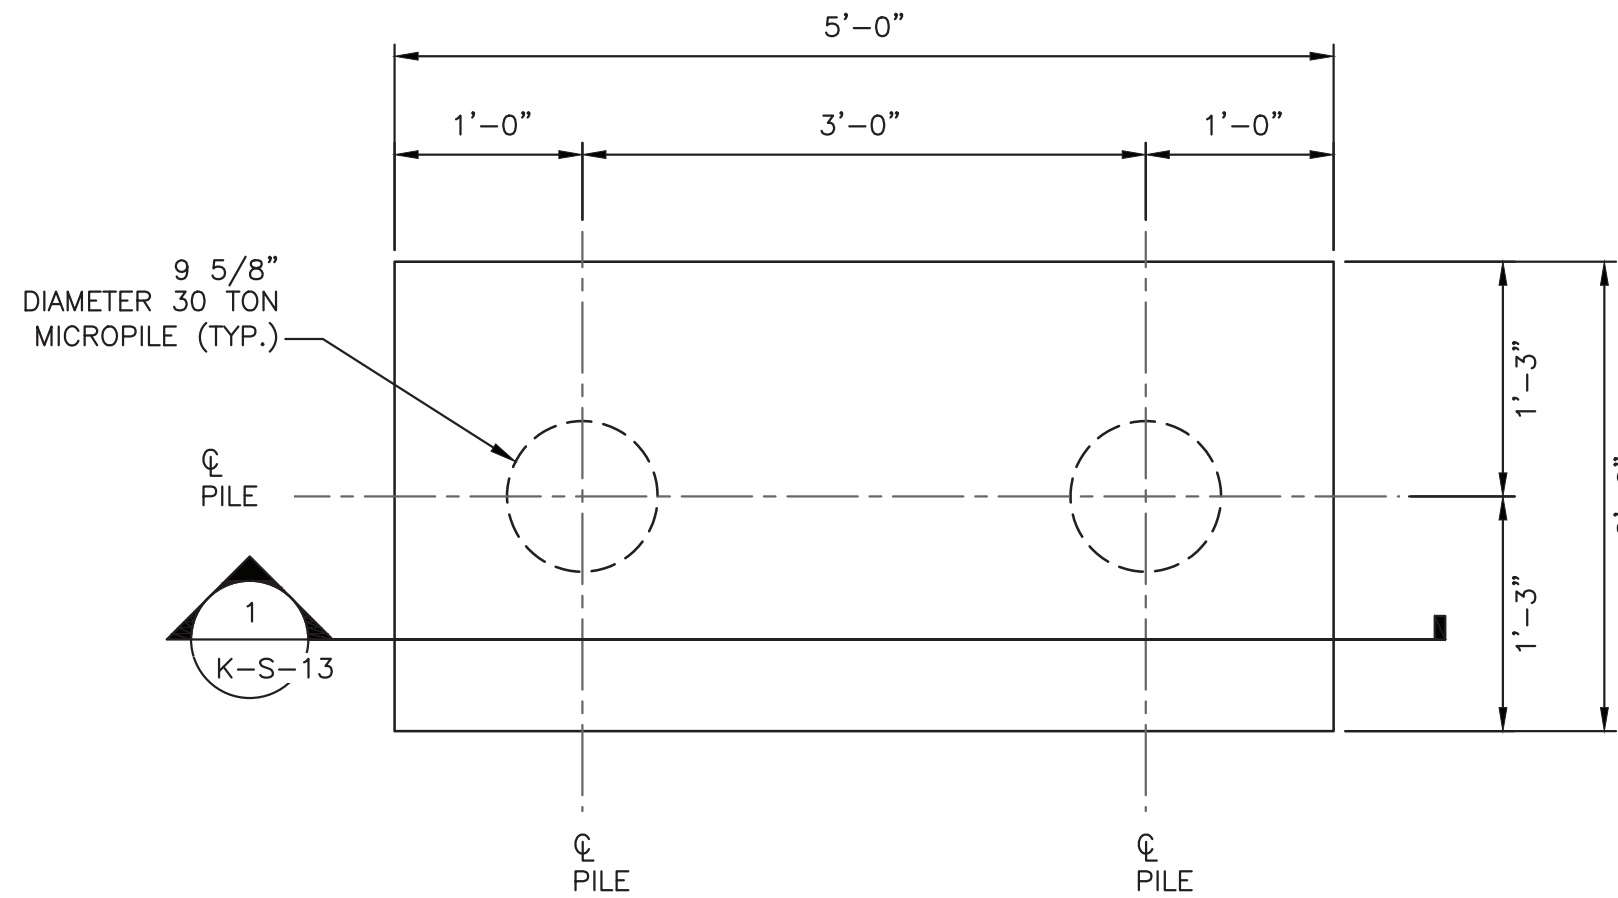


A PART PLAN
K-S-06 SCALE: N.T.S.

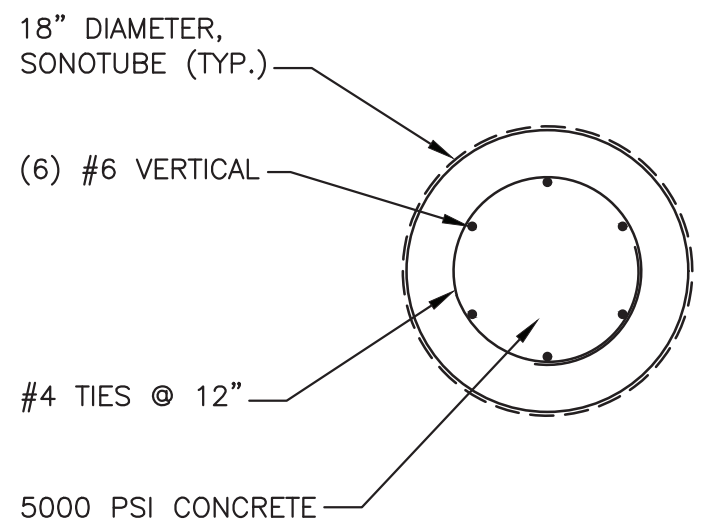


4 SECTION
K-S-13 SCALE: N.T.S.

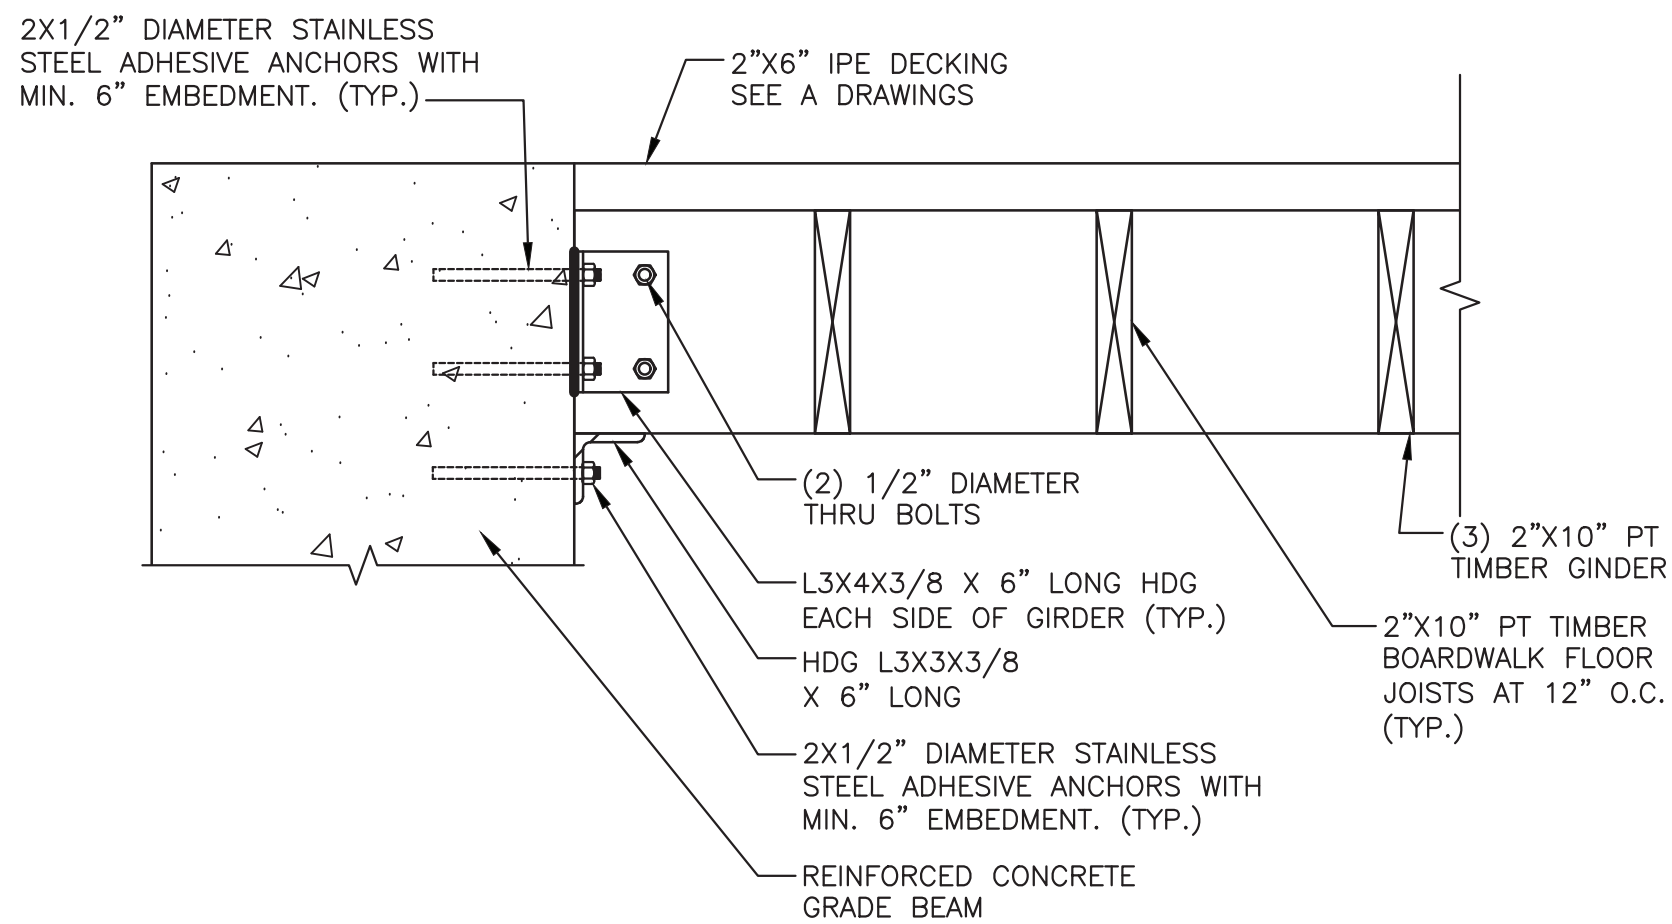

5 SECTION
K-S-07 SCALE: N.T.S.

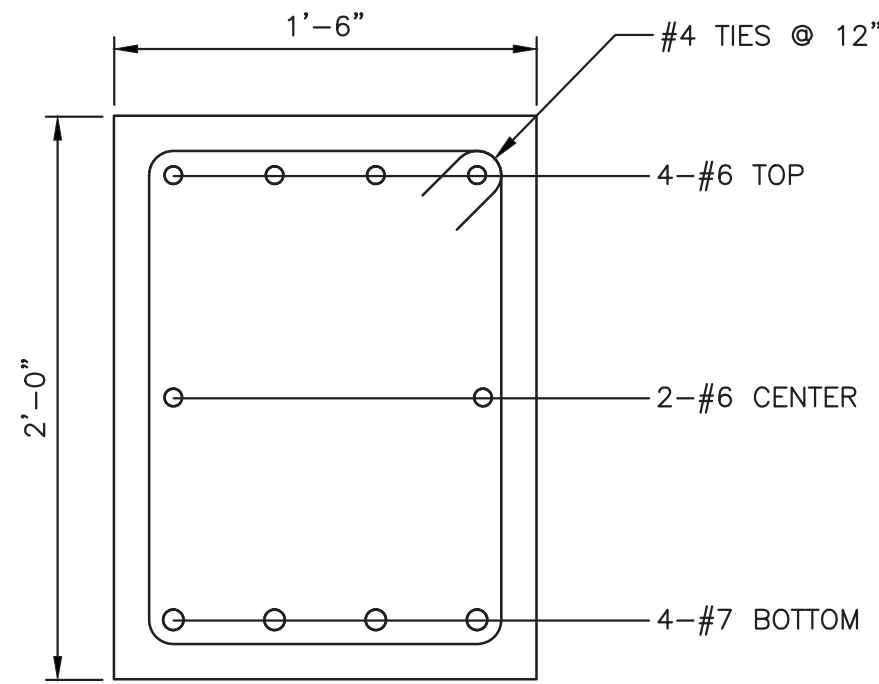

2 SECTION
K-S-06 SCALE: N.T.S.


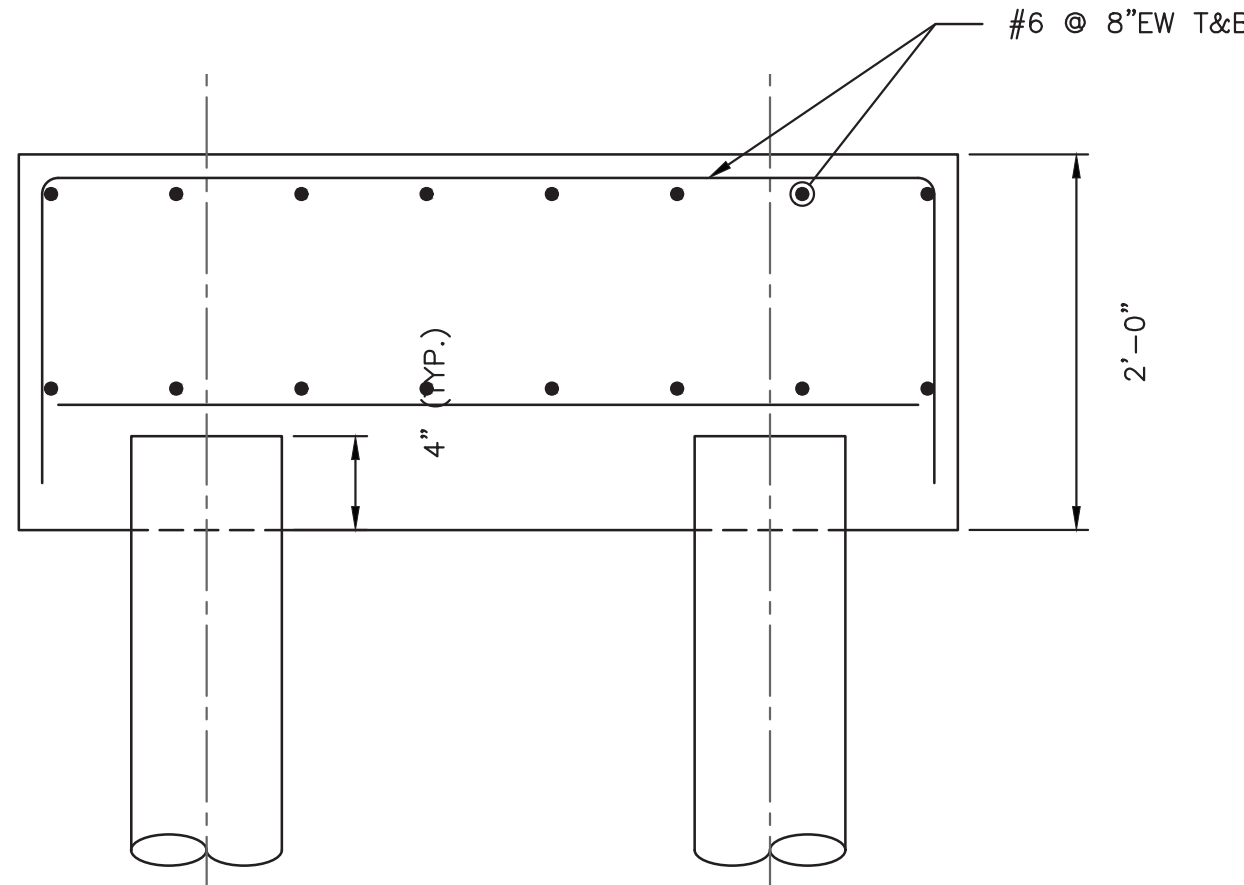


1 SECTION
K-S-13 SCALE: N.T.S.

BASIC DEVELOPMENT LENGTH AND SPLICE LENGTH								
FOR BARS IN TENSION								
fy = 60,000 psi				fc = 4000 psi OR GREATER, NORMAL WEIGHT CONCRETE				
BASIC DEVELOPMENT LENGTH ** l d				BAR SIZE	CLASS B SPLICE LENGTH ** 1.3 x l d			
CLEAR SPACING > 3"		CLEAR SPACING < 3"			CLEAR SPACING > 3"		CLEAR SPACING < 3"	
BASIC	TOP *	BASIC	TOP *		BASIC	TOP *	BASIC	TOP *
1'-0"	1'-4"	1'-9"	2'-2"	#3	1'-4"	1'-9"	2'-2"	2'-11"
1'-4"	1'-8"	2'-2"	2'-9"	#4	1'-8"	2'-2"	2'-9"	3'-7"
1'-8"	2'-2"	2'-10"	3'-7"	#5	2'-2"	2'-10"	3'-7"	4'-8"
2'-0"	2'-6"	3'-3"	4'-2"	#6	2'-6"	3'-3"	4'-2"	5'-5"
3'-6"	4'-7"	5'-11"	7'-7"	#7	4'-7"	5'-11"	7'-7"	9'-11"
4'-0"	5'-2"	6'-9"	8'-8"	#8	5'-2"	6'-9"	8'-8"	11'-4"
4'-6"	5'-10"	7'-7"	9'-10"	#9	5'-10"	7'-7"	9'-9"	12'-9"
5'-0"	6'-5"	8'-6"	11'-10"	#10	6'-5"	8'-6"	11'-0"	13'-7"
5'-7"	7'-4"	9'-5"	12'-6"	#11	7'-4"	9'-5"	12'-6"	14'-9"
NOTES:								
* TOP REINFORCEMENT IS HORIZONTAL REINFORCEMENT SO PLACED THAT MORE THAN 12 INCHES OF FRESH CONCRETE IS CAST IN THE MEMBER BELOW THE REINFORCEMENT								
** LENGTHS SHOWN IN CHART SHALL BE MODIFIED WHERE REQUIRED TO CONFORM TO THE PROVISIONS OF ACI 318, SECTION 12.2								
*** UNCOATED REINFORCEMENT								

DEVELOPMENT LENGTH OF STANDARD HOOKS		
FOR BARS IN TENSION		
fy = 60,000 psi fc = 4000 psi OR GREATER, NORMAL WEIGHT CONCRETE		
BAR SIZE	DEVELOPMENT LENGTH, l dh	
	BASIC	W/CONC. COVER *
#3	8"	6"
#4	10"	7"
#5	1'-0"	9"
#6	1'-3"	11"
#7	1'-5"	1'-0"
#8	1'-7"	1'-2"
#9	1'-10"	1'-4"
#10	2'-1"	1'-6"
#11	2'-3"	1'-7"
NOTES:		
* SIDE COVER NORMAL TO PLANE OF HOOK AT LEAST 2 1/2"; AND FOR 90° HOOK, END COVER BEYOND OUTSIDE END OF HOOK AT LEAST 2".		
** UNCOATED REINFORCEMENT		

- NOTES:
- FOR STRUCTURAL NOTES, SEE DRAWING K-S-01.
 - FOR STRUCTURAL ABBREVIATIONS AND SYMBOLS, SEE DRAWING K-S-02.

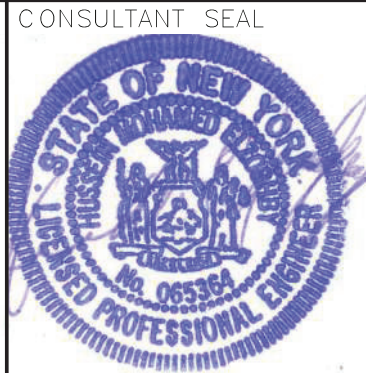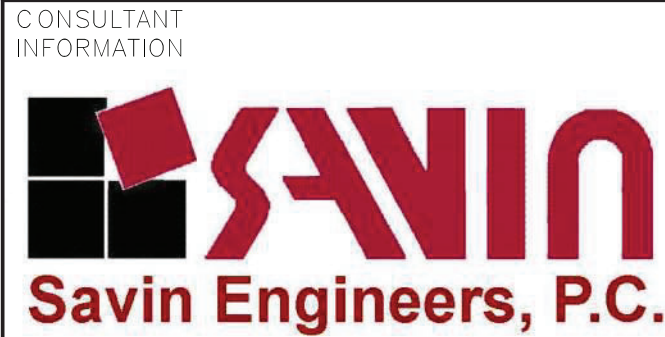

REVISION NUMBER	DATE	MADE BY	APP'D BY	REVISION

RECORD DRAWING CERTIFICATION	
<input type="checkbox"/> AS BUILT - CHANGES AS NOTED	<input type="checkbox"/> AS BUILT - NO CHANGES
CONTRACTOR	PROJECT COORDINATOR
NAME SIGNATURE TITLE	NAME SIGNATURE TITLE

WESTCHESTER COUNTY, NEW YORK DEPARTMENT OF PUBLIC WORKS AND TRANSPORTATION DIVISION OF ENGINEERING
INFRASTRUCTURE REHABILITATION - PHASE 3 PLAYLAND PARK, RYE, NEW YORK RESTAURANT KITCHEN WITH FOOD VENDING SECTIONS AND DETAILS

CONTRACT NUMBER 22-523	SHEET NUMBER K-S-13
DWG NO.: SCALE: AS SHOWN	540 of 664
DATE: 8/23/2022	REV. NO. 0
DPW FILE NUMBER 1-118-S-1289-0	

FIRE PROTECTION SAFETY NOTES:

1. SPECIAL PRECAUTION SHALL BE TAKEN BY THE CONTRACTOR SO THAT EQUIPMENT OF THIS APPLICATION AND ITS INSTALLATION WILL NOT AFFECT THE FOLLOWING: EGRESS TO AND FROM THE BUILDING, FIRE SAFETY OR CREATE A FIRE HAZARD, STRUCTURAL SAFETY OF THE BUILDING, ACCUMULATION OF DUST AND DEBRIS. (THE CONTRACTOR SHALL LEAVE THE SITE BROOM CLEANED EACH DAY.)

FIRE PROTECTION GENERAL NOTES:

1. DIMENSIONS, LOCATIONS AND SIZES INDICATED ON THE PLANS AND THE ELEVATION ARE APPROXIMATE AND SHALL BE VERIFIED BY FIELD INSPECTION BY THE CONTRACTOR.

2. SOME EXISTING PIPE AND EQUIPMENT IS SHOWN FOR CLARIFICATION OF THIS CONTRACT, BUT MUST BE PROTECTED BY THE CONTRACTOR.

3. NO WORK SHALL BE INITIATED UNTIL A WORK PERMIT IS OBTAINED BY THE CONTRACTOR AND A SAFETY PLAN IS SUBMITTED AND IS APPROVED.

4. CONTRACTOR IS RESPONSIBLE FOR OBTAINING ALL PERMITS, EQUIPMENT USE PERMITS, ALL INSPECTION APPROVALS, AND LETTER OF COMPLETION FROM THE DEPARTMENT OF BUILDINGS FOR WORK UNDER THIS CONTRACT AS APPLICABLE.

5. ANY EXISTING MATERIALS, PIPING, ETC., NOT INDICATED FOR DEMOLITION WHICH ARE REMOVED BY THE CONTRACTOR IN ORDER TO INSTALL NEW WORK SHALL BE REINSTALLED BY THE CONTRACTOR. IF EXISTING WORK IS DAMAGED IT SHALL BE REPLACED AT THE CONTRACTOR'S EXPENSE. ALL SURFACES OR FINISHES THAT ARE DAMAGED OR OTHERWISE AFFECTED BY WORK OF THIS CONTRACT SHALL BE PATCHED, REPAIRED, PAINTED OR REPLACED TO MATCH THE PRE-EXISTING CONDITION AND THE NEW WORK.

6. CONTRACTOR MAY PROPOSE ALTERNATE ROUTING IN DIFFICULT AREAS WHERE REPLACEMENT IN KIND IS NOT PRACTICAL. ANY AND ALL ALTERNATE ROUTING IS SUBJECT TO PRIOR REVIEW AND APPROVAL BY THE ENGINEER.

7. A FIRE WATCH SHALL BE PROVIDED WHEN SPRINKLER COVERAGE IS IMPACTED TO MAINTAIN BUILDING OPERATIONS OR AS REQUIRED.

FIRE PROTECTION SYMBOL LIST

— — — — FS DRY— —

NEW DRY SPRINKLER PIPING

— — — — DRY(E) —

EXISTING TO REMAIN DRY SPRINKLER PIPING

o

NEW UPRIGHT SPRINKLER HEAD

o

EXISTING UPRIGHT SPRINKLER HEAD

●

NEW CONCEALED PENDENT SPRINKLER HEAD-ORDINARY TEMPERATURE

⋈

SPRINKLER DRY PIPE VALVE

⌈

FIRE HOSE CABINET

SIAMESE CONNECTION

CHECK VALVE

CHECK VALVE W/ ALARM

WATER MOTOR ALARM BELL

o

PIPE RISER

o

PIPE DROP

o

PIPE UP

POINT OF CONNECTION

POINT OF DISCONNECTION

PREACTION 6" BELL

SOLENOID VALVE

OS & Y VALVE

REVISION SYMBOL

REFER TO SUPPLEMENTAL FIGURE INDICATED BY NUMBER (I.E. F2 REFERS TO FIGURE 2)

EQUIPMENT TAG

EQUIPMENT NUMBER

DETAIL TAG/ CALL OUT TAG

FIRE PROTECTION SHEET NUMBER

SHOP DWGS/EQUIPMENT SUBMITTALS

THE CONTRACTOR MUST SUBMIT ANY EQUIPMENT ALTERNATES 2 WEEKS PRIOR TO BIDS DUE FOR REVIEW AND COMMENTS. ALTERNATES MUST BE ACCEPTED BY LIRO ENGINEERS, INC., THE ARCHITECT, AND THE OWNER PRIOR TO INCLUSION IN BID. THE CONTRACTOR IS RESPONSIBLE TO COORDINATE EQUIPMENT ALTERNATES WITH OTHER TRADES AND MAKE ADJUSTMENTS TO THE MECHANICAL SYSTEMS, AS REQUIRED, TO ACCOMMODATE THESE NEW ALTERNATES.

THE CONTRACTOR IS RESPONSIBLE TO SUBMIT ALL OF THE FOLLOWING ITEMS FOR REVIEW/APPROVAL BY NO MORE THAN 3 WEEKS AFTER THE CONTRACTOR'S CONTRACT/BID HAS BEEN AWARDED. ALL SUBMITTALS MUST BE SENT TOGETHER AS A **SINGLE PACKAGE** WITH MANUFACTURER'S SPECIFIC MODELS AND SPECIFICATIONS OUTLINED TO MATCH THE SCHEDULED REQUIREMENTS. EACH SUBMITTAL MUST BE LABELED WITH THE UNIT DESIGNATION USED WITHIN THIS DRAWING SET. IF THE SUBMITTAL PACKAGE IS FOUND TO BE INCOMPLETE UPON RECEIPT, THE PACKAGE WILL BE HELD AND WILL NOT BE REVIEWED UNTIL THE REMAINDER OF THE PACKAGE IS RECEIVED. SIX (6) HARD COPIES OF THE SUBMITTAL PACKAGE MUST BE SENT TO LIRO ENGINEERS, INC. DIGITAL SHOP DRAWING SUBMISSIONS ARE ACCEPTABLE.

SCOPE OF WORK:

1. THE INSTALLATION OF NEW DRY FS EQUIPMENT.

2. PROPOSED FIRE SPRINKLER HEAD LOCATIONS AND PIPING ARE AS NOTED ON PLANS. EXACT PIPING FROM THE FIRE SPRINKLER MAIN TO ALL HEADS IS TO BE COORDINATED AND HYDRAULICALLY CALCULATED BY THE F.S.C. & SUBMITTED TO THE ENGINEER FOR APPROVAL.

NOTE: THIS SCOPE OF WORK DESCRIPTION IS PROVIDED TO GIVE AN OVERALL "MACRO" DESCRIPTION OF THIS PROJECT. F.S.C. IS RESPONSIBLE TO REVIEW ALL ENGINEERING AND ARCHITECTURAL DRAWINGS AND VISIT THE SITE IF NEEDED, PRIOR TO SUBMISSION OF BID.

SPRINKLER HEAD SCHEDULE					
	MANUFACTURER	MODEL	DESCRIPTION	K-FACTOR	QUANTITY
o	RELIABLE	F1FR	DRY ORDINARY UPRIGHT SPRINKLE HEAD	5.6	15
●	RELIABLE	F1FR	WET ORDINARY CONCEALED SPRINKLE HEAD	5.6	24
⋈	TYCO	DS1	DRY ORDINARY SIDEWALL SPRINKLE HEAD	5.6	4

ABBREVIATION

ACV

ALARM CHECK VALVE

B.O.P

BOTTOM OF PIPE

(E)

EXISTING TO REMAIN

F.S.C

FIRE SPRINKLER CONTRACTOR

P.C

PLUMBING CONTRACTOR

TYP

TYPICAL

W/

WITH

NYS

NEW YORK STATE

U/P

UNDERGROUND PIPING

W

WATER

DRAWING NOTATIONS

⊙

DRAWING NOTE TAB

⊕

RISER DESIGNATION

⊗

POINT OF CONNECTION

⊖

POINT OF DISCONNECTION

DESIGN CRITERIA

1. AREA OF APPLICATION = 1950 SQ. FT

2. OCCUPANCY CLASSIFICATION = ORDINARY HAZARD GROUP 2

3. MAXIMUM COVERAGE PER SPRINKLER HEAD = 130 SQ. FT

4. DESIGN DENSITY = 0.20 GPM/SQ. FT

5. NUMBER OF SPRINKLER HEADS WITHIN AREA OF APPLICATION = 26

6. "K" FACTOR OF SPRINKLER HEADS = 5.6

7. DESIGN CRITERIA REQUIREMENTS BASED ON:

- 2020 BUILDING CODE OF NEW YORK STATE

- 2016 NFPA 13

ORDINARY HAZARD PIPE SCHEDULE			
STEEL		COPPER	
1IN.	2 SPRINKLERS	1IN.	2 SPRINKLERS
1 1/4 IN.	3 SPRINKLERS	1 1/4 IN.	3 SPRINKLERS
1 1/2IN.	5 SPRINKLERS	1 1/2IN.	5 SPRINKLERS
2 IN.	10 SPRINKLERS	2 IN.	12 SPRINKLERS
2 1/2 IN.	20 SPRINKLERS	2 1/2 IN.	25 SPRINKLERS
3 IN.	40 SPRINKLERS	3 IN.	45 SPRINKLERS
3 1/2 IN.	65 SPRINKLERS	3 1/2 IN.	75 SPRINKLERS
4 IN.	100 SPRINKLERS	4 IN.	115 SPRINKLERS
5 IN.	160 SPRINKLERS	5 IN.	180 SPRINKLERS
6 IN.	275 SPRINKLERS	6 IN.	300 SPRINKLERS
8 IN.	SEE SECTION 8.2	8 IN.	SEE SECTION 8.2
FOR SI UNITS, 1 IN. = 25.4 MM.			

MAX DISTANCE BETWEEN HANGERS (FT.-IN.)												
NOMINAL PIPE SIZE (IN.)												
	3/4	1	1 1/4	1 1/2	2	2 1/2	3	3 1/2	4	5	6	8
STEEL PIPE EXCEPT THREADED LIGHTWALL	N/A	12-0	12-0	15-0	15-0	15-0	15-0	15-0	15-0	15-0	15-0	15-0
THREADED LIGHTWALL STEEL PIPE	N/A	12-0	12-0	12-0	12-0	12-0	12-0	N/A	N/A	N/A	N/A	N/A
COPPER TUBE	8-0	8-0	10-0	10-0	12-0	12-0	12-0	15-0	15-0	15-0	15-0	15-0

CODE REFERENCE

2020 NEW YORK STATE BUILDING CODE

2016 NFPA 13

FIRE PROTECTION NOTES

1. THE DRAWINGS SHOW THE LAYOUT OF THE SYSTEM AND INDICATE THE APPROXIMATE LOCATIONS OF EQUIPMENT AND PIPING. CONTRACTOR IS CAUTIONED NOT TO SCALE THE DRAWINGS. THE PIPING SHALL BE RUN APPROXIMATELY IN THE AREAS AS INDICATED ON THE DRAWINGS. HOWEVER, TO THE ARRANGEMENT OF THE PIPING SYSTEMS AS MAY BE REFERENCED WITH WORK OF OTHER TRADES, CONTRACTOR SHALL REVIEW AND COORDINATE WITH STRUCTURAL, ELECTRICAL AND MECHANICAL DRAWINGS, PARTITIONS, STRUCTURAL MEMBERS, ETC. ARE DESIGNED TO BE FURRED OR CLOSED IN AND TO INCLUDE ROUGH-IN PIPING. CONTRACTOR SHALL FURNISH ALL OFFSETS, ADDITIONAL FITTINGS, ETC. WHETHER SHOWN ON DRAWINGS OR NOT, AS REQUIRED TO MEET INSTALLATION CONDITIONS.

2. CONTRACTOR IS TO COMPLY WITH LATEST NFPA AND N.Y.S. CODES, AND COORDINATE HIS WORK WITH OTHER TRADES AND MAKE NECESSARY ADJUSTMENTS.

3. CONTRACTOR IS TO PREPARE SHOP DRAWINGS FOR ENGINEERS REVIEW AFTER MAKING A COMPLETE FIELD SURVEY.

4. CONTRACTOR IS TO REPORT ANY CONDITION REQUIRING CHANGES FROM PLANS TO ENGINEER PRIOR TO STARTING WORK.

5. BRANCH LINES AND MAINS (1 1/2" OR LESS) - SCHEDULE 40 FM APPROVED

6. BRANCH LINES AND MAINS (2" OR LARGER) - THINWALL (THICKNESS LESS THEN SCHEDULE 40 MORE THEN SCHEDULE 10 & FM APPROVED)

7. CONTRACTOR IS TO PERFORM A HYDROSTATIC TEST FOR 2 HRS. @ 200 PSI WITH NO LEAKAGE AND PROVIDE A TEST CERTIFICATE TO ENGINEER

8. CONTRACTOR IS TO EMPLOY EXPERIENCED WORKMEN WHO ARE TO FAMILIARIZE THEMSELVES WITH THE BUILDING AND OBSERVE SAFETY REQUIREMENTS.

9. CONTRACTOR TO ADJUST HEAD LOCATION TO COORDINATE WITH LIGHTS, DUCTS, ETC.

10. PERMIT FROM LOCAL AUTHORITY, TO BE OBTAINED BY CONTRACTOR.

11. ALL WORK TO BE APPROVED BY OWNERS ENGINEER, STATE AUTHORITIES HAVING JURISDICTION AND MUNICIPAL FIRE, PLUMBING, BUILDING AND WATER DEPARTMENTS.

12. U.L. AND/OR FM APPROVED EQUIPMENT TO BE USED.

13. WORK TO BE IN ACCORDANCE WITH MUNICIPAL WATER DEPT. RULES

14. SYSTEM IS TO BE MAINTAINED AND TESTED BY THE OWNER OR HIS AGENT IN ACCORDANCE WITH APPLICABLE LOCAL AND STATE CODES AND IN CONFORMANCE WITH NFPA 13A, LATEST EDITION.

15. IF BUILDING OCCUPANCY OR CONSTRUCTION CHANGES, THE SPRINKLER SYSTEM IS TO BE UPDATED ACCORDINGLY BY THE OWNER OR HIS AGENT.

16. CONTRACTOR IS TO NEATLY CUT AND PATCH IN A FIRST CLASS WORKMANLIKE MANNER, ALL HOLES AND PENETRATIONS IN WALLS, CEILINGS, FLOORS, PARTITIONS, ETC.

17. THE ENGINEER IS NOT RETAINED FOR SUPERVISION.

18. THE INSTALLATION OF THIS SYSTEM WILL REQUIRE THE CLOSING OF ONE OR MORE FIRE PROTECTION CONTROL VALVES. THESE VALVE CLOSURES SHOULD BE CLOSELY COORDINATED WITH THE OWNERS WHO SHOULD CONTACT THE LOCAL FIRE DEPARTMENT, INSURANCE INTERESTS, ETC. PRIOR TO VALVE CLOSURES.

19. ACTUAL DESIGN DENSITY MAY EXCEED STANDARDS, HOWEVER, IT IS A MINIMUM TO BE USED BY THE CONTRACTOR.

20. ALL ALARMS RELATING TO THE SPRINKLER SYSTEM SHOULD BE ACTIVATED UPON PLACING THE SPRINKLER SYSTEM IN SERVICE.

21. THE INSTALLATION COMPONENTS, SIZING, SPACING, MATERIALS LOCATION CLEARANCES, POSITION AND TYPE OF SYSTEM SHALL CONFORM TO NFPA 13 AND NYS UNIFORM FIRE PREVENTION BUILDING CODE LATEST EDITION.

22. SPRINKLERS SHALL BE PROTECTED AGAINST FREEZING AND INJURY AS PER NFPA CODE.

23. INSPECTION AND TESTS OF SPRINKLER SYSTEM SHALL BE CONDUCTED AS SPECIFIED IN NFPA CODE.

24. WATER SUPPLY TEST PIPES AND GAUGES SHALL BE PROVIDED AS SPECIFIED IN CHAPTER 2-9 OF NFPA 13.

25. PIPING SPECIFICATIONS, PIPE SCHEDULES, SYSTEM TEST PIPES, PROTECTION AGAINST CORROSION, DAMAGE FITTINGS, VALVES, HANGERS, SPRINKLERS, GUARDS AND SHIELDS SHALL BE IN ACCORDANCE WITH CHAPTER 3 AND CHAPTER 8 OF NFPA 13, LATEST EDITION. PIPING SHALL BE PAINTED TO PREVENT CORROSION.

26. STOCK OF EXTRA SPRINKLERS WILL BE FURNISHED AS PER CHAPTER 3 OF NFPA 13 (REQUIRED FOR EACH TEMPERATURE RATING).

27. SPRINKLER ALARMS WILL BE IN ACCORDANCE WITH NFPA 13.

28. SPACING, LOCATION AND POSITION OF SPRINKLERS SHALL BE IN ACCORDANCE WITH CHAPTER 4 OF NFPA 13.

29. ALL PIPING PASSING THROUGH WALLS SHALL COMPLY WITH NFPA FOR FIRE PROOFING.

30. DISTANCE OF SPRINKLERS FROM HEAT SOURCES SHALL BE IN ACCORDANCE WITH TABLE 3-16.6.3 OF NFPA 13.

31. PROVIDE WATER SUPPLY LETTER WITH FLOW TEST DATA.

32. ALL PIPES PASSING THROUGH FOUNDATION WALLS TO BE PROTECTED.

33. ALL VALVES SHALL BE IDENTIFIED AS REQUIRED BY NFPA 13.

34. DRAINAGE TO CONFORM TO CHAPTER 3-11 OF NFPA 13.

35. A ONE PIECE REDUCING FITTING OF GOOD DESIGN SHOULD BE USED WHEREVER A CHANGE IS MADE IN THE SIZE OF PIPE AS PER SECTION 3-12.2.7 OF NFPA 13.

36. ALL VALVES ON CONNECTIONS TO WATER SUPPLIES AND IN SUPPLY TO SPRINKLERS SHALL BE APPROVED O.S. &Y. OR APPROVED INDICATOR TYPE WITH TAMPER SWITCHES.

37. DRAIN VALVES AND TEST VALVES SHALL BE APPROVED TYPE AS PER SECTION 3-14.1.2 OF NFPA 13.

38. HANGERS SHALL BE OF A TYPE APPROVED FOR USE WITH THE PIPE OR TUBE INVOLVED, SPRINKLER PIPING SHOULD BE SUPPORTED BY ADJUSTABLE HANGERS PER NFPA 13, SECTION 3-15.

39. PROVISIONS SHOULD BE MADE TO FACILITATE FLUSHING SYSTEM PIPING BY PROVIDING FLUSHING CONNECTIONS CONSISTING OF A CAPPED NIPPLE 4" LONG ON THE END OF THE CROSS MAIN, AS PER SECTION 3- 8.2 OF NFPA 13.

40. SPRINKLER SHALL BE AN APPROVED TYPE AS PER SECTION 3-16 OF NFPA 13.

41. TEMPERATURE RATING SHALL COMPLY WITH SEC. 3-16.6 OF NFPA 13.

42. CLEARANCES BETWEEN SPRINKLERS AND STORAGE OR PARTITIONS AS PER NFPA 13, SECTION 4-2.5

43. SPACING AND LOCATION OF SPRINKLER SHALL COMPLY WITH CHAPTER 4 NFPA 13.

44. CONTRACTOR TO COORDINATE HIS WORK WITH OTHER TRADES.

45. ONLY EXPERIENCED SPRINKLER MECHANICS TO WORK ON THE SYSTEM.

46. ALL PIPING TO BE A MINIMUM OF 1" UNLESS OTHERWISE NOTED.

47. PROVIDE SHOP DRAWINGS WITH HYDRAULIC CALCULATIONS FOR REVIEW TO LOCAL FIRE MARSHALL AND INSURANCE UNDERWRITER AND ENGINEER FOR APPROVAL PRIOR TO INSTALLATION.

48. ALL FIRE PROTECTION EQUIPMENT SHALL BE INSTALLED PER MANUFACTURER'S REQUIREMENTS/SPECIFICATIONS.

49. ALL FIRE PROTECTION EQUIPMENT SHALL BE MOUNTED ON MINIMUM 6" HIGH CONCRETE PAD UNLESS OTHERWISE NOTED (PAVER AND CINDER BLOCK IS NOT ACCEPTABLE).

50. PERMIT IS REQUIRED PRIOR TO INSTALLATION. TO INCLUDE SIGNED AND SEALED SHOP DRAWINGS, HYDRAULIC CALCULATION, SHOP DRAWINGS, MANUFACTURERS INFORMATION ON HEADS AND APPLIANCES, COMPLIANCE WITH NFPA 13 AND SECTION 903 2020 NYSBC/FC.

FIRE PROTECTION DRAWING LIST			
SHEET NO.	SHEET NAME	REVISION NO.	REVISION DATE
K-FP-01	FIRE PROTECTION NOTES, SYMBOLS, ABBREVIATIONS, AND DRAWING LIST	0	-
K-FP-11	FIRE PROTECTION GROUND FLOOR DEMOLITION PLAN	0	-
K-FP-21	FIRE PROTECTION GROUND FLOOR AND ATTIC CONSTRUCTION RCP	0	-
K-FP-81	FIRE PROTECTION DETAILS	0	-

CONSULTANT INFORMATION

LiRo Engineers, Inc.

A LiRo Group Company

Syosset, N.Y. 516-214-8157[T]

CONSULTANT SEAL

REVISION NUMBER

DATE

MADE BY

APP'D BY

REVISION

RECORD DRAWING CERTIFICATION

☐ AS BUILT — CHANGES AS NOTED

☐ AS BUILT — NO CHANGES

CONTRACTOR

NAME _____

SIGNATURE _____

TITLE _____ DATE _____

PROJECT COORDINATOR

NAME _____

SIGNATURE _____

TITLE _____ DATE _____

WESTCHESTER COUNTY, NEW YORK

DEPARTMENT OF PUBLIC WORKS AND TRANSPORTATION

DIVISION OF ENGINEERING

INFRASTRUCTURE REHABILITATION - PHASE 3

PLAYLAND PARK, RYE, NEW YORK

RESTAURANT KITCHEN WITH FOOD VENDING

FIRE PROTECTION NOTES, SYMBOLS, ABBREVIATIONS & DWG LIST

CONTRACT NUMBER

22-523

SHEET NUMBER

K-FP-01

DWG. NO.:

541 of 664

SCALE:

AS INDICATED

DATE:


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1-118-FP-1290-0



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- SPRINKLER DEMOLITION NOTES:**
 - ① DEMOLISH ALL EXISTING SPRINKLER HEADS WITHIN THE NATHAN'S BUILDING.
 - ② DEMOLISH ALL EXISTING DRY SPRINKLER PIPING WITHIN THE NATHAN'S BUILDING INCLUDING ATTIC SPACE.
 - ③ CUT AND TEMPORARY CAP EXISTING 3" DRY SPRINKLER LINE FOR FUTURE RECONNECTION.
- GENERAL NOTES:**
 - 1. COORDINATE WITH FACILITY PRIOR TO SHUTDOWN OF FIRE PROTECTION SYSTEM FOR ANY DEMOLITION AND CONSTRUCTION WORK.
 - 2. CONTRACTOR SHALL PROVIDE FIRE WATCH AS NEEDED FOR THE DEPENDENT BUILDINGS BY THE DEMOLITION AND CONSTRUCTION WORK WHILE SPRINKLER COVERAGE IS IMPACTED.
 - 3. CONTRACTOR TO COORDINATE WITH FACILITY WHEN WORKING AROUND OR ABOVE THE RIDE COMPONENTS, AND PROVIDE ALL NECESSARY MEASURES TO PROTECT THESE COMPONENTS PER THE REQUIREMENTS OF THE FACILITY.

FIRE PROTECTION GROUND FLOOR DEMOLITION PLAN
SCALE: 1/4" = 1'-0"



<div>CONSULTANT INFORMATION</div> <div><div></div><div><div>LiRo Engineers, Inc.</div><div>A LiRo Group Company</div><div>Syosset, N.Y. 516-214-8157[T]</div></div></div>		<div>CONSULTANT SEAL</div> <div><div></div><div>Frank F. Udesse</div></div>																																																																																																																																																																																																																																																																																																																																																																																																																																																																																																																																																																																																																																																																																																																																															
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FIRE PROTECTION CONSTRUCTION NOTES:

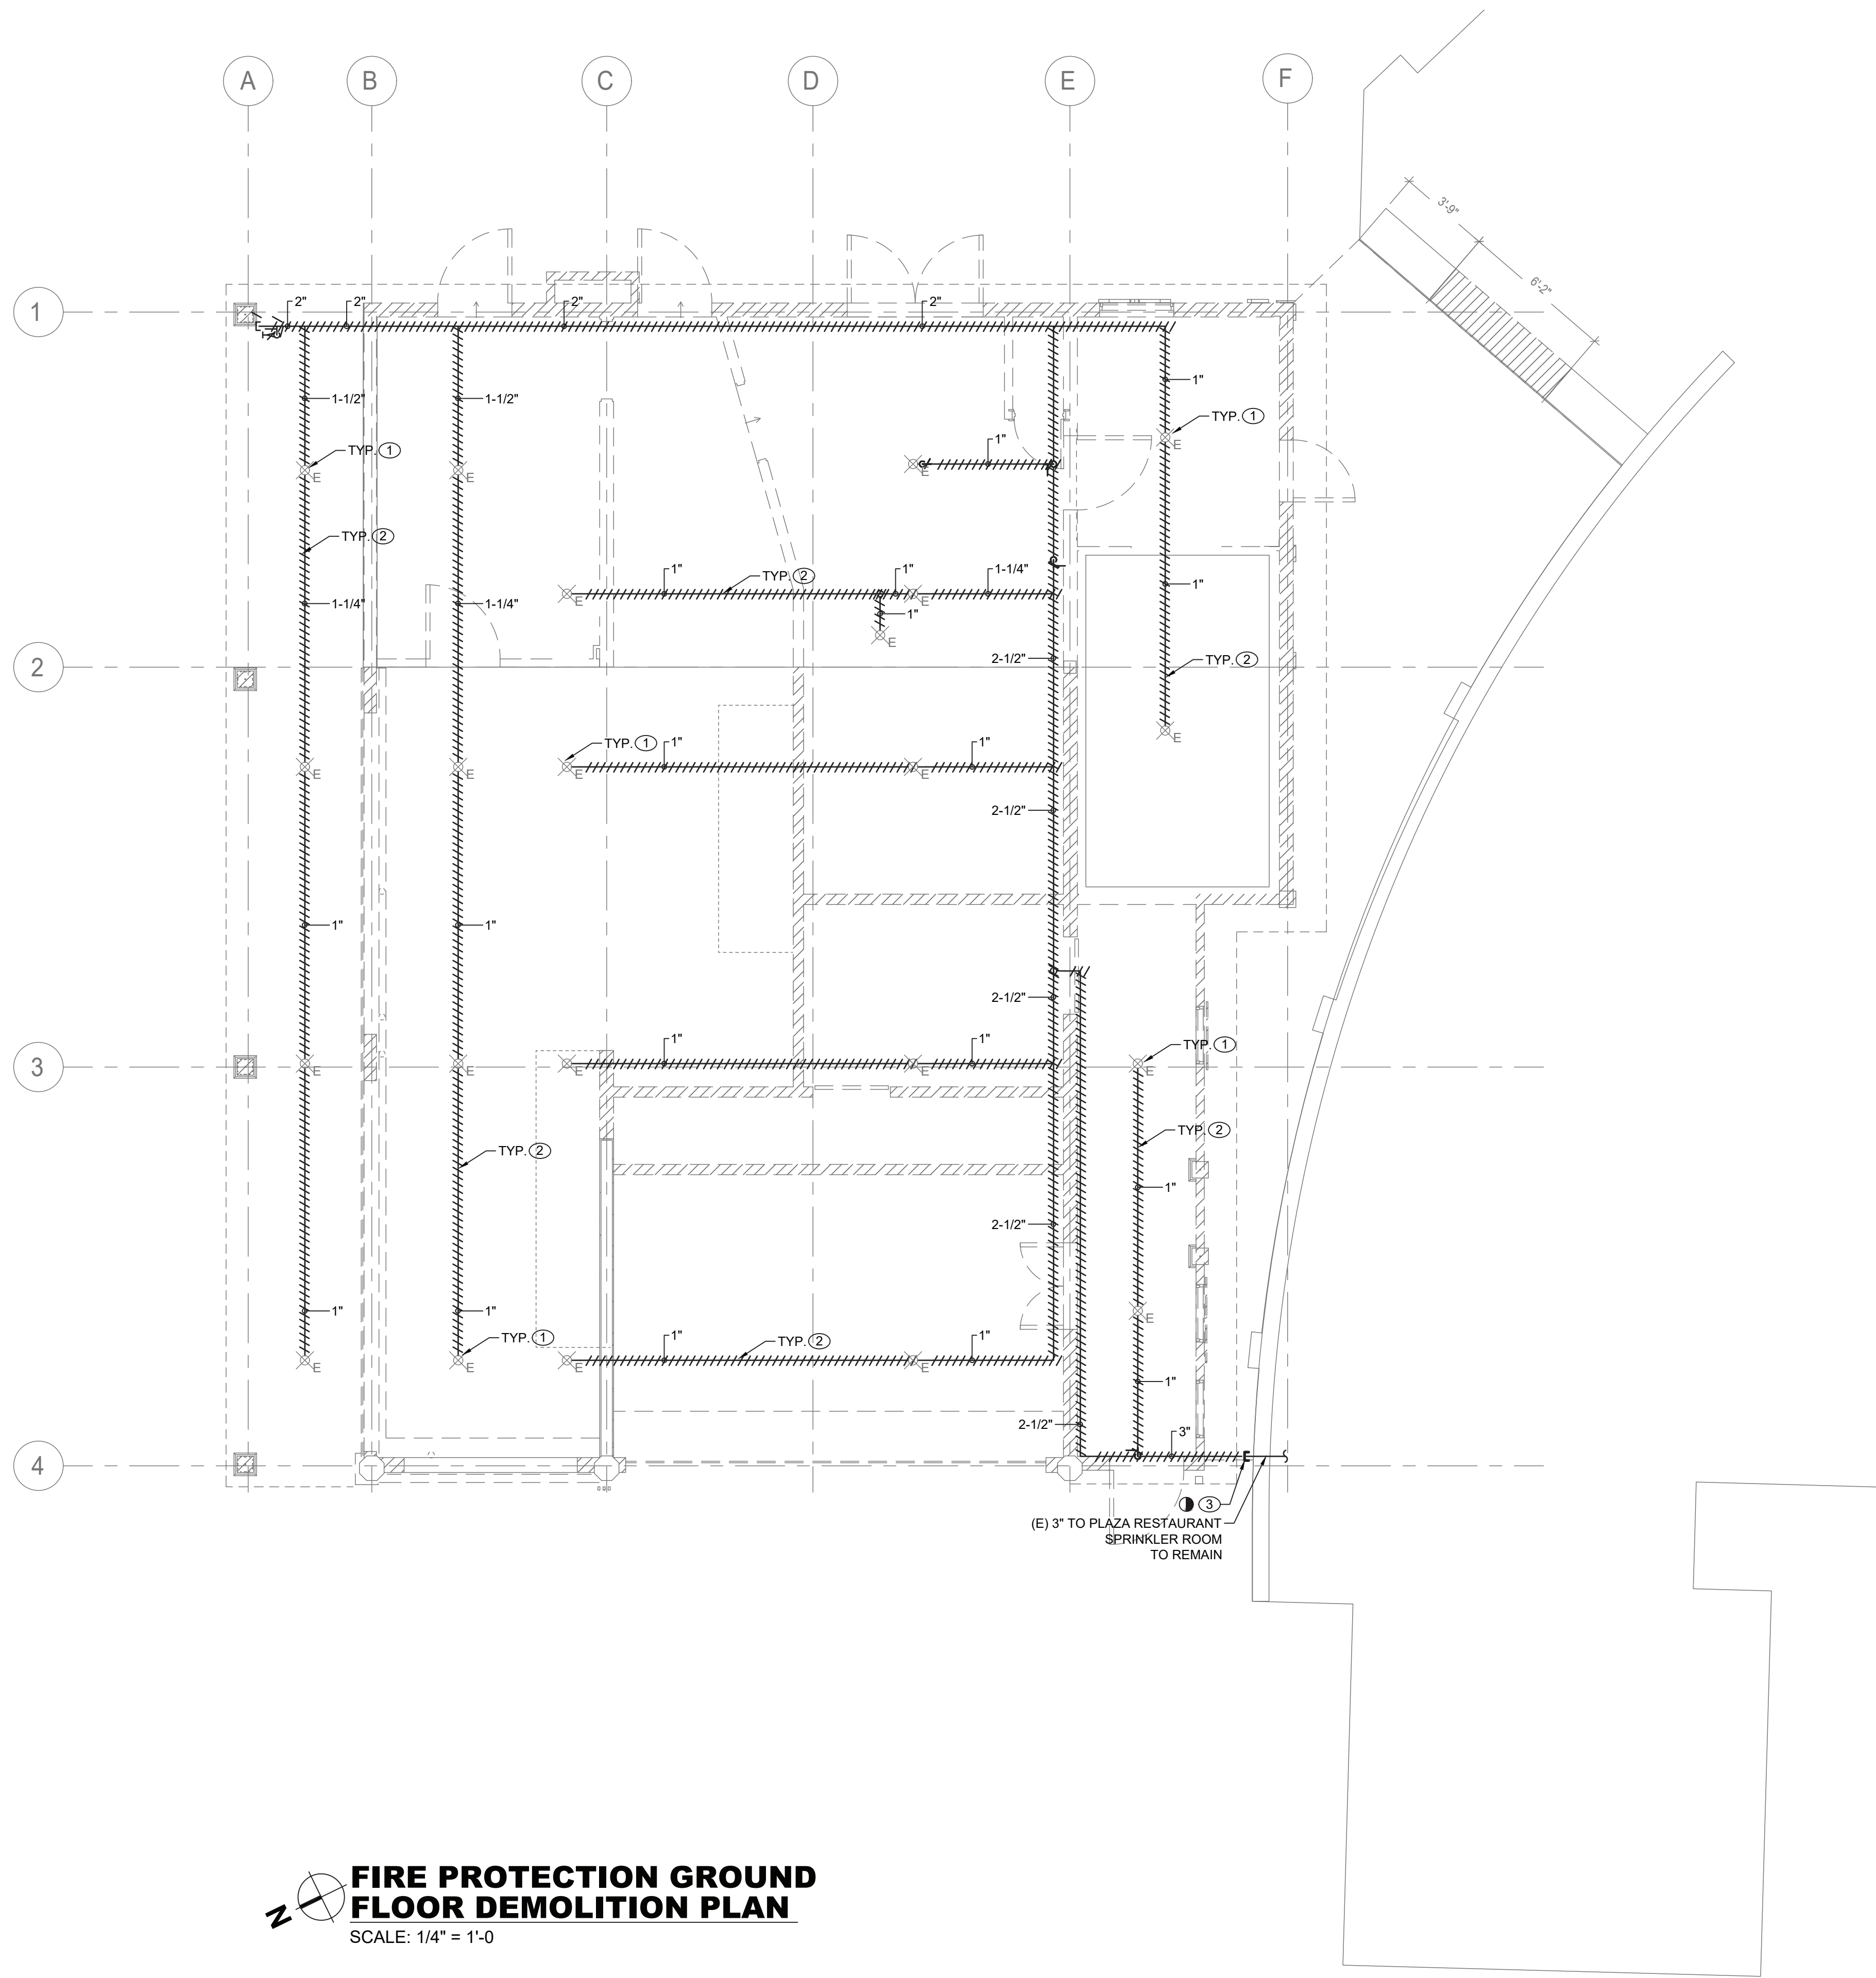- ① RECONNECT NEW 3" WET SPRINKLER LINE TO EXISTING 6" LINE WITHIN SPRINKLER ROOM OF PLAZA RESTAURANT.
- ② RECONNECT NEW 3" DRY SPRINKLER LINE WITH EXISTING.



GENERAL NOTES:




1. ALL DISTRIBUTION PIPING, SHALL BE PAINTED AS DIRECTED BY ARCHITECT. REFER TO SPECIFICATION FOR PAINT TYPE AND APPLICATION PROCEDURE.
2. COORDINATE WITH FACILITY PRIOR TO SHUTDOWN OF FIRE PROTECTION SYSTEM FOR ANY DEMOLITION AND CONSTRUCTION WORK.
3. CONTRACTOR SHALL PROVIDE FIRE WATCH AS NEEDED FOR ALL AFFECTED BUILDINGS WHILE SPRINKLER COVERAGE IS IMPACTED.
4. CONTRACTOR TO COORDINATE WITH FACILITY WHEN WORKING AROUND OR ABOVE THE RIDE COMPONENTS, AND PROVIDE ALL NECESSARY MEASURES TO PROTECT THESE COMPONENTS PER THE REQUIREMENTS OF THE FACILITY.
5. UPON COMPLETION, SYSTEM SHALL BE TESTED FOR PROPER OPERATION.

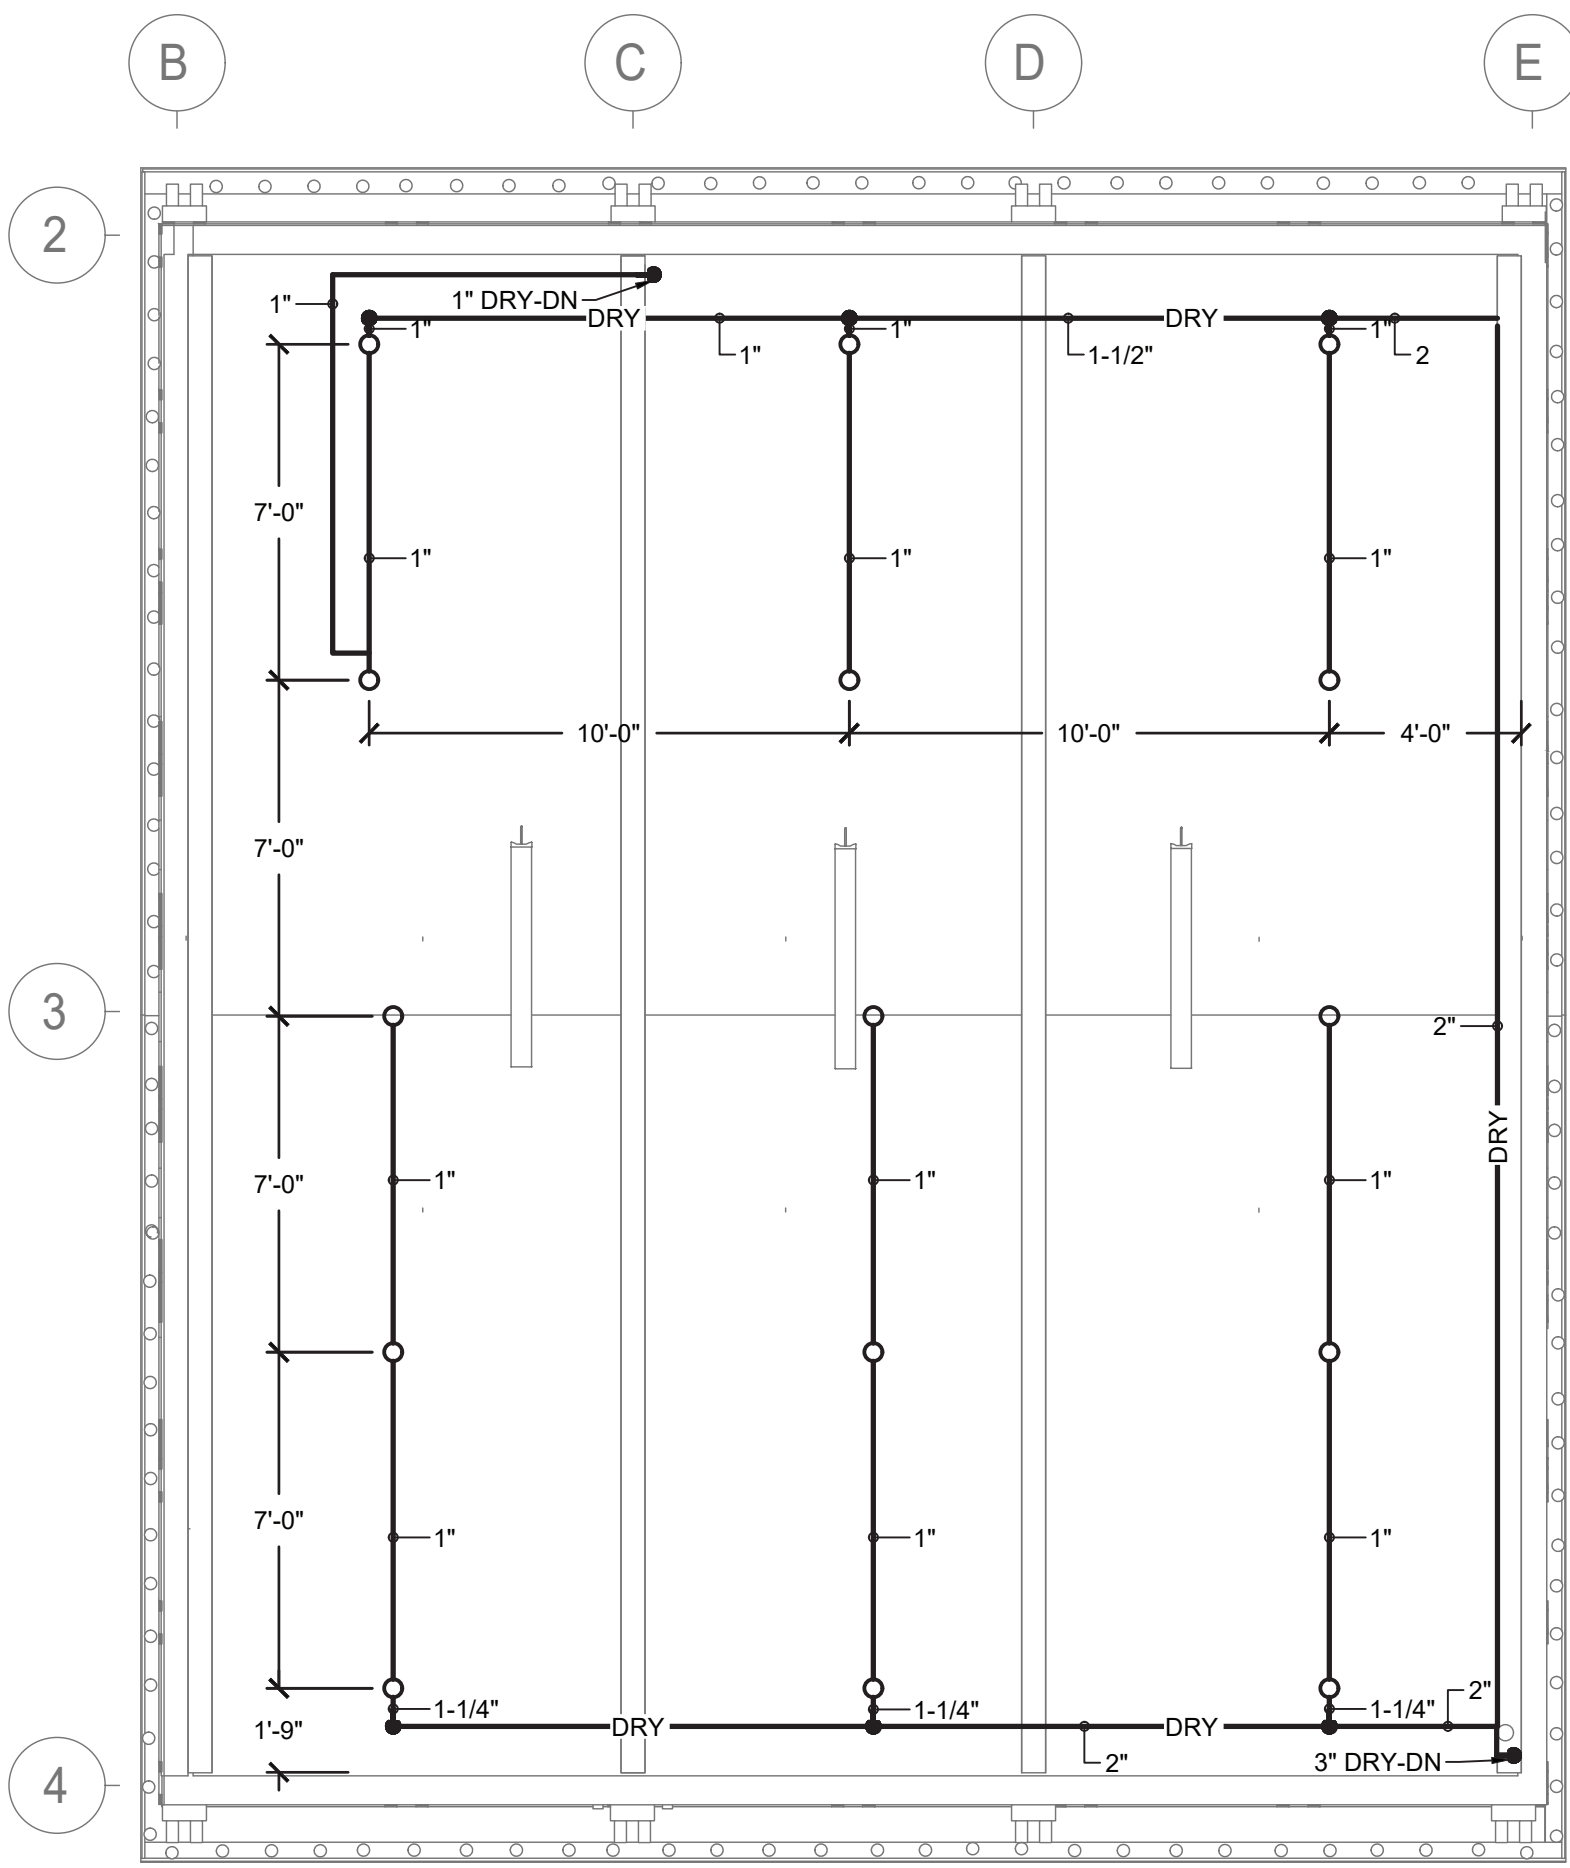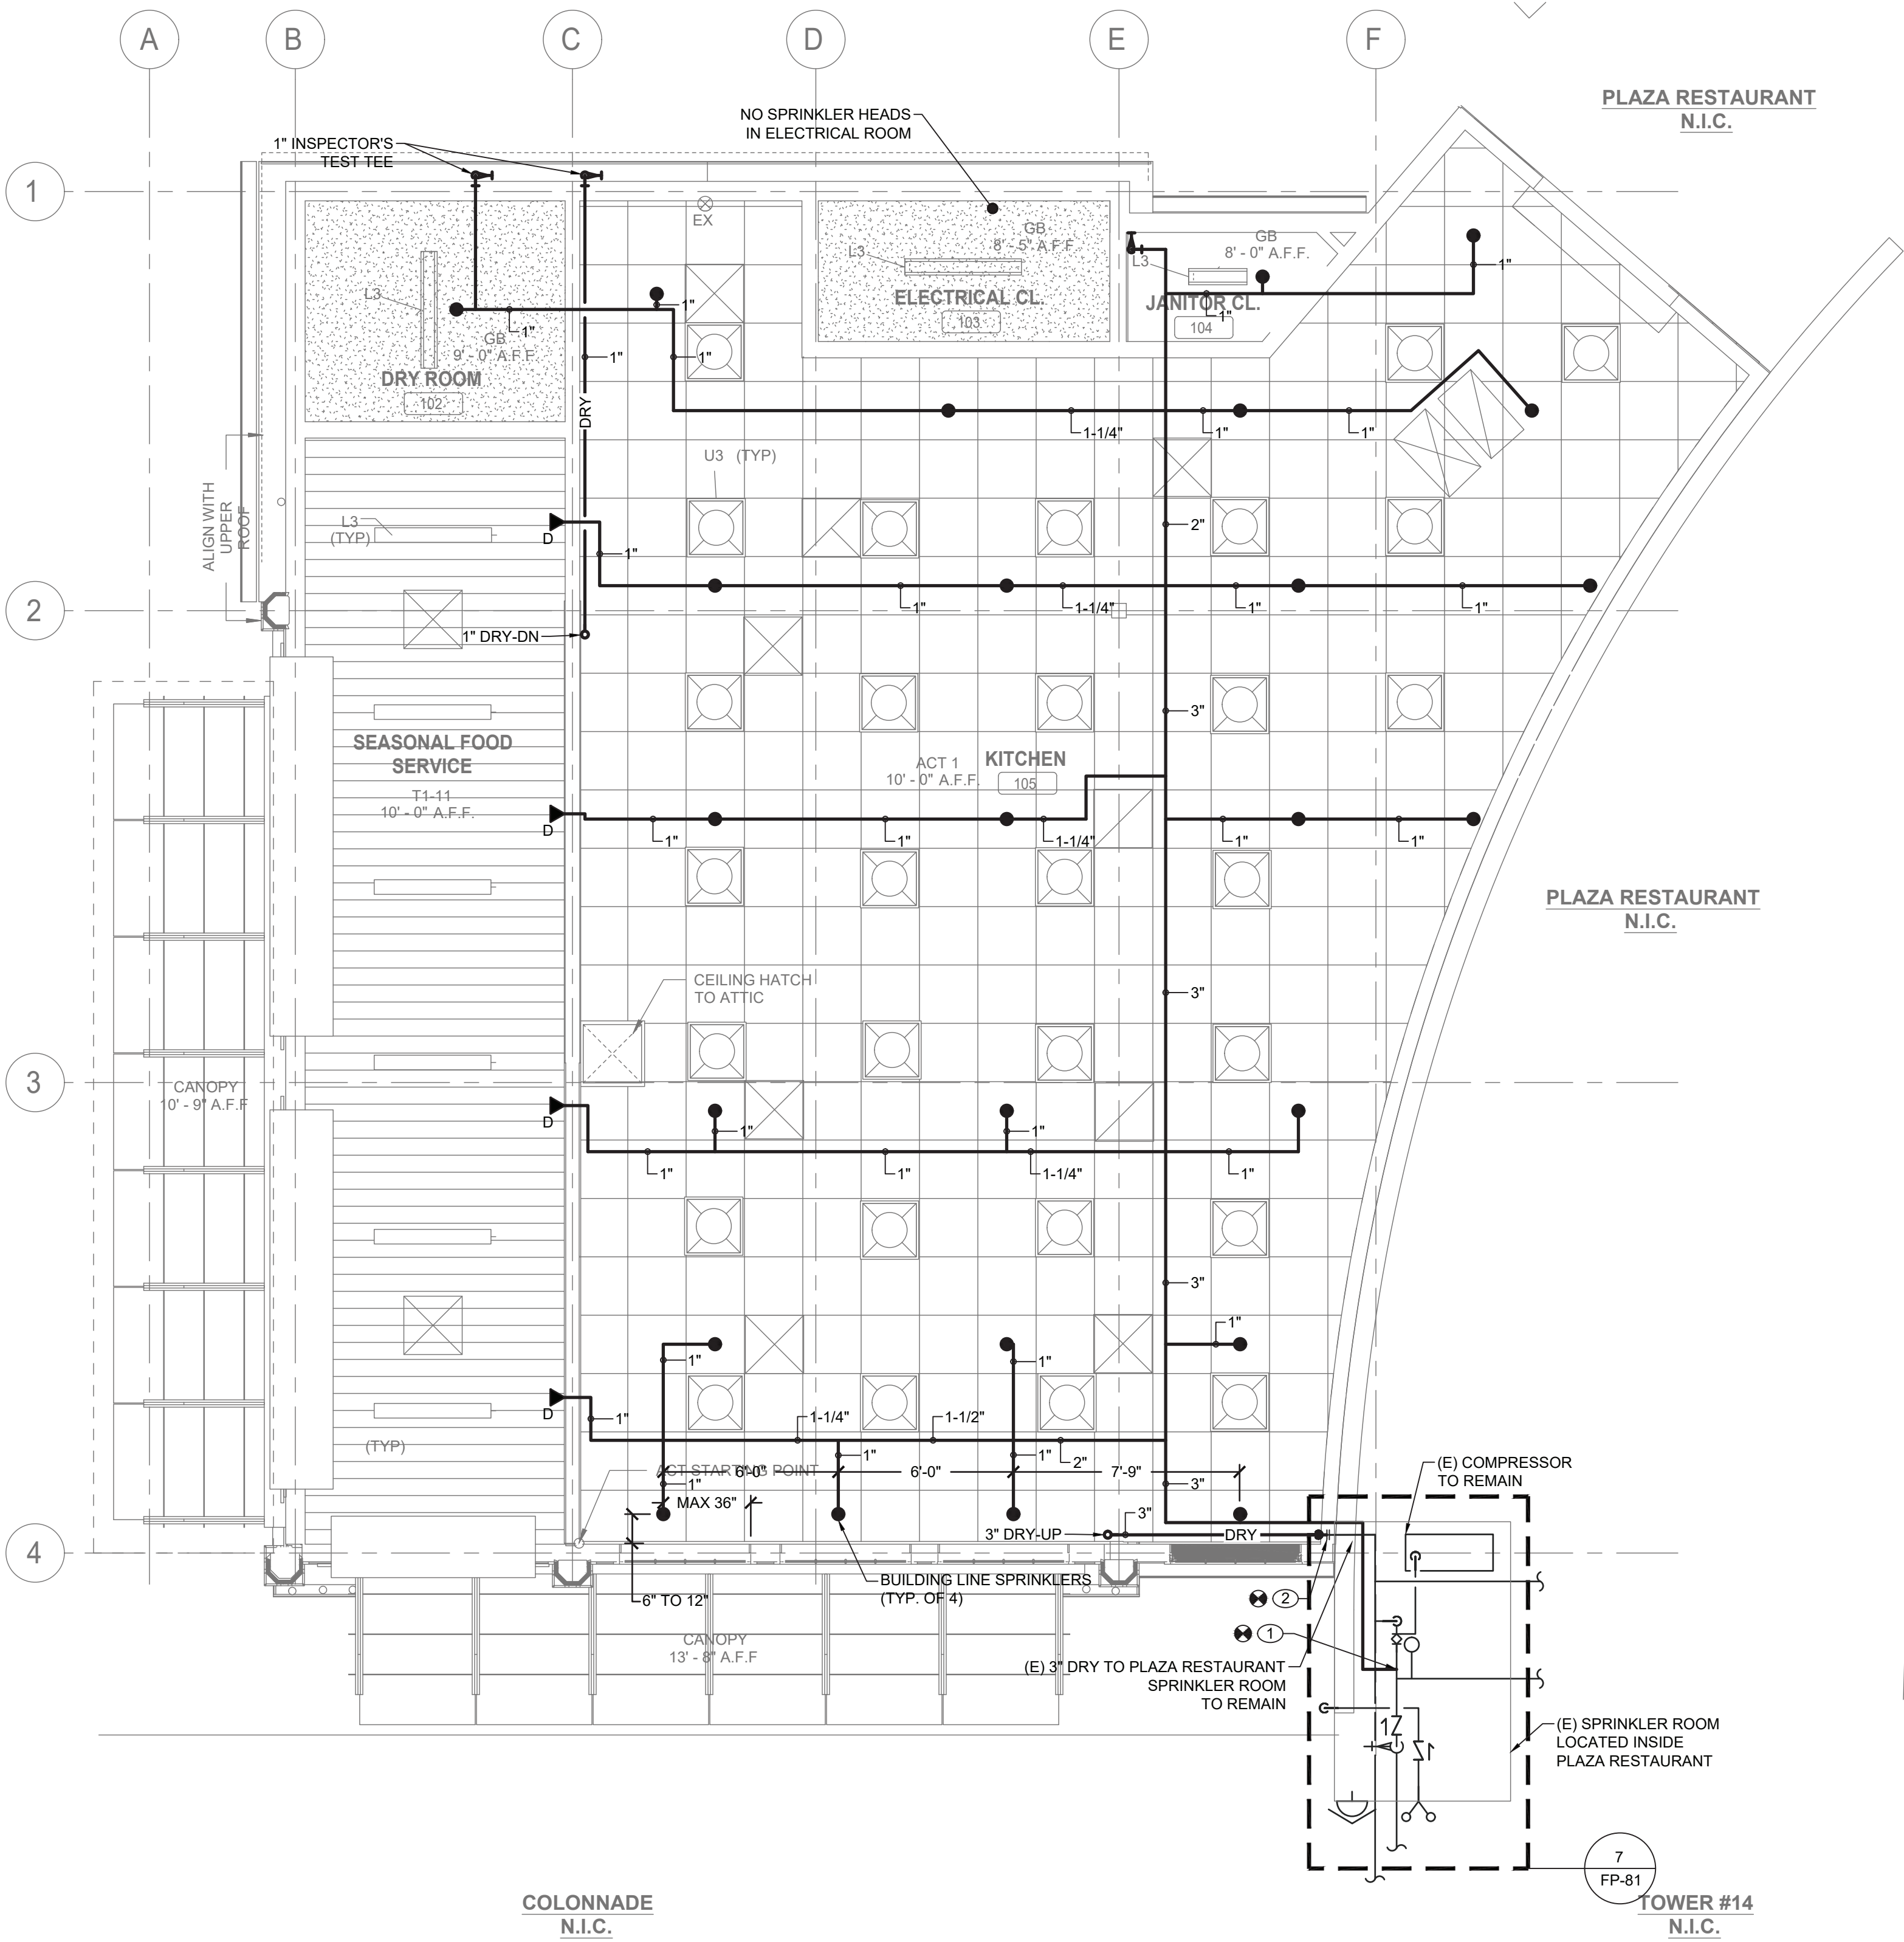







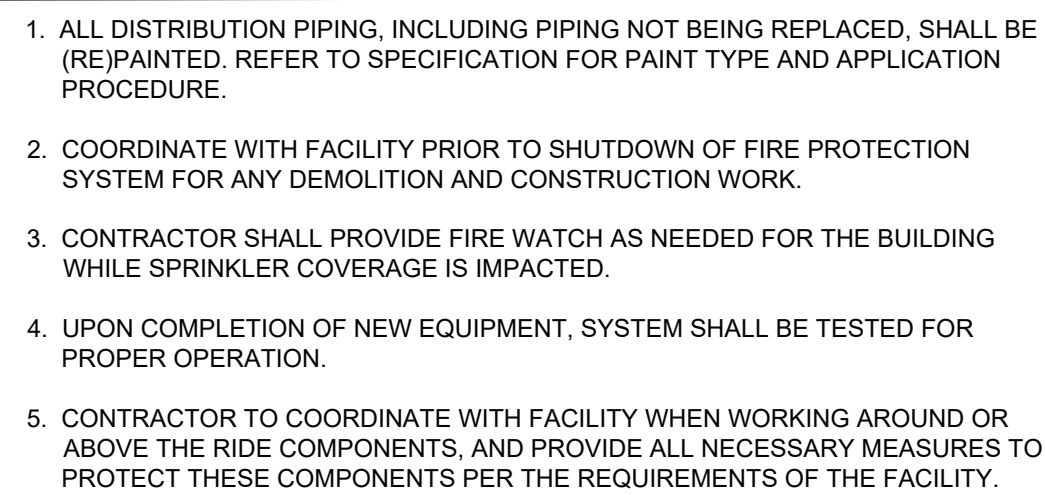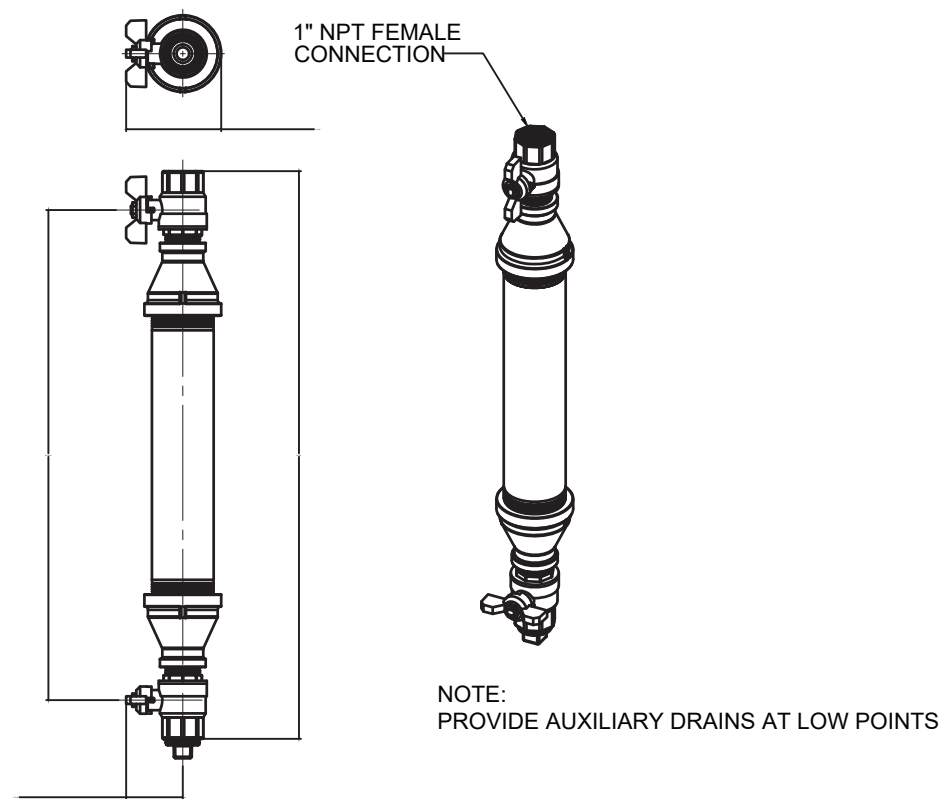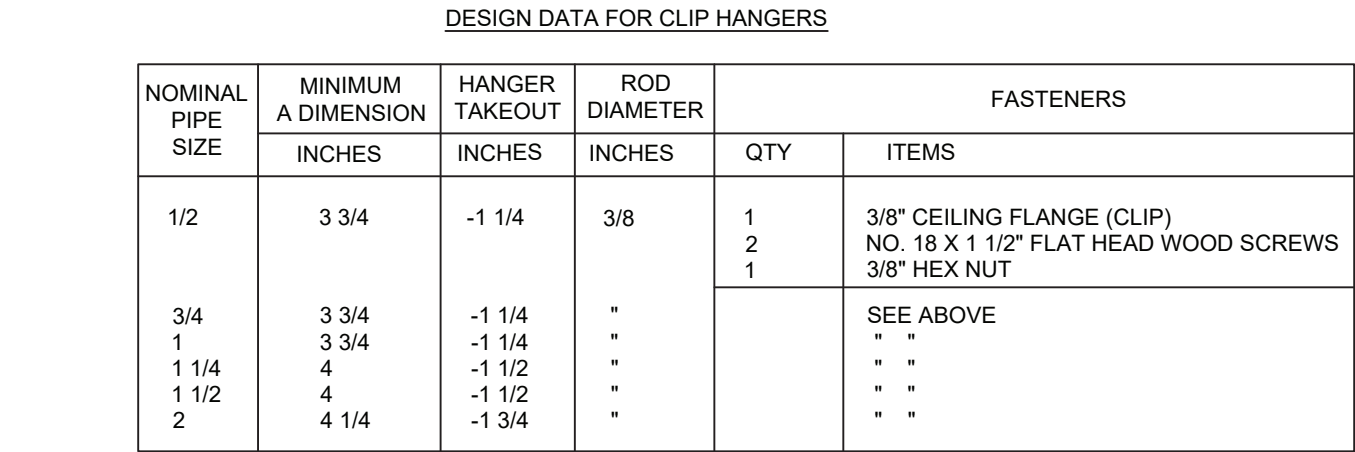











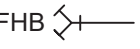


FIRE PROTECTION ATTIC CONSTRUCTION PLAN
SCALE: 1/4" = 1'-0"

FIRE PROTECTION GROUND FLOOR CONSTRUCTION RCP
SCALE: 1/4" = 1'-0"

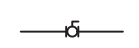CONSULTANT INFORMATION		CONSULTANT SEAL				RECORD DRAWING CERTIFICATION		WESTCHESTER COUNTY, NEW YORK DEPARTMENT OF PUBLIC WORKS AND TRANSPORTATION DIVISION OF ENGINEERING		CONTRACT NUMBER 22-523		SHEET NUMBER K-FP-21	
<div><div><div>LiRo Engineers, Inc.</div><div>A LiRo Group Company</div><div>Syosset, N.Y. 516-214-8157/11</div></div></div>		<div></div>				<div><input type="checkbox"/> AS BUILT – CHANGES AS NOTED</div> <div><input type="checkbox"/> AS BUILT – NO CHANGES</div>				DWG. NO.: 543 of 664			
								SCALE: AS INDICATED					
								DATE: 08/23/2022					
												DPW FILE NUMBER 1-118-FP-1292-0	

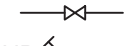

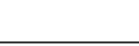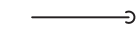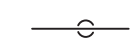PLUMBING SYMBOL LIST	
IDENTIFIER	DESCRIPTION
-----CW-----	DOMESTIC COLD WATER
-----W-----	WASTE PIPING (ABOVE SLAB)
-----W-----	WASTE PIPING (UNDER SLAB)
-----S-----	SANITARY PIPING (ABOVE SLAB)
-----S-----	SANITARY PIPING (UNDER SLAB)
-----V-----	SANITARY VENT PIPING
	FIELD CONNECT
	FIELD DISCONNECT
	REFER TO SUPPLEMENTAL FIGURE INDICATED BY NUMBER (I.E. F2 REFERS TO FIGURE 2)
	EQUIPMENT TAG
	EQUIPMENT NUMBER
	DETAIL TAG/CALL OUT TAG
	PLUMBING SHEET NUMBER

PIPING ELEMENTS/VALVING	
	BACKFLOW PREVENTER (DOUBLE CHECK VALVE ASSEMBLY)
	BALL VALVE
	CAP ON END OF PIPE
	CLEANOUT
	FLOOR DRAIN
	GATE VALVE
	HOSE BIBB
	VALVE IN VALVE BOX
	PIPE DROPPING DOWN
	PIPE RISING UP
	TEE OUTLET DOWN
	TEE OUTLET UP
	VALVE IN RISE OR DROP
	NON FREEZE HOSE BIBB IN BOX W/VACUUM BREAKER

SCOPE OF WORK
PLUMBING SCOPE OF WORK INCLUDES, BUT IS NOT LIMITED TO:
1. REMOVAL OF EXISTING WATER SERVICE.
2. THE INSTALLATION OF NEW PLUMBING FIXTURES AND ALL ASSOCIATED PIPING AND ACCESSORIES.
3. THE INSTALLATION OF NEW SANITARY AND DOMESTIC WATER SERVICES.
NOTE: THIS SCOPE OF WORK DESCRIPTION IS PROVIDED TO GIVE AN OVERALL "MACRO" DESCRIPTION OF THIS PROJECT. P.C. IS RESPONSIBLE TO REVIEW ALL ENGINEERING & ARCHITECTURAL DRAWINGS & VISIT THE SITE IF NEEDED, PRIOR TO SUBMISSION OF BID.

CODE REFERENCE
2020 NEW YORK STATE BUILDING CODE 2020 NEW YORK STATE MECHANICAL CODE 2020 NEW YORK STATE PLUMBING CODE 2020 NEW YORK STATE ENERGY CONSERVATION CODE

SECTION 704

DRAINAGE PIPING INSTALLATION

704.1 SLOPE OF HORIZONTAL DRAINAGE PIPING.

HORIZONTAL DRAINAGE PIPING SHALL BE INSTALLED IN UNIFORM ALIGNMENT AT UNIFORM SLOPES. THE MINIMUM SLOPE OF HORIZONTAL DRAINAGE PIPE SHALL BE IN ACCORDANCE WITH TABLE 704.1.

TABLE 704.1
SLOPE OF HORIZONTAL DRAINAGE PIPE

SIZE (INCHES)	MINIMUM SLOPE (INCH PER FOOT)
2 1/2 OR LESS	1/4
3 TO 6	1/8
8 OR LARGER	1/16

LEED NOTES
1. ALL ADHESIVES, SEALANTS, PAINTS & COATINGS APPLIED TO THE INTERIOR OF THE BUILDING (WITHIN THE WEATHER PROOFING SYSTEM, INCLUDING WALL CAVITIES) MUST NOT EXCEED THE LEED VOC LIMITS. PROVIDE A VOC SUBMITTAL AND MSDS FOR ALL ADHESIVES, SEALANTS, PAINTS AND COATINGS TO BE APPLIED.

PLUMBING GENERAL NOTES:
1. ALL PLUMBING WORK UNDER THIS CONTRACT SHALL CONFORM TO THE LATEST EDITION OF THE PLUMBING CODE OF NEW YORK STATE (PC-NYS), THE NEW YORK STATE ENERGY CODE, AND THE REQUIREMENTS OF THE UTILITY AND THE LOCAL WATER COMPANY.
2. ALL MATERIALS SHALL BE NEW UNLESS NOTED OTHERWISE.
3. THE PLUMBING CONTRACTOR SHALL ASSUME RESPONSIBILITY FOR ALL LABOR AND MATERIALS SUPPLIED AND INSTALLED UNDER THIS CONTRACT AND SHALL GUARANTEE THE WORK PERFORMED UNDER THIS CONTRACT FOR A PERIOD OF ONE (1) YEAR FROM THE DATE OF ACCEPTANCE OF THIS WORK.
4. PLUMBING CONTRACTOR SHALL CONSULT WITH, COOPERATE AND COORDINATE WITH THE GENERAL CONTRACTOR, MECHANICAL CONTRACTOR, SPRINKLER CONTRACTOR, ELECTRICAL CONTRACTOR, ETC. IN ORDER TO MINIMIZE INTERFERENCES BETWEEN TRADES DURING PERFORMANCE OF THIS WORK.
5. THE PLUMBING CONTRACTOR SHALL PREPARE AND FILE ALL REQUIRED PLANS AND PERMITS WITH THE LOCAL AUTHORITIES. PC SHALL PAY THE FILING FEES AS REQUIRED. PC SHALL OBTAIN ALL APPROVALS AND SHALL PAY FOR ALL WORK PERMITS, INSPECTIONS AND SIGN-OFFS AS REQUIRED TO EXECUTE THIS WORK IN A MANNER IN CONFORMANCE WITH THE CODES AND AUTHORITIES HAVING JURISDICTION.
6. THE PLUMBING CONTRACTOR SHALL PERFORM ALL TESTS AND ARRANGE FOR ALL INSPECTIONS FOR WORK UNDER HIS CONTRACT AS REQUIRED BY LAW AND SHALL SUPPLY ALL CERTIFICATES OF INSURANCE AS REQUIRED BY THE LAW AND THE OWNER. REFER TO SECTION 107 (INSPECTIONS) OF THE PC-NYS.
7. THE PLUMBING CONTRACTOR SHALL MAKE ALL FINAL CONNECTIONS TO ALL PLUMBING EQUIPMENT REGARDLESS WHETHER ILLUSTRATED HEREIN WITHOUT ANY ADDITIONAL COSTS TO THE OWNER.
8. PLUMBING CONTRACTOR SHALL VISIT THE SITE & BECOME FAMILIAR WITH THE EXISTING CONDITIONS, INCLUDING THE SIZE OF CONNECTIONS, ROUGHING DIMENSIONS, ETC. BEFORE SUBMITTING A QUOTATION FOR THE WORK.
9. PLUMBING CONTRACTOR SHALL PERFORM ALL CUTTING, EXCAVATION, BACKFILLING, ROUGH & FINISH PATCHING AS PER THE SPECIFICATIONS AS REQUIRED FOR THE INSTALLATION OF THE WORK, UNLESS NOTED OTHERWISE.
10. ALL CONNECTIONS TO NEW AND/OR EXISTING EQUIPMENT SHALL BE SIZED AND INSTALLED IN ACCORDANCE WITH THE MANUFACTURER'S INSTRUCTIONS.
11. IT IS THE INTENT OF THIS CONTRACT THAT THE COMPLETED WORK BE FULLY OPERATIONAL.
12. ALL PIPE HANGERS AND SUPPORTS SHALL BE INSTALLED AT INTERVALS AND BE FABRICATED OF MATERIALS AS REQUIRED BY THE PC-NYS.
13. ALL NEW PLUMBING FIXTURES SHALL BE INSTALLED WITH ANGLE STOP VALVES IN THE SUPPLY LINES SERVING THE FIXTURE.
14. ALL NEW EXPOSED WATER AND WASTE PIPING SERVING THE FIXTURES SHALL BE CHROME PLATED AND SHALL HAVE CHROME PLATED ESCUTCHEONS RIGIDLY ATTACHED TO THE PIPING AT THE POINT OF WALL OR FLOOR PENETRATIONS.
15. PLUMBING CONTRACTOR SHALL SUBMIT SHOP DRAWINGS FOR ALL NEW PLUMBING FIXTURES AND EQUIPMENT TO BE SUPPLIED AND INSTALLED UNDER THIS CONTRACT FOR APPROVAL BEFORE INSTALLATION OF SAME.
16. WATERPROOF PIPE SLEEVES SHALL BE INSTALLED AT ALL PENETRATIONS THROUGH EXTERIOR WALLS. PIPE SLEEVES SHALL BE INSTALLED AT ALL WALL PENETRATIONS THROUGH INTERIOR WALLS AND FLOORS.
17. WATER HAMMER ELIMINATORS (APPROVED - FIELD FABRICATED OR MANUFACTURED) SHALL BE INSTALLED AT ALL RUN OUTS IN HOT AND/OR COLD WATER LINES SERVING TOILET ROOMS AND OTHER AREAS WHICH INCORPORATE "RAPID - ACTION" VALVES SUCH AS FLUSHMETERS, SOLENOID VALVES, ETC.
18. ALL PIPING SHALL BE TESTED AT A MINIMUM PRESSURE OF 1-1/2 TIMES THE MAXIMUM OPERATING PRESSURE UNLESS OTHERWISE NOTED ON THE DOCUMENTS OR THE PLUMBING CODE AND IN ACCORDANCE WITH THE UTILITY REQUIREMENTS.
19. ALL REMOVALS PERFORMED UNDER THIS CONTRACT SHALL INCLUDE REMOVAL OF ALL DEBRIS AND DISPOSAL AT AN APPROPRIATE SITE.
20. ALL LAVATORIES DESIGNED FOR USE BY PERSONS CONFINED TO WHEELCHAIRS SHALL HAVE THE HOT & COLD WATER SERVICES, AS WELL AS THE TRAP, RECESSED & INSULATED IN ACCORDANCE WITH ADA REQUIREMENTS.
21. REFER TO THE ARCHITECTURAL PLANS FOR ALL STRUCTURAL DIMENSIONS.
22. ALL WORK TO BE COORDINATED WITH OTHER TRADES.
23. ALL PIPING PENETRATIONS TO BE SEALED AROUND WITH "NELSON" FIRE SEAL.
24. ALL WATER SERVICE PIPING WITHIN THE BUILDING IS TO BE INSULATED IN ACCORDANCE WITH ALL NEW YORK STATE PLUMBING CODE (NYS-PC) AND NYS ENERGY CODES.
25. ALL PLUMBING FIXTURES TO BE INSTALLED AS PER FACTORY RECOMMENDATIONS.
26. ALL PLUMBING FIXTURES TO BE TRAPPED, VENTED AND PROVIDED WITH AIR SHOCKS WHEN REQUIRED.
27. PLUMBING FIXTURES SHALL COMPLY WITH "WATER CONSERVATION" REQUIREMENT AS DETAILED IN THE NYS-PC.
28. GC IS RESPONSIBLE TO SUBMIT APPLICATION AND TAP FEES TO LOCAL WATER AUTHORITY AND HAVE OWNER FILL OUT APPLICATION UPON COMPLETION OF PLUMBING ROUGH-IN INSPECTION.
29. ALL WATER AND HORIZONTAL STORM DRAIN PIPING INCLUDING ROOF DRAIN BODY SHALL BE INSULATED.
30. FLOOR DRAINS AND FLOOR CLEAN-OUTS SHALL BE SET LEVEL WITH FINISHED FLOORS.
31. ALL PIPE DIMENSIONS ARE INSIDE CLEAR.
32. ALL PLUMBING FIXTURES TO HAVE ISOLATION VALVES.
33. P.C. IS RESPONSIBLE TO ADJUST HOT WATER HEATER (WH) TEMPERATURE TO ENSURE A TEMPERATURE RANGE OF 110°F TO 120°F AT THE INDIVIDUAL FIXTURE OUTPUT. P.C. MUST ENSURE A TEMPERATURE OF 120° F MAXIMUM AT THE FIXTURES TO PREVENT SCALDING.
34. BUILDING DOMESTIC WATER DEMAND & SIZING IS CALCULATED FROM NYS-PC SECTION 603, 604 & APPENDIX E.
35. BUILDING SANITARY DEMAND & SIZING IS CALCULATED FROM NYS-PC SECTIONS 709 AND 710.
36. ALL DFU CALCULATIONS ARE BASED OFF OF TABLE 709.1 OF THE NYS-PC.
37. ALL SANITARY WATER PIPING SHALL BE PITCHED IN ACCORDANCE WITH NYS-PC SECTION 704 BASED ON TABLE 704.1 SLOPE OF HORIZONTAL DRAINAGE PIPE.
38. ALL VENT SIZING IS BASED OFF OF SECTION 916 OF THE NYS PLUMBING CODE.
39. ALL PLUMBING EQUIPMENT SHALL BE INSTALLED PER MANUFACTURER'S REQUIREMENTS/SPECIFICATIONS.

ABBREVIATIONS:
AD ACCESS DOOR
BFP BACKFLOW PREVENTER
CO CLEAN OUT
CW COLD WATER
DCV DOUBLE CHECK VALVE
DFU DRAINAGE FIXTURE UNIT
DPCO DECK PLATE CLEAN OUT
FC FIELD CONNECT
FD FLOOR DRAIN
FFD FUNNEL FLOOR DRAIN
FU FIXTURE UNIT
HW HOT WATER
HWR HOT WATER RETURN
IAW IN ACCORDANCE WITH
IWFD INDIRECT WASTE FUNNEL DRAIN
LAV LAVATORY
JS JANITOR'S SINK
NC NORMALLY CLOSED
NO NORMALLY OPEN
NYS-PC NEW YORK STATE PLUMBING CODE
RD ROOF DRAIN
S SANITARY
SD STORM DRAIN
TMV THERMOSTATIC MIXING VALVE
U.O.N. UNLESS OTHERWISE NOTED
UR URINAL
V VENT
WC WATER CLOSET
PC PLUMBING CONTRACTOR
MC MECHANICAL CONTRACTOR
TYP. TYPICAL
VIF VERIFY IN FIELD
WCO WALL CLEAN OUT
WFU WATER FIXTURE UNITS
(N) NEW
(E) EXISTING
(D) DEMO
THE ABBREVIATIONS ARE SHOWN FOR GENERAL REFERENCE ONLY. THE PRESENCE OF AN ABBREVIATION ON THIS LIST DOES NOT IMPLY ITS USE ON THIS PROJECT. REFER TO DRAWINGS FOR SPECIFIC ABBREVIATIONS USED.

PLUMBING FIXTURE SCHEDULE											
MARK	DESCRIPTION	SERVICE						BASED ON:			REMARKS
		TRAP	S/W	V	CW	TW	HW	ITEM	MANUFACTURER	MODEL	
PF-5	SERVICE SINK	3"	3"	2"	1/2"	-	1/2"	FAUCET DRAIN TRIM	MUSTEE	63M	FAUCET AMERICAN STANDARD 8344.212
NOTES:											
1. PROVIDE ALL REQUIRED HANGERS, MOUNTING BRACKETS, AND HARDWARE FOR A COMPLETE INSTALLATION PER MANUFACTURES INSTRUCTIONS.											



ELECTRIC DOMESTIC HOT WATER HEATER SCHEDULE										
TAG	MANUFACTURER	MODEL	LOCATION	HEATER KW	STORAGE CAPACITY GAL.	STORAGE WATER TEMP SETPOINT (DEG F)	ELECTRICAL		DIMENSION HxD (IN)	APPROX. SHIPPING WEIGHT (LBS)
							V-PH-HZ	AMPS		
WH-1	BRADFORD WHITE	LE120L3-3	JANITOR CLOSET	1.5	19	140	120-1-60	12.5	24.75x18	58
NOTES:										


FLOOR DRAIN SCHEDULE				
TAG	TYPE	MANUFACTURER	MODEL	SERVICE
FD-1	ADJUSTABLE	ZURN	FD-2320-R5	ALL SPACES
NOTES:				
1. PROVIDE THE FOLLOWING FOR FD-1: CHORME PLATED STRAINER ASSEMBLY, 6" NICKEL HEAD ASSEMBLY, AND VANDAL PROOF.				
2. PROVIDE BARRIER-TYPE TRAP SEAL PROTECTION DEVICE ZURN Z1072 OR APPROVED EQUAL.				

REDUCED PRESSURE ZONE VALVE SCHEDULE					
TAG	MANUFACTURER	MODEL	LOCATION	SIZE (IN)	PRESSURE DROP (PSI)
RPZ-1	WATTS	LF009-S	SPRINKLER ROOM	2	10
NOTES:					
1. PROVIDE STRAINER.					

WALL HYDRANT SCHEDULE			
TAG	TYPE	MANUFACTURER	MODEL
NFHB	WALL HYDRANT	ZURN	Z1320XL

PLUMBING DRAWING LIST			
SHEET NO.	SHEET NAME	REVISION NO.	REVISION DATE
K-P-01	PLUMBING NOTES, SYMBOLS, ABBREVIATIONS AND DRAWING LIST	0	-
K-P-21	PLUMBING GROUND FLOOR DEMOLITION PLAN	0	-
K-P-21	PLUMBING GROUND FLOOR CONSTRUCTION PLAN	0	-
K-P-81	PLUMBING DETAILS	0	-

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														<div>DWG. NO.:</div> <div>545 of 664</div>					
																<div>SCALE:</div> <div>AS INDICATED</div>			
																		<div>DATE:</div> <div>08/23/2022</div>	

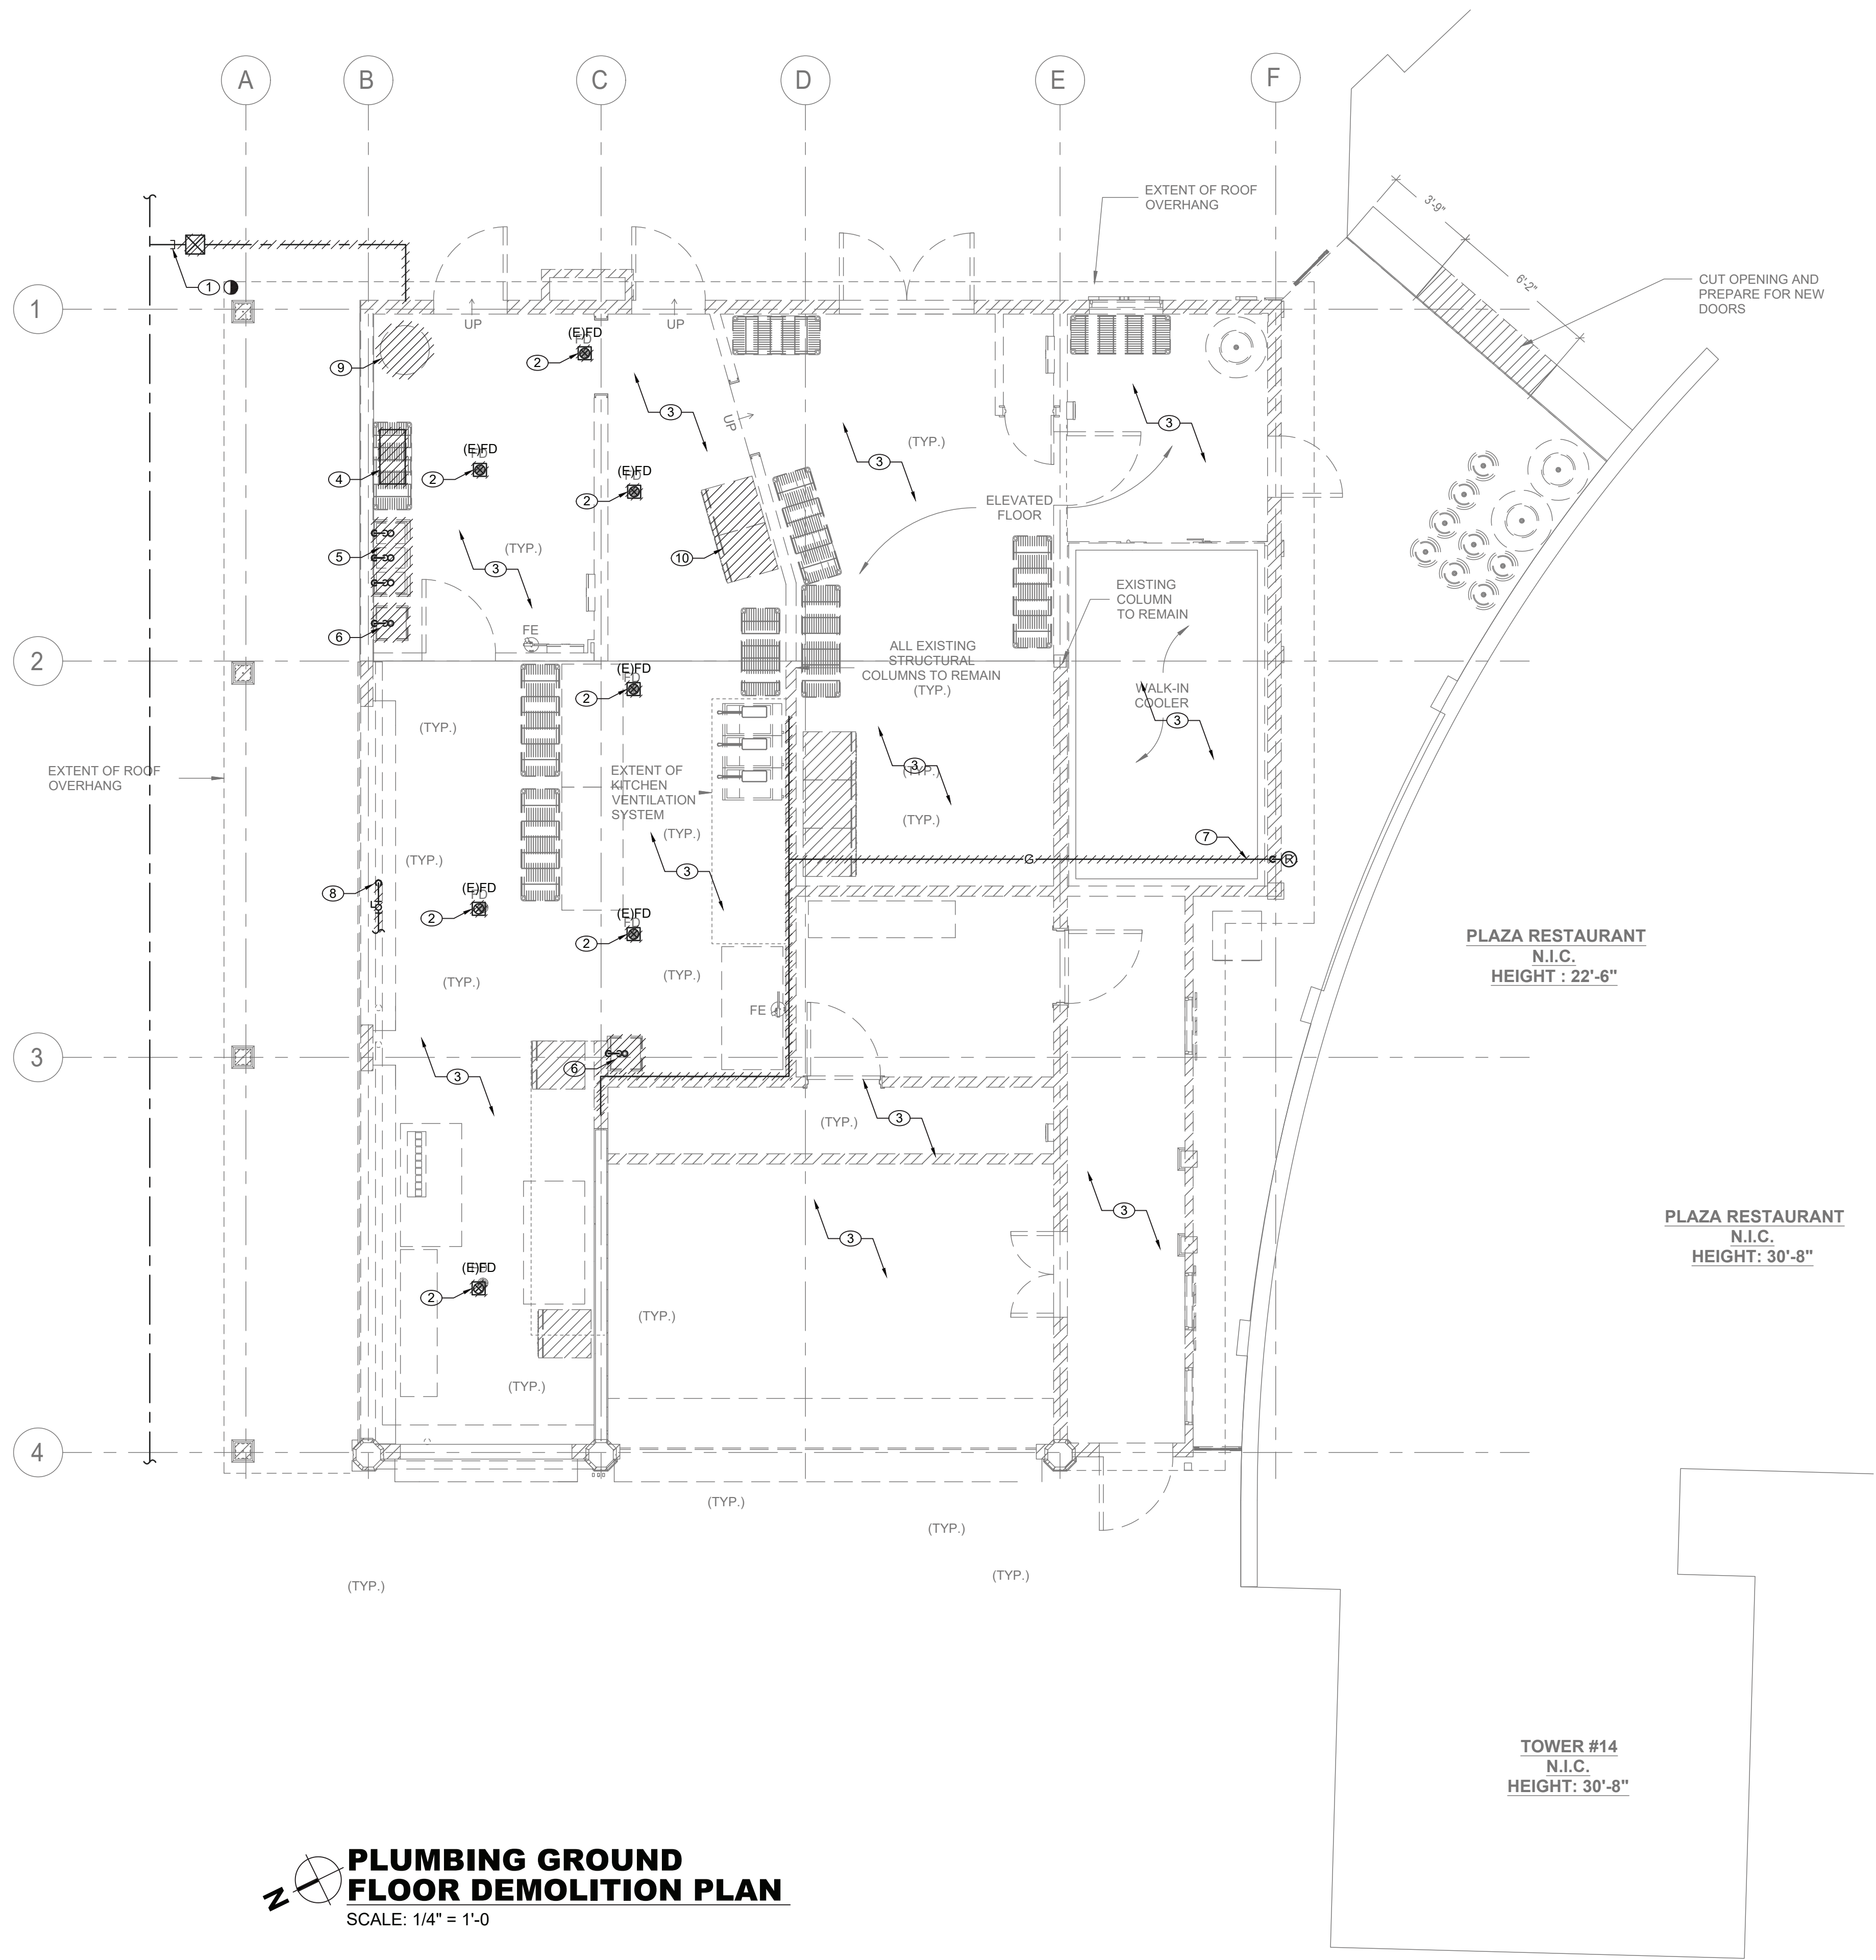

PLUMBING DEMOLITION NOTES:

- ① CONTRACTOR CUT AND CAP UNDERGROUND EXISTING DOMESTIC WATER SERVICE OUTSIDE OF AREA OF WORK. REMOVE EXISTING CURB VALVE.
- ② REMOVE EXISTING FLOOR DRAIN WITH ALL ASSOCIATED PIPING. CUT AND CAP EXISTING SANITARY PIPING BELOW FINISH FLOOR.
- ③ CONTRACTOR TO REMOVE ALL PLUMBING FIXTURES, EQUIPMENT, PIPING AND VALVES. ABANDON EXISTING UNDERGROUND PIPING IN PLACE. SANITARY PIPING SHALL NOT HAVE UNVENTED DEAD ENDS LONGER THAN TWO FEET. REMOVE UNDERGROUND PIPING THAT IN CONFLICT WITH NEW CONSTRUCTION.
- ④ REMOVE EXISTING GREASE INTERCEPTOR WITH ALL ASSOCIATED PIPING.
- ⑤ REMOVE EXISTING 3-COMPARTMENT SINK WITH ALL ASSOCIATED PIPING.
- ⑥ REMOVE EXISTING SINK WITH ALL ASSOCIATED PIPING.
- ⑦ DISCONNECT EXISTING PROPANE LINE FROM PROPANE EQUIPMENT AND REMOVE ALL PROPANE PIPING INCLUDING VALVES AND REGULATOR. REMOVE PROPANE EQUIPMENT.
- ⑧ REMOVE ALL EXISTING DOMESTIC WATER PIPING ABOVE FINISH FLOOR AND ABONDON BELOW FINISH FLOOR.
- ⑨ REMOVE EXISTING ELECTRIC WATER HEATER WITH ALL ASSOCIATED PIPING.
- ⑩ REMOVE EXISTING ICE MAKING MACHINE WITH ALL ASSOCIATED PIPING.

GENERAL NOTES:

1. ALL EXISTING PIPING ARE SHOWN AS A REFERENCE ONLY. CONTRACTOR SHALL FIELD VERIFY LOCATIONS AND SIZES FOR ALL EXISTING SERVICES PRIOR TO DEMOLITION.
2. COORDINATE WITH FACILITY PRIOR TO SHUTDOWN OF DOMESTIC WATER SYSTEM FOR ANY DEMOLITION AND CONSTRUCTION WORK.

PLUMBING GROUND FLOOR DEMOLITION PLAN
SCALE: 1/4" = 1'-0"

CONSULTANT INFORMATION



CONSULTANT SEAL



REVISION NUMBER	DATE	MADE BY	APP'D BY	REVISION

RECORD DRAWING CERTIFICATION

☐ AS BUILT - CHANGES AS NOTED ☐ AS BUILT - NO CHANGES

CONTRACTOR
NAME _____
SIGNATURE _____
TITLE _____ DATE _____

PROJECT COORDINATOR
NAME _____
SIGNATURE _____
TITLE _____ DATE _____

WESTCHESTER COUNTY, NEW YORK
DEPARTMENT OF PUBLIC WORKS AND TRANSPORTATION
DIVISION OF ENGINEERING

INFRASTRUCTURE REHABILITATION - PHASE 3
PLAYLAND PARK, RYE, NEW YORK
RESTAURANT KITCHEN WITH FOOD VENDING
PLUMBING GROUND FLOOR DEMOLITION PLAN

CONTRACT NUMBER
22-523

SHEET NUMBER
K-P-11

DWG NO.: **546 of 664**

SCALE: **AS INDICATED**

DATE: **08/23/2022**


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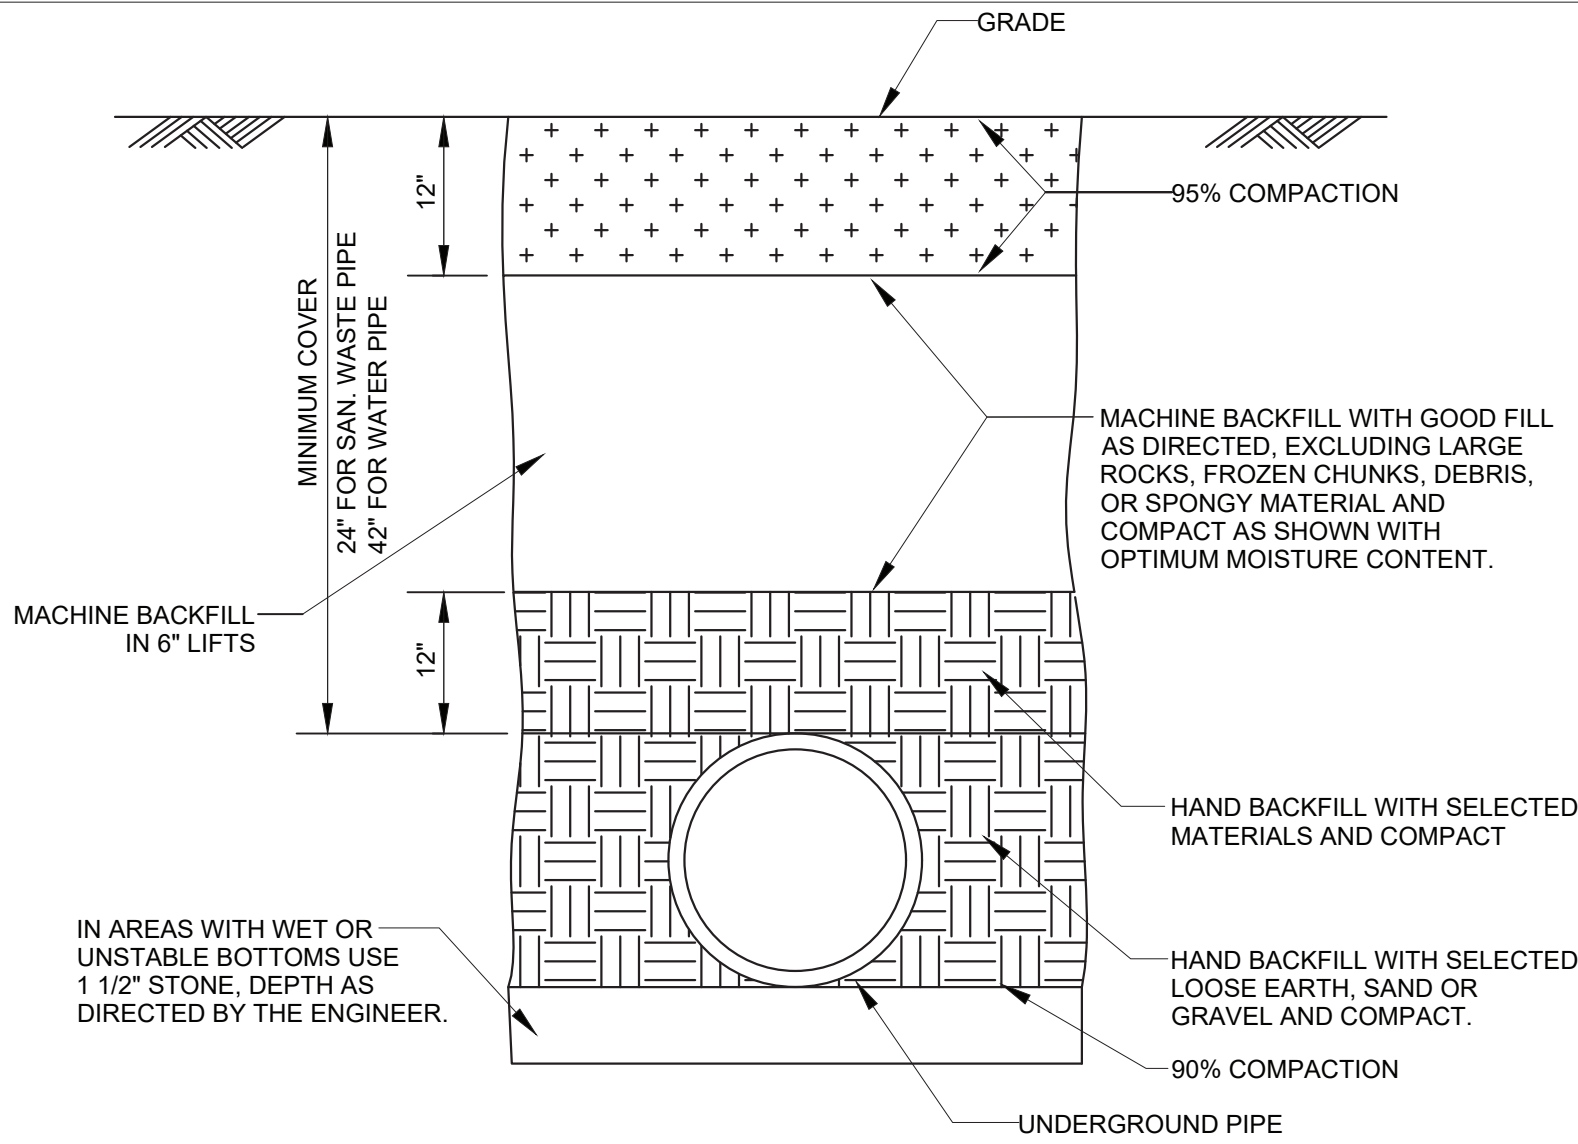


1. COORDINATE WITH FACILITY PRIOR TO SHUTDOWN OF WATER DISTRIBUTION SYSTEM FOR ANY DEMOLITION AND CONSTRUCTION WORK.
2. PROVIDE DRAIN VALVES AT BOTTOM FOR EACH BRANCH, PROVIDE ACCESS PANELS TO ALL VALVES ABOVE CEILING AND BEHIND WALLS.
3. INSTALL NEW WATER PIPING WITH PROPER SLOPES TO AVOID WATER TRAPS DURING WINTER SEASON.
4. CONTRACTOR TO COORDINATE WITH FACILITY WHEN WORKING AROUND OR ABOVE THE RIDE COMPONENTS, AND PROVIDE ALL NECESSARY MEASURES TO PROTECT THESE COMPONENTS PER THE REQUIREMENTS OF THE FACILITY.
5. UPON COMPLETION, SYSTEM SHALL BE TESTED FOR PROPER OPERATION.
6. SEWER CROSSING WATER MAINS, CONDUITS, OR OTHER UTILITY SHALL BE MINIMUM 18" CLEARANCE BETWEEN THE OUTSIDE OF THE UTILITY AND OUTSIDE OF THE SEWER. THE CROSSINGS SHALL BE ARRANGED SO THAT THE SEWER JOINTS WILL BE EQUIDISTANT AND AS FAR AS POSSIBLE FROM THE WATER MAIN JOINTS.







1 **PIPE SLEEVE THROUGH WALL DETAIL**
P-81 SCALE: NOT TO SCALE

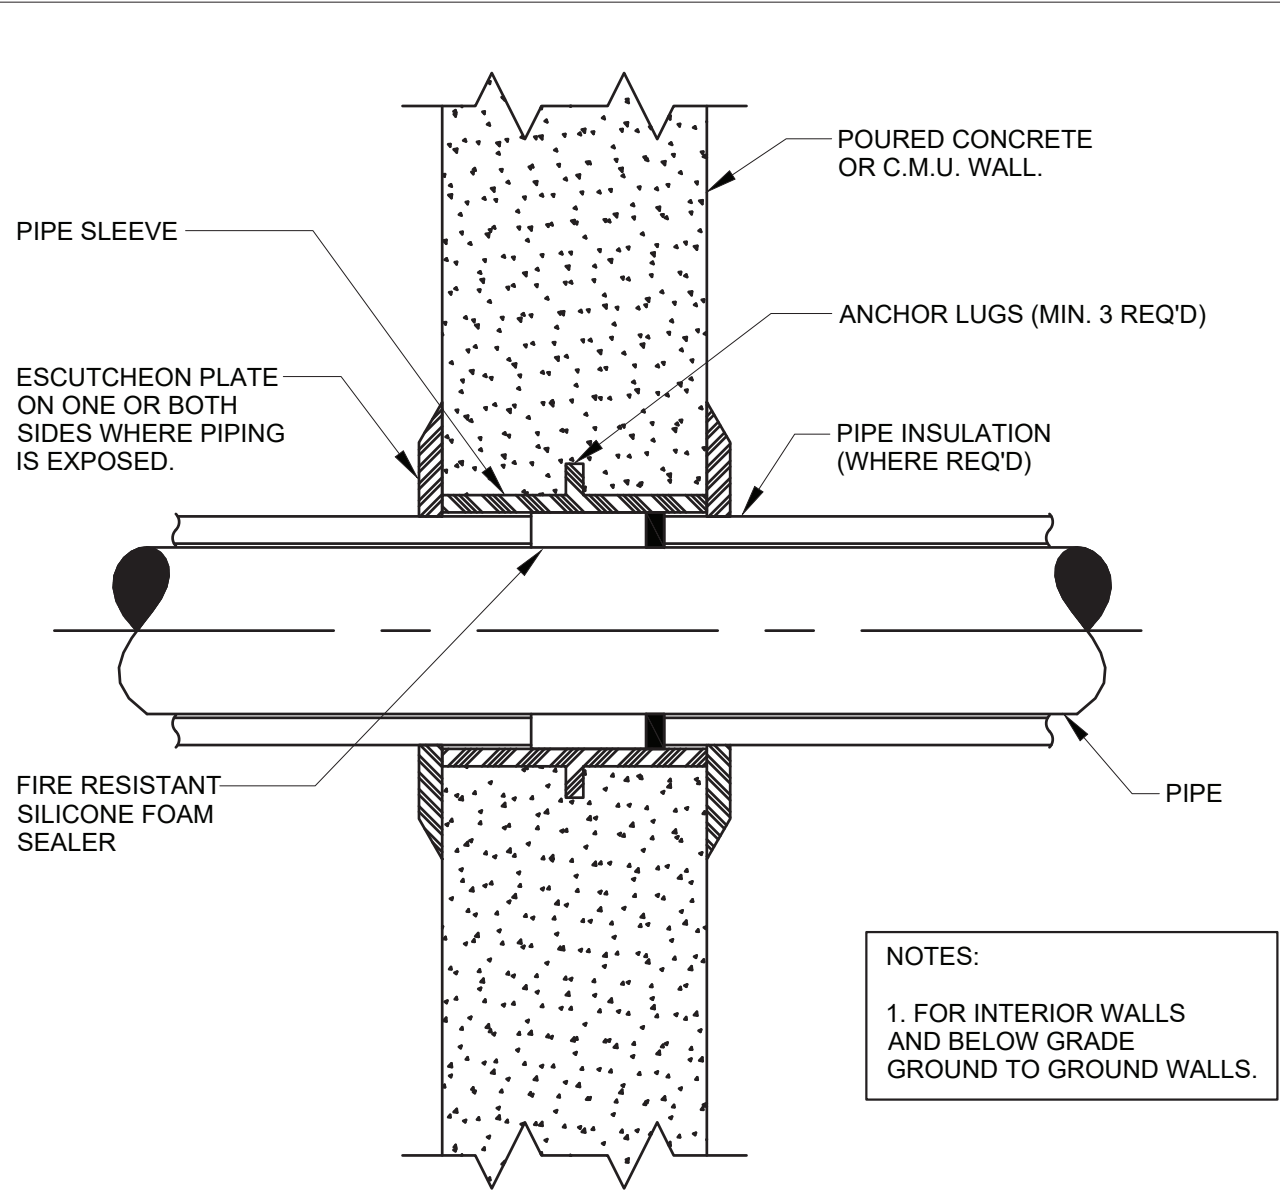


2 **PIPE TRENCH DETAIL**
P-81 SCALE: NOT TO SCALE

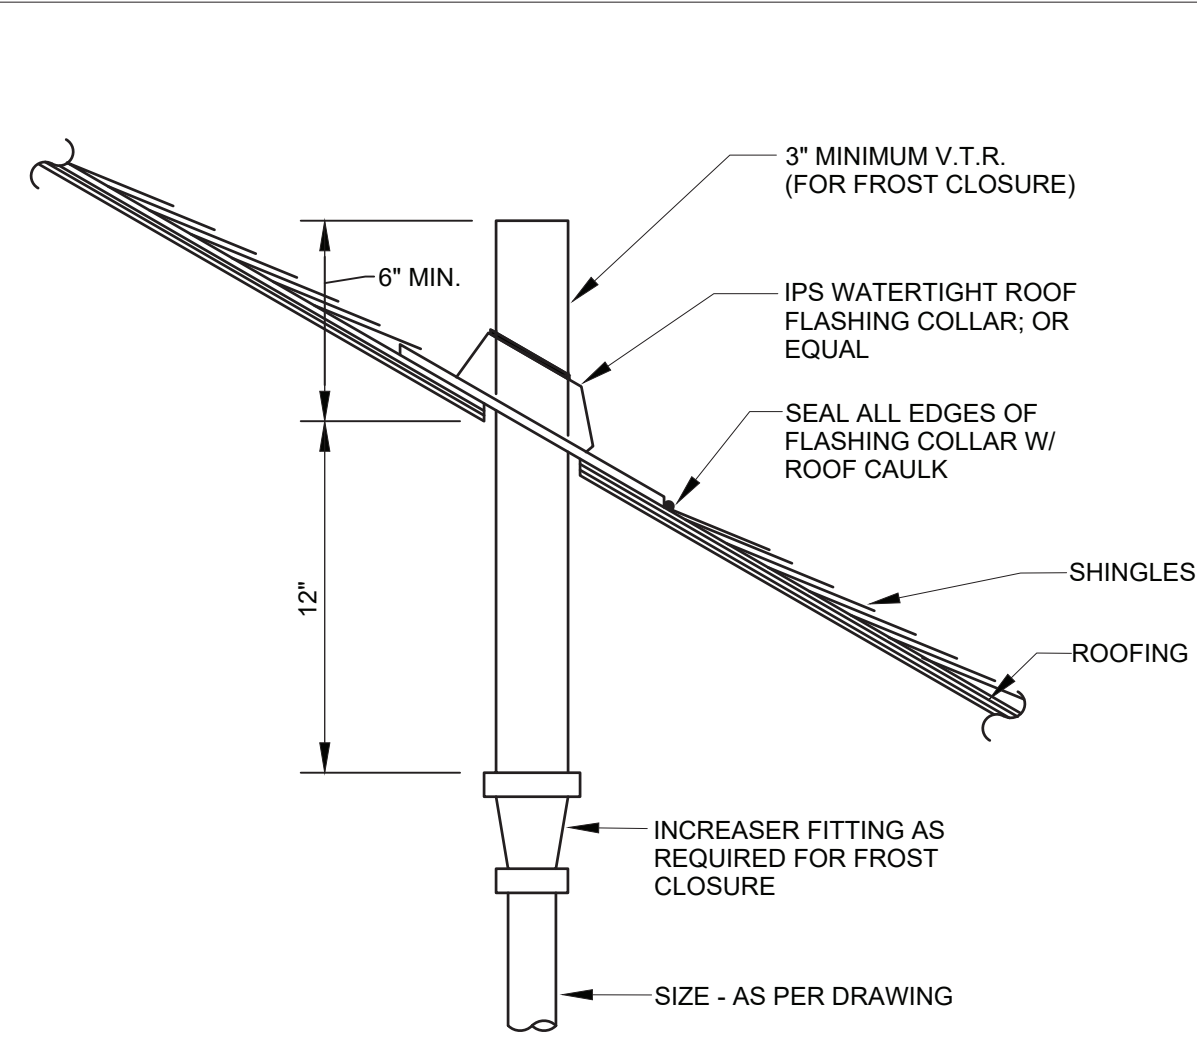


3 **PLUMBING VENT THROUGH PITCHED ROOF DETAIL**
P-81 SCALE: NOT TO SCALE

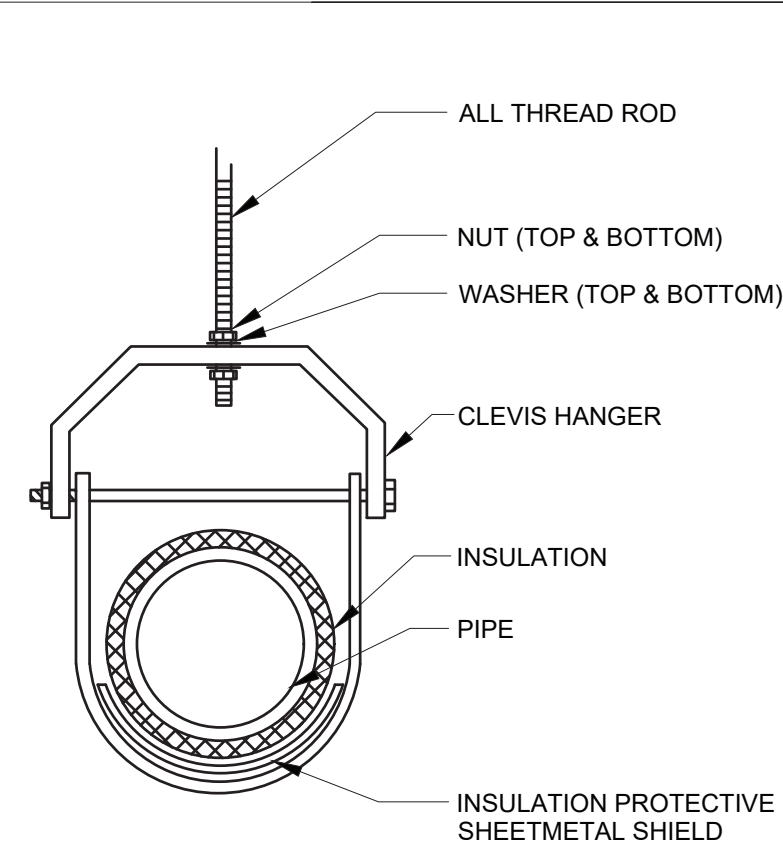


4 **TYPICAL CLEVIS HANGER DETAIL**
P-81 SCALE: NOT TO SCALE

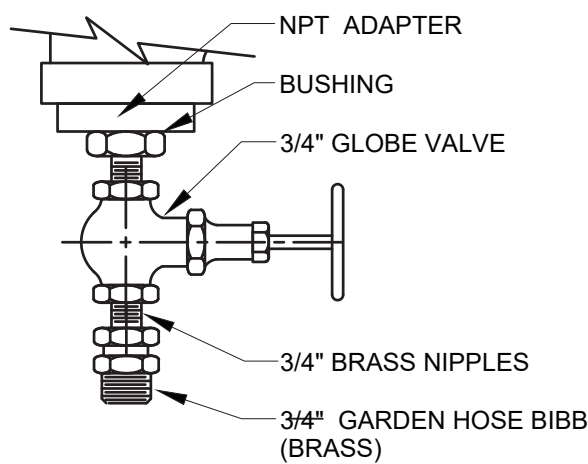


5 **DRAIN VALVE DETAIL**
P-81 SCALE: NOT TO SCALE

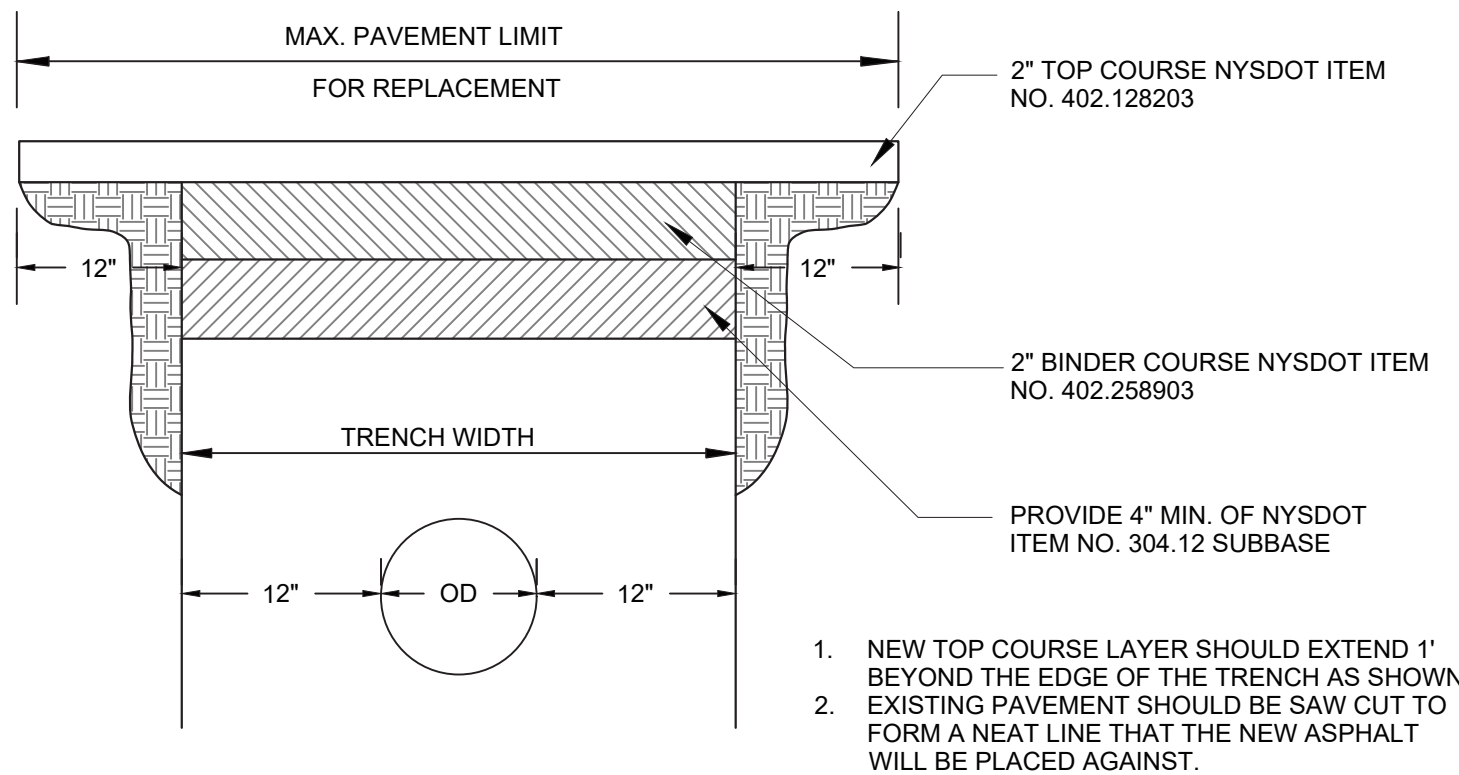


6 **ASPHALTIC MACADAM PAVEMENT REPLACEMENT**
P-81 SCALE: NOT TO SCALE

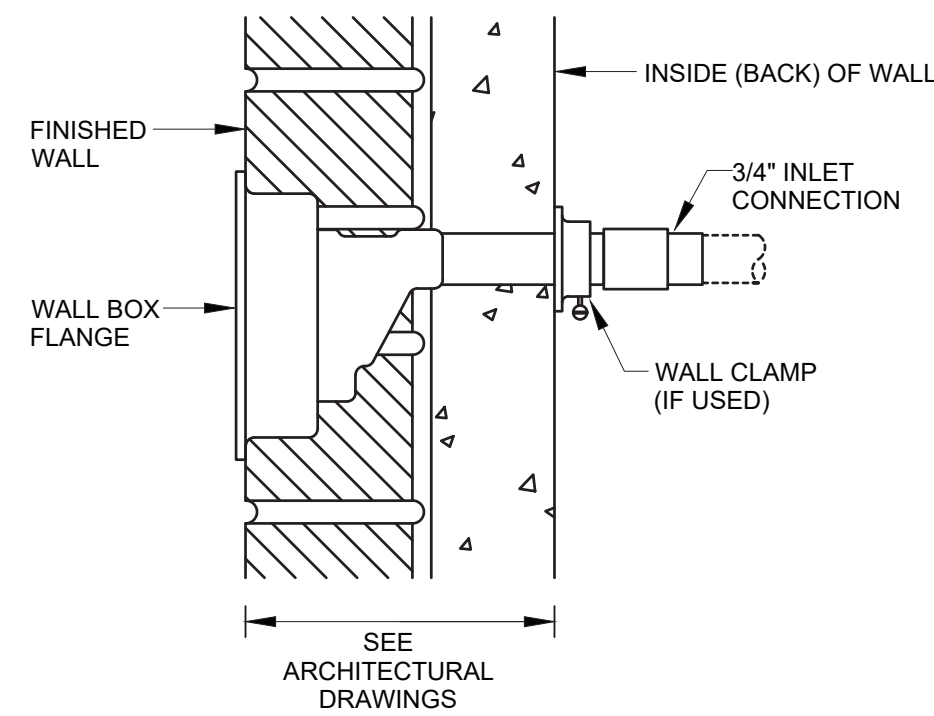


7 **FREEZE PROOF WALL HYDRANT**
P-81 SCALE: NOT TO SCALE

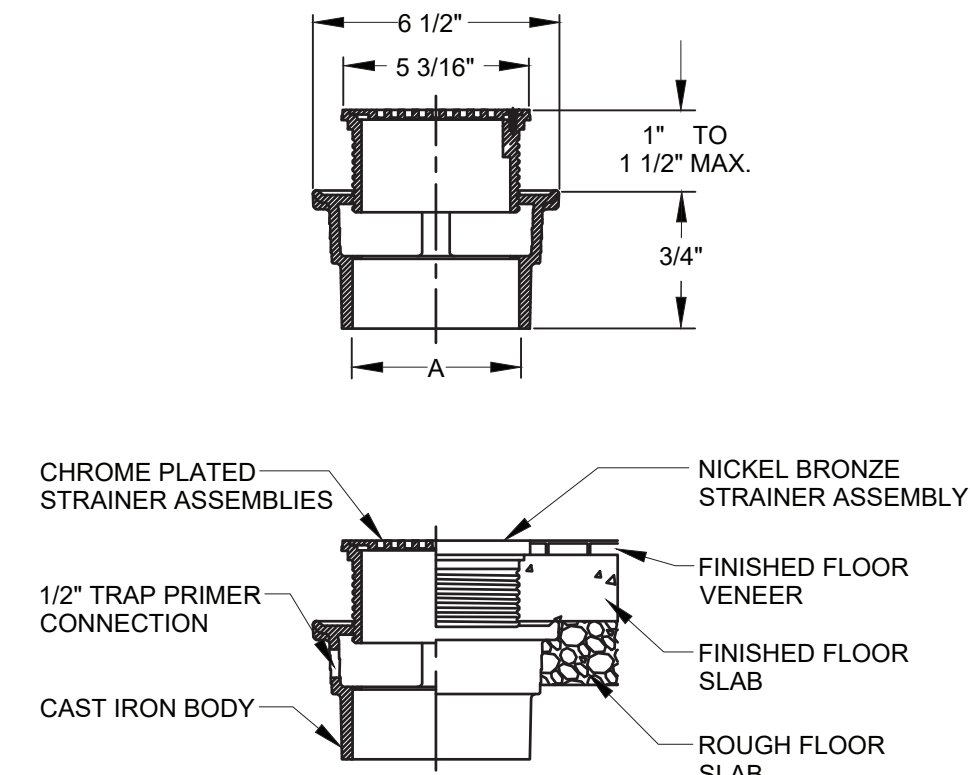


8 **FLOOR DRAIN DETAIL**
P-81 SCALE: NOT TO SCALE

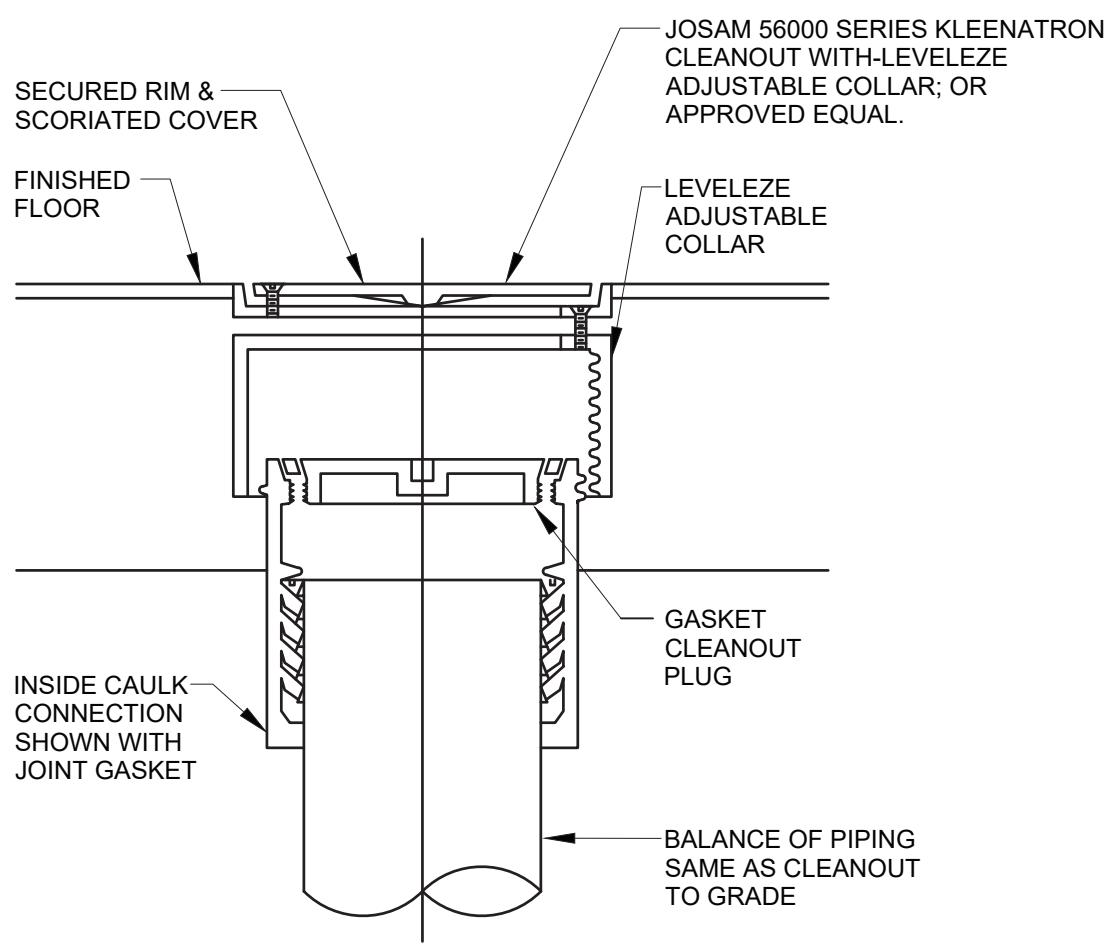

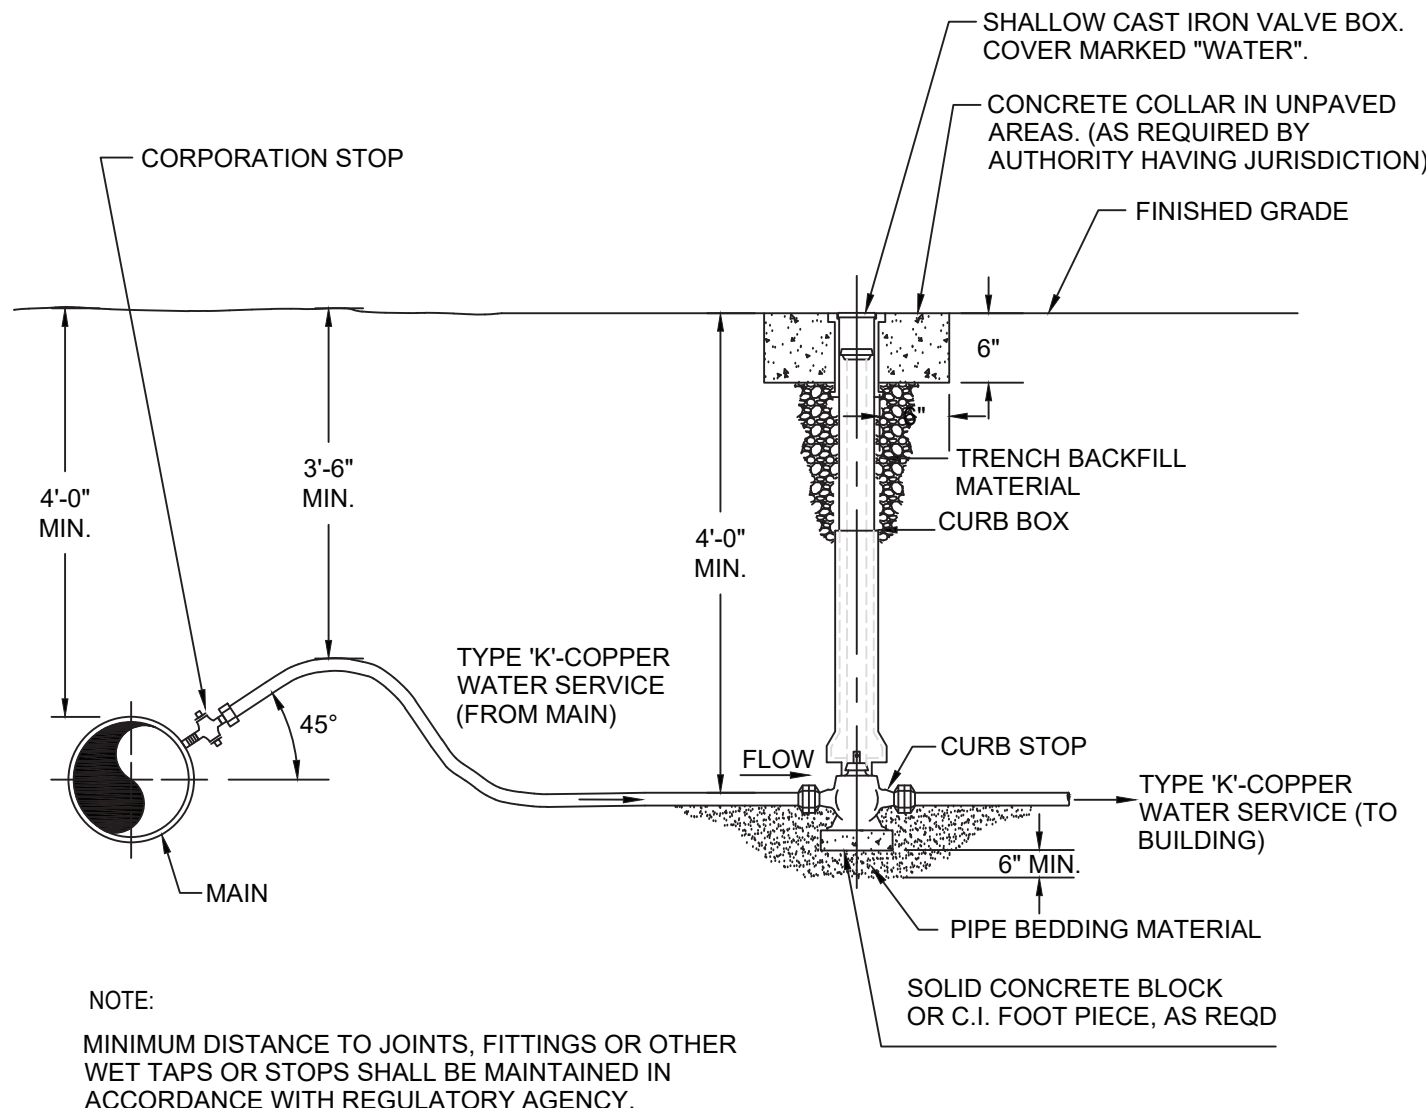

9 **FLOOR CLEANOUT DETAIL**
P-81 SCALE: NOT TO SCALE

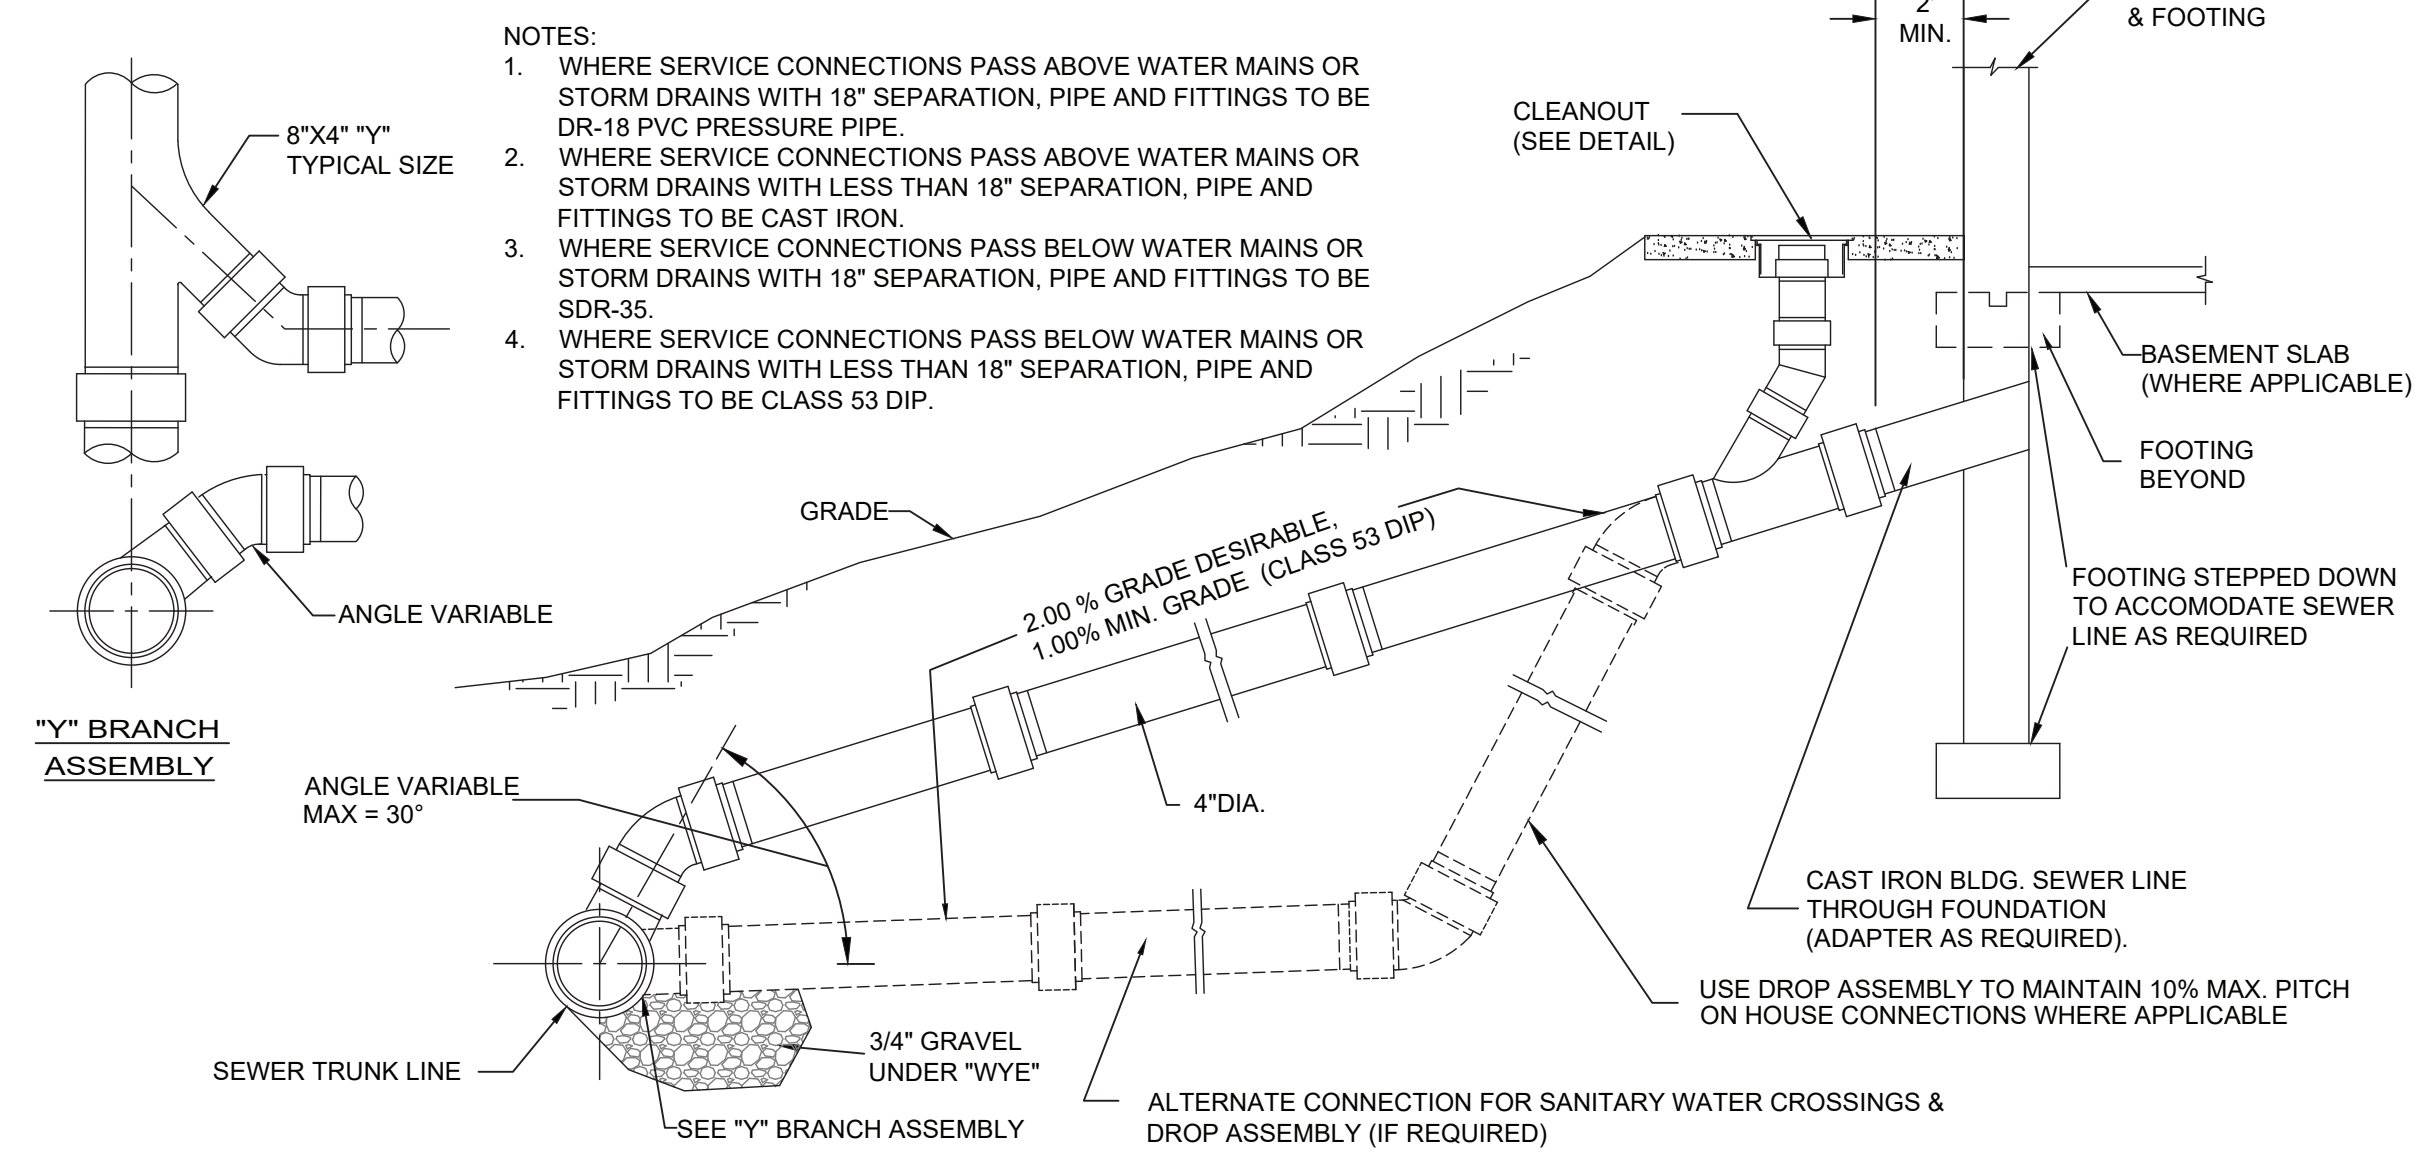

10 **COPPER WATER SERVICE AND CURB STOP**
P-81 SCALE: NOT TO SCALE



11 **SEWER SERVICE CONNECTION/ DROP ASSEMBLY**
P-81 SCALE: NOT TO SCALE

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								<div>DWG. NO.:</div> <div>548 of 664</div>						<div>SCALE:</div> <div>AS INDICATED</div>	
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MECHANICAL GENERAL NOTES

1.

ALL WORK AND MATERIALS SHALL BE PURCHASED AND INSTALLED IN ACCORDANCE WITH ALL NATIONAL & NEW YORK STATE CODES AND REGULATIONS (AS WELL AS ALL APPLICABLE LOCAL CODES & REGULATIONS). THE CONTRACTOR SHALL BE RESPONSIBLE TO ENSURE THAT ALL HVAC WORK IS PROVIDED AND INSTALLED IN STRICT ACCORDANCE WITH SEISMIC REQUIREMENTS.
2.

DO NOT SCALE FROM THESE DRAWINGS.
3.

THE EXACT MOUNTING HEIGHTS AND LOCATIONS OF ALL HVAC EQUIPMENT SHALL BE FIELD VERIFIED & COORDINATED WITH ALL OTHER MECHANICAL, ELECTRICAL, PLUMBING, FIRE SPRINKLER, ARCHITECTURAL AND STRUCTURAL SYSTEMS. DURING SHOP DRAWINGS SUBMISSIONS, SHOW ALL MOUNTING HEIGHTS OF DUCTWORK, UNITS, ETC.
4.

VERIFY ALL EQUIPMENT VOLTAGES WITH THE ELECTRICAL DESIGN PRIOR TO ORDERING EQUIPMENT.
5.

PROVIDE PHASE LOSS PROTECTION FOR ALL POLY-PHASE MOTOR DEVICES.
6.

DUCTWORK SHALL BE CONSTRUCTED OF GALVANIZED SHEET STEEL IN STRICT COMPLIANCE WITH THE LATEST EDITION OF THE ASHRAE, NFPA, AND SMACNA GUIDE RECOMMENDATIONS. ALL DUCTS TO HAVE PITTSBURGH TYPE LOCK FOR LONGITUDINAL SEAMS AND DRIVE SLIP / "S" SLIP FOR TRANSVERSE JOINTS. "DUCT-MATE" JOINT SYSTEM IS ACCEPTABLE IN LIEU OF PRIOR SEAM SYSTEMS. SIZES AS SHOWN INDICATE INSIDE CLEAR DIMENSIONS OF THE AIR PASSAGE. DUCTWORK SHALL BE FULLY INSULATED AS PER APPLICABLE CODES AND WRITTEN SPECIFICATIONS.
7.

DUCT SIZES MUST BE VERIFIED FOR CLEARANCES AT THE JOB SITE PRIOR TO FABRICATION. DIMENSIONS MAY BE CHANGED TO ACCOMMODATE CONSTRUCTION AS LONG AS EFFECTIVE CROSS-SECTIONAL AREA IS MAINTAINED. DUCT TRANSITIONS SHALL BE CONSTRUCTED WITH A SLOPE OF 1" TO 4". ALL DEVIATIONS FROM ORIGINAL CONTRACT DRAWINGS SHALL BE REVIEWED BY ENGINEER DURING THE SHOP DRAWING PROCESS.
8.

PROVIDE MANUAL BALANCING DAMPERS AS REQUIRED TO PROPERLY BALANCE EACH INDIVIDUAL AIR DISTRIBUTION SYSTEM. IF THE LOCATION OF THE BALANCING DAMPER IS NOT DEFINED ON THE DRAWINGS, THE FOLLOWING MINIMUM STANDARDS SHALL GOVERN. ALL SUPPLY, RETURN, AND EXHAUST MAIN BRANCHES FROM TRUNKS, EACH SPLIT AND ALL SUB-BRANCHES FROM MAIN SHALL INCORPORATE BALANCING DAMPERS.
9.

PROVIDE FLEXIBLE CONNECTORS AT ALL DUCT CONNECTIONS TO VIBRATING EQUIPMENT. THESE CONNECTORS SHALL BE INSTALLED IN CLOSE PROXIMITY TO SUCH EQUIPMENT.
10.

PROVIDE FIRE DAMPERS WITH RATED ACCESS DOORS AT ALL DUCT PENETRATIONS THROUGH FIRE RATED WALLS, SMOKE AND FIRE STOPPING, SHAFT, FLOORS, RATED CEILINGS AND PARTITIONS AS REQUIRED TO MAINTAIN ARCHITECTURAL FIRE RATINGS. REFER TO THE ARCHITECTURAL PLANS AND SPECIFICATIONS FOR LOCATIONS AND FIRE RATING REQUIREMENTS. CONTRACTOR MUST FULLY REVIEW ALL ARCHITECTURAL AND ENGINEERING DRAWINGS AND VISIT THE SITE PRIOR TO SUBMITTING THE BID. NO EXTRAS WILL BE ALLOWED.
11.

ALL ACCESS DOORS REQUIRED IN GENERAL CONSTRUCTION ARE TO BE PROVIDED AND INSTALLED BY THE CONTRACTOR. IT IS THE RESPONSIBILITY OF THE CONTRACTOR TO IDENTIFY SIZE, TYPE AND LOCATION OF SUCH DOORS FOR PROPER ACCESS TO ALL CONCEALED HVAC EQUIPMENT, VALVES AND OTHER RELATED EQUIPMENT. THE CONTRACTOR SHALL IDENTIFY THESE REQUIREMENTS ON A COORDINATED SHOP DRAWING PRIOR TO SYSTEM FABRICATION AND INSTALLATION.
12.

ALL CEILING MOUNTED EQUIPMENT MUST BE SUPPORTED DIRECTLY FROM BUILDING STRUCTURE WITH COMBINATION SPRING AND NEOPRENE-IN-SHEAR HANGERS AND ROD. PROVIDE SUPPLEMENTARY STEEL AS REQUIRED TO ADEQUATELY SUPPORT THE LOAD.
13.

THE CONTRACTOR MUST CONTRACT AN INDEPENDENT NEBB CERTIFIED AIR BALANCING & TESTING COMPANY TO PERFORM THE AIR BALANCING WORK AND ASSOCIATED SYSTEM AIR BALANCING REPORT. ALL WORK SHALL BE PERFORMED IN STRICT COMPLIANCE WITH ALL APPLICABLE CODES, REGULATIONS, PLANS AND WRITTEN SPECIFICATIONS. SUBMIT THE FINAL AIR BALANCE REPORT TO THE ENGINEER FOR REVIEW AND APPROVAL PRIOR TO SUBSTANTIAL COMPLETION OF THE PROJECT. AS DETERMINED BY THE AIND OWNER/CLIENT, THE AIR BALANCE REPORT MUST INCLUDE ALL SUPPLY, RETURN, & EXHAUST AIR TERMINALS, FRESH AIR (OUTSIDE AIR) INTAKE AND VENTILATION EXHAUST CFM RATES FOR ALL UNITS. ALSO INCLUDE ACTUAL SUPPLY & RETURN AIR VELOCITY & STATIC PRESSURE READINGS ALONG WITH ALL MOTOR AMPERAGES FOR ALL UNITS.
14.

THE CONTRACTOR IS TO INCLUDE IN THEIR BID ALL LOW VOLTAGE CONTROL WIRING, THERMOSTATS, RELAYS, TRANSFORMERS, STARTERS ETC FOR A COMPLETE OPERATING CONTROL SYSTEM AS DESCRIBED IN THE SEQUENCE OF OPERATIONS. THE CONTRACTOR IS ALSO RESPONSIBLE FOR LINE VOLTAGE CONTROL FOR EXHAUST FANS CONTROLLED FROM LIGHT SWITCH AND THERMOSTATS. ALL CONTROL WIRING IN THE AREAS THAT DO NOT HAVE DROPPED CEILINGS THE CONTRACTOR MUST PROVIDE ALL CONTROL WIRING CONDUIT, IN AREAS OF DROPPED CEILING PLENUM RATED CONTROL WIRING CAN BE RUN EXPOSED ABOVE CEILING.
15.

ALL MECHANICAL EQUIPMENT SHALL BE INSTALLED PER MANUFACTURER'S REQUIREMENTS/SPECIFICATIONS.

MECHANICAL DEMOLITION NOTES

1.

CONTRACTOR SHALL BE RESPONSIBLE FOR DEMOLITION OF MECHANICAL EQUIPMENT AND MATERIAL RELATING TO THEIR RESPECTIVE TRADE.
2.

THE CONTRACTOR SHALL REMOVE, RELOCATE, REPLACE, ADJUST, ADAPT AND MODIFY EXISTING EQUIPMENT AND/OR SYSTEMS AS REQUIRED WHEN SUCH WORK IS UNCOVERED AND FOUND TO INTERFERE WITH COMPLETION OF WORK IN THIS CONTRACT OR OTHER CONTRACT WORK.
3.

EXECUTE THE DEMOLITION IN CAREFUL AND ORDERLY MANNER WITH THE LEAST POSSIBLE DISTURBANCE TO THE PUBLIC, EGRESS OR THE FUNCTIONING OF THE EXISTING BUILDING.
4.

TAKE NECESSARY PRECAUTIONS TO PREVENT DUST AND DIRT FROM RISING BY WETTING DEMOLISHED DEBRIS. EXCESSIVE USE OF WATER WILL NOT BE PERMITTED.
5.

PRIOR TO DEMOLITION, CONTRACTOR SHALL REVIEW WITH OWNER ALL MATERIALS TO BE REMOVED, SHOULD THE OWNER WANT TO KEEP ANY MATERIALS THE CONTRACTOR SHALL REMOVE AND DELIVER THE PARTS TO THE OWNER ON THE SITE WHERE SO DIRECTED. OTHERWISE ALL DEMOLISHED OR REMOVED MATERIALS SHALL BECOME THE PROPERTY OF THE CONTRACTOR AND SHALL BE REMOVED FROM THE SITE AND BE DISPOSED OF IN A LEGAL MANNER.
6.

DEMOLITION SHALL INCLUDE REMOVAL OF ALL PARTS AND PIECES IN THEIR ENTIRETY BACK TO POINTS INDICATED OR IF NOT INDICATED BACK TO THEIR POINT OF SOURCE.
7.

WHERE CONDITIONS PROHIBIT TOTAL REMOVAL OF THE WORK, THE REMAINING PORTION SHALL BE CUT FLUSH WITH THE SURROUNDING SURFACE AND BE CAPPED, PLUGGED OR SEALED AND THE SURROUNDING SURFACE SHALL BE REFINISHED IN AN APPROVED MANNER.
9.

DO NOT REMOVE EXISTING STRUCTURAL WORK. DO NOT REMOVE OPERATIONAL ELEMENTS AND SAFETY-RELATED COMPONENTS IN A MANNER RESULTING IN A REDUCTION OF CAPACITIES TO PERFORM IN THE MANNER INTENDED OR RESULTING IN DECREASED OPERATIONAL LIFE, INCREASED MAINTENANCE, OR DECREASED SAFETY.
10.

REMOVALS, DISCONNECTIONS, AND RELOCATIONS SHALL BE PERFORMED BY WORKMEN SKILLED IN THE TRADE INVOLVED AND SHALL BE EMPLOYED BY A CONTRACTOR LICENSED IN THE TRADE INVOLVED. ALL WORK SHALL BE DONE IN ACCORDANCE WITH ACCEPTED TRADE PRACTICES.
11.

PROVIDE ADEQUATE TEMPORARY SUPPORT FOR WORK TO REMAIN, TO PREVENT FAILURE. DO NOT ENDANGER OTHER WORK.
12.

PROTECTION: PROVIDE ADEQUATE PROTECTION WHERE REQUIRED FOR THE PRESENT BUILDING AND ITS CONTENTS. TEMPORARY DUSTPROOF BARRIERS AND BARRICADES SHALL BE ERRECTED WHERE REQUIRED FOR PROTECTION OF PERSONNEL, PROTECTION FROM DUST AND DIRT, FOR SECURITY, FIRE AND WEATHER PROTECTIVE REASONS.
13.

CONTRACTOR SHALL TAKE EVERY PRECAUTION AGAINST FIRE BY EMPLOYING FIRE DEPARTMENT TYPE HOSES AND PORTABLE FIRE EXTINGUISHERS AS REQUIRED BY OSHA AND/OR THE OWNER'S INSURANCE UNDERWRITER.
14.

BEFORE STARTING DEMOLITION OPERATIONS, PROVIDE THE NECESSARY PROTECTIVE DEVICES, WHERE REQUIRED, AND IN STRICT ACCORDANCE WITH OSHA RULES AND REGULATIONS.
14.

USE TEMPORARY ENCLOSURES, OR OTHER SUITABLE METHODS TO LIMIT DUST AND DIRT RISING AND SCATTERING TO LOWEST PRACTICAL LEVEL. COMPLY WITH GOVERNING REGULATIONS PERTAINING TO ENVIRONMENTAL PROTECTION.
15.

FIELD VERIFY DEMOLITION REQUIREMENTS AND EXISTING CONDITIONS. DEMOLITION NOTES ARE INDICATED IN NOTE FORM.
16.

CONTRACTOR SHALL ESTABLISH A PATH OF TRAVEL AND TIME SCHEDULE FOR THE REMOVAL OF ALL DEBRIS AND WASTE, AND HAVE THIS APPROVED BY OWNER. CONTRACTOR IS TO ENSURE THAT ALL CORRIDORS AND PUBLIC AREAS BE KEPT FREE OF OBSTRUCTIONS, DEBRIS, AND ARE TO BE BROOM SWEEP CLEAN AT ALL TIMES.
17.

CONTRACTOR SHALL VISIT THE SITE AND BECOME INFORMED AS TO THE CONDITION OF THE PREMISES AND THE EXTENT AND CHARACTER OF WORK REQUIRED. NO ADDITIONAL COMPENSATION WILL BE APPROVED DUE TO FIELD CONDITIONS.

NYSECC ENERGY COMPLIANCE STATEMENT:

PER SECTION C101.7 OF THE 2020 NYSECC HISTORIC BUILDINGS ARE EXEMPT FROM THE REQUIREMENTS OF THE ENERGY CODE.

HVAC SYMBOL LIST

IDENTIFIER	DESCRIPTION
	NEW DUCTWORK OR PIPING
	EXISTING DUCTWORK OR PIPING TO BE REMOVED
	EXISTING DUCTWORK OR PIPING TO REMAIN
	DOUBLE-LINE AND SINGLE-LINE RECTANGULAR DUCT, FIRST NUMBER INDICATES SIDE IN VIEW IN INCHES, SECOND NUMBER INDICATES SIDE IN DEPTH IN INCHES
	FLEXIBLE DUCTWORK
	REGULAR SUPPLY AIR DUCT (UP AND DOWN)
	REGULAR RETURN AIR DUCT (UP AND DOWN)
	REGULAR EXHAUST AIR DUCT (UP AND DOWN)
	REGULAR OUTSIDE AIR DUCT (UP AND DOWN)
	VOLUME DAMPER
	BACKDRAFT DAMPER
	MOTOR OPERATED DAMPER
	EQUIPMENT TAG EQUIPMENT NUMBER
	DETAIL TAG/CALL OUT TAG MECHANICAL SHEET NUMBER
	THERMOSTAT
	EXHAUST GRILLE
	REFER TO SUPPLEMENTAL FIGURE INDICATED BY NUMBER (I.E. F2 REFERS TO FIGURE 2)

HVAC ABBREVIATIONS

IDENTIFIER	DESCRIPTION
AC	DIRECT EXPANSION AIR CONDITION UNIT
CFM	CUBIC FEET PER MINUTE
COND	CONDENSATE
CU	CONDENSING UNIT
CUH	CABINET UNIT HEATER
DB	DRY BULB
DN	DOWN
EA	EXHAUST AIR
EF	EXHAUST FAN
EG	EXHAUST GRILLE
EUH	ELECTRIC UNIT HEATER
EER	ENERGY EFFICIENCY RATIO
EG	EXHAUST GRILLE
FAI	FRESH AIR INTAKE
GC	GENERAL CONTRACTOR
MBH	THOUSAND BTU PER HOUR
PC	PLUMBING CONTRACTOR
RG	RETURN GRILLE
RGL	REFRIGERANT GAS LINE
RL	REFRIGERANT LIQUID LINE
RTU	ROOFTOP UNIT
SA	SUPPLY AIR
SD	SUPPLY DIFFUSER
TYP.	TYPICAL
VIF	VERIFY IN FIELD

SCOPE OF WORK

- DEMOLITION

1. REMOVE TWO (2) EXISTING RANGE HOODS AS INDICATED.
2. REMOVE TWO (2) EXISTING FLUES AS INDICATED.
3. REMOVE TWO (2) EXISTING CEILING VENTILATION GRILLES AS INDICATED.
4. REMOVE ONE (1) EXISTING RELIEF VENT AS INDICATED.
5. REMOVE TWO (2) EXISTING ROOFTOP FANS AND ASSOCIATED DUCTWORK, CONTROLS AND ACCESSORIES.
- CONSTRUCTION

1. PROVIDE ONE (1) NEW ROOFTOP AIR HANDLING UNIT RTU-1. PROVIDE DUCTWORK TO NEW SPACES AS INDICATED.
2. PROVIDE ONE (1) NEW OUTDOOR SPLIT CONDENSER AIR CONDITIONER UNIT AS INDICATED.
3. PROVIDE TWO (2) NEW CEILING RECESSED INDOOR AIR CONDITIONER UNITS AS INDICATED.
4. PROVIDE ONE (1) NEW PACKAGED TERMINAL AIR CONDITIONER UNIT AS INDICATED
5. PROVIDE ONE (1) NEW GENERAL KITCHEN/TRASH ROOM EXHAUST FAN ON ROOF AND ASSOCIATED DUCTWORK AS INDICATED.
6. PROVIDE ONE (1) NEW ATTIC EXHAUST FAN AS INDICATED.
7. PROVIDE ONE (1) NEW WALL MOUNTED ELECTRIC UNIT HEATER AS INDICATED.
8. PROVIDE TWO (2) NEW RAIN RESISTANT LOUVERS AS INDICATED.

MECHANICAL VENTILATION SCHEDULE

SPACE DETAILS		MECH CODE REQUIREMENTS							DESIGN				NOTES
ROOM	AREA (FT²)	# PEOPLE	OA / SQ FT	OA PER PERSON	# OF FIXT (TOILET/URINALS/SLOP SINK)	EXH CFMSQFT	EXH CFM/FIXTURE	NET OA	MIN DESIGN OA FLOW (CFM)	ACTUAL SA FLOW (CFM)	ACTUAL RA FLOW (CFM)	ACTUAL EA FLOW (CFM)	
105 KITCHEN	1347	27	0.12	7.5	-	0.7	-	943	1000	2400	1400	1000	1
102 DRY ROOM	67	-	0.12	-	-	-	-	8	100	100	-	100	1
NOTES: 1. NEW YORK STATE MECHANICAL CODE.													

NATURAL VENTILATION SCHEDULE

SPACE DETAILS			DESIGN			NOTES
ROOM	AREA (SF)	4% FLOOR AREA (SF)	WINDOW FREE AREA (SF)	DOOR AREA (SF)	TOTAL OPENABLE AREA (SF)	
101 SEASONAL FOOD SERVICE	343	14	-	156	156	1,2
NOTES:						
1. NEW YORK STATE MECHANICAL CODE.						
2. NATURAL VENTILATION OF AN OCCUPIED SPACE SHALL BE THROUGH WINDOWS, DOORS, LOUVERS, AND OTHER OPENINGS TO THE OUTDOORS. THE MINIMUM OPENABLE AREA TO THE OUTDOORS SHALL BE 4 PERCENT OF THE FLOOR AREA BEING VENTILATED.						

TABLE 1: ENERGY CODE ANALYSIS TABLE FOR MECHANICAL SYSTEMS

(PER 2020 NYS ENERGY CODE)						
ITEM DESCRIPTION	UNIT TAG	EQUIPMENT TYPE	PROPOSED VALUE	MINIMUM EFFECENCY	CODE PRECRIBED VALUE AND CITATION	CITATION SUPPORTING DOCUMENTATION
HVAC EQUIPMENT PERFORMANCE	RTU-1	SINGLE PACKAGED UNIT	SEER= 12.6	SEER=11.2	MINIMUM EFFICIENCY REQUIREMENTS: ELECTRICALLY OPERATED UNITARY AIR CONDITIONERS AND CONDENSING UNITS > 65,000 Btu/h < 135,000 Btu/h	C403.2.3(1) MECHANICAL SCHEDULES
HVAC EQUIPMENT PERFORMANCE	AC-1,AC-2, CU-1	SPLIT SYSTEM HEAT PUMP	HSPF = 11.2 SEER= 15.0	HSPF = 8.2 SEER= 14.0	MINIMUM EFFICIENCY REQUIREMENTS: ELECTRICALLY OPERATED UNITARY AIR CONDITIONERS AND CONDENSING UNITS < 65,000 Btu/h	C403.2.3(1) MECHANICAL SCHEDULES
HVAC SYSTEM CONTROLS	ALL HEATING COOLING EQUIPMENT	THERMOSTATIC CONTROLS	DIGITAL THERMOSTATS	-	THERMOSTATIC CONTROLS FOR HVAC SYSTEM	C403.2.6 MECHANICAL SCHEDULES AND PLANS
SHUTOFF DAMPERS			GRAVITY/BACKDRAFT DAMPERS PROVIDED IN LIEU OF MOTORIZED DAMPER MOTORIZED DAMPERS PER EXCEPTIONS 1		-	BACKDRAFT DAMPER INSTALLED AT EXHAUST OPENINGS C403.7.7 MECHANICAL SCHEDULES AND PLANS
DUCT LEAKAGE			SMACNA HVAC DUCT LEAKAGE TEST		-	SMACNA HVAC DUCT LEAKAGE TEST PER C403 MECHANICAL DWGS. & SPECS

TABLE 2: ENERGY CODE COMPLIANCE INSPECTIONS FOR MECHANICAL SYSTEMS

(IIB - MECHANICAL AND SERVICE WATER HEATING INSPECTIONS)					
	INSPECTION TEST	FREQUENCY	REFERENCE STANDARDS	INSPECTION DESCRIPTION	ECC CITATION
IIB2	SHUT-OFF DAMPERS	AS REQUIRED DURING INSTALLATION	APPROVED CONSTRUCTION DOCUMENTS	DAMPERS FOR STAIR AND ELEVATOR SHAFT VENTS AND OTHER OUTDOOR AIR INTAKES AND EXHAUST OPENINGS INTEGRAL TO THE BUILDING ENVELOPE SHALL BE VISUALLY INSPECTED TO VERIFY THAT SUCH DAMPERS, EXCEPT WHERE PERMITTED TO BE GRAVITY DAMPERS, COMPLY WITH APPROVED CONSTRUCTION DRAWINGS. MANUFACTURER'S LITERATURE SHALL BE REVIEWED TO VERIFY THAT THE PRODUCT HAS BEEN TESTED AND FOUND TO MEET THE STANDARD.	NYSECC C403.2.4.4, C403.7.7, OR ASHRAE 90.1-6.4.3.4
IIB3	HVAC AND SERVICE WATER HEATING EQUIPMENT	PRIOR TO FINAL MECHANICAL AND CONSTRUCTION INSPECTION	APPROVED CONSTRUCTION DOCUMENTS	EQUIPMENT SIZING, EFFICIENCIES AND OTHER PERFORMANCE FACTORS OF ALL MAJOR EQUIPMENT UNITS, AS DETERMINED BY THE APPLICANT OF RECORD, AND NO LESS THAN 15% OF MNOR EQUIPMENT UNITS, SHALL BE VERIFIED BY VISUAL INSPECTION AND, WHERE NECESSARY, REVIEW OF MANUFACTURER'S DATA. POOL HEATERS AND COVERS SHALL BE VERIFIED BY VISUAL INSPECTION	NYSECC C403.2, C404.2, C404.7, C406.2
IIB4	HVAC AND SERVICE WATER HEATING SYSTEM CONTROLS	AFTER INSTALLATION AND PRIOR TO FINAL ELECTRICAL AND CONSTRUCTION INSPECTION, EXCEPT THAT FOR CONTROLS WITH SEASONALLY DEPENDENT FUNCTIONALITY, SUCH TESTING SHALL BE PERFORMED BEFORE SIGN-OFF FOR ISSUANCE OF A FINAL CERTIFICATE OF OCCUPANCY	APPROVED CONSTRUCTION DOCUMENTS INCLUDING CONTROL SYSTEM NARRATIVES	NO LESS THAN 20% OF EACH TYPE OF REQUIRED CONTROLS AND ECONOMIZERS SHALL BE VERIFIED BY VISUAL INSPECTION AND TESTED FOR FUNCTIONALITY AND PROPER OPERATION. SUCH CONTROLS SHALL INCLUDE, BUT ARE NOT LIMITED TO, THERMOSTATIC AND ECONOMIZER CONTROLS	NYSECC C403.2.4, C403.2.5.1, C403.2.11, C403.3, C403.4, C404.3, C404.6, C404.7
IIB6	HVAC DUCT LEAKAGE TESTING	PRIOR TO CLOSING CEILINGS AND WALLS AND PRIOR TO FINAL CONSTRUCTION INSPECTION	APPROVED CONSTRUCTION DOCUMENTS; NYC MECHANICAL CODE	WHERE THE AIR HANDLER AND/OR SOME DUCTWORK IS IN UNCONDITIONED SPACE, DUCT-LEAKAGE TESTING SHALL BE PERFORMED EITHER AFTER ROUGH-IN OR POST-CONSTRUCTION TO ENSURE COMPLIANCE WITH ECC R403.3.3 AND R403.3.4. NOT LESS THAN 20% OF SUCH DUCTWORK SHALL BE TESTED	NYSECC C403

CONSULTANT INFORMATION

LiRo Engineers, Inc.

A LiRo Group Company

Syosset, N.Y. 516-214-8157[T]

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WESTCHESTER COUNTY, NEW YORK
DEPARTMENT OF PUBLIC WORKS AND TRANSPORTATION
DIVISION OF ENGINEERING

INFRASTRUCTURE REHABILITATION - PHASE 3
PLAYLAND PARK, RYE, NEW YORK
RESTAURANT KITCHEN WITH FOOD VENDING
MECHANICAL NOTES, SYMBOLS AND LEGENDS

CONTRACT NUMBER
22-523

SHEET NUMBER
K-M-01


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SCALE: AS INDICATED

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DPW FILE NUMBER 1-118-M-1298-0

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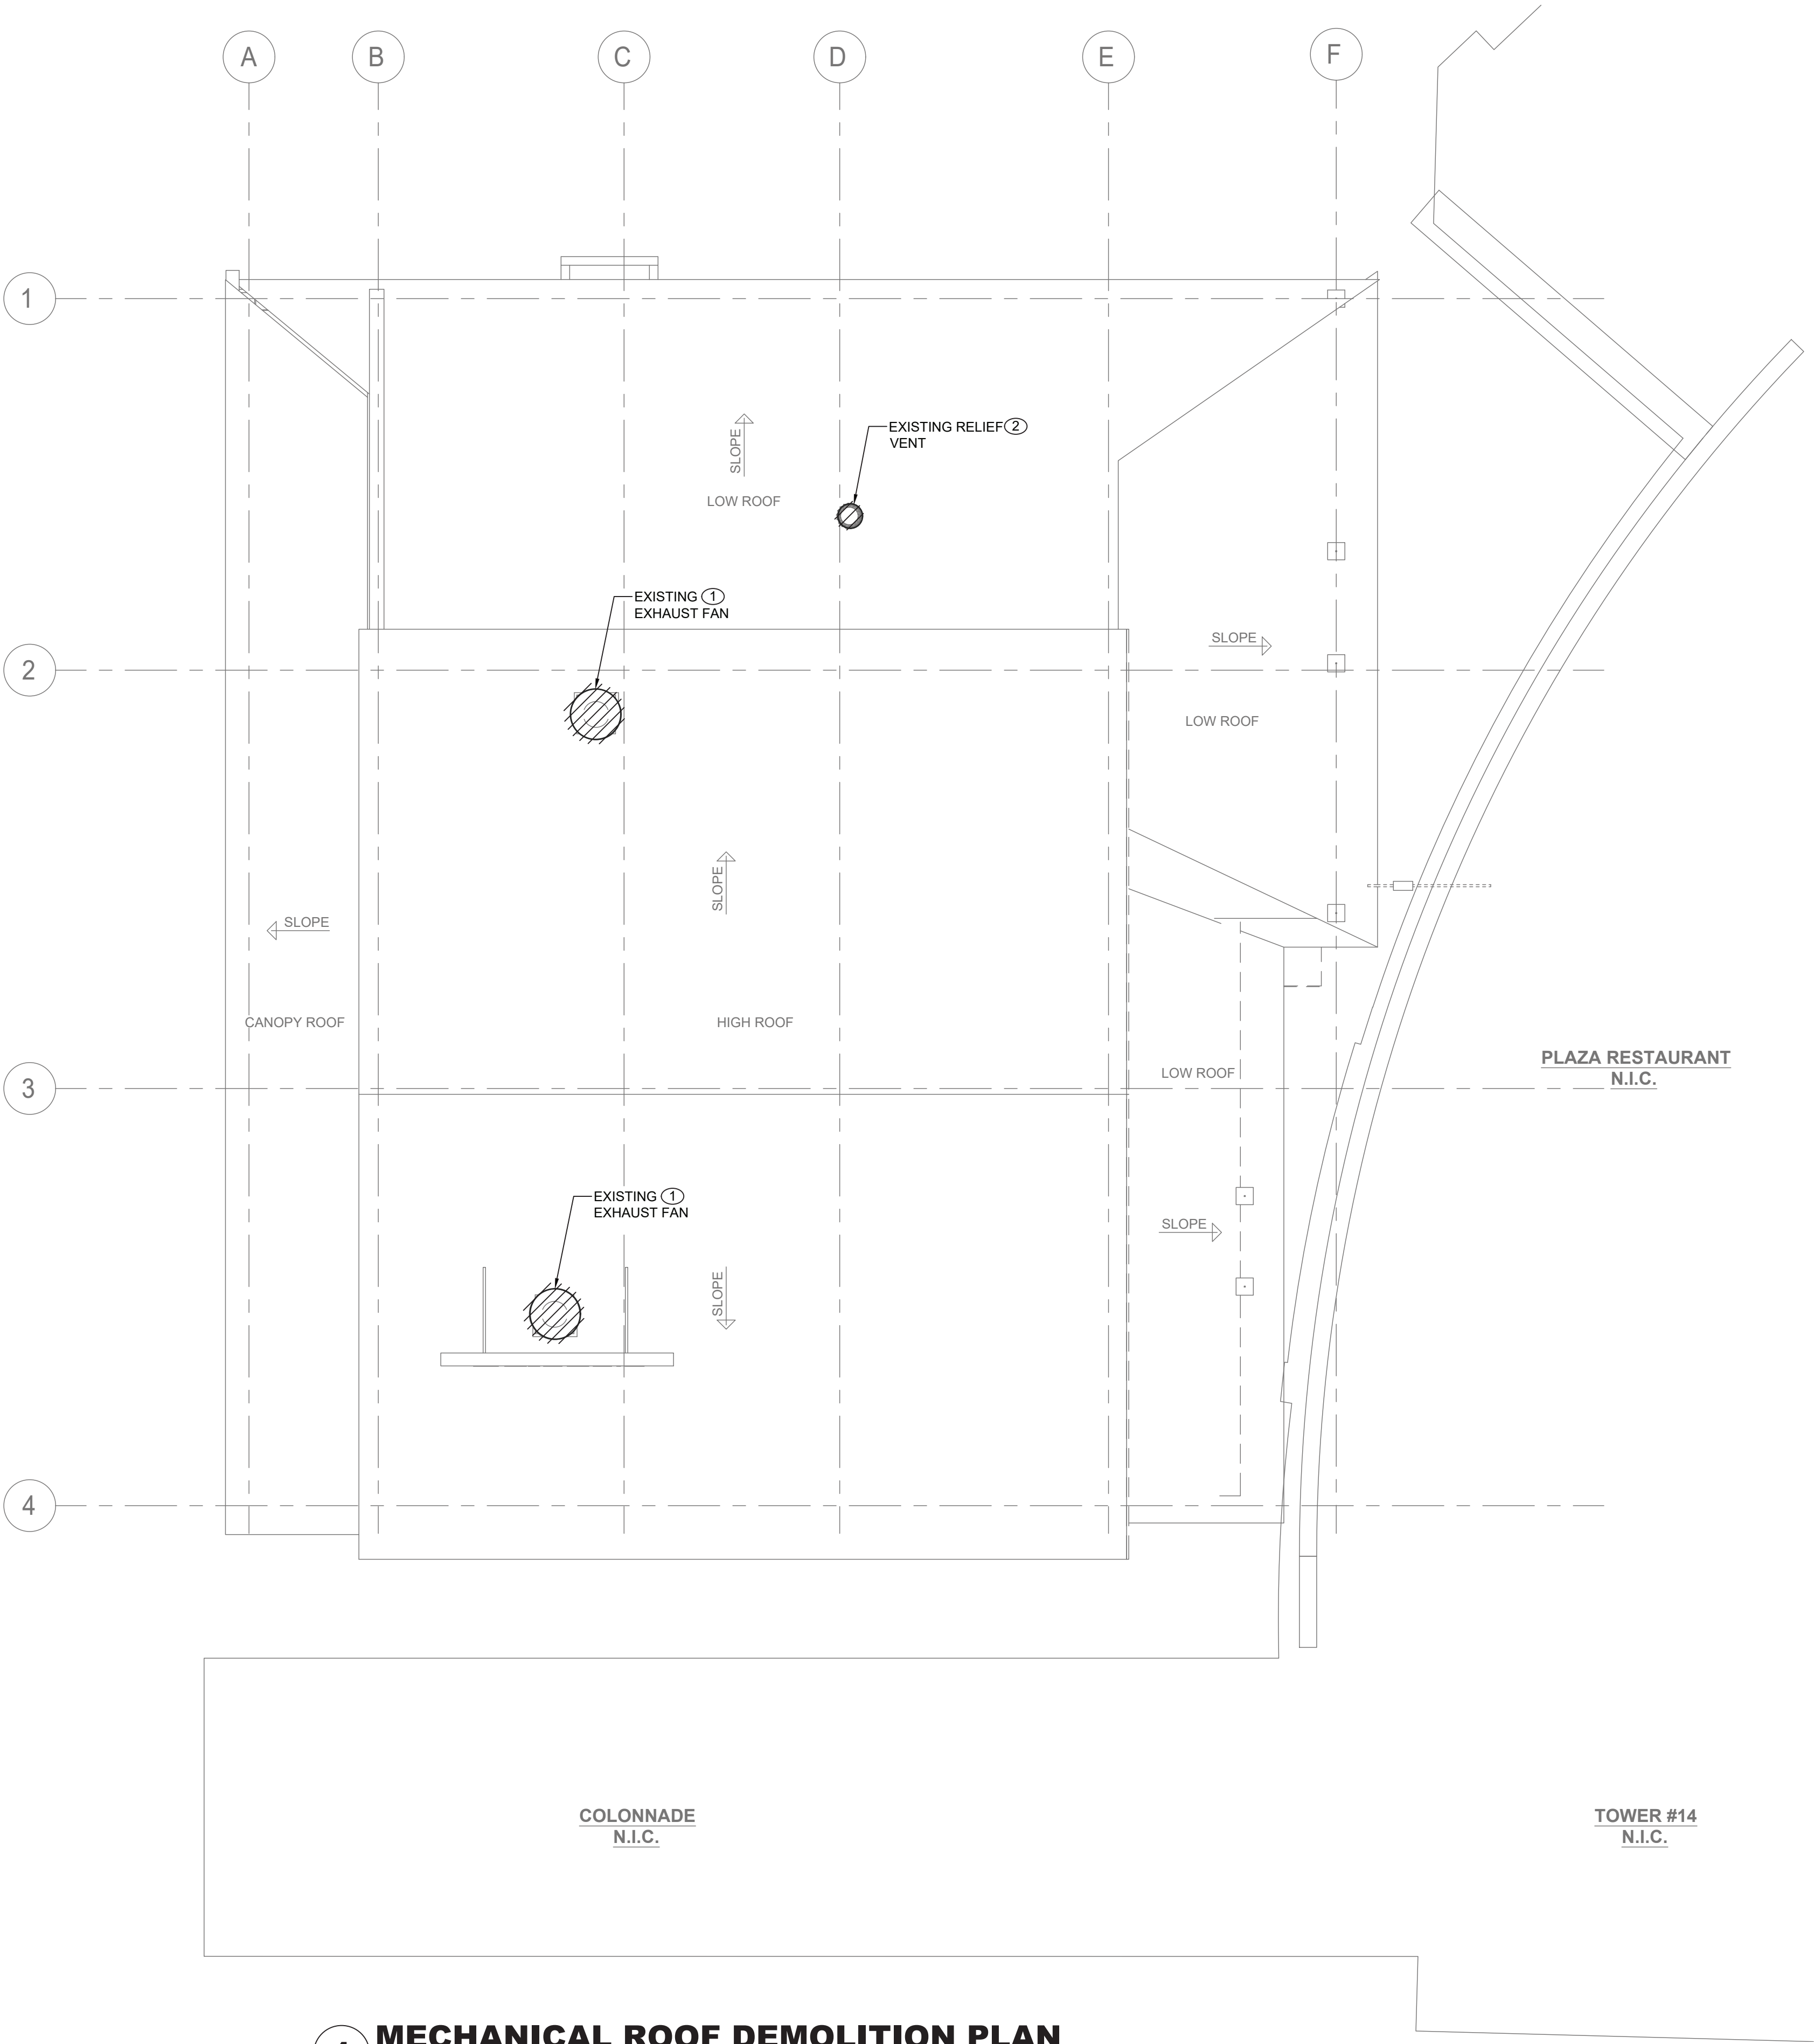
GENERAL NOTES:

1. RETURN REMOVED EXISTING EQUIPMENT TO OWNER IF IT IS IN WORKING CONDITION.
2. CONTRACTOR TO COORDINATE WITH FACILITY WHEN WORKING AROUND OR ABOVE THE RIDE COMPONENTS, AND PROVIDE ALL NECESSARY MEASURES TO PROTECT THESE COMPONENTS PER THE REQUIREMENTS OF THE FACILITY.

MECHANICAL DEMOLITION NOTES:

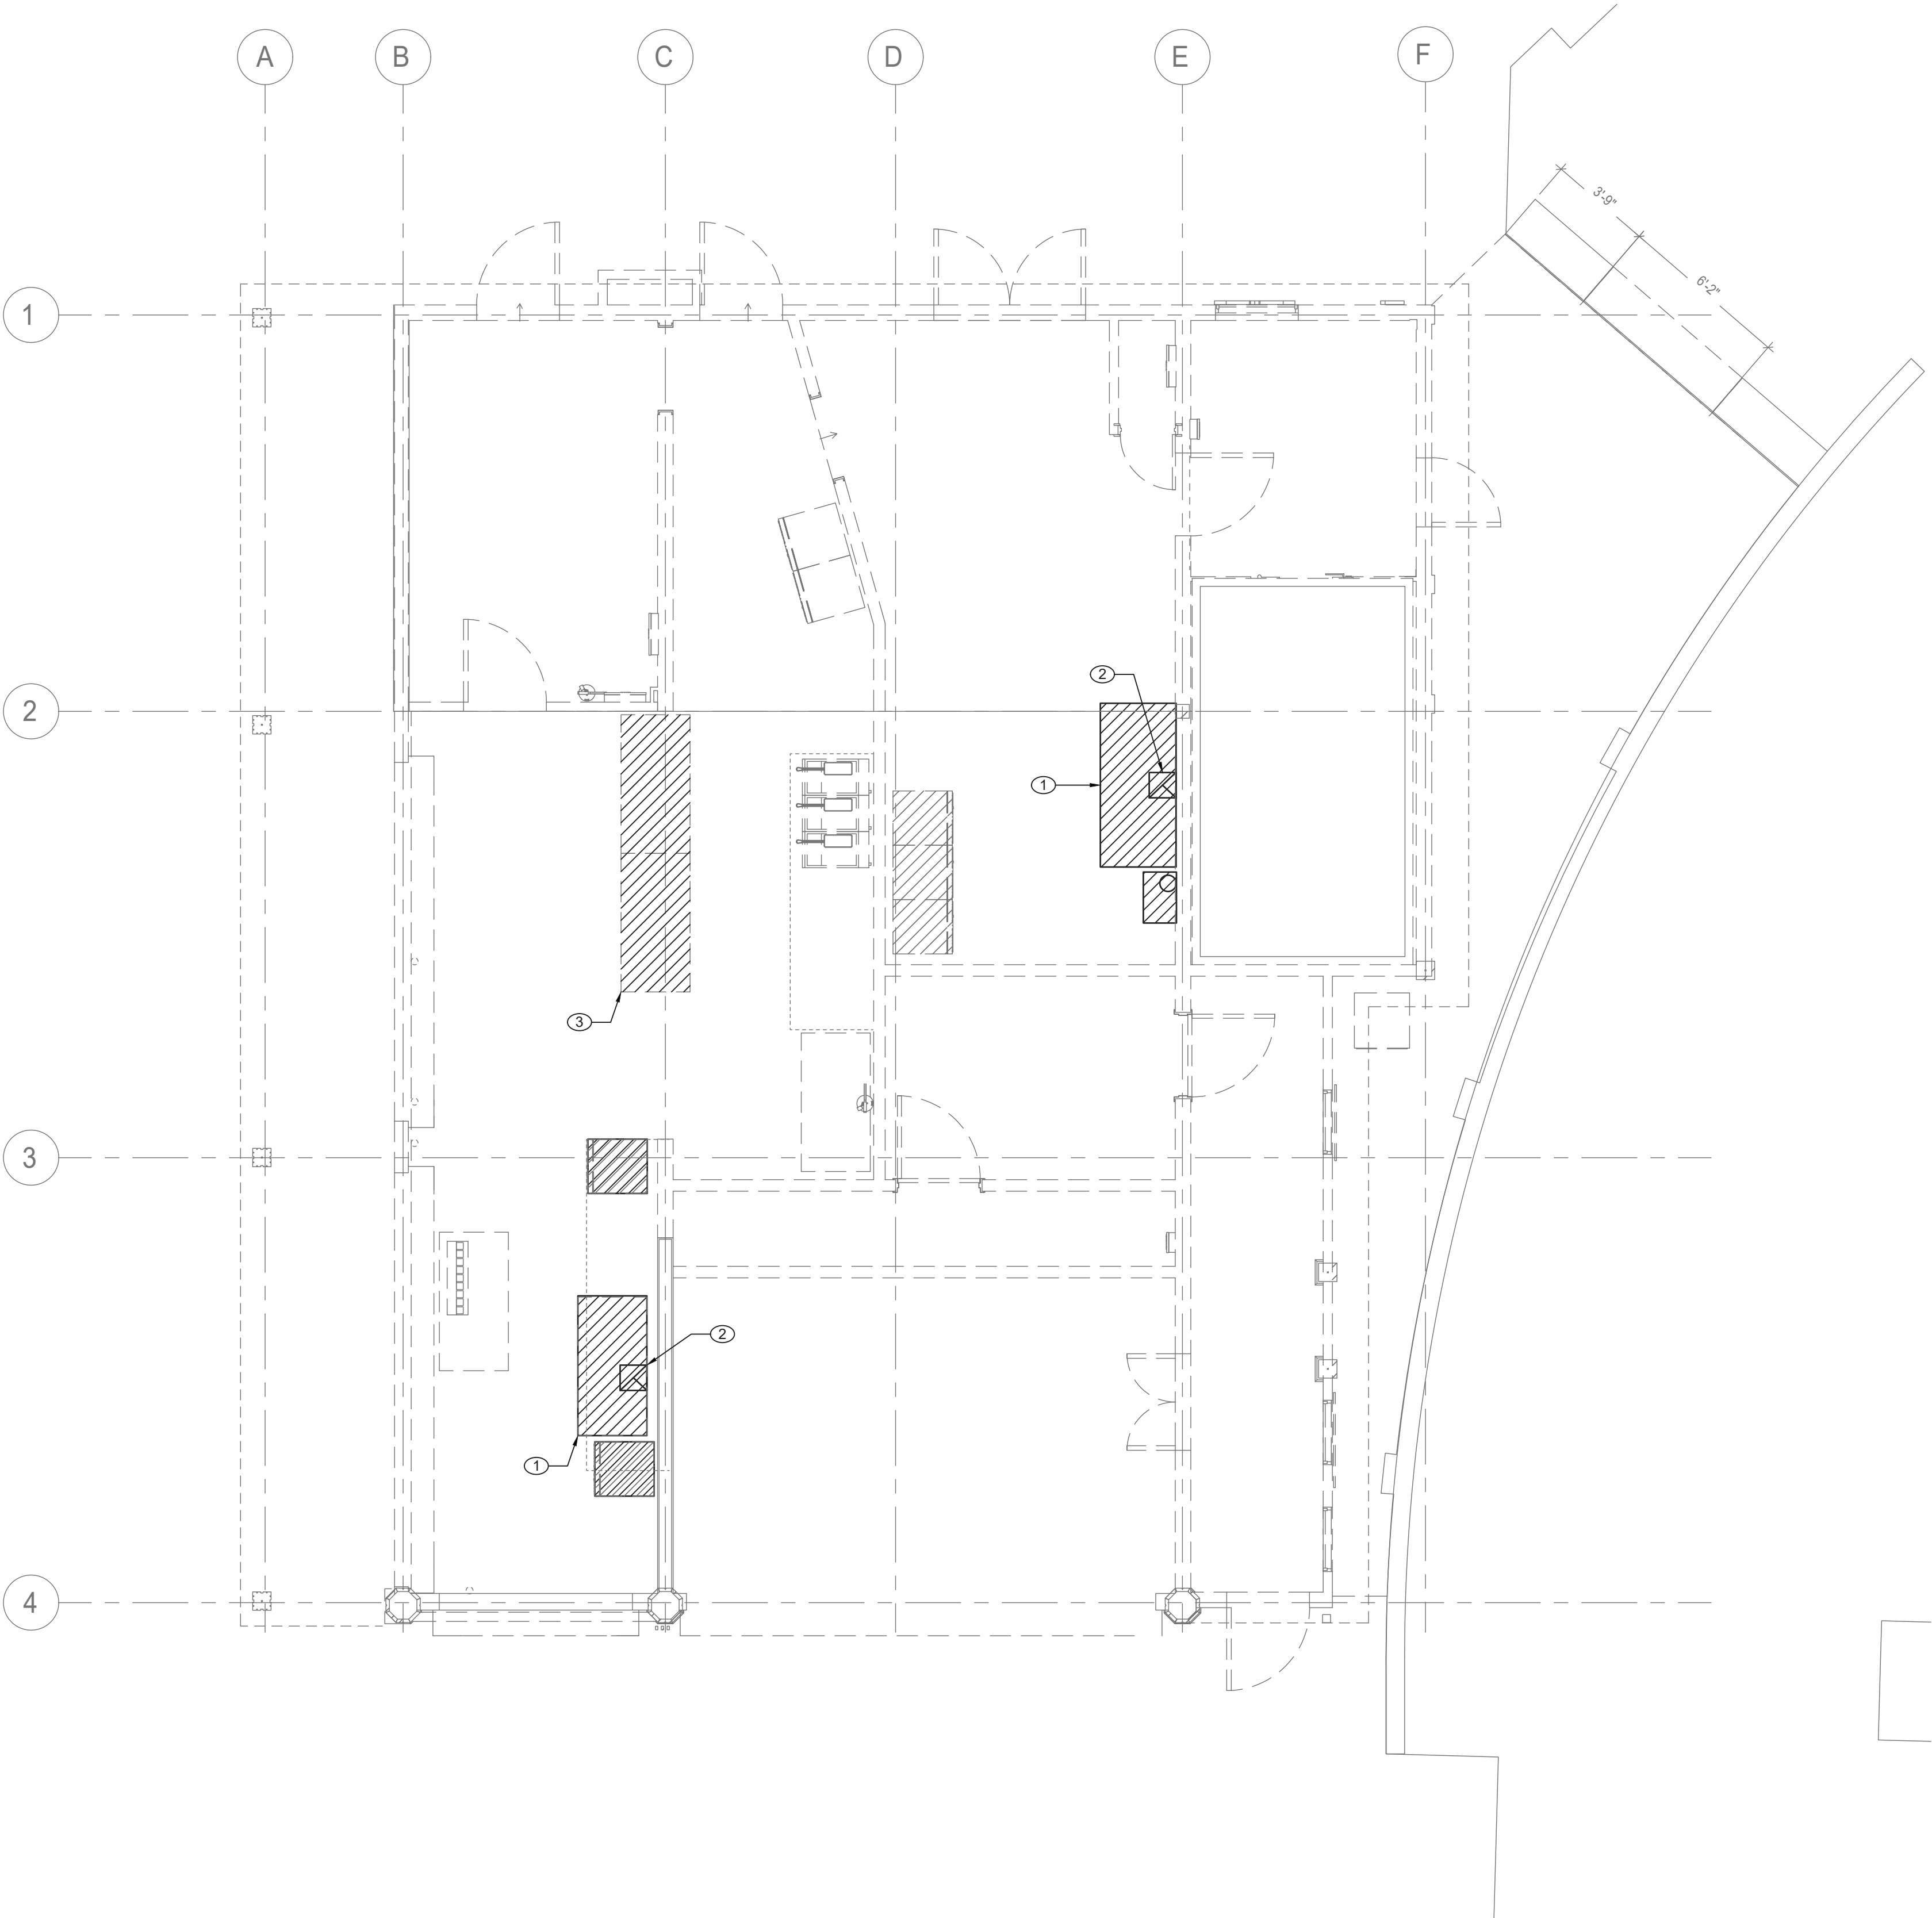- ① REMOVE EXISTING RANGE HOOD AND ASSOCIATED DUCTWORK AND PIPING. DEMOLISH EXISTING ANSUL FIRE PROTECTION SYSTEM AND ASSOCIATED CONTROLS. COORDINATE REMOVAL OF ANSUL SYSTEM WITH FIRE PROTECTION CONTRACTOR AND OWNER.
- ② REMOVE EXISTING FLUE VENT FOR OVEN. COORDINATE WITH GC TO SEAL EXISTING WALL PENETRATION. PROVIDE FIRE STOPPING TO MATCH EXISTING.
- ③ REMOVE EXISTING CEILING VENTILATION GRILLES.

1 MECHANICAL FIRST FLOOR DEMOLITION PLAN
SCALE: 1/4" = 1'-0"



GENERAL NOTES:

1. RETURN REMOVED EXISTING EQUIPMENT TO OWNER IF IT IS IN WORKING CONDITION.
2. CONTRACTOR TO COORDINATE WITH FACILITY WHEN WORKING AROUND OR ABOVE THE RIDE COMPONENTS, AND PROVIDE ALL NECESSARY MEASURES TO PROTECT THESE COMPONENTS PER THE REQUIREMENTS OF THE FACILITY.

MECHANICAL DEMOLITION NOTES:

- ① DEMOLISH EXISTING EXHAUST FAN AND ASSOCIATED CONTROLS, DUCTWORK AND ACCESSORIES. COORDINATE REMOVAL OF ELECTRICAL POWER AND WIRING WITH ELECTRICAL CONTRACTOR. CONTRACTOR SHALL PATCH EXISTING ROOF PENETRATION TO MATCH EXISTING ROOF.
- ② DEMOLISH EXISTING RELIEF VENT. CONTRACTOR SHALL PATCH EXISTING ROOF PENETRATION TO MATCH EXISTING ROOF.

1 MECHANICAL ROOF DEMOLITION PLAN
SCALE: 1/4" = 1'-0"

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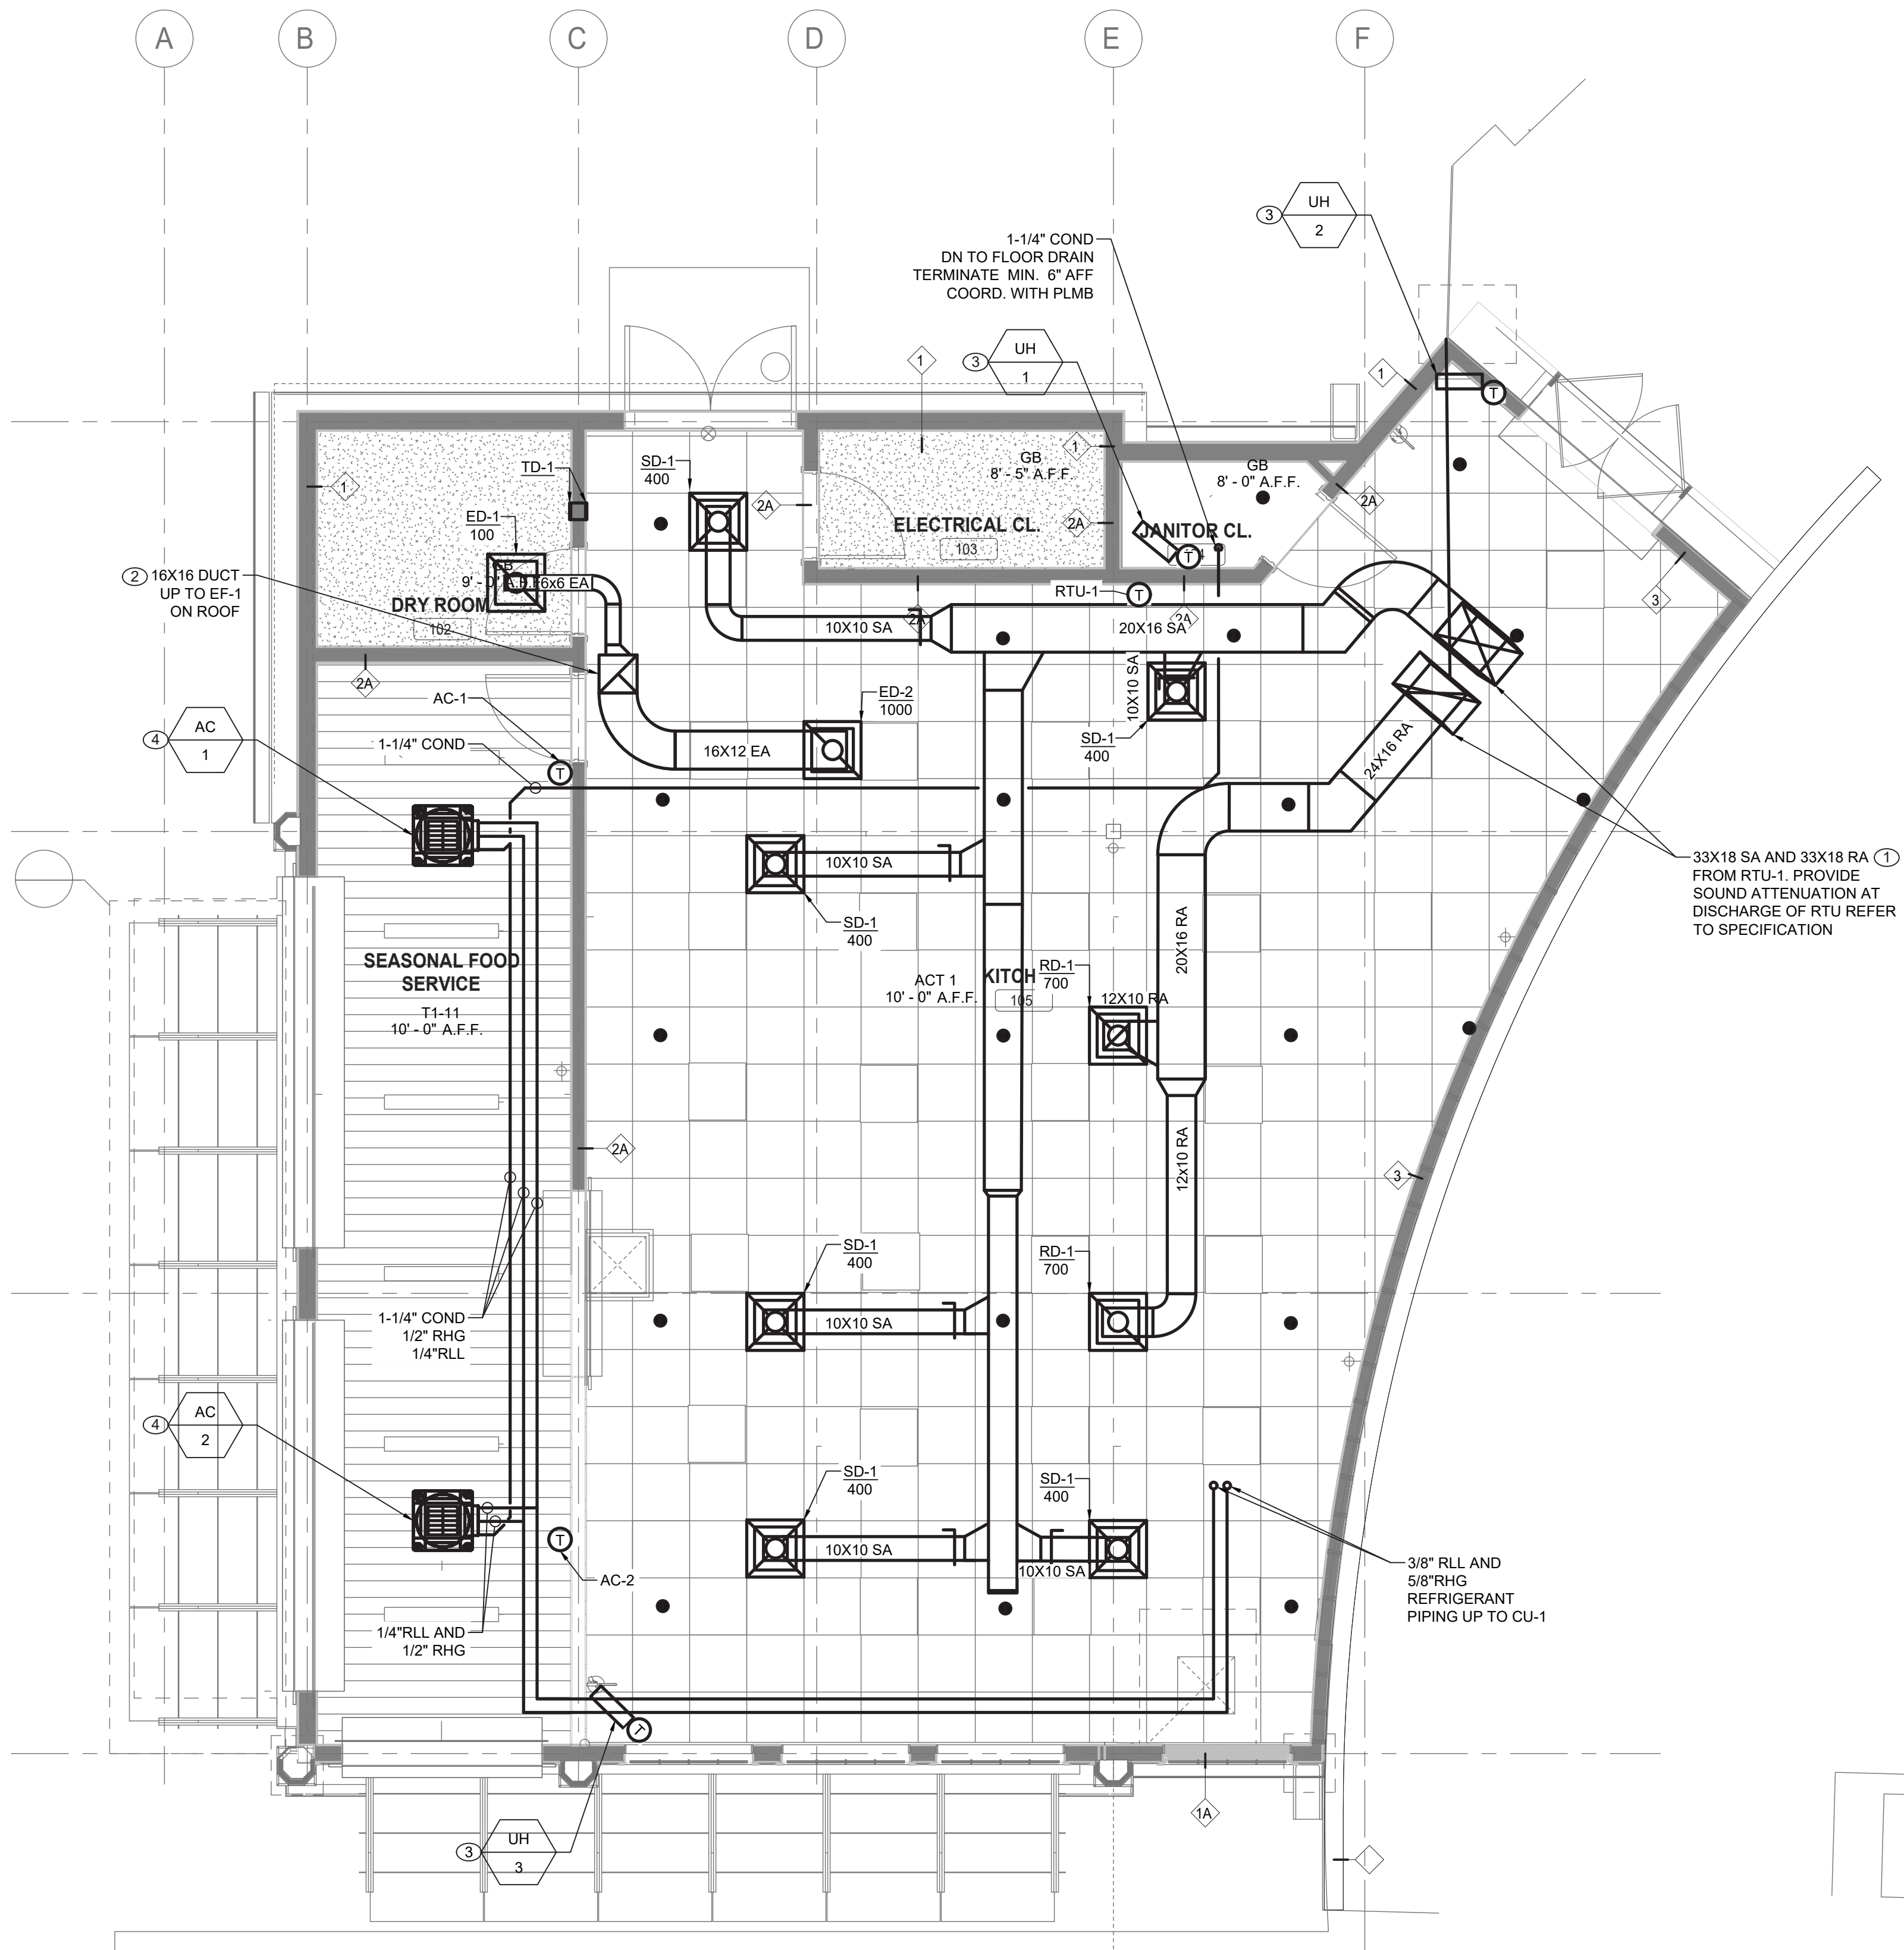
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DATE _____	DATE _____	DATE _____	DATE _____

WESTCHESTER COUNTY, NEW YORK
DEPARTMENT OF PUBLIC WORKS AND TRANSPORTATION
DIVISION OF ENGINEERING

INFRASTRUCTURE REHABILITATION - PHASE 3
PLAYLAND PARK, RYE, NEW YORK
RESTAURANT KITCHEN WITH FOOD VENDING
MECHANICAL ROOF DEMOLITION PLAN

CONTRACT NUMBER 22-523	SHEET NUMBER K-M-12
DWG. NO.: 551 of 664	SCALE: AS INDICATED
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DPW FILE NUMBER 1-118-M-1300-0	



GENERAL NOTES:

- CONTRACTOR TO COORDINATE WITH FACILITY WHEN WORKING AROUND OR ABOVE THE RIDE COMPONENTS, AND PROVIDE ALL NECESSARY MEASURES TO PROTECT THESE COMPONENTS PER THE REQUIREMENTS OF THE FACILITY.
- UPON COMPLETION, SYSTEM SHALL BE TESTED FOR PROPER OPERATION.

MECHANICAL CONSTRUCTION NOTES:

- PROVIDE SUPPLY AND RETURN DUCTWORK FROM ROOFTOP UNIT RTU-1 AND ROUTE ALONG INDICATED PATH. PROVIDE INSULATION TO ALL SUPPLY DUCTWORK. PROVIDE VOLUME DAMPERS AND SUPPLY DIFFUSERS/GRILLES AND BALANCE TO INDICATED VALUES.
- PROVIDE EXHAUST DUCTWORK FROM KITCHEN UP TO ROOFTOP EXHAUST FAN AS INDICATED.
- PROVIDE NEW WALL MOUNTED ELECTRIC UNIT HEATER. COORDINATE INSTALL HEIGHT IN FIELD.
- PROVIDE NEW CEILING MOUNTED INDOOR UNITS AC-1 AND AC-2 AS SHOWN. COORDINATE ELECTRICAL POWER AND WIRING WITH ELECTRICAL DRAWINGS.

1 MECHANICAL FIRST FLOOR CONSTRUCTION PLAN
SCALE: 1/4" = 1'-0"

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WESTCHESTER COUNTY, NEW YORK
DEPARTMENT OF PUBLIC WORKS AND TRANSPORTATION
DIVISION OF ENGINEERING

INFRASTRUCTURE REHABILITATION - PHASE 3
PLAYLAND PARK, RYE, NEW YORK
RESTAURANT KITCHEN WITH FOOD VENDING
MECHANICAL FIRST FLOOR CONSTRUCTION PLAN

CONTRACT
NUMBER

22-523

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K-M-21


552 of 664

GENERAL NOTES:

1. CONTRACTOR TO COORDINATE WITH FACILITY WHEN WORKING AROUND OR ABOVE THE RIDE COMPONENTS, AND PROVIDE ALL NECESSARY MEASURES TO PROTECT THESE COMPONENTS PER THE REQUIREMENTS OF THE FACILITY.
2. UPON COMPLETION, SYSTEM SHALL BE TESTED FOR PROPER OPERATION.

MECHANICAL CONSTRUCTION NOTES:

1. PROVIDE SUPPLY AND RETURN DUCTWORK FROM ROOFTOP UNIT RTU-1 AND ROUTE ALONG INDICATED PATH. PROVIDE INSULATION TO ALL SUPPLY DUCTWORK. PROVIDE VOLUME DAMPERS AND SUPPLY DIFFUSERS/GRILLES AND BALANCE TO INDICATED VALUES. PLACE UNIT ON NEW ROOF CURB AS SHOWN ON K-M-82.
2. PROVIDE NEW OUTDOOR SPLIT CONDENSER AIR CONDITIONER UNIT ON ROOF AS SHOWN. COORDINATE ELECTRICAL POWER AND WIRING WITH ELECTRICAL DRAWINGS. PLACE UNIT ON EQUIPMENT RAILS AS SHOWN ON K-M-81
3. PROVIDE NEW PACKAGED TERMINAL AIR CONDITIONER UNIT. COORDINATE ELECTRICAL POWER AND WIRING WITH ELECTRICAL DRAWINGS.
4. PROVIDE NEW EXHAUST FAN AS SCHEDULED. COORDINATE ELECTRICAL POWER AND WIRING WITH ELECTRICAL CONTRACTOR. INSTALL EF-2 AT 6'0" ABOVE ATTIC FLOOR TO CENTER.
5. PROVIDE NEW RAIN RESISTANT LOUVERS AS SCHEDULED. INSTALL LV-1 AND LV-2 AT 6'0" ABOVE ATTIC FLOOR TO CENTER.

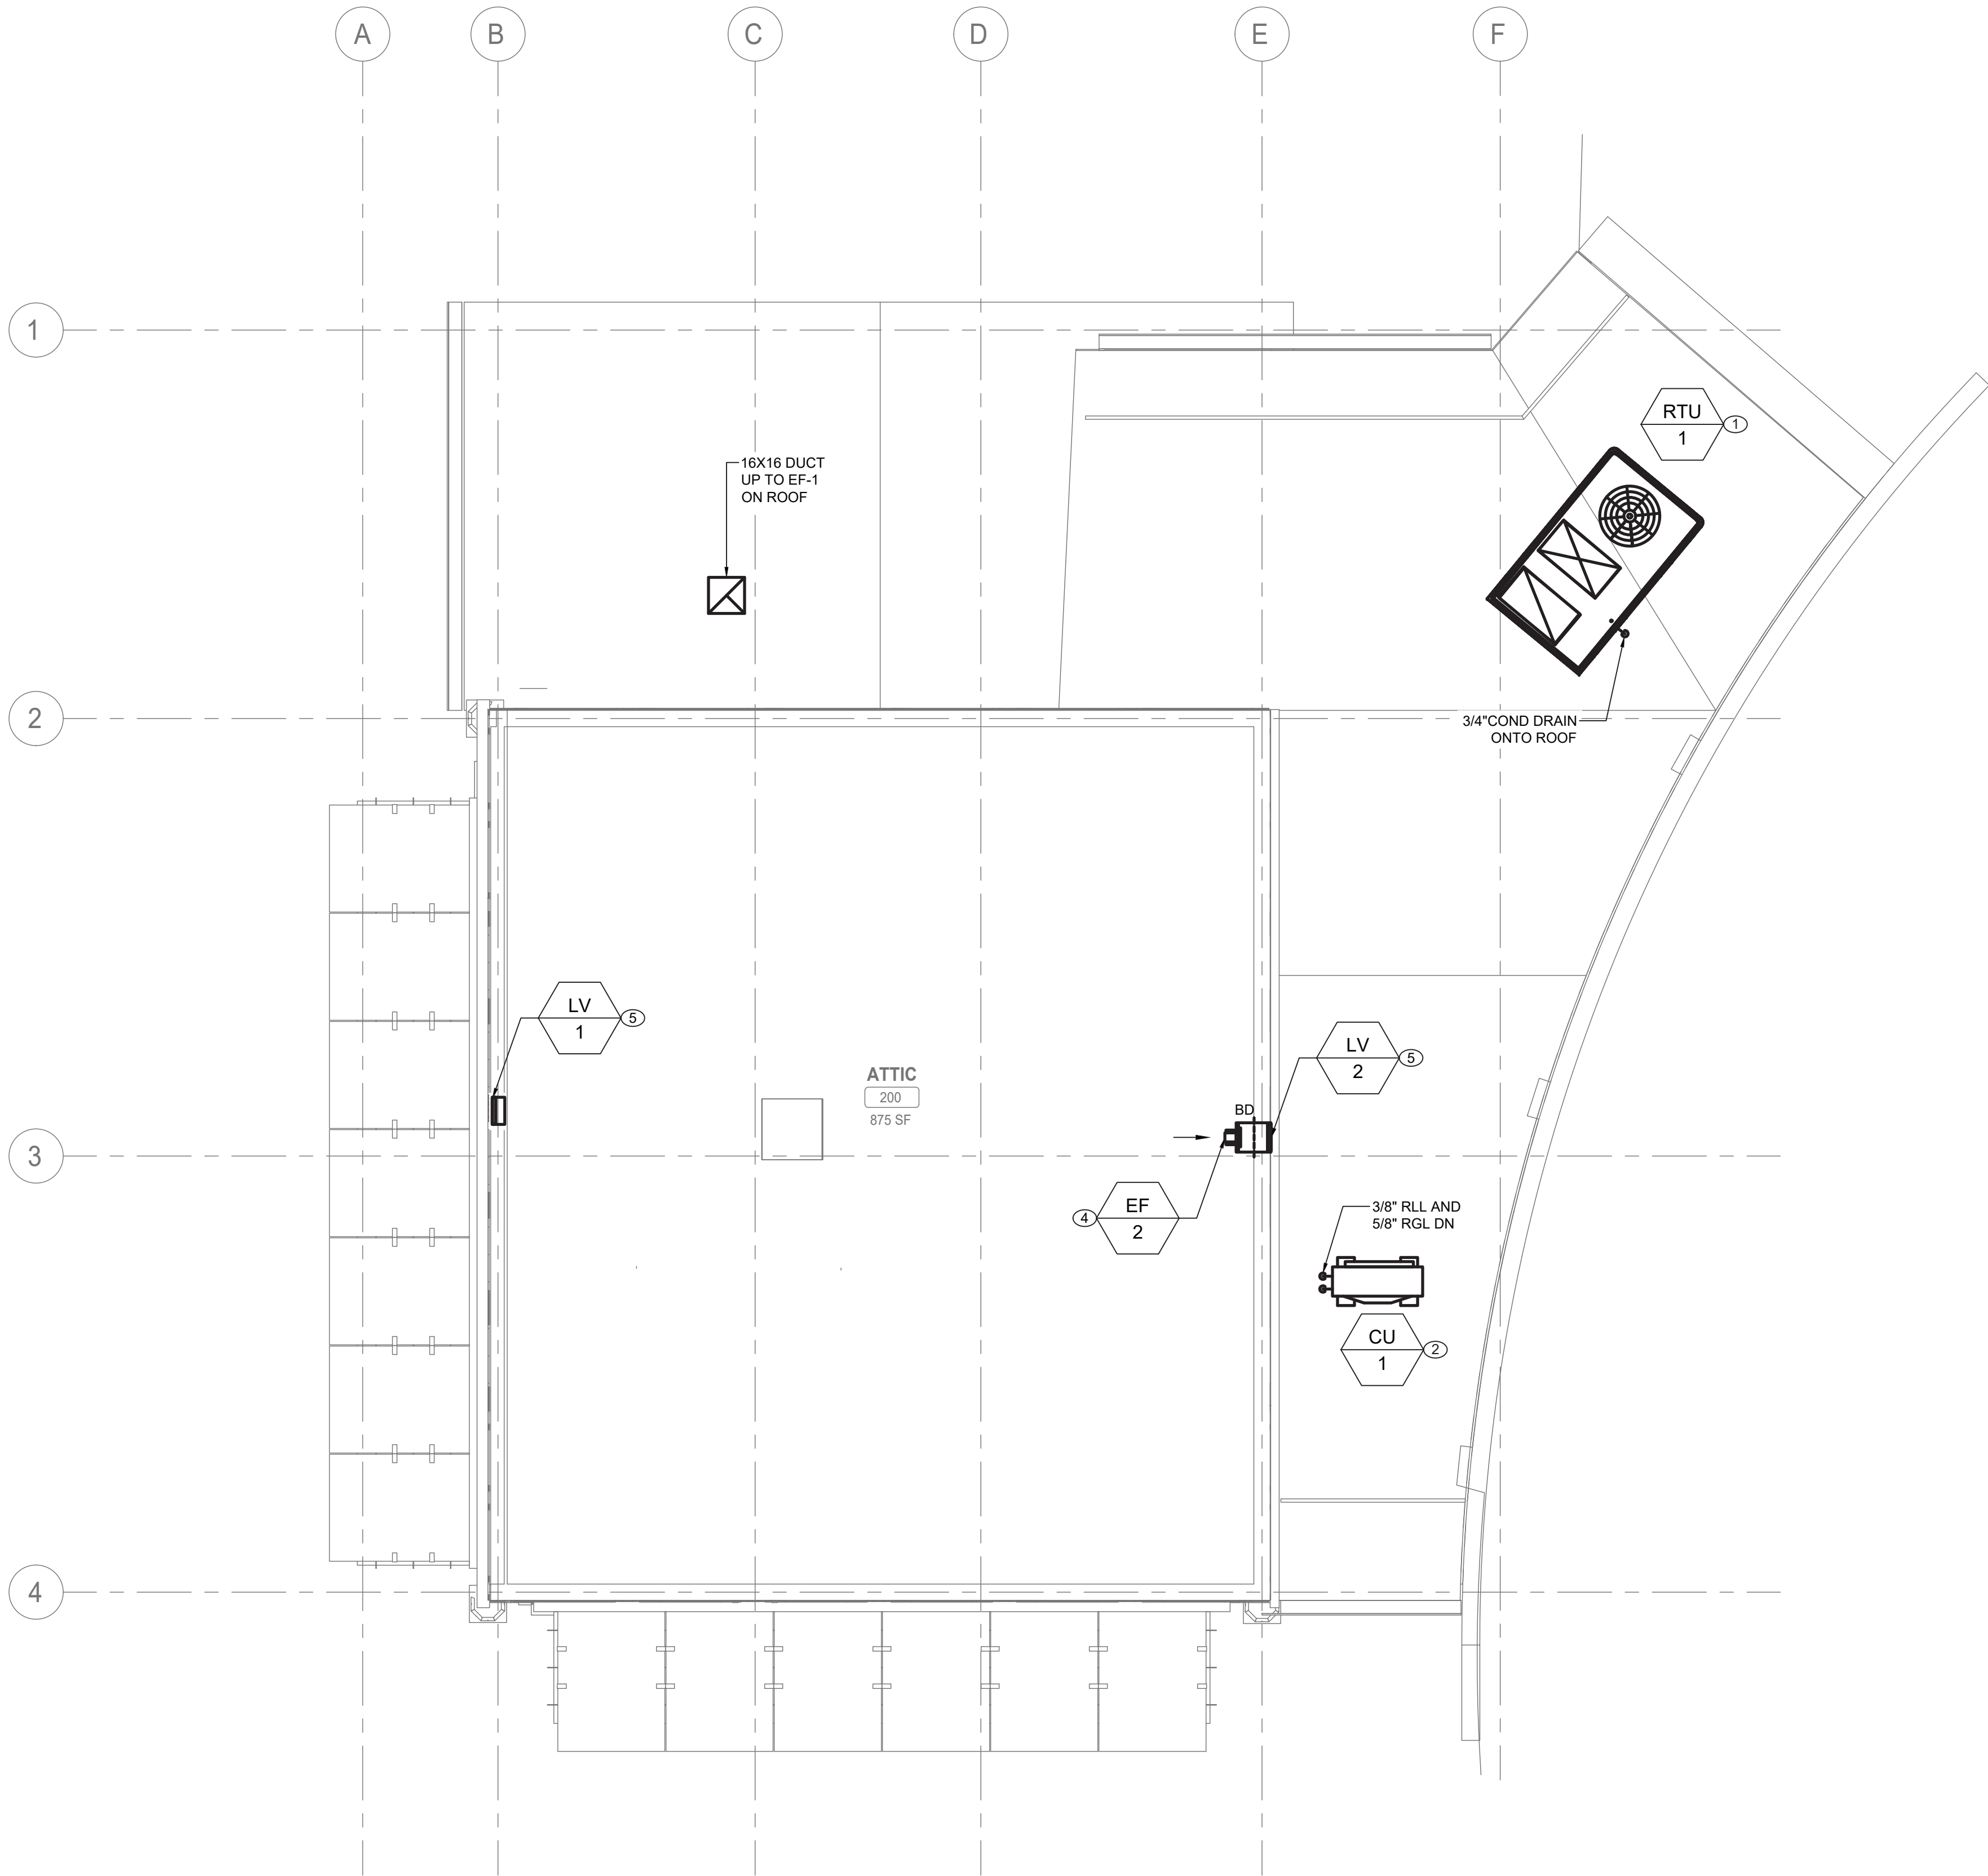

1 MECHANICAL ATTIC FLOOR CONSTRUCTION PLAN
SCALE: 1/4" = 1'-0"

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WESTCHESTER COUNTY, NEW YORK
DEPARTMENT OF PUBLIC WORKS AND TRANSPORTATION
DIVISION OF ENGINEERING

INFRASTRUCTURE REHABILITATION - PHASE 3
PLAYLAND PARK, RYE, NEW YORK
RESTAURANT KITCHEN WITH FOOD VENDING
MECHANICAL ATTIC FLOOR CONSTRUCTION PLAN

CONTRACT
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22-523

SHEET
NUMBER

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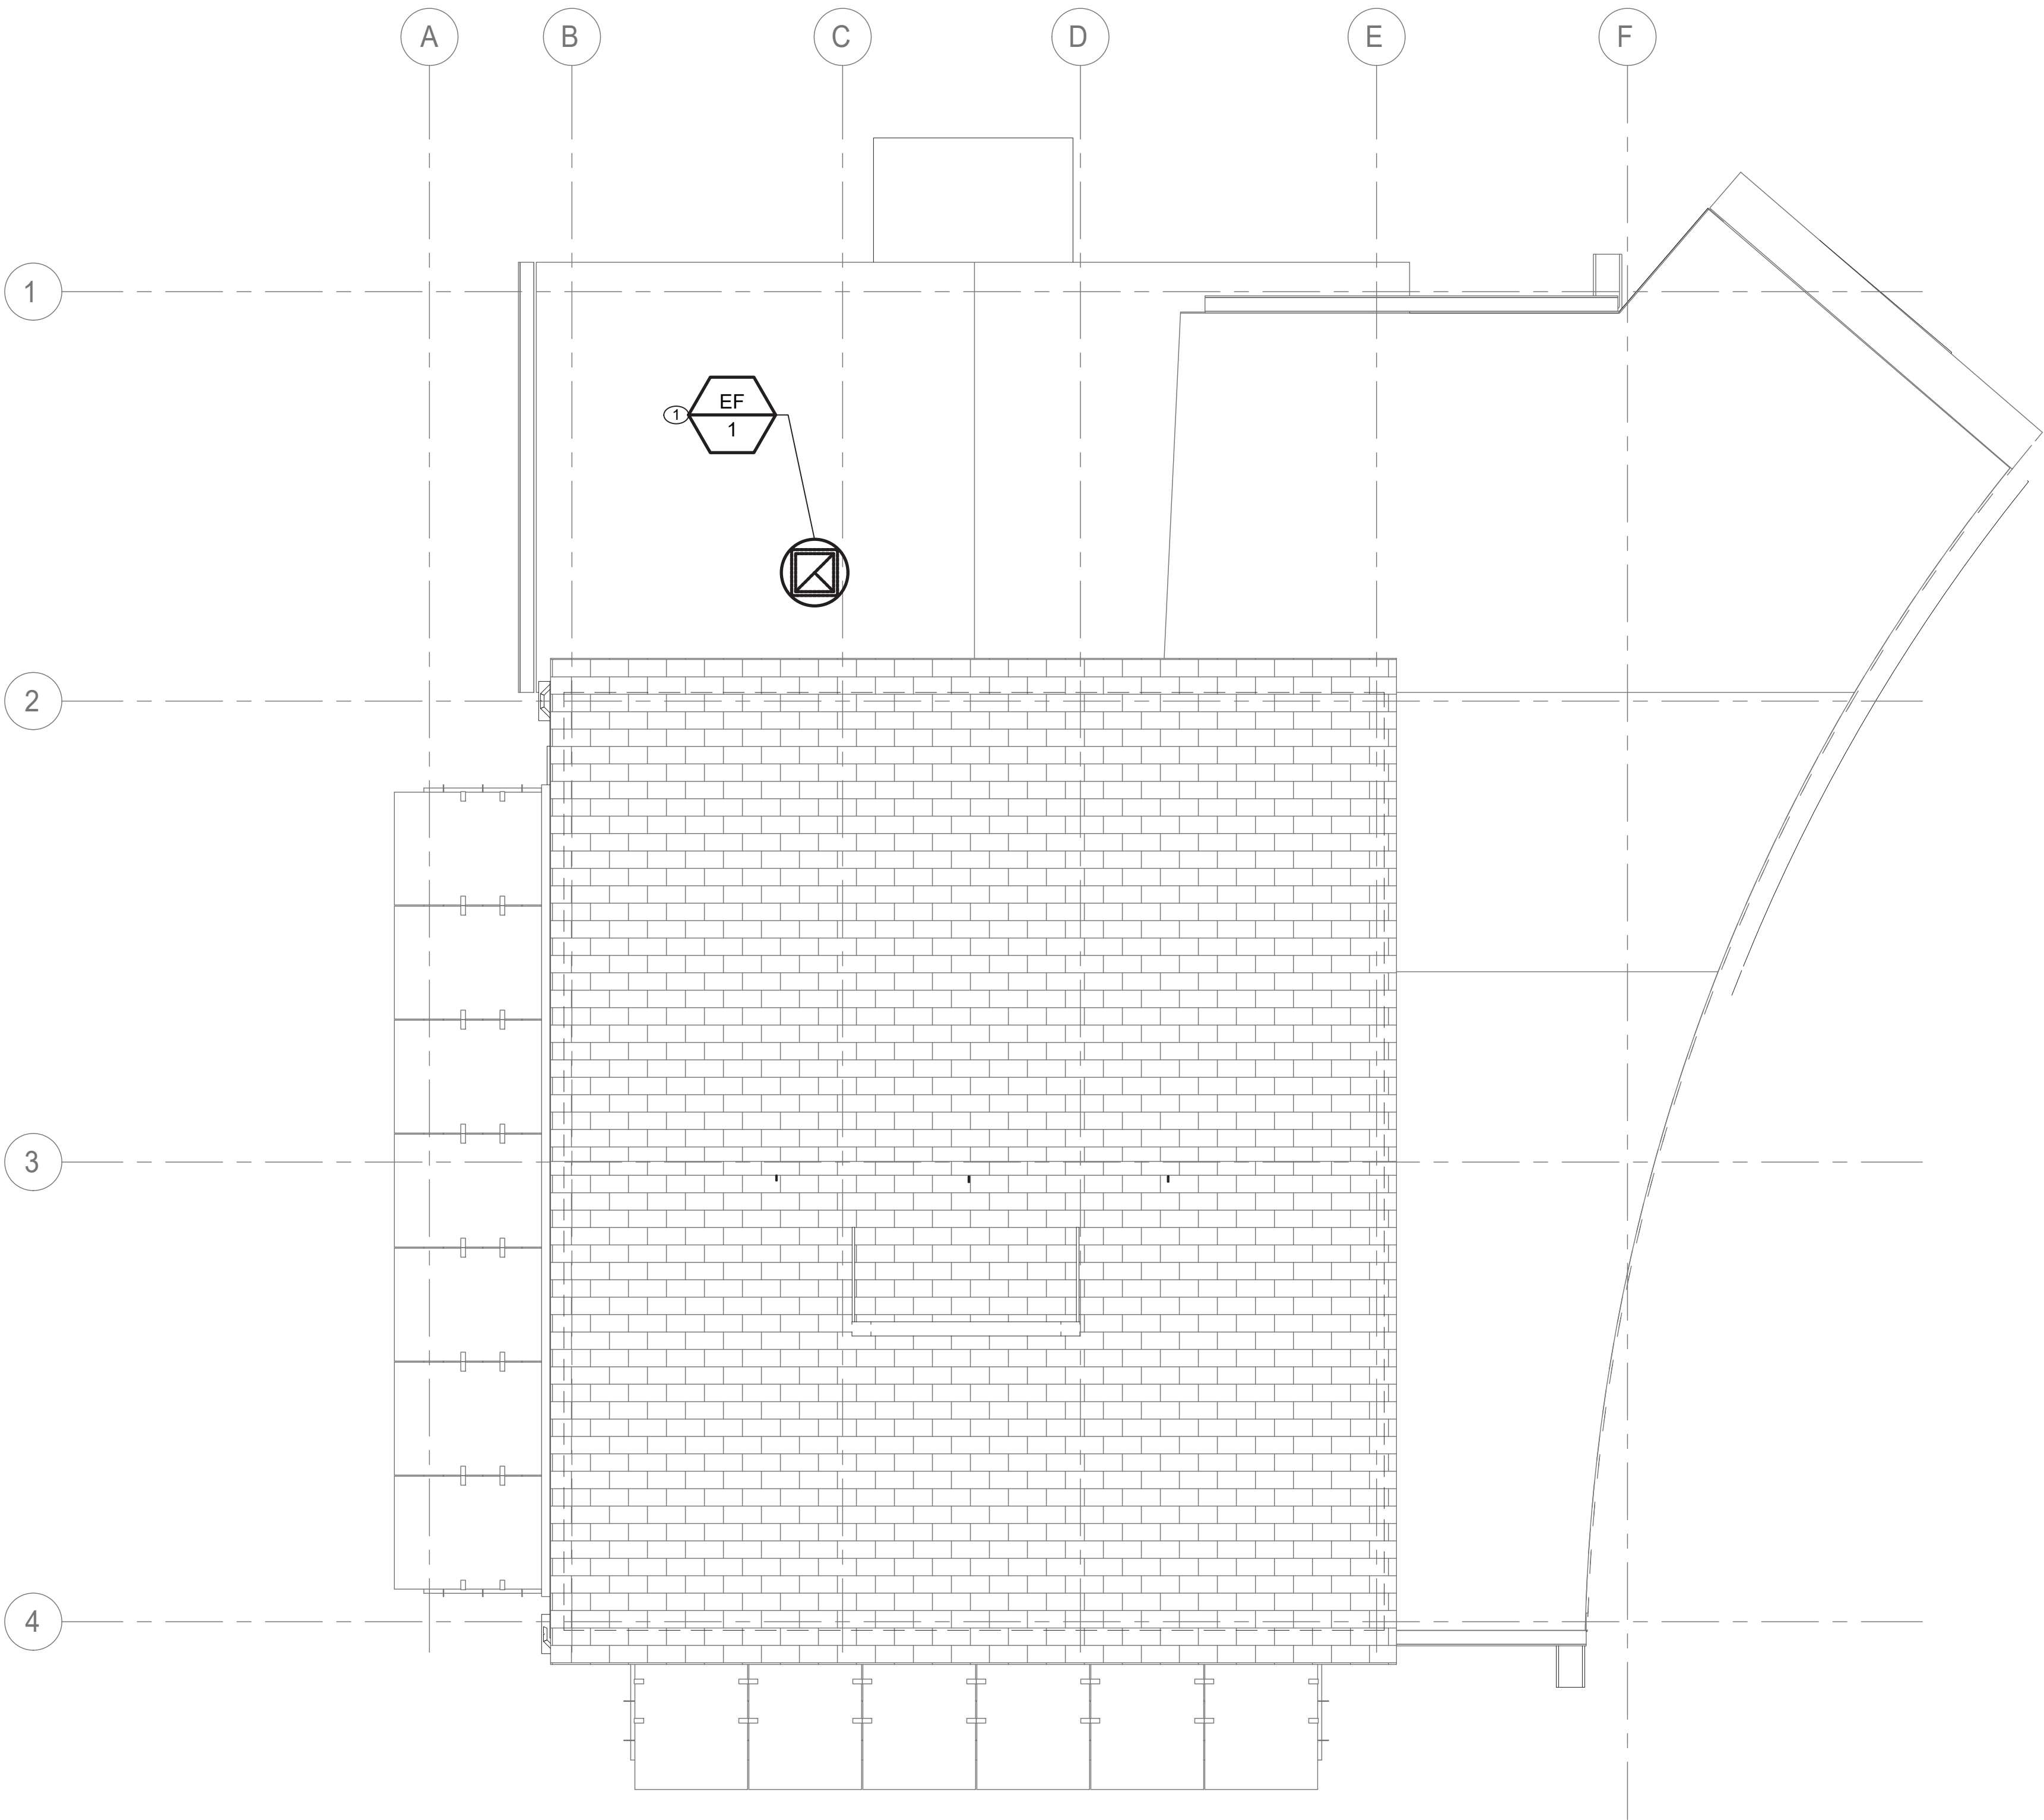
- GENERAL NOTES:
1.

CONTRACTOR TO COORDINATE WITH FACILITY WHEN WORKING AROUND OR ABOVE THE RIDE COMPONENTS, AND PROVIDE ALL NECESSARY MEASURES TO PROTECT THESE COMPONENTS PER THE REQUIREMENTS OF THE FACILITY.
2.

UPON COMPLETION, SYSTEM SHALL BE TESTED FOR PROPER OPERATION.

- MECHANICAL CONSTRUCTION NOTES:
- ①

PROVIDE NEW EXHAUST FAN AS SCHEDULED. COORDINATE ELECTRICAL POWER AND WIRING WITH ELECTRICAL DRAWINGS. ENSURE ALL WORK IMPACTING ROOF IS DONE IN ACCORDANCE WITH ROOFING MANUFACTURER WARRANTY.



1

MECHANICAL ROOF CONSTRUCTION PLAN

SCALE: 1/4" = 1'-0"

ROOFTOP AIR CONDITIONING UNIT SCHEDULE																															
TAG	MANUFACTURER	MODEL	LOCATION	NOM. CAP. (TONS)	MIN. OA (CFM)	MAX. OA (CFM)	SUPPLY FAN			FILTER		DX COOLING						HEATING		COMPRESSOR	CONDENSER			EER	ELECTRICAL			OPERATING WEIGHT (±LBS)	DIMENSIONS LxWxH (FT)	NOTES	
							AIR FLOW (CFM)	ESP (IN)	MOTOR BHP	TYPE	MER V	REFRIG TYPE	TOTAL CAP. (MBH)	SENSIBLE CAP. (MBH)	EAT DB (°F)	EAT WB (°F)	LAT DB (°F)	LAT WB (°F)	ELEC. KW	TOTAL CAP. (MBH)	TYPE/QTY	AMB. TEMP (°F)	FAN QTY		Kw	MCA	MOCp				V-PH-HZ
RTU-1	TRANE	THC092F3RNA	ROOF	7.5	1100	-	2400	0.50	0.55	2" PLEATED	13	R-410A	87.5	70.4	80.2	64.3	54.4	52.1	36.0	122.9	SCROLL/2	89	1	0.72	12.60	104	110	208-3-60	1228	7.4X4.4X3.9	1,2,3,4
NOTES:																															
1. PROVIDE DOWNFLOW SUPPLY AND RETURN UNIT CONFIGURATION, OVERSIZE SUPPLY FAN MOTOR, MOTORIZED OUTSIDE AIR DAMPER, NON-FUSED DISCONNECT, ECONOMIZER, ECONOMIZER HOOD, BAROMETRIC RELIEF HOOD AND 14" ROOF CURB.																															
2. FACTORY CONTROLS TO BE PROVIDED BY MANUFACTURER.																															
3. PROVIDE WITH MERV 13 FILTERS AND OPTION FOR UV LIGHT FILTRATION KIT.																															
4. PROVIDE DIGITAL CONTROLLER WITH DISPLAY CAPABLE OF DEMAND CONTROL VENTILATION AND ECONOMIZER MODE. CONTRACTOR TO PROVIDE TRANSFORMER AND POWER AS REQUIRED.																															

DUCTLESS SPLIT SYSTEM HEAT PUMP SCHEDULE															
UNIT TAG (INDOOR)	ASSOCIATED OUTDOOR UNIT	MANUFACTURER	MODEL	LOCATION/SERVICE	REFRIGERANT	SUPPLY FAN	COOLING		HEATING		ELECTRICAL			WEIGHT	NOTES
						CFM	TOTAL/SENS. (MBH)	EAT DB/WB	MBH	EAT/LAT DB	V.-PH.-CY.	MCA	MOCP		
AC-1	CU-1	MITSUBISHI	PLFY-P18NFMU-E	SEASONAL FOOD SERVICE	R410A	460	18.0/18.0	81/66	20.0	68/90	208-1-60	0.50	15	31.3	1,2,3,4
AC-2	CU-1	MITSUBISHI	PLFY-P18NFMU-E	SEASONAL FOOD SERVICE	R410A	460	18.0/18.0	81/66	20.0	68/90	208-1-60	0.50	15	31.3	1,2,3,4
NOTES:															
1. UNIT CAPACITY INDICATED AS SIZING CRITERIA.															
2. PROVIDE UNIT WITH WIRED WALL MOUNTED THERMOSTAT.															
3. PROVIDE ALL INDOOR UNIT WITH INTREGATED CONDENSATE PUMP															
4. INSTALL AND SIZE REFRIGERANT PIPING PER MANUFACTURER'S SPECIFICATION.															



DUCTLESS SPLIT SYSTEM HEAT PUMP CONDENSING UNIT SCHEDULE												
UNIT TAG (OUTDOOR)	MANUFACTURER	MODEL	NOMINAL COOLING (BTU/HR)	NOMINAL HEATING (BTU/HR)	SERVICE	SEER	COP	V.-PH.-CY.	MCA	MOCP	WEIGHT	NOTES
CU-1	MITSUBISHI	PUMY-P36NKMU3-BS	36000	42000	SEASONAL FOOD SERVICE	22.3	4	208-1-60	29.0	44.0	271.0	1,2
NOTES:												
1. UNIT CAPACITY INDICATED AS SIZING CRITERIA.												
2. PROVIDE UNIT WITH 16" ROOF STAND.												

FAN SCHEDULE															
TAG	MANUFACTURER	MODEL	LOCATION	SERVICE	TYPE	DRIVE	AIR FLOW (CFM)	TSP (IN. WG)	ELECTRICAL				OPERATING WEIGHT (±LBS)	DIMENSIONS DxH (IN)	NOTES
									HP	BHP	RPM	V-PH-HZ			
EF-1	GREENHECK	G-130-VG	ROOF	KITCHEN / TRASH RM	CENTRIFUGAL	DIRECT	1100	0.25	0.25	0.09	906	115-1-60	24	19x19	1,2,3,4,5
EF-2	GREENHECK	SE1-8-440-VG	ATTIC	ATTIC	AXIAL	DIRECT	50	0.05	0.07	0.00	638	115-1-60	16	13X13	1,2,3,4,6
NOTES:															
1. PROVIDE ALL CONTACTS, RELAYS, AND DEVICES NECESSARY FOR BMS CONTROL OF FANS PER SEQUENCE OF OPERATIONS.															
2. PROVIDE THERMAL OVERLOAD FOR ALL SINGLE PHASE MOTORS.															
3. PROVIDE SALT WATER RESISTANT HI-PRO POLYESTER COATING FOR ALL FANS.															
4. FAN SHALL BE FURNISHED WITH NON FUSED DISCONNECT.															
5. PROVIDE 12" ROOF CURBS FOR ALL ROOF MOUNTED FANS. INCLUDE 1.5" INSULATION ON CURB.															
6. PROVIDE WALL HOUSING.															


ELECTRIC UNIT HEATER SCHEDULE								
TAG	MANUFACTURER	MODEL	SERVICE	TYPE	KW	AMPS	V-PH-HZ	NOTES
UH-1	TRANE	UHEC-031A0C0	WATER SERVICES RM	WALL HUNG	3.3	15.9	208-1-60	1
UH-2	TRANE	UHEC051AACA	KITCHEN	WALL HUNG	5	24.1	208-1-60	1
UH-3	TRANE	UHEC051AACA	KITCHEN	WALL HUNG	5	24.1	208-1-60	1
NOTES:								
1. PROVIDE UNIT MOUNTED 2 STAGE THERMOSTAT.								

LOUVER SCHEDULE												
TAG	MANUFACTURER	MODEL	SERVICE	LOCATION	MATERIAL	FINISH TYPE	WIDTH (INCH)	HEIGHT (INCH)	FREE AIR VELOCITY (FFM)	PRESSURE DROP (IN. WG)	MINIMUM FREE AREA (SQUARE FEET)	NOTES
LV-1	GREENHECK	ESD-635	EXHAUST	ATTIC	ALUMINUM	BAKED ENAMEL	12	12	-	-	0.19	2
LV-2	GREENHECK	ESD-635	EXHAUST	ATTIC	ALUMINUM	BAKED ENAMEL	12	12	263	0.05	0.19	1
NOTES:												
1. PROVIDE WITH ALUMINUM BIRD SCREEN AND BACKDRAFT DAMPERS.												
2. PROVIDE WITH ALUMINUM BIRD SCREEN ONLY.												

AIR INLET / OUTLET SCHEDULE											
TAG	MANUFACTURER	MODEL	SERVICE	NECK SIZE (IN)	FACE SIZE (IN)	MOUNTING	CFM	MAX PD (wg)	MAX VELOCITY	MAX NC	NOTES
SD-1	TITUS	TMS	GENERAL SUPPLY	12	24x24	LAY-IN / GYP	321-425	0.10	600	30	1, 2, 3
RD-1	TITUS	50F	GENERAL RETURN	14X14	24x24	LAY-IN / GYP	528-732	0.05	600	30	1, 3
ED-1	TITUS	50F	GENERAL EXHAUST	6X6	24X24	LAY-IN / GYP	0-95	0.05	600	30	1, 3
ED-2	TITUS	50F	GENERAL EXHAUST	16X16	24X24	LAY-IN / GYP	732-972	0.50	600	30	1, 3
TG-1	TITUS	SG-LFF	TRANSFER	-	6X6	WALL MOUNTED	70	0.03	400	-	1
NOTES:											
1. COORDINATE AND CONFIRM CEILING AND/OR WALL MOUNT (T-BAR, SURFACE, REINFORCEMENT, ETC) WITH ARCHITECTURAL RCP AND WALL CONSTRUCTION BEFORE ORDERING.											
2. PROVIDE WITH MOLDED INSULATION BLANKET.											
3. INTEGRAL VOLUME DAMPERS NOT ACCEPTABLE. VOLUME DAMPERS PROVIDED BY MECHANICAL CONTRACTOR ON ALL RUN-OUTS. EXCEPTIONS REQUIRE APPROVAL WHEN REQUIRED.											


<div>CONSULTANT INFORMATION</div> <div> LiRo Engineers, Inc. <i>A LiRo Group Company</i> Syosset, N.Y. 516-214-8157[T]</div>	<div>CONSULTANT SEAL</div> <div></div>					RECORD DRAWING CERTIFICATION				WESTCHESTER COUNTY, NEW YORK DEPARTMENT OF PUBLIC WORKS AND TRANSPORTATION DIVISION OF ENGINEERING		CONTRACT NUMBER 22-523	SHEET NUMBER K-M-81
						<input type="checkbox"/> AS BUILT – CHANGES AS NOTED <input type="checkbox"/> AS BUILT – NO CHANGES						DWG. NO.: 555 of 664	
						CONTRACTOR				PROJECT COORDINATOR		SCALE: AS INDICATED	
						NAME _____ SIGNATURE _____ TITLE _____ DATE _____				NAME _____ SIGNATURE _____ TITLE _____ DATE _____		DATE: 08/23/2022	
		REVISION NUMBER	DATE	MADE BY	APP'D BY	REVISION						DPW FILE NUMBER 1-118-M-1304-0	REV. NO. 0



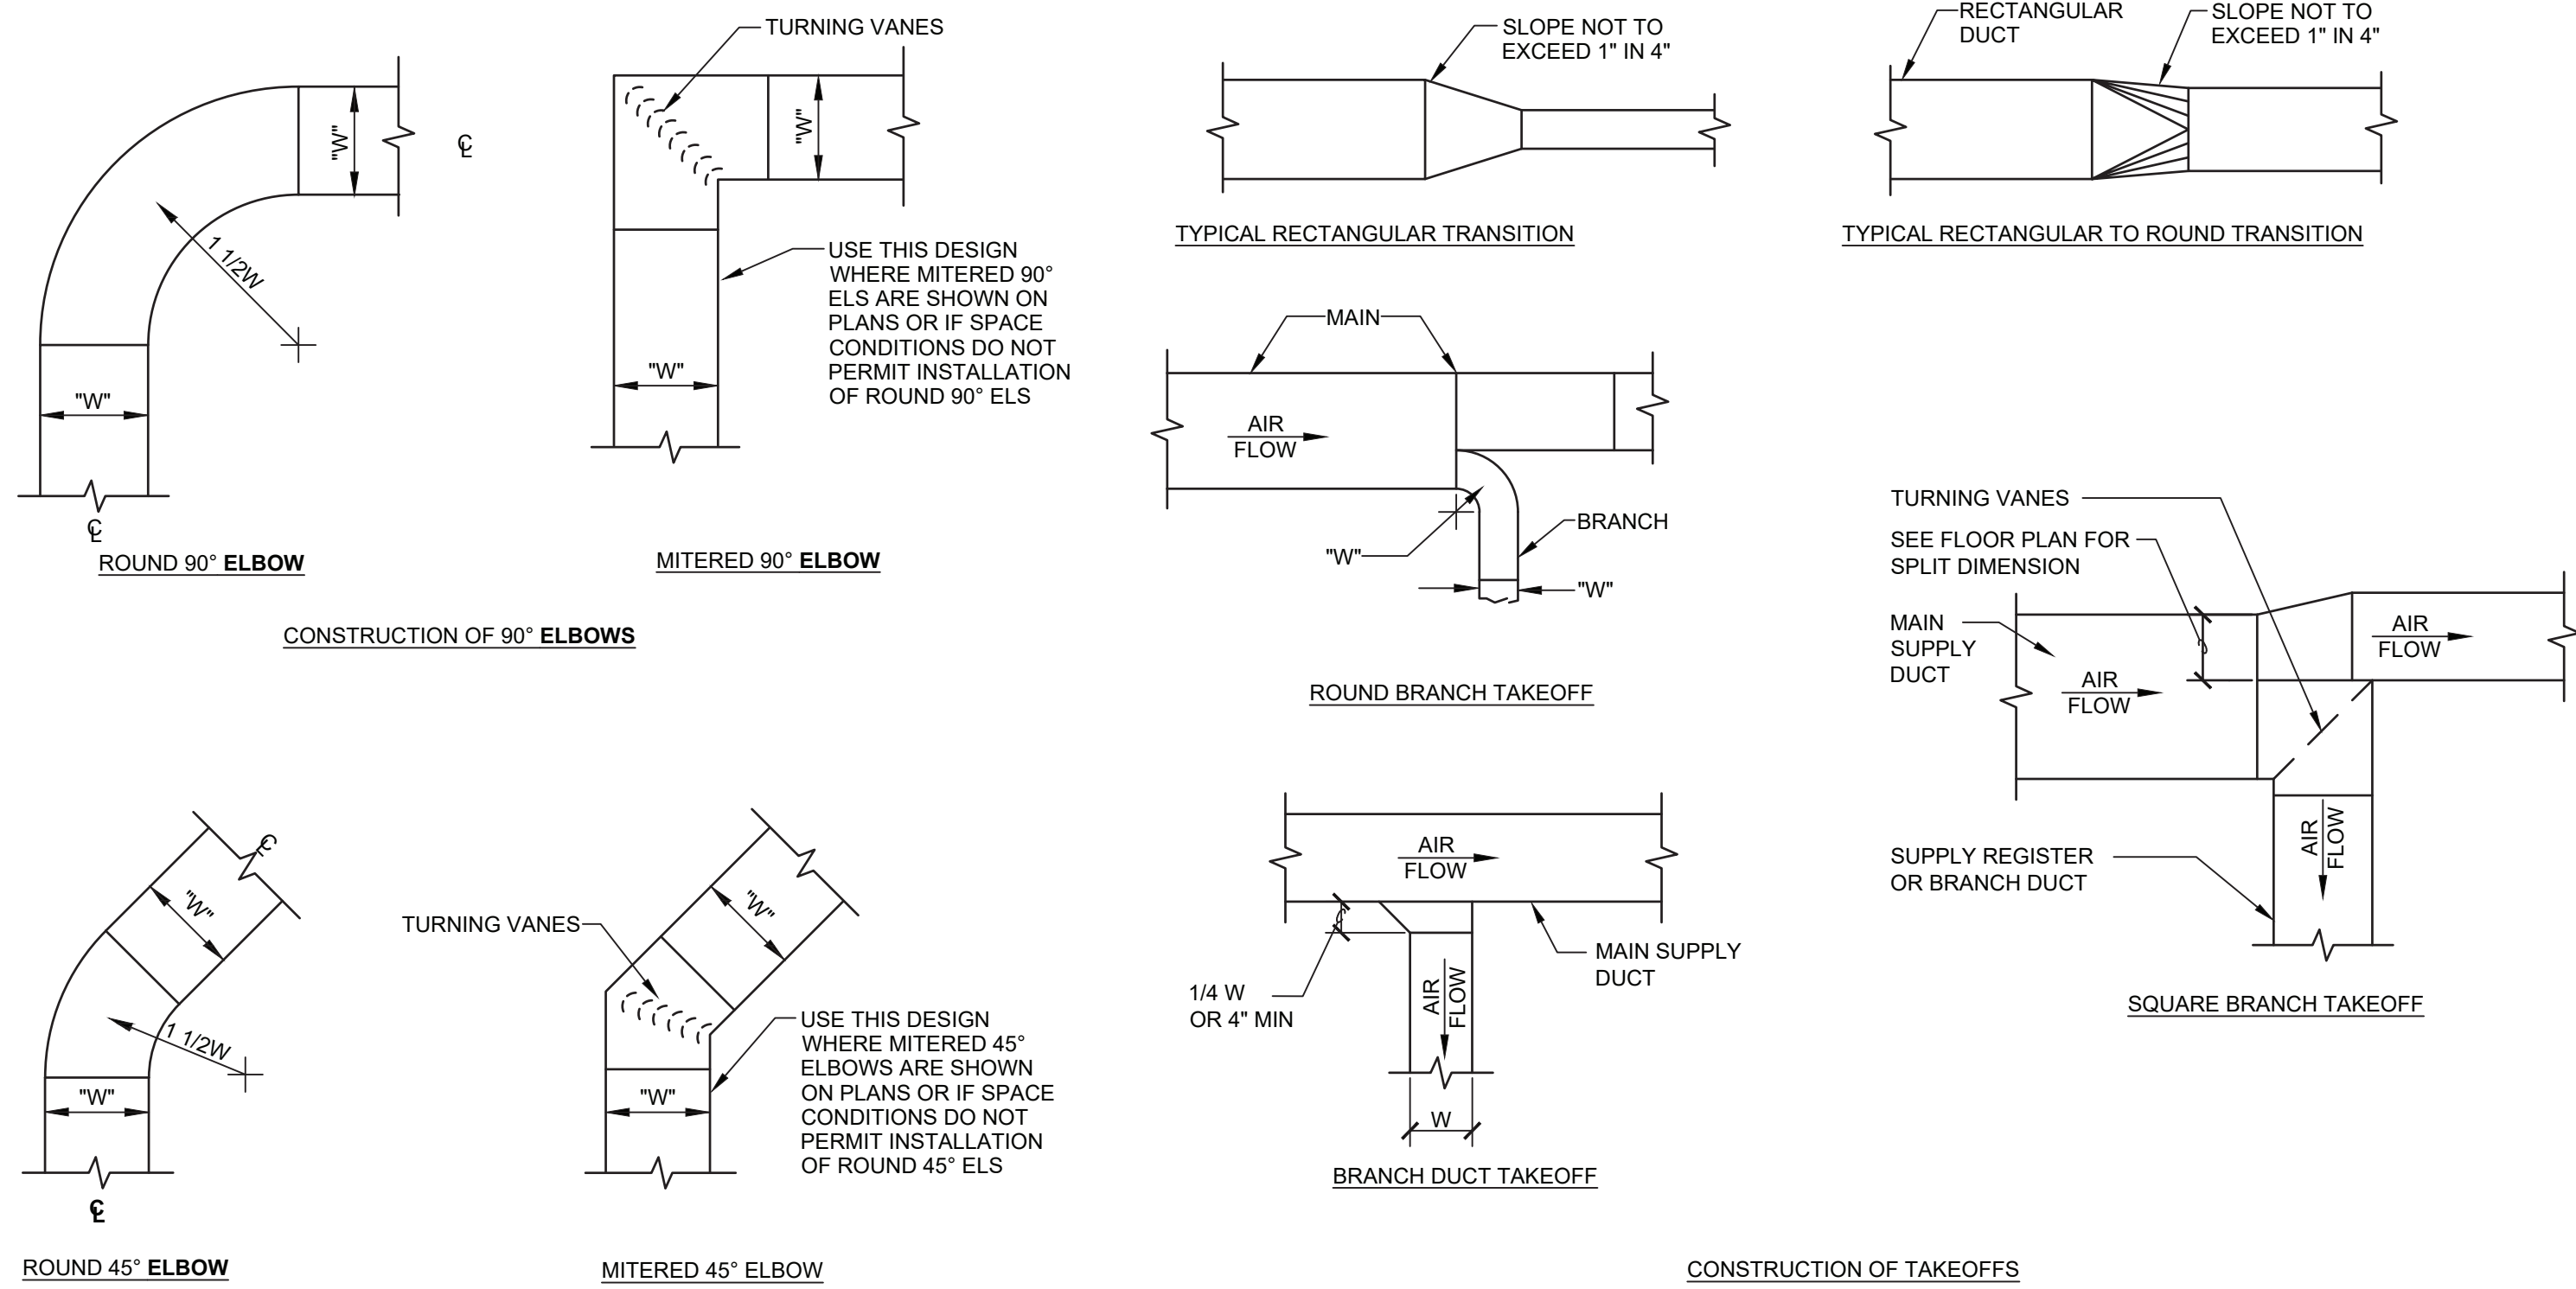


INSTALLATION NOTES:


- ALL DUCT TRANSITIONS SHALL BE CONSTRUCTED AND INSTALLED AS DETAILED BY SMACNA.
- ALL DUCTS SHALL BE CONSTRUCTED AND ERECTED IN A NEAT AND WORKABLE MANNER.
- DUCTS SHALL BE CONSTRUCTED OF THE WEIGHTS, GAUGES AND MATERIAL SPECIFIED.
- THE DIMENSION SHOWN FOR ALL DUCTS SHOWN IN PLAN GIVE THE WIDTH FIRST AND THEN THE HEIGHT.
- DUCT RISERS SHOULD BE SUPPORTED BY ANGLES AT EVERY FLOOR.
- AIR TURN SHALL BE INSTALLED IN ALL ABRUPT ELBOWS TO PREVENT TURBULENCE.
- DUCTS SHALL BE SECURELY ATTACHED TO THE BUILDING CONSTRUCTION IN AN APPROVED MANNER.
- DIVERGING TRANSITION PIECES SHALL BE MADE AS GRADUAL AS POSSIBLE.
- INSTALL FIRE DAMPERS IN ACCORDANCE WITH UL 555.
- ACCESS PANELS SHOULD BE PLACED BEFORE AND/OR AFTER EQUIPMENT INSTALLED IN THE DUCT.
- DUCT AREA SHOULD NOT BE DECREASED MORE THAN 10 PERCENT WHEN OBSTRUCTIONS CANNOT BE AVOIDED, AND THEN A STREAMLINED FITTING SHOULD BE USED.
- FLEXIBLE FABRIC CONNECTIONS (OR EQUAL) SHOULD BE USED ON BOTH INLETS AND OUTLETS OF ALL FANS AND AIR HANDLING UNIT.
- JOINTS AND SEAMS OF SUPPLY DUCTS SHALL BE FASTENED SECURELY AND MADE AIR TIGHT.
- VANES SHORTER THAN 36" SHALL BE SINGLE WALL, WITH A 2" RADIUS AND 1 1/2" SPACING. VANES LARGER THAN 36" AND SHORTER THAN 48" SHALL BE DOUBLE WALL, WITH A 2" OUTER RADIUS, 1" INNER RADIUS, AND 2 1/8" SPACING. VANES LONGER THAN 48" SHALL BE DOUBLE WALL, WITH A 4 1/2" OUTER RADIUS, 2 1/4" INNER RADIUS, AND 3 1/4" SPACING. NO TURNING VANES SHALL INCLUDE A TRAILING EDGE.

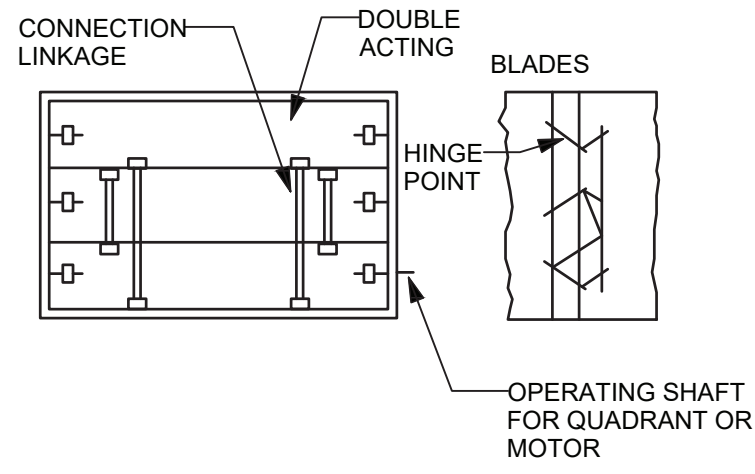


1 MECHANICAL DUCT CONSTRUCTION DETAIL
M-82 SCALE: NOT TO SCALE

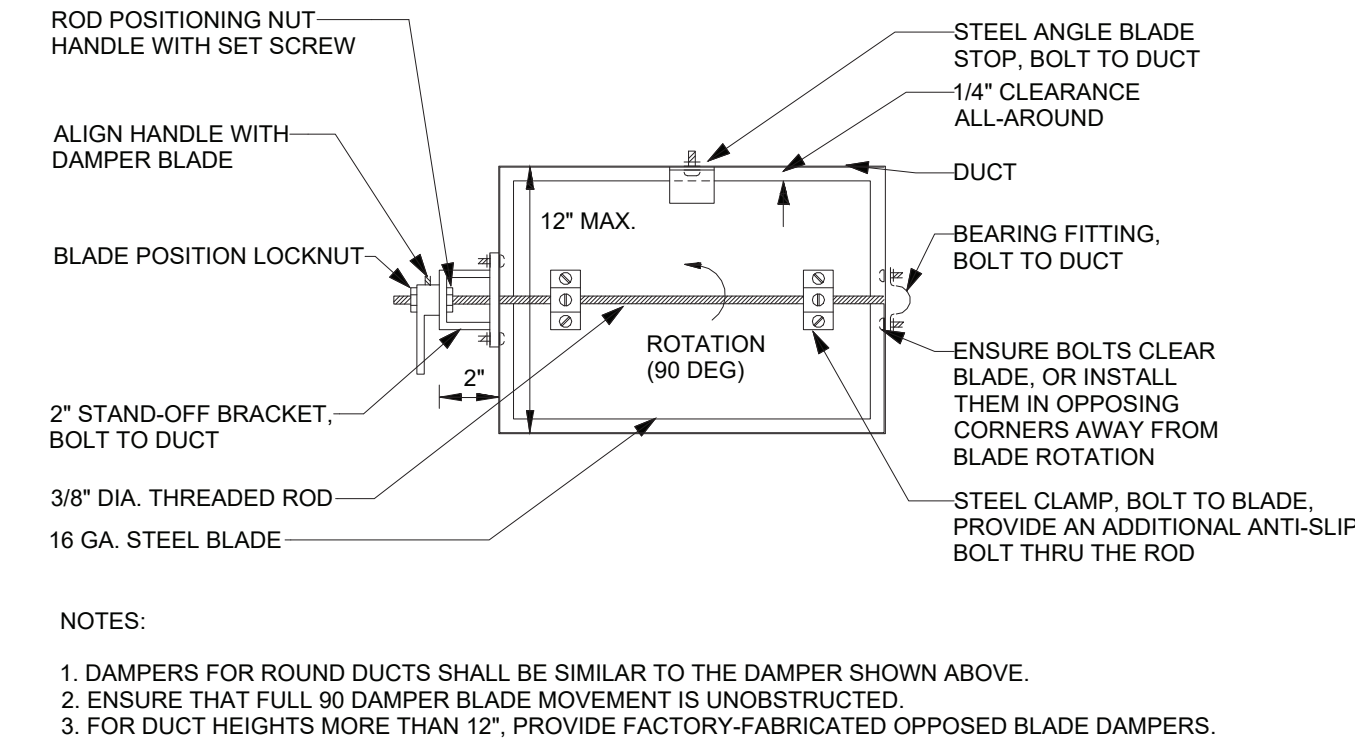


3 MECHANICAL VOLUME DAMPER DETAIL
M-82 SCALE: NOT TO SCALE

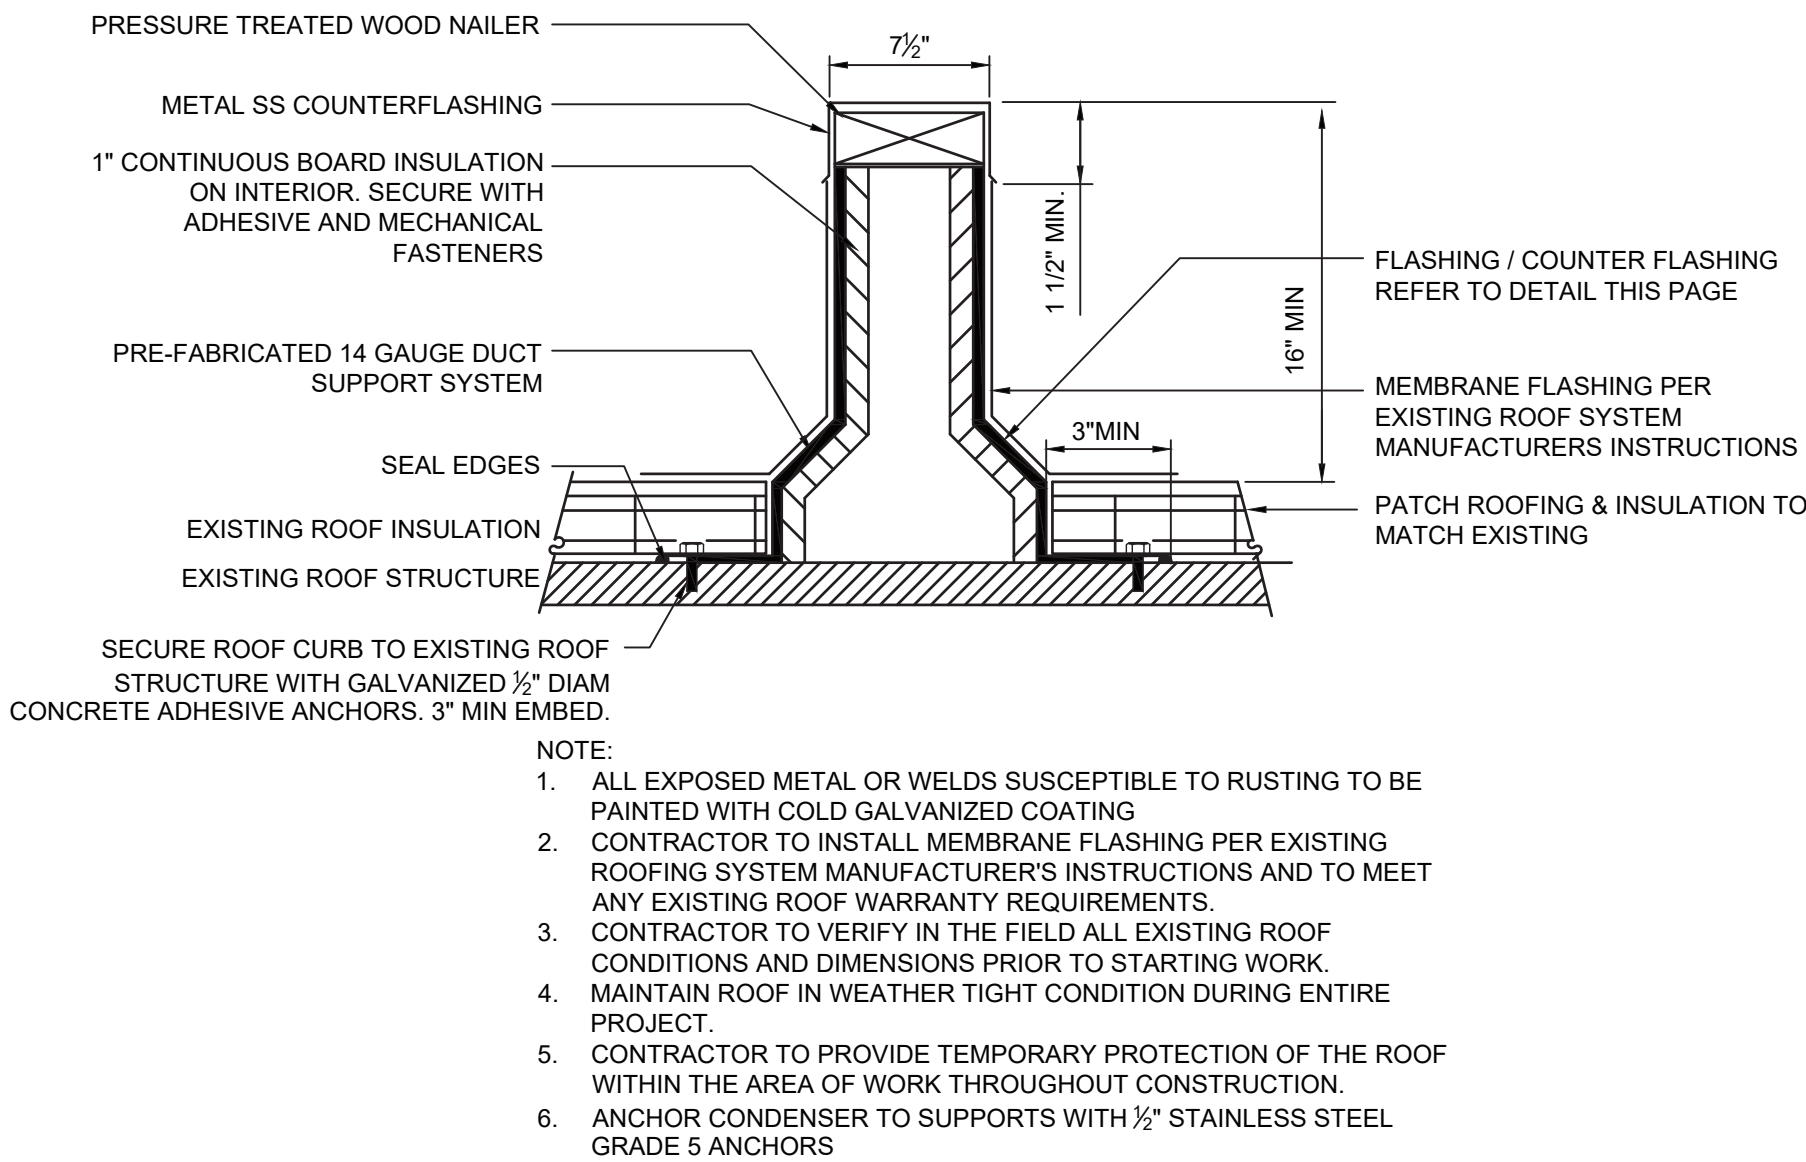

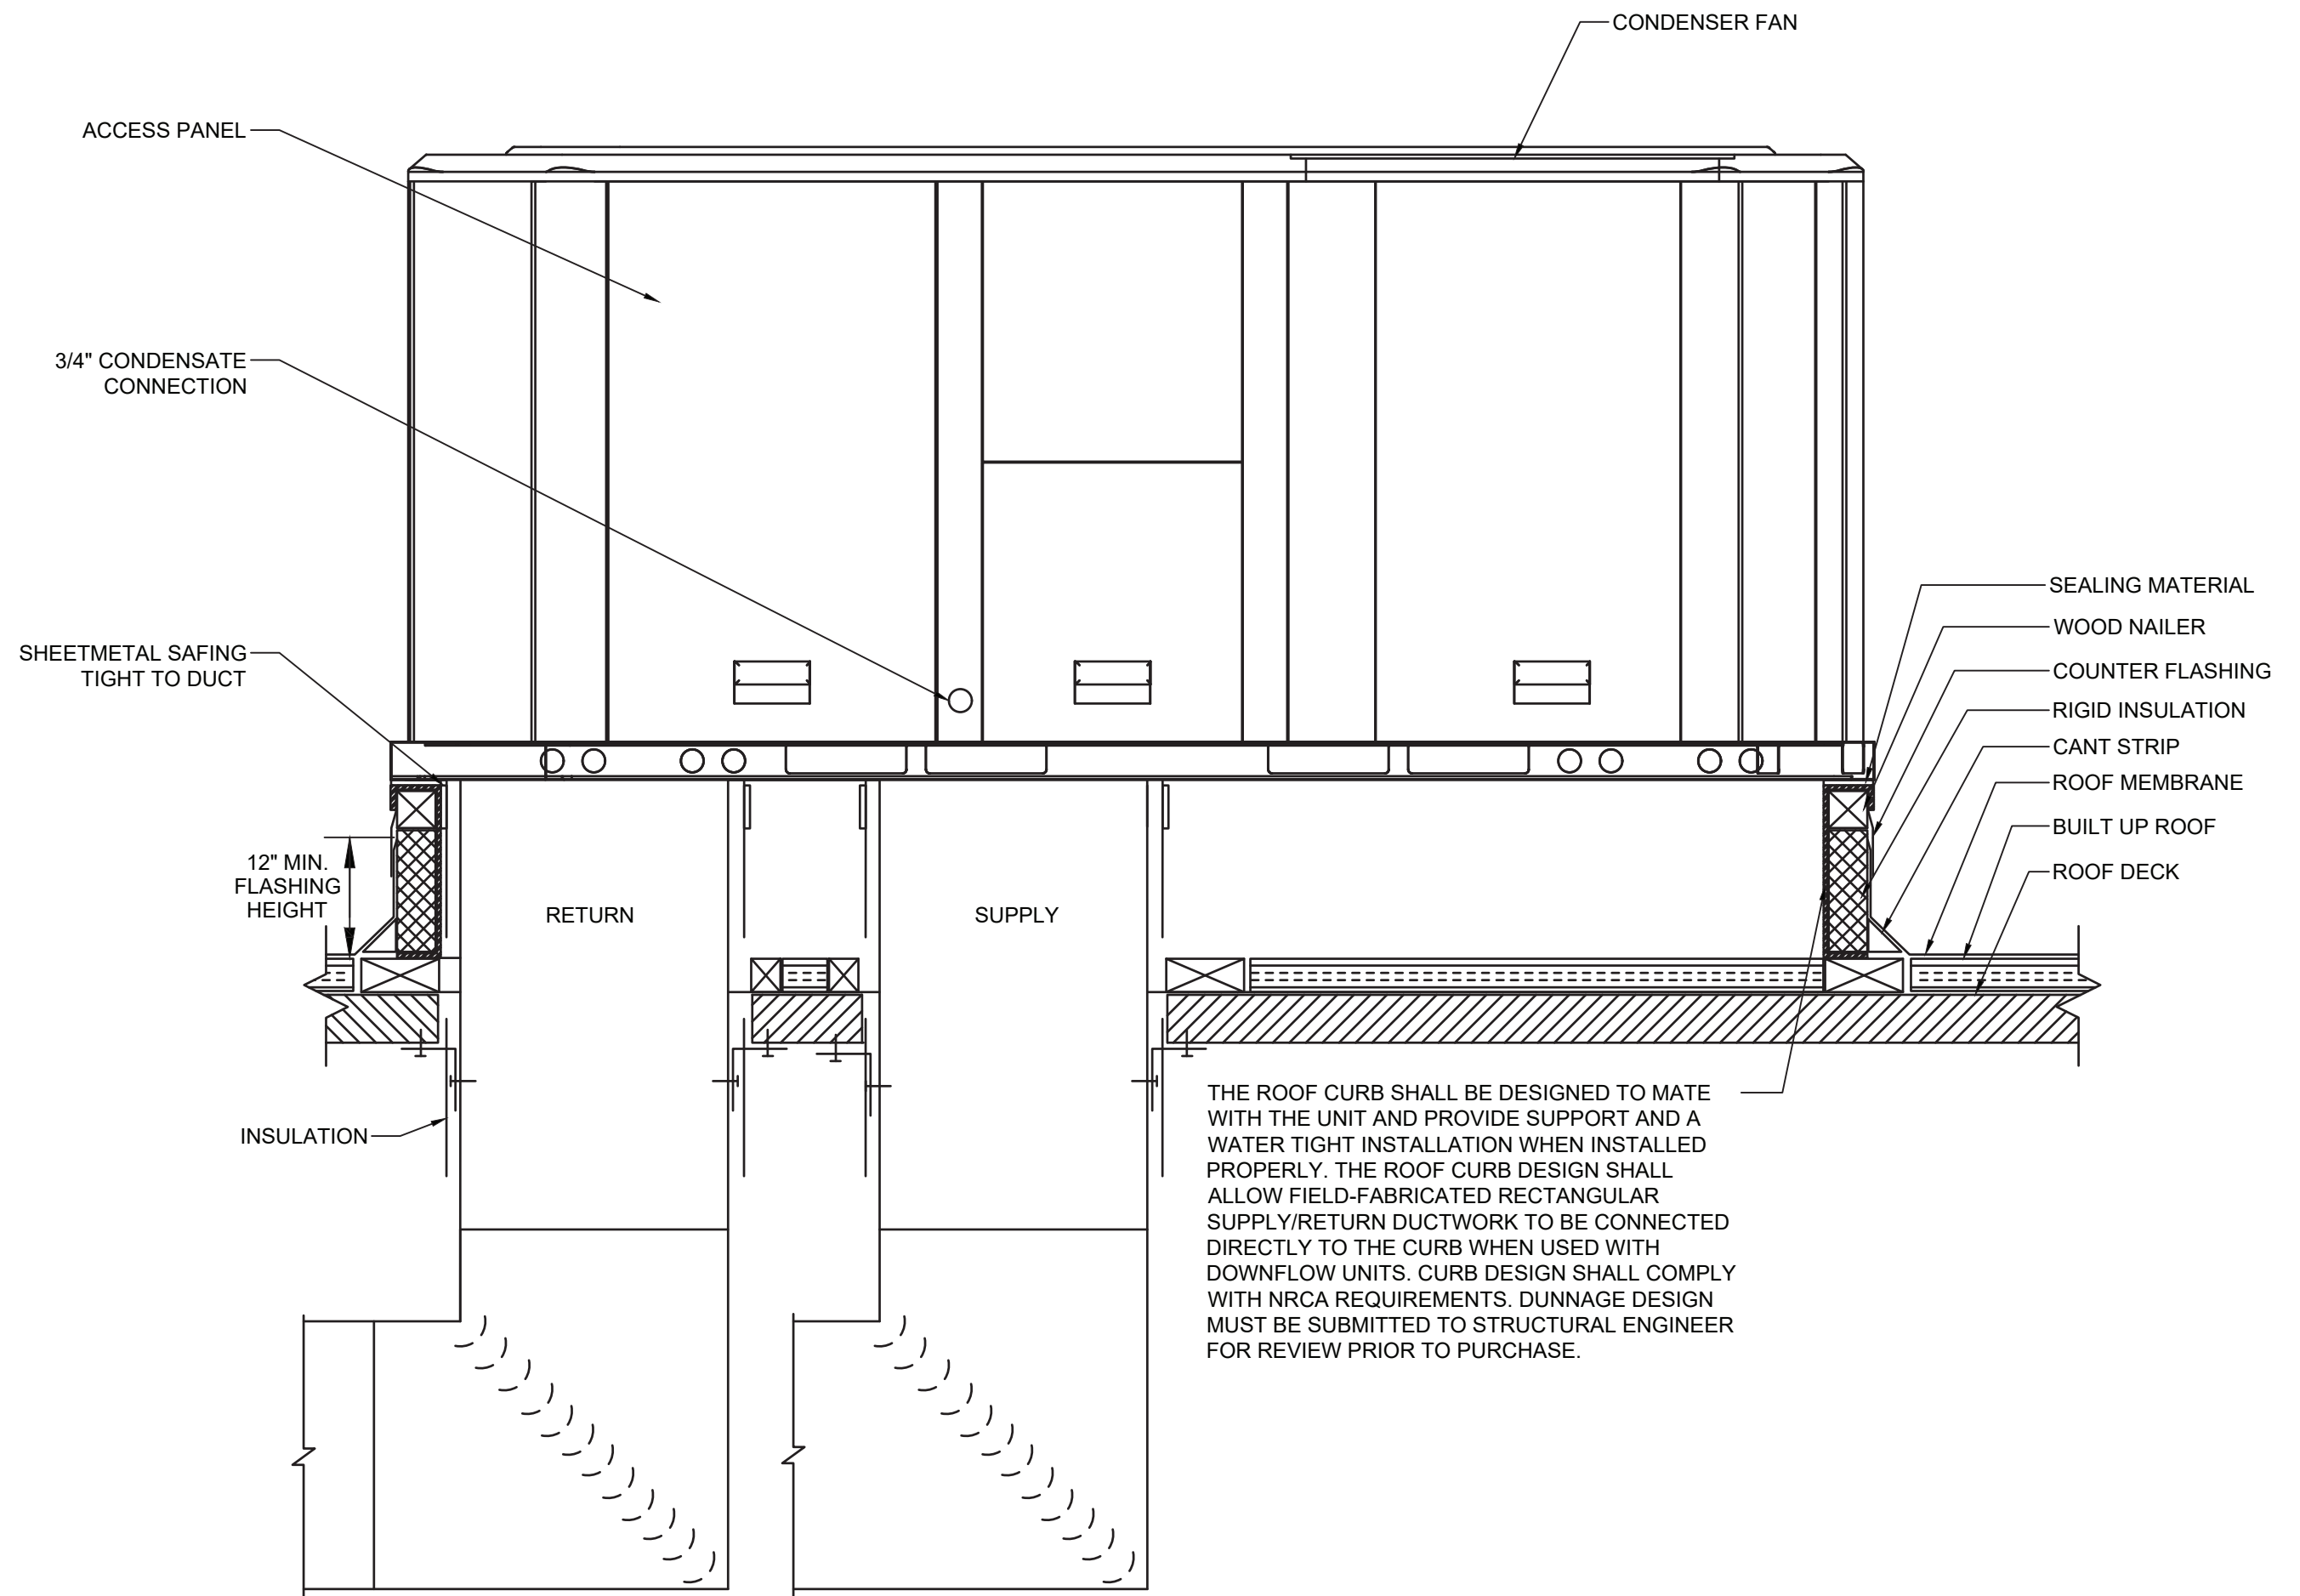

4 MECHANICAL EQUIP RAILS DETAIL
M-81 SCALE: NOT TO SCALE

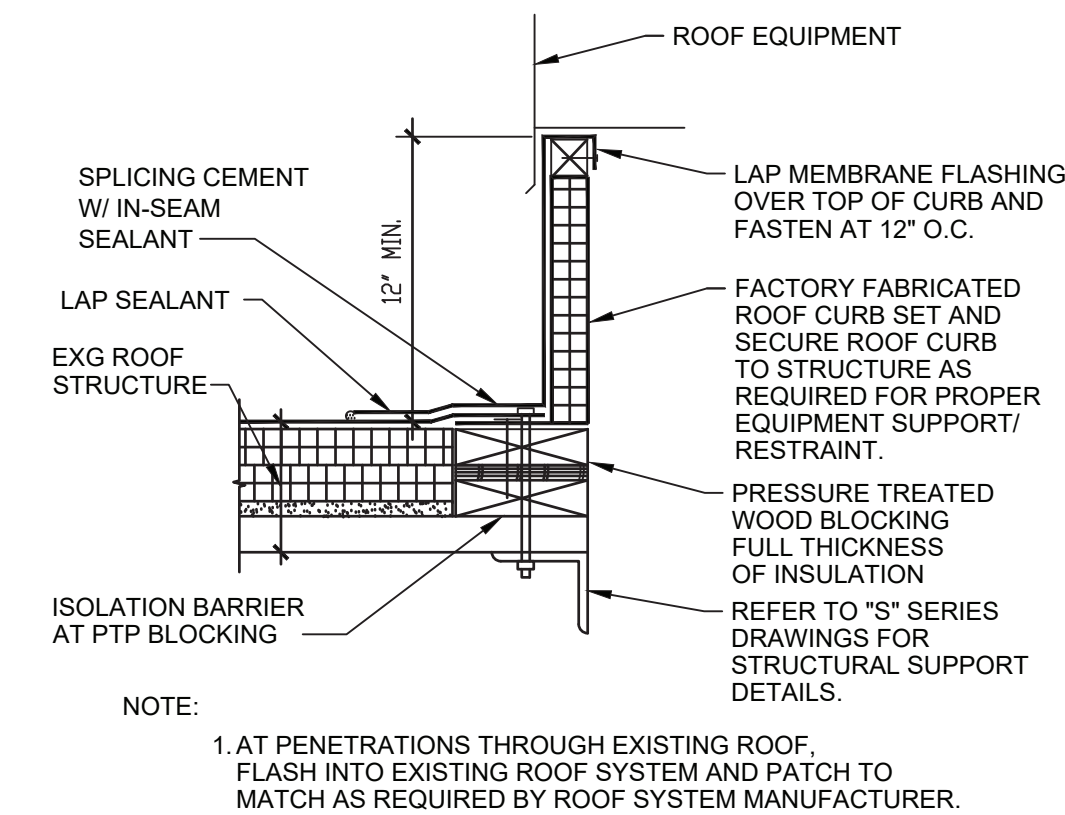


2 ROOF TOP UNIT (RTU) DETAIL
M-82 SCALE: NOT TO SCALE



5 ROOF CURB DETAIL
M-82 SCALE: NOT TO SCALE

CONSULTANT INFORMATION		CONSULTANT SEAL				RECORD DRAWING CERTIFICATION		WESTCHESTER COUNTY, NEW YORK DEPARTMENT OF PUBLIC WORKS AND TRANSPORTATION DIVISION OF ENGINEERING		CONTRACT NUMBER 22-523	SHEET NUMBER K-M-82
<div><div>LiRo Engineers, Inc. <i>A LiRo Group Company</i> Syosset, N.Y. 516-214-8157[T]</div></div>		<div></div>				<input type="checkbox"/> AS BUILT - CHANGES AS NOTED		<input type="checkbox"/> AS BUILT - NO CHANGES			
						CONTRACTOR		PROJECT COORDINATOR			
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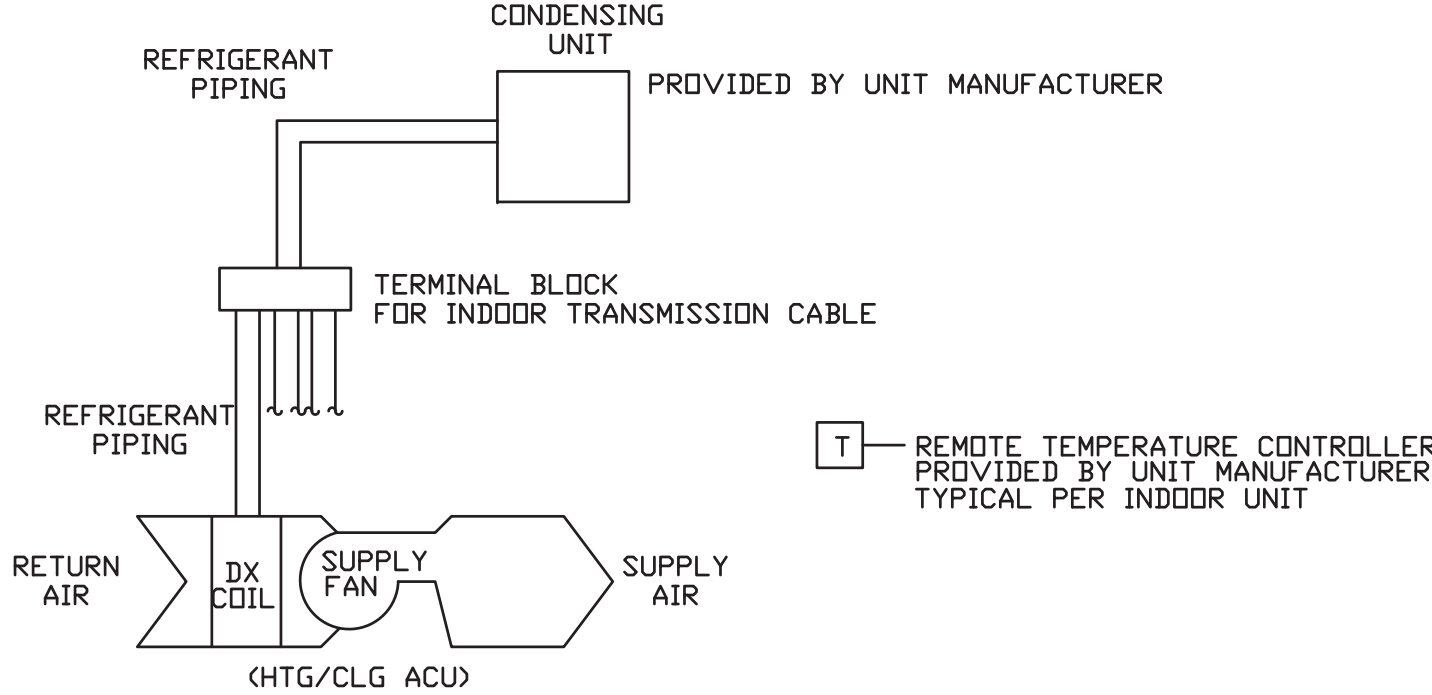


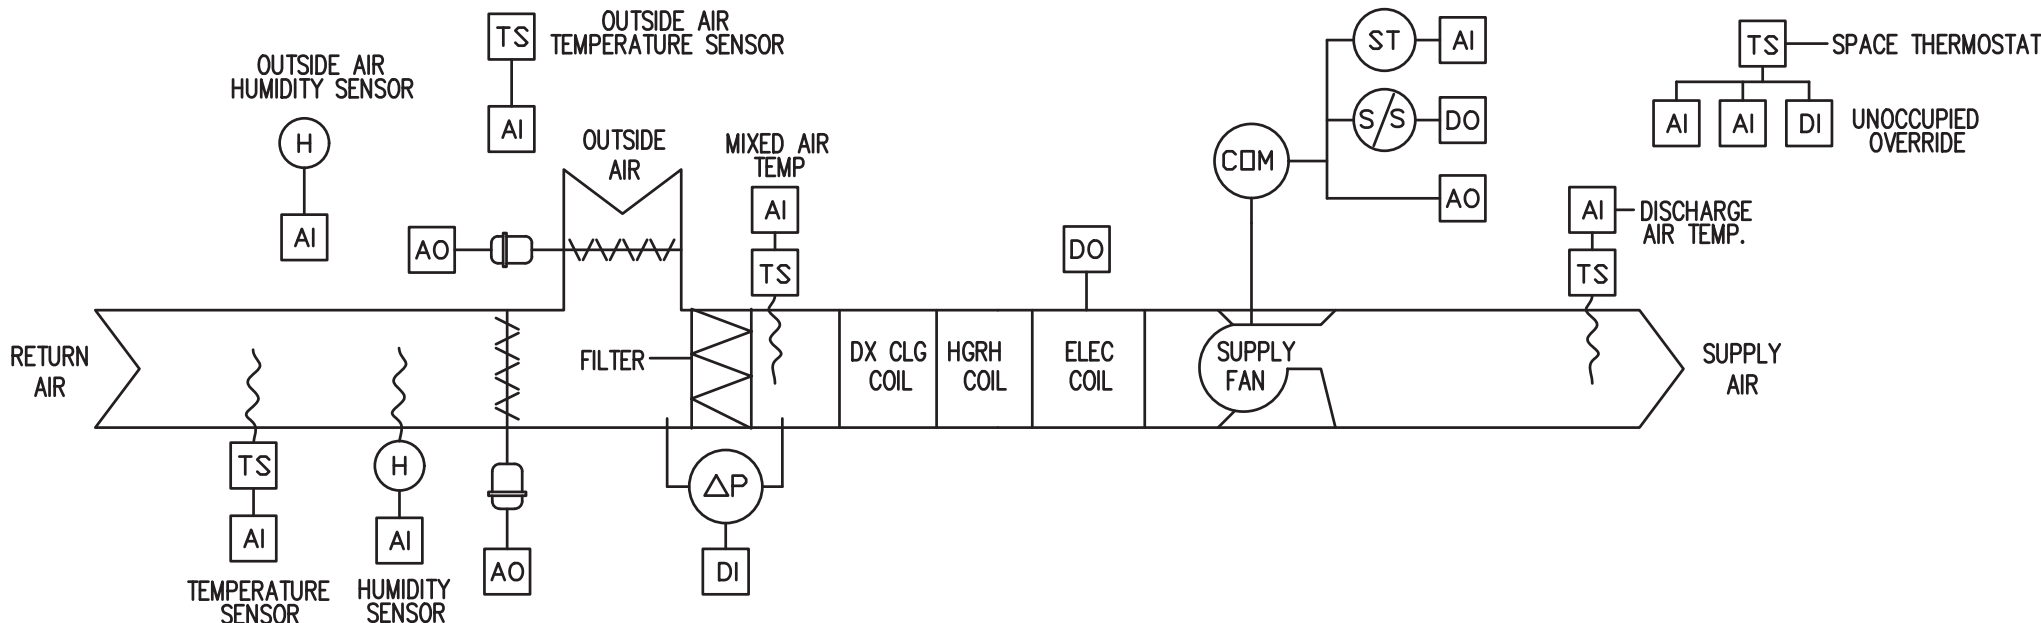ROOFTOP UNIT - ELECTRIC HEATING COIL AND DX COOLING - SEQUENCE OF OPERATIONS:

- GENERAL:
 - SUPPLY FAN AND ASSOCIATED EXHAUST FANS SHALL RUN CONTINUOUSLY. THE SUPPLY FAN SHALL RUN AT THE FREQUENCY DETERMINED BY THE BALANCING CONTRACTOR. THE RTU SYSTEMS CONSISTS OF SUPPLY FANS W/ EC MOTOR CONTROLLER, BAROMETRIC (PASSIVE) RELIEF, RETURN AIR DAMPERS, ECONOMIZER, DAMPERS, DX COOLING COIL, HOT-GAS REHEAT COIL, AND GAS-FIRED HEATING COIL.
 - THE RTU SYSTEM IS DESIGNED TO PROVIDE VENTILATION, HEATING AND COOLING SUPPLY AIR, AND MAKEUP FOR GENERAL KITCHEN EXHAUST TO A SINGLE ZONE. FUTURE KITCHEN HOOD MAKEUP AIR TO BE PROVIDED BY RESTAURANT VENDOR WITH DEDICATED SYSTEMS.
 - THE RTU SYSTEM IS PROVIDED AS A PACKAGED SYSTEM, WITH MANUFACTURER PROVIDED UNIT CONTROLLER.
 - THE CONTROL CONTRACTOR SHALL REVIEW MANUFACTURER SHOP DRAWINGS AND CONTROL DEVICE INSTALLATION, FURNISH AND INSTALL ALL REMAINING CONTROL DEVICES AND FIELD INSTALLED ACCESSORIES TO PERFORM THE SEQUENCES INDICATED. REFER TO EQUIPMENT SCHEDULES AND DETAILS FOR DEVICES INCLUDED WITH THE EQUIPMENT.
- OCCUPIED MODE:
 - SUPPLY FAN AND ASSOCIATED EXHAUST FANS SHALL RUN CONTINUOUSLY (SINGLE ZONE VAV).
 - THE OUTSIDE AIR DAMPER SHALL OPEN TO THE POSITION REQUIRED TO MAINTAIN THE MINIMUM OUTSIDE AIR QUANTITY INDICATED. OUTSIDE AIR DAMPER SHALL NEVER BE POSITIONED BELOW THIS MINIMUM POSITION EXCEPT IN CASE OF ALARM.
 - HEATING: WHEN THE SPACE TEMPERATURE IS AT OR BELOW THE HEATING SETPOINT, THE ELECTRIC COIL SHALL MODULATE TO MAINTAIN SPACE HEATING SETPOINT SUBJECT TO A DISCHARGE HIGH LIMIT OF 100 DEG. F (ADJUSTABLE) AND DISCHARGE LOW LIMIT OF 70 DEG. F (ADJUSTABLE).
 - FREE COOLING: WHEN THE SPACE TEMPERATURE RISES 3 DEG. F (ADJUSTABLE) ABOVE THE SPACE HEATING SETPOINT, AND THE OUTSIDE AIR ENTHALPY IS LOWER THAN THE SPACE ENTHALPY, THE OUTSIDE AIR DAMPER SHALL MODULATE OPEN AND THE ASSOCIATED RELIEF DAMPER SHALL OPEN TO MAINTAIN THE OCCUPIED SETPOINT. THIS SHALL BE DONE SUBJECT TO LOW LIMIT OF 55 DEG. F (ADJUSTABLE) AND WITH THE ELECTRIC HEATING COIL DISABLED.
 - COOLING: WHEN THE SPACE TEMPERATURE IS 3 DEG. F (ADJUSTABLE) ABOVE THE COOLING SETPOINT, AND THE OUTSIDE AIR CANNOT COOL THE SPACE, THE RESPECTIVE CONDENSING UNIT SHALL BE CYCLED WITH THE ELECTRIC HEATING COIL DISABLED TO MAINTAIN SPACE TEMPERATURE. USE 5 DEG. F (ADJUSTABLE) DEADBAND BETWEEN HEATING AND COOLING SETPOINTS.
- ECONOMIZER OPERATION
 - ECONOMIZER OPERATION IS ENABLED WHEN OUTDOOR AIR ENTHALPY IS LESS THAN RETURN AIR ENTHALPY.
 - THE OUTSIDE AIR AND RETURN AIR DAMPERS SHALL MODULATE AS REQUIRED TO OPTIMIZE SUPPLY AIR TEMPERATURE SETPOINT VIA FREE COOLING. THIS IS TYPICALLY A FULLY OPEN OUTSIDE AIR DAMPER DURING SUMMER MONTHS, AND PARTIALLY OPEN OUTSIDE AIR AND RETURN AIR DAMPERS DURING WINTER MONTHS.
 - IF ECONOMIZER MODE CAN NOT FULLY PROVIDE THE REQUIRED DISCHARGE AIR TEMPERATURE, THE DX COOLING COIL SHALL SUPPLEMENT AS REQUIRED.
- UNOCCUPIED MODE:
 - THE SUPPLY AND ASSOCIATED EXHAUST FAN SHALL BE OFF.
 - THE OUTSIDE AIR DAMPER AND THE ASSOCIATED RELIEF AIR HOOD DAMPER SHALL BE FULLY CLOSED AND THE RETURN AIR DAMPER SHALL BE FULLY OPEN.
 - ON DROP IN SPACE TEMPERATURE BELOW THE UNOCCUPIED HEATING SETPOINT, CYCLE THE FAN ON AND ELECTRICAL COIL SHALL OPERATE AT THE FULL RATE TO MAINTAIN REDUCED SPACE TEMPERATURE. USE 5 DEG. F (ADJUSTABLE) DEADBAND TO MINIMIZE SHORT CYCLING.
 - A TIMED LOCAL OVERRIDE CONTROL SHALL ALLOW AN OCCUPANT TO OVERRIDE THE SCHEDULE AND PLACE THE UNIT IN OCCUPIED MODE FOR 1 HOUR (ADJUSTABLE). AT EXPIRATION OF THIS TIME, CONTROL OF THE UNIT SHALL AUTOMATICALLY RETURN TO THE SCHEDULE.
- WARM-UP MODE:
 - THE UNIT SHALL START PER AN OPTIMUM START PROGRAM.
 - THE OUTSIDE AIR DAMPER AND THE ASSOCIATED RELIEF HOOD DAMPER SHALL BE FULLY CLOSED, THE RETURN AIR DAMPER SHALL BE FULLY OPEN, AND THE ASSOCIATED EXHAUST FAN SHALL BE OFF.
 - THE SUPPLY FAN SHALL RUN AND THE ELECTRIC HEATING COIL SHALL MODULATE TO MAINTAIN OCCUPIED SETPOINT.
- SAFETIES:
 - DIFFERENTIAL PRESSURE ACROSS THE AIR FILTERS SHALL GENERATE AN ALARM AT UNIT CONTROLLER WHENEVER THE DIFFERENTIAL PRESSURE EXCEEDS ITS ADJUSTABLE SETPOINT.
 - IF THE DISCHARGE AIR TEMPERATURE DROPS BELOW 35 DEG F (ADJUSTABLE), THE SUPPLY FAN SHALL TURN OFF AND SHALL BE LOCKED OUT, AND AN ALARM SHALL BE ACTIVATED.
 - IF THE DISCHARGE AIR TEMPERATURE RISES ABOVE 120 DEG. F (ADJUSTABLE), THE ELECTRIC HEATING COIL SHALL TURN OFF AND AN ALARM SHALL BE ACTIVATED.

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ROOFTOP UNIT - ELECTRIC COIL AND DX COOLING
SCALE: NOT TO SCALE




MULTIPLE DUCTLESS SPLIT SYSTEMS - HEATING AND COOLING - SEQUENCE OF OPERATIONS:

- UNITS SHALL BE CONTROLLED WITH UNIT PROVIDED THERMOSTATS AND CONNECTED TO CONTROLLER.
- GENERATE AN ALARM AT CONTROLLER WHEN THE TEMPERATURE GOES ABOVE OR BELOW ROOM TEMPERATURE RANGE (ADJUSTABLE).

2

MULTIPLE DUCTLESS SPLIT SYSTEM
SCALE: NOT TO SCALE

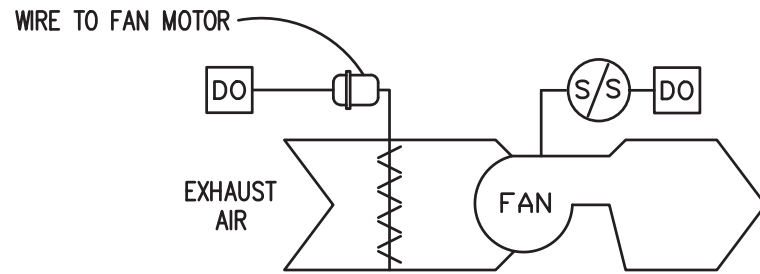


EXHAUST FAN - CONSTANT SPEED - SEQUENCE OF OPERATIONS:

INTERLOCK THE OPERATION OF THE EXHAUST FANS AND AUTOMATIC DAMPERS WITH THEIR RESPECTIVE HEATING AND COOLING EQUIPMENT, RTU-1.

- OCCUPIED MODE:
 - THE EXHAUST FAN SHALL RUN CONTINUOUSLY AND THE AUTOMATIC AIR DAMPER SHALL OPEN.
- UNOCCUPIED MODE:
 - THE EXHAUST FAN SHALL BE OFF AND THE AUTOMATIC AIR DAMPER SHALL BE CLOSED.
- WARM-UP MODE:
 - THE EXHAUST FAN SHALL BE OFF AND THE AUTOMATIC AIR DAMPER SHALL BE CLOSED.

4

EXHAUST FAN - CONSTANT SPEED
SCALE: NOT TO SCALE

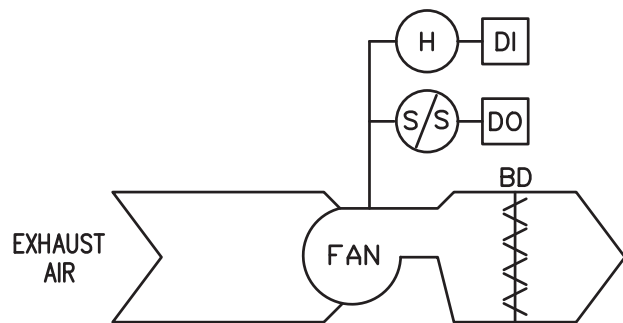


EXHAUST FAN - CONSTANT SPEED - SEQUENCE OF OPERATIONS:

GENERAL: EACH EXHAUST FAN CONSISTS OF FAN, BACKDRAFT DAMPER, AND EC MOTOR CONTROLLER

- OCCUPIED MODE:
 - THE EXHAUST FAN SHALL RUN WHEN THE RELATIVE HUMIDITY IN THE SPACE SERVED EXCEEDS 60 PERCENT.
- UNOCCUPIED MODE:
 - THE EXHAUST FAN SHALL RUN WHEN THE RELATIVE HUMIDITY IN THE SPACE SERVED EXCEEDS 60 PERCENT.
- WARM-UP MODE:
 - THE EXHAUST FAN SHALL RUN WHEN THE RELATIVE HUMIDITY IN THE SPACE SERVED EXCEEDS 60 PERCENT.

5

ATTIC EXHAUST FAN - CONSTANT SPEED
SCALE: NOT TO SCALE

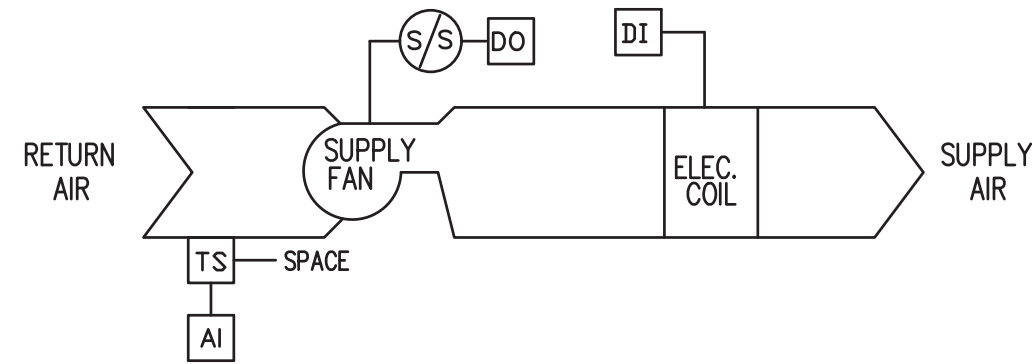


UNIT HEATER - ELECTRIC - SEQUENCE OF OPERATIONS:

- ON DROP IN SPACE TEMPERATURE BELOW OCCUPIED HEATING SETPOINT, CYCLE THE FAN ON AND MODULATE (2 STAGE) ELECTRIC COIL TO MAINTAIN SPACE OCCUPIED SETPOINT. FAN SHALL HAVE DELAYED SHUT OFF AFTER VALVE CLOSSES. USE 5 DEG. F (ADJUSTABLE) DEADBAND TO MINIMIZE SHORT CYCLING.

6

UNIT HEATER - ELECTRIC
SCALE: NOT TO SCALE

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														SCALE: AS INDICATED			
														DATE: 08/23/2022			
																DPW FILE NUMBER 1-118-M-1307-0	
REVISION NUMBER	DATE	MADE BY	APP'D BY	REVISION				NAME SIGNATURE TITLE		PROJECT COORDINATOR NAME SIGNATURE DATE		INFRASTRUCTURE REHABILITATION - PHASE 3 PLAYLAND PARK, RYE, NEW YORK RESTAURANT KITCHEN WITH FOOD VENDING MECHANICAL CONTROLS					