MONTEFIORE NYACK HOSPITAL

NYACK, NY 10994

**OBGYN CLINICS** 

**CONSTRUCTION TYPES:** NFPA: III (211) / NYS BUILDING CODE : 3B - NONCOMBUSTIBLE

**OCCUPANCY TYPE:** BUSINESS

# Montefiore

- **160 NORTH MIDLAND AVENUE**

## HIGHLAND MEDICAL 17 SQUADRON BLVD. NEW CITY, NY 10956

CODES AND STANDARDS

DATE SCALE 02/06/2022 AS NOTED DRAWING NUMBER

CON #

-

BUILDING CODE: 2020 NEW YORK STATE BUILDING CODE

STRUCTURAL CODE: 2020 NEW YORK STATE BUILDING CODE

FIRE CODE: FIRE CODE 2020 OF NEW YORK STATE

ENERGY CODE: 2020 ENERGY CONSERVATION CONSTRUCTION CODE OF NEW YORK STATE

MECHANICAL CODE: 2020 NEW YORK STATE MECHANICAL CODE FUEL GAS CODE: 2020 NEW YORK STATE FUEL GAS CODE

PLUMBING CODE: 2020 NEW YORK STATE PLUMBING CODE ELECTRICAL CODE: THE NATIONAL ELECTRICAL CODE, 2014

LIFE SAFETY CODE: LIFE SAFETY CODE NFPA 101, 2012

SPRINKLER CODE: 2020 NEW YORK STATE FIRE CODE

BARRIER FREE REQUIREMENTS: 2003 ICC/ANCI A117.1 & 2010 ADA STANDARDS FOR ACCESSIBLE DESIGN (ADAAG)

ISSUED DOCUMENTS: Date: **BID ISSUE - ARC** ADDENDA #03 3/16/22 SEAL IT IS A VIOLATION OF THE LAW FOR ANY PERSON, UNLESS ACTING UNDER THE DIRECTION OF A LICENSED ARCHITECT, TO ALTER THIS DOCUMENT IN ANY WAY. IF ALTERED, THE ALTERING ARCHITECT SHALI

AFFIX HIS SEAL AND THE NOTATION "ALTERED BY" FOLLOWED BY HIS SIGNATURE AND THE DATE OF SUCH ALTERATION, AND A SPECIFIC

COVER SHEET

DESCRIPTION OF THE ALTERATION.

DRAWING TITLE:


PROJECT NUMBER

21035a

433 STATE STREET, SUITE 410 518.533.217 SCHENECTADY, NY 12305 www.meengineering.com

STRUCTURAL ENGINEER

19 Front Street elephone: 845.561.0448 Newburgh, NY 12550 Facsimile: 845.561.0446 33 Irving Place, 3rd Floor ds@HealthCareDesign.co New York, NY 10004 www.healthcaredesign.co MEP ENGINEEF **ENGINEERING** Mechanical/Electrical Engineering Consultants Schenectady | Rochester | Buffalo | Syracuse

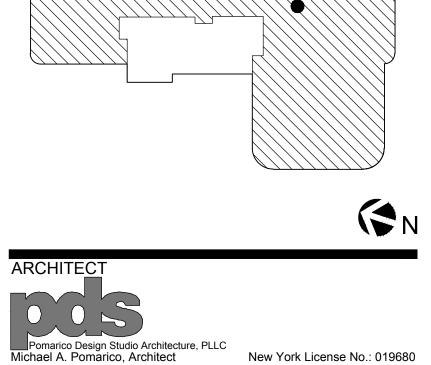

ARFA O WORK

THIRD FLOOR **17 SQUADRON BLVD** NEW CITY, NY 10956 **KEY PLAN: NOT TO SCALE** 

NYACK, NY 10960

**OBGYN CLINICS** 

HIGHLAND MEDICAL

MONTEFIORE NYACK HOSPITAL

**160 NORTH MIDLAND AVENUE** 

Montefiore

#### ALTERATION WORK:

- 1. THE ALTERATION WORK SHALL INCLUDE ALL MODIFICATIONS NECESSARY TO THE EXISTING SPACE TO ACCOMMODATE THE ALTERATION AS CALLED FOR ON THE DRAWINGS OR SPECIFIED. WORK SHALL ALSO INCLUDE SUCH AS IS NECESSARY OR REASONABLY INFERABLE FROM SPECIFIC WORK WHERE INDICATED OR SPECIFIED IN ORDER TO PRODUCE A COMPLETE JOB READY FOR BUILDINGS OPERATIONS, SUCH AS PATCHING WALLS, CEILINGS AND FLOORS AND FINISHES DISTURBED DUE TO ALTERATIONS AND MECHANICAL AND ELECTRICAL TRADES WORK, BLOCKING UP OPENINGS, NEW OPENINGS, RELOCATION OF EQUIPMENT, ETC. RELOCATION WORK SHALL BE ASSIGNED BY THE CONTRACTOR TO TRADES HAVING JURISDICTION AND BEST QUALIFIED.
- 2. UNLESS OTHERWISE SHOWN ON THE DRAWINGS OR SPECIFICATIONS, ALL EXISTING WORK SHALL BE PATCHED TO MATCH NEW OR EXISTING ADJOINING SURFACES WHERE;
- A. NEW WORK IS ADDED TO EXISTING WORK.
- B. EXISTING OPENINGS ARE TO BE SEALED. C. EXISTING WORK IS REMOVED.
- D. NEW OPENINGS OCCUR IN EXISTING WORK.
- 3. REMOVE, RELOCATE, REROUTE, TERMINATE OR CAP AS REQUIRED ALL PLUMBING ELECTRICAL OR OTHER MECHANICAL WORK LOCATED IN WALLS, PARTITIONS, FLOORS OR CEILINGS THAT OCCUR WHERE EXISTING WORK IS REMOVED AND WHERE NEW OPENINGS ARE TO BE CUT IN EXISTING WORK (EXCEPT OF OTHERWISE SPECIFIED OR NOTED BY OTHER TRADES)
- 4. PATCH AND FINISH ALL EXISTING WORK TO MATCH EXISTING (EXCEPT IF OTHERWISE SPECIFIED) WHERE DISTURBED BY THE REMOVAL, RELOCATION OR NEW INSTALLATION OF ELECTRICAL, MECHANICAL OR PLUMBING WORK, SEE ARCHITECTURAL, ELECTRICAL, HEATING AND VENTILATION OR PLUMBING DRAWINGS FOR EXTENT OF REMOVAL WORK
- 5. IN ALL ROOMS AND/OR AREAS OF EXISTING BUILDING, GENERAL CONTRACTOR SHALL DO ALL NECESSARY CUTTING. REPAIRS. PATCHING OR REPLACING OF EXISTING FLOORS. BASES. WALLS AND CEILINGS, ETC., SO AS TO LEAVE SUCH ROOMS AND/OR SPACES IN A NEAT AND ORDERLY FINISH.
- 6. FLASH PATCH ALL FLOOR VOIDS FOR SMOOTH FINISH, WHERE RESULTING FROM REMOVAL OF ITEM CAUSING A FLOOR OPENING.
- WHERE EXISTING PARTITIONS ARE INDICATED TO BE EXTENDED, THE FINISH SURFACES OF EXISTING AND NEW PARTITIONS SHALL ALIGN.
- 8. WHERE NEW WALL FINISH IS DESIGNATED IN FINISH SCHEDULE, SAME SHALL APPLY BOTH TO NEW AND EXISTING SURFACE WITHIN SPACE. 9. WHERE PARTITIONS ARE REMOVED TO COMBINE TWO OR MORE AREAS INTO ONE SINGLE
- AREA, THE FLOORS OF THE AREAS AFFECTED SHALL BE LEVELED TO FORM ONE CONTINUOUS LEVEL FLOOR, UNLESS OTHERWISE NOTED.
- 10. WHEN CLOSING DOORS, PROVIDE STUDS AS REQ. TO FLUSH NEW FINISH WITH ADJOINING 14. ALL NEW PIPING AND ELECTRIC CONDUITS SHALL BE CONCEALED WITHIN NEW EXISTING FINISH.
- 11. NEW DOORS TO BE PLACED IN EXISTING PARTITIONS SHALL BE COORDINATED WITH THE EXISTING PARTITION FOR ALL REQUIRED MOUNTING REQUIREMENTS.
- 12. WHEN EXISTING WORK REQUIRES REMOVAL FOR THE INSTALLATION OF MECHANICAL, ELECTRICAL, OR PLUMBING WORK, ALL EXISTING SURFACES SHALL BE REPAIRED W/ CONSTRUCTION THAT SHALL MATCH THE REMOVED WORK, BUT BE NO LESS THAN THAT REQUIRED FOR CODE CONFORMANCE.
- 13. WHEN EXISTING CEILINGS REQUIRE REMOVAL FOR THE INSTALLATION OF MECHANICAL ELECTRICAL, OR PLUMBING WORK, ALL AREAS REMOVED SHALL BE REPLACED W/ NEW CEILING CONSTRUCTION EQUAL TO THE EXISTING CEILING REMOVED, BUT NO LESS THAN THAT REQUIRED FOR CODE CONFORMANCE.
- 14. ALL NEW AND EXISTING DUCTS, PIPES AND ELECTRICAL CONDUIT SHALL BE CONCEALED WITHIN NEW AND/OR EXISTING CEILING AND PARTITIONS. SEE MECHANICAL, PLUMBING AND ELECTRICAL DRAWINGS FOR EXTENT OF WORK.
- 15. THE CONTRACTOR SHALL FURNISH AND INSTALL ALL GYPSUM BOARD ON METAL STUD FURRING AS IS NECESSARY TO FURR IN ALL PIPES AND CHASES OR TO CONTINUE THE NORMAL LINE OF APPLIED FINISH.

#### **DEMOLITION NOTES:**

- 1. THE CONTRACTOR SHALL COORDINATE WITH, REVIEW, AND EXAMINE THE DRAWINGS OF ALL TRADES I.E., STRUCTURAL, ELECTRICAL, PLUMBING, AND HEATING VENTILATING AND AIR CONDITIONING TO ASCERTAIN THE EXTENT OF DEMOLITION REQUIRED THEREIN. THE CONTRACTOR SHALL ALSO VISIT THE SITE AND CAREFULLY EXAMINE THE WORK TO BE DEMOLISHED SO AS TO BE FAMILIAR WITH EXISTING CONDITIONS, THE NATURE AND SCOPE 21. ALL GYPSUM WALL BOARD DIRECTLY BEHIND OR ADJACENT TO ALL SINKS INCLUDING OF THE WORK AND THE DIFFICULTIES THAT ATTEND ITS EXECUTION.
- 2. EXISTING FLOORS SHALL BE LEVELED BEFORE APPLICATION OF NEW FINISH AS REQUIRED. IF IN THESE CASES, A PORTION OF THE EXISTING FLOOR IS TO REMAIN INTACT, THE PORTION WHICH IS TO RECEIVE NEW APPLIED FLOOR FINISH MUST BE PATCHED AND LEVELED SO THAT THE NEW APPLIED FLOOR FINISH WILL BE FLUSH AND CONTINUOUS WITH THE INTACT PORTION. THE NEW FLOORING SUBSTRATE SHALL BE PREPARED SO AS TO PREVENT NEEDLING THROUGH THE TILE FINISH.
- 3. WHERE EXISTING WALLS OR PARTITIONS ARE TO RECEIVE NEW FINISH (EXCEPT PAINT) THE EXISTING FINISH UNLESS OTHERWISE SPECIFIED OR DIRECTED SHALL BE ENTIRELY REMOVED, WALL SURFACES THOROUGHLY CLEANED DOWN, PLUMBED AND THE WALL OR PARTITION PREPARED TO RECEIVE THE NEW WALL FINISH.
- 4. WHERE NEW HUNG CEILINGS ARE CALLED FOR, IT SHALL BE UNDERSTOOD THAT THE CONTRACTOR SHALL REMOVE THE EXISTING CEILINGS COMPLETELY, UNLESS OTHERWISE NOTED HEREIN.
- 5. GENERAL CONTRACTOR SHALL CAREFULLY REMOVE ALL EXISTING HUNG CEILINGS AS NECESSARY TO PERMIT INSTALLATION OF MECHANICAL, PLUMBING AND ELECTRICAL WORK. WHERE FLOOR PLAN DOES NOT INDICATE A NEW CEILING GRID, CONTRACTOR SHALL THEN REINSTALL THE SAME AFTER THE WORK HAS BEEN COMPLETED. REFER TO MECHANICAL, PLUMBING AND ELECTRICAL DRAWINGS FOR EXTENT OF WORK TO BE PERFORMED. REFER TO FINISH SCHEDULE FOR NEW CEILING TILE SPECIFICATION TYPE
- 6. CONTRACTOR SHALL ERECT AND BE RESPONSIBLE FOR ALL TEMPORARY BRACING, SHORING, UNDER PINNING AND WEATHER PROTECTION AS REQUIRED TO CONSTRUCT THE 27. CONTRACTOR SHALL AT ALL TIMES MAINTAIN TEMPORARY ELECTRICAL, MECHANICAL, WORK.
- 7. IT SHALL BE THE CONTRACTORS RESPONSIBILITY TO PROTECT ALL WORK INDICATED TO REMAIN
- 8. ANY EXISTING WORK DISTURBED BY THIS CONTRACT SHALL BE REPAIRED TO MATCH EXISTING ADJACENT MATERIALS AND FINISHES UNLESS OTHERWISE NOTED.
- 9. ANY PATCH OR FINISH WORK NECESSARY AFTER DEMOLITION OF WALLS, FLOORS, SLABS, MECHANICAL EQUIPMENT, ETC. SHALL BE PART OF THE CONTRACTORS SCOPE OF WORK. ALL NEW FINISH SHALL MATCH EXISTING.

#### SPECIAL INSPECTIONS:

- SPECIAL INSPECTIONS FOR FIRE-RESISTANT PENETRATIONS AND JOINTS 1 A. MATERIALS AND PLACEMENT: VERIFY EACH ITEM BELOW COMPLIES WITH APPROVED 30 CONSTRUCTION DOCUMENTS AND MANUFACTURER'S REQUIREMENTS.
  - a. PENETRATIONS THROUGH FIRE RATED FLOOR ASSEMBLIES.
  - b. PENETRATIONS THROUGH FIRE RATED WALL ASSEMBLIES;.
- c. FIRE BLOCKING.
- d. RATED EXPANSION JOINTS.
- B. INSPECTOR REQUIRED TO PROVIDE CERTIFICATION ATTESTATION THAT FIRE-STOPPING THROUGHOUT PROJECT HAS BEEN INSTALLED IN COMPLIANCE TO APPROVED UL ASSEMBLIES.

#### GENERAL NOTES:

- ALL NOTES HEREIN MENTIONED WITH THOSE ON THE VARIOUS DRAWINGS SHALL APPLY TO ALL DRAWINGS AND FORM PART OF THE CONTRACT.
- ALL CONSTRUCTION DIMENSIONS AND DETAILS SHALL CONCUR WITH AND BE DETERMINED FROM THESE DRAWINGS ONLY.
- FIGURED DIMENSIONS TAKE PRECEDENCE OVER SCALED DIMENSIONS, LARGE SCALE DETAILS OVER SMALL, REPETITIVE FEATURES NOT COMPLETELY DESCRIBED AND/OR DETAILED SHALL BE CONSTRUCTED IN EXACT ACCORDANCE WITH CORRESPONDING FEATURES THAT ARE COMPLETELY DESCRIBED OR DETAILED.
- THE CONTRACTOR SHALL CHECK AND VERIFY ALL NEW AND EXISTING DIMENSIONS AND CONDITIONS AT THE SITE AND ON THE JOB AGAINST DRAWINGS AND INFORM THE SHOULD BE NOTED RELATIVE TO NEW AND EXISTING MECHANICAL, PLUMBING AND ELECTRICAL CONDITIONS, INCLUDING ROUGHED IN UNDERSLAB WORK.
- THE OWNER RESERVES THE RIGHT AT ALL TIMES TO DELIVER, PLACE AND INSTALL EQUIPMENT AND FURNISHINGS AS THE WORK PROGRESSES, SO LONG AS THERE IS NO INTERFERENCE WITH THE WORK OF THE CONTRACTORS.
- ALL DIMENSIONS ARE ACTUAL EXCEPT DIMENSIONS OF CONCRETE, MASONRY, BRICK 6 UNITS AND DRYWALL PARTITIONS WHICH ARE NOMINAL.
- ALL DIMENSIONS TO GYPSUM WALL BOARD PARTITIONS ARE TO FACE OF WALLBOARD UNLESS OTHERWISE NOTED.
- CONTRACTOR SHALL BE RESPONSIBLE FOR THE FILING OF THE PLANS WITH THE BUILDING DEPARTMENT AND THE SECURING OF ALL REQUIRED PERMITS.
- ALL WORK SHALL BE GUARANTEED TO BE FREE FROM DEFECTS IN MATERIALS AND
- 10 HOSPITAL'S PRE-CONSTRUCTION RISK ASSESSMENTS.
- ALL MATERIALS. EQUIPMENT AND TYPES OR METHODS OF CONSTRUCTION SHALL IN NO EVENT BE LESS THAN THAT NECESSARY TO CONFORM TO THE REQUIREMENTS OF ALL APPLICABLE CODES, ACCESSIBILITY REQUIREMENTS, ORDINANCES, CHARTER, ETC., OF THE REQUIRED GOVERNING AUTHORITIES.
- 12 ALL WALLS AND/OR PARTITIONS SHALL EXTEND FROM FLOOR SLAB TO UNDERSIDE OF SLAB CONSTRUCTION ABOVE, UNLESS OTHERWISE NOTED.
- 13. PARTITIONS SHALL BE CONTINUOUS OVER ALL BUILT-IN EQUIPMENT WHERE INDICATIVE
- PARTITIONS
- DRAINS ARE SPECIFIED, CONTOUR ALL EXISTING SLABS TO DRAIN TO INSURE PONDING OF WATER DOES NOT OCCUR.
- MANUFACTURERS REQUIREMENTS. THESE MAY CHANGE WITH UPDATED OR UPDATED BY CONTRACTOR(S). CONFIRM ALL EQUIPMENT SPECIFICATIONS WITH HOSPITAL AND ARCHITECT PRIOR TO ROUGH-IN.
- 17. THE ELECTRICAL OUTLETS AND PLUMBING SHOWN ON THE ARCHITECTURAL DRAWINGS REFER TO MECHANICAL AND ELECTRICAL DRAWINGS FOR COMPLETE LAYOUT OF MECHANICAL AND ELECTRICAL SERVICES. WHEN RECEPTACLES ARE SHOWN ON ARCHITECTURAL ELEVATIONS, FOLLOW ARCHITECTURAL ELEVATIONS FOR PHYSICAL LOCATIONS REQUIRED.
- COORDINATE THE INSTALLATION OF ALL COMPONENTS OF THE PROJECT ENSURE COMPLETE AND FUNCTIONAL INSTALLATION OF ALL WORK, AND SYSTEMS. CONDUCT COORDINATION MEETINGS AS REQUIRED WITH TRADES, ARCHITECT, AND OWNER TO ENSURE COMPLETE UNDERSTANDING OF EQUIPMENT AND SYSTEMS REQUIREMENTS
- 19. WHEN PENETRATIONS THROUGH EXISTING CONSTRUCTION ARE REQUIRED, REPLACE WORK COMPLETELY, WITH CONSTRUCTION OF NO LESS QUALITY THAN THE EXISTING. ALL EXTERIOR PENETRATIONS SHALL BE WATERTIGHT.
- 20. GYPSUM WALL BOARD IN ALL WET AREAS I.E. TOILET, WASH AREAS, ETC., SHALL BE WATER RESISTANT TYPE.
- SINKS IN CASEWORK EXTENDING A MINIMUM DISTANCE OF 3'-0" HORIZONTALLY FROM CENTERLINE OF FIXTURE AND FROM FLOOR TO FINISHED CEILING SHALL BE WATER RESISTANT TYPE.
- 22. WHERE FIRE RATED PARTITIONS ARE SCHEDULED CONTRACTOR SHALL PROVIDE TYPE X GYPSUM WALL BOARD.
- 23. OWNER RESERVES THE RIGHT TO ACCESS TO THE SPACE THROUGHOUT THE EQUIPMENT REQUIRED IN CONJUNCTION WITH THE PROJECT. CONTRACTOR SHALL COORDINATE WITH THE OWNER AS TO REQUIRED DELIVERY DATES, AND INSTALLATION REQUIREMENTS.
- 24. THE CONTRACTOR SHALL AT ALL TIMES MAINTAIN TEMPORARY WATER, ELECTRIC, AND SANITARY SERVICES TO THE SPACE. IN ADDITION, THE CONTRACTOR SHALL BE RESPONSIBLE FOR MAINTENANCE OF SECURITY TO THE SITE.
- 25. CONTRACTOR SHALL FURNISH AND INSTALL ANGLES, STRUTS, BRACKETS, TOGGLES, EYE BOLTS AND ALL ACCESSORIES REQUIRED TO PROPERLY SUPPORT BRACE AND/OR REINFORCE ALL FINISHES, FRAMES, EQUIPMENT, ETC.
- 26. CONTRACTOR SHALL CLOSE ALL OPENINGS DUE TO CUTTING, REMOVAL, AND NEW WORK
- PLUMBING, AND LIFE SAFETY SYSTEMS. IN ADDITION TEMP, TELEPHONE AND SANITARY FACILITIES SHALL BE PROVIDED.
- 28. THE CONTRACTOR MAY STORE REQUIRED COMPONENTS, TOOLS, EQUIPMENT ETC. IN HOSPITAL. ALL STORAGE LOCATIONS MUST BE APPROVED BY HOSPITAL ADVANCE.
- 29. CONTRACTOR SHALL BE RESPONSIBLE FOR PROVIDING A COMPLETE OPERATIONAL PROJECT. ALL SYSTEMS SHALL BE WHOLE, WEATHER SPECIFIED IN FULL OR PART IN NOTIFY THE ARCHITECT IMMEDIATELY. ANY INSTANCE WHERE THE CONTRACTOR PROCEEDS WITH THE INSTALLATION OF A CONTRADICTORY DIRECTIVE, WITH OUT THE ARCHITECTS PRIOR APPROVAL, THE ARCHITECT RESERVES THE RIGHT TO REJECT THE WORK.

REFER TO DRAWINGS AND SPECIFICATIONS FOR TYPICAL DETAILS AT PENETRATIONS THROUGH FIRE-RESISTANCE RATED CONSTRUCTION. ALL FRR PENETRATION SYSTEMS MUST BE UL APPROVED AND SUBMITTED FOR APPROVAL PRIOR TO COMMENCEMENT OF WORK. IF HOSPITAL MAINTAINS A PROPRIETARY MANUFACTURER SYSTEM(S) CONTRACTOR SHALL CONFORM TO HOSPITALS STANDARDS.

ARCHITECT OF ANY DISCREPANCIES PRIOR TO COMMENCING WORK. SPECIAL ATTENTION

WORKMANSHIP FOR A PERIOD OF ONE YEAR. FROM THE DATE OF OWNERS OCCUPANCY. REMOVE ALL RUBBISH ON A REGULAR BASIS, PERFORM ALL WORK IN ACCORDANCE WITH

ON PLANS. FURNISH NECESSARY ANGLES, HANGERS, ETC. TO COMPLETE INSTALLATION.

FOR LOCATIONS OF NEW FLOOR DRAINS REFER TO PLUMBING DRAWINGS. WHERE FLOOR

EQUIPMENT SERVICES FOR EQUIPMENT, SLAB OPENINGS, ETC., ARE BASED ON CURRENT SUBSTITUTED EQUIPMENT, SERVICES AND SLAB OPENINGS SHALL BE COORDINATED AND

ARE TO CLARIFY THE FUNCTIONAL PATTERNS OF THE ROOMS. THE CONTRACTOR SHALL

CONSTRUCTION PROCESS. IN ADDITION THE OWNER RESERVES THE RIGHT TO INSTALL

REQUIRED BY MECHANICAL AND ELECTRICAL TRADES. OPENINGS SHALL BE CLOSED AND FINISH SHALL MATCH EXISTING. SEE MECHANICAL AND ELECTRICAL DRAWINGS.

THE BUILDING, SPACE, OR OTHER LOCKABLE STORAGE CONTAINER ON SITE, AT HIS OWN RISK, AND SHALL IN NO WAY IMPEDE UPON THE NORMAL FUNCTIONAL PATTERNS OF THE

THESE DRAWINGS. IN CASES WHERE DISCREPANCIES OCCUR, THE CONTRACTOR SHALL

#### SITE PLAN KEY NOTES: (1) HANDICAPPED ACCESSIBLE PARKING


APPROXIMATE LOCATION OF 3RD FLOOR CLINIC.

🕻 3 > MAIN ENTRANCE - ACCESSIBLE

#### Architectural Drawings

COVER SHEET	E0.0	ELECTRICAL LEGEND, ABBREVIATIONS & NOTES
DRAWING LIST, INFORMATION, GENERAL NOTES, OVERALL SITE PLAN	ED1.0	THIRD FLOOR ELECTRICAL REMOVALS PLAN
ABBREVIATION, SYMBOL LEGEND, MOUNTING AND FINISH SCHEDULE	ED2.0	THIRD FLOOR LIGHTING REMOVALS PLAN
BARRIER FREE NOTES & DETAILS	E1.0	THIRD FLOOR POWER & SYSTEMS PLAN
EGRESS AND LIFE SAFETY PLANS - THIRD FLOOR	E2.0	THIRD FLOOR LIGHTING PLAN
DEMOLITION PLAN - THIRD FLOOR	E3.0	THIRD FLOOR FIRE ALARM & NURSE CALL PLAN
PROPOSED FLOOR PLAN - THIRD FLOOR	E5.0	ELECTRICAL DETAILS & SCHEDULES
PROPOSED REFLECTED CEILING PLAN - THIRD FLOOR	E6.0	ELECTRICAL ONE-LINE DIAGRAM
ENLARGED PROPOSED REFLECTED CEILING PLAN - THIRD FLOOR	E7.0	ELECTRICAL SCHEDULES
PROPOSED EQUIPMENT PLAN - THIRD FLOOR		
ENLARGED EQUIPMENT PLAN - THIRD FLOOR	>	
ENLARGED EQUIPMENT PLAN - THIRD FLOOR	>	Plumbing Drawings:
ENLARGED EQUIPMENT PLAN - THIRD FLOOR		
DOOR & HARDWARE SCHEDULE AND MISCELLANEOUS DETAILS	(	PLUMBING SYMBOLS, NOTES AND SCHEDULES
MISCELLANEOUS DETAILS	>	THIRD FLOOR PLUMBING REMOVALS PLAN
INTERIOR ELEVATIONS	P1.0	THIRD FLOOR PLUMBING PLAN
INTERIOR ELEVATIONS		
INTERIOR ELEVATIONS	$\rangle$ —	Fire Sprinkler Drawings:
MILLWORK SECTIONS		File Sphilkler Diawings.
	FP0.0	FIRE SPRINKLER SYMBOLS, NOTES, AND SCHEDULES
Interior Design Drawings:		THIRD FLOOR FIRE SPRINKLER REMOVALS PLAN
		THIRD FLOOR FIRE SPRINKLER NEW WORK
MATERIAL SCHEDULE + NOTES, MILLWORK SCHEDULE		
FINISH LOCATION PLAN: FLOORING/BASE		
FINISH LOCATION PLAN WALLS + MILLWORK		
	DRAWING LIST, INFORMATION, GENERAL NOTES, OVERALL SITE PLAN ABBREVIATION, SYMBOL LEGEND, MOUNTING AND FINISH SCHEDULE BARRIER FREE NOTES & DETAILS EGRESS AND LIFE SAFETY PLANS - THIRD FLOOR DEMOLITION PLAN - THIRD FLOOR PROPOSED FLOOR PLAN - THIRD FLOOR PROPOSED REFLECTED CEILING PLAN - THIRD FLOOR ENLARGED PROPOSED REFLECTED CEILING PLAN - THIRD FLOOR PROPOSED EQUIPMENT PLAN - THIRD FLOOR ENLARGED EQUIPMENT PLAN - THIRD FLOOR ENLARGED EQUIPMENT PLAN - THIRD FLOOR ENLARGED EQUIPMENT PLAN - THIRD FLOOR DOOR & HARDWARE SCHEDULE AND MISCELLANEOUS DETAILS MISCELLANEOUS DETAILS INTERIOR ELEVATIONS INTERIOR ELEVATIONS MILLWORK SECTIONS MILLWORK SECTIONS MATERIAL SCHEDULE + NOTES, MILLWORK SCHEDULE FINISH LOCATION PLAN: FLOORING/BASE	DRAWING LIST, INFORMATION, GENERAL NOTES, OVERALL SITE PLAN ABBREVIATION, SYMBOL LEGEND, MOUNTING AND FINISH SCHEDULE BARRIER FREE NOTES & DETAILS EGRESS AND LIFE SAFETY PLANS - THIRD FLOOR EGRESS AND LIFE SAFETY PLANS - THIRD FLOOR PROPOSED FLOOR PLAN - THIRD FLOOR PROPOSED REFLECTED CEILING PLAN - THIRD FLOOR ENLARGED PROPOSED REFLECTED CEILING PLAN - THIRD FLOOR ENLARGED EQUIPMENT PLAN - THIRD FLOOR FP0.0 FP0.0 FP1.0P0.0 P0.0 P0.0 PD1.0 P1.0INTERIOR ELEVATIONS INTERIOR ELEVATIONS MILLWORK SECTIONS MILLWORK SECTIONS MILLWORK SECTIONS MILLWORK SECTIONS MILLWORK SCHEDULE + NOTES, MILLWORK SCHEDULE FINISH LOCATION PLAN: FLOORING/BASEFP0.0 FP1.0

SQUADRON BLVD.  $\langle 3 \rangle$ 

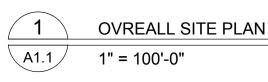

#### Mechanical Drawings

MECHANICAL SYMBOLS LISTS, AND GENERAL NOTES MECHANICAL AIRFLOWS THIRD FLOOR MECHANICAL REMOVALS PLAN

THIRD FLOOR MECHANICAL NEW WORK PLAN ROOF MECHANICAL NEW WORK PLAN MECHANICAL DETAILS MECHANICAL DETAILS MECHANICAL SCHEDULES MECHANICAL CONTROLS

M0.0

M0.1

M1.0

M1.1

M5.0

M5.1

M7.0

M8.0

ADD. #03

MD 1.0

#### **Electrical Drawings:**

#### Plumbing Drawings:

#### Fire Sprinkler Drawings:

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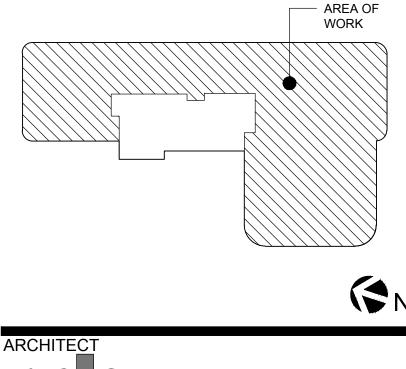
## Montefiore


MONTEFIORE NYACK HOSPITAL

160 NORTH MIDLAND AVENUE NYACK. NY 10960

HIGHLAND MEDICAL **OBGYN CLINICS** THIRD FLOOR **17 SQUADRON BLVD NEW CITY, NY 10956** 

**KEY PLAN: NOT TO SCALE** 



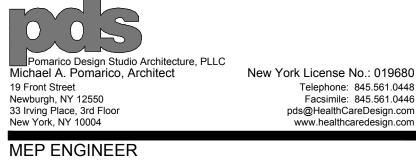

### **ENGINEERING**

Mechanical/Electrical Engineering Consultants Schenectady | Rochester | Buffalo | Syracuse 433 STATE STREET, SUITE 410 518.533.217

www.meengineering.com

STRUCTURAL ENGINEER

SCHENECTADY, NY 12305

No:	Date:	Description:	
	2/11/22	BID ISSUE - ARCH	
1	3/16/22	ADDENDA #03	
SEAL			
IT IS A VI	OLATION OF THE	E LAW FOR ANY	
PERSON,	UNLESS ACTIN	G UNDER THE	
DIRECTIO	ON OF A LICENSE	ED ARCHITECT, TO	
	HIS DOCUMENT		
ALTERED	), THE ALTERING	G ARCHITECT SHALL	
AFFIX HIS	S SEAL AND THE	NOTATION "ALTERED	
BY" FOLL	OWED BY HIS S	IGNATURE AND THE	
DATE OF	SUCH ALTERAT	ION, AND A SPECIFIC	
	TION OF THE AL	TERATION.	
DESCRIP			

#### DRAWING LIST, **INFORMATION, GEN. NOTES** AND OVERALL SITE PLAN

PROJECT NUMBER CON # 21035a


02/06/2022 DRAWING NUMBER

DATE

SCALE AS NOTED

ABBREVIATION	FULL WORD/TERM	ABBREVIATION	FULL WORD/TERM	ABBREVIATION	FULL WORD/TERM
A	MEDICAL AIR	GYP.	GYPSUM	S.S.	STAINLESS STEEL
A.C.T.	ACOUSTIC CEILING TILE	HGT.	HEIGHT	SECT.	SECTION
ADJ.	ADJUSTABLE	H.M.	HOLLOW METAL	SIM.	SIMILAR
A.F.F.	ABOVE FINISH FLOOR	H.R.	HANDRAIL	SOIL.	SOILED
ALUM.	ALUMINUM	H.W.	HOT WATER	SPEC.	SPECIFICATION
BD.	BOARD	IN.	INCH	SPRK	SPRINKLER
CAB.	CABINET	INFO.	INFORMATION	STO./STOR.	STORAGE
CL./CLOS.	CLOSET	INT.	INTERIOR	STRUC.	STRUCTURAL
CLG	CEILING	ISO.	ISOLATION	SUPR.	SUPERVISOR
CLR	CLEAR	K.D.	KNOCK DOWN	S.V.	SHEET VINYL
COL.	COLUMN	K.O.	KNOCK OUT	TLT.	TOILET
COMM.	COMMUNICATION	LAB.	LABORATORY	TELE.	TELEPHONE
CONC.	CONCRETE	LVT	LUXURY VINYL TILE	TREAT.	TREATMENT
CONST.	CONSTRUCTION	MANUF.	MANUFACTURER	TYP.	TYPICAL
CONT.	CONTINUOUS	MAT.	MATERIAL	U.L.	UNDERWRITER'S LAB.
C.J.	CONTROL JOINT	MAX.	MAXIMUM	U.O.N.	UNLESS OTHERWISE NOTED
CORR.	CORRIDOR	MECH.	MECHANICAL	UTIL.	UTILITY
C.M.	CONSTRUCTION MANAGEMENT	MED	MEDICINE/MEDICATION	V	VACUUM
CPT	CARPET	MEP	MECH./ELEC./PLUMB.	V.C.T.	VINYL COMPOSITION TILE
C.T.	CERAMIC TILE	MIN.	MINIMUM	VERT.	VERTICAL
CTR	CENTER	MISC.	MISCELLANEOUS	VEST.	VESTIBULE
DBL	DOUBLE	MTL.	METAL	V.I.F.	VERIFY IN FIELD
DEPT.	DEPARTMENT	N.I.C.	NOT IN CONTRACT	W/	WITH
D.F.	DRINKING FOUNTAIN	NO.	NUMBER	W/O	WITHOUT
DIA.	DIAMETER	N/S	NURSE STATION		
DIM./DIMEN.	DIMENSION	N.T.S.	NOT TO SCALE		
DN	DOWN	02	OXYGEN		
DWG	DRAWING	0.C.	ON CENTER		
ELEC.	ELECTRICAL	OFF.	OFFICE		
ELEV	ELEVATOR/ELEVATION	PAT.	PATIENT		
EVS	ENVIRONMENTAL SERVICES CL.	PERF.	PERFORATED		
EQ	EQUAL	P.LAM	PLASTIC LAMINATE		
EQUIP.	EQUIPMENT	PLUMB.	PLUMBING		
EXIST.	EXISTING	PLY	PLYWOOD		
E.J.	EXPANSION JOINT	PT.	PAINT		
F.D.	FLOOR DRAIN	RCP	REFLECTED CEILING PLAN		
FLR.	FLOOR	REF.	REFRIGERATOR		
F.R.R.	FIRE RESISTANCE RATED	REINF.	REINFORCED		
GA.	GAUGE	REQ.	REQUIRED		
GALV.	GALVANIZED	RM.	ROOM		
GC	GENERAL CONTRACTOR	R.D.	ROOF DRAIN		
G.W.B.	GYPSUM WALLBOARD	S.	SLIDE		

ELECTRICAL SYMBOLS			
SYMBOL	DESCRIPTION		
$\bigcirc$	FLOOR OUTLET		
$\bigcirc$	DUPLEX POWER RECEPTACLE		
$\bigoplus$	QUADRAPLEX POWER RECEPTACLE		
	COMBINATION DUPLEX POWER/USB RECEPTACLE		
	USB RECEPTACLE		
$\bigtriangledown$	TELEPHONE RECEPTACLE		
$\mathbf{\nabla}$	DATA/TELE RECEPTACLE		
▼	DATA		
J	JUNCTION BOX		
\$	SINGLE SWITCH		
\$ <sub>3</sub>	3-WAY SWITCH		
\$4	4-WAY SWITCH		
\$ <sub>D</sub>	SINGLE SWITCH WITH DIMMER		
T	THERMOSTAT		
$(\mathbf{H})$	HUMIDISTAT		

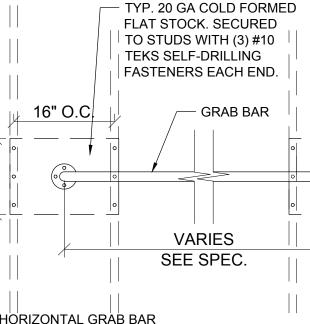


HORIZONTAL GRAB BAR

GRAB BAR BLOCKING DETAIL - IBC-1607.8.2 SINGLE CONCENTRATED LOAD 250 LBS APPLIED IN ANY POINT OR DIRECTION.

1 ` ∖ A1.2 ∕

44

#### NOT TO SCALE

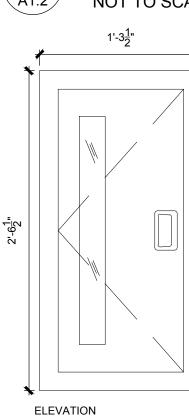


VARIES COORD. MIN. DEPTH W/ CABINET



- 1. ALL ACCESSIBLE SIGNAGE SHALL MEET ALL OF THE REQUIREMENTS OF ICC/ANSI A117.1-2003, CHAPTER 7 -COMMUNICATION ELEMENTS AND FEATURES.
- 2. VISUAL AND TACTILE SIGNS SHALL BE PROVIDED AT EACH ACCESSIBLE TOILET ROOM DOOR, EACH EXIT DOOR, AND AS INDICATED ON THE PLAN
- 3. PROVIDE UNISEX ACCESSIBLE SIGN AT ALL TOILETS.
- 4. ALL SIGN SIZES, SYMBOL SIZES, BRAILE CONFIGURATIONS AND OTHER GRAPHICAL INFORMATION MUST STRICTLY CONFORM TO THE 2010 ADA CRITERIA.
- 5. CHARACTERS MUST BE NO LONGER THAN 48" AND NO HIGHER THAN 60" AFF

NOTE: ALL WALL MOUNTED ACCESSIBLE. SIGNAGE MOUNTED AT 42" TO CENTER OF MOUNTING POINT.

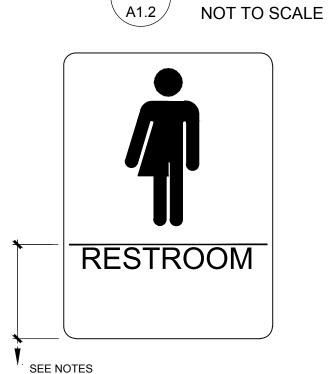


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∖A1.3 /



TYPICAL ACCESSIBLE TOILET ROOM SIGNAGE - COORDINATE EXACT DECRIPTION WITH FLOOR PLAN NOT TO SCALE



ULE	
COLOR AND STYLE	REMARKS
-	CLEAN HOLD 310, 330, SOILED 309 & 329,
-	WAITING 319, 358, PASSAGE 360, 361, 362, 363, 364, 366, 367 368, 369, TOUCH DOWN 365,
-	RECEPTION 320, 343, PROVIDER STATION 322, 332, & 350
-	
-	EXAM ROOMS 304, 305, 306 307, 308 321, 336, 337, 338, 340, 342, 344, 345 346, 347,349, 351, 352 & 353 &
-	ULTRASOUND ROOMS 333 & 335.
-	
-	
-	STAFF LOUNGE 311
-	
-	
-	
-	OFFICE 301, 312, 313, 315, 316, 317, 318, 323, 354, 355, 356 & MD OFFICE 302 & 303
-	
-	
-	
-	TOILETS / WET WALL CONDITIONS, INCLUDING THOSE ON EITHER SIDE OF THE TOILET AND
-	SURROUNDING THE HAND-WASHING SINK
-	ALL OTHER WALLS TO BE PAINTED WITH
-	INTEGRAL CERAMIC COVE BASE. USE ALL MANUFACTURES JOLLY TRIMS FOR ANY
-	OUTSIDE CORNERS. STAFF TOILET 326, 327, PATIENT TOILET 324, 334, 341 & 348,
-	LAB 314, 325, 357, PROCEDURE ROOM 331 &
-	EVS 339 & IT 328
-	_
-	

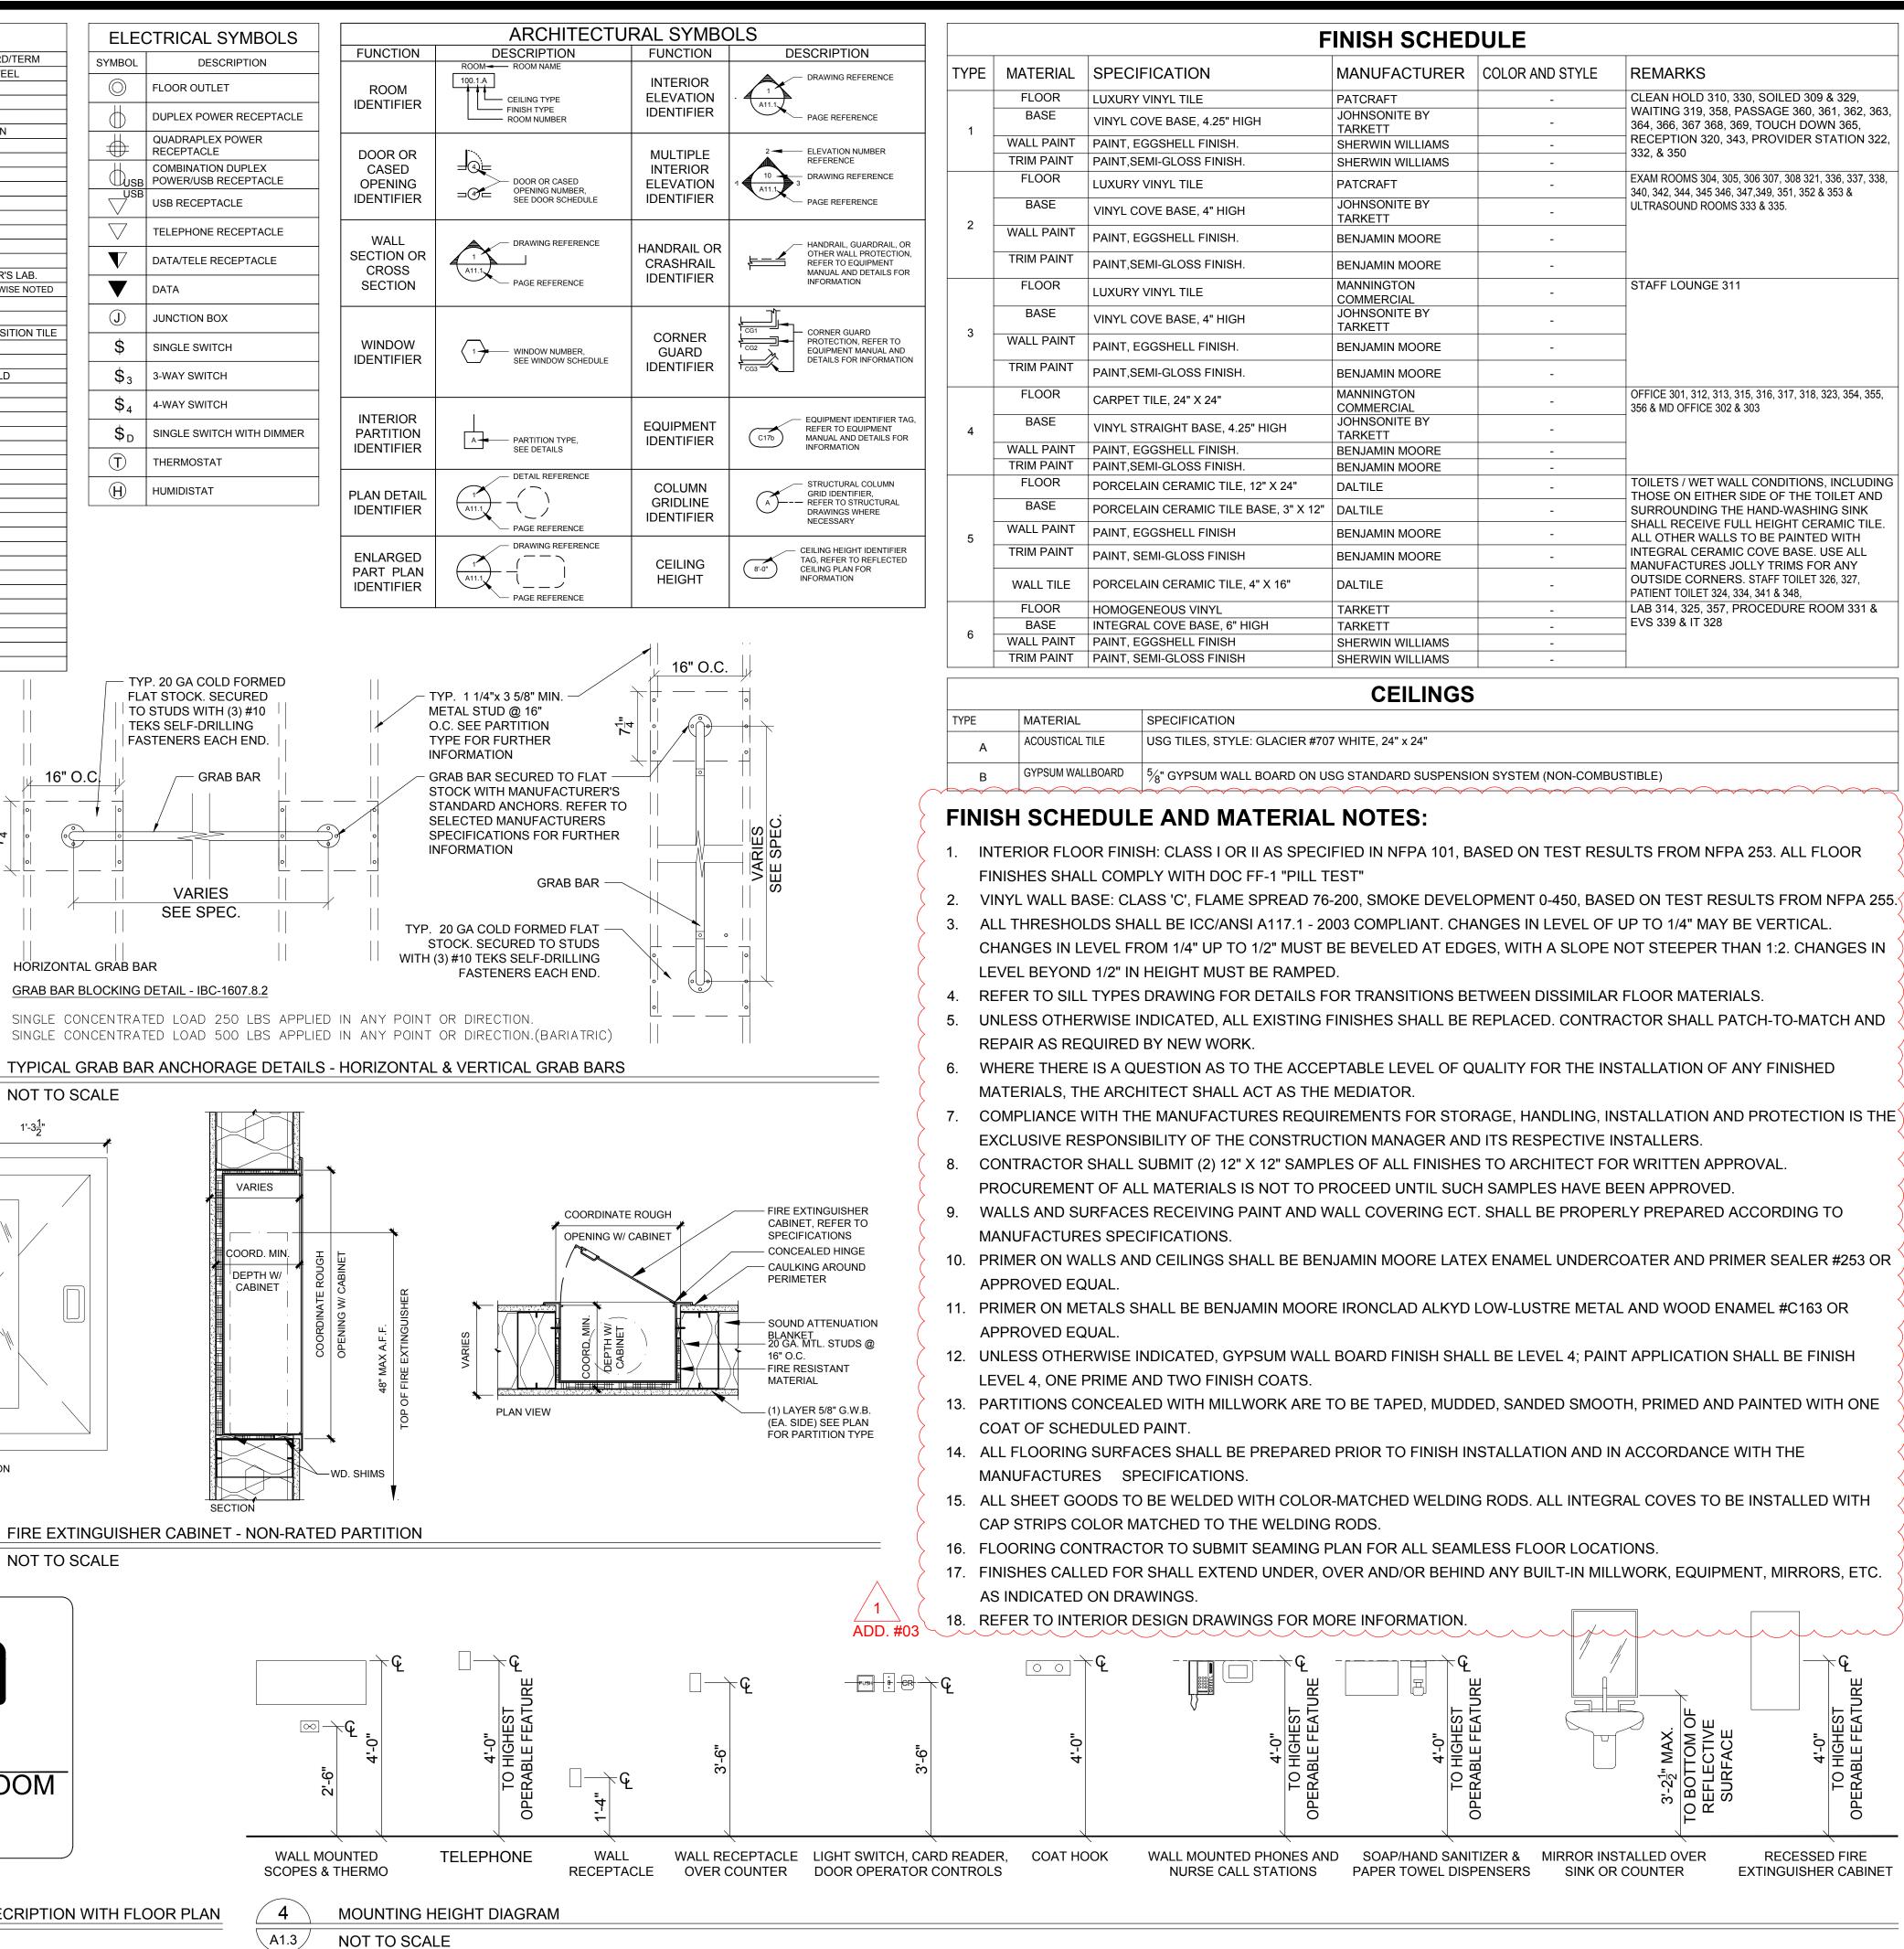
## Montefiore

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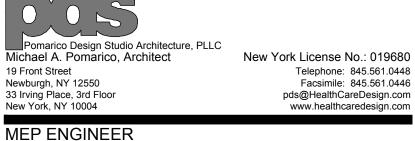
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HIGHLAND MEDICAL **OBGYN CLINICS** THIRD FLOOR **17 SQUADRON BLVD NEW CITY, NY 10956** 

**KEY PLAN: NOT TO SCALE** 



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STRUCTURAL ENGINEER
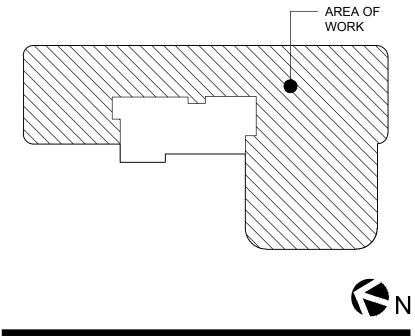
#### **ISSUED DOCUMENTS:** Date: Description **BID ISSUE - ARCH** ADDENDA #03 3/16/22

SEAL

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DRAWING TITLE:

#### ABBREVIATION, SYMBOL LEGEND, MOUNTING AND FINISH SCHEDULE

PROJECT NUMBER CON # 21035a DATE

02/06/2022 DRAWING NUMBER


SCALE AS NOTED

#### **BARRIER FREE NOTES**

BARRIER-FREE STANDARDS INDICATED HEREIN ARE TYPICAL. DIMENSIONS SHOWN ARE TYPICAL UNLESS INDICATED OTHERWISE ELSEWHERE IN THE DRAWINGS


- 1. REFER TO COVER SHEET FOR APPLICABLE CODES, STANDARDS, AND GUIDELINES.
- 2. THE CLEAR WIDTH OF A PASSAGEWAY FOR A SINGLE WHEELCHAIR SHALL BE 32 INCHES FOR A PASSAGEWAY OF 24 INCHES OR LESS AND 36 INCHES FOR A PASSAGEWAY LONGER THAN 24 INCHES.
- 3. THE CLEAR FLOOR SPACE REQUIRED FOR A SINGLE WHEELCHAIR SHALL BE 30 INCHES BY 48 INCHES.
- 4. THE CLEAR WIDTH OF AN ACCESSIBLE ROUTE SHALL BE 36 INCHES.
- 5. HANDRAILS: THE TOP OF GRIPPING SURFACE OF HANDRAILS SHALL BE 34 INCHES MINIMUM AND 38 INCHES MAXIMUM VERTICALLY ABOVE THE STAIR NOSING OR RAMP SURFACE. CLEAR SPACE BETWEEN HANDRAILS AND WALL SURFACE SHALL BE 1 1/2" MINIMUM.
- 6. PROTRUDING OBJECTS: OBJECTS WITH LEADING EDGES LOCATED MORE THAN 27 INCHES AND NOT MORE THAN 80 INCHES ABOVE THE FLOOR SHALL PROTRUDE NOT MORE THAN 4 INCHES FROM THE WALL
- 7. GUARDRAILS OR OTHER BARRIERS SHALL BE PROVIDED WHEN VERTICAL CLEARANCE OF AN AREA ADJOINING AN ACCESSIBLE ROUTE IS LESS THAN 80 INCHES HIGH
- 8. CHANGES IN LEVEL: A CHANGE IN LEVEL OF 1/4 INCH HIGH MAXIMUM SHALL BE PERMITTED TO BE VERTICAL AND WITHOUT EDGE TREATMENT. A CHANGE IN LEVEL OF BETWEEN 1/4 INCH AND 1/2 INCH HIGH MAXIMUM SHALL BE BEVELED WITH A SLOPE NOT STEEPER THAN 1:2.
- 9. RAMPS SHALL HAVE A SLOPE NOT STEEPER THAN 1:12. THE MAXIMUM RISE FOR ANY RAMP WITHOUT A LANDING IS 30 INCHES. THE RAMP SHALL HAVE A CLEAR WIDTH OF 36 INCHES. LANDING LENGTH SHALL BE A MINIMUM OF 60 INCHES.
- 10. STAIR TREADS AND RISERS SHALL BE AS FOLLOWS: STAIR TREADS SHALL BE MINIMUM OF 11 INCHES DEEP. STAIR RISERS SHALL BE A MAXIMUM OF 7 INCHES HIGH.
- 11. DOOR CLOSERS SHALL BE ADJUSTED SO THAT FROM AN OPEN POSITION OF 90 DEGREES, THE TIME REQUIRED TO MOVE THE DOOR TO AN OPEN POSITION OF 12 DEGREES WILL BE 5 SECONDS MINIMUM
- 12. DOOR OPENING FORCE WHERE CLOSERS ARE USED SHALL BE 5 POUNDS MAXIMUM.
- 13. THE BOTTOM 12 INCHES OF ALL DOORS EXCEPT AUTOMATIC DOORS SHALL HAVE A SMOOTH UNINTERRUPTED SURFACE TO ALLOW THE DOOR TO BE OPENED BY A WHEELCHAIR FOOTREST WITHOUT CREATING A TRAP OR HAZARDOUS CONDITION.
- 14. POWER ASSISTED DOORS: THE TIME REQUIRED FOR SUCH DOORS TO OPEN TO A BACK CHECK POSITION SHALL BE 3 SECONDS MINIMUM. THE FORCE REQUIRED TO STOP DOOR MOVEMENT SHALL BE 15 POUNDS MAXIMUM
- 15. EXPOSED PIPES AND SURFACES UNDER LAVATORIES AND SINKS SHALL BE INSULATED OR OTHERWISE CONFIGURED TO PROTECT AGAINST CONTACT.
- 16. GRAB BARS SHALL HAVE A DIAMETER OR WIDTH OF GRIPPING SURFACE FROM 1 1/4 TO 2 INCHES. THE CLEAR SPACE BETWEEN THE GRAB BAR SURFACE AND THE WALL SURFACE SHALL BE 1-1/2 INCHES MINIMUM.
- 17. STRUCTURAL STRENGTH: ALLOWABLE STRESSES IN BENDING, SHEAR AND TENSION SHALL NOT BE EXCEEDED FOR MATERIALS USED WHERE A VERTICAL OR HORIZONTAL FORCE OF 250 POUNDS IS APPLIED AT ANY POINT ON THE GRAB BAR OR SEAT, FASTENER MOUNTING DEVICE OR SUPPORTING STRUCTURE

<u>∕</u>1'-0"

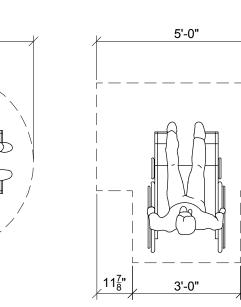



CIRCULAR TURNING SPACE T-SHAPED TURNING SPACE


5'-0"

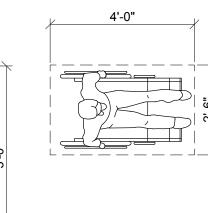



CLEAR FLOOR SPACE

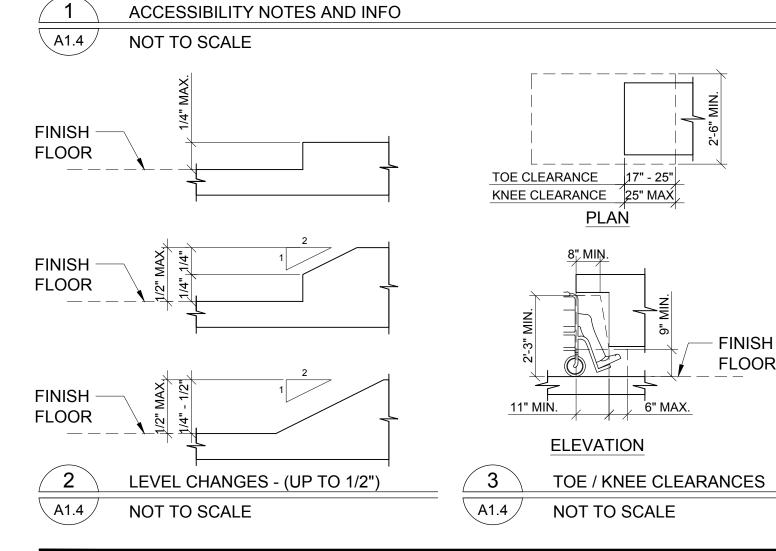

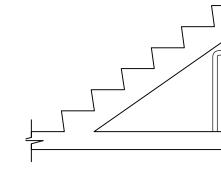

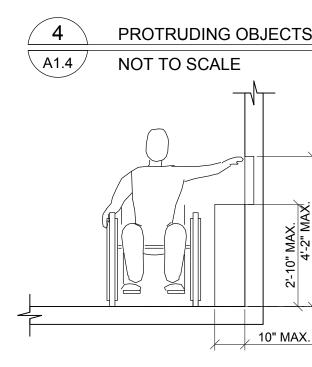

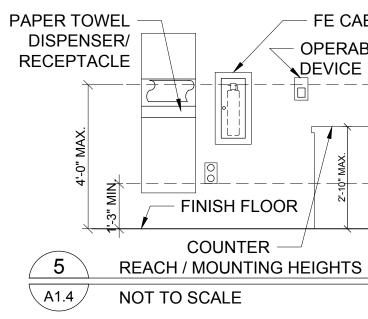

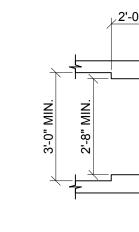



	CLEAR WI
	SEGMENT LEN
	≤ 24 INCHE
	> 24 INCHE
6	ACCESSIBLE ROUT
\A1.4	NOT TO SCALE

MANEUVERING CLE				
TYPE OF US	E			
APPROACH DIRECTION	DOOR SIDE			
FROM FRONT	PULL			
FROM FRONT	PUSH			
FROM HINGE SIDE	PULL			
FROM HINGE SIDE	PULL			
FROM HINGE SIDE	PUSH			
FROM LATCH SIDE	PULL			
FROM LATCH SIDE	PUSH			

NOTES:

- 1. ADD 6" IF CLOSER AND LATCH
- PROVIDED.
- 2. ADD 6" IF CLOSER PROVIDED. 3. ADD 12" BEYOND LATCH IF CLOSER
- AND LATCH PROVIDED.
- 4. BEYOND HINGE SIDE.

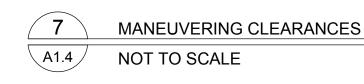

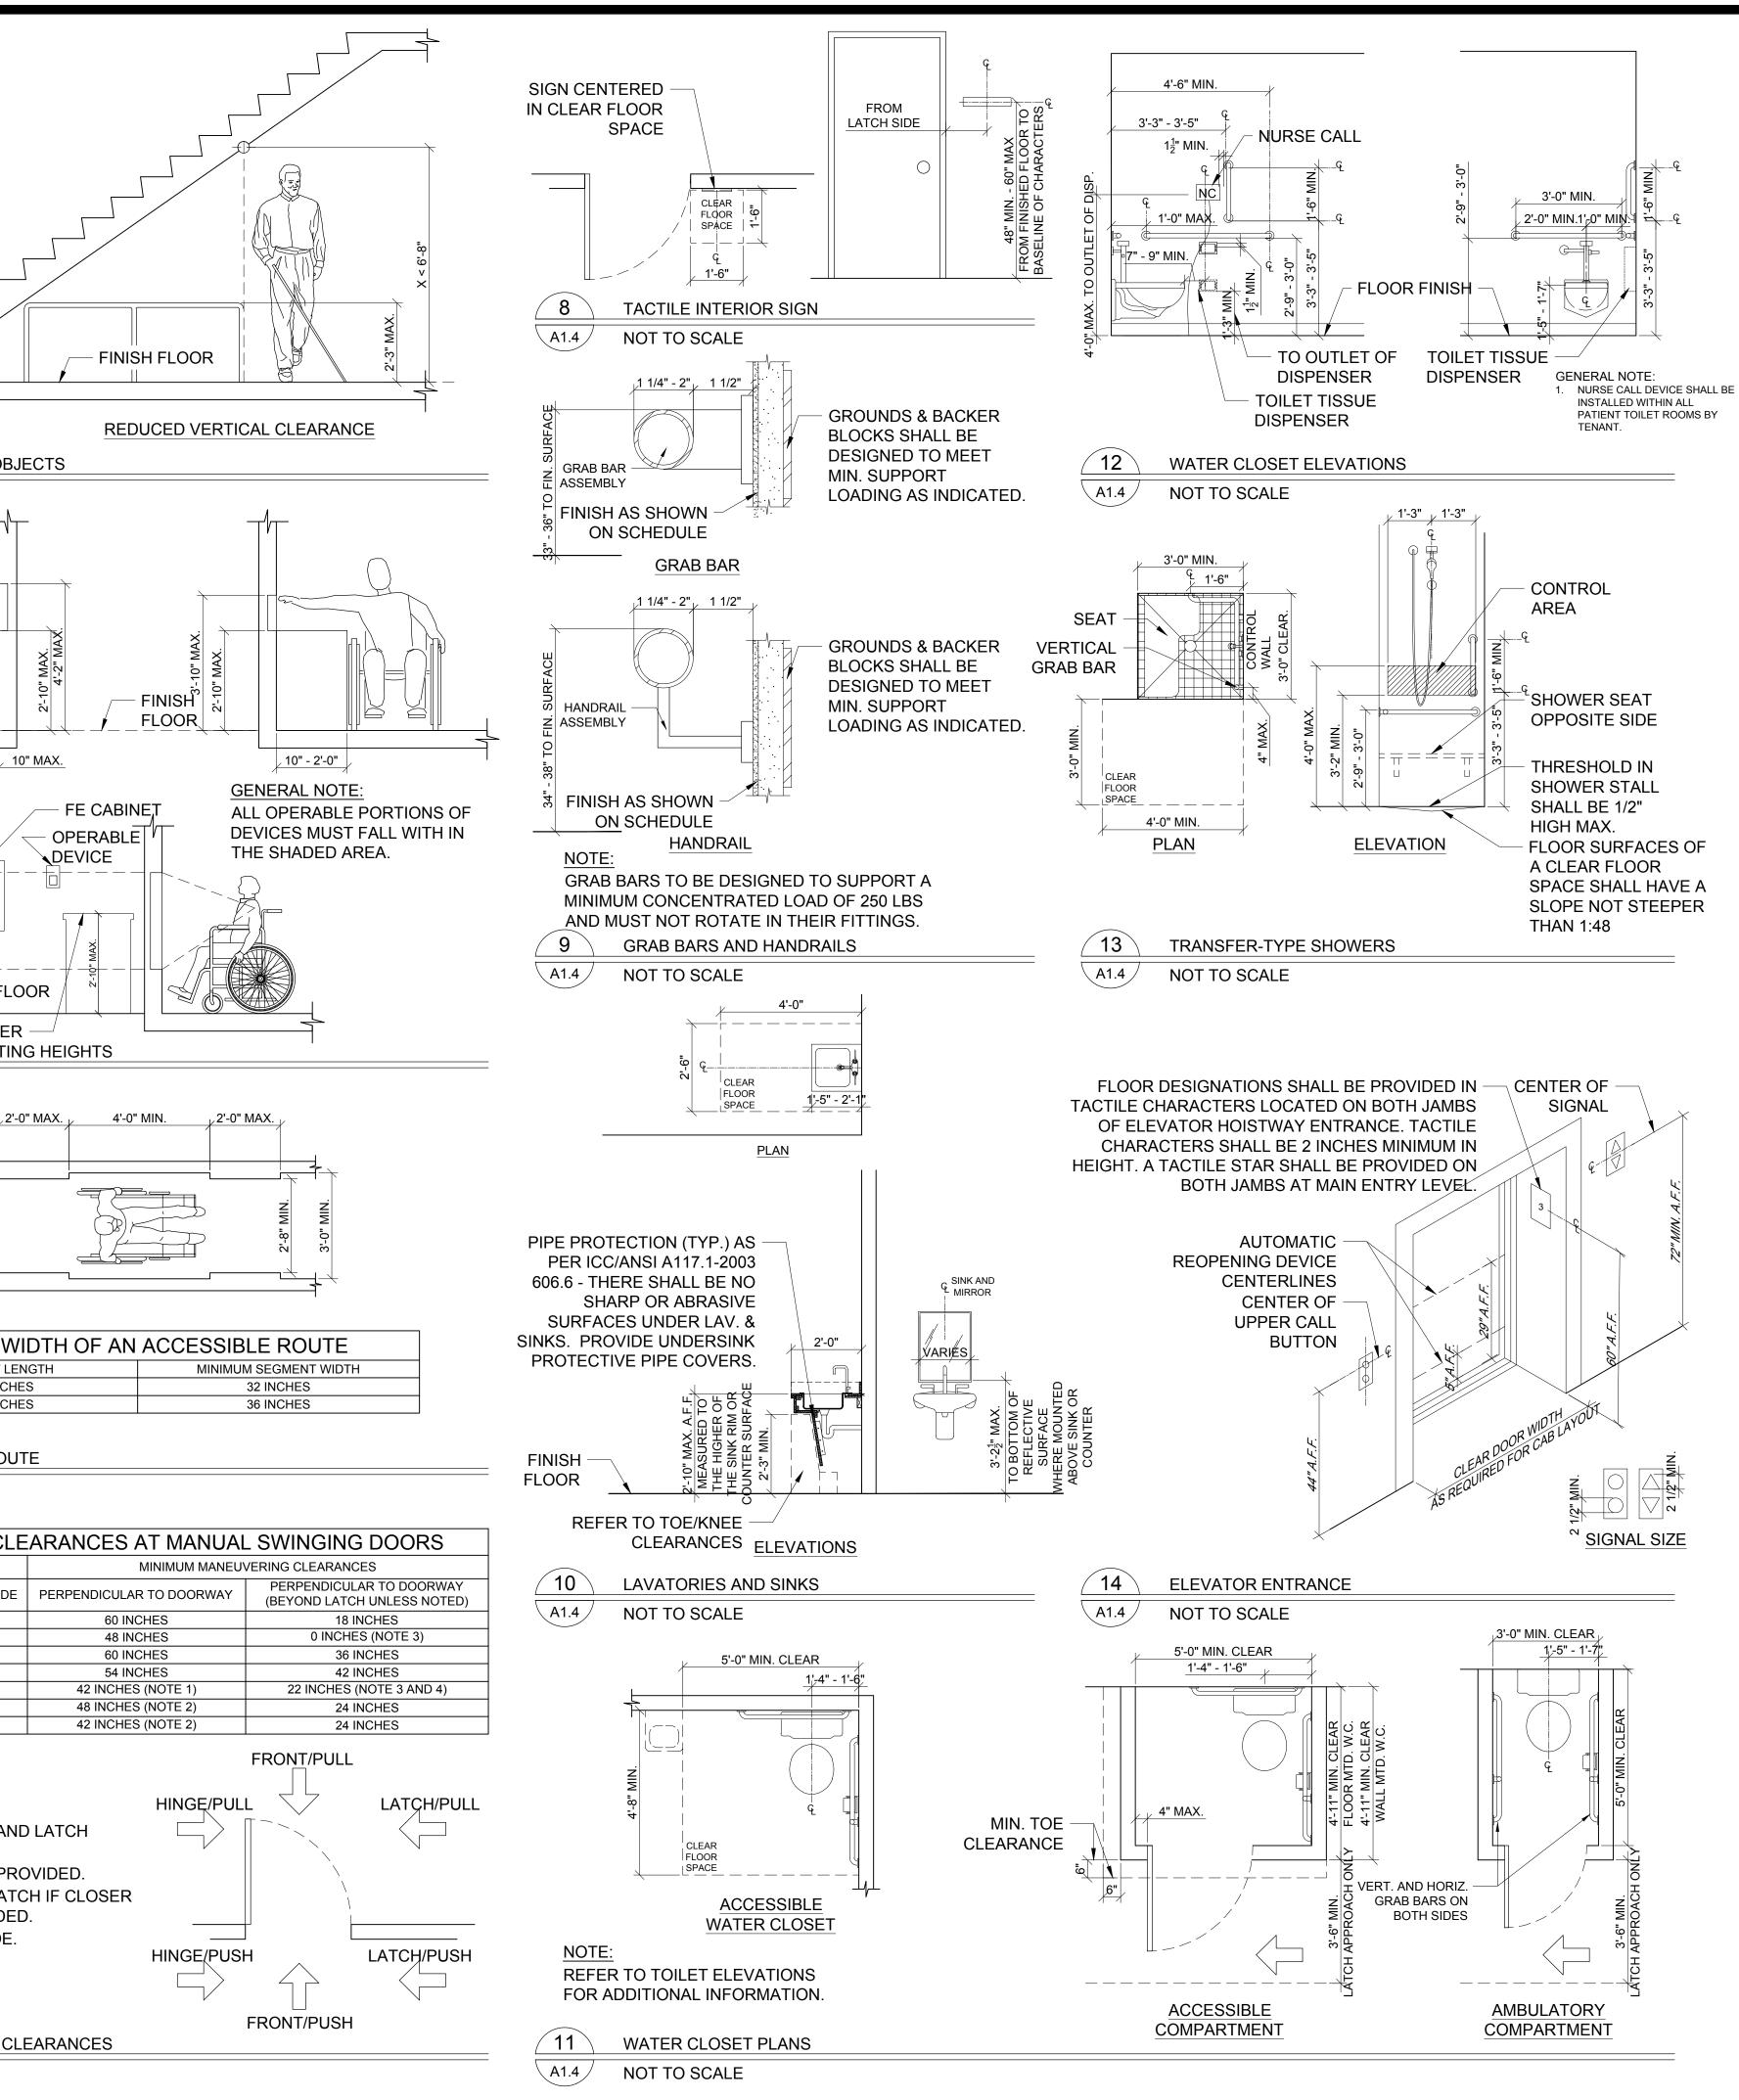


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HIGHLAND MEDICAL **OBGYN CLINICS** THIRD FLOOR 17 SQUADRON BLVD **NEW CITY, NY 10956** 

**KEY PLAN: NOT TO SCALE** 



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No:	Date:	Description:	
	2/11/22	BID ISSUE - ARCH	
1	3/16/22	ADDENDA #03	
SEAL	_		
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		D ARCHITECT, TO	

AFFIX HIS SEAL AND THE NOTATION "ALTERED BY" FOLLOWED BY HIS SIGNATURE AND THE DATE OF SUCH ALTERATION, AND A SPECIFIC DESCRIPTION OF THE ALTERATION.

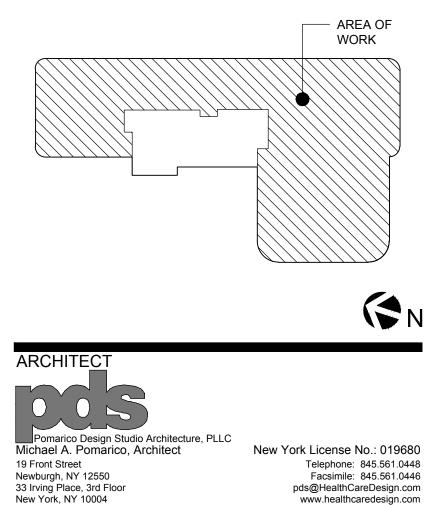DRAWING TITLE:


#### BARRIER FREE **NOTES & DETAILS**

PROJECT NUMBER CON # 21035a DATE SCALE

02/06/2022 DRAWING NUMBER

AS NOTED

EXIII	•	NS, AND FIRE PROTECTIO CH. 38 NFPA 101)	JN REQUIREMENTS	
ITEM/ DESCRIPTION	REQUIRED		PROVIDED	REMARKS/SECT. REFERENCE
TOTAL OCCUPANT LOAD SERVED, BASED ON 100 SQ. FT./PERSON	CALCULATED	ACTUAL	EGRESS TOTAL CAPACITY FOR 390 OCCUPANTS	7.3.1.2 NOTE: ACTUAL NUMBER OF PERSONS IS AN ESTIMATE
	- PERSONS SEE PLANS TOTAL PROGRAM AREA = 9,079 SQ. FT./100 SQ. FT. PER PERSON = 91 OCCUPANTS			AND INCLUDES COHABITATION
NUMBER OF EXITS	2 SEPARATE		- SEPARATE	38.2.4
EGRESS WIDTH PER OCCUPANT				
LEVEL COMPONENTS	0.2 INCHES		COMPLIES	38.2.3.1
STAIRS, RAMPS	0.3 INCHES		COMPLIES	38.2.3.1
MINIMUM CORRIDOR WIDTH	44 INCHES		COMPLIES	38.2.3.2
MINIMUM EXIT ACCESS DOOR WIDTH	32 INCHES CLEAR		COMPLIES	38.2.2.2
MAXIMUM DEAD END CORRIDOR	50 FEET		COMPLIES	38.2.5.2.1
REQUIRED RESISTANCE RATING: -ENCLOSURE CONNECTING 4 OR MORE STORIES -OTHER ENCLOSURES IN NEW CONSTRUCTION -EXISTING BARRIERS IN EXISTING BUILDING	REQUIRED FIRE BARRIER (HOURS) -2 HOUR -1 HOUR -1/2 HOUR		COMPLIES	38.3.1
MAXIMUM DISTANCE BETWEEN ANY POINT IN A NON-SLEEPING SUITE TO AN EXIT	300 FEET		COMPLIES - SEE PLANS	38.2.6.3
PROTECTION OF VERTICAL OPENINGS, SHAFTS, CHUTES, HOISTWAYS, STAIRWAYS, ETC.	1 - HOUR FIRE RESISTANCE RATING SEPARATING THE EXIT STAIR CONNECTING 3 OR LESS FLOOR IN NEW CONSTRUCTION. 1/2-HOUR FIRE RESISTANCE RATING IN EXISTING BUILDING		COMPLIES	38.3.2.1
HAZARDOUS AREAS	1 - HOUR FIRE RESISTANCE RATING OR SPRINKLER PROTECTION AND SMOKE RESISTING PARTITION		COMPLIES	38.3.1
FIRE ALARM	YES		COMPLIES	38.3.4.1
CORRIDOR WALLS AND SUITES, MINIMUM FIRE RESISTANCE RATING	MULTIPLE TENANTS - 1 HOUR		COMPLIES	38.3.6.1
SMOKE BARRIER	NOT REQUIRED		N/A	38.3.7
INTERIOR WALL AND CEILING FINISH REQUIREMENTS	CLASS A OR B IN EXITS AND CLASS A, B, OR C IN OTHER		COMPLIES	38.3.3.2
INTERIOR FLOOR FINISH REQUIREMENTS	CLASS I OR II IN EXIT ENCLOSURES		COMPLIES	38.3.3.3

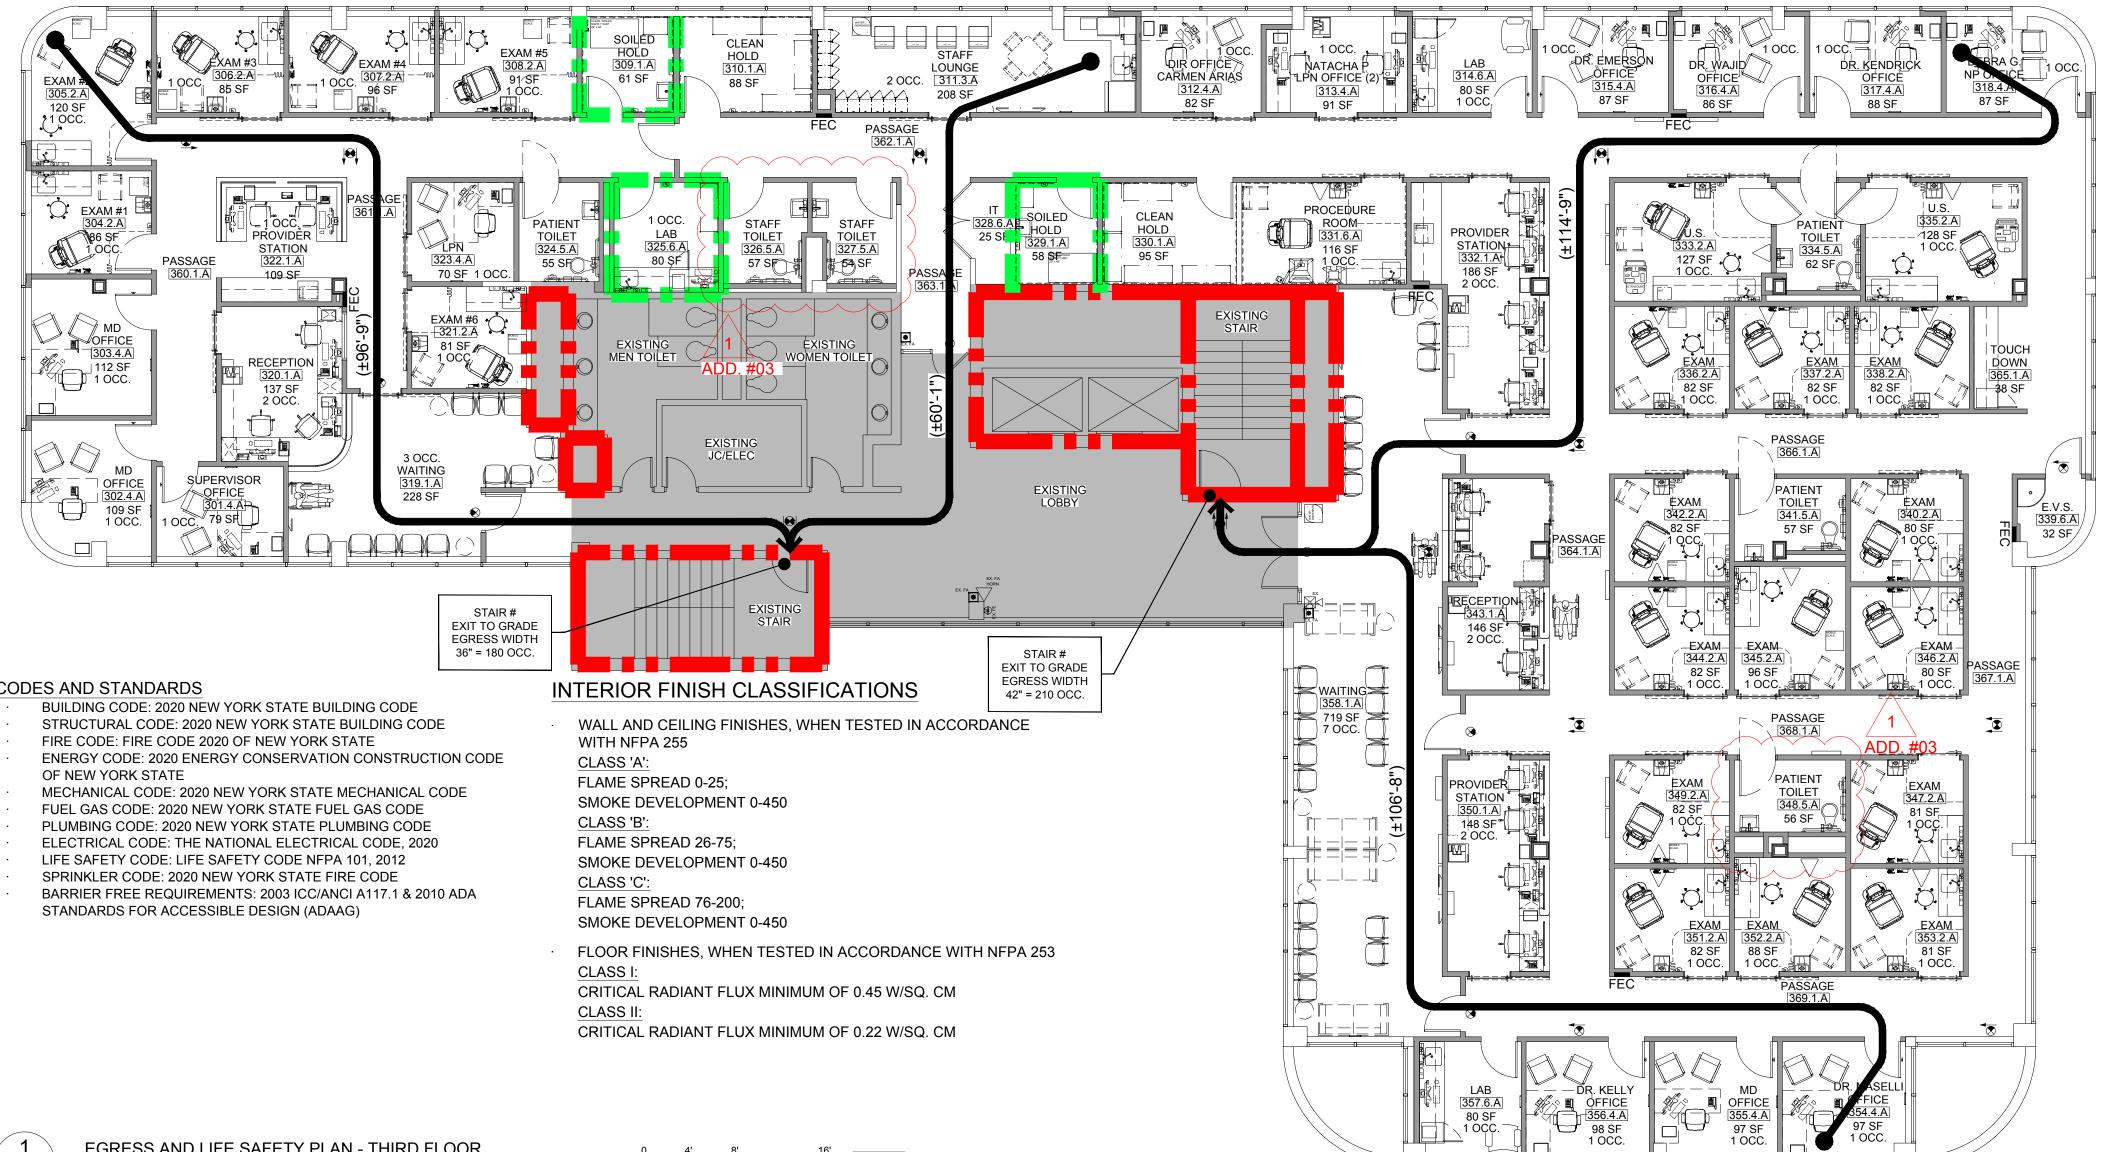

#### CODES AND STANDARDS



EGRESS AND LIFE SAFETY PLAN - THIRD FLOOR SCALE: 1/8" = 1'-0"

Scale: 1/8" = 1


NFPA 101 OCCUPANCY INFORMATION		
OCCUPANCY TYPE	B - BUSINESS	
OCCUPANCY USE	BUSINESS	
OCCUPANCY LOAD FACTOR TABLE 7.3.1.2	100 GROSS SQ. FT. PER PERSON	
NO. OF BUILDING STORIES	3	
CONSTRUCTION TYPE	TYPE III (211)	
TOTAL WORK AREA	9,079 SQ. FT.	
RENOVATION WORK AREA	9,079 SQ. FT.	
NEW WORK AREA	0 SQ. FT.	
AUTOMATIC SPRINKLER SYSTEM		
THROUGHOUT BUILDING	FULLY PROTECTED	
LIMITED AREAS		

#### **GENERAL NOTES**


- 1. IN ACCORDANCE WITH NFPA 101, SECTION 38.3.1, ALL CORRIDOR WALLS AND PARTITIONS ENCLOSING EXIT ACCESS CORRIDORS SHALL FORM A BARRIER TO LIMIT THE TRANSFER OF SMOKE. CONTRACTOR SHALL EVALUATE EXISTING PARTITIONS THROUGHOUT THE ENTIRE WORK SCOPE AND ADJACENCIES TO PROVIDE CLOSURE WHEREVER NECESSARY TO MAINTAIN BARRIER TO LIMIT THE TRANSFER OF SMOKE. CLOSURE MAY INCLUDE, BUT IS NOT NECESSARILY LIMITED TO, THE INSTALLATION OF SAFING MATERIAL OR SEALANT AROUND EXISTING PENETRATIONS. EXTENSION OF EXISTING PARTITIONS, WALLS OR DRYWALL ABOVE ADJACENT CEILINGS.
- 2. OCCUPANT LOADS LISTED ARE FOR VENTILATION SCHEDULE CALCULATIONS. EGRESS BASED ON S.F. OCCUPANT CALCULATIONS.
- 3. EXISTING RATED ASSEMBLIES IN OUT OF SCOPE AREAS SHALL REMAIN AND BE REPAIRED WITH LIKE KIND IF ALTERED.

#### EGRESS AND LIFE SAFETY GENERAL NOTES

- 1. ALL PARTITIONS WHICH ARE PART OF THE EXIT ACCESS CORRIDOR SYSTEM SHALL BE SMOKE PARTITIONS CAPABLE OF LIMITING THE TRAVEL OF SMOKE.
- 2. SEE PHASING PLAN SHEETS FOR INTERIM LIFE SAFETY MEASURES.

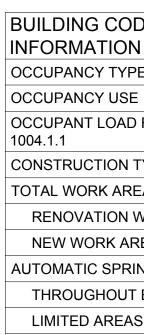

**BUILDING EL** STRUCTURA **BEARING WA** \* EXTERIOR \* INTERIOR NONBEARIN \* EXTERIOR NONBEARIN \* INTERIOR FLOOR CONS ROOF CONS

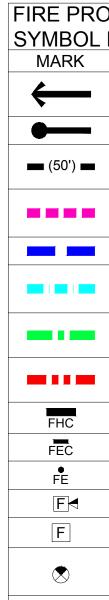

CODE OF NEW YORK	STATE OCCUPANCY
Y TYPE	B - BUSINESS
Y USE	BUSINESS
LOAD FACTOR TABLE	100 GROSS SQ. FT. PER PERSON
FION TYPE	TYPE 3B
K AREA	9,079 SQ. FT.
FION WORK AREA	9,079 SQ. FT.
RK AREA	0 SQ. FT.
SPRINKLER SYSTEM	
HOUT BUILDING	FULLY PROTECTED
AREAS	

#### BUILDING CODE OF NEW YORK STATE - TABLE 601

LEMENTS	TYPE 3B
AL FRAME	0
ALLS	2 HOUR 0 HOUR
G WALL/PARTITION	SEE TABLE 602
G WALL/PARTITION	0
STRUCTION	0
STRUCTION	0

)	TECTION AND MEANS OF EGRESS
L	EGEND
	DESCRIPTION
	POINT OF EXIT ACCESS AND DIRECTION OF EGRESS TRAVEL
	REMOTE POINT OF EXIT ACCESS TRAVEL
	DISTANCE OF TRAVEL FROM REMOTE POINT TO POINT OF EXIT ACCESS
	SMOKE BARRIER (1-HOUR FIRE RESISTANCE-RATED CONSTRUCTION)
	SMOKE PARTITION (SMOKE-LIMITING)
	SUITE SEPARATION PARTITION (SMOKE-LIMITING)
	1-HOUR FIRE RESISTANCE-RATED CONSTRUCTION
	2-HOUR FIRE RESISTANCE-RATED CONSTRUCTION
	FIRE HOSE CABINET
	FIRE EXTINGUISHER IN CABINET
	FIRE EXTINGUISHER ON HOOK (EX = EXISTING )
	FIRE ALARM HORN/STROBE (EX = EXISTING )
	FIRE ALARM MANUAL PULL (EX = EXISTING )
	EXIT SIGNAGE (FILL INDICATES DIRECTION TO EXIT)
	HAZARDOUS AREA: SMOKE / PARTITION ENCLOSURE REQUIRED (DOORS SHALL BE SELF-CLOSING OR AUTOMATIC CLOSING)
	AREA NOT IN THE SCOPE U.N.O.


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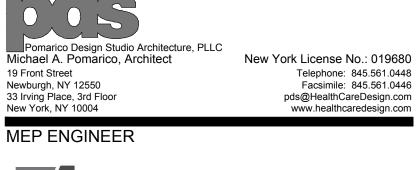
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KEY PLAN: NOT TO SCALE







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No:	Date:	Description:
	2/11/22	BID ISSUE - ARCH
1	3/16/22	ADDENDA #03
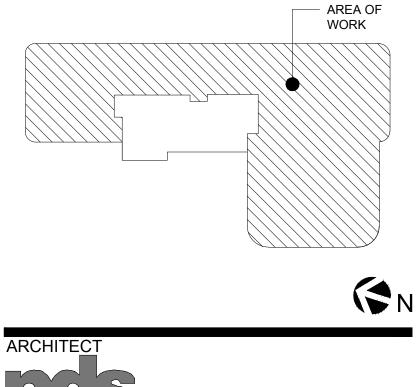
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DRAWING TITLE:

#### EGRESS AND LIFE SAFETY PLAN - THIRD FLOOR

PROJECT NUMBER 21035a

DATE

-

02/06/2022 DRAWING NUMBER


SCALE

CON #

AS NOTED



TO FLOOR PLAN.

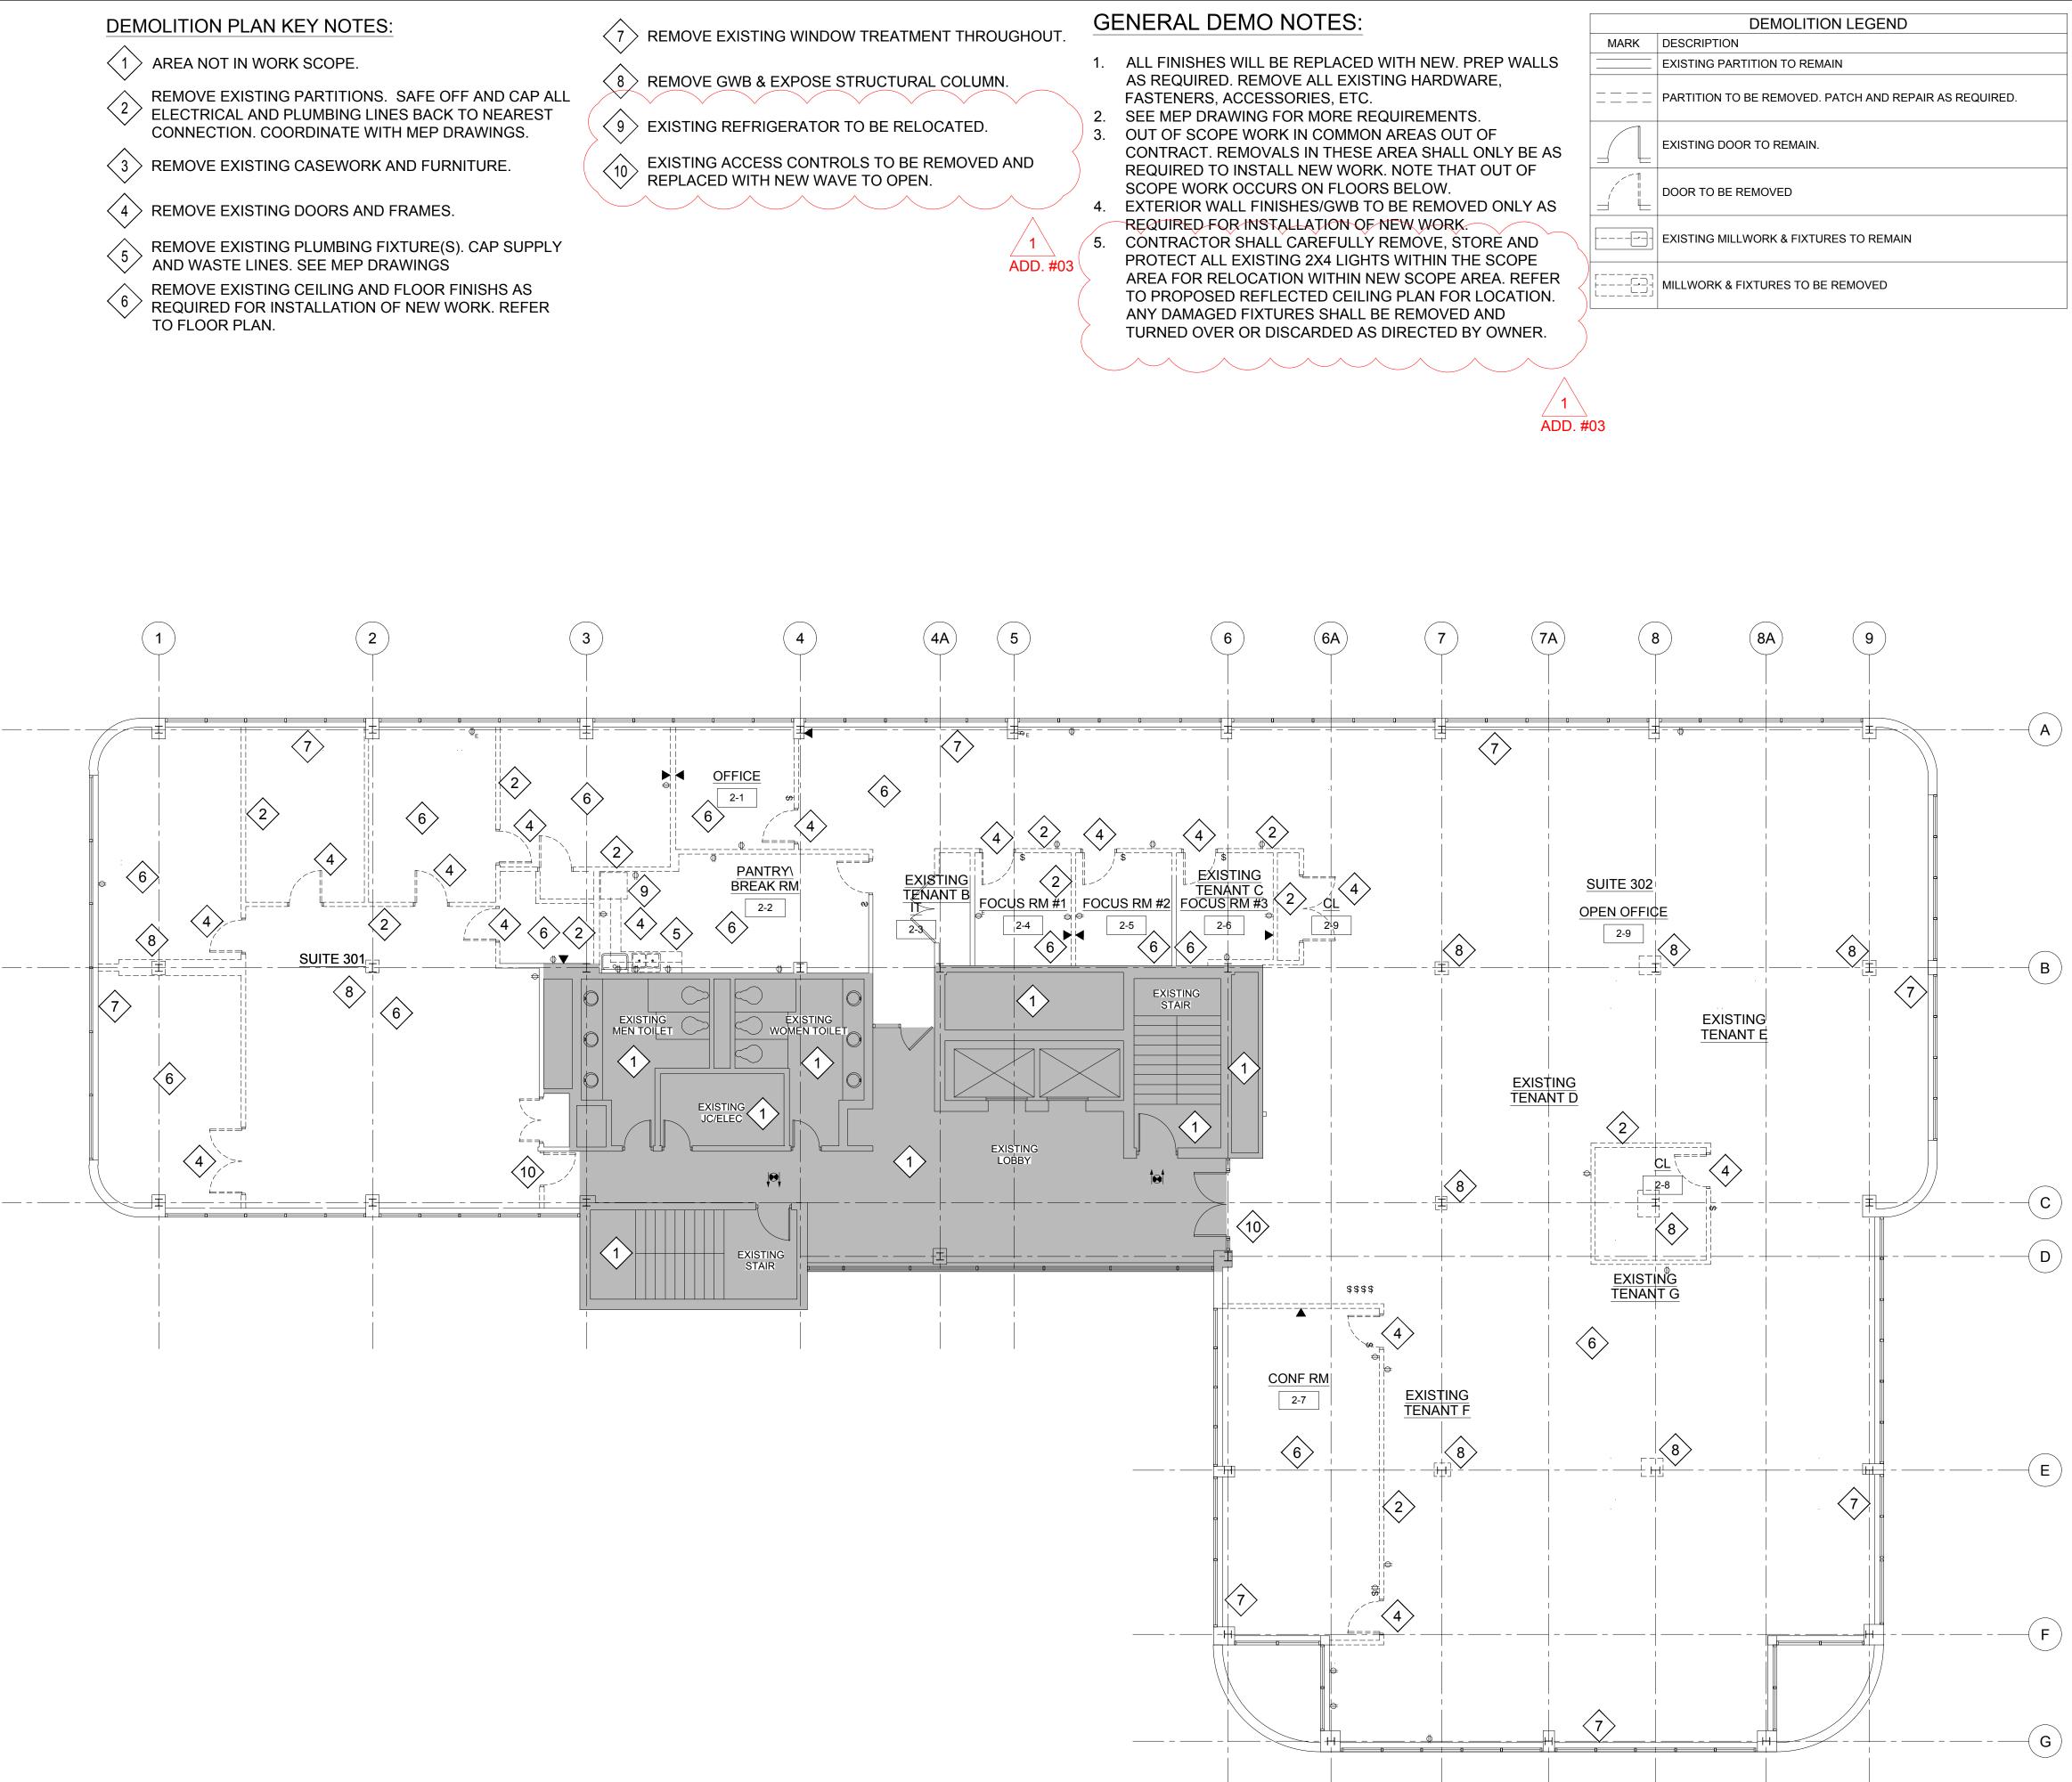



**DEMOLITION PLAN - THIRD FLOOR** 

SCALE: 1/8" = 1'-0"

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HIGHLAND MEDICAL **OBGYN CLINICS** THIRD FLOOR 17 SQUADRON BLVD NEW CITY, NY 10956

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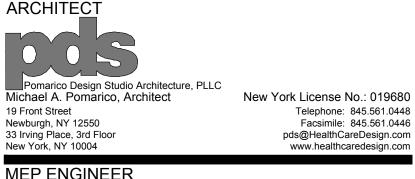
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Description: BID ISSUE - ARCH

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433 STATE STREET, SUITE 410

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BY" FOLLOWED BY HIS SIGNATURE AND THE DATE OF SUCH ALTERATION, AND A SPECIFIC

THIRD FLOOR

DEMOLITION PLAN -

CON #

SCALE

AS NOTED

-

DESCRIPTION OF THE ALTERATION.

DRAWING TITLE:

PROJECT NUMBER

02/06/2022

DRAWING NUMBER

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21035a

DATE

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ALTER THIS DOCUMENT IN ANY WAY. IF

Date:

2/11/22

3/16/22


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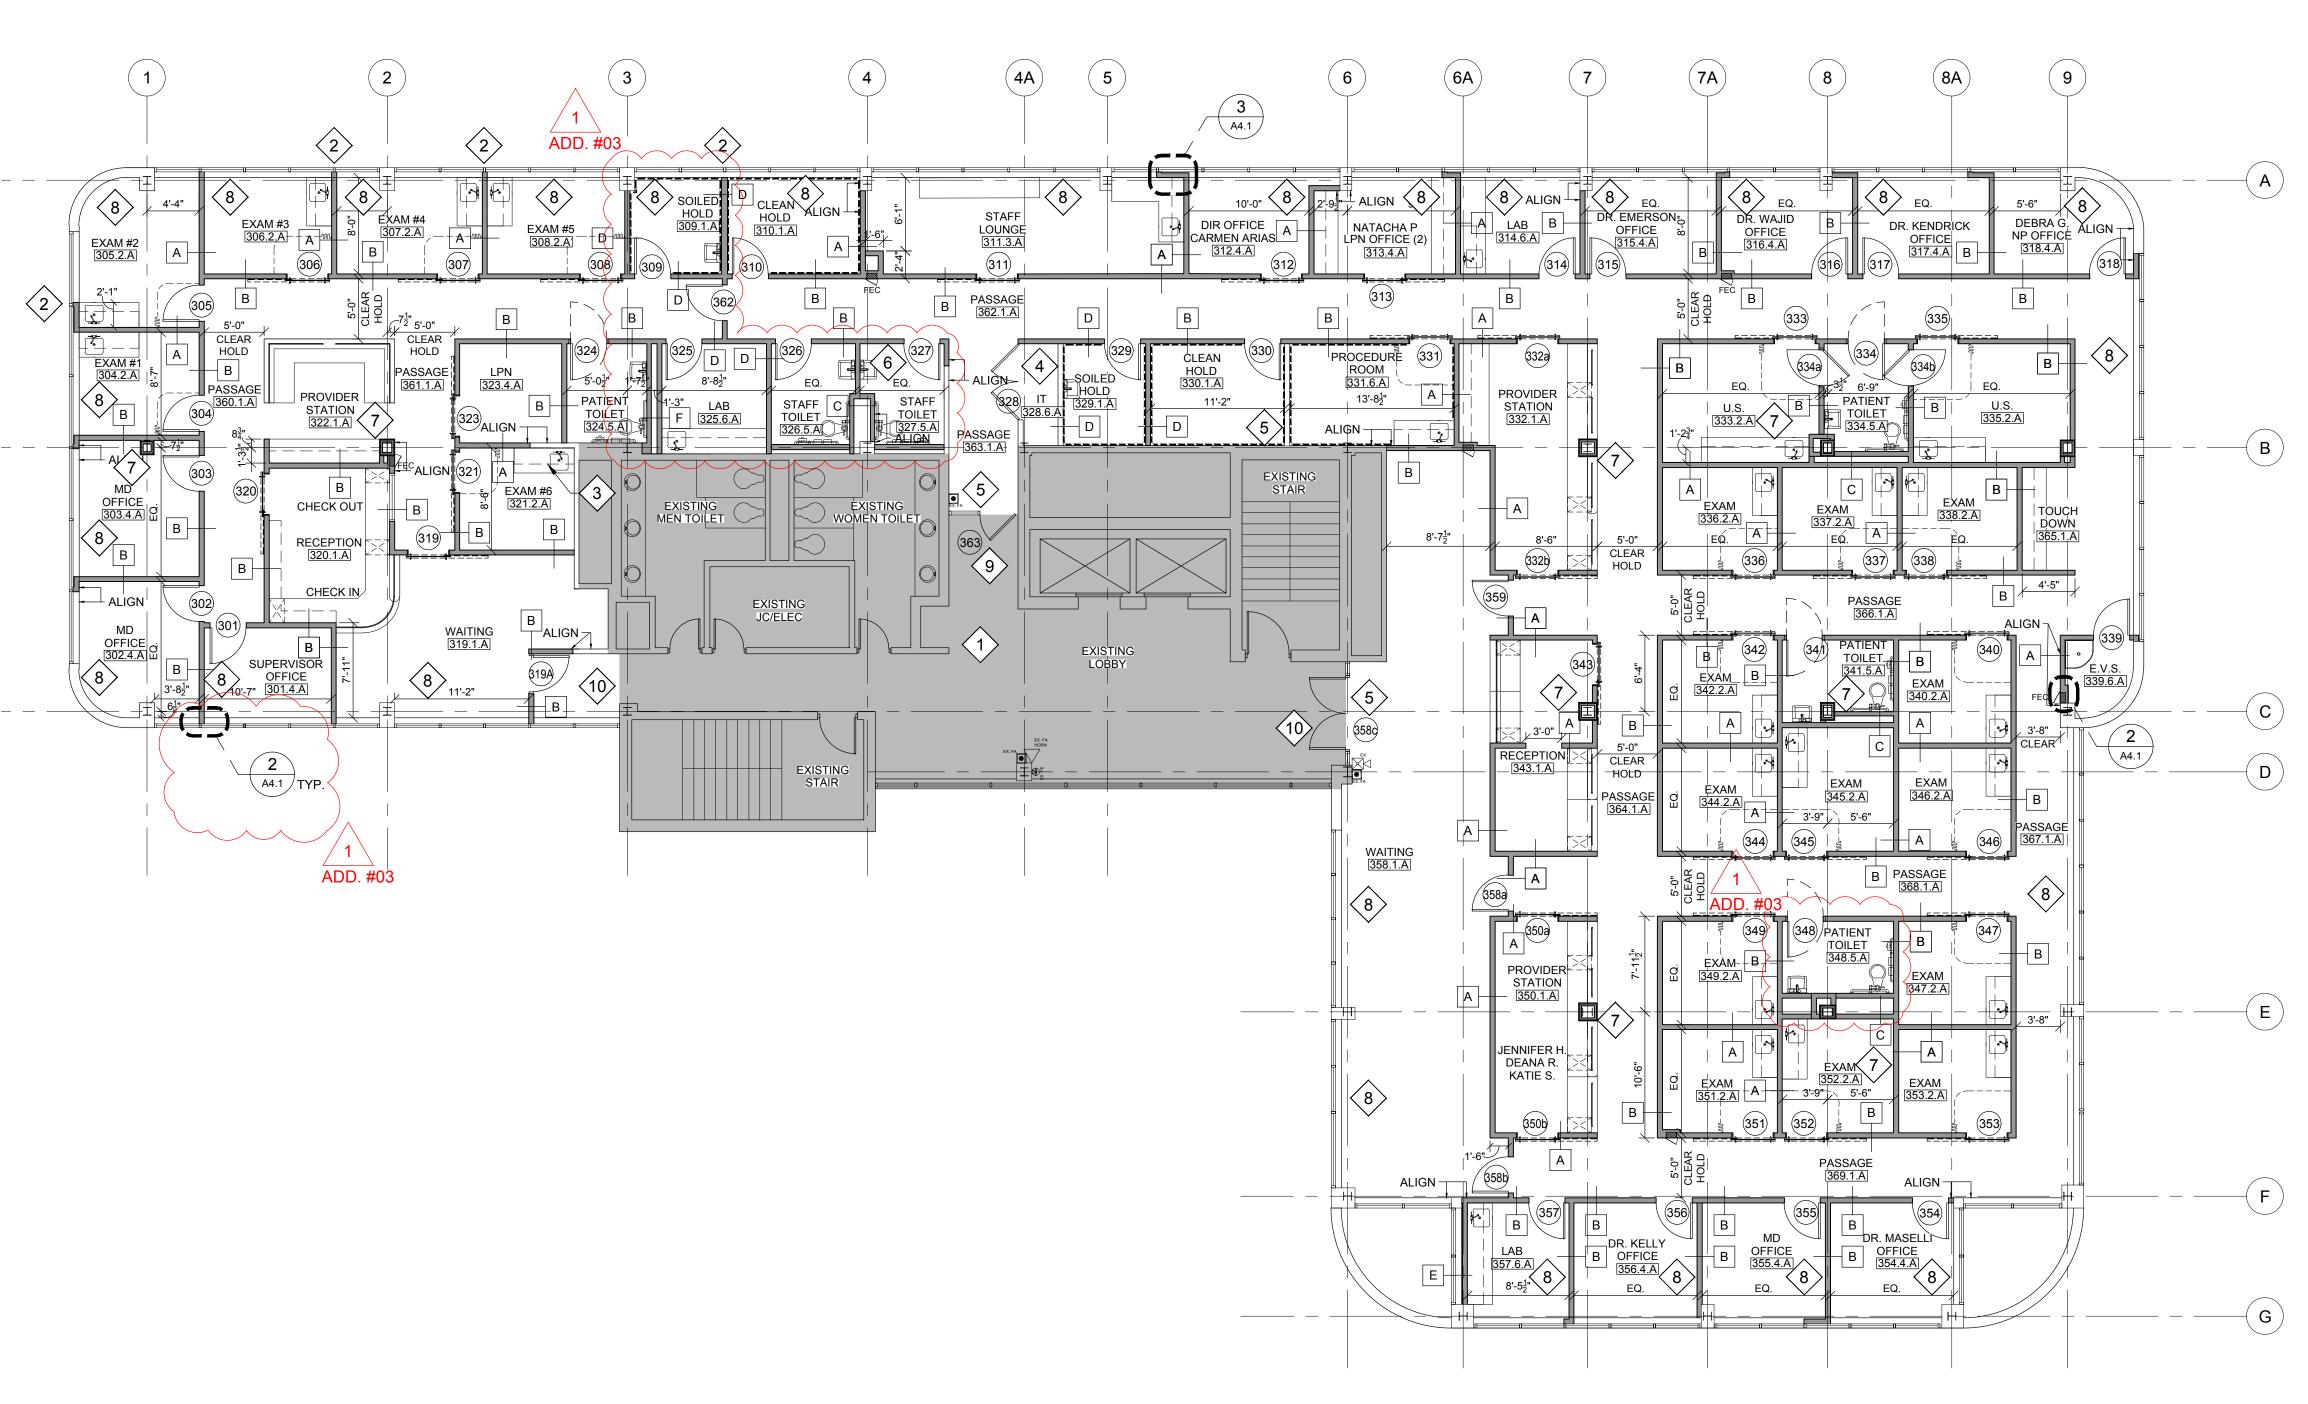
SCHENECTADY, NY 12305


New York, NY 10004

ME





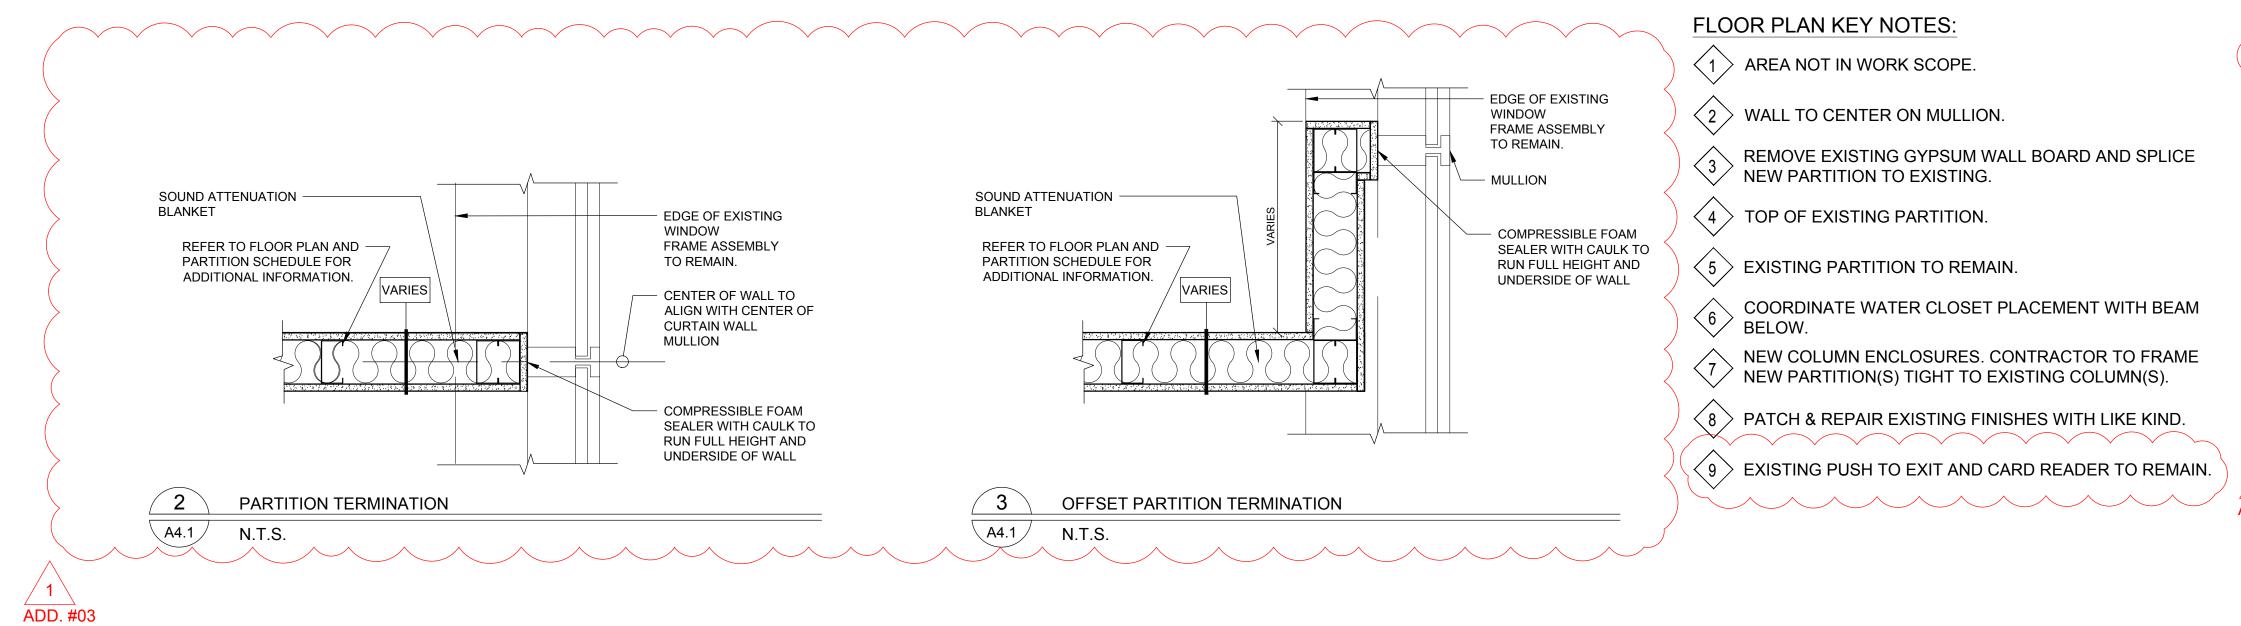

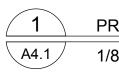

PROPOSED FLOOR PLAN - THIRD FLOOR

1/8" = 1'-0"



EXISTING ACCESS CONTROLS TO BE REMOVED AND REPLACED WITH NEW WAVE TO OPEN.

#### **GENERAL NOTES:**

- ALL PARTITIONS ARE NEW, UNLESS OTHERWISE NOTED. SEE EQUIP. PLAN FOR MILLWORK ELEV. REFERENCES.
- EXISTING FINISHES TO REMAIN IN ALL OUT OF SCOPE AREAS. PATCH & REPAIR WITH LIKE KIND AS MAY BE REQUIRED FOR NEW WORK. NOTED THAT OUT OF SCOPE WORK WILL OCCUR ON FLOORS BELOW.

## Montefiore

MONTEFIORE NYACK HOSPITAL

ADD. #03

160 NORTH MIDLAND AVENUE NYACK, NY 10960

HIGHLAND MEDICAL **OBGYN CLINICS** THIRD FLOOR 17 SQUADRON BLVD NEW CITY, NY 10956

KEY PLAN: NOT TO SCALE



ARCHITECT	
DOS	
Pomarico Design Studio Architecture, PLLC	New York Lic

- AREA OF


Telephone: 845.561.0448

Facsimile: 845.561.0446

518.533.2171

www.meengineering.com

WORK

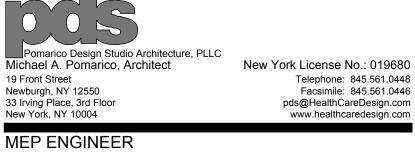

Mechanical/Electrical Engineering Consultants

Schenectady | Rochester | Buffalo | Syracuse

Description: BID ISSUE - ARCH

ADDENDA #03

MEP ENGINEER

ME

433 STATE STREET, SUITE 410

STRUCTURAL ENGINEER

ISSUED DOCUMENTS:

IT IS A VIOLATION OF THE LAW FOR ANY PERSON, UNLESS ACTING UNDER THE

DIRECTION OF A LICENSED ARCHITECT, TO

ALTERED, THE ALTERING ARCHITECT SHALL AFFIX HIS SEAL AND THE NOTATION "ALTERED BY" FOLLOWED BY HIS SIGNATURE AND THE

DATE OF SUCH ALTERATION, AND A SPECIFIC

PROPOSED FLOOR

PLAN - THIRD FLOOR

CON #

SCALE

AS NOTED

-

DESCRIPTION OF THE ALTERATION.

DRAWING TITLE:

PROJECT NUMBER

02/06/2022

DRAWING NUMBER

21035a

DATE

AREA NOT IN SCOPE U.N.O.

ALTER THIS DOCUMENT IN ANY WAY. IF

Date:

2/11/22

3/16/22


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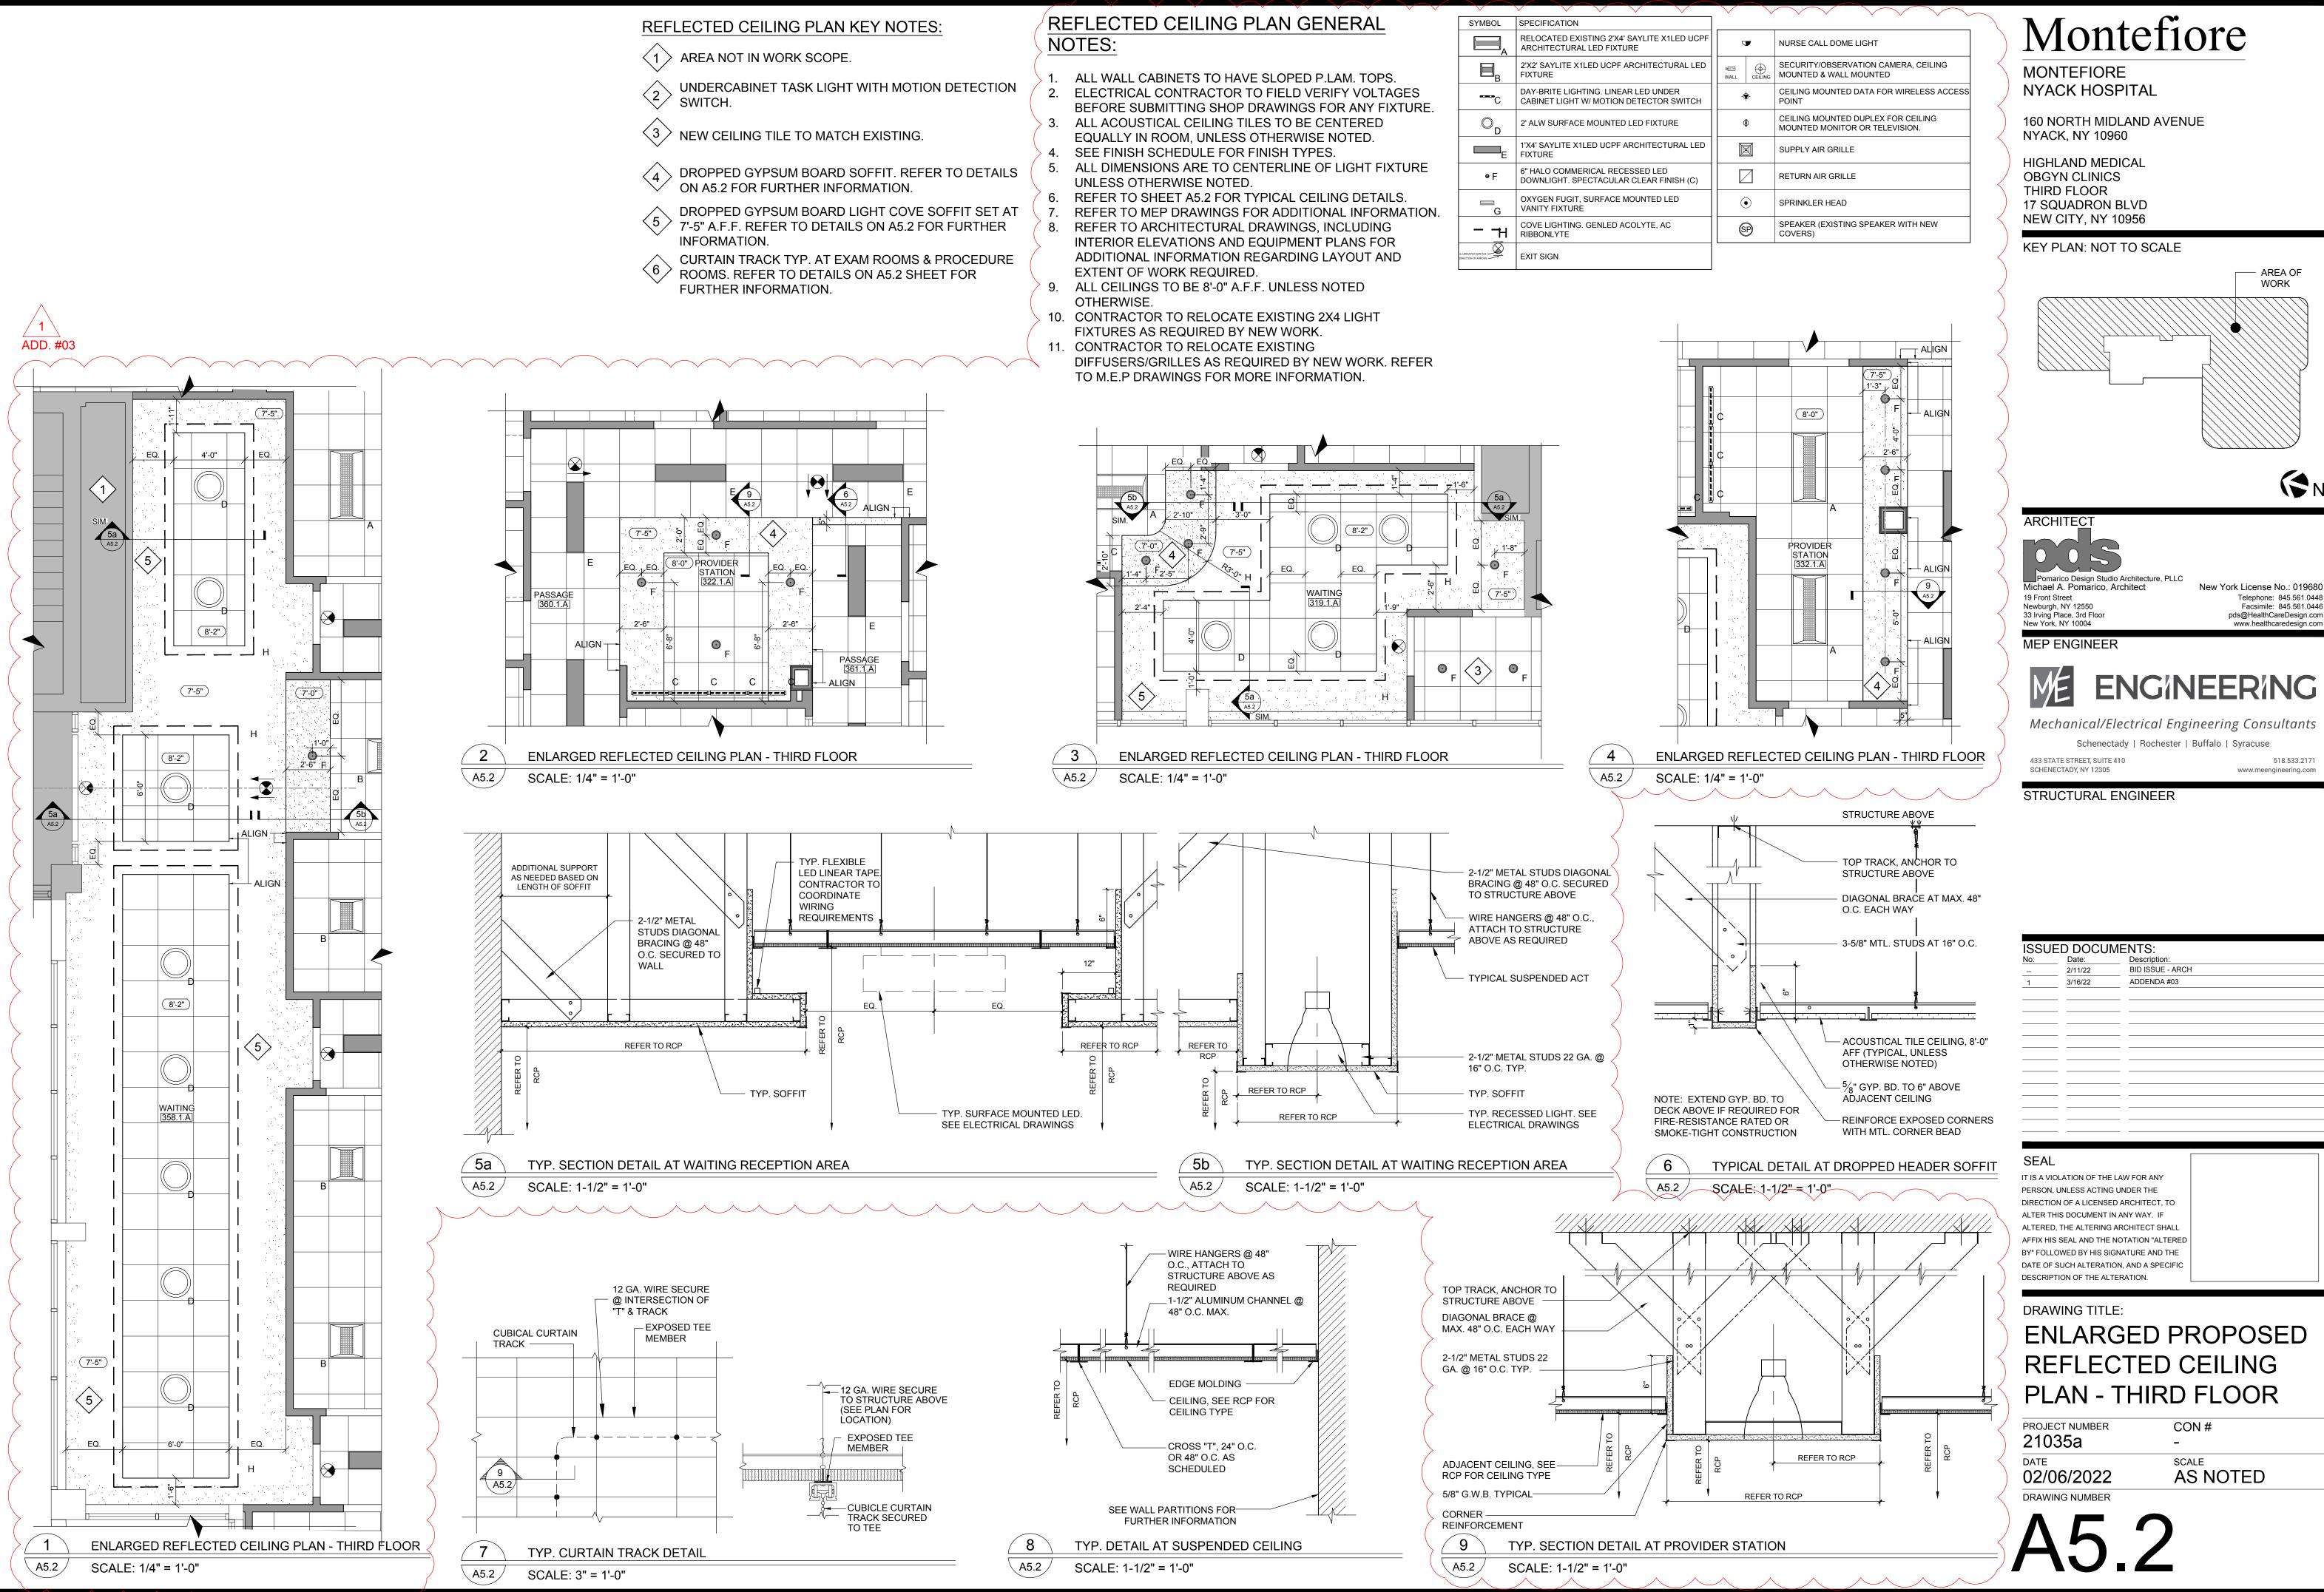



PROPOSED REFLECTED CEILING PLAN - THIRD FLOOR

SCALE: 1/8" = 1'-0"

SYMBOL	SPECIFICATION
A	RELOCATED EXISTING ARCHITECTURAL LED
⊟ <sub>B</sub>	2'X2' SAYLITE X1LED U FIXTURE
С	DAY-BRITE LIGHTING. CABINET LIGHT W/ MC
$\bigcirc_{D}$	2' ALW SURFACE MOL
E	1'X4' SAYLITE X1LED U FIXTURE
© F	6" HALO COMMERICAL DOWNLIGHT. SPECTA
G	OXYGEN FUGIT, SURF VANITY FIXTURE
	COVE LIGHTING. GEN RIBBONLYTE
NATED SURFACE	EXIT SIGN



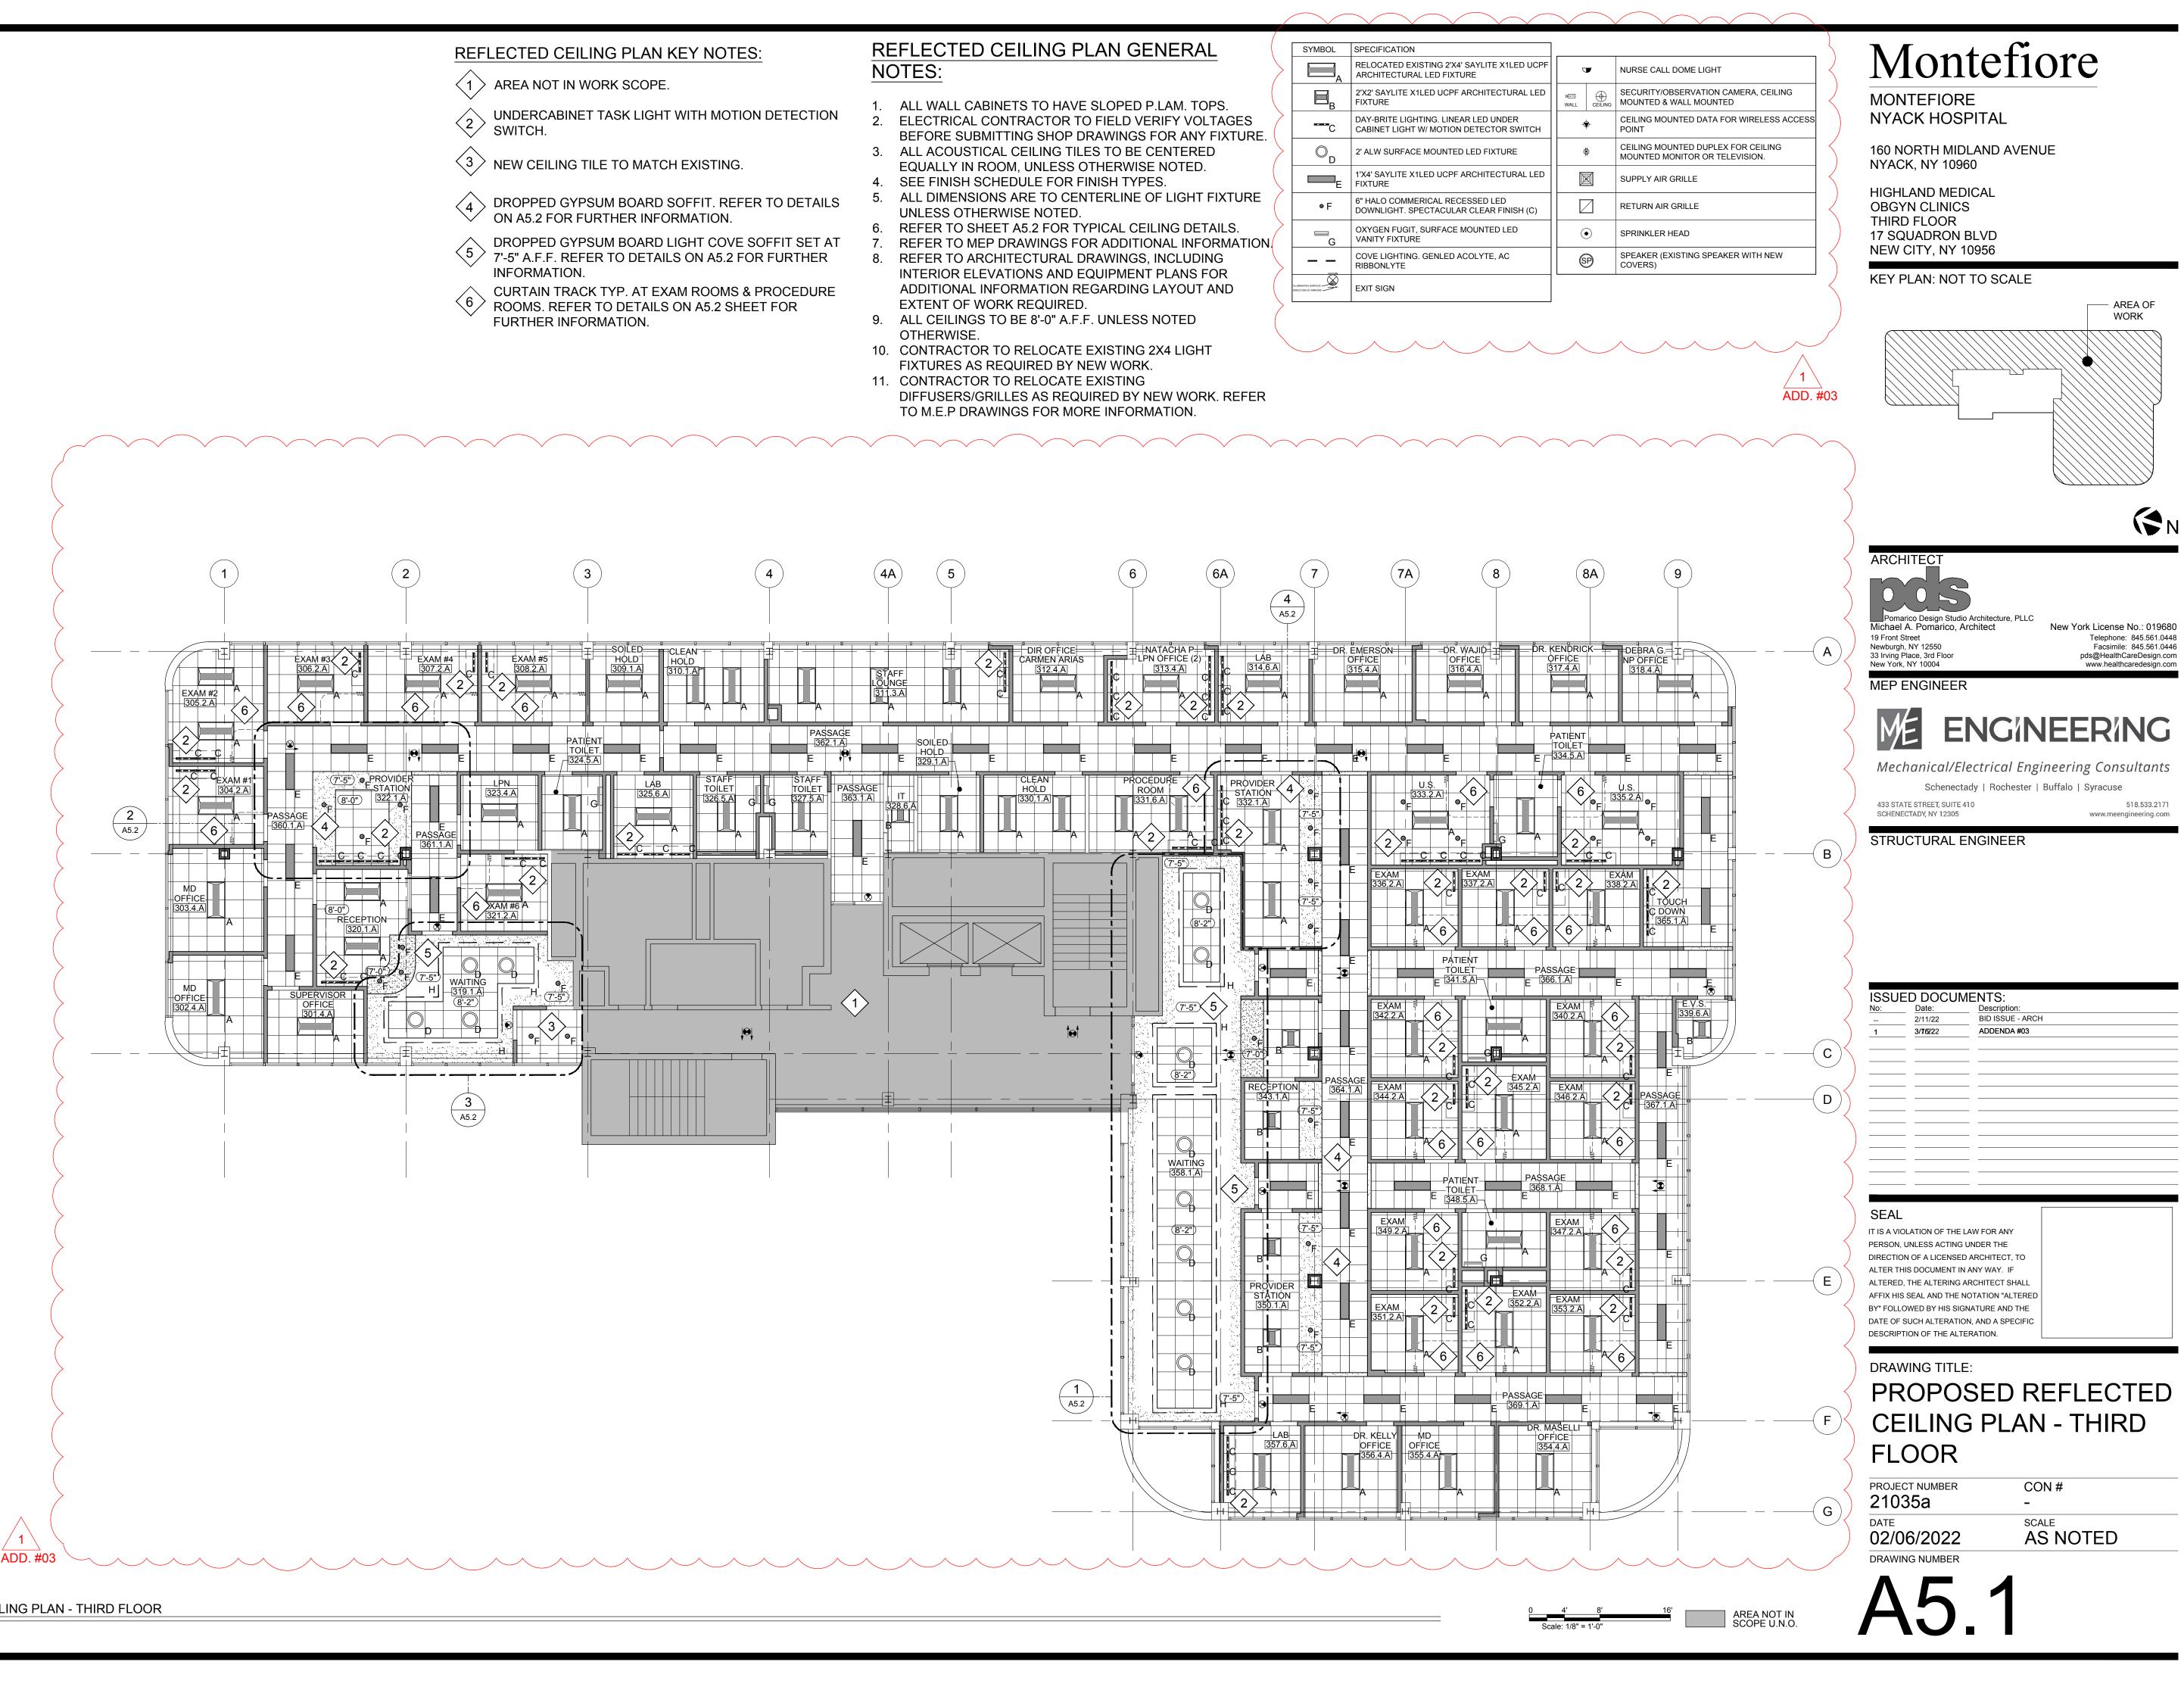

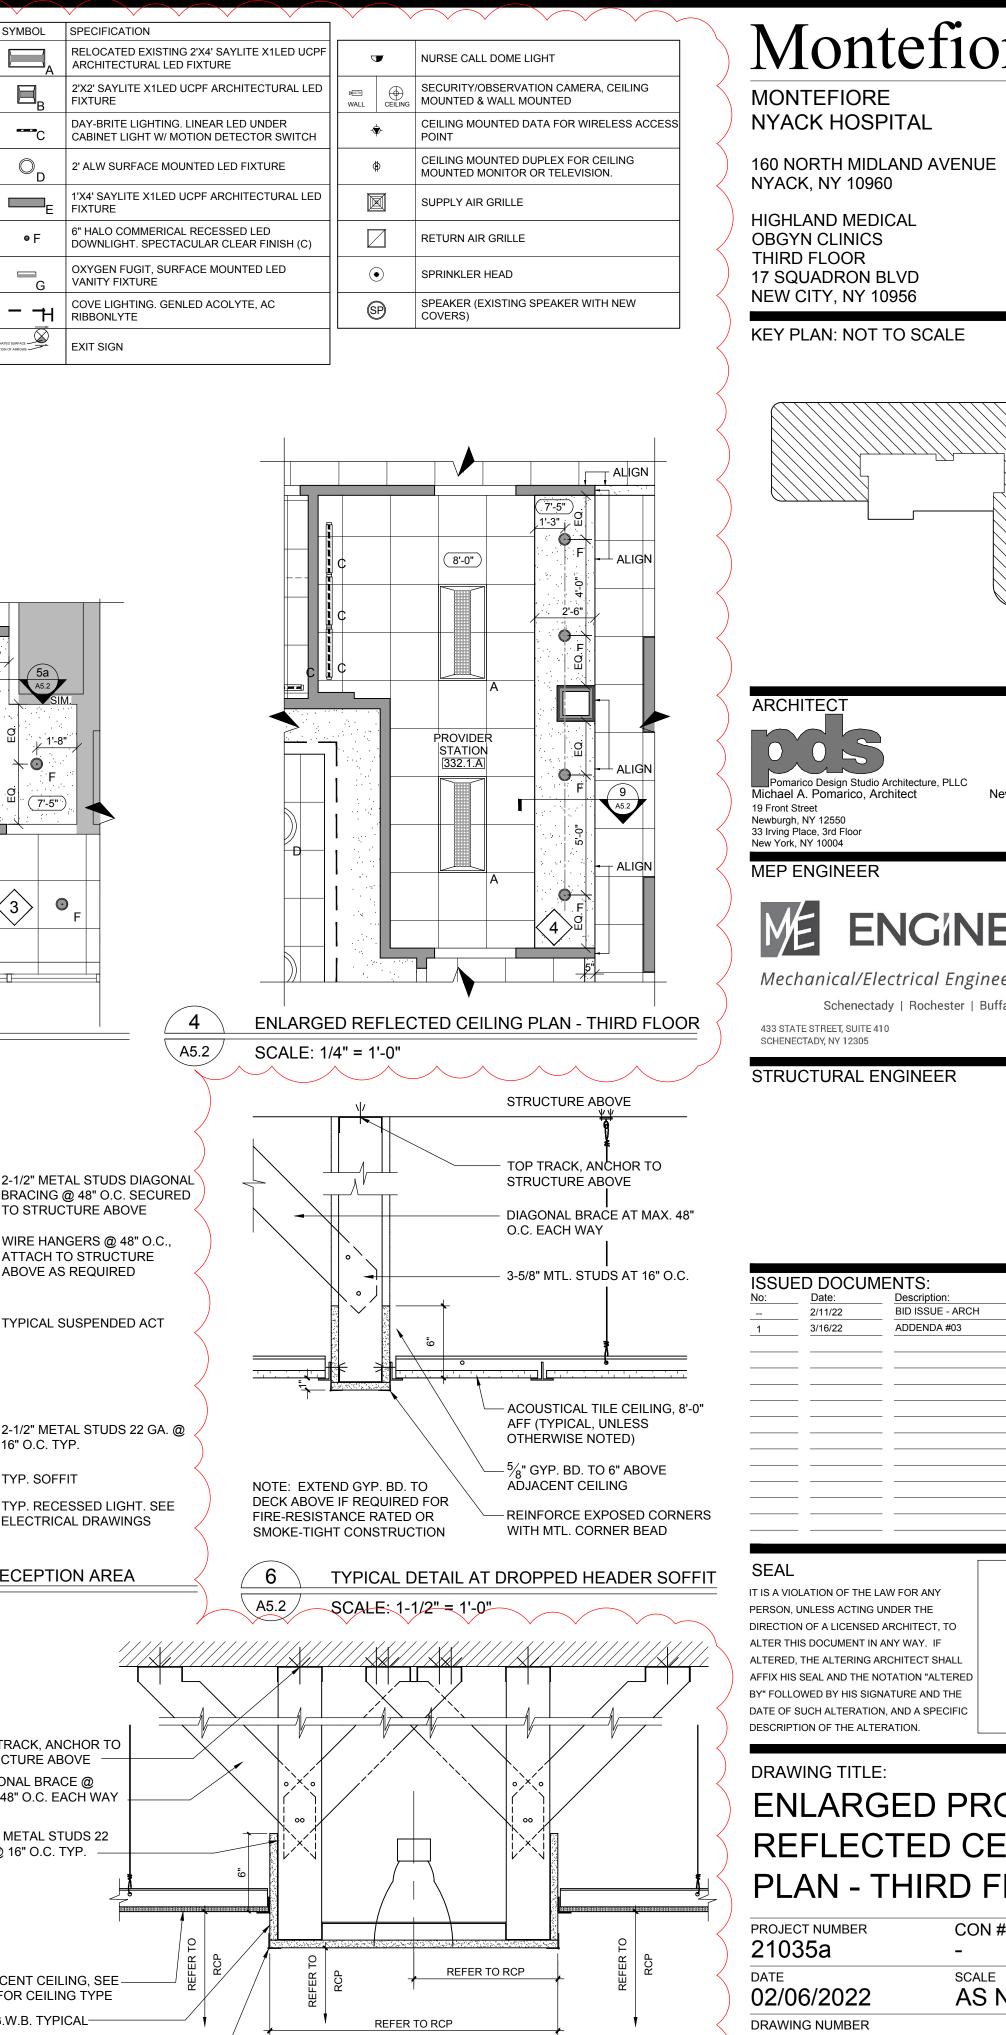

AREA OF WORK

Telephone: 845.561.0448


Facsimile: 845.561.0446


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www.meengineering.com

pds@HealthCareDesign.com

www.healthcaredesign.com



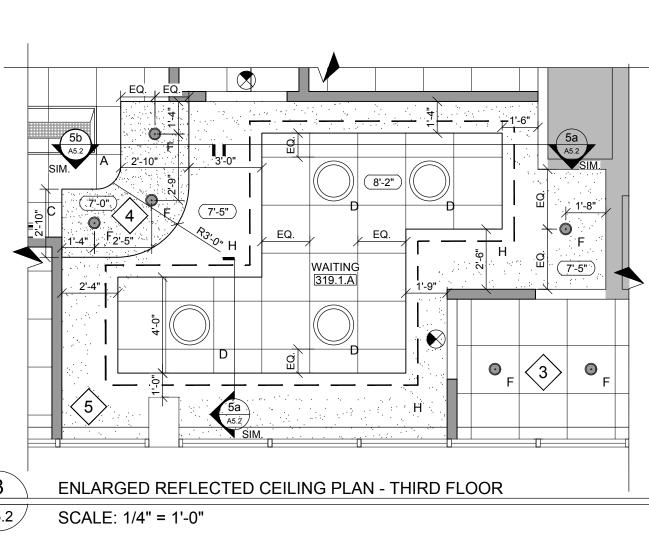

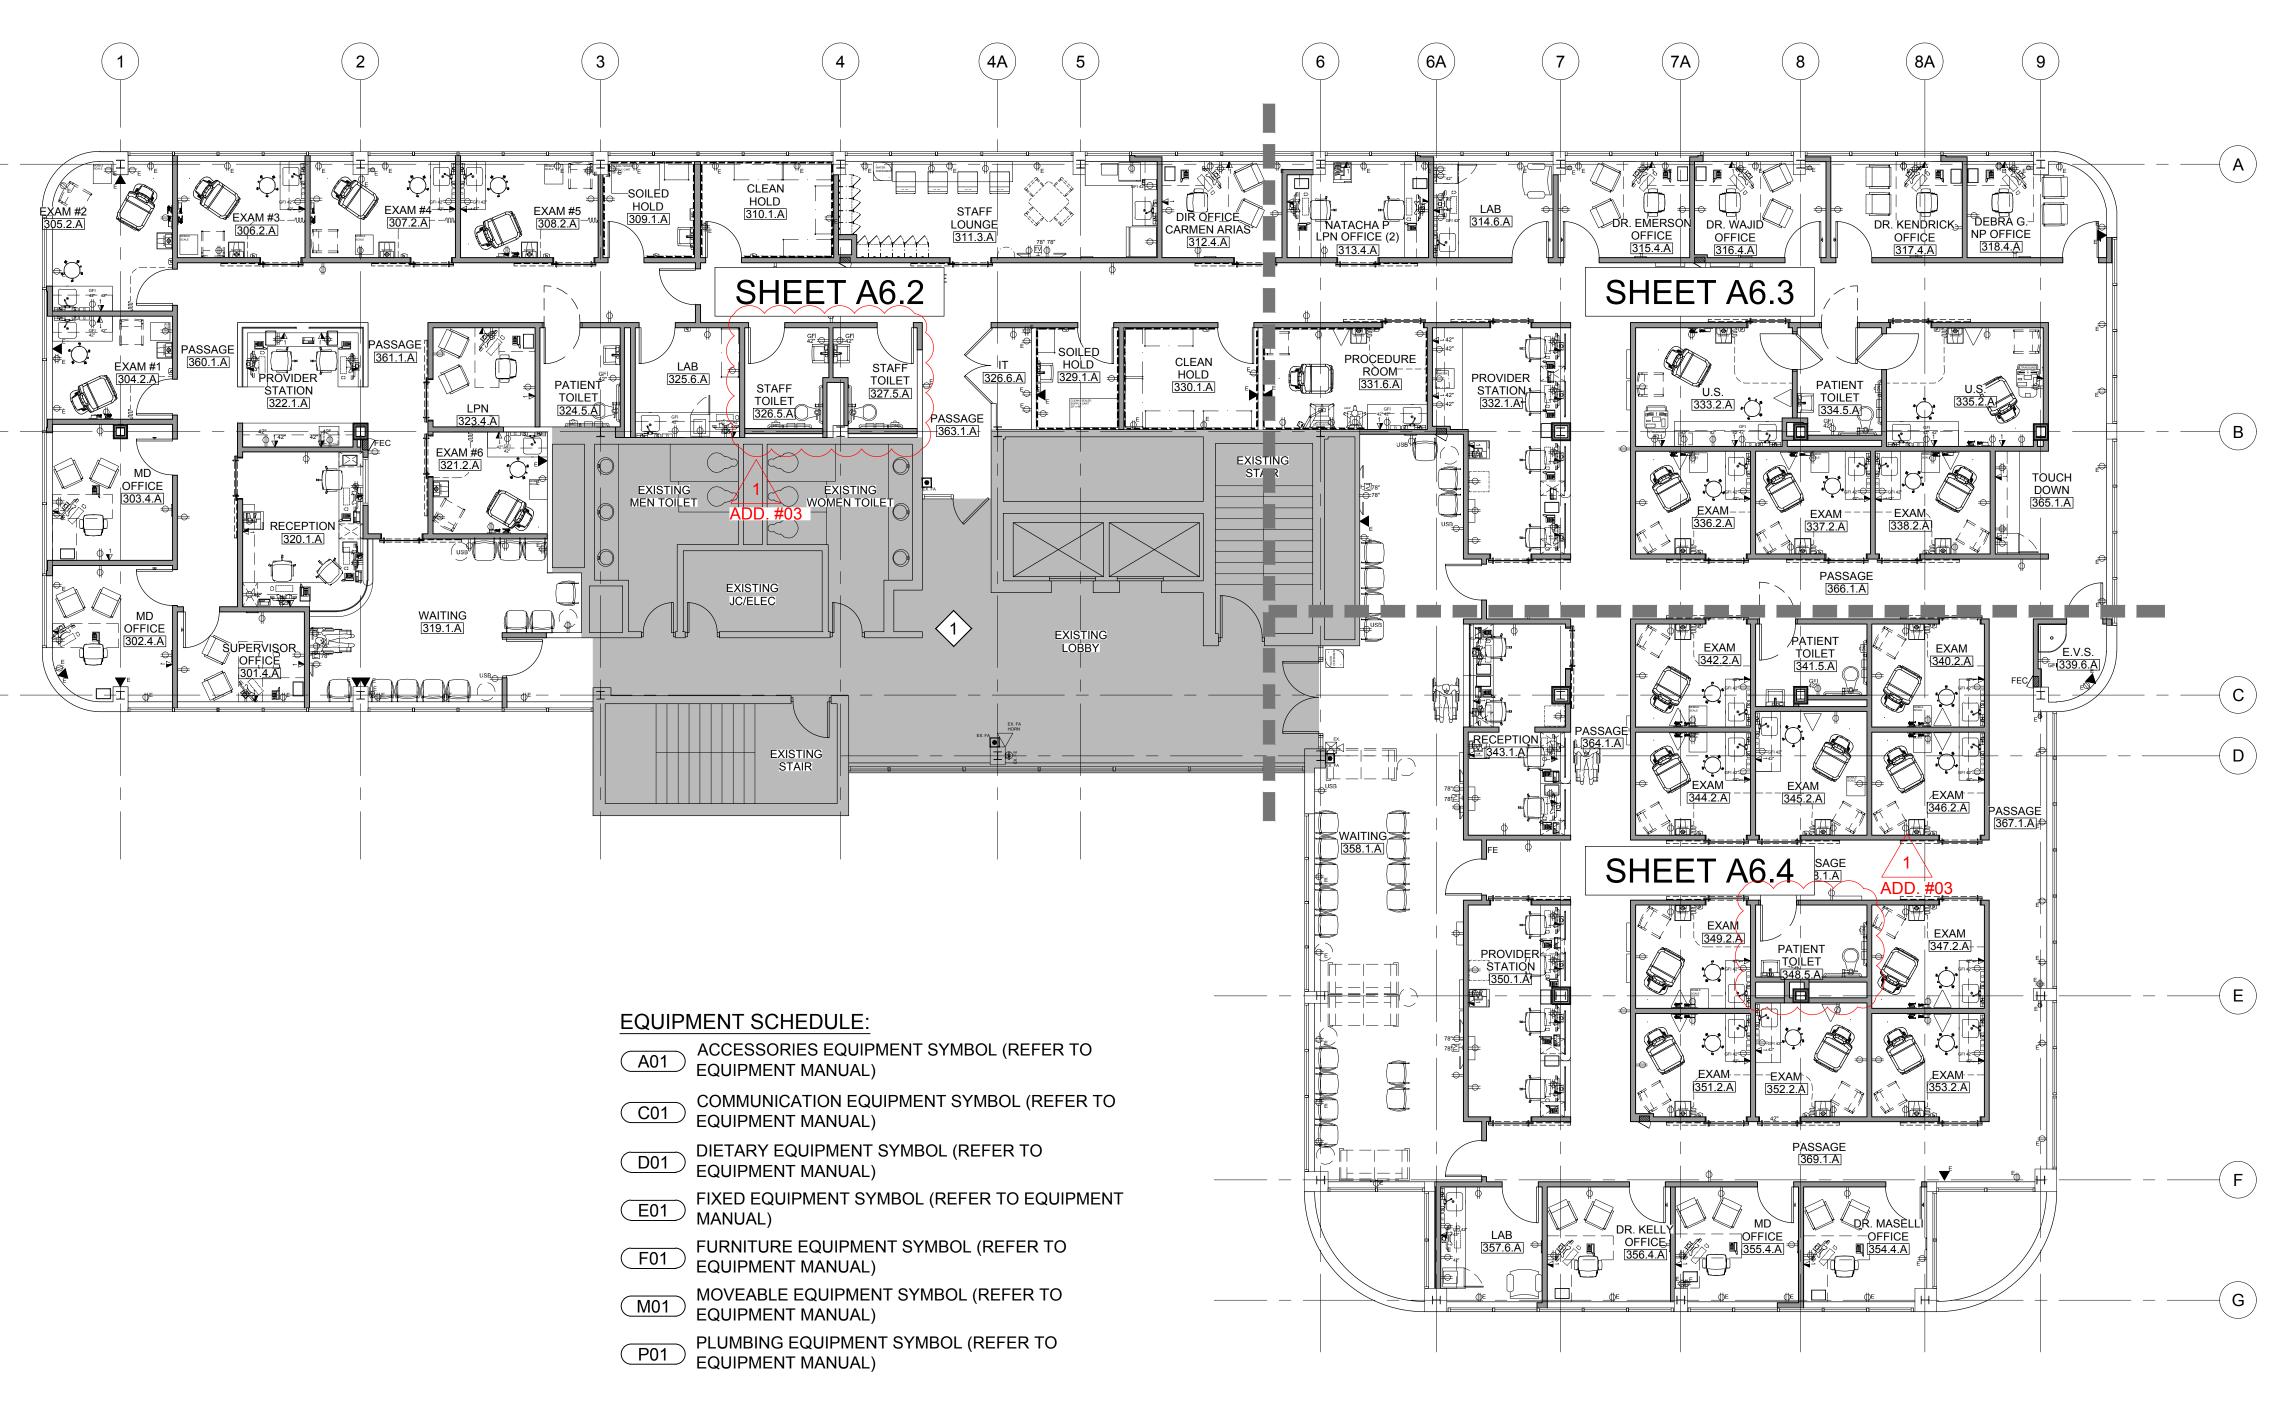

PROPOSED EQUIPMENT PLAN - THIRD FLOOR

SCALE: 1/8" = 1'-0"

#### ARCHITECTURAL SYMBOLS .....

FUNCTION	DESCRIPTION
EQUIPMENT IDENTIFIER	C17b EQUIPMENT IDENTIFIER TAG, REFER TO EQUIPMENT MANUAL AND DETAILS FOR INFORMATION

#### **GENERAL NOTES:**

- 1. REFER TO MEP DRAWINGS FOR ADDITIONAL INFORMATION.
- 2. REFER TO INTERIOR ELEVATIONS FOR ADDITIONAL INFORMATION REGARDING LAYOUT, POWER, DATA
- 3. REFER TO SHEET A9.2 FOR TYPICAL WALL PROTECTION DETAILS.

#### EQUIPMENT PLAN KEY NOTES:

(1) AREA NOT IN WORK SCOPE.


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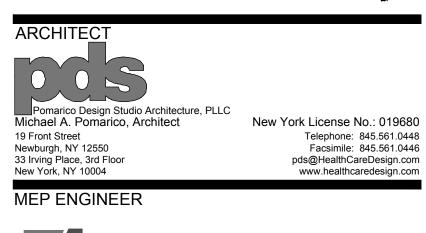
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HIGHLAND MEDICAL **OBGYN CLINICS** THIRD FLOOR 17 SQUADRON BLVD NEW CITY, NY 10956

KEY PLAN: NOT TO SCALE





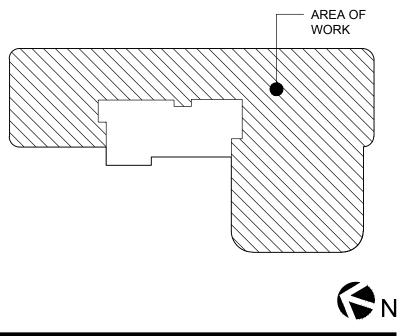

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ALTERE	D, THE ALTERING	ARCHITECT SHALL	
AFFIX HI	S SEAL AND THE	NOTATION "ALTERED	
BY" FOLL	LOWED BY HIS SIG	SNATURE AND THE	

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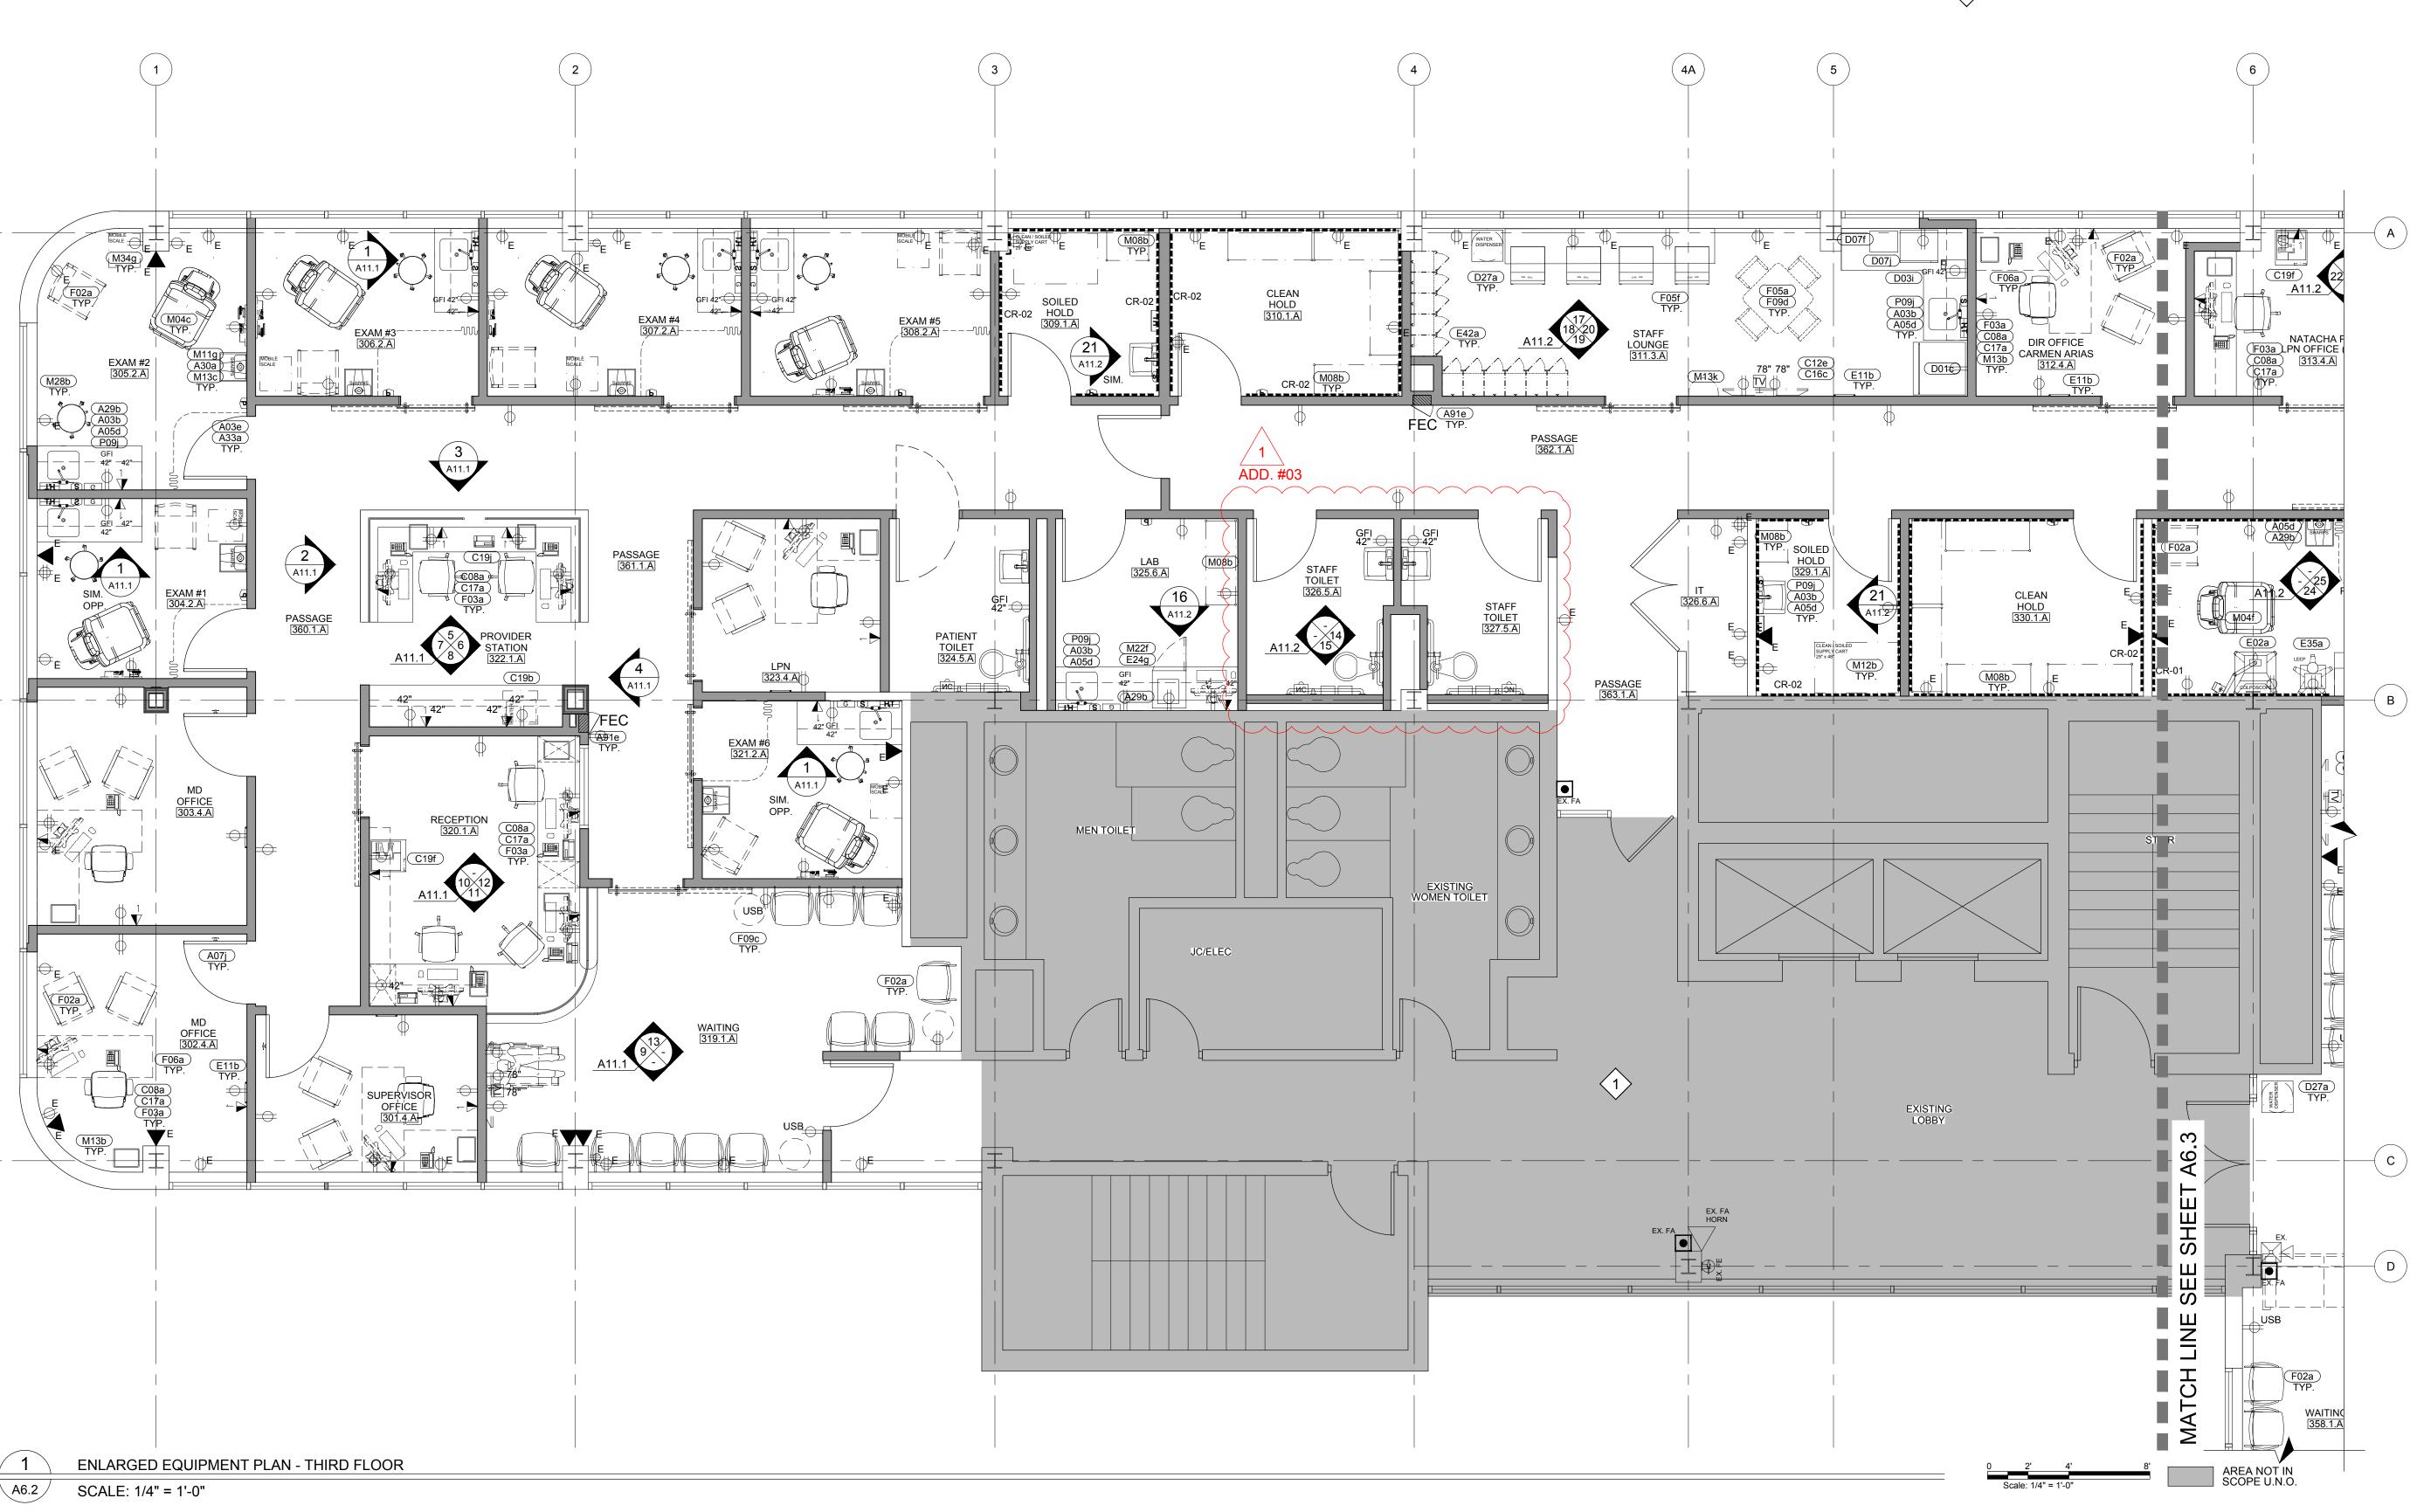
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21035a	-	
DATE	SCALE	
02/06/2022	AS NOTED	
DRAWING NUMBER		

A6.1

AREA NOT IN SCOPE U.N.O.



#### ARCHITECTURAL SYMBOLS

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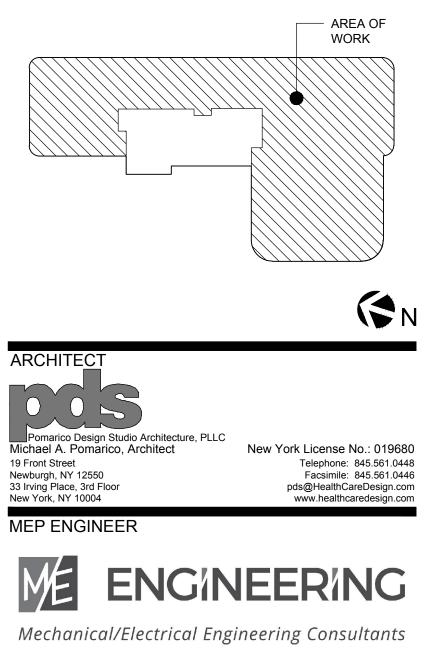
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No:	ED DOCUI	Description:
	2/11/22	BID ISSUE - ARCH
1	3/16/22	ADDENDA #03
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ENLARGED EQUIPMENT PLAN - THIRD FLOOR

DRAWING TITLE:

PROJECT NUMBER

02/06/2022 DRAWING NUMBER

A6.2

21035a

DATE



#### ARCHITECTURAL SYMBOLS FUNCTION DESCRIPTION

FUNCTION	DESCRIPTION
EQUIPMENT IDENTIFIER	C17b C17b EQUIPMENT IDENTIFIER TAG, REFER TO EQUIPMENT MANUAL AND DETAILS FOR INFORMATION

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#### EQUIPMENT PLAN KEY NOTES:

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KEY PLAN: NOT TO SCALE

- AREA OF



#### ARCHITECTURAL SYMBOLS

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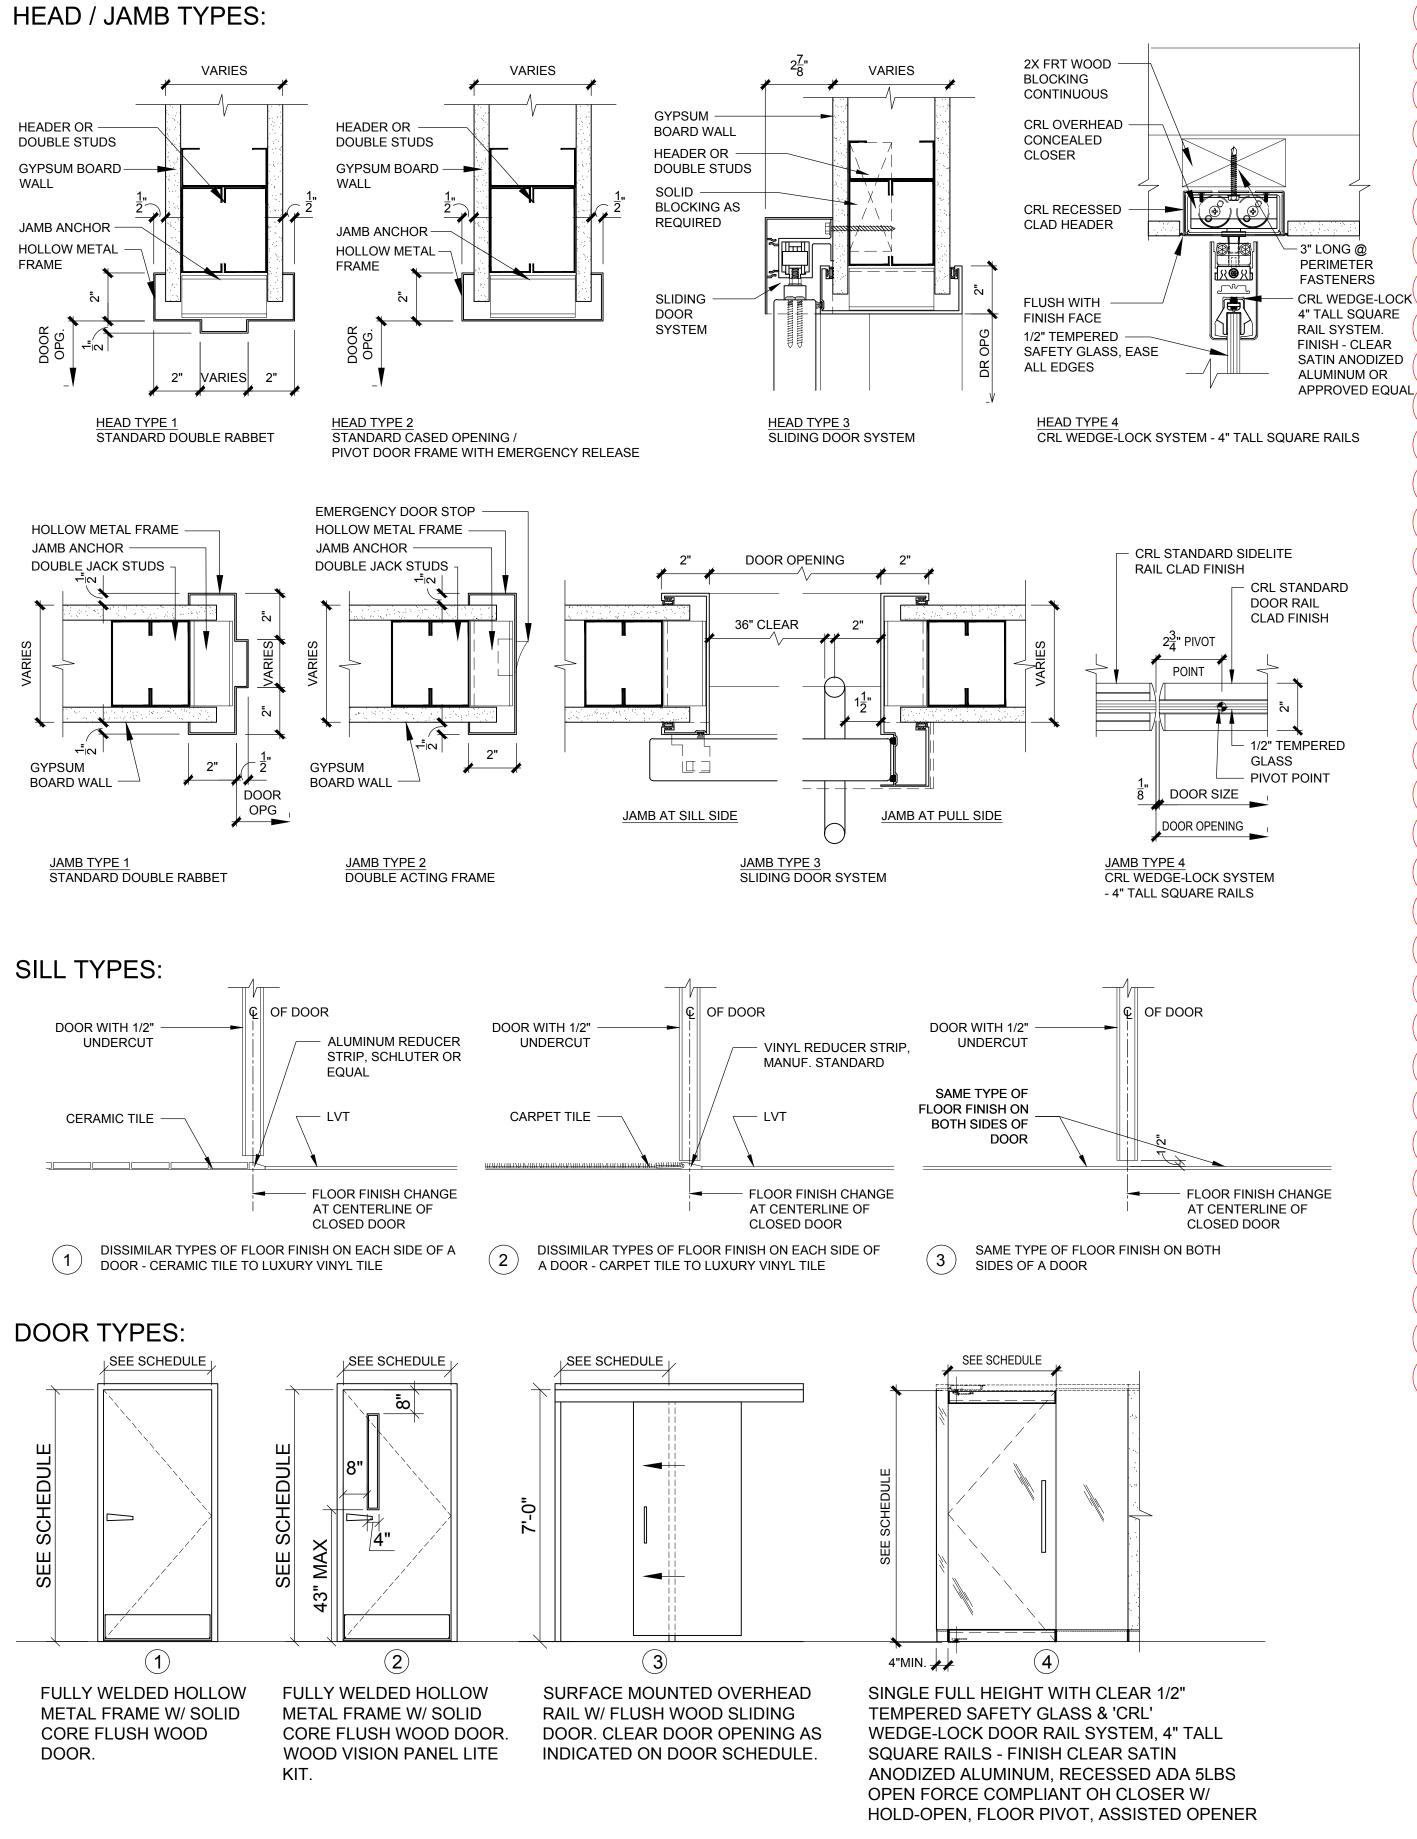
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#### Ó DÓOR AND HARDWARF SCHEDULF.

IO.	TYPE	SIZE	ROOM NAME	LABEL	HEAD J	АМВ	SILL	STOP	CLOSER	HARDWARE	FUNCTION	REMARKS	ACCES
801	1	3'-0" X 7'-0"	SUPERVISOR OFFICE		1	1	2	WALL		1.0	CLASSROOM		CONTRO
02	1	3'-0" X 7'-0"	MD OFFICE	_	1	1	2	WALL	_	1.0	CLASSROOM		_
02	1	3'-0" X 7'-0"	MD OFFICE	-	1	1	2	WALL	-	1.0	CLASSROOM		
03 04	1	3'-0" X 7'-0	EXAM #1	-	1	1	3	WALL	-	11.0	PASSAGE	-	-
	1	3'-0" X 7'-0	EXAM #1 EXAM #2	-	1	1			-			-	-
05	1			-		<u>ו</u>	3	WALL		11.0	PASSAGE	-	-
06	3	3'-4" X 7'-0"	EXAM #3	-	3	3	3	-	SOFT CLOSE	16.0	PASSAGE	-	-
07	3	3'-4" X 7'-0"	EXAM #4	-	3	3	3	-	SOFT CLOSE	16.0	PASSAGE	-	-
808	3	3'-4" X 7'-0"	EXAM #5	-	3	3	3	-	SOFT CLOSE	16.0	PASSAGE	-	-
09	1	3'-0" X 7'-0"	SOILED HOLD	-	1	1	3	WALL	-	7.0	STORE ROOM	-	-
10	1	3'-0" X 7'-0"	CLEAN HOLD	-	1	1	3	WALL	-	7.0	STORE ROOM	-	-
811	3	3'-4" X 7'-0"	STAFF LOUNGE	-	3	3	3	-	SOFT CLOSE	16.0	PASSAGE	-	-
12	3	3'-4" X 7'-0"	DIR OFFICE	-	3	3	3	-	SOFT CLOSE	17.0	CLASSROOM	-	-
13	3	3'-4" X 7'-0"	LPN OFFICE (2)	-	3	3	2	-	SOFT CLOSE	17.0	CLASSROOM	-	
14	2	3'-0" X 7'-0"	LAB	-	1	1	3	WALL	-	1.0	CLASSROOM	-	-
15	1	3'-0" X 7'-0"	DR. EMERSON OFFICE	-	1	1	2	WALL	-	1.0	CLASSROOM	-	-
16	1	3'-0" X 7'-0"	DR. WASIA OFFICE	-	1	1	2	WALL	-	1.0	CLASSROOM	-	
17	1	3'-0" X 7'-0"	DR. KENDRICK OFFICE	-	1	1	2	WALL	-	1.0	CLASSROOM	_	-
18	1	3'-0" X 7'-0"	DEBRA G. NP OFFICE	-	1	1	2	WALL	_	1.0	CLASSROOM	_	_
19	2	3'-4" X 7'-0"	WAITING	_	3	3	3	-	SOFT CLOSE	16.0	PASSAGE	_	_
19a	4	3'-0" X 7'-0"	WAITING	_	4	4	1	-	ADA CLOSER	97.0	ENTRY	WAVE TO OPEN. COORDINATE KEYING W/	•
				ļ			ļ					OTHER KEYLOCKS	
20	3	3'-4" X 7'-0"	RECEPTION	-	3	3	3	-	SOFT CLOSE	16.0	PASSAGE	-	-
321	3	3'-4" X 7'-0"	EXAM #6	-	3	3	3	-	SOFT CLOSE	16.0	PASSAGE		-
23	3	3'-4" X 7'-0"	LPN	-	3	3	3	-	SOFT CLOSE	17.0	CLASSROOM	-	-
24	1	3'-0" X 7'-0"	PATIENT TOILET	-	2	2	1	WALL	-	9.0	EMERGENCY EGRESS WITH PRIVACY LATCH	-	-
25	2	3'-0" X 7'-0"	LAB	_	1	1	3	WALL	_	1.0	CLASSROOM	_	_
26	1	3'-0" X 7'-0"	STAFF TOILET	_	1	1	3	WALL	_	6.0	PRIVACY		
27	1	3'-0" X 7'-0"	STAFF TOILET	_	1	1	3	WALL	_	6.0	PRIVACY		_
	E.T.R			-	1	I	5	VVALL	-		FRIVACT	-	-
28		<u>6'-4" X 7'-0"</u>		-	-	-	-	-	-	98.0		-	-
29	1	3'-0" X 7'-0"	SOILED HOLD	-	1	1	3	WALL	-	7.0	STORE ROOM	-	-
30	2	3'-0" X 7'-0"	CLEAN HOLD	-	1	1	3	WALL	-	7.0	STORE ROOM	-	-
31	3	3'-4" X 7'-0"	PROC. ROOM	-	3	3	3	-	SOFT CLOSE	16.0	PASSAGE	-	-
32a	3	3'-4" X 7'-0"	PROVIDER STATION	-	3	3	3	-	SOFT CLOSE	16.0	PASSAGE	-	-
32b	3	3'-4" X 7'-0"	PROVIDER STATION	-	3	3	3	-	SOFT CLOSE	16.0	PASSAGE	-	-
33	3	3'-4" X 7'-0"	U.S.	-	3	3	3	-	SOFT CLOSE	16.0	PASSAGE	-	-
34	1	3'-0" X 7'-0"	PATIENT TOILET	-	2	2	1	O.H	-	10.0	EMERGENCY EGRESS WITH PRIVACY LATCH	-	-
34a	1	3'-0" X 7'-0"	PATIENT TOILET	-	2	2	1	O.H	-	10.0	EMERGENCY EGRESS WITH PRIVACY LATCH	-	-
34b 35	1	3'-0" X 7'-0" 3'-4" X 7'-0"	PATIENT TOILET U.S.	-	2	2	1	O.H	- SOFT CLOSE	10.0	EMERGENCY EGRESS WITH PRIVACY LATCH PASSAGE	-	-
36	3	3'-4" X 7'-0	EXAM	-	3	3	3		SOFT CLOSE	16.0	PASSAGE	-	-
37	3	3'-4" X 7'-0	EXAM	-	3	3	3	-	SOFT CLOSE	16.0	PASSAGE	-	-
	-			-	_	-	-	-				-	-
38	3	3'-4" X 7'-0"	EXAM	-	3	3	3	-	SOFT CLOSE	16.0	PASSAGE	-	-
39		3'-0" X 7'-0"	E.V.S.	-		1	3	O.H	-	8.0	-	-	-
40	3	3'-4" X 7'-0"	EXAM	-	3	3	3	-	SOFT CLOSE	16.0	PASSAGE	-	-
841	3	3'-4" X 7'-0"	PATIENT TOILET	_	3	3	3	_	SOFT CLOSE	9.0	EMERGENCY EGRESS	-	-
						0					WITH PRIVACY LATCH		
42	3	3'-4" X 7'-0"	EXAM	-	3	3	3	-	SOFT CLOSE	16.0	PASSAGE	-	-
43	3	3'-4" X 7'-0"	RECEPTION	-	3	3	3	-	SOFT CLOSE	16.0	PASSAGE	-	-
44	3	3'-4" X 7'-0"	EXAM	-	3	3	3	-	SOFT CLOSE	16.0	PASSAGE	-	-
45	3	3'-4" X 7'-0"	EXAM	-	3	3	3	-	SOFT CLOSE	16.0	PASSAGE	-	-
646	3	3'-4" X 7'-0"	EXAM	-	3	3	3	-	SOFT CLOSE	16.0	PASSAGE	-	-
47 48	3 1	3'-4" X 7'-0" 3'-0" X 7'-0"	EXAM PATIENT TOILET	-	3 2	3	3	- WALL	SOFT CLOSE	16.0 9.0	PASSAGE EMERGENCY EGRESS	-	-
40				+		0	-				WITH PRIVACY LATCH		
49	3	3'-4" X 7'-0"		-	3	3	3	-	SOFT CLOSE	16.0	PASSAGE	-	-
50a	3	3'-4" X 7'-0"	PROVIDER STATION	-	3	3	3	-	SOFT CLOSE	16.0	PASSAGE	-	-
50b	3	3'-4" X 7'-0"	PROVIDER STATION	-	3	3	3	-	SOFT CLOSE	16.0	PASSAGE	-	-
851	3	3'-4" X 7'-0"	EXAM	-	3	3	3	-	SOFT CLOSE	16.0	PASSAGE	-	-
52	3	3'-4" X 7'-0"	EXAM	-	3	3	3	-	SOFT CLOSE	16.0	PASSAGE	-	-
53	3	3'-4" X 7'-0"	EXAM	-	3	3	3	-	SOFT CLOSE	16.0	PASSAGE	-	-
54	1	3'-0" X 7'-0"	DR. MASELLI OFFICE	-	1	1	2	WALL	-	1.0	CLASSROOM	-	-
55	1	3'-0" X 7'-0"	MD OFFICE	-	1	1	2	WALL	-	1.0	CLASSROOM	-	-
56	1	3'-0" X 7'-0"	DR. KELLY OFFICE	-	1	1	2	WALL	-	1.0	CLASSROOM	-	-
57	2	3'-0" X 7'-0"	LAB	-	1	1	3	WALL	-	1.0	CLASSROOM	-	-
58a	2	3'-0" X 7'-0"	WAITING	-	1	1	3	WALL	ADA CLOSER	3.0	CLASSROOM	-	-
58b	2	3'-0" X 7'-0"	WAITING	-	1	1	3	WALL	ADA CLOSER	3.0	CLASSROOM	-	-
58c	E.T.R	3'-0" X 7'-0"	WAITING	-	-	-	_	-	ADA CLOSER	98.0	-	WAVE TO OPEN. COORDINATE KEYING W/	•
												OTHER KEYLOCKS	
59	2	3'-0" X 7'-0"	WAITING	-	1	1	3	WALL	ADA CLOSER	3.0	CLASSROOM	-	-
62	2	3'-0" X 7'-0"	PASSAGE	-	1	1	1	WALL	ADA CLOSER	3.0	CLASSROOM	-	-
		3'-0" X 7'-0"	PASSAGE	1		-	r	T	ADA CLOSER	98.0			

FIRE RATED DOOR LABELS / RATINGS: DOORS AND FRAMES ARE RATED AND GIVEN A LABEL AFTER EXTENSIVE TESTING BY THE UNDERWRITERS LABORATORY. RATED DOORS

MUST BE SELF-CLOSING AND MUST HAVE A POSITIVE LATCH.

UL LABEL RATING	RATING	MAX. GLASS AREA
A	3 HR. (180 MIN.)	NO GLAZING PERMITTED
В	1-1/2 HR. (90 MIN.)	100 SQ. IN. PER LEAF
С	3/4 HR. (45 MIN.)	1296 SQ. IN. PER LITE
D	(20 MIN.)	-

#### HARDWARE SETS:

1. PASSAGE LATCH; 1-1/2 PAIR BUTTS; CLOSER; WALL STOP;

- SILENCERS. STORE ROOM LATCH; 1-1/2 PAIR BUTTS; WALL STOP; SILENCERS
- 3. PASSAGE LATCH; 1-1/2 PAIR BUTTS; WALL STOP; SILENCERS. 4. PRIVACY LATCH; 1-1/2 PAIR BUTTS; CLOSER; WALL STOP;
- SILENCERS. 5. PASSAGE LATCH; 1-1/2 PAIR BUTTS; OVERHEAD STOP;
- SILENCERS.
- 6. CLASSROOM LATCH; 1-1/2 PAIR BUTTS; WALL STOP; SILENCERS. 7. PRIVACY LATCH; 1-1/2 PAIR BUTTS EMERGENCY EGRESS STRIKE; CLOSER; WALL STOP; SILENCERS.
- 8. CLASSROOM LATCH; 1-1/2 PAIR BUTTS, CLOSER; SILENCERS.
- 9. ENTRY LATCH 1<sup>1</sup>/<sub>2</sub> PAR BUTTS, CLOSER, SILENCERS, WALLSTOP

- DOOR GENERAL NOTES:
- 1. REFER TO DOOR/HARDWARE SPECIFICATIONS IN SPECIFICATION MANUAL FOR DOOR ADD, #03 HARDWARE SCHEDULE AND ADDITIONAL REQUIREMENTS.
- 2. ALL FRAMES SHALL BE FULLY WELDED UNLESS OTHERWISE NOTED. PROVIDE DEDUCT
- ALT FOR K.D FRAMES 3. ALL DOORS SHALL BE SOLID CORE UNLESS OTHERWISE NOTED.
- 4. IT IS THE RESPONSIBILITY OF THE CONTRACTOR TO COORDINATE FRAME MODIFICATIONS OR ELEC. ACCESS CONTROL DEVICES.
- 5. PROVIDE SAFETY GLAZING IN ALL LOCATIONS DEEMED TO BE HAZARDOUONS, IN ACCORDANCE WITH IBC SECTION 2406 "SAFETY GLAZING." SPECIFIC LOCATIONS INCLUDE BUT ARE NOT LIMITED TO: GLAZING IN DOORS, GLAZING ADJACENT TO DOORS, GLAZING IN PANES 9 SQ. FT. OR GREATER, WHERE BOTTOM EDGE IS LESS THAN 18 INCHES ABOVE FLOOR. PROVIDE FIRE RATED GLAZING LITES IN ALL FRR DOOR ASSEMBLIES. ALL GLAZING MUST HAVE APPROPRIATE, VISIBLE LABEL.
- 6. ALL THRESHOLDS SHALL BE ICC/ANSI A117.1 2003 COMPLIANT. CHANGES IN LEVEL OF UP TO 1/4" MAY BE VERTICAL. CHANGES FROM 1/4" UP TO 1/2" MUST BE BEVELED AT EDGES, WITH SLOPE NOT STEEPER THAN 1:2. CHANGES IN BEYOND 1/2" IN HEIGHT MUST BE RAMPED. SEE ALSO A2 SERIES DRAWINGS FOR ADDITIONAL DETAIL AND REQUIREMENTS.
- 7. COORDINATE PLACEMENT OF ARMOUR PLATES SUCH THAT PLATES ARE LOCATED ON THE ACTIVE SIDE OF THE DOOR. 8. DOORS, FRAMES AND HARDWARE MUST NOT GO INTO FABRICATION OR PROCUREMENT
- UNTIL ALL SHOP DRAWINGS AND SUBMITTALS HAVE BEEN APPROVED.
- 9. IT IS THE CONSTRUCTION MANAGERS RESPONSIBILITY TO FULLY COORDINATE ALL FRAME THROAT DEPTHS WITH FIELD CONDITIONS.
- 10. ALL FIRE RATED DOORS AND FRAMES MUST BEAR A UL LISTED LABEL WHICH MUST REMAIN FIXED TO THE DOOR AND VISIBLE AT ALL TIMES. 11. REFER TO ELEC. DRAWINGS FOR CUTOUTS REQUIRED IN BUCKS FOR ELEC. AND MECH.
- DEVICES. 12. CONTRACTOR SHALL PROVIDE BACK-BOXES, CONDUIT STUBS, RACEWAYS, PUSH BUTTONS, LOCKS, AND ELECTRIC STRIKES IN DOOR FRAMES AS PART OF BASE SCOPE.


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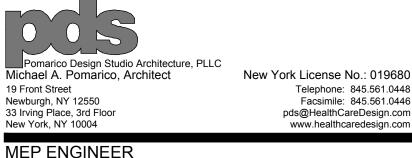
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KEY PLAN: NOT TO SCALE





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ISSUED DOCUMENTS:		
No:	Date:	Description:
	2/11/22	BID ISSUE - ARCH
1	3/16/22	ADDENDA #03
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SEAL

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DRAWING TITLE:
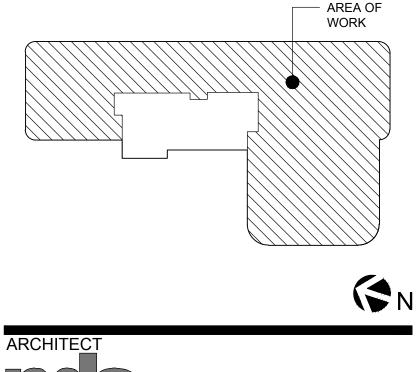
#### **DOOR & HARDWARE** SCHEDULE AND MISCELLANEOUS DETAILS

PROJECT NUMBER 21035a

DATE


CON # -


SCALE AS NOTED


02/06/2022 DRAWING NUMBER


COORDINATION WITH HOSPITAL AS REQUIRED FOR NEW INSTALLATION.

13. CORING REQUIREMENTS SHALL BE CORBIN-RUSSWIN 6 PIN L4 SYSTEM.

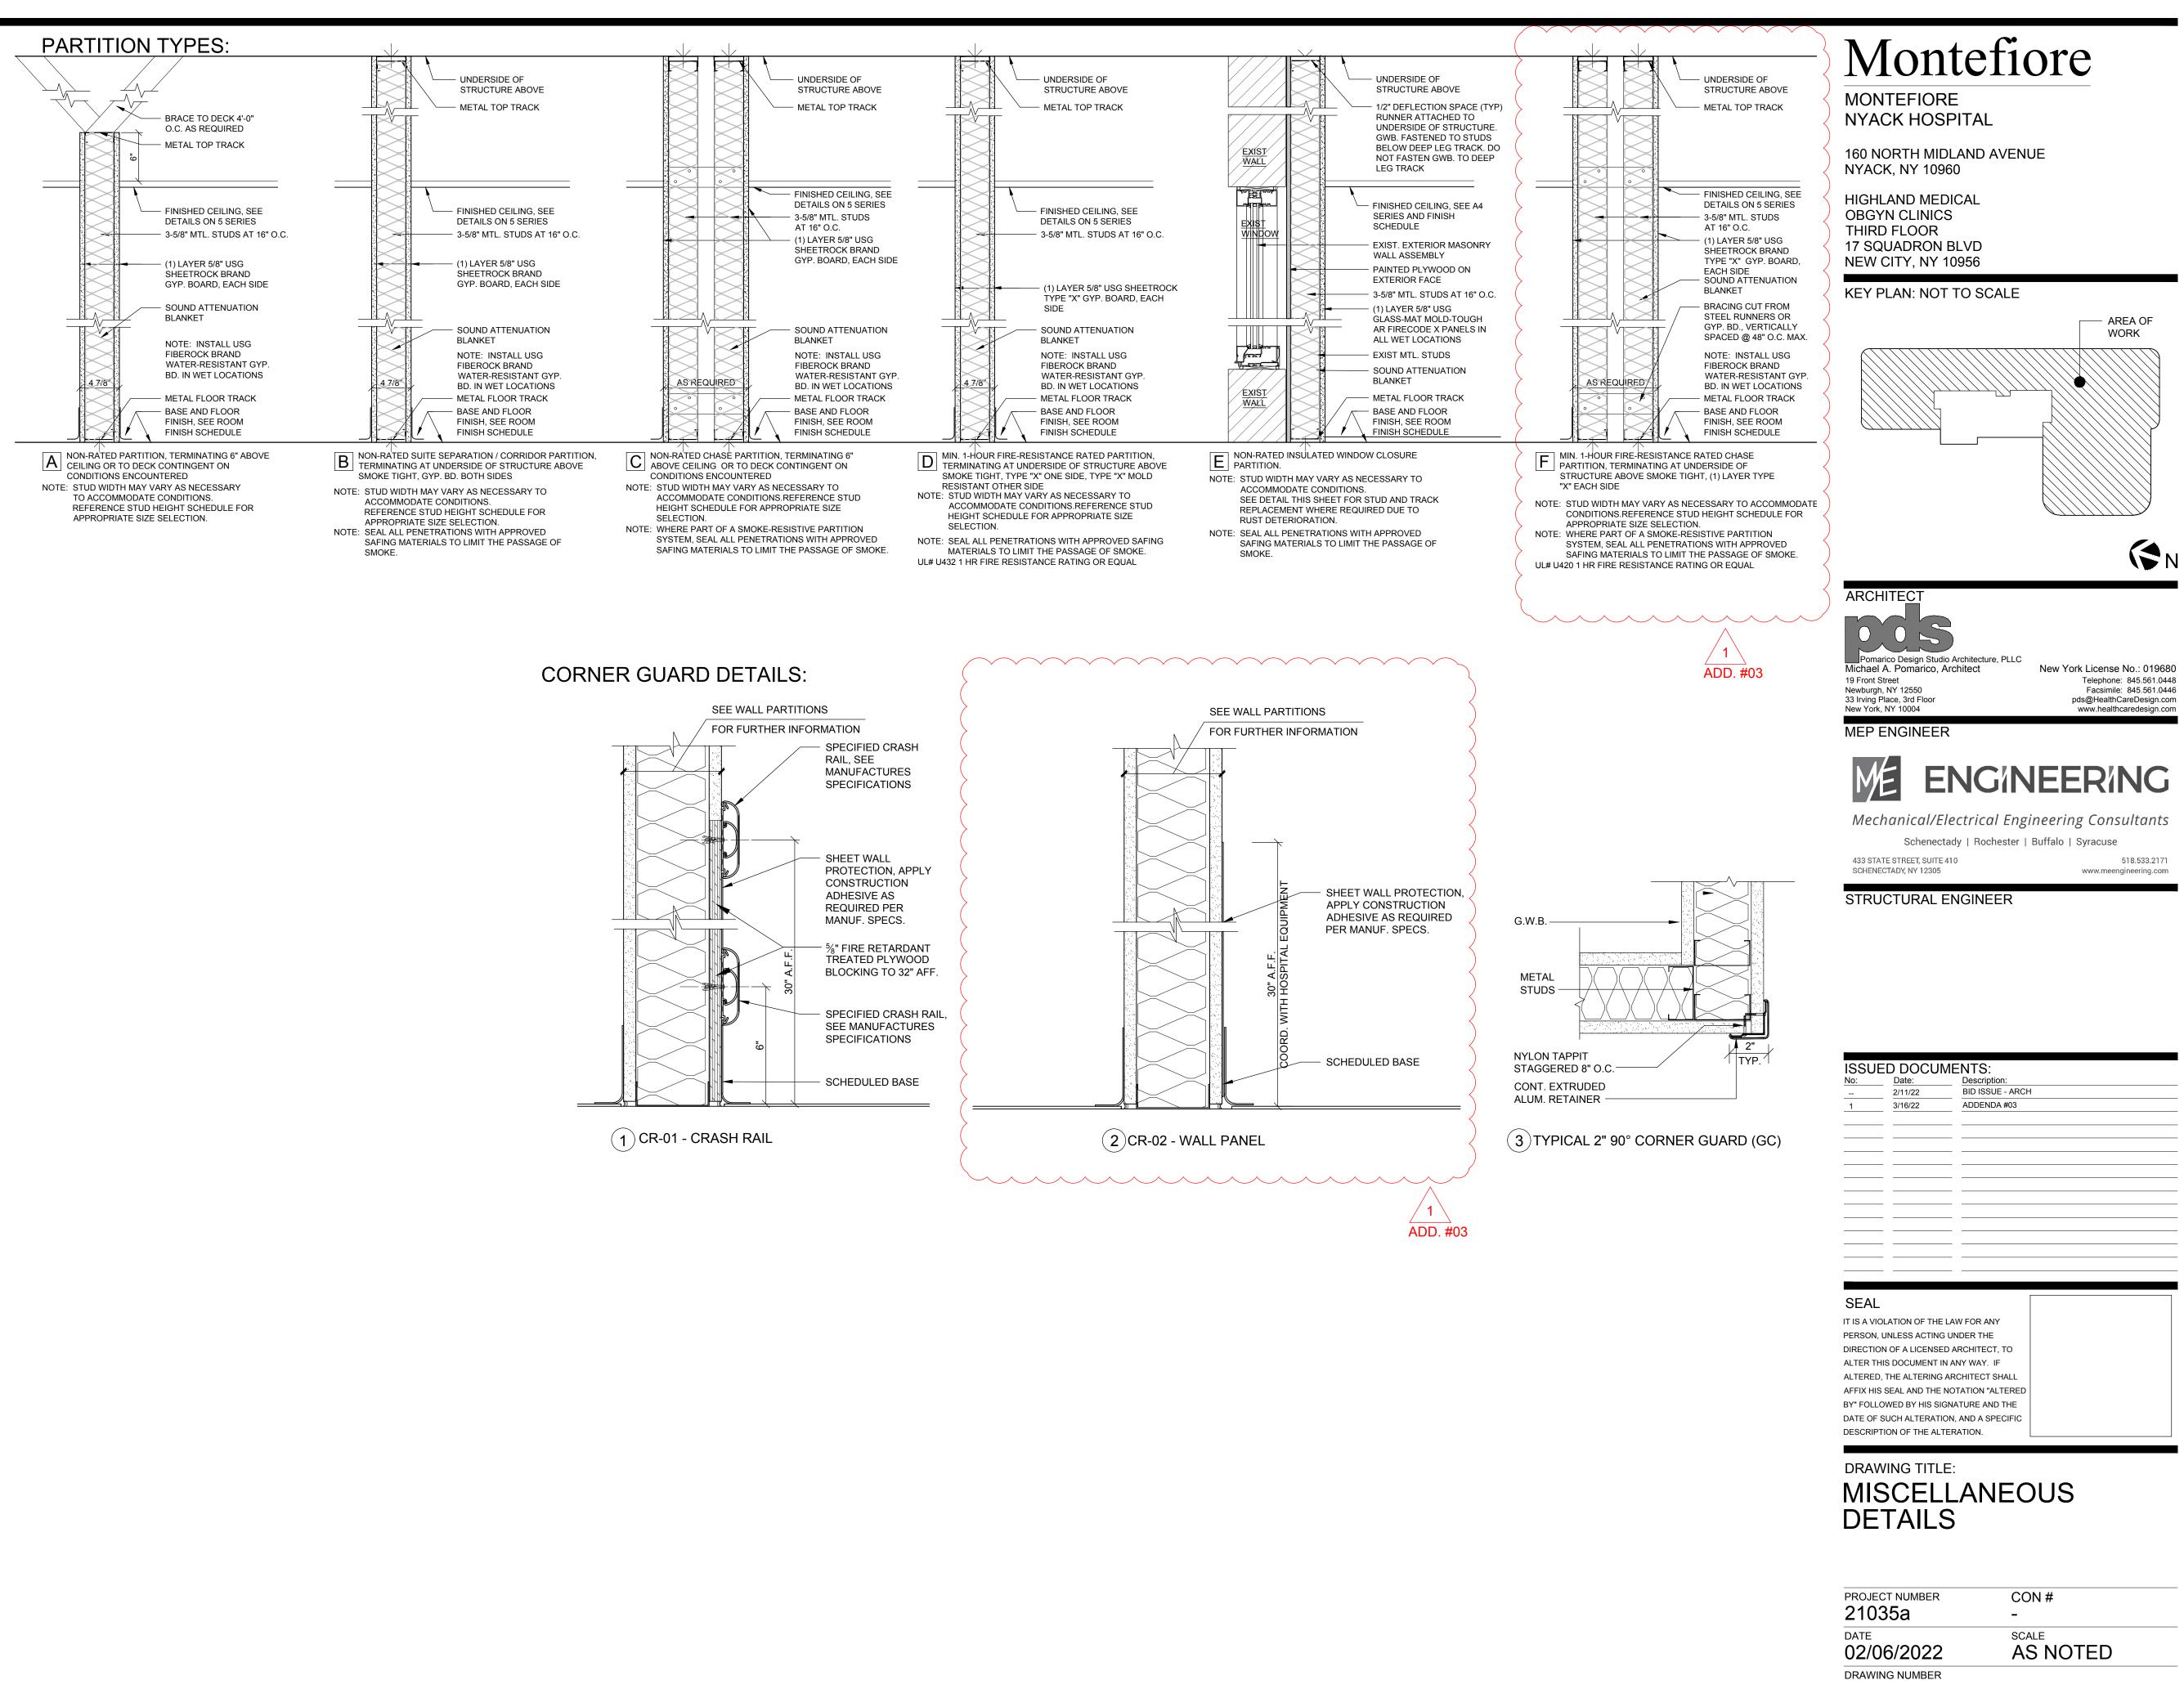


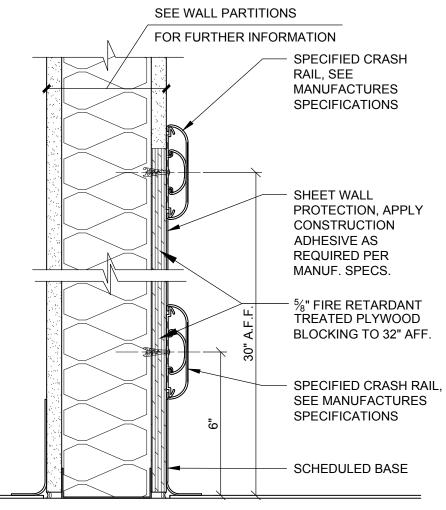


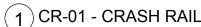

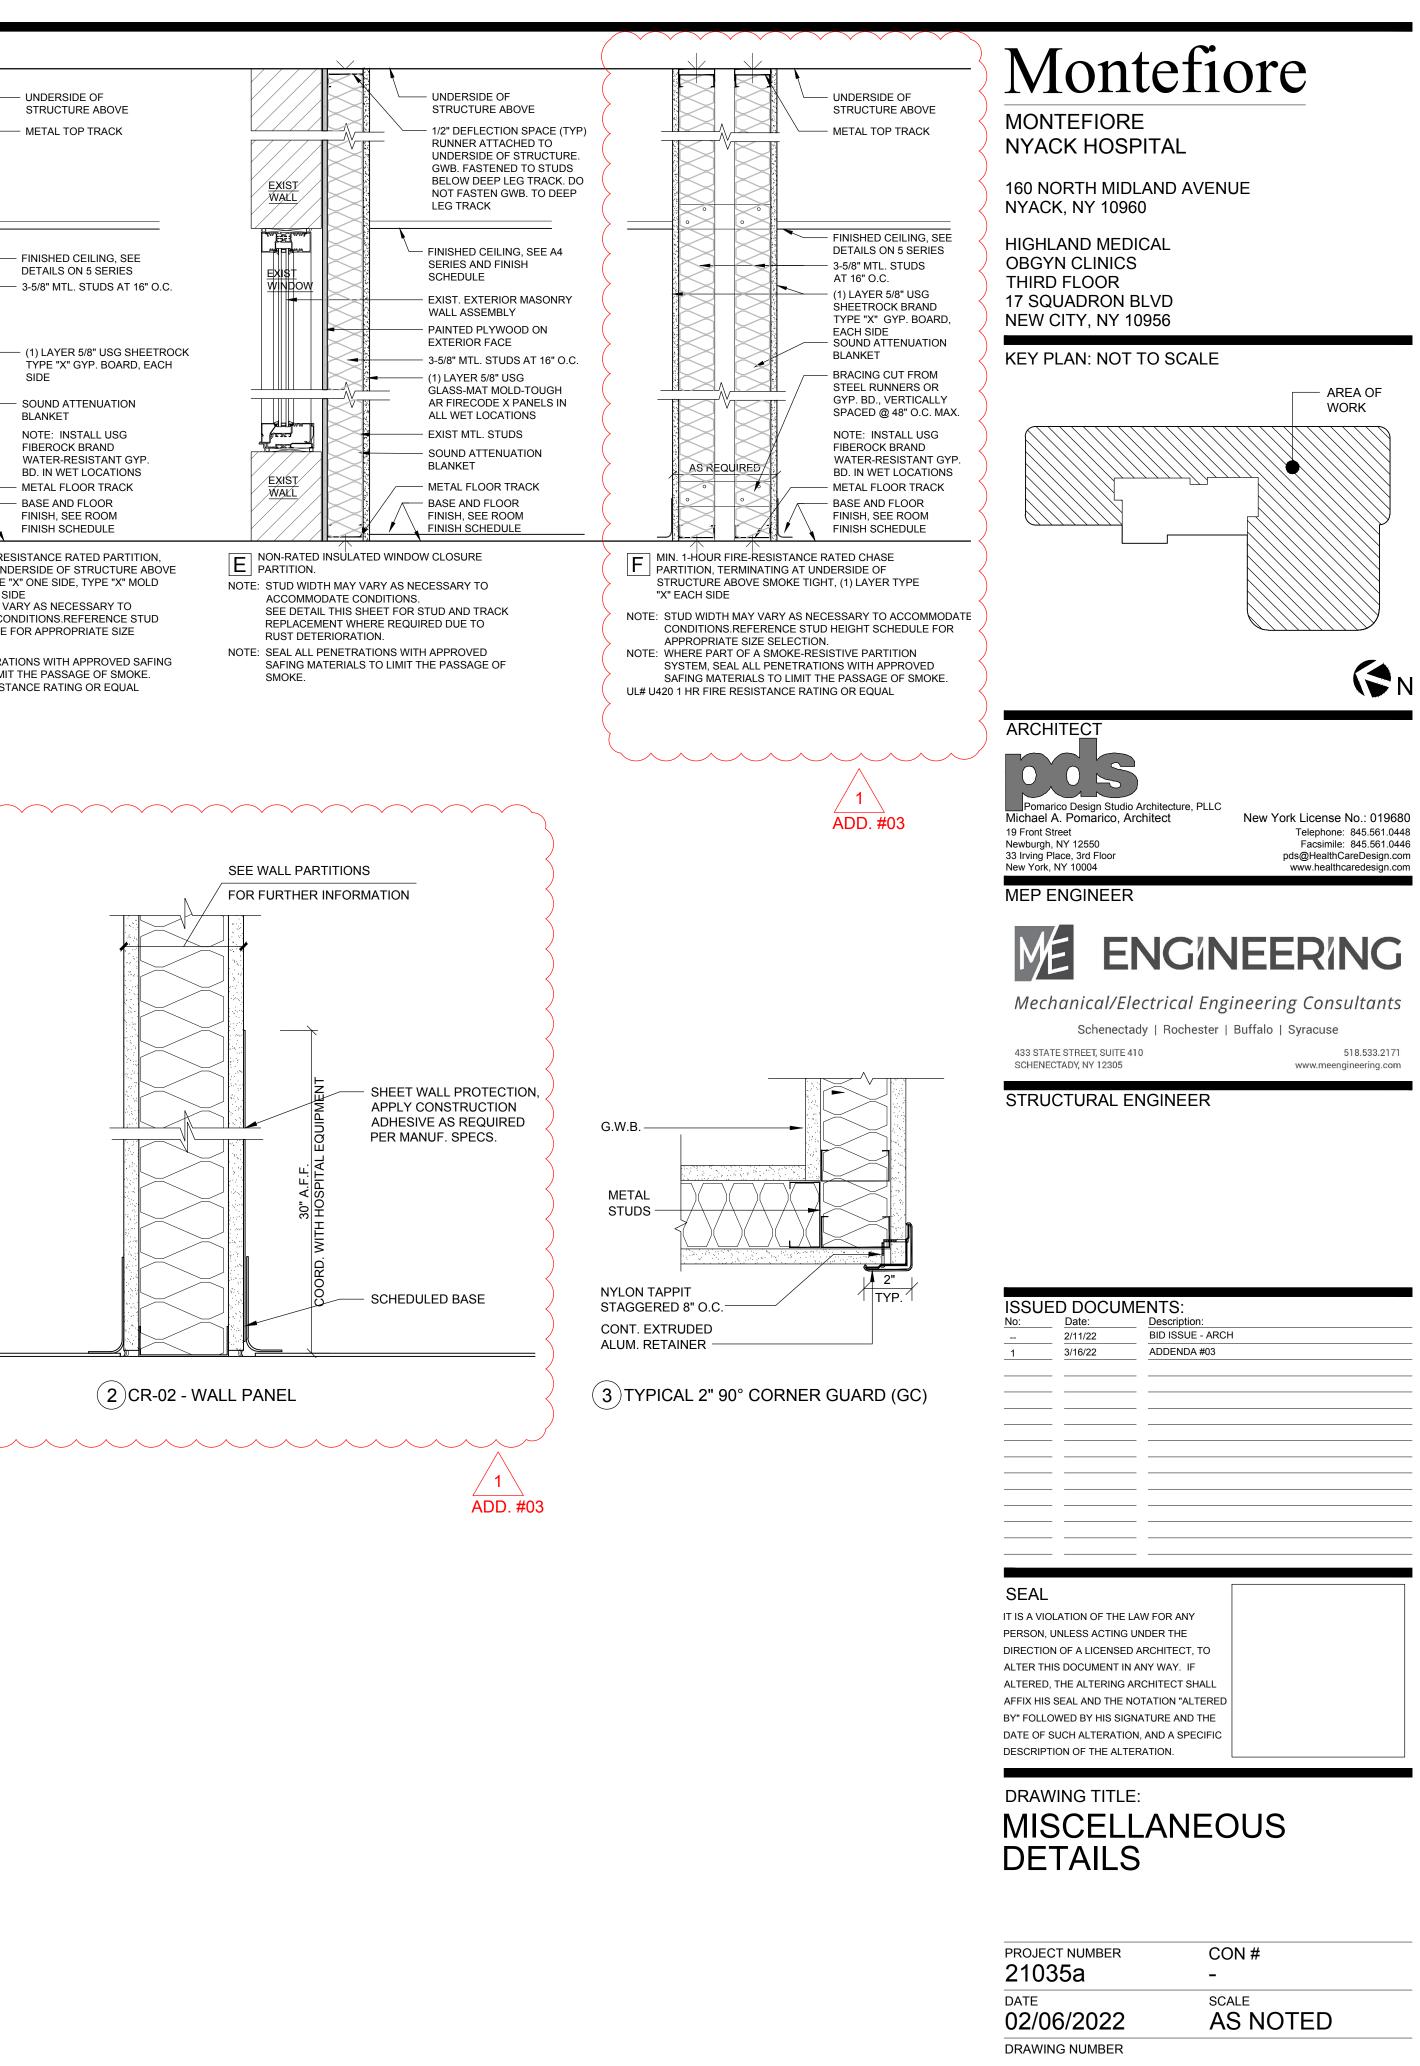


A9.2

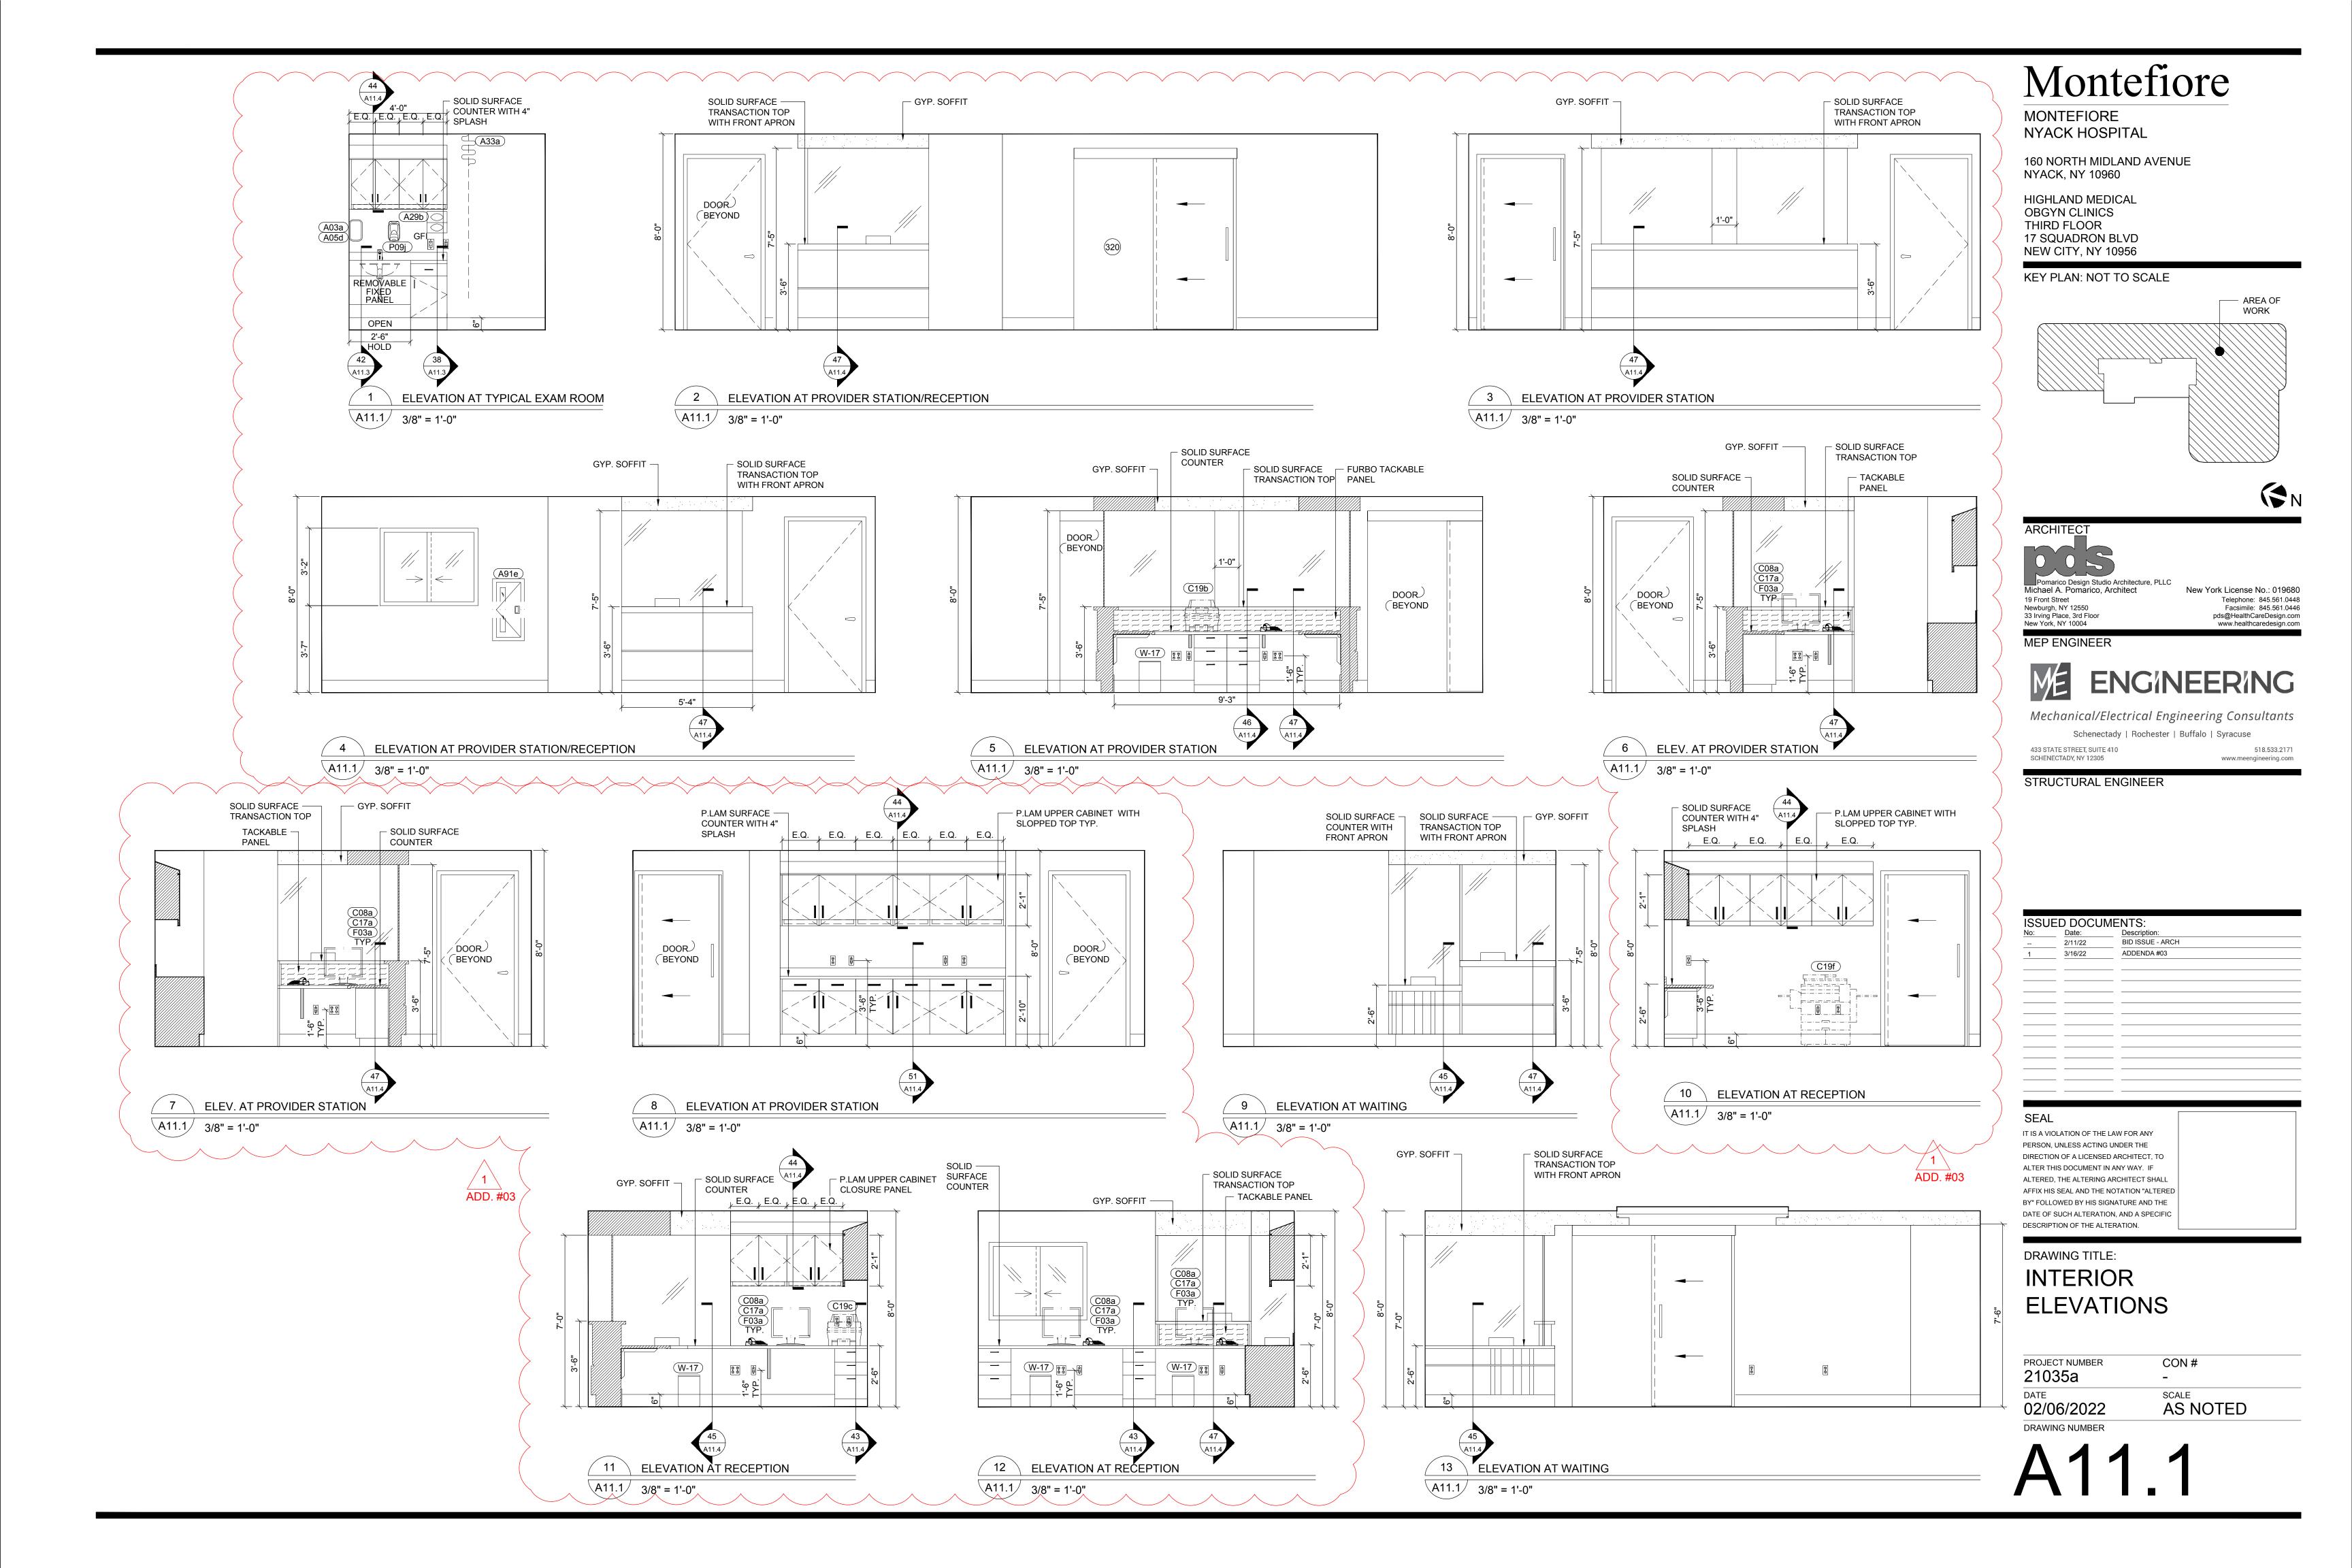

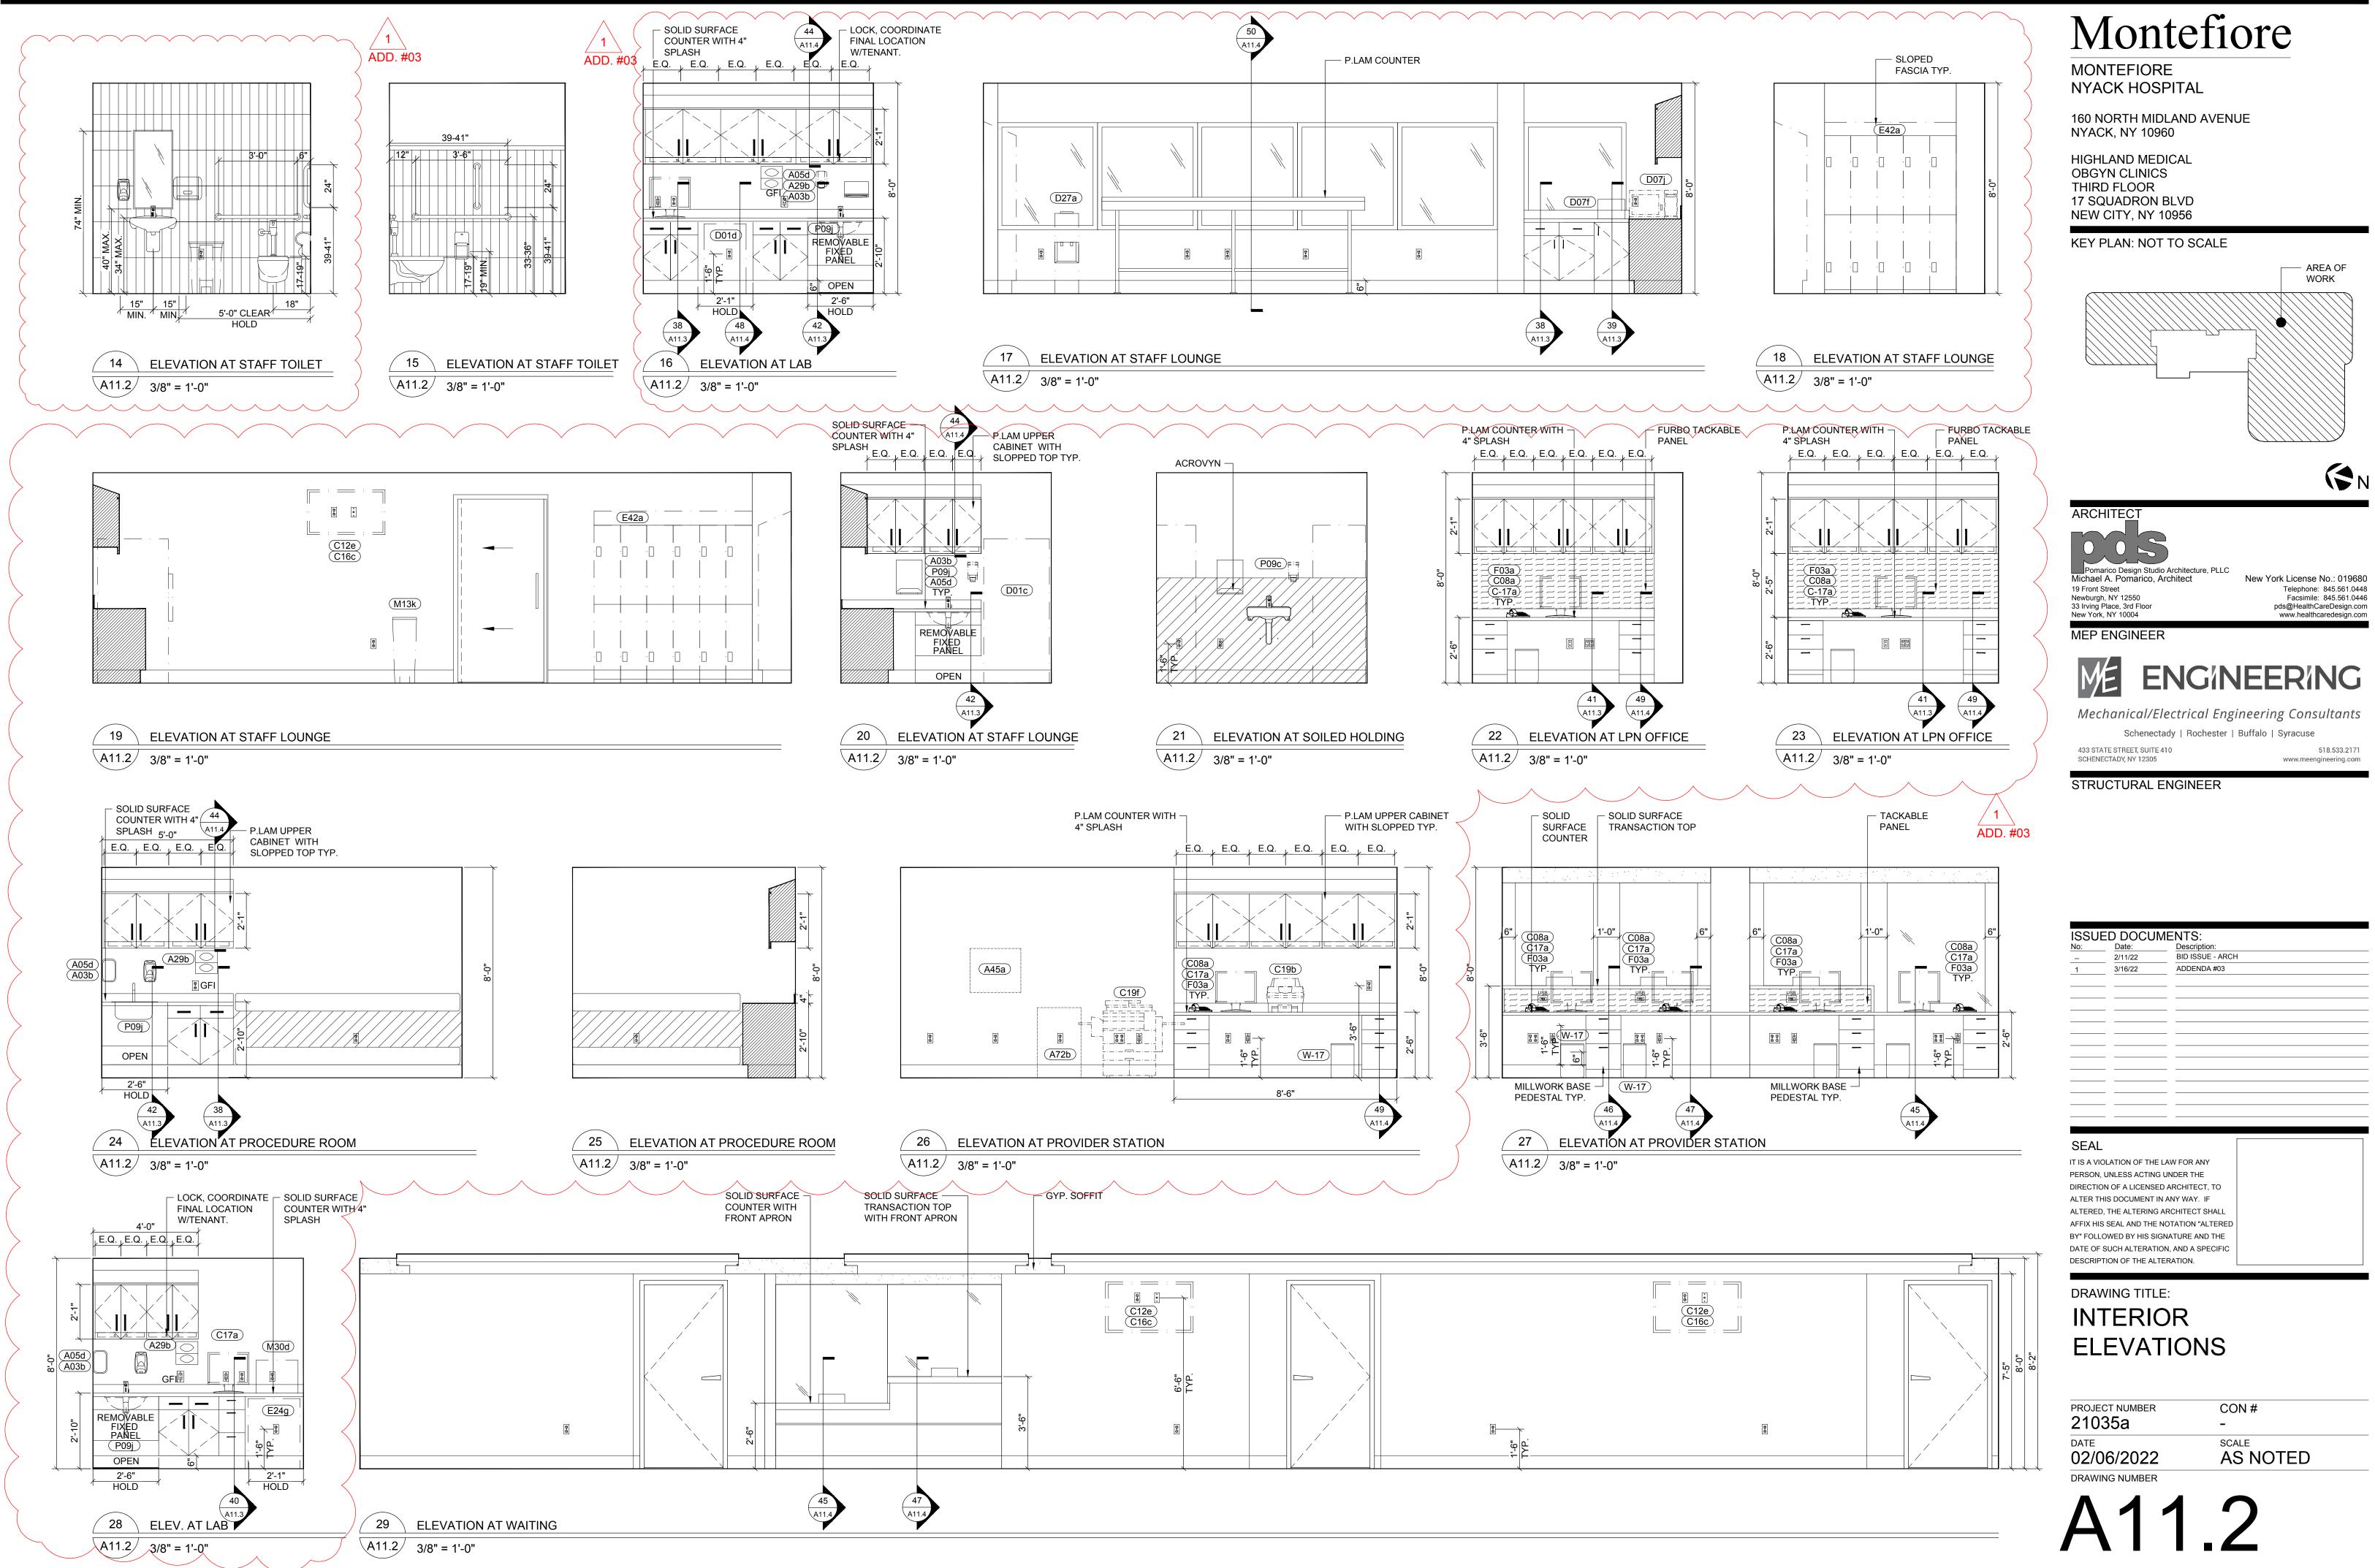


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PROJECT NUMBER 21035a	CON # -
<sup>date</sup> 02/06/2022	SCALE AS NOTED
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PROJECT NUMBER	CON #
21035a	-
DATE	SCALE
02/06/2022	AS NOTED
DRAWING NUMBER	
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ACCESSORIES, TYP. ON BASE PEDESTAL

P.LAM DRAWER FACES ON 3/4" PLYWOOD SUBSTRATE W/ FULL EXTENSION SLIDES.

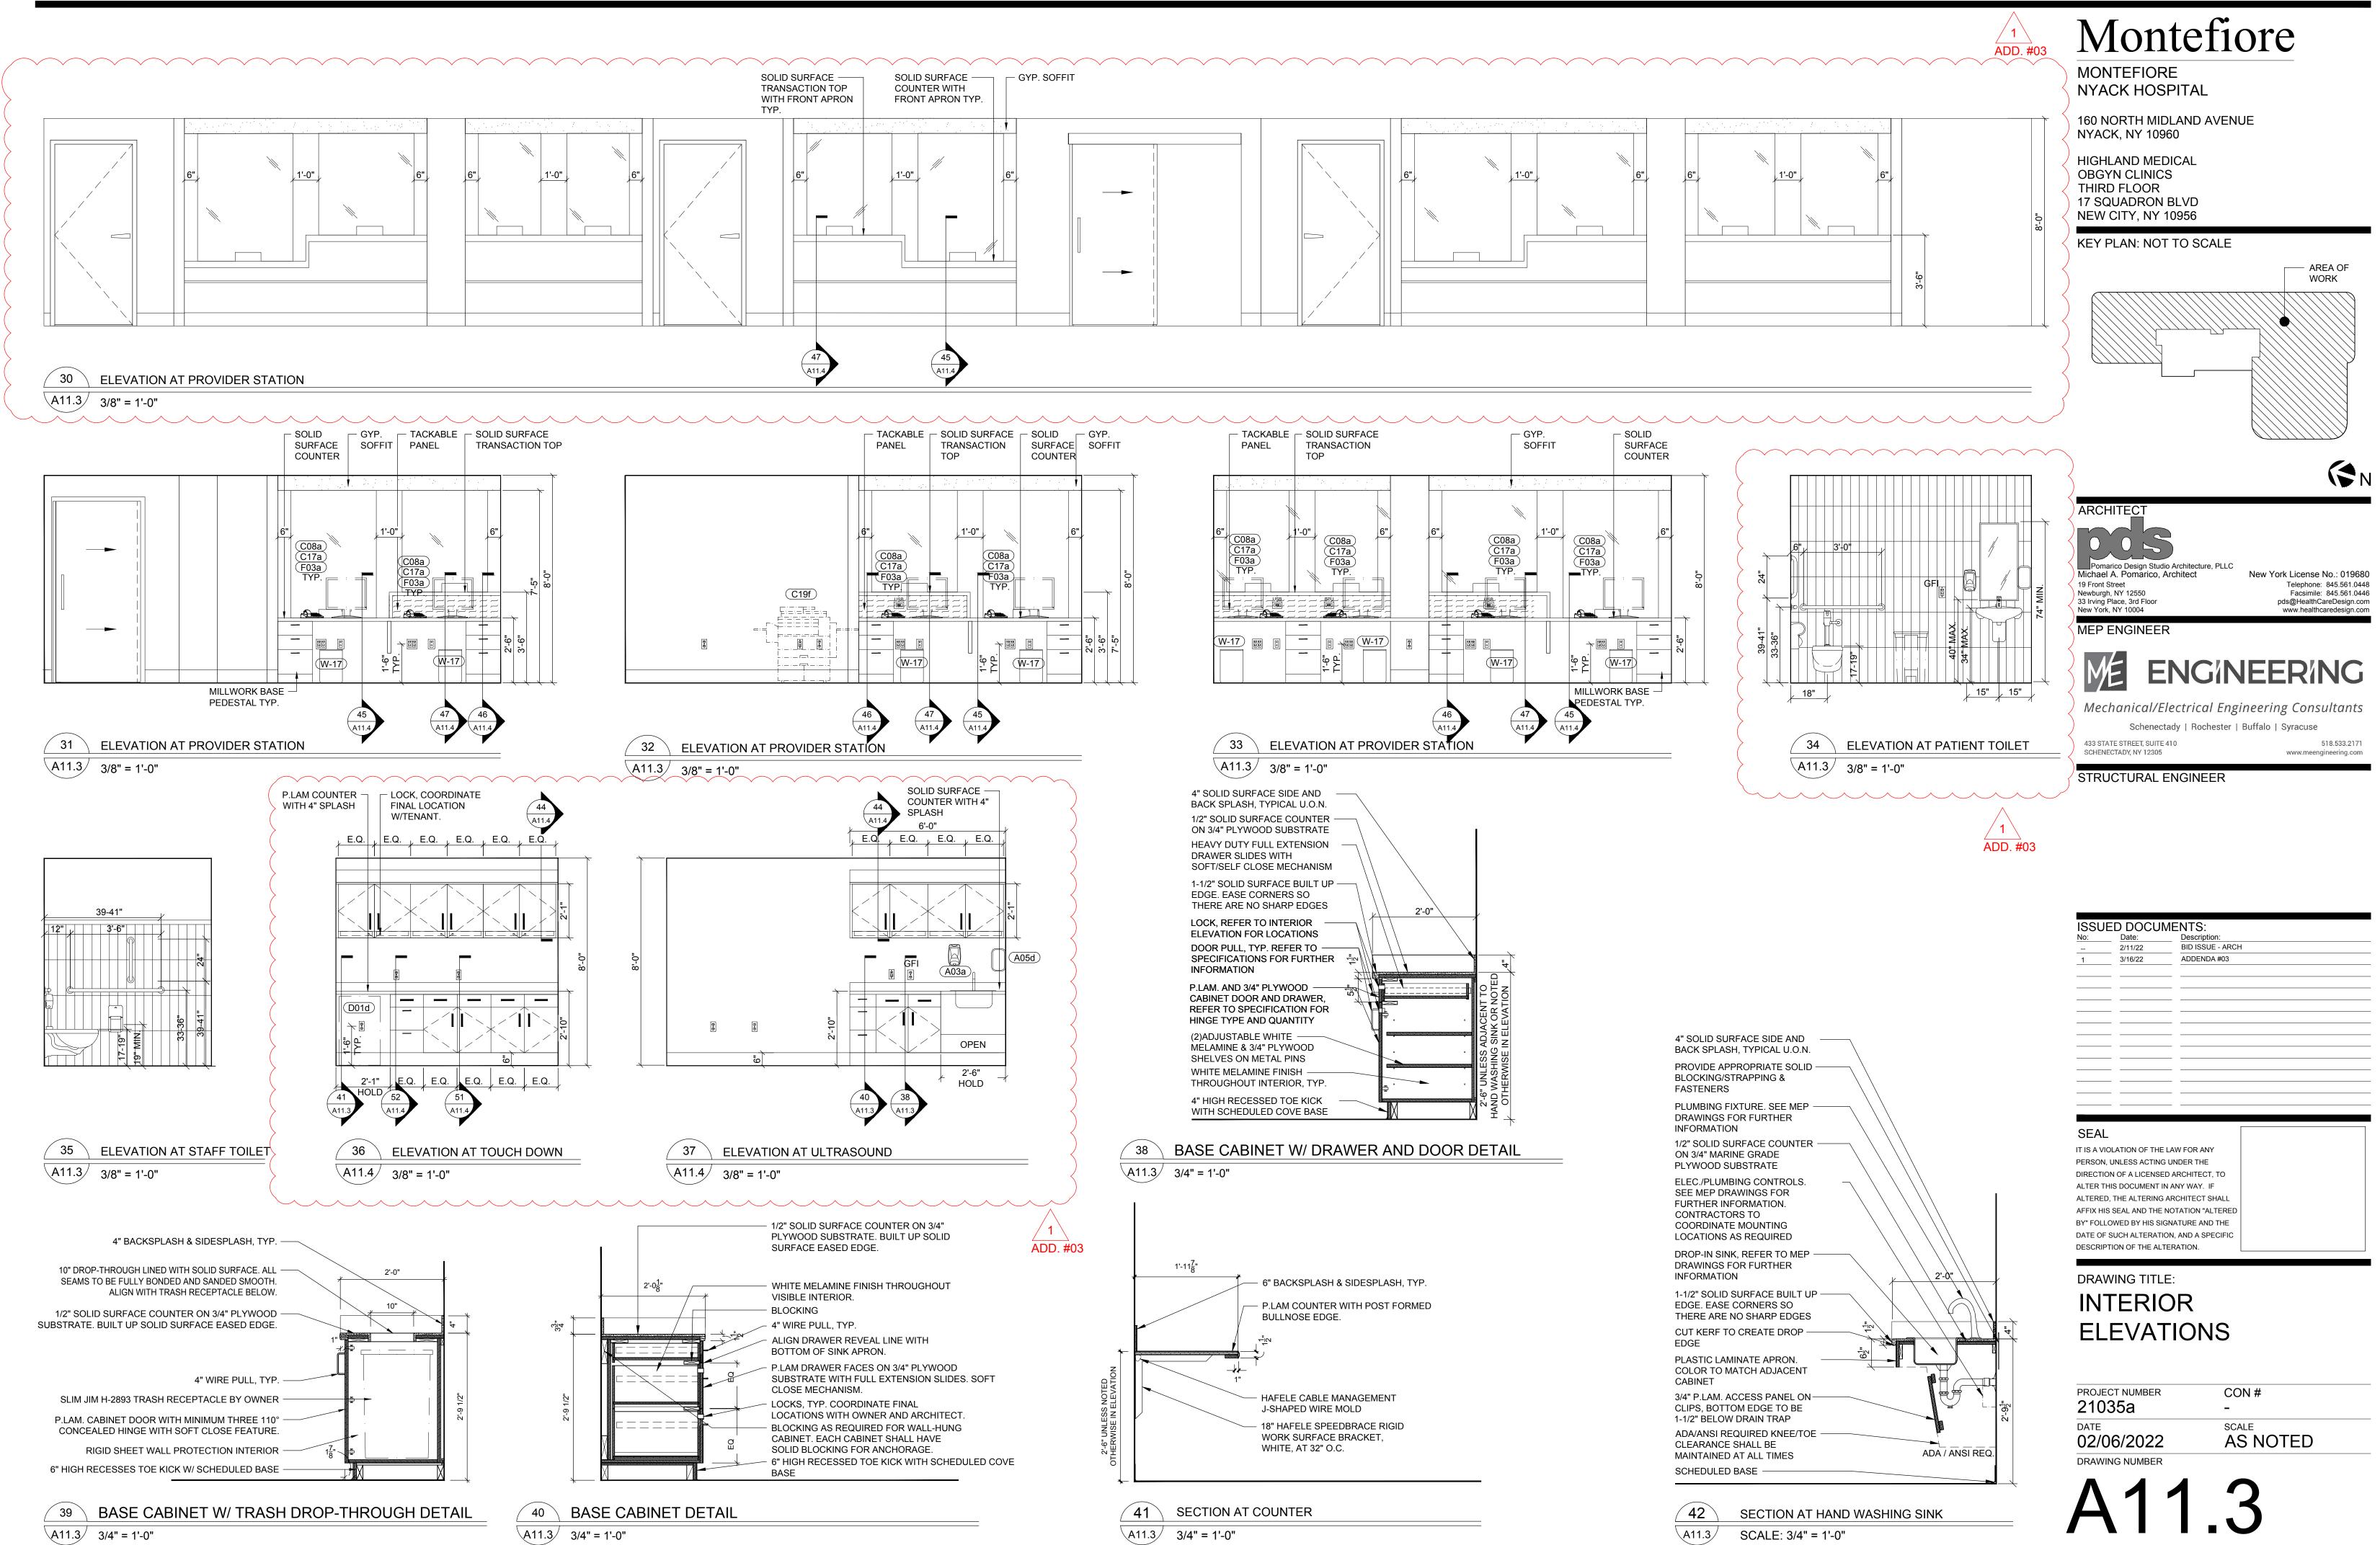Montefiore

MONTEFIORE NYACK HOSPITAL

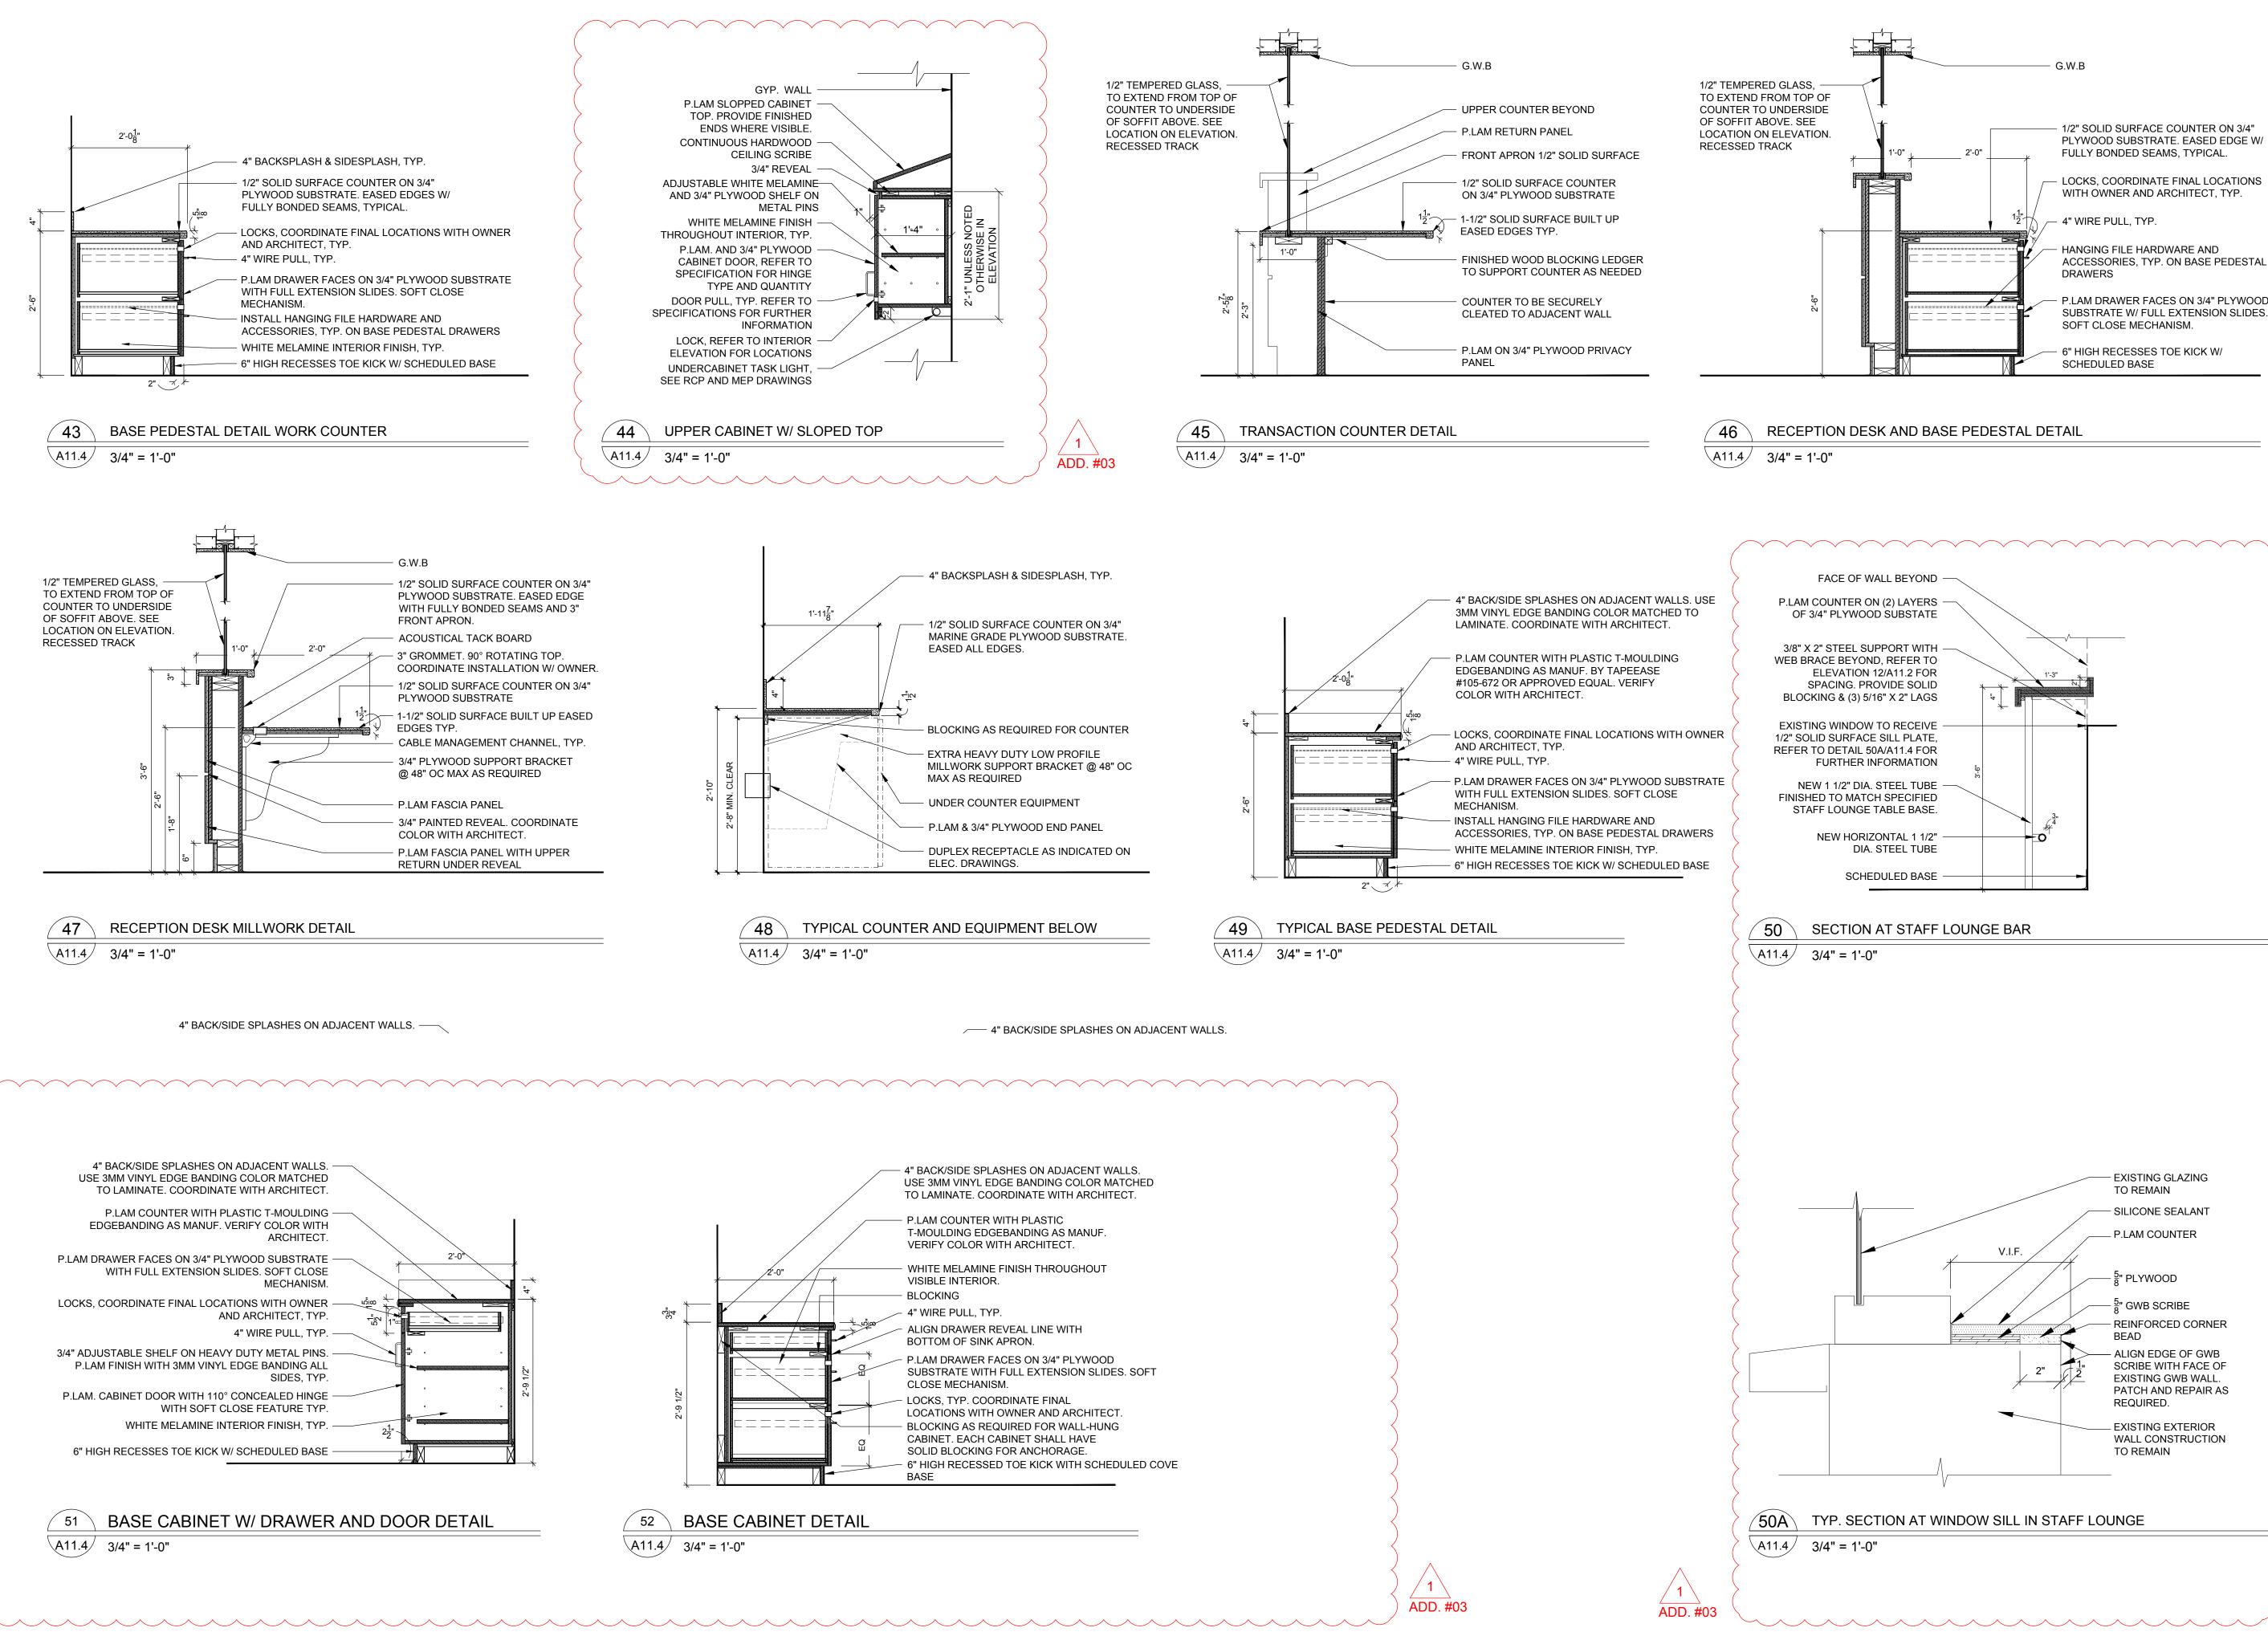160 NORTH MIDLAND AVENUE NYACK, NY 10960

HIGHLAND MEDICAL **OBGYN CLINICS** THIRD FLOOR 17 SQUADRON BLVD NEW CITY, NY 10956

KEY PLAN: NOT TO SCALE - AREA OF WORK



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**ISSUED DOCUMENTS:** Date: Description **BID ISSUE - ARCH** 2/11/22 ADDENDA #03 3/16/22

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MILLWORK SECTIONS

DRAWING TITLE:

CON # -

AS NOTED

DRAWING NUMBER

02/06/2022

21035a DATE

SCALE

PROJECT NUMBER