NYACK UFSD PROFESSIONAL DEVELOPMENT CENTER

CONSTRUCTION DOCUMENTS



LIST OF DRAWINGS

GENERAL	
C000	

0000	COVER
6001	GENERAL INFORMATION
6002	ACCESSIBILITY DIAGRAMS
G003	ACCESSIBILITY DIAGRAMS

CODE COMPLIANCE CC001 CODE COMPLIANCE INFORMATION

CC002 CODE COMPLIANCE PLAN

STRUCTURAL S101 LOW ROOF FRAMING PLAN

ARCHITEC	TURAL
A101	DEMOLITION PLA
A201	FLOOR PLAN & IN
A301	EXTERIOR ELEVA
A302	ALTERNATE - EXT
A421	MILLWORK DETA
A501	FINISH PLAN & SO
A601	REFLECTED CEIL
A701	STAIR DETAILS
A801	WALL SECTIONS
A802	INTERIOR DETAIL
A901	WALL TYPES AND
A911	DOOR SCHEDULE
A912	TYPICAL DOOR D

13A DICKINSON AVENUE NYACK, NY 10960

J	
TERIOR ELEVATIONS	
TIONS	
ERIOR ELEVATIONS	
S	
HEDULE	
NG PLAN	

& PLAN DETAILS

ND GENERAL NOTES LE, DOOR & FRAME TYPES DETAILS

PLUMBIN	NG	
P101	LEGENDS, SCHEDULES, NOTES, & PART BASEMENT & 1ST FLOOR PLANS	ELEC
	(REMOVALS)	E001
P201	PART BASEMENT & 1ST FLOOR PLANS (NEW WORK)	E101
		E201
MECHAN	VICAL	E301
H101	LEGENDS, NOTES, & PART BASEMENT, 1ST AND 2ND FLOOR PLANS (REMOVALS)	E501
H201	PART BASEMENT, 1ST & 2ND FLOOR PLANS (NEW WORK)	E601
H301	SCHEDULES	
H401	DETAILS	
H402	DETAILS	

ELECTRICA	λL
E001	NOTES, ABBREVIATIONS AND LEGENDS
E101	ELECTRICAL REMOVALS
E201	LIGHTING PLAN
E301	POWER PLAN
E501	RISERS
E601	DETAILS & SCHEDULES

PROFESSIONAL **DEVELOPMENT CENTER**

NY SED Project. No 50-03-04-03-1-005-006

KG+D Project No. 2021-1048

JULY 12, 2022

DESIGN TEAM

ARCHITECT **KG+D** Architects

285 Main Street Mount Kisco, NY 10549 phone: 914-666-5900

MECHANICAL ENGINEER BGA

99 Bauer Drive Oakland, NJ 07436 phone: 201-416-4012

STRUCTURAL ENGINEER THE DISALVO ENGINEERING GROUP

Lee Farm Corporate Park - Suite 200 Danbury, CT 06810 phone: 203-490-4140

SPECIFICATION CONSULTANT SUE MCCLYMONDS


200 Robb Road Amsterdam, NY 12010 phone: 518-843-4054

MAINT MAX MFG MSNRY MO MATL MECH MTL MCP MCB MS MLWK MIN MISC MLDG MTG	MASONRY OPENING MATERIAL MECHANICAL METAL METAL COMPOSITE PANEL	S SCHED SECT SFB SH SIM SL STC SPEC SQFT ST STSTL STSTL STR SUSP	SAFETY GLZING/SEE SPEC SCHEDULE/SCHEDULED SECTION SPLIT FACE BLOCK SHELVING/SHELF/SHELVES SIMILAR SLATE SOUND TRANSMISSION CLASS SPECIFICATION SQUARE FOOT SAND, STAIN & SEAL STAINLESS STEEL STEEL STRUCTURAL/STRUCTURE SUSPENDED/SUSPENSION
NIC NTS NO	NOT IN CONTRACT NOT TO SCALE NUMBER	T TB TBD TERR TFF	TOP TACKBOARD TO BE DETERMINED TERRAZZO TOP FINISHED FLOOR
OC OPNG OPP OH OTS OUT OD OF	ON CENTER OPENING OPPOSITE OPPOSITE HAND OPEN TO STRUCTURE OUTLET OUTSIDE DIAMETER OUTSIDE FACE	TMP GL THERMO T&B TO TOS TOSS TOES TRT TYP	TEMPERED GLASS THERMOSTAT TOP AND BOTTOM TOP OF TOP OF STEEL TOP OF STRUCTURAL SLAB TOP OF EXISTING SLAB TERRAZZO RESILIENT TILE TYPICAL
P PT PTB PR PNL PTN	PAINTED PORCELAIN TILE PORCELAIN TILE BASE PAIR PANEL PARTITION	UNFIN UNO UR UTIL	UNFINISHED UNLESS NOTED OTHERWISE UNRINAL UTILITY
PL PLAM PLMB PLYWD PTWD	PROPERTY LINE PLASTIC LAMINATE PLUMBING PLYWOOD	VAT VCT VEN VERT VET VIF	VINYL ASBESTOS TILE VINYL COMPOSITE TILE VENEER VERTICAL VINYL ENHANCED TILE VERIFY IN FIELD
QT QTB QTY	QUARRY TILE QUARRY TILE BASE QUANTITY	VRS VT VWC	VINYL REDUCER STRIP VINYL TILE VINYL WALL COVERING
RCP REFL REQD RB RTN RA REV RFI RO RT RTB RTT RW	REFLECTED CEILING PLAN REFLECTED REQUIRED RUBBER BASE RETURN RETURN AIR REVISED/REVISION REQUEST FOR INFORMATION ROUGH OPENING RUBBER TREATD/TILE RUBBER TREAD BASE RESILIENT TERRAZZO TILE RESCUE WINDOW	WB WC WF W/C W/O WOM WD BLKG WD DR WP WR WW	WHITEBOARD WATER CLOSET WATER FOUNTAIN WIRE GLASS WITH WHEEL CHAIR WITHOUT WALK OFF MAT WOOD WOOD BLOCKING WOOD DOOR WATERPROOFING WARDROBE WINDOW WALL
		YD YCO	YARD YARD CLEANOUT
		ZCC	ZINC COATED COPPER

SUM

IDITIONING

DRAWING ANNOTATIONS

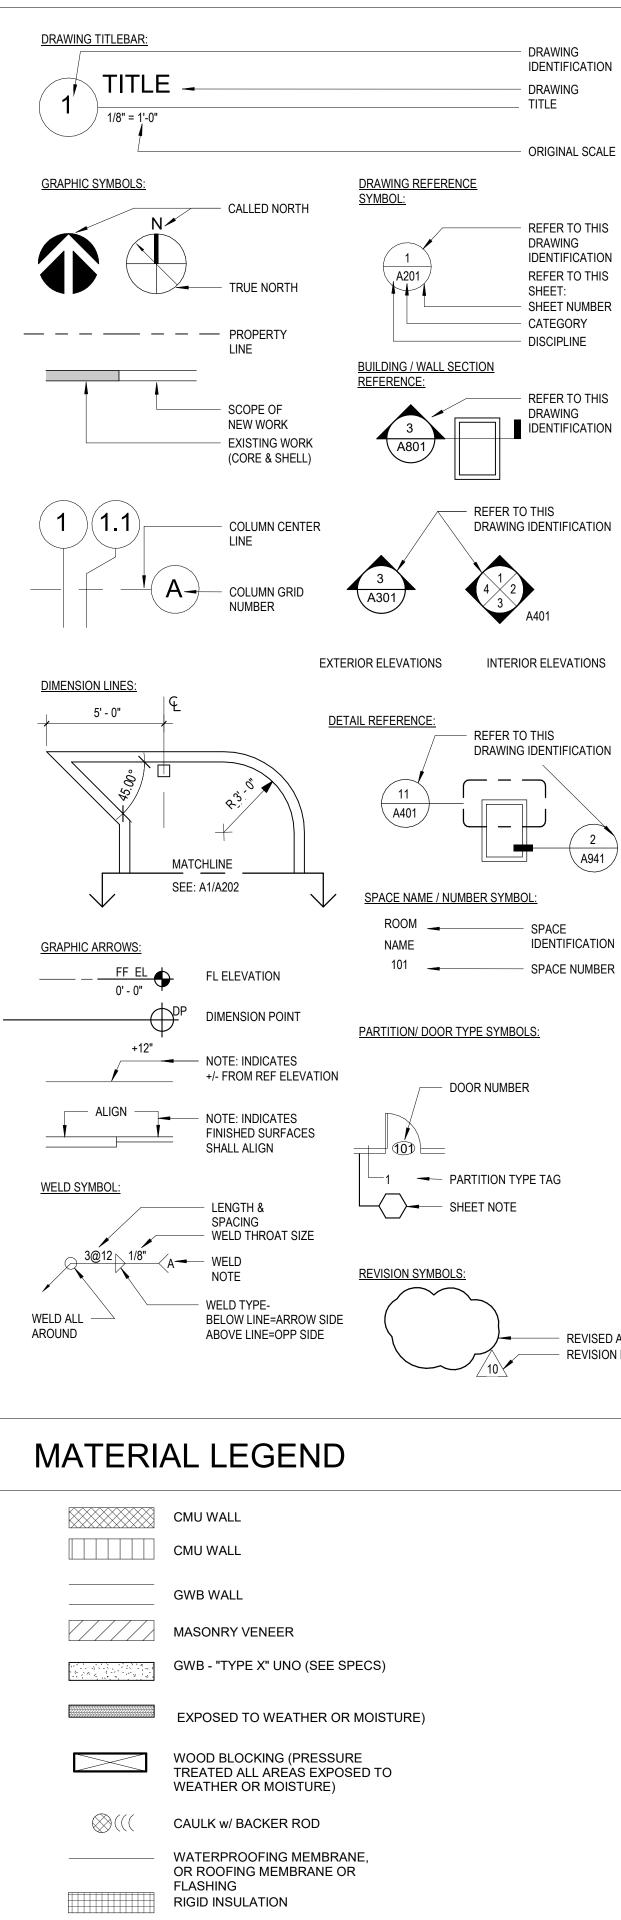

BATT INSULATION

POROUS FILL

SUITABLE COMPACTED BACKFILL (SEE SPEC)

UNDISTURBED SOIL

CAST-IN-PLACE CONCRETE OR CAST STONE

GLASS SURFACE

• • • •

///

REVISED AREA **REVISION NUMBER**

GENERAL NOTES

A. GENERAL NOTES:

1. THE CONTRACTOR SHALL PROVIDE COMPLETE PROJECT SYSTEMS AND COMPONENTS AND COMPLY WITH ALL REQUIREMENTS INDICATED ON THE PROJECT DOCUMENTS. ALL WORK TO BE COMPLETED IN MANNER TO PROVIDE OCCUPANCY PERMIT PRIOR TO LEASE COMMENCEMENT.

2. WORK WITHIN THE AREA BOUNDARIES INDICATED IN THE PROJECT DOCUMENTS, SHALL COMPLY WITH ALL APPLICABLE BUILDING CODE, REGULATION, & ORDINANCE REQUIREMENTS. OCCUPANTS ADJACENT TO THE PROJECT AREA BOUNDARIES SHALL CONTINUE UNINTERRUPTED OCCUPANCY DURING CONSTRUCTION OF THE PROJECT.

3. VERIFY FIELD CONDITIONS AND COORDINATION WITH THE PROJECT DOCUMENTS PRIOR TO PROCEEDING WITH THE WORK.

4. COORDINATE THE WORK WITH ALL REQUIREMENTS INDICATED IN THE PROJECT DOCUMENTS.



6. COORDINATE THE WORK WITH EQUIPMENT, FURNISHINGS, AND SYSTEMS.

B. DEFINITIONS:

1. "TYPICAL" OR "TYP" INDICATES IDENTICAL COMPLETE SYSTEM SHALL BE PROVIDED FOR EACH OCCURRENCE OF THE CONDITION NOTED. 2. "SIMILAR" OR "SIM" INDICATES COMPLETE SYSTEM AND COMPONENTS SHALL BE PROVIDED COMPARABLE TO THE CHARACTERISTICS FOR THE CONDITION NOTED. 3. "OPPOSITE HAND" OR "OH" INDICATES COMPLETE SYSTEM AND COMPONENTS SHALL BE PROVIDED AS A MIRROR IMAGE TO THE CHARACTERISTICS FOR THE CONDITION NOTED. 3. "AS REQUIRED" INDICATES COMPONENTS REQUIRED TO COMPLETE THE NOTED SYSTEM, AS INDICATED IN THE PROJECT DOCUMENTS, SHALL BE PROVIDED 4. "ALIGN" INDICATES ACCURATELY PROVIDE FINISH FACES OF MATERIALS IN STRAIGHT, TRUE, AND PLUMB RELATION TO ADJACENT

C. DIMENSIONS:

MATERIALS.

1. DIMENSIONS ARE INDICATED TO THE CENTERLINE OF THE STRUCTURAL GRID, FACE OF CONCRETE WALL, NOMINAL FACE OF CMU WALL, FACE OF PARTITION AS SCHEDULED, UNLESS OTHERWISE NOTED. 2. ALIGNMENT OF PARTITIONS AND FINISHES AS SCHEDULED SHALL BE STRAIGHT, TRUE & PLUMB. THE PRIORITY FOR PROJECT DIMENSIONS SHALL BE IN THE FOLLOWING ORDER:

- STRUCTURAL DRAWINGS
- LARGE SCALE DETAILS
- SMALL SCALE DETAILS ENLARGED VIEWS
- FLOOR PLANS AND ELEVATIONS

3. MINIMUM DIMENSIONS FOR ACCESSIBILITY CLEARANCES AND BUILDING CODE REQUIREMENTS SHALL BE MAINTAINED.

4. FLOOR ELEVATIONS ARE INDICATED TO THE FACE OF THE STRUCTURAL SLAB, UNLESS OTHERWISE NOTED.

5. VERTICAL DIMENSIONS ARE INDICATED FROM THE FLOOR ELEVATION TO FACE OF FINISHED MATERIAL, UNLESS NOTED ABOVE FINISH FLOOR -"AFF".

6. CEILING HEIGHTS ARE INDICATED FROM THE FLOOR ELEVATION TO THE FACE OF SUSPENDED ACOUSTIC PANEL CEILING GRID OR FACE OF FINISH MATERIAL FOR OTHER CEILING TYPES, UON.

7. DIMENSIONS SHOWN ON THE DRAWINGS SHALL INDICATE THE REQUIRED SIZE, CLEARANCE, AND DIMENSIONAL RELATIONSHIP BETWEEN PROJECT SYSTEMS AND COMPONENTS. DIMENSIONS SHALL NOT BE DETERMINED BY SCALING THE DRAWINGS.

D. DRAWING SET ORGANIZATION:

1. EACH DRAWING SET SHEET IS IDENTIFIED BY THE SHEET NUMBER IN THE LOWER RIGHT HAND CORNER OF THE DRAWING TITLE BLOCK. THE SHEET TITLE PROVIDES A GENERAL DESCRIPTION OF THE CONTENTS OF THE SHEET. SHEET NUMBER EXAMPLE: A201

- "A" INDICATES THE DISCIPLINE THAT CREATED THE DRAWING "2" INDICATES THE DRAWING CATEGORY CONTAINED ON THE SHEET
- "01" INDICATES THE SHEET NUMBER

2. SHEET NUMBERS MAY INCLUDE SUPPLEMENTAL CHARACTERS TO PROVIDE ADDITIONAL INFORMATION, SUCH AS DRAWING CONTENT, PROJECT SECTOR OR PHASE, REFER TO THE DRAWING INDEX FOR A COMPLETE LIST OF SHEETS INCLUDED IN THE DOCUMENT SET. EXAMPLE: EL201A

"EL" INDICATES THE DISCIPLINE THAT CREATED THE DRAWING AND THE DRAWING CONTENT = ELECTRICAL LIGHTING INDICATES SECTOR "A" OF PLAN SHEET "201". REFER TO THE PROJECT KEY PLAN OR COMPOSITE PLAN INDICATING "A" THE RELATIONSHIP OF THE SECTORS.

3. DRAWING SET INDEX INDICATES THE COMPLETE LIST OF SHEETS CONTAINED IN THE DRAWING SET, INDEXED BY DISCIPLINE, SHEET NUMBER AND SHEET TITLE, IN SEQUENTIAL ORDER. NOTE THAT ALL SEQUENTIAL SHEET NUMBERS MAY BE NOT USED IN THE DRAWING SET.


4. DISCIPLINE IDENTIFICATION, IN ORDER BOUND IN THE DRAWING SET. REFER TO THE DRAWING SET INDEX FOR DISCIPLINE CONTAINED IN THIS DRAWING SET:


G	GENERAL INFORMATION	М	MECHANICAL
CC	CODE COMPLIANCE	E	ELECTRICAL
S	STRUCTURAL	Р	PLUMBING
А	ARCHITECTURAL		


5. DRAWING CATEGORY IDENTIFICATION. REFER TO THE DRAWING SET INDEX FOR DISCIPLINES, CATEGORIES, AND SHEET NUMBERS CONTAINED IN THIS DRAWING SET:

PROJECT INFORMATION


OWNER	NYACK PUBLIC SCHOOLS 13A DICKINSON AVE, NYACK, NY 10960	
	TELEPHONE:845.353.7000FAX:845.353.7019	
PROJECT LOCATION	NYACK PROFESSIONAL DEVELOPMENT CENTER 13A DICKINSON AVE, NYACK, NY 10960	
TYPE OF PROJECT	RENOVATION	
NYSED NUMBER	66-23-00-01-0-008-011	
PROJECT COMMENCEMENT	SUMMER 2022	
PROJECT COMPLETION	FALL 2022	
APPLICABLE CODES	1. 2020 NEW YORK STATE UNIFORM FIRE PREVENTION AND BUILDING CODE	
	2. 2020 UNIFORM CODE SUPPLEMENTS	
	3. 1998 MANUAL OF PLANNING STANDARDS, THE UNIVERSITY OF THE STATE OF NEW YORK, THE STATE EDUCATION DEPARTMENT	
WORK AREA	LEVEL 2	

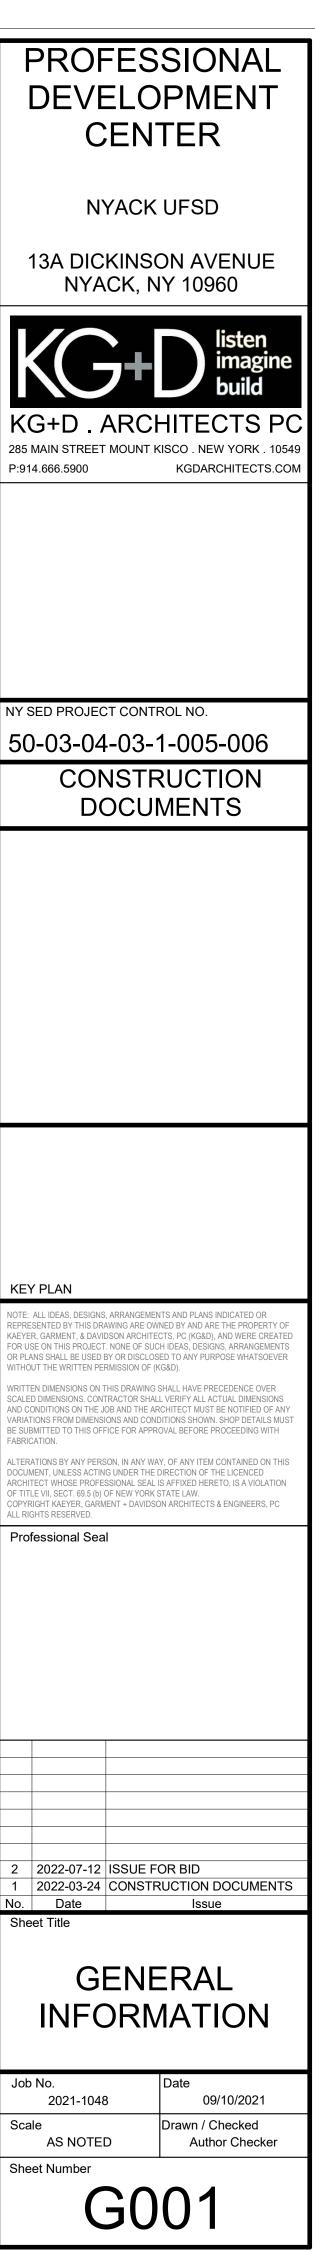


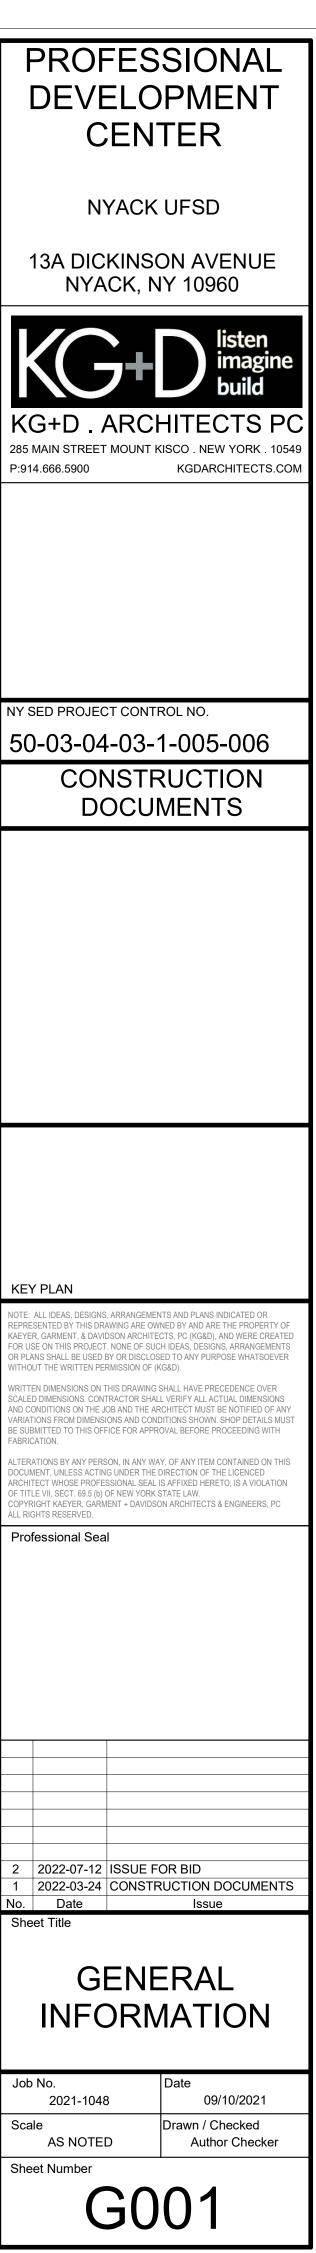


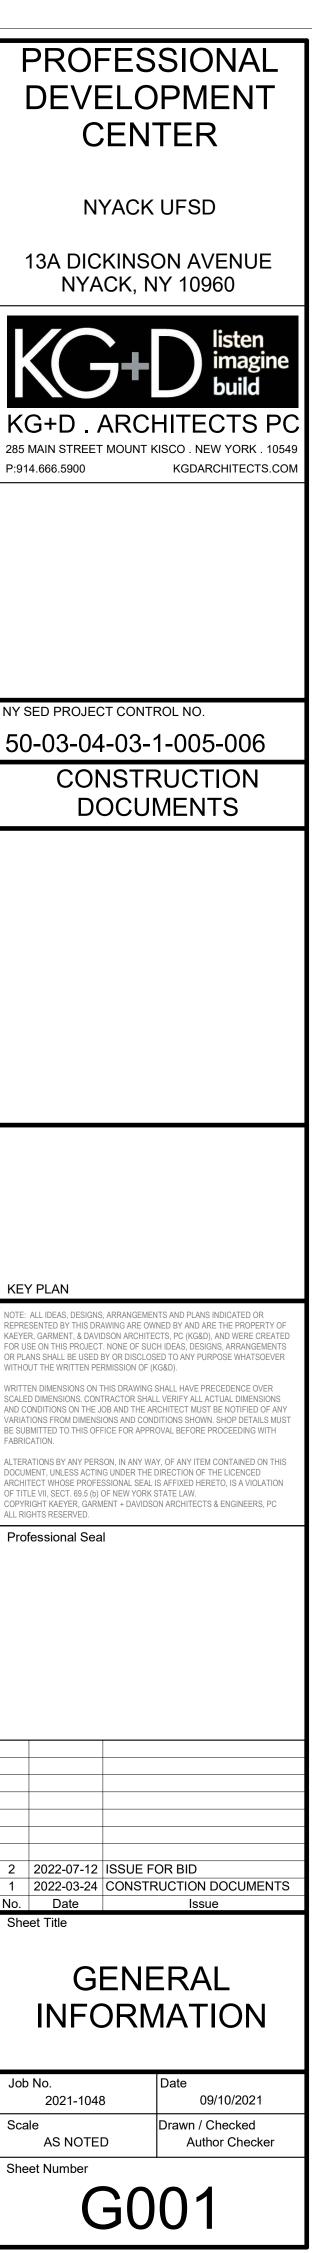




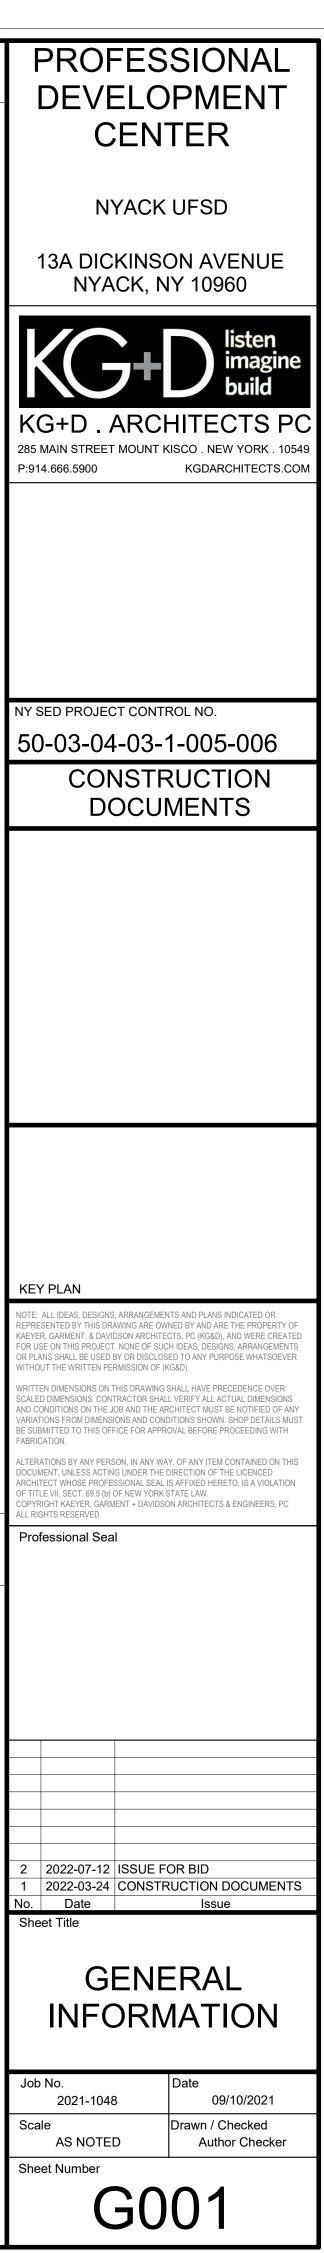

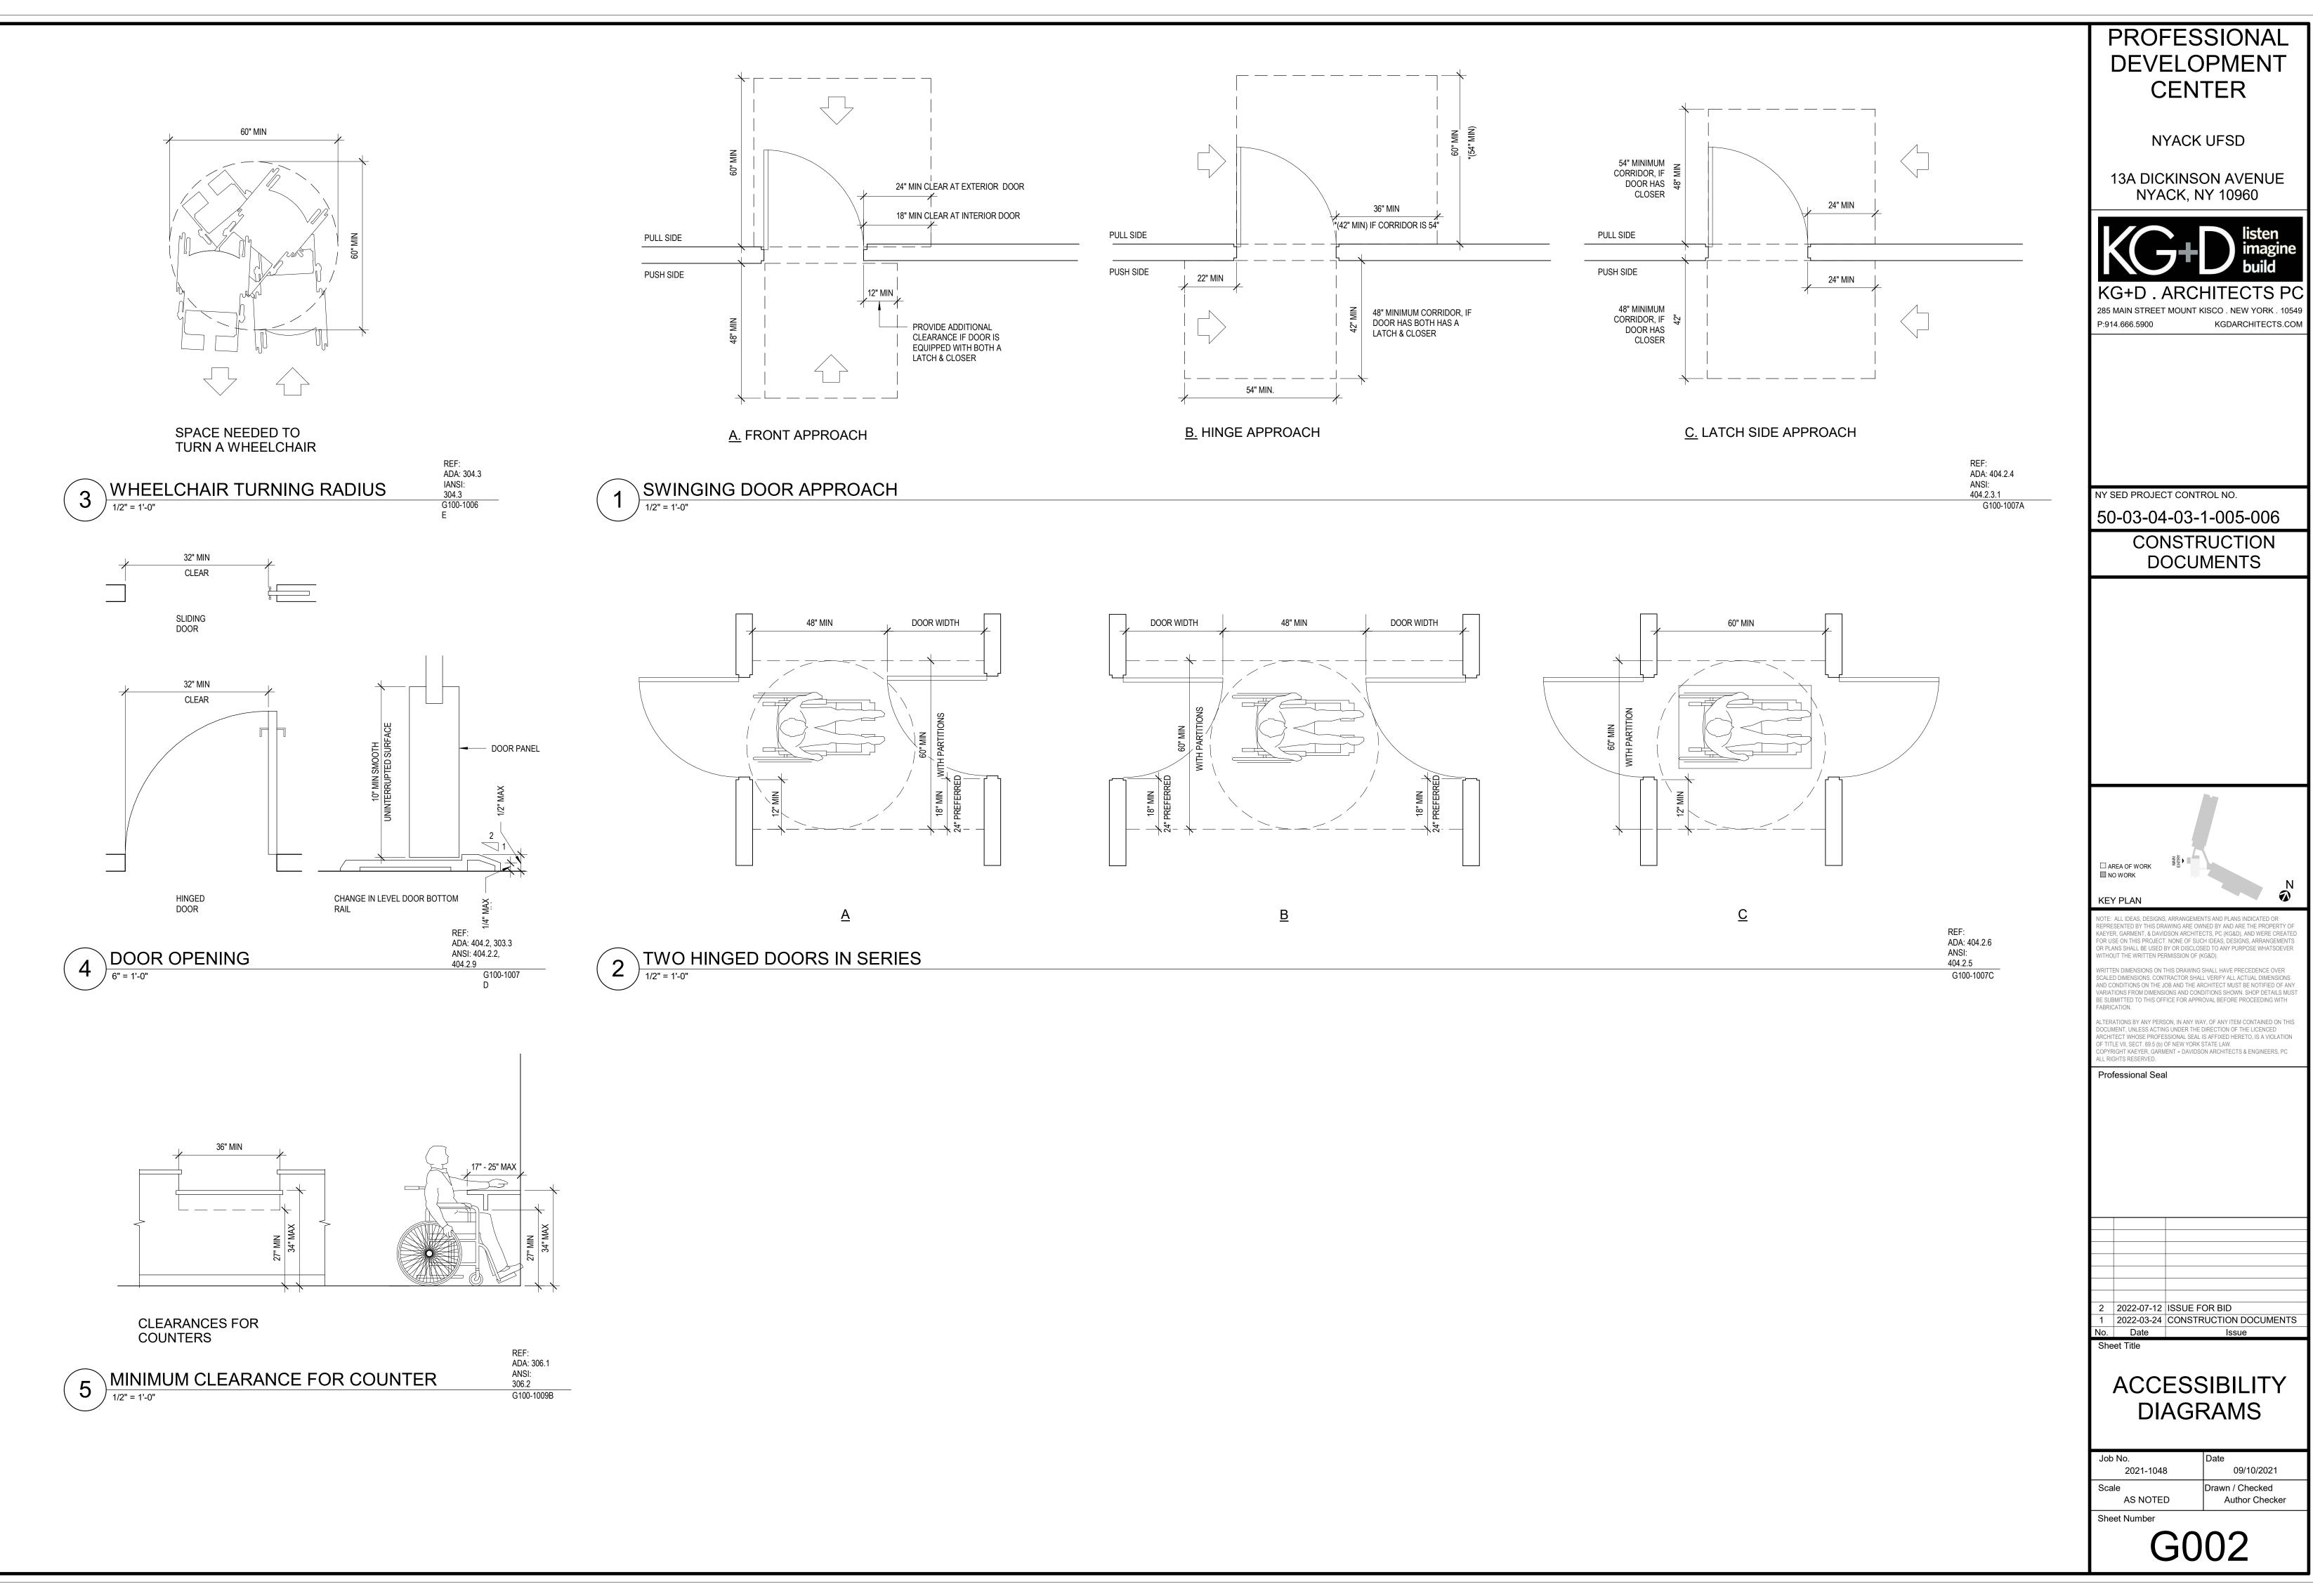

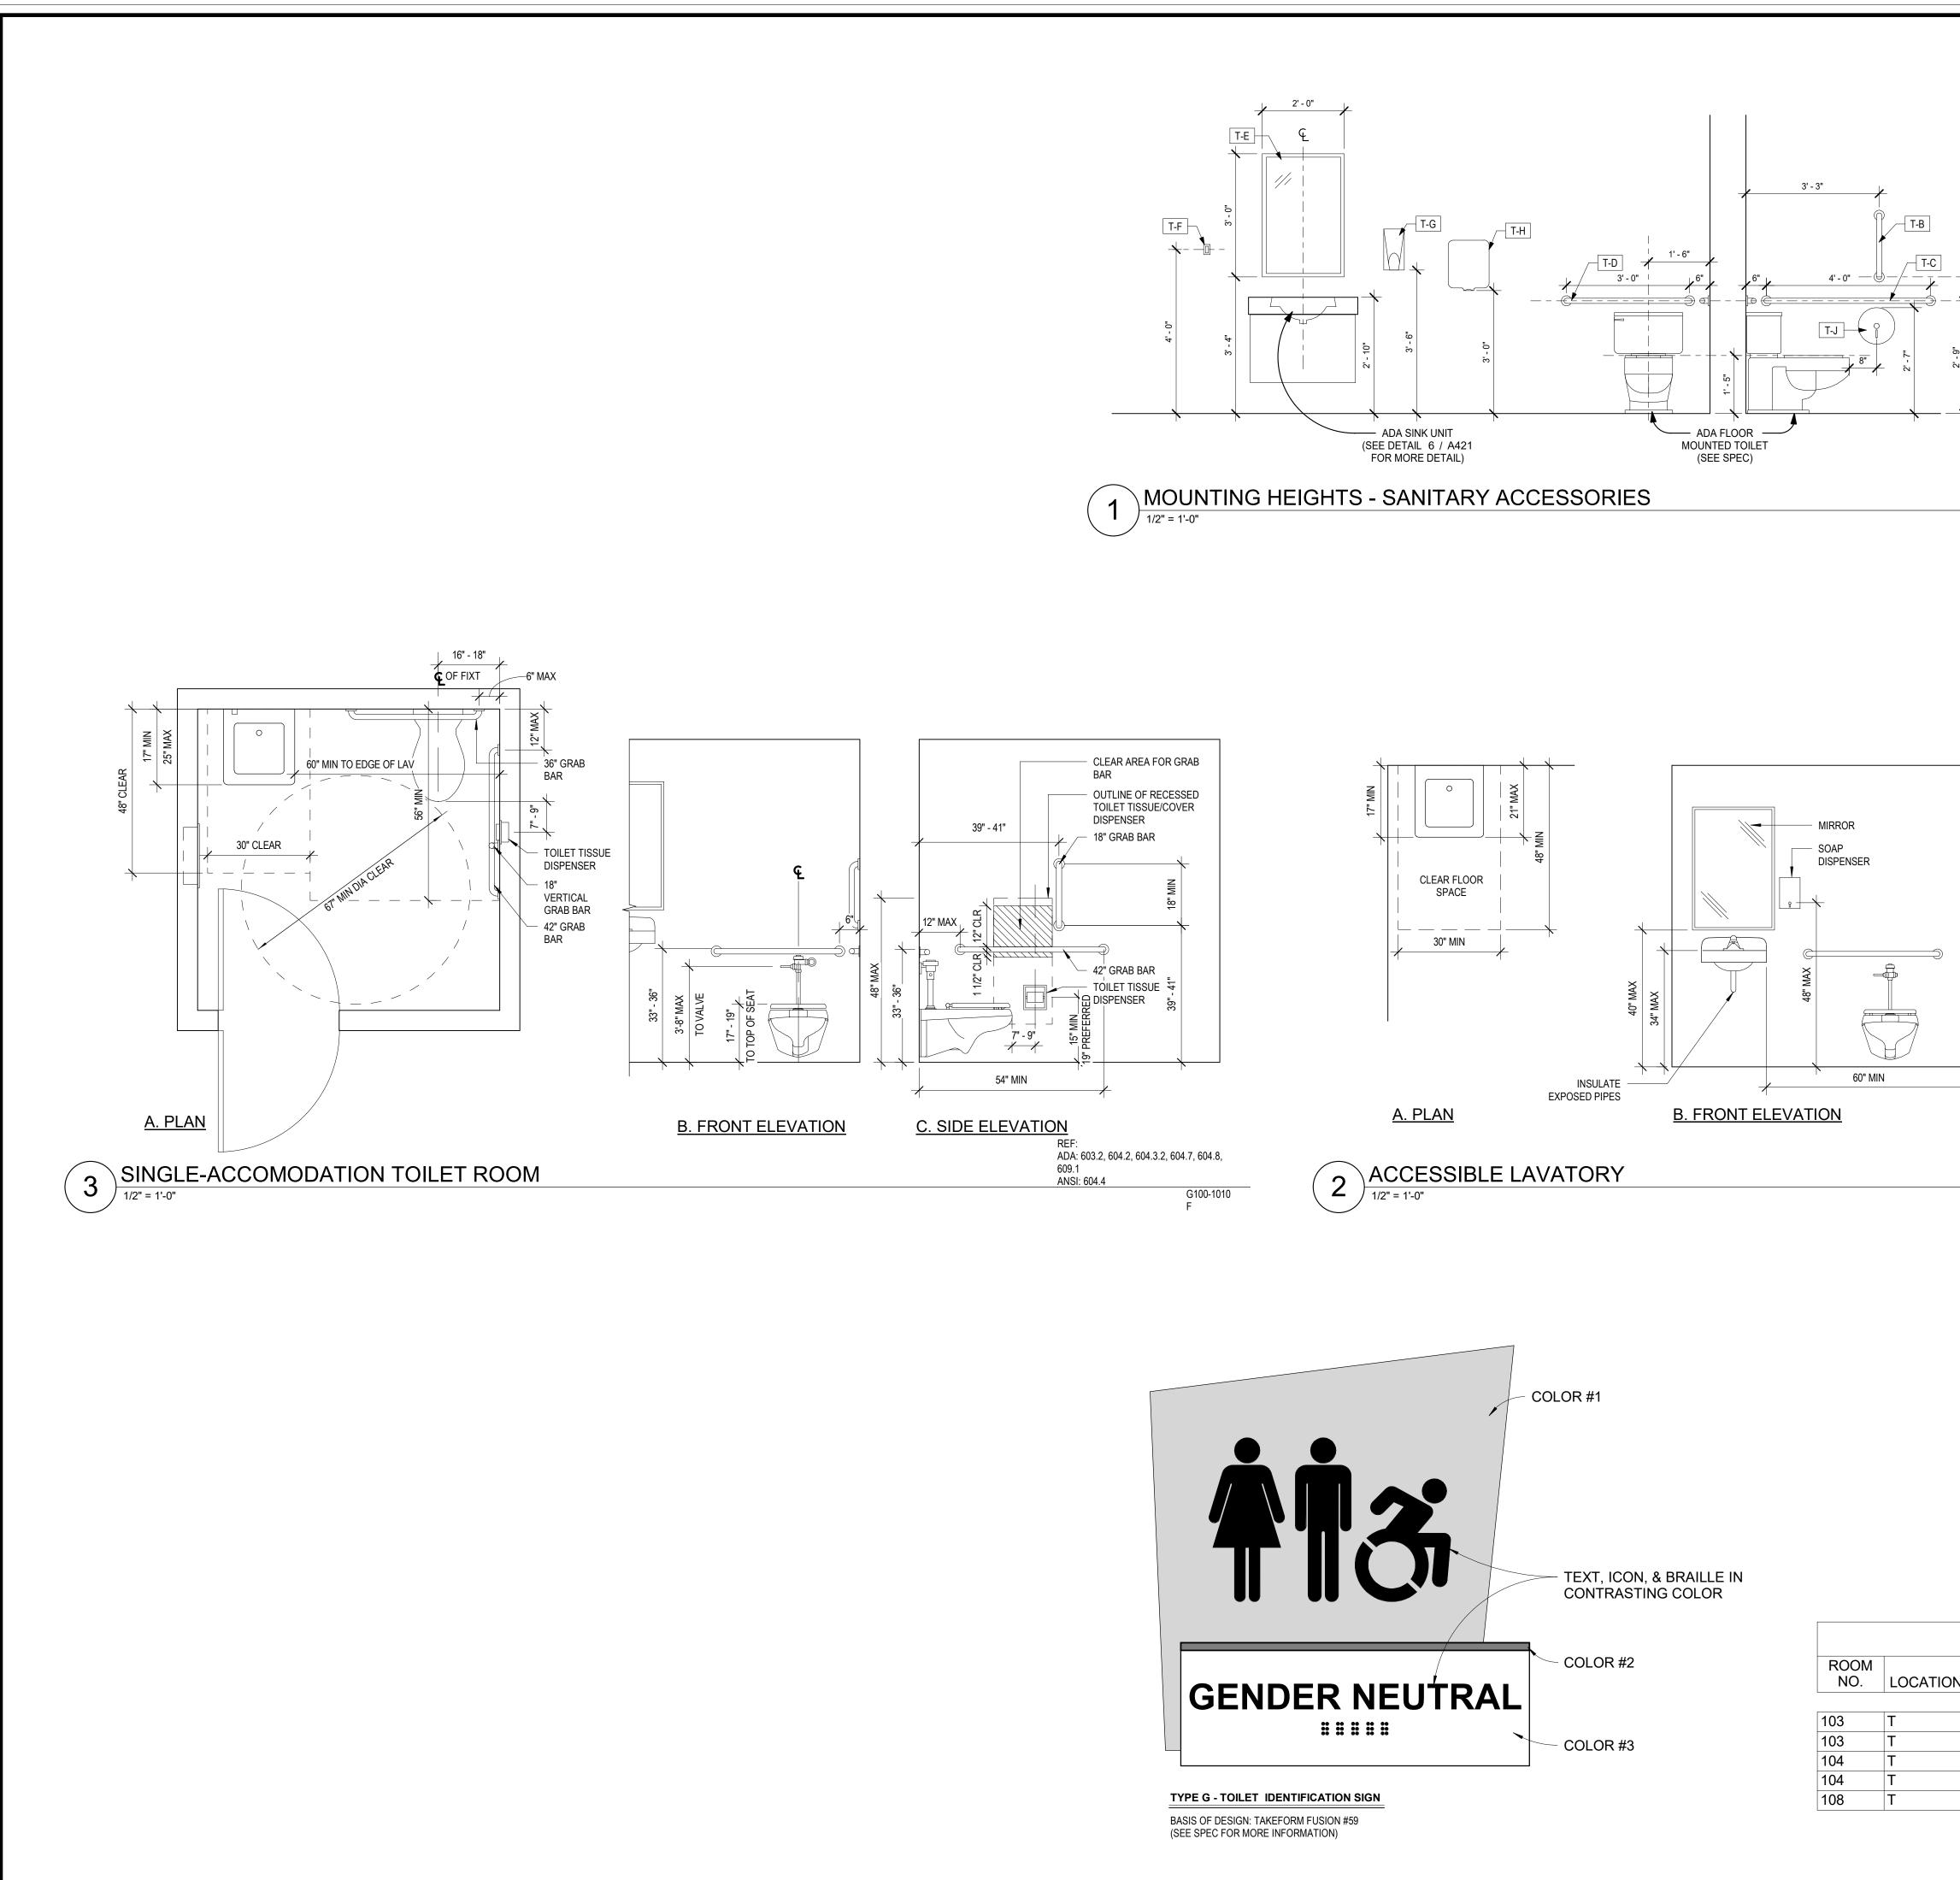

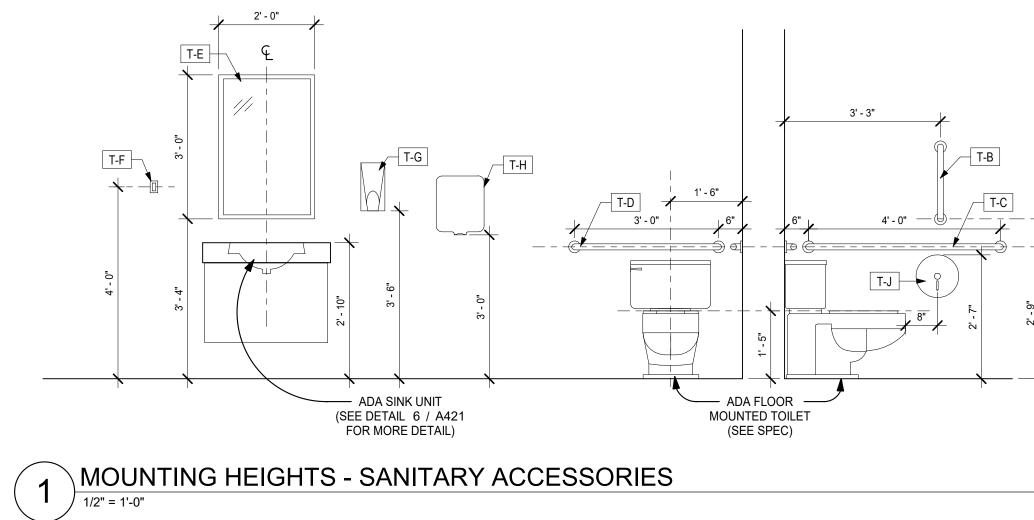

						EVEL	SSIONAL OPMENT NTER	
	-		<u>IS</u> GRAB BAR GRAB BAI GRAB BAI MIRRORS DISPENSEI	R (SIDE) R (REAR/BACK) SHALL USE TEMPERED GLASS* R	13A	A DICKIN	K UFSD SON AVENUE NY 10960	
2' - 9"	3' - 4"	REF: ADA: 308.2.1,604.7 ANSI: 604.7 G100-1010C				STREET MOUN	CHITECTS F NT KISCO . NEW YORK . 10 KGDARCHITECTS.C)5
		G100-1010C			50-0	CONST	NTROL NO. 3-1-005-006 FRUCTION UMENTS	
			29"	17" MIN 3"	KEY PL	AN		
	/	<u>C. SIDE ELEVA</u>	ATION	REF: ADA: 603.3, 604.3.2, 606.1, 606.5 ANSI: 606.1 G100-1010E	NOTE: ALL IDE REPRESENTED KAEVER, GARI FOR USE ON T OR PLANS SHJ WITHOUT THE WRITTEN DIME SCALED DIME! AND CONDITIC VARIATIONS FI	EAS, DESIGNS, ARRANG D BY THIS DRAWING AR MENT, & DAVIDSON ARC THIS PROJECT. NONE OI ALL BE USED BY OR DIS WRITTEN PERMISSION ENSIONS ON THIS DRAW NSIONS. CONTRACTOR DNS ON THE JOB AND TI 'ROM DIMENSIONS AND D TO THIS OFFICE FOR J	EMENTS AND PLANS INDICATED OR E OWNED BY AND ARE THE PROPERTY CHITECTS, PC (KG&D), AND WERE CREA F SUCH IDEAS, DESIGNS, ARRANGEMEN CLOSED TO ANY PURPOSE WHATSOEVI OF (KG&D). VING SHALL HAVE PRECEDENCE OVER SHALL VERIFY ALL ACTUAL DIMENSION HE ARCHITECT MUST BE NOTIFIED OF A CONDITIONS SHOWN. SHOP DETAILS M APPROVAL BEFORE PROCEEDING WITH	ITE IT: EF
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		SIGNAGE SCI	HEDUL	E	1 202	Date	E FOR BID STRUCTION DOCUMEN Issue	T
N	SIGN TYPE	SIGN TEXT	QTY	DESCRIPTION	A	CCES	SIBILITY	
•		GENDER NEUTRAL	1	GENDER NEUTRAL TOILET ROOM		DIAG	RAMS	
			1				Data	
	G	GENDER NEUTRAL	1	GENDER NEUTRAL TOILET ROOM	Job No. 20	021-1048	Date 09/10/2021	


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Scale

AS NOTED

Drawn / Checked

Author Checker

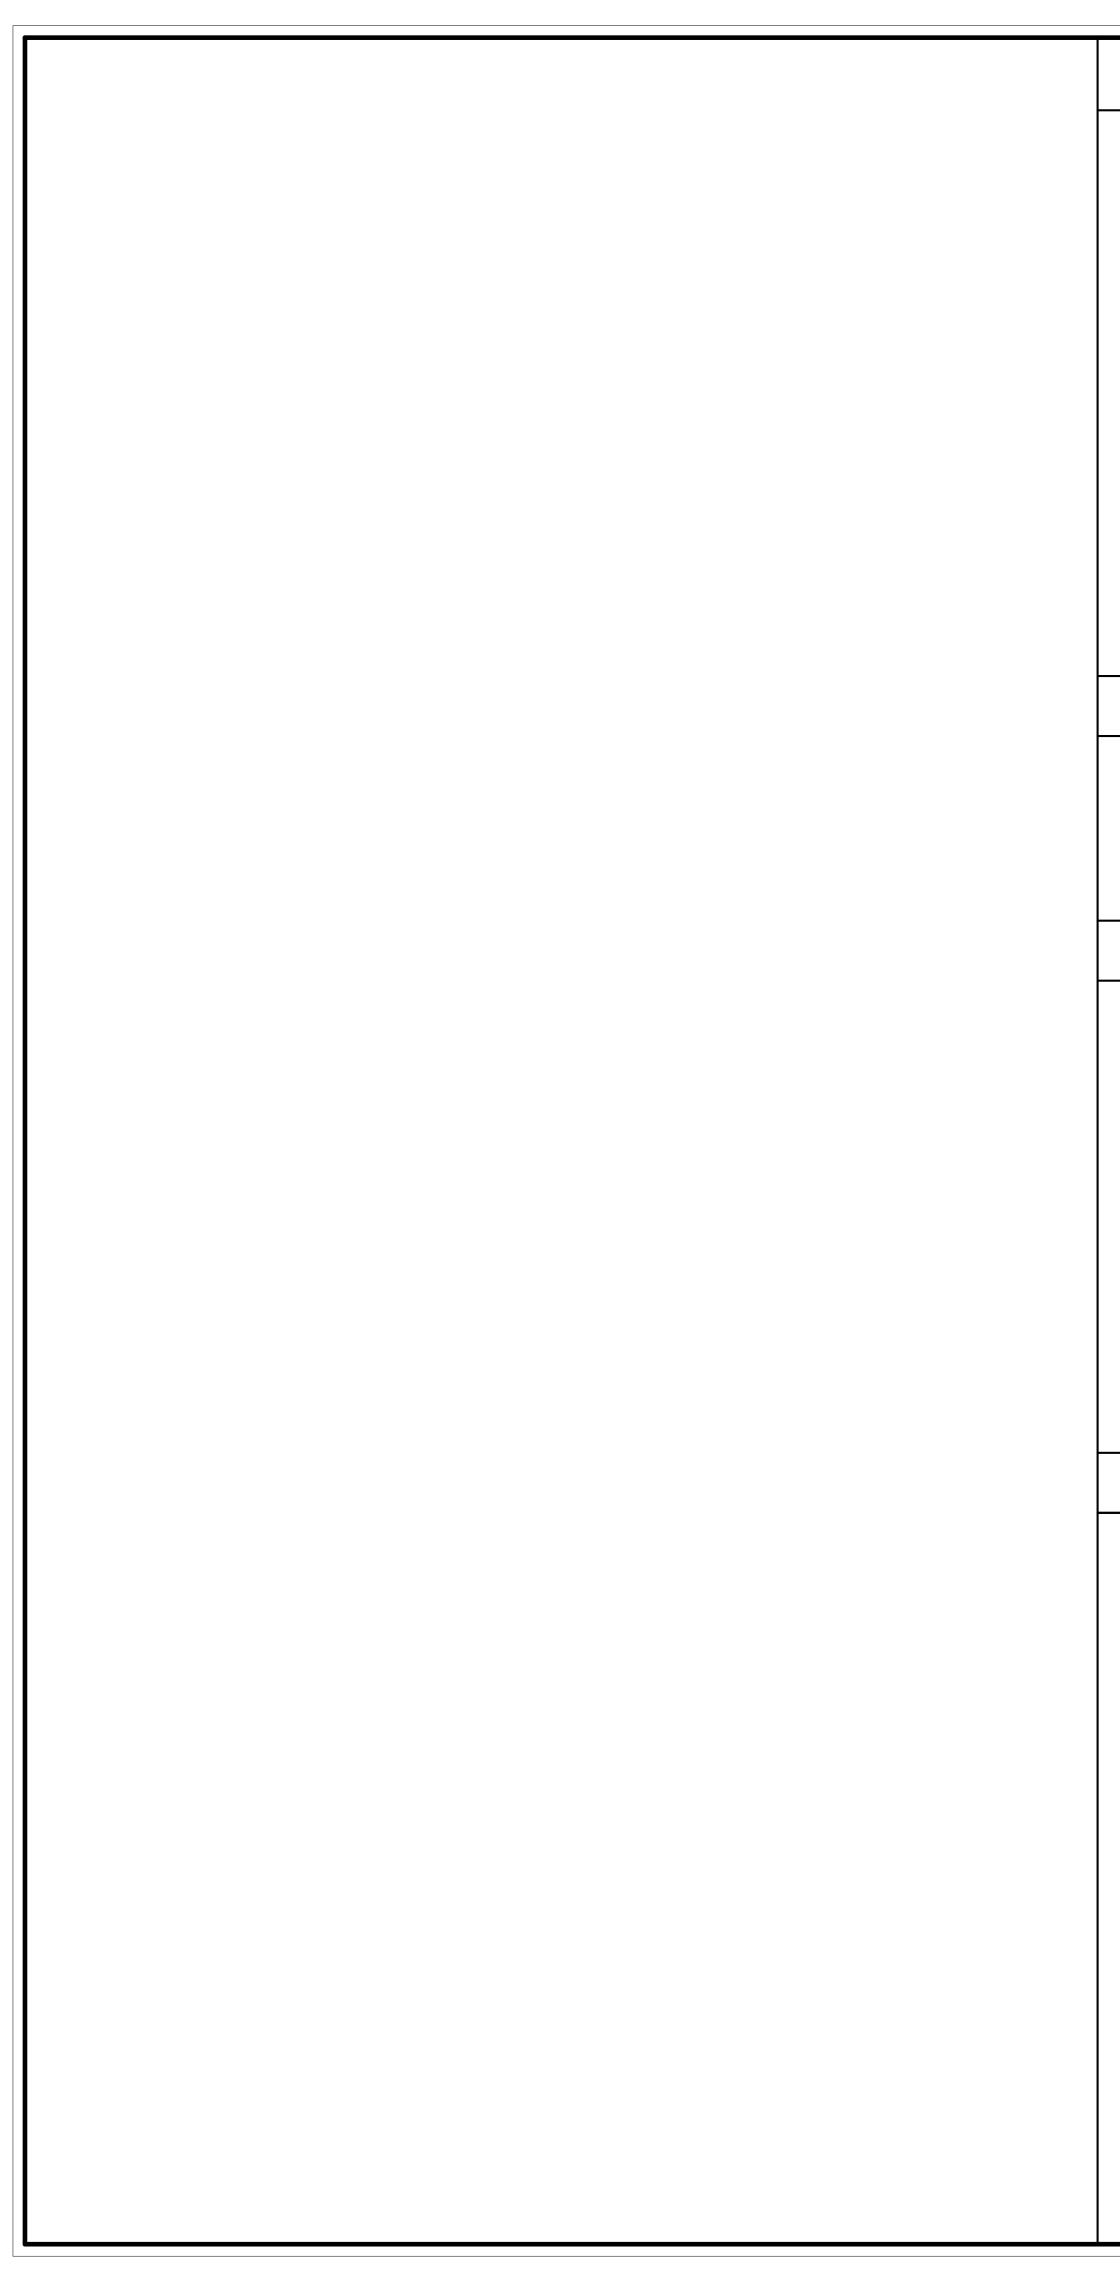

CHAPTERS 3-6 OCCUPANC	Y, AREA & CONSTR. TYPES	UNIFORM SAFETY STA MAINTENANCE PROJEC
BUILDING INFORMATION		
USE & OCCUPANCY CLASSIFICATION:	ASSEMBLY (A - 3)	THE OCCUPIED PORTION OF THE OCCUPIED PORTION OF THE REQUIREMENTS NECESSARY T
WORK CHARACTERIZATION:	RENOVATION LEVEL 2	ALL SCHOOL AREAS TO BE DIS
CONSTRUCTION CLASSIFICATION:	TYPE IIIB	TESTED FOR LEAD AND ASBES
FIRE RATING FOR BEARING WALLS		GENERAL SAFETY AND SECUR
	1 HR 0 HRS IB): 0 HRS 3): 0 HRS 3): 0 HRS IES: 2 REA: 7,356 SF 500 SF	 (A) ALL CONSTRUCTION (B) FENCES AROUND C (C) GATES SHALL ALWA UNAUTHORIZED EN (D) DURING EXTERIOR ANY SIDEWALKS OF SHALL BE FENCED (E) WORKERS SHALL B FOR IDENTIFICATIO SEPARATION OF CONSTRUCTION SEPARATION SEPARATION
		ONLY FOR A VAPOR, FINE DUS OCCUPIED SPACES FROM CON
ASSEMBLY FIRE & SMOKE F		(A) A SPECIFIC STAIRW USE DURING WORK ELEVATORS DESIG
ASSEMBLY FIRE-RESISTANCE RATING	TYPICAL LOCATIONS	(B) LARGE AMOUNTS C

FIRE BARRIER 1 HOUR FIRE PARTITION 1 HOUR

CHAPTER 10 MEANS OF EGRESS

ITEM	DWG SHOWN	
ROOM USE DESIGNATIONS	CC DWGS	
ROOM SQUARE FOOTAGE	CC DWGS	
ROOM OCCUPANCY LOADS	CC DWGS	
EXIT ACCESSTRAVEL DISTAN	CE CC DWGS	
GROUND FL:	150 FT MAX TO EXTERIOR DOOR	
BASEMENT / 2ND FL:	120 FT MAX TO STAIR ENCLOSURE	

EGRESS CAPACITY CALCULATIONS:											
PER BC NYS			REQUIRE	ED		PROVIDED					
SPACE	AREA	OCC LOAD	EGRESS	# EXITS	MAX TRAV DISTANCE**	EGRESS	# EXITS	MAX TRAV DISTANCE**			
HILLTOP DEVELOPMENT CENTER	3,198 SF	255	51" (255 * 0.2")	2	200' / 75'	204"	4	63'/53'			
** TRAVEL DISTAN	** TRAVEL DISTANCE/COMMON PATH OF TRAVEL DISTANCE										

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CHAPTER 11 ACCESSIBILITY

ITEM INTERIOR ACCESSIBLE ROUTE ACCESSIBLE ENTRANCES ACCESSIBLE TOILET FACILITIES SIGNAGE


DWG SHOWN ACCESSIBILITY DIAGRAMS ACCESSIBILITY DIAGRAMS ACCESSIBILITY DIAGRAMS ACCESSIBILITY DIAGRAMS, SPECIFICATIONS


SURFACES THAT WILL BE DISTINE PRESENCE OF LEAD. PRO SPECIFICATIONS A PLAN PRE DETAILS PROVISIONS FOR OC AND CLEARANCE TESTING WI


PROJECT INFORMATION


PROJECT SCOPE:	
THIS PROJECT INVOLVES LIMITED ALT TO A FLEXIBLE PROFESSIONAL DEVEN	
CLASSIFICATION OF WORK:	ALTE
APPLICABLE CODES:	2020 2020
	NEW
	MANU THE U
	THE S
PROJECT LOCATION:	13A D
NOTE: CONSTRUCTION TO TAKE PLA COMPLETION TO TAKE PLACE	


 (c) GATES SHALL ALWATS BE LOCKED UNLESS A WORKER IS IN ATTEINDANCE TO PREVENT UNAUTHORIZED ENTRY. (d) DURING EXTERIOR RENOVATION WORK, OVERHEAD PROTECTION SHALL BE PROVIDED FOR ANY SIDEWALKS OR AREAS IMMEDIATELY BENEATH THE WORK SITE OR SUCH AREAS SHALL BE FENCED OFF AND PROVIDED WITH WARNING SIGNS TO PREVENT ENTRY. (e) WORKERS SHALL BE REQUIRED TO WEAR PHOTO-IDENTIFICATION BADGES AT ALL TIMES EOR IDENTIFICATION AND SECURITY RUPPOSES WHILE WORKING AT OCCUPIED SITES. 	ENT ENUE So isten magine build CTS PC YORK 10549 HITECTS.COM
THE OCCUPIED PORTION OF THE EXISTING SCHOOL BUILDING SHALL ALWAYS COMPLY WITH THE MINIMUM THE CONCUPIED PORTION OF THE EXISTING SCHOOL BUILDING SHALL ALWAYS COMPLY WITH THE MINIMUM CENTRE GUIREMENTS DECESSARY TO MAINTAIN A CERTIFICATE OF OCCUPIENCY. ALL SCHOOL AREAS TO BE DISTURBED DURING RENOVATION OR DEMOLITION HAVE BEEN OR WILL BE GENERAL SAFETY AND SCHOOL BY STANDARDS FOR CONSTRUCTION PROJECTS: (A) AL CONSTRUCTION MATERNAL SHALL BE STOPED IN A SAFE AND SCHOLE MANNER. (B) FORDES AROUND CONSTRUCTION SUPPLIES OR DEBRIS SHALL BE MATTERNAL BE MAINTER. (C) CATES SHALL ALWAYS BE LOCKED UNLESS A WORKEN IS IN ATTEINDANCE TO PREVENT UNATIONED ENTITUDINS UPPLIED OR DEBRIS SHALL BE MATCHINANCE TO PREVENT UNATIONED ENTITUDINS UPPLIED OR DEBRIS SHALL BE MATCHINANCE TO PREVENT (B) WORKERS SHALL BE RECOURED TO WEAR HOTOLOGINING CATE OR SUCH AREAS SHALL BE RECOURED TO WEAR HOTOLOGINAL MORE TO CONTINUED SITES. SEPARATION OF CONSTRUCTION AND REPARS FOR DOCUPIED STRES. SEPARATION OF CONSTRUCTION AREAS FRAM OCCUPIED STRES. CONSTRUCTION AREAS WINCH ARE UNDER THE CONTROL OF A CONTINUE TO WORKER (B) WORKERS SHALL BE RECOURED TO WEAR HOTOLOGINAL RECOUNDED ARTIS OF THE WAILS CONSTRUCTION AREAS WINCH ARE UNDER THE CONTROL OF A CONTROL TO MAINTEEN TANDON SEPARATION OF CONSTRUCTION AREAS FRAM OSCILPTED AND THERE FOR DOTIONAL TO MARKER AND SHALL BE MADE DOT OF AR INFITUTION SAFERER AND SHALL NOT BE USED TO SEPARATE CONSTRUCTION AREAS FRAM ORALINED AND CONTRINUES TO CONTROL TON WORKER BUILDING, PERCENT HE RESARDLE OF DURING AND THERE SMILLS BE MADE TO ONLY FOR A VAPOR, FINE BUST OR ARINGHILTRATION BARRIER, AND SHALL NOT BE USED TO SEPARATE COUCHING SYNCH, AND MAINS IN OTIOLOGINAL WORKER MORE THE CONTROL TON WORKER BUILDING, PERCENT HE RESARDLE OF DURING CONSTRUCTION. (C) AS SPECIFIC STAIL MERGING BUST DER SHOULDE DATION OF THE WAILS (C) AS SPECIFIC STAILLE BE MAINTAIN RECOURDED AND THE THE WAILS (C) AS SPECIFIC STAIL AND AREAS SHALL BE DUDING OCCUPIED DURING A (C) AS SPECIFIC STAILL MARKER MING SHALL AND BE DEROSTRUCTIO	ENUE o isten magine ouild CTS PC YORK. 10549 HITECTS.COM
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THE PRESENCE OF LEAD. PROJECTS WHICH DISTURB SURFACES THAT CONTAIN LEAD SHALL HAVE IN THE SPECIFICATIONS A PLAN PREPARED BY A CERTIFIED LEAD RISK ASSESSOR OR SUPERVISOR WHICH DETAILS PROVISIONS FOR OCCUPANT PROTECTION, WORKSITE PREPARATION, WORK METHODS, CLEANING AND CLEARANCE TESTING WHICH ARE IN GENERAL ACCORDANCE WITH THE HUD GUIDELINES.	,
PROJECT INFORMATION, SCOPE & CLASSIFICATION OF WORK	
PROJECT SCOPE:	
THIS PROJECT INVOLVES LIMITED ALTERATION OF AN EXISTING DEVELOPMENT CENTER TO RENOVATED THE SPACE Image: Classification of the space <td></td>	
CLASSIFICATION OF WORK:ALTERATION LEVEL 212022-03-24CONSTRUCTION DOAPPLICABLE CODES:2020 UNIFORM FIRE PREVENTION AND BUILDING CODE 2020 UNIFORM CODE SUPPLEMENTSDateIssueSheet Title	
NEW YORK STATE ENERGY CONSERVATION CONSTRUCTION CODE MANUAL OF PLANNING STANDARDS - 1998 THE UNIVERSITY OF OF THE STATE OF NEW YORK COMPLIANCE	
THE STATE EDUCATION DEPARTMENT INFORMATION DEPARTMENT	
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COMPLETION TO TAKE PLACE IN FALL 2022 Scale Drawn / Ch	CE ON 10/2021
CC001	CE ON 10/2021

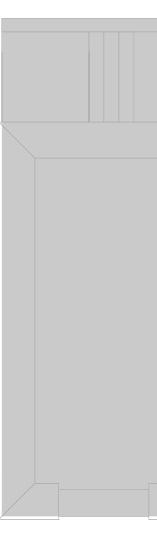

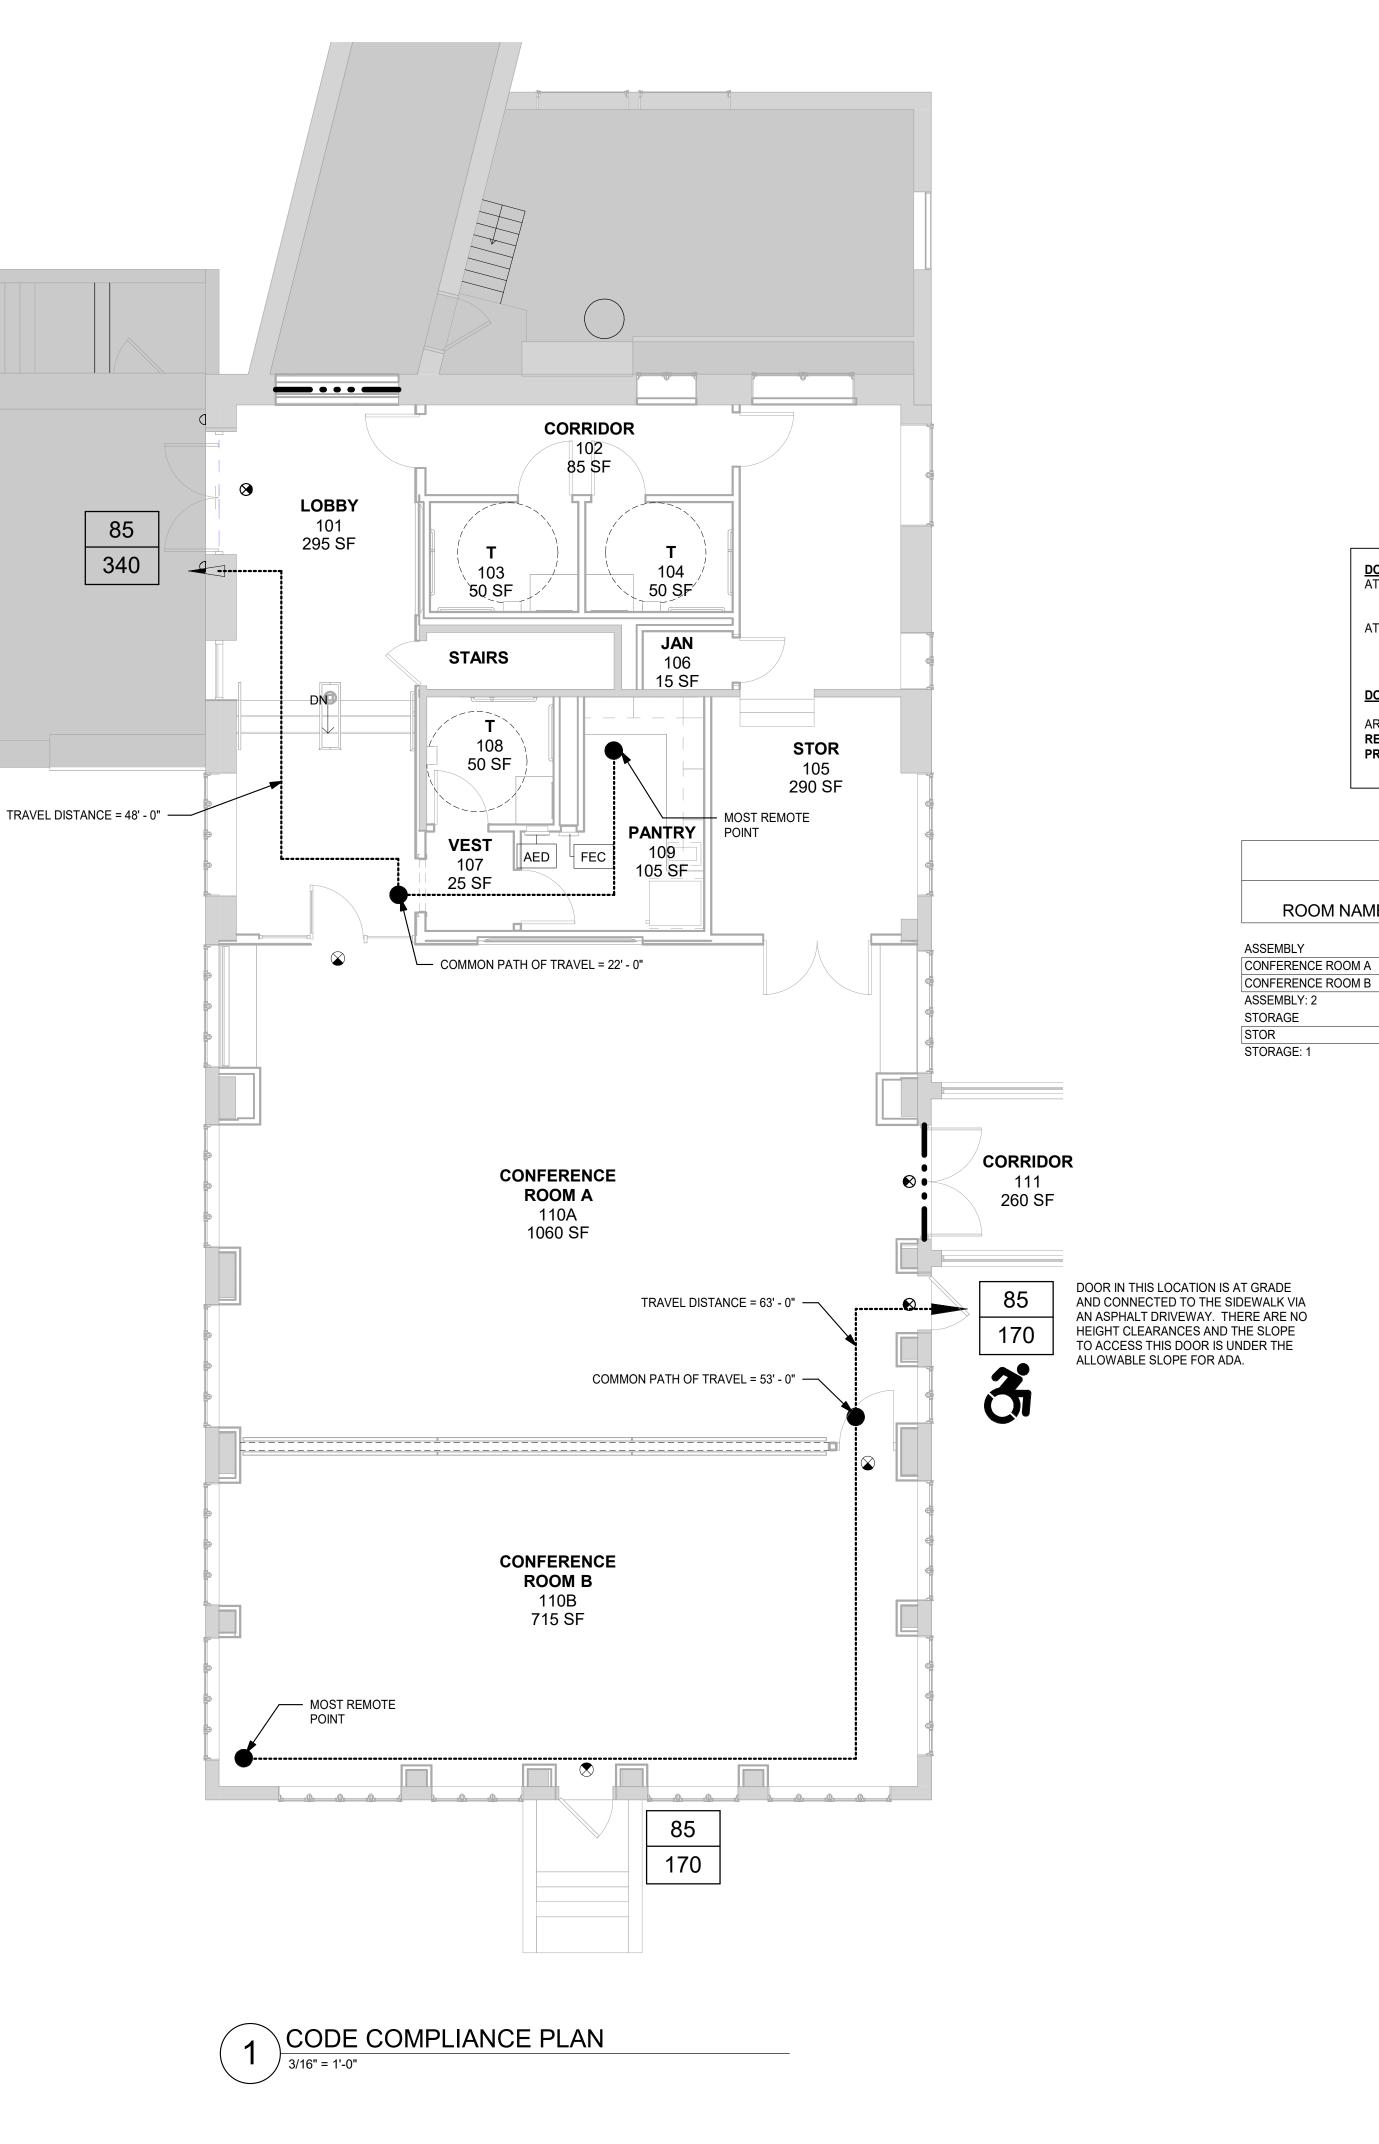

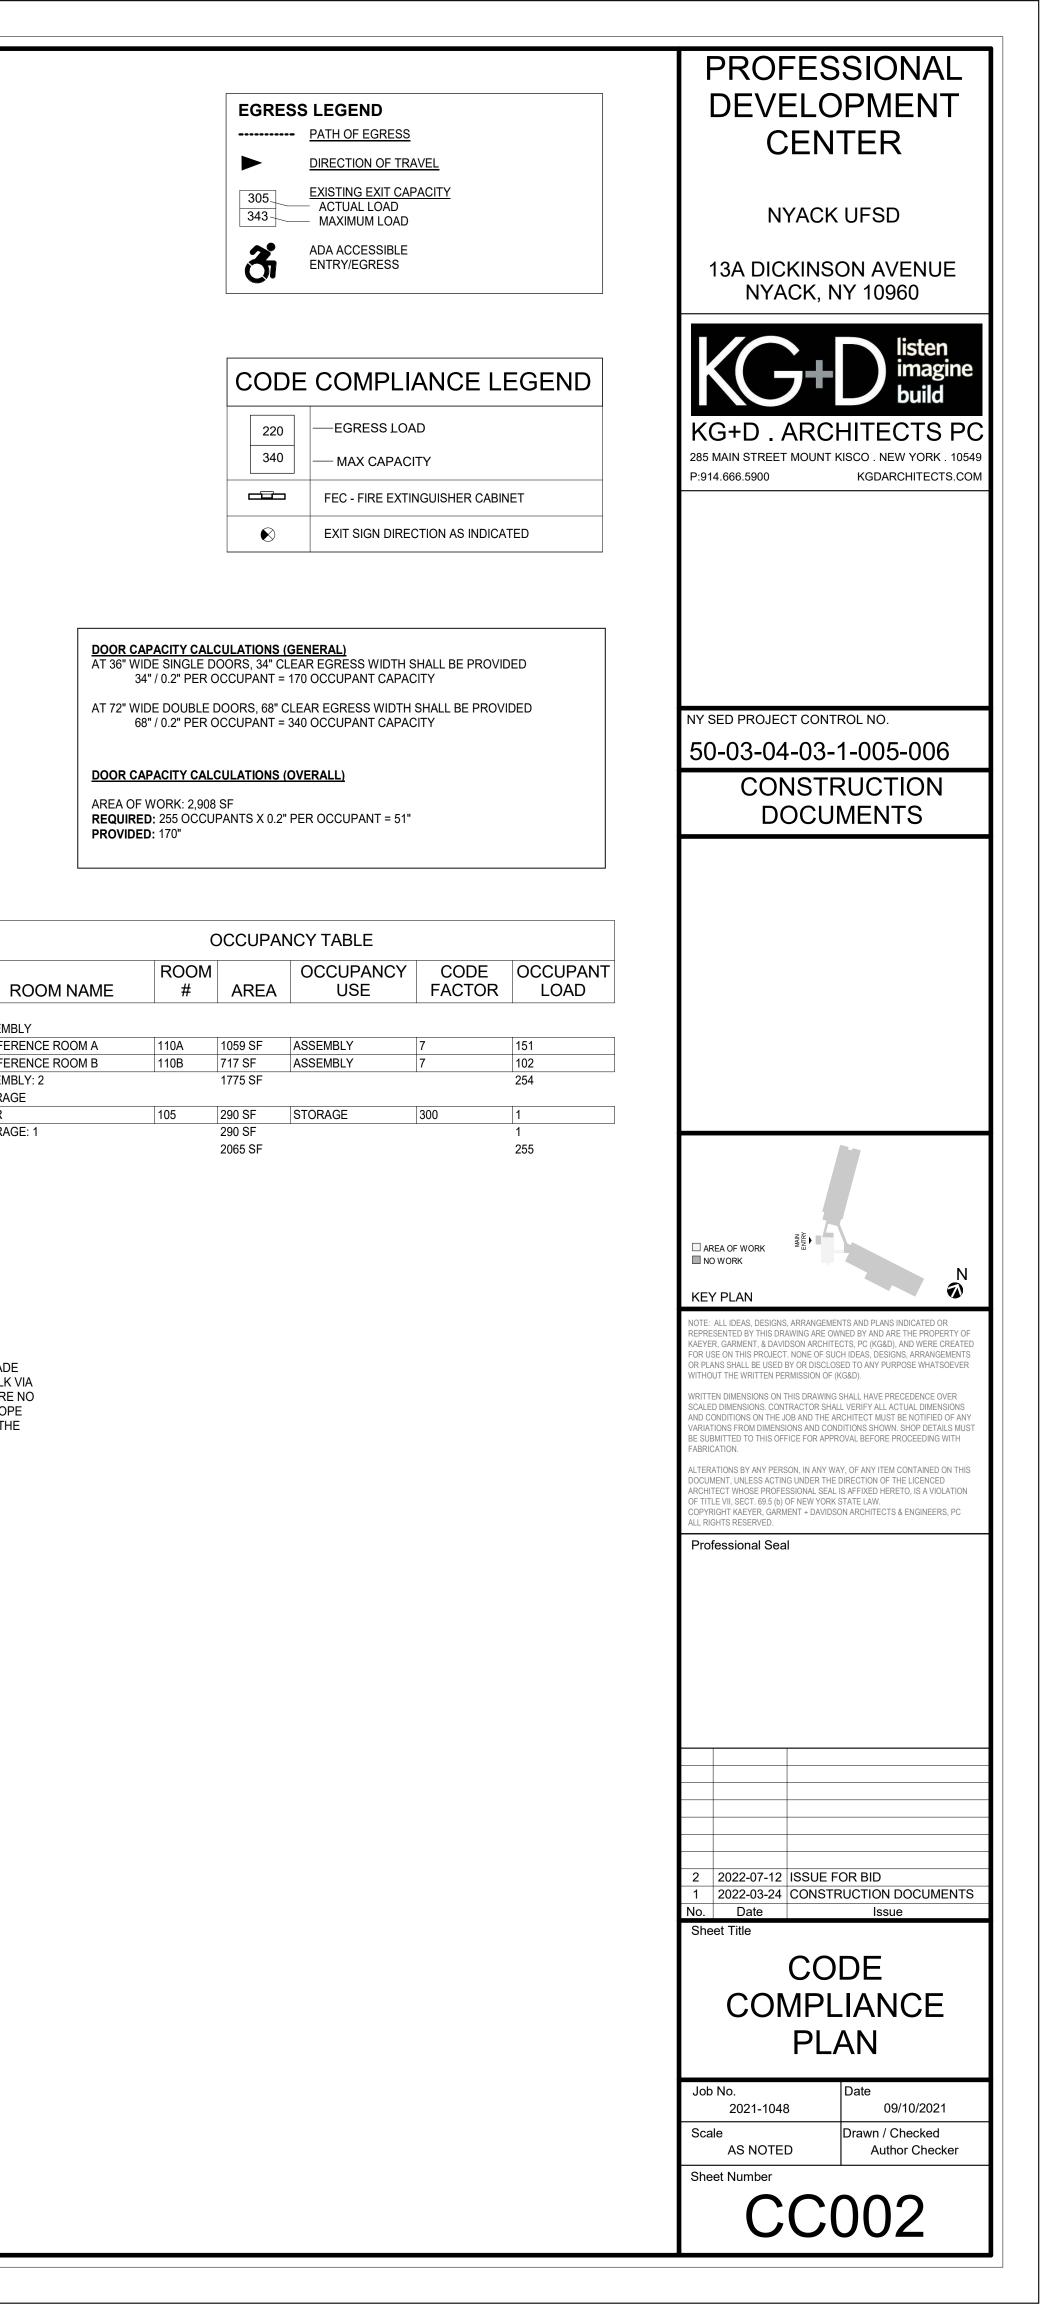

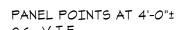

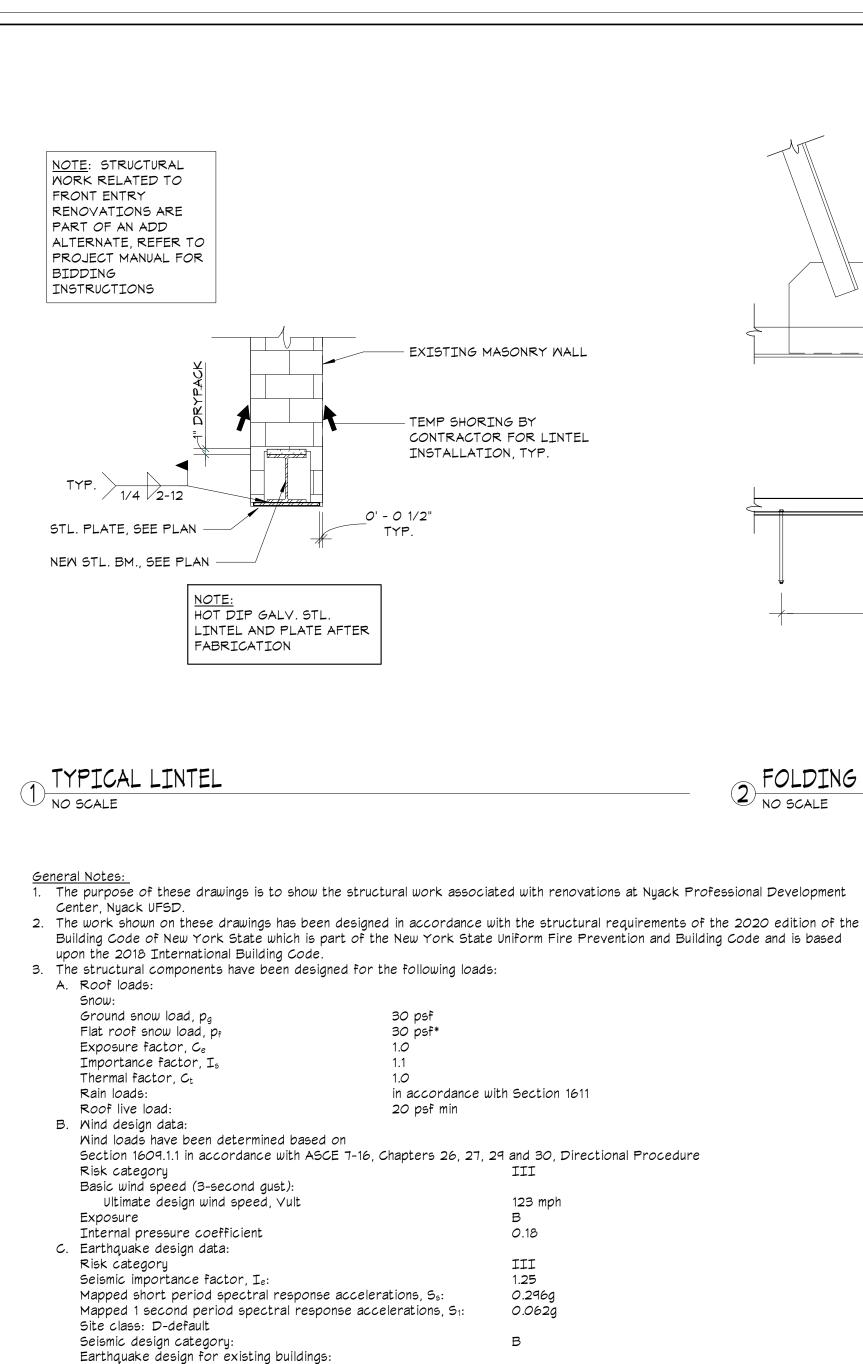

Not required since the proposed alterations do not increase the demand-capacity ratio of any seismic load carrying

structural element by more than 10 percent cumulative since the original construction. This structure has been designed to be self-supporting and stable after the work shown on these drawings has been completed. The stability of the structure prior to completion is solely the responsibility of the contractor. This responsibility extends to all related aspects of the construction activity including, but not limited to, erection methods, erection sequence, temporary bracing, forms, shoring, use of equipment, and similar construction procedures. Review of the construction by the engineer is for conformance with design aspects only, not to review the contractor's construction procedures. Lack of comment on the part of

the engineer with regard to construction procedures is not to be interpreted as approval of those procedures. Shoring note: The contractor is responsible for designing, providing and installing all temporary shoring that is required to support instabilities of existing structure during construction and due to the removal of existing supporting walls and existing framing members for installation of new framing and foundations. Shoring shall be fully installed and stable prior to removal of existing structural elements.

6 Jobsite safety and construction procedures are solely the responsibility of the contractor. Review of the construction by the engineer is for conformance with design aspects only, not to review the contractor's provisions for job site safety. Lack of comment by the engineer is not to be interpreted as approval of those aspects of work.

7 PDF digital files of all erection and detail shop drawings for steel indicating the fabricator, manufacturer, finish, layout, and all accessories, must be submitted to and be checked by the contractor and subcontractor and bear the checker's initials before submission to the architect for review prior to fabrication. Fabrication and/or delivery to the site of components prior to receiving approved shop drawings shall be at the fabricator's own risk.

8 Testing and inspections are described in the project "Statement of Special Inspections". The contractor shall review the "Statement of Special Inspections" and coordinate the scheduling of inspections with the special inspector. Uninspected work that required inspections may be rejected solely on that basis.

9 If faulty construction procedures, or material, result in defective work that requires additional engineering time to devise corrective measures, professional fees may be charged to the contractor at the standard hourly rate of additional services. Such fees may be withheld from the general contractor's payment.

10 The contractor shall verify all dimensions, elevations and angles with architectural drawings and existing conditions before proceeding with any work.

11 Some details of the work are shown on the architectural drawings. A careful review and study of these details are necessary before the full scope of the work can be comprehended. 12 Do not scale drawings.

Codes and Standards References

1. Structural steel: Design, fabrication and erection of structural steel shall conform to the "Specification for Structural Steel for Buildings" as adopted on July 7, 2016, by the American Institute of Steel Construction (AISC) and the 15th Edition of the AISC Steel Construction Manual.

Structural Steel Notes:

1. Design fabrication and erection of structural steel shall conform to the American Institute of Steel Construction's "Specification for Structural Steel for Buildings", as specified in the code reference section of these general notes. 2. Materials:

Wide flange shapes: ASTM A 992 Grade 50

American standard shapes, angles,


Plates and bars: ASTM A 36 Bolts ASTM F3125, Grade A 325

Welding electrode ASTM E 70xx, low hydrogen

3 All welding shall conform to American Welding Society's AWS D1.1 "Structural Welding Code-Steel" code for arc and gas welding and be performed by a certified welder in accordance with A.W.S. standards.

4 Structural steel shall be cleaned in accordance with the Steel Structures Painting Council Specification SP 3 for Power Tool Cleaning (except for steel exposed to weather) and painted to a minimum dry film thickness of 2 mils with a shop coat of Themec # 10-99 alkyd rust inhibitive primer as manufactured by Tnemec Company, Inc. of Kansas City, MO, or an approved equal. 5 For miscellaneous steel, see architectural drawings.

6 Existing steel surfaces to receive field welds shall be thoroughly cleaned and free from paint, rust, grease, etc. 7 Submittals to the engineer are required for certificates of compliance for structural steel, bolts, nuts, washers, and weld filler material prior to the fabrication of any steel

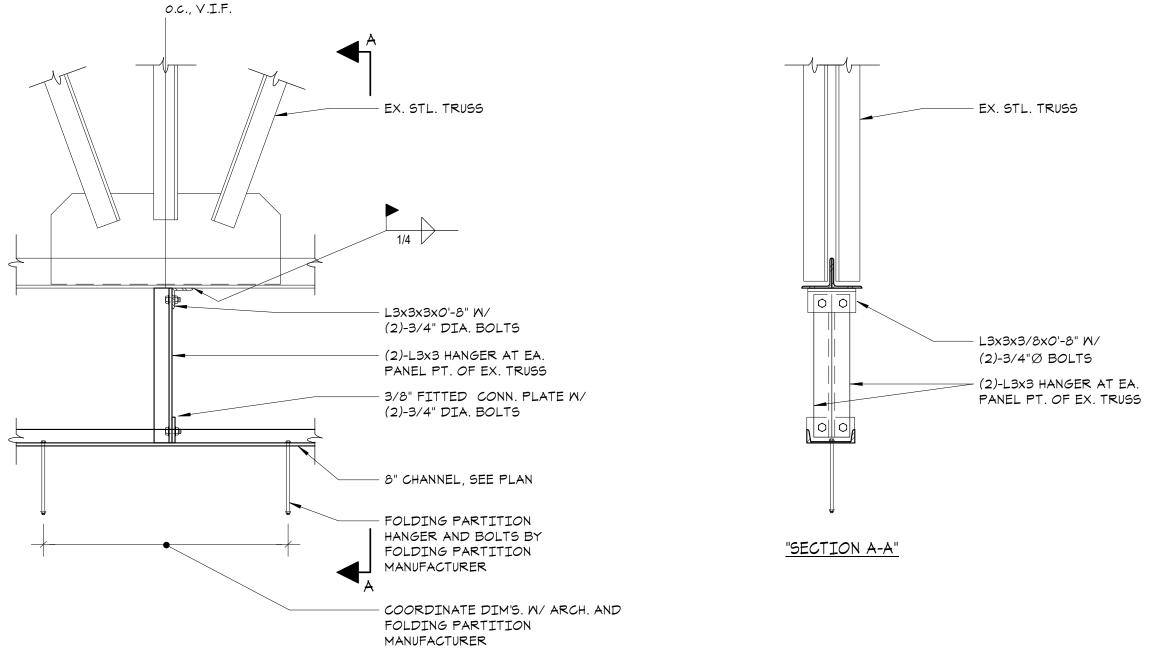

FOLDING PARTITION SUPPORT DETAIL 🖌 NO SCALE

<u>Lintel Notes:</u>

Angle size Max. M.O. Bearing each end 3 1/2" x 3/8" flat plate2'-0" 6" 3 1/2" x 4" x 5/16" (LLV) 3'-6" 6' 3 1/2" x 5" x 5/16" (LLV) 5'-0" 6' 3 1/2" x 6" x 5/16" (LL∨) 6'-0" 8 3 1/2" x 6" x 3/8" (LLV) 8'-0" 8" 2 Openings in non-bearing walls masonry where no specific lintels or lintel sizes are indicated shall have 8" bearing at each end and shall have the following sizes: Max. M.O. Wall thickness Lintel size 9'-0" 8" W8x24

9'-0" 9"-13" 12'-0" 8" 12'-0" 9"-13"

Plates indicated in above lintels shall have a width 1" less than the wall thickness and a length 1" less than the masonry opening. Provide 7 1/2" x 5/8" x 0'-7 1/2" bearing plates on 3/4" grout bed with (2)-5/8" diameter x 6" long

with 1/4" weld at each side of flange.

11 Lintels for openings in walls: These plans do not show the full scope of steel lintels required for new wall openings for doors, windows, ducts, louvers, etc.. For masonry opening size and location of all wall openings, see architectural and mechanical drawings. Do not scale openings. For steel lintel size for corresponding masonry opening size, see notes, above, unless otherwise noted on plans.

1. Unless otherwise noted, for lintels over doors, windows, ducts, and miscellaneous openings in non-bearing 4", 8" and 12" CMU walls and brick walls use for each 4" of masonry:

W8x31 + 5/16" plate

M8x28 W8x35 + 5/16" plate

welded anchor studs at 3" o.c. unless otherwise noted. Field weld bottom flange of beam to bearing plate

3 For 6" masonry partitions use WT 7x13 for spans up to 7'-0" with 6" bearing each end. 4 For 10" masonry partitions use WT 7x21.5 for spans up to 7'-0" with 8" bearing each end.

5 Fill the first two courses directly under bearing with grout for 16" length.

6 See architectural and mechanical drawings for size and location of openings. 7 When openings occur in bearing walls or the height of masonry above the lintel is less than the opening

width or when a control joint is located directly above or within 16" of the jamb opening and drawings do not otherwise indicate a specific lintel design, consult with the architect to confirm lintel requirements. 8 Lintels over adjacent openings with piers between less than 2'-8" wide shall be continuous over piers. Masonry units of such piers shall be filled with grout for full story height.

9 Connect lintel to structural steel columns when there is less than 16" of masonry between the masonry opening and the outermost face of column. 10 Lintels supporting exterior masonry shall be hot-dipped galvanized. See structural steel notes.

12 Contractor shall design and provide shoring system as indicated in shoring note in general notes. Shoring capacity shall exceed 1000 bs. per linear foot per foot of wall width unless otherwise noted.

2 (5101)

NOTE: STRUCTURAL

WORK RELATED TO

RENOVATIONS ARE

ALTERNATE, REFER TO

PROJECT MANUAL FOR

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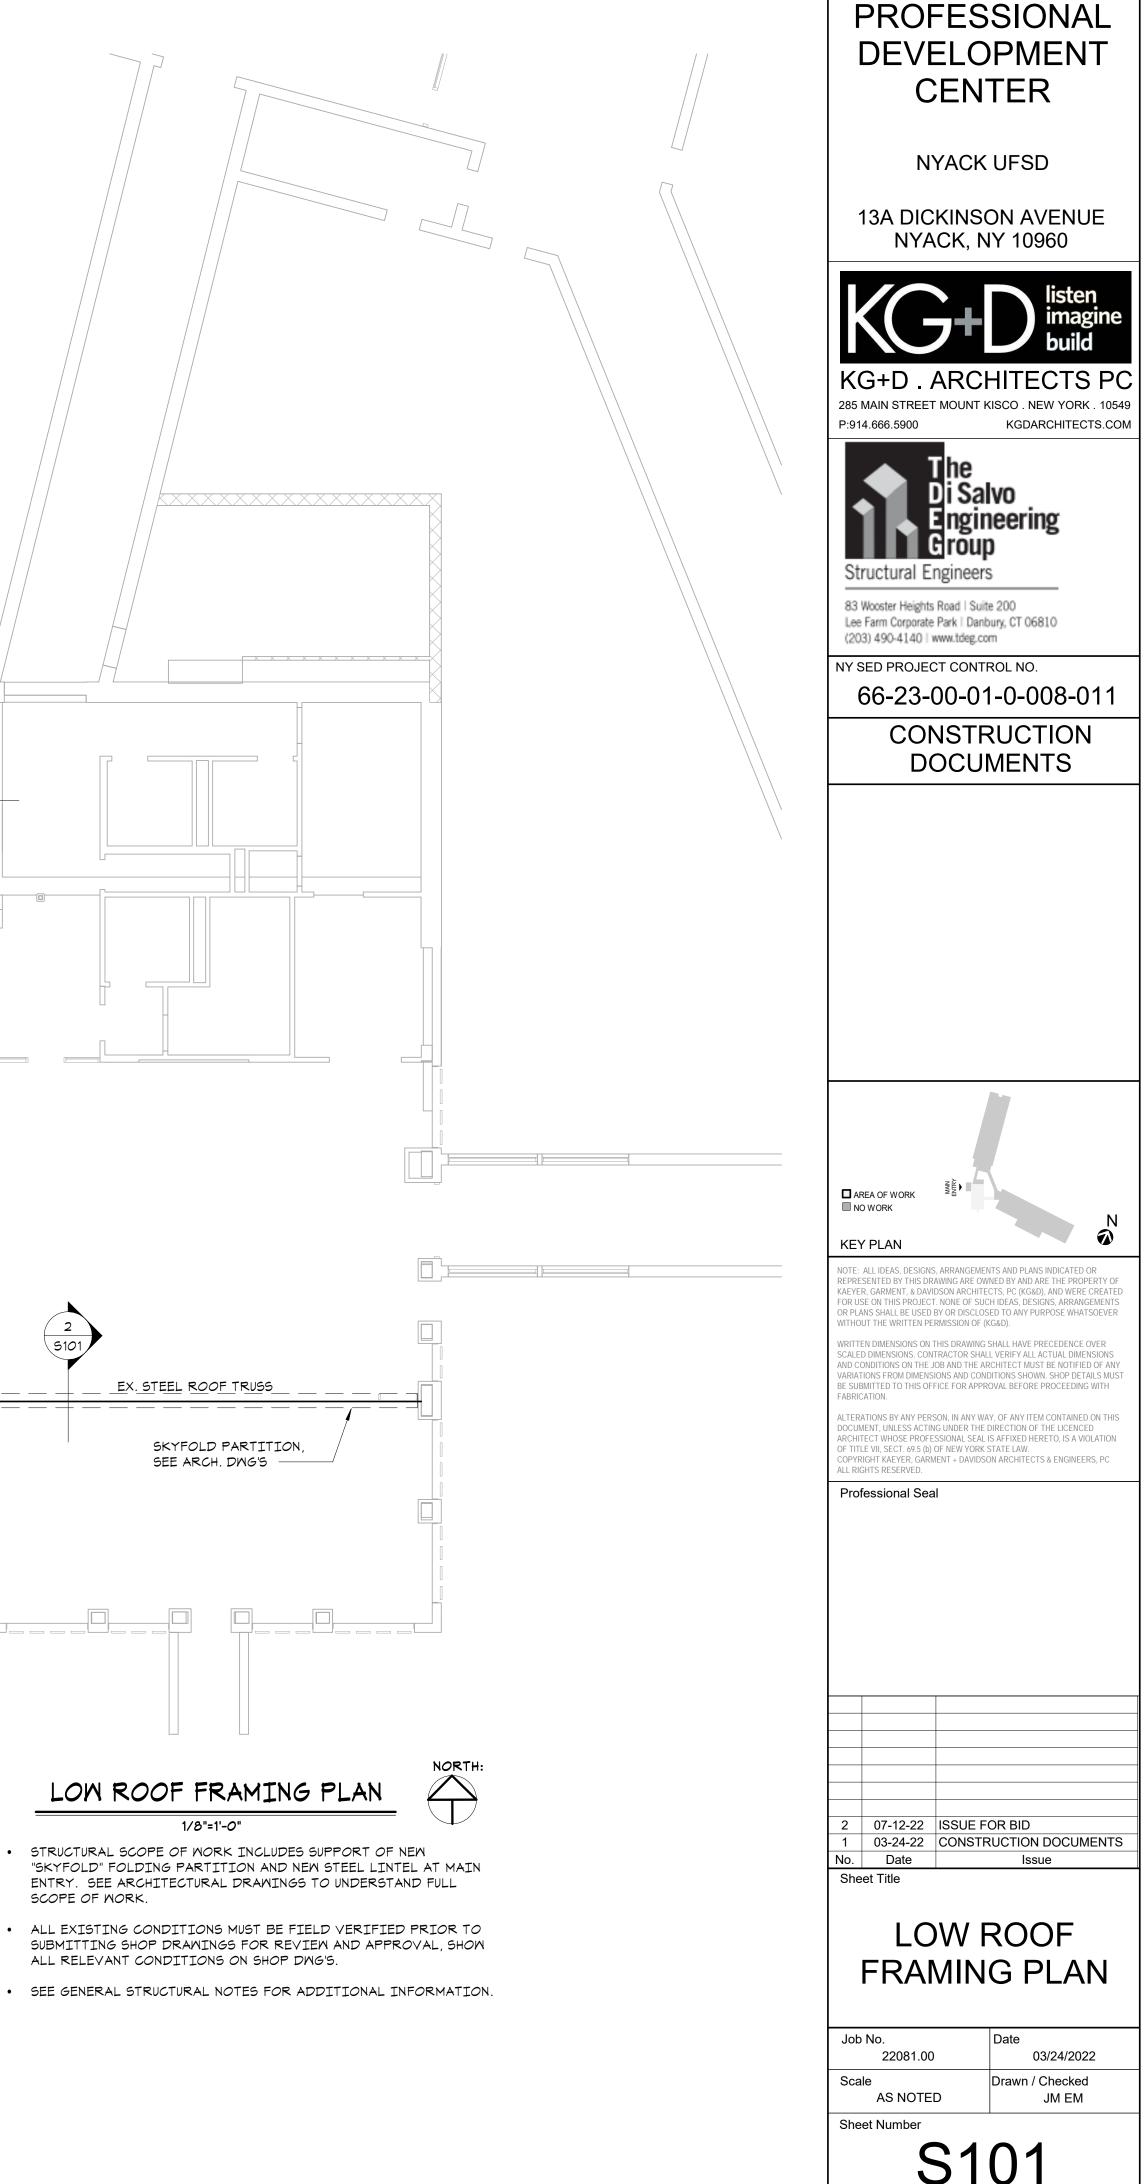
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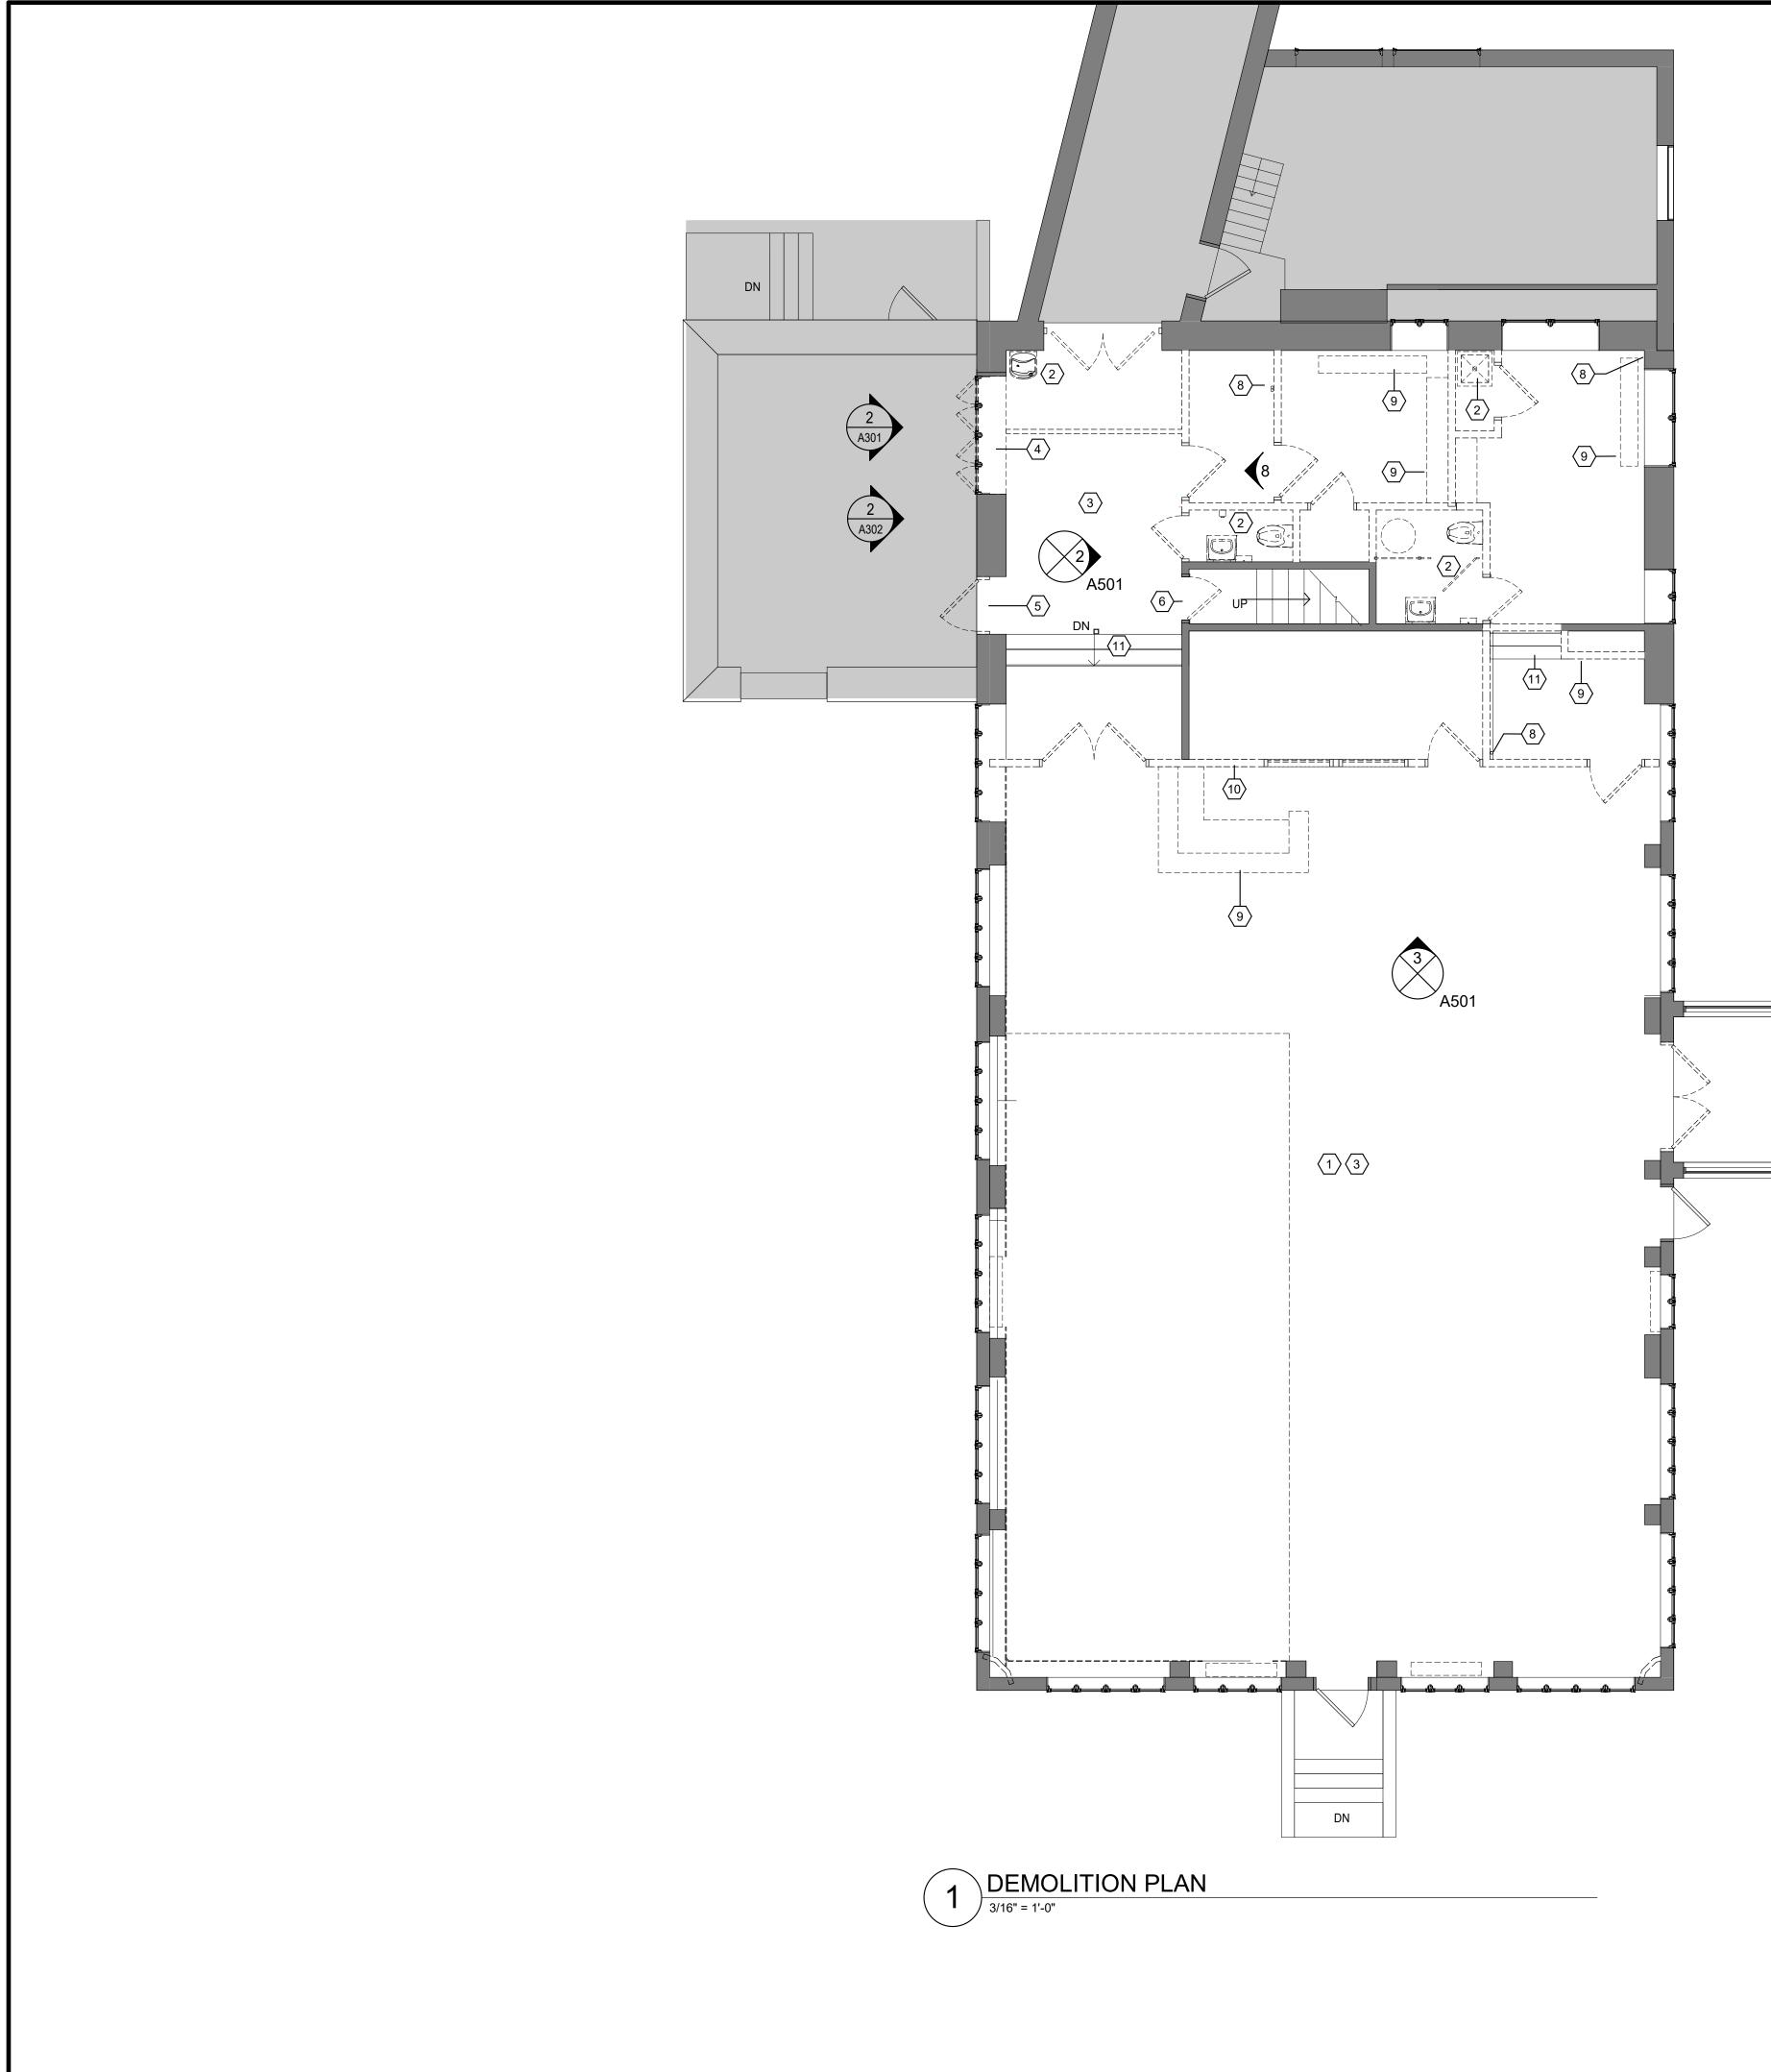
FRONT ENTRY

INSTRUCTIONS

BIDDING

- SCOPE OF WORK.





ARCHITECT.

2. COORDINATE ALL DEMOLITION w/ M.E.P. REMOVALS. NOTE: ALL WIRING, DEVICES & M.E.P. SYSTEMS NOT BEING REMOVED AS PART OF THE WORK, WHICH RUN THROUGH THE WORK AREA, SHALL BE TESTED, LABELED & PROTECTED FROM DISTURBANCE SO THEY REMAIN OPERATIONAL THROUGHOUT THE PROJECT.

3. BEFORE STARTING DEMOLITION OPERATIONS CONTRACTOR SHALL REVIEW ABATEMENT SPECIFICATIONS & DRAWINGS, WHICH IDENTIFIED AREAS & MATERIALS THAT ARE ASBESTOS CONTAINING MATERIALS & LEAD PAINT. CONTRACTOR SHALL FOLLOW PROCEDURES AS SET FORTH IN ABATEMENT SPECIFICATIONS AND BALANCE OF SPECIFICATIONS. ALL ABATEMENT WORK SHALL BE PART GENERAL TRADES CONTRACTORS BASE BID.

4. AT ANY SPACE BEING RENOVATED CONTRACTOR SHALL REMOVE EQUIPMENT AND MISCELLANEOUS ITEMS SUCH AS PLAQUES, SIGNAGE, DISPLAY BOARDS, TACK BOARDS, INTERCOMS, SPEAKERS, AND THE LIKE, AND TURN OVER TO THE OWNER.

5. ALL FLOOR AND WALL BASE TO BE REMOVED IN AREAS SHOWN IN CONTRACT.

6. ALL CEILING AND LIGHTING TO BE REMOVED IN AREAS SHOWN IN CONTRACT, UNO.

7. RETURN ALL EXISTING AV EQUIPMENT (I.E. PROJECTORS, SCREENS, MONITORS, AND SPEAKERS) TO OWNER.

8. DEMOLITION OF DOOR ASSEMBLIES TYPICALLY SHALL INCLUDE DEMO OF DOOR(S), FRAME SIDELITES (IF PRESENT), TRANSOMS (IF PRESENT), DOOR SADDLE, HARDWARE, AND RELATED ACCESSORIES. PATCH WALL, FLOOR, & HEAD. PREP FOR NEW DOOR ASSEMBLY (IF APPLICABLE)

9. DEMOLITION OF WINDOW ASSEMBLIES TYPICALLY SHALL WINDOW ASSEMBLY (IF APPLICABLE).

HAZARDOUS MATERIAL NOTES:

1.THIS PROJECT REQUIRES REMOVAL OF HAZARDOUS MATERIALS. SEE SPECIFICATIONS FOR THE REPORT WHICH INCLUDES THE TYPES, EXPECTED LOCATIONS, HANDLING, REMOVAL PROCEDURES & OTHER INFO.

2. DEMOLITION &/OR TIE-INS TO EXISTING M.E.P. SYSTEMS MAY ENCOUNTER CONCEALED HAZARDOUS MATERIAL. NOTIFY THE ARCHITECT IMMEDIATELY SHOULD SUCH MATERIALS BE SUSPECTED & DO NOT DISTURB SUCH MATERIAL

GENERAL DEMOLITION NOTES:

1. DEMOLITION IS NOT NECESSARYILY LIMITED TO WHAT IS SHOWN ON DRAWINGS. THE INTENT IS TO INDICATE THE GENERAL SCOPE OF DEMOLITION REQUIRED TO COMPLETE THE WORK IN ACCORDANCE WITH THE CONTRACT DRAWINGS. PRIOR TO ANY DEMOLITION CONTRACTORS ARE REQUIRED TO VISIT SITE AND FAMILIARIZE THEMSELVES WITH EXISTING CONDITIONS AND NOTE ANY DISCREPENCIES IN WRITING TO

INCLUDE DEMO OF WINDOW(S), FRAME, GLAZING, FLASHING, SILL TRIM/SURROUND/RETURN, HARDWARE, AND RELATED ACCESSORIES. PATCH ADJACENT AREAS. PREP FOR NEW

10. WHEN DEMOLISHING PORTIONS OF THE WALLS OR ROOFS, CONTRACTOR SHALL PROVIDE TEMPORARY SHORING AND SUPPORT LINTELS. REGARDLESS OF WHETHER OPENING SPECIFICALLY CALLS OUT FOR A NEW LINTEL OR NOT. ALL MASONRY OPENINGS THAT CONTRACTOR CUTS IN SHALL RECEIVE A SUPPORT LINTEL. SEE STRUCTURAL DRAWINGS FOR DETAILS ON LINTEL TYPES & SIZES.

11. WHEN DEMOLISHING PORTIONS OF MASONRY WALLS IN AREAS VISIBLE TO THE PUBLIC CONTRACTOR SHALL "SAW CUT" AT MASONRY WALLS AND "TOOTH IN" AT ANY PATCHING OF MASONRY WALLS. ALL SCARS TO CEILINGS, ADJACENT WALLS, AND FLOORS SHALL BE PATCHED & RESTORED TO MATCH EXISTING ADJACENT MATERIALS.

12. BEFORE CUTTING AND OPENING/HOLE/TRENCH SPECIFICALLY FOR OTHER TRADE, CONTRACTOR SHALL REVIEW & VERIFY EXACT SIZE & LAYOUT WITH THAT TRADE CONTRACTOR.

13. WHEN DEMOLISHING PORTIONS OF EXTERIOR WALLS, CONTRACTOR SHALL SAVE PORTIONS OF DEMOLISHED MASONRY AND USE MASONRY INFILL OPENINGS AND TOOTH-IN AROUND ALL NEW OPENINGS.

14. WHEN DEMOLISHING FLOORS CONTRACTORS SHALL REMOVE FINISH FLOORING & SCRAPE SLAB/SUB-FLOORINGCLEAN. SUB-FLOOR SHALL BE LEVELED PRIOR TO INSTALLATION OF NEW SCHEDULED FINISH FLOOR. ANY DAMAGE TO ADJ. FLOORS SHALL BE PATCHED.

15. AFTER DEMOLITION OPERATIONS, WHEN FINISH PATCHING IF SPECIFIC FINISH/MATERIAL IS NOT CALLED OUT, CONTRACTOR SHALL MATCH EXISTING ADJACENT MATERIALS

16. AFTER DEMOLITION, WHERE SPECIFICALLY CALLED OUT OR NO, CONTRACTOR SHALL REPAIR ALL SCARS TO EXISTING ADJACENT MATERIALS AND RESTORE TO PRIOR CONDITION.

17. OWNER HAS RIGHT OF FIRST REFUSAL OF ANY MATERIAL

ABATEMENT NOTES: SEE HAZARDOUS MATERIALS SURVEY REPORT, SPECIFICATIONS, AND DRAWINGS.

GENERAL KEYNOTES

PATCH AND REPAIR AS REQUIRED IN PREPARATION FOR NEW CONSTRUCTION GC TO COORDINATE PLUMBING TERMINATION BACK TO SOURCE REMOVE EXISTING FLOORING MATERIAL AND PREPARE FLOOR SUBSTRATE FOR NEW CONSTRUCTION REMOVE EXISTING WINDOWS, FRAMES AND ALL ASSOCIATED TRIM & HARDWARE -PREPARE MASONRY OPENING FOR NEW STOREFRONT AND DOOR. REMOVE EXISTING WINDOW TREATMENT. REMOVE EXISTING DOOR, FRAME, AND ALL ASSOCIATED HARDWARE. INFILL WALL TO MATCH EXISTING FINISHES. REMOVE EXISTING DOOR FRAME AND ALL ASSOCIATED HARDWARE. PREP AREA TO RECEIVE NEW DOOR AS SCHEDULED. REMOVE EXPOSED PIPING. COORDINATE WITH PLUMBING DRAWINGS. COORDINATE REMOVAL OF BUILT-IN MILLWORK AND FURNITURE W/DISTRICT. LOOSE FURNITURE TO BE REMOVED BY OWNER. BUILT-IN MILLWORK TO BE REMOVED BY CONTRACTOR.


REMOVE STEEL SLAT ROLL UP DOOR 11 STAIRS TO REMAIN. PREP TO RECEIVE NEW FINISHES AS SCHEDULED.


> DEMOLITION LEGEND DENOTES AREA OF NO MAJOR ARCHITECTURAL WORK. SPECIFIC WORK MAY BE SHOWN ELSEWHERE INCLUDING WORK THAT MAY REQUIRE ACCESS, PATCHING & RESTORATION, REFER TO STRUCTURAL & M.E.P. DWGS. EXISTING CONSTRUCTION TO REMAIN (DOOR, WALL, GLAZING, ETC.) EXISTING CONSTRUCTION TO BE REMOVED (DOOR, WALL, GLAZING, ETC.) $\langle \rangle$ KEYNOTES

PROFESSIONAL DEVELOPMENT CENTER

NYACK UFSD

13A DICKINSON AVENUE NYACK, NY 10960

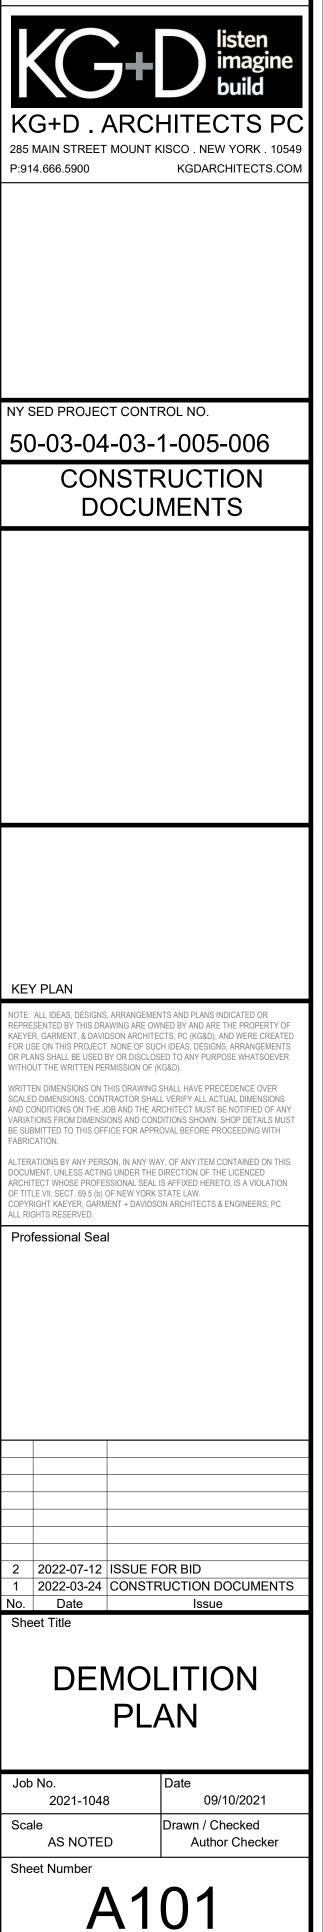

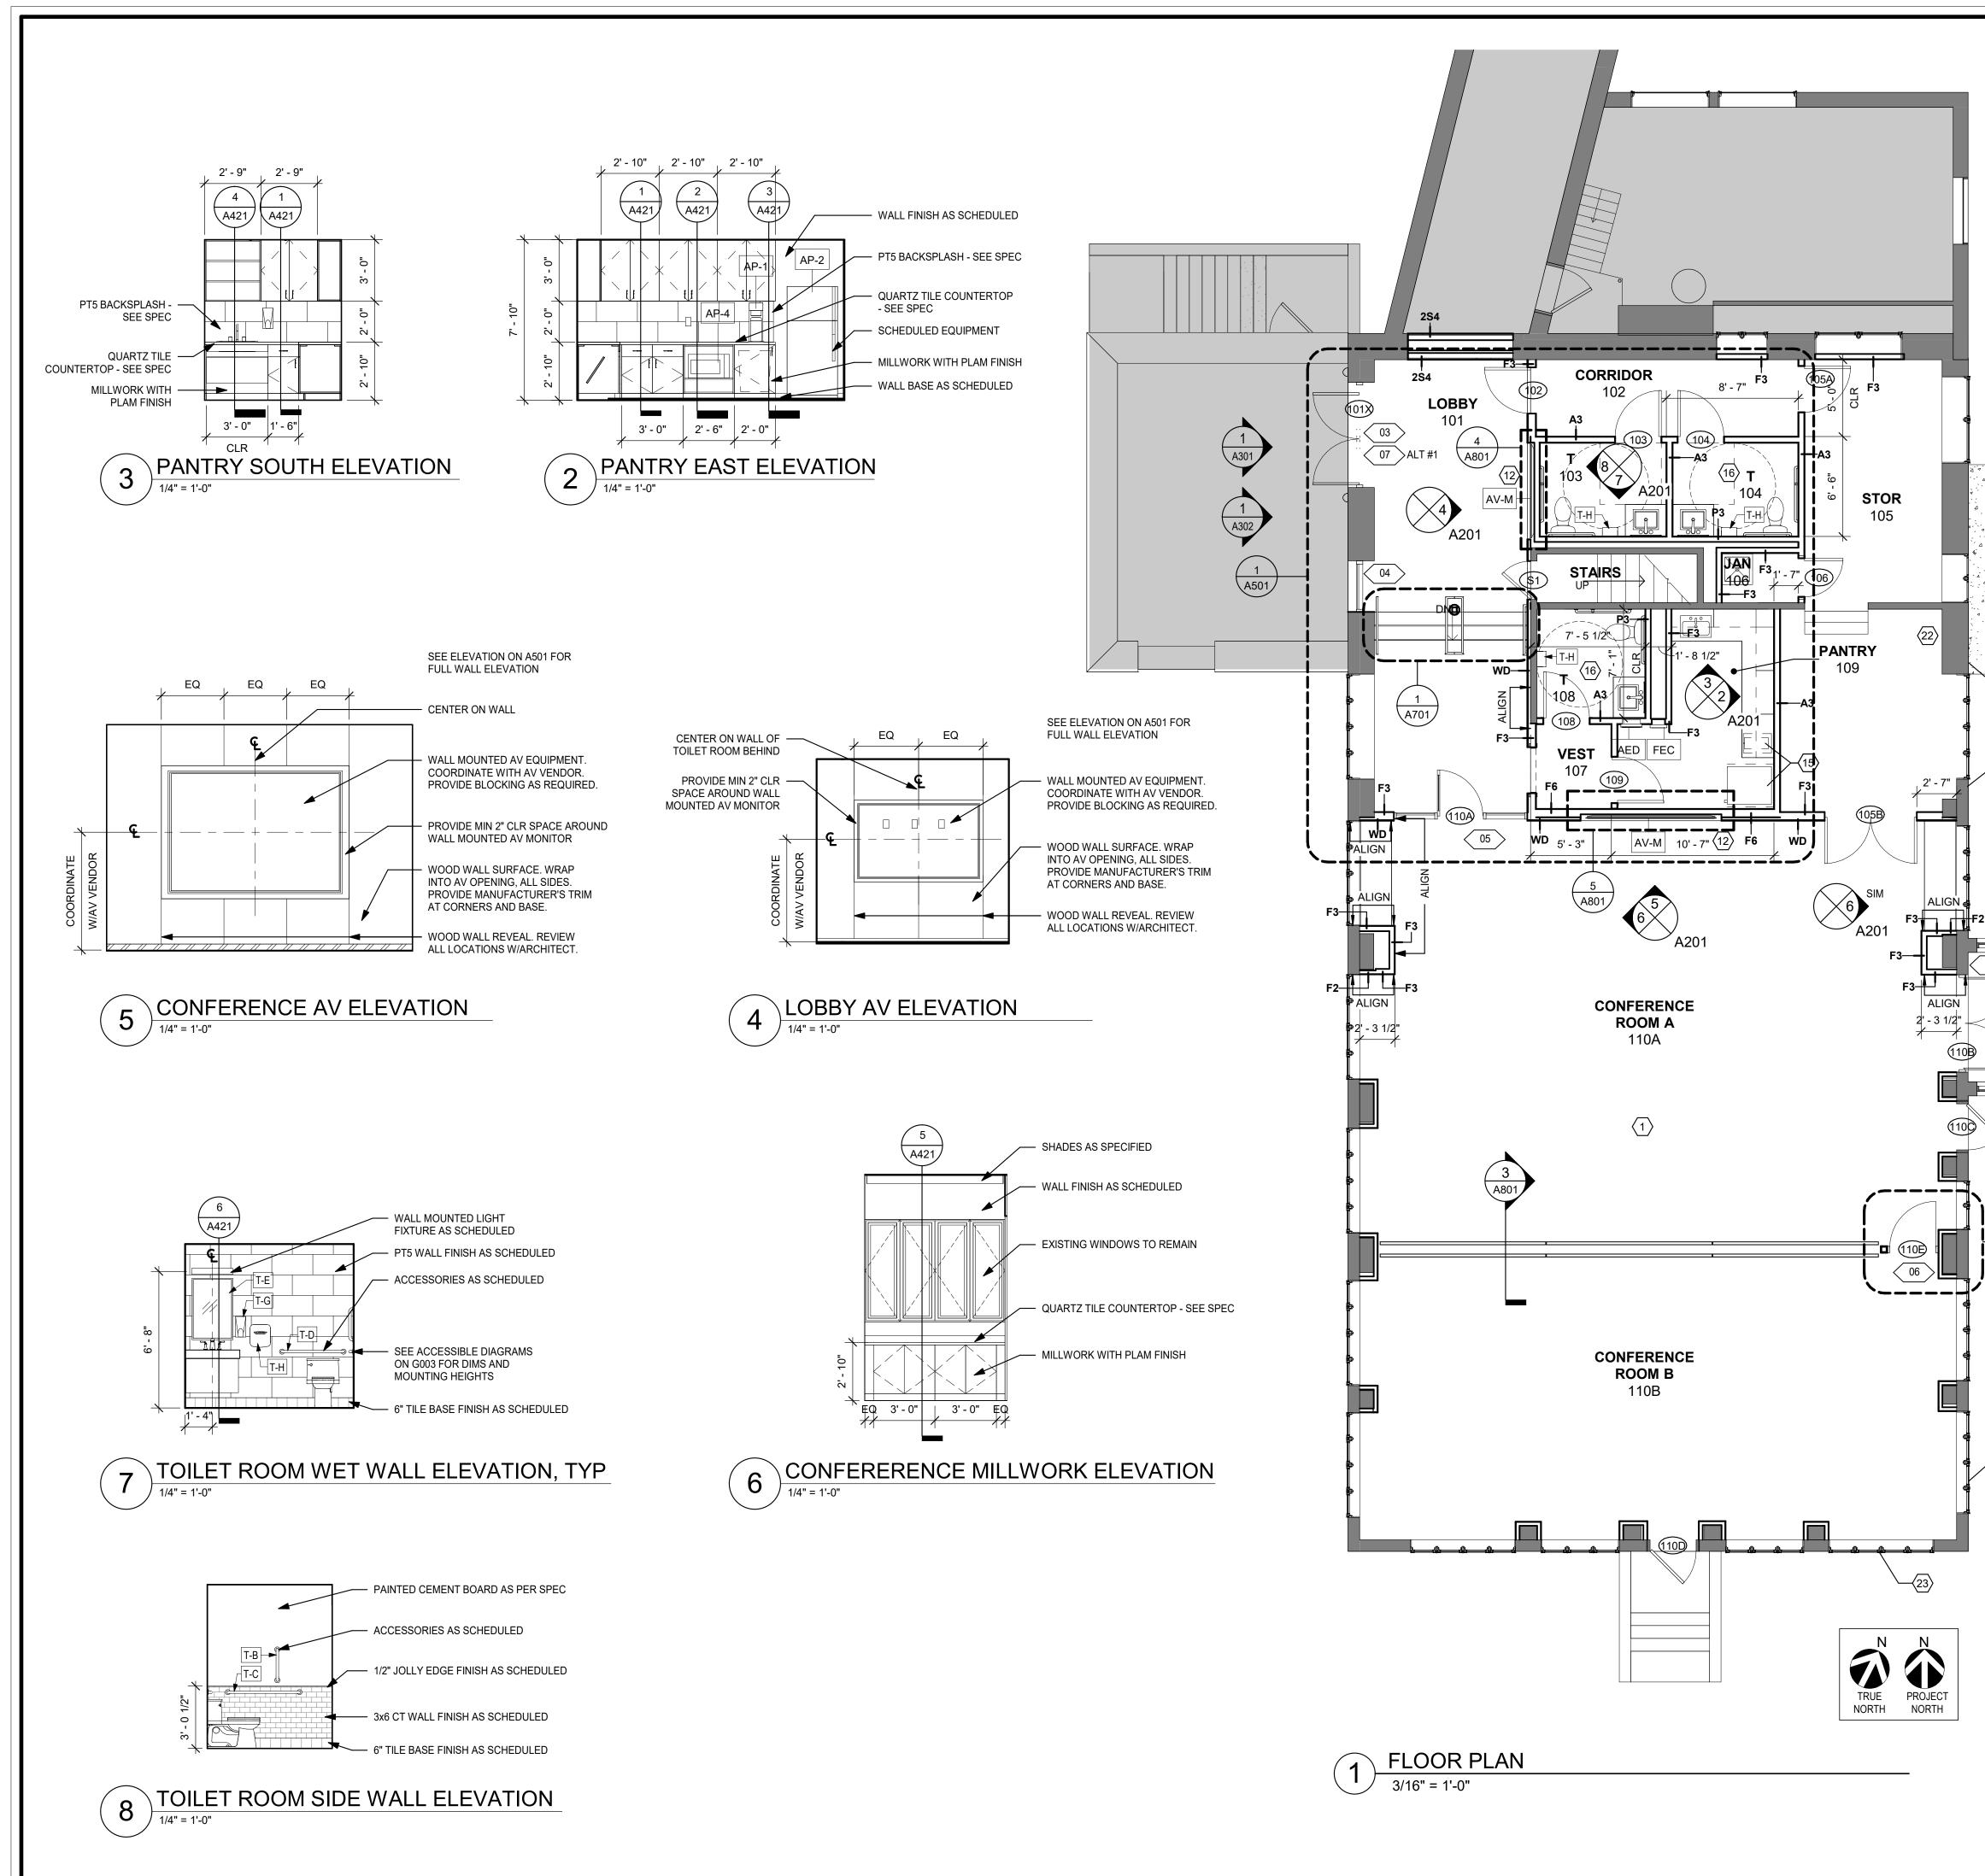

GENERAL FLOOR PLAN NOTES

1. WHERE FURRED PARTITIONS EXCEED MAXIMUM HEIGHT, BRACE TO ADJACENT STRUCTURE.

2. ALL INTERIOR PARTITION, PENETRATIONS, OTHER OPENINGS IN THE BUILDING SHELL SHALL BE SEALED, GASKETED, OR WEATHER STRIPPED.

3. PROVIDE METAL STUD ANCHOR BRACKETS AT LOCATIONS INCLUDING BUT NOT LIMITED TO: GRAB BARS, SHELVING, OVERHEAD CABINETS, SIGNAGE, TOILET ROOMS ACCESSORIES, WALL MOUNTED AV EQUIPMENT, ETC.

4. ALL DIMENSIONS TO THE EXTERIOR WALL ARE TO THE INSIDE FACE OF EXISTING SILL OR FINSH SURFACE. ALL PARTITIONS ARE DIMENSIONED FROM FACE OF PARTITION TYPE AS INDICATED UON. ALL DIMENSIONS MARKED "CLEAR" OR "CLR" SHALL BE MAINTAINED AND SHALL ALLOW FOR THICKNESSES OF ALL WALL FINISHES. DIMENSIONS SHALL NOT VARY MORE THAN +/- 1/8" WITHOUT WRITTEN CONSENT FROM THE ARCHITECT.

5. EXISTING STUD WALLS TO REMAIN TO BE FLOATED AS REQUIRED TO PROVIDE SMOOTH SUBSTRATE (LEVEL 4). PREPARE FOR INSTALLATION OF NEW FINISHES.

6. PATCH AND REPAIR EXISTING SLAB WITH HYDRAULIC CEMENT UNDRELAYMENT AS REQUIRED IN PREPERATION FOR NEW CONSTUCTION. FLOORING TO BE LEVEL WITHIN A TOLERANCE OF 1/8" OVER 10'-0". FOR MAJOR DISCREPENCIES, VERIFY WITH ARCHITECT BEFORE PERFORMING ANY LEVELING WORK.

7. PROVIDE ADJACENT PARTITION TYPE ABOVE ALL STOREFRONT SYSTEMS. 8. REFER TO DEVICE ALIGNMENT DIAGRAMS ON SHEET A911 FOR TYPICAL LOCATIONS OF SWITCHES, CONTROLS, AND DEVICES.

9. PROVIDE CORNER GUARDS AT ALL OUTSIDE CORNERS UON.

10. ALL DEMISING WALLS TO EXTEND TO DECK WITH GYP BOARD EXTENDING FULL HEIGHT OF PARTITION UON.

11. LOCATE DOORS 4" FROM WALL, TYP.

12. WHERE INFILLING MASONRY WALLS, MASONRY IS TO MATCH THE EXISTING SIZE,. JOINTS ARE TO BE ALIGNED, AND THE WALL SHOULD HAVE A CLEAN APPEARANCE.

GENERAL KEYNOTES

- PATCH AND REPAIR AS REQUIRED IN PREPARATION FOR NEW CONSTRUCTION 12 COORDINATE POWER REQUIREMENTS AND MOUNTING HEIGHTS WITH
- SCHEDULED EQUIPMENT 15 PROVIDE WATER LINE AND SHUT OFF VALVE FOR COFFEE MAKER AND
- REFRIGERATOR 16 REFERENCE ACCESSIBILITY DIAGRAMS ON SHEET G003 FOR ADA CLEARANCES AND MOUNTING HEIGHTS.
- 19 PROVIDE CONCRETE PAD AT THIS LOCATION FOR NEW MECHANICAL EQUIPMENT. COORDINATE W/ MECH DRAWINGS.
- 22 GC TO PROVIDE 4'X8' SHEET OF 3/4" PLYWOOD AND PAINT TO MATCH WALL. 23 PROVIDE EXTERIOR EXHAUST LOUVER IN THIS LOCATION ON SECOND STORY. COORDINATE W/ MECH DRAWINGS.

RIDOR 111		
	FLOOR	PLAN LEGEND
		EXISITING ROOM OR ZONE TO REMAIN, NOT INCLUDED IN THIS SCOPE OF WORK
5		EXISTING CONSTRUCTION TO REMAIN (DOOR, WALL, GLAZING, ETC.)
A802		NEW PARTITION AS INDICATED
		NEW GLAZED OPENING WITH ALUM OR HM FRAME AS INDICATED
		FEC - FIRE EXTINGUISHER CABINET
		AED - DEFIBRILATOR
		NEW DOOR, DOOR NUMBER
>		WALL TYPE
	\bigcirc	FRAME TYPE
	\bigcirc	KEY NOTES


		FFE SCHEDU	JLE
TAG	QTY	TYPE	COMMENTS
AED	1	Defibrillator	
AP-1	1	Coffee Maker	
AP-2	1	Refrigerator	
AP-4	1	Microwave	
AV-M	2	AV Monitor	1 in Lobby 1 in Conference Room A
AV-P	1	Projector	See RCP
AV-S	1	Projector Screen	See RCP
FEC	1	FEC - Semi Recessed - Red Die Cut	
SH-1	13	Window Shade	Located in Conference Room A and B - See RCP
T-H	3	Hand Dryer	
Grand total	25	•	

Granu Iolai. Za NOTE:

ADDITIONAL ACCESSORIES INCLUDE, BUT NOT LIMITED TO, SOAP DISPENSERS, TOILET PAPER DISPENSERS, ETC.

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	ITER
	K UFSD
_	SON AVENUE
	NY 10960
IKG+	listen imagine
KG+D . ARC	build CHITECTS PC
285 MAIN STREET MOUNT P:914.666.5900	KISCO . NEW YORK . 10549 KGDARCHITECTS.COM
NY SED PROJECT CON	TROL NO.
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KEY PLAN	MENTS AND PLANS INDICATED OR OWNED BY AND ARE THE PROPERTY OF
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	HALL VERIFY ALL ACTUAL DIMENSIONS ARCHITECT MUST BE NOTIFIED OF ANY ONDITIONS SHOWN. SHOP DETAILS MUST
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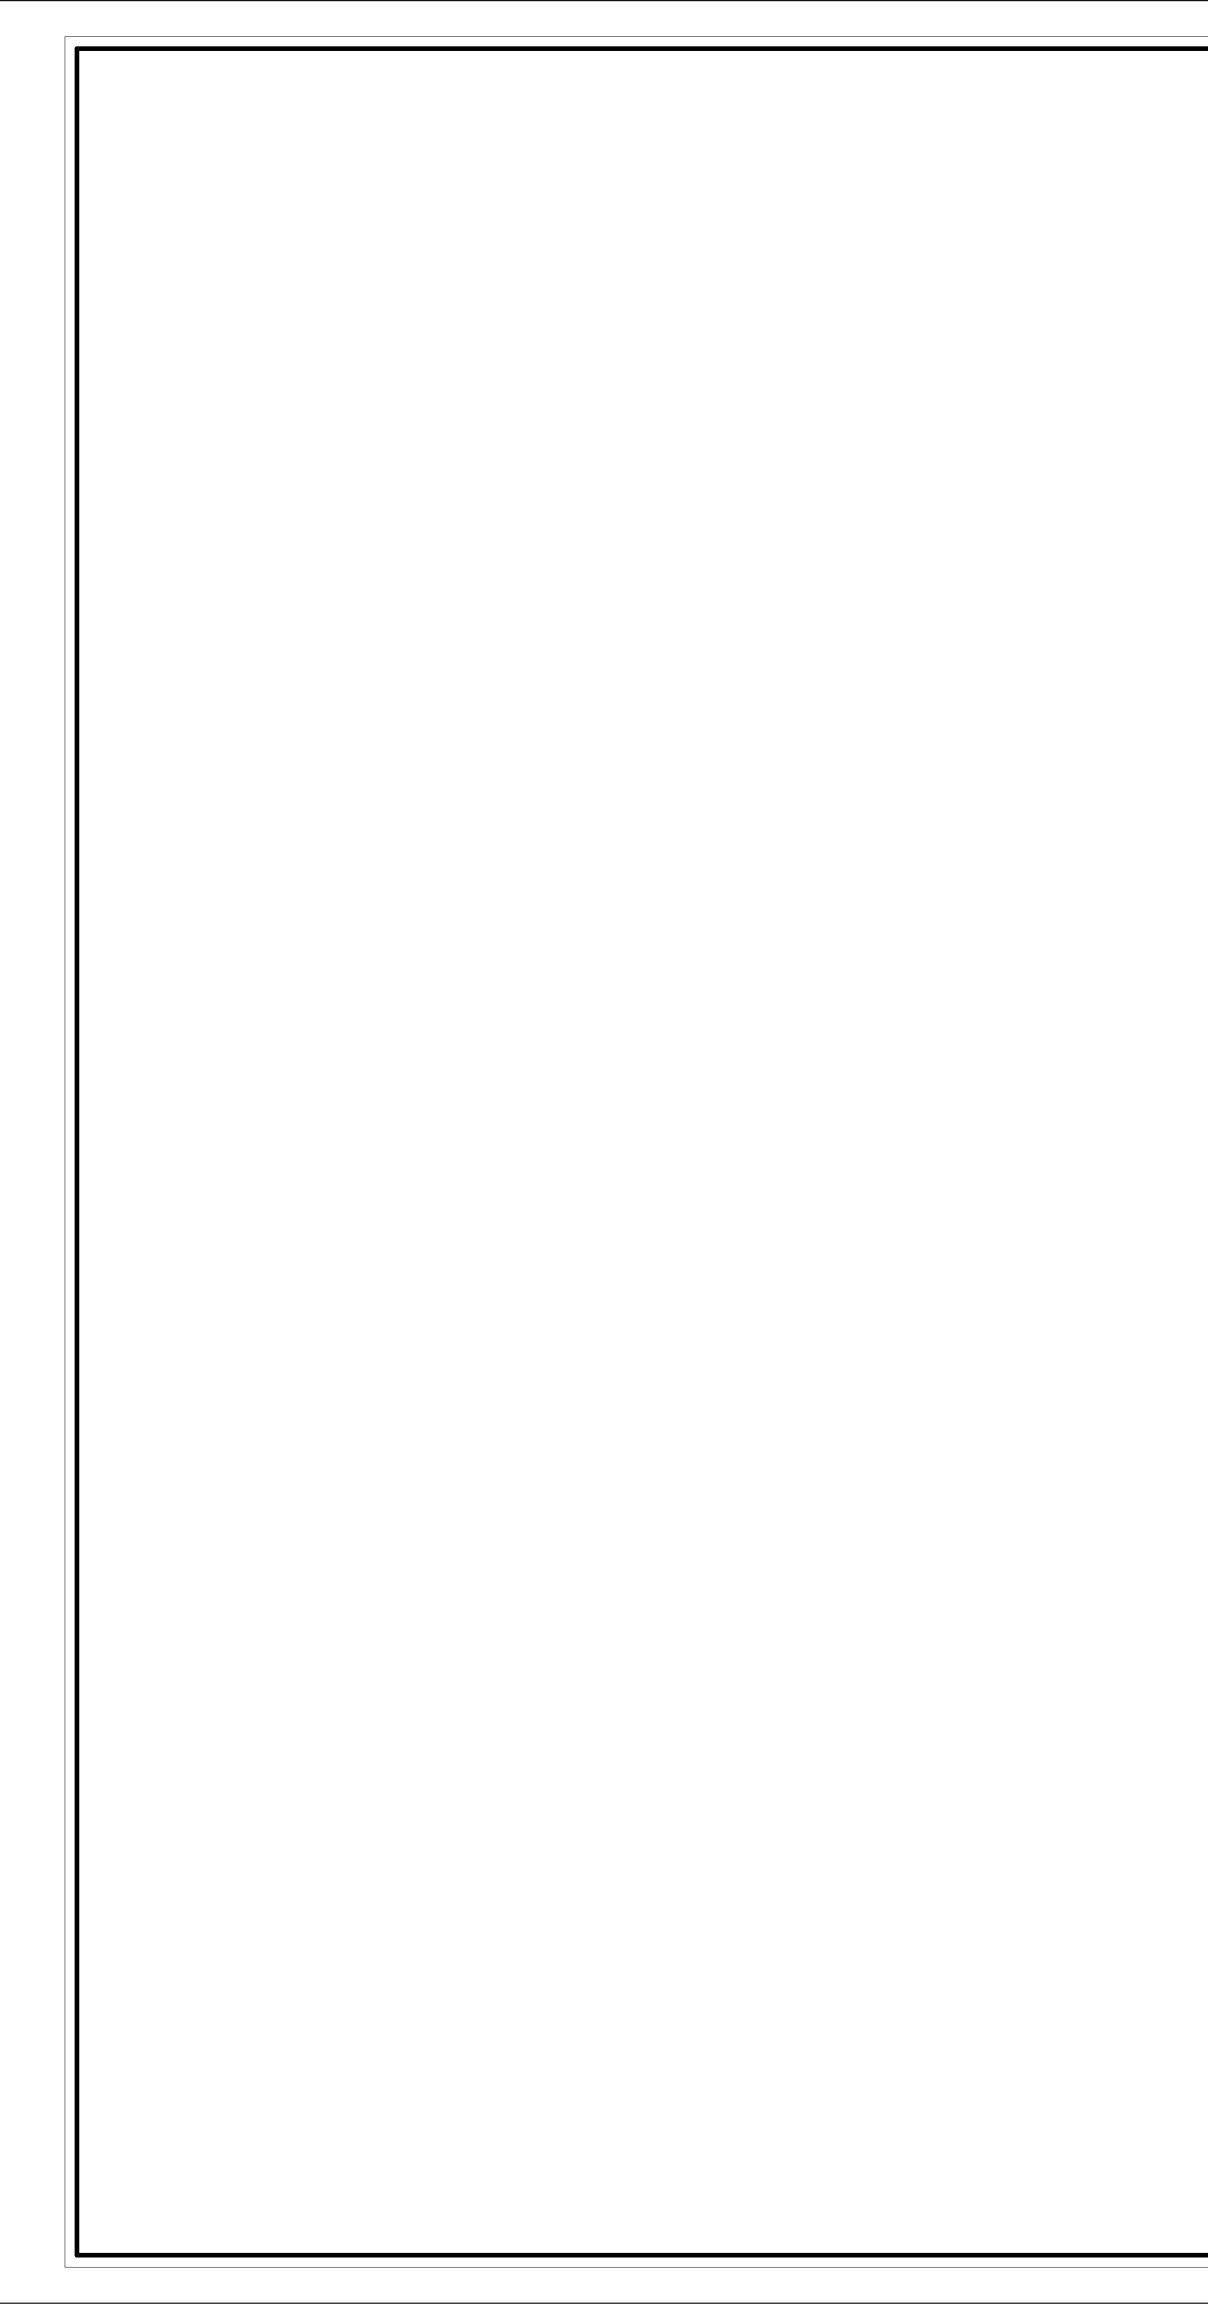
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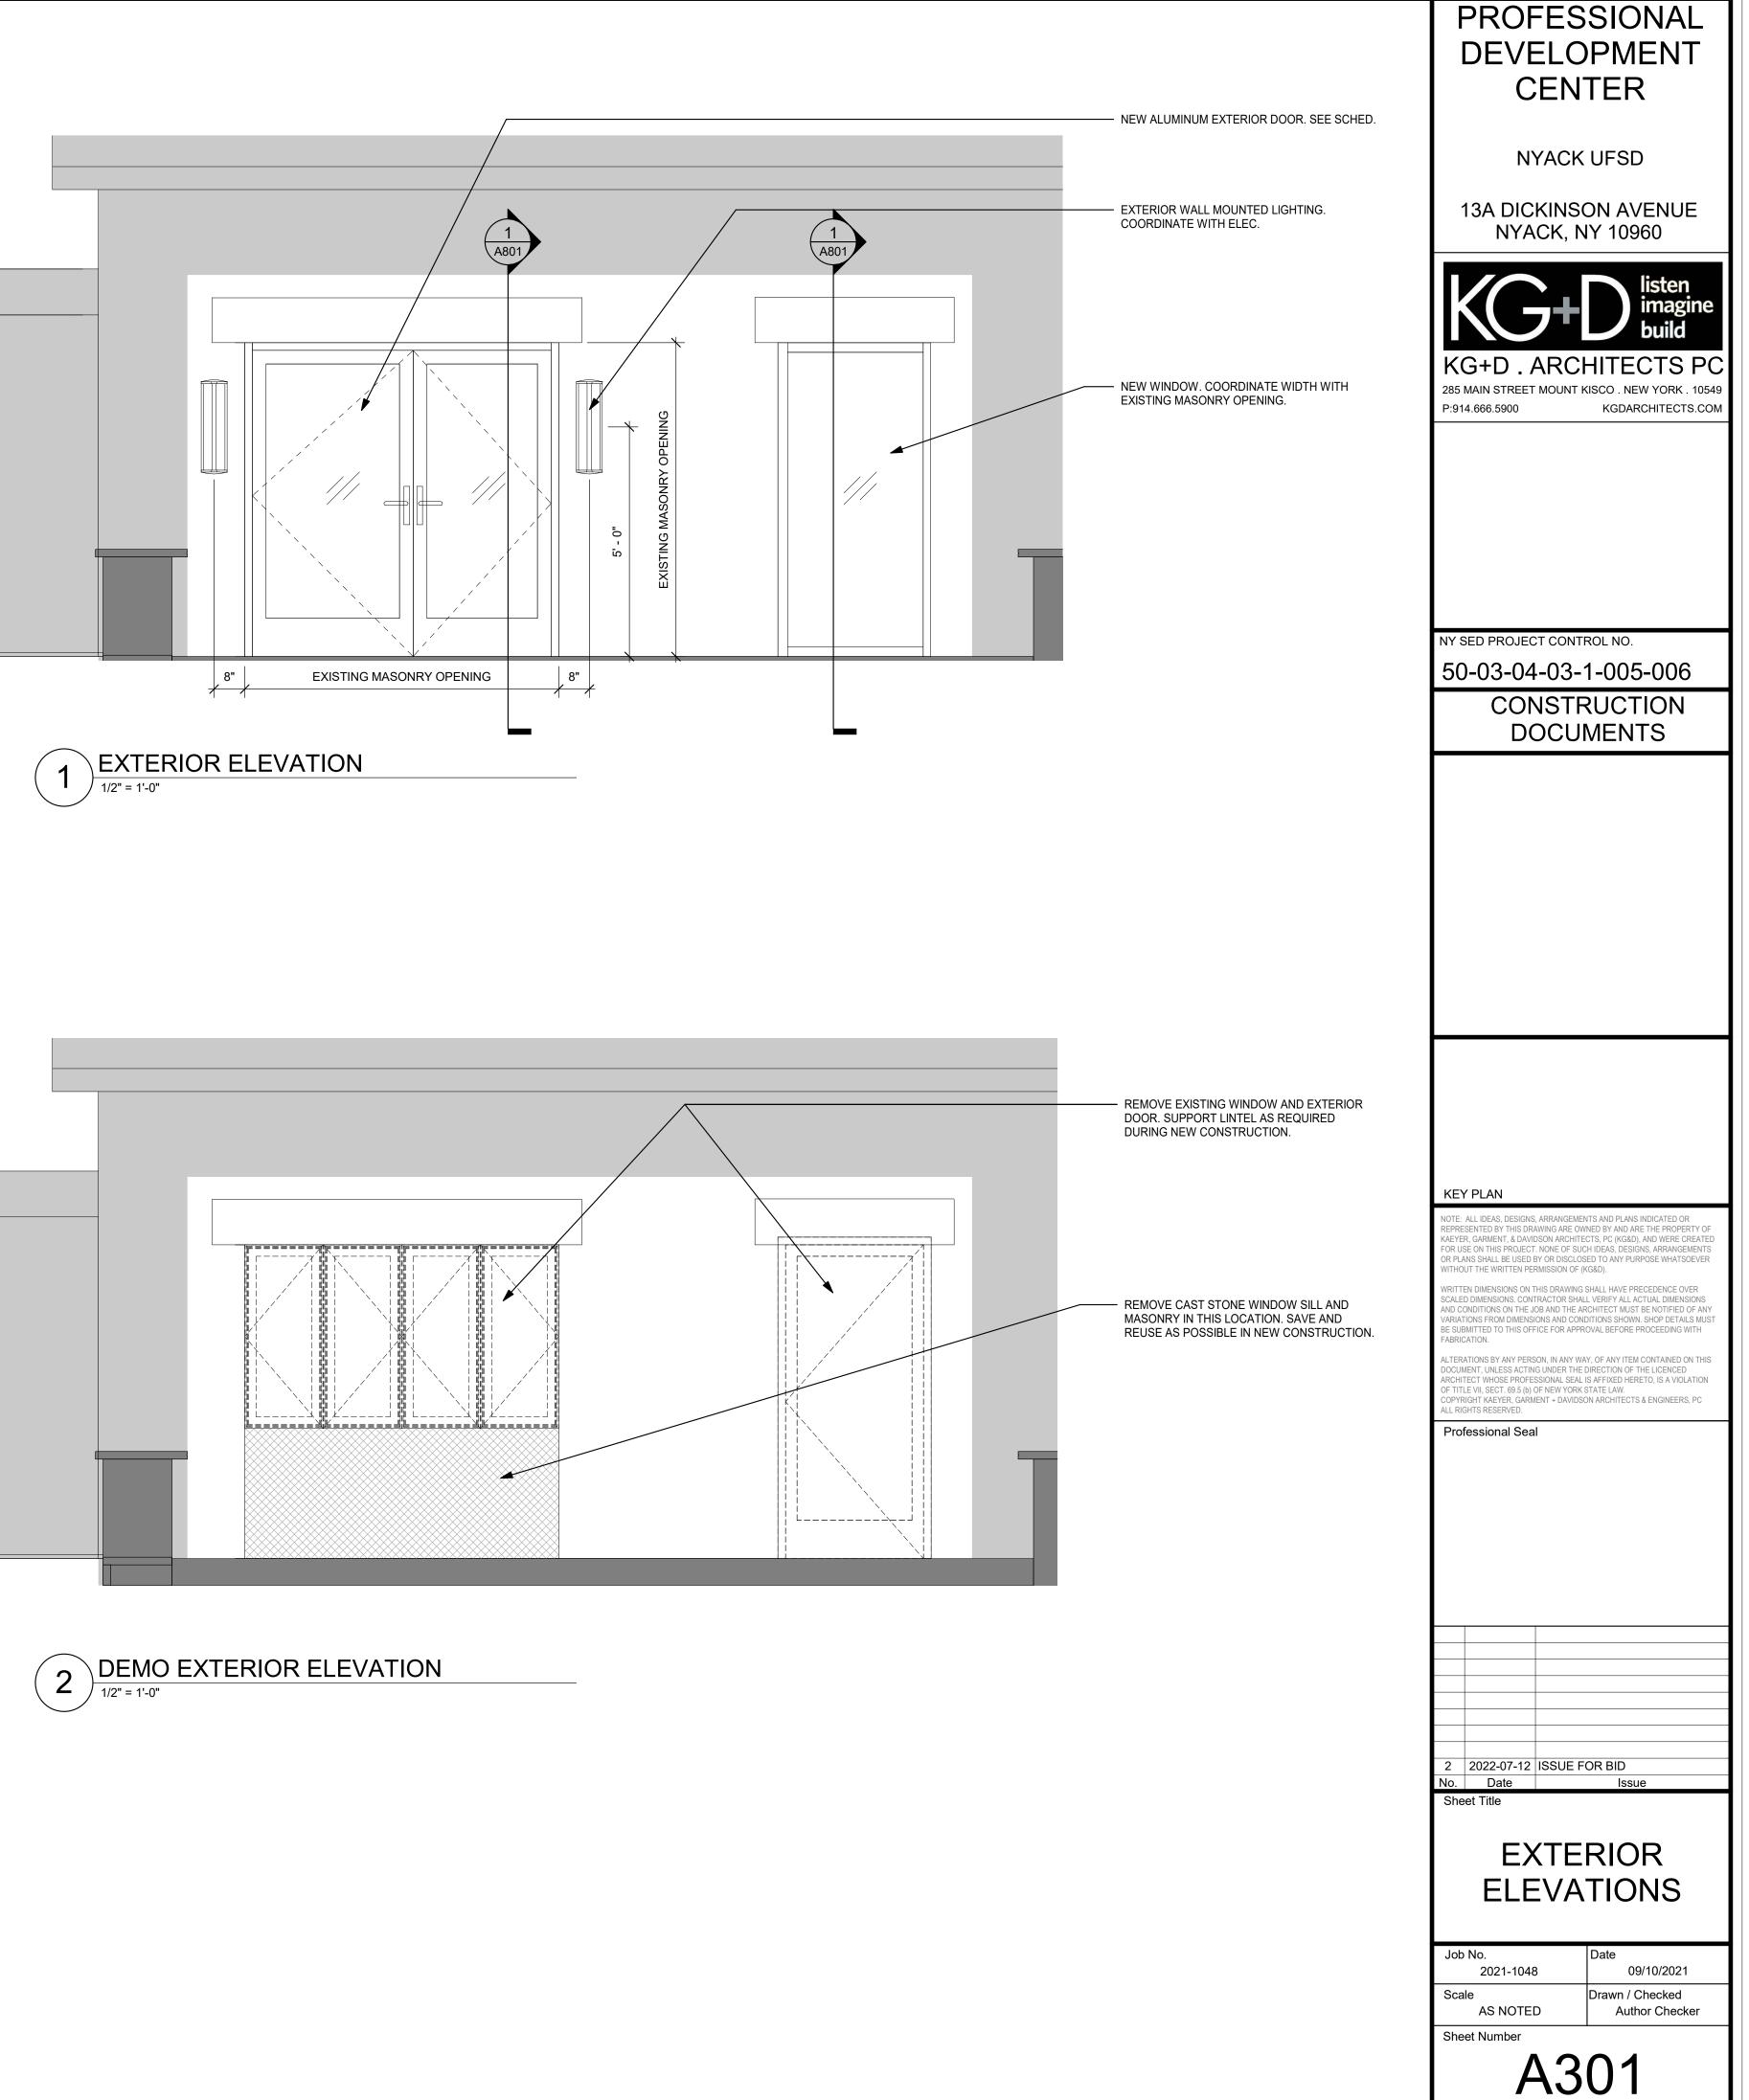



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CORRID

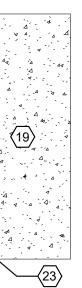










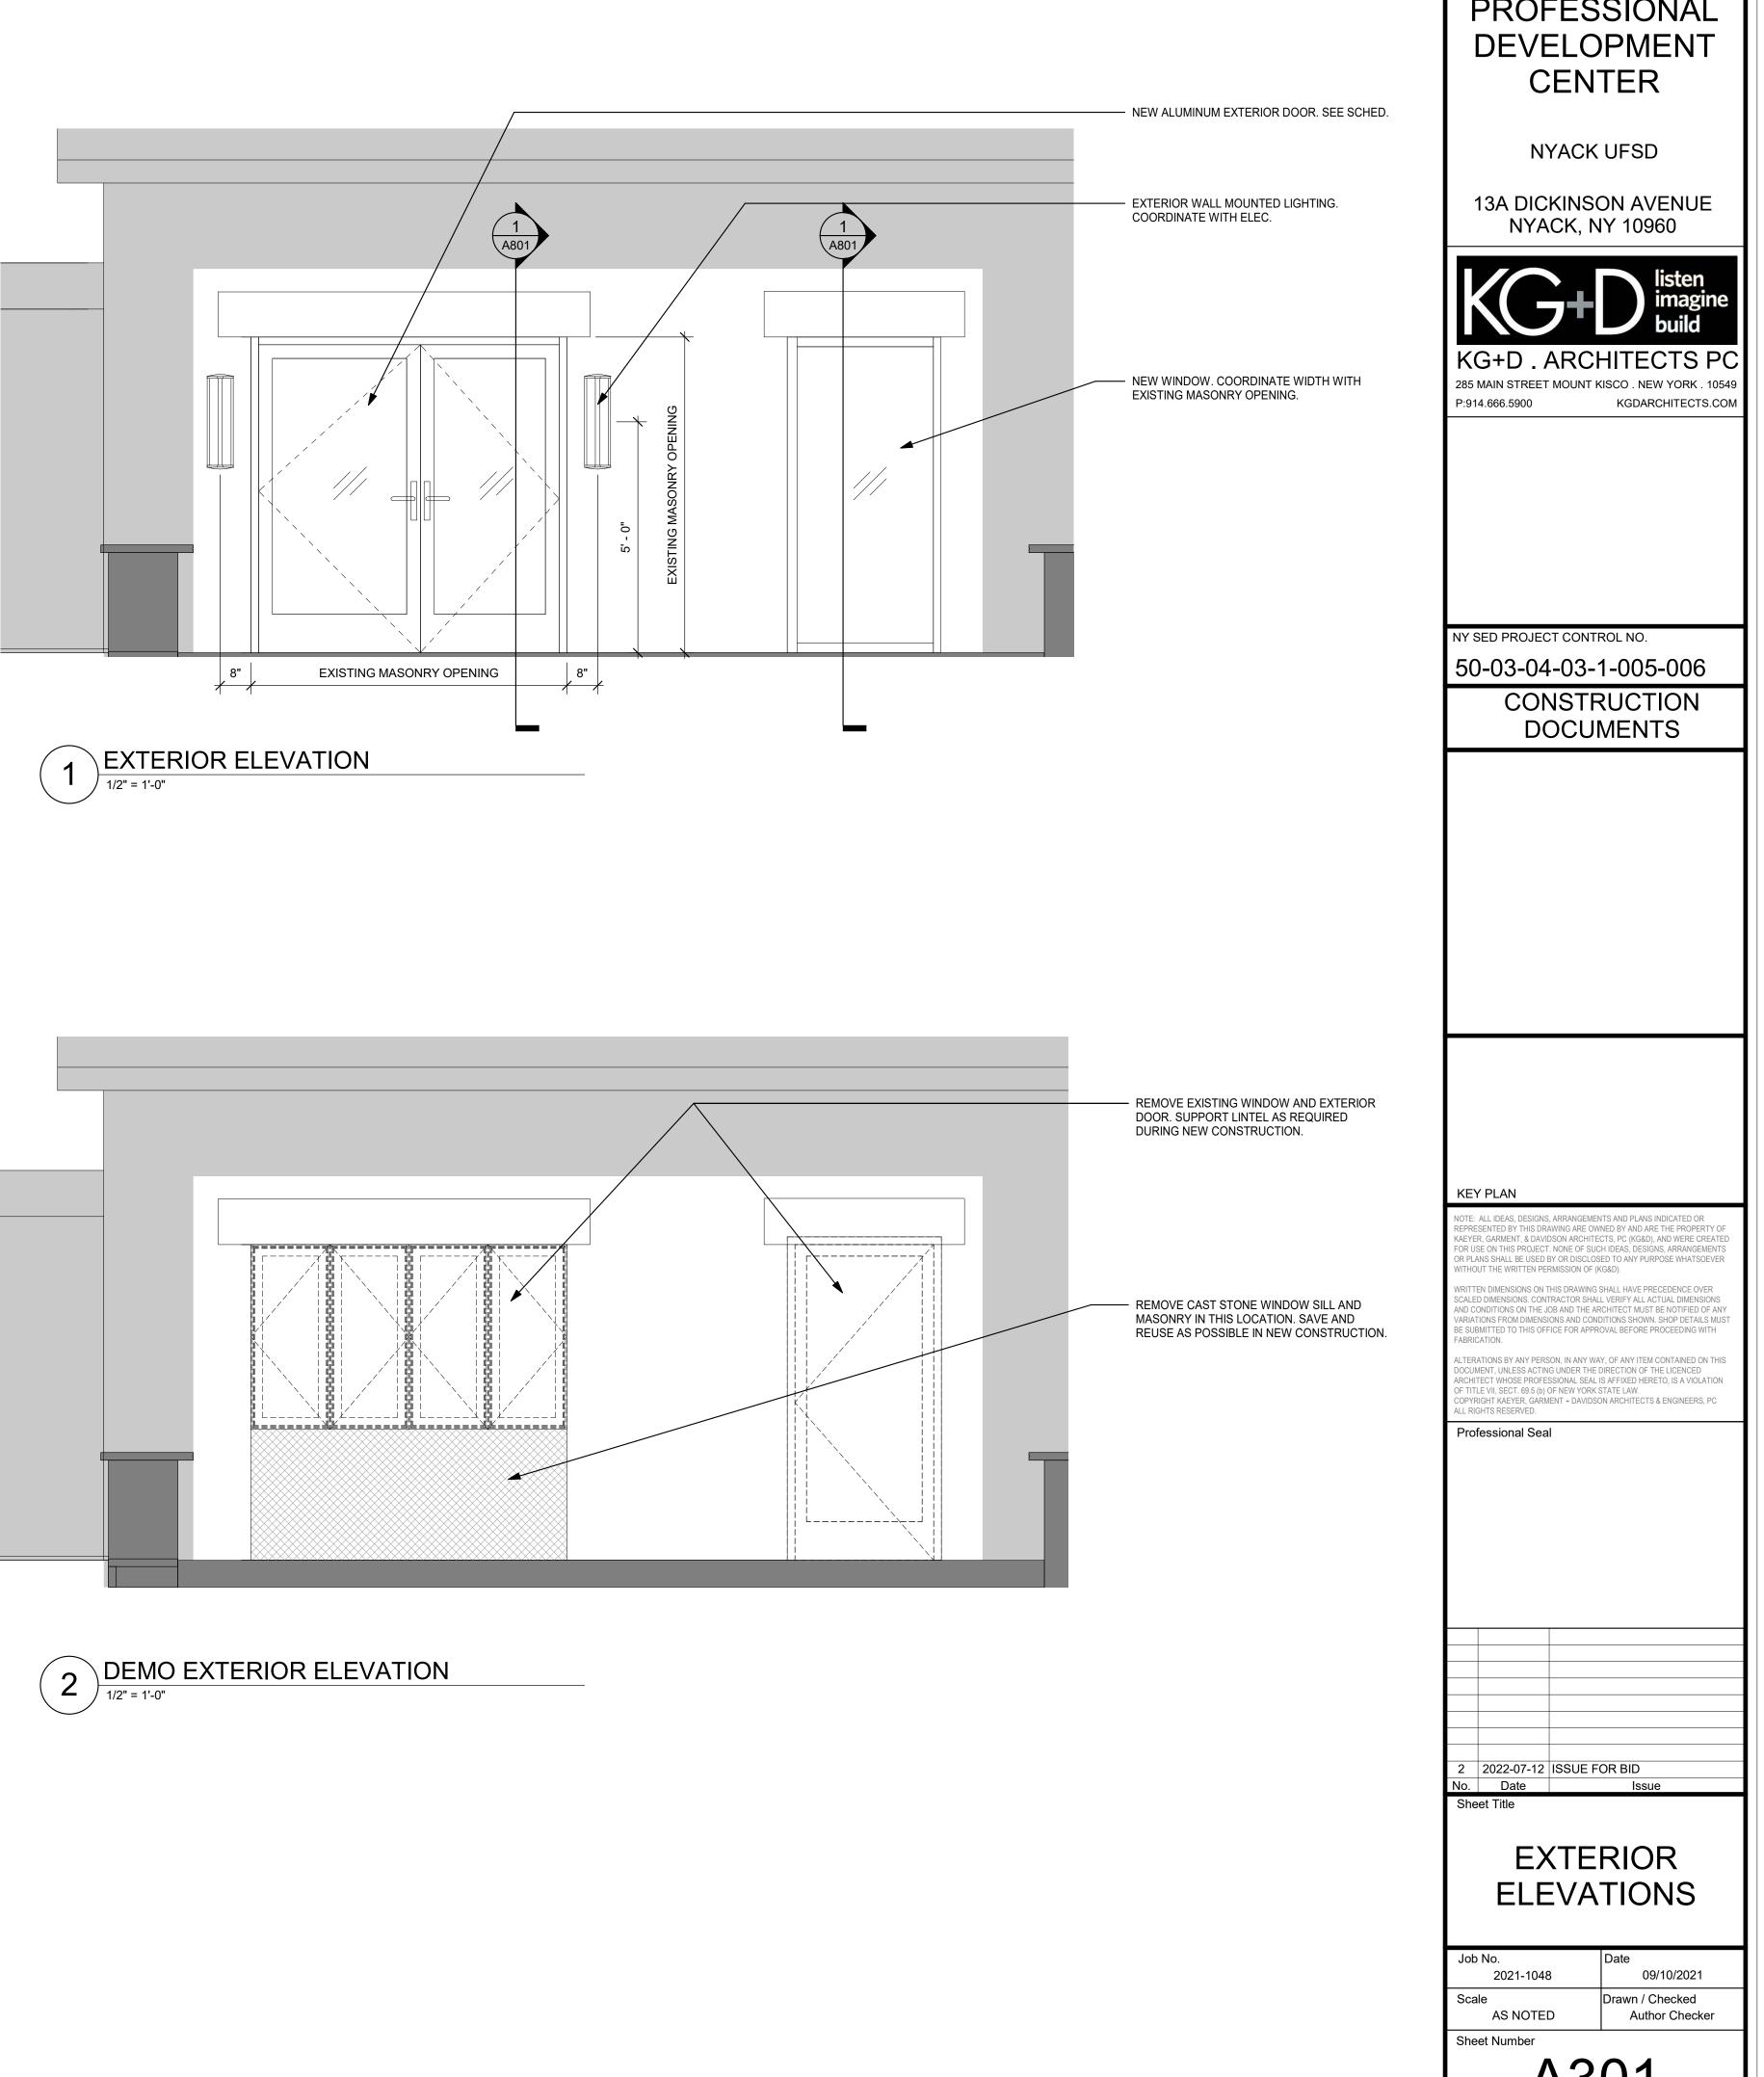


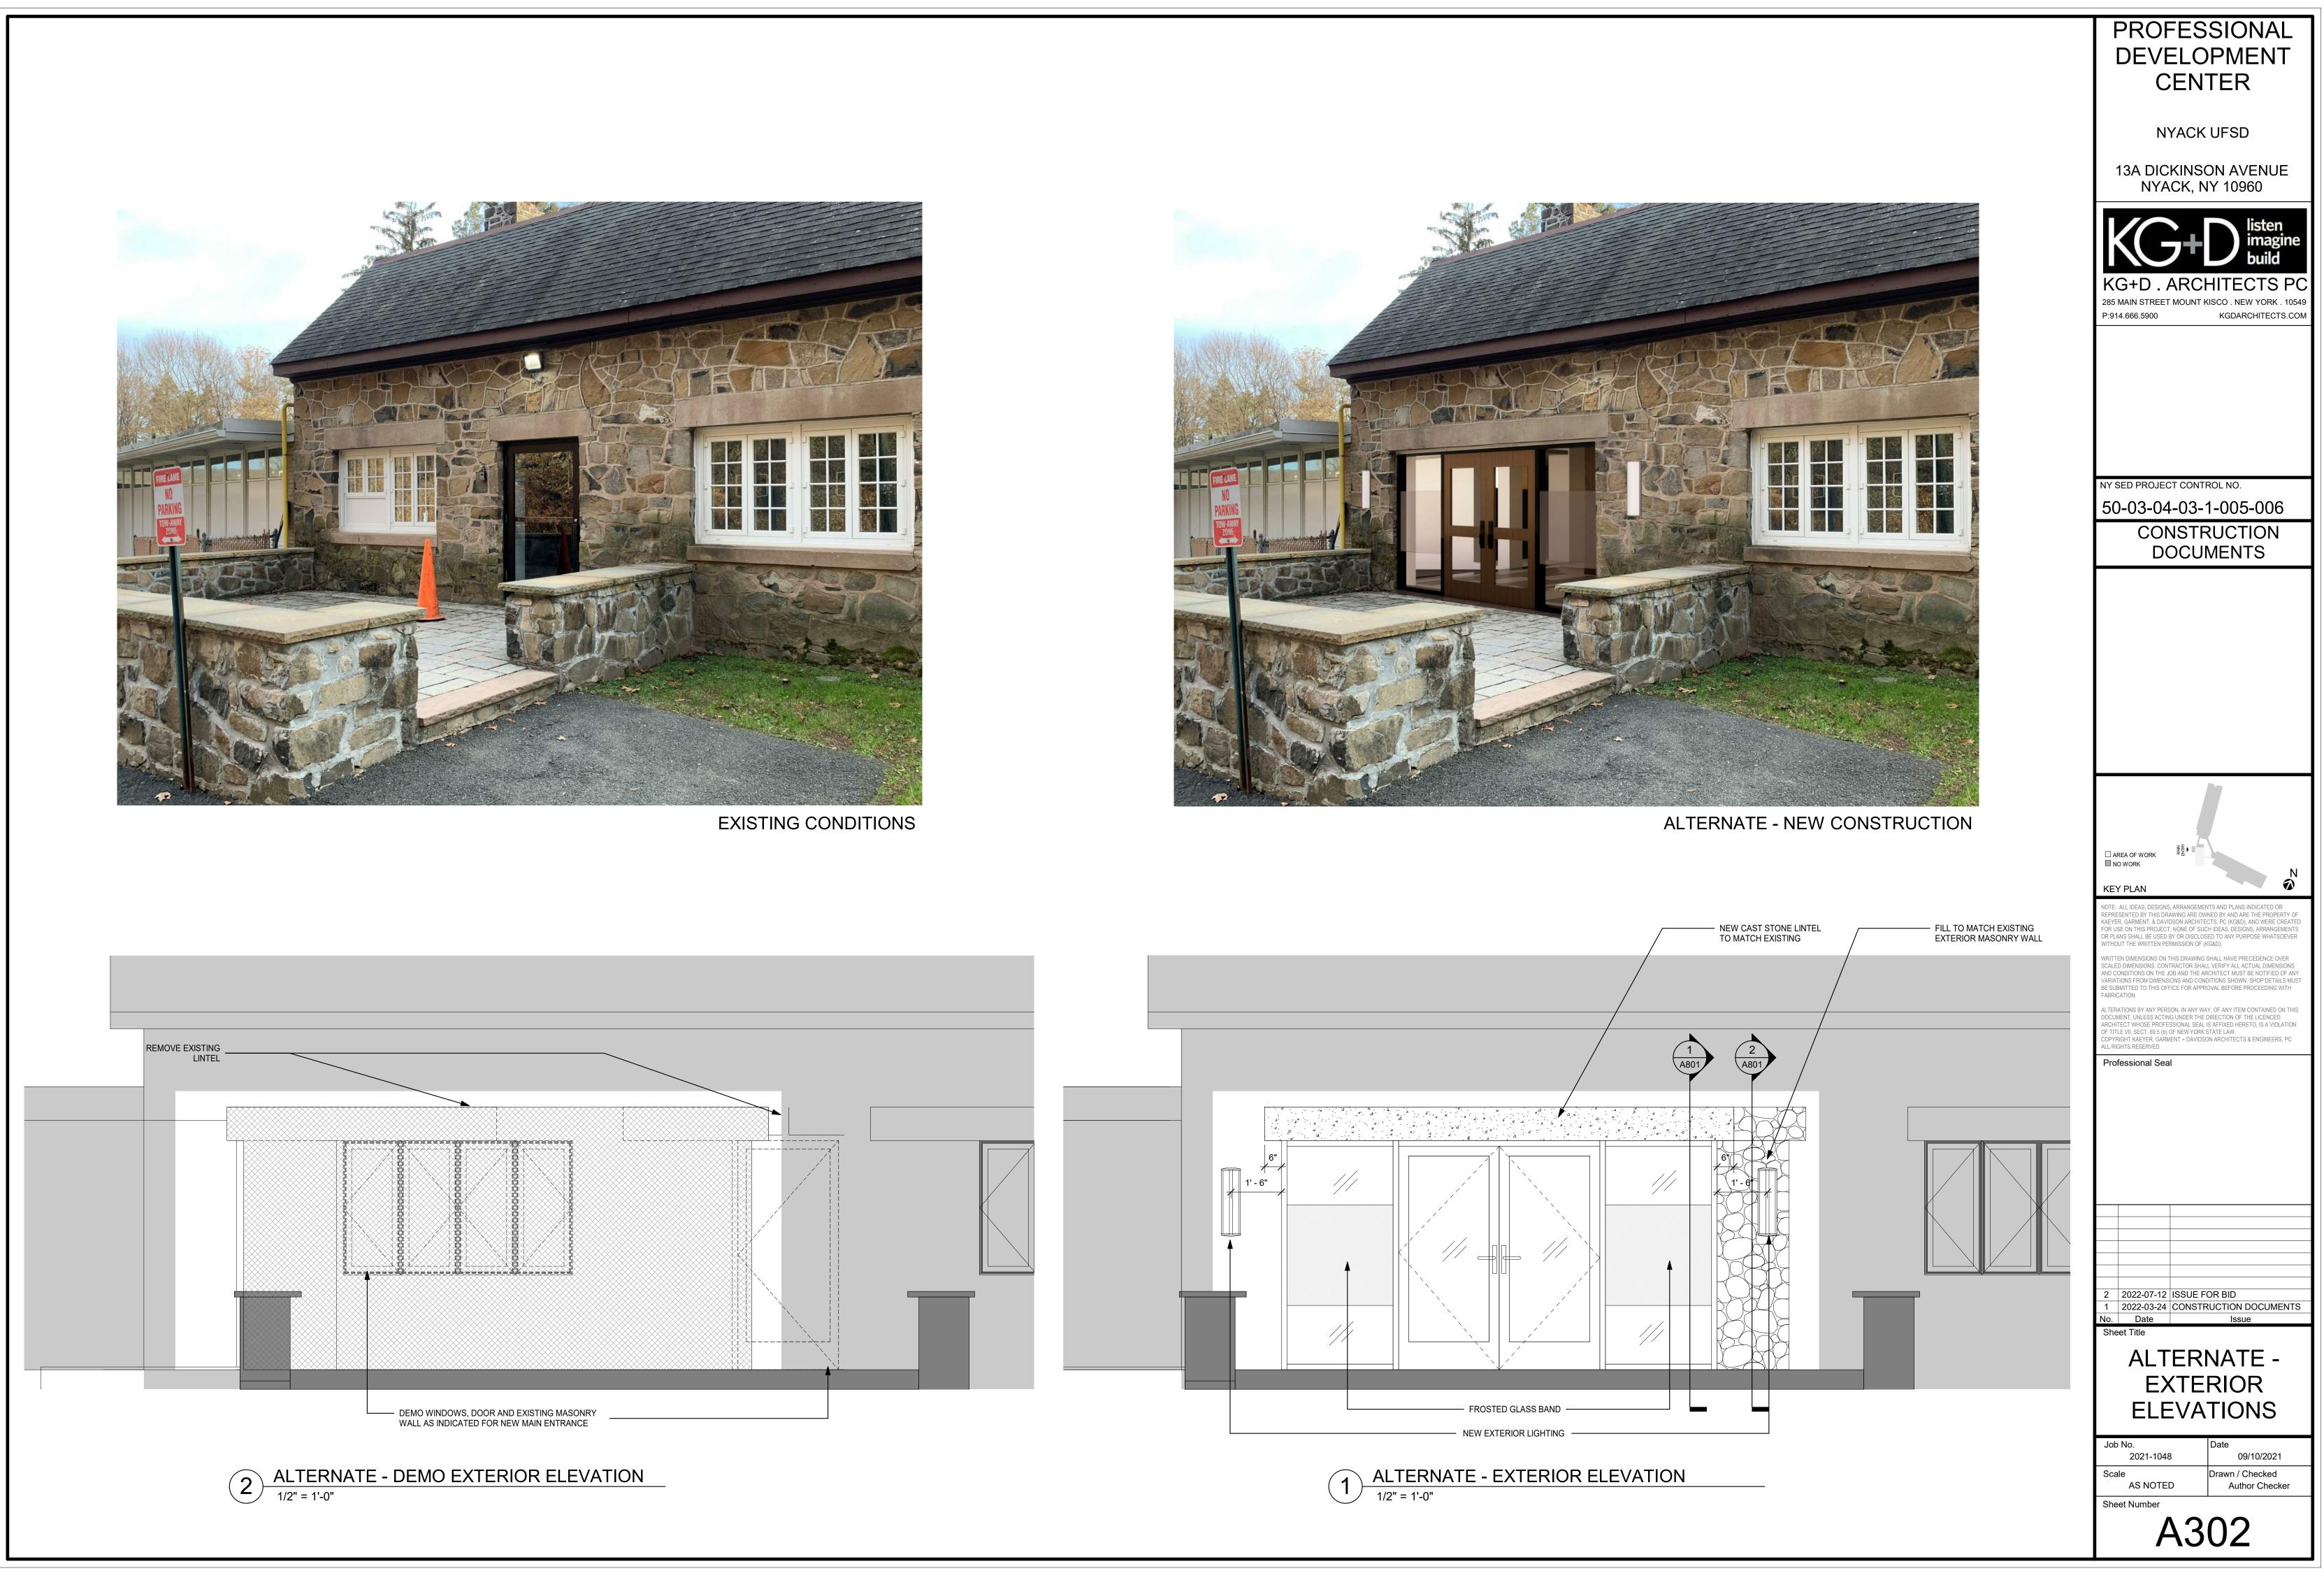

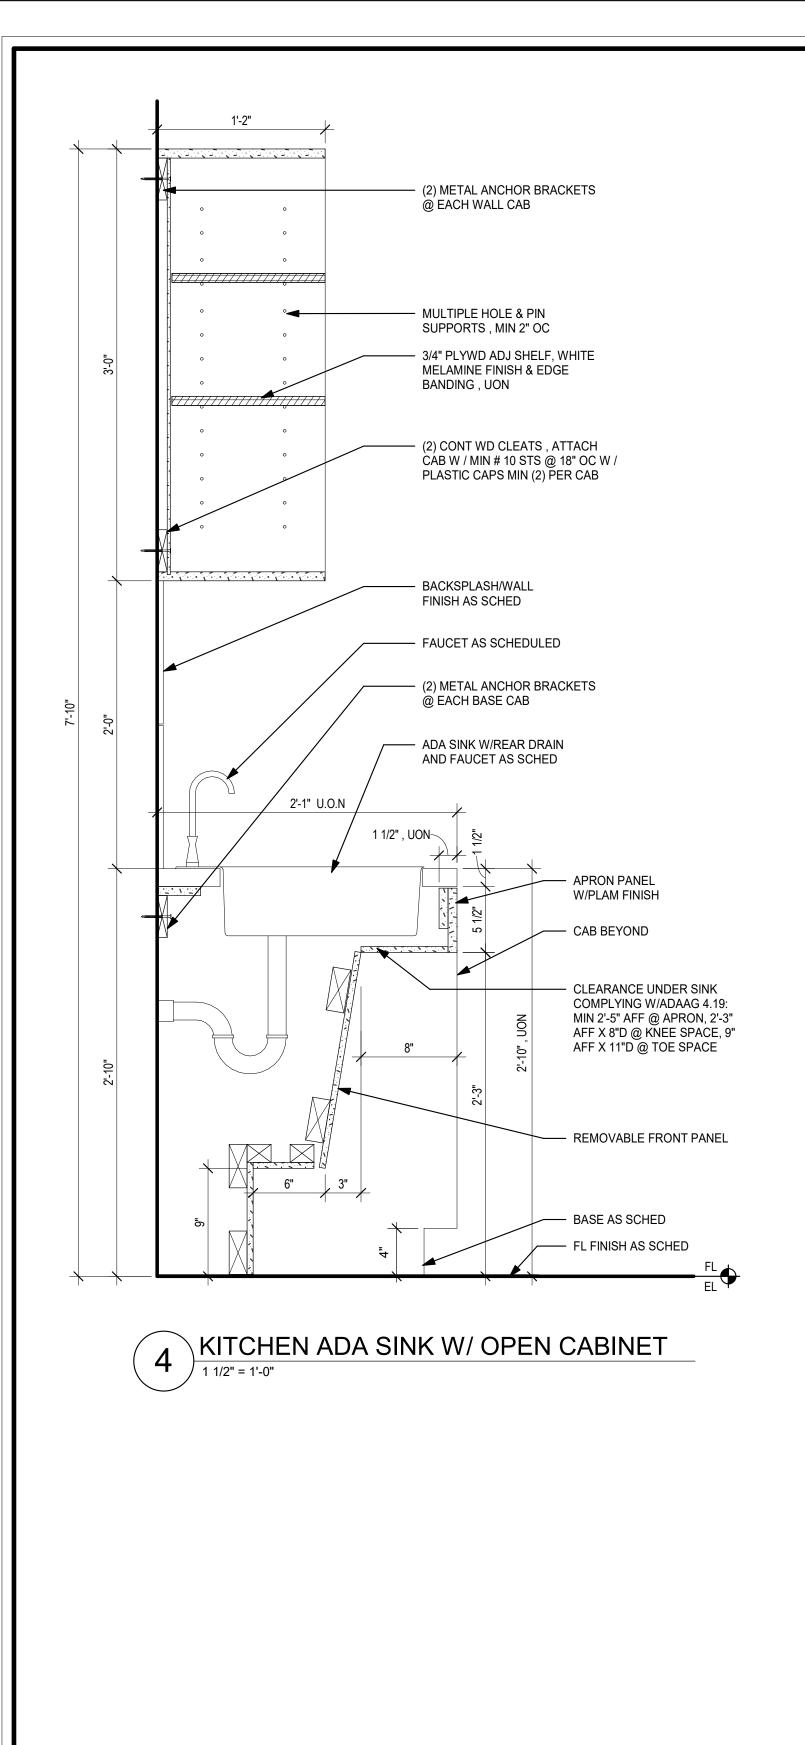

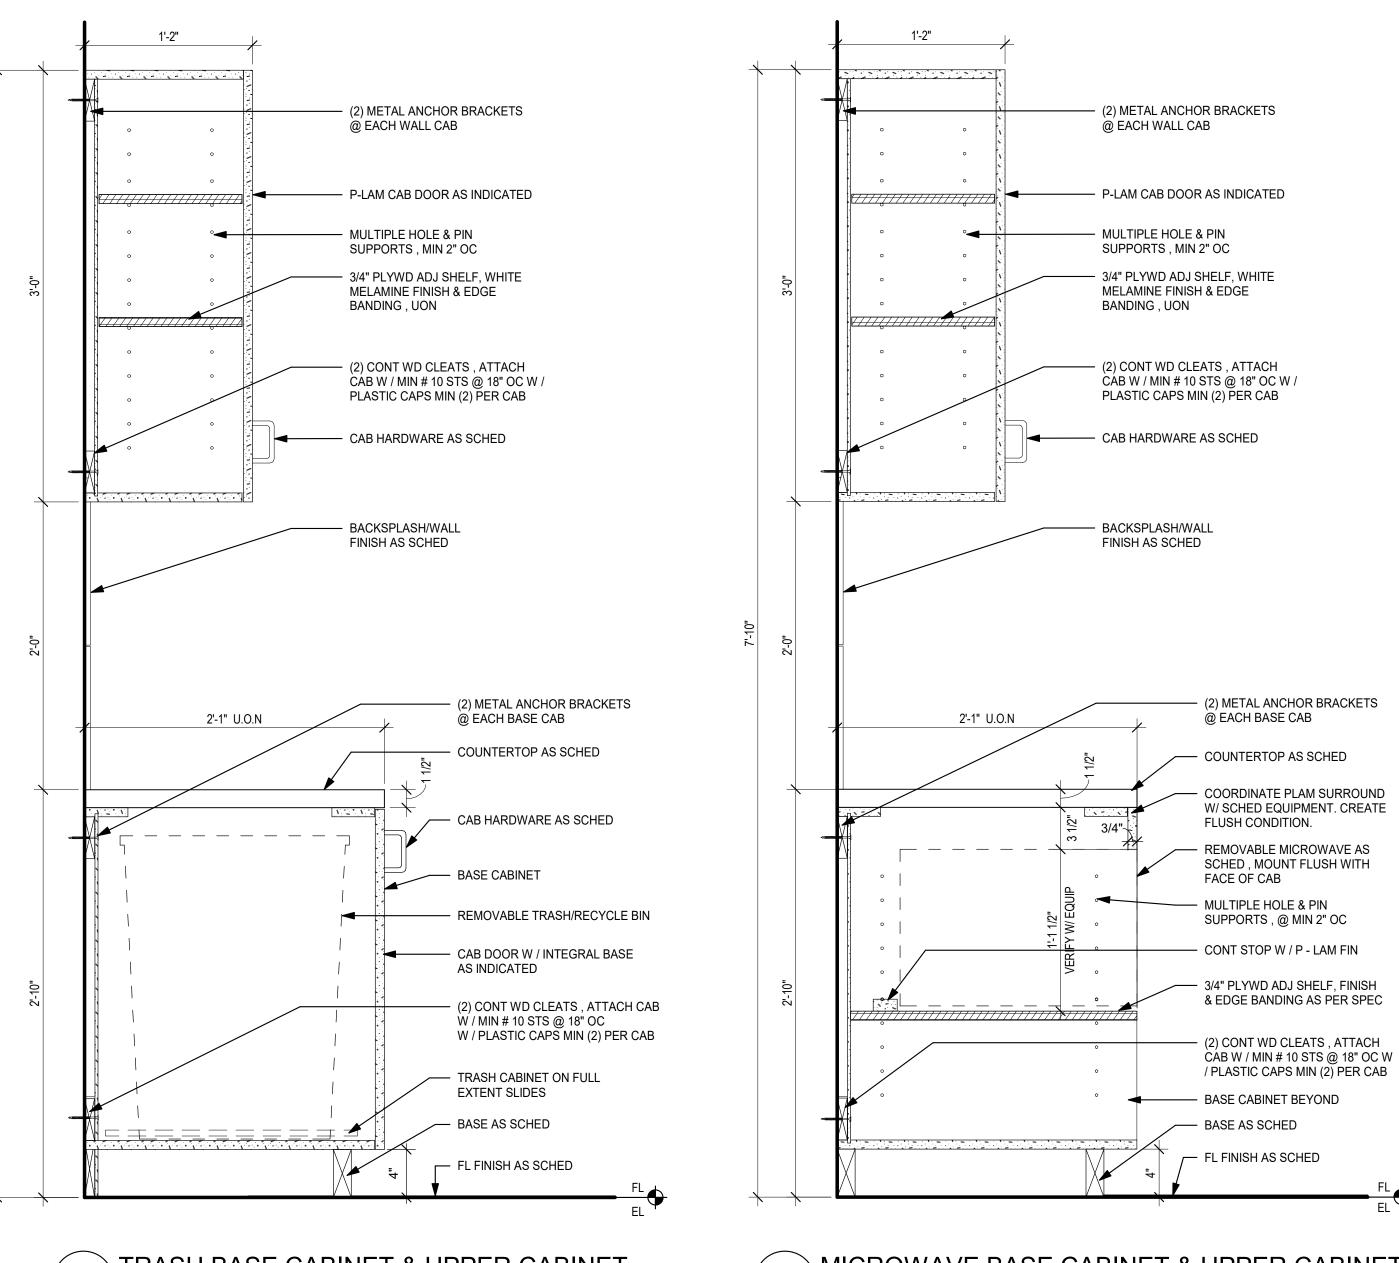



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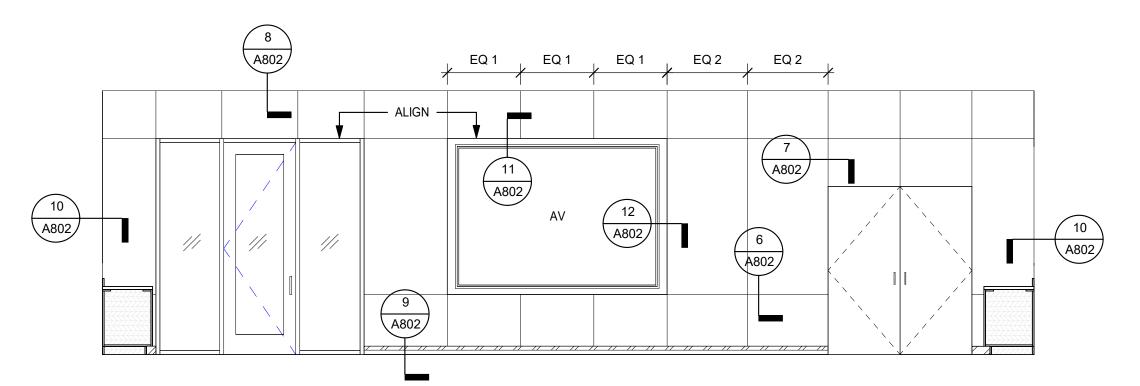


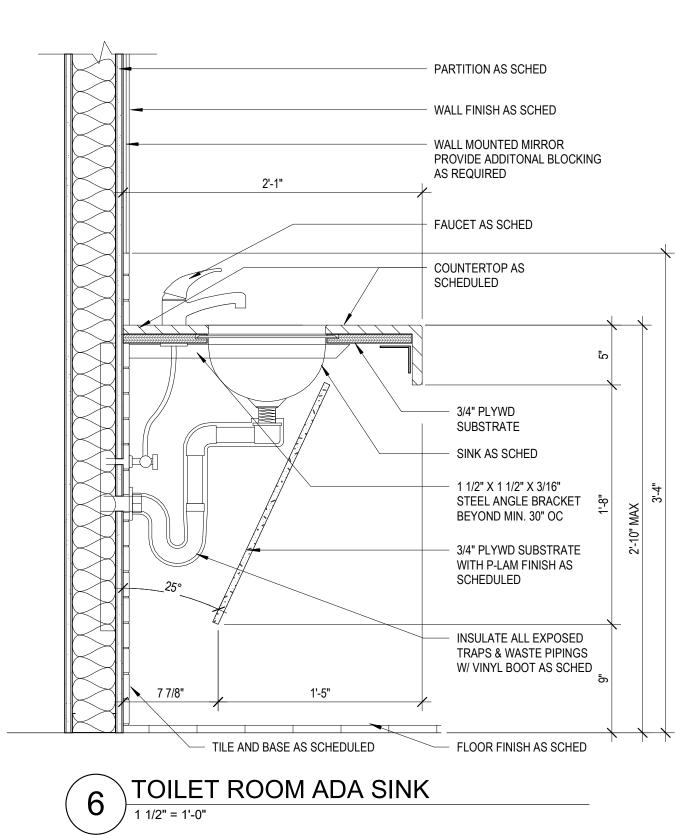
TRASH BASE CABINET & UPPER CABINET





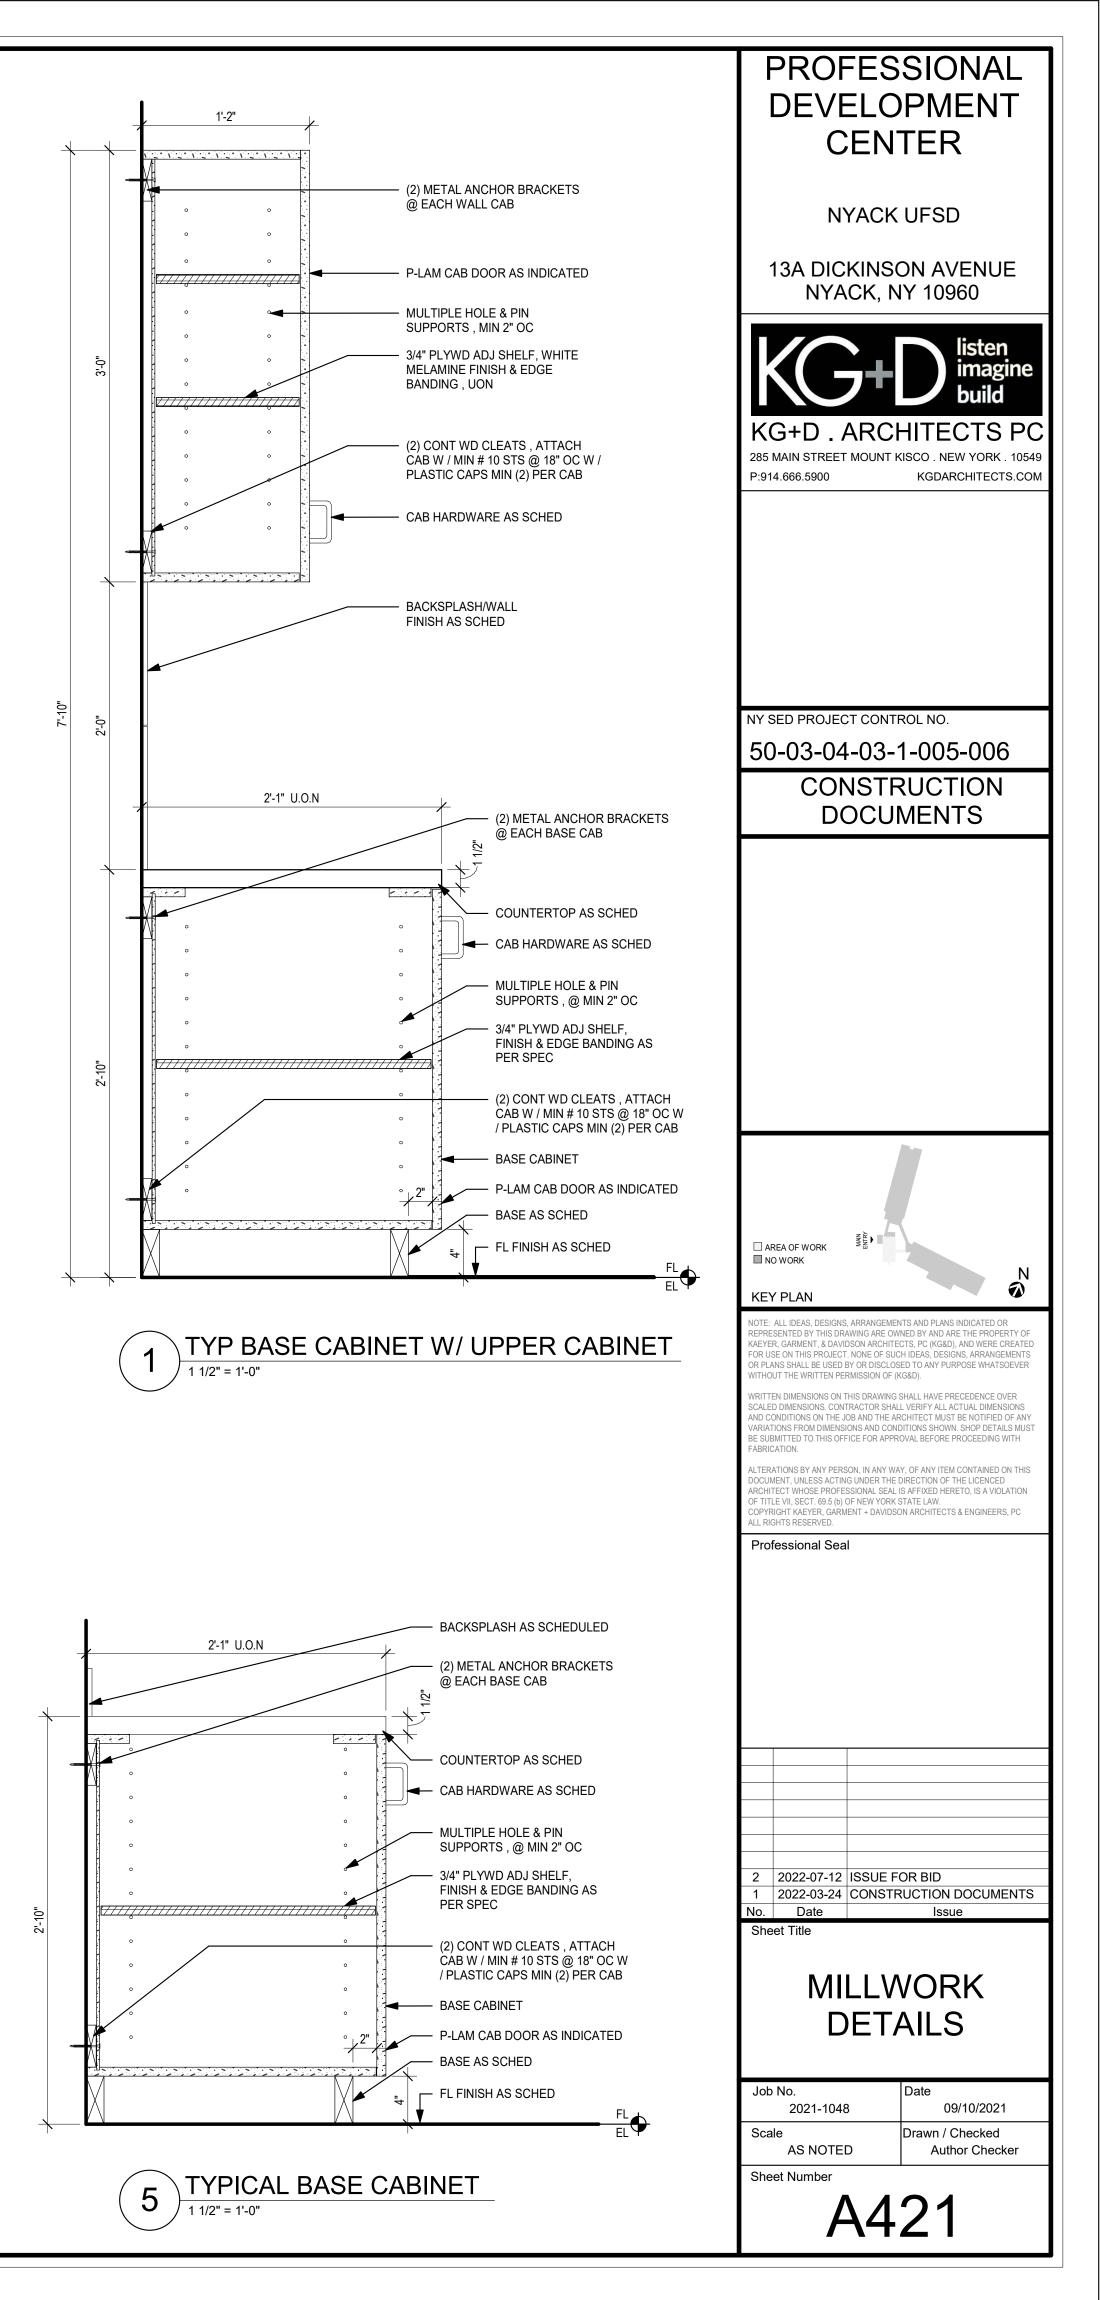


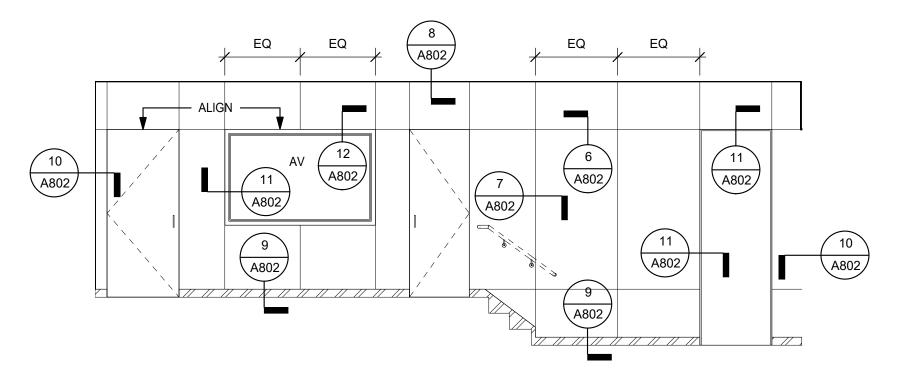

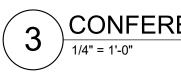

3 CONFERENCE WALL PANEL ELEVATION

						F	inish S	0
		FLC	DOR	NORT	H WALL	EAS	Г WALL	
ROOM #	ROOM NAME	FIN	BASE	MAT	FIN	MAT	FIN	
101	LOBBY	PT1 thru PT4	WRB	GWB/EX	PTD	CB/EX	WDP	1
102	CORRIDOR	PT1, PT3	WRB	GWB	PTD	GWB	PTD	
103	Т	PT1	РТВ	СВ	CT @ 36.5" w/ GWB above	СВ	CT @ 36.5" w/ GWB above	(
104	Т	PT1	РТВ	СВ	CT @ 36.5" w/ GWB above	СВ	CT @ 36.5" w/ GWB above	1
105	STOR	VCT 1	RB	GWB/EX	PTD	EXIST	PTD	
106	JAN	CONC	S&S	GWB	PTD	GWB	PTD	Γ
107	VEST	PT1 thru PT4	WRB	GWB	PTD	GWB	PTD	
108	Т	PT1	РТВ	СВ	CT @ 36.5" w/ GWB above	СВ	PT5	1
109	PANTRY	PT2	РТВ	СВ	PT5/PTD	СВ	PT5/PTD	
110A	CONFERENCE ROOM A	CPT	RB/WRB	СВ	WDP	GWB	PTD	[
110B	CONFERENCE ROOM B	CPT	RB	-	-	GWB	PTD	

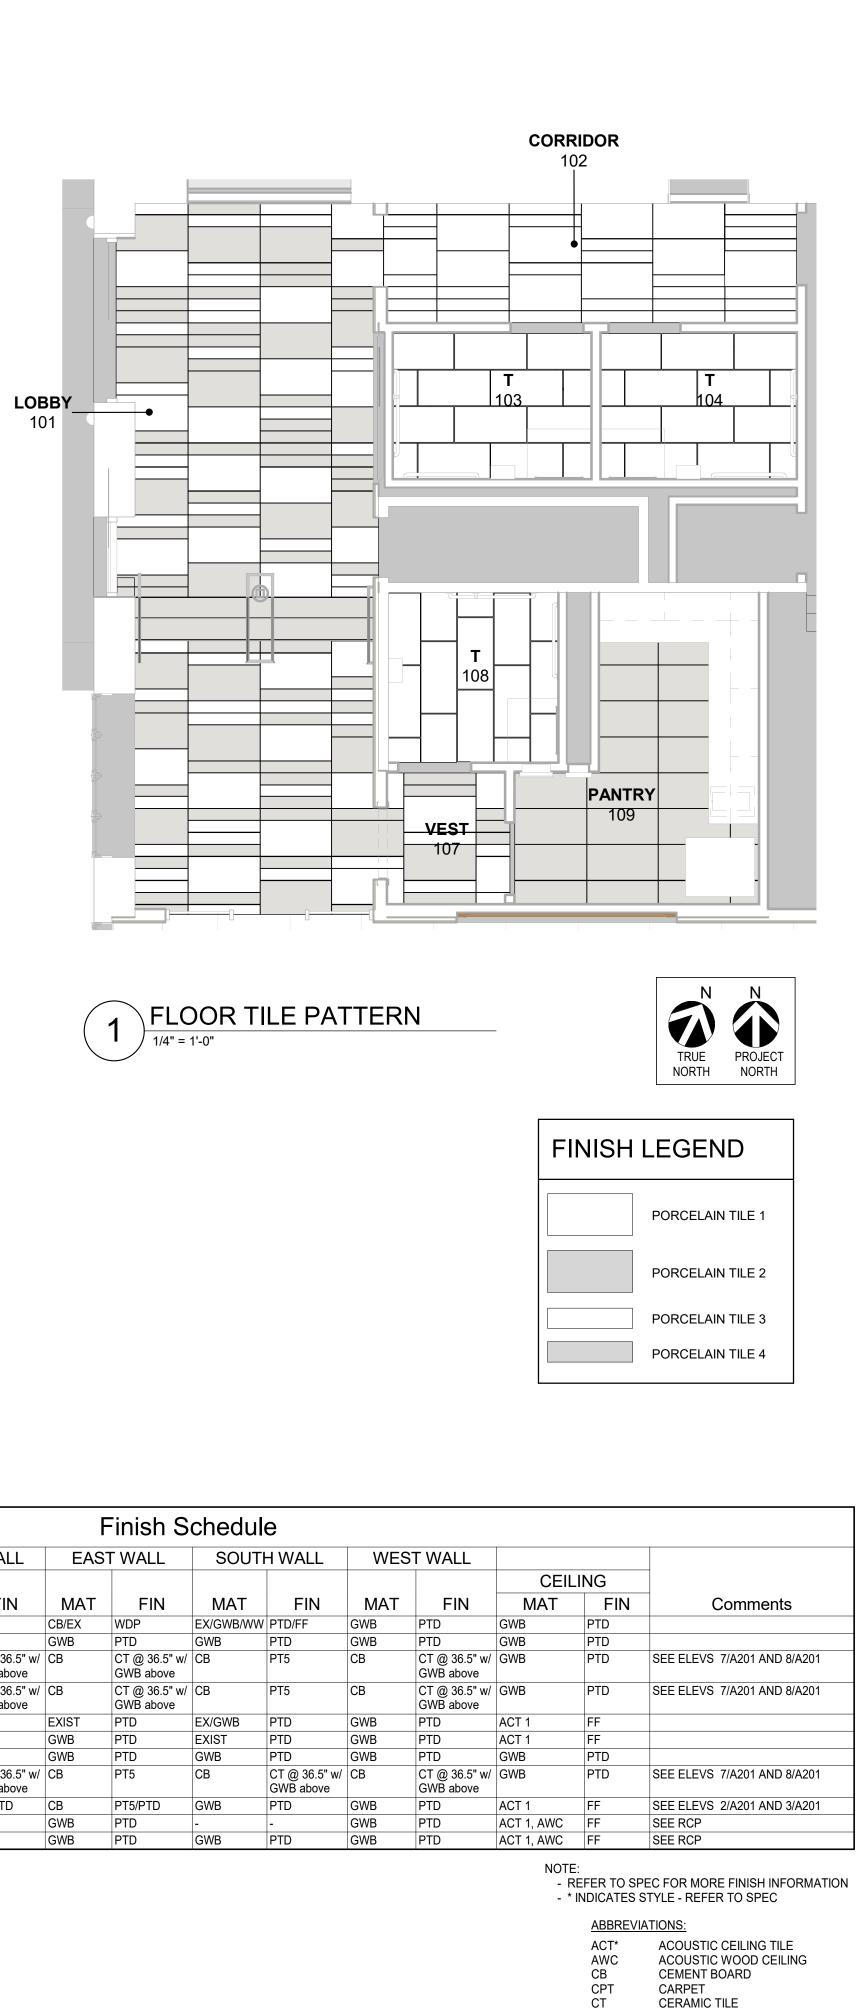

EX/EXIST EXISTING

FF GWB

PT* PTB PTD

RB VCT* WDP WRB

FACTORY FINISH


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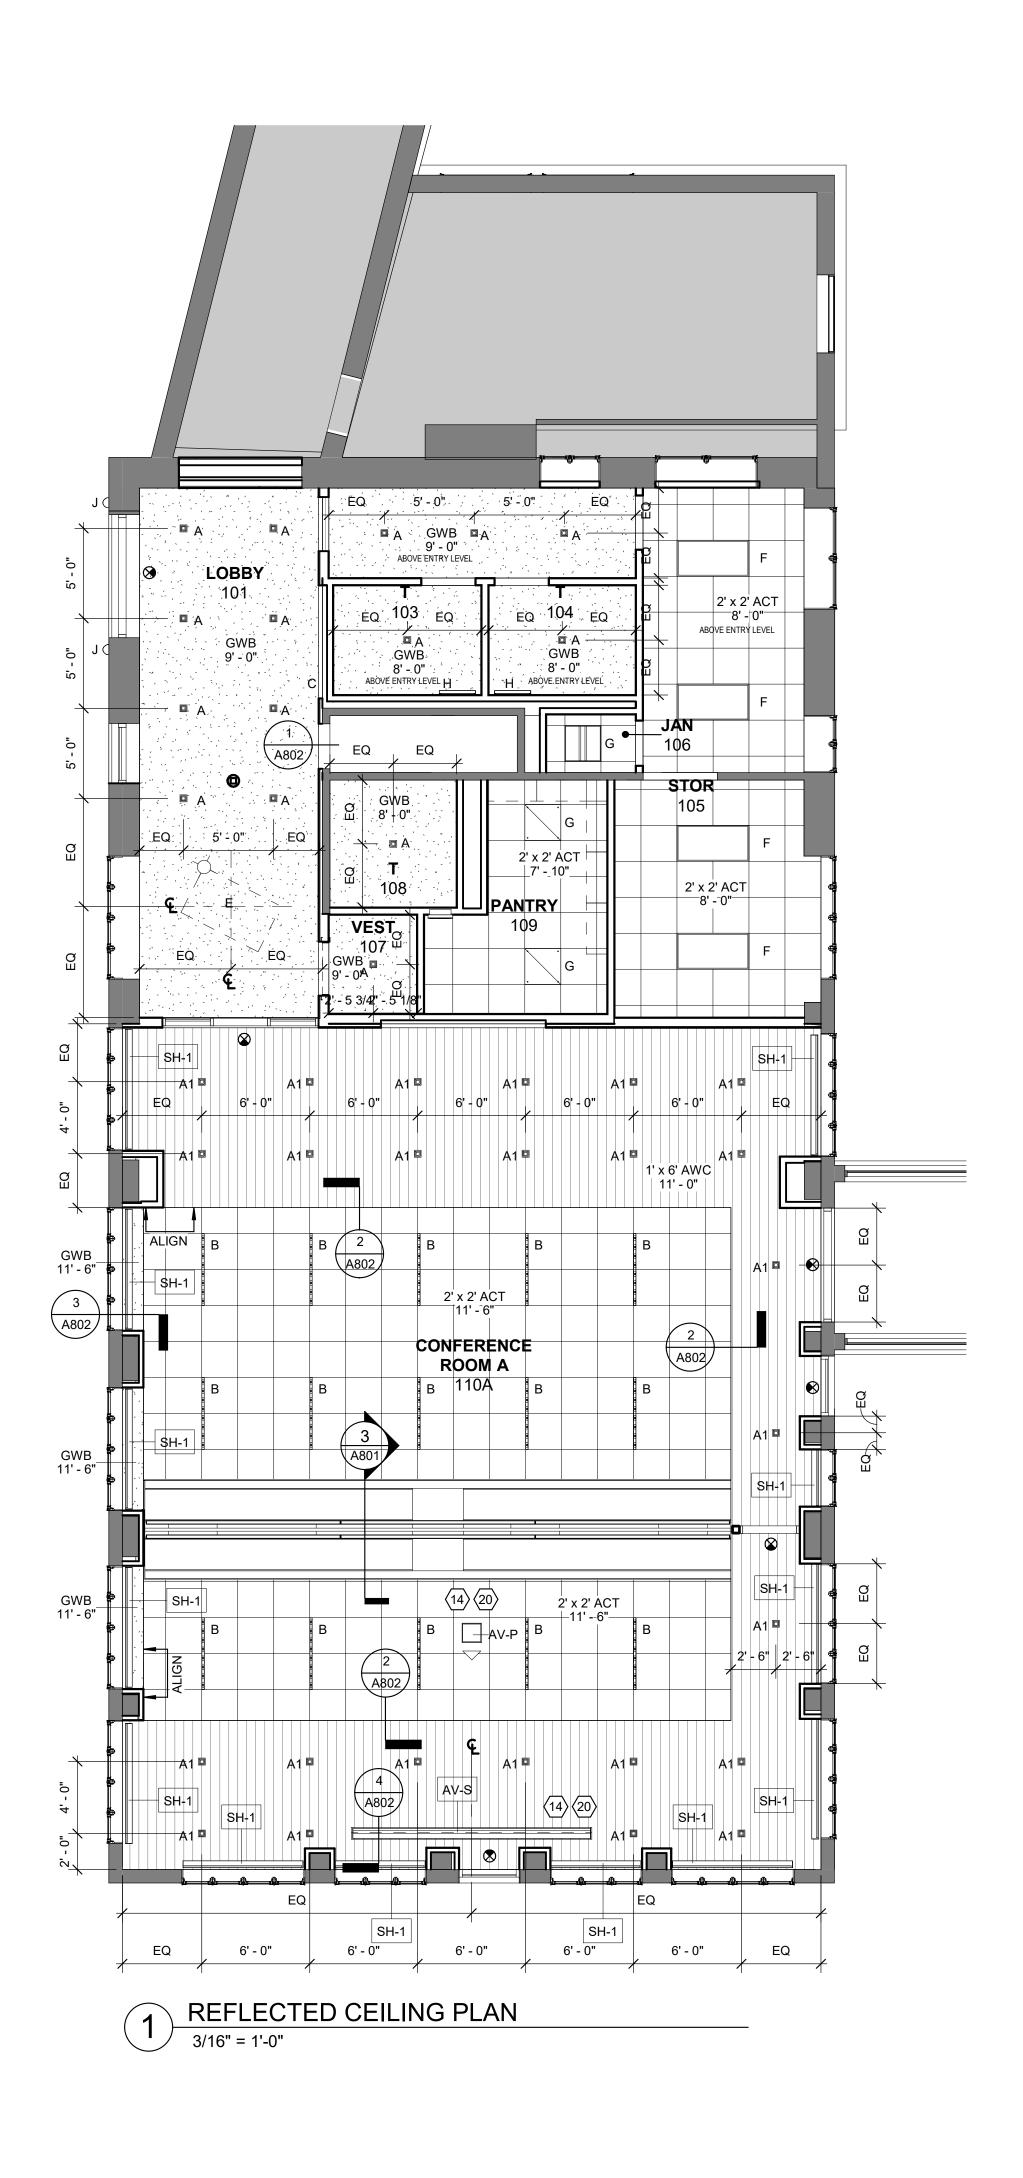
RUBBER BASE


GYPSUM WALLBOARD PORCELAIN TIL PORCELAIN TILE BASE


VINYL COMPOSITE TILE WOOD PANELS WOOD RUBBER BASE


PROFESSIONAL DEVELOPMENT CENTER
NYACK UFSD 13A DICKINSON AVENUE NYACK, NY 10960
KG+D.ARCHITECTS PC 85 MAIN STREET MOUNT KISCO . NEW YORK . 10549 2:914.666.5900 KGDARCHITECTS.COM
Y SED PROJECT CONTROL NO. 50-03-04-03-1-005-006 CONSTRUCTION DOCUMENTS
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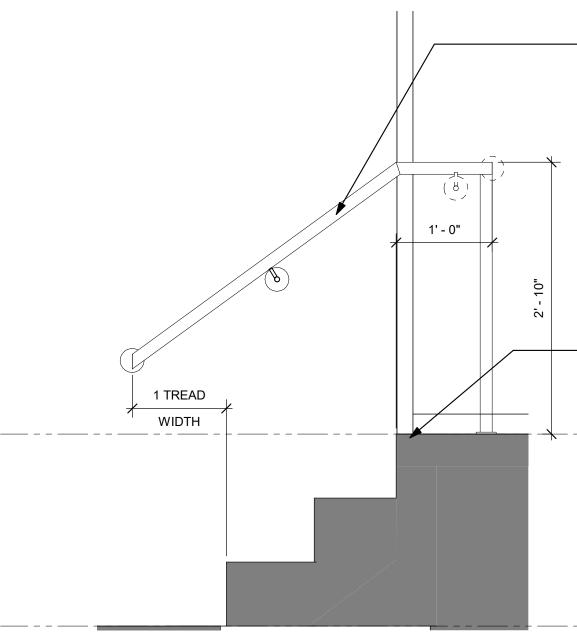




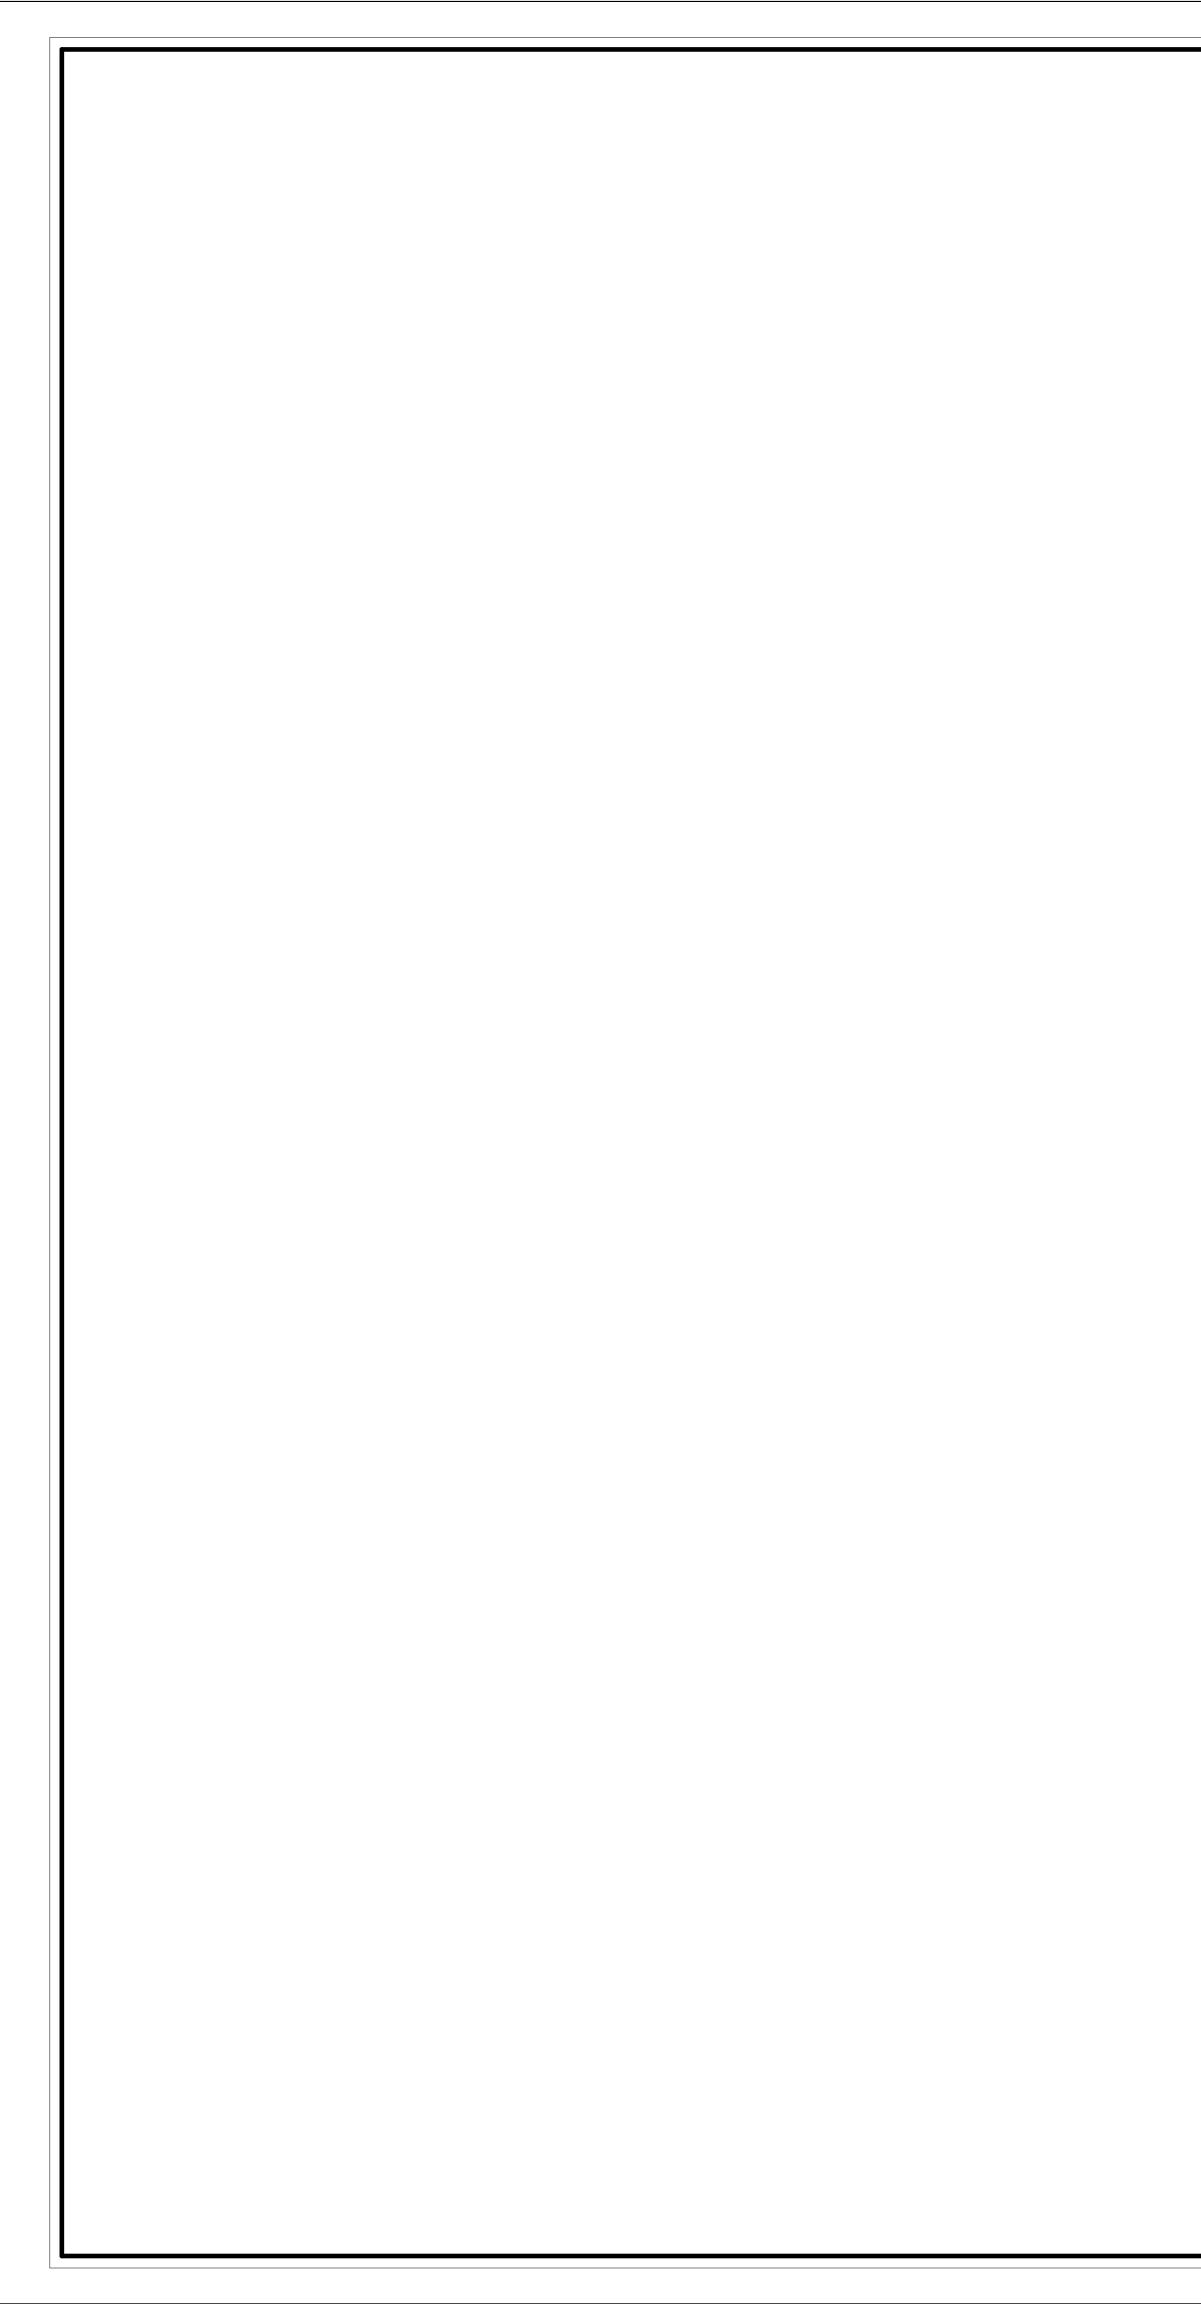


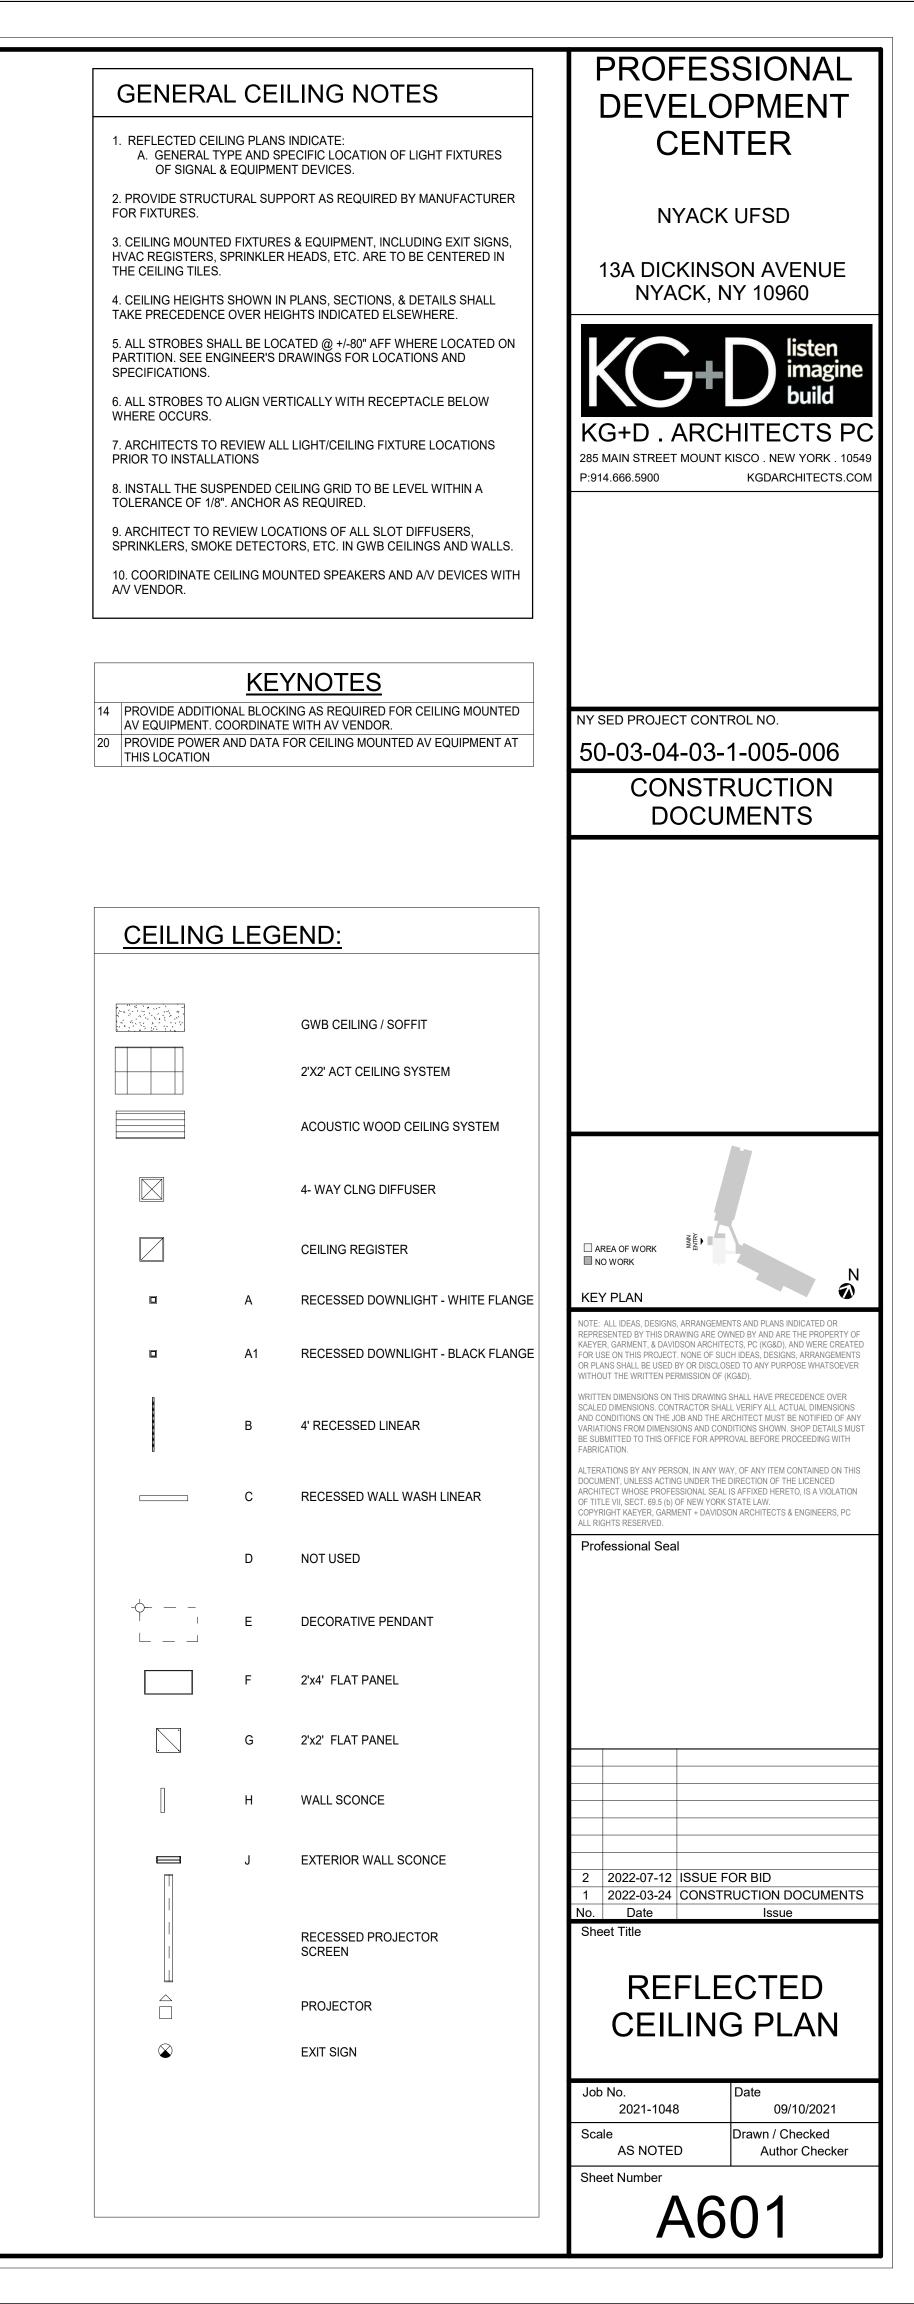


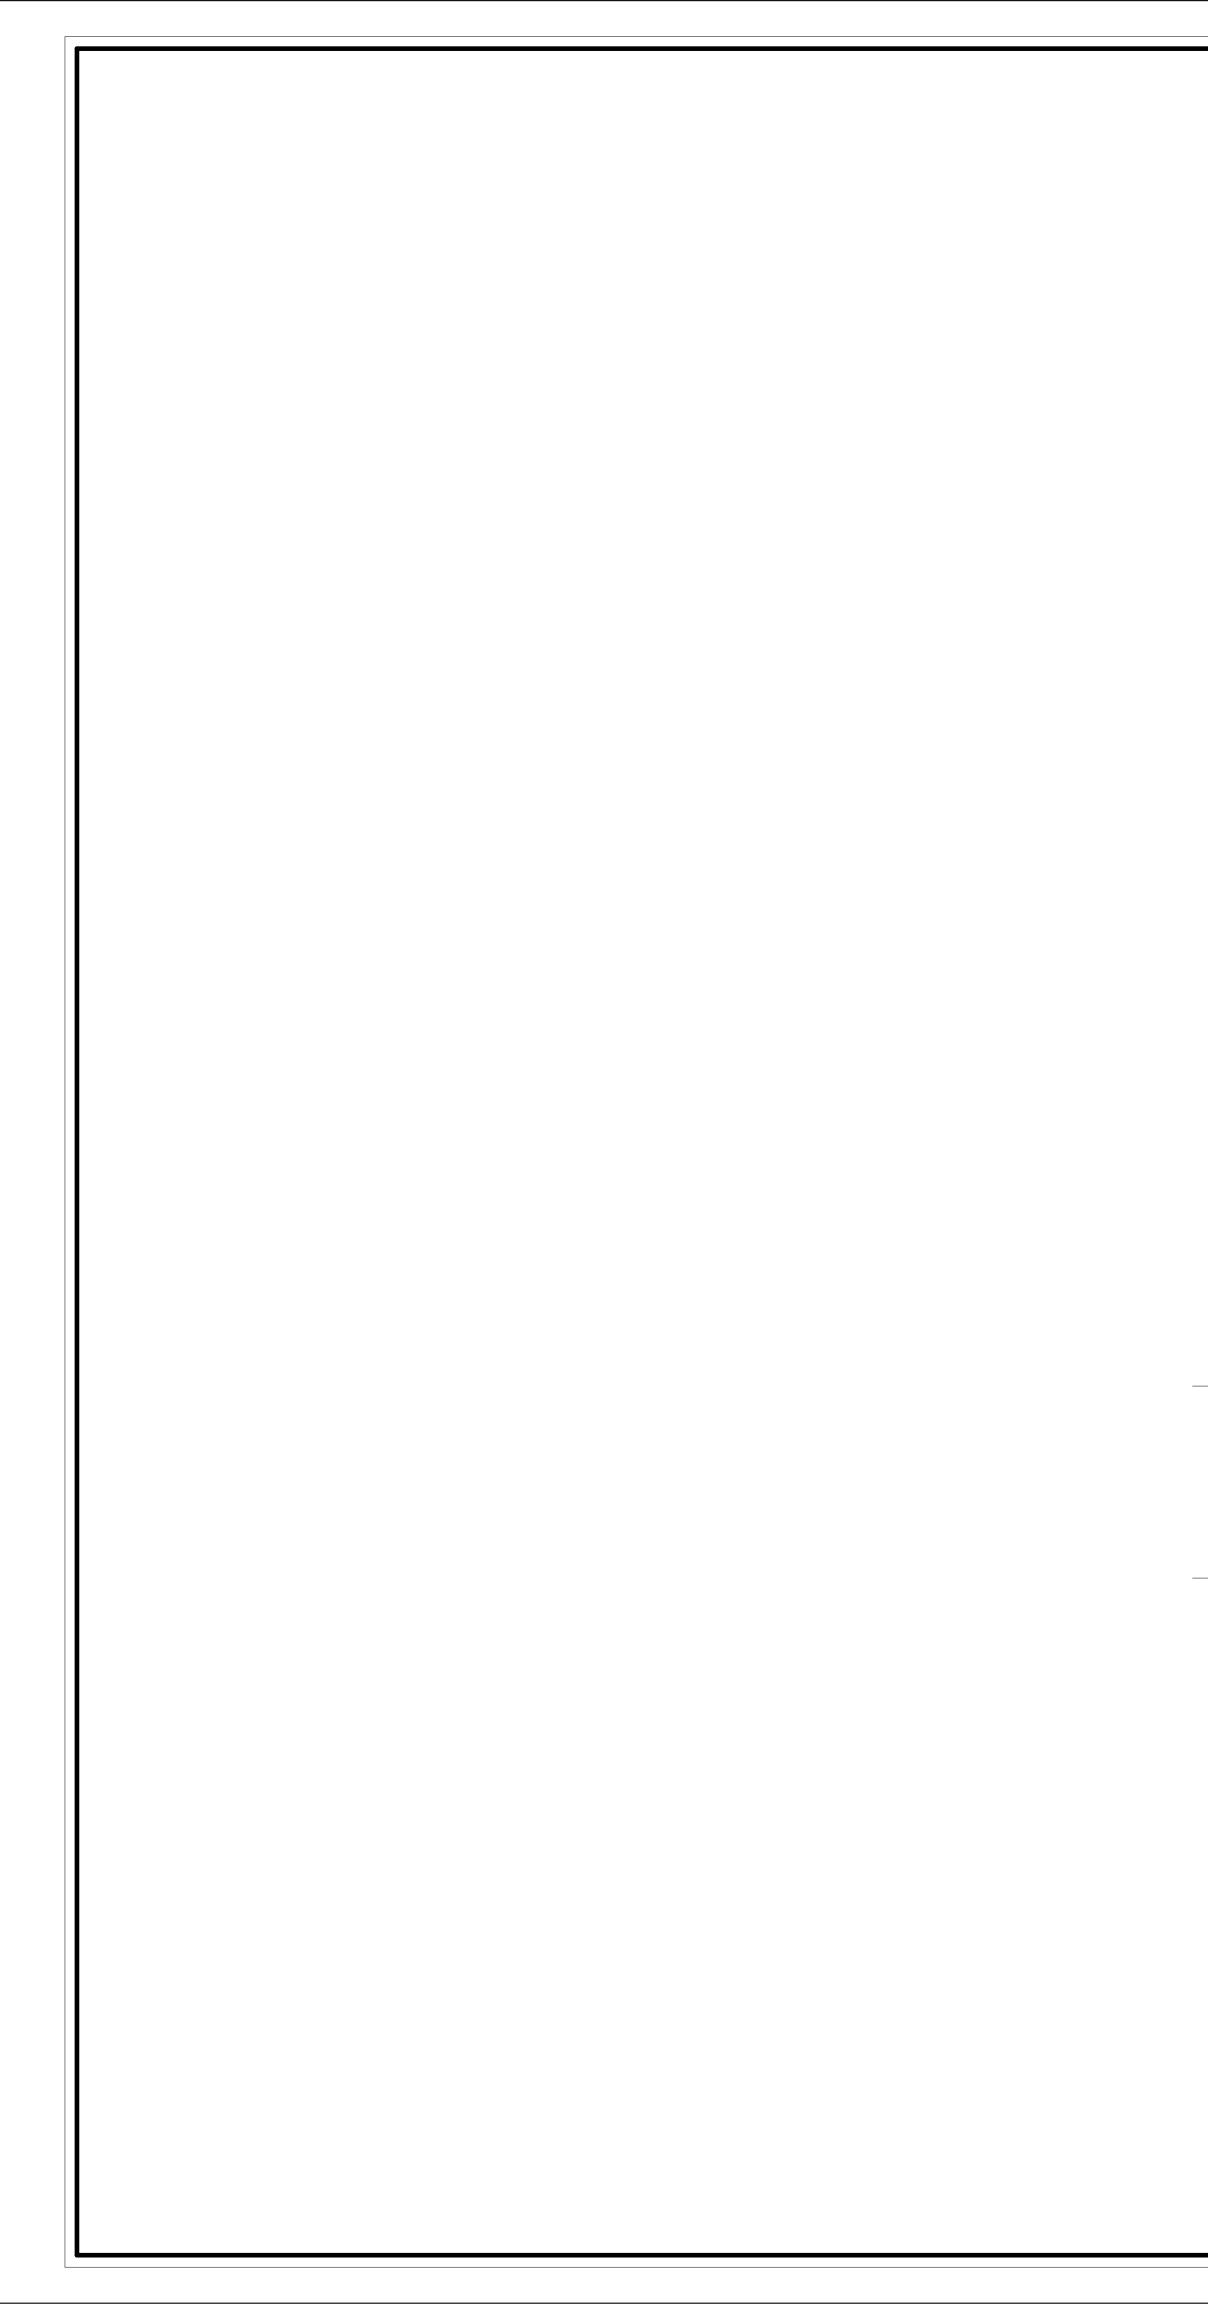

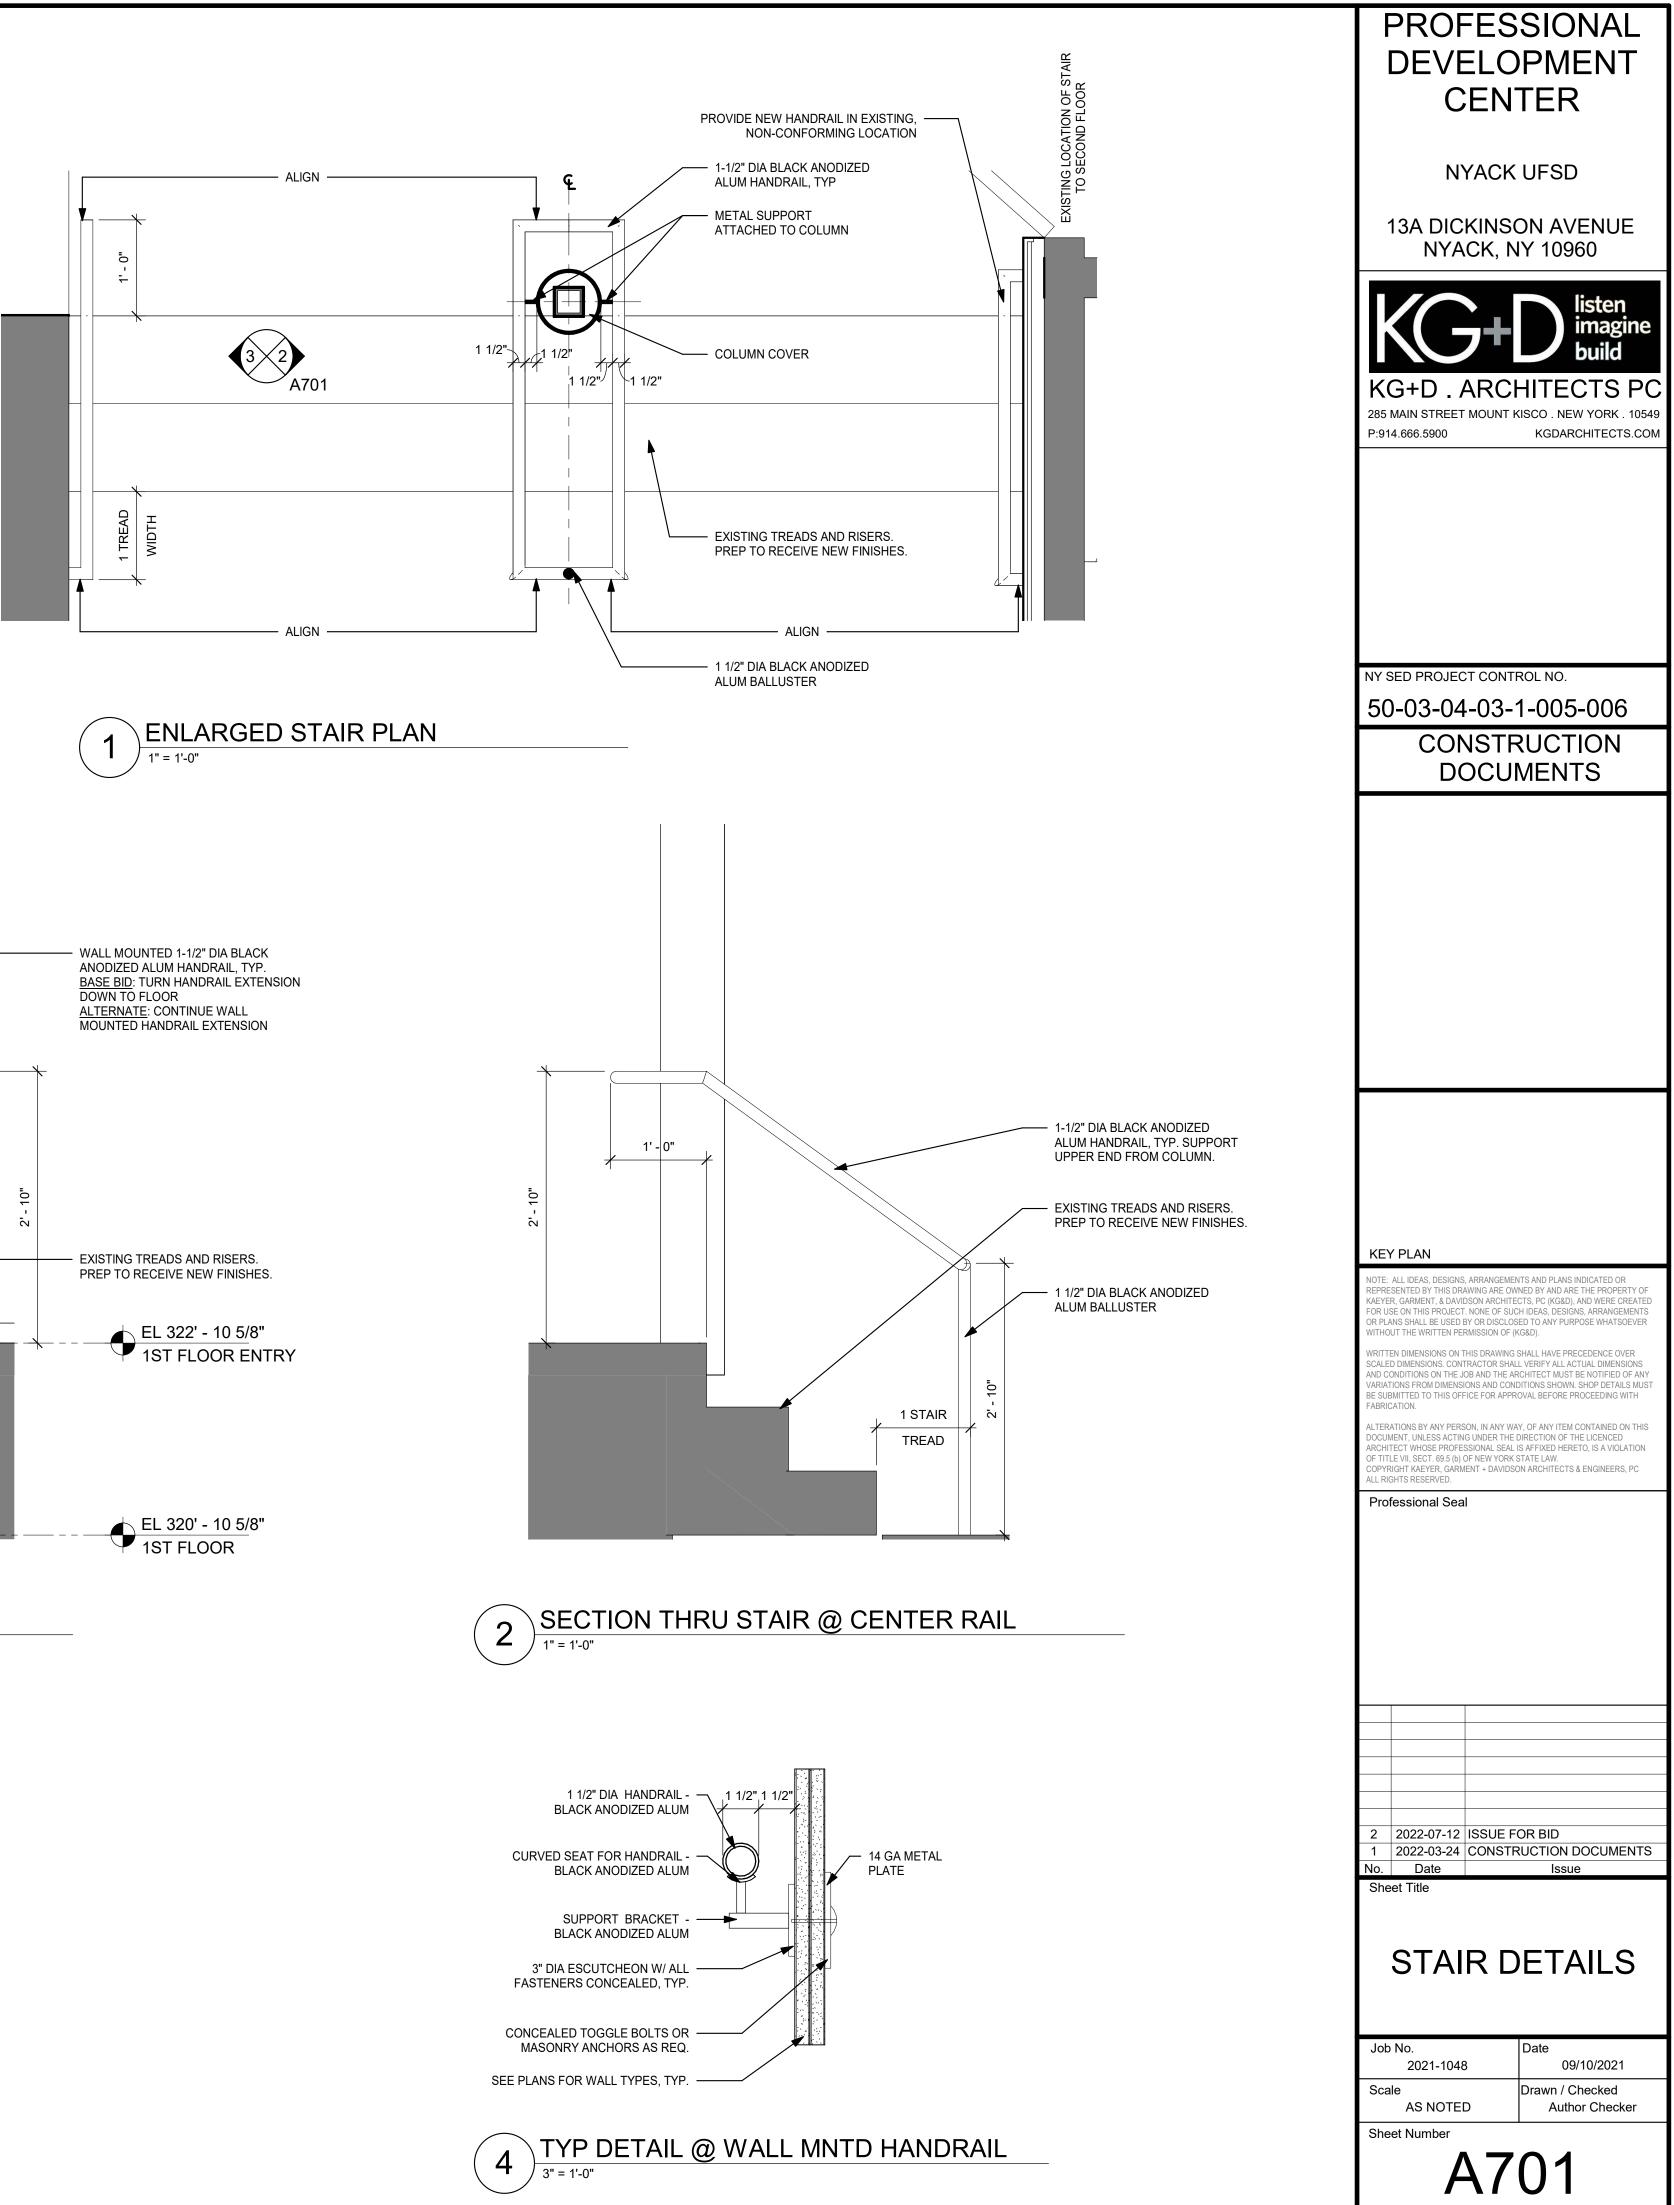


3 SECTION THRU STAIR

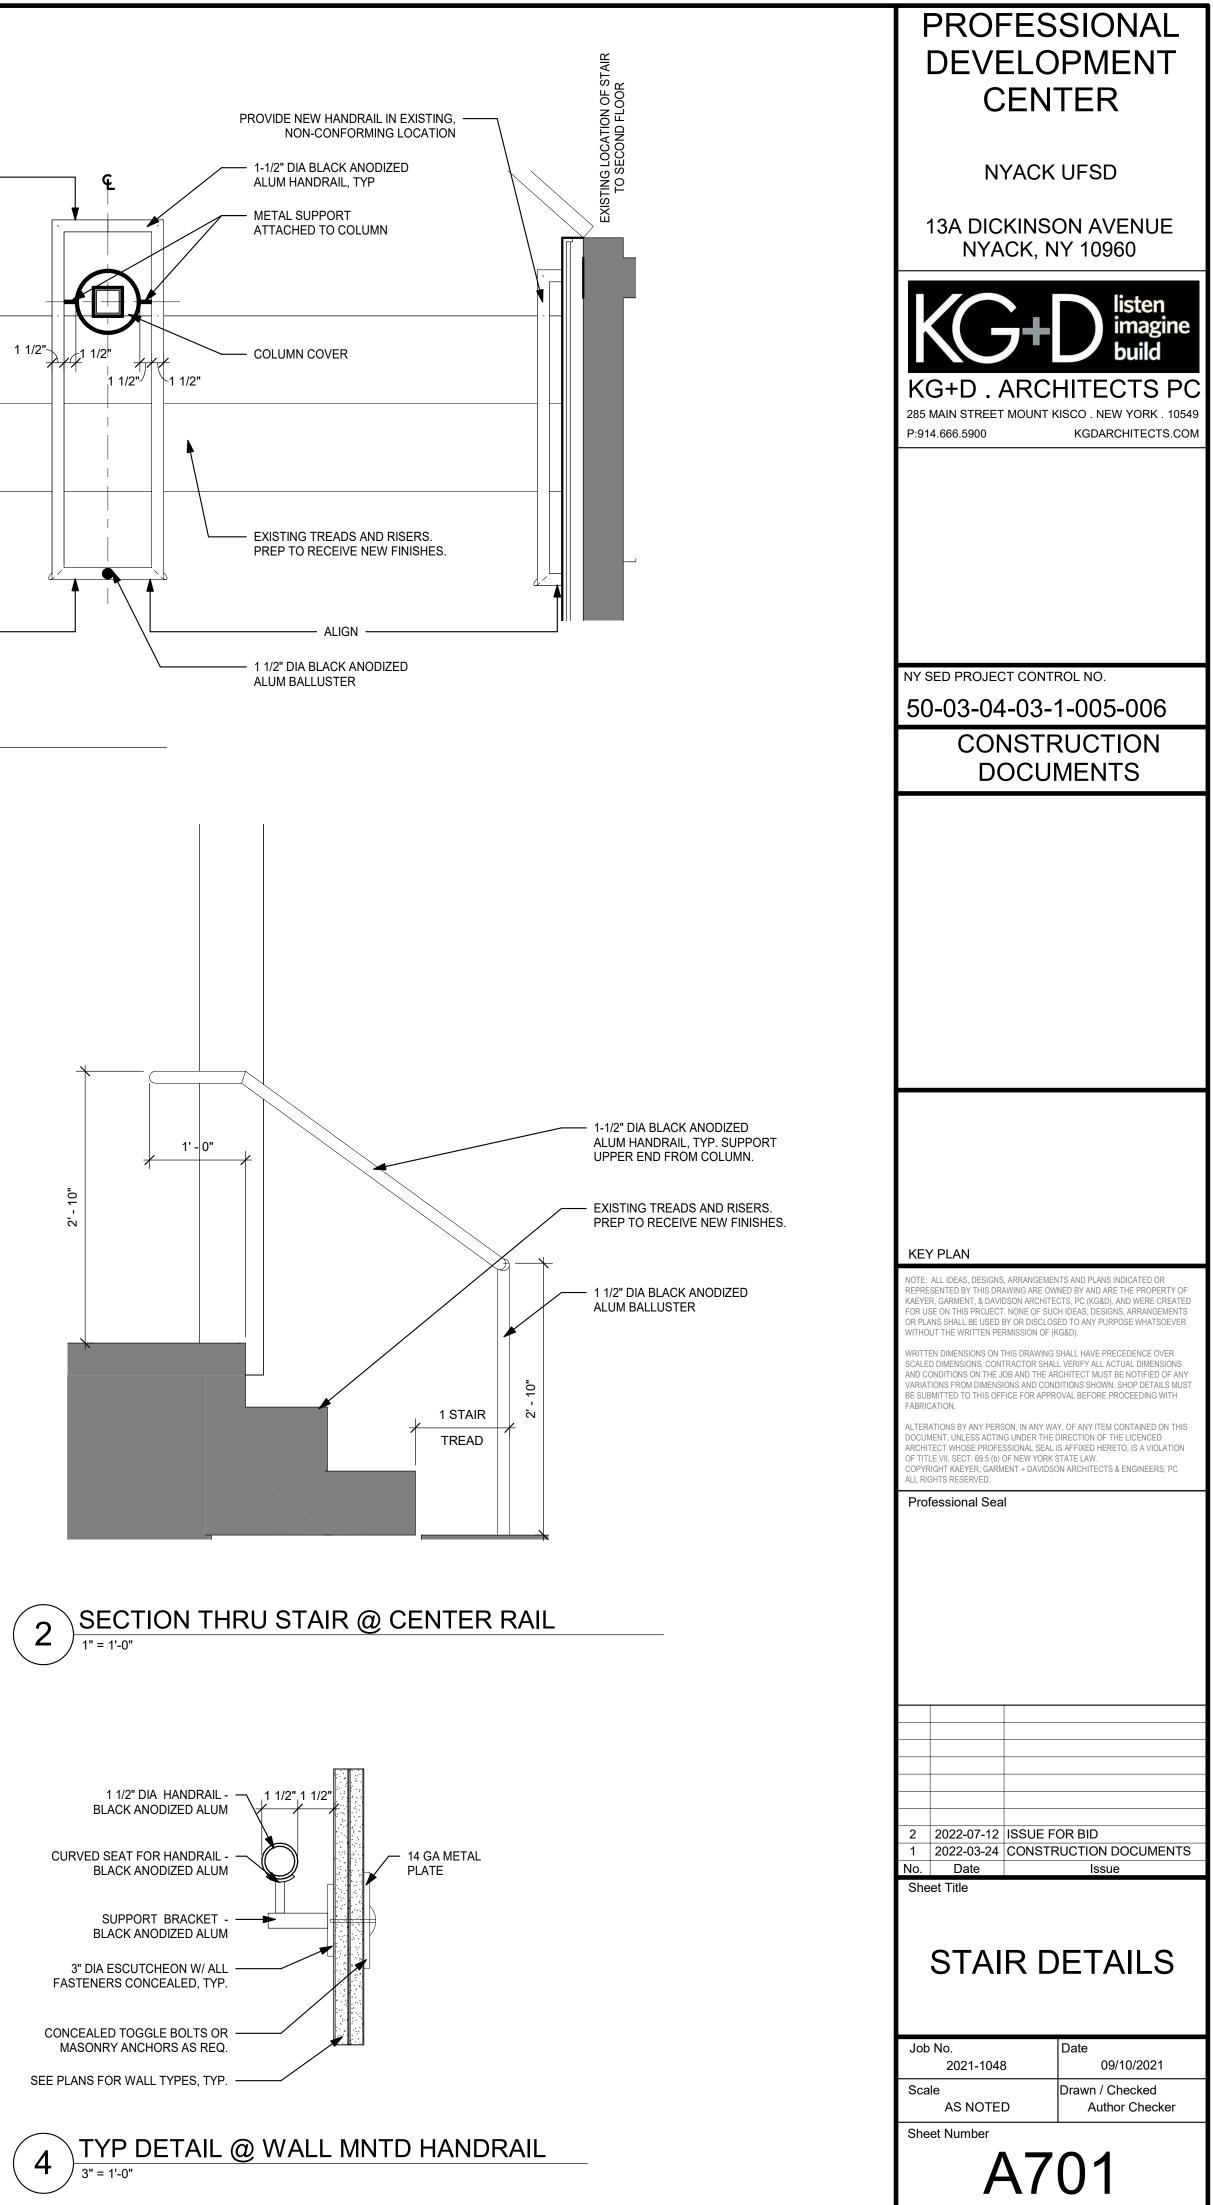


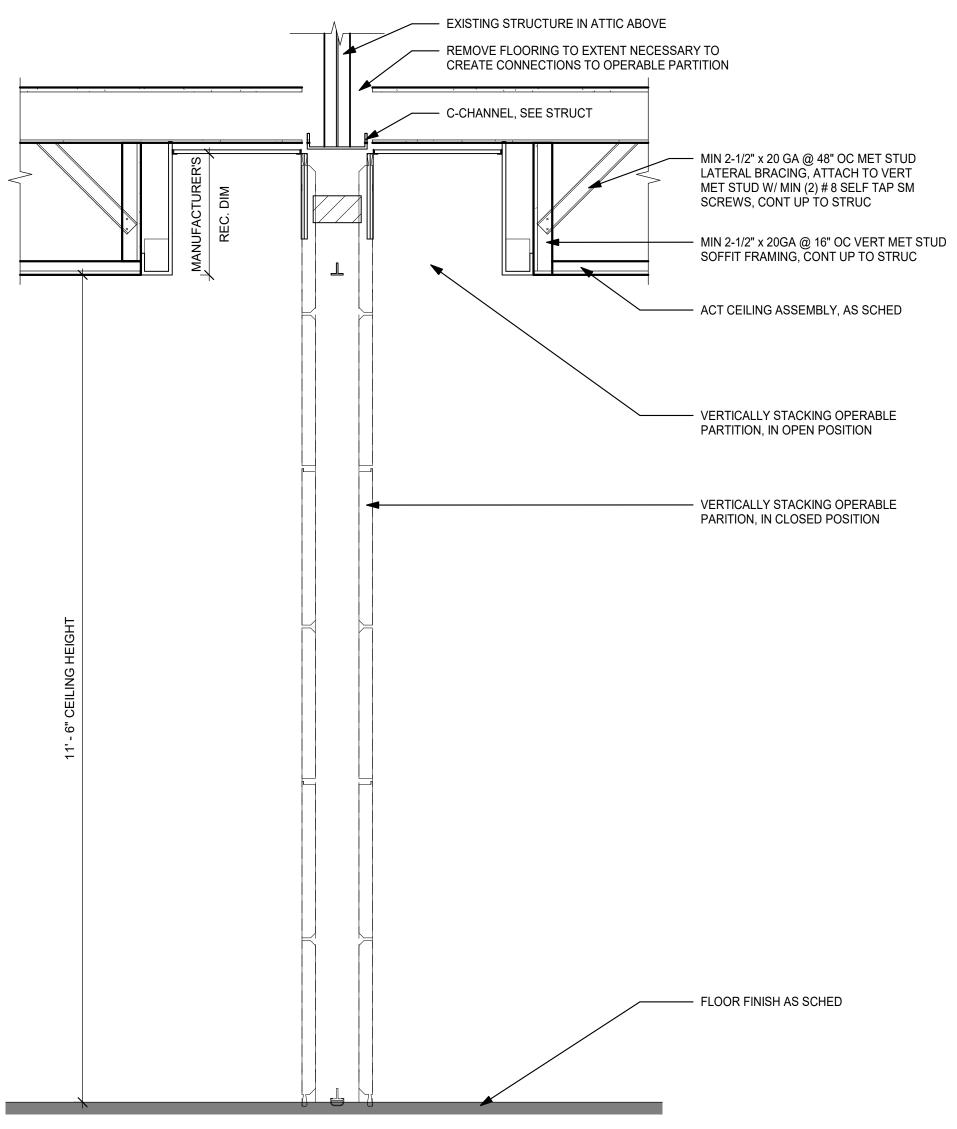



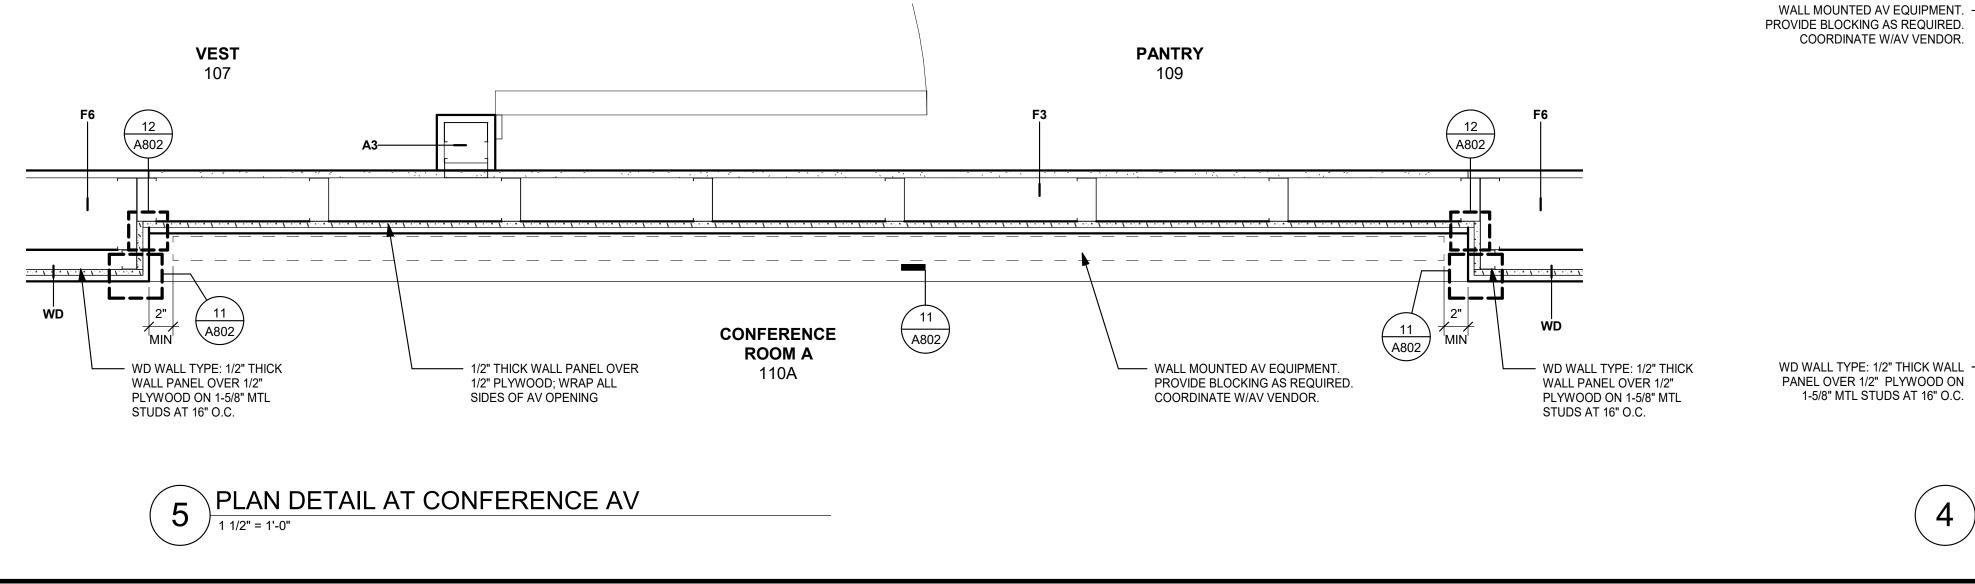


· VERTICALLY STACKING OPERABLE

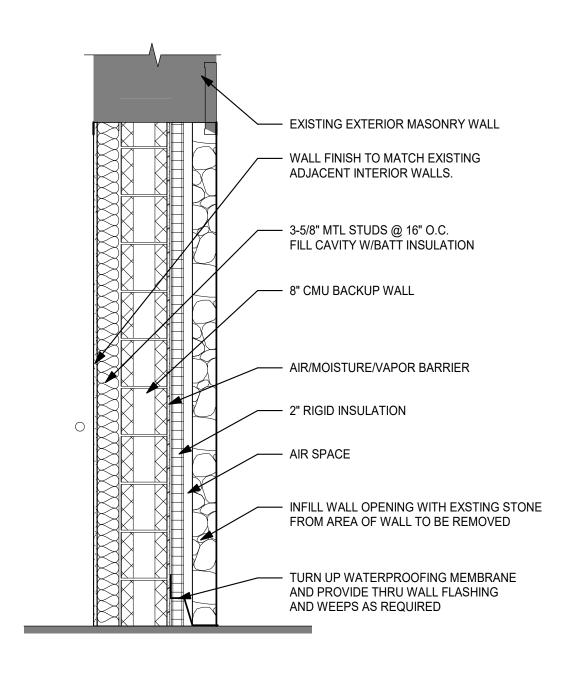




WD WALL TYPE: 1/2" THICK WALL PANEL OVER 1/2" PLYWOOD ON 1-5/8" MTL STUDS AT 16" O.C.

1/2" THICK WALL PANEL OVER 1/2" PLYWOOD; WRAP ALL SIDES OF AV OPENING

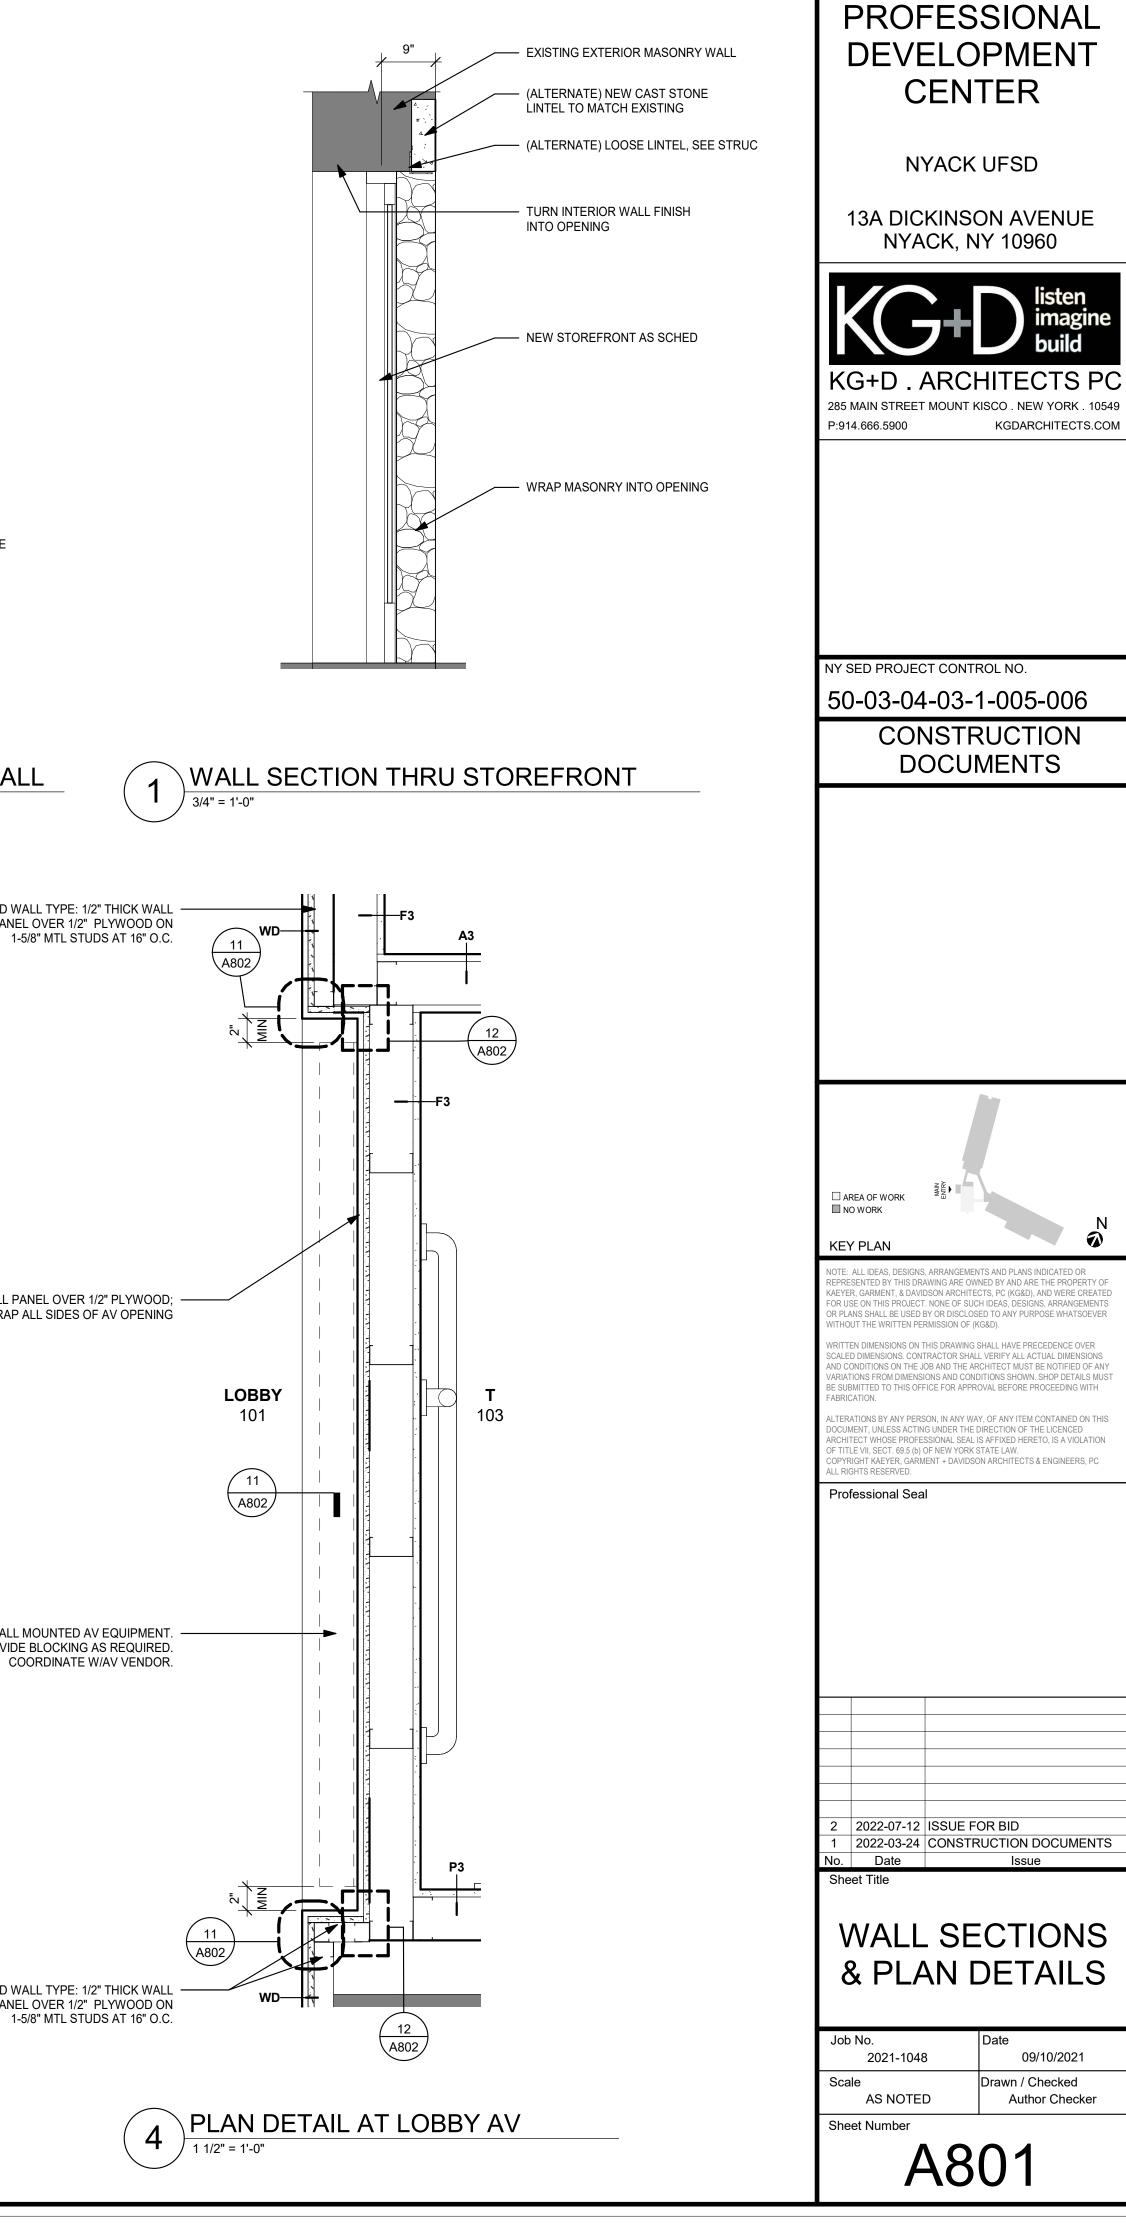


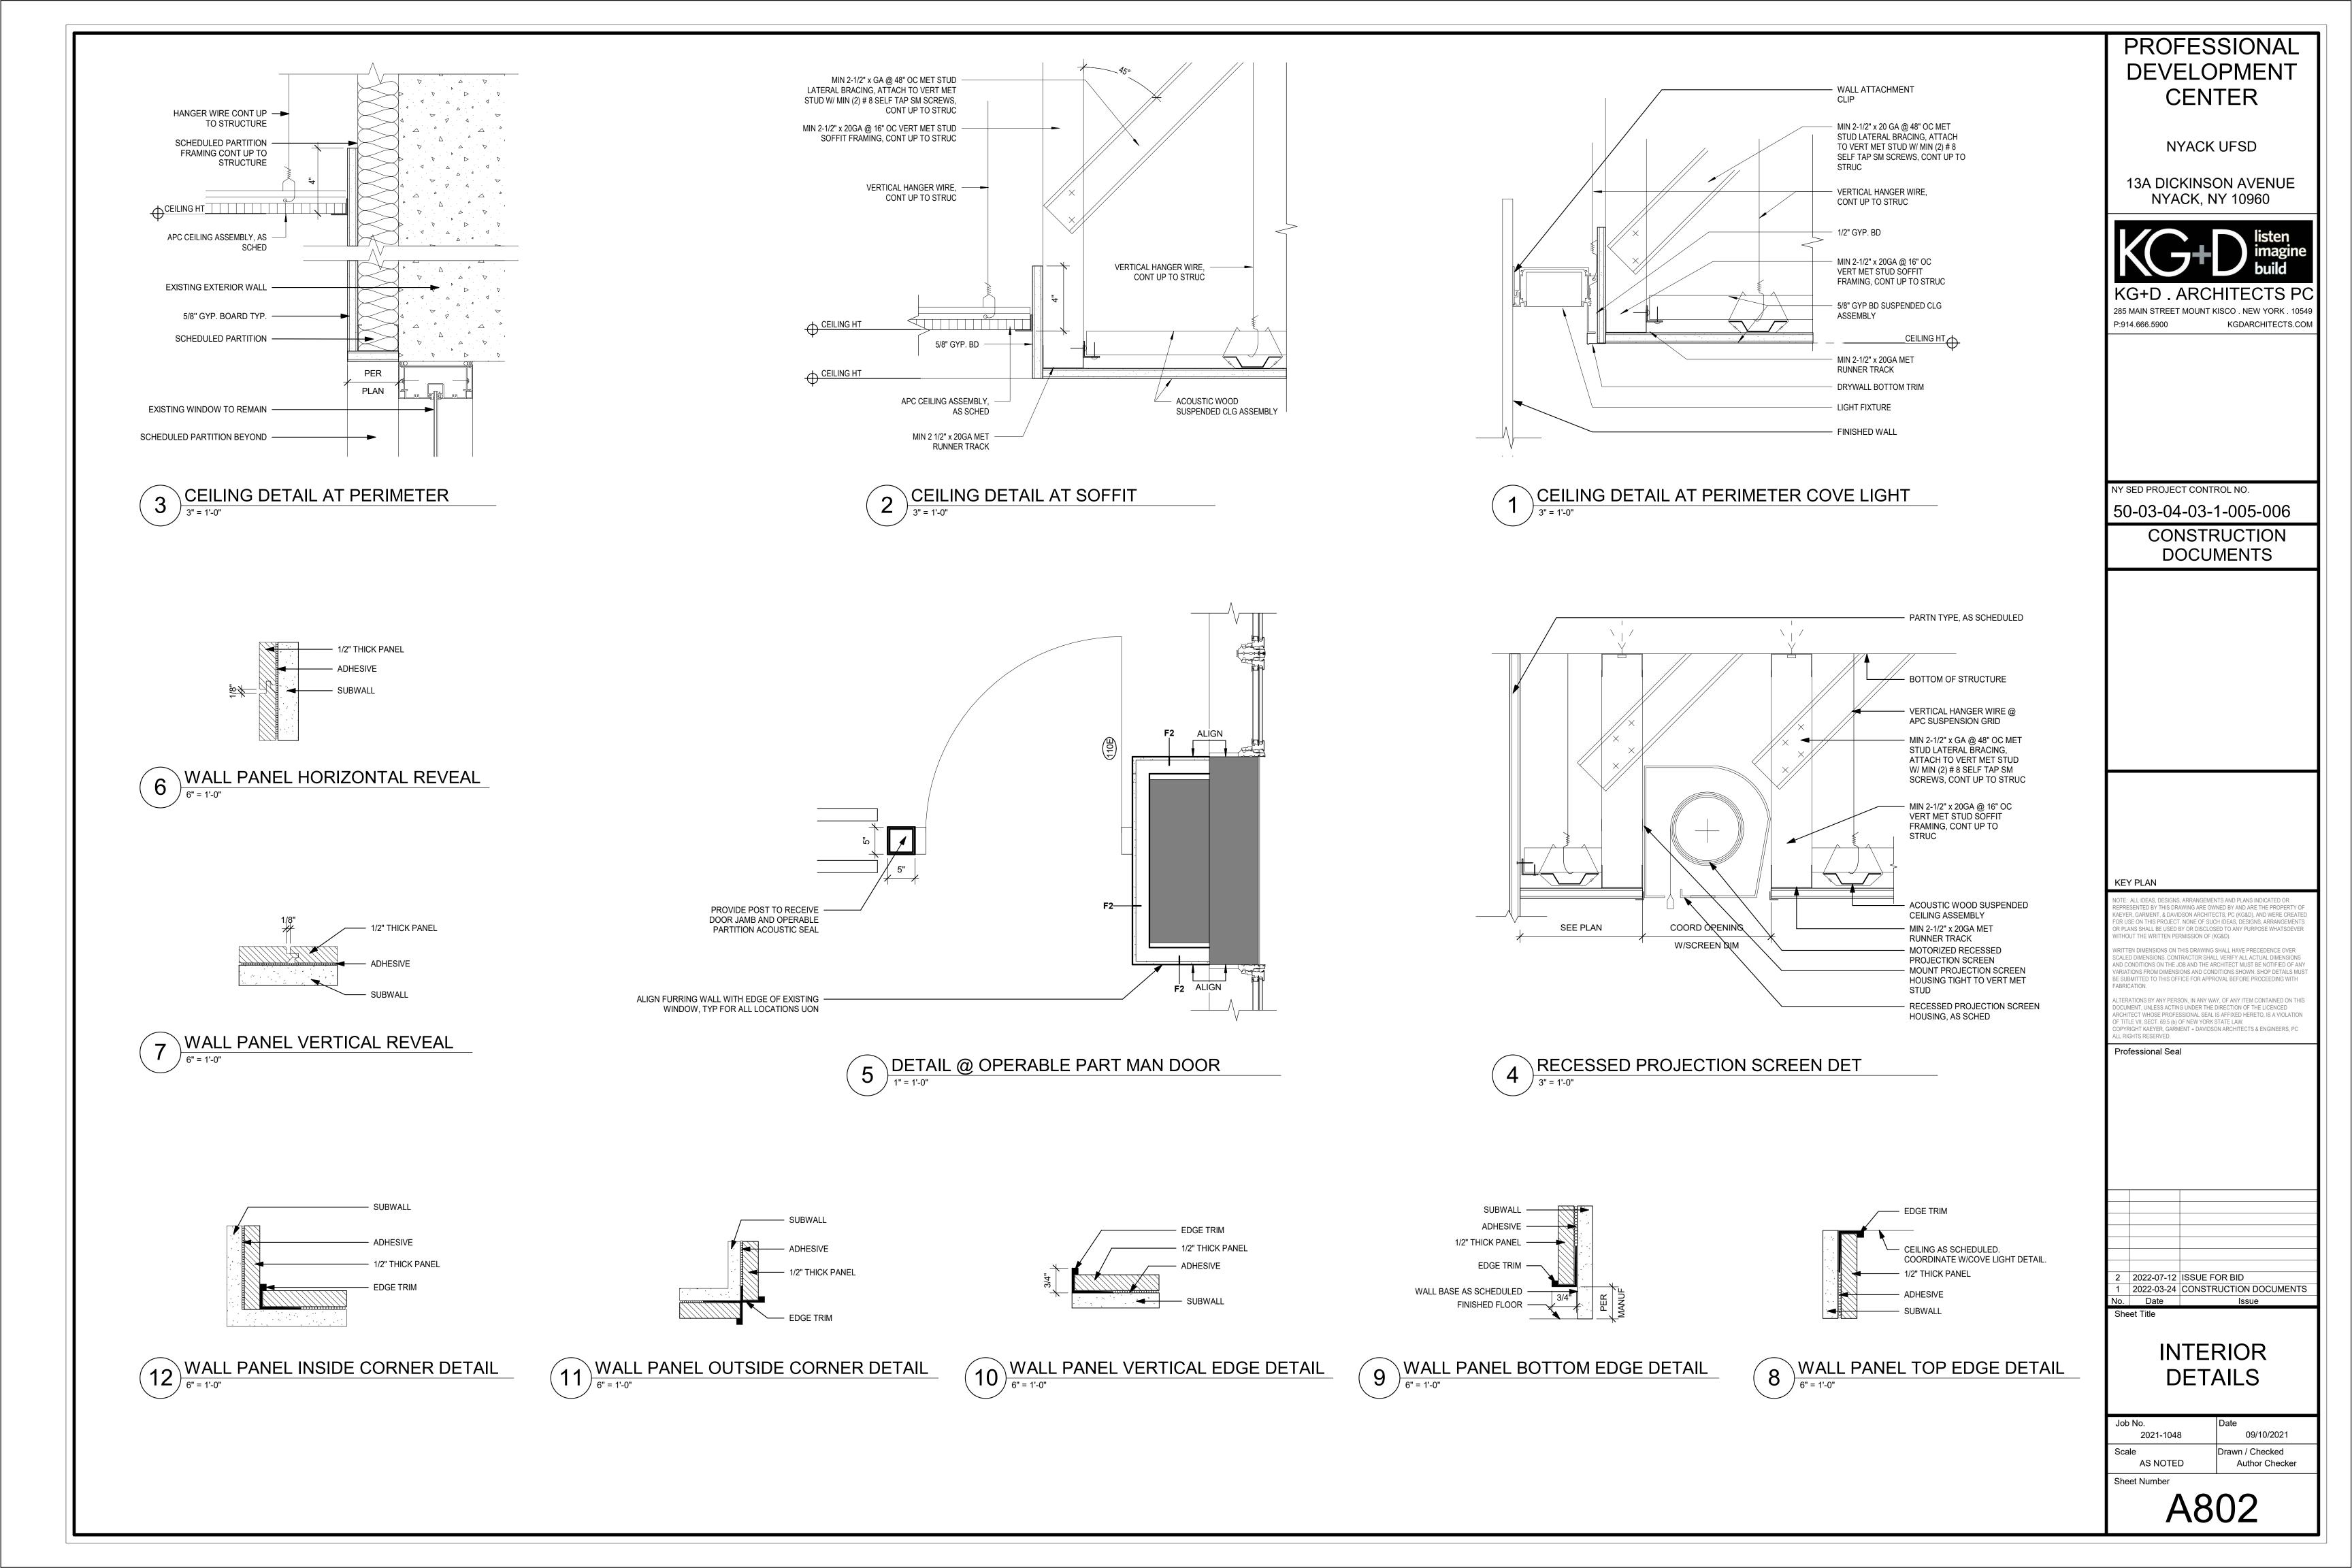

EXTEND PARTITION TO UNDERSIDE OF STRUCTURE CONT. BEAD FIRE RATED CAULK HEAD & SILL OF FINISHED SIDE (2) LAYERS 5/8" TYPE 'X' GYP BD INSTALLED VERTICALLY, STAGGE MIN. INNER LAYER FASTENING: 1" TYPE S SCREWS, 24" O.C. OUTLED LAYER FASTENING: 1 TYPE S SCREWS, 24" O.C.
FINISHED SIDE SIDE SIDE SIDE SIDE SIDE SIDE SI
TYPE 2S2 3 3/4" SILL ENDS, MAX. RUNNER SHALL HAVE UNEQUAL LEGS OF 1" AND 2" WITH SHORTER LEG POSITIONED TOWARDS FINISHED SIDE. TYPE 2S2 3 3/4" 2S4 DENOTES 4" CH STEEL STUDS - 4-5/8" OA WIDTH 2S6 DENOTES 4" CH STEEL STUDS - 6-5/8" OA WIDTH 2SX 2 HR SHAFT PARTITION - UL #U415 - SYSTEM B DESIGN STC = 45 FIELD STC = 38 (MIN)
HEAD-OF-PARTITION TRAPEZOIDAL INSULATION. IN RATED ASSEMBLIES PROVIDE UL RATED MATERIAL TESTED IN ACCORDANCE WITH ASTM E119. RETENTION CLIP REQUIRED WHEN PARTITION IS PERPENDICULAR TO DECK IN RATED ASSEMBLIES PROVIDE SMOKE SEALANT IN ACCORDANCE WITH THE UL ASSEMBLY. CONCRETE SLAB ON METAL DECK TOP DEFLECTION TRACK W/ 3" DOWN TURN
LEGS, DO NOT SECURE GYP BD OR STUD TO TOP TRACK. TRACK GAUGE TO MATCH STUD GAUGE SEE PLANS FOR PARTITION TYPE NOTE: PROVIDE U.L. ASSEMBLY AT ALL RATED PARTITIONS FOR PARTITION TO DECK CLOSURE
TYPICAL PARTITION HEAD DETAIL @ METAL DECK PERPENDICULAR TO DECK

ION HEAD DETAIL @ RPENDICULAR TO DECK


DENOTES 4" CH STEEL STUDS - 4-5/8" OA WIDTH DENOTES 4" CH STEEL STUDS - 6-5/8" OA WIDTH

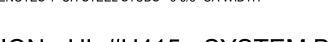

DR, SIDE & CEILING J-RUNNER ATTACHED 24" O.C. MAX, 2" FROM

DS. FASTEN TO J-RUNNER WITH 1 5/8" TYPE S SCREWS, 12" O.C.

I. BEAD FIRE RATED CAULK HEAD & SILL OF FINISHED SIDE AYERS 5/8" TYPE 'X' GYP BD INSTALLED VERTICALLY, STAGGERED 12" INNER LAYER FASTENING: 1" TYPE S SCREWS, 24" O.C. 'LER LAYER FASTENING: 1 5/8" TYPE S SCREWS, 12" O.C.,

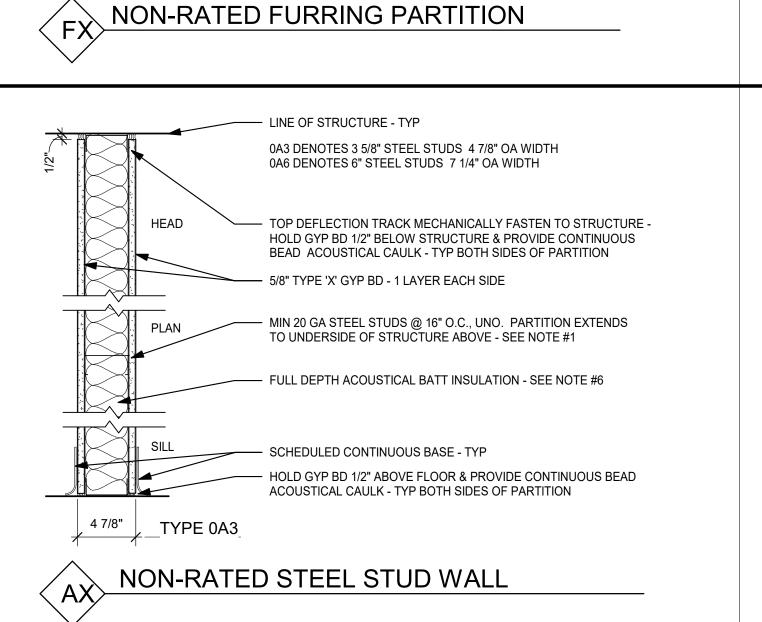

— LINE OF STRUCTURE - TYP

HEAD

PLAN

0P2 DENOTES 1 1/2" STEEL STUDS

0P3 DENOTES 3 5/8" STEEL STUDS

- TOP DEFLECTION TRACK MECHANICALLY FASTEN TO STRUCTURE -HOLD GYP BD 1/2" BELOW STRUCTURE & PROVIDE CONTINUOUS

BEAD ACOUSTICAL CAULK - TYP BOTH SIDES OF PARTITION - TYP

INSULATION - RETAINED W/ 14 GA WIRE INSULATION SUPPORTS

· USE 5/8" THK CEMENTITIOUS BOARD @ TILE FACED PARTITIONS W/ 5/8" TYPE 'X' GYP BD @ NON-TILED AREAS.

MIN 20 GA STEEL STUDS @ 16" O.C., UNO. PARTITION

EXTENDS TO UNDERSIDE OF STRUCTURE ABOVE


· FULL DEPTH (MATCH STUD SIZE) ACOUSTICAL BATT

HOLD GWB & CEMENT BD 1/2" ABOVE FLOOR & PROVIDE

CONTINUOUS BEAD ACOUSTICAL CAULK - TYP BOTH SIDES OF

0P6 DENOTES 6" STEEL STUDS

4 1/4" **A** VARIES * * *

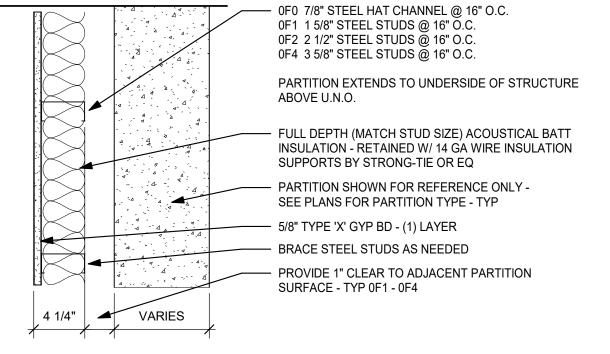

TYPICAL GYP BD CONTROL JOINT A

3 1/8" CL-CL

+

1/2" max[/]

1 7/8" CL

<u>
</u>

- MINERAL WOOL FIRESAFING - TYP FOR RATED PARTITIONS - SEE PLANS FOR PARTITION TYPE & FIRE RATING - VERTICAL CONTROL JOINT @ 30' (MAX) SEE SPECIFICATION FOR COMPLETE INFO

- CONTROL JOINT - TYP BOTH SIDES

- (2) LAYERS 5/8" TYPE 'X' GYP BD

- 4 _____

 \star

VARIES - SEE PLANS

DESIGN STC = 55 FIELD STC = 51 (MIN)

PARTITION


BY STRONG-TIE OR EQ


NON-RATED CAVITY PARTITION - PLUMBING, ETC. Γ ΡΧ


		PROFESSIONAL
VARIES	FOR CORRIDOR & INTERIOR WALLS IN RENOVATED SPACES	DEVELOPMENT
	OR FOR WALLS IDENTIFIES W/ 'EX' TAG, THE G.C. SHALL: CONFIRM EXTENT TO UNDERSIDE OF STRUCTURE ABOVE. GC TO NOTIFY ARCHITECT OF ANY DEFICIENCIES IN WALL CONSTRUCTION THAT DO NOT MEET THE REQUIRED HOURLY FIRE RATING OF WALL	CENTER
	IT IS THE DESIGN INTENTION THAT EXISTING MASONRY WALLS IN RENOVATED AREAS, ONCE CONFIRMED, SHALL BE CONSIDERED TO HAVE 1hr FIRE RATING	
	EXISTING MASONRY OR FRAMED WALL - SIZE VARIES - SEE PLANS & VERIFY IN FIELD	13A DICKINSON AVENUE NYACK, NY 10960
	FORMER EXTERIOR WALLS IN THE EXISTING CLASSROOM BUILDING, WHICH ARE KNOWN TO CONSIST OF 4" BRICK	listen imagine
	VENEER & 6" MASONRY BACKUP (MANY ALSO HAVE AIRSPACE & ANOTHER 4" INNER WYTHE OF MASONRY) SHALL BE CONSIDERED TO HAVE A 2hr FIRE RATING EQUIVALENT TO UL #U906	build KG+D.ARCHITECTS PC 285 MAIN STREET MOUNT KISCO . NEW YORK . 10549 P:914.666.5900 KGDARCHITECTS.COM
EX E	EXISTING MASONRY WALL	
<u>P/</u>	ARTITION TAG NAMING MATRIX	
1st N	NUMBER = FIRE RATING	NY SED PROJECT CONTROL NO.
	0 = NON-RATED PARTITION TYPE 1 = 1 HR FIRE RATED PARTITION TYPE	50-03-04-03-1-005-006
and	2 = 2 HR FIRE RATED PARTITION TYPE	CONSTRUCTION
2na	A = GYPSUM BOARD - BOTH SIDES	DOCUMENTS
	B = CEMENTITIOUS BOARD - 1 OR BOTH SIDES C = ABUSE RESISTANT BOARD - 1 OR BOTH SIDES F = FURRING PARTITION M = MASONRY PARTITION - CMU P = PLUMBING CHASE	
3rd I	S = SHAFT PARTITION NUMBER = PARTITION CORE THICKNESS / WIDTH	
	0 = 7/8" HAT CHANNEL 1 = 1-5/8" STUD	
	2 = 2-1/2" STUD 3 = 3-5/8" STUD OR 4" CMU BLOCK	
	4 = 4" STUD 6 = 6" STUD OR 5-5/8" CMU BLOCK 8 = 8" STUD OR 7-5/8" CMU BLOCK	
	10 = 10" STUD OR 9-5/8" CMU BLOCK 12 = 12" STUD ORT 11-5/8" CMU BLOCK	
1.	PROVIDE DEFLECTION TRACK AT TOP OF ALL PARTITIONS THAT EXTEND TO	KEY PLAN
2.	STRUCTURE ABOVE, (TYPICAL). PROVIDE FIRE-RATED DEFLECTION TRACK SYSTEM AT TOP OF ALL FIRE-RATED PARTITIONS, (TYPICAL). SEE DETAIL H1 ON THIS SHEET. SEE SPECIFICATIONS FOR FOR FIRESTOPPING REQUIREMENTS.	NOTE: ALL IDEAS, DESIGNS, ARRANGEMENTS AND PLANS INDICATED OR REPRESENTED BY THIS DRAWING ARE OWNED BY AND ARE THE PROPERTY OF KAEYER, GARMENT, & DAVIDSON ARCHITECTS, PC (KG&D), AND WERE CREATED FOR USE ON THIS PROJECT. NONE OF SUCH IDEAS, DESIGNS, ARRANGEMENTS OR PLANS SHALL BE USED BY OR DISCLOSED TO ANY PURPOSE WHATSOEVER WITHOUT THE WRITTEN PERMISSION OF (KG&D).
3.	WHERE ACOUSTICAL BATT INSULATION IS USED IN PARTITIONS: SEAL	WRITTEN DIMENSIONS ON THIS DRAWING SHALL HAVE PRECEDENCE OVER SCALED DIMENSIONS. CONTRACTOR SHALL VERIFY ALL ACTUAL DIMENSIONS AND CONDITIONS ON THE JOB AND THE ARCHITECT MUST BE NOTIFIED OF ANY
	AIRTIGHT W/ NON-HARDENING ACOUSTICAL SEALANT AT TOP, BOTTOM & SIDES. PARTITION MOUNTED ELECTRICAL BOXES SHOULD BE OFFSET MIN 24" (NOT BACK TO BACK) W/ PERIMETER OF BOXES SEALED AIR-TIGHT W/	VARIATIONS FROM DIMENSIONS AND CONDITIONS SHOWN. SHOP DETAILS MUST BE SUBMITTED TO THIS OFFICE FOR APPROVAL BEFORE PROCEEDING WITH FABRICATION.
	NON-HARDENING ACOUSTICAL PUTTY PADS. PIPE & DUCT PENETRATIONS SHALL BE SLEEVED, PACKED W/ 10Ib. DENSITY CLOSED CELL FOAM, & SEALED TO PARTITION W/ NON-HARDENING ACOUSTICAL SEALANT. FIRE RATED PARTITIONS TO RECEIVE FIRE RATED PUTTY PADS - TYP	ALTERATIONS BY ANY PERSON, IN ANY WAY, OF ANY ITEM CONTAINED ON THIS DOCUMENT, UNLESS ACTING UNDER THE DIRECTION OF THE LICENCED ARCHITECT WHOSE PROFESSIONAL SEAL IS AFFIXED HERETO, IS A VIOLATION OF TITLE VII, SECT. 69.5 (b) OF NEW YORK STATE LAW. COPYRIGHT KAEYER, GARMENT + DAVIDSON ARCHITECTS & ENGINEERS, PC ALL RIGHTS RESERVED.
4.	PROVIDE 'INSULHOLD' HANGERS OR EQ BATT RETAINING CLIPS HORIZONTALLY @ MAX 48" SPACING PER MFG SPECS IN ALL SINGLE SIDED (GYP BD) FURRING PARTITIONS.	Professional Seal
5.	COORDINATE REQUIRED STUD GAUGE WITH STRUCTURAL DRAWINGS - TYP	
6.	WHEN (2) LAYERS OF TYPE 'X' GYP BD ARE REQUIRED, ONLY OUTER LAYER TO BE 5/8" THK ABUSE RESISTANT TYPE.	
7.	REFER TO SPECIFICATIONS AND MANUFACTURER RECOMMENDATIONS FOR ENVIRONMENTAL CONDITIONS REQUIRED FOR STORAGE AND INSTALLATION OF GYPSUM PARTITION BOARD PRODUCTS. PRODUCTS IMPROPERLY STORED OR INSTALLED WITHOUT INDOOR ENVIRONMENTAL CONTROL MAY BE REJECTED.	
8.	SEE SPECIFICATIONS FOR FINISH REQUIREMENTS OF GYP BD AT WET AREAS. USE TILE BACKER BOARD (CEMENT BOARD) FOR ALL TILED AREAS. GREEN BOARD &/OR BLUE BOARD ARE PROHIBITED FROM USE ON THIS PROJECT.	
9.	ASSEMBLE ALL RATED PARTITION TYPES PER UNDERWRITERS LABORATORY FIRE RESISTANCE RATING REQUIREMENTS.	
10.	METALLIC BOXES LOCATED ON OPPOSITE SIDES OF PARTITIONS OR PARTITIONS SHOULD BE SEPARATED BY A MINIMUM HORIZONTAL DISTANCE OF 24 IN. THIS MINIMUM SEPARATION DISTANCE BETWEEN METALLIC BOXES MAY BE REDUCED WHEN WALL-OPENING PROTECTIVE MATERIALS (CLIV) ARE INSTALLED ACCORDING TO THE REQUIREMENTS OF THEIR CERTIFICATION.	22022-07-12ISSUE FOR BID12022-03-24CONSTRUCTION DOCUMENTSNo.DateIssueSheet Title
11.	METALLED ACCORDING TO THE REQUIREMENTS OF THEIR CERTIFICATION. METALLIC BOXES SHALL NOT BE INSTALLED ON OPPOSITE SIDE OF PARTITIONS OR PARTITIONS OF STAGGERED STUD CONSTRUCTION UNLESS WALL-OPENING PROTECTIVE MATERIALS ARE INSTALLED WITH THE METALLIC BOXES IN ACCORDANCE WITH CERTIFICATION REQUIREMENTS FOR THE PROTECTIVE MATERIALS.	WALL TYPES AND GENERAL NOTES
		Job No. Date 2021-1048 09/10/2021
		Scale Drawn / Checked AS NOTED Author Checker
		Sheet Number
		A901


Door Schedule																
Level	Mark	From Room	From #	To Room	# LEA VES	WI	нт	ELEV	Door Mat	Door Fin	Frame Mat	Frame Fin	Fire Label	Saddle	HDWE SET	Comments
1ST FLOOR ENTRY	101X	LOBBY	101		2	3' - 3"	6' - 8"	G								DOOR IS PART OF ALTERNATE #1
IST FLOOR ENTRY	102	LOBBY	101	CORRIDOR	1	3' - 0"	7' - 0"	F	WD	WD	HM	Р			6.0	DOOR TO BE INTEGRAL TO WOOD FEATURE WALL
1ST FLOOR ENTRY	103	CORRIDOR	102	Т	1	3' - 0"	7' - 0"	F	WD	WD	HM	Р		SL	5.0	
1ST FLOOR ENTRY	104	CORRIDOR	102	Т	1	3' - 0"	7' - 0"	F	WD	WD	HM	Р		SL	5.0	
1ST FLOOR ENTRY	105A	CORRIDOR	102	STOR	1	3' - 0"	7' - 0"	F	HM	PTD	HM	Р			4.0	
1ST FLOOR ENTRY	106	STOR	105	JAN	1	2' - 6"	7' - 0"	F	HM	PTD	HM	Р			4.0	
IST FLOOR ENTRY	S1	LOBBY	101	STAIRS	1	2' - 6"	7' - 0"	F	WD	WD	HM	Р			7.0	DOOR TO BE INTEGRAL TO WOOD FEATURE WALL
IST FLOOR	105B	CONFERENCE ROOM A	110A	STOR	2	3'-0"	7' - 0"	F	WD	WD	HM	Р			3.0	DOOR TO BE INTEGRAL TO WOOD FEATURE WALL
1ST FLOOR	108	VEST	107	Т	1	3' - 0"	7' - 0"	F	HM	PTD	HM	Р		SL	5.0	
1ST FLOOR	109	VEST	107	PANTRY	1	3' - 0"	7' - 0"	F	HM	PTD	HM	Р			6.0	
IST FLOOR	110A	CONFERENCE ROOM A	110A	LOBBY	1	3' - 0"	8' - 10'	' G	AL	FF	AL	FF			2.0	ADD GRADIANT FILM TO GLASS PANEL. SEE SPEC
1ST FLOOR	110B	CONFERENCE ROOM A	110A	CORRIDOR	2	3' - 0"	7' - 0"	FLNG	HM	PTD	HM	Р	90 MIN		1.0	
IST FLOOR	110C	CONFERENCE ROOM A	110A		1	3' - 0"	7' - 0"	ETR	ETR	PTD	ETR	Р			8.0	PAINT EXISTING DOOR AND FRAME. ADD FROSTED FILM TO TRANSOM GLASS.
1ST FLOOR	110D	CONFERENCE ROOM B	110B		1	3' - 0"	7' - 0"	ETR	ETR	PTD	ETR	P			8.0	PAINT EXISTING DOOR AND FRAME. REPLACE SOLID TRANSOM PANEL WITH GLASS AND FROSTED FILM.
IST FLOOR	110E	CONFERENCE ROOM B	110B	CONFERENCE ROOM A	1	3' - 0"	8' - 9"	FG	GL-1	GL-1	AL	FF			9.0	


DOOR TYPES

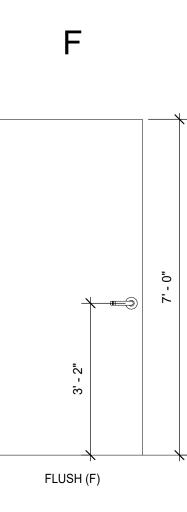


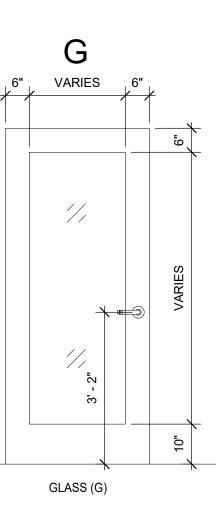

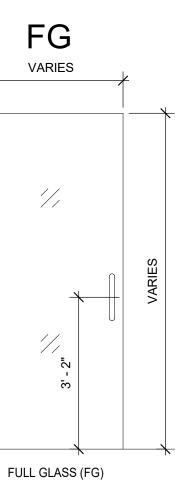

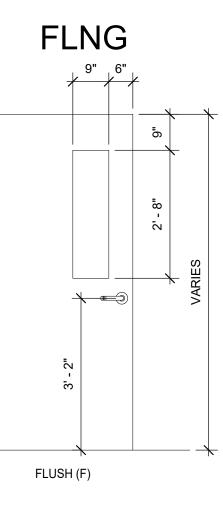

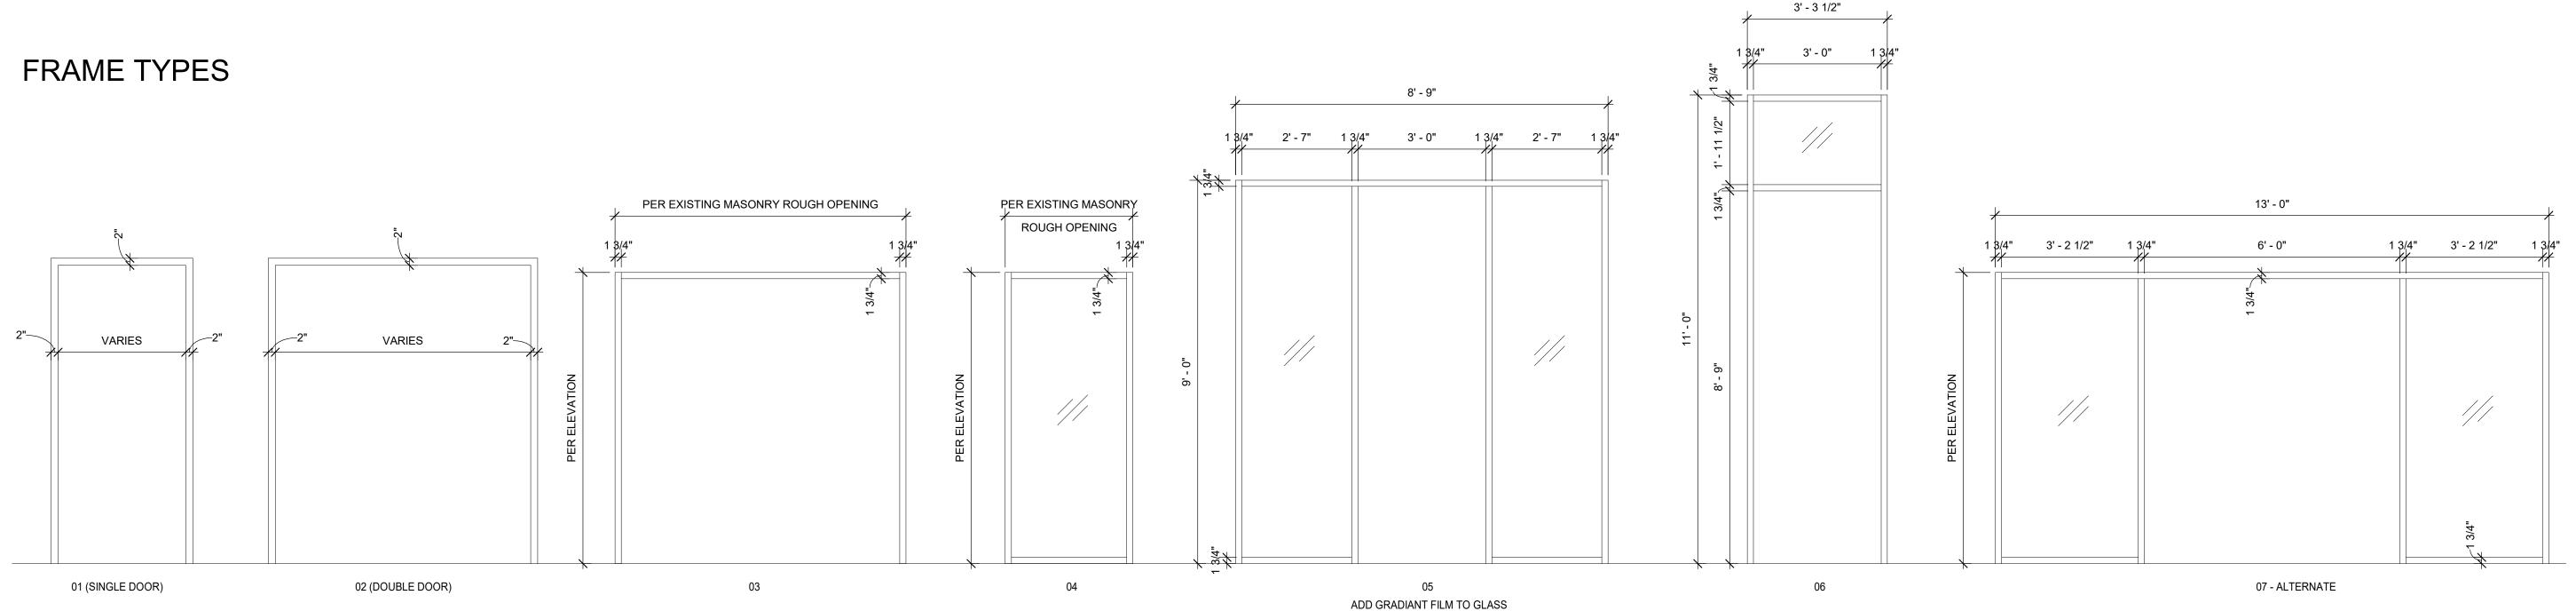

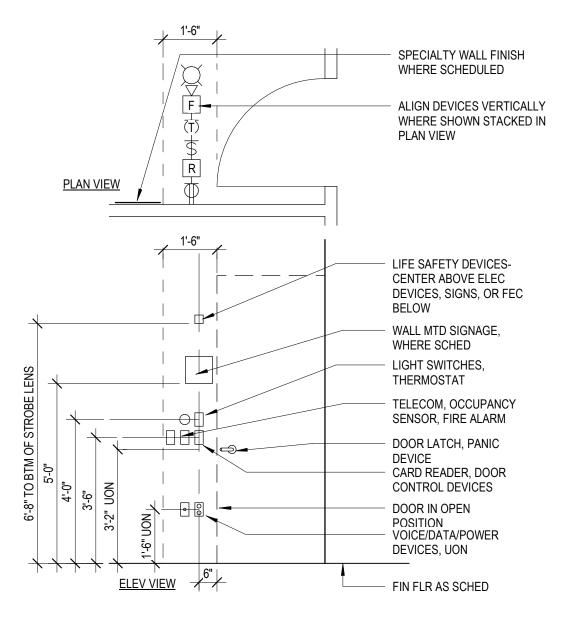

A900-3020A OPEN



ADD GRADIANT FILM TO GLASS PANELS IN <u>FRAME 05</u>. SEE SPEC

GLASS NOTES:

PLAN VIEW

ELEV VIEW

3/8" = 1'-0"

1

GL-1 = 1/4" TEMPERED

GL-2 = LOW-E COATED, CLEAR INSULATING GLASS

GENERAL NOTES

- G.C. SHALL VERIFY SIZE OF REPLACEMENT DOORS & FRAMES IN THE EXISTING BUILDING 1.
- BEFORE ORDERING. SEE SPEC. SECTION 08 71 00 FOR DOOR HARDWARE SETS, HARDWARE NOTES, COMPONENTS 2
- & OTHER INFORMATION. EXTERIOR DOOR SYSTEMS SHALL BE FULLY PERIMETER CAULKED TO ADJACENT FINISHED


+

6" , UON

+ - =

× - ----

SURFACES, BOTH INTERIOR & EXTERIOR - TYP. FACE OF ADJACENT WALL TO EDGE OF DOOR FRAME IS 4" (TYPICAL) U.N.O. SEE DETAILS A & B ON A903

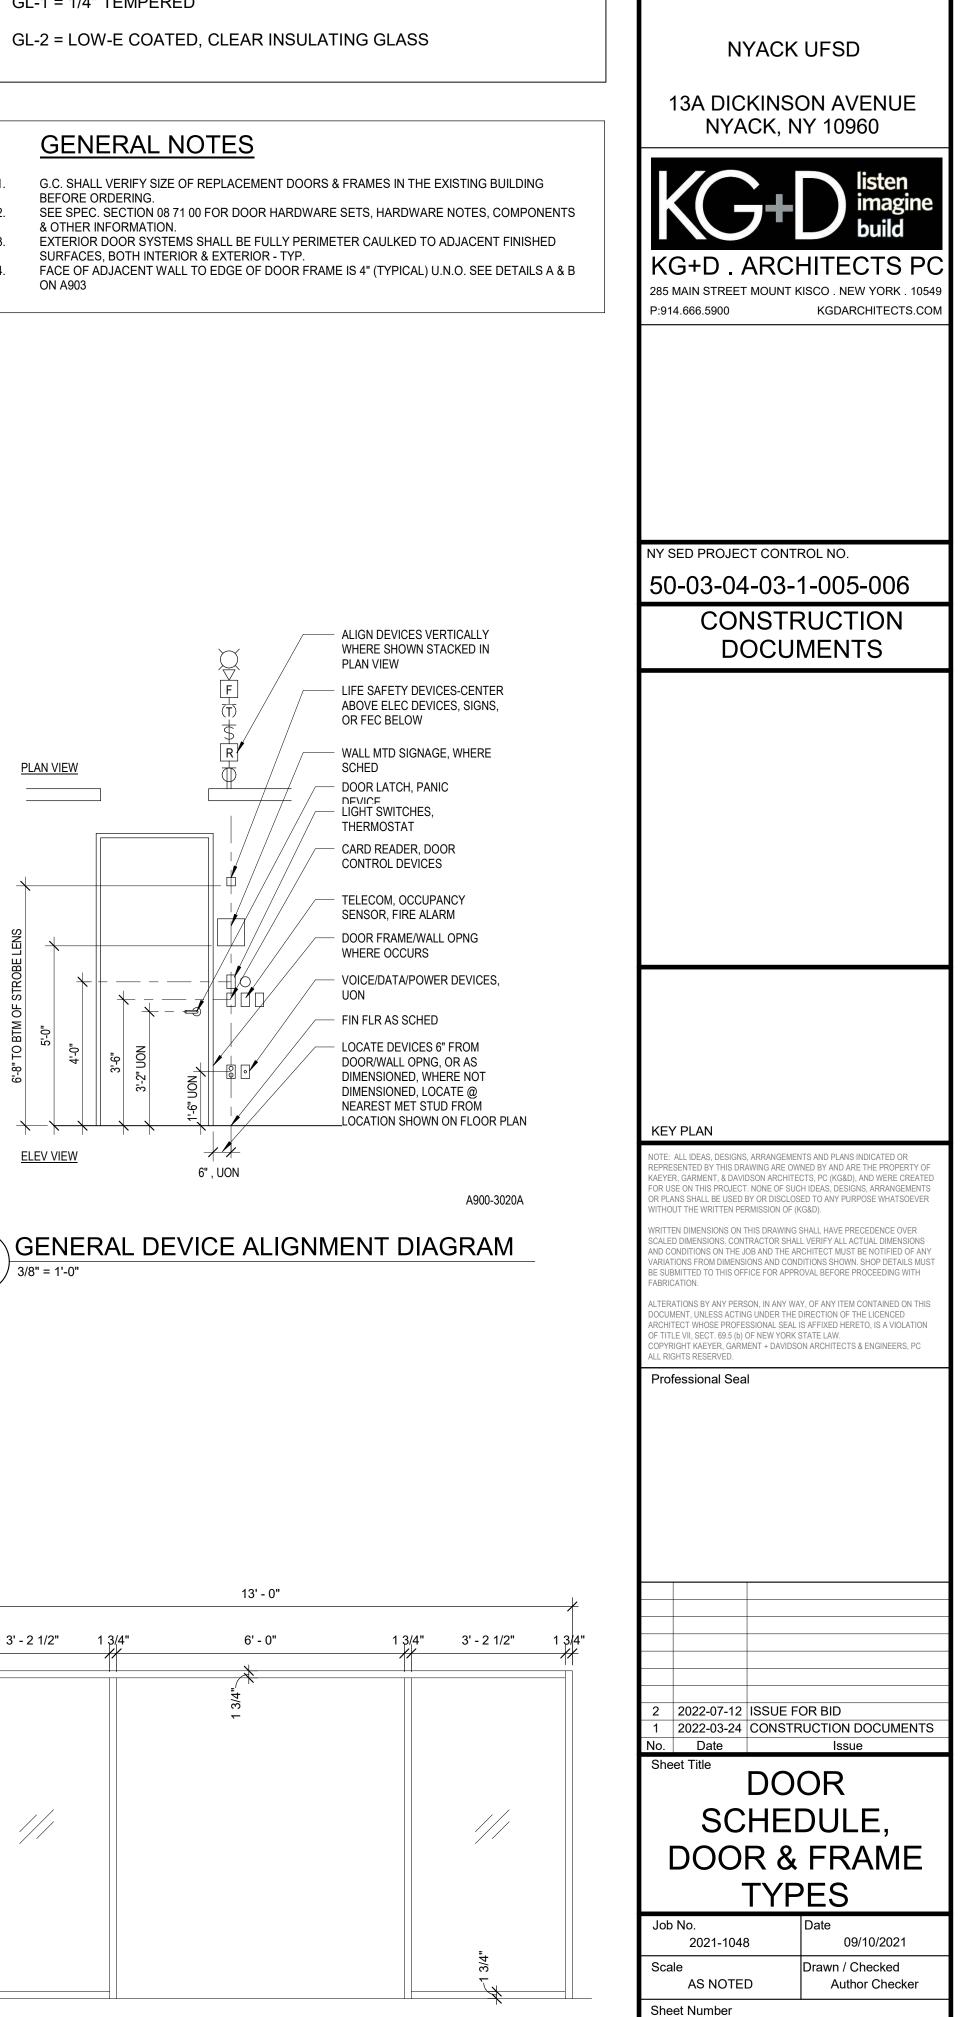



A911


PROFESSIONAL


DEVELOPMENT

CENTER

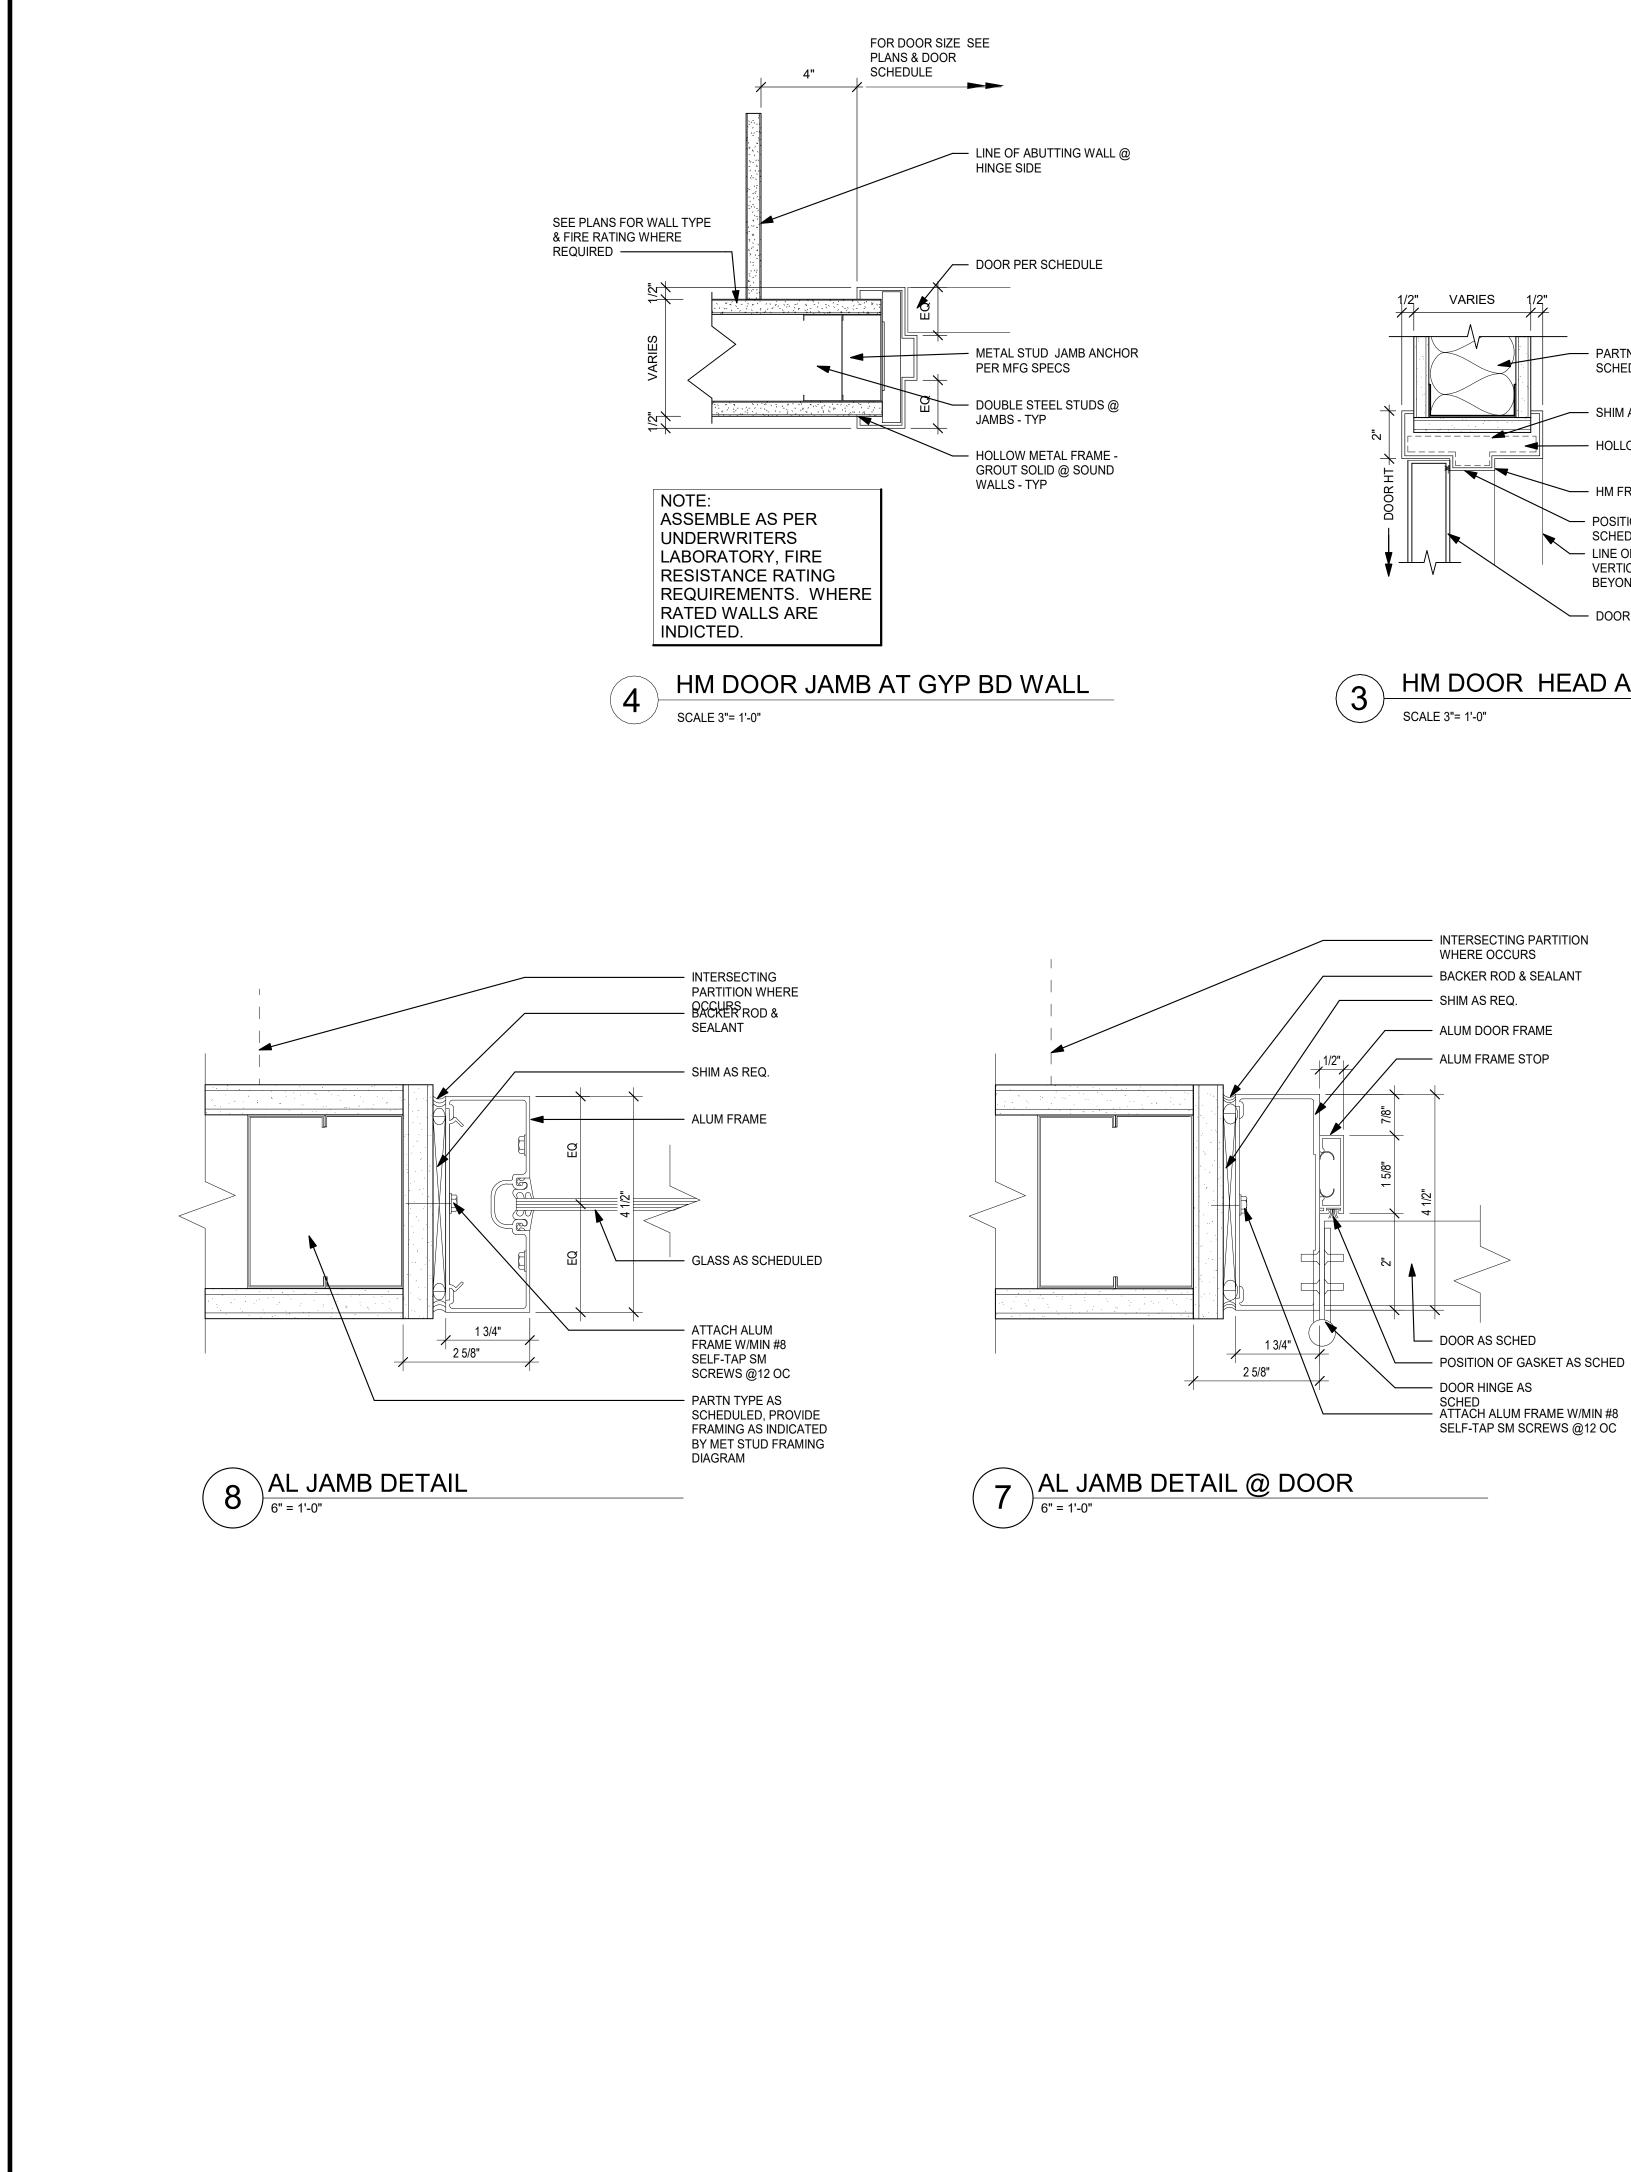


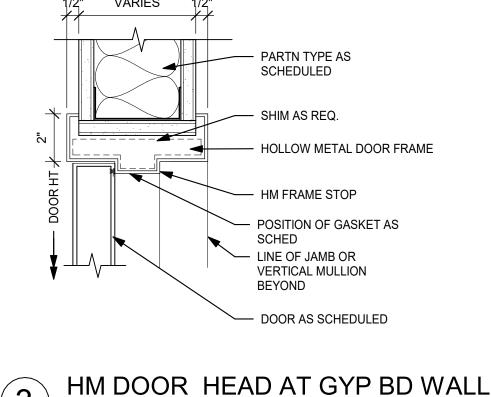


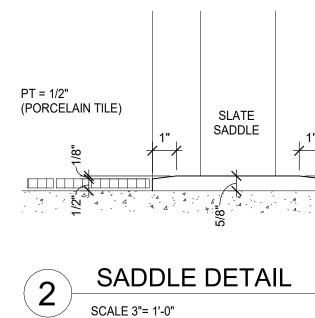

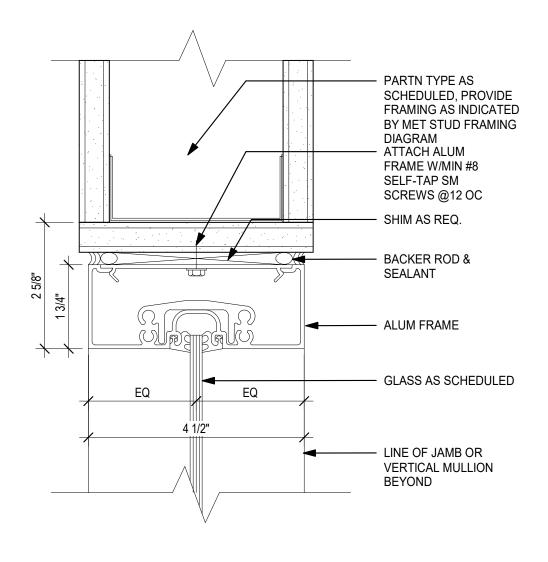

6 AL HEAD DETAIL

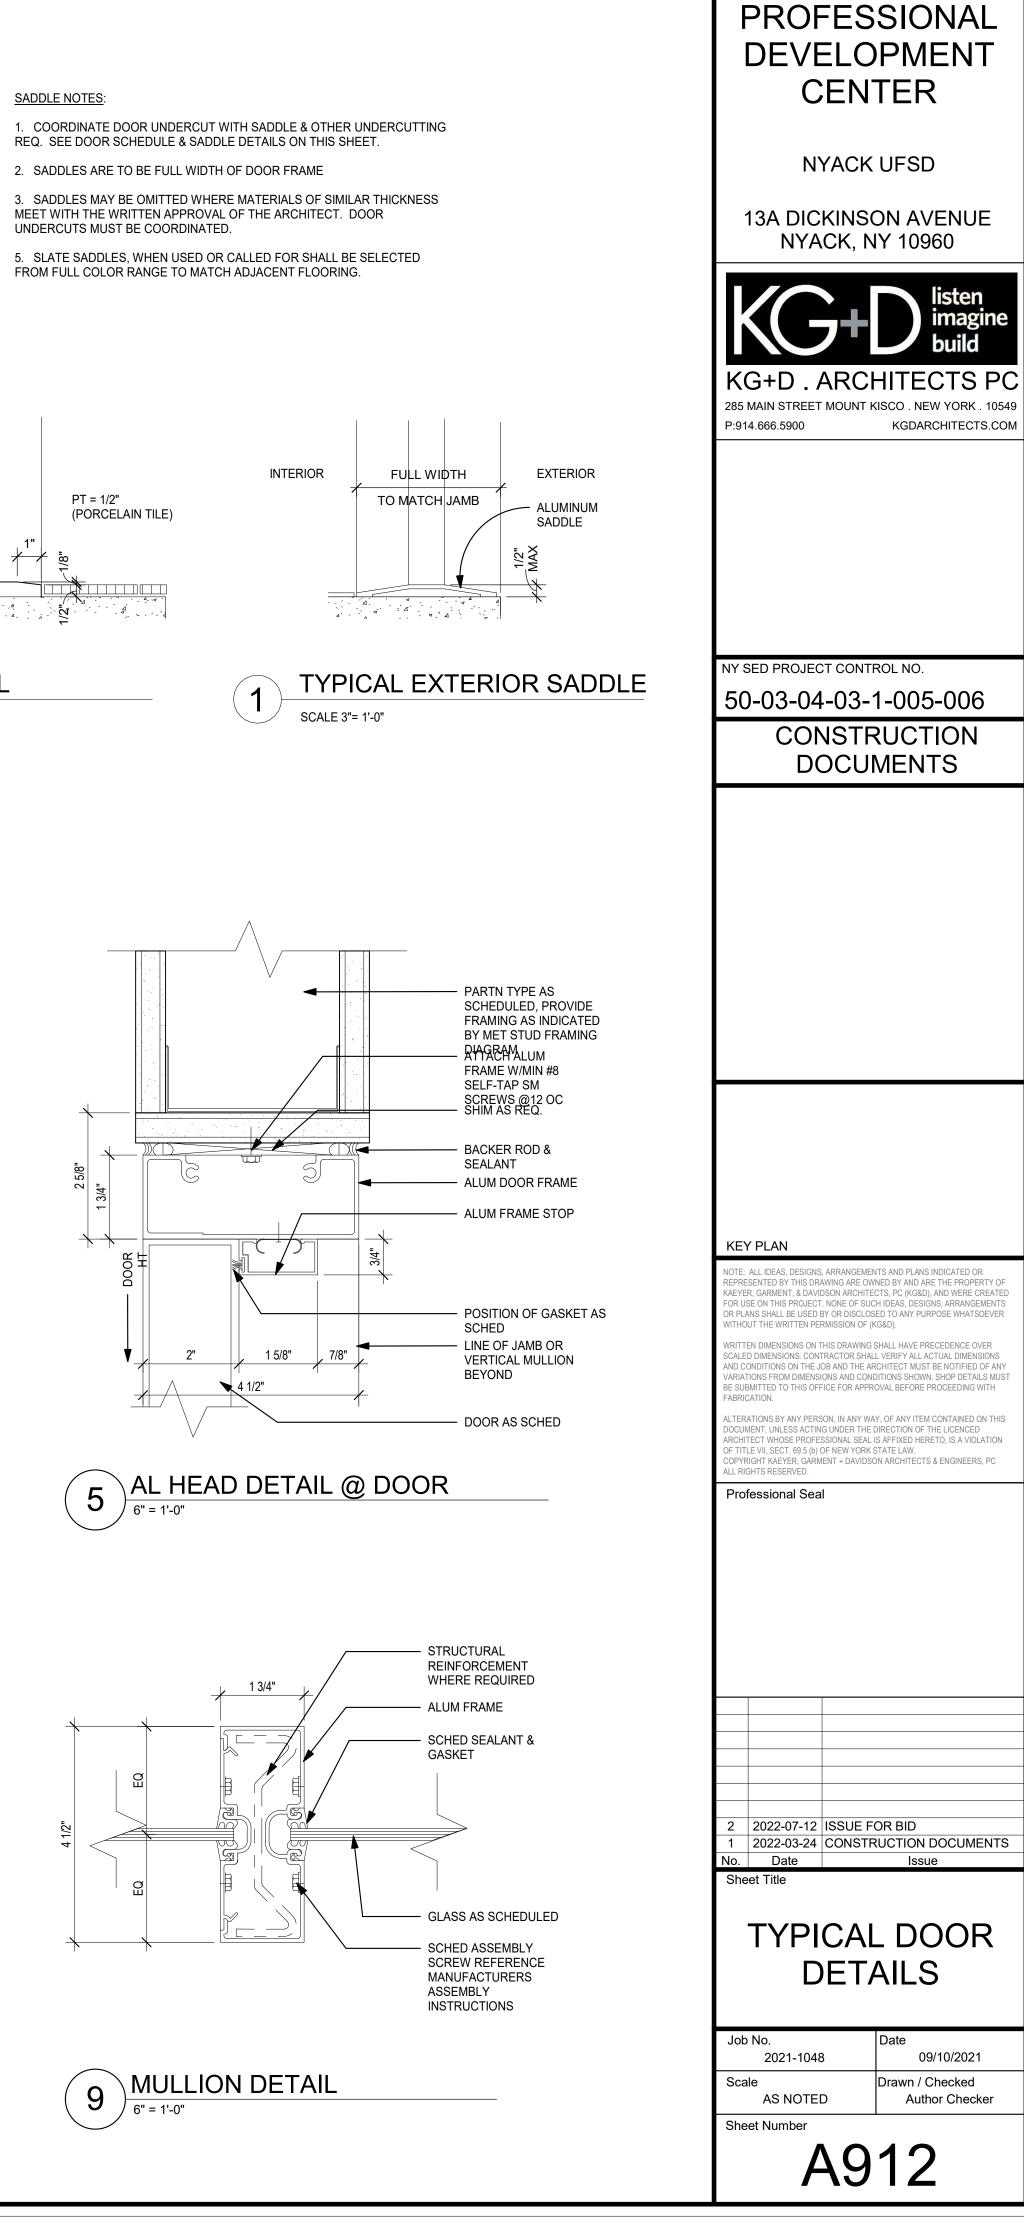

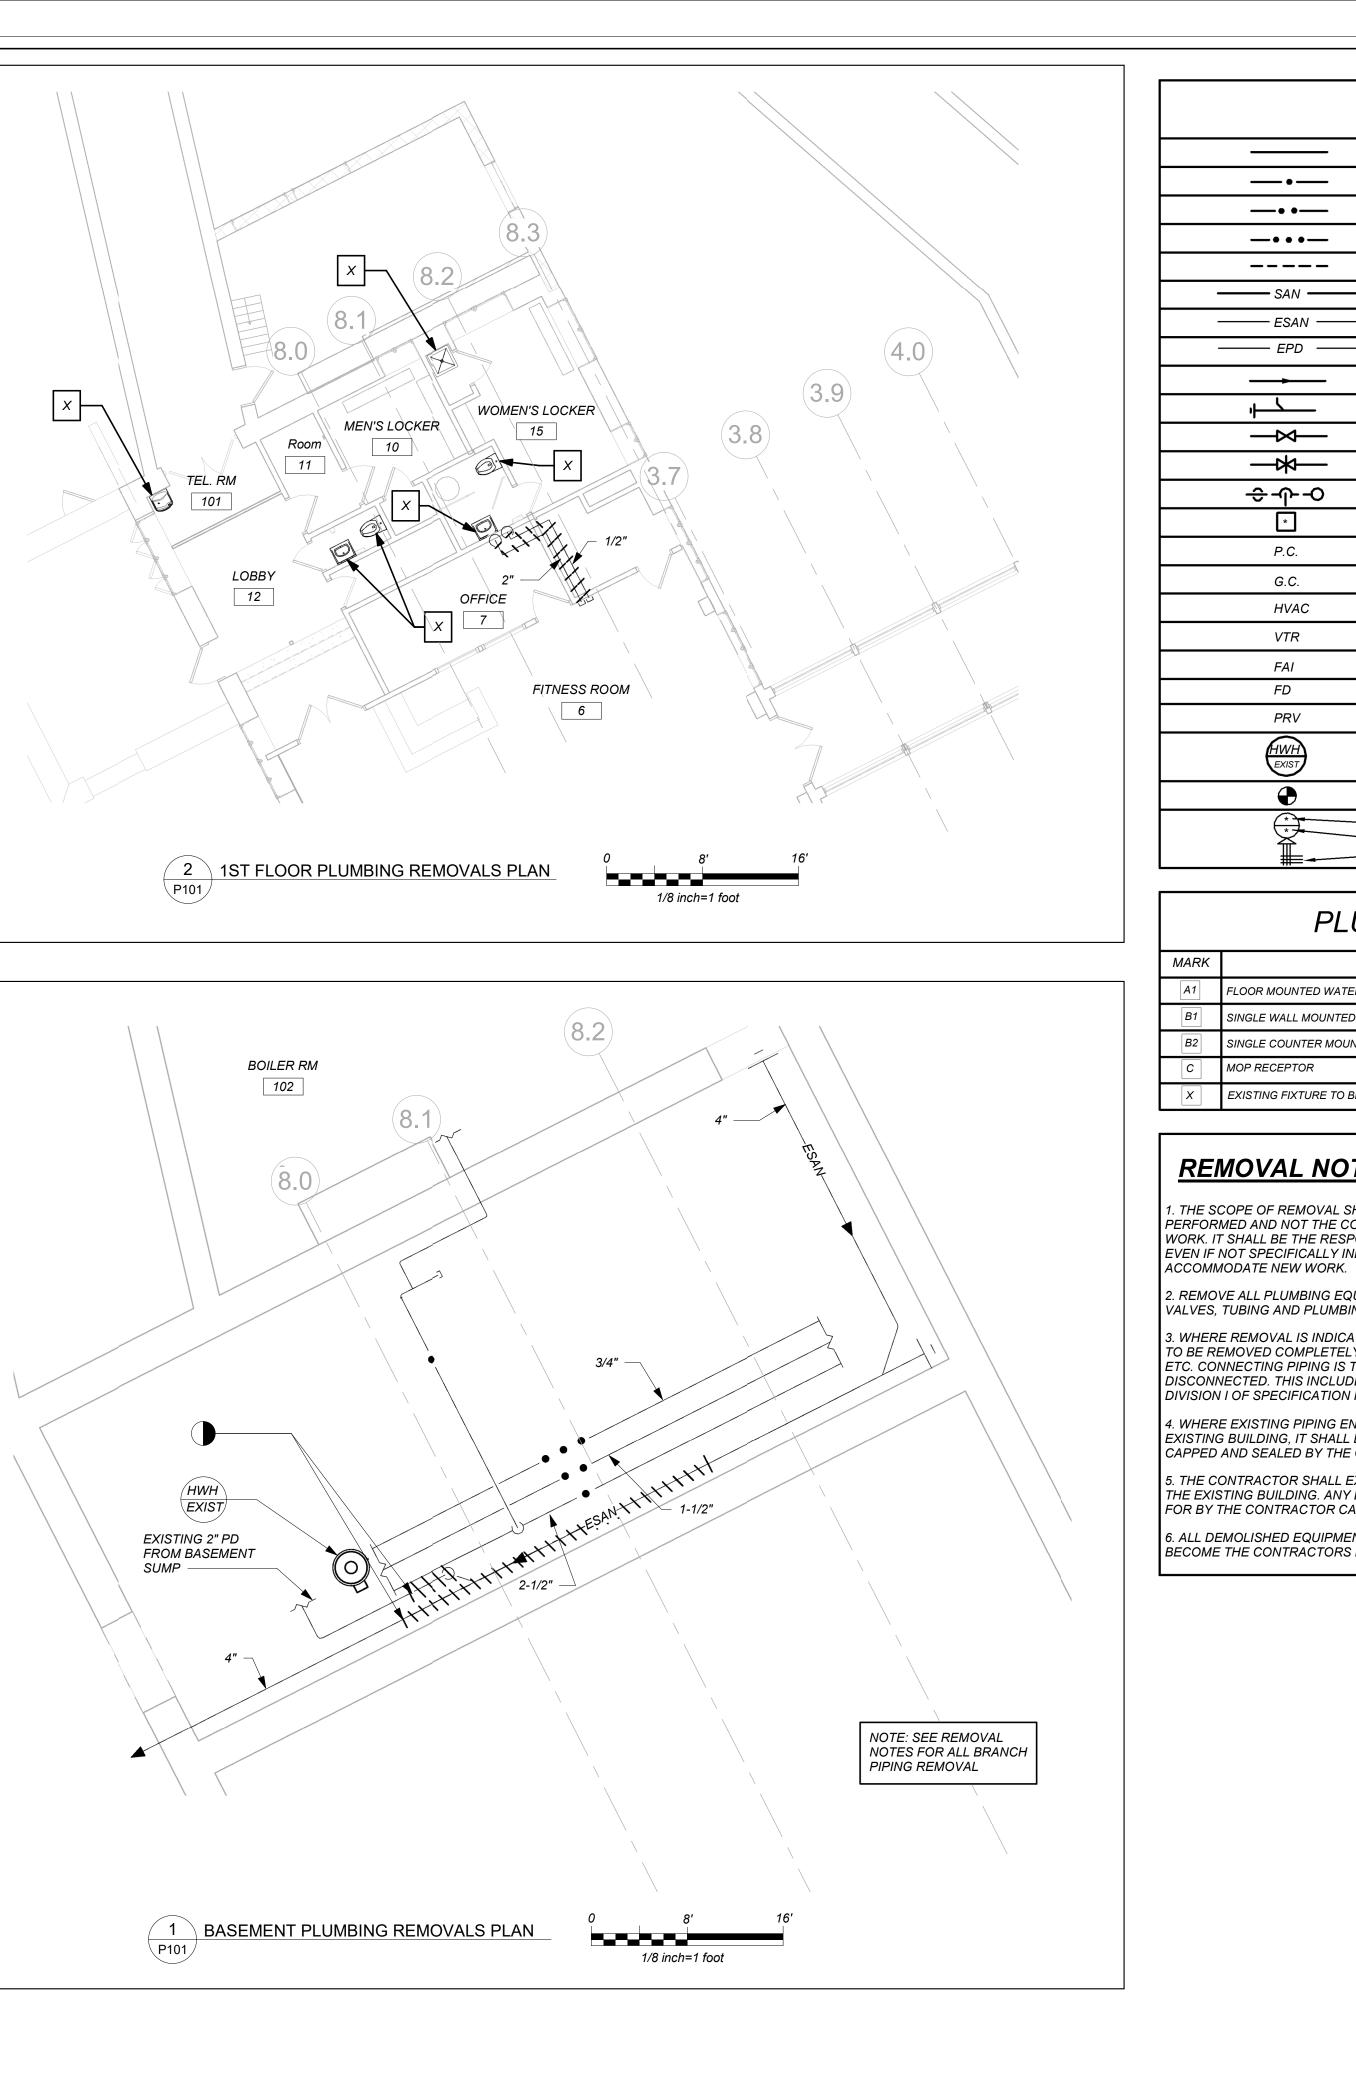

	LEGEND
	NEW PIPING, FIXTURES, ETC.
•	COLD WATER PIPING
• •	HOT WATER PIPING
	HOT WATER RETURN PIPING
	PLUMBING VENT PIPING
SAN	SANITARY PIPING
ESAN	EXISTING SANITARY PIPING
——————————————————————————————————————	EXISTING PUMP DISCHARGE PIPING
	FLOW DIRECTION WITHIN PIPE
، 	CLEANOUT
	SHUT-OFF VALVE
—————————————————————————————————————	COMBINATION BALANCING & SHUT-OFF VALVE
÷ቍ-୦	PIPE CONNS. (BOTTOM; TOP 45 OR 90; PIPE UP)
*	PLUMBING FIXTURE IDENTIFICATION
P.C.	PLUMBING CONTRACTOR
G.C.	GENERAL CONTRACTOR
HVAC	HVAC CONTRACTOR
VTR	VENT THRU ROOF
FAI	FRESH AIR INTAKE
FD	FLOOR DRAIN
PRV	PRESSURE REDUCING VALVE
HWH EXIST	HOT WATER HEATER IDENTIFICATION
\bullet	POINT OF CONNECTION
	PART PLAN, DETAIL, SECTION NUMBER SECTION IDENTIFICATION

PLUMBING FIXTURE SCHEDULE

DESCRIPTION				
	W	V	H	С
R MOUNTED WATER CLOSET (FLUSH VALVE) (HANDICAPPED)	4"	2"	-	1"
LE WALL MOUNTED LAVATORY (HANDICAPPED)	1-1/2"	1-1/2"	1/2"	1/2"
LE COUNTER MOUNTED LAVATORY	1-1/2"	1-1/2"	1/2"	1/2"
RECEPTOR	3"	3"	3/4"	3/4"
TING FIXTURE TO BE REMOVED	-	-	-	-

REMOVAL NOTES:

1. THE SCOPE OF REMOVAL SHOWN IS DIAGRAMMATIC ONLY AND INDICATES THE INTENT OF THE WORK TO BE PERFORMED AND NOT THE COMPLETE SCOPE OF DEMOLITION AND/OR REMOVAL WORK. IT SHALL BE THE RESPONSIBILITY OF THIS CONTRACTOR TO REMOVE ANY RELATED MECHANICAL DEVICES EVEN IF NOT SPECIFICALLY INDICATED TO BE REMOVED IN ORDER TO

2. REMOVE ALL PLUMBING EQUIPMENT, SPECIALTIES, DRAINS, CONTROLS, HANGERS, BASES, SUPPORTS, PIPING, VALVES, TUBING AND PLUMBING ACCESSORIES THAT ARE NOT INCORPORATED IN THE NEW LAYOUT.


3. WHERE REMOVAL IS INDICATED OR IMPLIED OR NOT INCORPORATED IN THE NEW LAYOUT, THE ITEM ITSELF IS TO BE REMOVED COMPLETELY TOGETHER WITH ALL CONNECTING PIPING, SPECIALTIES, SUPPORTS, CONTROLS, ETC. CONNECTING PIPING IS TO BE REMOVED BACK TO MAINS WHERE THE ARE TO BE CAPPED OR DISCONNECTED. THIS INCLUDES ALL GAS, SANITARY, VENT, WATER, AND PUMP DISCHARGE PIPING. REFER TO DIVISION I OF SPECIFICATION FOR CUTTING AND PATCHING REQUIREMENTS.

4. WHERE EXISTING PIPING ENTERS INACCESSIBLE TRENCHES, TUNNELS, SHAFTS, WALLS AND CEILINGS INSIDE THE EXISTING BUILDING, IT SHALL BE CUT BACK AT LEAST 2" INTO SUCH INACCESSIBLE SPACES AND SHALL BE SUITABLY CAPPED AND SEALED BY THE CONTRACTOR.


5. THE CONTRACTOR SHALL EXERCISE NORMAL CAUTION TO PREVENT UNNECESSARY CUTTING AND DAMAGE TO THE EXISTING BUILDING. ANY EXCESSIVE DAMAGE AS DETERMINED BY THE OWNER SHALL BE REPAIRED AND PAID FOR BY THE CONTRACTOR CAUSING THE DAMAGE.


6. ALL DEMOLISHED EQUIPMENT ETC. EXCEPT THOSE ITEMS SPECIFICALLY REQUESTED BY THE OWNER SHALL BECOME THE CONTRACTORS PROPERTY, SHALL BE REMOVED FROM THE PREMISES, AND DISPOSED OF LEGALLY.


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NYACK UFSD
13A DICKINSON AVE NYACK,NY 10960
KG+D.ARCHITECTS PC 285 MAIN STREET MOUNT KISCO . NEW YORK . 10549 P:914.666.5900 KGDARCHITECTS.COM
BARILE GALLAGHER & ASSOCIATES CONSULTING ENGINEERS 39 MARBLE AVE PLEASANTVILLE, NY 10570 PHONE: 914.328.6060 FAX: 914.328.9304 General@BGA-Eng.com
66-23-00-01-0-008-011 CONSTRUCTION
DOCUMENTS
AREA OF WORK
KEY PLAN
FOR USE ON THIS PROJECT. NONE OF SUCH IDEAS, DESIGNS, ARRANGEMENTS OR PLANS SHALL BE USED BY OR DISCLOSED TO ANY PURPOSE WHATSOEVER WITHOUT THE WRITTEN PERMISSION OF (KG&D). WRITTEN DIMENSIONS ON THIS DRAWING SHALL HAVE PRECEDENCE OVER SCALED DIMENSIONS. CONTRACTOR SHALL VERIFY ALL ACTUAL DIMENSIONS
AND CONDITIONS ON THE JOB AND THE ARCHITECT MUST BE NOTIFIED OF ANY VARIATIONS FROM DIMENSIONS AND CONDITIONS SHOWN. SHOP DETAILS MUST BE SUBMITTED TO THIS OFFICE FOR APPROVAL BEFORE PROCEEDING WITH FABRICATION. ALTERATIONS BY ANY PERSON, IN ANY WAY, OF ANY ITEM CONTAINED ON THIS
DOCUMENT, UNLESS ACTING UNDER THE DIRECTION OF THE LICENCED ARCHITECT WHOSE PROFESSIONAL SEAL IS AFFIXED HERETO, IS A VIOLATION OF TITLE VII, SECT. 69.5 (b) OF NEW YORK STATE LAW. COPYRIGHT KAEYER, GARMENT + DAVIDSON ARCHITECTS & ENGINEERS, PC ALL RIGHTS RESERVED. Professional Seal
Professional Seal
2 2022-07-12 ISSUE FOR BID 1 2022-03-24 CONSTRUCTION DOCUMENTS No. Date Issue
Sched Title LEGEND, SCHEDULE, NOTES, & PART BASEMENT & 1ST FLOOR PLANS (REMOVALS)
Job No. Date 2021-1048 09/10/2021
Scale Drawn / Checked AS NOTED BGA / BGA Sheet Number Sheet Number
P101

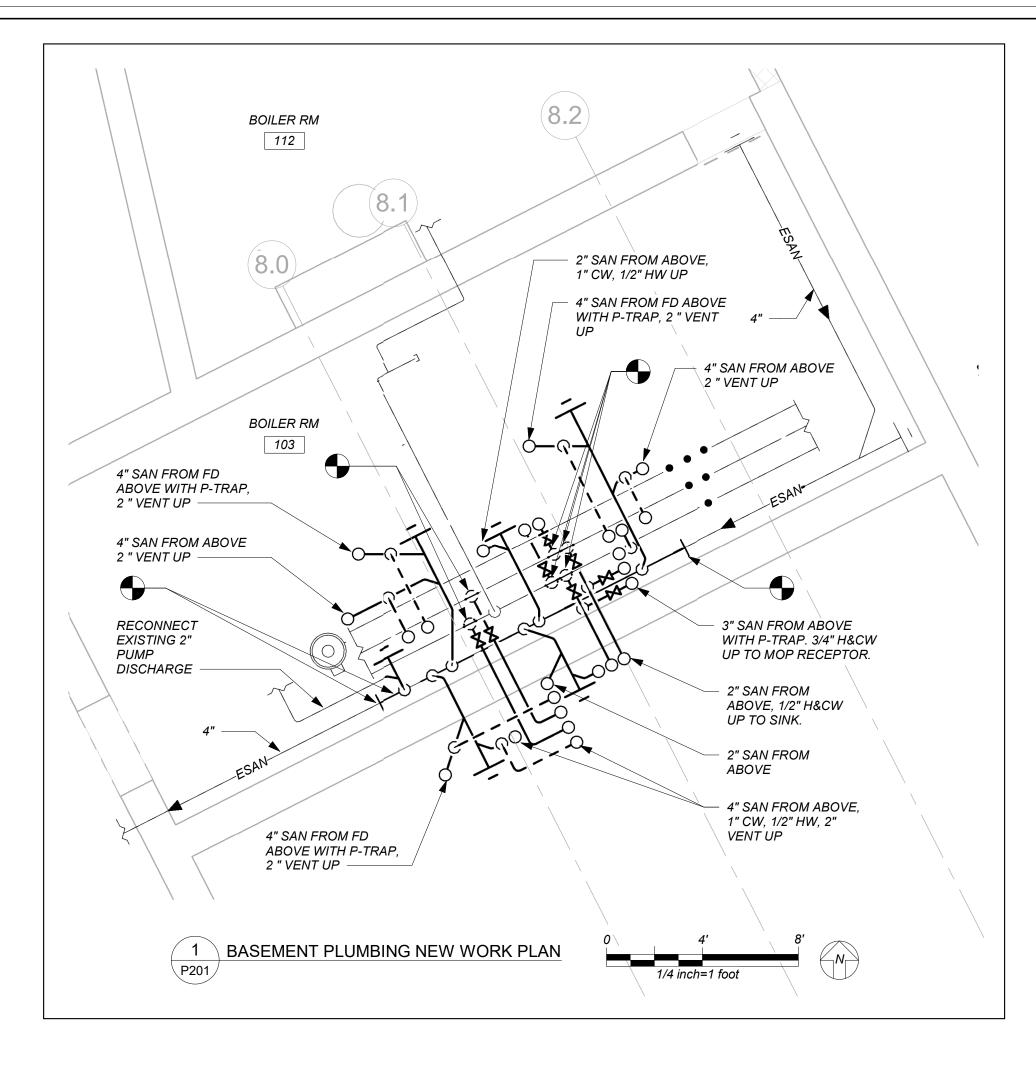


BEFORE FABRICATION THIS CONTRACTOR SHALL VERIFY ALL MEASUREMENTS AND CONDITIONS ON JOB AND COORDINATE HIS WORK WITH THE WORK OF ALL THE OTHER CONTRACTORS

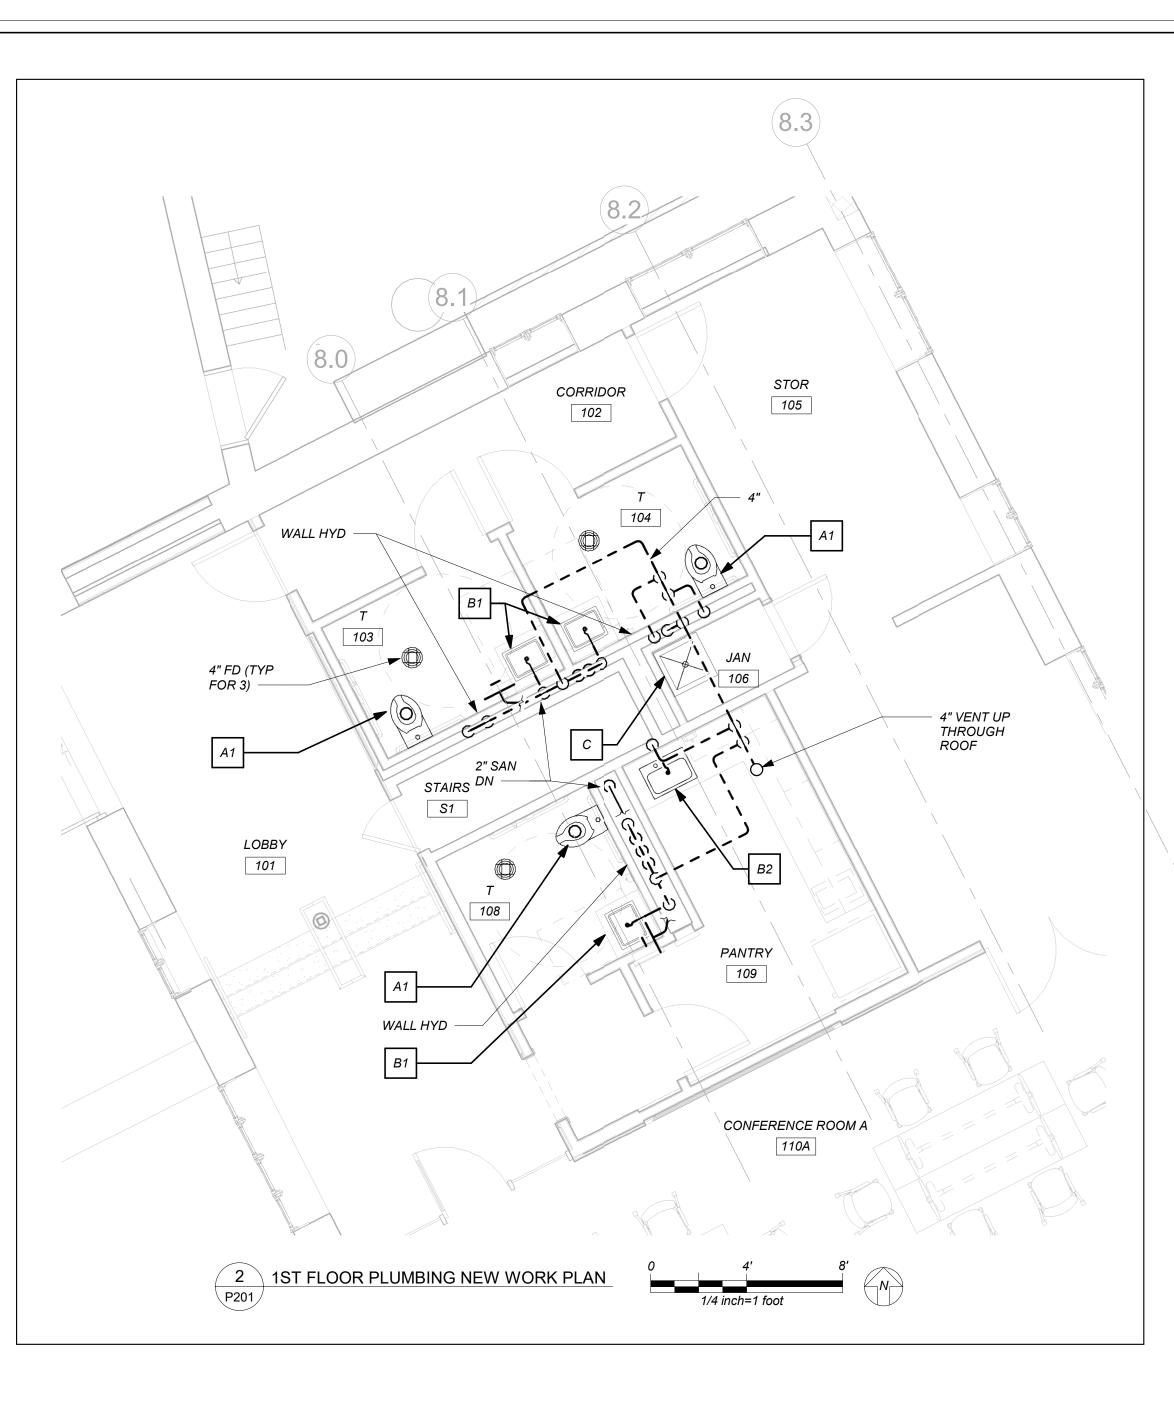

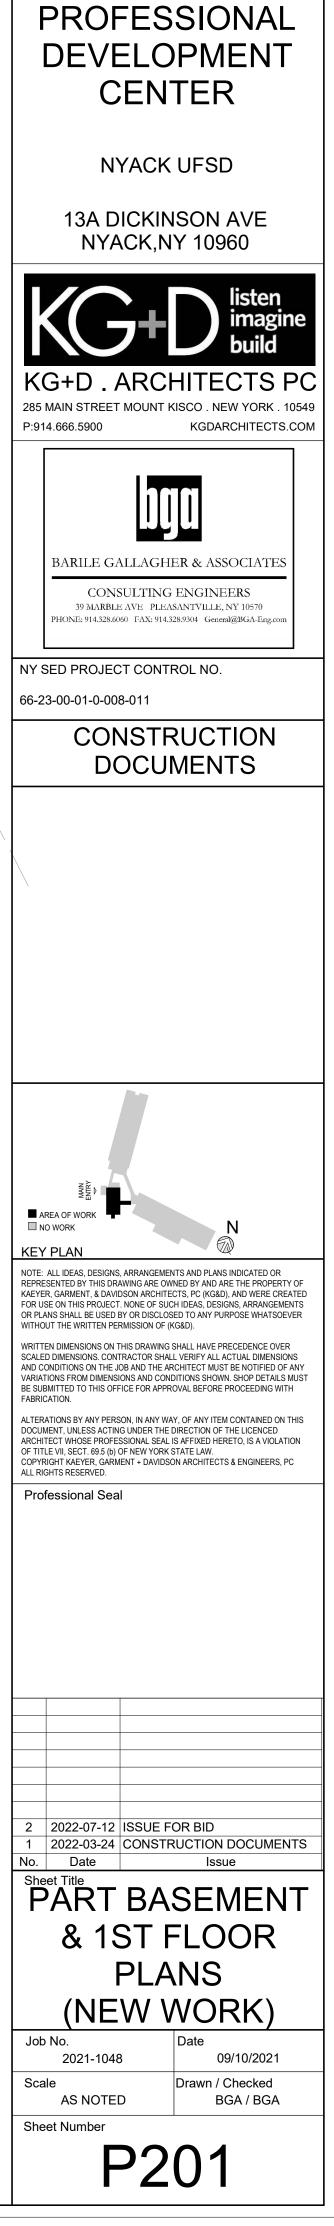

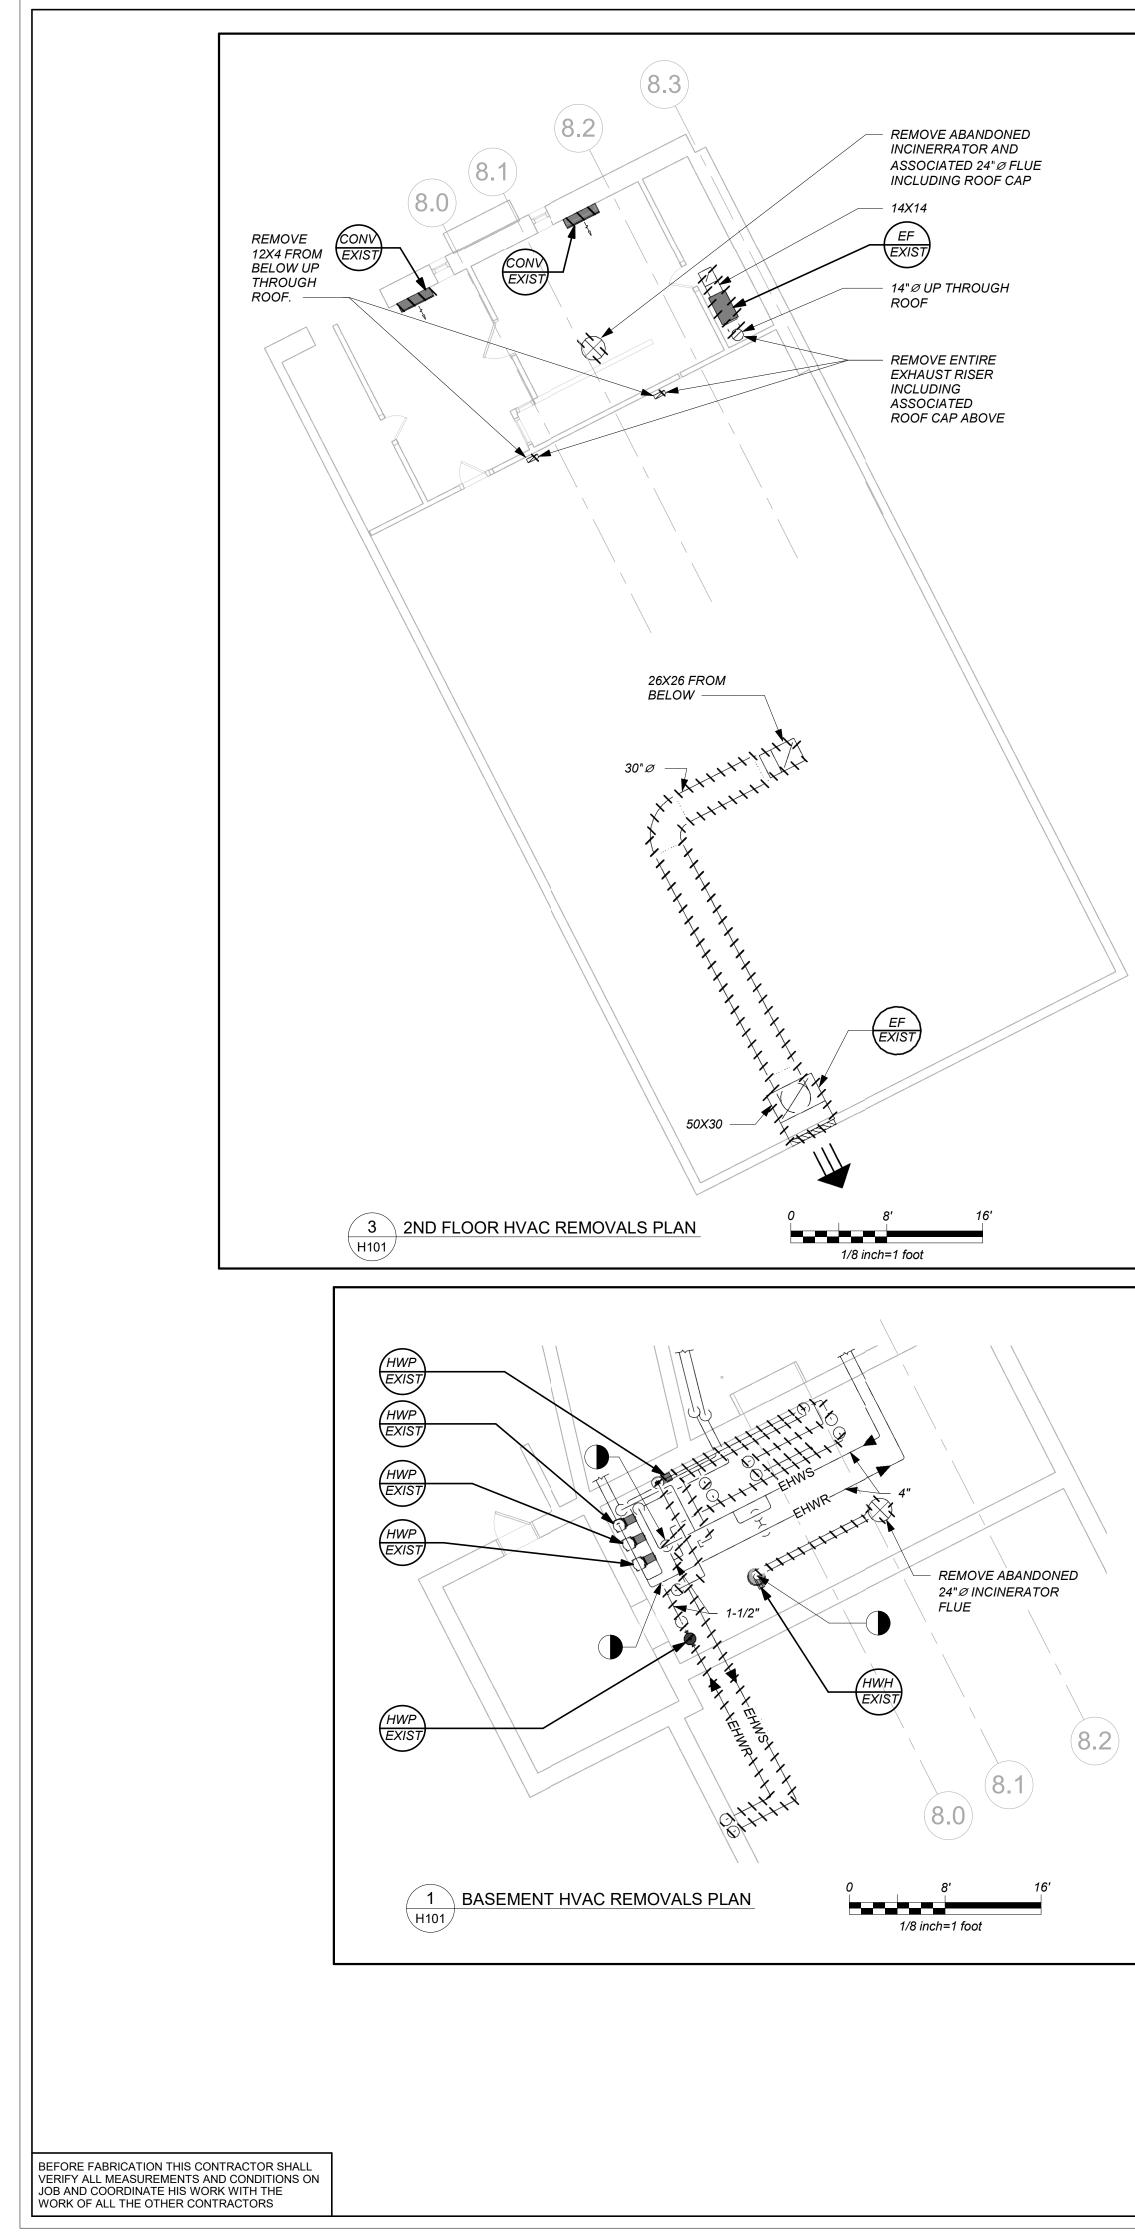


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	LEGEND	_ DEVE
5	EXISTING DUCTWORK, EQUIPMENT, ETC. TO REMAIN	
<u>,,,,,,,,,,,,,,,,,,,,,,,,,,,,,,,,,,,,,</u>	EXISTING DUCTWORK, EQUIPMENT, ETC. TO BE REMOVED	
	POINT OF CHANGE IN DUCT SIZE POINT OF CHANGE IN DUCT SIZE 1" THERMAL ACOUSTIC LINING-DUCT SIZES ON PLANS ARE CLEAR INSIDE DIMENSIONS FLEXIBLE CONNECTION	
	NEW DUCTWORK — POINT OF CHANGE IN DUCT SIZE	
<u> </u>	SQUARE DUCT TURN WITH TURNING VANES	13A DI0
	NEW 4-WAY CEILING DIFFUSER	
	CEILING EXHAUST/RETURN REGISTER — сғм	
(*)* * *	REGISTER/DIFFUSER IDENTIFICATION TYPE -SEE SCHEDULE	
	DUCT MTD. MANUAL AIR VOLUME DAMPER (W/LOCKING DEVICE) MOTORIZED AIR VOLUME DAMPER (W/ACCESS DOOR)	- KG+D.A
		285 MAIN STREET M P:914.666.5900
	FIRE DAMPER (U.L. APPROVED) & ACCESS DOOR	-
— EHWR ——	COMBINATION FIRE/SMOKE DAMPER (U.L. APPROVED) & ACCESS DOOR EXISTING HOT WATER SUPPLY PIPING	
— EHWS ——	EXISTING HOT WATER RETURN PIPING	
— HWR —	HOT WATER SUPPLY PIPING	
— HWS ——	HOT WATER RETURN PIPING	BARILE GAL
	LIQUID REFRIGERANT PIPING	CONSU 39 MARBLE A PHONE: 914.328.6060
— s —— — HG ——	SUCTION REFRIGERANT PIPING HOT GAS REFRIGERANT PIPING	NY SED PROJECT
— CD ——	CONDENSATE DRAIN PIPING	66-23-00-01-0-008-0
X	FLOW DIRECTION WITHIN PIPE	CON
	GATE VALVE (HORIZONTAL/VERTICAL)	- DO
 ₩	COMBINATION BALANCING & SHUT-OFF VALVE (CIRCUIT SETTER)	-
	2 - WAY CONTROL VALVE	
&	3 - WAY CONTROL VALVE	
₹-ø	CHECK VALVES	
€-φΟ	PIPE CONNS. (BOTTOM; TOP 45 OR 90; PIPE UP)	7
EF	EXISTING EXHAUST FAN IDENTIFICATION	
B		
EXIST	EXISTING BOILER IDENTIFICATION	
HWH EXIST	EXISTING HOT WATER HEATER IDENTIFICATION	4
CH EXIST	EXISTING HOT WATER CABINET HEATER IDENTIFICATION	
CONV	EXISTING CONVECTOR IDENTIFICATION	
HWP	EXISTING HOT WATER PUMP IDENTIFICATION	-
ERV	ENERGY RECOVERY VENTILATOR IDENTIFICATION	
		AREA OF WORK
FC	AIR SOURCE HEAT PUMP UNIT IDENTIFICATION	KEY PLAN
	FAN COIL UNIT IDENTIFICATION	REPRESENTED BY THIS DRAWI KAEYER, GARMENT, & DAVIDSC FOR USE ON THIS PROJECT. NO
CH *	HOT WATER CABINET HEATER IDENTIFICATION	OR PLANS SHALL BE USED BY O WITHOUT THE WRITTEN PERMI
(UH)	HOT WATER UNIT HEATER IDENTIFICATION	WRITTEN DIMENSIONS ON THIS SCALED DIMENSIONS. CONTRA AND CONDITIONS ON THE JOB
HWP	HOT WATER PUMP IDENTIFICATION	VARIATIONS FROM DIMENSION BE SUBMITTED TO THIS OFFICE FABRICATION.
	TYPE	ALTERATIONS BY ANY PERSON DOCUMENT, UNLESS ACTING U
*	NEW FIN TUBE RADIATION IDENTIFICATION	ARCHITECT WHOSE PROFESSION OF TITLE VII, SECT. 69.5 (b) OF 1 COPYRIGHT KAEYER, GARMEN
EBB EXIST	EXISTING ELECTRIC BASEBOARD IDENTIFICATION	ALL RIGHTS RESERVED. Professional Seal
(T _S)•	→ TO CONTROLLED ITEM WALL MTD.(5'-2"±.A.F.F-U.O.N.) TEMPERATURE SENSOR	
<u></u> •	TO CONTROLLED ITEM WALL MTD.(5'-2"±.A.F.F-U.O.N.) CARBON DIOXIDE SENSOR	
-U- >	DOOR UNDERCUT	1
SMRE	POWDER COATED SHEET METAL RISER ENCLOSURE	7
ATC	AUTOMATIC TEMPERATURE CONTROLS	7
CD	CEILING DIFFUSER	
CR	CEILING REGISTER	
TR	TOP WALL REGISTER	
CFM	CUBIC FEET PER MINUTE	
OAI/FAI	OUTSIDE (FRESH) AIR INTAKE	2 2022-07-12 IS
CO	CLEAN OUT	1 2022-03-24 C
HVAC	HEATING, VENTILATING, AIR CONDITIONING CONTRACTOR	Sheet Title
GC	GENERAL TRADES CONTRACTOR	
FC		
FSC	FULL SIZE CONNECTION	_ 1ST, &
AD	ACCESS DOOR	
WMG ED	1/2" SQ. WIRE MESH GRILLE	Job No.
FD VIF		2021-1048 Scale
	VERIFY IN FIELD — SECTION/DETAIL/ELEVATION/PART PLAN NUMBER	AS NOTED
		Sheet Number
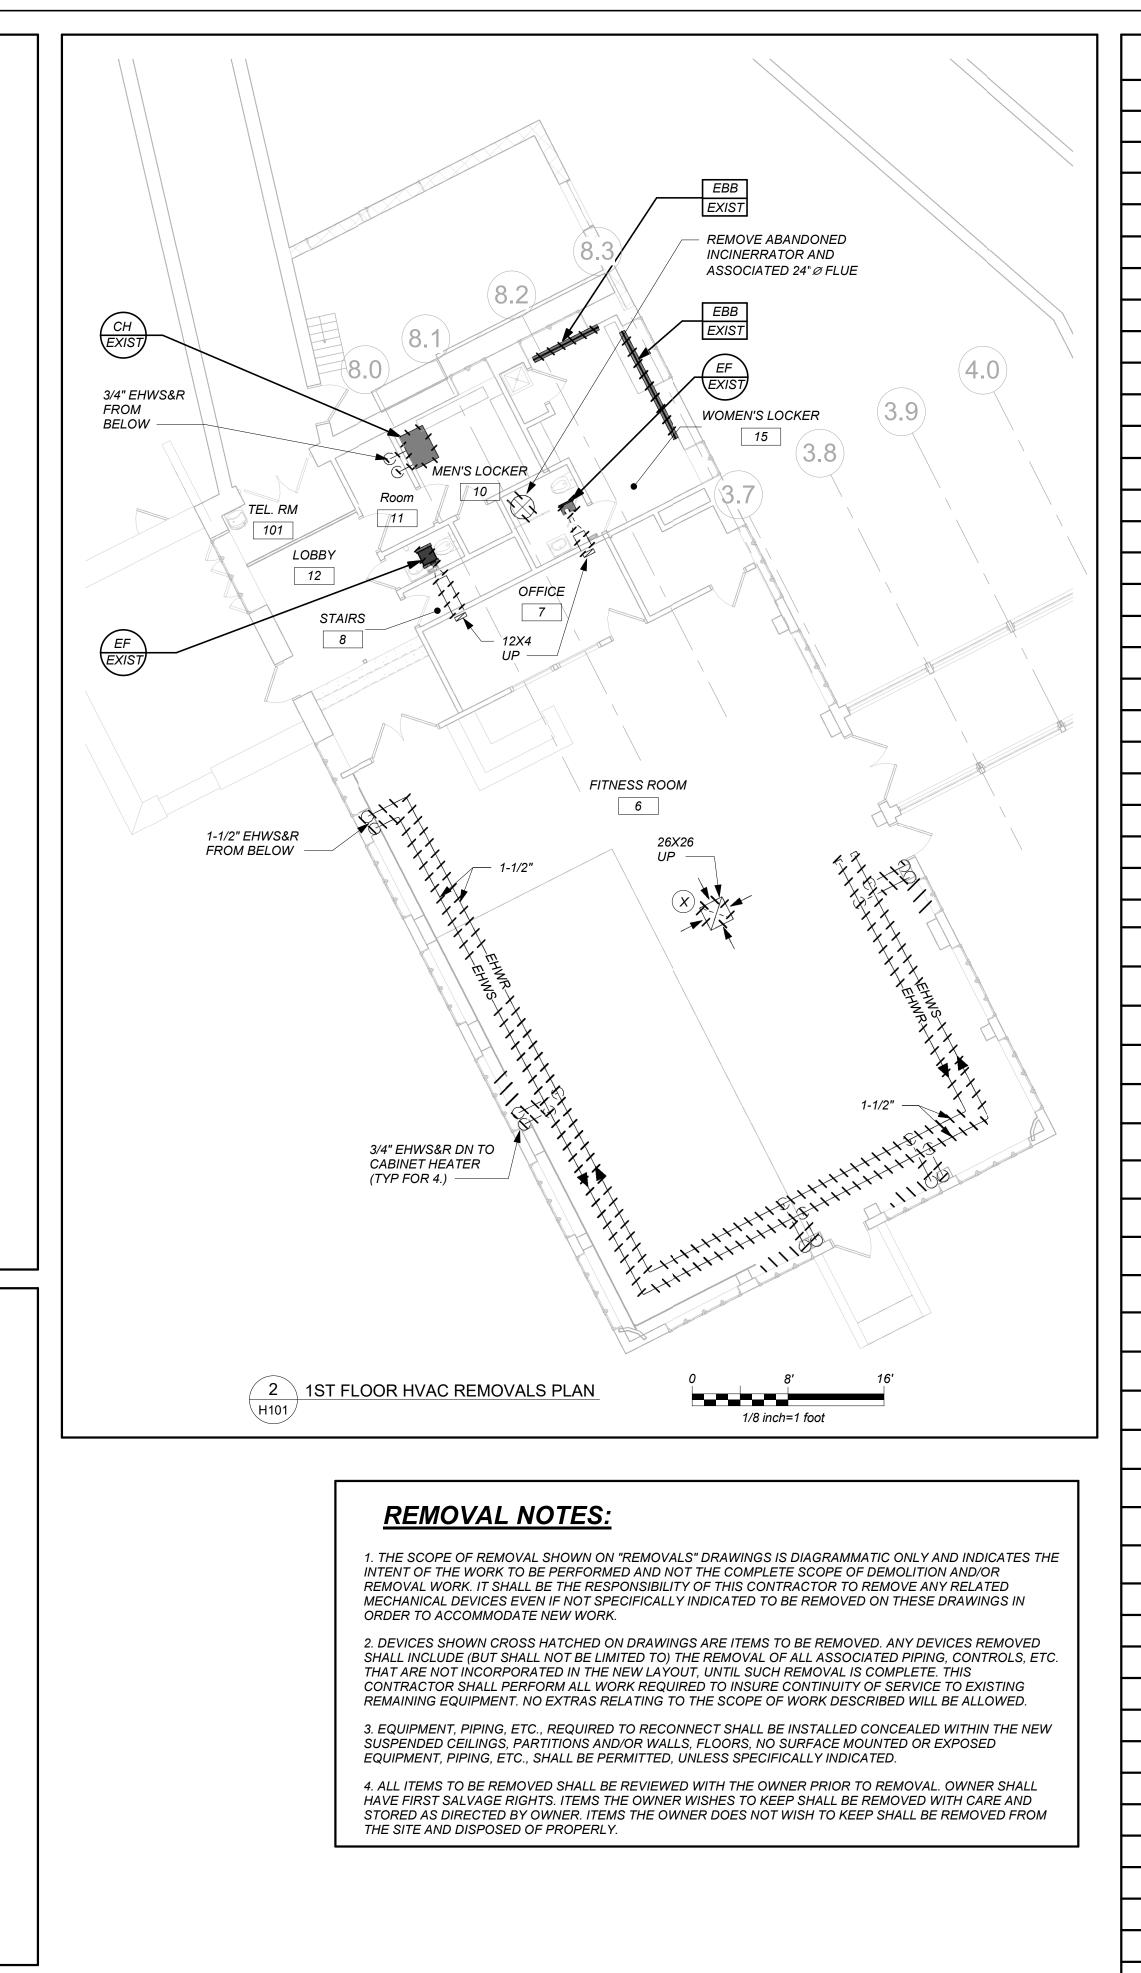
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13A DICKINSON AVE NYACK,NY 10960
KG+D.ARCHITECTS PC 285 MAIN STREET MOUNT KISCO . NEW YORK . 10549 P:914.666.5900 KGDARCHITECTS.COM
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NY SED PROJECT CONTROL NO. 66-23-00-01-0-008-011 CONSTRUCTION DOCUMENTS
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6																								
							S	SCH	EDL	ILE C	OF EN	VERGY	<pre></pre>	PEC (OVE	RY	VE	NTI	LATORS					
	GENERAL	DATA		SUPPLY	FAN DATA	EXHAUS1	FAN DATA	ELE	CTRICA	L DATA	HEAT EX	CHANGER		НОТ	WAT	ER CC				DX CO	11L (4)			FILT
MARK	SERVICE	LOCATION	I MODEL No.	OUTSIDE AIR CFM	EXT. S.P. IN WG	CFM	EXT. S.P. IN WG	MCA	MOP	ELECTRICAL SERVICE	TYPE	EFFIC.	CAP. MBH	EAT (°F)	LAT (°F)	COIL FACE VELOCITY FPI	ROWS	GPM	TOTAL CLG. CAP. BTU/HR	TOTAL HTG. CAP. BTU/HR	ENT. AIR TEMP. CLG. / HTG.	. LVG. AIR TEMP. CLG. / HTG.	· QTY.	SIZ. (IN.
(ERV)	CONFERENCE ROOM 110	ATTIC 16	FR800HW_ 208-3-CAV	800	1.25	800	1.25	5.2	15	208/3/60	WHEEL	75	53	10		475	1	5	24,000	27,000	90/40	75/70		17X13
(ERV)2	LOBBY, STORAGE TOILET ROOMS	ATTIC 16	[] U−ERV−600	450	1.0	450	1.0	8.3	15	208/1/60	CORE	69	N/A	N/A	N/A	N/A	N/A	N/A	24,000	27,000	90/10	75/70	4	6X21
N 00	AS MANUFACTURE	D BY "TOPVE)	ζ."																					3— CO

T (b) AS MANUFACTURED BY "ENERGYWALL."

E 2 INSTALL PER MANUFACTURER'S RECOMMENDATIONS.

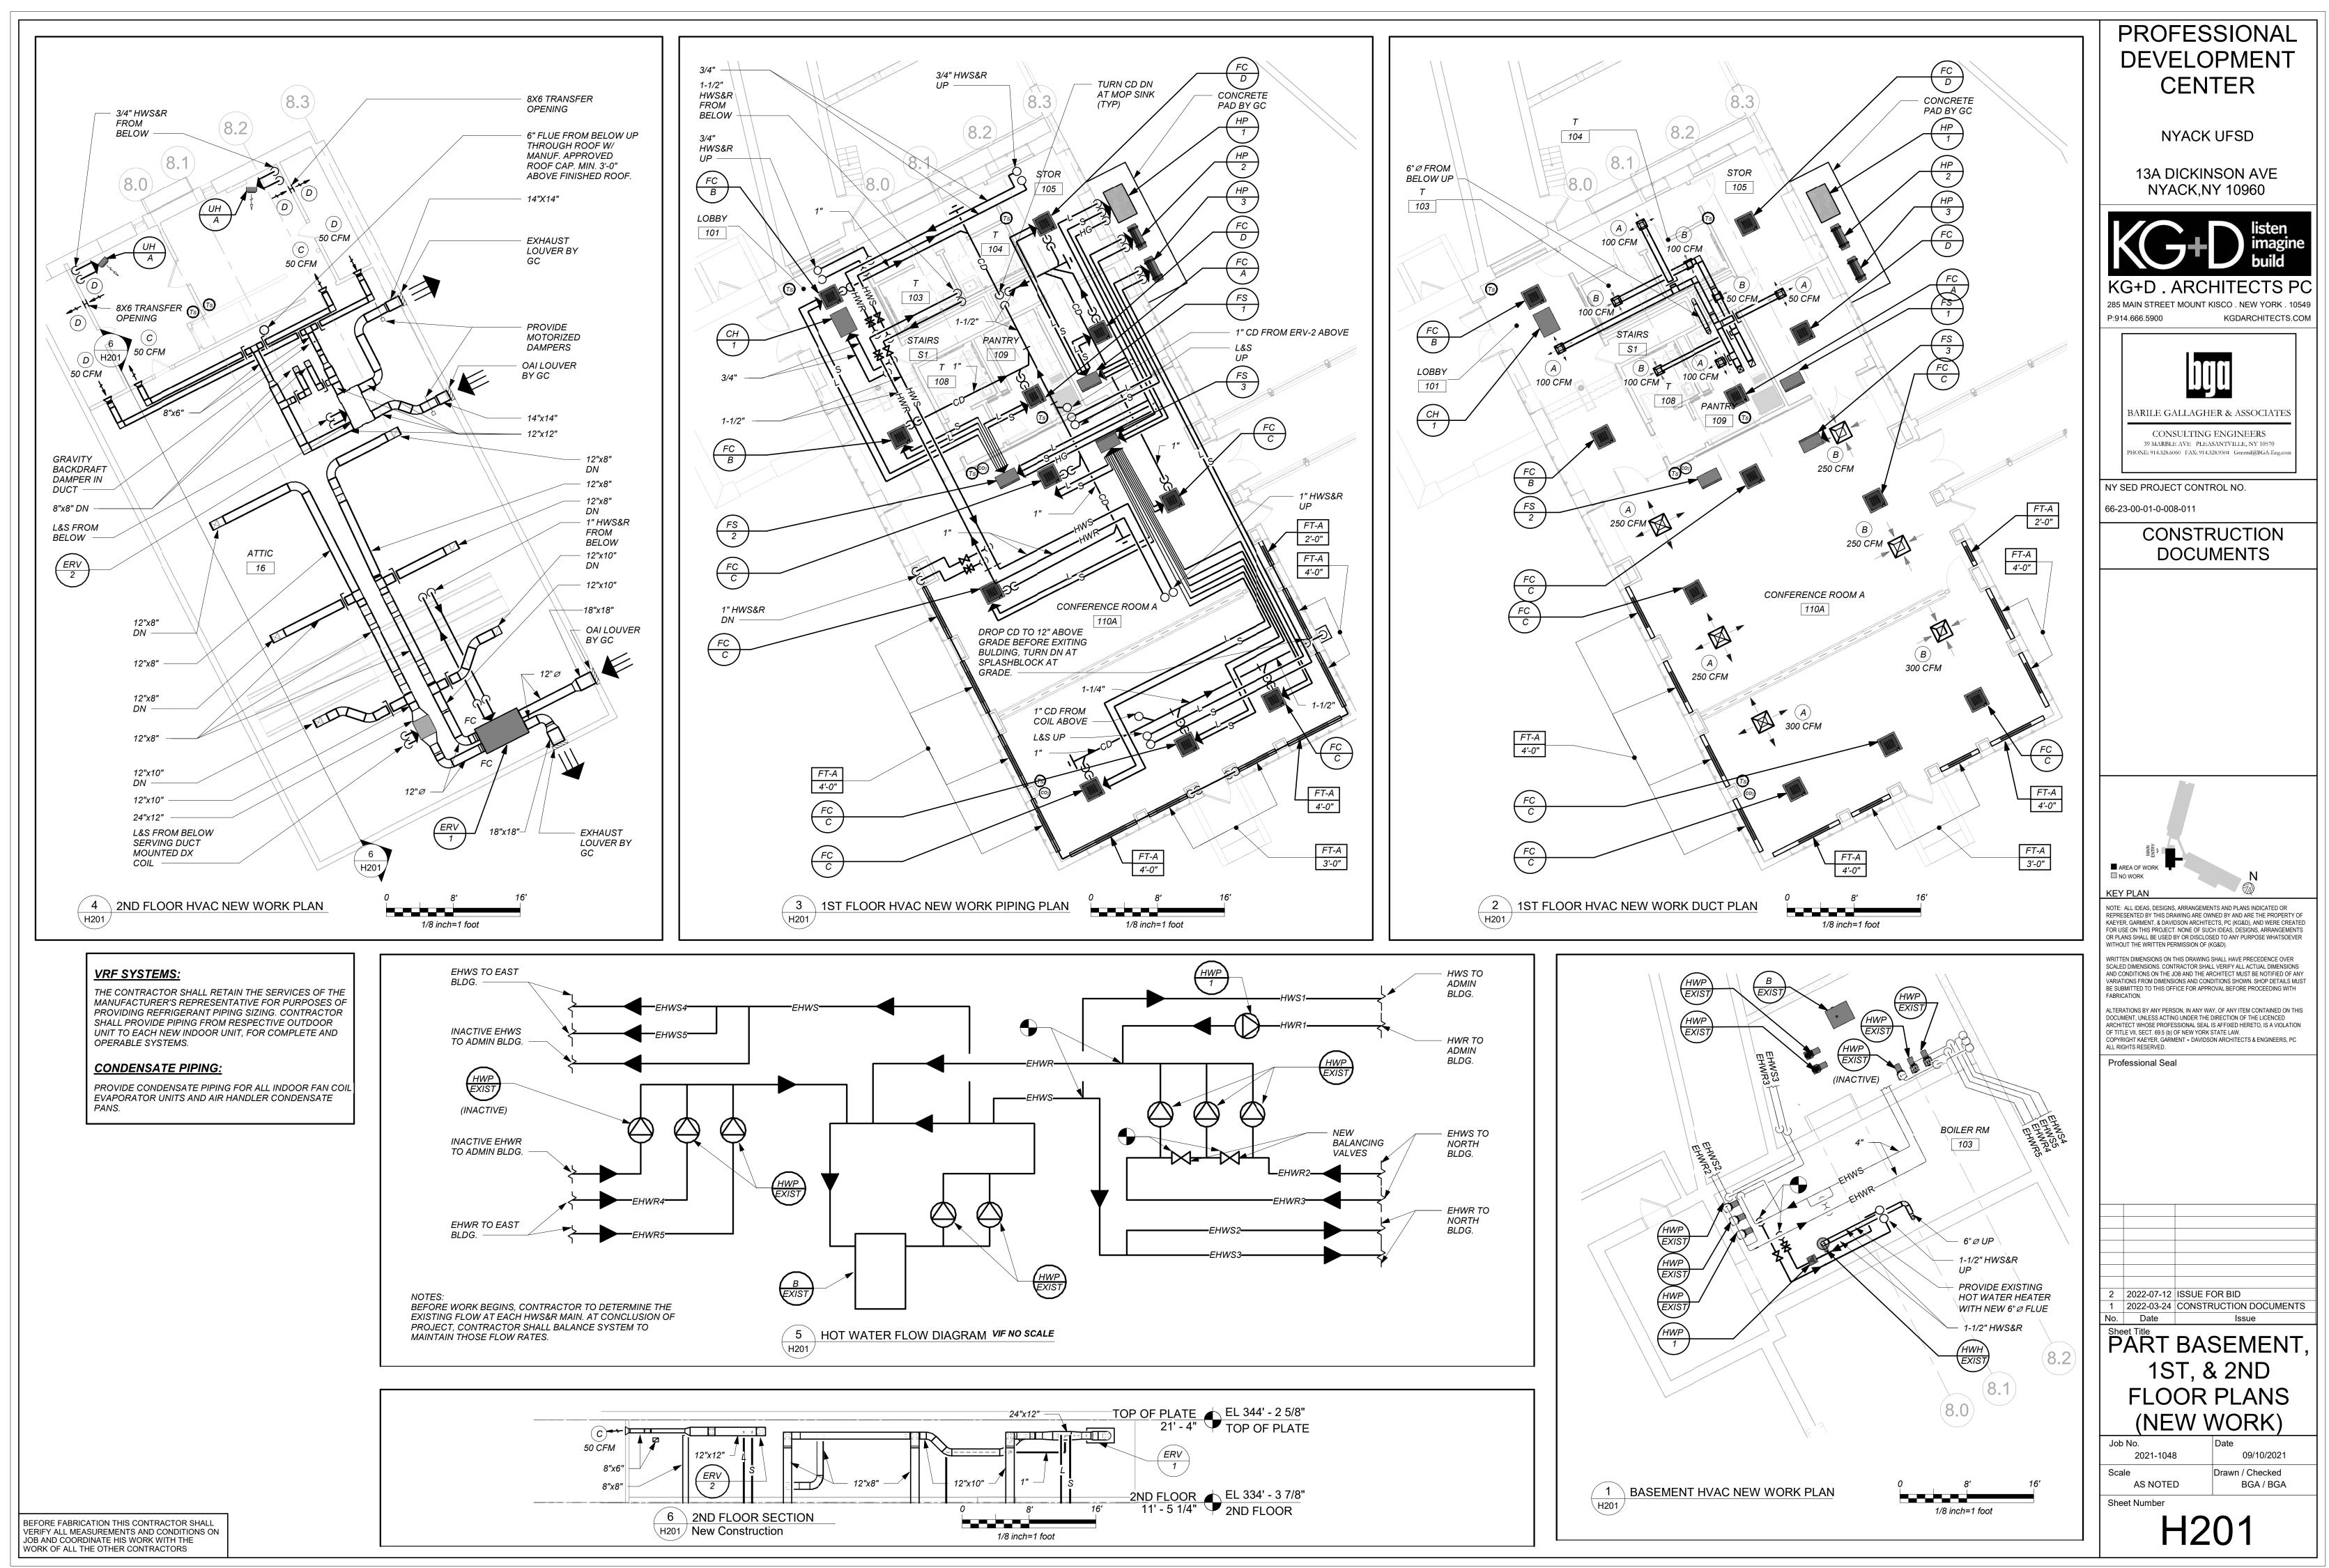(3) INTEGRAL HOT WATER COIL. PROVIDE FREEZE STAT.

E.W.T=180° F. L.W.T.=160° F.

- BASED ON A.R.I. CERTIFIED COIL SELECTIONS; REFRIGERANT R-410A.
- 5 FLOOR MOUNTED UNIT WITH INTEGRAL HIGH CAPACITY HOT WATER COIL AND DUCT MOUNTED DX COIL. PROVIDE VIBRATION ISOLATORS EXHAUST/DEFROST CONTROLS, DEMAND CONTROL VENTILATION, LOW TEMPERATURE LIMIT CONTROLS, DIFFERENTIAL ENTHALPY ECONOMIZER CONTROÉS, MOTORIZED OA AND EA DAMPERS, DIRTY FILTER CONTACTS, PHASE PROTECTION AND DISCONNECT SWITCH. TIE INTO BMS.
- 6 FLOOR MOUNTED UNIT WITH INTEGRAL DX COIL. PROVIDE VIBRATION ISOLATORS EXHAUST/DEFROST CONTROLS, LOW TEMPERATURE LIMIT CONTROLS, DIFFERENTIAL ENTHALPY ECONOMIZER CONTROLS, DIRTY FILTER CONTACTS, MOTORIZED OA AND EA DAMPERS, AND DISCONNECT SWITCH. TIE INTO BMS.

																		AL IIUI				<u> </u>	FIFING CON	<u>///5</u>
			SCHEDU	LE OF MINIM	JM VENTILATION	ROOM FLO	W RATES							SCHEL	DULE	OF	Alf	7 <i>SO</i>	UR	CE	HEA	AT PL	JMP UN	ITS
		A	В	С	D	E	F	G	Н	1							1	COMPRES	<u> </u>	FLF		DATA	PHYSICAL DATA	
	OCCUPANCY	ROOM AREA	PEOPLE DENSITY	PEOPLE OUTDOOR AIR	AREA OUTDOOR AIR FLOW	KHAUST AIR FLOW RATE	NUMBER OF	OUTDOOR AIR FLOW RATE WITHOUT ZONE	ZONEAIR	MINIMUM ROOM	MINIMUM EXHAUST	MARK	LOCATION	MODEL Nº ①	COOLING CAPACITY (MBH)	CAPACITY (MBH)	´ EER	TYPE	QTY	MCA	MOP	ELECTRICAL SERVICE	DIMENSION/WEIGH (L"XW"XH")/(LBS)	T REMARKS
ROOM NAME/NUMBER	CATEGORY	(SQ.FT.)	(#P/1000 SQ.FT.)	FLOW RATE (CFM/PERSON)	RATE IN BREATHING ZONE	(CFM/SQ.FT.)	<i>PEOPLE</i> (A×B)÷1000=#P	EFFECTIVENESS FACTOR (F×C)+(A×D)=CFM	EFFECTIVENESS FACTOR		AIR FLOW RATE A×E=CFM	HP	ON GRADE	ARUM168BTE5	168	189	11.7	DC SCROLL	2	54	70	208/3/60	49X30X67/666	REFER TO 2345
Lobby/ 101	MAIN ENTRY LOBBIES	300	10	5	0.06	0	3	33	0.8		0	$(HP)_2$	ON GRADE	ARUN024GSS4	24	27	12.2	DC INVERTER	ד 1	20	30	208/1/60	38X16X33/176	REFER TO 2346
Corridor/102	CORRIDORS	70	0	0	0.06	0	0	4	0.8	5	0	HP												
Stor/ 105	OCCUPIABLE STORAGE ROOMS FOR DRY MATERIALS	310	2	5	0.06	0	1	24	0.8	30	0		AS MANUFAC	ARUN024GSS4		27	12.2	DC INVERTER	7	20	30	208/1/60	38X16X33/176	REFER TO 2346
Pantry/109	KITCHENETTES	100	20	7.5	0.12	0.3	2	27	0.8	34	30	02	INSTALL PER	MANUFACTURER'S F	RECOMMENDAT	TONS.								
Conf/ 110	CONFERENCE/MEETING	1795	50	5	0.06	0	90	558	0.8	697	0		REFRIGERANT	USED SHALL BE R	9–410a.									
Second Floor Storage	OCCUPIABLE STORAGE ROOMS FOR DRY MATERIALS	300	2	5	0.06	0	1	23	0.8	29	0		MOUNT ON P	CONDITIONS: SUMM PRECAST CONCRETE	E PAD BY G	C. THREE I	PIPE SYS	TEM. PROVIDE	E STAND), NEOPRE	NE VIBRAT	TION ISOLATIO	N PADS, EQUIPMENT	SUPPORTS, DISCONNECT
Second Floor Storage	OCCUPIABLE STORAGE ROOMS FOR DRY MATERIALS	300	2	5	0.06	0	1	23	0.8	29	0	6	•	•									BASED ON SYSTEM L PADS, EQUIPMENT S EED CONTROL BASEL	LOAD. SUPPORTS, CONVENIENCE O ON SYSTEM LOAD.


	SCHEDULE OF REGISTERS AND DIFFUSERS											SCH	HEL	DULE	OF	VR	F	IN	DOC	OR UNITS
MARK	TYPE	SERVICE	MODEL No. (1)	NOMINAL FACE SIZE	DIRECTION DISCHARGE	DAMPER TYPE	FINISH	REMARKS	MARK	MODEL			1	DATA ELECTRIC	TOTAL	147	0	1	/EIGHT	REMARKS
A	CEILING DIFFUSER	SUPPLY	SCD	12X12/24X24	FOUR-WAY	OPPOSED BLADE	PER ARCH.	REFER TO 2345		No. (1)	HIGH	MCA	МОСР	ELECTRIC SERVICE	COOL/HEAT MBH	W (IN.)	(IN.)	(IN.)	LBS	
B	CEILING REGISTER	RETURN/EXHAUST	635	8X4/24X24	-	OPPOSED BLADE	PER ARCH.	REFER TO 2346	\mathcal{FC}	ARNU053TRD4	265	0.25	15	208/1/60	5.5/6.1	25	25	10	45	REFER TO 2345
\bigcirc	SIDE WALL REGISTER	SUPPLY	620	8X4	DOUBLE DEFLECTION	OPPOSED BLADE	PER ARCH.	REFER TO 2345	FC B	ARNU093TRD4	388				9.6/10.9	25	25	10	49	
\bigcirc	SIDE WALL REGISTER	RETURN/EXHAUST	635	8X4	-	OPPOSED BLADE	PER ARCH.	REFER TO 2346	FC	ARNU153TQD4	396				15.4/17.1	25	25	12	51	
	S MANUFACTURED B				-				(FC)	ARNU183TQD4	812	V			19.1/21.5	25	25	12	51	
0 Ø /	NSTALL PER MANUFA	ACTURERS RECOMMENDA							FS	PRHR023A	N/A	0.17			N/A	20	19	9	46	REFER TO 236
		RATED DAMPERS IN UN∙ RAME COMPATIBLE W∕I		AS.	SUPPLY NECK SIZ	'E PER CFM RANG 700 fpm)	GE 6 RETURN N (NOT TO E	IECK SIZE PER CFM RANGE EXCEED 675 fpm)	$\frac{FS}{2}$	PRHR033A		0.17				20	19	9	50	
S S	URFACE. COORDINATI INISHES AND DIMENS	RAME COMPATIBLE W/ 1 E ALL BORDER TYPES, NONS WITH ARCHITECT.	COLORS,		50 100 246 . TO TO TO			400 600 800 1100 1200 TO TO TO TO TO TO 9 599 799 1099 1199 2399	FS 3	PRHR063A		0.27				32	19	9	75	

	SCHEDULE OF UNIT HEATERS													
MARK	MODEL No. (1)	BTU/HR	CAPACIT EWT °F	Y DATA LWT °F	GPM	MOTOR WATTS	ELECTRIC SERVICE	PHYSICAL LxWxH	DATA WEIGHT (LBS)	REMARKS				
	110. U	<i>ΒΤΟΥ Π</i> Κ		LVVIT	GEIVI	114115	JENVICE		WEIGHT (LDS)	REFER TO				
(UH)	HS—36	20,100	180	160	3	25	120/1/60	15"x10"x18"	40	23				
	AS MANUFACTU NSTALL PER I PROVIDE UNIT	MANUFACTURE	ER'S RECOM			r, remote W	ALL SENSOR, I	DISCONNECT SWI	TCH, AND MOUNTIN	IG HARDWARE.				

D BY "STERLING".										
UFACTURER'S RECOMMENDATIONS DUNTED MANUAL VARIABLE SPEED CONTROLLER, REMOTE WALL SENSOR, DISCONNECT SWITCH, AND MOUNTING HARDWARE.			S	CHE	DUL	Ε (DF C	ABIN	IET HEA	ATERS
THE MANDAL VARIABLE SILLE CONTROLLER, REMOTE WALL SENSOR, DISCONNECT SWITCH, AND MOONTING HARDWARE.	MARK	TYPE UNIT	MODEL Nº ①		PACITY DA	1TA GPM PD.	MOTOR FT. HP	° MOTOR RPM	ELECTRIC SERVICE	REMARKS
SCHEDULE OF PUMPS	CH A	CEILING MTD.	RC 1170 03	20.6	335	2.0 0.2	25 1/15	1050	120/1/60	23456
MARKSERVICELOCATIONMODEL N $^{\circ}$ $^{\circ}$ GPMHEAD FT.H20RPMMOTOR HPELECTRIC SERVICEREMARKS \overrightarrow{HWP} $\overset{CONFERENCE}{BLDG}$ BOILER ROOMSERIES E-90 1AAB172518001/2208/1/60REFER TO 23 \overrightarrow{MP} $\overset{O}{O}$ AS MANUFACTURED BY "BELL & GOSSETT". \overrightarrow{O} $\overset{O}{O}$ INSTALL PUMPS PER MANUFACTURER'S RECOMMENDATIONS. \overrightarrow{F} $\overset{O}{O}$ PROVIDE ECM PERMANENT MAGNET VARIABLE SPEED MOTOR WITH MOUNTED USER INTERFACE, DISCONNECT SWITC AND STEAL BRAIDED FLEXIBLE CONNECTIONS		5 FRAME. COORD 5 UNIT DIMENSIO	MANUFACTURER'S SED ON LOW SPL W COIL, THROWAN DINATE FINISH AND WNS 36"x25"x9.5",	RECOMME EED FAN S WAY FILTEH D COLOR WEIGHT	SETTING, RS, INTEG WITH ARG 150 LBS	AND 160 GRAL SPE CHITECT.	ED CONTRO			OTE WALL SENSOR, GASKET AND PERMA LAP WATER TEMPERATURE BELOW 110 DEGREES F.
$S \xrightarrow{4}$ PUMP DIMENSIONS 8" W x 12" L x 16" H / WEIGHT 55 LBS										

BEFORE FABRICATION THIS CONTRACTOR SHALL VERIFY ALL MEASUREMENTS AND CONDITIONS ON JOB AND COORDINATE HIS WORK WITH THE WORK OF ALL OTHER CONTRACTORS

C:\Users\NPedlow\AppData\Local\Temp\AcPublish_6964\214800H301.dwg July 11, 2022

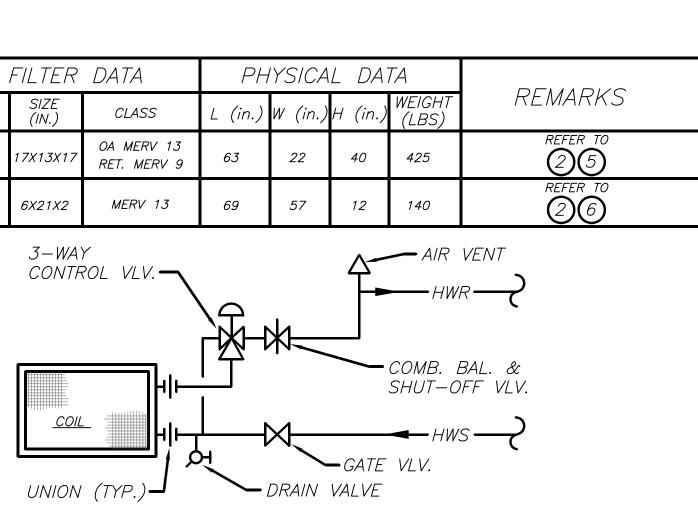

5	SL (N	IPPLY OT TO	NECK S EXCEE	SIZE PEI D 700 i	R CFM I fpm)	RANGE	6	RETUI (NOT	RN NEO TO EX	CK SIZE CEED E	E PER 675 fp	CFM R. m)	ANGE	
50 TO 13		100 TO 245	246 TO 380	381 TO 550	551 TO 750	751 TO 860	50 TO 149	150 TO 249	250 TO 399	400 TO 599	600 TO 799	800 TO 1099	1100 TO 1199	1200 TO 2399
6"	ø	8"ø	10"ø	12"ø	14"ø	15"ø	6x6	8X8	10X10	12X12	14X14	16X16	18X18	24X24

N (1) AS MANUFACTURED BY "LG."


0 2 install per manufacturer's recommendations.

 $E \xrightarrow{\prime} BASED ON A.R.I. CERTIFIED COIL SELECTIONS; REFRIGERANT R-410A.$ s of provide factory mounted integral condensate pump, check valve, anti sweat sleeve, ball valves, and auto shutdown overflow switch.


DROVIDE MOUNTING HARDWARE, VIBRATION ISOLATORS, DISCONNECT AND HARDWIRED REMOTE WALL MOUNTED CONTROLLER/THERMOSTAT. WHERE MULTIPLE UNITS TIE INTO ONE ZONE CONTROLLER PROVIDE WIRED REMOTE GROUP CONTROL CABLE ASSEMBLE PZCWRC1 AS REQUIRED. TIE INTO BMS. 6 PROVIDE MOUNTING HARDWARE. MOUNT HORIZONTALLY.

TYPICAL HOT WATER HEATING COIL PIPING CONNS.

]	PROFESSIONAL DEVELOPMENT
	CENTER
	NYACK UFSD
	13A DICKINSON AVE NYACK,NY 10960
	listen imagine
	build
	KG+D. ARCHITECTS PC 285 MAIN STREET MOUNT KISCO . NEW YORK . 10549 P:914.666.5900 KGDARCHITECTS.COM
	BARILE GALLAGHER & ASSOCIATES
ך ר	CONSULTING ENGINEERS 39 MARBLE AVE PLEASANTVILLE, NY 10570 914.328.6060 GENERAL@BGA-ENG.com www.BGA-ENG.com
	NY SED PROJECT CONTROL NO. 66-23-00-01-0-008-011
	CONSTRUCTION DOCUMENTS
╡	MANN ¢
	AREA OF WORK NO WORK NO WORK KEY PLAN
+	NOTE: ALL IDEAS, DESIGNS, ARRANGEMENTS AND PLANS INDICATED OR REPRESENTED BY THIS DRAWING ARE OWNED BY AND ARE THE PROPERTY OF KAEYER, GARMENT, & DAVIDSON ARCHITECTS, PC (KG&D), AND WERE CREATED FOR USE ON THIS PROJECT. NONE OF SUCH IDEAS, DESIGNS, ARRANGEMENTS OR PLANS SHALL BE USED BY OR DISCLOSED TO ANY PURPOSE WHATSOEVER
	WITHOUT THE WRITTEN PERMISSION OF (KG&D). WRITTEN DIMENSIONS ON THIS DRAWING SHALL HAVE PRECEDENCE OVER SCALED DIMENSIONS. CONTRACTOR SHALL VERIFY ALL ACTUAL DIMENSIONS AND CONDITIONS ON THE JOB AND THE ARCHITECT MUST BE NOTIFIED OF ANY VARIATIONS FROM DIMENSIONS AND CONDITIONS SHOWN, SHOP DETAILS MUST
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	2 2022-07-12 ISSUE FOR BID 1 2022-03-24 CONSTRUCTION DOCUMENTS
	No. Date Issue Sheet Title OOUEDUED
	SCHEDULES
	Job No. Date 2021-1048 09/10/2021 Scale Drawn / Checked
	AS NOTED BGA / BGA Sheet Number
	H301

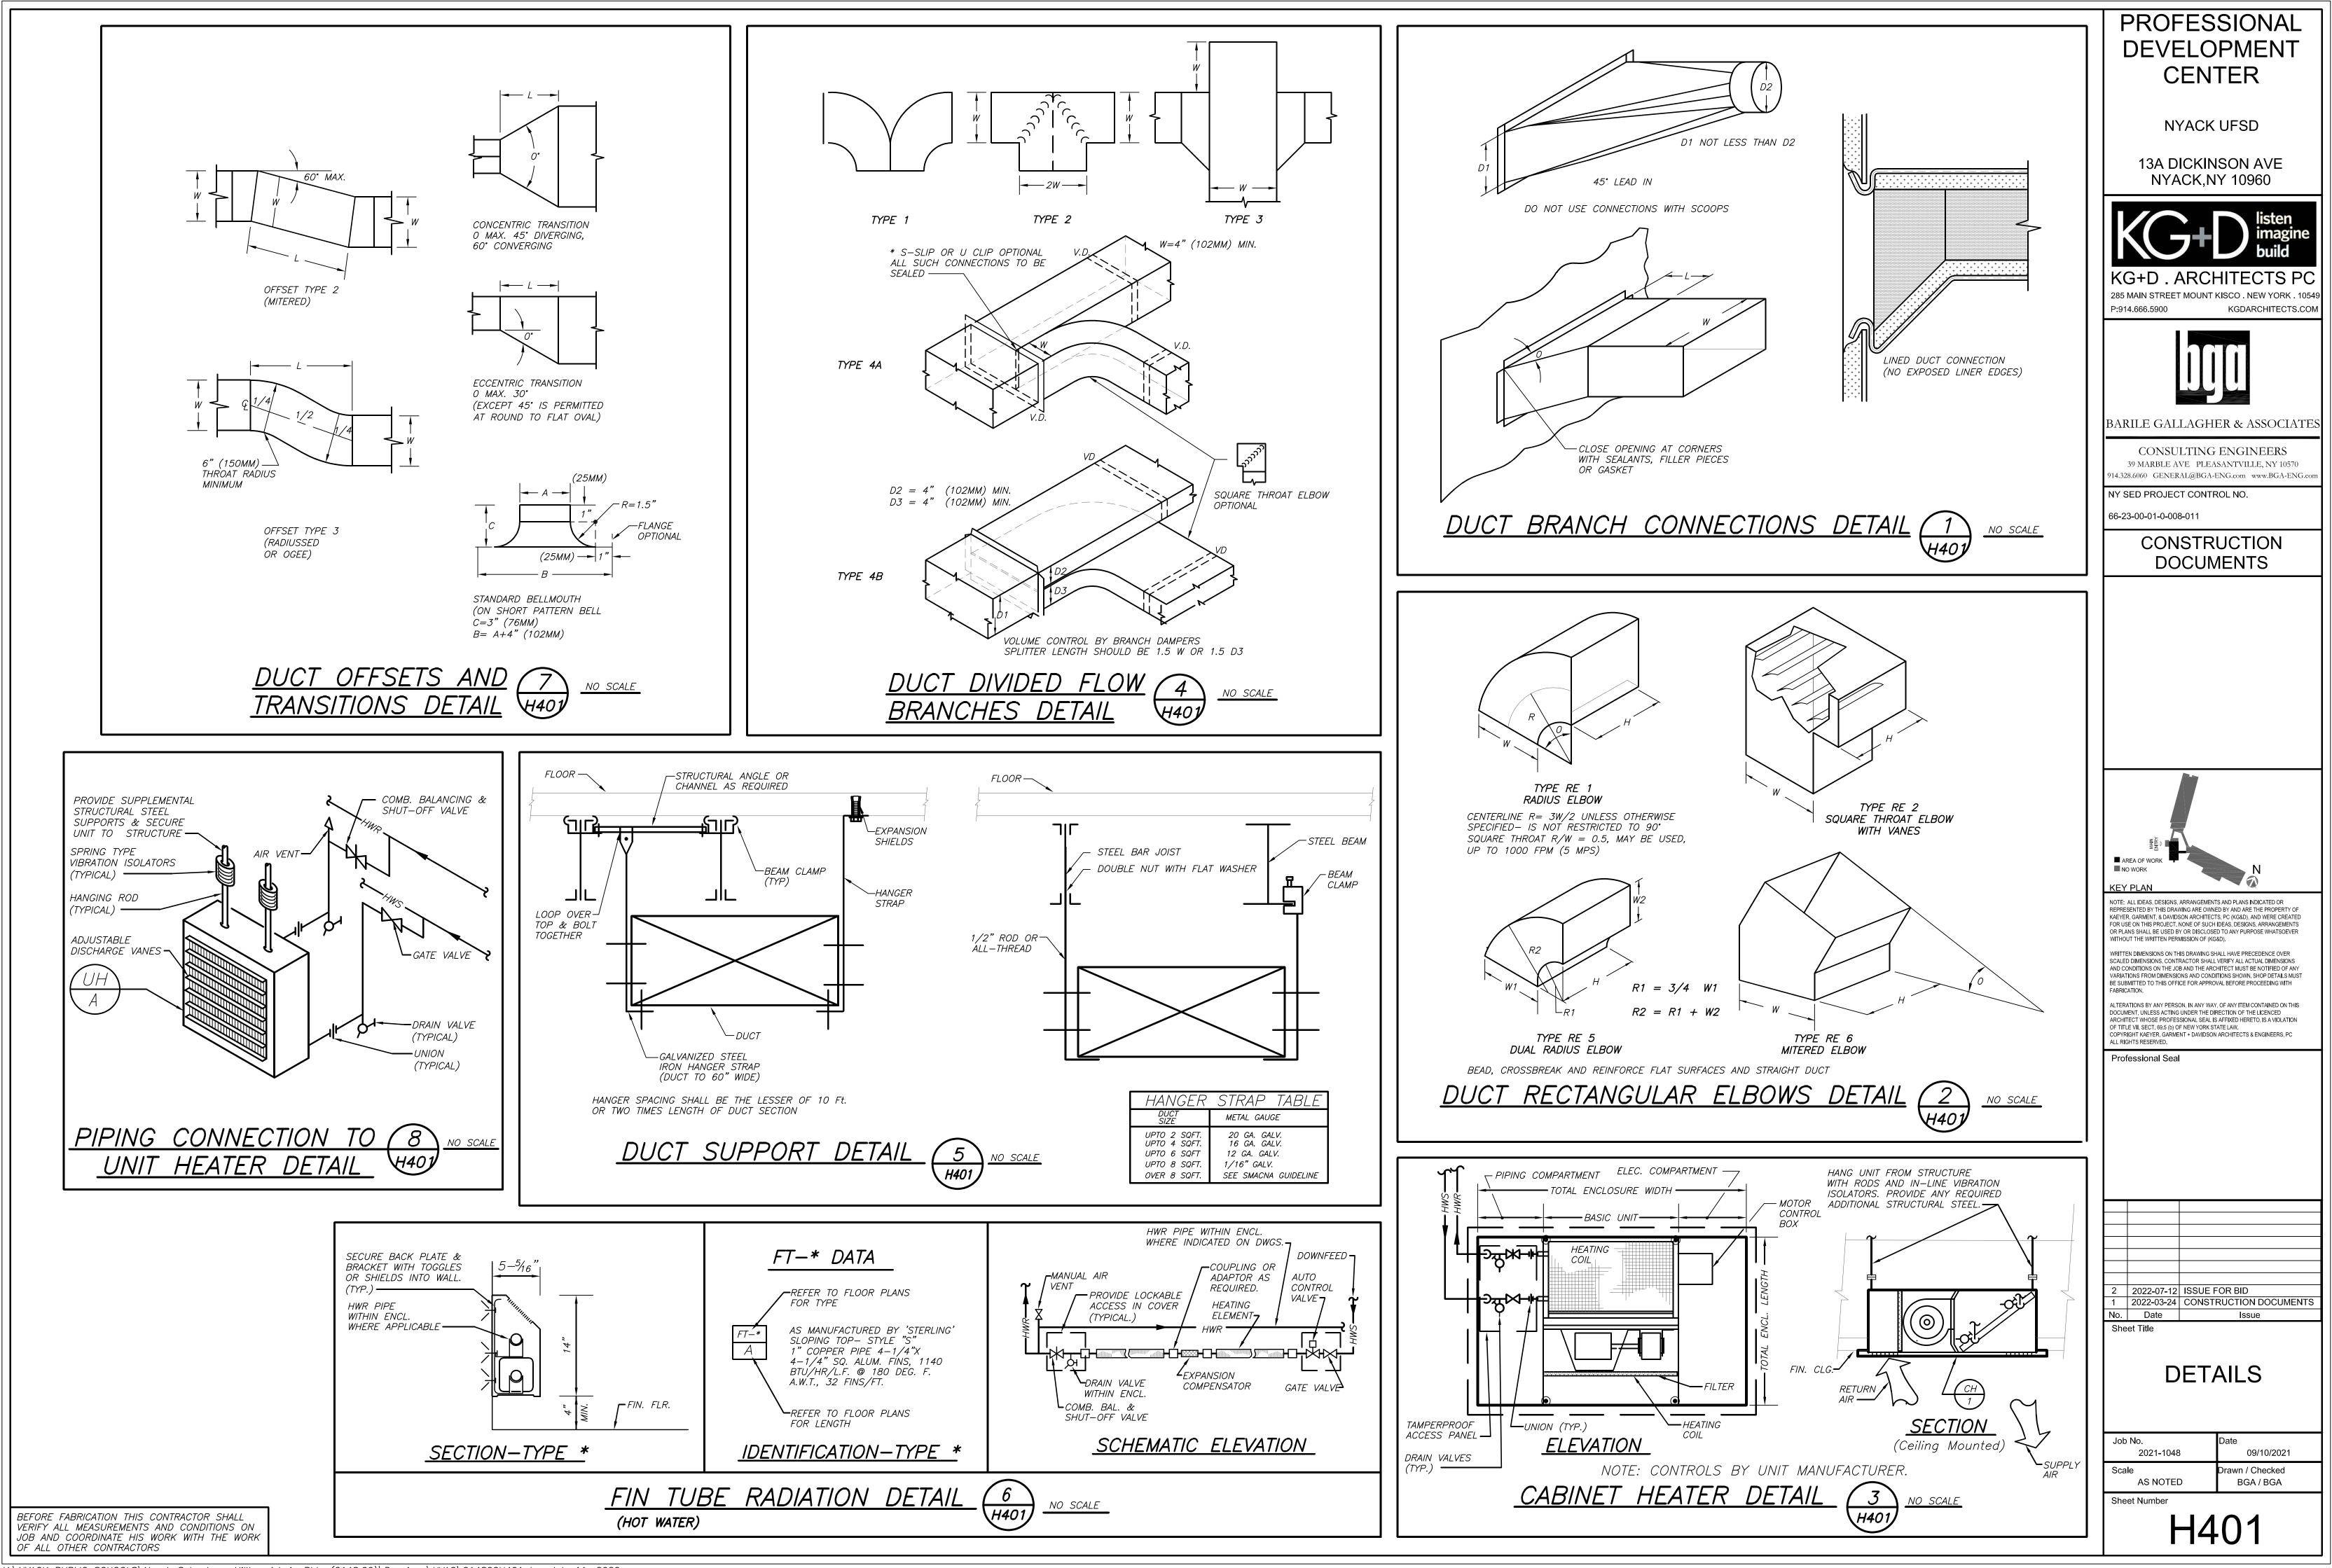

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	DRAWINGS ARE DIAGRAMMATIC AND INDICATE THE GENERAL ARRANGEMENT OF SYSTEMS AND WORK. CONTRACTOR SHALL FURNISH ALL NECESSARY OUTLETS, SUPPORTS, FITTINGS AND ACCESSORIES TO FULFILL APPLICABLE CODES, REGULATIONS, BUILDING STANDARDS AND THE BE PRACTICES OF THE TRADE FOR FIRST CLASS ELECTRICAL INSTALLATION.
2.	THE DRAWINGS INDICATE SIZE AND GENERAL LOCATION OF WORK. SCALED DIMENSIONS SHALL NOT BE USED. THE EXACT LOCATION AND ELEVATION OF ALL ELECTRICAL EQUIPMENT SHALL BE COORDINATED IN FIELD WITH RESPECTIVE CONTRACTOR/OWNER.
3.	THE CONTRACTOR SHALL COORDINATE WITH THE OWNER PRIOR TO SUBMISSION OF BID TO DETERMINE WHAT WORK MUST BE PERFORMED AFTER NORMAL BUSINESS HOURS. UNLESS OTHERWISE DIRECTED ANY NOISY WORK (CHOPPING, CORE DRILLING,HAMMERING, ETC.) AND BUILDING POWER INTERRUPTIONS SHALL BE PERFORMED OUTSIDE OF NORMAL BUSINESS HOURS CONFIRM NORMAL BUSINESS HOURS WITH BUILDING OWNER. NO ADDITIONAL COST WILL BE CHARGEDTO OWNER FOR WORK PERFORMED OUTSIDE NORMAL BUSINESS HOURS.
4.	ALL WORK WHERE SHOWN WITH DARK/SOLID LINES ON THE DRAWINGS IS NEW UNLESS OTHERWI NOTED.
5.	FEEDERS AND BRANCH CIRCUITRY SHALL BE RUN IN MINIMUM 3/4" CONDUIT UNLESS OTHERWISE NOTED. FINAL CONNECTIONS TO MOTORS MAY BE MADE WITH FLEXIBLE METALLIC CONDUIT (NO LONGER THAN 18"). IN UNFINISHED AREAS CONDUIT SHALL BE RUN EXPOSED AND IN FINISHED AREAS CONDUIT SHALL BE RUN CONCEALED.
6.	PROVIDE PANEL NAME PLATE MADE OF BLACK LAMINATED PLASTIC WITH WHITE ENGRAVED LETTERING AND TYPE WRITTEN DIRECTORY FOR ALL NEW AND EXISTING PANELS BEING USED FO THIS PROJECT.
7.	ALL CONDUCTORS SHALL BE COPPER, TYPE THHN/THWN INSULATED. ALL CONDUCTORS SHALL HA 600 VOLT RATED INSULATION UNLESS OTHERWISE NOTED.
8.	PROVIDE LOCK-ON CIRCUIT BREAKERS FOR CIRCUITS SERVING EXIT SIGN FIXTURES AND EMERGENCY BATTERY PACK FIXTURES.
9.	REFER TO ARCHITECT'S REFLECTED CEILING PLAN FOR EXACT LOCATION OF ALL CEILING MOUNT. LIGHTING FIXTURES AND OTHER CEILING INSTALLED ITEMS.
10.	THE USE OF FLEXIBLE CONDUIT FROM LIGHTING FIXTURES TO JUNCTION BOX IS PERMITTED ONLY WEN A SEPARATE GROUND WIRE IS INSTALLED WITH THE CONDUCTORS INSIDE FLEXIBLE CONDU THE GROUND WIRE MUST BOND THE FIXTURE HOUSING TO THE JUNCTION BOX. MAXIMUM LENGTH 6'-0".
11.	EXACT LOCATION AND MOUNTING HEIGHTS OF ALL DEVICES SHALL BE COORDINATED WITH THE ARCHITECT PRIOR TO THE INSTALLATION.
12.	WALL MOUNTED EQUIPMENT (SWITCHES, RECEPTACLES, ETC.,) SHALL BE SURFACE MOUNTED IN UNFINISHED AREAS AND ON EXISTING CONCRETE BLOCK WALLS AND FLUSH MOUNTED IN NEW WALLS/PARTITIONS.
13.	CONDUIT RUNS SHALL BE PARALLEL WITH OR AT RIGHT ANGLES TO WALLS AND CEILINGS. CONDUIT SHALL BE SUPPORTED BY APPROVED MEANS. SUPPORTS FOR HORIZONTAL RUNS OF CONDUIT SHALL NOT EXCEED SEVEN FEET ON CENTERS.
14.	PROVIDE PULL BOXES, JUNCTION BOXES, CONDUIT ELBOWS AND OFFSETS TO SUIT FIELD CONDITIONS AND THE NATIONAL ELECTRICAL CODE.
15.	ALL EMPTY CONDUIT SHALL BE PROVIDED WITH A DRAGWIRE.
16.	THE MINIMUM WIRE SIZE FOR 120 VOLT BRANCH CIRCUITS SHALL BE NO. 12 AWG, EXCEPT OVER 100' IN LENGTH SHALL BE NO. 10 AWG.
17.	PROVIDE ALL REQUIRED AND NECESSARY ACCESSORIES (EX. CONNECTORS, ADAPTERS, BUSHINGS, CLAMPS, ETC.) TO FACILITATE COMPLETE INSTALLATION.
18.	THE ELECTRICAL CONTRACTOR SHALL CONFIRM THE CONFIGURATION TYPE FOR ALL SPECIAL RECEPTACLES FOR COPIERS, DATA PROCESSING EQUIPMENT. ETC. WITH OWNER AND ENGINEER PRIOR TO ORDERING.
19.	COORDINATE LOCATION OF ALL MECHANICAL EQUIPMENT WITH HVAC CONTRACTOR IN FIELD. FUSES FOR ALL MOTOR LOADS SHALL BE DUAL ELEMENT TIME DELAY TYPE.
20.	ALL JUNCTION OR OUTLET BOXES SHALL BE INSTALLED SO AS TO ALLOW ACCESS TO COVER. PROVIDE ARCHITECT APPROVED ACCESS DOORS OR PLATES AS REQUIRED IN AREAS WHERE UNOBSTRUCTED ACCESS TO BOX OR OUTLET IS NOT POSSIBLE.
21.	PRIOR TO ORDERING LIGHTING FIXTURES, COORDINATE WITH ARCHITECTURAL DRAWINGS AND SPECIFICATIONS. IF DISCREPANCIES EXIST BETWEEN ARCHITECTURAL AND ENGINEERING INFORMATION OBTAIN CLARIFICATION PRIOR TO PROCEEDING.
22.	MULTIPLE SWITCHES SHOWN IN SAME LOCATION SHALL BE GANGED TOGETHER WITH A COMMON FACEPLATE.
23.	ALL LIGHTING FIXTURES UTILIZING ELECTRONIC BALLASTS SHALL BE PROVIDED WITH A DEDICATE NEUTRAL OR AN OVERSIZED NEUTRAL WHEN SHARED.
24.	ALL LIGHTING FIXTURES CONTROLLED BY DIMMER SWITCHES SHALL BE PROVIDED WITH A DEDICATED NEUTRAL CONDUCTOR.
25.	ALL EMERGENCY LIGHT FIXTURES DESIGNATED 'EM' SHALL BE SWITCHED UNLESS OTHERWISE NOTED. PROVIDE UL924 EMERGENCY RELAY TO BYPASS SWITCH UPON INTERRUPTION OF NORMA POWER AND ILLUMINATE REGARDLESS OF SWITCH POSITION.
26.	OPENINGS AROUND ELECTRICAL PENETRATIONS THROUGH FIRE RESISTANCE RATED WALLS, ALL SLEEVES MUST HAVE BUSHINGS. SEALANT SHALL BE 3 HOUR FIRE BARRIER #CP-25 (NO LESS THAN 3" THICK BACKED UP WITH MINERAL WOOL).
27.	ALL PANELBOARD COVERS SHALL BE INSTALLED IN PLACE AT THE COMPLETION OF EACH DAYS W
28.	PREPARE 'AS-BUILT' DRAWINGS THAT REFLECT ACTUAL CONSTRUCTION AND SHOW DEVIATIONS FROM DESIGN DRAWINGS.
29.	LIGHT FIXTURES SHALL BE CONSTRUCTED TO SUIT PARTICULAR TYPE OF CEILING AND WALL CONSTRUCTION AND SHALL BE PROVIDED WITH APPROPRIATE TRIMS, MOUNTING FRAMES AND ADAPTERS AS REQUIRED.
30.	CONTRACTOR IS OBLIGATED TO INSTALL THE LIGHTING SYSTEM AND CONTROLS IN OBSERVANCE ALL APPLICABLE LOCAL AND NATIONAL CODES IN ACCORDANCE WITH APPROVED SUBMITTALS, INCLUDING ALL NOTES AND REVISIONS.
31.	LIGHTING CONTROL SYSTEM MANUFACTURER OR REPRESENTATIVE SHALL PROVIDE ORCHESTRA PROJECT MANAGEMENT AND QUALIFIED STARTUP OR COMMISSIONING SERVICES TO MEET THE SPECIFICATION AND CONTROL INTENT.
32.	CONTRACTOR SHALL BE RESPONSIBLE FOR THE PROPER INSTALLATION, WIRING, PLACEMENT, AN ADJUSTMENT OF ALL SENSORS AS PER MANUFACTURER'S SPECIFICATIONS, ENGINEER'S DESIGN INTENT, AND APPROVED SUBMITTALS.

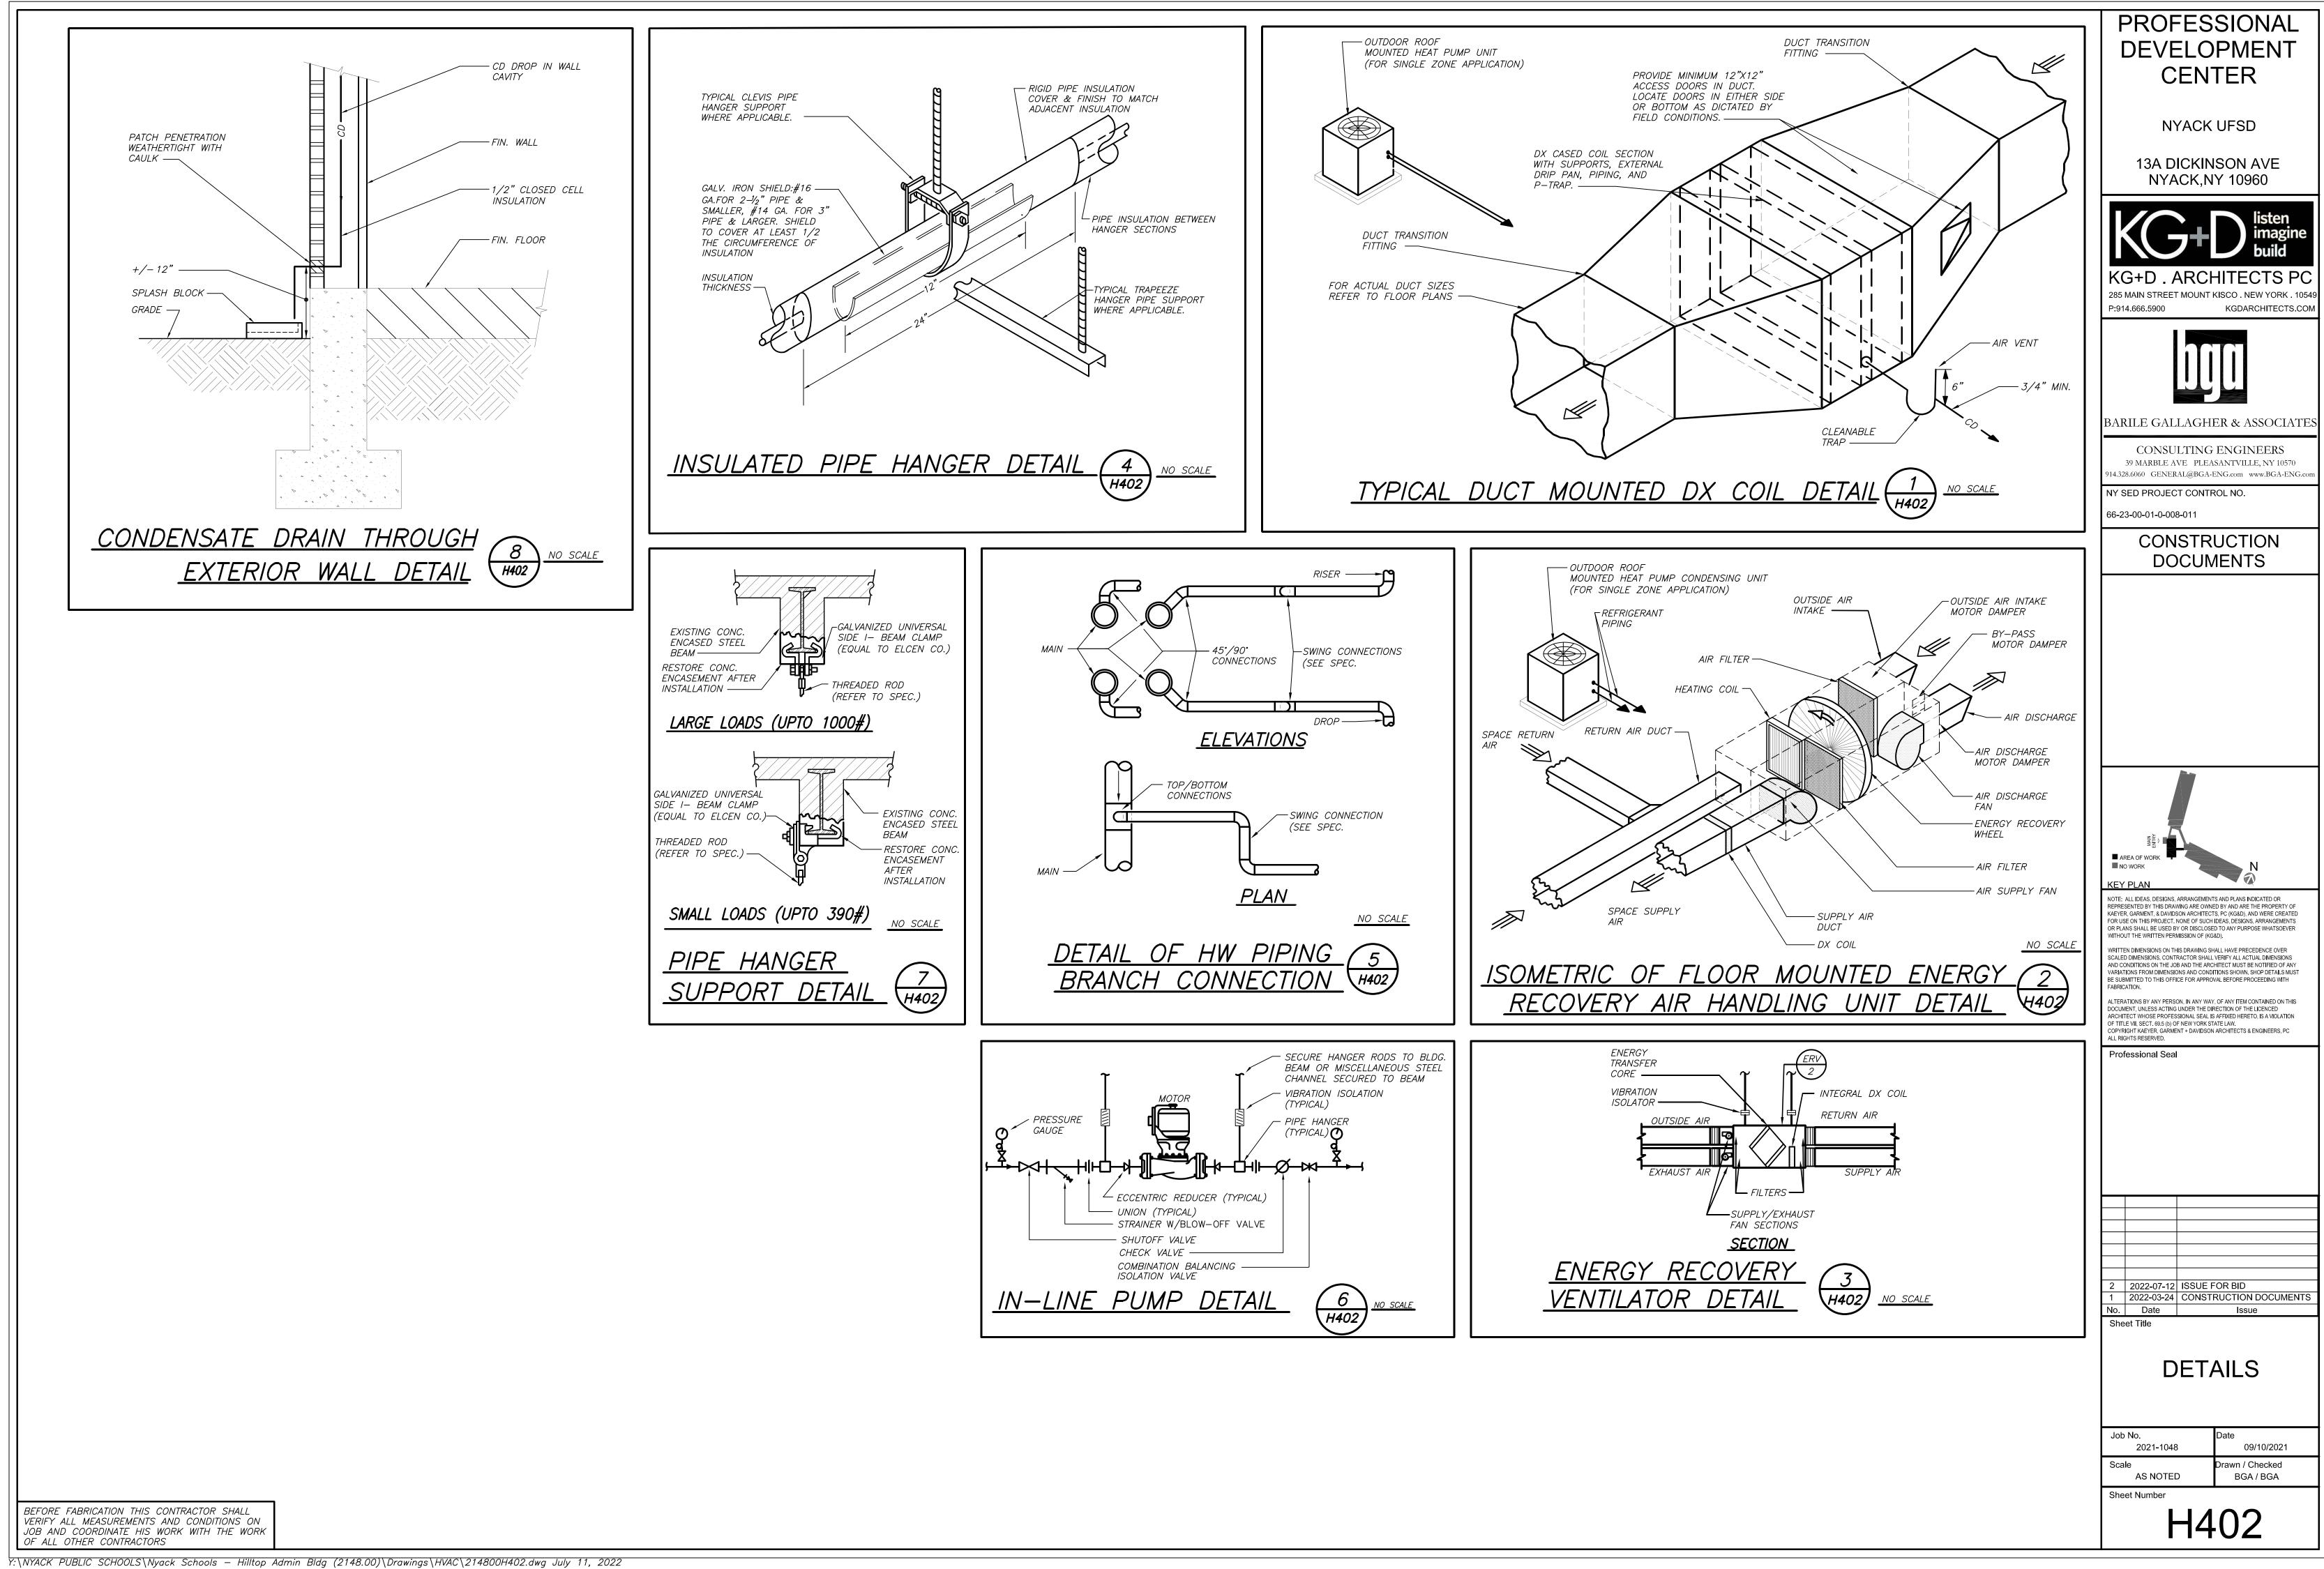BEFORE FABRICATION THIS CONTRACTOR SHALL VERIFY ALL MEASUREMENTS AND CONDITIONS ON JOB AND COORDINATE HIS WORK WITH THE WORK OF ALL THE OTHER CONTRACTORS

GENERAL REMOVAL NOTES

- 1. BEFORE COMMENCING WORK, EXAMINE ALL ADJOINING AREAS THAT MAY BE AFFECTED BY REMOVAL. REPORT TO THE GENERAL CONTRACTOR ANY CONDITION THAT PREVENTS PERFORMANCE OF THE WORK.
- 2. BECOME THOROUGHLY FAMILIAR WITH EXISTING CONDITIONS WHERE CONNECTIONS MUST BE MADE, CHANGED OR ALTERED. THE INTENT OF THE WORK IS SHOWN ON THE DRAWINGS AND DESCRIBED HEREINAFTER AND NO CONSIDERATION WILL BE GRANTED BY REASON OF LACK OF
- 3. FAMILIARITY ON THE PART OF THE CONTRACTOR WITH ACTUAL PHYSICAL CONDITIONS AT THE SITE. INSPECT EACH AND EVERY AREA AFFECTED BY THE ALTERATION OF THE SPACE BEFORE SUBMITTAL OF BID.
- 4. ALL ELECTRICAL EQUIPMENT IN THE AREA OF WORK IS EXISTING TO BE REMOVED UNLESS OTHERWISE NOTED. THIS SHALL INCLUDE BUT NOT BE LIMITED TO THE FOLLOWING:
- A. LIGHTING FIXTURES AND SWITCHES.B. CIRCUIT BREAKERS AND DISCONNECT SWITCHES.
- C. RECEPTACLES, OUTLETS AND DEVICES.
- 5. ALL CONDUCTORS AND CONDUIT ASSOCIATED WITH REMOVED ELECTRICAL EQUIPMENT SHALL BE REMOVED COMPLETELY BACK TO ITS SOURCE OF POWER AND DISCONNECTED.
- 6. ALL POWER CONDUCTORS, CONTROL WIRING AND CONDUIT ASSOCIATED WITH MECHANICAL EQUIPMENT SUCH AS FANS, AIR CONDITIONING UNITS, PUMPS, ETC. DESIGNATED FOR REMOVAL ON THE HVAC AND PLUMBING REMOVAL DRAWINGS SHALL BE REMOVED CLEAR BACK TO THE SOURCE OF POWER AND DISCONNECTED. ALL MOTOR STARTERS, DISCONNECT SWITCHES, CONTROL DEVICES, ETC. SHALL BE REMOVED. REFER TO MECHANICAL AND PLUMBING DRAWINGS FOR ADDITIONAL INFORMATION.
- 7. CIRCUIT BREAKERS AND/OR SWITCHES IN PANELBOARD(S) OR DISTRIBUTION BOARD(S) MADE SPARE DUE TO REMOVAL SHALL BE DESIGNATED AS SUCH ON THE PANEL SCHEDULE.
- 8. THE ELECTRICAL CONTRACTOR SHALL BE RESPONSIBLE TO TRACE AND RELOCATE ALL EXISTING FEEDERS AND BRANCH CIRCUIT WIRING WHICH PASSES THROUGH THE REMOVAL AREA THAT SERVE EXISTING OCCUPIED SPACES TO REMAIN. COORDINATE WITH BUILDING MANAGER PRIOR TO ANY SHUTDOWNS OR DISRUPTIONS THAT MAY BE REQUIRED TO ACCOMPLISH THIS WORK.
- 9. DISPOSE OF ALL REMOVED EQUIPMENT, WHICH IS NOT INTENDED TO BE REUSED. PRIOR TO DISPOSAL, CONTACT BUILDING MANAGER TO DETERMINE IF ANY REMOVED EQUIPMENT IS DESIRED FOR STOCK.
- 10. EXISTING CIRCUIT BREAKERS IN PANEL(S) ARE TO BE RE-USED. ELECTRICAL CONTRACTOR TO DISCONNECT PANEL AND CIRCUIT BREAKERS WITH GREAT CARE TO ENSURE AGAINST DAMAGE. THIS CONTRACTOR SHALL PROVIDE NEW CIRCUIT BREAKERS AS REQUIRED. ALL NEW CIRCUIT BREAKERS INSTALLED INTO EXISTING PANELBOARDS SHALL BE UL LISTED FOR USE IN THE PANEL.
- 11. ALL FIRE ALARM DEVICES IN THE AREA OF WORK ARE EXISTING TO BE REMOVED UNLESS OTHERWISE NOTED.
- 12. EXISTING EQUIPMENT DESIGNATED FOR REUSE SHALL BE CLEANED, REFURBISHED AND RESTORED TO OPTIMUM PERFORMANCE. THIS SHALL INCLUDE BUT NOT LIMITED TO CLEANING OF LIGHT FIXTURES, REPLACEMENT OF INOPERABLE BALLASTS AND LAMPS, RESISTANCE TESTING OF BRANCH CIRCUITRY AND FEEDERS, ETC.
- 13. EXTEND EXISTING CIRCUITRY TO THOSE DEVICES THAT ARE TO BE RELOCATED. MATCH EXISTING TYPE AND SIZE. RELOCATION OF EXISTING EQUIPMENT SHALL BE PERFORMED ONLY UPON OWNERS ACCEPTANCE OF EXISTING EQUIPMENT.
- 14. EXTEND EXISTING CIRCUITS SERVING EQUIPMENT TO REMAIN FROM PANELS THAT ARE TO BE REMOVED TO NEW PANELS OR EXISTING PANELS THAT ARE TO REMAIN.

DISPOSAL OF MERCURY CONTAINING LAMPS

- 1. ALL FLUORESCENT AND HID LAMPS WITHIN REMOVED LIGHT FIXTURES ARE CONSIDERED MERCURY CONTAINING AND SHALL BE TREATED AS HAZARDOUS MATERIAL.
- 2. FLUORESCENT AND HID LAMPS SHALL BE REMOVED FROM DEMOLISHED LIGHT FIXTURES AND DISPOSED OF AS PER NEW YORK STATE DEC REGULATIONS AND METHODS
- 3. LAMPS MUST BE BAGGED IN NON-LEACHING PLASTIC BAGS AND SEALED TO PREVENT LEAKING.
- 4. EACH LAMP OR BAGGED CONTAINER IN WHICH THESE LAMPS ARE CONTAINED MUST BE LABELED OR MARKED CLEARLY WITH ONE OF THE FOLLOWING PHRASES; UNIVERSAL WASTE LAMPS, OR WASTE LAMPS, OR USED LAMPS
- 5. THESE MARKED BAGS MUST BE DELIVERED TO THE PROPER NEW YORK STATE D.E.C. AUTHORIZED LANDFILL OR RECYCLE CENTERS.

ABBREVIATIONS

BBV.	DESCRIPTION	
A	AMP/AMPERE	
A.F.F.	ABOVE FINISHED FLOOR	
AIC	AMP INTERRUPTING CURRENT	
AWG	AMERICAN WIRE GAUGE	
СН	CABINET HEATER	
EM	EMERGENCY	
E.C.	ELECTRICAL CONTRACTOR	
EF	EXHAUST FAN	
.A.C.P.	FIRE ALARM CONTROL PANEL	
G,GRD	GROUND	
GFI	GROUND FAULT INTERRUPTER	
kcmil	THOUSAND CIRCULAR MILLS	
KVA	KILOVOLT AMPERE	
KW	KILOWATT	
LTG	LIGHTING	
МСВ	MAIN CIRCUIT BREAKER	
MDP	MAIN DISTRIBUTION PANEL	
MLO	MAIN LUGS ONLY	
MTD	MOUNTED	
NTS	NOT TO SCALE	
P.A.	PUBLIC ADDRESS	
TYP.	TYPICAL	
UH	UNIT HEATER	
J.O.N.	UNLESS OTHERWISE NOTED	
UV	UNIT VENTILATOR	
W	WATT	
WP	WEATHERPROOF	

a	2'x4' CEIL INDICATE
$\otimes / $	CEILING/ INDICATE
VS	WALL MO
OS	NETWOR WATTSTO SENSITIV
RC	NETWOR MODEL L DENOTES
3 WD2	NETWOR WATTSTO ENGRAVI SWITCH.
3 WD3	NETWOR WATTSTC ENGRAVI 3 WAY SV
3	HOMERU CONSIST
2,4,6	HOMERU U.O.N.
Φ	125V-2P-3 RECEPTA
φ	20A FLUS #GF5362.
۲	CEILING I AREAS M
	RECESSE GROUND
\bigtriangledown	FLUSH W AND 1-1/4
\mathbf{V}	FLUSH W OPENING
s _{R/L}	RAISE LC
	SURFACE
	HEAVY D
240 3 60 40 WP	CONNEC INDICATE ENCLOSU
60 40	CONNEC INDICATE
60 40 WP	CONNEC INDICATE ENCLOSU THERMAL WHERE II
60 40 WP	CONNEC INDICATE ENCLOSU THERMAL WHERE II ENCLOSU 208 VOLT
60 40 WP S _T S _{2T}	CONNEC INDICATE ENCLOSU THERMAL WHERE II ENCLOSU 208 VOLT EATON #/
60 40 WP S _T S _{2T}	CONNEC INDICATE ENCLOSU THERMAL WHERE II ENCLOSU 208 VOLT EATON #/ MOTOR (I WIRING A WALL MC
60 40 WP S _T S _{2T} S F F S	CONNEC INDICATE ENCLOSU THERMAL WHERE II ENCLOSU 208 VOLT EATON #/ MOTOR (WIRING A WALL MC
60 40 WP S _T S ₂ T 5 F F S ST	CONNEC INDICATE ENCLOSU THERMAL WHERE II ENCLOSU 208 VOLT EATON #/ MOTOR (I WIRING A WALL MC CEILING I WALL MC
60 40 WP S _T S _{2T} S F F S	CONNEC INDICATE ENCLOSU THERMAL WHERE II ENCLOSU 208 VOLT EATON #/ MOTOR (I WIRING A WALL MC WALL MC CEILING I
60 40 WP S _T S _{2T} 5 F F S ST FACP	CONNEC INDICATE ENCLOSU THERMAL WHERE II ENCLOSU 208 VOLT EATON #/ MOTOR (I WIRING A WALL MO CEILING I WALL MO FIRE ALA
60 40 WP S _T S _{2T} 5 F F F S ST FACP WAP	CONNEC INDICATE ENCLOSU THERMAL WHERE II ENCLOSU 208 VOLT EATON #/ MOTOR (I WIRING A WALL MC CEILING I WALL MC FIRE ALA JUNCTIO OWNERP
60 40 WP S _T S _{2T} 5 F F F S ST FACP WAP	CONNEC INDICATE ENCLOSU THERMAL WHERE II ENCLOSU 208 VOLT EATON #/ MOTOR (I WIRING A WALL MC CEILING I WALL MC FIRE ALA JUNCTIO OWNERP TAG SYME
60 40 WP S _T S _{2T} 5 F F F S ST FACP WAP	CONNEC INDICATE ENCLOSU THERMAL WHERE II ENCLOSU 208 VOLT EATON #/ MOTOR (I WIRING A WALL MO CEILING I WALL MO FIRE ALA JUNCTION OWNERP TAG SYME MECHANI
60 40 WP S _T S _{2T} 5 F F F S ST FACP WAP	CONNEC INDICATE ENCLOSU THERMAL WHERE II ENCLOSU 208 VOLT EATON #/ MOTOR (I WALL MC CEILING I WALL MC CEILING I WALL MC FIRE ALA JUNCTIO OWNERP TAG SYME MECHAN

AEM

LEGEND

2'x4' LED CEILING MOUNTED LIGHT FIXTURE. UPPER CASE LETTER DENOTES TYPE,LOWER CASE LETTER DENOTES SWITCH CONTROL. FIXTURE SCHEDULE DENOTES TYPE.

2'x4' CEILING MOUNTED LED LIGHT FIXTURE FOR EMERGENCY OPERATION. 'EM' INDICATES SWITCHED EMERGENCY FIXTURE, 'EM/NL'-UNSWITCHED EMERGENCY/NIGHT FIXTURE.

ING/WALL MOUNTED EXIT LIGHT WITH OUTLET BOX, DIRECTIONAL ARROWS SHADED PORTION CATES ILLUMINATED FACE. SCHEDULE DENOTES TYPE.

MOUNTED VACANCY SENSOR SIMILAR TO HUBBELL LIGHTHAWK MODEL #LHMTS1-G

WORK DIGITAL CEILING MOUNTED DUAL TECHNOLOGY OCCUPANCY SENSOR, SIMILAR TO TSTOPPER MODEL LMDC-100.. WORKS WITH DIGITAL ROOM CONTROLLER. PROGRAM TO MAXIMUM SITIVITY AND TIME DELAY TO 20 MIN.

WORK DIGITAL DIMMABLE ROOM CONTROLLER FOR LIGHTING CONTROL. SIMILAR TO WATTSTOPPER DEL LMRC-213. HOT WIRE TO LOAD, CAT 5 WIRE CONNECTION TO CONTROL THE DEVICE. RC# OTES LMRC-21# WITH '#' OF ZONES

WORK DIGITAL FLUSH MOUNTED PRESET 3-ZONE DIMMABLE WALL STATION.SIMILAR TO TSTOPPER MODEL LMSW-104, WORKS WITH DIGITAL ROOM CONTROLLER. INCLUDES BUTTON RAVING AND PROGRAMMING PER ZONE. A,B, RAISE, LOWER. SUPERSCRIPT '3' DENOTES 3 WAY TCH

WORK DIGITAL FLUSH MOUNTED PRESET 3-ZONE DIMMABLE WALL STATION.SIMILAR TO TSTOPPER MODEL LMSW-105, WORKS WITH DIGITAL ROOM CONTROLLER. INCLUDES BUTTON RAVING AND PROGRAMMING PER ZONE. A,B,C, ON/ RAISE, OFF/LOWER. SUPERSCRIPT '3' DENOTES AY SWITCH.

ERUN TO DESIGNATED PANEL, ARROWHEAD INDICATES SINGLE POLE CIRCUIT. HOMERUN SHALL SIST OF 2#12-3/4"C U.O.N.

ERUN TO DESIGNATED PANEL, NUMBERS INDICATE MULTIPLE CIRCUIT, I.E. 3-HOTS AND 1-GROUND N.

2-2P-3W-20A GROUNDED TYPE, SPECIFICATION GRADE TAMPER RESISTANCE WALL MOUNTED DUPLEX

LUSH WALL MOUNTED GROUND FAULT INTERRUPTING TYPE DUPLEX RECEPTACLE HUBBELL

ING MOUNTED 125V-2P-3W-20A GROUNDED TYPE RECEPTACLE . PROVIDE BRIDGE SUPPORT IN ALL AS MOUNTED ON CEILING TILE.

ESSED WALL BOX 2-GANG ENCLOSURE SIMILAR TO HUBBLE# FPTV WITH 125V-2P-3W-20A OUNDED TYPE SPECIFICATION GRADE RECEPTACLE SIMILAR TO HUBBELL #5362

SH WALL MOUNTED DATA OUTLET CONSISTING OF A COVER PLATE WITH 1" GROMMETED OPENING 1-1/4" EMPTY CONDUIT WITH DRAG LINE STUBBED UP 6" ABOVE FINISHED CEILING.

SH WALL MOUNTED TELE DATA OUTLET CONSISTING OF A COVER PLATE WITH 1" GROMMETED NING AND 1-1/4" EMPTY CONDUIT WITH DRAG LINE STUBBED UP 6" ABOVE FINISHED CEILING.

ELOW SWITCH

FACE MOUNTED NEW ELECTRICAL PANELBOARD.

VY DUTY TYPE DISCONNECT SWITCH WITH FINAL FLEXIBLE EQUIPMENT INECTION. 240 INDICATES VOLTAGE, 3 INDICATES NO. OF POLES, 60 INDICATES AMPERE RATING, NF CATES NON-FUSED(OR FUSE SIZE) U.O.N. REFER TO SPECIFICATION AND DRAWINGS FOR LOSURE. 'WP' WHERE USED INDICATES WEATHERPROOF ENCLOSURE (NEMA 3R).

RMAL SWITCH, CUTLER-HAMMER MS SERIES MANUAL STARTERS SINGLE-PHASE 20AMP, 12OV U.O.N. ERE INDICATED WITH `WP' PROVIDE WATERTIGHT LOSURE TYPE 3.

VOLT, SINGLE PHASE 2 POLE, THERMAL OVERLOAD PROTECTED TOGGLE TYPE SWITCH. SIMILAR TO ON #AH4361 + #AH27940G NEMA 1 ENCLOSURE.

OR (F.B.O. WIRED BY ELEC.) - NUMBER INDICATES HORSEPOWER. REFER TO PANEL SCHEDULES FOR ING AND OVER CURRENT PROTECTION.

MOUNTED COMBINATION FIRE ALARM HORN STROBE DEVICE.

L MOUNTED FIRE ALARM MANUAL PULL STATION

ING MOUNTED IONIZATION TYPE SMOKE DETECTOR

L MOUNTED FIRE ALARM STROBE LIGHT.

ALARM CONTROL PANEL.

CTION BOX FOR CEILING MOUNTED WIRELESS ACCESS POINT. DEVICE AND WIRING PROVIDED BY NERPROVIDE BRIDGE SUPPORT IN ALL AREAS MOUNTED ON CEILING TILE.

SYMBOL. NUMERAL DENOTES REFERENCE TO A WORK NOTE.

HANICAL EQUIPMENT IDENTIFICATION:

EQUIPMENT ABBREVIATION (FE, SF, HV, ETC. SEE ABBREVIATIONS ON THIS DWG.)

EQUIPMENT NUMBER

DETAIL/PART PLAN NUMBER IDENTIFICATION:

DETAIL/PART PLAN NUMBER

PROFESSIONAL DEVELOPMENT CENTER
NYACK UFSD 13A DICKINSON AVE NYACK,NY 10960
KGPHD listen imagine build KG+D.ARCHITECTS PC 285 MAIN STREET MOUNT KISCO . NEW YORK . 10549 P:914.666.5900 KGDARCHITECTS.COM
BARILE GALLAGHER & ASSOCIATES CONSULTING ENGINEERS 39 MARBLE AVE PLEASANTVILLE, NY 10570 PHONE: 914.328.6060 FAX: 914.328.9304 General@BGA-Eng.com
NY SED PROJECT CONTROL NO. 66-23-00-01-0-008-011 CONSTRUCTION
DOCUMENTS
AREA OF WORK
KEY PLAN
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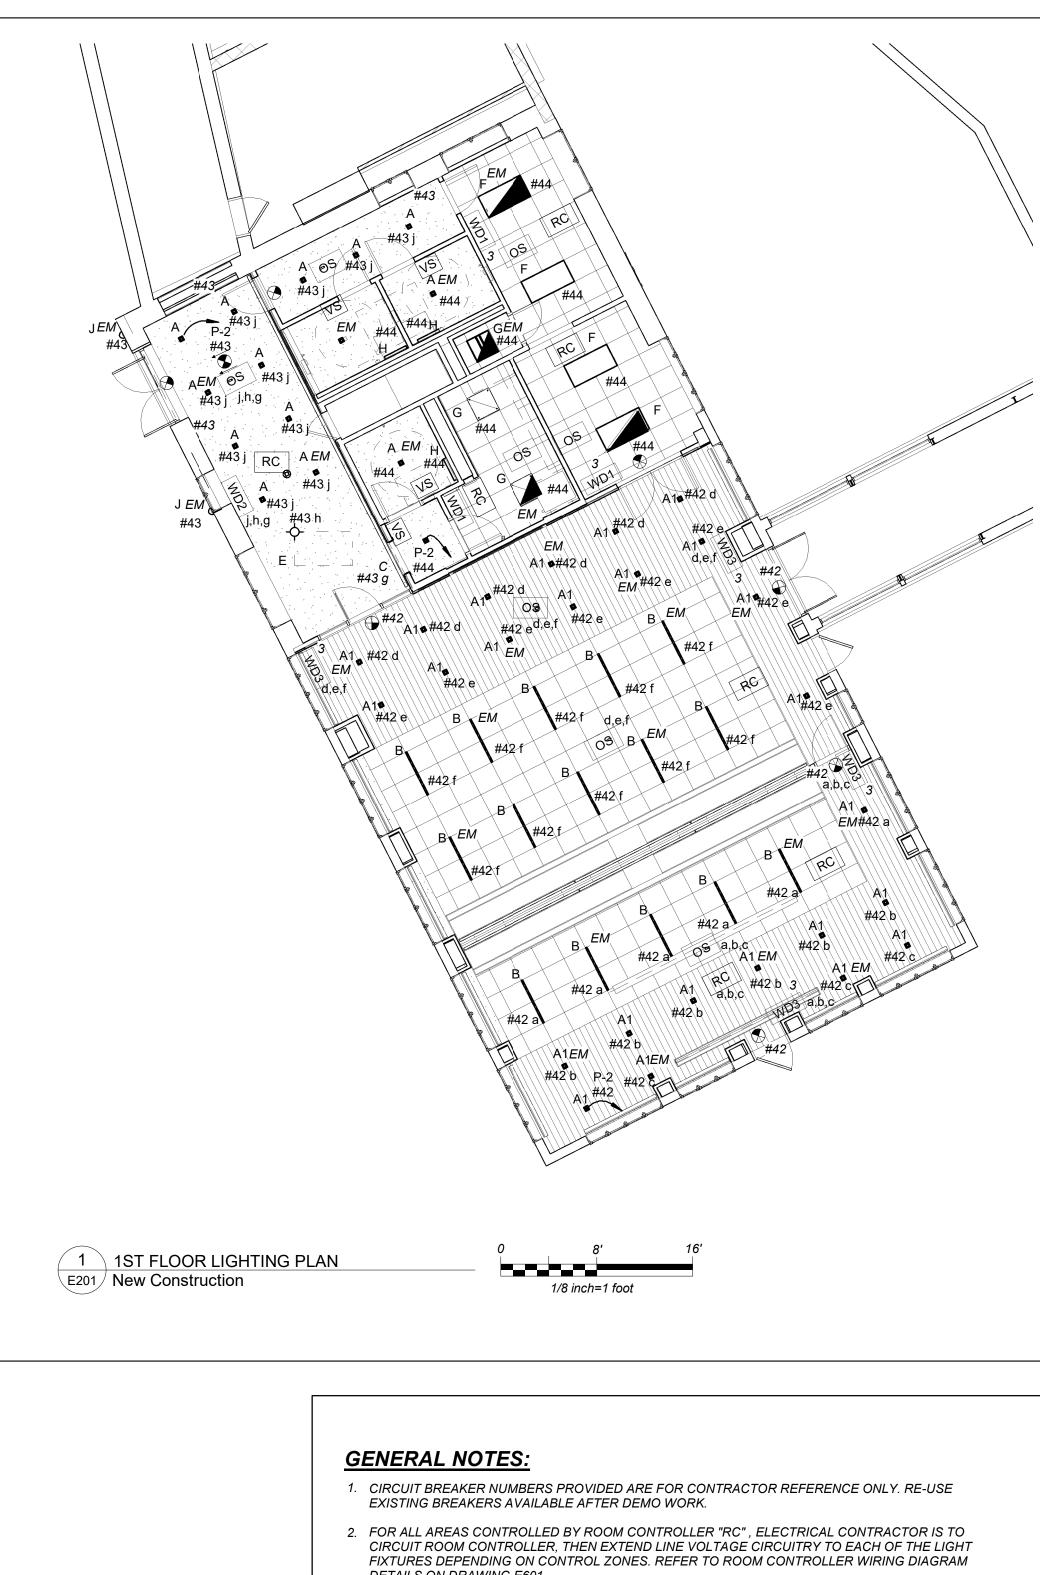
BEFORE FABRICATION THIS CONTRACTOR SHALL
VERIFY ALL MEASUREMENTS AND CONDITIONS O
JOB AND COORDINATE HIS WORK WITH THE
WORK OF ALL THE OTHER CONTRACTORS



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REMOVAL NOTES	
ELECTRICAL CONTRACTOR TO REMOVE EXISTING RECESSED MOUNTED PANELBOARD BACK TO THE SOURCE. EXTEND ANY EXISTING BRANCH CIRCUITRY TO NEW PANELBOARDS SHOWN ON DRAWING E301. REFER TO RISER ON E501 FOR ADDITIONAL SCOPE OF WORK.	
	2 2022-07-12 ISSUE FOR BID 1 2022-03-24 CONSTRUCTION DOCUMENTS No. Date Issue
	Sheet Title ELECTRICAL REMOVALS
	Job No. Date 2021-1048 09/10/2021
	Scale Drawn / Checked AS NOTED Author Checker Sheet Number Sheet Number
	E101

BEFORE FABRICATION THIS CONTRACTOR SHALL
VERIFY ALL MEASUREMENTS AND CONDITIONS O
JOB AND COORDINATE HIS WORK WITH THE
WORK OF ALL THE OTHER CONTRACTORS

1.



DETAILS ON DRAWING E601.

3. ALL EXIT LIGHTS SHALL BE CIRCUITED TO NARMAL LIGHTING CIRCUIT IN THE AREA, AHEAD OF SWITCHING.

4. SET LIGHTING CONTROL SENSORS TO HIGHEST SENSITIVITY AVAILABLE PRIOR TO INSTALLATION.


LIGHTING CONTROL AND SEQUENCE OF OPERATION:

 CONFERENCE ROOM AND LOBBY ARE CONTROLLED VIA MANUAL ON DIMMABLE WALL SWITCH AND OCCUPANCY SENSORS. EACH CLASSROOMS CONSISITS OF FULL DIMMING CAPABILITY OF THREE ZONES. WALL SWITCHES CONSISTS OF 'A', 'B', 'C' 'OFF', 'RAISE' AND 'LOWER' BUTTONS. THE OCCUPANCY SENSORS SHALL HAVE AUTO OFF FEATURE WHICH SHALL TURN ALL LIGHTS OFF AFTER 20 MINUTES WHEN THE ROOM IS VACANT. FIXTURES WITH IN BUILT EMEGENCY BATTERY PACK ARE INCLUDED TO OVVERIDE SWITCHING AND FORCE EMERGENCY LIGHTS ON 100% IN EVENT OF EMERGENCY.

 SINGLE TOILETS SHALL BE CONTROLLED VIA WALL MOUNTED VACANCY SENSOR. THE VACANCY SENSORS CONSISITS OF MANUAL 'ON' AND AUTO 'OFF'. THE AUTO OFF FEATURE WHICH SHALL TURN ALL LIGHTS OFF AFTER 20 MINUTES WHEN THE BATHROOM IS VACANT. SELF CONTAINED BATTERY PACKS TO OVERIDE ALL CONTROLS IN EVENT IF EMERGENCY.

3. EXTERIOR LIGHTS ARE CONTROLLED VIA INTEGRAL PHOTOCELL AND OCCUPANCY SENSOR . IN BUILT BATTERY BACK UP SHALL OVERIDE ALL CONTROLS IN EVENT OF EMERGENCY.

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CONSTRUCTION DOCUMENTS
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E201

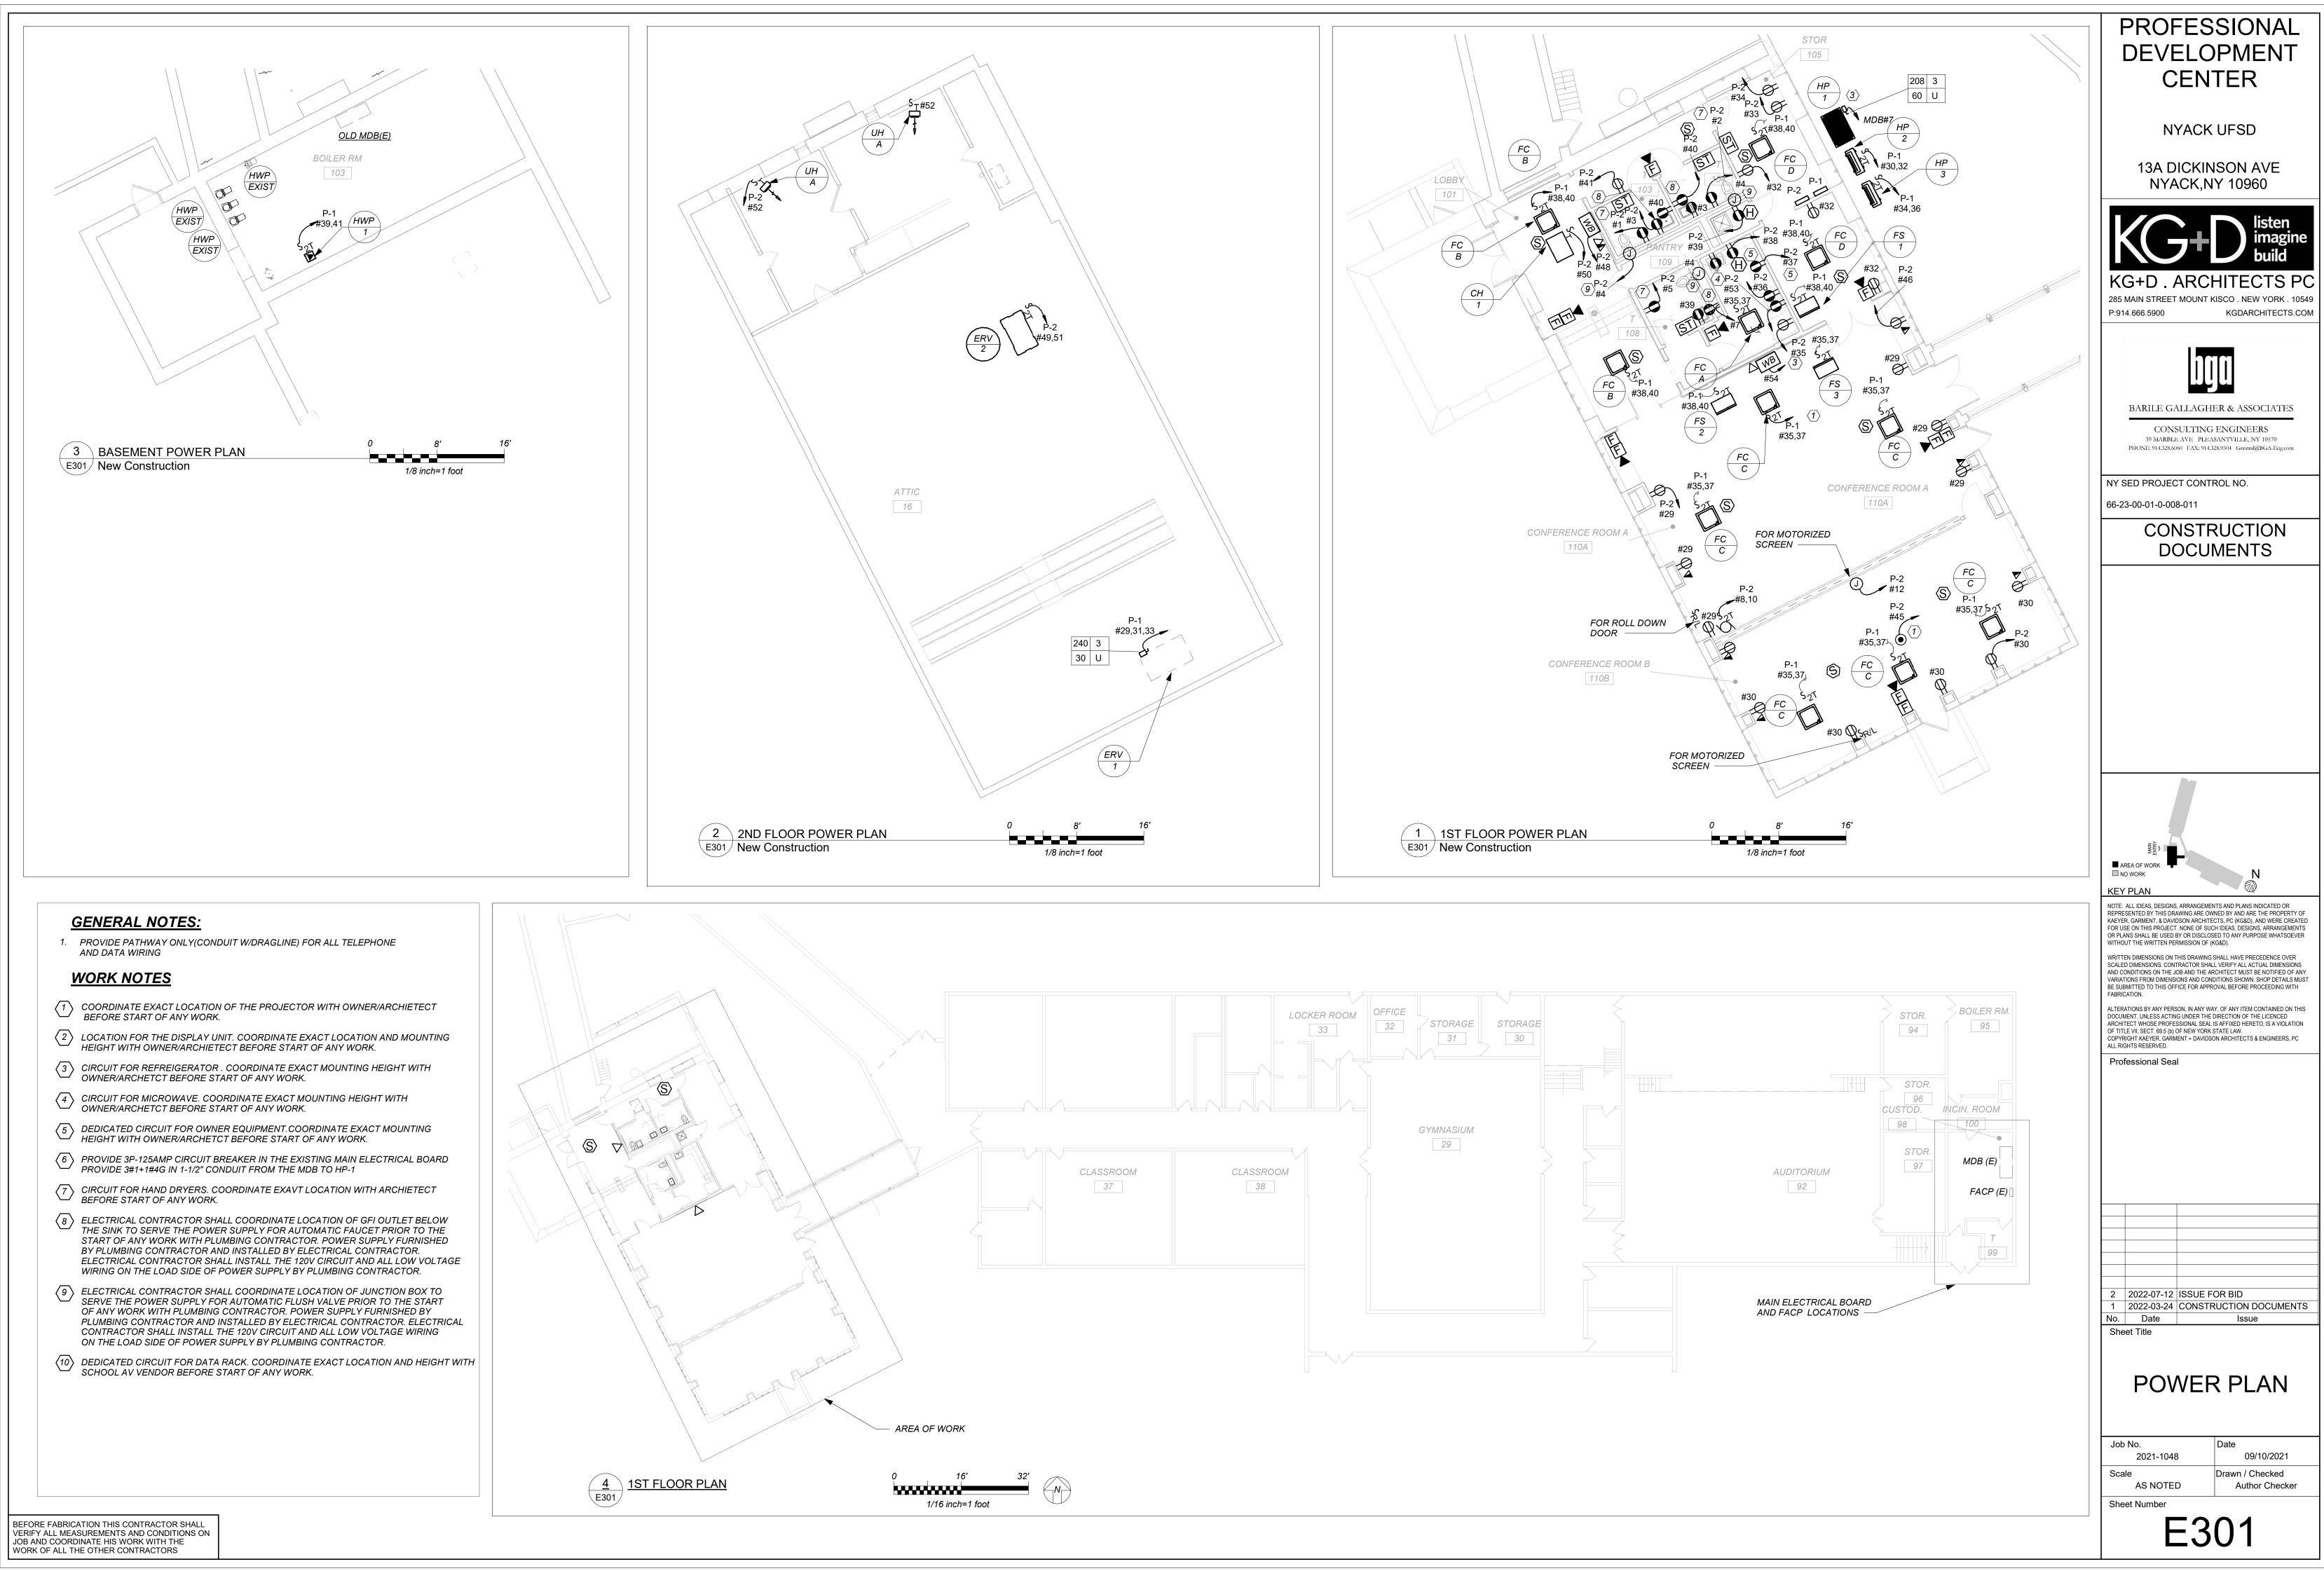

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FIRE ALARM RISER GENERAL NOTES:

- FIRE ALARM WIRING DIAGRAMS SHOWN ARE FOR GENERAL ARRANGEMENT ONLY. ELECTRICAL CONTRACTOR SHALL VERIFY AND OBTAIN POINT TO POINT WIRING DIAGRAM PRIOR TO INSTALLATION FROM MANUFACTURER.
- PERMITS AND APPROVALS NECESSARY FOR INSTALLATION OF THE WORK SHALL BE OBTAINED PRIOR TO THE COMMENCEMENT OF THE WORK. ALL PERMIT COSTS AND INSPECTION FEES SHALL BE INCLUDED AS PART OF THIS CONTRACT.
- IN AREAS WHERE DUST AND DIRT WILL BE AIRBORNE DURING DEMOLITION AND CONSTRUCTION THE CONTRACTOR SHALL PROVIDE PLASTIC WRAP OVER SMOKE DETECTORS AND THEN REMOVE ONCE SPACE IS CLEAN.
- 4. UNLESS DIRECTED OTHERWISE BY FIRE ALARM SYSTEM MANUFACTURER FIRE ALARM DEVICE WIRING SHALL BE AS FOLLOWS (FOR BIDDING PURPOSES ONLY):


HORN WIRING - #16 AWG TWISTED STROBE WIRING - #14 AWG TWISTED

SIGNAL WIRING - #14 AWG TWISTED/SHIELDED

- THE WIRING SHALL HAVE THE FOLLOWING CHARACTERISTICS: A. A MINIMUM TEMPERATURE RATING OF 150 C
- B. A MINIMUM AVERAGE INSULATION THICKNESS OF 15 MILS
- C. A MINIMUM AVERAGE JACKET THICKNESS OF 25 MILS D. THE COLOR OF THE CABLE SHALL BE RED
- E. THE CABLE SHALL BE A TYPE FPLP (PLENUM TYPE) WHEN CONDUIT IS USED. SEE NOTE 5 FOR ADDITIONAL CLARIFICATION.
- F. THE CABLE SHALL BE VISIBLY MARKED EXTERNALLY THAT IT MEETS THE ABOVE REQUIREMENTS AND IS LISTED BY UL. CONFIRM WIRING TYPE AND QUANTITY WITH FIRE ALARM SYSTEM MANUFACTURER PRIOR TO PURCHASING.


F.A.C.P.


- PROVIDE MC FIRE ALARM CABLE WITH RED STRIPE AS MANUFACTURED BY AFC SERIES 1800 WHEN CABLE IS CONCEALED OR ABOVE HUNG CEILING. WHEN FIRE ALARM CABLE IS RUN EXPOSED IN FINISHED AREAS, CABLE SHALL RUN IN WIREMOLD V-700. WHEN FIRE ALARM CABLE IS RUN EXPOSED IN UNFINISHED AREAS. PROVIDE PLENUM RATED CABLE IN MIN. 3/4" CONDUIT.
- 6. STROBES SHALL HAVE A MINIMUM LIGHT OUTPUT OF 75 CANDELA AND A FLASH RATE OF 1-3 HZ.
- PER NFPA72-18.4.3.1, TO MEET PUBLIC MODE AUDIBLE REQUIREMENTS, ALL HORNS SHALL HAVE A SOUND LEVEL AT LEAST 15 dB ABOVE THE AVERAGE AMBIENT SOUND LEVEL.
- WALL MOUNTED HORN STROBE UNITS SHALL NOT HAVE ANY OTHER DEVICES OR APPURTENANCES WITHIN 5 FEET OF THE DEVICE. THE ENTIRE LENS OF THE UNIT SHALL NOT BE LESS THAN 80", AND NOT GREATER THAN 96" ABOVE FINISHED FLOOR, WHILE MAINTAINING 6" BELOW THE CEILING . DEVICES SHALL BE FLUSH MOUNTED IN ALL FINISHED AREAS. PROVIDE DOUBLE DEEP DEVICE BOX IN WALL.
- AFTER THE SYSTEM IS COMPLETE, TEST ALL COMPONENTS IN ACCORDANCE WITH SEQUENCE OF OPERATION PRIOR TO FIRE DEPARTMENT INSPECTION.
- 10. ALL PULL STATIONS SHALL BE PROVIDED WITH CLEAR PROTECTIVE LEXAN COVER. COVER SHALL BE AS MANUFACTURED . BY SAFETY TECHNOLOGY INTERNATIONAL INC. CAT. #STI 1100 STOPPER II.
- 11. COORDINATE F.A WORK WITH F.A VENDOR.
- 12. VERIFY EXACT QUANTITIES OF FIRE ALARM DEVICES WITH PLANS.
- 13. ALL DEVICES SHALL BE SUPERVISED AS PER N.F.P.A. 72. PROVIDE END OF LINE RESISTORS AS REQUIRED PER INDIVIDUAL MANUFACTURER. PROVIDE LOAD RELAYS AS REQUIRED FOR PROPER OPERATION OF EQUIPMENT.
- 14. THIS CONTRACTOR IS RESPONSIBLE FOR ALL PROGRAMMING AND MAPPING OF EACH DEVICE AS REQUIRED.

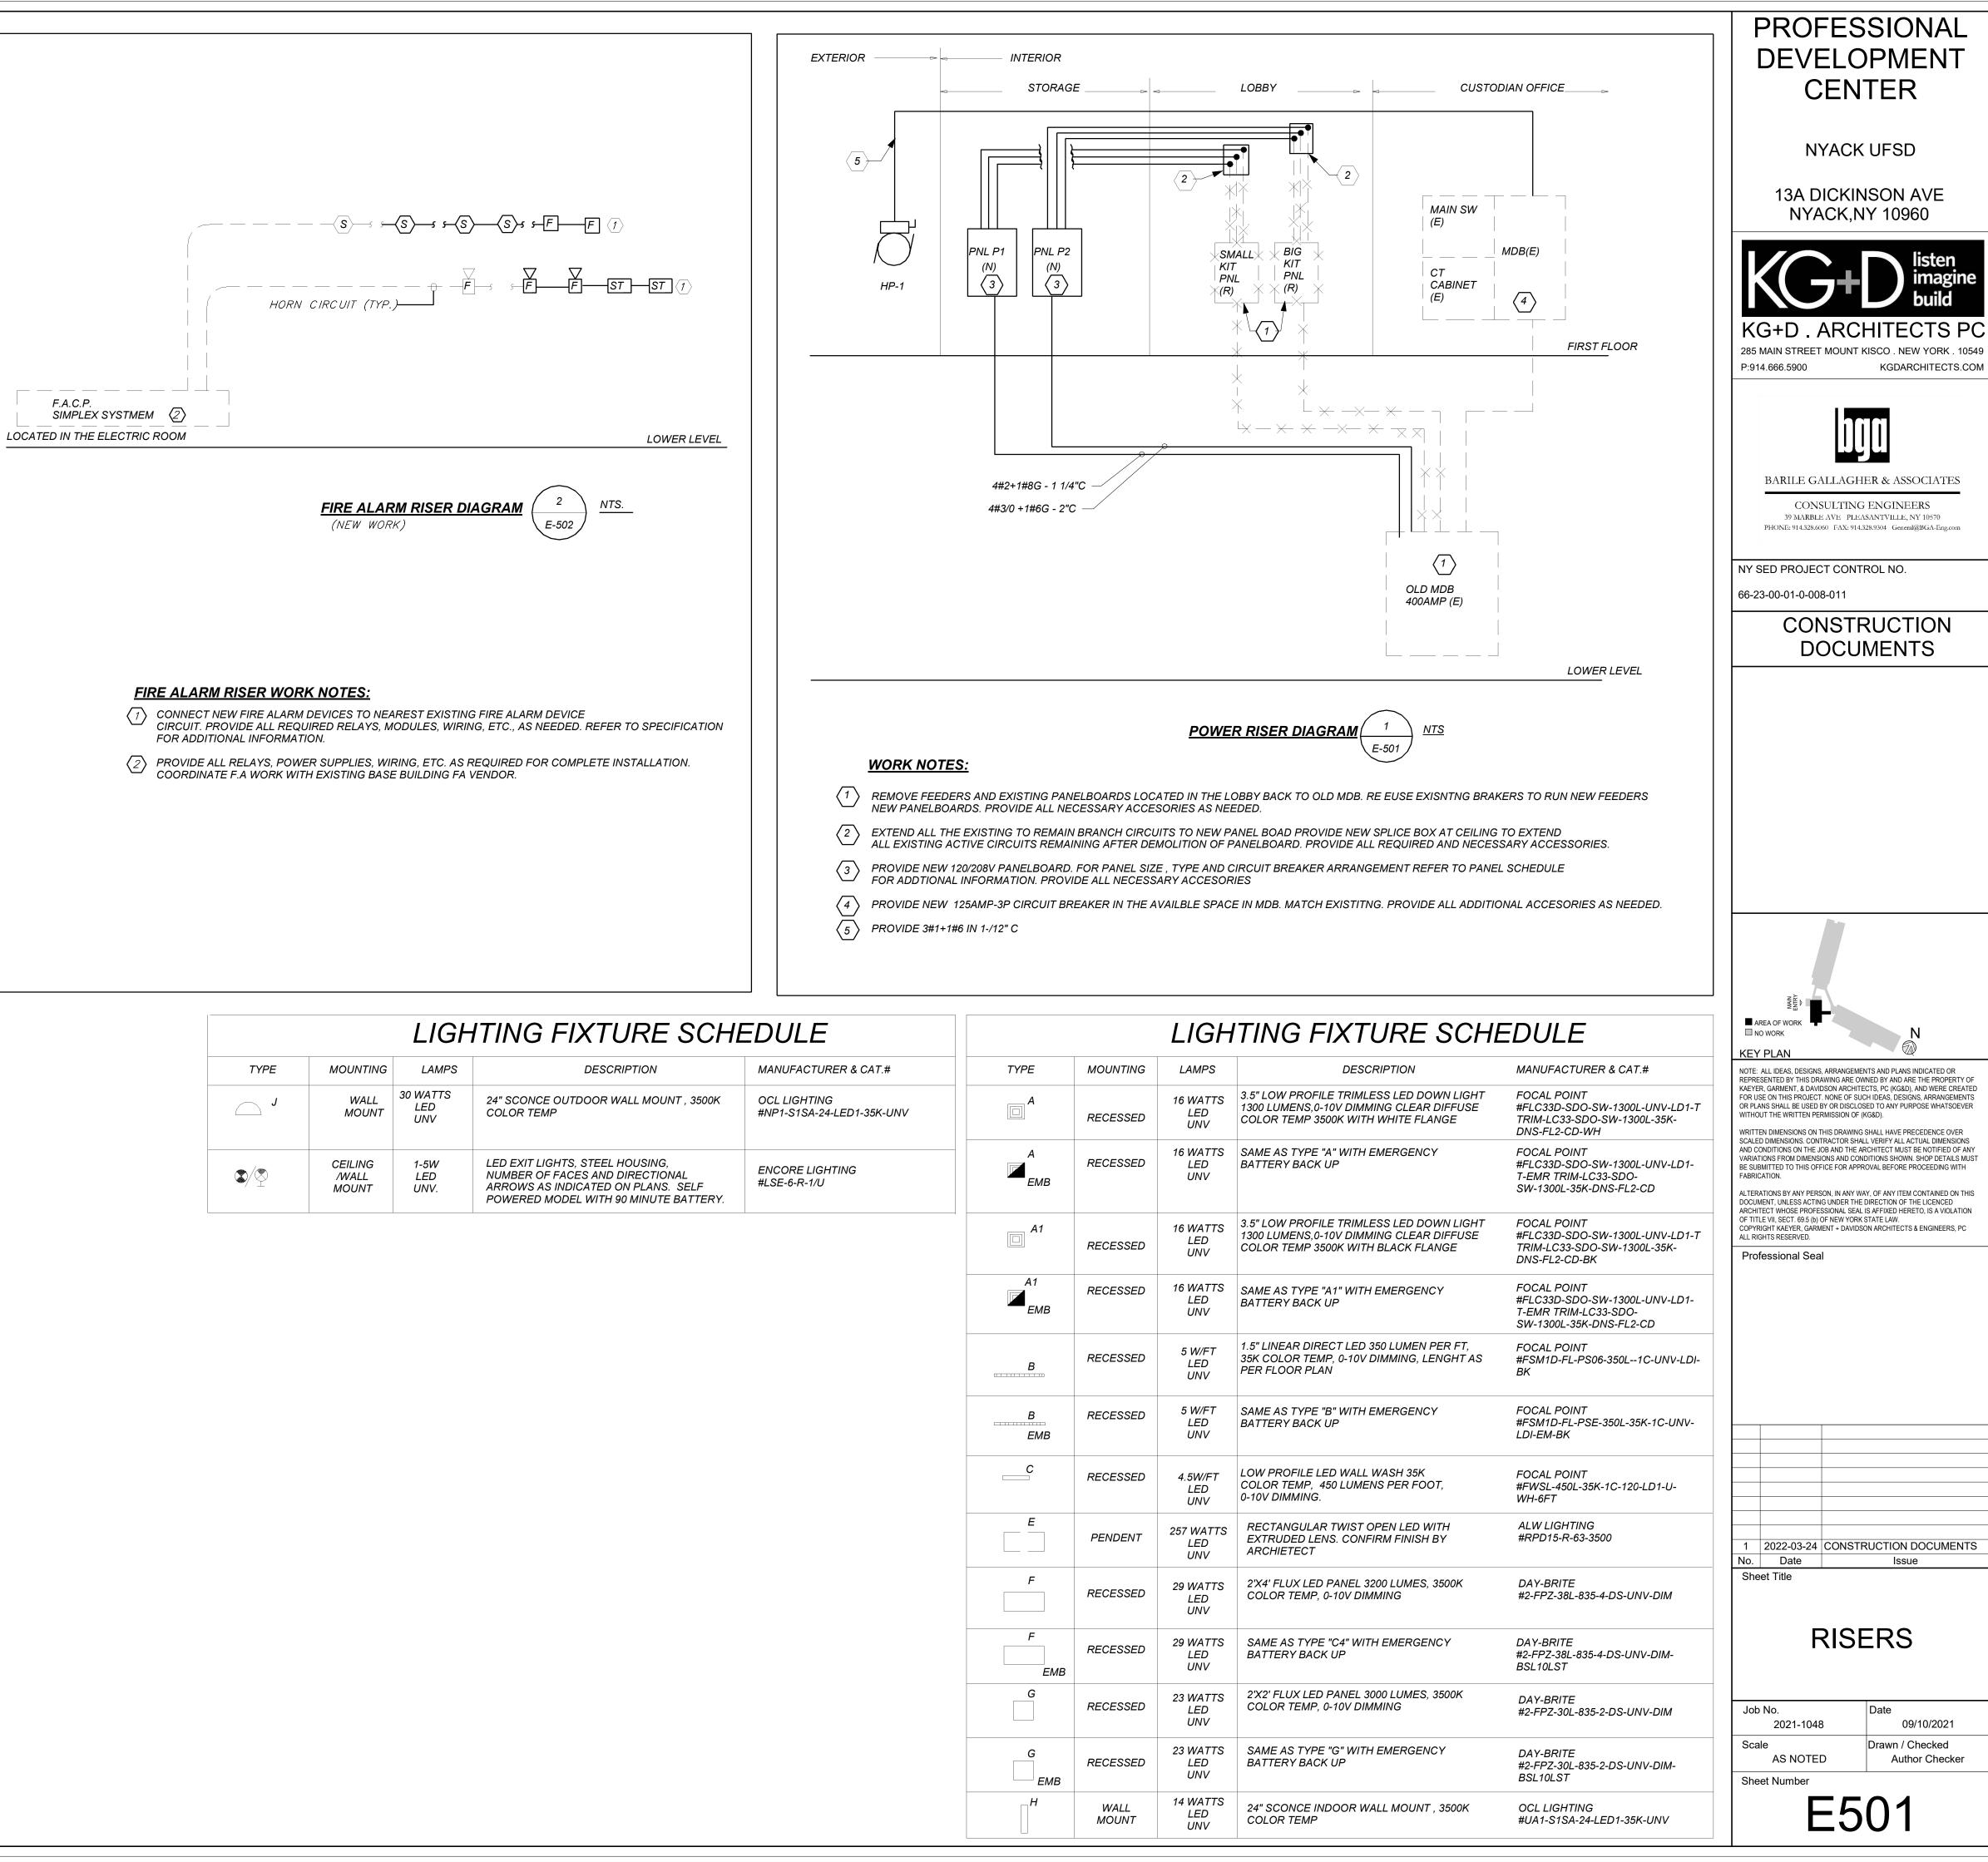

5	PROVIDE 3#1+1#6 IN 1-/12" C	

LED UNV LED EXIT LIGHTS, STEEL HOUSING, LED ENCORE LIGHTING A REC	WALL MOUNT30 WATTS LED UNVCEILING /WALL MOUNT1-5W LED 	
1-5W LED EXIT LIGHTS, STEEL HOUSING, NUMBER OF FACES AND DIRECTIONAL ARROWS AS INDICATED ON PLANS. SELF POWERED MODEL WITH 90 MINUTE BATTERY. ENCORE LIGHTING #LSE-6-R-1/U ENCORE LIGHTING Image: Analysis of the second seco	/WALL LED	
$\begin{bmatrix} \Box & REC \\ A1 \\ \blacksquare & B \\ EMB \end{bmatrix} \begin{bmatrix} REC \\ B \\ \blacksquare & B \\ EMB \end{bmatrix} \begin{bmatrix} REC \\ B \\ \blacksquare & C \\$		
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E		
F EMB EMB		

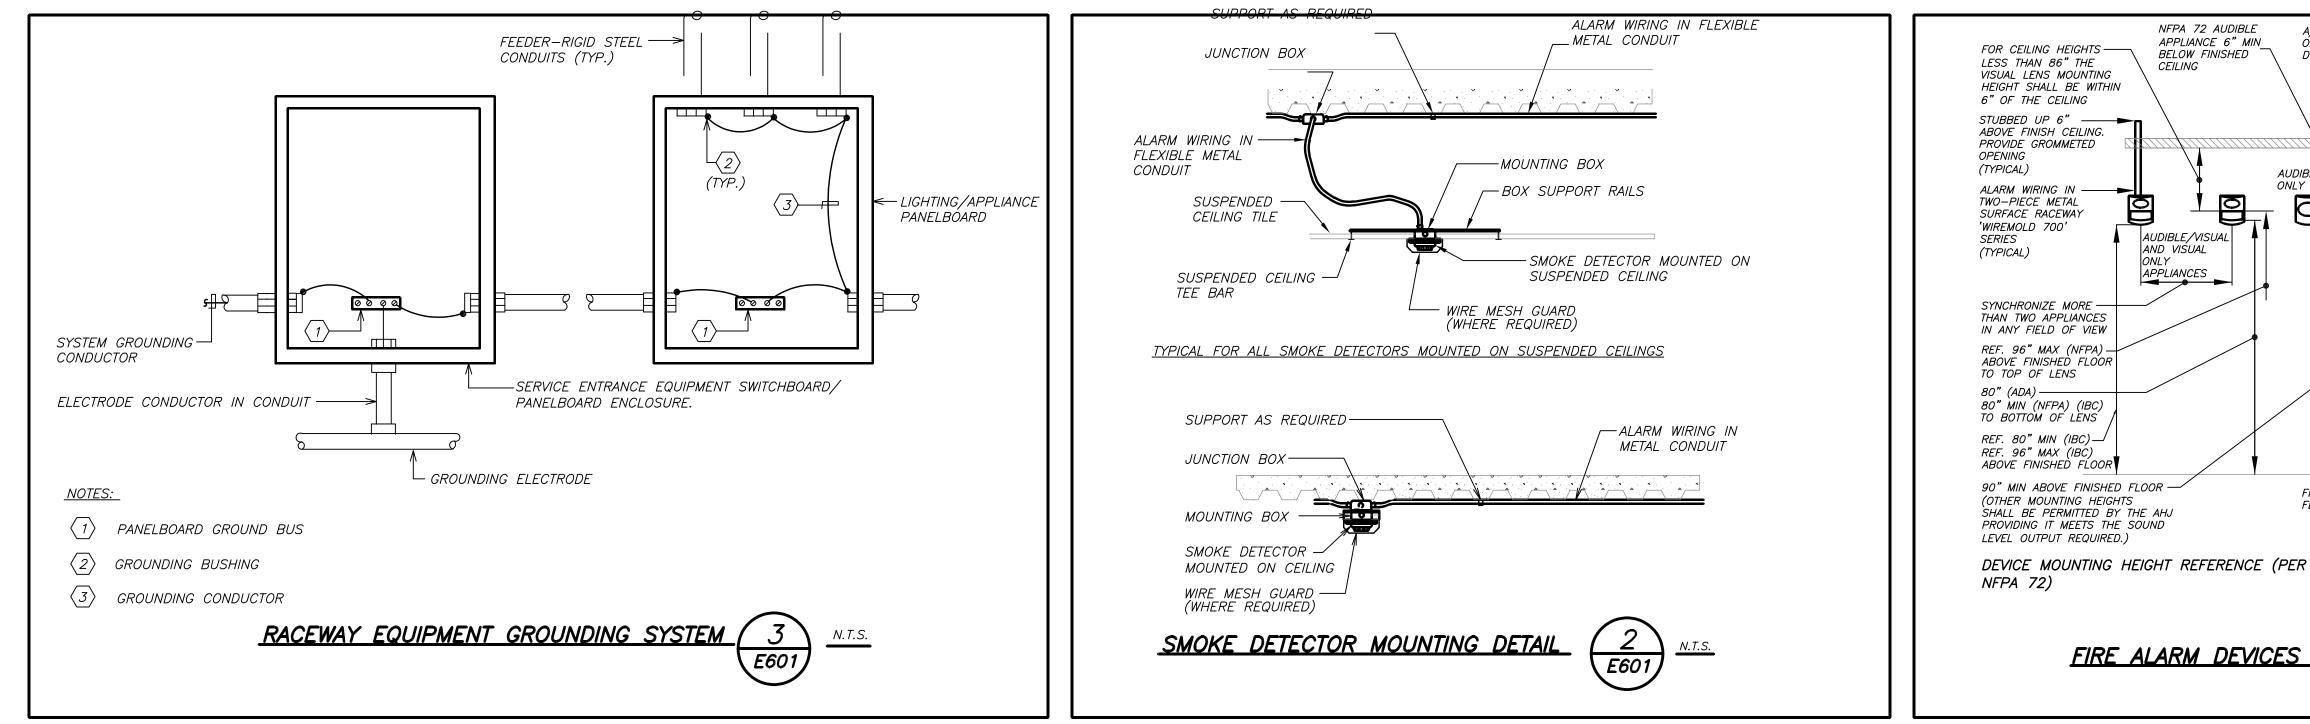

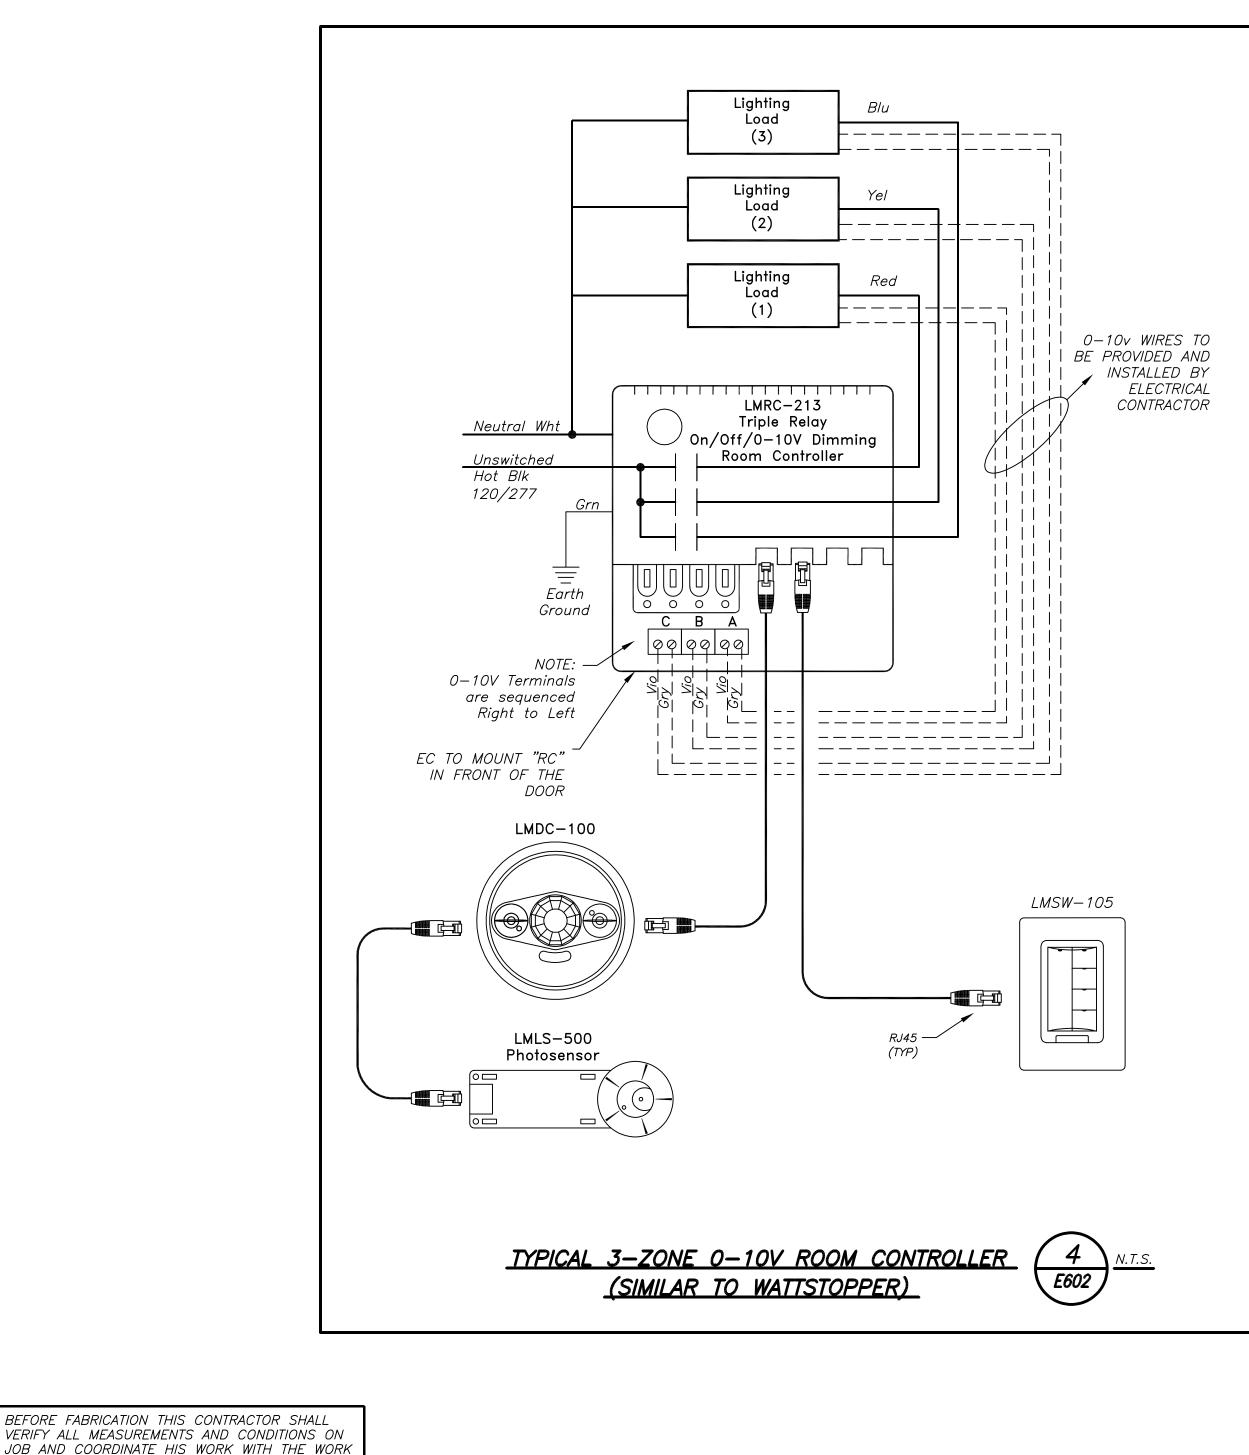

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OF ALL OTHER CONTRACTORS

NE	ĪW		ELEC	TR	RICA	AL I	PA	NE	LS	СН	ED	UL	E				NE	ΞW	
PNL: P-1			MOUNTING:	: SURFACE <u>X</u> MAI			IAIN LUGS ONLY MAIN C BKR-				N C BKR-	GROUND BUS: X			PNL: P-2				
208Y/120, 3 PHASE, 4 WIRE		<u>(NEMA 1)</u>	Fi	LUSH	LUSH DOUBLE LUG		UGS		100A/3P		ISOLATED GROUND BUS:			208)	//120,	3 PHASE, 4 WIRE			
22 ,000MIN A.I.C. SYM			IN	мсс			FEED	THRU	LUG	<u>×</u>	MAIN BUS -		TVSS:			22	,000	MIN A.I.C. SYM	
NEUTRAL: 100%						S	HUNT	TRIP	MAIN			100 A NUMB		POLES:	<u>54</u>	<u>NEUTRAL: 100%</u>			
скт	TRIP	LOAD	WIRE	CND.	KV	A/PH	ASE		KV	4 / PH.	ASE	CND.	WIRE	LOAD	TRIP	СКТ	скт	TRIP	LOAD
No.	(AMP)			(IN.)	A	В	С	1	A	В	С	(IN.)			(AMP)	No.	No.	(AMP)	
1	50	EXISTING LOAD	EXIST	-								-	EXIST	EXISTING LOAD	50	2	1	20	HAND DRYER
3	20	EXISTING LOAD	EXIST	-				-				-	EXIST		2 /	4	3	20	AUTO FAUCET
5	20	EXISTING LOAD	EXIST	-				1				-	EXIST	EXISTING LOAD	20	6	5	20	HAND DRYER
7	20	EXISTING LOAD	EXIST	-								-	EXIST	EXISTING LOAD	20	8	7	20	AUTO FAUCET
9	20	EXISTING LOAD	EXIST	-								-	EXIST	EXISTING LOAD	20	10	9	20	EXISTING LOAD
11	20	EXISTING LOAD	EXIST	-				1				-	EXIST	EXISTING LOAD	20	12	11	3 /	
13	20	EXISTING LOAD	EXIST	-				1				-	EXIST	EXISTING LOAD	20	14	13		EXISTING LOAD
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17	20	EXISTING LOAD	EXIST	-				1				-	EXIST	EXISTING LOAD	20	18	17	3	
19	20	EXISTING LOAD	EXIST	-								-	EXIST	EXISTING LOAD	20	20	19		EXISTING LOAD
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25	20	EXISTING LOAD	EXIST	-								-	EXIST	EXISTING LOAD	20	26	25		EXISTING LOAD
27	20	HAND DRYER	2#12+1#12G	3/4		0.20						-	EXIST	EXISTING LOAD	20	28	27	/ 20	
29	3 /						0.60]			1.20	3/4	3#10+1#10G	HP-2	2	30	29	20	CONV RECEP
31		ERV-1	3#10+1#10G	3/4	0.60				1.20			0/4		171 10	/ 30	32	31	20	DISPLAY RECEP
33	30	,				0.60				1.20		3/4	3#10+1#10G	HP-3	2	34	33	20	DATA RACK
35	2 /	FC-C	2#12+1#12G	3/4			0.19				1.20				/ 30	36	35	20	REFRIGERATOR
37	20				0.19				0.19			3/4	2#12+1#12G	FC-C	2	38	37	20	PANTRY GFI
39	2	HWP	2#12+1#12G	3/4		0.19				0.19					20	40	39	20	GFI BATHROOM
41	/ 20						0.19					-	-	SPARE	20	42	41	20	CORR RECEP
43	20	SPARE	-	-				_				-	-	SPARE	20	44	43	20	LIGHTING
45	20	SPARE	-	-								-	-	SPARE	20	46	45	20	PROJECTOR
47	20	SPARE	-	-								-	-	SPARE	20	48	47	20	SPARE
49	20	SPARE	-	-				-				-	-	SPARE	20	50	49	2 /	ERV-2
51	20	SPARE	-	-								-	-	SPARE	20	52	51	/ 20	
53	20	SPARE	-	-								-	-	SPARE	20	54	53	20	SPARE
		SUBTOTALS		1		0.99			1.39	1.39	2.40			SUBTOTALS	_				SUBTOTALS
		TOTAL LOADS			KVA								LIGHTING:	0.00 KVA	_				TOTAL LOADS
					KVA							RE	CEPTACLE:	0.00 KVA					
					KVA								KITCHEN:	0.00 KVA	_				
		TOTAL CONN. LOAD			KVA								MOTOR:	7.94 KVA	_				TOTAL CONN. LO
		TOTAL DEMAND LOA	AD	7.9	KVA	22.0	A]					POWER:	0.00 KVA	_				TOTAL DEMAND
													TOTAL:	7.94 KVA					

