



**VICINITY MAP** 

SITEPLAN FOR HUMANE SOCIETY OF PORT JERVIS / DEERPARK

> 202 U.S. ROUTE 209 SECTION 53 BLOCK 1 LOT 4 TOWN OF DEERPARK, NY

# PROJECT INFORMATION

HM-U (HAMLET/MIXED USE DISTRICT) ZONING TAX ID SECTION 53 BLOCK 1 LOT 4

LOT AREA 150,493 S.F. / 3.46± ACRES

DRAWING LIST				
T-1	TITLE SHEET			
S-1	EXISTING CONDITIONS			
S-2	SITE PLAN			
S-3	GRADING PLAN			
S-4	LIGHTING & LANDSCAPING PLAN			
S-5	EROSION & SEDIMENTATION PLAN			
S-6	SITE DETAILS			

**AERIAL MAP** 

TOWN OF DEERPARK

THIS PLAN CONTAINS 7 SHEETS. THIS SHEET SHALL NOT BE CONSIDERED VALID UNLESS ACCOMPANIED BY THE REMAINING SHEETS.

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UNAUTHORIZED ALTERATION OR ADDITIONS TO A PLAN BEARING	DL	1	REVISED PER TOWN COM
THE SEAL OF A LICENSED ENGINEER OR LAND SURVEYOR IS A VIOLATION OF SECTION 7209 SUBDIVISION 2 OF THE NEW YORK STATE EDUCATION LAW.			
COPIES OF THIS DOCUMENT WITHOUT A FACSIMILE OF THE			
SIGNATURE AND AN ORIGINAL EMBOSSED SEAL OR ORIGINAL STAMP IN BLUE OR RED INK OF THE PROFESSIONAL ENGINEER OR			
LAND SURVEYOR SHALL NOT BE CONSIDERED VALID COPIES.			

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DL	0	FOR APPROVAL	06/09/21		1, 1//
DL	1	REVISED PER TOWN COMMENT	09/28/21		1/1 1 kg len
DL	1	REVISED PER TOWN COMMENT	10/29/21		Man I Fuller
					•
					JOHN D. FULLER
					REG. NO. 077703

JOHN D. FULLER, P.E., P.C. PORT JERVIS, NY 12771

202 U.S. ROUTE 209 SECTION 53 BLOCK 1 LOT 4 TOWN OF DEERPARK, NY

TITLE SHEET				DWG NO.
SCALE	AS NOTED	JOB NO.	2235.	001

# REFERENCE MAP:

SURVEY MAP ENTITLED, "SURVEY MAP OF LAND, PREPARED HUMANE SOCIETY OF PORT JERVIS -DEERPARK, INC.", PREPARED BY CONRAD, CLOSE & EWALD, DATED OCTOBER 13, 2015, LATEST REVISION DATE10-18-19, AS DRAWING NUMBER 10969-A.

# UTILITY POLE (TYP.) CONC.

BENCHMARK - SPIKE

IN U.P. #41378 \_ ELEV=462.7

SIĞN & \_ PLANTER \_

CONC.\_ MON.

2 STORY DWELLING -F.F.=461.5

GARAGE W/ DWELLING —/ ABOVE

PAVED PARKING >

\_EXIST. TREES

TO BE CLEARED

CONC.

· WALK


SEPTIC TANK

STORAGE

(NGVD29 DATUM)

BLDG. REF.	EXISTING USE
A	FELINE BUILDING
B	OFFICE & KENNELS
©	ISOLATION KENNELS

### LEGEND

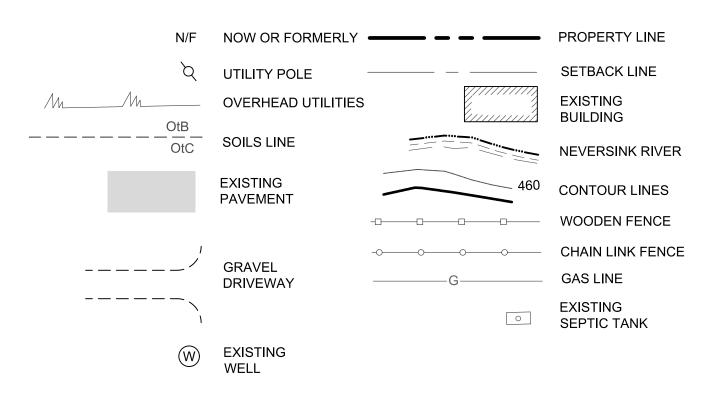

## **GENERAL NOTES**

- 1. OWNER OF RECORD / APPLICANT: HUMANE SOCIETY OF PORT JERVIS / DEERPARK 202 U.S. ROUTE 209 PORT JERVIS, NY 12771
- 2. TAX MAP DESIGNATION: SECTION 53 BLOCK 1 LOT 4
- 3. PARCEL ZONED: HM-U (HAMLET/MIXED USE DISTRICT)
- 4. TOTAL AREA: 150,493 S.F. / 3.46± ACRES
- 5. SITE IS SERVICED BY AN EXISTING WELL AND SEPTIC SYSTEM.

# **BULK TABLE REQUIREMENTS:**

ZONED DISTRICT: (HM-U) HAMLET/MIXED USE DISTRICT

F	MINIMUM REQUIREMENTS	TAX LOT 53-1-4
LOT AREA: LOT WIDTH: LOT DEPTH: FRONT YARD: SIDE YARD: REAR YARD: FLOOR AREA:	40,000 S.F. 200 FEET 200 FEET 35 FEET 35 FEET 35 FEET 1,000 S.F.	3.46± ACRES 306.9± FEET 495.5± FEET 58.9± FEET 6.7± FEET * 269.3± FEET > 1,000 S.F.
	MAXIMUM PERMITTED	
BUILDING HEIGHT: BUILDING COVERAGE:	35 FEET 20 %	< 35 FEET < 20%

\*PRE-EXISTING CONDITION

SCALE: 1" = 40'

PADDOCK & BARN

TO BE REMOVED

T.M. 53-1-4

*3.46*± *ACRES* 

COVERED

BASIN

\_EXISTING DUMPSTER

IRON PIPE

CREMATORIÙM

PROPANÈ

EXIST. - WELL

\_\_S 40°09'18" W 12.31'

TANK


FXIST	ING CONDITIONS / 1 \			REVISIONS			
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		DL	1	REVISED PER TOWN COMMENT	09/28/21		11 1 feb.
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SHEET SHALL NOT BE CONSIDERED	COPIES OF THIS DOCUMENT WITHOUT A FACSIMILE OF THE						
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INEMAINING SHEETS.	LAND SURVEYOR SHALL NOT BE CONSIDERED VALID COPIES.						REG. NO. 077703


JOHN D. FULLER, P.E., P.C. 4 SOUTH STREET PORT JERVIS, NY 12771 (845) 856-1536


HUMANE SOCIETY OF PORT JERVIS / DEERPARK 202 U.S. ROUTE 209 SECTION 53 BLOCK 1 LOT 4 TOWN OF DEERPARK, NY

TOWN OF DEERPARK PLANNING BOARD APPROVAL

DWG NO. **EXISTING CONDITIONS** JOB NO.

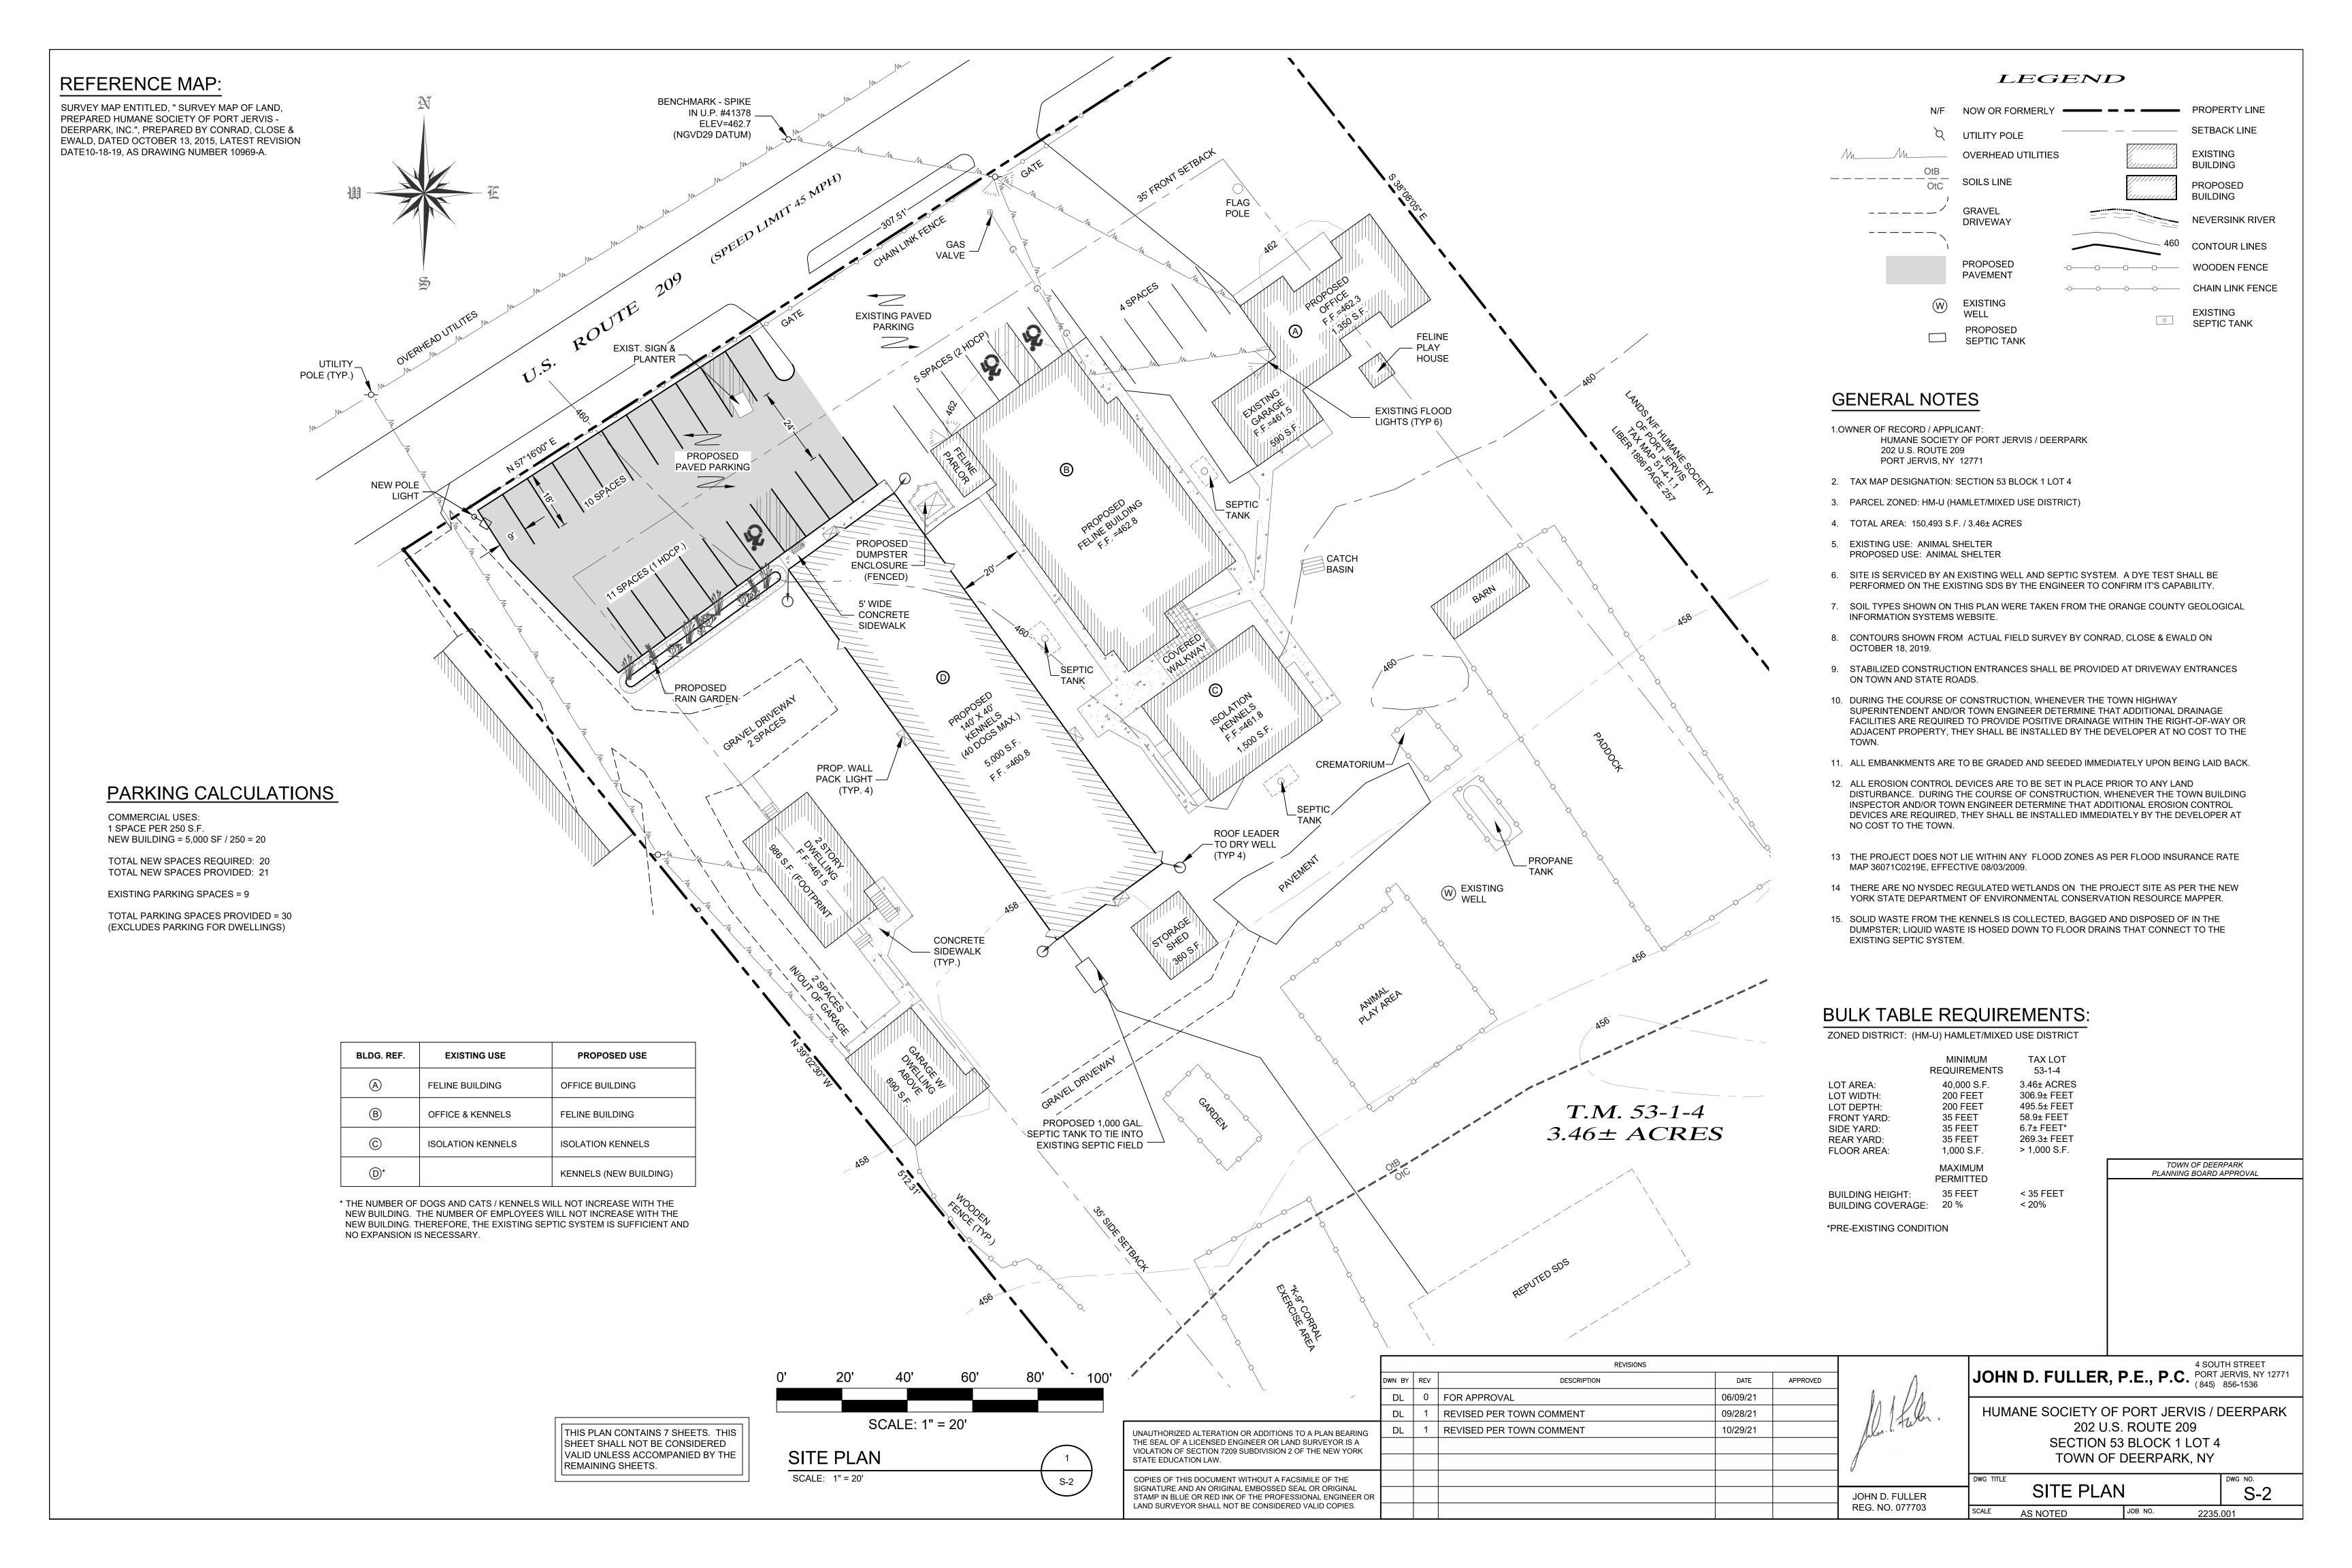

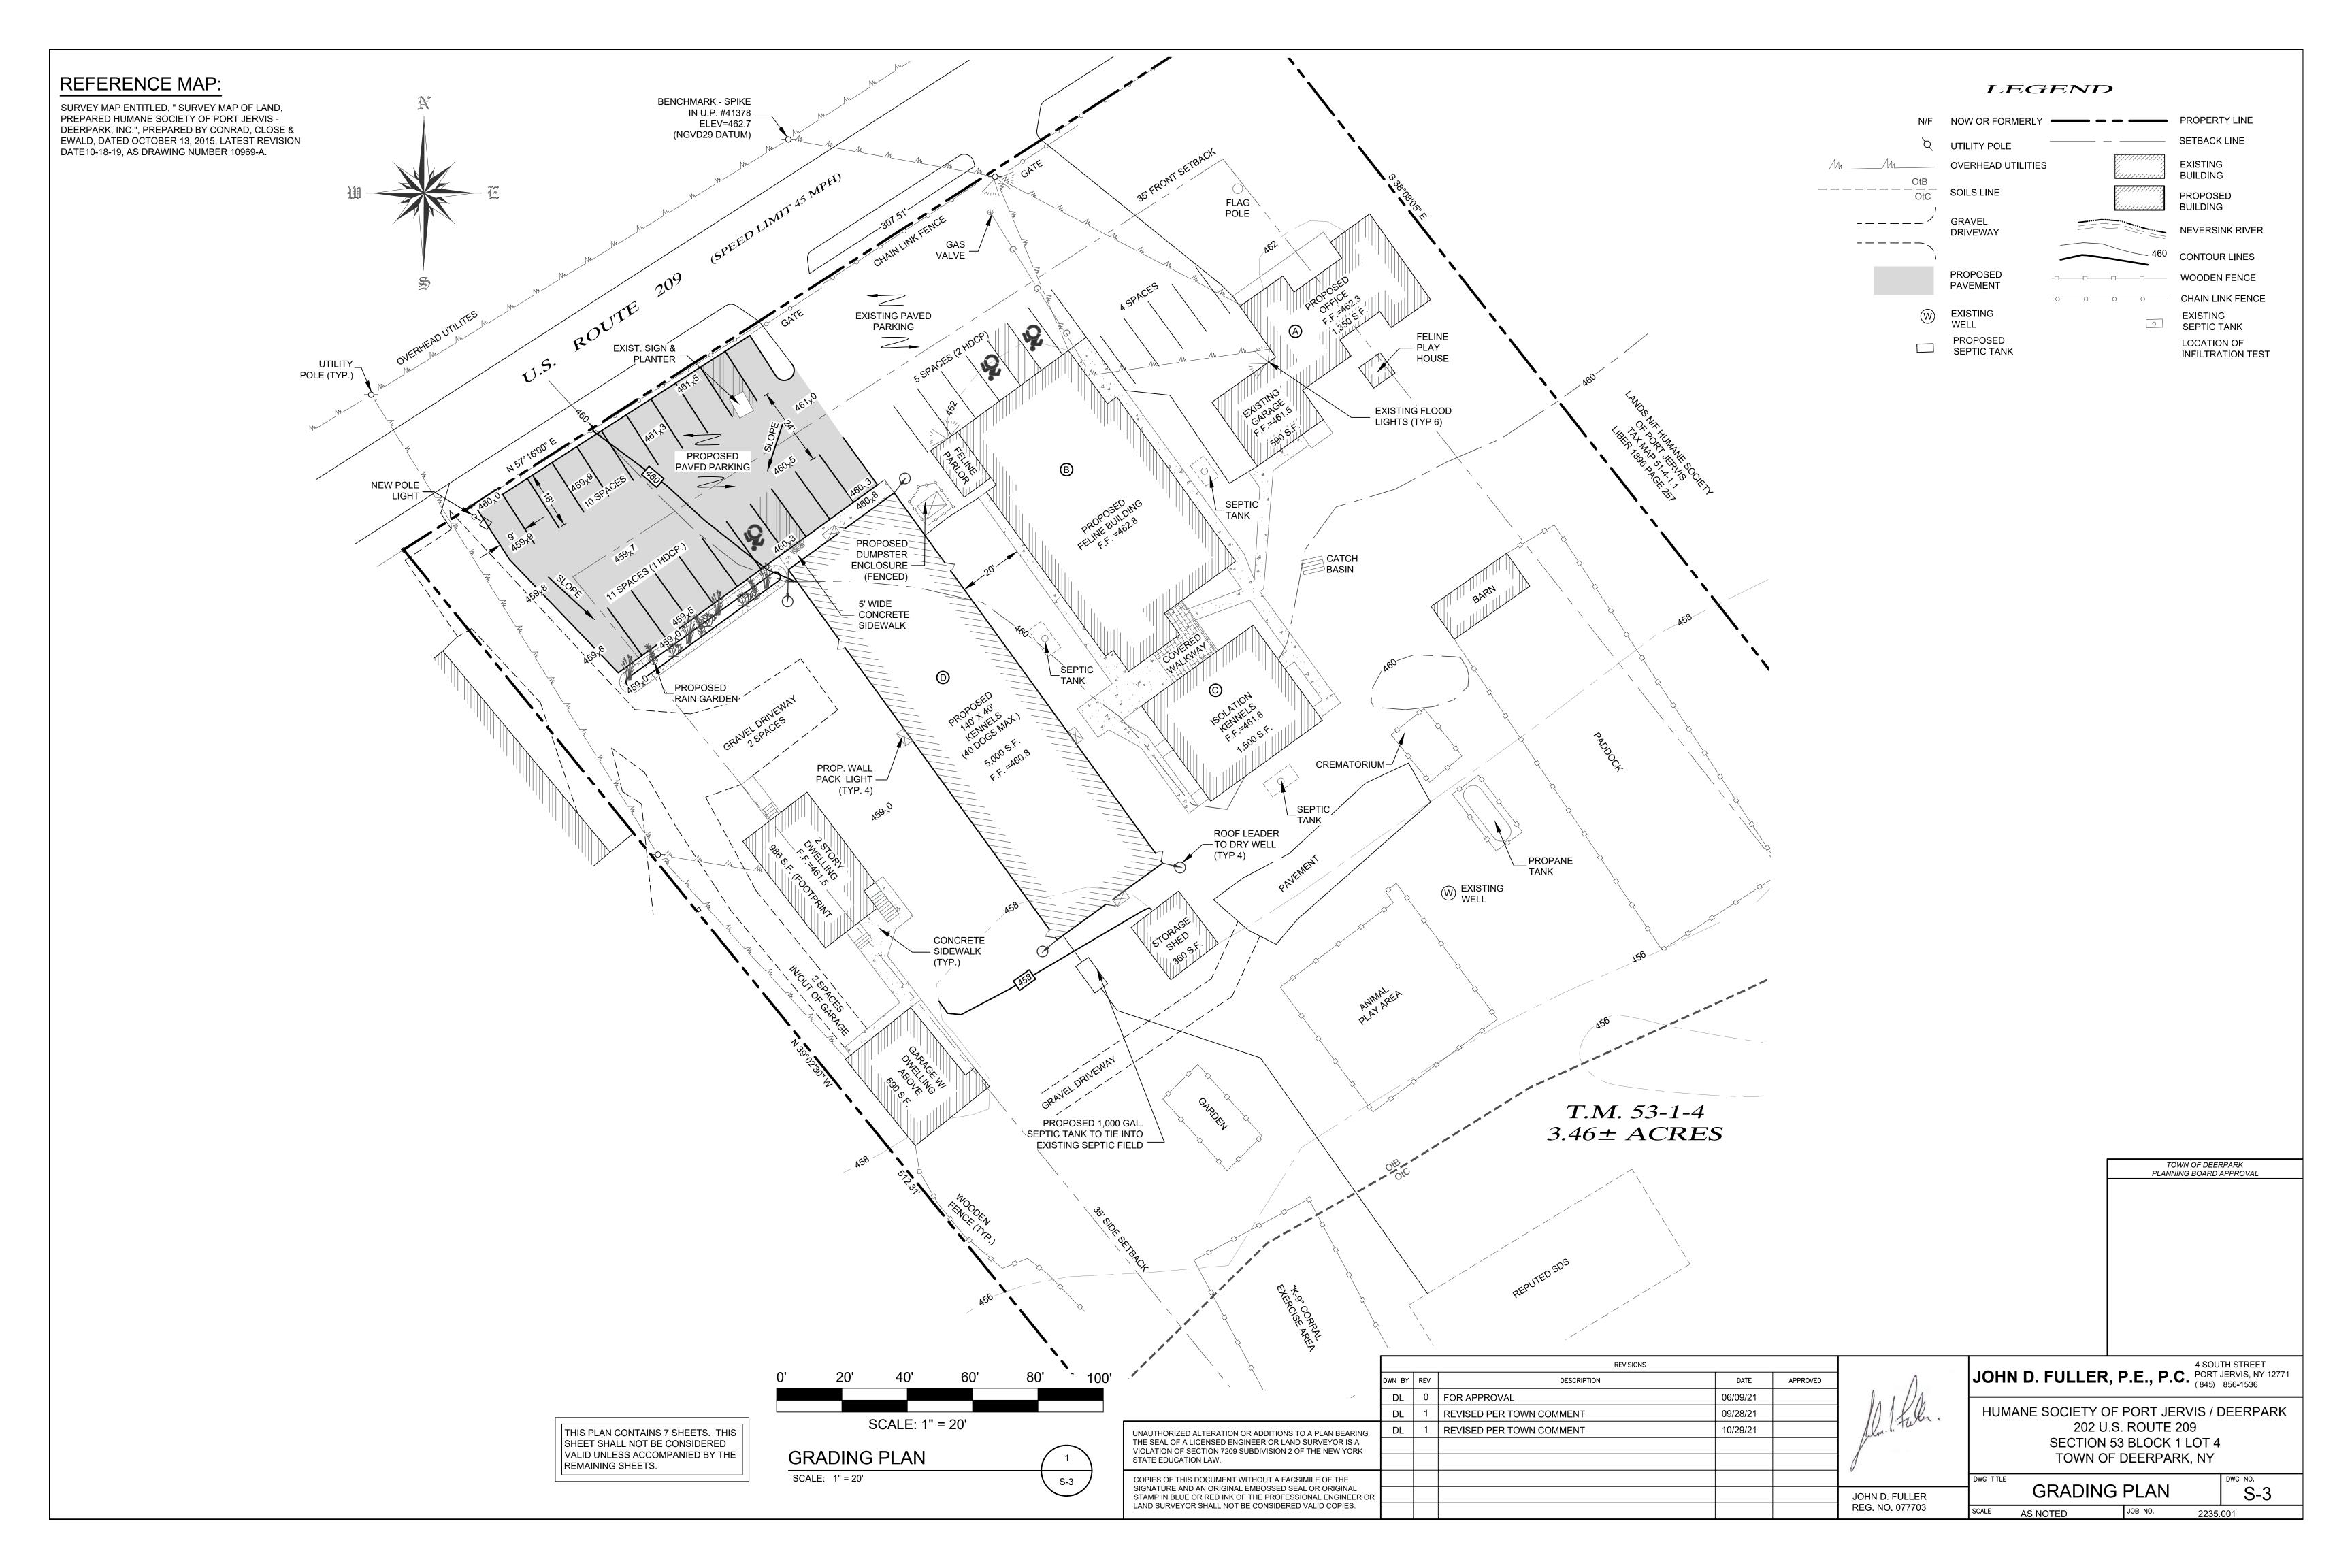

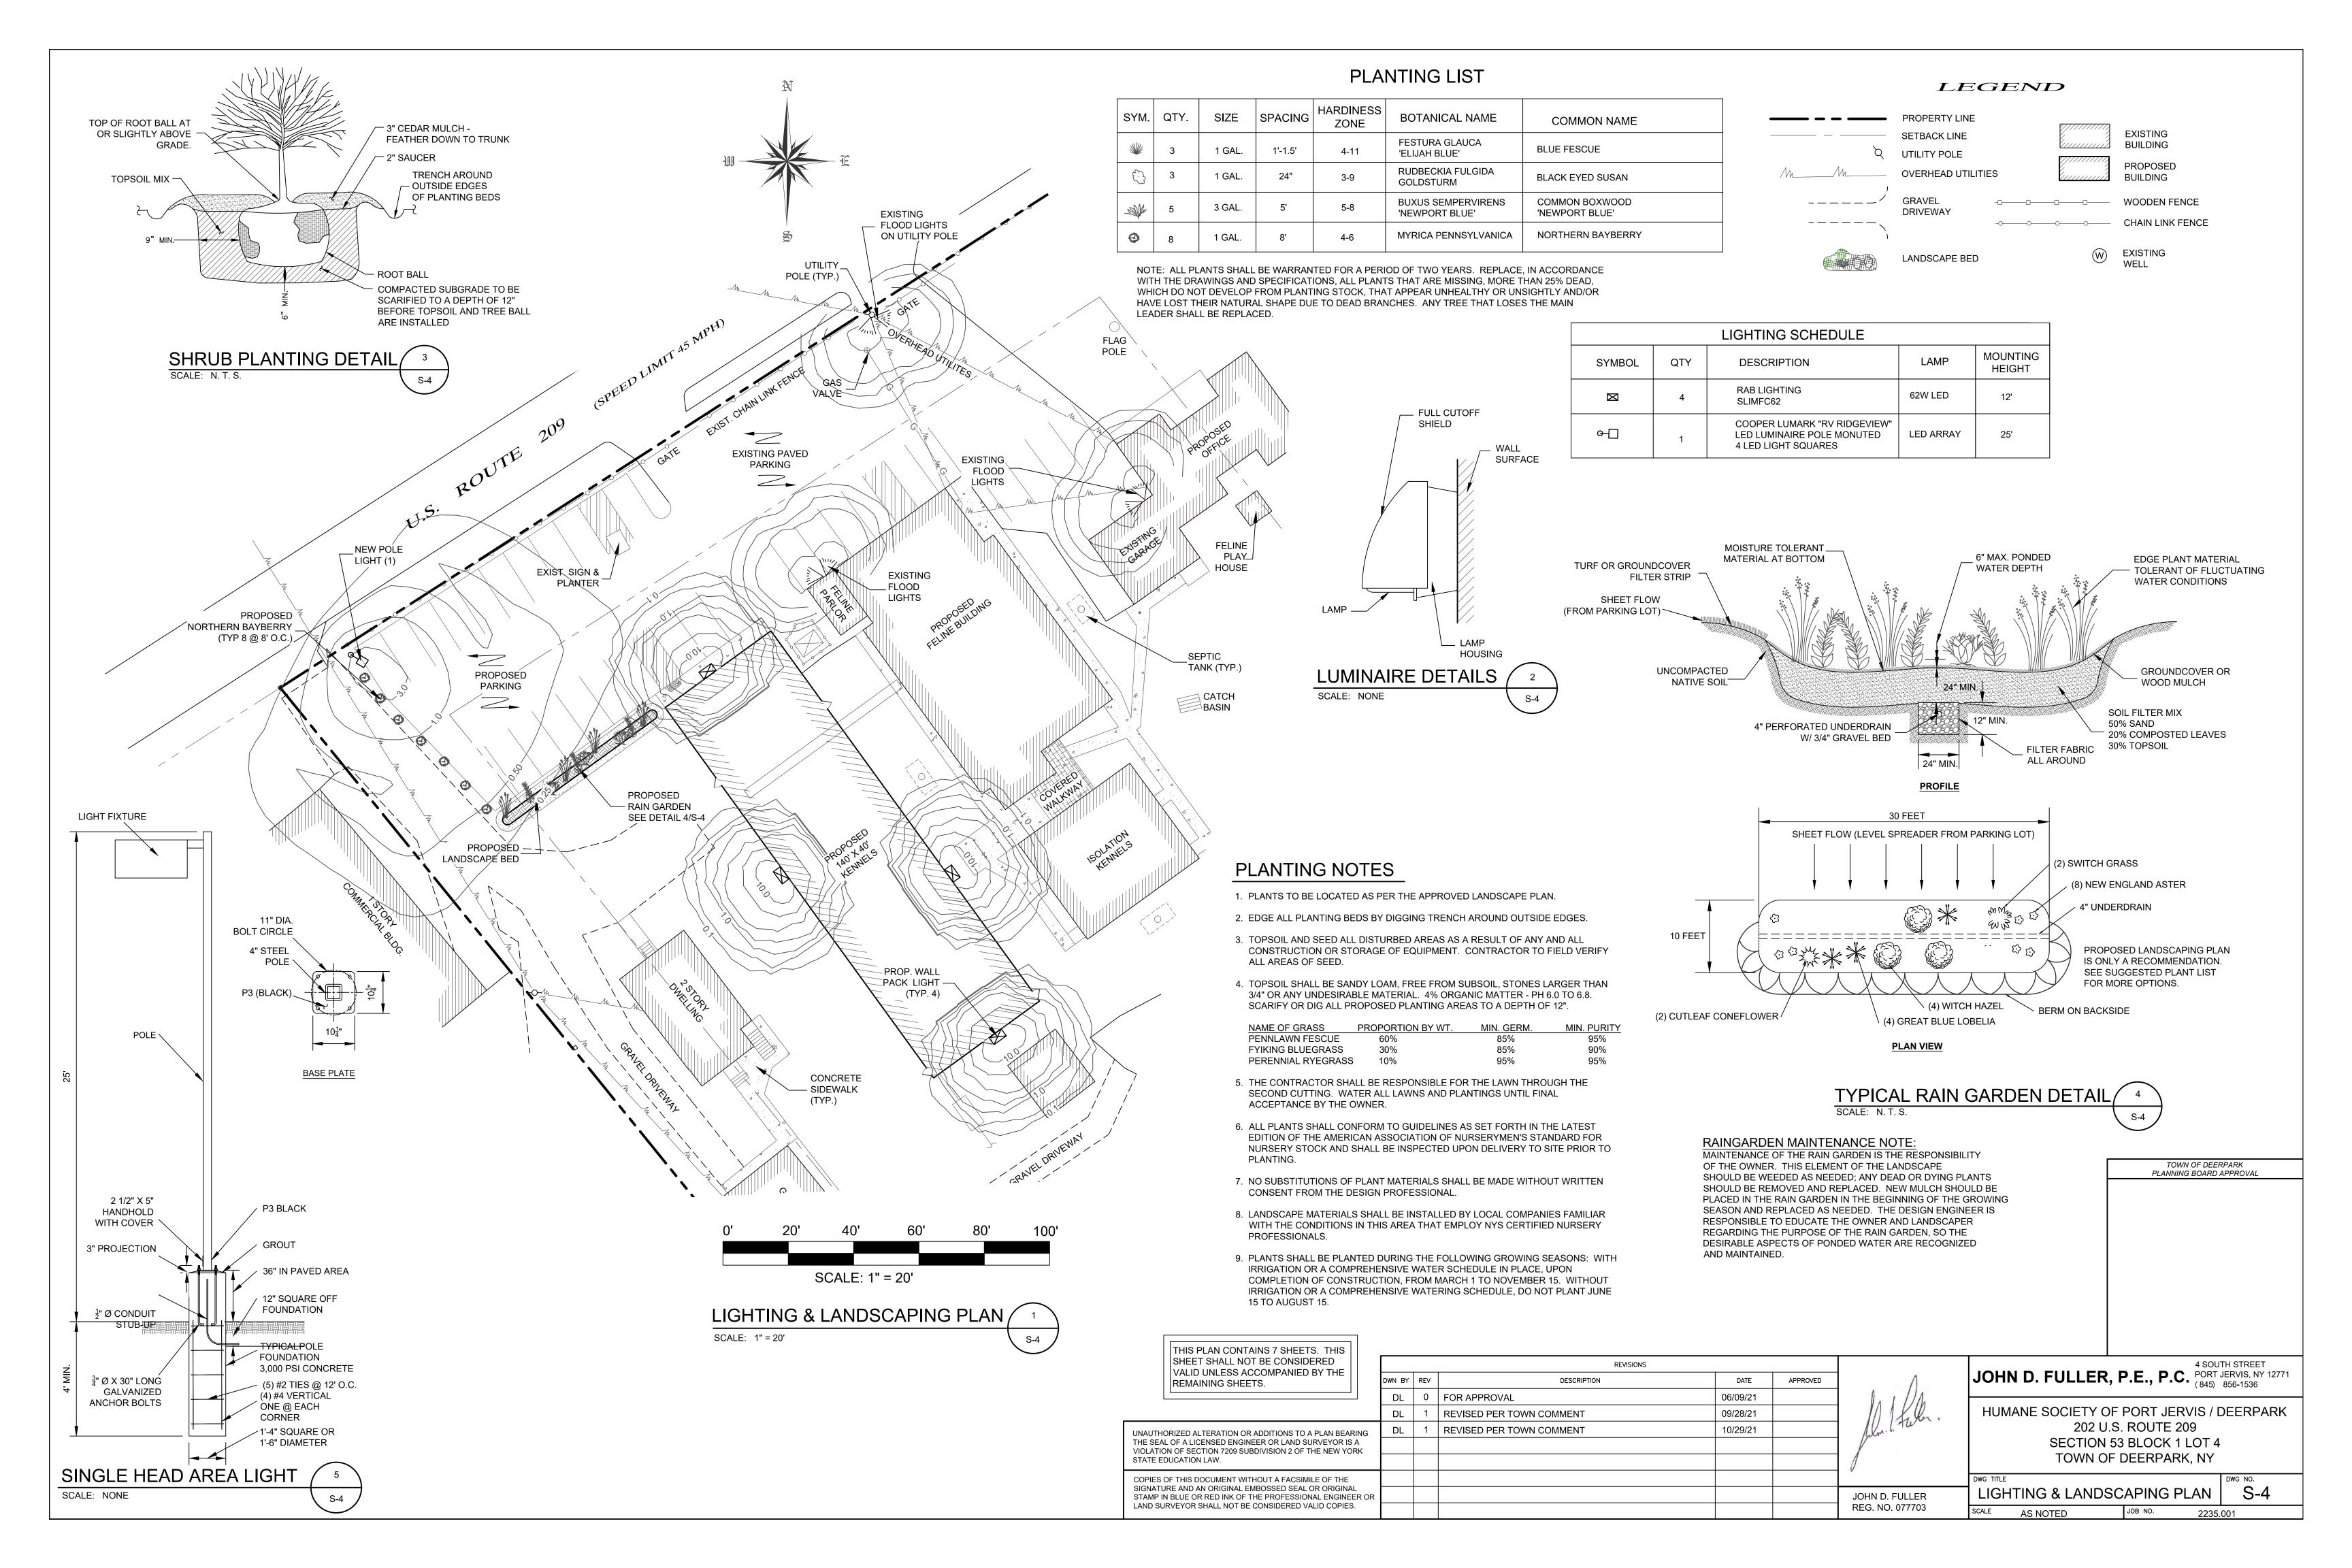

#### LEGEND PROPERTY LINE UTILITY POLE SETBACK LINE OVERHEAD UTILITIES **EXISTING** GRAVEL BUILDING DRIVEWAY **PROPOSED** \_ \_ \_ \_ \_ \_ \_ BUILDING **EROSION & SEDIMENTATION CONTROL NOTES** PROPOSED CONTOUR LINES UTILITY PAVEMENT POLE (TYP.) 1. ALL SEDIMENT AND EROSION CONTROL MEASURES SHALL BE DONE IN ACCORDANCE WITH ANY AND ALL FEDERAL, STATE, AND LOCAL REGULATIONS. **EXISTING** 2. THOSE AREAS UNDERGOING ACTUAL CONSTRUCTION WILL BE LEFT IN AN UNTREATED OR UNVEGETATED CONDITION FOR A MINIMUM TIME. AREAS SHALL BE PERMANENTLY STABILIZED WITHIN 15 DAYS OF **EXISTING** CONSTRUCTION FINAL GRADING AND TEMPORARY STABILIZED WITHIN 30 DAYS OF INITIAL DISTURBANCE OF THE SOIL IF FLAG ` SEPTIC TANK ENTRANCE THE DISTURBANCE IS WITHIN 100 FEET OF A STREAM OR POND. THE AREA SHALL BE STABILIZED POLE LIMITS OF DISTURBANCE WITHIN 7 DAYS OR PRIOR TO ANY STORM EVENT (THIS WOULD INCLUDE WETLANDS). 3. SEDIMENT BARRIERS (SILT FENCE, HAY BARRIERS, ETC.) SHOULD BE INSTALLED PRIOR TO ANY SOIL DISTURBANCE OF THE CONTRIBUTING DRAINAGE AREA ABOVE THEM. MULCH NETTING SHALL BE USED TO ANCHOR MULCH IN ALL AREAS WITH SLOPES GREATER THAN 15% AFTER OCTOBER 1ST THE SAME APPLIES FOR ALL SLOPES GREATER THAN 8%. 4. INSTALL SILT FENCE AT TOE OF SLOPE TO FILTER SILT FROM RUNOFF. SEE SILT FENCE DETAIL FOR PROPER INSTALLATION. SILT FENCE WILL REMAIN IN PLACE PER NOTE #5. **EXISTING PAVED** SEEDING AND MULCHING SPECIFICATIONS PARKING 5. ALL EROSION CONTROL STRUCTURES WILL BE INSPECTED, REPLACED AND/OR REPAIRED EVERY 7 DAYS AND IMMEDIATELY FOLLOWING ANY SIGNIFICANT RAINFALL OR SNOW MELT OR WHEN NO LONGER — PLAY TEMPORARY STABILIZATION: EXIST. SIGN & SERVICEABLE DUE TO SEDIMENT ACCUMULATION OR DECOMPOSURE. SEDIMENT DEPOSITS SHOULD BE HOUSE **PLANTER** REMOVED AFTER EACH STORM EVENT. THEY MUST BE REMOVED WHEN DEPOSITS REACH <u>TYPE</u> APPROXIMATELY ONE HALF THE HEIGHT OF THE BARRIER. SEDIMENT CONTROL DEVICES SHALL REMAIN IN PLACE AND BE MAINTAINED BY THE CONTRACTOR UNTIL AREAS UPSLOPE ARE STABILIZED BY TURF. ANNUAL RYE GRASS 1 LB/1,000 SQ FT 6. NO SLOPES, EITHER PERMANENT OR TEMPORARY, SHALL BE STEEPER THAN TWO TO ONE (2 TO 1). 3.0 TONS/ACRE MULCH AGRICULTURAL GRADE LIMESTONE 1.0 TONS/ACRE 7. IF FINAL SEEDING OF THE DISTURBED AREAS IS NOT COMPLETED 45 DAYS PRIOR TO THE FIRST LIME **NEW POLE** KILLING FROST USE TEMPORARY MULCH (DORMANT SEEDING MAY BE ATTEMPTED AS WELL) TO PROTECT **FERTILIZER** 10-20-10 50 LBS./ACRE THE SITE AND DELAY SEEDING UNTIL THE NEXT RECOMMENDED SEEDING PERIOD. 8. THE TEMPORARY SEEDING OF DISTURBED AREAS THAT HAVE NOT BEEN FINAL GRADED SHALL BE COMPLETED PERMANENT STABILIZATION: 45 DAYS PRIOR TO THE FIRST KILLING FROST TO PROTECT FROM SPRING RUNOFF PROBLEMS. 50' CONSTRUCTION 9. DURING THE CONSTRUCTION PHASE, INTERCEPTED SEDIMENT WILL BE RETURNED TO SITE AND **ENTRANCE** SEPTIC REGRADED ONTO OPEN AREAS. PERENNIAL RYE GRASS (20%) 0.45 LBS/1,000 SQ FT TANK (TYP.) **REDTOP (50%)** 0.35 LBS/1,000 SQ FT 10. ALL TEMPORARY EROSION CONTROL MEASURES SHALL BE REMOVED ONCE THE SITE IS STABILIZED. 1.4 LBS/1,000 SQ FT ORCHARD GRASS (30%) PROPOSED 695 CATCH PAVED PARKING MULCH 3.0 TONS/ACRE BASIN AGRICULTURAL GRADE LIMESTONE 6.0 TONS/ACRE FERTILIZER 10-20-10 1,000 LBS./ACRE CONSTRUCTION SEQUENCE STAGE 1 (SITE PREPARATION) 1. SCHEDULE ON-SITE PRE-CONSTRUCTION MEETING WITH ENGINEER, CONTRACTOR, LANDOWNER, AND TOWNSHIP AT LEAST ONE WEEK PRIOR TO THE START OF CONSTRUCTION. INSTALL CONSTRUCTION ENTRANCE AND PERIMETER SILT FENCE. 3. EROSION CONTROLS MUST BE CONSTRUCTED, STABILIZED, AND FUNCTIONAL BEFORE NEW SITE DISTURBANCE BEGINS. 4. CLEAR AND GRUB SITE. STRIP TOPSOIL AND STOCKPILE AS SHOWN ON THE EROSION AND CREMATORIUM SEDIMENTATION CONTROL PLAN AND STABILIZE IN ACCORDANCE WITH THE SEEDING AND MULCHING 5. INITIATE EARTH MOVING ACTIVITIES FOR SITE DEVELOPMENT. UNSUITABLE MATERIAL IS TO BE REMOVED FROM THE PROJECT SITE. CONTRACTOR SHALL BE SOLELY RESPONSIBLE FOR ALL EROSION AND SEDIMENTATION CONTROL MEASURES AT ANY OFF-SITE SPOIL AREAS. PLACE AND ROOF LEADER COMPACT MATERIAL IN AREAS OF FILL TO OBTAIN NECESSARY GRADES. TO DRY WELL 6. ROUGH GRADE SITE, STABILIZE AND SEED EXCESS STOCKPILE MATERIAL AS NECESSARY. INSTALL PROPANE SILT FENCE AROUND THE STOCKPILE IMMEDIATELY AFTER THE SOIL IS STOCKPILED. W EXISTING WELL 7. THE SITE GRADING ACTIVITIES SHALL BE INITIATED AND PROCEED IN SUCH A MANNER AS TO DIRECT ALL STORM WATER FROM DISTURBED AREAS TO THE SEDIMENT CONTROL STRUCTURES. 8. STABILIZE ALL GRASS AREAS IN ACCORDANCE WITH THE SEEDING AND MULCHING SPECIFICATIONS. CONCRETE SIDEWALK STAGE 2 (CONSTRUCTION) 1. INITIATE CONSTRUCTION OF BUILDING FOUNDATION AND SUPER STRUCTURE. SILT FENCE 2. INSTALL WASTEWATER AND WATER SUPPLY SYSTEMS INCLUDING PIPING AND TRENCHING AS SHOWN ON THE SITE PLAN. ROUGH GRADE SITE, WORKING GRADE TOWARDS "ROUGH" FINAL GRADE ELEVATIONS OF TOWN OF DEERPARK PLACE AND COMPACT SUB-BASE IN AREAS TO BE PAVED AND PLACE THEGRAVEL / ITEM #4 PLANNING BOARD APPROVAL COURSE AS SOON AS IT IS PRACTICAL. 5. RESEED, RE-MULCH AND RE-STABILIZE WHERE NECESSARY. \DISTURBANCE\_ LIMITS REMOVE SILT FENCING ONLY AFTER ENTIRE SITE HAS BEEN STABILIZED, VEGETATED AREAS SHALL BE CONSIDERED PERMANENTLY STABILIZED WHEN A UNIFORM 70% VEGETATIVE COVER OF EROSION RESISTANT PERENNIAL SPECIFIED HAS BEEN ACHIEVED, OR THE DISTURBED AREA IS COVERED WITH AN ACCEPTABLE BMP WHICH PERMANENTLY MINIMIZE ACCELERATED EROSION AREA OF DISTURBANCE AND SEDIMENTATION. UNTIL SUCH TIME AS THIS STANDARD IS ACHIEVED, INTERIM STABILIZATION MEASURES AND TEMPORARY EROSION AND SEDIMENT CONTROL BMPS THAT ARE USED TO TREAT PROJECT RUNOFF MAY NOT BE REMOVED. DURING PERIODS OF DROUGHT, IRRIGATION 18,973 S.F. / 0.44± ACRES SHOULD BE UTILIZED UNTIL STABILIZATION HAS OCCURRED. REVISIONS JOHN D. FULLER, P.E., P.C. PORT JERVIS, NY 12771 (845) 856-1536 DWN BY REV DESCRIPTION DATE APPROVED DL 0 FOR APPROVAL 06/09/21 HUMANE SOCIETY OF PORT JERVIS / DEERPARK DL | 1 | REVISED PER TOWN COMMENT 09/28/21 202 U.S. ROUTE 209 REVISED PER TOWN COMMENT 10/29/21 SCALE: 1" = 20' JNAUTHORIZED ALTERATION OR ADDITIONS TO A PLAN BEARING THIS PLAN CONTAINS 7 SHEETS. THIS SECTION 53 BLOCK 1 LOT 4 THE SEAL OF A LICENSED ENGINEER OR LAND SURVEYOR IS A SHEET SHALL NOT BE CONSIDERED VIOLATION OF SECTION 7209 SUBDIVISION 2 OF THE NEW YORK **EROSION & SEDIMENTATION CONTROL PLAN** TOWN OF DEERPARK, NY STATE EDUCATION LAW. VALID UNLESS ACCOMPANIED BY THE REMAINING SHEETS. SCALE: 1" = 20' DWG TITLE EROSION & SEDIMENTATION COPIES OF THIS DOCUMENT WITHOUT A FACSIMILE OF THE

SIGNATURE AND AN ORIGINAL EMBOSSED SEAL OR ORIGINAL

STAMP IN BLUE OR RED INK OF THE PROFESSIONAL ENGINEER OR LAND SURVEYOR SHALL NOT BE CONSIDERED VALID COPIES.

S-5

2235.001


JOHN D. FULLER

REG. NO. 077703

CONTROL PLAN

AS NOTED

JOB NO.

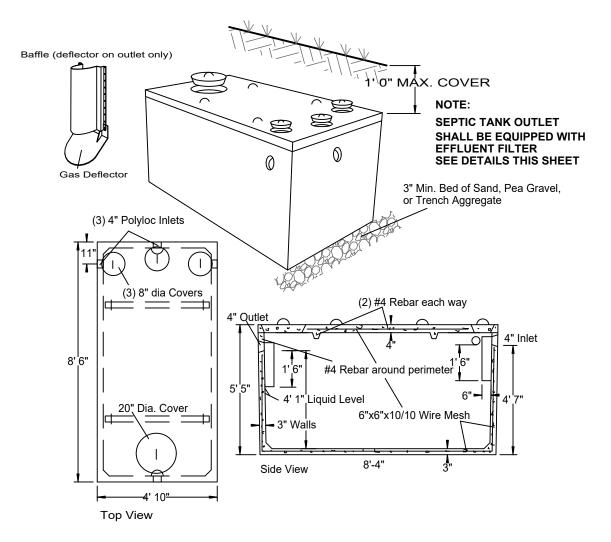

SPECIFICATIONS


Concrete Min. Strength: 4,000 psi at 28 days Reinforcement: #4 Rebar, 6x6x10ga. WWM Air Entrainment: 5%
Construction Joint: Butyl Rubber Sealant Pipe Connection: Polylok Seal (patented) Weight = 9,500 lbs
Load Rating: 300 psf

PRECAST SEPTIC TANKS
MODEL ST-1000 / 1000 GALLONS

Woodard's Concrete Products, Inc. 629 Lybolt Road, Bullville,
(845) 361-3471 / Fax 361-1050


TYPICAL CONCRETE SEPTIC TANK

SCALE: N.T.S.

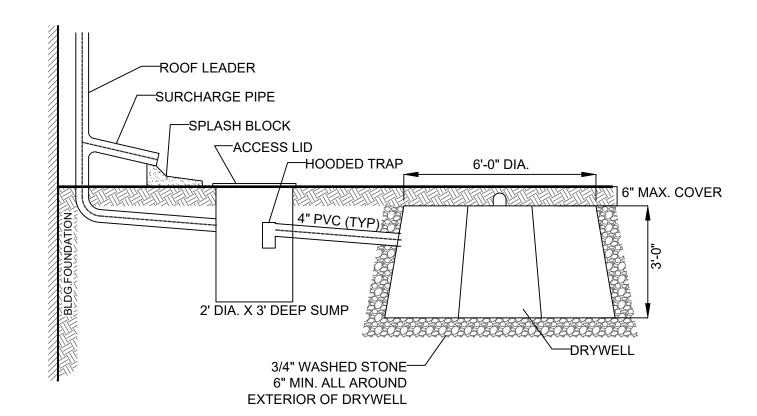


S-6

S-6

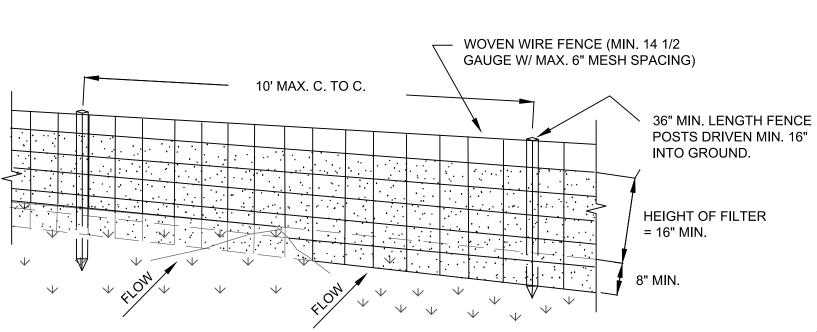


## PERSPECTIVE VIEW


TYPICAL DRYWELL DETAIL

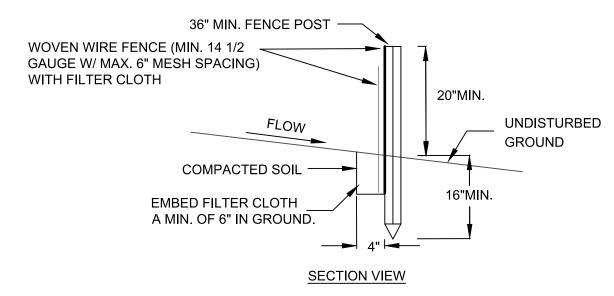



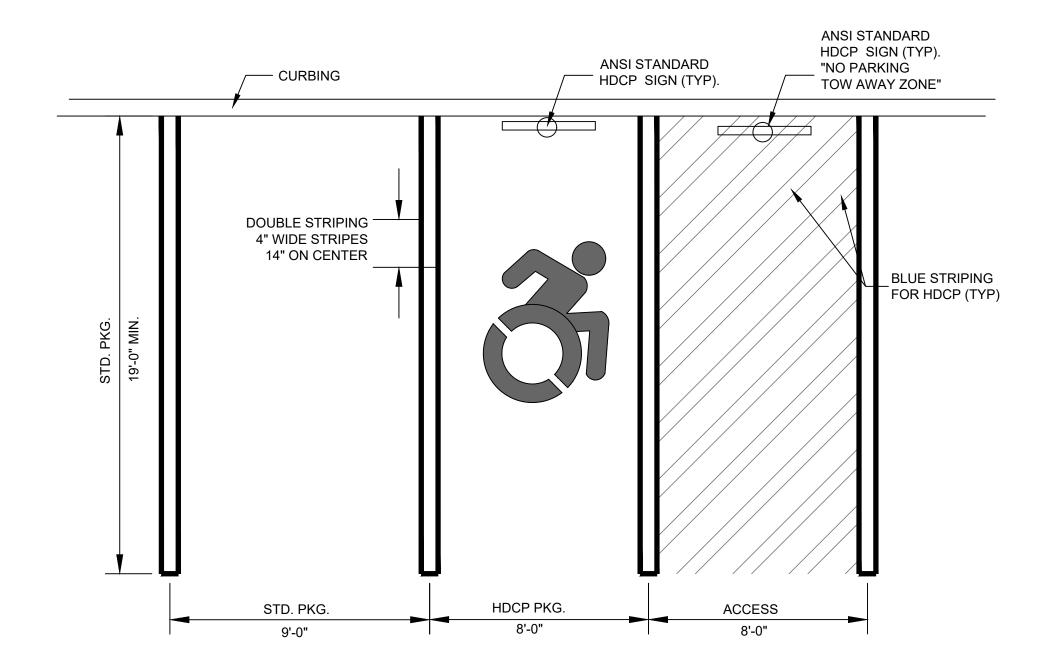

# TYPICAL HANDICAP PARKING SPACE DETAIL 2 SCALE: N. T. S. S-6

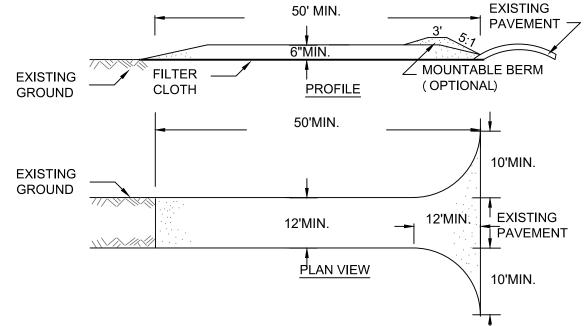

# CONSTRUCTION SPECIFICATIONS


- 1. STONE SIZE = USE 2" STONE, OR RECLAIMED OR RECYCLED CONCRETE EQUIVALENT.
- 2. LENGTH = NOT LESS THAN FIFTY (50) FEET (EXCEPT ON A SINGLE RESIDENCE LOT WHERE A 30 FOOT MINIMUM LENGTH WOULD APPLY).
- 3. THICKNESS = NOT LESS THAN SIX (6) INCHES.
- 4. WIDTH = TWELVE (12) FOOT MINIMUM, BUT NOT LESS THAN THE FULL WIDTH AT POINTS WHERE INGRESS OR EGRESS OCCUR. TWENTY-FOUR (24) FEET IF SINGLE ENTRANCE TO SITE.
- 5. FILTER CLOTH WILL BE PLACED OVER THE ENTIRE AREA PRIOR TO PLACING OF STONE.
- 6. SURFACE WATER ALL SURFACE WATER FLOWING OR DIVERTED TOWARD CONSTRUCTION ENTRANCES SHALL BE PIPED ACROSS THE ENTRANCE. IF PIPING IS IMPRACTICAL, A MOUNTABLE BERM WITH 5:1 SLOPES WILL BE PERMITTED.
- 7. MAINTENANCE THE ENTRANCE SHALL BE MAINTAINED IN A CONDITION WHICH WILL PREVENT TRACKING OR FLOWING OF SEDIMENT ONTO PUBLIC RIGHTS-OF-WAY. ALL SEDIMENT SPILLED, DROPPED, WASHED OR TRACKED ONTO PUBLIC RIGHTS-OF-WAY MUST BE REMOVED IMMEDIATELY.
- 8. WHEN WASHING IS REQUIRED, IT SHALL BE DONE ON AN AREA STABILIZED WITH STONE AND WHICH DRAINS INTO AN APPROVED SEDIMENT TRAPPING DEVICE.
- 9. PERIODIC INSPECTION AND NEEDED MAINTENANCE SHALL BE PROVIDED AFTER EACH RAIN.


# CONSTRUCTION ENTRANCE SCALE: N. T. S.

# CONSTRUCTION SPECIFICATIONS


- 1. WOVEN WIRE FENCE TO BE FASTENED SECURELY TO FENCE POSTS WITH WIRE TIES OR STAPLES. POSTS SHALL BE STEEL EITHER "T" OR "U" TYPE OR HARDWOOD.
- 2. FILTER CLOTH TO BE TO BE FASTENED SECURELY TO WOVEN WIRE FENCE WITH TIES SPACED EVERY 24" AT TOP AND MID SECTION. FENCE SHALL BE WOVEN WIRE, 12 1/2 GAUGE, 6" MAXIMUM MESH OPENING.
- 3. WHEN TWO SECTIONS OF FILTER CLOTH ADJOIN EACH OTHER THEY SHALL BE OVER-LAPPED BY SIX INCHES AND FOLDED. FILTER CLOTH SHALL BE EITHER FILTER X, MIRAFI 100X, STABILINKA T140N, OR APPROVED EQUIVALENT.
- 4. PREFABRICATED UNITS SHALL BE GEOFAB, ENVIROFENCE, OR APPROVED EQUIVALENT.
- 5. MAINTENANCE SHALL BE PERFORMED AS NEEDED AND MATERIAL REMOVED WHEN "BULGES" DEVELOP IN THE SILT FENCE.


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TYPICAL ACCESSIBLE PARKING SIGN (
SCALE: N. T. S.

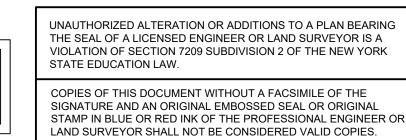

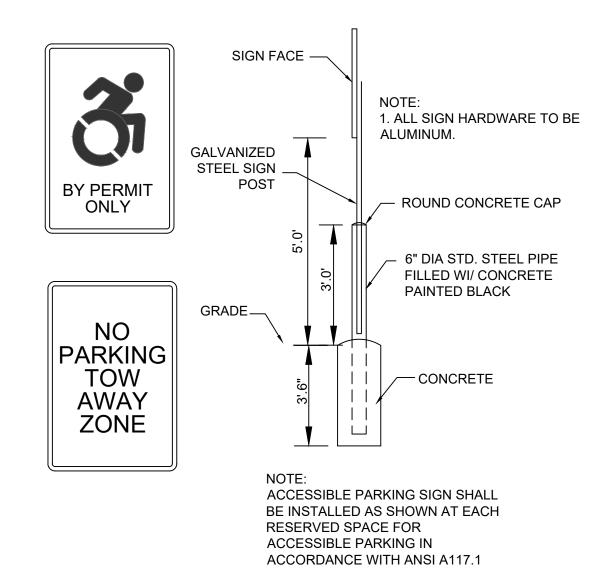

REG. NO. 077703

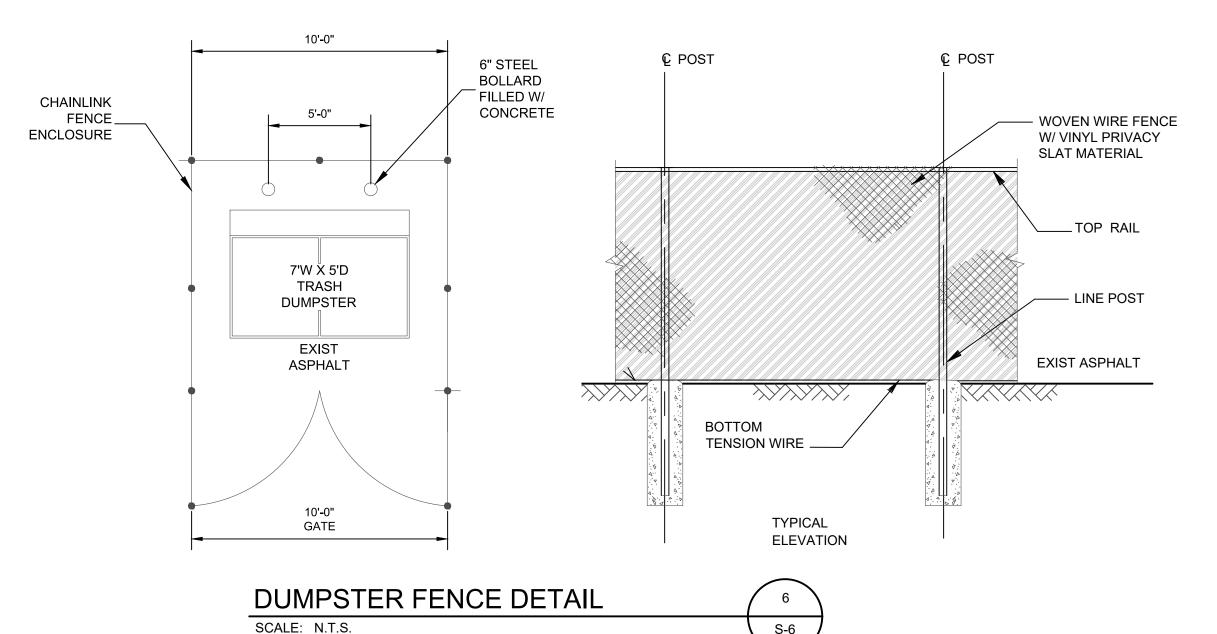REVISIONS					
DWN BY	REV	DESCRIPTION	DATE	APPROVED	Λ
DL	0	FOR APPROVAL	06/09/21		1, 1/1/1
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DL	1	REVISED PER TOWN COMMENT	10/29/21		Man 1. 7 W
					JOHN D. FULLER

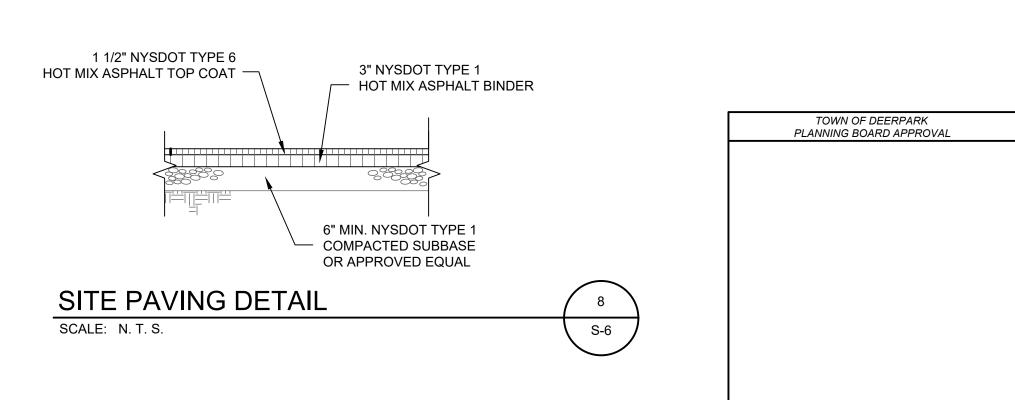JOHN D. FULLER, P.E., P.C. PORT JERVIS, NY 12771

HUMANE SOCIETY OF PORT JERVIS / DEERPARK

202 U.S. ROUTE 209

SECTION 53 BLOCK 1 LOT 4

TOWN OF DEERPARK, NY

DWG TITLE

SITE DETAILS

SCALE AS NOTED

DWG NO.

S-6

SCALE AS NOTED

DWG NO.

2235.001