

### **ADDENDUM NO.** 02

PROJECT: Pleasantville Union Free School District

PMS HVAC Replacement

CPL PROJECT NO. 15131.07

SED PROJECT NO. Pleasantville Middle School 66-08-09-03-0-003-025

DATE: November 10, 2022

Include this Addendum as part of the Contract Documents. It supplements portions of the original specifications and drawings, the extent of which shall remain, except as revised herein:

#### **CLARIFICATIONS**:

- 1.1 The HVAC controls scope is to provide a new front end BMS system to control all the new equipment that is being installed including the RTU's, VRF system, exhaust fans, and both new and existing fin tubes in areas of work. Some of the existing fin tubes will need new electronic control valves to replace old pneumatic valves. All other existing to remain equipment will not be connected to the new BMS system.
- 1.2 The project schedule was built to accommodate recent equipment lead times we are experiencing. Time is of the essence as it relates to the completion of this project. The substantial completion dates are intended to be the latest date to complete the work. Work may only occur from 7:00am to 3:30pm Monday through Friday from June 26, 2023 through September 1, 2023. Upon the start of school, work will be limited to second shift and school breaks. Work may resume from 7:00am to 3:30pm Monday through Friday after the last day of school in June of 2023 (exact date has yet to be established). It is the District' desire to have the work completed as soon as reasonably possible given the constraints noted above.

#### TO THE DRAWINGS:


- 3.1 Drawing A200B: **Revise** sheet with attached sketch AD-2 SK-1.
- 3.2 Drawing A201C: **Revise** sheet with attached sketch AD-2 SK-3 and AD-2 SK-4.





- 3.3 <u>Drawing A200A through A201C</u>: **Revise** sheet with attached sketch AD-2 SK-2. Note Reconstruction Keynotes have been revised for all Reconstruction sheets.
- 3.4 Drawing H300B: **Replace** sheet with attached sheet H300B
- 3.5 <u>Drawing H301C</u>: **Replace** sheet with attached sheet H301C
- 3.6 Add drawing H805 to drawing set.

END OF ADDENDUM NO. 02

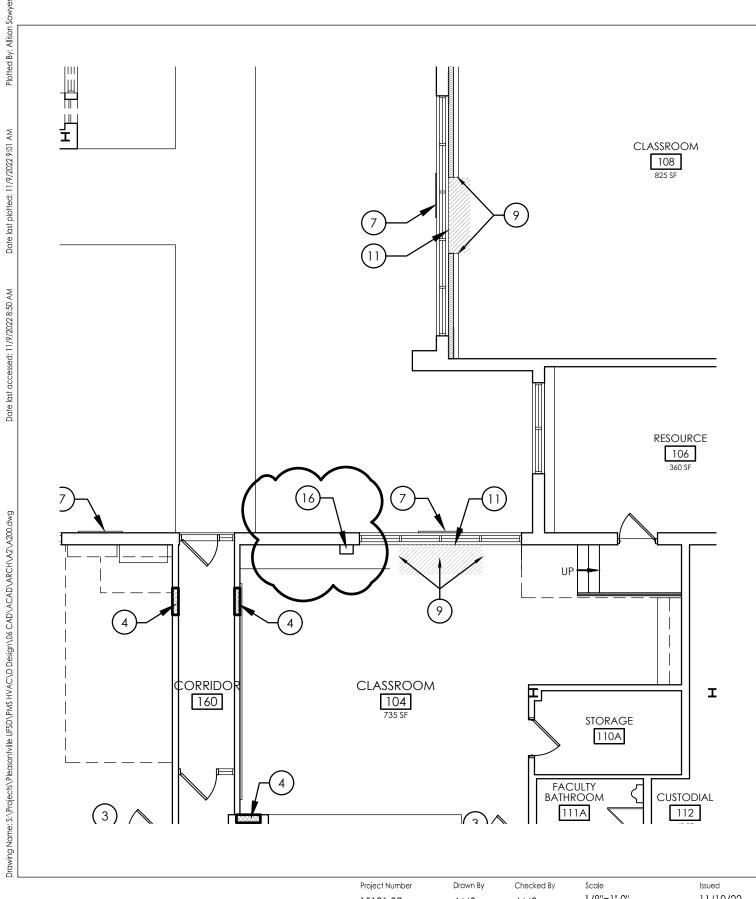



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15131.07

**AMS** 

**AMS** 

Drawing Title

1/8"=1'-0"

11/10/22

Client Name

**PLEASANTVILLE UFSD** 

Project Name

A200B **PMS HVAC** 

Drawing Number

SK-1

- NEW UV TO BE INSTALLED BY MC.
- PREP, PRIME AND PAINT WALL AT LOCATION OF SPLIT SYSTEM REMOVAL.
- PREP, PRIME AND PAINT WALL AT LOCATION OF TEMPERATURE CONTROL REMOVAL.
- INFILL WALL PENETRATION WITH 1-HOUR RATED WALL CONSTRUCTION.
- EXTERIOR WALL PENETRATION TO BE INFILLED MASONRY CONSTRUCTION.
- 6 INFILL WALL PENETRATION.
- INFILL WALL OPENING PER DETAIL 6/A700 AT UV GRILLE
- RECOVER EXPOSED WALL WITH 3/8" LAMINATING GYPSUM BOARD.
- REFINISH EXPOSED ENDS OF EXISTING CASEWORK, INCLUDING NEW BASE.
- PAINT AND RE-INSTALL EXISTING VENT COVER.
- PATCH WALL WITH GYPSUM BOARD AND PAINT TO MATCH EXISTING.
- 12) ENCLOSE FRONT OF GAP AT END OF CASEWORK WITH MATCHING PANEL. PROVIDE FINISHED EDGE WHERE SOLID COUNTER WAS CUT; EASE COUNTER AGAINST NEW WALL.
- INFILL WALL OPENING PER DETAIL 3/A700 AT UV GRILLE
- PAINT NEW WALL TO MATCH EXISTING ADJACENT. PROVIDE NEW WALL BASE TO MATCH EXISTING ADJACENT.
- PROV<u>IDE</u> 2'x2<u>' Wall Mou</u>nted <u>access door. Basis-of-de</u>sign<u>:</u> AVUDOR 10-2002.
- PROVIDE METAL SHROUD OVER NEW CONDENSATE LINES. SHROUD TO BE PAINTED TO MATCH EXISTING WALL AND FOLLOW (16) CONDENSATE LINES FROM THE CEILING TO THE NEW UNIT VENTILATOR.

### ONSTRUCTION LEGENDA



PATCH VCT FLOORING AND WALL BASE TO MATCH EXISTING. WHERE VAT TILE WAS REMOVED, PATCH WITH VCT BEST MATCH.



INFILL WALL PENETRATION WITH LIKE CONSTRUCTION.



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Project Number

Drawn By **AMS** 

Checked By AMS

Scale NTS Issued 11/10/22

15131.07 Client Name

PLEASANTVILLE UFSD

Project Name


PLEASANTVILLE HVAC

Drawing Title

RECONSTRUCTION **KEYNOTES** 

Drawina Number



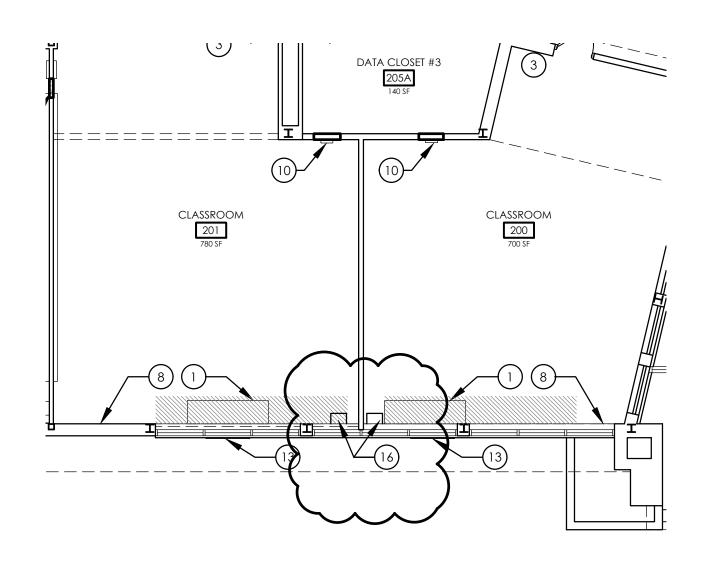



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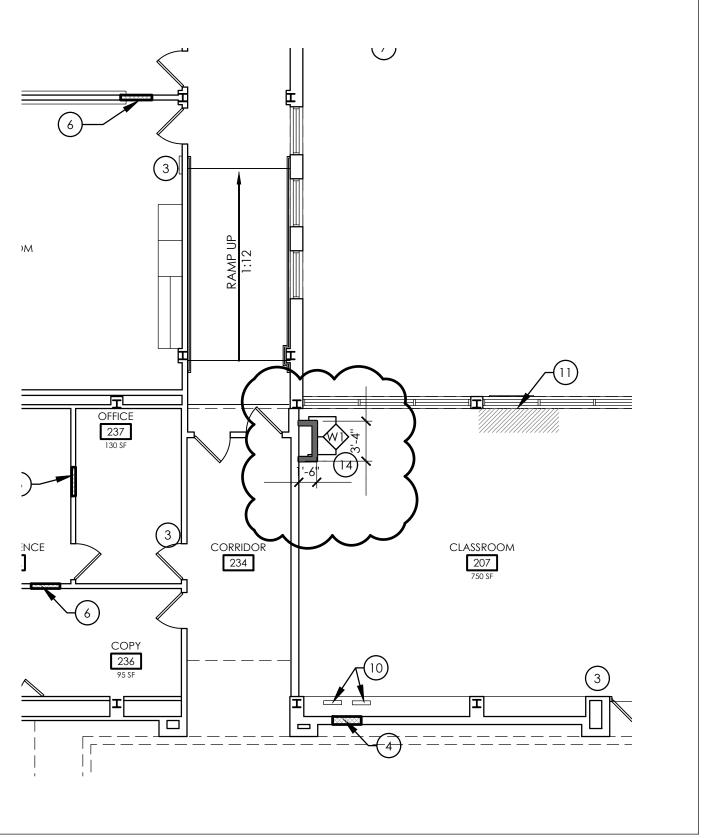
PLEASANTVILLE HVAC A201C

Drawing Title

Drawing Number

ad-2 SK-3







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Client Name

### **PLEASANTVILLE UFSD**


Project Name

Drawing Title

**PLEASANTVILLE HVAC** 

A201C

AD-2 SK-4

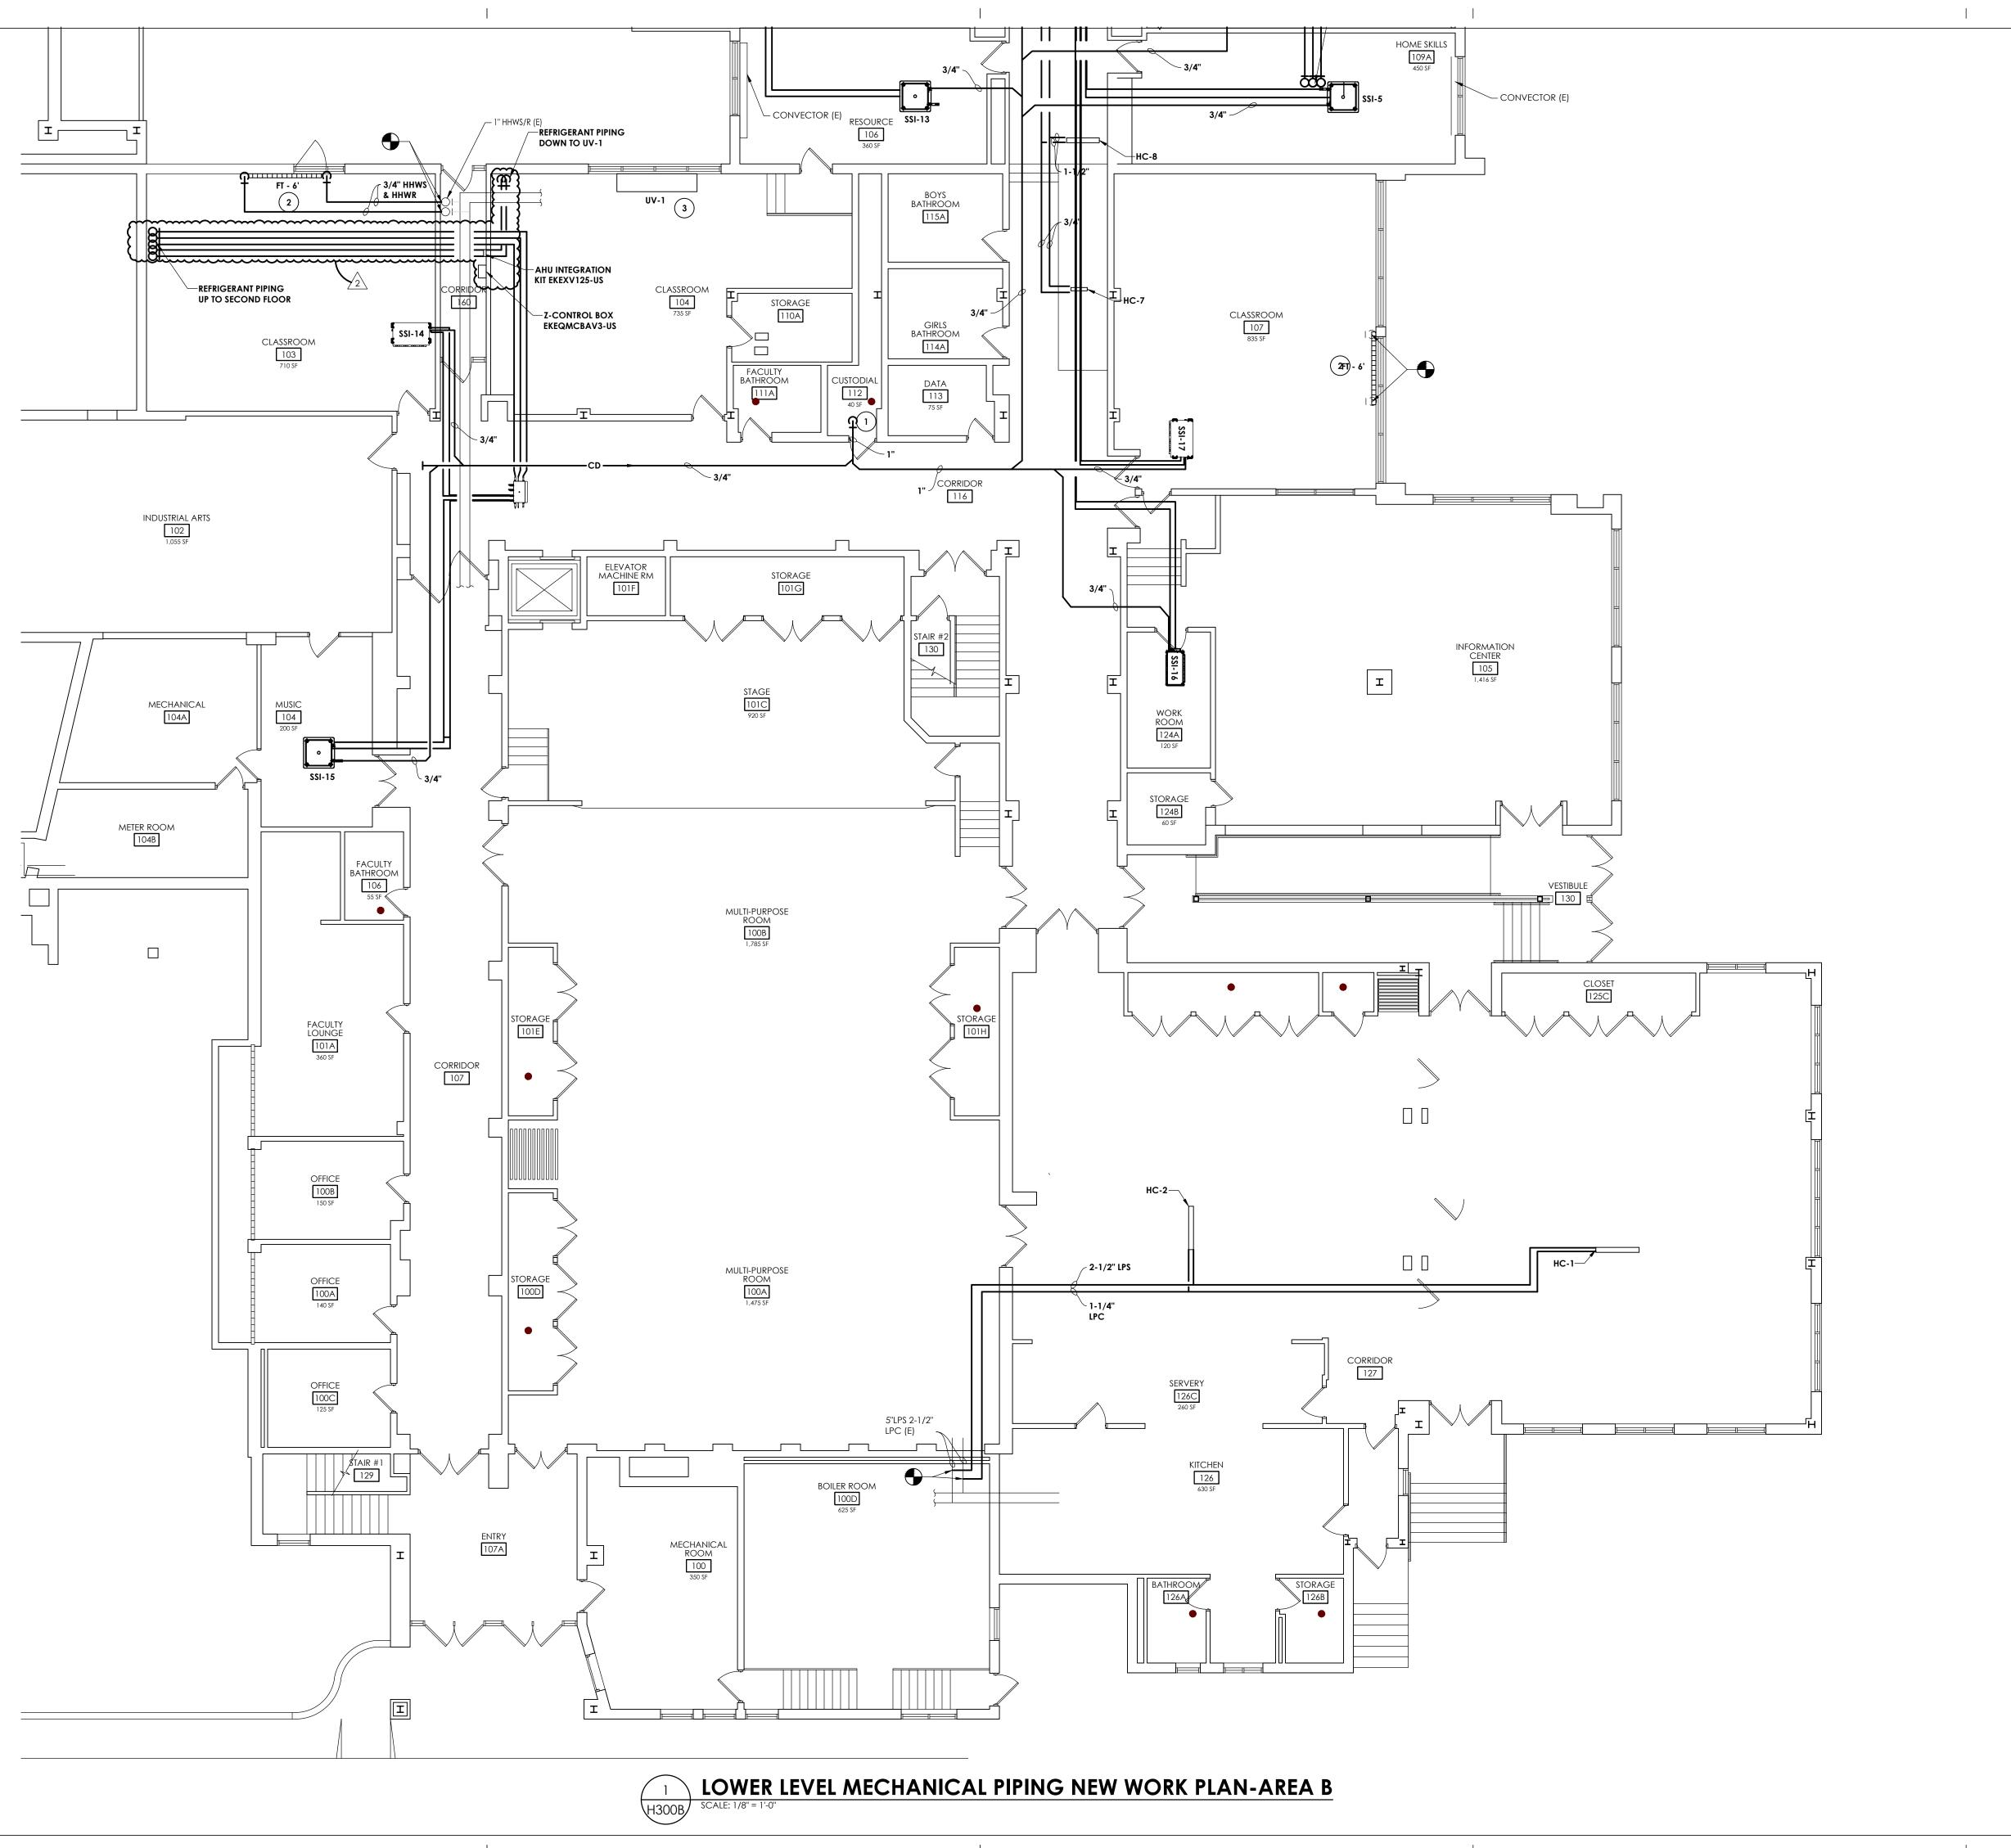

# **GENERAL NOTES:**

1. SEE THE H800 DRAWINGS FOR REFRIGERANT PIPING SIZING.

# **KEY NOTES:**

- 1 ROUTE NEW CONDENSATE DRAIN LINE TO MOP SINK IN CUSTODIAL CLOSET.
- 2 INSTALL NEW FIN TUBE. CONNECT TO EXISTING HOT WATER PIPING AT FLOOR OF REMOVED UNIT.
- 3 RECONNECT NEW UNIT VENTILATOR TO EXISTING HHWS AND HHWR PIPING OF REMOVED UNIT VENTILATOR FROM BELOW.

KEY PLAN:

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50 Front St. Suite 202
Newburgh, NY 12550
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PROJECT INFORMATION

Project Number
15131.07

PLEASANTVILLE UFSD

Project Name
PMS HVAC REPLACEMENT

District Office Address

40 ROMER AVE. PLEASANTVILLE, NY 10570

PLEASANTVILLE UFSD 66-08-09-03-0-001-017

 PROJECT ISSUE & REVISION SCHEDULE

 No.
 Date 10/31/2022
 Description BID ADDENDUM 1 2 11/10/2022
 BID ADDENDUM 2

PROFESSIONAL STAMPS

NEW YORK STATE EDUCATION STATEMENT

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REGULATIONS FOR ANY PERSON, UNLESS ACTING UNDER THE DIRECTION OF A LICENSEE
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BEARING THE SEAL OF AN ACHITECT, ENGINEER OR SURVEYOR IS ALTERED, THE ALTERN
PARTY SHALL AFRIX TO THE ITEM THEIR SEAL AND THE NOTATION "ALTERED BY" FOLLOWER

Issued 10/21/22

10/21/22 AS SHOWN
Project Status
BID SUBMISSION
Drawn By Checked By
BKM BKM
Drawing Title
LOWER LEVEL MECHANICAL

PIPING NEW WORK PLAN AREA B

PMS H300B

# **GENERAL NOTES:**

1. SEE THE H800 DRAWINGS FOR REFRIGERANT PIPING SIZING.

## **KEY NOTES:**

- SSO-5 UTP-RU04BH CHANGE OVER BOX. SEE H800 DRAWINGS FOR WIRING DETAILS.
- 2 EXTEND LPS AND LPC PIPING TO EXISTING FIN TUBE RADIATORS. PROVIDE NEW STERLING JVB-ARS ENCLOSURE WALL TO WALL.
- 3 INSTALL NEW FIN TUBE. CONNECT TO EXISTING HOT WATER PIPING AT FLOOR OF REMOVED UNIT.
- install new unit ventilator and fin tube radiators. Connect to existing LPS and LPC at Floor.

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PMS HVAC REPLACEMENT

District Office Address 40 ROMER AVE. PLEASANTVILLE, NY 10570


PLEASANTVILLE UFSD

 No.
 Date 10/31/2022
 Description BID ADDENDUM 1 BID ADDENDUM 2

 2
 11/10/2022
 BID ADDENDUM 2

PROFESSIONAL STAMPS

UPPER LEVEL MECHNICAL PIPING NEW WORK PLAN-AREA C

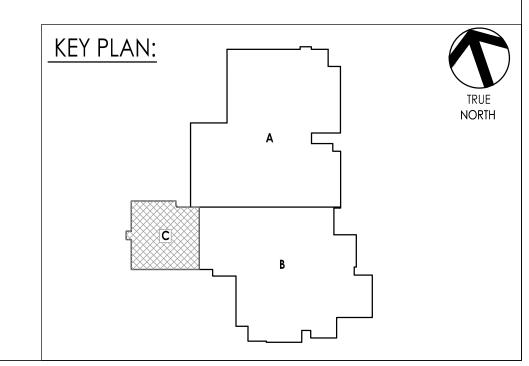



SHEET INFORMATION


10/21/22 as shown Project Status BID SUBMISSION Drawn By BKM

Drawing Title UPPER LEVEL MECHANICAL PIPING PLAN-AREA C




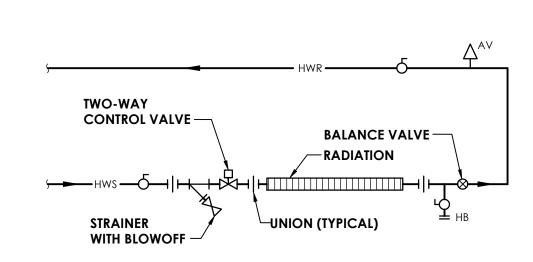

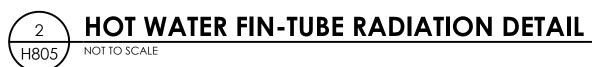


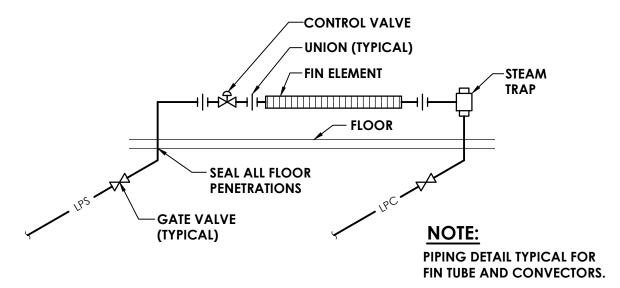




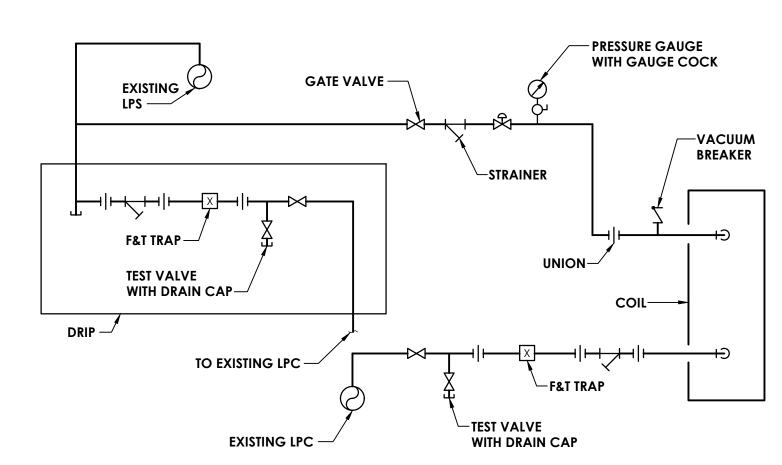



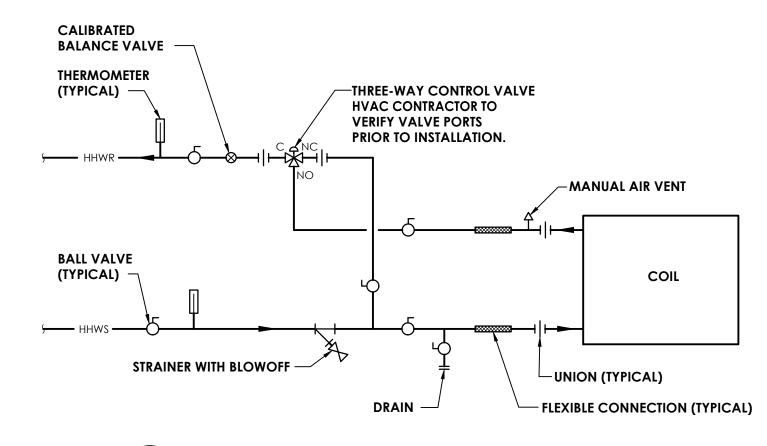



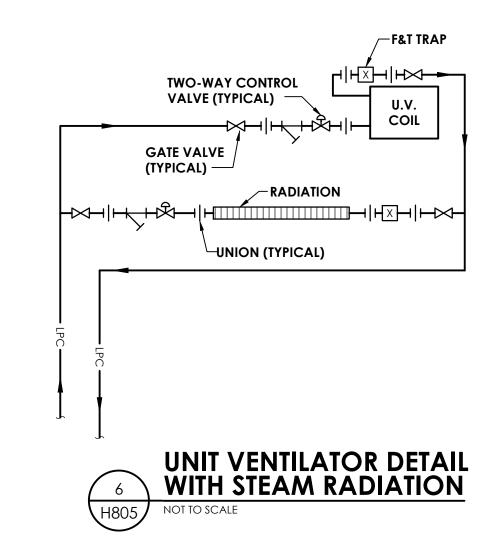



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PLEASANTVILLE UFSD

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PARTY SHALL AFFIX TO THE ITEM THEIR SEAL AND THE NOTATION "ALTERED BY FOLLOW
THEIR SIGNATURE AND THE DATE OF SUCH ALTERATION, AND A SPECIFIC DESCRIPTION

as shown

SHEET INFORMATION

Issued
10/21/22
Project Status
BID SUBMISSION
Drawn By

Drawn By Checked By BKM BKM

Drawing Title

MECHANICAL DETAILS

Drawing Number

PMS H805