NYACK UFSD

PROFESSIONAL DEVELOPMENT CENTER

13A DICKINSON AVENUE NYACK, NY 10960

OCTOBER 12, 2022

ARCHITECT

2021-1048

KG+D Architects

DESIGN TEAM

NY SED Project. No

KG+D Project No.

50-03-04-03-1-005-006

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PROFESSIONAL

DEVELOPMENT CENTER

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STRUCTURAL ENGINEER THE DISALVO ENGINEERING GROUP

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200 Robb Road Amsterdam, NY 12010 phone: 518-843-4054

ISSUE FOR REBID



LIST OF DRAWINGS

ACCESSIBILITY DIAGRAMS

CC001 CODE COMPLIANCE INFORMATION CC002 CODE COMPLIANCE PLAN

ACCESSIBILITY DIAGRAMS

ARCHITECTURAL

DEMOLITION PLAN FLOOR PLAN & INTERIOR ELEVATIONS **EXTERIOR ELEVATIONS & SECTIONS**

MILLWORK DETAILS FINISH PLAN & SCHEDULE REFLECTED CEILING PLAN A701 STAIR DETAILS

INTERIOR DETAILS WALL TYPES AND GENERAL NOTES DOOR SCHEDULE, DOOR & FRAME TYPES A912 TYPICAL DOOR DETAILS

LEGENDS, SCHEDULES, NOTES, & PART BASEMENT & 1ST FLOOR PLANS (REMOVALS) PART BASEMENT & 1ST FLOOR PLANS (NEW WORK)

LEGENDS, NOTES, & PART BASEMENT, 1ST AND 2ND FLOOR PLANS (REMOVALS) PART BASEMENT, 1ST & 2ND FLOOR PLANS (NEW WORK)

H301 SCHEDULES DETAILS


E501 RISERS E601 DETAILS & SCHEDULES


E101 REMOVAL PLAN


E201 LIGHTING PLAN


E301 POWER PLAN


E001 NOTES, ABBREVIATIONS AND LEGENDS

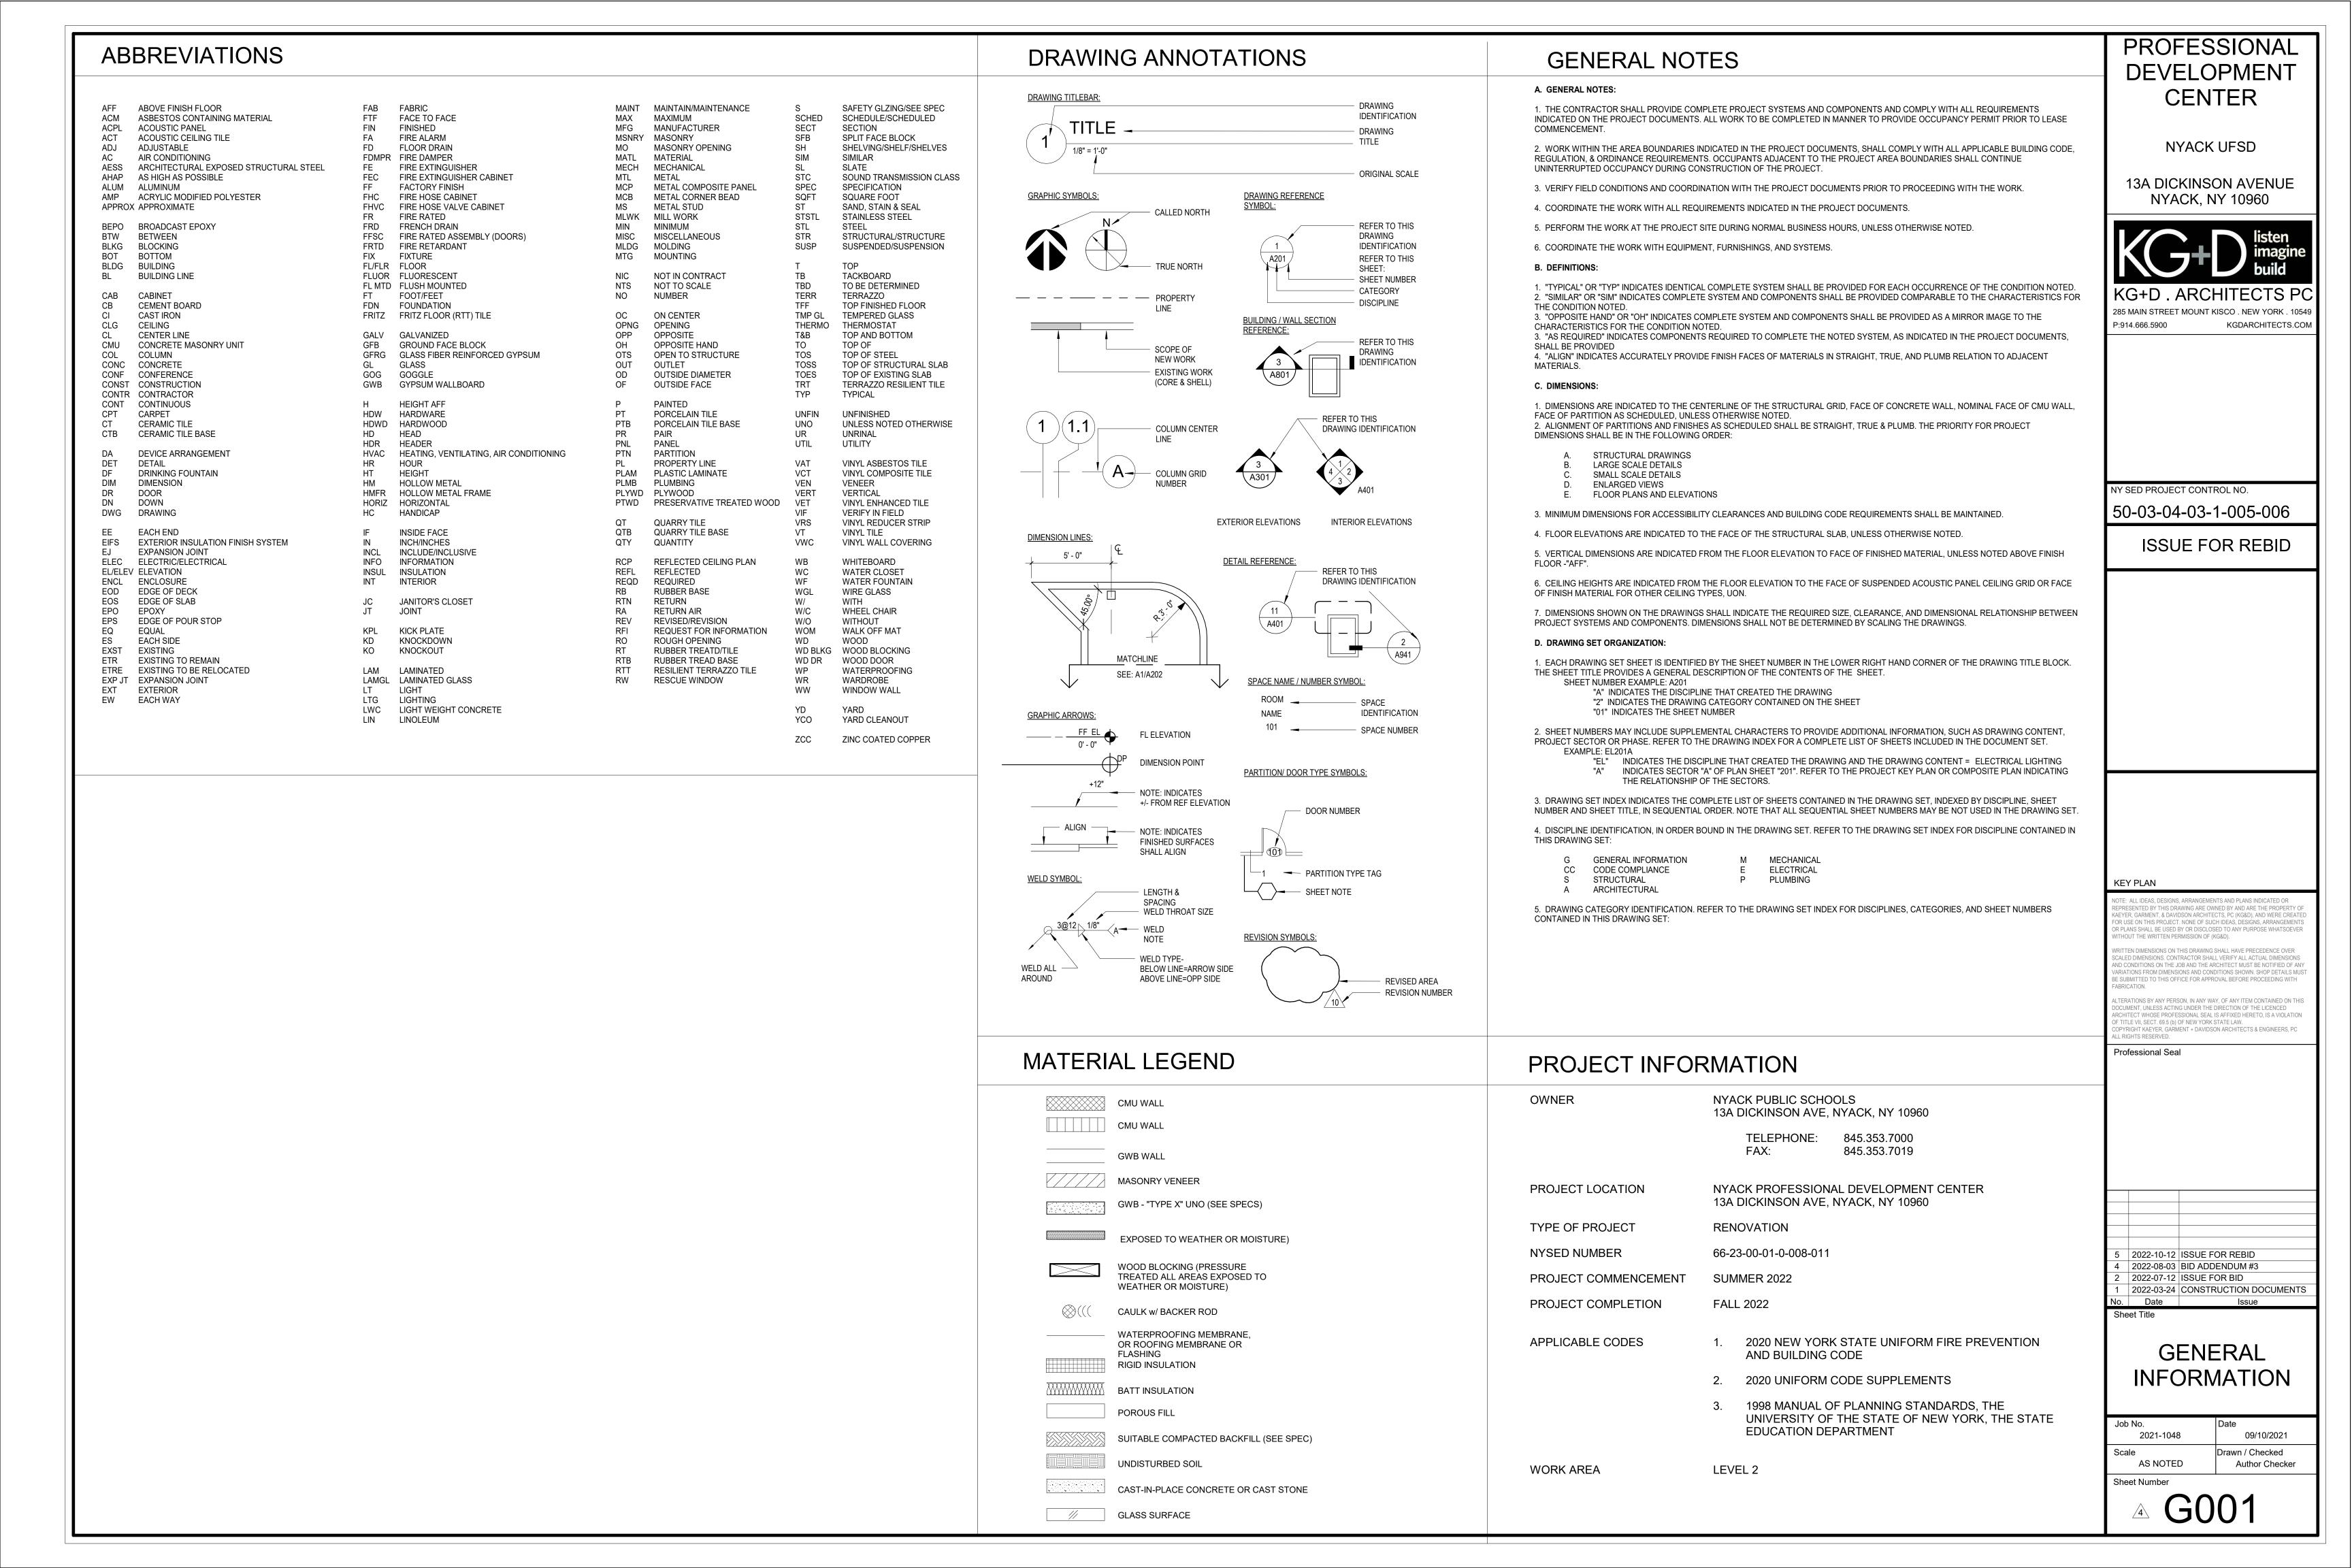


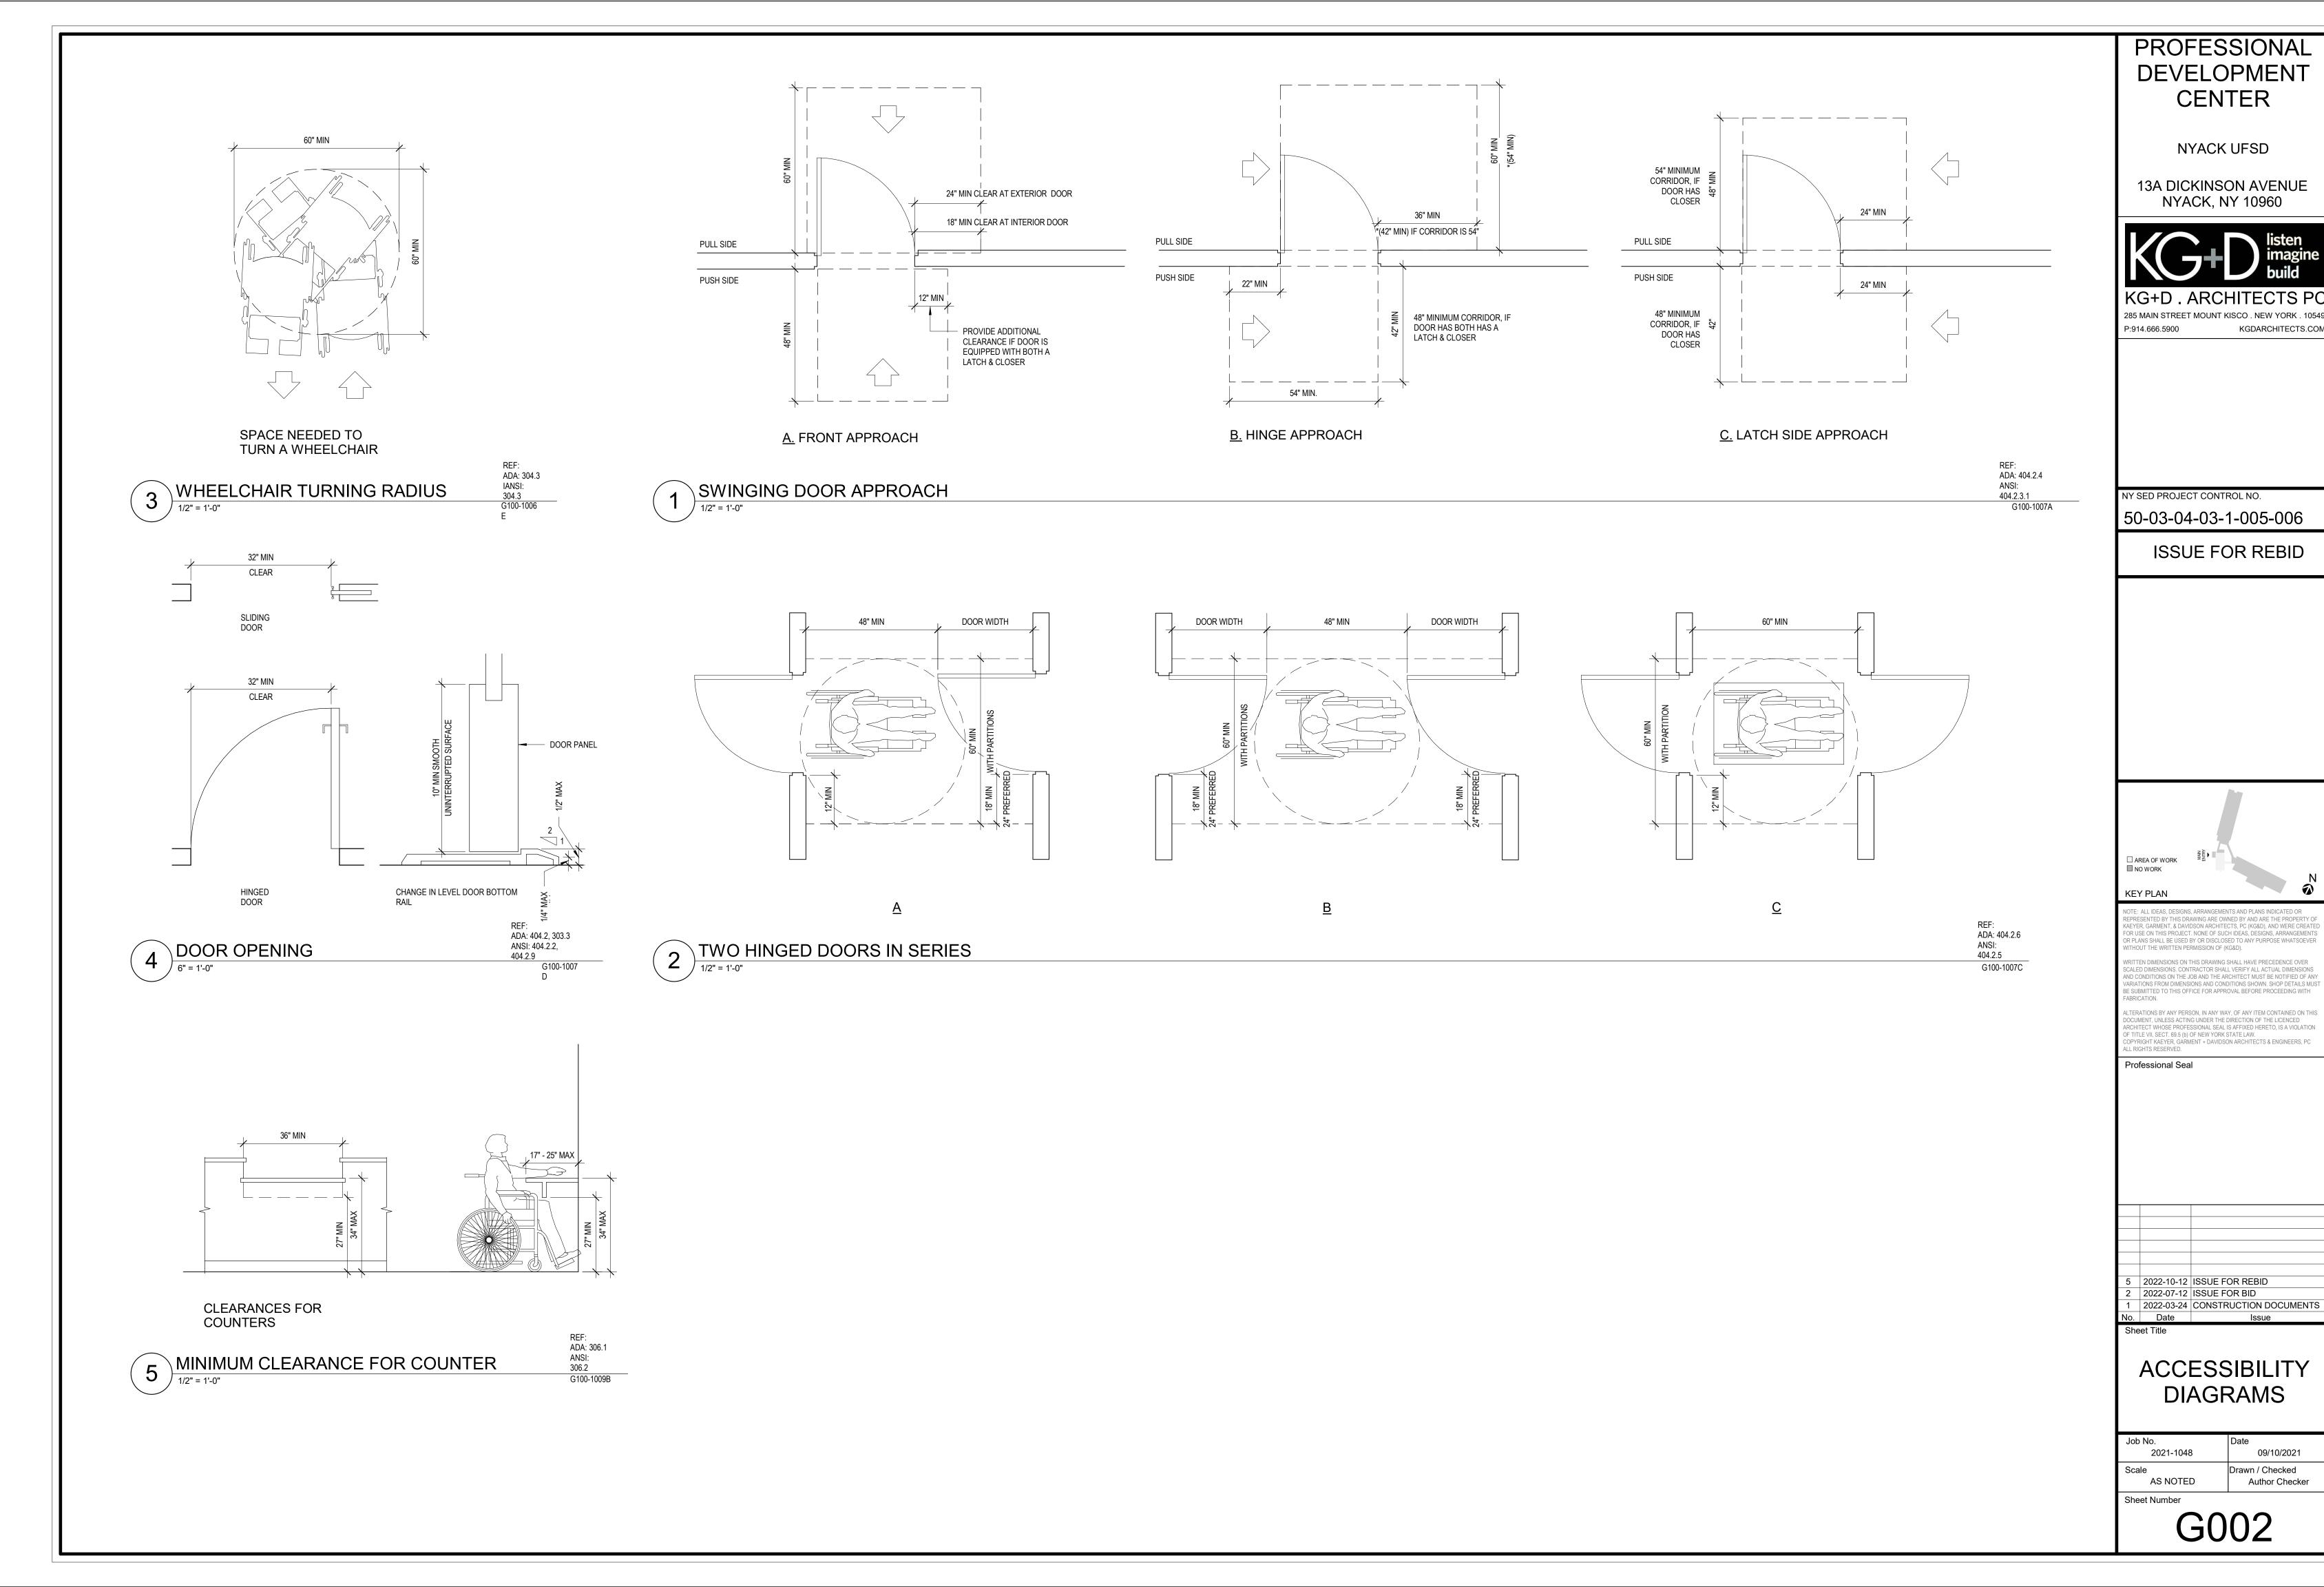

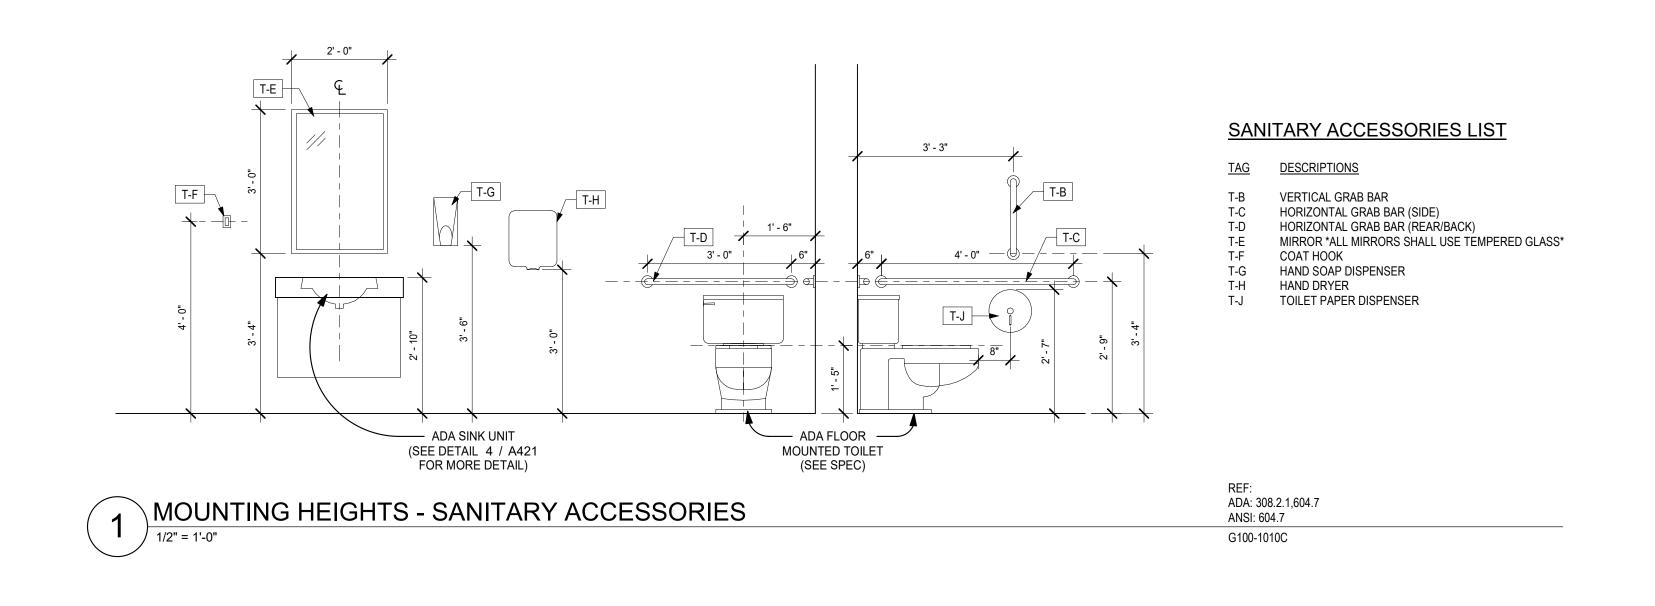

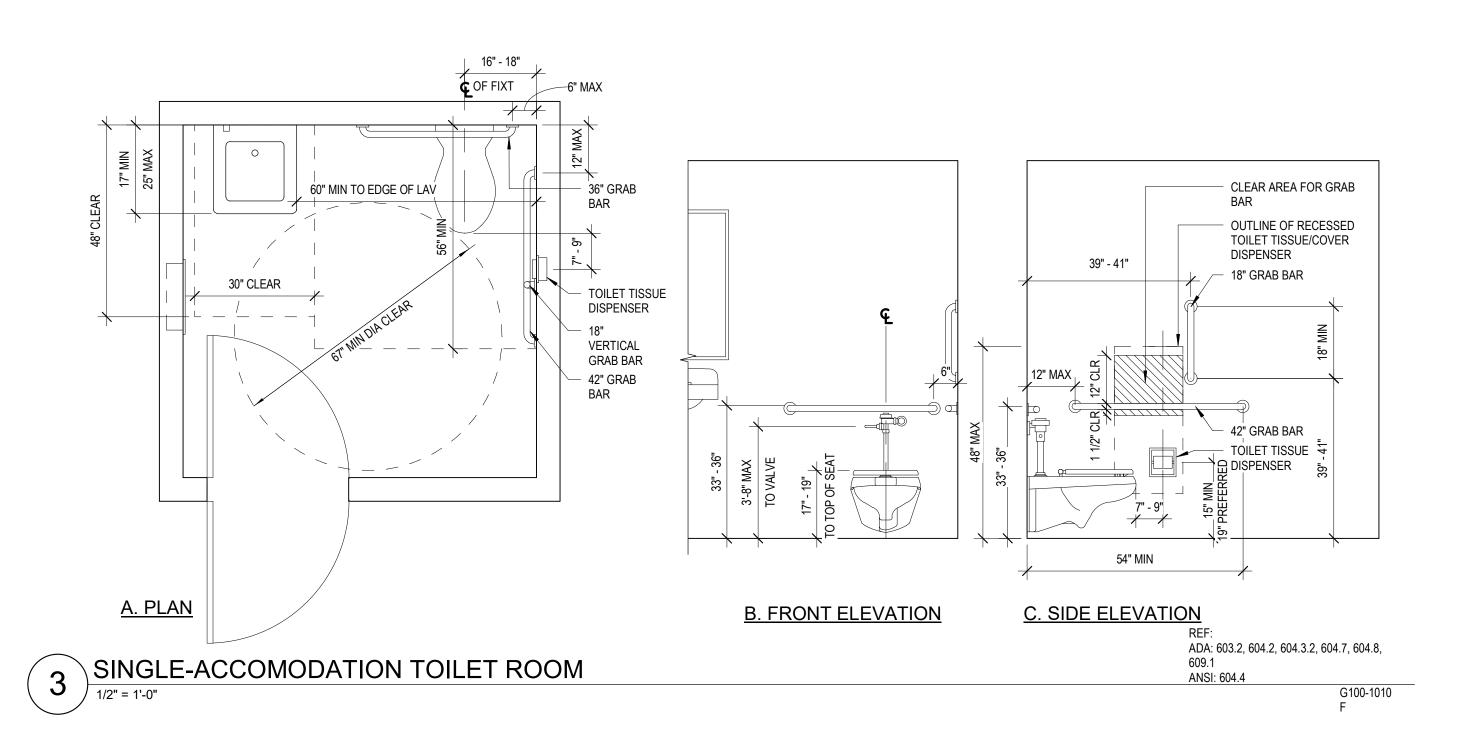

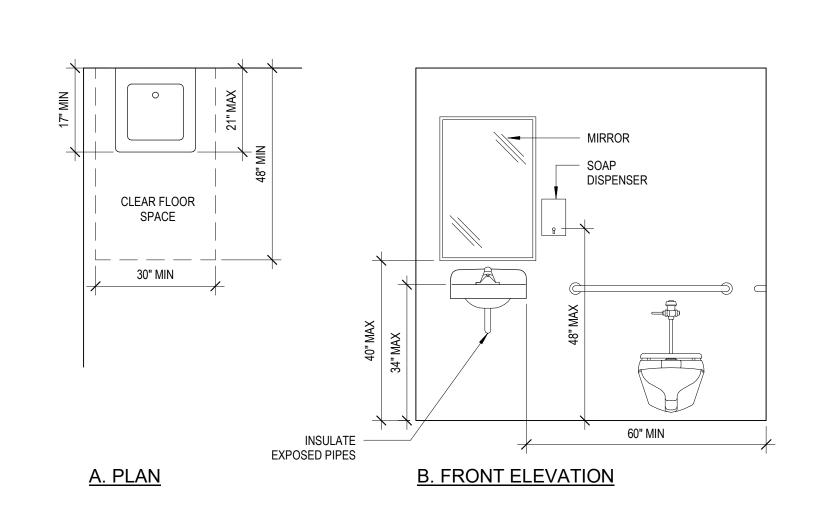

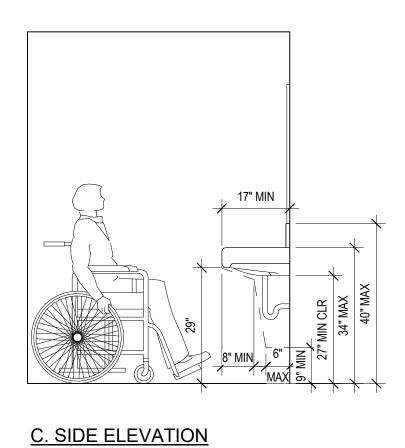

ADA: 603.3, 604.3.2, 606.1, 606.5 ANSI: 606.1

G100-1010E

- COLOR #1 TEXT, ICON, & BRAILLE IN CONTRASTING COLOR COLOR #2 GENDER NEUTRAL COLOR #3

ACCESSIBLE LAVATORY

			SIGNAGE SC	HEDUL	.E
ROOM NO.	LOCATION	SIGN TYPE	SIGN TEXT	QTY	DESCRIPTION
	T	I _			
103	T	G	GENDER NEUTRAL	1	GENDER NEUTRAL TOILET ROOM
103	Т				
107	Т				
108	PANTRY				
		1	1		1

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2022-10-12 ISSUE FOR REBID 2 2022-07-12 ISSUE FOR BID 1 2022-03-24 CONSTRUCTION DOCUMENTS No. Date

ACCESSIBILITY DIAGRAMS

09/10/2021 2021-1048 Drawn / Checked AS NOTED Author Checker

G003

TYPE G - TOILET IDENTIFICATION SIGN BASIS OF DESIGN: TAKEFORM FUSION #59 (SEE SPEC FOR MORE INFORMATION)

CHAPTERS 3-6 OCCUPANCY, AREA & CONSTR. TYPES

BUILDING INFORMATION USE & OCCUPANCY CLASSIFICATION:

ASSEMBLY (A - 3)

WORK CHARACTERIZATION:

RENOVATION LEVEL 2

CONSTRUCTION CLASSIFICATION:

TYPE IIIB

FIRE RATING FOR BEARING WALLS

2 HRS **EXTERIOR***: **INTERIOR:** 0 HRS

FIRE RATING FOR NON-BEARING WALLS AND PARITIONS **EXTERIOR:** 1 HR

INTERIOR:

0 HRS FIRE RATING FOR FLOORS (TYPE IIIB): 0 HRS

FIRE RATING FOR ROOFS (TYPE IIIB):

BUILDING AREA:

EXISTING HEIGHT IN STORIES: 2

ALLOWABLE HEIGHT IN STORIES: 2 EXISTING TOTAL BUILDING AREA: 7.356 SF

TOTAL ALLOWABLE AREA: 9,500 SF TOTAL PROJECT SCOPE AREA: 2,908 SF

*NOT LESS THAN THE FIRE-RESISTANCE RATING BASED ON FIRE SEPARATION DISTANCE (SEE TABLE 602). FROM TABLE 602, FIRE SEPARATION DISTANCE = X > 30, FIRE RATING = 0 HRS.

CHAPTER 7 FIRE & SMOKE PROTECTION

CHAPTER 10 MEANS OF EGRESS

ITEM		DWG SHOWN
ROOM USE DESIGNATIONS		CC DWGS
ROOM SQUARE FOOTAGE		CC DWGS
ROOM OCCUPANCY LOADS		CC DWGS
EXIT ACCESSTRAVEL DISTANG	CE	CC DWGS
GROUND FL:	150 FT MAX TO EXTE	ERIOR DOOR
BASEMENT / 2ND FL:	120 FT MAX TO STAI	R ENCLOSURE

PER BC NYS	REQUIRE	ΞD		PROVIDED				
SPACE	AREA	OCC LOAD	EGRESS	# EXITS	MAX TRAV DISTANCE**	EGRESS	# EXITS	MAX TRAV DISTANCE**
HILLTOP DEVELOPMENT CENTER	3,198 SF	255	51" (255 * 0.2")	2	200' / 75'	204"	4	63'/53'

CHAPTER 11 ACCESSIBILITY

ITEM	DWG SHOWN
INTERIOR ACCESSIBLE ROUTE	ACCESSIBILITY DIAGRAMS
ACCESSIBLE ENTRANCES	ACCESSIBILITY DIAGRAMS
ACCESSIBLE TOILET FACILITIES	ACCESSIBILITY DIAGRAMS
SIGNAGE	ACCESSIBILITY DIAGRAMS, SPECIFICATIONS

UNIFORM SAFETY STANDARDS FOR SCHOOL CONSTRUCTION & MAINTENANCE PROJECTS

THE OCCUPIED PORTION OF THE EXISTING SCHOOL BUILDING SHALL ALWAYS COMPLY WITH THE MINIMUM REQUIREMENTS NECESSARY TO MAINTAIN A CERTIFICATE OF OCCUPANCY.

ALL SCHOOL AREAS TO BE DISTURBED DURING RENOVATION OR DEMOLITION HAVE BEEN OR WILL BE TESTED FOR LEAD AND ASBESTOS.

GENERAL SAFETY AND SECURITY STANDARDS FOR CONSTRUCTION PROJECTS:

- ALL CONSTRUCTION MATERIALS SHALL BE STORED IN A SAFE AND SECURE MANNER. FENCES AROUND CONSTRUCTION SUPPLIES OR DEBRIS SHALL BE MAINTAINED.
- GATES SHALL ALWAYS BE LOCKED UNLESS A WORKER IS IN ATTENDANCE TO PREVENT UNAUTHORIZED ENTRY.
- DURING EXTERIOR RENOVATION WORK, OVERHEAD PROTECTION SHALL BE PROVIDED FOR ANY SIDEWALKS OR AREAS IMMEDIATELY BENEATH THE WORK SITE OR SUCH AREAS SHALL BE FENCED OFF AND PROVIDED WITH WARNING SIGNS TO PREVENT ENTRY.
- WORKERS SHALL BE REQUIRED TO WEAR PHOTO-IDENTIFICATION BADGES AT ALL TIMES FOR IDENTIFICATION AND SECURITY PURPOSES WHILE WORKING AT OCCUPIED SITES.

SEPARATION OF CONSTRUCTION AREAS FROM OCCUPIED SPACES:

CONSTRUCTION AREAS WHICH ARE UNDER THE CONTROL OF A CONTRACTOR AND THEREFORE NOT OCCUPIED BY DISTRICT STAFF OR STUDENTS SHALL BE SEPARATED FROM OCCUPIED AREAS. PROVISIONS SHALL BE MADE TO PREVENT THE PASSAGE OF DUST AND CONTAMINANTS INTO OCCUPIED PARTS OF THE BUILDING. PERIODIC INSPECTION AND REPAIRS OF THE CONTAINMENT BARRIERS MUST BE MADE TO PREVENT EXPOSURE TO DUST OR CONTAMINANTS. GYPSUM BOARD MUST BE USED IN EXIT WAYS OR OTHER AREAS THAT REQUIRE FIRE RATED SEPARATION. HEAVY DUTY PLASTIC SHEETING MAY BE USED ONLY FOR A VAPOR, FINE DUST OR AIR INFILTRATION BARRIER, AND SHALL NOT BE USED TO SEPARATE OCCUPIED SPACES FROM CONSTRUCTION AREAS.

- (A) A SPECIFIC STAIRWELL AND/OR ELEVATOR SHOULD BE ASSIGNED FOR CONSTRUCTION WORKER USE DURING WORK HOURS. IN GENERAL, WORKERS MAY NOT USE CORRIDORS, STAIRS OR ELEVATORS DESIGNATED FOR STUDENTS OR SCHOOL STAFF.
- LARGE AMOUNTS OF DEBRIS MUST BE REMOVED BY USING ENCLOSED CHUTES OR A SIMILAR SEALED SYSTEM. THERE SHALL BE NO MOVEMENT OF DEBRIS THROUGH HALLS OF OCCUPIED SPACES OF THE BUILDING. NO MATERIAL SHALL BE DROPPED OR THROWN OUTSIDE THE WALLS OF THE BUILDING.
- ALL OCCUPIED PARTS OF THE BUILDING AFFECTED BY RENOVATION ACTIVITY SHALL BE CLEANED AT THE CLOSE OF EACH WORKDAY. SCHOOL BUILDINGS OCCUPIED DURING A CONSTRUCTION PROJECT SHALL MAINTAIN REQUIRED HEALTH, SAFETY AND EDUCATIONAL CAPABILITIES AT ALL TIMES THAT CLASSES ARE IN SESSION.

A PLAN DETAILING HOW EXITING REQUIRED BY THE APPLICABLE BUILDING CODE WILL BE MAINTAINED.

A PLAN DETAILING HOW ADEQUATE VENTILATION WILL BE MAINTAINED DURING CONSTRUCTION.

CONSTRUCTION AND MAINTENANCE OPERATIONS SHALL NOT PRODUCE NOISE IN EXCESS OF 60 DBA IN OCCUPIED SPACES OR SHALL BE SCHEDULED FOR TIMES WHEN THE BUILDING OR AFFECTED BUILDING SPACES ARE NOT OCCUPIED OR ACOUSTICAL ABATEMENT MEASURES SHALL BE TAKEN.

THE CONTRACTOR SHALL BE RESPONSIBLE FOR THE CONTROL OF CHEMICAL FUMES, GASES, AND OTHER CONTAMINATES PRODUCED BY WELDING, GASOLINE OR DIESEL ENGINES, ROOFING, PAVING, PAINTING, ETC. TO ENSURE THEY DO NOT ENTER OCCUPIED PORTIONS OF THE BUILDING OR AIR INTAKES.

THE CONTRACTOR SHALL BE RESPONSIBLE TO ENSURE THAT ACTIVITIES AND MATERIALS WHICH RESULT IN "OFF-GASSING" OF VOLATILE ORGANIC COMPOUNDS SUCH AS GLUES, PAINTS, FURNITURE, CARPETING, WALL COVERING, DRAPERY, ETC. ARE SCHEDULED, CURED OR VENTILATED IN ACCORDANCE WITH MANUFACTURERS RECOMMENDATIONS BEFORE A SPACE CAN BE OCCUPIED.

LARGE AND SMALL ASBESTOS ABATEMENT PROJECTS AS DEFINED BY 12NYCRR56 SHALL NOT BE PERFORMED WHILE THE BUILDING IS OCCUPIED". NOTE, IT IS OUR INTERPRETATION THAT THE TERM "BUILDING", AS REFERENCED IN THIS SECTION, MEANS A WING OR MAJOR SECTION OF A BUILDING THAT CAN BE COMPLETELY ISOLATED FROM THE REST OF THE BUILDING WITH SEALED NON COMBUSTIBLE CONSTRUCTION. THE ISOLATED PORTION OF THE BUILDING MUST CONTAIN EXITS THAT DO NOT PASS THROUGH THE OCCUPIED PORTION AND VENTILATION SYSTEMS MUST BE PHYSICALLY SEPARATED AND SEALED AT THE ISOLATION BARRIER.

EXTERIOR WORK SUCH AS ROOFING, FLASHING, SIDING, OR SOFFIT WORK MAY BE PERFORMED ON OCCUPIED BUILDINGS PROVIDED PROPER VARIANCES ARE IN PLACE AS REQUIRED. AND COMPLETE ISOLATION OF VENTILATION SYSTEMS AND AT WINDOWS IS PROVIDED. CARE MUST BE TAKEN TO SCHEDULE WORK SO THAT CLASSES ARE NOT DISRUPTED BY NOISE OR VISUAL DISTRACTION.

SURFACES THAT WILL BE DISTURBED BY RECONSTRUCTION MUST HAVE A DETERMINATION MADE AS TO THE PRESENCE OF LEAD. PROJECTS WHICH DISTURB SURFACES THAT CONTAIN LEAD SHALL HAVE IN THE SPECIFICATIONS A PLAN PREPARED BY A CERTIFIED LEAD RISK ASSESSOR OR SUPERVISOR WHICH DETAILS PROVISIONS FOR OCCUPANT PROTECTION, WORKSITE PREPARATION, WORK METHODS, CLEANING AND CLEARANCE TESTING WHICH ARE IN GENERAL ACCORDANCE WITH THE HUD GUIDELINES

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PROJECT INFORMATION, SCOPE & CLASSIFICATION OF WORK

PROJECT SCOPE:

THIS PROJECT INVOLVES LIMITED ALTERATION OF AN EXISTING DEVELOPMENT CENTER TO RENOVATED THE SPACE TO A FLEXIBLE PROFESSIONAL DEVELOPMENT SPACE WITH INTERIOR UPGRADES.

CLASSIFICATION OF WORK: **ALTERATION LEVEL 2**

APPLICABLE CODES:

PROJECT LOCATION:

2020 UNIFORM FIRE PREVENTION AND BUILDING CODE 2020 UNIFORM CODE SUPPLEMENTS

NEW YORK STATE ENERGY CONSERVATION CONSTRUCTION CODE

MANUAL OF PLANNING STANDARDS - 1998 THE UNIVERSITY OF OF THE STATE OF NEW YORK

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THE STATE EDUCATION DEPARTMENT


NOTE: CONSTRUCTION TO TAKE PLACE SUMMER 2022 COMPLETION TO TAKE PLACE IN FALL 2022


2022-10-12 ISSUE FOR REBID 2022-07-12 ISSUE FOR BID

2022-03-24 CONSTRUCTION DOCUMENTS

CODE COMPLIANCE INFORMATION

09/10/2021 2021-1048 Drawn / Checked AS NOTED Author Checker Sheet Number

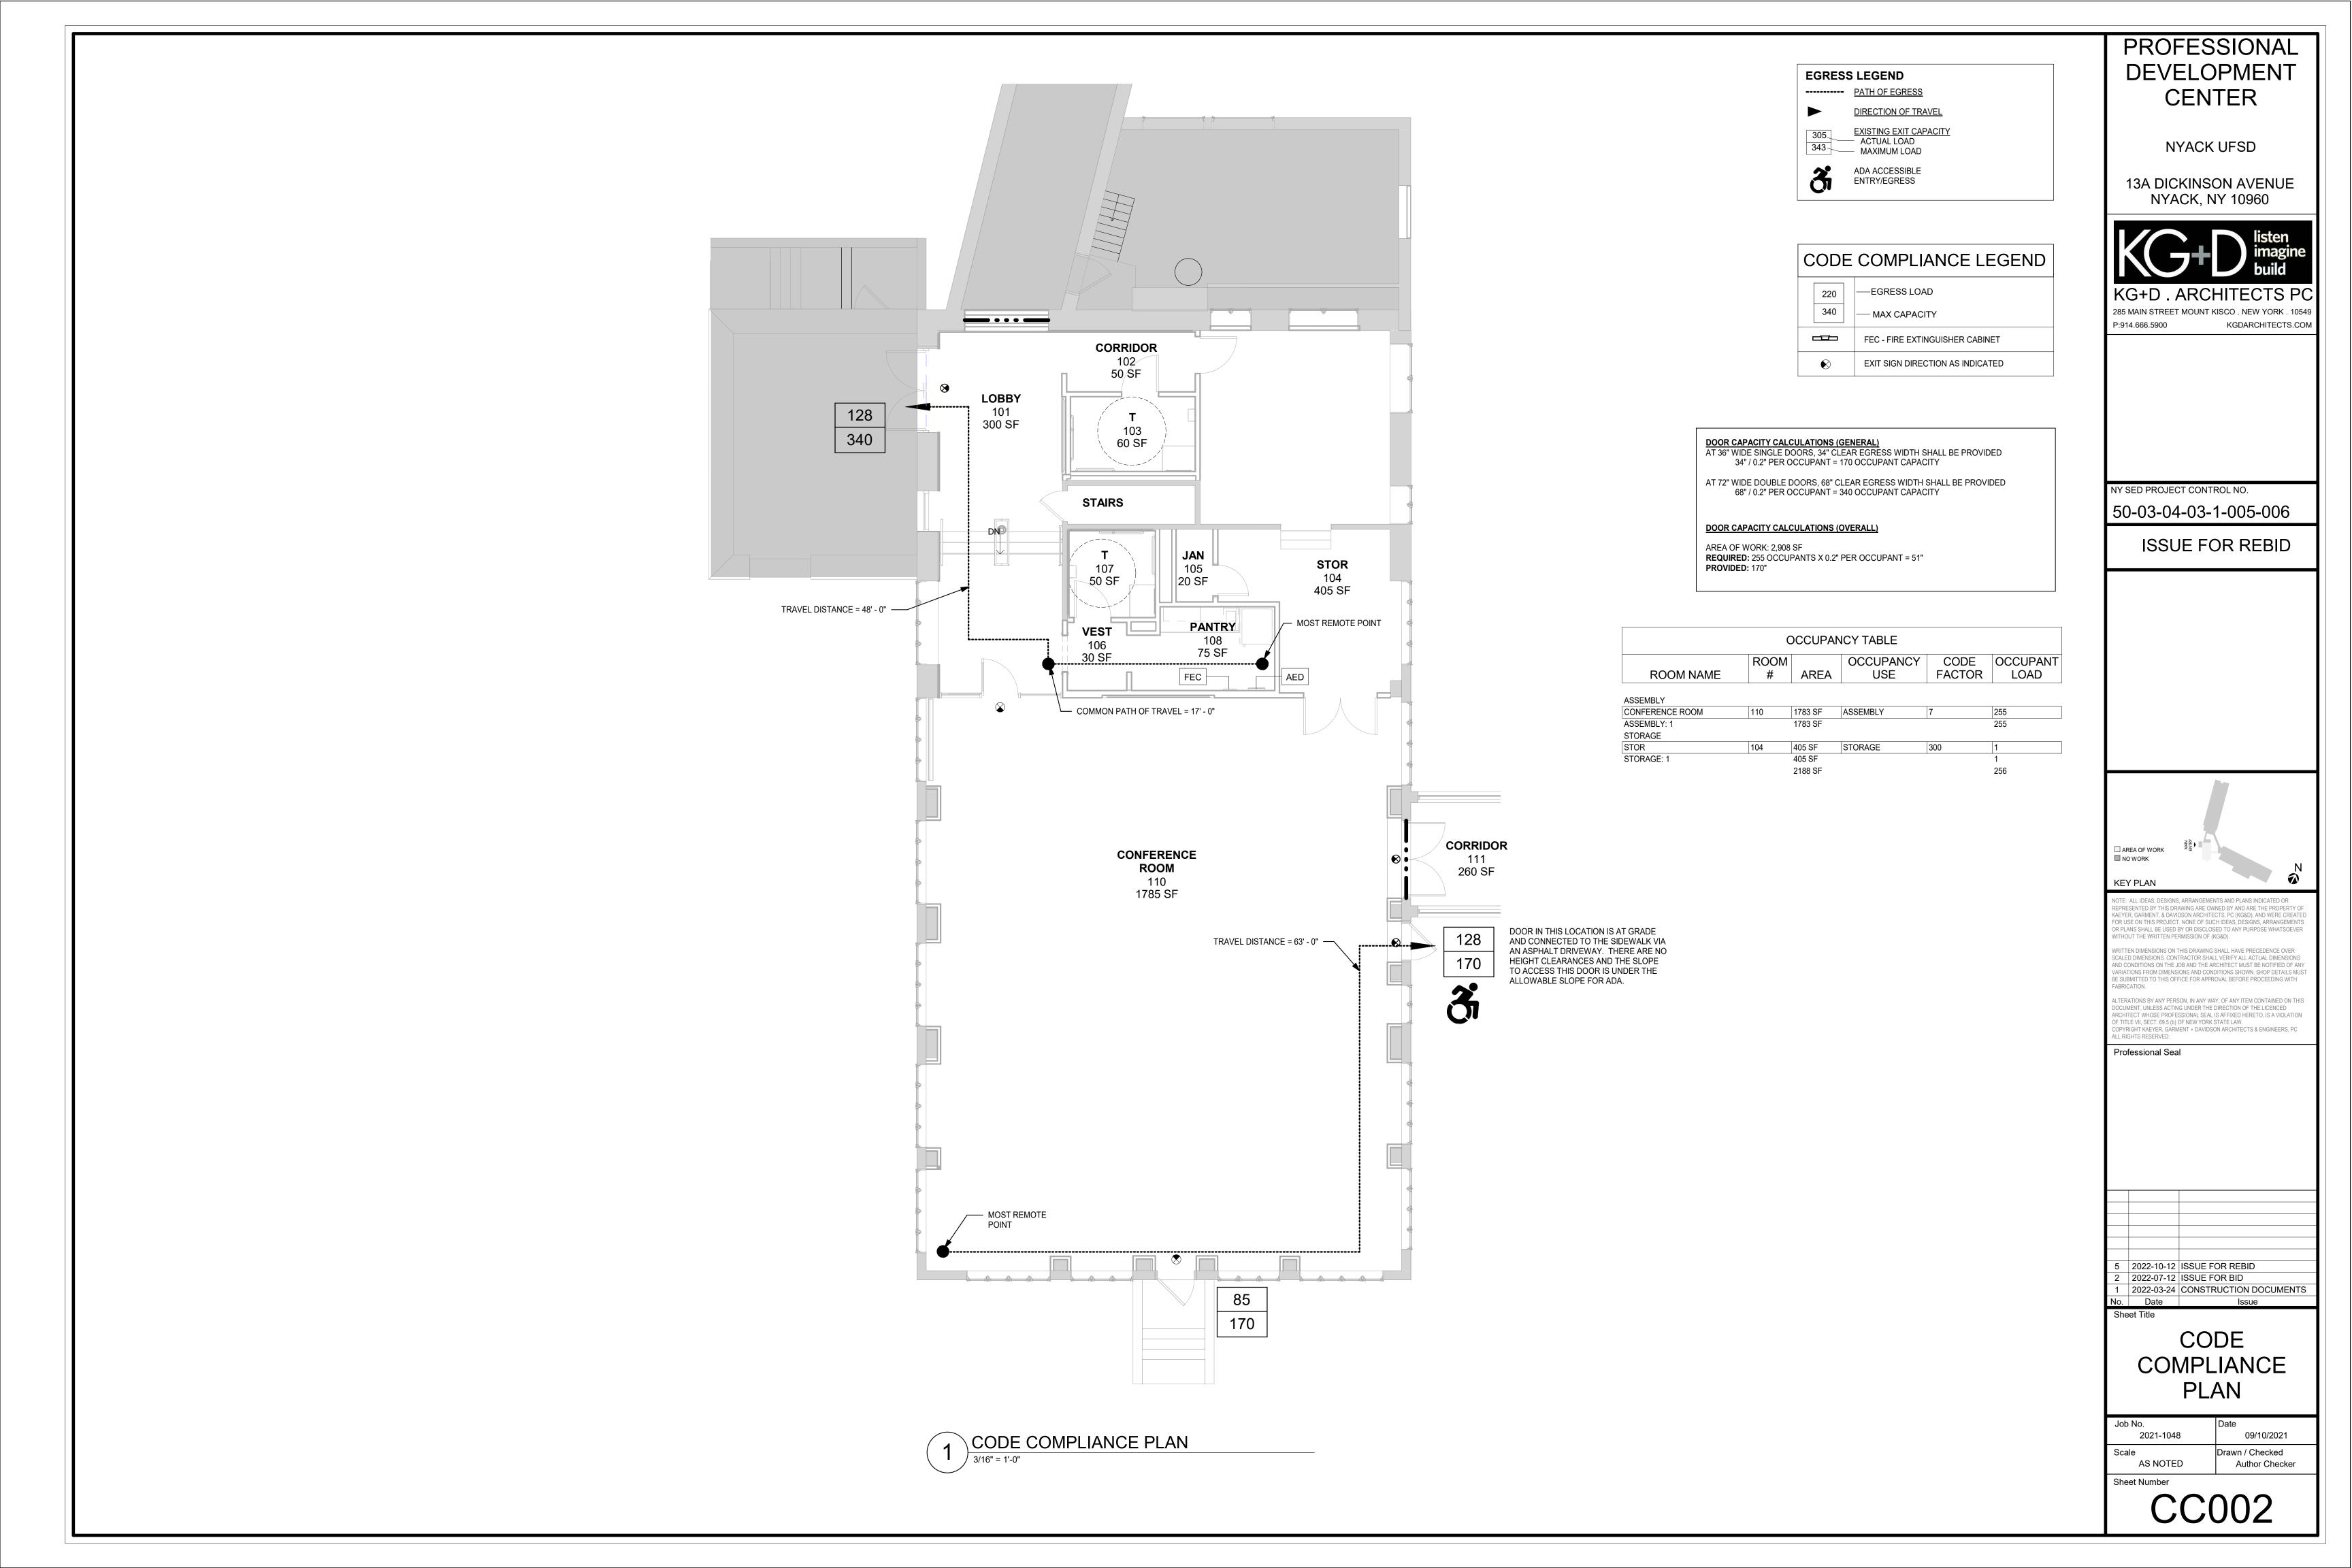

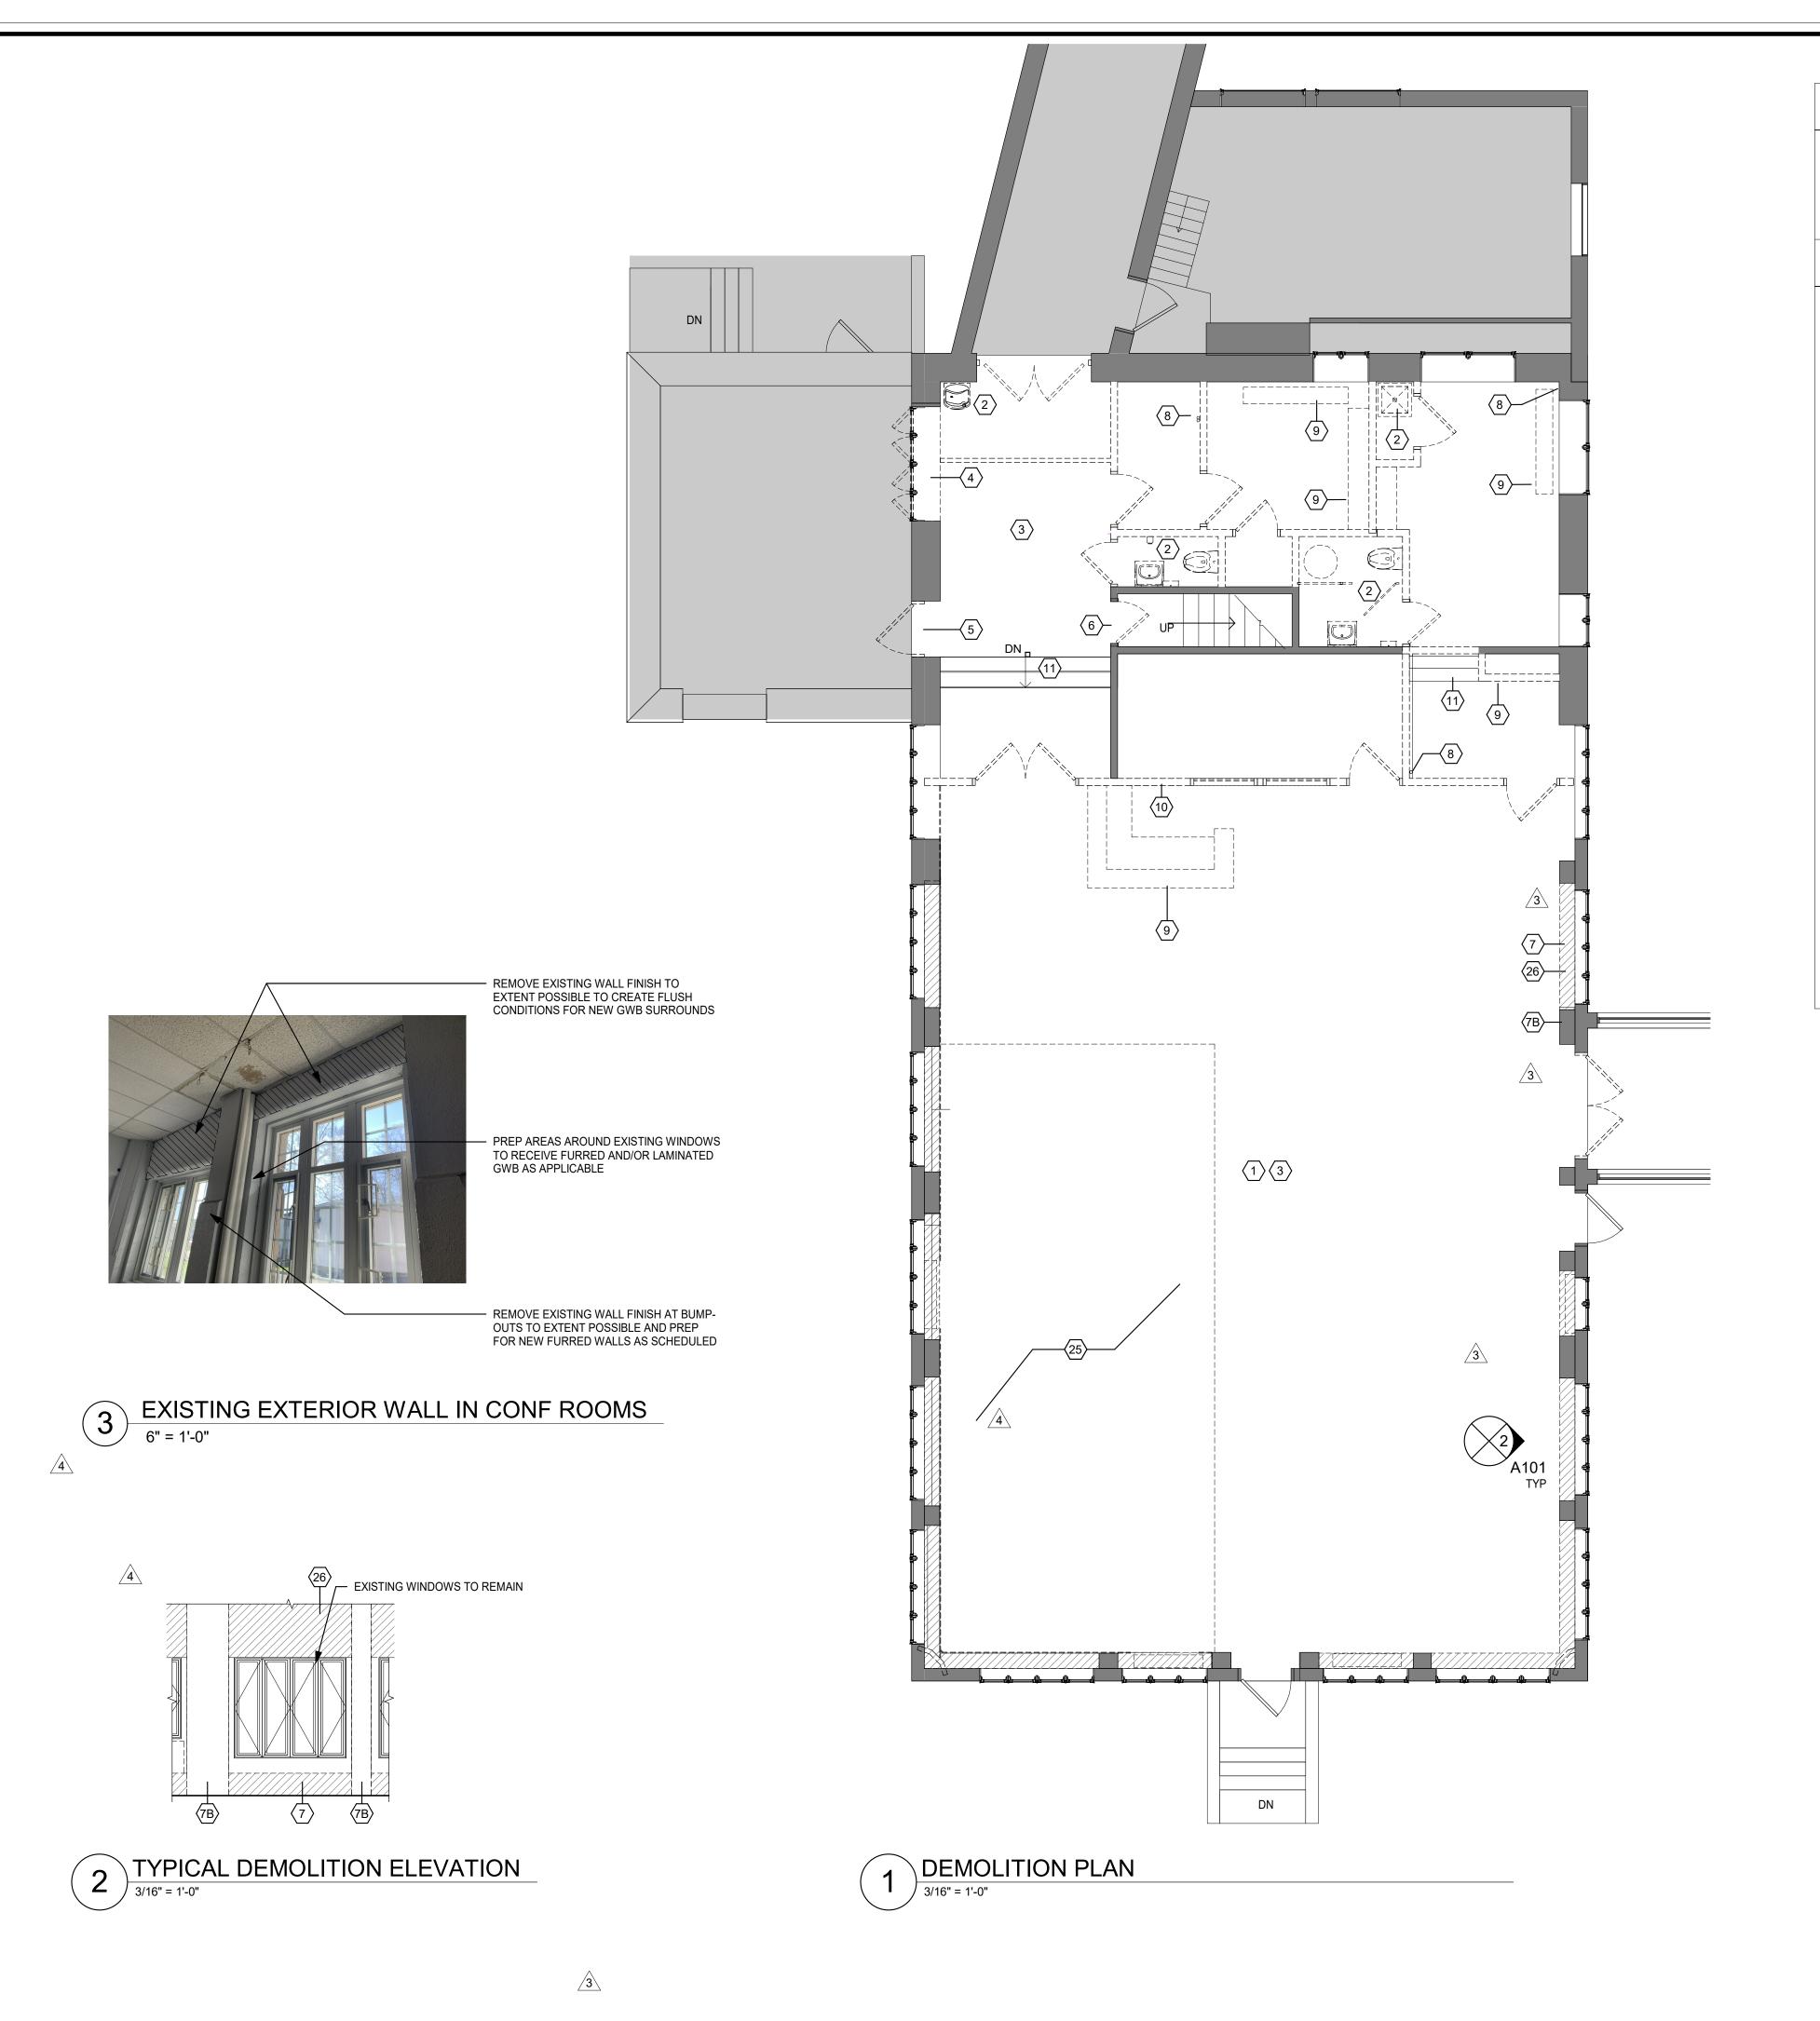

HAZARDOUS MATERIAL NOTES:

1.THIS PROJECT REQUIRES REMOVAL OF HAZARDOUS MATERIALS. SEE SPECIFICATIONS FOR THE REPORT WHICH INCLUDES THE TYPES, EXPECTED LOCATIONS, HANDLING, REMOVAL PROCEDURES & OTHER INFO.

2. DEMOLITION &/OR TIE-INS TO EXISTING M.E.P. SYSTEMS MAY ENCOUNTER CONCEALED HAZARDOUS MATERIAL. NOTIFY THE ARCHITECT IMMEDIATELY SHOULD SUCH MATERIALS BE SUSPECTED & DO NOT DISTURB SUCH MATERIAL

GENERAL DEMOLITION NOTES:

1. DEMOLITION IS NOT NECESSARYILY LIMITED TO WHAT IS SHOWN ON DRAWINGS. THE INTENT IS TO INDICATE THE GENERAL SCOPE OF DEMOLITION REQUIRED TO COMPLETE THE WORK IN ACCORDANCE WITH THE CONTRACT DRAWINGS. PRIOR TO ANY DEMOLITION CONTRACTORS ARE REQUIRED TO VISIT SITE AND FAMILIARIZE THEMSELVES WITH EXISTING CONDITIONS AND NOTE ANY DISCREPENCIES IN WRITING TO ARCHITECT.

2. COORDINATE ALL DEMOLITION w/ M.E.P. REMOVALS. NOTE: ALL WIRING, DEVICES & M.E.P. SYSTEMS NOT BEING REMOVED AS PART OF THE WORK, WHICH RUN THROUGH THE WORK AREA, SHALL BE TESTED, LABELED & PROTECTED FROM DISTURBANCE SO THEY REMAIN OPERATIONAL THROUGHOUT THE PROJECT.

3. BEFORE STARTING DEMOLITION OPERATIONS CONTRACTOR SHALL REVIEW ABATEMENT SPECIFICATIONS & DRAWINGS, WHICH IDENTIFIED AREAS & MATERIALS THAT ARE ASBESTOS CONTAINING MATERIALS & LEAD PAINT. CONTRACTOR SHALL FOLLOW PROCEDURES AS SET FORTH IN ABATEMENT SPECIFICATIONS AND BALANCE OF SPECIFICATIONS. ALL ABATEMENT WORK SHALL BE PART GENERAL TRADES CONTRACTORS BASE BID.

4. AT ANY SPACE BEING RENOVATED CONTRACTOR SHALL REMOVE EQUIPMENT AND MISCELLANEOUS ITEMS SUCH AS PLAQUES, SIGNAGE, DISPLAY BOARDS, TACK BOARDS, INTERCOMS, SPEAKERS, AND THE LIKE, AND TURN OVER TO THE OWNER.

5. ALL FLOOR AND WALL BASE TO BE REMOVED IN AREAS SHOWN IN CONTRACT.

6. ALL CEILING AND LIGHTING TO BE REMOVED IN AREAS SHOWN IN CONTRACT, UNO.

7. RETURN ALL EXISTING AV EQUIPMENT (I.E. PROJECTORS, SCREENS, MONITORS, AND SPEAKERS) TO OWNER.

8. DEMOLITION OF DOOR ASSEMBLIES TYPICALLY SHALL INCLUDE DEMO OF DOOR(S), FRAME SIDELITES (IF PRESENT), TRANSOMS (IF PRESENT), DOOR SADDLE, HARDWARE, AND RELATED ACCESSORIES. PATCH WALL, FLOOR, & HEAD. PREP FOR NEW DOOR ASSEMBLY (IF APPLICABLE)

9. DEMOLITION OF WINDOW ASSEMBLIES TYPICALLY SHALL INCLUDE DEMO OF WINDOW(S), FRAME, GLAZING, FLASHING, SILL TRIM/SURROUND/RETURN, HARDWARE, AND RELATED ACCESSORIES. PATCH ADJACENT AREAS. PREP FOR NEW WINDOW ASSEMBLY (IF APPLICABLE).

10. WHEN DEMOLISHING PORTIONS OF THE WALLS OR ROOFS, CONTRACTOR SHALL PROVIDE TEMPORARY SHORING AND SUPPORT LINTELS. REGARDLESS OF WHETHER OPENING SPECIFICALLY CALLS OUT FOR A NEW LINTEL OR NOT. ALL MASONRY OPENINGS THAT CONTRACTOR CUTS IN SHALL RECEIVE A SUPPORT LINTEL. SEE STRUCTURAL DRAWINGS FOR DETAILS ON LINTEL TYPES & SIZES.

11. WHEN DEMOLISHING PORTIONS OF MASONRY WALLS IN AREAS VISIBLE TO THE PUBLIC CONTRACTOR SHALL "SAW CUT" AT MASONRY WALLS AND "TOOTH IN" AT ANY PATCHING OF MASONRY WALLS. ALL SCARS TO CEILINGS, ADJACENT WALLS, AND FLOORS SHALL BE PATCHED & RESTORED TO MATCH EXISTING ADJACENT MATERIALS.

12. BEFORE CUTTING AND OPENING/HOLE/TRENCH SPECIFICALLY FOR OTHER TRADE, CONTRACTOR SHALL REVIEW & VERIFY EXACT SIZE & LAYOUT WITH THAT TRADE CONTRACTOR.

13. WHEN DEMOLISHING PORTIONS OF EXTERIOR WALLS, CONTRACTOR SHALL SAVE PORTIONS OF DEMOLISHED MASONRY AND USE MASONRY INFILL OPENINGS AND TOOTH-IN AROUND ALL NEW OPENINGS.

14. WHEN DEMOLISHING FLOORS CONTRACTORS SHALL REMOVE FINISH FLOORING & SCRAPE SLAB/SUB-FLOORINGCLEAN. SUB-FLOOR SHALL BE LEVELED PRIOR TO INSTALLATION OF NEW SCHEDULED FINISH FLOOR. ANY DAMAGE TO ADJ. FLOORS SHALL BE PATCHED.

15. AFTER DEMOLITION OPERATIONS, WHEN FINISH PATCHING IF SPECIFIC FINISH/MATERIAL IS NOT CALLED OUT, CONTRACTOR SHALL MATCH EXISTING ADJACENT MATERIALS

16. AFTER DEMOLITION, WHERE SPECIFICALLY CALLED OUT OR NO, CONTRACTOR SHALL REPAIR ALL SCARS TO EXISTING

ADJACENT MATERIALS AND RESTORE TO PRIOR CONDITION.

17. OWNER HAS RIGHT OF FIRST REFUSAL OF ANY MATERIAL

ABATEMENT NOTES: SEE HAZARDOUS MATERIALS SURVEY REPORT, SPECIFICATIONS, AND DRAWINGS.

GENERAL KEYNOTES

PATCH AND REPAIR AS REQUIRED IN PREPARATION FOR NEW CONSTRUCTION

GC TO COORDINATE PLUMBING TERMINATION BACK TO SOURCE

REMOVE EXISTING FLOORING MATERIAL AND PREPARE FLOOR SUBSTRATE FOR NEW CONSTRUCTION

REMOVE EXISTING WINDOWS, FRAMES AND ALL ASSOCIATED TRIM & HARDWARE - PREPARE MASONRY OPENING FOR NEW STOREFRONT AND DOOR. REMOVE EXISTING WINDOW TREATMENT.

REMOVE EXISTING DOOR, FRAME, AND ALL ASSOCIATED HARDWARE. INFILL WALL TO MATCH EXISTING FINISHES.

REMOVE EXISTING DOOR FRAME AND ALL ASSOCIATED HARDWARE. PREP AREA TO

RECEIVE NEW DOOR AS SCHEDULED.

REMOVE LOWER WALL BETWEEN COLUMN FURRINGS AND PREP FOR NEW WORK PATCH & MATCH EXISTING ADJACENT WALLS - TYP AT HATCH PATTERN IN MEETING

ROOM - SEE DEMO ELEVATION

REMOVE PLASTER WALL TO EXTENT POSSIBLE AT ALL COLUMN LOCATIONS IN MEETING ROOM AND PREP FOR NEW WORK - STRUCTURE TO REMAIN - SEE DEMO ELEVATION

REMOVE EXPOSED PIPING. COORDINATE WITH PLUMBING DRAWINGS.

COORDINATE REMOVAL OF BUILT-IN MILLWORK AND FURNITURE W/DISTRICT. LOOSE FURNITURE TO BE REMOVED BY OWNER. BUILT-IN MILLWORK TO BE REMOVED BY CONTRACTOR.

REMOVE STEEL SLAT ROLL UP DOOR
STAIRS TO REMAIN. PREP TO RECEIVE NEW FINISHES AS SCHEDULED.

LOCATION OF EXISTING RUBBER FLOORING ON +/- 1" HIGH ELEVATED WOOD PLATFORM TO BE REMOVED. GC TO COORDINATE DEMOLITION AND ABATEMENT AS REQUIRED PER SPECIFICATIONS.

REMOVE EXISTING PLASTER TO EXTENT POSSIBLE TO CREATE FLUSH CONDITION ABLE TO RECEIVE GYP BOARD IN WALL RECESS.

DEMOLITION LEGEND

DENOTES AREA OF NO MAJOR
ARCHITECTURAL WORK. SPECIFIC WORK
MAY BE SHOWN ELSEWHERE INCLUDING
WORK THAT MAY REQUIRE ACCESS,
PATCHING & RESTORATION, REFER TO
STRUCTURAL & M.E.P. DWGS.

EXISTING CONSTRUCTION TO REMAIN (DOOR, WALL, GLAZING, ETC.)

EXISTING CONSTRUCTION TO BE REMOVED (DOOR, WALL, GLAZING, ETC.)

KEYNOTES

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2022-10-12 ISSUE FOR REBID

4 2022-08-03 BID ADDENDUM #3 3 2022-07-20 BID ADDENDUM #2 2 2022-07-12 ISSUE FOR BID


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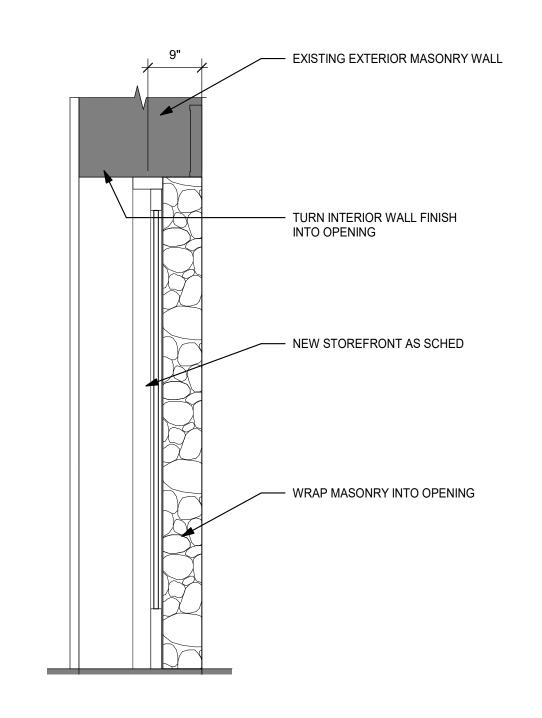
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DEMOLITION PLAN


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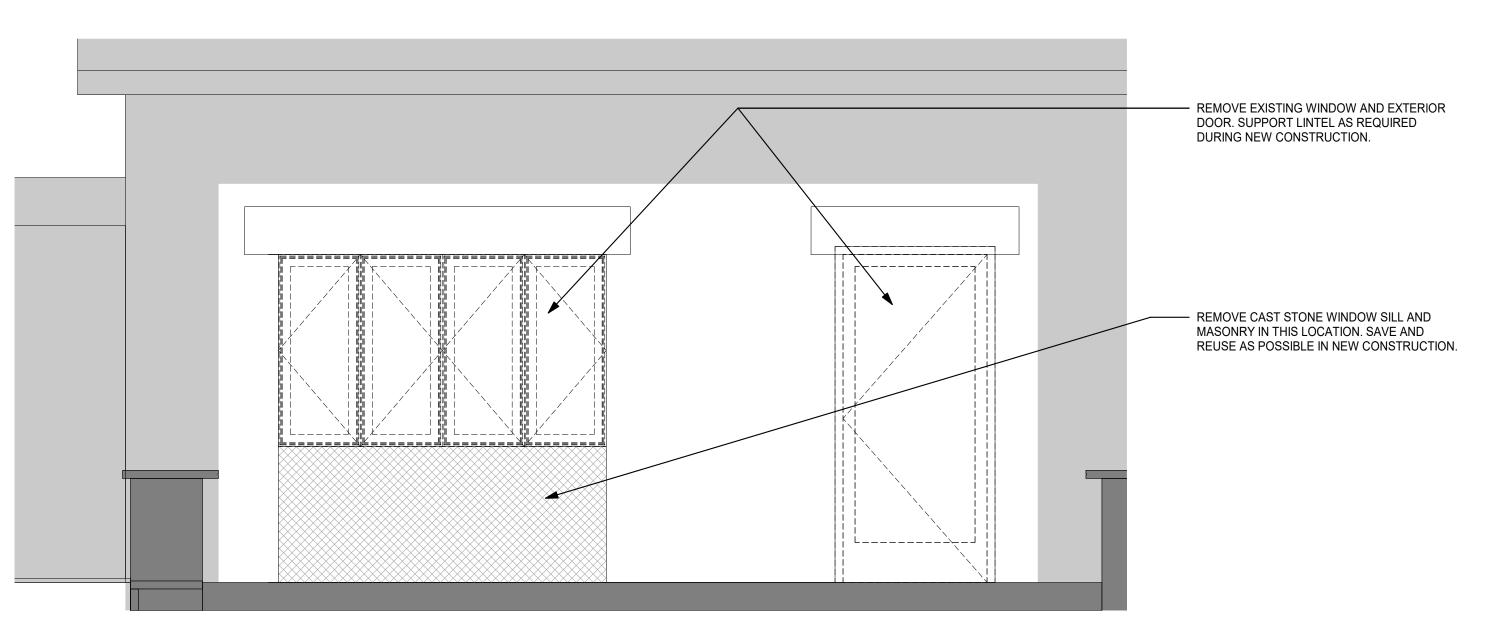
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3 WALL SECTION THRU STOREFRONT
3/4" = 1'-0"





2 DEMO EXTERIOR ELEVATION

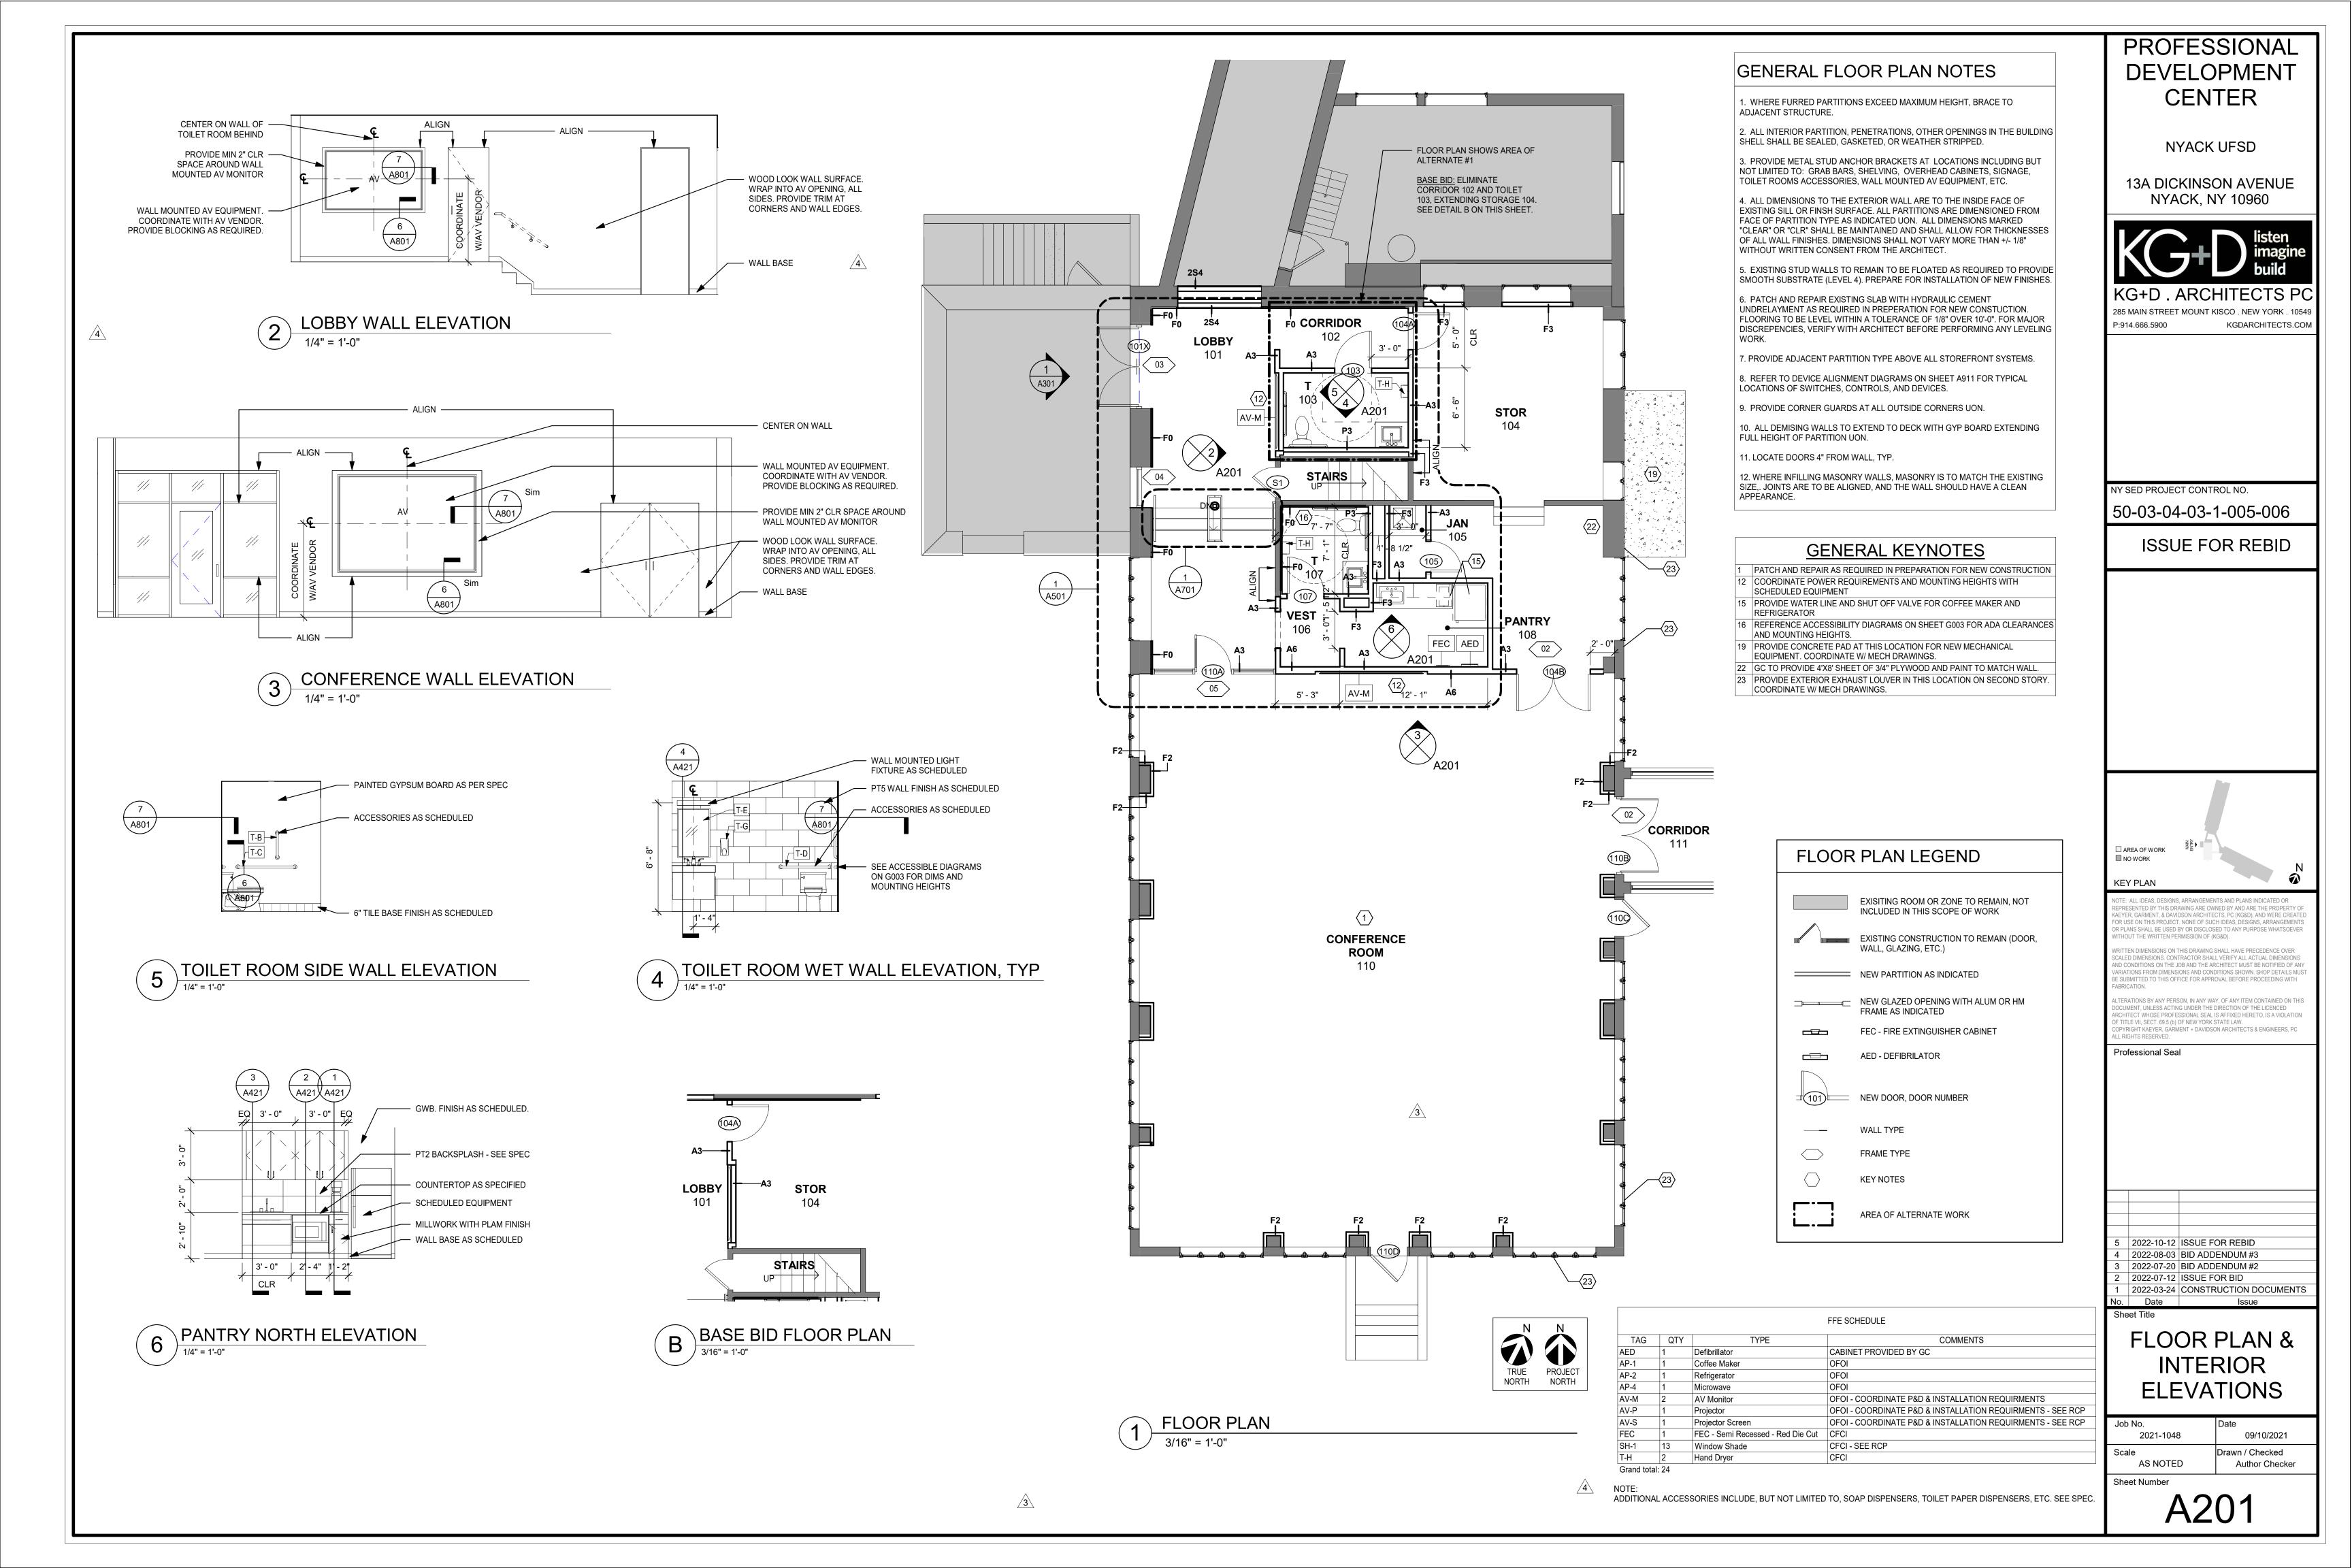1/2" = 1'-0"
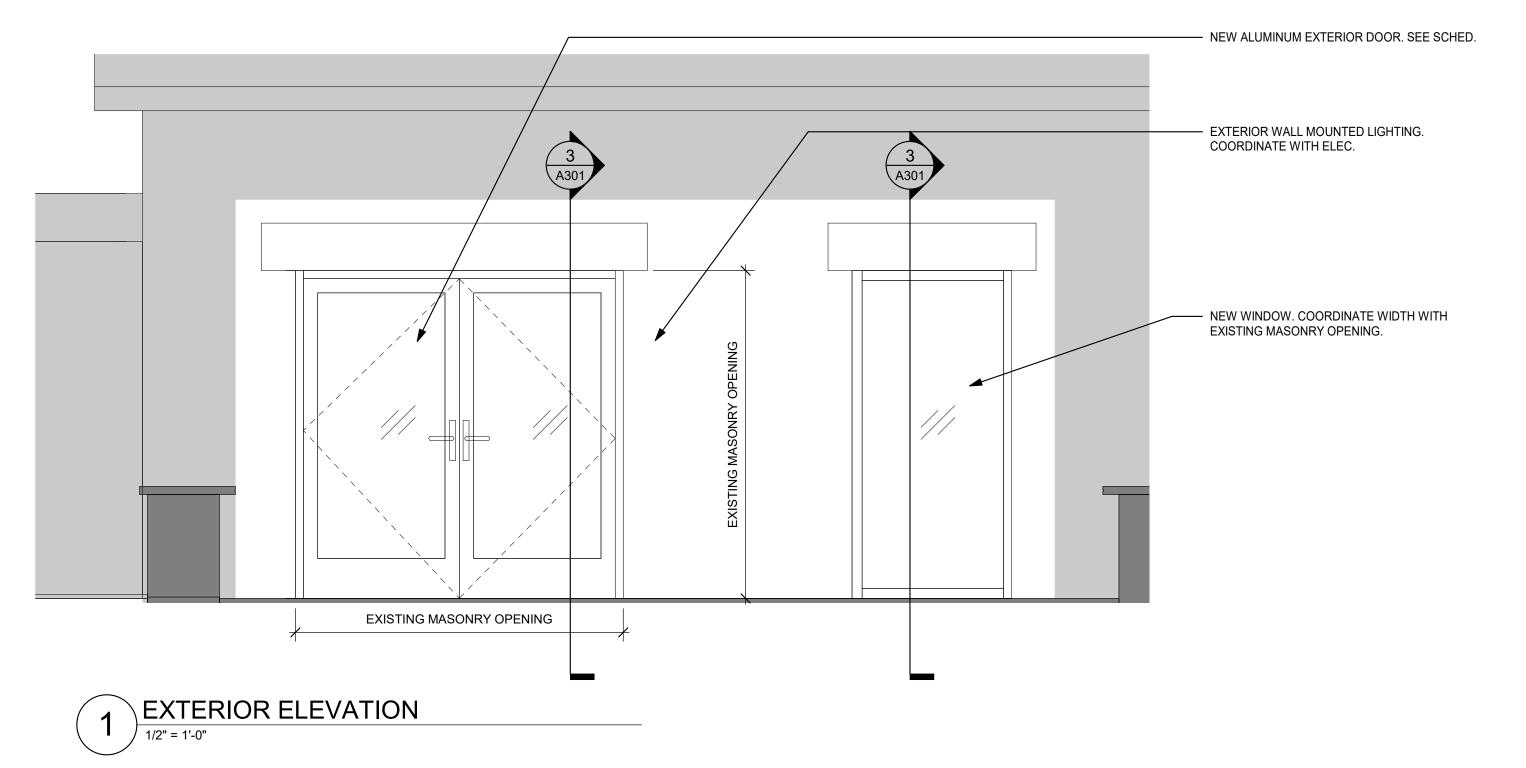
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2 2022-07-12 ISSUE FOR BI

Sheet Title

EXTERIOR ELEVATIONS & SECTIONS


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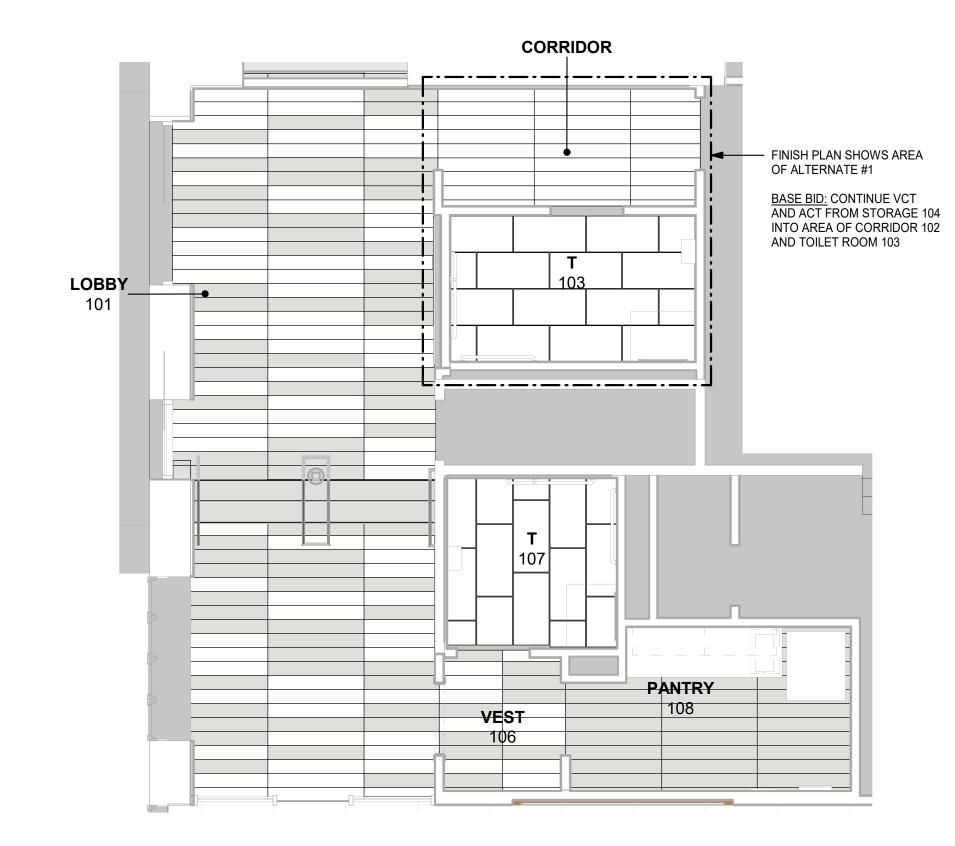
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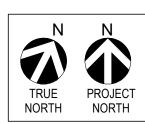
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						F	Finish S	chedul	е					
		FLO	OOR	NORT	NORTH WALL EAST WALL S			SOUT	SOUTH WALL WEST WALL					
												CEIL	ING	
OM#	ROOM NAME	FIN	BASE	MAT	FIN	MAT	FIN	MAT	FIN	MAT	FIN	MAT	FIN	Comments
	LOBBY	LVT1/LVT2	RB/WRB	GWB	PTD	GWB	WC	GWB	PTD	GWB	PTD	GWB	PTD	
	CORRIDOR	LVT1	RB	GWB	PTD	GWB	PTD	GWB	PTD	GWB	PTD	GWB	PTD	
	T	PT1	PTB	GWB	PTD	GWB	PTD	СВ	PT2	GWB	PTD	GWB	PTD	
	STOR	VCT1	RB	GWB/EX	PTD	EXIST	PTD	GWB/EX	PTD	GWB/EX	PTD	ACT	FF	
	JAN	CONC	S&S	EXIST	PTD	GWB	PTD	GWB	PTD	GWB	PTD	ACT	FF	
	VEST	LVT1/LVT2	RB	GWB	PTD	GWB	PTD	GWB	PTD	GWB	PTD	GWB	PTD	
	T	PT1	PTB	GWB	PTD	СВ	PT5	СВ	PTD	СВ	PTD	GWB	PTD	
	PANTRY	LVT2	RB	GWB/CB	PTD/PTS	GWB	PTD	GWB	PTD	GWB	PTD	ACT	FF	
	CONFERENCE ROOM	CPT	RB/WRB	GWB	WC	GWB	PTD	GWB	PTD	GWB	PTD	ACT, AMC	FF	SEE RCP

NOTE:
- REFER TO SPEC FOR MORE FINISH INFORMATION

ABBREVIATIONS:

ACT ACOUSTIC CEILING TILE
AMC ACOUSTIC METAL CEILING
CB CEMENT BOARD
CPT CARPET
CT CERAMIC TILE
EX/EXIST EXISTING
FF FACTORY FINISH
GWB GYPSUM WALLBOARD
LVT LUXURY VINYL TILE
PT PORCELAIN TILE
PTB PORCELAIN TILE
PTB PORCELAIN TILE BASE
PTD PAINTED
RB RUBBER BASE
VCT VINYL COMPOSITE TILE
WRB WOOD RUBBER BASE

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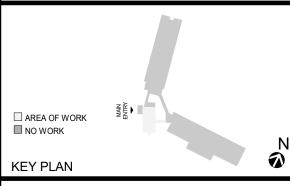
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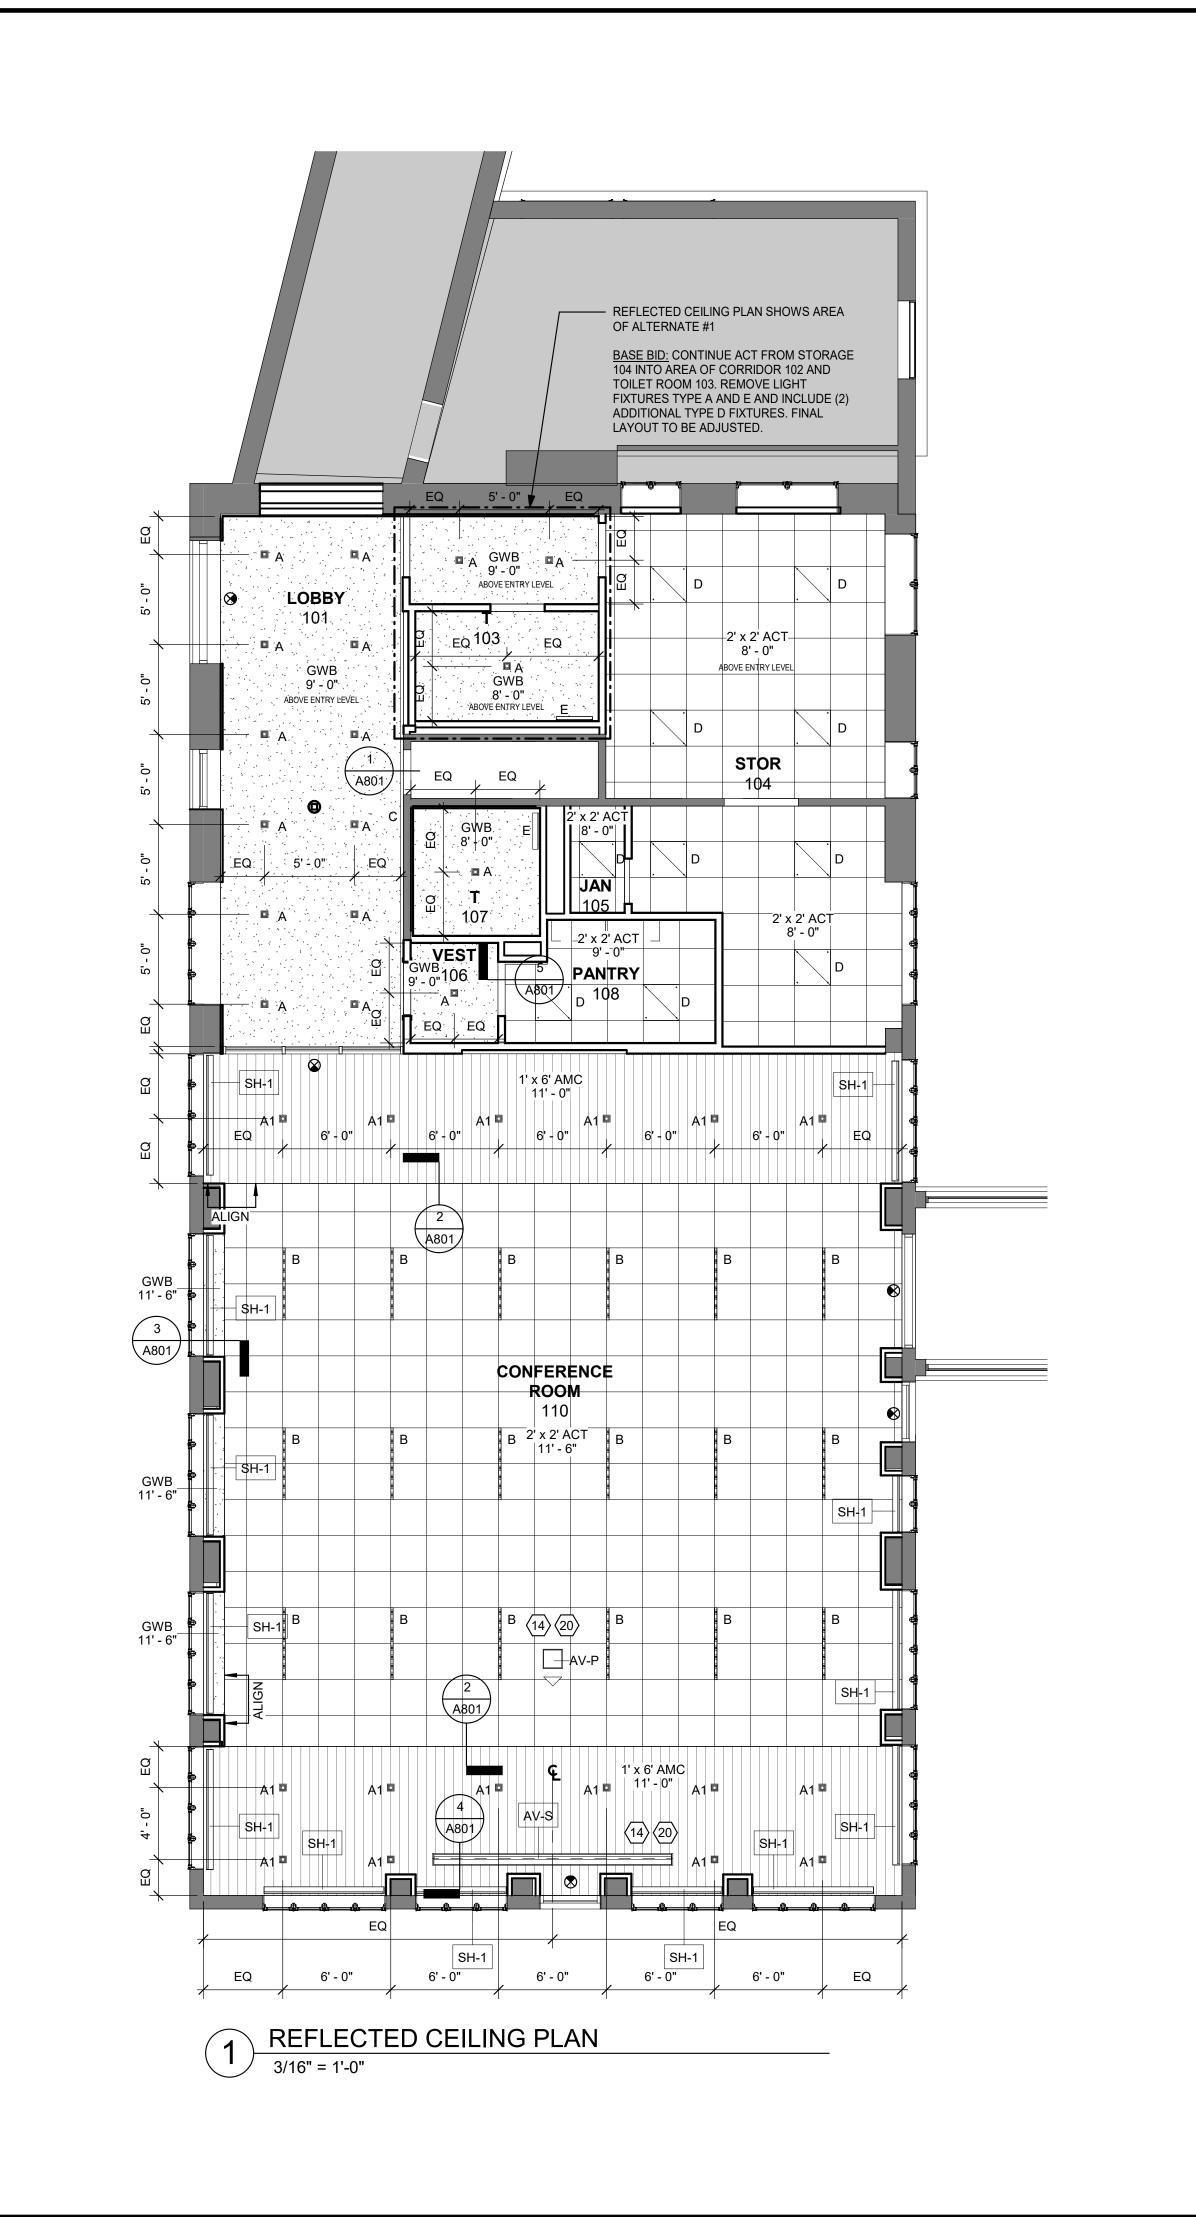
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FINISH PLAN & SCHEDULE
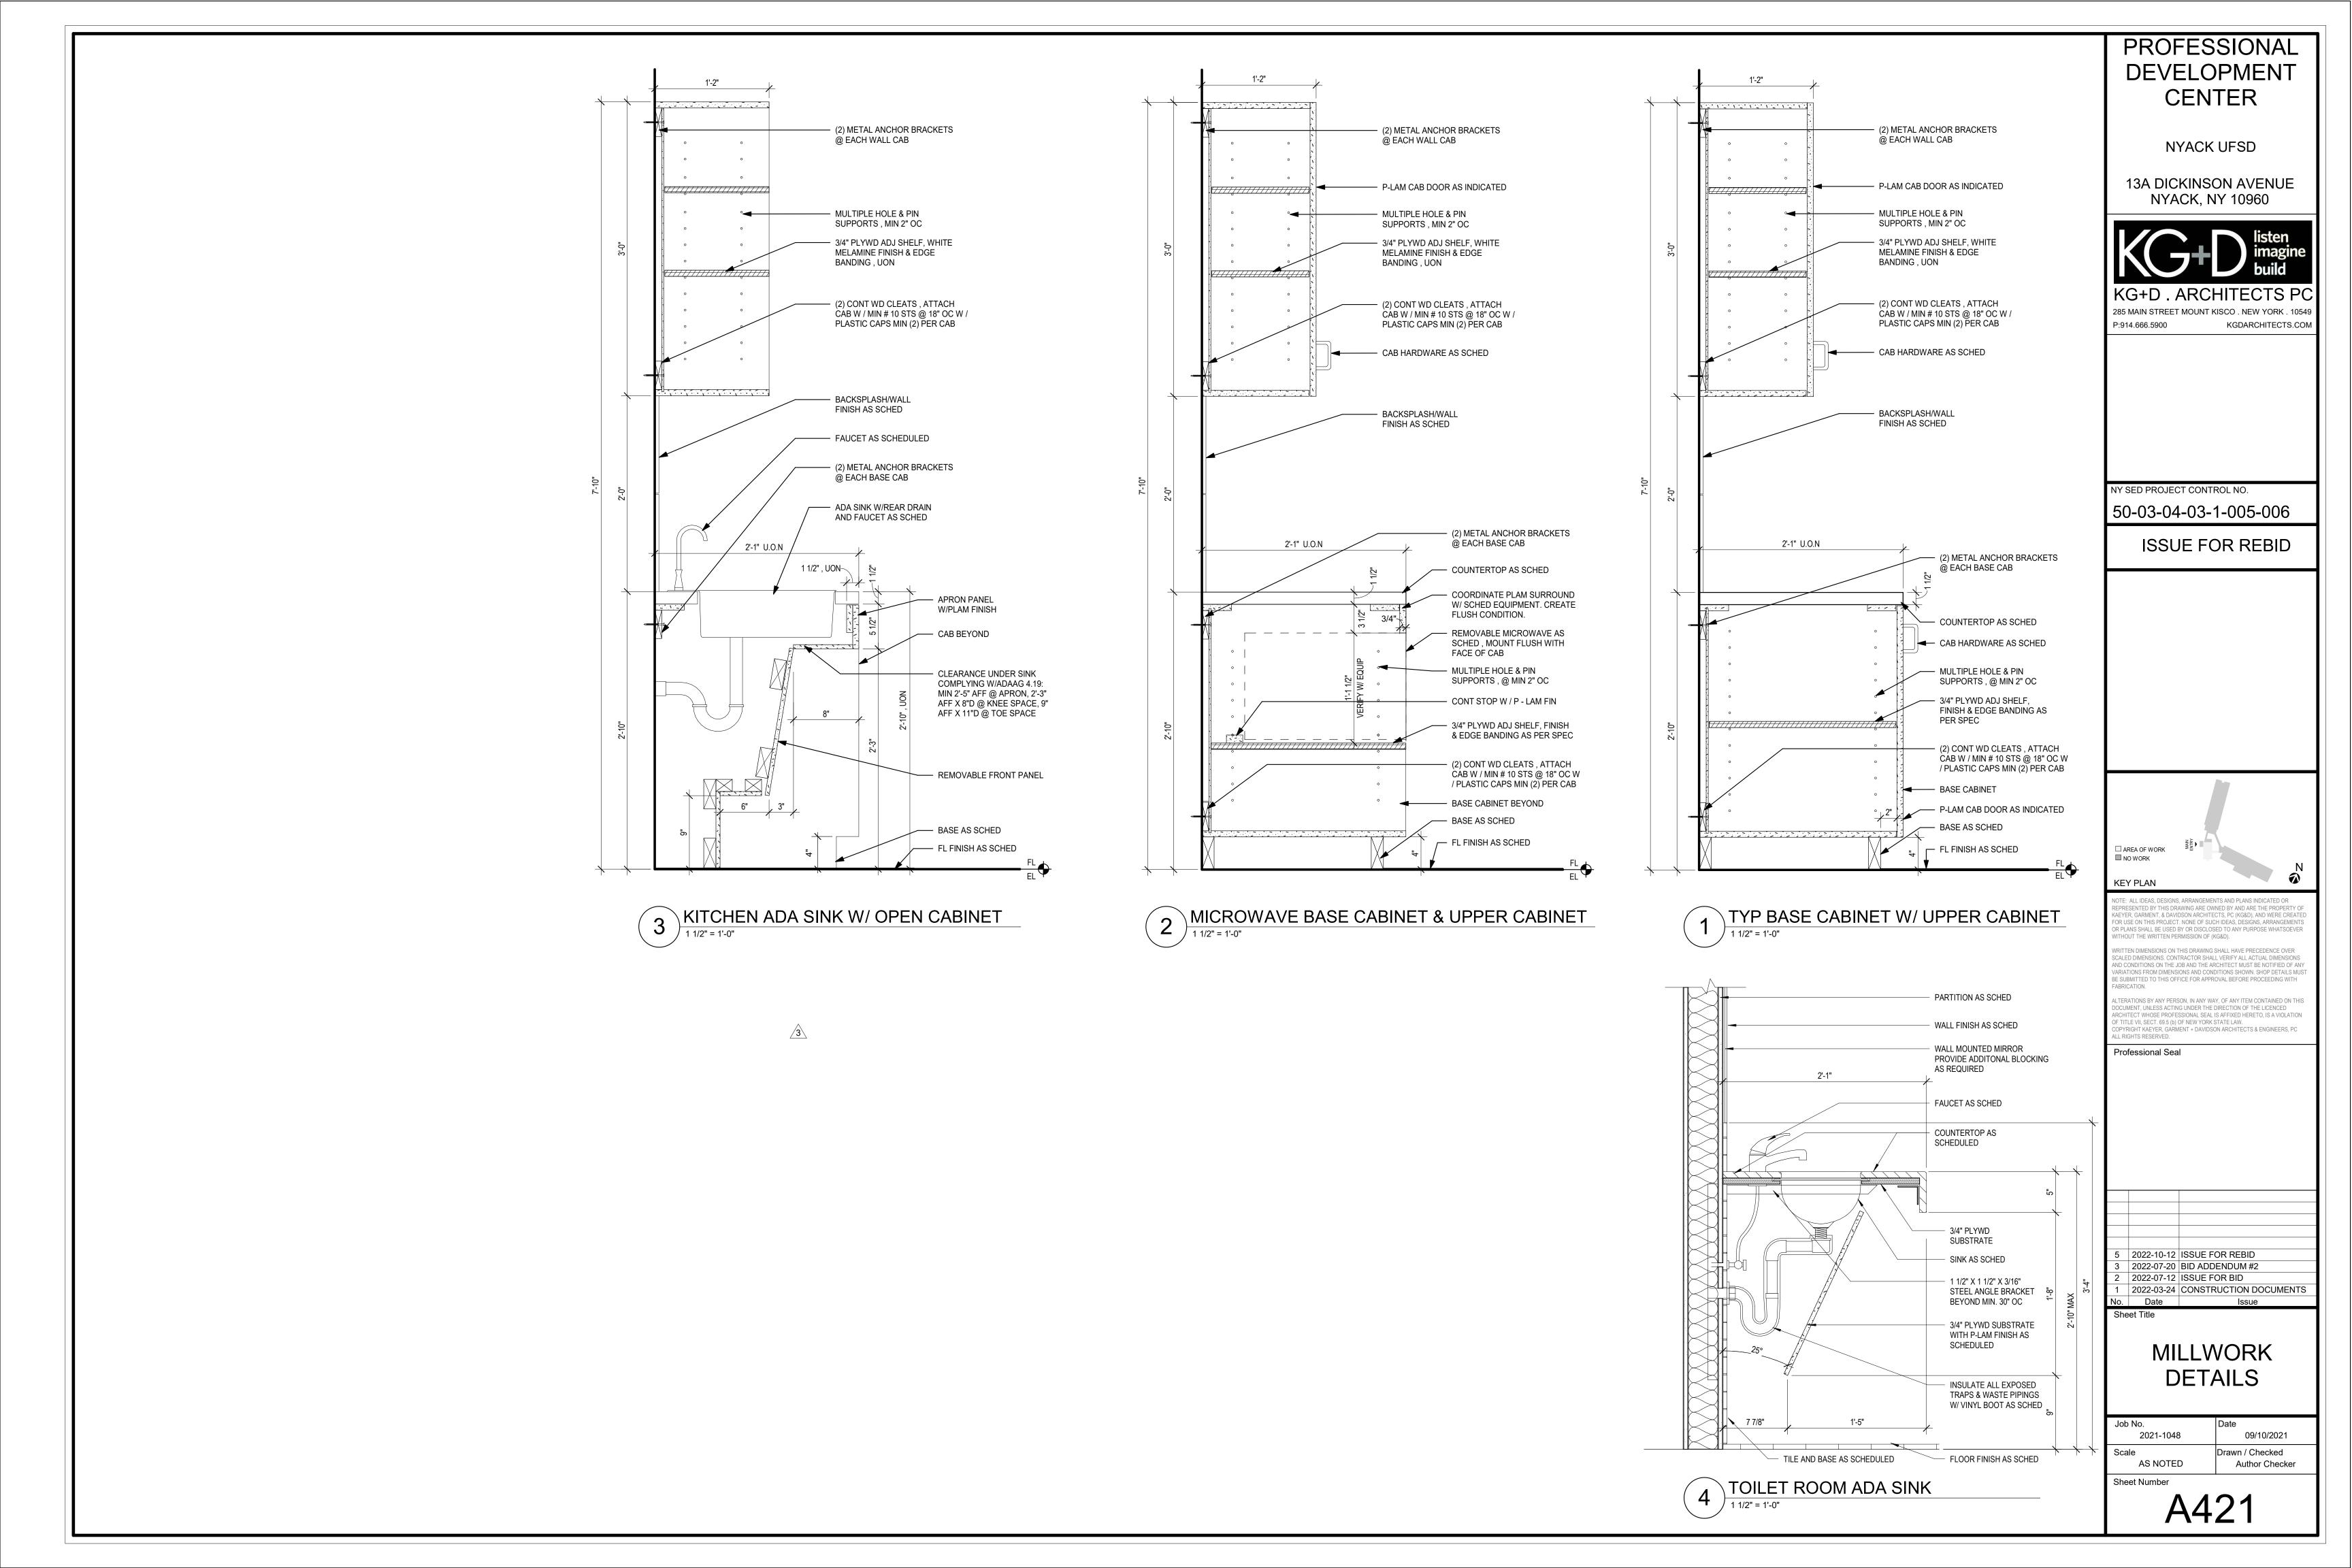
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2021-1048	09/10/2021
Job No.	Date



GENERAL CEILING NOTES

REFLECTED CEILING PLANS INDICATE:
 A. GENERAL TYPE AND SPECIFIC LOCATION OF LIGHT FIXTURES,
 SIGNAL & EQUIPMENT DEVICES.

2. PROVIDE STRUCTURAL SUPPORT AS REQUIRED BY MANUFACTURER FOR FIXTURES

3. CEILING MOUNTED FIXTURES & EQUIPMENT, INCLUDING EXIT SIGNS, HVAC REGISTERS, SPRINKLER HEADS, ETC. ARE TO BE CENTERED IN THE CEILING TILES.

4. CEILING HEIGHTS SHOWN IN PLANS, SECTIONS, & DETAILS SHALL TAKE PRECEDENCE OVER HEIGHTS INDICATED ELSEWHERE.

5. ALL STROBES SHALL BE LOCATED @ +/-80" AFF WHERE LOCATED ON PARTITION. SEE ENGINEER'S DRAWINGS FOR LOCATIONS AND SPECIFICATIONS.

6. ALL STROBES TO ALIGN VERTICALLY WITH RECEPTACLE BELOW WHERE OCCURS.

7. ARCHITECTS TO REVIEW ALL LIGHT/CEILING FIXTURE LOCATIONS PRIOR TO INSTALLATIONS

8. INSTALL THE SUSPENDED CEILING GRID TO BE LEVEL WITHIN A TOLERANCE OF 1/8". ANCHOR AS REQUIRED.

9. ARCHITECT TO REVIEW LOCATIONS OF ALL SLOT DIFFUSERS, SPRINKLERS, SMOKE DETECTORS, ETC. IN GWB CEILINGS AND WALLS.

10. COORIDINATE CEILING MOUNTED SPEAKERS AND A/V DEVICES WITH

KEYNOTES

CEILING LEGEND:

PROVIDE ADDITIONAL BLOCKING AS REQUIRED FOR CEILING MOUNTED AV EQUIPMENT. COORDINATE WITH AV VENDOR.
 PROVIDE POWER AND DATA FOR CEILING MOUNTED AV EQUIPMENT AT THIS LOCATION

GWB CEILING / SOFFIT

2'X2' ACT CEILING SYSTEM

4- WAY CLNG DIFFUSER

CEILING REGISTER

4' RECESSED LINEAR

D 2'x2' FLAT PANEL

WALL SCONCE

PROJECTOR

EXIT SIGN

RECESSED WALL WASH LINEAR

RECESSED PROJECTOR SCREEN

ACOUSTIC WOOD CEILING SYSTEM

RECESSED DOWNLIGHT - WHITE FLANGE

RECESSED DOWNLIGHT - BLACK FLANGE

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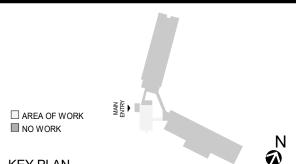


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REFLECTED CEILING PLAN


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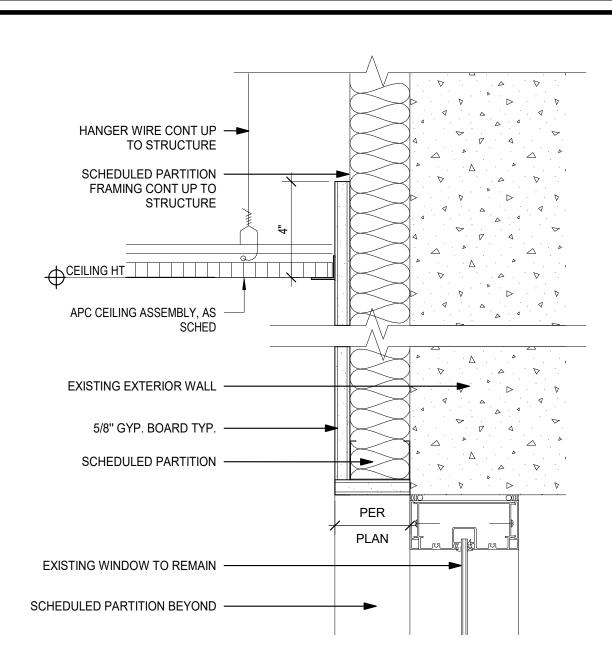
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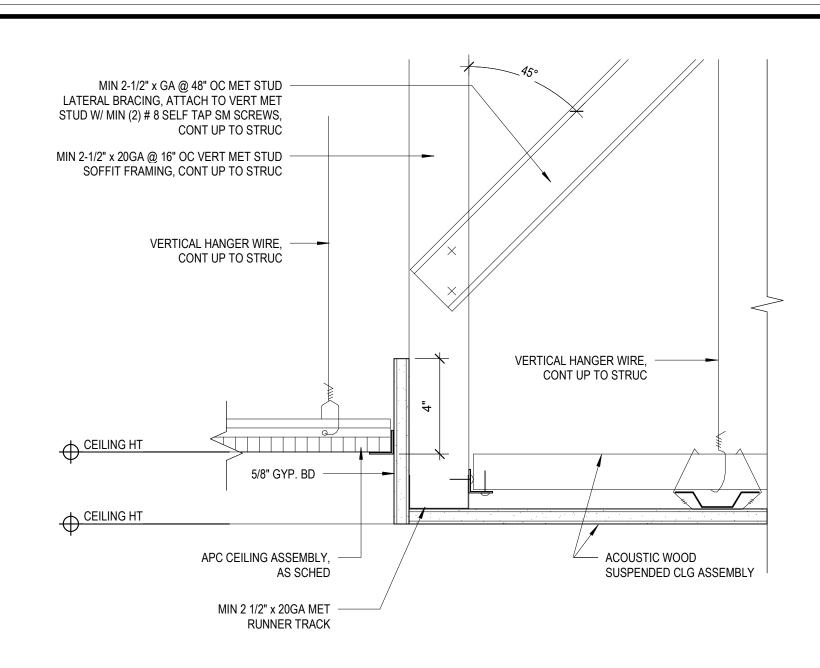
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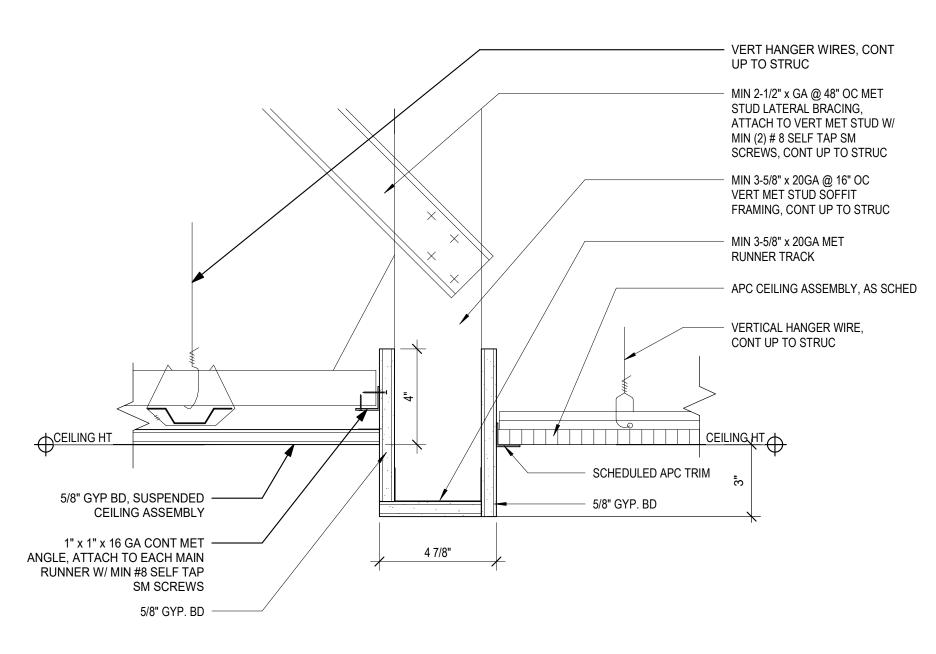




3 CEILING DETAIL AT PERIMETER




2 CEILING DETAIL AT SOFFIT

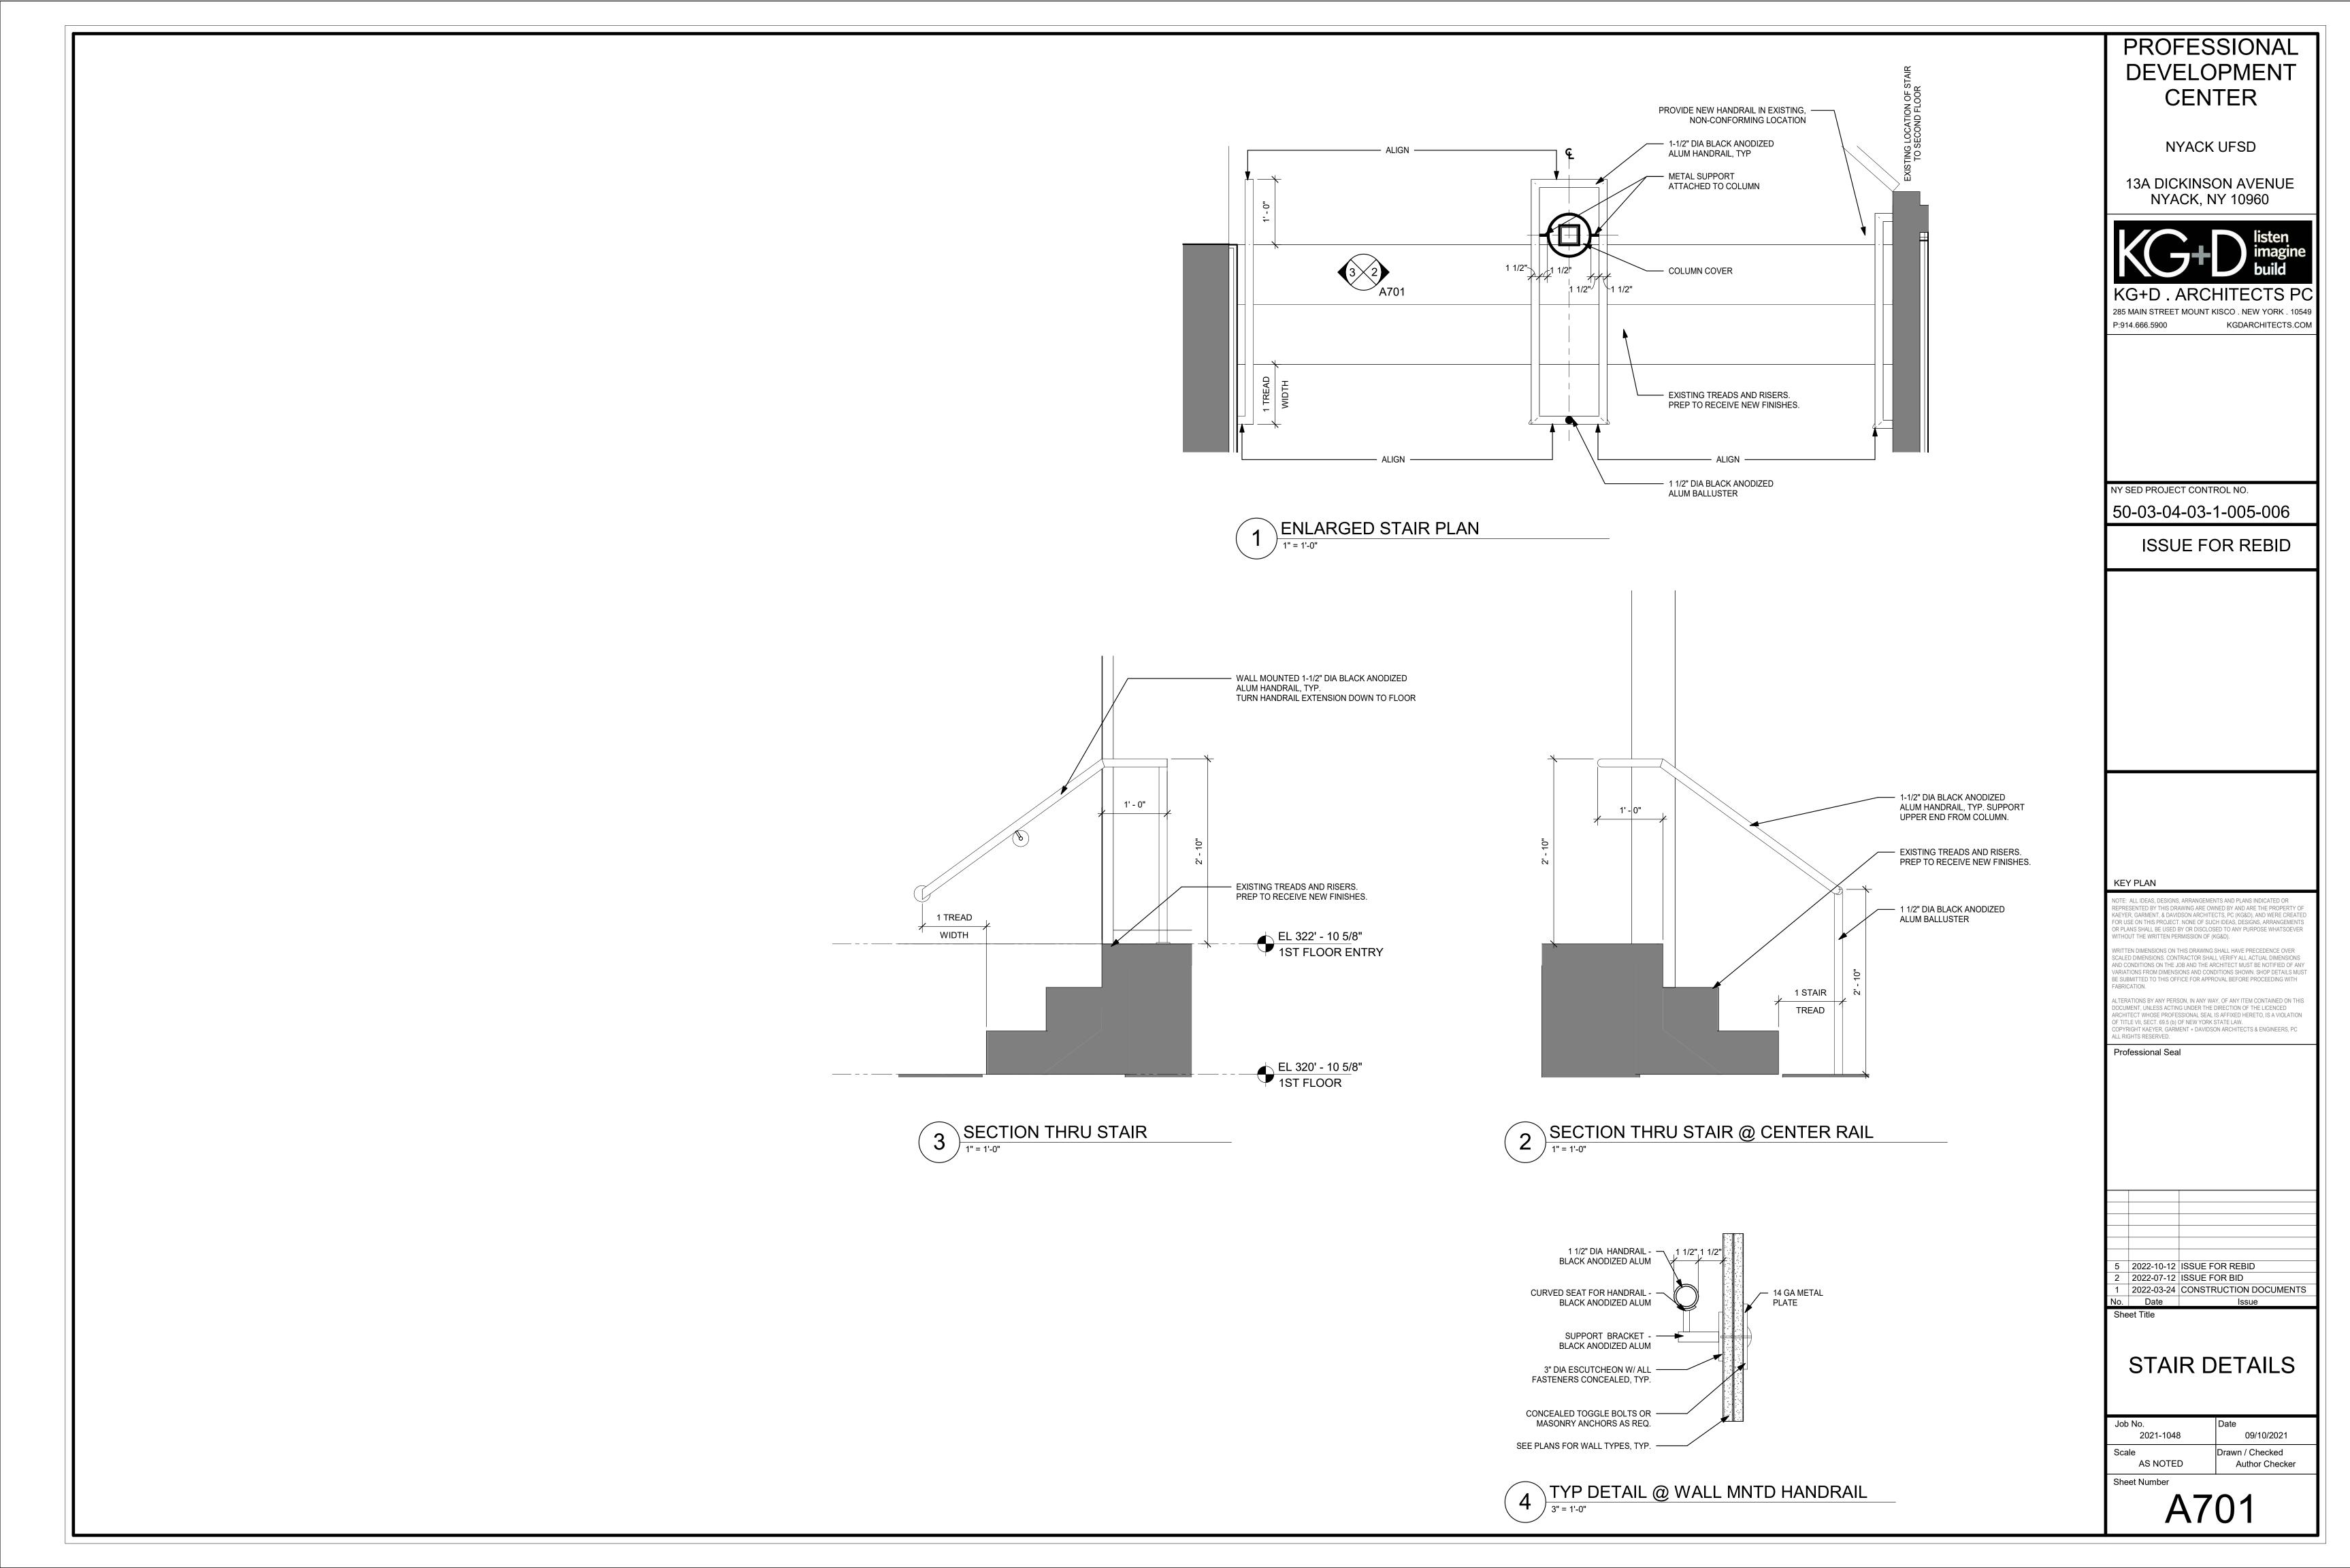


5 CEILING DETAIL AT BULKHEAD


3" = 1'-0"

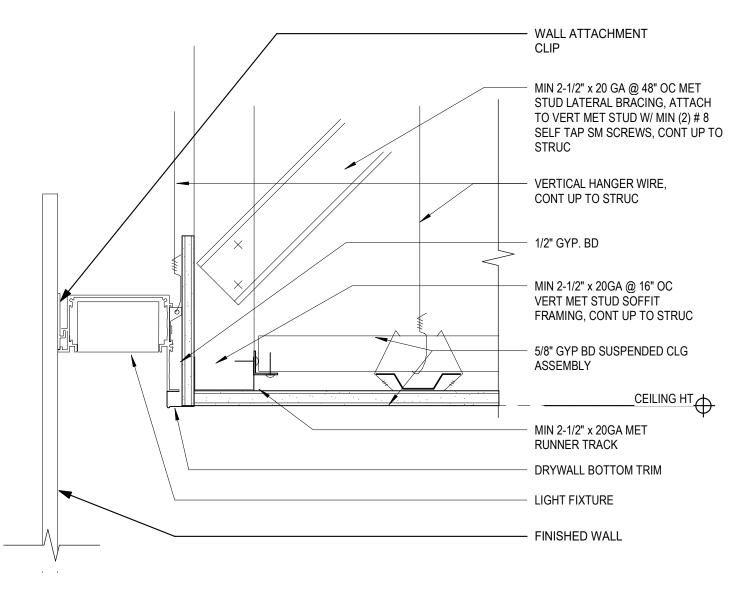


CEILING DETAIL AT PERIMETER COVE LIGHT 3" = 1'-0"

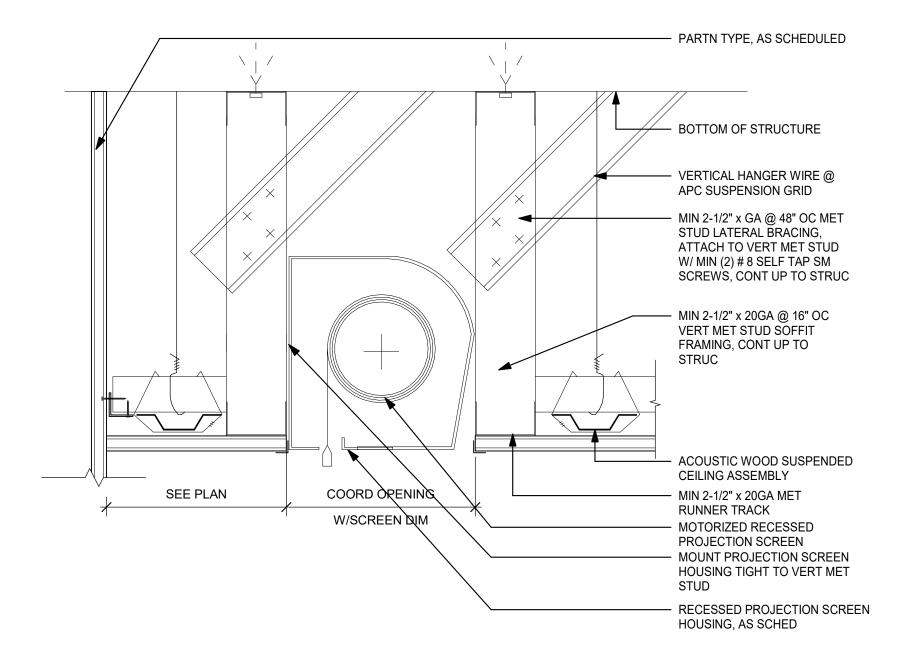



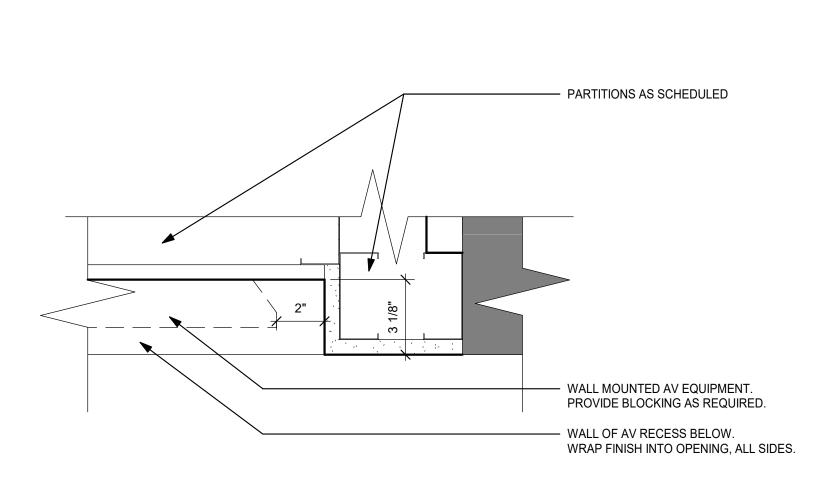



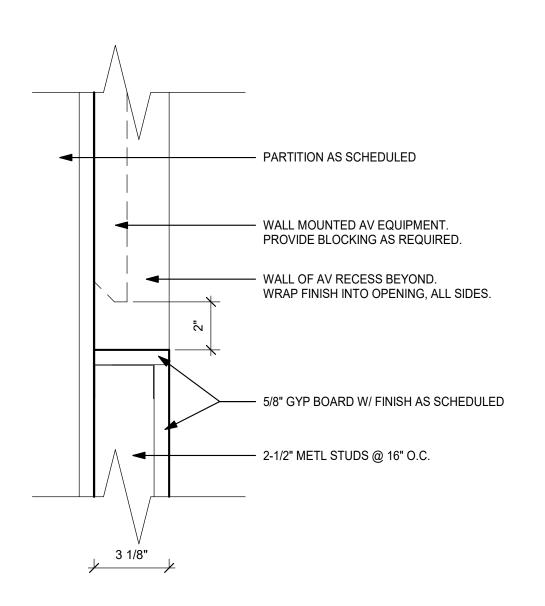



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INTERIOR DETAILS


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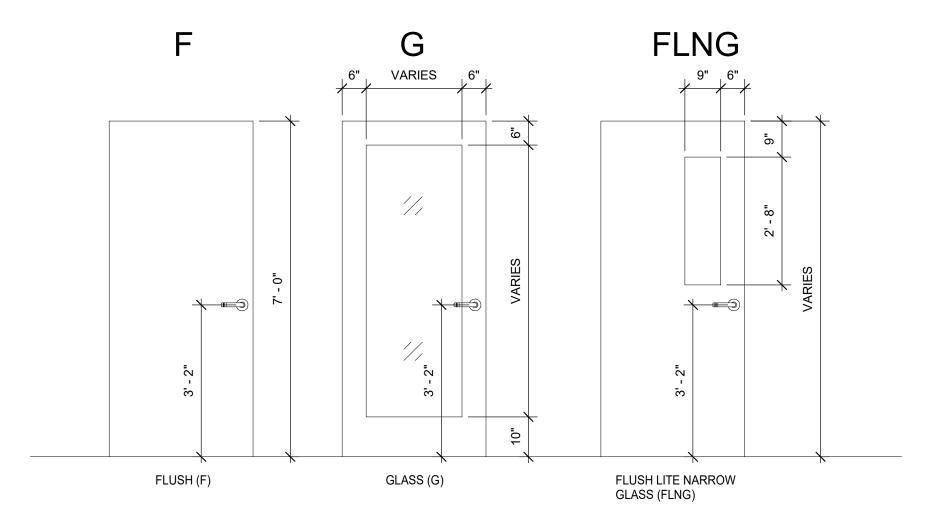
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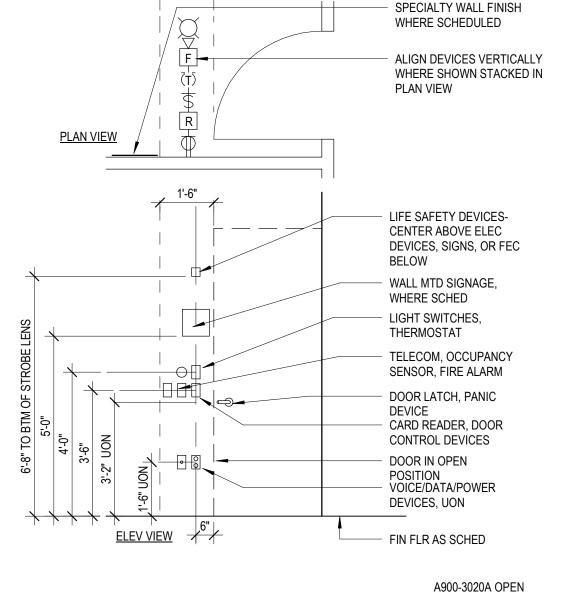


								Door S	Schedu	le							
Level	Mark	From Room	From #	To Room	# LEA VES	WI	нт	ELEV	Door Mat	Door Fin	Frame Mat	Frame Fin	Frame Type	Fire Label	Saddle	HDWE SET	Comments
1ST FLOOR ENTRY	101X	LOBBY	101		2	3' - 3"	6' - 8"	G					03			1.0	SEE A301. REUSE EXISTING MASONRY OPENING.
1ST FLOOR ENTRY	103	CORRIDOR	102	Т	1	3' - 0"	7' - 0"	F	WD	WD	НМ	Р	01		SL	5.0	DOOR IS PART OF ALTERNATE #1
1ST FLOOR ENTRY	104A	CORRIDOR	102	STOR	1	3' - 0"	7' - 0"	F	НМ	PTD	НМ	Р	01			4.0	DOOR IS PART OF ALTERNATE #1
1ST FLOOR ENTRY	105	STOR	104	JAN	1	2' - 6"	7' - 0"	F	НМ	PTD	НМ	Р	01			4.0	
1ST FLOOR ENTRY	S1	LOBBY	101	STAIRS	1	2' - 6"	7' - 0"	F	WD	WD	НМ	Р	01			6.0	DOOR STAIN TO MATCH WOOD LOOK WALL COVERING. MATCH EXISTING DOOR OPENING SIZE.
1ST FLOOR	104B	CONFERENCE ROOM	110	STOR	2	3'-0"	7' - 0"	F	WD	WD	НМ	Р	02			3.0	DOOR STAIN TO MATCH RECEIVE WOOD LOOK WALL COVERING
1ST FLOOR	107	VEST	106	Т	1	3' - 0"	7' - 0"	F	НМ	PTD	НМ	Р	01		SL	5.0	
1ST FLOOR	110A	CONFERENCE ROOM	110	LOBBY	1	3' - 0"	7' - 0"	G					05			2.0	
1ST FLOOR	110B	CONFERENCE ROOM	110	CORRIDOR	2	3' - 0"	7' - 0"	FLNG	НМ	PTD	НМ	Р	02	90 MIN		8.0	
1ST FLOOR	110C	CONFERENCE ROOM	110		1	3' - 0"	7' - 0"	ETR	ETR	PTD	ETR	Р	01			7.0	PAINT EXISTING DOOR AND FRAME. ADD FROSTED FILM TO TRANSOM GLASS.
1ST FLOOR	110D	CONFERENCE ROOM	110		1	3' - 0"	7' - 0"	ETR	ETR	PTD	ETR	Р	01			7.0	PAINT EXISTING DOOR AND FRAME. REPLACE SOLID TRANSOM PANEL WITH GLASS AND FROSTED FILM.

	Door Schedule Base Bid Level Mark From Room From # To Room # LEAVES WI HT ELEV Door Mat Door Fin Frame Mat Frame Fin Frame Type Fire Label Saddle HDWE SET Comments																
Level	Mark	From Room	From #	To Room	# LEAVES	WI	HT	ELEV	Door Mat	Door Fin	Frame Mat	Frame Fin	Frame Type	Fire Label	Saddle	HDWE SET	Comments
1ST FLOOR ENTRY	104A'	LOBBY	101	STOR	1	3' - 0"	7' - 0"	F	WD	WD	НМ	Р	1			90	BASE BID. DOOR STAIN TO MATCH WOOD LOOK WALL COVERING.


DOOR TYPES



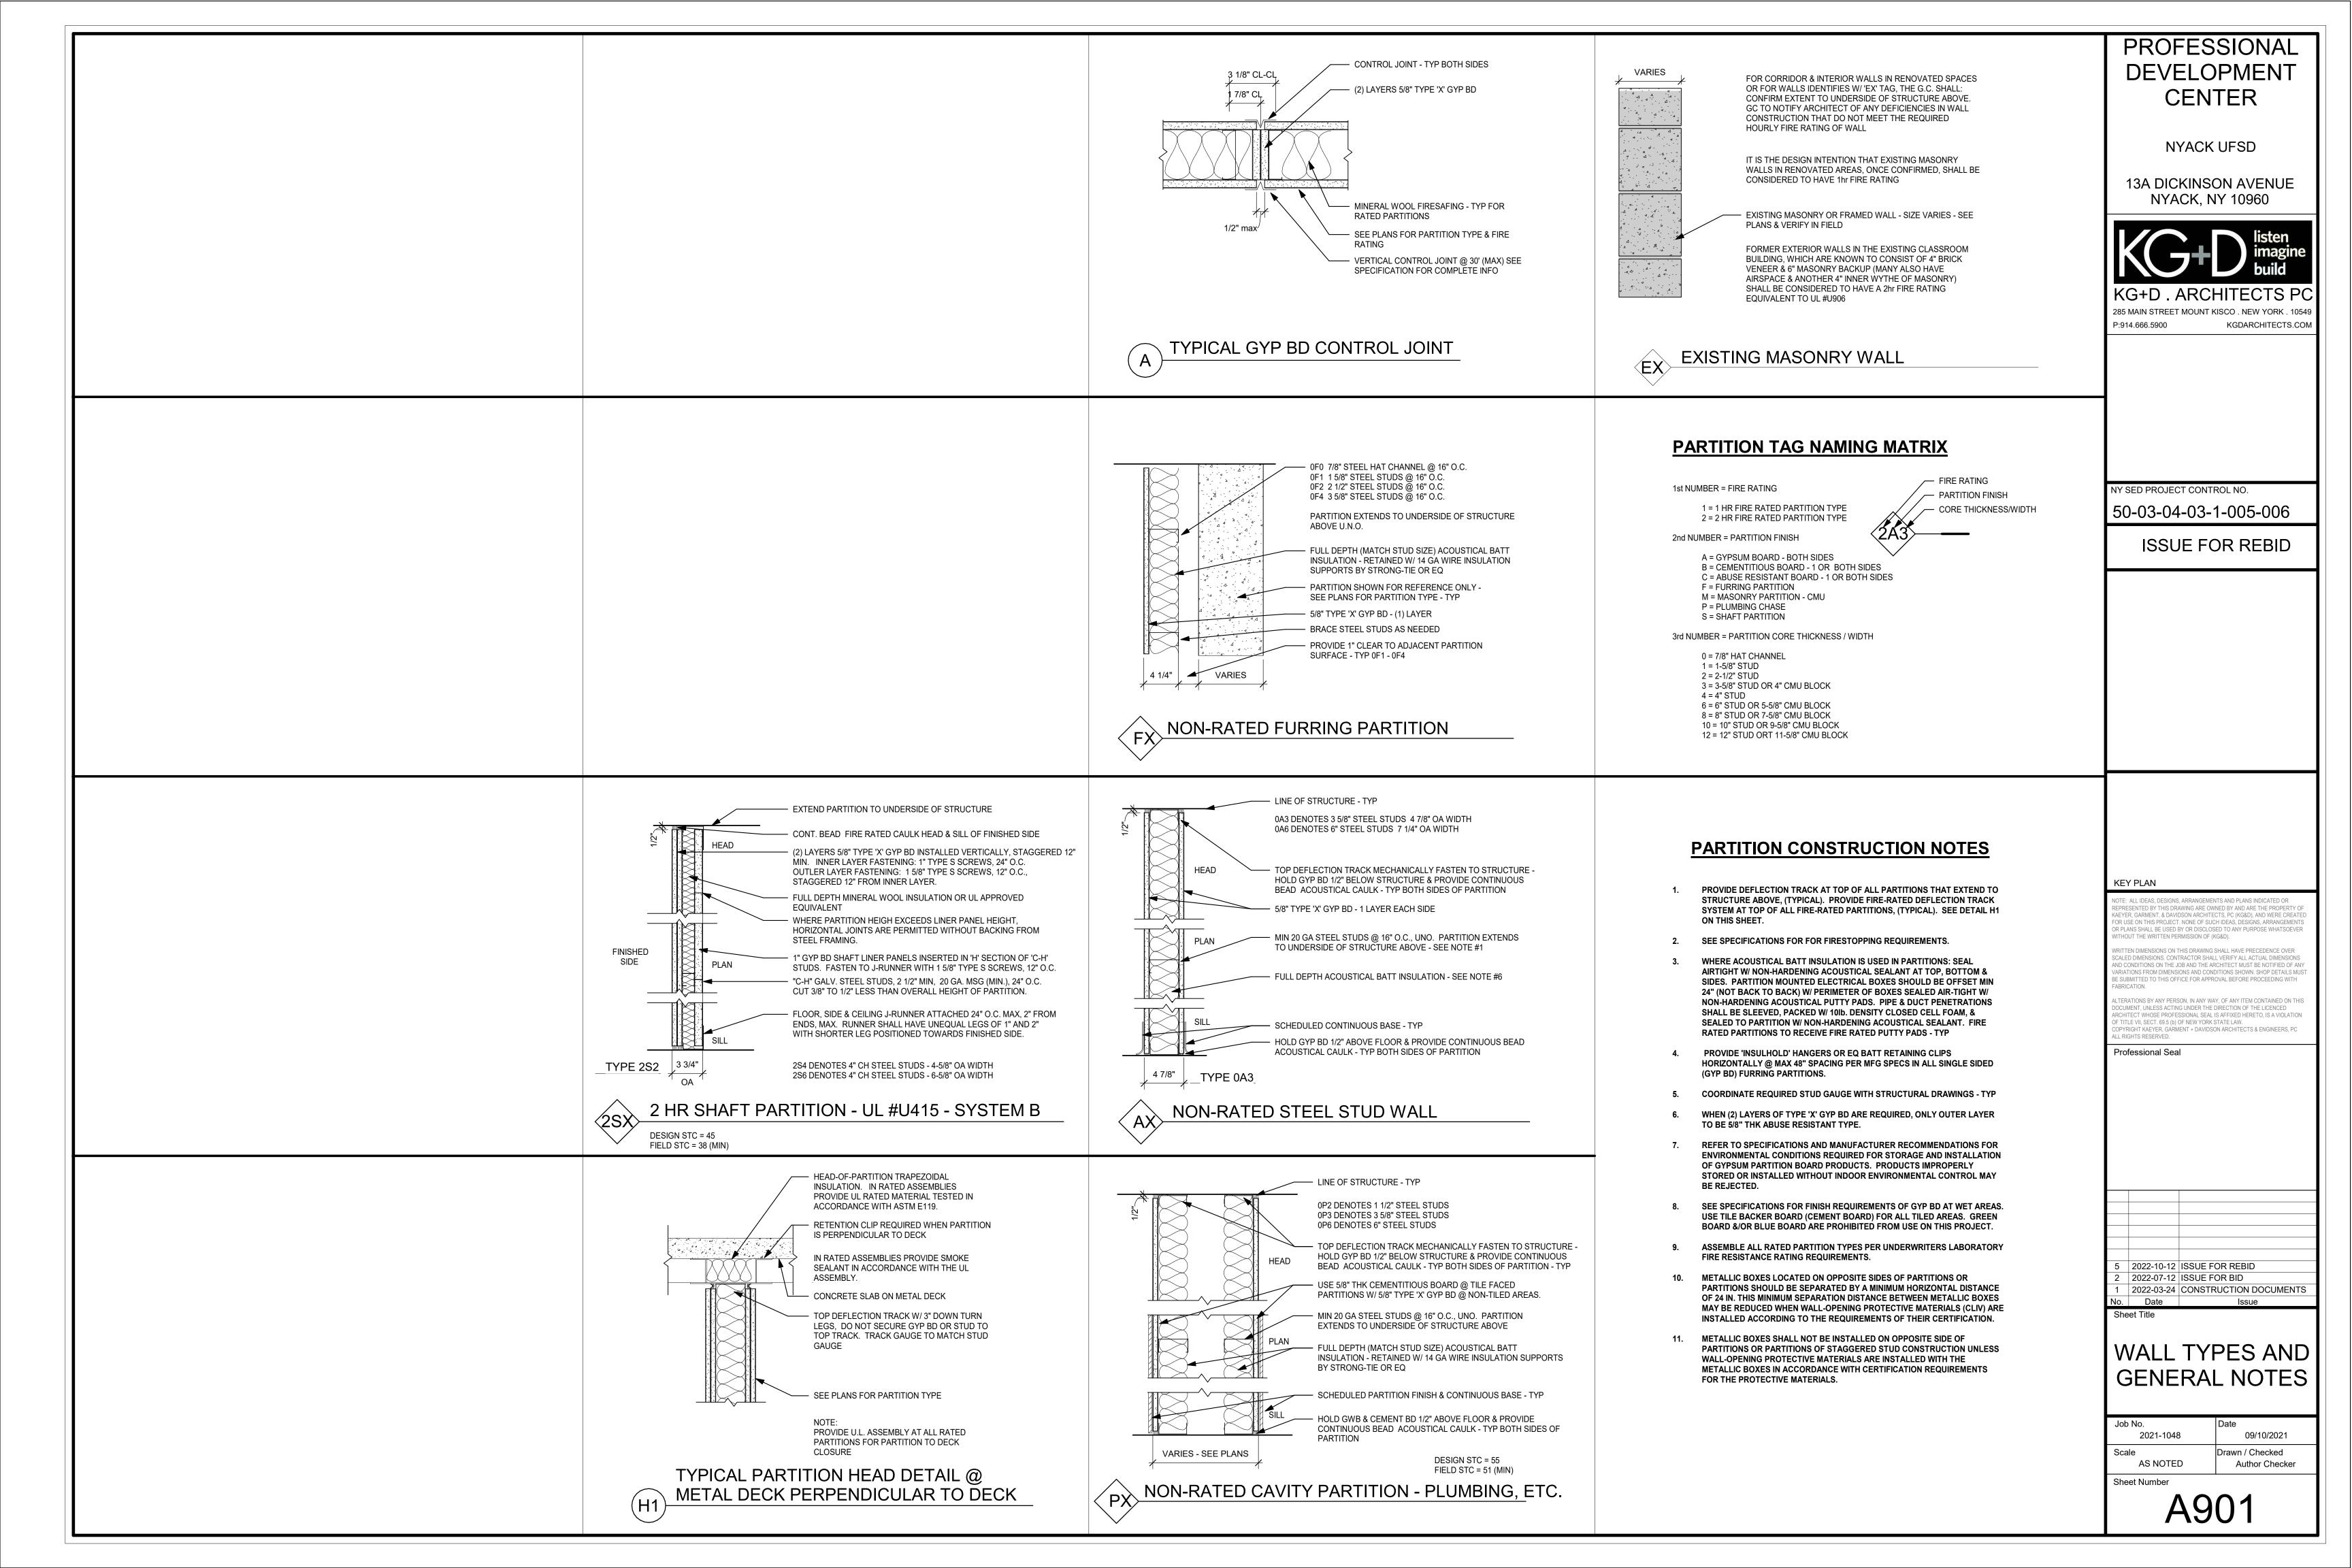





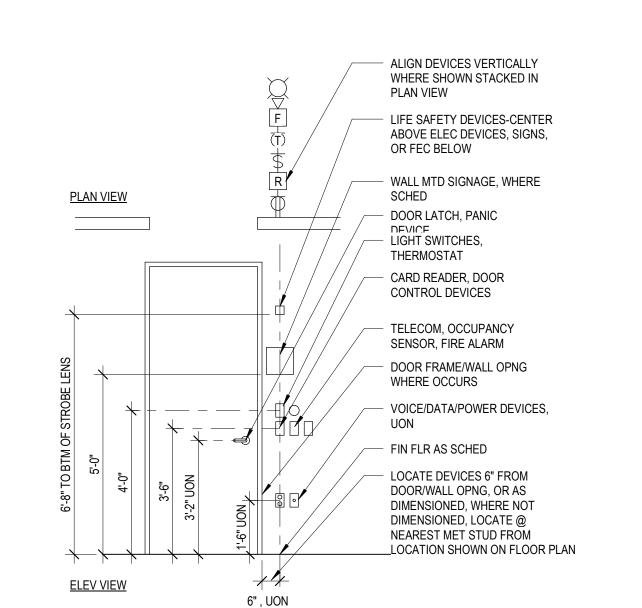

GENERAL DEVICE ALIGNMENT DIAGRAM

GLASS NOTES:

GL-1 = 1/4" TEMPERED

GL-2 = LOW-E COATED, CLEAR INSULATING GLASS

GENERAL NOTES

- 1. G.C. SHALL VERIFY SIZE OF REPLACEMENT DOORS & FRAMES IN THE EXISTING BUILDING SEE SPEC. SECTION 08 71 00 FOR DOOR HARDWARE SETS, HARDWARE NOTES, COMPONENTS
- & OTHER INFORMATION. EXTERIOR DOOR SYSTEMS SHALL BE FULLY PERIMETER CAULKED TO ADJACENT FINISHED
- SURFACES, BOTH INTERIOR & EXTERIOR TYP.
- FACE OF ADJACENT WALL TO EDGE OF DOOR FRAME IS 4" (TYPICAL) U.N.O. SEE A201 FLOOR PLAN FOR FRAME TYPE LOCATIONS. PROVIDE FRAME TYPE 01 FOR DOORS THAT ARE UNLABELED.

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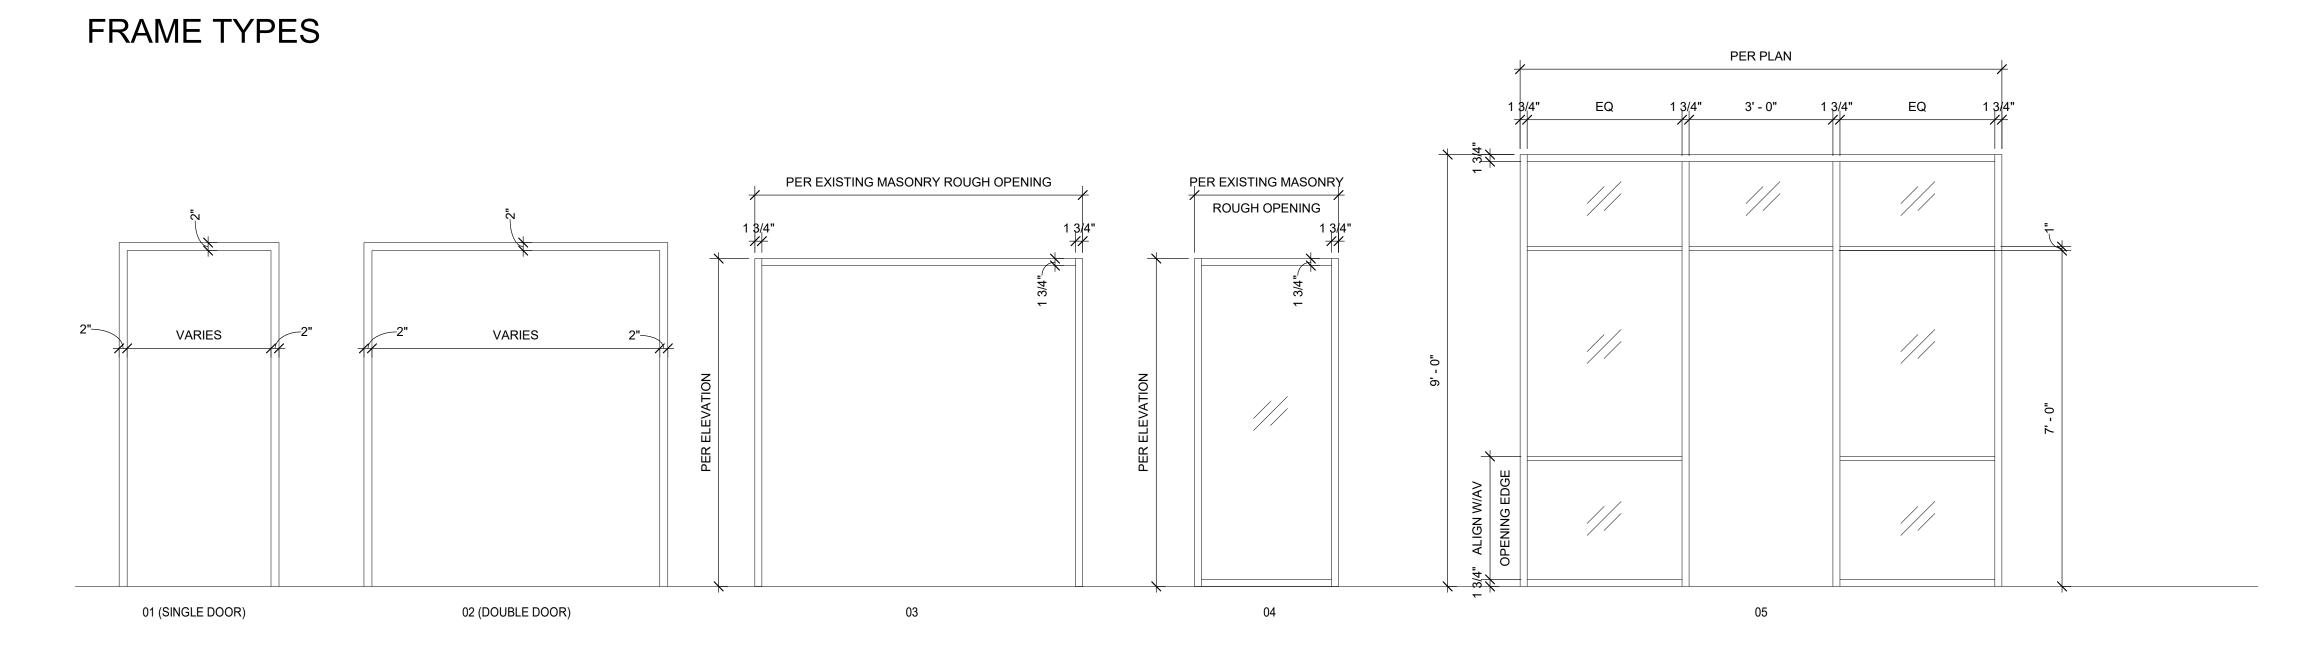
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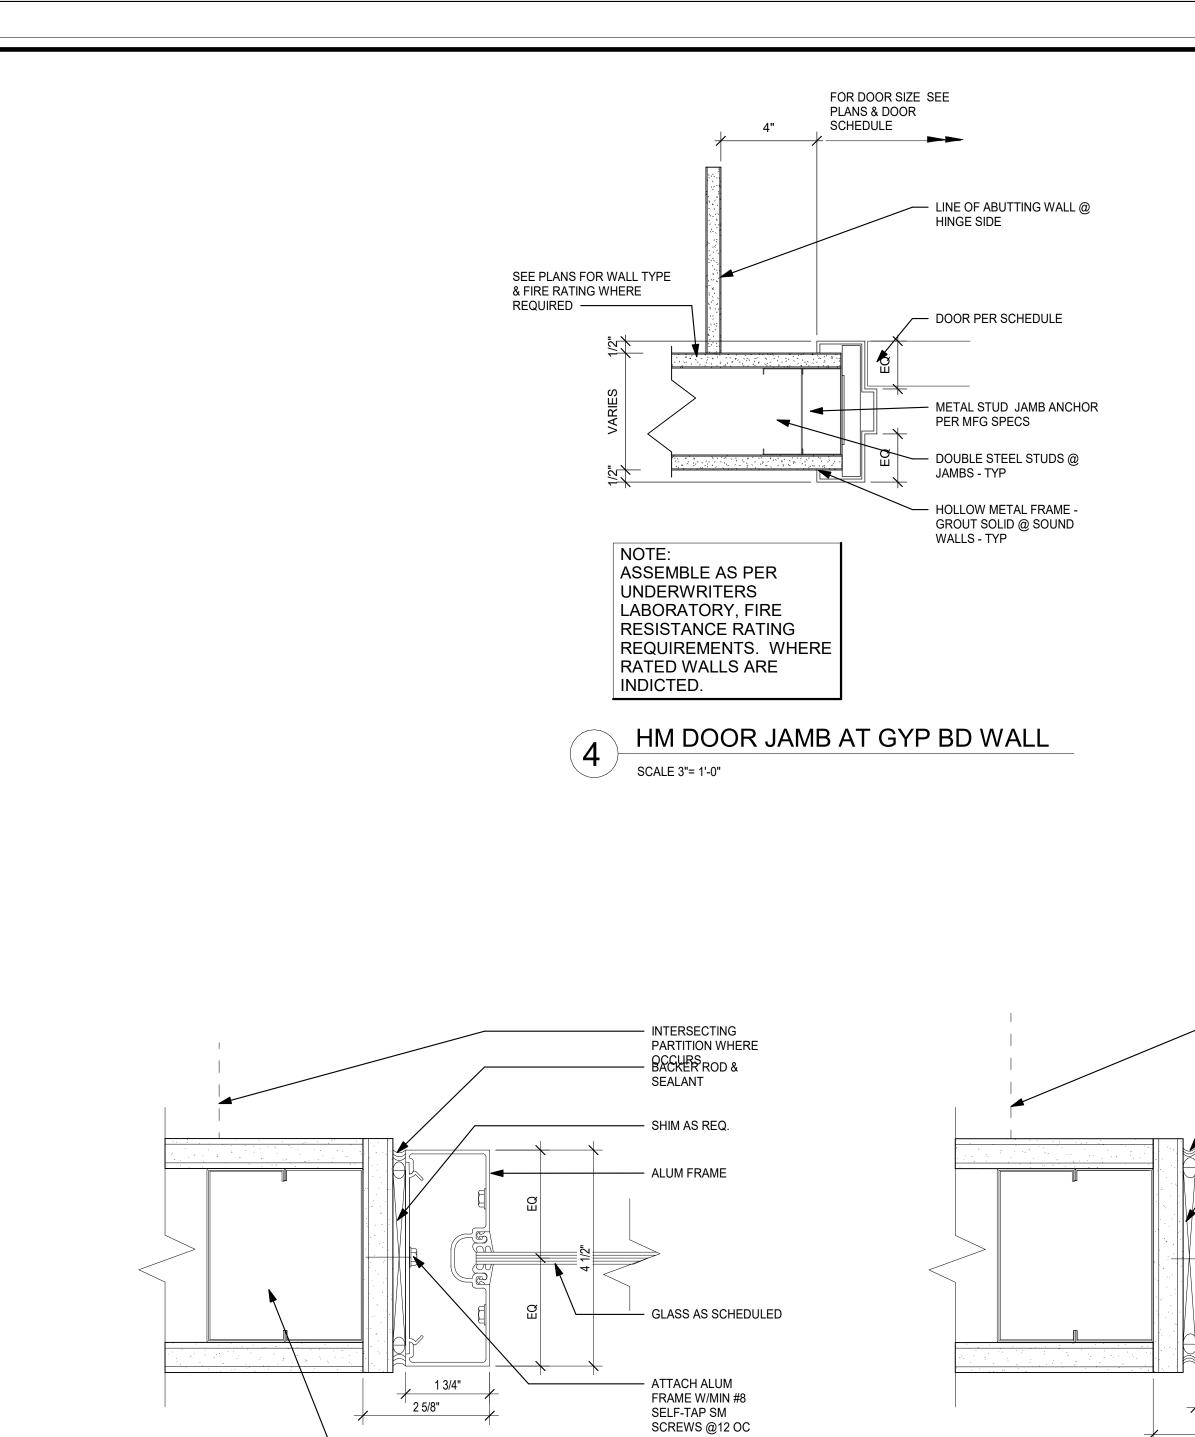
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DOOR SCHEDULE, DOOR & FRAME **TYPES**

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Sheet Number





- PARTN TYPE AS


DIAGRAM

8 AL JAMB DETAIL
6" = 1'-0"

SCHEDULED, PROVIDE

FRAMING AS INDICATED

BY MET STUD FRAMING

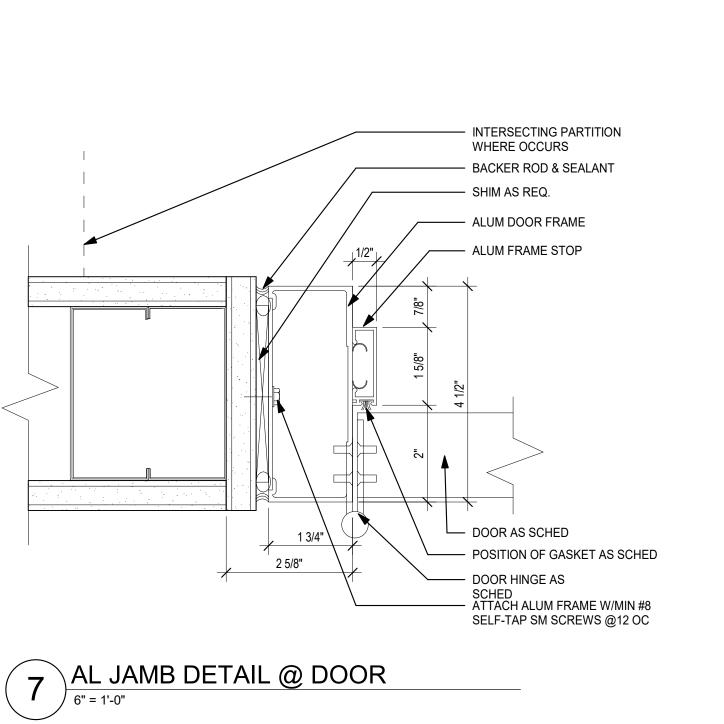

- PARTN TYPE AS

SCHEDULED

- SHIM AS REQ.

HM FRAME STOP

LINE OF JAMB OR

VERTICAL MULLION

DOOR AS SCHEDULED

SCHED


BEYOND

HM DOOR HEAD AT GYP BD WALL

SCALE 3"= 1'-0"

POSITION OF GASKET AS


— HOLLOW METAL DOOR FRAME

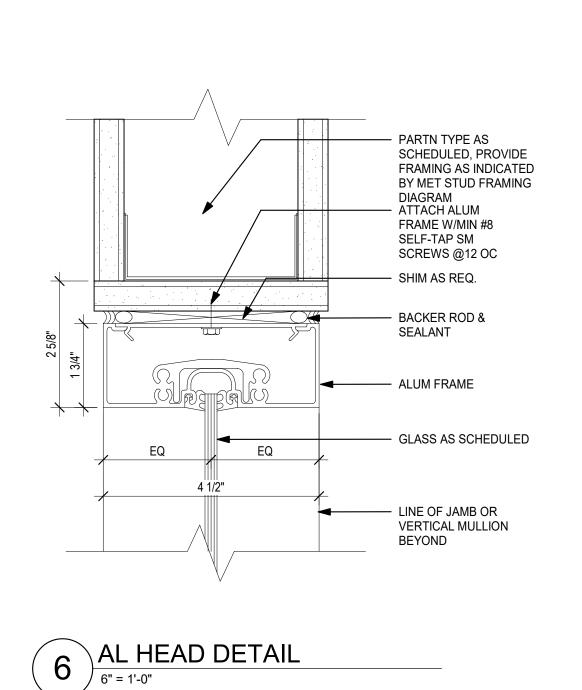

PT = 1/2"

(PORCELAIN TILE)

SCALE 3"= 1'-0"

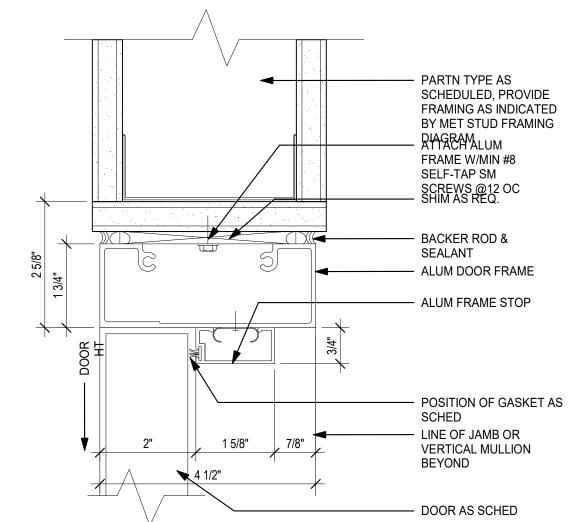

SADDLE NOTES:

1. COORDINATE DOOR UNDERCUT WITH SADDLE & OTHER UNDERCUTTING

3. SADDLES MAY BE OMITTED WHERE MATERIALS OF SIMILAR THICKNESS

REQ. SEE DOOR SCHEDULE & SADDLE DETAILS ON THIS SHEET.

MEET WITH THE WRITTEN APPROVAL OF THE ARCHITECT. DOOR

5. SLATE SADDLES, WHEN USED OR CALLED FOR SHALL BE SELECTED FROM FULL COLOR RANGE TO MATCH ADJACENT FLOORING.

INTERIOR

SCALE 3"= 1'-0"

FULL WIDTH

TO MATCH JAMB

TYPICAL EXTERIOR SADDLE

EXTERIOR

- ALUMINUM

SADDLE

2. SADDLES ARE TO BE FULL WIDTH OF DOOR FRAME


UNDERCUTS MUST BE COORDINATED.


PT = 1/2"

SLATE

SADDLE

(PORCELAIN TILE)

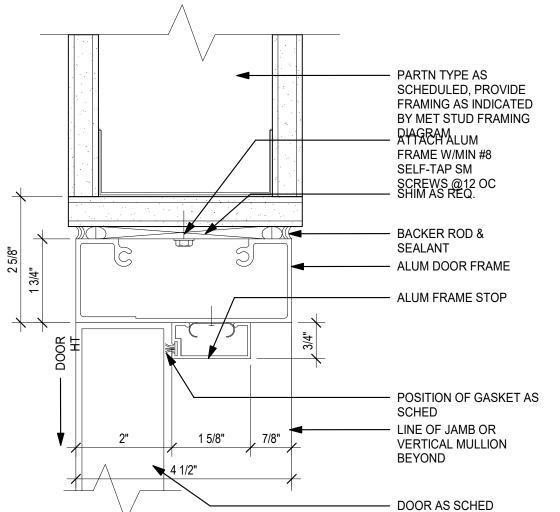

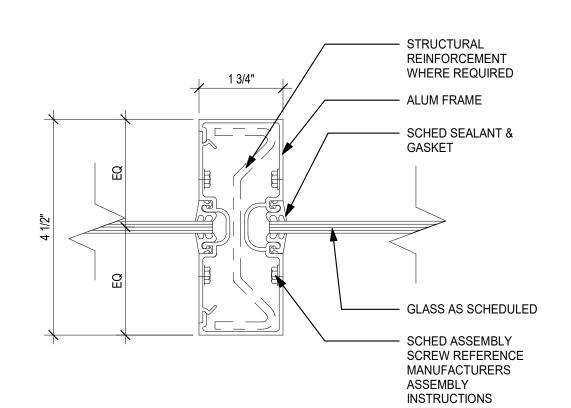

5 AL HEAD DETAIL @ DOOR



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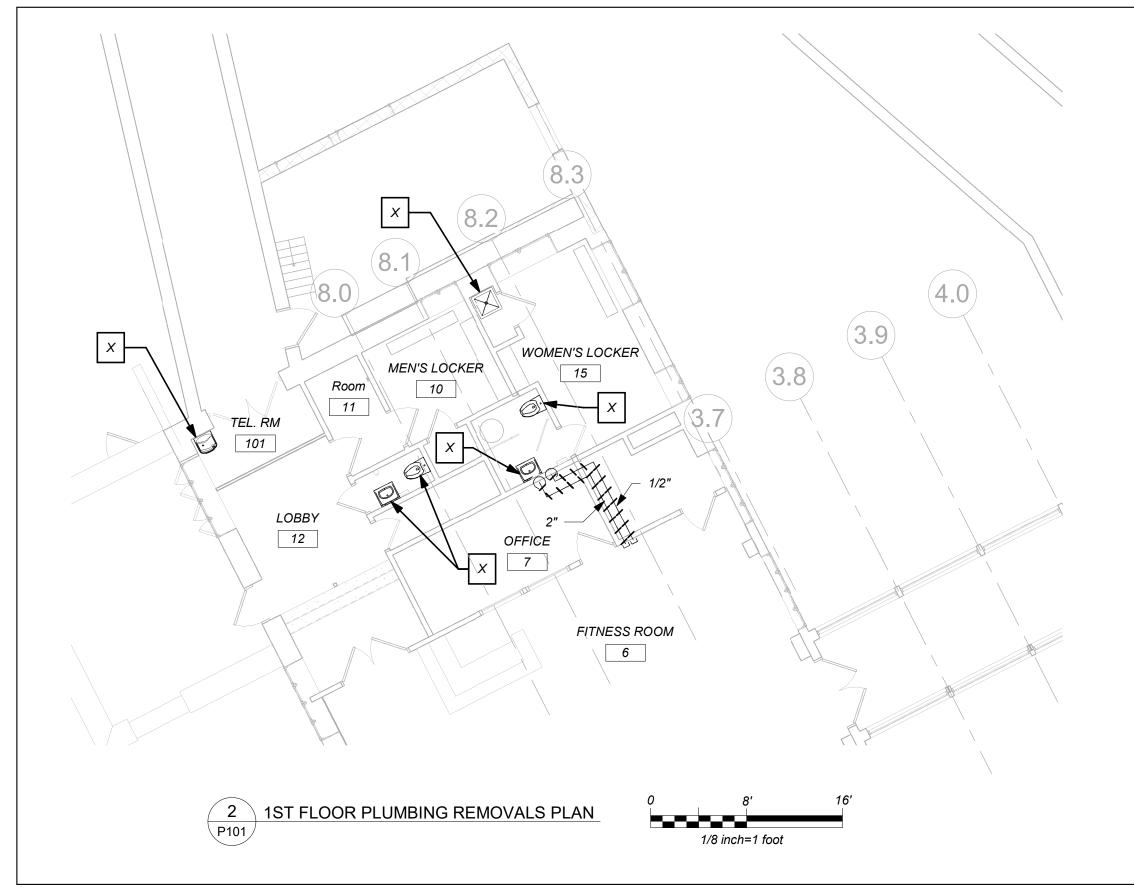
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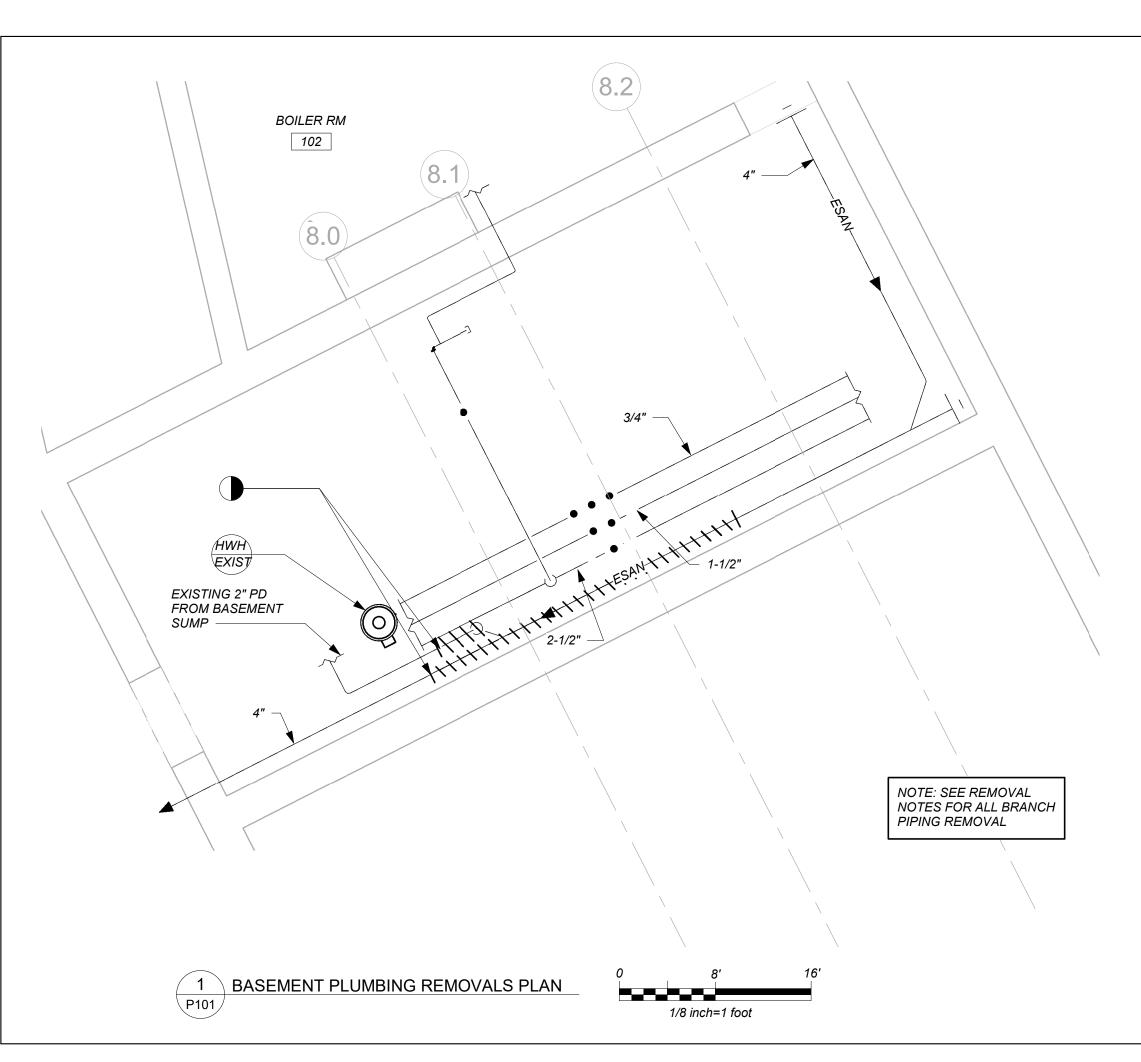
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DETAILS

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	NEW PIPING, FIXTURES, ETC.
—• —	COLD WATER PIPING
••	HOT WATER PIPING
-•••	HOT WATER RETURN PIPING
	PLUMBING VENT PIPING
SAN —	SANITARY PIPING
ESAN ——	EXISTING SANITARY PIPING
EPD	EXISTING PUMP DISCHARGE PIPING
	FLOW DIRECTION WITHIN PIPE
 	CLEANOUT
─ ₩─	SHUT-OFF VALVE
─────	COMBINATION BALANCING & SHUT-OFF VALVE
\$	PIPE CONNS. (BOTTOM; TOP 45 OR 90; PIPE UP)
*	PLUMBING FIXTURE IDENTIFICATION
P.C.	PLUMBING CONTRACTOR
G.C.	GENERAL CONTRACTOR
HVAC	HVAC CONTRACTOR
VTR	VENT THRU ROOF
FAI	FRESH AIR INTAKE
FD	FLOOR DRAIN
PRV	PRESSURE REDUCING VALVE
HWH	HOT WATER HEATER IDENTIFICATION
•	POINT OF CONNECTION
*	PART PLAN, DETAIL, SECTION NUMBER SECTION IDENTIFICATION

PLUMBING FIXTURE SCHEDULE

MARK	DESCRIPTION		BRANC	CH SIZE	
	BESONII TION	W	V	H	С
A1	WALL MOUNTED WATER CLOSET (FLUSH VALVE) (HANDICAPPED)	4"	2"	-	1"
A1	FLOOR MOUNTED WATER CLOSET (FLUSH VALVE) (HANDICAPPED)	4"	2"	-	1"
B1	SINGLE WALL MOUNTED LAVATORY (HANDICAPPED)	1-1/2"	1-1/2"	1/2"	1/2"
B2	SINGLE COUNTER MOUNTED LAVATORY	1-1/2"	1-1/2"	1/2"	1/2"
С	MOP RECEPTOR	3"	3"	3/4"	3/4"
X	EXISTING FIXTURE TO BE REMOVED	-	-	-	-

REMOVAL NOTES:

1. THE SCOPE OF REMOVAL SHOWN IS DIAGRAMMATIC ONLY AND INDICATES THE INTENT OF THE WORK TO BE PERFORMED AND NOT THE COMPLETE SCOPE OF DEMOLITION AND/OR REMOVAL WORK. IT SHALL BE THE RESPONSIBILITY OF THIS CONTRACTOR TO REMOVE ANY RELATED MECHANICAL DEVICES EVEN IF NOT SPECIFICALLY INDICATED TO BE REMOVED IN ORDER TO ACCOMMODATE NEW WORK.

2. REMOVE ALL PLUMBING EQUIPMENT, SPECIALTIES, DRAINS, CONTROLS, HANGERS, BASES, SUPPORTS, PIPING, VALVES, TUBING AND PLUMBING ACCESSORIES THAT ARE NOT INCORPORATED IN THE NEW LAYOUT.

3. WHERE REMOVAL IS INDICATED OR IMPLIED OR NOT INCORPORATED IN THE NEW LAYOUT, THE ITEM ITSELF IS TO BE REMOVED COMPLETELY TOGETHER WITH ALL CONNECTING PIPING, SPECIALTIES, SUPPORTS, CONTROLS, ETC. CONNECTING PIPING IS TO BE REMOVED BACK TO MAINS WHERE THE ARE TO BE CAPPED OR DISCONNECTED. THIS INCLUDES ALL GAS, SANITARY, VENT, WATER, AND PUMP DISCHARGE PIPING. REFER TO DIVISION I OF SPECIFICATION FOR CUTTING AND PATCHING REQUIREMENTS.

4. WHERE EXISTING PIPING ENTERS INACCESSIBLE TRENCHES, TUNNELS, SHAFTS, WALLS AND CEILINGS INSIDE THE EXISTING BUILDING, IT SHALL BE CUT BACK AT LEAST 2" INTO SUCH INACCESSIBLE SPACES AND SHALL BE SUITABLY CAPPED AND SEALED BY THE CONTRACTOR.

5. THE CONTRACTOR SHALL EXERCISE NORMAL CAUTION TO PREVENT UNNECESSARY CUTTING AND DAMAGE TO THE EXISTING BUILDING. ANY EXCESSIVE DAMAGE AS DETERMINED BY THE OWNER SHALL BE REPAIRED AND PAID FOR BY THE CONTRACTOR CAUSING THE DAMAGE.

6. ALL DEMOLISHED EQUIPMENT ETC. EXCEPT THOSE ITEMS SPECIFICALLY REQUESTED BY THE OWNER SHALL

BECOME THE CONTRACTORS PROPERTY, SHALL BE REMOVED FROM THE PREMISES, AND DISPOSED OF LEGALLY.

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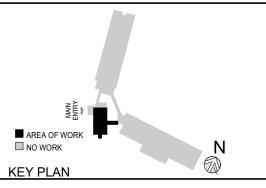


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NY SED PROJECT CONTROL NO.

66-23-00-01-0-008-011

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3	2022-10-12	ISSUE FOR REBID
2	2022-07-12	ISSUE FOR BID
1	2022-03-24	CONSTRUCTION DOCUMENTS
No.	Date	Issue
She	et Title	_EGEND,

Sheet Title LEGEND,
SCHEDULE, NOTES, &
PART BASEMENT &
1ST FLOOR PLANS
(REMOVALS)

 Job No.
 Date

 2021-1048
 09/10/2021


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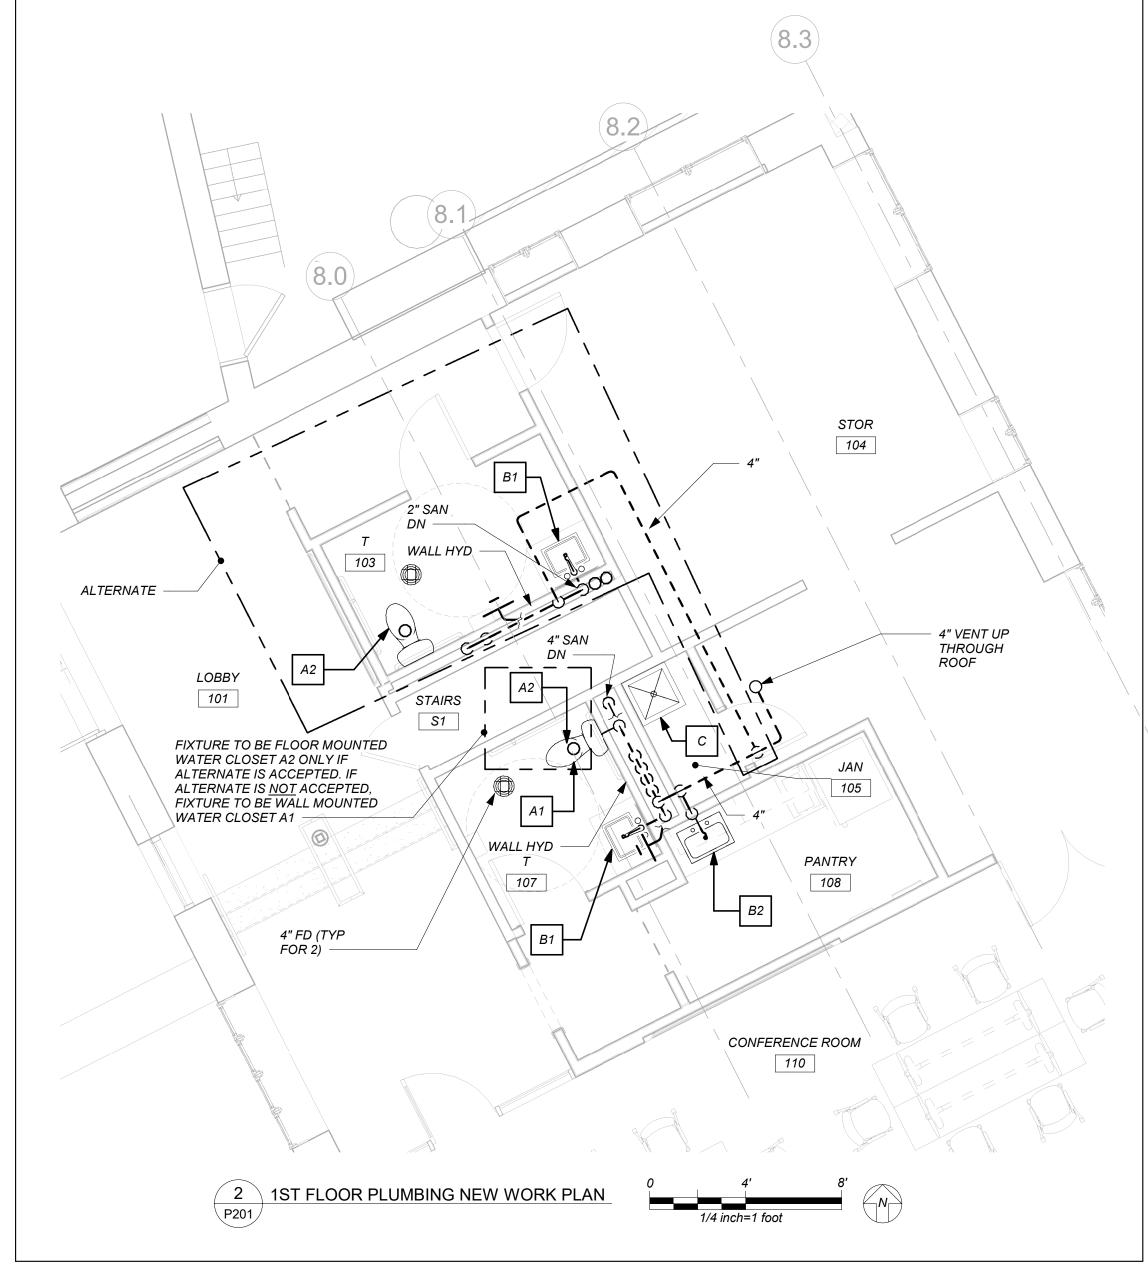
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Sheet Number

P101

BEFORE FABRICATION THIS CONTRACTOR SHALL VERIFY ALL MEASUREMENTS AND CONDITIONS ON JOB AND COORDINATE HIS WORK WITH THE WORK OF ALL THE OTHER CONTRACTORS



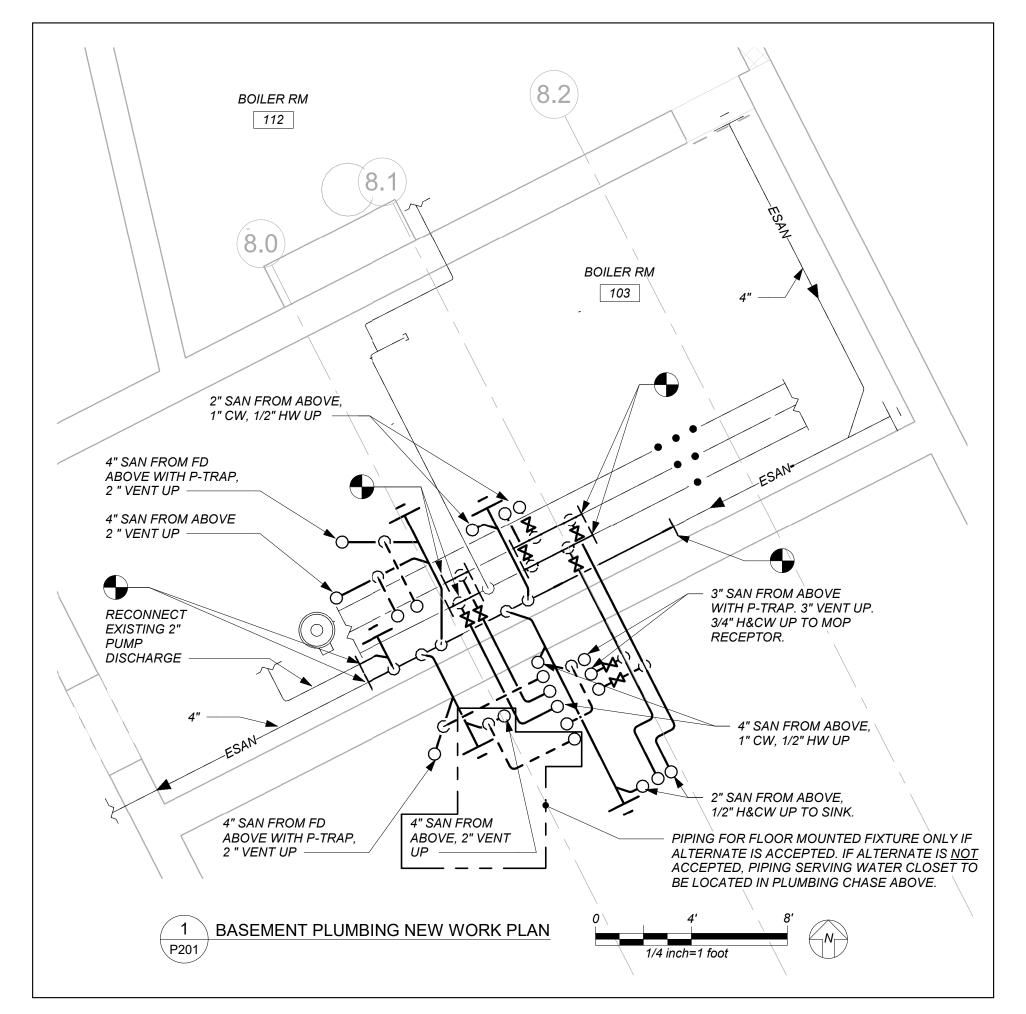

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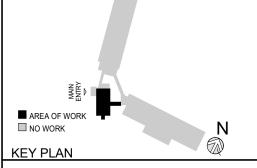
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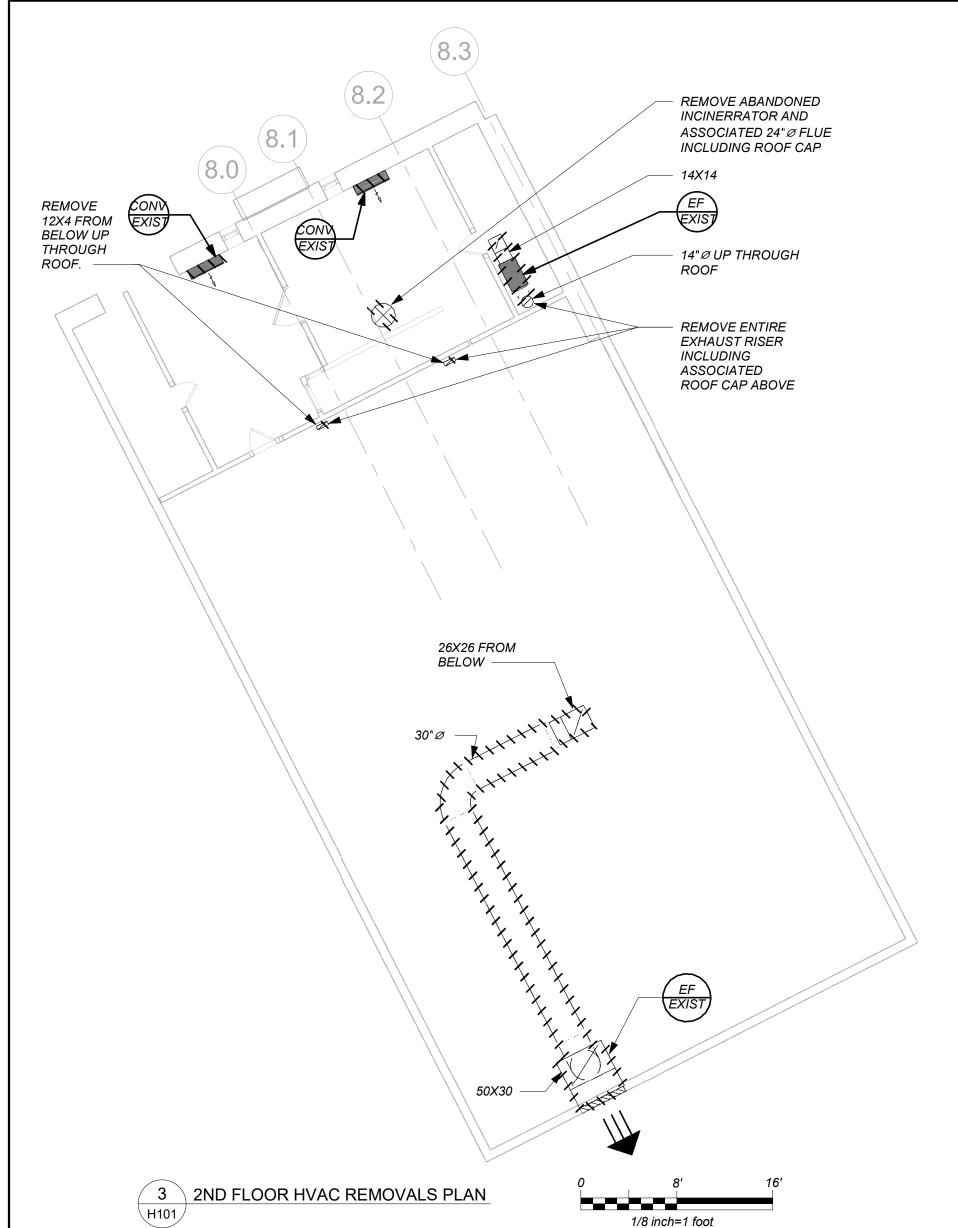
3	2022-10-12	ISSUE FOR REBID
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1	2022-03-24	CONSTRUCTION DOCUMENTS
No.	Date	Issue
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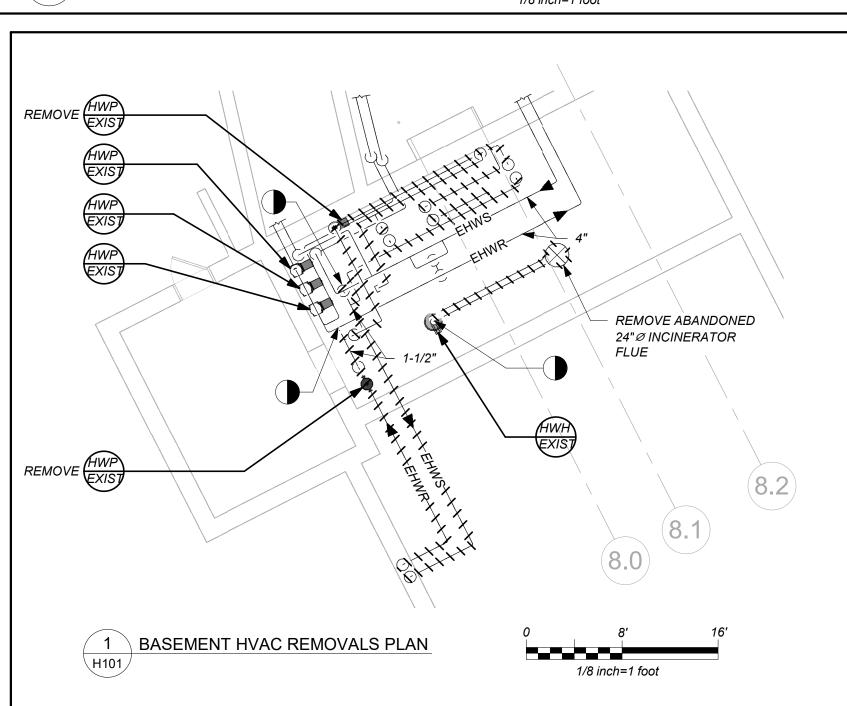
PART BASEMENT & 1ST FLOOR PLANS (NEW WORK)


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Sheet Number

BEFORE FABRICATION THIS CONTRACTOR SHALL VERIFY ALL MEASUREMENTS AND CONDITIONS ON JOB AND COORDINATE HIS WORK WITH THE WORK OF ALL THE OTHER CONTRACTORS





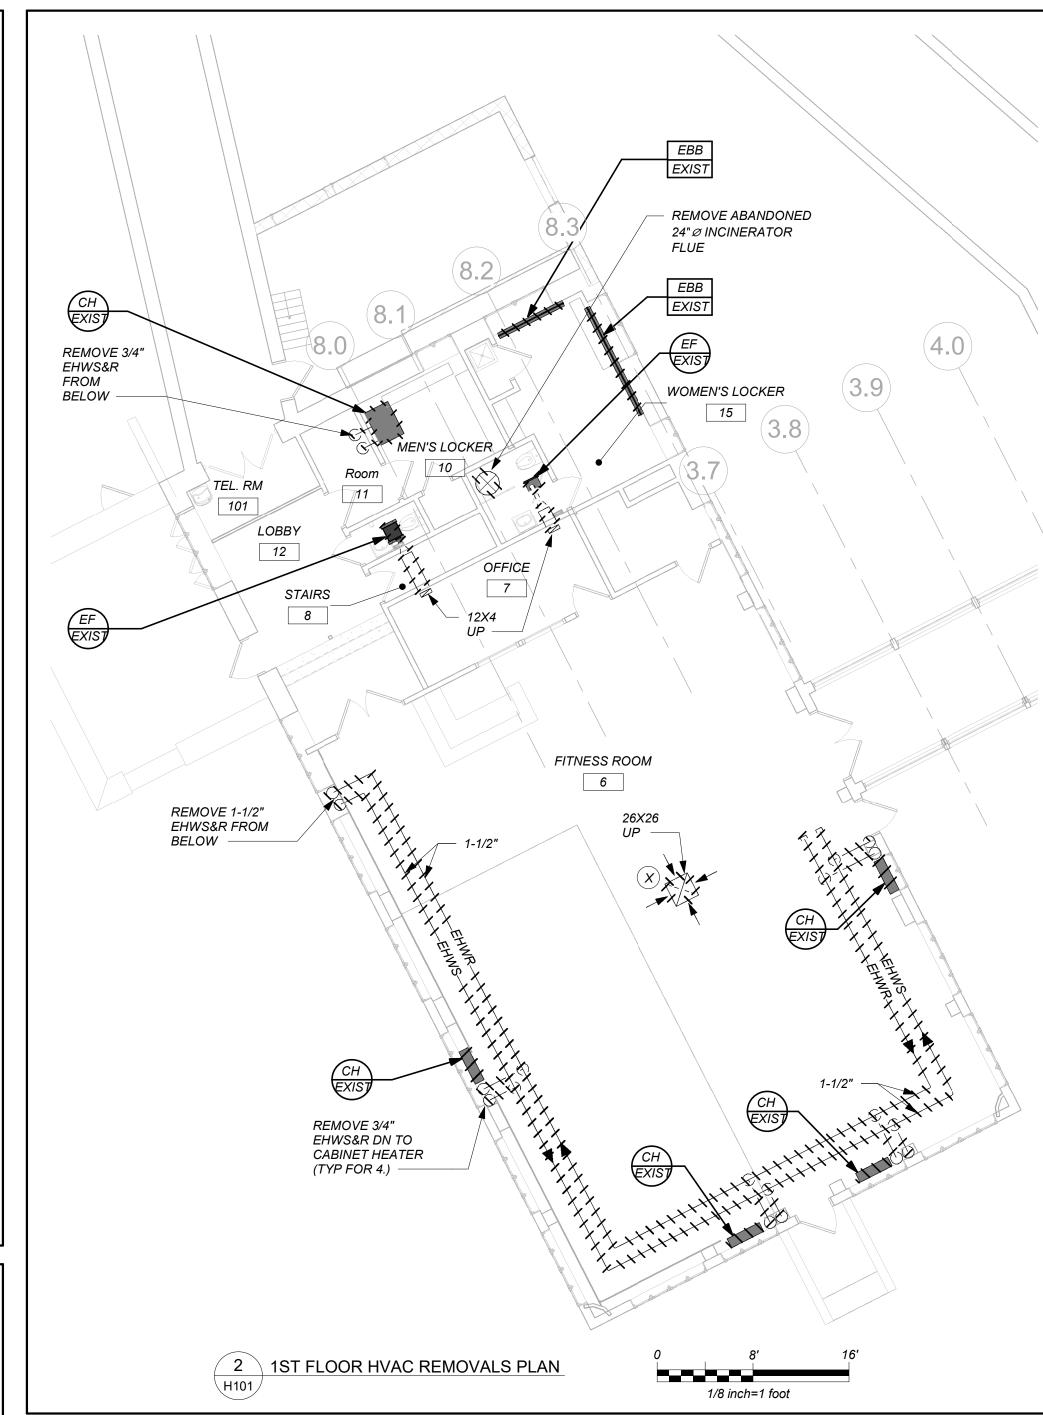

REMOVAL NOTES:

1. THE SCOPE OF REMOVAL SHOWN ON "REMOVALS" DRAWINGS IS DIAGRAMMATIC ONLY AND INDICATES THE INTENT OF THE WORK TO BE PERFORMED AND NOT THE COMPLETE SCOPE OF DEMOLITION AND/OR REMOVAL WORK. IT SHALL BE THE RESPONSIBILITY OF THIS CONTRACTOR TO REMOVE ANY RELATED MECHANICAL DEVICES EVEN IF NOT SPECIFICALLY INDICATED TO BE REMOVED ON THESE DRAWINGS IN ORDER TO ACCOMMODATE NEW WORK.

2. DEVICES SHOWN CROSS HATCHED ON DRAWINGS ARE ITEMS TO BE REMOVED. ANY DEVICES REMOVED SHALL INCLUDE (BUT SHALL NOT BE LIMITED TO) THE REMOVAL OF ALL ASSOCIATED PIPING, CONTROLS, ETC. THAT ARE NOT INCORPORATED IN THE NEW LAYOUT, UNTIL SUCH REMOVAL IS COMPLETE. THIS CONTRACTOR SHALL PERFORM ALL WORK REQUIRED TO INSURE CONTINUITY OF SERVICE TO EXISTING REMAINING EQUIPMENT. NO EXTRAS RELATING TO THE SCOPE OF WORK DESCRIBED WILL BE ALLOWED.

3. EQUIPMENT, PIPING, ETC., REQUIRED TO RECONNECT SHALL BE INSTALLED CONCEALED WITHIN THE NEW SUSPENDED CEILINGS, PARTITIONS AND/OR WALLS, FLOORS, NO SURFACE MOUNTED OR EXPOSED EQUIPMENT, PIPING, ETC., SHALL BE PERMITTED, UNLESS SPECIFICALLY INDICATED.

4. ALL ITEMS TO BE REMOVED SHALL BE REVIEWED WITH THE OWNER PRIOR TO REMOVAL. OWNER SHALL HAVE FIRST SALVAGE RIGHTS. ITEMS THE OWNER WISHES TO KEEP SHALL BE REMOVED WITH CARE AND STORED AS DIRECTED BY OWNER. ITEMS THE OWNER DOES NOT WISH TO KEEP SHALL BE REMOVED FROM THE SITE AND DISPOSED OF PROPERLY.

	EXISTING DUCTWORK, EQUIPMENT, ETC. TO REMAIN
*********	EXISTING DUCTWORK, EQUIPMENT, ETC. TO BE REMOVED
<u> </u>	NEW DUCTWORK
	1" THERMAL ACOUSTIC LINING-DUCT SIZES ON PLANS ARE CLEAR INSIDE DIMENSIONS NEW DUCTWORK
<u> </u>	SQUARE DUCT TURN WITH TURNING VANES
	NEW 4-WAY CEILING DIFFUSER
	CEILING EXHAUST/RETURN REGISTER
***	REGISTER/DIFFUSER IDENTIFICATION TYPE -SEE SCHEDULE
-D → -R →	DUCT DROP; DUCT RISE
	DUCT MTD. MANUAL AIR VOLUME DAMPER (W/LOCKING DEVICE)
	MOTORIZED AIR VOLUME DAMPER (W/ACCESS DOOR)
	FD & AD
	FIRE DAMPER (U.L. APPROVED) & ACCESS DOOR FSD & AD
	COMBINATION FIRE/SMOKE DAMPER (U.L. APPROVED) & ACCESS DOOR EXISTING HOT WATER SUPPLY PIPING
	EXISTING HOT WATER RETURN PIPING
— EHWS —— ————	HOT WATER SUPPLY PIPING
—HWR ——	HOT WATER SUPPLY PIPING HOT WATER RETURN PIPING
— HWS ——	
<u> </u>	LIQUID REFRIGERANT PIPING
<u> </u>	SUCTION REFRIGERANT PIPING
<u> Н</u> G —	HOT GAS REFRIGERANT PIPING
— CD ——	CONDENSATE DRAIN PIPING
	FLOW DIRECTION WITHIN PIPE
×- →>-	GATE VALVE (HORIZONTAL/VERTICAL)
─ ₩	COMBINATION BALANCING & SHUT-OFF VALVE (CIRCUIT SETTER)
1	CLEAN OUT
-	PIPE CONNS. (BOTTOM; TOP 45 OR 90; PIPE UP)
EF EVICT	EXISTING EXHAUST FAN IDENTIFICATION
EXIST	
EXIST	EXISTING BOILER IDENTIFICATION
HWH	EXISTING HOT WATER HEATER IDENTIFICATION
CH	EXISTING HOT WATER CABINET HEATER IDENTIFICATION
CONV	EXISTING CONVECTOR IDENTIFICATION
EXIST	LAISTING CONVECTOR IDENTIFICATION
EXIST	EXISTING HOT WATER PUMP IDENTIFICATION
ERV *	ENERGY RECOVERY VENTILATOR IDENTIFICATION
(HP)	AIR SOURCE HEAT PUMP UNIT IDENTIFICATION
FC	FAN COIL UNIT IDENTIFICATION
FS	
<u> </u>	VRF FLOW SELECTOR UNIT IDENTIFICATION
(CH)	HOT WATER CABINET HEATER IDENTIFICATION
(UH)	HOT WATER UNIT HEATER IDENTIFICATION
EF	
·	EXHAUST FAN IDENTIFICATION
HWP *	HOT WATER PUMP IDENTIFICATION
FT.*	TYPE NEW FIN TUBE RADIATION IDENTIFICATION ELEMENT LENGTH
EBB	EXISTING ELECTRIC BASEBOARD IDENTIFICATION
EXIST	TO CONTROLLED ITEM
(T _S)	WALL MTD.(5'-2"±.A.F.F-U.O.N.) TEMPERATURE SENSOR
© ₂ —•—	TO CONTROLLED ITEM WALL MTD.(5'-2"±.A.F.F-U.O.N.) CARBON DIOXIDE SENSOR
- U →	DOOR UNDERCUT
SMRE	POWDER COATED SHEET METAL RISER ENCLOSURE
ATC	AUTOMATIC TEMPERATURE CONTROLS
CD	CEILING DIFFUSER
CR	CEILING REGISTER
TR	TOP WALL REGISTER
CFM	CUBIC FEET PER MINUTE
	OUTSIDE (FRESH) AIR INTAKE
OAI/FAI	
MD	MOTORIZED DAMPER
HVAC	HEATING, VENTILATING, AIR CONDITIONING CONTRACTOR
GC	GENERAL TRADES CONTRACTOR
FC	FLEXIBLE CONNECTION
FSC	FULL SIZE CONNECTION
AD	ACCESS DOOR
WMG	1/2" SQ. WIRE MESH GRILLE
FD	FIRE DAMPER
VIF	VERIFY IN FIELD
	SECTION/DETAIL/ELEVATION/PART PLAN NUMBER DRAWING NUMBER
_	DIAMING NOWDER

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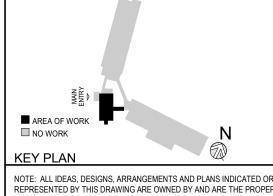


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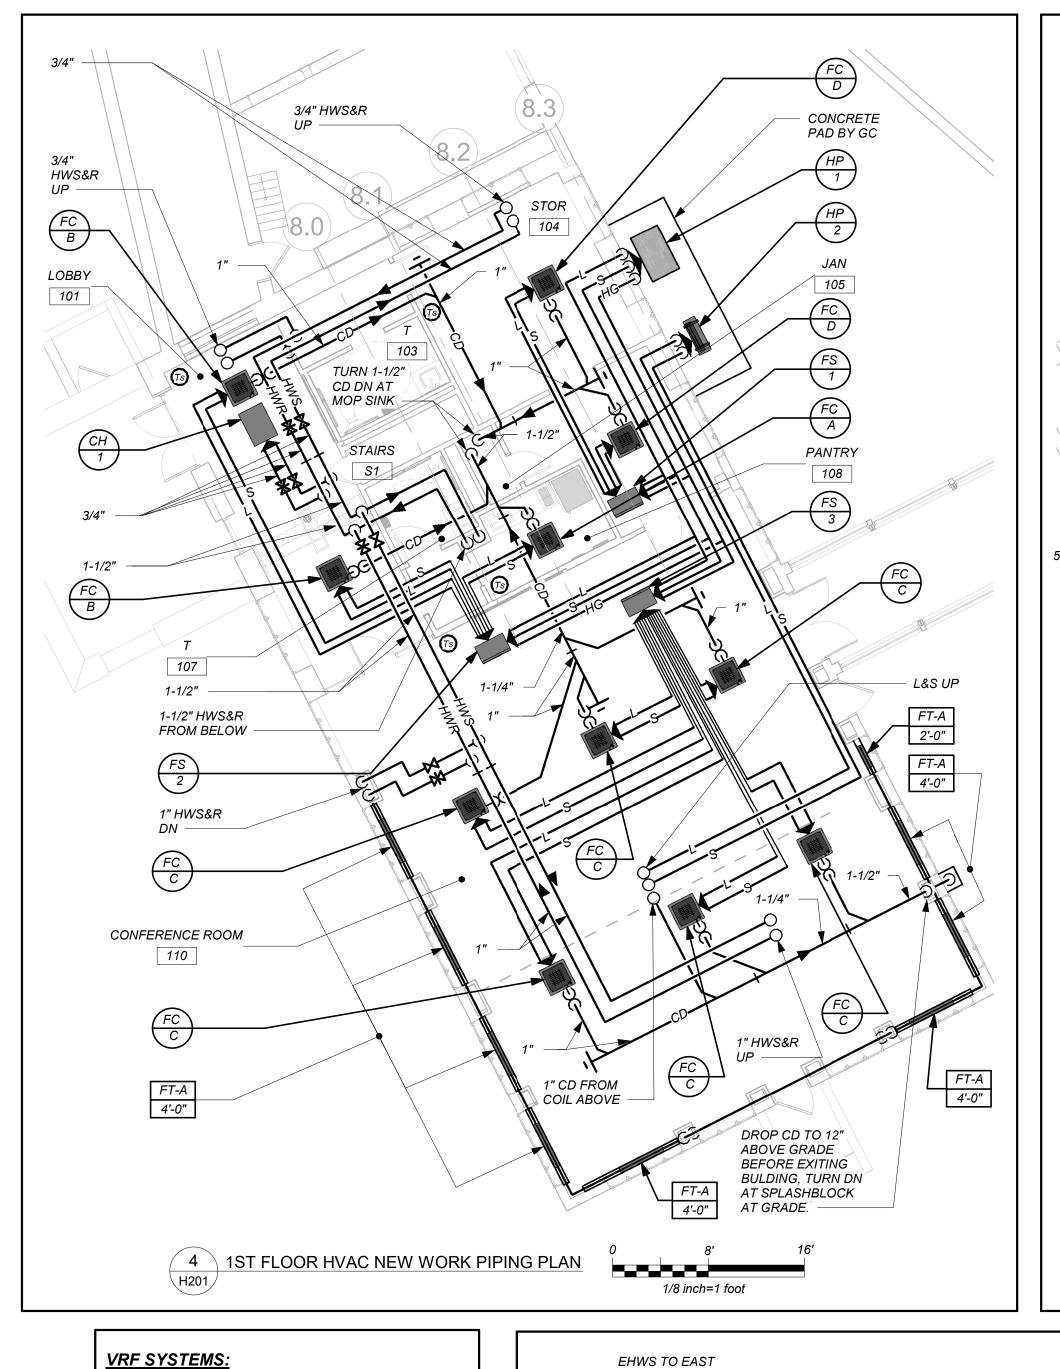
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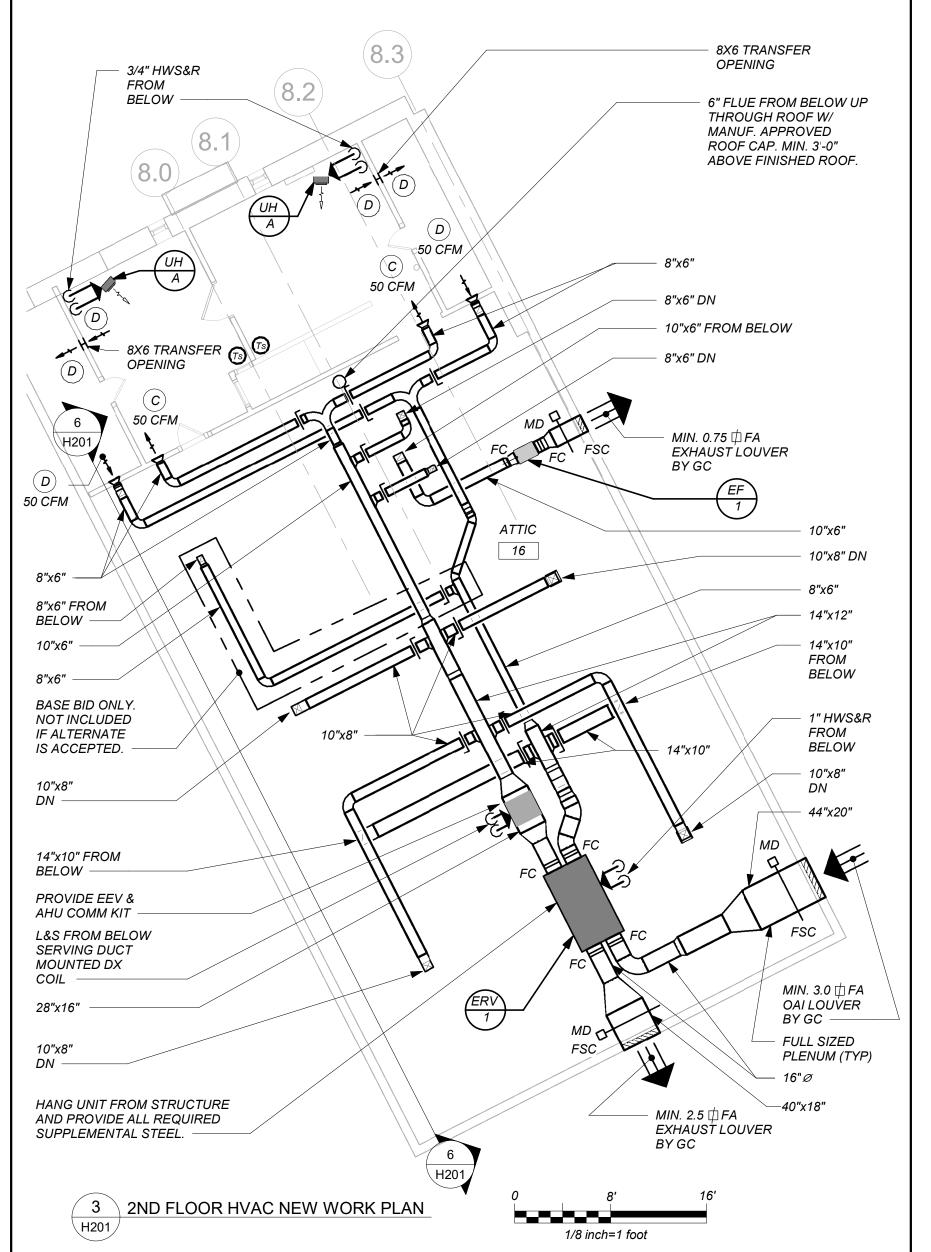
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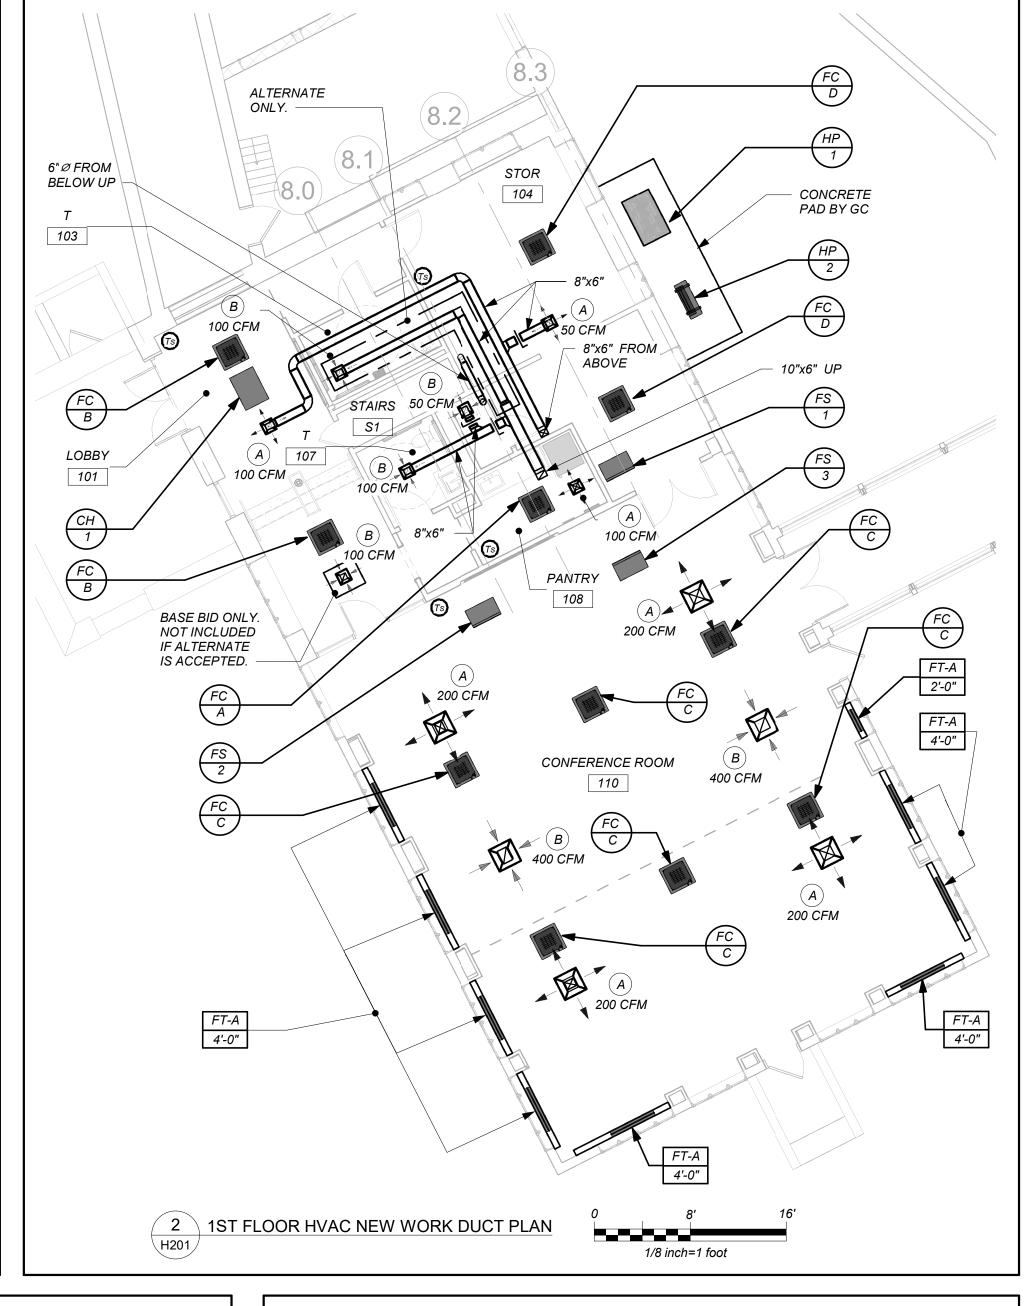
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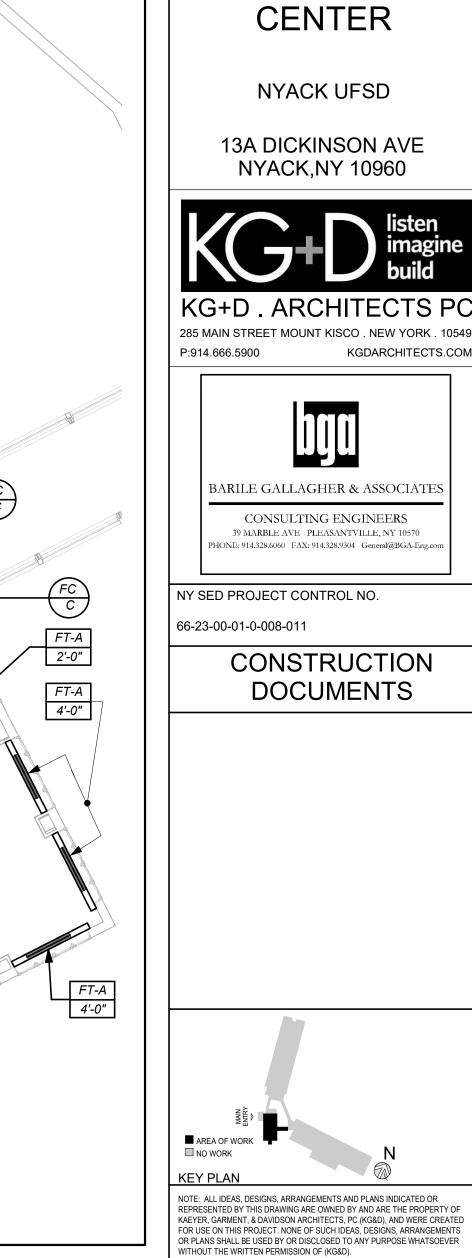
LEGEND, NOTES, & PART BASEMENT, 1ST, & 2ND FLOOR PLANS (REMOVALS)

BEFORE FABRICATION THIS CONTRACTOR SHALL VERIFY ALL MEASUREMENTS AND CONDITIONS ON JOB AND COORDINATE HIS WORK WITH THE WORK OF ALL THE OTHER CONTRACTORS










PROFESSIONAL


DEVELOPMENT


THE CONTRACTOR SHALL RETAIN THE SERVICES OF THE MANUFACTURER'S REPRESENTATIVE FOR PURPOSES OF PROVIDING REFRIGERANT PIPING SIZING. CONTRACTOR SHALL PROVIDE PIPING FROM RESPECTIVE OUTDOOR UNIT TO EACH NEW INDOOR UNIT, FOR COMPLETE AND OPERABLE SYSTEMS.

CONDENSATE PIPING:

PROVIDE CONDENSATE PIPING FOR ALL INDOOR FAN COIL EVAPORATOR UNITS AND AIR HANDLER CONDENSATE PANS.

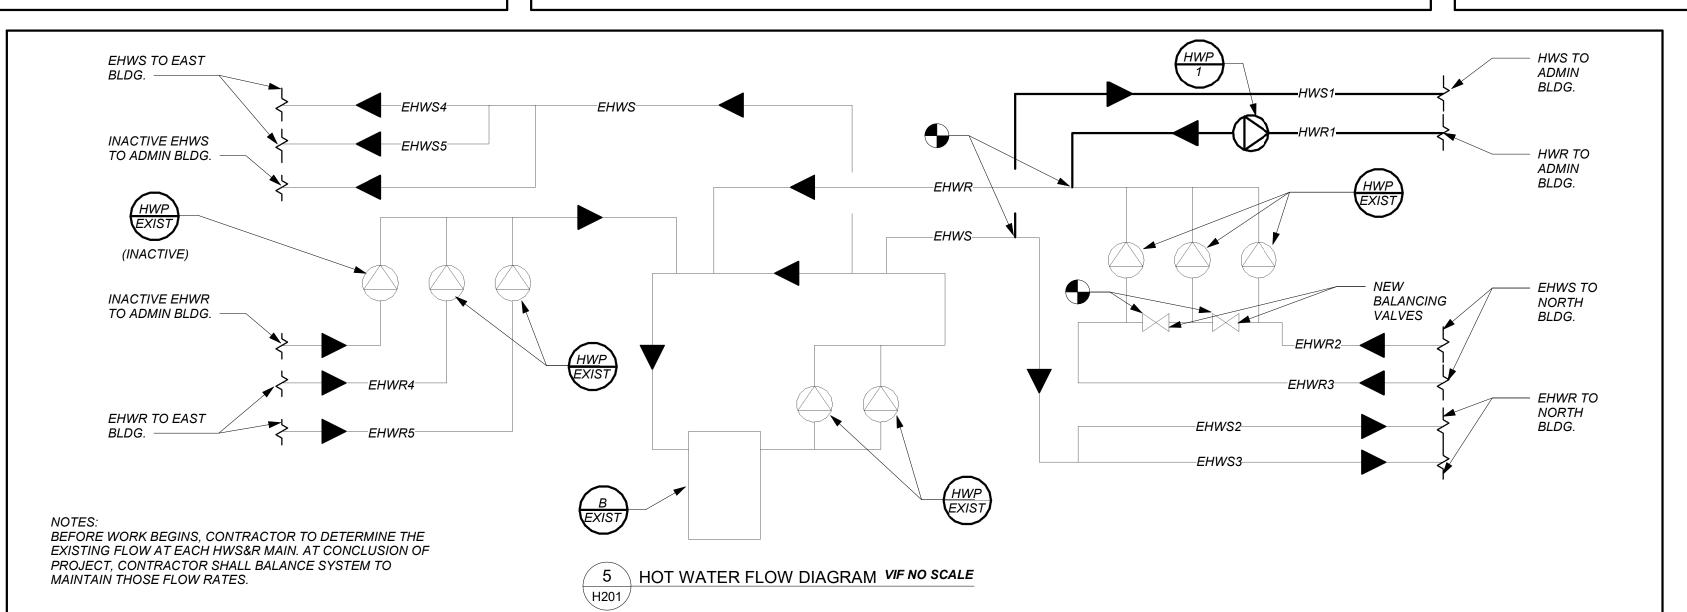

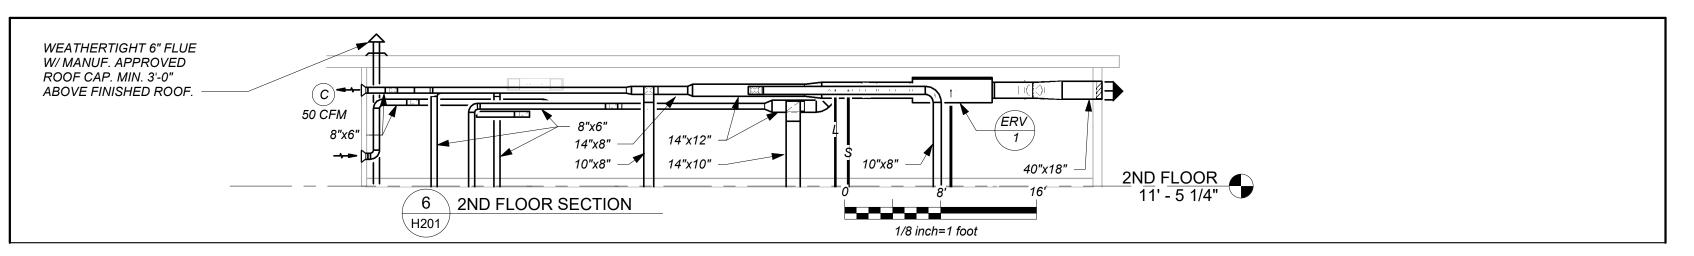

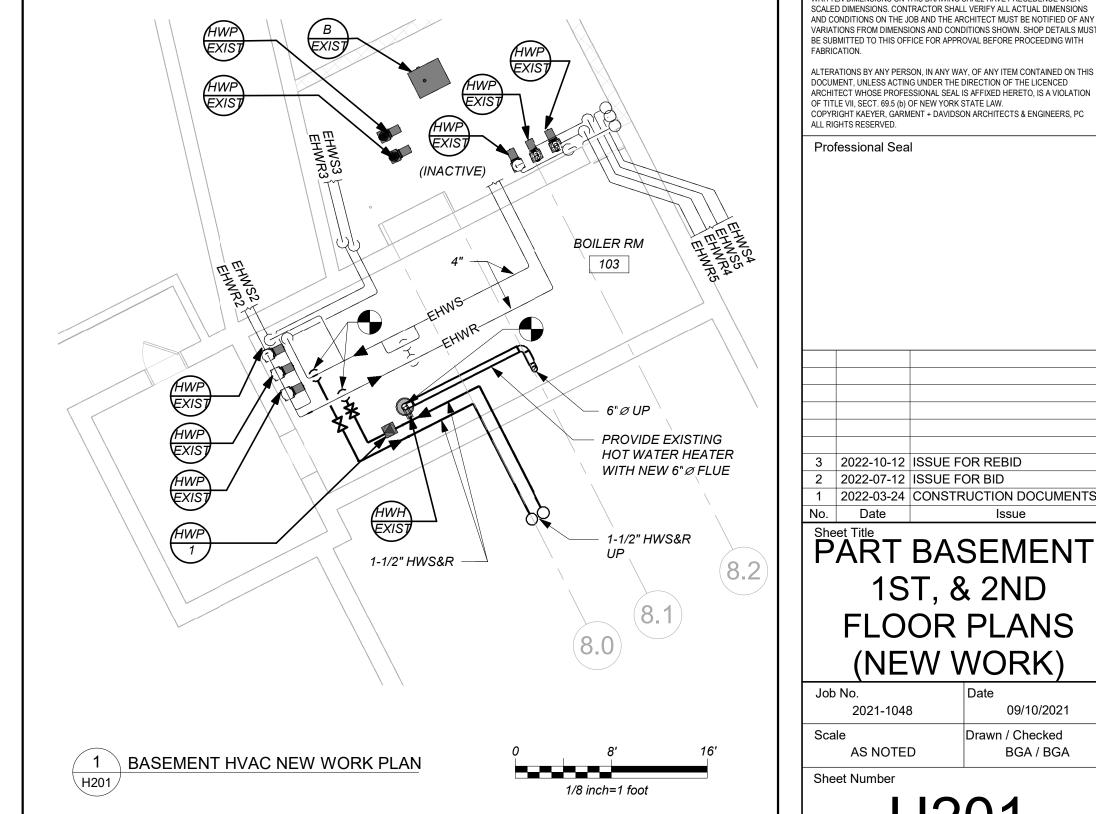



Job No. 2021-1048 Scale Drawn / Checked BGA / BGA AS NOTED Sheet Number

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BEFORE FABRICATION THIS CONTRACTOR SHALL VERIFY ALL MEASUREMENTS AND CONDITIONS ON JOB AND COORDINATE HIS WORK WITH THE

WORK OF ALL THE OTHER CONTRACTORS

COLLEDING OF ENERGY DECOVEDY VENITH ATORS

						<u> </u>	$C \cap L$		ILE C		ILKGI	\mathcal{L}	としし	JVC	\mathcal{T}	VEIV	IILAIO	バン											
GENE	RAL DAT	4	SUPPLY	FAN DATA	<i>EXHAUST</i>	FAN DATA	ELEC	CTRICAL	L DATA	HEAT EXC	CHANGER		HOT	WATE	ER CO.	/L 4			DX COIL (<u></u>		FILTER	DATA	PH	'YSICA	L DAT	TA		
MARK SERVIC	E LOCATI	ON MODEL No. ①	OUTSIDE AIR CFM	EXT. S.P. IN WG	CFM	EXT. S.P. IN WG	MCA	MOP	ELECTRICAL SERVICE	TYPE	EFFIC.	CAP. MBH	EAT (°F)	LAT (°F)	COIL FACE VELOCITY FPM	ROWS GF	M TOTAL CL BTU/F	.G. CAP. HR	ENT. AIR TEMP. CLG.	LVG. AIR TEMP. CLG.	QTY.	SIZE (IN.)	CLASS	L (in.)	W (in.)	H (in.)	WEIGHT (LBS)	REMARKS	
PROFESSI 1 DEV. CEN	ONAL ATTIC	16 FR1600HW- 208-3-CAV	1,100	1.25	950(850)	1.25	6.1	15	208/3/60	WHEEL	<i>75</i>	72.6	35	95	<i>475</i>	1	, 24,00	00	95	75	2	17X13X17	, OA MERV 13 RET. MERV 9	86	44	26	<i>575</i>	REFER TO (2)(3)(6)(7)	

N (1) AS MANUFACTURED BY "TOPVEX."

INSTALL PER MANUFACTURER'S RECOMMENDATIONS.

VALUES SHOWN IN PARENTHESIS () ARE FOR ALTERNATE ONLY.


(4) INTEGRAL HOT WATER COIL. PROVIDE FREEZE STAT.

E.W.T=180° F. L.W.T.=160° F.

(5) BASED ON A.R.I. CERTIFIED COIL SELECTIONS; REFRIGERANT R-410A.

HUNG UNIT WITH INTEGRAL HIGH CAPACITY HOT WATER COIL AND DUCT MOUNTED DX COIL. PROVIDE VIBRATION ISOLATORS EXHAUST/DEFROST CONTROLS, LOW TEMPERATURE LIMIT CONTROLS, DIFFERENTIAL ENTHALPY ECONOMIZER CONTROLS, MOTORIZED OA AND EA DAMPERS, DIRTY FILTER CONTACTS, PHASE PROTECTION, DISCONNECT SWITCH, AND CONVENIENCE OUTLET. TIE INTO BMS.

INDICATED EQUIPMENT DESIGNATIONS ARE FOR USE IN CONSTRUCTION ONLY. CONTRACTOR SHALL COORDINATE WITH OWNER ON DESIRED FINAL TAG IDENTIFICATION/NUMBERING/LETTERING. OWNER APPROVED DESIGNATIONS SHALL BE USED IN BMS PROGRAMMING AND ON PERMANENT EQUIPMENT IDENTIFICATION TAGS. AS-BUILT DRAWINGS SHALL BE UPDATED WITH FINAL IDENTIFICATION TAG DESIGNATIONS.

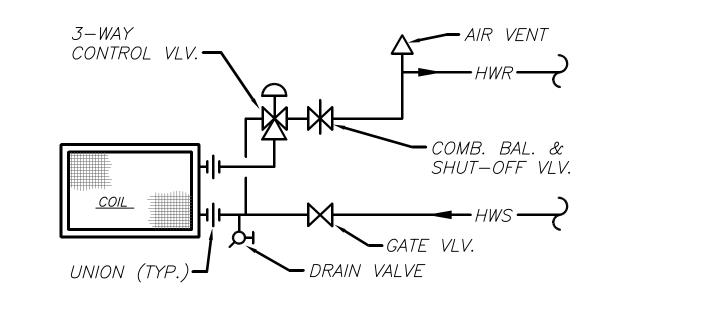

208/3/60 | 49X30X67/666

(2)(3)(4)(5)(6)

TYPICAL HOT WATER HEATING COIL PIPING CONNS.

SCHEDULE OF MINIMUM VENTILATION ROOM FLOW RATES Α OUTDOOR AIR FLOW MINIMUM **ZONE AIR** MINIMUM ROOM PEOPLE OUTDOOR AIR AREA OUTDOOR AIR FLOW RATE WITHOUT ZONE NUMBER OF **EXHAUST** DISTRIBUTION | VENTILATION AIR OCCUPANCY ROOM AREA PEOPLE DENSITY EXHAUST AIR FLOW RATE ROOM NAME/NUMBER FLOW RATE RATE IN BREATHING ZONE PEOPLE **EFFECTIVENESS** AIR FLOW **EFFECTIVENESS** CATEGORY (SQ.FT.) (#P/1000 SQ.FT.) (CFM/SQ.FT.) FLOW RATE (CFM/PERSON) (CFM/SQ.FT.) (A×B)÷1000=#P **FACTOR** RATE **FACTOR** G÷H=CFM $(F \times C) + (A \times D) = CFM$ A×E=CFM MAIN ENTRY LOBBIES 0.06 41 300 10 5 0 3 33 0.8 OCCUPIABLE STORAGE ROOMS FOR DRY 310 24 0.06 MATERIALS **KITCHENETTES** 100 7.5 0.12 0.3 Pantry/109 27 0.8 34 30 20 2 Conf/110 CONFERENCE/MEETING 1785 50 0.06 557 696 0 OCCUPIABLE STORAGE 23 Second Floor Storage **ROOMS FOR DRY** 0.06 MATERIALS CCUPIABLE STORAGE 23 0.06 Second Floor Storage ROOMS FOR DRY MATERIALS

		SCHEDU	JLE OF	REGIS	TERS AN	D DIFF	USERS	
MARK	TYPE	SERVICE	MODEL No. (1)	NOMINAL FACE SIZE	DIRECTION DISCHARGE	DAMPER TYPE	FINISH	REMARKS
A	CEILING DIFFUSER	SUPPLY	SCD	12X12/24X24	FOUR-WAY	OPPOSED BLADE	PER ARCH.	REFER TO 2345
B	CEILING REGISTER	RETURN/EXHAUST	635	8X4/24X24	_	OPPOSED BLADE	PER ARCH.	REFER TO 2346
\bigcirc	SIDE WALL REGISTER	SUPPLY	620	8X4	DOUBLE DEFLECTION	OPPOSED BLADE	PER ARCH.	REFER TO 2345
D	SIDE WALL REGISTER	RETURN/EXHAUST	635	8X4	_	OPPOSED BLADE	PER ARCH.	REFER TO 2346

AS MANUFACTURED BY "PRICE". INSTALL PER MANUFACTURERS RECOMMENDATIONS. PROVIDE CABLE OPERATED DAMPERS IN UN-ACCESSIBLE AREAS. PROVIDE MOUNTING FRAME COMPATIBLE W/ MOUNTING SURFACE. COORDINATE ALL BORDER TYPES, COLORS, FINISHES AND DIMENSIONS WITH ARCHITECT.

(N	JPPLY IOT TO	NECK S EXCEE	SIZE PEI D 700 :	R CFM I fpm)	RANGE	6	RETUI (NOT	RN NEO	CK SIZE CEED 6	- PER 675 fp.	CFM R. m)	ANGE	
50 TO 135	100 TO 245	246 TO 380	381 TO 550	551 TO 750	751 TO 860	50 TO 149	150 TO 249	250 TO 399	400 TO 599	600 TO 799	800 TO 1099	1100 TO 1199	1200 TO 2399
6"ø	8"ø	10 " ø	12 " ø	14"ø	15 " ø	6x6	8X8	10X10	12X12	14X14	16X16	18X18	24X2·

		S	CHE	DULE	OF	EX	HAUS	ST F	ANS			
MARK	SERVICE	LOCATION	TYPE	MODEL No. 🕦	CFM	EXT. S.P. IN H ₂ O	RPM	HP	ELECTRIC SERVICE	LxWxH (IN.)	WEIGHT (LBS.)	REMARKS
(EF)	TOILET ROOMS	ATTIC 16	IN-LINE	SQ-97-VG	150(250)	1.0	1819 (2075)	1/2	120/1/60	21x15x15	52	REFER TO 234

1) AS MANUFACTURED BY "GREENHECK."

(2) INSTALL PER MANUFACTURER'S RECOMMENDATIONS.

(3) VALUES SHOWN IN PARENTHESIS () ARE FOR ALTERNATE ONLY.

4 PROVIDE DISCONNECT SWITCH, BACKDRAFT DAMPER, VIBRATION ISOLATORS, SPEED CONTROL, AND NAMEPLATE

IDENTIFYING FAN MARK, MODEL NO., CFM, RPM, HP, AND ELECTRICAL SERVICE.

			SC	HEDL	JLE (OF UI	VIT H	EATERS		
MARK	MODEL No. 1	BTU/HR	CAPACIT EWT °F	Y DATA LWT °F	GPM	MOTOR WATTS	ELECTRIC SERVICE	PHYSICAL LxWxH	DATA WEIGHT (LBS)	REMARKS
UH A	HS-36	20,100	180	160	3	25	120/1/60	15"x10"x18"	40	REFER TO

(1) AS MANUFACTURED BY "STERLING".

2 INSTALL PER MANUFACTURER'S RECOMMENDATIONS

(3) PROVIDE UNIT MOUNTED MANUAL VARIABLE SPEED CONTROLLER, REMOTE WALL SENSOR, DISCONNECT SWITCH, AND MOUNTING HARDWARE.

		SCF	HEDUL	E	DF I	PUM	IPS		
MARK	SERVICE	LOCATION	MODEL Nº ①	GPM	HEAD FT.H₂O	RPM	MOTOR HP	ELECTRIC SERVICE	REMARKS
HWP	CONFERENCE BLDG	BOILER ROOM	SERIES E-90 1AAB	17	25	1800	1/2	208/1/60	REFER TO 234

(1) AS MANUFACTURED BY "BELL & GOSSETT".

o 2 INSTALL PUMPS PER MANUFACTURER'S RECOMMENDATIONS.

 $\mathbb{Z} ext{ } ext{ }$

AND STEAL BRAIDED FLEXIBLE CONNECTIONS

 ${\mathcal S}$ ${\mathcal G}$ PUMP DIMENSIONS 8" W x 12" L x 16" H / WEIGHT 55 LBS

	SCHED	ULE	OF	All	R SO	UR	CE	HEA	T PL	IMP (JN	ITS
T/ 0.1 /	MODEL	COOLING	HEATING		COMPRES.	DATA	ELE	CTRICAL	DATA	PHYSICAL [DATA	5 = 1 5
TION	Nº T	CAPACITY (MBH)	CAPACITY (MBH)	EER	TYPE	QTY	MCA	MOP	ELECTRICAL SERVICE		VEIGHT (LBS)	REMARKS
									SEAVIOL	(= ,,,, ,,, ,,, ,,, ,,, ,,, ,,,, ,,,,,,,,		

N (1) AS MANUFACTURED BY "LG."

MARK

(HP) ON GRADE

(2) INSTALL PER MANUFACTURER'S RECOMMENDATIONS.

ARUN024GSS4

E (3) REFRIGERANT USED SHALL BE R-410a.

DESIGN AIR CONDITIONS: SUMMER: OA (95°F); WINTER: OA (47°F/43°F)

(5) MOUNT ON PRECAST CONCRETE PAD BY GC. THREE PIPE SYSTEM. PROVIDE STAND, NEOPRENE VIBRATION ISOLATION PADS, EQUIPMENT SUPPORTS, DISCONNECT SWITCH, CONVENIENCE OUTLET, LOW AMBIENT CONTROLS AND PHASE PROTECTION. COMPRESSOR SPEED CONTROL BASED ON SYSTEM LOAD. (6) MOUNT ON PRECAST CONCRETE PAD BY GC. TWO PIPE SYSTEM. PROVIDE STAND, NEOPRENE VIBRATION ISOLATION PADS, EQUIPMENT SUPPORTS, CONVENIENCE

OUTLET, LOW AMBIENT CONTROLS, EEV AND AHU COMMUNICATION KIT, AND DISCONNECT SWITCH. COMPRESSOR SPEED CONTROL BASED ON SYSTEM LOAD.

(7) INDICATED EQUIPMENT DESIGNATIONS ARE FOR USE IN CONSTRUCTION ONLY. CONTRACTOR SHALL COORDINATE WITH OWNER ON DESIRED FINAL TAG IDENTIFICATION/NUMBERING/LETTERING. OWNER APPROVED DESIGNATIONS SHALL BE USED IN BMS PROGRAMMING AND ON PERMANENT EQUIPMENT IDENTIFICATION TAGS. AS-BUILT DRAWINGS SHALL BE UPDATED WITH FINAL IDENTIFICATION TAG DESIGNATIONS.

SCHEDULE OF VRF INDOOR UNITS

		MODEL	SU	<i>IPPLY</i>	FAN	DATA	TOTAL	DIM	ENSIC	ON/WL	EIGHT	
	MARK	No. (1)	CFM HIGH	MCA	МОСР	SERVICE	COOL/HEAT MBH	W (IN.)	D (IN.)	H (IN.)	LBS	REMARKS
	FC A	ARNU053TRD4	265	0.25	15	208/1/60	5.5/6.1	25	25	10	45	REFER TO 2345
	FC B	ARNU093TRD4	388				9.6/10.9	25	25	10	49	
	FC C	ARNU153TQD4	396				15.4/17.1	25	25	12	51	
	FC D	ARNU183TQD4	812				19.1/21.5	25	25	12	51	V
	FS ₁	PRHR023A	N/A	0.17			N/A	20	19	9	46	REFER TO 236
	FS 2	PRHR033A		0.17				20	19	9	50	
1	$\frac{FS}{3}$	PRHR063A	V	0.27		\	+	32	19	9	<i>75</i>	

N (1) AS MANUFACTURED BY "LG."

O (2) INSTALL PER MANUFACTURER'S RECOMMENDATIONS.

 $m{F}$ $m{\Im}$ Based on A.R.I. Certified coil selections; refrigerant R-410A.

FOUNDE FACTORY MOUNTED INTEGRAL CONDENSATE PUMP, CHECK VALVE, ANTI SWEAT SLEEVE, BALL VALVES, AND AUTO SHUTDOWN OVERFLOW SWITCH.

335 2.0 0.25 1/15

PROVIDE MOUNTING HARDWARE, VIBRATION ISOLATORS, DISCONNECT AND HARDWIRED REMOTE WALL MOUNTED CONTROLLER/THERMOSTAT. WHERE MULTIPLE UNITS TIE INTO ONE ZONE CONTROLLER PROVIDE WIRED REMOTE GROUP CONTROL CABLE ASSEMBLE PZCWRC1 AS REQUIRED. TIE INTO BMS.

(6) PROVIDE MOUNTING HARDWARE. MOUNT HORIZONTALLY.

SCHEDULE OF CABINET HEATERS REMARKS N<u>º</u> **①** RPM **SERVICE** MBH CFM GPM PD.FT.

1050

120/1/60

N (1) AS MANUFACTURED BY "STERLING".

CEILING MTD.

2 INSTALL PER MANUFACTURER'S RECOMMENDATIONS.

RC 1170 03

(3) capacities based on low speed fan setting, and 160° f a.w.t.

20.6

PROVIDE 2 ROW COIL, THROWAWAY FILTERS, INTEGRAL SPEED CONTROL, DISCONNECT SWITCH, REMOTE WALL SENSOR, GASKET AND PERMA LAP FRAME. COORDINATE FINISH AND COLOR WITH ARCHITECT.

(5) UNIT DIMENSIONS 36"x25"x9.5", WEIGHT 150 LBS.

6 PROVIDE WITH HOT WATER RETURN AQUASTAT. AQUASTAT SHALL NOT ALLOW FAN TO OPERATE AT WATER TEMPERATURE BELOW 110 DEGREES F.

PROFESSIONAL DEVELOPMENT **CENTER**

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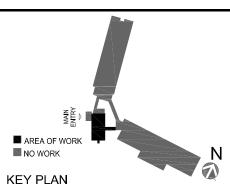
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REFER TO 23457

REFER TO 23467

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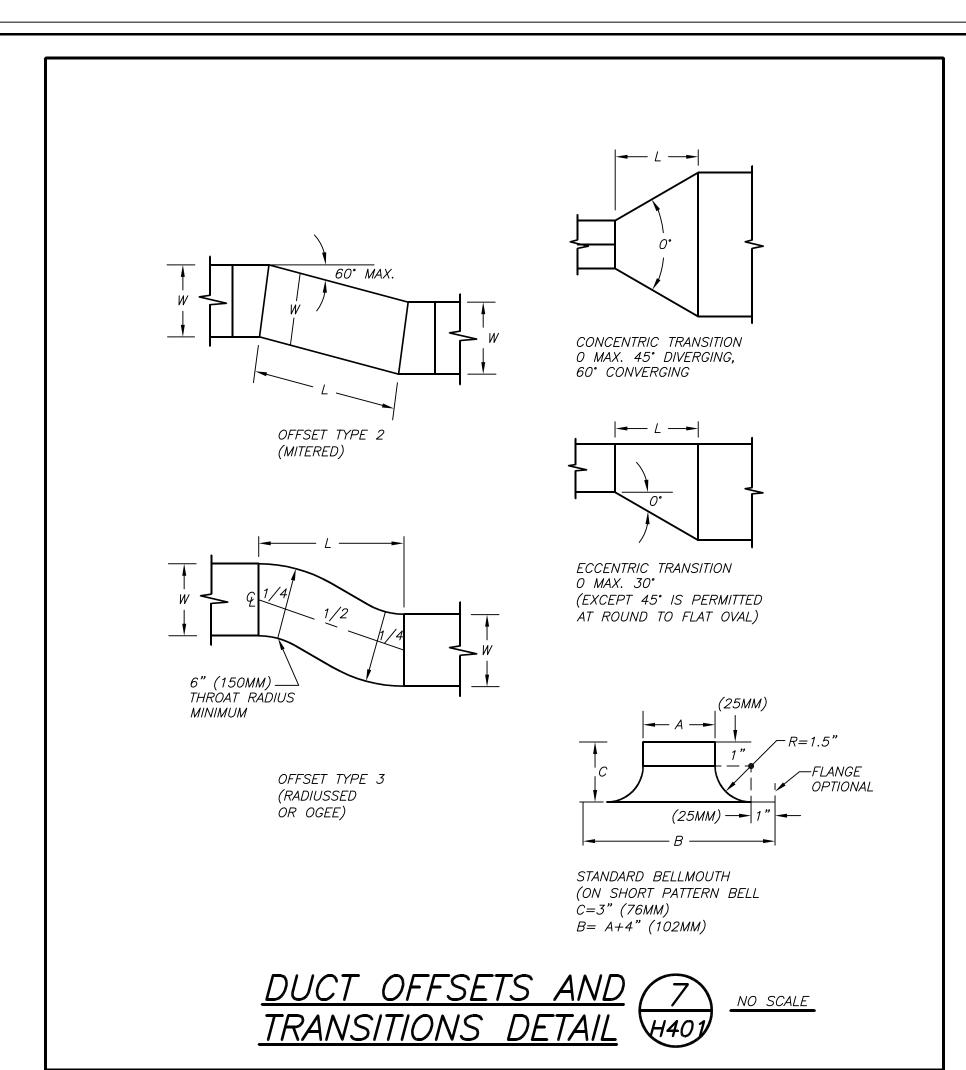
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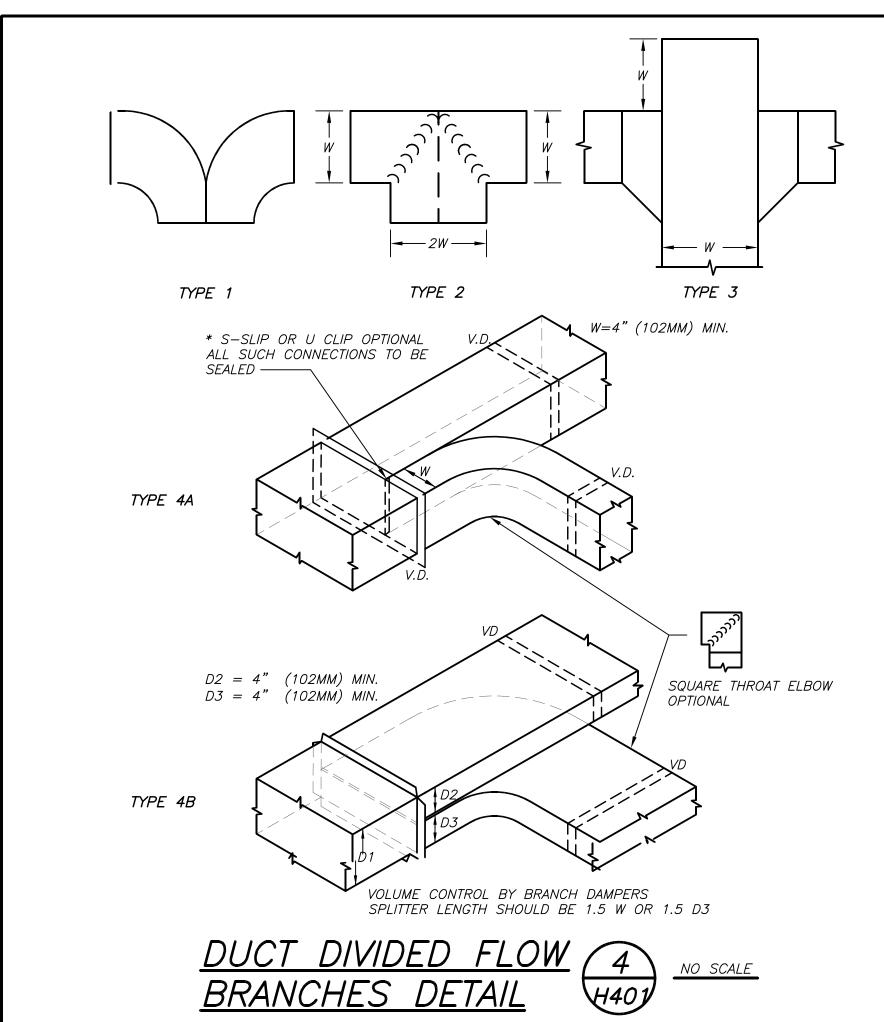
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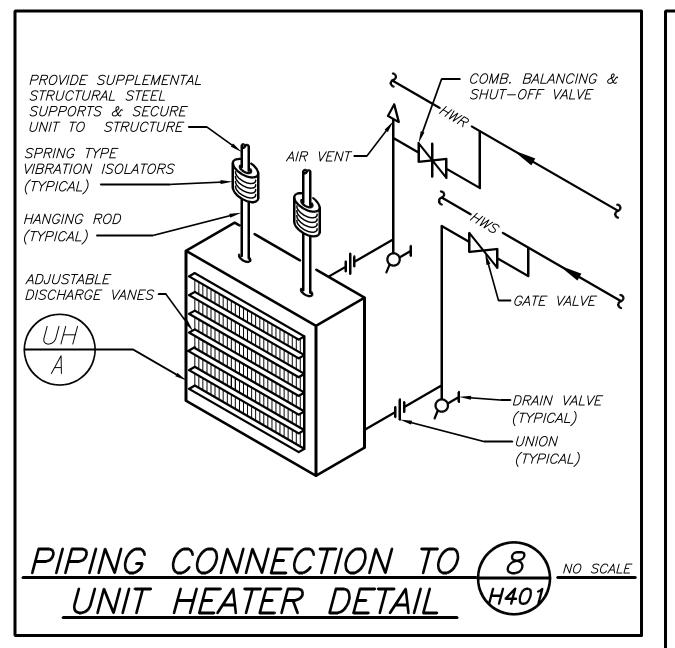
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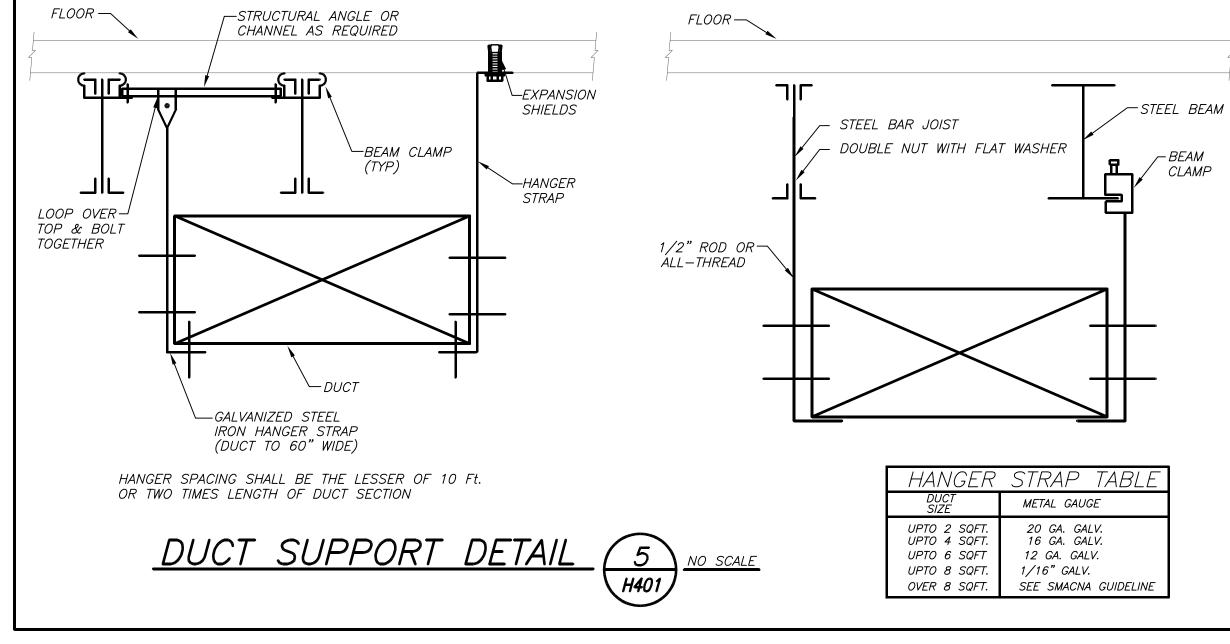
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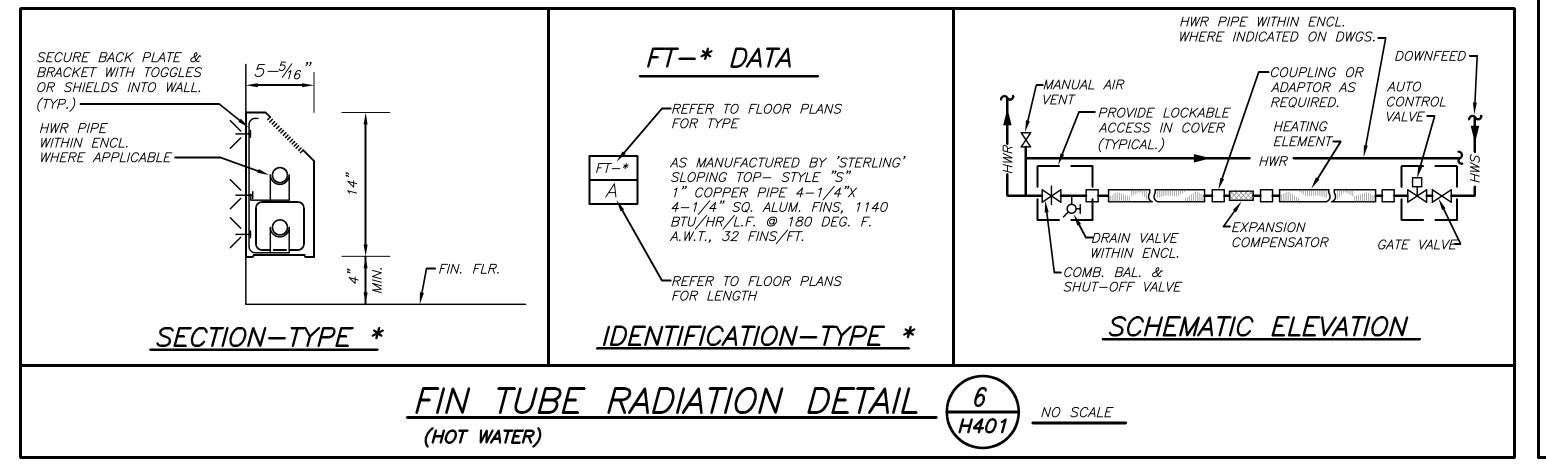
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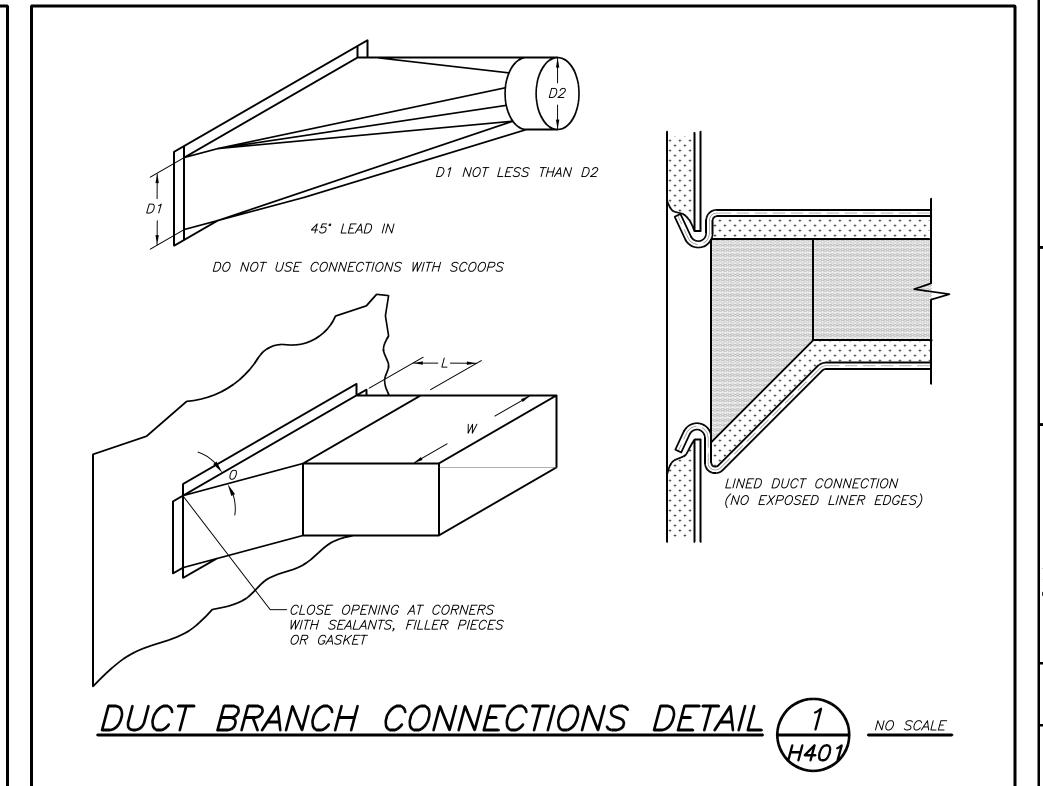














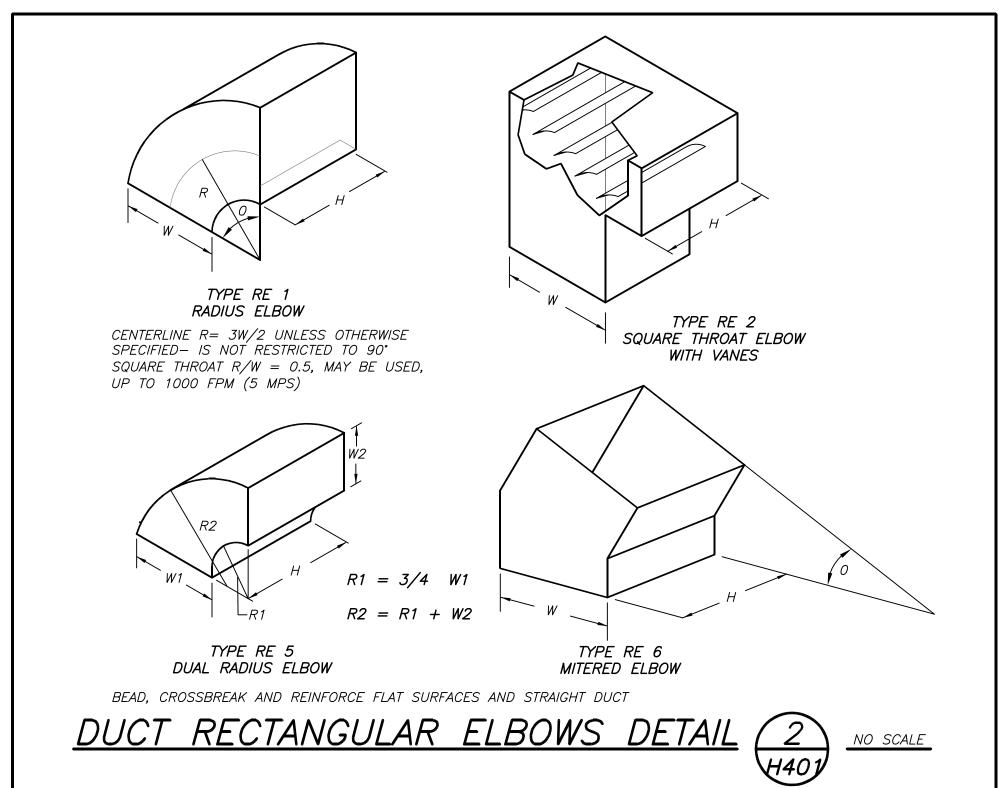

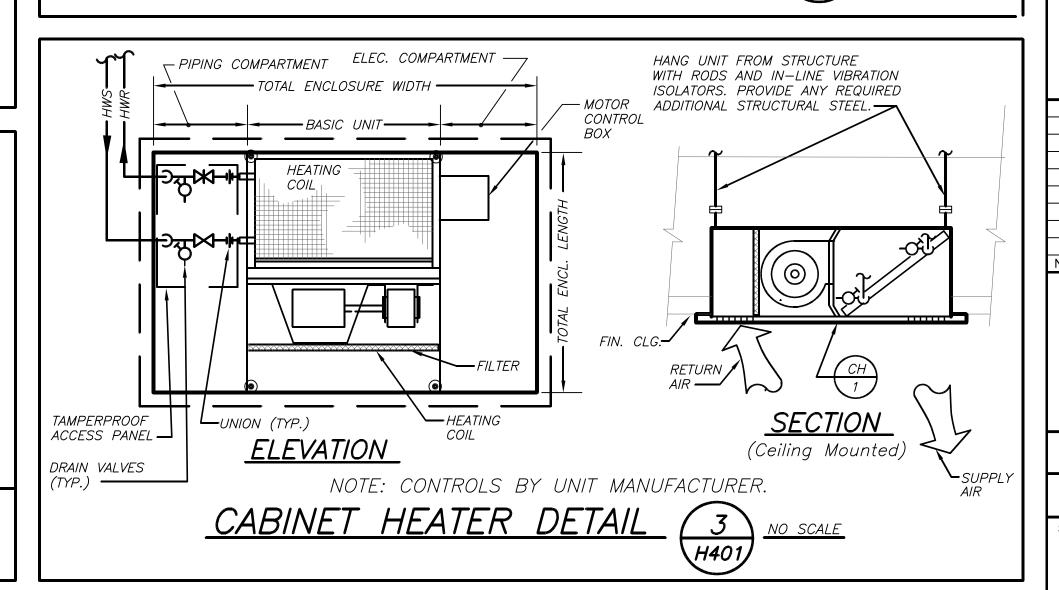



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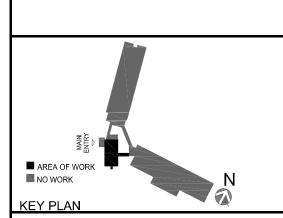
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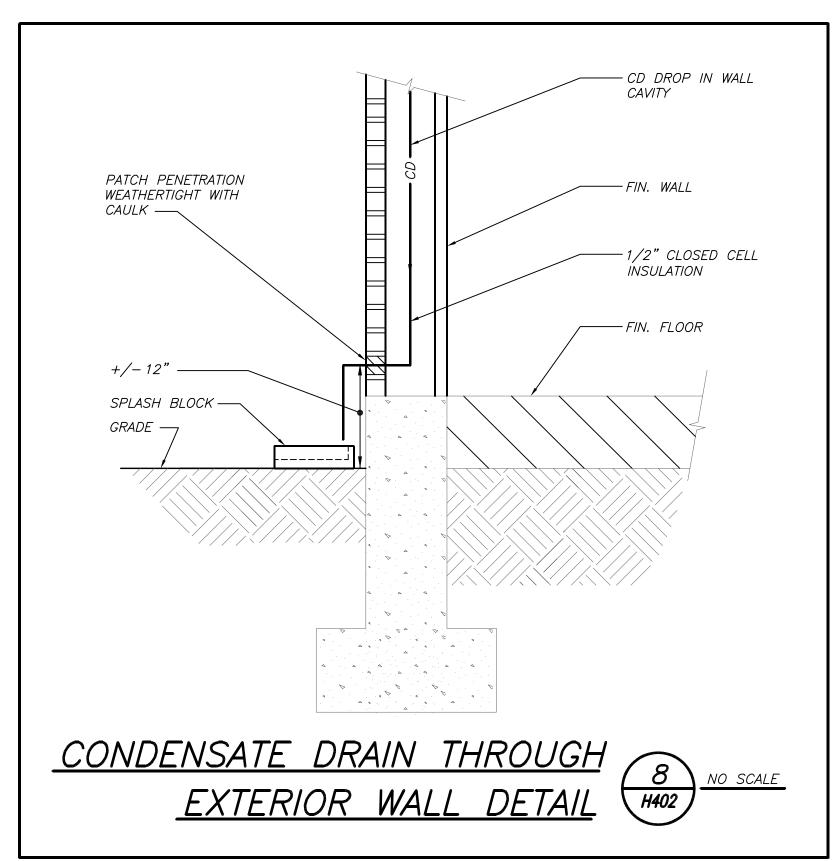
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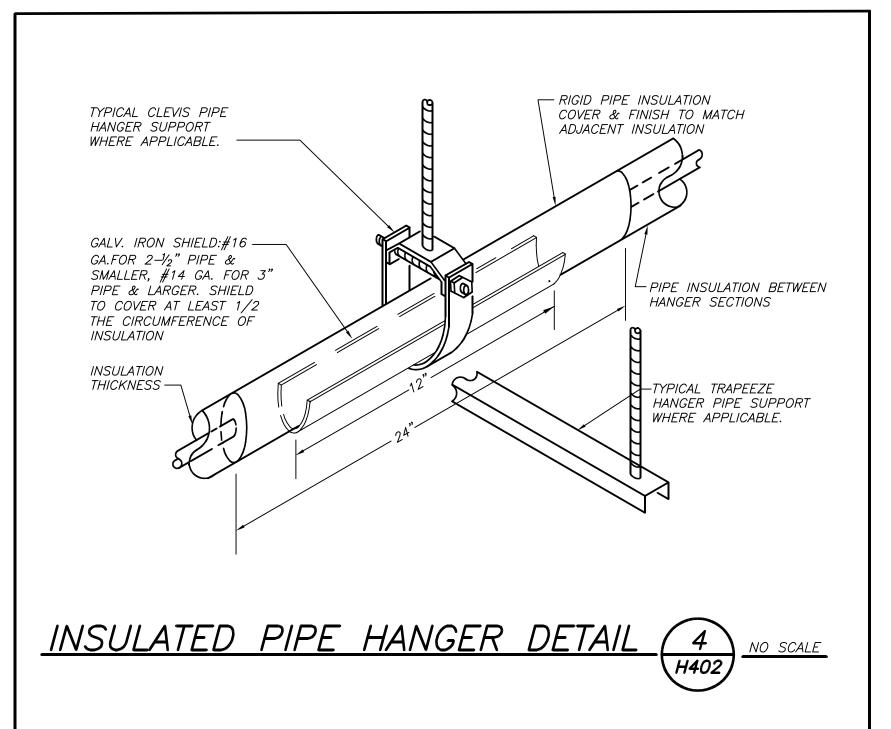
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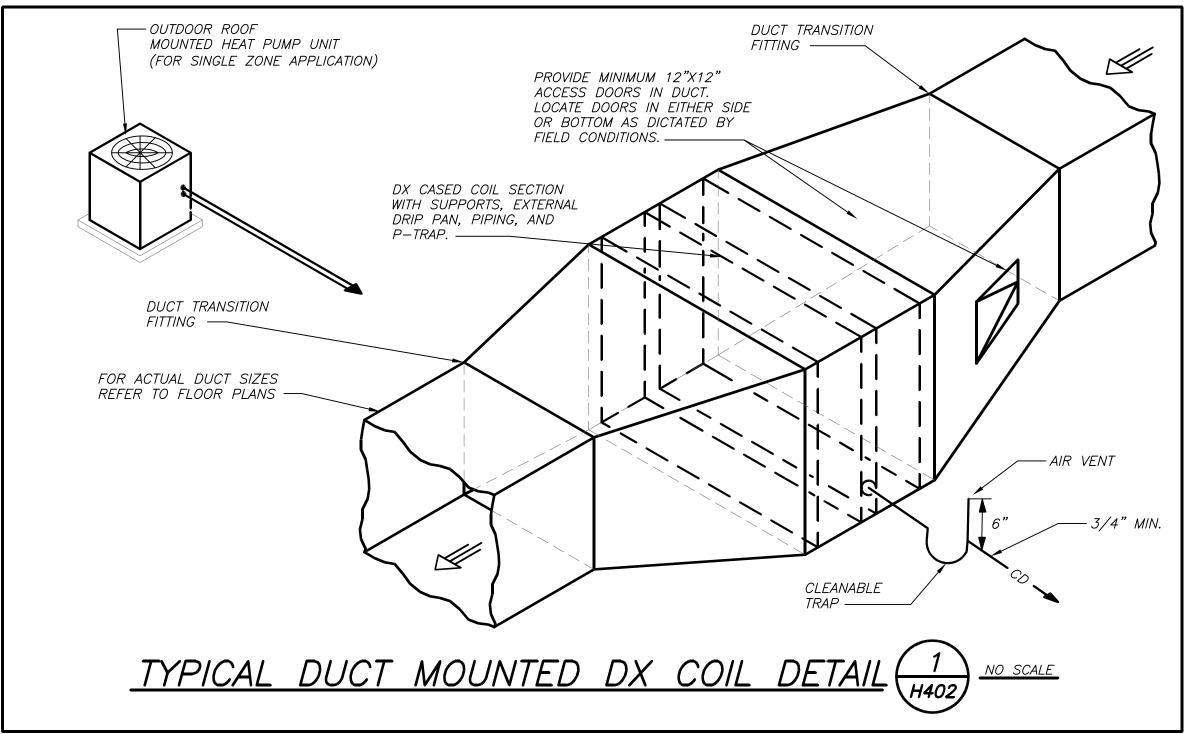
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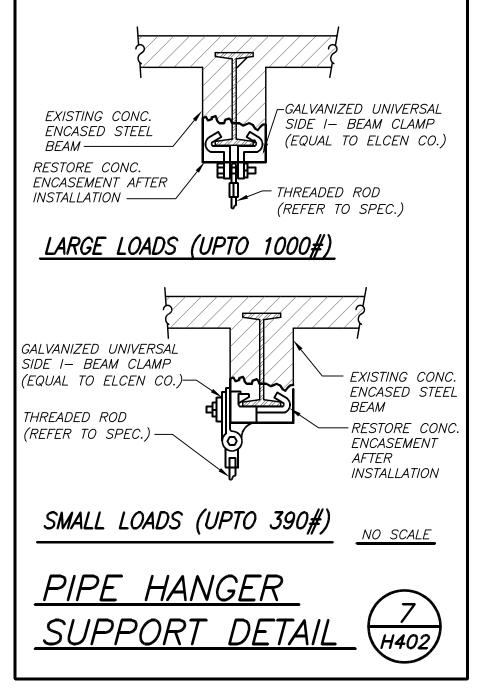
JOB AND COORDINATE HIS WORK WITH THE WORK


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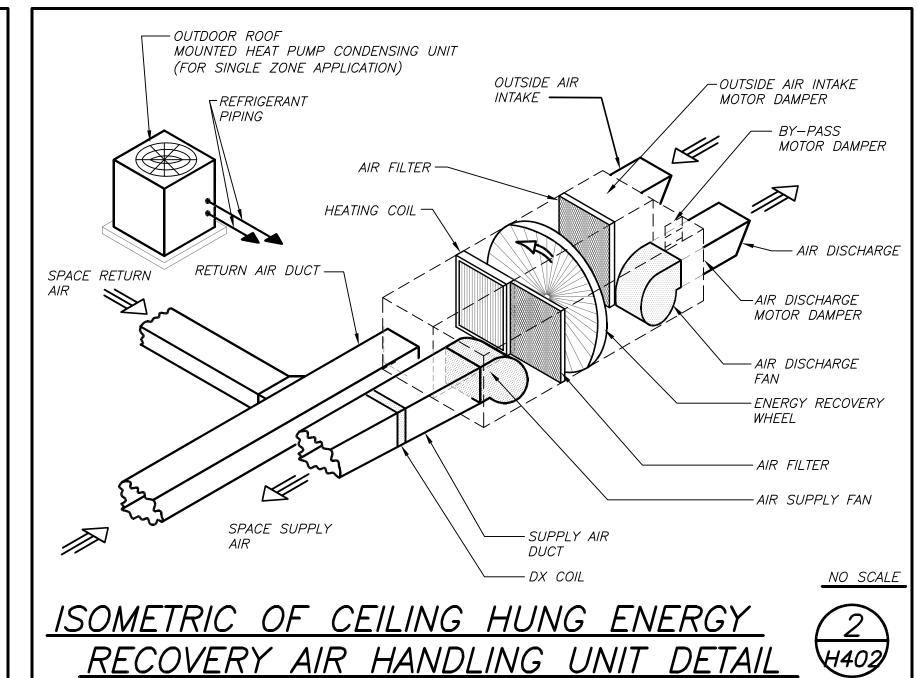












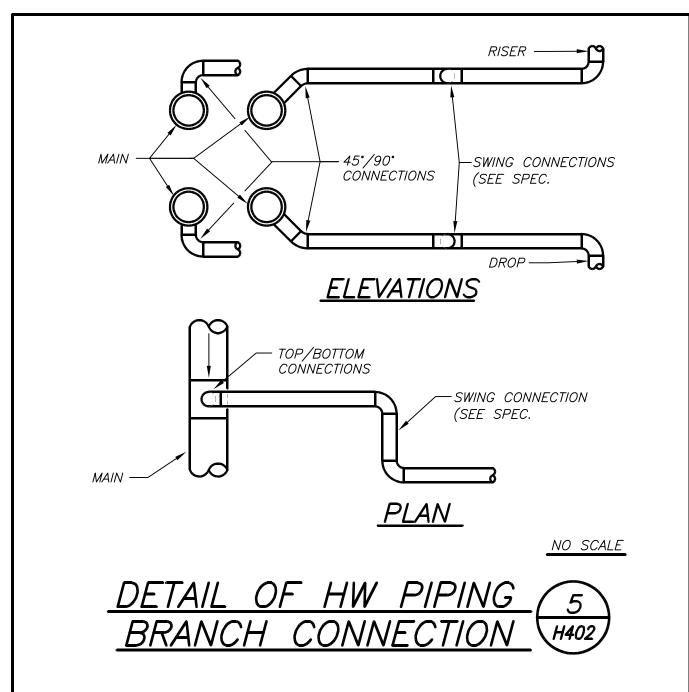

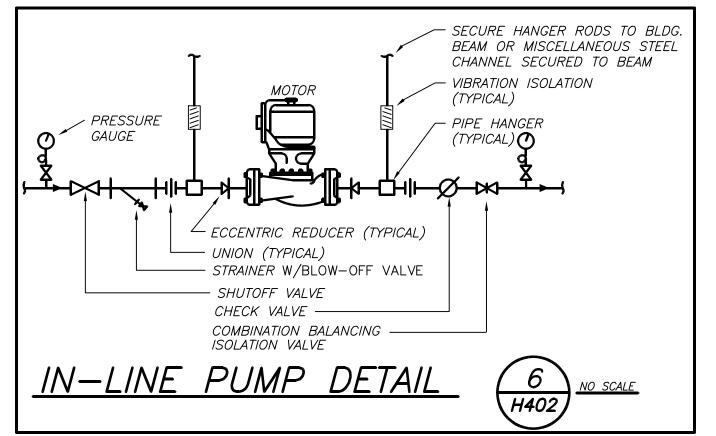

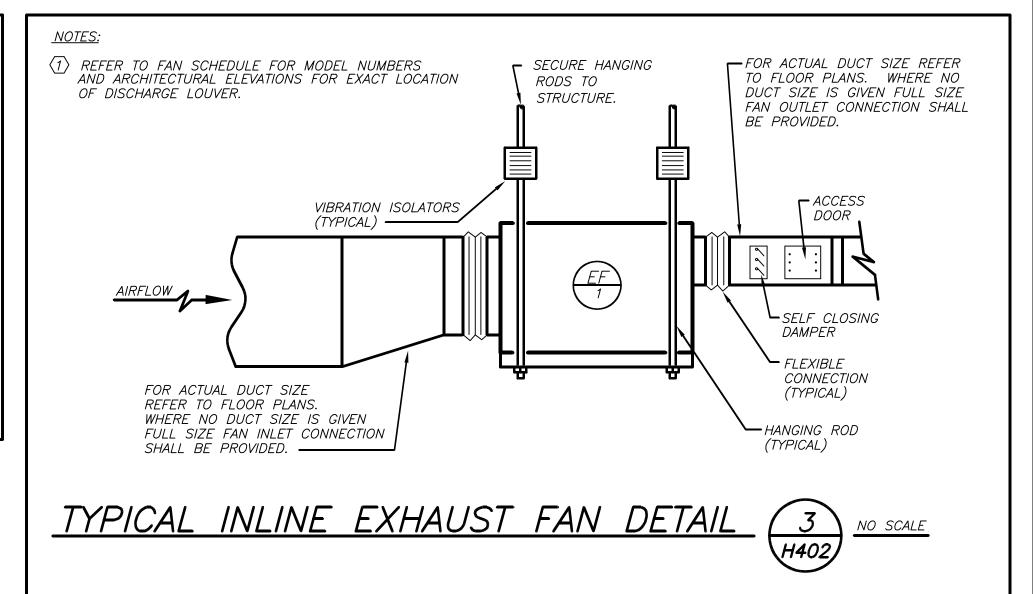



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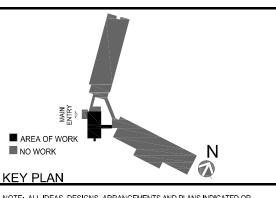
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BEFORE FABRICATION THIS CONTRACTOR SHALL VERIFY ALL MEASUREMENTS AND CONDITIONS ON JOB AND COORDINATE HIS WORK WITH THE WORK OF ALL OTHER CONTRACTORS

GENERAL NOTES

- DRAWINGS ARE DIAGRAMMATIC AND INDICATE THE GENERAL ARRANGEMENT OF SYSTEMS AND WORK. CONTRACTOR SHALL FURNISH ALL NECESSARY OUTLETS, SUPPORTS, FITTINGS AND ACCESSORIES TO FULFILL APPLICABLE CODES, REGULATIONS, BUILDING STANDARDS AND THE BEST PRACTICES OF THE TRADE FOR FIRST CLASS ELECTRICAL INSTALLATION.
- THE DRAWINGS INDICATE SIZE AND GENERAL LOCATION OF WORK. SCALED DIMENSIONS SHALL NOT BE USED. THE EXACT LOCATION AND ELEVATION OF ALL ELECTRICAL EQUIPMENT SHALL BE COORDINATED IN FIELD WITH RESPECTIVE CONTRACTOR/OWNER.
- THE CONTRACTOR SHALL COORDINATE WITH THE OWNER PRIOR TO SUBMISSION OF BID TO DETERMINE WHAT WORK MUST BE PERFORMED AFTER NORMAL BUSINESS HOURS. UNLESS OTHERWISE DIRECTED ANY NOISY WORK (CHOPPING, CORE DRILLING, HAMMERING, ETC.) AND BUILDING POWER INTERRUPTIONS SHALL BE PERFORMED OUTSIDE OF NORMAL BUSINESS HOURS. CONFIRM NORMAL BUSINESS HOURS WITH BUILDING OWNER. NO ADDITIONAL COST WILL BE CHARGEDTO OWNER FOR WORK PERFORMED OUTSIDE NORMAL BUSINESS HOURS.
- ALL WORK WHERE SHOWN WITH DARK/SOLID LINES ON THE DRAWINGS IS NEW UNLESS OTHERWISE
- 5. FEEDERS AND BRANCH CIRCUITRY SHALL BE RUN IN MINIMUM 3/4" CONDUIT UNLESS OTHERWISE NOTED. FINAL CONNECTIONS TO MOTORS MAY BE MADE WITH FLEXIBLE METALLIC CONDUIT (NO LONGER THAN 18"). IN UNFINISHED AREAS CONDUIT SHALL BE RUN EXPOSED AND IN FINISHED AREAS CONDUIT SHALL BE RUN CONCEALED.
- 6. PROVIDE PANEL NAME PLATE MADE OF BLACK LAMINATED PLASTIC WITH WHITE ENGRAVED LETTERING AND TYPE WRITTEN DIRECTORY FOR ALL NEW AND EXISTING PANELS BEING USED FOR
- 7. ALL CONDUCTORS SHALL BE COPPER, TYPE THHN/THWN INSULATED. ALL CONDUCTORS SHALL HAVE 600 VOLT RATED INSULATION UNLESS OTHERWISE NOTED.
- PROVIDE LOCK-ON CIRCUIT BREAKERS FOR CIRCUITS SERVING EXIT SIGN FIXTURES AND EMERGENCY BATTERY PACK FIXTURES.
- 9 REFER TO ARCHITECT'S REFLECTED CEILING PLAN FOR EXACT LOCATION OF ALL CEILING MOUNTED LIGHTING FIXTURES AND OTHER CEILING INSTALLED ITEMS.
- 10. THE USE OF FLEXIBLE CONDUIT FROM LIGHTING FIXTURES TO JUNCTION BOX IS PERMITTED ONLY WEN A SEPARATE GROUND WIRE IS INSTALLED WITH THE CONDUCTORS INSIDE FLEXIBLE CONDUIT. THE GROUND WIRE MUST BOND THE FIXTURE HOUSING TO THE JUNCTION BOX. MAXIMUM LENGTH 6'-0".
- 11. EXACT LOCATION AND MOUNTING HEIGHTS OF ALL DEVICES SHALL BE COORDINATED WITH THE ARCHITECT PRIOR TO THE INSTALLATION.
- 12. WALL MOUNTED EQUIPMENT (SWITCHES, RECEPTACLES, ETC..) SHALL BE SURFACE MOUNTED IN UNFINISHED AREAS AND ON EXISTING CONCRETE BLOCK WALLS AND FLUSH MOUNTED IN NEW
- 13. CONDUIT RUNS SHALL BE PARALLEL WITH OR AT RIGHT ANGLES TO WALLS AND CEILINGS. CONDUIT SHALL BE SUPPORTED BY APPROVED MEANS. SUPPORTS FOR HORIZONTAL RUNS OF CONDUIT SHALL NOT EXCEED SEVEN FEET ON CENTERS.
- 14. PROVIDE PULL BOXES, JUNCTION BOXES, CONDUIT ELBOWS AND OFFSETS TO SUIT FIELD CONDITIONS AND THE NATIONAL ELECTRICAL CODE.
- 15. ALL EMPTY CONDUIT SHALL BE PROVIDED WITH A DRAGWIRE.
- 16. THE MINIMUM WIRE SIZE FOR 120 VOLT BRANCH CIRCUITS SHALL BE NO. 12 AWG, EXCEPT OVER 100' IN LENGTH SHALL BE NO. 10 AWG.
- 17. PROVIDE ALL REQUIRED AND NECESSARY ACCESSORIES (EX. CONNECTORS, ADAPTERS. BUSHINGS, CLAMPS, ETC.) TO FACILITATE COMPLETE INSTALLATION.
- 18. THE ELECTRICAL CONTRACTOR SHALL CONFIRM THE CONFIGURATION TYPE FOR ALL SPECIAL RECEPTACLES FOR COPIERS, DATA PROCESSING EQUIPMENT. ETC. WITH OWNER AND ENGINEER PRIOR TO ORDERING.
- 19 COORDINATE LOCATION OF ALL MECHANICAL EQUIPMENT WITH HVAC CONTRACTOR IN FIELD. FUSES FOR ALL MOTOR LOADS SHALL BE DUAL ELEMENT TIME DELAY TYPE.
- 20. ALL JUNCTION OR OUTLET BOXES SHALL BE INSTALLED SO AS TO ALLOW ACCESS TO COVER. PROVIDE ARCHITECT APPROVED ACCESS DOORS OR PLATES AS REQUIRED IN AREAS WHERE UNOBSTRUCTED ACCESS TO BOX OR OUTLET IS NOT POSSIBLE.
- 21. PRIOR TO ORDERING LIGHTING FIXTURES, COORDINATE WITH ARCHITECTURAL DRAWINGS AND SPECIFICATIONS. IF DISCREPANCIES EXIST BETWEEN ARCHITECTURAL AND ENGINEERING INFORMATION OBTAIN CLARIFICATION PRIOR TO PROCEEDING.
- 22. MULTIPLE SWITCHES SHOWN IN SAME LOCATION SHALL BE GANGED TOGETHER WITH A COMMON FACEPLATE.
- 23. ALL LIGHTING FIXTURES UTILIZING ELECTRONIC BALLASTS SHALL BE PROVIDED WITH A DEDICATED NEUTRAL OR AN OVERSIZED NEUTRAL WHEN SHARED.
- 24 ALL LIGHTING FIXTURES CONTROLLED BY DIMMER SWITCHES SHALL BE PROVIDED WITH A DEDICATED NEUTRAL CONDUCTOR.
- 25. ALL EMERGENCY LIGHT FIXTURES DESIGNATED 'EM' SHALL BE SWITCHED UNLESS OTHERWISE NOTED. PROVIDE UL924 EMERGENCY RELAY TO BYPASS SWITCH UPON INTERRUPTION OF NORMAL POWER AND ILLUMINATE REGARDLESS OF SWITCH POSITION.
- 26. OPENINGS AROUND ELECTRICAL PENETRATIONS THROUGH FIRE RESISTANCE RATED WALLS. ALL SLEEVES MUST HAVE BUSHINGS. SEALANT SHALL BE 3 HOUR FIRE BARRIER #CP-25 (NO LESS THAN 3" THICK BACKED UP WITH MINERAL WOOL).
- 27. ALL PANELBOARD COVERS SHALL BE INSTALLED IN PLACE AT THE COMPLETION OF EACH DAYS WORK
- 28. PREPARE 'AS-BUILT' DRAWINGS THAT REFLECT ACTUAL CONSTRUCTION AND SHOW DEVIATIONS FROM DESIGN DRAWINGS.
- 29. LIGHT FIXTURES SHALL BE CONSTRUCTED TO SUIT PARTICULAR TYPE OF CEILING AND WALL CONSTRUCTION AND SHALL BE PROVIDED WITH APPROPRIATE TRIMS, MOUNTING FRAMES AND ADAPTERS AS REQUIRED.
- 30. CONTRACTOR IS OBLIGATED TO INSTALL THE LIGHTING SYSTEM AND CONTROLS IN OBSERVANCE OF ALL APPLICABLE LOCAL AND NATIONAL CODES IN ACCORDANCE WITH APPROVED SUBMITTALS, INCLUDING ALL NOTES AND REVISIONS.
- 31. LIGHTING CONTROL SYSTEM MANUFACTURER OR REPRESENTATIVE SHALL PROVIDE ORCHESTRATE PROJECT MANAGEMENT AND QUALIFIED STARTUP OR COMMISSIONING SERVICES TO MEET THE SPECIFICATION AND CONTROL INTENT.
- 32. CONTRACTOR SHALL BE RESPONSIBLE FOR THE PROPER INSTALLATION, WIRING, PLACEMENT. AND ADJUSTMENT OF ALL SENSORS AS PER MANUFACTURER'S SPECIFICATIONS, ENGINEER'S DESIGN INTENT, AND APPROVED SUBMITTALS.

GENERAL REMOVAL NOTES

- 1. BEFORE COMMENCING WORK, EXAMINE ALL ADJOINING AREAS THAT MAY BE AFFECTED BY REMOVAL. REPORT TO THE GENERAL CONTRACTOR ANY CONDITION THAT PREVENTS PERFORMANCE OF THE WORK.
- 2. BECOME THOROUGHLY FAMILIAR WITH EXISTING CONDITIONS WHERE CONNECTIONS MUST BE MADE, CHANGED OR ALTERED. THE INTENT OF THE WORK IS SHOWN ON THE DRAWINGS AND DESCRIBED HEREINAFTER AND NO CONSIDERATION WILL BE GRANTED BY REASON OF LACK OF
- 3. FAMILIARITY ON THE PART OF THE CONTRACTOR WITH ACTUAL PHYSICAL CONDITIONS AT THE SITE. INSPECT EACH AND EVERY AREA AFFECTED BY THE ALTERATION OF THE SPACE BEFORE SUBMITTAL OF BID.
- 4. ALL ELECTRICAL EQUIPMENT IN THE AREA OF WORK IS EXISTING TO BE REMOVED UNLESS OTHERWISE NOTED. THIS SHALL INCLUDE BUT NOT BE
- A. LIGHTING FIXTURES AND SWITCHES.

LIMITED TO THE FOLLOWING:

- B. CIRCUIT BREAKERS AND DISCONNECT SWITCHES. C. RECEPTACLES, OUTLETS AND DEVICES.
- 5. ALL CONDUCTORS AND CONDUIT ASSOCIATED WITH REMOVED ELECTRICAL EQUIPMENT SHALL BE REMOVED COMPLETELY BACK TO ITS SOURCE OF POWER AND DISCONNECTED.
- 6. ALL POWER CONDUCTORS, CONTROL WIRING AND CONDUIT ASSOCIATED WITH MECHANICAL EQUIPMENT SUCH AS FANS, AIR CONDITIONING UNITS, PUMPS. ETC. DESIGNATED FOR REMOVAL ON THE HVAC AND PLUMBING REMOVAL DRAWINGS SHALL BE REMOVED CLEAR BACK TO THE SOURCE OF POWER AND DISCONNECTED. ALL MOTOR STARTERS, DISCONNECT SWITCHES. CONTROL DEVICES, ETC. SHALL BE REMOVED. REFER TO MECHANICAL AND PLUMBING DRAWINGS FOR ADDITIONAL INFORMATION.
- CIRCUIT BREAKERS AND/OR SWITCHES IN PANELBOARD(S) OR DISTRIBUTION BOARD(S) MADE SPARE DUE TO REMOVAL SHALL BE DESIGNATED AS SUCH ON THE PANEL SCHEDULE.
- 8. THE ELECTRICAL CONTRACTOR SHALL BE RESPONSIBLE TO TRACE AND RELOCATE ALL EXISTING FEEDERS AND BRANCH CIRCUIT WIRING WHICH PASSES THROUGH THE REMOVAL AREA THAT SERVE EXISTING OCCUPIED SPACES TO REMAIN. COORDINATE WITH BUILDING MANAGER PRIOR TO ANY SHUTDOWNS OR DISRUPTIONS THAT MAY BE REQUIRED TO ACCOMPLISH THIS WORK.
- 9. DISPOSE OF ALL REMOVED EQUIPMENT, WHICH IS NOT INTENDED TO BE REUSED. PRIOR TO DISPOSAL, CONTACT BUILDING MANAGER TO DETERMINE IF ANY REMOVED EQUIPMENT IS DESIRED FOR STOCK.
- 10. EXISTING CIRCUIT BREAKERS IN PANEL(S) ARE TO BE RE-USED. ELECTRICAL CONTRACTOR TO DISCONNECT PANEL AND CIRCUIT BREAKERS WITH GREAT CARE TO ENSURE AGAINST DAMAGE. THIS CONTRACTOR SHALL PROVIDE NEW CIRCUIT BREAKERS AS REQUIRED. ALL NEW CIRCUIT BREAKERS INSTALLED INTO EXISTING PANELBOARDS SHALL BE UL LISTED FOR USE IN THE PANEL.
- 11. ALL FIRE ALARM DEVICES IN THE AREA OF WORK ARE EXISTING TO BE REMOVED UNLESS OTHERWISE NOTED.
- 12. EXISTING EQUIPMENT DESIGNATED FOR REUSE SHALL BE CLEANED, REFURBISHED AND RESTORED TO OPTIMUM PERFORMANCE. THIS SHALL INCLUDE BUT NOT LIMITED TO CLEANING OF LIGHT FIXTURES, REPLACEMENT OF INOPERABLE BALLASTS AND LAMPS, RESISTANCE TESTING OF BRANCH CIRCUITRY AND FEEDERS, ETC.
- 13. EXTEND EXISTING CIRCUITRY TO THOSE DEVICES THAT ARE TO BE RELOCATED. MATCH EXISTING TYPE AND SIZE. RELOCATION OF EXISTING EQUIPMENT SHALL BE PERFORMED ONLY UPON OWNERS ACCEPTANCE OF EXISTING EQUIPMENT.
- 14. EXTEND EXISTING CIRCUITS SERVING EQUIPMENT TO REMAIN FROM PANELS THAT ARE TO BE REMOVED TO NEW PANELS OR EXISTING PANELS THAT ARE TO REMAIN.

DISPOSAL OF MERCURY CONTAINING LAMPS

1. ALL FLUORESCENT AND HID LAMPS WITHIN REMOVED LIGHT FIXTURES ARE CONSIDERED MERCURY CONTAINING AND SHALL BE TREATED AS HAZARDOUS

2. FLUORESCENT AND HID LAMPS SHALL BE REMOVED FROM DEMOLISHED LIGHT

- FIXTURES AND DISPOSED OF AS PER NEW YORK STATE DEC REGULATIONS
- 3. LAMPS MUST BE BAGGED IN NON-LEACHING PLASTIC BAGS AND SEALED TO PREVENT LEAKING.
- 4. EACH LAMP OR BAGGED CONTAINER IN WHICH THESE LAMPS ARE CONTAINED MUST BE LABELED OR MARKED CLEARLY WITH ONE OF THE FOLLOWING PHRASES: UNIVERSAL WASTE LAMPS, OR WASTE LAMPS, OR USED
- 5. THESE MARKED BAGS MUST BE DELIVERED TO THE PROPER NEW YORK

STATE D.E.C. AUTHORIZED LANDFILL OR RECYCLE CENTERS.

ABBREVIATIONS DESCRIPTION AMP/AMPERE ABOVE FINISHED FLOOR AMP INTERRUPTING CURRENT AMERICAN WIRE GAUGE CH CABINET HEATER **EMERGENCY ELECTRICAL CONTRACTOR** EXHAUST FAN F.A.C.P. FIRE ALARM CONTROL PANEL G,GRDGROUND GFI **GROUND FAULT INTERRUPTER** THOUSAND CIRCULAR MILLS kcmil KILOVOLT AMPERE KILOWATT LIGHTING MAIN CIRCUIT BREAKER MAIN DISTRIBUTION PANEL MAIN LUGS ONLY MTDMOUNTED NTS NOT TO SCALE P.A. **PUBLIC ADDRESS** TYP. TYPICAL UNIT HEATER UNLESS OTHERWISE NOTED UNIT VENTILATOR

WATT

WEATHERPROOF

	LLGLND
A a	2'x4' LED CEILING MOUNTED LIGHT FIXTURE. UPPER CASE LETTER DENOTES TYPE DENOTES SWITCH CONTROL. FIXTURE SCHEDULE DENOTES TYPE.
AEM a	2'x4' CEILING MOUNTED LED LIGHT FIXTURE FOR EMERGENCY OPERATION. 'EM' INDICATES SWITCHED EMERGENCY FIXTURE, 'EM/NL'-UNSWITCHED EMERGENCY/
\otimes/Φ	CEILING/WALL MOUNTED EXIT LIGHT WITH OUTLET BOX, DIRECTIONAL ARROWS S INDICATES ILLUMINATED FACE. SCHEDULE DENOTES TYPE.
VS	WALL MOUNTED VACANCY SENSOR SIMILAR TO HUBBELL LIGHTHAWK MODEL #L
OS	NETWORK DIGITAL CEILING MOUNTED DUAL TECHNOLOGY OCCUPANCY SENSOR, WATTSTOPPER MODEL LMDC-100 WORKS WITH DIGITAL ROOM CONTROLLER. PR
RC	NETWORK DIGITAL DIMMABLE ROOM CONTROLLER FOR LIGHTING CONTROL. SIMI MODEL LMRC-213. HOT WIRE TO LOAD, CAT 5 WIRE CONNECTION TO CONTROL TH DENOTES LMRC-21# WITH '#' OF ZONES
WD2	NETWORK DIGITAL FLUSH MOUNTED PRESET 3-ZONE DIMMABLE WALL STATION.S WATTSTOPPER MODEL LMSW-104, WORKS WITH DIGITAL ROOM CONTROLLER. INCENGRAVING AND PROGRAMMING PER ZONE. A,B, RAISE, LOWER. SUPERSCRIPT 'S SWITCH.
3 WD3	NETWORK DIGITAL FLUSH MOUNTED PRESET 3-ZONE DIMMABLE WALL STATION.S WATTSTOPPER MODEL LMSW-105, WORKS WITH DIGITAL ROOM CONTROLLER. INCENGRAVING AND PROGRAMMING PER ZONE. A,B,C, ON/ RAISE, OFF/LOWER. SUPE 3 WAY SWITCH.
3	HOMERUN TO DESIGNATED PANEL, ARROWHEAD INDICATES SINGLE POLE CIRCUIC CONSIST OF 2#12-3/4"C U.O.N.
2,4,6	HOMERUN TO DESIGNATED PANEL, NUMBERS INDICATE MULTIPLE CIRCUIT, I.E. 3- U.O.N.
\bigcirc	125V-2P-3W-20A GROUNDED TYPE, SPECIFICATION GRADE TAMPER RESISTANCE I RECEPTACLE SIMILAR TO HUBBELL #5362WTR
O	20A FLUSH WALL MOUNTED GROUND FAULT INTERRUPTING TYPE DUPLEX RECEP #GF5362.
•	CEILING MOUNTED 125V-2P-3W-20A GROUNDED TYPE RECEPTACLE . PROVIDE BR AREAS MOUNTED ON CEILING TILE.
WB	RECESSED WALL BOX 2-GANG ENCLOSURE SIMILAR TO HUBBLE# FPTV . FOR POI 125V-2P-3W-20A GROUNDED TYPE SPECIFICATION GRADE RECEPTACLE SIMILAR TO FOR DATA PROVIDE 1-1/4" EMPTY CONDUIT WITH DRAG LINE STUBBED UP 6" ABOVE CEILING.
$\overline{}$	FLUSH WALL MOUNTED DATA OUTLET CONSISTING OF A COVER PLATE WITH 1" GI AND 1-1/4" EMPTY CONDUIT WITH DRAG LINE STUBBED UP 6" ABOVE FINISHED CE

CEILING MOUNTED IONIZATION TYPE SMOKE DETECTOR

TAG SYMBOL. NUMERAL DENOTES REFERENCE TO A WORK NOTE.

WALL MOUNTED FIRE ALARM STROBE LIGHT.

MECHANICAL EQUIPMENT IDENTIFICATION:

DETAIL/PART PLAN NUMBER


DETAIL/PART PLAN NUMBER IDENTIFICATION:


EQUIPMENT NUMBER

DRAWING NUMBER

FACP FIRE ALARM CONTROL PANEL.

* -

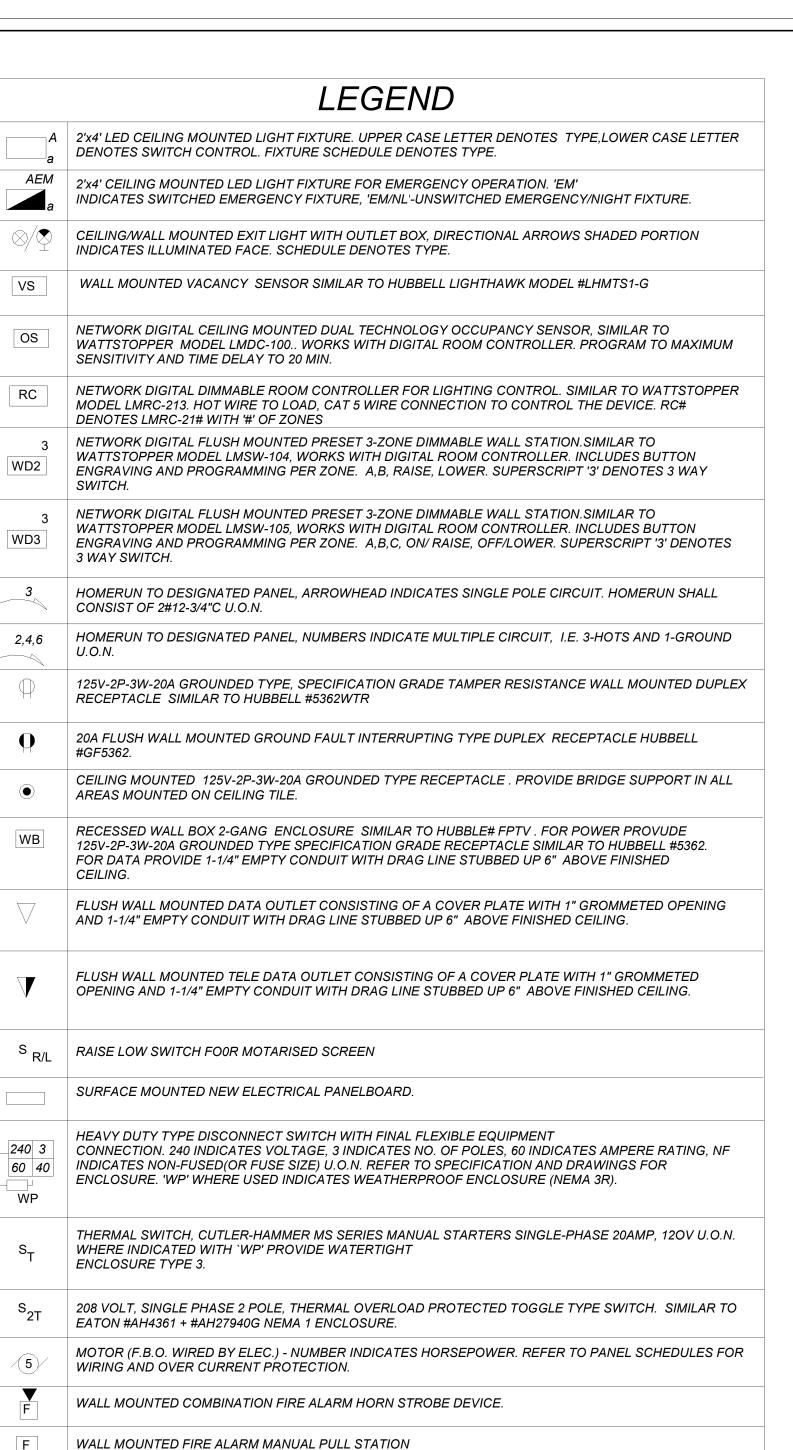

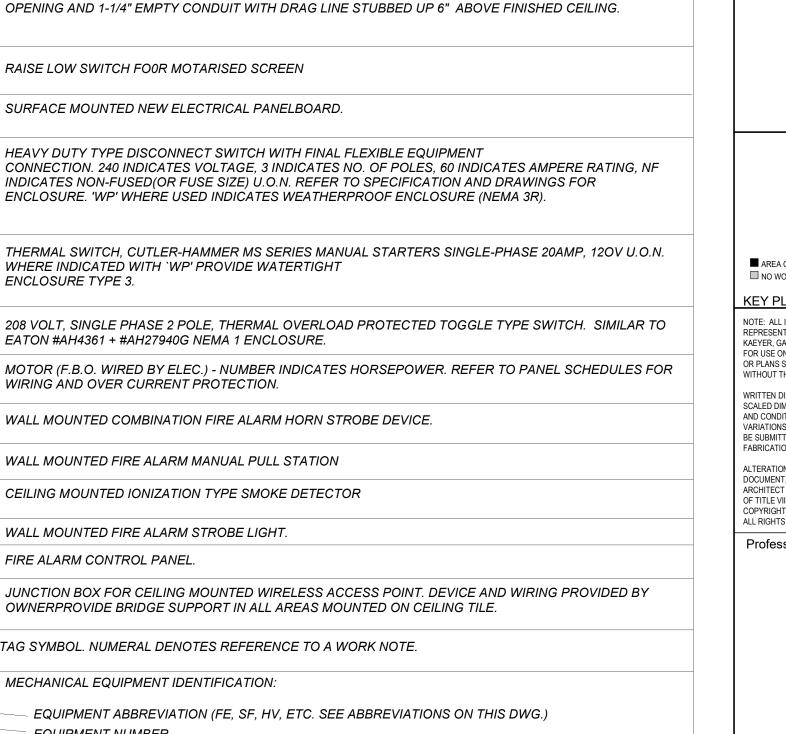

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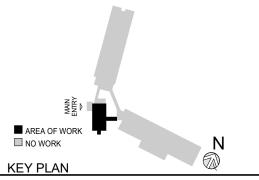
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NOTES **ABBREVIATIONS** AND LEGENDS

2021-1048 09/10/2021 Scale Drawn / Checked AS NOTED **Author Checker**

Sheet Number

BEFORE FABRICATION THIS CONTRACTOR SHALL VERIFY ALL MEASUREMENTS AND CONDITIONS ON JOB AND COORDINATE HIS WORK WITH THE WORK OF ALL THE OTHER CONTRACTORS



REMOVAL NOTES:

ELECTRICAL CONTRACTOR TO REMOVE EXISTING RECESSED MOUNTED PANELBOARD BACK TO THE SOURCE. EXTEND ANY EXISTING BRANCH CIRCUITRY TO NEW PANELBOARD SHOWN IN DRAWINGS E301. REFER TO RISER ON E201 FOR ADDITIONAL SCOPE OF WORK.

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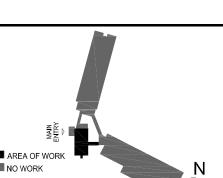
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KEY PLAN

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REMOVAL PLAN

Job No. Date 09/10/2021

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Sheet Number

E101

BEFORE FABRICATION THIS CONTRACTOR SHALL
VERIFY ALL MEASUREMENTS AND CONDITIONS ON
JOB AND COORDINATE HIS WORK WITH THE WORK
OF ALL OTHER CONTRACTORS



ALTERNATE #1

GENERAL NOTES:

- 1. CIRCUIT BREAKER NUMBERS PROVIDED ARE FOR CONTRACTOR REFERENCE ONLY. RE-USE EXISTING BREAKERS AVAILABLE AFTER DEMO WORK.
- 2. FOR ALL AREAS CONTROLLED BY ROOM CONTROLLER "RC", ELECTRICAL CONTRACTOR IS TO CIRCUIT ROOM CONTROLLER, THEN EXTEND LINE VOLTAGE CIRCUITRY TO EACH OF THE LIGHT FIXTURES DEPENDING ON CONTROL ZONES. REFER TO ROOM CONTROLLER WIRING DIAGRAM DETAILS ON DRAWING E601.
- 3. ALL EXIT LIGHTS SHALL BE CIRCUITED TO NARMAL LIGHTING CIRCUIT IN THE AREA, AHEAD OF
- 4. SET LIGHTING CONTROL SENSORS TO HIGHEST SENSITIVITY AVAILABLE PRIOR TO INSTALLATION.

LIGHTING CONTROL AND SEQUENCE OF OPERATION:

- 1. CONFERENCE ROOM IS CONTROLLED VIA MANUAL ON DIMMABLE WALL SWITCH AND OCCUPANCY SENSORS. IT CONSISITS OF FULL DIMMING CAPABILITY OF THREE ZONES. WALL SWITCHES CONSISTS OF 'A', 'B', 'C' 'OFF', 'RAISE' AND 'LOWER' BUTTONS. THE OCCUPANCY SENSORS SHALL HAVE AUTO OFF FEATURE WHICH SHALL TURN ALL LIGHTS OFF AFTER 20 MINUTES WHEN THE ROOM IS VACANT. FIXTURES WITH IN BUILT EMEGENCY BATTERY PACK ARE INCLUDED TO OVERIDE SWITCHING AND FORCE EMERGENCY LIGHTS ON 100% IN EVENT OF EMERGENCY.
- 2. LOBBY IS CONTROLLED VIA MANUAL ON DIMMABLE WALL SWITCH AND OCCUPANCY SENSORS CONSISITING OF FULL DIMMING CAPABILITY OF TWO ZONES. WALL SWITCHES CONSISTS OF 'D', 'E', 'OFF', 'RAISE' AND 'LOWER' BUTTONS. THE OCCUPANCY SENSORS SHALL HAVE AUTO OFF FEATURE WHICH SHALL TURN ALL LIGHTS OFF AFTER 20 MINUTES WHEN THE ROOM IS VACANT. FIXTURES WITH IN BUILT EMEGENCY BATTERY PACK ARE INCLUDED TO OVVERIDE SWITCHING AND FORCE EMERGENCY LIGHTS ON 100% IN EVENT OF EMERGENCY.
- 3. SINGLE TOILETS SHALL BE CONTROLLED VIA WALL MOUNTED VACANCY SENSOR. THE VACANCY SENSORS CONSISITS OF MANUAL 'ON' AND AUTO 'OFF'. THE AUTO OFF FEATURE WHICH SHALL TURN ALL LIGHTS OFF AFTER 20 MINUTES WHEN THE BATHROOM IS VACANT. SELF CONTAINED BATTERY PACKS TO OVERIDE ALL CONTROLS IN EVENT IF EMERGENCY.

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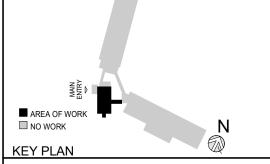




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1 2022-03-24 CONSTRUCTION DOCUMENTS No. Date


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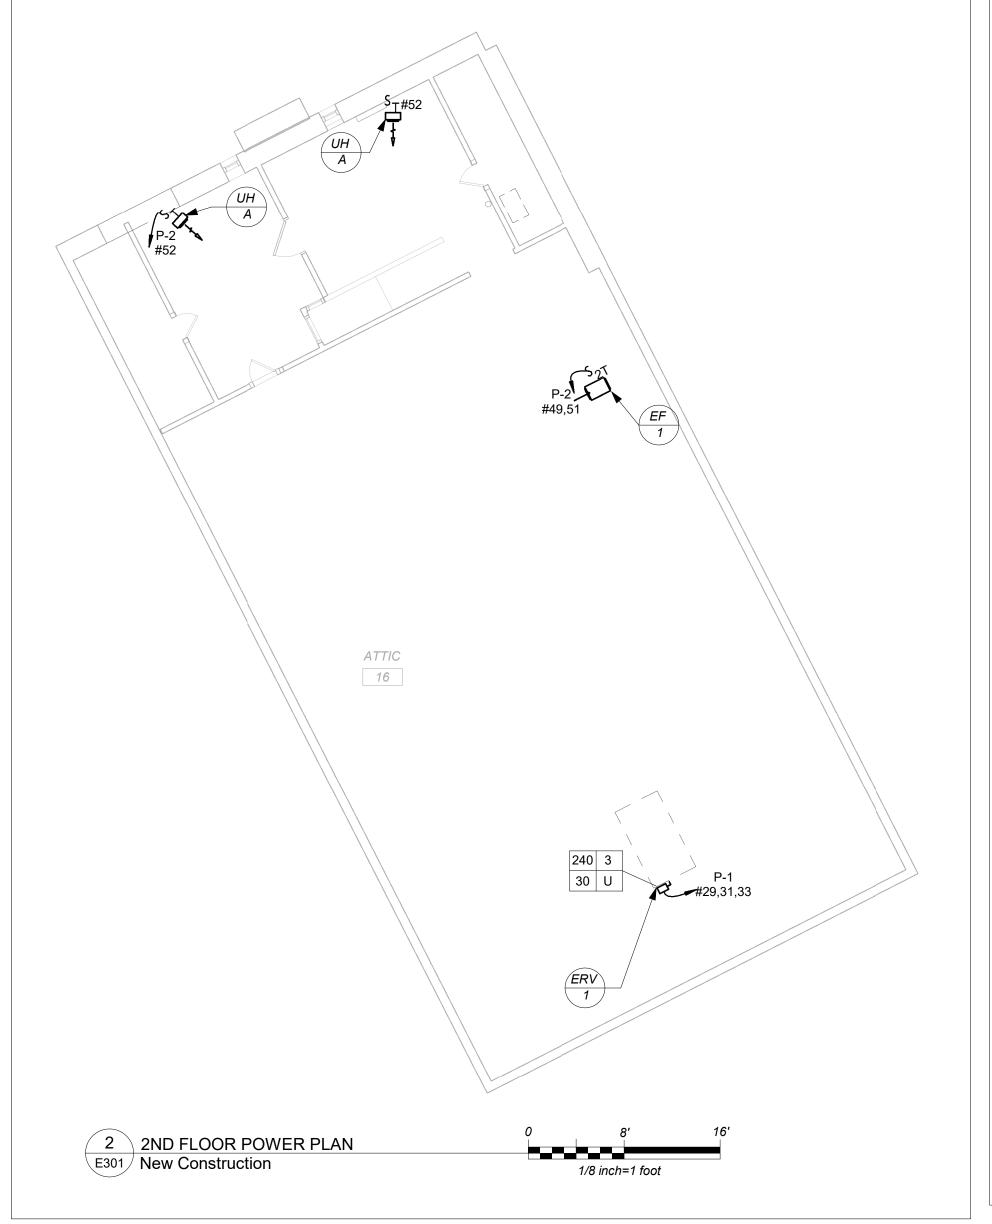
LIGHTING PLAN


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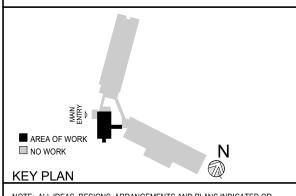
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Job No. 09/10/2021 2021-1048 Scale Drawn / Checked AS NOTED Author Checker

2 2022-07-12 ISSUE FOR BID No. Date Sheet Title POWER PLAN Sheet Number E301

GENERAL NOTES:

1. PROVIDE PATHWAY ONLY(CONDUIT W/DRAGLINE) FOR ALL TELEPHONE AND DATA WIRING

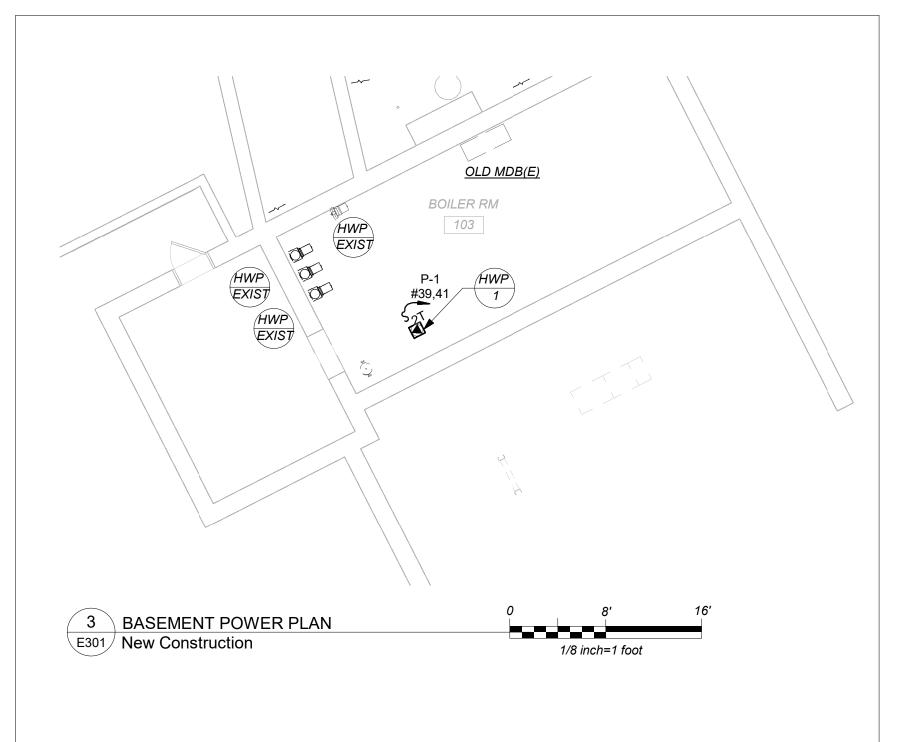WORK NOTES

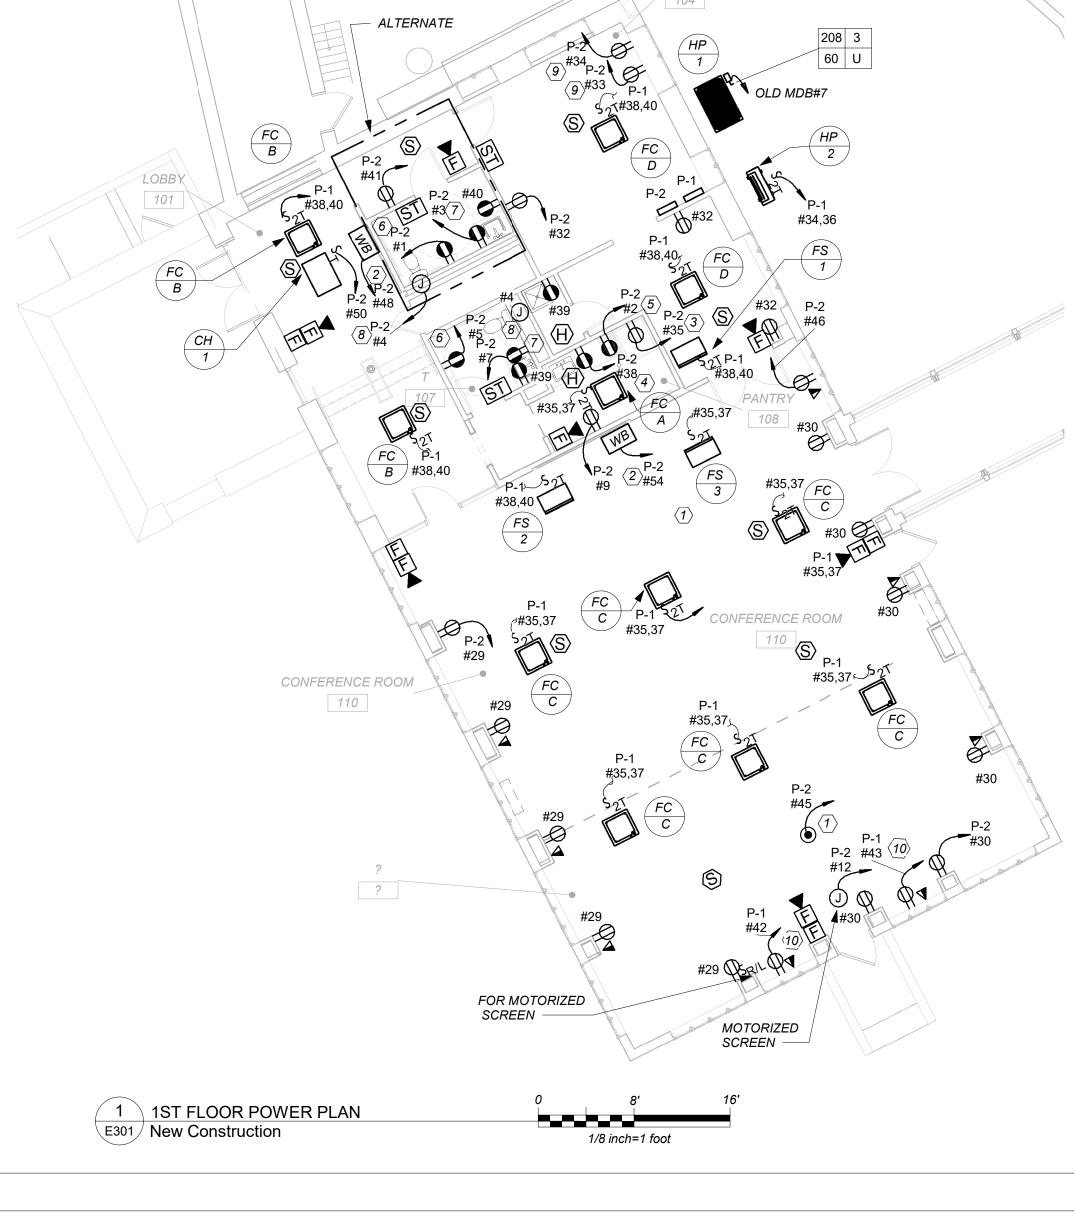- (1) COORDINATE EXACT LOCATION OF THE PROJECTOR WITH OWNER/ARCHIETECT BEFORE START OF ANY WORK.
- 2 LOCATION FOR THE DISPLAY UNIT. COORDINATE EXACT LOCATION AND MOUNTING HEIGHT WITH OWNER/ARCHIETECT BEFORE START OF ANY WORK.
- CIRCUIT FOR REFREIGERATOR. COORDINATE EXACT MOUNTING HEIGHT WITH OWNER/ARCHETCT BEFORE START OF ANY WORK.
- CIRCUIT FOR MICROWAVE. COORDINATE EXACT MOUNTING HEIGHT WITH OWNER/ARCHETCT BEFORE START OF ANY WORK.
- DEDICATED CIRCUIT FOR OWNER EQUIPMENT. COORDINATE EXACT MOUNTING HEIGHT WITH OWNER/ARCHETCT BEFORE START OF ANY WORK.
- 6 CIRCUIT FOR HAND DRYERS. COORDINATE EXACT LOCATION WITH ARCHIETECT BEFORE START OF ANY WORK.
- 7 ELECTRICAL CONTRACTOR SHALL COORDINATE LOCATION OF GFI OUTLET BELOW THE SINK TO SERVE THE POWER SUPPLY FOR AUTOMATIC FAUCET PRIOR TO THE START OF ANY WORK WITH PLUMBING CONTRACTOR. POWER SUPPLY FURNISHED BY PLUMBING CONTRACTOR AND INSTALLED BY ELECTRICAL CONTRACTOR. ELECTRICAL CONTRACTOR SHALL INSTALL THE 120V CIRCUIT AND ALL LOW VOLTAGE WIRING ON THE LOAD SIDE OF POWER SUPPLY BY PLUMBING CONTRACTOR.
- 8 ELECTRICAL CONTRACTOR SHALL COORDINATE LOCATION OF JUNCTION BOX TO SERVE THE POWER SUPPLY FOR AUTOMATIC FLUSH VALVE PRIOR TO THE START OF ANY WORK WITH PLUMBING CONTRACTOR. POWER SUPPLY FURNISHED BY PLUMBING CONTRACTOR AND INSTALLED BY ELECTRICAL CONTRACTOR. ELECTRICAL CONTRACTOR SHALL INSTALL THE 120V CIRCUIT AND ALL LOW VOLTAGE WIRING ON THE LOAD SIDE OF POWER SUPPLY BY PLUMBING CONTRACTOR.
- 9 DEDICATED CIRCUIT FOR DATA RACK. COORDINATE EXACT LOCATION AND HEIGHT WITH SCHOOL AV VENDOR BEFORE START OF ANY WORK.
- PROVIDE DEDICATED CIRCUITS FOR AV STORAGE. PROVIDE 2#12+1#12-3/4"C TO INDICATED PANELBOARD.



BEFORE FABRICATION THIS CONTRACTOR SHALL VERIFY ALL MEASUREMENTS AND CONDITIONS ON JOB AND COORDINATE HIS WORK WITH THE WORK OF ALL THE OTHER CONTRACTORS

FIRE ALARM RISER GENERAL NOTES:

- FIRE ALARM WIRING DIAGRAMS SHOWN ARE FOR GENERAL ARRANGEMENT ONLY. ELECTRICAL CONTRACTOR SHALL VERIFY AND OBTAIN POINT TO POINT WIRING DIAGRAM PRIOR TO INSTALLATION FROM MANUFACTURER.
- PERMITS AND APPROVALS NECESSARY FOR INSTALLATION OF THE WORK SHALL BE OBTAINED PRIOR TO THE COMMENCEMENT OF THE WORK. ALL PERMIT COSTS AND INSPECTION FEES SHALL BE INCLUDED AS PART OF THIS CONTRACT.
- 3. IN AREAS WHERE DUST AND DIRT WILL BE AIRBORNE DURING DEMOLITION AND CONSTRUCTION THE CONTRACTOR SHALL PROVIDE PLASTIC WRAP OVER SMOKE DETECTORS AND THEN REMOVE ONCE SPACE IS CLEAN.
- 4. UNLESS DIRECTED OTHERWISE BY FIRE ALARM SYSTEM MANUFACTURER FIRE ALARM DEVICE WIRING SHALL BE AS FOLLOWS (FOR BIDDING PURPOSES

HORN WIRING - #16 AWG TWISTED STROBE WIRING - #14 AWG TWISTED SIGNAL WIRING - #14 AWG TWISTED/SHIELDED

THE WIRING SHALL HAVE THE FOLLOWING CHARACTERISTICS:

A. A MINIMUM TEMPERATURE RATING OF 150 C

B. A MINIMUM AVERAGE INSULATION THICKNESS OF 15 MILS

C. A MINIMUM AVERAGE JACKET THICKNESS OF 25 MILS D. THE COLOR OF THE CABLE SHALL BE RED

E. THE CABLE SHALL BE A TYPE FPLP (PLENUM TYPE) WHEN CONDUIT IS USED. SEE NOTE 5 FOR ADDITIONAL

CONFIRM WIRING TYPE AND QUANTITY WITH FIRE ALARM SYSTEM MANUFACTURER PRIOR TO PURCHASING.


CLARIFICATION. F. THE CABLE SHALL BE VISIBLY MARKED EXTERNALLY THAT IT MEETS THE ABOVE REQUIREMENTS AND IS LISTED BY UL.

PROVIDE MC FIRE ALARM CABLE WITH RED STRIPE AS MANUFACTURED BY AFC SERIES 1800 WHEN CABLE IS CONCEALED OR ABOVE HUNG CEILING. WHEN FIRE ALARM CABLE IS RUN EXPOSED IN FINISHED AREAS, CABLE SHALL RUN IN WIREMOLD V-700. WHEN FIRE ALARM CABLE IS RUN EXPOSED IN UNFINISHED AREAS, PROVIDE PLENUM RATED CABLE IN MIN. 3/4"

- 6 STROBES SHALL HAVE A MINIMUM LIGHT OUTPUT OF 75 CANDELA AND A FLASH RATE OF 1-3 HZ.
- PER NFPA72-18.4.3.1. TO MEET PUBLIC MODE AUDIBLE REQUIREMENTS. ALL HORNS SHALL HAVE A SOUND LEVEL AT LEAST 15 dB ABOVE THE AVERAGE AMBIENT SOUND LEVEL.
- WALL MOUNTED HORN STROBE UNITS SHALL NOT HAVE ANY OTHER DEVICES OR APPURTENANCES WITHIN 5 FEET OF THE DEVICE. THE ENTIRE LENS OF THE UNIT SHALL NOT BE LESS THAN 80", AND NOT GREATER THAN 96" ABOVE FINISHED FLOOR, WHILE MAINTAINING 6" BELOW THE CEILING . DEVICES SHALL BE FLUSH MOUNTED IN ALL FINISHED AREAS. PROVIDE DOUBLE DEEP DEVICE BOX IN WALL.
- 9 AFTER THE SYSTEM IS COMPLETE, TEST ALL COMPONENTS IN ACCORDANCE WITH SEQUENCE OF OPERATION PRIOR TO FIRE DEPARTMENT INSPECTION.
- 10. ALL PULL STATIONS SHALL BE PROVIDED WITH CLEAR PROTECTIVE LEXAN COVER. COVER SHALL BE AS MANUFACTURED BY SAFETY TECHNOLOGY INTERNATIONAL INC. CAT. #STI 1100 STOPPER II.
- 11. COORDINATE F.A WORK WITH F.A VENDOR.

CONDUIT.


- 12. VERIFY EXACT QUANTITIES OF FIRE ALARM DEVICES WITH PLANS.
- 13. ALL DEVICES SHALL BE SUPERVISED AS PER N.F.P.A. 72. PROVIDE END OF LINE RESISTORS AS REQUIRED PER INDIVIDUAL MANUFACTURER. PROVIDE LOAD RELAYS AS REQUIRED FOR PROPER OPERATION OF EQUIPMENT.
- 14. THIS CONTRACTOR IS RESPONSIBLE FOR ALL PROGRAMMING AND MAPPING OF EACH DEVICE AS REQUIRED.

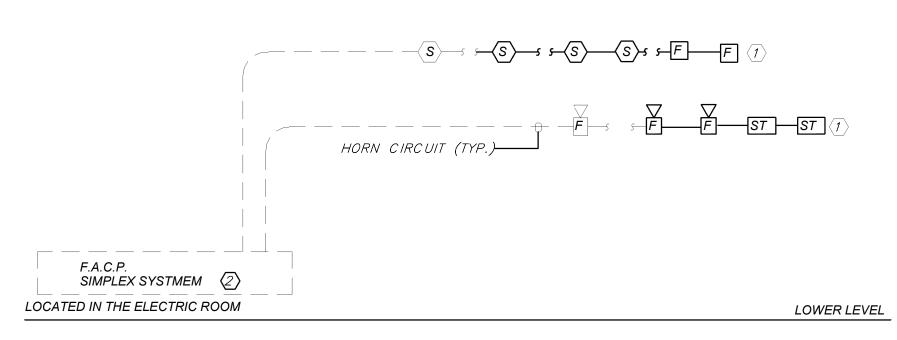



FIRE ALARM RISER WORK NOTES:

- (1) CONNECT NEW FIRE ALARM DEVICES TO NEAREST EXISTING FIRE ALARM DEVICE CIRCUIT. PROVIDE ALL REQUIRED RELAYS, MODULES, WIRING, ETC., AS NEEDED. REFER TO SPECIFICATION FOR ADDITIONAL INFORMATION.
- PROVIDE ALL RELAYS, POWER SUPPLIES, WIRING, ETC. AS REQUIRED FOR COMPLETE INSTALLATION. COORDINATE F.A WORK WITH EXISTING BASE BUILDING FA VENDOR.

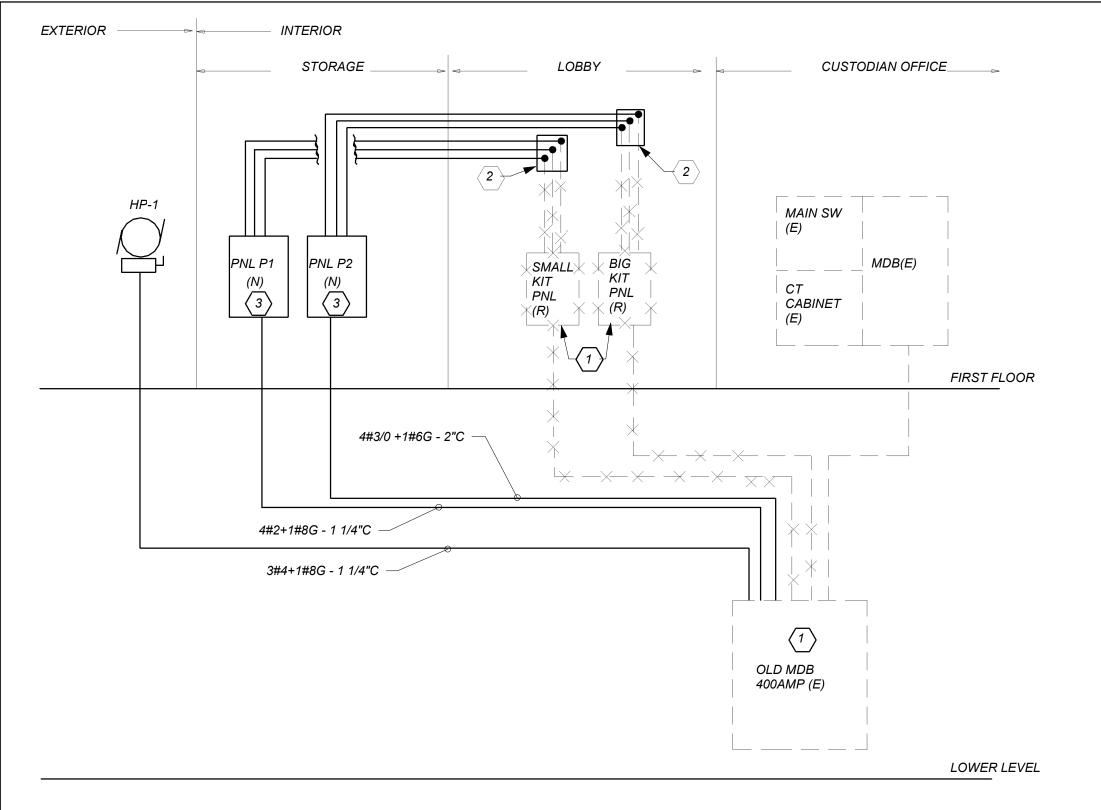



WORK NOTES:

- REMOVE FEEDERS AND EXISTING PANELBOARDS LOCATED IN THE LOBBY BACK TO OLD MDB. RE EUSE EXISNTNG BRAKERS TO RUN NEW FEEDERS NEW PANELBOARDS. PROVIDE ALL NECESSARY ACCESORIES AS NEEDED.
- (2) EXTEND ALL THE EXISTING TO REMAIN BRANCH CIRCUITS TO NEW PANEL BOAD PROVIDE NEW SPLICE BOX AT CEILING TO EXTEND ALL EXISTING ACTIVE CIRCUITS REMAINING AFTER DEMOLITION OF PANELBOARD. PROVIDE ALL REQUIRED AND NECESSARY ACCESSORIES.
- PROVIDE NEW 120/208V PANELBOARD. FOR PANEL SIZE, TYPE AND CIRCUIT BREAKER ARRANGEMENT REFER TO PANEL SCHEDULE FOR ADDITIONAL INFORMATION PROVIDE ALL NECESSARY ACCESSARY. FOR ADDTIONAL INFORMATION. PROVIDE ALL NECESSARY ACCESORIES

STORAGE	LOBBY	CUST	ODIAN OFFICE
		MAIN SW (E)	
PNL P1 PNL P2 (N) (N)	SMALL BIG KIT		MDB(E)
3 3	PNL PNL (R)	CABINET (E)	į į
	*_1_		
	* - '		FIRST FLOOR
4#3/0 +1#6G ·	- 2"C — *		
	\backslash \uparrow \vdash \times \rightarrow $-$		
		××	
4#2+1#8G - 1 1/4"C			
	2		
3#4+1#8G - 1 1/4"C	<i>≫</i>		
3#4+1#8G - 1 1/4"C			
3#4+1#8G - 1 1/4"C		OLD MDB 400AMP (E)	
3#4+1#8G - 1 1/4"C		OLD MDB	
	PNL P1 (N) (N) (3) (3) (4#3/0 +1#6G -	PNL P1 (N) 3 SMALL BIG KIT KIT PNL PNL PNL (R) (R) (R) (R)	PNL P1 (N) (SMALL) (B) (E) (N) (R) (R) (R) (E) (P) (A) (A) (A) (A) (A) (A) (A) (A) (A) (A

		LIGH	ITING FIXTURE SCH	EDULE	N N WORK ■ AREA OF WORK □ NO WORK
TYPE	MOUNTING	LAMPS	DESCRIPTION	MANUFACTURER & CAT.#	KEY PLAN NOTE: ALL IDEAS, DESIGNS, ARRANGEMENT: REPRESENTED BY THIS DRAWING ARE OWNED
A	RECESSED	16 WATTS LED UNV	3.5" LOW PROFILE TRIMLESS LED DOWN LIGHT 1300 LUMENS,0-10V DIMMING CLEAR DIFFUSE COLOR TEMP 3500K WITH WHITE FLANGE	FOCAL POINT #FLC33D-SDO-SW-1300L-UNV-LD1-T TRIM-LC33-SDO-SW-1300L-35K- DNS-FL2-CD-WH	KAEYER, GARMENT, & DAVIDSON ARCHITECT FOR USE ON THIS PROJECT. NONE OF SUCH OR PLANS SHALL BE USED BY OR DISCLOSED WITHOUT THE WRITTEN PERMISSION OF (KG WRITTEN DIMENSIONS ON THIS DRAWING SH
A EMB	RECESSED	16 WATTS LED UNV	SAME AS TYPE "A" WITH EMERGENCY BATTERY BACK UP	FOCAL POINT #FLC33D-SDO-SW-1300L-UNV-LD1- T-EMR TRIM-LC33-SDO- SW-1300L-35K-DNS-FL2-CD	SCALED DIMENSIONS. CONTRACTOR SHALL Y AND CONDITIONS ON THE JOB AND THE ARC VARIATIONS FROM DIMENSIONS AND CONDIT BE SUBMITTED TO THIS OFFICE FOR APPROV FABRICATION. ALTERATIONS BY ANY PERSON, IN ANY WAY, DOCUMENT, UNLESS ACTING UNDER THE DIF
A1	RECESSED	16 WATTS LED UNV	3.5" LOW PROFILE TRIMLESS LED DOWN LIGHT 1300 LUMENS,0-10V DIMMING CLEAR DIFFUSE COLOR TEMP 3500K WITH BLACK FLANGE	FOCAL POINT #FLC33D-SDO-SW-1300L-UNV-LD1-T TRIM-LC33-SDO-SW-1300L-35K- DNS-FL2-CD-BK	ARCHITECT WHOSE PROFESSIONAL SEAL IS OF TITLE VII, SECT. 69.5 (b) OF NEW YORK ST COPYRIGHT KAEYER, GARMENT + DAVIDSON ALL RIGHTS RESERVED. Professional Seal
A1 EMB	RECESSED	16 WATTS LED UNV	SAME AS TYPE "A1" WITH EMERGENCY BATTERY BACK UP	FOCAL POINT #FLC33D-SDO-SW-1300L-UNV-LD1- T-EMR TRIM-LC33-SDO- SW-1300L-35K-DNS-FL2-CD	
В	RECESSED	5 W/FT LED UNV	1.5" LINEAR DIRECT LED 350 LUMEN PER FT, 35K COLOR TEMP, 0-10V DIMMING, LENGHT AS PER FLOOR PLAN	FOCAL POINT #FSM1D-FL-PS06-350L1C-UNV-LDI- BK	
B EMB	RECESSED	5 W/FT LED UNV	SAME AS TYPE "B" WITH EMERGENCY BATTERY BACK UP	FOCAL POINT #FSM1D-FL-PSE-350L-35K-1C-UNV- LDI-EM-BK	
C	RECESSED	4.5W/FT LED UNV	LOW PROFILE LED WALL WASH 35K COLOR TEMP, 450 LUMENS PER FOOT, 0-10V DIMMING.	FOCAL POINT #FWSL-450L-35K-1C-120-LD1-U- WH-6FT	
D	RECESSED	23 WATTS LED UNV	2'X2' FLUX LED PANEL 3000 LUMES, 3500K COLOR TEMP, 0-10V DIMMING	DAY-BRITE #2-FPZ-30L-835-2-DS-UNV-DIM	3 2022-10-12 ISSUE FO 2 2022-07-12 ISSUE FO 1 2022-03-24 CONSTRU No. Date
D EMB	RECESSED	23 WATTS LED UNV	SAME AS TYPE "G" WITH EMERGENCY BATTERY BACK UP	DAY-BRITE #2-FPZ-30L-835-2-DS-UNV-DIM- BSL10LST	Sheet Title
E	WALL MOUNT	14 WATTS LED UNV	24" SCONCE INDOOR WALL MOUNT , 3500K COLOR TEMP	OCL LIGHTING #UA1-S1SA-24-LED1-35K-UNV	RISE
	CEILING /WALL MOUNT	1-5W LED UNV.	LED EXIT LIGHTS, STEEL HOUSING, NUMBER OF FACES AND DIRECTIONAL ARROWS AS INDICATED ON PLANS. SELF POWERED MODEL WITH 90 MINUTE BATTERY.	ENCORE LIGHTING #LSE-6-R-1/U	Job No. [2021-1048] Scale [

BEFORE FABRICATION THIS CONTRACTOR SHALL VERIFY ALL MEASUREMENTS AND CONDITIONS ON JOB AND COORDINATE HIS WORK WITH THE WORK OF ALL THE OTHER CONTRACTORS

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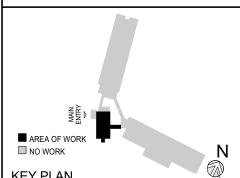


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NY SED PROJECT CONTROL NO. 66-23-00-01-0-008-011

> CONSTRUCTION **DOCUMENTS**




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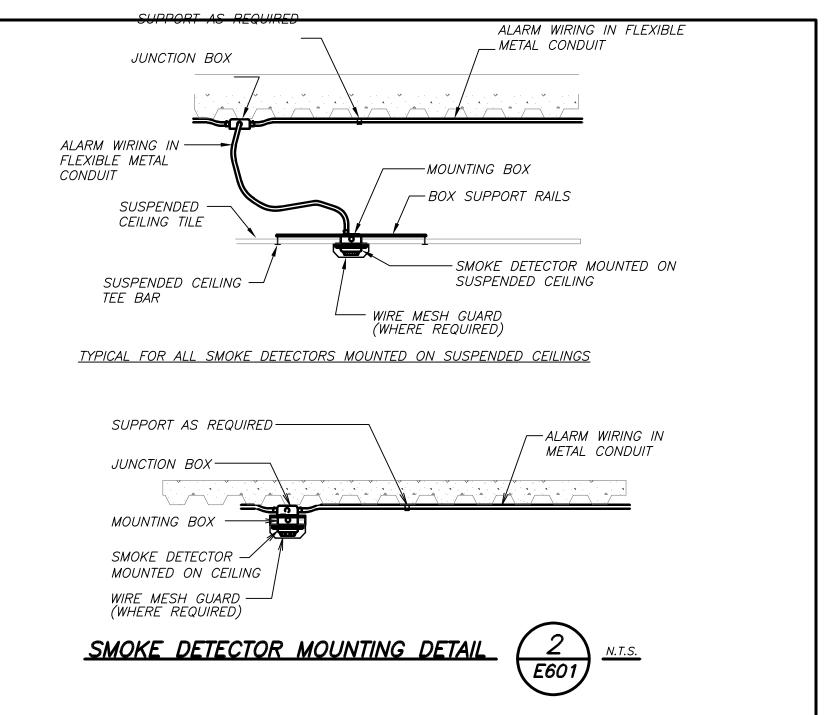
G SHALL HAVE PRECEDENCE OVER HALL VERIFY ALL ACTUAL DIMENSIONS
ARCHITECT MUST BE NOTIFIED OF ANY PROVAL BEFORE PROCEEDING WITH


WAY, OF ANY ITEM CONTAINED ON THIS E DIRECTION OF THE LICENCED AL IS AFFIXED HERETO, IS A VIOLATION RK STATE LAW. DSON ARCHITECTS & ENGINEERS, PC


RUCTION DOCUMENTS

09/10/2021 Drawn / Checked AS NOTED Author Checker



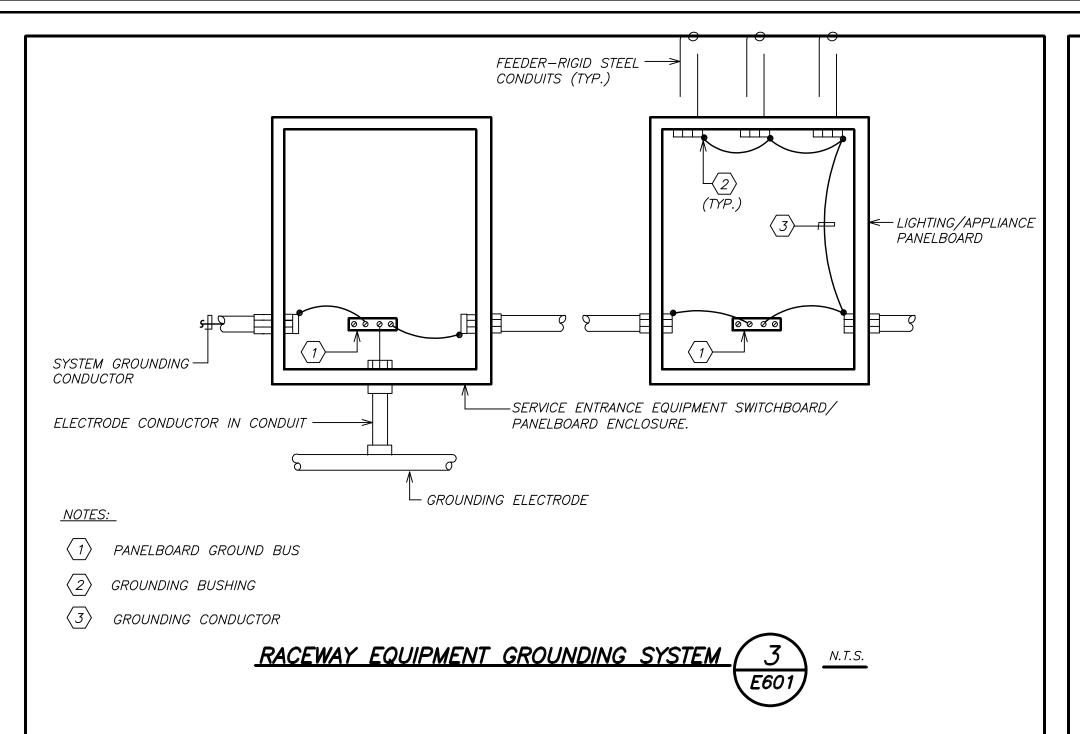

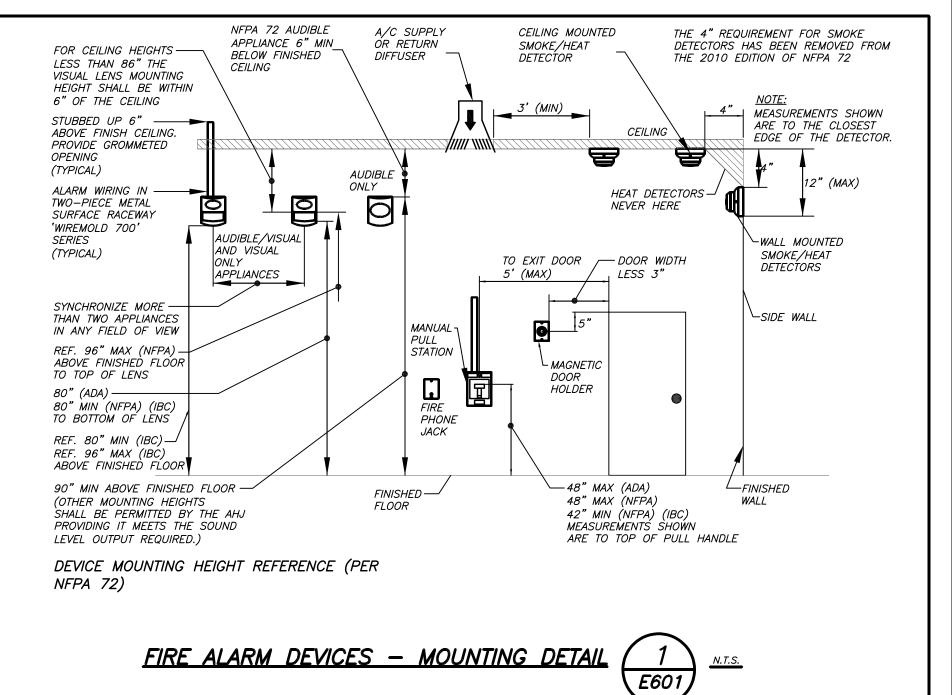

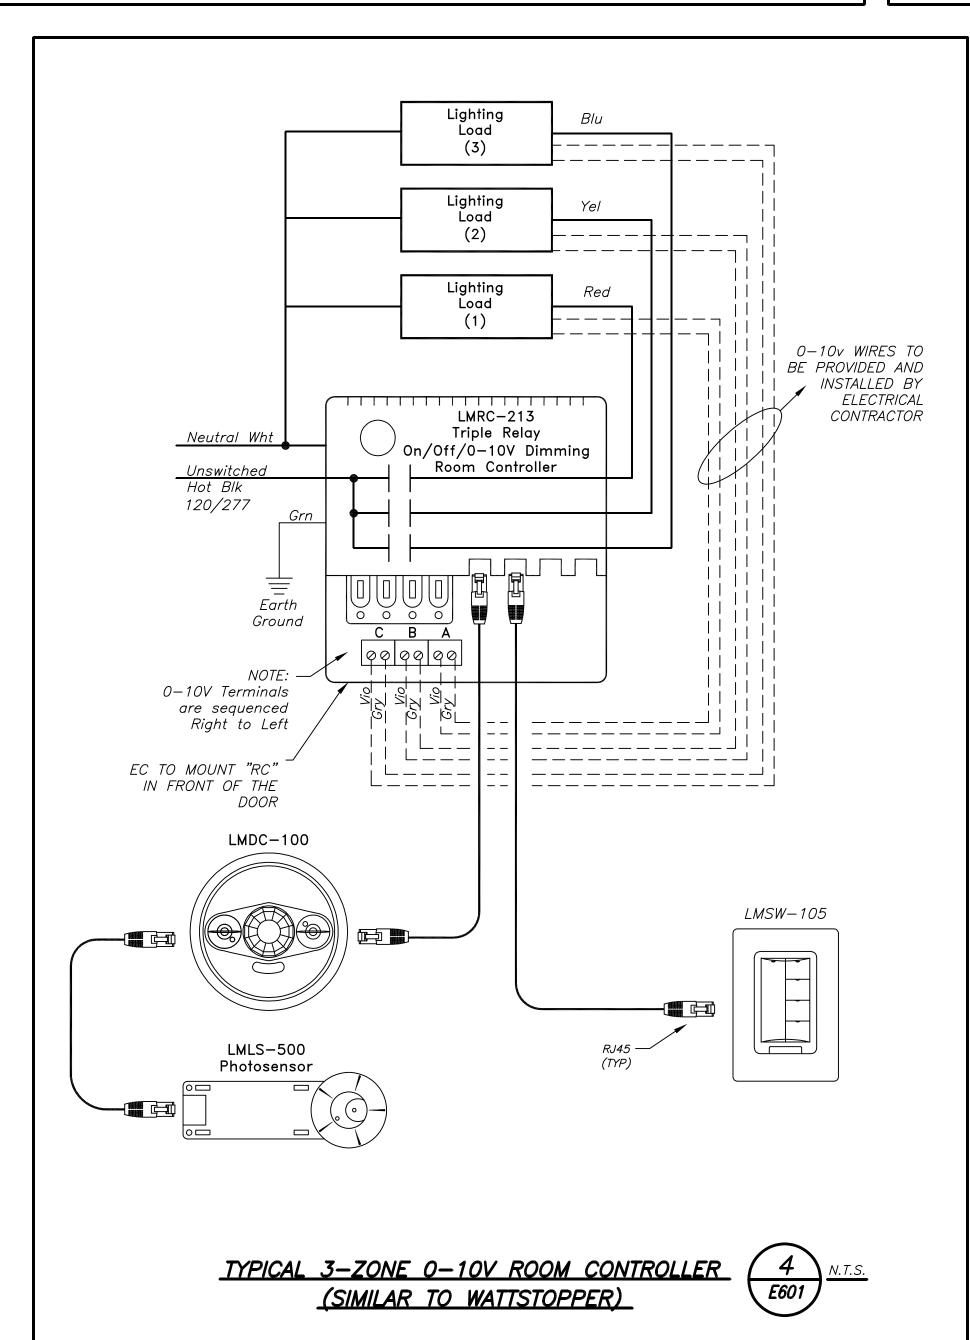

1 V C	EW		ELEC			111	- <i> </i> -		_ 3	<u> </u>		UL				
PNL: P-1 MOUNTING:		NOUNTING: SURFACE		ACE X MAII			LUGS ONLY			MAI	I C BKR-	GROUND	BUS:	<u>X</u>		
208 Y	/120,	3 PHASE, 4 WIRE	(NEM A 1)	F	LUSH			DOL	JBLE I	UGS		100A/3P		ISOLATED GROUND BUS		
22	,0001	MIN A.I.C. SYM		IN	мсс		FEED 7		THRU LUG		<u>X</u>	MAI	I BUS -		TVSS:	
NEU	TRAL:	100%					SHUNT		TRIP MAIN				100 A	NUMBER OF P	OLES:	<u>54</u>
СКТ	TRIP	LOAD	WIRE	CND.	KV	A / PH	ASE		KV	4 / PH	ASE	CND.	WIRE	LOAD	TRIP	СКТ
No.	(AMP)			(IN.)	А	В	С		Α	В	С	(IN.)	-		(AMP)	No.
1	50	EXISTING LOAD	EXIST	_								-	EXIST	EXISTING LOAD	50	2
3	20	EXISTING LOAD	EXIST	-								-	EXIST		2 /	4
5	20	EXISTING LOAD	EXIST	-				1				-	EXIST	EXISTING LOAD	20	6
7	20	EXISTING LOAD	EXIST	-								-	EXIST	EXISTING LOAD	20	8
9	20	EXISTING LOAD	EXIST	-								-	EXIST	EXISTING LOAD	20	10
11	20	EXISTING LOAD	EXIST	-				1				-	EXIST	EXISTING LOAD	20	12
13	20	EXISTING LOAD	EXIST	-								-	EXIST	EXISTING LOAD	20	14
15	20	EXISTING LOAD	EXIST	-								-	EXIST	EXISTING LOAD	20	16
17	20	EXISTING LOAD	EXIST	-								-	EXIST	EXISTING LOAD	20	18
19	20	EXISTING LOAD	EXIST	-								-	EXIST	EXISTING LOAD	20	20
21	20	EXISTING LOAD	EXIST	-								-	EXIST	EXISTING LOAD	20	22
23	20	EXISTING LOAD	EXIST	-				1				-	EXIST	EXISTING LOAD	20	24
25	20	EXISTING LOAD	EXIST	-								-	EXIST	EXISTING LOAD	20	26
27	20	HAND DRYER	2#12+1#12G	3/4		0.20						-	EXIST	EXISTING LOAD	20	28
29	3						0.60				1.20	3/4	3#10+1#10G	HP-2	2 /	30
31		ERV-1	3#12+1#12G	3/4	0.60				1.20			3/4	3#10+1#10G	1117-2	30	32
33	20					0.60						-	-	SPARE	20	34
35	2	FC-C	2#12+1#12G	3/4			0.19					-	-	SPARE	20	36
37	20	, 0-0	2#12*1#120	3/4	0.19				0.19			3/4	2#12+1#12G	FC-C	2 /	38
39	2	HWP	2#12+1#12G	3/4		0.19				0.19		0,7	2,,,,,,,,,,,,,,,,,,,,,,,,,,,,,,,,,,,,,,	7 0-0	20	40
41	20		21712 - 117120	0/4			0.19					3/4	2#12+1#12G	AV STORAGE	20	42
43	20	AV STORAGE	2#12+1#12G	3/4								-	-	SPARE	20	44
45	20	SPARE	-	-								-	-	SPARE	20	46
47	20	SPARE	-	-								-	-	SPARE	20	48
49	20	SPARE	-	-								-	-	SPARE	20	50
51	20	SPARE	-	-								-	-	SPARE	20	52
53	20	SPARE	-	-				_				-	-	SPARE	20	54
		SUBTOTALS			0.79	0.99	0.98		1.39	0.19	1.20			SUBTOTALS		
		TOTAL LOADS		2.2	KVA	PHAS	SE A						LIGHTING:	0.00 KVA		
					KVA							RE	CEPTACLE:	0.00 KVA		
					KVA								KITCHEN:	0.00 KVA		
		TOTAL CONN. LOAD)		KVA			-					MOTOR:	5.54 KVA		
		TOTAL DEMAND LO	AD	5.5	KVA	15.0	Α						POWER:	0.00 KVA		
													TOTAL:	5.54 KVA		

PNL	.: P-2		MOUNTING:	SUR	FACE		М	AIN L	.UGS (ONLY		MAIN	I C BKR-	GROUND	BUS:
2081	//120,	3 PHASE, 4 WIRE	(NEMA 1)	F	LUSH	X		DOL	JBLE I	UGS		2	00A/3P	ISOLATED GROUND	BUS:
22	,0001	MIN A.I.C. SYM		IN	мсс		,	FEED	THRU	LUG		MAIN	I BUS -	7	vss:
NEU	TRAL:	100%					SF	IUNT	TRIP I	MAIN			200 A	NUMBER OF PO	DLES:
СКТ	TRIP	LOAD	WIRE	CND.	KV	A / PH	ASE		KV	A / PH	ASE	CND.	WIRE	LOAD	TRIP
No.	(AMP)	-		(IN.)	А	В	С		A	В	С	(IN.)			(AMP)
1	20	HAND DRYER	2#12+#12G	3/4	1.40				0.50			3/4	2#12+#12G	MICROWAVE	20
3	 	AUTO FAUCET	2#12+#12G	3/4	1.40	0.20			0.30	0.20		3/4		AUTO FLUSH	20
 5	-	HAND DRYER	2#12+#12G	3/4		0.20				0.20		-	EXIST	EXISTING LOAD	20
7	-	AUTO FAUCET	2#12+#12G	3/4	0.20								LXISI	SPARE	20
9	20	PANTRY RECP	2#12+#12G	3/4	0.20	0.20							_	SPARE	20
11	3	FANIRIKECF	EXIST	J. 4		0.20					0.20	3/4	2#12+#12G	MOTARISED SCREEN	
13		EXISTING LOAD	EXIST		-						0.20	3/4	EXIST	SPARE	20
15	40		EXIST										EXIST	SPARE	20
17	3		EXIST										EXIST	OF ARE	3 /
19	+	EXISTING LOAD	EXIST										EXIST	EXISTING LOAD	
21	20		EXIST										EXIST	27.01.110 207.12	20
23	3 /		EXIST										EXIST		20
25	+	EXISTING LOAD	EXIST										EXIST	EXISTING LOAD	20
27	20		EXIST										EXIST		20
29	20	CONV RECEP	2#12+#12G	3/4			0.72				0.72	3/4	2#12+#12G	CONV RECEP	20
31	20	SPARE	-				0.72		0.54			3/4	2#12+#12G		20
33	20	DATA RACK	2#12+#12G	0		1.00			-	1.00		3/4		DATA RACK	20
35	 	REFRIGERATOR	2#12+#12G				0.50					_	-	SPARE	20
37	<u> </u>	SPARE	-						0.50			3/4	2#12+#12G	PANTRY GFI	20
39	20	GFI BATHROOM	2#12+#12G	3/4		0.50				0.50		3/4		GFI BATHROOM	20
41	20	CORR RECEP	2#12+#12G				0.20				0.80	3/4	2#12+#12G		20
43	-	LIGHTING	2#12+#12G		0.60				0.50			3/4	2#12+#12G		20
45	20	PROJECTOR	2#12+#12G	3/4		1.00				1.00		3/4	2#12+#12G		20
47	-	SPARE	-	-							0.50	3/4		DISPAY TV	20
49	2				0.20				0.20			3/4	2#12+#12G		20
51	20	EF-1	2#12+#12G	3/4		0.20				0.20		3/4	2#12+#12G		20
53	20	SPARE	-	-							0.50	3/4	2#12+#12G	DISPAY TV	20
		SUBTOTALS			2.40	3.10	1.42		2.24	2.90	2.72			SUBTOTALS	
		TOTAL LOADS	1	4.6	KVA	PHA:	SE A						LIGHTING:	1.90 KVA	1
				6.0	KVA	PHA:	SE B					RE	CEPTACLE:	0.00 KVA	1
				4.1	KVA	PHA:	SE C						KITCHEN:	0.00 KVA	1
		TOTAL CONN. LOAD			KVA	41.0	Α						0.80 KVA	1	
		TOTAL DEMAND LO	DAD	14.8	KVA	41.0	Α						POWER:	12.08 KVA	1
									—				TOTAL:	14.78 KVA	ł

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KGDARCHITECTS.COM

BARILE GALLAGHER & ASSOCIATE


CONSULTING ENGINEERS
39 MARBLE AVE PLEASANTVILLE, NY 10570
914.328.6060 GENERAL@BGA-ENG.com www.BGA-ENG.co

NY SED PROJECT CONTROL NO.

66-23-00-01-0-008-011

P:914.666.5900

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3	2022-10-12	ISSUE FOR REBID
2	2022-07-12	ISSUE FOR BID
1	2022-03-24	CONSTRUCTION DOCUMENTS
No.	Date	Issue
She	et Title	

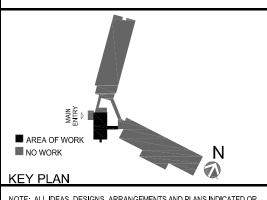DETAILS & SCHEDULES

Job No.	Date				
2021-1048	09/10/2021				
Scale AS NOTED	Drawn / Checked				
AS NOTED	BGA / BGA				
Sheet Number					

E601

BEFORE FABRICATION THIS CONTRACTOR SHALL VERIFY ALL MEASUREMENTS AND CONDITIONS ON JOB AND COORDINATE HIS WORK WITH THE WORK OF ALL OTHER CONTRACTORS