KEY OF SYMBOLS

	THE KEY OF SYMBOLS INDICATED IS FOR CONVENIEN INDICATED ARE NOT NECESSARILY WITHIN THE SCOPE		
	SOIL OR WASTE PIPING (S) (W)	A.B.D.	AUTOMATIC BALL DRIP
	SOIL OR WASTE PIPING BELOW GROUND	A.D.	ACCESS DOOR
L	LEADER (L) (LDR)	A. DR.	AREA DRAIN
IW	INDIRECT WASTE	B.T.	BATH TUB
	VENT PIPING	C.D.	CANOPY DRAIN
\times	EXISTING PIPING TO BE REMOVED	CLG.	CEILING
	EXISTING PIPING TO REMAIN	C.O.	CLEANOUT
•	COLD WATER PIPING (C.W.)	C.O.D.P.	CLEAN OUT DECK
••	HOT WATER PIPING (H.W.)		PLATE
•••	HOT WATER CIRCULATING PIPING (H.W.C.)	C.V.	CHECK VALVE BOX
G	GAS PIPING (G)	C.V.B.	CHECK VALVE BOX
		D.I. D.F.	DROP INLET DRINKING
		D.I .	FOUNTAIN
T		DN.	DOWN
г г	GATE VALVE (G.V.)	EL.	ELEVATION
	LOCKSHIELD VALVE (GLOBE VALVE)	E.W.C.	ELECTRIC WATER COOLER
V	PLUG COCK	F.A.I.	FRESH AIR INLET
<u> </u>	CHECK VALVE (C.V.)	F.D.	FLOOR DRAIN
<u> </u>	HOSE BIBB (H.B.) SILL COCK (S.C.) VACUUM BREAKER (V.B.)	FL. DR.	
<u> </u>	PRESSURE RELIEF VALVE	F.F.D.	FUNNEL DRAIN
T	PRESS. & TEMP. RELIEF VALVE	FL.	FLOOR
 \	PRESSURE REGULATING VALVE	F.O.	FLOOR OUTLET
	STRAINER	F.U.	FIXTURE UNITS
	"P" TRAP FOR LAV., SINK, ETC.	F.V.	FLUSH VALVE FLUSHOMETER
<u></u>	CLEANOUT DECK PLATE (C.O.D.P.)	G.V.	GATE VALVE
<u> </u>	SHOCK ABSORBER	H.C.	HUNG CEILING
X	ANCHOR	H.R.	HOSE RACK
$\overline{}$	GUIDE	INV.	INVERT
Y	PRESSURE GAUGE	LAV.	LAVATORY
T T	THERMOMETER	MH.	MANHOLE
	TEMPERATURE REGULATOR	M.S.	MOP SINK
	WALL HYDRANT (W.H.)	N.I.C.	NOT IN CONTRACT
	YARD HYDRANT (Y.H.) (D.H.)	O.S.&Y.	OUTSIDE SCREW
///////	PIPING COVERED WITH ELECTRIC HEAT TRACING CABLE AND INSULATION	D C	& YOKE
 	UNION CONNECTION	P.C.	PLUG COCK
, 	EXPANSION JOINT	P.O.	PLUGGED OUTLET
		R.P.B. F.P.	REDUCED PRESSUR BACKFLOW PREVENTER
		R.D.	ROOF DRAIN
		R.T.	RUNNING TRAP
		R.C.V.	RISER CONTROL VALVE
		S.P.O.	SOIL PLUGGED OUTLET
		S.H.	SHOWER HEAD
		SH.—	SHOWER
		SHWR.	CINIIZ
		SK.	SINK
		S.S.	SERVICE SINK
		S.E.	SEWAGE EJECTOR
		T.D.	TERRACE DRAIN
		T.E.	TERRACE ELEVATION
		T.P.	TRAP PRIMER
		T.S.	TAMPER SWITCH
		UR.	URINAL
		U.O.S.W.	UNDER ANOTHER SECTION OF THE WORK
		VAL. O. V.O.	VALVED OUTLET
		V.T.R.	VENT THRU ROOF
		V.T.R. V.P.O.	VENT THRU ROOF VENT PLUGGED OUTLET

PLUMBING INSTALLATION CRITERIA

EACH BIDDER SHALL VISIT THE SITE AND BECOME INFORMED AS TO THE CONDITION OF THE PREMISES AND THE EXTENT AND CHARACTER OF WORK REQUIRED, NO ADDITIONAL COMPENSATION WILL BE APPROVED DUE TO FIELD CONDITIONS.

- 1. PROVIDE ROUGH-IN AND FINAL CONNECTIONS FOR ALL PLUMBING FIXTURES INCLUDING WASTE, VENTS, HOT AND COLD WATER, AND PROVIDE ALL PLUMBING WORK NECESSARY TO MAKE THE PANTRY, ELECTRIC WATER COOLER(S) BATH, ETC. ENTIRELY OPERABLE AND ACCEPTABLE TO LOCAL HEALTH AND BUILDING OFFICIALS.
- 2. PLUMBING CONTRACTOR SHALL LOCATE ALL PIPING AND PLUMBING ROUGH-IN FOR PLUMBING FIXTURES IN ACCORDANCE WITH ROUGH-IN DRAWINGS PROVIDED BY EQUIPMENT MANUFACTURERS.
- 3. ALL VISIBLY EXPOSED PIPE TO EQUIPMENT SHALL BE CHROME PLATED BRASS.
- 4. PROVIDE SHUT-OFF VALVES FOR EACH PLUMBING FIXTURE AND PIECE OF EQUIPMENT,
- 5, PROVIDE TRAPS ON ALL WASTE PIPING FROM PLUMBING FIXTURES AND PIECE OF EQUIPMENT.
- 6. COORDINATE POSITION OF SLEEVES AND OPENINGS THROUGH FLOOR WITH THE GENERAL CONTRACTOR.
- 7. PROVIDE VACUUM BREAKERS AND CHECK VALVES FOR THE PLUMBING FIXTURES WHERE AND WHEN REQUIRED BY CODE.
- 8. ALL PIPING AND EQUIPMENT SHALL BE SUBSTANTIALLY SUPPORTED FROM THE BUILDING STRUCTURE, HANGER AND SUPPORTS SHALL BE SPECIFICALLY APPROVED FOR USE IN PLUMBING SYSTEMS.

A. WHERE OVERHEAD CONSTRUCTION DOES NOT PERMIT FASTENING OF

- HANGER RODS IN REQUIRED LOCATIONS, PROVIDE ADDITIONAL STEEL FRAMING AS REQUIRED AND APPROVED. B, NO PLUMBING PIPING SHALL BE HUNG FROM THE PIPING OF OTHER TRADES OR DUCTWORK, HANGERS SHALL BE OF HEAVY
- CONSTRUCTION, SUITABLE FOR THE SIZE OF PIPE TO BE SUPPORTED. 9. PLUMBING FIXTURES TO BE APPROVED BY THE GENERAL CONTRACTOR
- 11. ALL PLUMBING FIXTURES SPECIFIED BY THE ARCHITECT, SEE ARCHITECTURAL DRAWINGS, SPECIFICATIONS, DETAILS AND ELEVATIONS OF THE PANTRY, BATH, ETC. FOR REQUIRED PLUMBING CONNECTIONS.

AND INSTALLED BY THE PLUMBING CONTRACTOR, 10, PLUMBING

FIXTURES SHALL BE AS SPECIFIED BY ARCHITECT.

	DRAWING LIST	
SHEET	TITLE	SCALE
P-000	PLUMBING SYMBOLS, ABBREVIATIONS, NOTES AND	
P-000	DRAWING LIST	NTS
P-100	PLUMBING UNDERGROUND PLAN	1/8" = 1'-0"
P-101	PLUMBING 1ST FLOOR PLAN	1/8" = 1'-0"
P-102	PLUMBING ROOF PLAN	1/8" = 1'-0"
P-500	PLUMBING DETAILS	NTS

BUILDING DEPARTMENT PLUMBING NOTES

THE PLUMBING SYSTEMS (SANITARY, WASTE, VENT, STORM, AND WATER DISTRIBUTION) AND ALL ASSOCIATED EQUIPMENT WILL BE INSTALLED AND MAINTAINED IN ACCORDANCE WITH THE FULL REQUIREMENTS OF THE PLUMBING CODE. COMPLIANCE WITH THE FULL PROVISIONS OF ALL BUILDING AND PLUMBING CODE ACCESSIBILITY REQUIREMENTS AND PLUMBING FIXTURE FLOW REQUIREMENTS OF THE PLUMBING CODE.

- THE SANITARY SYSTEM SHALL BE PROVIDED IN FULL ACCORDANCE WITH THE
- THE MATERIALS USED IN THE PLUMBING SYSTEMS WILL BE PROVIDED IN FULL ACCORDANCE WITH SECTIONS PC302 AND PC303.
- SECTIONS PC605 AND PC705.
- THE INSTALLATION OF FIXTURES WILL BE IN FULL ACCORDANCE WITH
- 6. VERTICAL AND HORIZONTAL PIPING WILL BE HUNG AND SUPPORTED AS DIRECTED IN SPECIFICATIONS AND WITH THE FULL COMPLIANCE WITH
- 7. THE WATER SUPPLY SYSTEMS OF THE SUBJECT BUILDING SHALL BE
- SHOCK ABSORBERS SHALL BE PROVIDED IN FULL COMPLIANCE WITH PC 604,9 WHERE ALL QUICK CLOSING VALVES ARE INSTALLED AND ALL EQUIPMENT CONTAINING QUICK CLOSING SOLENDID VALVES SUCH AS ICE MAKERS ,COFFE MACHINES , DISHWASHERS ,CLOTHES WASHERS, ELECTRONIC OPERATED FLUSH VALVES AND FAUCETS, AND SHOWER MIXING VALVES THAT HAVE A SINGLE LEVER HANDLE.
- 10. THE VENT PIPING FOR THE SANITARY DRAINAGE SYSTEM OF THE SUBJECT BUILDING WILL BE INSTALLED IN FULL COMPLIANCE WITH SECTION PC702 & PC CHAPTER 9.
- 12. ALL TRENCHING SHALL BE DONE IN ACCORDANCE WITH THE REQUIREMENTS
- 14. TEMPORARY TOILET FACILITIES SHALL BE PROVIDED FOR CONSTRUCTION PERSONNEL AS PER SECTION PC311.

	DRAWING LIST	
SHEET	TITLE	SCALE
P-000	PLUMBING SYMBOLS, ABBREVIATIONS, NOTES AND	
1 -000	DRAWING LIST	NTS
P-100	PLUMBING UNDERGROUND PLAN	1/8" = 1'-0"
P-101	PLUMBING 1ST FLOOR PLAN	1/8" = 1'-0"
P-102	PLUMBING ROOF PLAN	1/8" = 1'-0"
P-500	PLUMBING DETAILS	NTS
P-600	PLUMBING SCHEDULES	NTS
P-700	PLUMBING RISER DIAGRAMS	NTS

- GENERAL PROVISIONS OF SECTION PC301.
- 3. EQUIPMENT HOOK-UP AND THE JOINING WILL BE FULL COMPLIANCE WITH
- PC CHAPTER 4.
- 5. TRAPS FOR FIXTURES AND DRAIN LINES WILL BE PROVIDED AND CLEANOUTS INSTALLED IN FULL COMPLIANCE WITH SECTIONS PC412, PC708 AND PC CHAPTER 10.
- SECTION PC308.
- INSTALLED AND MAINTAINED IN FULL COMPLIANCE WITH PC CHAPTER 6.
- 9. THE SANITARY DRAINAGE SYSTEM WILL BE SIZED AND INSTALLED IN FULL COMPLIANCE WITH PC CHAPTER 7.
- 11. THE STORM DRAINAGE SYSTEM AND PIPING WILL BE INSTALLED IN FULL COMPLIANCE WITH PC CHAPTER 11.
- OF SECTION PC306.
- 13. RAT PROOFING SHALL BE IN ACCORDANCE WITH SECTION PC304.

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REAL ESTATE &

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Building #17 Campus Expansion Child Day-care Center

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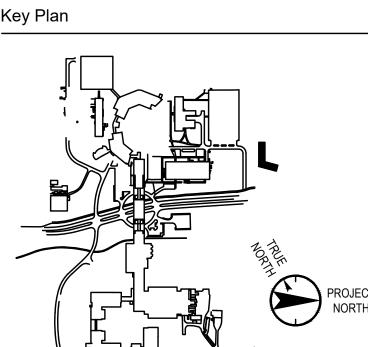
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No.	Date	Description

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Vendor Project No.:151-210104

Discipline: PLUMBING Drawn By: DH

SYMBOLS, ABBREVIATIONS, AND DRAWING LIST

Scale: NTS Floor: N/A

TO THE BEST OF MY KNOWLEDGE, BELIEF AND PROFESSIONAL JUDGMENT, THESE PLANS AND SPECIFICATIONS ARE IN COMPLIANCE WITH THE 2020 ENERGY CONSERVATION CODE OF NYS

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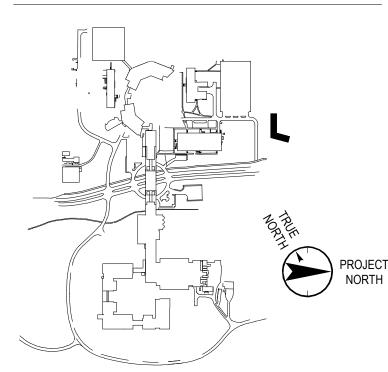
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Key Plan



No. Date Description

0 05.20.2022 ISSUED FOR PERMIT

Plot Date: 11/23/21

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Vendor Name: COSENTINI Vendor Project No.: 151-210104

Discipline: PLUMBING Drawn By: DH PLUMBING UNDERGROUND PLAN

Scale: 1/8" = 1'-0" Floor: UNDERSLAB

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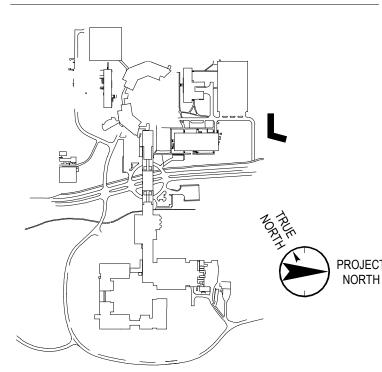
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Key Plan



No. Date Description

0 05.20.2022 ISSUED FOR PERMIT

Plot Date: 10/25/21

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Vendor Name: COSENTINI Vendor Project No.: 151-210104 Discipline: PLUMBING Drawn By: DH PLUMBING 1ST FLOOR PLAN

Scale: 1/8" = 1'-0" Floor: 1ST

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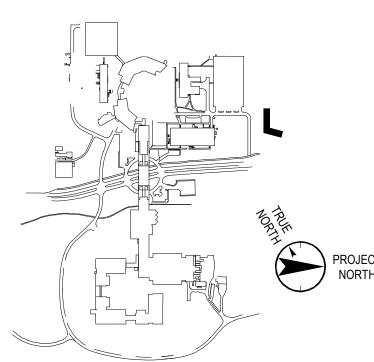
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Campus Expansion Child

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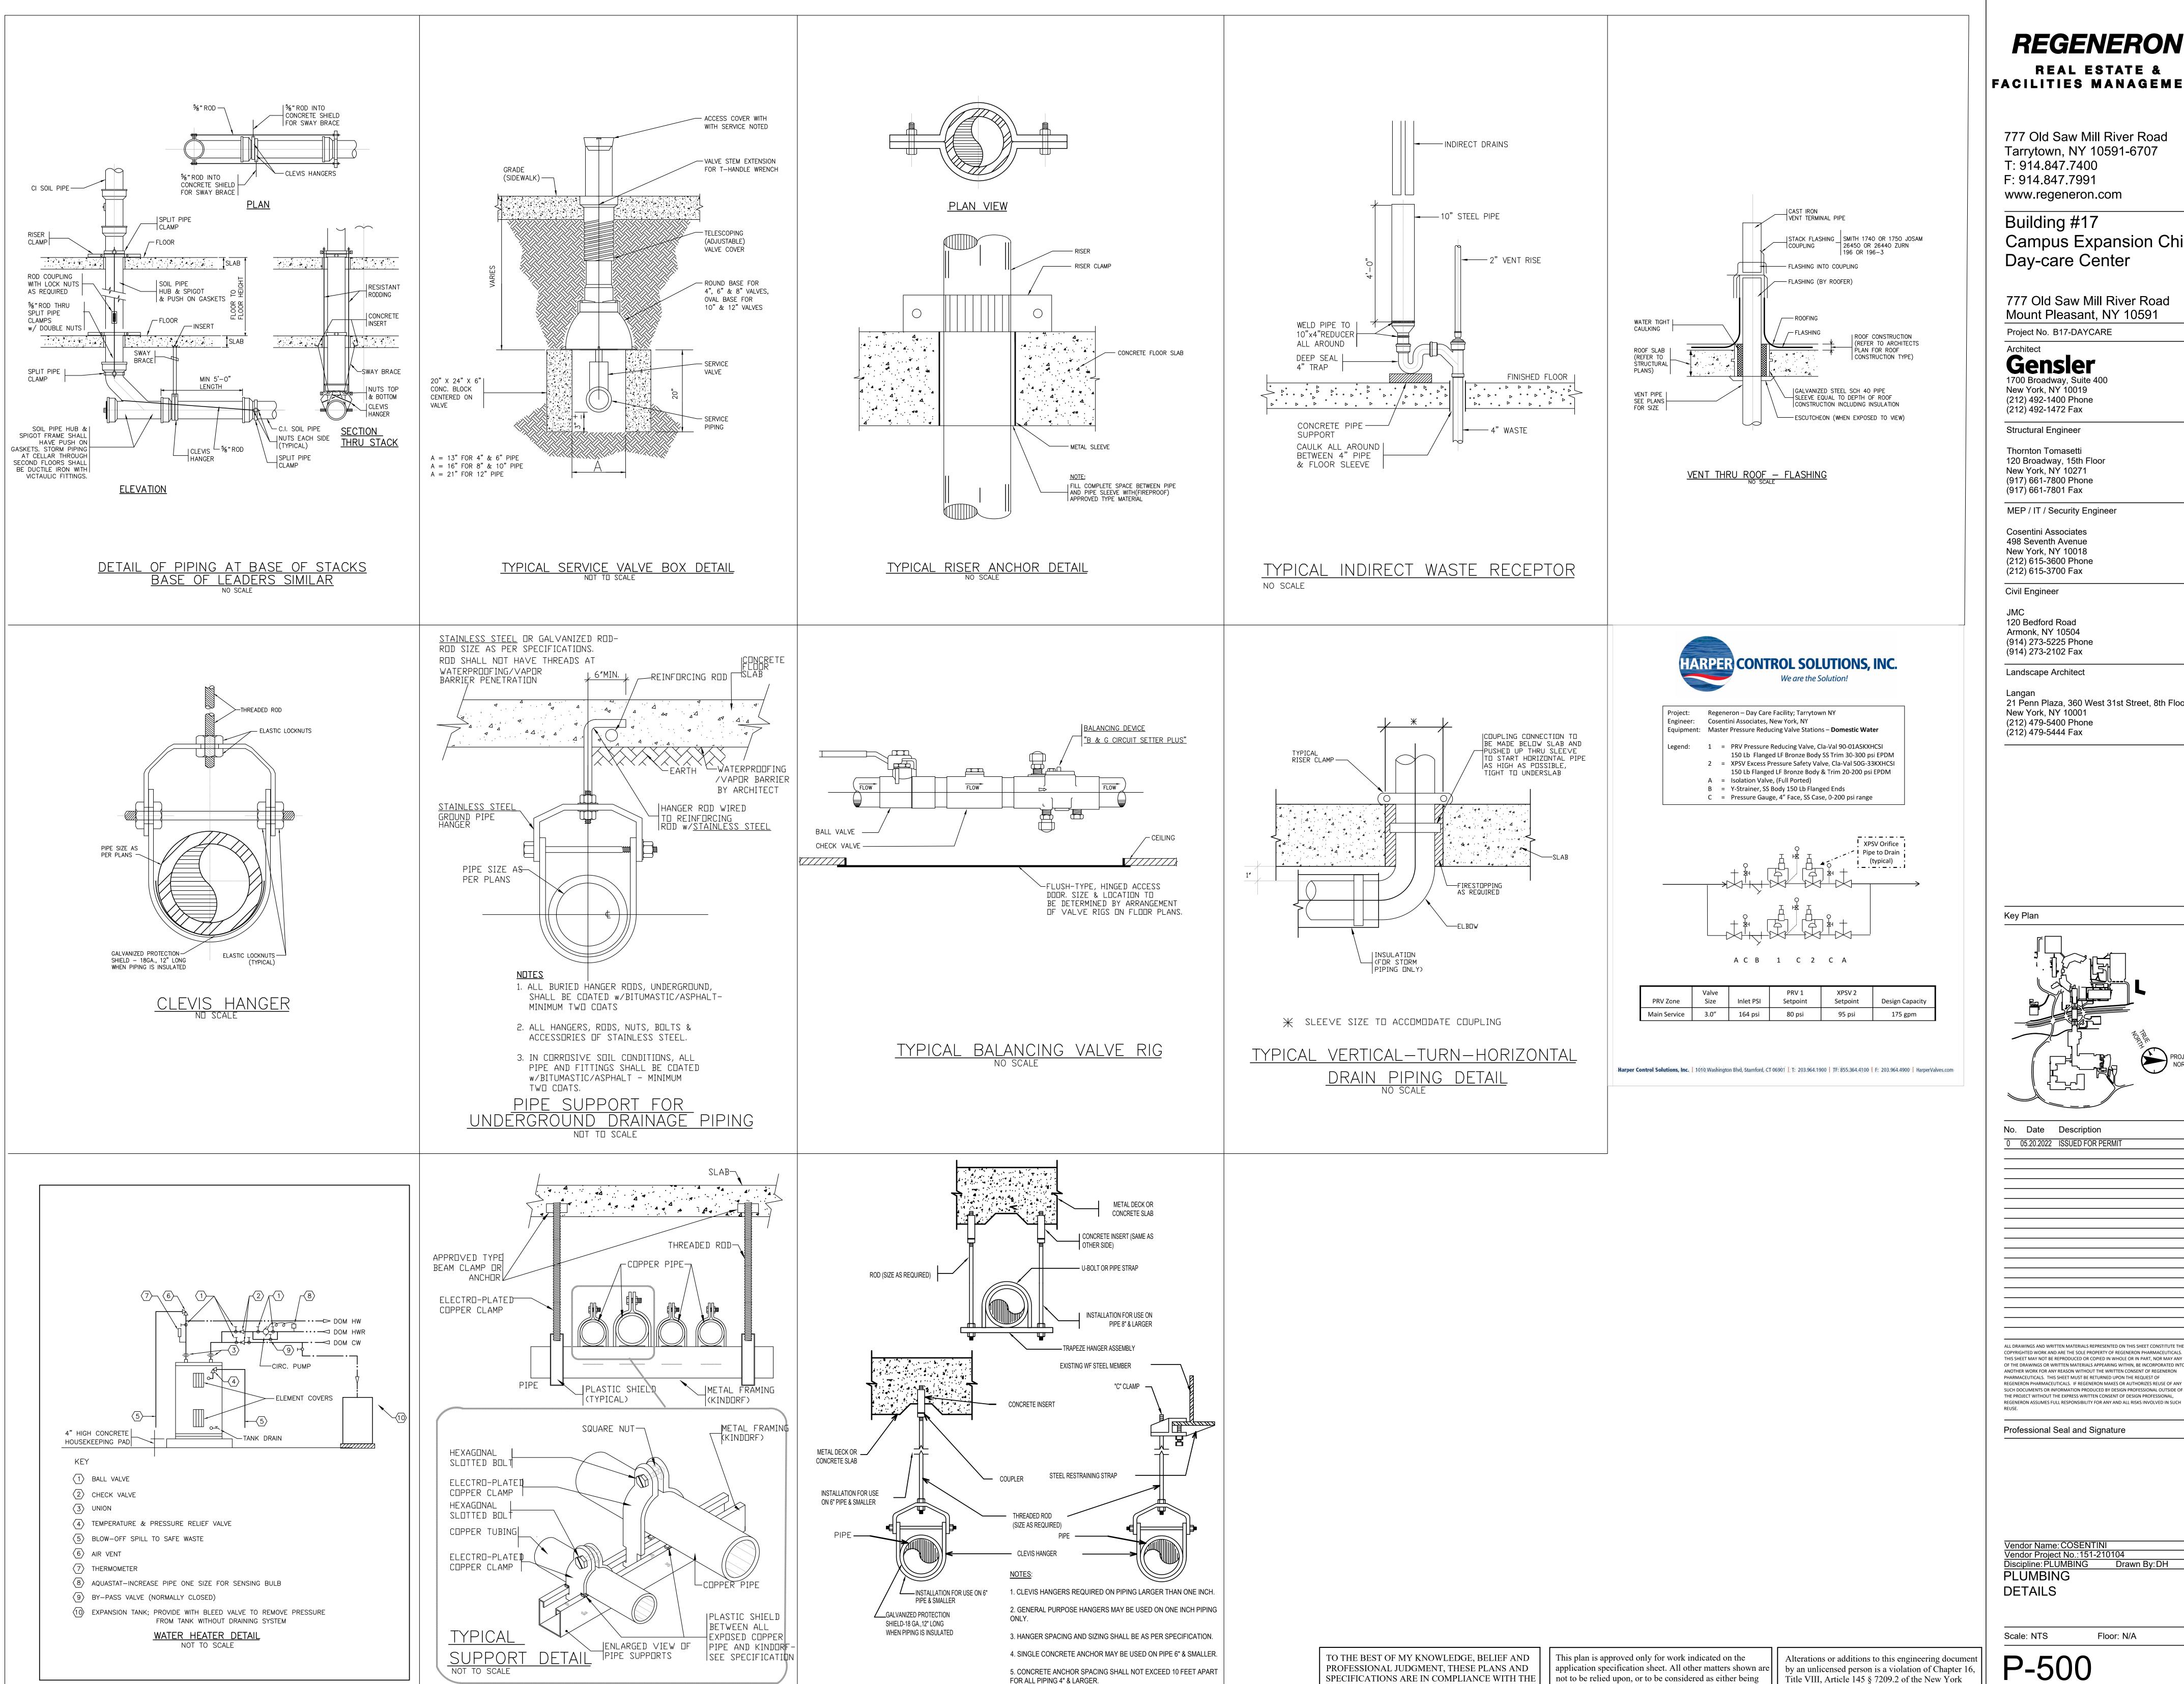
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Vendor Project No.: 151-210104
Discipline: PLUMBING Drawn By: DH
PLUMBING ROOF PLAN

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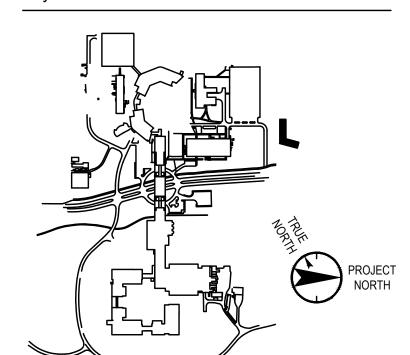
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Floor: N/A

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	PLUMBING MATERIAL SO	CHEDULE	
SYSTEM	PIPE	FITTINGS	JOINTS
NOTES: 1. FOR REQUIRED PRESSURE RATINGS SEE RISER DIAGRAM. 2. INSTALL IN TRENCH OR SPLIT TILE CONDUIT. 3. ALL MATERIALS SELECTED ON THIS SCHEDULE MUST BE APPROVED BY THE LOCAL AUTHORITIES.	REQUIRED CAST IRON SOIL PIPE CAST IRON WTR PIPE DUCTILE IRON STEEL SCHED 10 STEEL SCHED 30 STEEL SCHED 40 TYPE "K" OR "L" MEDICAL GAS TUBE TYPE"K"COPPER TUBING TYPE"K"COPPER TUBING RED BRASS PIPE DWV COPPER DRAINAGE BLACK GALVANIZED CEMENT LINED COATED MILL WRAPPED UNPIGMENTED NATURAL POLYPROPYLENE ACID RESIST. C.I. — SILICONE POLYPROPYLENE — FIRE RETARDANT BOROSILICATE GLASS 304 STAINLESS STEEL CUT GROOVE	& SPIGOT AGE PATTERN ON NO-HUB AGE PATTERN ON SILE IRON SONZE IT COPPER ON SAPPED SAPP	LKED EADED DERED DERED ZED H.JOINT—GASKE H.JOINT—GASKE H.JOINT—FLANG AULIC GALUAN T SOCKET FUSI ION RESISTANCI HANICAL JOINT VICTAULIC FLEX
DRAINAGE BURIED			
VENTS BURIED			
HOUSE DRAINS — INSIDE OF BLDG. WALL			
HOUSE SEWERS - PUTBLIBELISES EWER WALL			
SANITARY STACKS			
SANITARY BRANCHES			
LEADERS & STORM DRAINAGE SYSTEM			
VENTS			
FIXTURE CONNECTIONS—WATER			
C.W 4" & SMALLER			
C.W 5" & LARGER			
C.W. — BURIED BUILDING SERVICE			
C.W. — BURIED INSIDE BUILDING			

DESIGNATION

WALL HYDRANT SCHEDULE

MANUFACTURER & MODEL NO.

Z1320XL

140 WATER HEATER ROOM

NOTES

COORDINATE LOCATIONS WITH ARCHITECT

									\/ΔΙ	VE S	PFCI	FICAT	ION										PI	IIMRI	ING '	SYSTE	<u>-</u>	
TYPE	FIG. NO.: MILWAUKEE * NORDSTROM	REQUIRED	SIZE	FLANGED	SCREWED	SOLDER	LEAD-FREE	0.S.&Y.	N.R.S.	R.S.	FULL PORT	STANDARD PORT	BRONZE	I.B.B.M.	ALL IRON	200# wwP	250# WWP	300# WWP	500# WWP	600# WWP	SUMP DISCH.	EJECTOR DISCH.	NATURAL GAS	C.W. SERVICE	C.W. 2-1/2" & UP	C.W. 2" & UNDER	NON POTABLE 2" & UNDER	HW & HWC 2-1/2" & UP
					S	S		0	Z	<u>~</u>	<u> </u>	S		<u> </u>	¥	2	2	3	5	9	S	Щ	Z	<u>ی</u>	O	S	Z	<u> </u>
CATE	F-2885A		3" - 12"	•										•		•												
VALVES		_	3" - 12"	•					•																			
	F-2894A		3" - 12"																									_
	BA-400		3/8" - 2 1/2"		•						•																	
BA4	UPBA400		3/8" - 2 1/2"		•						•																	
			3/8" - 2 1/2"			•																						
BALL VALVES	UPBA450		3/8' - 2 1/2' 3/8' - 2 1/2'		•																							
	UPBA100		3/8" - 2 1/2"		•		•																			•		
	BA150		3/8" - 2 1/2"																									
	UPBA150		3/8" - 2 1/2"			•	•					•																
	509T		3/8" - 2"		•											•												
	UP509		3/8" - 2"		•													•										
CLIECK			3/8" - 3"										•								•							
VALVES	UP1509		3/8" - 3"			•	•						•															
	F-2974A		2-1/2" - 12"	•										•		•					•				•			
	502		3/8" - 2"		•								•			•												
	UP502		3/8" - 2"		•		•						•			•										•		
	1502		3/8" - 2"			•							•					•										
GLOBE VALVES		_	3/8" - 2"			•	•						•					•								•		
VALVE3	595T		3/8" - 2"		•								•					•										
	F-2981A	_	2-1/2" - 10"	•				•						•		•									•			•
	F-2983-M		2-1/2" - 6"	•				•						•					•						•			•
PLUG	142*		3/4" - 2"		•							•			•	•												

NOTES

1. THIS VALVE SCHEDULE IS BASED ON MILWAUKEE VALVES; OTHER MANUFACTURERS AS INDICATED 2. ALL VALVES USED FOR DOMESTIC WATER 2" OR SMALLER SHALL COMPLY WITH THE LEAD FREE REQUIREMENTS

			DOMESTI	C WATER	HEATERS / BOIL	LERS	<u> </u>			
HTR. MANUF. ABBREV.			TANK DATA		STEAM DATA		ELEC. COIL ELEMENT DATA	GAS DATA	-	
DESIGNATION	NO. REQUIRED	MANUFACTURER & MODEL NO.	STORAGE CAP.,GALS. PRESSURE RATING	RECOVERY IN GAL./HR.	EACH AM VAL. TERING ATER COIL IN C. STEAM PRE	STEAM VALVE TYPE	RATING IN K.W. VOLTS PHASE	GAS PRESS.,W.C. INPUT IN CFH	INPUT IN BTU/HR.	DOMESTIC HW TEMP. 0 Salar
899-DWH-1-01	1	AO SMITH DEN120	120	68			12 480 3			110 PLUMBING ROOM

123

PLACE ON 4" HIGH CONCRETE PAD

NOTES

1) ALL DOMESTIC WATER HEATING EQUIPMENT SHALL BE EQUIPPED WITH A TEMPERATURE & PRESSURE RELIEF VALVE, EXCEPT FOR POINT OF USE TYPE WITHOUT STORAGE. EACH DOMESTIC WATER SYSTEM SHALL BE EQUIPPED WITH AN EXPANSION TANK OF SUFFICIENT SIZE TO ACCOMODATE THERMAL EXPANSION OF THE WATER CONTAINED THEREIN.

WATER FILTER SCHEDULE

DESIGNATION

899-DWH-1-02

DIMENSIONS MANUFACTURER

TEKLEEN MTF3-L-SKID

LENGTH WIDTH & MODEL NO.

AO SMITH DVE200

		DOMESTIC HO	T WATI	ER RE	CIRCULA	TION F	PUMP	SCHE	DUL	.E			
PUMP CO ABBREV. BELL & GOSSETT B&G	RED	•	CTION WSR COUPLED	PRESS.					CONTROL	ONTROL GHT	JOZ	CENTER Y POWER	
• DESIGNATION	NO. REQUIRED G.P.M. T.D.H.	MODEL NO	STAGES END SUCTI VERT. CWS	: SU	н Н	R.P.M.	VOLTS	PHASE		AUTO CONTI	PRESSURE GAUGE RANGE	CONTROL C	LOCATION
RECIRCULATION PUMPS	2 25 20 _{EC}	DCIRC XL 55-45	1	• -	3/4	3333	208	1		- • •	0-50		PLUMBING ROOM & WATER HEATER ROOM

<u>NOTE:</u> (ALL RECIRCULATION PUMPS TO BE "ALL BRONZE" IN LINE)

PROFESSIONAL JUDGMENT, THESE PLANS AND SPECIFICATIONS ARE IN COMPLIANCE WITH THE

This plan is approved only for work indicated on the application specification sheet. All other matters shown are by an unlicensed person is a violation of Chapter 16, not to be relied upon, or to be considered as either being approved or in accordance with applicable codes.

Alterations or additions to this engineering document Title VIII, Article 145 § 7209.2 of the New York State Education Law.

REGENERON

REAL ESTATE &

FACILITIES MANAGEMENT

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Building #17
Campus Expansion Child
Day-care Center

777 Old Saw Mill River Road Mount Pleasant, NY 10591

Project No. B17-DAYCARE

Gensier

1700 Broadway, Suite 400
New York, NY 10019
(212) 492-1400 Phone
(212) 492-1472 Fax

Structural Engineer

Thornton Tomasetti 120 Broadway, 15th Floor New York, NY 10271 (917) 661-7800 Phone (917) 661-7801 Fax

MEP / IT / Security Engineer Cosentini Associates 498 Seventh Avenue


New York, NY 10018 (212) 615-3600 Phone

(212) 615-3700 Fax Civil Engineer

JMC 120 Bedford Road Armonk, NY 10504 (914) 273-5225 Phone (914) 273-2102 Fax

Landscape Architect

Langan 21 Penn Plaza, 360 West 31st Street, 8th Floor New York, NY 10001 (212) 479-5400 Phone (212) 479-5444 Fax

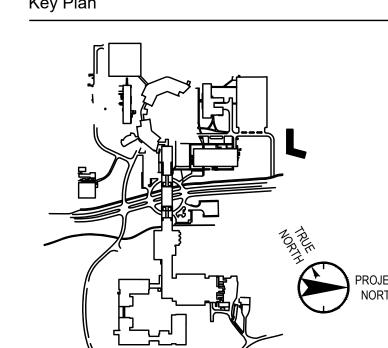

No. Date Description


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Professional Seal and Signature

Vendor Name: COSENTINI
Vendor Project No.:151-210104
Discipline: PLUMBING Drawn By: DH
PLUMBING SCHEDULES

Scale: NTS Floor: N/A

TO THE BEST OF MY KNOWLEDGE, BELIEF AND 2020 ENERGY CONSERVATION CODE OF NYS

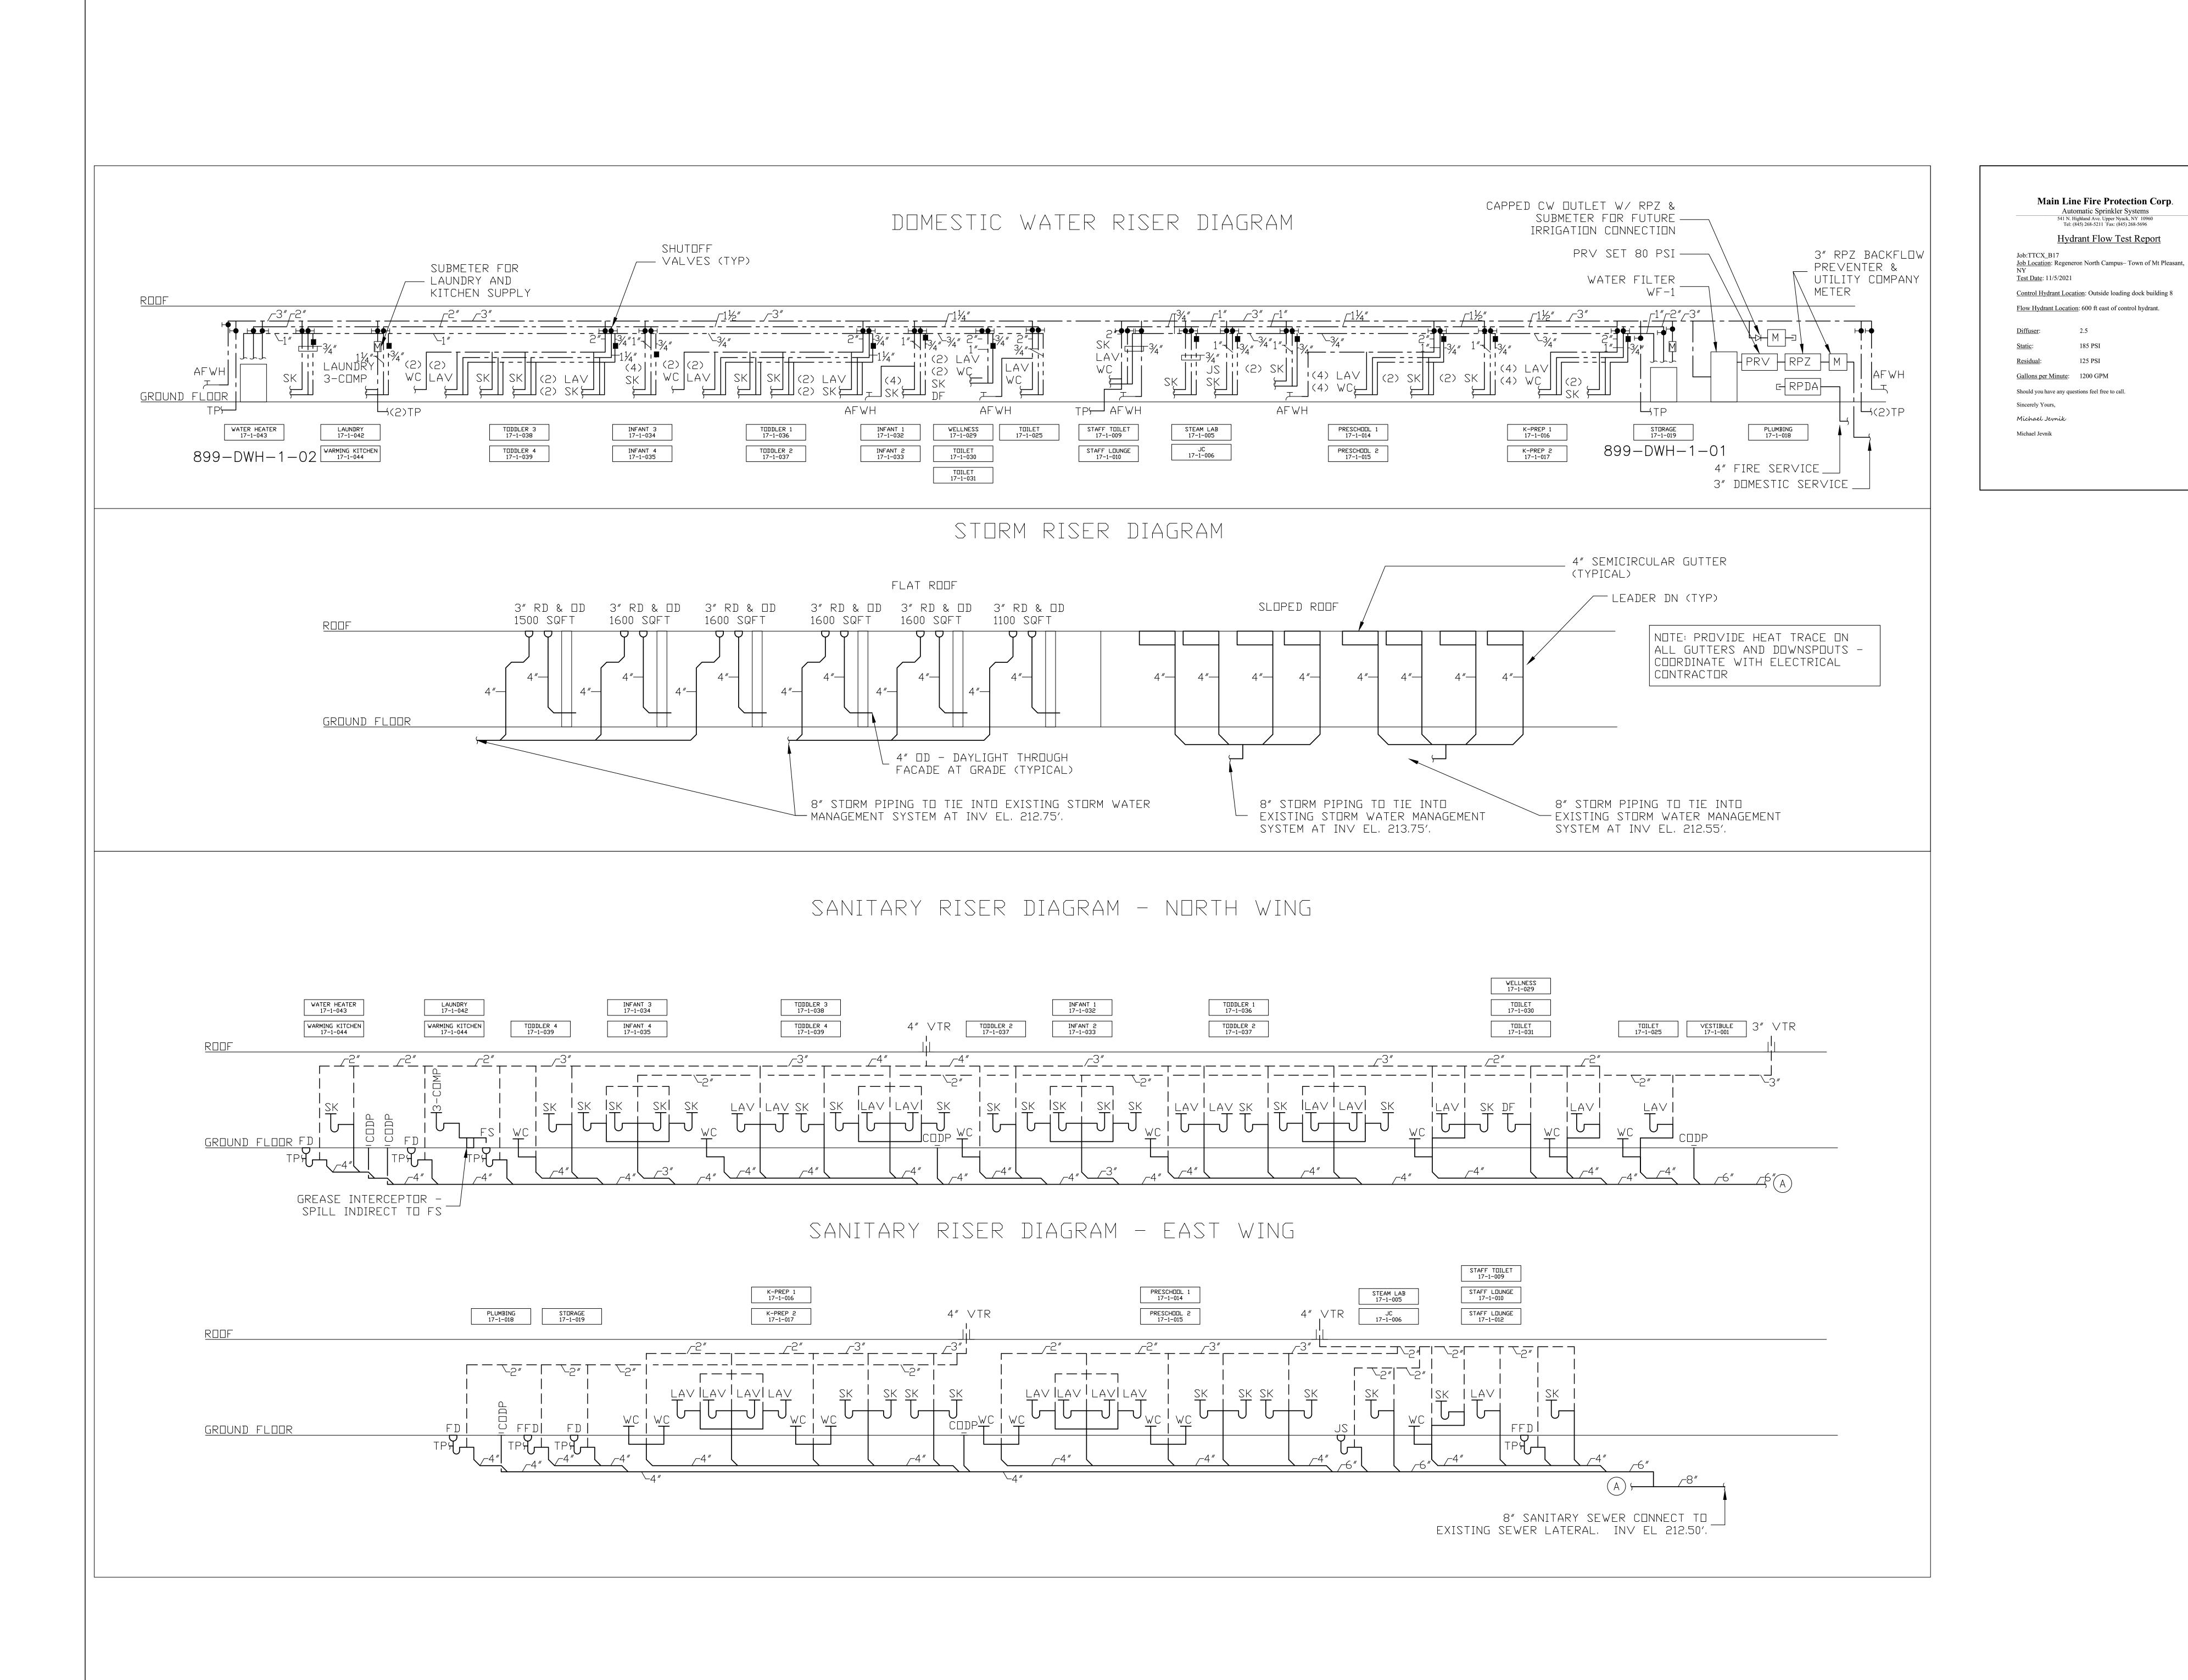

REAL ESTATE & FACILITIES MANAGEMENT

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Building #17 Campus Expansion Child Day-care Center

777 Old Saw Mill River Road Mount Pleasant, NY 10591

Project No. B17-DAYCARE

Automatic Sprinkler Systems

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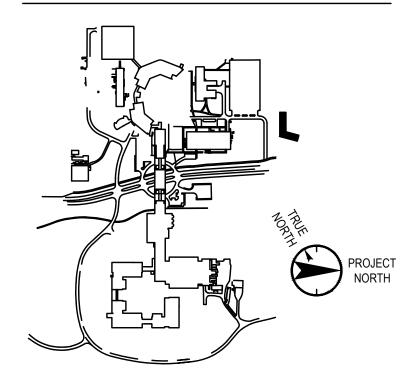
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Key Plan



No. Date Description

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Professional Seal and Signature

Vendor Name: COSENTINI
Vendor Project No.:151-210104
Discipline: PLUMBING Drawn By: DH RISER DIAGRAMS

Floor: N/A Scale: NTS

P-700