

ABBREVIATIONS
PERES
OVE COUNTER
CESS CONTROL ALARM MONITORING SYSTEM
CESS CONTROL SYSTEM
OVE FINISHED FLOOR
ERICAN WIRE GAUGE
NDUIT
TALOG
RCUIT BREAKER
OSED CIRCUIT TELEVISION
RCUIT
NTER LINE
ILING
NDUCTOR
PPER
AWING
ECTRONIC ARTICLE SURVEILLANCE
PTY CONDUIT
ERGENCY
ISTING
RE ALARM LIFE/SAFETY SYSTEM
E ALARM CONTROL PANEL
OUND
NERAL CONTRACTOR
NG CEILING
RTZ
RUSION ALARM SYSTEM
ERMEDIATE DISTRIBUTION FRAME
NCTION BOX
W VOLTAGE
NUAL TRANSFER SWITCH
UTRAL RMALLY CLOSED
T IN CONTRACT
RMALLY OPEN
MBER
T TO SCALE
BLIC ADDRESS
NEL
N/TILT/ZOOM
QUEST TO EXIT
ОМ
IELDED TWISTED PAIR
ANSFORMER
BE DETERMINED
ECOMMUNICATIONS
IE LAPSE RECORDER
MPER SWITCH
ECOMMUNICATIONS TERMINAL BOARD
ECOMMUNICATIONS TERMINAL CABINET
EVISION
PICAL
LESS OTHERWISE NOTED
INTERRUPTIBLE POWER SUPPLY
SHIELDED TWISTED PAIR
LTS
LT-AMPERES
LTMETER
POR PROOF

	LEGEND			
C	RECESSED DOOR CONTACT			
CR	CARD READER			
СК	CARD READER W/T KEYPAD			
СО	OVERHEAD DOOR CONTACT			
CS	SURFACE MOUNT CONTACT			
DC	ARMORED DOOR CHORD			
DG	DATA GATHERING PANELS			
DR	DOOR RELEASE PUSH BUTTON			
EC	EMERGENCY CALL BOX			
ACAM	ACCESS CONTROL ALARM MONITORING WORKSTATION			
EI	REQUEST TO EXIT MOTION DETECTOR			
EH	ELECTRIC POWER TRANSFER HINGE			
HP	HANDICAP PUSH PLATE			
L1	SINGLE ELECTROMAGNETIC LOCK WITH DSM FEATURE			
L2	DOUBLE ELECTROMAGNETIC LOCK WITH DSM FEATURE			
L3	ELECTRIC STRIKE FAIL SAFE			
L4	ELECTRIC STRIKE FAIL SECURE			
L5	ELECTRIC MORTISE LOCK FAIL SAFE WITH RX OPTION			
L6	ELECTRIC MORTISE LOCK FAIL SECURE WITH RX OPTION			
L7	EXIT DEVICE WITH ELECTRIFIED BREAKAWAY LEVER WITH REX OPT			
L8	AUTOMATIC SWINGING DOOR OPERATOR			
L9	QUIET EXIT DEVICE WITH ELECTRIC LATCH RETRACTION WITH REX OPTION			
CCTV	CCTV WORKSTATION			
MSP	MINIMUM 60 WATT PoE MIDSPAN			
NVR	NETWORK VIDEO RECORDER			
ACAM	ACCESS CONTROL/ALARM MONITORING WORKSTATION			
⊂⊂K <sup>xx</sup> <sub>C#</sub>	FIXED SURVEILLANCE CCTV CAMERA C1 = INDOOR CAMERA C2 = OUTDOOR CAMERA C3 = OUTDOOR PAN/TILT/ZOOM CAMERA C3 = OUTDOOR PAN/TILT/ZOOM CAMERA C3 = OUTDOOR PAN/TILT/ZOOM CAMERA C4 = RECESSED IN CEIL WM = WALL MOUNTED CM = CEILING SURFACE MOUNTED CN = CORNER MOUNTED			
PP	CAT6 PATCH PANEL			
SW	NETWORK SWITCH			
WF	SECURITY WALLFIELD			
ACP	SECURITY ACCESS CONTROL PANEL			
LPS	LOCK POWER SUPPLY			
FA	# = NUMBER OF ELECTRIFIED HARDWARE CONNECTED FA ALARM INTERFACE RELAY			
	DATA GATHERING PANEL			
EC	EMERGENCY CALL BOX MOTOROLA (PROVIDED AND INSTALLED			
	BY METROCOMM)			

123     ROOM NUROOM DE       123     ROOM NUROOM DE       X     DRAWING No. DETAIL No.     STANDAR       X     DETAIL No.     DETAIL No.       DETAIL No.     DETAIL No.		NOTE			
X     DRAWING No.       X     DETAIL No.         X     DETAIL No.			SEE NOTE NOTE NUM		
X     DETAIL No.     STANDAR       X     DETAIL No.     DETAIL No.       BEDVIDE 12" X 12	(123)		ROOM NUM ROOM DES		
		DETAIL No.			
PROVIDE 12" X 12" X 4" DEE	SECURITY				
ON THE PLANS	J1	PROVIDE 12" X 12" X 4" DEEF ON THE PLANS			

J1	ON THE PLANS
J2	PROVIDE 6" X 6" X 4" JUNCT
J3	PROVIDE 4" X 4" BOX

TY-001	SECURITY
TY-100	SECURITY
TY-500	SECURITY
TY-501	SECURITY
TY-700	SECURITY

GENERAL NOTES:

- EXACT LOCATION.
- LOCKS TYPES AND MODELS.
- POWER REQUIREMENTS.
- 5. SECURITY CABLES THAT RUN ABOVE CEILING SHALL BE
- INSTALLED ON J-HOOKS. PROVIDE J-HOOKS SPACED 5 FEET APART.
- 6. SECURITY CABLES RUN THROUGH AREAS WITH OPEN CEILING
- PROVIDED BY ELECTRICAL CONTRACTOR.

E INDICATIONS				
E ON THIS DRAWING. MBER INDICATED BY NUMERAL IN DIAMOND.				
IMBER INDICATED BY NUMERALS. SIGNATION AS INDICATED IN SCHEDULE.				
D DETAIL No. DESIGNATION				
D. DESIGNATION ON DETAIL SHEET				
JUNCTION BOXES				
EP BOX WITH LOCKING DOOR ABOVE CEILING, AS NOTED				
TION BOX WITH HINGED LOCKABLE COVER				
DRAWING LIST				

Y GENERAL NOTES, SYMBOLS AND ABBREVIATIONS Y LEVEL 01 PLAN Y DETAILS SHEET #1 Y DETAILS SHEET #2 Y WIRING RISER DIAGRAM & EQUIPMENT ELEVATIONS 

1. PRIOR TO INSTALLATION, SECURITY CONTRACTOR SHALL COORDINATE WITH ARCHITECT FOR EACH SECURITY DEVICE

2. SECURITY CONTRACTOR SHALL COORDINATE WITH WITH DOOR AND DOOR HARDWARE PROVIDER FOR ALL ELECTRIFIED

3. SECURITY CONTRACTOR SHALL COORDINATE WITH ELECTRICAL CONTRACTOR FOR THE SECURITY SYSTEMS

4. SECURITY CONTRACTOR SHALL COORDINATE WITH TELE/DATA PROVIDER FOR SECURITY SYSTEM TELE/DATA REQUIREMENTS.

SHALL BE ENCLOSED TO THE CONDUITS. CONDUITS SHALL BE

7. ALL CONDUITS SHOWN ON SECURITY DRAWINGS ARE FOR SECURITY SYSTEMS ONLY.

> TO THE BEST OF MY KNOWLEDGE, BELIEF AND PROFESSIONAL JUDGMENT, THESE PLANS AND SPECIFICATIONS ARE IN COMPLIANCE WITH THE 2020 ENERGY CONSERVATION CODE OF NYS

not to be relied upon, or to be considered as either being approved or in accordance with applicable codes.

This plan is approved only for work indicated on the<br/>application specification sheet. All other matters shown areAlterations or additions to this engineering document<br/>by an unlicensed person is a violation of Chapter 16, Title VIII, Article 145 § 7209.2 of the New York State Education Law.

ABBREVIATIONS Floor: Scale: NTS

TY-001


SYMBOLS AND

Vendor Name: GENSLER Vendor Project No.:006.3608.000 Discipline: Drawn By: Author SECURITY GENERAL NOTES,

REUSE. Professional Seal and Signature


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Key Plan

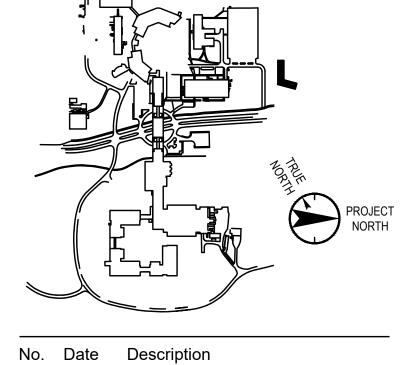

(914) 273-5225 Phone (914) 273-2102 Fax

Cosentini Associates 498 Seventh Avenue New York, NY 10018 (212) 615-3600 Phone (212) 615-3700 Fax

Civil Engineer JMC 120 Bedford Road

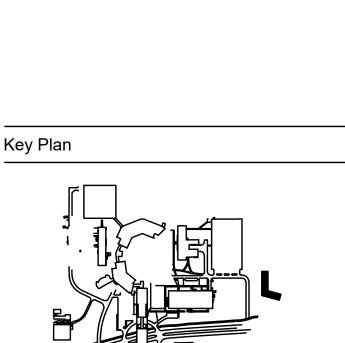Structural Engineer

Thornton Tomasetti 120 Broadway, 15th Floor New York, NY 10271 (917) 661-7800 Phone (917) 661-7801 Fax

MEP / IT / Security Engineer

Armonk, NY 10504

Landscape Architect

(212) 479-5444 Fax

\_\_\_\_\_

Langan 21 Penn Plaza, 360 West 31st Street, 8th Floor New York, NY 10001 (212) 479-5400 Phone

777 Old Saw Mill River Road

Tarrytown, NY 10591-6707

T: 914.847.7400


Building #17 Campus Expansion Child Day-care Center

F: 914.847.7991 www.regeneron.com

Mount Pleasant, NY 10591 Project No. B17-DAYCARE Architect **Gensier** 1700 Broadway, Suite 400 New York, NY 10019 (212) 492-1400 Phone (212) 492-1472 Fax

777 Old Saw Mill River Road

REGENERON REAL ESTATE & Facilities management

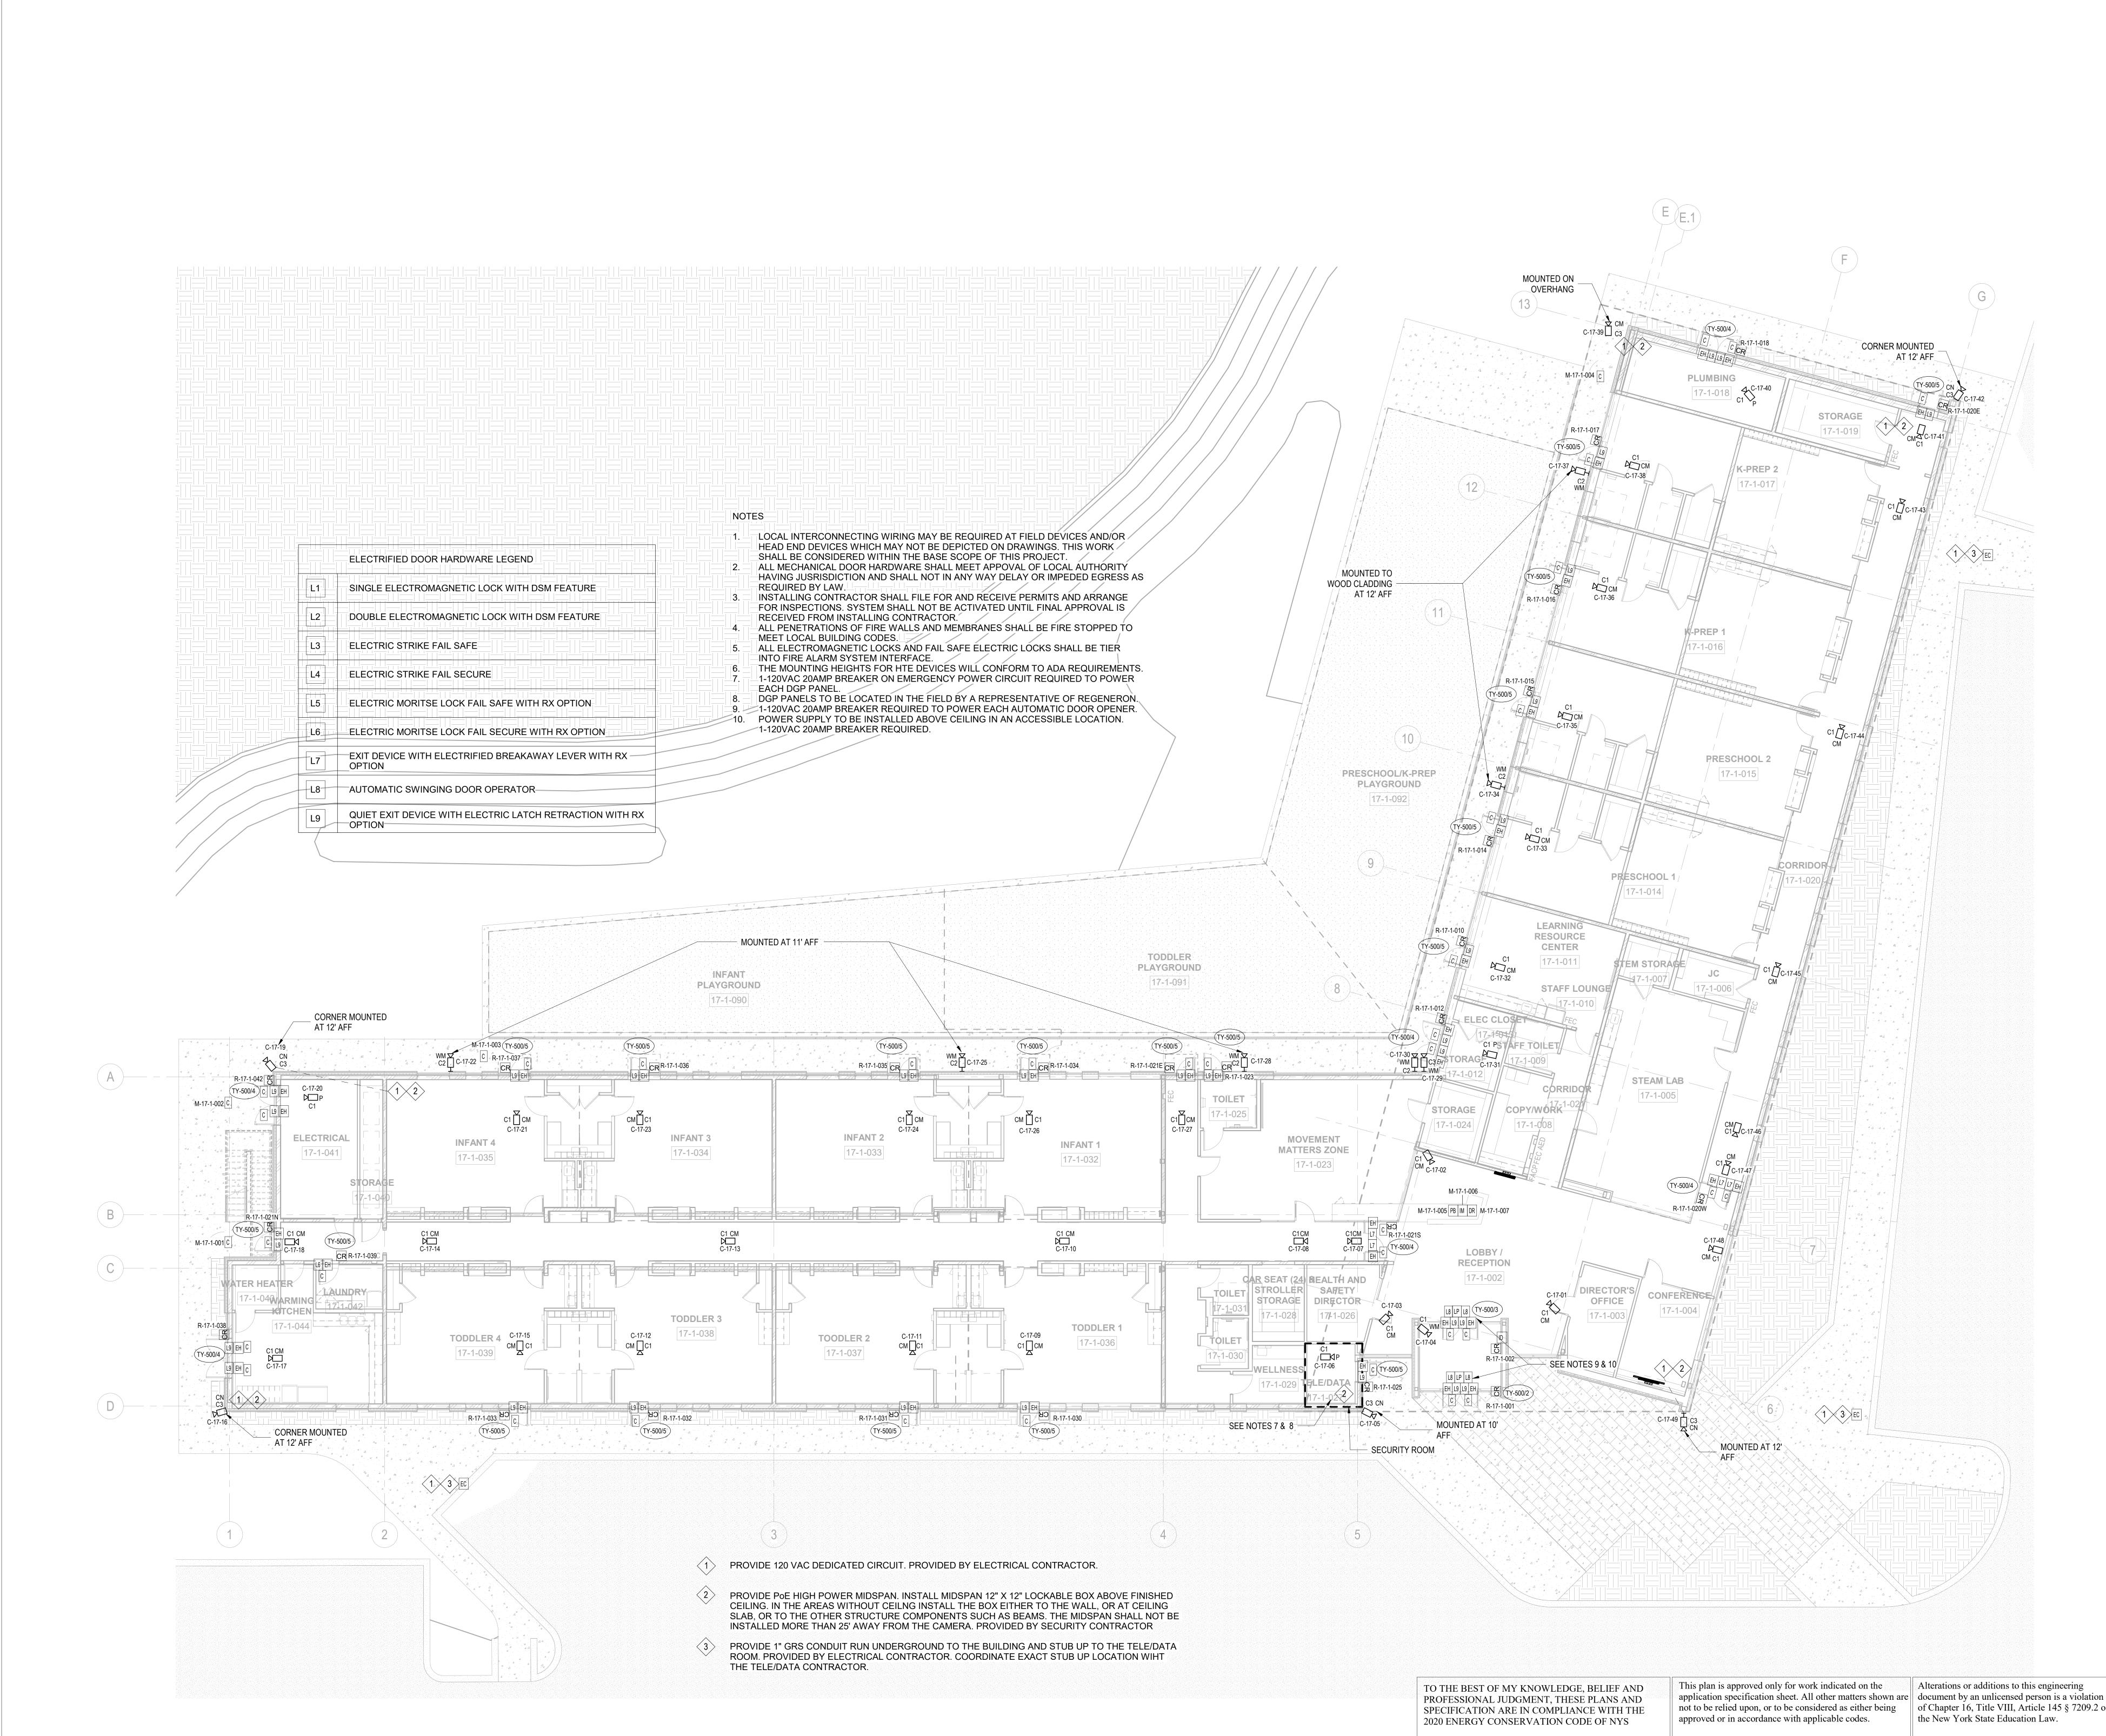

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TY-100

Scale: 1/8" = 1'-0" Floor:

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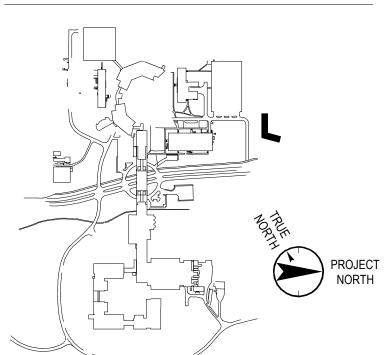
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JMC

120 Bedford Road Armonk, NY 10504 (914) 273-5225 Phone (914) 273-2102 Fax Landscape Architect

(212) 615-3600 Phone (212) 615-3700 Fax Civil Engineer

**Gensier** 1700 Broadway, Suite 400 New York, NY 10019 (212) 492-1400 Phone (212) 492-1472 Fax Structural Engineer

Y-500/5)

Thornton Tomasetti 120 Broadway, 15th Floor New York, NY 10271 (917) 661-7800 Phone (917) 661-7801 Fax

MEP / IT / Security Engineer

Cosentini Associates 498 Seventh Avenue New York, NY 10018


777 Old Saw Mill River Road Mount Pleasant, NY 10591 Project No. B17-DAYCARE Architect


Day-care Center

777 Old Saw Mill River Road Tarrytown, NY 10591-6707 T: 914.847.7400 F: 914.847.7991 www.regeneron.com Building #17

Campus Expansion Child

## REGENERON REAL ESTATE & FACILITIES MANAGEMENT

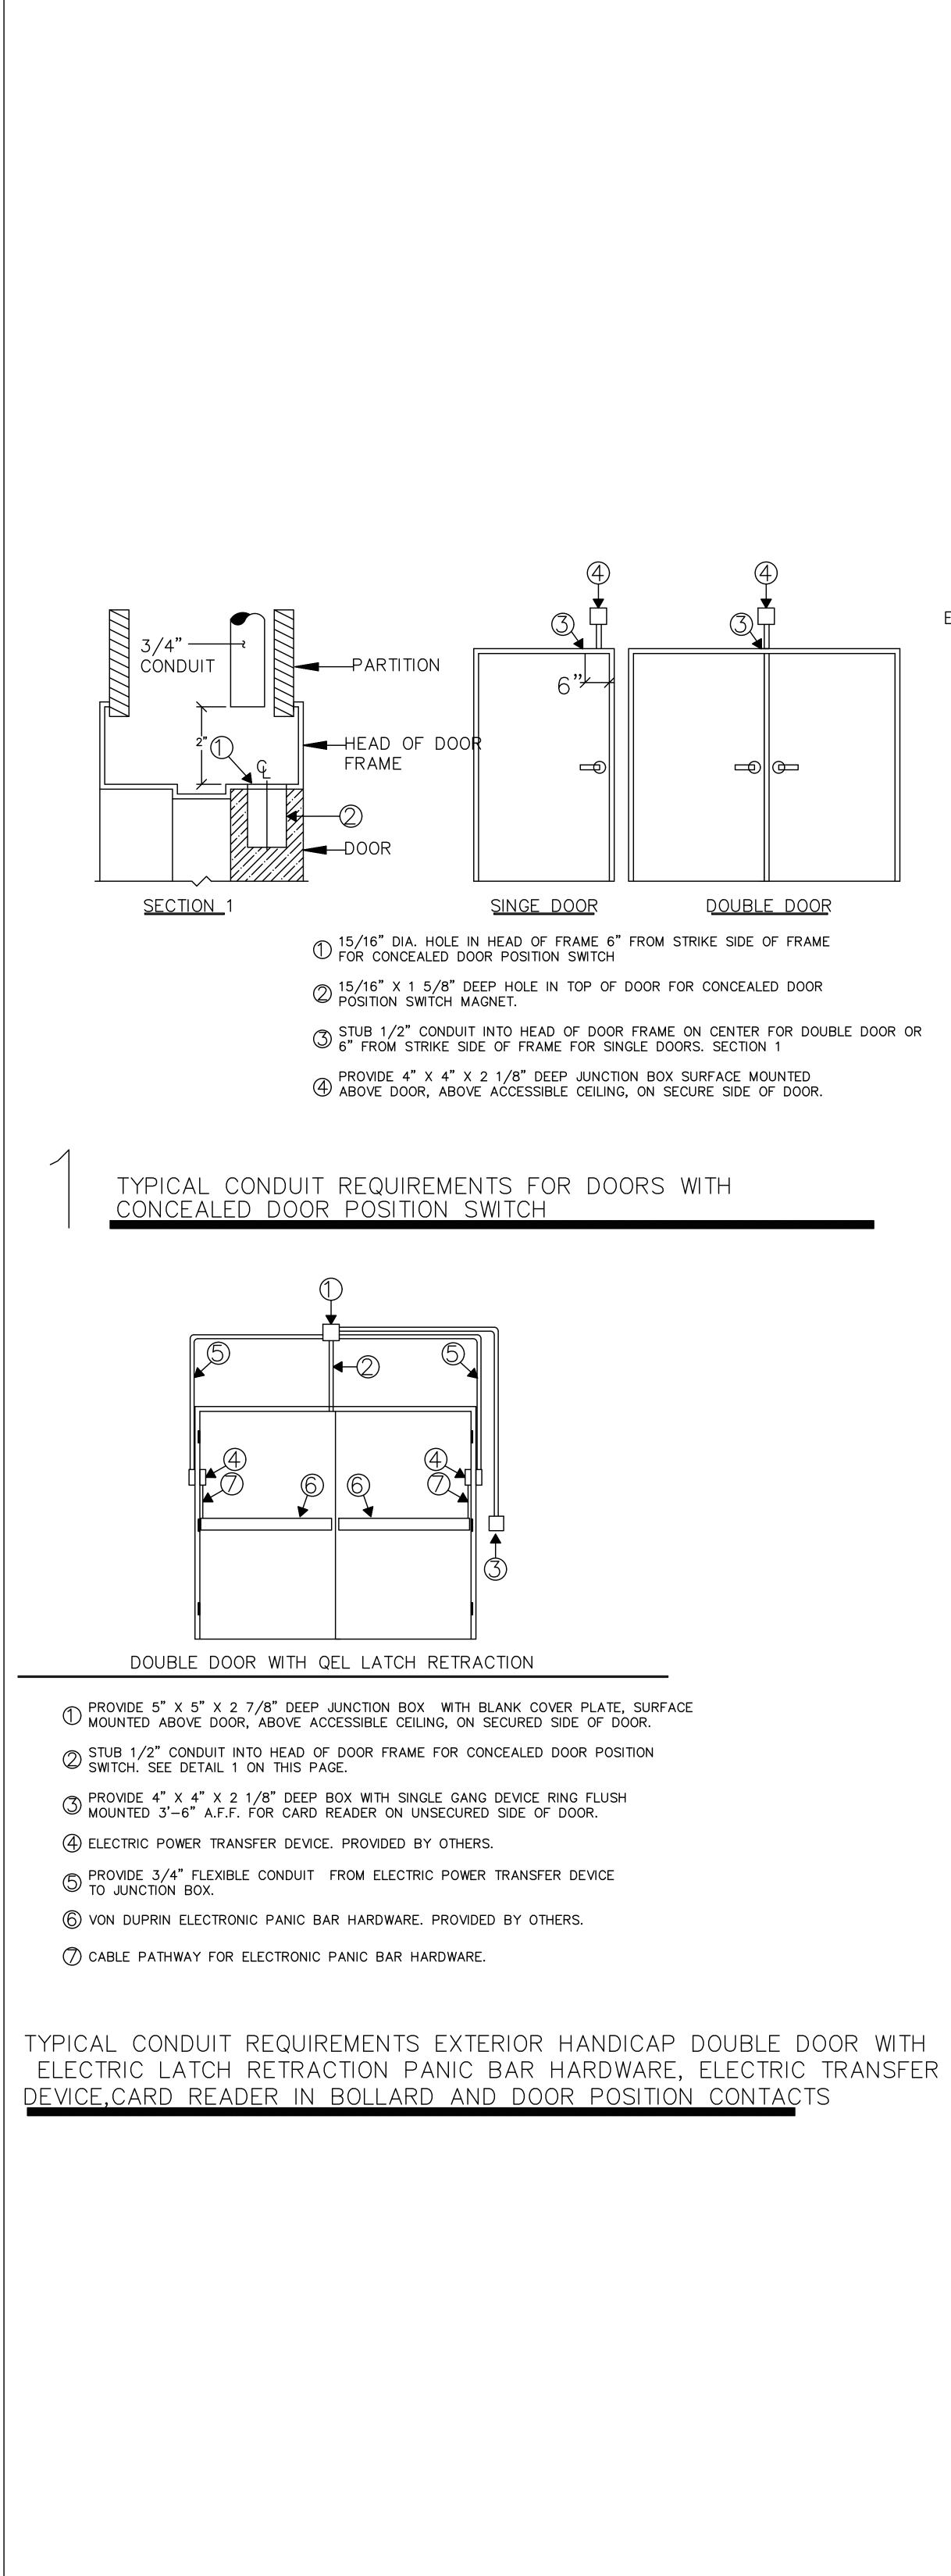


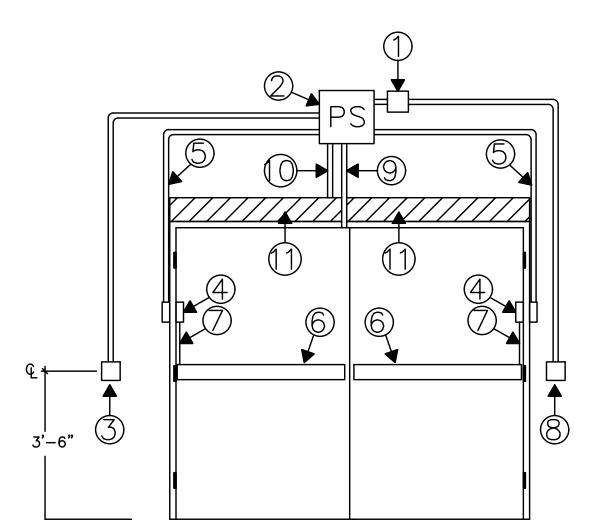

EXTERIOR DOUBLE DOOR WITH HANDICAP OPENER AND ELECTRIC LATCH RETRACTION

- D PROVIDE 5" X 5" X 2 7/8" DEEP JUNCTION BOX WITH BLANK COVER PLATE, SURFACE MOUNTED ABOVE DOOR, ABOVE ACCESSIBLE CEILING, ON SECURE SIDE OF DOOR.
- © POWER SUPPLY FOR ELECTRONIC PANIC BAR HARDWARE. PROVIDED BY OTHERS. SURFACE MOUNTED ABOVE DOOR, ABOVE ACCESSIBLE CEILING, ON SECURE SIDE OF DOOR. 120VAC REQUIRED
- PROVIDE 4" X 4" X 2 1/8" DEEP BOX WITH RAISED DEVICE COVER FLUSH MOUNTED 3'-6" A.F.F. FOR HANDWAVE EXIT BUTTONS.
- (4) VON DUPRIN EPT-10 ELECTRIC POWER TRANSFER DEVICE. PROVIDED BY OTHER.
- 5 PROVIDE 3/4" FLEXIBLE CONDUIT FROM ELECTRIC POWER TRANSFER DEVICE TO POWER SUPPLY FOR ELECTRONIC PANIC BAR HARDWARE.
- (6) VON DUPRIN ELECTRONIC PANIC BAR HARDWARE. PROVIDED BY OTHERS.
- (7) CABLE PATHWAY FOR ELECTRONIC PANIC BAR HARDWARE
- BROVIDE 4" X 4" X 2 1/8" DEEP BOX WITH SINGLE GANG DEVICE RING FLUSH MOUNTED 3'-6" A.F.F. FOR CARD READER ON UNSECURED SIDE OF DOOR.
- 9 STUB 1/2" CONDUIT INTO HEAD OF DOOR FRAME FOR CONCEALED DOOR POSITION SWITCH. SEE DETAIL 1 ON THIS PAGE.
- () PROVIDE CONDUIT INTO AUTOMATIC DOOR OPENER FOR LOW VOLTAGE CONNECTIONS RECORD DOOR OPERATORS TO BE SUPPLIED AND INSTALLED BY LONG ISLAND AUTOMATIC DOORS 85 SOUTH TERMINAL DRIVE, PLAINVIEW, NY 11803. PHONE: 516-931-2273. SALES FAX: 516-575-0041. ATTN: ANDREW CARR. EMAIL: andrewc@lilocksmith.com. 1 -120VAC BREAKER REQUIRED FOR DOOR OPENER.


TYPICAL CONDUIT REQUIREMENTS EXTERIOR HANDICAP DOUBLE DOOR WITH QEL LATCH RETRACTION PANIC BAR HARDWARE, ELECTRIC TRANSFER DEVICE, CARD READER AND DOOR POSITION CONTACTS

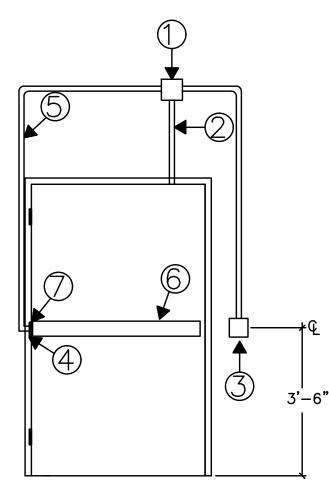

SINGLE DOOR WITH QEL LATCH RETRACTION

- PROVIDE 5" X 5" X 2 7/8" DEEP JUNCTION BOX WITH BLANK COVER PLATE, SURFACE  $\cup$  mounted above door, above accessible ceiling, on secured side of door.
- $\bigcirc$  STUB 1/2" CONDUIT INTO HEAD OF DOOR FRAME FOR CONCEALED DOOR POSITION SWITCH. SEE DETAIL 1 ON THIS PAGE.
- PROVIDE 4" X 4" X 2 1/8" DEEP BOX WITH SINGLE GANG DEVICE RING FLUSH  $\bigcirc$  MOUNTED 3'-6" A.F.F. FOR CARD READER ON UNSECURED SIDE OF DOOR.
- (4) ELECTRIC POWER TRANSFER DEVICE. PROVIDED BY OTHERS.
- © PROVIDE 3/4" FLEXIBLE CONDUIT FROM ELECTRIC POWER TRANSFER DEVICE TO JUNCTION BOX.
- 6 VON DUPRIN ELECTRONIC PANIC BAR HARDWARE. PROVIDED BY OTHERS.
- (7) CABLE PATHWAY FOR ELECTRONIC PANIC BAR HARDWARE.

TYPICAL CO	NDUIT REQ	UIREMENTS	INTERIOR	SINGLE	DOOR	WITH
	OUTSIDE -	TRIM PANIC	BAR HAR	DWARE.	ELECT	
DEVICE,CARI	d reader	AND DOOR	POSITION	CONTAC	)T	

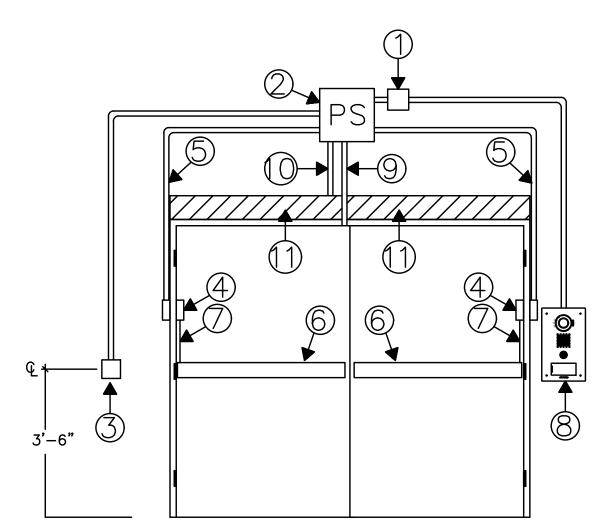


EXTERIOR DOUBLE DOOR WITH HANDICAP OPENER AND ELECTRIC LATCH RETRACTION

D PROVIDE 5" X 5" X 2 7/8" DEEP JUNCTION BOX WITH BLANK COVER PLATE, SURFACE MOUNTED ABOVE DOOR, ABOVE ACCESSIBLE CEILING, ON SECURE SIDE OF DOOR. POWER SUPPLY FOR ELECTRONIC PANIC BAR HARDWARE. PROVIDED BY OTHERS. SURFACE MOUNTED ABOVE DOOR, ABOVE ACCESSIBLE CEILING, ON SECURE SIDE OF DOOR. 120VAC REQUIRED

- PROVIDE 4" X 4" X 2 1/8" DEEP BOX WITH RAISED DEVICE COVER FLUSH MOUNTED 3'-6" A.F.F. FOR HANDWAVE EXIT BUTTONS.
- (4) VON DUPRIN EPT-10 ELECTRIC POWER TRANSFER DEVICE. PROVIDED BY OTHER.'
- 5 PROVIDE 3/4" FLEXIBLE CONDUIT FROM ELECTRIC POWER TRANSFER DEVICE TO POWER SUPPLY FOR ELECTRONIC PANIC BAR HARDWARE.
- (6) VON DUPRIN ELECTRONIC PANIC BAR HARDWARE. PROVIDED BY OTHERS. (7) CABLE PATHWAY FOR ELECTRONIC PANIC BAR HARDWARE
- ◎ AIPHONE SBX-IDVFRA 11-11?16" x 7" x 3-5 ?16" (top); 2-5 ?16" (bottom SURFACE MOUNT BOX) MOUNTED 3'-6" A.F.F. FOR CARD READER/INTERCOM ON UNSECURED SIDE OF DOOR.
- $\ensuremath{\textcircled{O}}$  STUB 1/2" CONDUIT INTO HEAD OF DOOR FRAME FOR CONCEALED DOOR POSITION SWITCH. SEE DETAIL 1 ON THIS PAGE.
- () PROVIDE CONDUIT INTO AUTOMATIC DOOR OPENER FOR LOW VOLTAGE CONNECTIONS RECORD DOOR OPERATORS TO BE SUPPLIED AND INSTALLED BY LONG ISLAND AUTOMATIC DOORS 85 SOUTH TERMINAL DRIVE, PLAINVIEW, NY 11803. PHONE: 516-931-2273. SALES FAX: 516-575-0041. ATTN: ANDREW CARR. EMAIL: andrewc@lilocksmith.com. 1 -120VAC BREAKER REQUIRED FOR DOOR OPENER.

TYPICAL CONDUIT REQUIREMENTS EXTERIOR HANDICAP DOUBLE DOOR WITH QEL LATCH RETRACTION PANIC BAR HARDWARE, ELECTRIC TRANSFER DEVICE, CARD READER AND DOOR POSITION CONTACTS

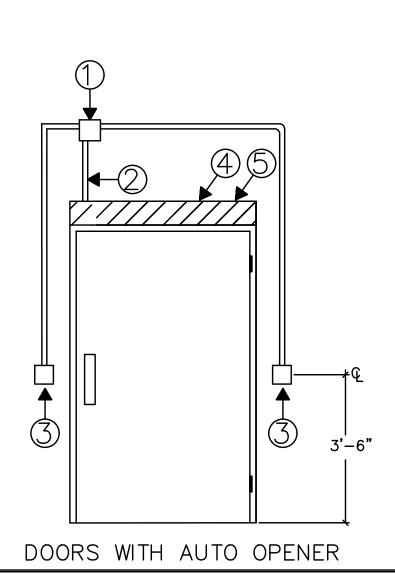

PROVIDE 5" X 5" X 2 7/8" DEEP JUNCTION BOX WITH BLANK COVER PLATE, SURFACE  $\cup$  mounted above door, above accessible ceiling, on secure side of door. (2) PROVIDE CONDUIT INTO AUTOMATIC DOOR OPENER FOR LOW VOLTAGE CONNECTIONS PROVIDE 3/4" CONDUIT AND 4" X 4" X 2 1/8" DEEP BOX WITH SINGLE GANG DEVICE RING FLUSH MOUNTED 3'-6" A.F.F. FOR HAND WAVE SENSOR. RECORD DOOR OPERATORS TO BE SUPPLIED AND INSTALLED BY LONG ISLAND AUTOMATIC DOORS (4) 85 SOUTH TERMINAL DRIVE, PLAINVIEW, NY 11803. PHONE: 516-931-2273. SALES FAX: 516-575-0041. ATTN: ANDREW CARR. EMAIL: andrewc@lilocksmith.com. (5) 1 –120VAC BREAKER REQUIRED FOR DOOR OPENER.

CTRIC TRANSFER



## TYPICAL CONDUIT REQUIREMENTS DOOR WITH AUTOMATIC OPENER, IN AND OUT HAND WAVE SENSORS.

TO THE BEST OF MY KNOWLEDGE, BELIEF AND PROFESSIONAL JUDGMENT, THESE PLANS AND SPECIFICATIONS ARE IN COMPLIANCE WITH THE 2020 ENERGY CONSERVATION CODE OF NYS

This plan is approved only for work indicated on the application specification sheet. All other matters shown are not to be relied upon, or to be considered as either being approved or in accordance with applicable codes.

REGENERON **REAL ESTATE &** FACILITIES MANAGEMENT

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Building #17 Campus Expansion Child Day-care Center

777 Old Saw Mill River Road Mount Pleasant, NY 10591 Project No. B17-DAYCARE

Architect Gensler 1700 Broadway, Suite 400 New York, NY 10019 (212) 492-1400 Phone (212) 492-1472 Fax **Structural Engineer** 

Thornton Tomasetti 120 Broadway, 15th Floor New York, NY 10271 (917) 661-7800 Phone (917) 661-7801 Fax

MEP / IT / Security Engineer Cosentini Associates 498 Seventh Avenue New York, NY 10018 (212) 615-3600 Phone


(212) 615-3700 Fax Civil Engineer

JMC 120 Bedford Road Armonk, NY 10504 (914) 273-5225 Phone (914) 273-2102 Fax

Landscape Architect

Langan 21 Penn Plaza, 360 West 31st Street, 8th Floor New York, NY 10001 (212) 479-5400 Phone (212) 479-5444 Fax

Key Plan

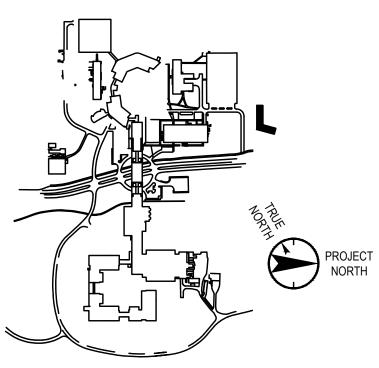

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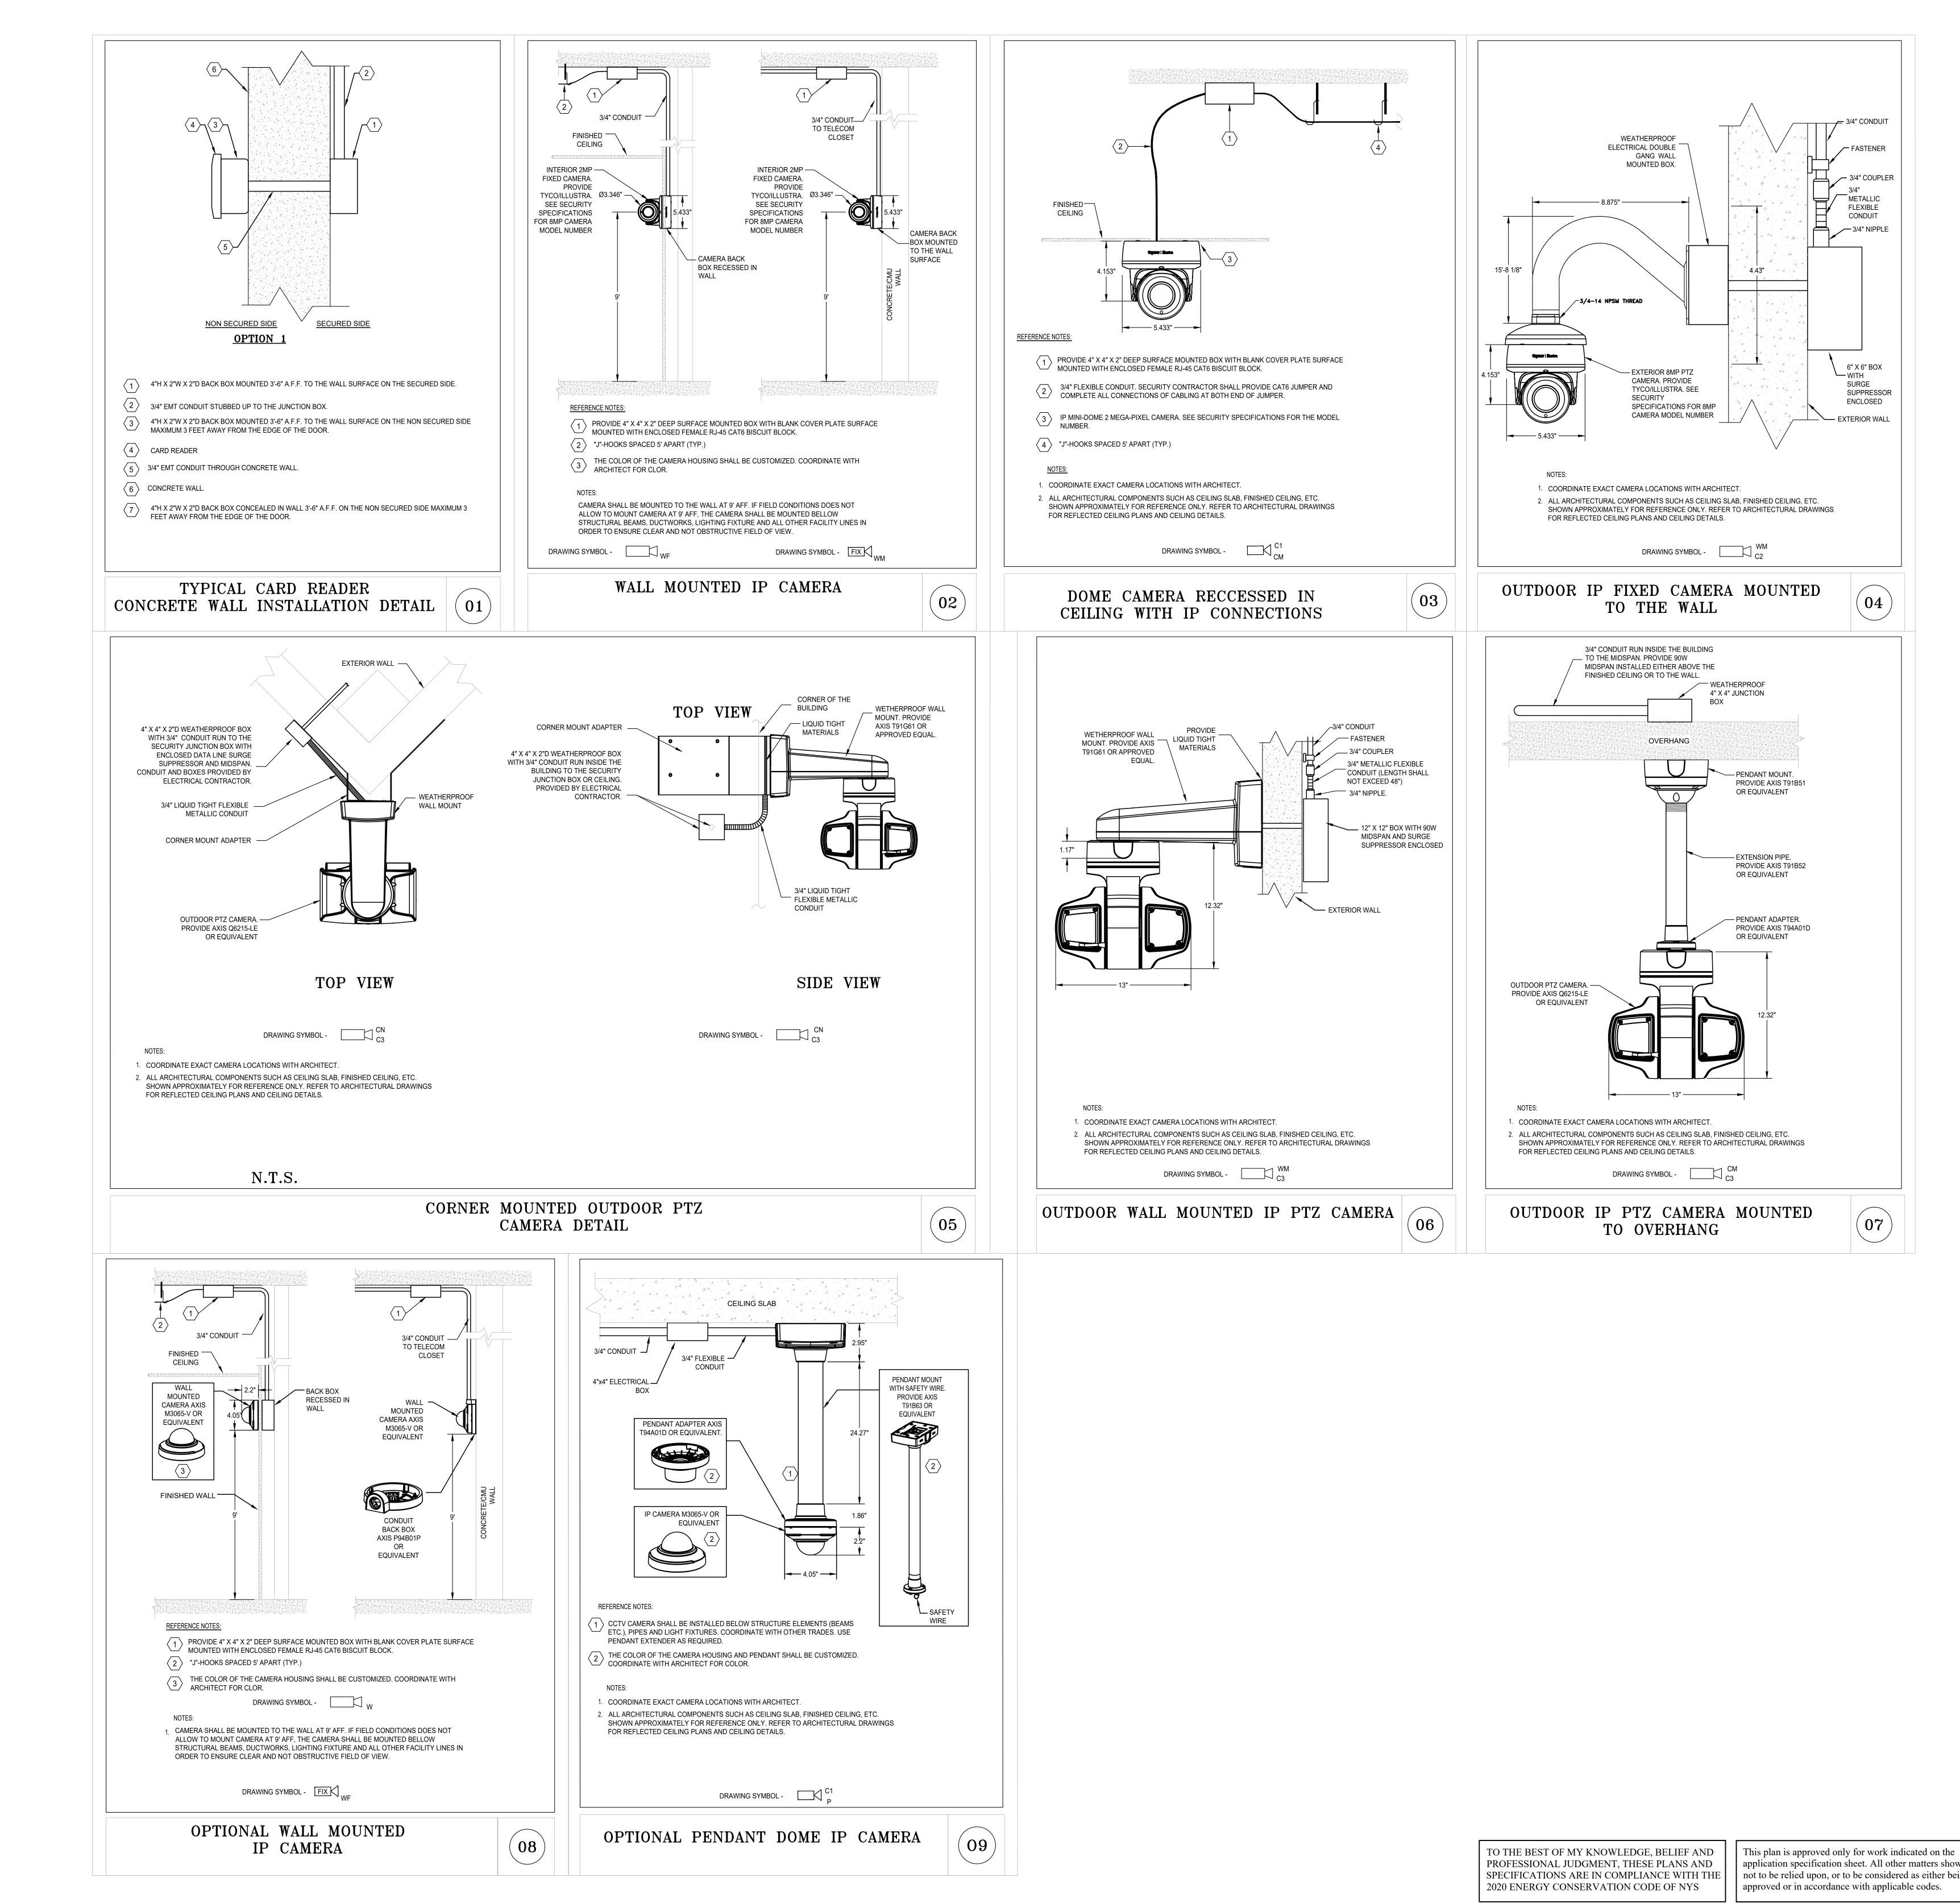
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Scale: NTS TY-500

SHEET #1

Vendor Name: GENSLER Vendor Project No.:006.3608.000 Drawn By: Author SECURITY DETAILS

Floor:



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Drawn By: Author

State Education Law.


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SHEET #2

Floor: Scale: NTS TY-501

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SECURITY DETAILS



## NOTES

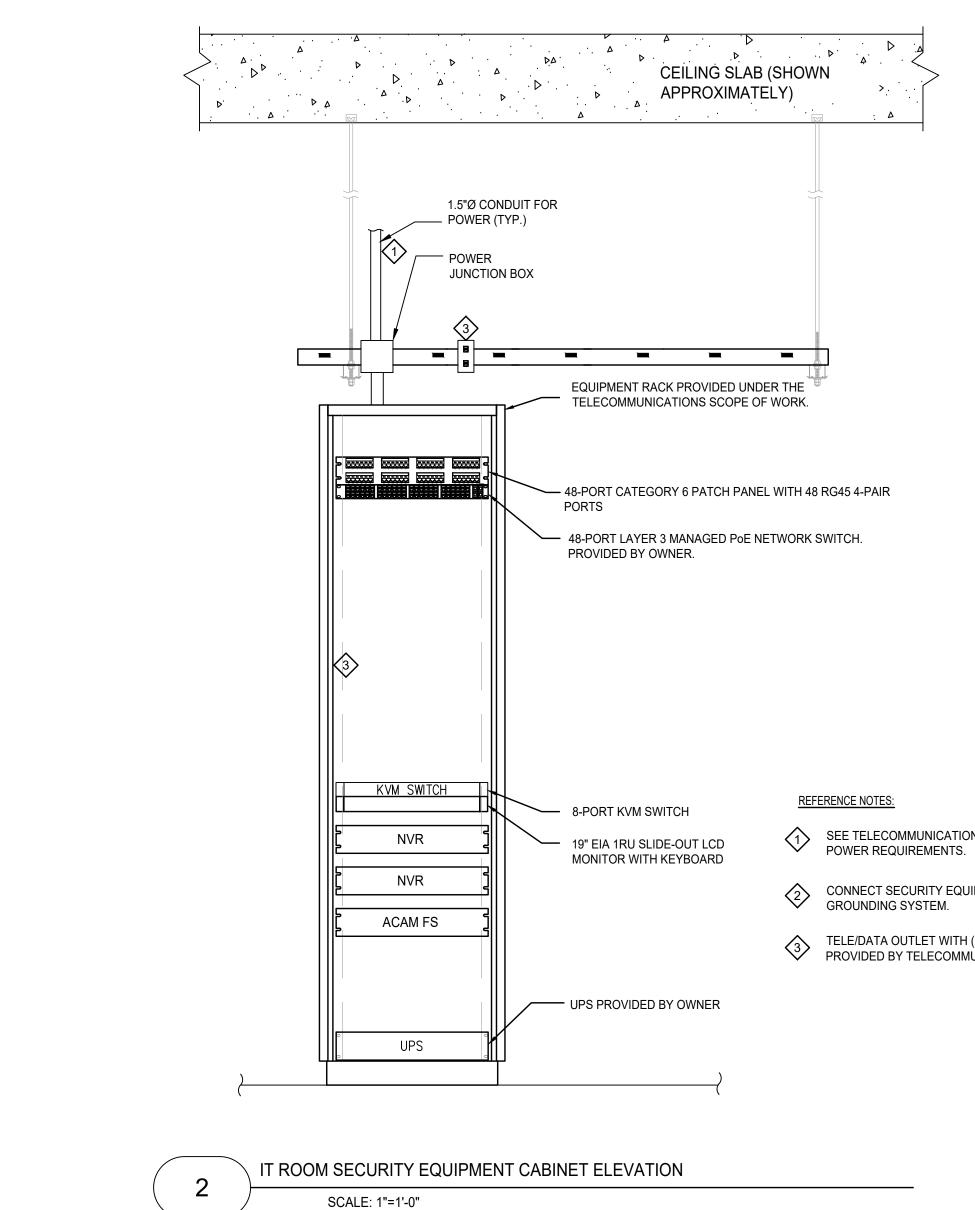1 LOCAL INTERCONNECTING WIRING MAY BE REQUIRED AT FIELD DEVICES AND/OR HEAD END DEVICES WHICH MAY NOT BE DEPICTED ON DRAWINGS. THIS WORK SHALL BE CONSIDERED WITHIN THE BASE SCOPE OF THIS PROJECT.

2 ALL MECHANICAL DOOR HARDWARE SHALL MEET APPROVAL OF LOCAL AUTHORITY HAVING JURISDICTION AND SHALL NOT IN ANY WAY DELAY OR IMPEDED EGRESS AS REQUIRED BY LAW.

3 INSTALLING CONTRACTOR SHALL FILE FOR AND RECEIVE PERMITS AND ARRANGE FOR INSPECTIONS. SYSTEM SHALL NOT BE ACTIVATED UNTIL FINAL APPROVAL IS RECEIVED FROM INSTALLING CONTRACTOR.

4 ALL PENETRATIONS OF FIRE WALLS AND MEMBRANES SHALL BE FIRE STOPPED TO MEET LOCAL BUILDING CODE. INSTALLATION OF DEVICES, CABLES, CONDUIT, POWER SHALL MEET ALL LOCAL BUILDING CODES.

5 ALL ELECTROMAGNETIC LOCKS AND FAIL SAFE ELECTRIC LOCKS SHALL BE TIED INTO FIRE ALARM SYSTEM INTERFACE.


6 THE MOUNTING HEIGHTS FOR THE DEVICES WILL CONFORM TO ADA REQUIREMENTS.


7 1-120VAC 20AMP BREAKER ON EMERGENCY POWER CIRCUIT REQUIRED TO POWER EACH DGP PANEL. 8 DGP PANELS TO BE LOCATED IN THE FIELD BY A

REPRESENTATIVE OF REGENERON. 9 1-120VAC 20AMP BREAKER REQUIRED TO POWER EACH

AUTOMATIC DOOR OPENER 10 POWER SUPPLY TO BE INSTALLED ABOVE CEILING IN AN

ACCESSIBLE LOCATION. 1-120VAC 20AMP BREAKER REQUIRED.

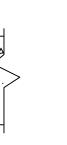


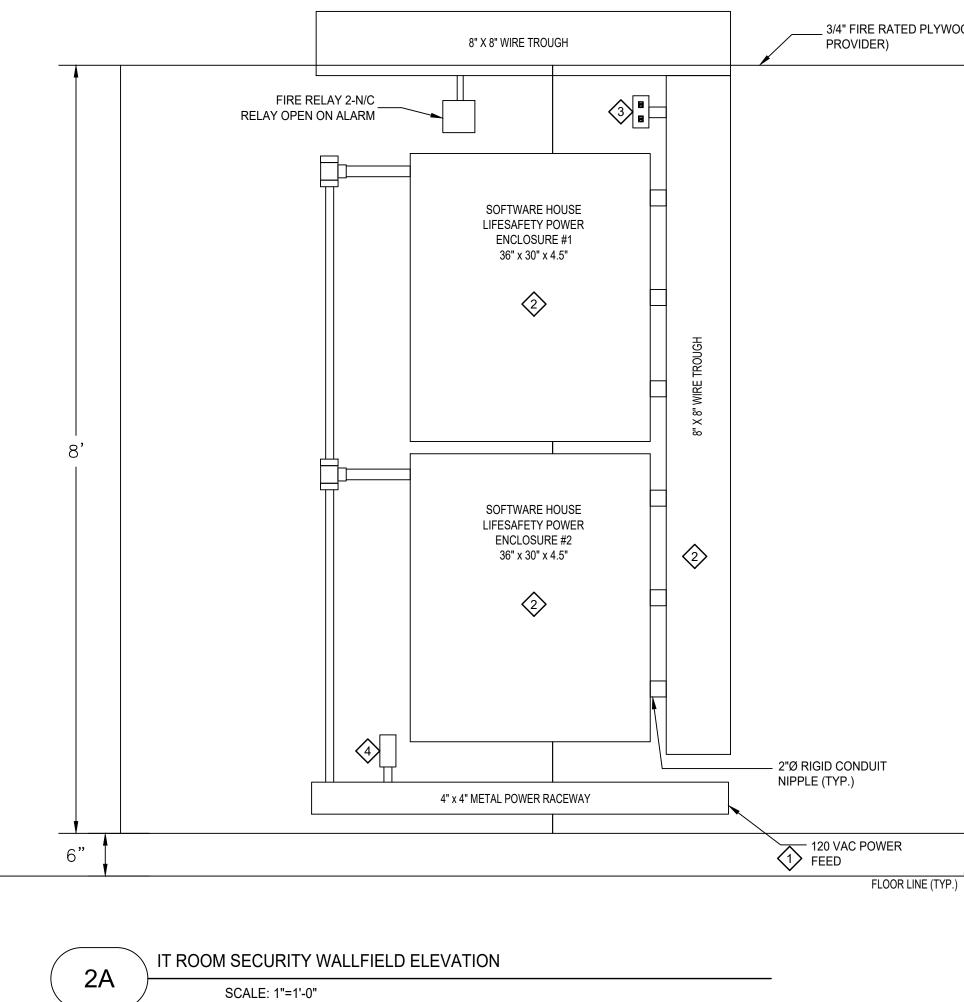



SEE TELECOMMUNICATIONS DRAWINGS FOR THE RACK

CONNECT SECURITY EQUIPMENT TO THE TELECOM

TELE/DATA OUTLET WITH (2) RJ-45 NETWORK DROPS PROVIDED BY TELECOMMUNICATION SERVICE CONTRACTOR.

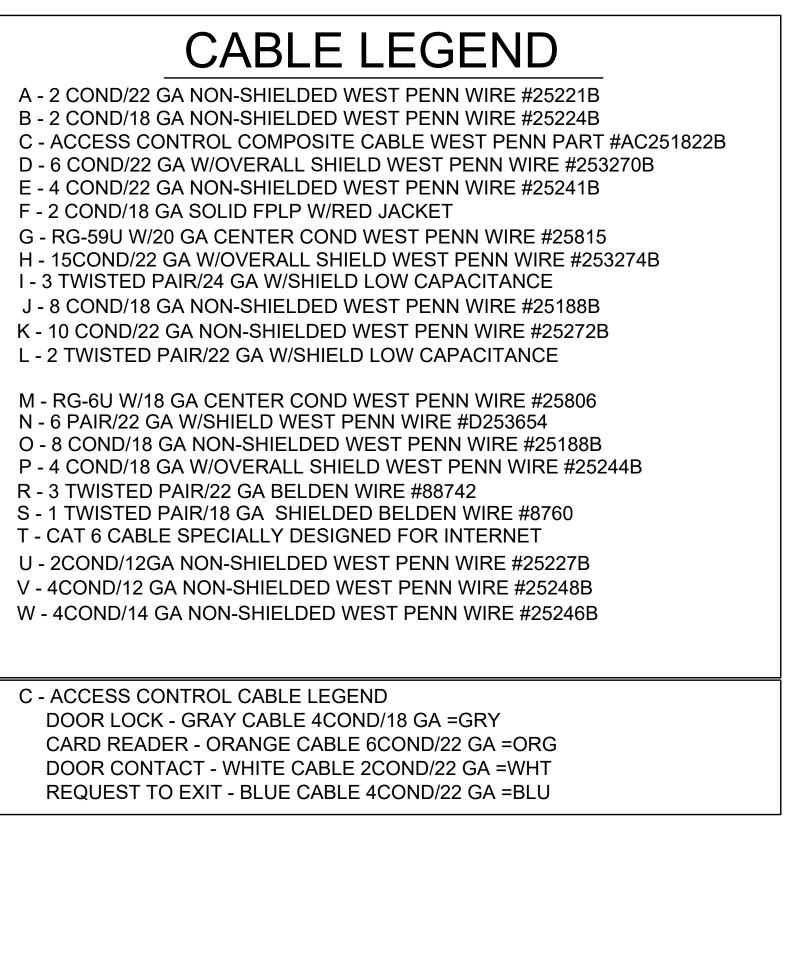

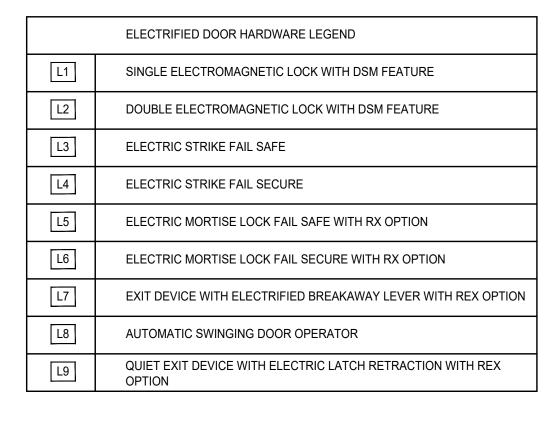

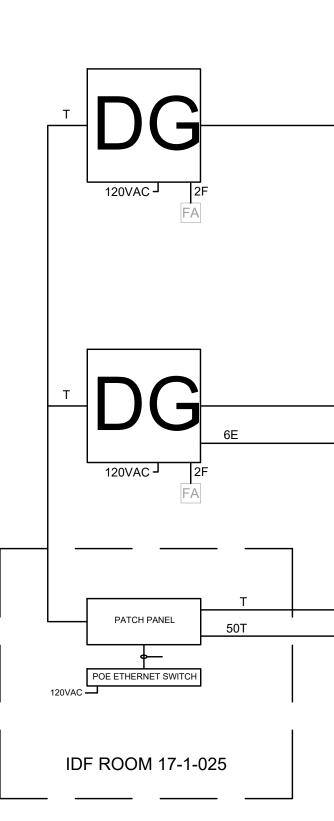

WIRING DIAGRAM

SCALE: NTS TO THE BEST OF MY KNOWLEDGE, BELIEF AND PROFESSIONAL JUDGMENT, THESE PLANS AND SPECIFICATIONS ARE IN COMPLIANCE WITH THE 2020 ENERGY CONSERVATION CODE OF NYS

This plan is approved only for work indicated on the not to be relied upon, or to be considered as either being approved or in accordance with applicable codes.

		C.4A.2P JBORGCR	WHT EHGRY L9 RY A,2P HP E L8 110VAC REQUIRED 110VAC REQUIRED WHT	C R-17-01-025 WHT 4A,2P U9 W EH W LP W EH W L9 GRY WHT 4A,2P U9 W EH W LP W EH W L9 GRY U9 W EH W LP W EH W L9 GRY U9 W EH W LP W EH W L9 GRY U9 W EH W LP W EH W L9 GRY	□ R-17-01-002 <sup>T</sup>
		E		–С M-17-001	
		E		—ⓒ M-17-002	
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		T		— <u>IM</u> M-17-007	

	C R-17-01-020W
C JBORGCR EHGRYL9	ि R-17-01-020E
C JBORGCR EHGRYL9	С ЕН <sup>GRY</sup> L9 С R-17-01-018
C JBORGCR ENGRYL9 GRY	ि R-17-01-017
C JBORGCR EHGRYL9	© R-17-01-016
C JBORGCR EHGRYL9 GRY	C R-17-01-015
C JBORGCR EHGRY L9 GRY	C R-17-01-014
C JBORGCR EHGRYL9 GRY WHT	C R-17-01-010
	С ЕН <mark>СКУ</mark> ЦЭ С R-17-01-012 <sub>GRY</sub>
	C EHGRY L7 C R-17-01-021S
C JBORGCR EHGRY L9 GRY WHT	C R-17-01-023
C JBORGCR EHGRYL9 GRY WHT	C R-17-01-021E
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	C R-17-01-021N
C JBORGCR EHGRY L6 GRY WHT C JBORGCR EHGRY L9	ট R-17-01-039 
	С ЕН <sup>GRY</sup> L9 С R-17-01-038   С R-17-01-033
	ि R-17-01-032
	ि R-17-01-031
	ि R-17-01-030
	 C R-17-01-025
WHT	–с M-17-001

CONVENIENCE 120VC OUTLET . LOCATION SHOWN APPROXIMATELY. COORDINATE EXACT LOCATION IN THE FIELD

REFERENCE NOTES:

DATA OUTLET WITH (2) DATA JACKS. COORDINATE EXACT LOCATION
 IN THE FIELD

(2) CONNECT SECURITY EQUIPMENT TO THE TELECOM GROUNDING SYSTEM.

PROVIDE (2) 120 VAC 20A EMERGENCY CIRCUIT FOR SECURITY EQUIPMENT. PROVIDED BY ELECTRICAL CONTRACTOR.

\_ 3/4" FIRE RATED PLYWOOD (BY TELECOM

T: 914.847.7400 F: 914.847.7991 www.regeneron.com Building #17 Campus Expansion Child Day-care Center 777 Old Saw Mill River Road Mount Pleasant, NY 10591 Project No. B17-DAYCARE Architect Gensler 1700 Broadway, Suite 400 New York, NY 10019 (212) 492-1400 Phone (212) 492-1472 Fax Structural Engineer Thornton Tomasetti 120 Broadway, 15th Floor New York, NY 10271 (917) 661-7800 Phone (917) 661-7801 Fax MEP / IT / Security Engineer Cosentini Associates 498 Seventh Avenue New York, NY 10018 (212) 615-3600 Phone (212) 615-3700 Fax Civil Engineer JMC 120 Bedford Road Armonk, NY 10504 (914) 273-5225 Phone (914) 273-2102 Fax Landscape Architect Langan 21 Penn Plaza, 360 West 31st Street, 8th Floor New York, NY 10001 (212) 479-5400 Phone (212) 479-5444 Fax Key Plan PROJECT No. Date Description 0 05.20.2022 ISSUED FOR PERM! ALL DRAWINGS AND WRITTEN MATERIALS REPRESENTED ON THIS SHEET CONSTITUTE THE COPYRIGHTED WORK AND ARE THE SOLE PROPERTY OF REGENERON PHARMACEUTICALS. THIS SHEET MAY NOT BE REPRODUCED OR COPIED IN WHOLE OR IN PART, NOR MAY ANY OF THE DRAWINGS OR WRITTEN MATERIALS APPEARING WITHIN, BE INCORPORATED INTO ANOTHER WORK FOR ANY REASON WITHOUT THE WRITTEN CONSENT OF REGENERON PHARMACEUTICALS. THIS SHEET MUST BE RETURNED UPON THE REQUEST OF REGENERON PHARMACEUTICALS. IF REGENERON MAKES OR AUTHORIZES REUSE OF ANY SUCH DOCUMENTS OR INFORMATION PRODUCED BY DESIGN PROFESSIONAL OUTSIDE OF THE PROJECT WITHOUT THE EXPRESS WRITTEN CONSENT OF DESIGN PROFESSIONAL. REGENERON ASSUMES FULL RESPONSIBILITY FOR ANY AND ALL RISKS INVOLVED IN SUCH Professional Seal and Signature

REGENERON

REAL ESTATE &

FACILITIES MANAGEMENT

777 Old Saw Mill River Road

Tarrytown, NY 10591-6707

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Vendor Name: GENSLER Vendor Project No.:006.3608.000 Drawn By: Author Discipline:

SECURITY WIRING RISER **DIAGRAM & EQUIPMENT** ELEVATIONS

Scale: AS NOTED Floor: TY-700

Alterations or additions to this engineering document application specification sheet. All other matters shown are by an unlicensed person is a violation of Chapter 16 Title VIII, Article 145 § 7209.2 of the New York State Education Law.