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Building #17  
Campus Expansion Child  
Day-care Center

899 Old Saw Mill River Road  
Mount Pleasant, NY 10591

Project No. B17-DAYCARE

Architect

**Gensler**  
1700 Broadway, Suite 400  
New York, NY 10019  
(212) 492-1400 Phone  
(212) 492-1472 Fax

Structural Engineer

Thornton Tomasetti  
120 Broadway, 15th Floor  
New York, NY 10271  
(917) 661-7800 Phone  
(917) 661-7801 Fax

MEP / IT / Security Engineer

Cosentini Associates  
498 Seventh Avenue  
New York, NY 10018  
(212) 615-3600 Phone  
(212) 615-3700 Fax


Civil Engineer

JMC  
120 Bedford Road  
Armonk, NY 10504  
(914) 273-5225 Phone  
(914) 273-2102 Fax

Landscape Architect

Langan  
21 Penn Plaza, 360 West 31st Street, 8th Floor  
New York, NY 10001  
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(212) 479-5444 Fax

Key Plan

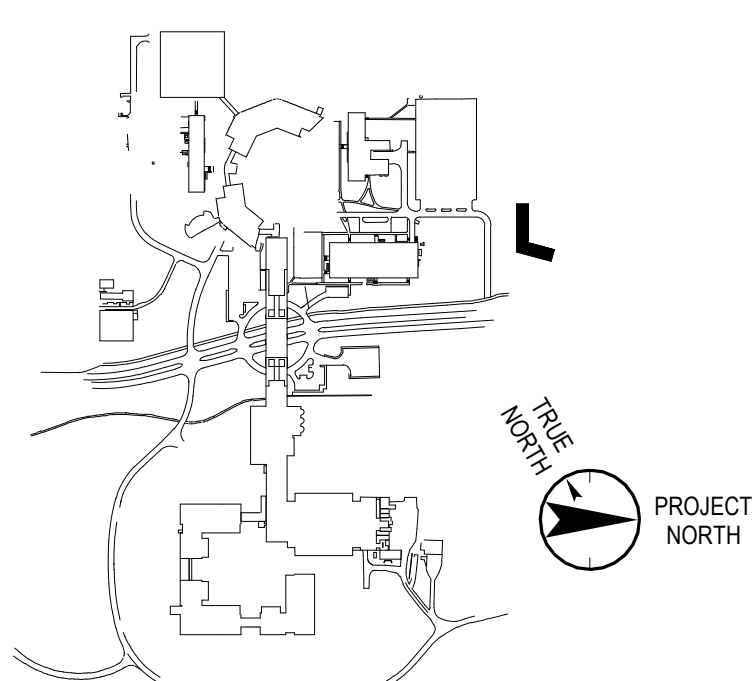

No. Date Description

0 06.20.2022 ISSUED FOR PERMIT  
1 06.22.2022 100% CONSTRUCTION DOCUMENTS  
2 07.01.2022 100% CONSTRUCTION DOCUMENTS-1

Plot Date: 07.01.2022

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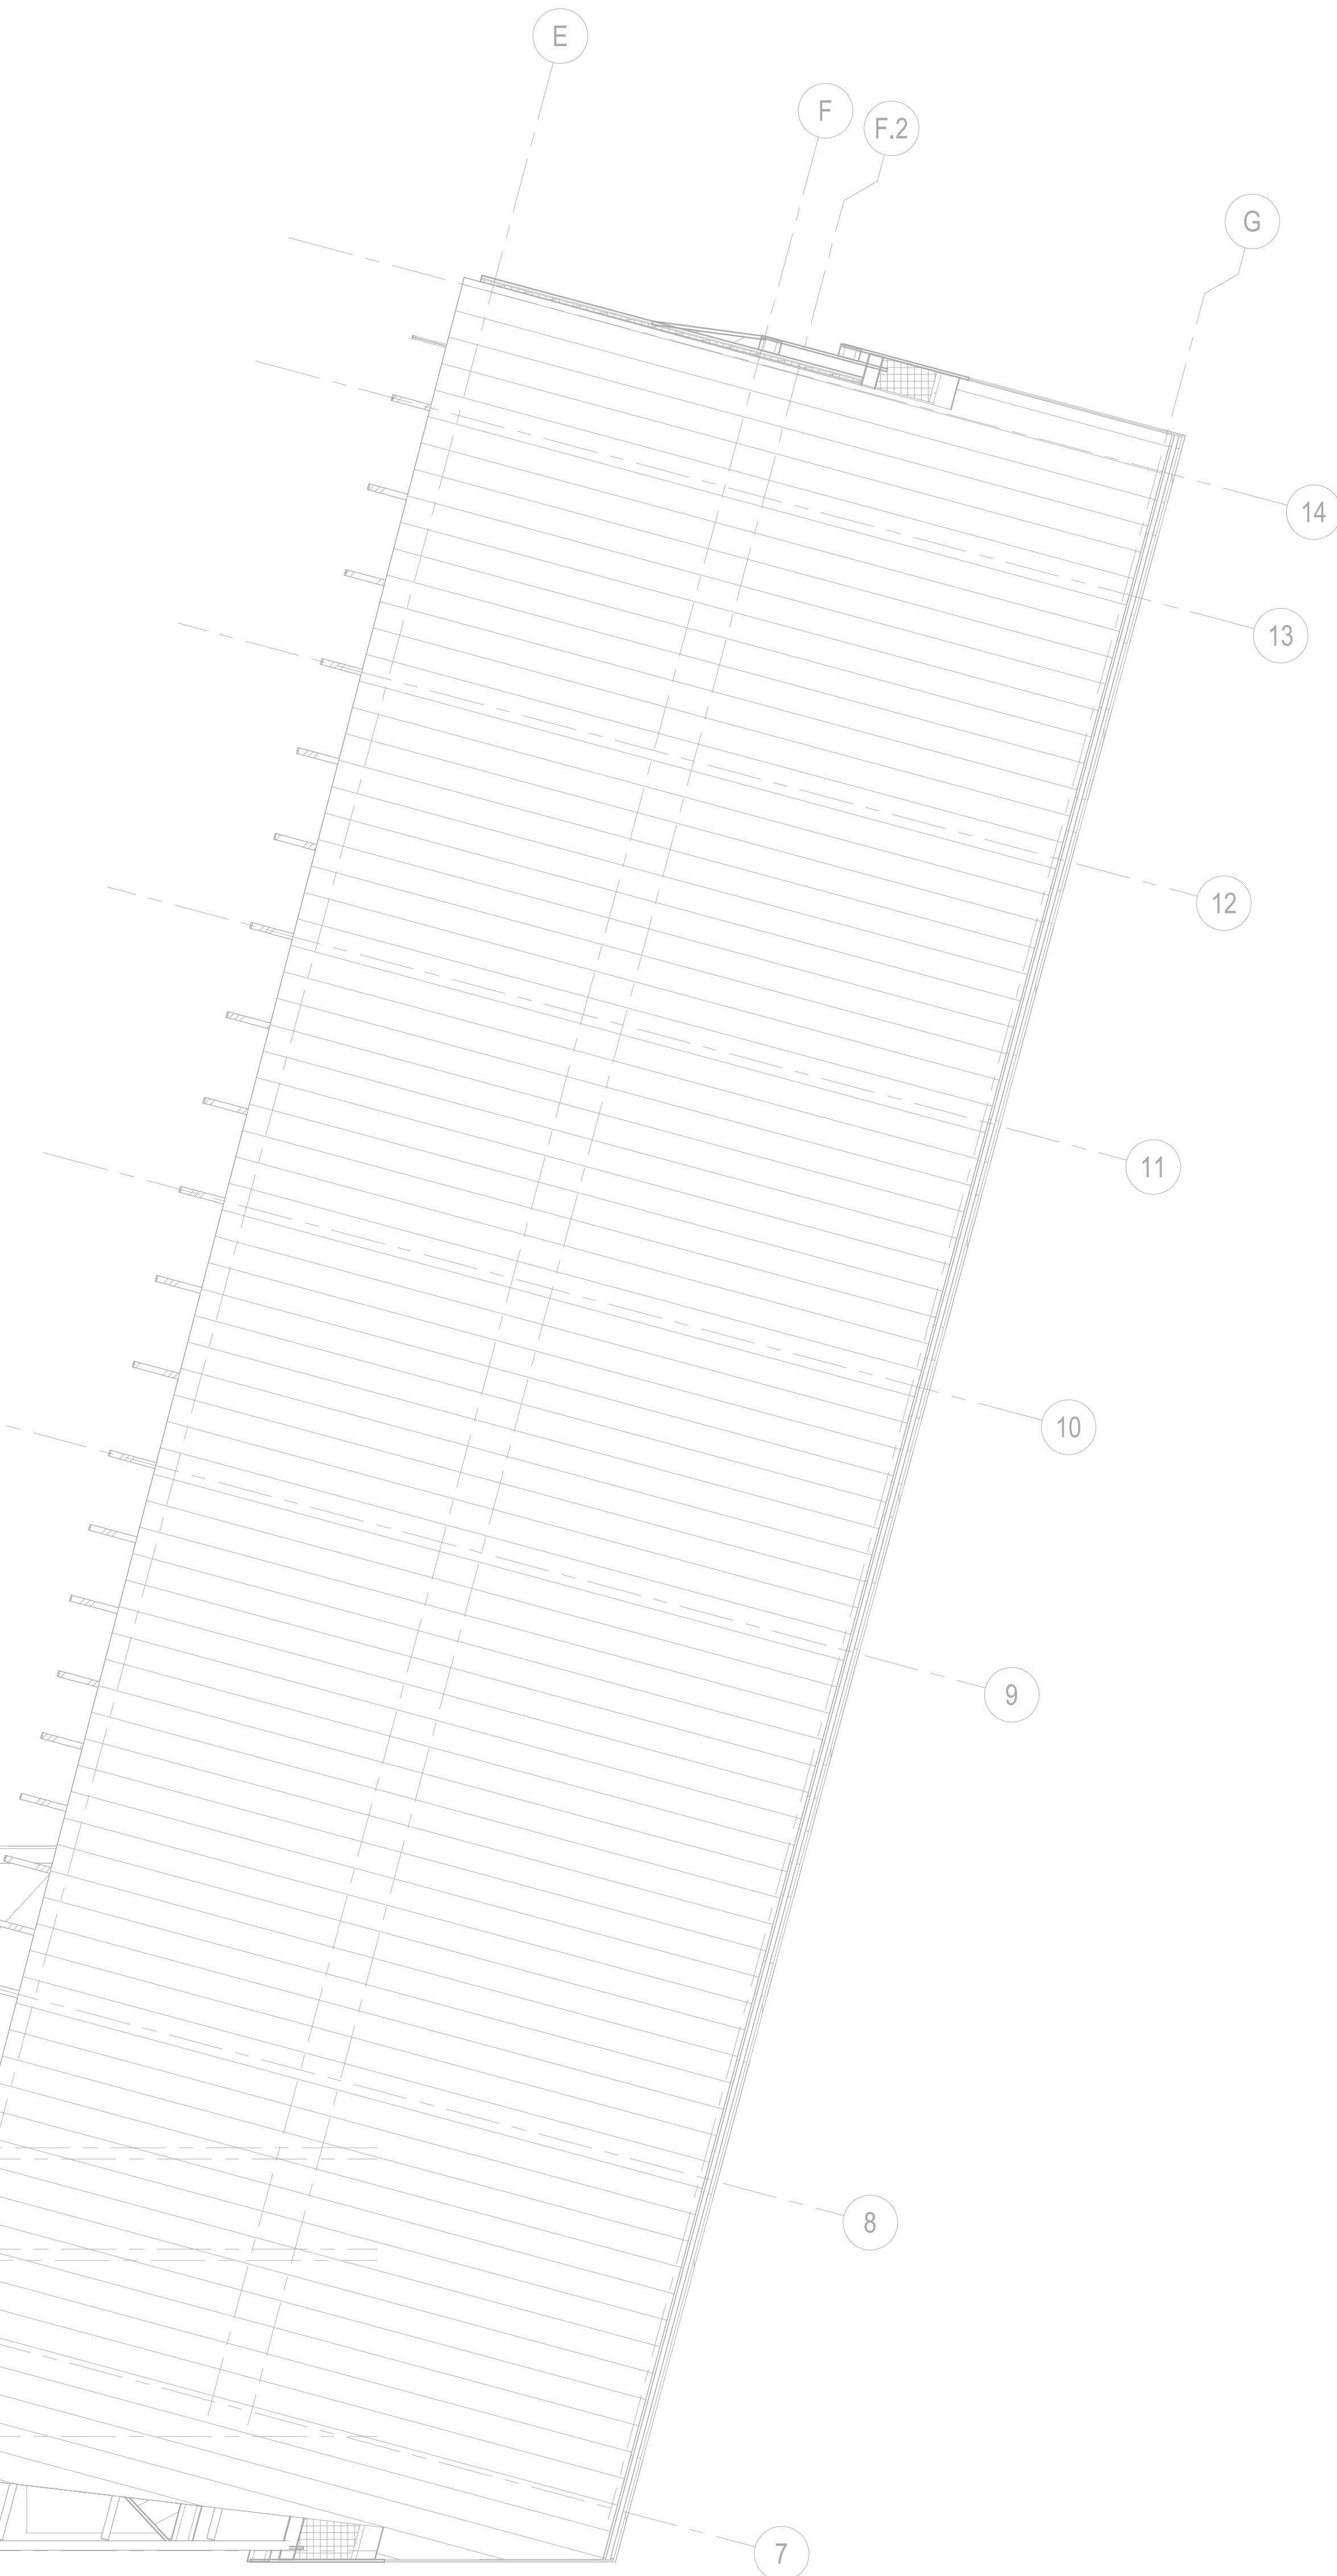
Professional Seal and Signature

Vendor Name: GENSLER  
Vendor Project No.: 008.3608.000  
Discipline: Mechanical Drawn By: BC

MECHANICAL ROOF  
DUCTWORK PLAN

Scale: 1/8" = 1'-0" Floor: ROOF

M-101



**SHEET NOTES:**  
1. PROVIDE DUCTED DISCHARGE FROM EXHAUST FANS WITH A 45 DEGREE OUTBACK TO PREVENT WATER PENETRATION. PROVIDE WITH WIRE MESH SCREEN (WMS) AT TERMINATION.  
2. LAUNDRY EXHAUST TO BE PROVIDED WITH A BACKDRAFT DAMPER PER MCNYS CODE SECTION 504.4, AND TO BE PROVIDED WITH PROTECTIVE SHIELD PLATES WHERE SUBJECT TO PENETRATION FROM NAILS OR SCREWS PER MCNYS CODE SECTION 504.7

**CODE NOTES:**  
1) WHEREVER REQUIRED AND ACCEPTED, FLEXIBLE AIR DUCT AND/OR FLEXIBLE AIR CONNECTIONS SHALL BE TESTED IN ACCORDANCE WITH UL 181, LISTED AND LABELED AS CLASS 0 OR CLASS 1, AND SHALL BE INSTALLED PER REQUIREMENTS OF THEIR LISTING, THE MANUFACTURER INSTALLATION INSTRUCTIONS, SPECIFICATION SECTION 233300, AND THE MCNYS CODE SECTIONS 603.6.1, 603.6.2, AND 304.1.

LAUNDRY EXHAUST TO BE PROVIDED WITH A BACKDRAFT DAMPER PER MCNYS CODE SECTION 504.4, AND TO BE PROVIDED WITH PROTECTIVE SHIELD PLATES WHERE SUBJECT TO PENETRATION FROM NAILS OR SCREWS PER MCNYS CODE SECTION 504.7

TO THE BEST OF MY KNOWLEDGE, BELIEF AND PROFESSIONAL JUDGMENT, THESE PLANS AND SPECIFICATION ARE IN COMPLIANCE WITH THE 2020 ENERGY CONSERVATION CODE OF NYS

This plan is approved only for work indicated on the application specification sheet. All other matters shown are not to be relied upon, or to be considered as either being approved or in accordance with applicable codes.

Alterations or additions to this engineering document by an unlicensed person is a violation of Chapter 16, Title VIII, Article 145 § 7209.2 of the New York State Education Law.