REGENERON REAL ESTATE & FACILITIES MANAGEMENT

777 Old Saw Mill River Road Tarrytown, NY 10591-6707 T: 914.847.7400 F: 914.847.7991 www.regeneron.com

Building #17 Campus Expansion Child Day-care Center

899 Old Saw Mill River Road Mount Pleasant, NY 10591

Architect **Gensier**1700 Broadway, Suite 400 New York, NY 10019 (212) 492-1400 Phone (212) 492-1472 Fax

Project No. B17-DAYCARE

Structural Engineer Thornton Tomasetti 120 Broadway, 15th Floor New York, NY 10271 (917) 661-7800 Phone (917) 661-7801 Fax

MEP / IT / Security Engineer

Cosentini Associates 498 Seventh Avenue New York, NY 10018 (212) 615-3600 Phone (212) 615-3700 Fax

Civil Engineer


JMC 120 Bedford Road Armonk, NY 10504 (914) 273-5225 Phone (914) 273-2102 Fax

Landscape Architect

Langan 21 Penn Plaza, 360 West 31st Street, 8th Floor New York, NY 10001 (212) 479-5400 Phone (212) 479-5444 Fax

Geotechnical Engineer

Carlin-Simpson & Associates, LLC 61 Main Street Sayreville, NJ 08872 (732) 432-5757 Phone (732) 432-5717 Fax

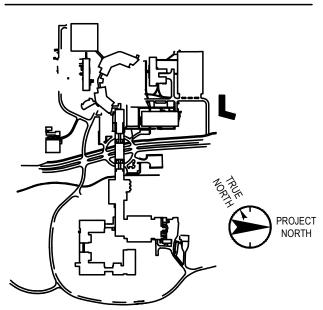

No. Date Description

 0
 05.13.2022
 100% CONSTRUCTION DOCUMENTS

 0
 05.20.2022
 ISSUED FOR PERMIT

Plot Date: 07.01.2022

GENERAL NOTES:

LIST OF DRAWINGS

LEGEND:

05/12/2022, ENTITLED "GRADING PLAN".

3. ALL BORING LOCATIONS ARE APPROXIMATE.

GT-100 OVERALL DRAINAGE PLAN

GT-101 CROSS-SECTIONS A & B

GT-200 SLOPE DRAINAGE PLAN

GT-300 BUILDING DRAINAGE PLAN

GT-400 PAVEMENT DRAINS & POND DRAINAGE BLANKET

BORING LOCATION PERFORMED IN MARCH 2021 (BD SERIES)

BORING LOCATION PERFORMED IN FEB 2020 (B-1 THRU B-14)

- BORING LOCATION PERFORMED IN MARCH 2016 (B-5 THRU B-10)

- BORING LOCATION PERFORMED IN 2011 (B-101, B-102, AND RW-3 TO RW-6)

GT-102 CROSS SECTIONS C, D, & E

1. GENERAL LAYOUT WAS OBTAINED FROM A DRAWING PREPARED BY JMC, PLLC., DATED

2. REFER TO THE REPORT ON SUBSURFACE SOIL AND FOUNDATION INVESTIGATION BY CARLIN-SIMPSON & ASSOCIATES LLC DATED 20 APRIL 2022 FOR BORING LOGS.

4. CROSS-SECTIONS ARE SHOWN ON SHEETS GT-101 AND GT-102. ALL BEDROCK AND

- BORING AND/OR WELL LOCATION PERFORMED IN DECEMBER 2021 (DC-100 SERIES)

GROUNDWATER ELEVATIONS ON THE CROSS-SECTIONS ARE APPROXIMATE.

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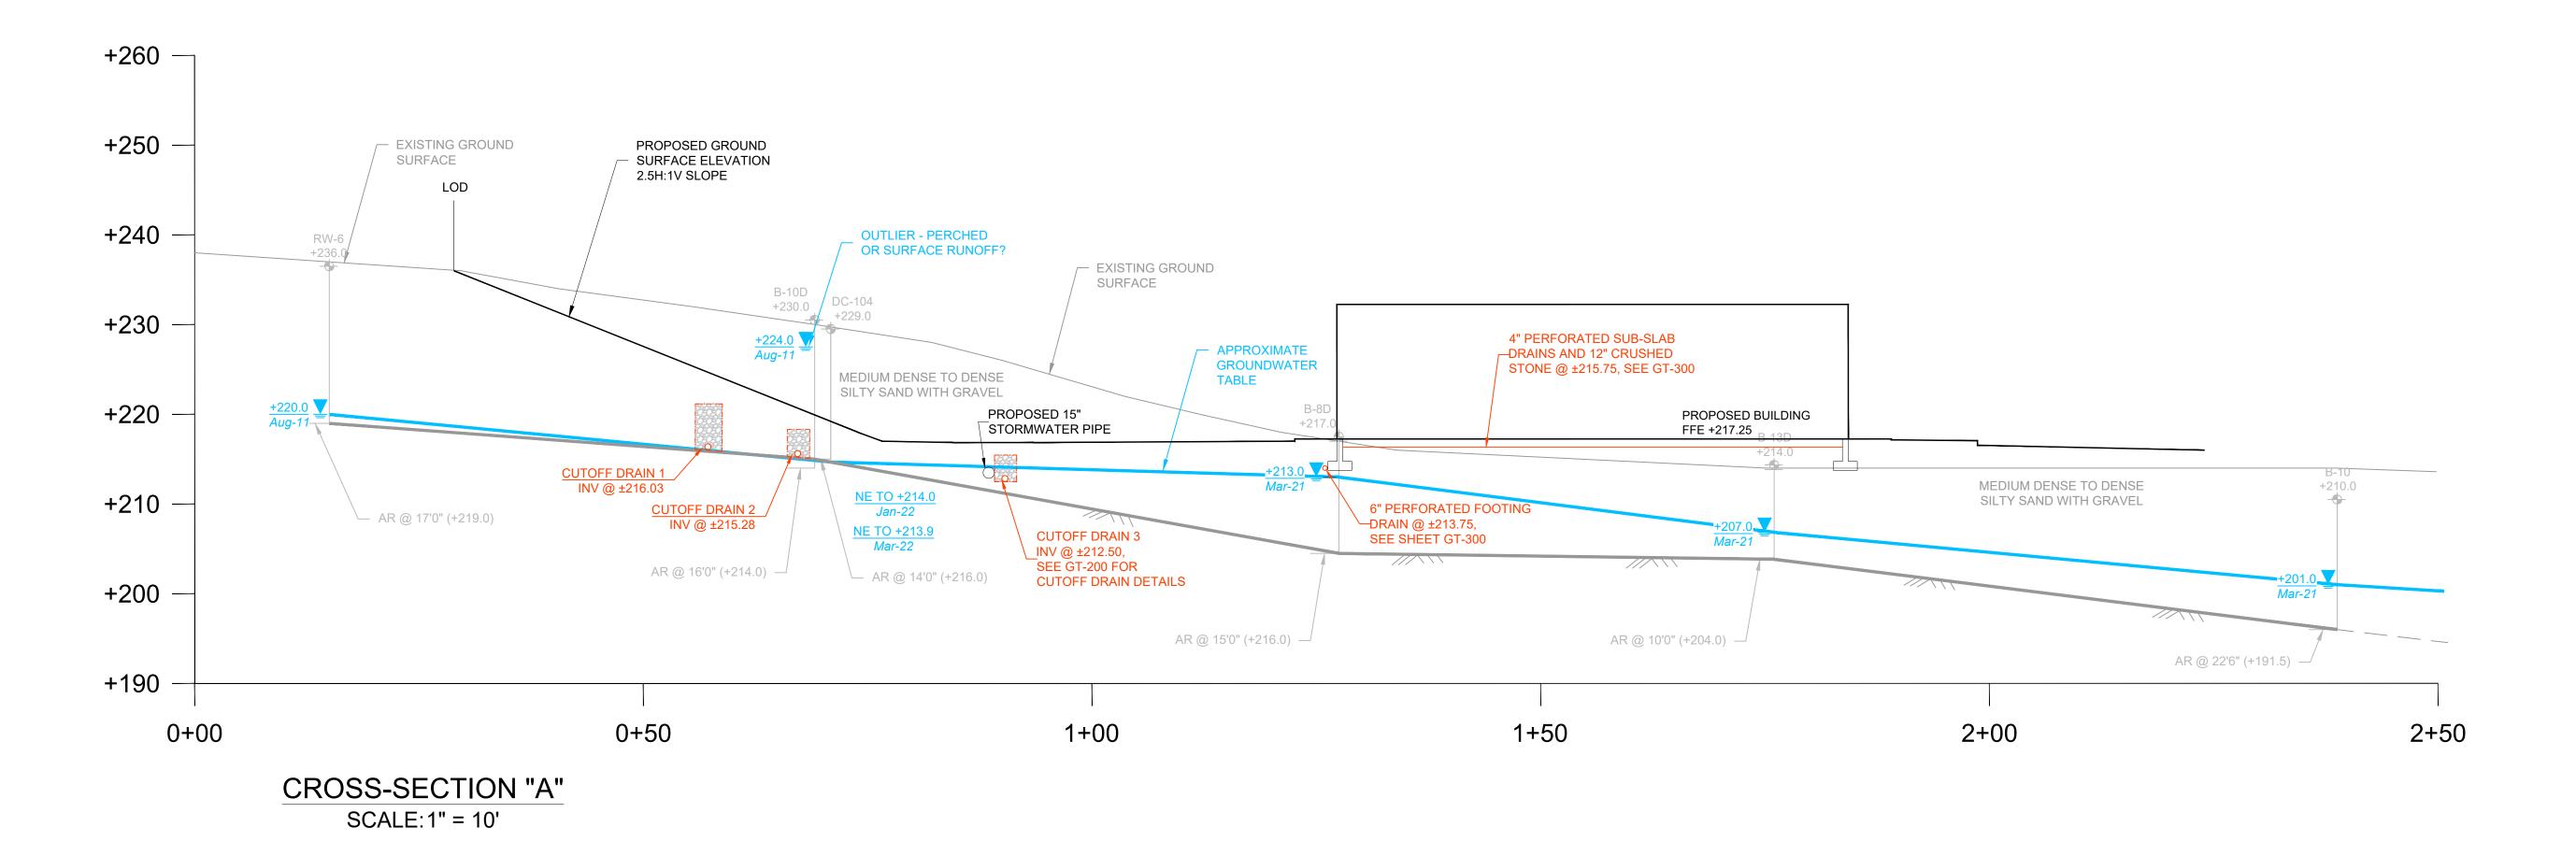
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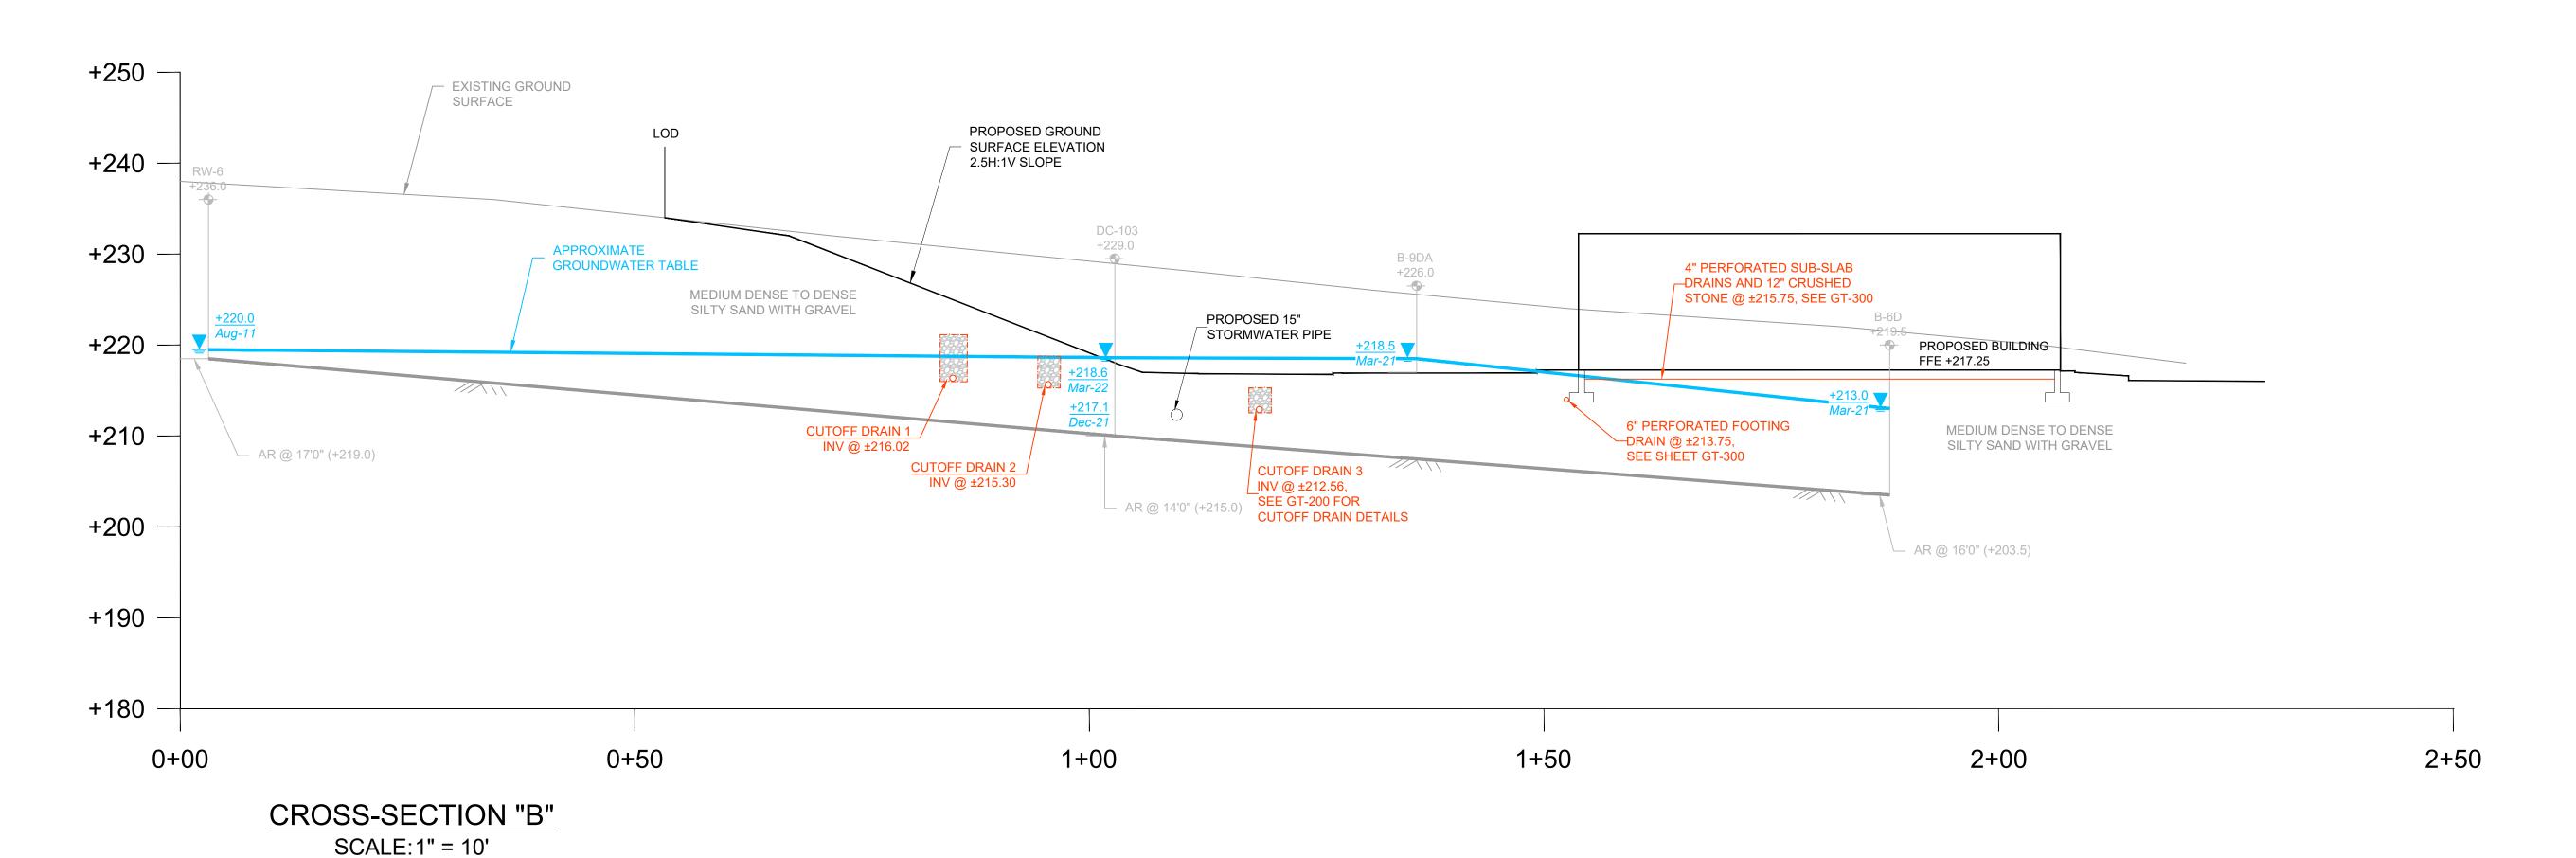
YORK STATE EDUCATION LAW, EXCEPT AS PROVIDED FOR BY SECTION 7209, SUBSECTION 2.

Vendor Name: Carlin-Simpson & Associates LLC
Vendor Project No.: 20-166
Discipline: Geotechnical Drawn By: MRA

OVERALL DRAINAGE PLAN

Scale: 1" = 20' Floor:





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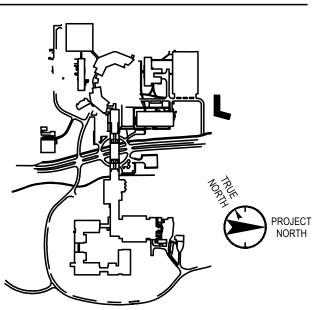
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Key Plan



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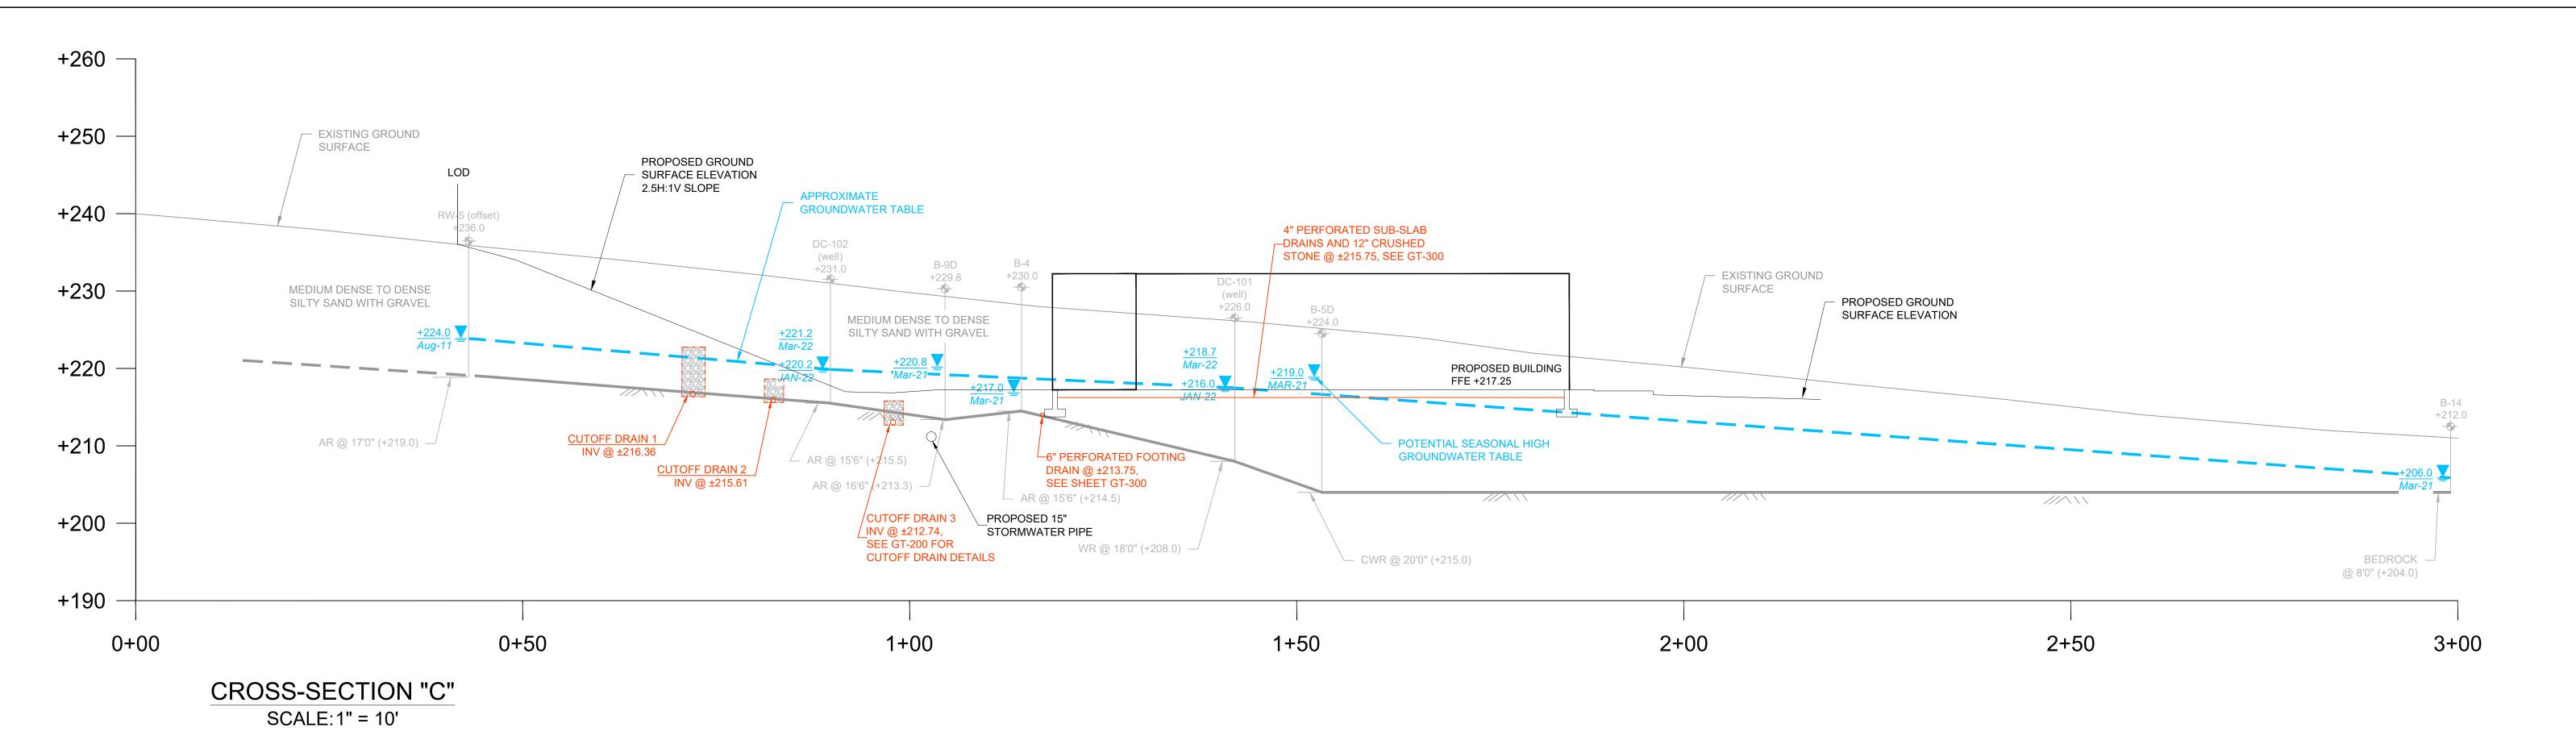
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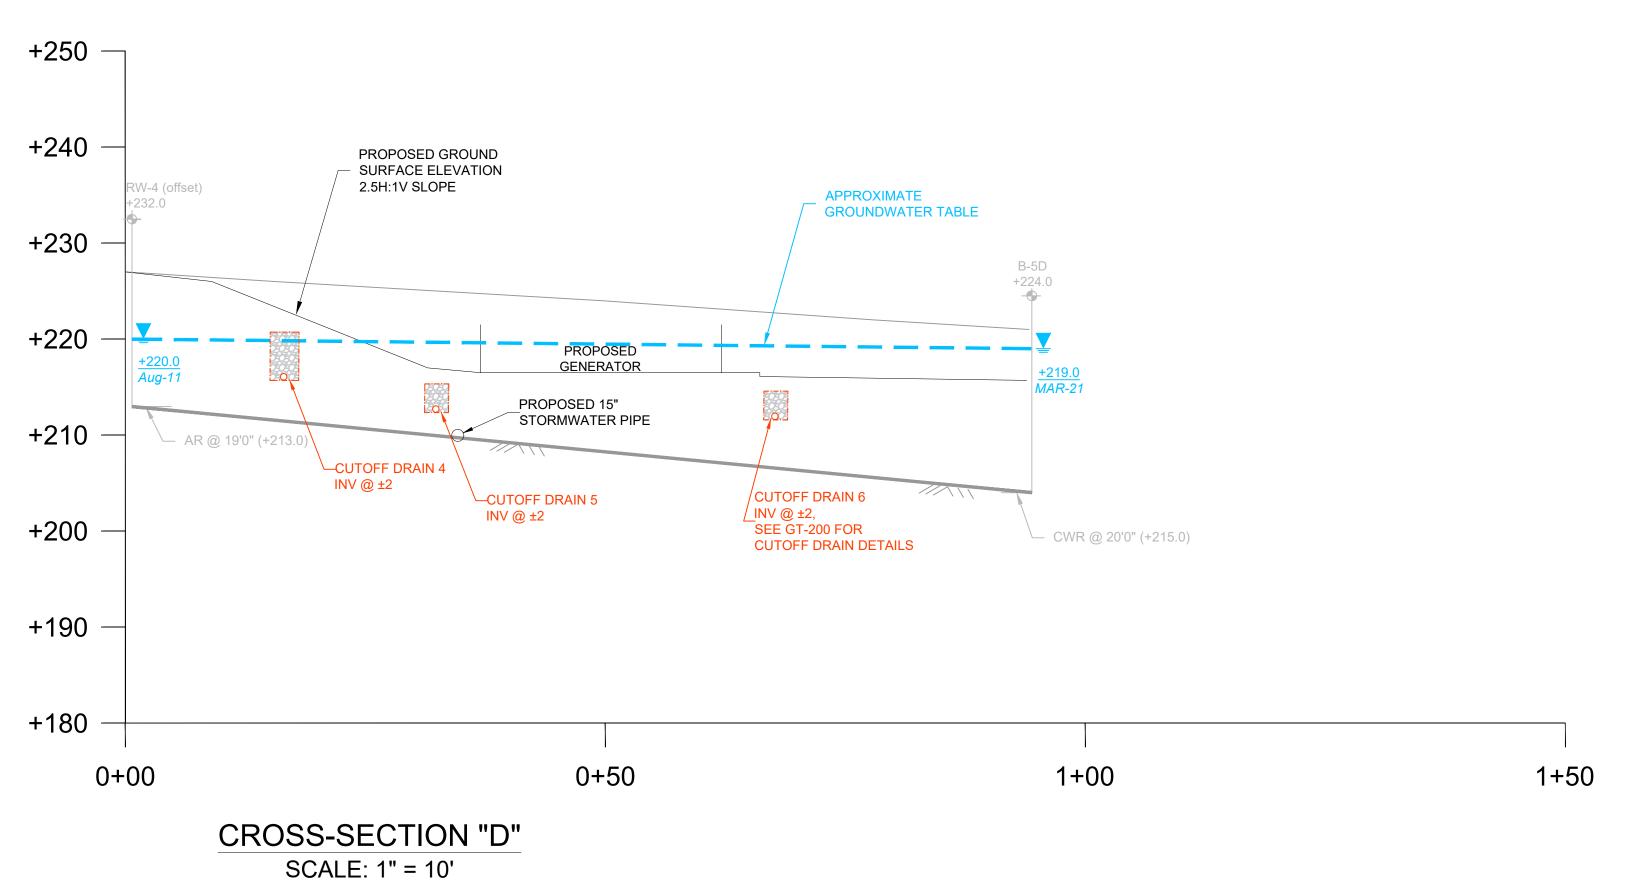
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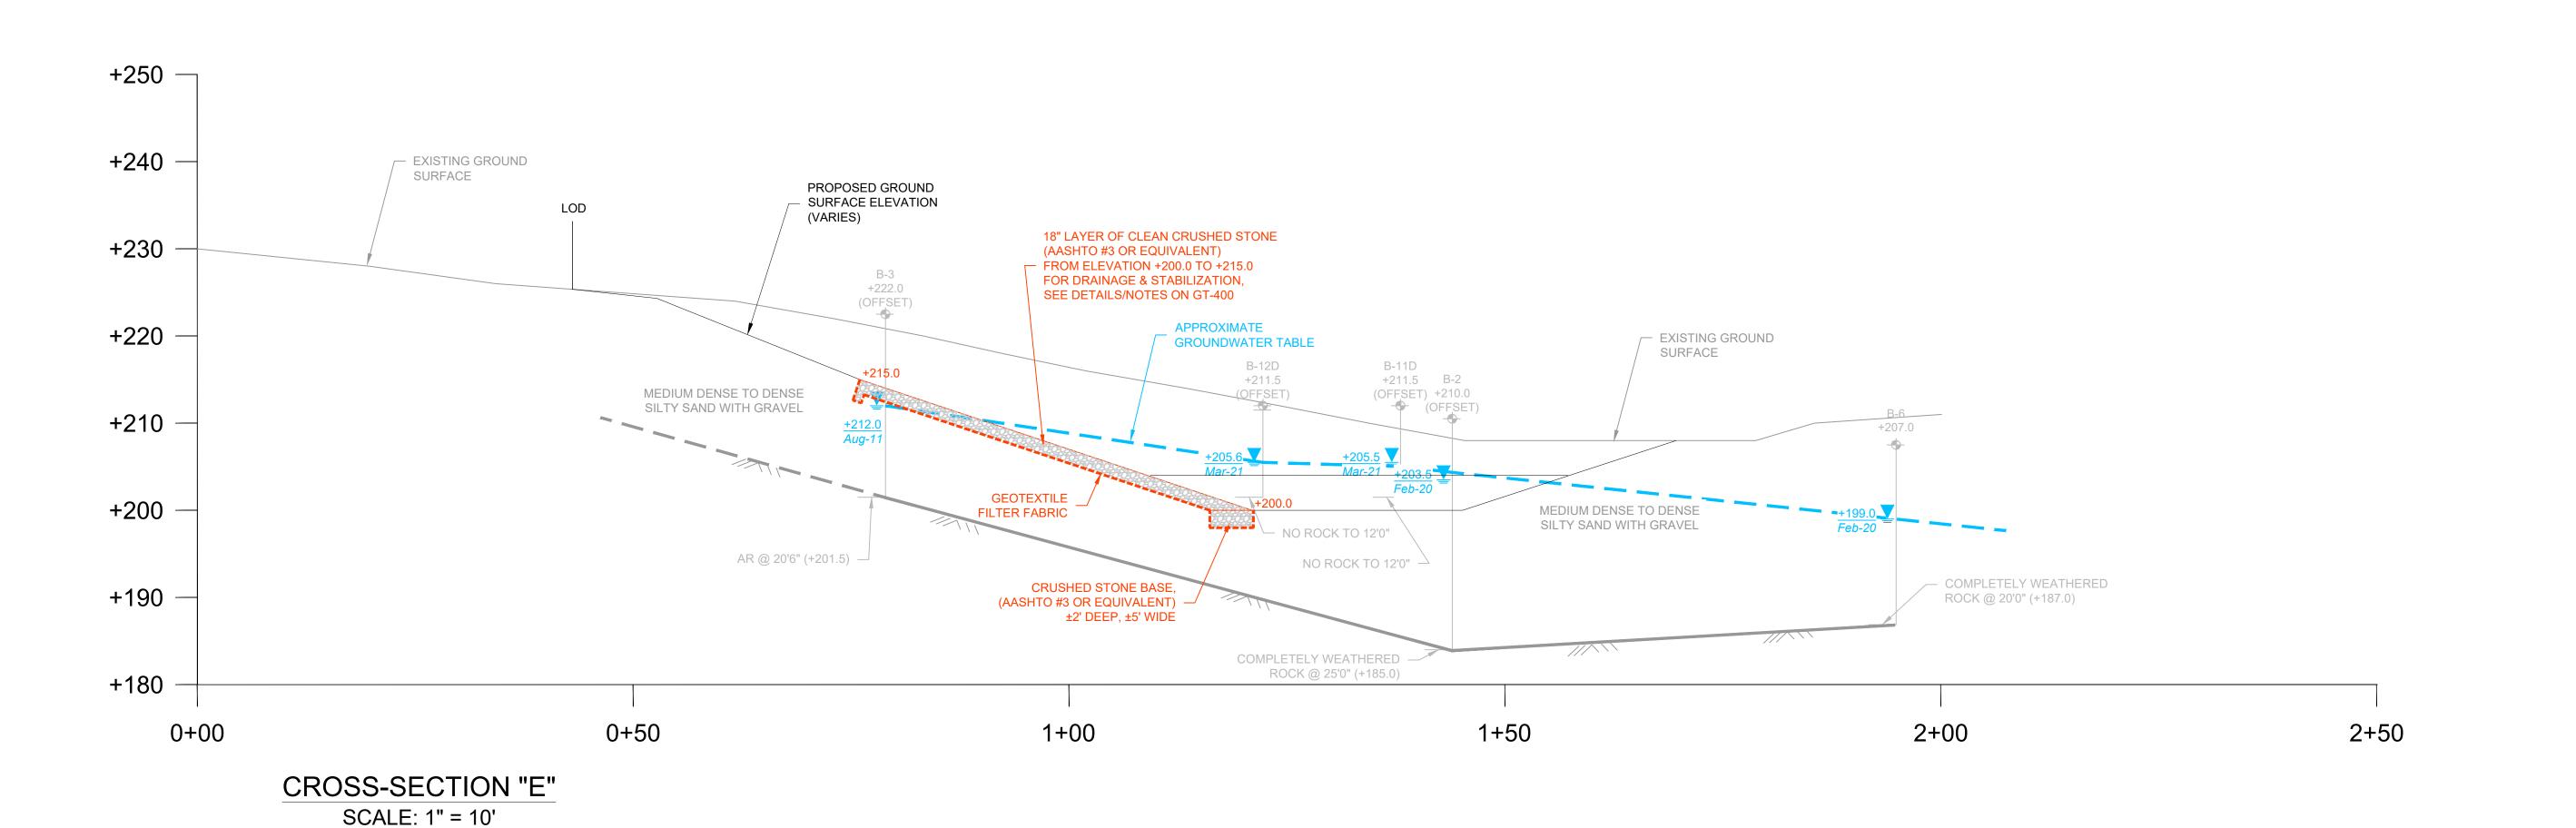
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Vendor Project No.: 20-166
Discipline: Geotechnical Drawn By: MRA

CROSS-SECTIONS A & B

Scale: 1" = 10' Floor:







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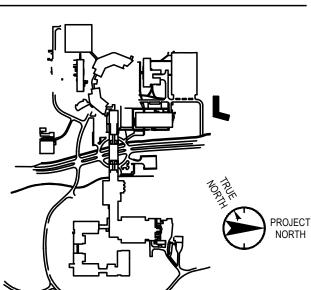
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Discipline: Geotechnical Drawn By: MRA

CROSS-SECTIONS C, D, & E

Scale: 1" = 10' Floor:

GT-102

SLOPE CUTOFF DRAIN LOCATION PLAN SCALE: 1" = 20'

> **CUTOFF DRAIN SCHEDULE** MINIMUM MINIMUM **APPROXIMATE** PIPE TRENCH WIDTH **FRENCH HEIGHT** NO. LENGTH DIAMETER (W) (3) (H) (1,2) 370 LF 3'-0" 5'-0" 3'-0" 365 LF 2'-6" 2'-6" 3'-0" 312 LF 56 LF 3'-0" 5'-0" 3'-0" 82 LF 2'-6' 67 LF 2'-6" 3'-0"

(1) THE TRENCHES FOR DRAINS 1 AND 4 ARE EXPECTED TO BE THE MINIMUM HEIGHT OF 5'-0" FOR THE MAJORITY OF THE DRAIN LINES. HOWEVER, THE TRENCHES ARE ALSO EXPECTED TO BE INSTALLED TO AT LEAST 1'-0" ABOVE THE GROUNDWATER TABLE. IN AREAS, THE TRENCH HEIGHT WILL EXCEED 5'-0".

(2) THE TRENCHES FOR DRAINS 2, 3, 5, AND 6 ARE EXPECTED TO BE 3'-0" IN HEIGHT, BUT MAY BE SLIGHTLY LESS THAN 3'-0" IN HEIGHT IN AREAS SO THAT THE TOP OF THE CRUSHED STONE REMAINS AT LEAST 1'-6" BELOW THE FINISHED GRADE.

(3) THE TRENCH WIDTHS ARE MINIMUM WIDTHS. DEPENDING ON THE INSTALLATION METHOD, WIDER TRENCHES MAY BE EXCAVATED. IN THIS CASE. THE ENTIRE TRENCH SHALL BE FILLED WITH CLEAN CRUSHED STONE THAT IS WRAPPED IN GEOTEXTILE FILTER FABRIC AS SHOWN IN THE TYPICAL CUTOFF DRAIN DETAIL.

SLOPE CUTOFF DRAIN NOTES

- GENERAL NOTES
- GENERAL LAYOUT FOR THE SLOPE DRAINAGE PLAN WAS OBTAINED FROM DRAWINGS THAT WERE PREPARED BY JMC PLLC, BR+A CONSULTING ENGINEERS PC, WHICH INCLUDE THE FOLLOWING:

-GRADING PLAN (C-200) -UTILITIES PLAN (C-300)

- CONTRACTOR SHALL REFER TO CIVIL DRAWINGS FOR GRADING, EXTERIOR UTILITIES, AND STORMWATER STRUCTURE DETAILS.
- CONTRACTOR SHALL HAVE AN APPROVED SET OF CONSTRUCTION DRAWINGS, SHOP DRAWINGS. AND SPECIFICATIONS ON SITE AT ALL TIMES DURING CONSTRUCTION.
- ALL OF THE WORK SHALL CONFORM TO ALL APPLICABLE FEDERAL, STATE, AND CITY CODES, REGULATIONS, AND REQUIREMENTS. IN CASE OF CONFLICT, THE MOST STRINGENT REQUIREMENTS SHALL GOVERN.
- THE CONTRACTOR SHALL PROVIDE THE FOLLOWING CONSTRUCTION SUBMITTALS (MINIMUM) TO CARLIN-SIMPSON & ASSOCIATES LLC AND THE OWNER'S REPRESENTATIVE: 1) A DETAILED DESCRIPTION OF THE PROPOSED CONSTRUCTION PROCEDURE, INCLUDING EXCAVATION SEQUENCE AND TECHNIQUES; 2) THE DEWATERING PLAN AND THE TEMPORARY DISCHARGE LOCATION(S); 3) SHOP DRAWINGS FOR SUPPORT OF EXCAVATION (SOE) AND/OR DEWATERING SYSTEMS, IF APPLICABLE; 4) MATERIALS TO BE USED IN THE SLOPE DRAINAGE SYSTEM; AND 5) DETAILS REGARDING BACKWATER CHECK VALVES. WORK SHALL NOT BEGIN UNTIL THE APPROPRIATE SUBMITTALS HAVE BEEN RECEIVED, REVIEWED, AND ACCEPTED IN WRITING BY THE ENGINEER.
- **GROUND CONDITIONS**
- THE CONTRACTOR SHALL REFER TO THE BORING LOGS INCLUDED IN THE SUBSURFACE SOIL AND FOUNDATION INVESTIGATION REPORT DATED 20 APRIL 2022 THAT WAS PREPARED BY CARLIN-SIMPSON & ASSOCIATES LLC.
- THE TEST BORING DATA AS SHOWN ON THE BORING LOCATION PLAN AND BORING LOGS ARE BELIEVED TO BE REPRESENTATIVE OF THE CONDITIONS LIKELY TO BE ENCOUNTERED ON THE SITE. THE BORING LOGS, HOWEVER, ARE NOT GUARANTEED TO REPRESENT ALL CONDITIONS THAT MAY BE ENCOUNTERED AND CONDITIONS MAY VARY BETWEEN BORING LOCATIONS.
- THE CONTRACTOR SHALL MAKE ITS OWN DEDUCTIONS OF THE SUBSURFACE CONDITIONS WHICH MAY AFFECT THE METHODS OR COST OF CONSTRUCTION OF THE WORK HEREUNDER, AND AGREES THAT IT WILL MAKE NO CLAIMS FOR DAMAGES OR COMPENSATIONS, EXCEPT AS ARE PROVIDED UNDER THE AGREEMENT SHOULD THE CONTRACTOR FIND CONDITIONS DURING THE PROGRESS OF THE WORK SUBSTANTIALLY DIFFERENT FROM THOSE INDICATED ON THE
- ADDITIONAL BORINGS AND OTHER EXPLORATORY OPERATIONS (I.E. TEST PITS) MAY BE PERFORMED BY THE CONTRACTOR, AT THE CONTRACTOR'S OPTION AND EXPENSE, FOLLOWING THE OWNER'S APPROVAL.
- C. SLOPE CUTOFF DRAIN EXCAVATION AND DEWATERING
- THE CONTRACTOR SHALL FURNISH ALL LABOR, MATERIALS, AND EQUIPMENT REQUIRED TO COMPLETE THE WORK. THE CONTRACTOR SHALL SELECT THE GENERAL CONSTRUCTION SEQUENCE AND THE METHOD OF EXCAVATION.
- CONTRACTOR SHALL PROVIDE ALL EQUIPMENT AND TEMPORARY CONSTRUCTION NECESSARY, INCLUDING SUPPORT OF EXCAVATION (SOE) AND TEMPORARY DEWATERING, FOR THE SLOPE DRAIN TRENCH EXCAVATIONS.
- IT IS EXPECTED THAT THE SLOPE DRAINS WILL BE INSTALLED PRIOR TO CONSTRUCTION OF THE STORMWATER COLLECTION SYSTEM. THEREFORE, THE CONTRACTOR MUST DETERMINE AN APPROPRIATE DISCHARGE LOCATION FOR THE SLOPE DRAINS UNTIL THE STORMWATER COLLECTION AND MANAGEMENT SYSTEMS ARE COMPLETED. THE WATER COULD BE DISCHARGED TO THE TEMPORARY SEDIMENT TRAPS OR TO ANOTHER LOCATION APPROVED BY THE SITE ENGINEER.
- TEMPORARY CONSTRUCTION EXCAVATIONS SHALL BE CONDUCTED IN ACCORDANCE WITH THE MOST RECENT OSHA GUIDELINES OR APPLICABLE FEDERAL, STATE OR LOCAL CODES. BASED ON THE BORING DATA, THE SITE SOILS SHOULD BE CLASSIFIED AS TYPE C AS DEFINED BY THE OSHA GUIDELINES.
- TEMPORARY CUT SLOPES SHALL BE 1.5 HORIZONTAL TO 1.0 VERTICAL (1.5H:1.0V) OR FLATTER IN ALL AREAS UNLESS A DIFFERENT SOIL CLASSIFICATION AND SLOPE ARE AUTHORIZED BY AN OSHA-QUALIFIED INSPECTOR.
- IT IS EXPECTED THAT THE SLOPE AREA WILL BE EXCAVATED IN VERTICAL STAGES AND THAT THE TRENCH EXCAVATIONS WILL BE COMPLETED IN HORIZONTAL SECTIONS THAT ALLOWS THE CONTRACTOR TO PROPERLY CONTROL THE INFLOW OF GROUNDWATER.
- BEDROCK MAY BE ENCOUNTERED IN AREAS DURING THE EXCAVATIONS FOR THE CUTOFF DRAINS. THE USE OF HYDRAULIC HAMMERS MAY BE REQUIRED TO EXCAVATE THE BEDROCK.


- DEPENDING ON THE EXCAVATION METHOD, THE RESULTING CUTOFF DRAIN TRENCHES MAY BE WIDER THAN SPECIFIED. IN THIS CASE, THE ENTIRE TRENCH WIDTH SHALL BE FILLED WITH CLEAN CRUSHED STONE THAT IS WRAPPED IN GEOTEXTILE FILTER FABRIC. THE COST FOR THE ADDITIONAL CRUSHED STONE AND FILTER FABRIC WILL BY BORNE BY THE CONTRACTOR.
- 9. IF REQUIRED, UP TO SIX (6) INCHES OF CRUSHED STONE MAY BE INSTALLED BELOW THE GEOTEXTILE FILTER FABRIC (AND BELOW THE PIPE INVERT ELEVATION) FOR SUBGRADE STABILIZATION.
- 10. IN THE EVENT THAT THE TEMPORARY CONSTRUCTION EXCAVATIONS ARE EXCAVATED BELOW THE FINISHED SLOPE ELEVATION IN ORDER TO INSTALL THE SLOPE CUTOFF DRAINS, THE FINAL SLOPE SHALL BE BACKFILLED AS FOLLOWS:
- a. THE SLOPE BACKFILL SHALL CONSIST OF EITHER ENGINEER-APPROVED ON-SITE SOIL OR IMPORTED SAND AND GRAVEL FILL. IMPORTED FILL SHALL CONTAIN LESS THAN 20% BY WEIGHT PASSING A NO. 200 SIEVE.
- b. THE FILL SHALL BE PLACED FROM THE BOTTOM UP IN LAYERS NOT EXCEEDING 12 INCHES IN THICKNESS. EACH LAYER MUST BE BENCHED INTO THE EXISTING
- c. EACH LAYER SHALL BE COMPACTED TO AT LEAST 95% OF ITS MAXIMUM MODIFIED DRY DENSITY (ASTM D1557). FILL LAYERS SHALL BE COMPACTED,

TESTED, AND APPROVED BEFORE PLACING SUBSEQUENT LAYERS.

- EROSION CONTROL BLANKETS OR PERMANENT TURF REINFORCEMENT MATS (TRM) ARE REQUIRED FOR ALL SLOPES STEEPER THAN 3H:1V TO PROTECT THE SLOPE FROM SURFACE EROSION. FOR ALL SLOPES, VEGETATION SHOULD BE ESTABLISHED AS SOON AS POSSIBLE AFTER CONSTRUCTION TO HELP STABILIZE THE SLOPE AND TO MINIMIZE SURFACE EROSION. REFER TO THE CIVIL PLANS AND LANDSCAPE PLANS FOR EROSION CONTROL AND VEGETATION REQUIREMENTS.
- D. SLOPE CUTOFF DRAINS

THE SLOPE CUTOFF DRAINS SHALL CONSIST OF EIGHT (8) INCH DIAMETER RIGID WALL PERFORATED PVC PIPES WITH HOLES FACING DOWN AND SHALL BE INSTALLED AT THE LOCATIONS AND ELEVATIONS INDICATED ON THIS PLAN WITH A PIPE SLOPE OF APPROXIMATELY 0.5% (MINIMUM) UNLESS OTHERWISE NOTED.

- THE PIPE SHALL CONSIST OF SCHEDULE 40 PVC.
- THE CUTOFF DRAIN PIPE SHALL BE SURROUNDED BY 3/4-INCH CLEAN CRUSHED STONE THAT IS WRAPPED IN A GEOTEXTILE FILTER FABRIC (MIRAFI 140N OR EQUIVALENT). ADJACENT FILTER FABRIC PANELS SHALL OVERLAP BY A MINIMUM OF 12 INCHES. REFER TO THE TYPICAL CUTOFF DRAIN DETAIL FOR MORE INFORMATION.
- THE CRUSHED STONE SHALL EXTEND VERTICALLY AND HORIZONTALLY AS INDICATED IN THE CROSS-SECTIONS AND CUTOFF DRAIN SCHEDULE OR TO APPROXIMATELY 18 INCHES BELOW THE FINISHED GROUND SURFACE ELEVATION, WHICHEVER IS LOWER. THE GEOTEXTILE FILTER FABRIC SHALL BE WRAPPED OVER THE STONE AND THE OVERLYING MATERIAL SHALL CONSIST OF ENGINEER APPROVED ON-SITE SOIL, IMPORTED SAND AND GRAVEL FILL, TOPSOIL, AND/OR ASPHALT PAVEMENT AS PER THE CONTRACT PLANS AND SPECIFICATIONS.
- THE PERFORATED PVC DRAINPIPES SHALL CONNECT TO AN EIGHT (8) INCH DIAMETER RIGID WALL SOLID PVC PIPE THAT DISCHARGES TO MULTIPLE STORMWATER STRUCTURES AS INDICATED ON THE SLOPE DRAINAGE PLAN. BACKWATER CHECK VALVES ARE REQUIRED FOR EACH DISCHARGE LOCATION. THE BACKWATER CHECK VALVE TYPE IS TO BE SELECTED BY THE CONTRACTOR AND SUBMITTED FOR APPROVAL BY THE MEP ENGINEER AND GEOTECHNICAL ENGINEER.
- QUALITY ASSURANCE AND INSPECTION
- THE OWNER SHALL RETAIN. AT THEIR COST. CARLIN-SIMPSON & ASSOCIATES LLC TO PERFORM QUALITY ASSURANCE INSPECTION AND MONITORING SERVICES RELATED TO THE INSTALLATION OF SLOPE DRAINAGE SYSTEM AND THE CONSTRUCTION OF
- CONTRACTOR SHALL ARRANGE FOR AND SCHEDULE ALL REQUIRED INSPECTIONS.
- THE ABOVE FIELD INSPECTION AND MONITORING WILL NOT RELIEVE THE CONTRACTOR OF HIS RESPONSIBILITY TO MEET THE MORE STRINGENT OF THE CONSTRUCTION DRAWINGS, MANUFACTURER'S REQUIREMENTS, AND THE PROJECT SPECIFICATIONS.
- CONTRACTOR SHALL TAKE PROMPT ACTION TO PREVENT OR CORRECT ANY CONDITIONS WHICH HAVE RESULTED OR COULD RESULT IN THE SUBMITTAL TO ENGINEER OF ITEMS OR SERVICES WHICH DO NOT CONFORM TO THE QUALITY PERFORMANCE OF THE CONTRACT, THE TESTS SPECIFIED IN THE CONTRACT AND OTHER TESTS AS MAY BE REQUIRED TO SUBSTANTIATE CONFORMANCE.

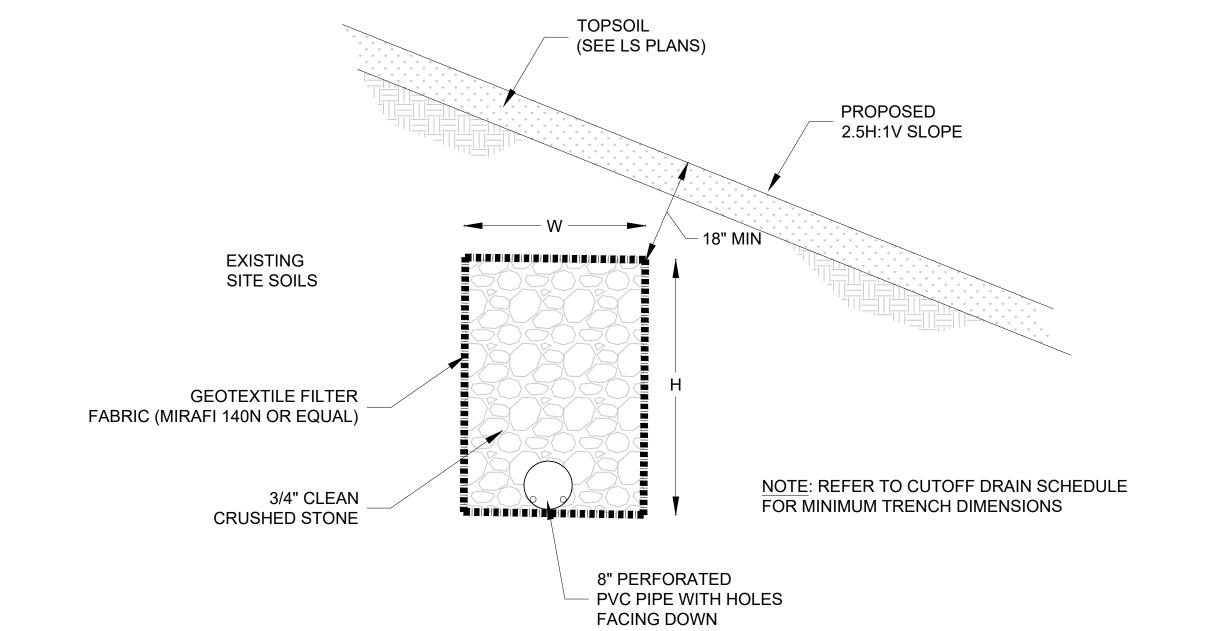

TYP. SLOPE CUTOFF DRAIN DETAIL 3/4" = 1'-0"

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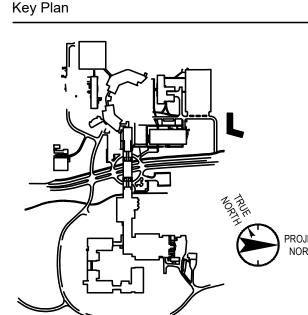
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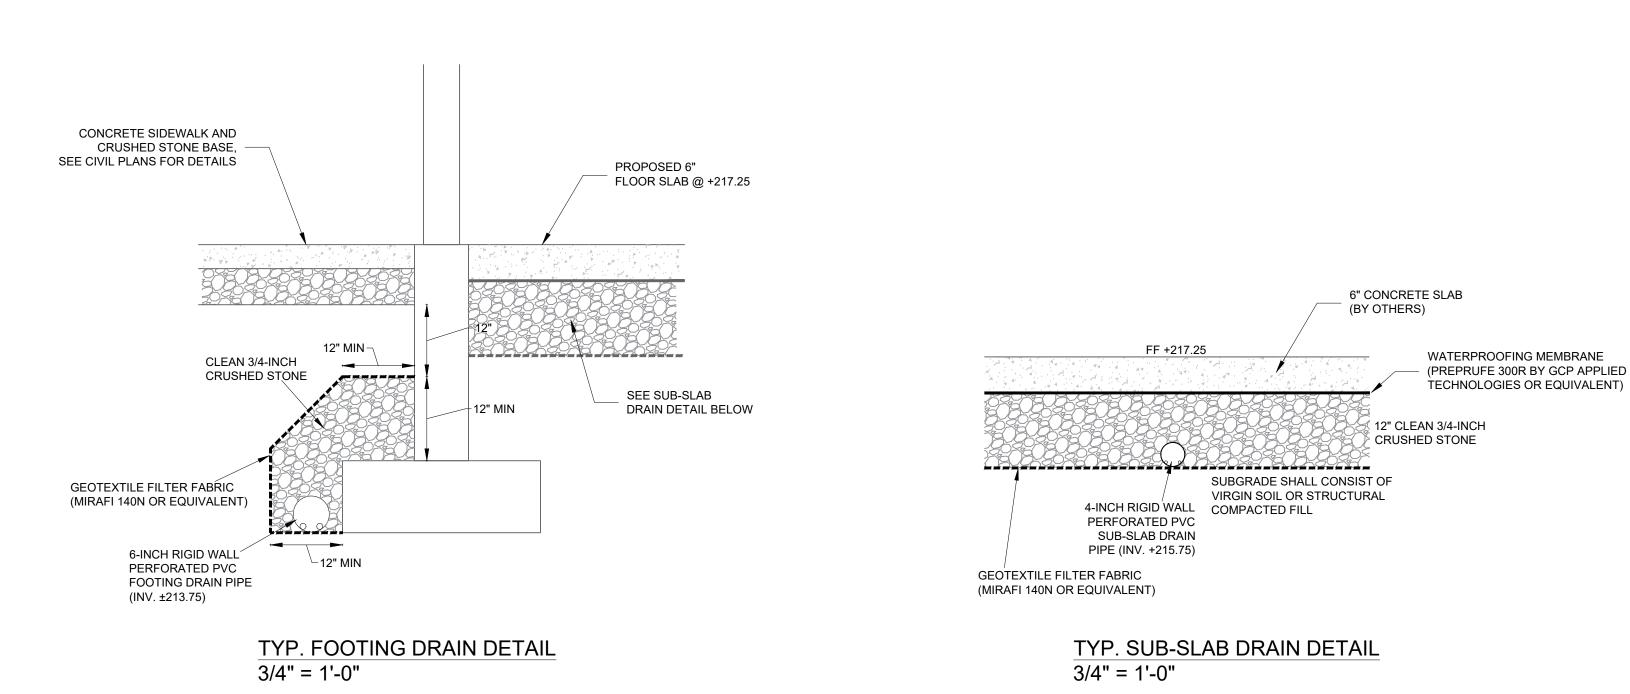
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> Discipline: Geotechnical Drawn By: MRA

SLOPE DRAINAGE PLAN

Scale: AS SHOWN Floor:

BUILDING DRAINAGE LOCATION PLAN SCALE: 1" = 15'



AND WEST SIDES ONLY)

BUILDING DRAINAGE NOTES

- A. GENERAL NOTES
- GENERAL LAYOUT FOR THE BUILDING DRAINAGE PLANS WAS OBTAINED FROM DRAWINGS THAT WERE PREPARED BY BR+A CONSULTING ENGINEERS PC AND THORNTON TOMASETTI, WHICH INCLUDE THE FOLLOWING:

-GROUND FLOOR PLAN (S-100) -PLUMBING UNDERGROUND PLAN (P-100)

- CONTRACTOR SHALL REFER TO STRUCTURAL AND ARCHITECTURAL DRAWINGS FOR ALL FOUNDATION, FLOOR SLAB, WATERPROOFING, AND VAPOR BARRIER DETAILS. CONTRACTOR SHALL REFER TO MEP DRAWINGS FOR ALL SUB-SLAB PIPE DETAILS AND DISCHARGE DETAILS. CONTRACTOR SHALL REFER TO CIVIL DRAWINGS FOR GRADING, EXTERIOR UTILITIES, AND STORMWATER STRUCTURE DETAILS.
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- ALL OF THE WORK SHALL CONFORM TO ALL APPLICABLE FEDERAL, STATE, AND CITY CODES, REGULATIONS, AND REQUIREMENTS. IN CASE OF CONFLICT, THE MOST STRINGENT REQUIREMENTS SHALL GOVERN.
- THE CONTRACTOR SHALL PROVIDE THE FOLLOWING CONSTRUCTION SUBMITTALS (MINIMUM) TO CARLIN-SIMPSON & ASSOCIATES LLC AND THE OWNER'S REPRESENTATIVE: 1) MATERIALS TO BE USED IN THE BUILDING DRAINAGE SYSTEM; 2) DAMP PROOFING AND WATERPROOFING MATERIALS AND INSTALLATION PROCEDURES; AND 3) DETAILS REGARDING BACKWATER CHECK VALVES. WORK SHALL NOT BEGIN UNTIL THE APPROPRIATE SUBMITTALS HAVE BEEN RECEIVED, REVIEWED, AND ACCEPTED IN WRITING BY THE ENGINEER.

B. FOOTING PERIMETER DRAIN

- 1. A PERIMETER DRAIN OR FOOTING DRAIN, CONSISTING OF A SIX (6) INCH DIAMETER PERFORATED PVC PIPE WITH HOLES FACING DOWN, SHALL BE INSTALLED AROUND THE OUTSIDE PERIMETER OF THE BUILDING AS SHOWN ON THIS PLAN TO PREVENT WATER FROM ACCUMULATING AGAINST THE FOUNDATION WALLS.
- THE PIPE SHALL CONSIST OF SDR-26 OR SCHEDULE 40 PVC.
- DAMP PROOFING IS REQUIRED FOR THE FOUNDATION WALLS WHERE THE PERIMETER DRAIN IS INSTALLED. CONTRACTOR TO SUBMIT DAMP PROOFING MATERIALS AND PROCEDURES FOR REVIEW AND APPROVAL
- 4. THE FOOTING DRAIN PIPE SHALL BE SURROUNDED BY A MINIMUM OF 12 INCHES OF CLEAN 3/4-INCH CRUSHED STONE THAT IS WRAPPED IN A GEOTEXTILE FILTER FABRIC (MIRAFI 140N OR EQUIVALENT) AND EXTENDS TO APPROXIMATELY 12 INCHES BELOW THE SIDEWALK SUBGRADE ELEVATION. REFER TO THE TYPICAL FOOTING DRAIN DETAIL FOR MORE INFORMATION.
- THE FOOTING DRAIN PIPE SHALL BE PIPED INTO STORMWATER STRUCTURE DI B-4 AS INDICATED ON THIS PLAN. REFER TO THE CIVIL DRAWINGS FOR STRUCTURE DETAILS. A BACKWATER CHECK VALVE IS REQUIRED FOR THE DISCHARGE LOCATION. THE BACKWATER CHECK VALVE TYPE IS TO BE SELECTED BY THE CONTRACTOR AND SUBMITTED FOR APPROVAL BY THE MEP ENGINEER AND GEOTECHNICAL ENGINEER.

C. SUB-SLAB DRAINAGE SYSTEM

- 1. SUB-SLAB WATERPROOFING IS REQUIRED FOR THE ENTIRE BUILDING. THE WATERPROOFING MEMBRANE SHALL CONSIST OF PREPRUFE 300R BY GCP APPLIED TECHNOLOGIES OR AN ENGINEER-APPROVED EQUIVALENT
- THE SUB-SLAB DRAINAGE SYSTEM SHALL CONSIST OF DRAIN LINES AS SHOWN ON THE BUILDING DRAINAGE PLAN. THE DRAINPIPES SHALL CONSIST OF FOUR (4) INCH DIAMETER RIGID WALL PERFORATED PVC PIPES WITH HOLES FACING DOWN, PLACED AT THE BOTTOM OF 12 INCHES OF CLEAN 3/4-INCH CRUSHED STONE GRAVEL. THIS CORRELATES TO A PIPE INVERT ELEVATION OF APPROXIMATELY +215.75. REFER TO THE TYPICAL SUB-SLAB DRAIN DETAIL FOR MORE INFORMATION.
- THE PIPE SHALL CONSIST OF SDR-26 OR SCHEDULE 40 PVC.
- 4. A LAYER OF GEOTEXTILE FILTER FABRIC (MIRAFI 140N OR EQUIVALENT) SHALL BE PLACED BETWEEN THE SUBGRADE SOIL AND THE CRUSHED STONE TO PREVENT SOIL FROM CLOGGING THE PIPES. THE EDGES OF THE FILTER FABRIC SHALL BE FOLDED ON TOP OF THE CRUSHED STONE FILL. THE SUBGRADE SHALL BE GRADED ("PITCHED") TOWARDS THE UNDERDRAIN. ADJACENT FILTER FABRIC PANELS SHALL OVERLAP BY A MINIMUM OF 12 INCHES.
- THE SUB-SLAB DRAINS WILL CROSS THE NEW SHEAR WALLS AT SEVERAL LOCATIONS. SLEEVES WILL BE REQUIRED DURING SHEAR WALL CONSTRUCTION TO ALLOW FUTURE INSTALLATION OF THE DRAINAGE PIPES. REFER TO THE STRUCTURAL PLANS FOR PENETRATION DETAILS.
- THE PERFORATED PVC DRAINPIPES SHALL CONNECT TO FOUR (4) INCH DIAMETER RIGID WALL SOLID PVC PIPES THAT DISCHARGE TO STORMWATER STRUCTURE DI B-4 OFF THE NORTHEAST CORNER OF THE BUILDING AND TO STRUCTURE DI-10 OFF THE SOUTHEAST SIDE OF THE BUILDING. SLEEVES THROUGH THE EXTERIOR WALLS WILL BE REQUIRED FOR THE DISCHARGE PIPES.
- BACKWATER CHECK VALVES ARE REQUIRED FOR BOTH DISCHARGE LOCATIONS. THE BACKWATER CHECK VALVE LOCATION AND TYPE ARE TO BE SELECTED BY THE CONTRACTOR AND SUBMITTED FOR APPROVAL BY THE MEP ENGINEER AND GEOTECHNICAL ENGINEER.
- 8. DRAIN PIPE LOCATIONS MAY BE FIELD ADJUSTED TO AVOID CONFLICTS WITH SUB-SLAB STRUCTURES AND UTILITIES PROVIDED THAT THE MINIMUM SPACING IS MAINTAINED AND THAT THE LOCATIONS ARE APPROVED BY THE GEOTECHNICAL ENGINEER.

D. QUALITY ASSURANCE AND INSPECTION

- 1. THE OWNER SHALL RETAIN, AT THEIR COST, CARLIN-SIMPSON & ASSOCIATES LLC TO PERFORM QUALITY ASSURANCE INSPECTION AND MONITORING SERVICES RELATED TO THE INSTALLATION OF BUILDING DRAINAGE SYSTEM.
- CONTRACTOR SHALL ARRANGE FOR AND SCHEDULE ALL REQUIRED INSPECTIONS.
- 3. THE ABOVE FIELD INSPECTION AND MONITORING WILL NOT RELIEVE THE CONTRACTOR OF HIS RESPONSIBILITY TO MEET THE MORE STRINGENT OF THE CONSTRUCTION DRAWINGS, MANUFACTURER'S REQUIREMENTS, AND THE PROJECT SPECIFICATIONS.
- 4. CONTRACTOR SHALL TAKE PROMPT ACTION TO PREVENT OR CORRECT ANY CONDITIONS WHICH HAVE RESULTED OR COULD RESULT IN THE SUBMITTAL TO ENGINEER OF ITEMS OR SERVICES WHICH DO NOT CONFORM TO THE QUALITY PERFORMANCE OF THE CONTRACT, THE TESTS SPECIFIED IN THE CONTRACT AND OTHER TESTS AS MAY BE REQUIRED TO SUBSTANTIATE CONFORMANCE.

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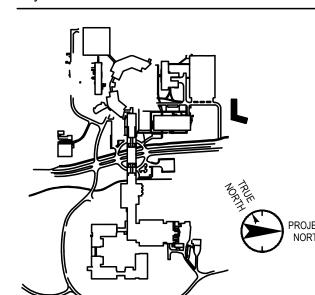
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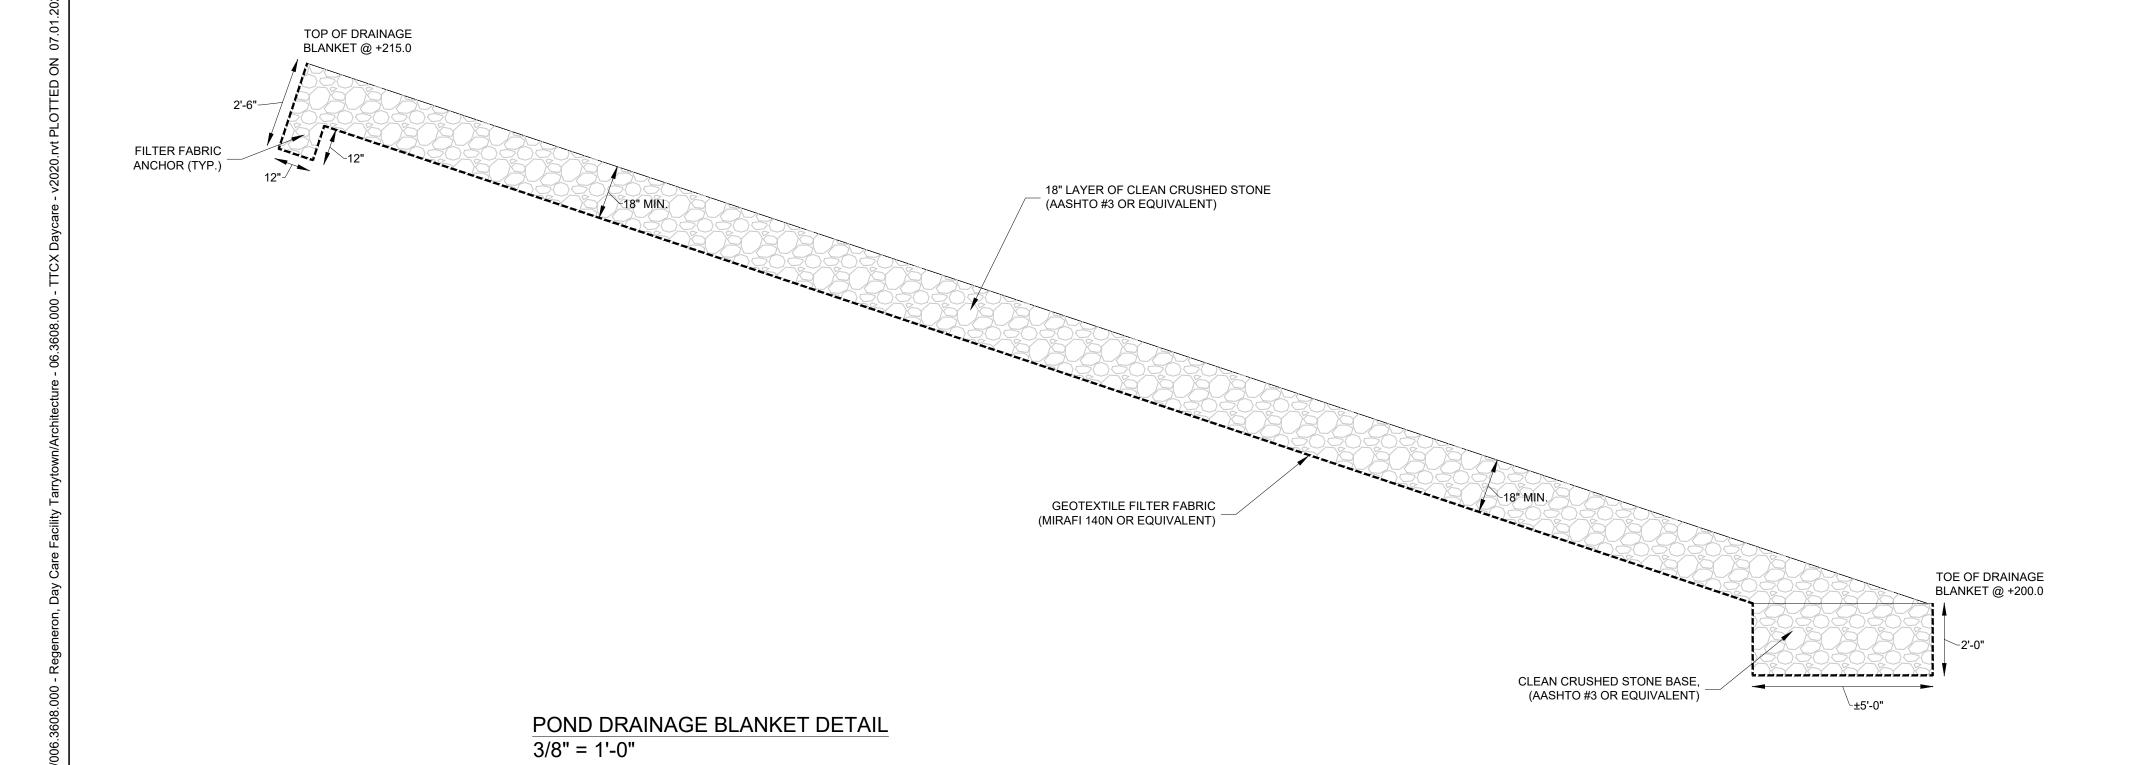
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SECTION 7209, SUBSECTION 2. Vendor Name: Carlin-Simpson & Associates LLC
Vendor Project No.: 20-166 Discipline: Geotechnical Drawn By: MRA

BUILDING DRAINAGE PLAN

Scale: AS SHOWN Floor:

POND DRAINAGE BLANKET LOCATION PLAN SCALE: 1" = 15'



PAVEMENT DRAIN AND POND DRAINAGE BLANKET NOTES

A. GENERAL NOTES

GENERAL LAYOUT FOR THE DRAINAGE PLANS WAS OBTAINED FROM DRAWINGS THAT WERE PREPARED BY JMC PLLC, WHICH INCLUDE THE FOLLOWING:

-GRADING PLAN (C-200) -UTILITIES PLAN (C-300)

CONTRACTOR SHALL REFER TO CIVIL DRAWINGS FOR GRADING, EXTERIOR UTILITIES, AND STORMWATER STRUCTURE DETAILS.

- CONTRACTOR SHALL HAVE AN APPROVED SET OF CONSTRUCTION DRAWINGS, SHOP DRAWINGS, AND SPECIFICATIONS ON SITE AT ALL TIMES DURING CONSTRUCTION.
- ALL OF THE WORK SHALL CONFORM TO ALL APPLICABLE FEDERAL, STATE, AND CITY CODES, REGULATIONS, AND REQUIREMENTS. IN CASE OF CONFLICT, THE MOST STRINGENT REQUIREMENTS SHALL GOVERN.
- THE CONTRACTOR SHALL PROVIDE THE FOLLOWING CONSTRUCTION SUBMITTALS (MINIMUM) TO CARLIN-SIMPSON & ASSOCIATES LLC AND THE OWNER'S REPRESENTATIVE: 1) A DETAILED DESCRIPTION OF THE PROPOSED CONSTRUCTION PROCEDURE, INCLUDING EXCAVATION SEQUENCE AND TECHNIQUES; 2) A DEWATERING PLAN AND THE TEMPORARY DISCHARGE LOCATION(S); 3) SHOP DRAWINGS FOR SUPPORT OF EXCAVATION (SOE) AND/OR DEWATERING SYSTEMS, IF APPLICABLE; AND 4) MATERIALS TO BE USED IN THE SLOPE DRAINAGE AND STABILIZATION SYSTEM. WORK SHALL NOT BEGIN UNTIL THE APPROPRIATE SUBMITTALS HAVE BEEN RECEIVED, REVIEWED, AND ACCEPTED IN WRITING BY THE ENGINEER.

B. POND DRAINAGE BLANKET

- THE DRAINAGE BLANKET SHALL CONSIST OF 18-INCHES OF CLEAN CRUSHED STONE INSTALLED FROM ELEVATION +200.0 TO ELEVATION +215.0 TO THE HORIZONTAL LIMITS SHOWN ON THE DRAINAGE BLANKET LOCATION PLAN.
- A CRUSHED STONE BASE SHALL ALSO BE CONSTRUCTED AT THE TOE OF THE SLOPE AS SHOWN ON THE DRAINAGE BLANKET DETAIL.
- THE CLEAN CRUSHED STONE FOR THE DRAINAGE BLANKET AND THE BASE SHALL MEET AASHTO #3 OR EQUIVALENT. A TYPICAL GRADATION IS AS FOLLOWS:

2.5-INCH 100 2.0-INCH 90-100 1.5-INCH 35-70

> 1.0-INCH 0-15 0.5-INCH 0-5

- 4. A LAYER OF GEOTEXTILE FILTER FABRIC (MIRAFI 140N OR EQUIVALENT) SHALL BE PLACED BETWEEN THE SUBGRADE SOIL AND THE CRUSHED STONE TO PREVENT SOIL MIGRATION INTO THE CRUSHED STONE. ADJACENT FILTER FABRIC PANELS SHALL OVERLAP BY A MINIMUM OF 12 INCHES.
- THE GEOTEXTILE FILTER FABRIC SHALL BE ANCHORED AT THE TOP OF THE DRAINAGE BLANKET AS SHOWN IN THE DRAINAGE BLANKET DETAIL.

C. PAVEMENT UNDERDRAINS

- 1. PAVEMENT UNDERDRAINS (AKA FINGER DRAINS) SHALL BE INSTALLED AT SELECT STORMWATER STRUCTURES AS SHOWN ON THE OVERALL DRAINAGE PLAN (GT-100).
- 2. EACH UNDERDRAIN PIPE SHALL EXTEND A MINIMUM OF 25 FEET FROM THE STRUCTURE.
- THE DRAINPIPES SHALL CONSIST OF FOUR (4) INCH DIAMETER RIGID WALL PERFORATED PVC PIPES WITH HOLES FACING DOWN, PLACED AT THE BOTTOM OF 24 INCHES OF 3/4-INCH CLEAN CRUSHED STONE GRAVEL.
- 4. THE PIPE SHALL CONSIST OF SCHEDULE 40 PVC.
- 5. A LAYER OF GEOTEXTILE FILTER FABRIC (MIRAFI 140N OR EQUIVALENT) SHALL BE PLACED BETWEEN THE SUBGRADE SOIL AND THE CRUSHED STONE TO PREVENT SOIL FROM CLOGGING THE PIPES. THE EDGES OF THE FILTER FABRIC SHALL BE FOLDED ON TOP OF THE CRUSHED STONE FILL. ADJACENT FILTER FABRIC PANELS SHALL OVERLAP BY A MINIMUM OF 12 INCHES.
- REFER TO THE TYPICAL PAVEMENT DRAIN DETAIL FOR MORE INFORMATION.
- 7. PAVEMENT UNDERDRAIN PIPE LOCATIONS MAY BE FIELD ADJUSTED TO AVOID CONFLICTS WITH OTHER UTILITIES AND STRUCTURES PROVIDED THAT THE LOCATIONS ARE APPROVED BY THE GEOTECHNICAL ENGINEER.
- D. QUALITY ASSURANCE AND INSPECTION
- 1. THE OWNER SHALL RETAIN, AT THEIR COST, CARLIN-SIMPSON & ASSOCIATES LLC TO PERFORM QUALITY ASSURANCE INSPECTION AND MONITORING SERVICES RELATED TO THE INSTALLATION OF PAVEMENT UNDERDRAINS, THE BLANKET DRAINAGE SYSTEM, AND THE CONSTRUCTION OF THE SOIL SLOPES.
- 2. CONTRACTOR SHALL ARRANGE FOR AND SCHEDULE ALL REQUIRED INSPECTIONS.
- 3. THE ABOVE FIELD INSPECTION AND MONITORING WILL NOT RELIEVE THE CONTRACTOR OF HIS RESPONSIBILITY TO MEET THE MORE STRINGENT OF THE CONSTRUCTION DRAWINGS, MANUFACTURER'S REQUIREMENTS, AND THE PROJECT SPECIFICATIONS.
- CONTRACTOR SHALL TAKE PROMPT ACTION TO PREVENT OR CORRECT ANY CONDITIONS WHICH HAVE RESULTED OR COULD RESULT IN THE SUBMITTAL TO ENGINEER OF ITEMS OR SERVICES WHICH DO NOT CONFORM TO THE QUALITY PERFORMANCE OF THE CONTRACT, THE TESTS SPECIFIED IN THE CONTRACT AND OTHER TESTS AS MAY BE REQUIRED TO SUBSTANTIATE CONFORMANCE.

ASPHALT PAVEMENT, PAVEMENT SUBBASE, SEE CIVIL DRAWINGS SEE CIVIL DRAWINGS APPROVED COMPACTED SUBGRADE GEOTEXTILE FILTER FABRIC (MIRAFI 140N OR EQUAL) 3/4" CLEAN CRUSHED STONE 4-INCH RIGID WALL PERFORATED PVC

> TYP. PAVEMENT UNDERDRAIN DETAIL 3/4" = 1'-0"

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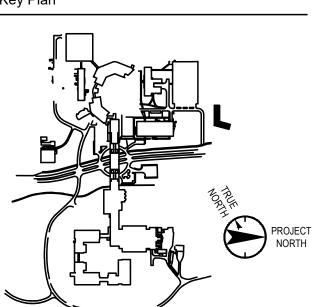
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PAVEMENT DRAINS & POND DRAIN BLANKET

Scale: AS SHOWN Floor: