

SHEET NAME NUMBER M-700 MECHANICAL RISER DIAGRAM M-701 MECHANICAL VRF DIAGRAM SHEET M-702 MECHANICAL VRF DIAGRAM SHEET 2 M-703 MECHANICAL VRF DIAGRAM SHEET 3 M-704 MECHANICAL CONTROL DIAGRAM SHEET M-705 MECHANICAL CONTROL DIAGRAM SHEET 2 E-001 | ELECTRICAL SYMBOLS AND DRAWING LIST E-051 ELECTRICAL SITE PLAN E-052 ELECTRICAL SITE LIGHTING PLAN E-100 ELECTRICAL POWER PLAN - 1ST FLOOR E-110 ELECTRICAL EQUIPMENT POWER PLAN - 1ST FLOOR E-111 ELECTRICAL EQUIPMENT POWER PLAN - ROOF E-121 ELECTRICAL LIGHTNING PROTECTION PLAN E-150 ELECTRICAL LIGHTING PLAN - 1ST FLOOR E-400 ELECTRICAL ENLARGED VIEWS - SHEET 1 E-500 ELECTRICAL DETAIL SHEET 1 E-501 ELECTRICAL DETAIL SHEET 2

HVAC GENERAL NOTES:

- CONTRACTOR, WITH OWNER, SHALL PAY ALL FEES AND OBTAIN ALL PERMITS REQUIRED BY LOCAL AND STATES CODES.
- WHERE PIPING, LIGHTS AND DUCTWORK CONFLICT, DUCTWORK SHALL BE COORDINATED IN THE FIELD TO SUIT CONDITIONS. 3. ALL DUCTWORK TO BE KEPT AS HIGH AS POSSIBLE SO AS TO
- MAINTAIN CEILING HEIGHTS SHOWN ON ARCHITECTURAL DRAWINGS. 4. ACCESS IS REQUIRED BELOW ALL DAMPERS, VALVES, AND EQUIPMENT. ACCESS DOORS TO BE PROVIDED IN GYPSUM CEILINGS AS REQUIRED.
- 5. FOR EXACT LOCATION OF CEILING DIFFUSERS AND REGISTERS REFER TO THE ARCHITECTURAL REFLECTED CEILING PLAN. 6. FOR EXACT LOCATION AND ARRANGEMENT OF ROOM THERMOSTATS
- AND EXHAUST FAN SWITCHES, SEE THE ARCHITECT'S DRAWINGS. IF NONE IS SHOWN, THERMOSTAT/SWITCH SHALL BE NEXT TO THE LIGHT SWITCH, MAINTAINING A DISTANCE FROM THE LIGHT SWITCHES.
- 7. DUCT SIZES SHOWN ARE CLEAR INSIDE DIMENSIONS. 8. DUCTWORK SHALL BE CONSTRUCTED AND INSTALLED PER LATEST

EDITION OF THE SMACNA DUCT CONSTRUCTION STANDARDS.

- 9. MOUNT THERMOSTAT ABOVE FINISHED FLOOR PER ARCHIECT, PROVIDE THERMOSTAT WITH HEAVY GUARDS OR LOCKABLE COVER APPROVED
- BY ARCH. & ENGINEER IN COMMON PUBLIC OR UNSUPERVISED AREA. 0. FOR EXACT LOCATION OF THERMOSTATS, GRILLES, AND
- DIFFUSERS REFER TO ARCHITECT DRAWINGS. ALL GRILLES AND DIFFUSERS PAINTED TO MATCH ADJACENT COLORS. COLORS TO BE APPROVED BY ARCH.&OWNER. . ALL SUPPLY, RETURN, EXHAUST AND OUTSIDE AIR DUCTWORK SHALL BE
- OR DWGS. WHERE BRANCH DUCTS ARE SERVING "WET" AREAS, ALUMINUM DUCT MATERIAL SHALL BE PROVIDED. 12. ALL STRAP HANGER & SUPPORTS FOR FLEXIBLE DUCTWORK SHALL BE SIZES & INSTALLED IN ACCORDANCE W/SMACNA STANDARDS, BUT

NOT LESS THAT 1-1/2" WIDE.

GALV. SHEET METAL UNLESS OTHERWISE SPECIFIED IN THE SPECS

CONSISTING OF A CORE STANDARD TRIPLE LOCK METAL FLEXIBLE DUCTING FOR STRENGTH AND AIRTIGHTNESS. UNITS OVER 2,000 CFM SHALL HAVE SMOKE DETECTORS ON THE SUPPLY AND RETURN DUCTWORK PER MCNYS CODE SECTION 606.2.

13. PROVIDE MINIMUM OF R-6 ON DUCTWORK ABOVE CEILING.

ALL FLEXIBLE DUCTWORK SHALL BE ALL METAL CONSTRUCTION

- 15. ALL EXTERIOR INSULATED DUCTWORK SHALL HAVE POLYISOCYANURATE BOARD
- WITH EPDM COVER ON DUCTWORK. 16. PROVIDE VOLUME DAMPERS IN LOW PRESSURE DUCTWORK FOR ALL SUPPLY,
- RETURN, AND EXHAUST OUTLETS, PROVIDE VOLUME DAMPERS (VD) AT EVERY DUCTWORK BRANCH, TAP AND SPLIT. DO NOT INSTALL VOLUME DAMPERS ON MEDIUM PRESSURE DUCTWORK. PROVIDE ACCESS DOORS IN DUCTWORK WHERE INDICATED OR REQUIRED FOR ACCESS TO SYSTEM COMPONENTS INCLUDING, BUT NOT LIMITED TO
- THE FOLLOWING: A. AUTOMATIC DAMPERS 18. PROVIDE INSULATED CONDENSATE DRAIN TO NEAREST FLOOR DRAIN
- FOR ALL AC UNITS. PROVIDE CONDENSATE PUMP WITH A MIN.CAPACITY OF 20'TDH@120GPH, 115/1/60, 6FT.PLUG IN, RESERVOIR, COMPLETE VALVE PACKAGE AND ACCESSORIES IF THE CONDENSATE CAN NOT BE DRAINED BY GRAVITY.
- 19. ALL MOTOR STARTERS LOCATED OUTDOORS OR EXPOSED TO WET OR DAMP CONDITIONS SHALL BE NEMA TYPE 4. 20. ALL COILS AND FILTERS SHALL BE INSTALLED ON TRACKS FOR EASY
- REMOVAL. INSTALLATIONS THAT REQUIRE DISASSEMBLY OF THE UNIT OR PLENUM FOR COIL REMOVAL ARE NOT ACCEPTABLE.

COMMISSIONING NOTES

AGENCY TO PROVIDE COMMISSIONING SERVICES IN COMPLIANCE WITH 2020

ECCNYS. THE SPECIFICATIONS SHALL BE PROVIDED BY A COMMISSIONING

- YSTEMS AND ASSOCIATED CONTROLS TO BE COMMISSIONED: 1. HEATING, COOLING, AIR HANDLING AND DISTRIBUTION, VENTILATION,
- EXHAUST SYSTEMS, AND THEIR RELATED AIR QUALITY MONITORING

AGENT TO BE SUBMITTED WITH DESIGN DOCUMENTS FOR BID.

- 2. AIR, WATER, AND OTHER ENERGY RECOVERY SYSTEMS 3 MANUAL OR AUTOMATIC CONTROLS, WHETHER LOCAL OR REMOTE, ON ENERGY USING SYSTEMS INCLUDING BUT NOT LIMITED TO TEMPERATURE CONTROLS, SETBACK SEQUENCES, AND OCCUPANCY BASED CONTROL. INCLUDING ENERGY MANAGEMENT FUNCTIONS OF THE BUILDING
- 4. PLUMBING. INCLUDING INSULATION OF PIPING AND ASSOCIATED VALVES. DOMESTIC AND PROCESS WATER PUMPING, AND MIXING SYSTEMS. 5. MECHANICAL HEATING SYSTEMS AND SERVICE WATER HEATING SYSTEMS. 6. REFRIGERATION SYSTEMS.
- 7. RENEWABLE ENERGY AND ENERGY STORAGE SYSTEMS. 8. OTHER SYSTEMS, EQUIPMENT AND COMPONENTS THAT ARE USED FOR HEATING, COOLING OR VENTILATION AND THAT AFFECT ENERGY USE.
- COMMISSIONING PLAN SHALL FOLLOW ALL NECESSARY STEPS AS PER 2020

MANAGEMENT SYSTEM.

TRAINING AND MANUALS: UPON COMPLETION OF THE JOB, ALL APPLICABLE OPERATING AND SPECIFICATION MANUALS TO BE DELIVERED TO THE BUILDING STAFF. CONTRACTOR SHALL PROVIDE TRAINING FOR THE BUILDING MAINTENANCE STAFF TO ASSURE THAT THE SYSTEM IS MAINTAINED AND OPERATED

THE MAXIMUM AIR LEAKAGE RATE FOR ALL TYPES OF FENESTRATION ASSEMBLIES AND THEIR TEST PROCEDURE, FROM AN INDEPENDENT AND ACCREDITED LABORATORY, SHALL FOLLOW SECTION C402.5.2 AND TABLE 402.5.2 OF THE ECCCNYS.

Campus Expansion Child Day-care Center 899 Old Saw Mill River Road

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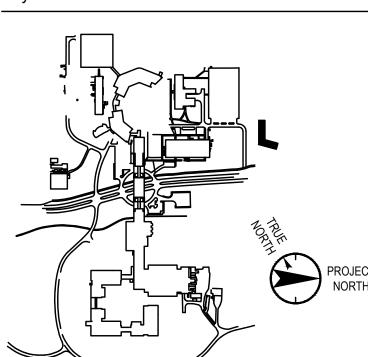
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Key Plan



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Vendor Name: COSENTINI Vendor Project No.: 210104 Discipline: Mechanical Drawn By: BC MECHANICAL SYMBOLS, ABBREVIATIONS, AND DRAWING LIST

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Vendor Name: GENSLER Vendor Project No.: 006.3608.000 Discipline: Mechanical Drawn By: BC MECHANICAL 1ST FLOOR **DUCTWORK PLAN**

Scale: 1/8" = 1'-0" Floor: 1ST

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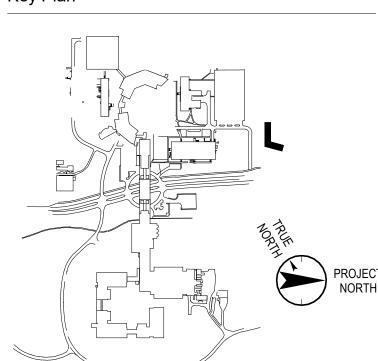
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MECHANICAL ROOF **DUCTWORK PLAN**

Scale: 1/8" = 1'-0" Floor: ROOF

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Vendor Name: GENSLER Vendor Project No.: 006.3608.000 Discipline: Mechanical Drawn By: BC MECHANICAL 1ST FLOOR PIPING PLAN

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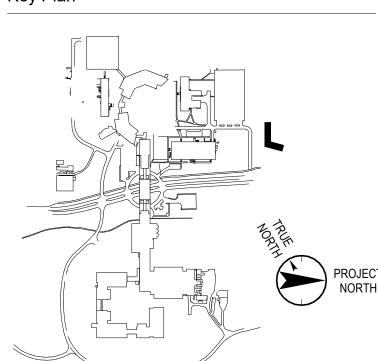
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MECHANICAL ROOF PIPING PLAN

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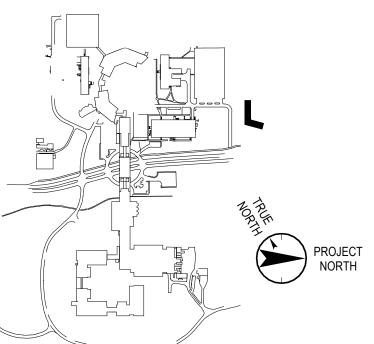
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Vendor Name: GENSLER
Vendor Project No.: 006.3608.000
Discipline: Mechanical Drawn By: BC MECHANICAL ENLARGÉD VIEWS SHEET 1

Scale: 1/4" = 1'-0" Floor: ROOF

Alterations or additions to this engineering

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of Chapter 16, Title VIII, Article 145 § 7209.2 of

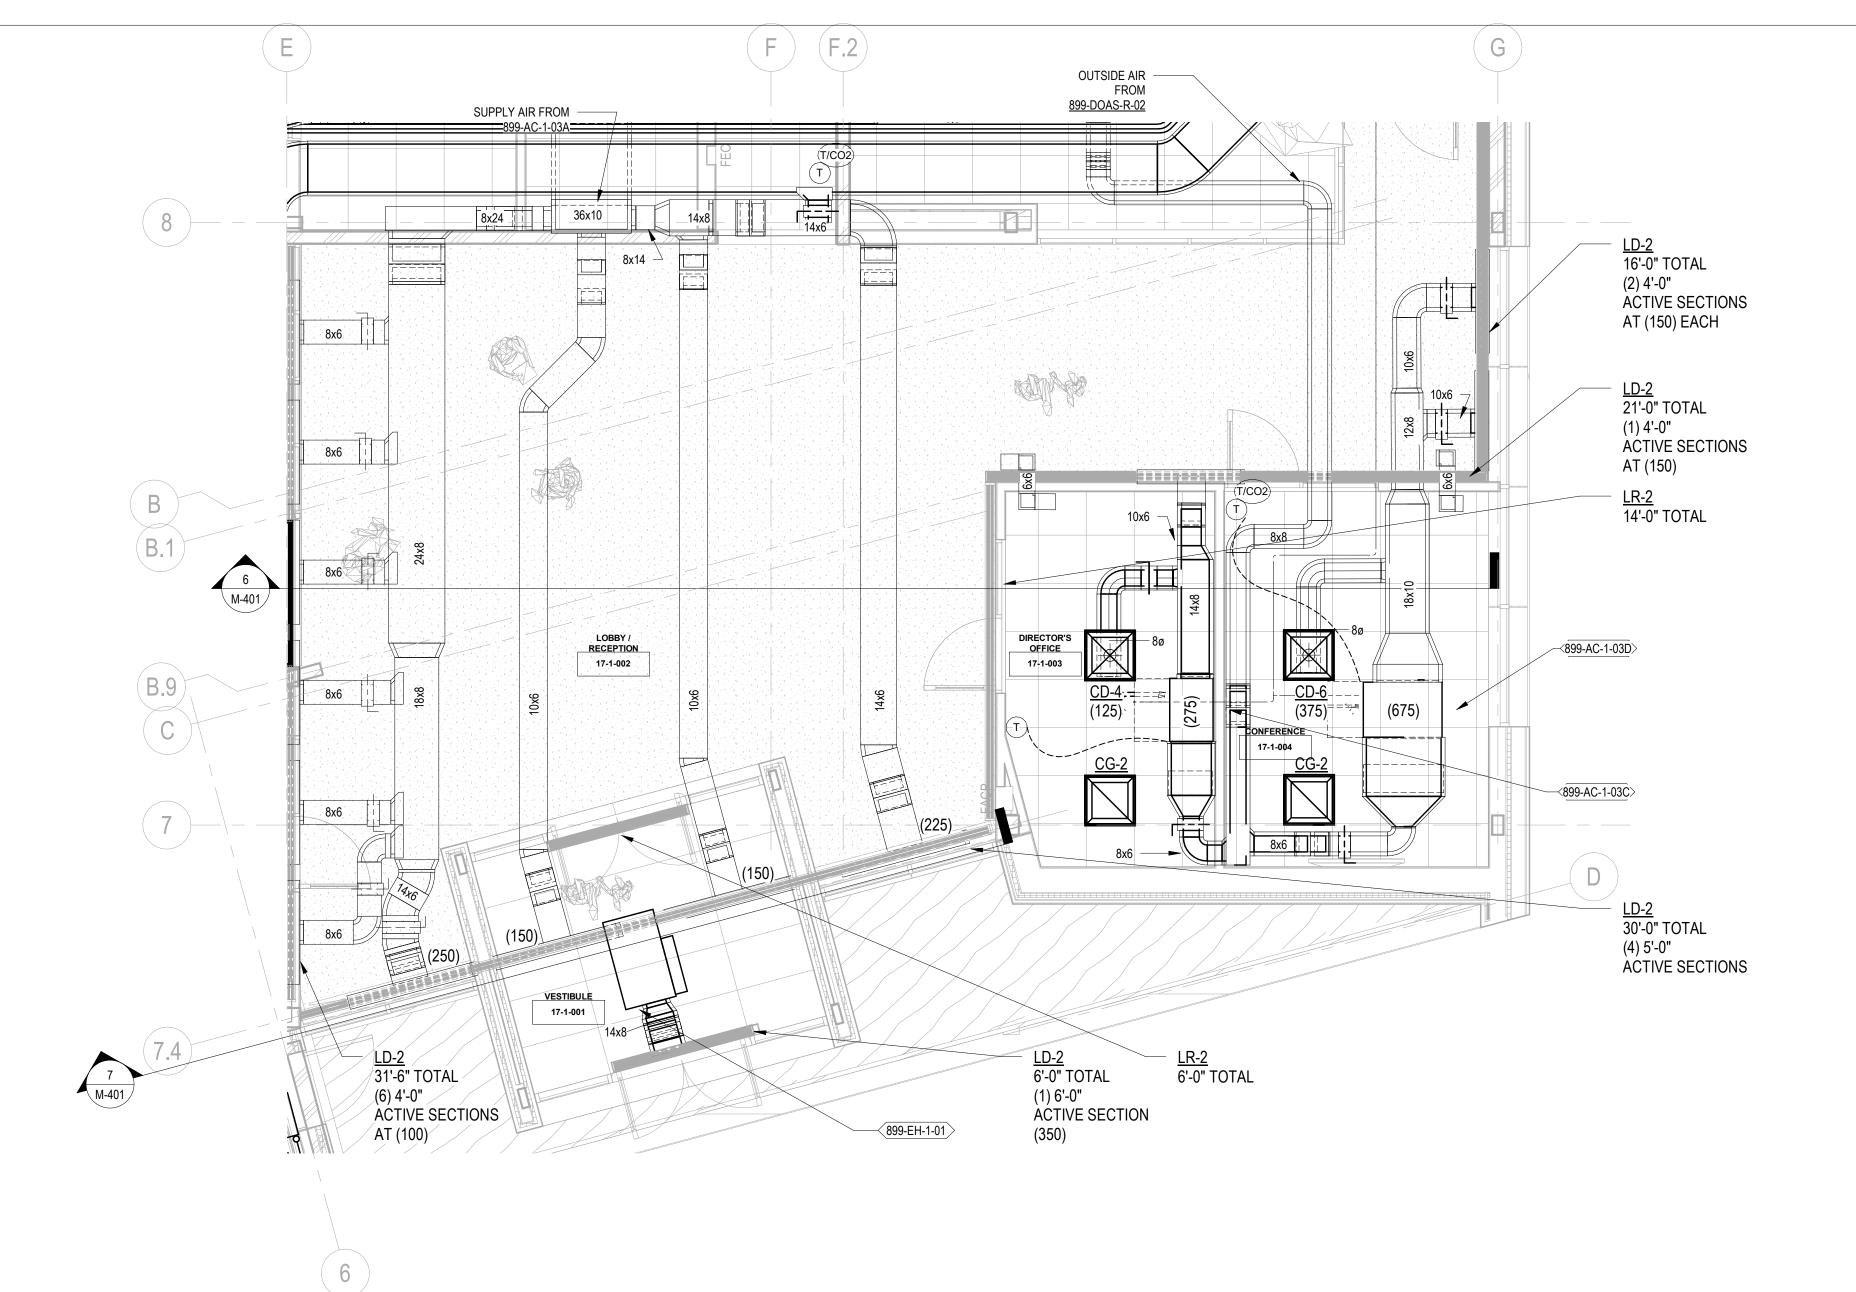
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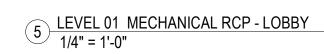
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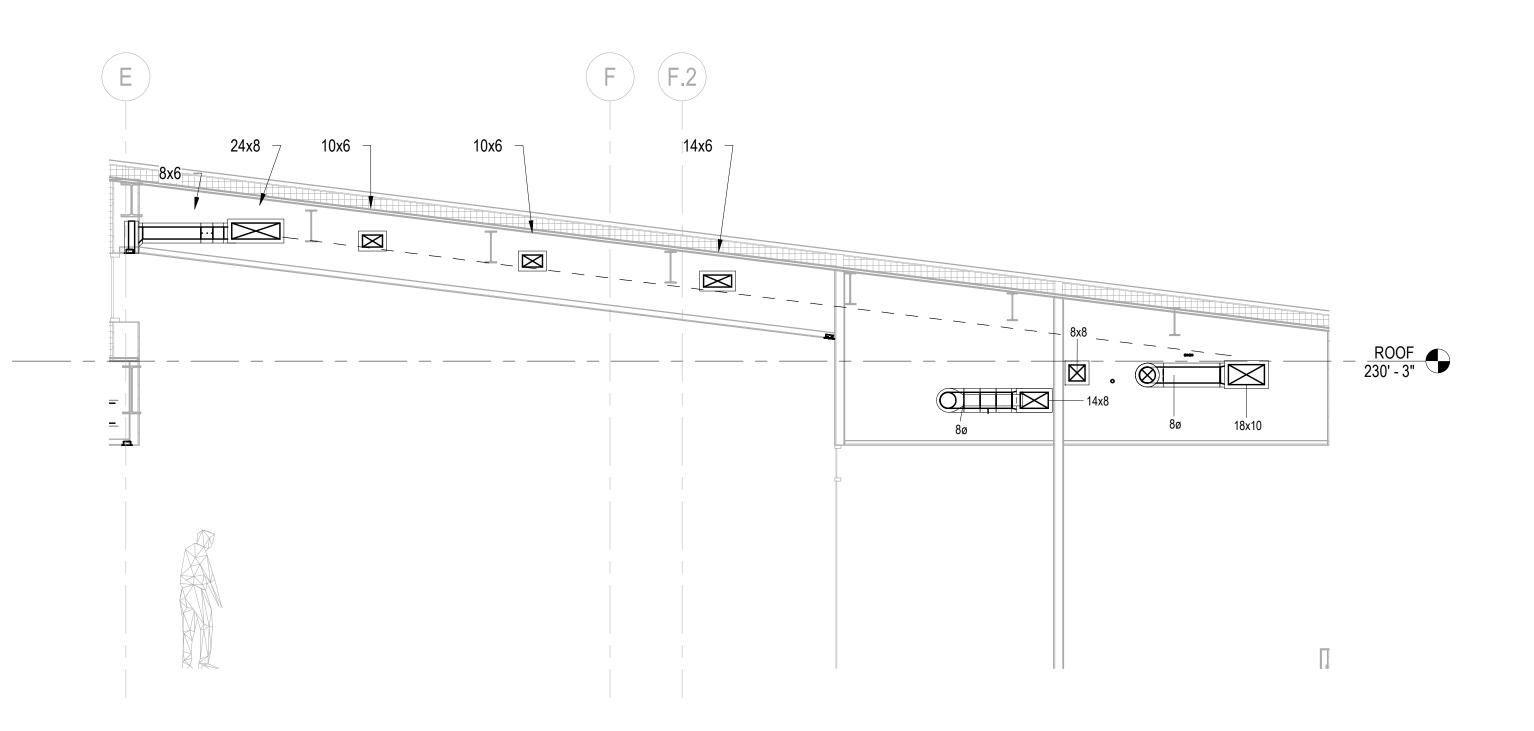
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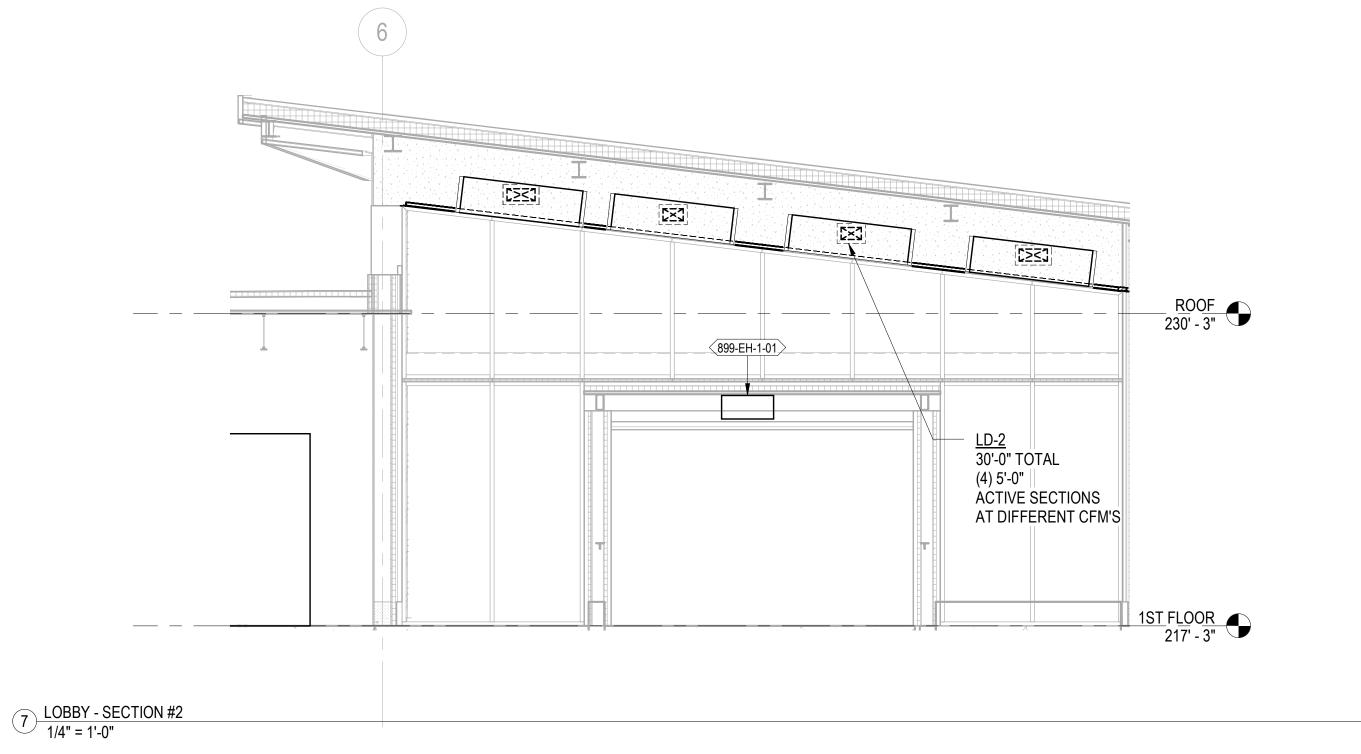
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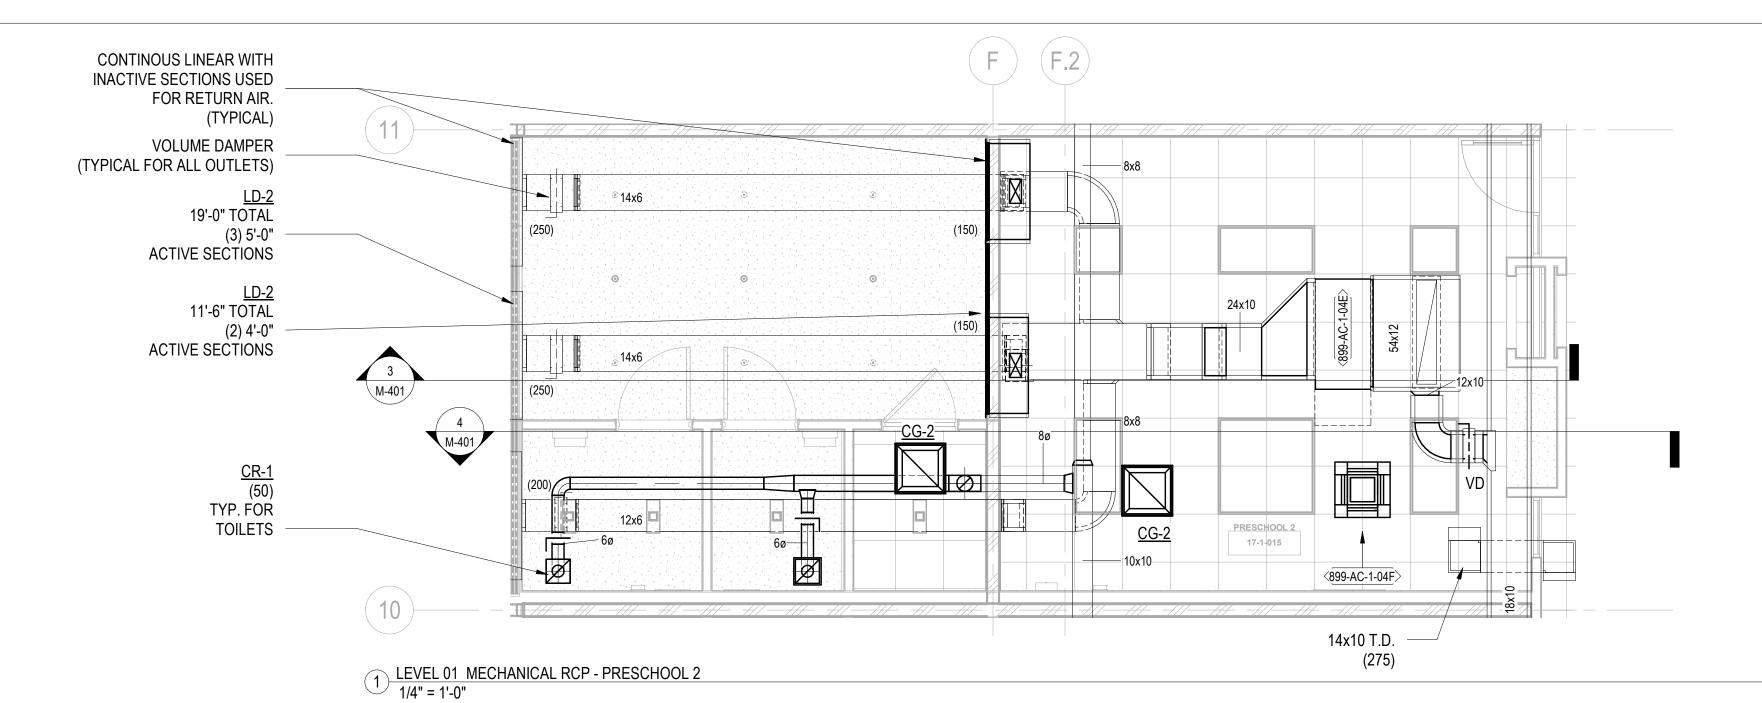


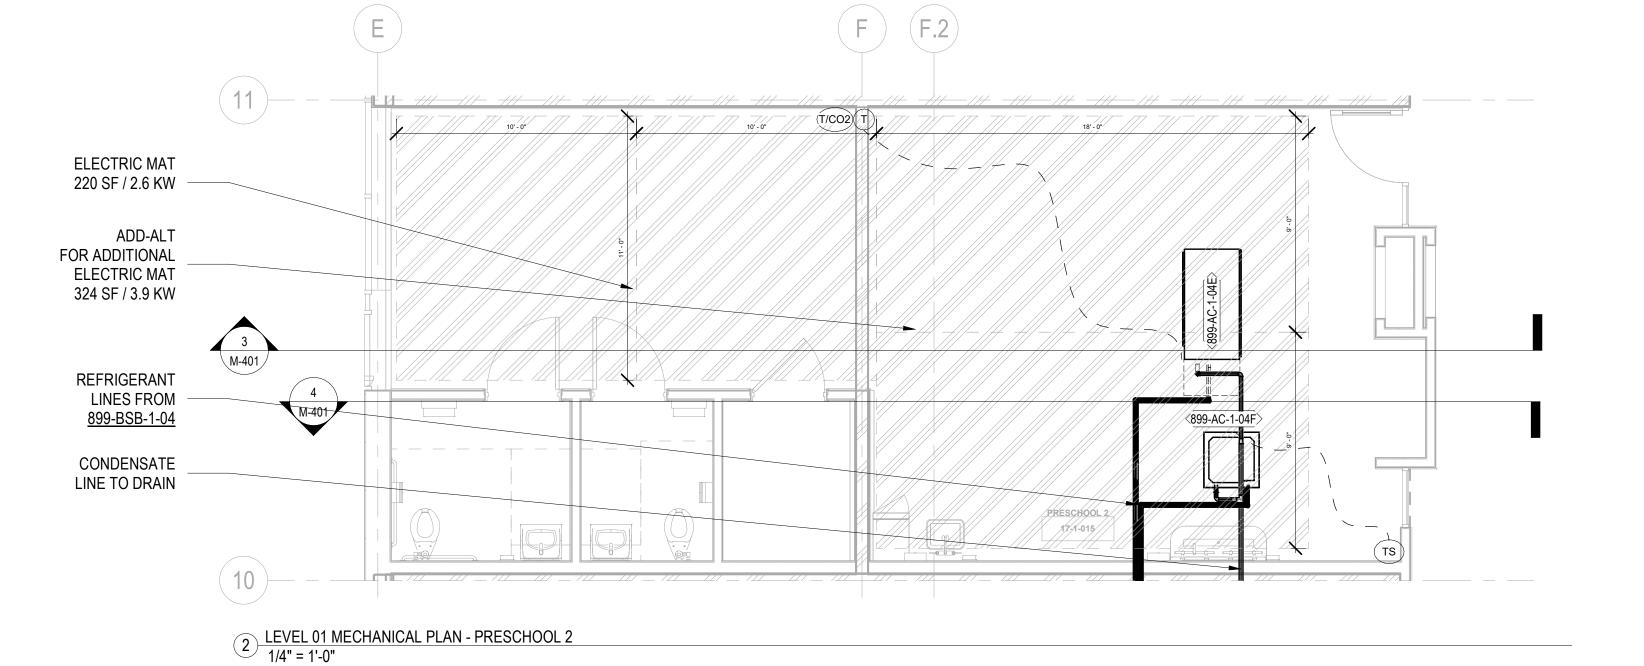


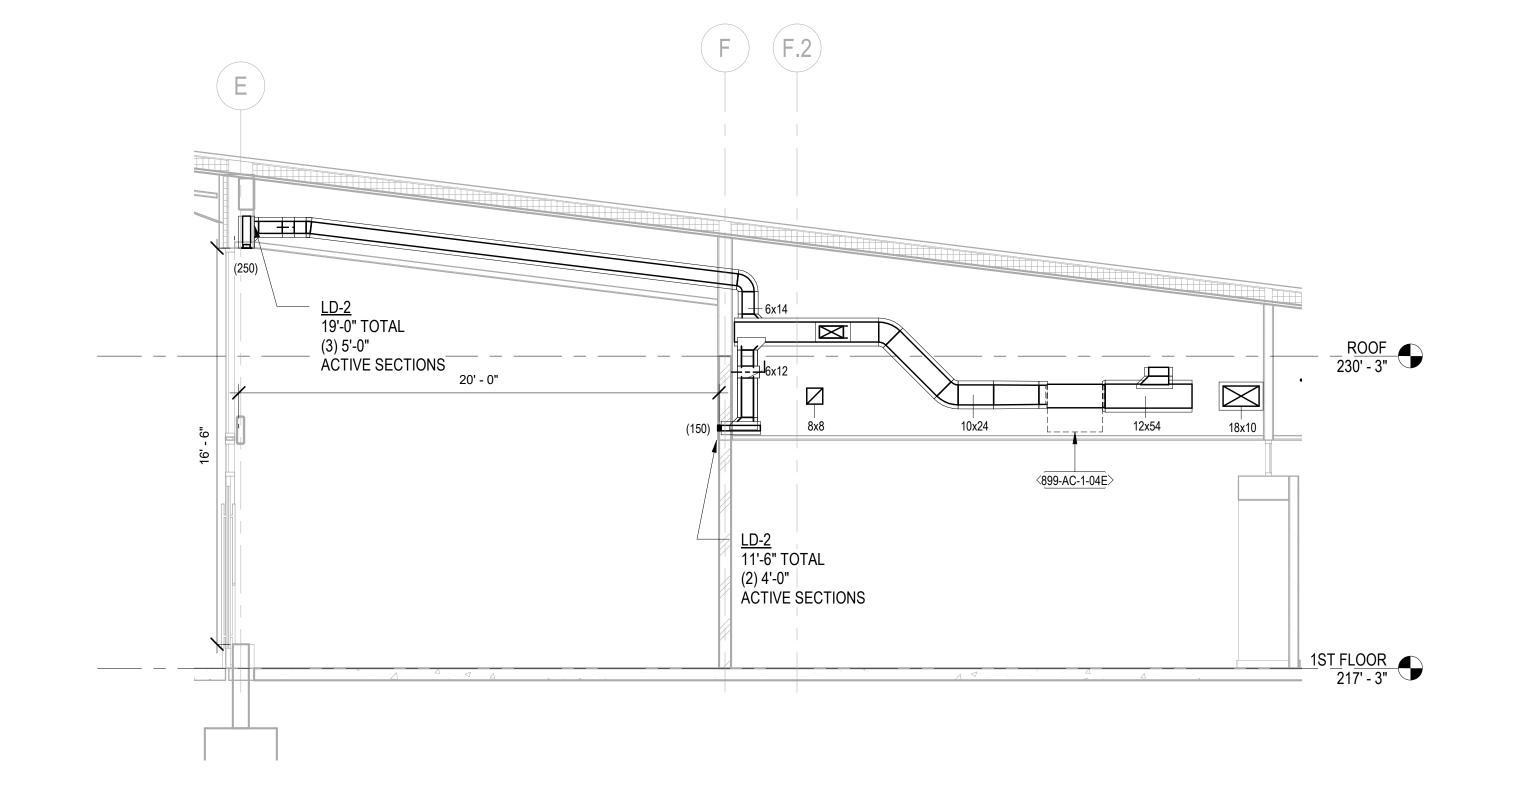


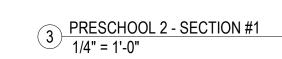
6 LOBBY - SECTION #1 1/4" = 1'-0"

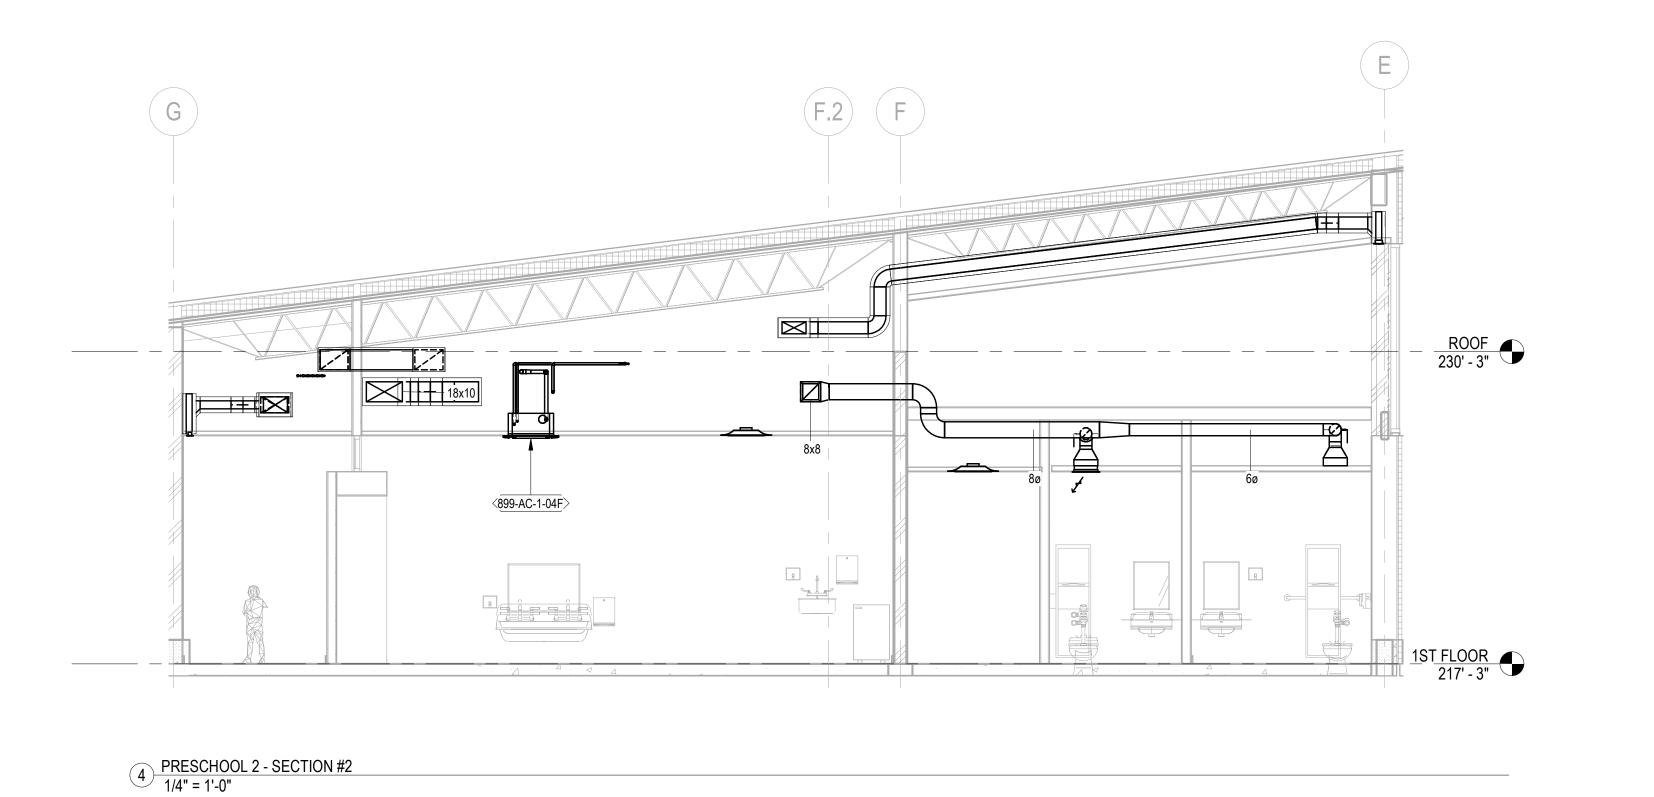












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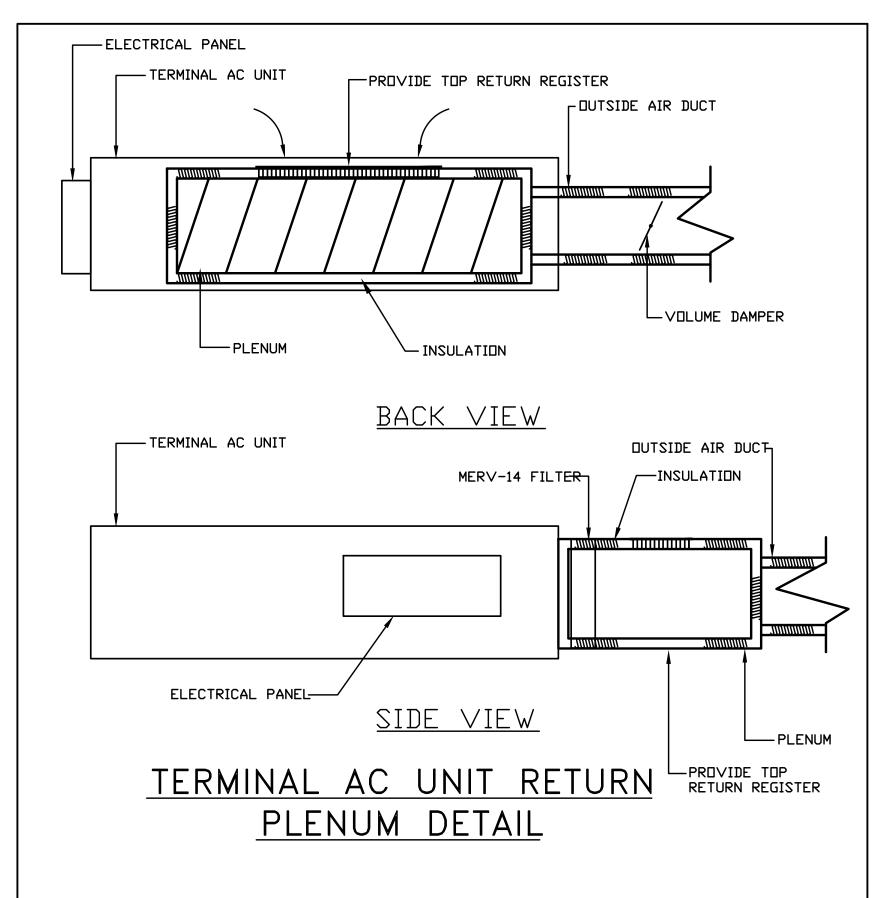
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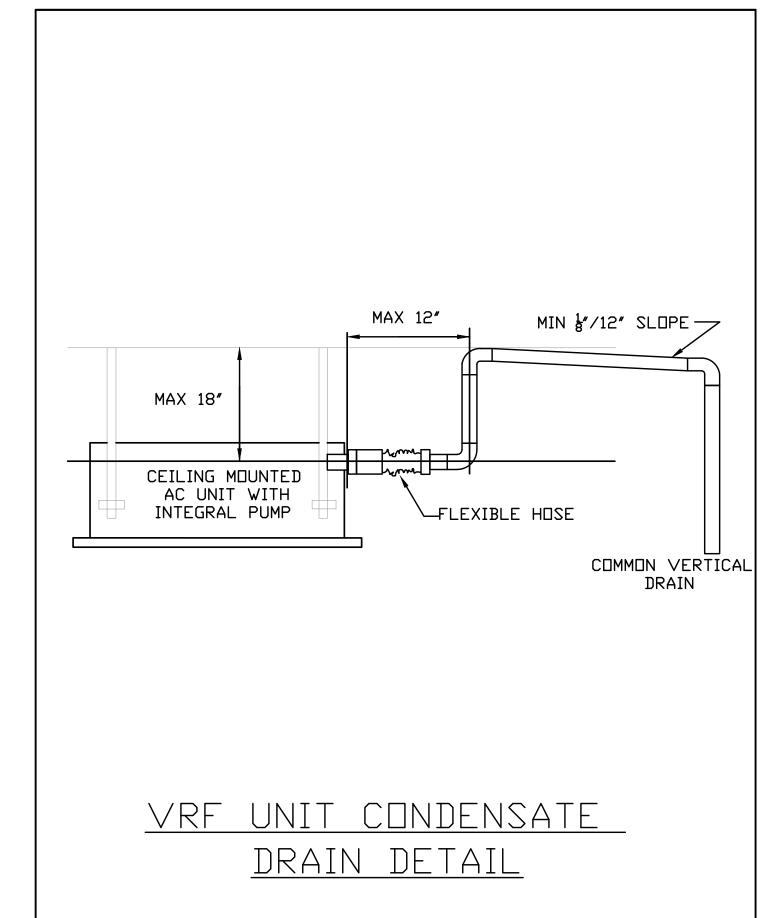
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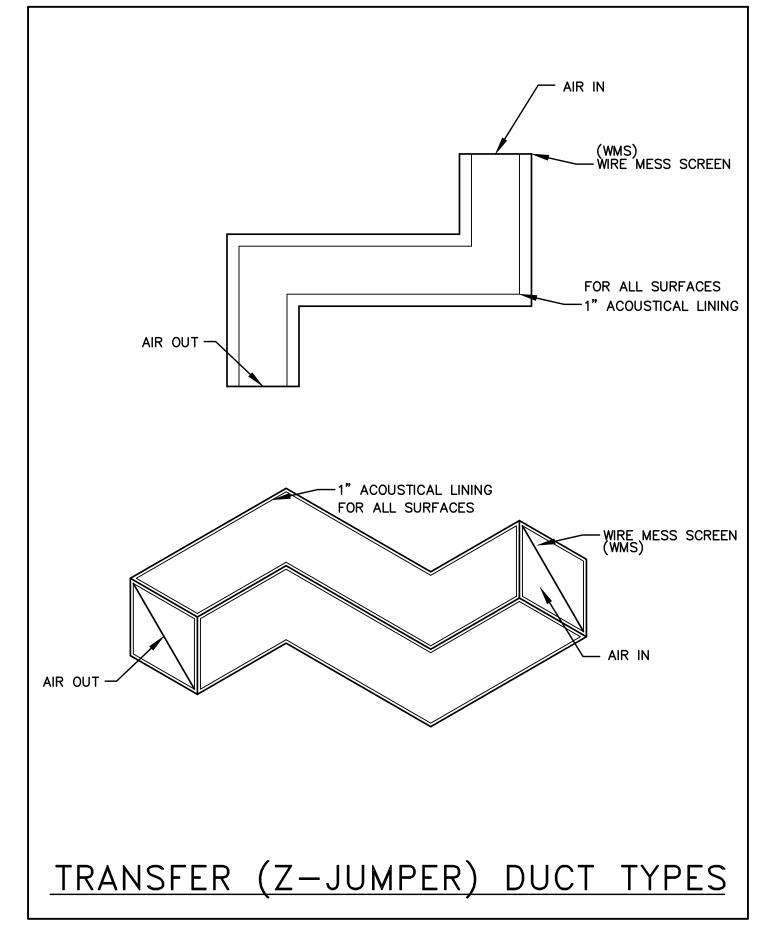
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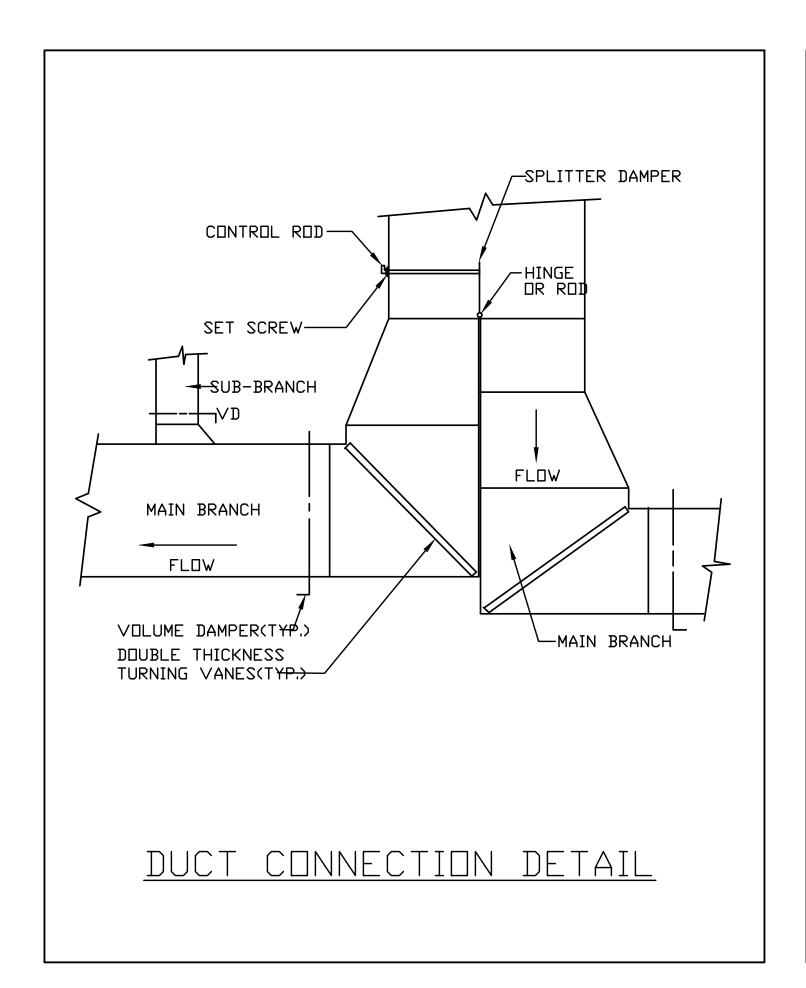
Vendor Name: GENSLER
Vendor Project No.: 006.3608.000
Discipline: Mechanical Drawn By: BC
MECHANICAL ENLARGED VIEWS SHEET 2

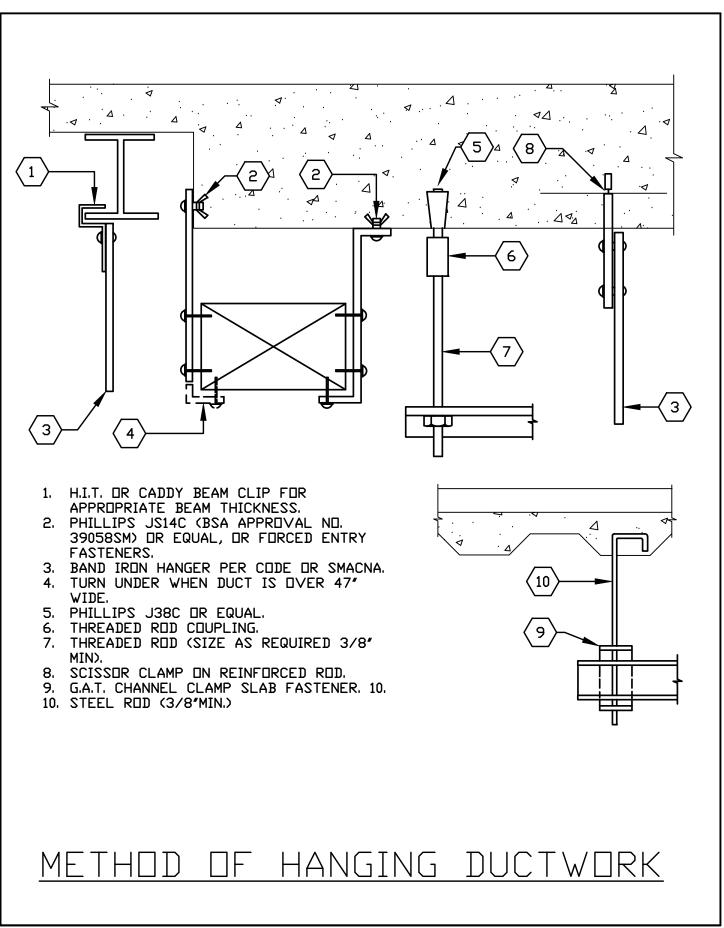
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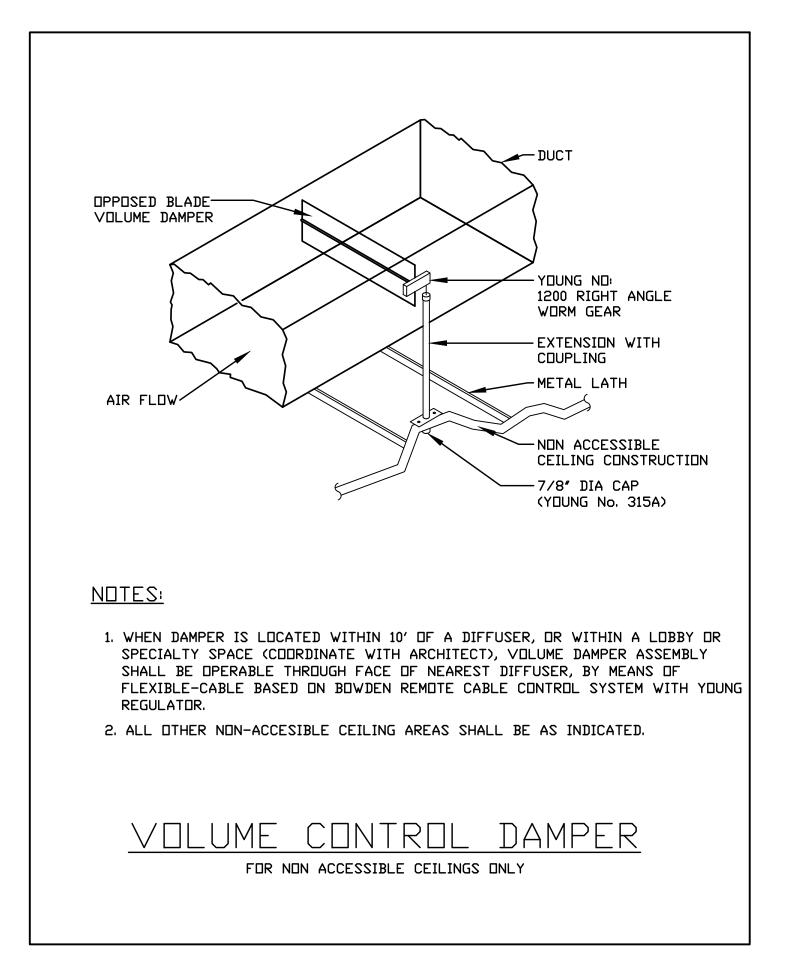


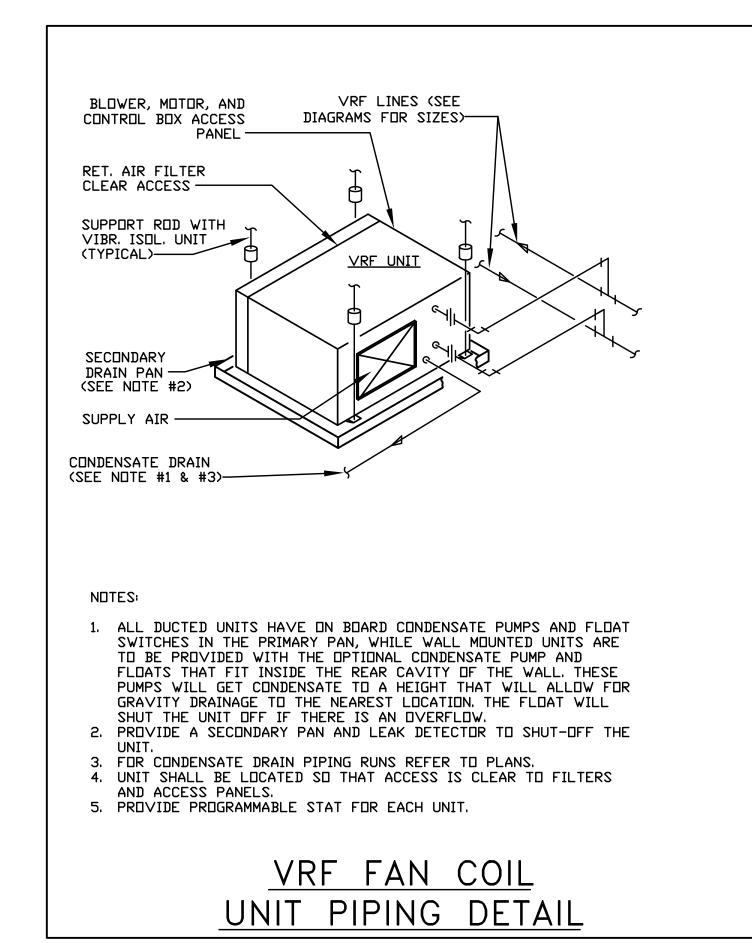


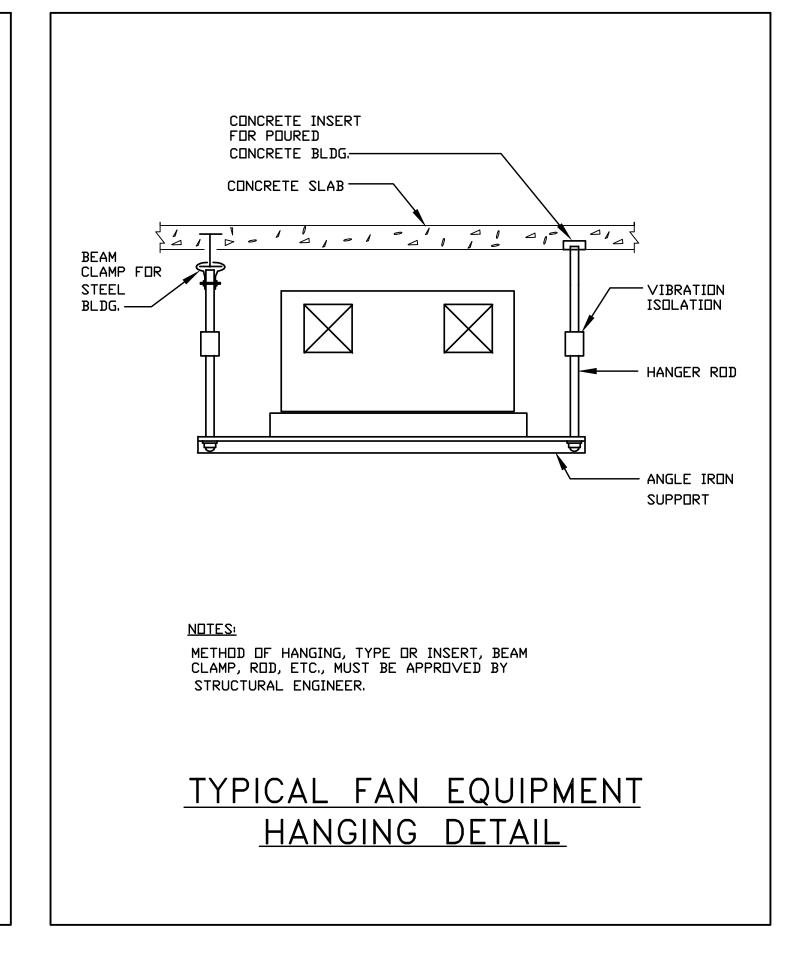


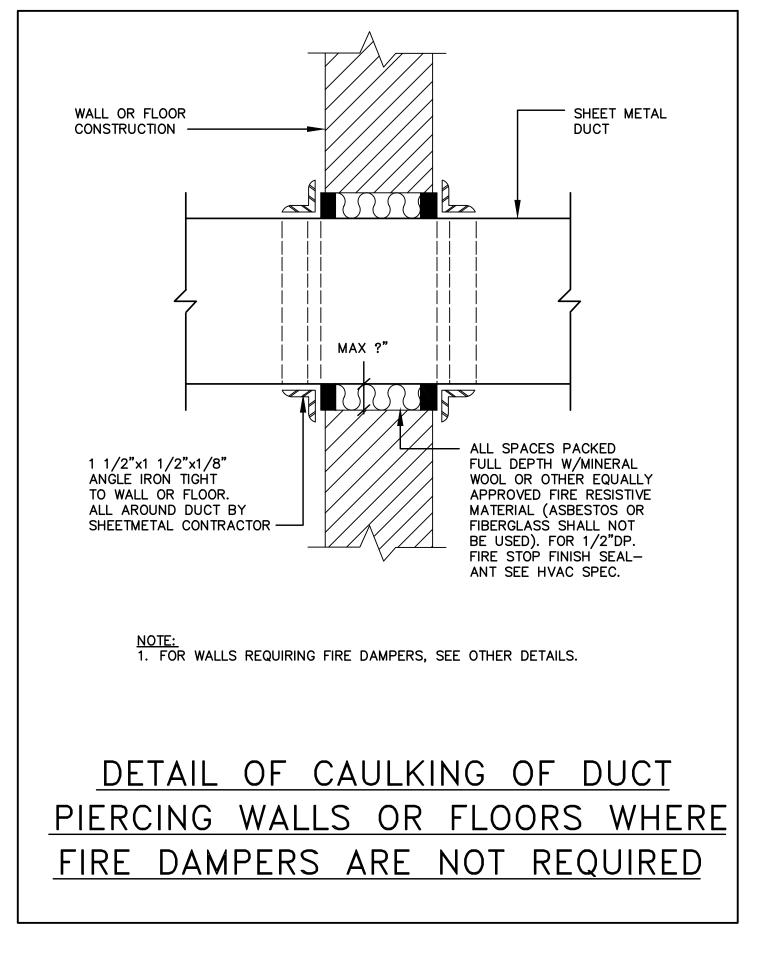












PROFESSIONAL JUDGMENT, THESE PLANS AND SPECIFICATIONS ARE IN COMPLIANCE WITH THE 2020 ENERGY CONSERVATION CODE OF NYS

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REAL ESTATE & FACILITIES MANAGEMENT

777 Old Saw Mill River Road Tarrytown, NY 10591-6707 T: 914.847.7400 F: 914.847.7991 www.regeneron.com

Building #17 Campus Expansion Child Day-care Center

899 Old Saw Mill River Road Mount Pleasant, NY 10591

Project No. B17-DAYCARE

Gensler
1700 Broadway, Suite 400 New York, NY 10019 (212) 492-1400 Phone (212) 492-1472 Fax

Structural Engineer

Thornton Tomasetti 120 Broadway, 15th Floor New York, NY 10271 (917) 661-7800 Phone (917) 661-7801 Fax

MEP / IT / Security Engineer

Cosentini Associates 498 Seventh Avenue New York, NY 10018 (212) 615-3600 Phone

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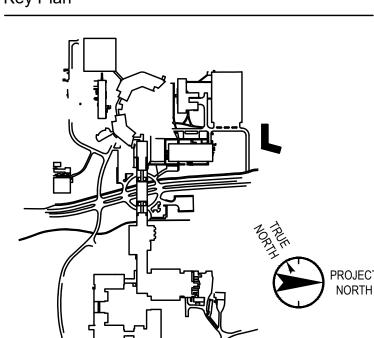
Civil Engineer

120 Bedford Road Armonk, NY 10504 (914) 273-5225 Phone (914) 273-2102 Fax

Landscape Architect

21 Penn Plaza, 360 West 31st Street, 8th Floor New York, NY 10001 (212) 479-5400 Phone (212) 479-5444 Fax

Key Plan



No. Date Description 1 06.20.2022 100% CONSTRUCTION DOCUMENTS

2 07.01.2022 100% CONSTRUCTION DOCUMENTS-1

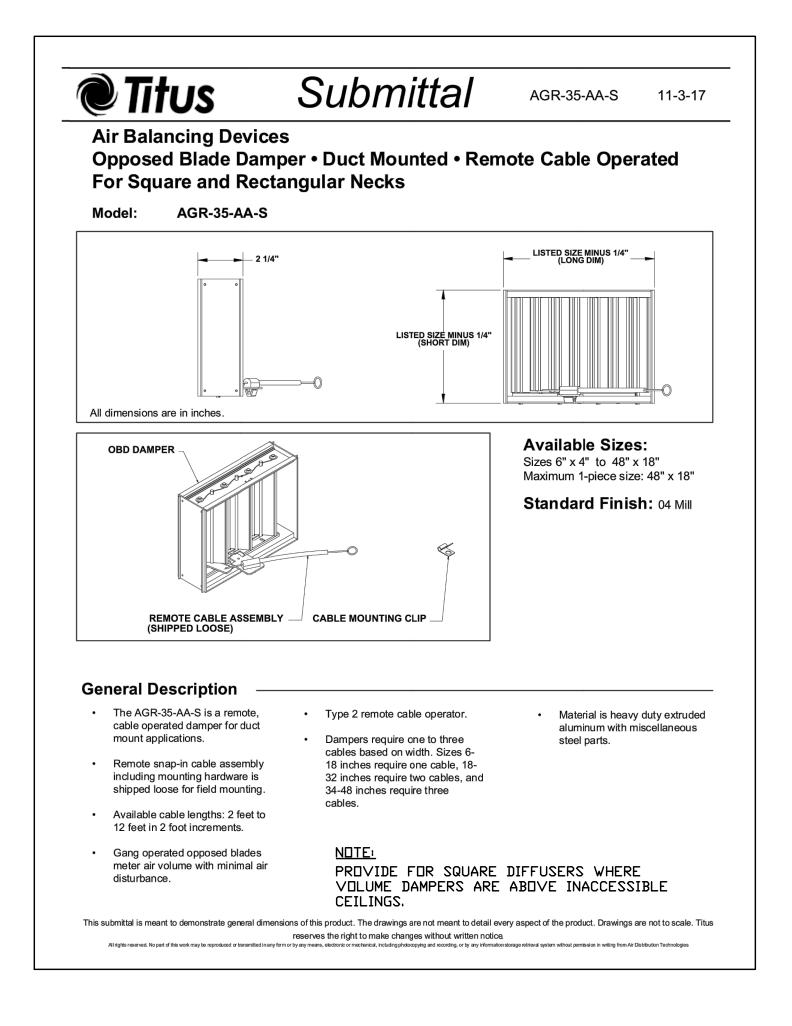
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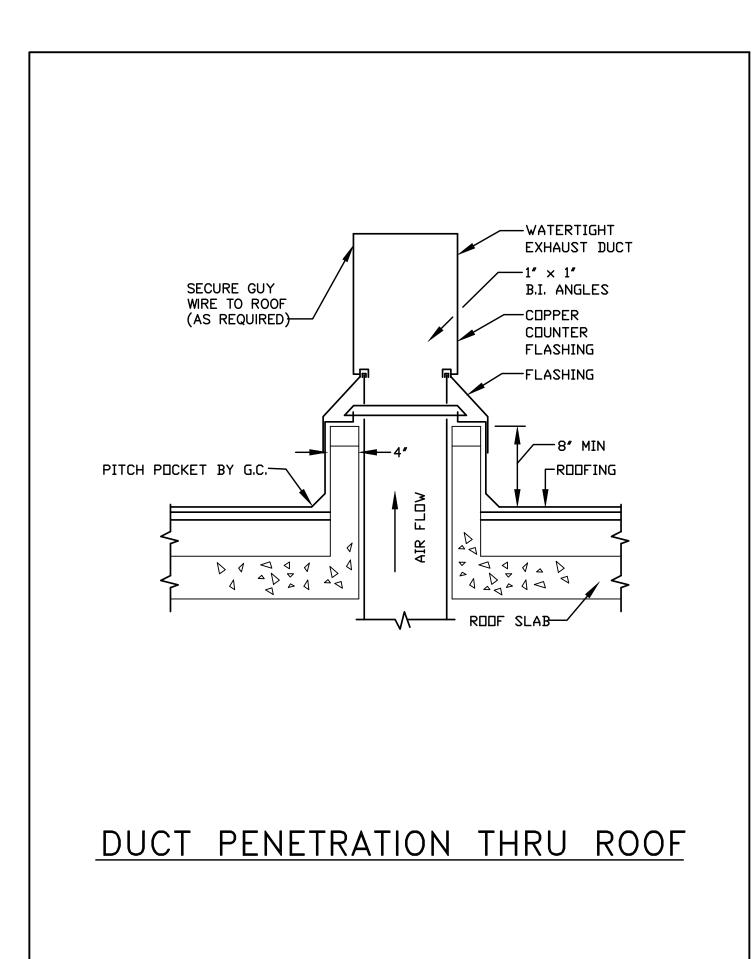
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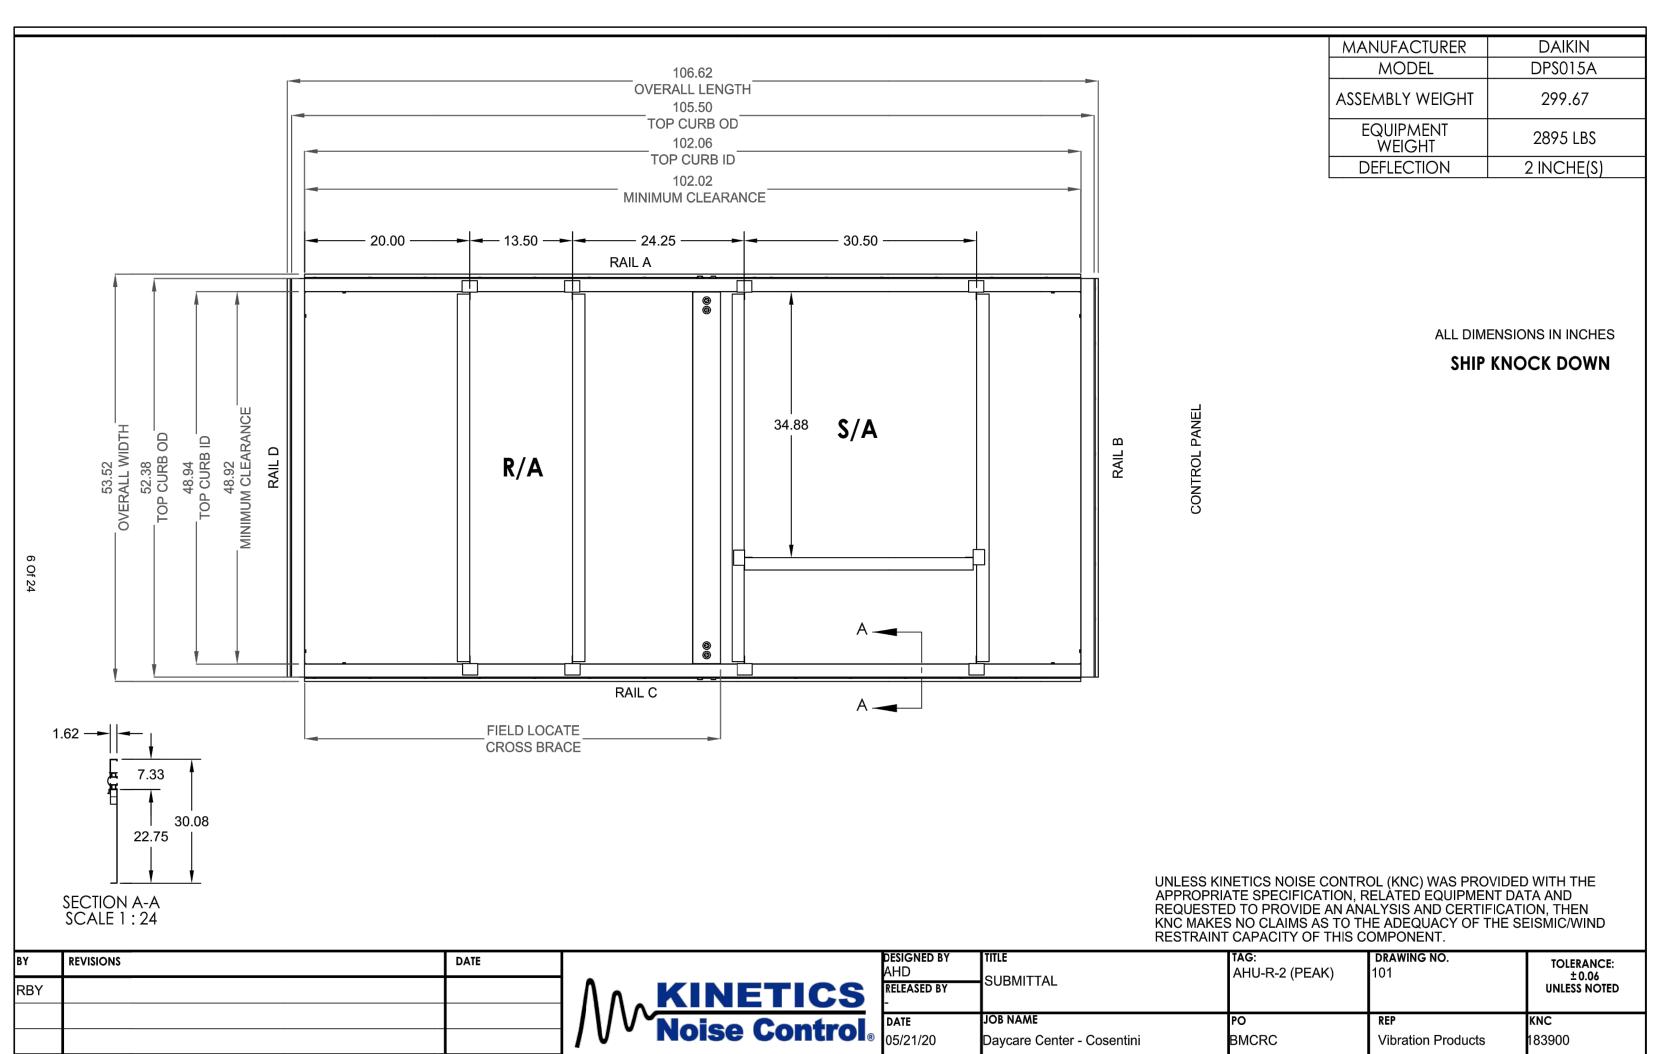
Discipline: Mechanical Drawn By: BC **MECHANICAL DETAILS**

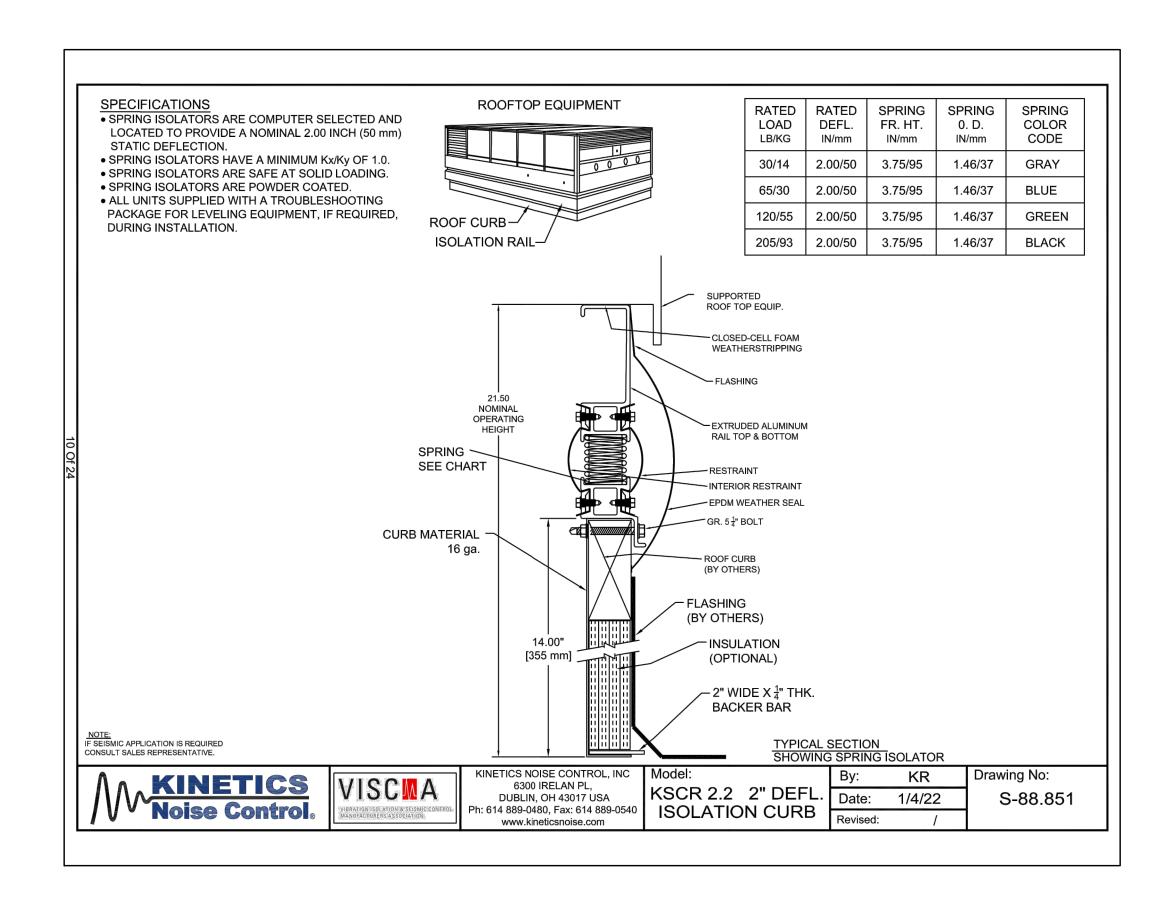
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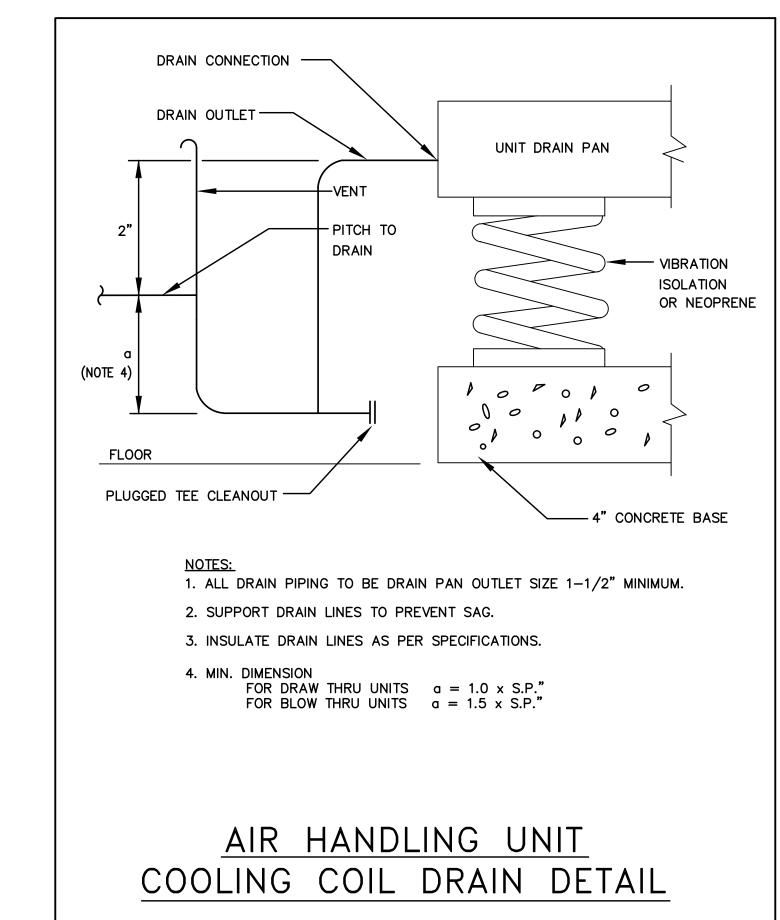
SHEET 1

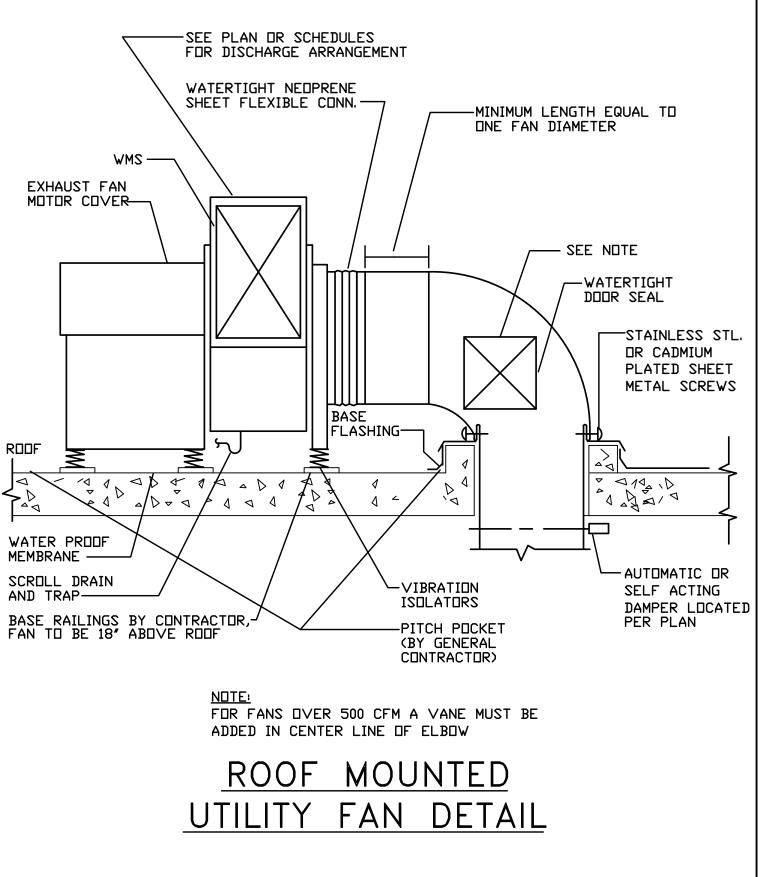


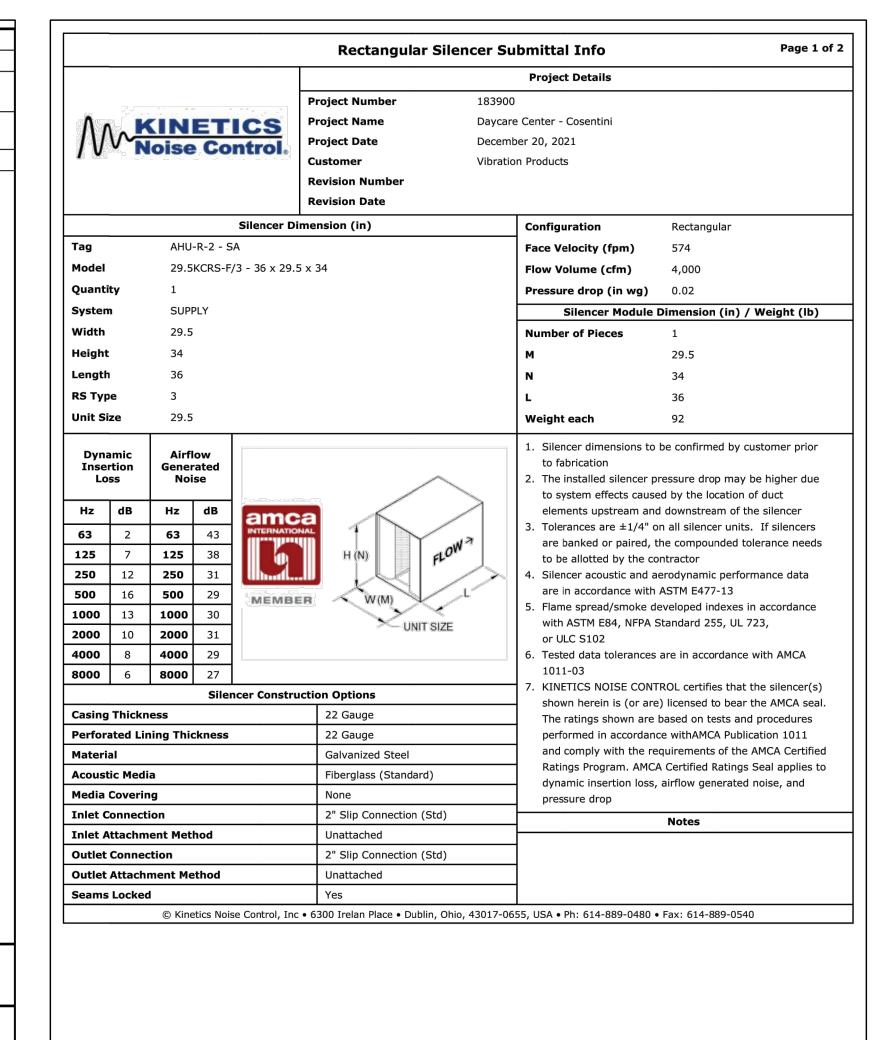


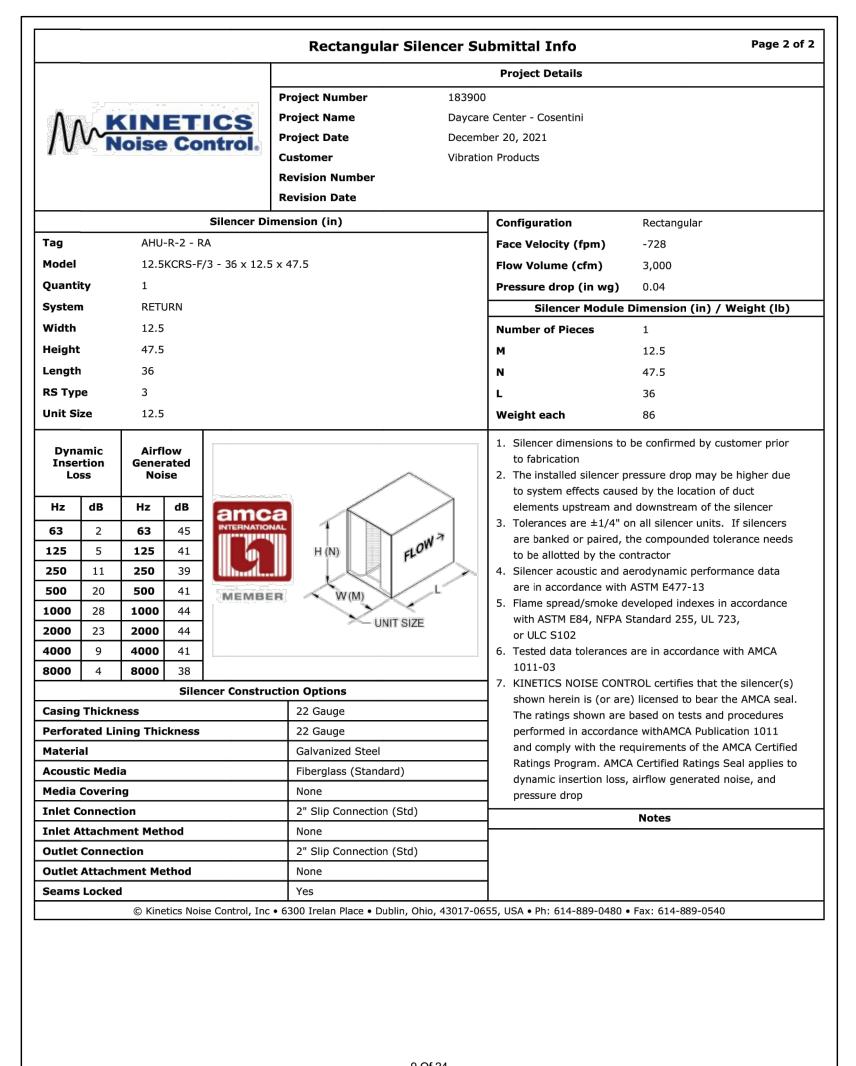


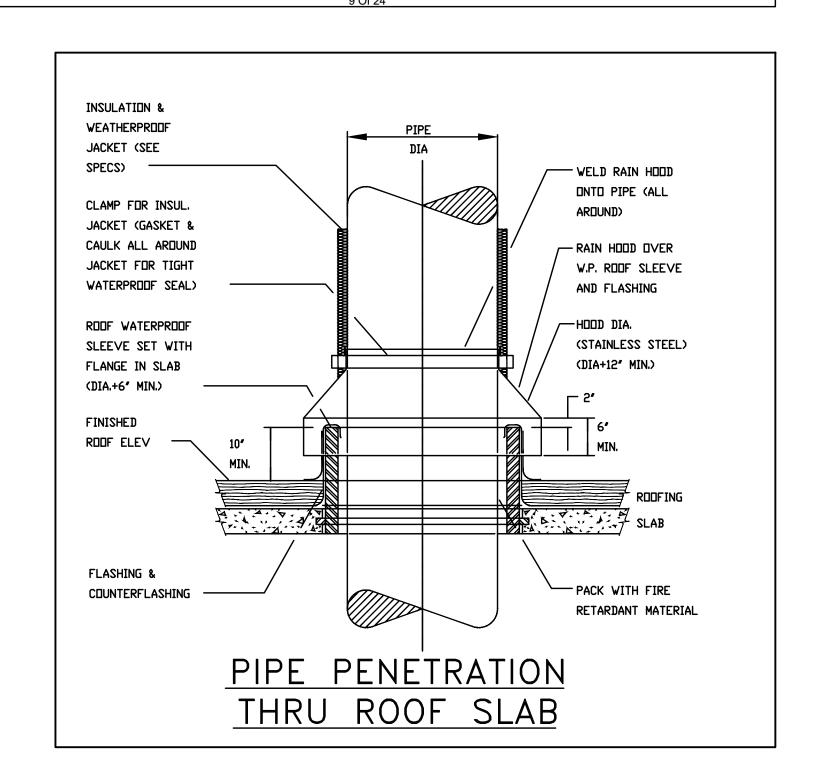












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Landscape Architect

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Key Plan

No.	Date	Description
0	05.20.2022	ISSUED FOR PERMIT
1	06.20.2022	100% CONSTRUCTION DOCUMENTS
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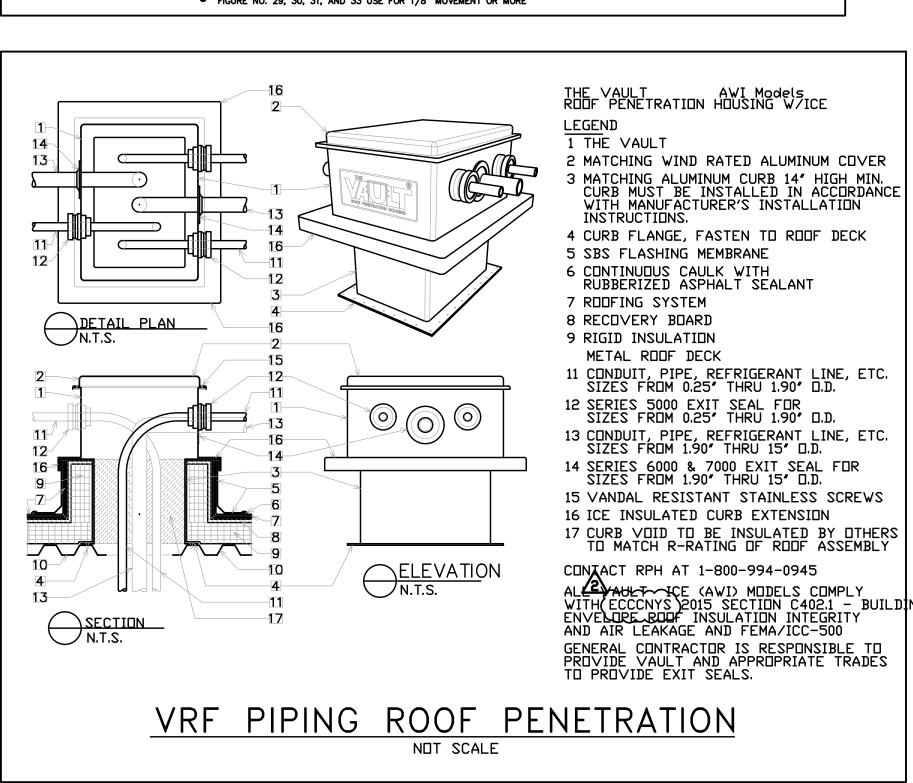
PHARMACEUTICALS. THIS SHEET MUST BE RETURNED UPON THE REQUEST OF

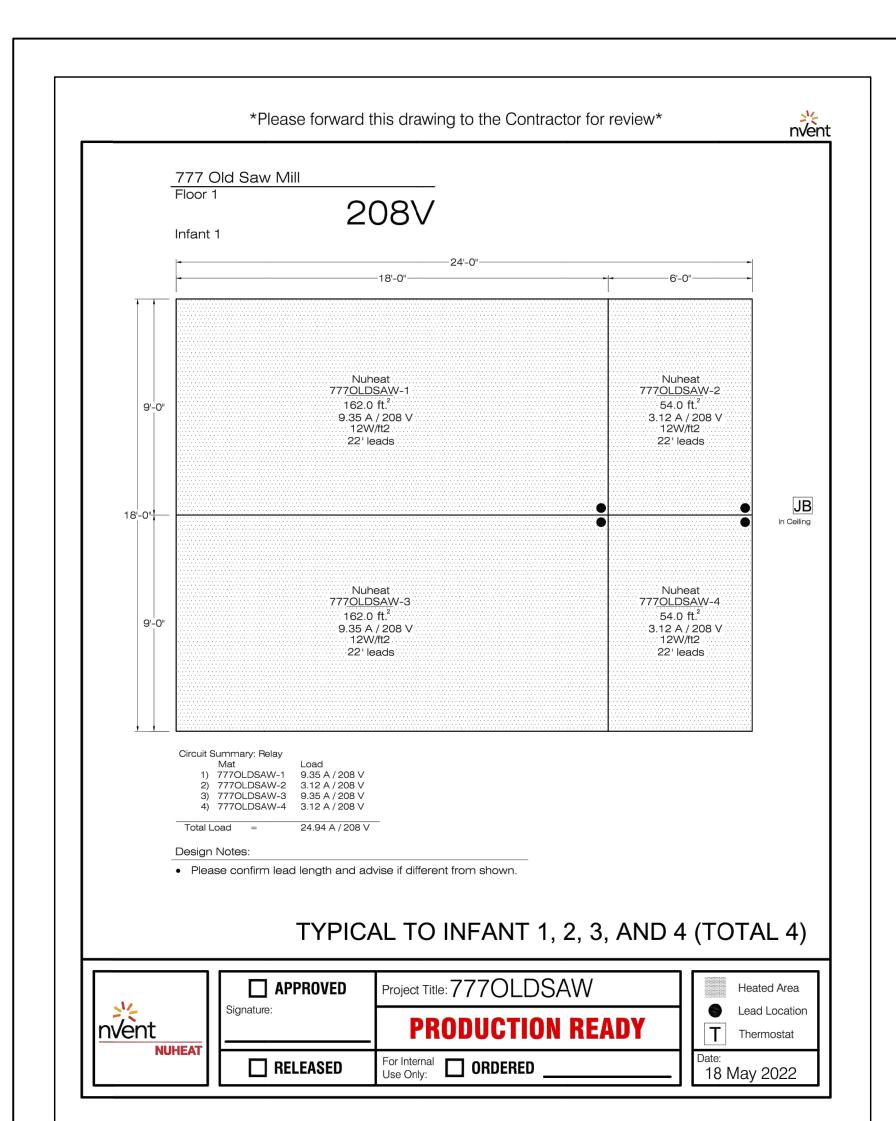
Professional Seal and Signature

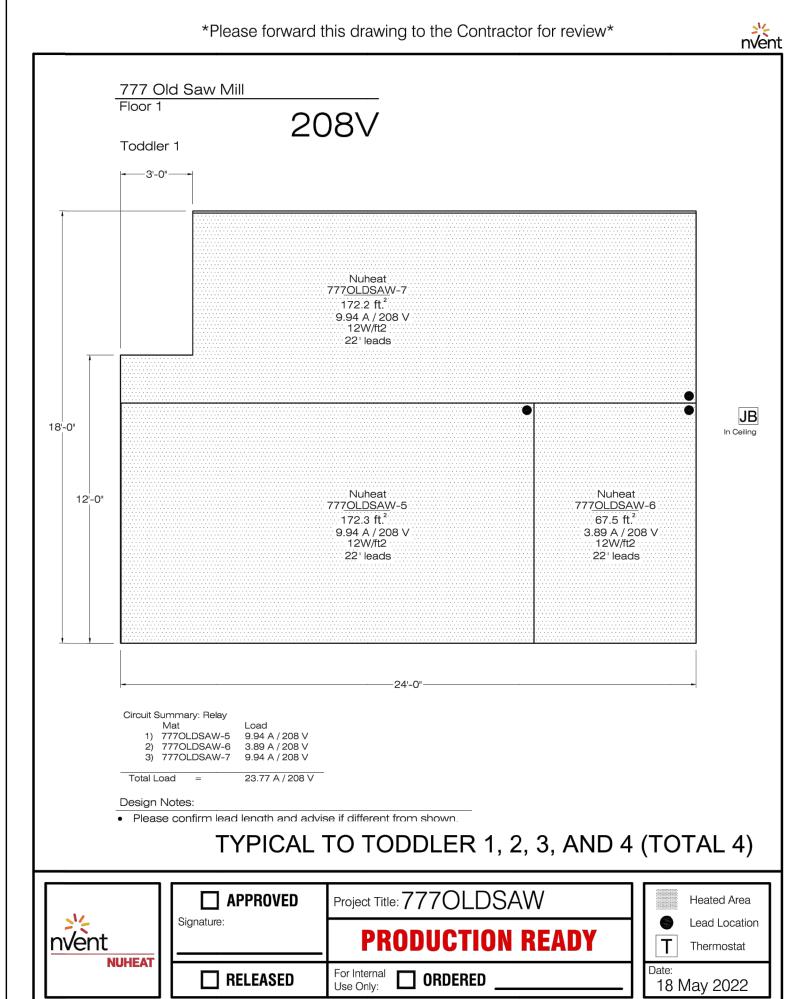
Vendor Name: COSENTINI Vendor Project No.: 210104 Discipline: Mechanical Drawn By: BC **MECHANICAL DETAILS** SHEET 2

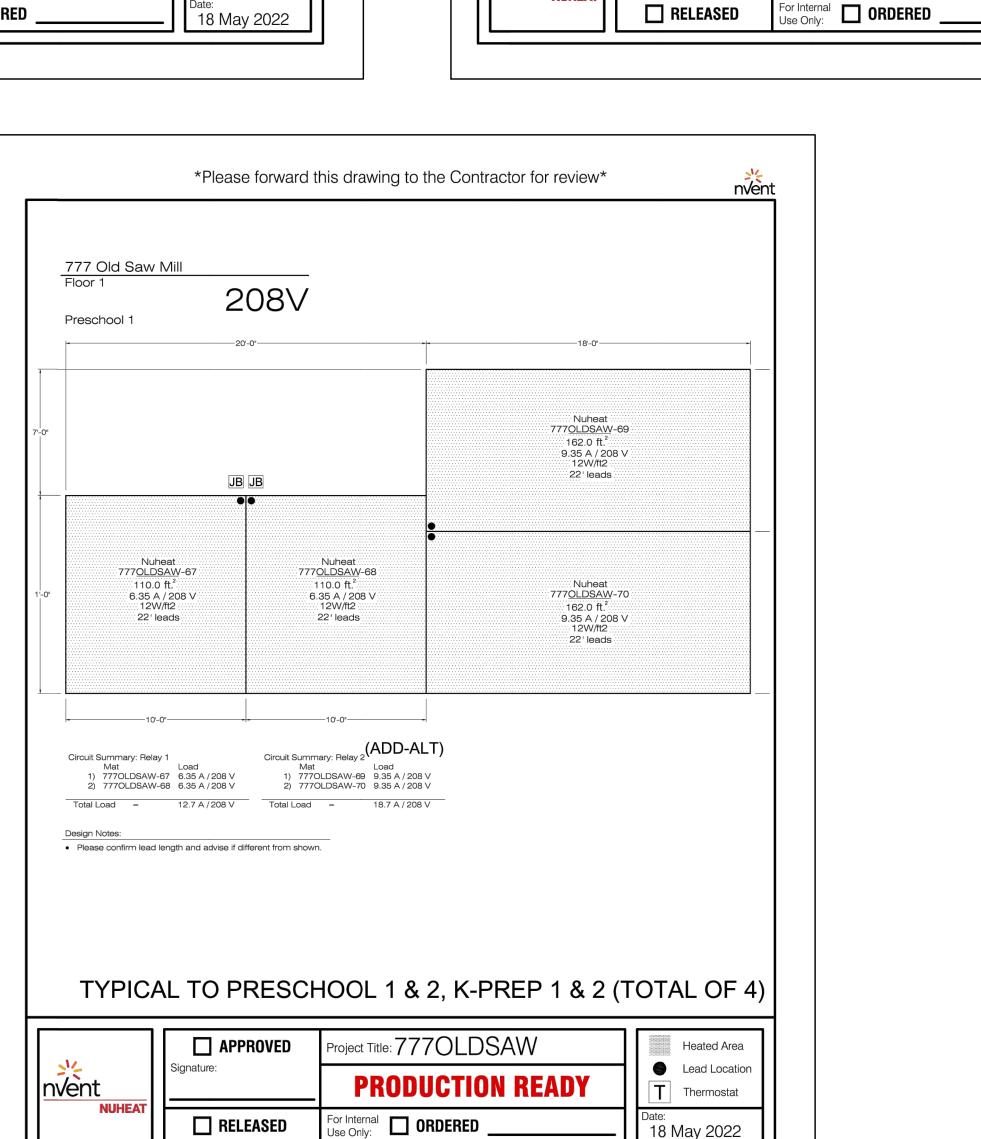
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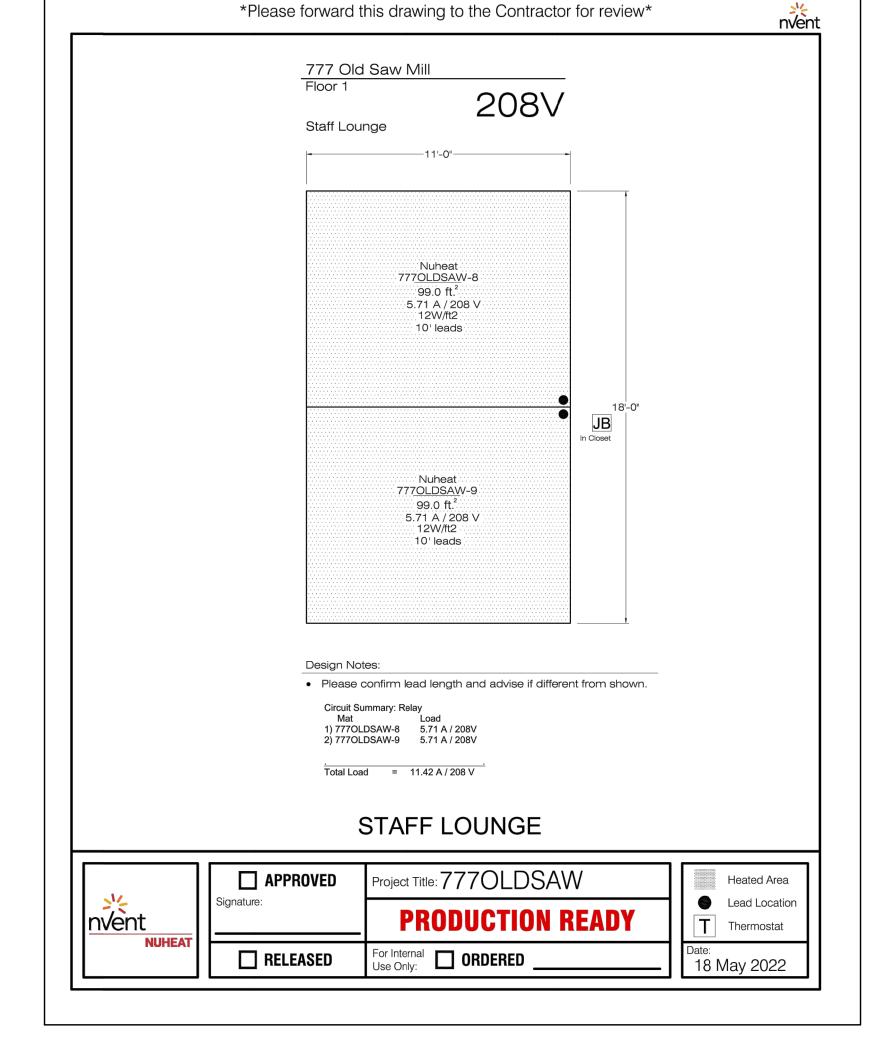
by an unlicensed person is a violation of Chapter 16 Title VIII, Article 145 § 7209.2 of the New York State Education Law.











ELECTRIC MAT LAYOUT **DETAILS**

MCNYS NOTES: ALL HVAC PIPING TO FOLLOW REQUIREMENTS FOR MAXIMUM SPACING BETWEEN SUPPORTS, AS OUTLINED IN SECTION C305.4 AND TABLE C405.4 OF THE MCNYS CODE. ALSO REFER TO BOOK SPECIFICATION SECTION 230529.

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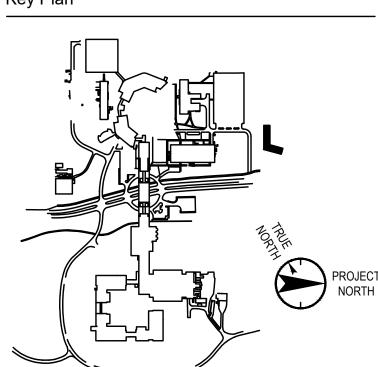
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Professional Seal and Signature

Discipline: Mechanical Drawn By: BC **MECHANICAL DETAILS**

Scale: NTS Floor:

SHEET 3

Alterations or additions to this engineering document

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Please forward this drawing to the Contractor for review

Nuheat 777<u>OLDSAW</u>-42 148.3 ft.² 8.56 A / 208 V 12W/ft2

Nuheat 777<u>OLDSAW</u>-41 156.0 ft.² 9 A / 208 V 12W/ft2 22' leads

Nuheat 777<u>OLDSAW</u>-39 72.0 ft.² 4.15 A / 208 V 12W/ft2 22' leads

Nuheat 777<u>OLDSAW</u>-40 96.0 ft.² 5.54 A / 208 V 12W/ft2 22' leads

Circuit Summary: Relay 2

Total Load = 15.92 A / 208 V Total Load = 17.55 A / 208 V

Please confirm lead length and advise if different from shown.

18 May 2022

Mat Load 1) 7770LDSAW-41 9.00 A / 208 V 2) 7770LDSAW-42 8.56 A / 208 V

MOVEMENT MATTERS ZONE

Project Title: 7770LDSAW

PRODUCTION READY

Heated Area

Thermostat

18 May 2022

Movement Matters Zone

Nuheat 777<u>OLDSAW</u>-38 108.0 ft.² 6.23 A / 208 V 12W/ft2

by an unlicensed person is a violation of Chapter 16 Title VIII, Article 145 § 7209.2 of the New York

NOTES: 1). REFER TO FLOORPLANS FOR LOCATION OF AIR CONNECTIONS

2). ONE ELECTRICAL POINT OF CONNECTION FOR THE 480V OPERATION OF THE UNIT, WITH A SEPARATE CONVENIENCE OUTLET POWERED THROUGH THE UNIT WITH ITS OWN DISCONNECT AND FUSING.

3). UNIT MOUNTED OUTSIDE AIR AND SPILL AIR DAMPER 4). R410A VARIABLE CAPACITY SCROLL COMPRESSOR

5). MODULATING HOT GAS REHEAT

6). ENLARGE OUTSIDE AIR CONNECTION TO PREVENT SNOW BEING PULLED IN; 7) CUSTOM SOUND ATTENUATED CURB BY KINETICS NOISE CONTROL, OR APPROVED EQUAL, AND SUPPLIED BY AHU MANUFACTURER 7). FULLY MODULATING SCR ELECTRIC HEAT CONTROL. PROVIDE VFD CONTROL OF WHEEL.

8). BACNET COMMUNICATION CARD, AS REQUIRED BY BMS. REFER TO SPECIFICATION AND CONTROL DRAWING M-705.

9). HEAT PUMP PRIMARY HEAT SHALL BE PROVIDED. BACK UP HEAT SHALL BE AS SCHEDULED. CONTROLS SHALL AUTOMATICALLY USE BACK UP HEAT WHEN NEEDED AND LOCK OUT HEAT PUMP OPERATION WHEN AMBIENT IS TOO COLD. 10). A FACTORY INSTALLED, ENERGY 'CORE' SHALL BE PROVIDED COMPLETE WITH OA AND RA PREFILTERS, AND DEFROST CONTROL. PROVIDE ALL REQUIRED CONTROLS AS INDICATED IN CONTROL DIAGRAMS AND REQUIRED PER SEQUENCE

							DEDICAT	ED O	UTSIDE AIR	SYST	EM (DOA	S) S	CHEDUL	E (CONTINUE	D)														"DAIKIN" AS STD.
UNIT	TAG TABEL EAT LAT OF OPEGE											EXHAL	JST FAN				PRE FILTERS	FINAL FILTERS	PRE FILTERS		ELECTRIC	CAL INFO	WEIG		NOTES				
TAG	TN	МВН	(DEG F)	(DEG F)	@ 47 DEG_F	(0 DEG F - 60 DEG F)	TYPE	CFM	E.S.P. T	.S.P. . W.C.)	RPM BHP	НР	FLA/ MOTOR	TYPE	CFM	E.S.P. (IN. W.C.	T.S.P.) (IN. W.C.)	RPM	внр нр	FLA/ MOTOR	SUPPLY ONLY	SUPPLY ONLY	RETURN ONLY	FLA N	иса мо	P V/PH/HZ	(LBS	S) MODEL 110.	110120
899-DOAS-I	R-01 16	64.2	45.0	97.2	3.64	72	SWSI AF, ECM DIRECT DRIVE	2,900/ 3,700		3.9	1,550 3.3	8	6.1	SWSI AF, ECM DIRECT DRIVE	2,100/ 2,900	2.5	3.8	2,050	1.67 4	4	2" MERV 8	4" MERV 14	2" MERV 8	119	122 128	5 460/3/60	2,80	00 DPS015A	1 TO 10
899-DOAS-I	R-02 16	65.5	45.00	94.2	3.64	72	SWSI AF, ECM DIRECT DRIVE	3,100/ 3,900		4	1,600 3.5	8	6.1	SWSI AF, ECM DIRECT DRIVE	2,100 2,900	2.5	3.8	2,100	1.7 4	4	2" MERV 8	4" MERV 14	2" MERV 8	119	122 125	5 460/3/60	2,80	00 DPS015A	1 TO 10

					F	AN SCHE	DULE									"GREENH	ECK" AS STANDARD
				STATIC		OUTLET					MOTO	R		VIBRAT	ONISOLATION	ECM/	
FAN TAG	LOCATION	SERVICE	CFM	PRESS. (IN.W.G.)	RPM	VELOC. (FPM)	TYPE	DRIVE	MODEL NO.	BHP (AMPS)	HP (WATTS)	VOLT/PH/HZ	WEIGHT (LBS.)	SPEC. TYPE	DEFLECTION (IN.)	EMERGENCY POWER	NOTES
899-TXF-R-01	ROOF	TOILET ROOM EXHAUST	400	0.6	1,450	600	UTILITY - UNIVERSAL SINGLE WIDTH FAN	ECM	USF-06	0.09	0.25	208/1/60	100	S	EE SPECS	YES/ NO	1,2
899-TXF-R-02	ROOF	TOILET ROOM EXHAUST	650	1.0	1,750	1,000	UTILITY - UNIVERSAL SINGLE WIDTH FAN	ECM	USF-08	0.19	0.50	208/1/60	100	S	EE SPECS	YES/ NO	1,2
899-GXF-R-01	ROOF	WARMING KITCHEN	225	0.4	1,225	350	UTILITY - UNIVERSAL SINGLE WIDTH FAN	ECM	USF-04	0.04	0.25	208/1/60	100	S	EE SPECS	YES/ NO	1,2
899-TF-1-01	ELECTRICAL CLOSET	CLOSET HEAT TRANSFER	225	0.10	875	-	CEILING EXHAUST FAN	ECM	SP-A390-VG	(.8)	(100)	277/1/60	25	S	EE SPECS	YES/ YES	1,3
899-TF-1-02	IDF ROOM	BACK-UP HEAT TRANSFER	225	0.10	875	-	CEILING EXHAUST FAN	ECM	SP-A390-VG	(.8)	(100)	277/1/60	25	S	EE SPECS	YES/ YES	1,3
899-TF-1-03	ELECTRICAL ROOM	BACK-UP HEAT TRANSFER	675	0.20	1,025		INLINE CABINET	ECM	CSP-A700-VG	(4.1)	(104)	120/1/60	40	S	EE SPECS	YES/ YES	1,3
	A). PROVIDE UNIT-M 1) VARI-GREEN EC I	OUNTED DISCONNECT. MOTOR.	'				•	•	,					,		·	

		AIR OUTLET & INL	LET SCH	EDULE					N	MANUFAC	TURER "T	ritus'
				SIZE IN INCHES			TOTAL	VELOCITY			MODEL	
TAG	SERVICE	SPEC. TYPE	FACE	NECK/ NOM. DUCT SIZE	BLADE SPACING	MAX CFM	PRESSURE (IN. W.C.)	PRESSURE (IN. W.C.)	THROW	MAX NC	NUMBER	NOTES
CD-1	SUPPLY AIR	SQUARE CEILING DIFFUSER	12x12	4" Ø	-	75	0.134	0.040	2-3-6	21	OMNI	
CD-2	SUPPLY AIR	SQUARE CEILING DIFFUSER	12x12	6" Ø	-	157	0.194	0.040	4-6-12	21	OMNI	
CD-3	SUPPLY AIR	SQUARE CEILING DIFFUSER	12x12	8" Ø	-	244	0.213	0.031	5-8-16	17	OMNI	
CD-4	SUPPLY AIR	SQUARE CEILING DIFFUSER	24x24	6" Ø	-	160	0.044	0.040	2-4-7	13	OMNI	
CD-5	SUPPLY AIR	SQUARE CEILING DIFFUSER	24x24	8" Ø	-	280	0.072	0.040	4-6-12	17	OMNI	
CD-6	SUPPLY AIR	SQUARE CEILING DIFFUSER	24x24	10" Ø	-	450	0.107	0.040	5-8-14	20	OMNI	
CG-1	EXHAUST/RETURN AIR	CEILING GRILLE (SQUARE PANEL)	12x 12	-	-	350					OMNI	
CG-2	EXHAUST/RETURN AIR	CEILING GRILLE (SQUARE PANEL)	24x24	-	-	800					OMNI	
SG-1	SUPPLY AIR	SUPPLY GRILLE	8x8	6x6	3/4"	150	0.131	0.040	10-12-18	24	301RL	
SG-2	SUPPLY AIR	SUPPLY GRILLE	10x10	8x8	3/4"	300	0.131	0.040	14-17-25	27	301RL	
SG-3	SUPPLY AIR	SUPPLY GRILLE	12x12	10x10	3/4"	450	0.131	0.040	18-22-31	29	301RL	
EG-1	EXHAUSTAIR	EXHAUST GRILLE	8x8	6x6	3/4"	150	-	0.040		25	350RL	
EG-2	EXHAUSTAIR	EXHAUST GRILLE	14x 12	12x10	3/4"	360	0.051	0.016	-	11	350RL	
EG-3	EXHAUSTAIR	EXHAUST GRILLE	20x14	18x12	3/4"	675	0.051	0.016	-	13	350RL	

COMMON NOTES:

A. DATA OBTAINED FROM TESTS CONDUCTED IN ACCORDANCE WITH ANSI/ASHRAE STANDARD 70-1991. B. THROW VALUES ARE GIVEN FOR TERMINAL VELOCITIES OF 150, 100 AND 50 FPM AND FOR ISOTHERMAL CONDITIONS.

C. NC VALUES BASED ON OCTAVE BAND 2 TO 7 SOUND POWER LEVELS MINUS A ROOM ABSORPTION OF 10 DB. D. EACH NC VALUE REPRESENTS THE NOISE CRITERIA CURVE WHICH WILL NOT BE EXCEEDED BY THE SOUND PRESSURE IN ANY OF THE OCTAVE BANDS, 2 THROUGH 7, WITH A ROOM ABSORPTION OF 10 DB, RE 10^-12 WATTS.

E. DATA UNDER TOTAL PRESSURE FOR RETURN GRILLES IS NEGATIVE STATIC PRESSURE. F. COORDINATE BORDER TYPE WITH ARCHITECTURAL REFLECTED CEILING PLANS. OFFICE BATHROOMS TO HAVE BORDER TYPE 3.

2) PROVIDE WITH MOTORIZED EXHAUST DAMPER TO BE INTERLOCKED WITH FAN OPERATION.

G. PROVIDE CABLE OPERATED DAMPER THRU DIFFUSER IN UN-ACCESSIBLE CEILING (SEE DETAIL). H. PROVIDE LIGHT SHEILD FOR RETURN GRILLES

1.) THROW AND PRESSURE DROP INFO PROVIDED FOR 45 DEG DEFLECTION ANGLE

2) BORDER TYPE 7. INSTALL AS PER MANUFACTURER'S RECOMMENDATIONS. GRILLE TO BE HEAVY DUTY CONSTRUCTION. DAMPER ACCESS IS THROUGH THE GRILLE. FINISH BY ARCHITECT. 3.) PROVIDE WITH REMOTE CABLE OPERATED DAMPER; FOR AIR OUTLETS NEAR INACCESSIBLE CEILINGS.

3) VARI-GREEN MOTOR TO INCLUDE MANUAL DIAL FOR BALANCING. CONTRACTOR TO PROVIDE NECESSARY CONTROLS FOR ON/OFF OPERATION VIA SPACE TEMPERATURE SENSOR.

4.) THROW AND PRESSURE DROP INFO PROVIDED FOR 22.5DEG DEFLECTION ANGLE

			LINEAR D	IFFUSER	SCHED	ULE					(TITUS AS	STANDARD
TAG	LOCATION	MODEL NO.	THROW DIRECTION	SIZE OF DUCT CONNECTION TO PLENUM (IN.)	NOTES							
LD-1	REFER TO PLANS	ML-39	VERTICAL &/OR HORIZONTAL	SEE PLANS	1,2,3,4,5							
LD-2	REFER TO PLANS	ML-39	50	SEE PLAN	2	1	0.05	23	ADJUSTABLE	VERTICAL &/OR HORIZONTAL	SEE PLANS	1,2,3,4,5
LR-1	OFFICE SPACE	MLR-39	25 (50)	SEE PLAN	1	1		10 (25)	NA	SEE PLAN	N/A	1,2,3
LR-2	OFFICE SPACE	MLR-39	50 (100)	SEE PLAN	2	1		12 (28)	NA	SEE PLAN	N/A	1,2,3

1). NC VALUE REPRESENTS THE NOISE CRITERA THAT WILL NOT BE EXCEEDED BY THE SOUND PRESSURE IN ANY OF THE OCTAVE BANDS, 2 THOUGH 7, WITH A ROOM ABSORPTION OF 10 DB, RE 10^-12 WATTS. 2). DATA OBTAINED FROM TESTS CONDUCTED IN ACCORDANCE WITH ASHRAE STANDARD 70-1991 "METHOD OF TESTING FOR RATING THE PERFORMANCE OF AIR OUTLETS AND INLETS."

3). COORDINATE BORDER TYPE WITH ARCHITECTURAL REFLECTED CEILING PLANS. 4), CONTRACTOR SHALL FIELD SET PATTERN DEFLECTORS AS REQUIRED,. 5). PROVIDE WITH REMOTE CABLE OPERATED DAMPER

										VARIAB	LE REFF	RIGERANT	VOLUME AIR	R CONDITION	ONING UNIT	Γ SCHEDULE	E - CRITIC	AL SPACE	S												MANUFAC	TURER "DAIKIN" OR APPROVED EQUAI
								OUTDOOR	UNIT										IN	DOOR UNIT					REFRI	GERANT		PI	PING		VIBRATION ISOLATION	
INDOOR	OUTDOOR CONDENSING	SERVICE	TYPE	OPERATI	NG RANGE	ELECTRICAL			SOUND	WEIGH		⊘S ED	Region IV			SENSIBLE COOLING			ELECTRIC	AL	FAN	SOUND	WEIGHT	-		CHARGE	LIQUID	VAPOR	MAX PIPE	MAX ELEVATIO	DEEL ECTIO	REMARKS
UNIT TAG	UNIT TAG	92.00		COOLING DB	HEATING DB	V / PH / HZ MOP MC	QUANTITY	MAX AIR FLOW RATE (CFM)	PRESSURE (DBA)	T (LBS)	EER	SCOP-127)	RATING (HEATING)	MODEL NO	CAPACIT (BTU/HR)	Y CAPACITY	Y	V/PH/H	Z MOP	MCA	AIR FLOW (CFM) H/L	PRESSURE (DBA) H/L	(LBS)	MODEL NO.	TYPE	(I BC)	LINE (IN., OD)	LINE (IN., OD)	LENGTH (FT.)	N (FT.)	TYPE N (IN.)	712.77
899-AC-1-06	899-CU-R-06	ELECTRICAL ROOM	SINGLE ZONE EXTENDED PIPE	95	5	208/1/60 20 18.3	1	2,800	59	150	9.1	15.9 (5.8)	9.2	RX36NMVJU	34,400	22,800	15,740	208 / 1 / 60	64 WATTS	.37 FLA	915 / 575	54/40	40	FTX36NVJU	410A	3.96	1/4	5/8	98	65	SEE SPECS	
899-AC-1-07	899-CU-R-07	IT CLOSET	SINGLE ZONE EXTENDED PIPE	95	0	208/1/60 20 16.5	1	2,900	58	175	10.2	17.6 (5.8)	8.4	FAQ24TAVJ	U 24,000	18,000	27,000	208 / 1 / 60	15	0.6	635 / 470	43 / 37	35	RZQ24TAVJUA	410A	6.44	3/8	5/8	25	-	SEE SPECS	

a) PROVIDE TEMPERATURE SENSOR AND BACNET INTERFACES TO BE MONITORED BY BMS b) PROVIDE CONDENSATE PUMP TO BE POWERED THROUGH THE UNIT. PROVIDE SHELF ON WALL FOR PUMP

c) VIBRATION ISOLATORS. d) DISCONNECT SWITCHES.

			ELECTRIC HEA	ATER S	CHEDU	LE						
								HEAT	ING CAPA	ACITY	ELECTRICAL	
UNIT TAG	TYPE	LOCATION	MODEL NO.	CFM	EXT S.P. IN.W.G.	FAN SPEED	FLA	E.A.T.	L.A.T.	BTUH	DATA	NOTES/ REMARKS
							AMPS	(°F) DB	(°F) DB	TOTAL	VOLTS/PH/HZ	
899-EH-1-01	HORIZONTAL	LOBBY VESTIBULE	P-963U1T05U-DEU6L4	350 (170-950)	0.2	HIGH	8	30.0	75.0	5 KW	480/3/60	INDEECO MODE
899-EH-1-02	VERTICAL	PLUMBING ROOM	T33D052033B30D0F	250	0.2	HIGH	7.8	30.0	75.0	5 KW	480/3/60	REDD-I MODEL
IOTES	1) PROVIDE WIT	H INTEGRAL TH	ERMOSTAT IN RETURN A	IR PATHWA	Y of Unit Ai	ND DISCONI	NECT SWI	TCH.				•

TO THE BEST OF MY KNOWLEDGE, BELIEF AND PROFESSIONAL JUDGMENT, THESE PLANS AND SPECIFICATIONS ARE IN COMPLIANCE WITH THE 2020 ENERGY CONSERVATION CODE OF NYS

This plan is approved only for work indicated on the application specification sheet. All other matters shown are by an unlicensed person is a violation of Chapter 16 not to be relied upon, or to be considered as either being approved or in accordance with applicable codes.

MCNYS NOTES:

1) FACTORY-BUILT REFRIGERATION COOLING EQUIPMENT SHALL

INSTRUCTIONS. REFER TO MCNYS CODE SECTION 1101.2

BE TESTED IN ACCORDANCE WITH UL 1995, AND INSTALLED IN

ACCORDANCE WITH THEIR LISTING AND THE MANUFACTURER'S

Alterations or additions to this engineering document Title VIII, Article 145 § 7209.2 of the New York State Education Law.

REAL ESTATE &

REGENERON

FACILITIES MANAGEMENT

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899 Old Saw Mill River Road Mount Pleasant, NY 10591

Project No. B17-DAYCARE

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Key Plan

No	. Date	Description
0	05.20.2022	ISSUED FOR PERMIT
1	06.20.2022	100% CONSTRUCTION DOCUMENTS
2	07.01.2022	100% CONSTRUCTION DOCUMENTS-1

Plot Date: 07.01.2022 ALL DRAWINGS AND WRITTEN MATERIALS REPRESENTED ON THIS SHEET CONSTITUTE THE COPYRIGHTED WORK AND ARE THE SOLE PROPERTY OF REGENERON PHARMACEUTICALS. THIS SHEET MAY NOT BE REPRODUCED OR COPIED IN WHOLE OR IN PART, NOR MAY ANY OF THE DRAWINGS OR WRITTEN MATERIALS APPEARING WITHIN, BE INCORPORATED INTO ANOTHER WORK FOR ANY REASON WITHOUT THE WRITTEN CONSENT OF REGENERON PHARMACEUTICALS. THIS SHEET MUST BE RETURNED UPON THE REQUEST OF REGENERON PHARMACEUTICALS. IF REGENERON MAKES OR AUTHORIZES REUSE OF ANY SUCH DOCUMENTS OR INFORMATION PRODUCED BY DESIGN PROFESSIONAL OUTSIDE OF

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Professional Seal and Signature

Discipline: Mechanical Drawn By: BC **MECHANICAL EQUIPMENT** SCHEDULE SHEET 1

Floor:

Scale: NTS

1. PROVIDE VIBRATION ISOLATORS. 2. PROVIDE DISCONNECT SWITCHES.

3. PROVIDE LOW AMBIENT BAFFLE KIT - ZLABGP04A

4. MANUFACTURER MUST BE CERTIFIED, LISTED, AND LABELED PER AHRI 1230.

5. SYSTEM RATING DATA BASED ON DESIGN AMBIENT CONDITIONS FOR COOLING AND FOR HEATING.

6. SUBMITTED PERFORMANCE DATA MUST BE FULLY DE-RATED FOR ALL COMPONENTS AND ACCESSORIES, INCLUDING BUT NOT LIMITED TO, LINE LENGTH, VERTICAL SEPARATION, CONNECTION RATIO, DESIGN CONDITIONS, CONDENSER COIL COATING.

7.CONDENSING UNITS MUST HAVE FULLY MODULATING INVERTER COMPRESSORS. 8. CONDENSING UNITS MUST HAVE HAVE AUTO CHANGEOVER FUNCTIONS

9. DEMAND LIMITING RELAY CONTACT MUST BE PROVIDED.

10. EEV ACTUATORS MUST BE REMOVABLE FROM VALVE BODY WITHOUT DISTURBING THE REFRIGERANT SYSTEM.

11. AC THERMOSTATS MUST PROVIDE +/- 1 DEGREE DEAD-BAND SET-POINT AND CONTROL CAPABILITY. 12. SYSTEM SHALL BE PROVIDED WITH I-TOUCH MANAGER CONTROLLER WITH WEB BASED SOFTWARE FOR DISPLAYING UP TO 8 DIII-NET SYSTEMS WITH 128 INDOOR UNITS PER SYSTEM.PC BY OTHERS.

13. MANUFACTURERS SUBMITTAL MUST INCLUDE REFRIGERANT PIPING DIAGRAM WITH PIPE DIAMETERS, LENGTHS, AND REFRIGERANT VOLUME. 14. SUBSTITUTE MANUFACTURER SHALL BE RESPONSIBLE FOR ADDITIONAL PIPING AND REFRIGERANT.

15. CONTRACTOR TO VERIFY PIPING DIMENSIONS.

16. INSTALLING CONTRACTOR MUST HAVE SUCCESSFULLY COMPLETED MANUFACTURERS CERTIFIED INSTALLATION CLASS WITHIN PAST 36 MONTHS.

17. CONTRACTOR TO FURNISH AND INSTALL INSULATION ON REFRIGERANT PIPING. 18. MANUFACTURERS REPRESENTATIVE MUST HAVE LOCAL STOCK OF PARTS AND FACTORY CERTIFIED TECHNICIAN ON STAFF.

19. MANUFACTURERS REPRESENTATIVE SHALL PROVIDE PROOF OF ONGOING INSTALLATION TRAINING AT THEIR LOCAL FACILITY FOR AT LEAST THE PAST 5 YEARS.

20. MANUFACTURERS REPRESENTATIVE SHALL PROVIDE PROOF OF CONTINUOUS SALES AND SUPPORT OF THEIR PRODUCTS FOR AT LEAST 15 YEARS. 21. MECHANICAL CONTRACTOR SHALL BE RESPONSIBLE FOR ALL DIRECT COSTS AND OPERATING COSTS INCREASES FOR 20 YEARS ASSOCIATED WITH ANY DEVIATIONS RESULTING FROM CHANGES IN DESIGN.

22. MANUFACTURER MUST PROVIDE 10 YEARS PARTS WARRANTY ON ALL ACS, CONDENSING UNITS, AND MODE CHANGEOVER DEVICES. WARRANTY CONDITIONS MUST BE CLARIFIED DURING SUBMITTAL PHASE. 23. 3-PHASE AIR COOLED CONDENSING UNITS MUST HAVE PUBLISHED PERFORMANCE DATA WITH 200% INDOOR CONNECTED CAPACITY.

24. CONDENSING UNITS MUST BE FURNISHED WITH PROTECTIVE COIL COATING TO WITHSTAND ASTM B117 SALT SPRAY TEST FOR A MINIMUM OF 1000 HOURS. PERFORMANCE OF SYSTEM MUST BE DE-RATED FOR COIL COATING. 25. MANUFACTURER MUST CERTIFY AND SUBMIT SYSTEM PERFORMANCE AT EXTREME CONDITIONS OF 122 DEGREES FDB AMBIENT IN COOLING MODE AND -13 DEGREES FWB IN HEATING MODE.

INSTALLING CONTRACTOR MUST HAVE SUCCESSFULLY COMPLETED MANUFACTURERS CERTIFIED INSTALLATION CLASS WITHIN PAST 36 MONTHS.

						VARIABL	E REFRI	GERANT	VOLUME A	AIR CONE	DITIONING	UNIT SC	HEDULE													MANUFACTURER "DAIKIN" OR APPROVED EQUAL
						NOMINAL (CAPACITY	COR	RECTED CAI	PACITY		ERING (RETU	,		FAN	MAX		P	OWER	₹					VIBRATION ISOLATION	
UNIT TAG	CONNECTED WITH	LOCATION	SERVICE	TYPE	NOMINAL TONS	TOTAL COOLING	HEATING (MBH)	TOTAL COOLING	SENSIBLE COOLING	HEATING (MBH)	COOLING			OUTSIDE AIR (CFM)	AIRFLOW (CFM DESIGN)/ (CFM HH/H/L)	STATIC PRESS. (IN.W.G.)	VOLTS	S PHASE	HZ	MCA	MOP	OPERATING WEIGHT (LBS)	DIMENSION (W"xH"xD")	MODEL	TYPE DEFLECTION	REMARKS
	ACC BSB	40T EL 00D	INFANT			(MBH)	(IVIDIT)	(MBH)	(MBH)	(IVIDIT)	DB	VVD			,	(114.77.0.)									(IN.)	CEE MOTEC DELOW ODTIONO.
899-AC-1-01A		1ST FLOOR (SOUTH)	(ROOM #4)	HORIZONTAL	1.5	18.0	20.0	15.5	13.2	20	75	63	70	275	600 635/580/530	0.8	208	1	60	1.6	15	79.4	39.4 x 11.8 x 27.6	FXMQ18PBVJU	PER SPECIFICATIONS	SEE NOTES BELOW, OPTIONS: BRC1E73 (1)
899-AC-1-01B		1ST FLOOR (SOUTH)	INFANT (ROOM #3)	HORIZONTAL	1.5	18.0	20.0	15.5	13.2	20	75	63	70	275	600 635/580/530	0.8	208	1	60	1.6	15	79.4	39.4 x 11.8 x 27.6	FXMQ18PBVJU	PER SPECIFICATIONS	SEE NOTES BELOW, OPTIONS: BRC1E73 (1)
899-AC-1-01C		1ST FLOOR (SOUTH)	TODDLER (ROOM #3)	HORIZONTAL	2	24.0	27.0	20.6	16.0	27.0	75	63	70	275	675 690/620/565	0.8	208	1	60	1.8	15	79.4	39.4 x 11.8 x 27.6	FXMQ24PBVJU	PER SPECIFICATIONS	SEE NOTES BELOW, OPTIONS: BRC1E73 (1)
899-AC-1-01D	899-CU-R-01 899-BSB-1-01	1ST FLOOR (SOUTH)	TODDLER (ROOM #4)	HORIZONTAL	2	24.0	27.0	20.6	16.0	27.0	75	63	70	275	675 690/620/565	0.8	208	1	60	1.8	15	79.4	39.4 x 11.8 x 27.6	FXMQ24PBVJU	PER SPECIFICATIONS	SEE NOTES BELOW, OPTIONS: BRC1E73 (1)
899-AC-1-01E		1ST FLOOR (SOUTH)	LAUNDRY	HORIZONTAL	0.75	9.5	10.5	8.5	6.1	10.6	75	63	70	50	315 315/265/230)	0.6	208	1	60	0.8	15	55.0	21.7 x 9.6 x 31.5	FXSQ09TAVJU	PER SPECIFICATIONS	SEE NOTES BELOW, OPTIONS: BRC1E73 (1)
899-AC-1-01F		1ST FLOOR (SOUTH)	WARMING KITCHEN	HORIZONTAL	1.25	15.0	17.0	12.9	10.2	16.5	75	63	70	110	550 560/530/500	0.8	208	1	60	1.5	15	79.4	39.4 x 11.8 x 27.6	FXMQ15PBVJU	PER SPECIFICATIONS	SEE NOTES BELOW, OPTIONS: BRC1E73 (1)
899-AC-1-01G		1ST FLOOR (SOUTH)	INTERIOR CORRIDOR (NORTH)	HORIZONTAL	1	12.0	13.5	10.5	8.4	13.6	75	63	70	175	335 335/280/250	0.6	208	1	60	0.8	15	55.0	21.7 x 9.6 x 31.5	FXSQ12TAVJU	PER SPECIFICATIONS	SEE NOTES BELOW, OPTIONS: BRC1E73 (1)
899-AC-1-02A		1ST FLOOR (SOUTH)	INFANT (ROOM #2)	HORIZONTAL	1.5	18.0	20.0	15.5	13.2	20	75	63	70	275	600 635/580/530	0.8	208	1	60	1.6	15	79.4	39.4 x 11.8 x 27.6	FXMQ18PBVJU	PER SPECIFICATIONS	SEE NOTES BELOW, OPTIONS: BRC1E73 (1)
899-AC-1-02B		1ST FLOOR (SOUTH)	INFANT (ROOM #1)	HORIZONTAL	1.5	18.0	20.0	15.5	13.2	20	75	63	70	275	600 635/580/530	0.8	208	1	60	1.6	15	79.4	39.4 x 11.8 x 27.6	FXMQ18PBVJU	PER SPECIFICATIONS	SEE NOTES BELOW, OPTIONS: BRC1E73 (1)
899-AC-1-02C		1ST FLOOR (SOUTH)	TODDLER (ROOM #2)	HORIZONTAL	2	24.0	27.0	20.6	16.0	27.0	75	63	70	275	675 690/620/565	0.8	208	1	60	1.8	15	79.4	39.4 x 11.8 x 27.6	FXMQ24PBVJU	PER SPECIFICATIONS	SEE NOTES BELOW, OPTIONS: BRC1E73 (1)
899-AC-1-02D	899-CU-R-02 899-BSB-1-02	1ST FLOOR (SOUTH)	TODDLER (ROOM #1)	HORIZONTAL	2	24.0	27.0	20.6	16.0	27.0	75	63	70	275	675 690/620/565	0.8	208	1	60	1.8	15	79.4	39.4 x 11.8 x 27.6	FXMQ24PBVJU	PER SPECIFICATIONS	SEE NOTES BELOW, OPTIONS: BRC1E73 (1)
899-AC-1-02E		1ST FLOOR (SOUTH)	INTERIOR CORRIDOR (SOUTH)	HORIZONTAL	1	12.0	13.5	10.5	8.4	13.6	75	63	70	175	335 335/280/250	0.6	208	1	60	0.8	15	55.0	21.7 x 9.6 x 31.5	FXSQ12TAVJU	PER SPECIFICATIONS	SEE NOTES BELOW, OPTIONS: BRC1E73 (1)
899-AC-1-02F		1ST FLOOR (SOUTH)	HEALTH OFFCE/ STROLLER STORAGE	HORIZONTAL	0.5	5.8	6.5	5.2	4.3	6.5	75	63	70	35	275 280/265/230	0.6	208	1	60	0.8	15	55.0	21.7 x 9.6 x 31.5	FXSQ05TAVJU	PER SPECIFICATIONS	SEE NOTES BELOW, OPTIONS: BRC1E73 (1)
899-AC-1-02G		1ST FLOOR (SOUTH)	WELLNESS/ CORRIDOR	HORIZONTAL	0.75	9.5	10.5	8.5	6.1	10.6	75	63	70	30	315 315/265/230)	0.6	208	1	60	0.8	15	55.0	21.7 x 9.6 x 31.5	FXSQ09TAVJU	PER SPECIFICATIONS	SEE NOTES BELOW, OPTIONS: BRC1E73 (1)
899-AC-1-03A		1ST FLOOR (CENTER)	LOBBY/RECEPTION	HORIZONTAL	4	48	54	41.3	30.5	54	75	63	70	300	1,375 1,375/1,165/990	0.8	208	1	60	3.4	15	101.4	55.1 x 11.8 x 27.6	FXMQ48PBVJU	PER SPECIFICATIONS	SEE NOTES BELOW, OPTIONS: BRC1E73 (1)
899-AC-1-03B		1ST FLOOR (CENTER)	MOVEMENT MATTERS ZONE	HORIZONTAL	2	24.0	27.0	20.6	16.0	27.0	75	63	70	300	675 690/620/565	0.8	208	1	60	1.8	15	79.4	39.4 x 11.8 x 27.6	FXMQ24PBVJU	PER SPECIFICATIONS	SEE NOTES BELOW, OPTIONS: BRC1E73 (1)
899-AC-1-03C	899-CU-R-03 899-BSB-1-03	1ST FLOOR (CENTER)	DIRECTOR OFFICE/ LOBBY	HORIZONTAL	0.5	5.8	6.5	5.2	4.3	6.5	75	63	70	45	275 280/265/230	0.6	208	1	60	0.8	15	55.0	21.7 x 9.6 x 31.5	FXSQ05TAVJU	PER SPECIFICATIONS	SEE NOTES BELOW, OPTIONS: BRC1E73 (1)
899-AC-1-03D		1ST FLOOR (CENTER)	CONFERENCE ROOM/ LOBBY	HORIZONTAL	2	24.0	27.0	20.6	16.0	27.0	75	63	70	75	675 690/620/565	0.8	208	1	60	1.8	15	79.4	39.4 x 11.8 x 27.6	FXMQ24PBVJU	PER SPECIFICATIONS	SEE NOTES BELOW, OPTIONS: BRC1E73 (1)
899-AC-1-03E		1ST FLOOR (CENTER)	PERIMETER CORRIDOR (WEST)	HORIZONTAL	1	12.0	13.5	10.5	8.4	13.6	75	63	70	75	335 335/280/250	0.6	208	1	60	0.8	15	55.0	21.7 x 9.6 x 31.5	FXSQ12TAVJU	PER SPECIFICATIONS	SEE NOTES BELOW, OPTIONS: BRC1E73 (1)
899-AC-1-04A		1ST FLOOR (SOUTH)	INNOVATION STUDIO)	HORIZONTAL	1.5	18.0	20.0	15.5	13.2	20	75	63	70	325	600 635/580/530	0.8	208	1	60	1.6	15	79.4	39.4 x 11.8 x 27.6	FXMQ18PBVJU	PER SPECIFICATIONS	SEE NOTES BELOW, OPTIONS: BRC1E73 (1)
899-AC-1-04B		1ST FLOOR (SOUTH)	STAFF LOUNGET COPY AREA / STORAGE	HORIZONTAL	2.5	30.0	34.0	25.8	20.1	34	75	63	70	215	1,075 1,095/950/810	0.8	208	1	60	2.8	15	101.4	55.1 x 11.8 x 27.6	FXMQ30PBVJU	PER SPECIFICATIONS	SEE NOTES BELOW, OPTIONS: BRC1E73 (1)
899-AC-1-04C		1ST FLOOR (SOUTH)	PRESCHOOL #1	HORIZONTAL	2.5	30.0	34.0	25.8	20.1	34	75	63	70	375	1,075 1,095/950/810	0.8	208	1	60	2.8	15	101.4	55.1 x 11.8 x 27.6	FXMQ30PBVJU	PER SPECIFICATIONS	SEE NOTES BELOW, OPTIONS: BRC1E73 (1)
899-AC-1-04D	899-CU-R-04 899-BSB-1-04	1ST FLOOR (SOUTH)	PRESCHOOL #1	CASSETTE	0.5			5	4.3	6.5	75	63	70	0	300		208	1	60	0.3	15	35	22.6 x 10.2 x 22.6	FXZQ05TAVJU	PER SPECIFICATIONS	SEE NOTES BELOW, OPTIONS: BRC1E73 (1), BYFQ60C3W1W (1)
899-AC-1-04E		1ST FLOOR (SOUTH)	PRESCHOOL #2	HORIZONTAL	2.5	30.0	34.0	25	20.1	34	75	63	70	375	1,075 1,095/950/810	0.8	208	1	60	2.8	15	101.4	55.1 x 11.8 x 27.6	FXMQ30PBVJU	PER SPECIFICATIONS	SEE NOTES BELOW, OPTIONS: BRC1E73 (1)
899-AC-1-04F		1ST FLOOR (SOUTH)	PRESCHOOL #2	CASSETTE	0.5			5	4.3	6.5	75	63	70	0	300		208	1	60	0.3	15	35	22.6 x 10.2 x 22.6	FXZQ05TAVJU	PER SPECIFICATIONS	SEE NOTES BELOW, OPTIONS: BRC1E73 (1), BYFQ60C3W1W (1)
899-AC-1-04G		1ST FLOOR (SOUTH)	PERIMETER CORRIDOR (WEST)	HORIZONTAL	1	12.0	13.5	10.5	8.4	13.6	75	63	70	70	335 335/280/250	0.6	208	1	60	0.8	15	55.0	21.7 x 9.6 x 31.5	FXSQ12TAVJU	PER SPECIFICATIONS	SEE NOTES BELOW, OPTIONS: BRC1E73 (1)
899-AC-1-05A		1ST FLOOR (SOUTH)	K-PREP #1	HORIZONTAL	2.5	30.0	34.0	25.8	20.1	34	75	63	70	375	1,075 1,095/950/810	0.8	208	1	60	2.8	15	101.4	55.1 x 11.8 x 27.6	FXMQ30PBVJU	PER SPECIFICATIONS	SEE NOTES BELOW, OPTIONS: BRC1E73 (1)
899-AC-1-05B		1ST FLOOR (SOUTH)	K-PREP #1	CASSETTE	0.5			5	4.3	6.5	75	63	70	0	300		208	1	60	0.3	15	35	22.6 x 10.2 x 22.6	FXZQ05TAVJU	PER SPECIFICATIONS	SEE NOTES BELOW, OPTIONS: BRC1E73 (1), BYFQ60C3W1W (1)
899-AC-1-05C		1ST FLOOR (SOUTH)	K-PREP #2	HORIZONTAL	2.5	30.0	34.0	25.8	20.1	34	75	63	70	375	1,075 1,095/950/810	0.8	208	1	60	2.8	15	101.4	55.1 x 11.8 x 27.6	FXMQ30PBVJU	PER SPECIFICATIONS	SEE NOTES BELOW, OPTIONS: BRC1E73 (1)
899-AC-1-05D	899-CU-R-05 899-BSB-1-05	1ST FLOOR (SOUTH)	K-PREP #1	CASSETTE	0.5			5	4.3	6.5	75	63	70	0	300		208	1	60	0.3	15	35	22.6 x 10.2 x 22.6	FXZQ05TAVJU	PER SPECIFICATIONS	SEE NOTES BELOW, OPTIONS: BRC1E73 (1), BYFQ60C3W1W (1)
899-AC-1-05E		1ST FLOOR (SOUTH)	PERIMETER CORRIDOR (WEST)	HORIZONTAL	1	12.0	13.5	10.5	8.4	13.6	75	63	70	70	335 335/280/250	0.6	208	1	60	0.8	15	55.0	21.7 x 9.6 x 31.5	FXSQ12TAVJU	PER SPECIFICATIONS	SEE NOTES BELOW, OPTIONS: BRC1E73 (1)
899-AC-1-05F		1ST FLOOR (SOUTH)	PLUMBING/STORAGE	HORIZONTAL	1	12.0	13.5	10.5	8.4	13.6	75	63	70	125	335 335/280/250	0.6	208	1	60	0.8	15	55.0	21.7 x 9.6 x 31.5	FXSQ12TAVJU	PER SPECIFICATIONS	SEE NOTES BELOW, OPTIONS: BRC1E73 (1)

a) PROVIDE MANUFACTURER THERMOSTATS AS INDICATED IN PLAN, TO BE MONITORED AND PROGRAMMED BY THE BMS, WITH CAPABILITY FOR OCCUPANT TO ADJUST TEMPERATURE BY +/- 2 DEG F. b) VIBRATION ISOLATORS.

c) DISCONNECT SWITCHES. INTEGRAL CONDENSATE PUMPS

PROVIDE UNITS WITH THE FOLLOWING:

d) OPTIONS AND ACCESSORIES: THERMOSTAT PER CONTROL DIAGRAM; e) PROVIDE FILTER KIT AND PROVIDE WITH 4" MERV 14 FILTERS MANUFACTURER "DAIKIN"

	VARIABLE R	EFRIGERANT V	OLUME - ZO	ONE HE	EAT REC	COVE	ERY D	EVICE	SCHEDULE	<u> </u>		OR APPROVED EQUA
	CONNE	CTED WITH	MAX		PC	OWER			OPERATING			
UNIT TAG	CONTRACT	0125 WIII	CAPACITY PER PORT	VOLTS	PHASE	HZ	MCA	MOP	WEIGHT (LBS)	DIMENSION (W"xH"xD")	MODEL	REMARKS
	ACC	BSB	(MBH)	VOLIO	TTIMOL	112	WOX	IVIOI	(223)			
899-BSB-1- 01	899-CU-R-01	899-AC-1-01A TO 899-AC-1-01G	54	208	1	60	0.8	15	85	23.3 x 9.5 x 23.7	BSF8Q54TVJ	KHFP26A100C, A KIT TO CLOSE UNUSED POR
899-BSB-1- 02	899-CU-R-02	899-AC-1-02A TO 899-AC-1-02G	54	208	1	60	0.8	15	85	23.3 x 9.5 x 23.7	BSF8Q54TVJ	KHFP26A100C, A KIT TO CLOSE UNUSED POR
899-BSB-1- 03	899-CU-R-03	899-AC-1-03A TO 899-AC-1-03E	54	208	1	60	0.6	15	75	23.3 x 9.5 x 23.7	BSF6Q54TVJ	KHFP26A100C, A KIT TO CLOSE UNUSED POR
899-BSB-1- 04	899-CU-R-04	899-AC-1-04A TO 899-AC-1-04G	54	208	1	60	0.6	15	85	23.3 x 9.5 x 23.7	BSF8Q54TVJ	KHFP26A100C, A KIT TO CLOSE UNUSED POR
899-BSB-1- 05	899-CU-R-05	899-AC-1-05A TO 899-AC-1-5F	54	208	1	60	0.04	15	75	23.3 x 9.5 x 23.7	BSF6Q54TVJ	ALL PORTS ARE USED

MCNYS NOTES:

FACTORY-BUILT REFRIGERATION COOLING EQUIPMENT SHALL BE TESTED IN ACCORDANCE WITH UL 1995, AND INSTALLED IN

ACCORDANCE WITH THEIR LISTING AND THE MANUFACTURER'S INSTRUCTIONS. REFER TO MCNYS CODE SECTION 1101.2

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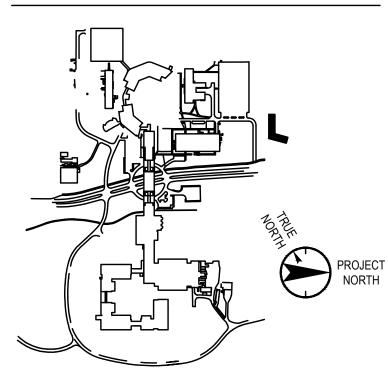
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Discipline: Mechanical Drawn By: BC MECHANICAL **EQUIPMENT** SCHEDULE SHEET #2

TO THE BEST OF MY KNOWLEDGE, BELIEF AND PROFESSIONAL JUDGMENT, THESE PLANS AND SPECIFICATIONS ARE IN COMPLIANCE WITH THE

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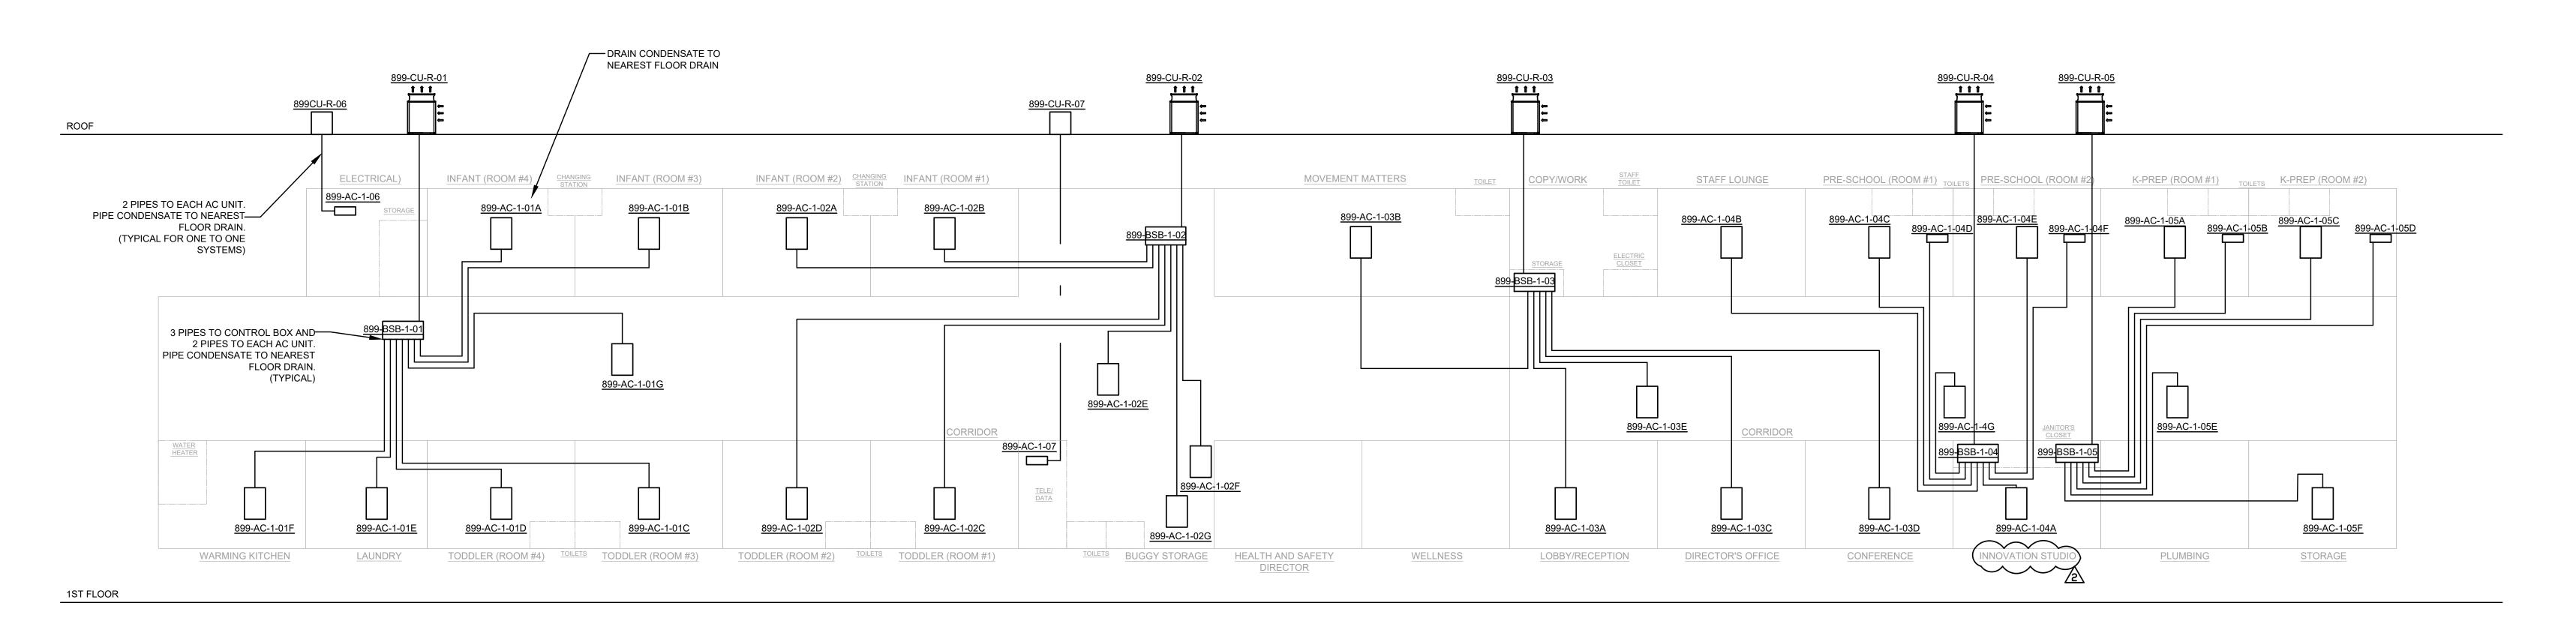
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Scale: NTS

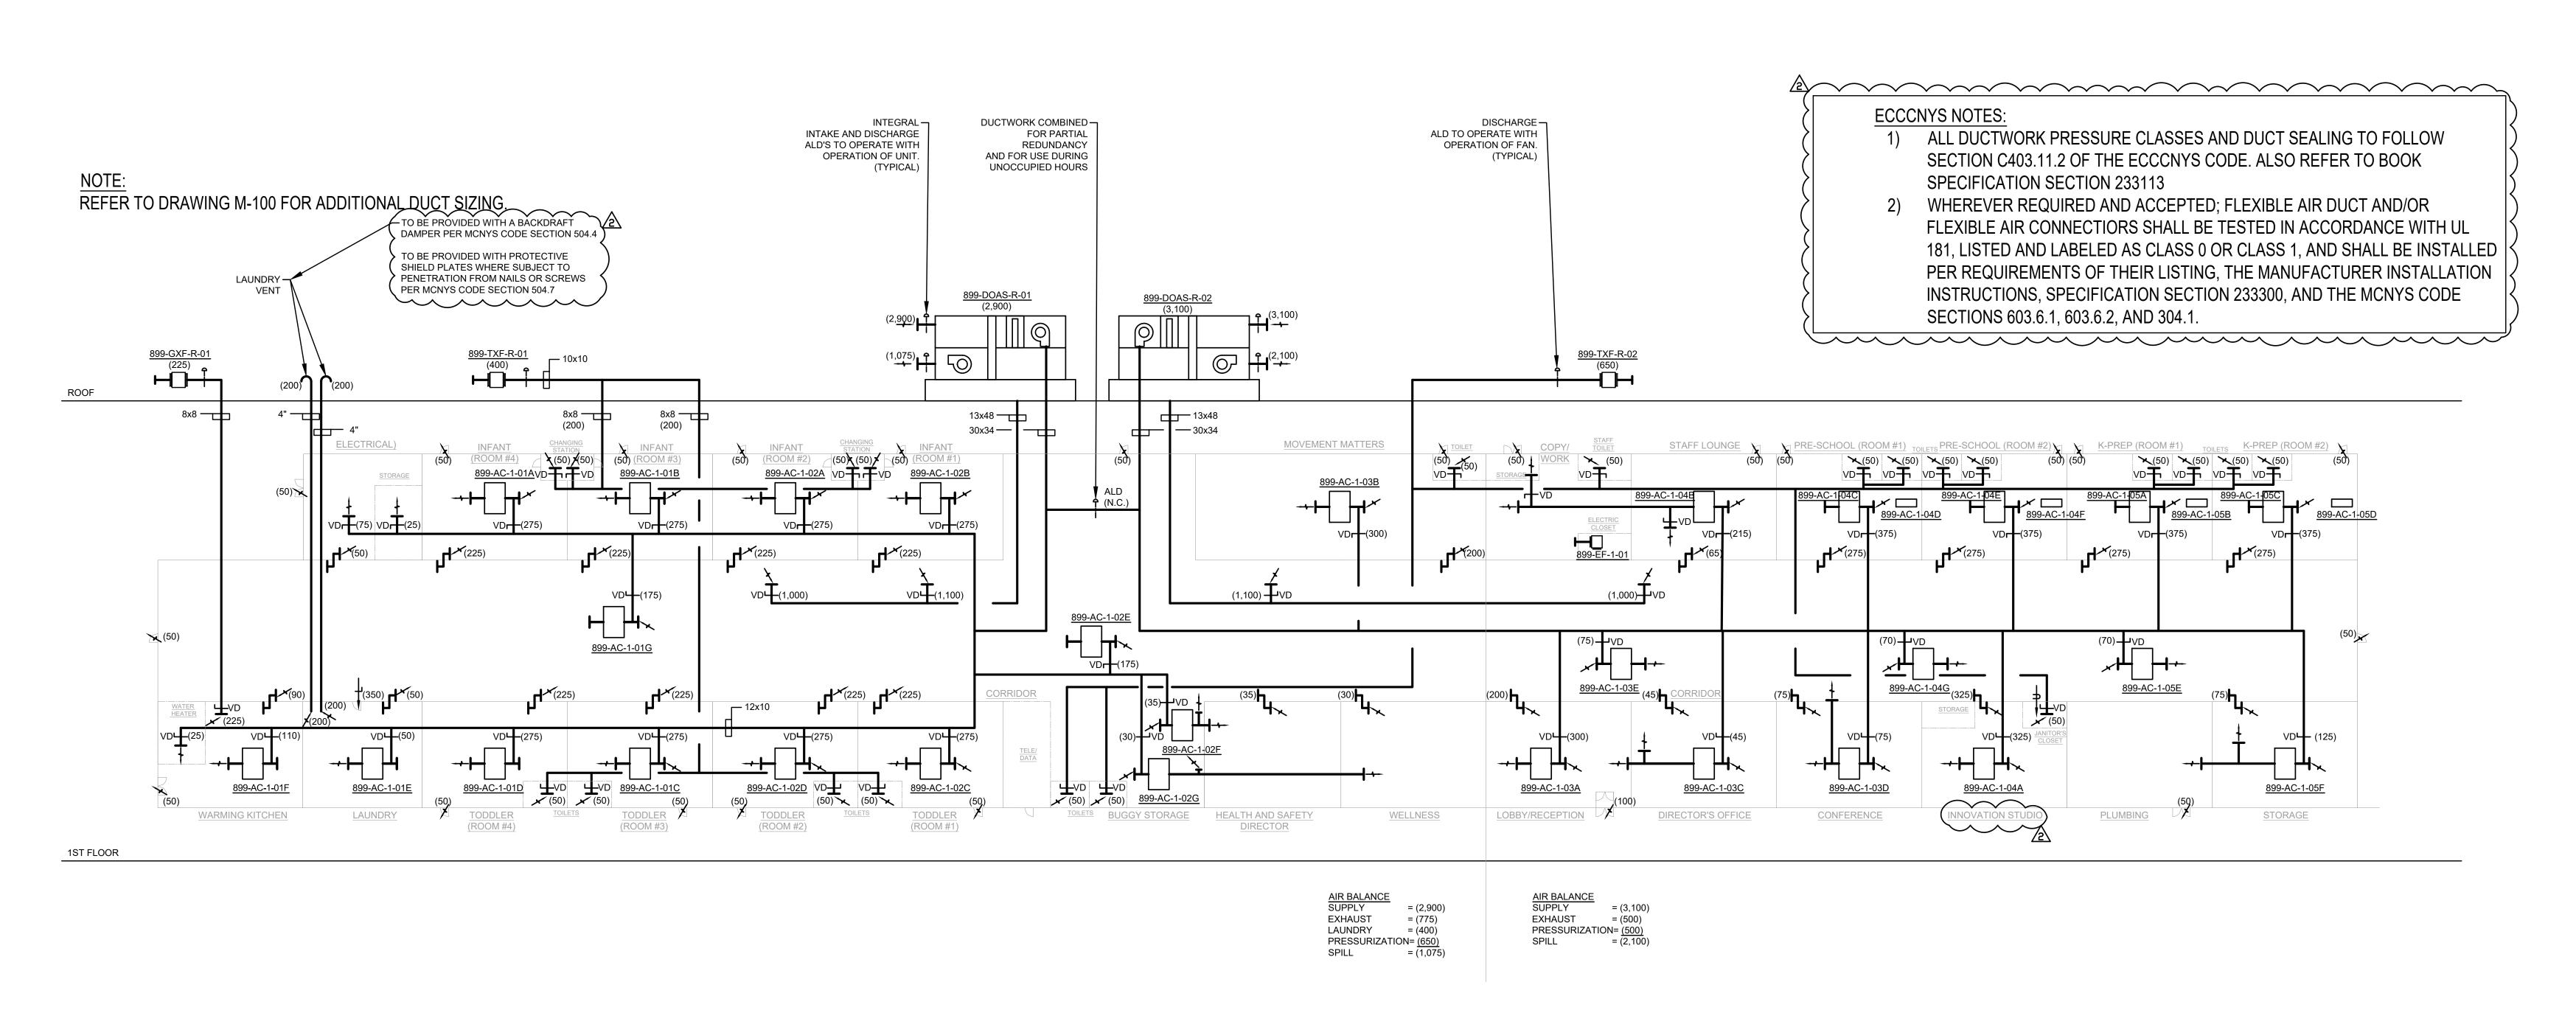
MCNYS NOTES: 1) ALL REFRIGERANT PIPING TO FOLLOW MCNYS CODE SECTION 1107 AND **BOOK SPECIFICATION SECTION 232300**

ECCCNYS NOTES:

ALL HVAC PIPING TO BE INSULATED TO FOLLOW SECTION C403.11.3 AND TABLE C403.11.3 OF THE ECCCNYS CODE. ALSO REFER TO BOOK SPECIFICATION SECTION 230719



REFRIGERANT RISER DIAGRAM



AIR RISER DIAGRAM

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Key Plan

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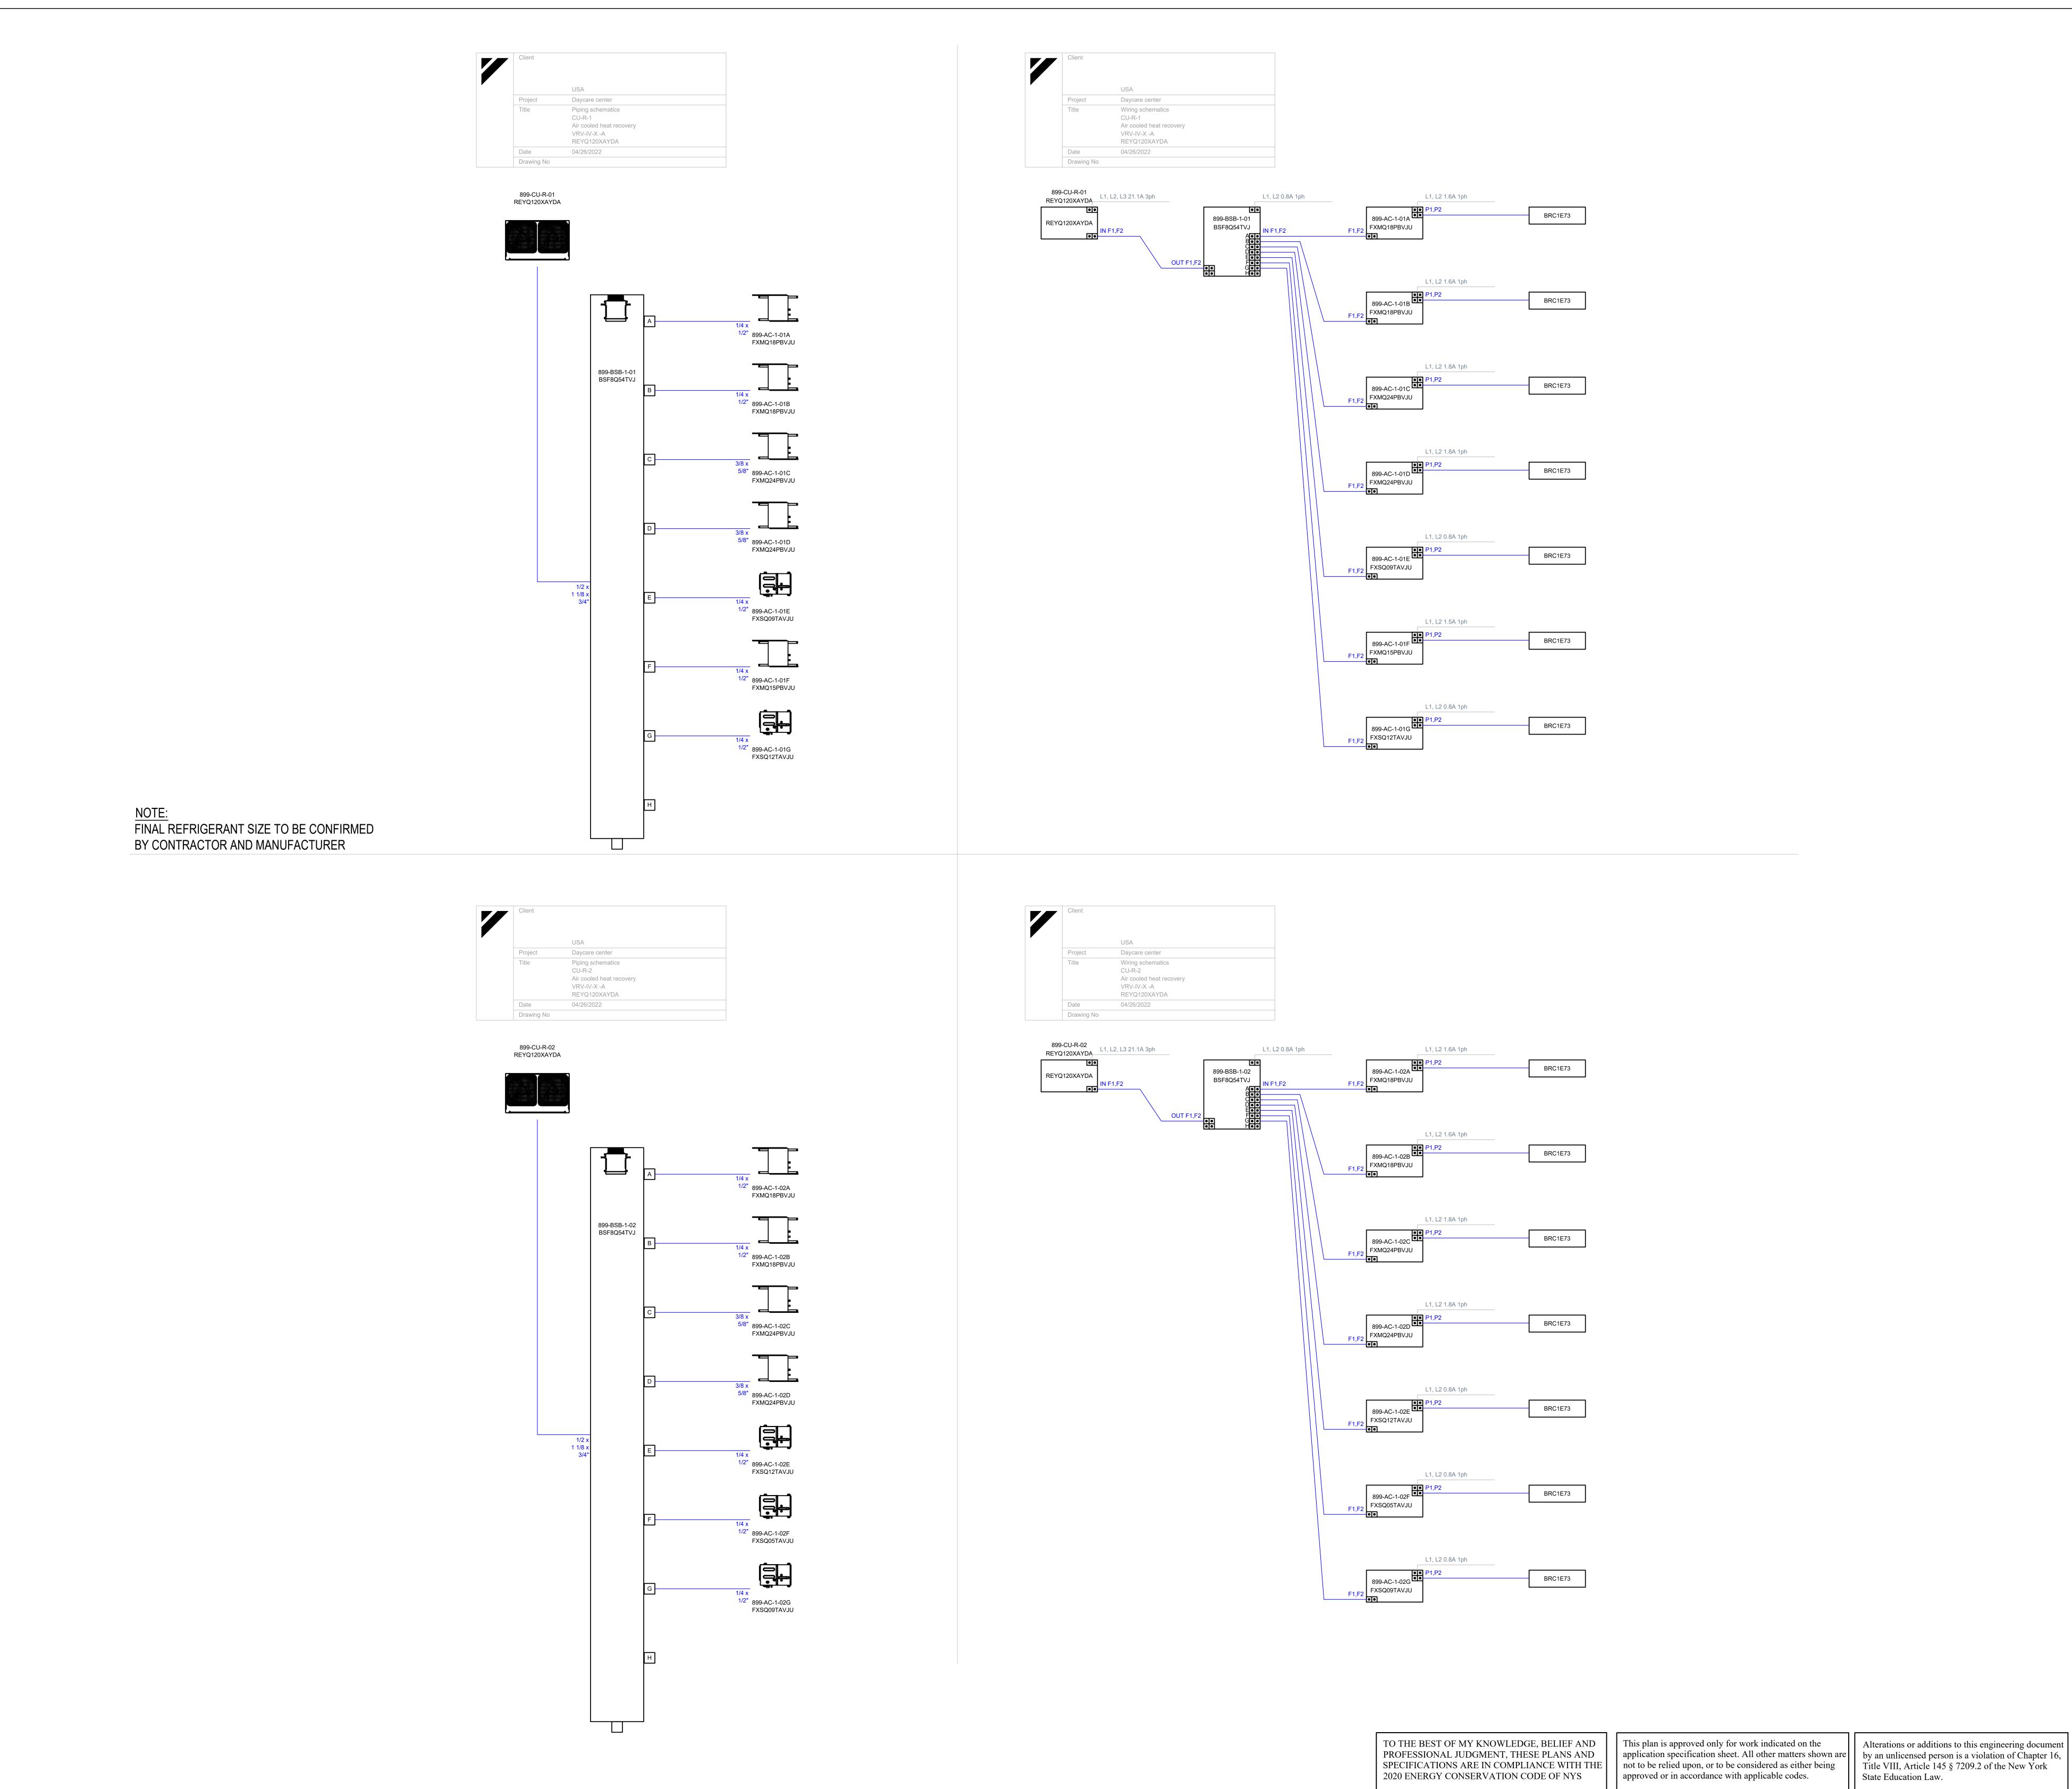
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MECHANICAL DIAGRAM

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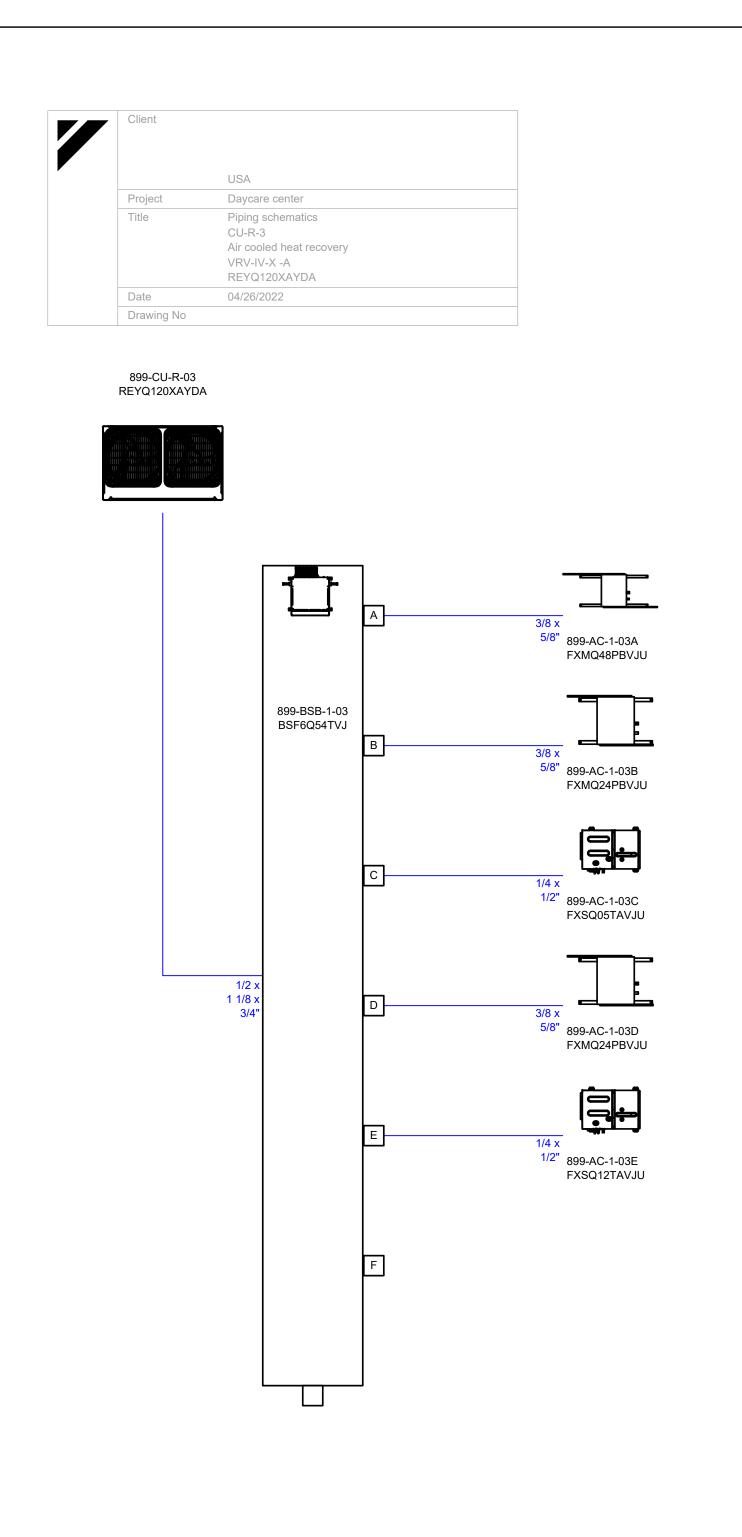
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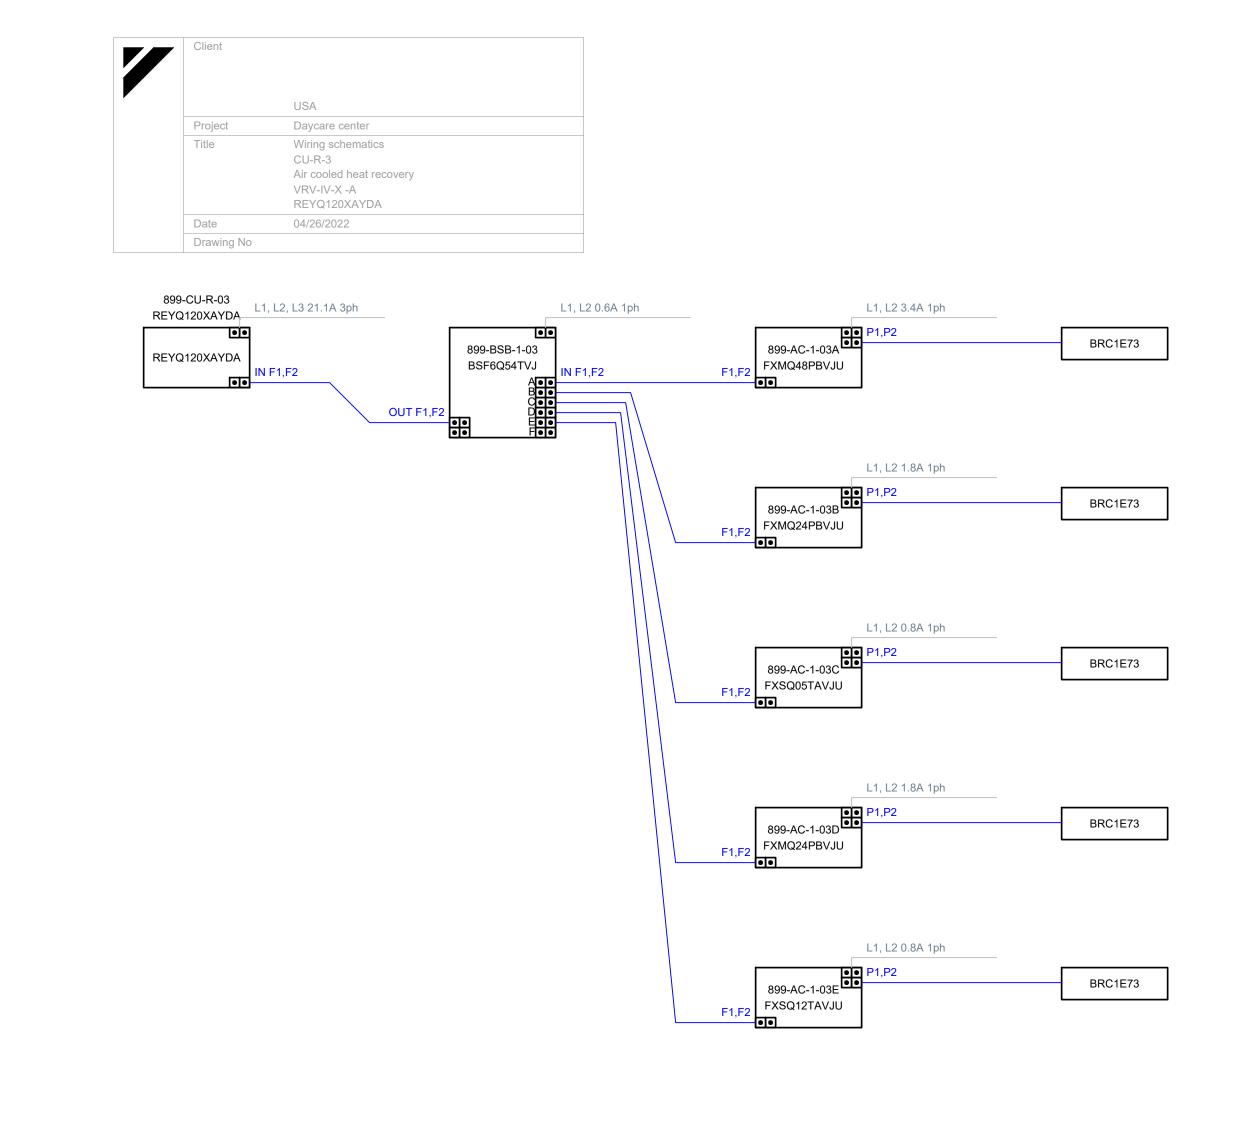
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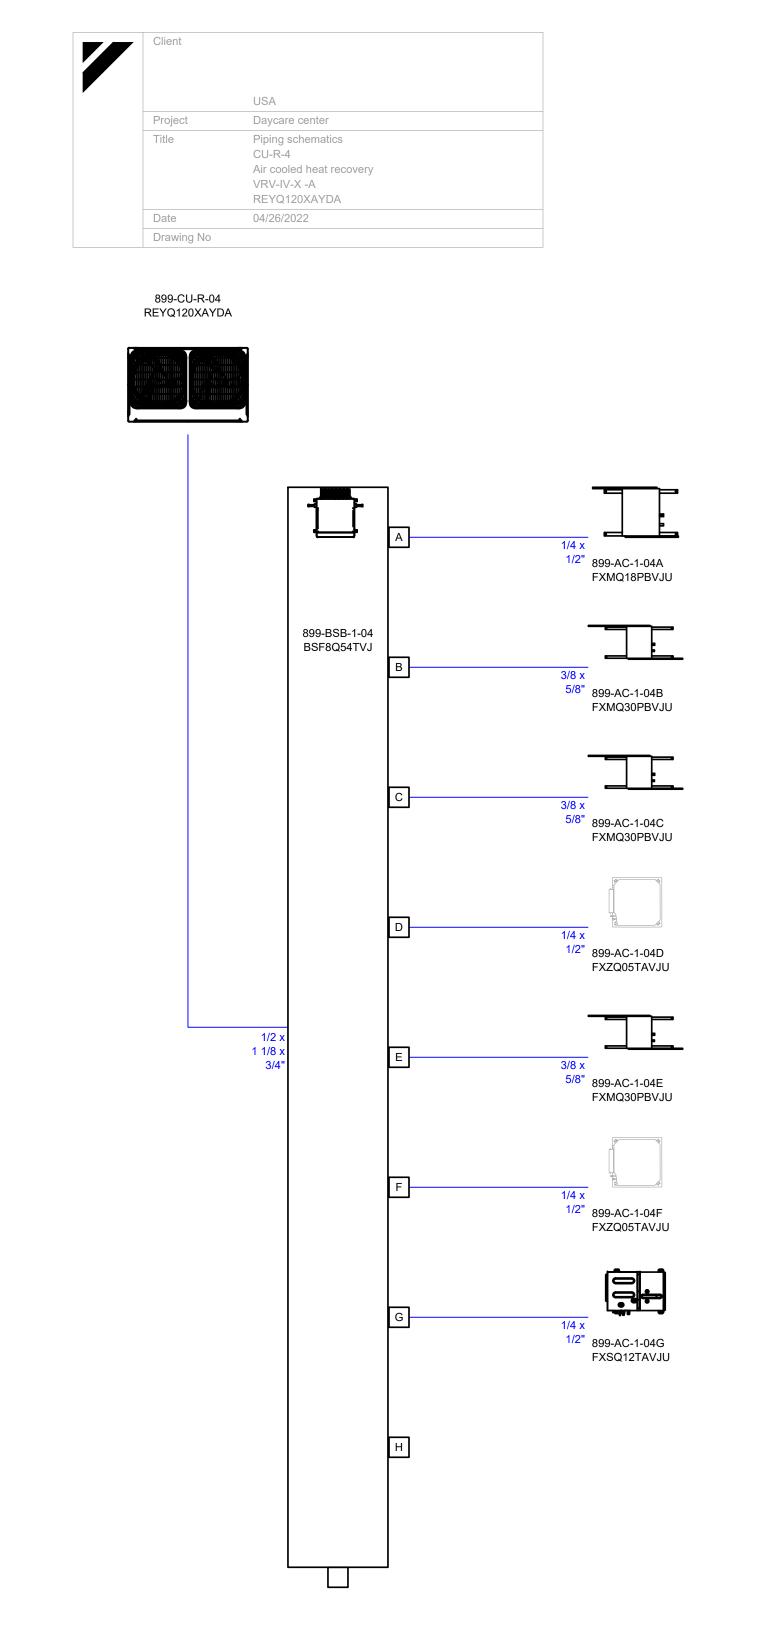
Drawn By: MECHANICAL VRF DIAGRAM

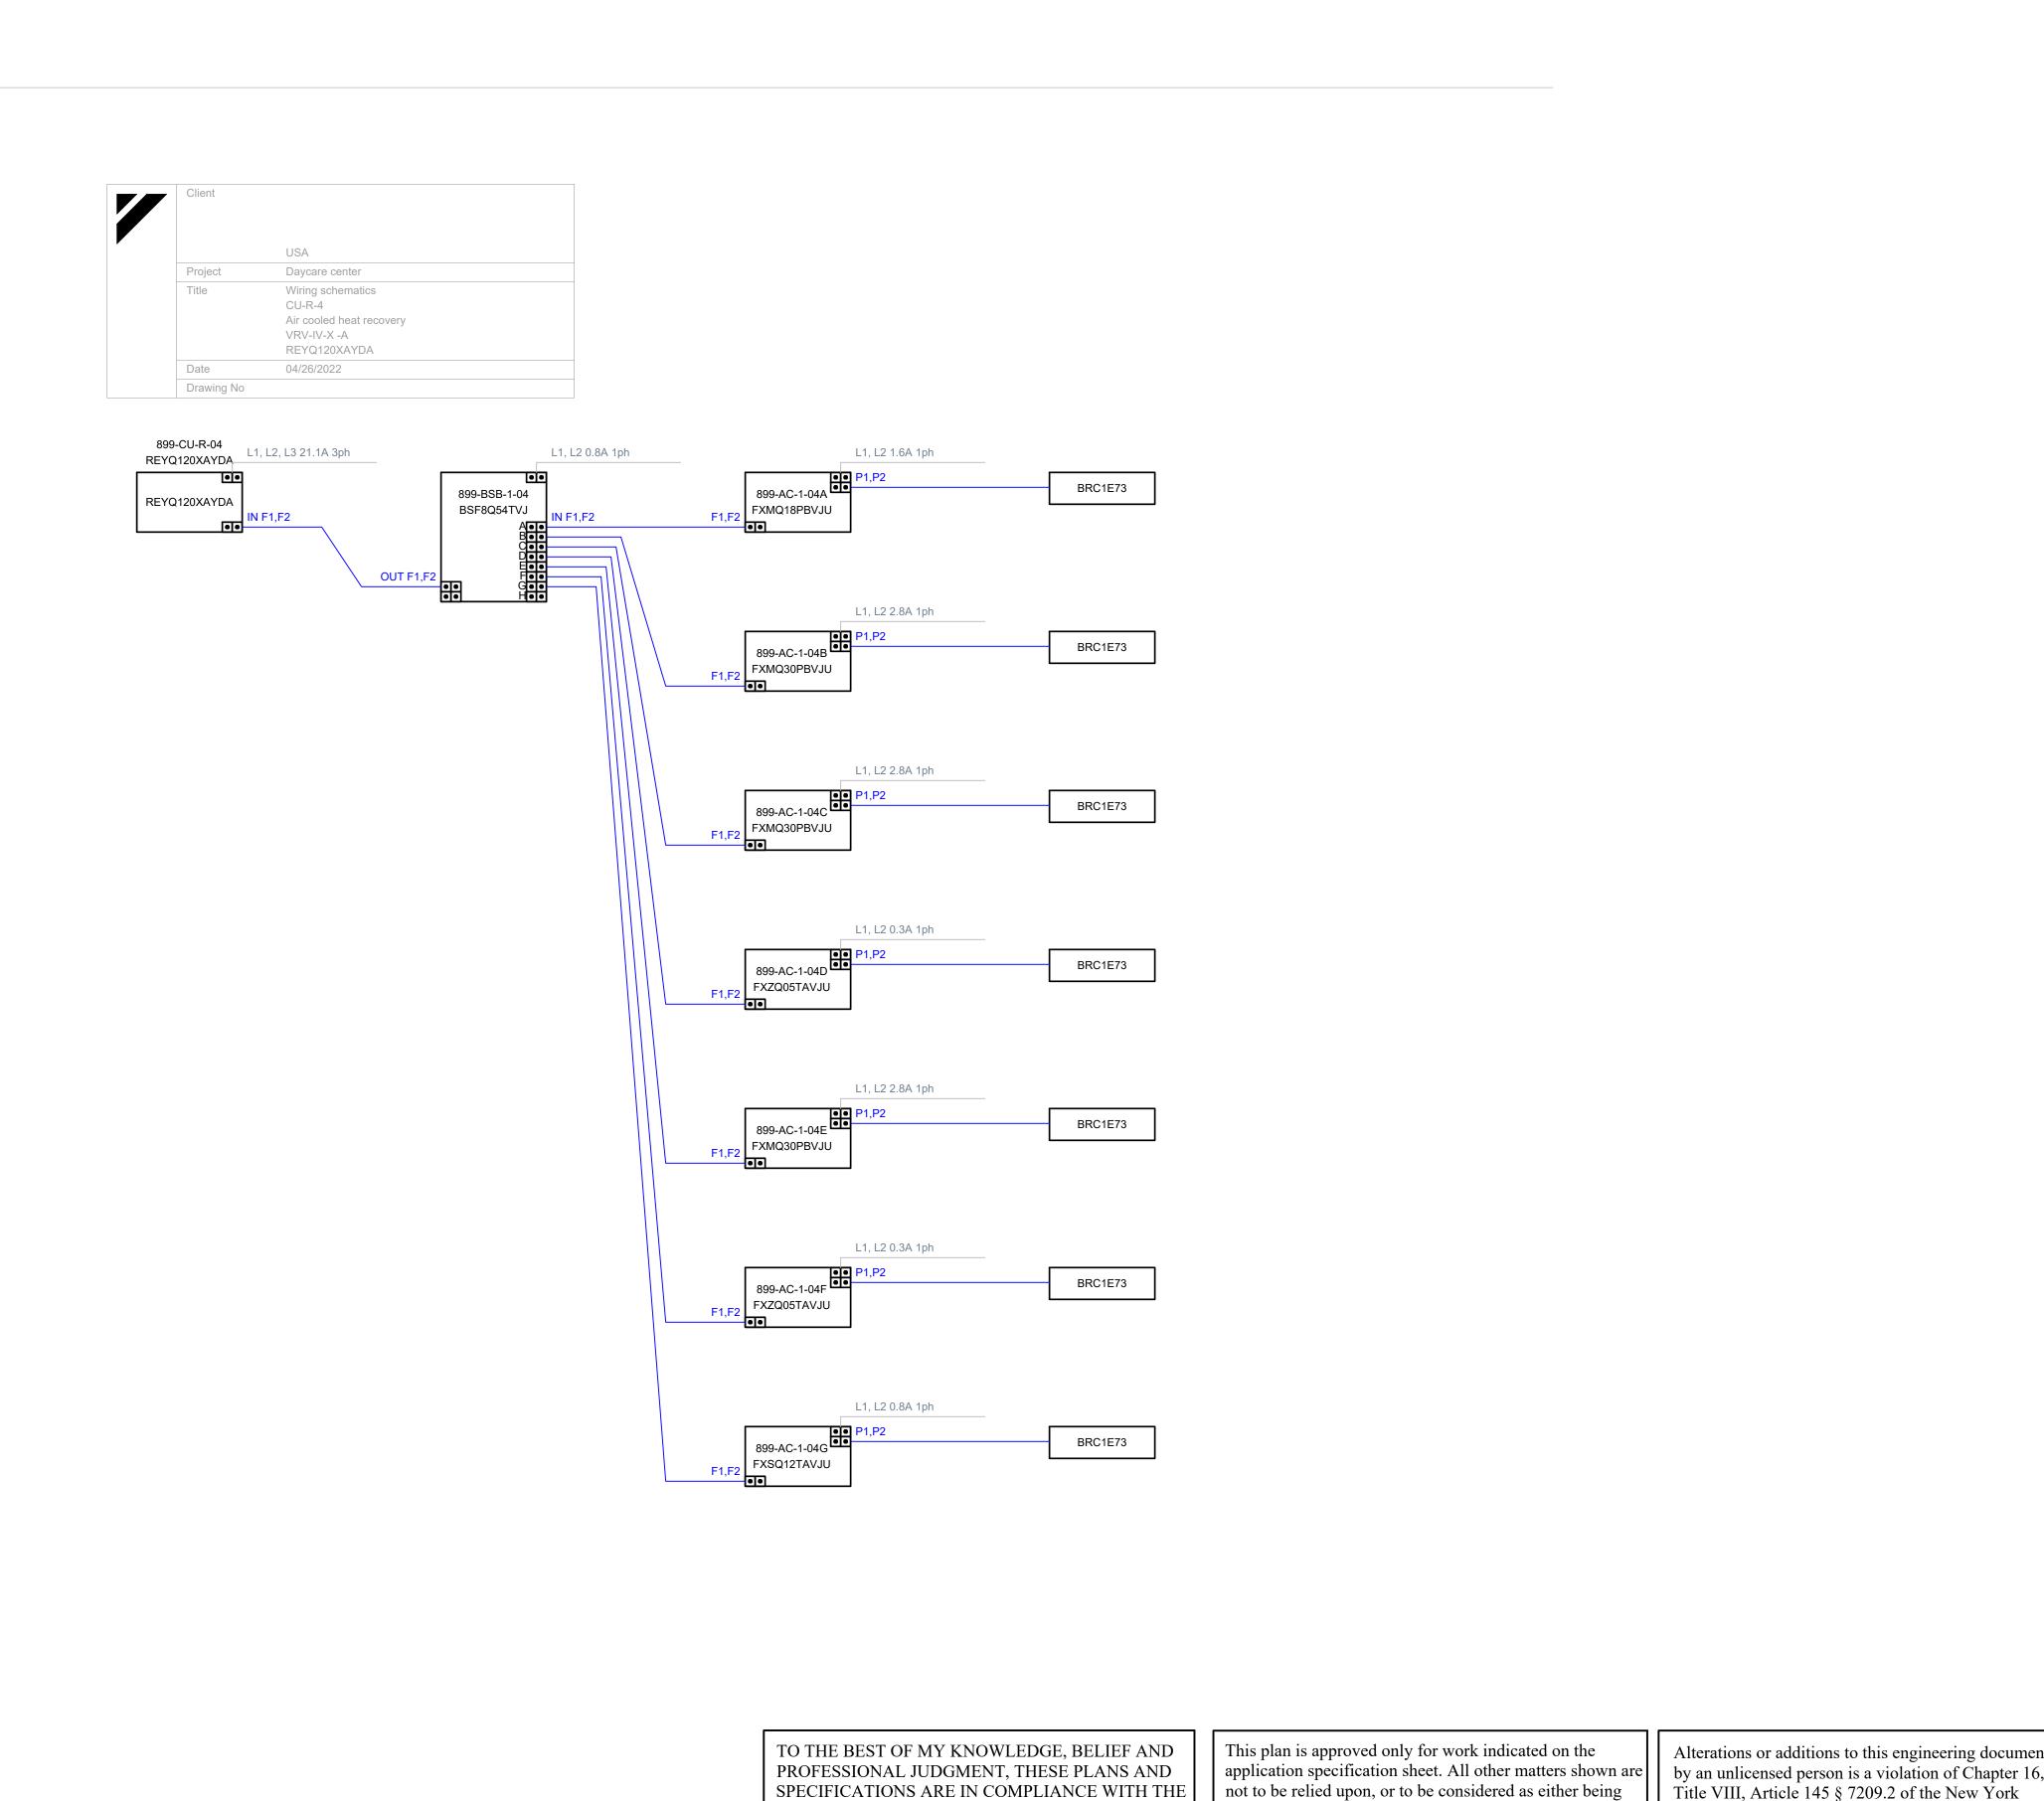
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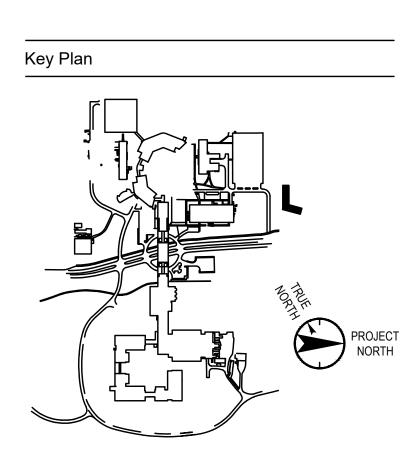
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Floor:

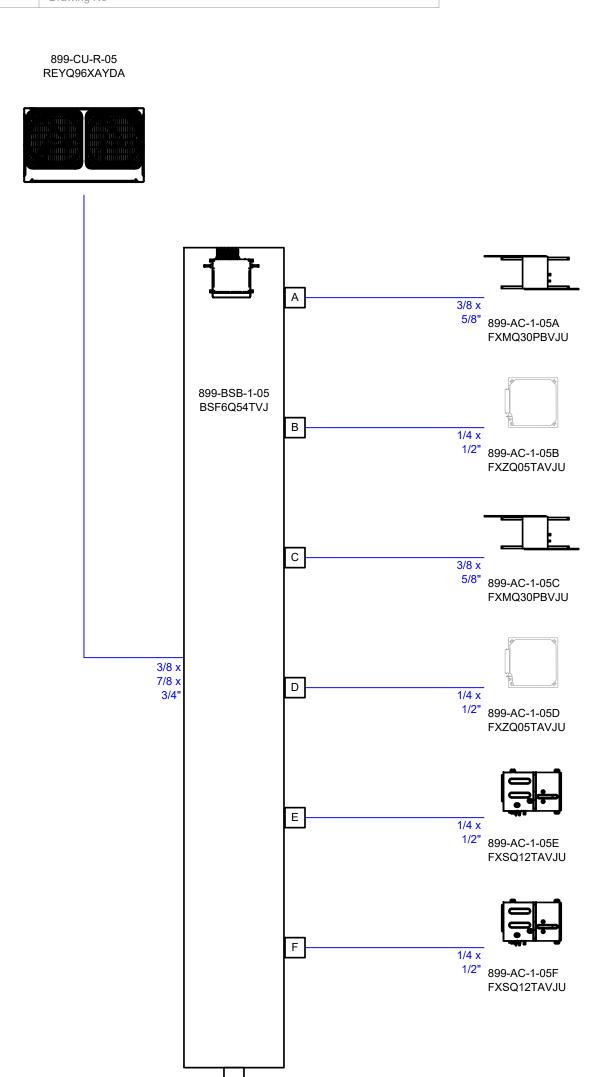
SHEET 2

Scale: NTS

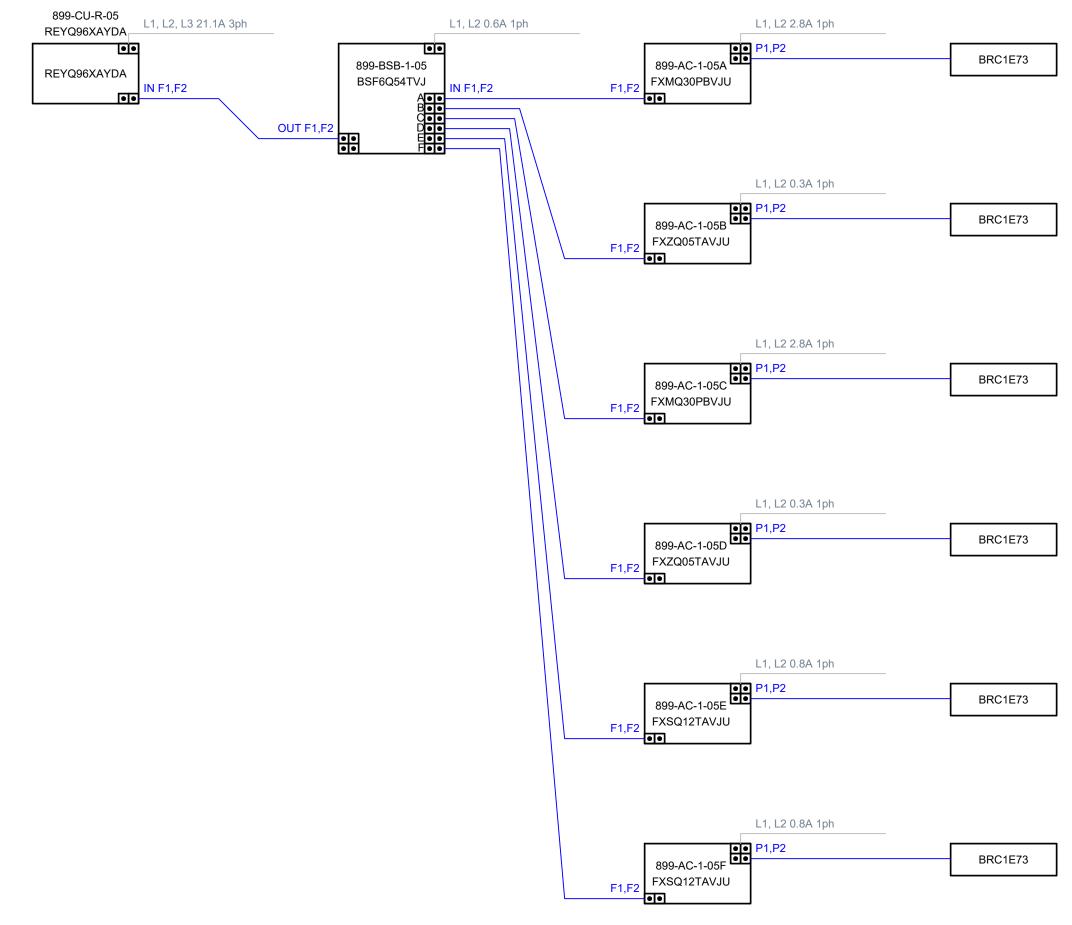
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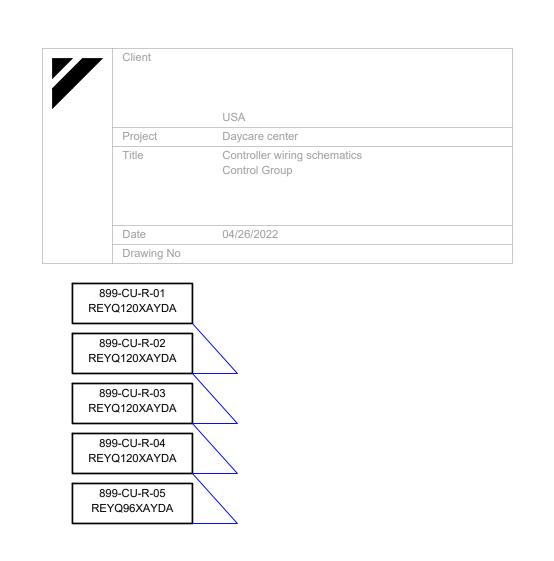
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NOTE: FINAL REFRIGERANT SIZE TO BE CONFIRMED BY CONTRACTOR AND MANUFACTURER



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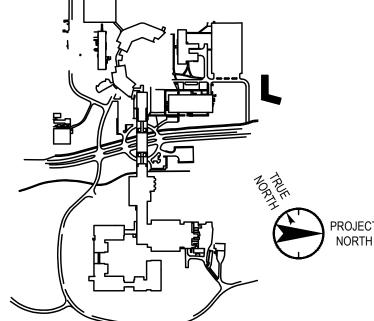
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MECHANICAL VRF DIAGRAM

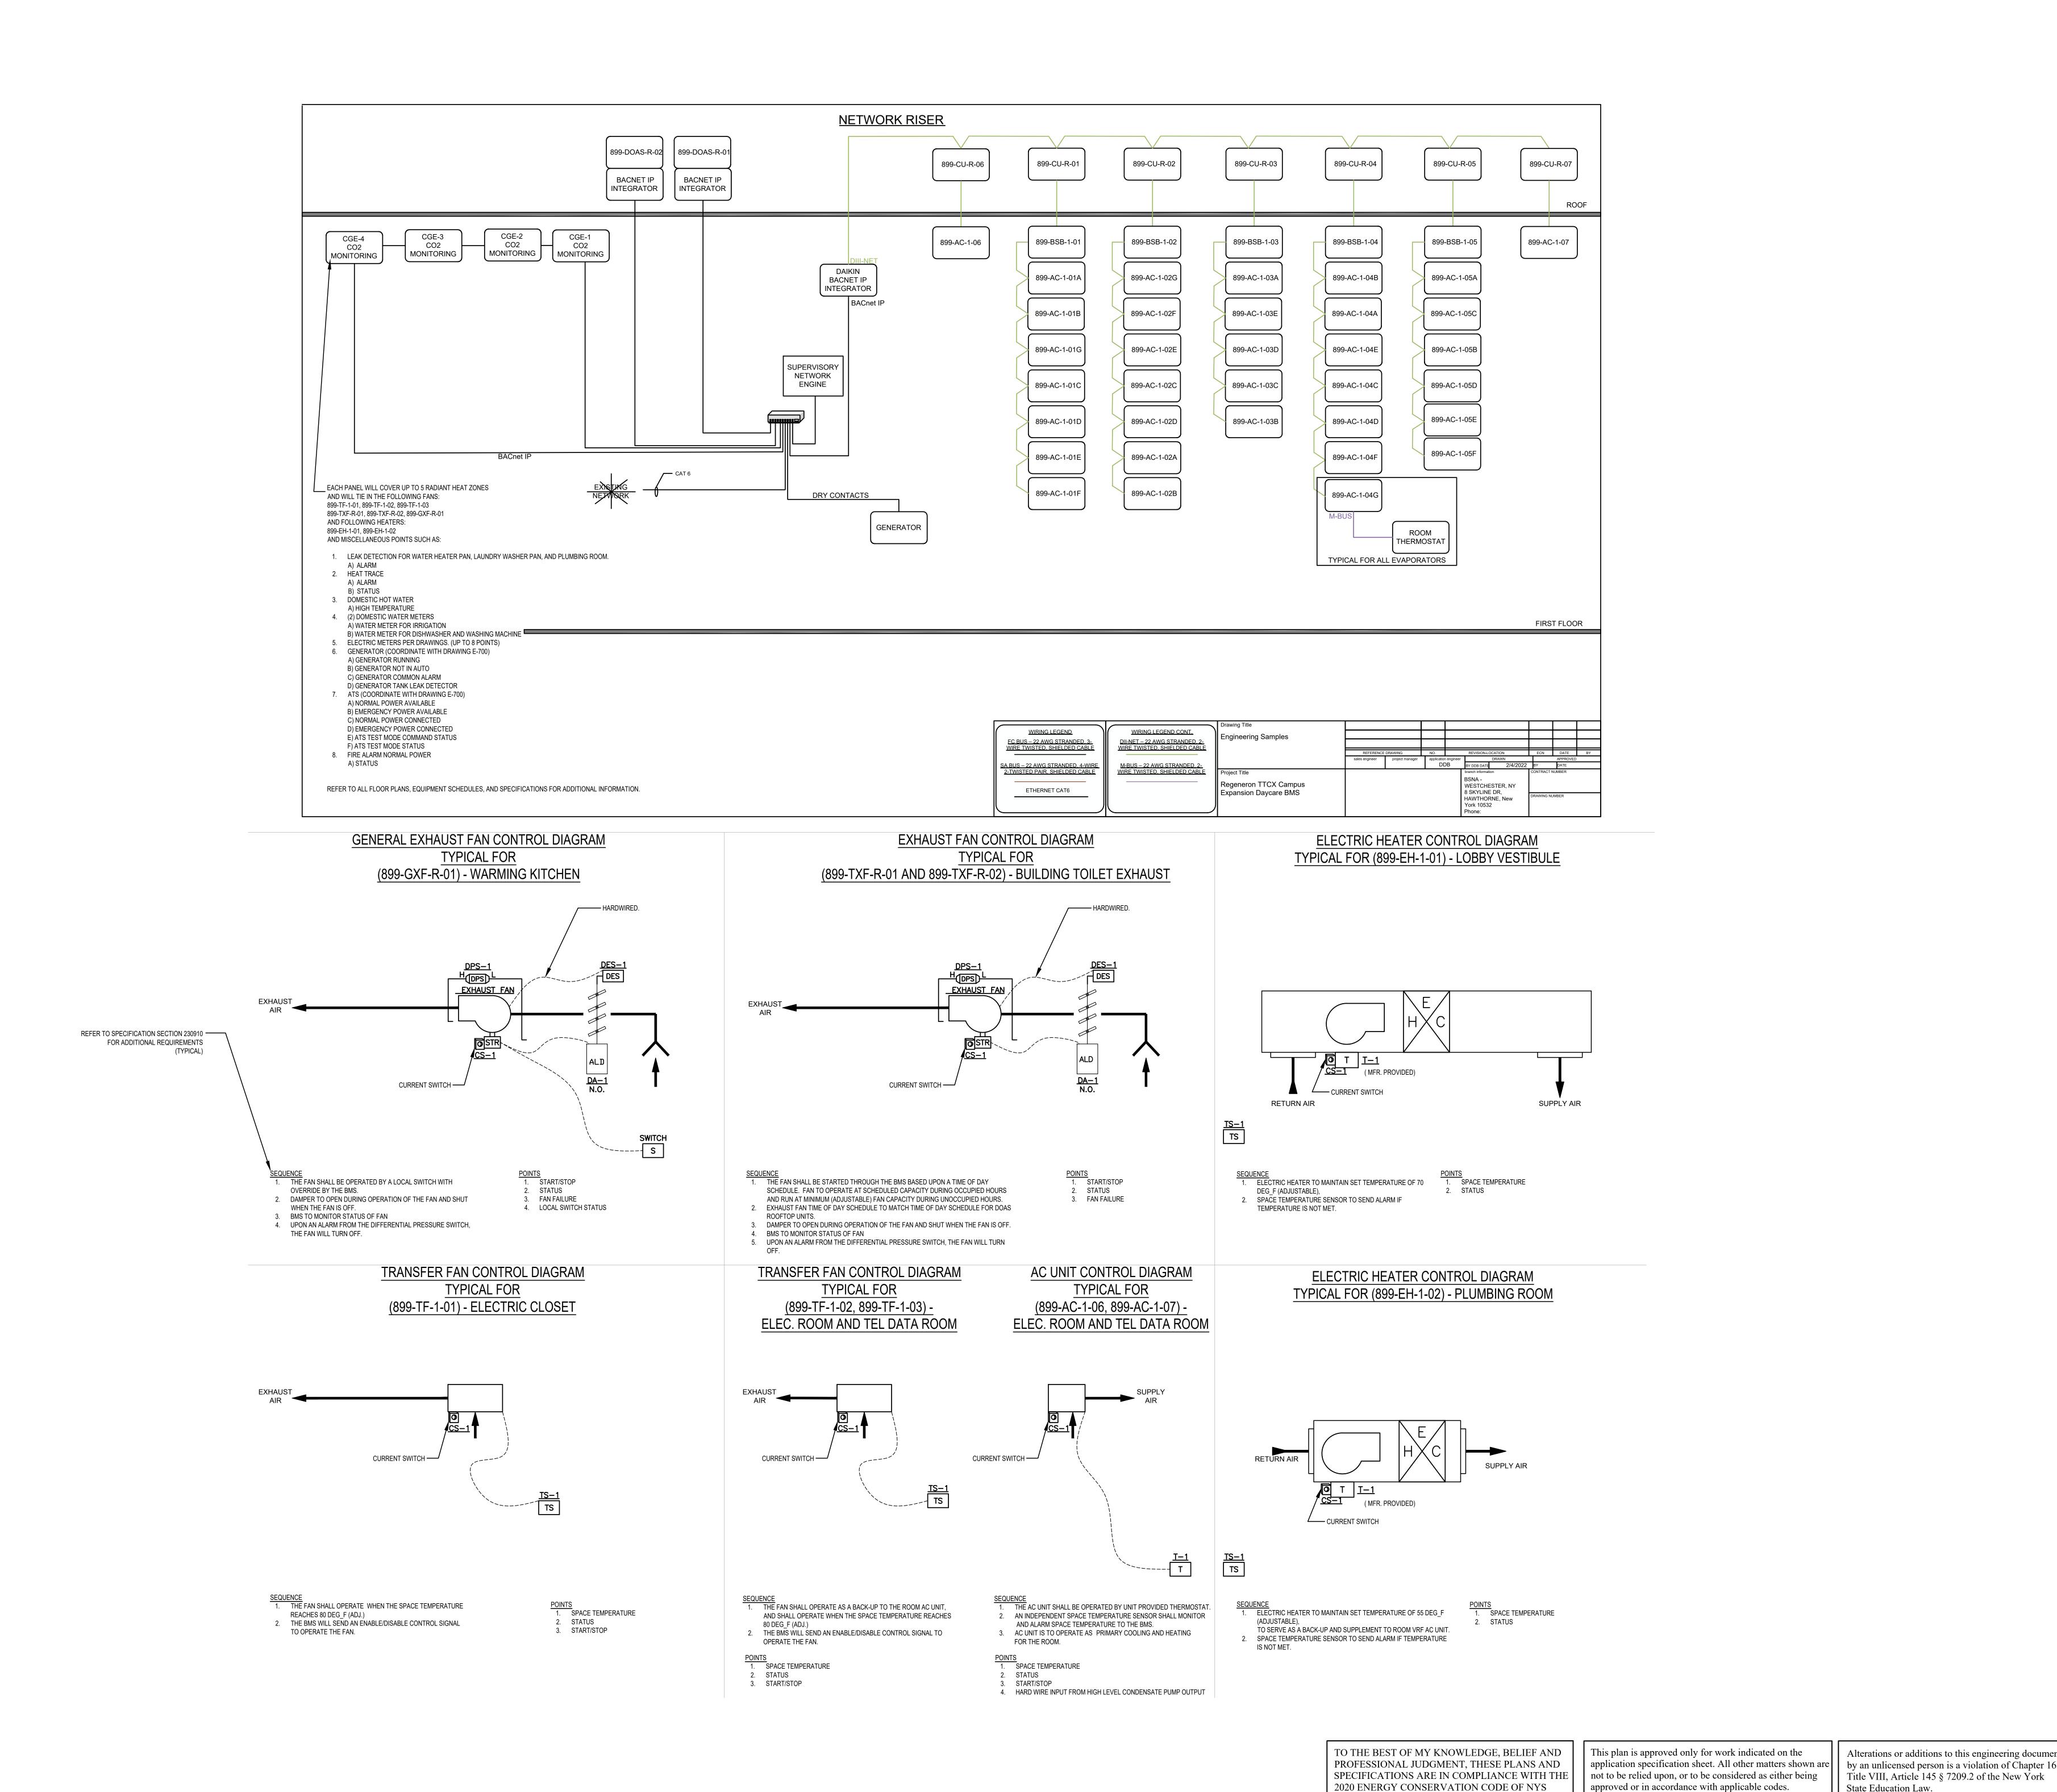
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Vendor Name: COSENTINI Vendor Project No.: 210104 Drawn By: MECHANICAL **CONTROL DIAGRAM** SHEET 1

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Discipline: Mechanical Drawn By: BC MECHANICAL CONTROL DIAGRAM SHEET 2

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