THE KEY OF SYMBOLS INDICATED IS FOR CONVENIENCE ONLINITION INDICATED ARE NOT NECESSARILY WITHIN THE SCOPE OF TH
SOIL OR WASTE PIPING (S) (W)
SOIL OR WASTE PIPING BELOW GROUND
LEADER (L) (LDR)
INDIRECT WASTE
VENT PIPING
EXISTING PIPING TO BE REMOVED
EXISTING PIPING TO REMAIN
COLD WATER PIPING (C.W.)
HOT WATER PIPING (H.W.)
HOT WATER CIRCULATING PIPING (H.W.C.)
GAS PIPING (G)
BALL VALVE BALANCING VALVE
GATE VALVE (G.V.)
LOCKSHIELD VALVE (GLOBE VALVE)
PLUG COCK
CHECK VALVE (C.V.)
HOSE BIBB (H.B.) SILL COCK (S.C.)
VACUUM BREAKER (V.B.)
PRESSURE RELIEF VALVE PRESS. & TEMP. RELIEF VALVE
PRESSURE REGULATING VALVE
STRAINER
"P" TRAP FOR LAV., SINK, ETC.
CLEANOUT DECK PLATE (C.O.D.P.)
SHOCK ABSORBER
ANCHOR
GUIDE PRESSURE GAUGE
THERMOMETER
TEMPERATURE REGULATOR
WALL HYDRANT (W.H.)
YARD HYDRANT (Y.H.) (D.H.)
PIPING COVERED WITH ELECTRIC HEAT TRACING CABLE AND INSULATION
PIPING COVERED WITH ELECTRIC HEAT

		PLUMBING INSTALLATION CRITERIA
and items		EACH BIDDER SHALL VISIT THE SITE AND BECOME INFORMED AS TO THE CONDITION OF THE PREMISES AND THE EXTENT AND CHARACTER OF WORK REQUIRED NO ADDITIONAL COMPENSATION WILL BE APPROVED DUE
WORK.		WORK REQUIRED, NO ADDITIONAL COMPENSATION WILL BE APPROVED DUE TO FIELD CONDITIONS,
A.B.D.	AUTOMATIC BALL DRIP	1. PROVIDE ROUGH-IN AND FINAL CONNECTIONS FOR ALL PLUMBING FIXTURES INCLUDING WASTE, VENTS, HOT AND COLD WATER, AND PROVIDE ALL PLUMBING WORK NECESSARY TO MAKE THE PANTRY,
A.D.	ACCESS DOOR	ELECTRIC WATER COOLER(S) BATH, ETC. ENTIRELY OPERABLE AND ACCEPTABLE TO LOCAL HEALTH AND BUILDING OFFICIALS.
A. DR.	AREA DRAIN	2. PLUMBING CONTRACTOR SHALL LOCATE ALL PIPING AND PLUMBING Rough-in for plumbing fixtures in accordance with rough-in
B.T.	BATH TUB	DRAWINGS PROVIDED BY EQUIPMENT MANUFACTURERS.
C.D.	CANOPY DRAIN	3. ALL VISIBLY EXPOSED PIPE TO EQUIPMENT SHALL BE CHROME PLATED BRASS.
CLG.	CEILING	4, PROVIDE SHUT-OFF VALVES FOR EACH PLUMBING FIXTURE AND PIECE OF EQUIPMENT,
C.O.	CLEANOUT	5. PROVIDE TRAPS ON ALL WASTE PIPING FROM PLUMBING FIXTURES
C.O.D.P.	CLEAN OUT DECK PLATE	AND PIECE OF EQUIPMENT.
C.V.	CHECK VALVE	6. COORDINATE POSITION OF SLEEVES AND OPENINGS THROUGH FLOOR WITH THE GENERAL CONTRACTOR.
C.V.B.	CHECK VALVE BOX	7. PROVIDE VACUUM BREAKERS AND CHECK VALVES FOR THE PLUMBING FIXTURES WHERE AND WHEN REQUIRED BY CODE.
D.I.	DROP INLET	8. ALL PIPING AND EQUIPMENT SHALL BE SUBSTANTIALLY SUPPORTED
D.F.	DRINKING FOUNTAIN	FROM THE BUILDING STRUCTURE, HANGER AND SUPPORTS SHALL BE SPECIFICALLY APPROVED FOR USE IN PLUMBING SYSTEMS,
DN.	DOWN	A. WHERE OVERHEAD CONSTRUCTION DOES NOT PERMIT FASTENING OF HANGER RODS IN REQUIRED LOCATIONS, PROVIDE ADDITIONAL STEEL
EL.	ELEVATION	FRAMING AS REQUIRED AND APPROVED.
E.W.C.	ELECTRIC WATER	B, NO PLUMBING PIPING SHALL BE HUNG FROM THE PIPING OF OTHER TRADES OR DUCTWORK, HANGERS SHALL BE OF HEAVY
	COOLER	CONSTRUCTION, SUITABLE FOR THE SIZE OF PIPE TO BE SUPPORTED. 9. PLUMBING FIXTURES TO BE APPROVED BY THE GENERAL CONTRACTOR
F.A.I.	FRESH AIR INLET	AND INSTALLED BY THE PLUMBING CONTRACTOR, 10, PLUMBING FIXTURES SHALL BE AS SPECIFIED BY ARCHITECT.
F.D. FL. DR.	FLOOR DRAIN	10. ALL PLUMBING FIXTURES SPECIFIED BY THE ARCHITECT. SEE
F.F.D.	FUNNEL DRAIN	ARCHITECTURAL DRAWINGS, SPECIFICATIONS, DETAILS AND ELEVATIONS OF THE PANTRY, BATH, ETC. FOR REQUIRED PLUMBING CONNECTIONS.
FL.	FLOOR	(11. ALL VENT AND BRANCH PIPES SHALL BE GRADED AND CONNECTED AS
F.O.	FLOOR OUTLET	<pre>     TO DRAIN BACK TO THE DRAINAGE PIPE BY GRAVITY.     </pre>
F.U.	FIXTURE UNITS	
F.V.	FLUSH VALVE FLUSHOMETER	
G.V.	GATE VALVE	
H.C.	HUNG CEILING	
H.R.	HOSE RACK	308.5 Interval of Support         Pipe shall be supported in accordance with Table 308.5.
INV.	INVERT	Exception: The interval of support for piping systems designed to provide for expansion/contraction shall conform to the engineered design in accordance with Section 316.1. TABLE 308.5
LAV.	LAVATORY	HANGER SPACING PIPING MATERIAL HORIZONTAL VERTICAL
MH.	MANHOLE	Acrylonitrile butadiene styrene (ABS) pipe     4     10 <sup>b</sup>
M.S.	MOP SINK	Aluminum tubing     10     15       Brass pipe     10     10
N.I.C.	NOT IN CONTRACT	Cast-iron pipe     5 <sup>a</sup> 15       Chlorinated polyvinyl chloride (CPVC) pipe and tubing, 1 inch and smaller     3     10 <sup>b</sup>
0.S.&Y.	OUTSIDE SCREW & YOKE	Chlorinated polyvinyl chloride (CPVC) pipe and tubing, 1 <sup>1</sup> / <sub>4</sub> inches and larger 4 10 <sup>b</sup>
P.C.	PLUG COCK	Copper or copper-alloy pipe 12 10 Copper or copper-alloy tubing, 1 <sup>1</sup> /4-inch diameter and smaller 6 10
P.0.	PLUGGED OUTLET	Copper or copper-alloy tubing, 1 <sup>1</sup> /2-inch diameter and larger     10     10       Cross-linked polyethylene (PEX) pipe 1 inch and smaller     2.67 (32 inches)     10 <sup>b</sup>
R.P.B.	REDUCED PRESSURE	Cross-linked polyethylene (PEX) pipe 1 <sup>1</sup> /4 inch and larger 4 10 <sup>b</sup>
F.P.	BACKFLOW PREVENTER	Cross-linked polyethylene/aluminum/cross-linked polyethylene (PEX-AL-PEX) pipe     4       Lead pipe     Continuous     4
R.D.	ROOF DRAIN	Polyethylene/aluminum/polyethylene (PE-AL-PE) pipe     2.67 (32 inches)     4       Polyethylene/aluminum/polyethylene (PE-AL-PE) pipe     2.67     4
R.T.	RUNNING TRAP	Polyethylene of raised temperature (PE-RT) pipe 1 inch and smaller     10 <sup>b</sup> Polyethylene of raised temperature (PE-RT) pipe 1 <sup>1</sup> / <sub>4</sub> inch and larger     4
R.C.V.	RISER CONTROL	Polypropylene (PP) pipe or tubing 1 inch and smaller     2.67 (32 inches)     10 <sup>b</sup> Polypropylene (PP) pipe or tubing, 1 <sup>1</sup> /4 inches and larger     4     10 <sup>b</sup>
	VALVE	Polyvinyl chloride (PVC) pipe 4 10 <sup>b</sup>
S.P.O.	SOIL PLUGGED OUTLET	Stainless steel drainage systems     10     10 <sup>b</sup> Steel pipe     12     15
S.H.	SHOWER HEAD	For SI: 1 inch = 25.4 mm, 1 foot = 304.8 mm.
SH.— SHWR	SHOWER	a. The maximum horizontal spacing of cast-iron pipe hangers shall be increased to 10 feet where 10-foot lengths of pipe are installed. b. For sizes 2 inches and smaller, a guide shall be installed midway between required vertical supports. Such guides shall prevent pipe movement in a direction
SHWR. SK.	SINK	b. For sizes 2 incres and smaller, a guide shall be installed midway between required vertical supports. Such guides shall prevent pipe movement in a direction perpendicular to the axis of the pipe.
Sr.	SINK SERVICE SINK	
S.E.	SEWAGE EJECTOR	
T.D.	TERRACE DRAIN	
T.E.	TERRACE	
	ELEVATION	
T.P.	TRAP PRIMER	
T.S.	TAMPER SWITCH	
UR.	URINAL	
U.O.S.W.	UNDER ANOTHER SECTION OF THE WORK	
VAL. O. V.O.	VALVED OUTLET	
V.T.R. V.P.O.	VENT THRU ROOF VENT PLUGGED OUTLET	
W.C.	WATER CLOSET	

## PLUMBING INSTALLATION CRITERIA CH BIDDER SHALL VISIT THE SITE AND BECOME INFORMED AS TO THE NDITION OF THE PREMISES AND THE EXTENT AND CHARACTER OF RK REQUIRED, NO ADDITIONAL COMPENSATION WILL BE APPROVED DUE FIELD CONDITIONS, PROVIDE ROUGH-IN AND FINAL CONNECTIONS FOR ALL PLUMBING FIXTURES INCLUDING WASTE, VENTS, HOT AND COLD WATER, AND PROVIDE ALL PLUMBING WORK NECESSARY TO MAKE THE PANTRY, ELECTRIC WATER COOLER(S) BATH, ETC. ENTIRELY OPERABLE AND ACCEPTABLE TO LOCAL HEALTH AND BUILDING OFFICIALS, PLUMBING CONTRACTOR SHALL LOCATE ALL PIPING AND PLUMBING ROUGH-IN FOR PLUMBING FIXTURES IN ACCORDANCE WITH ROUGH-IN DRAWINGS PROVIDED BY EQUIPMENT MANUFACTURERS. ALL VISIBLY EXPOSED PIPE TO EQUIPMENT SHALL BE CHROME PLATED BRASS, PROVIDE SHUT-OFF VALVES FOR EACH PLUMBING FIXTURE AND PIECE DF EQUIPMENT, PROVIDE TRAPS ON ALL WASTE PIPING FROM PLUMBING FIXTURES AND PIECE OF EQUIPMENT. COORDINATE POSITION OF SLEEVES AND OPENINGS THROUGH FLOOR WITH THE GENERAL CONTRACTOR. PROVIDE VACUUM BREAKERS AND CHECK VALVES FOR THE PLUMBING FIXTURES WHERE AND WHEN REQUIRED BY CODE. ALL PIPING AND EQUIPMENT SHALL BE SUBSTANTIALLY SUPPORTED FROM THE BUILDING STRUCTURE, HANGER AND SUPPORTS SHALL BE SPECIFICALLY APPROVED FOR USE IN PLUMBING SYSTEMS. WHERE OVERHEAD CONSTRUCTION DOES NOT PERMIT FASTENING OF HANGER RODS IN REQUIRED LOCATIONS, PROVIDE ADDITIONAL STEEL FRAMING AS REQUIRED AND APPROVED. NO PLUMBING PIPING SHALL BE HUNG FROM THE PIPING OF OTHER TRADES OR DUCTWORK, HANGERS SHALL BE OF HEAVY CONSTRUCTION, SUITABLE FOR THE SIZE OF PIPE TO BE SUPPORTED. PLUMBING FIXTURES TO BE APPROVED BY THE GENERAL CONTRACTOR AND INSTALLED BY THE PLUMBING CONTRACTOR, 10. PLUMBING FIXTURES SHALL BE AS SPECIFIED BY ARCHITECT. ALL PLUMBING FIXTURES SPECIFIED BY THE ARCHITECT, SEE ARCHITECTURAL DRAWINGS, SPECIFICATIONS, DETAILS AND ELEVATIONS OF THE PANTRY, BATH, ETC. FOR REQUIRED PLUMBING CONNECTIONS, ALL VENT AND BRANCH PIPES SHALL BE GRADED AND CONNECTED AS TO DRAIN BACK TO THE DRAINAGE PIPE BY GRAVITY.

HANGER SPACING		
PIPING MATERIAL	MAXIMUM HORIZONTAL SPACING (feet)	MAXIMUM VERTICAL SPACING (fe
Acrylonitrile butadiene styrene (ABS) pipe	4	10 <sup>b</sup>
Aluminum tubing	10	15
Brass pipe	10	10
Cast-iron pipe	5 <sup>a</sup>	15
Chlorinated polyvinyl chloride (CPVC) pipe and tubing, 1 inch and smaller	3	10 <sup>b</sup>
Chlorinated polyvinyl chloride (CPVC) pipe and tubing, $1^{1}\!/_{4}$ inches and larger	4	10 <sup>b</sup>
Copper or copper-alloy pipe	12	10
Copper or copper-alloy tubing, $1^{1}l_{4}$ -inch diameter and smaller	6	10
Copper or copper-alloy tubing, $1^1\!\ell_2$ inch diameter and larger	10	10
Cross-linked polyethylene (PEX) pipe 1 inch and smaller	2.67 (32 inches)	10 <sup>b</sup>
Cross-linked polyethylene (PEX) pipe $1^{1/4}$ inch and larger	4	10 <sup>b</sup>
Cross-linked polyethylene/aluminum/cross-linked polyethylene (PEX-AL-PEX) pipe	2.67 (32 inches)	4
Lead pipe	Continuous	4
Polyethylene/aluminum/polyethylene (PE-AL-PE) pipe	2.67 (32 inches)	4
Polyethylene of raised temperature (PE-RT) pipe 1 inch and smaller	2.67 (32 inches)	10 <sup>b</sup>
Polyethylene of raised temperature (PE-RT) pipe $1^{1}I_{4}$ inch and larger	4	10 <sup>b</sup>
Polypropylene (PP) pipe or tubing 1 inch and smaller	2.67 (32 inches)	10 <sup>b</sup>
Polypropylene (PP) pipe or tubing, 11/4 inches and larger	4	10 <sup>b</sup>
Polyvinyl chloride (PVC) pipe	4	10 <sup>b</sup>
Stainless steel drainage systems	10	10 <sup>b</sup>
Steel pipe	12	15

	DRAWING LIST	
SHEET	TITLE	SCALE
P-000	PLUMBING SYMBOLS, ABBREVIATIONS, NOTES AND	
F-000	DRAWING LIST	NTS
P-100	PLUMBING UNDERGROUND PLAN	1/8" = 1'-0"
P-101	PLUMBING 1ST FLOOR PLAN	1/8" = 1'-0"
P-102	PLUMBING ROOF PLAN	1/8" = 1'-0"
P-500	PLUMBING DETAILS	NTS
P-600	PLUMBING SCHEDULES	NTS
P-700	PLUMBING RISER DIAGRAMS	NTS

## BUILDING DEPARTMENT PLUMBING NOTES

THE PLUMBING SYSTEMS (SANITARY, WASTE, VENT, STORM, AND WATER DISTRIBUTION) AND ALL ASSOCIATED EQUIPMENT WILL BE INSTALLED AND MAINTAINED IN ACCORDANCE WITH THE FULL REQUIREMENTS OF THE PLUMBING CODE. COMPLIANCE WITH THE FULL PROVISIONS OF ALL BUILDING AND PLUMBING CODE ACCESSIBILITY REQUIREMENTS AND PLUMBING FIXTURE FLOW REQUIREMENTS OF THE PLUMBING CODE,

- THE SANITARY SYSTEM SHALL BE PROVIDED IN FULL ACCORDANCE WITH THE GENERAL PROVISIONS OF SECTION PC301.
- THE MATERIALS USED IN THE PLUMBING SYSTEMS WILL BE PROVIDED IN 2. FULL ACCORDANCE WITH SECTIONS PC302 AND PC303.
- 3. EQUIPMENT HOOK-UP AND THE JOINING WILL BE FULL COMPLIANCE WITH SECTIONS PC605 AND PC705.
- THE INSTALLATION OF FIXTURES WILL BE IN FULL ACCORDANCE WITH PC CHAPTER 4.
- 5. TRAPS FOR FIXTURES AND DRAIN LINES WILL BE PROVIDED AND CLEANOUTS INSTALLED IN FULL COMPLIANCE WITH SECTIONS PC412, PC708 AND PC CHAPTER 10.
- VERTICAL AND HORIZONTAL PIPING WILL BE HUNG AND SUPPORTED AS 6, DIRECTED IN SPECIFICATIONS AND WITH THE FULL COMPLIANCE WITH SECTION PC308,
- 7. THE WATER SUPPLY SYSTEMS OF THE SUBJECT BUILDING SHALL BE INSTALLED AND MAINTAINED IN FULL COMPLIANCE WITH PC CHAPTER 6.
- SHOCK ABSORBERS SHALL BE PROVIDED IN FULL COMPLIANCE WITH PC 604.9 WHERE ALL QUICK CLOSING VALVES ARE INSTALLED AND ALL EQUIPMENT CONTAINING QUICK CLOSING SOLENDID VALVES SUCH AS ICE MAKERS ,COFFE MACHINES , DISHWASHERS ,CLOTHES WASHERS, ELECTRONIC OPERATED FLUSH VALVES AND FAUCETS, AND SHOWER MIXING VALVES THAT HAVE A SINGLE LEVER HANDLE.
- THE SANITARY DRAINAGE SYSTEM WILL BE SIZED AND INSTALLED IN FULL COMPLIANCE WITH PC CHAPTER 7.
- THE VENT PIPING FOR THE SANITARY DRAINAGE SYSTEM OF THE SUBJECT 10, BUILDING WILL BE INSTALLED IN FULL COMPLIANCE WITH SECTION PC702 & PC CHAPTER 9.
- 11. THE STORM DRAINAGE SYSTEM AND PIPING WILL BE INSTALLED IN FULL COMPLIANCE WITH PC CHAPTER 11.
- 12. ALL TRENCHING SHALL BE DONE IN ACCORDANCE WITH THE REQUIREMENTS OF SECTION PC306. 13. RAT PROOFING SHALL BE IN ACCORDANCE WITH SECTION PC304.
- 14. TEMPORARY TOILET FACILITIES SHALL BE PROVIDED FOR CONSTRUCTION PERSONNEL AS PER SECTION PC311.

REGENERON REAL ESTATE &

FACILITIES MANAGEMENT

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Building #17 Campus Expansion Child Day-care Center

899 Old Saw Mill River Road Mount Pleasant, NY 10591 Project No. B17-DAYCARE

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Thornton Tomasetti 120 Broadway, 15th Floor New York, NY 10271 (917) 661-7800 Phone (917) 661-7801 Fax

Structural Engineer

MEP / IT / Security Engineer

Cosentini Associates 498 Seventh Avenue New York, NY 10018 (212) 615-3600 Phone (212) 615-3700 Fax


Civil Engineer JMC

120 Bedford Road Armonk, NY 10504 (914) 273-5225 Phone (914) 273-2102 Fax

Landscape Architect

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Key Plan

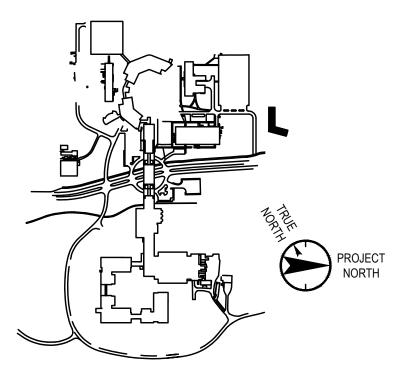

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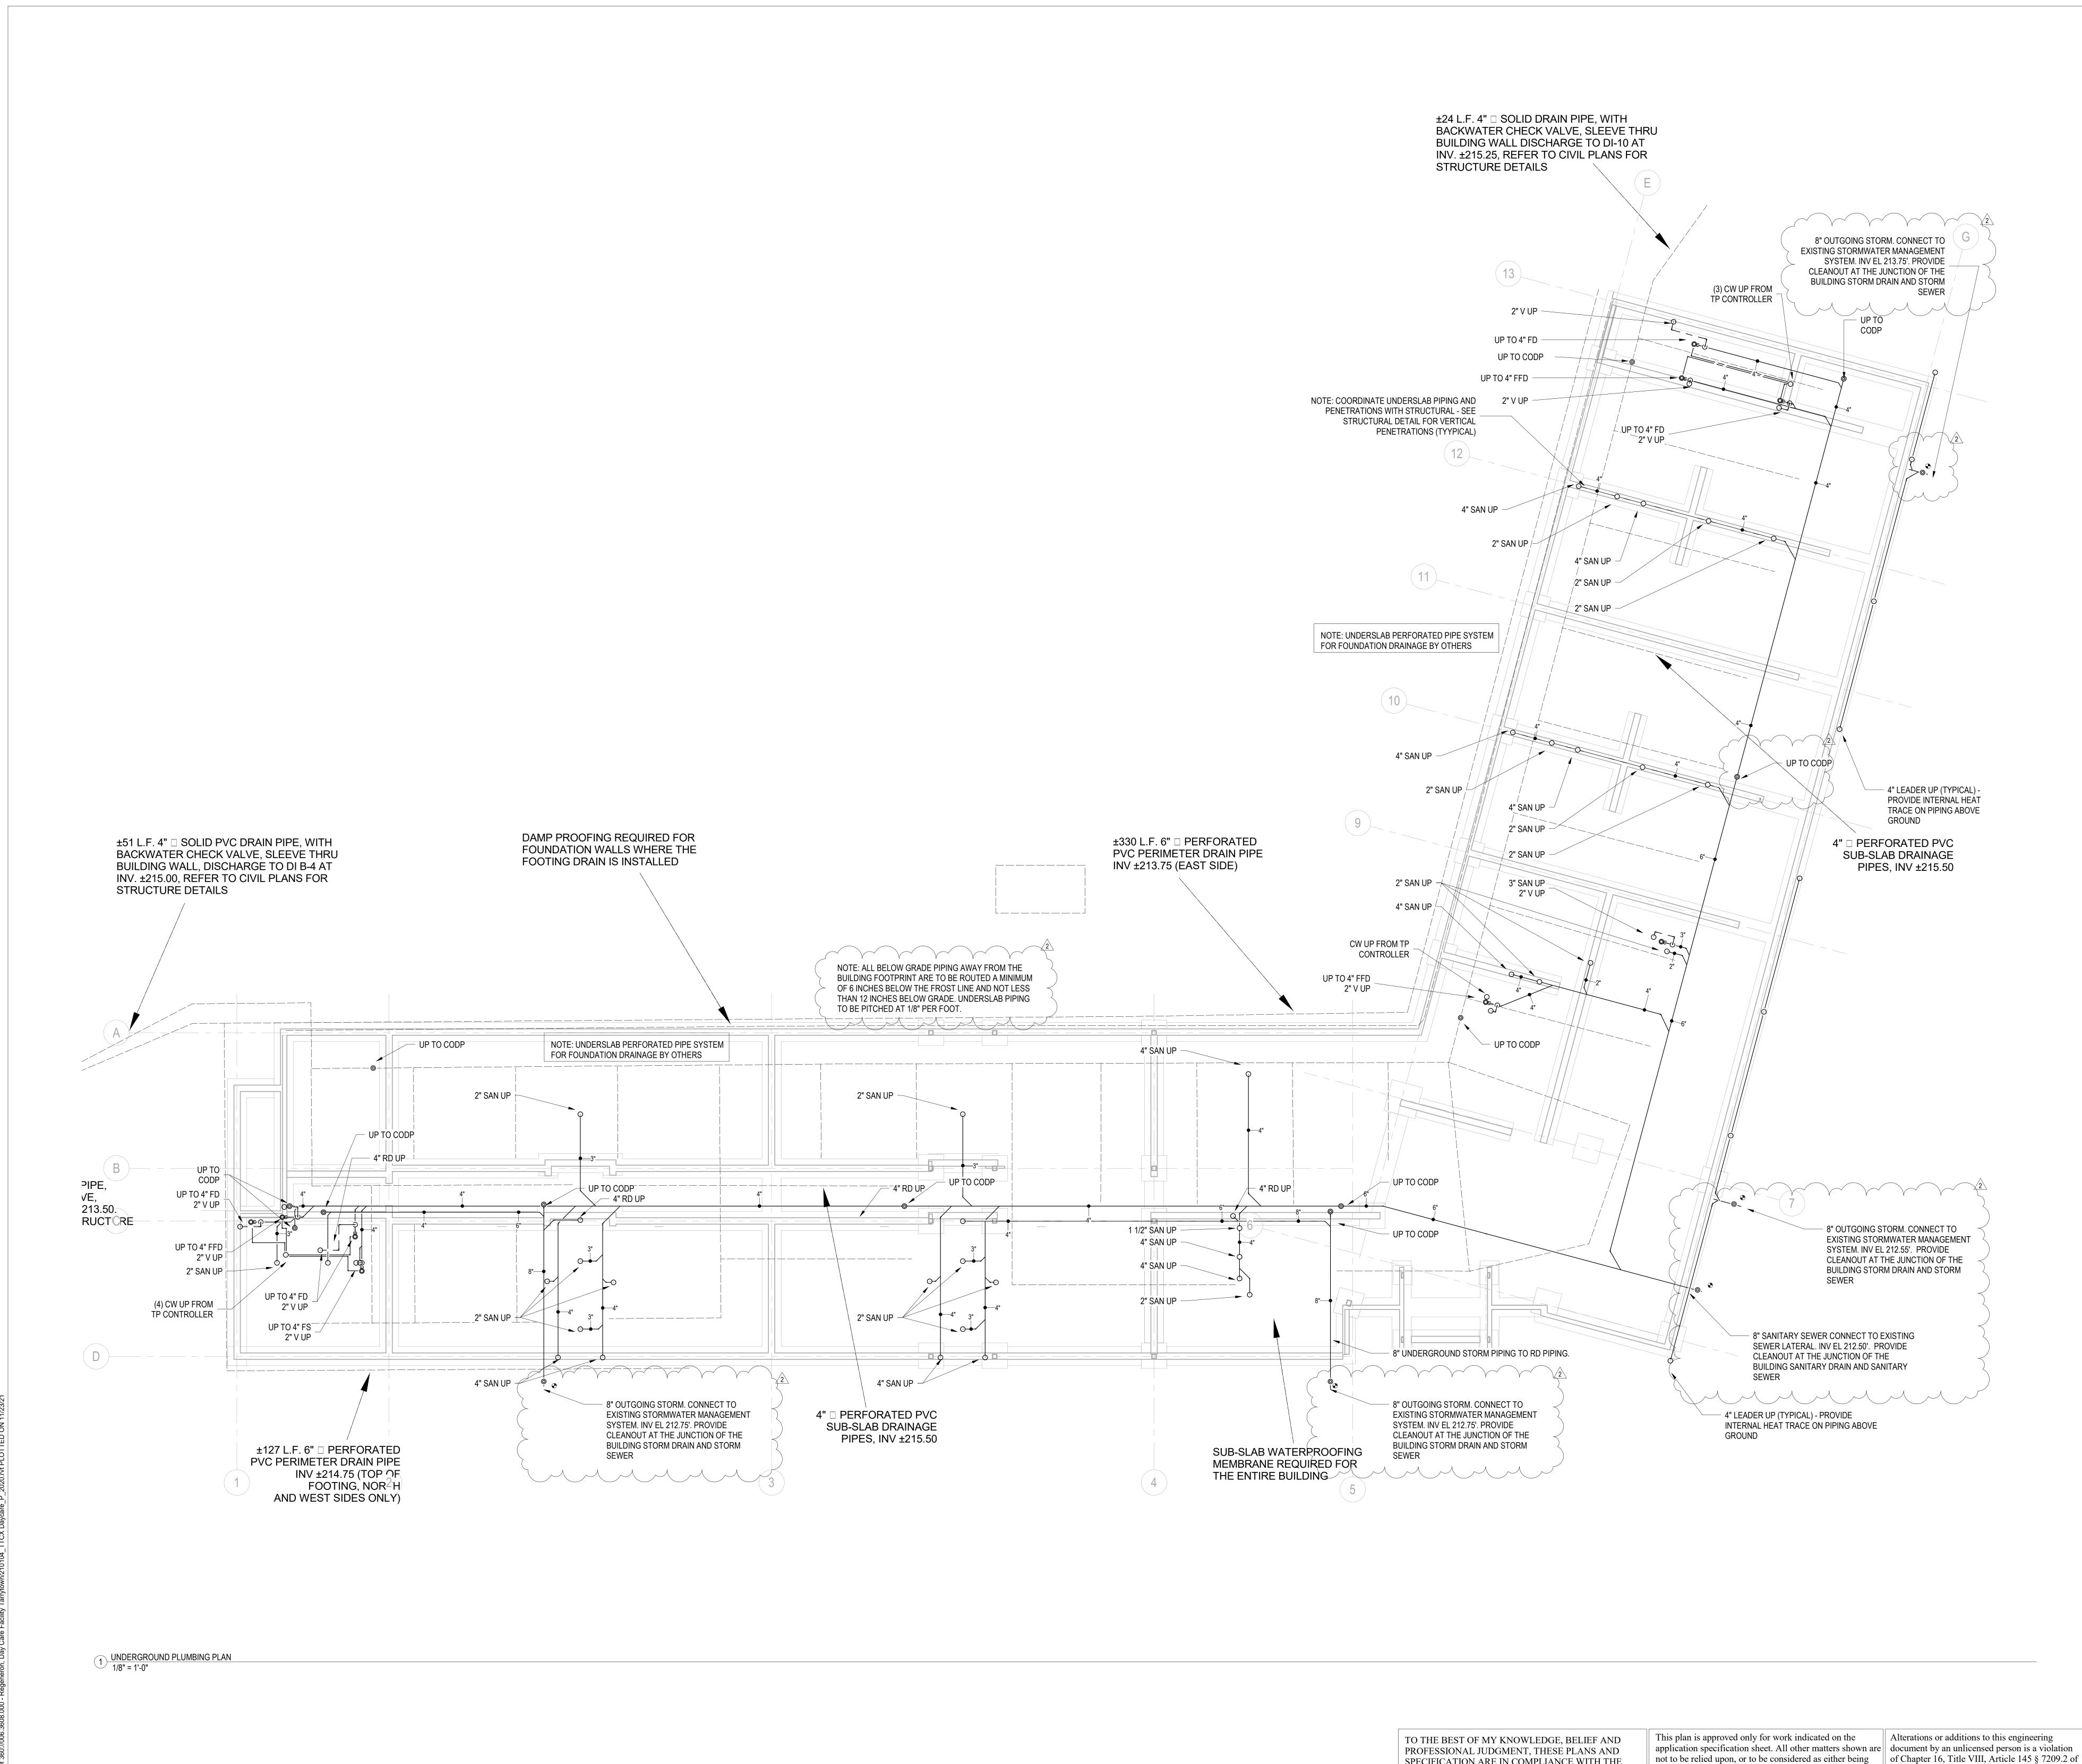
Professional Seal and Signature

Vendor Name: COSENTIN Vendor Project No.: Drawn By:DH Discipline: Plumbing

PLUMBING SYMBOLS, ABBREVIATIONS AND DRAWING LIST

Scale: NTS

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SPECIFICATION ARE IN COMPLIANCE WITH THE 2020 ENERGY CONSERVATION CODE OF NYS

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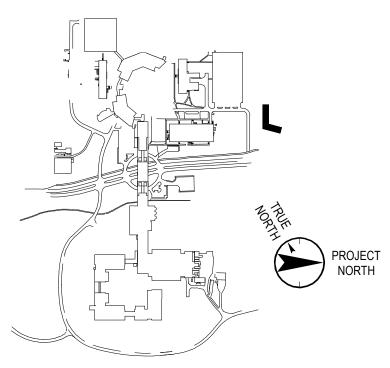
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Professional Seal and Signature

Vendor Name: COSENTINI Vendor Project No.: 210104

PLUMBING UNDERGROUND

Discipline: Plumbing


Drawn By: DH

Scale: 1/8" = 1'-0" Floor: UNDERSLAB


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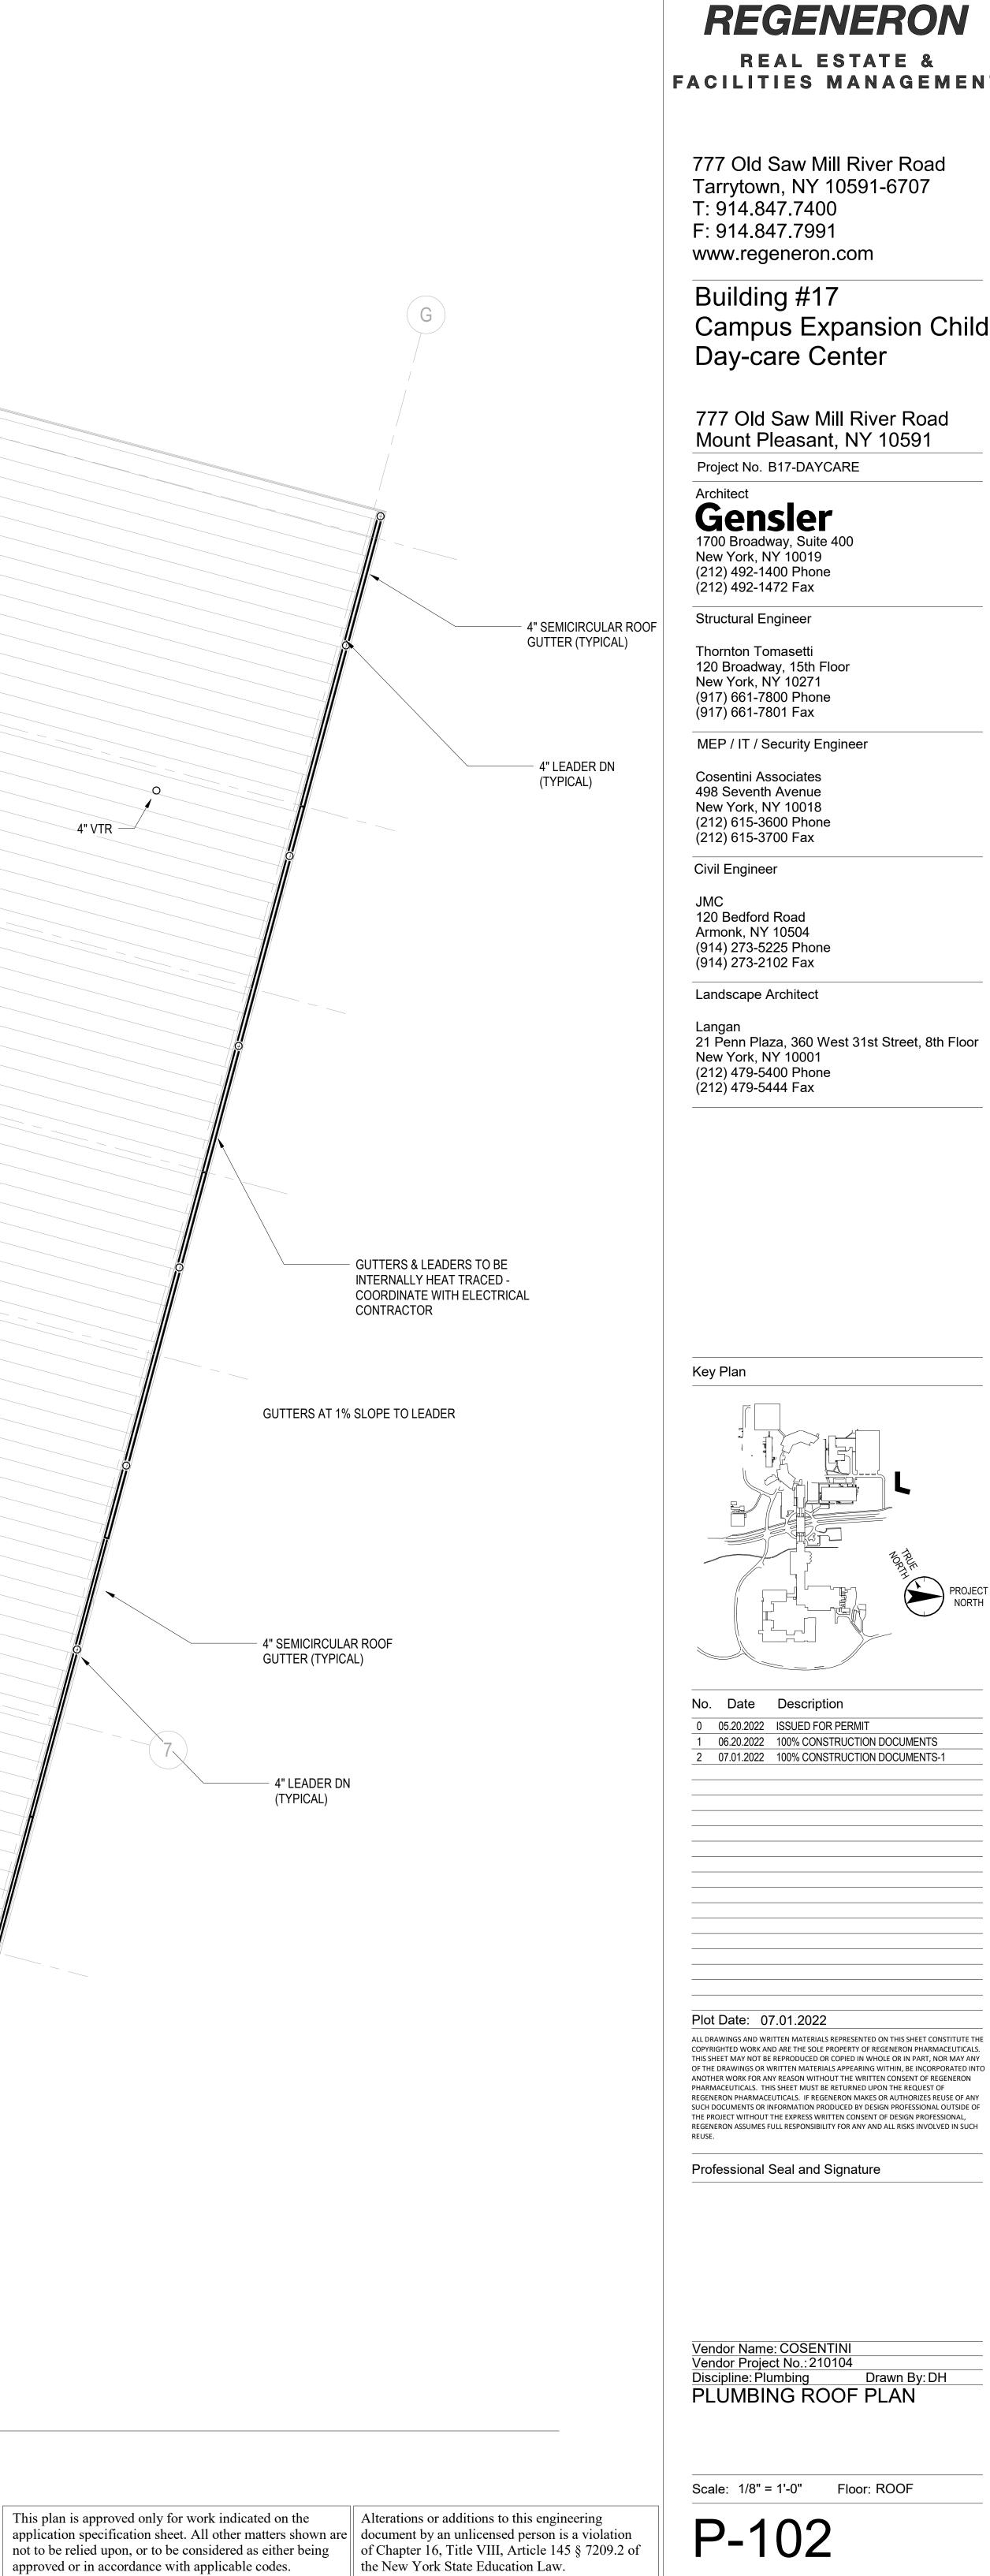
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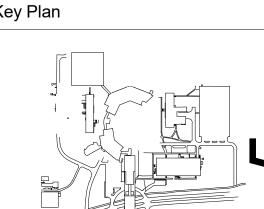
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PROJECT NORTH

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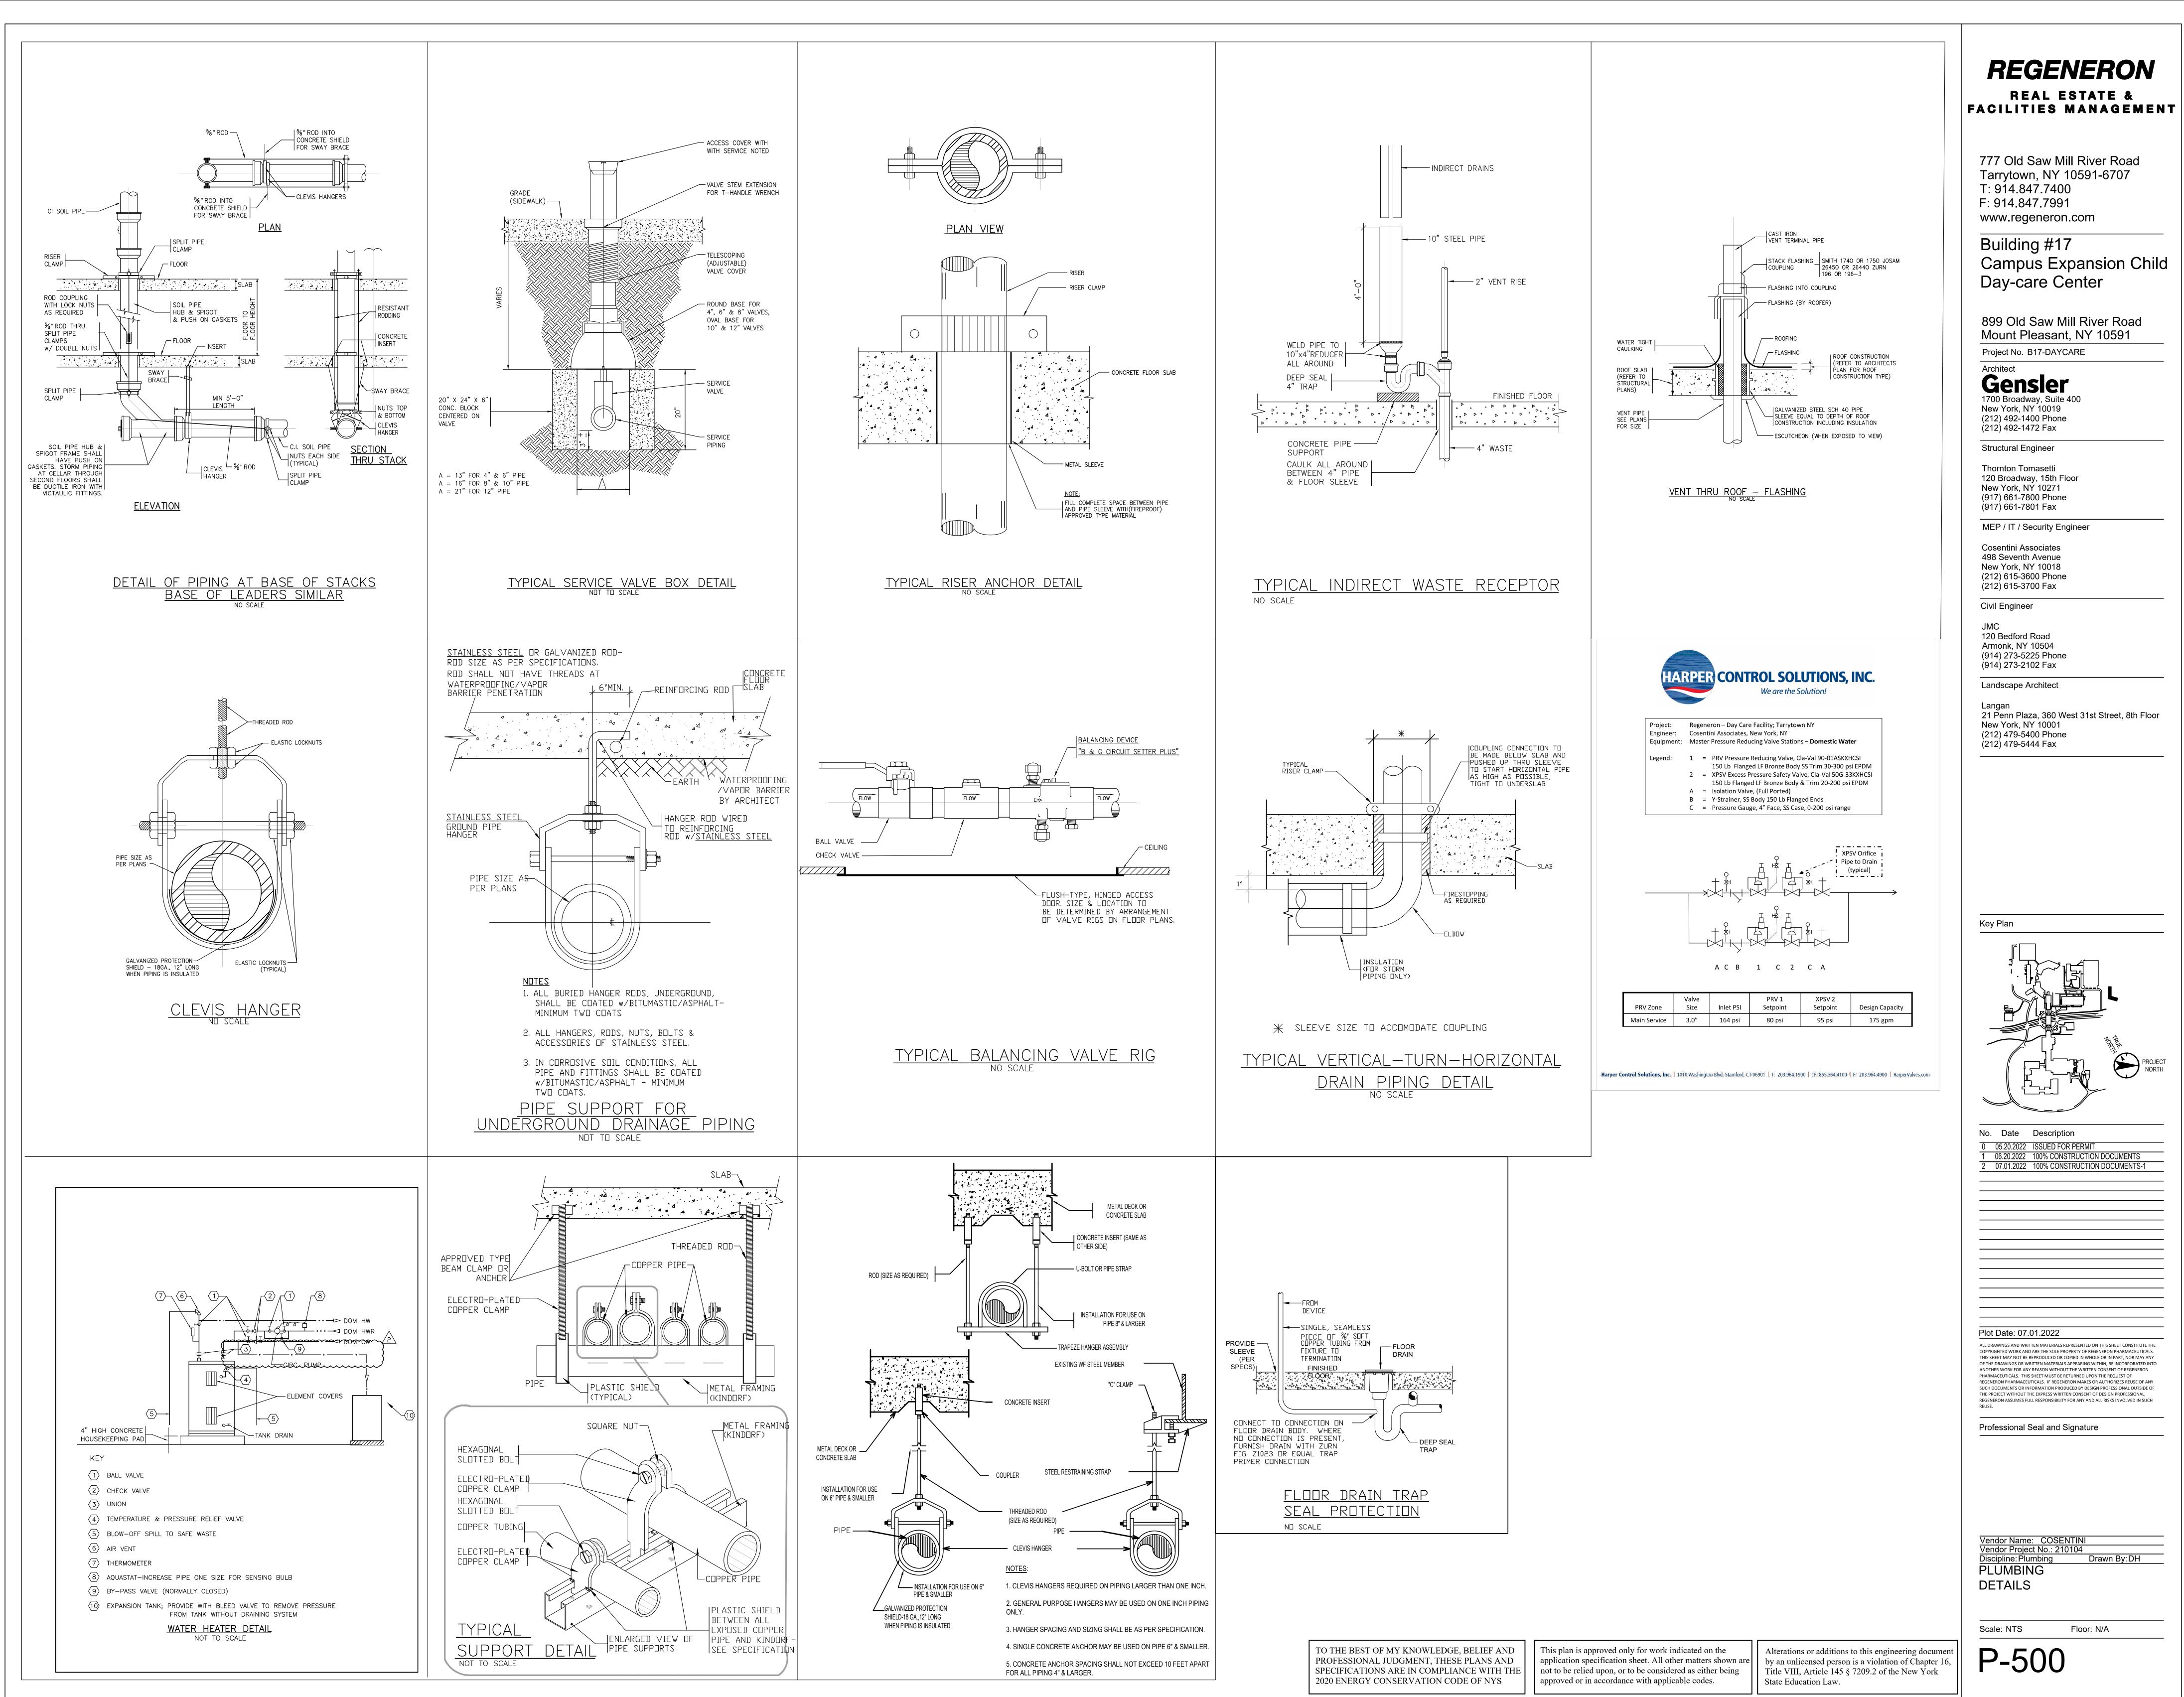
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Professional Seal and Signature

Vendor Name: COSENTINI Vendor Project No.: 210104 Discipline: Plumbing Drawn By: DH PLUMBING ROOF PLAN

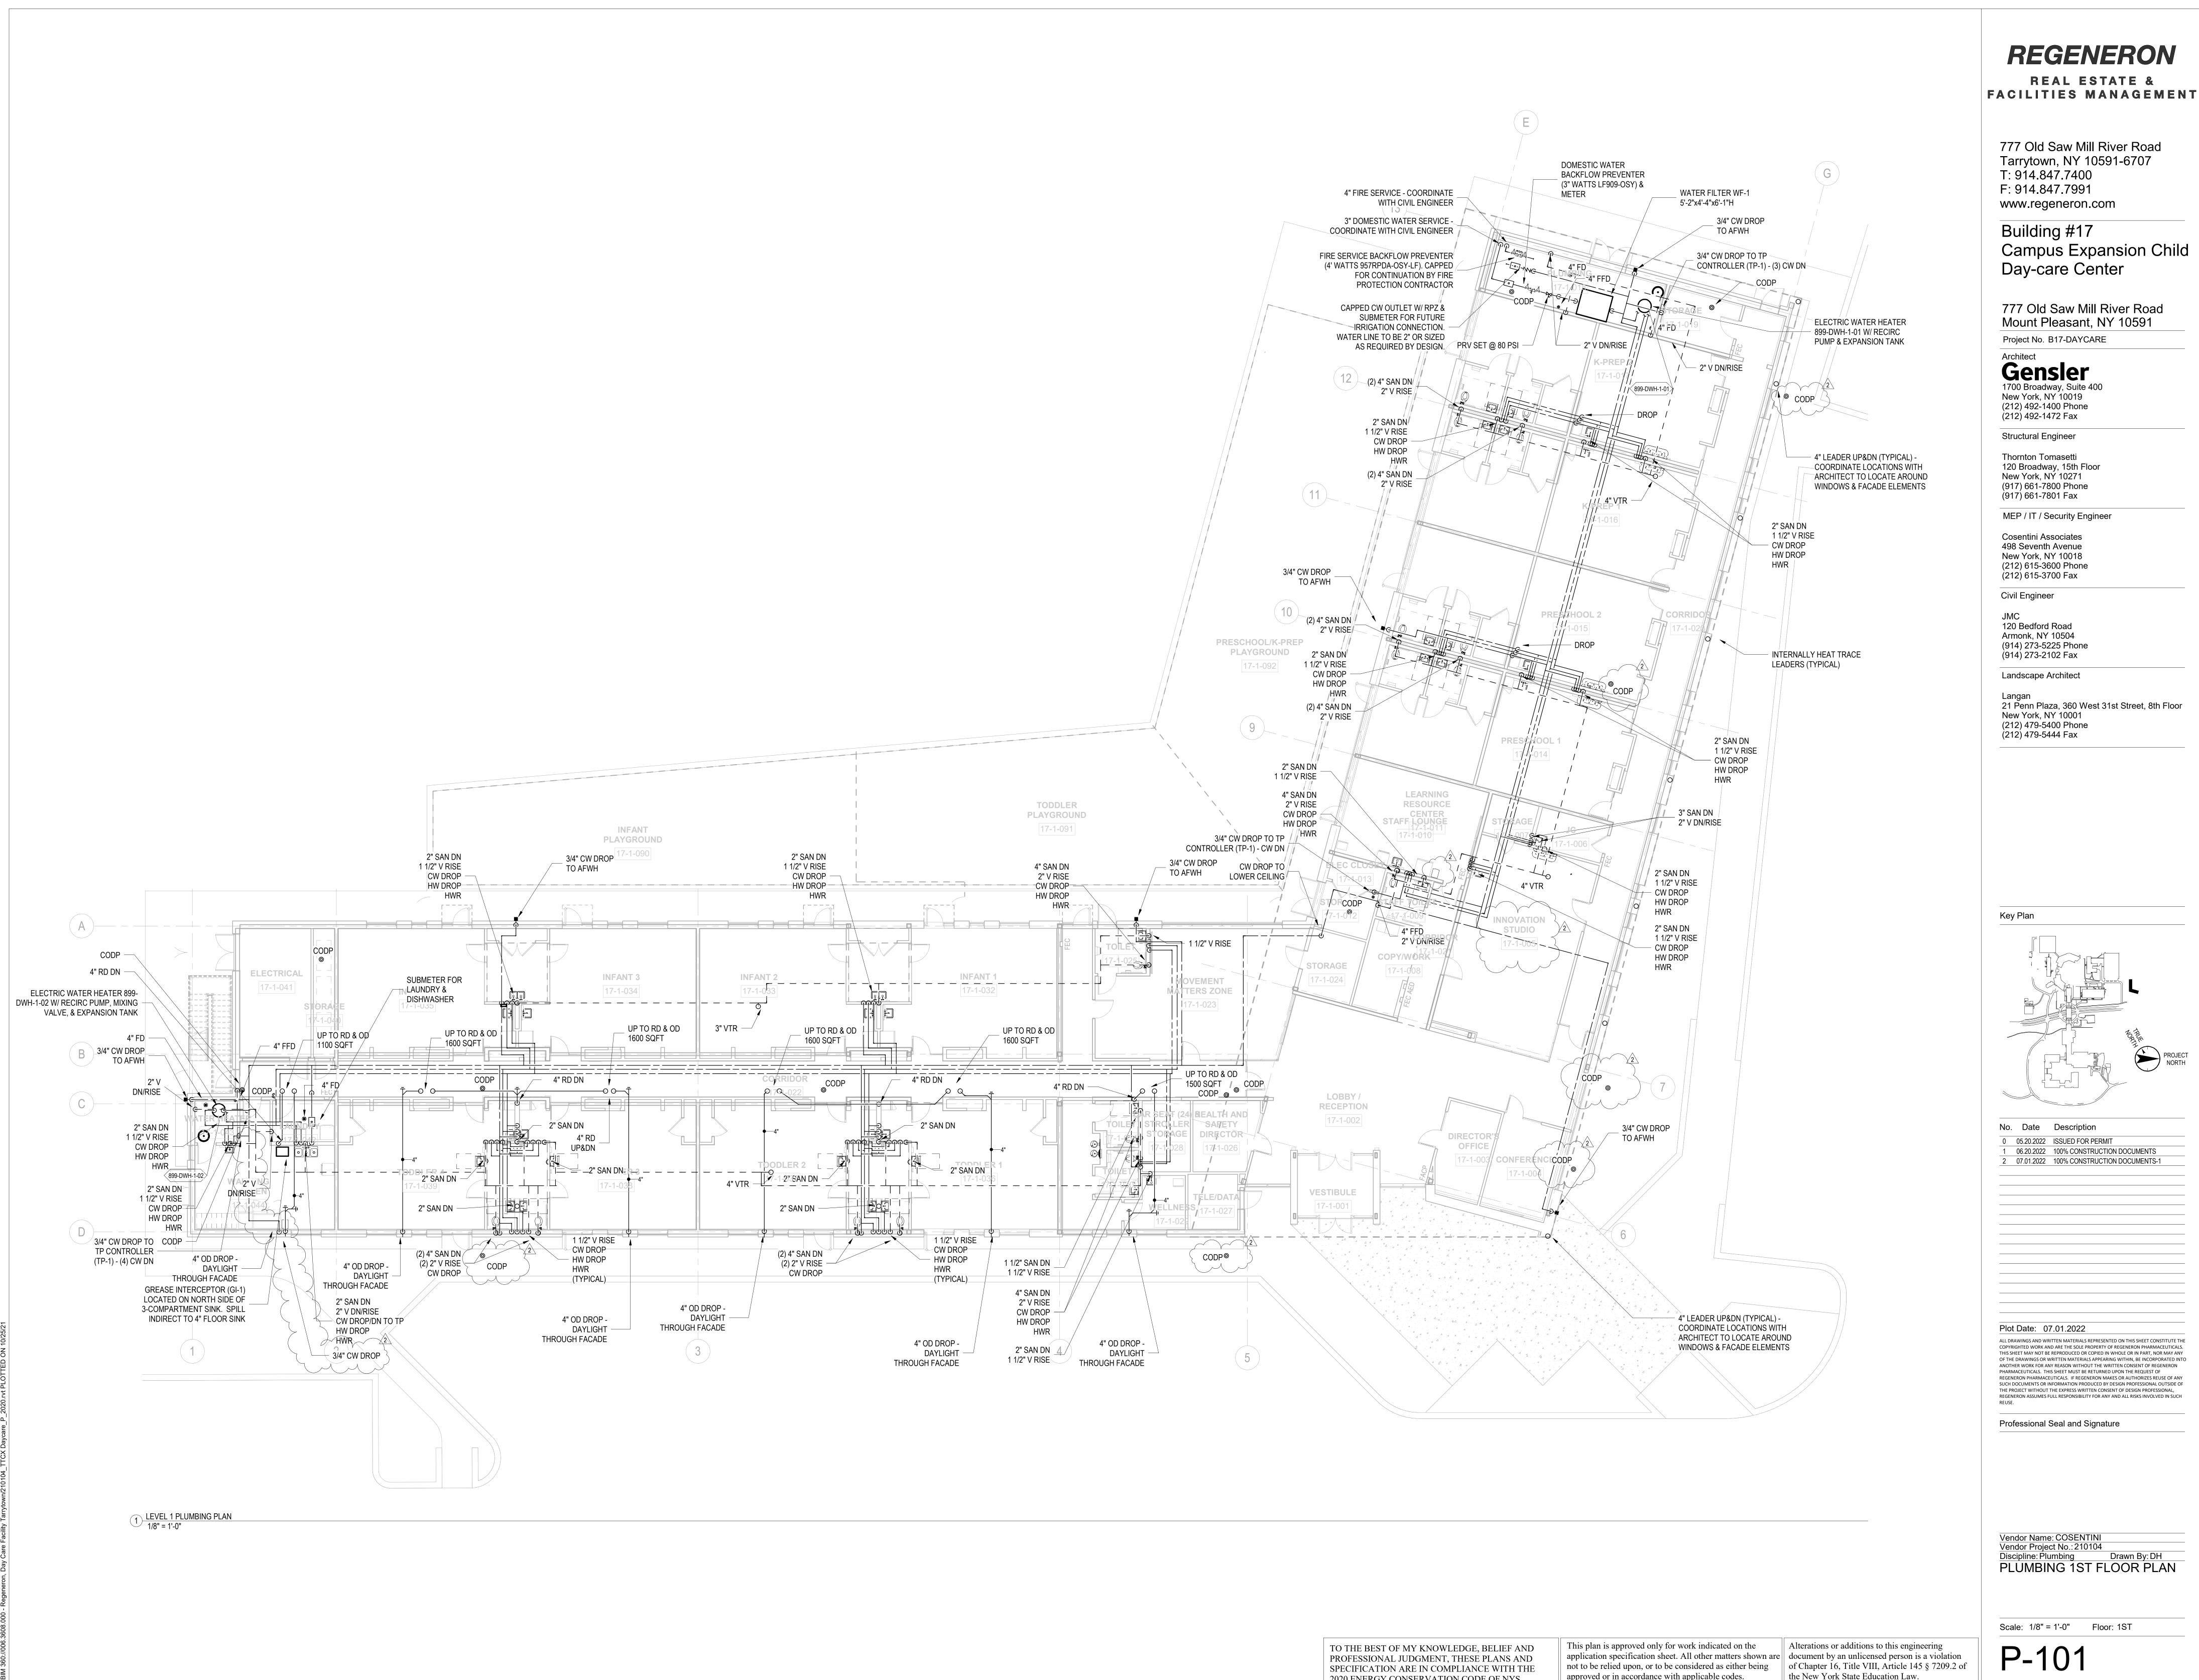Scale: 1/8" = 1'-0" Floor: ROOF

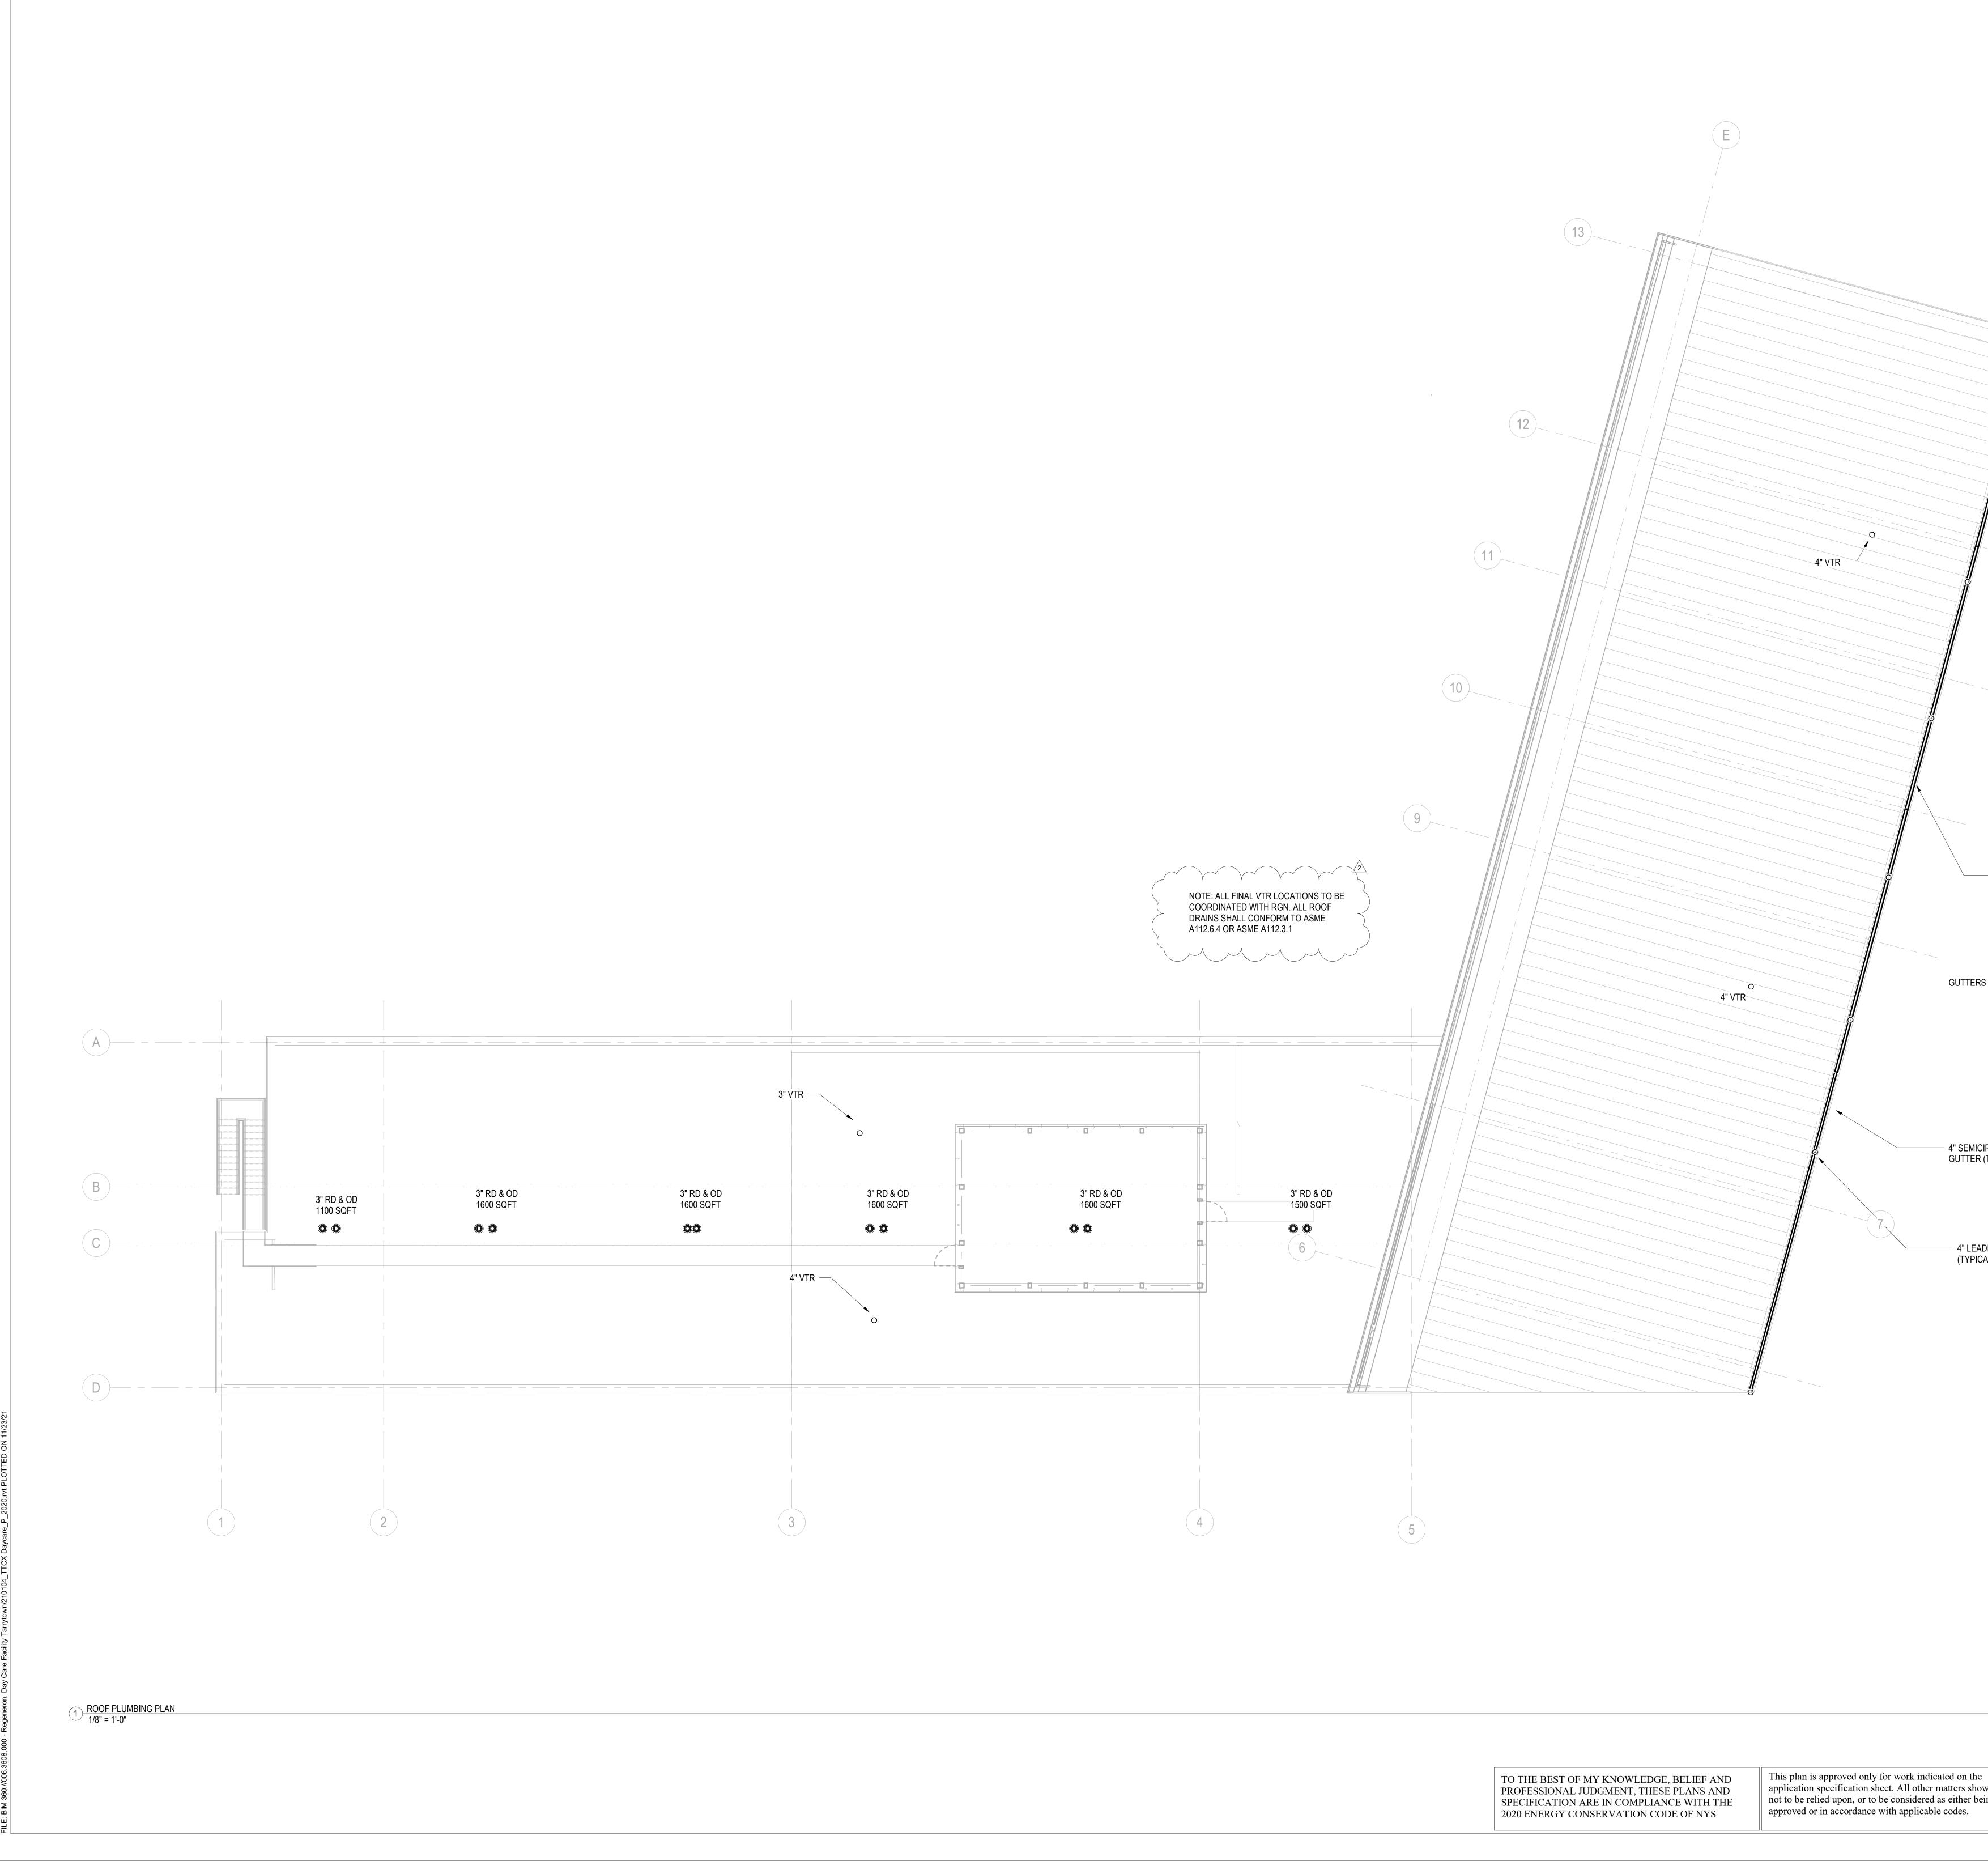


	SYSTEM											JN PIPE		NC	6	MA	\⊤[	ERI	AL	S	5C 
NOTES: 1. FOR REQUIRED PRESSURE 2. INSTALL IN TRENCH OR S 3. ALL MATERIALS SELECTED BY THE LOCAL AUTHORITIE	APPROVED	RED		IRON WIR PIPE	DUCTILE IRON STEEL SCHED 10	L SCHED 30	L SCHED 40	"K" OR "L" MEDICAL GAS TUBE	"L'CUPPER TUBING	BRASS PIPE	COPPER DRAINAGE	BLACK Gai vanizen	ENT LINED		WRAPPED	UNPIGMENTED NATURAL POLYPROPYLENE	PROPYLENE – FIR	SILICATE GLASS	SIAINLESS SIEEL CUI GROUVE		
DRAINAGE BURIED				REQU	CAST	CASI	DUCI	STEE	STEE			RED L		BLACK	CEMENT	COATED	MILL		POLY	BORO	504
	S	OF BLDG. C sewer	_ Wall				•		•				•								
FIXTURE CONNECTION C.W. – 4" & SMAL C.W. – BURIED INS	LER								•		•				•						
NOTE: PLUMBING CONT	RACTOR	TO COORDINA	TE CONN		NS	T(	0 0	)UT	GO	ING	S	TOR	M .	AN[	) S	AN	ITA	RY	SEV	VER	'S
	WATER F	TILTER SCHEDULE	MANUFACTU																		
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	KED	RER &				CAP., GALS			Z		_	PRES	1.	Z		VALVE,	/F TVDF		K.W.		
	REQUIRED	MANUFACTURER MODEL NO.				SIURAGE C			RECOVERY	/HR.	- C L	IU EACH STFAM VAI	TERING	HEATER COIL	<ul><li>STEAM</li></ul>	RU EACH	STEAM VALVE		RATING IN		<u>ר</u>
DESIGNATION 899-DWH-1-01	Ó 1 1	AO SMITH D	DEN120 DVE200		1	20	)	2	6	8				ЦЦ Н	MAX.				12	4	
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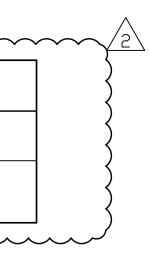
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TYPE"L"COPPER TUBING	TYPE"K"COPPER TUBING RED BRASS PIPE	BLACK	CEMENT LINED		ACID RESIST. C.I SILICONE POLYPROPYLENE - FIRE RETARDANT	ITEEL CUT GRO	CLIDRAINAGF PAT	CAST IRON MALLEABLE IRON	LEABLE IRON RONZE	r		VICTAULIC DUCTILE IRON	WELDED MILL WRAPPED UNPIGMENTED NATURAL POLYPROPYLENE	JPYLENE – UR ICATE GLASS 2 & SPIGOT	THREADED THREADLESS BRONZE		SOLDERED       WELDED	MECH.JOINT-NO HUB		HEAT SOCKET FUSION FUSION RESISTANCE WIRE	MECHANICAL JOINT SS VICTAULIC FLEXIBLE COUPLING	RED		TYPE GATE /ALVES BALL /ALVES	WOLLSON .:.ON .914 F-2885A F-2885A F-2894A BA-400 UPBA400 BA450 UPBA450 BA-100 UPBA450 BA-100 UPBA150 BA150 UPBA150 509T UP509 1509T UP1509 F-2974A	3/8" - 3/8" -	2' 2' 2' 2 1/2' - 2 1/2' - 3' • • • • • • • • • • • • • • • • • •			O.S.&Y. O.S.&Y. O.S.&Y. O.S.&Y. O.S.&Y. O.S.&Y. O.S. O.S. •			● 200# WWP 201 WWP 1 0 0 0 0 0 0 0 0 0 0 0 0 0 0 0 0 0 0 0	500# WWP	
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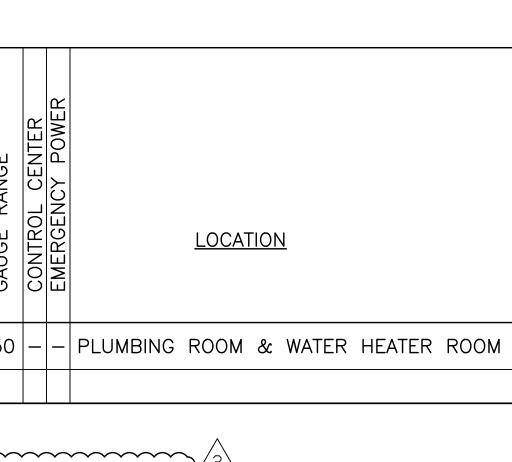
TO THE BEST OF MY KNOWLEDGE, BELIEF AND PROFESSIONAL JUDGMENT, THESE PLANS AND SPECIFICATIONS ARE IN COMPLIANCE WITH THE 2020 ENERGY CONSERVATION CODE OF NYS

not to be relied upon, or to be considered as either being approved or in accordance with applicable codes.



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777 Old Saw Mill River Road Tarrytown, NY 10591-6707 T: 914.847.7400 F: 914.847.7991 www.regeneron.com

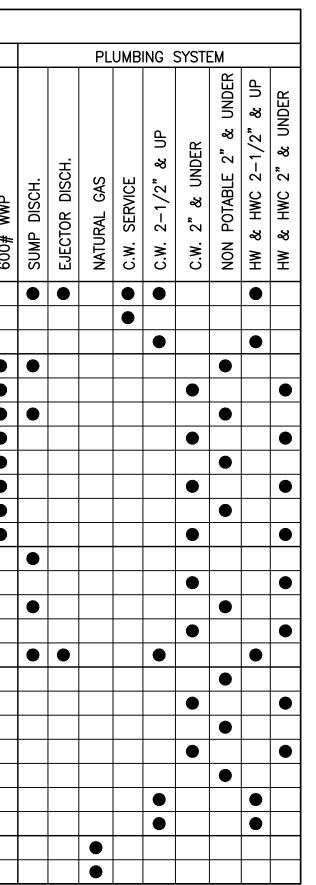Building #17 Campus Expansion Child Day-care Center

899 Old Saw Mill River Road Mount Pleasant, NY 10591 Project No. B17-DAYCARE

Architect **Gensier** 1700 Broadway, Suite 400 New York, NY 10019 (212) 492-1400 Phone (212) 492-1472 Fax Structural Engineer

Thornton Tomasetti 120 Broadway, 15th Floor New York, NY 10271 (917) 661-7800 Phone (917) 661-7801 Fax

MEP / IT / Security Engineer

Cosentini Associates 498 Seventh Avenue New York, NY 10018 (212) 615-3600 Phone (212) 615-3700 Fax


Civil Engineer

JMC 120 Bedford Road Armonk, NY 10504 (914) 273-5225 Phone (914) 273-2102 Fax

Landscape Architect

Langan 21 Penn Plaza, 360 West 31st Street, 8th Floor New York, NY 10001 (212) 479-5400 Phone (212) 479-5444 Fax



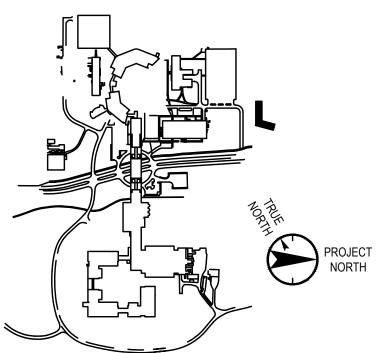

No. Date Description 
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 05.20.2022
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 06.20.2022
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 07.01.2022 100% CONSTRUCTION DOCUMENTS-1

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Plot Date: 07.01.2022

REUSE.

Professional Seal and Signature

Vendor Name: COSENTINI Vendor Project No.: 210104 Discipline: Plumbing PLUMBING Drawn By:DH

SCHEDULES



This plan is approved only for work indicated on the<br/>application specification sheet. All other matters shown areAlterations or additions to this engineering document<br/>by an unlicensed person is a violation of Chapter 16, Title VIII, Article 145 § 7209.2 of the New York State Education Law.

Floor: N/A

