		CATION ENHANCEMENT SYSTEMS T & DEVICES
ERCES	EMERGENCY RADIO COMMUNICATION ENHANCEMENT SYSTEMS	RADIO SOLUTIONS INC. BDA SYSTEMS SPECIFICATIONS: SB400M2A-1 FREQUENCY RANGE: 450-490M PASSBAND: 100KHz - 3MHz NEMA-4 (UL TYPE-4) ENCLOSU 20.55"WX24"HX8.32"D - TOTAL INCLUDING HEATSINKS: 23.23" - TOTAL HEIGHT INCLUDING M TABS: 26.22"
ERRA	EMERGENCY RADIO COMMUNICATION ENHANCEMENT SYSTEMS REMOTE ANNUNCTIATOR	
DA	ERCES DONOR ANTENNA (EXTERIOR DAS ANTENNA)	RADIO SOLUTIONS INC. BDA SYSTEMS MODEL #: DA-465490-1 CAT. #: BDA-DA-465490-1
DAS	ERCES ULTRA-WIDEBAND DAS ANTENNA (INDOOR DAS ANTENNA)	RADIO SOLUTIONS INC. BDA SYSTEMS MODEL #: LPA-4502700-1 CAT. #: BDA-LPA-4502700-1
DC	ERCES DIRECTION COUPLER	

/ICES RADIO SOLUTIONS INC. BDA SYSTEMS SPECIFICATIONS: SB400M2A-1-UL FREQUENCY RANGE: 450-490MHz UHF ASSBAND: 100KHz - 3MHz EMA-4 (UL TYPE-4) ENCLOSURE: 0.55"WX24"HX8.32"D - TOTAL WIDTH NCLUDING HEATSINKS: 23.23" TOTAL HEIGHT INCLUDING MOUNTING TABS: 26.22"

	FIRE PROTECTIVE ALARM SYSTEM SOUNDING AND VISUAL DEVICES											
		SYMBOLS, AS SHOWN, REPRESENT FLUSH MOUNTED WALL DEVICES UNLESS SPECIFICALLY NOTED OTHERWISE.										
∇ st	HORN WITH INTEGRAL VISUAL DEVICE	INTENSITY OF VISUAL DEVICE SHALL BE 75 CD										
ST ST	HORN WITH INTEGRAL VISUAL DEVICE CEILING MOUNTED	SUBSCRIPT UPPER CASE LETTERS DENOTE THE FOLLOWING: WP - WEATHERPROOF										
ST	VISUAL/STROBE, WALL MOUNTED											
ST	VISUAL/STROBE, CEILING MOUNTED											

FIRE PROTECTIVE ALARM SYSTEM EQUIPMENT & DEVICES										
FCS	FIRE ALARM CONTROL PANEL									
RA	FIRE ALARM REMOTE ANNUNCIATOR									

CONTRACTOR TO FURNISH AND INSTALL AN APPROVED EMERGENCY RESPONDER RADIO SYSTEM IN ACCORDANCE WITH CHAPTER 5 SECTION 510 OF THE NEW YORK STATE FIRE CODE 2020 EDITION.

EMERGENCY RESPONDER RADIO SYSTEM SHALL BE AS MANUFACTURED BY SIEMENS.

		FIRE PROTECTIVE ALARM SYSTEM ADDRESSABLE MODULE BOXES							
CT1		ADDRESSABLE SINGLE INPUT MODULE							
Ст2	2	ADDRESSABLE DUAL INPUT MODULE							
		ACTUATING DEVICES							
F	MANUAL FIRE ALARM ACTUATING DEVICE OR STATION PROVIDE CLEAR PROTECTIVE COVER OVER EACH MANUAL PULL STATION								
WF	WATERFLOW DETECTOR								
TS	TAMPER SWITCH								
GR	GENERATOR RUNNING RELAY CONTACTS								
GF	GENERATOR FAILURE TO START RELAY CONTACTS								
GL	GENERATOR LOW FUEL RELAY CONTACTS								
•		RESSABLE SMOKE CTOR							
? -	ADDRESSABLE DUCT DETECTOR WITH SAMPLING TUBE AND REMOTE ALARM LED								

ABBREVIAT (THIS LIST OF ABBREVIATIONS DOES	
USED IN CONJUNCTION	
A - AMPS AC - ALTERNATING CURRENT	MISC - MISCELLANEOUS MTD - MOUNTED
ADJ - ADJACENT	MTR - MOTOR
AFD - AUTOMATIC FIRE DETECTION AFF - ABOVE FINISHED FLOOR	N - NEUTRAL NEC - NATIONAL ELECTRIC
AFG - ABOVE FINISHED GRADE	
AIR COND - AIR CONDITIONING AP - APPLIANCE PANEL	NEMA - NATIONAL ELECTRICAL MANUFACTURERS
ARCH - ARCHITECTURAL	ASSOC.
ASYM - ASYMMETRICAL AUTO - AUTOMATIC	NL - ON NIGHT LIGHTING CIRCUIT
AVG - AVERAGE	OL - OVERLOAD
BL - BLANK BLDG - BUILDING	P - POLES PB - PULL BOX
C - CONDUIT	PC - PULL CHAIN
CAB - CAB CD - CANDELA	PF - POWER FACTOR PG - PAGING
CAT - CATALOGUE	PH - PHASE
CEL - CELLAR	PLB - PLUMBING
CKT - CIRCUIT CL - CLOCK	PNL - PANEL PP - POWER PANEL
CLG - CEILING	PWR - POWER
CLOS - CLOSET CM - CIRCULAR MIL	RC - REMOTE CONTROL REC - RECEPTACLE
COL - COLUMN	REQ - REQUIRED
CONC - CONCRETE CONST - CONSTRUCTION	ROF - ROOF RM - ROOM
CONT - CONTINUOUS	RMS - ROOT MEAN SQUARE
CONV - CONVENIENCE CS - CABLE SUPPORT	S - SOUND SC - SQUIRREL CAGE
CU - CUBIC	SC - SQUIRRELCAGE SO - SOUTH
DC - DIRECT CURRENT	SP - SPARE
DIA - DIAMETER DN - DOWN DP - DISTRIBUTION PANEL	SPECS - SPECIFICATIONS SPKLR - SPRINKLER
DP - DISTRIBUTION PANEL	SPKR - SPEAKER
DTL - DETAIL DWG - DRAWING	SQ - SQUARE STD - STANDARD
EA - EAST	SURF - SURFACE
EC - EMPTY CONDUIT EL - ELEVATION	SW - SWITCH SWBD - SWITCHBOARD
ELEC - ELECTRIC	SYM - SYMETRICAL
ELEC - ELECTRIC ELEV - ELEVATOR	TEL - TELEPHONE
EM - ON EMERGENCY CIRCUIT ENTR - ENTRANCE	TELCO - TELEPHONE CO. TYP - TYPICAL
EP - EXPLOSION PROOF	V - VOLTS
EQ - EQUAL EQPMT - EQUIPMENT	VENT - VENTILATING VERT - VERTICAL
EXIST - EXISTING	VP - VAPORPROOF
F - FLOOR FA - FIRE ALARM	W - WATTS WE - WEST
FDR - FEEDER	WGD - WITH GUARD
FIN - FINISH FIXT - FIXTURE FL - FLUSH	WP - WEATHERPROOF
FL - FLUSH	WT - WIRING TROUGH XFMR - TRANSFORMER
FLUOR - FLUORESCENT FSTP - FIRE-STANDPIPE	# (UNRELA WIRE GAUGE NUMBER
FSTP - FIRE-STANDPIPE FT - FEET	TED TO
GA - GAUGE	OTHER
GALV - GALVANIZED GD - GROUND	WORDS) Ø - PHASE
H - HERMETIC	F@ - FUSED AT
HC - HUNG CEILING HGT - HEIGHT	C - CENTER LINE
HOR - HORIZONTAL	O/C - OVERCURRENT C/C - CENTER TO CENTER
HP - HORSEPOWER IN - INCHES	1/C,2/C - ONE CONDUCTOR
IN - INCHES INT - INTERCOM	3/C TWO CONDUCTORS,
JB - JUNCTION BOX	ETC.
LS - LOUDSPEAKER LT - LOW TENSION	
LTG - LIGHTING	
M - MAIN MA - MILLIAMPS	
MCM - THOUSAND CIRCULAR MILS	
L	

FIRE ALARM DRAWING LIST

SHEET NUMBER	SHEET NAME
FA-001	FIRE ALARM GENERAL NOTES, SYMBOLS, AND DRAWING LIST
FA-100	FIRE ALARM PLAN - 1ST FLOOR
FA-101	FIRE ALARM PLAN - ROOF
FA-500	FIRE ALARM DETAIL SHEET AND RISER DIAGRAM

TO THE BEST OF MY KNOWLEDGE, BELIEF AND PROFESSIONAL JUDGMENT, THESE PLANS AND SPECIFICATIONS ARE IN COMPLIANCE WITH THE 2020 ENERGY CONSERVATION CODE OF NYS

not to be relied upon, or to be considered as either being approved or in accordance with applicable codes.

This plan is approved only for work indicated on the
application specification sheet. All other matters shown areAlterations or additions to this engineering document
by an unlicensed person is a violation of Chapter 16, Title VIII, Article 145 § 7209.2 of the New York State Education Law.

Scale: NTS



SYMBOLS, GENERAL NOTES, AND DRAWING LIST

REGENERON

REAL ESTATE & Facilities management

777 Old Saw Mill River Road

Building #17 Campus Expansion Child Day-care Center

899 Old Saw Mill River Road

Mount Pleasant, NY 10591

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21 Penn Plaza, 360 West 31st Street, 8th Floor

Civil Engineer

JMC

Langan

Key Plan _____

No. Date Description

Plot Date: 07.01.2022

Professional Seal and Signature

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Architect

Tarrytown, NY 10591-6707

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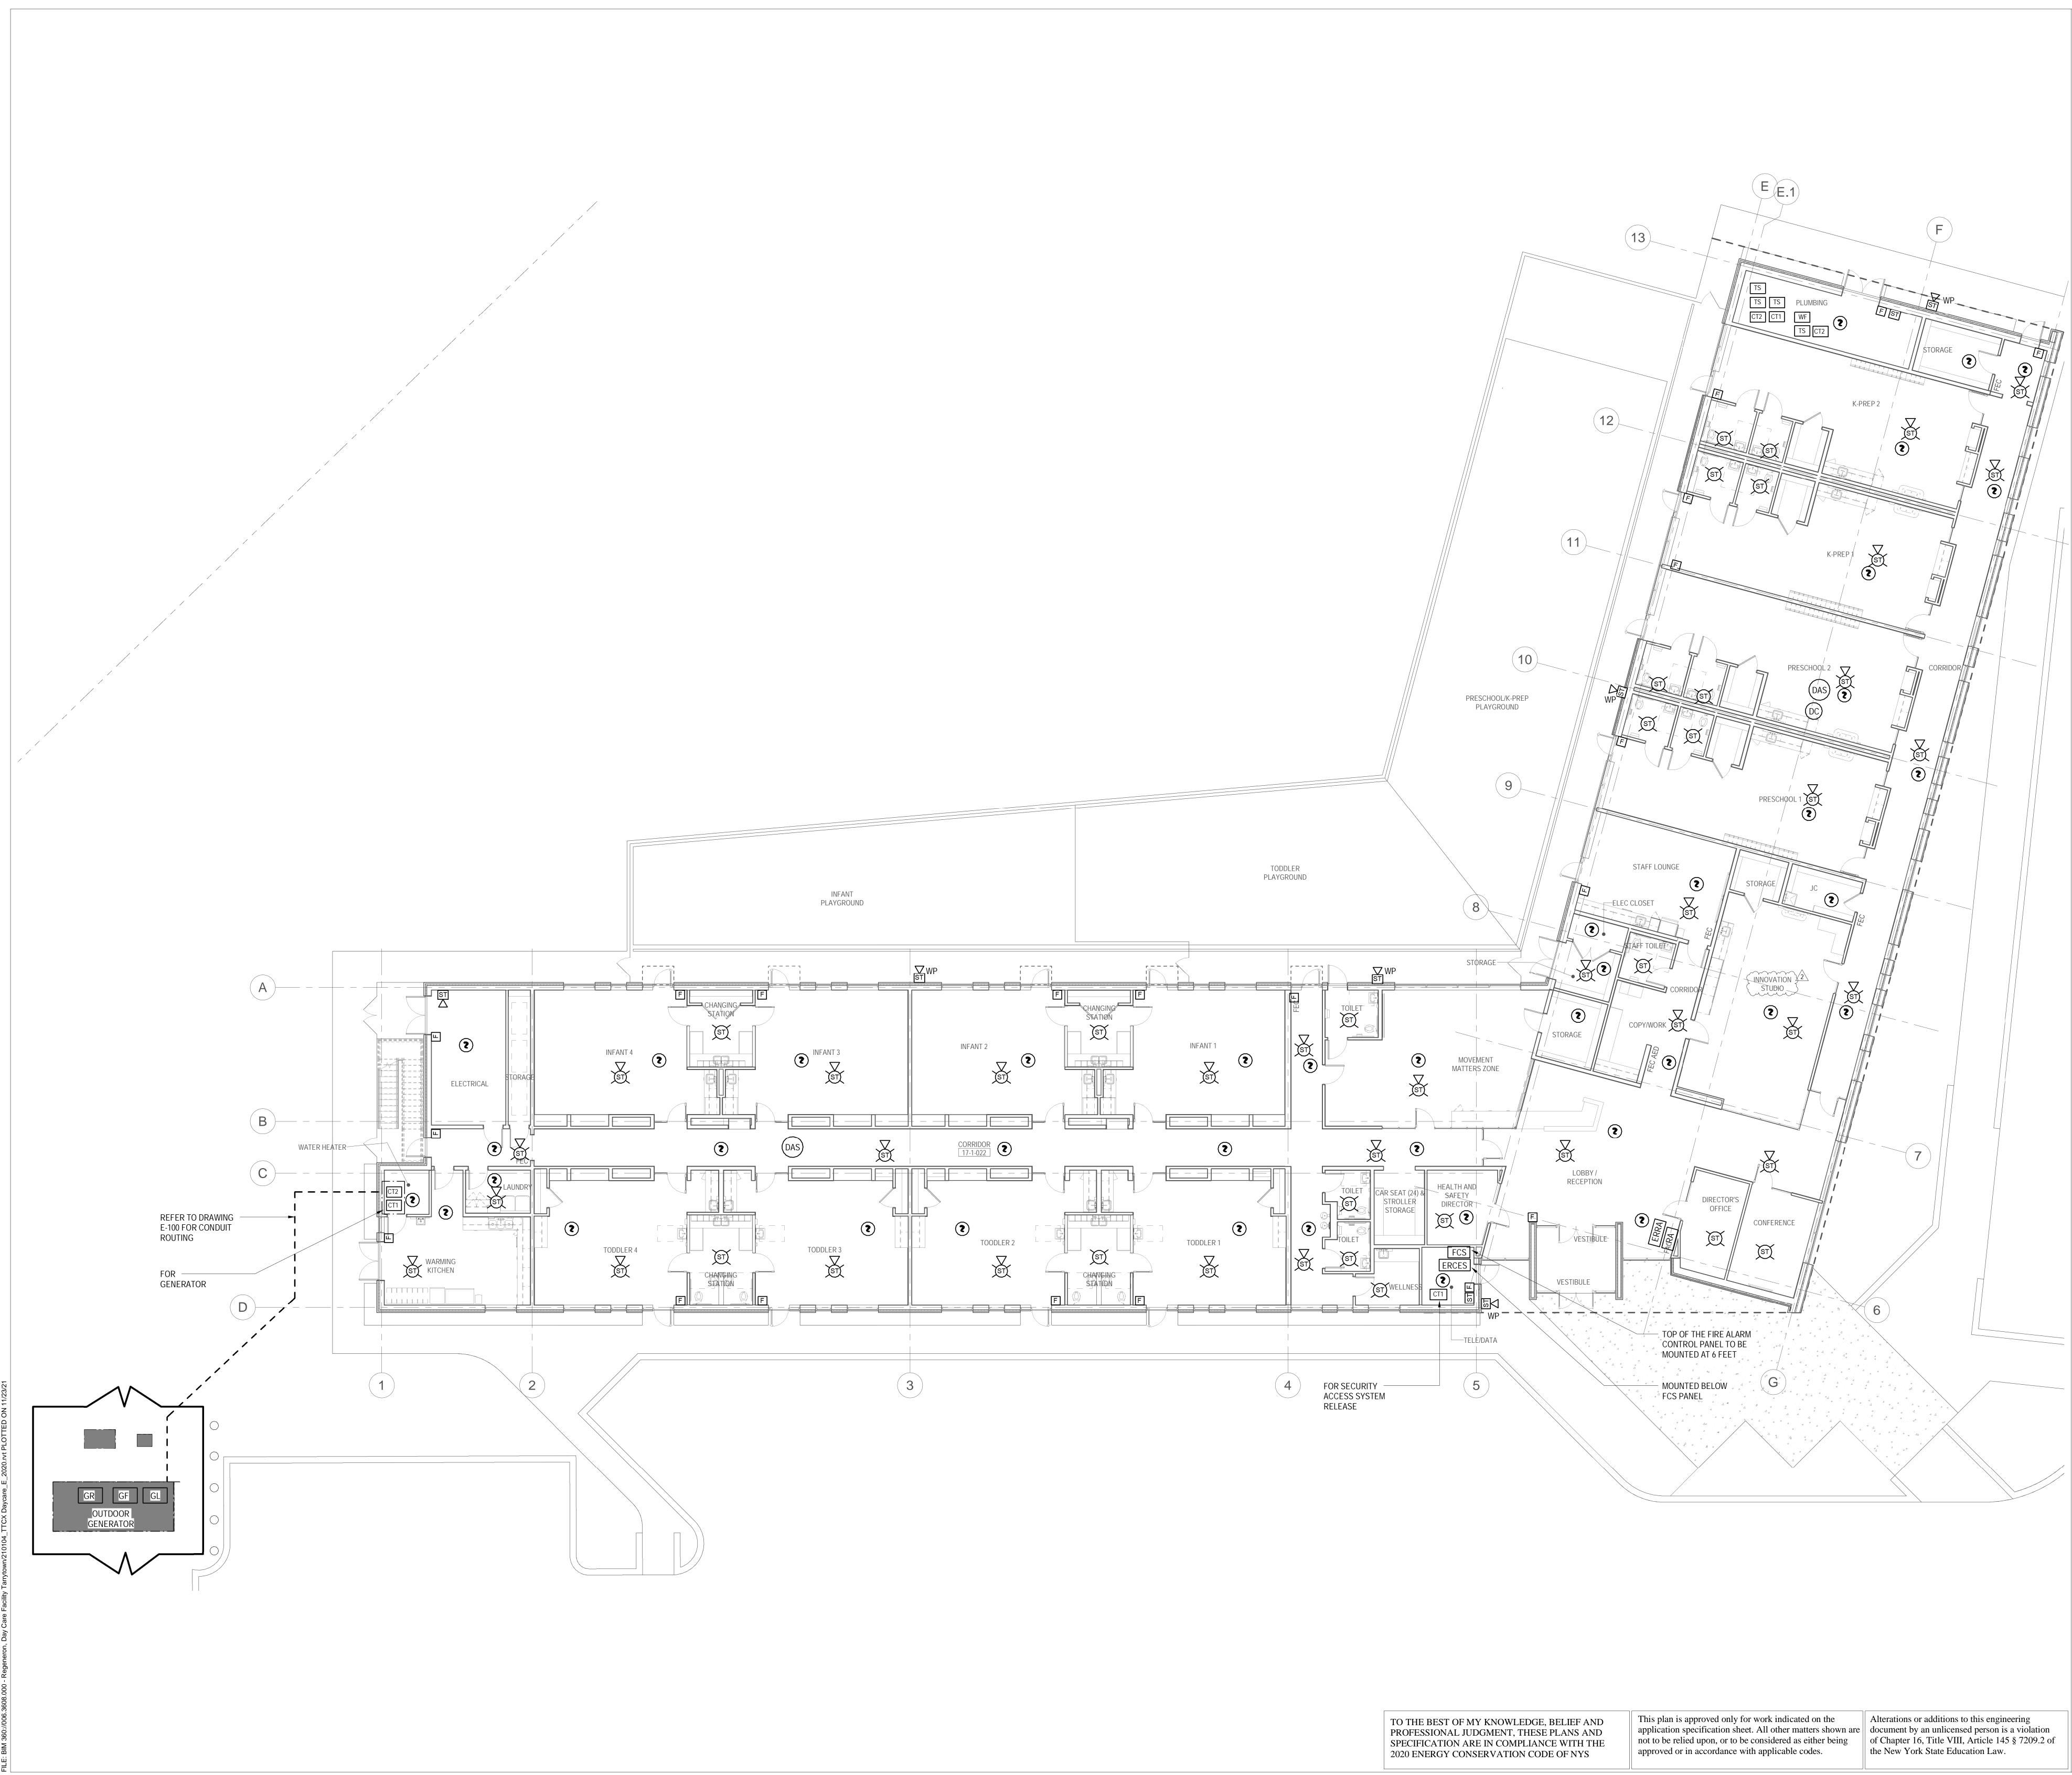
F: 914.847.7991

www.regeneron.com

Vendor Name: COSENTINI Vendor Project No.: 210104 Discipline: FireAlarm Drawn By: Al

FIRE ALARM

PROJECT NORTH



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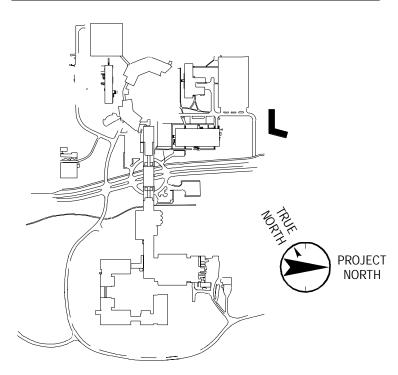
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Key Plan



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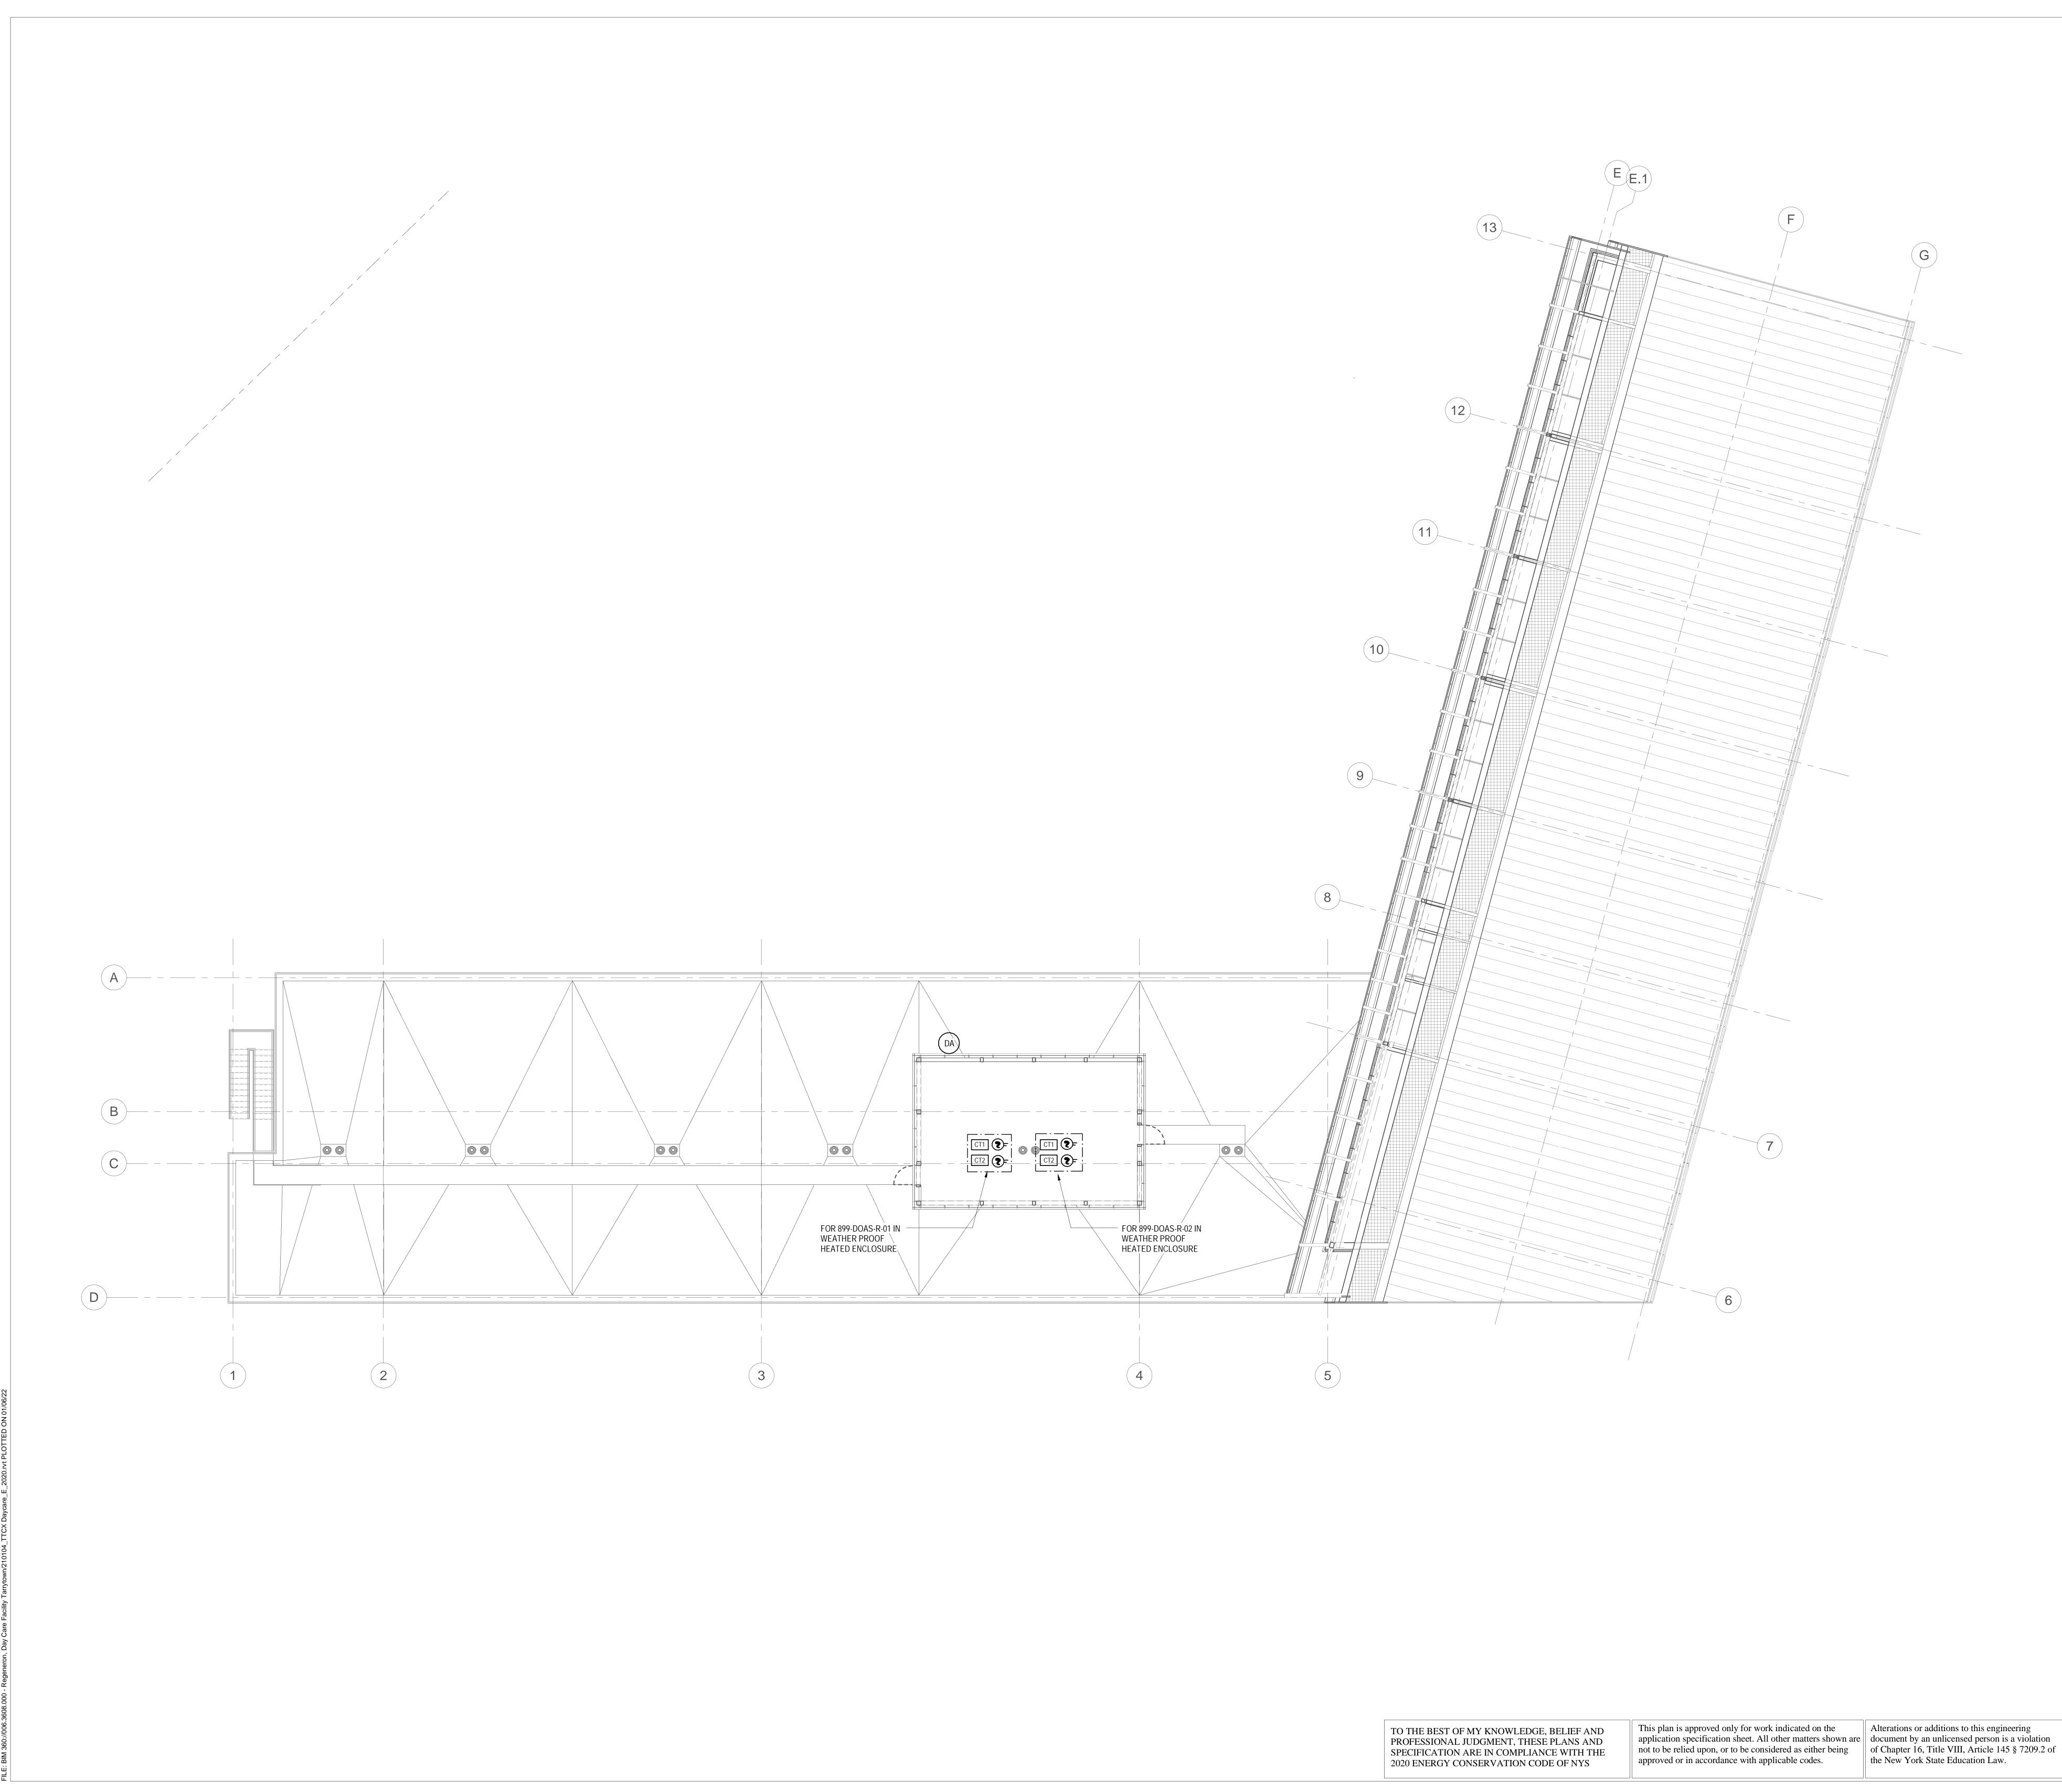
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Professional Seal and Signature

Vendor Name: COSENTINI Vendor Project No.: 210104 Discipline: FireAlarm Drawn By: Al FIRE ALARM PLAN - 1ST FLOOR

Scale: 1/8" = 1'-0" Floor:

FA-100



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Civil Engineer

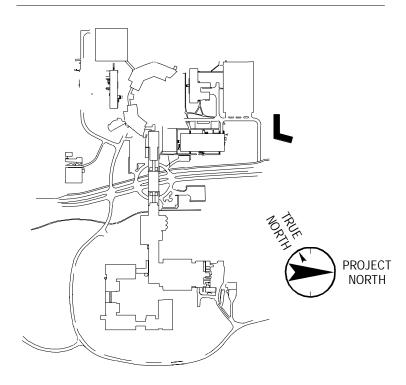
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Key Plan

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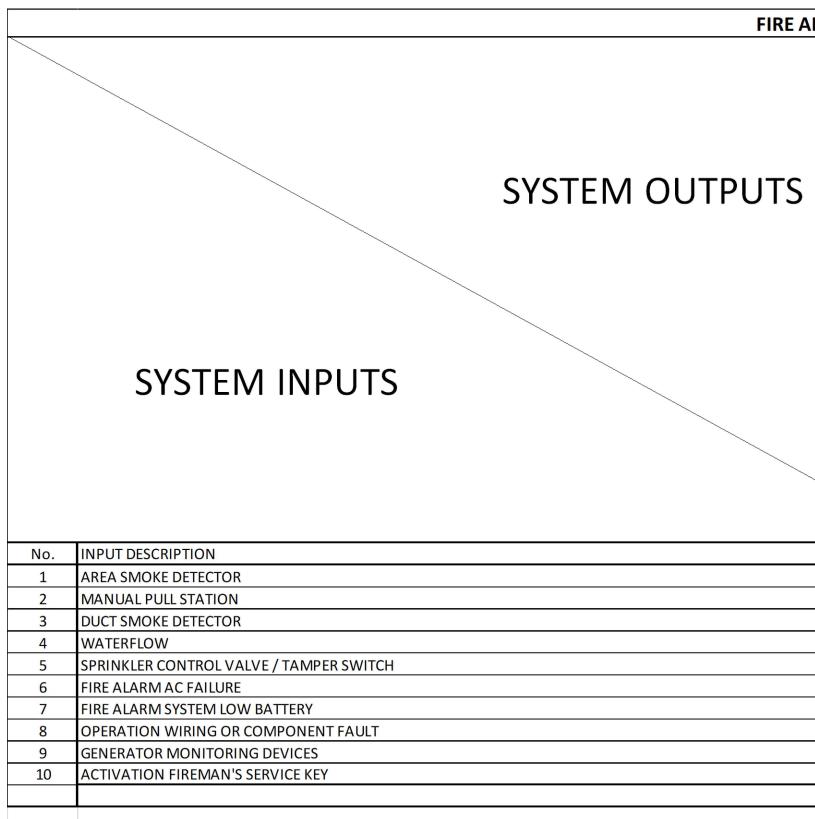
Professional Seal and Signature

Vendor Name: COSENTINI Vendor Project No.: 210104 Discipline: FireAlarm Drawn By: Al FIRE ALARM PLAN - ROOF

Alterations or additions to this engineering the New York State Education Law.

Scale: 1/8" = 1'-0" Floor:

FA-101

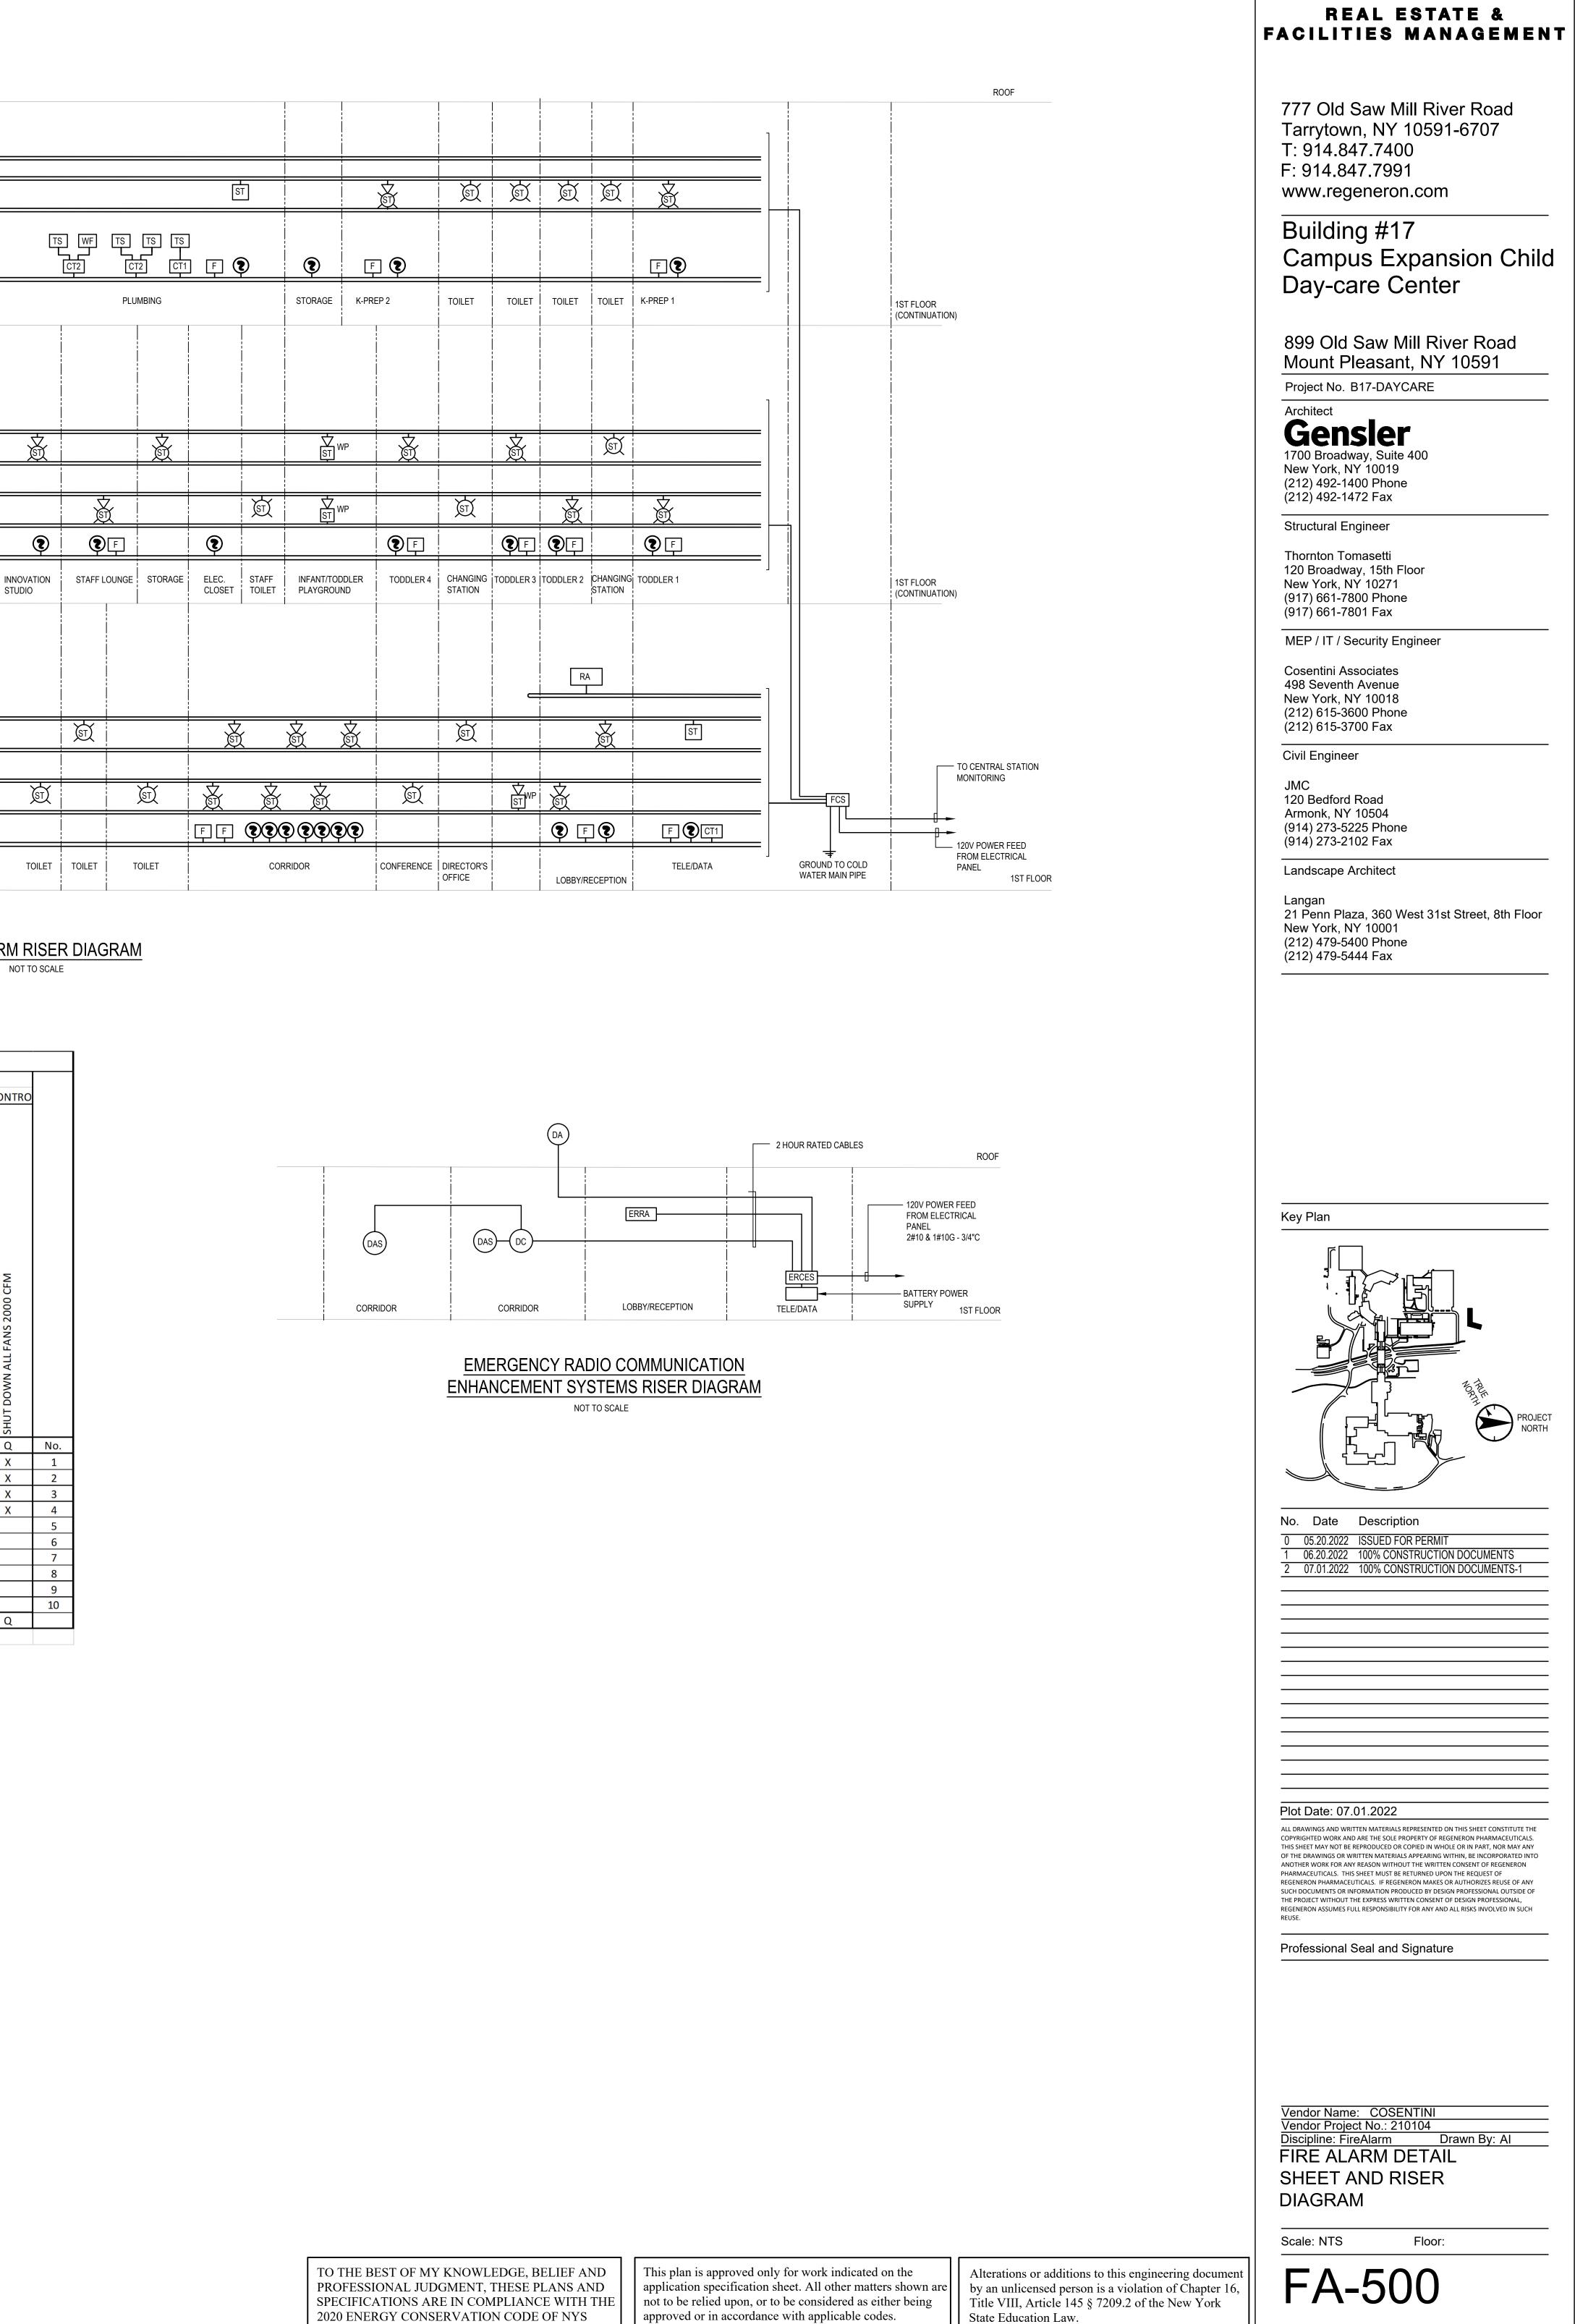


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FIRE ALARM RISER DIAGRAM

E ALARM SYSTEM	/I OPERA		ATRIX (1	EMPOR	AL-3 SYS	TEM)									
							00	TPUT DESCRIPTI	ON				1		
			CONTROL		UNCIATION		1		NOT		REQUIRED FIRE SAFETY CONTI				
S	ALARM SIGNAL INDICATOR & VISUALLY E DEVICE AT FACP	IGNAL AT FACP	ACTUATE VISIBLE SUPERVISORY SIGNAL INDICATOR & VISUALLY ANNUNCIATE THE DEVICE AT FACP	SORY SIGNAL AT FACP	ACTUATE VISIBLE TROUBLE SIGNAL INDICATOR & VISUALLY ANNUNCIATE THE DEVICE AT FACP	SIGNAL AT FACP	DISPLAY/PRINT CHANGE OF STATUS AT FACP AND CHANGE OF STATUS	ACTIVATE AUDIBLE DEVICES IN THREE PULSE TEMPORAL PATTERN AND ACTIVATE VISIBLE DEVICES THROUGHOUT BUILDING FOR A PERIOD THAT IS APPROPORATE FOR PURPOSES OF EVACUATION THE BUILDING, BUT NOT LESS THAN 180 SECONDS	ALARM SIGNAL TO CENTRAL MONITORING	TRANSMIT WATERFLOW SIGNAL TO CENTRAL MONITORING STATION	SNAL TO CENTRAL MONITORING	TO CENTRAL MONITORING STATION	ALLY HELD DOORS		CFM
	ACTUATE VISIBLE ALARM SIGNAL II ANNUNCIATE THE DEVICE AT FACP	ACTUATE AUDIBLE ALARM SIGNAL AT FACP	ACTUATE VISIBLE SUPERVISORY SIC ANNUNCIATE THE DEVICE AT FACP	ACTUATE AUDIBLE SUPERVISORY SIGNAL AT FACP	ACTUATE VISIBLE TROUBLE SIGNAL INDICATOR & VISUALLY ANNUNCIA	ACTUATE AUDIBLE TROUBLE SIGNAL AT FACP	DISPLAY/PRINT CHANGE OF 5 STATUS	ACTIVATE AUDIBLE DEVICES IN THREE PULSE TEMP AND ACTIVATE VISIBLE DEVICES THROUGHOUT BU PERIOD THAT IS APPROPORATE FOR PURPOSES OF THE BUILDING, BUT NOT LESS THAN 180 SECONDS	TRANSMIT AUTOMATIC ALA STATION	TRANSMIT WATERFLOW SIGN STATION	TRANSMIT SUPERVISORY SIGNAL TO STATION	TRANSMIT TROUBLE SIGNAL TO	RELEASE ELECTROMAGNETICALLY HELD DOORS	UNLOCK FAIL SAFE DOORS	SHUT DOWN ALL FANS 2000 CFM
	А	В	С	D	E	F	G	Н	I	J	К	L	М	Р	Q
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FIRE ALARM SYSTEM OPERATION MATRIX (TEMPORAL-3 SYSTEM)



REGENERON