

## **GENERAL NOTES**

- . COORDINATE ALL MECHANICAL WORK WITH ALL OTHER TRADES TO AVOID CONFLICTS. CONTRACTOR WILL NOT BE ALLOWED TO INSTALL SYSTEMS UNTIL COORDINATION DRAWINGS ARE SIGNED OFF BY ALL TRADES. MECHANICAL CONTRACTOR SHALL COORDINATE FINAL SIZES AND LOCATION OF ALL ROOF OPENINGS WITH G.C. BASED ON APPROVED EQUIPMENT AND SHEET METAL SHOP DRAWINGS.
- DUCT DIMENSIONS SHOWN ON THE DRAWINGS ARE CLEAR INSIDE DIMENSIONS. WHERE DUCT REQUIRES INTERNAL LINING, THE DUCT SIZE SHALL BE INCREASED ACCORDINGLY. CONDENSATE DRAIN PIPING FROM COOLING COIL DRAIN PANS SHALL BE PITCHED DOWN IN THE DIRECTION
- OF FLOW AT A MINIMUM OF 1/8" PER FOOT. 4. MOUNT ALL THERMOSTATS AND SENSORS AS PER SPECIFICATION AND MANUFACTURER REQUIREMENTS. 5. DUCTWORK SHOULD BE INSTALLED AS HIGH AS PRACTICAL.
- 6. HORIZONTAL WATER PIPING SHALL BE INSTALLED LEVEL OR SLOPE UP IN DIRECTION OF FLOW A MIN. OF 1/4" IN 10'. PIPE FITTINGS (VALVES, BALANCING, FLOW MEASURING, ETC.) INSTALLED ABOVE CEILING SHALL BE LOCATED TO BE ACCESSIBLE. PROVISION SHALL BE MADE FOR ADDITIONAL MANUAL VENTING OF PIPING WHERE TRAPPING OF AIR
- CANNOT BE AVOIDED. EACH LOW POINT IN A MAIN SHALL BE PROVIDED WITH A 1" BRONZE HOSE GATE VALVE, HAVING A BRONZE CAP TO PERMIT DRAINING OF ENTIRE SYSTEM. INSTALL IN ACCESSIBLE LOCATIONS. MECHANICAL CONTRACTOR SHALL COORDINATE LOCATION AND RATING OF FIRE AND COMBINATION FIRE
- SMOKE DAMPERS WITH "FIRE PROTECTION PLANS" DRAWINGS. DAMPERS USED FOR PROTECTION OF OPENINGS IN WALL OR PARTITIONS WITH FIRE RESISTANCE RATING OF LESS THAN 3 HOURS SHALL POSSESS 1 1/2 HOUR FIRE RATING. DAMPERS USED FOR PROTECTION OF OPENINGS IN WALL OR PARTITIONS WITH FIRE RESISTANCE RATING OF 3 HOURS OR MORE, SHALL POSSESS 3 - HOUR FIRE RATING. ALL EXTERIOR WALL OPENINGS SHALL BE PROVIDED WITH FIRE/SMOKE DAMPERS. ALL REFRIGERANT PIPING INSULATION AND SIZING MUST FOLLOW STANDARD REFRIGERANT PIPING
- INSTALLATION TECHNIQUES. REFRIGERANT PIPING SHOP DRAWINGS SHALL INCLUDE ALL REQUIRED ACCESSORIES (VALVES, TRAPS, STRAINERS, SIGHT GLASS, ETC.). SIZES OF PIPING SHALL BE COORDINATED WITH THE SYSTEM MANUFACTURER BEFORE INSTALLATION. 10. MECHANICAL CONTRACTOR SHALL COORDINATE WITH GENERAL CONTRACTOR LOCATION OF ACCESS DOORS IN WALLS, CEILINGS, TO PERMIT INSPECTIONS, BALANCING, MAINTENANCE OF ALL CONTROLS,
- DAMPERS, VALVES, FAN-COIL UNITS, UNIT VENTILATORS, OTHER APPARATUS CONCEALED BEHIND WALLS OR CEILING. ACCESS DOORS FOR FIRE AND SMOKE DAMPERS SHALL BE IDENTIFIED ON EXTERIOR BY LABEL (0.5" HIGH LETTERS) READING "SMOKE DAMPER" OR "FIRE DAMPER" AS PER MC 607.4. 11. MECHANICAL CONTRACTOR SHALL PROVIDE NECESSARY SUPPLEMENTARY STEEL MEMBERS FOR THE SUPPORT OF SUSPENDED EQUIPMENT. 12. ALL FLOOR-MOUNTED EQUIPMENT SHALL BE INSTALLED ON 4" CONCRETE PADS OR OTHER WISE AS
- INDICATED ON DRAWINGS. 13. ALL DOOR UNDERCUTS SHALL COMPLY WITH NFPA 80. 14. EXPANSION LOOPS: MECHANICAL CONTRACTOR TO PROVIDE SHOP DRAWINGS WITH LOCATION OF EXPANSION LOOPS AND FABRICATE EXPANSION LOOPS FOR ADEQUATE EXPANSION OF INSTALLED PIPING
- SYSTEMS. PROVIDE PIPE ANCHORS AND PIPE ALIGNMENT GUIDES AS DETERMINED TO PROPERLY ANCHOR PIPING IN RELATIONSHIP TO EXPANSION LOOPS. WHERE NOT OTHERWISE INDICATED, INSTALL ANCHORS AT ENDS OF PRINCIPAL PIPE-RUNS, AND AT INTERMEDIATE POINTS IN PIPE-RUNS BETWEEN EXPANSION LOOPS AND BENDS. 15. ALL OUTDOOR AIR DUCTWORK TO BE INSULATED TO R-12 (PER ECC C403.2.9).

DUCT SY	MBOLS AND ABBR
≀ <del></del>	NEW GALVANIZED SHEET METAL DUCTWORK
₹	FIRE DAMPER AND ACCESS DOOR
$\cdot + \cdot$	VOLUME DAMPER
AHU-X	AIR HANDLING UNIT
₹	BELL OPENING WITH WIRE MESH SCREEN
$\square$	FOUR WAY BLOW SUPPLY AIR CEILIN DIFFUSER
	THREE WAY BLOW SUPPLY AIR CEILI DIFFUSER
	RETURN/EXHAUST AIR CEILING MOUNTED GRILLE
<b>≀──</b>	RETURN EXHAUST GRILLE
}— —►	SUPPLY AIR GRILLE
	TRANSFER AIR WALL OPENING
≀—₩₩₩ <del>_ ≀</del>	FLEXIBLE CONNECTION
	GRAVITY DAMPER
M	MOTORIZED DAMPER
	DUCT SMOKE DETECTOR
-F <sub>S</sub>	FIRE-SMOKE DAMPER AND ACCESS DOOR
—( <b>s</b> )	SMOKE DAMPER AND ACCESS DOOR
—U—	DOOR UNDERCUT
EUH-X	ELECTRIC UNIT HEATER
	CEILING MOUNTED HOT WATER CAB UNIT HEATER
WUH-X	HOT WATER UNIT HEATER
WCUH-X	WALL OR FLOOR MOUNTED HOT WA CABINET UNIT HEATER
FCU-X	FAN COIL-UNIT

HVAC DESIGN PARA	<u>METERS</u>
INSIDE AMBIENT DESIGN PARA SUMMER: WINTER:	METERS: 75°F(DB)/50% RH 72°F(DB)
OUTSIDE AMBIENT DESIGN PAR	RAMETERS FOR DO
SUMMER:	85.6°F(DB)/72.1°F(WB)
OUTSIDE WINTER AMBIENT DE	SIGN PARAMETER
WINTER TEMP.:	15.1°F(DB)
<u>"U-VALUES"</u>	
ROOF: WALLS: WHOLE WINDOW: SOLAR HEAT GAIN COEFFICIENT:	0.026 BTU/HRxFT <sup>2</sup> x°F 0.47 BTU/HRxFT <sup>2</sup> x°F 0.38 BTU/HRxFT <sup>2</sup> x°F 0.40
HEATING & COOLING LOAD CA	
DESIGN LOADS ASSOCIATED WITH I BUILDING SHALL BE DETERMINED I OR BY AN APPROVED EQUIVALENT PARAMETERS SPECIFIED IN CHAPTI	N ACCORDANCE WITH A COMPUTATIONAL PROC

**REVIATIONS** AC AIR CONDITIONING UNIT(S) (INDOOR UNIT) ACCU AIR COOLED CONDENSING UNIT AFF ABOVE FINISHED FLOOR AHU AIR HANDLING UNIT AMB AMBIENT B BOILER BTU BRITISH THERMAL UNIT CAV CONSTANT AIR VOLUME BOX CC COOLING COIL CFM CUBIC FEET PER MINUTE CH CHILLER CHWP CHILLED WATER PUMP CMPR COMPRESSOR CO CLEAN-OUT COND. CONDENS(-ER, -ING, -ATION) DB DRY-BULB TEMPERATURE DIA DIAMETER DWG/s DRAWING/S EAT ENTERING AIR TEMPERATURE LING EF EXHAUST FAN EXIST. EXISTING F FAHRENHEIT FD/AD FIRE DAMPER & ACCESS DOOR FM FLOW MEASURING STATION FPM FEET PER MINUTE FSD COMBINATION FIRE/SMOKE DAMPER AND ACCESS DOOR FT FOOT OR FEET HC HEATING COIL HD HEAD HP HORSEPOWER HR HOUR(S) HRW HEAT RECOVERY WHEEL HX HEAT EXCHANGER HZ FREQUENCY KEF KITCHEN EXHAUST FAN KW KILOWATT LAT LEAVING AIR TEMPERATURE LBS POUNDS MAX MAXIMUM MBH BTU PER HOUR (THOUSAND) MIN MINIMUM N/A NOT APPLICABLE OAI OUTSIDE AIR INTAKE PH PHASE (ELECTRICAL) POC PROOF OF CLOSURE PSI POUNDS PER SQUARE INCH RA RETURN AIR RH RELATIVE HUMIDITY RP RADIANT PANEL RPM REVOLUTIONS PER MINUTE SA SUPPLY AIR

ST SOUND ATTENUATOR (TRAP) BINET TEF TOILET EXHAUST FAN T'STAT THERMOSTAT V VOLT VAV VARIABLE AIR VOLUME BOX VENT. VENTILATION W WATT WB WET BULB ATER WH WATT-HOUR

ERS FOR DOAS UNITS:

B)/72.1°F(WB) RAMETERS:

U/HRxFT<sup>2</sup>x°F J/HRxFT<sup>2</sup>x°F

VENTILATING AND AIR CONDITIONING OF THE DANCE WITH ANSI/ASHRAE/ACCA STANDARD 183 ATIONAL PROCEDURE USING THE DESIGN

LEGEND FOR AUTOMATIC TEMPERATURE CONTROLS
AI ANALOG INPUT
AO ANALOG OUTPUT
BMS BUILDING MANAGEMENT SYSTEM C COMMON
CO2 CARBON DIOXIDE SENSOR D DAMPER
DA DAMPER ACTUATOR DCP DIGITAL CONTROL PANEL
DI DIGITAL INPUT
DO DIGITAL OUTPUT D/N DAY/NIGHT SIGNAL
DPS DIFFERENTIAL PRESSURE SWITCH DPT DIFFERENTIAL PRESSURE TRANSMITTER
EP ELECTRIC TO PNEUMATIC SWITCH, EP ENERGIZED SIGNAL
ES END SWITCH, POSITION SWITCH FS FLOW SWITCH
H HUMIDITY SENSOR
HI HUMIDITY INDICATOR HS HIGH SIGNAL SELECTOR
INWC INCHES WATER COLUMN M MAIN AIR
NC NORMALLY CLOSED NO NORMALLY OPEN
OA OUTDOOR AIR
PT PRESSURE TRANSMITTER PSH PRESSURE SWITCH HIGH
S SWITCH SD SMOKE DETECTOR
SPS STATIC PRESSURE SENSOR S/W SUMMER-WINTER SIGNAL
T THERMOSTAT
TS TEMPERATURE SENSOR TDR TIME DELAY RELAY
THL TEMPERATURE HIGH LIMIT THERMOSTAT
TLL TEMPERATURE LOW LIMIT THERMOSTAT
V VALVE VFD VARIABLE FREQUENCY DRIVE
WB WET BULB WU WARM-UP SIGNAL
** DYNAMIC GRAPHIC VALUE
SYSTEM LEGEND/SYMBOL
H C HEATING COIL
(TS) TEMPERATURE SENSOR BY TCC
SD SMOKE DAMPER
DUCT SMOKE DETECTOR
T SPACE THERMOSTAT
$\bigcirc$
TEMPERATURE CONTROL SYMBOL
PARALLEL BLADE DAMPER
OPPOSED BLADE DAMPER

<u>1. PERMITS:</u>		
	FILE FOR AND OBTAIN PERMITS I CHAPTER 1 ADMINISTRATION, TIL	FOR ALL MECHANICAL SYSTEMS. PERMITS TLE 28 SECTION MC 105.
2. LISTED AND LABE	<u>_ED:</u>	
	ULATED BY NYSMC SHALL BE LIS Shall Comply with Requirem	STED AND LABELED AS REQUIRED BY MC 30 ENTS OF MC 301.8.
3. VIBRATION ISOLAT	<u>10N:</u>	
ALL MECHANICAL EQU	JIPMENT SHALL BE MOUNTED AN	D SUPPORTED AS REQUIRED BY MC 301.13.
4. WIND RESISTANCE	<u>.</u>	
	JIPMENT, APPLIANCES AND SUPP LLED AS PER BC 1609 "WIND LOA	ORTS THAT EXPOSED TO WIND SHALL BE .DS."
6. FIRE STOPPING CO	OMPLIANCE NOTE:	
A. ALL DUCT AND PIP SECTION 078400.	PE PENETRATIONS OF RATED CO	NSTRUCTION SHALL COMPLY WITH SPECS
7. DUCT CONSTRUCT	ION AND INSTALLATION:	
DURABILITY PER NYS SMACNA HVAC DUCT	MC 603. ALL METALIC DUCTS SH/ CONSTRUCTION STANDARDS-ME	LLED TO PROVIDE STRUCTURAL STRENGTH ALL BE CONSTRUCTED AS SPECIFIED IN THE TAL AND FLEXIBLE PER NYS MC 603.4.
	• •	
8. DUCT INSULATION		MENTS OF NVSECC CA02 44 4 ALL SUDDLV A
DUCT INSULATION SH		MENTS OF NYSECC C403.11.1. ALL SUPPLY A ED WITH A MINIMUM OF R-12 INSULATION.
DUCT INSULATION SHA	ND PLENUMS SHALL BE INSULAT	
DUCT INSULATION SH	ND PLENUMS SHALL BE INSULAT	
DUCT INSULATION SHARETURN AIR DUCTS AN RETURN AIR DUCTS AN 9. HYDRONIC PIPING SYST	ND PLENUMS SHALL BE INSULAT	ED WITH A MINIMUM OF R-12 INSULATION. HALL COMPLY WITH MC CHAPTER 12. PIPE IN
DUCT INSULATION SHARETURN AIR DUCTS AN RETURN AIR DUCTS AN 9. HYDRONIC PIPING SYST	ND PLENUMS SHALL BE INSULAT	ED WITH A MINIMUM OF R-12 INSULATION. HALL COMPLY WITH MC CHAPTER 12. PIPE IN
DUCT INSULATION SHA RETURN AIR DUCTS A 9. HYDRONIC PIPING HYDRONIC PIPING SYST INSTALLED IN BUILDING FLUID HOT WATER	ND PLENUMS SHALL BE INSULAT EMS THAT ARE PART OF HVAC SI S SHALL CONFORM TO THE REQ PIPE DIA. < 1.5" 1-1/2"	ED WITH A MINIMUM OF R-12 INSULATION. HALL COMPLY WITH MC CHAPTER 12. PIPE IN UIREMENTS OF NYSECC R403.4. PIPE DIA. >= 1.5" 2"
DUCT INSULATION SHA RETURN AIR DUCTS A 9. HYDRONIC PIPING: HYDRONIC PIPING SYST INSTALLED IN BUILDING FLUID HOT WATER CHILLED WATER	ND PLENUMS SHALL BE INSULAT EMS THAT ARE PART OF HVAC SI S SHALL CONFORM TO THE REQ PIPE DIA. < 1.5" 1-1/2" 1/2"	ED WITH A MINIMUM OF R-12 INSULATION. HALL COMPLY WITH MC CHAPTER 12. PIPE IN UIREMENTS OF NYSECC R403.4. PIPE DIA. >= 1.5" 2" 1"
DUCT INSULATION SHA RETURN AIR DUCTS A 9. HYDRONIC PIPING SYST INSTALLED IN BUILDING FLUID HOT WATER CHILLED WATER REFRIGERANT HYDRONIC PIPING SYST HYDROSTATICALLY AT O THAN 100 PSI FOR DURA 1208.	ND PLENUMS SHALL BE INSULAT EMS THAT ARE PART OF HVAC SI S SHALL CONFORM TO THE REQ PIPE DIA. < 1.5" 1-1/2" 1/2" 1" (1/2" FOR RS) EMS OTHER THAN GROUND-SOU DNE AND ONE HALF TIMES THE S	ED WITH A MINIMUM OF R-12 INSULATION. HALL COMPLY WITH MC CHAPTER 12. PIPE IN UIREMENTS OF NYSECC R403.4. PIPE DIA. >= 1.5" 2" 1" 1-1/2" RCE HEAT PUMP LOOP SYSTEMS SHALL BE YSTEM DESIGN OPERATING PRESSURE, BUT HOURS. HYDRONIC TESTING SHALL COMPL

		REQU	IRED OUTDOOR	VENILATION	AIR				
						REQUIRE	D OUTDO	DOR AIR	
ROOM				OCCUDANT	OCCUPANCY	QUA	NTITIES (	CFM)	DESIGNED 0.4
ROOM	ROOM NAME	NET AREA	MC 403.3.1.1	OCCUPANT		NYS M	C 2014:	403.3	AIR QUANTITIE
NUMBER		(SQ.FT)	OCCUPANCY USE	LOAD FACTOR	LOAD		0.A./S		(CFM)
						RSON	Q.FT.	0.A.	
			DOAS-1					0.1.1	
ST FLOOR									
101	TRAINING KITCHEN	180	B - BUSINESS	100 GROSS	2	5	0.06	21	50
105	CAFE SEATING	846	B - BUSINESS	100 GROSS	9	5	0.06	96	100
106	CAFÉ STORAGE	103	B - BUSINESS	300 GROSS	1	5	0.06	12	25
108	SUPERVISOR OFFICE	195	B - BUSINESS	100 GROSS	2	5	0.06	22	25
109	STORAGE	108	B - BUSINESS	300 GROSS	1	5	0.06	12	25
110	BREAK ROOM/CHART ROOM	156	B - BUSINESS	100 GROSS	2	5	0.06	20	25
111	EMPLYMENT/COMPUTER ROOM	310	B - BUSINESS	100 GROSS	4	5	0.06	39	50
112	COMMUNITY LIVING	230	B - BUSINESS	100 GROSS	3	5	0.06	29	50
113	COMMUNITY CONNECTION	236	B - BUSINESS	100 GROSS	3	5	0.06	30	50
114	LIVING MUSEUM	2,454	B - BUSINESS	100 GROSS	25	7.5	0.06	335	400
115	GATHERING SPACE	369	B - BUSINESS	100 GROSS	4	5	0.06	43	50
116	OFFICE COBICLES	252	B - BUSINESS	100 GROSS	3	5	0.06	31	50
126	CORRIDOR	380	B - BUSINESS		0	0	0.06	23	300
ID FLOOR									-
200	PURGED CHARTING	187	B - BUSINESS	100 GROSS	2	5	0.06	22	25
201	TRATMENT ROOM	170	B - BUSINESS	100 GROSS	2	5	0.06	21	25
204	OFFICE	138	B - BUSINESS	100 GROSS	2	5	0.06	19	25
205	TELE PSECH OFFICE	181	B - BUSINESS	100 GROSS	2	5	0.06	21	25
206	TELE PSECH OFFICE	188	B - BUSINESS	100 GROSS	2	5	0.06	22	25
207	TELE PSECH OFFICE	182	B - BUSINESS	100 GROSS	2	5	0.06	21	25
208	PRESCRIBER OFFICE	178	B - BUSINESS	100 GROSS	2	5	0.06	21	25
209	OFFICE	137	B - BUSINESS	100 GROSS	2	5	0.06	19	25
210	PRESCRIBER OFFICE	137	B - BUSINESS	100 GROSS	2	5	0.06	19	25
211	OFFICE	208	B - BUSINESS	100 GROSS	3	5	0.06	24	25
212	SERVER	121	B - BUSINESS	100 GROSS	2	5	0.06	18	25
213	WAITING ROOM	214	B - BUSINESS	100 GROSS	3	5	0.06	25	25
214	RECEPTION / CHARTS	414	B - BUSINESS	100 GROSS	5	5	0.06	50	50
215	SERVICE DIRECTOR OFFICE	190	B - BUSINESS	100 GROSS	2	5	0.06	22	25
216	OFFICE	152	B - BUSINESS	100 GROSS	2	5	0.06	20	25
217	OFFICE	152	B - BUSINESS	100 GROSS	2	5	0.06	20	25
218	OFFICE	178	B - BUSINESS	100 GROSS	2	5	0.06	21	25
220	STAFF CONF ROOM	295	B - BUSINESS	100 GROSS	3	5	0.06	33	50
221	OFFICE / SWING SPACE	264	B - BUSINESS	100 GROSS	3	5	0.06	31	50
225	OFFICE	178	B - BUSINESS	100 GROSS	2	5	0.06	21	25
226	OFFICE	172	B - BUSINESS	100 GROSS	2	5	0.06	21	25
227	OFFICE	172	B - BUSINESS	100 GROSS	2	5	0.06	21	25
228	OFFICE	161	B - BUSINESS	100 GROSS	2	5	0.06	20	25
231	GROUP ROOM	268	B - BUSINESS	100 GROSS	3	5	0.06	32	50
232	CORRIDOR	1368	B - BUSINESS	0	0	0	0.06	83	200
			TOTAL						2300

	HVAC DRAWINGS LIST
M001.00	HVAC NOTES, SYMBOLS, ABBREVIATIONS, DESIGN PARAMETERS & DRAWING LIST
M002.00	HVAC SCHEDULES SHEET #1
M060.00	HVAC CELLAR DEMO PLAN
M061.00	HVAC FIRST FLOOR DEMO PLAN
M062.00	HVAC SECOND FLOOR DEMO PLAN
M063.00	HVAC ATTIC DEMO PLAN
M100.00	HVAC CELLAR PLAN
M101.00	HVAC FIRST FLOOR PLAN
M102.00	HVAC SECOND FLOOR PLAN
M103.00	HVAC ATTIC PLAN
M200.00	HVAC PIPING CELLAR PLAN
M201.00	HVAC PIPING FIRST FLOOR PLAN
M202.00	HVAC PIPING SECOND FLOOR PLAN
M203.00	HVAC PIPING ATTIC FLOOR PLAN
M401.00	HVAC AIR RISER DIAGRAM
M402.00	HVAC HOT GLYCOL RISER DIAGRAMS
M403.00	HVAC CHILLED GLYCOL RISER DIAGRAMS
M404.00	HVAC HYDRONIC FLOW DIAGRAMS
M405.00	HVAC CONDENSATE RISER DIAGRAMS
M406.00	CONTROL DIAGRAM SHEET#1
M407.00	CONTROL DIAGRAM SHEET#2
M501.00	HVAC DETAILS SHEET#1
M502.00	HVAC DETAILS SHEET #2

NEW YORK STATE OF OPPORTUNITY. Y 515 Broadway, Albany, NY 12207-2964 WWW. DASNY.ORG NEW YORK Office of STATE OF OPPORTUNITY. Mental Health Y 10 Ross Circle, Suite 5N, Poughkeepsie, NY 1260 WWW.OMH.NY.GOV ESE DOCUMENTS CONTAIN POTENTIALLY SENSITIVE INFORMATIO JSED FOR THEIR INTENDED PURPOSE. ONCE THE INTENDED PURPOSE HAS IT IS A VIOLATION OF STATE EDUCATION LAW FOR ANY PERSON, UNLESS DIRECTION OF A LICENSED ARCHITECT/ENGINEER TO ALTER THIS DOCUM ANYWAY. ALTERATIONS MUST HAVE THE SEAL AFFIXED ALONG WITH A DES OF THE ALTERATIONS, DATE AND ARCHITECT'S/ENGINEER'S SIGNATURE. CC Consultants: 589 8TH AVE, 7 FL, NEW YORK, NY 10018 PHONE 212-242-3735 / FAX 212-242-7460 DVL CONSULTING ENGINEERS, INC. MEP ENGINEER / FIRE ALARM / FIRE PROTECTION 276 5TH AVENUE, SUITE 704 | NEW YORK, NY 10001 PHONE 212.947.7740 WSP GROUP STRUCTURAL ENGINEER ONE PENN PLAZA, 2ND FL | NEW YORK, NY 10119 PHONE 212.465.5000 QUALITY ENVIRONMENTAL SOLUTIONS & TECHNOLOGIES HAZMAT CONSULTANT 1376 US 9 | WAPPINGERS FALLS, NY 12590 PHONE 845.298.6031 GEORGE D. CATTABIANI & ASSOCIATES INC. ELEVATOR CONSULTANT 420 PAULDING AVENUE | NORTHVALE NJ 07647 PHONE 201.768.7331 TROPHY POINT COST ESTIMATOR 4588 SOUTH PARK AVENUE | NEW YORK NY 10001 PHONE 716.823.0006 HIRANI ENGINEERING & LAND SURVEYING, P.C. LAND SURVEY CONSULTANT 120 WEST JOHN STREET | HICKSVILLE NY 11801 PHONE 516.248.1010 KEY PLAN REVISIONS NO DESCRIPTION DATE Client DORMITORY AUTHORITY STATE OF NEW YORK 515 BROADWAY ALBANY, NY 12207 Project Title **BUILDING 1 RENOVATION AND** HAZARDOUS MATERIALS ABATEMENT 140 OLD ORANGEBURG RD ORANGETOWN, NY 10962 Drawing Title HVAC NOTES, SYMBOLS, ABBREVIATIONS, DESIGN PARAMETERS & DRAWING LIST Phase 100 SUBMISSION Ďrawn By: Checked By: Date: AK 05 / 13 / 2 Seal & Signature DASNY Project No 3536 rawing Numbe M001.00

DOAS-1			TOTAL SUPPLY	TOTAL S.P. (IN	. EXT.		N			EAT (		LAT	(°F)	EWT	LWT	
OTES:	OCATION ATTIC ( CELLAR	SERVICE DFFICE SPACES CELLAR	(CFM) 2200 1500	W.G.) 3.27 2.36		V.G.) QT 50 1	Y. HP 3.00	2.68 18	800 9	DB 5.0 5.0	WB 75.0 75.0	DB 66.4 66.3	WB 65.3 65.4	(°F) 45.0 45.0	(°F) 57.1 56.2	
DOAS-1 UNIT SH 100% OA UNIT, P DOAS-2 UNIT SHA	ROVIDE UNIT WITH	WITH VARIABLE FREQUI OUTDOOR AIRFLOW MC WITH CONDENSATE OVE ER CONTROL.	NITORING SE					LER.								
UNIT NO.	S	ERVICE	VOLT/	AGE	MCA	MROP	D CF		VER	EDB (	EAT F)	EWB (F)		LDB (F)	LAT	LW
FCU-A FCU-B FCU-C FCU-D	MULT MULT	IPLE ROOM IPLE ROOM IPLE ROOM G TOILETS	115/6 115/6 115/6 115/6	60/1 60/1	3.1 5.3 5.3 3.1	5.6 9.6 9.6 5.6	24 35 52 30	4 1/- 0 1/-	4	72 72 72 72 72		60 60 60 60		57.4 55.3 53.8 57.4		5 5 5 5
. THE FOLLOWING . PROVIDE UNITS	G DEVICES SHALL WITH 4" EXTENDE	DED WITH DISCONNECT BE SHIPPED LOOSE FOR D END POCKET ON COIL	R FIELD INSTA	N SIDE, CON									G BUT NO	T LIMITED	) TO THE	CON
. ALL FAN COIL U	NIIS TO BE PROVI	DED WITH LOW VOLTAG	EINTERFACE	BUARD.												
								0.0.0.T./	V	VATER	TEMP	HO	r wa	TER (	MAX V	VATE
UNIT NO. WCUH-C.1 WCUH-C.2		SERVICE STAIR B STAIR B	S	ERVICE STAIR B STAIR B		RFLOW (CFM) 230 230	(BT	CAPACITY <sup>-</sup> U/HR) 0169 0169	LWT ( 160 160		EWT (F) 180 180	)	GPM 1.64 1.64			
UNIT NO.	LOCATION	SEE	RVICE		CFM		CAPACITY J/HR)		ER TEMP	(E)	HOT GPM		MAX PRESSI	WATER JRE DR <sup>(</sup> . W.G.)	2	ER EA
WUH-C.1 WUH-A.1 WUH-A.2	CELLAR ATTIC ATTIC	MECHANI AT	CAL ROOM TIC TIC	Λ	450 450 450	14 14	912 912 912 912	180 180 180	, 16 16 16	0	1.8 1.8 1.8		0	.014 .014 .014		
							SPLI	T-TYPE	ΗΕΔΤ	PUM	IP SYS	TEMS	SCH	FDIII	F *	
			CAPA	ACITY PEF (BTU	r indoo J/HR)	DR UNIT	EAT									
UNIT NO. AC-1 AC-2		ERVICE MACHINE ROOM IT	24	OLING 4000 4000	2	EATING 28000 28000	DB 80.0 80.0		TYPE /ALL MOU /ALL MOU	INTED	AIR F LOW 635 635	LOW (CF HIC 77 77	GH N 15	MOTOR	OUTPL 56 56	ELE JT (W
	0		SING UNIT NO. OF	E	ELECTR	ICAL	R		NT	_						
UNIT NO. ACCU-1 ACCU-2	LOCATI ON GRA	ADE 54	COMP. 1 1	V 208 208	PH     H       1     6       1     6	0 19.5	TYPE R410A R410A	(LE	3S.) 6 6	19.3	CIENCY 3 SEER 3 SEER	PUZ	/ODEL -A24NH -A24NH	A7	UNIT V	VEIG 179 179
2. ALL AIR CONDI	TIONING UNITS TO	IG BETWEEN INDOOR AN BE PROVIDED WITH WIR TH TIME-DELAY, FILTER-I	ED PROGRAM	MABLE THE	ERMOSTA	J.						. All Uni . Providi				
								FAN	SCHE	DULE						
JNIT NO. EF-1 ELE EF-2	SERVICE ECTRICAL ROC CELLAR	LOCAT DM ELECTRICA CELL/	L ROOM	CAP.	AL AIR (CFM) 00 60	EXT. S.P. (IN. W.G.) 0.55 0.55		R FAN 1 SQUARE SQUARE	INLINE	DRIV TYPE DIREC	E IN CT TEMF	ITERLOC PERATUF PERATUF	RE SENS	SOR 1	115	TRIC PH 1
EF-3 TEF-1 TEF-2	CELLAR TOILETS TOILET	CELL/ ATTI 121-TO	AR C LET	10 84	000 40 70	0.55 0.50 0.50	0.17 0.33 0.17	SQUARE SQUARE CEILING	INLINE INLINE G FAN	DIREC DIREC DIREC	CT CT T	DOAS TIME CI LIGHT	3-2 ₋OCK SWITCI	1 1 H 1	115 115 15	1 1 1 1
OTES: ALL FAN SHAL ALL DIRECT DF	RIVEN FAN SHALL E	T   118-J TH DISCONNECT SWITC BE PROVIDED WITH FAN L MATCH THE MOTOR V	H. SPEED CONT	ROLLER.	70 E THAT IS	0.50		CEILING			4. ALL WHI	LIGHT MOTORIZE EN TESTED	D DAMPE	RS TO BE RDANCE W	VITH AMC	A 500
MATTER WHAT MOTOR FROM	THE VOLTAGE OF	THE FAN MOTOR. THE NO SEPERATE CIRCUIT	<b>MECHANICAL</b>	CONTRACTO	OR SHALL	BE RESPON	SIBLE FOR	THE WIRING (	OF THIS DAM	IPER						
										CHE		F	LECTRI			
UNIT NO. P-1 & P-2 P-3 & P-4	SECONDARY	SERVICE 1 HOT GLYCOL LOC		LOCATIC HANCIAL	ROOM	FLUID T 30% GL 30% GL	YPE	(GPM) 103 126		(FT.) 60 60	HP 5.0 5.0	RPM 1475 1608	V 208	PH 3 3	60	)
P-5 & P-6		IILLED WATER LOC		CHANCIAL		WATE	ER	119		40	2.0	1725	208	3 3	60	)
		) WITH INTEGRATED VAF ADDITIONAL INFORMAT		UENCY DRIV	'ES (VFD).											
									_	_	<u>LE</u>					
	SERVICE OT WATER HEA	LOCA ATING MECHAN OOLING MECHAN	IICAL RM	TANK DI HEIGHT 30 30		AMETER 16 16	ACCEPT VOLU (GA 11.	JME V JL) 3	ERATING VEIGHT (LBS) 271 271	CAPA (G.	1.7 [	IODEL D-40V D-40V	Bell &	ACTUR R Gossett Gossett	t A	SME SME
DTES:		ist bladder as per manufact	I		final fill pres		1	I				-				
			MAX. AIR			INET U		EATER	TOTAL							
UNIT NO. ECUH-1.1 ECUH-1.2	ST VES	RVICE TAIR B TIBULE	FLOW (CFM) 300 300		) INPUT 5000 5000	208 208	3 3	HZ 60 60	CAPACIT (MBH) 17.1 17.1	Y	MODEL CDF-558 CDF-558	3		UFACTL QMARK QMARK	( (	
ECUH-1.3	ST 121-	TAIR A TAIR C TOILET TOR CLOSET	300 300 100 100		5000 5000 1500 1500	208 208 120 120	3 3 ) 1 ) 1	60 60 60 60	17.1 17.1 5.1 5.1		CDF-558 CDF-558 LFK-151 LFK-151	}		QMARK QMARK QMARK QMARK	< < <	
ECUH-1.4 ECUH-1.5 ECUH-1.6		To:: ==			4	400	) 1	60	5.1	1	LFK-151	1		- 38 4 A DI		
ECUH-1.4 ECUH-1.5 ECUH-1.6 ECUH-2.1 NOTES: REFER TO SP	223-	TOILET ADDITIONAL INFORMATI TH NON FUSED DICONNE			<u>1500</u> 3.	120 Built in tem		THERMOSTAT		E PROVID				QMARK		
ECUH-1.4 ECUH-1.5 ECUH-1.6 ECUH-2.1 NOTES: REFER TO SP	223-	ADDITIONAL INFORMATI	ON. ECT.		3.	BUILT IN TEN	IPERATURE		E SHALL BE	E PROVID				QMARK		

NOTES: 1. REFER TO SPECIFICATION FOR ADDITIONAL INFORMATION. 2. ALL UNITS TO BE PROVIDED WITH NON FUSED DICONNECT.

3. BUILT IN TEMPERATURE THERMOSTATE SHALL BE PROVIDED INSIDE THE UNITS

S S	SCHEDL	ILE																								
G CC	DIL (30% PR	OPLYENE GL	YCOL)				HOT V	VATER HE	EATIIMG	COIL (30% PRO	PLYENE (	GLYCOL)				ELEC	CTRICA	-		DIM	IENSIONS (II	N.)				
_	CAPACI	TY (MBH)		WATER						TOTAL		WATER														
Т				P.D. (FT.	NO. OF	EAT	LAT (DB	EWT	LWT	CAPACITY		P.D. (FT.	NO. OF										WEIGHT			
)	TOTAL	SENSIBLE	GPM	W.G.)	ROWS	(DB °F)	°F)	(°F)	(°F)	(MBH)	GPM	W.G.)	ROWS	V	PH	ΗZ	FLA	MCA	MOP	L	W	Н	(LBS.)	MODEL	MANUFACTURER	REMARKS
1	81990	69160	15	5.42	6	11	73.4	180.0	158.1	148500	15	6.15	2	208	3	60	9	11	15	74.4	48.2	28.0	1200	HHA25BACAAAH2AGDBAAABM	MAGIC AIRE	
2	39723	30147	8	4.32	4	11	74.5	180.0	160.0	118469	11	5.83	2	208	3	60	4	5	15	46.0	37.0	18.0	257	BCHD0101	DAIKIN	

				FAI	N COIL UN	T SCHEDU	ILE															
	CHIL	LED WATER COOLI	NG COIL								HOT WATER H	HEATING COIL					DIMENSIONS					
Г	TOTAL CAPACITY	TOTAL SENSIBLE	ENTERING WATER	LEAVING WATER	FLUID FLOW					TOTAL CAPACITY	ENTERING WATER	LEAVING WATER	FLUID FLOW									
LWB (F)	(BTU/HR)	(BTU/HR)	TEMP. (F)	TEMP (F)	RATE GPM	FLUID TYPE	COIL ROWS	EDB (F)	LDB (F)	(BTU/HR)	TEMP. (F)	TEMP. (F)	RATE GPM	FLUID TYPE	COIL ROWS	DEPTH (IN)	WIDTH (IN)	HEIGHT (IN)	QUANTITY	MODEL	MANUFACTURER	REMARKS
54.5	8800	6400	45	55	1.8	30% GLYCOL	4	70	89.8	7800	180	160	1.2	30% GLYCOL	1	10.0	48.5	27.6	28	FCVS103	DAIKIN	WALL MOUNTED
53.6	10100	8100	45	55	2.1	30% GLYCOL	3	70	89.8	11000	180	160	1.8	30% GLYCOL	1	10.0	54.0	27.6	7	FCVS104	DAIKIN	WALL MOUNTED
52.4	16700	12400	45	55	3.4	30% GLYCOL	3	70	93.2	15000	180	160	2.7	30% GLYCOL	1	10.0	65.0	27.6	10	FCVS106	DAIKIN	WALL MOUNTED
54 5	5500	5100	45	55	1.1	30% GLYCOL	2	70	89.8	6900	180	160	0.9	30% GLYCOL	1	21.5	30.48	9.88	4	FCHH103	DAIKIN	CEILING RECESSED

ROL VALVES SHALL BE FURNISHED AND INSTALLED AT THE FACTORY.

NET UN	IT HEAT	ER SCHE	DULE						
VATER	AIR	TEMP		ELEC	CTRICAL I	DATA			
RE DROP N.G.)	EAT (F)	LAT (F)	VOLTAGE	PHASE	HZ	AMPERES	MODEL NO	MANUFACTURER	REMARKS
15	60	96	115	1	60	0.8	FS-1005-03	VULCAN	Cabinet Unit Heater - Floor
15	60	96	115	1	60	0.8	FS-1005-03	VULCAN	Cabinet Unit Heater - Floor

R	S	<u>C</u> l	ΗE	D	U	

AIR TEMP ELECTRICAL DATA									
EAT (F)	LAT (F)	VOLTAGE	PHASE	HZ	AMPERES	MOTOR HP	MODEL NO	MANUFACTURER	REMARKS
60	96	115	1	60	0.8	16 WATTS	HA-24	VULCAN	
60	96	115	1	60	0.8	16 WATTS	HA-24	VULCAN	
60	96	115	1	60	0.8	16 WATTS	HA-24	VULCAN	

PORAT	TOR							
ELECT	RICAL							
「(W)	V	PH	HZ	MODEL	MANU	FACTURER		
	208	1	60	PKA-A24KA	MIT	MITSUBISHI		
	208	1	60	PKA-A24KA	MITSUBISHI			
EIGHT (LBS) MANUFACTURE		ACTURE	R REMARKS					
179				REFER TO NOTES	3			
179		MITS	UBISHI	REFER TO NOTES	3			

MBIENT CONTROLLER (FLOODED CONDENSER), WINTER START CONTROL EVAPORATOR FREEZE THERMOSTAT. IT BRACKET.

RIG	CAL			
Н	HZ	MODEL NO.	MANUFACTURER	REMARKS
	60	90SQN15D	LOREN COOK	SEE NOTES
	60	90SQN15D	LOREN COOK	SEE NOTES
	60	100SQN28D	LOREN COOK	SEE NOTES
	60	100SQN28D	LOREN COOK	SEE NOTES
	60	GC-148	LOREN COOK	SEE NOTES
	60	GC-148	LOREN COOK	SEE NOTES

ORIZED DAMPERS (WITH A MAXIMUM LEAKAGE RATE OF 4 CFM/SF AT 1.0" W.C. D) THAT WILL AUTOMATICALLY SHUT OFF WHEN THE SYSTEM OR SPACES

 MODEL	MANUFACTURER	REMARKS
e-80 2x2x9.5C	BELL & GOSSETT	INLINE MOUNTED PUMP
e-80 2x2x9.5C	BELL & GOSSETT	INLINE MOUNTED PUMP
e-80 2.5x2.5x7B	BELL & GOSSETT	INLINE MOUNTED PUMP

REMARKS
ME Rated Pre-Charged Diaphragm Tanks
ME Rated Pre-Charged Diaphragm Tanks

REMARKS
REFER TO NOTES

	HEAT EXCHANGER SCHEDULE													
					COLD SI	DE				HOT SI	DE			
UNIT NO.	SERVICE	LOCATION	FLUID TYPE	GPM	EWT (°F)	LWT (°F)	WATER P.D. (PSI)	FLUID TYPE	GPM OR LB/HR	INLET TEMP (°F)	OUT TEMP (°F)	P.D. (PSI)	MODEL	MANUFACTURER
HX-1	SECONDARY HOT GLYCOL LOOP	MECHANCIAL ROOM	30% GLYCOL	103	160	180	2.86	STEAM	1019	239	239	0.16	SU-66-2	BELL & GOSSETT
HX-2 (STANDBY)	SECONDARY HOT GLYCOL LOOP	MECHANCIAL ROOM	30% GLYCOL	103	160	180	2.86	STEAM	1019	239	239	0.16	SU-66-2	BELL & GOSSETT
HX-3	SECONDARY CHILLED GLYCOL LOOP	MECHANICAL ROOM	WATER	119	42	52	6.89	30% GLYCOL	127	55	45	9.73	AP64	BELL & GOSSETT

<u>NOTES:</u> 1. CONNECTIONS TO BE 150# ANSI FLANGE, 4" DIA. 2. PROVIDE RELIEF VALVE FOR THE PLATE AND FRAM HEAT EXCHANGER.

SCHEDULE FOR WALL MOUNTED SUPPLY AIR REGISTER											
CFM RANGE	CORE AREA (SQ. FT.)	NOMINAL DUCT SIZE W X H (IN.)	ANGLE OF DEFLECTION (DEGREES)(IN.)	SPACING	MAX. NOISE RATING (NC)	MODEL	MANUFACTURE				
50-200	5	10 X 6	22.5	0.75	20	300RL	TITUS				
201-360	6	16 X 8	22.5	0.75	20	300RL	TITUS				
361-450	7	18 X 8	22.5	0.75	20	300RL	TITUS				
451-500	8	24 X 8	22.5	0.75	20	300RL	TITUS				
501-600	10	20 X 10	22.5	0.75	20	300RL	TITUS				
601-700	12	28 X 8	22.5	0.75	20	300RL	TITUS				

NOTES: 1. CONTRACTOR SHALL COORDINATE REGISTER'S BORDER TYPE WITH ARCHITECT. 2. CONTRACTOR SHALL COORDINATE REGISTER'S COLOR WITH ARCHITECT.

	SCHEDULE FOR WALL MOUNTED RETURN AIR GRILLE											
CFM RANGE	NECK SIZE W X H (IN.)	MAX. DUCT VELOCITY (FPM)	CORE AREA (SQ. FT.)	MAX. NOISE RATING (NC)	MODEL	MANUFACTURER						
0-120	10 X 6	400	0.37	20	355RL	TITUS						
121-300	18 X 6	500	0.63	20	355RL	TITUS						
301-440	18 X 8	500	0.88	20	355RL	TITUS						
441-650	22 X 10	500	1.37	20	355RL	TITUS						
651-900	24 X 12	500	1.82	20	355RL	TITUS						

NOTES: 1. CONTRACTOR SHALL COORDINATE GRILLE'S COLOR WITH ARCHITECT.



		GL	YCOL WAT			<u>0P</u>	UNII	-			
			TANK CAPACITY	ELECTRICAL DATA			DIMENSIONS (IN.)			MANUFACTURE	
UNIT NO.	SERVICE	LOCATION	(GALLONS)	V	PH	HZ	н	D	MODEL	R	REMARKS
GMU-1	HOT WATER	MECHANCIAL ROOM	55	120	1	60	59	28	GMU-55	TIGERFLOW	
GMU-2	CHILLED WATER	MECHANCIAL ROOM	55	120	1	60	59	28	GMU-55	TIGERFLOW	

	AIR SEPARATOR SCHEDULE											
UNIT				MAXIMUM UNIT	OPERATING WEIGHT							
NO.	LOCATION	SERVICE	TYPE	CAPACITY (GPM)	(LBS)	MODEL	MANUFACTURER	REMARKS				
AS-1	MECHANICAL RM	HOT WATER LOOP	FLANGED NO STRAINER	140	63	RL-2N	BELL & GOSSET	REFER TO NOTES				
AS-2	MECHANICAL RM	CHILLED WATER LOOP	FLANGED NO STRAINER	140	63	RL-2N	BELL & GOSSET	REFER TO NOTES				
AS-3	MECHANICAL RM	CHILLED WATER LOOP	FLANGED NO STRAINER	140	63	RL-2N	BELL & GOSSET	REFER TO NOTES				

<u>NOTES:</u> 1. PROVIDE FOLLOWING OPTIONS: - BLOW DOWN VALVE (SIZED PER MANUFACTURER'S RECOMMENDATION)

- SKIM VALVE (WITH HOSE BIB) - AIR VENT (INSTALLED & PROVIDED BY MANUFACTURER) - BASE RING (ONLY REQUIRED ON FLOOR MOUNTED APPLICATION)

DUPLEX STEAM CONDENSATE RETURN PUMP UNIT											
SERVICE	LOCATION	SYSTEM CAPACITY LBS/HR	TOTAL RECEIVER CAPACITY (GALLONS)	PUMP CAPACITY GPM (EACH)	TOTAL PUMP PSIG. (EACH)	MOTOR RPM (EACH)	MOTOR HP (EACH)	V/PH/HZ	MANUFACTURER	MODEL NO.	
STEAM SYSTEM	MECHANICAL ROOM	3491	14	15	25	3500	1/2	208/3/60	BELL & GOSSETT	152CC	

NOTES: 1. PUMP TO BE PROVIDED WITH FACTORY MOUNTED CONTROL PANEL, WATER LEVEL GAUGE, DIAL THERMOMETER, INLET STRAINERS, DISCHARGE PRESSURE GAUGES, ELECTRIC ALTERNATOR, MAGNETIC STARTERS, DISCONNECT SWITCHES, CIRCUIT BREAKERS, SELECTOR SWOTCHES, TRANSFORMER AND PILOT LIGHT.

3. REFER TO SPECIFICATIONS FOR ADDITIONAL INFORMATION. 4. INCOMING STEAM PRESSURE=12PSI.

SCHEDULE FOR CEILING MOUNTED SUPPLY AIR DIFFUSERS											
CFM RANGE	NECK DIA. (IN.)	MAX. DUCT VELOCITY (FPM)	NOMINAL LOUVERED AREA SIZE W X H (IN.)	MAX. NOISE RATING (NC)	MODEL	MANUFACTURER					
0-68	5	500	12 X 12	20	TMSA	TITUS					
69-100	6	500	12 X 12	20	TMSA	TITUS					
101-135	7	500	12 X 12	20	TMSA	TITUS					
136-175	8	500	24 X 24	20	TMSA	TITUS					
176-270	10	500	24 X 24	20	TMSA	TITUS					
271-390	12	500	24 X 24	20	TMSA	TITUS					
391-600	14	500	24 X 24	20	TMSA	TITUS					


NOTES: 1. KITCHEN DIFFUSERS SHALL BE ALUMINUM WITH CLEAR SATIN ANODIZED FINISH. 2. CONTRACTOR SHALL COORDINATE DIFFUSER'S FRAME TYPE WITH APPROVED CEILING TYPE.


SCHEDULE FOR CEILING MOUNTED RETURN AIR GRILLES							
CFM RANGE	NECK SIZE W X H (IN.)	MAX. DUCT VELOCITY (FPM)	CORE AREA (SQ. FT.)	MAX. NOISE RATING (NC)	MODEL	MANUFACTURER	
0-160	8 X 8	400	0.37	20	355RL	TITUS	
161-340	12 X 12	500	0.88	20	355RL	TITUS	
341-540	16 X 16	500	1.62	20	355RL	TITUS	
541-1250	24 X 24	400	3.75	20	355RL	TITUS	
1250-3000	48 X 24	400	7.63	20	355RL	TITUS	
NOTES:	40 / 24	+00	1.00	20		1100	

NOTES. 1. ALL NON-DUCTED GRILLES SHALL BE SIZE 24X24. 2. ALL RETURN GRILLES IN CLASSROOM SHALL BE SIZE 24X24 REGARDLESS OF CFM. 3. CONTRACTOR SHALL COORDINATE REGISTER'S BORDER TYPE WITH APPROVED CEILING TYPE.

4. KITCHEN GRILLES SHALL BE ALUMINUM WITH CLEAR SATIN ANODIZED FINISH MODEL 350 ZFS.


NEW YORK STATE OF OPPORTUNITY. Y 515 Broadway, Albany, NY 12207-2964 WWW. DASNY.ORG NEW YORK STATE OF OPPORTUNITY. I Mental Health Y 10 Ross Circle, Suite 5N, Poughkeepsie, NY 12601 WWW.OMH.NY.GOV HESE DOCUMENTS CONTAIN POTENTIALLY SENSITIVE INFORMATION A SHALL BE USED FOR THEIR INTENDED PURPOSE. ONCE THE INTENDED PURPOSE HAS ITS A VIOLATION OF STATE EDUCATION LAW FOR ANY PERSON, UNLESS UND DIRECTION OF A LICENSED ARCHITECT/ENGINEER TO ALTER THIS DOCUMENT ANYWAY. ALTERATIONS MUST HAVE THE SEAL AFFIXED ALONG WITH A DESCI OF THE ALTERATIONS, DATE AND ARCHITECT'S/ENGINEER'S SIGNATURE. COP Consultants: 589 8TH AVE, 7 FL, NEW YORK, NY 10018 PHONE 212-242-3735 / FAX 212-242-7460 DVL CONSULTING ENGINEERS, INC. MEP ENGINEER / FIRE ALARM / FIRE PROTECTION 276 5TH AVENUE, SUITE 704 | NEW YORK, NY 10001 PHONE 212.947.7740 WSP GROUP STRUCTURAL ENGINEER ONE PENN PLAZA, 2ND FL | NEW YORK, NY 10119 PHONE 212.465.5000 QUALITY ENVIRONMENTAL SOLUTIONS & TECHNOLOGIES HAZMAT CONSULTANT 1376 US 9 | WAPPINGERS FALLS, NY 12590 PHONE 845.298.6031 GEORGE D. CATTABIANI & ASSOCIATES INC. ELEVATOR CONSULTANT 420 PAULDING AVENUE | NORTHVALE NJ 07647 PHONE 201.768.7331 TROPHY POINT COST ESTIMATOR 4588 SOUTH PARK AVENUE | NEW YORK NY 10001 PHONE 716.823.0006 HIRANI ENGINEERING & LAND SURVEYING, P.C. 120 WEST JOHN STREET | HICKSVILLE NY 11801 PHONE 516.248.1010 KEY PLAN REVISIONS REV NO DESCRIPTION DATE Date 1 Revision 1 Client DORMITORY AUTHORITY STATE OF NEW YORK 515 BROADWAY ALBANY, NY 12207 Project Title BUILDING 1 RENOVATION AND HAZARDOUS MATERIALS ABATEMENT 140 OLD ORANGEBURG RD ORANGETOWN, NY 10962 Drawing Title HVAC SCHEDULES SHEET Phase 100 SUBMISSION Drawn By: Checked By: Date: 05 / 13 / Seal & Signature DASNY Project No 3536 ving Numbe 1002.00 rawing

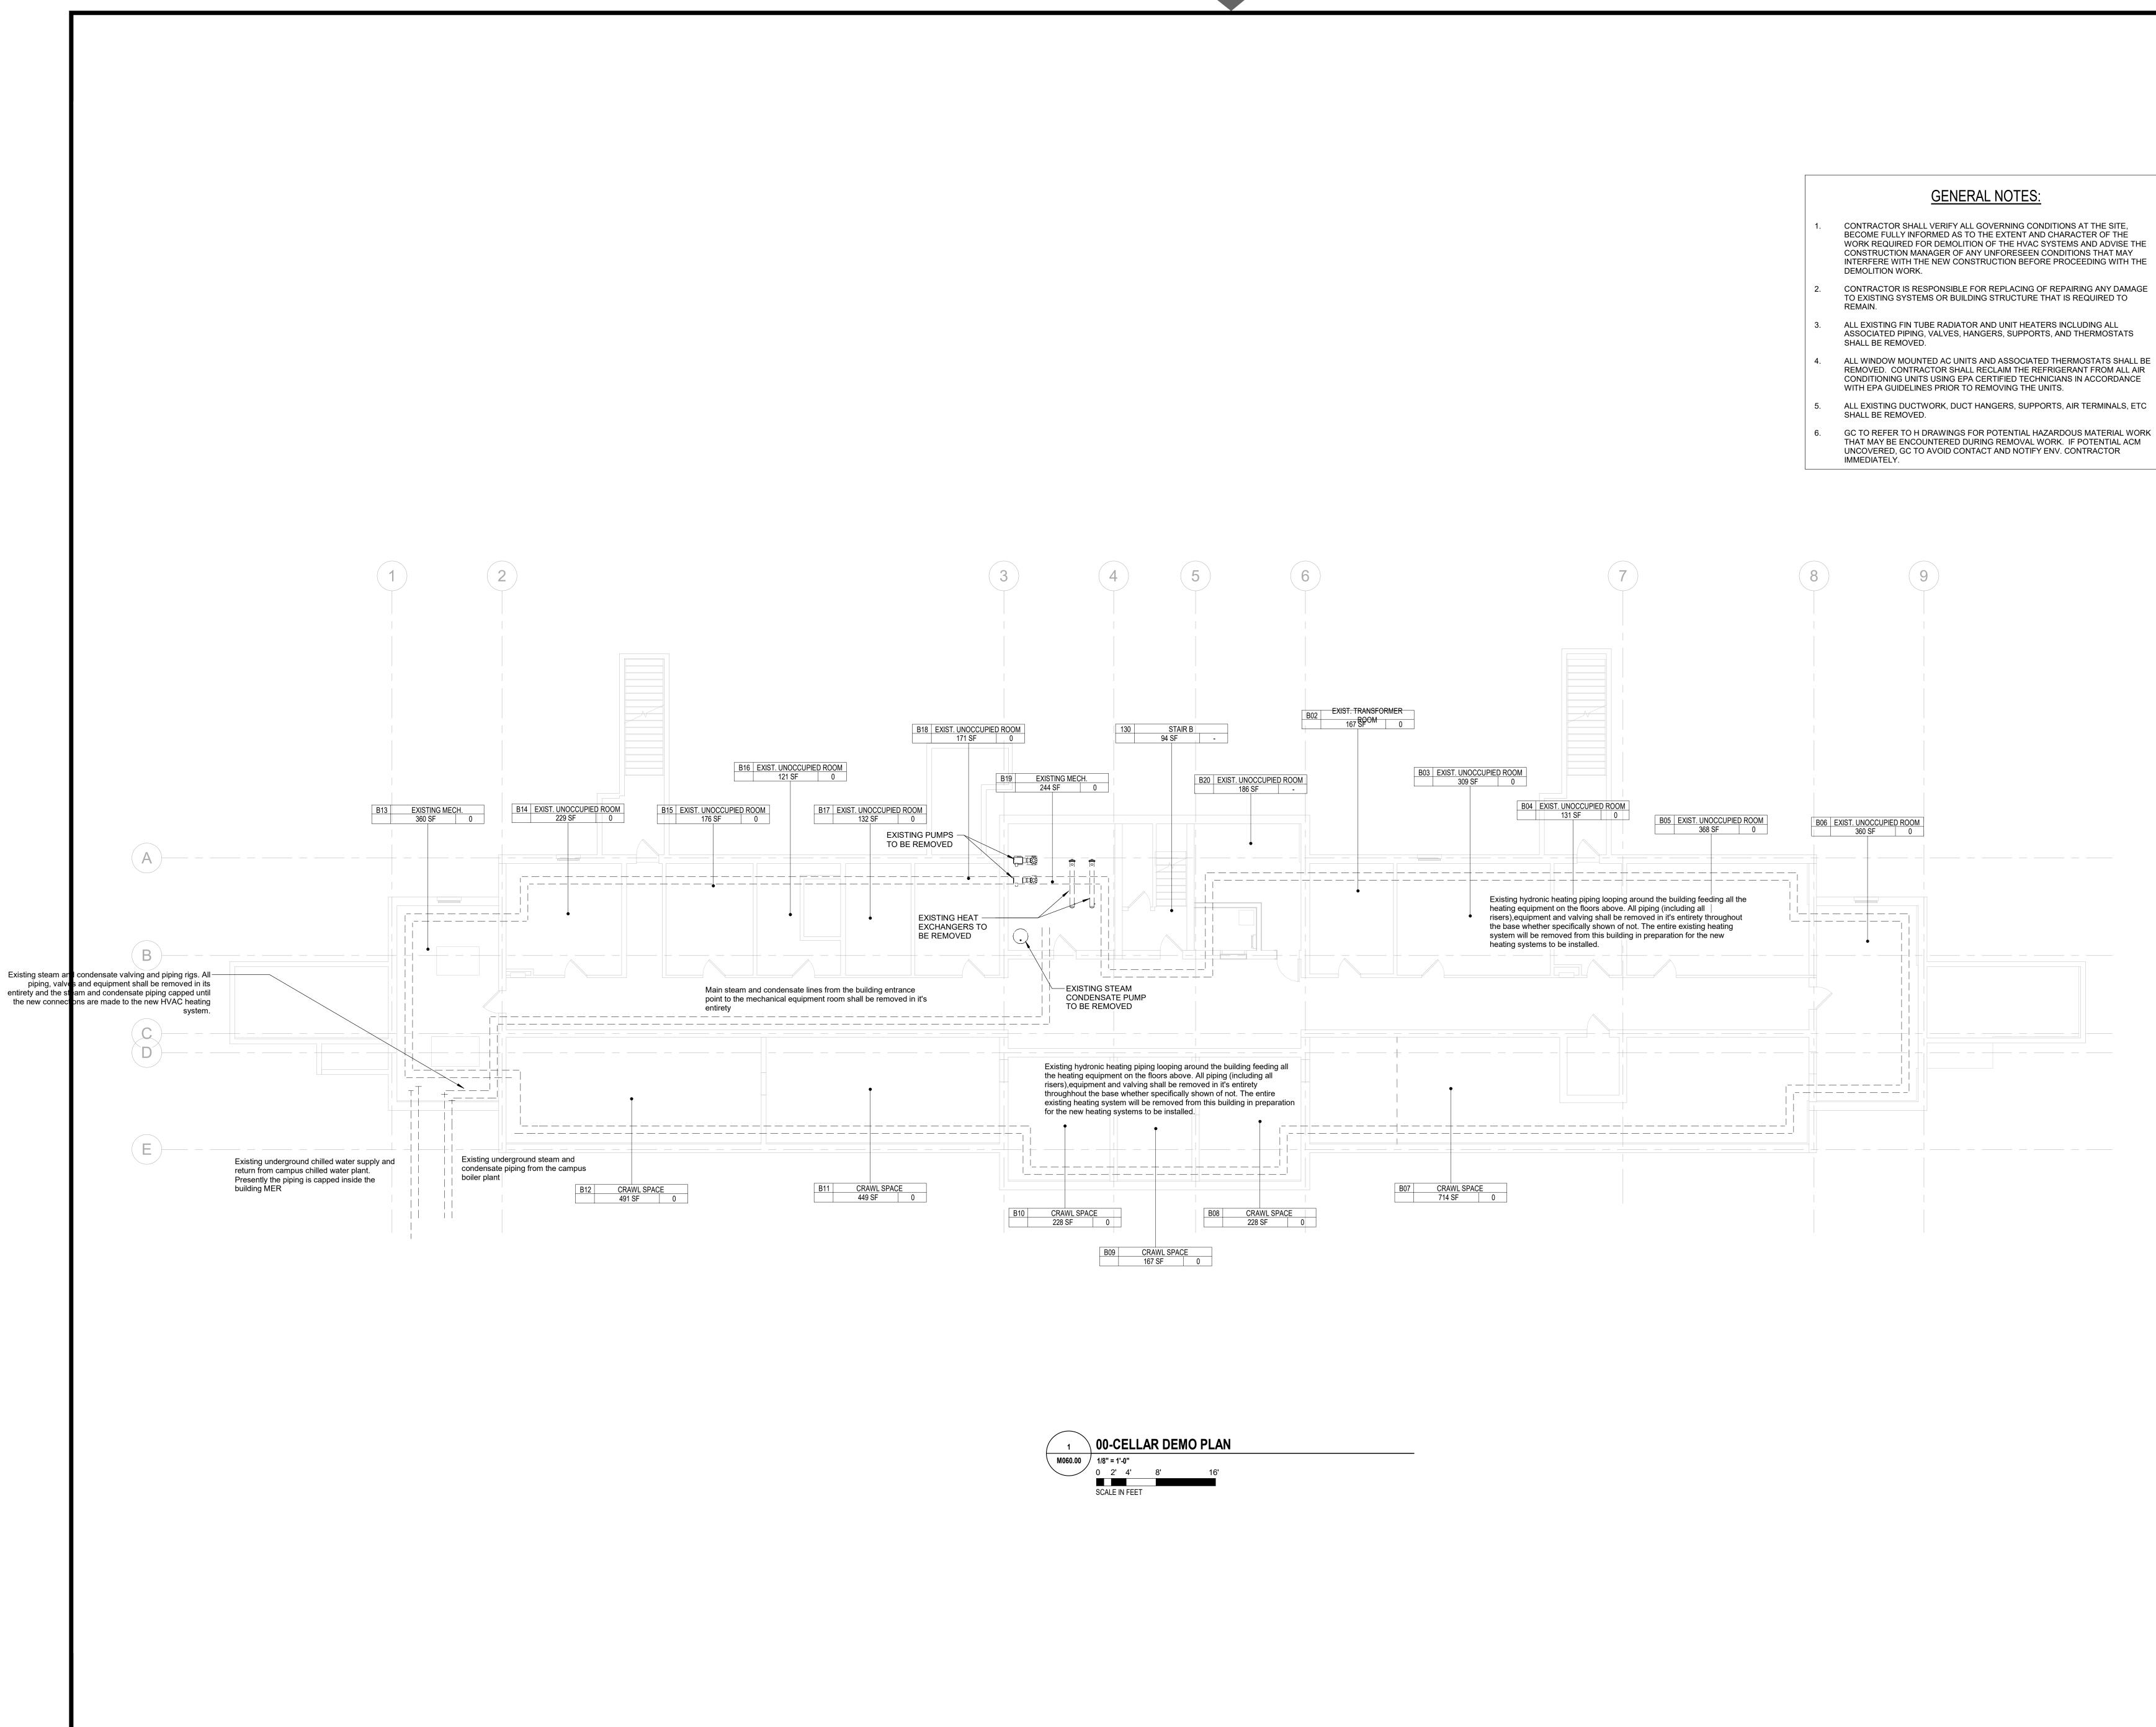

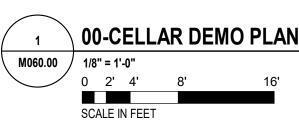



- BECOME FULLY INFORMED AS TO THE EXTENT AND CHARACTER OF THE WORK REQUIRED FOR DEMOLITION OF THE HVAC SYSTEMS AND ADVISE THE CONSTRUCTION MANAGER OF ANY UNFORESEEN CONDITIONS THAT MAY INTERFERE WITH THE NEW CONSTRUCTION BEFORE PROCEEDING WITH THE
- TO EXISTING SYSTEMS OR BUILDING STRUCTURE THAT IS REQUIRED TO
- ASSOCIATED PIPING, VALVES, HANGERS, SUPPORTS, AND THERMOSTATS
- REMOVED. CONTRACTOR SHALL RECLAIM THE REFRIGERANT FROM ALL AIR CONDITIONING UNITS USING EPA CERTIFIED TECHNICIANS IN ACCORDANCE
- THAT MAY BE ENCOUNTERED DURING REMOVAL WORK. IF POTENTIAL ACM UNCOVERED, GC TO AVOID CONTACT AND NOTIFY ENV. CONTRACTOR

NEW YORK STATE OF OPPORTUNITY. Y 515 Broadway, Albany, NY 12207-2964 WWW. DASNY.ORG NEW YORK STATE OF OPPORTUNITY. Office of Mental Health Y 10 Ross Circle, Suite 5N, Poughkeepsie, NY 12601 WWW.OMH.NY.GOV HESE DOCUMENTS CONTAIN POTENTIALLY SENSITIVE INFORMATION A SHALL BE USED FOR THEIR INTENDED PURPOSE. ONCE THE INTENDED PURPOSE HAS IT IS A VIOLATION OF STATE EDUCATION LAW FOR ANY PERSON, UNLESS UI DIRECTION OF A LICENSED ARCHITECT/ENGINEER TO ALTER THIS DOCUMEI ANYWAY. ALTERATIONS MUST HAVE THE SEAL AFFIXED ALONG WITH A DES OF THE ALTERATIONS, DATE AND ARCHITECT'S/ENGINEER'S SIGNATURE. CO Consultants: 589 8TH AVE, 7 FL, NEW YORK, NY 10018 PHONE 212-242-3735 / FAX 212-242-7460 DVL CONSULTING ENGINEERS, INC. MEP ENGINEER / FIRE ALARM / FIRE PROTECTION 276 5TH AVENUE, SUITE 704 | NEW YORK, NY 10001 PHONE 212.947.7740 WSP GROUP STRUCTURAL ENGINEER ONE PENN PLAZA, 2ND FL | NEW YORK, NY 10119 PHONE 212.465.5000 QUALITY ENVIRONMENTAL SOLUTIONS & TECHNOLOGIES HAZMAT CONSULTANT 1376 US 9 | WAPPINGERS FALLS, NY 12590 PHONE 845.298.6031 GEORGE D. CATTABIANI & ASSOCIATES INC. ELEVATOR CONSULTANT 420 PAULDING AVENUE | NORTHVALE NJ 07647 PHONE 201.768.7331 TROPHY POINT COST ESTIMATOR 4588 SOUTH PARK AVENUE | NEW YORK NY 10001 PHONE 716.823.0006 HIRANI ENGINEERING & LAND SURVEYING, P.C. LAND SURVEY CONSULTANT 120 WEST JOHN STREET | HICKSVILLE NY 11801 PHONE 516.248.1010 KEY PLAN REVISIONS REV NO DESCRIPTION DATE Client DORMITORY AUTHORITY STATE OF NEW YORK 515 BROADWAY ALBANY, NY 12207 Project Title **BUILDING 1 RENOVATION AND** HAZARDOUS MATERIALS ABATEMEN 140 OLD ORANGEBURG RD ORANGETOWN, NY 10962 Drawing Title HVAC CELLAR DEMO PLAN Phase 100 SUBMISSION Ďrawn By: 05 / 13 / Seal & Signature ASNY Project No ing Numbe /1060.00

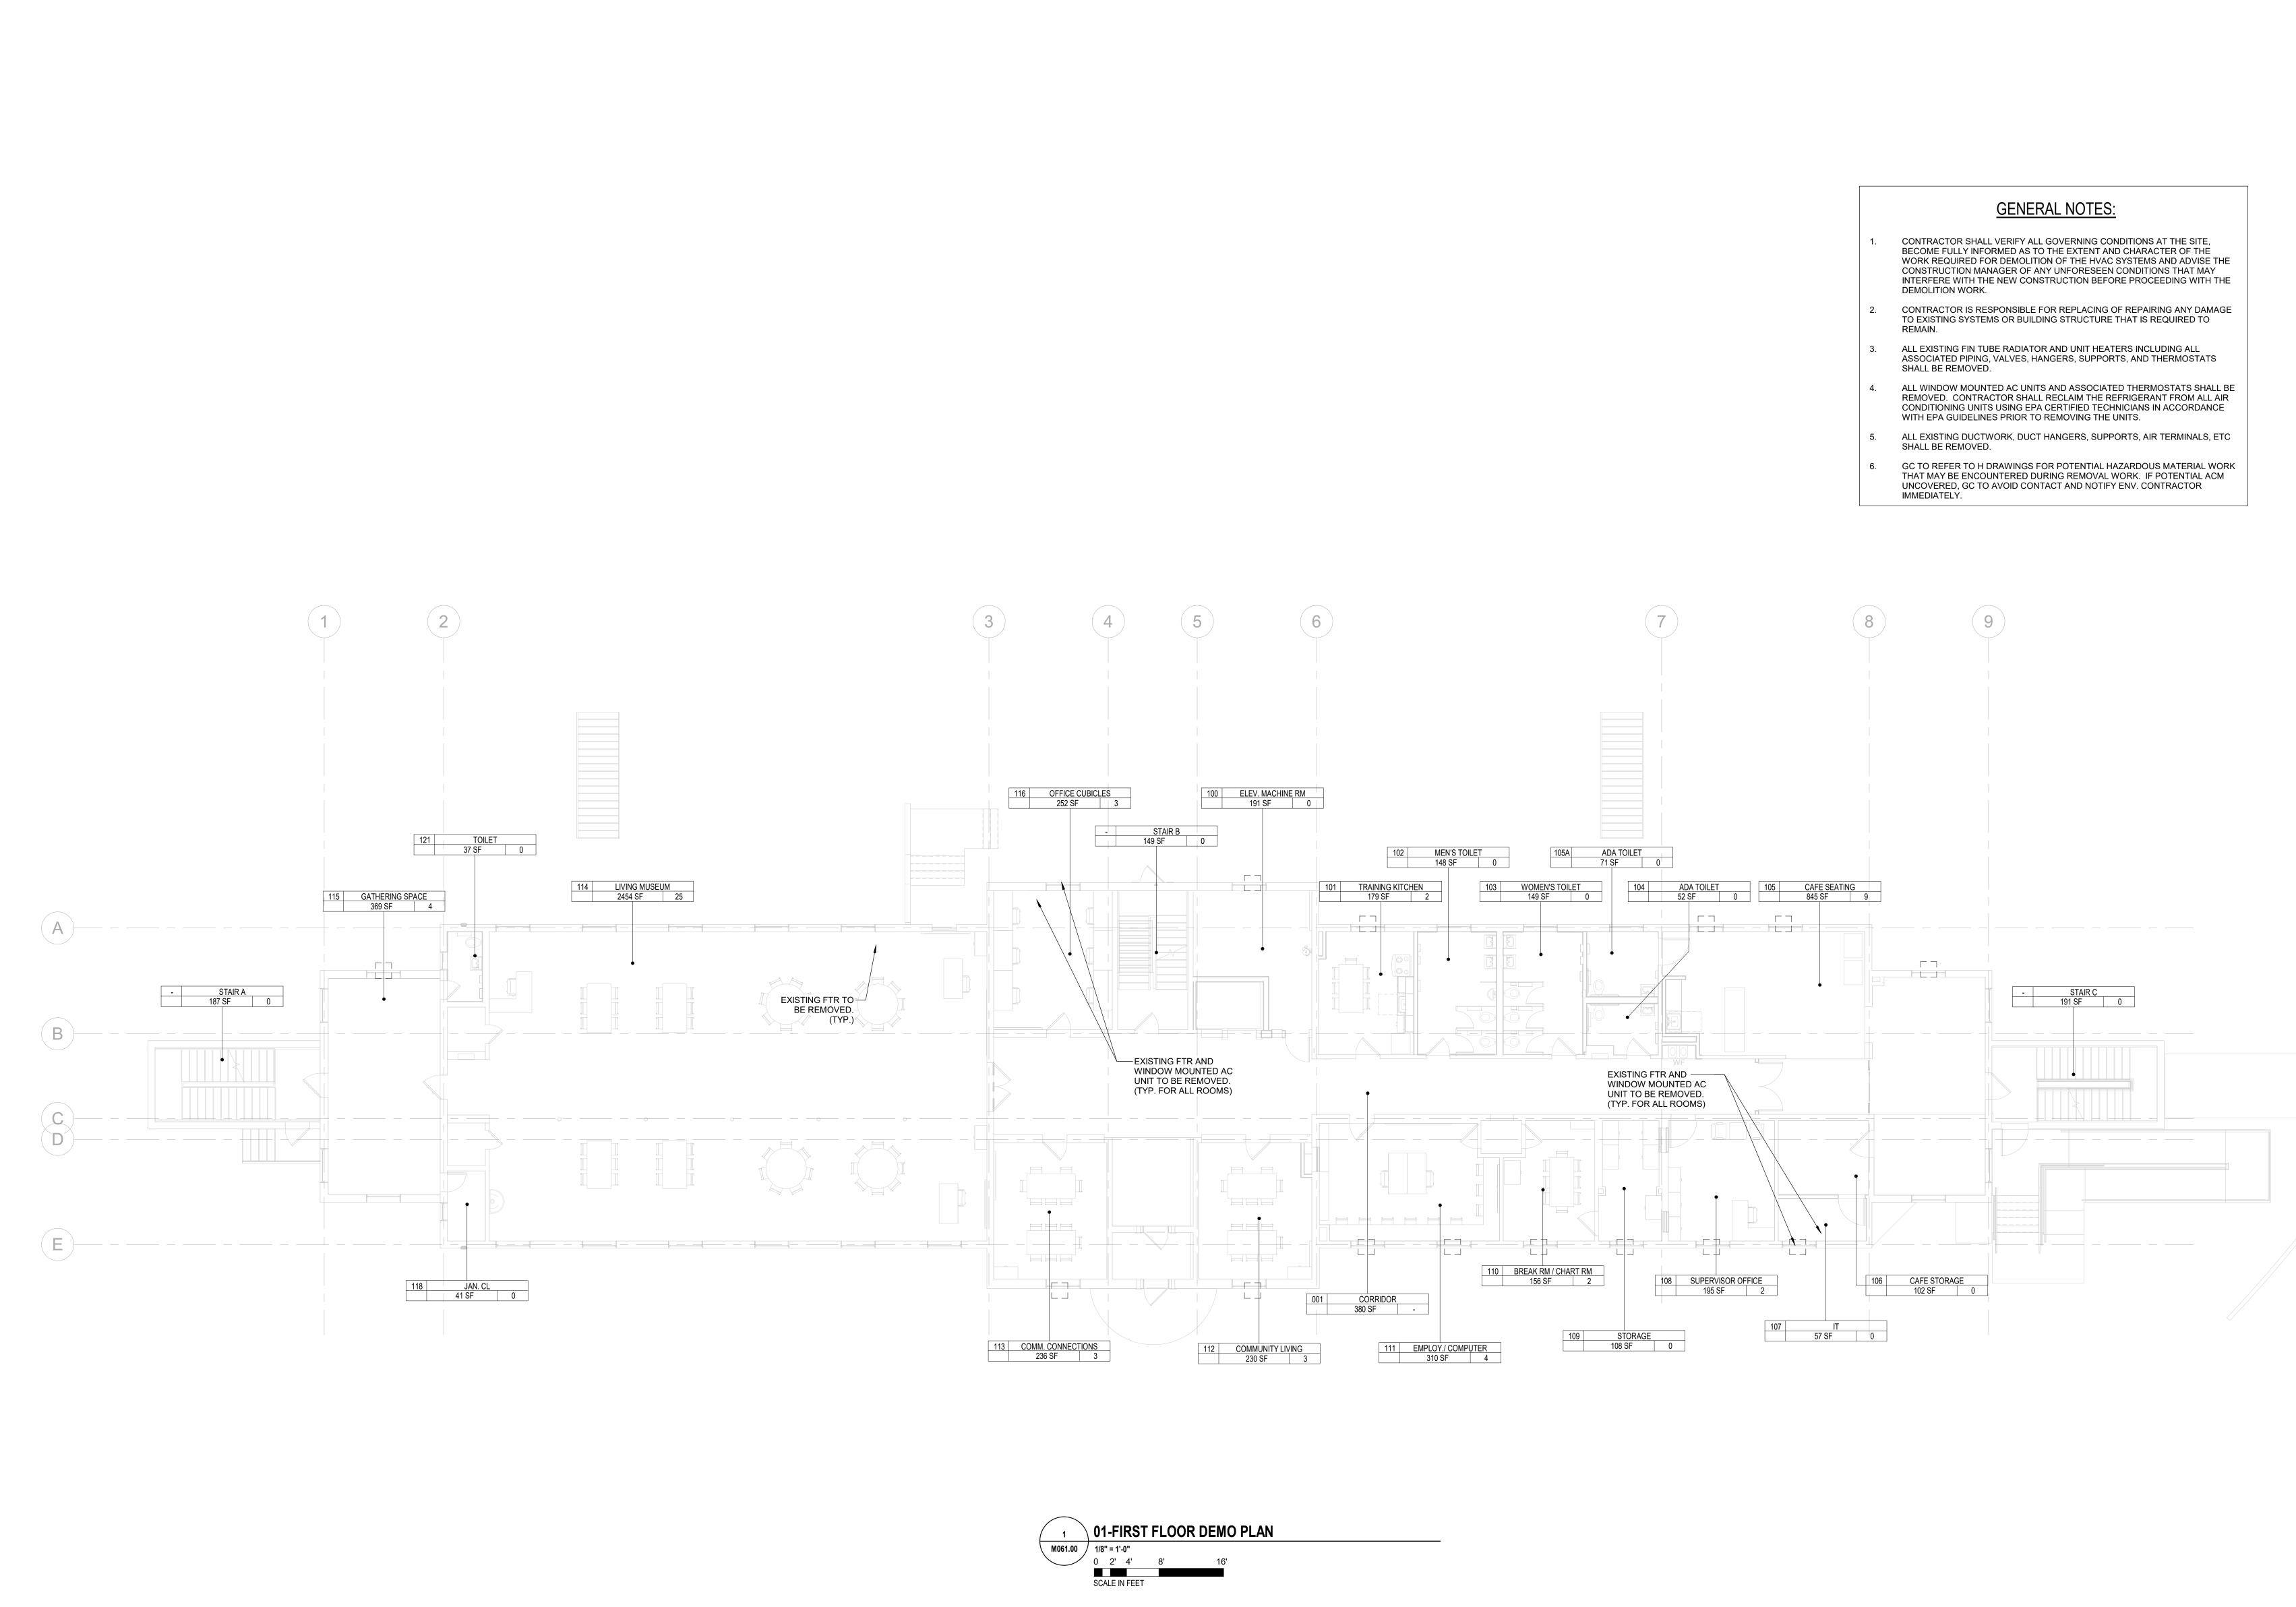


STATE OF OPPORTUNITY. DASNY Y 515 Broadway, Albany, NY 12207-2964 WWW. DASNY.ORG NEW YORK STATE OF OPPORTUNITY. Office of Mental Health Y 10 Ross Circle, Suite 5N, Poughkeepsie, NY 12601 WWW.OMH.NY.GOV HESE DOCUMENTS CONTAIN POTENTIALLY SENSITIVE INFORMATION A SHALL BE USED FOR THEIR INTENDED PURPOSE. ONCE THE INTENDED PURPOSE HAS IT IS A VIOLATION OF STATE EDUCATION LAW FOR ANY PERSON, UNLESS UND DIRECTION OF A LICENSED ARCHITECT/ENGINEER TO ALTER THIS DOCUMENT ANYWAY. ALTERATIONS MUST HAVE THE SEAL AFFIXED ALONG WITH A DESCI OF THE ALTERATIONS, DATE AND ARCHITECT'S/ENGINEER'S SIGNATURE. COP Consultants: 589 8TH AVE, 7 FL, NEW YORK, NY 10018 PHONE 212-242-3735 / FAX 212-242-7460 DVL CONSULTING ENGINEERS, INC. MEP ENGINEER / FIRE ALARM / FIRE PROTECTION 276 5TH AVENUE, SUITE 704 | NEW YORK, NY 10001 PHONE 212.947.7740 WSP GROUP STRUCTURAL ENGINEER ONE PENN PLAZA, 2ND FL | NEW YORK, NY 10119 PHONE 212.465.5000 QUALITY ENVIRONMENTAL SOLUTIONS & TECHNOLOGIES HAZMAT CONSULTANT 1376 US 9 | WAPPINGERS FALLS, NY 12590 PHONE 845.298.6031 GEORGE D. CATTABIANI & ASSOCIATES INC. ELEVATOR CONSULTANT 420 PAULDING AVENUE | NORTHVALE NJ 07647 PHONE 201.768.7331 TROPHY POINT COST ESTIMATOR 4588 SOUTH PARK AVENUE | NEW YORK NY 10001 PHONE 716.823.0006 HIRANI ENGINEERING & LAND SURVEYING, P.C. LAND SURVEY CONSULTANT 120 WEST JOHN STREET | HICKSVILLE NY 11801 PHONE 516.248.1010 KEY PLAN REVISIONS NO DESCRIPTION DATE Client DORMITORY AUTHORITY STATE OF NEW YORK 515 BROADWAY ALBANY, NY 12207 Project Title **BUILDING 1 RENOVATION AND** HAZARDOUS MATERIALS ABATEMEN 140 OLD ORANGEBURG RD ORANGETOWN, NY 10962 Drawing Title HVAC FIRST FLOOR DEMO PLAN Phase 100 SUBMISSION Ďrawn By: hecked By: 05 / 13 / Seal & Signature DASNY Project No ving Ňumbe M061.00

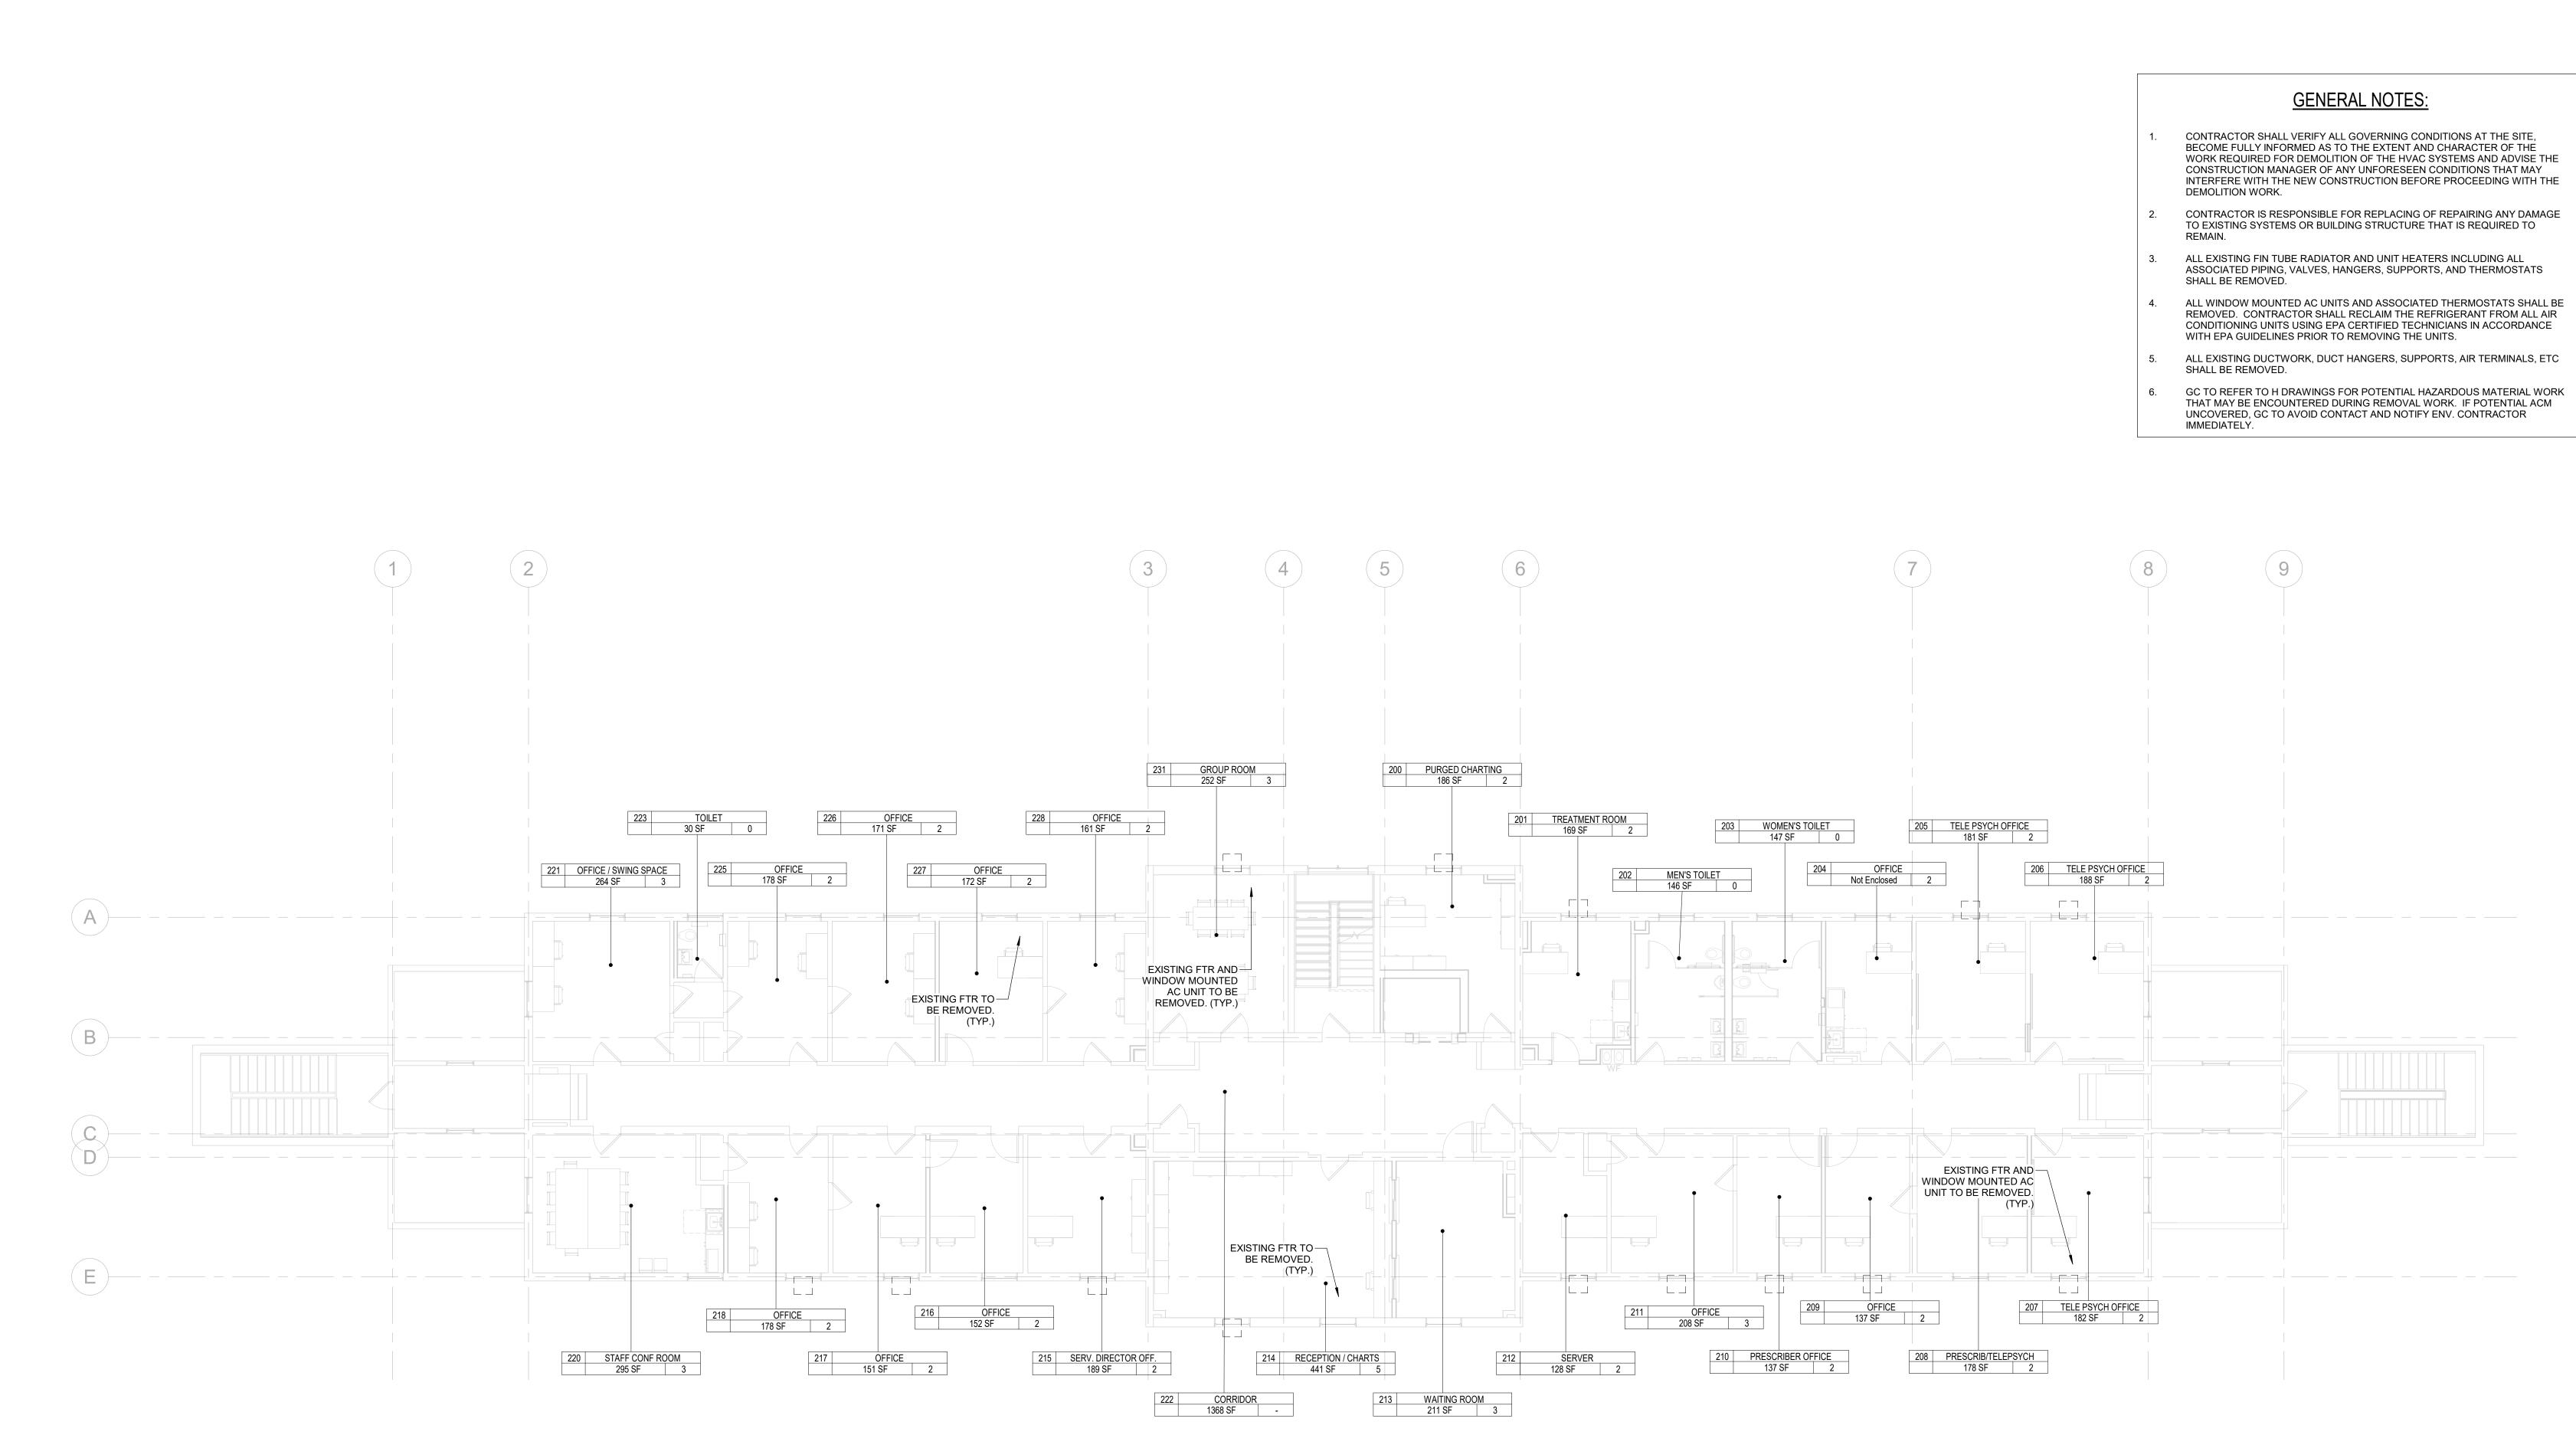


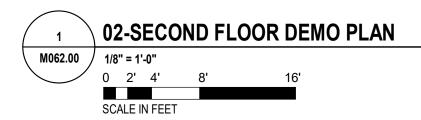

- BECOME FULLY INFORMED AS TO THE EXTENT AND CHARACTER OF THE WORK REQUIRED FOR DEMOLITION OF THE HVAC SYSTEMS AND ADVISE THE CONSTRUCTION MANAGER OF ANY UNFORESEEN CONDITIONS THAT MAY INTERFERE WITH THE NEW CONSTRUCTION BEFORE PROCEEDING WITH THE
- CONTRACTOR IS RESPONSIBLE FOR REPLACING OF REPAIRING ANY DAMAGE TO EXISTING SYSTEMS OR BUILDING STRUCTURE THAT IS REQUIRED TO
- ASSOCIATED PIPING, VALVES, HANGERS, SUPPORTS, AND THERMOSTATS
- CONDITIONING UNITS USING EPA CERTIFIED TECHNICIANS IN ACCORDANCE
- UNCOVERED, GC TO AVOID CONTACT AND NOTIFY ENV. CONTRACTOR

NEW YORK STATE OF OPPORTUNITY. Y 515 Broadway, Albany, NY 12207-2964 WWW. DASNY.ORG NEW YORK STATE OF OPPORTUNITY. Mental Health Y 10 Ross Circle, Suite 5N, Poughkeepsie, NY 12601 WWW.OMH.NY.GOV HESE DOCUMENTS CONTAIN POTENTIALLY SENSITIVE INFORMATION AN SHALL BE USED FOR THEIR INTENDED PURPOSE. ONCE THE INTENDED PURPOSE HAS ITIS A VIOLATION OF STATE EDUCATION LAW FOR ANY PERSON, UNLESS UI DIRECTION OF A LICENSED ARCHITECT/ENGINEER TO ALTER THIS DOCUMEI ANYWAY. ALTERATIONS MUST HAVE THE SEAL AFFIXED ALONG WITH A DESC OF THE ALTERATIONS, DATE AND ARCHITECT'S/ENGINEER'S SIGNATURE. CO Consultants: 589 8TH AVE, 7 FL, NEW YORK, NY 10018 PHONE 212-242-3735 / FAX 212-242-7460 DVL CONSULTING ENGINEERS, INC. MEP ENGINEER / FIRE ALARM / FIRE PROTECTION 276 5TH AVENUE, SUITE 704 | NEW YORK, NY 10001 PHONE 212.947.7740 WSP GROUP STRUCTURAL ENGINEER ONE PENN PLAZA, 2ND FL | NEW YORK, NY 10119 PHONE 212.465.5000 QUALITY ENVIRONMENTAL SOLUTIONS & TECHNOLOGIES HAZMAT CONSULTANT 1376 US 9 | WAPPINGERS FALLS, NY 12590 PHONE 845.298.6031 GEORGE D. CATTABIANI & ASSOCIATES INC. ELEVATOR CONSULTANT 420 PAULDING AVENUE | NORTHVALE NJ 07647 PHONE 201.768.7331 TROPHY POINT COST ESTIMATOR 4588 SOUTH PARK AVENUE | NEW YORK NY 10001 PHONE 716.823.0006 HIRANI ENGINEERING & LAND SURVEYING, P.C. LAND SURVEY CONSULTANT 120 WEST JOHN STREET | HICKSVILLE NY 11801 PHONE 516.248.1010 KEY PLAN REVISIONS REV NO DESCRIPTION DATE Client DORMITORY AUTHORITY STATE OF NEW YORK 515 BROADWAY ALBANY, NY 12207 Project Title **BUILDING 1 RENOVATION AND** HAZARDOUS MATERIALS ABATEMEN 140 OLD ORANGEBURG RD ORANGETOWN, NY 10962 Drawing Title
HVAC SECOND FLOOR DEMO PLAN Phase 100 SUBMISSION Ďrawn By: hecked By: 05 / 13 / Seal & Signature DASNY Project No ving Numbe M062.00

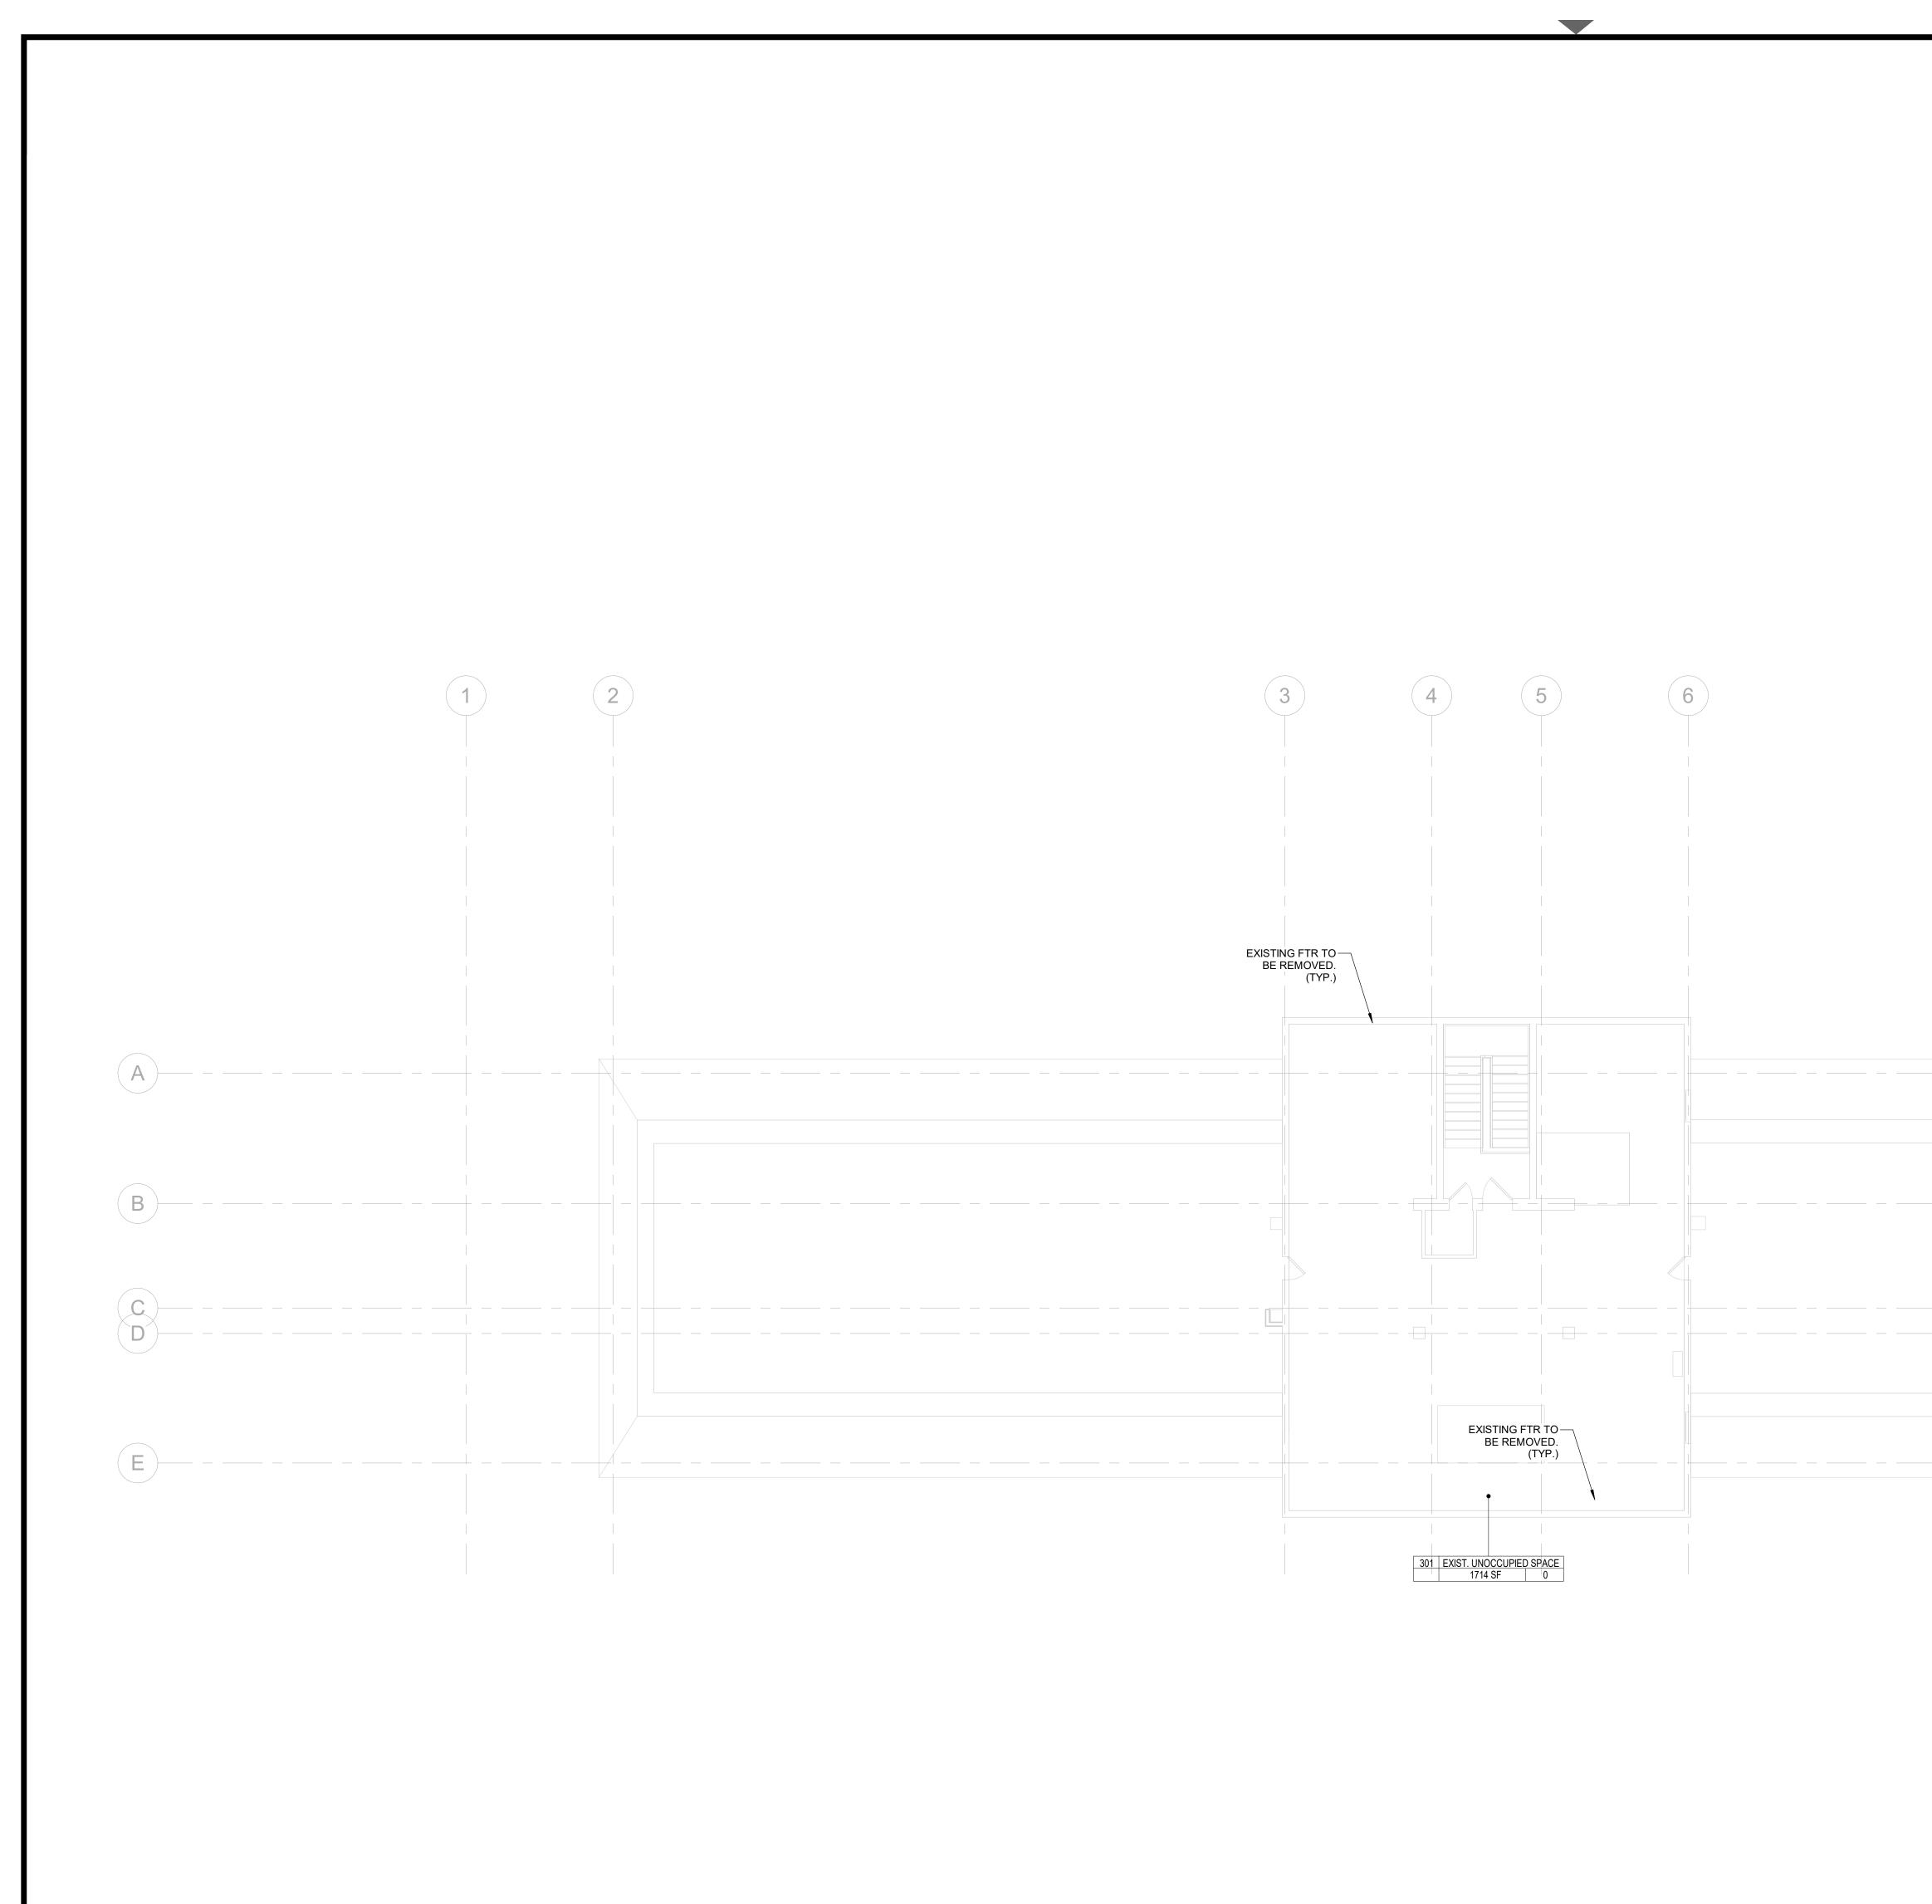

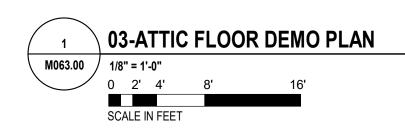

# GENERAL NOTES:


- CONTRACTOR SHALL VERIFY ALL GOVERNING CONDITIONS AT THE SITE, BECOME FULLY INFORMED AS TO THE EXTENT AND CHARACTER OF THE WORK REQUIRED FOR DEMOLITION OF THE HVAC SYSTEMS AND ADVISE THE CONSTRUCTION MANAGER OF ANY UNFORESEEN CONDITIONS THAT MAY INTERFERE WITH THE NEW CONSTRUCTION BEFORE PROCEEDING WITH THE DEMOLITION WORK.
- CONTRACTOR IS RESPONSIBLE FOR REPLACING OF REPAIRING ANY DAMAGE TO EXISTING SYSTEMS OR BUILDING STRUCTURE THAT IS REQUIRED TO REMAIN.
- ALL EXISTING FIN TUBE RADIATOR AND UNIT HEATERS INCLUDING ALL ASSOCIATED PIPING, VALVES, HANGERS, SUPPORTS, AND THERMOSTATS SHALL BE REMOVED.
- 4. ALL WINDOW MOUNTED AC UNITS AND ASSOCIATED THERMOSTATS SHALL BE REMOVED. CONTRACTOR SHALL RECLAIM THE REFRIGERANT FROM ALL AIR CONDITIONING UNITS USING EPA CERTIFIED TECHNICIANS IN ACCORDANCE WITH EPA GUIDELINES PRIOR TO REMOVING THE UNITS.
- ALL EXISTING DUCTWORK, DUCT HANGERS, SUPPORTS, AIR TERMINALS, ETC SHALL BE REMOVED.
   GC TO REFER TO H DRAWINGS FOR POTENTIAL HAZARDOUS MATERIAL WORK THAT MAY BE ENCOUNTERED DURING REMOVAL WORK. IF POTENTIAL ACM UNCOVERED, GC TO AVOID CONTACT AND NOTIFY ENV. CONTRACTOR


IMMEDIATELÝ.

NEW YORK STATE OF OPPORTUNITY. Y-515 Broadway, Albany, NY 12207-2964 WWW. DASNY.ORG NEW YORK STATE OF OPPORTUNITY. CONTRACTION OF Mental Health Y 10 Ross Circle, Suite 5N, Poughkeepsie, NY 12601 WWW.OMH.NY.GOV THESE DOCUMENTS CONTAIN POTENTIALLY SENSITIVE INFORMATION AND SHALL BE USED FOR THEIR INTENDED PURPOSE. ONCE THE INTENDED PURPOSE HAS IT IS A VIOLATION OF STATE EDUCATION LAW FOR ANY PERSON, UNLESS UND DIRECTION OF A LICENSED ARCHITECT/ENGINEER TO ALTER THIS DOCUMENT ANYWAY. ALTERATIONS MUST HAVE THE SEAL AFFIXED ALONG WITH A DESCI OF THE ALTERATIONS, DATE AND ARCHITECT'S/ENGINEER'S SIGNATURE. COP Consultants: GoshowArchitects 589 8TH AVE, 7 FL, NEW YORK, NY 10018 PHONE 212-242-3735 / FAX 212-242-7460 DVL CONSULTING ENGINEERS, INC. MEP ENGINEER / FIRE ALARM / FIRE PROTECTION 276 5TH AVENUE, SUITE 704 | NEW YORK, NY 10001 PHONE 212.947.7740 WSP GROUP STRUCTURAL ENGINEER ONE PENN PLAZA, 2ND FL | NEW YORK, NY 10119 PHONE 212.465.5000 QUALITY ENVIRONMENTAL SOLUTIONS & TECHNOLOGIES HAZMAT CONSULTANT 1376 US 9 | WAPPINGERS FALLS, NY 12590 PHONE 845.298.6031 GEORGE D. CATTABIANI & ASSOCIATES INC. ELEVATOR CONSULTANT 420 PAULDING AVENUE | NORTHVALE NJ 07647 PHONE 201.768.7331 TROPHY POINT COST ESTIMATOR 4588 SOUTH PARK AVENUE | NEW YORK NY 10001 PHONE 716.823.0006 HIRANI ENGINEERING & LAND SURVEYING, P.C. LAND SURVEY CONSULTANT 120 WEST JOHN STREET | HICKSVILLE NY 11801 PHONE 516.248.1010 KEY PLAN REVISIONS REV NO DESCRIPTION DATE Client DORMITORY AUTHORITY STATE OF NEW YORK 515 BROADWAY ALBANY, NY 12207 Project Title **BUILDING 1 RENOVATION AND** HAZARDOUS MATERIALS ABATEMEN 140 OLD ORANGEBURG RD ORANGETOWN, NY 10962 Drawing Title HVAC ATTIC DEMO PLAN Phase 100 SUBMISSION Ďrawn By: hecked By: Date: 05 / 13 / 2 Seal & Signature DASNY Project No. 35363 e awing Numbe M063.00 rawing


## **GENERAL NOTES:**

- 1. FOR HYDRAULIC HEATING EQUIPMENT REFER TO THE "200" SERIES DRAWINGS. HYDRAULIC HEATING EQUIPMENT SHOWN ON THIS DRAWING IS FOR TEMPERATURE CONTROL COORDINATION ONLY.
- 2. MECHANICAL CONTRACTOR SHALL PROVIDE NECESSARY SUPPLEMENTARY STEEL MEMBERS FOR THE SUPPORT OF SUSPENDED EQUIPMENTS.
- 3. COORDINATE FINAL LOCATIONS, TAGS, QUANTITY, ETC. OF FAN COIL UNITS WITH 200" SERIES DRAWINGS.
- 4. THE CONTRACTOR SHALL BE RESPONSIBLE TO CONSTRUCT A FULL SCALE MOCK-UP, UTILIZING A MINIMUM DAMPER SIZE OF 24"X12", OF ALL FIRE AND/OR FIRE-SMOKE DAMPER INSTALLATIONS. THERE SHALL BE SEPARATE MOCK-UP FOR EACH WALL AND/OR FLOOR PENETRATION SHOWING THE ACTUAL SIZE MATERIAL AND CONSTRUCTION OF THE WALL/ FLOOR AS WELL AS ALL REQUIRED INSTALLATION MATERIALS REQUIRED TO COMPLY WITH THE DAMPER MANUFACTURER'S UL LISTED REQUIREMENTS. WITH EACH DAMPER, PROVIDE A HARD COPY OF THE SPECIFIC MANUFACTURER'S INSTALLATION REQUIREMENTS WHICH MATCH THE ACTUAL INSTALLATIONS.

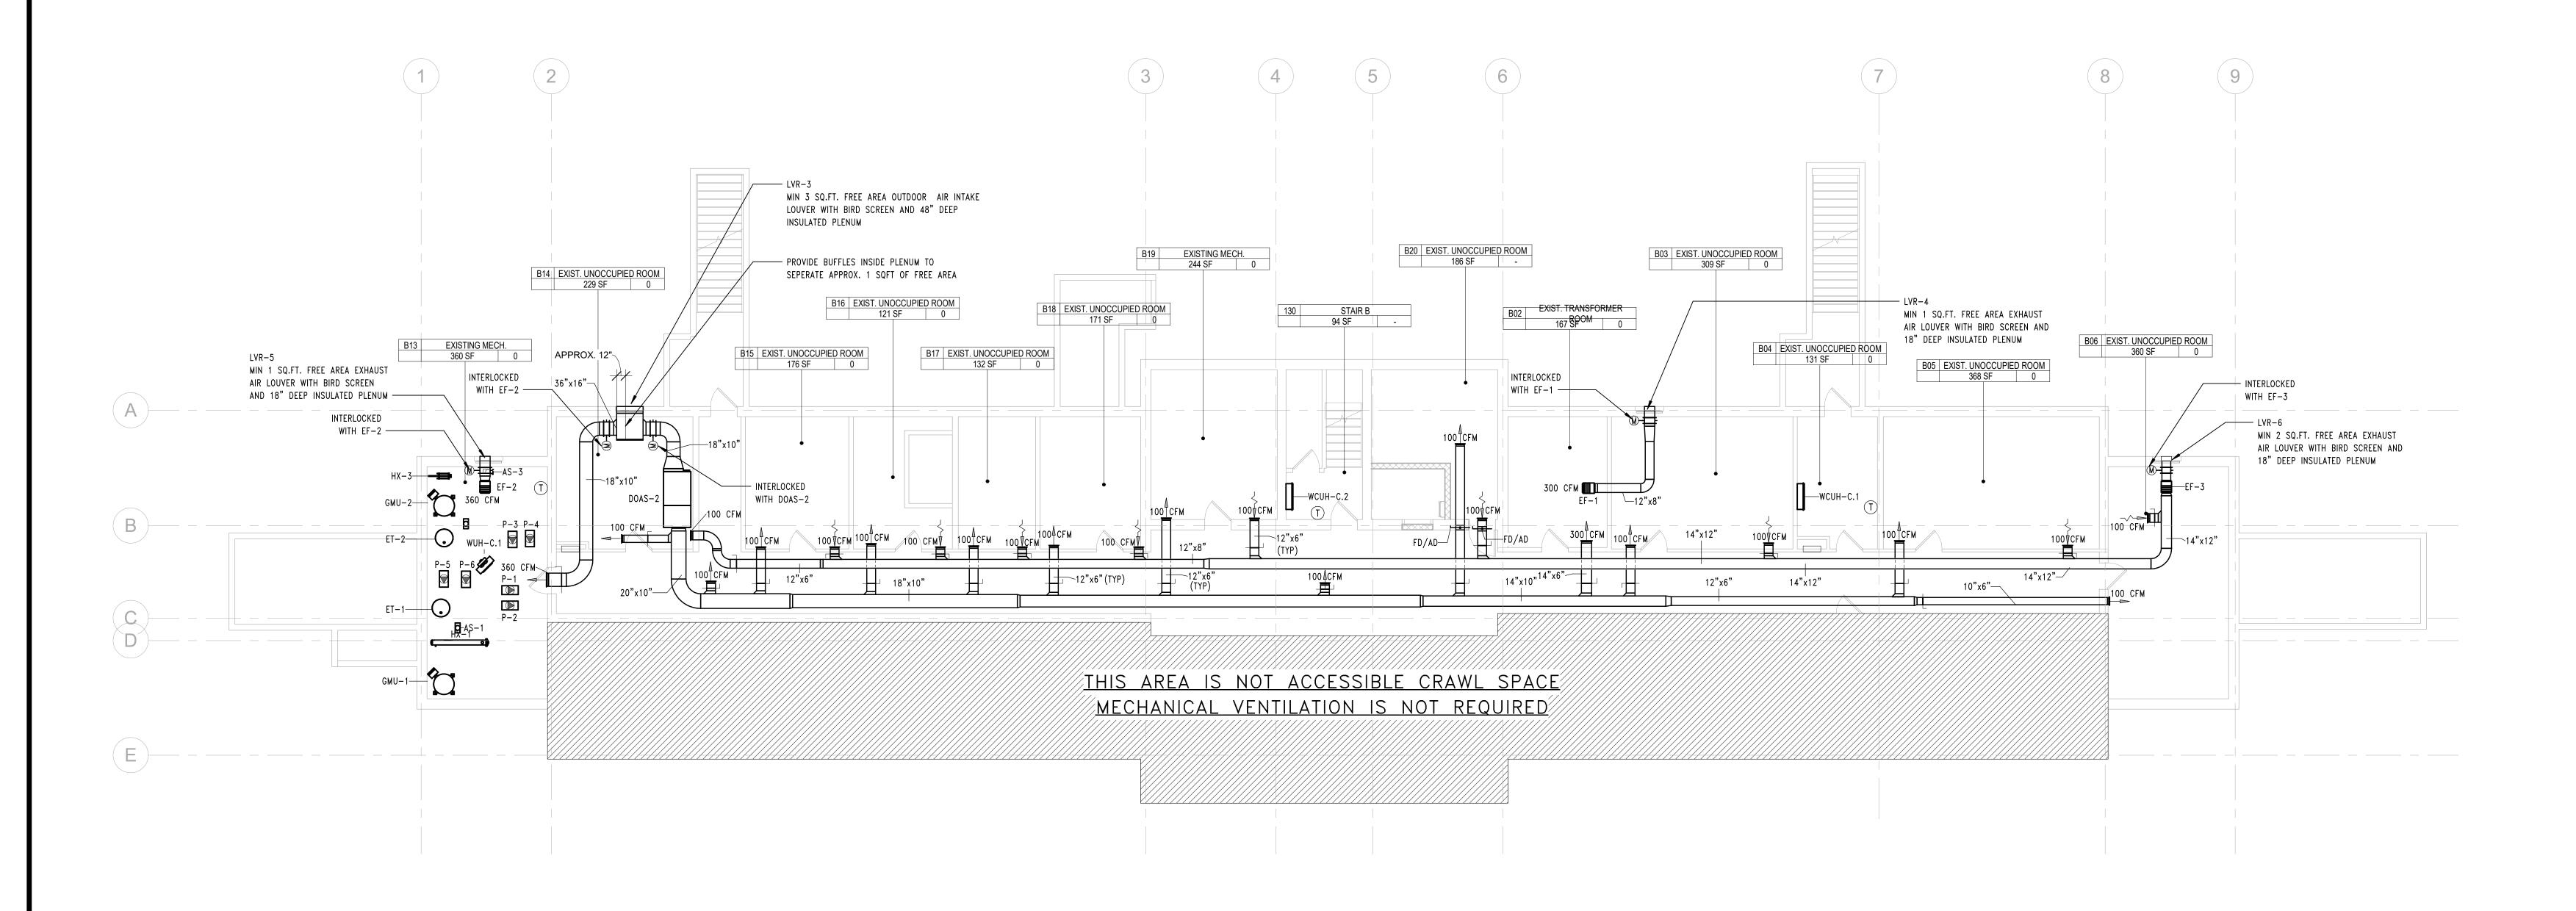


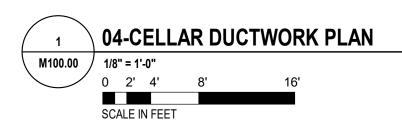


NEW YORK STATE OF OPPORTUNITY. 515 Broadway, Albany, NY 12207-2964 WWW. DASNY.ORG NEW YORK STATE OF OPPORTUNITY. C Y 10 Ross Circle, Suite 5N, Poughkeepsie, NY 1260 WWW.OMH.NY.GOV ESE DOCUMENTS CONTAIN POTENTIALLY SENSITIVE INFORMATION SHALL BE USED FOR THEIR INTENDED PURPOSE. ONCE THE INTENDED PURPOSE HAS IT IS A VIOLATION OF STATE EDUCATION LAW FOR ANY PERSON, UNLESS U DIRECTION OF A LICENSED ARCHITECT/ENGINEER TO ALTER THIS DOCUME ANYWAY. ALTERATIONS MUST HAVE THE SEAL AFFIXED ALONG WITH A DESC OF THE ALTERATIONS, DATE AND ARCHITECT'S/ENGINEER'S SIGNATURE. CO Consultants: 589 8TH AVE, 7 FL, NEW YORK, NY 10018 PHONE 212-242-3735 / FAX 212-242-7460 DVL CONSULTING ENGINEERS, INC. MEP ENGINEER / FIRE ALARM / FIRE PROTECTION 276 5TH AVENUE, SUITE 704 | NEW YORK, NY 10001 PHONE 212.947.7740 WSP GROUP STRUCTURAL ENGINEER ONE PENN PLAZA, 2ND FL | NEW YORK, NY 10119 PHONE 212.465.5000 QUALITY ENVIRONMENTAL SOLUTIONS & TECHNOLOGIES HAZMAT CONSULTANT 1376 US 9 | WAPPINGERS FALLS, NY 12590 PHONE 845.298.6031 GEORGE D. CATTABIANI & ASSOCIATES INC. ELEVATOR CONSULTANT 420 PAULDING AVENUE | NORTHVALE NJ 07647 PHONE 201.768.7331 TROPHY POINT COST ESTIMATOR 4588 SOUTH PARK AVENUE | NEW YORK NY 10001 PHONE 716.823.0006 HIRANI ENGINEERING & LAND SURVEYING, P.C. LAND SURVEY CONSULTANT 120 WEST JOHN STREET | HICKSVILLE NY 11801 PHONE 516.248.1010 KEY PLAN REVISIONS REV NO DESCRIPTION DATE Client DORMITORY AUTHORITY STATE OF NEW YORK 515 BROADWAY ALBANY, NY 12207 Project Title BUILDING 1 RENOVATION AND HAZARDOUS MATERIALS ABATEMEN 140 OLD ORANGEBURG RD ORANGETOWN, NY 10962 Drawing Title HVAC CELLAR PLAN Phase 100 SUBMISSION Ďrawn By: hecked By: 05 / 13 / Seal & Signature ASNY Project No ving Numbe /1100.00

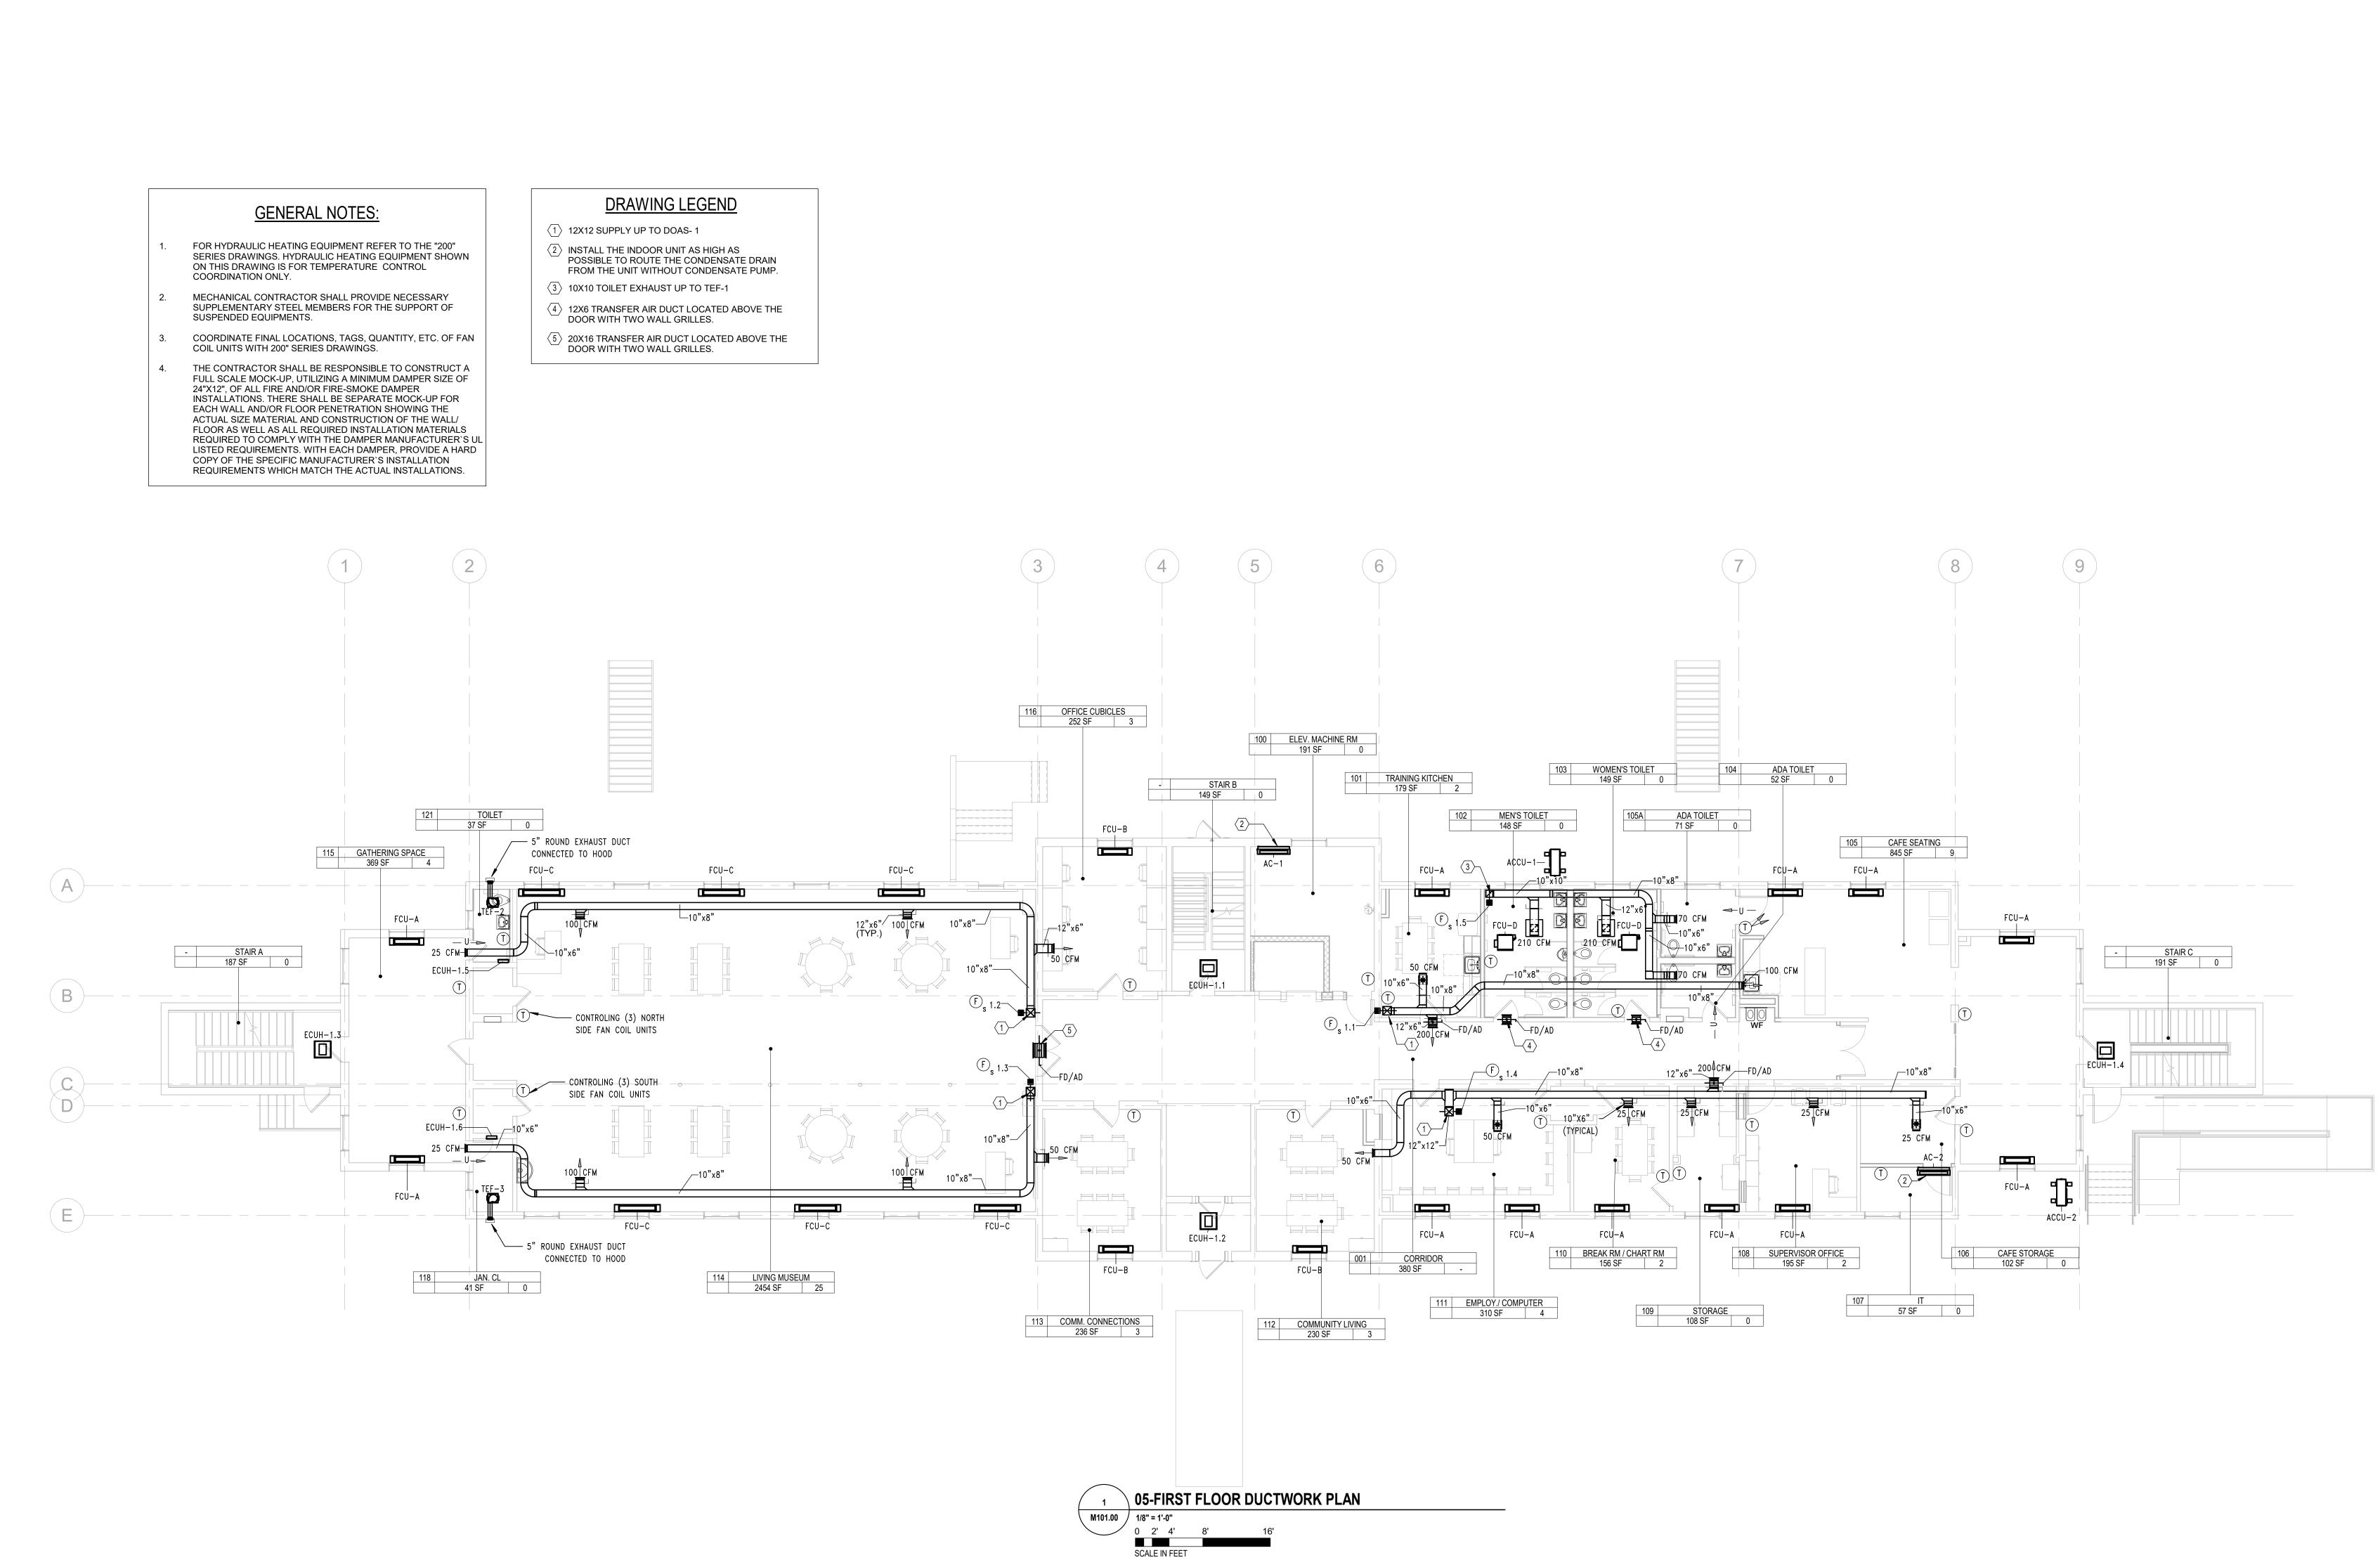



STATE OF OPPORTUNITY. Y 515 Broadway, Albany, NY 12207-2964 WWW. DASNY.ORG NEW YORK STATE OF OPPORTUNITY. Office of Mental Health Y 10 Ross Circle, Suite 5N, Poughkeepsie, NY 1260 WWW.OMH.NY.GOV HESE DOCUMENTS CONTAIN POTENTIALLY SENSITIVE INFORMATION / SHALL BE USED FOR THEIR INTENDED PURPOSE. ONCE THE INTENDED PURPOSE HAS ITIS A VIOLATION OF STATE EDUCATION LAW FOR ANY PERSON, UNLESS UND DIRECTION OF A LICENSED ARCHITECT/ENGINEER TO ALTER THIS DOCUMENT ANYWAY. ALTERATIONS MUST HAVE THE SEAL AFFIXED ALONG WITH A DESCI OF THE ALTERATIONS, DATE AND ARCHITECT'S/ENGINEER'S SIGNATURE. COP Consultants: 589 8TH AVE, 7 FL, NEW YORK, NY 10018 PHONE 212-242-3735 / FAX 212-242-7460 DVL CONSULTING ENGINEERS, INC. MEP ENGINEER / FIRE ALARM / FIRE PROTECTION 276 5TH AVENUE, SUITE 704 | NEW YORK, NY 10001 PHONE 212.947.7740 WSP GROUP STRUCTURAL ENGINEER ONE PENN PLAZA, 2ND FL | NEW YORK, NY 10119 PHONE 212.465.5000 QUALITY ENVIRONMENTAL SOLUTIONS & TECHNOLOGIES HAZMAT CONSULTANT 1376 US 9 | WAPPINGERS FALLS, NY 12590 PHONE 845.298.6031 GEORGE D. CATTABIANI & ASSOCIATES INC. ELEVATOR CONSULTANT 420 PAULDING AVENUE | NORTHVALE NJ 07647 PHONE 201.768.7331 TROPHY POINT COST ESTIMATOR 4588 SOUTH PARK AVENUE | NEW YORK NY 10001 PHONE 716.823.0006 HIRANI ENGINEERING & LAND SURVEYING, P.C. LAND SURVEY CONSULTANT 120 WEST JOHN STREET | HICKSVILLE NY 11801 PHONE 516.248.1010 KEY PLAN REVISIONS REV NO DESCRIPTION DATE Client DORMITORY AUTHORITY STATE OF NEW YORK 515 BROADWAY ALBANY, NY 12207 Project Title **BUILDING 1 RENOVATION AND** HAZARDOUS MATERIALS ABATEMEN 140 OLD ORANGEBURG RD ORANGETOWN, NY 10962 Drawing Title HVAC FIRST FLOOR PLAN Phase 100 SUBMISSION Ďrawn By: 05 / 13 / Seal & Signature ASNY Project No ing Ňumbe

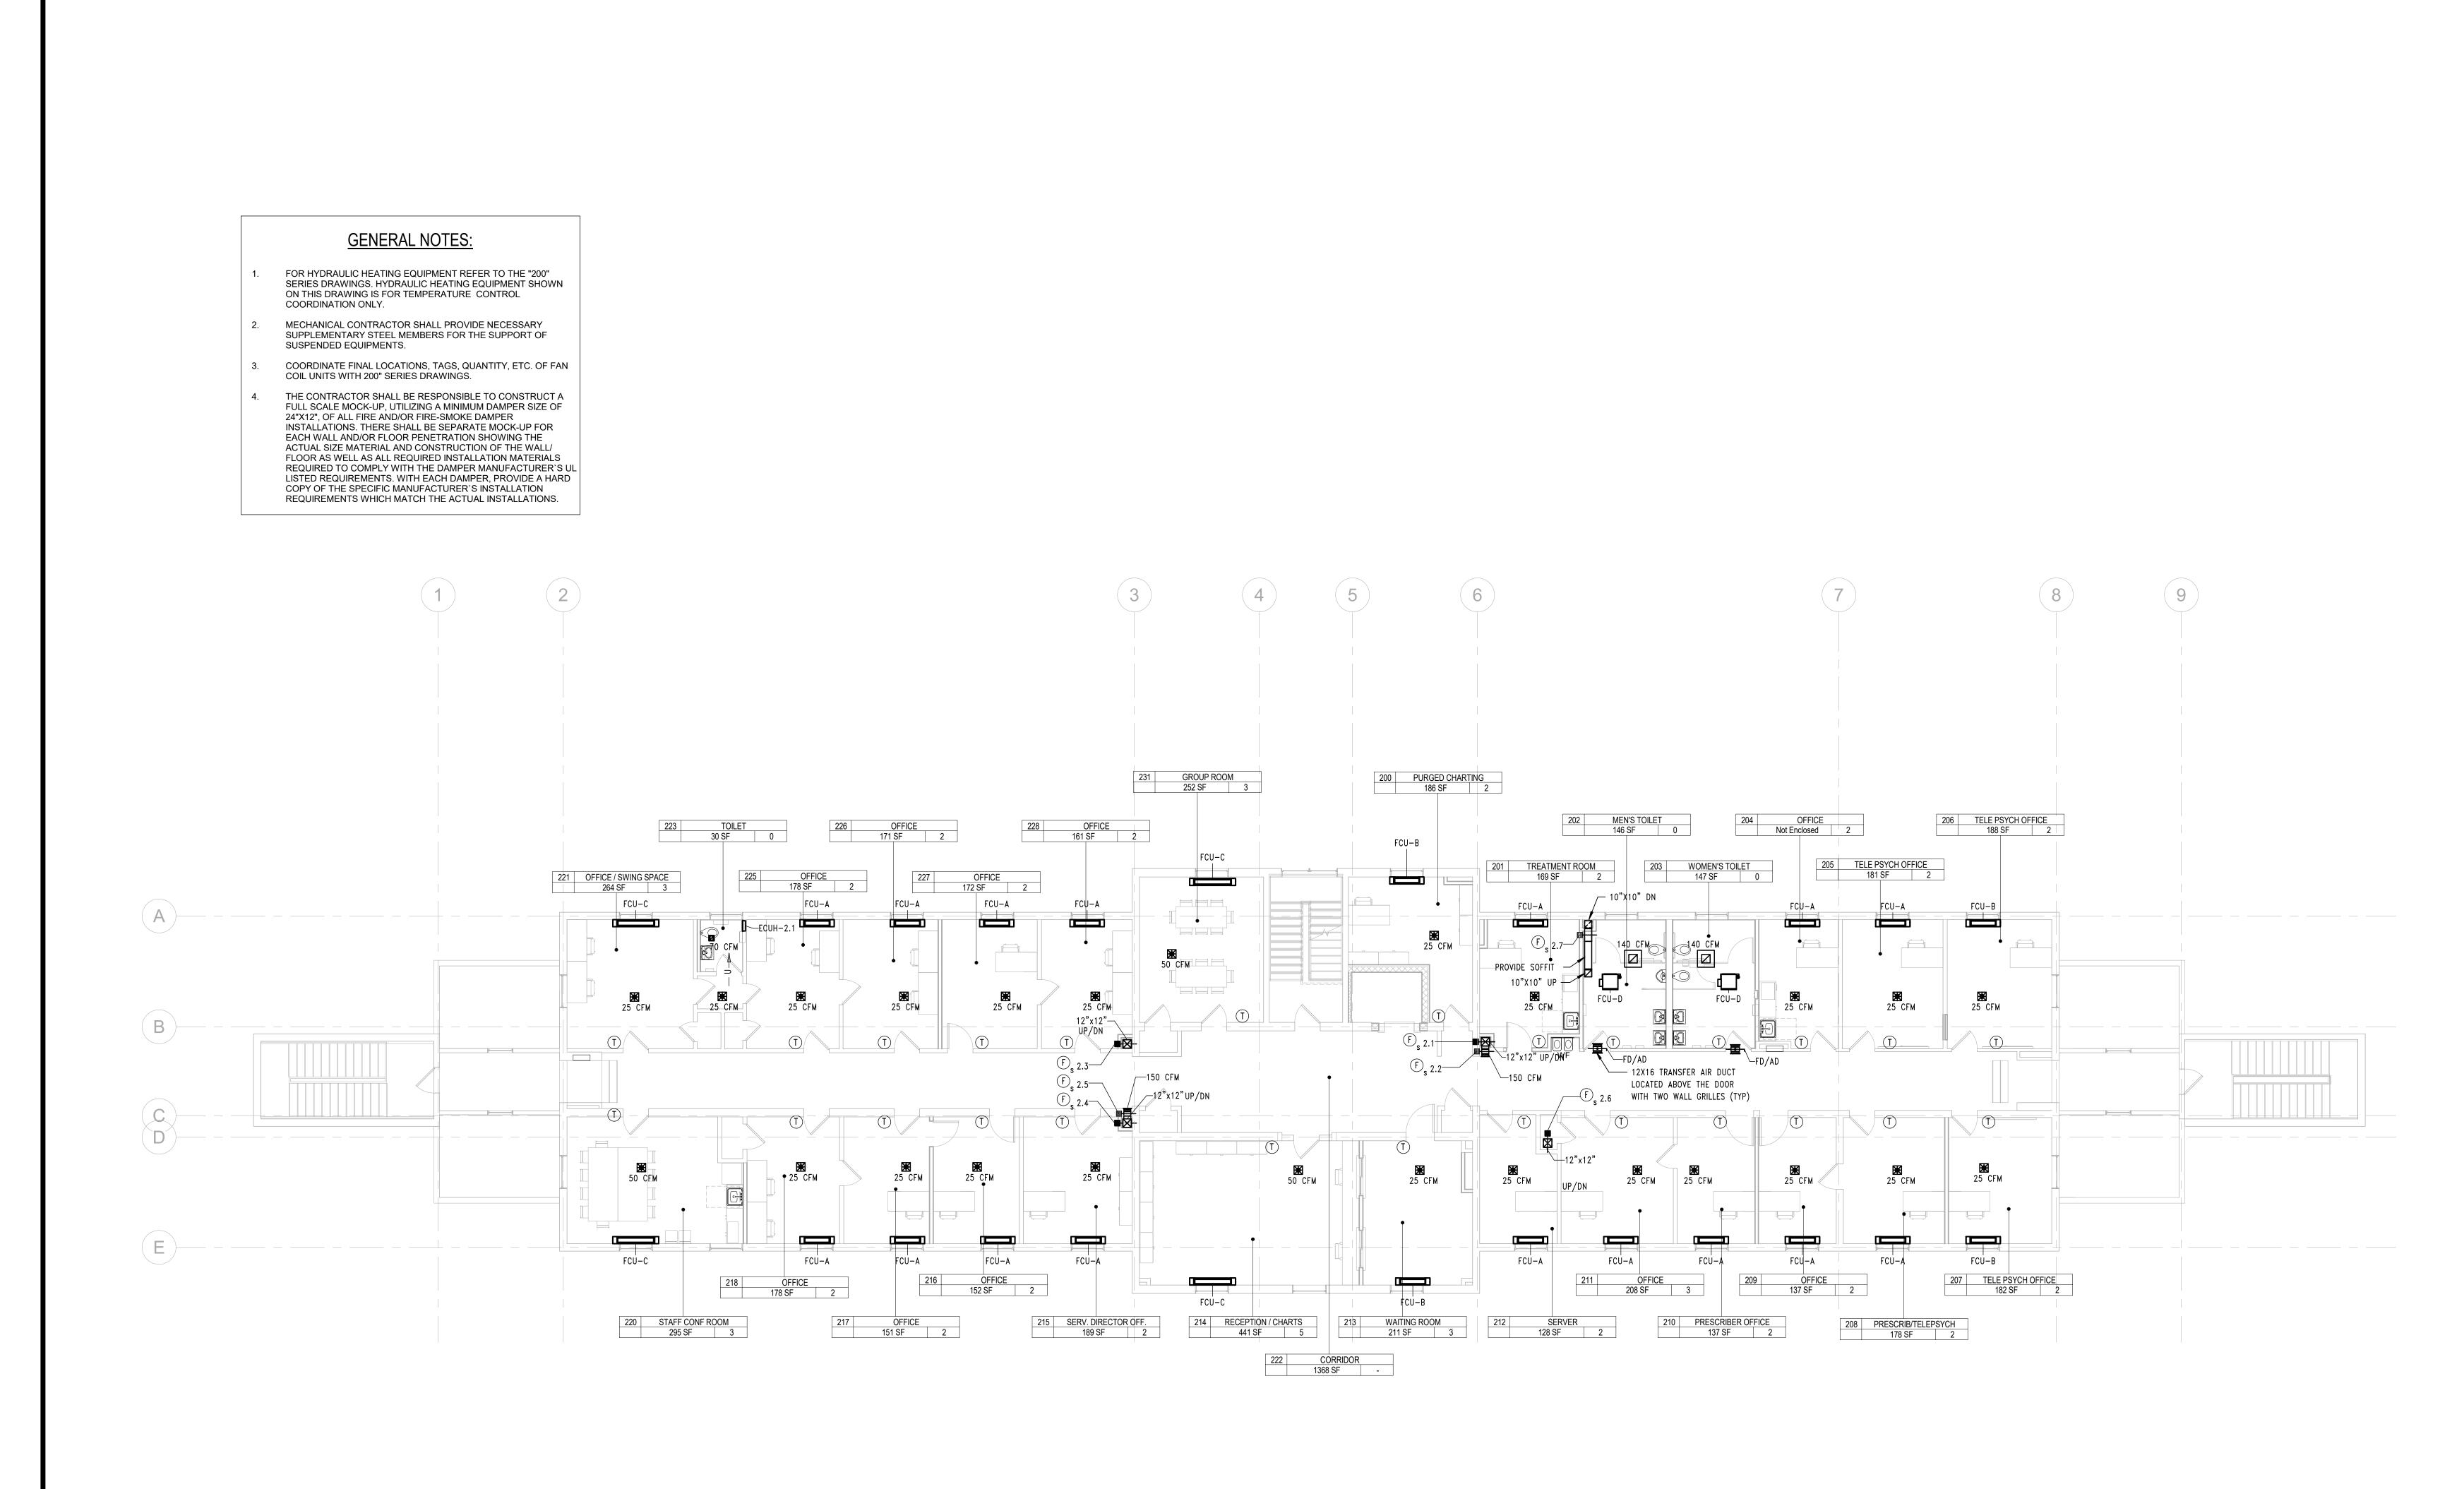

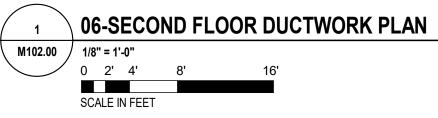


NEW YORK STATE OF OPPORTUNITY. Y 515 Broadway, Albany, NY 12207-2964 WWW. DASNY.ORG NEW YORK STATE OF OPPORTUNITY. C Mental Health Y 10 Ross Circle, Suite 5N, Poughkeepsie, NY 12601 WWW.OMH.NY.GOV HESE DOCUMENTS CONTAIN POTENTIALLY SENSITIVE INFORMATION A SHALL BE USED FOR THEIR INTENDED PURPOSE. ONCE THE INTENDED PURPOSE HAS IT IS A VIOLATION OF STATE EDUCATION LAW FOR ANY PERSON, UNLESS UNE DIRECTION OF A LICENSED ARCHITECT/ENGINEER TO ALTER THIS DOCUMENT ANYWAY. ALTERATIONS MUST HAVE THE SEAL AFFIXED ALONG WITH A DESCI OF THE ALTERATIONS, DATE AND ARCHITECT'S/ENGINEER'S SIGNATURE. COP Consultants: 589 8TH AVE, 7 FL, NEW YORK, NY 10018 PHONE 212-242-3735 / FAX 212-242-7460 DVL CONSULTING ENGINEERS, INC. MEP ENGINEER / FIRE ALARM / FIRE PROTECTION 276 5TH AVENUE, SUITE 704 | NEW YORK, NY 10001 PHONE 212.947.7740 WSP GROUP STRUCTURAL ENGINEER ONE PENN PLAZA, 2ND FL | NEW YORK, NY 10119 PHONE 212.465.5000 QUALITY ENVIRONMENTAL SOLUTIONS & TECHNOLOGIES HAZMAT CONSULTANT 1376 US 9 | WAPPINGERS FALLS, NY 12590 PHONE 845.298.6031 GEORGE D. CATTABIANI & ASSOCIATES INC. ELEVATOR CONSULTANT 420 PAULDING AVENUE | NORTHVALE NJ 07647 PHONE 201.768.7331 TROPHY POINT COST ESTIMATOR 4588 SOUTH PARK AVENUE | NEW YORK NY 10001 PHONE 716.823.0006 HIRANI ENGINEERING & LAND SURVEYING, P.C. LAND SURVEY CONSULTANT 120 WEST JOHN STREET | HICKSVILLE NY 11801 PHONE 516.248.1010 KEY PLAN REVISIONS REV NO DESCRIPTION DATE DORMITORY AUTHORITY STATE OF NEW YORK 515 BROADWAY ALBANY, NY 12207 Project Title **BUILDING 1 RENOVATION AND** HAZARDOUS MATERIALS ABATEMEN 140 OLD ORANGEBURG RD ORANGETOWN, NY 10962 Drawing Title HVAC SECOND FLOOR PLAN Phase 100 SUBMISSION Ďrawn By: hecked Bv 05 / 13 / Seal & Signature DASNY Project No ing Numbe

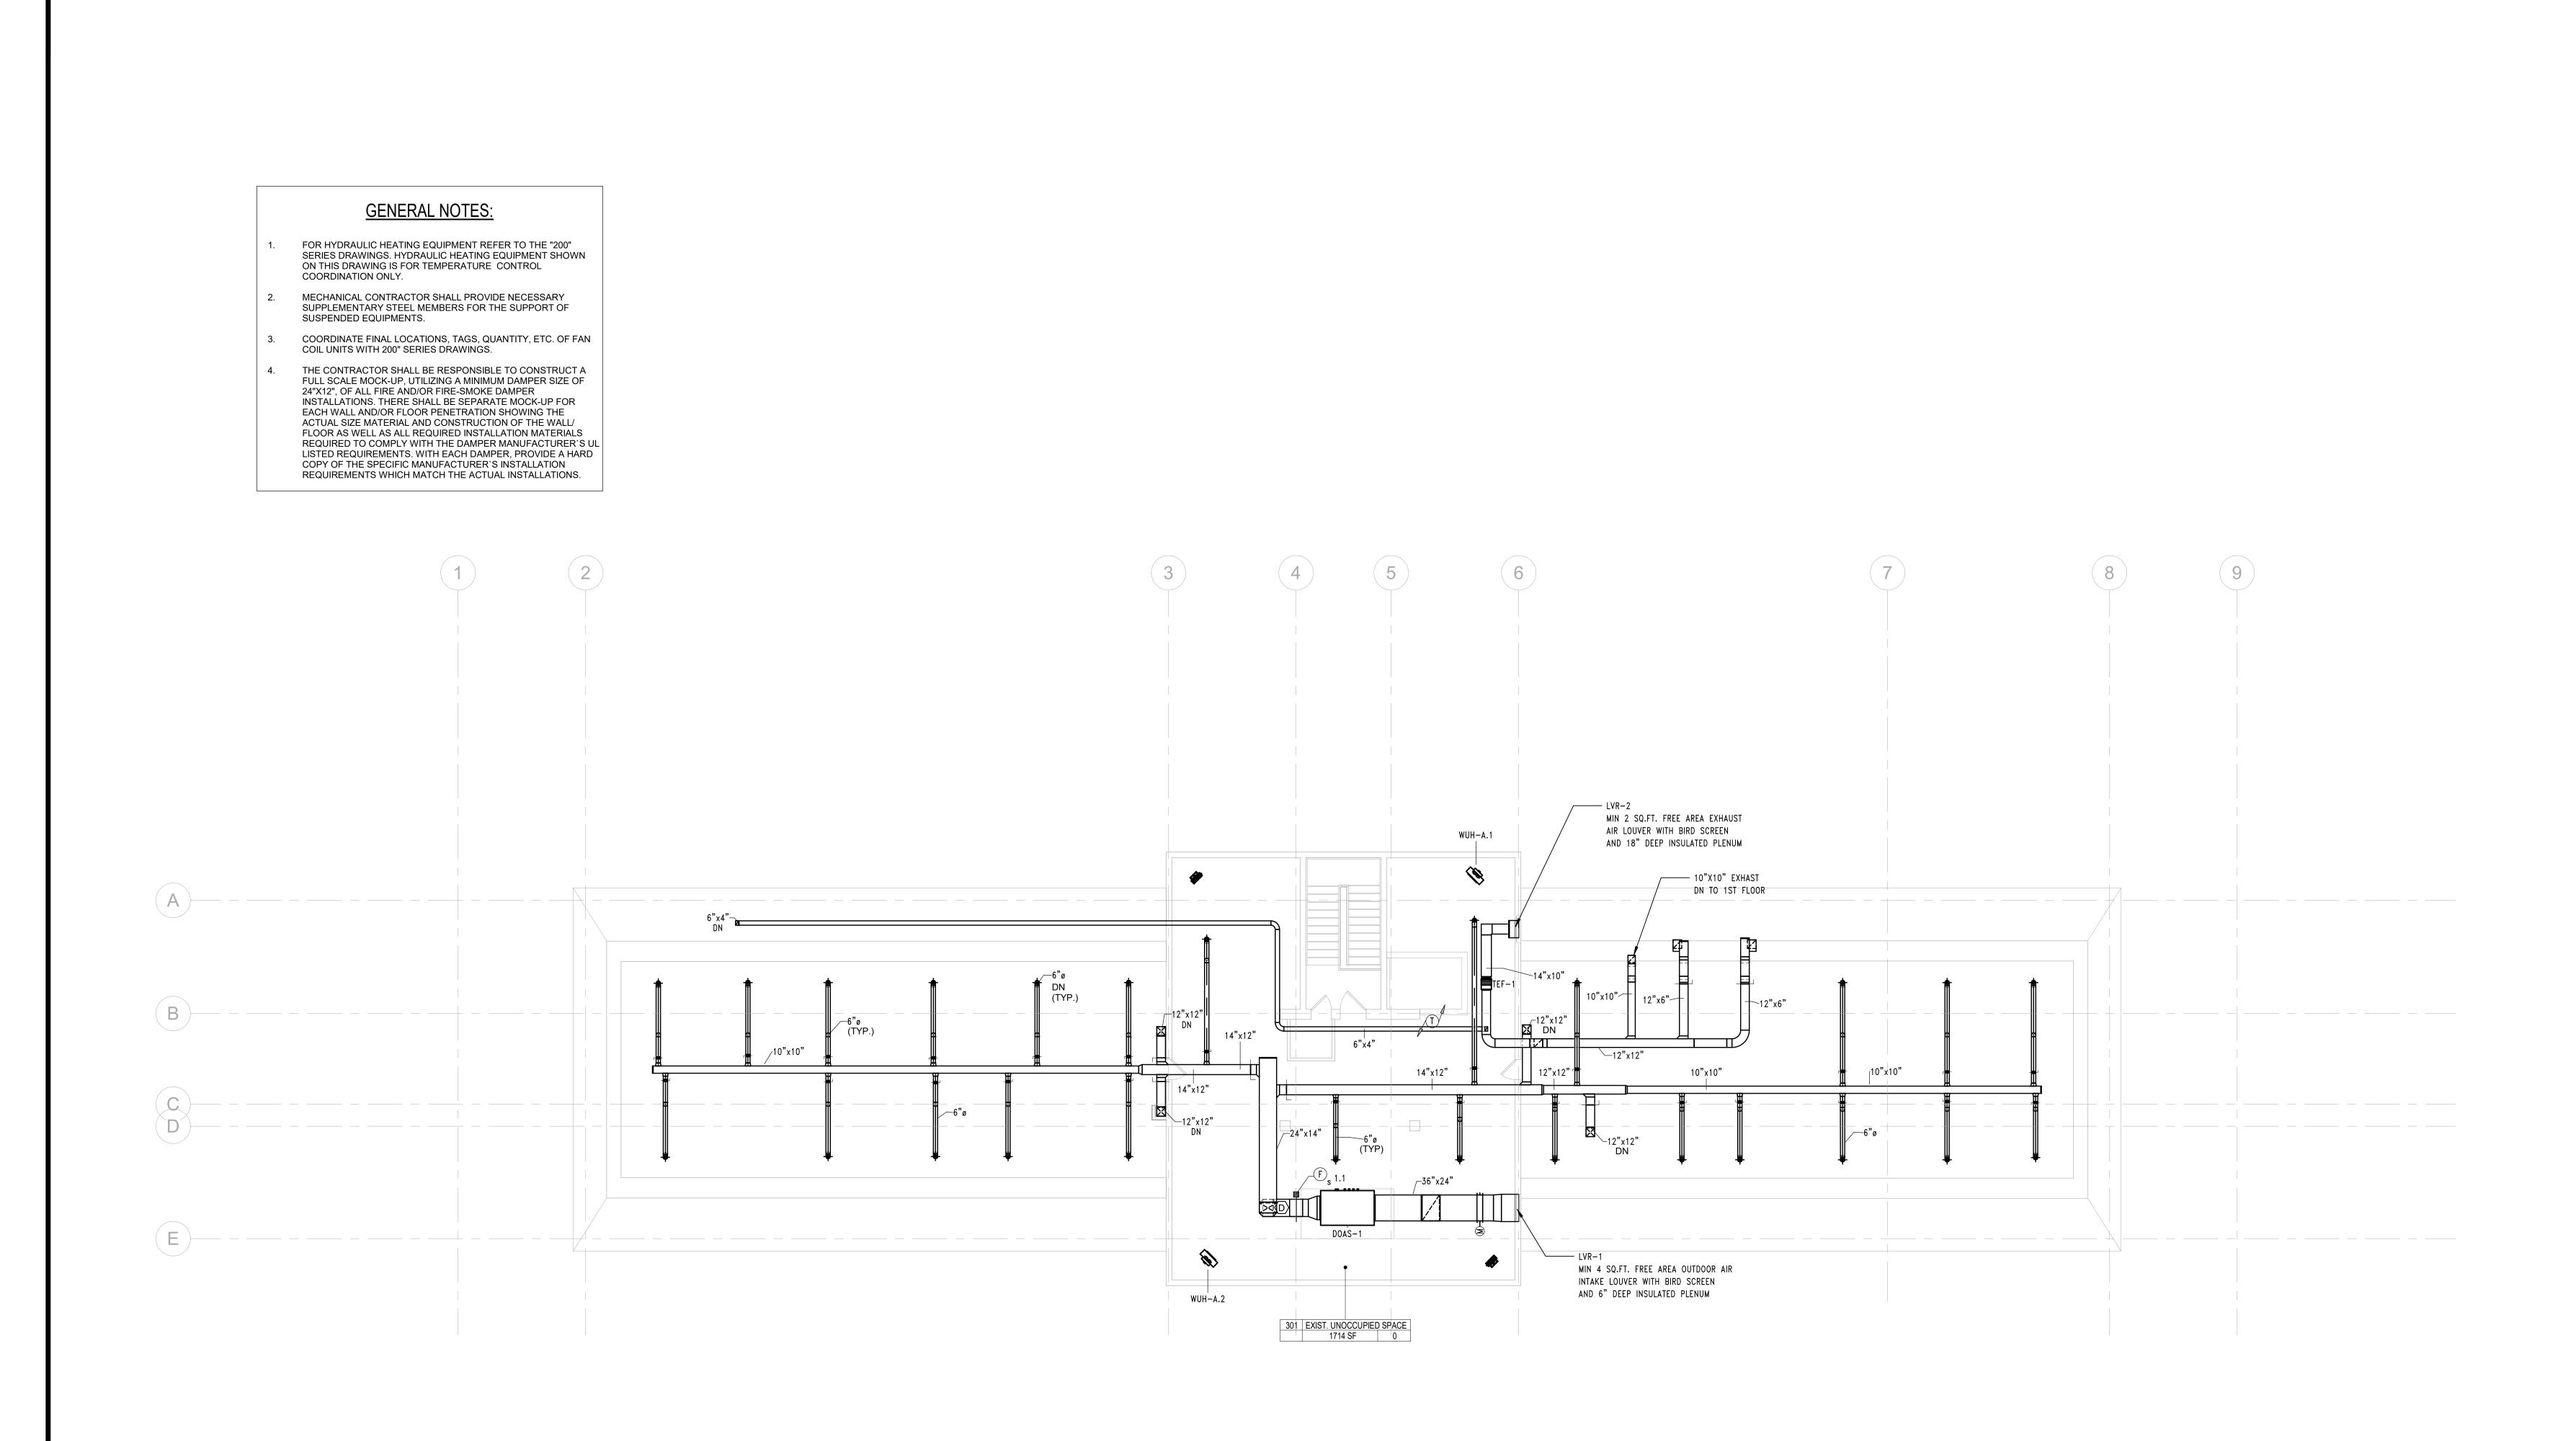


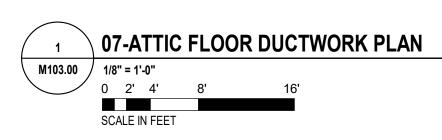


NEW YORK STATE OF OPPORTUNITY. Y 515 Broadway, Albany, NY 12207-2964 WWW. DASNY.ORG NEW YORK STATE OF OPPORTUNITY. Office of Mental Health 10 Ross Circle, Suite 5N, Poughkeepsie, NY 12601 WWW.OMH.NY.GOV THESE DOCUMENTS CONTAIN POTENTIALLY SENSITIVE INFORMATION AND SHALL BE USED FOR THEIR INTENDED PURPOSE. ONCE THE INTENDED PURPOSE HAS IT IS A VIOLATION OF STATE EDUCATION LAW FOR ANY PERSON, UNLESS UND DIRECTION OF A LICENSED ARCHITECT/ENGINEER TO ALTER THIS DOCUMENT ANYWAY. ALTERATIONS MUST HAVE THE SEAL AFFIXED ALONG WITH A DESCI OF THE ALTERATIONS, DATE AND ARCHITECT'S/ENGINEER'S SIGNATURE. COP Consultants: GoshowArchitects 589 8TH AVE, 7 FL, NEW YORK, NY 10018 PHONE 212-242-3735 / FAX 212-242-7460 DVL CONSULTING ENGINEERS, INC. MEP ENGINEER / FIRE ALARM / FIRE PROTECTION 276 5TH AVENUE, SUITE 704 | NEW YORK, NY 10001 PHONE 212.947.7740 WSP GROUP STRUCTURAL ENGINEER ONE PENN PLAZA, 2ND FL | NEW YORK, NY 10119 PHONE 212.465.5000 QUALITY ENVIRONMENTAL SOLUTIONS & TECHNOLOGIES HAZMAT CONSULTANT 1376 US 9 | WAPPINGERS FALLS, NY 12590 PHONE 845.298.6031 GEORGE D. CATTABIANI & ASSOCIATES INC. ELEVATOR CONSULTANT 420 PAULDING AVENUE | NORTHVALE NJ 07647 PHONE 201.768.7331 TROPHY POINT COST ESTIMATOR 4588 SOUTH PARK AVENUE | NEW YORK NY 10001 PHONE 716.823.0006 HIRANI ENGINEERING & LAND SURVEYING, P.C. LAND SURVEY CONSULTANT 120 WEST JOHN STREET | HICKSVILLE NY 11801 PHONE 516.248.1010 KEY PLAN REVISIONS REV NO DESCRIPTION DATE Client DORMITORY AUTHORITY STATE OF NEW YORK 515 BROADWAY ALBANY, NY 12207 Project Title **BUILDING 1 RENOVATION AND** HAZARDOUS MATERIALS ABATEMEN 140 OLD ORANGEBURG RD ORANGETOWN, NY 10962 Drawing Title HVAC ATTIC PLAN Phase 100 SUBMISSION Ďrawn By: hecked By: ate: 05 / 13 / Seal & Signature DASNY Project No 35363 ving Numbe /103.00 rawing

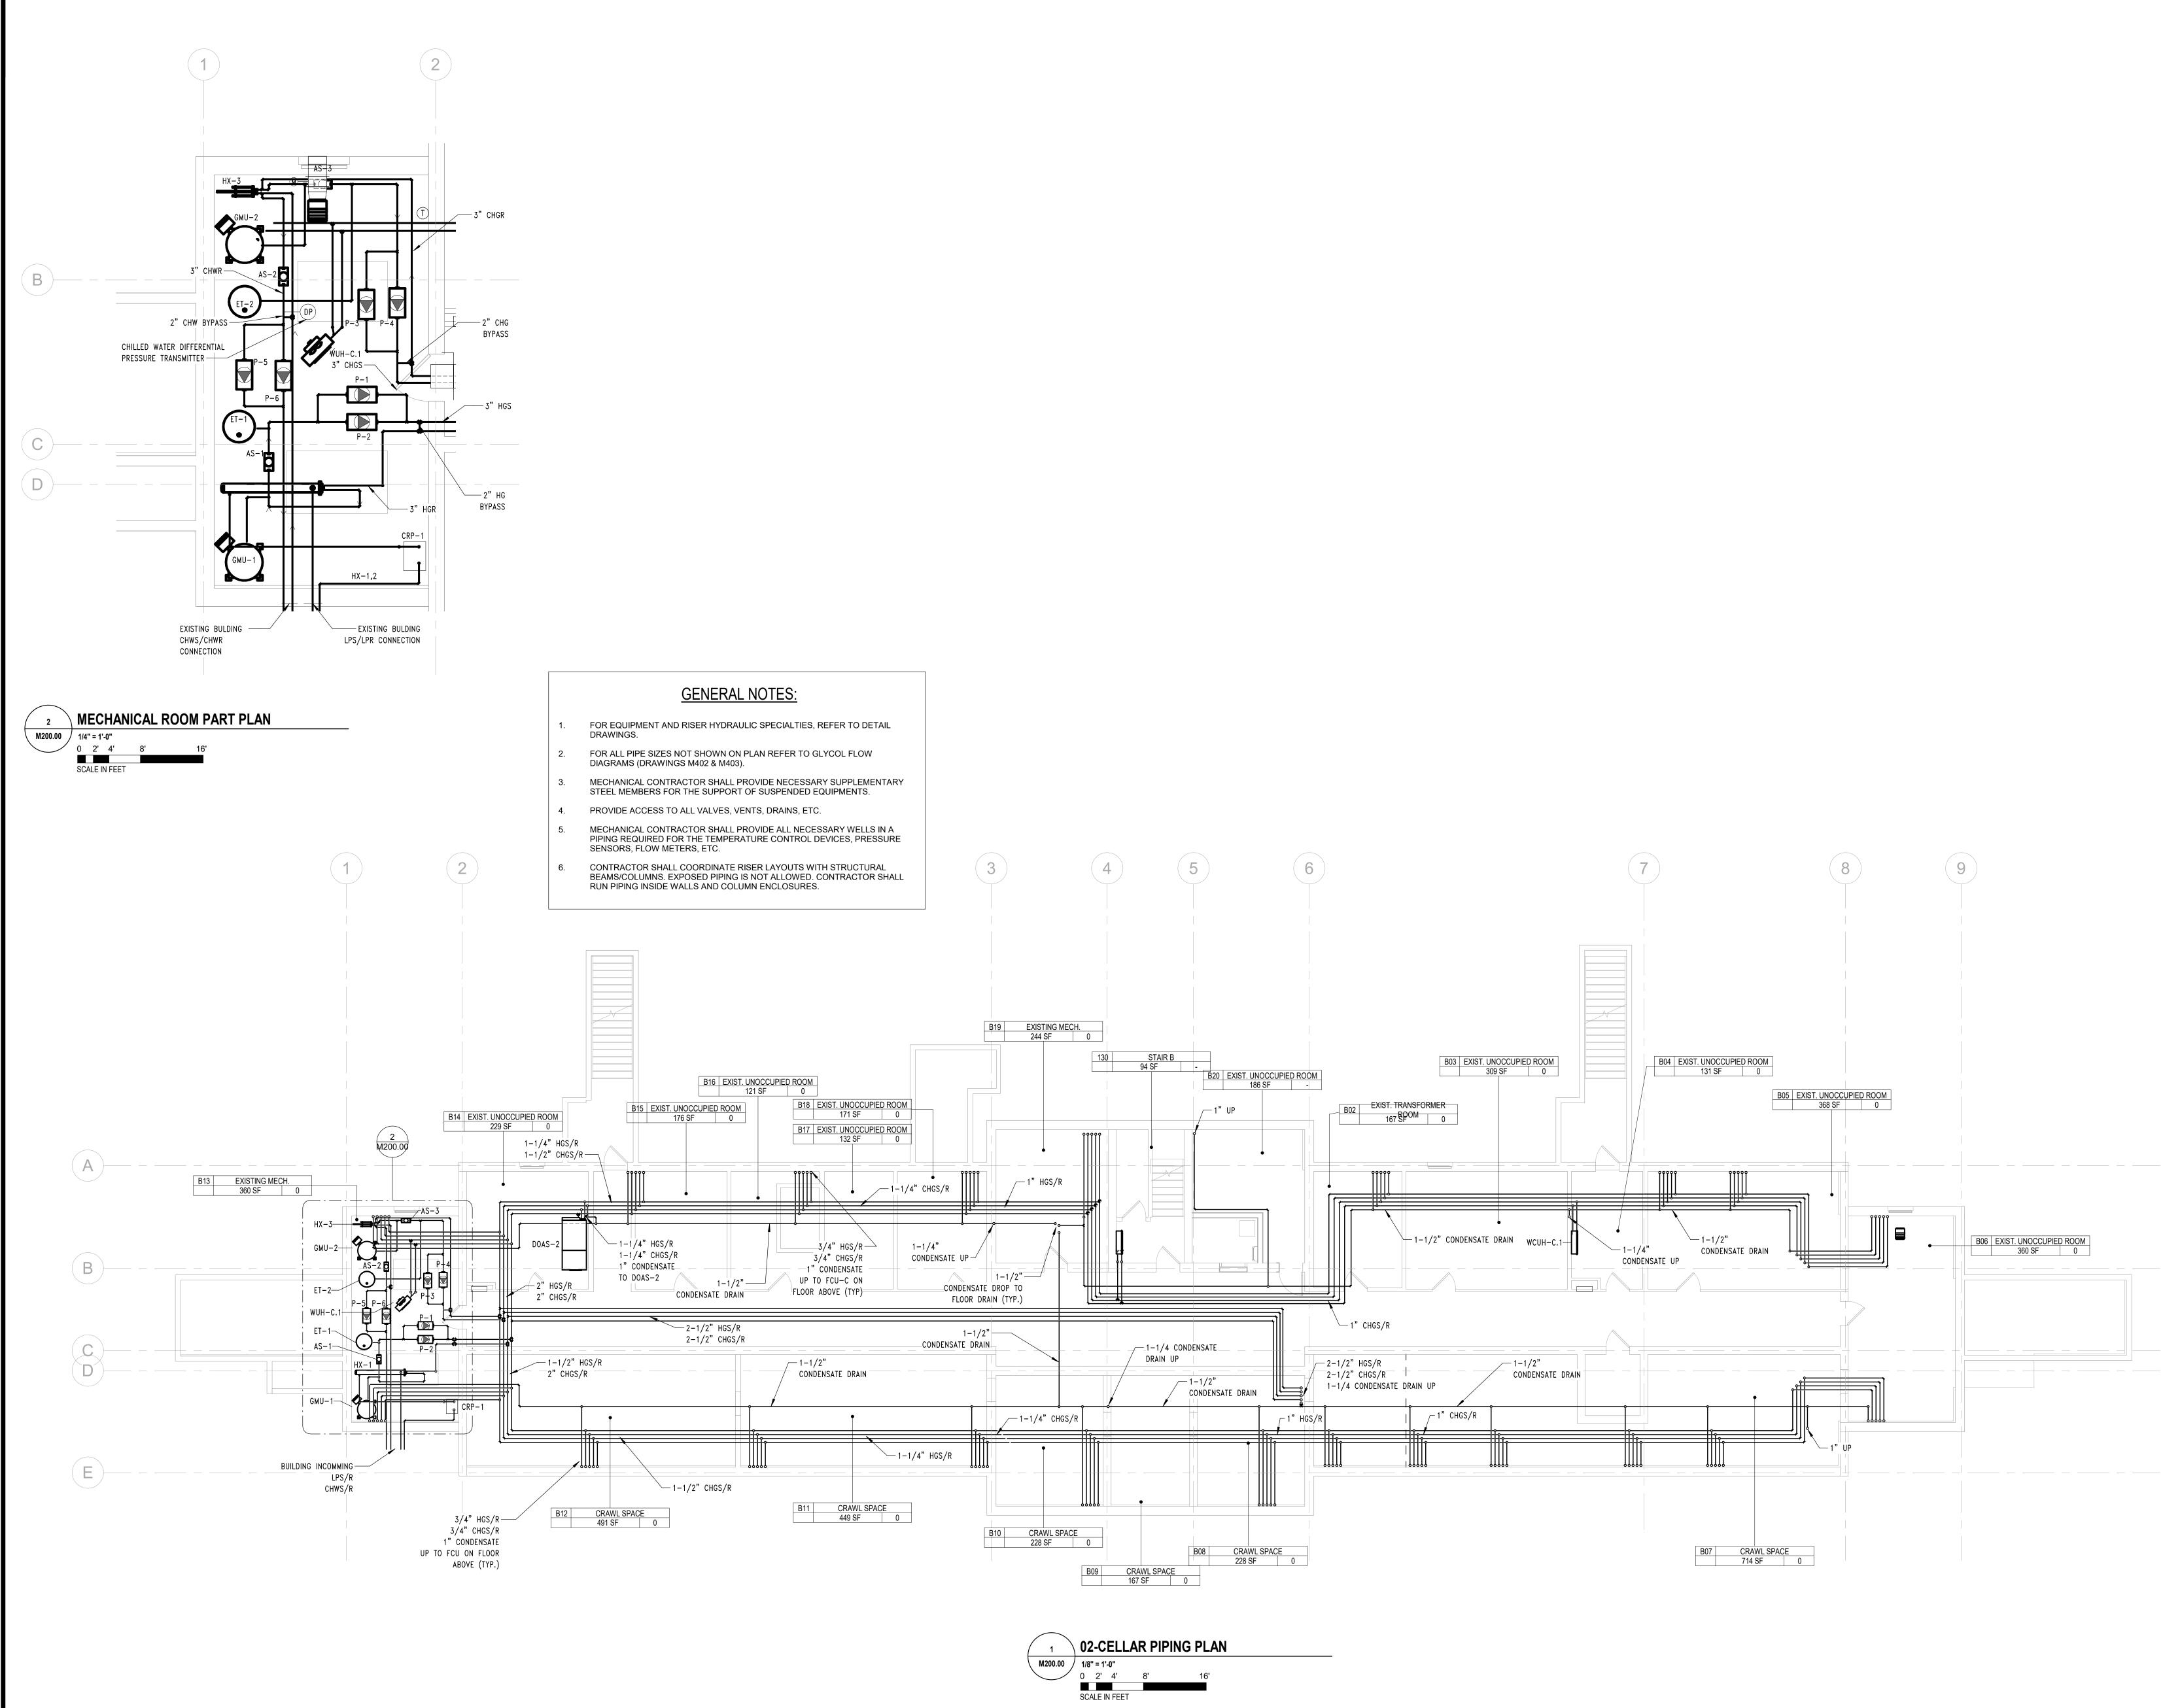

NEW YORK STATE OF OPPORTUNITY. y-515 Broadway, Albany, NY 12207-2964 WWW. DASNY.ORG NEW YORK STATE OF OPPORTUNITY. Office of Mental Health Y 10 Ross Circle, Suite 5N, Poughkeepsie, NY 1260 WWW.OMH.NY.GOV SE DOCUMENTS CONTAIN POTENTIALLY SENSITIVE INFORMATIC SED FOR THEIR INTENDED PURPOSE. ONCE THE INTENDED PURPOSE HAS IRECTION OF A LICENSED ARCHITECT/ENGINEER TO ALTER THIS DOCUM ANYWAY. ALTERATIONS MUST HAVE THE SEAL AFFIXED ALONG WITH A DES OF THE ALTERATIONS, DATE AND ARCHITECT'S/ENGINEER'S SIGNATURE. CO Consultants: 589 8TH AVE, 7 FL, NEW YORK, NY 10018 PHONE 212-242-3735 / FAX 212-242-7460 DVL CONSULTING ENGINEERS, INC. MEP ENGINEER / FIRE ALARM / FIRE PROTECTION 276 5TH AVENUE, SUITE 704 | NEW YORK, NY 10001 PHONE 212.947.7740 WSP GROUP STRUCTURAL ENGINEER ONE PENN PLAZA, 2ND FL | NEW YORK, NY 10119 PHONE 212.465.5000 QUALITY ENVIRONMENTAL SOLUTIONS & TECHNOLOGIES HAZMAT CONSULTANT 1376 US 9 | WAPPINGERS FALLS, NY 12590 PHONE 845.298.6031 GEORGE D. CATTABIANI & ASSOCIATES INC. ELEVATOR CONSULTANT 420 PAULDING AVENUE | NORTHVALE NJ 07647 PHONE 201.768.7331 TROPHY POINT COST ESTIMATOR 4588 SOUTH PARK AVENUE | NEW YORK NY 10001 PHONE 716.823.0006 HIRANI ENGINEERING & LAND SURVEYING, P.C. LAND SURVEY CONSULTANT 120 WEST JOHN STREET | HICKSVILLE NY 11801 PHONE 516.248.1010 KEY PLAN REVISIONS REV NO DESCRIPTION DATE Client DORMITORY AUTHORITY STATE OF NEW YORK 515 BROADWAY ALBANY, NY 12207 Project Title **BUILDING 1 RENOVATION AND** HAZARDOUS MATERIALS ABATEMEN 140 OLD ORANGEBURG RD ORANGETOWN, NY 10962 Drawing Title HVAC PIPING CELLAR PLAN Phase 100 SUBMISSION Drawn By: hecked By: Date: AK 05 / 13 / JA Seal & Signature DASNY Project No 3536 rawing Numbe M200.00 No. 075087 Drawing

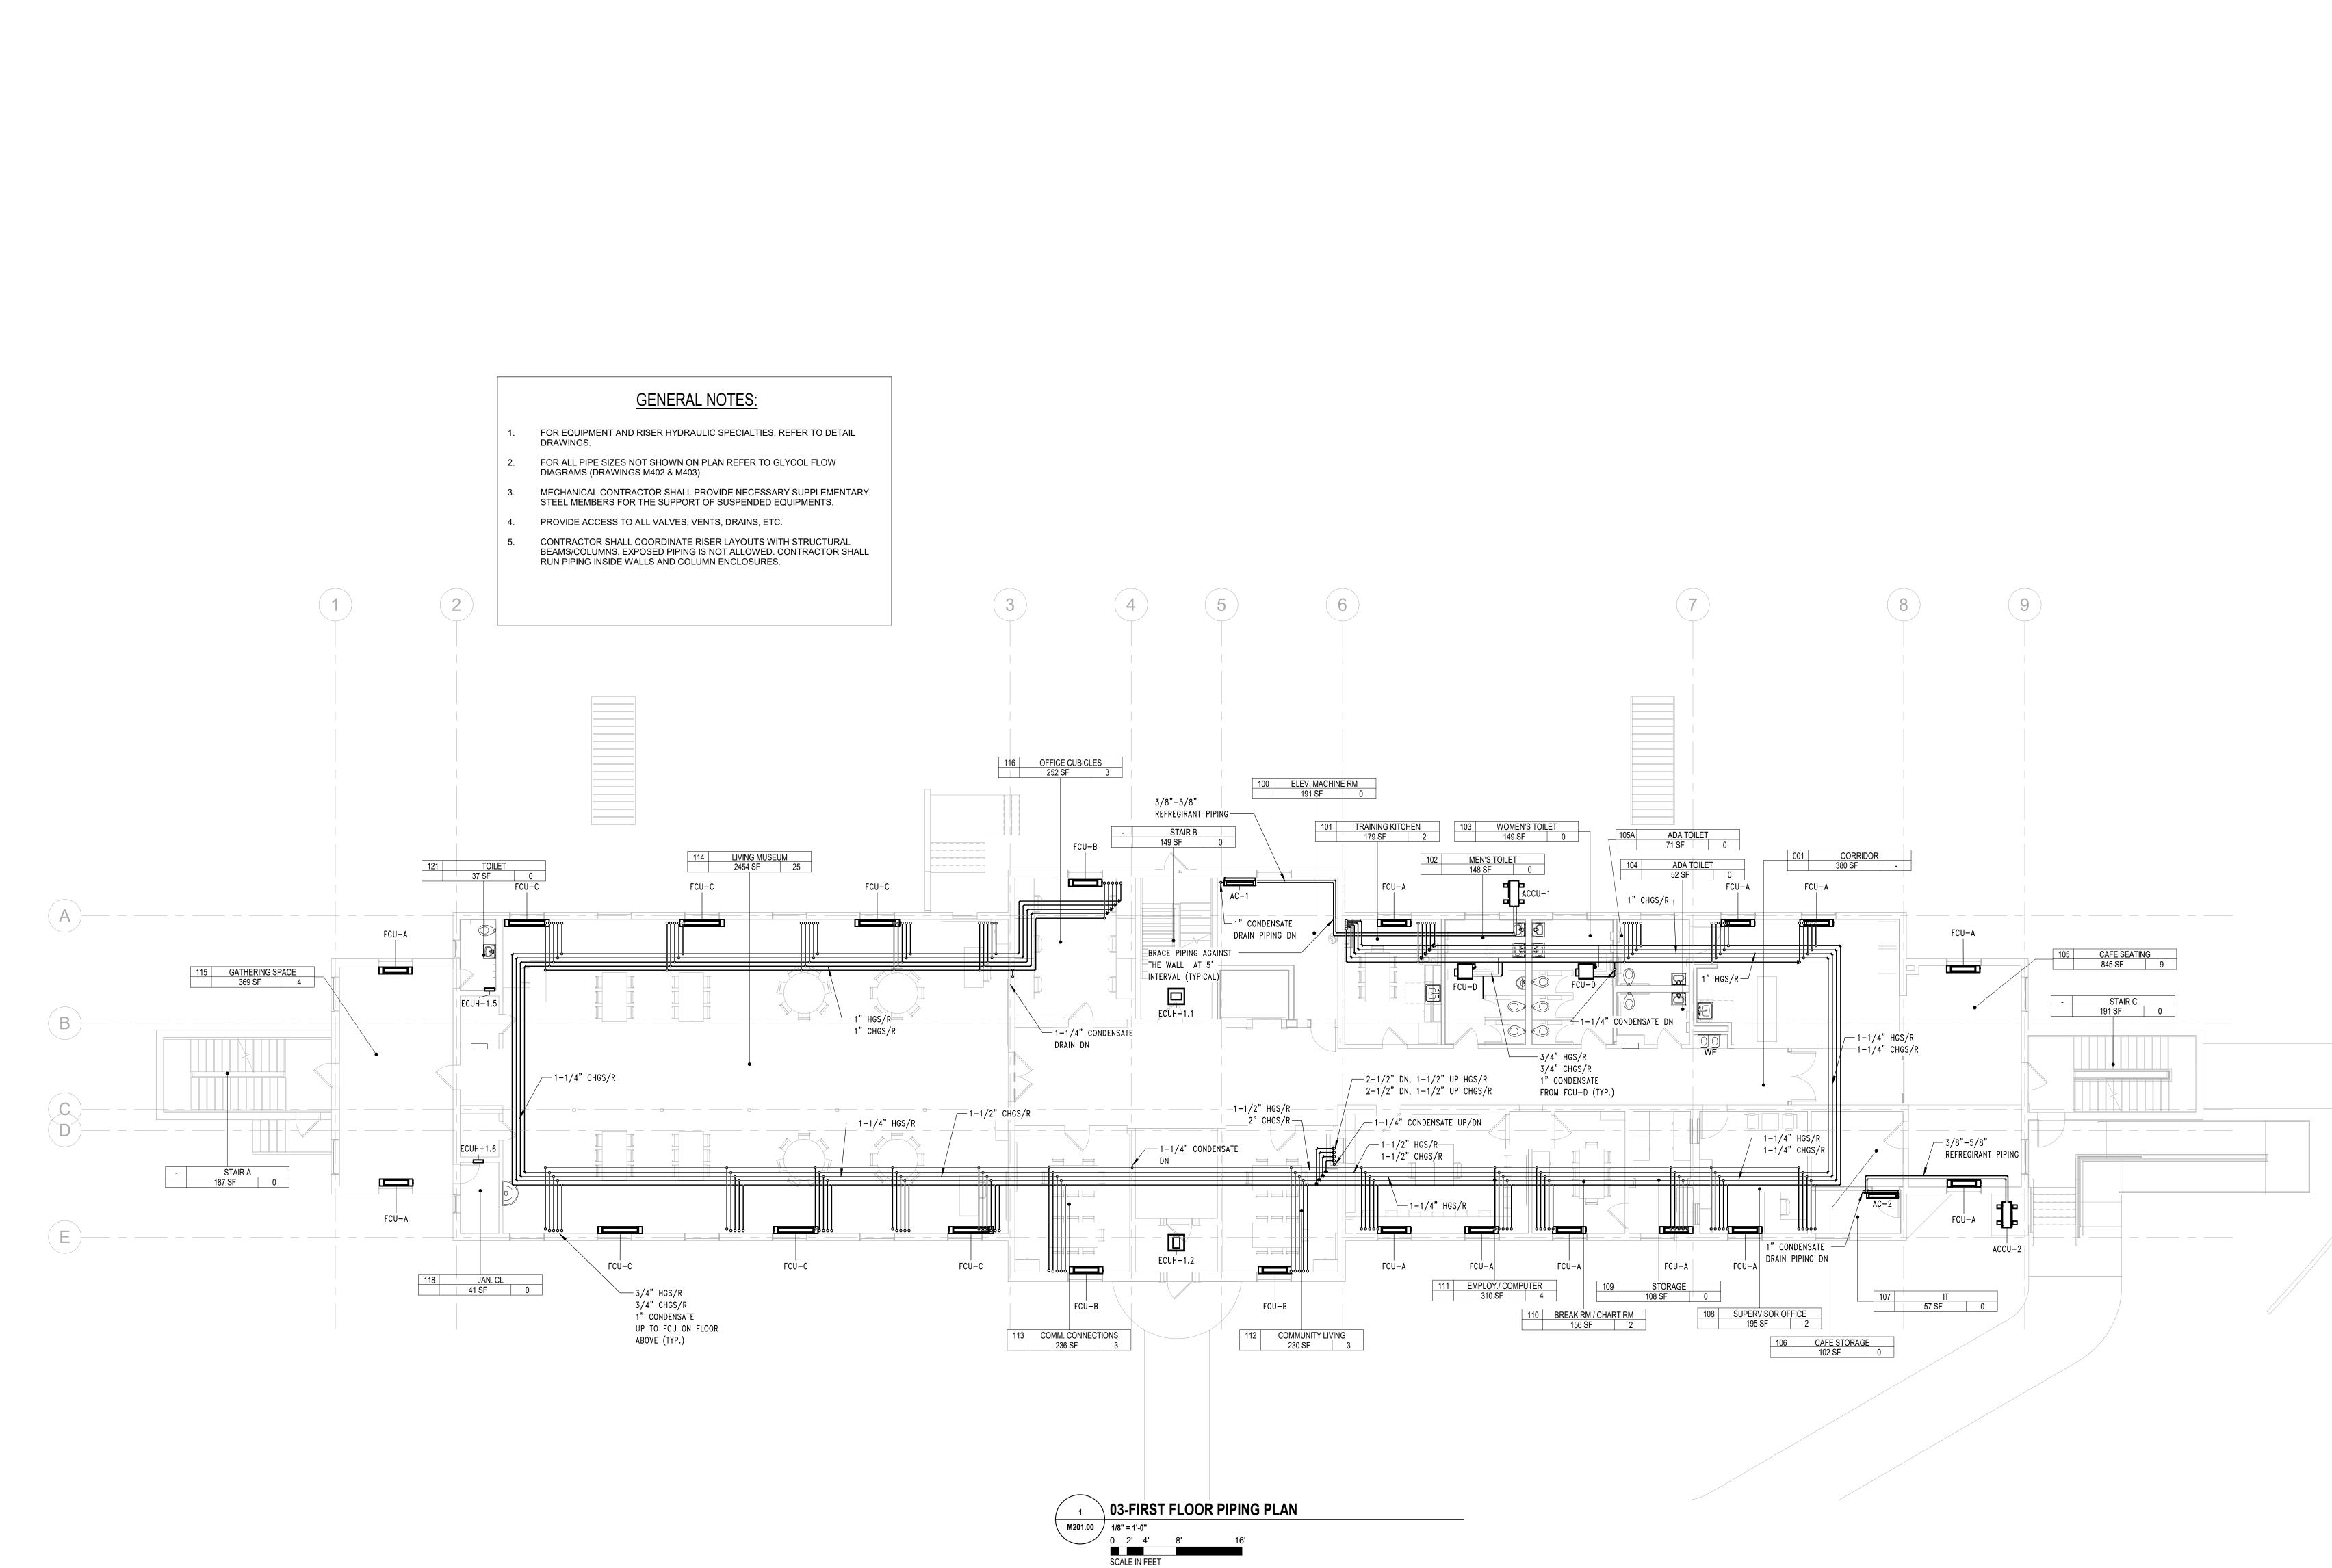

NEW YORK STATE OF OPPORTUNITY. Y-515 Broadway, Albany, NY 12207-2964 WWW. DASNY.ORG NEW YORK STATE OF OPPORTUNITY. Office of Mental Health 10 Ross Circle, Suite 5N, Poughkeepsie, NY 12601 WWW.OMH.NY.GOV HESE DOCUMENTS CONTAIN POTENTIALLY SENSITIVE INFORMATION A SHALL BE USED FOR THEIR INTENDED PURPOSE. ONCE THE INTENDED PURPOSE HAS IT IS A VIOLATION OF STATE EDUCATION LAW FOR ANY PERSON, UNLESS UND DIRECTION OF A LICENSED ARCHITECT/ENGINEER TO ALTER THIS DOCUMENT ANYWAY. ALTERATIONS MUST HAVE THE SEAL AFFIXED ALONG WITH A DESCI OF THE ALTERATIONS, DATE AND ARCHITECT'S/ENGINEER'S SIGNATURE. COP Consultants: 589 8TH AVE, 7 FL, NEW YORK, NY 10018 PHONE 212-242-3735 / FAX 212-242-7460 DVL CONSULTING ENGINEERS, INC. MEP ENGINEER / FIRE ALARM / FIRE PROTECTION 276 5TH AVENUE, SUITE 704 | NEW YORK, NY 10001 PHONE 212.947.7740 WSP GROUP STRUCTURAL ENGINEER ONE PENN PLAZA, 2ND FL | NEW YORK, NY 10119 PHONE 212.465.5000 QUALITY ENVIRONMENTAL SOLUTIONS & TECHNOLOGIES HAZMAT CONSULTANT 1376 US 9 | WAPPINGERS FALLS, NY 12590 PHONE 845.298.6031 GEORGE D. CATTABIANI & ASSOCIATES INC. ELEVATOR CONSULTANT 420 PAULDING AVENUE | NORTHVALE NJ 07647 PHONE 201.768.7331 TROPHY POINT COST ESTIMATOR 4588 SOUTH PARK AVENUE | NEW YORK NY 10001 PHONE 716.823.0006 HIRANI ENGINEERING & LAND SURVEYING, P.C. LAND SURVEY CONSULTANT 120 WEST JOHN STREET | HICKSVILLE NY 11801 PHONE 516.248.1010 KEY PLAN REVISIONS REV NO DESCRIPTION DATE Client DORMITORY AUTHORITY STATE OF NEW YORK 515 BROADWAY ALBANY, NY 12207 Project Title **BUILDING 1 RENOVATION AND** HAZARDOUS MATERIALS ABATEMEN 140 OLD ORANGEBURG RD ORANGETOWN, NY 10962 Drawing Title HVAC PIPING FIRST FLOOR PLAN Phase 100 SUBMISSION Ďrawn By: hecked By: 05 / 13 / Seal & Signature DASNY Project No ving Numbe M201.00

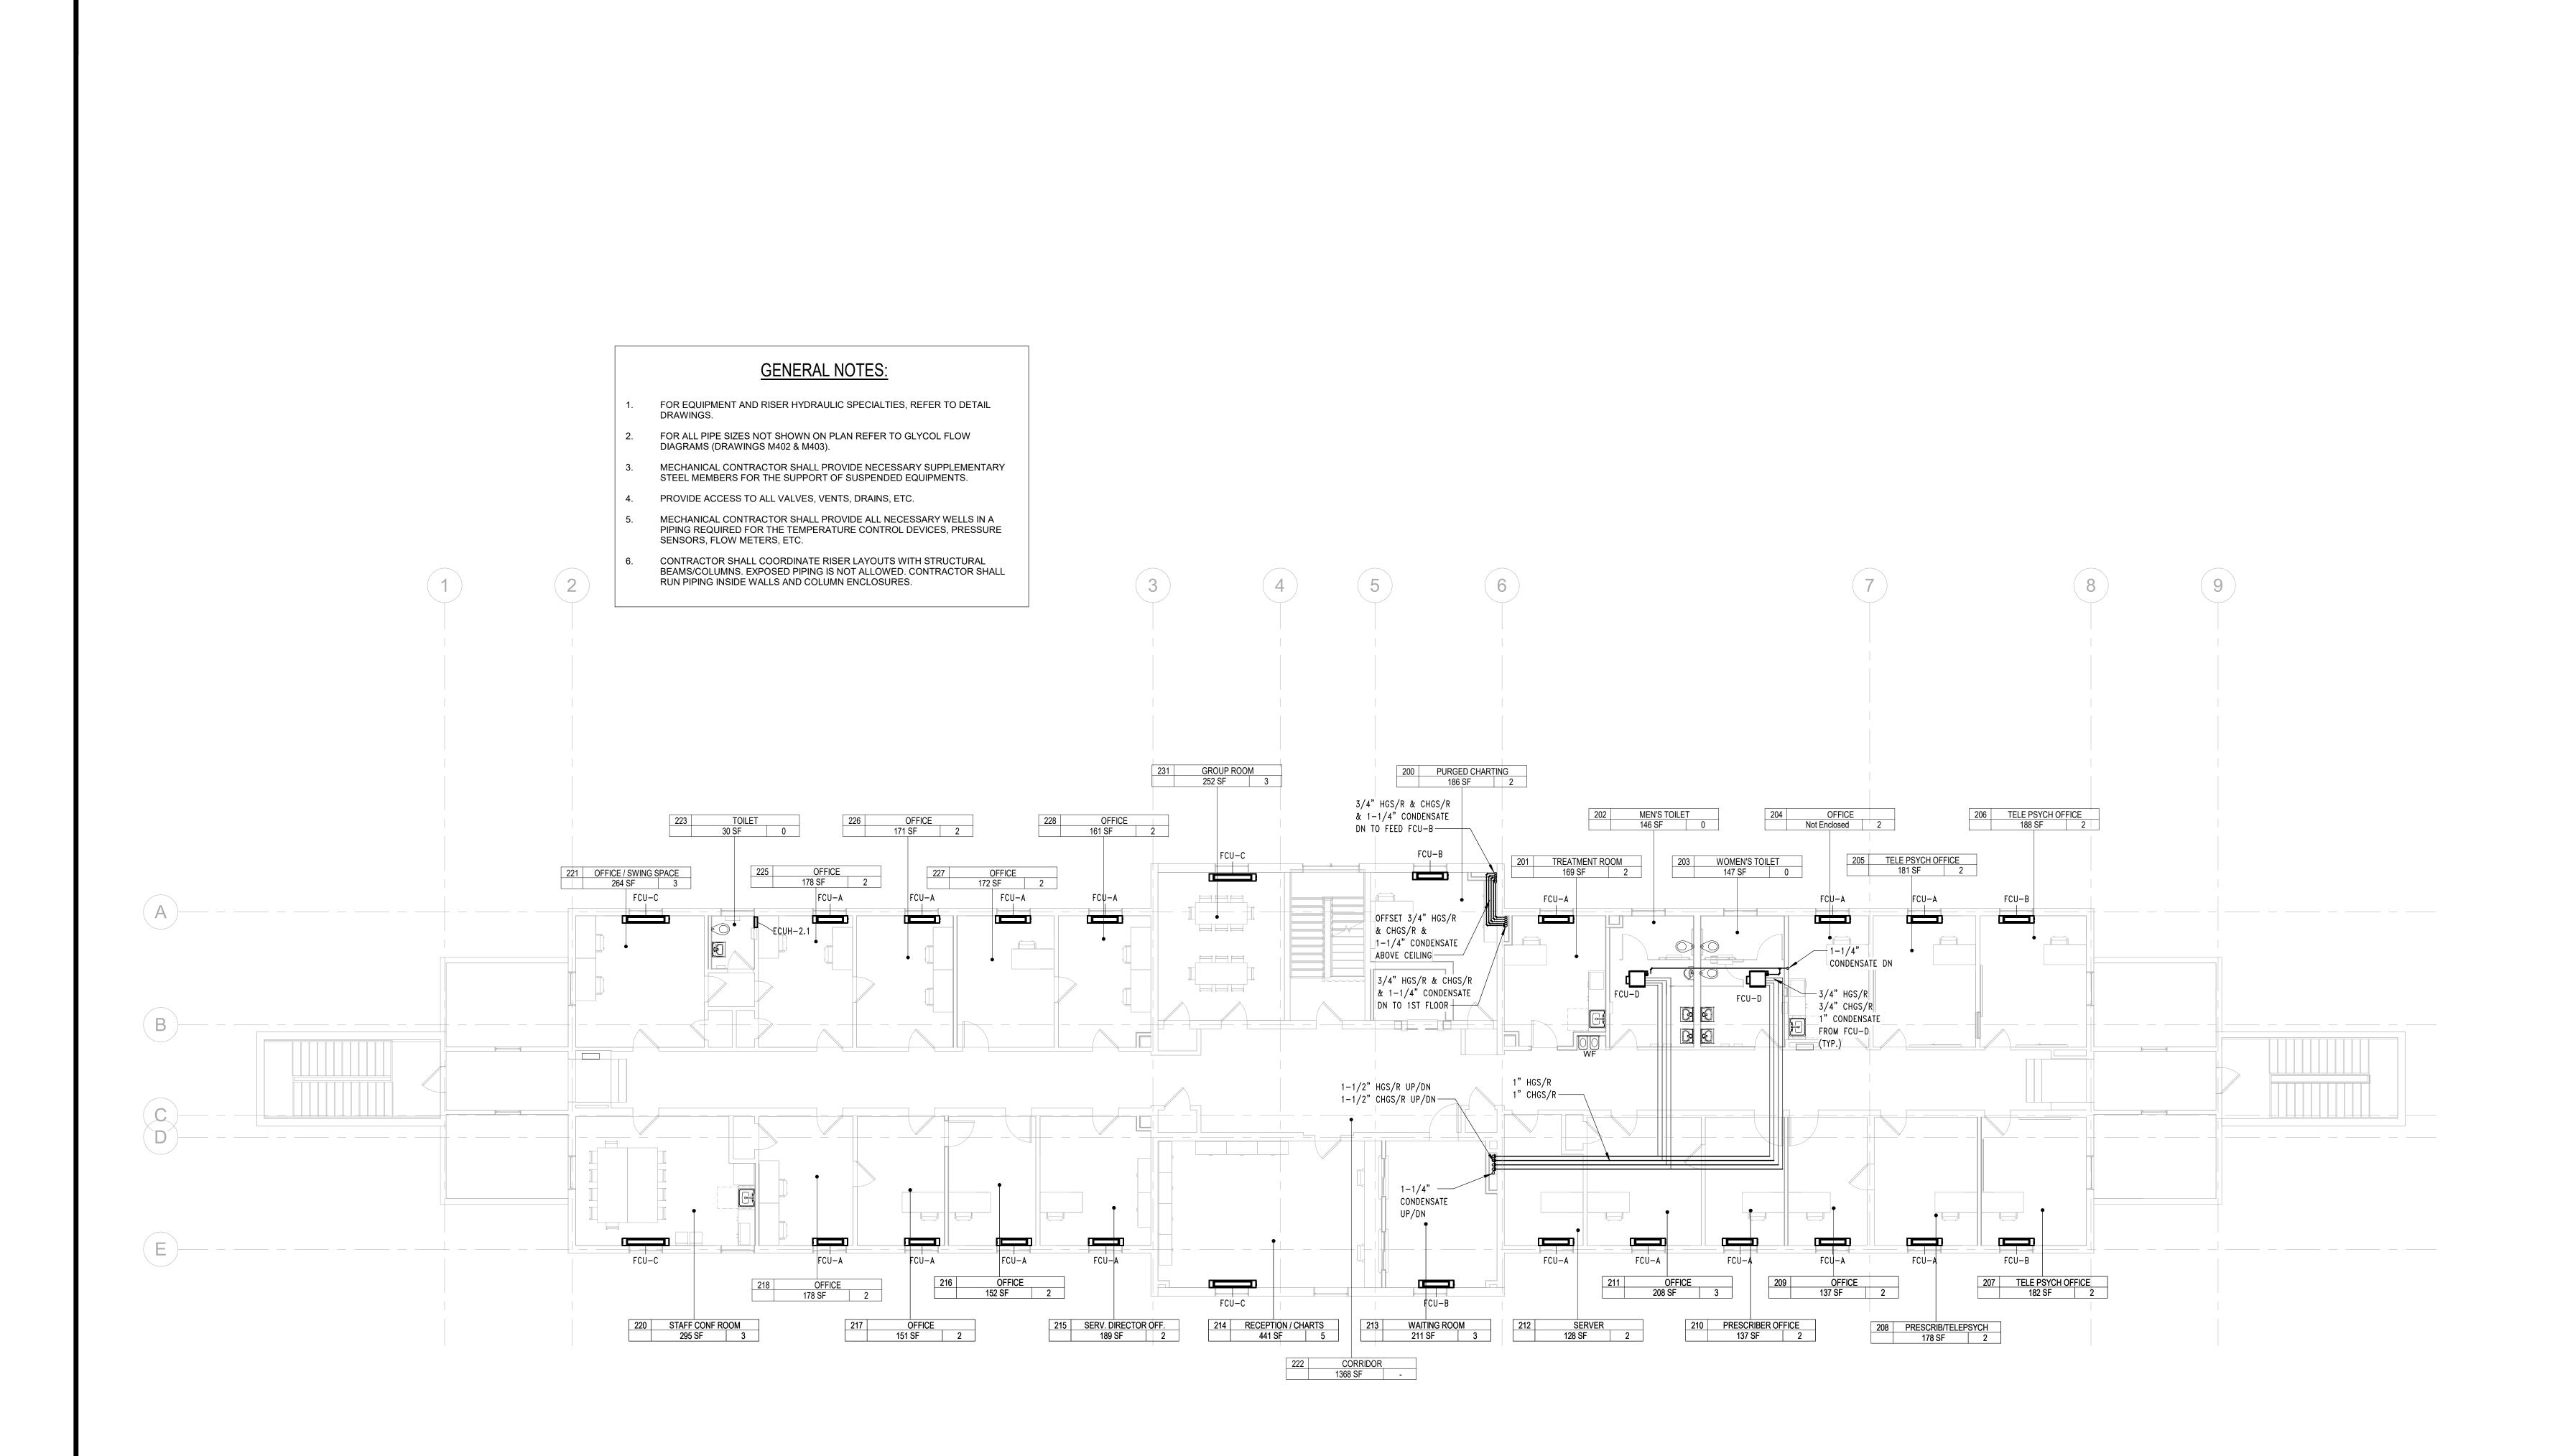

 1
 04-SECOND FLOOR PIPING PLAN

 M202.00
 1/8" = 1'-0"


 0
 2'
 4'
 8'
 16'


 SCALE IN FEET
 SCALE IN FEET
 SCALE IN FEET
 SCALE IN FEET

STATE OF OPPORTUNITY. DASNY Y 515 Broadway, Albany, NY 12207-2964 WWW. DASNY.ORG NEW YORK STATE OF OPPORTUNITY. Office of Mental Health Y 10 Ross Circle, Suite 5N, Poughkeepsie, NY 1260 WWW.OMH.NY.GOV HESE DOCUMENTS CONTAIN POTENTIALLY SENSITIVE INFORMATION A SHALL BE USED FOR THEIR INTENDED PURPOSE. ONCE THE INTENDED PURPOSE HAS ITS A VIOLATION OF STATE EDUCATION LAW FOR ANY PERSON, UNLESS U DIRECTION OF A LICENSED ARCHITECT/ENGINEER TO ALTER THIS DOCUME ANYWAY, ALTERATIONS MUST HAVE THE SEAL AFFIXED ALONG WITH A DESC OF THE ALTERATIONS, DATE AND ARCHITECT'S/ENGINEER'S SIGNATURE. COM Consultants: 589 8TH AVE, 7 FL, NEW YORK, NY 10018 PHONE 212-242-3735 / FAX 212-242-7460 DVL CONSULTING ENGINEERS, INC. MEP ENGINEER / FIRE ALARM / FIRE PROTECTION 276 5TH AVENUE, SUITE 704 | NEW YORK, NY 10001 PHONE 212.947.7740 WSP GROUP STRUCTURAL ENGINEER ONE PENN PLAZA, 2ND FL | NEW YORK, NY 10119 PHONE 212.465.5000 QUALITY ENVIRONMENTAL SOLUTIONS & TECHNOLOGIES HAZMAT CONSULTANT 1376 US 9 | WAPPINGERS FALLS, NY 12590 PHONE 845.298.6031 GEORGE D. CATTABIANI & ASSOCIATES INC. ELEVATOR CONSULTANT 420 PAULDING AVENUE | NORTHVALE NJ 07647 PHONE 201.768.7331 TROPHY POINT COST ESTIMATOR 4588 SOUTH PARK AVENUE | NEW YORK NY 10001 PHONE 716.823.0006 HIRANI ENGINEERING & LAND SURVEYING, P.C. LAND SURVEY CONSULTANT 120 WEST JOHN STREET | HICKSVILLE NY 11801 PHONE 516.248.1010 KEY PLAN REVISIONS REV NO DESCRIPTION DATE Client DORMITORY AUTHORITY STATE OF NEW YORK 515 BROADWAY ALBANY, NY 12207 Project Title BUILDING 1 RENOVATION AND HAZARDOUS MATERIALS ABATEMEN 140 OLD ORANGEBURG RD ORANGETOWN, NY 10962 Drawing Title HVAC PIPING SECOND FLOOR PLAN Phase 100 SUBMISSION Ďrawn By: hecked By: 05 / 13 / DASNY Project No Seal & Signature 3536 awing Numbe M202.00 rawing




BEAMS/COLUMNS. EXPOSED PIPING IS NOT ALLOWED. CONTRACTOR SHALL

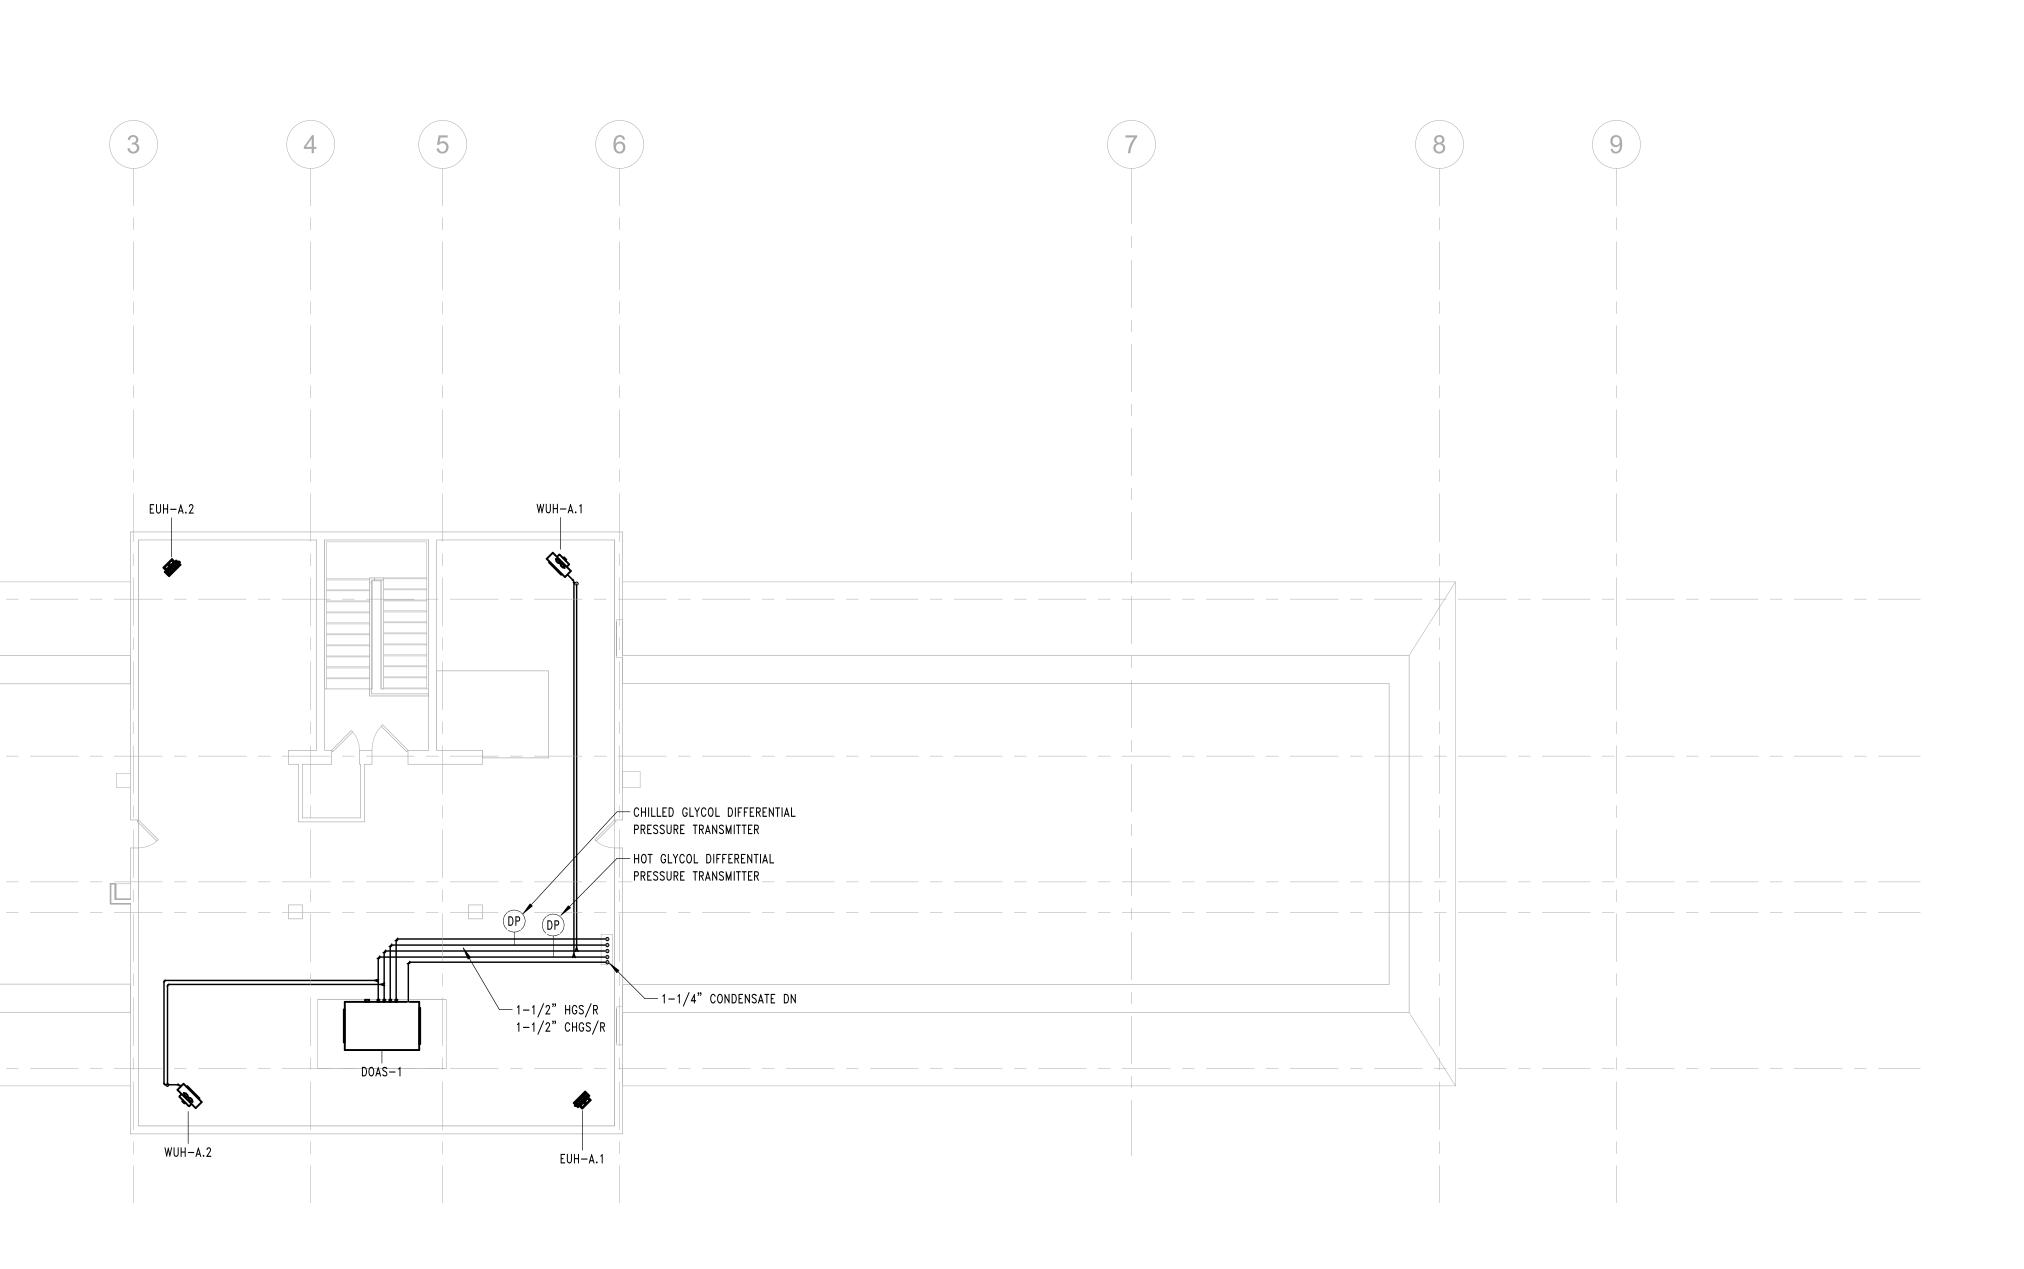

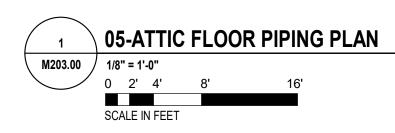



NEW YORK STATE OF OPPORTUNITY. Y 515 Broadway, Albany, NY 12207-2964 WWW. DASNY.ORG NEW YORK STATE OF OPPORTUNITY. Office of Mental Health 10 Ross Circle, Suite 5N, Poughkeepsie, NY 12601 WWW.OMH.NY.GOV THESE DOCUMENTS CONTAIN POTENTIALLY SENSITIVE INFORMATION AND SHALL BE USED FOR THEIR INTENDED PURPOSE. ONCE THE INTENDED PURPOSE HAS IT IS A VIOLATION OF STATE EDUCATION LAW FOR ANY PERSON, UNLESS UND DIRECTION OF A LICENSED ARCHITECT/ENGINEER TO ALTER THIS DOCUMENT ANYWAY. ALTERATIONS MUST HAVE THE SEAL AFFIXED ALONG WITH A DESCI OF THE ALTERATIONS, DATE AND ARCHITECT'S/ENGINEER'S SIGNATURE. COP Consultants: GoshowArchitects 589 8TH AVE, 7 FL, NEW YORK, NY 10018 PHONE 212-242-3735 / FAX 212-242-7460 DVL CONSULTING ENGINEERS, INC. MEP ENGINEER / FIRE ALARM / FIRE PROTECTION 276 5TH AVENUE, SUITE 704 | NEW YORK, NY 10001 PHONE 212.947.7740 WSP GROUP STRUCTURAL ENGINEER ONE PENN PLAZA, 2ND FL | NEW YORK, NY 10119 PHONE 212.465.5000 QUALITY ENVIRONMENTAL SOLUTIONS & TECHNOLOGIES HAZMAT CONSULTANT 1376 US 9 | WAPPINGERS FALLS, NY 12590 PHONE 845.298.6031 GEORGE D. CATTABIANI & ASSOCIATES INC. ELEVATOR CONSULTANT 420 PAULDING AVENUE | NORTHVALE NJ 07647 PHONE 201.768.7331 TROPHY POINT COST ESTIMATOR 4588 SOUTH PARK AVENUE | NEW YORK NY 10001 PHONE 716.823.0006 HIRANI ENGINEERING & LAND SURVEYING, P.C. LAND SURVEY CONSULTANT 120 WEST JOHN STREET | HICKSVILLE NY 11801 PHONE 516.248.1010 KEY PLAN REVISIONS REV NO DESCRIPTION DATE DORMITORY AUTHORITY STATE OF NEW YORK 515 BROADWAY ALBANY, NY 12207 Project Title **BUILDING 1 RENOVATION AND** HAZARDOUS MATERIALS ABATEMEN 140 OLD ORANGEBURG RD ORANGETOWN, NY 10962 Drawing Title HVAC PIPING ATTIC FLOOR PLAN Phase 100 SUBMISSION Ďrawn By: Checked By: Date: 05 / 13 / 2 JA Seal & Signature DASNY Project No. 35363 e awing Numbe M203.00 No. 075087 rawing

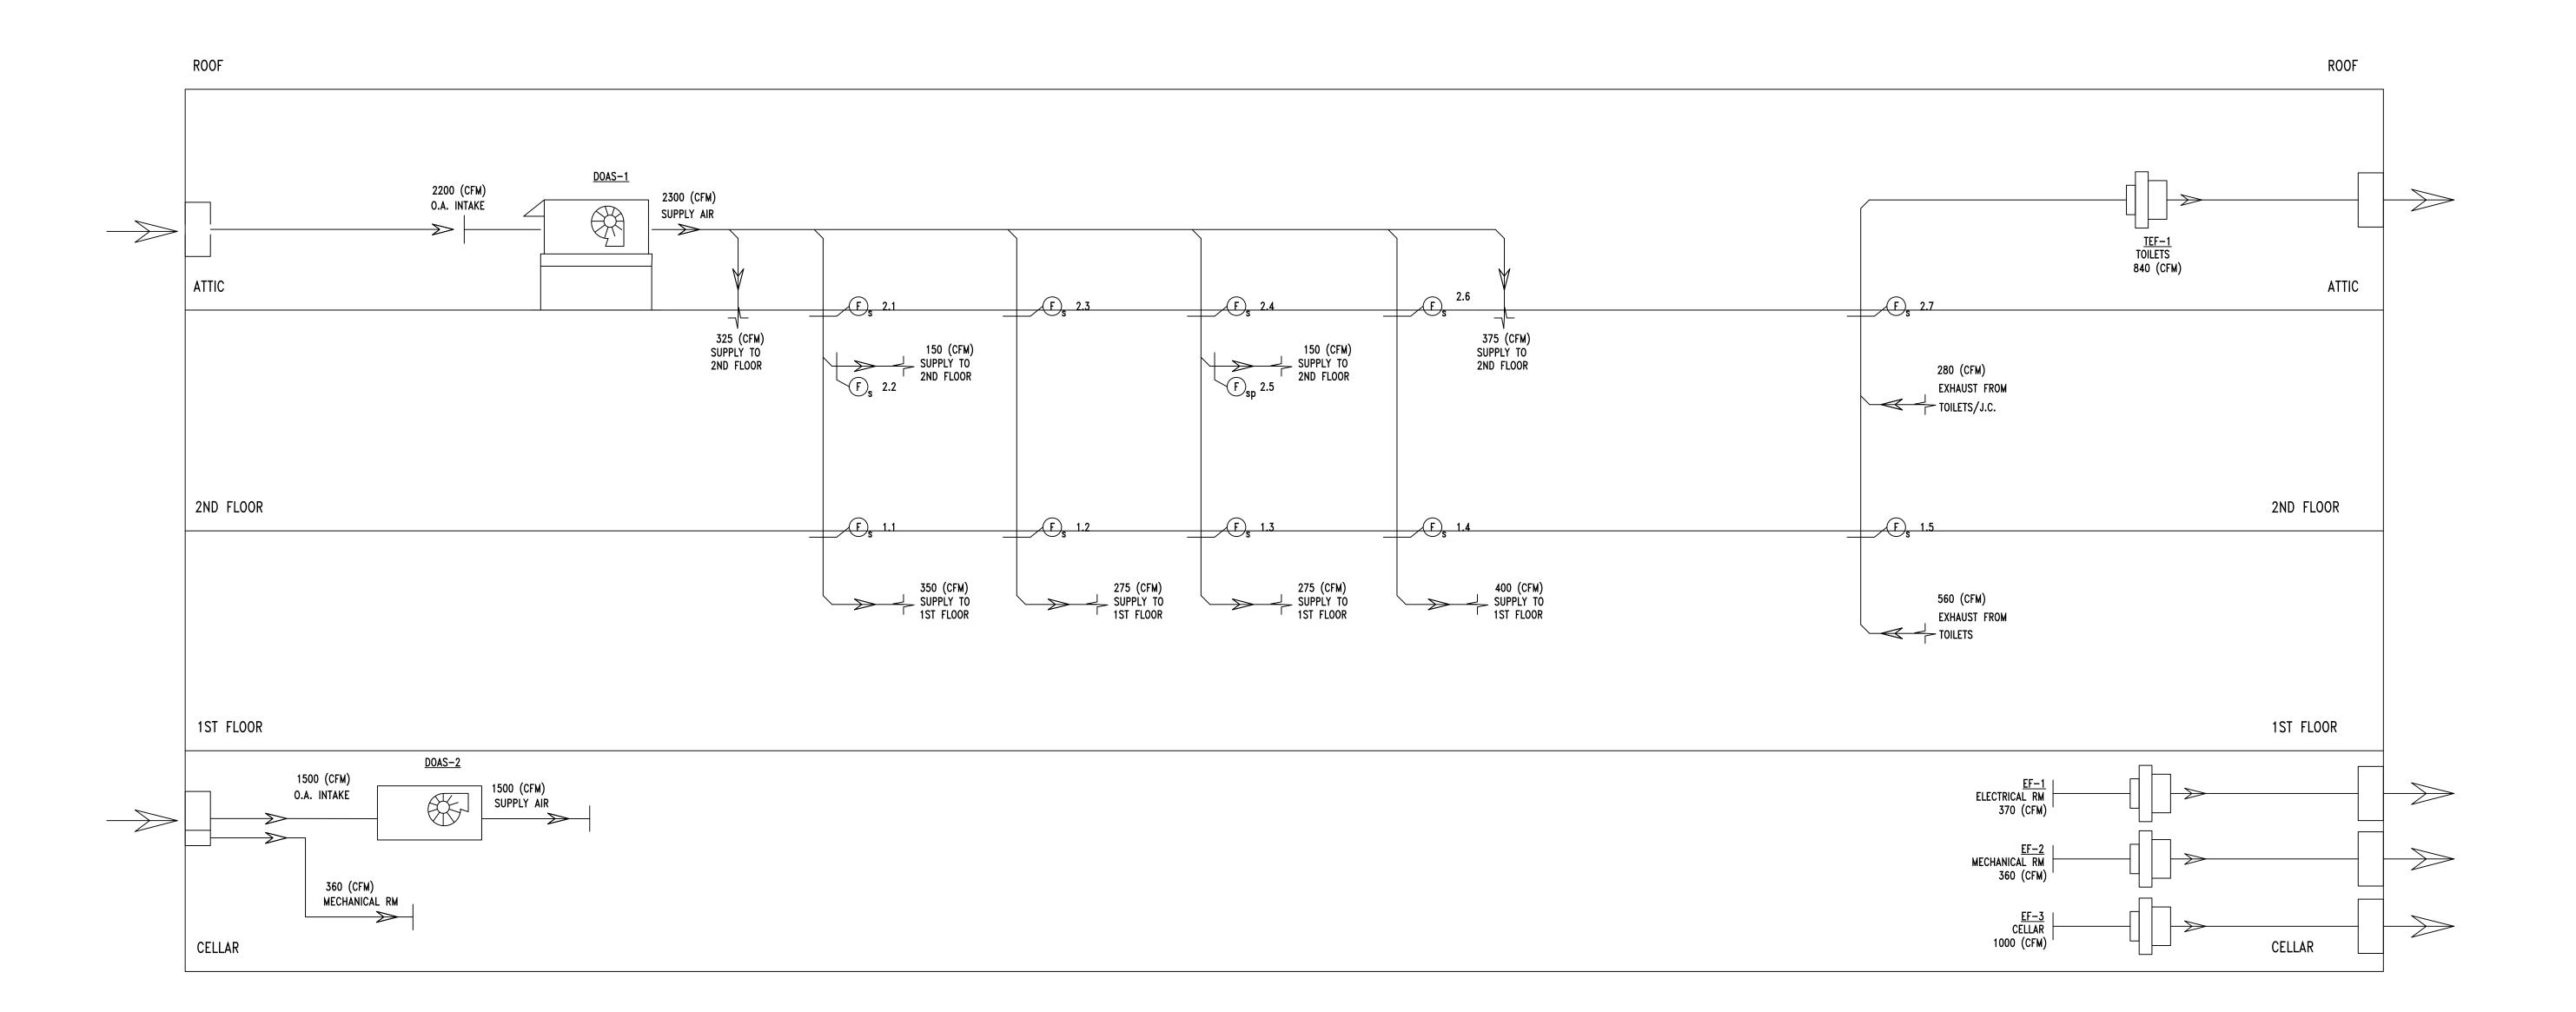

AIR RISER DIAGRAM

STATE OF OPPORTUNITY. Y 515 Broadway, Albany, NY 12207-2964 WWW. DASNY.ORG NEW YORK STATE OF OPPORTUNITY. Office of Mental Health Y 10 Ross Circle, Suite 5N, Poughkeepsie, NY 1260 WWW.OMH.NY.GOV THESE DOCUMENTS CONTAIN POTENTIALLY SENSITIVE NFORMATION AND SHALL BE JSED FOR THEIR INTENDED PURPOSE. ONCE THE INTENDE OSE HAS CEASED. TIS A VIOLATION OF STATE EDUCATION LAW FOR ANY PERSON, UNLESS NDER THE DOCUMENTS SHALL BE DESTROYED IN A SECURE MANNER, IRECTION OF A LICENSED ARCHITECT/ENGINEER TO ALTER THIS DOCUM NYVIAY, ALTERATIONS MUST HAVE THE SEAL AFFIXED ALONG WITH A DESCRIPTION PF THE ALTERATIONS, DATE AND ARCHITECT'S/ENGINEER'S SIGNATURE. Consultants: GoshowArchitects 589 8TH AVE, 7 FL, NEW YORK, NY 10018 PHONE 212-242-3735 / FAX 212-242-7460 DVL CONSULTING ENGINEERS, INC. MEP ENGINEERS / FIRE ALARM / FIRE PROTECTION 276 5TH AVENUE, SUITE 704 | NEW YORK, NY 10001 PHONE 212.947.7740 WSP GROUP ONE PENN PLAZA, 2ND FL | NEW YORK, NY 10119 PHONE 212.465.5000 QUALITY ENVIRONMENTAL SOLUTIONS & TECHNOLOGIES HAZMAT CONSULTANT 1376 US 9 [WAPPINGERS FALLS, NY 12590 PHONE 845.298.6031 GEORGE D. CATTABIANI & ASSOCIATES INC. VERTICAL TRANSPORTATION CONSULTANT'S ELEVATOR CONSULTANT 420 PAULDING AVENUE | NORTHVALE NJ 07647 PHONE 201.768.7331 TROPHY POINT COST CONSULTANT 4588 SOUTH PARK AVENUE | NEW YORK NY 10001 PHONE 716.823.0006 HIRANI ENGINEERING & LAND SURVEYING, P.C. LAND SURVEY CONSULTANT 120 WEST JOHN STREET HICKSVILLE, NY 11801 PHONE 516.248.1010 KEY PLAN REVISIONS REV NO DESCRIPTION DATE DORMITORY AUTHORITY STATE OF NEW YORK 515 BROADWAY ALBANY, NY 12207 Project Title BUILDING 1 RENOVATION AND HAZARDOUS MATERIALS ABATEMENT 140 OLD ORANGEBURG RD ORANGETOWN, NY 10962 Drawing Title HVAC AIR RISER DIAGRAM Phase 100 % SUBMISSION Drawn By: necked By. 05 / 13 / 2 JA Seal & Signature DASNY Project No THE OF NEW 35363 ing Number No. 17087 M401.00

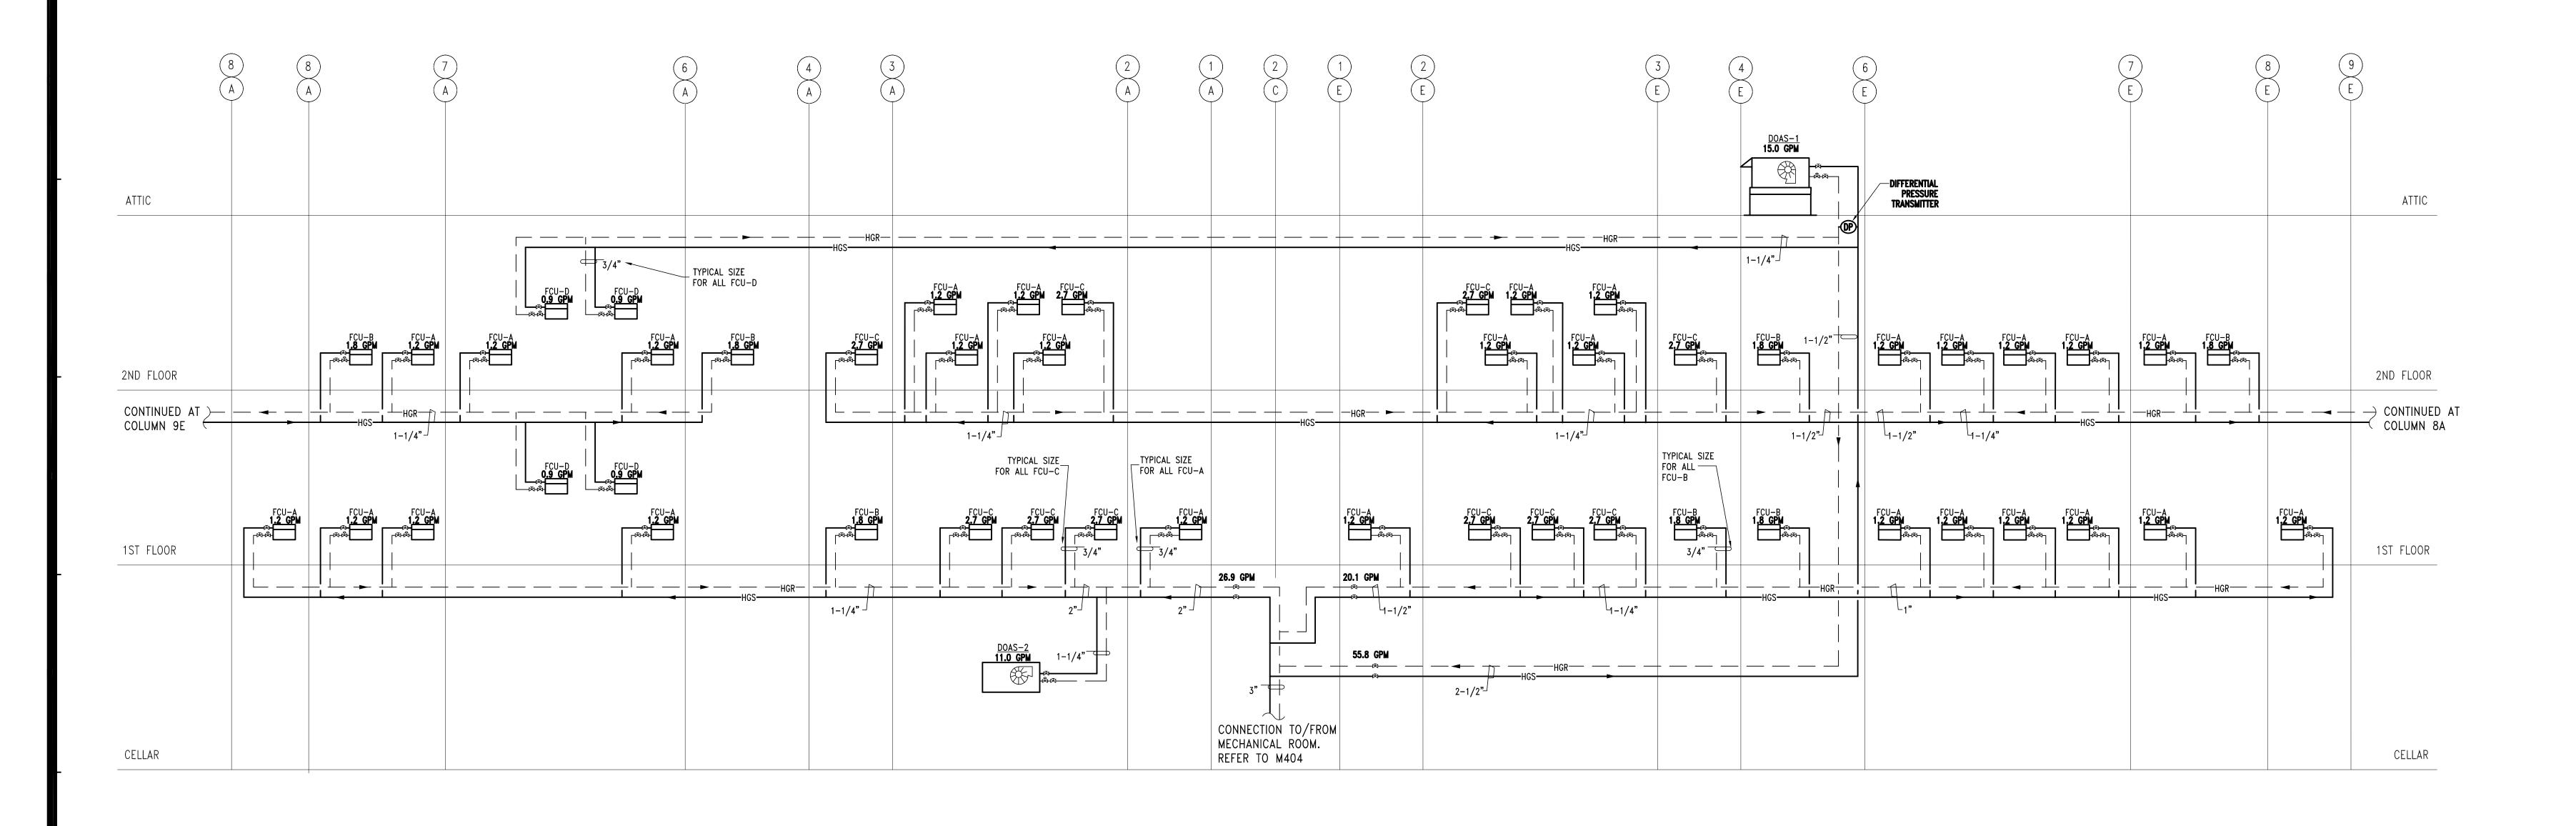

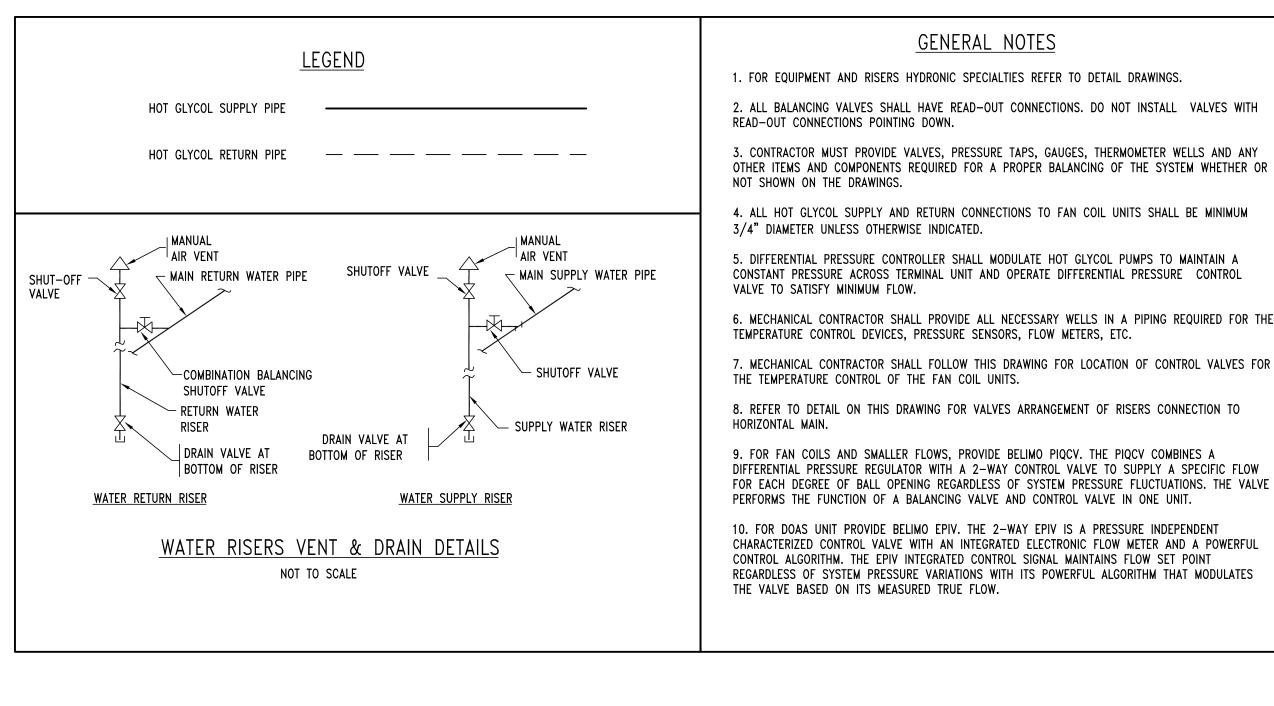

## HOT GLYCOL RISER DIAGRAM NOT TO SCALE

### <u>GENERAL NOTES</u>

1. FOR EQUIPMENT AND RISERS HYDRONIC SPECIALTIES REFER TO DETAIL DRAWINGS.

3. CONTRACTOR MUST PROVIDE VALVES, PRESSURE TAPS, GAUGES, THERMOMETER WELLS AND ANY

4. ALL HOT GLYCOL SUPPLY AND RETURN CONNECTIONS TO FAN COIL UNITS SHALL BE MINIMUM


5. DIFFERENTIAL PRESSURE CONTROLLER SHALL MODULATE HOT GLYCOL PUMPS TO MAINTAIN A CONSTANT PRESSURE ACROSS TERMINAL UNIT AND OPERATE DIFFERENTIAL PRESSURE CONTROL


6. MECHANICAL CONTRACTOR SHALL PROVIDE ALL NECESSARY WELLS IN A PIPING REQUIRED FOR THE TEMPERATURE CONTROL DEVICES, PRESSURE SENSORS, FLOW METERS, ETC. 7. MECHANICAL CONTRACTOR SHALL FOLLOW THIS DRAWING FOR LOCATION OF CONTROL VALVES FOR


8. REFER TO DETAIL ON THIS DRAWING FOR VALVES ARRANGEMENT OF RISERS CONNECTION TO

9. FOR FAN COILS AND SMALLER FLOWS, PROVIDE BELIMO PIQCV. THE PIQCV COMBINES A DIFFERENTIAL PRESSURE REGULATOR WITH A 2-WAY CONTROL VALVE TO SUPPLY A SPECIFIC FLOW FOR EACH DEGREE OF BALL OPENING REGARDLESS OF SYSTEM PRESSURE FLUCTUATIONS. THE VALVE PERFORMS THE FUNCTION OF A BALANCING VALVE AND CONTROL VALVE IN ONE UNIT.

10. FOR DOAS UNIT PROVIDE BELIMO EPIV. THE 2-WAY EPIV IS A PRESSURE INDEPENDENT CHARACTERIZED CONTROL VALVE WITH AN INTEGRATED ELECTRONIC FLOW METER AND A POWERFUL CONTROL ALGORITHM. THE EPIV INTEGRATED CONTROL SIGNAL MAINTAINS FLOW SET POINT REGARDLESS OF SYSTEM PRESSURE VARIATIONS WITH ITS POWERFUL ALGORITHM THAT MODULATES

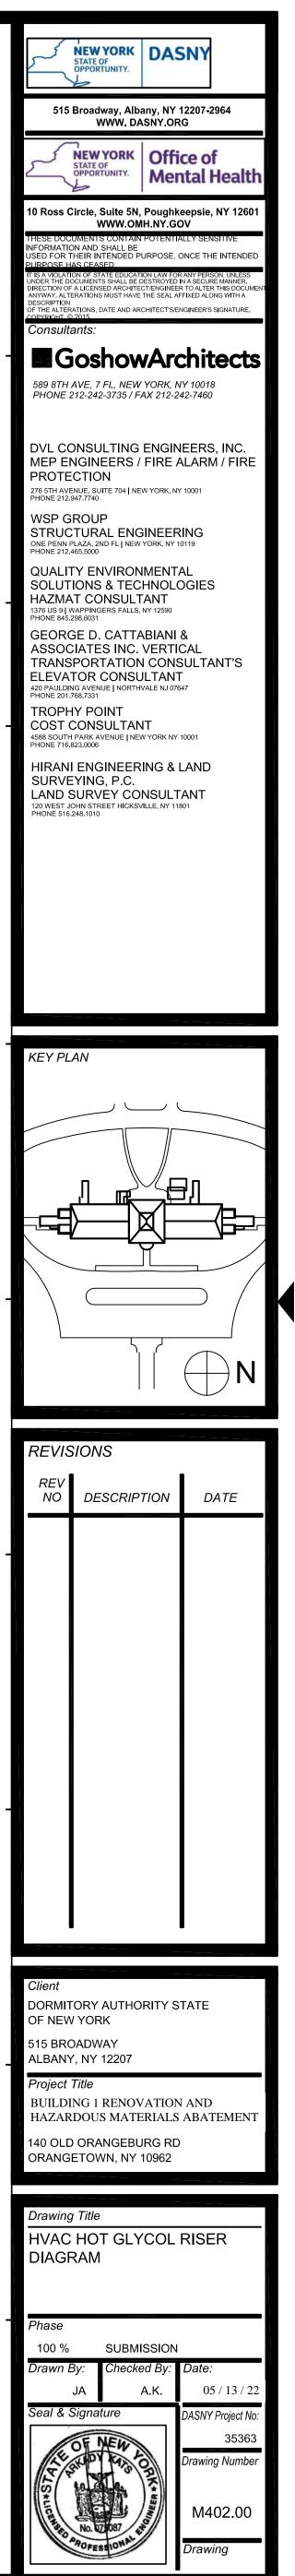

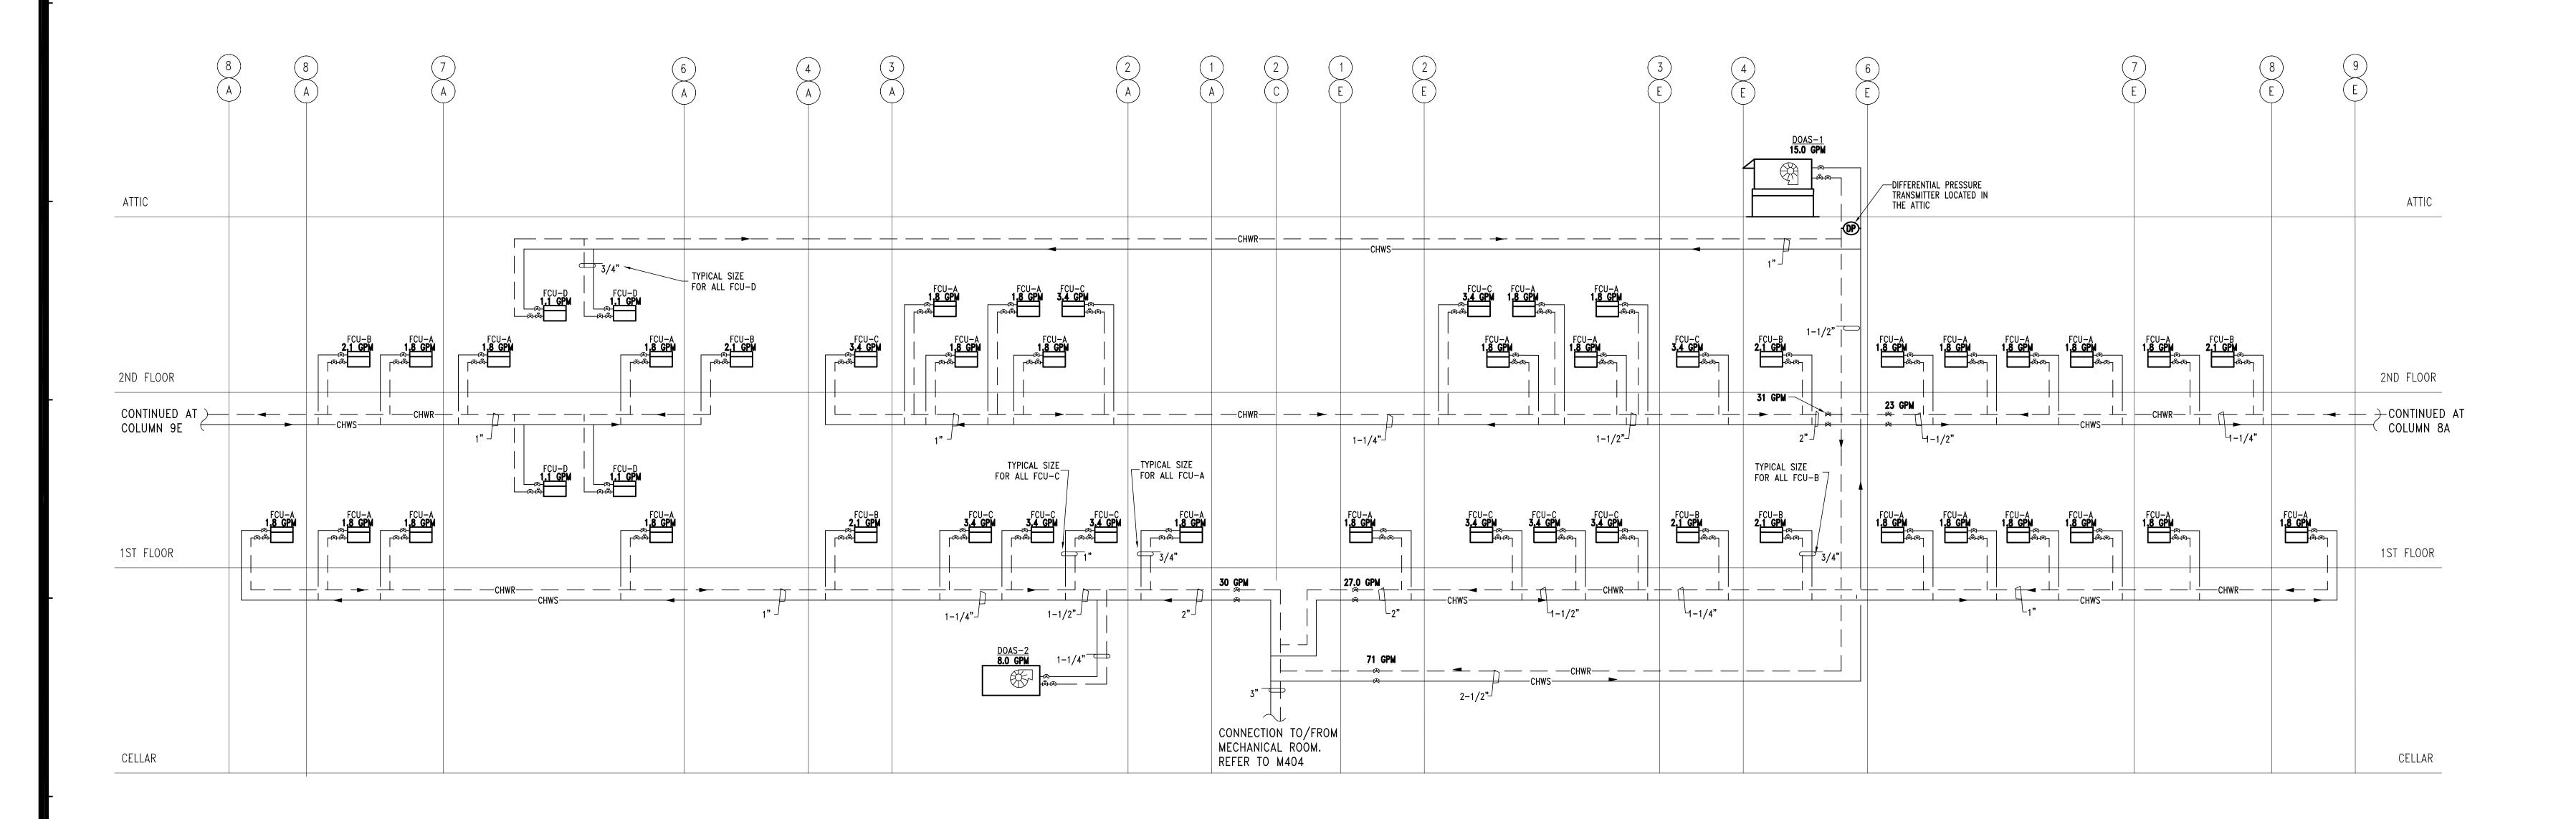

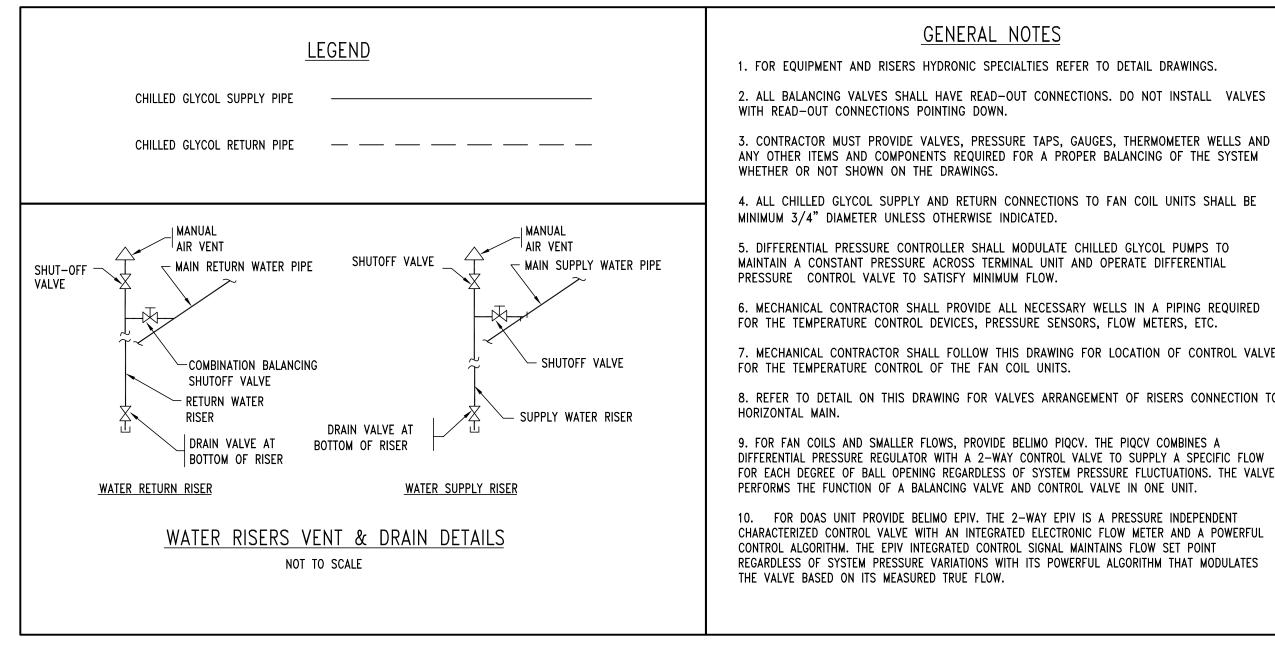

## CHILLED GLYCOL RISER DIAGRAM NOT TO SCALE

### <u>GENERAL NOTES</u>

1. FOR EQUIPMENT AND RISERS HYDRONIC SPECIALTIES REFER TO DETAIL DRAWINGS.

3. CONTRACTOR MUST PROVIDE VALVES, PRESSURE TAPS, GAUGES, THERMOMETER WELLS AND ANY OTHER ITEMS AND COMPONENTS REQUIRED FOR A PROPER BALANCING OF THE SYSTEM WHETHER OR NOT SHOWN ON THE DRAWINGS.

4. ALL CHILLED GLYCOL SUPPLY AND RETURN CONNECTIONS TO FAN COIL UNITS SHALL BE


MAINTAIN A CONSTANT PRESSURE ACROSS TERMINAL UNIT AND OPERATE DIFFERENTIAL


FOR THE TEMPERATURE CONTROL DEVICES, PRESSURE SENSORS, FLOW METERS, ETC. 7. MECHANICAL CONTRACTOR SHALL FOLLOW THIS DRAWING FOR LOCATION OF CONTROL VALVES

8. REFER TO DETAIL ON THIS DRAWING FOR VALVES ARRANGEMENT OF RISERS CONNECTION TO

DIFFERENTIAL PRESSURE REGULATOR WITH A 2-WAY CONTROL VALVE TO SUPPLY A SPECIFIC FLOW FOR EACH DEGREE OF BALL OPENING REGARDLESS OF SYSTEM PRESSURE FLUCTUATIONS. THE VALVE PERFORMS THE FUNCTION OF A BALANCING VALVE AND CONTROL VALVE IN ONE UNIT.

10. FOR DOAS UNIT PROVIDE BELIMO EPIV. THE 2-WAY EPIV IS A PRESSURE INDEPENDENT CHARACTERIZED CONTROL VALVE WITH AN INTEGRATED ELECTRONIC FLOW METER AND A POWERFUL CONTROL ALGORITHM. THE EPIV INTEGRATED CONTROL SIGNAL MAINTAINS FLOW SET POINT REGARDLESS OF SYSTEM PRESSURE VARIATIONS WITH ITS POWERFUL ALGORITHM THAT MODULATES

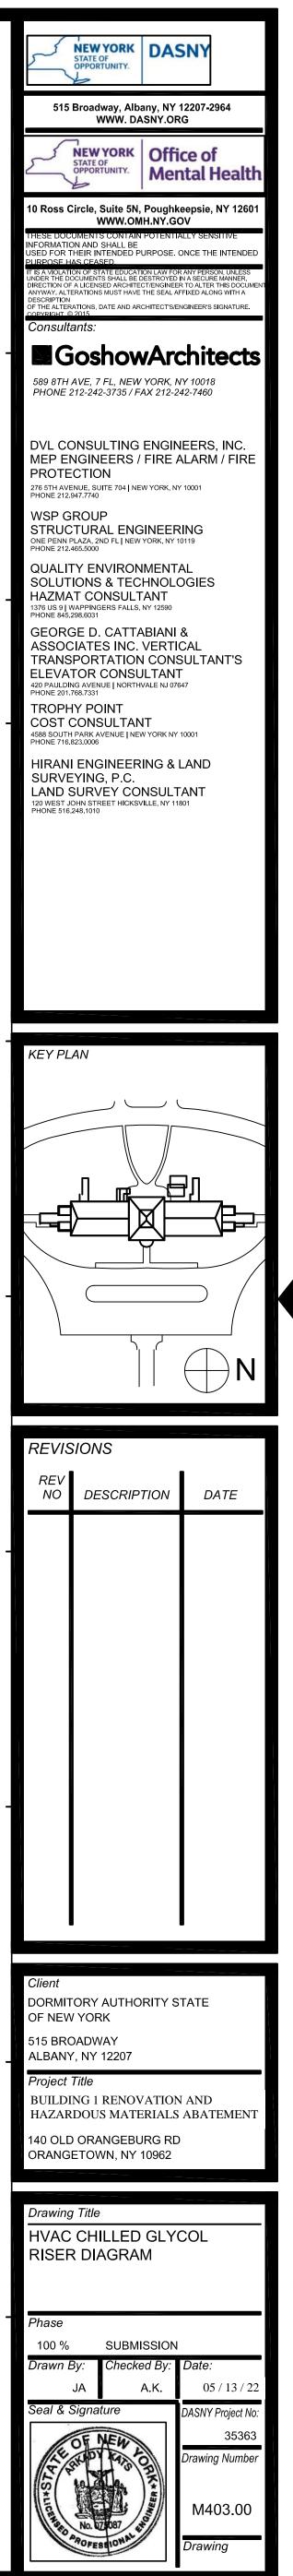


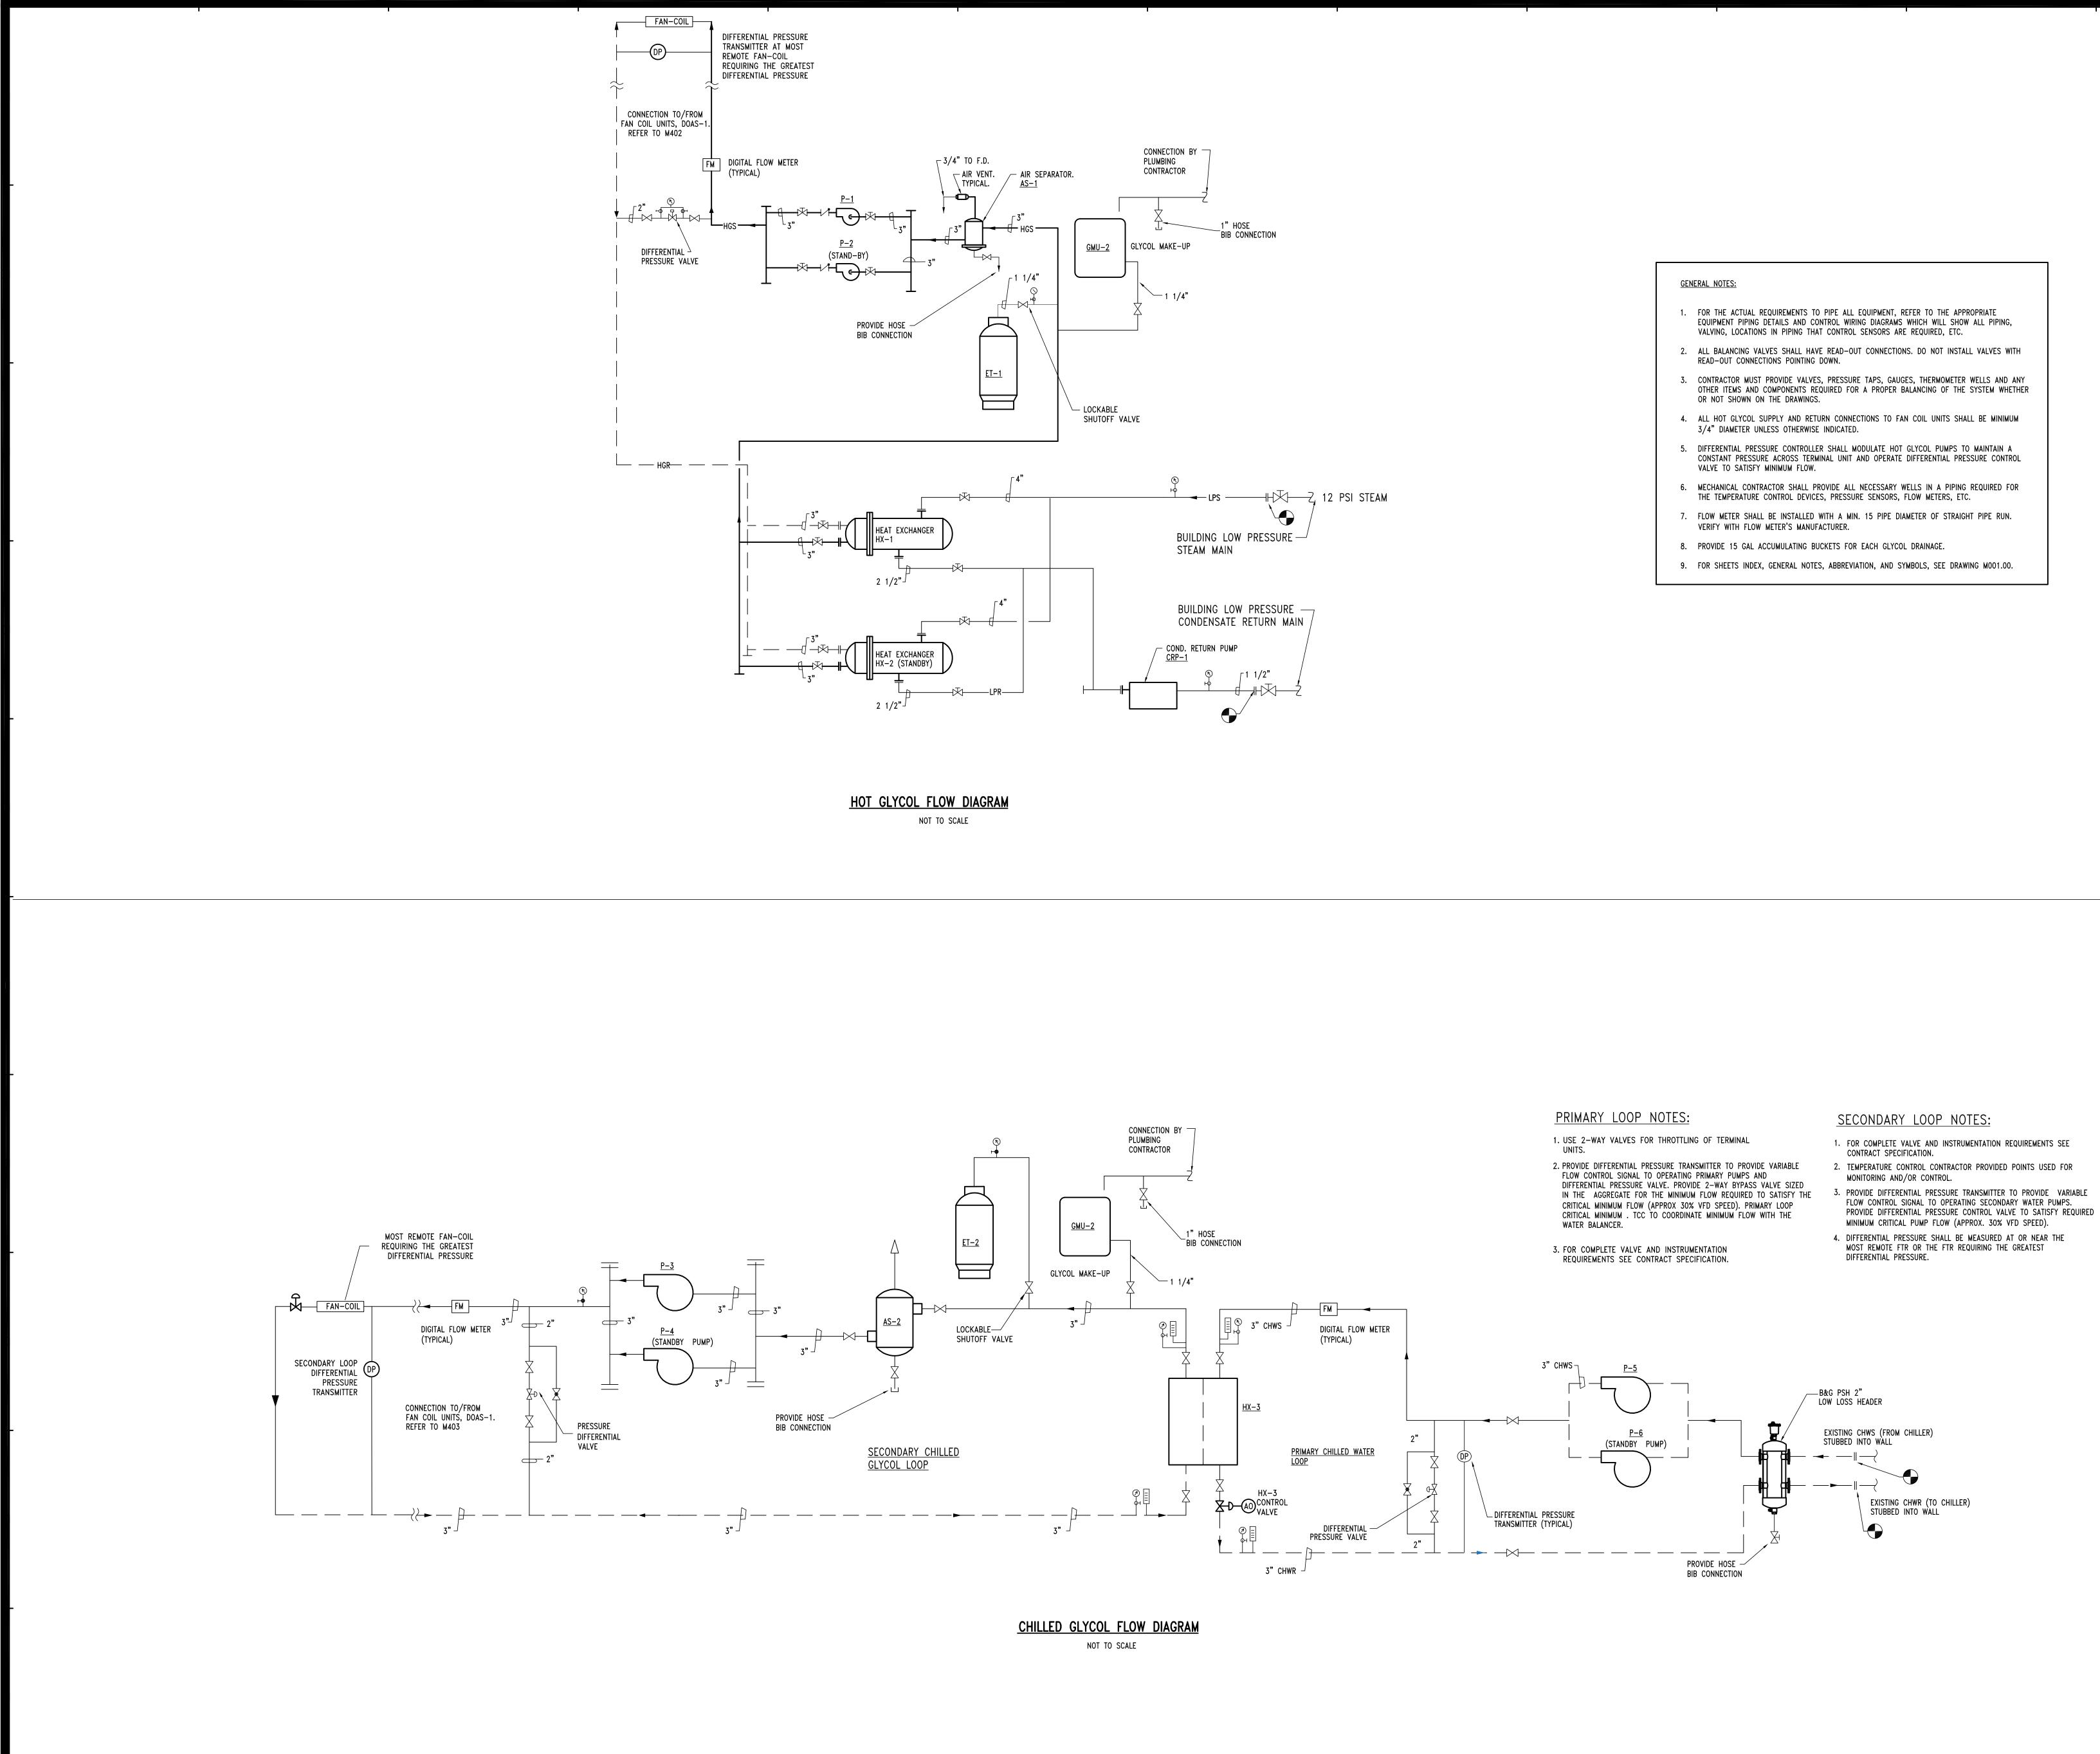


- EQUIPMENT PIPING DETAILS AND CONTROL WIRING DIAGRAMS WHICH WILL SHOW ALL PIPING,
- OTHER ITEMS AND COMPONENTS REQUIRED FOR A PROPER BALANCING OF THE SYSTEM WHETHER
- 5. DIFFERENTIAL PRESSURE CONTROLLER SHALL MODULATE HOT GLYCOL PUMPS TO MAINTAIN A CONSTANT PRESSURE ACROSS TERMINAL UNIT AND OPERATE DIFFERENTIAL PRESSURE CONTROL
- 6. MECHANICAL CONTRACTOR SHALL PROVIDE ALL NECESSARY WELLS IN A PIPING REQUIRED FOR
- 7. FLOW METER SHALL BE INSTALLED WITH A MIN. 15 PIPE DIAMETER OF STRAIGHT PIPE RUN.
- 9. FOR SHEETS INDEX, GENERAL NOTES, ABBREVIATION, AND SYMBOLS, SEE DRAWING MOO1.00.

### SECONDARY LOOP NOTES:

- 1. FOR COMPLETE VALVE AND INSTRUMENTATION REQUIREMENTS SEE 2. TEMPERATURE CONTROL CONTRACTOR PROVIDED POINTS USED FOR
- 3. PROVIDE DIFFERENTIAL PRESSURE TRANSMITTER TO PROVIDE VARIABLE FLOW CONTROL SIGNAL TO OPERATING SECONDARY WATER PUMPS.
- MINIMUM CRITICAL PUMP FLOW (APPROX. 30% VFD SPEED). 4. DIFFERENTIAL PRESSURE SHALL BE MEASURED AT OR NEAR THE MOST REMOTE FTR OR THE FTR REQUIRING THE GREATEST

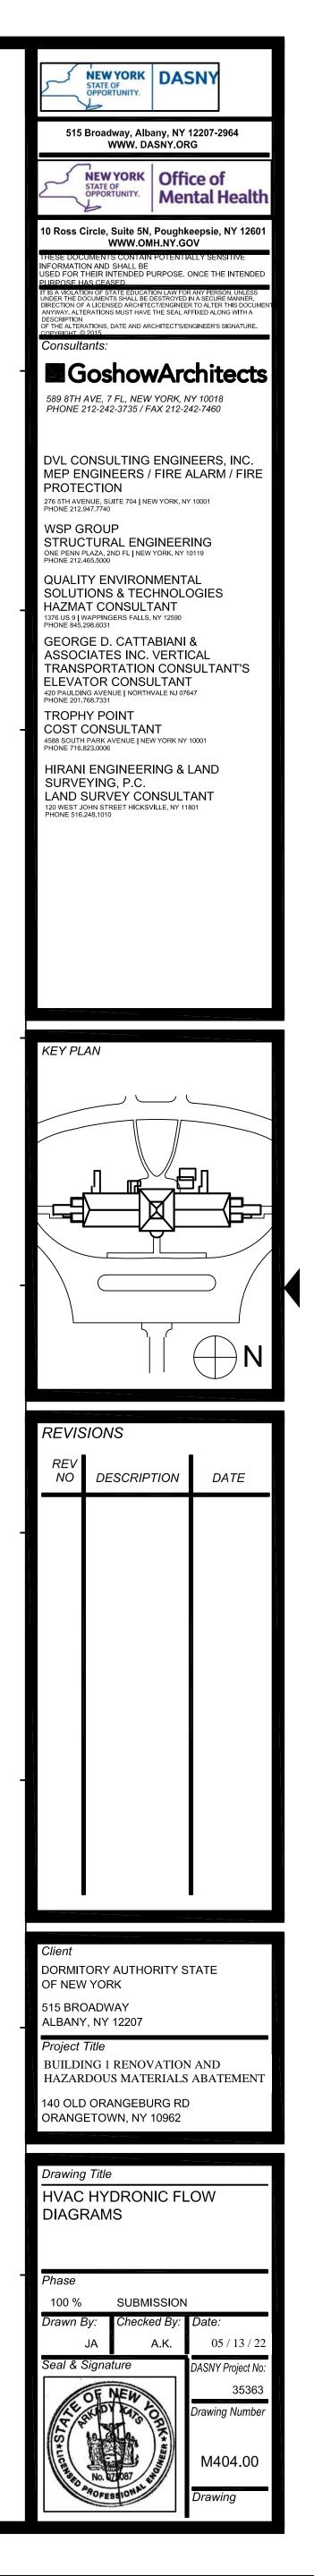


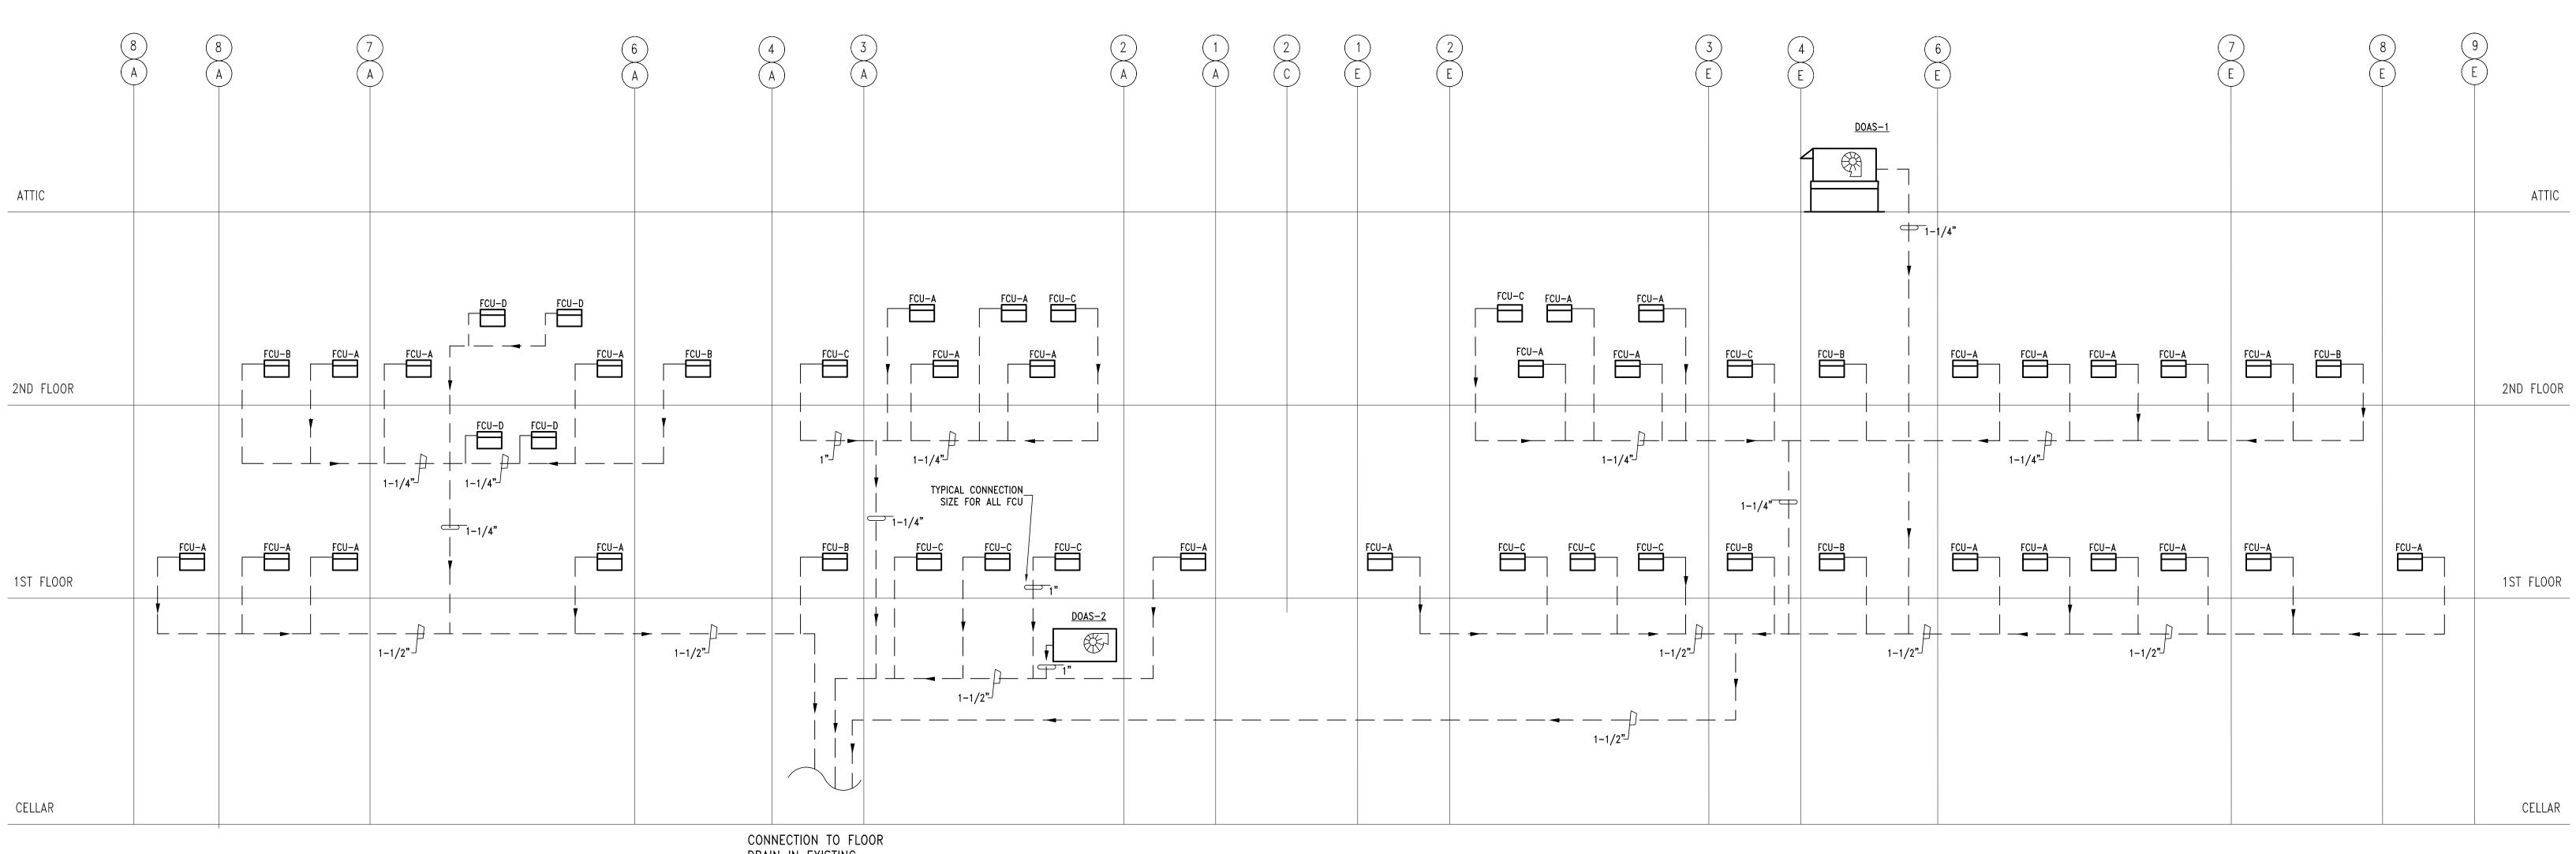


GENERAL NOTES: 1. REFER TO 200 SERIES DRAWINGS FOR CONDENSATE PIPING MAIN SIZING


CONNECTION TO FLOOR DRAIN IN EXISTING MECHANICAL ROOM B19.

CONDENSATE RISER DIAGRAM NOT TO SCALE

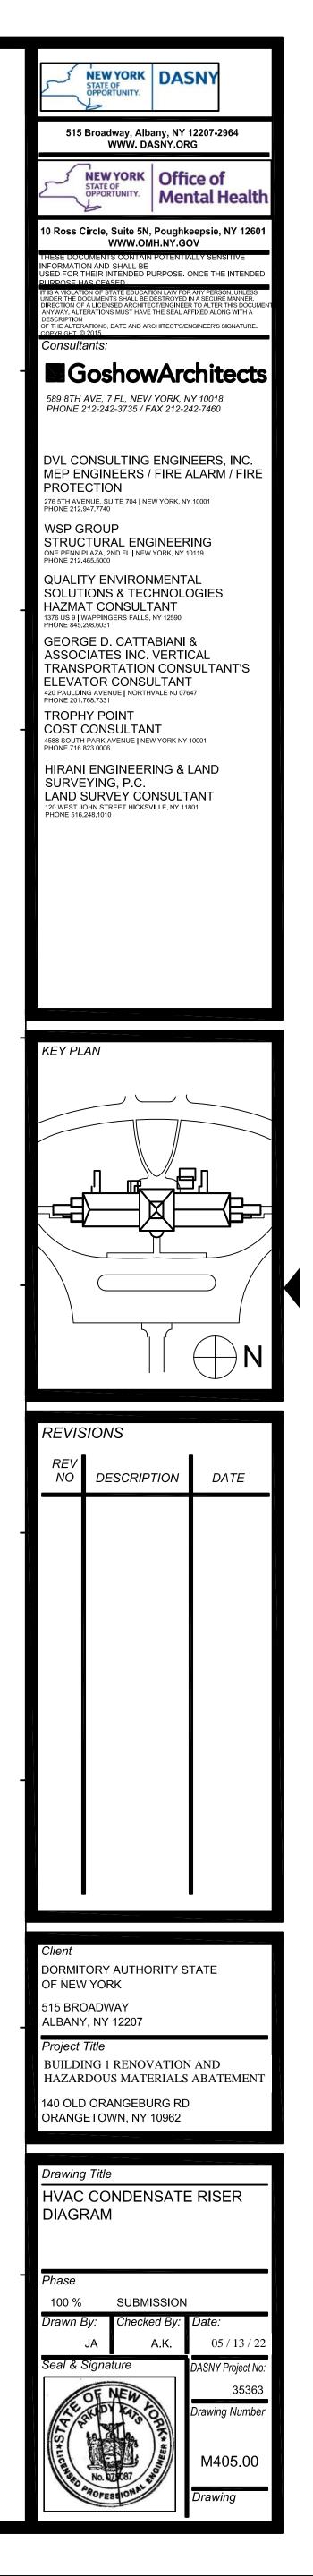

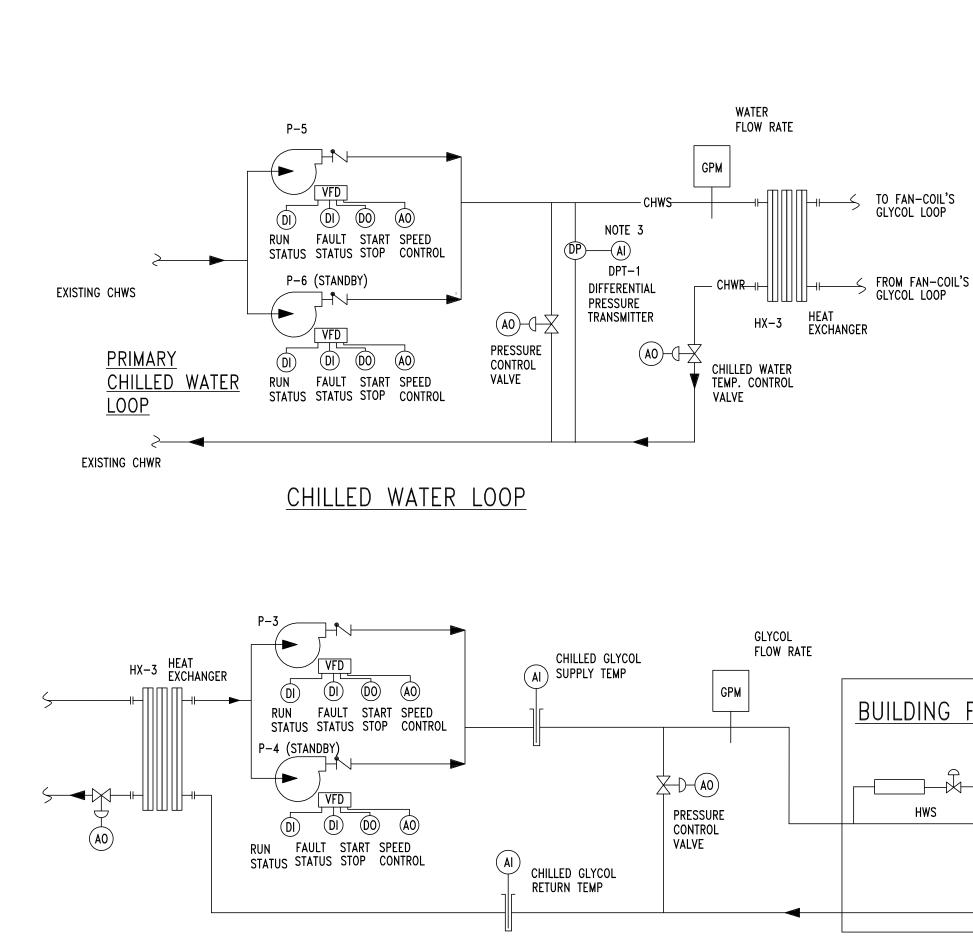

TYPICAL SYSTEM CONTROL DIAGRAM CHILLED GLYCOL PIPING (GLYCOL LOOP)

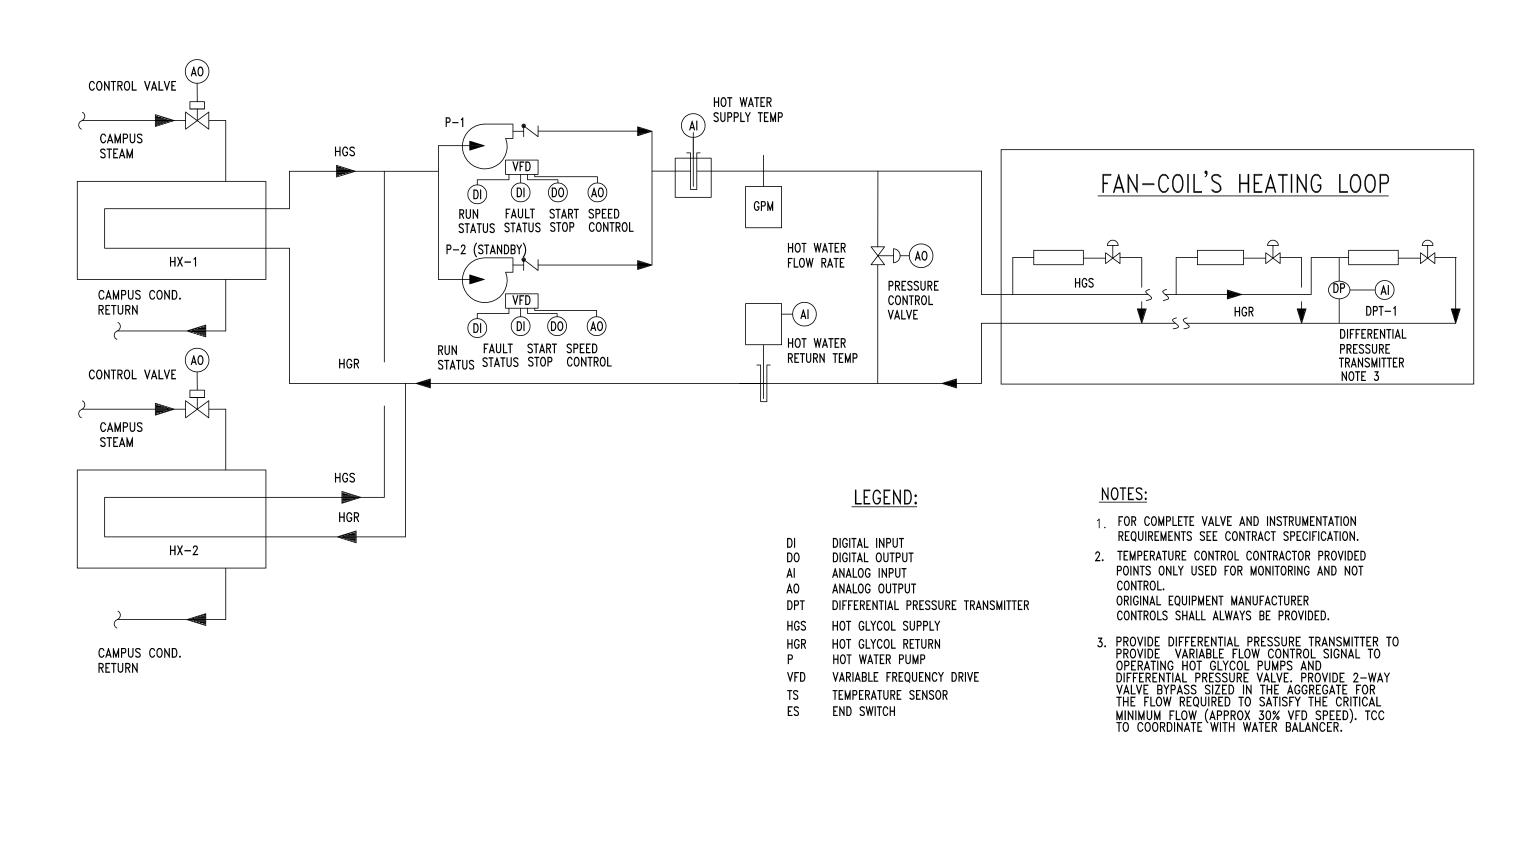

### TYPICAL HOT WATER CONDENSING BOILER PLANT PRIMARY LOOP NOTES: SECONDARY LOOP NOTES: POINT NAME 1. USE 2-WAY VALVES FOR THROTTLING OF TERMINAL 1. FOR COMPLETE VALVE AND INSTRUMENTATION REQUIREMENTS SEE UNITS. CONTRACT SPECIFICATION. 2. PROVIDE DIFFERENTIAL PRESSURE TRANSMITTER TO PROVIDE 2. TEMPERATURE CONTROL CONTRACTOR PROVIDED POINTS USED FOR DIFFERENTIAL WATER PRESSURE VARIABLE FLOW CONTROL SIGNAL TO OPERATING PRIMARY HOT MONITORING AND/OR CONTROL. WATER PUMPS AND DIFFERENTIAL PRESSURE VALVE. PROVIDE DIFFERENTIAL GLYCOL PRESSURE 3. PROVIDE DIFFERENTIAL PRESSURE TRANSMITTER TO PROVIDE VARIABLE 2-WAY BYPASS VALVE SIZED IN THE AGGREGATE FOR THE FLOW CONTROL SIGNAL TO OPERATING SECONDARY WATER PUMPS. MINIMUM FLOW REQUIRED TO SATISFY THE CRITICAL MINIMUM FLOW CHGS TEMP. PROVIDE DIFFERENTIAL PRESSURE CONTROL VALVE TO SATISFY REQUIRED (40–45% VFD SPEED). PRIMARY LOOP CRITICAL MINIMUM FLOW CHGR TEMP. MINIMUM CRITICAL PUMP FLOW (40-45% VFD SPEED). SHALL ALSO BE DETERMINED IN CONSIDERATION OF BOILER MINIMUM FLOW. TCC TO COORDINATE WITH THE WATER BALANCER. 4. DIFFERENTIAL PRESSURE SHALL BE MEASURED AT OR NEAR THE MOST REMOTE UNIT REQUIRING THE GREATEST DIFFERENTIAL PUMP #3 VFD S/S 3. FOR COMPLETE VALVE AND INSTRUMENTATION PRESSURE. PUMP #3 VFD STATUS REQUIREMENTS SEE CONTRACT SPECIFICATION. PUMP #3 VFD SPEED 4. AIR SEPARATOR, EXPANSION TANK, MAKEUP WATER LINE PUMP #3 VFD FAULT NOT SHOWN, REFER TO MECHANICAL PIPING DRAWINGS. PUMP #4 VFD S/S PUMP #4 VFD STATUS PUMP #4 VFD SPEED 14 PUMP #4 VFD FAULT PUMP #5 VFD S/S LEGEND: 18 PUMP #5 VFD STATUS 19 PUMP #5 VFD SPEED BUILDING FAN-COIL UNITS 20 PUMP #5 VFD FAULT DIGITAL INPUT MOST REMOTE FAN-COIL DIGITAL OUTPUT REQUIRING THE GREATEST ANALOG INPUT 22 PUMP #6 VFD S/S DIFFERENTIAL PRESSURE ANALOG OUTPUT DPT DIFFERENTIAL PRESSURE TRANSMITTER PUMP #6 VFD STATUS CHWP CHILLED WATER PUMP PUMP #6 VFD SPEED LHWT LEAVING HOT WATER TEMPERATURE DP-AI DPT-2 NOTE 3 25 | PUMP #6 VFD FAULT CHILLED WATER SUPPLY TEMPERATURE CHWST CHILLED WATER RETURN TEMPERATURE CHWRT 26 Chilled Water Temp. Control Valve SECONDARY LOOP VFD VARIABLE FREQUENCY DRIVE DIFFERENTIAL TEMPERATURE SENSOR PRESSURE HWR TRANSMITTER LEGEND: INCLUDE MULTIPLE POINTS WITHIN EACH MECHANICAL SYSTEM AS NECESSARY. COORDINATE WITH EQUIPMENT VENDOR. NOTES: COORDINATED BY THE GENERAL AND MECHANICAL CONTRACTORS.

## TYPICAL SYSTEM CONTROL DIAGRAM FOR HOT GLYCOL LOOP

	TYPICAL PRIMARY/ SECONDARY LOOPS			Input/Output Sensed			
Reference No.	Point Name	Analog Input	Analog Output	Digital Input	Digital Output		
1	Hot Water Supply Temp	X					
2	Hot Water Return Temp	X					
3	Differential Water pressure	X					
4	Pump #1 VFD						
5	Pump #1 VFD S/S				X		
6	Pump #1 VFD Status			X			
7	Pump #1 VFD Speed	X					
8	Pump #1 VFD Fault			X			
9	Pump #2 VFD						
10	Pump #2 VFD S/S				X		
11	Pump #2 VFD Status			X			
12	Pump #2 VFD Speed	X					
13	Pump #2 VFD Fault			X			
14	HW Bypass Valve		X				
15	Steam HX'S Control Valve		X				
16							

### <u>LEGEND:</u>

X = PROVIDE QUANTITY AS REQUIRED TO INCLUDE ALL INSTANCES OF THE INDICATED FEATURE.INCLUDE MULTIPLE POINTS WITHIN EACH MECHANICAL SYSTEM AS NECESSARY. COORDINATE WITH EQUIPMENT VENDOR.

### NOTES:

1. THE POINT LISTED HEREIN ARE THE MINIMUM POINTS REQUIRED FOR THE CONTROL . THIS POINT LIST IS TYPICAL FOR EACH MECHANICAL/ELECTRICAL SYSTEM OF THIS TYPE. IF THE SEQUENCE OF OPERATION REQUIRES ADDITIONAL OR DIFFERING INFORMATION IT MUST BE PROVIDED BY THE RESPECTIVE PROVIDER OF THE CONTROLS FOR THIS TYPE OF EQUIPMENT AS COORDINATED BY THE GENERAL AND MECHANICAL CONTRACTORS. 2. THE TCC SHALL PROVIDE ALL DIGITAL ALARM LOGIC.


CHILLED GLYCOL CIRCUIT

- A. THE CHILLED GLYCOL PUMPS SHALL BE ENABLE BY MANUEL SWITCH.
- B. THE SEASONAL ON/OFF ENABLING OF THE CHILLED WATER PUMPS DOES NOT NECESSARY MEAN THAT PUMPS SHALL START; RATHER IT HAS BEEN COMMANDED TO BE IN AUTOMATIC MODE.
- C. PRIMARY CHILLED WATER SIDE (CAMPUS SIDE) CONTROL VALVE SHALL MODULATE AS REQUIRED TO MAINTAIN THE SECONDARY SIDE SUPPLY GLYCOL
- TEMPERATURE. D. ONE PUMP OF EACH LOOP SHALL BE OPERATIONAL. THE STAND-BY PUMP SHALL BE OFF AND ONLY OPERATING IF THERE IS A FAILURE OF THE OTHER PUMP. IN THE CASE OF FAILURE OF A LEAD PUMP, THE STAND-BY PUMP SHALL BE STARTED AUTOMATICALLY.
- E. EACH PAIR OF PUMPS SHALL OPERATE IN AN AUTOMATIC LEAD/STANDBY FASHION.
- 1.THE LEAD PUMP SHALL RUN FIRST.
- 2.THE LEAD PUMP SHALL BE ROTATED ON A SCHEDULE BASIS, 1000 HOURS (ADJ.) F. TO PREVENT SHORT CYCLING, THE HOT WATER PUMP SYSTEM SHALL RUN FOR AND BE OFF FOR MINIMUM ADJUSTABLE TIMES (BOTH
- OPERATOR-DEFINABLE).
- G. PUMP'S ALARMS SHALL BE PROVIDED AS FOLLOWS:
  - (A) FAILURE: COMMANDED ON, BUT THE STATUS IS OFF. (B)RUNTIME EXCEEDED: STATUS RUNTIME EXCEEDS A USER DEFINABLE LIMIT.
- (C)VFD FAULT. H. CHILLED GLYCOL FLOW MODULATION:
  - 1. DOAS UNITS AND FAN-COIS ARE EQUIPPED WITH TWO-WAY MODULATING VALVES. 2. VARIABLE FREQUENCY DRIVE (VFD) SHALL CONTROL THE PUMP SPEED TO MAINTAIN DIFFERENTIAL PRESSURE DEFINED BY BALANCER
  - MEASURED AT MOST REMOTE FAN-COIL UNIT. 3. WHEN VARIABLE FREQUENCY DRIVE MEETS ITS LOWEST SETTING, DIFFERENTIAL BYPASS SHALL MODULATE OPEN TO MAINTAIN MINIMUM DIFFERENTIAL PRESSURE WHILE PUMP REMAINS AT ITS LOWEST SETTING.
- I. PUMP #5 & 6 FLOW MODULATION:
- 1. CHILLED WATER LOOP IS EQUIPPED WITH TWO-WAY MODULATING VALVE. 2. VARIABLE FREQUENCY DRIVE (VFD) SHALL CONTROL THE PUMP SPEED TO MAINTAIN DIFFERENTIAL PRESSURE DEFINED BY BALANCER MEASURED IN THE SAME MECHANICAL ROOM NEAR PUMPS.
- 3. WHEN VARIABLE FREQUENCY DRIVE MEETS ITS LOWEST SETTING, DIFFERENTIAL BYPASS SHALL MODULATE OPEN TO MAINTAIN MINIMUM DIFFERENTIAL PRESSURE WHILE PUMP REMAINS AT ITS LOWEST SETTING. J. ALARMS ARE TO BE PROVIDED AS FOLLOWS:
- 1. HIGH CHILLED WATER DIFFERENTIAL PRESSURE: IF THE CHILLED WATER DIFFERENTIAL PRESSURE IS 25% (ADJ.) GREATER THAN SETPOINT. 2. LOW CHILLED WATER DIFFERENTIAL PRESSURE: IF THE CHILLED WATER DIFFERENTIAL PRESSURE IS 25% (ADJ.) LESS THAN SETPOINT. 3. HIGH CHILLED GLYCOL DIFFERENTIAL PRESSURE: IF THE CHILLED WATER DIFFERENTIAL PRESSURE IS 25% (ADJ.) GREATER THAN SETPOINT. 2. LOW CHILLED GLYCOL DIFFERENTIAL PRESSURE: IF THE CHILLED WATER DIFFERENTIAL PRESSURE IS 25% (ADJ.) LESS THAN SETPOINT.
- (A) CHILLED GLYCOL SUPPLY TEMPERATURE SHALL BE MONITORED. (B) CHILLED GLYCOL RETURN TEMPERATURE SHALL BE MONITORED.
- L. ALARMS SHALL BE PROVIDED AS FOLLOWS:

K. CHILLED GLYCOL TEMPERATURE MONITORING:


- (A) HIGH CHILLED GLYCOL SUPPLY TEMP: IF THE CHILLED GLYCOL SUPPLY TEMPERATURE IS GREATER THAN 55 DEGREES F (ADJ.). M. GLYCOL WATER MAKE-UP UNIT (GMU)
- 1. GLYCOL WATER MAKE-UP UNIT SHALL OPERATE WITH ITS INTEGRAL CONTROLS TO MAINTAIN SYSTEM PRESSURE (ADJUSTABLE). 2. LOW LEVEL SHALL BE ALARMED.


X = PROVIDE QUANTITY AS REQUIRED TO INCLUDE ALL INSTANCES OF THE INDICATED FEATURE

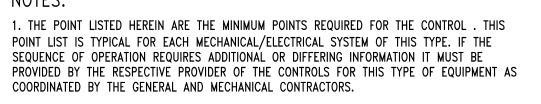


HEATING HOT GLYCOL LOOP

- A. THE HEATING GLYCOL PUMPS SHALL BE ENABLE BY MANUEL SWITCH. THE SEASONAL ON/OFF ENABLING OF THE HOT GLYCOL PUMPS DOES NOT NECESSARY MEAN THAT PUMPS SHALL START; RATHER IT HAS BEEN COMMANDED TO BE IN AUTOMATIC MODE.
- B. STEAM CONTROL VALVE SHALL MODULATE AS REQUIRED TO MAINTAIN THE GLYCOL WATER TEMPERATURE.
- C. ONE PUMP SHALL BE OPERATIONAL. THE STAND-BY PUMP SHALL BE OFF AND ONLY OPERATING IF THERE IS A FAILURE OF THE OTHER PUMP. IN THE CASE OF FAILURE OF A LEAD PUMP, THE STAND-BY PUMP SHALL BE STARTED AUTOMATICALLY. D. THE TWO PUMPS SHALL OPERATE IN AN AUTOMATIC LEAD/STANDBY FASHION.
- 1.THE LEAD PUMP SHALL RUN FIRST.
- 2.THE LEAD PUMP SHALL BE ROTATED ON A SCHEDULE BASIS, 1000 HOURS (ADJ.) E. TO PREVENT SHORT CYCLING, THE HOT GLYCOL WATER PUMP SYSTEM SHALL RUN FOR AND BE OFF FOR MINIMUM ADJUSTABLE TIMES (BOTH OPERATOR-DEFINABLE).
- F. ALARMS SHALL BE PROVIDED AS FOLLOWS: 1.HOT GLYCOL PUMP: P-1
  - (A) FAILURE: COMMANDED ON, BUT THE STATUS IS OFF.
  - (B) VFD FAULT. (C) RUNTIME EXCEEDED: STATUS RUNTIME EXCEEDS A USER DEFINABLE LIMIT.
  - 2. HOT GLYCOL PUMP: P-2
  - (A) FAILURE: COMMANDED ON, BUT THE STATUS IS OFF.
  - (B) VFD FAULT. (C) RUNTIME EXCEEDED: STATUS RUNTIME EXCEEDS A USER DEFINABLE LIMIT.
- G. HOT GLYCOL SUPPLY TEMPERATURE SETTING SHALL BE 180F
  - 1. ALARMS SHALL BE PROVIDED AS FOLLOWS:
  - (A) LOW SUPPLY TEMP: IF THE SUPPLY TEMPERATURE IS LOWER THAN THE SET PINT BY 10°F (ADJ.) FOR MORE THAN 15 MINUTES.
- H. VARIABLE FREQUENCY DRIVE (VFD) SHALL CONTROL THE PUMP SPEED TO MAINTAIN DIFFERENTIAL PRESSURE DEFINED BY BALANCER MEASURED AT MOST REMOTE FAN-COIL UNIT.
- WHEN VARIABLE FREQUENCY DRIVE IS AT ITS LOWEST RECOMMENDED SETTING, THE DIFFERENTIAL BYPASS SHALL MODULATE OPEN TO MAINTAIN MINIMUM DIFFERENTIAL PRESSURE WHILE PUMP VFD REMAINS AT ITS LOWEST SEETTING.
- J. ALARMS SHALL BE PROVIDED AS FOLLOWS: (A) HIGH HOT GLYCOL DIFFERENTIAL PRESSURE: IF THE DIFFERENTIAL PRESSURE IS 15% (ADJ.) GREATER THAN SETPOINT. (B) LOW HOT GLYCOL DIFFERENTIAL PRESSURE: IF THE DIFFERENTIAL PRESSURE IS 15% (ADJ.) LESS THAN SETPOINT.
- K. HEAT EXCHANGERS: HX-1, HX-2 (STANDBY) 1. ONLY ONE HEAT EXCHANGER IS IN OPERATION AT A TIME. THE OTHER IS AVAILABLE FOR STANDBY USE (MANUALLY SELECTED). L. GLYCOL WATER MAKE-UP UNIT (GMU)
- 1.GLYCOL WATER MAKE-UP UNIT SHALL OPERATE WITH ITS INTEGRAL CONTROLS TO MAINTAIN SYSTEM PRESSURE (ADJUSTABLE). 2. LOW LEVEL SHALL BE ALARMED

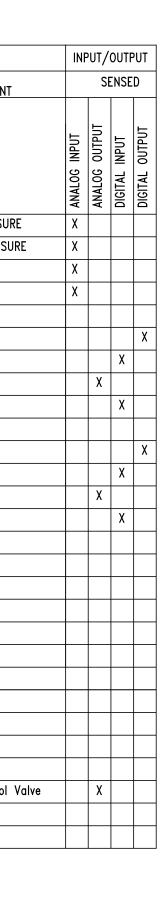

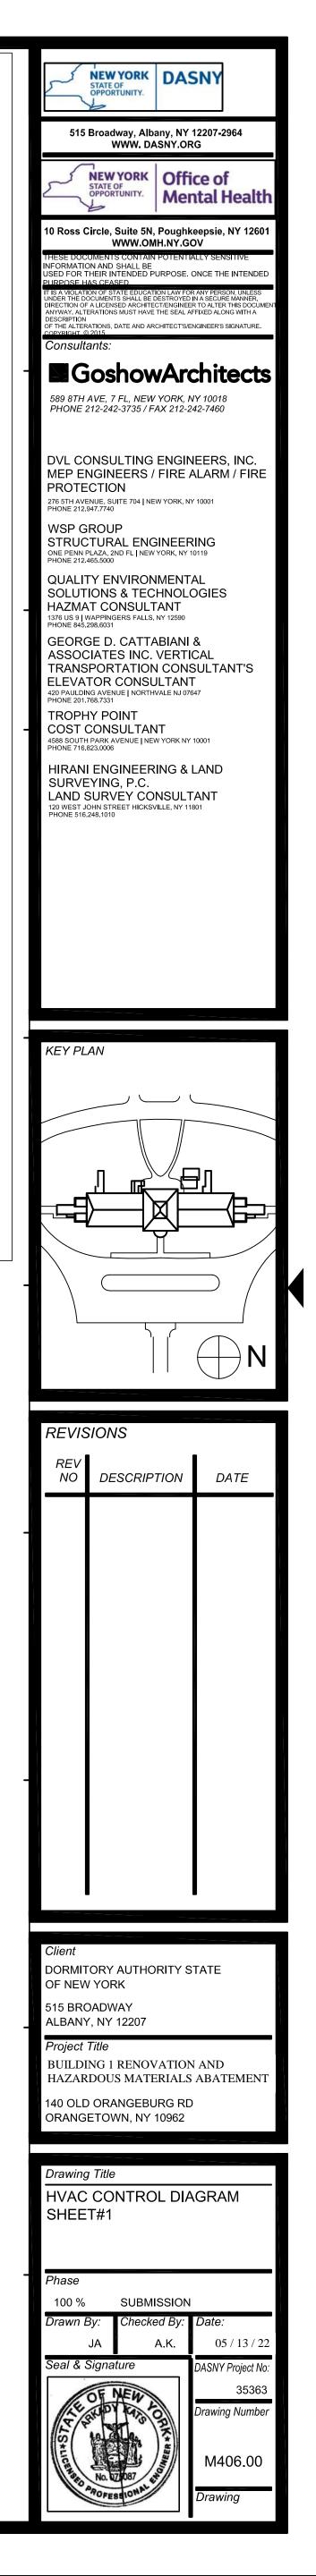

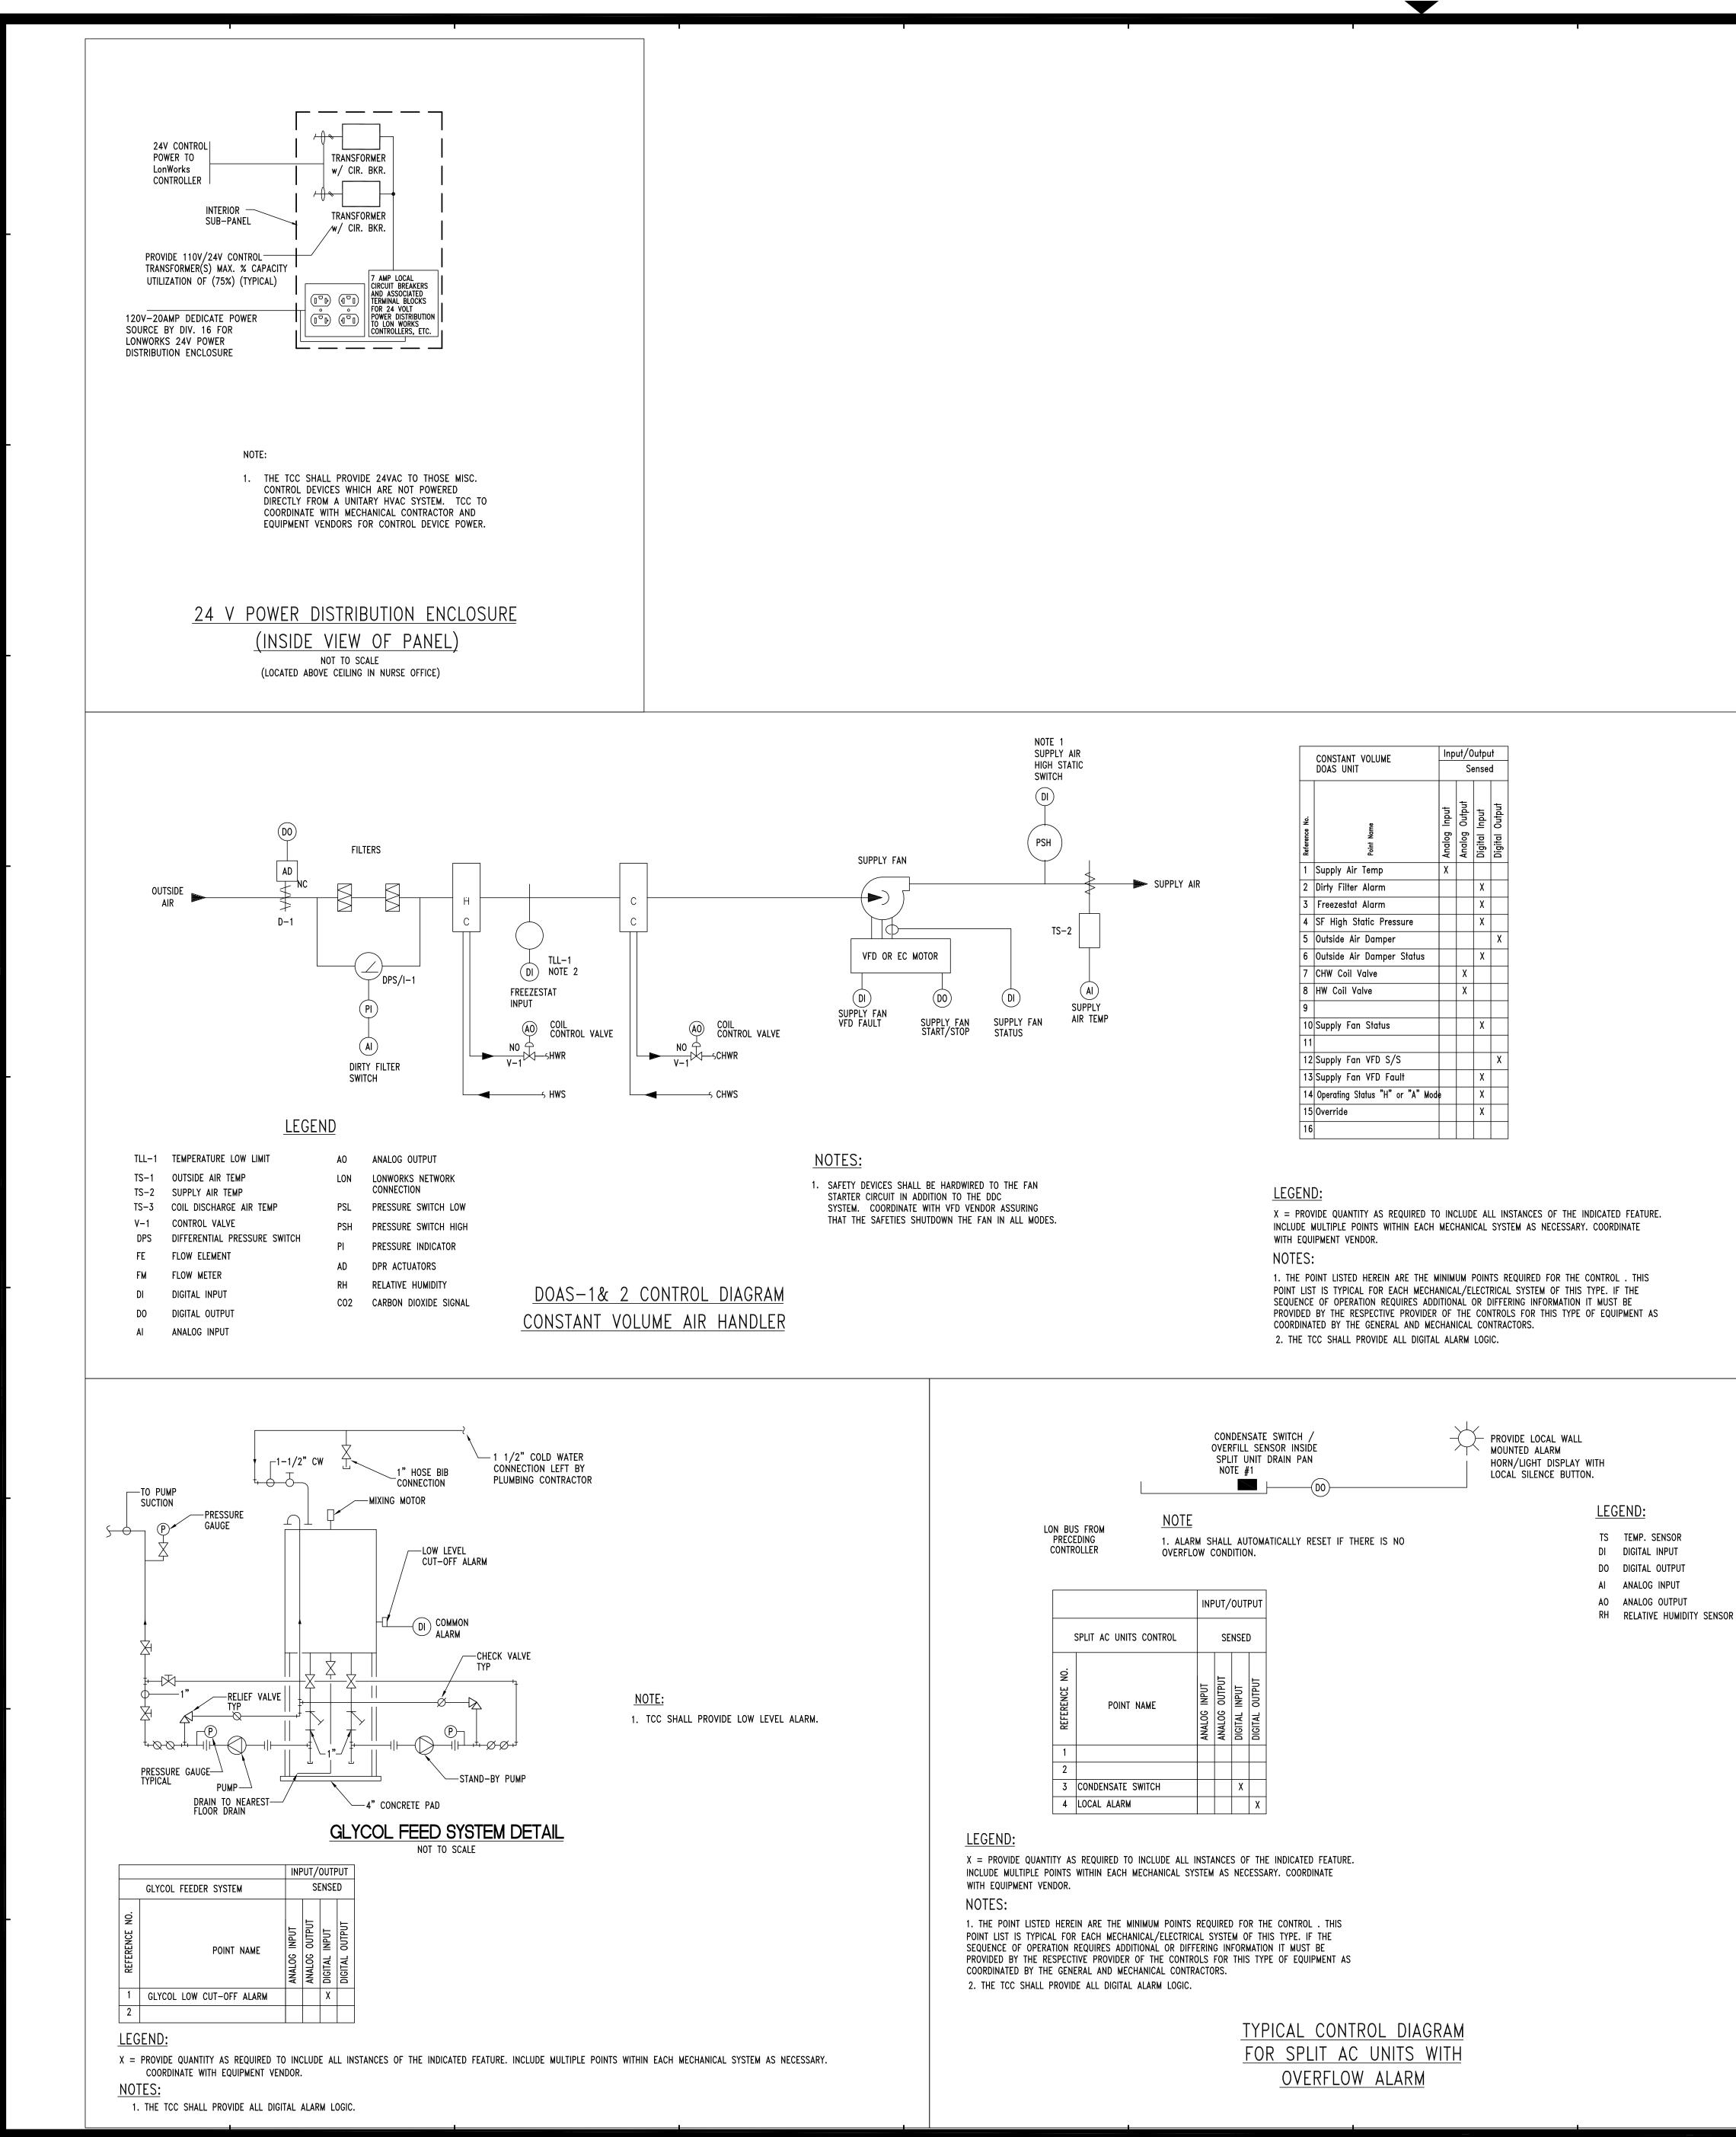

CONSTANT VOLUME			Input/Output				
	DOAS UNIT			Sensed			
Reference No.	Point Name	Analog Input	Analog Output	Digital Input	Digital Output		
1	Supply Air Temp	Х					
2	Dirty Filter Alarm			X			
3	Freezestat Alarm			X			
4	SF High Static Pressure			X			
5	Outside Air Damper				Х		
6	Outside Air Damper Status			Х			
7	CHW Coil Valve		X				
8	HW Coil Valve		Х				
9							
10	Supply Fan Status			Х			
11							
12	Supply Fan VFD S/S				Х		
13	Supply Fan VFD Fault			Х			
14	Operating Status "H" or "A" Mode	)		Х			
15	Override			Х			
16							


### DOAS-1 AND DOAS-2


- A. RUN CONDITIONS: 1. THE UNIT SHALL OPERATE WHENEVER THE BUILDING IS OCCUPIED, ON A SCHEDULE BY COMMAND FROM UNIT'S CONTROLLER. 2. THE DOAS UNIT SHALL RUN TO MAINTAIN A CONSTANT SUPPLY AIR TEMPERATURE OF 65 DEGREES F (ADJUSTABLE).
- B. OUTSIDE AIR DAMPERS: 1. THE OUTSIDE AIR DAMPER SHALL OPEN ANYTIME THE UNIT RUNS AND SHALL CLOSE ANYTIME THE UNIT STOPS. THE SUPPLY FAN SHALL START ONLY AFTER THE DAMPER STATUS HAS PROVEN THE DAMPER IS OPEN. THE OUTSIDE AIR DAMPER SHALL CLOSE FOUR SECONDS
- (ADJ.) AFTER THE SUPPLY FAN STOPS. 2. SHOULD THE DAMPER FAIL IN THE CLOSED POSITION, AN ALARM SHALL BE PROVIDED AND THE UNIT SHALL SHUT DOWN. C. SUPPLY AIR TEMPERATURE:
- 1. THE CONTROLLER SHALL MONITOR THE SUPPLY AIR TEMPERATURE
- 2. ALARMS SHALL BE PROVIDED AS FOLLOWS: (A)HIGH SUPPLY AIR TEMP: IF THE SUPPLY AIR TEMP IS 5 DEGREES ABOVE SUPPLY AIR TEMP. SETPOINT (ADJ.). (B)LOW SUPPLY AIR TEMP: IF THE SUPPLY AIR TEMP IS 5 DEGREES BELOW SUPPLY AIR
- TEMP. SETPOINT (ADJ.). D. SUPPLY FAN: 1. THE SUPPLY FAN SHALL RUN ANYTIME THE UNIT IS COMMANDED TO RUN, ALARMS SHALL BE
- PROVIDED AS FOLLOWS: (A) SUPPLY FAN FAILURE: COMMANDED ON, BUT THE STATUS IS OFF.
- STATIC PRESSURE DISCHARGE: 1. A PRESSURE SENSOR SHALL MEASURE THE STATIC PRESSURE IN THE DISCHARGE PLENUM. 2. AN ALARM SHALL BE PROVIDED AND THE UNIT SHALL SHUT DOWN WHENEVER A USER-DEFINED HIGH STATIC PRESSURE LIMIT IS EXCEEDED.
- F. COOLING: 1. THE COOLING SHALL BE ENABLED WHENEVER;
- (A)OUTSIDE AIR TEMPERATURE IS GREATER THAN 73 DEGREES F (ADJ.). (B) AND CHILLED WATER PROVIDED TO THE BUILDING
- G. HEATING: 1. THE HEATING SHALL BE ENABLED WHENEVER; (A) OUTSIDE AIR TEMPERATURE ISLOW THAN 65 DEGREES F (ADJ.).
- (B) AND STEAM IS AVAILABLE. H. FILTER DIFFÉRENTIAL PRESSURE MONITOR:
- . THE CONTROLLER SHALL MONITOR THE DIFFERENTIAL PRESSURE ACROSS THE PREFILTER. 2. ALARMS SHALL BE PROVIDED AS FOLLOWS: (A)FILTER CHANGE REQUIRED: FILTER DIFFERENTIAL PRESSURE EXCEEDS A USER DEFINABLE LIMIT (ADJ.).

## FAN COIL UNIT


FAN-COIL UNITS SHALL BE CONTROLLED BY OEM PROGRAMMABLE THERMOSTAT

- BEDROOM, LIVING ROOM, AND LAUNDRY ROOM FAN COIL UNITS A. RUN CONDITIONS:
- 1. THE FAN COIL UNIT SHALL OPERATE WHENEVER ENABLED BY PROGRAMMABLE THERMOSTAT. 2. THE FAN COIL UNIT SHALL MAINTAIN:
- (A) 75 DEGREES F (ADJ.) COOLING SETPOINT. (B) 70 DEGREES F (ADJ.) HEATING SETPOINT.
- HEATING COIL VALVE OPERATION SHALL BE DISABLED HEATING IN THE BUILDING IS NOT OPERATING.
- 4. COOLING COIL VALVE OPERATION SHALL BE DISABLED WHENEVER THERE IS NO THE CHILLED WATER SUPPLY. B. UNOCCUPIED CYCLE: 1. WHEN THE ROOM IS UNOCCUPIED AS DETERMINED BY THE PROGRAMMABLE THERMOSTAT, THE FAN COIL UNIT SHALL CYCLE TO MAINTAIN:
  - (A) 80 DEGREES F (ADJ.) COOLING SETPOINT. (B) 65 DEGREES F (ADJ.) HEATING SETPOINT
  - 2. WHEN THE FAN COIL UNIT IS SHUTDOWN HEATING AND COOLING COIL VALVE SHALL BE 1. THE HEATING COIL VALVE SHALL BE ENABLED WHENEVER THE FAN IS OPERATING AND THE HEATING SYSTEM IS
- ON. THE HEATING VALVE SHALL MODULATE TO MAINTAIN THE SETPOINT. 2. THE COOLING COIL VALVE SHALL BE ENABLED WHENEVER THE FAN IS OPERATING AND THE COOLING SYSTEM IS
- ON. THE COOLING COIL VALVE SHALL MODULATE TO MAINTAIN THE SETPOINT. 3. HEATING AND COOLING SETPOINTS SHALL BE SET BY OEM ROOM THERMOSTATS.
- C. DEADBAND CONTROL: 1. THERE SHALL BE A 3 DEGREE F (ADJ) DEADBANS SUCH THAT THE HEATING COIL WILL NOT OPERATE WHENEVER THE ROOM SETPOINT MEASURES A TEMPERATURE LESS THAN 3 DEGREES F BELOW THE COOLING TEMPERATURE SETPOINT, AND THE COOLING COIL WILL NOT OPERATE WHENEVER THE ROOM SENSOR MEASURES A TEMPERATURE LESS THAN 3 DEGREES ABOVE THE HEATING TEMPERATURE SETPOINT RUN CONDITIONS.

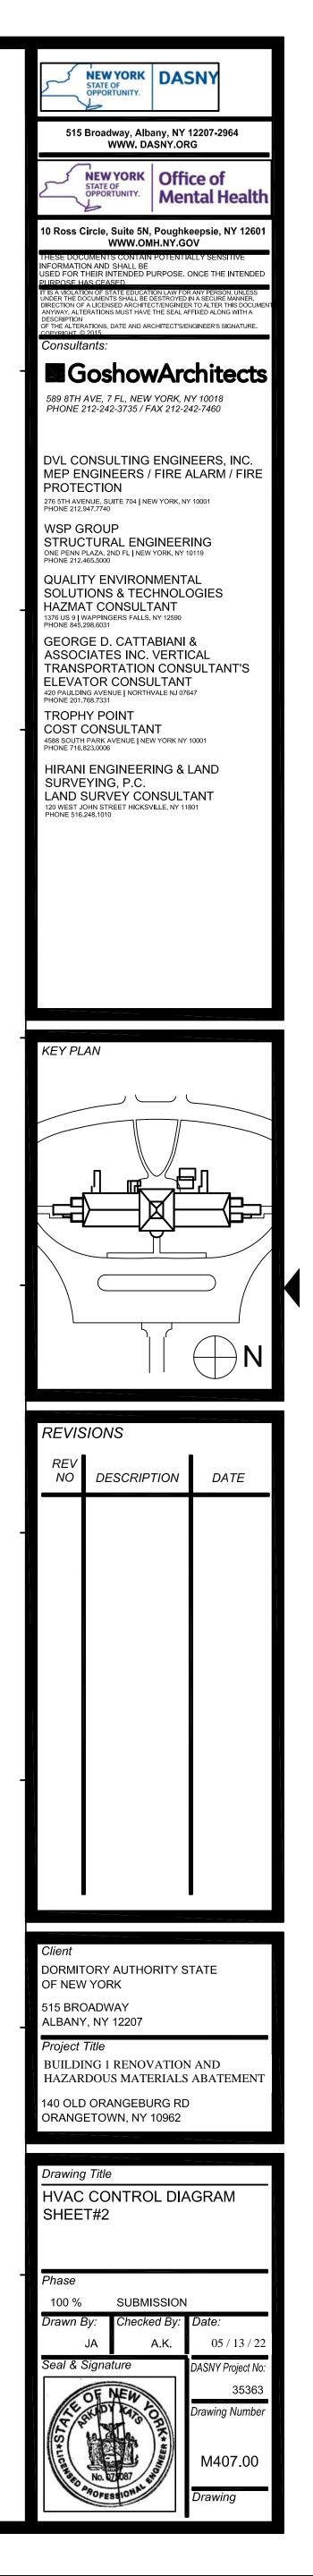


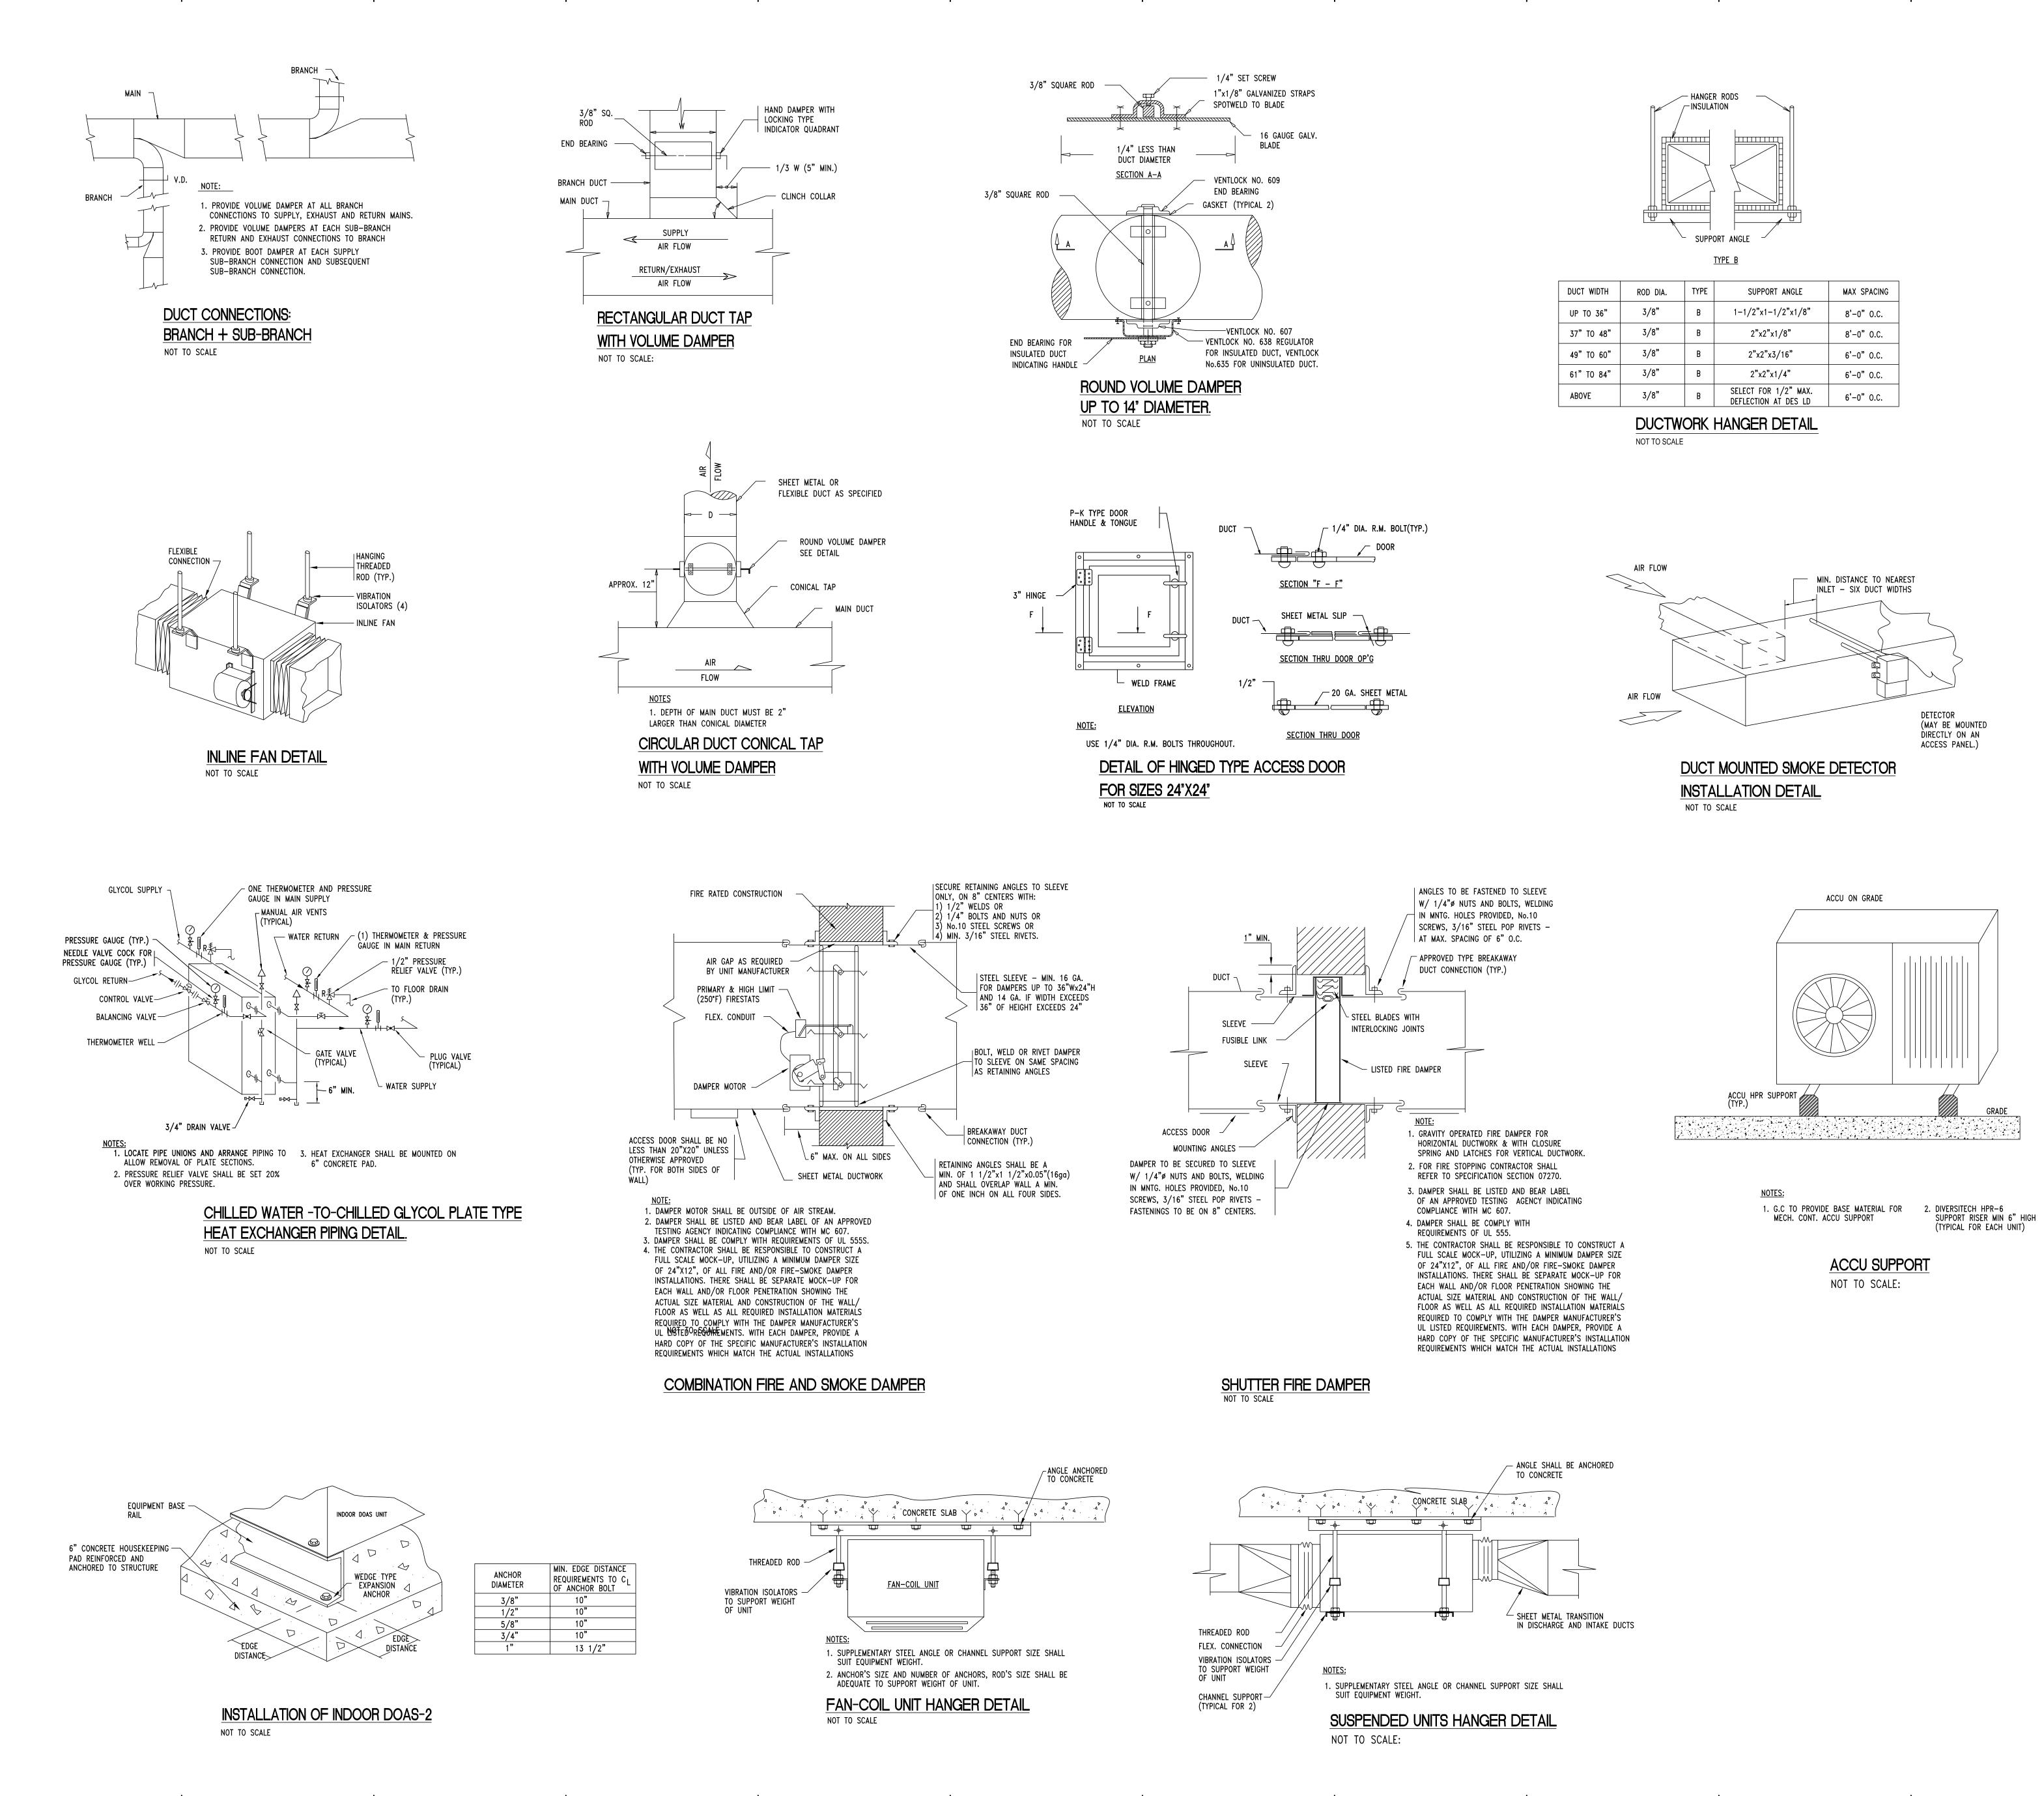

V

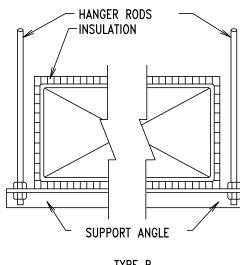

DUCT WIDTH	ROD DIA.	TYPE	SUPPORT ANGLE	MAX SPACING
UP TO 36"	3/8"	В	1-1/2"x1-1/2"x1/8"	8'-0" O.C.
37" TO 48"	3/8"	В	2"x2"x1/8"	8'-0" O.C.
49" TO 60"	3/8"	В	2"x2"x3/16"	6'-0" O.C.
61" TO 84"	3/8"	В	2"x2"x1/4"	6'-0" O.C.
ABOVE	3/8"	В	SELECT FOR 1/2" MAX.	6'-0" O.C.

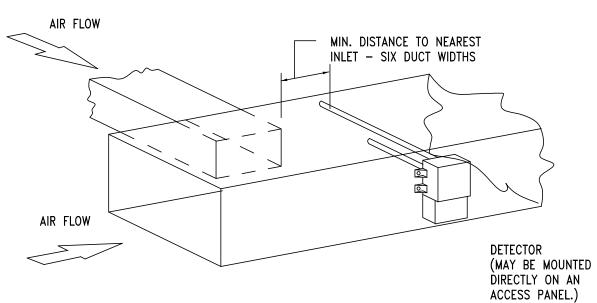

(TYPICAL FOR EACH UNIT)

