# Site Plans

Issued for

Date Issued March 18, 2020

Latest Issue June 17, 2022

# Storm King Art Center - Site Development

1 Museum Road New Windsor, NY 12553



Storm King Art Center

1 Museum Road

New Windsor, NY 12553


## **Applicant**

Storm King Art Center

1 Museum Road
New Windsor, NY 12553

## **Plans Prepared By**

VHB Engineering, Surveying, Landscape Architecture and Geology, PC 100 Great Oaks Boulevard Suite 118 Albany, NY 12203

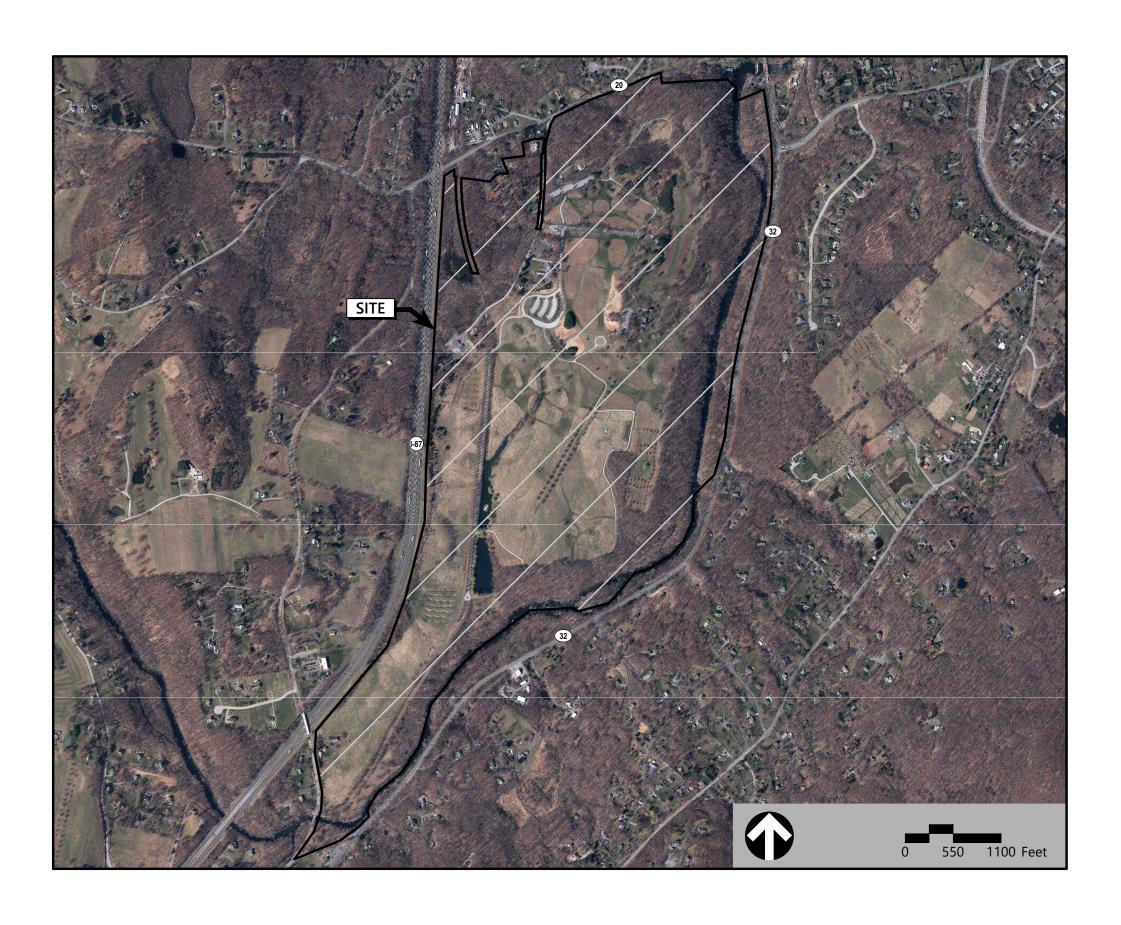

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1	LANDSCAPE PLANS (BY OTHERS)
2	SURVEY PLANS (BY OTHERS)

## Legend

	Prop.		Exist.	Prop.	
		PROPERTY LINE	2 - 2 - 4 - 4 - 4 - 4 - 4 - 4 - 4 - 4 -		CONCRETE
		PROJECT LIMIT LINE			HEAVY DUTY PAVEMENT
		RIGHT-OF-WAY/PROPERTY LINE			BUILDINGS
		EASEMENT			RIPRAP
			6210621	DE WOLDE W	CONSTRUCTION EXIT
		BUILDING SETBACK		///// 	CONSTRUCTION EXIT
10+00	10+00	PARKING SETBACK	27.35 TC×	27.35 TC×	TOP OF CURB ELEVATION
-		BASELINE	26.85 BC×	26.85 BC×	BOTTOM OF CURB ELEVATION
		CONSTRUCTION LAYOUT	170 7E V	170 7E V	
		ZONING LINE	132.75 × 45.0 TW <sub>×</sub>	132.75 × 45.0 TW _	SPOT ELEVATION
		TOWN LINE	38.5 BW ×	45.0 TW 38.5 BW	TOP & BOTTOM OF WALL ELEVATION
			-	<b>•</b>	BORING LOCATION
		LIMIT OF DISTURBANCE		<b>₽</b>	TEST PIT LOCATION
<u> </u>		WETLAND LINE WITH FLAG	<b>₩</b> W	→ MW	MONITORING WELL
		FLOODPLAIN			
DI OF		BORDERING LAND SUBJECT	———UD——— 12"D	——UD——	UNDERDRAIN
BLSF		TO FLOODING	12.0	12″D→	DRAIN
BZ		WETLAND BUFFER ZONE	6"RD	6″RD	ROOF DRAIN
NDZ		NO DISTURB ZONE	1 <u>2</u> "S	1 <u>2</u> "S	SEWER
200'RA-		2001 DIVEDEDONIT ADEA	FM	<u>FM</u>	FORCE MAIN
200 NA-		200' RIVERFRONT AREA	OHW	—— OHW ——	OVERHEAD WIRE
		GRAVEL ROAD	6"W	6"W	WATER
EOP	EOP	EDGE OF PAVEMENT			
BB	BB	BITUMINOUS BERM	4"FP	4"FP	FIRE PROTECTION
	BC			2"DW	DOMESTIC WATER
BC BC		BITUMINOUS CURB	3"G	———G——	GAS
CC	CC	CONCRETE CURB	——Е——	——Е——	ELECTRIC
	CG	CURB AND GUTTER	STM	STM	STEAM
CC	ECC	EXTRUDED CONCRETE CURB	——т—	T	TELEPHONE
CC	MCC	MONOLITHIC CONCRETE CURB	——FA——	——FA——	FIRE ALARM
CC	PCC	PRECAST CONC. CURB			CABLE TV
SGE	SGE	SLOPED GRAN. EDGING			CABLE IV
VGC	VGC				CATCH BASIN CONCENTRIC
		VERT. GRAN. CURB			CATCH BASIN ECCENTRIC
		LIMIT OF CURB TYPE			DOUBLE CATCH BASIN CONCENTRIC
		SAWCUT			DOUBLE CATCH BASIN ECCENTRIC
V.					
(1/1/1//		BUILDING		<b>=</b>	GUTTER INLET
](	<b>]</b> ⊲EN	BUILDING ENTRANCE	0	•	DRAIN MANHOLE CONCENTRIC
		LOADING DOCK	<b>(D)</b>		DRAIN MANHOLE ECCENTRIC
•		BOLLARD	=TD=		TRENCH DRAIN
D	D	DUMPSTER PAD	Ľ	ŗ	PLUG OR CAP
_		SIGN	CO	eco	CLEANOUT
-0-	•		<b>&gt;</b>	<b>&gt;</b>	FLARED END SECTION
-	<b>=</b>	DOUBLE SIGN			HEADWALL
		CTTT 011122211			
	<u></u>	STEEL GUARDRAIL	(\$)	ledot	SEWER MANHOLE CONCENTRIC
		WOOD GUARDRAIL	(\$)	lacksquare	SEWER MANHOLE ECCENTRIC
				 CS ●	
	= = = =	PATH			CURB STOP & BOX
		TREE LINE	₩V ⊚	₩V •	WATER VALVE & BOX
~~~	$\sim$				
× ×	***	WIRE FENCE	TSV	TSV <del></del>	TAPPING SLEEVE, VALVE & BOX
× ×	* * * * * * * * * * * * * * * * * * *	WIRE FENCE FENCE	—•► ♦÷	<b>•</b> ≻ •	TAPPING SLEEVE, VALVE & BOX SIAMESE CONNECTION
× × ×	<del>-x x -</del>	FENCE	<b>+</b>	<b>→→</b>	
× × ×	* ×	FENCE STOCKADE FENCE	<b>&gt;</b> ♦♦ . HYD	HYD	SIAMESE CONNECTION
	<del>-x x -</del>	FENCE STOCKADE FENCE STONE WALL	→ ← HYD ⑤ WM	HYD  WM  PIV	SIAMESE CONNECTION  FIRE HYDRANT  WATER METER
* * * * * * * * * * * * * * * * * * * *	* ×	FENCE STOCKADE FENCE STONE WALL RETAINING WALL	HYD  WM  PIV	HYD  WM  PIV	SIAMESE CONNECTION  FIRE HYDRANT  WATER METER  POST INDICATOR VALVE
	* ×	FENCE STOCKADE FENCE STONE WALL	HYD  WM  PIV  W	HYD  WM  PIV  W	SIAMESE CONNECTION  FIRE HYDRANT  WATER METER
	* * * * * * * * * * * * * * * * * * * *	FENCE STOCKADE FENCE STONE WALL RETAINING WALL	HYD  WM  PIV	HYD  WM  PIV	SIAMESE CONNECTION  FIRE HYDRANT  WATER METER  POST INDICATOR VALVE
	* * * * * * * * * * * * * * * * * * *	FENCE STOCKADE FENCE STONE WALL RETAINING WALL STREAM / POND / WATER COURSE	HYD  WM  PIV  W	HYD  WM  PIV  W	SIAMESE CONNECTION  FIRE HYDRANT  WATER METER  POST INDICATOR VALVE  WATER WELL
	* * * * * * * * * * * * * * * * * * *	FENCE STOCKADE FENCE STONE WALL RETAINING WALL STREAM / POND / WATER COURSE DETENTION BASIN	HYD  WM  PIV  GG  GM  GM	HYD  WM  PIV  GG  GM  GM	SIAMESE CONNECTION  FIRE HYDRANT  WATER METER  POST INDICATOR VALVE  WATER WELL  GAS GATE  GAS METER
	* * * * * * * * * * * * * * * * * * *	FENCE STOCKADE FENCE STONE WALL RETAINING WALL STREAM / POND / WATER COURSE DETENTION BASIN HAY BALES	HYD WM PIV G GG GM GM E	HYD  WM  PIV  GG  GG  GM  EMH	SIAMESE CONNECTION  FIRE HYDRANT  WATER METER  POST INDICATOR VALVE  WATER WELL  GAS GATE
	* * * * * * * * * * * * * * * * * * *	FENCE STOCKADE FENCE STONE WALL RETAINING WALL STREAM / POND / WATER COURSE DETENTION BASIN HAY BALES SILT FENCE	HYD  WM  PIV  GG  GM  GM	HYD  WM  PIV  GG  GM  GM	SIAMESE CONNECTION  FIRE HYDRANT  WATER METER  POST INDICATOR VALVE  WATER WELL  GAS GATE  GAS METER
	* * * * * * * * * * * * * * * * * * *	FENCE STOCKADE FENCE STONE WALL RETAINING WALL STREAM / POND / WATER COURSE DETENTION BASIN HAY BALES SILT FENCE	HYD WM PIV G GG GM C E EM	HYD WM PIV  GC GM GM EMH EM	SIAMESE CONNECTION  FIRE HYDRANT  WATER METER  POST INDICATOR VALVE  WATER WELL  GAS GATE  GAS METER  ELECTRIC MANHOLE
	* * * * * * * * * * * * * * * * * * *	FENCE STOCKADE FENCE STONE WALL RETAINING WALL STREAM / POND / WATER COURSE DETENTION BASIN HAY BALES SILT FENCE SILT SOCK / STRAW WATTLE	HYD  HYD  WM  PIV  GG  GM  C  EM  C  EM	HYD WM PIV  GC GM GM EMH EM	SIAMESE CONNECTION  FIRE HYDRANT  WATER METER  POST INDICATOR VALVE  WATER WELL  GAS GATE  GAS METER  ELECTRIC MANHOLE  ELECTRIC METER  LIGHT POLE
——————————————————————————————————————	* * *	FENCE STOCKADE FENCE STONE WALL RETAINING WALL STREAM / POND / WATER COURSE DETENTION BASIN HAY BALES SILT FENCE SILT SOCK / STRAW WATTLE MINOR CONTOUR MAJOR CONTOUR	HYD  WM  PIV  GG  GM  CM  CM  T	HYD WM PIV  GG GM  EMH EM  TMH	SIAMESE CONNECTION  FIRE HYDRANT  WATER METER  POST INDICATOR VALVE  WATER WELL  GAS GATE  GAS METER  ELECTRIC MANHOLE  ELECTRIC METER
	* * *	FENCE STOCKADE FENCE STONE WALL RETAINING WALL STREAM / POND / WATER COURSE DETENTION BASIN HAY BALES SILT FENCE SILT SOCK / STRAW WATTLE MINOR CONTOUR MAJOR CONTOUR PARKING COUNT	HYD  HYD  WM  PIV  GG  GM  C  EM  C  EM	HYD WM PIV  GG GM GM EMH EM  EM	SIAMESE CONNECTION  FIRE HYDRANT  WATER METER  POST INDICATOR VALVE  WATER WELL  GAS GATE  GAS METER  ELECTRIC MANHOLE  ELECTRIC METER  LIGHT POLE
——————————————————————————————————————	* * *	FENCE STOCKADE FENCE STONE WALL RETAINING WALL STREAM / POND / WATER COURSE DETENTION BASIN HAY BALES SILT FENCE SILT SOCK / STRAW WATTLE MINOR CONTOUR MAJOR CONTOUR	HYD  WM  PIV  GG  GM  CM  CM  T	HYD WM PIV  GG GM  EMH EM  TMH	SIAMESE CONNECTION FIRE HYDRANT WATER METER POST INDICATOR VALVE WATER WELL GAS GATE GAS METER ELECTRIC MANHOLE ELECTRIC METER LIGHT POLE TELEPHONE MANHOLE TRANSFORMER PAD
——————————————————————————————————————	* * *	FENCE STOCKADE FENCE STONE WALL RETAINING WALL STREAM / POND / WATER COURSE DETENTION BASIN HAY BALES SILT FENCE SILT SOCK / STRAW WATTLE MINOR CONTOUR MAJOR CONTOUR PARKING COUNT	HYD WM PIV GG GG GM T	HYD WM PIV  GG GM  EMH EM  TMH	SIAMESE CONNECTION  FIRE HYDRANT  WATER METER  POST INDICATOR VALVE  WATER WELL  GAS GATE  GAS METER  ELECTRIC MANHOLE  ELECTRIC METER  LIGHT POLE  TELEPHONE MANHOLE
——————————————————————————————————————	* * * * * * * * * * * * * * * * * * *	FENCE STOCKADE FENCE STONE WALL RETAINING WALL STREAM / POND / WATER COURSE DETENTION BASIN HAY BALES SILT FENCE SILT SOCK / STRAW WATTLE MINOR CONTOUR MAJOR CONTOUR PARKING COUNT COMPACT PARKING STALLS DOUBLE YELLOW LINE	HYD WM PIV GG GM C EM T	HYD WM PIV  GG GM  EMH EM  TMH	SIAMESE CONNECTION FIRE HYDRANT WATER METER POST INDICATOR VALVE WATER WELL GAS GATE GAS METER ELECTRIC MANHOLE ELECTRIC METER LIGHT POLE TELEPHONE MANHOLE TRANSFORMER PAD
——————————————————————————————————————	* * *	FENCE STOCKADE FENCE STONE WALL RETAINING WALL STREAM / POND / WATER COURSE DETENTION BASIN HAY BALES SILT FENCE SILT SOCK / STRAW WATTLE  MINOR CONTOUR MAJOR CONTOUR PARKING COUNT COMPACT PARKING STALLS DOUBLE YELLOW LINE STOP LINE	HYD WM PPV  GG GM  E  E  T	HYD WM PIV  GG GM  EMH EM  TMH  T	SIAMESE CONNECTION FIRE HYDRANT WATER METER POST INDICATOR VALVE WATER WELL GAS GATE GAS METER ELECTRIC MANHOLE ELECTRIC METER LIGHT POLE TELEPHONE MANHOLE TRANSFORMER PAD UTILITY POLE
——————————————————————————————————————	* * *	FENCE STOCKADE FENCE STONE WALL RETAINING WALL STREAM / POND / WATER COURSE DETENTION BASIN HAY BALES SILT FENCE SILT SOCK / STRAW WATTLE MINOR CONTOUR MAJOR CONTOUR PARKING COUNT COMPACT PARKING STALLS DOUBLE YELLOW LINE	HYD WM PIV  GG GM  E EM  T  O HH	HYD WM PIV  GG GM  EMH EM  TMH  TH	SIAMESE CONNECTION FIRE HYDRANT WATER METER POST INDICATOR VALVE WATER WELL GAS GATE GAS METER  ELECTRIC MANHOLE ELECTRIC METER LIGHT POLE TELEPHONE MANHOLE TRANSFORMER PAD UTILITY POLE GUY POLE
——————————————————————————————————————	* * *	FENCE STOCKADE FENCE STONE WALL RETAINING WALL STREAM / POND / WATER COURSE DETENTION BASIN HAY BALES SILT FENCE SILT SOCK / STRAW WATTLE  MINOR CONTOUR MAJOR CONTOUR PARKING COUNT COMPACT PARKING STALLS DOUBLE YELLOW LINE STOP LINE	HYD WM PIV  GG GM  E EM  T  HH	HYD WM PIV  GG GM  EMH EM  TMH	SIAMESE CONNECTION FIRE HYDRANT WATER METER POST INDICATOR VALVE WATER WELL GAS GATE GAS METER  ELECTRIC MANHOLE ELECTRIC METER LIGHT POLE TELEPHONE MANHOLE TRANSFORMER PAD UTILITY POLE GUY POLE GUY WIRE & ANCHOR
	* * *	FENCE STOCKADE FENCE STONE WALL RETAINING WALL STREAM / POND / WATER COURSE DETENTION BASIN HAY BALES SILT FENCE SILT SOCK / STRAW WATTLE  MINOR CONTOUR MAJOR CONTOUR  PARKING COUNT COMPACT PARKING STALLS DOUBLE YELLOW LINE STOP LINE CROSSWALK	HYD WM PIV  GG GM C EM C HH PB	HYD WM PPV WM PPV WM CGC CM PM EMH EM TMH T	SIAMESE CONNECTION FIRE HYDRANT WATER METER POST INDICATOR VALVE WATER WELL GAS GATE GAS METER  ELECTRIC MANHOLE ELECTRIC METER LIGHT POLE TELEPHONE MANHOLE TRANSFORMER PAD UTILITY POLE GUY POLE GUY WIRE & ANCHOR HAND HOLE

## **Abbreviations**

General

General	
ABAN	ABANDON
ACR	ACCESSIBLE CURB RAMP
ADJ	ADJUST
A DDR∩Y	APPROXIMATE
BIT	BITUMINOUS
BS	BOTTOM OF SLOPE
BWLL	BROKEN WHITE LANE LINE
CONC	CONCRETE
DYCL	DOUBLE YELLOW CENTER LINE
EL	ELEVATION
ELEV	ELEVATION
EX	EXISTING
FDN	FOUNDATION
FFE	FIRST FLOOR ELEVATION
GRAN	GRANITE
GTD	GRADE TO DRAIN
LA	LANDSCAPE AREA
LOD	LIMIT OF DISTURBANCE
MAX	MAXIMUM
MIN	MINIMUM
NIC	NOT IN CONTRACT
-	
NTS	NOT TO SCALE
PERF	PERFORATED
PROP	PROPOSED
REM	REMOVE
RET	RETAIN
R&D	REMOVE AND DISPOSE
R&R	REMOVE AND RESET
SWEL	SOLID WHITE EDGE LINE
SWLL	SOLID WHITE LANE LINE
TS	TOP OF SLOPE
TYP	TYPICAL
1.14*1*4	
Utility	
CB	CATCH BASIN
	CATCH BASIN  CORRUGATED METAL PIPE
CB CMP	CORRUGATED METAL PIPE
CB CMP	CORRUGATED METAL PIPE CLEANOUT
CB CMP CO DCB	CORRUGATED METAL PIPE CLEANOUT DOUBLE CATCH BASIN
CB CMP CO DCB DMH	CORRUGATED METAL PIPE CLEANOUT DOUBLE CATCH BASIN DRAIN MANHOLE
CB CMP CO DCB	CORRUGATED METAL PIPE CLEANOUT DOUBLE CATCH BASIN
CB CMP CO DCB DMH	CORRUGATED METAL PIPE CLEANOUT DOUBLE CATCH BASIN DRAIN MANHOLE
CB CMP CO DCB DMH CIP	CORRUGATED METAL PIPE CLEANOUT DOUBLE CATCH BASIN DRAIN MANHOLE CAST IRON PIPE
CB CMP CO DCB DMH CIP COND	CORRUGATED METAL PIPE  CLEANOUT  DOUBLE CATCH BASIN  DRAIN MANHOLE  CAST IRON PIPE  CONDUIT
CB CMP CO DCB DMH CIP COND	CORRUGATED METAL PIPE  CLEANOUT  DOUBLE CATCH BASIN  DRAIN MANHOLE  CAST IRON PIPE  CONDUIT  DUCTILE IRON PIPE
CB CMP CO DCB DMH CIP COND DIP FES FM	CORRUGATED METAL PIPE  CLEANOUT  DOUBLE CATCH BASIN  DRAIN MANHOLE  CAST IRON PIPE  CONDUIT  DUCTILE IRON PIPE  FLARED END SECTION
CB CMP CO DCB DMH CIP COND DIP FES FM F&G	CORRUGATED METAL PIPE  CLEANOUT  DOUBLE CATCH BASIN  DRAIN MANHOLE  CAST IRON PIPE  CONDUIT  DUCTILE IRON PIPE  FLARED END SECTION  FORCE MAIN
CB CMP CO DCB DMH CIP COND DIP FES FM F&G	CORRUGATED METAL PIPE  CLEANOUT  DOUBLE CATCH BASIN  DRAIN MANHOLE  CAST IRON PIPE  CONDUIT  DUCTILE IRON PIPE  FLARED END SECTION  FORCE MAIN  FRAME AND GRATE
CB CMP CO DCB DMH CIP COND DIP FES FM F&G F&C GI	CORRUGATED METAL PIPE  CLEANOUT  DOUBLE CATCH BASIN  DRAIN MANHOLE  CAST IRON PIPE  CONDUIT  DUCTILE IRON PIPE  FLARED END SECTION  FORCE MAIN  FRAME AND GRATE  FRAME AND COVER  GUTTER INLET
CB CMP CO DCB DMH CIP COND DIP FES FM F&G F&C GI GT	CORRUGATED METAL PIPE  CLEANOUT  DOUBLE CATCH BASIN  DRAIN MANHOLE  CAST IRON PIPE  CONDUIT  DUCTILE IRON PIPE  FLARED END SECTION  FORCE MAIN  FRAME AND GRATE  FRAME AND COVER  GUTTER INLET  GREASE TRAP
CB CMP CO DCB DMH CIP COND DIP FES FM F&G F&C GI GT HDPE	CORRUGATED METAL PIPE  CLEANOUT  DOUBLE CATCH BASIN  DRAIN MANHOLE  CAST IRON PIPE  CONDUIT  DUCTILE IRON PIPE  FLARED END SECTION  FORCE MAIN  FRAME AND GRATE  FRAME AND COVER  GUTTER INLET  GREASE TRAP  HIGH DENSITY POLYETHYLENE PIPE
CB CMP CO DCB DMH CIP COND DIP FES FM F&G F&C GI GT HDPE	CORRUGATED METAL PIPE  CLEANOUT  DOUBLE CATCH BASIN  DRAIN MANHOLE  CAST IRON PIPE  CONDUIT  DUCTILE IRON PIPE  FLARED END SECTION  FORCE MAIN  FRAME AND GRATE  FRAME AND COVER  GUTTER INLET  GREASE TRAP
CB CMP CO DCB DMH CIP COND DIP FES FM F&G F&C GI GT HDPE HH	CORRUGATED METAL PIPE  CLEANOUT  DOUBLE CATCH BASIN  DRAIN MANHOLE  CAST IRON PIPE  CONDUIT  DUCTILE IRON PIPE  FLARED END SECTION  FORCE MAIN  FRAME AND GRATE  FRAME AND COVER  GUTTER INLET  GREASE TRAP  HIGH DENSITY POLYETHYLENE PIPE
CB CMP CO DCB DMH CIP COND DIP FES FM F&G F&C GI GT HDPE HH HW	CORRUGATED METAL PIPE  CLEANOUT  DOUBLE CATCH BASIN  DRAIN MANHOLE  CAST IRON PIPE  CONDUIT  DUCTILE IRON PIPE  FLARED END SECTION  FORCE MAIN  FRAME AND GRATE  FRAME AND COVER  GUTTER INLET  GREASE TRAP  HIGH DENSITY POLYETHYLENE PIPE  HANDHOLE
CB CMP CO DCB DMH CIP COND DIP FES FM F&G F&C GI GT HDPE HH HW HYD	CORRUGATED METAL PIPE  CLEANOUT  DOUBLE CATCH BASIN  DRAIN MANHOLE  CAST IRON PIPE  CONDUIT  DUCTILE IRON PIPE  FLARED END SECTION  FORCE MAIN  FRAME AND GRATE  FRAME AND COVER  GUTTER INLET  GREASE TRAP  HIGH DENSITY POLYETHYLENE PIPE  HANDHOLE  HEADWALL
CB CMP CO DCB DMH CIP COND DIP FES FM F&G F&C GI GT HDPE HH HW HYD	CORRUGATED METAL PIPE  CLEANOUT  DOUBLE CATCH BASIN  DRAIN MANHOLE  CAST IRON PIPE  CONDUIT  DUCTILE IRON PIPE  FLARED END SECTION  FORCE MAIN  FRAME AND GRATE  FRAME AND COVER  GUTTER INLET  GREASE TRAP  HIGH DENSITY POLYETHYLENE PIPE  HANDHOLE  HEADWALL  HYDRANT
CB CMP CO DCB DMH CIP COND DIP FES FM F&G F&C GI GT HDPE HH HW HYD INV	CORRUGATED METAL PIPE  CLEANOUT  DOUBLE CATCH BASIN  DRAIN MANHOLE  CAST IRON PIPE  CONDUIT  DUCTILE IRON PIPE  FLARED END SECTION  FORCE MAIN  FRAME AND GRATE  FRAME AND COVER  GUTTER INLET  GREASE TRAP  HIGH DENSITY POLYETHYLENE PIPE  HANDHOLE  HEADWALL  HYDRANT  INVERT ELEVATION
CB CMP CO DCB DMH CIP COND DIP FES FM F&G F&C GI GT HDPE HH HW HYD INV I= LP	CORRUGATED METAL PIPE  CLEANOUT  DOUBLE CATCH BASIN  DRAIN MANHOLE  CAST IRON PIPE  CONDUIT  DUCTILE IRON PIPE  FLARED END SECTION  FORCE MAIN  FRAME AND GRATE  FRAME AND COVER  GUTTER INLET  GREASE TRAP  HIGH DENSITY POLYETHYLENE PIPE  HANDHOLE  HEADWALL  HYDRANT  INVERT ELEVATION
CB CMP CO DCB DMH CIP COND DIP FES FM F&G F&C GI GT HDPE HH HW HYD INV I= LP MES	CORRUGATED METAL PIPE  CLEANOUT  DOUBLE CATCH BASIN  DRAIN MANHOLE  CAST IRON PIPE  CONDUIT  DUCTILE IRON PIPE  FLARED END SECTION  FORCE MAIN  FRAME AND GRATE  FRAME AND COVER  GUTTER INLET  GREASE TRAP  HIGH DENSITY POLYETHYLENE PIPE  HANDHOLE  HEADWALL  HYDRANT  INVERT ELEVATION  LIGHT POLE
CB CMP CO DCB DMH CIP COND DIP FES FM F&G F&C GI GT HDPE HH HW HYD INV I= LP MES PIV	CORRUGATED METAL PIPE  CLEANOUT  DOUBLE CATCH BASIN  DRAIN MANHOLE  CAST IRON PIPE  CONDUIT  DUCTILE IRON PIPE  FLARED END SECTION  FORCE MAIN  FRAME AND GRATE  FRAME AND COVER  GUTTER INLET  GREASE TRAP  HIGH DENSITY POLYETHYLENE PIPE  HANDHOLE  HEADWALL  HYDRANT  INVERT ELEVATION  LIGHT POLE  METAL END SECTION  POST INDICATOR VALVE
CB CMP CO DCB DMH CIP COND DIP FES FM F&G F&C GI GT HDPE HH HW HYD INV I= LP MES PIV	CORRUGATED METAL PIPE  CLEANOUT  DOUBLE CATCH BASIN  DRAIN MANHOLE  CAST IRON PIPE  CONDUIT  DUCTILE IRON PIPE  FLARED END SECTION  FORCE MAIN  FRAME AND GRATE  FRAME AND COVER  GUTTER INLET  GREASE TRAP  HIGH DENSITY POLYETHYLENE PIPE  HANDHOLE  HEADWALL  HYDRANT  INVERT ELEVATION  LIGHT POLE  METAL END SECTION  POST INDICATOR VALVE  PAVED WATER WAY
CB CMP CO DCB DMH CIP COND DIP FES FM F&G F&C GI GT HDPE HH HW HYD INV I= LP MES PIV PWW PVC	CORRUGATED METAL PIPE  CLEANOUT  DOUBLE CATCH BASIN  DRAIN MANHOLE  CAST IRON PIPE  CONDUIT  DUCTILE IRON PIPE  FLARED END SECTION  FORCE MAIN  FRAME AND GRATE  FRAME AND COVER  GUTTER INLET  GREASE TRAP  HIGH DENSITY POLYETHYLENE PIPE  HANDHOLE  HEADWALL  HYDRANT  INVERT ELEVATION  LIGHT POLE  METAL END SECTION  POST INDICATOR VALVE  PAVED WATER WAY  POLYVINYLCHLORIDE PIPE
CB CMP CO DCB DMH CIP COND DIP FES FM F&G F&C GI GT HDPE HH HW HYD INV I= LP MES PIV PWW PVC RCP	CORRUGATED METAL PIPE  CLEANOUT  DOUBLE CATCH BASIN  DRAIN MANHOLE  CAST IRON PIPE  CONDUIT  DUCTILE IRON PIPE  FLARED END SECTION  FORCE MAIN  FRAME AND GRATE  FRAME AND COVER  GUTTER INLET  GREASE TRAP  HIGH DENSITY POLYETHYLENE PIPE  HANDHOLE  HEADWALL  HYDRANT  INVERT ELEVATION  LIGHT POLE  METAL END SECTION  POST INDICATOR VALVE  PAVED WATER WAY  POLYVINYLCHLORIDE PIPE  REINFORCED CONCRETE PIPE
CB CMP CO DCB DMH CIP COND DIP FES FM F&G F&C GI GT HDPE HH HW HYD INV I= LP MES PIV PWW PVC	CORRUGATED METAL PIPE  CLEANOUT  DOUBLE CATCH BASIN  DRAIN MANHOLE  CAST IRON PIPE  CONDUIT  DUCTILE IRON PIPE  FLARED END SECTION  FORCE MAIN  FRAME AND GRATE  FRAME AND COVER  GUTTER INLET  GREASE TRAP  HIGH DENSITY POLYETHYLENE PIPE  HANDHOLE  HEADWALL  HYDRANT  INVERT ELEVATION  LIGHT POLE  METAL END SECTION  POST INDICATOR VALVE  PAVED WATER WAY  POLYVINYLCHLORIDE PIPE
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CB CMP CO DCB DMH CIP COND DIP FES FM F&G F&C GI GT HDPE HH HW HYD INV I= LP MES PIV PWW PVC RCP R=	CORRUGATED METAL PIPE  CLEANOUT  DOUBLE CATCH BASIN  DRAIN MANHOLE  CAST IRON PIPE  CONDUIT  DUCTILE IRON PIPE  FLARED END SECTION  FORCE MAIN  FRAME AND GRATE  FRAME AND COVER  GUTTER INLET  GREASE TRAP  HIGH DENSITY POLYETHYLENE PIPE  HANDHOLE  HEADWALL  HYDRANT  INVERT ELEVATION  LIGHT POLE  METAL END SECTION  POST INDICATOR VALVE  PAVED WATER WAY  POLYVINYLCHLORIDE PIPE  RIM ELEVATION
CB CMP CO DCB DMH CIP COND DIP FES FM F&G F&C GI GT HDPE HH HW HYD INV I= LP MES PIV PWW PVC RCP R= RIM=	CORRUGATED METAL PIPE  CLEANOUT  DOUBLE CATCH BASIN  DRAIN MANHOLE  CAST IRON PIPE  CONDUIT  DUCTILE IRON PIPE  FLARED END SECTION  FORCE MAIN  FRAME AND GRATE  FRAME AND COVER  GUTTER INLET  GREASE TRAP  HIGH DENSITY POLYETHYLENE PIPE  HANDHOLE  HEADWALL  HYDRANT  INVERT ELEVATION  LIGHT POLE  METAL END SECTION  POST INDICATOR VALVE  PAVED WATER WAY  POLYVINYLCHLORIDE PIPE  RIM ELEVATION  RIM ELEVATION  RIM ELEVATION  RIM ELEVATION  RIM ELEVATION  RIM ELEVATION  SEWER MANHOLE
CB CMP CO DCB DMH CIP COND DIP FES FM F&G F&C GI GT HDPE HH HW HYD INV I= LP MES PIV PWW PVC RCP R= RIM= SMH	CORRUGATED METAL PIPE  CLEANOUT  DOUBLE CATCH BASIN  DRAIN MANHOLE  CAST IRON PIPE  CONDUIT  DUCTILE IRON PIPE  FLARED END SECTION  FORCE MAIN  FRAME AND GRATE  FRAME AND COVER  GUTTER INLET  GREASE TRAP  HIGH DENSITY POLYETHYLENE PIPE  HANDHOLE  HEADWALL  HYDRANT  INVERT ELEVATION  LIGHT POLE  METAL END SECTION  POST INDICATOR VALVE  PAVED WATER WAY  POLYVINYLCHLORIDE PIPE  RIM ELEVATION  RIM ELEVATION  RIM ELEVATION  RIM ELEVATION  RIM ELEVATION  SEWER MANHOLE
CB CMP CO DCB DMH CIP COND DIP FES FM F&G F&C GI GT HDPE HH HW HYD INV I= LP MES PIV PWW PVC RCP R= RIM= SMH TSV	CORRUGATED METAL PIPE  CLEANOUT  DOUBLE CATCH BASIN  DRAIN MANHOLE  CAST IRON PIPE  CONDUIT  DUCTILE IRON PIPE  FLARED END SECTION  FORCE MAIN  FRAME AND GRATE  FRAME AND COVER  GUTTER INLET  GREASE TRAP  HIGH DENSITY POLYETHYLENE PIPE  HANDHOLE  HEADWALL  HYDRANT  INVERT ELEVATION  INVERT ELEVATION  LIGHT POLE  METAL END SECTION  POST INDICATOR VALVE  PAVED WATER WAY  POLYVINYLCHLORIDE PIPE  REINFORCED CONCRETE PIPE  RIM ELEVATION  RIM ELEVATION  SEWER MANHOLE  TAPPING SLEEVE, VALVE AND BOX

## Notes

### General

- 1. CONTRACTOR SHALL NOTIFY "DIG-SAFE" (1-888-344-7233) AT LEAST 72 HOURS BEFORE EXCAVATING.
- 2. CONTRACTOR SHALL BE RESPONSIBLE FOR SITE SECURITY AND JOB SAFETY. CONSTRUCTION ACTIVITIES SHALL BE IN ACCORDANCE WITH OSHA STANDARDS AND LOCAL REQUIREMENTS.
- ACCESSIBLE ROUTES, PARKING SPACES, RAMPS, SIDEWALKS AND WALKWAYS SHALL BE CONSTRUCTED IN CONFORMANCE WITH THE FEDERAL AMERICANS WITH DISABILITIES ACT AND WITH STATE AND
- 4. AREAS DISTURBED DURING CONSTRUCTION AND NOT RESTORED WITH IMPERVIOUS SURFACES (BUILDINGS, PAVEMENTS, WALKS, ETC.) SHALL RECEIVE [##] INCHES LOAM AND SEED.
- WITHIN THE LIMITS OF THE BUILDING FOOTPRINT, THE SITE CONTRACTOR SHALL PERFORM

LOCAL LAWS AND REGULATIONS (WHICHEVER ARE MORE STRINGENT).

EARTHWORK OPERATIONS REQUIRED UP TO SUBGRADE ELEVATIONS.

- WORK WITHIN THE LOCAL RIGHTS-OF-WAY SHALL CONFORM TO LOCAL MUNICIPAL STANDARDS. WORK WITHIN STATE RIGHTS-OF-WAY SHALL CONFORM TO THE LATEST EDITION OF THE STATE
- HIGHWAY DEPARTMENTS STANDARD SPECIFICATIONS FOR HIGHWAYS AND BRIDGES. 7. UPON AWARD OF CONTRACT, CONTRACTOR SHALL MAKE NECESSARY CONSTRUCTION NOTIFICATIONS AND APPLY FOR AND OBTAIN NECESSARY PERMITS, PAY FEES, AND POST BONDS ASSOCIATED WITH THE WORK INDICATED ON THE DRAWINGS. IN THE SPECIFICATIONS, AND IN THE CONTRACT

DOCUMENTS. DO NOT CLOSE OR OBSTRUCT ROADWAYS, SIDEWALKS, AND FIRE HYDRANTS, WITHOUT

- 8. TRAFFIC SIGNAGE AND PAVEMENT MARKINGS SHALL CONFORM TO THE MANUAL ON UNIFORM TRAFFIC CONTROL DEVICES.
- AREAS OUTSIDE THE LIMITS OF PROPOSED WORK DISTURBED BY THE CONTRACTOR'S OPERATIONS SHALL BE RESTORED BY THE CONTRACTOR TO THEIR ORIGINAL CONDITION AT THE CONTRACTOR'S
- 10. IN THE EVENT THAT SUSPECTED CONTAMINATED SOIL, GROUNDWATER, AND OTHER MEDIA ARE ENCOUNTERED DURING EXCAVATION AND CONSTRUCTION ACTIVITIES BASED ON VISUAL, OLFACTORY, OR OTHER EVIDENCE, THE CONTRACTOR SHALL STOP WORK IN THE VICINITY OF THE SUSPECT MATERIAL TO AVOID FURTHER SPREADING OF THE MATERIAL, AND SHALL NOTIFY THE OWNER IMMEDIATELY SO THAT THE APPROPRIATE TESTING AND SUBSEQUENT ACTION CAN BE TAKEN.
- 11. CONTRACTOR SHALL PREVENT DUST, SEDIMENT, AND DEBRIS FROM EXITING THE SITE AND SHALL BE RESPONSIBLE FOR CLEANUP, REPAIRS AND CORRECTIVE ACTION IF SUCH OCCURS.
- 12. DAMAGE RESULTING FROM CONSTRUCTION LOADS SHALL BE REPAIRED BY THE CONTRACTOR AT NO ADDITIONAL COST TO OWNER.
- 13. CONTRACTOR SHALL CONTROL STORMWATER RUNOFF DURING CONSTRUCTION TO PREVENT ADVERSE IMPACTS TO OFF SITE AREAS, AND SHALL BE RESPONSIBLE TO REPAIR RESULTING DAMAGES, IF ANY, AT NO COST TO OWNER.
- 14. THIS PROJECT DISTURBS MORE THAN ONE ACRE OF LAND AND FALLS WITHIN THE SPDES CONSTRUCTION GENERAL PERMIT (GP-0-20-001) PROGRAM AND NYSDEC JURISDICTION. PRIOR TO THE START OF CONSTRUCTION CONTRACTOR IS TO FILE A NOTICE OF INTENT WITH THE NYSDEC AND PREPARE A STORMWATER POLLUTION PREVENTION PLAN IN ACCORDANCE WITH THE SPDES REGULATIONS. CONTRACTOR SHALL CONFIRM THE OWNER HAS ALSO FILED A NOTICE OF INTENT WITH THE NYSDEC.

## Utilities

- THE LOCATIONS, SIZES, AND TYPES OF EXISTING UTILITIES ARE SHOWN AS AN APPROXIMATE REPRESENTATION ONLY. THE OWNER OR ITS REPRESENTATIVE(S) HAVE NOT INDEPENDENTLY VERIFIED THIS INFORMATION AS SHOWN ON THE PLANS. THE UTILITY INFORMATION SHOWN DOES NOT GUARANTEE THE ACTUAL EXISTENCE, SERVICEABILITY, OR OTHER DATA CONCERNING THE UTILITIES, NOR DOES IT GUARANTEE AGAINST THE POSSIBILITY THAT ADDITIONAL UTILITIES MAY BE PRESENT THAT ARE NOT SHOWN ON THE PLANS. PRIOR TO ORDERING MATERIALS AND BEGINNING CONSTRUCTION, THE CONTRACTOR SHALL VERIFY AND DETERMINE THE EXACT LOCATIONS, SIZES, AND ELEVATIONS OF THE POINTS OF CONNECTIONS TO EXISTING UTILITIES AND, SHALL CONFIRM THAT THERE ARE NO INTERFERENCES WITH EXISTING UTILITIES AND THE PROPOSED UTILITY ROUTES, INCLUDING ROUTES WITHIN THE PUBLIC RIGHTS OF WAY.
- WHERE AN EXISTING UTILITY IS FOUND TO CONFLICT WITH THE PROPOSED WORK, OR EXISTING CONDITIONS DIFFER FROM THOSE SHOWN SUCH THAT THE WORK CANNOT BE COMPLETED AS INTENDED. THE LOCATION, ELEVATION, AND SIZE OF THE UTILITY SHALL BE ACCURATELY DETERMINED WITHOUT DELAY BY THE CONTRACTOR, AND THE INFORMATION FURNISHED IN WRITING TO THE OWNER'S REPRESENTATIVE FOR THE RESOLUTION OF THE CONFLICT AND CONTRACTOR'S FAILURE TO NOTIFY PRIOR TO PERFORMING ADDITIONAL WORK RELEASES OWNER FROM OBLIGATIONS FOR ADDITIONAL PAYMENTS WHICH OTHERWISE MAY BE WARRANTED TO RESOLVE THE CONFLICT.
- 3. SET CATCH BASIN RIMS, AND INVERTS OF SEWERS, DRAINS, AND DITCHES IN ACCORDANCE WITH ELEVATIONS ON THE GRADING AND UTILITY PLANS.
- 4. RIM ELEVATIONS FOR DRAIN AND SEWER MANHOLES, WATER VALVE COVERS, GAS GATES, ELECTRIC AND TELEPHONE PULL BOXES, AND MANHOLES, AND OTHER SUCH ITEMS, ARE APPROXIMATE AND SHALL BE SET/RESET AS FOLLOWS:
  - A. PAVEMENTS AND CONCRETE SURFACES: FLUSH
- B. ALL SURFACES ALONG ACCESSIBLE ROUTES: FLUSH
- C. LANDSCAPE, LOAM AND SEED, AND OTHER EARTH SURFACE AREAS: ONE INCH ABOVE SURROUNDING AREA AND TAPER EARTH TO THE RIM ELEVATION.
- THE LOCATION, SIZE, DEPTH, AND SPECIFICATIONS FOR CONSTRUCTION OF PROPOSED PRIVATE UTILITY SERVICES SHALL BE INSTALLED ACCORDING TO THE REQUIREMENTS PROVIDED BY, AND APPROVED BY, THE RESPECTIVE UTILITY COMPANY (GAS, TELEPHONE, ELECTRIC, FIRE ALARM, ETC.). FINAL DESIGN LOADS AND LOCATIONS TO BE COORDINATED WITH OWNER AND ARCHITECT.
- 6. CONTRACTOR SHALL MAKE ARRANGEMENTS FOR AND SHALL BE RESPONSIBLE FOR PAYING FEES FOR POLE RELOCATION AND FOR THE ALTERATION AND ADJUSTMENT OF GAS, ELECTRIC, TELEPHONE, FIRE ALARM, AND ANY OTHER PRIVATE UTILITIES, WHETHER WORK IS PERFORMED BY CONTRACTOR OR BY THE UTILITIES COMPANY.
- 7. UTILITY PIPE MATERIALS SHALL BE AS FOLLOWS, UNLESS OTHERWISE NOTED ON THE PLAN:
- A. WATER PIPES SHALL BE [TYPE(S)]
- B. SANITARY SEWER PIPES SHALL BE POLYVINYL CHLORIDE (PVC) SEWER PIPE
- C. STORM DRAINAGE PIPES SHALL BE [TYPE(S)]
- D. PIPE INSTALLATION AND MATERIALS SHALL COMPLY WITH THE STATE PLUMBING CODE WHERE APPLICABLE. CONTRACTOR SHALL COORDINATE WITH LOCAL PLUMBING INSPECTOR PRIOR TO BEGINNING WORK.
- 8. CONTRACTOR SHALL COORDINATE WITH ELECTRICAL CONTRACTOR AND SHALL FURNISH EXCAVATION, INSTALLATION, AND BACKFILL OF ELECTRICAL FURNISHED SITEWORK RELATED ITEMS SUCH AS PULL BOXES, CONDUITS, DUCT BANKS, LIGHT POLE BASES, AND CONCRETE PADS. SITE CONTRACTOR SHALL FURNISH CONCRETE ENCASEMENT OF DUCT BANKS IF REQUIRED BY THE UTILITY COMPANY AND AS INDICATED ON THE DRAWINGS.
- 9. CONTRACTOR SHALL EXCAVATE AND BACKFILL TRENCHES FOR GAS IN ACCORDANCE WITH GAS COMPANY'S REQUIREMENTS.
- 10. ALL DRAINAGE AND SANITARY STRUCTURE INTERIOR DIAMETERS (4' MIN.) SHALL BE DETERMINED BY THE MANUFACTURER BASED ON THE PIPE CONFIGURATIONS SHOWN ON THESE PLANS AND LOCAL MUNICIPAL STANDARDS. FOR MANHOLES THAT ARE 20 FEET IN DEPTH AND GREATER, THE MINIMUM DIAMETER SHALL BE 5 FEET.

## **Layout and Materials**

- 1. DIMENSIONS ARE FROM THE FACE OF CURB, FACE OF BUILDING, FACE OF WALL, AND CENTER LINE OF PAVEMENT MARKINGS, UNLESS OTHERWISE NOTED.
- 2. CURB RADII ARE [##] FEET UNLESS OTHERWISE NOTED.
- 4. SEE ARCHITECTURAL DRAWINGS FOR EXACT BUILDING DIMENSIONS AND DETAILS CONTIGUOUS TO THE BUILDING, INCLUDING SIDEWALKS, RAMPS, BUILDING ENTRANCES, STAIRWAYS, UTILITY
- 6. PRIOR TO START OF CONSTRUCTION, CONTRACTOR SHALL VERIFY EXISTING PAVEMENT ELEVATIONS AT INTERFACE WITH PROPOSED PAVEMENTS, AND EXISTING GROUND ELEVATIONS ADJACENT TO

- CONTRACTOR SHALL REMOVE AND DISPOSE OF EXISTING MANMADE SURFACE FEATURES WITHIN THE LIMIT OF WORK INCLUDING BUILDINGS, STRUCTURES, PAVEMENTS, SLABS, CURBING, FENCES, UTILITY POLES, SIGNS, ETC. UNLESS INDICATED OTHERWISE ON THE DRAWINGS. REMOVE AND DISPOSE OF EXISTING UTILITIES, FOUNDATIONS AND UNSUITABLE MATERIAL BENEATH AND FOR A DISTANCE OF 10 FEET BEYOND THE PROPOSED BUILDING FOOTPRINT INCLUDING EXTERIOR COLUMNS.
- 2. EXISTING UTILITIES SHALL BE TERMINATED. UNLESS OTHERWISE NOTED. IN CONFORMANCE WITH LOCAL, STATE AND INDIVIDUAL UTILITY COMPANY STANDARD SPECIFICATIONS AND DETAILS. THE CONTRACTOR SHALL COORDINATE UTILITY SERVICE DISCONNECTS WITH THE UTILITY
- 3. CONTRACTOR SHALL DISPOSE OF DEMOLITION DEBRIS IN ACCORDANCE WITH APPLICABLE FEDERAL. STATE AND LOCAL REGULATIONS, ORDINANCES AND STATUTES.
- 4 THE DEMOLITION LIMITS DEPICTED IN THE PLANS IS INTENDED TO AID THE CONTRACTOR DURING THE BIDDING AND CONSTRUCTION PROCESS AND IS NOT INTENDED TO DEPICT EACH AND EVERY ELEMENT OF DEMOLITION. THE CONTRACTOR IS RESPONSIBLE FOR IDENTIFYING THE DETAILED SCOPE OF DEMOLITION BEFORE SUBMITTING ITS BID/PROPOSAL TO PERFORM THE WORK AND SHALL MAKE NO CLAIMS AND SEEK NO ADDITIONAL COMPENSATION FOR CHANGED CONDITIONS OR UNFORESEEN OR LATENT SITE CONDITIONS RELATED TO ANY CONDITIONS DISCOVERED DURING EXECUTION OF THE
- HAS NOT PREPARED DESIGNS FOR AND SHALL HAVE NO RESPONSIBILITY FOR THE PRESENCE, DISCOVERY, REMOVAL, ABATEMENT OR DISPOSAL OF HAZARDOUS MATERIALS, TOXIC WASTES OR POLLUTANTS AT THE PROJECT SITE. THE ENGINEER SHALL NOT BE RESPONSIBLE FOR ANY CLAIMS OF LOSS, DAMAGE, EXPENSE, DELAY, INJURY OR DEATH ARISING FROM THE PRESENCE OF HAZARDOUS MATERIAL AND CONTRACTOR SHALL INDEMNIFY AND HOLD HARMLESS THE ENGINEER FROM ANY CLAIMS MADE IN CONNECTION THEREWITH. MOREOVER, THE ENGINEER SHALL HAVE NO ADMINISTRATIVE OBLIGATIONS OF ANY TYPE WITH REGARD TO ANY CONTRACTOR AMENDMENT INVOLVING THE ISSUES OF PRESENCE, DISCOVERY, REMOVAL, ABATEMENT OR DISPOSAL OF ASBESTOS OR OTHER HAZARDOUS MATERIALS.

- 1. PRIOR TO STARTING ANY OTHER WORK ON THE SITE. THE CONTRACTOR SHALL NOTIFY APPROPRIATE AGENCIES AND SHALL INSTALL EROSION CONTROL MEASURES AS SHOWN ON THE PLANS AND AS IDENTIFIED IN FEDERAL, STATE, AND LOCAL APPROVAL DOCUMENTS PERTAINING TO THIS PROJECT.
- 3. CONTRACTOR SHALL BE FULLY RESPONSIBLE TO CONTROL CONSTRUCTION SUCH THAT SEDIMENTATION SHALL NOT AFFECT REGULATORY PROTECTED AREAS, WHETHER SUCH
- 4. CONTRACTOR SHALL PERFORM CONSTRUCTION SEQUENCING SUCH THAT EARTH MATERIALS ARE EXPOSED FOR A MINIMUM OF TIME BEFORE THEY ARE COVERED, SEEDED, OR OTHERWISE STABILIZED TO PREVENT EROSION.
- 5. UPON COMPLETION OF CONSTRUCTION AND ESTABLISHMENT OF PERMANENT GROUND COVER, CONTRACTOR SHALL REMOVE AND DISPOSE OF EROSION CONTROL MEASURES AND CLEAN SEDIMENT AND DEBRIS FROM ENTIRE DRAINAGE AND SEWER SYSTEMS.

## **Existing Conditions Information**

- CONDUCTED BY MJS ENGINEERING AND LAND SURVEYING. THE TOPOGRAPHY AND PHYSICAL FEATURES ARE BASED ON AN ACTUAL FIELD SURVEY PERFORMED ON THE GROUND BY MJS ENGINEERING AND LAND SURVEYING.
- A. DELINEATION OF THE WETLANDS AND PLACEMENT OF THE FLAGS WAS PERFORMED BY: VHB
- B. FLAGS MARKING THE WETLANDS WERE LOCATED BY: VHB VIA GPS
- 2. TOPOGRAPHY: ELEVATIONS ARE BASED ON [NGVD].
- 3. GEOTECHNICAL DATA INCLUDING TEST PIT AND BORING LOCATIONS AND ELEVATIONS WERE

## Document Use

- 1. THESE PLANS AND CORRESPONDING CADD DOCUMENTS ARE INSTRUMENTS OF PROFESSIONAL SERVICE, AND SHALL NOT BE USED, IN WHOLE OR IN PART, FOR ANY PURPOSE OTHER THAN FOR WHICH IT WAS CREATED WITHOUT THE EXPRESSED, WRITTEN CONSENT OF VHB. ANY UNAUTHORIZED USE, REUSE, MODIFICATION OR ALTERATION, INCLUDING AUTOMATED CONVERSION OF THIS
- 2. CONTRACTOR SHALL NOT RELY SOLELY ON ELECTRONIC VERSIONS OF PLANS, SPECIFICATIONS, AND DATA FILES THAT ARE OBTAINED FROM THE DESIGNERS, BUT SHALL VERIFY LOCATION OF PROJECT FEATURES IN ACCORDANCE WITH THE PAPER COPIES OF THE PLANS AND SPECIFICATIONS THAT ARE SUPPLIED AS PART OF THE CONTRACT DOCUMENTS.
- SYMBOLS AND LEGENDS OF PROJECT FEATURES ARE GRAPHIC REPRESENTATIONS AND ARE NOT NECESSARILY SCALED TO THEIR ACTUAL DIMENSIONS OR LOCATIONS ON THE DRAWINGS. THE CONTRACTOR SHALL REFER TO THE DETAIL SHEET DIMENSIONS, MANUFACTURERS' LITERATURE, SHOP DRAWINGS AND FIELD MEASUREMENTS OF SUPPLIED PRODUCTS FOR LAYOUT OF THE PROJECT

- 3. CURBING SHALL BE [TYPE] WITHIN THE SITE UNLESS OTHERWISE INDICATED ON THE PLANS.
- PENETRATIONS, CONCRETE DOOR PADS, COMPACTOR PAD, LOADING DOCKS, BOLLARDS, ETC.
- 5. PROPOSED BOUNDS AND ANY EXISTING PROPERTY LINE MONUMENTATION DISTURBED DURING CONSTRUCTION SHALL BE SET OR RESET BY A PROFESSIONAL LAND SURVEYOR.
- DRAINAGE OUTLETS TO ASSURE PROPER TRANSITIONS BETWEEN EXISTING AND PROPOSED FACILITIES.

### Demolition

- REPRESENTATIVES
- UNLESS OTHERWISE SPECIFICALLY PROVIDED ON THE PLANS OR IN THE SPECIFICATIONS, THE ENGINEER

### **Erosion Control**

- 2. CONTRACTOR SHALL INSPECT AND MAINTAIN EROSION CONTROL MEASURES ON A WEEKLY BASIS (MINIMUM) OR AS REQUIRED PER THE STORMWATER POLLUTION PREVENTION PLAN (SWPPP). THE CONTRACTOR SHALL ADDRESS DEFICIENCIES AND MAINTENANCE ITEMS WITHIN TWENTY-FOUR HOURS OF INSPECTION. CONTRACTOR SHALL PROPERLY DISPOSE OF SEDIMENT SUCH THAT IT DOES NOT ENCUMBER OTHER DRAINAGE STRUCTURES AND PROTECTED AREAS.

- 1. BASE PLAN: THE PROPERTY LINES SHOWN WERE DETERMINED BY AN ACTUAL FIELD SURVEY

- DOCUMENT SHALL BE AT THE USER'S SOLE RISK WITHOUT LIABILITY OR LEGAL EXPOSURE TO VHB.

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## Key Plan

Filing Set



06/17/22

## **Project** Storm King **Art Center**

## Site Development

NOT FOR CONSTRUCTION **Drawing Title** Legend and General **Notes** 

Date	06/17/22
Scale	N/A
Drawing Number	C-101
Sheet Size	ARCH D



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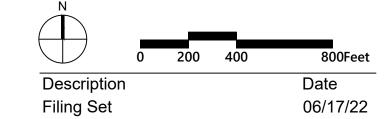
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**Key Plan** 



Storm King Art Center Site

Development

Seal


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Drawing Title

Existing Conditions

Existing Conditions
Plan - Overall

	Date	06/17/22
	Scale	1" = 400'
	Drawing Number	C-102
	Sheet Size	ARCH D

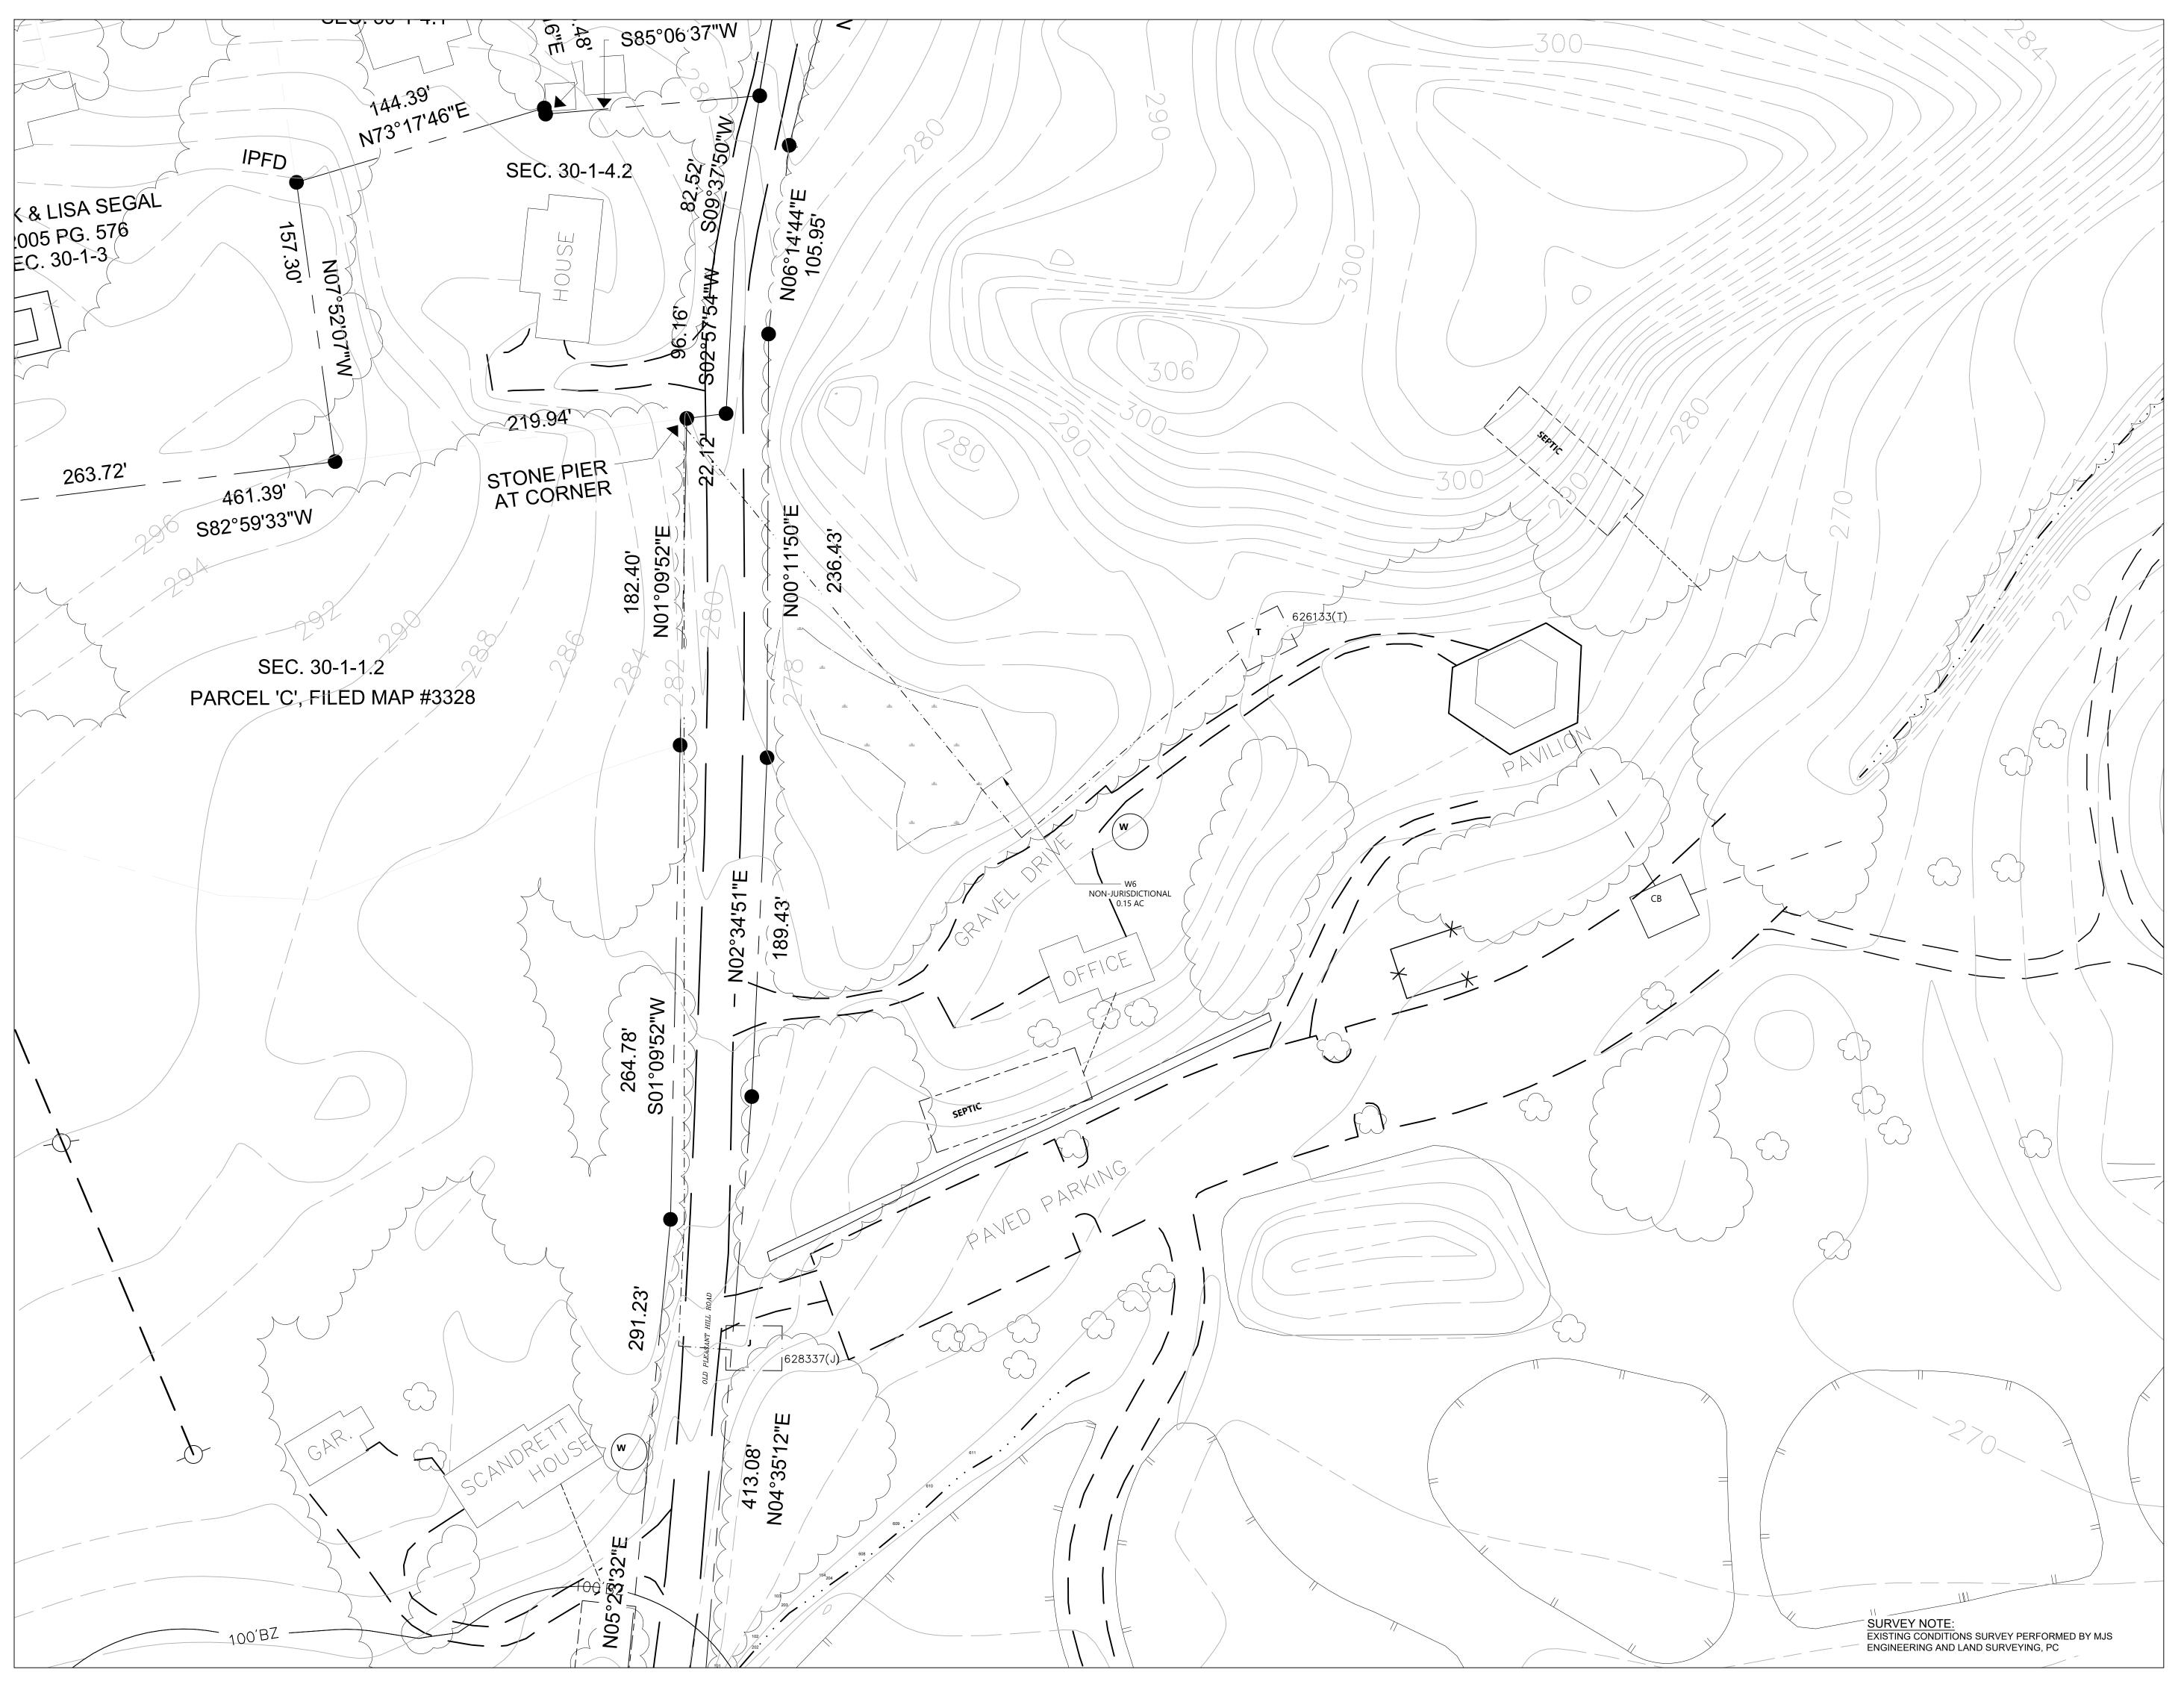

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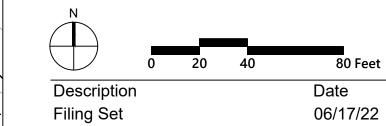
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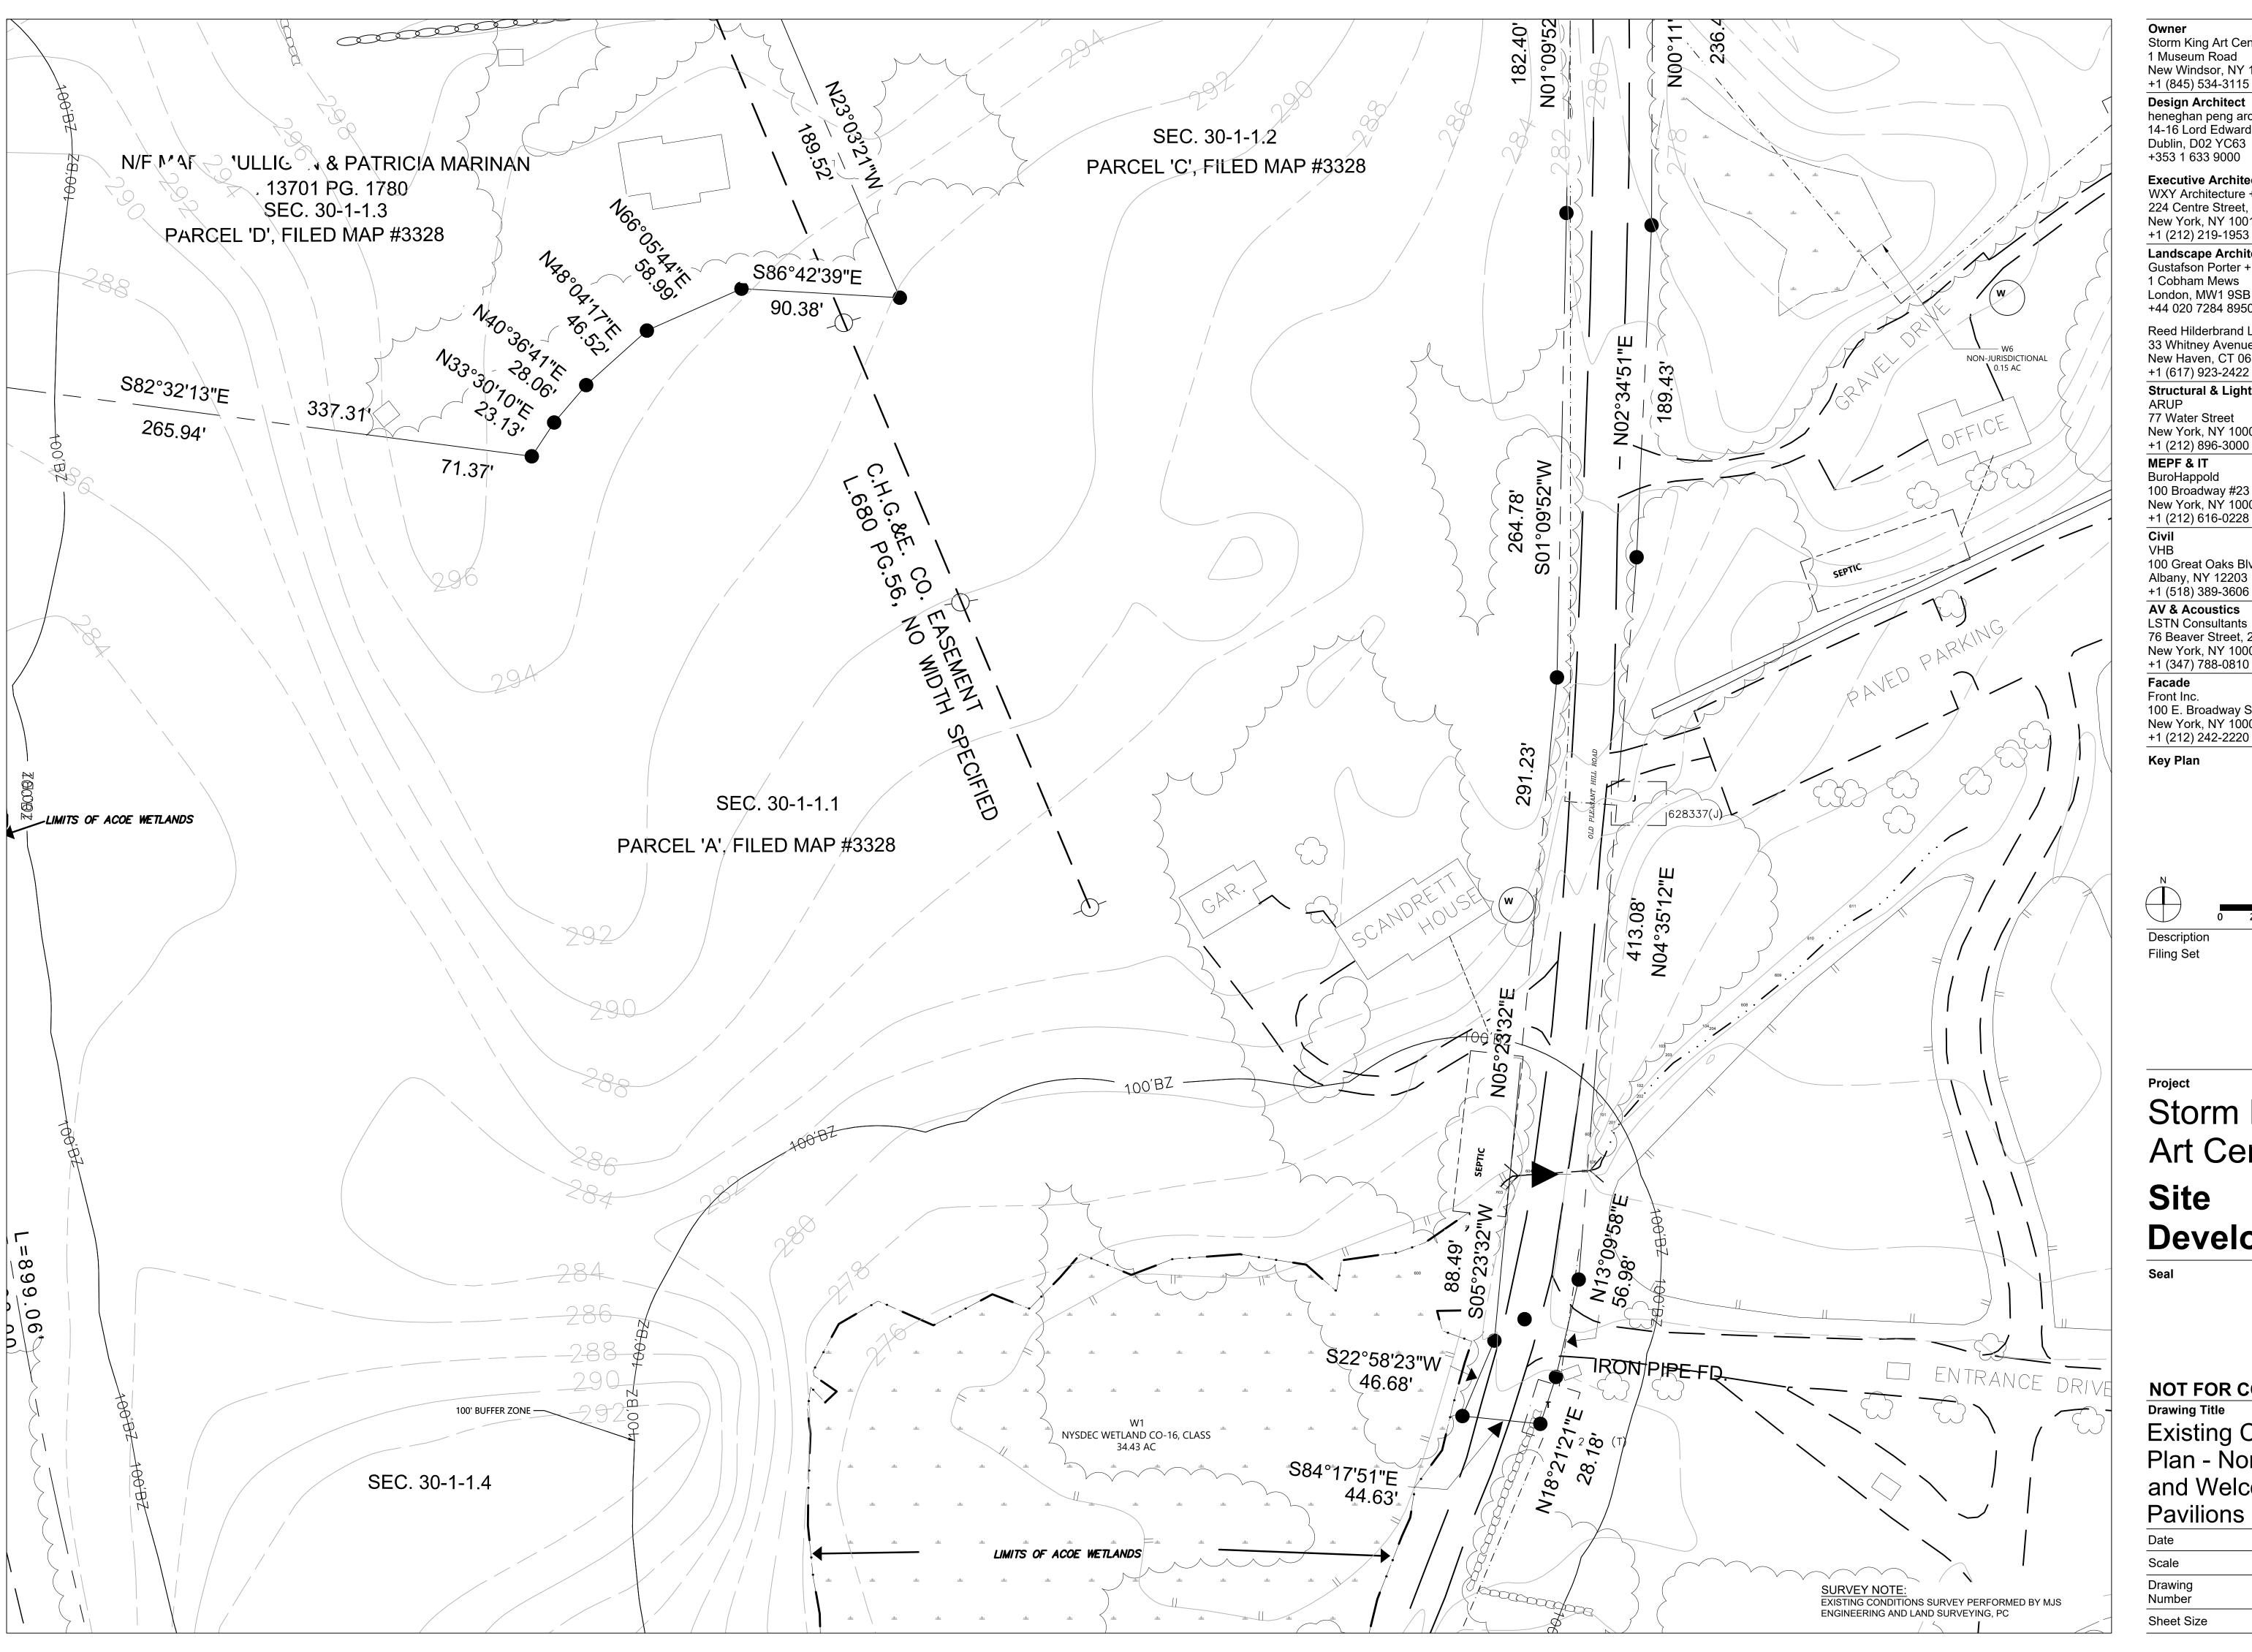


# Storm King Art Center Site Development

NOT FOR CONSTRUCTION **Drawing Title** 

Existing Conditions
Plan - Administration Building

Date	06/17/22
Scale	1" = 40'
Drawing Number	C-103
Sheet Size	ARCH D



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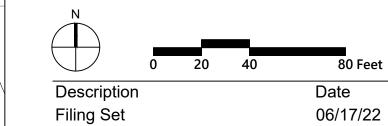
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**Key Plan** 



Storm King Art Center **Site** Development

NOT FOR CONSTRUCTION **Drawing Title** 

Existing Conditions
Plan - North Parking and Welcome **Pavilions** 

Date	06/17/22
Scale	1" = 40'
Drawing Number	C-104
Sheet Size	ARCH D



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Facade Front Inc.

100 E. Broadway Street, #501 New York, NY 10002 +1 (212) 242-2220

Key Plan




# Storm King Art Center Site Development

NOT FOR CONSTRUCTION

Existing Conditions
Plan - Pond Pavilion

Date	06/17/22
Scale	1" = 40'
Drawing Number	C-105
Sheet Size	ARCH D

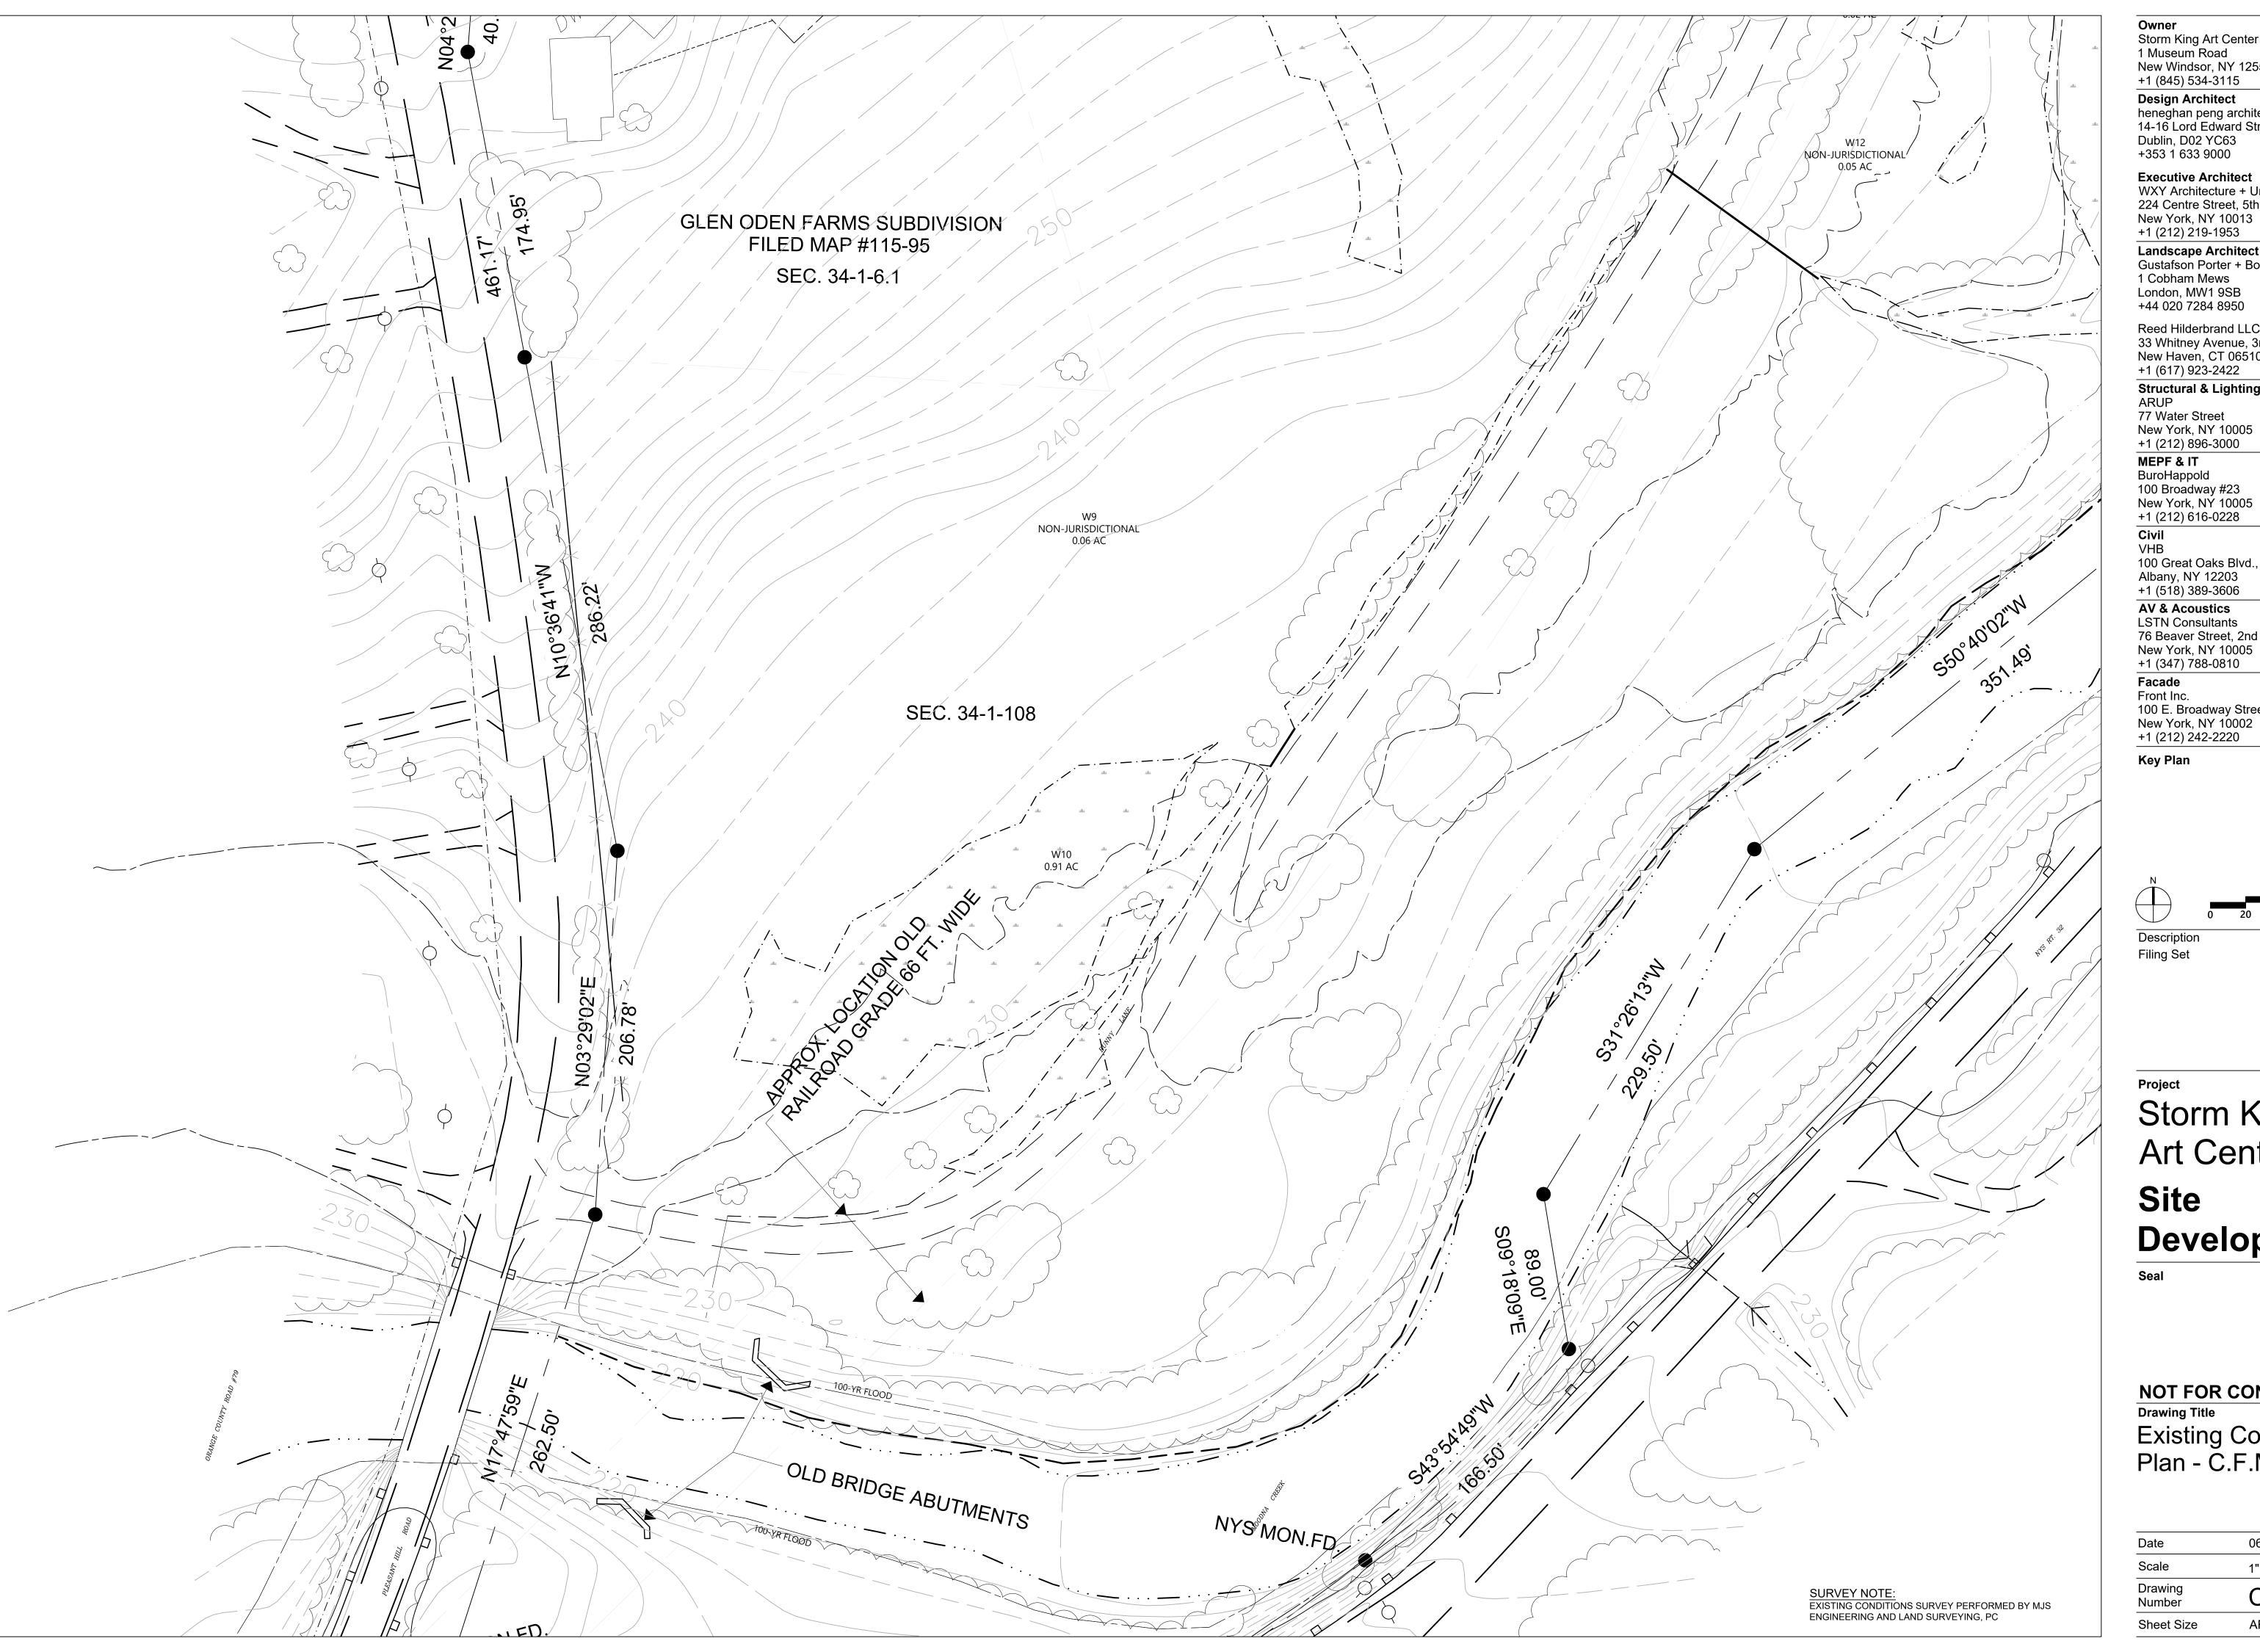

1 Museum Road New Windsor, NY 12553 +1 (845) 534-3115

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BuroHappold 100 Broadway #23 New York, NY 10005 +1 (212) 616-0228


Civil

100 Great Oaks Blvd., Suite 118 Albany, NY 12203 +1 (518) 389-3606

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Key Plan



Storm King Art Center Site Development

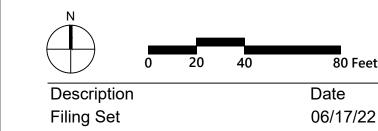NOT FOR CONSTRUCTION **Drawing Title** 

Existing Conditions
Plan - C.F.M Building

Date	06/17/22
Scale	1" = 40'
Drawing Number	C-106
Sheet Size	ARCH D



Owner

Storm King Art Center
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BuroHappold

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**Civil** VHB

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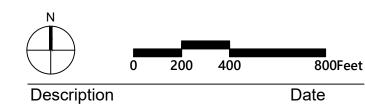
AV & Acoustics
LSTN Consultants
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**Key Plan** 



Filing Set

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Projec

Storm King Art Center Site

Development

Seal


NOT FOR CONSTRUCTION

Drawing Title

Layout and Material

Plan - Overall

Date	06/17/22
Scale	1" =400'
Drawing Number	C-201
Sheet Size	ARCH D

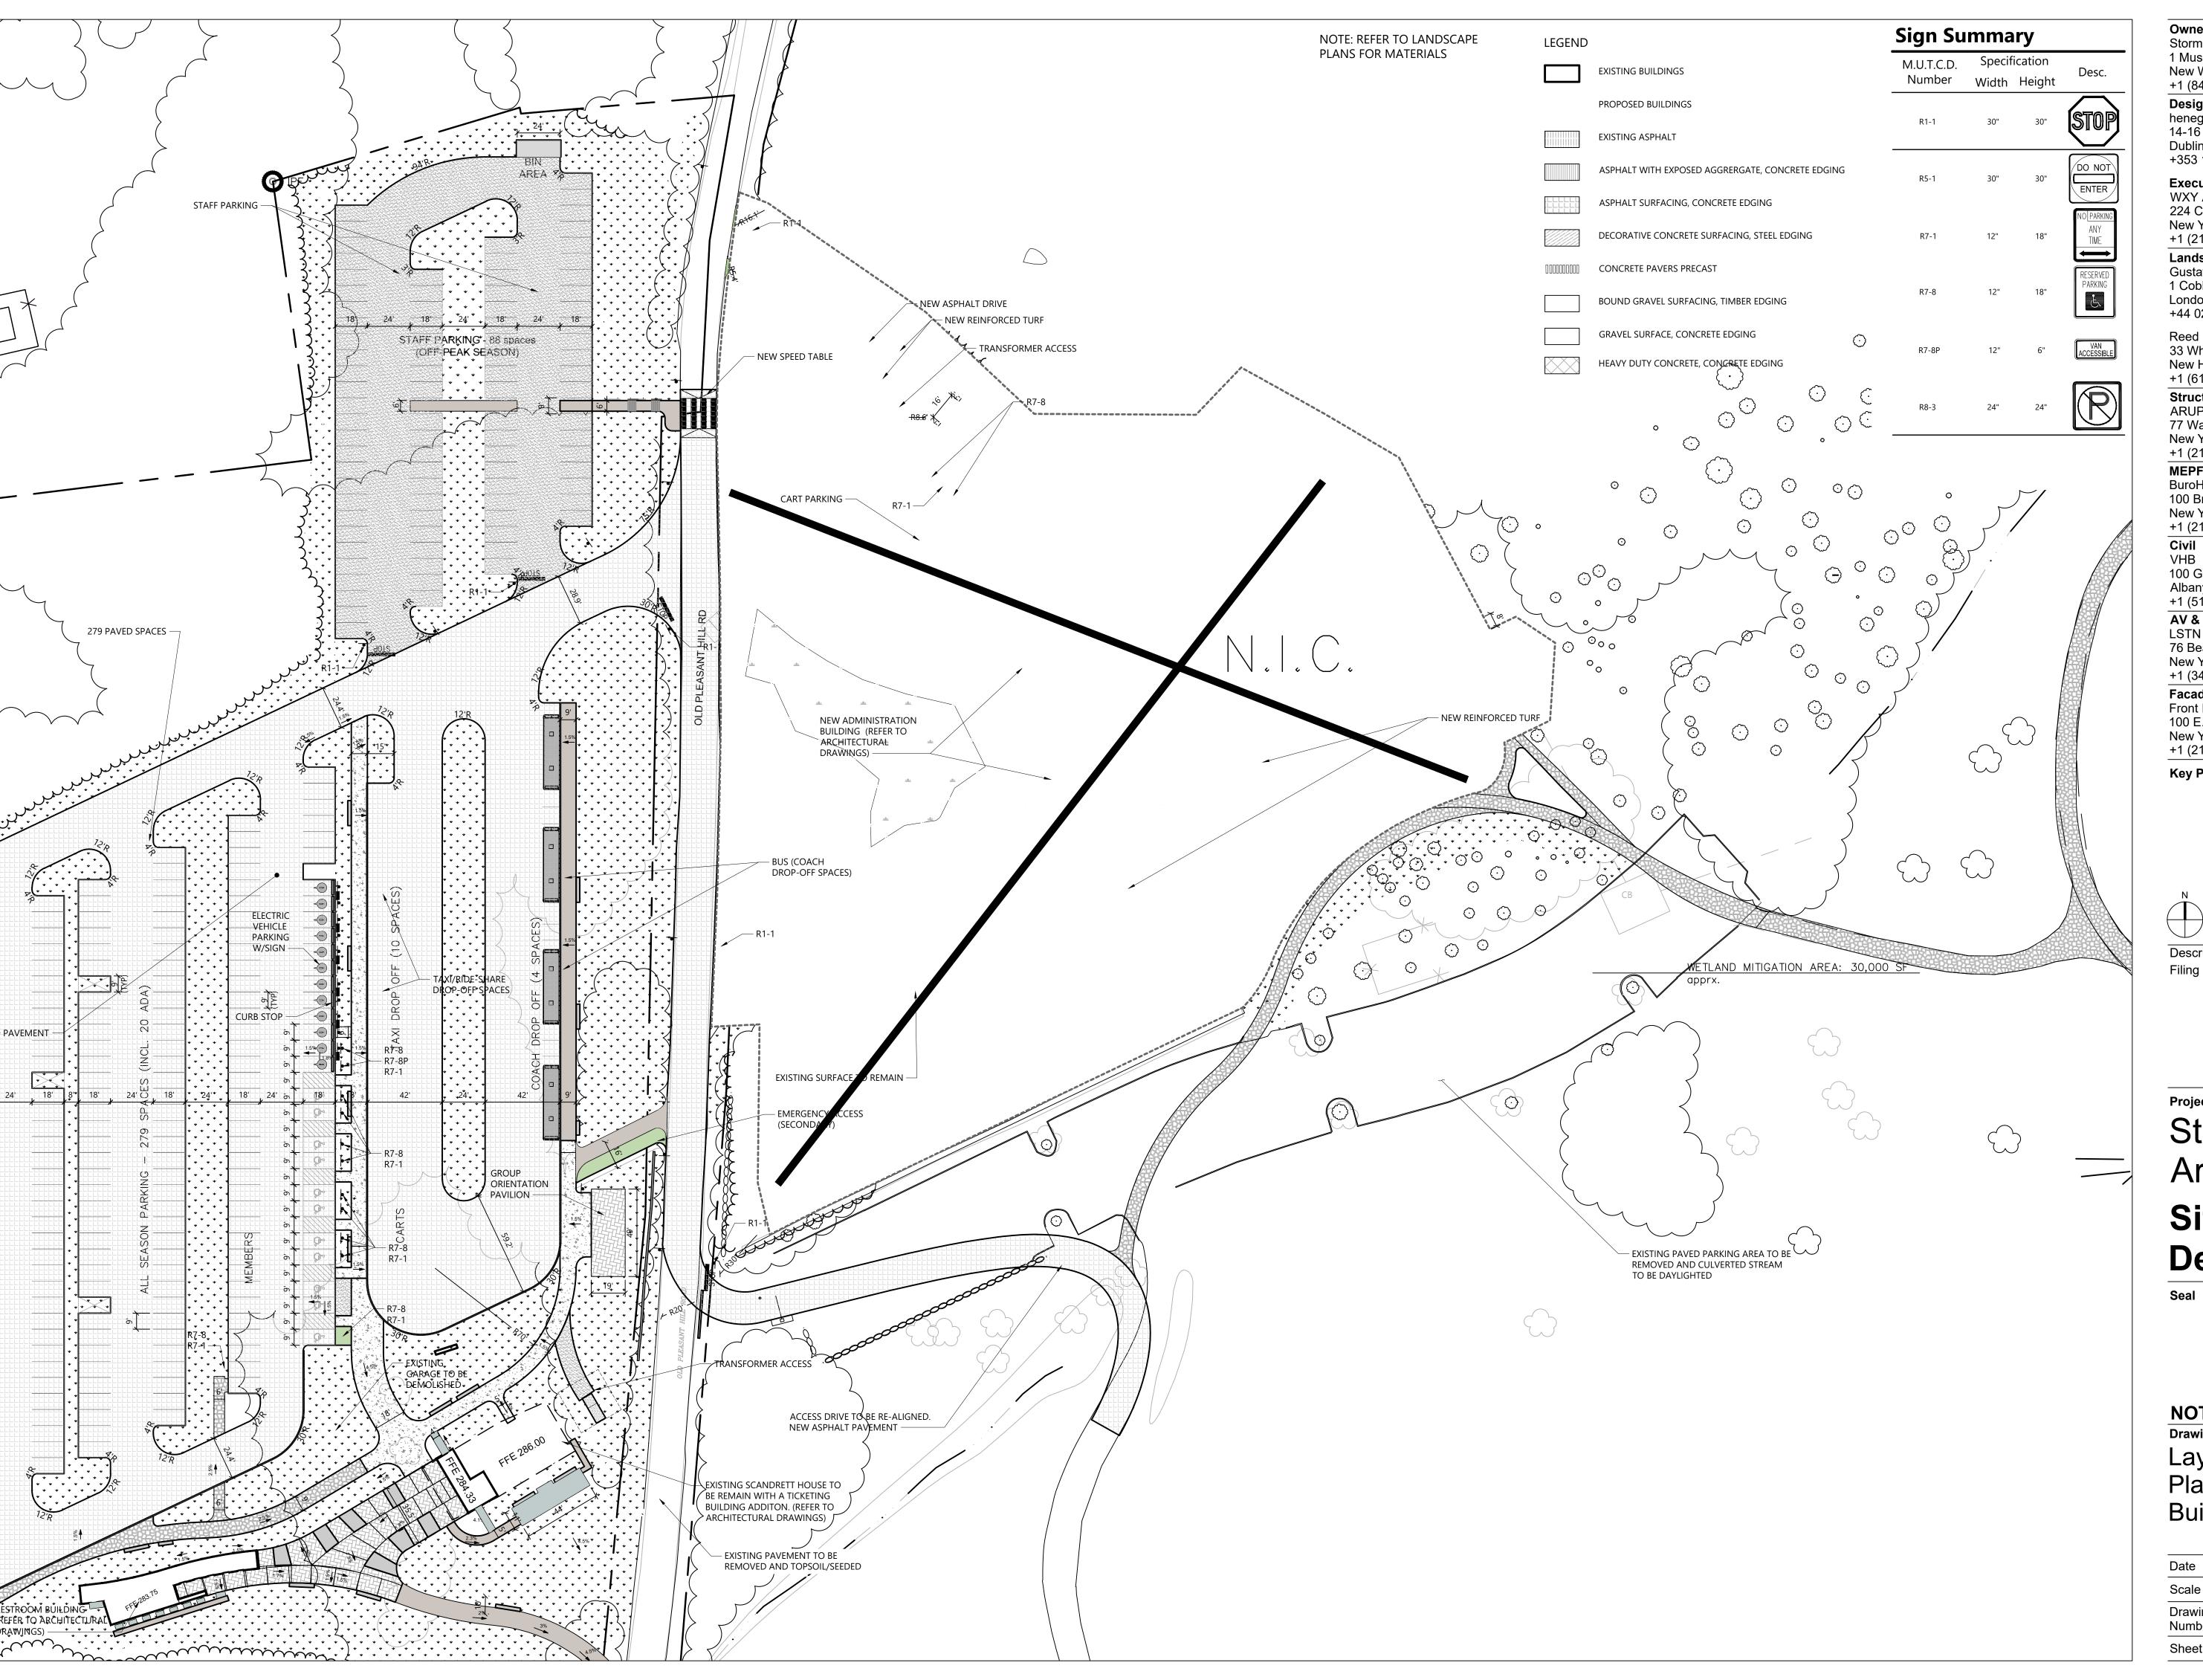

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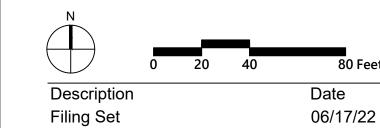
100 Great Oaks Blvd., Suite 118 Albany, NY 12203 +1 (518) 389-3606

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Facade Front Inc.

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Key Plan




Storm King Art Center Site Development

NOT FOR CONSTRUCTION **Drawing Title** 

Layout and Material Plan - Administration Building

Date	06/17/22
Scale	1" =40'
Drawing Number	C-202
Sheet Size	ARCH D

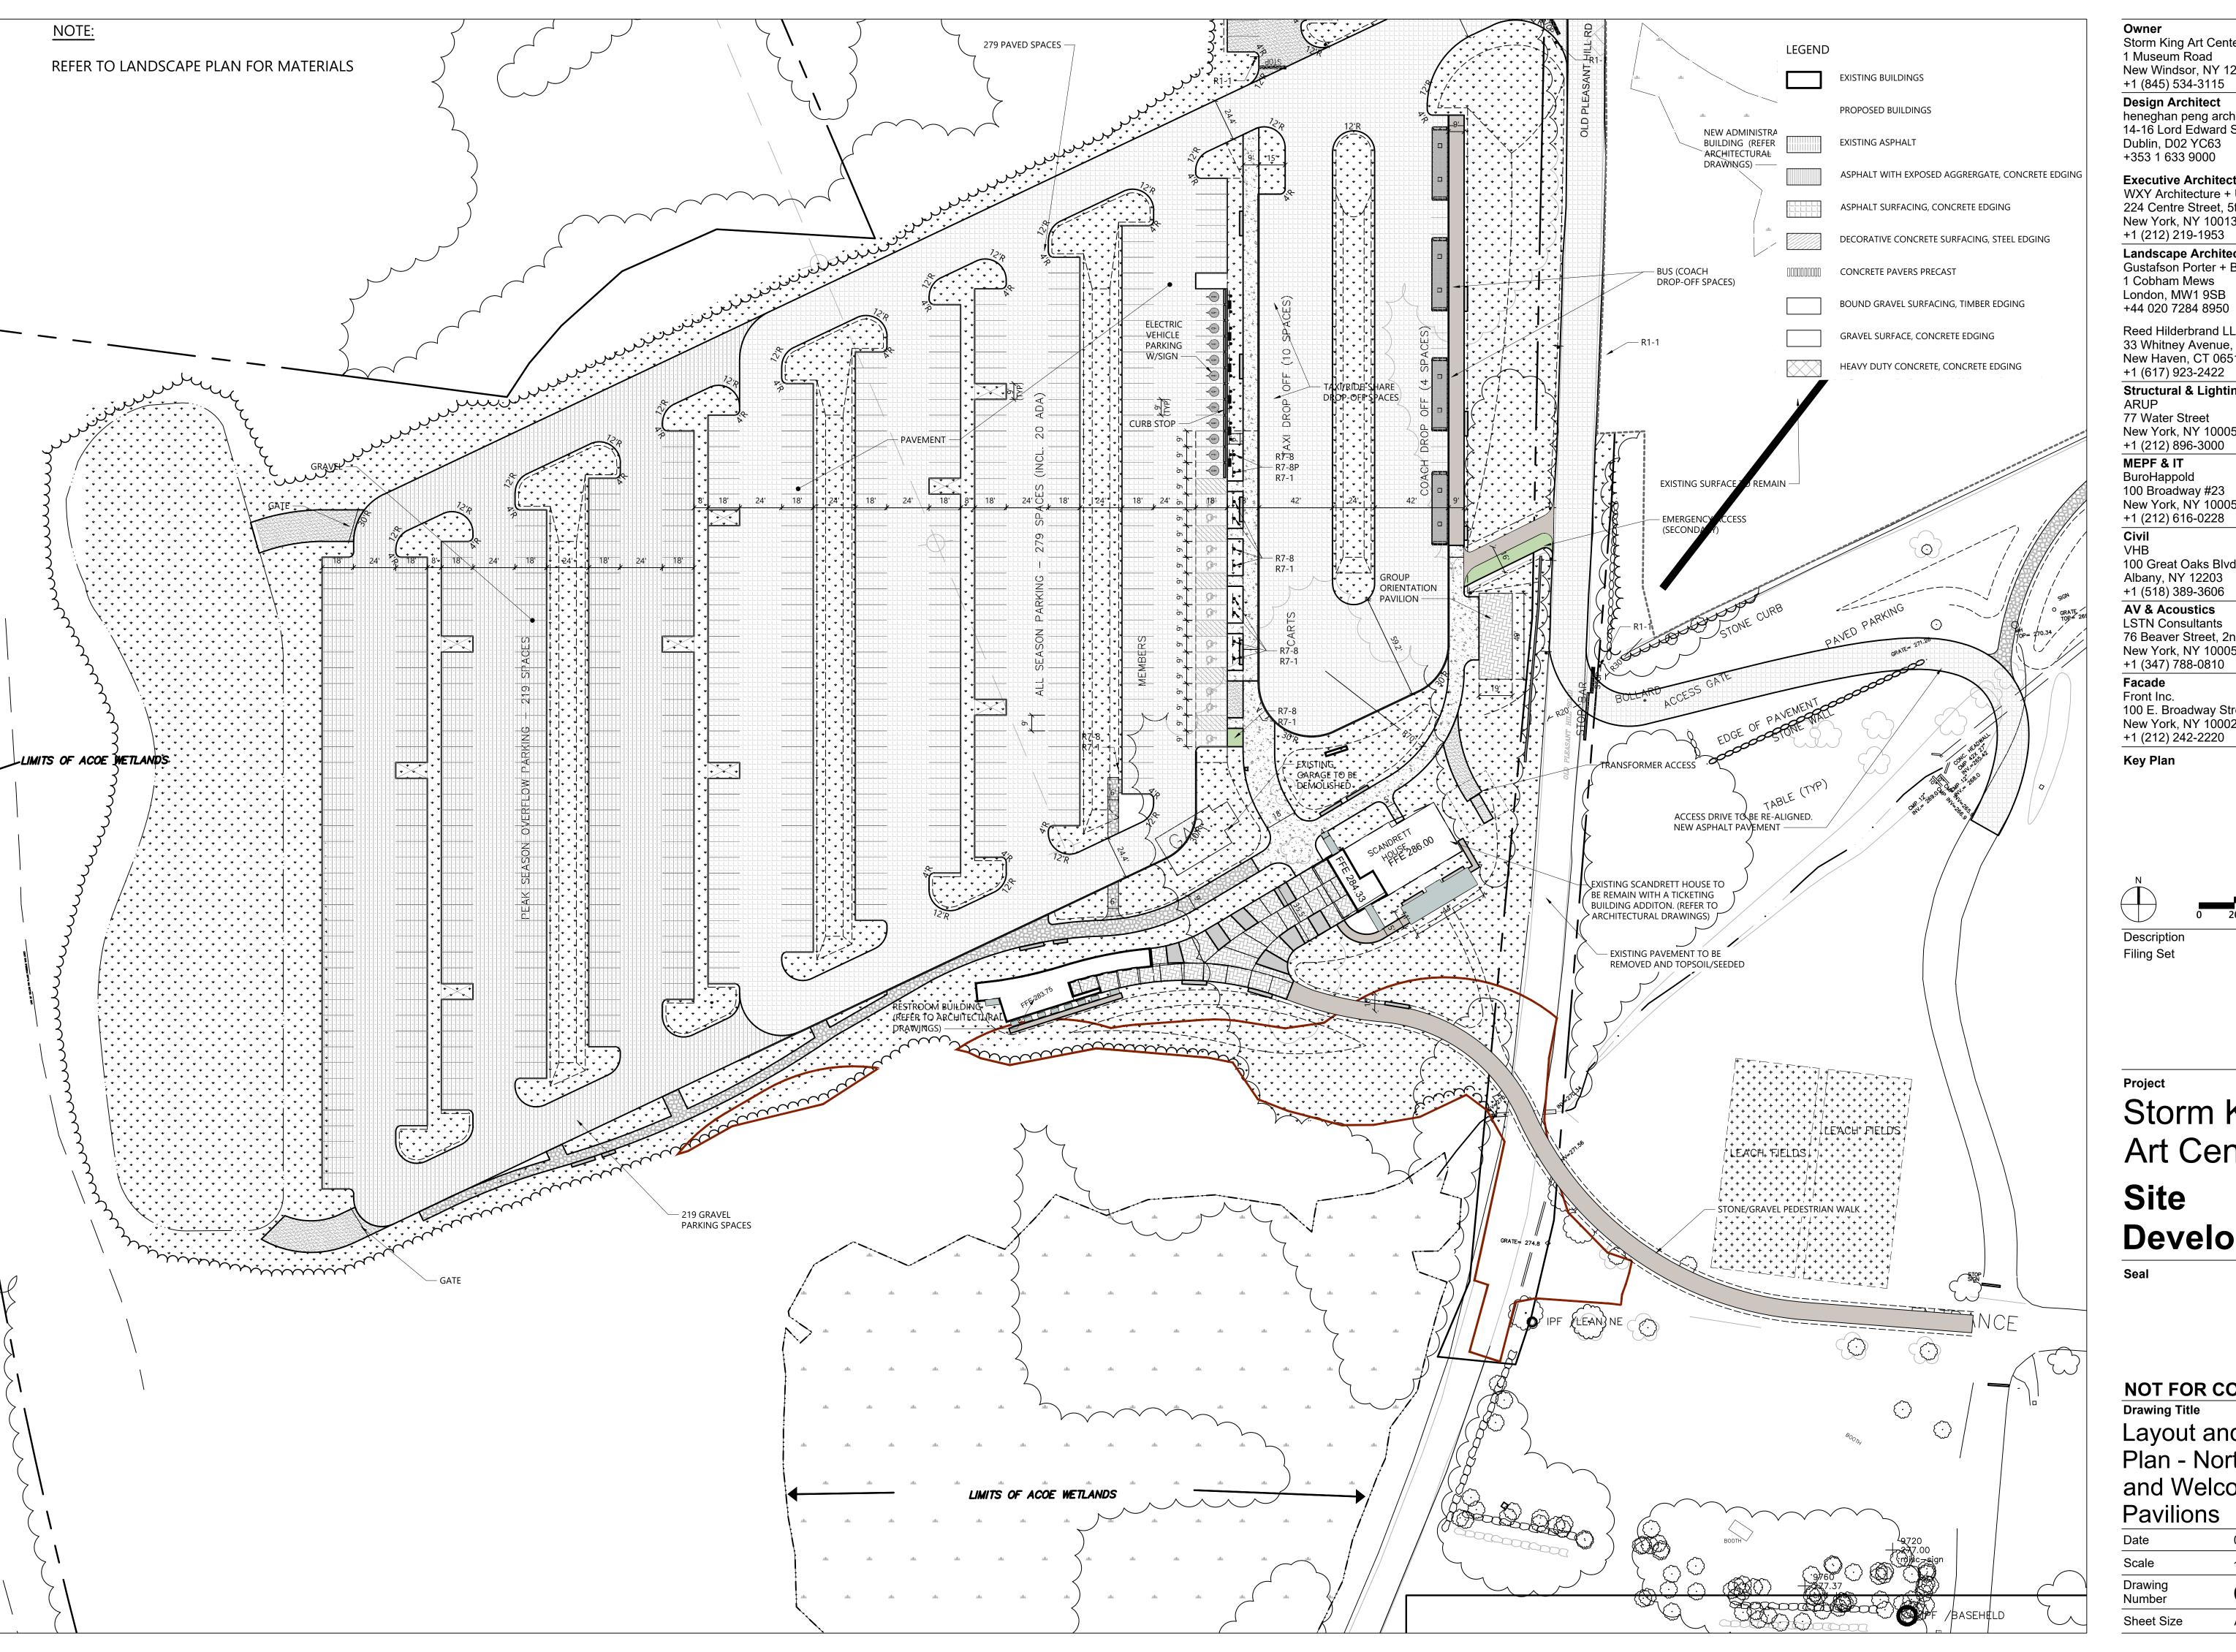

1 Museum Road New Windsor, NY 12553 +1 (845) 534-3115

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MEPF & IT BuroHappold 100 Broadway #23

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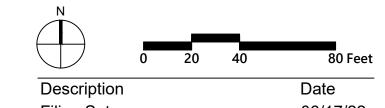
100 Great Oaks Blvd., Suite 118 Albany, NY 12203

**AV & Acoustics** LSTN Consultants 76 Beaver Street, 2nd Floor New York, NY 10005 +1 (347) 788-0810

**Facade** Front Inc.

100 E. Broadway Street, #501 New York, NY 10002 +1 (212) 242-2220

**Key Plan** 



Storm King Art Center Site Development

NOT FOR CONSTRUCTION

Layout and Material Plan - North Parking and Welcome **Pavilions** 

Date	06/17/22
Scale	1" =40'
Drawing Number	C-203
Sheet Size	ARCH D



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**Key Plan** 

Description Filing Set


Storm King **Art Center** 

Site Development

NOT FOR CONSTRUCTION

Layout and Material Plan - Pond Pavilion

Date	06/17/22	
Scale	1" =40'	
Drawing Number	C-204	
Sheet Size	ARCH D	

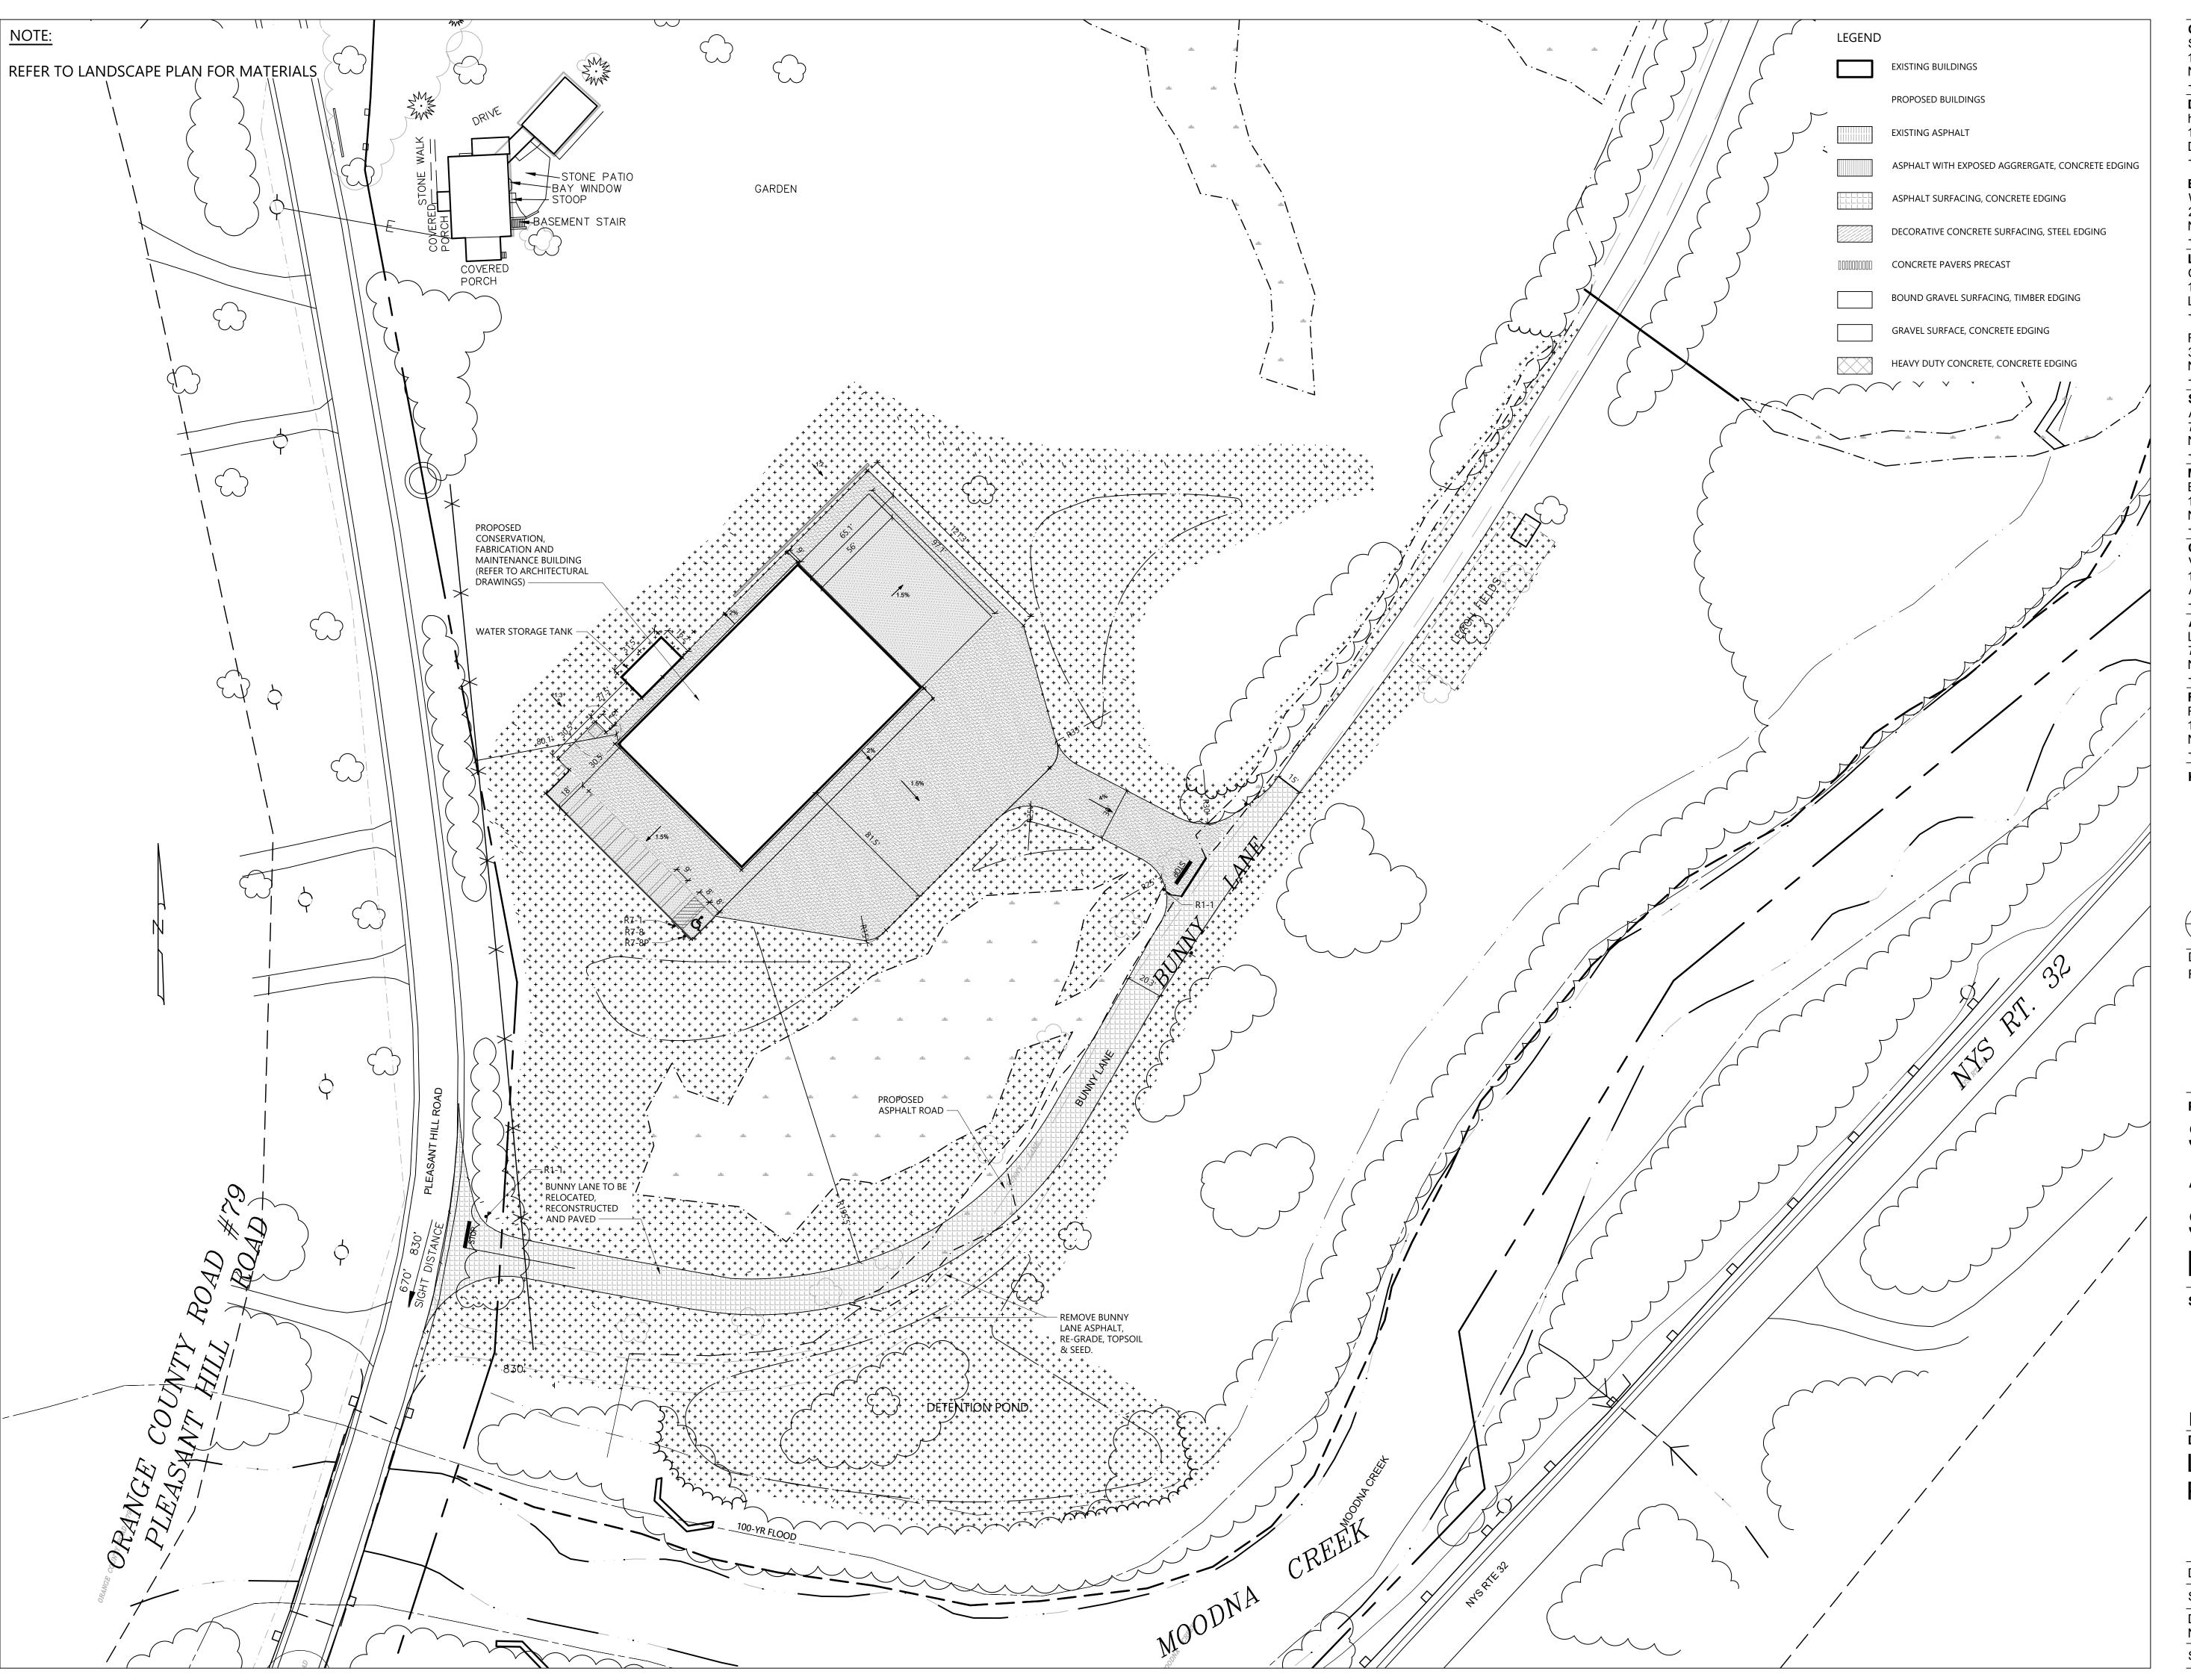

Owner
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VHB 100 Great Oaks Blvd., Suite 118 Albany, NY 12203


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Key Plan



Project


Storm King
Art Center
Site
Development

Spal

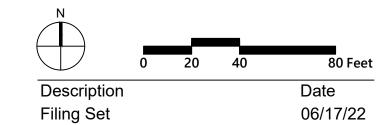NOT FOR CONSTRUCTION
Drawing Title

Layout and Material Plan - C.F.M. Building

Date	06/17/22
Scale	1" =40'
Drawing Number	C-205
Sheet Size	ARCH D

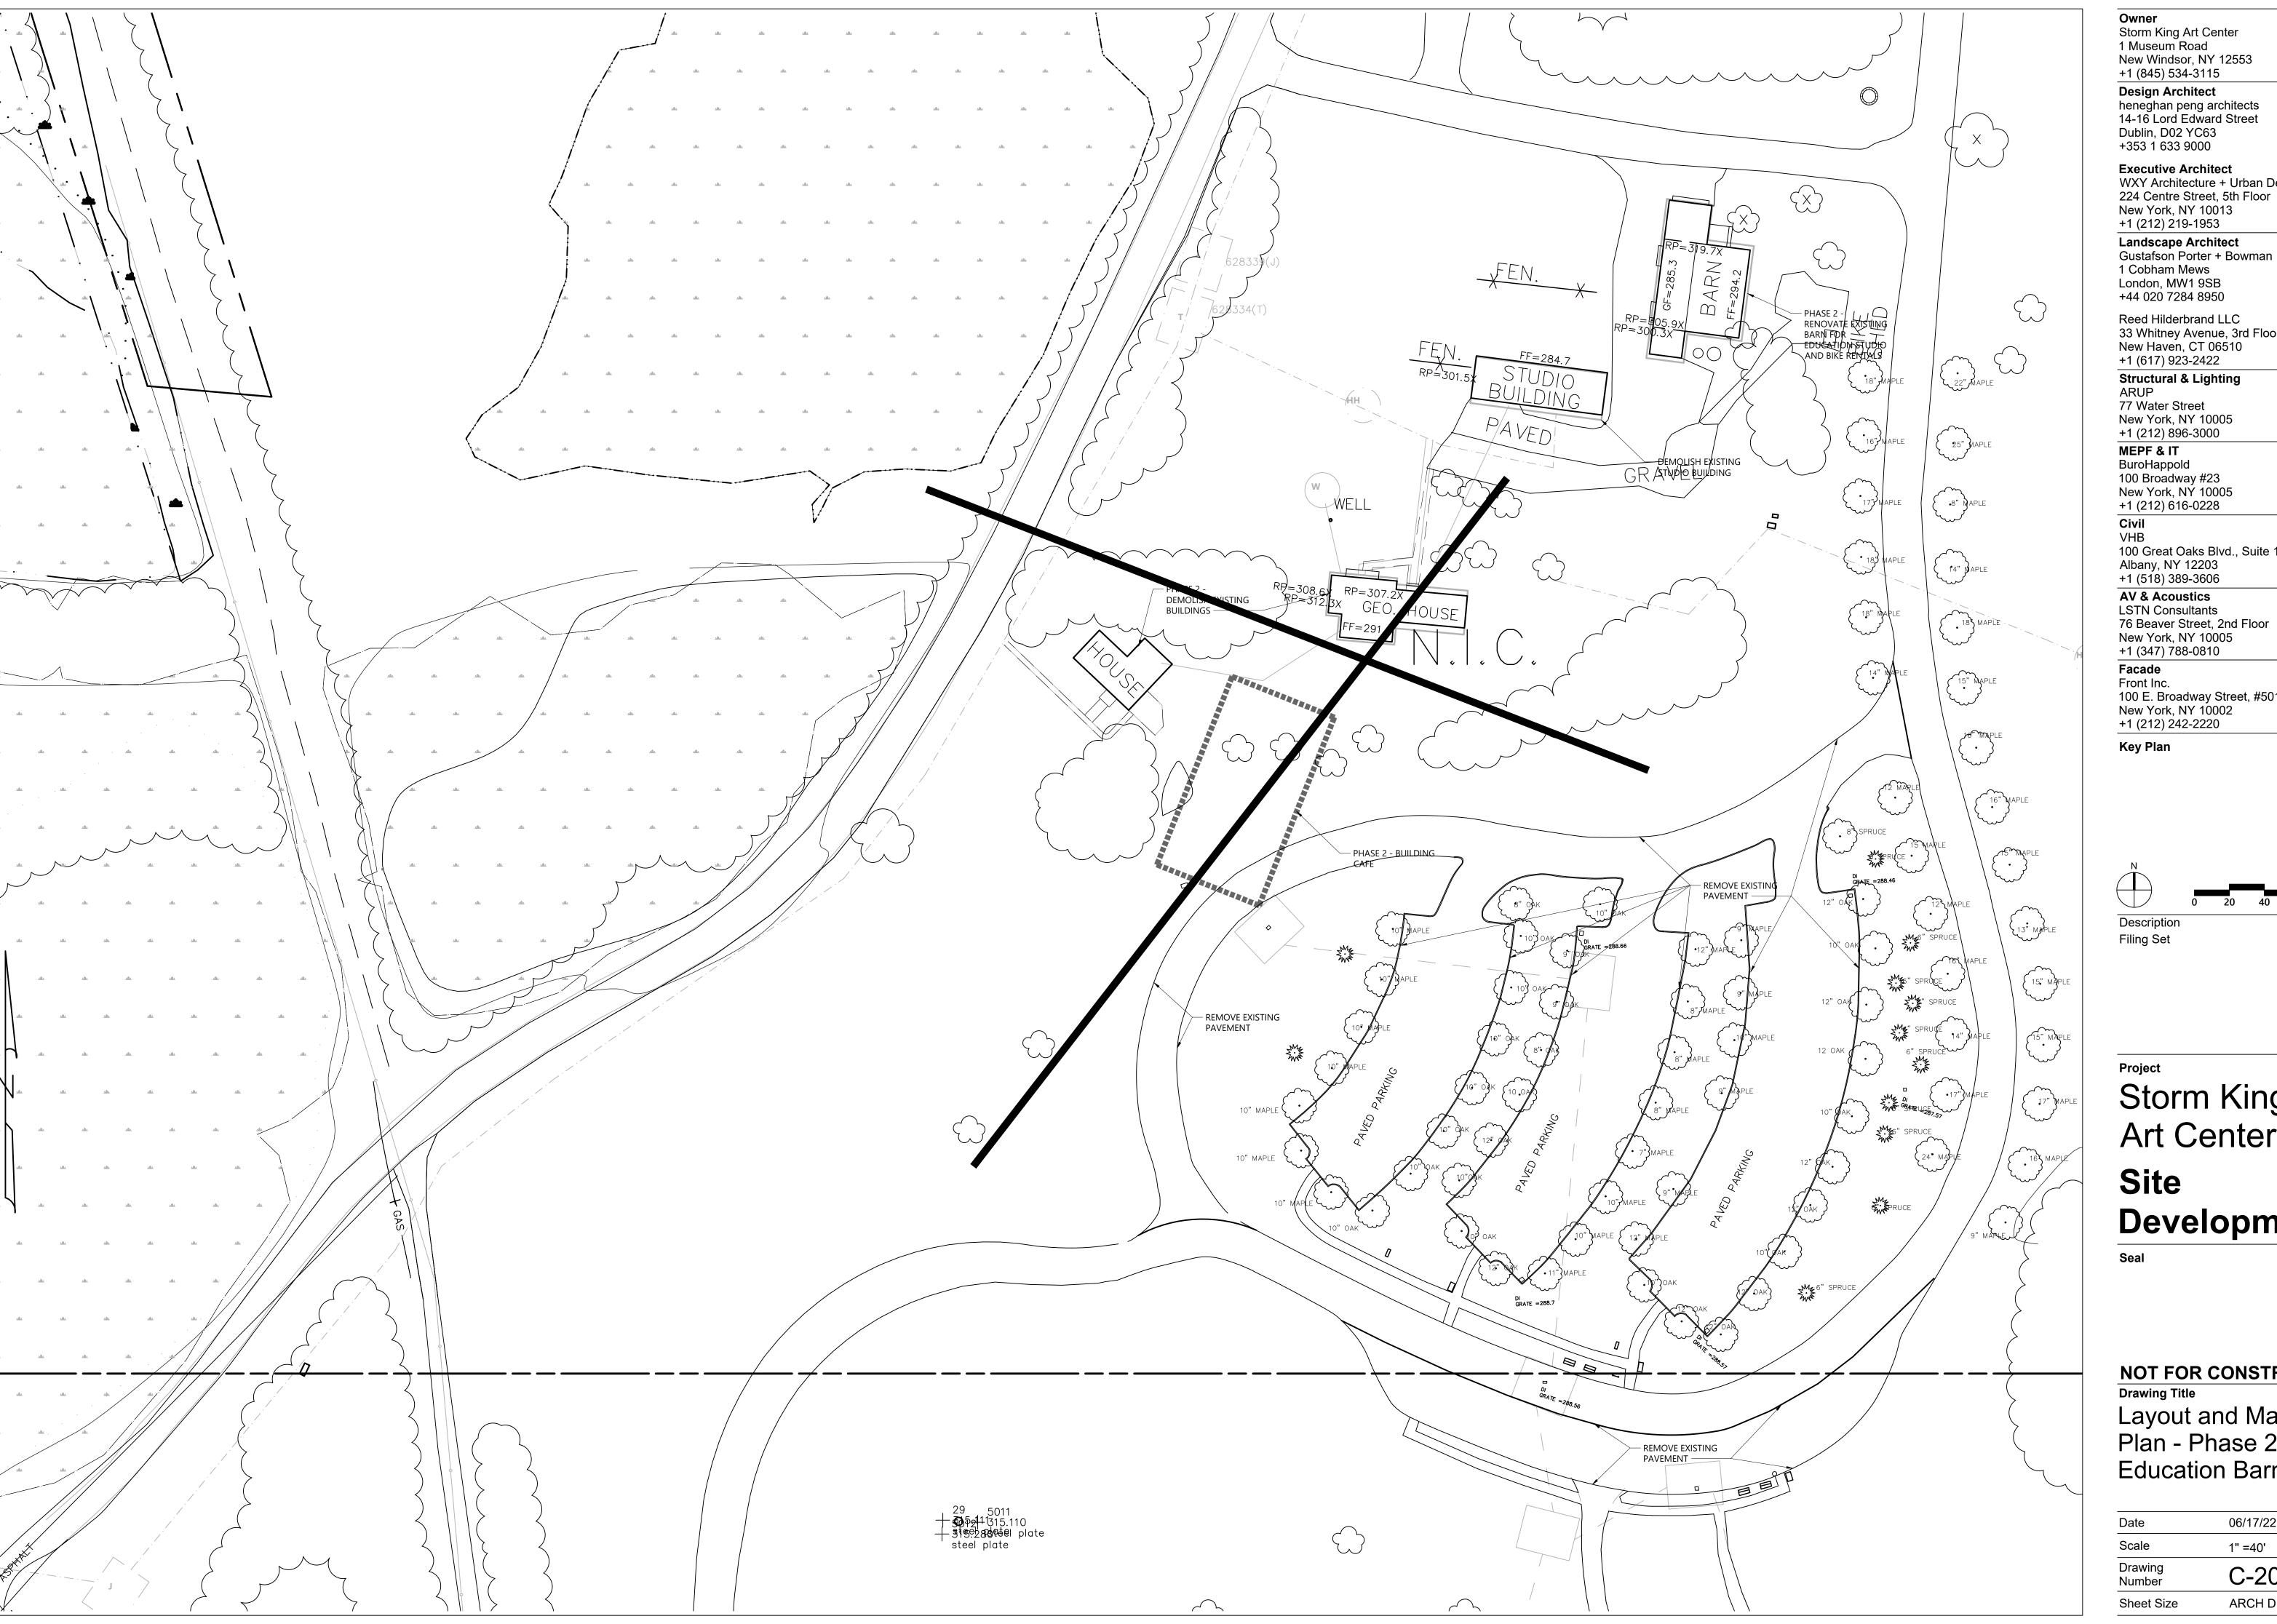

1 Museum Road New Windsor, NY 12553 +1 (845) 534-3115

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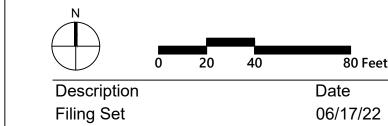
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Key Plan



Storm King Art Center Site Development

NOT FOR CONSTRUCTION **Drawing Title** 

Layout and Material Plan - Phase 2 **Education Barn** 

Date	06/17/22
Scale	1" =40'
Drawing Number	C-206
Sheet Size	ARCH D



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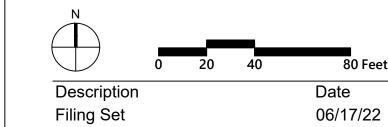
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**Key Plan** 



Project

Storm King Art Center **Site** 

Development

Seal

NOT FOR CONSTRUCTION
Drawing Title
Layout and Material

Layout and Material Plan - Phase 2 Exhibition Gallery

Date	06/17/22
Scale	1" =40'
Drawing Number	C-207
Sheet Size	ARCH D



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100 Great Oaks Blvd., Suite 118


Albany, NY 12203 +1 (518) 389-3606 **AV & Acoustics** 

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Facade

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**Key Plan** 




Storm King Art Center Site Development

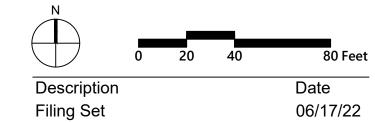NOT FOR CONSTRUCTION **Drawing Title** 

Grading and Drainage Plan -Administration Building

Date	06/17/22	
Scale	1" = 40'	
Drawing Number	C-301	
Sheet Size	ARCH D	

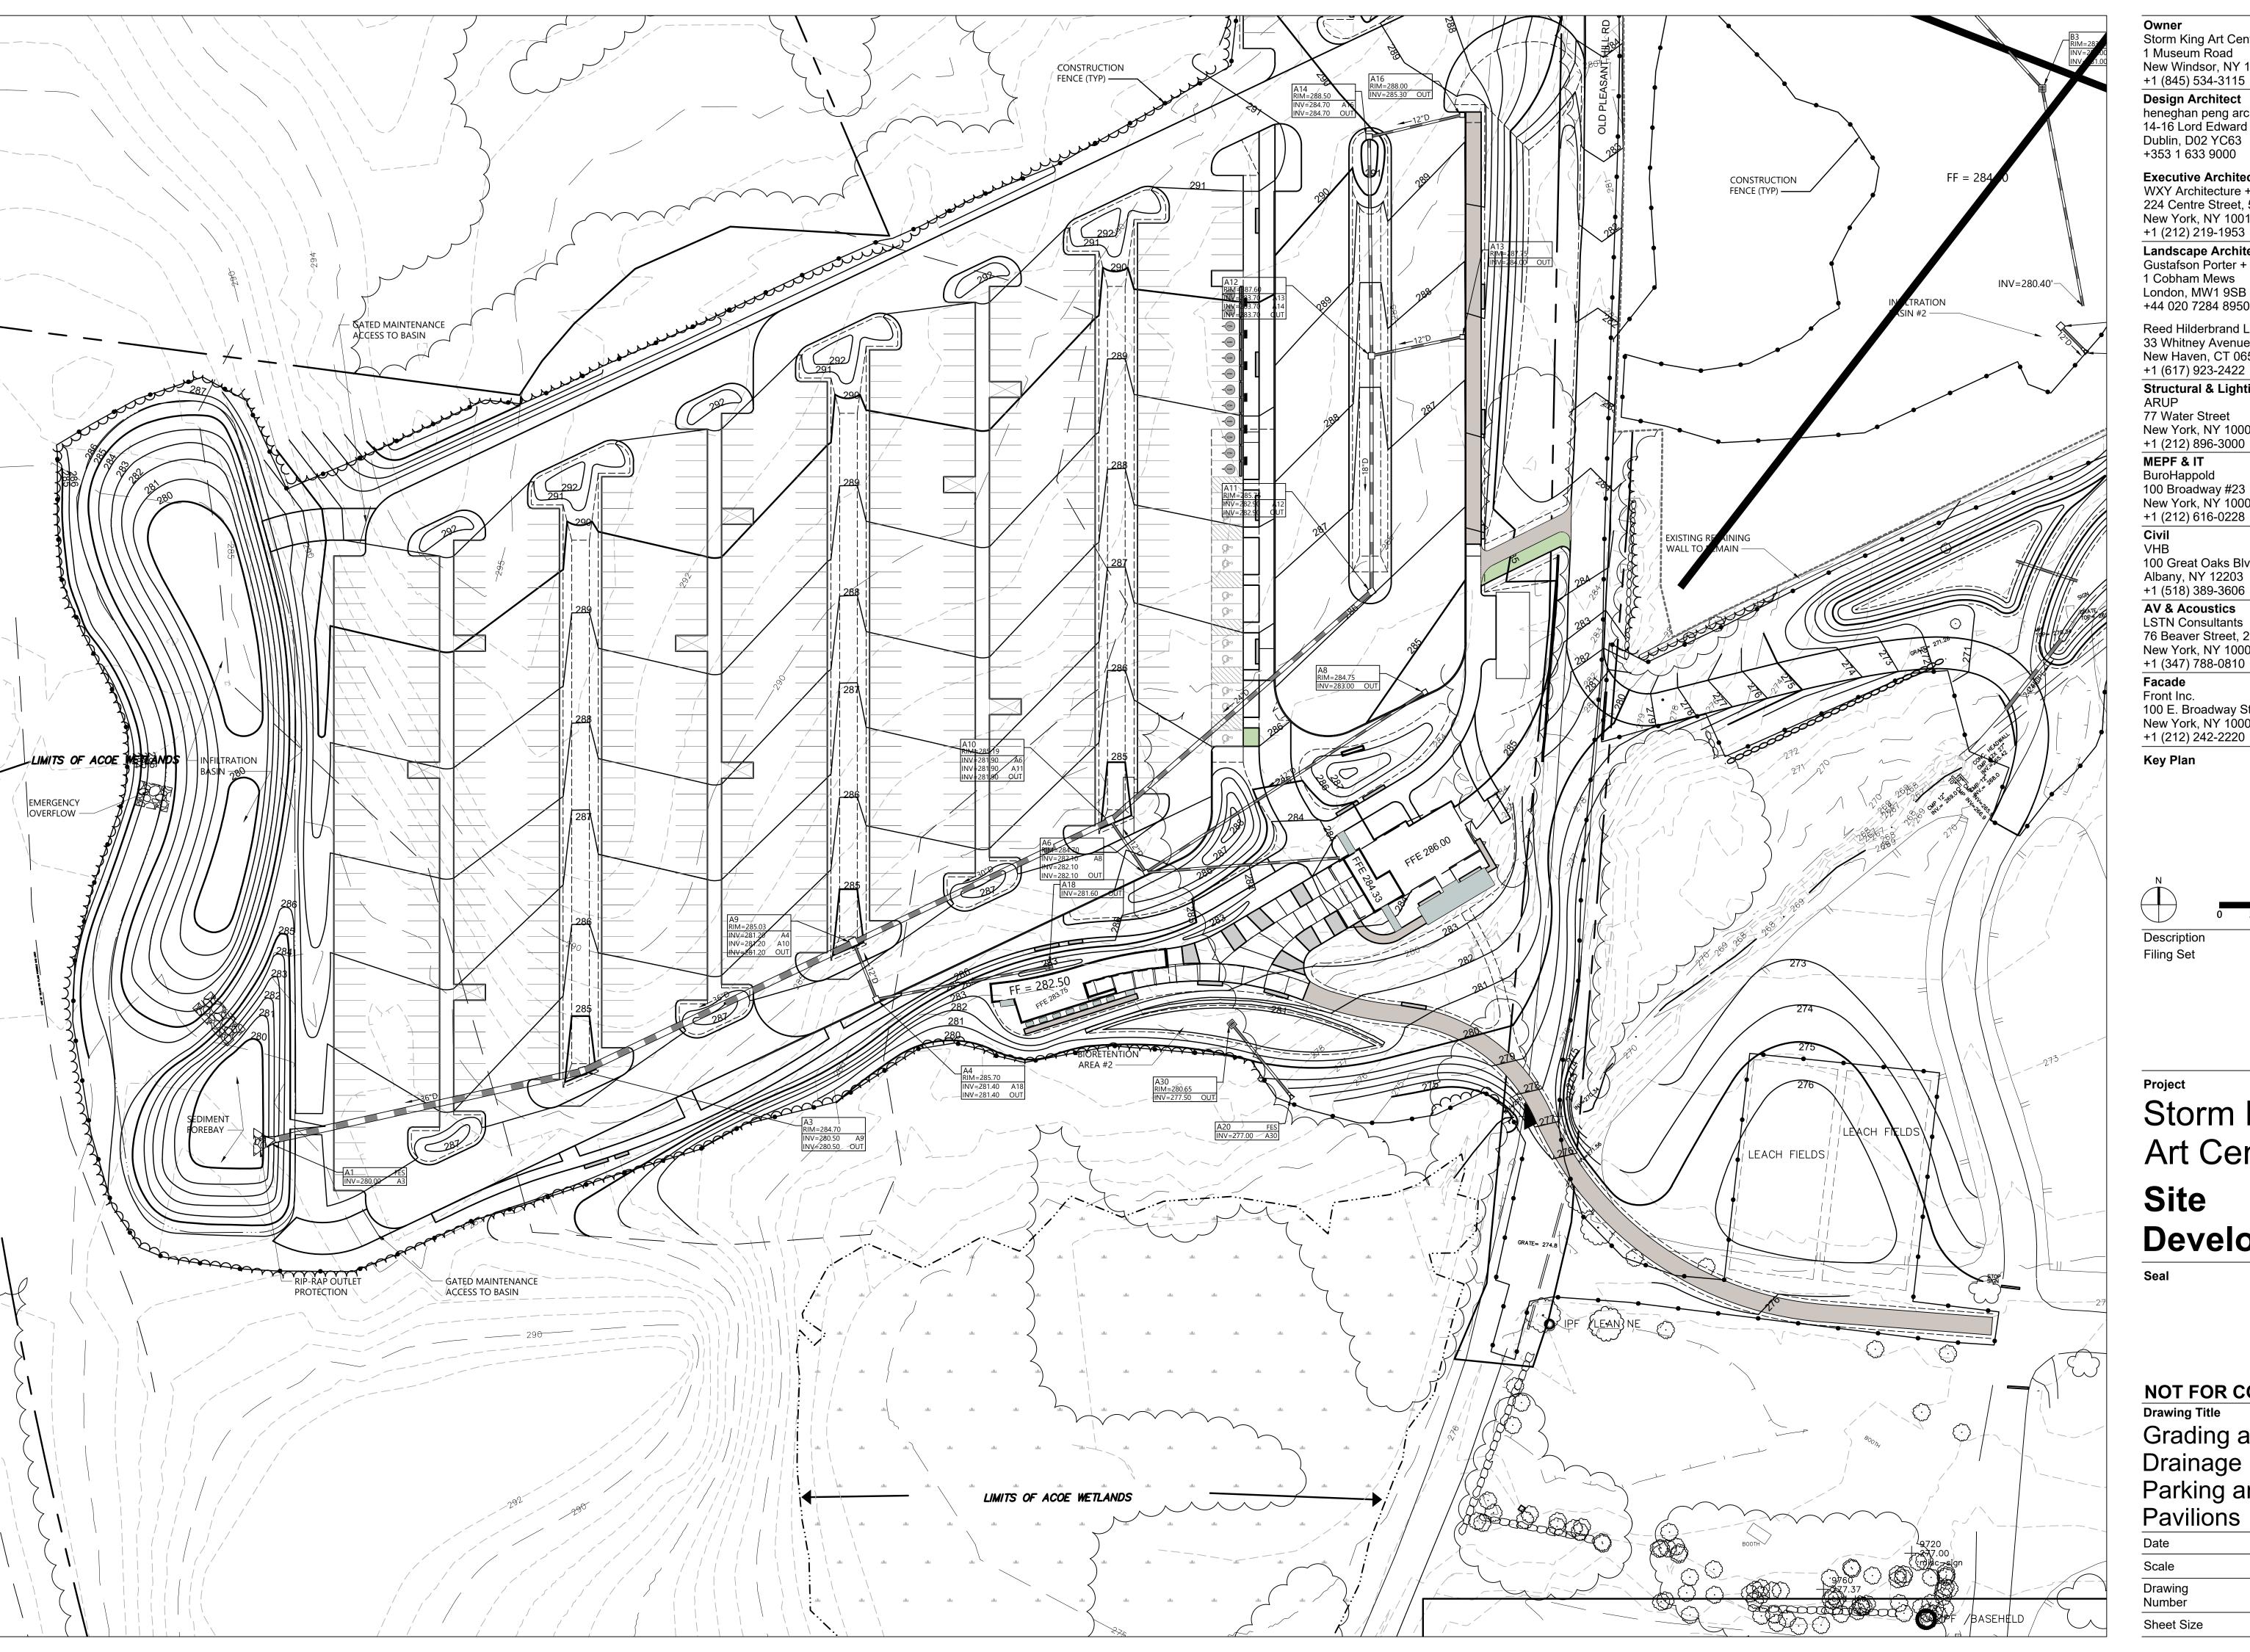

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77 Water Street New York, NY 10005 +1 (212) 896-3000

MEPF & IT BuroHappold 100 Broadway #23 New York, NY 10005

+1 (212) 616-0228 Civil


100 Great Oaks Blvd., Suite 118 Albany, NY 12203

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Facade Front Inc. 100 E. Broadway Street, #501 New York, NY 10002 +1 (212) 242-2220

**Key Plan** 



Storm King Art Center Site Development

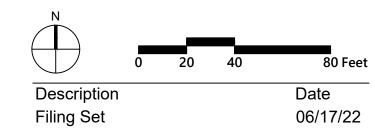NOT FOR CONSTRUCTION **Drawing Title** Grading and Drainage Plan - North Parking and Welcome

06/17/22 1" = 40' Drawing Number C-302 ARCH D



Storm King Art Center 1 Museum Road New Windsor, NY 12553

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Structural & Lighting ARUP 77 Water Street

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BuroHappold 100 Broadway #23 New York, NY 10005 +1 (212) 616-0228

Civil


100 Great Oaks Blvd., Suite 118 Albany, NY 12203 +1 (518) 389-3606

**AV & Acoustics** LSTN Consultants 76 Beaver Street, 2nd Floor New York, NY 10005 +1 (347) 788-0810

Facade Front Inc.

100 E. Broadway Street, #501 New York, NY 10002 +1 (212) 242-2220

Key Plan

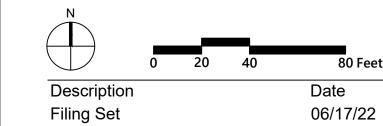


Storm King

**Art Center** Site Development

NOT FOR CONSTRUCTION
Drawing Title

Grading and Drainage Plan - Pond Pavilion

Date	06/17/22
Scale	1" = 40'
Drawing Number	C-303
Sheet Size	ARCH D

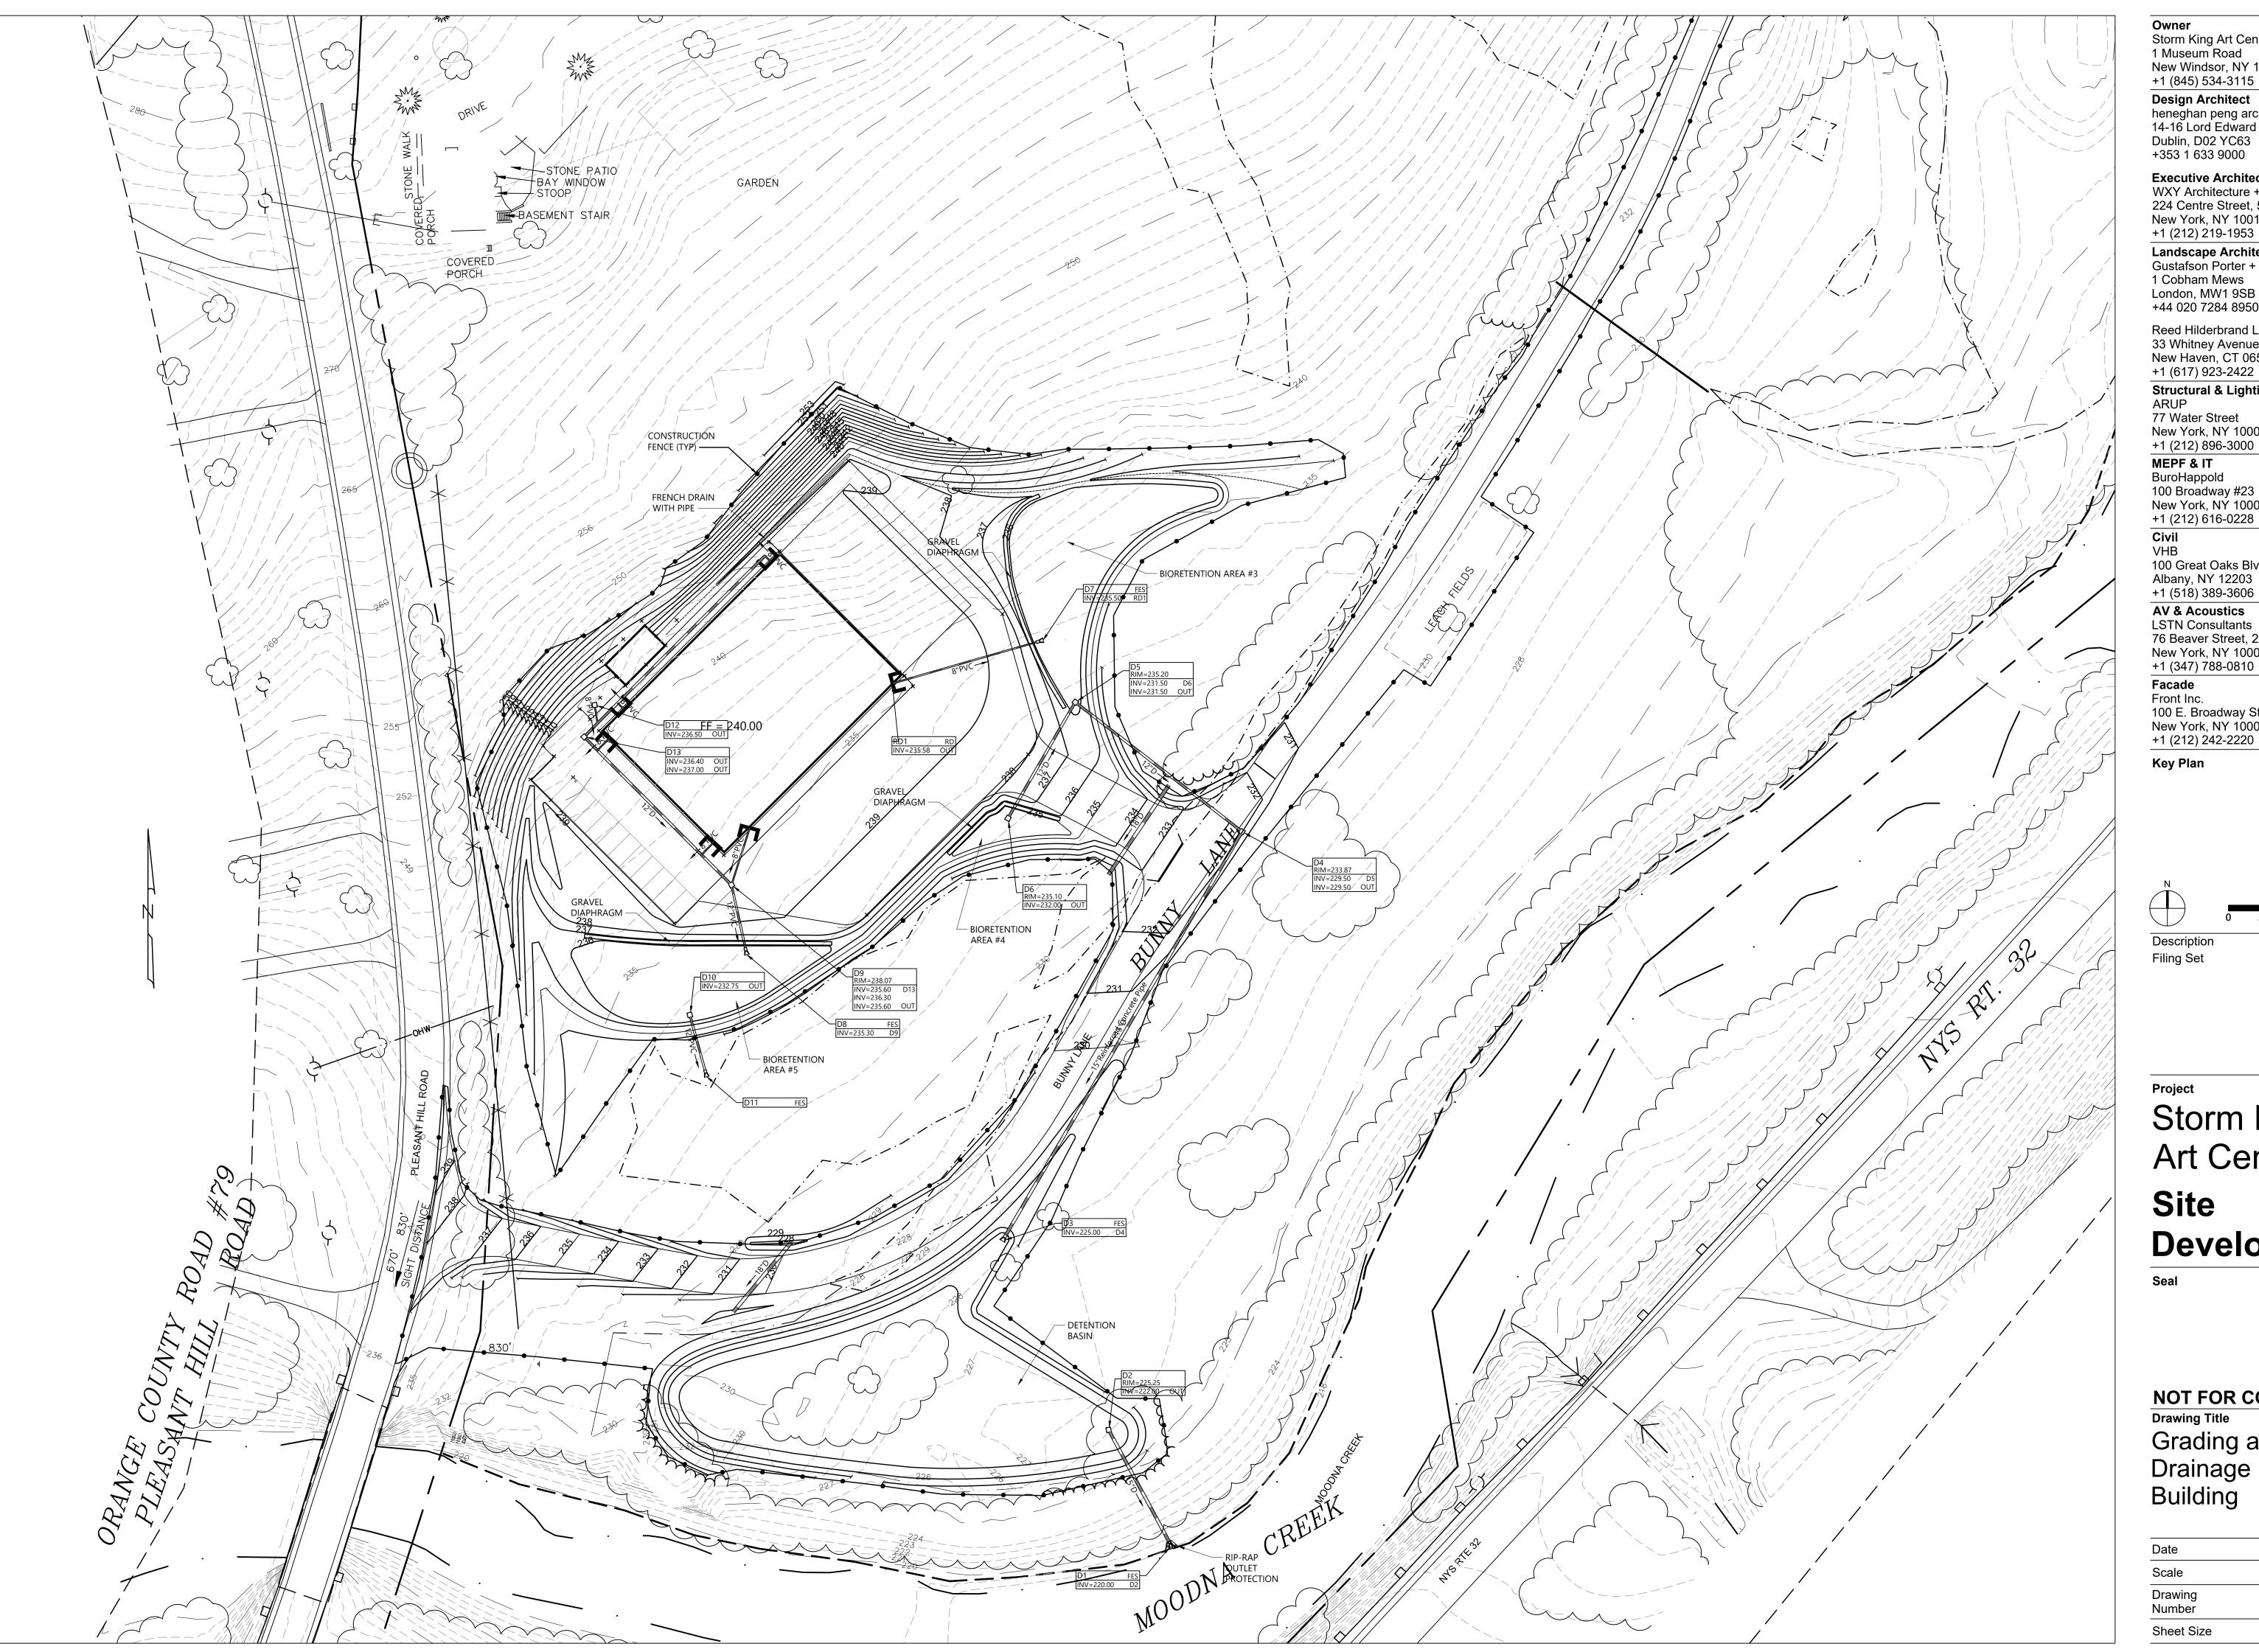

**Design Architect** 

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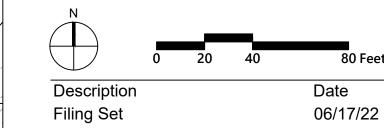
Civil

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**AV & Acoustics** LSTN Consultants 76 Beaver Street, 2nd Floor New York, NY 10005 +1 (347) 788-0810

Facade Front Inc. 100 E. Broadway Street, #501 New York, NY 10002

Key Plan




Storm King Art Center Site Development

NOT FOR CONSTRUCTION **Drawing Title** Grading and Drainage Plan - C.F.M.

Building 06/17/22 1" = 40' C-304

ARCH D

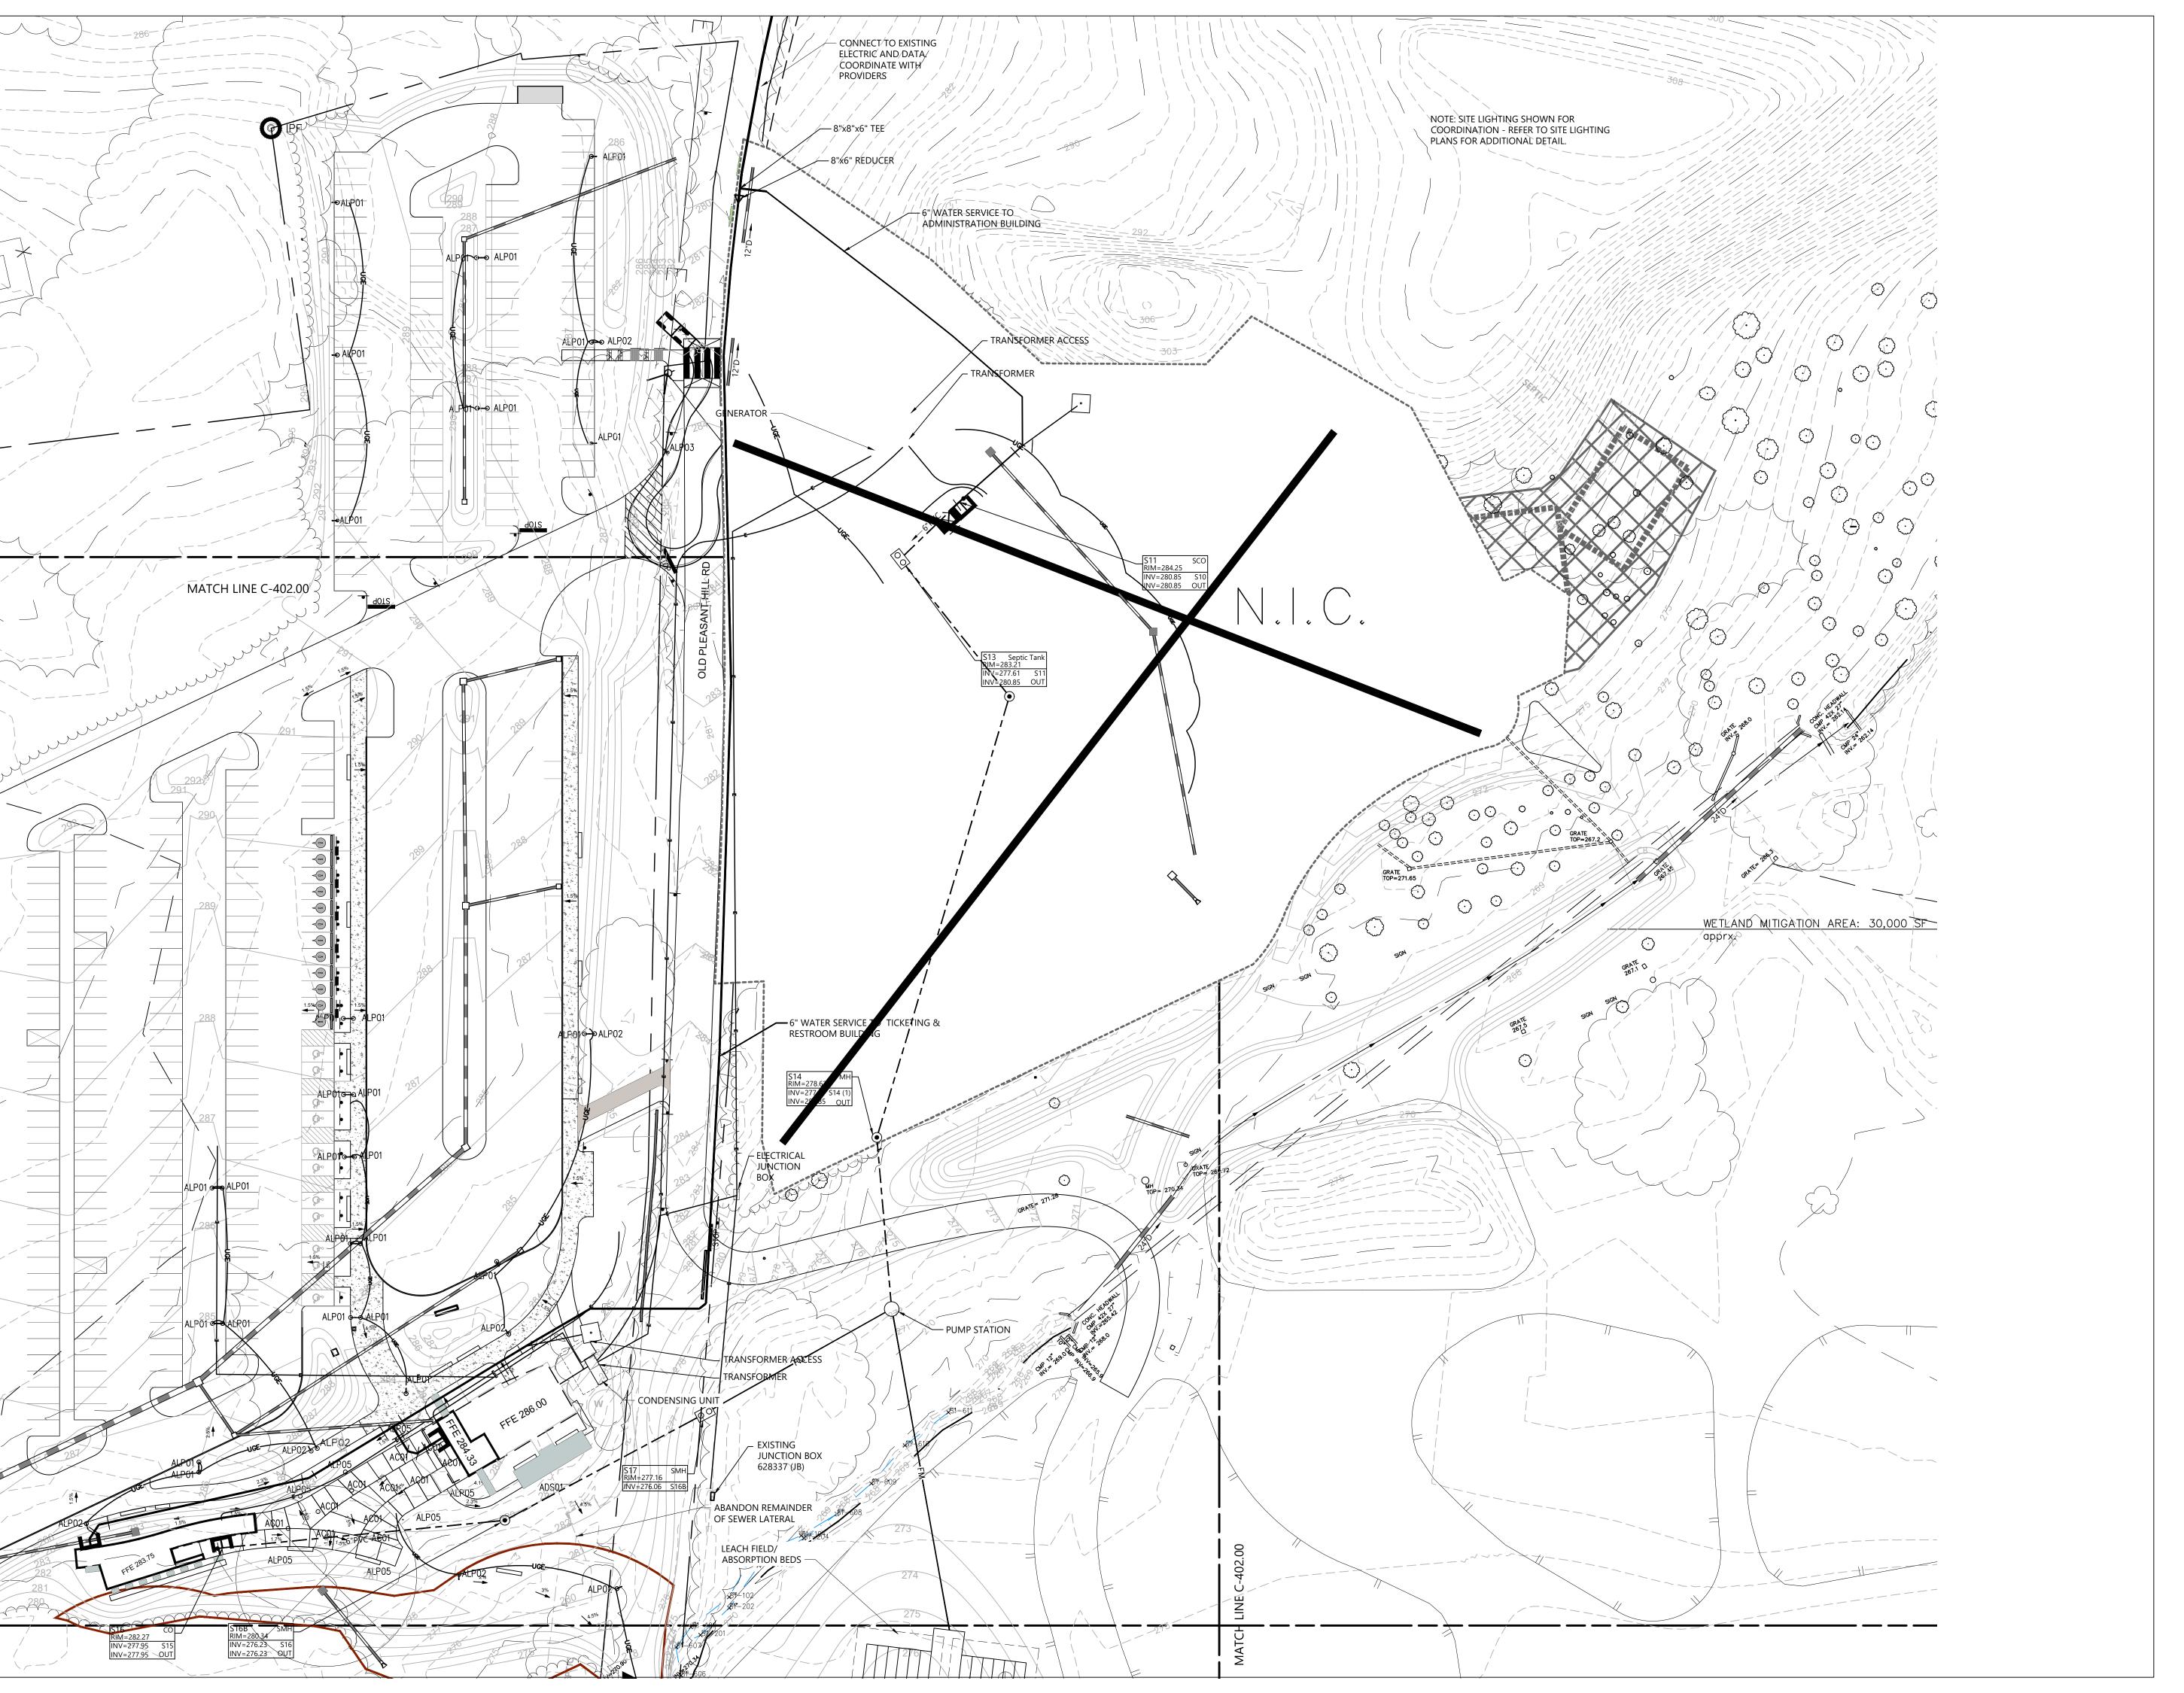

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MEPF & IT BuroHappold 100 Broadway #23 New York, NY 10005

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VHB 100 Great Oaks Blvd., Suite 118 Albany, NY 12203


+1 (518) 389-3606 **AV & Acoustics** LSTN Consultants

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Facade Front Inc.

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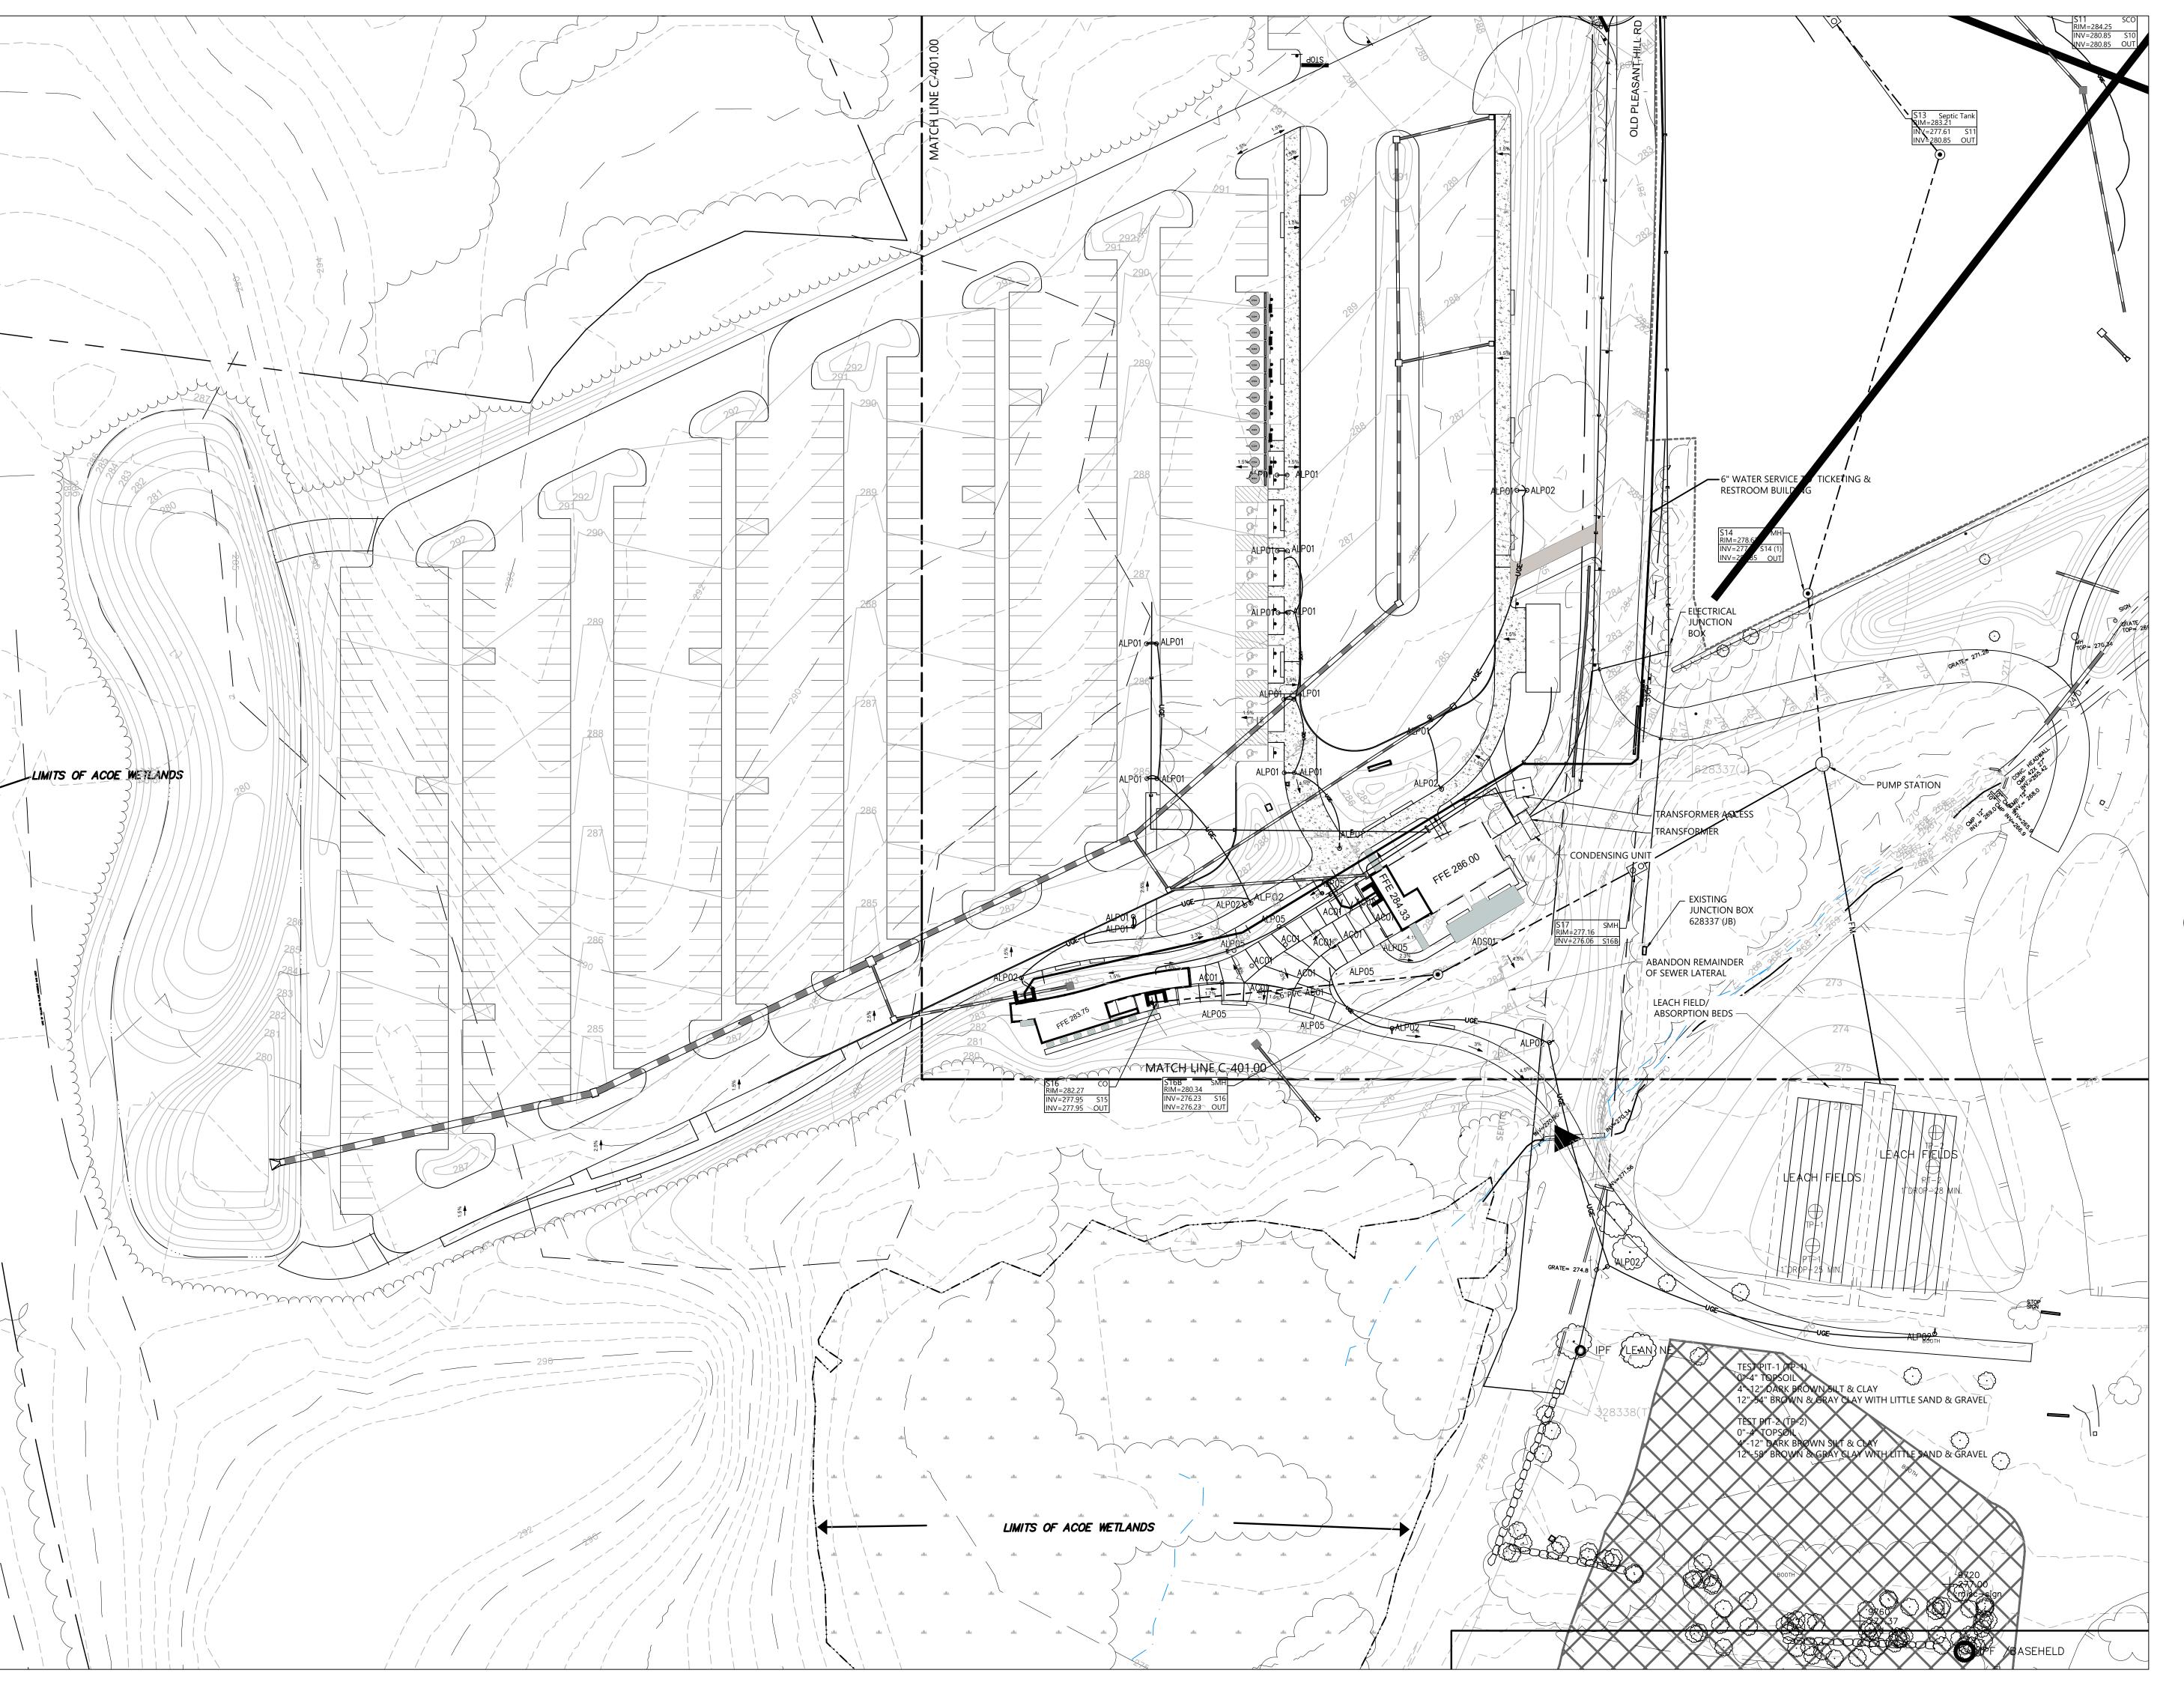
**Key Plan** 



# Storm King Art Center Site Development

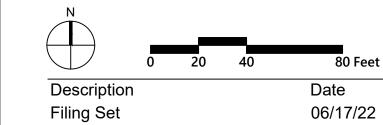NOT FOR CONSTRUCTION **Drawing Title** Utility Plan -Administration Building

Date	06/17/22	
Scale	1" = 40'	
Drawing Number	C-401	
Sheet Size	ARCH D	



1 Museum Road New Windsor, NY 12553 +1 (845) 534-3115

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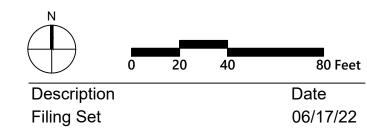
**AV & Acoustics** LSTN Consultants 76 Beaver Street, 2nd Floor

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Facade Front Inc. 100 E. Broadway Street, #501

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Key Plan



Storm King **Art Center** Site Development

NOT FOR CONSTRUCTION

Utility Plan - North Parking and Welcome **Pavilions** 

Date	06/17/22
Scale	1" = 40'
Drawing Number	C-402
Sheet Size	ARCH D



**Design Architect** 

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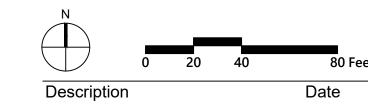
**AV & Acoustics** LSTN Consultants

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Facade Front Inc.

100 E. Broadway Street, #501 New York, NY 10002 +1 (212) 242-2220

**Key Plan** 



06/17/22

Filing Set

# Storm King Art Center Site Development

NOT FOR CONSTRUCTION **Drawing Title** Utility Plan -Pond Pavilion

Date	06/17/22	
Scale	1" = 40'	
Drawing Number	C-403	
Sheet Size	ARCH D	



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Structural & Lighting ARUP

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MEPF & IT BuroHappold 100 Broadway #23

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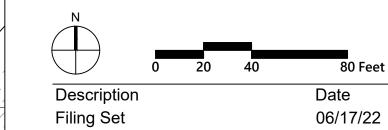
**AV & Acoustics** LSTN Consultants 76 Beaver Street, 2nd Floor New York, NY 10005

+1 (347) 788-0810 Facade

Front Inc. 100 E. Broadway Street, #501

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Key Plan





Storm King

Art Center Site Development

NOT FOR CONSTRUCTION **Drawing Title** Utility Plan -C.F.M. Building

Date	06/17/22
Scale	1" = 40'
Drawing Number	C-404
Sheet Size	ARCH D

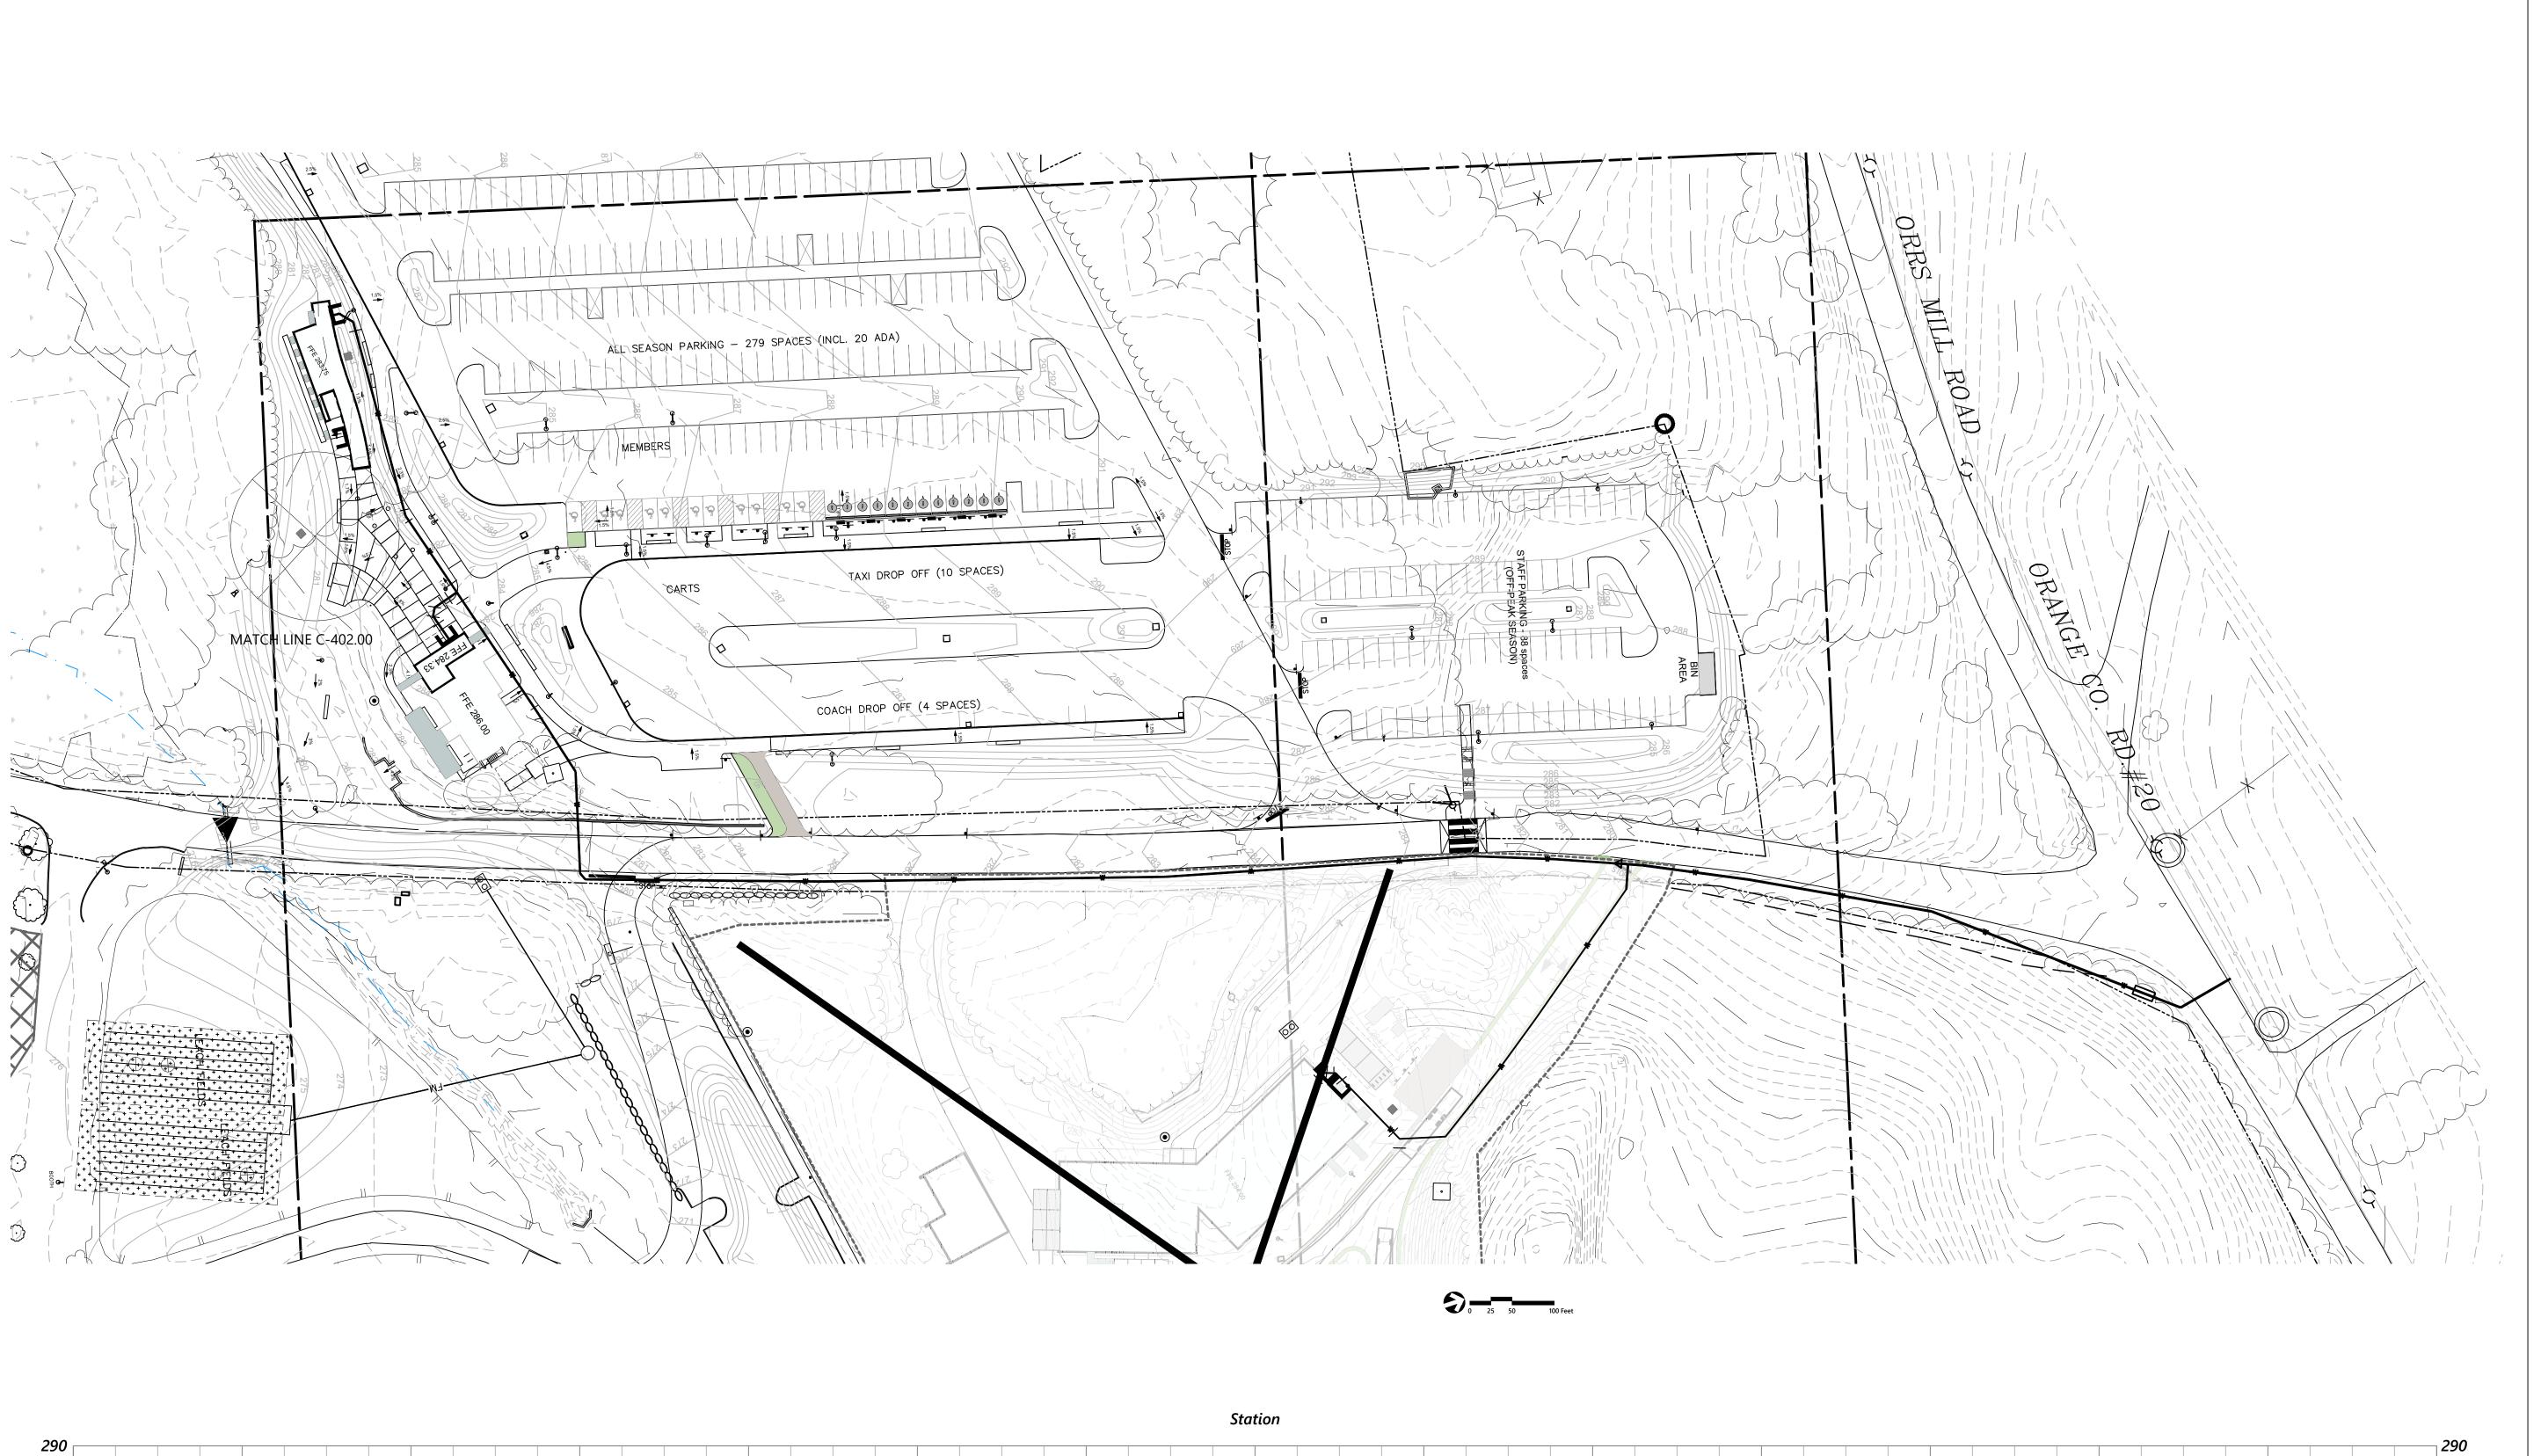

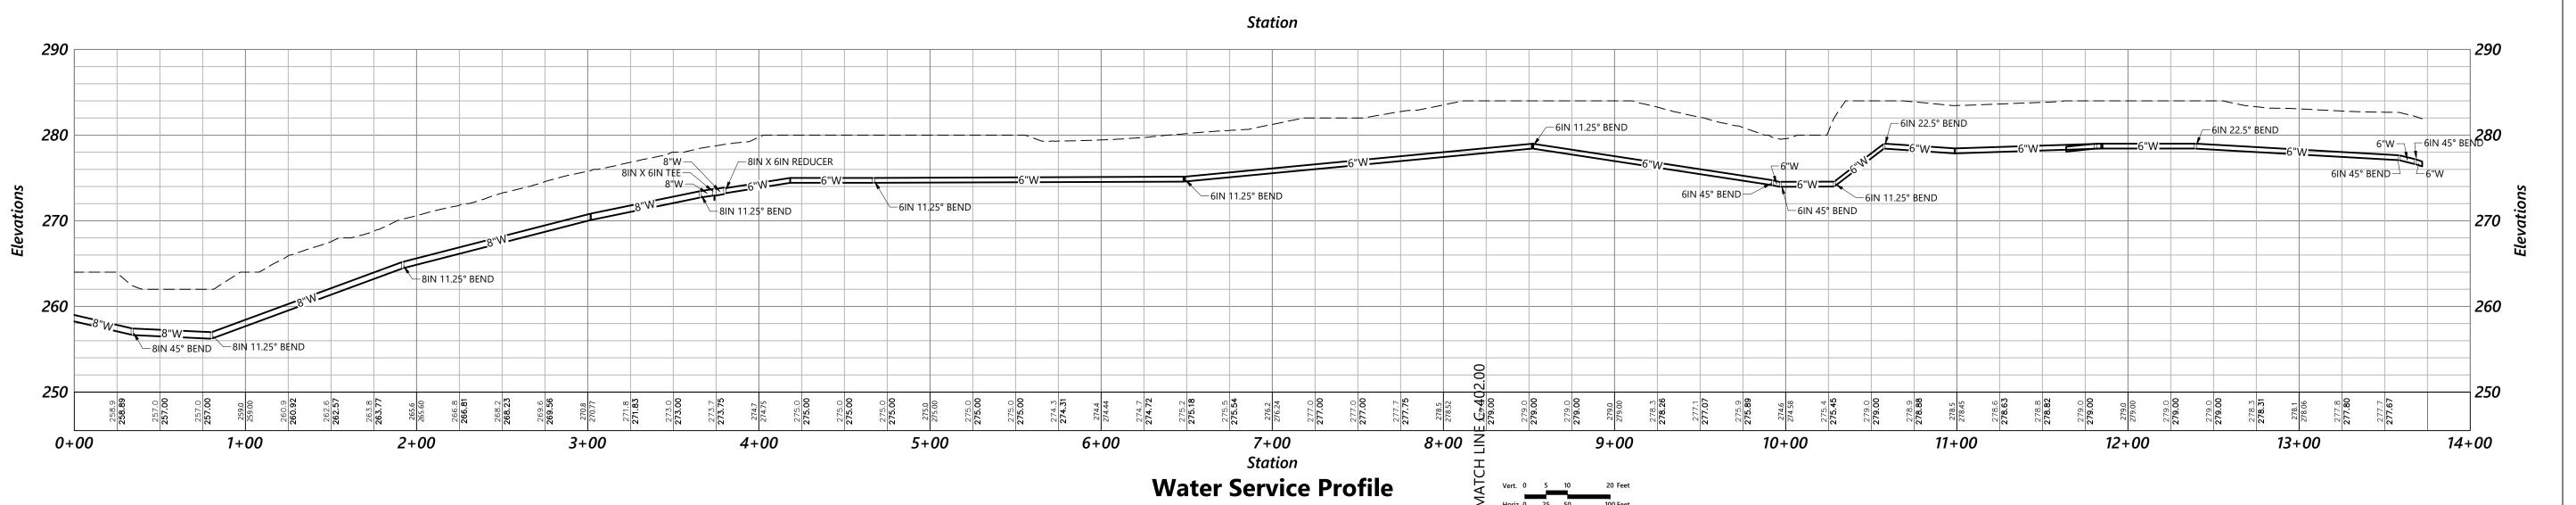

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Key Plan



Description
Filing Set

n Date 06/17/22

Project

# Storm King Art Center Site Development

Seal


NOT FOR CONSTRUCTION

Drawing Title

Utility Plan 
Water Main- Plan &

Profile

 Date	06/17/22
Scale	1" = 40'
Drawing Number	C-405
Sheet Size	ARCH D

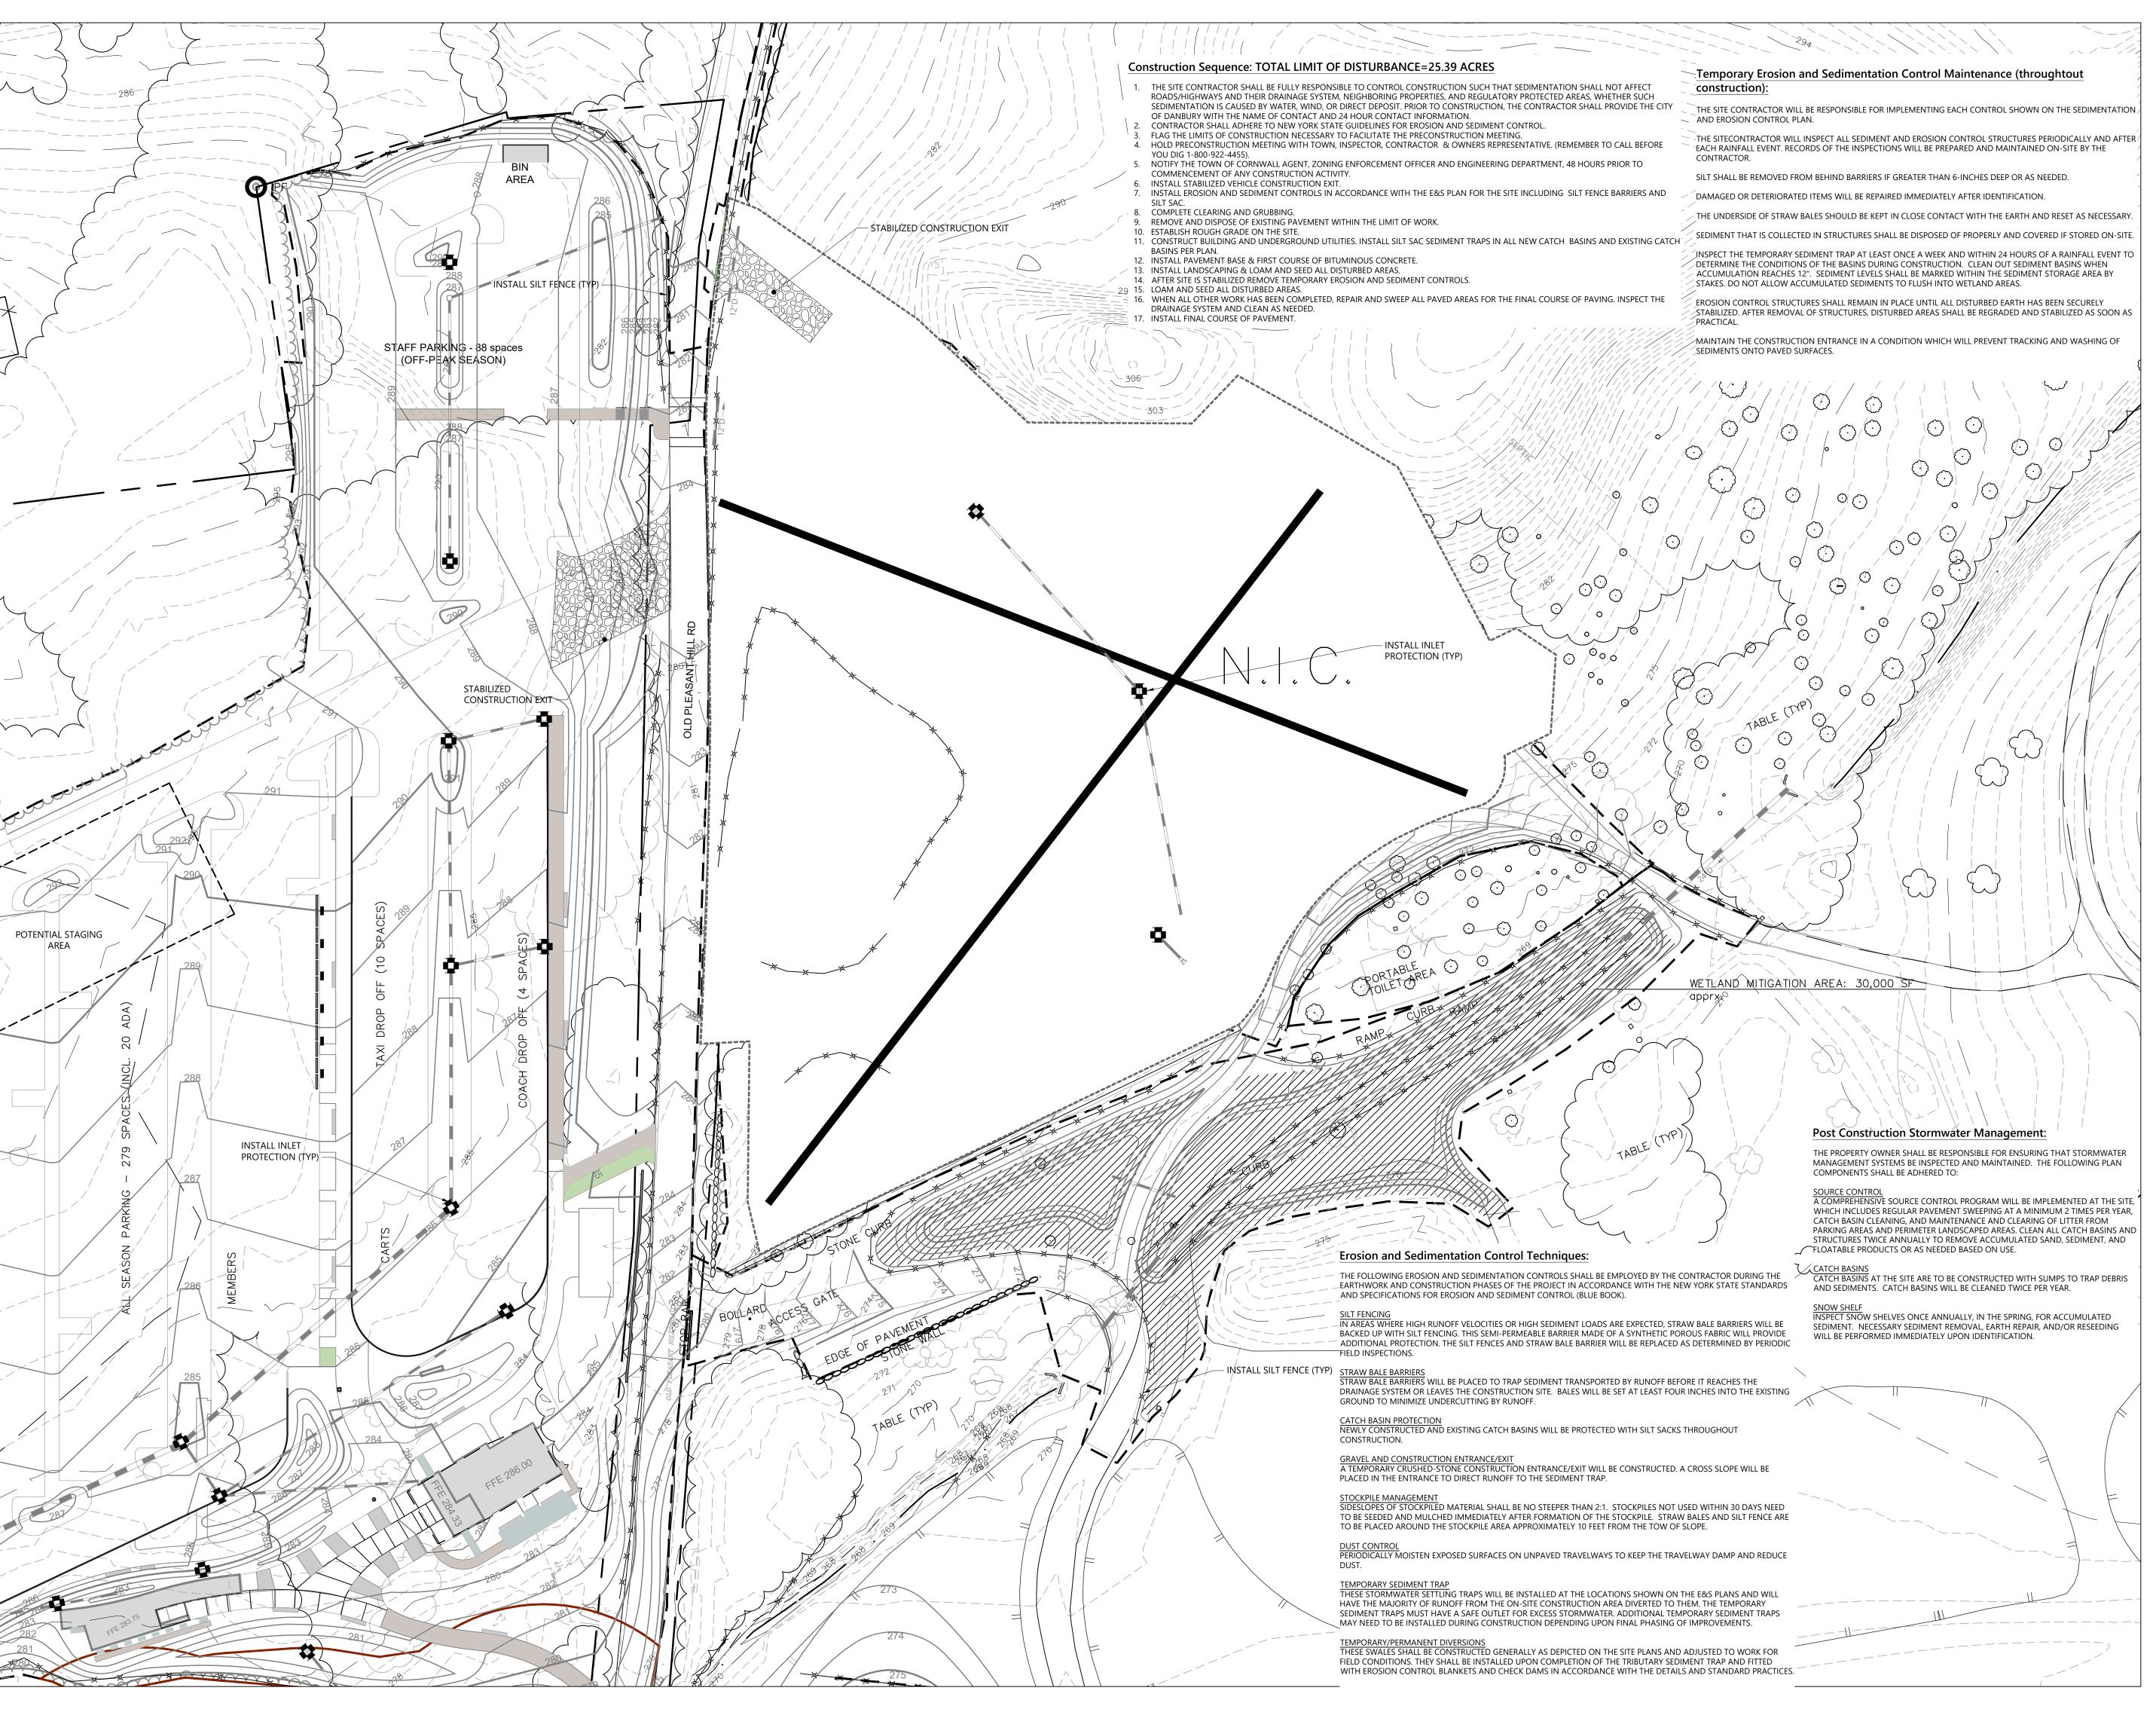

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Key Plan





 $\bigcap^{\mathsf{N}}$ 

Description

Description Filing Set

06/17/22

Project


# Storm King Art Center Site Development

Seal

## NOT FOR CONSTRUCTION Drawing Title

Erosion and Sediment Control Plan -Administration Building

Date	06/17/22	
Scale	1" = 40'	
Drawing Number	C-501	
Sheet Size	ARCH D	

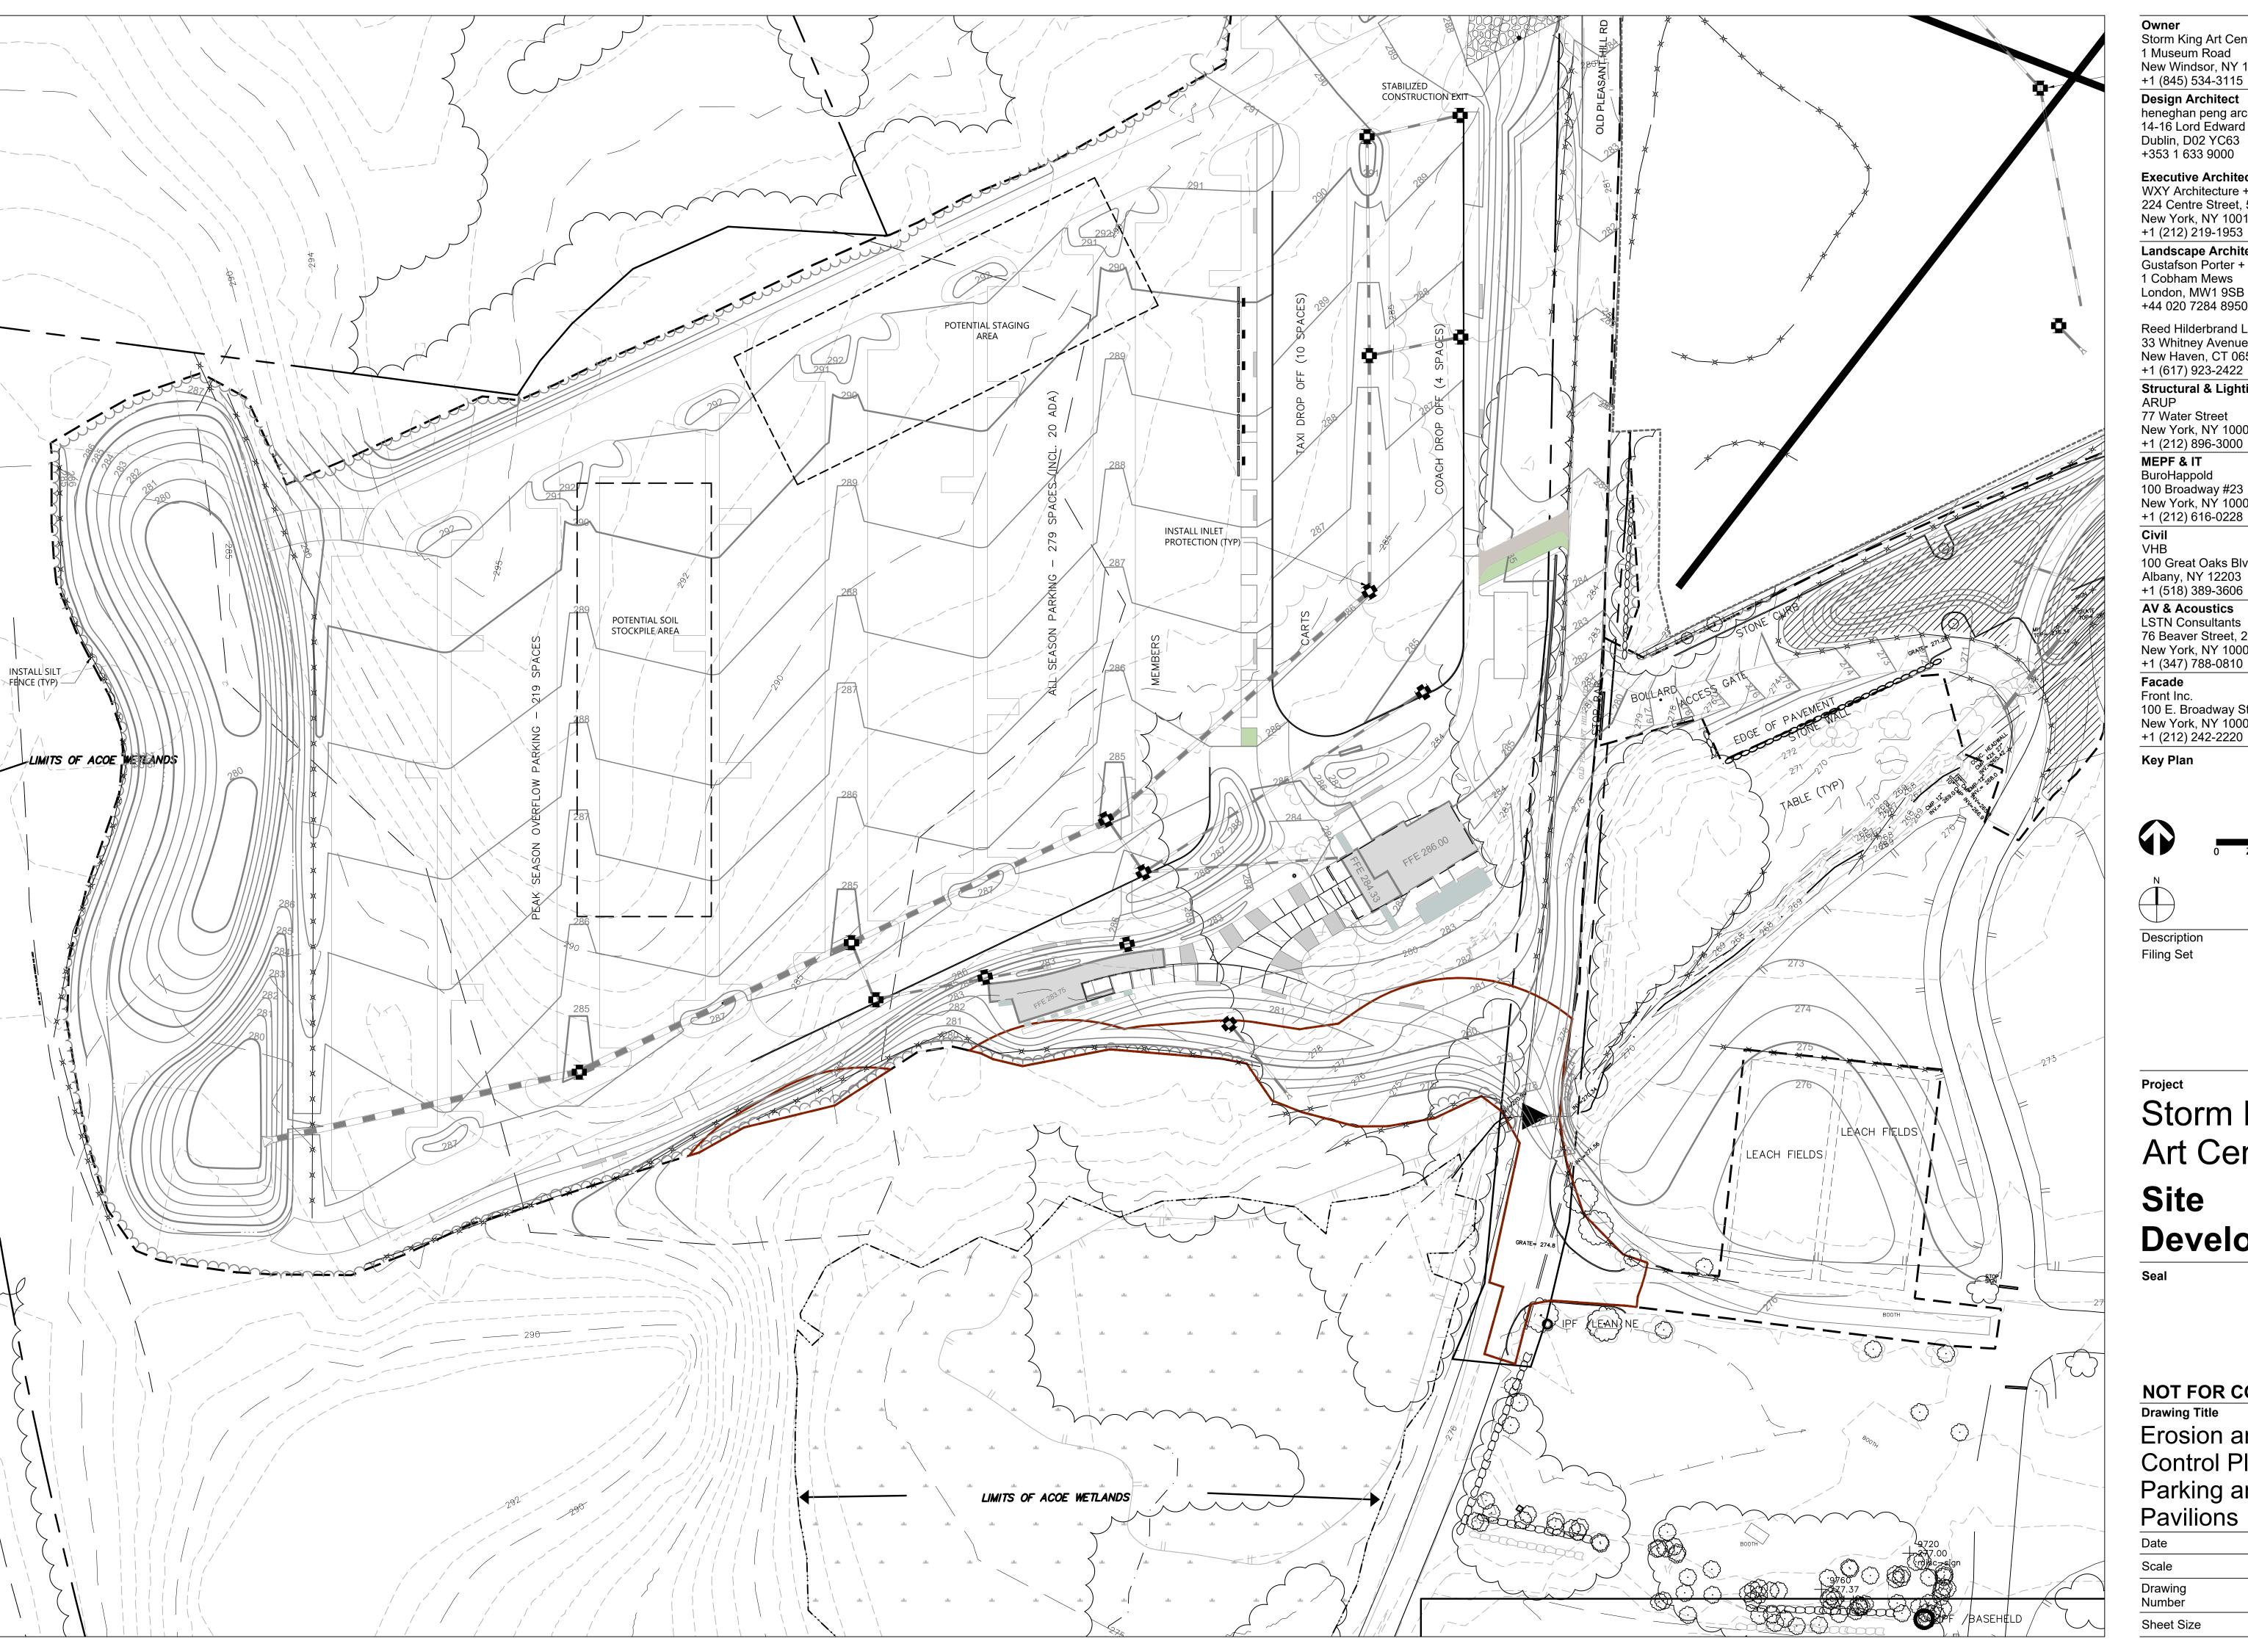

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Description Filing Set

06/17/22

# Storm King Art Center Site Development

NOT FOR CONSTRUCTION

**Erosion and Sediment** Control Plan - North Parking and Welcome Pavilions

Date	06/17/22
Scale	1" = 40'
Drawing Number	C-502
Sheet Size	ARCH D



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**Key Plan** 







Description Filing Set

Date 06/17/22

Project

# Storm King Art Center Site Development

Seal

NOT FOR CONSTRUCTION

Erosion and Sediment Control Plan - Pond Pavilion

Date	06/17/22	
Scale	1" = 40'	
Drawing Number	C-503	
Sheet Size	ARCH D	



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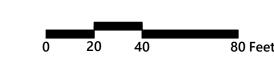
76 Beaver Street, 2nd Floor New York, NY 10005 +1 (347) 788-0810

Facade Front Inc.

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Key Plan





06/17/22




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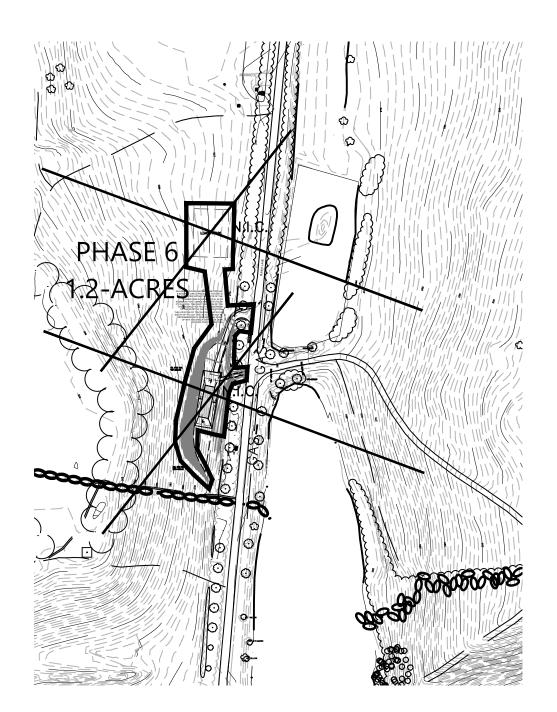
# Storm King Art Center Site Development


NOT FOR CONSTRUCTION **Drawing Title** 

**Erosion and Sediment** Control Plan - C.F.M. Building

Date	06/17/22	
Scale	1" = 40'	
Drawing Number	C-504	
Sheet Size	ARCH D	



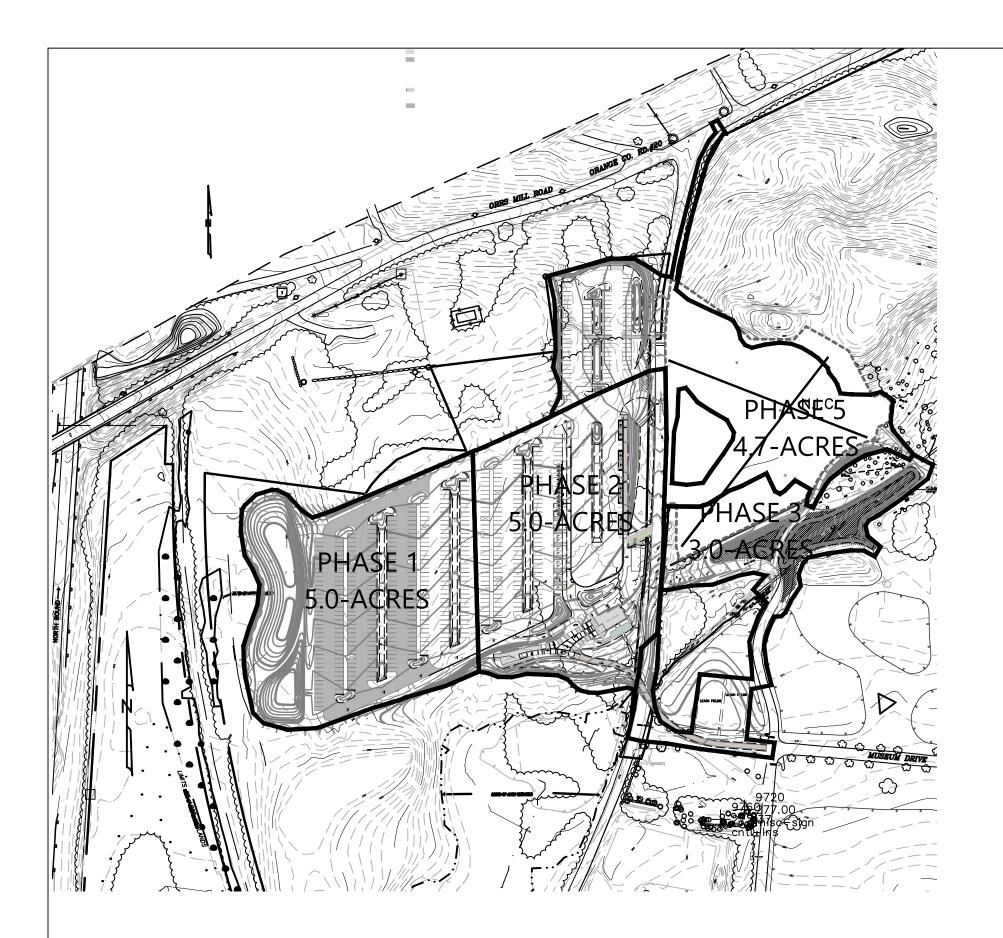

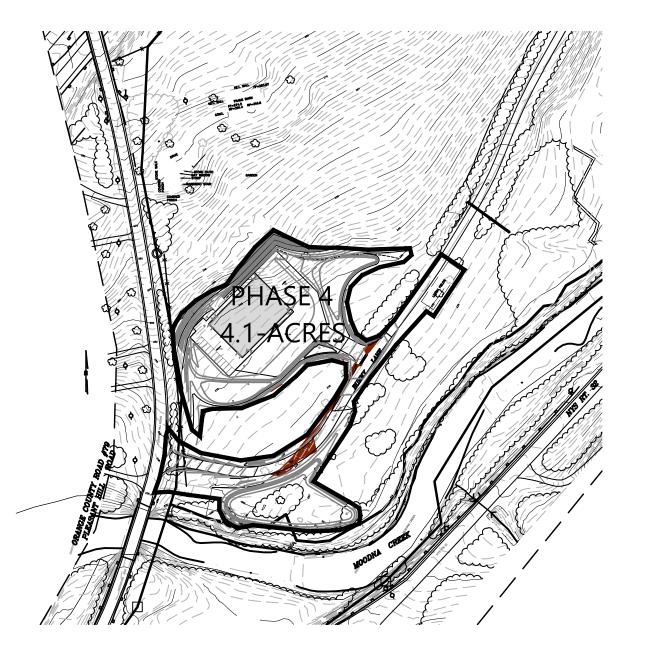

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Key Plan







Description Filing Set

Date 06/17/22


Storm King Art Center

Site

Development

NOT FOR CONSTRUCTION **Drawing Title Erosion and Sediment** Control Phasing Plan

06/17/22 1" = 200' Drawing Number C-505 ARCH D Sheet Size

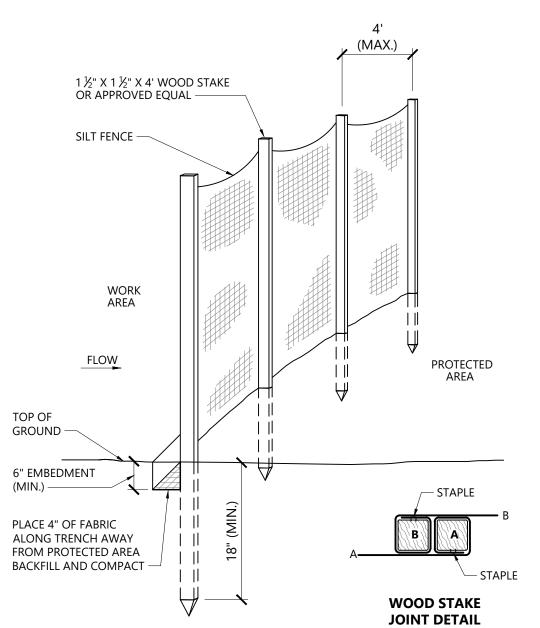

1. WOVEN WIRE FENCE TO BE FASTENED SECURELY TO FENCE POSTS WITH WIRE TIES OR STAPLES. POSTS SHALL BE STEEL EITHER "T" OR "U" TYPE OR HARDWOOD.


2. FILTER CLOTH TO BE TO BE FASTENED SECURELY TO WOVEN WIRE FENCE WITH TIES SPACED EVERY 24" AT TOP AND MID SECTION. FENCE SHALL BE WOVEN WIRE, 6" MAXIMUM MESH OPENING.


3. WHEN TWO SECTIONS OF FILTER CLOTH ADJOIN EACH OTHER THEY SHALL BE OVER- LAPPED BY SIX INCHES AND FOLDED. FILTER CLOTH SHALL BE EITHER FILTER X, MIRAFI 100X, STABILINKA T140N, OR APPROVED EQUIVALENT.

4. PREFABRICATED UNITS SHALL BE GEOFAB, ENVIROFENCE, OR APPROVED EQUIVALENT.

5. MAINTENANCE SHALL BE PERFORMED AS NEEDED AND MATERIAL REMOVED WHEN "BULGES" DEVELOP IN THE SILT FENCE.

<b>Silt Fence Barrier</b>			1/16
N.T.S.	Source: VHB	REV	LD_650

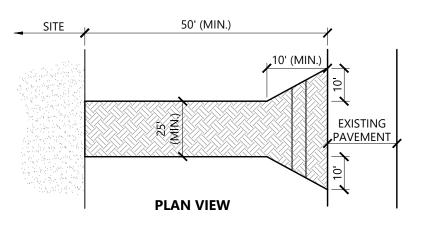


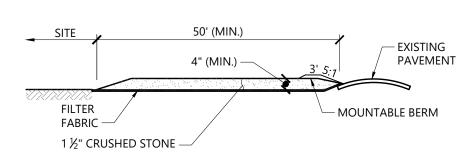


## **CROSS-SECTION**

- 1. EXIT WIDTH SHALL BE A TWENTY-FIVE (25) FOOT MINIMUM, BUT NOT LESS THAN THE FULL WIDTH AT POINTS WHERE INGRESS OR EGRESS
- 2. THE EXIT SHALL BE MAINTAINED IN A CONDITION WHICH SHALL PREVENT TRACKING OR FLOWING OF SEDIMENT ONTO PUBLIC RIGHTS-OF-WAY. THIS MAY REQUIRE PERIODIC TOP DRESSING WITH ADDITIONAL STONE AS CONDITIONS DEMAND AND REPAIR OR CLEANOUT OF ANY MEASURES USED TO TRAP SEDIMENT. ALL SEDIMENT SPILLED, DROPPED, WASHED OR TRACKED ONTO PUBLIC RIGHTS-OF-WAY MUST BE REMOVED IMMEDIATELY. BERM SHALL BE PERMITTED. PERIODIC INSPECTION AND MAINTENANCE SHALL BE PROVIDED AS NEEDED.
- 3. STABILIZED CONSTRUCTION EXIT SHALL BE REMOVED PRIOR TO FINAL FINISH MATERIALS BEING INSTALLED.

Stabilized Construction Exit		1/16
N.T.S.	Source: VHB	LD_682

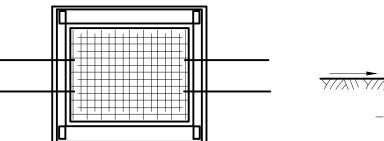

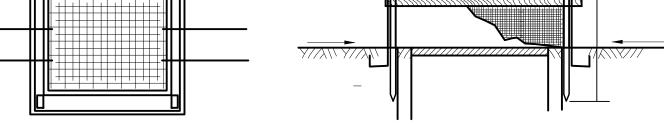

## <u>PLAN</u>

- 1. GEOTEXTILE SHALL BE CUT FROM A CONTINOUS ROLL TO ELIMINATE JOINTS. IF JOINTS ARE NECESSARY THEY WILL BE OVERLAPPED TO THE NEXT STAKE.
- 2. STAKE MATERIAL WILL BE STANDARD 2"x4" WOOD OR EQUIVALENT METAL WITH A MINIMUM LENGTH OF 3 FEET.


**ELEVATION** 

- 3. SPACE STAKES EVENLY AROUND INLET WITH A MAXIMUM SPACING OF 3 FEET DRIVE STAKES 18" MINIMUM INTO GROUND. WIRE MESH MAY BE REQUIRED
- 4. GEOTEXTILE SHALL BE EMBEDDED 12" BELOW GROUND AND BACKFILLED. IT SHALL BE SECURELY FASTENED TO STAKES AND FRAME.
- 5. GEOTEXTILE FABRIC SHALL HAVE EOS OF 40-85.

BEHIND GEOTEXTILE TO PROVIDE SUPPORT.

- 6. A 2"x 4" WOOD FRAME SHALL BE FORMED AROUND THE CREST OF FABRIC FOR OVERFLOW STABILITY.
- 7. INLET PROTECTION TO REMAIN IN PLACE UNTIL AREA IS STABILIZED.

<b>Drop Inlet Protection</b>		1/16
N.T.S.	Sorifive: VHB	LD_650

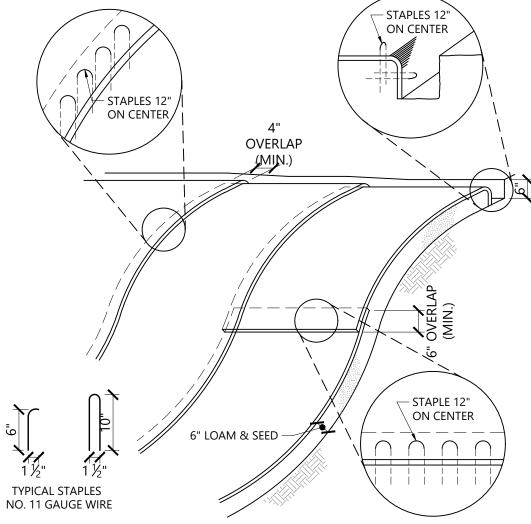


## NOTES

- 1. BEGIN AT THE TOP OF BLANKET INSTALLATION AREA BY ANCHORING BLANKET IN A 6" DEEP TRENCH BACKFILL AND COMPACT TRENCH AFTER STAPLING.
- 2. ROLL THE BLANKET DOWN THE SWALE IN THE DIRECTION OF THE WATER FLOW.
- 3. THE EDGES OF BLANKETS MUST BE STAPLED WITH APPROX. 4 INCH OVERLAP WHERE 2 OR MORE STRIP WIDTHS ARE REQUIRED.
- 4. WHEN BLANKETS MUST BE SPLICED DOWN THE SWALE, PLACE UPPER BLANKET END OVER LOWER END WITH 6 INCH (MIN.) OVERLAP AND STAPLE BOTH TOGETHER.
- 5. METHOD OF INSTALLATION SHALL BE AS PER MANUFACTURER'S RECOMMENDATIONS.
- 6. EROSION CONTROL BLANKETS SHALL BE USED IN ALL AREAS WHERE SLOPES EXCEED 3:1.

<b>Erosion Cor</b>	ntrol Blanket Slope Installation	1/16
NTS	Sorifye: VHB	LD 680




## 24" SQUARE 8" MIN. DIAMETER **ALTERNATIVE ECCENTRIC CONE SECTION ALTERNATIVE TOP SLAB** FINISH GRADE -

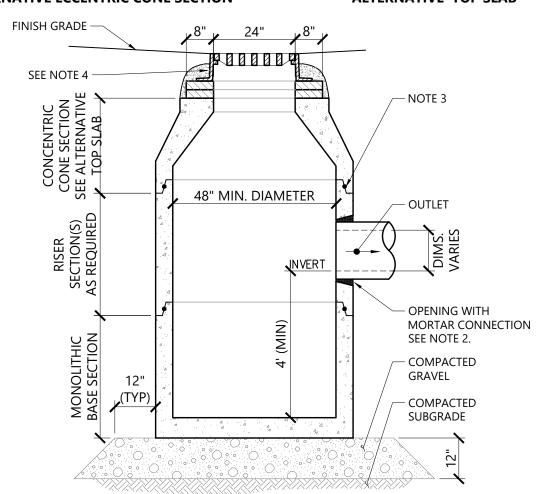

## **NOTES**

- 1. ALL SECTIONS SHALL BE DESIGNED FOR HS-20 LOADING.
- PROVIDE OPENINGS FOR PIPES WITH 2" MAX. CLEARANCE TO OUTSIDE OF PIPE. MORTAR ALL
- 3. JOINT SEALANT BETWEEN PRECAST SECTIONS SHALL BE PREFORMED BUTYL RUBBER.
- 4. CATCH BASIN FRAME AND GRATE SHALL BE SET IN FULL MORTAR BED. ADJUST TO GRADE WITH CLAY BRICK AND MORTAR (2 BRICK COURSES TYPICALLY, 5 BRICK COURSES MAXIMUM).


Catch Basin (CB)			1/16
N.T.S.	Source: VHB	REV	LD_100

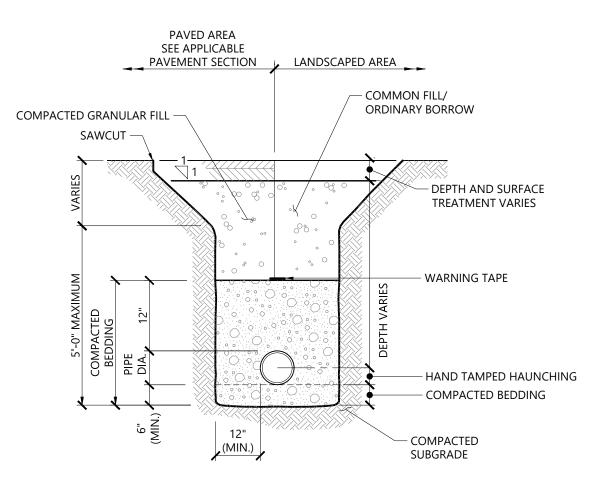

## **NOTES**


- 1. WHERE UTILITY TRENCHES ARE CONSTRUCTED THROUGH DETENTION BASIN BERMS OR OTHER SUCH SPECIAL SECTIONS, PLACE TRENCH BACKFILL WITH MATERIALS SIMILAR TO THE SPECIAL SECTION REQUIREMENTS.
- 2. USE METALLIC TRACING/WARNING TAPE OVER ALL PIPES.

Utility Trench		1/16
N.T.S.	Source: VHB	LD 300

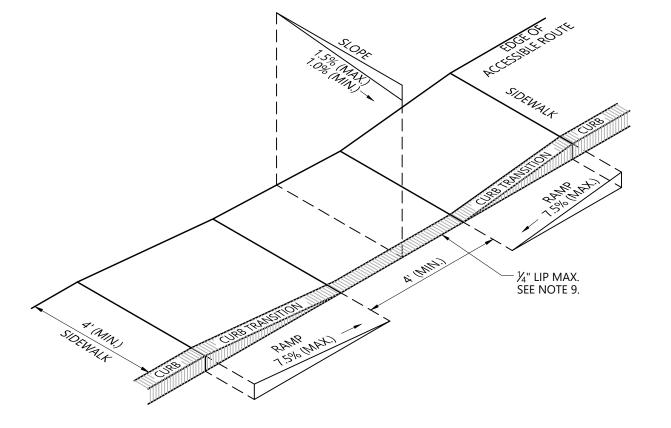

- 1. THE MAXIMUM ALLOWABLE SIDEWALK AND CURB RAMP CROSS SLOPES SHALL BE 1.5 (1% MIN.).
- 2. THE MAXIMUM ALLOWABLE SLOPE OF ACCESSIBLE ROUTE EXCLUDING CURB RAMPS SHALL BE 5% 3. THE MAXIMUM ALLOWABLE SLOPE OF ACCESSIBLE ROUTE AT CURB RAMPS SHALL BE 7.5%%%.
- A MINIMUM OF 3 FEET CLEAR SHALL BE MAINTAINED AT ANY PERMANENT OBSTACLE IN ACCESSIBLE ROUTE (I.E., HYDRANTS, UTILITY POLES, TREE WELLS, SIGNS, ETC.).
- 5. CURB TREATMENT VARIES, SEE PLANS FOR CURB TYPE.
- 6. RAMP, CURB, AND ADJACENT PAVEMENTS SHALL BE GRADED TO PREVENT PONDING.
- 7. SEE TYPICAL SIDEWALK SECTION FOR RAMP CONSTRUCTION.
- 8. WHERE ACCESSIBLE ROUTES ARE LESS THAN 5' IN WIDTH (EXCLUDING CURBING) A 5' x 5' PASSING AREA SHALL BE PROVIDED AT INTERVALS NOT TO EXCEED 200 FEET.
- 9. ELIMINATE CURBING AT RAMP (OTHER THAN VERTICAL CURBING, WHICH SHALL BE SET FLUSH) WHERE IT ABUTS ROADWAY.

Accessible Curb Ramp (ACR) Type 'A' 1/16 LD\_500 Source: VHB

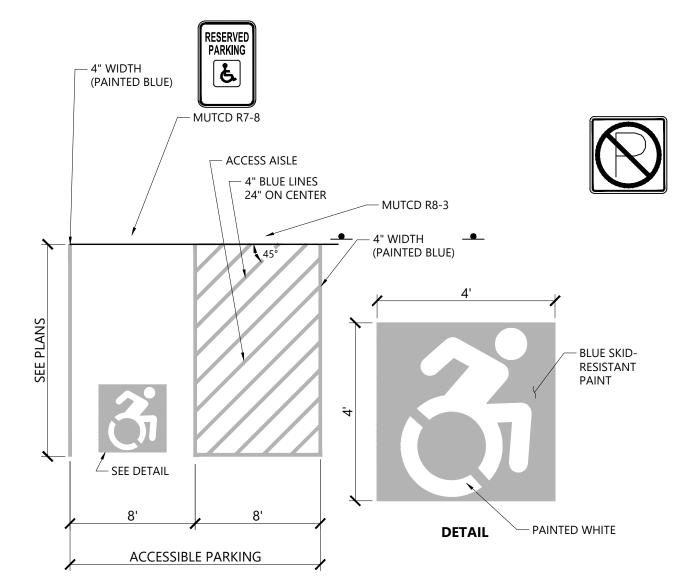

- 1. ALL DIMENSIONS TO CENTER OF PAVEMENT STRIPING.
- 2. ALL SLOPES THROUGHOUT THE ACCESSIBLE PARKING AND AISLE AREAS SHALL NOT EXCEED 1.5%.
- 3. THE ACCESSIBLE SYMBOL DEPICTED ABOVE DOES NOT COMPLY WITH THE AMERICANS WITH DISABILITIES ACT (ADA) AND IS SHOWN FOR COMPLIANCE WITH STATE AND LOCAL REGULATIONS ONLY.

**Accessible Parking Space** 1/16 LD\_552c Sorueve: VHB

NOT FOR CONSTRUCTION	N
Drawing Title	
Site Details	

Development

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VHB

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**Key Plan** 

Description

Site

Filing Set


BuroHappold

ARUP


+1 (212) 219-1953

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Date	06/17/22
Scale	N/A
Drawing Number	C-601
Sheet Size	ARCH D



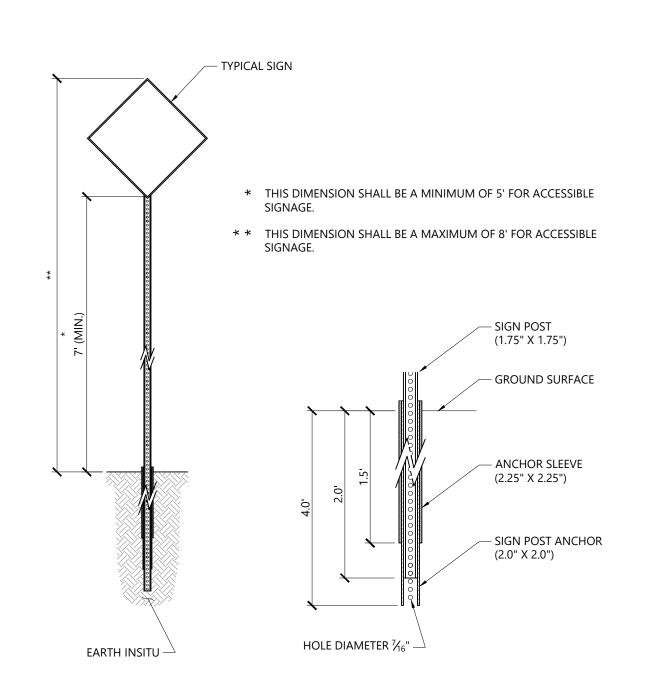

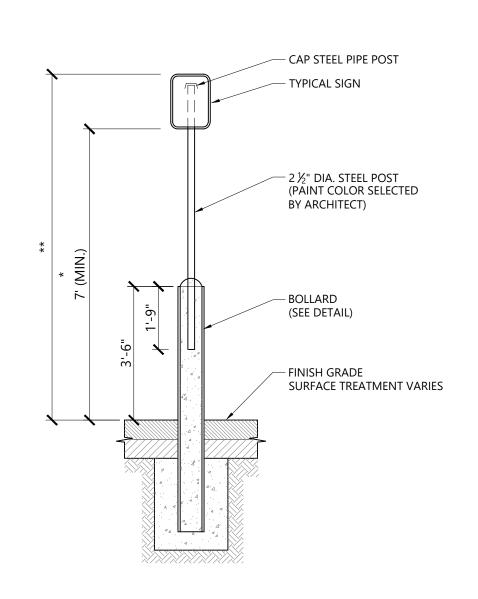


\* THIS DIMENSION SHALL BE A MINIMUM OF 5' FOR ACCESSIBLE SIGNAGE.
 \* \* THIS DIMENSION SHALL BE A MAXIMUM OF 8' FOR ACCESSIBLE


SIGNAGE.


Bollard Mounted Sign 1/16

RE**Source: VHB** 


LD\_703

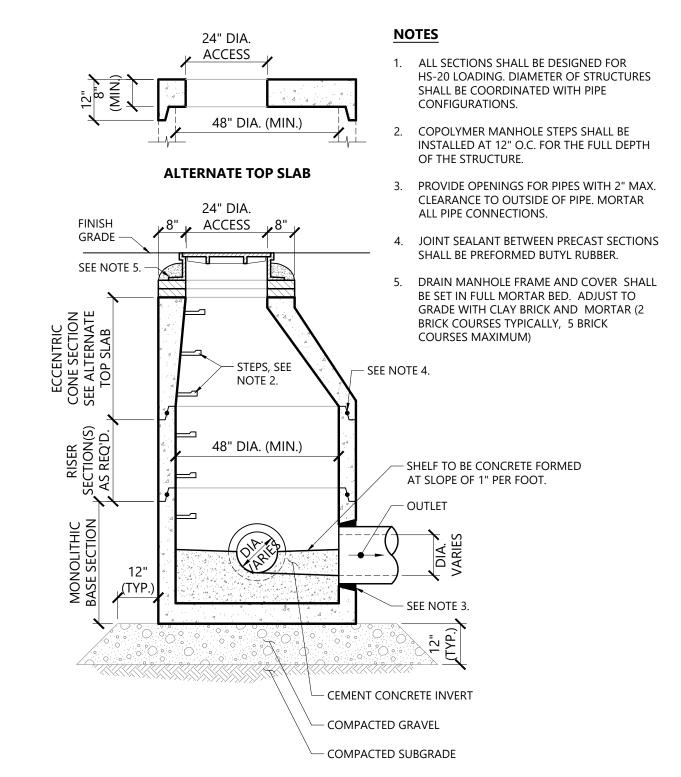


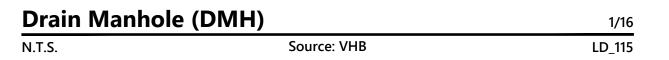

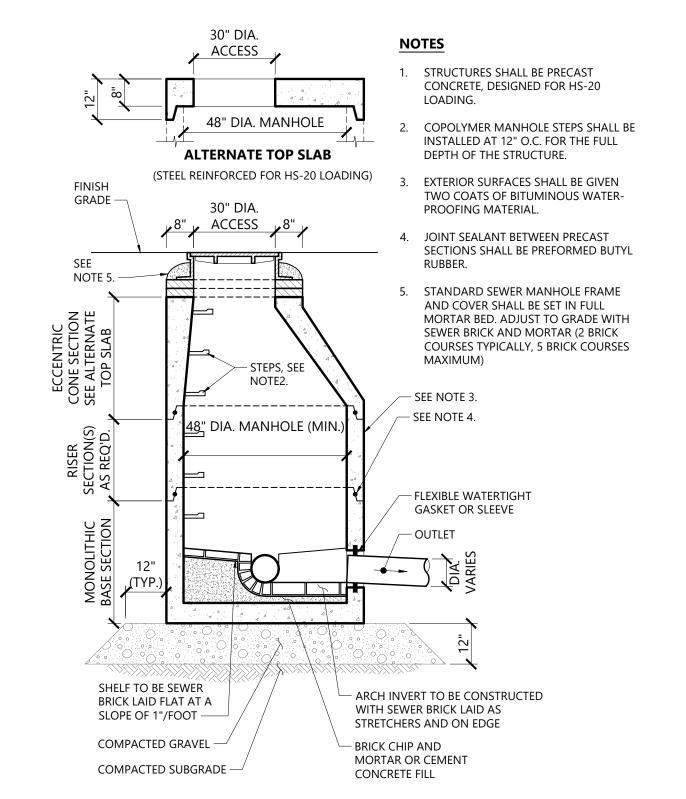


Sanitary Sewer Manhole (SMH)1/16N.T.S.RE\Source: VHBLD\_200

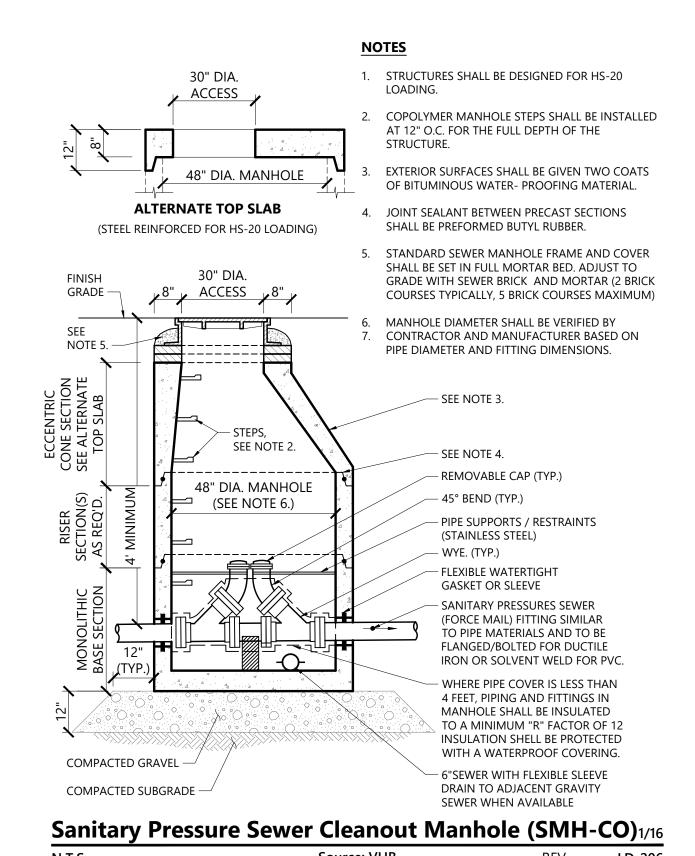

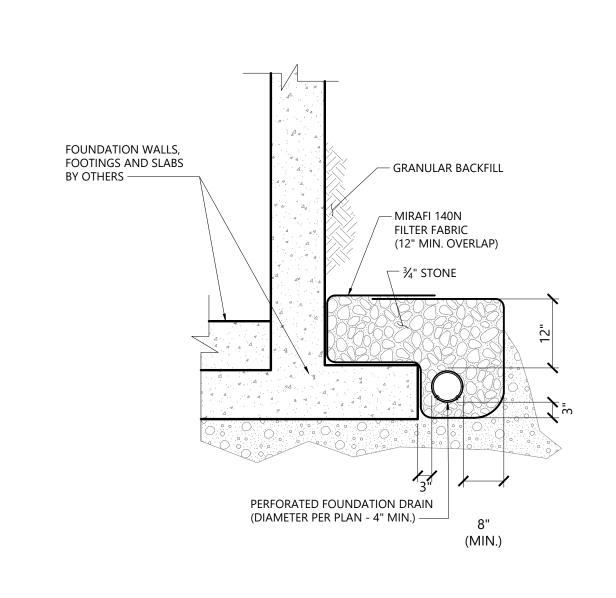




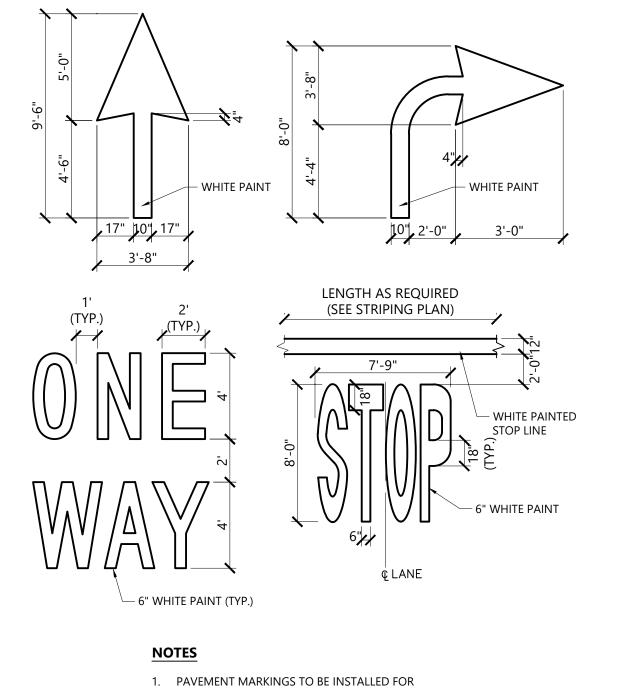

Painted Pavement Markings - Highway1/16N.T.S.Source: VHBREVLD\_555

ON SITE WORK IN LOCATIONS SHOWN.

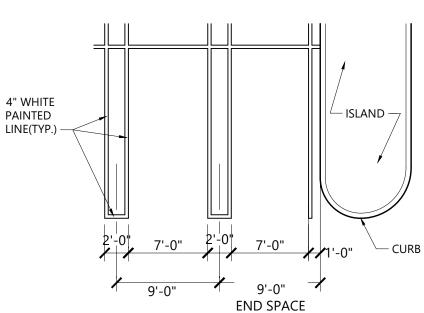

## NOTES

- 1. ALL PAINT SHALL BE FAST DRYING TRAFFIC PAINT, MEETING THE REQUIREMENTS OF AASHTO M248 TYPE F. PAINT SHALL BE APPLIED AS SPECIFIED BY THE MANUFACTURER.
- 2. SYMBOLS & PARKING STALLS SHALL CONFORM TO THE REQUIREMENTS OF THE AMERICANS WITH DISABLITIES ACT.
- ALL SLOPES THROUGHOUT THE ACCESSIBLE PARKING AND AISLE AREAS SHALL NOT EXCEED 1.5%.

Davoment Markings Stall Lavout

Pavement Markings - Stall Layout1/16N.T.S.Source: VHB REVLD\_551S

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**Key Plan** 



Description Date
Filing Set 06/17/22

Projec

Storm King
Art Center
Site
Development

Seal

NOT FOR CONSTRUCTION

Drawing Title

Site Details


Date 06/17/22

Scale N/A

Drawing C-602

Sheet Size ARCH D


## **SEPTIC TANK**

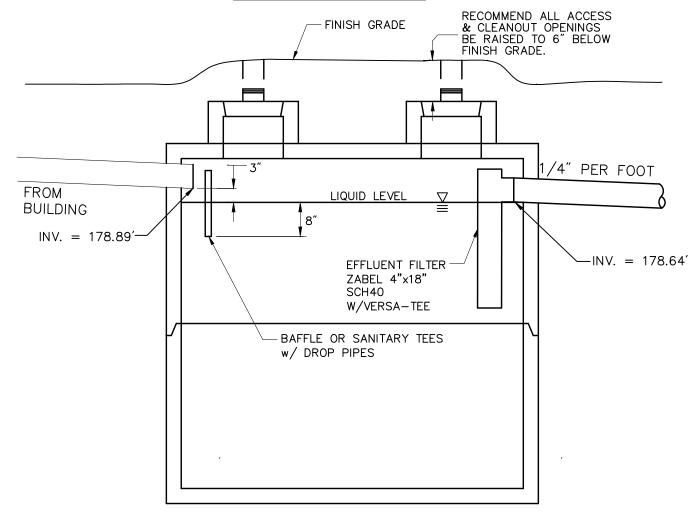


Septic Tank Notes:

- 1. UNIT SHALL BE PRECAST CONCRETE AS MANUFACTURED
- BY FORT MILLER OR EQUIVALENT.
- 2. STRUCTURE TO BE PLACED ON FIRM, COMPACT SAND OR GRAVEL FOUNDATION. WHEREVER EXISTING FOUNDATION CONDITIONS ARE UNSUITABLE, CRUSHED STONE SHALL BE PLACED AS NECESSARY TO ACHIEVE A STABLE FOUNDATION.
- 3. ANTI-BOUYANCY MEASURES SHALL BE INSTALLED ON SEPTIC TANK IF DETERMINED DURING CONSTRUCTION IF GROUNDWATER IS HIGH


Septic Tank		6/08
N.T.S.	Source: VHB	DEV ID

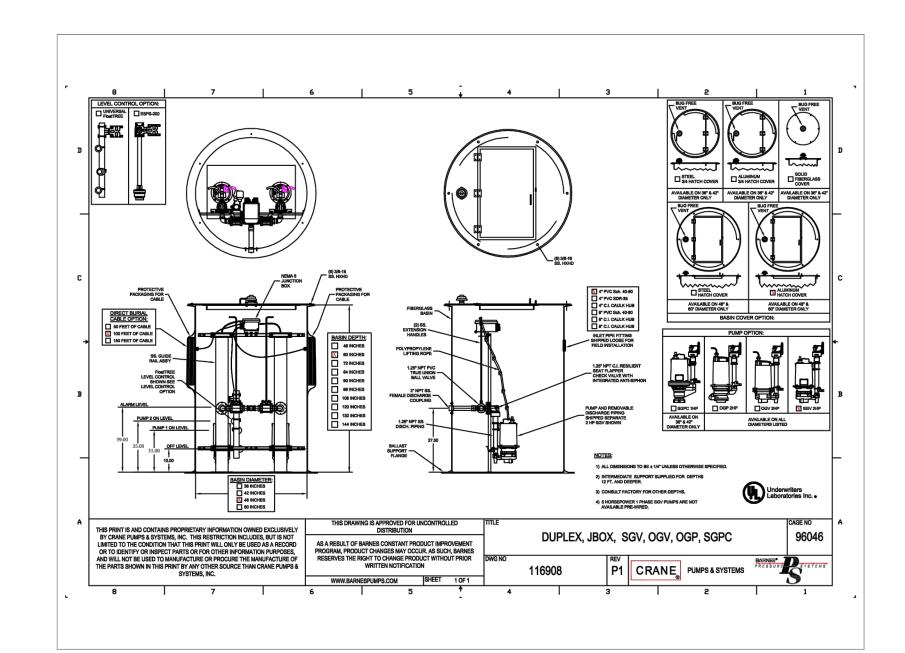

Fiberglass Pump Basin		6/08
N.T.S.	Source: VHB	LD

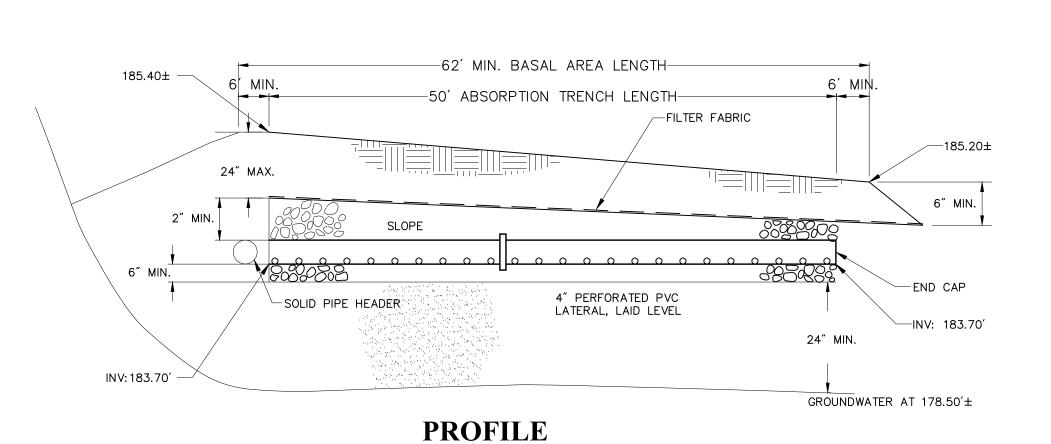


**NOTES:** END OF ALL DISTRIBUTOR PIPES MUST BE CAPPED.

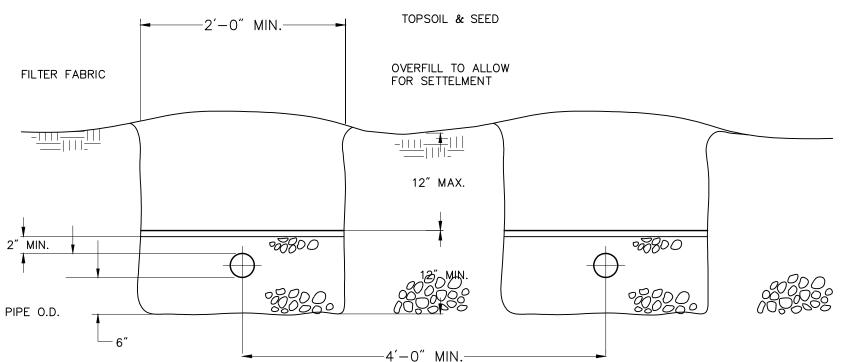

**SECTION** 

## Typical Septic Trench

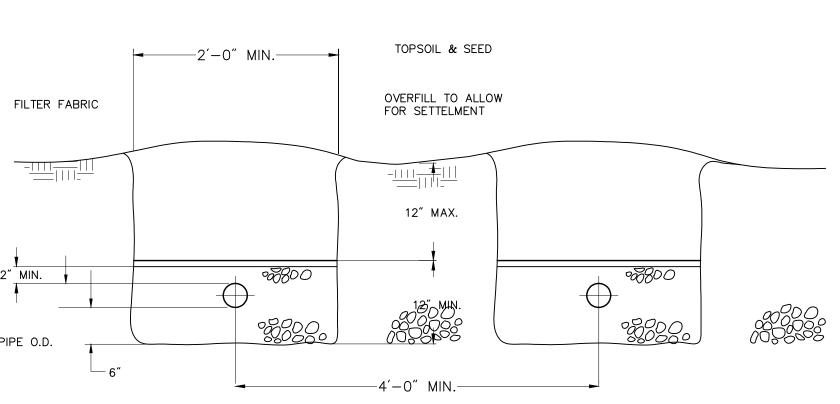

## - CONCRETE OR STONE MARKER ABOVE ALL BURIED COVERS IS RECOMMENDED FOR PERIODIC ACCESS SEE PLAN FOR INVERT ELEVATIONS PRECAST CONCRETE DISTRIBUTION BOX, FORT MILLER MODEL #1 OR EQUAL IN FROM PUMP STATION - ALL OUTLET INVERTS TO BE SET AT EXACTLY THE SAME ELEVATION. USE SPEED LEVELERS **Installation of Disposal Field Notes:**

1. CONSTRUCTION SHALL BE IN ACCORDANCE WITH N.Y.S. DEPARTMENT OF HEALTH INDIVIDUAL HOUSEHOLD SYSTEMS, AND ASTM F481-76 INSTALLATION OF THERMOPLASTIC PIPE AND CORRUGATED TUBING IN SEPTIC TANK LEACH FIELDS.

2. NO HEAVY EQUIPMENT SHALL BE ALLOWED WITHIN THE LIMITS OF THE DISPOSAL FIELDS AFTER PIPE INSTALLATION HAS BEGUN.

3. AFTER EXCAVATING 2' WIDE TRENCH TO THE DEPTHS REQUIRED, THE WALLS AND FLOOR OF EACH TRENCH SHOULD BE CLEANED AND RAKED TO ACHIEVE AN EVEN SURFACE AND TO LOOSEN SMEARED SECTIONS OF TRENCH.

4. PLACEMENT OF CRUSHED STONE, PERFORATED PIPE AND BUILDING PAPER OR FILTER FABRIC SHALL BE AS SHOWN, AND CARE SHALL BE EXERCISED TO AVOID INCLUSION OF FINE GRAINED SOILS AND OTHER WASTE MATERIAL IN THE STONE AND

5. THE PIPE SHOULD BE LAID AT THE GRADES AND TO THE RELATIONSHIPS SHOWN ON THIS DRAWING, MAINTAINING STRAIGHT CONTINUOUS GRADES WITHOUT SAGS, HUMPS, SEPARATED JOINTS OR OTHER UNSUITABLE CONDITIONS. THE PIPE SHALL BE LAID WITH THE HOLES DOWN IN ALL CASES.


6. DISPOSABLE FIELD SHALL BE GRADED TO SHED RAINFALL AND TO DIVERT SURFACE RUNOFF FROM ADJACENT AREAS AWAY FROM THE DISPOSAL FIELD.

7. FINISH GRADE TO BE TOPSOILED & SEEDED TO STABILIZE SIDE SLOPES AS SOON AS SYSTEM IS COMPLETED. USE EROSION CONTROL FABRIC AND/OR STRAW BALE DYKES TO MINIMIZE SOIL EROSION ALONG DRAINAGE SWALES.

8. PLACEMENT OF BORROW MATERIAL TO REQUIRED DEPTH AND CONFIGURATION SHALL BE AS SHOWN, AND CARE SHALL BE EXERCISED TO AVOID OVER-COMPACTION BY MOTORIZED EQUIPMENT. IN-SITU PERCOLATION RATE OF THE PLACED BORROW MATERIAL SHALL NOT EXCEED 30 MINUTES PER INCH DROP.

## **Distribution Box**

N.T.S.

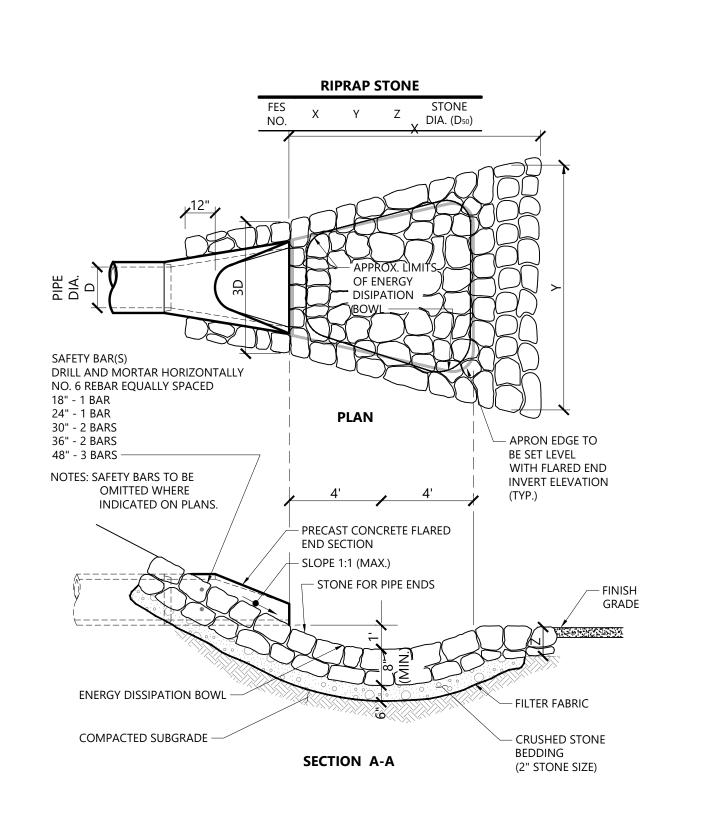

## Flared End Section (FES) with Stone Protection

## Storm King Art Center 1 Museum Road

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Key Plan




Description Date 06/17/22 Filing Set

**Project** 

# Storm King **Art Center** Site Development

NOT FOR CONSTRUCTION **Drawing Title** Site Details

Date	06/17/22	
Scale	N/A	
Drawing Number	C-603	
Sheet Size	ARCH D	

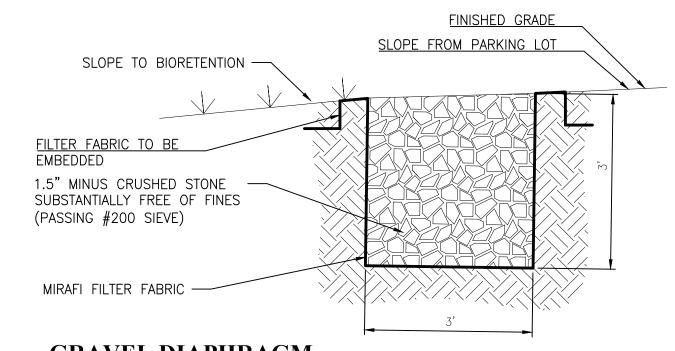


## GRAVEL DIAPHRAGM

12" HDPE (SEE PLAN) — FINISHED GRADE SLOPE FROM PARKING LOT SLOPE TO BIORETENTION -FILTER FABRIC TO BE 1.5" MINUS ROUND STONE SUBSTANTIALLY FREE OF FINES (PASSING #200 SIEVE) MIRAFI FILTER FABRIC -

## FRENCH DRAIN

N.T.S.

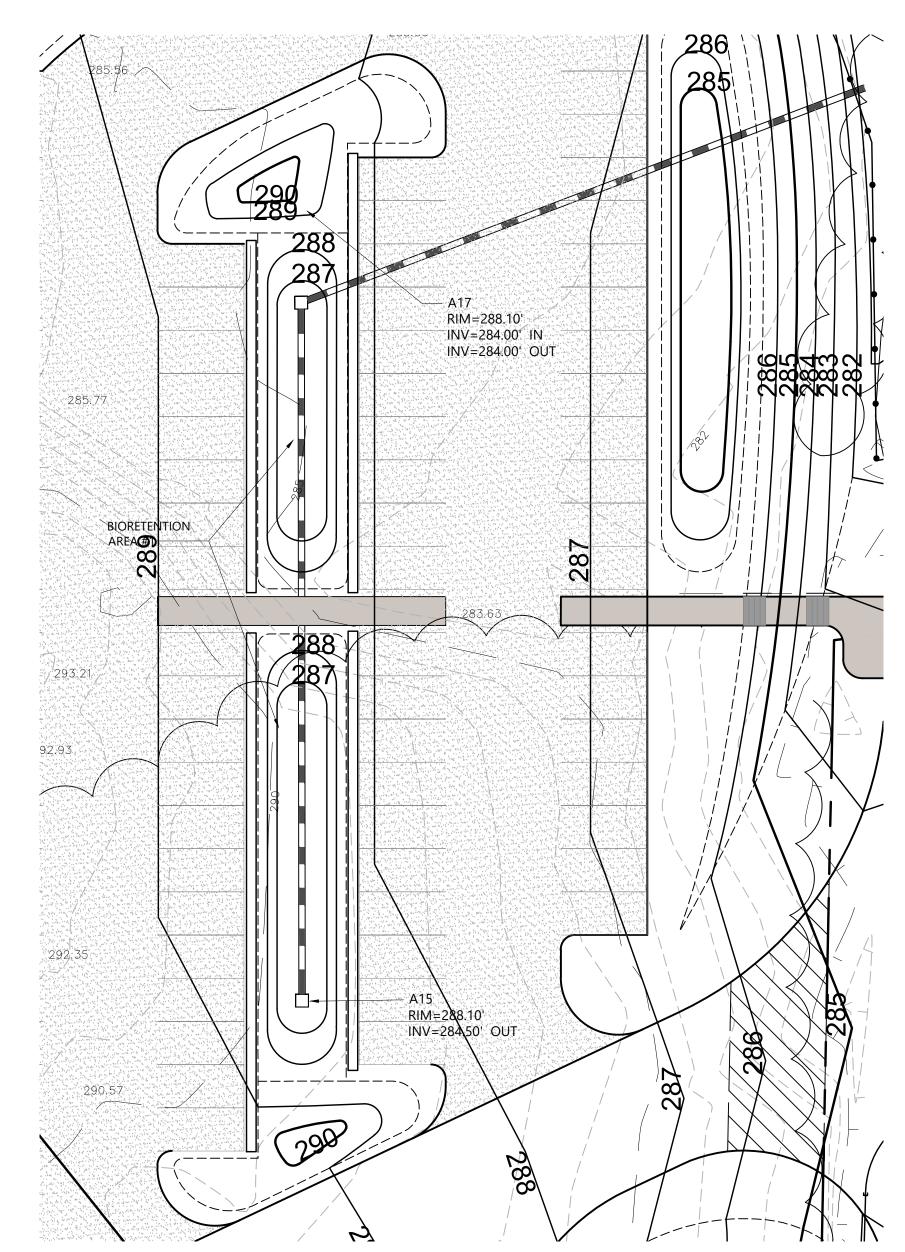

## NOTES:

- 1. BIORETENTION FACILITIES SHALL BE INSTALLED AND MAINTAINED IN ACCORDANCE WITH "THE NEW YORK STATE STORMWATER MANAGEMENT DESIGN MANUAL", CHAPTER 6.
- PLANTING SOIL SHALL BE TESTED & MEET THE FOLLOWING CRITERIA: 5.2-7.0 1.5-4% PH RANGE ORGANIC MATTER MAGNESIUM 35 LB/AC PHOSPHOROUS P<sub>2</sub>O<sub>5</sub> 75LB/AC POTASSIUM K2O 85/AC NOT TO EXCEED 500PPM

SOLUBLE SALTS


- 3. ROTOTILL 2"-3" OF SAND BASE INTO THE BASE OF THE BIORETENTION FACILITY.
- 4. BACK FILLING OF BIORETENTION FACILITY SHALL BE PLACED IN 12" LIFTS.
- 5. MAIN COLLECTOR PIPE OF THE UNDER DRAIN SYSTEM SHALL BE CONSTRUCTED AT A MINIMUM SLOPE OF 0.5%. OBSERVATION WELLS OR CLEAN OUT PIPES MUST BE PLACED EVERY 1000SF OF SURFACE AREA.
- 6. BIORETENTION AREA MAY NOT BE CONSTRUCTED UNTIL ALL CONTRIBUTING DRAINAGE AREA HAS BEEN
- 7. BIORETENTION MEDIA SHALL HAVE AN INFILTRATION RATE OF APPROXIMATELY 0.5" PER HOUR.
- 8. BIORETENTION AREA CANNOT BE INSTALLED UNTIL ALL TRIBUTARY AREAS ARE STABILIZED.

### / 36"x36" SQUARE FRAME & GRATE PAINT INSIDE AND OUTSIDE OF -(SYRACUSE CASTING OR APPROVED EQUAL) STRUCTURE W/ 2 COATS KOPPERS ÒR AS SPECIFIED ON PLANS BITUMASTIC BLACK OR OR APPROVED EQUAL PRECAST 36" SQ. ID. DIAMETER CONCRETE CATCH ~WATER TOLERABLE BASIN (ASTM C478 OR C858) PLANTINGS TOP BIORETENTION EL="A" OVERFLOW INV EL="B" GRATE EL="D' BOTTOM BIORETENTION EL="C" STONE INSTALL 30 MIL HDPE LINER IF MULCH GROUNDWATER IS 2.50' FILTER SOIL - 50% SAND [100% PASSING THE 1-INCH SIEVE AND 5% PASSING THE NO. 200 ENCOUNTERED SIEVE AND 50% TOPSOIL WITH AN AVERAGE OF 5% ORGANIC MATERIAL PASSING THE NO. 200 SIEVE. BOTTOM BIO-MEDIA EL="G" INV "E" OF "F" DIA HDPE INV 6" HDPE="H" 18" PEA GRAVEL WRAPPED-IN FILTER FABRIC. UNDER DRAIN SYSTEM TO STORM -6" PERFORATED PIPE (SEE DRAINAGE NETWORK MIRAFI 140N DRAINAGE -UNDISTURBED WATERTIGHT W/ PLAN FOR SIZE, TYPE & FABRIC OR EQUAL SUBGRADE PORTLAND LOCATION) CEMENT UNDISTURBED — SUBGRADE

## **BIO-RETENTION SECTION**


SEE PLANS FOR SIZE, LOCATION-

AND INVERTS OF PIPES, TYP.

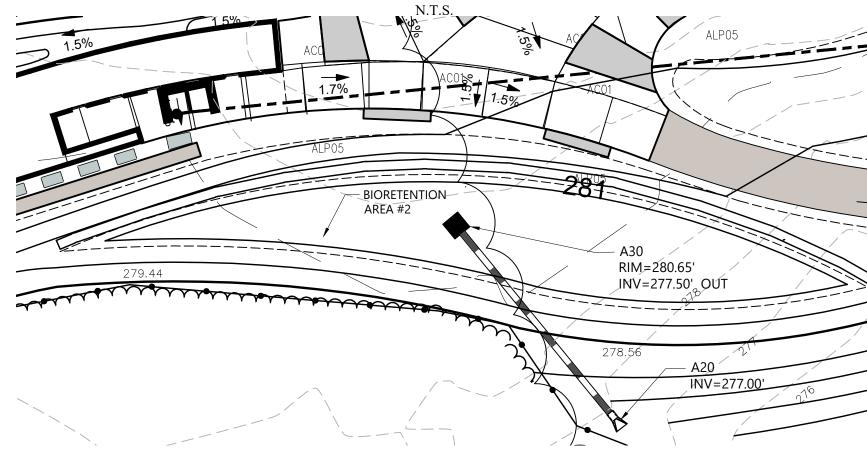

## **BIORETENTION BASIN #2**

SCALE: 1"=20'

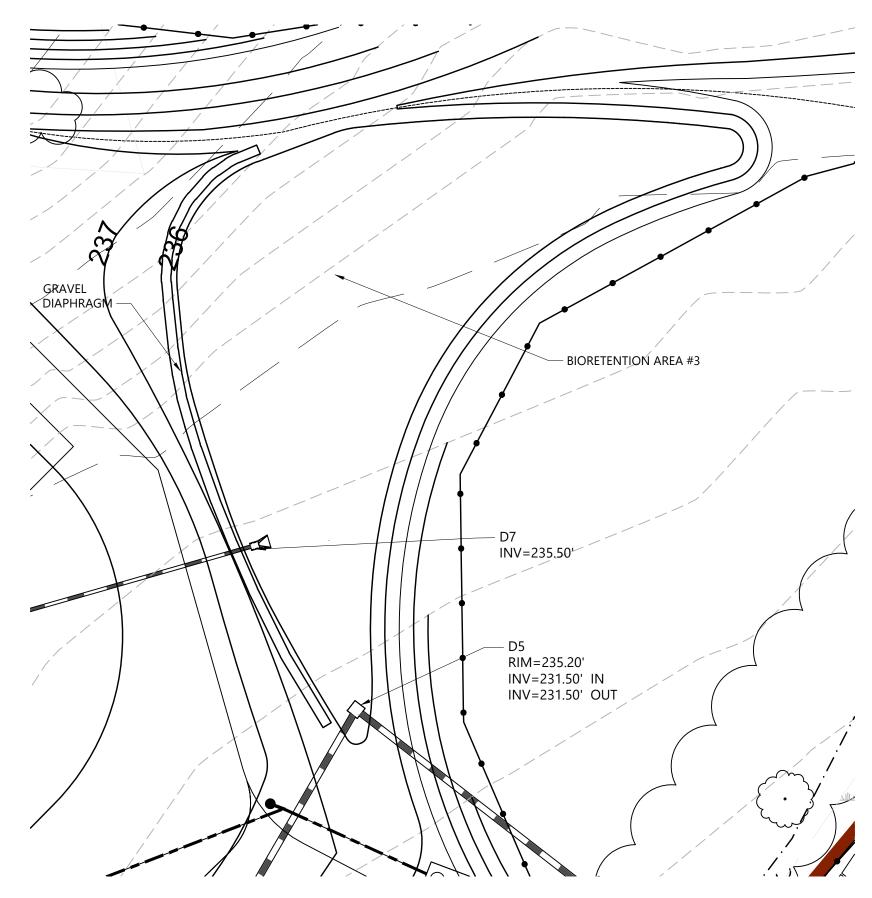


## RIORETENTION DESIGN INFORMATION

PRACTICE	Α	В	С	D	E	F	G	н	J	HYDROCAD POND #
No 1	288.50'	_	288.00'	288.10'	284.50'	12.0"	285.50'	284.50'	284.00'	1 <sub>P</sub>
No 2	281.00'	280.75	280.50'	280.65	277.50'	12.0"	278.50'	277.50'	277.00'	3P
No 3	235.50'	235.20'	235.00'	235.10'	232.00'	12.0"	233.00'	232.00'	231.50'	7AP
No 4	236.50'	236.40'	236.00'	236.20'	232.50'	12.0"	233.50'	232.50'	232.00'	7BP
No 5	235.50'	235.40'	235.00'	235.10'	232.00	12.0"	233.00'	232.00'	231.50'	7EP

## MATERIALS SPECIFICATION FOR BIORETENTION

PARAMETERS	SPECIFICATIONS	SIZE	NOTES:
PLANTINGS	SEE LANDSCAPING PLANS	N/A	PLANTINGS ARE SITE-SPECIFIC
PLANTING SOILS [2.5'=DEEP]	SAND 50% TOPSOIL 50%	N/A	USDA SOIL TYPES LOAMY SAND, SANDY LOAM OR LOAM
MULCH	RIVER RUN ROUND STONE	1"-2.5"	
GEOTEXTILE	CLASS "C" APPARENT OPPENING SIZE (ASTM-D-4751) GRAB TENSILE STREANGTH (ASTM-D-4632) BURST STRENGTH (ASTM-D-4833)	N/A	FOR USE AS NECESSARY BENEATH UNDERDRAINS ONLY
POUR IN PLACE CONCRETE (IF REQUIRED)	JR IN PLACE CONCRETE  SEE LOCAL DOT STANDARDS SPECS.;  f=c=3500PSL @ 28 DAYS NORMAL		ON-SITE TESTING OF POURED-IN-PLACE CONCRETE REQUIRED: 28 DAY STRENGTH AND SLUMP TEST: ALL CONCRETE DESIGN (CAST IN PLACE OR PRE-CAST) NOT USING PREVIOUSLY APPROVES STATE OR LOCAL STANDARDS REQUIRES DESIGN DRAWINGS SEAL & APPROVED BY A LICENCE PROFESSIONAL STRUCTURAL ENGINEER.
SAND [12"=DEEP]	AASHTO M-6 OR ASTM C-33	0.02" - 0.04"	SAND SUBSTITUTION SUCH AS DIABASE GRAYSTONE #10 ARE NOT ACCEPTABLE. NO CALCIUM CARBONATE OR DOLOMITIC SAND SUBSTITUTE ARE ACCEPTABLE. NO "ROCK DUST" CAN BE USED FOR SAND

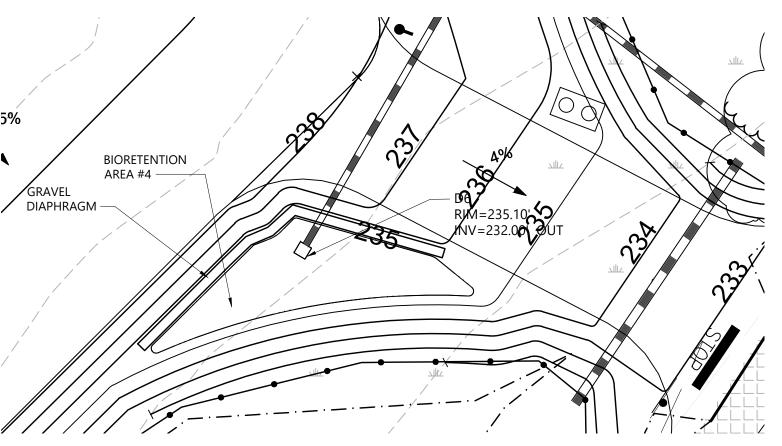

**BIORETENTION BASIN #4** 

SCALE: 1"=20'

SEE SHEET L-450 FOR PAVEMENT, GRAVEL AND PAVERS SECTION DETAILS.

SEE SHEET L-460 FOR TIMBER EDGE DETAILS SEE SHEET L-492 FOR FENCE DETAILS

Storm King Art Center

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**Key Plan** 



Description Filing Set 06/17/22

**Project** 

Storm King **Art Center** Site Development

NOT FOR CONSTRUCTION **Drawing Title** 

Site Details


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**BIORETENTION BASIN #1** 

SCALE: 1"=20'

SCALE: 1"=20'

**BIORETENTION BASIN #3** 

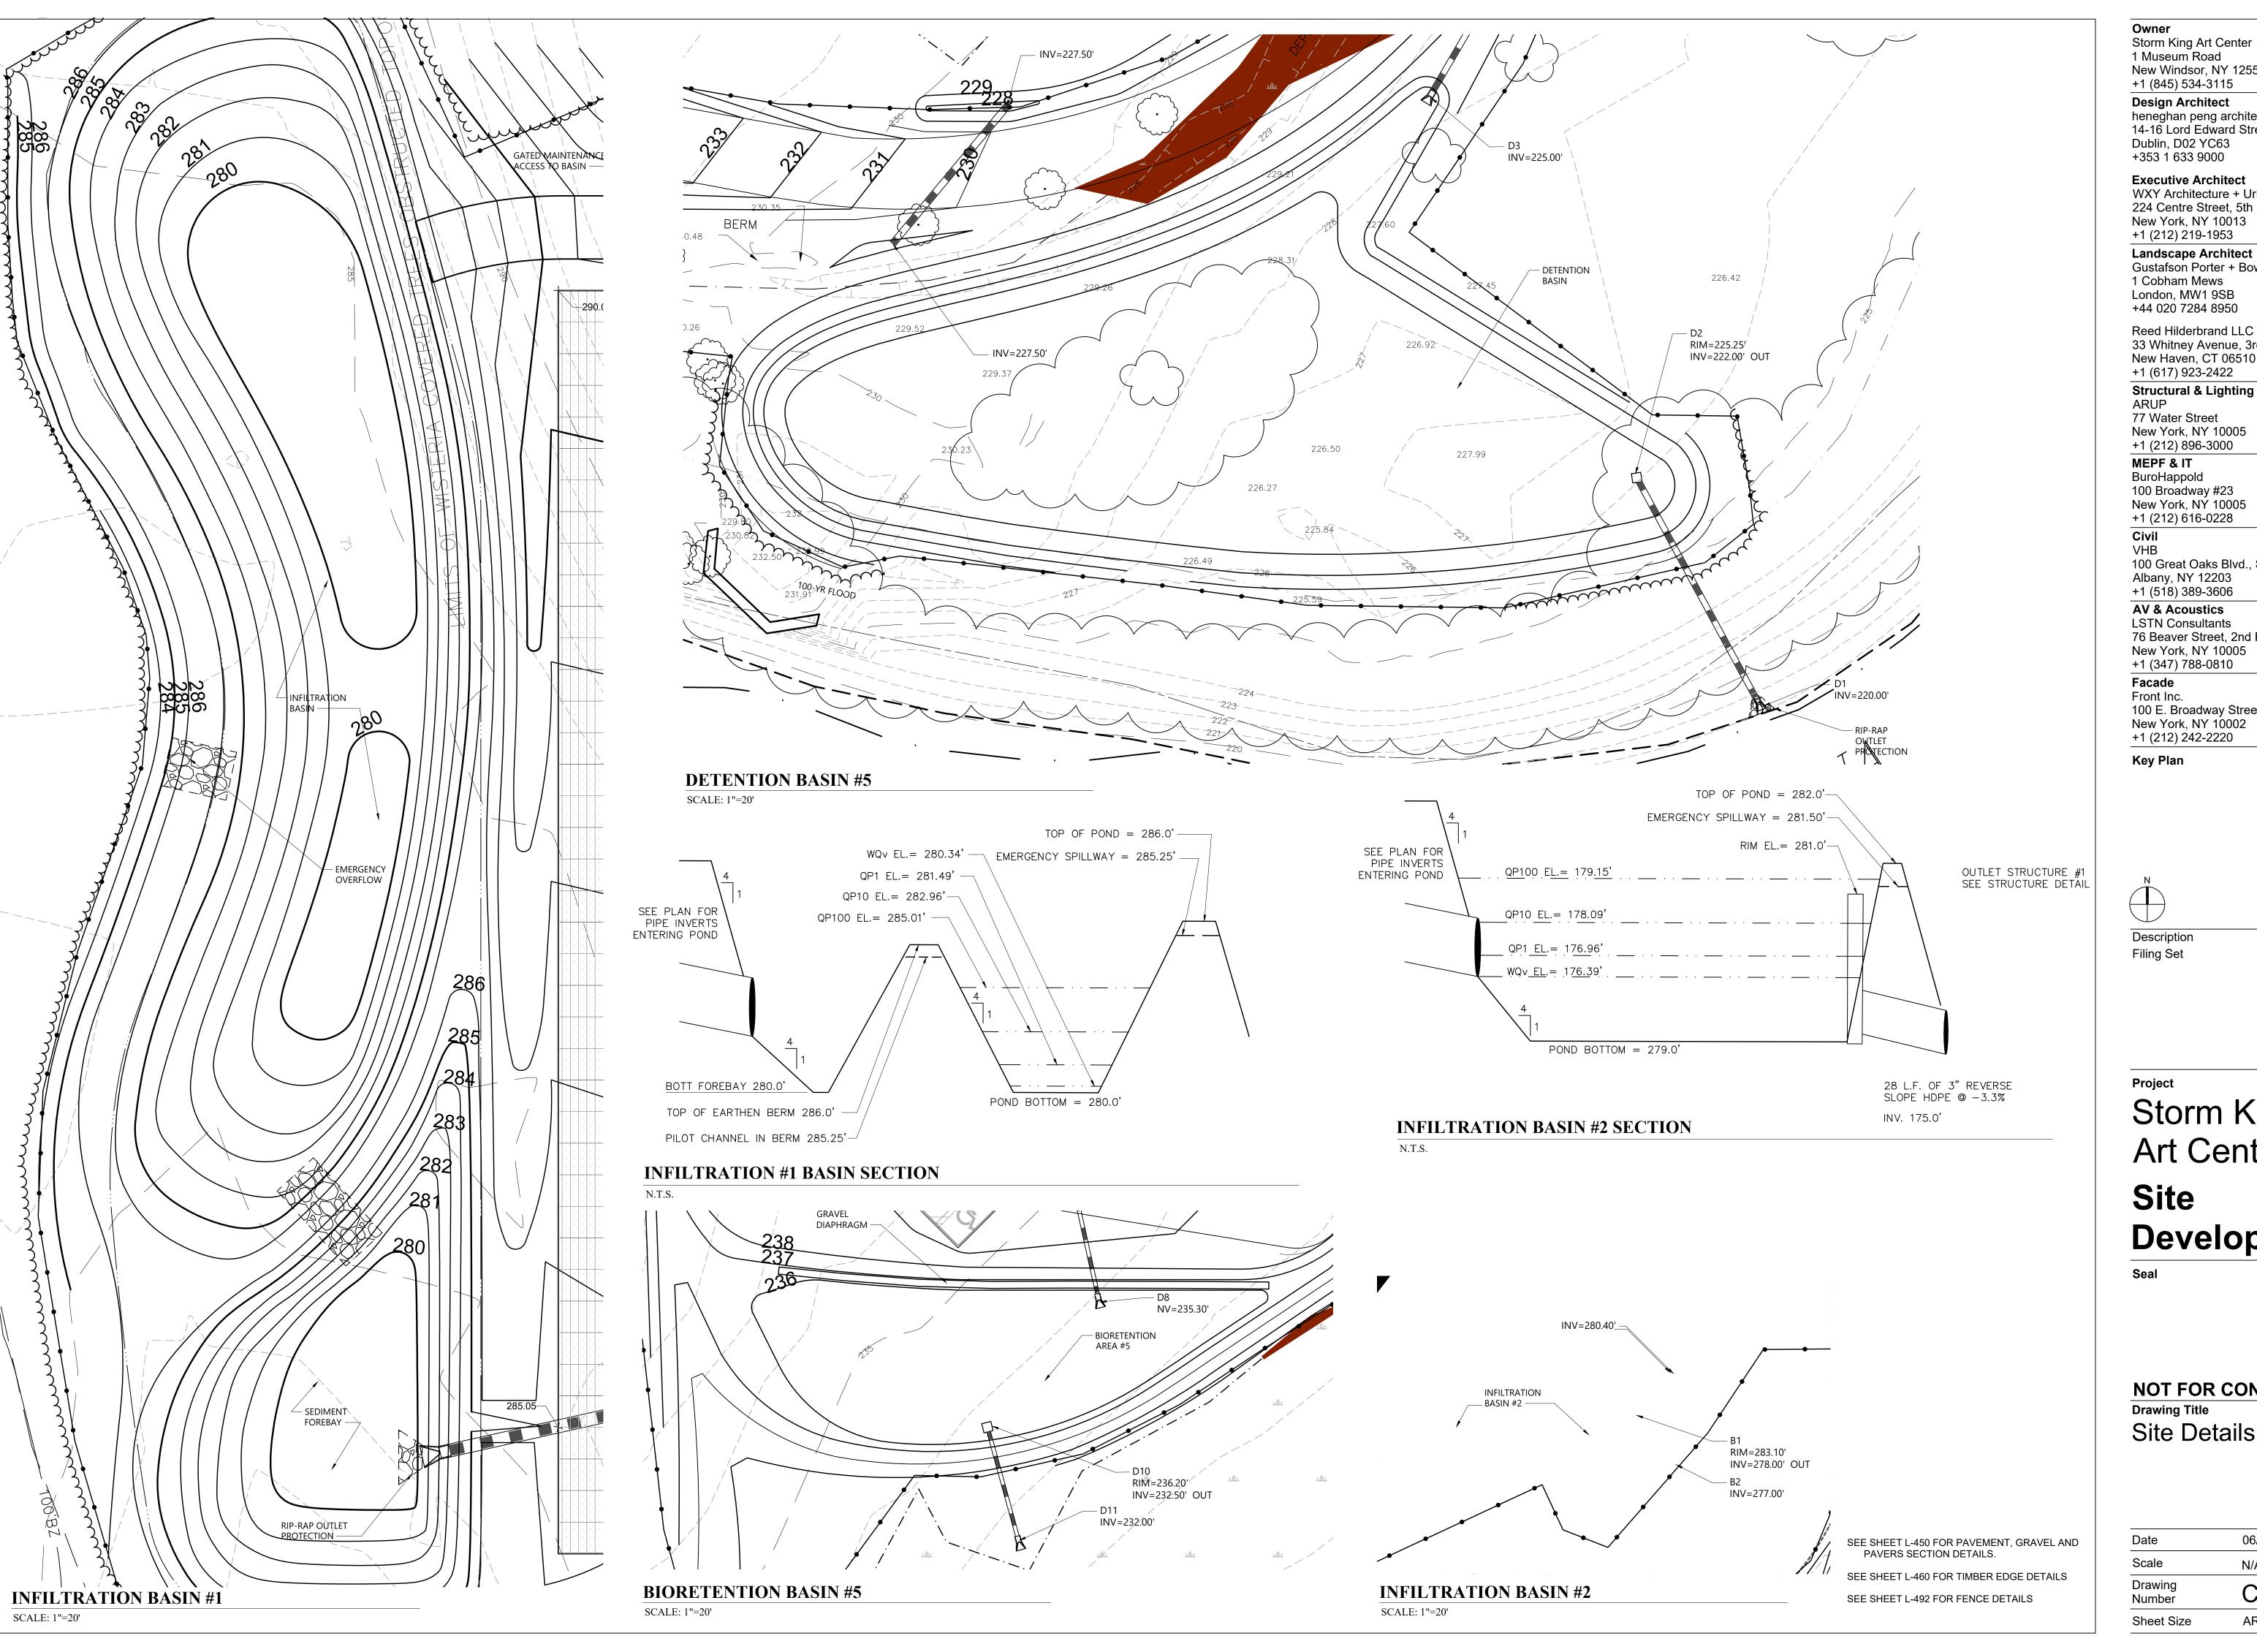

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Key Plan



Description Filing Set


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Project

# Storm King Art Center Site Development


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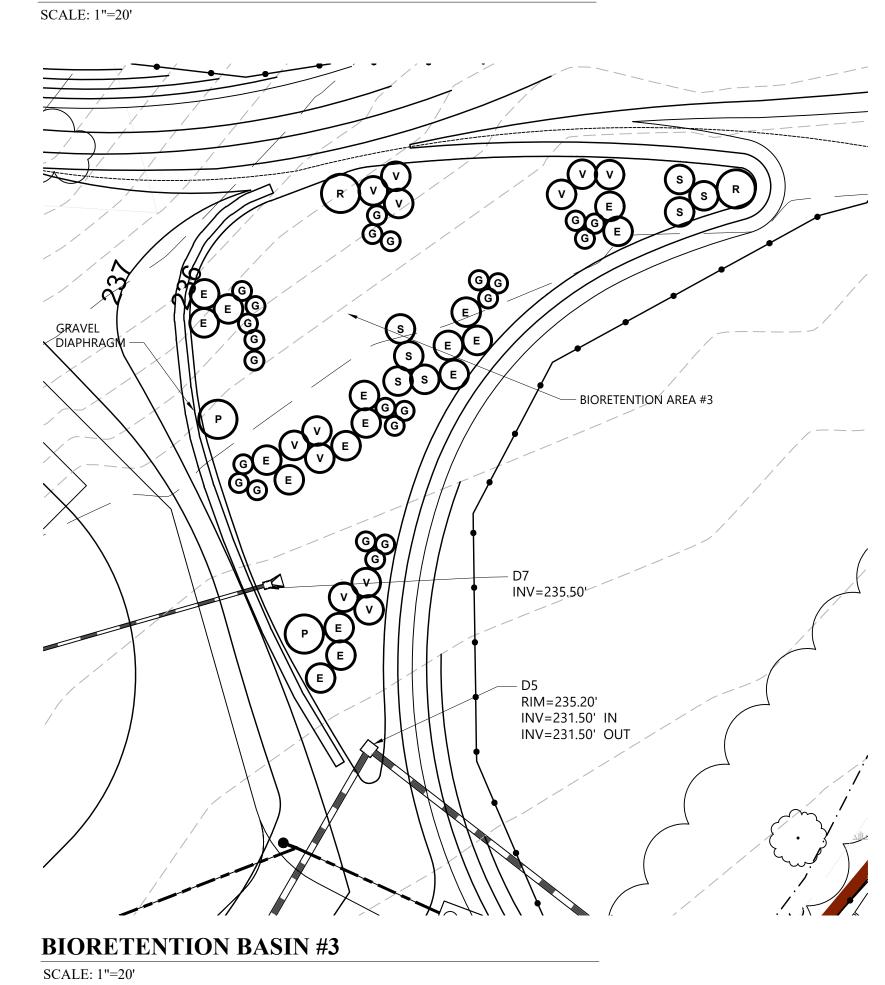



**BIORETENTION BASIN #1** 

SCALE: 1"=20'

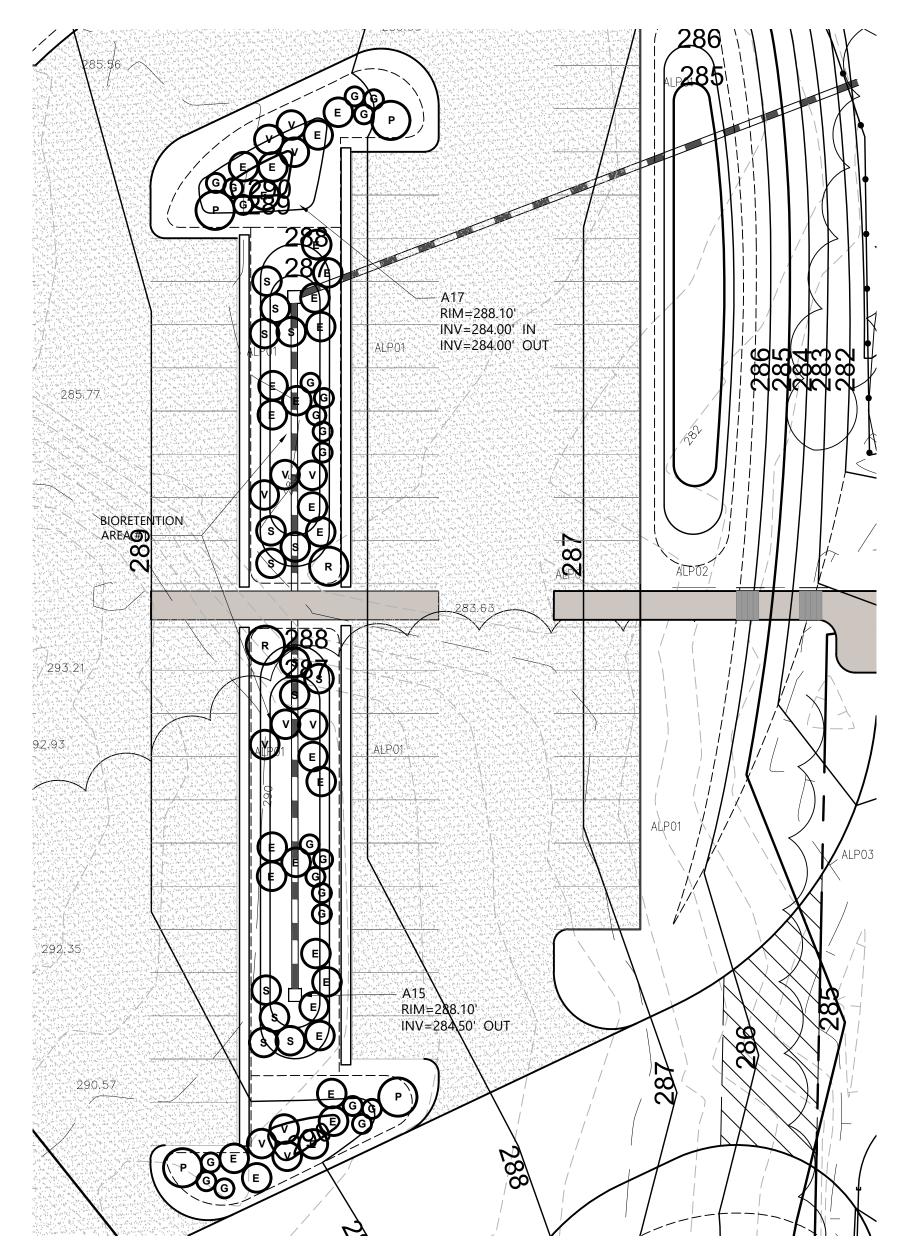


**BIORETENTION BASIN #2** 

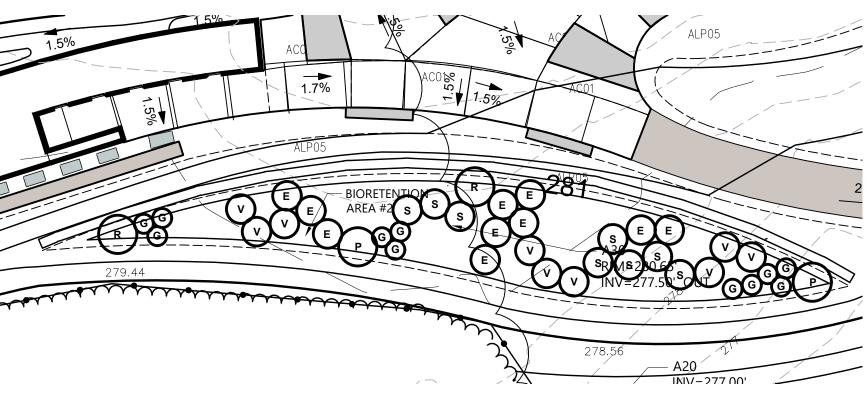

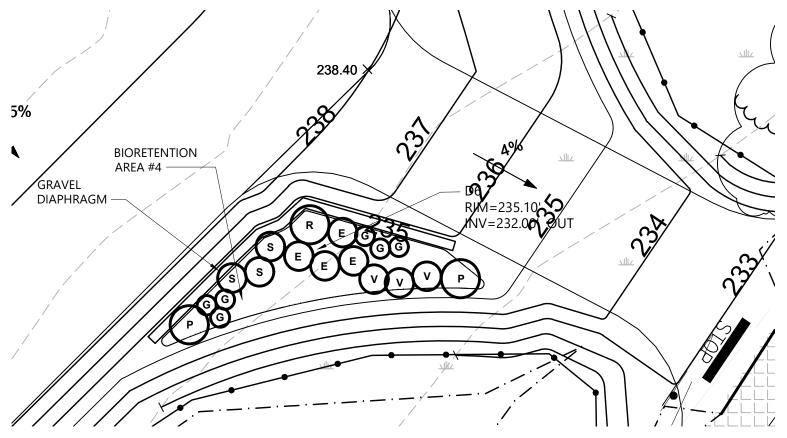

**BIORETENTION BASIN #4** 

SCALE: 1"=20'

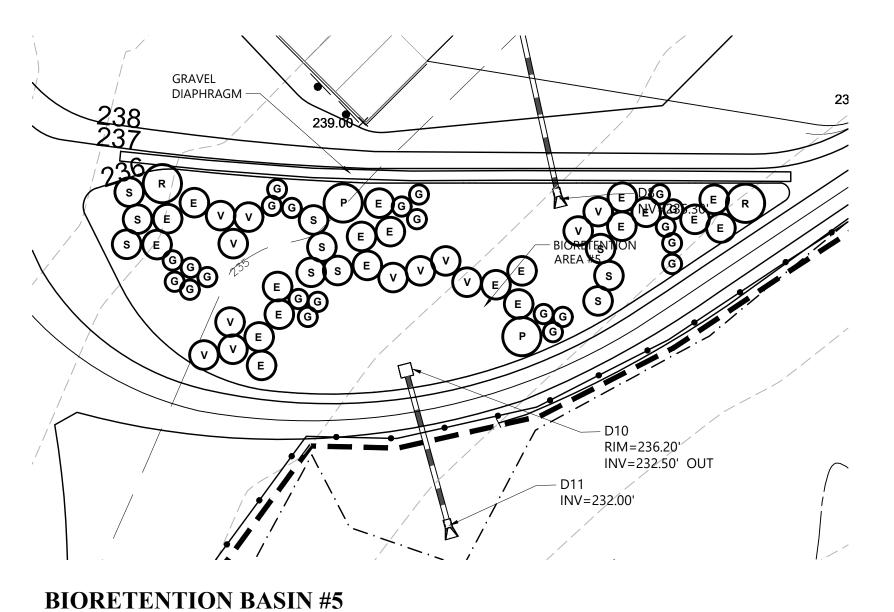

SCALE: 1"=20'

## **BIORETENTION PLANT LIST**

ABRV	QTY	BOTANICAL NAME	COMMON NAME	SIZE	SPACING
E	Х	EUTROCHIUM MACULATUM	SPOTTED JOE PYE WEED	#1 CONT.	24"
G	X	LOBELIA SIPHILITICA	GREAT BLUE LOBELIA	#1 CONT.	12"
R	Х	CORNUS SERICEA	REDOSIER DOGWOOD	#1 CONT.	4'
Р	X	ILEX VERTICILLATA	COMMON WINTERBERRY	#1 CONT.	4'
٧	X	CAREX VULPINOIDEA	FOX SEDGE	#1 CONT.	12"
S	X	ASCLEPIUS INCARNATA	BUTTERFLY MILKWEED	#1 CONT.	24"

VHB

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Key Plan



Description Filing Set

Date 06/17/22

Storm King Art Center Site Development

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06/17/22 Date Scale N/A Drawing C-606 Number ARCH D Sheet Size